

CONTRACT NO. 66607

ELECTRICAL LEGEND

●─● PROPOSED LIGHT POLE

PROPOSED NAVIGATION LIGHT

EXISTING LIGHT POLE

■ PROPOSED JUNCTION BOX

EXISTING LIGHTING CONTROLLER


PROPOSED LIGHTING CONTROLLER

PROPOSED ELECTRIC CONDUCTOR CIRCUITING


T EXISTING TELEPHONE UTILITY

EXISTING AERIAL CONDUCTORS

CONDUIT SLEEVE AS INDICATED

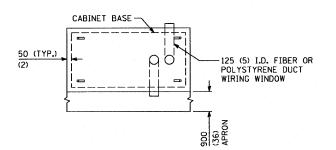



CONTROL CABINET FOUNDATION TOP VIEW

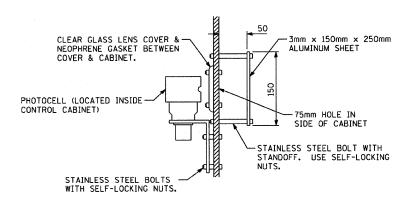

PHOTOCELL DETAIL

	REVISIONS NAME DATE		ILLINOIS DEPARTMENT OF TRANSPORTATION	
F	IL 17		ELECTRICAL DETAILS	
\vdash				
			IL 170 BRIDGE REPLA	CEMENT AT SENECA
L				
 -			SCALE: 1" = 50'	DRAWN BY CJO
-			DATE: OCTOBER, 2007	CHECKED BY JCL

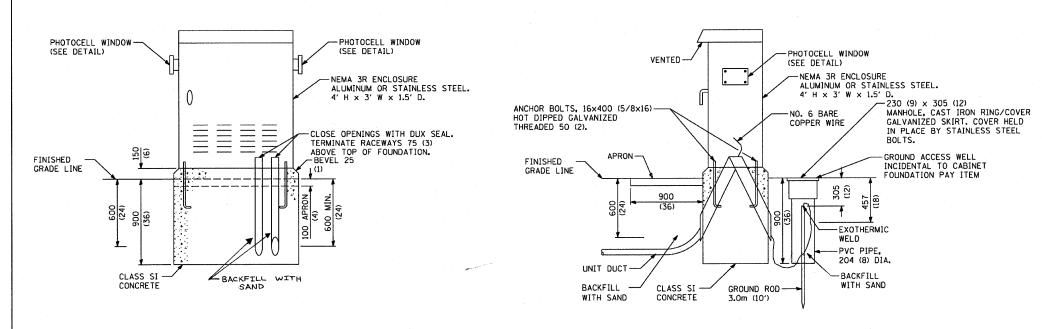

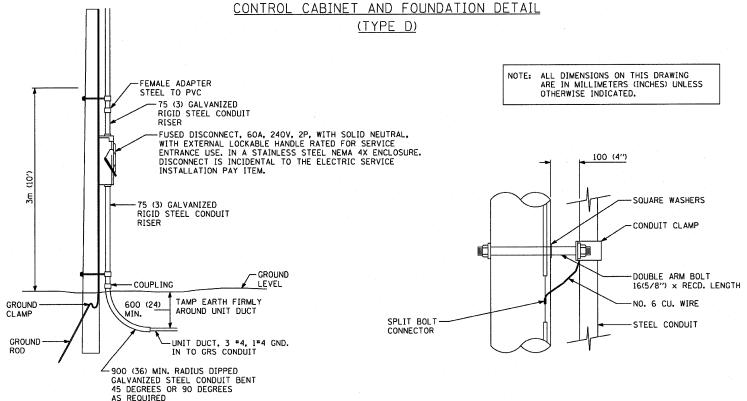

NOTES:

- INSTALL CONDUIT FROM FUSED DISCONNECT TO APPROXIMATELY 3m (10") UP THE POLE AS SHOWN.
 ILLINOIS POWER COMPANY TO INSTALL ALL GROUNDING EQUIPMENT ON RISER POLE.
- 2. CONSULT WITH LOCAL ILLINOIS POWER OFFICE BEFORE CONSTRUCTION.
- 3. PHOTOCELLS MAY ALSO BE MOUNTED EXTERNAL ON RIGID PIPE RISERS OR ON THE CUSTOMER SERVICE POLE AS APPROVED BY THE ENGINEER TO PREVENT VANDALISM

UTILITY RISER DETAIL

PLOT DATE = 10/4/2007 FILE NAME = \$FILEL\$ PLOT SCALE = \$SCALE\$ USER NAME = project