SHEET NO.	DESCRIPTION
1	TITLE SHEET
2	GENERAL NOTES AND IDOT STANDARDS
3	SUMMARY OF QUANTITIES
4	TYPICAL SECTIONS
5 - 6 1	PROPOSED PLAN - WOLF ROAD
7 - 8	PROPOSED PLAN - VILLAGE DRIVE
9 ~ 10	PROPOSED PLAN - DICKENS AVENUE
11	CONSTRUCTION DETAILS
12	CURB OR CURB AND GUTTER REMOVAL AND REPLACEMEN
13	BUTT JOINT AND HMA TAPER DETAILS
14	DISTRICT ONE TYPICAL PAVEMENT MARKINGS
15	TRAFFIC CONTROL AND PROTECTION FOR SIDE ROADS, INTERSECTIONS, AND DRIVEWAYS

STATE OF ILLINOIS **DEPARTMENT OF TRANSPORTATION DIVISION OF HIGHWAYS**

PLANS FOR PROPOSED FEDERAL AID HIGHWAY


WOLF ROAD (FAU 2690) - FROM LAKE ST. TO NORTH AV. VILLAGE DRIVE - FROM LaPORTE AV. TO ROY AV. DICKENS AVENUE - FROM ROBERTA AV. TO GENEVA AV.

> Section No.: 08-00067-00-RS STREET RESURFACING

Project No.: HD-M-9003 (024)

CITY OF NORTHLAKE **COOK COUNTY**

JOB NO.: C-91-406-08

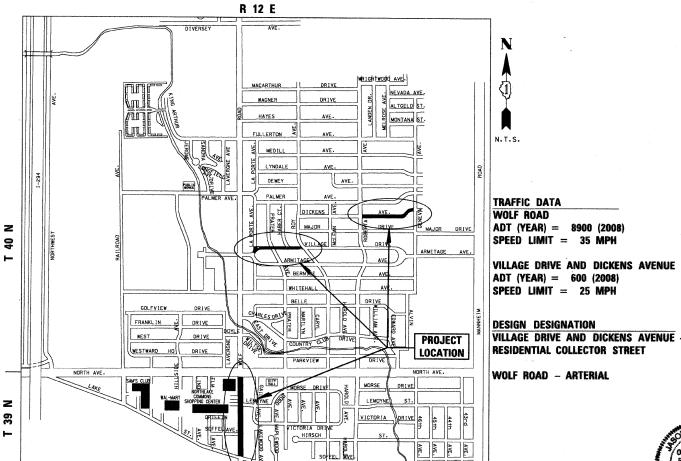


LOCATION MAP - PROVISO TOWNSHIP GROSS LENGTH OF PROJECT = 4413 LINEAL FEET (0.84 MI.) NET LENGTH OF PROJECT = 4413 LINEAL FEET (0.84 MI.)

SECTION 08-00067-00-RS COOK FED. ROAD DIST, NO. ILLINOIS FED. AID PROJECT

CONTRACT NO. 63103



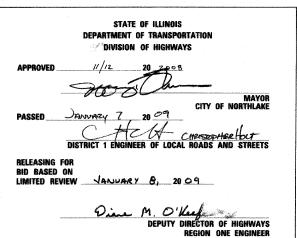


PRINTED BY THE AUTHORITY OF THE STATE OF ILLINOIS



N.T.S.

JASON G/SOUDEN ILLINOIS REGISTRATION No. 062-050850

THE CONTRACTOR SHALL BE SOLELY RESPONSIBLE FOR JOB SITE SAFETY AS WELL AS SUPERVISION/DIRECTION AND MEANS/METHODS OF CONSTRUCTION.

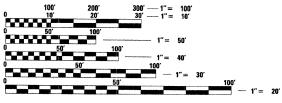

FULL SIZE PLANS HAVE BEEN PREPARED USING STANDARD ENGINEERING SCALES. REDUCED SIZED PLANS WILL NOT CONFORM TO STANDARD SCALES. IN MAKING MEASUREMENTS ON REDUCED PLANS, THE ABOVE SCALES MAY BE USED.

JOINT UTILITY LOCATION INFORMATION FOR EXCAVATION

CONTRACT NO. 63103

BURKE

œi œï

CHRISTOPHER 9575 West Higgins Rosemont, Illinois

SOLOMON MARILIN

SPECIFICATIONS, STANDARDS AND SPECIAL PROVISIONS

ALL CONSTRUCTION SHALL BE DONE IN ACCORDANCE WITH THE "STANDARD SPECIFICATIONS FOR ROAD AND BRIDGE CONSTRUCTION", ADDPTED JANUARY 1, 2007; THE "SUPPLEMENTAL SPECIFICATIONS AND RECURRING SPECIAL PROVISIONS", ADOPTED JANUARY 1, 2009; THE LATEST EDITION OF THE "ILLINOIS MANUAL ON UNIFORM TRAFFIC CONTROL DEVICES FOR STREETS AND HIGHWAYS" (IMUTCD), "THE STANDARD SPECIFICATIONS FOR WATER AND SEWER MAIN CONSTRUCTION IN ILLINOIS" MAY 1996 FIFTH EDITION, THE "DETAILS" IN THE PLANS, LATEST EDITION OF THE MANUAL OF TEST PROCEDURE OF MATERIALS, THE AMERICAN WITH DISABILITIES ACT OF 1990 ACCESSIBILITY GUIDELINES, THE "DRAFT" REHABILITATION ACT OF 1973 (SECTION 504), THE PUBLIC RIGHTS -OF-WAY ACCESSIBILITY GUIDELINES, AND THE "SPECIAL PROVISIONS" INCLUDED IN THE CONTRACT DOCUMENTS.

UTILITIES

THE CONTRACTOR SHALL COOPERATE WITH THE CITY IN ANY UNDERGROUND UTILITY CONSTRUCTION WHICH THE CITY MAY WANT TO PLACE DURING THE CONTRACTOR'S DEPARTIONS

THE CONTRACTOR SHALL BE RESPONSIBLE FOR CONTACTING THE OWNERS OF ALL EXISTING FACILITIES SO THAT THE UTILITIES AND THEIR APPURTENANCES MAY BE LOCATED AND ADJUSTED OR MOVED, IF NECESSARY, PRIOR TO THE START OF CONSTRUCTION OPERATIONS. THE CONTRACTOR SHALL COOPERATE WITH ALL UTILITY OWNERS AS PROVIDED FOR IN THE STANDARD SPECIFICATIONS.

THE LOCATIONS OF EXISTING DRAINAGE STRUCTURES, STORM AND SANITARY SEWERS, WATER SERVICE LINES AND OTHER UTILITY LINES ARE APPROXIMATE, AND THE CITY DOES NOT GUARANTEE THEIR ACCURACY. THEIR EXACT HORIZONTAL AND VERTICAL LOCATIONS ARE TO BE DETERMINED IN THE FIELD BY THE CONTRACTOR AT HIS OWN FYPENSE.

THE CONTRACTOR SHALL BE RESPONSIBLE FOR THE PROTECTION OF ALL UNDERGROUND OR SURFACE UTILITIES EVEN THOUGH THEY MAY NOT BE SHOWN ON THE PLANS. ANY UTILITY THAT IS DAMAGED DURING CONSTRUCTION SHALL BE REPAIRED OR REPLACED TO THE SATISFACTION OF THE ENGINEER OR THE CITY. THIS WORK SHALL BE AT THE CONTRACTOR'S EXPENSE.

COORDINATION OF ALL UTILITY WORK INVOLVED IN THE CONSTRUCTION AREA WILL BE DISCUSSED AT THE PRECONSTRUCTION CONFERENCE.

BEFORE STARTING ANY EXCAVATION, THE CONTRACTOR SHALL CALL "JULIE" AT 811 OR 800-892-0123 FOR FIELD LOCATIONS OF BURIED ELECTRIC, TELEPHONE, GAS AND CABLE TELEVISION FACILITIES. (48 HOURS NOTIFICATION IS REQUIRED.)

STAKIN

THE CONTRACTOR SHALL PROTECT AND CAREFULLY PRESERVE ALL SECTION OR SUBSECTION MONUMENTS OR PROPERTY OR REFERENCE MARKERS UNTIL THE CITY. HIS AGENT OR AN AUTHORIZED SURVEYOR HAS WITNESSED OR OTHERWISE REFERENCED THEIR LOCATIONS.

ALL RADII FOR PROPOSED CURB AND GUTTER ARE TO THE EDGE OF PAYEMENT UNLESS OTHERWISE NOTED. AND SHALL BE AS INDICATED ON THE PLANS. ELEVATIONS SHOWN AT POINT OF CURVE. ETC. IS EDGE OF PAYEMENT UNLESS OTHERWISE NOTED.

WATER, STORM SEWER AND SANITARY SEWER

WHENEVER DURING CONSTRUCTION OPERATIONS ANY LOOSE MATERIAL IS DEPOSITED IN THE FLOW LINE OF DRAINAGE STRUCTURES SUCH THAT THE NATURAL FLOW OF WATER IS OBSTRUCTED, IT SHALL BE REMOVED AT THE CLOSE OF EACH WORKING DAY. AT THE CONCLUSION OF CONSTRUCTION OPERATIONS, ALL UTILITY STRUCTURES SHALL BE FREE FROM DIRT AND DEBRIS. THE WORK SPECIFIED ABOVE WILL NOT BE PAID FOR SEPARATELY BUT SHALL BE INCIDENTAL TO THE CONTRACT.

ANY EXISTING OR PROPOSED STORM SEWER DAMAGED BY THE CONTRACTOR DURING CONSTRUCTION SHALL BE REPLACED BY THE CONTRACTOR AT NO COST TO THE OWNER.

THE CONTRACTOR SHALL NOT OPEN OR SHUT ANY WATER VALVES OR FIRE HYDRANTS WITHOUT PRIOR AUTHORIZATION FROM THE CITY WATER DEPARTMENT. UNAUTHORIZED USE SHALL SUBJECT THE OFFENDER TO ARREST AND PROSECUTION.

MISCELLANEOUS

ACCESS: THE CONTRACTOR SHALL PROVIDE ACCESS TO ABUTTING PROPERTY AT ALL TIMES DURING THE CONSTRUCTION OF THIS PROJECT. EXCEPT FOR PERIODS OF SHORT DURATION. THE COST TO PROVIDE ACCESS SHALL BE PAID FOR AND INCLUDED IN THE ITEM AGGREGATE FOR TEMPORARY ACCESS.

DIMENSIONS: IT SHALL BE THE CONTRACTOR'S RESPONSIBILITY TO VERIFY ALL DIMENSIONS AND CONDITIONS EXISTING IN THE FIELD PRIOR TO ORDERING MATERIALS AND BEGINNING CONSTRUCTION.

ALL SAWCUTTING SHALL BE INCIDENTAL TO REMOVAL ITEMS AND SHALL BE PERFORMED PRIOR TO BEGINNING REMOVAL. ANY ITEMS OF WORK REMOVED PRIOR TO SAWCUTTING WILL NOT BE MEASURED FOR PAYMENT.

COMBINATION CONCRETE CURB AND GUTTER REMOVAL AND REPLACEMENT, DRIVEWAY PAVEMENT REMOVAL, PORTLAND CEMENT CONCRETE DRIVEWAY PAVEMENT, 7 INCH, PORTLAND CEMENT CONCRETE SIDEWALK, 5 INCH AND 7 INCH, DETECTABLE WARNINGS, MIXTURE FOR CRACKS, JOINTS AND FLANGEWAYS, MEDIAN REMOVAL, CORRUGATED MEDIAN, CONCRETE MEDIAN, TYPE SB-6.12, CLASS B PATCHES 10" (SPECIAL) AND CLASS C AND D PATCHES 6" (SPECIAL) ARE NOT SHOWN ON THE PLANS BUT WILL BE DETERMINED BY THE ENGINEER IN THE FIELD AND WILL NOT EXCEED THE PLAN QUANTITY.

THE THICKNESSES OF HOT-MIX ASPHALT MIXTURES SHOWN IN THE PLANS ARE NOMINAL. DEVIATIONS MAY OCCUR DUE TO IRREGULARITIES IN THE SURFACES OR BASIS ON WHICH THEY ARE TO BE PLACED. PLAN THICKNESSES SHOULD BE CONSIDERED THE MINIMUM THICKNESS PERMITTED.

DETECTABLE WARNINGS MEETING ADA REQUIREMENTS SHALL BE INSTALLED AT ALL INTERSECTING STREETS, SIGNALIZED COMMERCIAL DRIVEWAYS, AND SIGNALIZED ALLEYS AS DIRECTED BY THE ENGINEER (SEE 100T STD. 424001-05 INCLUDED IN THE SPECIFICATIONS). CONTRACTOR SHALL VERIFY THAT ALL SLOPES MEET ADA REQUIREMENTS PRIOR TO INSTALLING SIDEWALK DETECTABLE WARNINGS AND ADJACENT CURB AND GUTTER.

PAVEMENT GRADES: THE ELEVATIONS INDICATED ON THE PLANS ARE FINISHED GRADES OF PROPOSED PAVEMENT OR SURFACE COURSE, UNLESS OTHERWISE INDICATED.

RELOCATING EXISTING SIGNS: EXISTING SIGNS WHICH ARE IN CONFLICT WITH PROPOSED IMPROVEMENTS SHALL BE REMOVED AND REINSTALLED UPON COMPLETION OF CONFLICTING IMPROVEMENTS IN ACCORDANCE WITH THE ILLINDIS DEPARTMENT OF TRANSPORTATION "MANUAL OF UNIFORM TRAFFIC CONTROL DEVICES" AND THE "STANDARD SPECIFICATIONS FOR ROAD AND BRIDGE CONSTRUCTION". STOP SIGNS. SPEED LIMIT SIGNS. AND STREET NAME SIGNS SHALL BE UP AND VISIBLE AT ALL TIMES. THIS WORK SHALL BE INCLUDED TO THE PAY ITEM TRAFFIC CONTROL AND PROTECTION.

PER ARTICLE 107.20, MAILBOXES WHICH ARE IN CONFLICT WITH PROPOSED IMPROVEMENTS SHALL BE REMOVED, TEMPORARILY RELOCATED, AND REPLACED UPON COMPLETION OF THE PROPOSED IMPROVEMENTS AS DIRECTED BY THE ENGINEER.

PROPOSED CONCRETE CURB AND GUTTER SHALL BE TRANSITIONED TO EXISTING CURB AND GUTTER OVER A LENGTH OF 6 FEET. THIS WORK SHALL BE PAID FOR AT THE CONTRACT UNIT PRICE PER FOOT FOR COMBINATION CONCRETE CURB AND GUTTER PERMOVAL AND DEPLACEMENT

ALL UNDERGROUND, DRIVEWAY, CONCRETE, AND LANDSCAPE RESTORATION WORK IS TO BE COMPLETED BEFORE THE SURFACE COURSE IS INSTALLED.

THE HMA SURFACE COURSE USED TO REPLACE DRIVEWAYS WILL BE PAID FOR PER TON. THE NUMBER OF DRIVEWAYS TO BE REPLACED WILL BE DETERMINED IN THE FIELD BY THE FINCINFER.

HIGHWAY STANDARDS

000001-05	STANDARD SYMBOLS, ABBREVIATIONS, AND PATTERNS
424001-05	CURB RAMPS FOR SIDEWALKS
442101-07	CLASS B PATCHES
442201-03	CLASS C AND D PATCHES
602011-01	CATCH BASIN TYPE C
604001-03	FRAME AND LIDS TYPE 1
606001-04	CONCRETE CURB TYPE B AND COMBINATION CONCRETE CURB AND GUTTER
606301-04	PC CONCRETE ISLANDS AND MEDIANS
606306-03	CORRUGATED PC CONCRETE MEDIANS
701301-03	LANE CLOSURE, 2L, 2W, SHORT TIME OPERATIONS
701501-05	URBAN LANE CLOSURE, 2L, 2W UNDIVIDED
701606-06	URBAN LANE CLOSURE, MULTILANE, 2W WITH MOUNTABLE MEDIA
701701-06	URBAN LANE CLOSURE, MULTILANE INTERSECTION
701801-04	LANE CLOSURE MULTILANE 1W OR 2W CROSSWALK OR SIDEWALK CLOSURE
701901-01	TRAFFIC CONTROL DEVICES
780001-02	TYPICAL PAVEMENT MARKINGS
886001-01	DETECTOR LOOP INSTALLATIONS
BLR 17-4	TRAFFIC CONTROL DEVICES - DAY LABOR CONSTRUCTION
BLR 18-5	TRAFFIC CONTROL DEVICES - DAY LABOR MAINTENANCE

FED. ROAD DIST. NO. | ILLINOIS | FED. AID PROJECT | CONTRACT NO. 63103

REVISIONS		
NAME DATE	ILLINOIS DEPARTMEN	NT OF TRANSPORTATION
	GENERAL NOTES A	AND IDOT STANDARDS
		NORTHLAKE DRIVE, DICKENS AVENUE
	SCALE N.T.S.	DRAWN BY EDT
	DATE 12/5/2008	CHECKED BY MW

SUMMARY OF QUANTITIES

					STP - LAPP	
	LOCATION OF WORK	WOLF ROAD	VILLAGE DR.	DICKENS AVE.		
		80% FED.	100% FED. (\$80,000 MAX.)			
	FUNDING COURCE	20% LOCAL STP	REMAINDER LOCAL	REMAINDER LOCAL		
·····	FUNDING SOURCE				SECTION 112	SECTION 112
	SUMMARY OF QUANTITIES		CONSTRUCTION TYPE CODE	E		
ITEM#	ITEM	UNIT	TOTAL QUANTITIES	L23 1000	LY60 1000	LY60 1000
	ILET FILTERS	EACH	65	44	12	9
	UB-BASE GRANULAR MATERIAL, TYPE B	CU YD	70	25	20	25
	GGREGATE BASE COURSE, TYPE B 6"	SQ YD	1080	825	80	175
	OT-MIX ASPHALT BASE COURSE, 6"	SQ YD	1155	900	80	175
	GGREGATE BASE REPAIR	TON	40	0	20	20
	GGREGATE FOR TEMPORARY ACCESS	TON	700	500	100	100
	ITUMINOUS MATERIALS (PRIME COAT)	GAL	2375	1530	455	390
	GGREGATE (PRIME COAT)	TON	47	30	. 9	8
	IXTURE FOR CRACKS, JOINTS AND FLANGEWAYS	TON	50	50	0	0
	EVELING BINDER (MACHINE METHOD), N50	TON	889	0	479	410
	EVELING BINDER (MACHINE METHOD), N70	TON	1610	1610	0	0
	OT-MIX ASPHALT SURFACE REMOVAL - BUTT JOINT	SQ YD	405	225	125	55
	OT-MIX ASPHALT SURFACE COURSE, MIX "C", N50	TON	860	100	405	355
	OT-MIX ASPHALT SURFACE COURSE, MIX "D", N70	TON	1320	1320	0	0
	ORTLAND CEMENT CONCRETE DRIVEWAY PAVEMENT, 7 INCH	SQ YD	75	75	0	0
	ORTLAND CEMENT CONCRETE SIDEWALK, 5 INCH	SQFT	5950	2450	1750	1750
	ORTLAND CEMENT CONCRETE SIDEWALK, 7 INCH	SQFT	2350	300	500	1550
	ETECTABLE WARNINGS	SQ FT	500	330	140	30
	OT-MIX ASPHALT SURFACE REMOVAL, 3 1/4" RIVEWAY PAVEMENT REMOVAL	SQ YD	23720	15300	4545	3875
	IDEWALK REMOVAL	SQ YD	1155	900	80	175
	OMBINATION CONCRETE CURB AND GUTTER REMOVAL AND REPLACEMENT	SQ FT	8300	2750	2250	3300
	EDIAN REMOVAL	FOOT	885	665	120	100
	REA REFLECTIVE CRACK CONTROL TREATMENT	SQ FT SQ YD	1000 23720	1000 15300	0 4545	0 3875
	ATCH BASINS, TYPE C, TYPE 1 FRAME, OPEN LID	EACH		15300		3875
	ATCH BASINS TO BE ADJUSTED WITH NEW TYPE 1 FRAME, OPEN LID	EACH	2	2	0 0	0
	ATCH BASINS TO BE ADJUSTED WITH NEW TYPE 24 FRAME AND GRATE	EACH	3	3	0	0
	ATCH BASINS TO BE RECONSTRUCTED	EACH	3	3	1 0	0
	ONCRETE MEDIAN, TYPE SB-6.12	SQ FT	300	300	, , , , , , , , , , , , , , , , , , ,	0
	ORRUGATED MEDIAN	SQFT	700	700	1 0	0
67100100 M		L SUM	1	0.6	0.2	0.2
	RAFFIC CONTROL AND PROTECTION, STANDARD 701501	L. SUM	1	0.6	0.2	0.2
70102635 TF	RAFFIC CONTROL AND PROTECTION, STANDARD 701701	L. SUM	1	0.6	0.2	0.2
70102640 TF	RAFFIC CONTROL AND PROTECTION, STANDARD 701801	L SUM	1	0.6	0.2	0.2
*78000100 TH	HERMOPLASTIC PAVEMENT MARKING - LETTERS AND SYMBOLS	SQFT	340	340	0	0
	HERMOPLASTIC PAVEMENT MARKING - LINE 4"	FOOT	3800	3800	0	0
	HERMOPLASTIC PAVEMENT MARKING - LINE 6"	FOOT	5270	4500	675	95
*78000600 TH	HERMOPLASTIC PAVEMENT MARKING - LINE 12"	FOOT	335	335	0	0
	HERMOPLASTIC PAVEMENT MARKING - LINE 24"	FOOT	450	265	165	20
	ETECTOR LOOP REPLACEMENT	FOOT	1450	1450	0	0
	LASS B PATCHES, 10 INCH	SQ YD	865	865	0	0
	LASS D PATCHES, 6" (SPECIAL)	SQ YD	205	0	110	95
	LASS C PATCHES, 6" (SPECIAL)	SQ YD	205	0	110	95
	ONSTRUCTION LAYOUT	L. SUM	1	0.6	0.2	0.2
	RAINAGE STRUCTURE ADJUSTMENT (SPECIAL)	EACH	17	9	7	1
	RAINAGE STRUCTURES TO BE ADJUSTED	EACH	57	36	12	9
	RAINAGE STRUCTURES TO BE REMOVED	EACH	1	0	0	1
Z0076600 TF	RAINEES SPECIAL PROVISION	HOUR	500	500	0	0

~ | Z0076600 | TRAINEES


~ INDICATES SPECIAL PROVISION

* INDICATES SPECIALTY ITEM

\$\triangle \text{ Y080}

REVISIONS		
NAME DATE	ILLINOIS DEPARTMEN	NT OF TRANSPORTATION
	•	
	SUMMARY C	F QUANTITIES
		NORTHLAKE
	WOLF ROAD, VILLAGE	DRIVE, DICKENS AVENUE
	SCALE N.T.S.	DRAWN BY EDT
	BATE 10 (5 (0000	OUEOVER BY WW
	DATE 12/5/2008	CHECKED BY MW

CHRISTOPHER B. BURKE ENGINEERING LTD. PLAN SINGERED POTED POTED NOTE BOOK RIT OF WAY CHECKED NOTE BOOK RIT OF WAY CHECKED NOT 823-0500

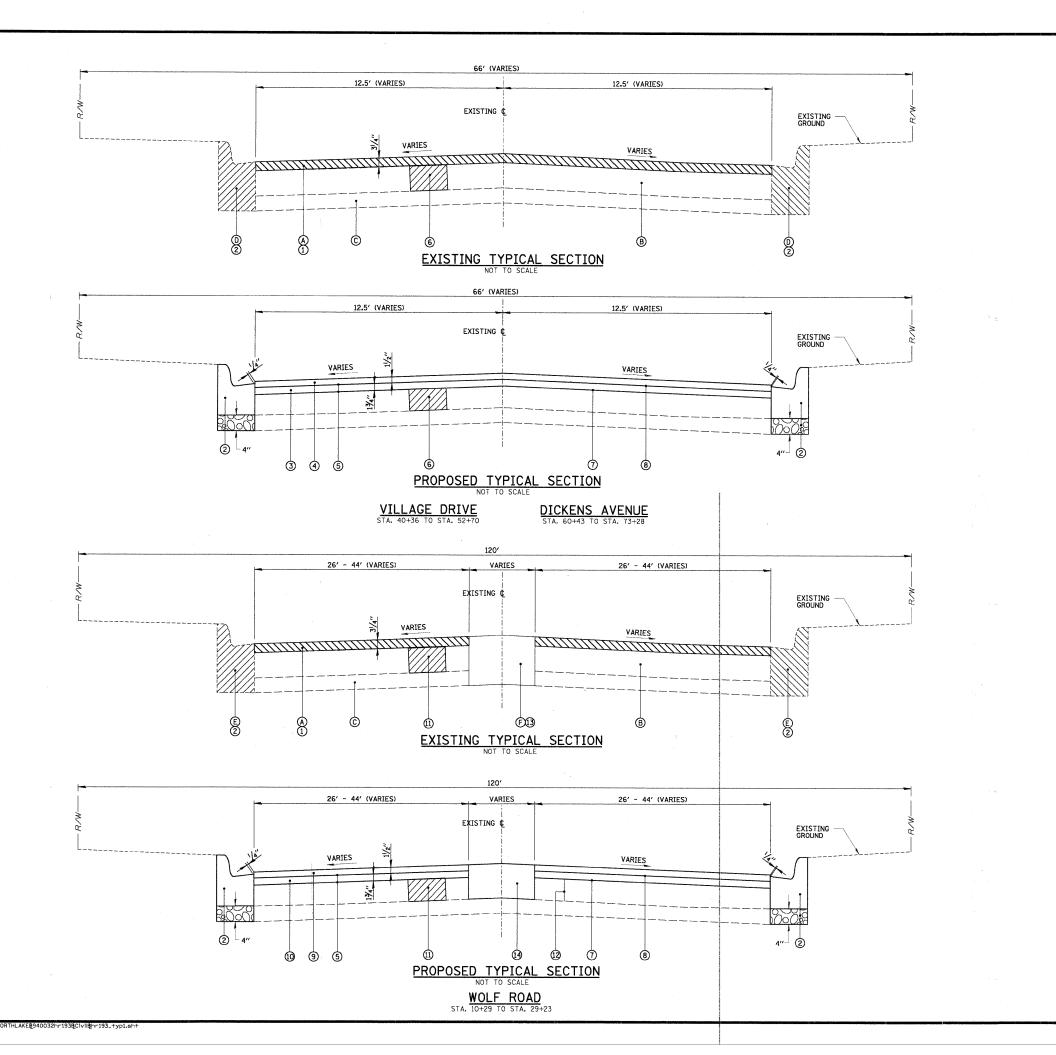

Om Om

CONTRACT NO. 63103

LEGEND

- (A) EXISTING ASPHALT PAVEMENT (+/- 2.4" TO 7.9")
- B EXISTING P. C. C. BASE (+/- 4" TO 7")
- © EXISTING AGGREGATE BASE (+/- 0" TO 7")
- (D) EXISTING COMBINATION CURB AND GUTTER; TYPE M-4.12
- E) EXISTING COMBINATION CURB AND GUTTER; TYPE B-6.24 OR B-6.12
- F EXISTING CORRUGATED/BARRIER CONCRETE MEDIAN
- 1) HOT-MIX ASPHALT SURFACE REMOVAL, 3 1/4"
- COMBINATION CONCRETE CURB AND GUTTER
 REMOVAL AND REPLACEMENT (AS DIRECTED BY ENGINEER)
 (SEE DETAIL SHEET 12) OF TYPE SPECIFIED.
- 3 LEVELING BINDER (MACHINE METHOD), N50 - 1 3/4" MIN.
- HOT-MIX ASPHALT SURFACE COURSE, MIX "C", N50 1 1/2"
- 5 BITUMINOUS MATERIALS (PRIME COAT)
- 6 CLASS C OR D PATCHES, 6" (SPECIAL)
- 7 AGGREGATE (PRIME COAT)
- AREA REFLECTIVE CRACK CONTROL TREATMENT
- 9 HOT-MIX ASPHALT SURFACE COURSE, MIX "D", N70 1 1/2"
- (MACHINE METHOD), N70 1 3/4" MIN.
- ① CLASS B PATCHES 10"
- (12) MIXTURE FOR CRACKS, JOINTS AND FLANGEWAYS
- (13) MEDIAN REMOVAL (AS DIRECTED BY ENGINEER)
- CORRUGATED MEDIAN OR CONCRETE MEDIAN, TYPE SB-6.12 (AS DIRECTED BY ENGINEER)


HOT-MIX ASPHALT MIXTURE REQUIREMENTS


ITEM	AC-TYPE	VOIDS
ROADWAYS		
HOT-MIX ASPHALT SURFACE COURSE,	PG 64-22	4% @ 50 GYR
MIX "C", N50 (IL-9.5 MM)		
HOT-MIX ASPHALT SURFACE COURSE, MIX "D", N70 (IL-9.5 MM)	PG 64-22	4% @ 70 GYR
LEVELING BINDER (MACHINE METHOD), N50 (IL-9.5 MM)	PG 64-22*	4% e 50 GYR
LEVELING BINDER (MACHINE METHOD), N70 (IL-9.5 MM)	PG 64-22*	4% @ 70 GYR
CLASS D PATCHES, (HMA BINDER IL-19 MM) 6" (SPECIAL)	PG 64-22*	4% @ 70 GYR
DRIVEWAYS		**************************************
HOT-MIX ASPHALT SURFACE COURSE,	PG 64-22	4% @ 50 GYR
MIX "C", N50 (IL-9.5 MM) - 2"		
HOT-MIX ASPHALT BASE COURSE, 6"	PG 64-22*	4% @ 50 GYR

NOT


- 1. THE UNIT WEIGHT USED TO CALCULATE ALL HOT-MIX ASPHALT SURFACE MIXTURE QUANTITIES IS 112 LBS/SY/IN.
- 2. •WHEN RAP EXCEEDS 20%, THE NEW ASPHALT BINDER IN THE MIX SHALL BE PG 58-22.


REVISIONS							
NAME D	ATE	ILLIN	OIS DE	PARTMEN	IT OF	TRANSPO	RTATION
				TYPICAL	SECT	IONS	
		WOLF	ROAD,	CITY OF VILLAGE		LAKE DICKENS	AVENUE
		SCALE !	N.T.S.		D	RAWN BY	EDT
		DATE	12/5/200	В	С	HECKED BY	MW

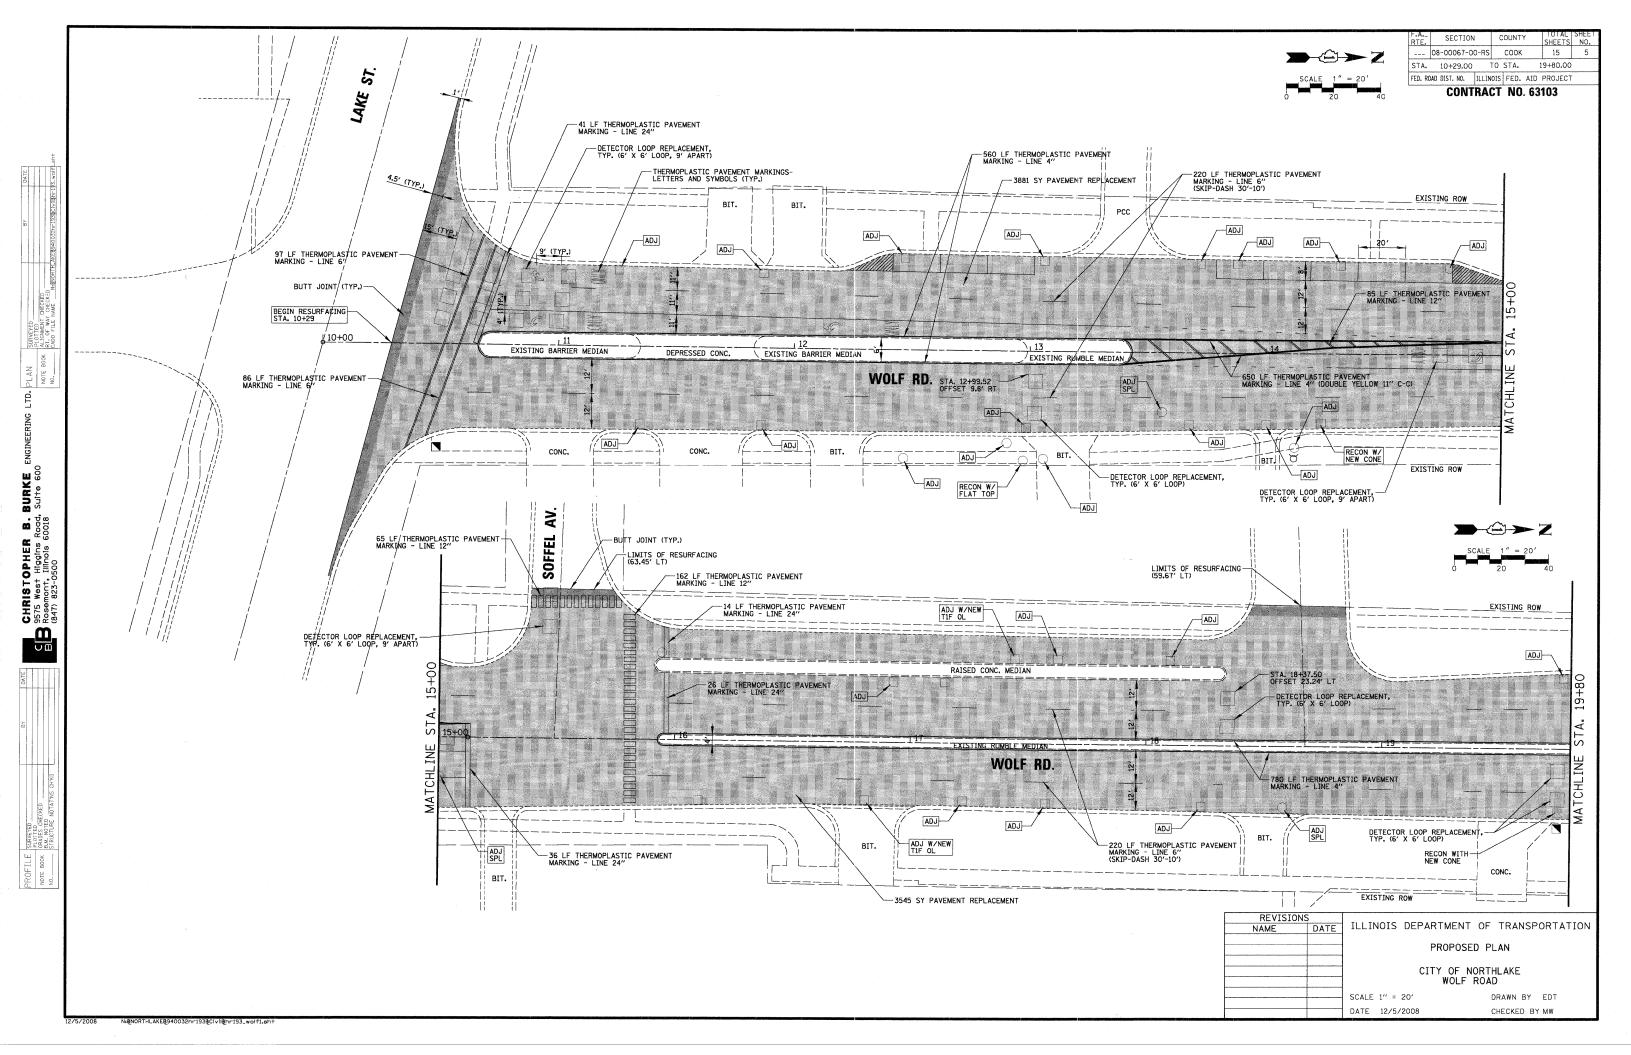

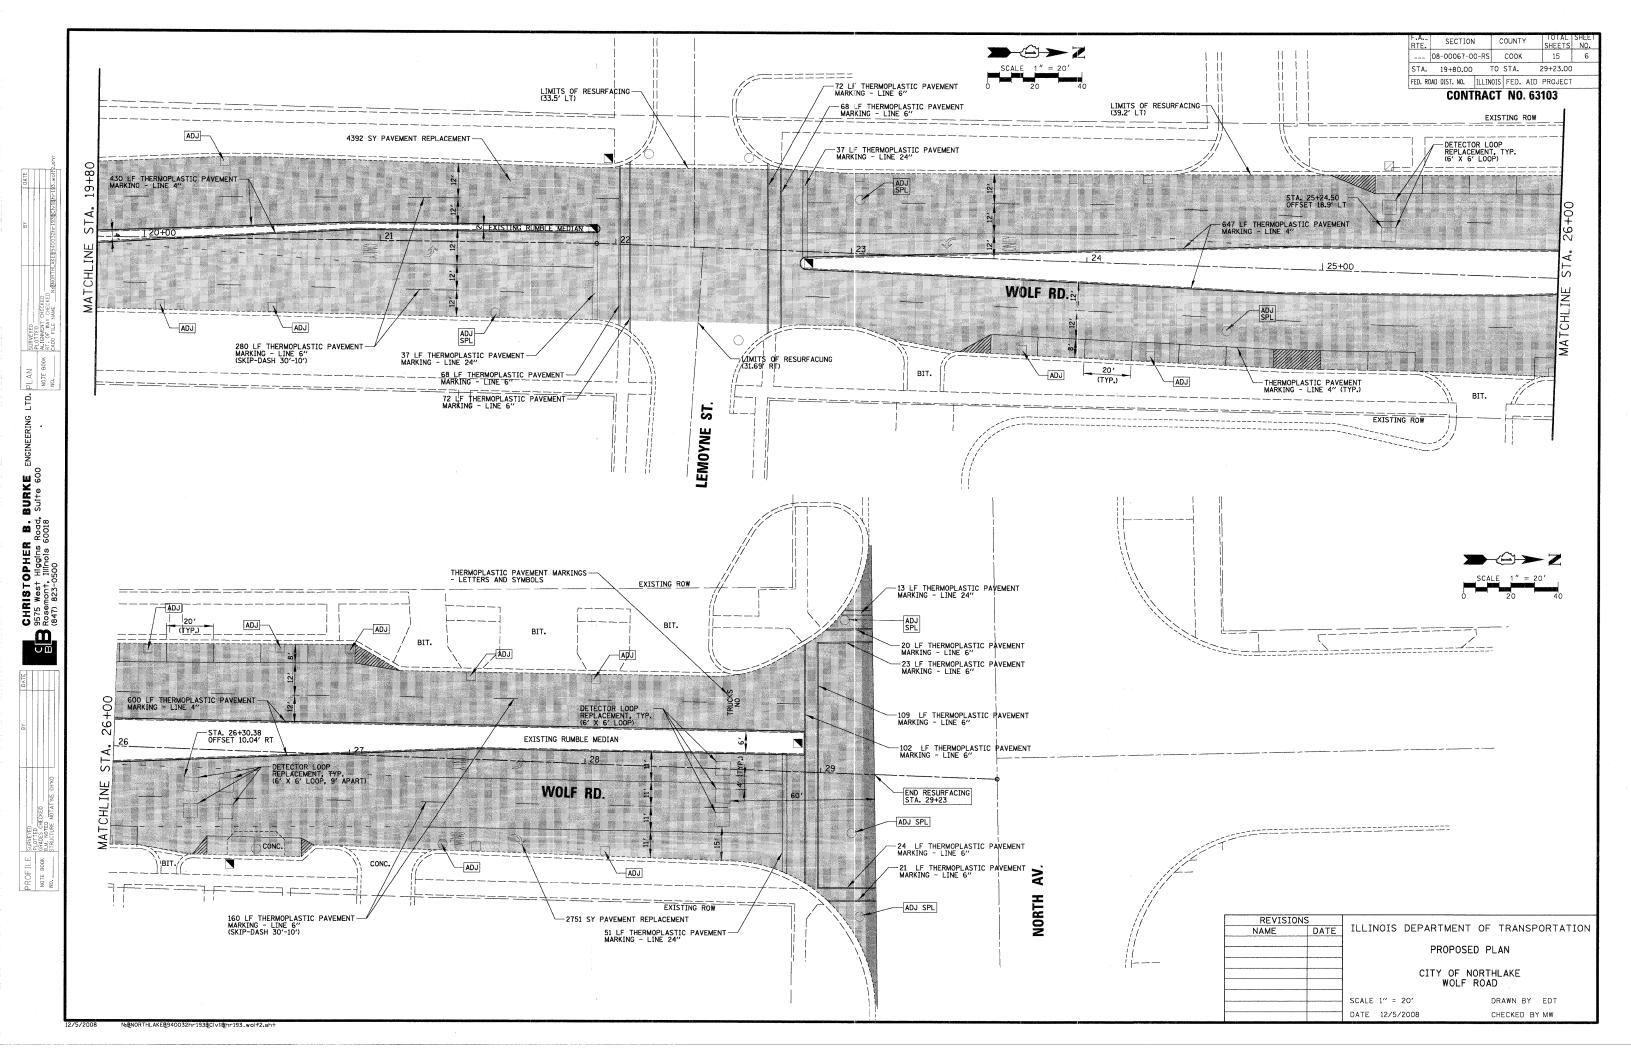

SECTION --- 08-00067-00-RS COOK STA. 40+36.00 TO STA. 44+00.00 FED. ROAD DIST. NO. ILLINOIS FED. AID PROJECT CONTRACT NO. 63103 **LaPORTE** -53 LF THERMOPLASTIC PAVEMENT MARKING - LINE 6" LIMITS OF CONSTRUCTION (68.92' LT) 43 LF THERMOPLASTIC PAVEMENT MARKING - LINE 6" 13 LF THERMOPLASTIC PAVEMENT MARKING - LINE 24" VILLAGE DR. 1266 SY PAVEMENT REPLACEMENT -20 LF THERMOPLASTIC PAVEMENT MARKING - LINE 24" 13 LF THERMOPLASTIC PAVEMENT MARKING - LINE 24" ÖÖDEGÜN RESURFACING-VILLAGE DR. PROP. CURVE VILL-1
PI STA. = 41+97.56
Δ = 49° 11′ 33″ (RT)
D = 33° 12′ 50″
R = 172.51′
T = 78.97′
L = 148.11′
E = 17.21′
P.C. STA = 41+18.59
P.T. STA = 42+66.70 REVISIONS NAME ILLINOIS DEPARTMENT OF TRANSPORTATION PROPOSED PLAN CITY OF NORTHLAKE VILLAGE DRIVE SCALE 1" = 20' DRAWN BY EDT DATE 12/5/2008 CHECKED BY MW

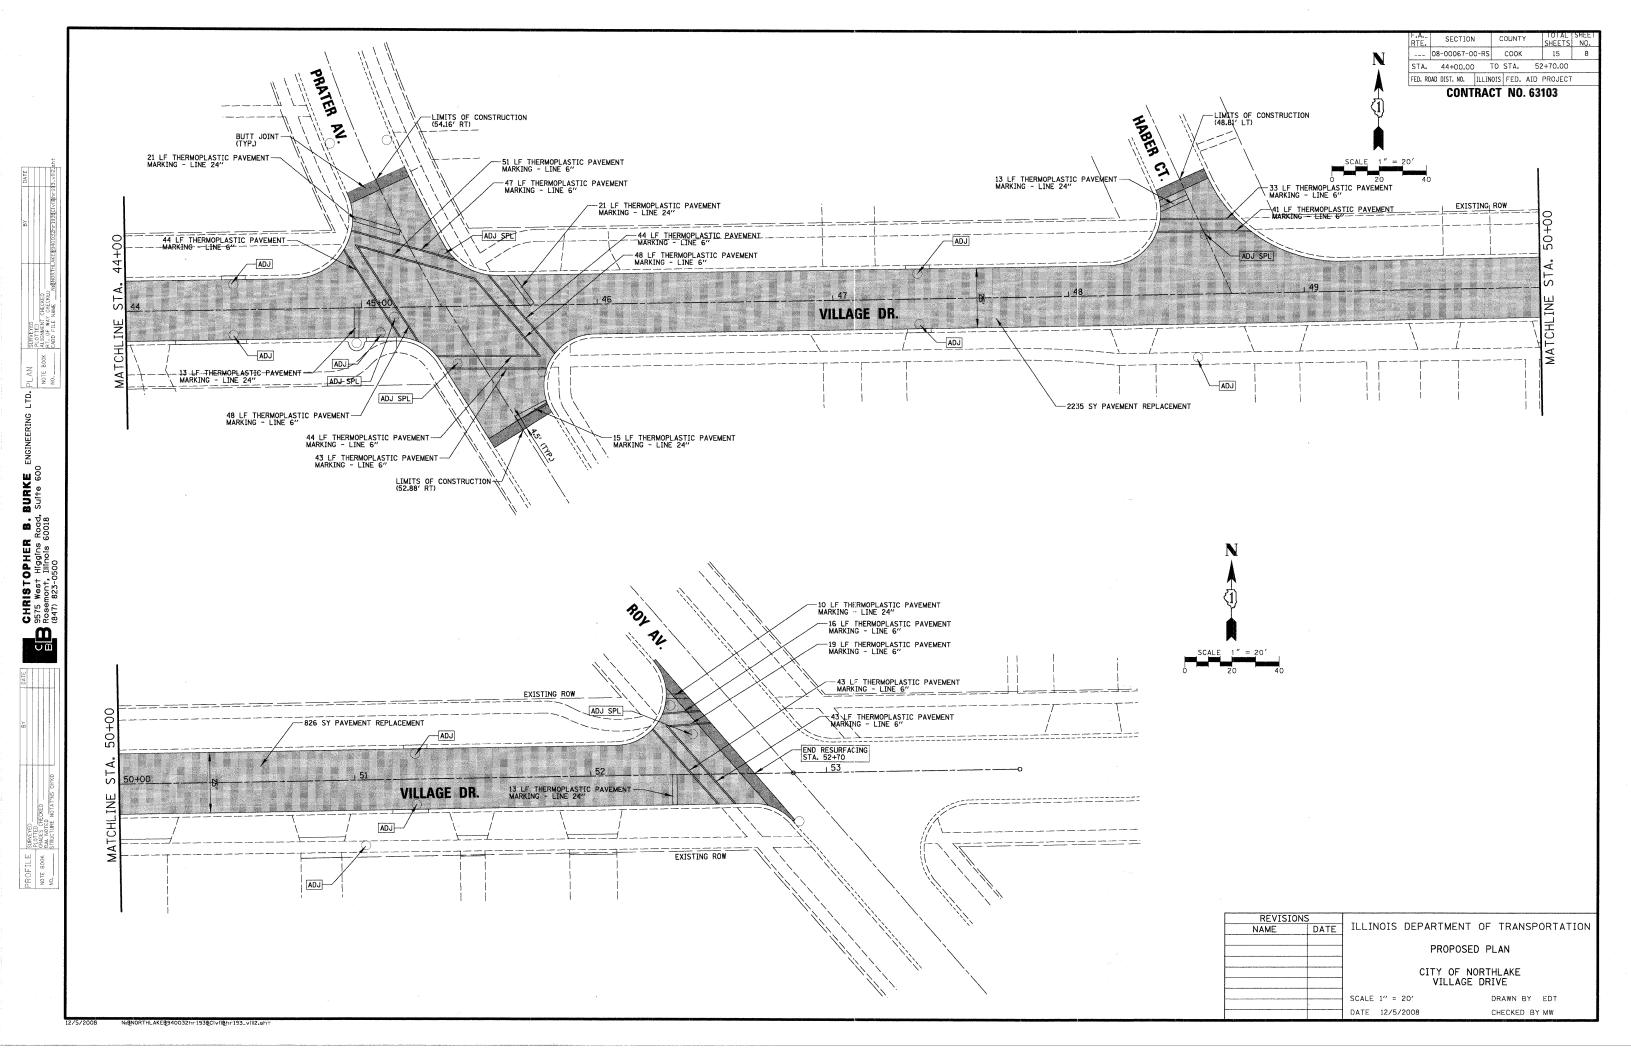

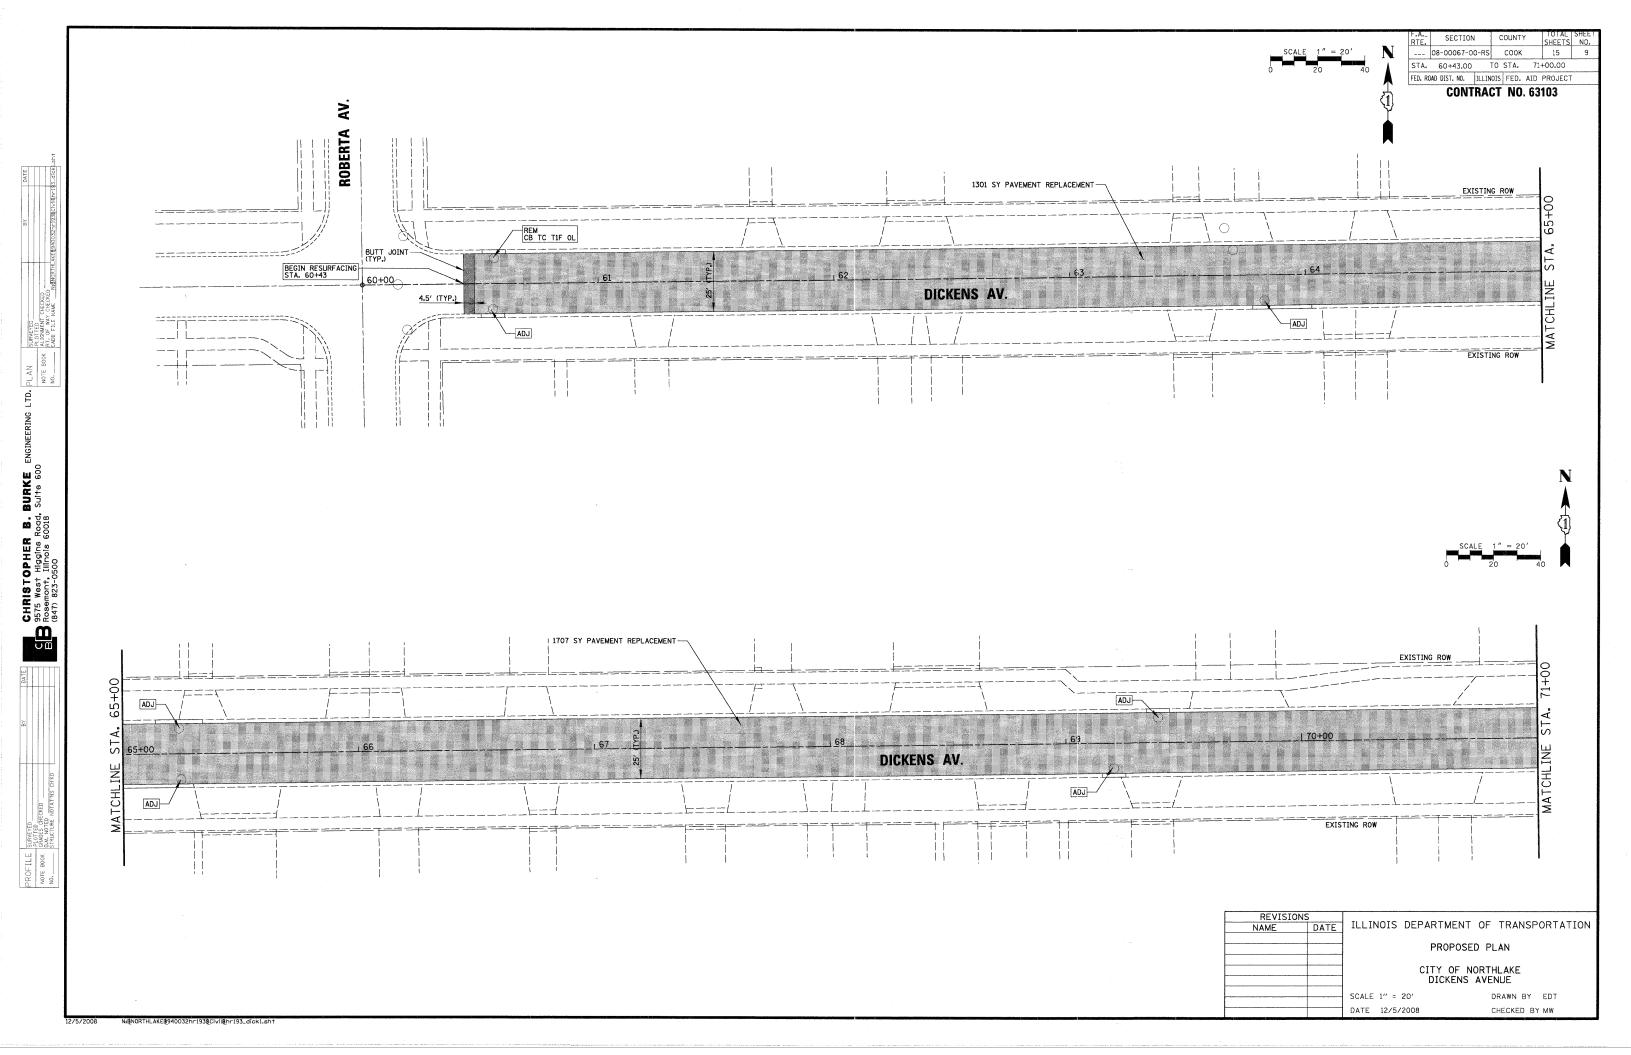

PROP. CURVE DICK-1
PI STA. = 72+26.79
\[\Delta = 23\circ 28' 21'' (LT)
\]
D = 13\circ 11' 24''
R = 434.39'
T = 90.24'
L = 177.96'
E = 9.28'
P.C. STA = 71+36.55
P.T. STA = 73+14.51 A. GENEVA -BUTT JOINT EXISTING ROW 685 SY PAVEMENT REPLACEMENT ----52 LF THERMOPLASTIC PAVEMENT MARKING - LINE 6" DICKENS AV. -40 LF THERMOPLASTIC PAVEMENT MARKING - LINE 6" 17 LF THERMOPLASTIC PAVEMENT -MARKING - LINE 24"

F.A.-	SECTION	COUNTY	TOTAL	SHEET
---	08-00067-00-RS	COOK	15	10
---	STA.	71+00.00	TO STA.	73+28.00
---	FED. ROAD DIST. NO.	ILLINOIS	FED. AID	PROJECT

CONTRACT NO. 63103

NAME DATE

ILLINOIS DEPARTMENT OF TRANSPORTATION

PROPOSED PLAN

CITY OF NORTHLAKE

CITY OF NORTHLAKE DICKENS AVENUE

 SCALE 1" = 20'
 DRAWN BY
 EDT


 DATE 12/5/2008
 CHECKED BY MW

N-RNORTHLAKER940032hr1938Clyll8hr193 dlok2 el

PROFILE SU

CHRISTOPHER B. BURKE 9575 West Higgins Road, Suite 600 B Rosemont, Illinois 60018 (847) 823-0500

5/2008 N:BNORTHLAKEB940032hr193BC

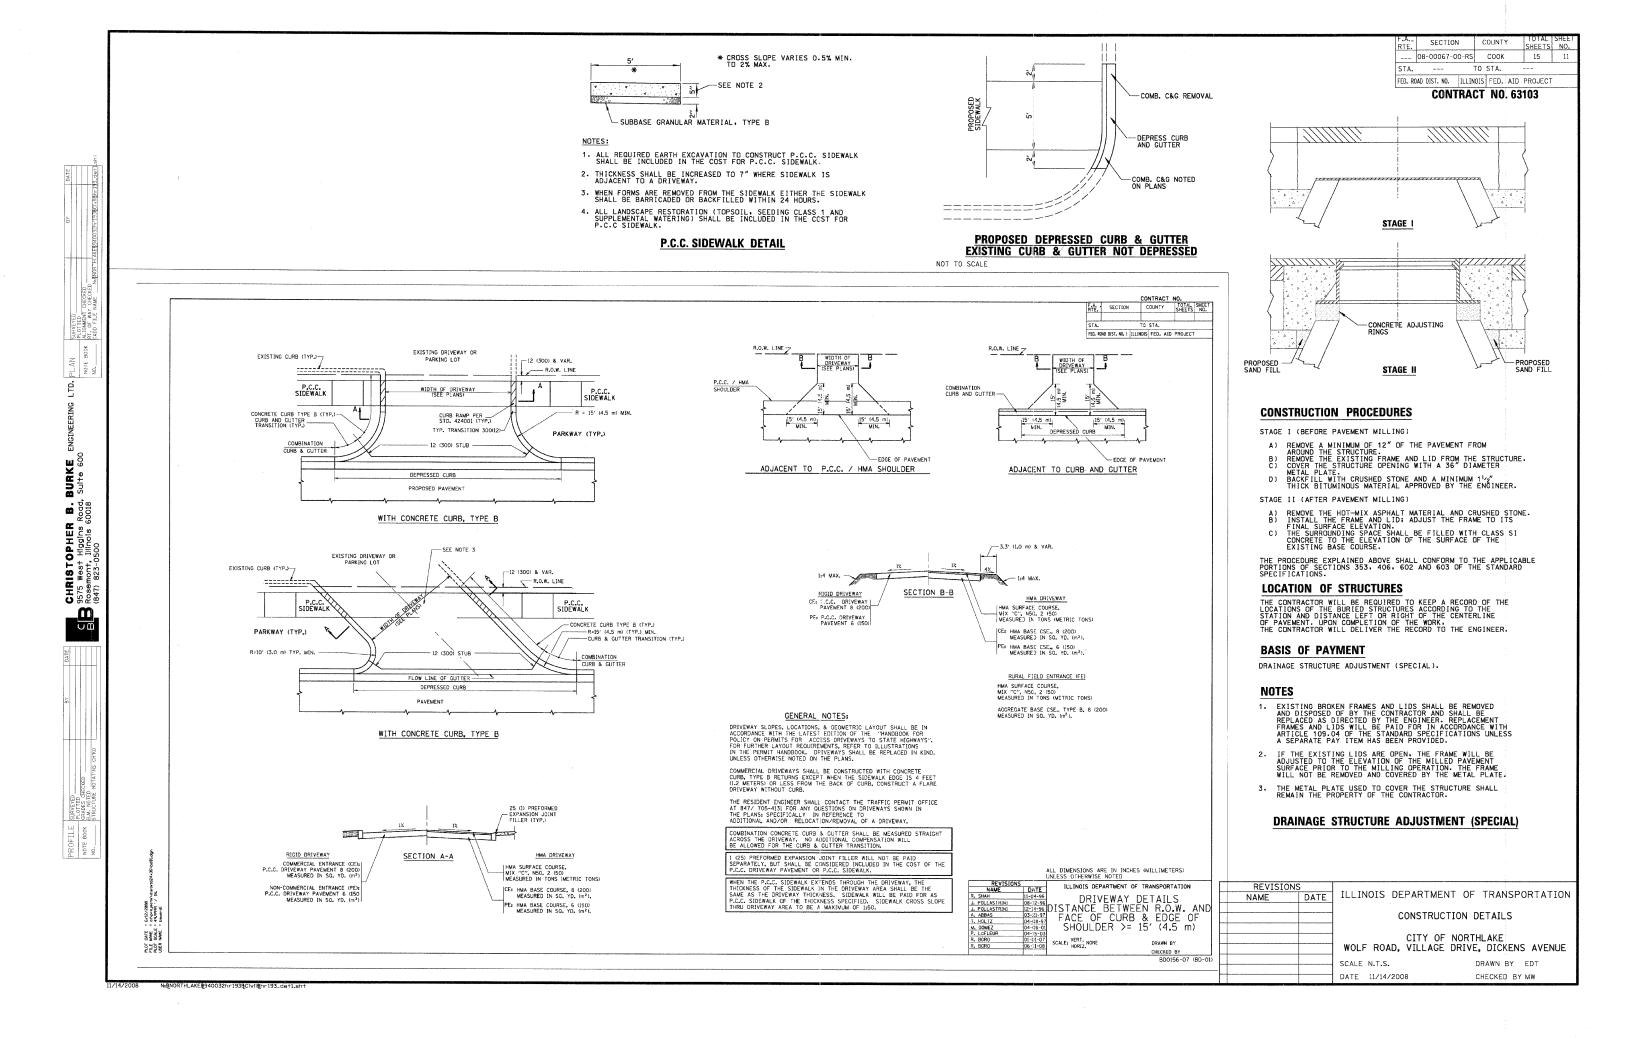

FED. ROAD DIST. NO. ILLINOIS FED. AID PROJECT CONTRACT NO. 63103 VARIABLE - TO MEET EXISTING DIMENSIONS_AND FIELD CONDITIONS (SEE NOTE (2)) PROP. CONC. CURB OR CURB AND GUTTER REPLACEMENT IN ACCORDANCE WITH STATE STANDARD 606001. (SEE NOTE (2)) SAW CUT FULL DEPTH - INCLUDED IN THE COST OF SIDEWALK, DRIVEWAY OR MEDIAN SURFACE REMOVAL PAY ITEM. SEE STATE STANDARD 606001 18" (450) MAX. EXISTING OR PROPOSED HMA SURFACE (IF APPLICABLE) 1/4" (5) EXISTING SIDEWALK, DRIVEWAY, MEDIAN SURFACE OR GROUND. PROPOSED SIDEWALK, DRIVEWAY PAVEMENT, MEDIAN SURFACE OR SEEDING, CLASS 1, EROSION CONTROL BLANKET AND TOP SOIL, 4 (100) RESTORATION (SEE NOTE 1). EXISTING CONCRETE PAVEMENT, CONCRETE BASE COURSE OR FLEXIBLE PAVEMENT SUITABLE BACKFILL MATERIAL - 3" (75) MIN. (INCLUDED IN THE COST OF CURB OR CURB AND GUTTER REMOVAL AND REPLACEMENT) * 3" (75) MINIMUM FROM TOP AND BOTTOM OF THE CONCRETE PAVEMENT OR BASE COURSE. PROPOSED 3/4" (20) PREFORMED EXPANSION JOINT AT CONCRETE SIDEWALKS, DRIVEWAYS, AND MEDIANS. (INCLUDED IN THE COST * * IF THE FINAL SURFACE OF THE PAVEMENT IS CONCRETE, THE GUTTER IS TO BE FLUSH OF CURB OR CURB AND GUTTER REMOVAL AND REPLACEMENT.) WITH THE PAVEMENT. NOTE: (1) SIDEWALK, DRIVEWAY PAVEMENT OR MEDIAN SURFACE SHALL BE SIMILAR TO THE MATERIAL BEING REMOVED AND WILL BE PAID FOR SEPARATELY. UNSUITABLE SUB-BASE MATERIAL TO BE REMOVED, IF DIRECTED BY THE ENGINEER, SHALL BE REPLACED WITH EITHER SUB-BASE GRANULAR SEEDING, CLASS 1, EROSION CONTROL BLANKET AND TOP SOIL, 4 (100) RESTORATION WILL NOT BE PAID FOR SEPARATELY, BUT SHALL BE INCLUDED IN THE COST OF CURB OR CURB MATERIAL, TYPE B OR ADDITIONAL THICKNESS OF CONCRETE. AND GUTTER REMOVAL AND REPLACEMENT. REMOVAL AND REPLACEMENT 4" (100) OR LESS IS INCLUDED IN THE COST OF CURB OR CURB AND GUTTER REMOVAL AND REPLACEMENT. (2) CURB OR CURB AND GUTTER REPLACEMENT SHALL MATCH THE SHAPE OF THE EXISTING CURB OR CURB AND GUTTER UNLESS OTHERWISE SPECIFIED. REMOVAL AND REPLACEMENT IN EXCESS OF 4" (100) WILL BE PAID FOR IN 3 FOR CURB OR CURB AND GUTTER REMOVAL AND REPLACEMENT ADJACENT TO FLEXIBLE ACCORDANCE WITH ARTICLE 109.04 OF THE STANDARD SPECIFICATIONS. PAVEMENT DELETE EPOXY COATED TIE BARS. (4) LONGITUDINAL BARS, IF ENCOUNTERED IN THE EXISTING CURB OR CURB AND GUTTER, ARE NOT TO BE REPLACED. CUTTING AND REMOVING LONGITUDINAL BARS SHALL BE INCLUDED PROPOSED #6 (20) EPOXY COATED TIE BARS 24" (600) LONG AT 24" (600) CENTERS WILL NOT BE PAID FOR SEPARATELY. DELETE EPOXY COATED TIE BARS IF EXISTING TIE BARS ARE USUABLE AS DETERMINED IN THE COST OF CURB OR CURB AND GUTTER REMOVAL AND REPLACEMENT. BY THE ENGINEER. (SEE NOTE 3). (5) THE COST OF HMA SURFACE REMOVAL IN THE EXISTING GUTTER FLAG SHALL BE INCLUDED IN THE COST OF THE CURB AND GUTTER REMOVAL AND REPLACEMENT. BASIS OF PAYMENT: (6) THE REMOVAL AND REPLACEMENT OF THE EXISTING CURB OR CURB AND GUTTER SHALL THIS WORK WILL BE PAID FOR AT THE CONTRACT UNIT PRICE PER BE DONE IN ACCORDANCE WITH THE APPLICABLE PORTIONS OF SECTION 440 AND 606 FOOT (METER) FOR "CURB REMOVAL AND REPLACEMENT" OR "COMBINATION CONCRETE CURB AND GUTTER REMOVAL AND REPLACEMENT". OF THE STANDARD SPECIFICATIONS. 7 THE LOCATIONS OF REMOVAL AND REPLACEMENT OF EXISTING CURB OR CURB AND GUTTER SHALL BE DETERMINED BY THE RESIDENT ENGINEER AT THE TIME OF CONSTRUCTION. ALL DIMENSIONS ARE IN INCHES (MILLIMETERS)
UNLESS OTHERWISE SHOWN. ILLINOIS DEPARTMENT OF TRANSPORTATION CURB OR 3/5/2007 Ki\distatd\ 56.600 '/ beuerdi CURB OR CURB AND GUTTER REMOVAL AND REPLACEMENT CURB AND GUTTER REMOVAL AND REPLACEMENT DATE NAME SCALE

SECTION COUNTY

TO STA.

DRAWN BY CHECKED BY BD600-06 (BD-24)

__ 08-00067-00-RS COOK

SHEETS NO


15 1


14/2008 N:@NORTHLAKE@940032hr193@CIVII@hr193_de+2.sh

BURKE Sulte 600


CHRISTOPHER 9575 West Higgins Re Rosemont, Illinois 60 (847) 823-0500


E E

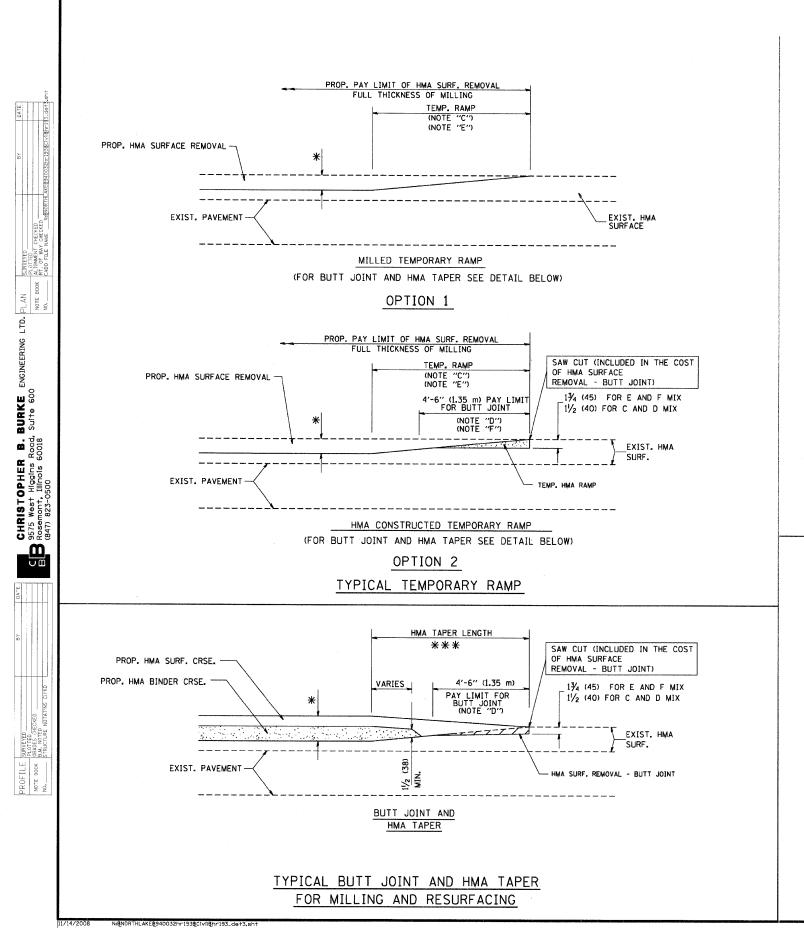

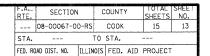

CONTRACT NO. 63103

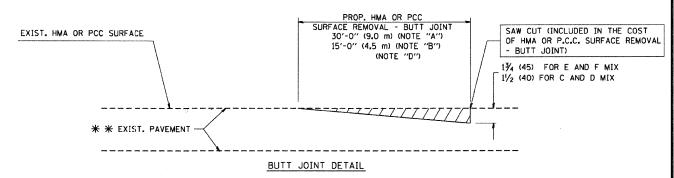

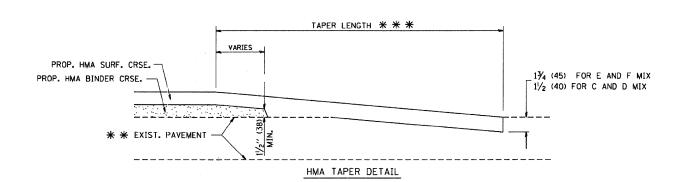

TYPICAL BUTT JOINT AND HMA TAPER FOR RESURFACING ONLY

* * PC CONCRETE, HMA OR HMA RESURFACED PAVEMENT.

- A: MAINLINE ROADWAYS AND MAJOR SIDE ROADS.
- C: THE TEMP, RAMP SHALL BE CONSTRUCTED IMMEDIATELY UPON REMOVAL OF THE EXISTING HMA SURFACE.
- D: THE BUTT JOINT SHALL BE CONSTRUCTED IMMEDIATELY PRIOR TO PLACING THE PROPOSED HMA COURSES.
- E: TAPER THE TEMP. RAMP AT A RATE OF 3'-0" (900 mm) PER 1 INCH (25 mm) OF MILLING THICKNESS.
- F: INSTALLATION AND REMOVAL OF THE 4'-6" (1.35 m) TEMP. RAMP IS INCLUDED IN COST OF HMA SURFACE REMOVAL - BUTT JOINT
- G# SEE ARTICLE 406.08 AND 406.14 OF THE STANDARD SPECIFICATIONS FOR "HMA AND/OR PCC SURFACE REMOVAL, BUTT JOINT".
- * SEE TYPICAL SECTIONS FOR MILLING THICKNESS.

** * 20'-0" (6.1 m) PER 1 (25) RESURFACING (NOTE "A") 10'-0" (3.0 m) PER 1 (25) RESURFACING (NOTE "B")

ALL DIMENSIONS ARE IN INCHES (MILLIMETERS) UNLESS OTHERWISE SHOWN.

THE BUTT JOINT WILL BE PAID FOR AT THE CONTRACT UNIT PRICE PER SOUARE YARD (SOUARE METER) FOR "HOIT-MIX ASPHALT SURFACE REMOVAL - BUTT JOINT" OR FOR "PORTLAND CEMENT CONCRETE SURFACE REMOVAL-BUTT JOINT".


REVISION	NS	
NAME	DATE	
M. DE YONG	6-13-90	
M. DE YONG	7-3-90	
M. DE YONG	3-27-92	
R. SHAH	09/09/94	
R, SHAH	10/25/94	
A. ABBAS	03/21/97	
M. GOMEZ	04/06/01	
R. BORO	01/01/07	SC
		St


ILLINOIS DEPARTMENT OF TRANSPORTATION

BUTT JOINT AND HMA TAPER DETAILS

CHECKED BY

BD400-05 (VI=BD32)

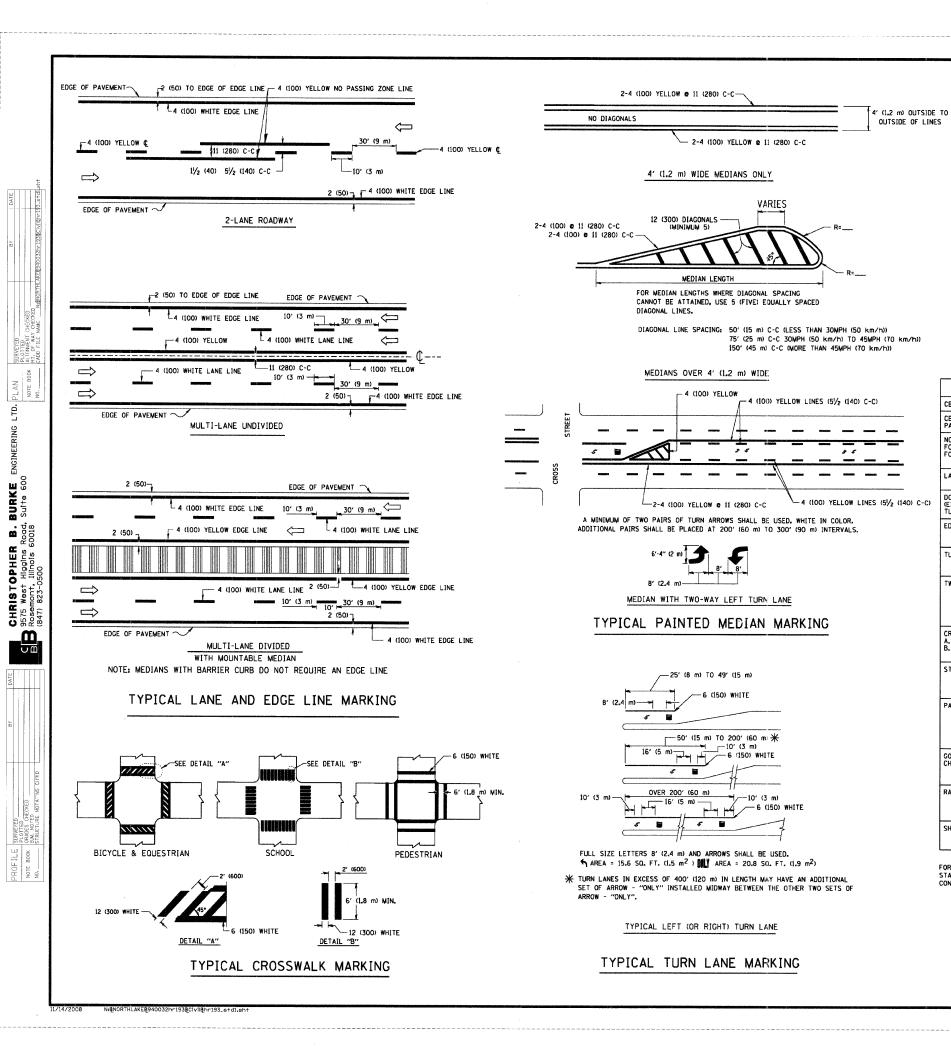

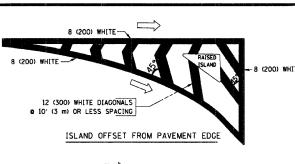

F.A.-	SECTION	COUNTY	SHEETS	NO.
---	08-00067-00-RS	COOK	15	14
---	STA.	---	TO STA.	---
FED. ROAD DIST. NO.	ILLINOIS	FED. AID	PROJECT	

CONTRACT NO. 63103

8 (200) WHITE 2 (50) RAISED 1 RAISED 2 (50) ISLAND AT PAVEMENT EDGE

TYPICAL ISLAND MARKING

TYPE OF MARKING	WIDTH OF LINE	PATTERN	COLOR	SPACING / REMARKS
CENTERLINE ON 2 LANE PAVEMENT	4 (100)	SKIP-DASH	YELLOW	10' (3 m) LINE WITH 30' (9 m) SPACE
CENTERLINE ON MULTI-LANE UNDIVEDED PAVEMENT	2 2 4 (100)	SOLID	YELLOW	11 (280) C-C
NO PASSING ZONE LINES: FOR ONE DIRECTION FOR BOTH DIRECTIONS	4 (100) 2 0 4 (100)	SOLID SOLID	YELLOW YELLOW	5½ (140) C-C FROM SKIP-DASH CENTERLINE 11 (280) C-C OMIT SKIP-DASH CENTERLINE BETWEEN
LANE LINES	4 (100) 5 (125) ON FREEWAYS	SKIP-DASH SKIP-DASH	WHITE WHITE	10' (3 m) LINE WITH 30' (9 m) SPACE
DOTTED LINES (EXTENSIONS OF CENTER, LANE OR TURN LANE MARKINGS)	SAME AS LINE BEING EXTENDED	SKIP-DASH	SAME AS LINE BEING EXTENDED	2' (600) LINE WITH 6' (1.8 m) SPACE
EDGE LINES	4 (100)	SOLID	YELLOW-LEFT WHITE-RIGHT	OUTLINE MOUNTABLE MEDIANS IN YELLOW: EDGE LINES ARE NOT USED NEXT TO BARRIER CURB
TURN LANE MARKINGS	6 (150) LINE; FULL SIZE LETTERS & SYMBOLS (8' (2.4m))	SOLID	WHITE	SEE TYPICAL TURN LANE MARKING DETAIL
TWO WAY LEFT TURN MARKING	2 e 4 (100) EACH DIRECTION	SKIP-DASH AND SOLID	YELLOW	10' (3 m) LINE WITH 30' (9 m) SPACE FOR SKIP-DASH; 51/2 (140) C-C BETWEEN SOLID LINE AND SKIP-DASH LINE
	8' (2.4m) LEFT ARROW	IN PAIRS	WHITE	SEE TYPICAL TWO-WAY LEFT TURN MARKING DETAIL
CROSSWALK LINES (PEDESTRIAN) A. DIAGONALS (BIKE & EQUESTRIAN) B. LONGITUDINAL BARS (SCHOOL)	2 m 6 (150) 12 (300) m 45° 12 (300) m 90°	SOLID SOLID SOLID	WHITE WHITE WHITE	NOT LESS THAN 6' (I.8 m) APART 2' (600) APART 2' (500) APART SEE TYPICAL CROSSWALK MARKING DETAILS.
STOP LINES	24 (600)	SOLID	WHITE	PLACE 4' (1.2 m) IN ADVANCE OF AND PARALLEL TO CROSSWALK, IF PRESENT. OTHERWISE, PLACE AT DESIRED STOPPING POINT, PARALLEL TO CROSSROAD CENTERLINE, WHERE POSSIBLE
PAINTED MEDIANS	2 & 4 (100) WITH 12 (300) DIAGONALS	SOLID	YELLOW: TWO WAY TRAFFIC	11 (280) C-C FOR THE DOUBLE LINE
	e 45° NO DIAGONALS USED FOR 4' (1.2 m) WIDE MEDIANS		WHITE: ONE WAY TRAFFIC	SEE TYPICAL PAINTED MEDIAN MARKING.
GORE MARKING AND CHANNELIZING LINES	8 (200) WITH 12 (300) DIAGONALS @ 45°	SOLID	WHITE	DIAGONALS; 15' (4.5 m) C-C (LESS THAN 30MPH (50 km/h)) 20' (6 m) C-C 30MPH (50 km/h) TO 45MPH (70 km/h)) 30' (9 m) C-C (OVER 45MPH (70 km/h))
RAILROAD CROSSING	24 (600) TRANSVERSE LINES; "RR" IS 6' (1.8 m) LETTERS; 16 (400) LINE FOR "X"	SOLID	WHITE	SEE STATE STANDARD 780001 AREA OF: "R"=3.6 SQ. FT. (0.33 m ²) EACH "X"=54.0 SQ. FT. (5.0 m ²)
SHOULDER DIAGONALS	12 (300) c 45°	SOLID	WHITE - RIGHT YELLOW - LEFT	50' (15 m) C-C (LESS THAN 30MPH (50 km/h)) 75' (25 m) C-C (30 MPH (50 km/h) TO 45MPH (70 km/h)) 150' (45 m) C-C (OVER 45MPH (70 km/h))

FOR FURTHER DETAILS ON PAVEMENT WARKING REFER TO STANDARD SPECIFICATIONS FOR ROAD AND BRIDGE CONSTRUCTION AND STATE STANDARD 780001.

All dimensions are in inches (millimeters) unless otherwise shown,

REVISIONS		THE INDIS DEPARTME	NT OF TRANSPORTATION	
NAME	DATE	ILLINOIS DEFARING	INT OF TRANSPORTATION	
EVERS	03-19-90			
T. RAMMACHER	10-27-94	nistr	ICT ONE	
ALEX HOUSEH	10-09-96			
ALEX HOUSEH	10-17-96	I TYPICAL	PAVEMENT	
T. RAMMACHER	01-06-00	MAG	NINCS	
		MARKINGS		
		SCALE: NONE	DRAWN BY CADD	
		07/25/05	CHECKED BY	

