### STATE OF ILLINOIS

# DEPARTMENT OF TRANSPORTATION PLANS FOR

## PROPOSED FEDERAL-AID HIGHWAY

F.A.P. ROUTE 348 WAUKEGAN ROAD (IL 43)
MAIN STREET TO F.A.U. ROUTE 1324 DEMPSTER STREET (IL 58)

STREET LIGHTING

SECTION 07-00102-00-LT PROJECT NO: HSIP-8003 (913) VILLAGE OF MORTON GROVE COOK COUNTY


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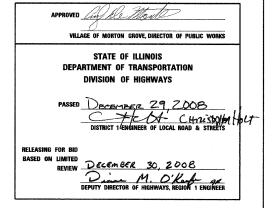
END PROJECT
STA. 35+75

BEGIN PROJECT
STA. 51+09

LOCATION MAP

DATE: 12/18/2008



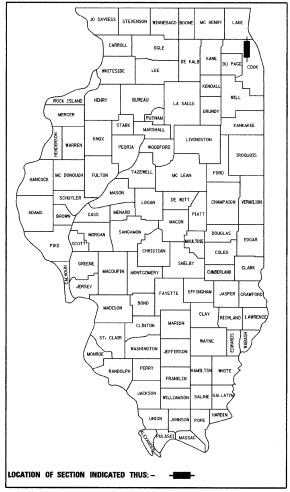

## PRINTED BY THE AUTHORITY OF THE STATE OF ILLINOIS


PLANS PREPARED BY: CIORBA GROUP

Ciorba Group, Inc.

DESIGN FIRM REGISTRATION NUMBER

184-001016

CONSULTING ENGINEERS
SUITE 402, 5507 NORTH CUMBERLAND AVE
CHICAGO, ILLINOIS 60656 # (773) 775-4009

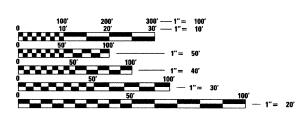

FOR INDEX OF SHEETS, SEE SHEET NO. 2

FULL SIZE PLANS HAVE BEEN PREPARED USING STANDARD ENGINEERING SCALES, REDUCED SIZED PLANS WILL NOT CONFORM TO STANDARD SCALES, IN MAKING MEASUREMENTS ON REDUCED PLANS, THE ABOVE SCALES MAY BE USED.



CONTRACT NO: 63099

J.U.L.I.E JOINT UTILITY LOCATION INFORMATION FOR EXCAVATION 1–800–892–0123

**BEGIN PROJECT** 

STA. 10 + 65

GROSS LENGTH OF PROJECT = 3650 FT = 0.69 MI
NET LENGTH OF PROJECT = 3650 FT = 0.69 MI

#### INDEX OF SHEETS

- INDEX OF SHEETS AND GENERAL NOTES
- SUMMARY OF QUANTITIES
- PROPOSED LIGHTING PLAN 4-9
- 10-11 ONE LINE DIAGRAMS
- 12-22 ELECTRICAL DETAILS
- TRAFFIC CONTROL AND PROTECTION 23 FOR SIDE ROADS, INTERSECTION AND DRIVEWAYS (TC-10)

#### LIST OF HIGHWAY STANDARDS

000001-05 STANDARD SYMBOLS, ABBREVIATIONS AND

701602-04 URBAN LANE CLOSURE, MULTILANE, 2W WITH BIDIRECTIONAL LEFT TURN LANE

701606-06 URBAN LANE CLOSURE, MULTILANE, 2W WITH MOUNTABLE MEDIAN

701801-04 LANE CLOSURE MULTILANE 1W OR 2W CROSSWALK OR SIDEWALK CLOSURE

701901-01 TRAFFIC CONTROL DEVICES

#### GENERAL NOTES

ALL CONSTRUCTION SHALL BE COMPLETED IN ACCORDANCE WITH THE CONTRACT SPECIFICATIONS AS WELL AS:

LINOIS DEPARTMENT OF TRANSPORTATION STANDARD SPECIFICATIONS OR ROAD AND BRIDGE CONSTRUCTION AS ADOPTED JANUARY 1, 2007.

ILLINOIS MANUAL ON UNIFORM TRAFFIC CONTROL DEVICES FOR STREETS AND HIGHWAYS (LATEST EDITION IN EFFECT ON THE DATE OF INVITATION FOR BIDS)

NATIONAL ELECTRIC CODE, 2008 EDITION.

DISTRICT ONE RECURRING SPECIAL PROVISIONS FOR ROADWAY LIGHTING, ADOPTED: JANUARY 1, 2008.

2. ALL UNDERGROUND UTILITY LOCATIONS, INCLUDING SANITARY SEWERS, STORM SEWERS, WATER MAINS, AND THEIR SERVICE LINES SHOWN ON THE PLANS ARE APPROXIMATE ONLY. IT SHALL BE THE CONTRACTOR'S RESPONSIBILITY TO HAVE THE RESPECTIVE UTILITY COMPANIES FIELD-LOCATE ALL UTILITIES, ASCERTAIN THEIR STATUS AND ADJUST OR RELOCATE THESE UTILITIES, AS NECESSARY, PRIOR TO STARTING CONSTRUCTION. THIS WORK SHALL BE CONSIDERED INCIDENTAL TO THE CONTRACT. THE CONTRACTOR SHALL NOTIFY ALL PUBLIC AND PRIVATE UTILITIES BEFORE STARTING CONSTRUCTION, INCLUDING BUT NOT LINED TO. INCLUDING, BUT NOT LIMITED TO:

NICOR GAS 1844 FERRY ROAD NAPERVILLE, IL 60563 (630) 388-2362

COMED

1500 FRANKLIN BLVD

LIBERTYVILLE, IL 60048

AT&T 2004 MINER STREET DES PLAINES, IL 60016 (847) 759-5581

(630) 437-2236

COMCAST 688 INDUSTRIAL DRIVE ELMHURST, IL 60126 (630) 600-6352

VILLAGE OF MORTON GROVE PUBLIC WORKS 7840 NAGLE AVE. MORTON GROVE, IL 60053 (847) 470-5235

3. THE VILLAGE OF MORTON GROVE DEPARTMENT OF PUBLIC WORKS SHALL BE NOTIFIED AT LEAST 48 HOURS PRIOR TO COMMENCING CONSTRUCTION.

4. THE CONTRACTOR SHALL OBTAIN ALL NECESSARY PERMITS PRIOR TO COMMENCING CONSTRUCTION.

5. THE DIMENSIONS AND LOCATIONS OF UTILITY FACILITIES AS SHOWN ON THESE PLANS ARE AN ESTIMATE FOR DESIGN PURPOSES ONLY, AND ARE NOT INTENDED FOR USE AS FIELD LOCATIONS FOR CONSTRUCTION. BEFORE BEGINNING ANY DIGGING OR EXCAVATION, IT SHALL BE THE CONTRACTOR'S RESPONSIBILITY TO CONTACT J.U.L.I.E. AT 1-800-892-0123 TO VERIFY UTILITY LOCATIONS.

6. THE CONTRACTOR SHALL MAINTAIN A SET OF CONSTRUCTION RECORD DRAWINGS NOTING ALL CHANGES TO THE PLANS AND THE LOCATION AND DEPTH OF ALL UNDERGROUND UTILITIES ENCOUNTERED. A MYLAR REPRODUCIBLE AS-BUILT DRAWING AND TWO (2) PAPER SETS MUST BE SUBMITTED TO VILLAGE OF MORTON GROVE DEPARTMENT OF PUBLIC WORKS FOR REVIEW AND APPROVAL UPON COMPLETION OF THE PROJECT. THIS WORK WILL BE CONSIDERED INCIDENTAL TO THIS CONTRACT.

7. ANY SIGN LOCATED IN THE PUBLIC RIGHT-OF-WAY WHICH INTERFERES WITH THE CONSTRUCTION OF THE PROPOSED LIGHTING SYSTEM SHALL BE REMOVED AND RE-ERECTED. ALL WORK INVOLVING SIGN REMOVAL AND RE-ERECTION SHALL BE GOVERNED BY THE FOLLOWING REQUIREMENTS:

A SIGN LOG SHALL BE CREATED BY THE CONTRACTOR PRIOR TO THE START OF CONSTRUCTION. A COPY SHALL BE GIVEN TO THE ENGINEER FOR REVIEW. UPON REVIEW BY THE ENGINEER, THE CONTRACTOR SHALL PROVIDE A COPY TO THE VILLAGE OF

B. SIGNS SHALL NOT BE MOVED UNTIL PROGRESS OF WORK NECESSITATES IT.

C. EVERY SIGN REMOVED MUST BE RE-ERECTED AT A TEMPORARY LOCATION IN A WORKMANLIKE MANNER AND BE VISIBLE TO TRAFFIC FOR WHICH IT WAS INTENDED. ALL SUCH SIGNS MUST BE MAINTAINED STRAIGHT AND CLEAN FOR THE DURATION OF THE

D. ALL SIGNS SHALL BE RE-ERECTED IN THE ORIGINAL LOCATION AS THE IMPROVEMENTS

E. THE CONTRACTOR SHALL BE RESPONSIBLE FOR ANY SIGNS DAMAGED BY HIS/HER CONSTRUCTION ACTIVITIES AND WILL REPLACE THEM AT NO COST TO THE VILLAGE. THIS WORK SHALL BE INCIDENTAL TO THE CONTRACT.

8. NOMINAL QUANTITIES FOR THE FOLLOWING PAY ITEMS HAVE BEEN INCLUDED IN THE PLANS 1. THE ATTENTION OF THE CONTRACTOR IS DIRECTED TO ARTICLE 801.04 OF THE AND SHALL BE UTILIZED AS DIRECTED BY THE ENGINEER:

PCC DRIVEWAY PAVEMENT. 8 INCH, SPECIAL 500 SQ. FT. PCC SIDEWALK, 5" 500 SQ. FT. LIGHT POLE FOUNDATION, 24" DIAMETER, OFFSET 220 F00T TEST HOLES 16 EACH

9. THE CONTRACTOR WILL CONFINE HIS OPERATIONS TO WITHIN THE AREAS DESIGNATED BY THE ENGINEER IN THE FIELD. DAMAGE TO PROPERTY OUTSIDE OF THESE LIMITS WILL BE RESTORED TO THE CONDITION THAT EXISTED PRIOR TO THE PROJECT AND SHALL BE INCIDENTAL TO THE CONTRACT. ANY AREAS WITHIN THE VILLAGE RIGHT OF WAY SHALL BE REPLACED WITH SOD.

10.THE CONTRACTOR SHALL PROTECT ALL TREES AND SHRUBS ADJACENT TO THE PROJECT DURING CONSTRUCTION OPERATIONS, IN ACCORDANCE WITH SECTION 201 OF THE STANDARD SPECIFICATIONS, THE SPECIAL PROVISIONS AND AS INDICATED ON THE PLAN.

11. ALL TREE TRIMMING WILL BE COMPLETED BY THE VILLAGE OF MORTON GROVE.

12. IT SHALL BE THE CONTRACTOR'S RESPONSIBILITY TO MAINTAIN SATISFACTORY DRAINAGE OF THE PROJECT SITE AND THOSE AREAS THAT PRESENTLY DRAIN THROUGH THE PROJECT SITE AT ALL TIMES DURING THE CONSTRUCTION PERIOD. THE COST OF PROVIDING, INSTALLING AND MAINTAINING THESE MEASURES SHALL BE INCIDENTAL TO THE COST OF THE CONTRACT.

13. IT SHALL BE THE CONTRACTOR'S RESPONSIBILITY TO CLEAN ALL DRAINAGE STRUCTURES OF ALL DEBRIS ACCUMULATED DURING CONSTRUCTION OPERATIONS. THIS WORK WILL NOT BE PAID FOR SEPARATELY BUT SHALL BE CONSIDERED INCIDENTAL TO THE CONTRACT.

14. NO CONSTRUCTION MATERIALS OR EQUIPMENT SHALL BE STORED IN OR MOVED THROUGH THE DRIPLINE OF ANY PARKWAY TREE. IF THIS CLEARANCE CANNOT BE MAINTAINED, THE FORESTRY SUPERINTENDANT MUST BE NOTIFIED PRIOR TO CONSTRUCTION.

SCALE: N/A

#### ROADWAY LIGHTING NOTES

STANDARD SPECIFICATIONS REGARDING THE PROPOSED LOCATIONS OF THE LIGHTING SYSTEM, ADDITIONALLY, THE UNIT DUCT ROUTING SHOWN ON THE PLANS IS MAINLY INTENDED TO SHOW ELECTRICAL CIRCUITRY. AN EFFORT HAS BEEN MADE TO AVOID UTILITY CONFLICTS BUT THE EXACT LOCATION OF ELECTRICAL CABLES AND CONDUITS SHOULD BE APPROVED BY THE ENGINEER AFTER THE UNDERGROUND UTILITIES HAVE BEEN LOCATED BY IT'S OWNER.

ALL PROPOSED LIGHT POLE LOCATIONS SHALL BE STAKED BY THE CONTRACTOR AND BE APRROVED BY THE VILLAGE PRIOR TO EXCAVATION. NO ADDITIONAL COMPENSATION SHALL BE PROVIDED THE FOR THIS STAKING.

2. THE CONTRACTOR SHALL KEEP DEVIATIONS FROM THE UNIT DUCT ROUTING SHOWN ON THE PLANS TO A MINIMUM. MAJOR DEVIATIONS SHALL BE REPORTED TO AND APPROVED BY THE ENGINEER BEFORE INSTALLATION.

 SHORT RUNS OF UNIT DUCT (FOR ROADWAY LIGHTING) MAY BE TRENCHED AT THE DISCRETION OF THE VILLAGE, NO ADDITIONAL COMPENSATION SHALL BE PROVIDED FOR TRENCHING THE UNIT DUCT.

4. WEEKDAY CONSTRUCTION ACTIVITY THAT WILL NECESSITATE LANE CLOSURE IN ACCORDANCE WITH STANDARD 701606 OR STANDARD 701801 MUST BE LIMITED TO THE HOURS BETWEEN 9:00 A.M. AND 3:00 P.M. IN ORDER TO AVOID THE PEAK RUSH

5. THE AREA OF SIDEWALK TO BE REMOVED AND REPLACED HAS BEEN ESTIMATED. THESE LIMITS AND LOCATIONS ARE SUBJECT TO CHANGE AS DIRECTED BY THE ENGINEER. THE REMOVAL LIMITS SHOULD BE LOCATED AT AN EXISTING JOINT IN THE SIDEWALK. THE EXACT LIMITS SHALL BE DETERMINED BY THE ENGINEER IN

6. REMOVAL OF THE EXISTING LIGHTING SYSTEM SHALL NOT BEGIN BEFORE THE PROPOSED LIGHTING SYSTEM IS OPERATIONAL. THE CONTRACTOR SHALL NOTIFY COMMONWEALTH EDISON WHEN THE PROPOSED LIGHTING SYSTEM WILL BE OPERATIONAL SO REMOVAL OF COMMONWEALTH EDISON LUMINAIRES AND MAST ARMS MAY COMMENCE.

7. WITHIN THIRTY (30) DAYS AFTER THE CONTRACT IS SIGNED AND BEFORE ANY WORK IS AUTHORIZED BY THE ENGINEER, THE CONTRACTOR SHALL SUBMIT MANUFACTURER'S LITERATURE PERTAINING TO LIGHTING WORK FOR THE ELECTRICAL ENGINEER'S

8. THE ENGINEER SHALL APPROVE THE LOCATION OF ALL PUSH PITS.

9. NO POLES SHALL BE ERECTED UNTIL THE RESPECTIVE FOUNDATIONS HAVE CURED.

10.NO UNDERGROUND SPLICES ARE ALLOWED.

Ciorba Group, Inc. ONSULTING ENGINEERS 507 North Cumberland Avenue, Suite 402 Chicago, Illinois 60656

DESIGNED -MLB REVISED DRAWN - MLB REVISED PLOT SCALE = 1.0000 '/ IN. CHECKED -JMV REVISED Fax 773.775.4014 PLOT DATE = 12/29/2008 DATE DECEMBER 2008 REVISED

V	VAUKEGAN ROAD LIGHTING IMPROVEMENTS	F.A.P. RTE.	SECTION	COUNTY	TOTAL	SHE
	INDEX OF SHEETS AND GENERAL NOTES	348	07-00102-00-LT	соок	23	2
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CODE NUMBER	DESCRIPTION	UNIT	QUANTITY
25200200	SUPPLEMENTAL WATERING	UNIT	2
25200700	SODDING, SPECIAL	SQ YD	550
42300800	PORTLAND CEMENT CONCRETE DRIVEWAY PAVEMENT, 8 INCH, SPECIAL	SQ YD	20
42400200	PORTLAND CEMENT CONCRETE SIDEWALK 5 INCH	SQ FT	500
44000600	SIDEWALK REMOVAL	SQ FT	500
67100100	MOBILIZATION	L SUM	1
70102625	TRAFFIC CONTROL AND PROTECTION, STANDARD 701606	L SUM	1
70102632	TRAFFIC CONTROL AND PROTECTION, STANDARD 701602	L SUM	1
70102640	TRAFFIC CONTROL AND PROTECTION, STANDARD 701801	L SUM	1
80400100	ELECTRIC SERVICE INSTALLATION	EACH	2
80400200	ELECTRIC UTILITY SERVICE CONNECTION	L SUM	1
81018600	CONDUIT PUSHED, 2 1/2" DIA., GALVANIZED STEEL	FOOT	200
81018700	CONDUIT PUSHED, 3" DIA., GALVANIZED STEEL	FOOT	2,950
81603210	UNIT DUCT, 600V, 3-1C NO.4, 1/C NO.6 GROUND, (EPR-TYPE RHW),1 1/4" DIA. POLYETHYLENE	FOOT	4,600
81603225	UNIT DUCT, 600V, 4-1C NO.4, 1/C NO.6 GROUND, (EPR-TYPE RHW),1 1/2" DIA. POLYETHYLENE	FOOT	4,800
81700120	ELECTRIC CABLE IN CONDUIT, 600V (EPR-TYPE RHW) 1/C NO. 6	FOOT	400
81700125	ELECTRIC CABLE IN CONDUIT, 600V (EPR-TYPE RHW) 1/C NO. 4	FOOT	1,600
81702170	ELECTRIC CABLE IN CONDUIT, 600V (XLP-TYPE USE) 1/C NO. 2/0	FOOT	850
82102250	LUMINAIRE, SODIUM VAPOR, HORIZONTAL MOUNT 250 WATT	EACH	30

\* - SPECIALTY ITEM

CODE NUMBER	DESCRIPTION	UNIT	QUANTITY
82102310	LUMINAIRE, SODIUM VAPOR, HORIZONTAL MOUNT 310 WATT	EACH	26
82500505	LIGHTING CONTROLLER, SPECIAL	EACH	1
82500540	LIGHTING CONTROLLER TYPE CB-RCS 100AMP - 480VOLT	EACH	1
83007400	LIGHT POLE, ALUMINUM, 35 FT. M.H., 10 FT. MAST ARM	EACH	30
83050800	LIGHT POLE, ALUMINUM, 47.5 FT. M.H., 12 FT. MAST ARM	EACH	18
83600200	LIGHT POLE FOUNDATION, 24" DIAMETER	F00T	260
83600215	LIGHT POLE FOUNDATION, 24" DIAMETER, OFFSET	FOOT	220
83800105	BREAKAWAY DEVICE, TRANSFORMER BASE, 11.5 INCH BOLT CIRCLE	EACH	30
83800205	BREAKAWAY DEVICE, TRANSFORMER BASE, 15 INCH BOLT CIRCLE	EACH	11
84200600	REMOVAL OF EXISTING LIGHTING UNIT, NO SALVAGE	EACH	10
87900200	DRILL EXISTING HANDHOLE	EACH	4
89502300	REMOVE ELECTRIC CABLE FROM CONDUIT	FOOT	1,800
X0324387	LUMINAIRE SAFETY CABLE ASSEMBLY	EACH	26
X0324599	ROD AND CLEAN EXISTING CONDUIT	FOOT	500
X8420110	REMOVE LIGHT POLE FOUNDATION, PARTIAL	EACH	10
XX003338	TEST HOLE	EACH	16
XX006937	GROUND ROD, 5/8" DIA. X 10 FT.	EACH	48


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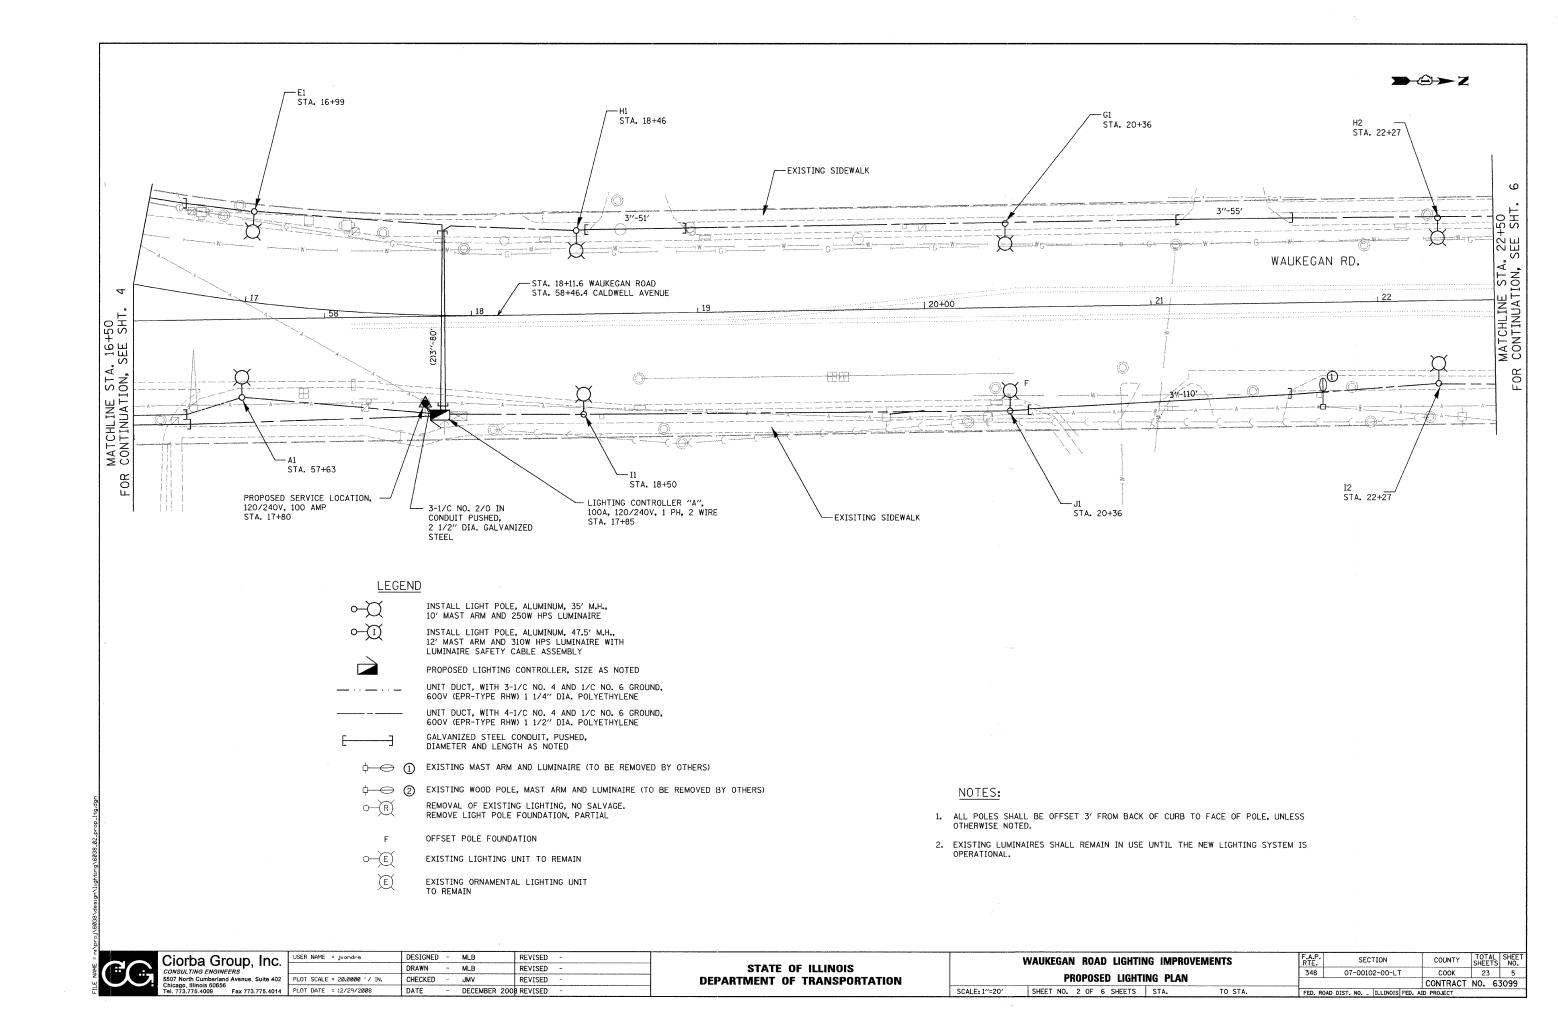
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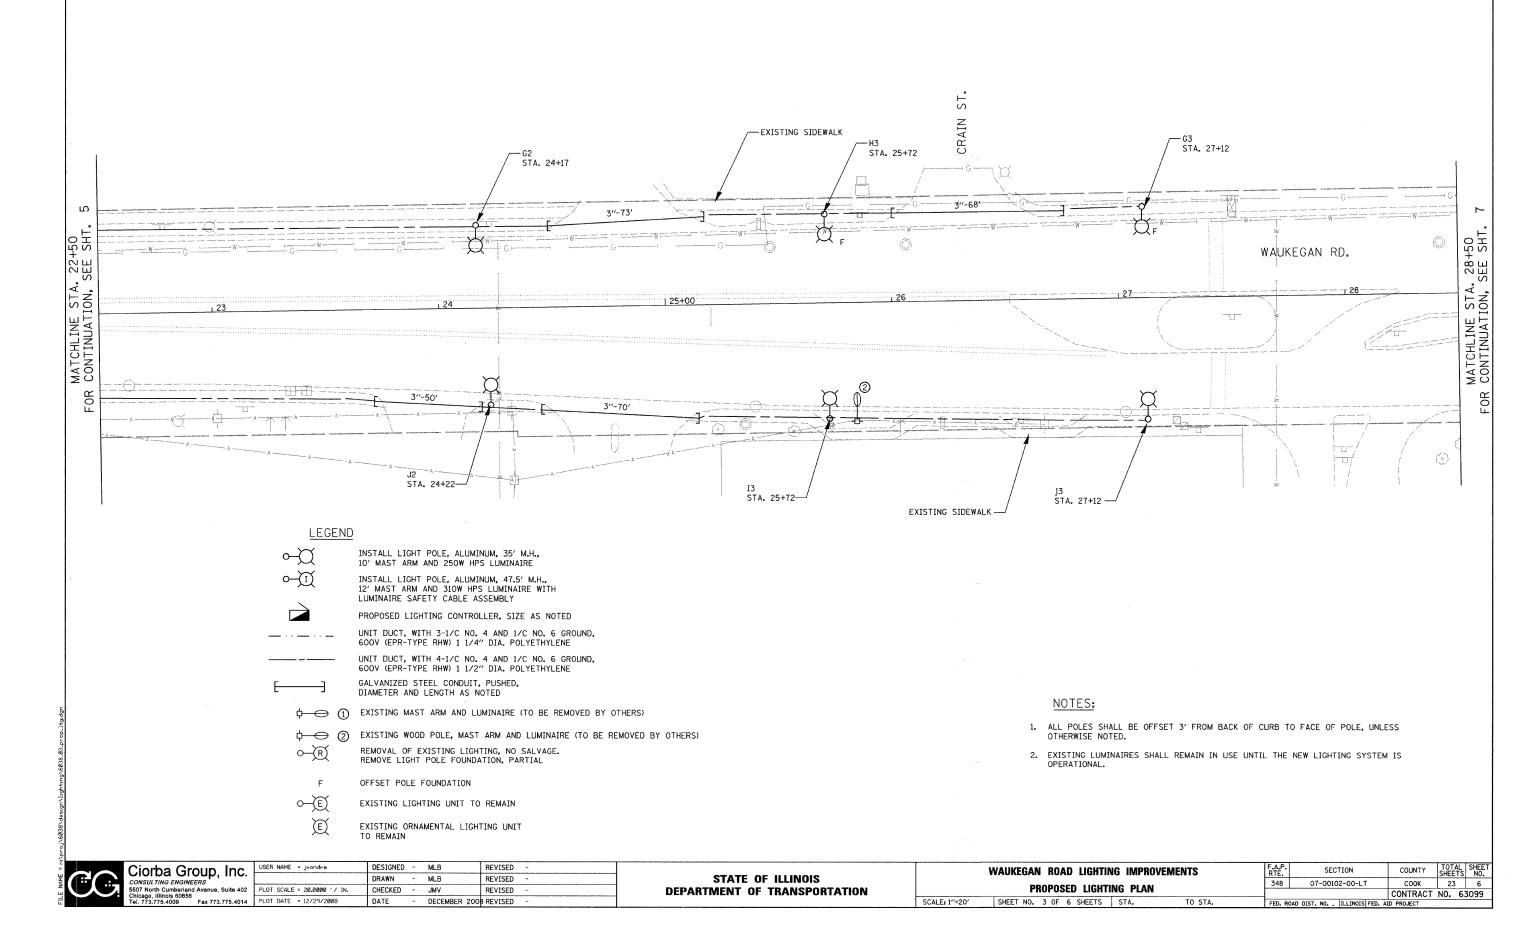
STATE OF ILLINOIS DEPARTMENT OF TRANSPORTATION	WAUKEGAN ROAD LIGHTING IMPROVEMENTS
	SUMMARY OF QUANTITIES
	SCALE: N/A SHEET NO. 1 OF 1 SHEETS STA. TO ST


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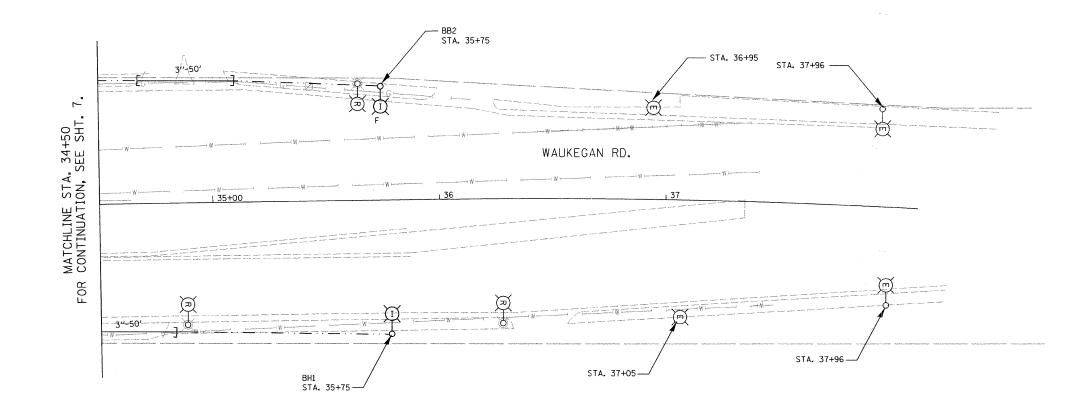
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#### **LEGEND**

INSTALL LIGHT POLE, ALUMINUM, 35' M.H., 10' MAST ARM AND 250W HPS LUMINAIRE

INSTALL LIGHT POLE, ALUMINUM, 47.5' M.H., 12' MAST ARM AND 310W HPS LUMINAIRE WITH LUMINAIRE SAFETY CABLE ASSEMBLY

PROPOSED LIGHTING CONTROLLER, SIZE AS NOTED

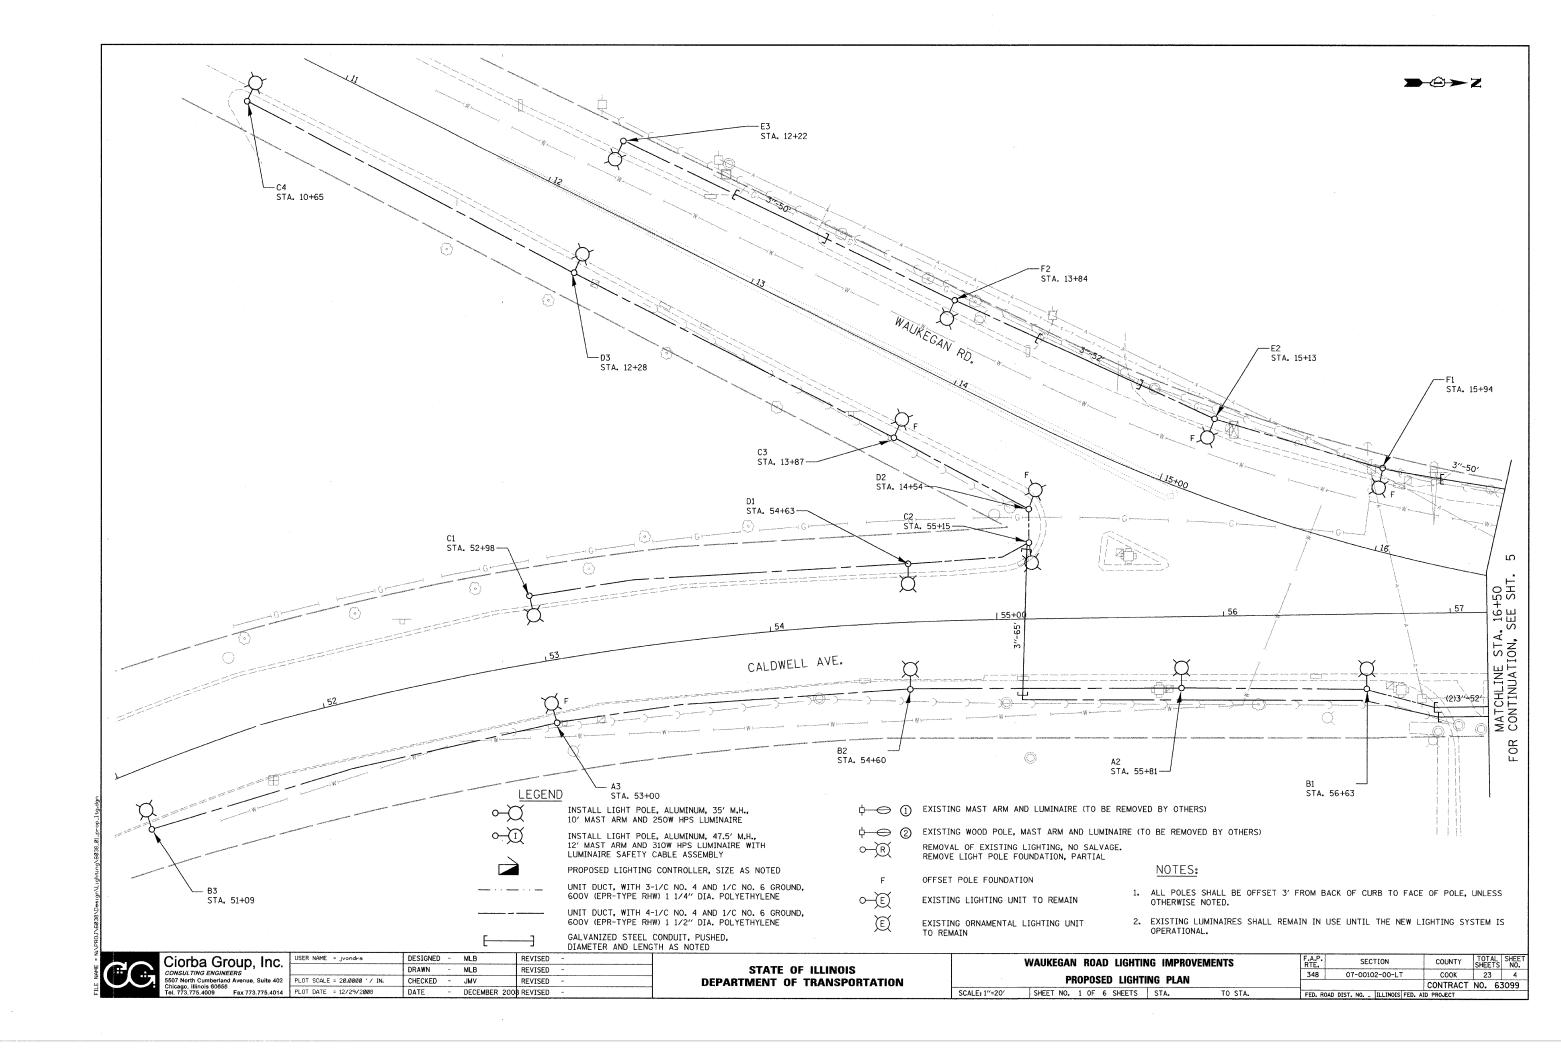UNIT DUCT, WITH 3-1/C NO. 4 AND 1/C NO. 6 GROUND, 600V (EPR-TYPE RHW) 1 1/4" DIA. POLYETHYLENE
UNIT DUCT, WITH 4-1/C NO. 4 AND 1/C NO. 6 GROUND, 600V (EPR-TYPE RHW) 1 1/2" DIA. POLYETHYLENE

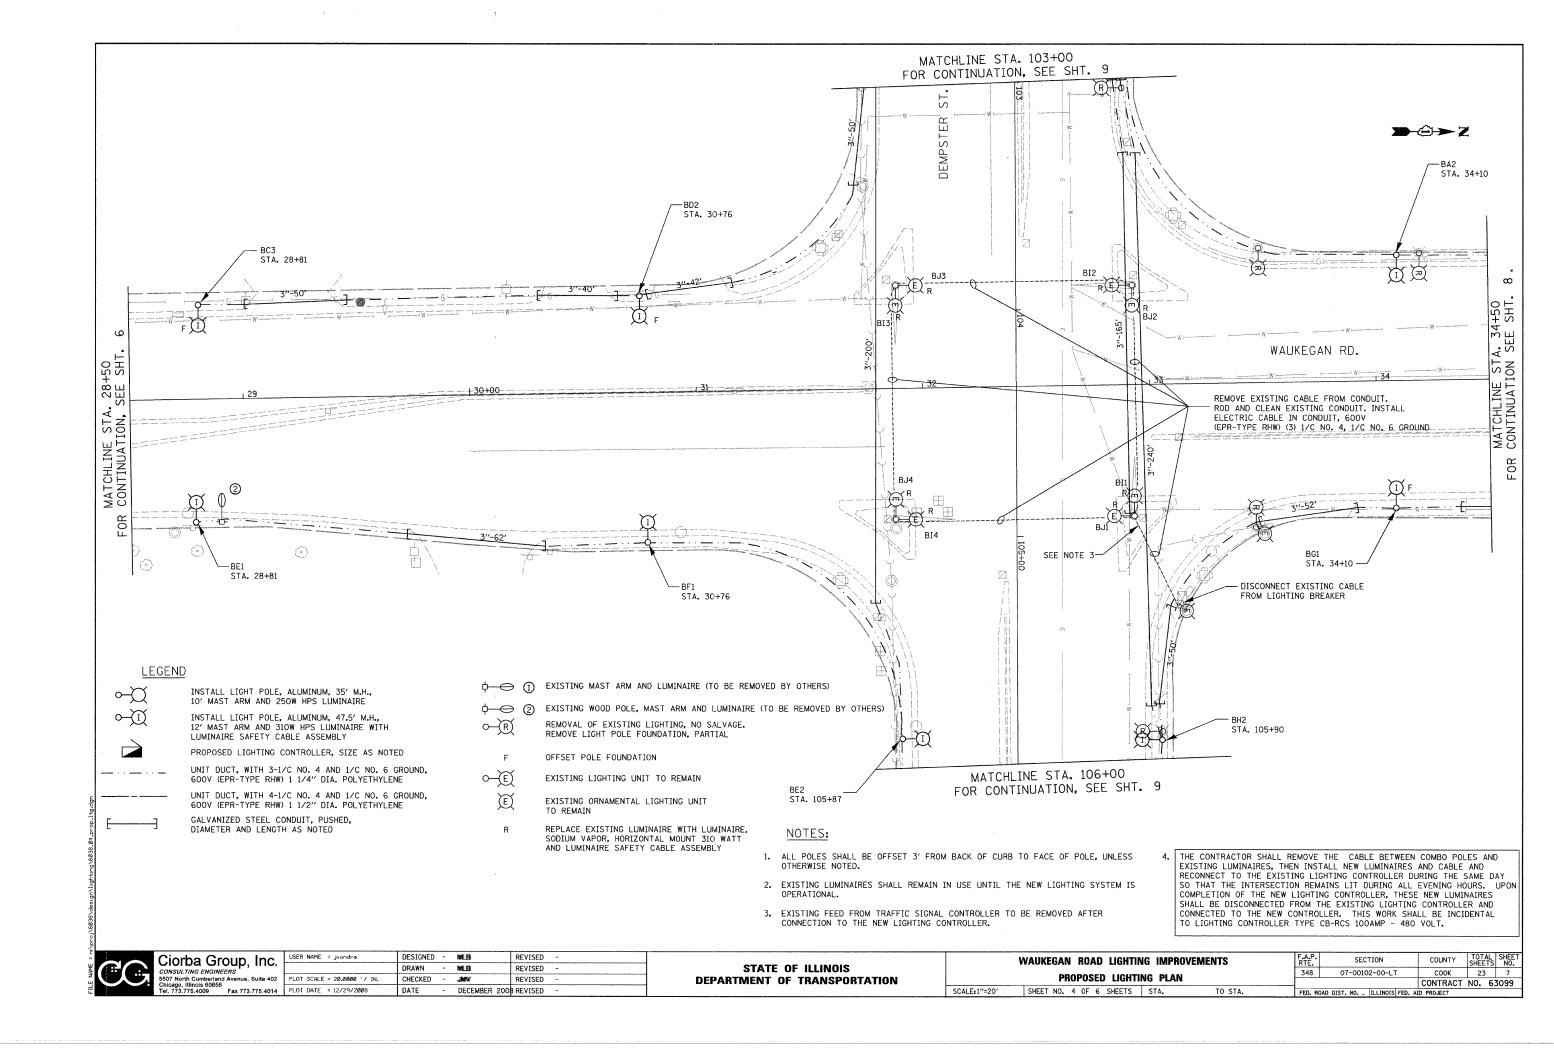GALVANIZED STEEL CONDUIT, PUSHED, DIAMETER AND LENGTH AS NOTED

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- \$\displaysquare \text{(TO BE REMOVED BY OTHERS)}\$\$ \text{OFR}\$\$ REMOVAL OF EXISTING LIGHTING, NO SALVAGE. REMOVE LIGHT POLE FOUNDATION, PARTIAL
  - F OFFSET POLE FOUNDATION
    - EXISTING LIGHTING UNIT TO REMAIN
- EXISTING ORNAMENTAL LIGHTING UNIT TO REMAIN

#### NOTES:

- 1. ALL POLES SHALL BE OFFSET 3' FROM BACK OF CURB TO FACE OF POLE, UNLESS OTHERWISE NOTED.
- 2. EXISTING LUMINAIRES SHALL REMAIN IN USE UNTIL THE NEW LIGHTING SYSTEM IS OPERATIONAL.
- REPLACE EXISTING WIRING FOR EXISTING LIGHTING ON COMBINATION POLES WITH NEW (3) 1/C NO. 4, 1/C NO. 6 GROUND AND TIED IN TO NEW UNIT DUCT FROM PROPOSED LIGHTING CONTROLLER "B" TO THE HANDHOLE IN FRONT OF EXISTING SERVICE.


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CONSULTING ENGINEERS
5507 North Cumberland Avenue, Suite 402 Chicago, Illinois 60656


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SCALE:1"=20'


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	PROPOSED LIGHTING PLAN										CONTRACT	NO. 6	3099
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CKT. #	LOAD DESCRIPTION	PHASE A	PHASE B
A	3-250W HPS	3.9	3.9
В	3-250W HPS	3.9	3.9
С	4-250W HPS	5.2	5.2
D	3-250W HPS	3.9	3.9
E	3-250W HPS	3.9	3.9
F	2-250W HPS	2.6	2.6
G	3-250W HPS	3.9	3.9
Н	3-250W HPS	3.9	3.9
I	3-250W HPS	3.9	3.9
J	3-250W HPS	3.9	3.9
	TOTAL	39.0	39.0

LOAD WAS CALCULATED BASED ON 1.3A PER 250W LUMINAIRE AT 240V

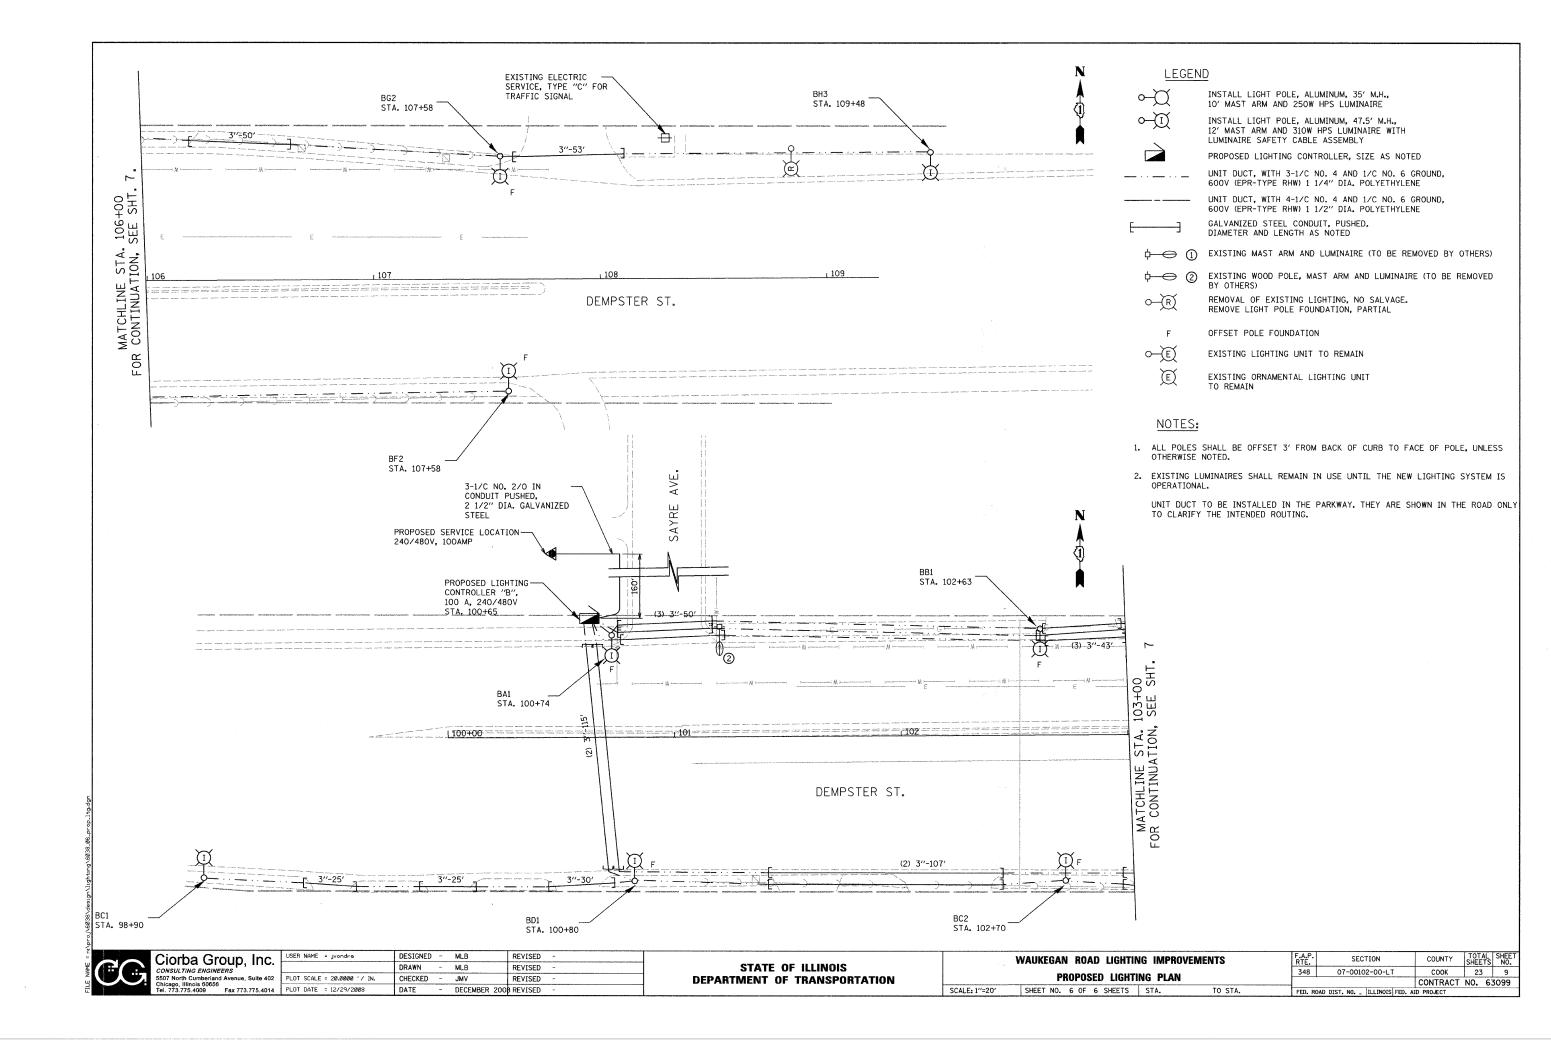

TYPICAL POLE WIRING DIAGRAM

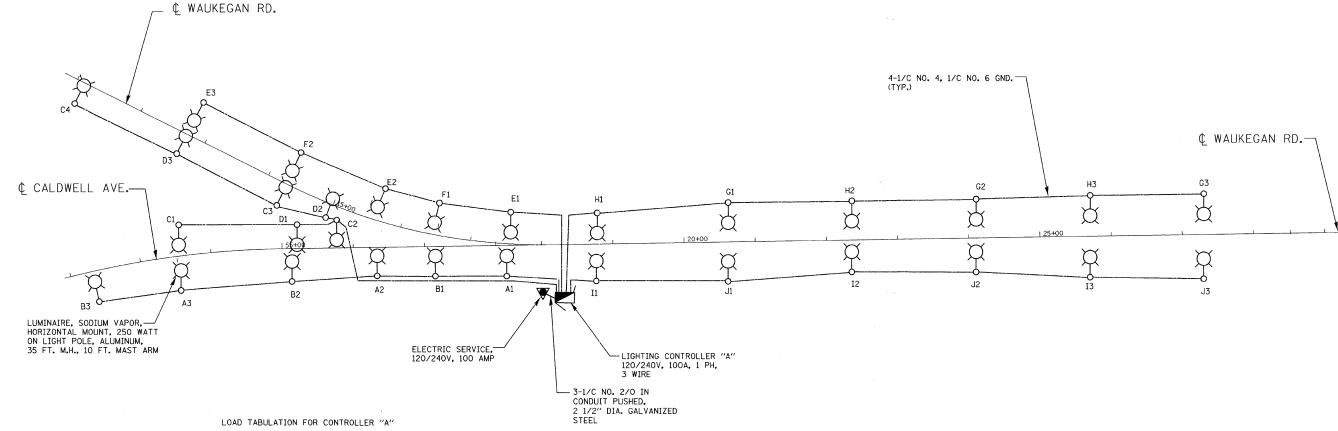
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	Tel. 773,775,4009	Fax 773.	775.401
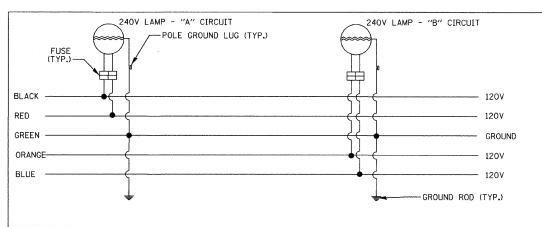
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STATE	: OF	- ILLINOIS
DEPARTMENT	OF	TRANSPORTATION

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SCALE: N/A

	Ciorba Group, Inc.	-
	CONSULTING ENGINEERS	L
W. W.	5507 North Cumberland Avenue, Suite 402	
	Chicago, Illinois 60656	-
	Tel. 773.775.4009 Fax 773.775.4014	

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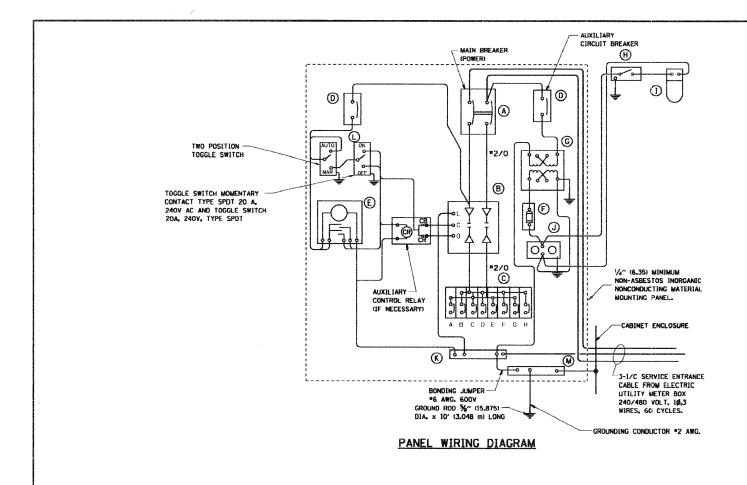
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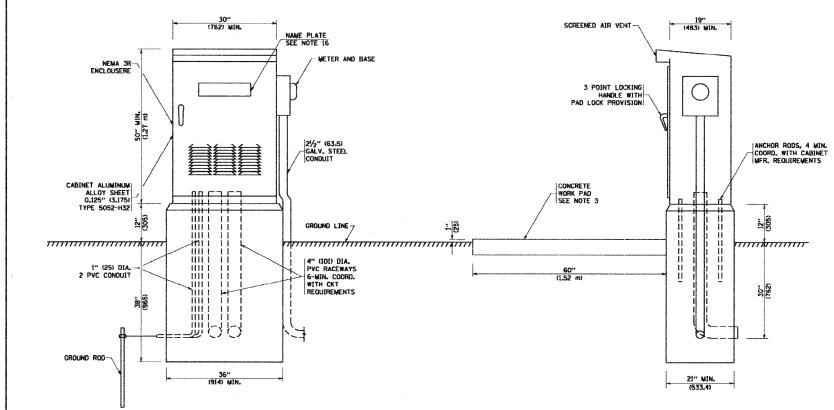
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STATE	: OF	ILLINOIS
DEPARTMENT	OF T	<b>TRANSPORTATION</b>

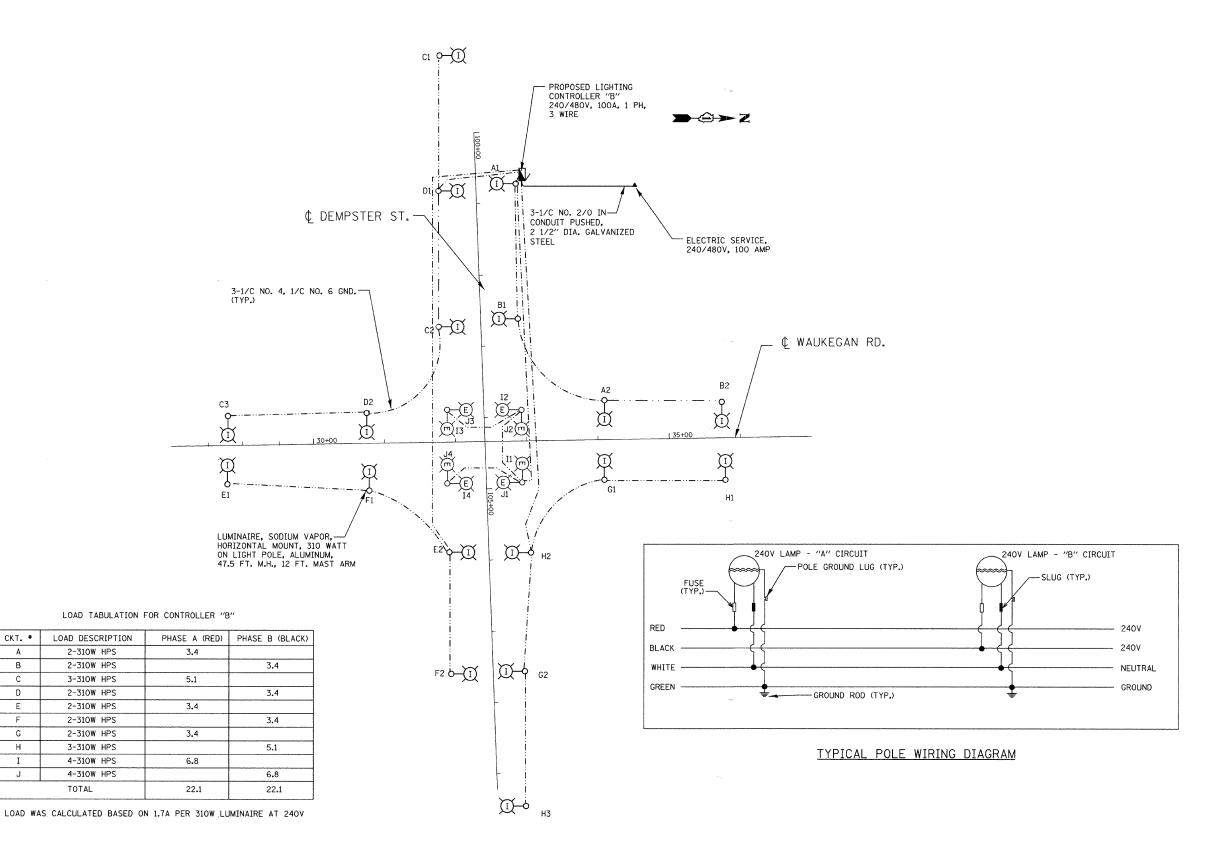WAUKEGAN ROAD LIGHTING IMPROVEMENTS	F.A.P. RTE.	SECTION	COUNTY TOTAL SHEETS		SHEET NO.
LIGHTING CONTROLLER "B" ONE LINE DIAGRAM	348	07-00102-00-LT	COOK	23	11
LIGHTING CONTROLLER D ONE LINE DIAGRAM			CONTRACT	NO. 63	3099 l
SHEET NO. 1 OF 1 SHEETS STA. TO STA.	FED. RO	DAD DIST. NO ILLINOIS FED. AI	D PROJECT		





#### PANEL EQUIPMENT


			BILL OF MATERIAL
	ITEM	QUANTITY	DESCRIPTION
15	Α	1	MAIN CIRCUIT BREAKER, 2 POLE, 600 VOLT 100 AMP. FRAME, 100 AMP. NON-INTERCHANGEABLE TRIP INTERRUPTING RATING NEMA-22000 AMP. AT 480 VOLT.
	В	1	REMOTE CONTROL SWITCH, ELECTRICALLY OPERATED, MECHANICALLY HELD, 2 POLE, SINGLE THROW, 100 AMP., 600 VOLTS CONTROL CIRCUIT 240 VOLT.
	С	8	CIRCUIT BREAKERS, 1 POLE, 100AMP. FRAME . 50 AMP. NON-INTERCHANGEABLE TRIP INTERRUPTING RATING NEMA-10,000 AMP. AT 240 V.
	D	2	CONTROL CIRCUIT-CIRCUIT BREAKER, 1 POLE, 240 V., 100 AMP. FRAME, 15 AMP. NON-INTERCHANGEABLE TRIP INTERRUPTING RATING NEMA-5000 AMP. AT 240 V.
	Ε	1	ASTRONOMIC MICROPROCESSOR-BASED 2-CHANNEL CONTROLLER [TIME SWITCH].
	F	1	20 A., 120 V. FUSE.
	G	1	1.5 KVA, SINGLE PHASE, ENCAPSULATED TRANSFORMER 240 X 480 / 120 X 240 VOLT, 60 Hz.
	Н	1	SPST 20A SWITCH ON DOOR, TO TURN LIGHT ON WHEN DOOR IS OPEN.
	Ι	1	INCANDESCENT LIGHTING FIXTURE ENCLOSED AND CASKETED WITH 60 WATT, 120 V. LAMP.
	J	1	20 A., 120 V., DUPLEX RECEPTACLE, GFCI.
	ĸ	1	COPPER GROUND BUS 1/4" (6.35) X 1" (25.4) X 12" (304.8 mm) LONG MOUNTED ON PANEL WITH LUGS AND 4 SPARE LUGS
	L	1	TOGGLE SWITCHES MOUNTED IN 4" (101.6) X 4" (101.6 mm) BOX.
	М	1	COPPER GROUND BUS 1/4" (6.35) X 1" (25.4) X 12" (304.8 mm) LONG MOUNTED ON PANEL WITH LUGS AND SPARE LUGS

#### NOTES:

- 1. ALL DIMENSIONS ARE IN INCHES (MILLIMETERS)
  UNLESS OTHERWISE SHOWN.
- 2. FOUNDATION SIZE SHALL BE COORDINATED WITH CABINET SIZE AND MFR.
- 3. IN FRONT OF CONTROL CABINET DOOR, REMOVE VEGETATION AND 2" (50.8 mm) TOP SOIL, LEVEL THE AREA AND ON TOP, PLACE LENGTH WISE PARALLEL TO CONTROL CABINET, A CONCRETE PAD 36" (914.4 mm) × 60" (18.288 m) × 4" (101 mm) MIN. SIZE. THE COST OF LABOR AND MATERIALS ARE INCLUDED IN THE COST OF THE CONTROLLER.
- 4. DOOR SHALL BE CONSTRUCTED FROM SAME TYPE OF MATERIAL AND THICKNESS AS CABINET.
- DOOR SHALL BE EQUIPPED WITH THREE POINT LATCHING MECHANISM WITH NYLON ROLLERS AT TOP THE BOTTOM.
- DOOR HINGE SHALL BE A HEAVY GAUGE CONTINUOUS HINGE WITH A ¼" (6.35 mm) DIA. STAINLESS STEEL HINGE PIN.
- 7. ALL EXTERNAL HARDWARE SHALL BE STAINLESS STEEL.
- 8. CONTROL WIRING TO BE \*12 AWG, 600V, TYPE
  "SIS" GRAY SWITCH BOARD WIRE, STRANDED
  CODDED
- METER BOX SHALL BE MOUNTED ON THE SIDE OF CONTROL CABINET, NEAR TO THE SERVICE POLE.


- CABINETS SHALL BE PRIMED AND PAINTED AS SPECIFIED.
- 11. THE HEADS OF CONNECTORS SCREWS SHALL BE PAINTED WHITE FOR NEUTRAL BAR CONNECTION AND GREEN FOR GROUND BAR CONNECTORS.
- E 12. ALL WIRING WITHIN THE CABINET SHALL BE COLOR CODED AS INDICATED. R = RED BL = BLUE W = WHITE B = BLACK Y = YELLOW G = GREEN
- 13. PROVIDE SEALING GROWMETS FOR ALL OPEN WIRING EXTENDED FROM DEVICES IN BOXES OR CABINETS WITHIN THE CONTROL CABINET.
- 14. ALL WIRING SHALL BE NEATLY DRESSED AND SUPPORTED.
- 15. THE CONTROLLER SHALL BE CONSTRUCTED TO U.L. STD. 508 AND BEAR THE U.L. LABEL "ENCLOSED INDUSTRIAL CONTROL PANEL".
- 16. 12" (304.8) X 16" (406.4 mm) STAINLESS STEEL EXTERIOR NAMEPLATE SHALL BE ENGRAVED TO "STATE OF ILLINOIS LIGHTING CONTROLS" UNLESS OTHERWISE SPECIFIED.

FILE NAME =	USER NAME = gaglianobt	DESIGNED -	REVISED - 08-20-04		LIGHTING CONTROLLER	F.A.	SECTION	COUNTY TO	OTAL SHEET
W:\diststd\22x34\be215.dgn		DRAWN -	REVISED -	STATE OF ILLINOIS	SINGLE DOOR	348	07-00102-00-LT	COOK	23 12
	PLOT SCALE = 50.0000 ' / IN.  PLOT DATE = 1/4/2008	CHECKED - DATE -	REVISED -	DEPARTMENT OF TRANSPORTATION	SCALE: NONE SHEET NO. 1 OF 1 SHEETS STA. TO STA.		BE-215 DIST, NO. 1   ILLINOIS FED. A	CONTRACT N	0.

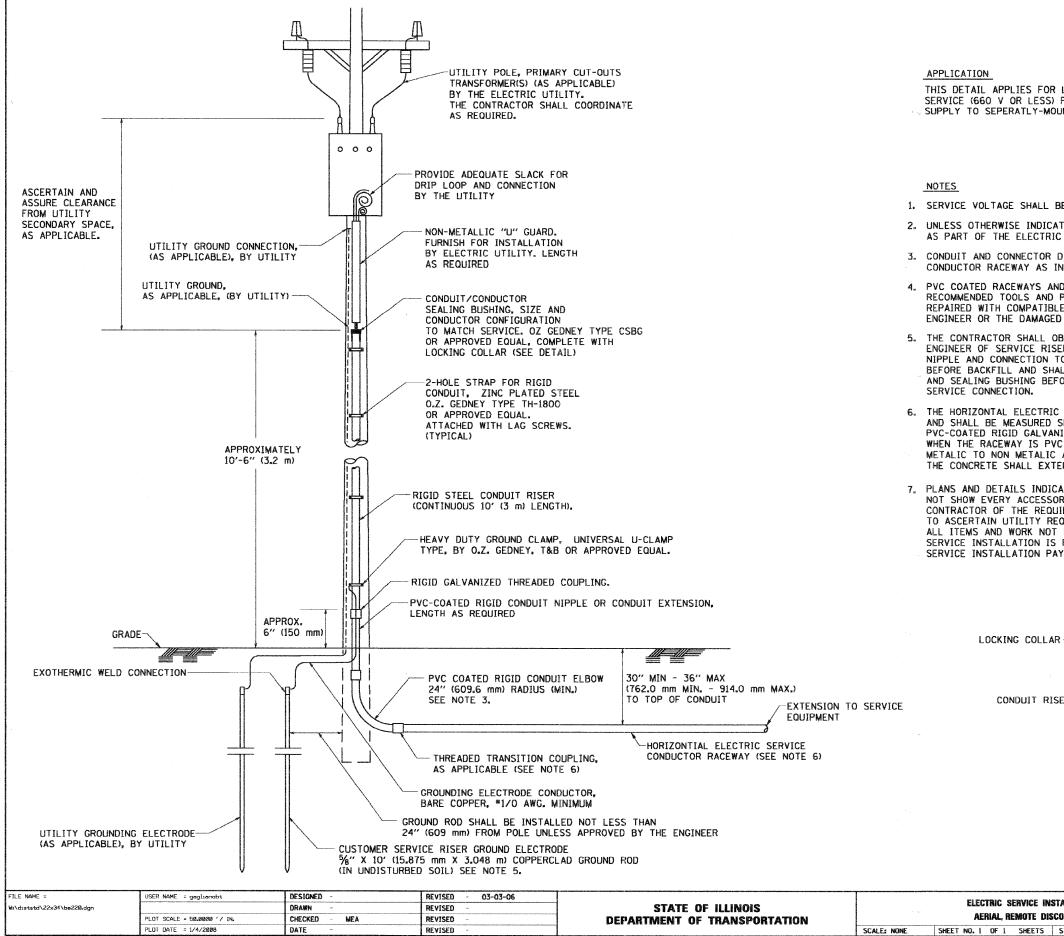

THIS DETAIL APPLIES FOR LOW VOLTAGE ELECTRIC SERVICE (660 V OR LESS) FROM AN OVERHEAD UTILITY SUPPLY TO SEPERATLY-MOUNTED SERVICE EQUIPMENT.

- 1. SERVICE VOLTAGE SHALL BE AS INDICATED ELSEWHERE IN THE DRAWINGS.
- 2. UNLESS OTHERWISE INDICATED, ITEMS AND WORK SHALL BE INCLUDED AND PAID AS PART OF THE ELECTRIC UTILITY SERVICE INSTALLATION PAY ITEM.
- 3. CONDUIT AND CONNECTOR DIAMETER SHALL MATCH THE DIAMETER OF THE SERVICE CONDUCTOR RACEWAY AS INDICATED ON THE PLANS.
- 4. PVC COATED RACEWAYS AND ACCESSORIES SHALL BE CAREFULLY INSTALLED WITH MFR RECOMMENDED TOOLS AND PROCEDURES TO AVOID DAMAGE. ANY DAMAGE SHALL BE REPAIRED WITH COMPATIBLE PVC TOUCH-UP MATERIAL TO THE SATISFACTION OF THE ENGINEER OR THE DAMAGED MATERIAL SHALL BE REPLACED AT NO ADDITIONAL COST.
- 5. THE CONTRACTOR SHALL OBTAIN INSPECTION AND APPROVAL BY THE ENGINEER OF SERVICE RISER GROUND ELECTRODE, RISER ELBOW, NIPPLE AND CONNECTION TO SERVICE CONDUCTOR RACEWAY EXTENSION BEFORE BACKFILL AND SHALL ALSO OBTAIN INSPECTION OF SERVICE RISER AND SEALING BUSHING BEFORE UTILITY "U" GUARD INSTALLATION AND
- 6. THE HORIZONTAL ELECTRIC SERVICE CONDUCTOR RACEWAY SHALL BE AS INDICATED AND SHALL BE MEASURED SEPARATELY FOR PAYMENT. WHEN THE RACEWAY IS PVC-COATED RIGID GALVANIZED STEEL, THE COUPLING SHALL BE THE SAME. WHEN THE RACEWAY IS PVC CONDUIT (IN CONCRETE), THE COUPLING SHALL BE A METALIC TO NON METALIC ADAPTER. WHEN THE RACEWAY IS ENCASED IN CONCRETE. THE CONCRETE SHALL EXTEND TO COVER THE COUPLING.
- 7. PLANS AND DETAILS INDICATE THE GENERAL NATURE AND REQUIREMENTS. THEY DO NOT SHOW EVERY ACCESSORY AND ATTACHMENT, AND THEY DO NOT RELIEVE THE CONTRACTOR OF THE REQUIREMENTS OF THE SPECIFICATIONS AND SPECIAL PROVISIONS TO ASCERTAIN UTILITY REQUIREMENTS AND TO COORDINATE ACCORDINGLY, FURNISHING ALL ITEMS AND WORK NOT PROVIDED BY THE UTILITY, BUT NECESSARY FOR A COMPLETE SERVICE INSTALLATION IS REQUIRED AND SHALL BE INCLUDED IN THE ELECTRIC UTILITY SERVICE INSTALLATION PAY ITEM.

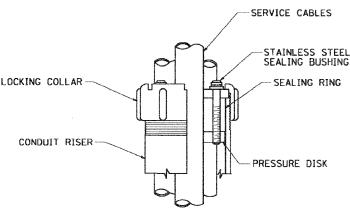

SEALING BUSHING DETAIL

COUNTY TOTAL SHEET NO.

COOK 23 13 SECTION **ELECTRIC SERVICE INSTALLATION** 348 07-00102-00-LT AERIAL REMOTE DISCONNECT BE-220 CONTRACT NO. SHEET NO. 1 OF 1 SHEETS STA. TO STA.

#### 24" (609.6) Dia. LIGHT POLE FOUNDATION DEPTH TABLE BOLT CIRCLE 30 FT. (9.144 m) TO 35 FT. (10.668 m) MOUNTING HEIGHT DESIGN DEPTH "D" OF FOUNDATION SINGLE ARM POLE TWIN ARM POLE IN FOUNDATION 0 SOFT CLAY 11'-0" 12'-8" Ou = 0.375 TON/SO. FT. (3.35 m) (3.85 m) MEDIUM CLAY 9'-0" 14'-10" Qu = 0.75 TON/SQ.FT (2.74 m) (4.52 m) STIFF CLAY Qu = 1.50 TON/SQ. FT (2,29 m) (2.61 m) LOOSE SAND RACEWAYS PARALLEL (3.22 m) d = 34° (2-90 m) TO EDGE OF PAVEMENT MEDIUM SAND 9'-10" Ø = 37,5° (2-74 m) (2,99 m) TOP VIEW DENSE SAND ANCHOR ROD (2.51 m) (2.91 m) 1-1" Dig. X 5'-0" (4-25.4 Dia. X 1.524 m) ¾" (20) CHAMFER 3" (76) \*2/0 BARE COPPER EXOTHERMIC WELD CONNECTION TO GND ROD. EXOTHERMIC WELD CONNECTION TO REINFORCING STEEL 6" (152.4) THREADED 3½" Dio. X 36" RADIUS (88.9 X 914.4) \*2/0 BARE COPPER PVC RACEWAY (2 MIN.) GROUND CLAMP IN LISTED 8-\*6 VERTICAL BARS PA PA GROUND ROD (WHEN SPECIFIED) %" T. X 4" DIA. WASHER, TACK WELDED ANCHOR BOLT DETAIL -3 LOOPS MIN. AT TOP & BOTTOM --- 2" (50.8) 3" (76,2) 24" Dia. (609.6) FOUNDATION DETAIL TOP OF ANCHOR ROD -4" (100) MAX. - GROUND LINE 60" (1500) FOUNDATION EXTENSION DETAIL SECTION A-A

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DATE

CHECKED

JSER NAME = gaglienobt

PLOT DATE = 1/4/2008

PLOT SCALE = 50.0000 '/ IN.

FILE NAME =

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#### NOTES

LIGHT POLE FOUNDATION

30' (9.144 m) TO 35' (10.668 m) M.H. 11 1/2" (292 mm) BOLT CIRCLE

SHEET NO. 1 OF 1 SHEETS STA.

SCALE: NONE

STATE OF ILLINOIS

**DEPARTMENT OF TRANSPORTATION** 

- 1. ALL DIMENSIONS ARE IN INCHES (MILLIMETERS) UNLESS OTHERWISE SHOWN.
- 2. THE ANCHOR RODS AND RACEWAYS SHALL BE PROPERLY SECURED IN PLACE BEFORE THE CONCRETE IN PLACED.
- 3. THE FOUNDATION SHALL NOT PROTRUDE MORE THAN 4 IN. (100 mm) ABOVE THE FINISHED GRADE WITHIN A 60 IN. (1,5 m) CHORD ACROSS THE FOUNDATION, WITH ANCHOR RODS INCLUDED, IN ACCORDANCE WITH AASHTO GUIDELINES. IF THE FOUNDATION HEIGHT, INCLUDING ANCHOR RODS, EXTENDS BEYOND THESE SPECIFIED LIMITS, THE FOUNDATION SHALL BE REPLACED AT THE CONTRACTOR'S EXPENSE. SEE FOUNDATION EXTENSION DETAIL.
- 4. THE HOLE FOR THE FOUNDATION SHALL BE MADE BY DRILLING WITH AN AUGER, OF THE SAME DIAMETER AS THE FOUNDATION. IF SOIL CONDITIONS REQUIRE THE USE OF A LINER TO FORM THE HOLE. THE LINER SHALL BE WITHDRAWN AS THE CONCRETE IS DEPOSITED.
- THE TOP OF THE FOUNDATION SHALL BE CONSTRUCTED LEVEL. A LINER OR FORM SHALL BE USED TO PRODUCE A UNIFORM SMOOTH SIDE TO THE TOP OF THE FOUNDATION. FOUNDATION TOP SHALL BE CHAMFERED ¾-IN. (20 mm).
- THE CONCRETE SHALL BE CLASS SI, CONCRETE SHALL CURE ACCORDING TO ARTICLE 1020,13 BEFORE LIGHT POLES ARE INSTALLED.
- 7. THE ANCHOR ROD SHALL BE A HOOK ROD TYPE. COLD BENDING OF THE ANCHOR ROD WILL NOT BE ALLOWED. THE RADIUS OF THE HOOK BEND SHALL NOT BE LESS THAN 4 TIMES THE NOMINAL DIAMETER OF THE ANCHOR ROD. A TACK WELDED ANCHOR ROD MAY BE SUBSTITUTED WITH THE APPROVAL OF THE ENGINEER.
- THE ANCHOR RODS SHALL BE ACCORDING TO ASTM F1554 GRADE 725 (GRADE 105). NUTS SHALL BE HEXAGON NUTS ACCORDING TO ASTM A 194 2H OR ASTM A 563 DM, AND WASHERS SHALL BE ACCORDING TO ASTM F 415.
- ANCHOR RODS, NUTS AND WASHERS SHALL BE COMPLETELY GALVANIZED BY EITHER THE HOT-DIPPED PROCESS COMFORMING WITH AASHTO M 232, THE MECHANICAL PLATING METHOD CONFORMING TO AASHTO M 298, CLASS 50 WITH A MAXIMUM COATING THICKNESS OF 150 LMMG MILS) OR THE ELECTROLYTIC PROCESS ACCORDING TO ASTM F 1136.
- THE ANCHOR RODS SHALL BE THREADED A MINIMUM OF 6 INCHES (150 mm) WITH A MINIMUM OF 3 INCHES (75 mm) OF THREADED ANCHOR ROD EMBEDDED IN THE FOUNDATION.
- . ANCHOR RODS SHALL PROJECT 2¾" (69.9 mm) ABOVE THE TOP OF THE FOUNDATION, IF BREAKAWAY COUPLINGS ARE SPECIFIED, THE CONTRACTOR SHALL CAREFULLY COORDINATE THE ANCHOR ROD PROJECTION WITH THE INSTALLATION REQUIREMENTS OF THE BREAKAWAY COUPLINGS.
- THE CONTRACTOR SHALL USE A \*3 SPIRAL AT 6" (152.4 mm) PITCH OR MAY SUBSTITUTE \*3 TIES AT 12" (304.8 mm) O.C. WITH THE APPROVAL OF THE ENGINEER.

COUNTY TOTAL SHEET NO.
COOK 23 14

CONTRACT NO.

SECTION


07-00102-00-LT

BF-300

348

- 13. THE CABLE TRENCHES AND FOUNDATION SHALL BE BACK FILLED AND COMPACTED AS SPECIFIED BEFORE THE LIGHT POLE IS ERECTED.
- 14. THE RACEWAYS SHALL PROJECT 1" (25.4 mm) ABOVE THE TOP OF THE FOUNDATION.

TO STA.

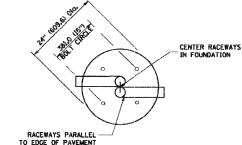

TOP VIEW


# CENTER RACEWAYS , jetjende RACEWAYS PARALLEL --TO EDGE OF PAVEMENT

ANCHOR ROD

TOP VIEW

#### DESIGN DEPTH "D" OF FOUNDATION SOIL CONDITIONS SINGLE ARM POLE TWIN ARM POLE SOFT CLAY Qu = 0.375 TON/SQ. F (4,57 m) MEDIUM CLAY 10'-9" Qu = 0.75 TON/SO.FT (2.09 m) (3,23 m) Qu = 1.50 TON/SQ. FT (2.13 m) (2.44 m) LOOSE SAND Ø = 34° (2,74 m) (3,05 m) MEDIUM SAND (2,52 m) (2,74 m) 9'-0"


LIGHT POLE FOUNDATION DEPTH TABLE 40 FT. (12,192 m) TO 47.5 FT. (14,478 m) MOUNTING HEIGHT

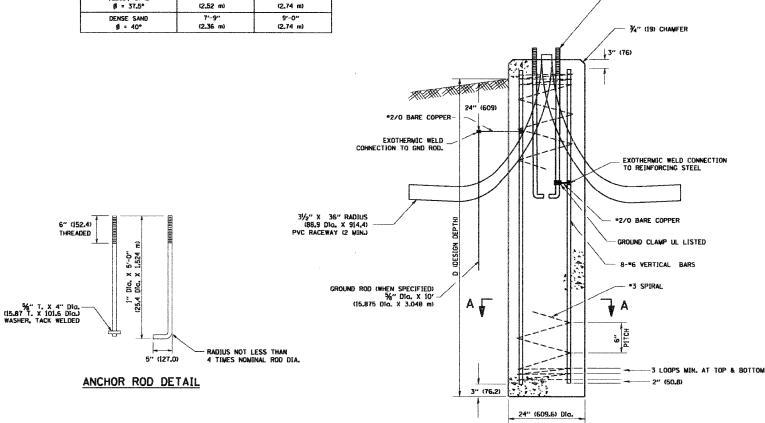

# 4" (100) MAX.


TOP OF ANCHOR ROD

FOUNDATION EXTENSION DETAIL

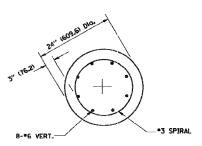

FOUNDATION DETAIL

SECTION A-A

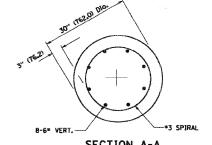

CEC	T T / N & 3	A-A	
SEL	IIUN	A-A	

FILE NAME = DESIGNED USER NAME = gaglianobt 04-22-02 v:\d:atstd\22x34\be3Ø1.dgn DRAWN REVISED PLOT SCALE = 50.0000 '/ IN. CHECKED REVISED PLOT DATE = 1/4/2008 DATE REVISED

STATE OF ILLINOIS **DEPARTMENT OF TRANSPORTATION** 

MENNEMBERGE			LIGHT POLE	FOUNDATION	
resonantial	40' (12.19	12 m) TO 47	1/2" (14.478	m) M.H. 15" (381	mm) BOLT CIRCLE
100000	SCALE: NONE	SHEET NO. 1	OF 1 SH	EETS STA.	TO STA.

F.A RTE.	SECTION	COUNTY	TOTAL SHEETS	SHEET NO.
348	07-00102-00-LT	COOK	23	15
	BE-301	CONTRACT	NO.	
FED. R	DAD DIST. NO. 1   ILLINOIS FED. A	ID PROJECT		

#### NOTES


- 1. ALL DIMENSIONS ARE IN INCHES OMILLIMETERS) LINLESS OTHERWISE SHOWN.
- THE ANCHOR RODS AND RACEWAYS SHALL BE PROPERLY SECURED IN PLACE
- 3. THE FOUNDATION SHALL NOT PROTRUDE MORE THAN 100MM (4 IN.) ABOVE THE FINISHED GRADE WITHIN A 60 IN. (1.5 m) CHORD ACROSS THE FOUNDATION, WITH ANCHOR RODS INCLUDED, IN ACCORDANCE WITH AASHTO GUIDELINES. IF THE FOUNDATION HEIGHT, INCLUDING ANCHOR RODS, EXTENDS BEYOND THESE SPECIFIED LIMITS, THE FOUNDATION SHALL BE REPLACED AT THE CONTRACTOR'S EXPENSE. SEE FOUNDATION EXTENSION DETAIL.
- 4. THE HOLE FOR THE FOUNDATION SHALL BE MADE BY DRILLING WITH AN AUGER, OF THE SAME DIAMETER AS THE FOUNDATION. IF SOIL CONDITIONS REQUIRE THE USE OF A LINER TO FORM THE HOLE, THE LINER SHALL BE WITHDRAWN AS THE CONCRETE IS DEPOSITED.
- THE TOP OF THE FOUNDATION SHALL BE CONSTRUCTED LEVEL, A LINER OR FORM SHALL BE USED TO PRODUCE A UNIFORM SMOOTH SIDE TO THE TOP OF THE FOUNDATION. FOUNDATION TOP SHALL BE CHAMFERED 1/4-IN. (20 mm).
- THE CONCRETE SHALL BE CLASS SI, CONCRETE SHALL CURE ACCORDING TO ARTICLE 1020.13 BEFORE LIGHT POLES ARE INSTALLED.
- 7. THE ANCHOR ROD SHALL BE A HOOK ROD TYPE, COLD BENDING OF THE ANCHOR ROD WILL NOT BE ALLOWED. THE RADIUS OF THE HOOK BEND SHALL NOT BE LESS THAN 4 TIMES THE NOMINAL DIAMETER OF THE ANCHOR ROD. A TACK WELDED ANCHOR ROD MAY BE SUBSTITUTED WITH THE
- 8. THE ANCHOR RODS SHALL BE ACCORDING TO ASTM F1554 GRADE 725 (GRADE 105), NUTS SHALL BE HEXAGON NUTS ACCORDING TO ASTM A 194 2H OR ASTM A 563 DH, AND WASHERS SHALL BE ACCORDING TO ASTM F 436.
- ANCHOR RODS, NUTS AND WASHERS SHALL BE COMPLETELY GALVANIZED BY EITHER THE HOT-DIPPED PROCESS CONFORMING WITH AASHTO M 232, THE MECHANICAL PLATING METHOD CONFORMING TO AASHTO W 298, CLASS 50 WITH A MAXIMUM COATING THICKNESS OF 150 UNK6 MILS) OR THE ELECTROLYTIC
- THE ANCHOR RODS SHALL BE THREADED A MINIMUM OF 6 INCHES (150 mm) WITH A MINIMUM OF 3 INCHES (75 mm) OF THREADED ANCHOR ROD EMBEDDED IN THE FOUNDATION.
- ANCHOR RODS SHALL PROJECT 23/4" (69.9 mm) ABOVE THE TOP OF THE FOUNDATION, IF BREAKAWAY COUPLINGS ARE SPECIFIED, THE CONTRACTOR SHALL CAREFULLY COORDINATE THE ANCHOR ROD PROJECTION WITH THE INSTALLATION REQUIREMENTS OF THE BREAKAWAY COUPLINGS.
- THE CONTRACTOR SHALL USE A \*3 SPIRAL AT 6" (152.4 mm) PITCH OR MAY SUBSTITUTE \*3 TIES AT 12" (304.8 mm) O.C. WITH THE APPROVAL OF THE ENGINEER.
- 13. THE CABLE TRENCHES AND FOUNDATION SHALL BE BACK FILLED AND COMPACTED AS SPECIFIED BEFORE THE LIGHT POLE IS ERECTED.
- 14. THE RACEWAYS SHALL PROJECT 1" (25.4 mm) ABOVE THE TOP OF THE FOUNDATION.


#### FOUNDATION DESIGN TABLE

	DESIGN DEPTH (	F FOUNDATION	REINFORCEMENT IN FOUNDATION					
TYPE OF SOIL	SINGLE ARM	TWIN ARM	SINGLE	ARM	TWIN	ARM:		
	D	D	VERT BARS	SPIRAL	VERT BARS	SPIRAL		
SOFT CLAY	13'-0''	15′-0″	8-*6X12'-6"	#3X122'	8-#6X14'-3"	*3X141′		
	(3.962 m)	(4 <b>.</b> 572 m)	(3.810 m)	(37.186 m)	(4.343 m)	(42.977 m)		
MEDIUM CLAY	9'-6''	10′-9″	8-#6X9'-0''	#3X90′	8-#6X10'-0''	#3X100'		
	(2 <b>.</b> 896 m)	(3 <b>.</b> 277 m)	(2.743 m)	(27.432 m)	(3.048 m)	(30.480 m)		
STIFF CLAY	7'-0''	8'-0''	8-#6X6'-6''	#3X66′	8-*6X7'-6''	#3X76′		
	(2.134 m)	(2.438 m)	(1.981 m)	(20.112 m)	(2.286 m)	(23.165 m)		
LOOSE SAND	OSE SAND 9'-0" (2.743 m)		8-*6X8'-6'' (2.591 m)	#3X85′ (25.908 m)	8-*6X9'-6'' (2.896 m)	#3X94′ (28 <b>.</b> 651 m)		
MEDIUM SAND	8′-3″	9′-0′′	8-#6X8'-0"	#3X78′	8-#6X8'-6''	#3X85'		
	(2 <b>.</b> 515 m)	(2.743 m)	(2.438 m)	(23.774 m)	(2 <sub>*</sub> 591 m)	(25.908 m)		
DENSE SAND	7′-9″	9′-0″	8-#6X7'-6''	#3X73'	8-#6X8'-6''	#3X85'		
	(2.362 m)	(2.743 m)	(2.286 m)	(22.250 m)	(2.591 m)	(25 <b>.</b> 908 m)		
ROCK OR SOLIDIFIED SLAG	5′-0″ (1 <b>.</b> 524 m)	5′-0" (1.524 m)	NONE	NONE	NONE	NONE		

#### NOTES

- 1. ALL DIMENSIONS ARE IN INCHES (MILLIMETERS) UNLESS OTHERWISE SHOWN.
- THE ENGINEER SHALL DETERMINE THE CLASS OF SOIL DURING EXCAVATION AND SELECT THE DESIGN DEPTH OF FOUNDATION FROM THE DESIGN TABLE.
- 3. EXCAVATION OF THE POLE FOUNDATION SHALL BE MADE WITH AN AUGER, 24" (609.6 mm) OR 30" (762.0 mm) IN DIAMETER.
- 4. THE ANCHOR ROD SHALL BE A HOOK ROD TYPE. COLD BENDING OF THE ANCHOR ROD WILL NOT BE ALLOWED. THE RADIUS OF THE HOOK BEND SHALL NOT BE LESS THAN 4 TIMES THE NOMINAL DIAMETER OF THE ANCHOR ROD. A TACK WELDED ANCHOR ROD MAY BE SUBSTITUTED WITH THE APPROVAL OF THE ENGINEER.
- 5. THE ANCHOR BOLTS AND RACEWAYS SHALL BE PROPERLY SECURED IN PLACE BEFORE THE CONCRETE IS PLACED IN THE FORM.
- 6. THE ANCHOR RODS SHALL BE ACCORDING TO ASTM F1554 GRADE 725 (GRADE 105). NUTS SHALL BE HEXAGON NUTS ACCORDING TO ASTM A 194 2H OR ASTM A 563 DH, AND WASHERS SHALL BE ACCORDING TO ASTM F 436.
- 7. THE CONTRACTOR SHALL COORDINATE EXTENSION OF ANCHOR BOLTS ABOVE TOP OF FOUNDATION WITH THE BREAKAWAY DEVICE MANUFACTURER'S REQUIREMENTS. IF LIGHT POLE IS MOUNTED WITHOUT BREAKAWAY DEVICE, ANCHOR BOLTS SHALL PROJECT 2¾" (69.9 mm) ABOVE TOP OF THE FOUNDATION. THE CONTRACTOR SHALL CONFIRM ANCHOR BOLT EXTENTION WITH ENGINEER.
- 8. RACEWAYS SHALL PROJECT 1" (25.4 mm) ABOVE THE TOP OF THE FOUNDATION.
- THE CABLE TRENCH SHALL BE BACKFILLED AND FIRMLY COMPACTED BEFORE THE LIGHT IS ERECTED.

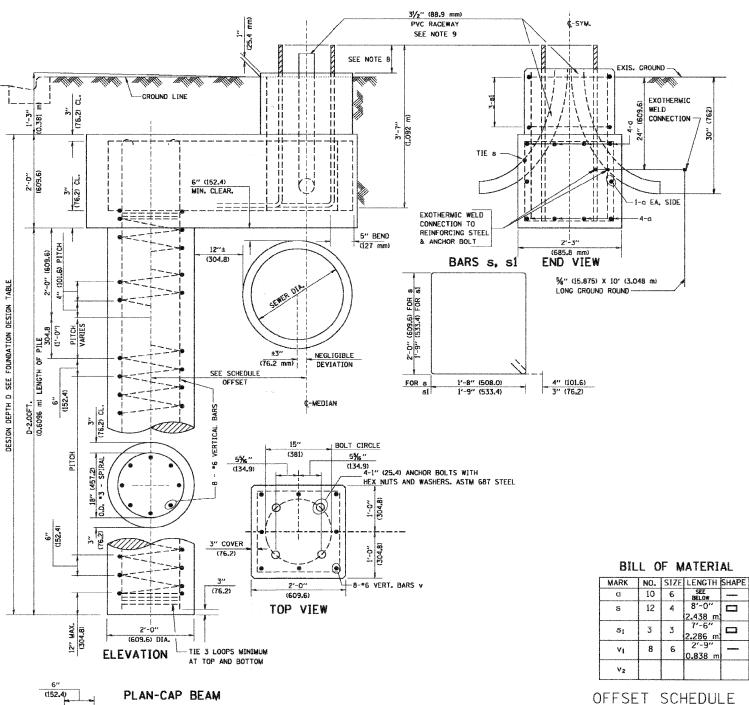

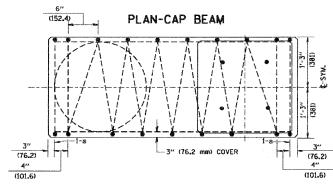



SCALE:

SEWER	PILE OFFSET	LENGTH
DIAM. d	From¢-MED'N	BAR a
IN.	FT.	FT.
UP TO 24"	3'-3"	*6 × 5'-3"
(609.6 mm)	(O.991 m)	(1.600 m)
27" (685.8 m)TO	3'-9"	5'-9"
36" (914.4 mm)	(1.143 m)	(1.753 m)
42" (1066.8 mm) TO	4'-6"	6′-6″
48" (1219.2 mm)	(1.372 m)	(1.981 m)
54" (1371.6 mm) TO	5'-0''	7'-0"
60" (1524.0 mm)	(1.524 m)	(2.134 m)
66" (1676,4 mm) TO	5′-6″	7'-6"
72" (1828 <sub>4</sub> 8 mm)	(1.676 m)	(2.286 m)

<u> </u>			
FILE NAME =	USER NAME = bauerdl	DESIGNED -	REVISED - 06-16-08 R. TOMSONS
Kı\dıststd22x34\be31Ø.dgn		DRAWN -	REVISED -
	PLOT SCALE = 50.000 '/ IN.	CHECKED -	REVISED -
	PLOT DATE = 6/16/2008	DATE -	REVISED -

LIGHT POLE FOUNDATION OFFSET	F.A. RTE.	SECTION	COUNTY TOTAL SHEET NO.		
40" (12.192 m) TO 47 1/2 " (14.478 m) M.H. 15" (381 mm) BOLT CIRCLE	348	07-00102-00-LT	COOK	23	16
		BE-310	CONTRACT	NO.	
HEET NO. 1 OF 1 SHEETS STA. TO STA.		ILLINOIS FED. AI	D PROJECT		

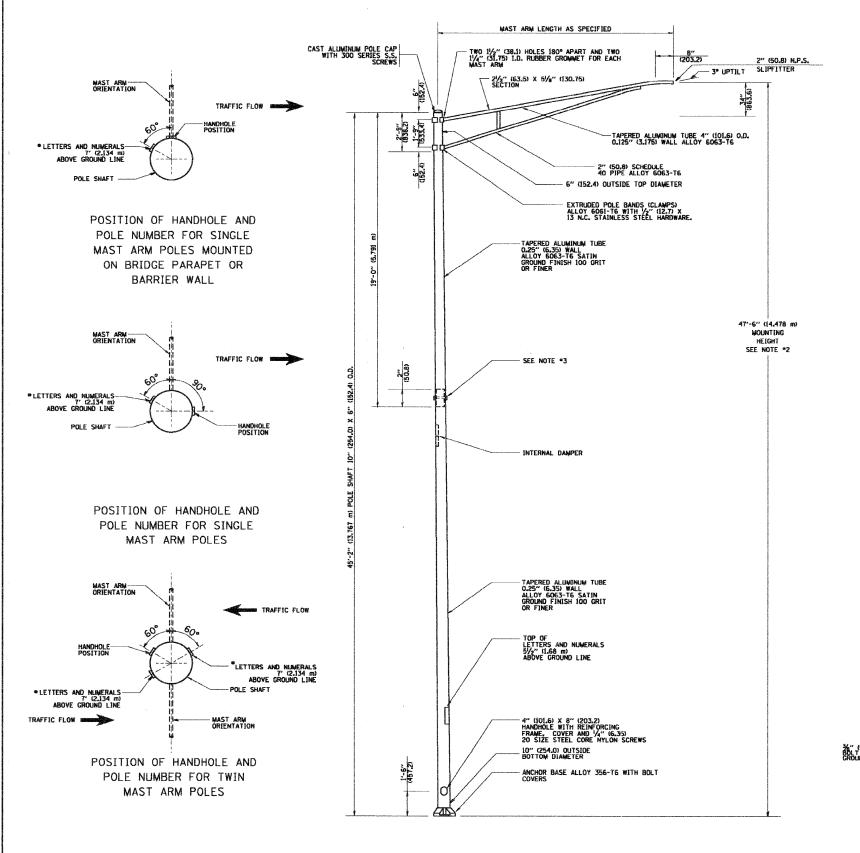

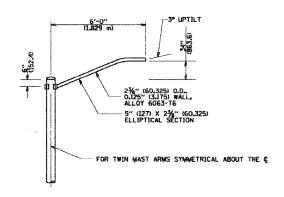


#### 6' (1.8 m) SINGLE MEMBER MAST ARM (N.T.S.)

- 1. ALL DIMENSIONS ARE IN INCHES (MILLIMETERS)
  UNLESS OTHERWISE SHOWN.

- I. THE LIGHT POLE WILL MEET AASHTO DESIGN CRITERIA AS SPECIFIED.


- CRITERIA AS SPECIFIED.

  5. THE INSTALLING CONTRACTOR WILL PROVIDE A UL LISTED GROUNDING CONNECTOR. BURNDY KZCZX, T8B SPADL OR APPROVED EQUID HAVE A CONTRACTOR AND A CONTRACT OF THE ADDRESS OF THE

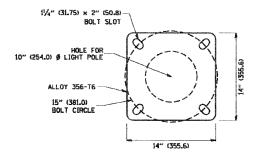


#### LIGHT POLE BASE PLATE DETAIL


15 INCH (381.0) BOLT CIRCLE

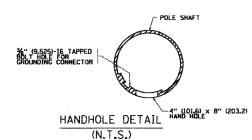

FILE NAME =	USER NAME = geglianobt	DESIGNED -	REVISED - R. TOMSONS 09-06-00
W:\diststd\22x34\be400.dgn		DRAWN	REVISED - R. TOMSONS 09-03-03
	PLOT SCALE = 50.000 '/ IN.	CHECKED -	REVISED -
	PLOT DATE = 1/4/2008	DATE -	REVISED -

		AL	UMINU	M LIGH	T POLE		F.A RTE.	SECTION	COUNTY	TOTAL	SHEET NO.
		A7'_8"  11.	4 479	MOLIN	TIME USIGHT		348	07-00102-00-LT	соок	23	17
ì		47'-6" (14.478 m) MOUNTING HEIGHT						BE-400	CONTRACT NO.		
	SCALE: NONE	SHEET NO. 1 O	F 1 :	SHEETS	STA.	TO STA.	FED. RO	DAD DIST. NO. 1   ILLINOIS FED. A	ID PROJECT		

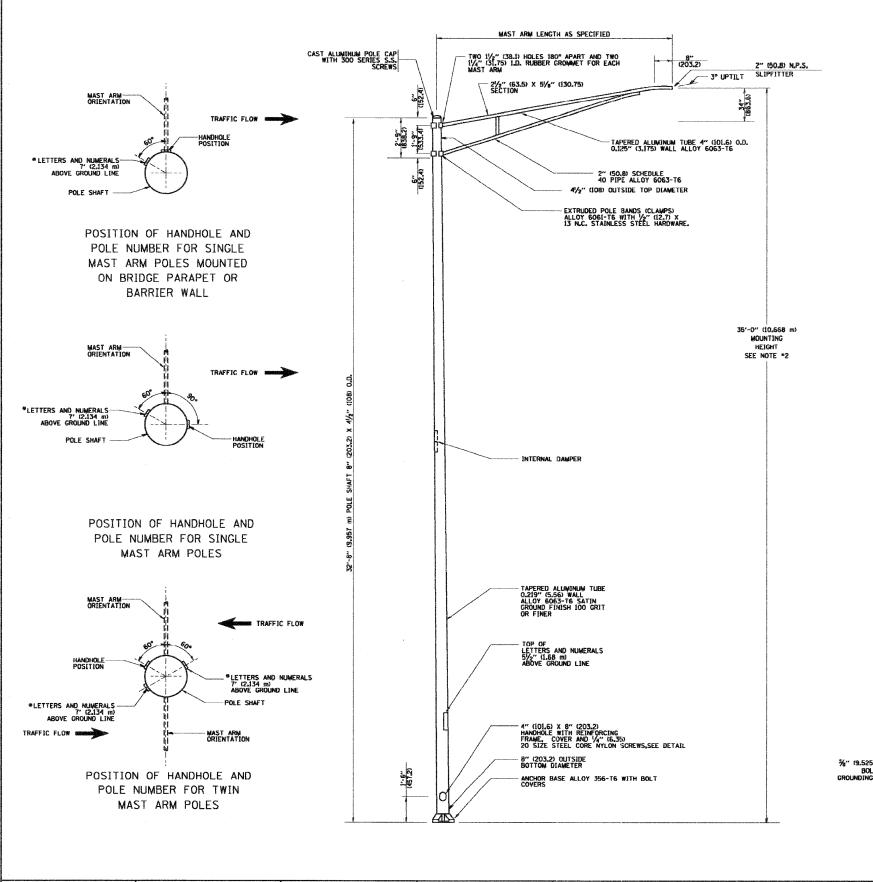

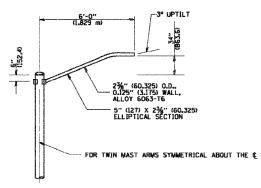

#### 6' (1.8 m) SINGLE MEMBER MAST ARM (N.T.S.)

- 1. ALL DIMENSIONS ARE IN INCHES (MILLIMETERS) UNLESS OTHERWISE SHOWN.
- 2. MOUNTING HEIGHT IS DEFINED AS THE DISTANCE FROM THE CHETELINE OF THE TENON TO THE BOTTOM OF THE ANCHOR BASE. 3. THE LIGHT POLE WILL MEET AASHTO DESIGN CRITERIA AS SPECIFIED.
- CRITERIA AS SPECIFIED.


  4. THE INSTALLING CONTRACTOR WILL PROVIDE A ULLISTED GROUNDING CONNECTOR. BURNDY K2C23, T&B SFADL OR APPROVED EQUAL.

  5. LIGHT POLES WILL NOT BE INSTALLED WITHOUT MAST ARMS AND LUMINAIRES.

- MASS ARMS AND LUMINAIRES,


  6. LIGHT POLES WILL BE SET PLUMB ON THE
  FOUNDATION WITHOUT THE USE OF LEVELING
  HUTS, WASHERS OR SHIMS.

  7. LIGHTING UNIT IDENTIFICATION NUMBERS
  SHALL BE INSTALLED BEFORE THE LIGHTING
  UNIT IS EMERGIZED.

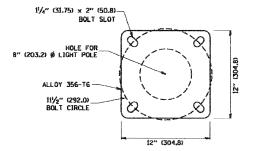


#### LIGHT POLE BASE PLATE DETAIL

111/2" (292.0) BOLT CIRCLE

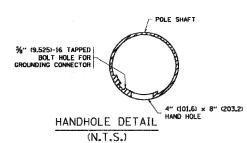


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	PLOT SCALE = 50.000 '/ IN.	CHECKED -	REVISED -
	PLOT DATE = 1/4/2008	DATE -	REVISED -

ALUMINUM LIGHT POLE	F.A RTÉ.	SECTION	COUNTY	TOTAL SHEETS	SHEET NO.
35'-0" (10.668 m) MOUNTING HEIGHT	348	07-00102-00-LT	COOK	23	18
33 TO (10.000 III) MOUNTING IILION	BE-402		CONTRACT NO.		
SCALE: NONE SHEET NO. 1 OF 1 SHEETS STA. TO STA.	FED. R	OAD DIST. NO. 1 ILLINOIS FED. AL	D PROJECT		

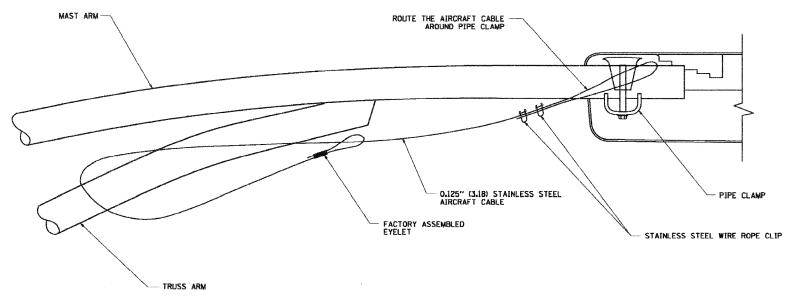

#### SIDE VIEW (TRUSS ARM)

N.T.S.

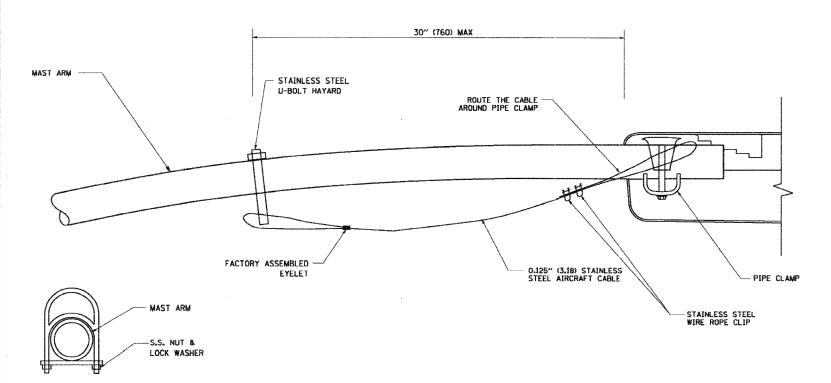


#### SIDE VIEW (SINGLE MEMBER OR DAVIT ARM)

STAINLESS STEEL U-BOLT HAYARD

N.T.S.

FILE NAME =	USER NAME = gaglianobt	DESIGNED -	REVISED - 08-08-03		LUMINAIRE SAFETY CABLE ASSEMBLY	F.A.	SECTION	COUNTY	TOTAL SHEET
W:\d:ststd\22x34\be7Ø1.dgn		DRAWN -	REVISED -	STATE OF ILLINOIS	LUMINAINE SAFETY GABLE ASSEMBLY	348	07-00102-00-LT	COOK	23 19
1.	PLOT SCALE = 50.000 '/ IN.	CHECKED -	REVISED -	DEPARTMENT OF TRANSPORTATION				CONTRACT	F NO.
	PLOT DATE = 1/4/2008	DATE -	REVISED -		SCALE: NONE SHEET NO. 1 OF 1 SHEETS STA. TO STA.		T. NO. 1 ILLINOIS FED. AL		-101

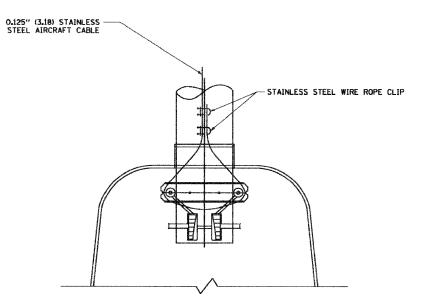


#### BOTTOM VIEW

N.T.S.


#### NOTES:

- ALL DIMENSIONS ARE IN MILLIMETERS (INCHES)
   UNLESS OTHERWISE SHOWN.
- 2. CONTRACTOR SHALL ADJUST THE WIRE CLIP TO ELIMINATE ANY SLACK FROM THE WIRE ROPE.
- THE 0.125" (3.18) STAINLESS STEEL AIRCRAFT CABLE SHALL REMAIN VISIBLE FROM THE GROUND LEVEL.
- 4. THE BREAKING STRENGTH OF THE CABLE SHALL BE 1700 LBS. MIN.

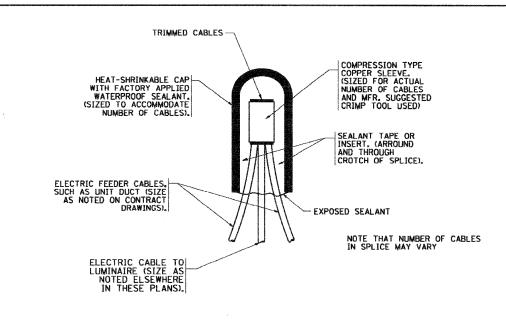

#### TYPICAL SPLICE DETAIL

N.T.S.

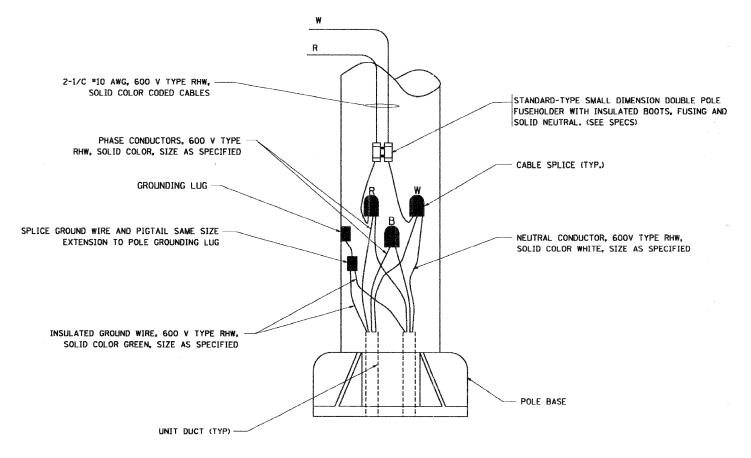

#### POLE WIRING DETAIL

N.T.S.

FILE NAME =	USER NAME = gaglianobt	DESIGNED -	REVISED - 08-08-03			MISC. ELECTRICAL DETAILS		F.A.	SECTION	COUNTY TOTAL SHEE
Wi\distatd\22x34\be	e702.dgn	DRAWN -	REVISED -	STATE OF ILLINOIS		MISC. ELECTRICAL DETAILS SHEET A		348	07-00102-00-LT	COOK 23 20
1	PLOT SCALE = 50.000 '/ IN.	CHECKED -	REVISED -	DEPARTMENT OF TRANSPORTATION				10.0	BE-702	CONTRACT NO.
	PLOT DATE = 1/4/2008	DATE -	REVISED -		SCALE: NONE	SHEET NO. 1 OF 1 SHEETS STA.	TO STA.	FED. ROAD DIST. NO. 1   ILLINOIS FED. AID PRO		AID PROJECT

12" (305) MAXIMUM WIDTH EXCEPT AS APPROVED BY THE ENGINEER

12" (305)

- WARNING TAPE AS SPECIFIED


UNIT DUCT OR OTHER RACEWAY
AND WIRING AS PER PLANS. COMPLETE

WITH INTERNAL INSULATED EQUIPMENT GROUND WIRE.

TYPICAL WIRING IN TRENCH DETAIL

N.T.S.

30" (762) MINIMUM COVER

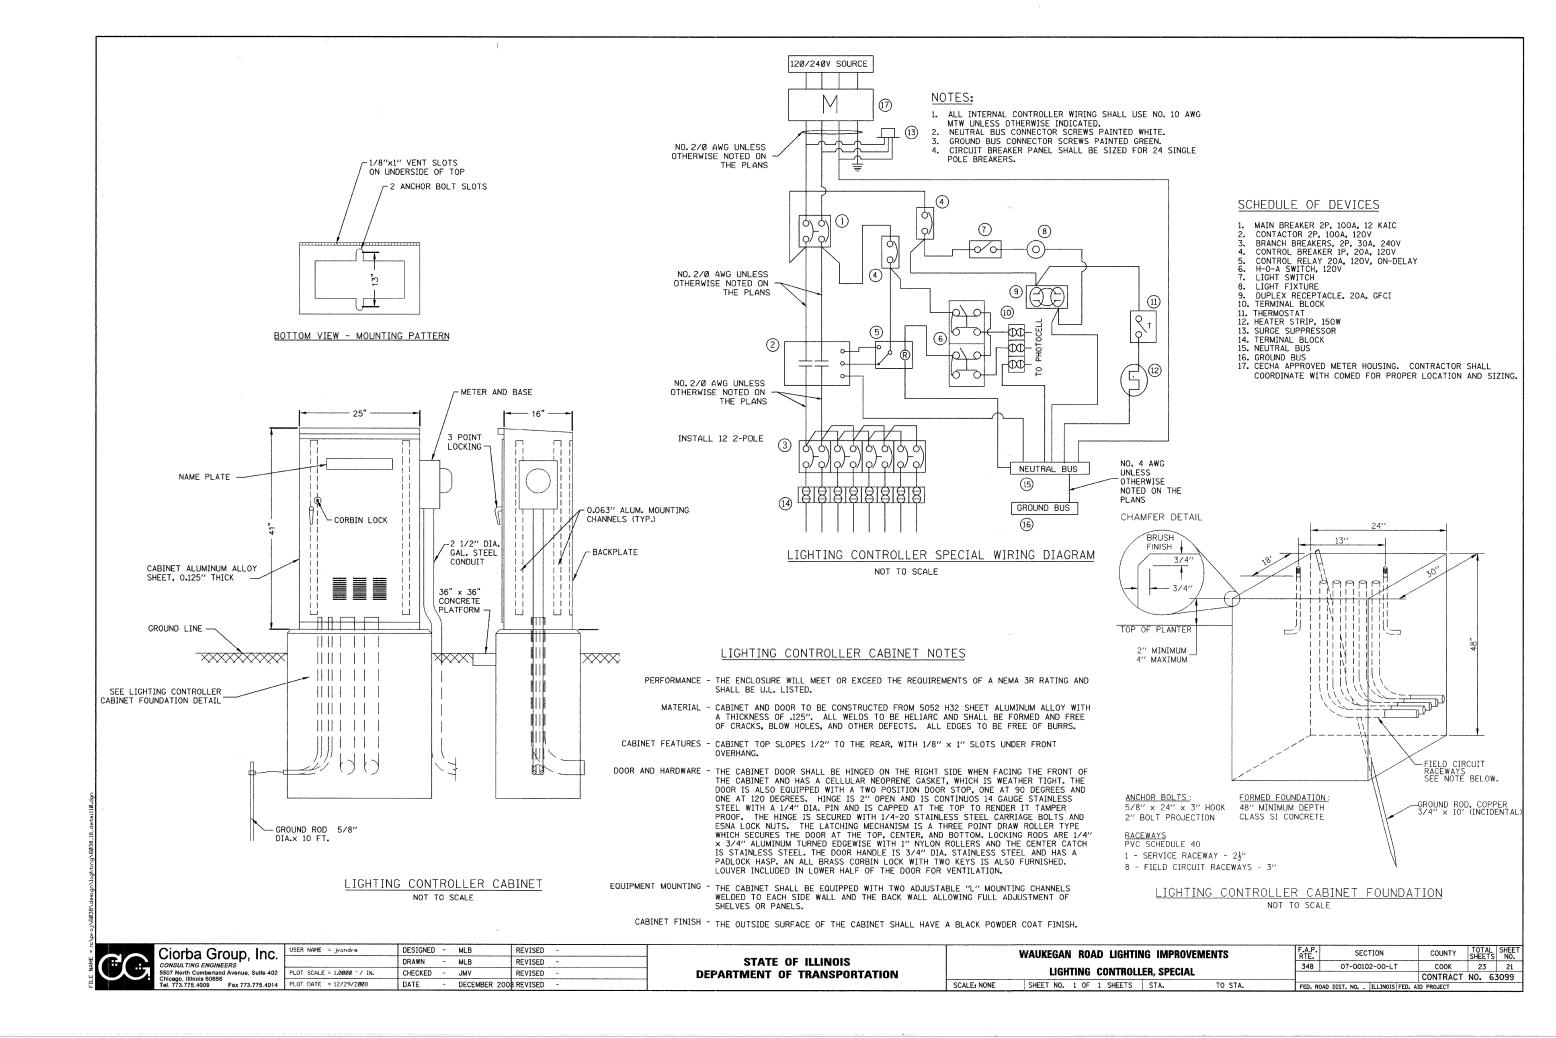


#### FOUNDATION DESIGN TABLE

	DESIGN DEPTH	OF FOUNDATION	REINFORCEMENT IN FOUNDATION								
TYPE OF SOIL	SINGLE ARM	TWIN ARM	SINGLE	ARM	TWIN ARM						
	D	D	VERT BARS	SPIRAL	VERT BARS	SPIRAL					
SOFT CLAY	3.962 m	4 <b>.</b> 572 m	8-#6X3.810 m	*3X37.186 m	8-#6X4.343 m	*3X42.977 m					
	(13'-0'')	(15′-0″)	(12'-6'')	(122')	(14'-3'')	(141') ·					
MEDIUM CLAY	2 <b>.</b> 896 m	3,277 m	8-#6X2.743 m	#3X27.432 m	8-#6X3.048 m	*3X30.480 m					
	(9'-6'')	(10′-9")	(9'-0'')	(90')	(10'-0'')	(100')					
STIFF CLAY	2.134 m	2.438 m	8-#6X1.981 m	#3X20 <sub>*</sub> 112 m	8-#6X2 <b>.</b> 286 m	*3X23.165 m					
	(7'-0'')	(8'-0'')	(6'-6'')	(66′)	(7'-6'')	(76')					
LOOSE SAND	2.743 m	3.048 m	8-#6X2 <b>.</b> 591 m	#3X25•908 m	8-#6X2 <b>.</b> 896 m	#3X28.651 m					
	(9'~0'')	(10'-0'')	(8'-6'')	(85')	(9'-6'')	(94')					
MEDIUM SAND	2.515 m	2.743 m	8-#6X2.438 m	#3X23.774 m	8-#6X2 <b>.</b> 591 m	#3X25.908 m					
	(8'-3'')	(9'-0''(	(8'-0'')	(78')	(8'-6'')	(85')					
DENSE SAND	2.362 m	2.743 m	8-#6X2.286 m	#3X22,250 m	8-#6X2 <b>.</b> 591 m	#3X25.908 m					
	(7'-9'')	(9'-0'')	(7'-6'')	(73')	(8'-6'')	(85')					
ROCK OR SOLIDIFIED SLAG	1.524 m (5'-0'')	1.524 m (5'-0'')	NONE	NONE	NONE	NONE					

#### NOTES

- THE ENGINEER WILL DETERMINE THE CLASS OF SOIL DURING EXCAVATION AND SELECT THE DESIGN DEPTH OF THE FOUNDATION FROM THE DESIGN TABLE.
- 2.) EXCAVATION OF THE POLE FOUNDATION MUST BE MADE WITH AN AUGER,  $24^{\prime\prime}$  OR 30  $^{\prime\prime}$  IN DIAMETER.
- 3.) THE ANCHOR MUST BE A TACK WELDED TYPE BOLT OR HOOK TYPE BOLT. COLD BENDING OF THE HOOK BOLT IS NOT ALLOWED.
- 4.) THE ANCHOR BOLTS AND RACEWAYS MUST BE PROPERLY SECURED IN PLACE BEFORE THE CONCRETE IS PLACED IN THE FORM.
- 5.) THE ENTIRE LENGTH OF THE ANCHOR BOLTS, AS WELL AS THE NUTS AND WASHERS, MUST BE HOT DIP GALVANIZED IN ACCORDANCE WITH THE REQUIREMENTS OF ASTM DESIGNATION A 153.
- 6.) THE CONTRACTOR MUST COORDINATE EXTENSION OF ANCHOR BOLTS ABOVE THE TOP OF FOUNDATION WITH THE BREAKAWAY DEVICE MANUFACTURER'S REQUIREMENTS. IF LIGHT POLE IS MOUNTED WITHOUT A BREAKAWAY DEVICE, ANCHOR BOLTS MUST COORDINATE WITH THE POLE MANUFACTURER'S REQUIREMENTS.
- 7.) THE CONTRACTOR MUST COORDINATE THE ANCHOR BOLT CIRCLE WITH THE LIGHT POLE MANUFACTURER'S RECOMMENDATIONS.
- 8.) RACEWAYS MUST PROJECT 1" ABOVE THE TOP OF FOUNDATION.
- CONCRETE SHALL BE CLASS "SI". CONCRETE FOUNDATIONS MUST BE CURED FOR TEN (10) DAYS BEFORE THE LIGHT STANDARD IS ERECTED.
- 10.) THE CABLE TRENCH SHALL BE BACKFILLED AND FIRMLY COMPACTED BEFORE THE LIGHT STANDARD IS ERECTED.

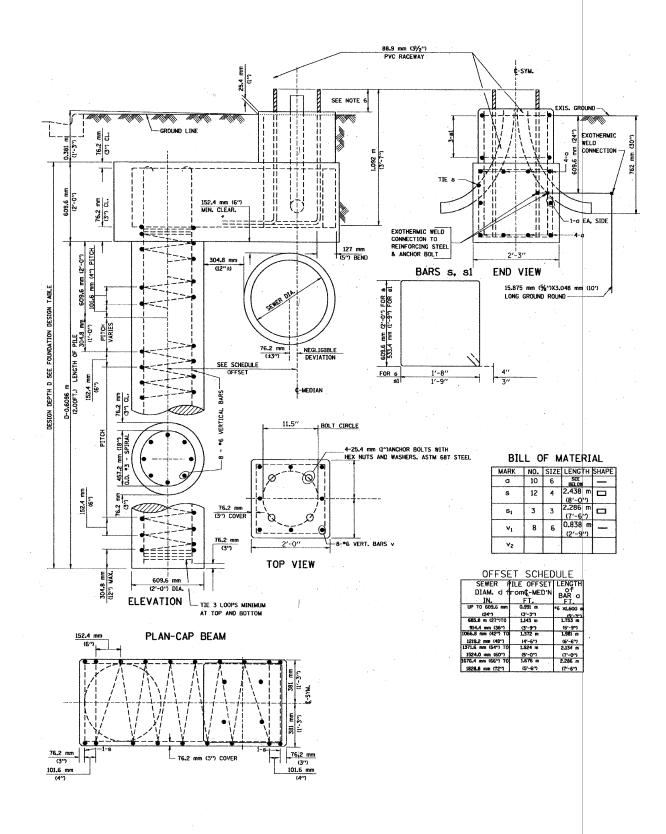




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WAUKEGAN ROAD LIGHTING IMPROVEMENTS
LIGHT POLE FOUNDATION, OFFSET
35' M.H., 11.5" BOLT CIRCLE

SCALE; NONE SHEET NO. 1 OF 1 SHEETS STA. TO S

RTE.			S	ECT	ΊO	N			COUNTY	SHEETS	NO.
348		07	-00	0102	2-(	00-L1	٢		COOK	23	22
								1	CONTRACT	NO. 6	3099
FED. R	OAD	DIST.	NO.	-	ILL	INOIS	FED.	AID	PROJECT		

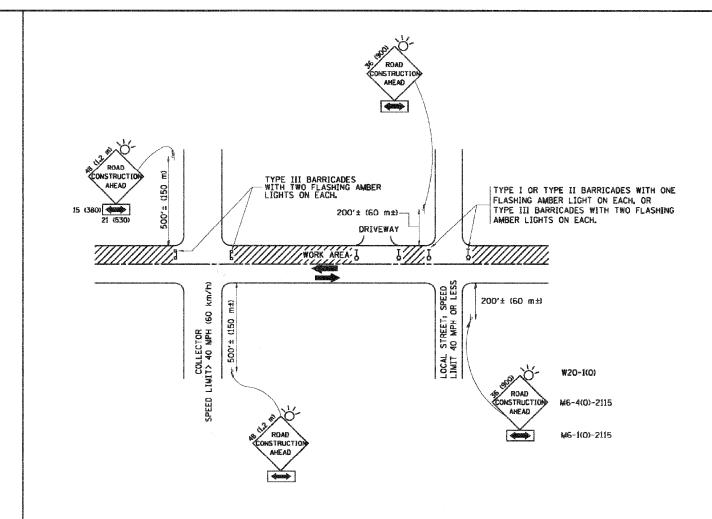

#### TRAFFIC CONTROL AND PROTECTION FOR SIDE ROADS, INTERSECTIONS, AND DRIVEWAYS

#### NOTES:

- A. FOR NO LANE RESTRICTION ON THE SIDE ROAD OR DRIVEWAYS
- 1. SIDE ROAD WITH A SPEED LIMIT OF 40 MPH (60 km/h) OR LESS AS SHOWN ON THE DRAWING AND AS DIRECTED BY THE ENGINEERs
- OF THE MATE POLITICAL OF THE PROXIMATELY 200' (60 m) IN ADVANCE OF THE MATE POLITICAL OF THE POLITI
- b) THE CLOSED PORTION OF THE MAIN ROUTE SHALL BE PROTECTED BY BLOCKING WITH TYPE I, TYPE II OR TYPE III BARRICADES, 1/3 OF THE CROSS SECTION OF THE CLOSED PORTION.
- 2. SIDE ROAD WITH A SPEED LIMIT GREATER THAN 40 MPH (60 km/h) AS SHOWN ON THE DRAWING AND AS DIRECTED BY THE ENGINEERS
- c) ONE ROAD CONSTRUCTION AMEAD SIGN 48 x 48 (1.2 m x 1.2 m) WITH A FLASHER MOUNTED ON IT APPROXIMATELY 500' (150 m) IN ADVANCE OF THE MAIN POLITY.
- b) THE CLOSED PORTION OF THE MAIN ROUTE SHALL BE PROTECTED BY BLOCKING WITH TYPE III BARRICADES, 1/2 OF THE CROSS SECTION OF THE CLOSED PORTION.
- 3. WHEN THE SIDE ROAD LIES BETWEEN THE BEGINNING OF THE MAINLINE SIGNING AND THE WORK ZONE, A SINGLE HEADED ARROW GM6-1) SHALL BE USED IN LIEU OF THE DOUBLE HEADED ARROW GM6-4).

- B. FOR A LANE CLOSURE ON A SIDE ROAD OR DRIVEWAY:
- USE APPLICABLE PORTIONS OF THE TYPICAL APPLICATION OF TRAFFIC CONTROL DEVICES (STD. 701501, STD. 701606 OR THE APPROPRIATE STANDARD). THE SPACING OF SICAS AND BARRICADES SHALL BE ADJUSTED FOR FIELD CONDITIONS AS DIRECTED BY THE ENGINEER. THE DIRECTIONAL ARROW SHALL BE COVERED OR REMOVED WHEN NO LONGER CONSISTENT WITH THE SIDE ROAD LANE CLOSURE.
- C. ADVANCE WARNING SIGNS ARE TO BE OMITTED ON DRIVEWAY UNLESS OTHERWISE NOTED.
- D. THE TRAFFIC CONTROL AND PROTECTION FOR SIDE ROADS, INTERSECTIONS, AND DRIVEWAYS SHALL BE INCIDENTAL TO THE COST OF SPECIFIED TRAFFIC CONTROL STANDARDS OR ITEMS.

All dimensions are in millimeters (inches) unless otherwise shown.

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FILE NAME =	USER NAME = gaglianobt	DESIGNED - LHA	REVISED	- J. OBERLE 10-18-95
W:\distatd\Z2x34\tc10.dgn		DRAWN -	REVISED	- A. HOUSEH 03-06-96
	PLOT SCALE = 50.000 '/ IN.	CHECKED -	REVISED	- A. HOUSEH 10-15-96
	PLOT DATE = 1/4/2008	DATE - 06-89	REVISED	T. RAMMACHER 01-06-0

	TR	affi	C	CON	m	OL AND	PROTEC	TION	FOR		
	SIDE	ROA	DS	, IN	TE	RSECTIO	VS, AND	DRIV	EWAYS		
CALE: NONE	SHEET	NO.	1	OF	1	SHEETS	STA.		1	го	ST.

RTE.	SECTION	COUNTY	SHEETS	NO.						
348	07-00102-00-LT	COOK	23	23						
	TC-10	CONTRACT	NO.							
FED. ROAD DIST. NO. 1 ILLINOIS FED. AND PROJECT										