


INDEX OF SHEETS

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1	COVER SHEET
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3	SUMMARY OF QUANTITIES
4-5	TYPICAL SECTIONS - EXISTING
6-7	TYPICAL SECTIONS - PROPOSED
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STATE OF ILLINOIS  
 DEPARTMENT OF TRANSPORTATION  
 DIVISION OF HIGHWAYS  
**PLANS FOR PROPOSED  
 PEDESTRIAN WALKWAY**

CITY OF MADISON  
 OHIO AVENUE  
 SECTION 09-00049-01-SW  
 PROJECT ARA-5011(275)  
 ST. CLAIR COUNTY  
 ARRA FUNDS  
 JOB NO. C-98-353-09

F.A. RTE.	SECTION	COUNTY	TOTAL SHEETS	SHEET NO.
	09-00049-01-SW	ST. CLAIR	26	1
FEDERAL-AID PROJECT	ILLINOIS	CONTRACT NO. 97420		

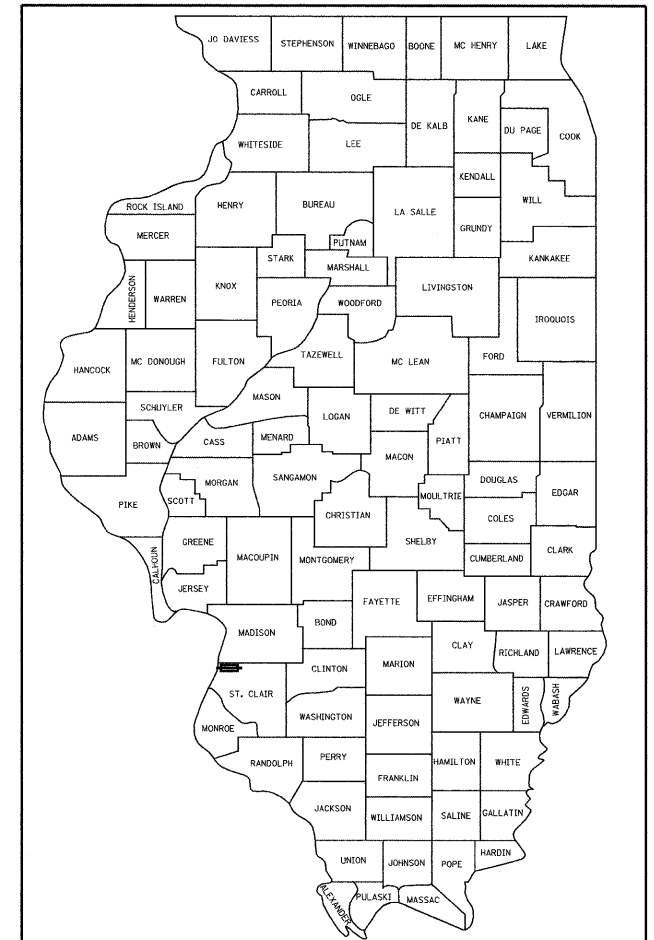

LOCATION OF SECTION INDICATED THUS:



STANDARDS

STD. NO.	
000001-05	701701-06
001006	701801-04
280001-05	701901-01
424001-05	704001-06
442201-03	720001-01
601001-03	720006-02
602401-02	720011-01
602701-02	729001-01
606001-04	780001-02
635011-02	814001-02
701606-06	886001-01

PLAN 1"=20'  
 PROFILE HORIZ. 1"=20'  
 PROFILE VERT. 1"=5'  
 CROSS SECTIONS 1"=10' HORIZ.  
 1"=5' VERT.

BEGIN PROJECT  
 STATION 101 + 19.57

END PROJECT  
 STATION 108 + 59.70

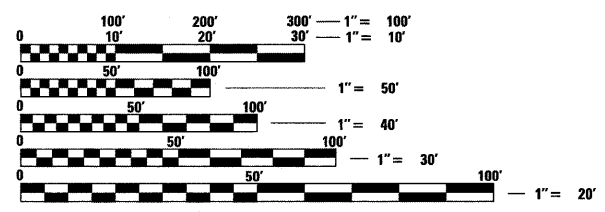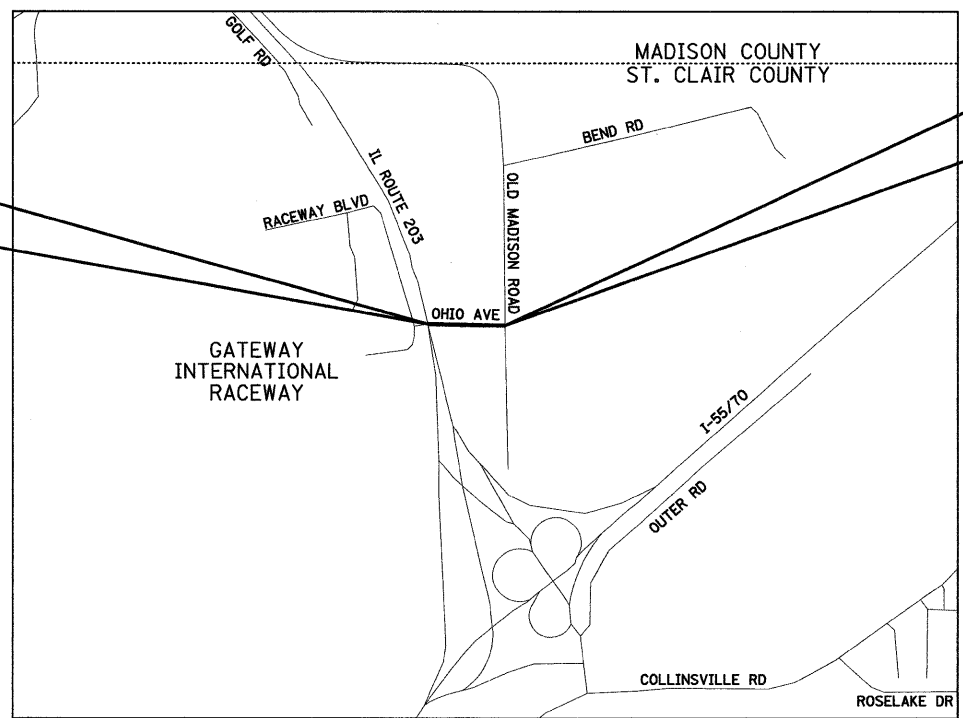

FULL SIZE PLANS HAVE BEEN PREPARED USING STANDARD ENGINEERING SCALES. REDUCED SIZED PLANS WILL NOT CONFORM TO STANDARD SCALES. IN MAKING MEASUREMENTS ON REDUCED PLANS, THE ABOVE SCALES MAY BE USED.

J.U.L.I.E.  
 JOINT UTILITY LOCATION INFORMATION FOR EXCAVATION  
 1-800-892-0123  
 OR 811

DESIGN DESIGNATION  
 FUNCTIONAL CLASSIFICATION: URBAN COLLECTOR  
 ADT: 5960 (2009) 6600 (2029)  
 DHV (2029): xx  
 DESIGN SPEED: 25 MPH

LOCATION MAP  
 SCALE: 1" = 1000'  
 NET LENGTH OF PROJECT: 740 LIN. FT. = 0.140 MILES  
 SECTION 5 & 6, T. 2 N., R. 9 W., 3RD P.M.







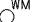
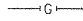




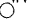
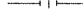
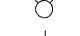
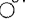
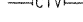





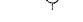
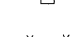




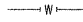

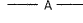




*Brian F. Kulick* 12/21/09  
 BRIAN F. KULICK, P.E. No. 49936 DATE  
 Job No. 081007

STATE OF ILLINOIS DEPARTMENT OF TRANSPORTATION	
Approved	<i>John H. ...</i> 12-21-09 Mayor, City of Madison
Passed	<i>Joseph ...</i> 12-22-09 District 8 Engineer of Local Roads & Streets
Releasing for Bid Based on Limited Review	<i>Mary C. ...</i> 12-22-09 Deputy Director of Highways, Region 5 Engineer

**Juneau Associates, Inc. P.C.**  
 CONSULTING ENGINEERS AND LAND SURVEYORS  
 2100 State Street, P.O. Box 1325  
 Granite City, Illinois 62040  
 Phone: (618) 877-1400 / (618) 452-5535  
 Fax: (618) 452-5541  
 100 North Research Drive  
 Edwardsville, Illinois 62025  
 Phone: (618) 659-0900 / (618) 659-0800  
 Fax: (618) 659-0941

Expires 11-30-11

**LEGEND**

 EVERGREEN (5" DIA)	 FOUND CONCRETE MONUMENT	 WATER LINE
 DECIDUOUS (8" DIA)	 WM WATER METER	 GAS LINE
 EVERGREEN SHRUB	 GM GAS METER	 OVERHEAD ELECTRIC LINE
 SHRUB	 WV WATER VALVE	 TELEPHONE LINE
 FIRE HYDRANT	 GV GAS VALVE	 CABLE TV LINE
 SIGN	(TBA) TO BE ADJUSTED	 STORM SEWER
 BOLLARD	(TBR) TO BE REMOVED	 SANITARY SEWER
 POWER POLE	(TBR&R) TO BE REMOVED & RELOCATED	 LIGHT POLE
 POWER POLE WITH DOWN GUY	(TBR&RBO) TO BE REMOVED & RELOCATED BY OTHERS	 STORM SEWER MANHOLE
 FENCE	DND DO NOT DISTURB	 SANITARY SEWER MANHOLE
 BENCH MARK	 PROPERTY LINE	 CATCH BASIN
 DITCH/SWALE	 EXIST R.O.W. LINE	 INLET
 EXISTING MAILBOX	 WOOD POST	

**GENERAL NOTES:**

ILLINOIS STATE LAW REQUIRES A 48-HR NOTICE BE GIVEN TO ALL UTILITIES BEFORE DIGGING. FIELD MARKING OF FACILITIES MAY BE OBTAINED BY CONTACTING J.U.L.I.E. OR FOR NON-J.U.L.I.E. MEMBERS, THE UTILITY COMPANY DIRECTLY. AGENCIES KNOWN TO HAVE FACILITIES WITHIN THE PROJECT AREA ARE AS FOLLOWS

- CITY OF MADISON STORM SEWERS  
615 MADISON AVE.  
MADISON, IL 62060  
(618) 876-6268
- AMEREN IP GAS/ELECTRIC  
2600 NORTH CENTER STREET  
P.O. BOX 378, MC Q-10  
MARYVILLE, IL 62062-0378  
GAS: (618) 346-1236  
ELECTRIC: (618) 346-1215
- AT & T TELEPHONE  
203 GOETHE STREET  
COLLINSVILLE, IL 62234  
(618) 346-7228
- CHARTER COMMUNICATIONS, INC. CABLE  
941 CHARTER COMMONS  
TOWN & COUNTRY, MO 63017  
(636) 220-2174
- WASTE MANAGEMENT OF PIPELINE  
ILLINOIS, INC.  
P.O. BOX 637  
EAST ST. LOUIS, IL 62202

(MEMBERS OF J.U.L.I.E. (800) 892-0123 ARE INDICATED BY \*.  
NON-J.U.L.I.E. MEMBERS MUST BE NOTIFIED INDIVIDUALLY)

FOR UTILITY LOCATION PURPOSES, THIS PROJECT IS LOCATED IN SECTIONS 5 AND 6 OF TOWNSHIP 2 NORTH, RANGE 9 WEST OF THE THIRD PRINCIPAL MERIDIAN.

TREES SHALL BE PRESERVED THROUGH OUT THIS SECTION AS SHOWN ON THE PLANS AND AS DIRECTED BY THE ENGINEER.

REMOVAL OF AGGREGATE MATERIAL AND OIL AND CHIP BITUMINOUS MATERIAL SHALL NOT BE PAID FOR SEPARATELY, BUT WILL BE INCLUDED IN THE CONTRACT.

WHERE RESURFACING DIRECTLY OVER THE EXISTING PAVEMENT, THE CONTRACTOR SHALL CLEAN THE EXISTING SURFACE PRIOR TO THE APPLICATION OF PRIMER COAT AND BITUMINOUS OVERLAY. REFER TO SECTION 406.06 OF THE STANDARD SPECIFICATIONS.

THE CONTRACTOR SHALL CONSTRUCT PAVEMENT SO THAT FLOW ALONG CURBS AND/OR GUTTERS IS MAINTAINED, INCLUDING FLOW THROUGH INTERSECTIONS, AROUND CURB RETURNS AND TO EXISTING INLETS.

ALL AREAS DISTURBED WITHIN CONSTRUCTION LIMITS SHALL BE SEEDED WITH CLASS 2A SEEDING AND MULCH, AS DIRECTED BY THE ENGINEER. NUTRIENTS SHALL CONFORM TO ARTICLE 250.04 AND WILL BE PAID FOR SEPARATELY. ALL AREAS DISTURBED OUTSIDE CONSTRUCTION LIMITS SHALL BE SEEDED AND MULCHED AT CONTRACTORS EXPENSE.

THE CONTRACTOR SHALL BE REQUIRED TO PERFORM SAWCUTTING AT THE EXISTING PAVEMENT, EXISTING WIDENING, OR EXISTING SHOULDER EDGE THROUGHOUT THE PROJECT LIMITS IN ORDER TO PERFORM REMOVAL OPERATIONS. THIS SAWING WILL NOT BE PAID FOR SEPARATELY, BUT WILL BE INCLUDED IN THE COST FOR THE REMOVAL ITEM INVOLVED.

AN AMOUNT OF TEMPORARY PAVEMENT MARKING WHICH EQUALS THE AMOUNT OF PERMANENT PAVEMENT MARKING HAS ALSO BEEN ADDED TO THE PLANS.

THE ROAD MUST REMAIN OPEN AT LEAST ONE LANE IN EACH DIRECTION OF TRAFFIC DURING CONSTRUCTION OPERATIONS. NO LANE CLOSURES PERMITTED ON IL RTE 203 DURING CONSTRUCTION OPERATIONS.

THE CONTRACTOR SHALL COORDINATE ALL CONSTRUCTION ACTIVITIES WITH GATEWAY INTERNATIONAL RACEWAY AND ALL EVENTS.

THE CONTRACTOR SHALL VERIFY ALL DIMENSIONS AND CONDITIONS IN THE FIELD PRIOR TO CONSTRUCTION AND ORDERING OF MATERIALS.

AT ALL AREAS SHOWN IN THE PLANS WHERE THERE IS MILLING AND RESURFACING, IT IS THE CONTRACTOR'S RESPONSIBILITY TO CONDUCT THE MILLING AND RESURFACING OPERATIONS SO THAT ALL PAVED AREAS SHALL DRAIN TO EXISTING DRAINAGE STRUCTURES ESPECIALLY IN INTERSECTION AREAS.

THE REMOVAL OF ANY CURB/CURB AND GUTTER SHALL ALSO INCLUDE THE DISCONNECTION OF THE EXISTING CURB/CURB AND GUTTER FROM ANY REINFORCEMENT OR COLLATERAL MATERIAL THAT MAY BE PRESENTLY ATTACHED. THERE SHALL NOT BE ANY ADDITIONAL RENUNERATION BUT THIS WORK SHALL BE CONSIDERED AS INCLUDED IN THE REMOVAL ITEM.

THE FOLLOWING CONSTANTS WERE USED IN THE CALCULATION OF QUANTITIES FOR THIS PROJECT:

NITROGEN FERTILIZER NUTRIENTS	90 LBS/ACRE
PHOSPHORUS FERTILIZER NUTRIENTS	90 LBS/ACRE
POTASSIUM FERTILIZER NUTRIENTS	90 LBS/ACRE
HOT-MIX ASPHALT	112 LBS/S.Y./INCH
BITUMINOUS MATERIALS (PRIME COAT)	0.07 GAL/S.Y. (PAVED SURFACE)
	0.25 GAL/S.Y. (AGGREGATE SURFACE)
GRANULAR MATERIALS	2.05 TONS/C.Y.

"ROAD CONSTRUCTION AHEAD" SIGNS SHALL BE PLACED AT THE BEGINNING AND END OF THE PROJECT PLUS THE INTERSECTING SIDE ROADS, AND WILL BE CONSIDERED INCLUDED IN THE TRAFFIC CONTROL PAY ITEMS. ALL CONSTRUCTION SIGNS SHALL BE FLUORESCENT ORANGE, 48".

NO OVERNIGHT LANE CLOSURES SHALL BE PERMITTED ON THIS PROJECT.

ALL EXCAVATED AREAS DUE TO WIDENING AND/OR PATCHING OPERATIONS SHALL BE PROTECTED WITH EXTENDED LEG BARRICADES WITH APPROPRIATE LIGHTS. THIS WILL NOT BE PAID FOR SEPARATELY BUT WILL BE INCLUDED IN THE CONTRACT.

THE CONTRACTOR SHALL BE RESPONSIBLE FOR AN ON-SITE INSPECTION PRIOR TO SUBMITTING A BID ON THIS PROJECT. UPON RECEIPT OF A BID, IT SHALL BE ASSUMED THAT THE CONTRACTOR IS FULLY FAMILIAR WITH THE CONSTRUCTION SITE.

OPEN STOCKPILING OF HOT-MIX ASPALT MIXTURES AT TRANSFER POINTS, WHETHER JOB SITE OR PLANT SITE, WILL NOT BE PERMITTED.

THE CONTRACTOR SHALL BE RESPONSIBLE FOR CONTACTING THE FIRE DEPARTMENT AND POLICE DEPARTMENT OF THE RESPECTIVE MUNICIPALITY ANY TIME NORMAL TRAFFIC FLOW ON ANY STREET OR ROAD IS TO BE INTERRUPTED, HOWEVER BRIEFLY.

CITY OF MADISON POLICE DEPARTMENT 618-876-4300 (NON-EMERGENCY)  
CITY OF MADISON FIRE DEPARTMENT 618-876-7287 (NON-EMERGENCY)

THE FOLLOWING MIXTURE REQUIREMENTS ARE APPLICABLE FOR THIS PROJECT:

THE FOLLOWING MIXTURE REQUIREMENTS ARE APPLICABLE FOR THIS PROJECT:			
MIXTURE USE	SURFACE	BINDER	BASE COURSE
AC/PG	PG 64-22	PG 64-22	PG 64-22
RAP % (MAX)	10	15	15
DESIGN AIR VOIDS	4.0% @ Ndes=70	4.0% @ Ndes=70	4.0% @ Ndes=70
MIX COMPOSITION		IL 19.0	IL 19.0 OR IL 25.0
(GRADATION MIXTURE)		MIXTURE B	MIXTURE B
FRICITION AGG	MIXTURE C	MIXTURE B	MIXTURE B

FILE NAME = general notes	USER NAME = Jeremy	DESIGNED - BFK	REVISED -	<b>OHIO AVENUE PEDESTRIAN WALKWAY MADISON, ILLINOIS</b>	<b>GENERAL NOTES</b>				F.A. RTE.	SECTION 09-00049-01-SW	COUNTY ST. CLAIR	TOTAL SHEETS 26	SHEET NO. 2
	PLOT SCALE = #SCALE#	CHECKED - BFK	REVISED -		SCALE:	SHEET NO.	OF	SHEETS	STA.	TO STA.	CONTRACT NO. 97420		
	PLOT DATE = 12/18/2009	DATE -	REVISED -		ILLINOIS FED. AID PROJECT								


# SUMMARY OF QUANTITIES

SUMMARY OF QUANTITIES			
CODE NO.	ITEM DESCRIPTION	UNIT	TOTAL QUANTITY
20200100	EARTH EXCAVATION	CU YD	203
25000210	SEEDING, CLASS 2A	ACRE	0.1
25000400	NITROGEN FERTILIZER NUTRIENT	POUND	9
25000500	PHOSPHORUS FERTILIZER NUTRIENT	POUND	9
25000600	POTASSIUM FERTILIZER NUTRIENT	POUND	9
25100115	MULCH, METHOD 2	ACRE	0.1
28000250	TEMPORARY EROSION CONTROL SEEDING	POUND	10
28000400	PERIMETER EROSION BARRIER	FOOT	50
28000500	INLET AND PIPE PROTECTION	EACH	4
35100300	AGGREGATE BASE COURSE, TYPE A 4"	SQ YD	683
35600708	HOT-MIX ASPHALT BASE COURSE WIDENING, 8"	SQ YD	551
40200700	AGGREGATE SURFACE COURSE, TYPE A 8"	SQ YD	38
40201000	AGGREGATE FOR TEMPORARY ACCESS	TON	100
40600100	BITUMINOUS MATERIALS (PRIME COAT)	GALLON	84
40603085	HOT-MIX ASPHALT BINDER COURSE, IL-19.0, N70	TON	49
40603315	HOT-MIX ASPHALT SURFACE COURSE, MIX "C", N70	TON	135
42001300	PROTECTIVE COAT	SQ YD	142
42300400	PORTLAND CEMENT CONCRETE DRIVEWAY PAVEMENT, 8 INCH	SQ YD	128
42400800	DETECTABLE WARNINGS	SQ FT	50
44000157	HOT-MIX ASPHALT SURFACE REMOVAL, 2"	SQ YD	646
44000200	DRIVEWAY PAVEMENT REMOVAL	SQ YD	194
44000500	COMBINATION CURB AND GUTTER REMOVAL	FOOT	34
44003100	MEDIAN REMOVAL	SQ FT	63
44004250	PAVED SHOULDER REMOVAL	SQ YD	1
44201737	CLASS D PATCHES, TYPE 1, 8 INCH	SQ YD	1
44300200	STRIP REFLECTIVE CRACK CONTROL TREATMENT	FOOT	677
60107700	PIPE UNDERDRAINS 6"	FOOT	2
60500060	REMOVING INLETS	EACH	1
60605000	COMBINATION CONCRETE CURB AND GUTTER, TYPE B-6.24	FOOT	34

• SPECIALTY ITEM

SUMMARY OF QUANTITIES			
CODE NO.	ITEM DESCRIPTION	UNIT	TOTAL QUANTITY
67100100	MOBILIZATION	L SUM	1
70103700	TRAFFIC CONTROL COMPLETE	L SUM	1
70300240	TEMPORARY PAVEMENT MARKING - LINE 6"	FOOT	553
70300260	TEMPORARY PAVEMENT MARKING - LINE 12"	FOOT	24
70301000	WORK ZONE PAVEMENT MARKING REMOVAL	SQ FT	301
72400310	REMOVE SIGN PANEL - TYPE 1	SQ FT	8
72400710	RELOCATE SIGN PANEL - TYPE 1	SQ FT	8
72900100	METAL POST - TYPE A	FOOT	12
72900200	METAL POST - TYPE B	FOOT	14
* 78000400	THERMOPLASTIC PAVEMENT MARKING - LINE 6"	FOOT	553
* 78003150	PREFORMED PLASTIC PAVEMENT MARKING, TYPE B - LINE 12"	FOOT	24
78200530	BARRIER WALL MARKERS, TYPE C	EACH	60
78300100	PAVEMENT MARKING REMOVAL	SQ FT	2
78300300	PREFORMED PLASTIC PAVEMENT MARKING REMOVAL	SQ FT	27
* 81400200	HEAVY-DUTY HANDHOLE	EACH	2
* 89502380	REMOVE EXISTING HANDHOLE	EACH	2
X0301894	REMOVE AND REINSTALL CONCRETE HEADWALL FOR PIPE UNDERDRAIN	EACH	1
* X0322951	CABLE SPLICE SPECIAL	EACH	1
X0325349	TEMPORARY CONCRETE BARRIER (TO REMAIN PERMANENTLY)	FOOT	375
X7040305	TEMPORARY CONCRETE BARRIER, TERMINAL SECTION (SPECIAL)	EACH	8
60242400	INLETS, SPECIAL	EACH	1
44002500	GUTTER OUTLET REMOVAL	EACH	1
X0324058	OUTLET SPECIAL	EACH	1




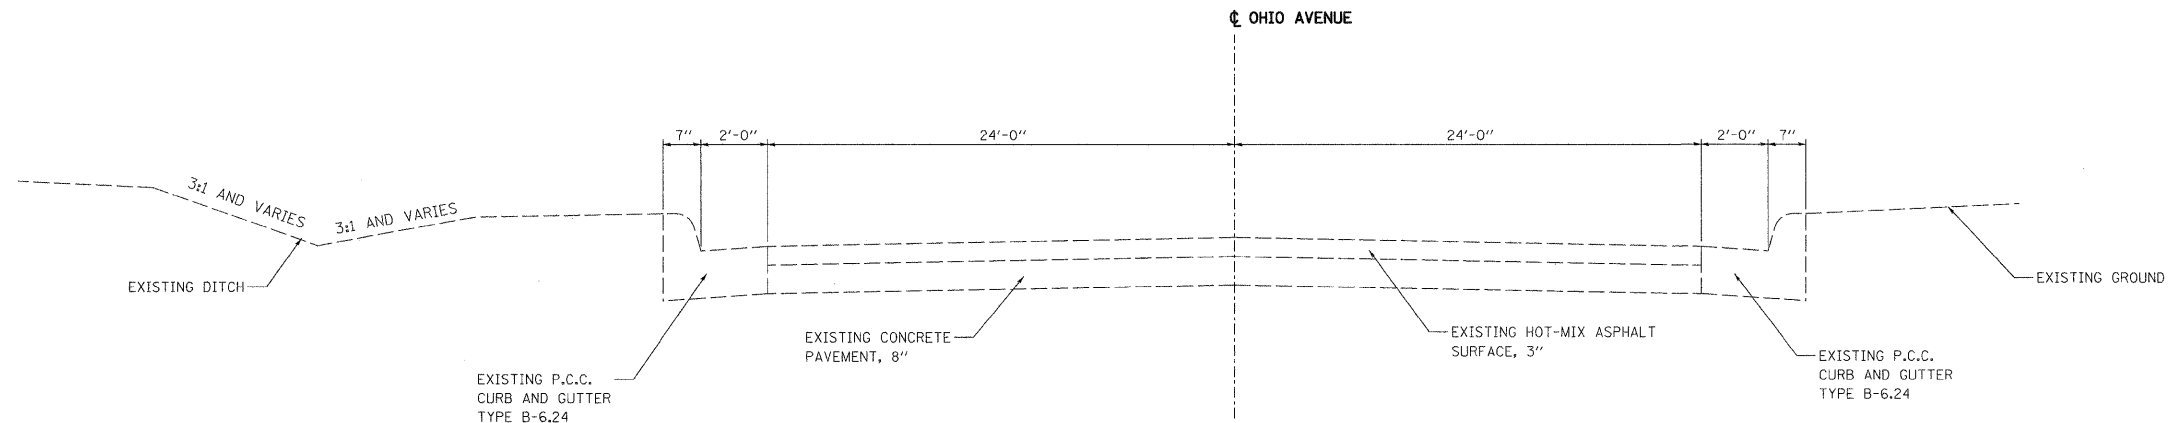


**OHIO AVENUE PEDESTRIAN WALKWAY TYPICAL**

STA. 107+89.07 TO STA. 108+59.70  
(NOT TO SCALE)

FILE NAME = tjp.ex	USER NAME = Jeremy	DESIGNED - BFK	REVISED -	<b>OHIO AVENUE PEDESTRIAN WALKWAY MADISON, ILLINOIS</b>	<b>EXISTING TYPICAL SECTIONS</b>				F.A. RTE.	SECTION	COUNTY	TOTAL SHEETS	SHEET NO.
	PLOT SCALE = #SCALE#	CHECKED - BFK	REVISED -						09-00049-01-SW	ST. CLAIR	26	5	
PLOT DATE = 12/18/2009	DATE - 05/14/09	REVISED -	REVISED -	SCALE: N.T.S.	SHEET NO.	OF	SHEETS	STA.	TO STA.	ILLINOIS FED. AID PROJECT <b>CONTRACT NO. 97420</b>			

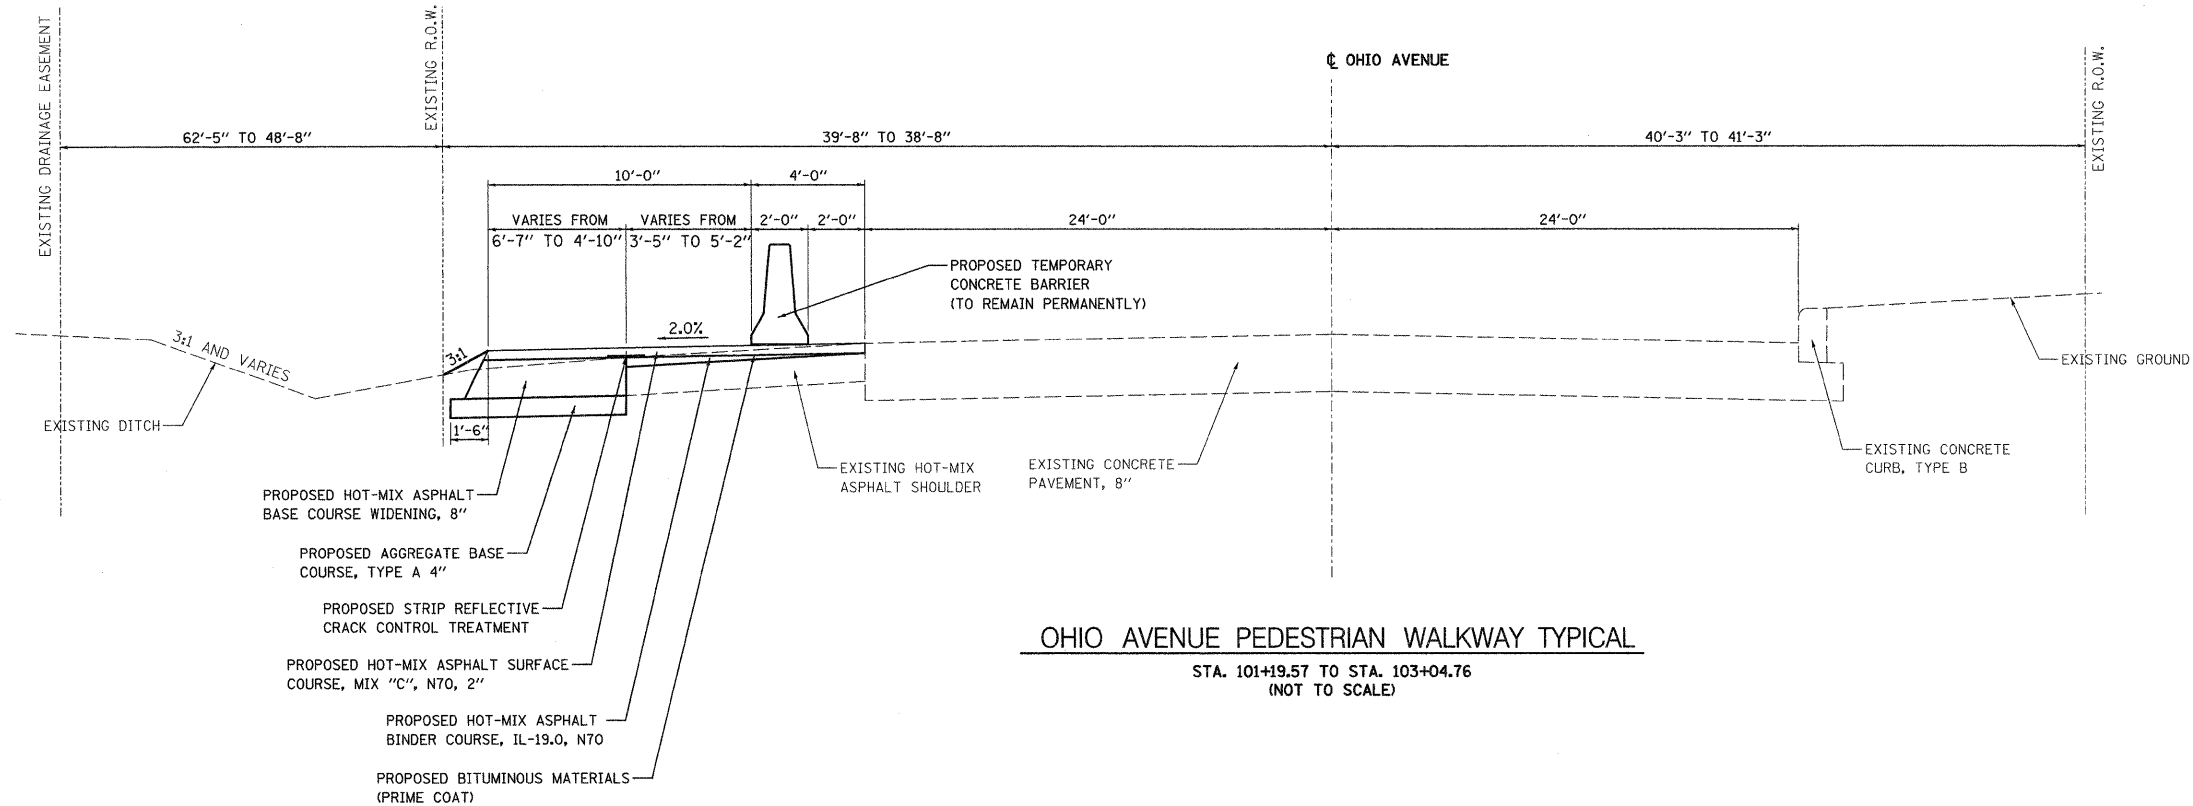

**OHIO AVENUE PEDESTRIAN WALKWAY TYPICAL**  
 STA. 101+19.57 TO STA. 103+04.76  
 (NOT TO SCALE)

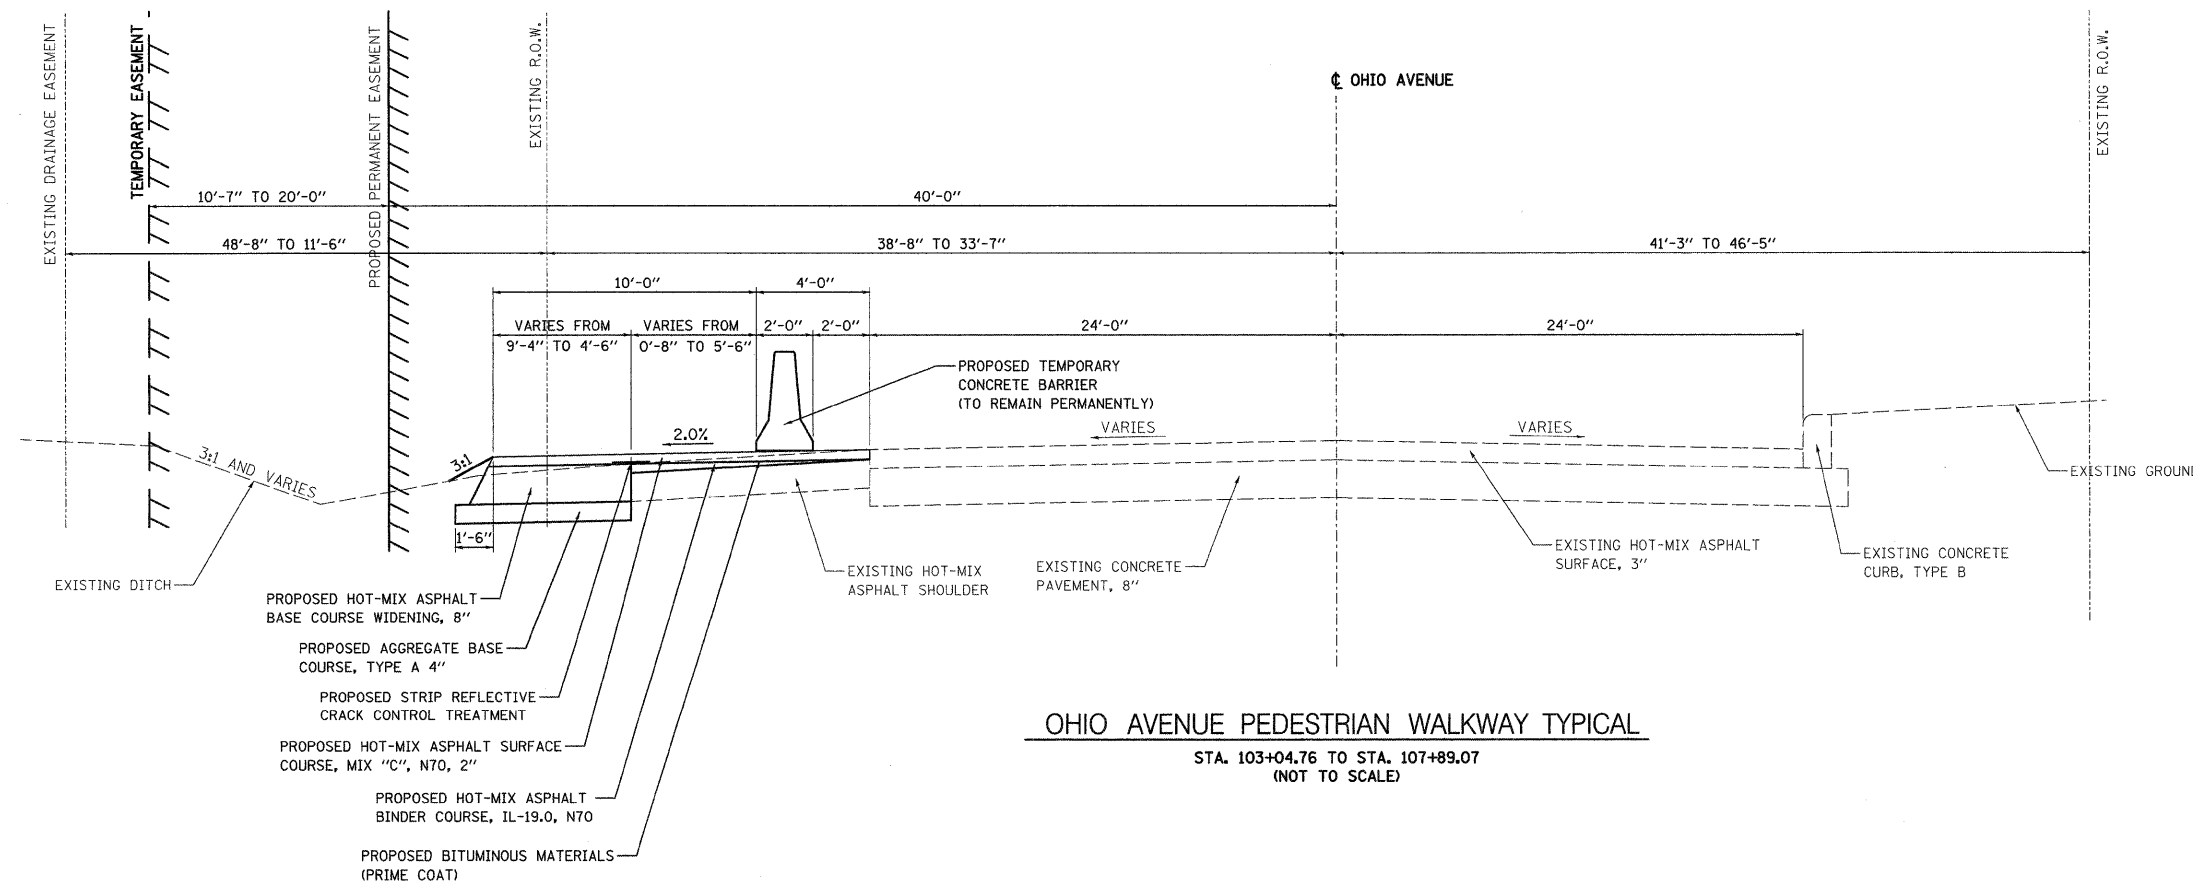


**OHIO AVENUE PEDESTRIAN WALKWAY TYPICAL**  
 STA. 103+04.76 TO STA. 107+89.07  
 (NOT TO SCALE)

FILE NAME = tjp-prop	USER NAME = Jeremy	DESIGNED - BFK	REVISED -	<b>OHIO AVENUE PEDESTRIAN WALKWAY MADISON, ILLINOIS</b>	<b>PROPOSED TYPICAL SECTIONS</b>				F.A. RTE.	SECTION	COUNTY	TOTAL SHEETS	SHEET NO.
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PLOT DATE = 12/18/2009	CHECKED - BFK	DATE - 05/14/09	REVISED -	SCALE: N.T.S.	SHEET NO.	OF	SHEETS	STA.	TO STA.	CONTRACT NO. 97420 ILLINOIS FED. AID PROJECT			

EXISTING R.O.W.

EXISTING R.O.W.

OHIO AVENUE

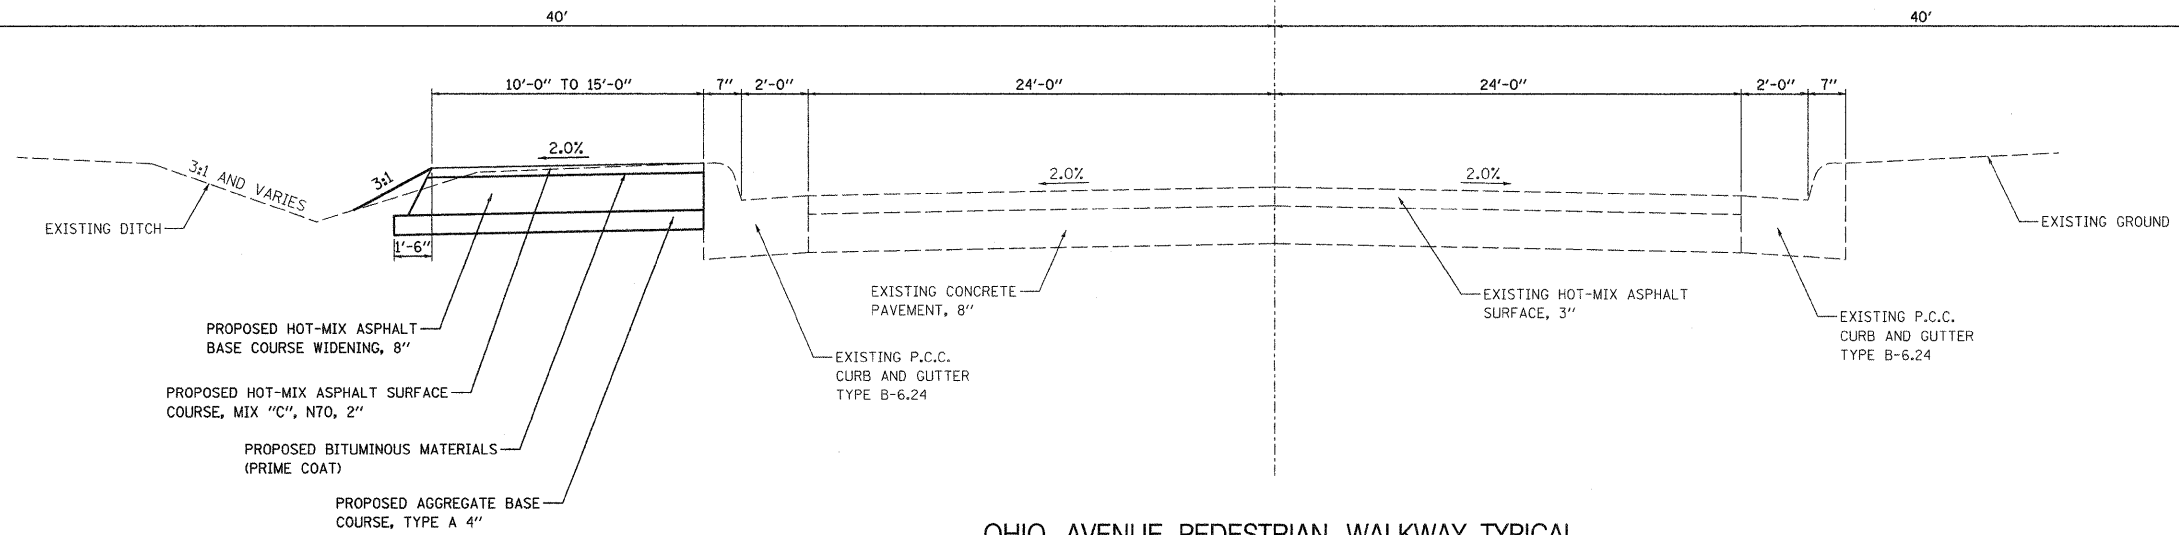

**OHIO AVENUE PEDESTRIAN WALKWAY TYPICAL**

STA. 107+89.07 TO STA. 108+59.70  
(NOT TO SCALE)

FILE NAME = typ-prop	USER NAME = jeremy	DESIGNED - BFK	REVISED -	<b>OHIO AVENUE PEDESTRIAN WALKWAY MADISON, ILLINOIS</b>	<b>PROPOSED TYPICAL SECTIONS</b>				F.A. RTE.	SECTION	COUNTY	TOTAL SHEETS	SHEET NO.
	PLOT SCALE = #SCALE#	DRAWN - JJB	REVISED -		SCALE: N.T.S.	SHEET NO.	OF	SHEETS	STA.	TO STA.	09-00049-01-SW	26	7
	PLOT DATE = 12/18/2009	CHECKED - BFK	REVISED -								ST. CLAIR		
		DATE - 05/14/09	REVISED -								CONTRACT NO. 97420		

ILLINOIS FED. AID PROJECT

**PAVING SCHEDULE**

LOCATION	BIT MATL PR CT (GALLON)	AGG. BASE COURSE TYPE A 4 IN (SQ YD)	HOT-MIX ASPHALT BASE COURSE WIDENING, 8" (SQ YD)	HOT-MIX ASPHALT SURF CSE, MIX C, N70, 2" (TON)	HOT-MIX ASPHALT BINDER COURSE, IL-19.0, N70 (TON)
OHIO AVENUE					
STA. 101+19.57 LT TO STA. 108+59.70 LT	80.9	632.8	509.2	130.0	48.5
STA. 109+18.52 - 4.99' LT TO STA. 109+18.29 - 55.15' LT	2.9	49.8	41.4	4.6	0.0
<b>TOTAL</b>	<b>84</b>	<b>683</b>	<b>551</b>	<b>135</b>	<b>49</b>

**STRIP REFLECTIVE CRACK CONTROL SCHEDULE**

LOCATION	LENGTH (FOOT)
OHIO AVENUE	
STA. 101+25.87 - 81.51' LT TO STA. 107+88.66 - 31.97' LT	677
<b>TOTAL</b>	<b>677</b>

**TEMPORARY CONCRETE BARRIER SCHEDULE**

LOCATION	TEMPORARY CONCRETE BARRIER (TO REMAIN PERMANENTLY) (FOOT)	TEMPORARY CONCRETE BARRIER TERMINAL SECTION (SPECIAL) (EACH)	BARRIER WALL MARKERS, TYPE C (EACH)
OHIO AVENUE			
STA. 101+52.51 - 51.92' LT TO STA 102+99.87 - 26.80' LT	150	2	20
STA. 103+88.28 - 26.50' LT TO STA. 104+00.94 - 26.51' LT	12.5	2	8
STA. 104+88.92 - 26.04' LT TO STA. 106+53.58 - 25.50' LT	162.5	2	22
STA. 107+29.84 - 25.60' LT TO STA. 107+80.34 - 28.87' LT	50	2	10
<b>TOTAL</b>	<b>375</b>	<b>8</b>	<b>60</b>

**COMBINATION CURB AND GUTTER SCHEDULE**

LOCATION	COMBINATION CONCRETE CURB & GUTTER TYPE B-6.24 (FOOT)
OHIO AVENUE	
STA. 107+88.80 - 30.43' LT TO STA 108+00.79 - 31.66' LT	12.0
STA. 108+42.11 - 47.26' LT TO STA. 108+57.62 - 63.01' LT	22.2
<b>TOTAL</b>	<b>34</b>

**PATCHING SCHEDULE**

LOCATION	SIZE			PAVEMENT PATCHING CLASS D PATCHES
	LENGTH	X	WIDTH	TYPE I 8 IN (SQ YD)
	(FOOT)		(FOOT)	
OHIO AVENUE				
STA. 102+97.90 - 26.01' LT TO STA. 103+03.08 - 26.01' LT	5.2	X	1.8	1.0
<b>TOTAL</b>				<b>1.0</b>

**EARTHWORK SCHEDULE**

LOCATION	EARTH EXCAVATION (CU YD)	EARTH EXCAVATION ADJUSTED FOR SHRINKAGE (CU YD)	EMBANKMENT (CU YD)	EARTHWORK BALANCE WASTE(+) OR SHORTAGE(-) (CU YD)
OHIO AVENUE	203	153	22	(+) 131
<b>TOTAL</b>	<b>203</b>	<b>153</b>	<b>22</b>	<b>131</b>

NOTE: BASED ON 25% SHRINKAGE

**ENTRANCE SCHEDULE**

LOCATION	"W" WIDTH (FT)	PCC DRIVEWAY PAVEMENT	PROTECTIVE COAT (SQ YD)	AGGREGATE SURFACE COURSE	"Y" DISTANCE (FT)
		8 IN. (SQ YD)		TYPE A 8 IN. (SQ YD)	
OHIO AVENUE					
CE @ 103+46.79 - LT	30.3	64.3	64.3		17.5
CE @ 104+41.97 - LT	30.0	63.7	63.7		17.5
CE @ 106+98.29 - LT	24.0			37.5	13.9
<b>TOTAL</b>		<b>128</b>	<b>128</b>	<b>38</b>	

**PAVEMENT MARKING SCHEDULE**

LOCATION	TYPE	THERMOPLASTIC PAVEMENT MARKINGS		PREFORMED PLASTIC PAVEMENT MARKINGS
		6" WHITE (FOOT)	6" YELLOW (FOOT)	12" WHITE (FOOT)
OLD MADISON ROAD				
	CROSSWALK	115		
	STOP BARS			24
	BARRIER EDGE		438	
<b>TOTAL</b>		<b>115</b>	<b>438</b>	<b>24</b>

PLAN SURVEYED, PLOTTED, CHECKED, REVISIONS, DATE, BY, NOTE BOOK NO., CADD FILE NAME

PROFILE SURVEYED, PLOTTED, CHECKED, REVISIONS, DATE, BY, NOTE BOOK NO., STRUCTURE NOTATIONS CHECKED



INLET SCHEDULE

STRUCTURE ID	LOCATION	INLETS SPECIAL (EACH)
	OHIO AVENUE	
H-01	STA. 103+04.82 - 43.25' LT	1
	<b>TOTAL</b>	<b>1</b>

RELOCATE SIGN PANEL SCHEDULE

EXISTING LOCATION	PROPOSED LOCATION	REMOVE SIGN PANEL TYPE 1 (SQ FT)	RELOCATE SIGN PANEL TYPE 1 (SQ FT)	METAL POST TYPE A (FOOT)	METAL POST TYPE B (FOOT)
OHIO AVENUE					
STA. 102+78.59 - 37.17' LT	STA. 102+78.59 - 40.75' LT	1.5	1.5	12.0	
STA. 108+56.63 - 66.13' LT	STA. 108+57.93 - 70.66' LT	6.25	6.25		13.5
<b>TOTAL</b>		<b>8</b>	<b>8</b>	<b>12</b>	<b>14</b>

PERIMETER EROSION BARRIER SCHEDULE

LOCATION	PERIMETER EROSION BARRIER (FOOT)
OHIO AVENUE	
STA. 109+24.31 - 5.02' LT TO STA. 109+24.09 - 55.18' LT	50.2
<b>TOTAL</b>	<b>50</b>

SEEDING SCHEDULE

LOCATION	SEEDING CLASS 2A (AC)	TEMPORARY SEEDING (LB)	NITROGEN FERT NUTR (LB)	PHOSPHORUS FERT NUTR (LB)	POTASSIUM FERT NUTR (LB)	MULCH METHOD 2 (AC)
OHIO AVENUE						
STA. 101+12.02 TO STA. 151+94.35	0.1	10.0	9.0	9.0	9.0	0.1
<b>TOTAL</b>	<b>0.1</b>	<b>10</b>	<b>9</b>	<b>9</b>	<b>9</b>	<b>0.1</b>

INLET AND PIPE PROTECTION SCHEDULE

LOCATION	DISTANCE (FOOT)	INLET PIPE PROTECTOR (EACH)
OHIO AVENUE		
STA. 103+04.82 LT	43.25	1
STA. 104+20.60 LT	45.81	1
STA. 104+62.16 LT	44.78	1
STA. 109+31.86 LT	49.28	1
<b>TOTAL</b>		<b>4</b>

HEADWALL RELOCATION SCHEDULE

EXISTING LOCATION	PROPOSED LOCATION	REMOVE AND REINSTALL CONCRETE HEADWALL FOR PIPE UNDERDRAINS (EACH)
OHIO AVENUE		
STA. 102+94.81 - 41.93' LT	STA. 102+94.99 - 43.90' LT	1
<b>TOTAL</b>		<b>1</b>

PIPE UNDERDRAIN SCHEDULE

LOCATION	PIPE UNDERDRAINS 6" (FOOT)
OHIO AVENUE	
STA. 102+94.61 - 39.32' LT TO STA. 102+94.76 - 41.41' LT	2
<b>TOTAL</b>	<b>2</b>

DETECTABLE WARNINGS SCHEDULE

LOCATION	DETECTABLE WARNINGS (SQ FT)
OHIO AVENUE	
STA. 101+28.27 - 67.39' LT TO STA. 101+34.83 - 64.43' LT	13.78
STA. 108+45.05 - 53.57' LT TO STA. 108+52.79 - 58.58' LT	18
STA. 109+08.90 - 36.33' LT TO STA. 109+10.95 - 45.09' LT	18
<b>TOTAL</b>	<b>50</b>

PLAN SURVEYED \_\_\_\_\_ DATE \_\_\_\_\_  
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 FILE NAME \_\_\_\_\_

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 PLOTTED \_\_\_\_\_  
 CHECKED \_\_\_\_\_  
 NOTE BOOK NO. \_\_\_\_\_  
 FILE NAME \_\_\_\_\_

OUTLET SPECIAL SCHEDULE

LOCATION	OUTLET SPECIAL (EACH)
OHIO AVENUE	
STA. 103+00.67 - 49.12' LT TO STA. 103+08.19 - 49.04' LT	1
<b>TOTAL</b>	<b>1</b>

PAVEMENT MARKING REMOVAL SCHEDULE

LOCATION	PAVEMENT MARKING REMOVAL 4" LANE LINE (SQ FT)	PERFORMED PLASTIC PAVEMENT MARKING REMOVAL 12" STOP BAR (SQ FT)
OHIO AVENUE		
STA. 108+84.29 - 53.85' LT TO STA. 108+84.26 - 59.22' LT	2	
STA. 108+59.68 - 62.48' LT TO STA. 108+84.29 - 53.85' LT		27.0
<b>TOTAL</b>	<b>2.0</b>	<b>27.0</b>

GUTTER OUTLET REMOVAL SCHEDULE

LOCATION	GUTTER OUTLET REMOVAL (EACH)
OHIO AVENUE	
STA. 103+00.67 - 49.12' LT TO STA. 103+08.19 - 49.04' LT	1
<b>TOTAL</b>	<b>1</b>

HANDHOLE REMOVAL SCHEDULE

LOCATION	REMOVE EXISTING HANDHOLE (EACH)
OHIO AVENUE	
STA. 101+75.20 - 500.50' LT	1
STA. 103+00.53 - 28.38' LT	1
<b>TOTAL</b>	<b>2</b>

HANDHOLE SCHEDULE

LOCATION	HEAVY-DUTY HANDHOLE (EACH)	CABLE SPLICE SPECIAL (EACH)
OHIO AVENUE		
STA. 101+75.20 - 500.50' LT	1	
STA. 103+00.53 - 30.20' LT	1	1
<b>TOTAL</b>	<b>2</b>	<b>1</b>

CURB & GUTTER REMOVAL SCHEDULE

LOCATION	COMBINATION CURB & GUTTER REMOVAL (FOOT)
OHIO AVENUE	
STA. 107+88.71 - 31.43' LT TO STA 108+00.67 - 31.64' LT	12.0
STA. 108+42.11 - 47.26' LT TO STA. 108+57.62 - 63.01' LT	22.2
<b>TOTAL</b>	<b>34</b>

PROTECTIVE COAT SCHEDULE

LOCATION	PROTECTIVE COAT (SQ YD)
OHIO AVENUE	
CONCRETE DRIVEWAY PAVEMENT, 8 INCH	128
CONCRETE OUTLET, 4"	2.2
CURB & GUTTER TYPE B-6.24	11.3
<b>TOTAL</b>	<b>142</b>

HOT-MIX ASPHALT SURFACE REMOVAL SCHEDULE

LOCATION	HOT-MIX ASPHALT SURFACE REMOVAL 2" (SQ YD)
OHIO AVENUE	
STA. 101+19.57 LT TO STA. 107+89.07 LT	646
<b>TOTAL</b>	<b>646</b>

PAVED SHOULDER REMOVAL SCHEDULE

LOCATION	PAVED SHOULDER REMOVAL (SQ YD)
OHIO AVENUE	
STA. 102+97.98 - 30.75' LT TO STA. 103+03.09 - 30.85' LT	1.00
<b>TOTAL</b>	<b>1</b>

DRIVEWAY PAVEMENT REMOVAL SCHEDULE

LOCATION	DRIVEWAY PAVEMENT REMOVAL (SQ YD)
OHIO AVENUE	
STA. 103+46.79 - LT	95.2
STA. 104+41.97 - LT	98.4
<b>TOTAL</b>	<b>194</b>

INLET REMOVAL SCHEDULE


LOCATION	REMOVING INLETS (EACH)
OHIO AVENUE	
STA. 103+04.82 - 43.25' LT	1
<b>TOTAL</b>	<b>1</b>

MEDIAN REMOVAL SCHEDULE

LOCATION	MEDIAN REMOVAL (SQ FT)
OHIO AVENUE	
STA. 103+41.87 - LT TO STA. 103+52.72 - LT	63.4
<b>TOTAL</b>	<b>63</b>


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NOTE BOOK NO.  
STRUCTURE NOTATIONS CHKD

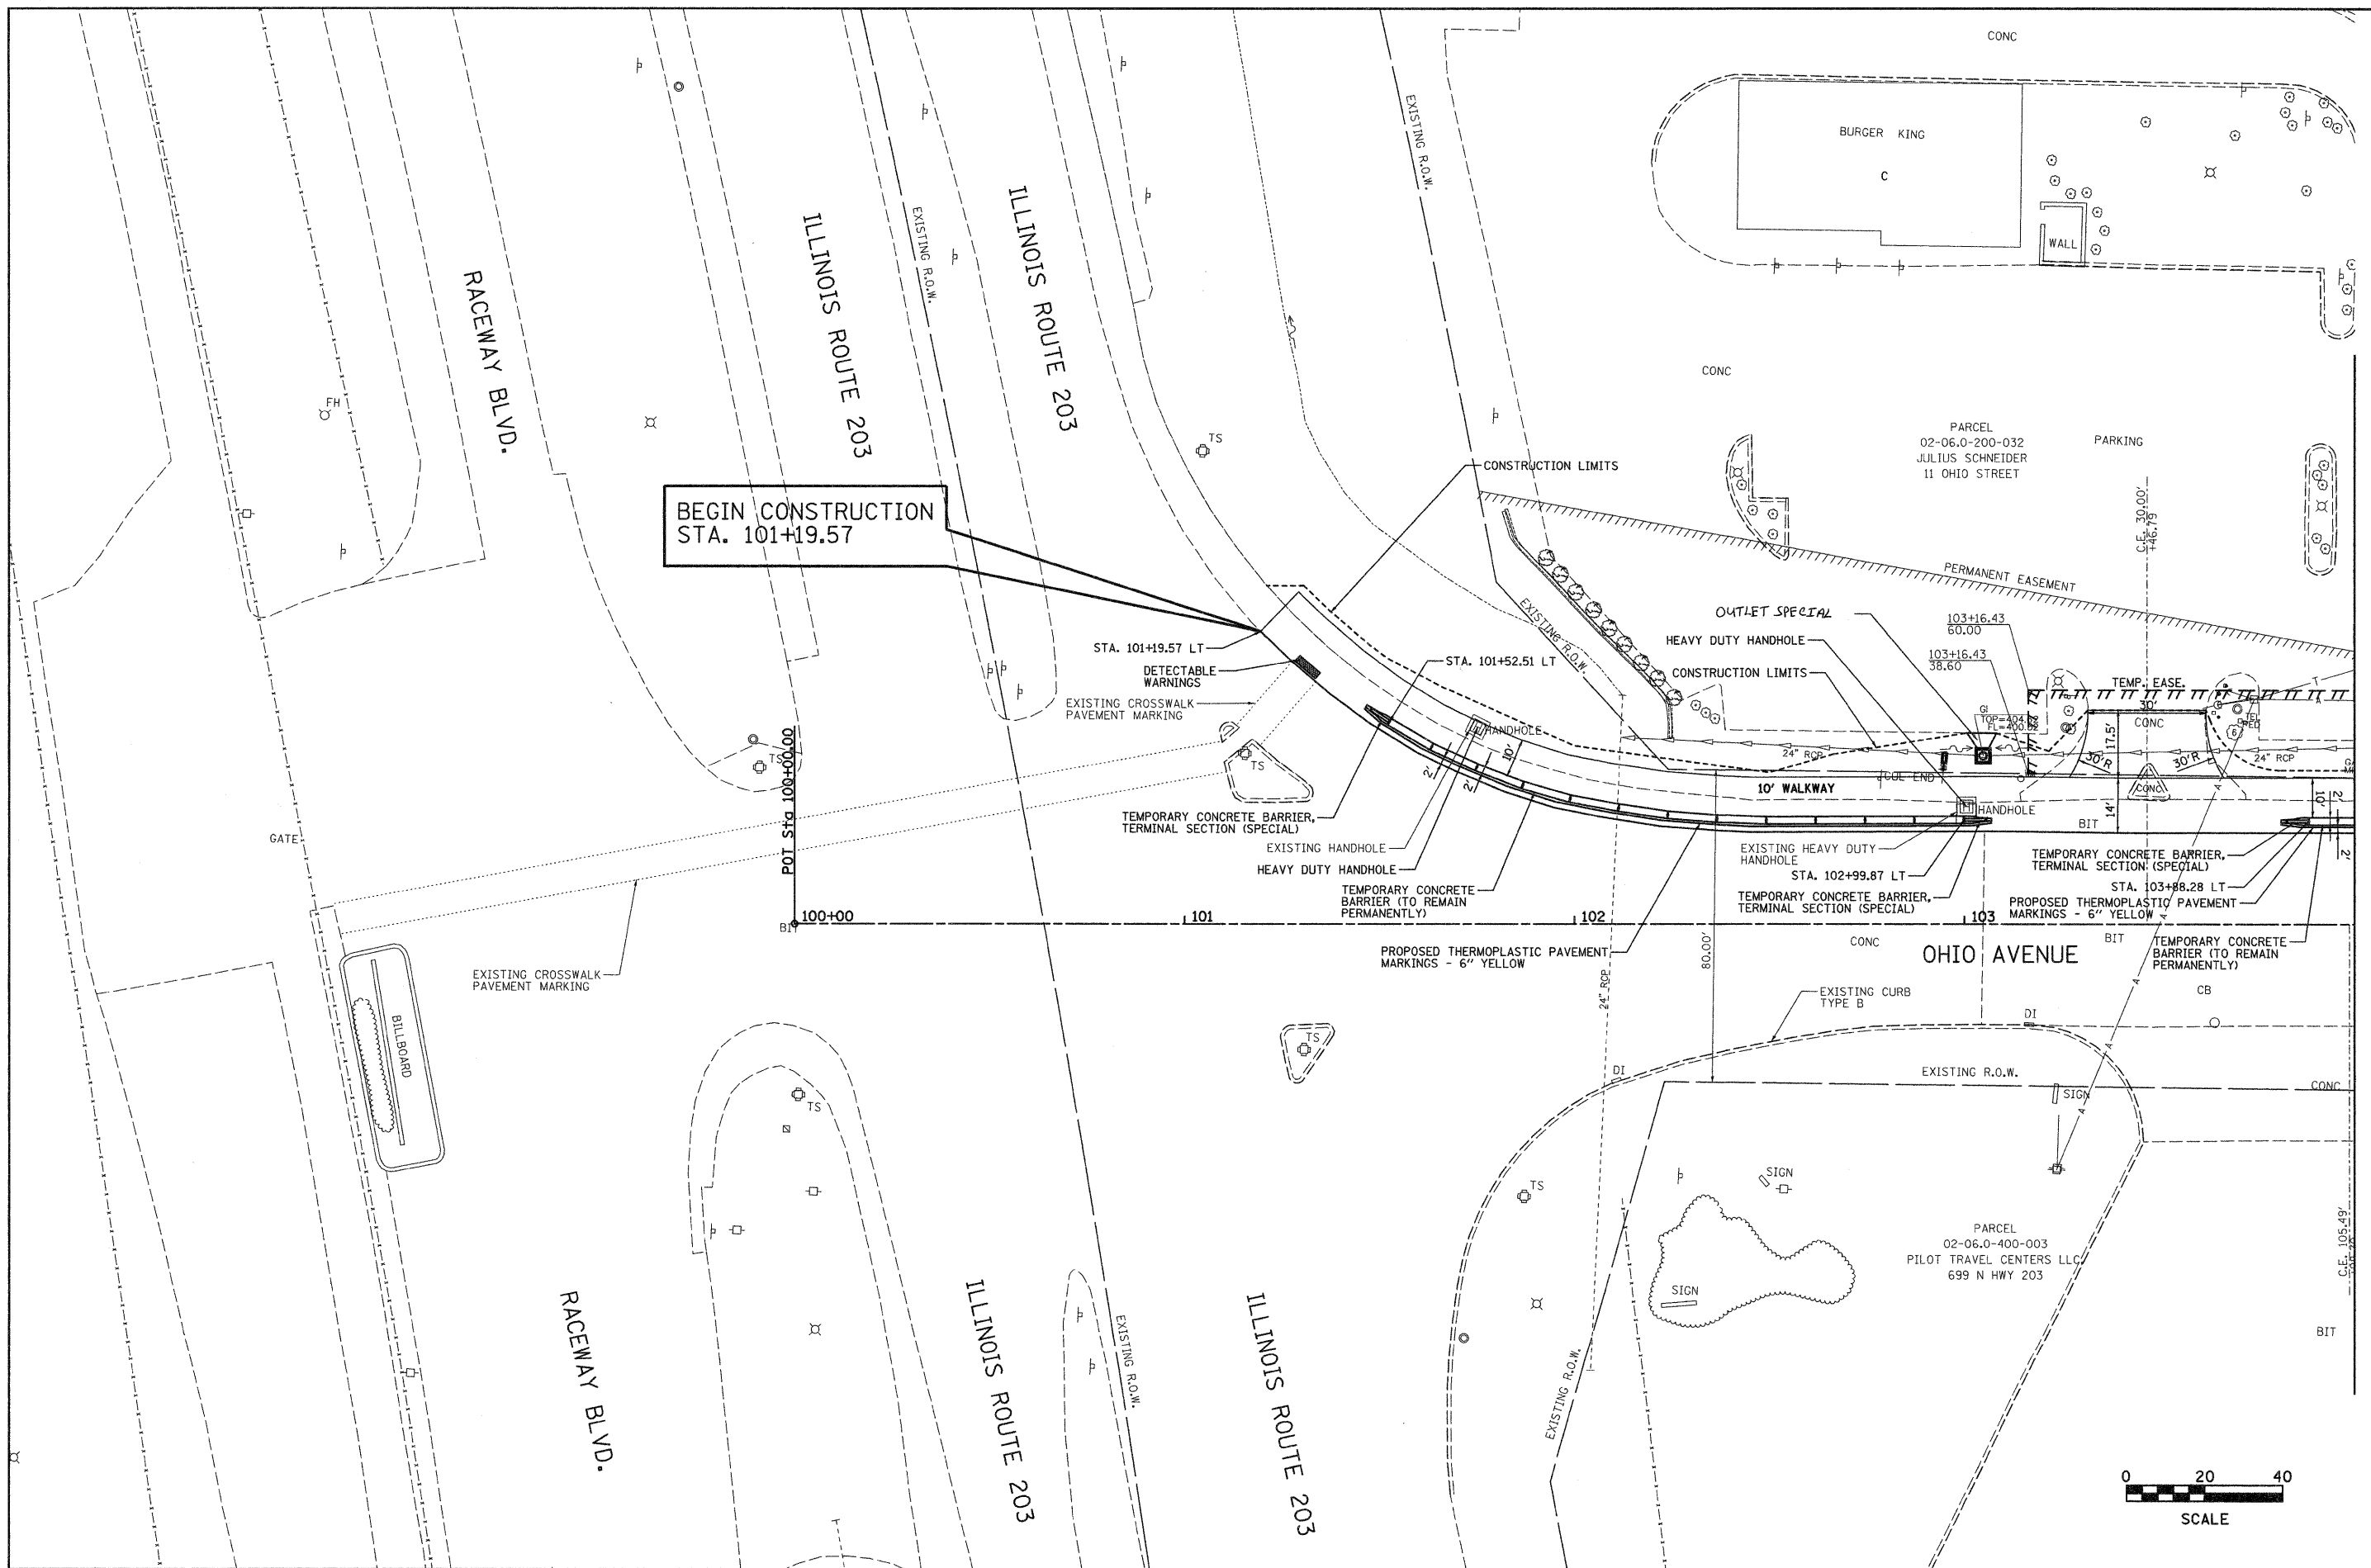

MATCH LINE STA. 104+00.00



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PLOT SCALE = #SCALE#	DRAWN - JJB	CHECKED - BFK	REVISED -			09-00049-01-SW	ST. CLAIR	26	11	
PLOT DATE = 12/18/2009	DATE - 05/14/09	REVISED -	REVISED -			CONTRACT NO. 97420				
						ILLINOIS FED. AID PROJECT				
SCALE: 1"=20'						SHEET NO.	OF	SHEETS	STA.	TO STA.

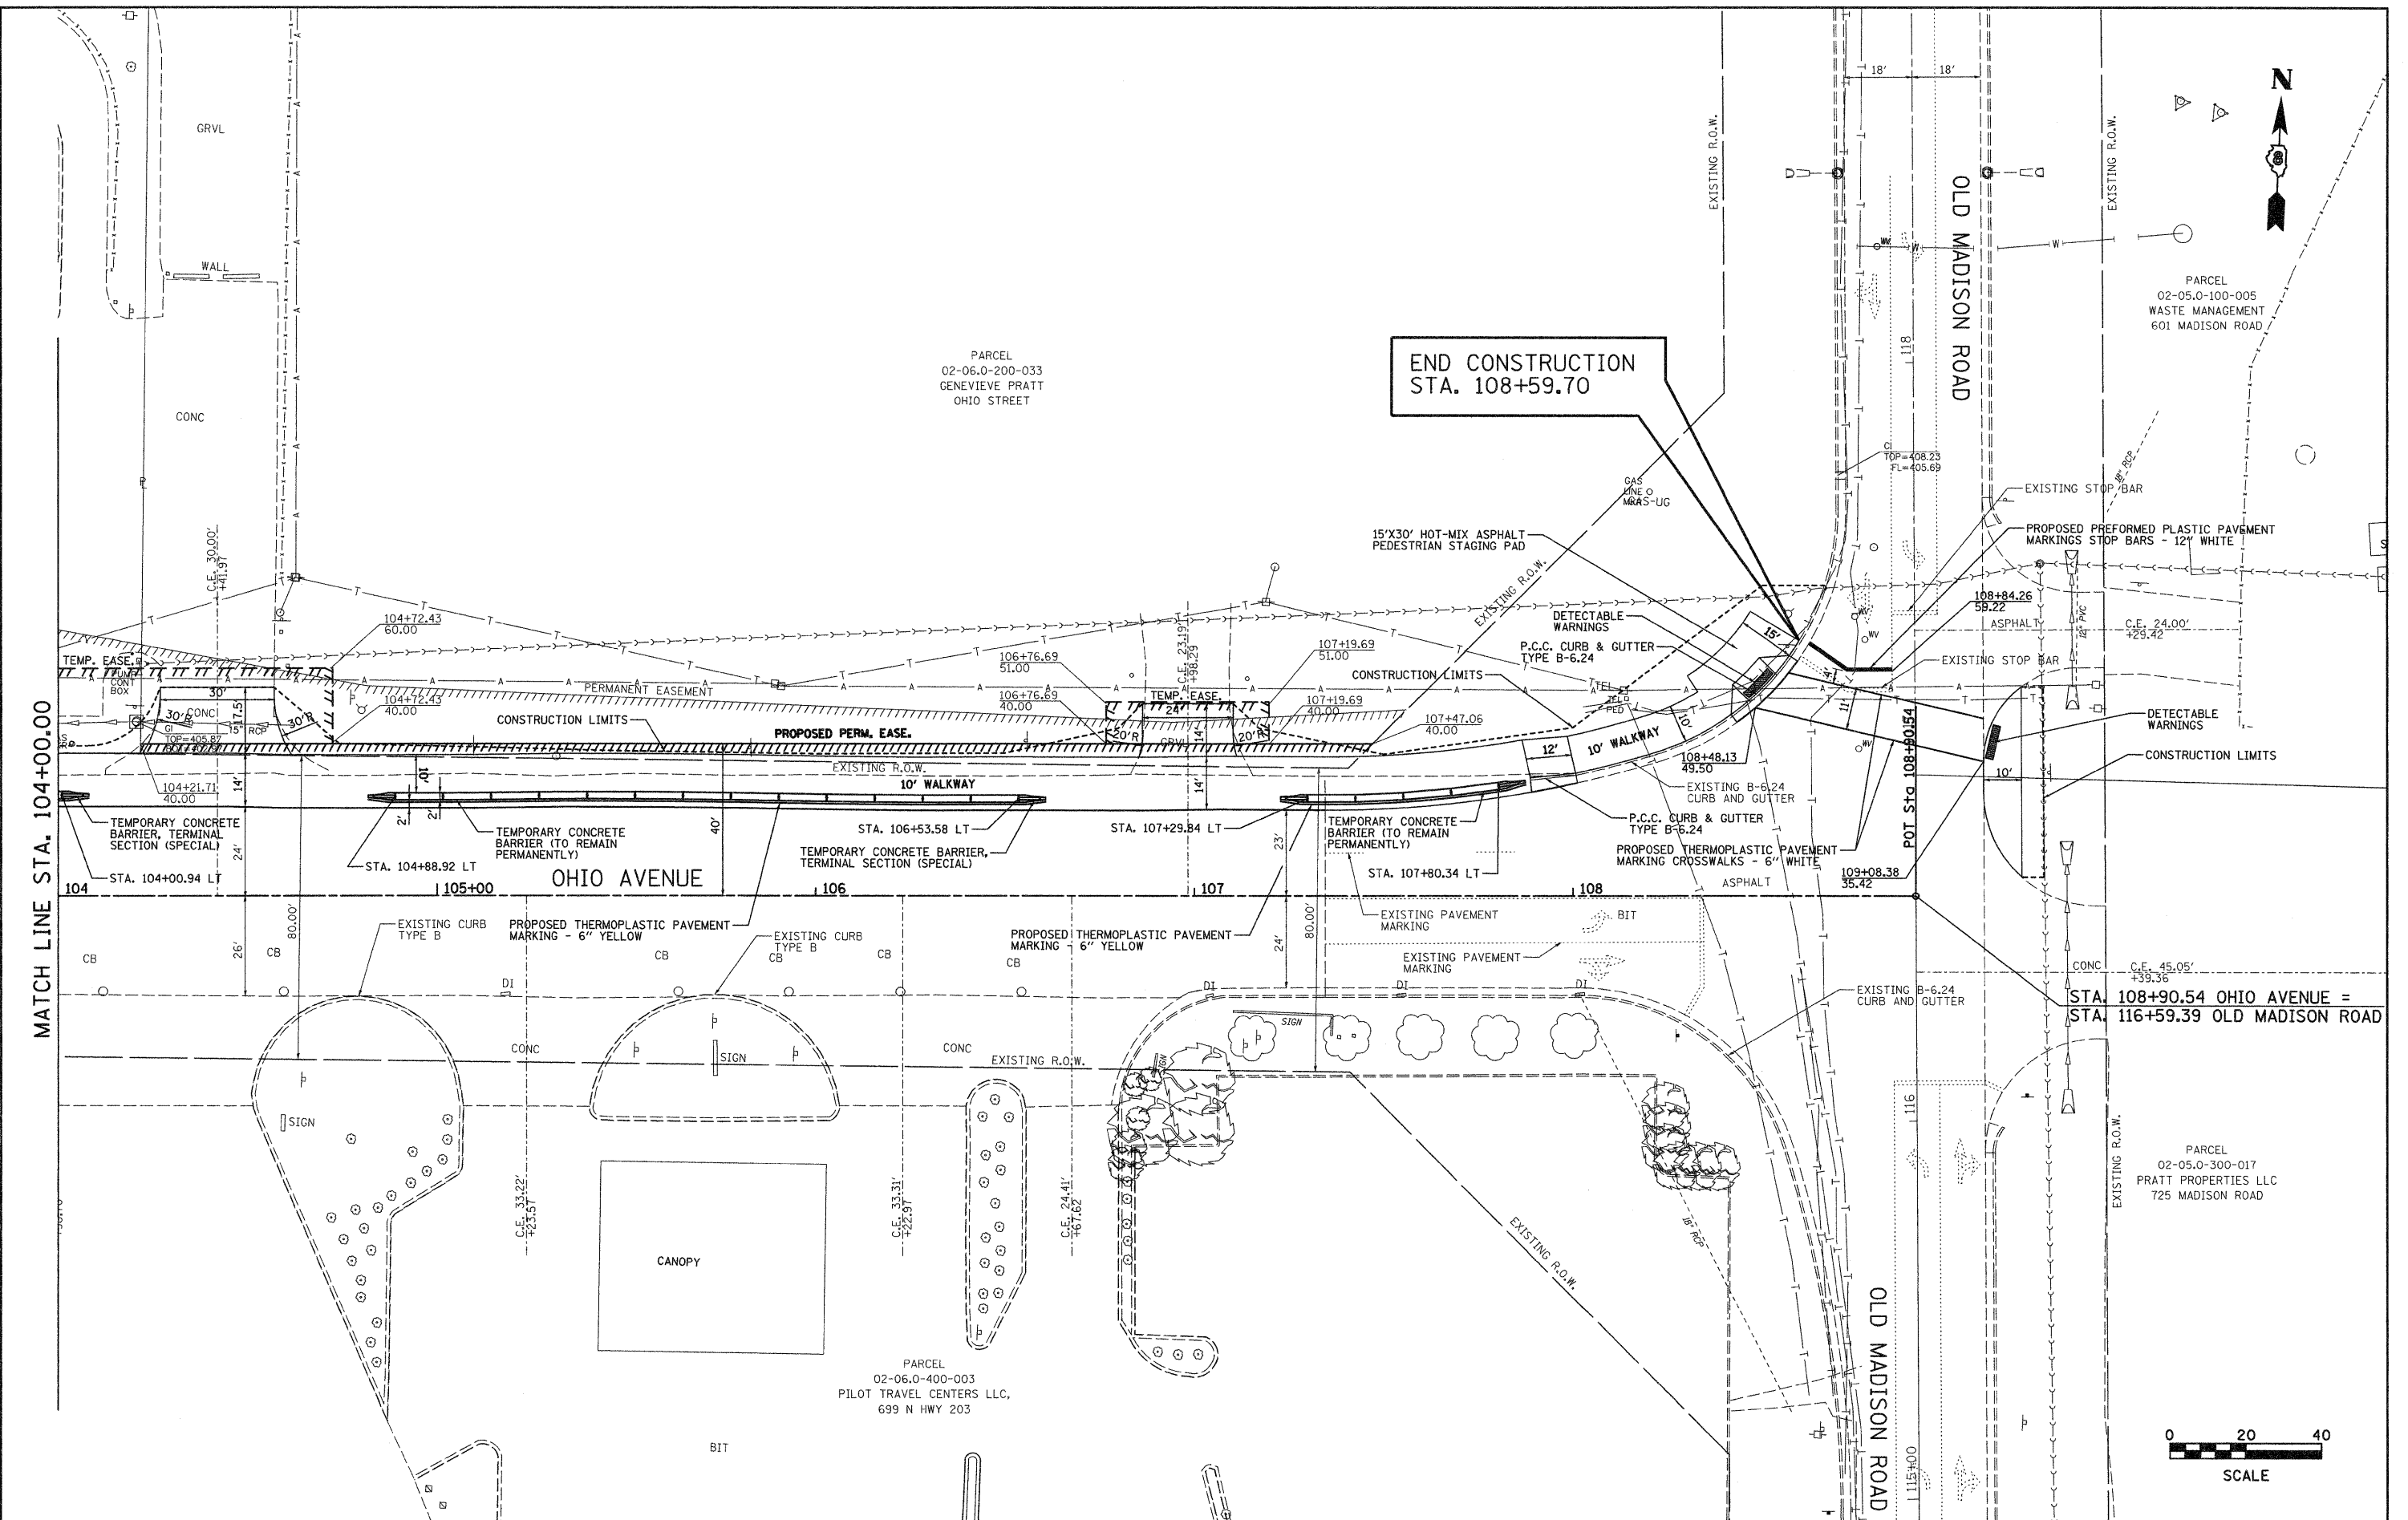


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PLOT DATE = 12/18/2009	CHECKED - BFK	DATE - 05/14/09	REVISED -	SCALE: 1"=20'	SHEET NO. OF SHEETS STA. TO STA.	CONTRACT NO. 97420				
						ILLINOIS FED. AID PROJECT				

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	CHECKED	
	BY	
	NO.	
	NOTE BOOK	
	NO.	
	ADD FILE NAME	

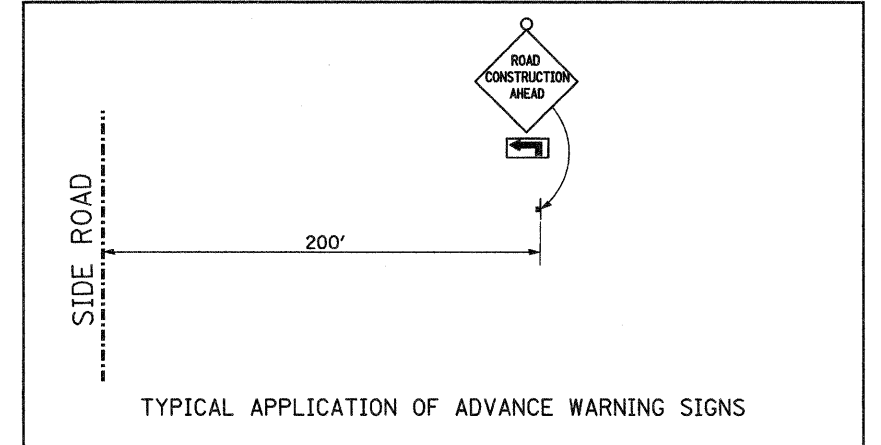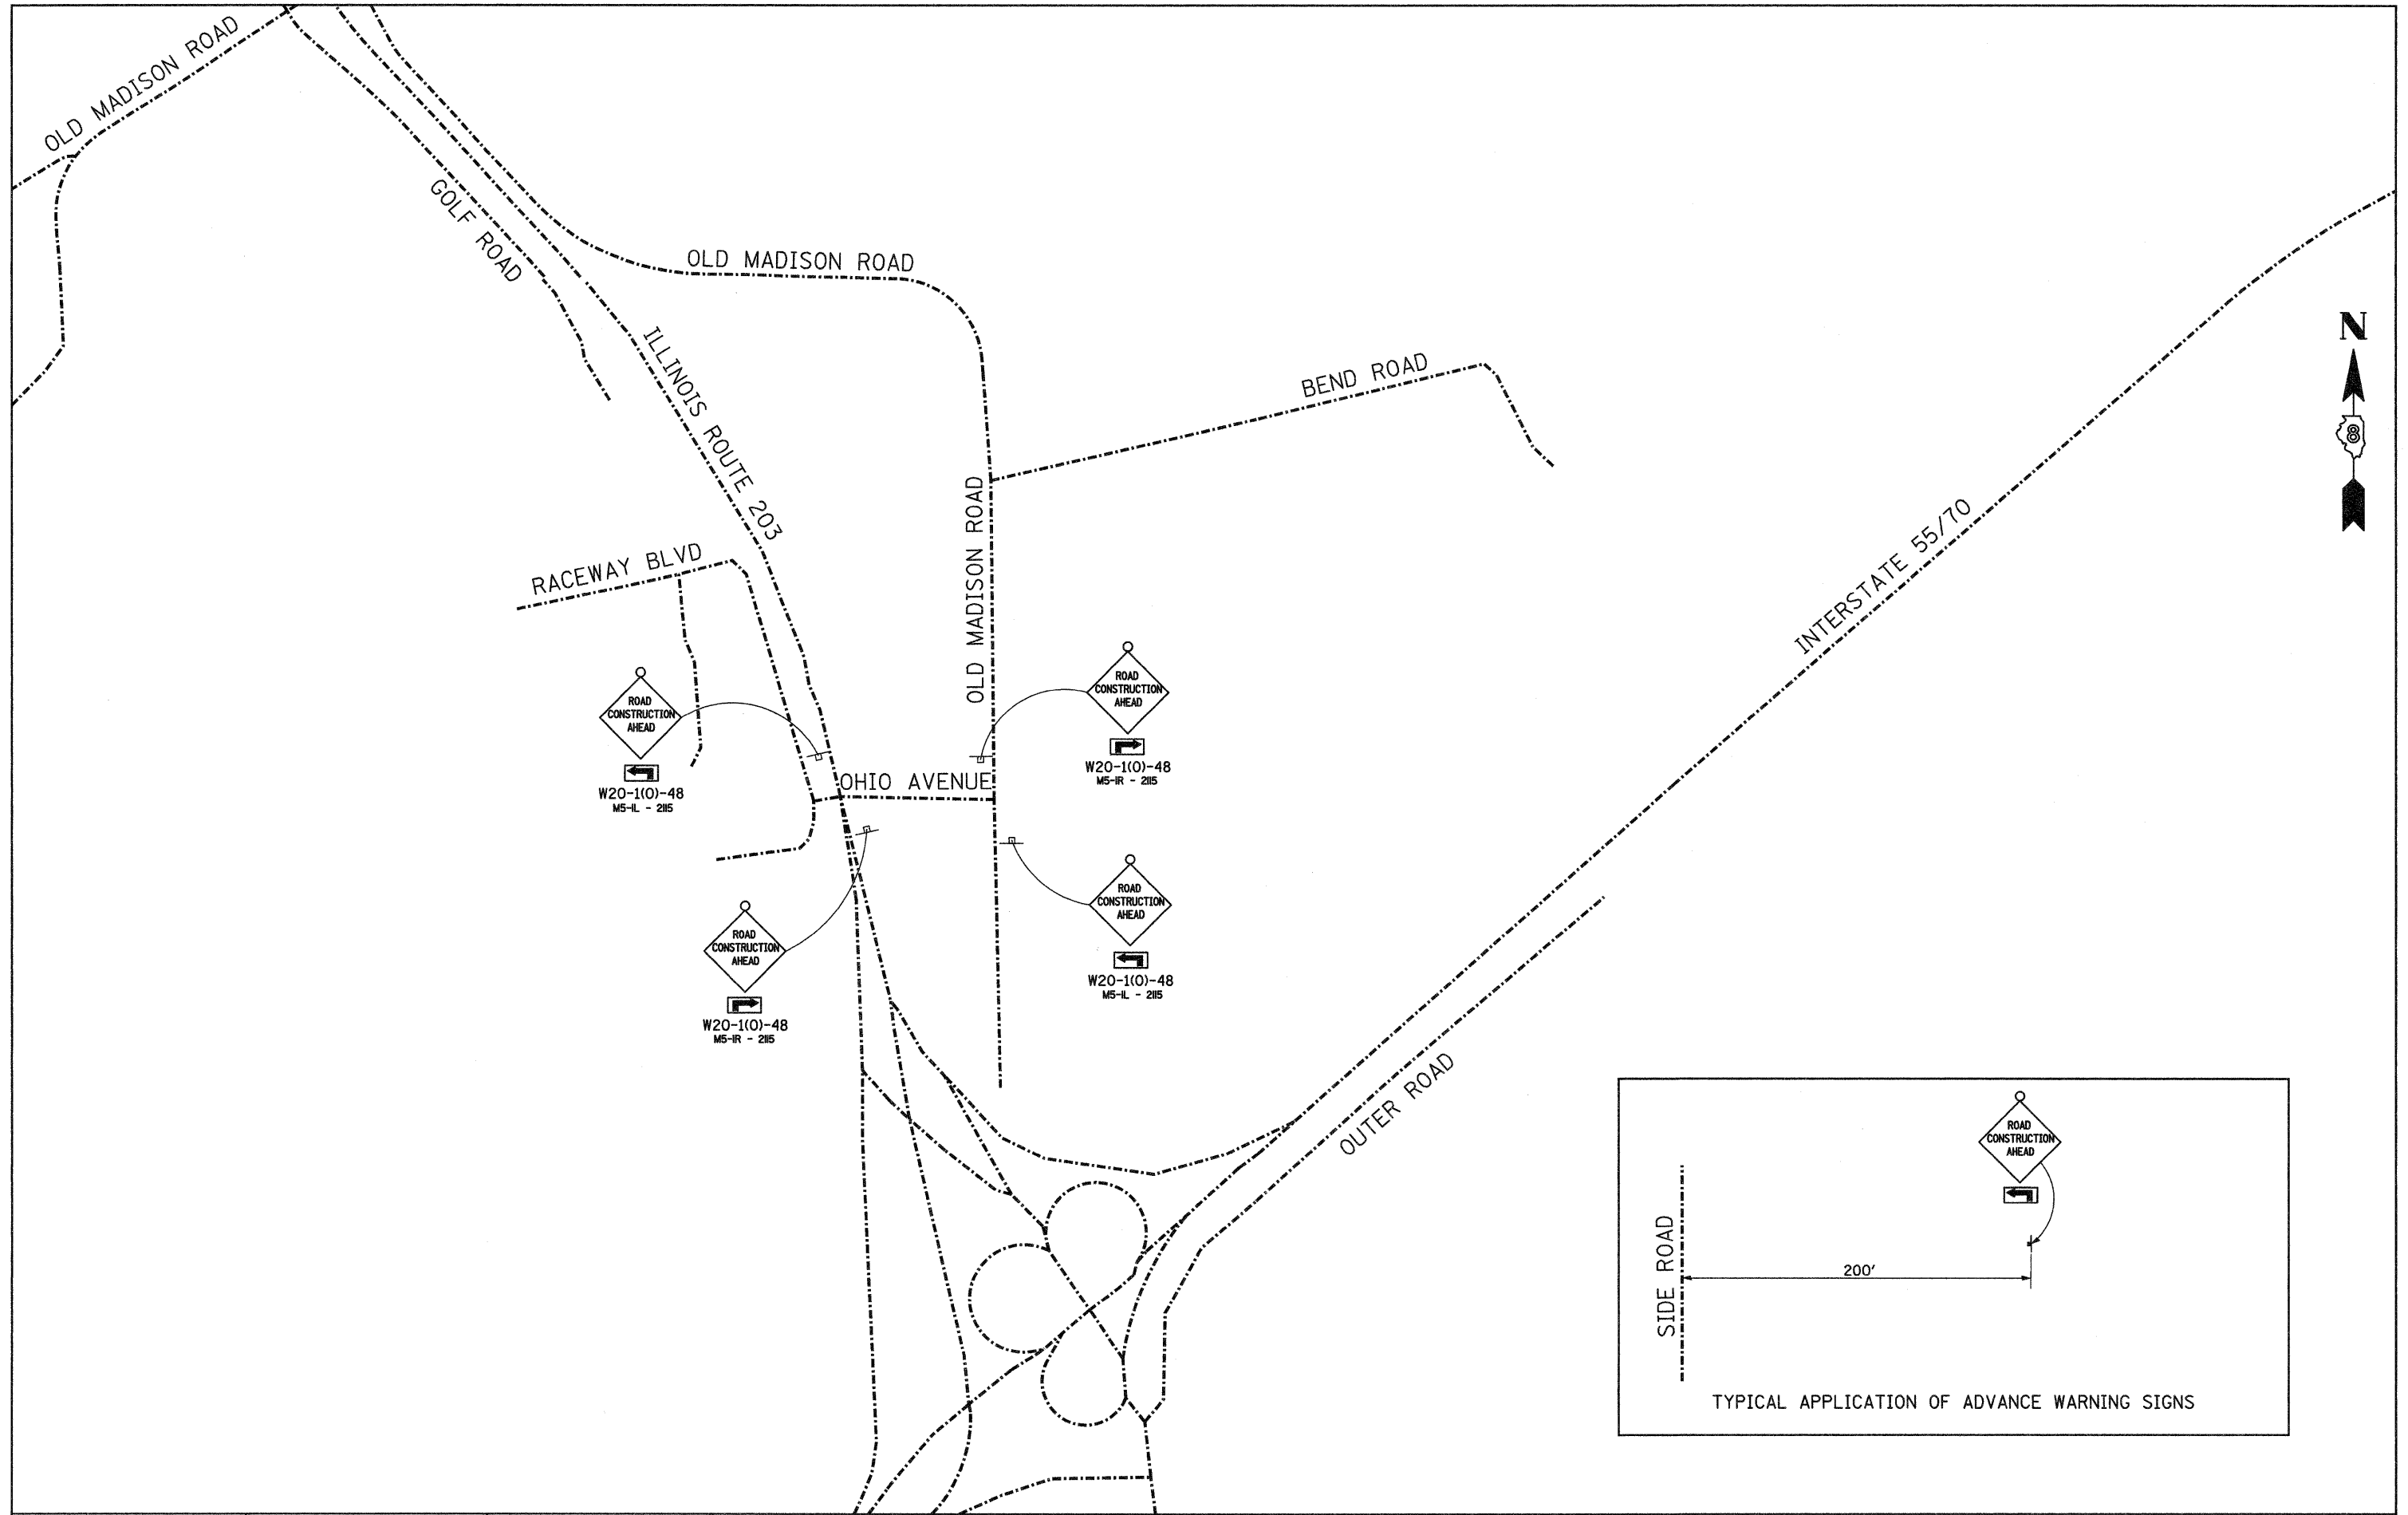

FILE NAME = warnsign	USER NAME = jeremy	DESIGNED - BFK	REVISED -	<b>OHIO AVENUE PEDESTRIAN WALKWAY MADISON, ILLINOIS</b>	<b>ADVANCED WARNING SIGNS</b>				F.A. RTE.	SECTION	COUNTY	TOTAL SHEETS	SHEET NO.	
	PLOT SCALE = #SCALE#	CHECKED - JJB	REVISED -		SCALE: N.T.S.	SHEET NO.	OF	SHEETS	STA.	TO STA.	09-00049-01-SW	ST. CLAIR	26	13
	PLOT DATE = 12/18/2009	DRAWN - BFK	REVISED -		CONTRACT NO. 97420									
		CHECKED -	REVISED -		ILLINOIS FED. AID PROJECT									

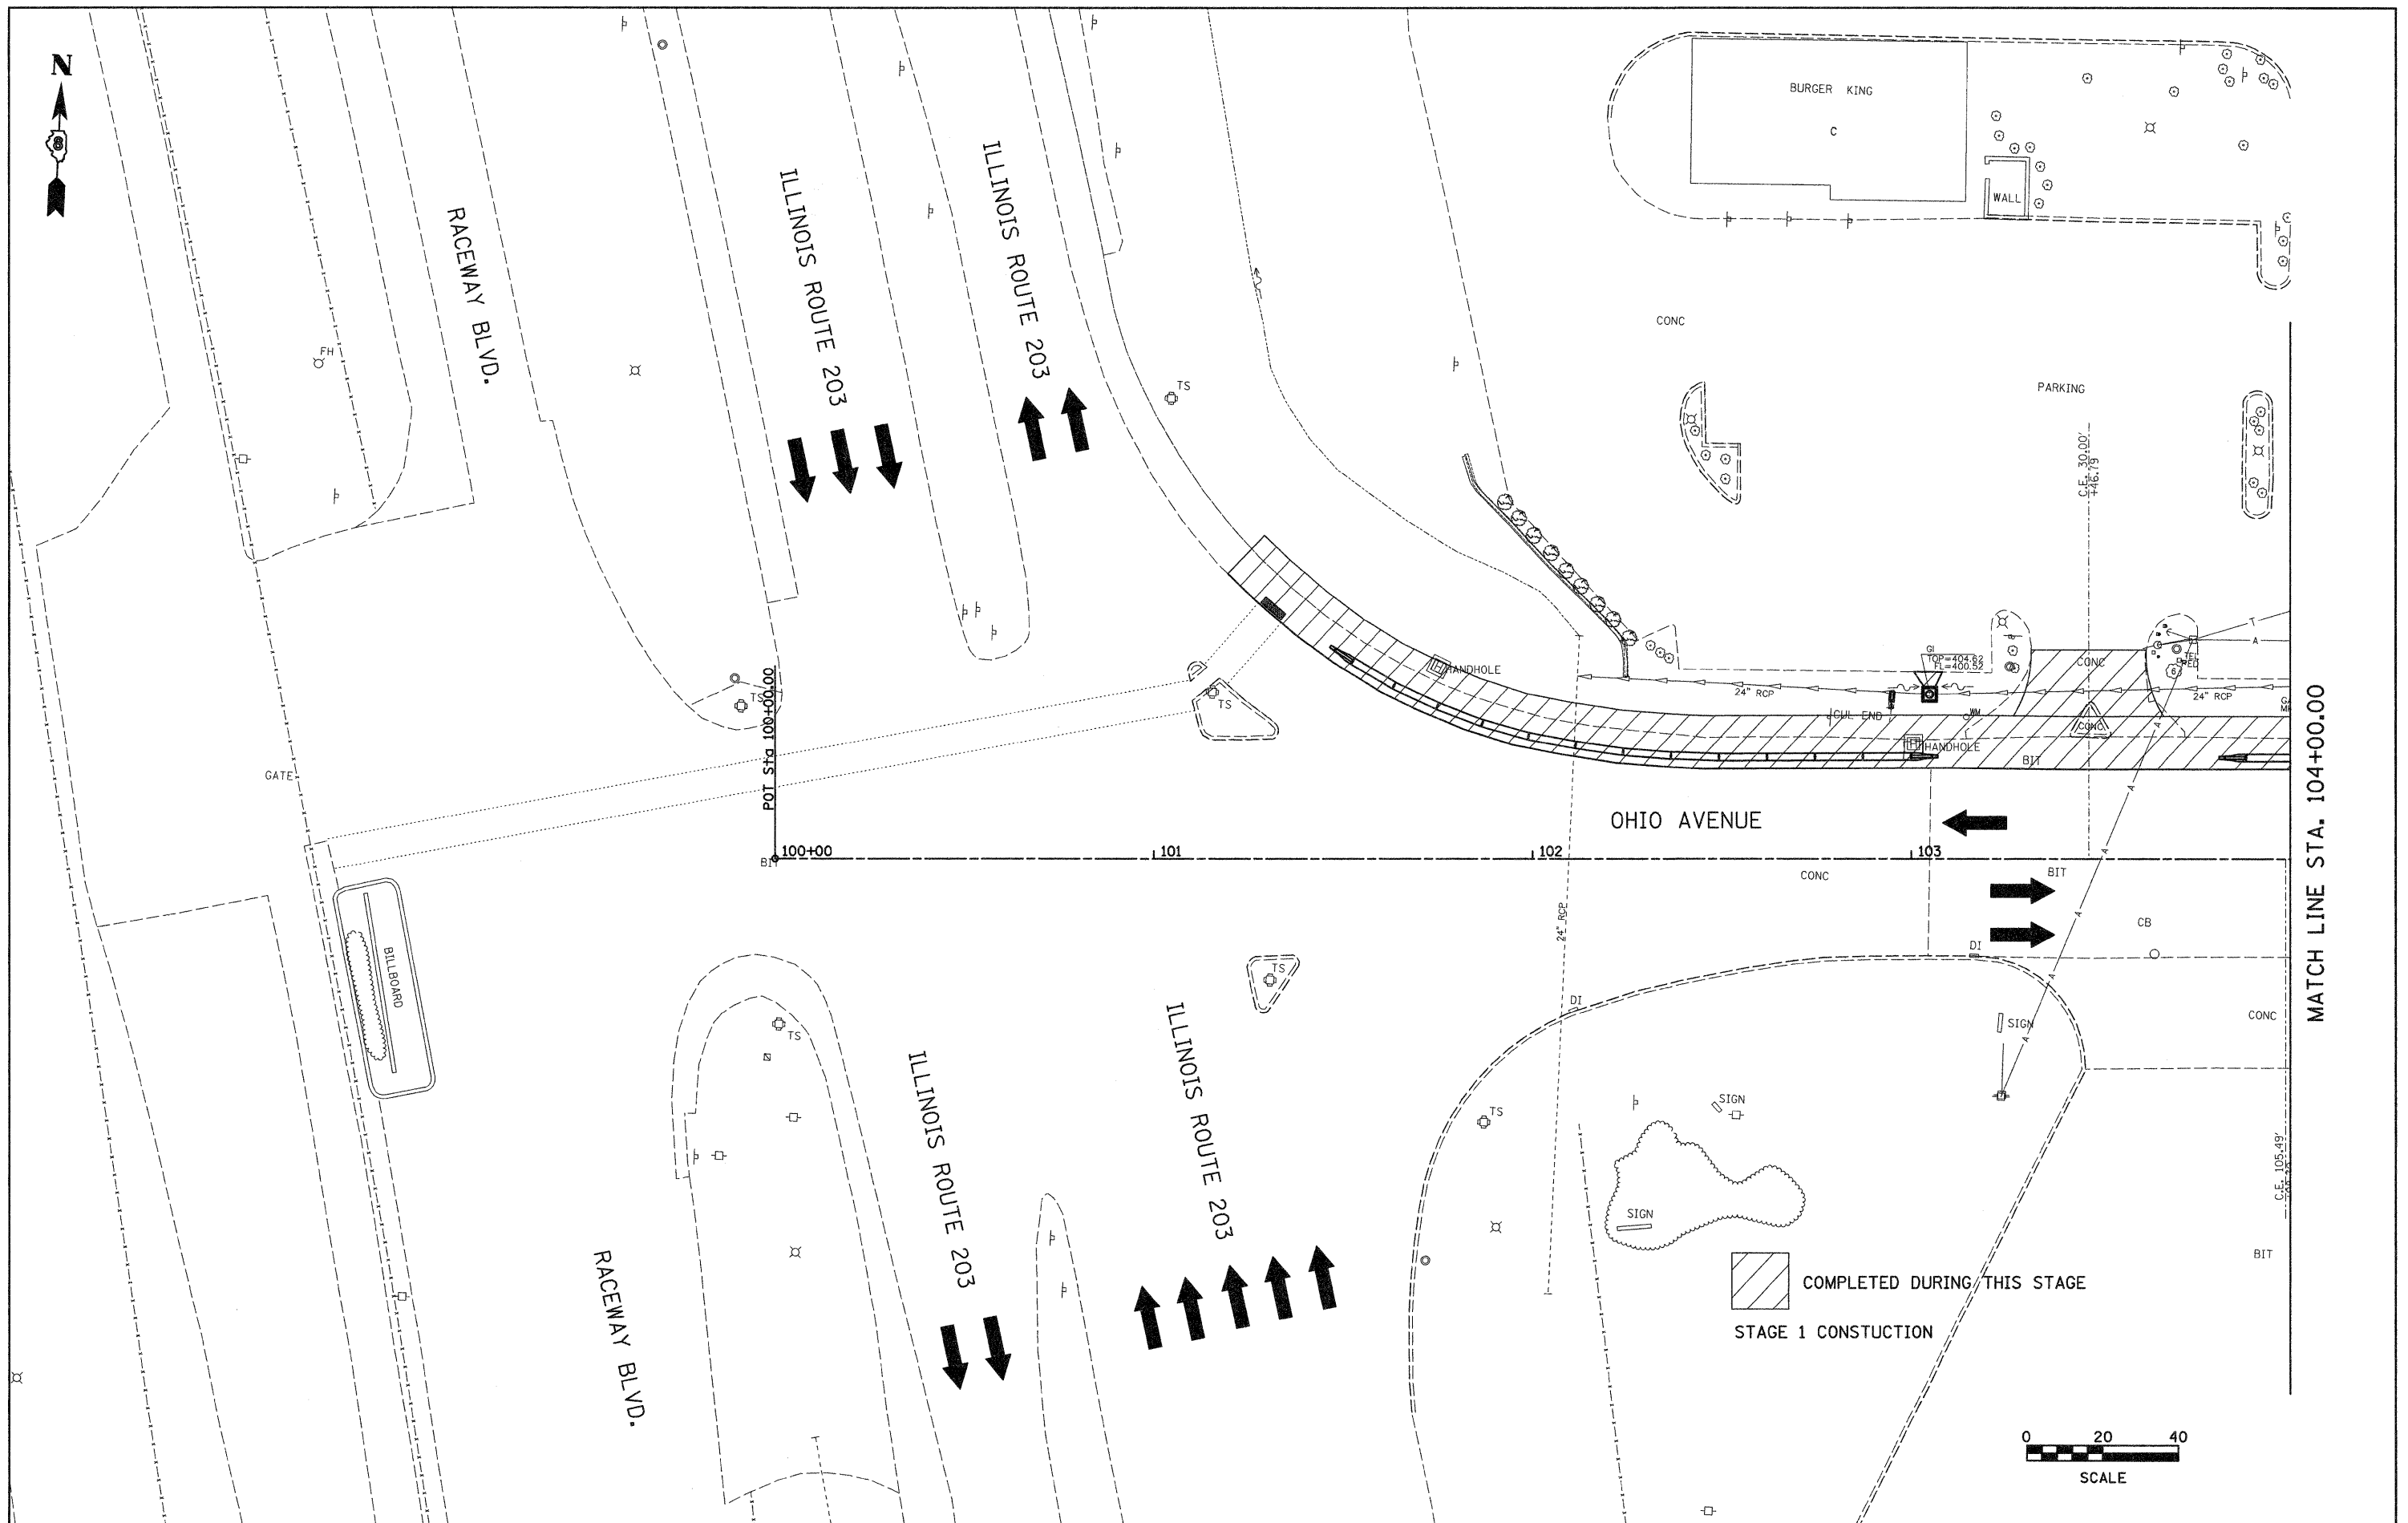

MATCH LINE STA. 104+00.00

FILE NAME = Stage\_Const\_01

USER NAME = Jeremy  
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 PLOT DATE = 12/18/2009

DESIGNED - BFK  
 DRAWN - JJB  
 CHECKED - BFK  
 DATE - 09/24/09


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**OHIO AVENUE  
 PEDESTRIAN WALKWAY  
 MADISON, ILLINOIS**

**STAGE CONSTRUCTION**


SCALE: 1"=20'    SHEET NO.    OF    SHEETS    STA.    TO STA.

F.A. RTE.	SECTION	COUNTY	TOTAL SHEETS	SHEET NO.
	09-00049-01-SW	ST. CLAIR	26	14
CONTRACT NO. 97420				
ILLINOIS FED. AID PROJECT				

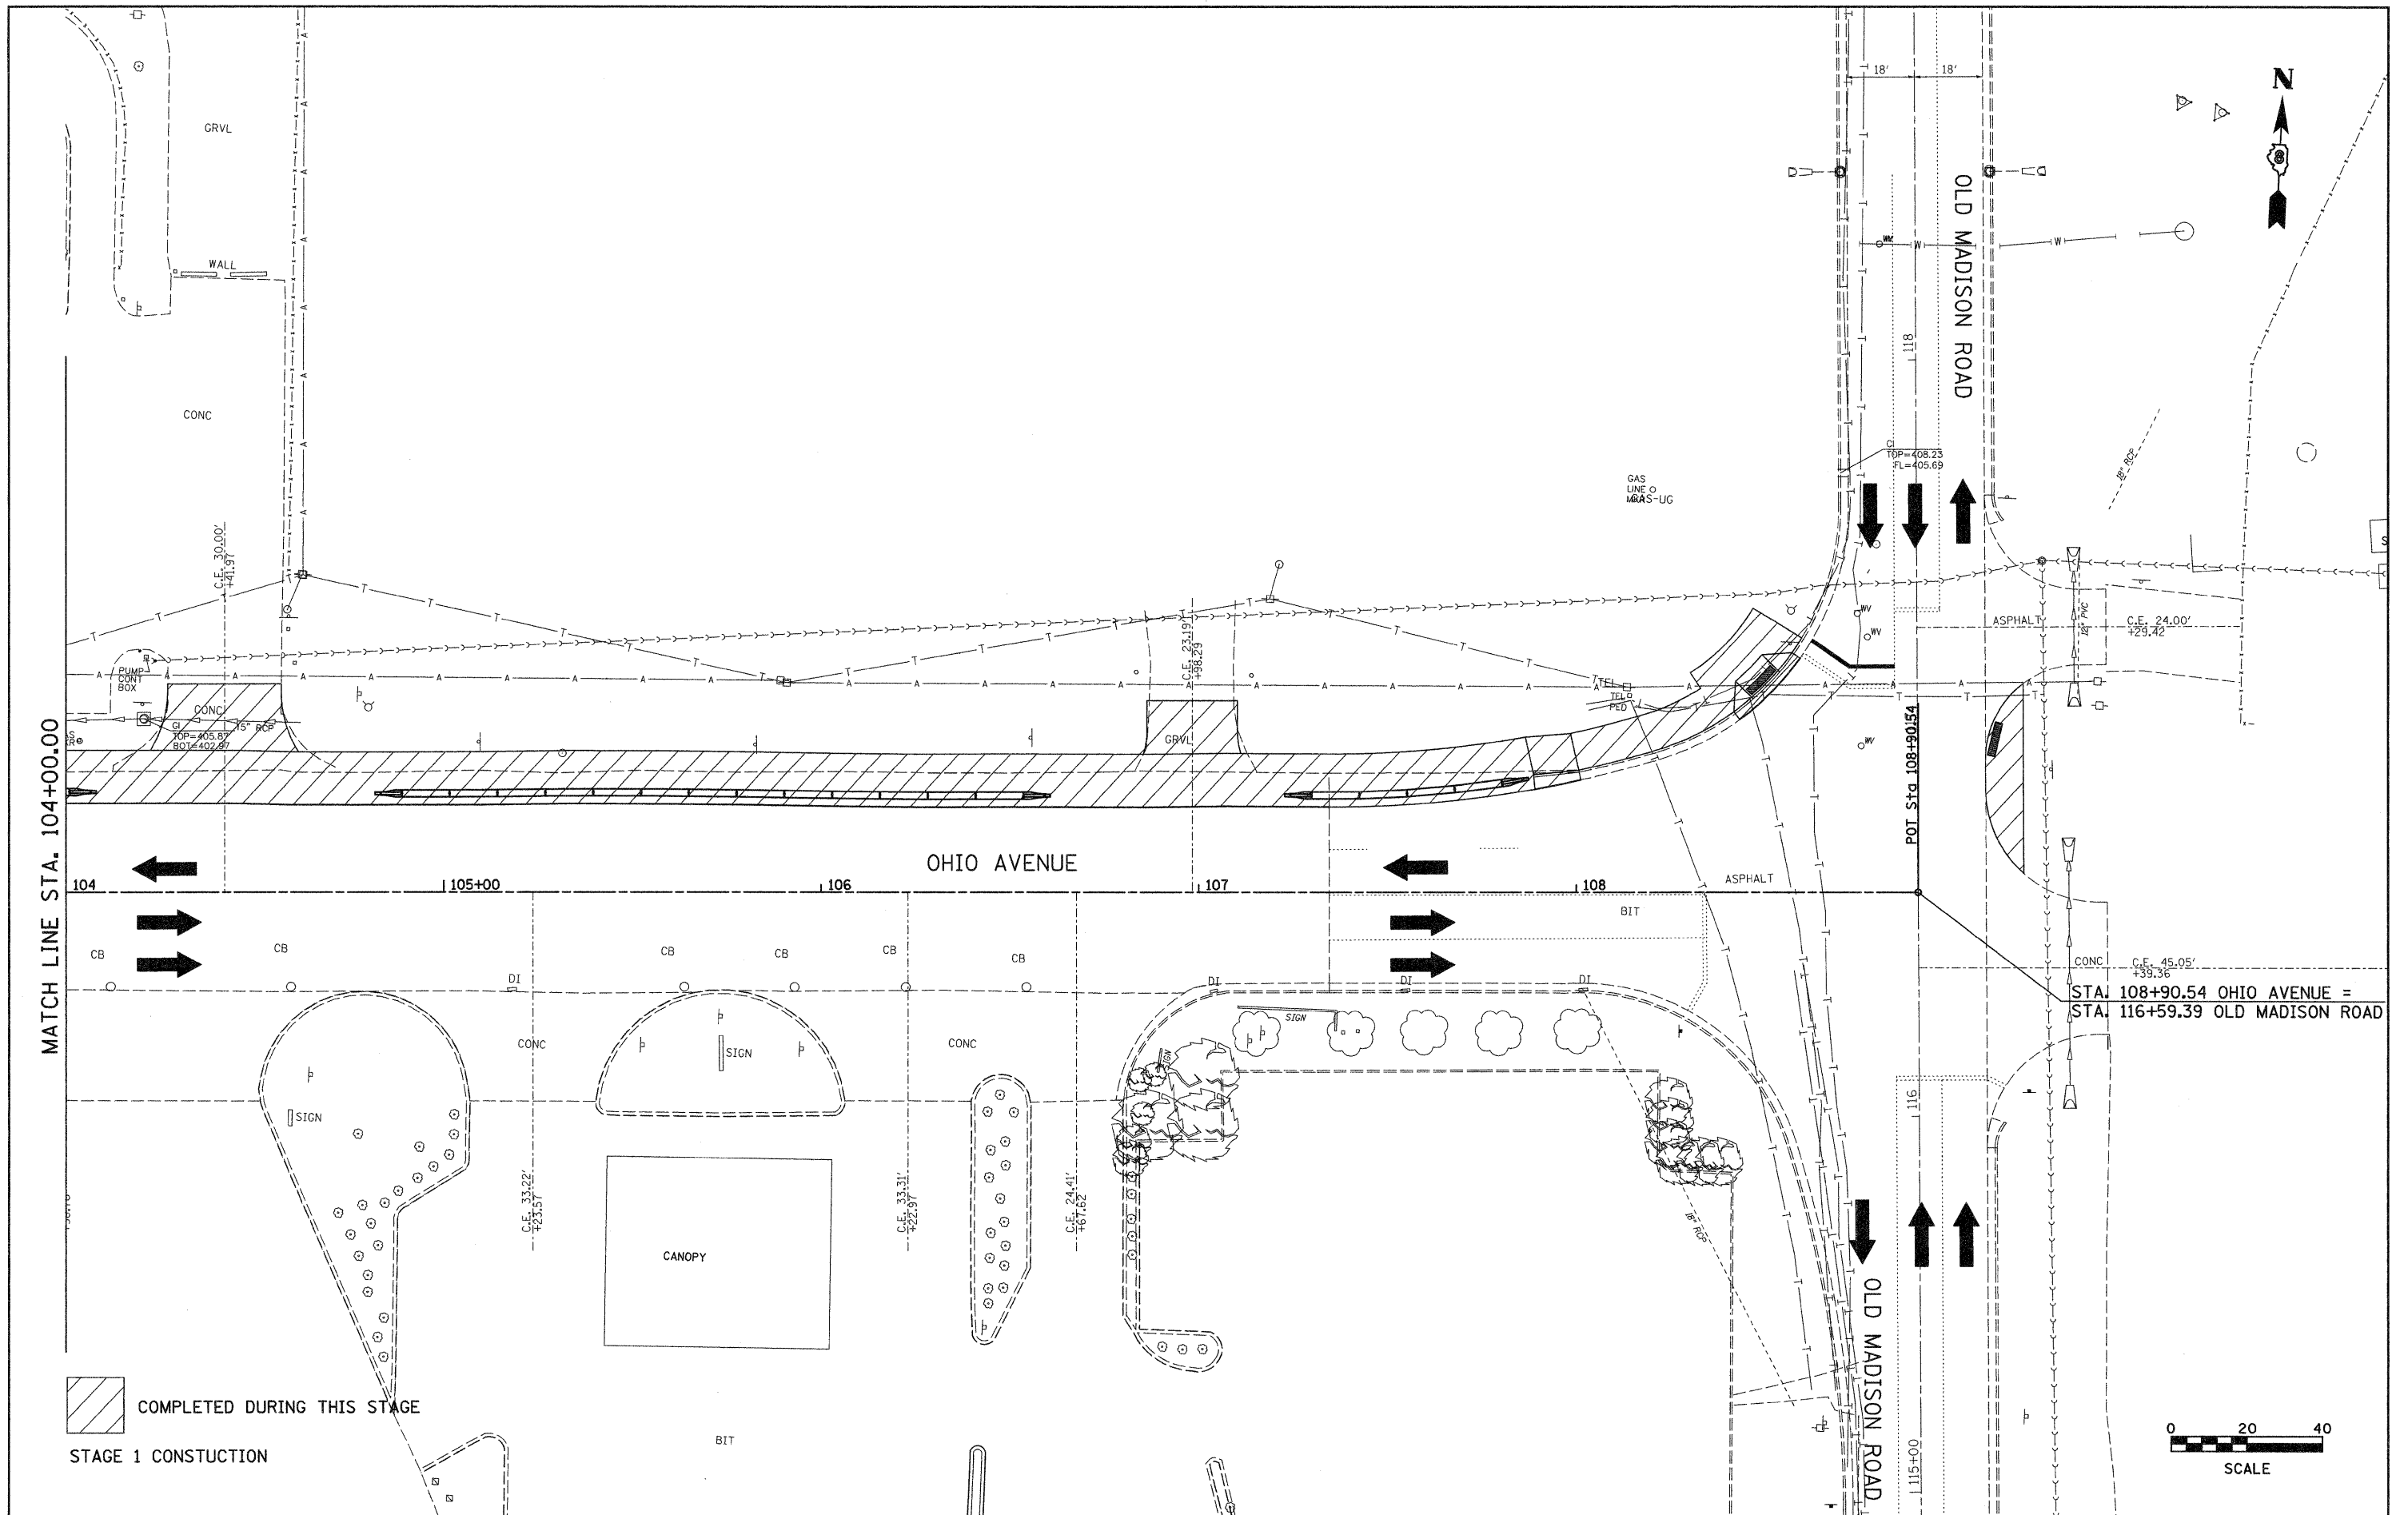

MATCH LINE STA. 104+00.00



STA. 108+90.54 OHIO AVENUE =  
STA. 116+59.39 OLD MADISON ROAD

 COMPLETED DURING THIS STAGE  
STAGE 1 CONSTRUCTION

FILE NAME = Stage_Const.02	USER NAME = Jeremy	DESIGNED - BFK	REVISED -	<b>OHIO AVENUE PEDESTRIAN WALKWAY MADISON, ILLINOIS</b>	<b>STAGE CONSTRUCTION</b>			F.A. RTE.	SECTION	COUNTY	TOTAL SHEETS	SHEET NO.
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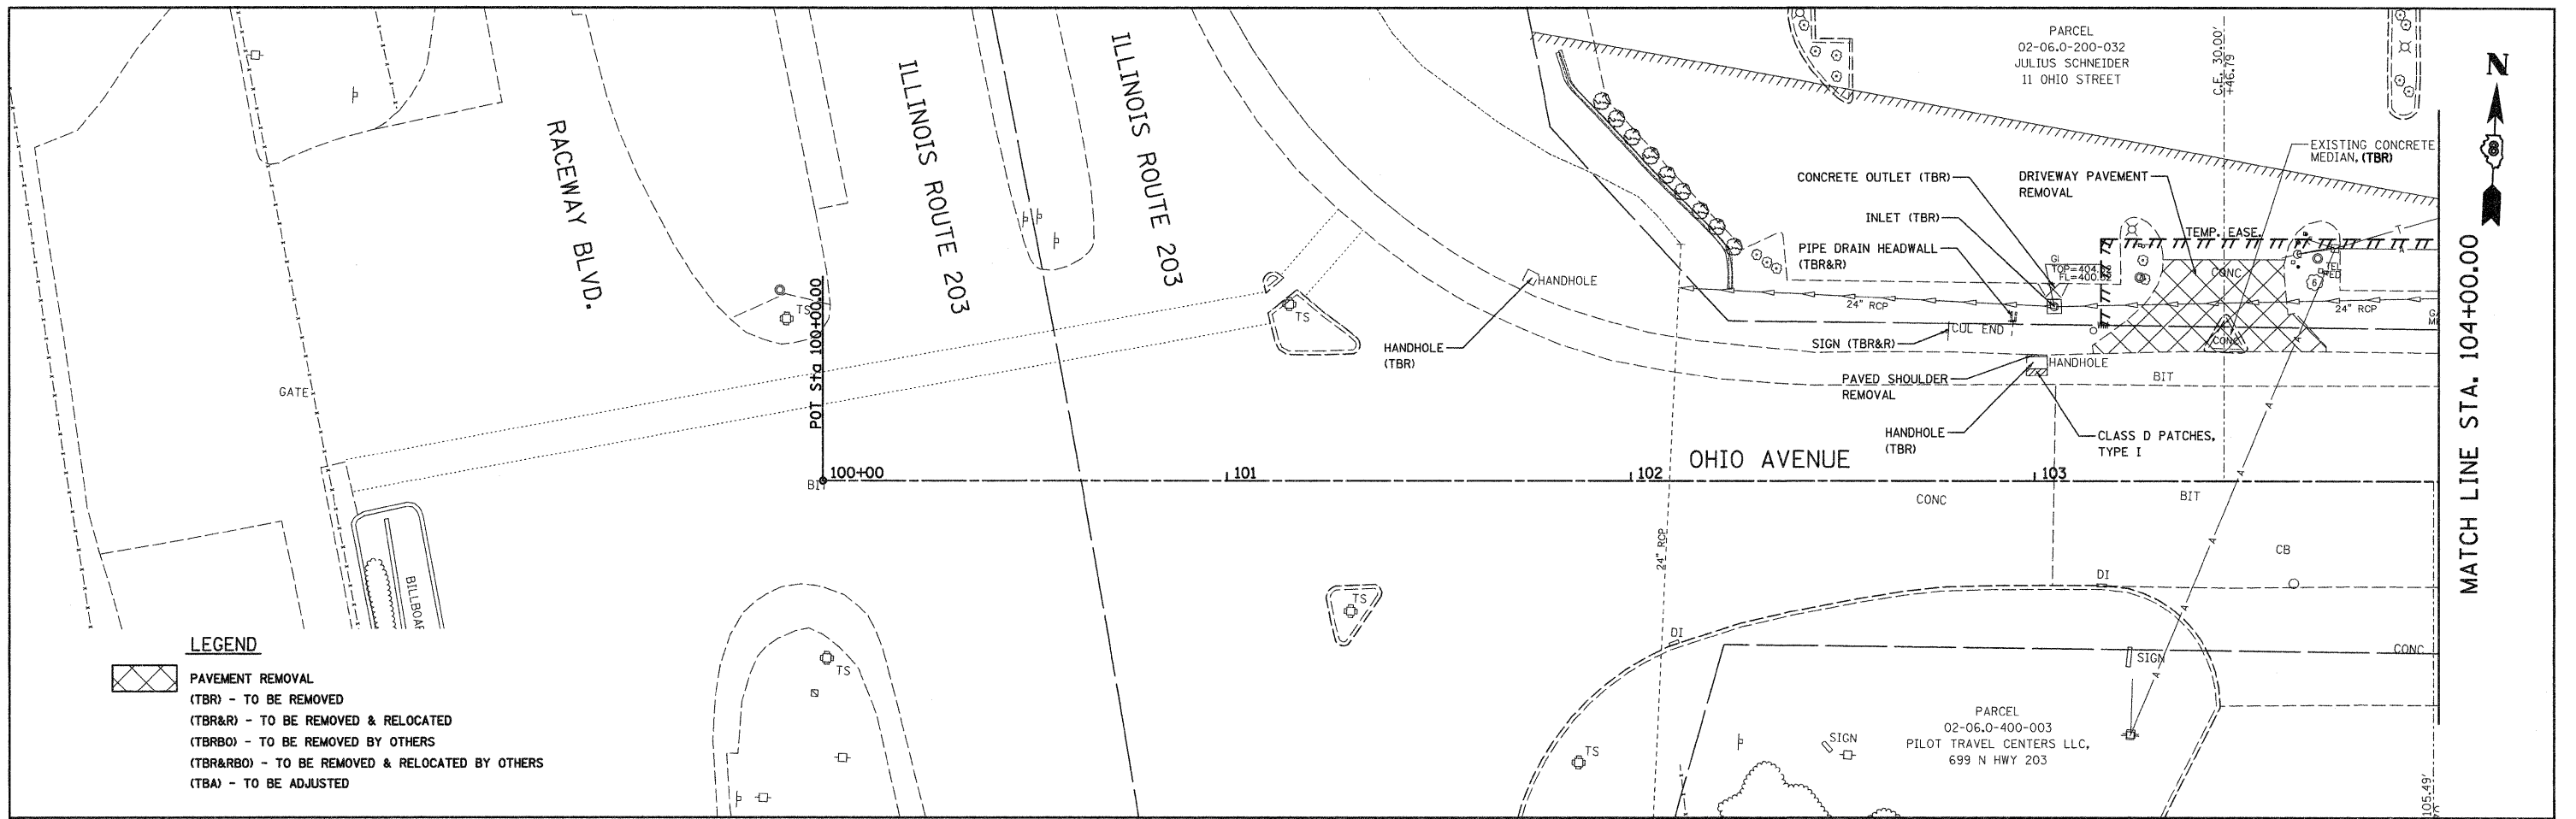
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	PLOTTED	BY
	NOTED	
	FILED	
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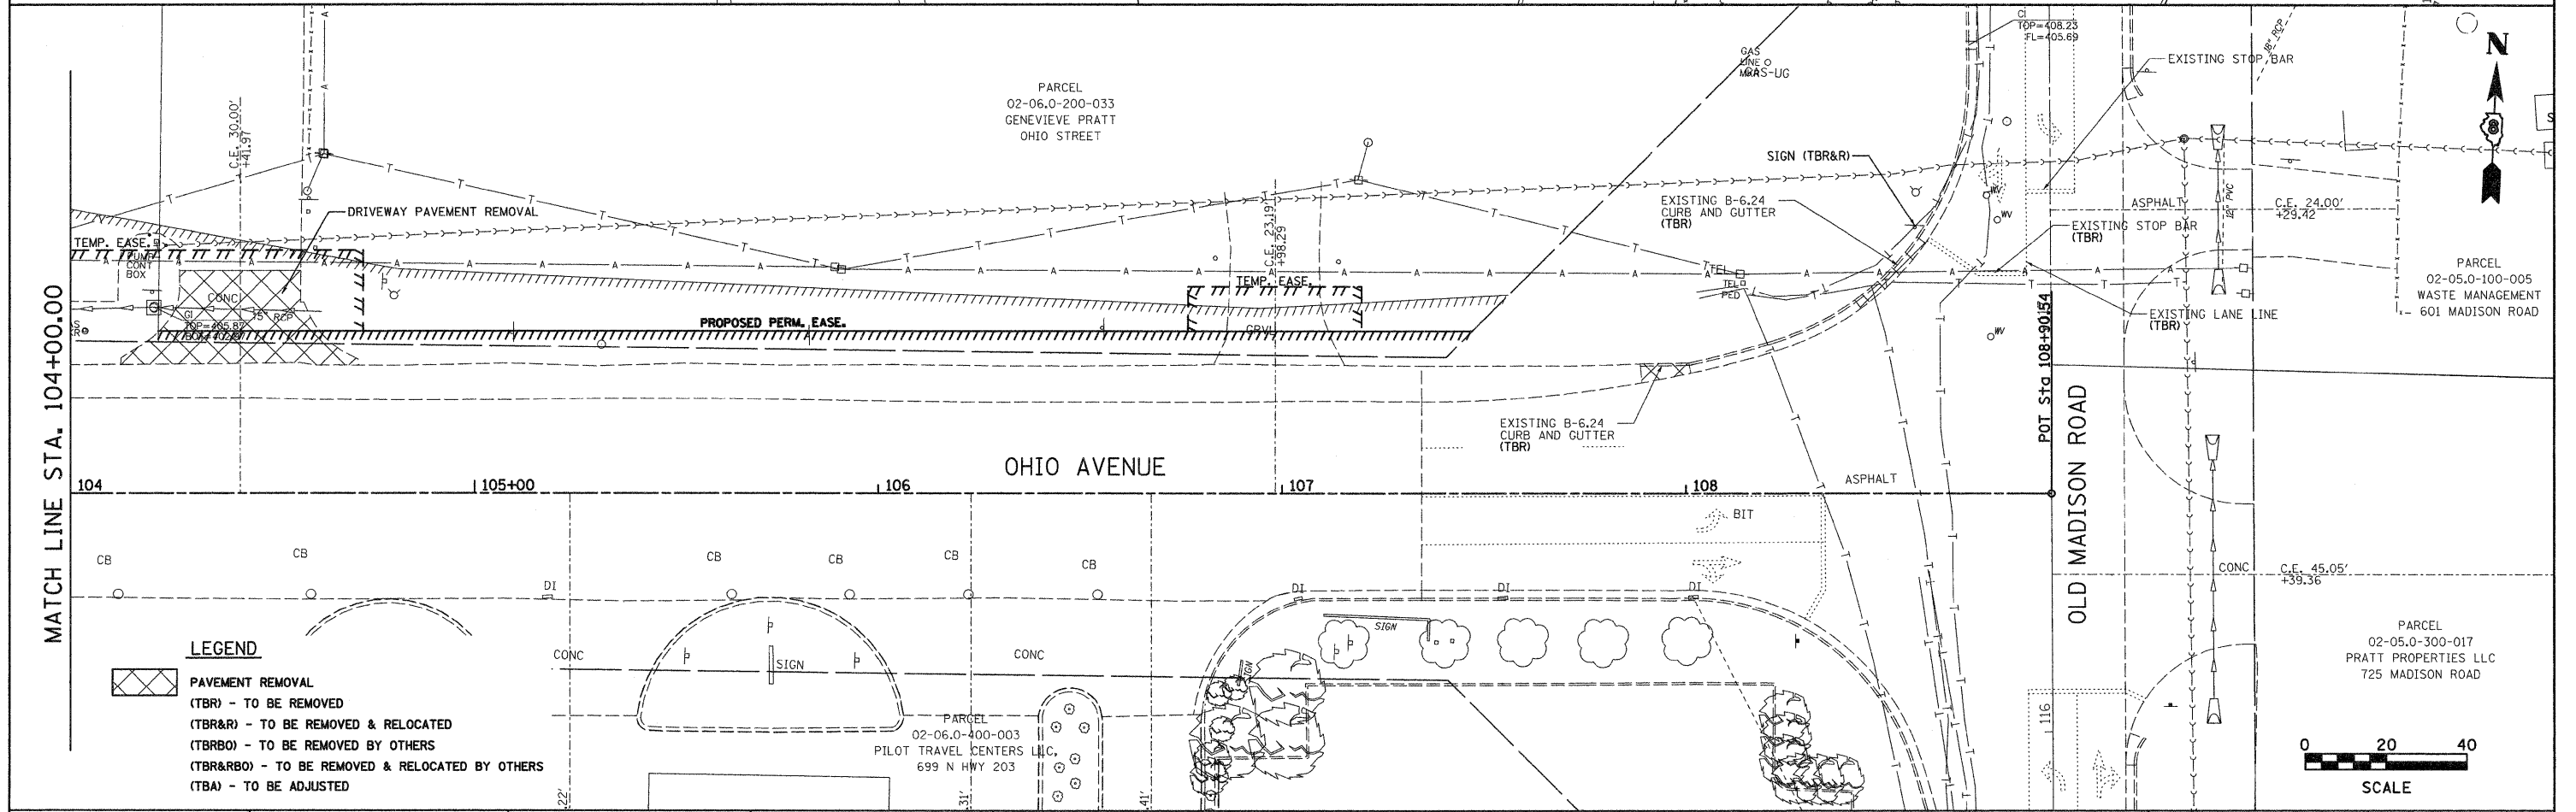
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		DATE -	REVISED -										ILLINOIS FED. AID PROJECT	



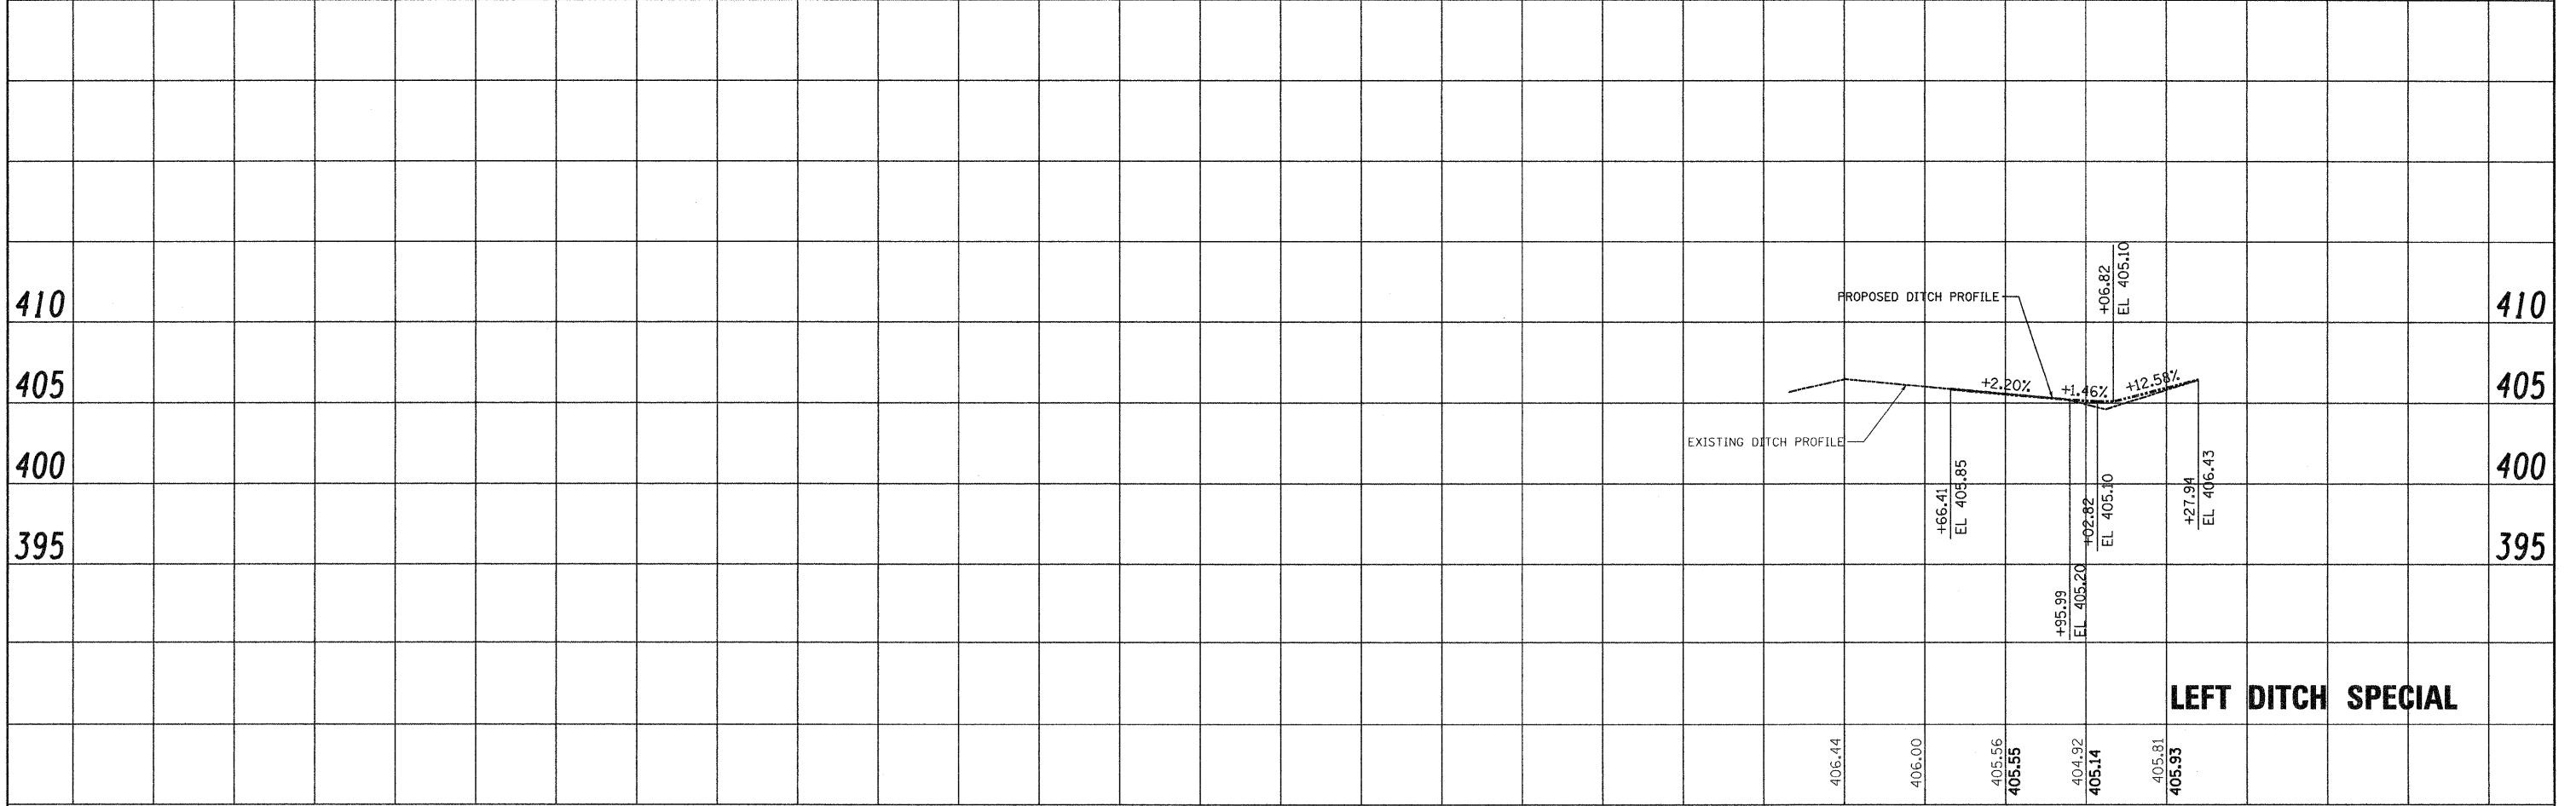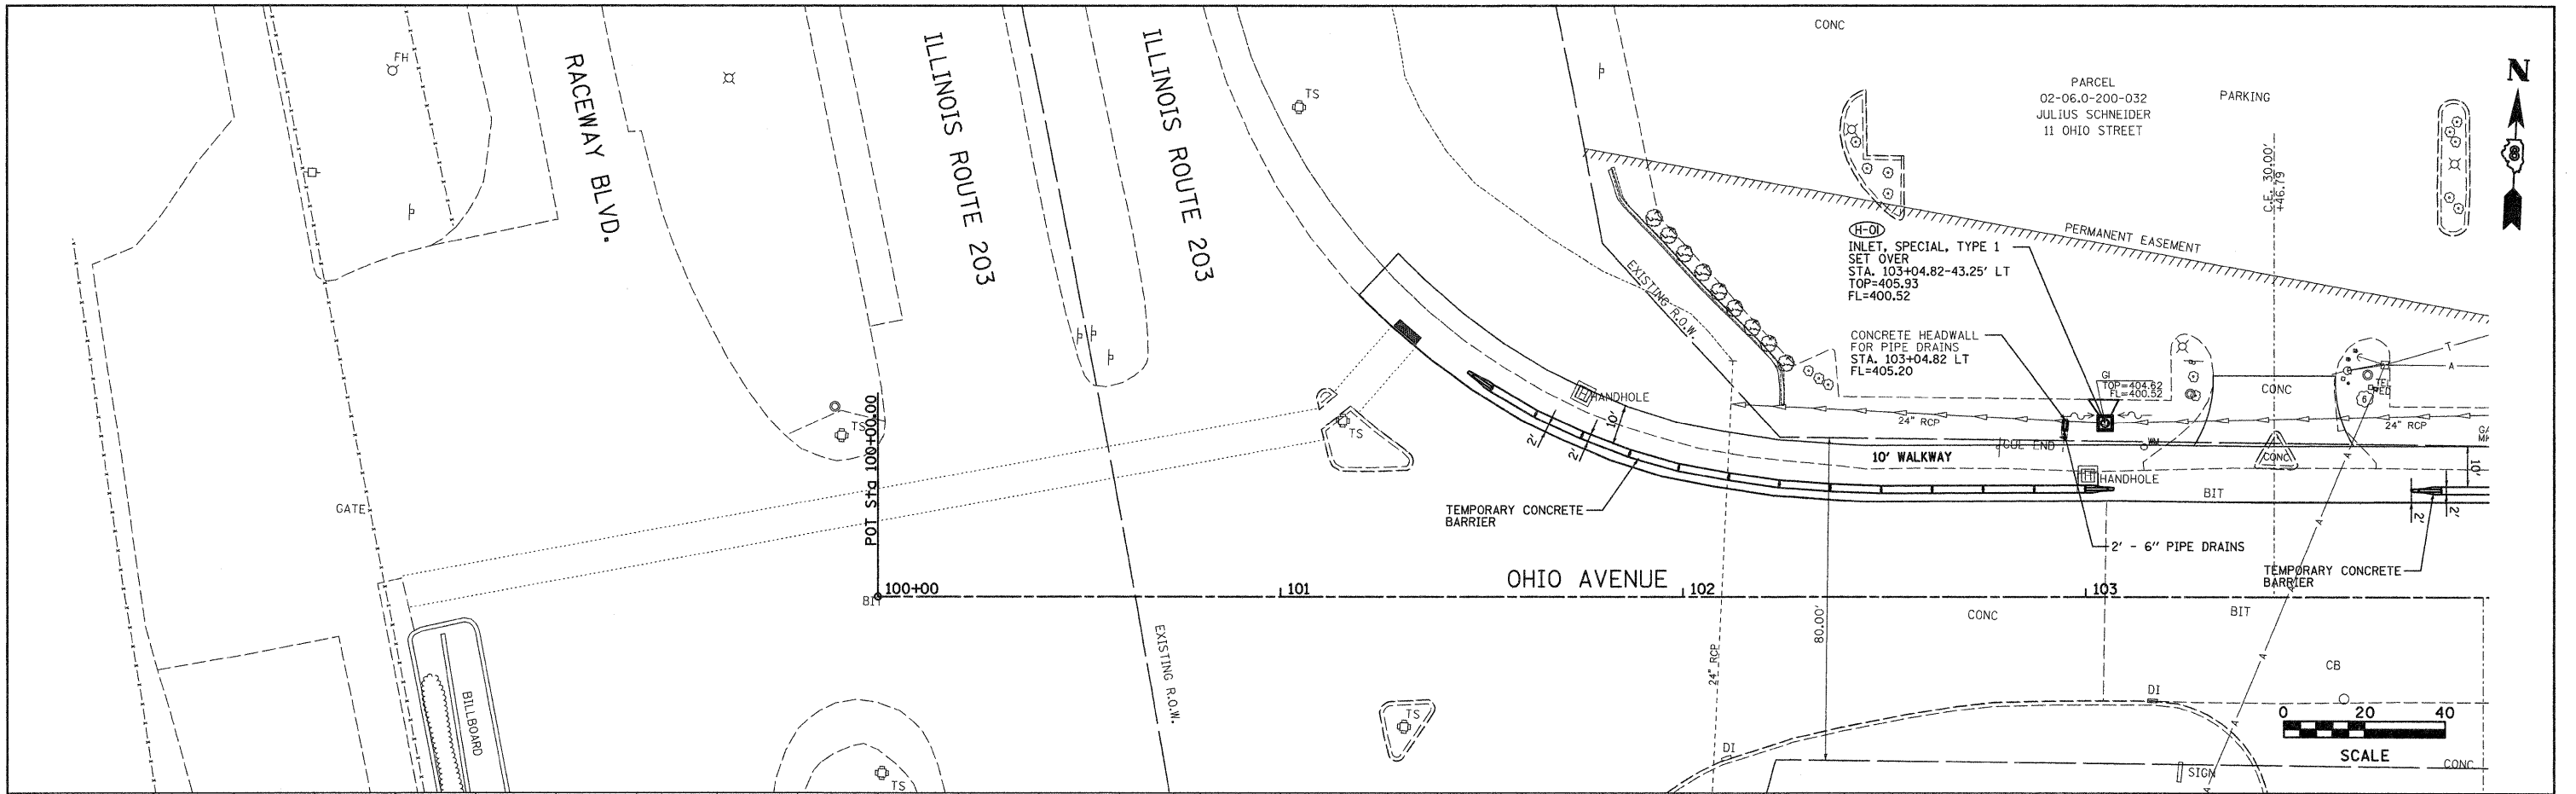

**LEGEND**



- PAVEMENT REMOVAL
- (TBR) - TO BE REMOVED
- (TBR&R) - TO BE REMOVED & RELOCATED
- (TBRBO) - TO BE REMOVED BY OTHERS
- (TBR&RBO) - TO BE REMOVED & RELOCATED BY OTHERS
- (TBA) - TO BE ADJUSTED




**LEGEND**

- PAVEMENT REMOVAL
- (TBR) - TO BE REMOVED
- (TBR&R) - TO BE REMOVED & RELOCATED
- (TBRBO) - TO BE REMOVED BY OTHERS
- (TBR&RBO) - TO BE REMOVED & RELOCATED BY OTHERS
- (TBA) - TO BE ADJUSTED


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	PLOT SCALE = #SCALE#	DRAWN - JJB	REVISED -		SCALE: 1"=20'			SHEET NO. OF SHEETS STA. TO STA.			CONTRACT NO. 97420	
	PLOT DATE = 12/18/2009	CHECKED - BFK	REVISED -		ILLINOIS FED. AID PROJECT							
		DATE - 05/14/09	REVISED -									

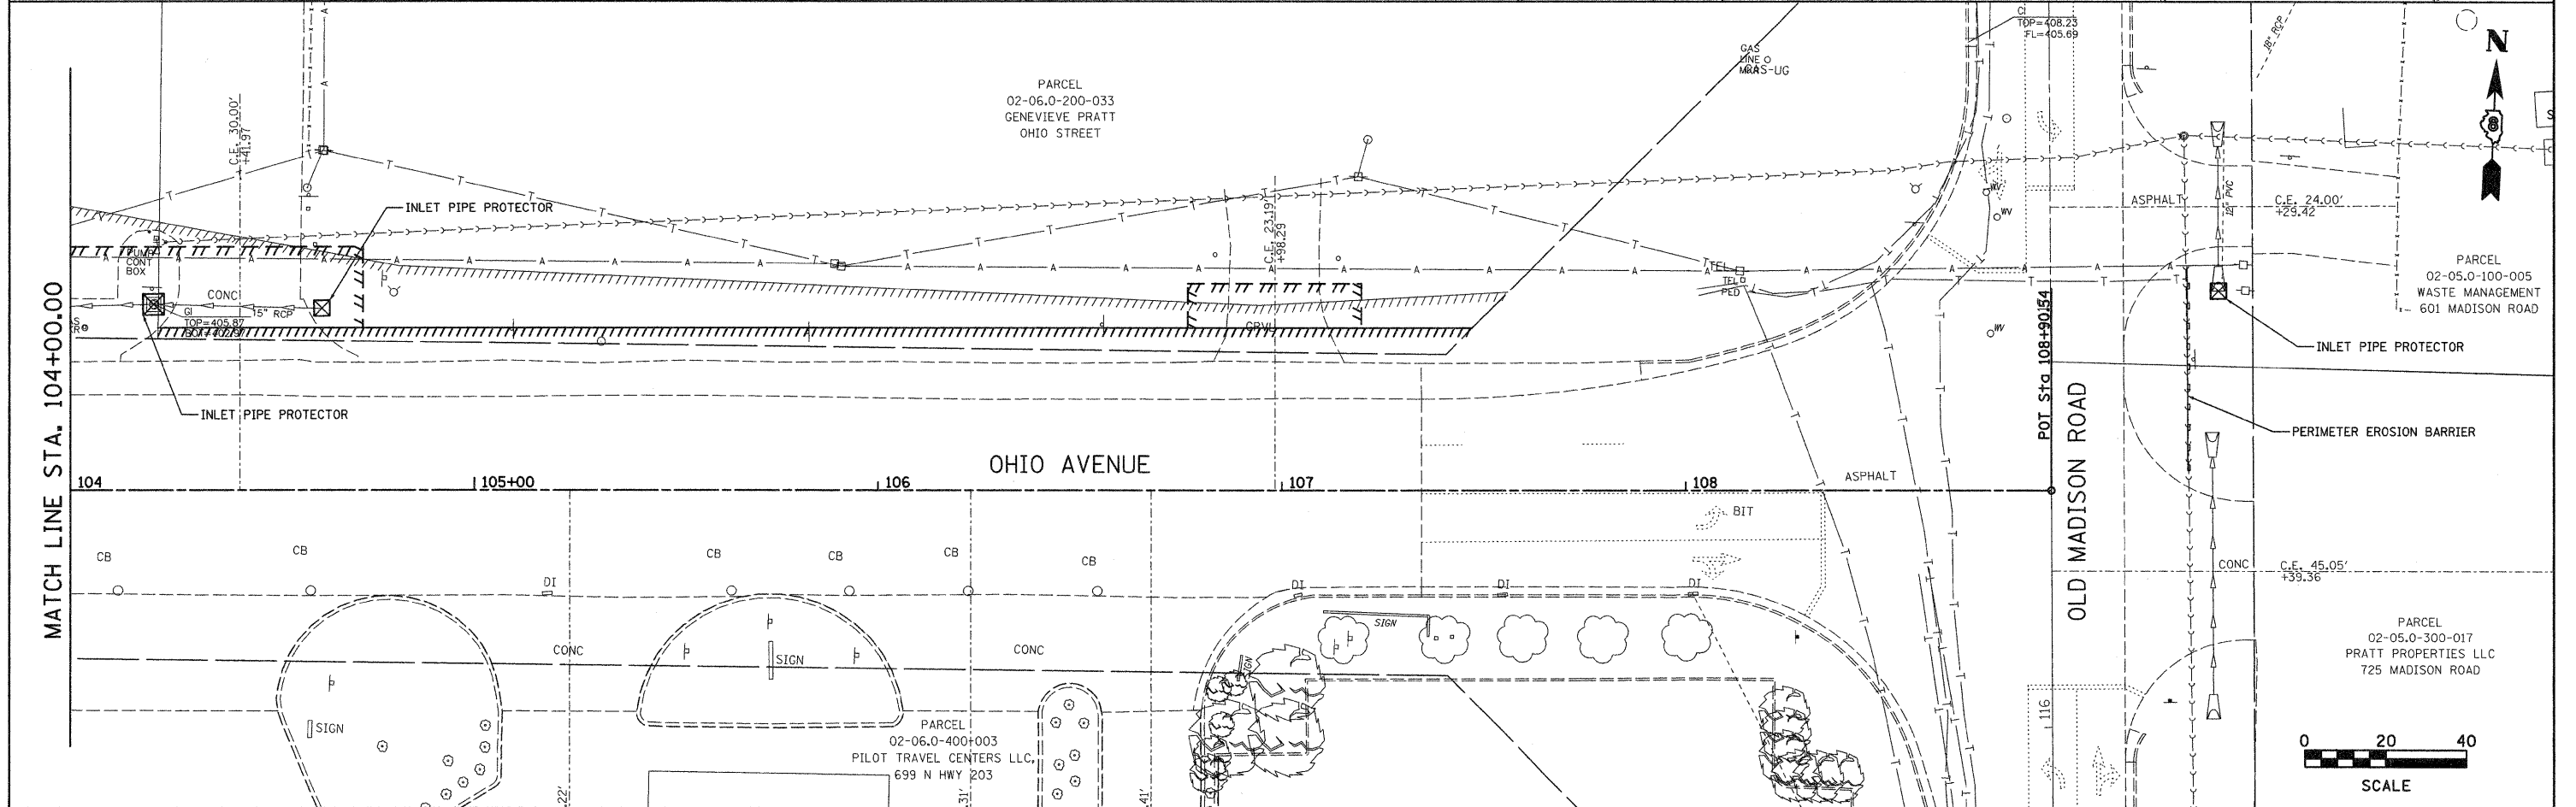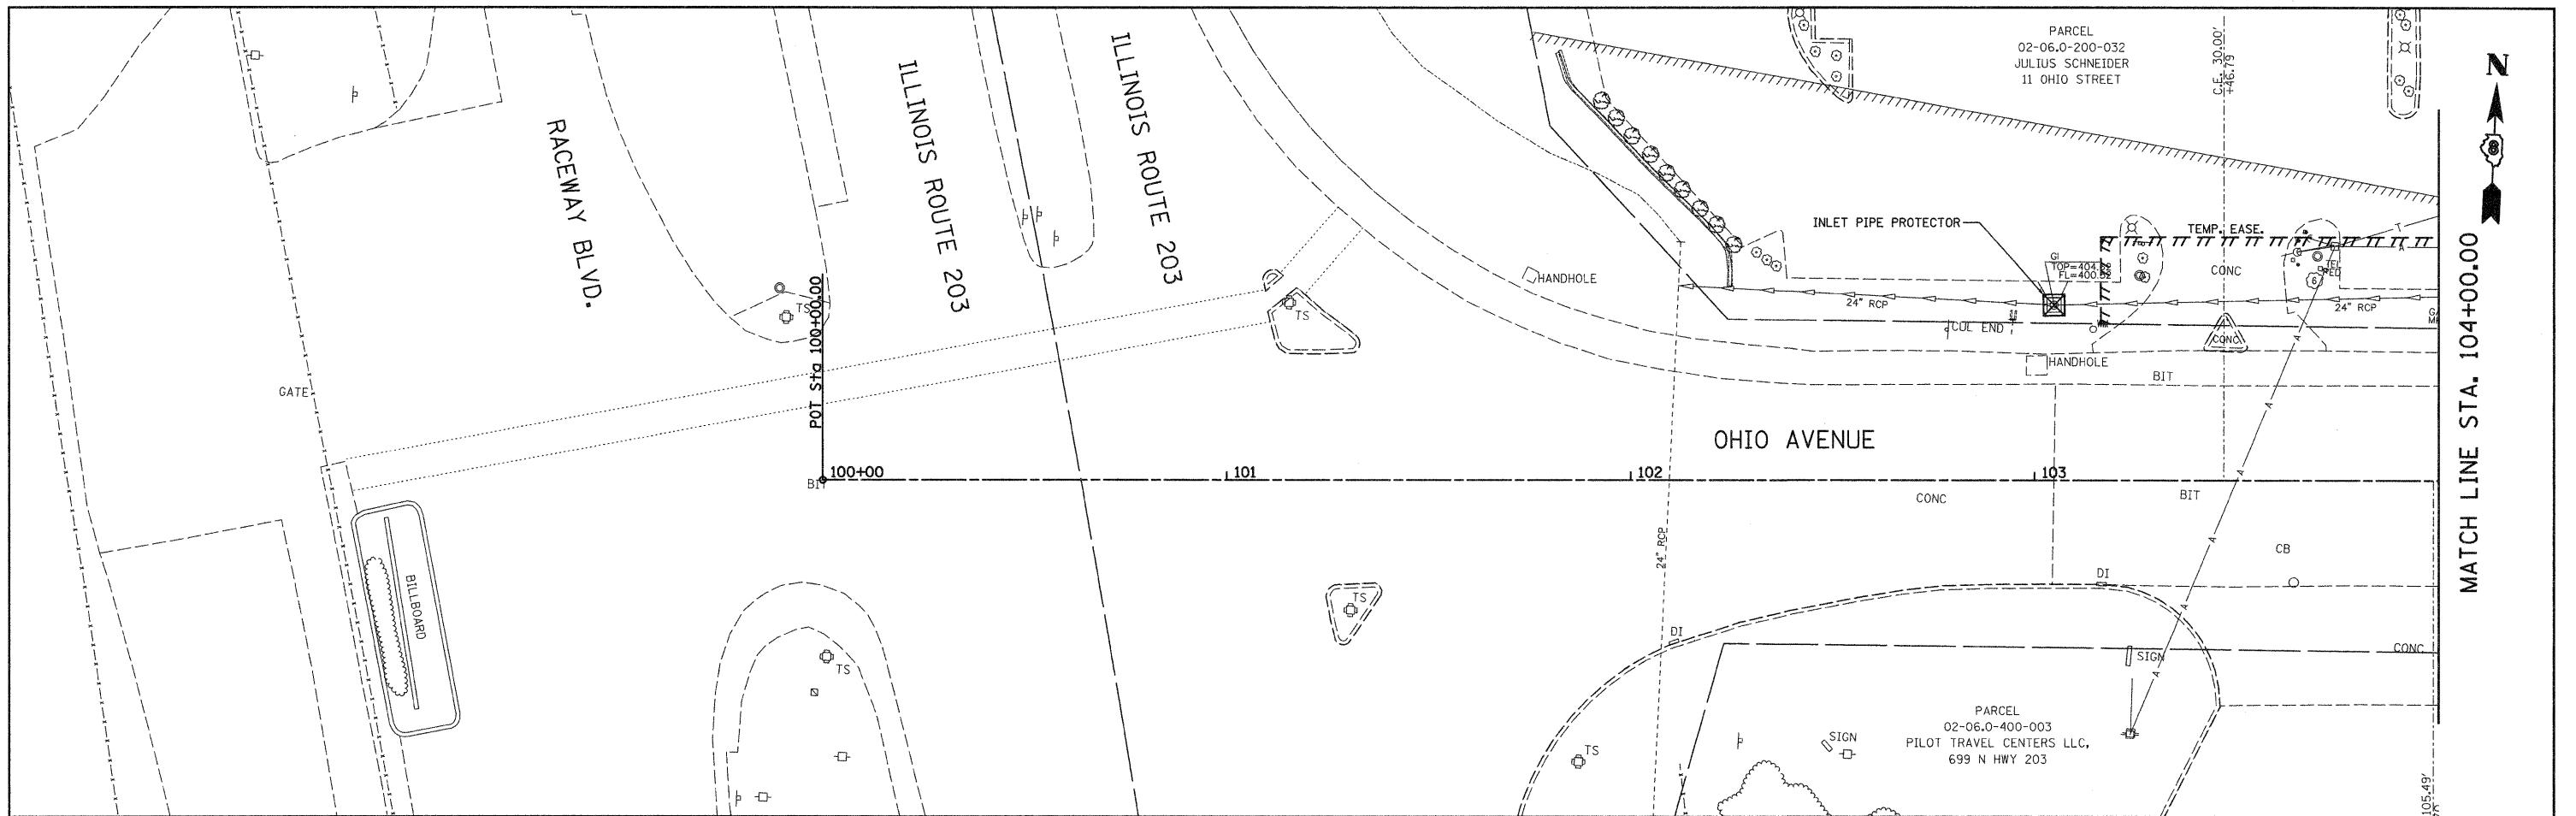


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	PLOT SCALE = #SCALE#	DRAWN - JJB	REVISED -					09-00049-01-SW	ST. CLAIR	26	18	
PLOT DATE = 12/21/2009	CHECKED - BFK	DATE - 05/14/09	REVISED -	SCALE: SHEET NO. OF SHEETS STA. TO STA.			CONTRACT NO. 97420					
ILLINOIS FED. AID PROJECT												

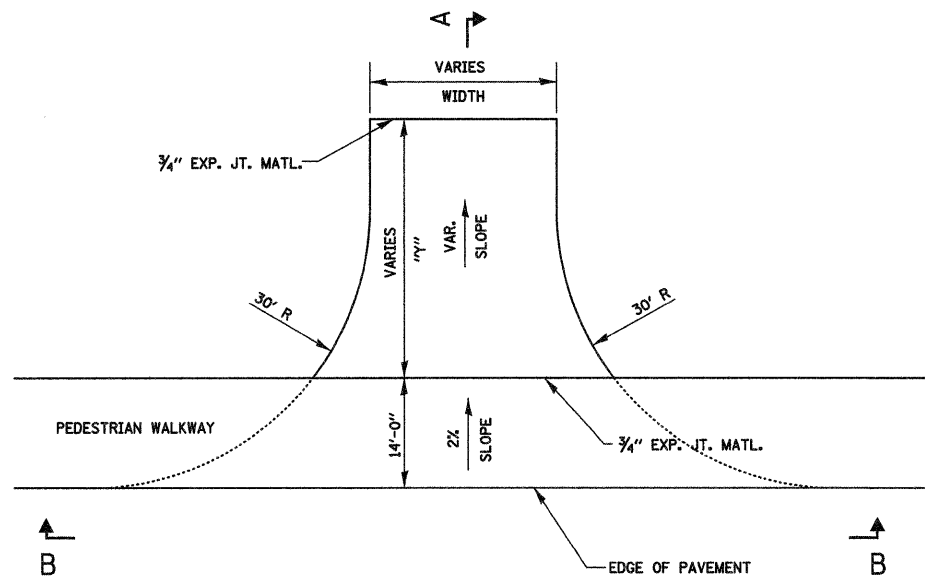


DRIVEWAY ENTRANCE DETAIL (C.E.)  
N.T.S.

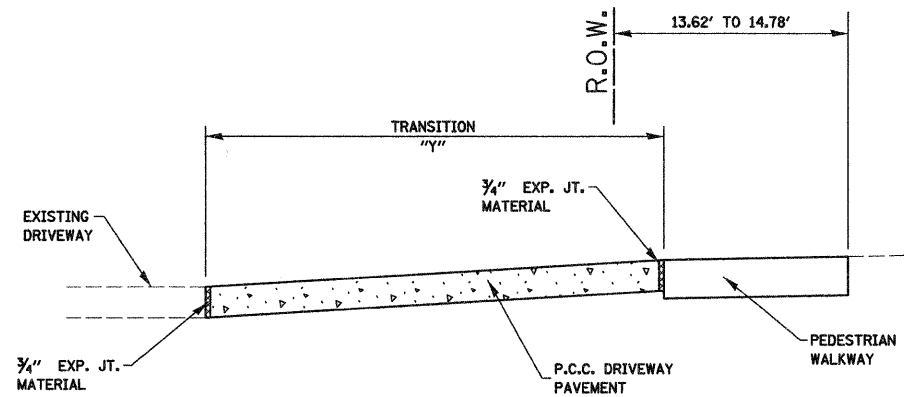


SECTION A-A  
N.T.S.

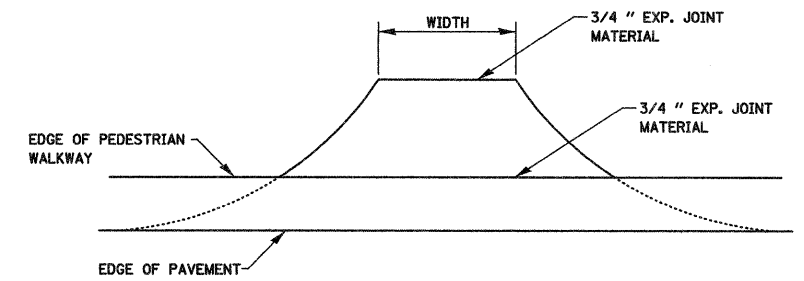


SECTION B-B  
N.T.S.

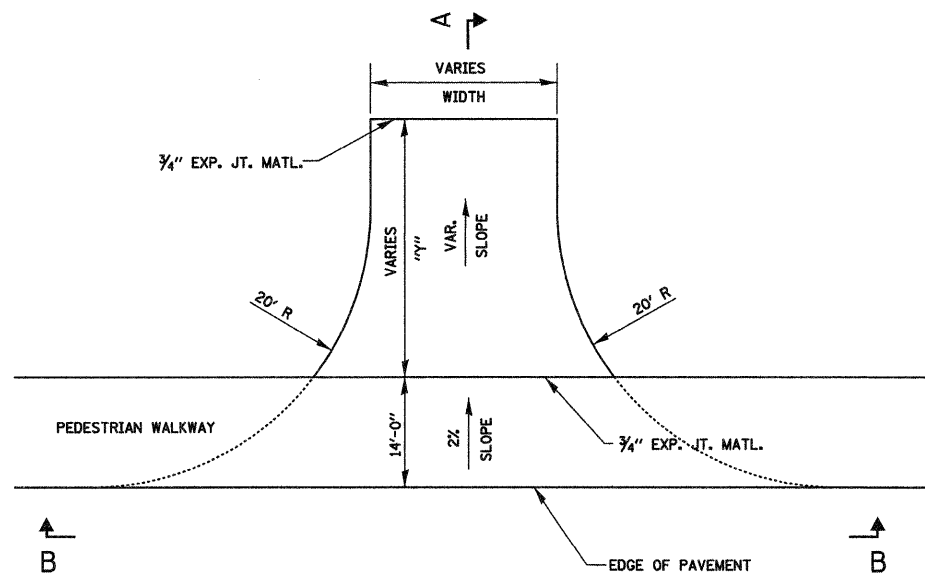

DRIVEWAY ENTRANCE DETAIL (C.E.)  
N.T.S.

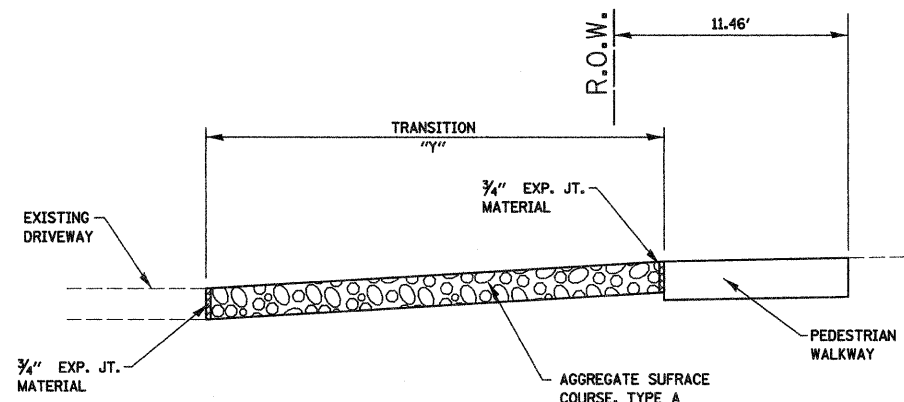


SECTION A-A  
N.T.S.

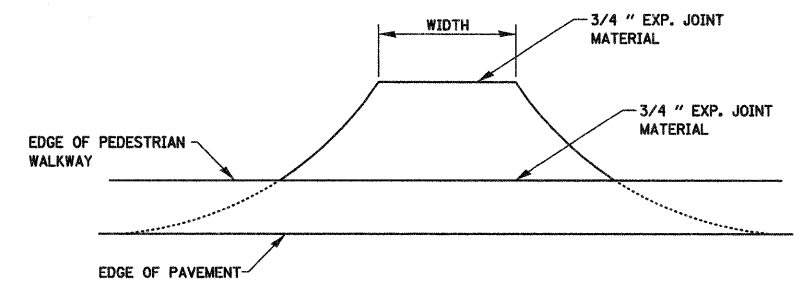


SECTION B-B  
N.T.S.

FILE NAME = entrance details	USER NAME = ike	DESIGNED - BFK	REVISED -	<b>OHIO AVENUE PEDESTRIAN WALKWAY MADISON, ILLINOIS</b>	<b>ENTRANCE DETAILS</b>				F.A. RTE.	SECTION	COUNTY	TOTAL SHEETS	SHEET NO.
	PLOT SCALE = #SCALE#	DRAWN - JJB	REVISED -						09-00049-01-SW	ST. CLAIR	26	19	
	PLOT DATE = 12/21/2009	CHECKED - BFK	REVISED -						CONTRACT NO. 97420				
				SCALE: SHEET NO. OF SHEETS STA. TO STA.				ILLINOIS FED. AID PROJECT					

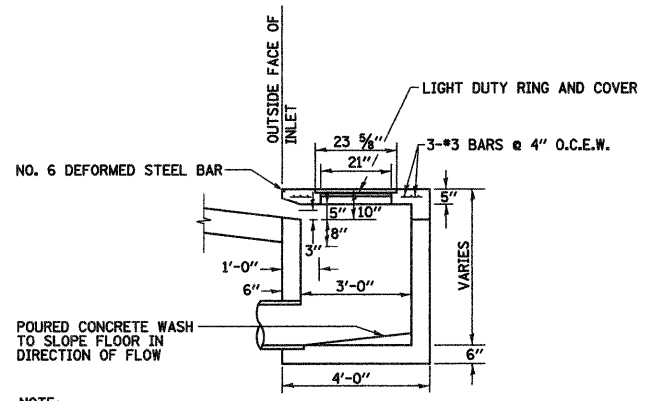


NOTE:  
REINFORCING BARS USED IN THE INLET SHALL BE #4 BARS @ 10" O.C. BOTH WAYS.

**SECTION A-A**  
N.T.S.

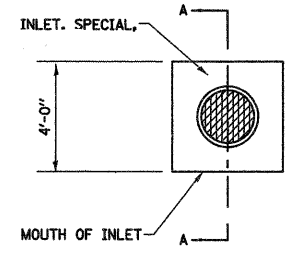


**PLAN**  
N.T.S.

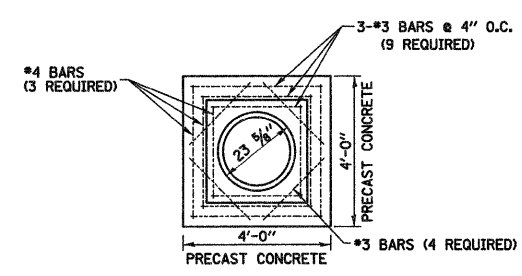

**CONCRETE LID PLAN**  
N.T.S.


INLET WALL	
TYPE	THICKNESS
PRECAST CONCRETE	6"
CAST-IN-PLACE CONCRETE	6"

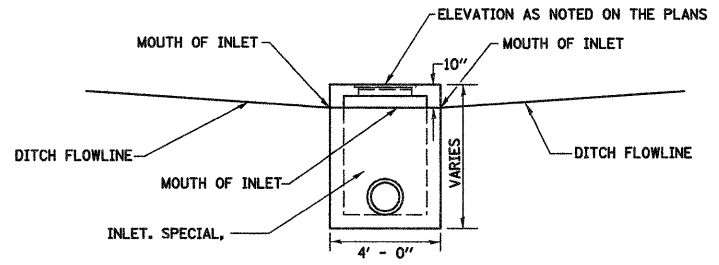

**FRONT ELEVATION**  
N.T.S.


TYPE	INSIDE WIDTH	LID TYPE
INLETS, SPECIAL	3' X 3'	AREA

NOTES:  
REINFORCING BARS, CLASS "PC" CONCRETE, CAST IRON RING AND COVER, AND ALL MATERIAL AND LABOR SHALL BE INCLUDED IN THE UNIT PRICE BID FOR "INLET, SPECIAL, TYPE 1" COMPLETE AND IN PLACE.  
THE TOPS OF ALL INLETS WHICH ARE LOCATED IN CURVES SHALL BE CONSTRUCTED TO CONFORM TO THE RADIUS OF THE CURVE.  
THE INLET SHALL BE A CATCH BASIN W/FLAT LID OR SIMILAR BASED ON STRUCTURE SIZE.  
THE INLET LID AS WELL AS THE RING AND COVER USED SHALL BE ACCORDING TO THE DETAILS AS SHOWN IN THE PLANS.  
DETAILS FOR THE INLET, SPECIAL AS SHOWN ABOVE ARE BASED UPON INSIDE DIMENSIONS OF 3'X3'.

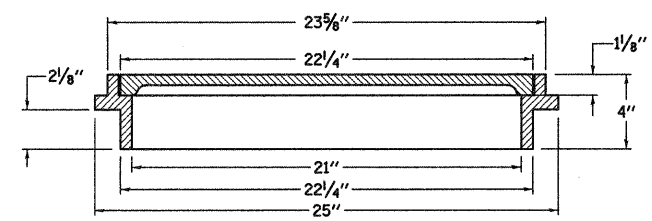


**LIGHT DUTY RING AND COVER,**  
N.T.S.

**INLETS, SPECIAL**  
N.T.S.

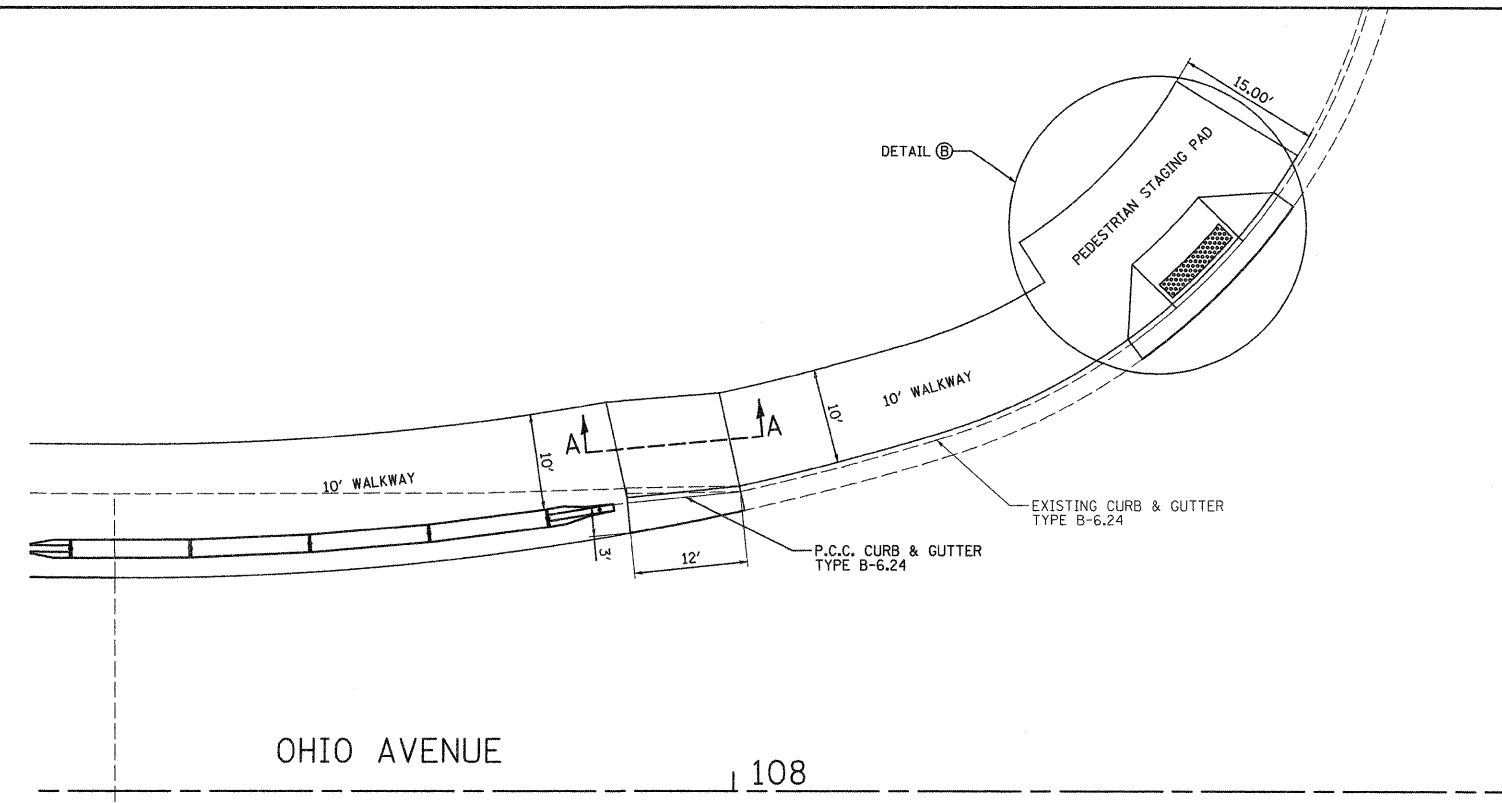


**OHIO AVENUE**  
108


**TRANSITION DETAIL**  
N.T.S.

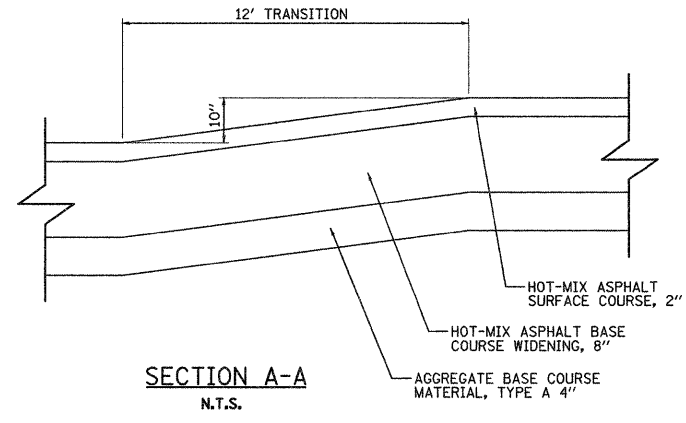


**SECTION A-A**  
N.T.S.

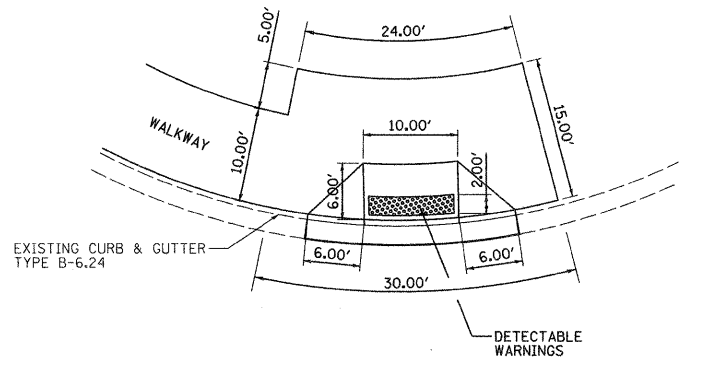


**DETAIL B**  
N.T.S.

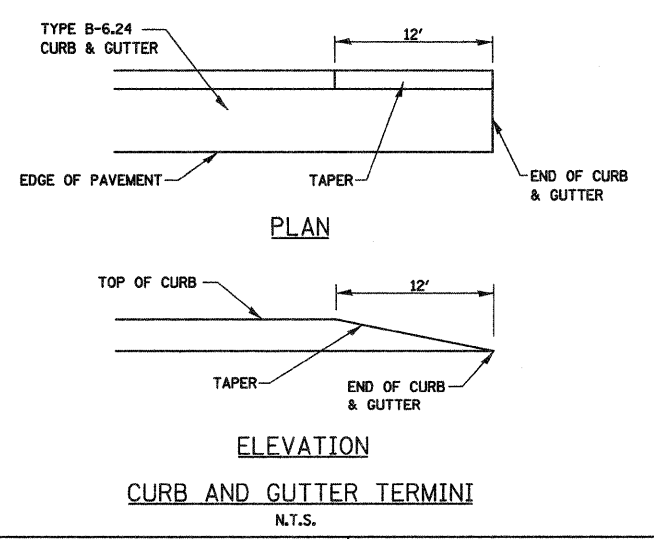


**CURB AND GUTTER TERMINI**  
N.T.S.

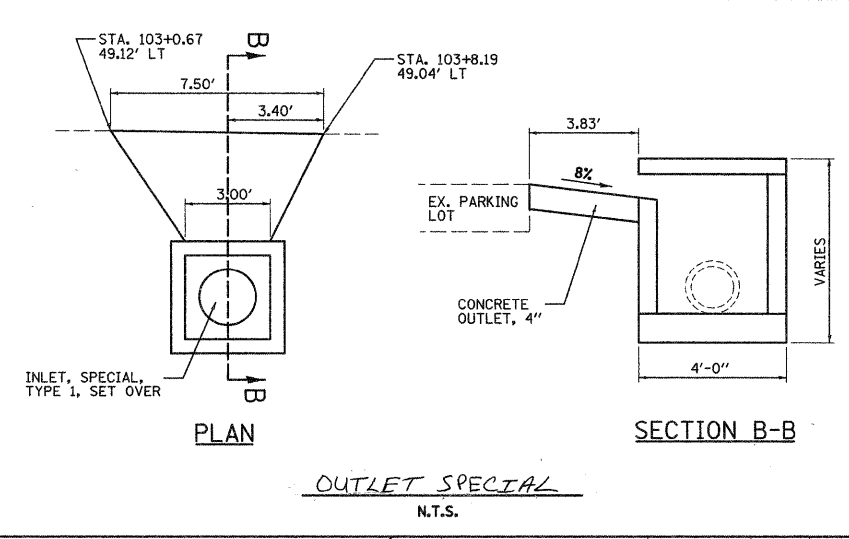

**OUTLET SPECIAL**  
N.T.S.

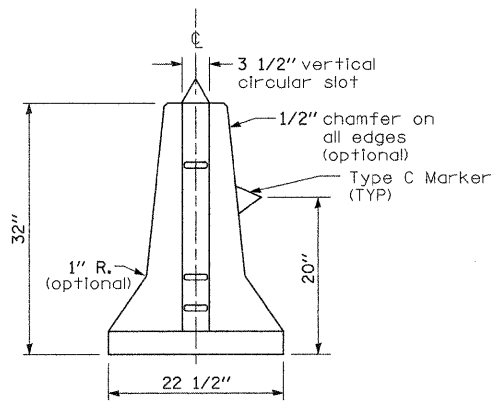


SECTION A-A  
N.T.S.

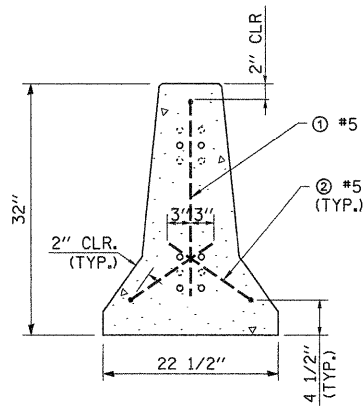


SECTION B-B  
N.T.S.

NOTES

1. Connecting Loop Bars shall be 3'-3" long, except for the top loop of the Barrier Terminal, which shall be 2'-0" long.
2. The vertical spacing of the Connecting Loop Bars in a Barrier Terminal is determined by the end of the Barrier Segment to which it is being connected. See Idot Highway Standard 704001.

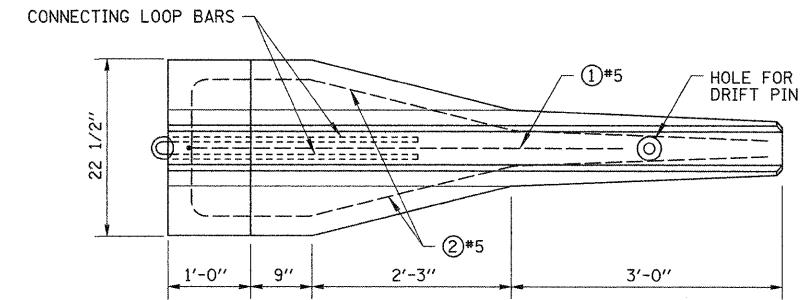


TOP VIEW

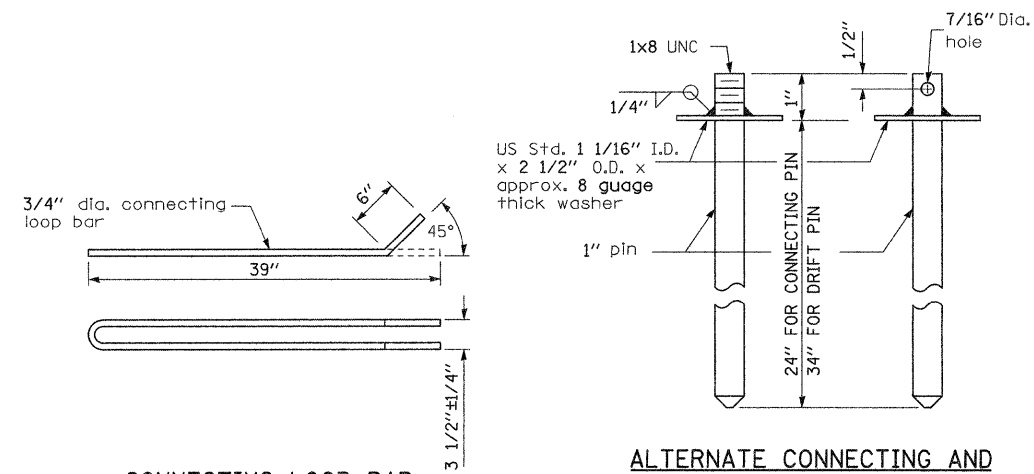


CONNECTING LOOP BAR  
N.T.S.

ALTERNATE CONNECTING AND  
DRIFT PINS  
(End may be beveled 1/4" max.)


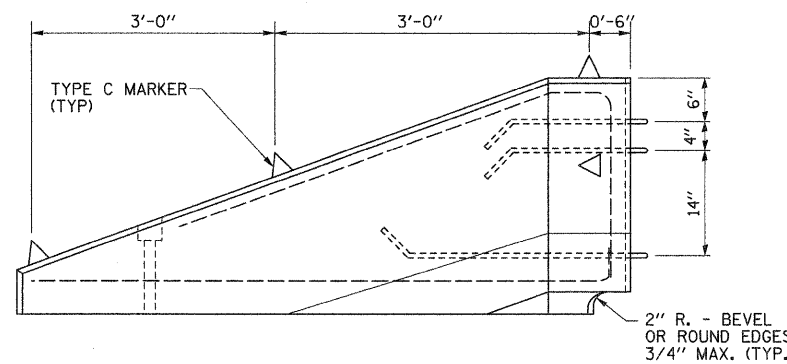


SIDE VIEW

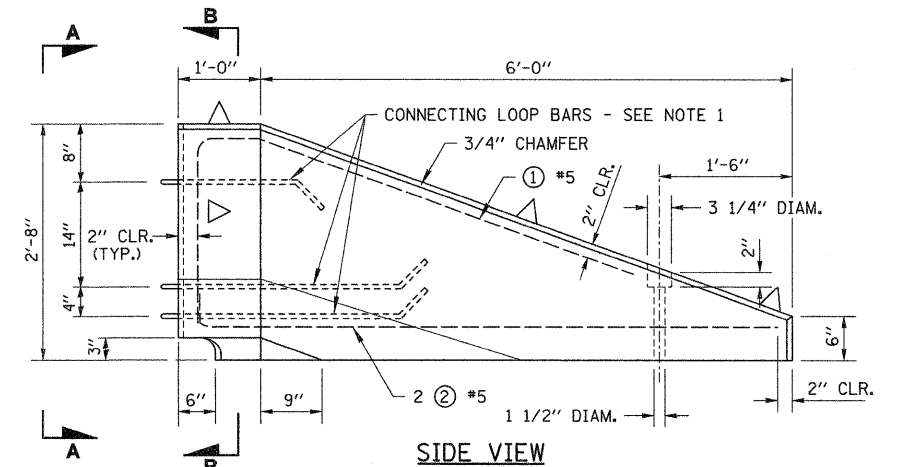


SIDE VIEW

TEMPORARY CONCRETE BARRIER, TERMINAL SECTION (SPECIAL) DETAIL  
N.T.S.

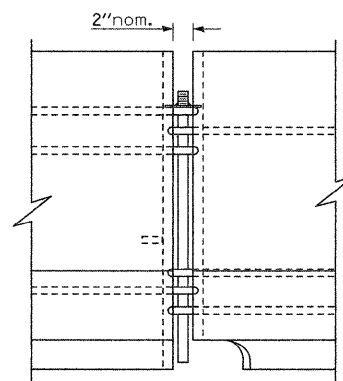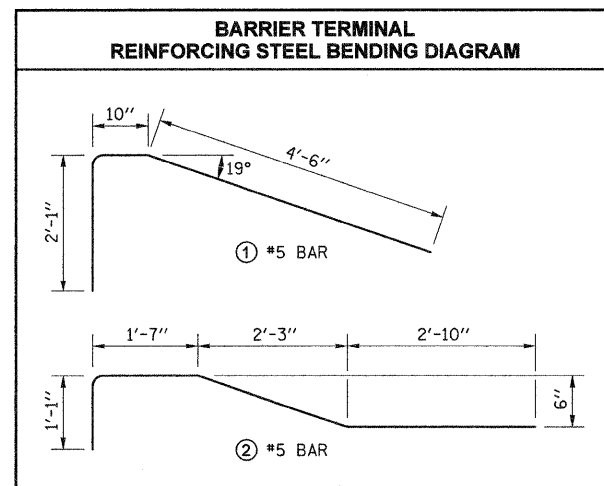

CONNECTING DETAIL  
N.T.S.

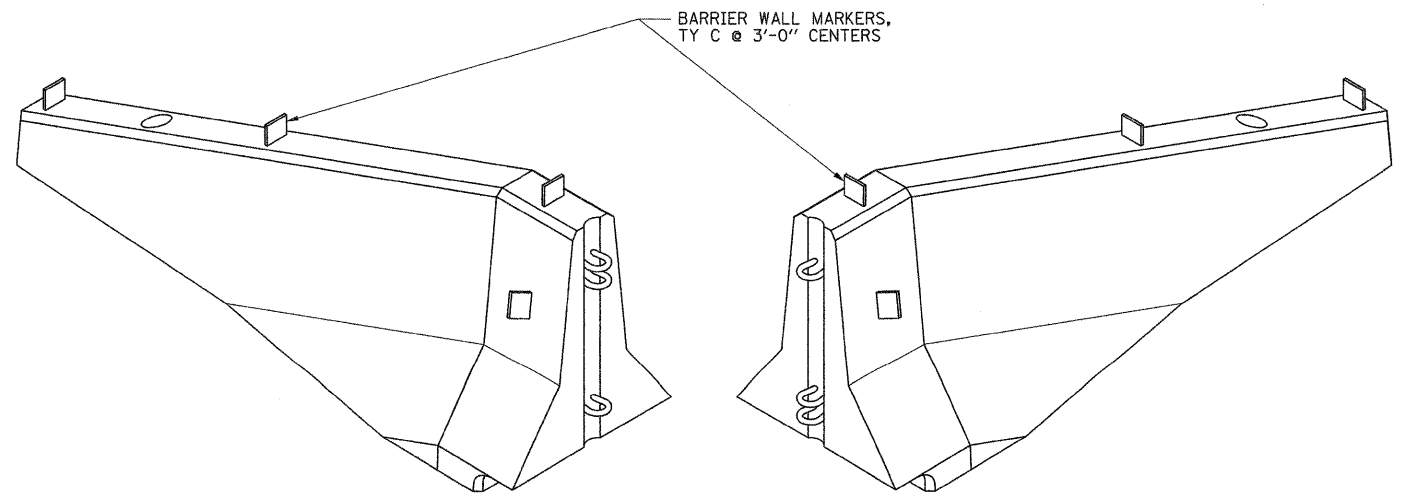


TEMPORARY CONCRETE BARRIER, TERMINAL SECTION (SPECIAL) DETAIL  
N.T.S.

FILE NAME = misc details	USER NAME = Jeremy	DESIGNED - BFK	REVISED -	<b>OHIO AVENUE PEDESTRIAN WALKWAY MADISON, ILLINOIS</b>	<b>MISCELLANEOUS DETAILS</b>				F.A. RTE.	SECTION	COUNTY	TOTAL SHEETS	SHEET NO.
	PLOT SCALE = #SCALE#	DRAWN - JJB	REVISED -						09-00049-01-SW	ST. CLAIR	26	21	
	PLOT DATE = 12/21/2009	CHECKED - BFK	REVISED -		SCALE:	SHEET NO.	OF SHEETS	STA.	TO STA.	CONTRACT NO. 97420			
		DATE -	REVISED -		ILLINOIS FED. AID PROJECT								

FINAL SURVEY	SURVEYED	BY	DATE
NOTE BOOK NO.	PLOTTED		
	TEMPLATE		
	AREAS CHECKED		

ORIGINAL SURVEY	SURVEYED	BY	DATE
NOTE BOOK NO.	PLOTTED		
	TEMPLATE		
	AREAS CHECKED		

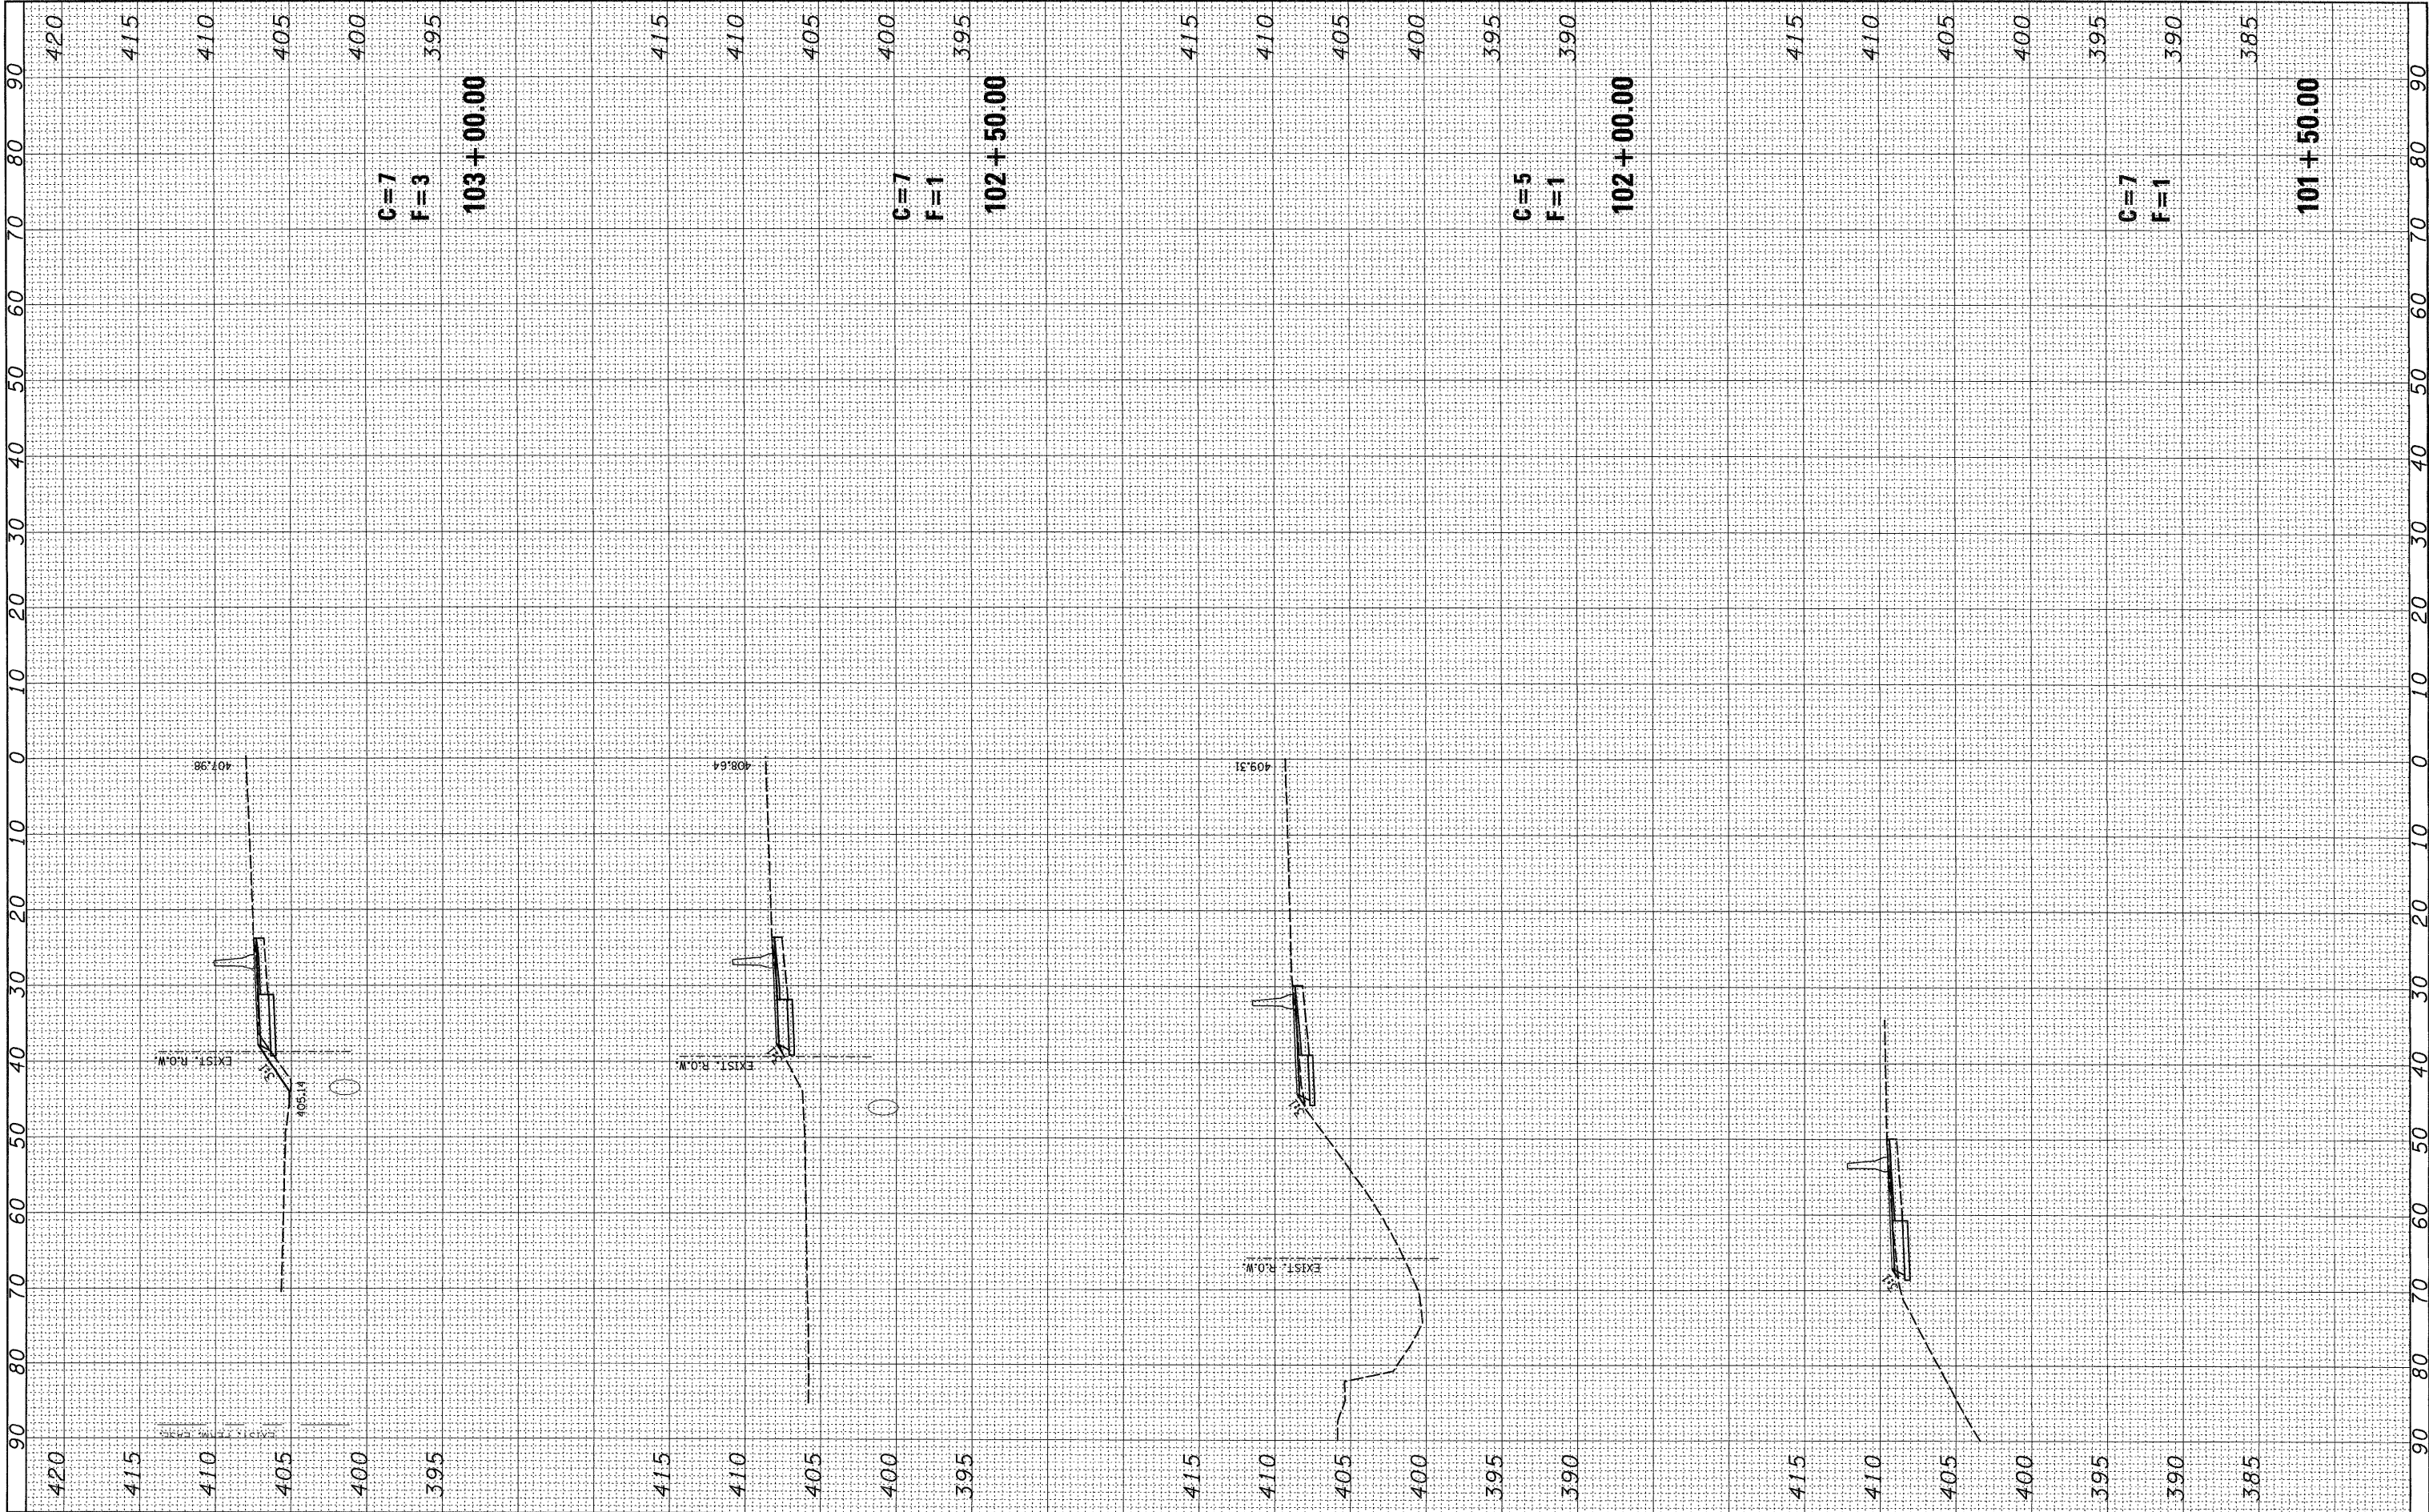

FILE NAME = xs\_Ohio PLOT

USER NAME = jeremy  
 PLOT SCALE = #SCALE#  
 PLOT DATE = 12/18/2009

DESIGNED - BFK  
 DRAWN - BFK  
 CHECKED - BFK  
 DATE -

REVISED -  
 REVISED -  
 REVISED -  
 REVISED -

**STATE OF ILLINOIS  
 DEPARTMENT OF TRANSPORTATION**


**OHIO AVENUE PEDESTRIAN WALKWAY**

SCALE: SHEET NO. OF SHEETS STA. 101+50.00 TO STA. 103+00.00

F.A. RTE.	SECTION	COUNTY	TOTAL SHEETS	SHEET NO.
	09-00049-01 SW	ST. CLAIR	26	22
CONTRACT NO. 97420				
ILLINOIS FED. AID PROJECT				

FINAL SURVEY	SURVEYED	BY	DATE
NOTE BOOK NO.	PLOTTED		
	TEMPLATE		
	AREAS CHECKED		

ORIGINAL SURVEY	SURVEYED	BY	DATE
NOTE BOOK NO.	PLOTTED		
	TEMPLATE		
	AREAS CHECKED		

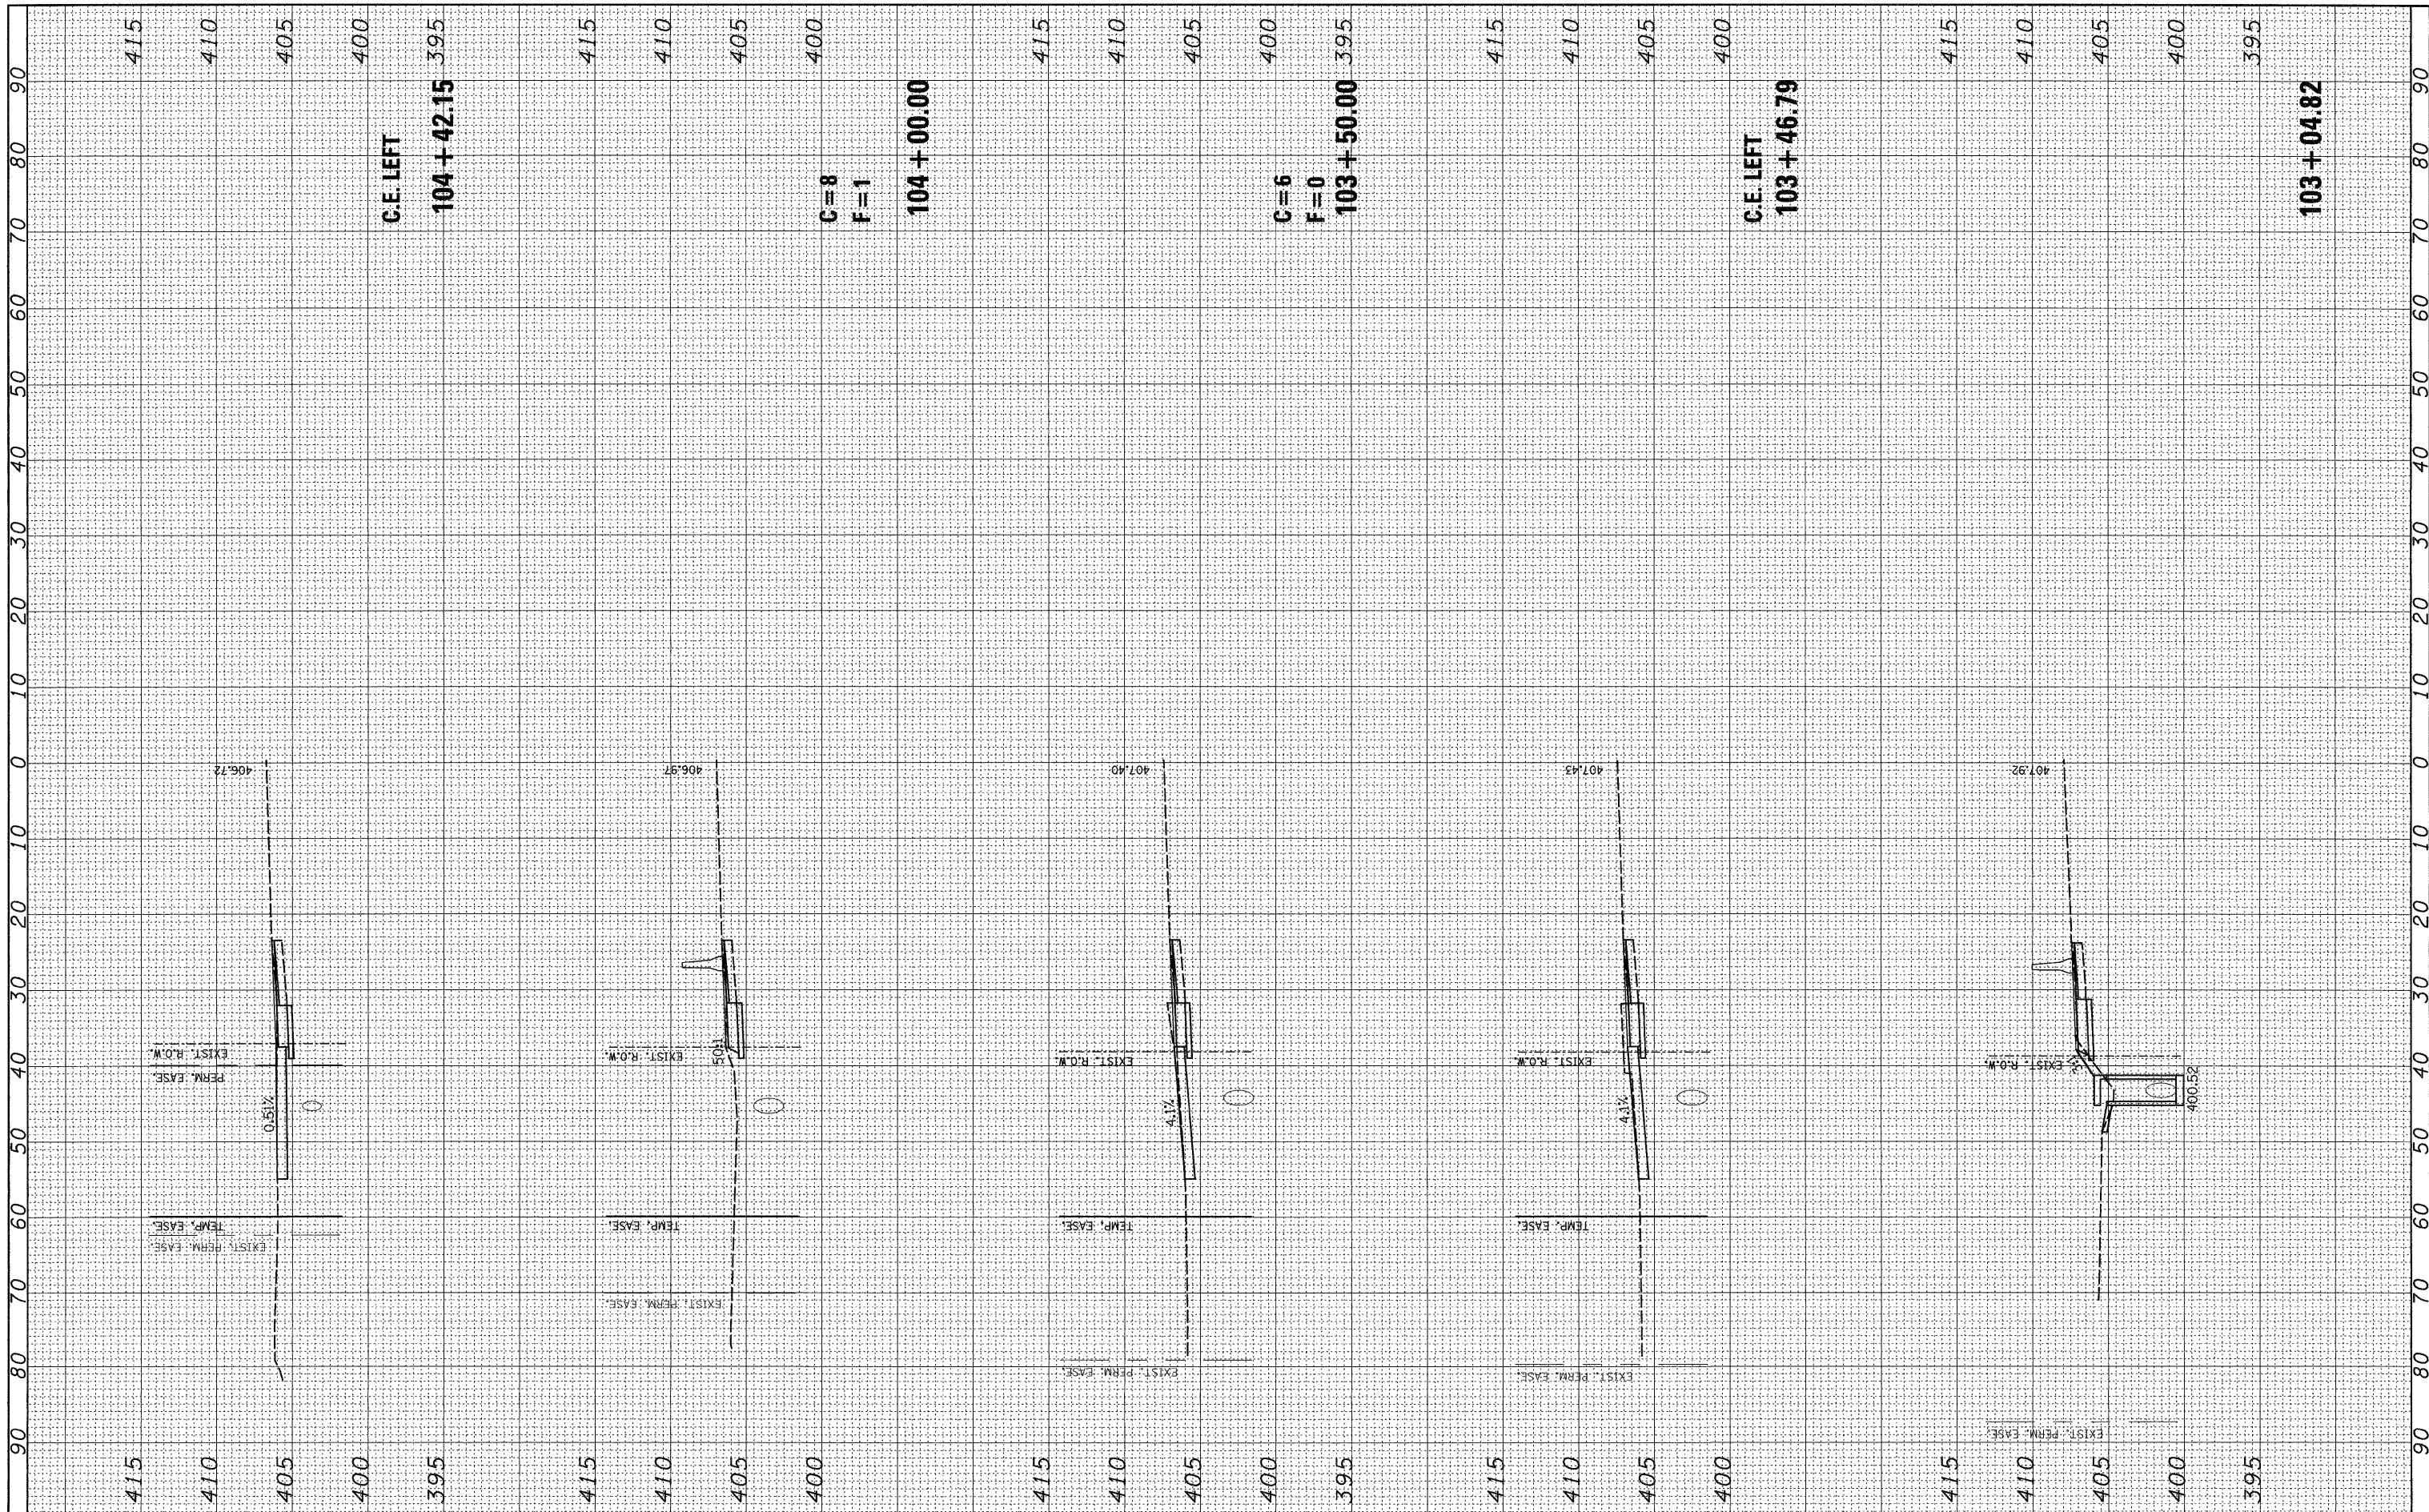

FILE NAME = xs\_01ho PLOT

USER NAME = jeremy  
 PLOT SCALE = #SCALE#  
 PLOT DATE = 12/18/2009

DESIGNED - BFK  
 DRAWN - BFK  
 CHECKED - BFK  
 DATE -

REVISED -  
 REVISED -  
 REVISED -  
 REVISED -

**STATE OF ILLINOIS  
 DEPARTMENT OF TRANSPORTATION**


**OHIO AVENUE PEDESTRIAN WALKWAY**

SCALE: SHEET NO. OF SHEETS STA. 103+04.82 TO STA. 104+42.15

F.A. RTE.	SECTION	COUNTY	TOTAL SHEETS	SHEET NO.
	09-00049-01 SW	ST. CLAIR	26	23
CONTRACT NO. 97420				
ILLINOIS FED. AID PROJECT				

FINAL SURVEY	SURVEYED	BY	DATE
NOTE BOOK NO.	PLOTTED		
	TEMPLATE		
	AREAS CHECKED		

ORIGINAL SURVEY	SURVEYED	BY	DATE
NOTE BOOK NO.	PLOTTED		
	TEMPLATE		
	AREAS CHECKED		

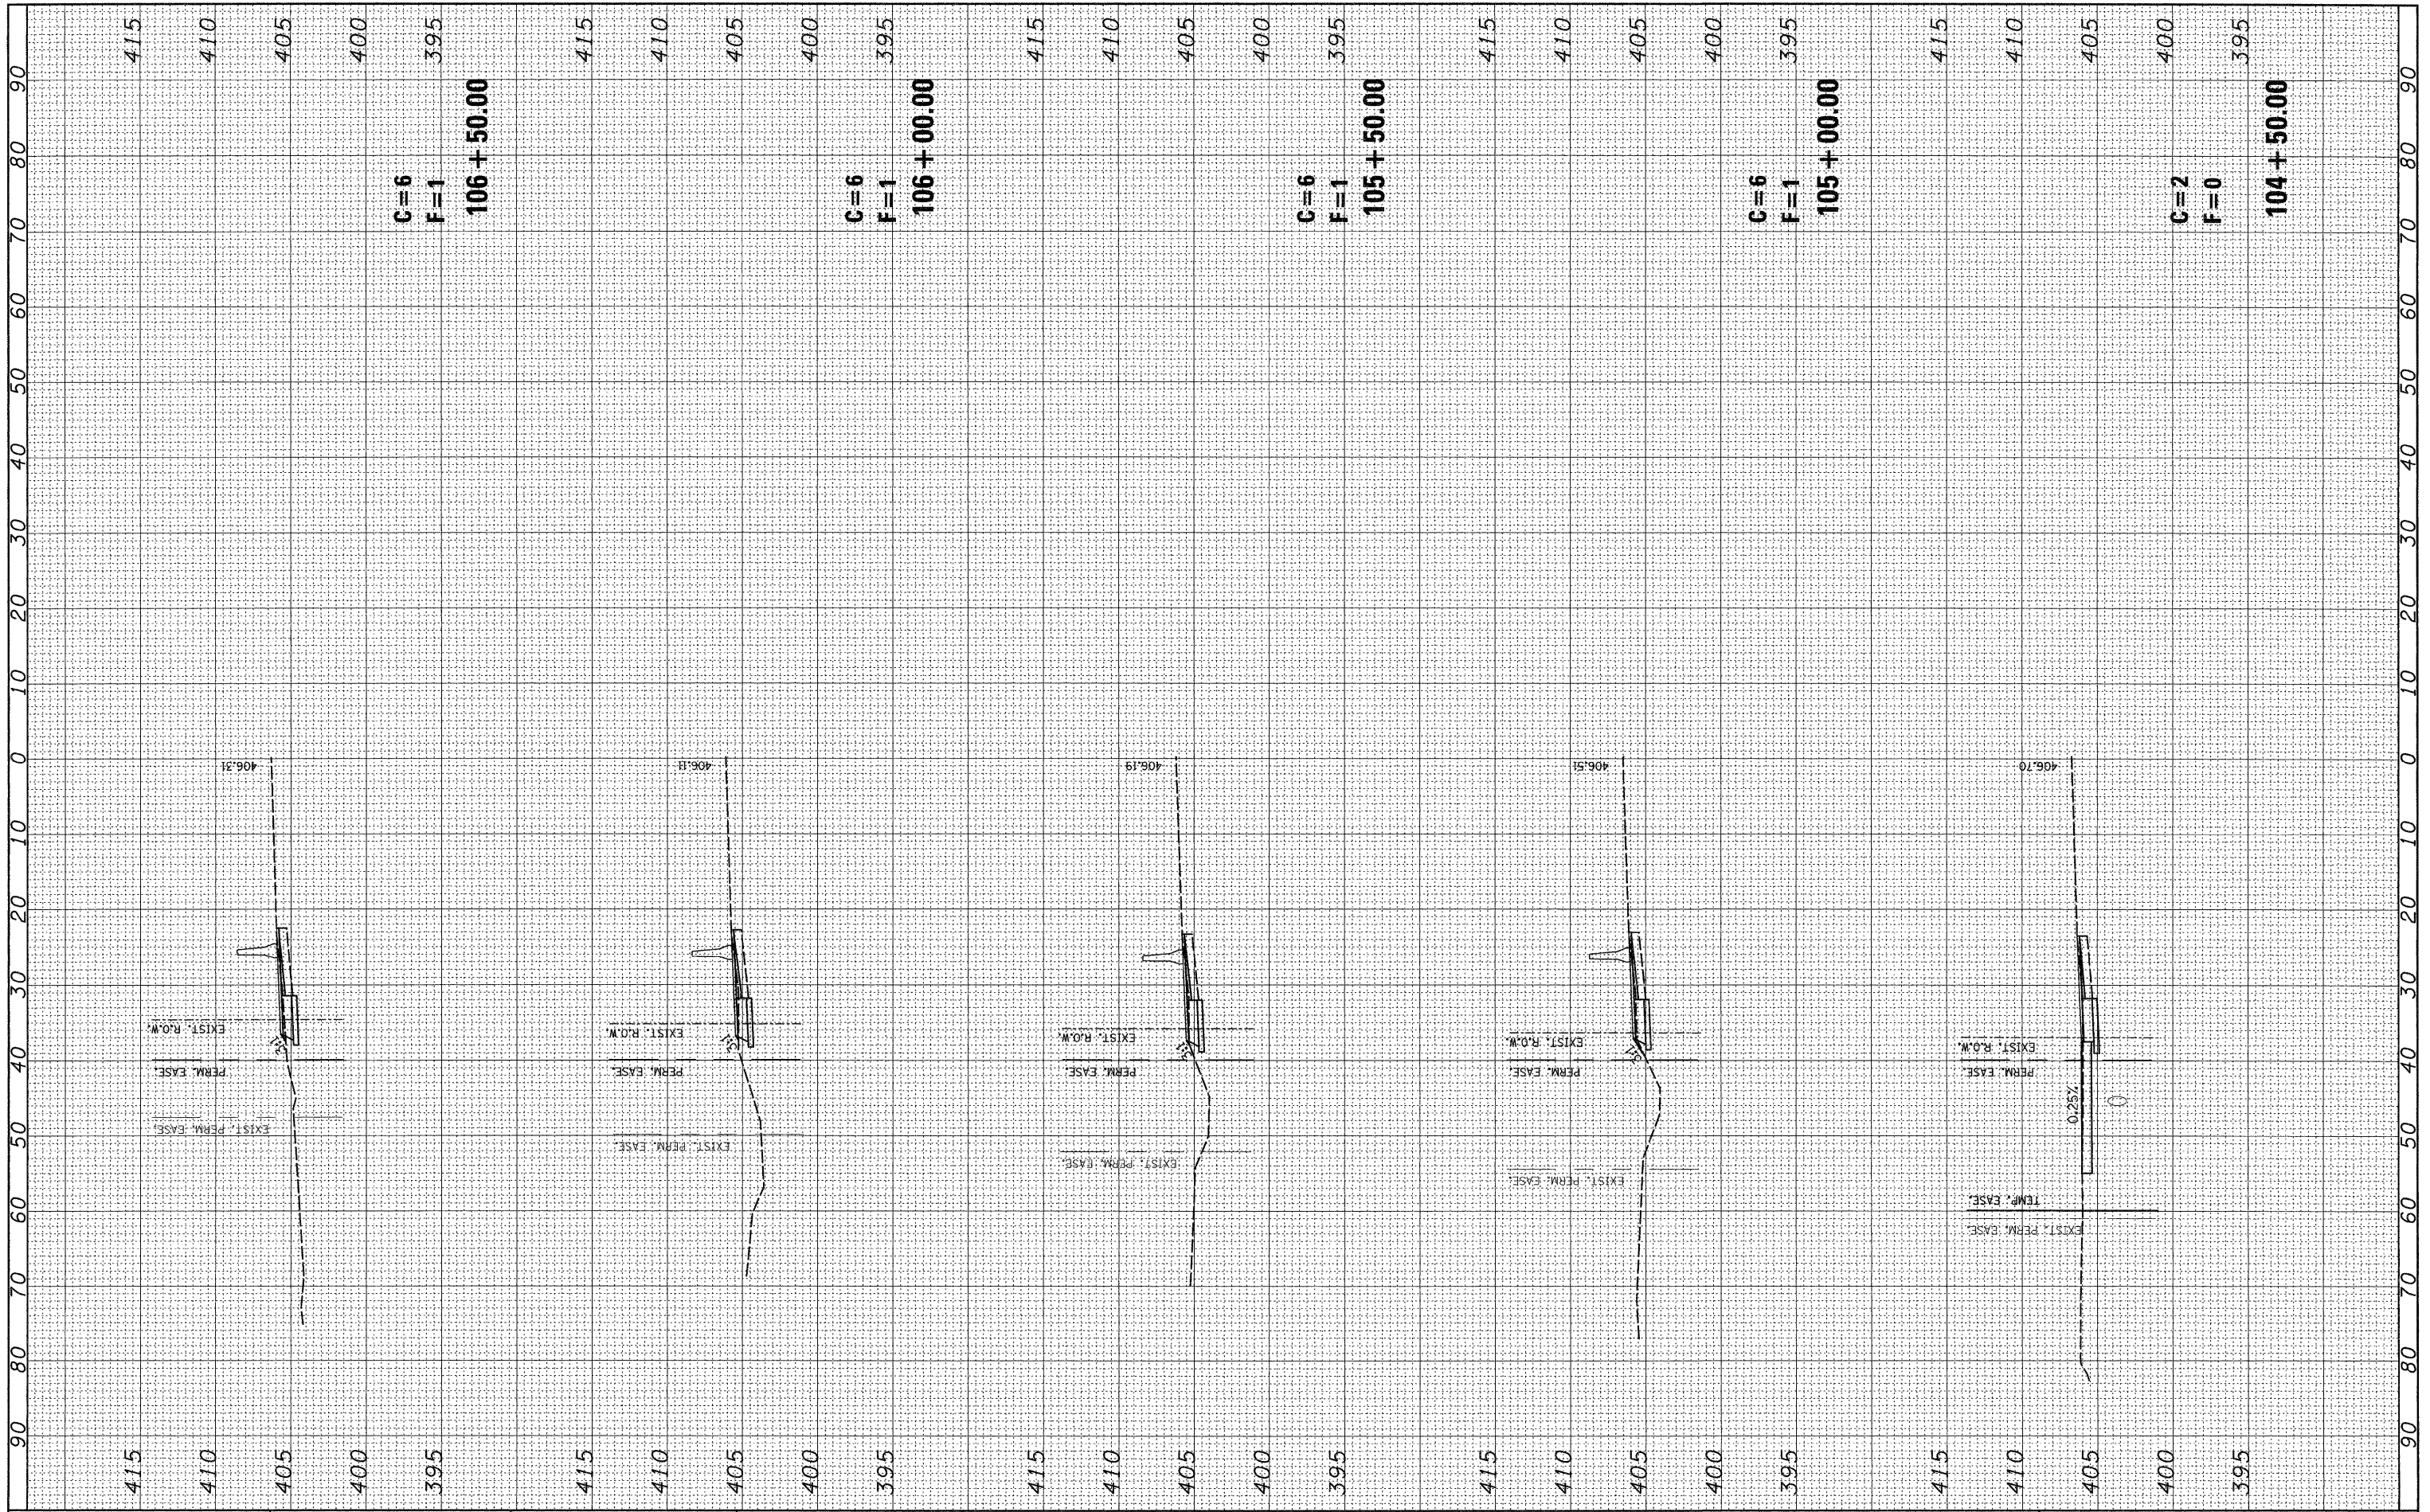

FILE NAME =  
xx\_Ohio PLOT

USER NAME = Jeremy  
PLOT SCALE = \*SCALE\*  
PLOT DATE = 12/18/2009

DESIGNED - BFK  
DRAWN - BFK  
CHECKED - BFK  
DATE -

REVISED -  
REVISED -  
REVISED -  
REVISED -

**STATE OF ILLINOIS  
DEPARTMENT OF TRANSPORTATION**

**OHIO AVENUE PEDESTRIAN WALKWAY**

SCALE: SHEET NO. OF SHEETS STA. 104+50.00 TO STA. 106+50.00

F.A. RTE.	SECTION	COUNTY	TOTAL SHEETS	SHEET NO.
	09-00049-01 SW	ST. CLAIR	26	24
CONTRACT NO. 97420				
ILLINOIS FED. AID PROJECT				




FINAL SURVEY	SURVEYED	BY	DATE
SURVEY	PLOTTED		
NOTE BOOK	TEMPLATE		
NO.	AREAS CHECKED		

ORIGINAL SURVEY	SURVEYED	BY	DATE
SURVEY	PLOTTED		
NOTE BOOK	TEMPLATE		
NO.	AREAS CHECKED		

420

420

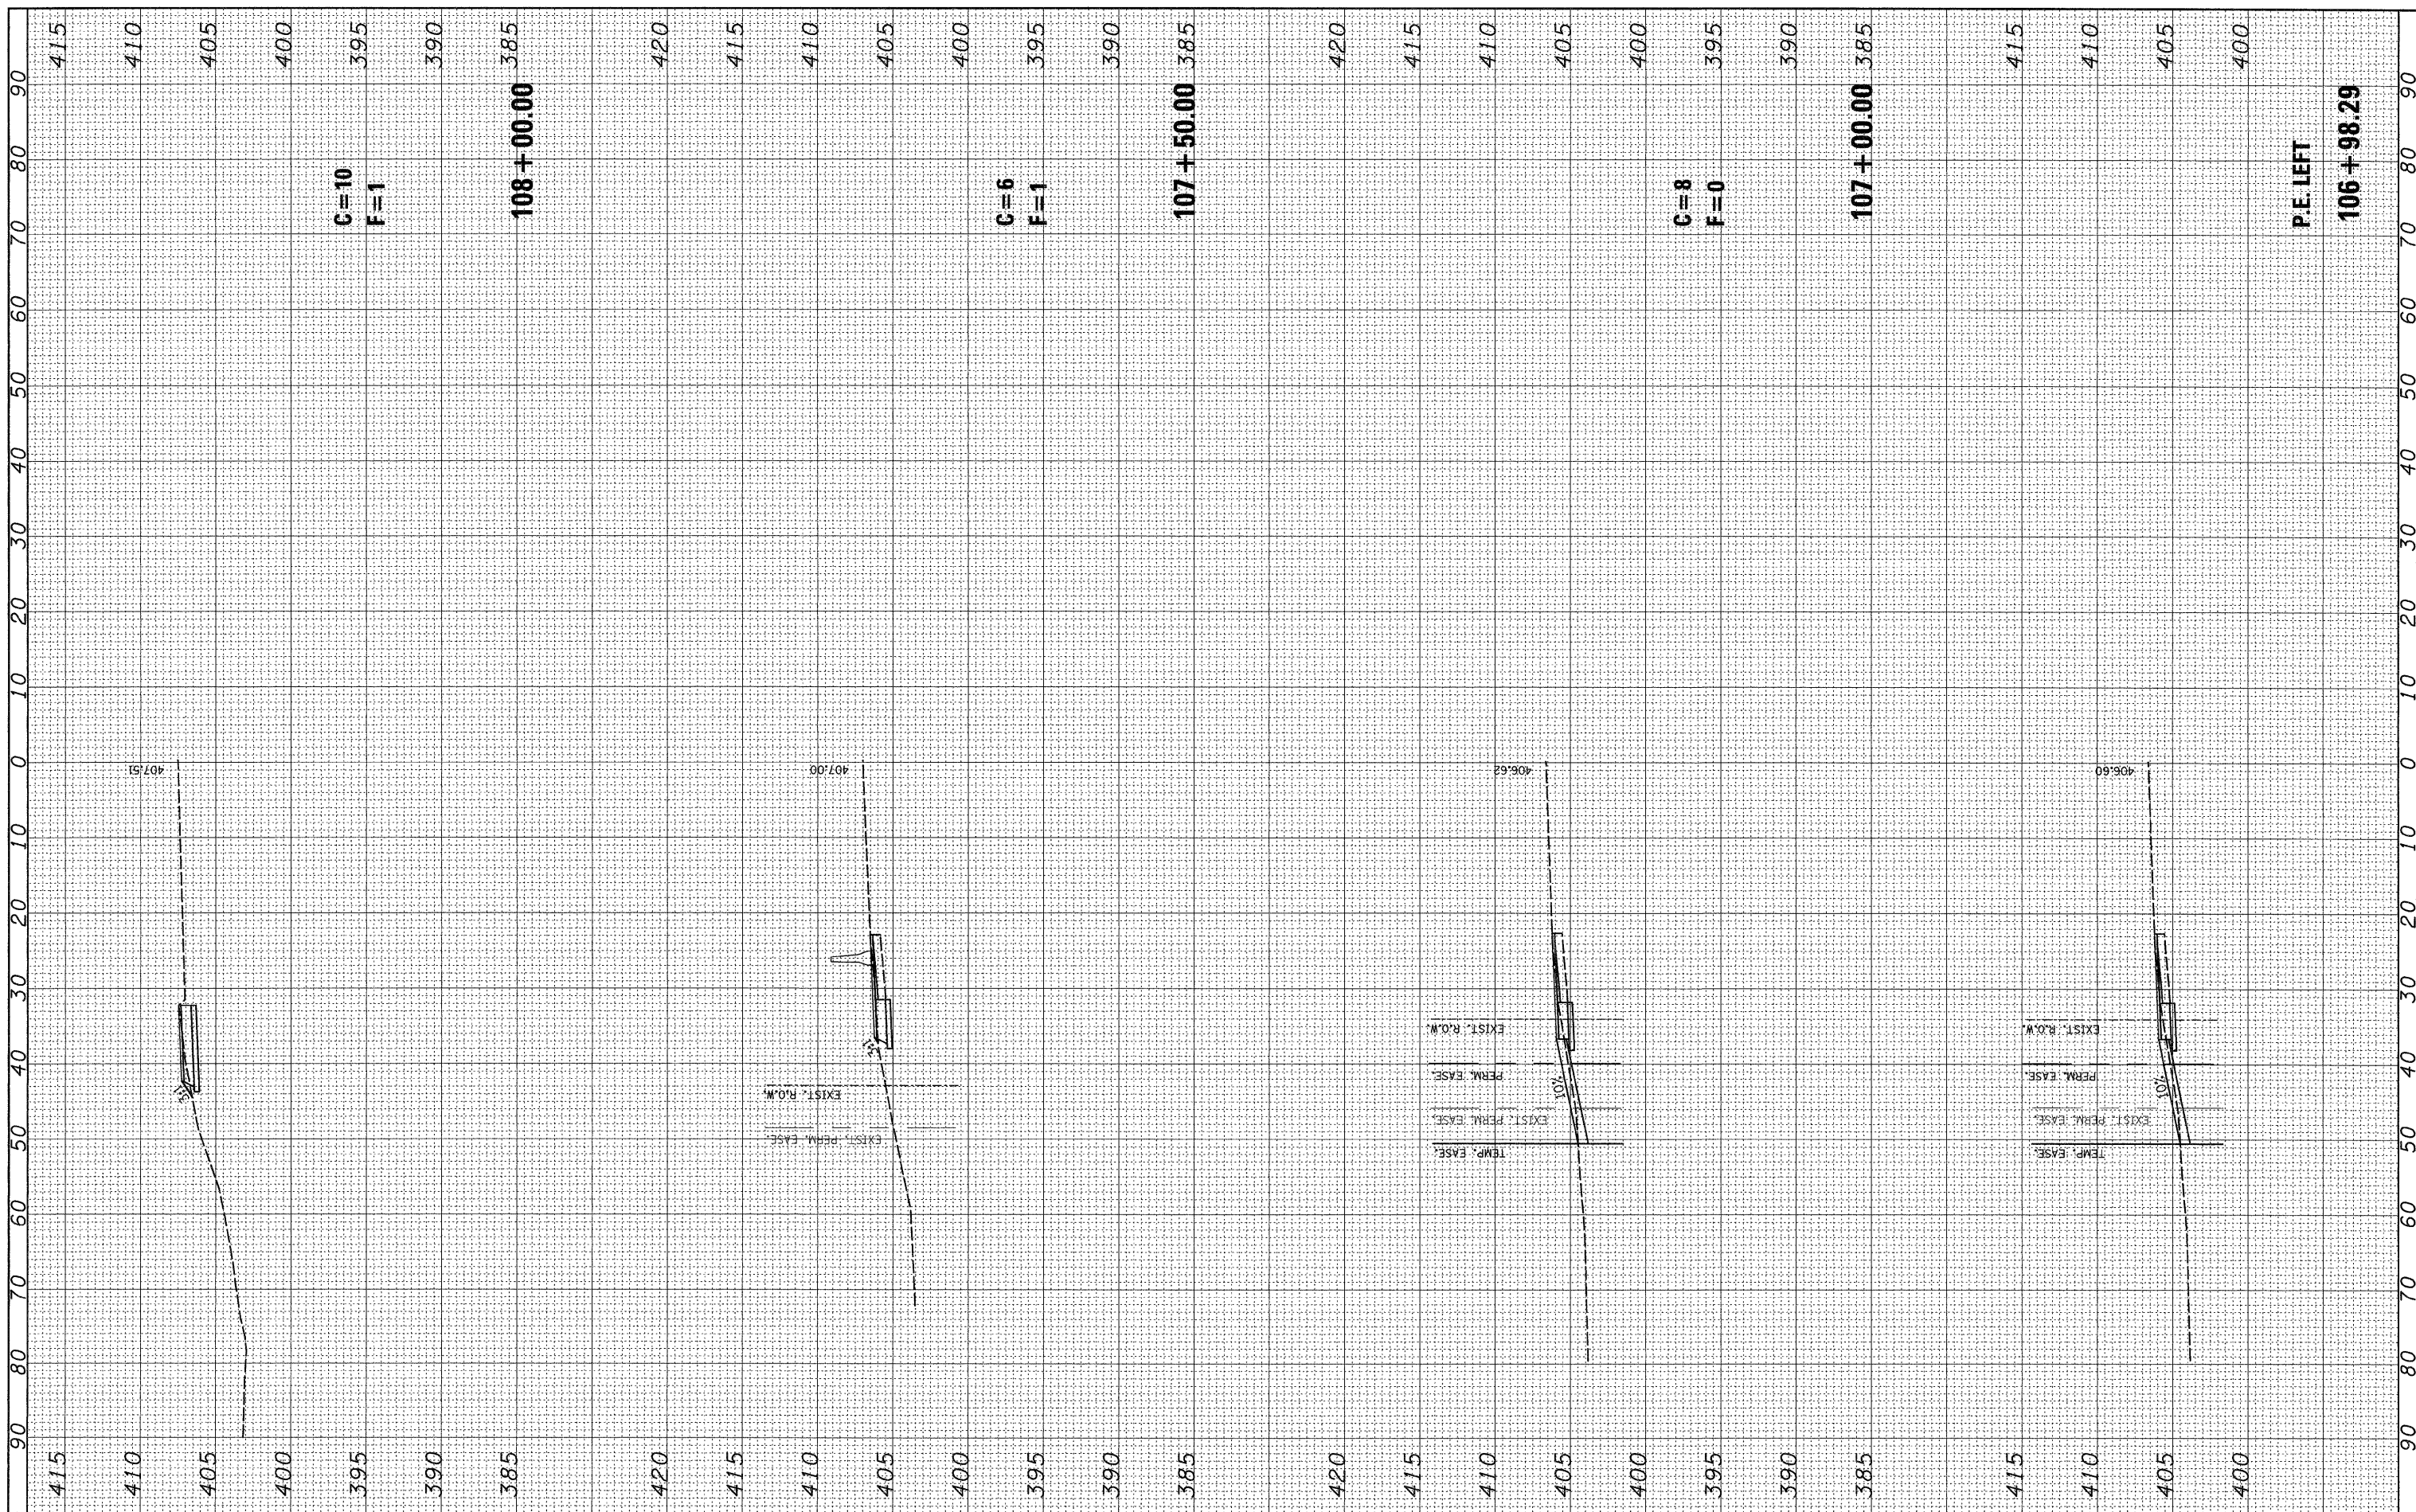

FILE NAME = ss\_Ohio PLOT

USER NAME = Jeremy  
 PLOT SCALE = #SCALE#  
 PLOT DATE = 12/18/2009

DESIGNED - BFK  
 DRAWN - BFK  
 CHECKED - BFK  
 DATE -

REVISED -  
 REVISED -  
 REVISED -  
 REVISED -

**STATE OF ILLINOIS  
 DEPARTMENT OF TRANSPORTATION**

**OHIO AVENUE PEDESTRIAN WALKWAY**

SCALE: SHEET NO. OF SHEETS STA. 106+98.29 TO STA. 108+00.00


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	09-00049-01 SW	ST. CLAIR	26	25
CONTRACT NO. 97420				
ILLINOIS FED. AID PROJECT				

P.E. LEFT

106+98.29

FINAL SURVEY NO.	SURVEYED	BY	DATE
	PLOTTED		
	TEMPLATE		
	AREAS CHECKED		

ORIGINAL SURVEY NO.	SURVEYED	BY	DATE
	PLOTTED		
	TEMPLATE		
	AREAS CHECKED		

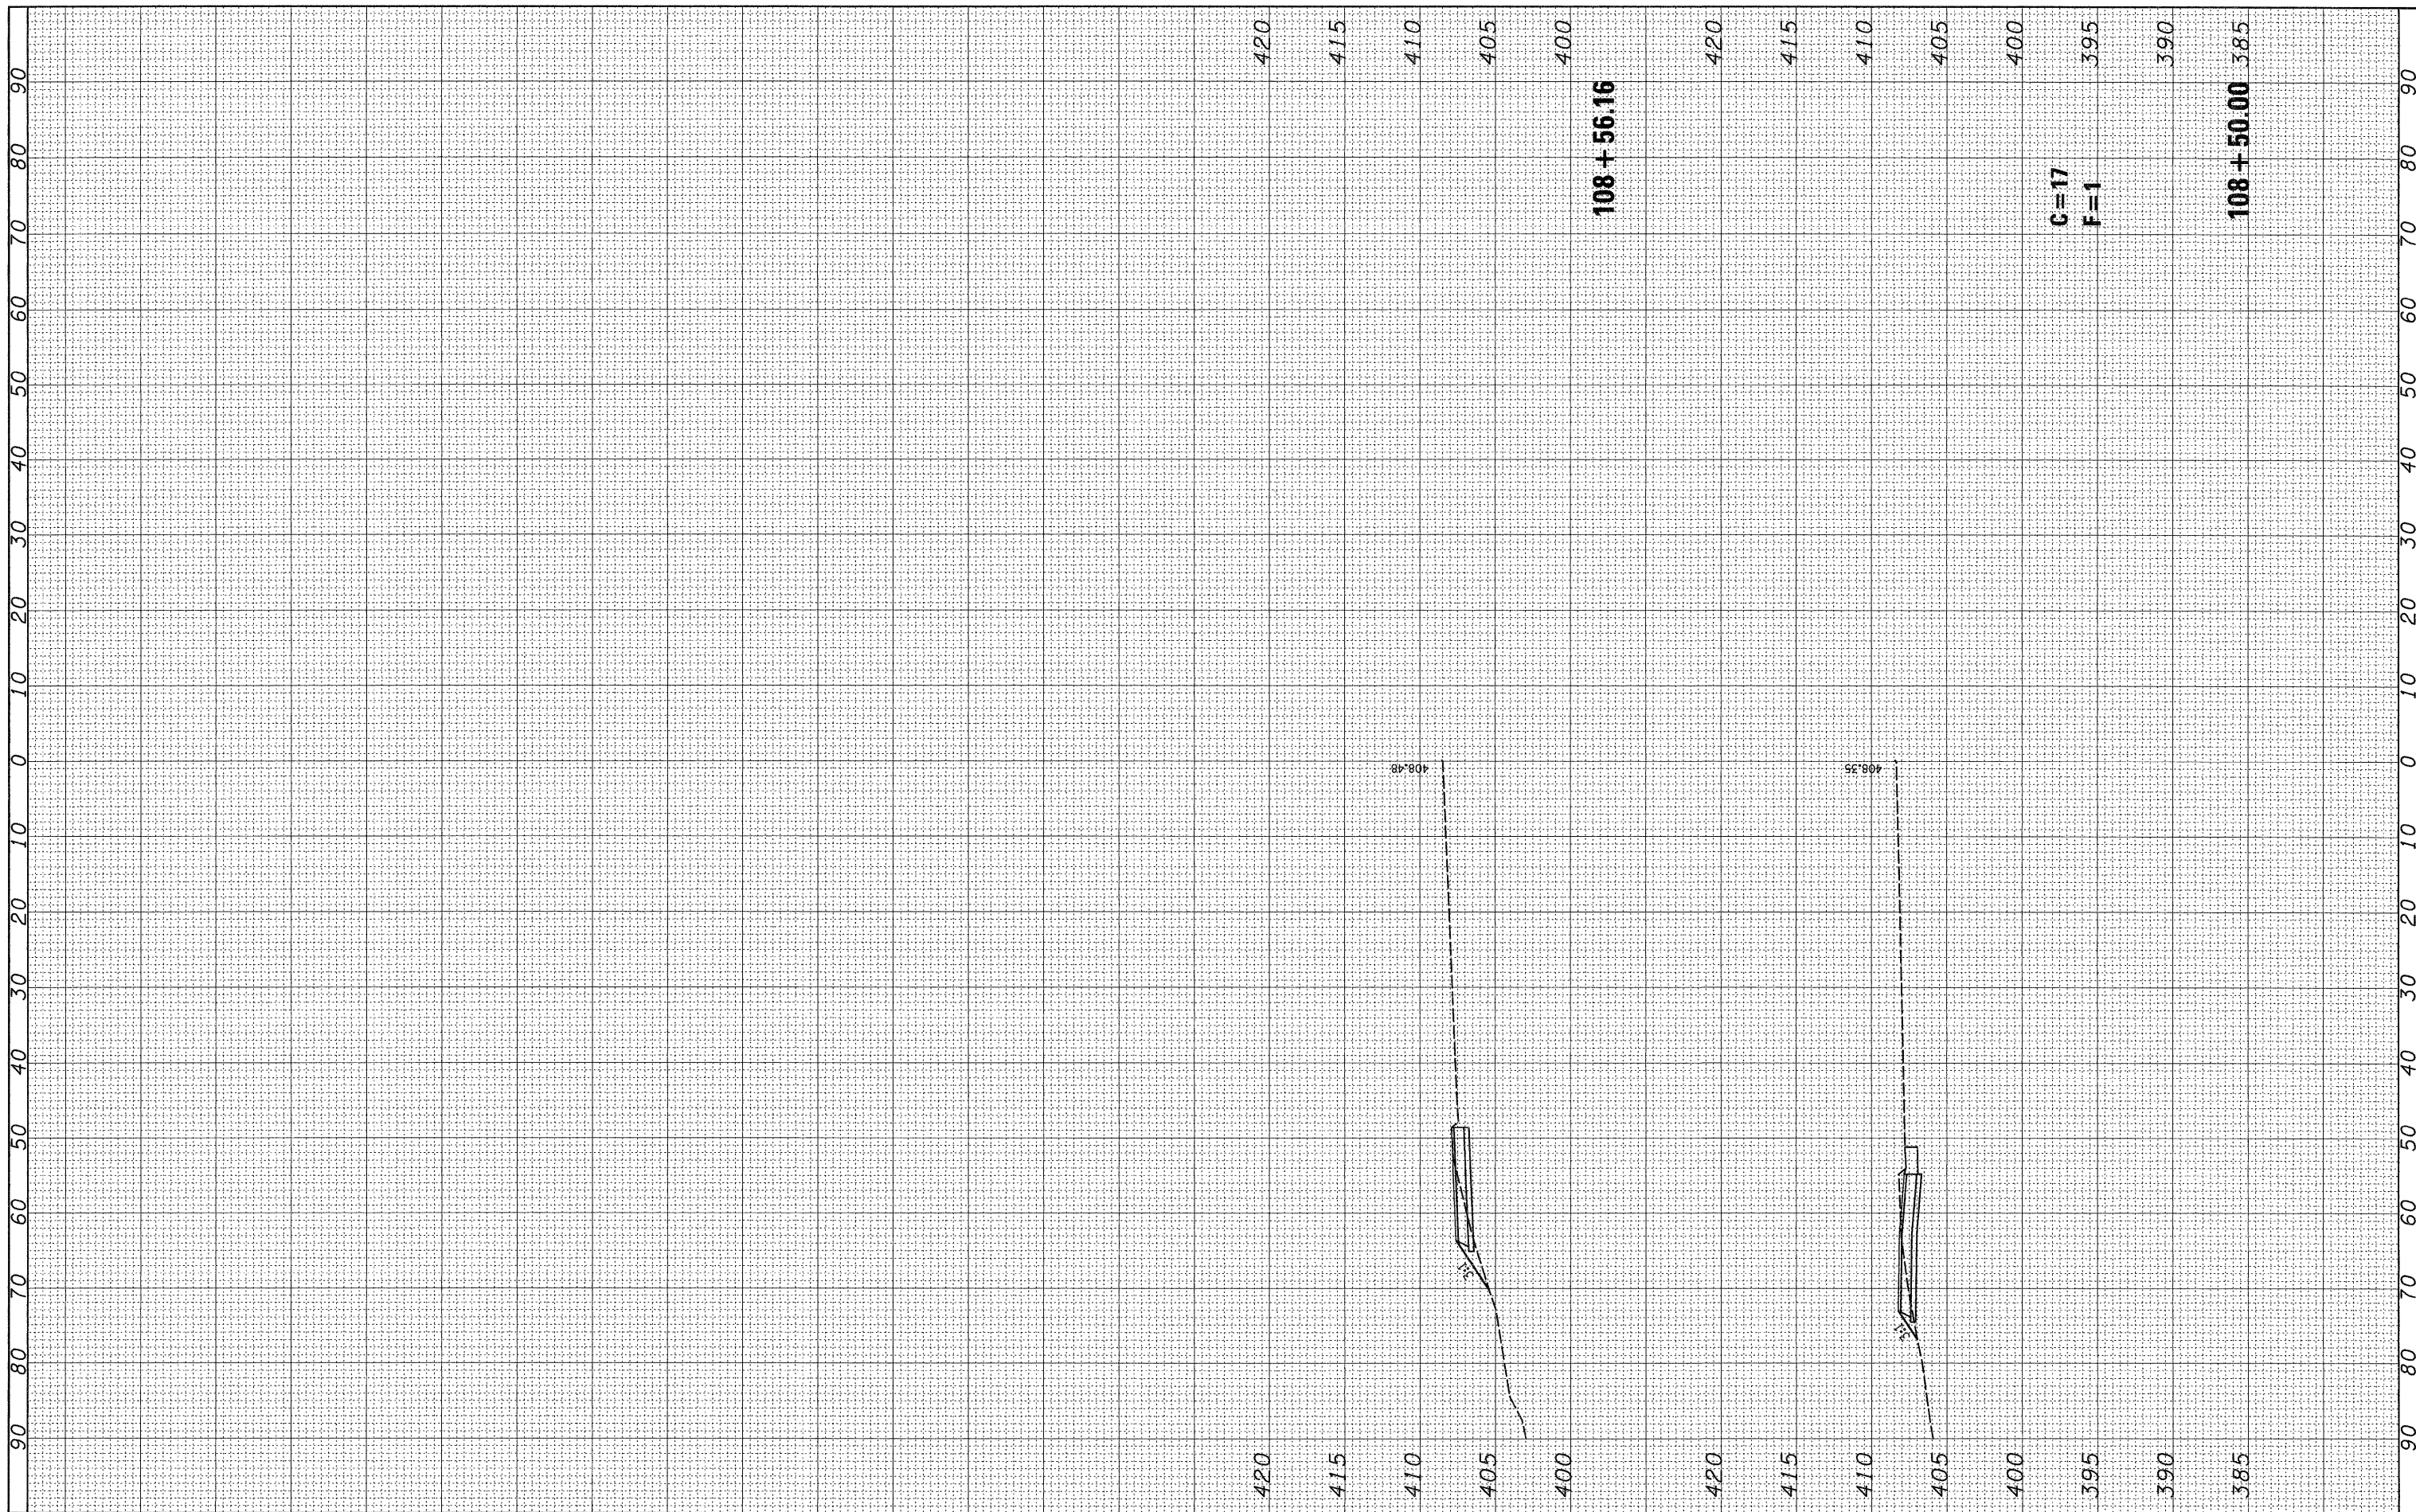

FILE NAME = ss\_0110 PLOT

USER NAME = jeremy

DESIGNED - BFK  
 DRAWN - BFK  
 CHECKED - BFK  
 DATE -

REVISED -  
 REVISED -  
 REVISED -  
 REVISED -

**STATE OF ILLINOIS  
 DEPARTMENT OF TRANSPORTATION**

**OHIO AVENUE PEDESTRIAN WALKWAY**

SCALE: SHEET NO. OF SHEETS STA. 108+50.00 TO STA. 108+56.16

F.A. RTE.	SECTION	COUNTY	TOTAL SHEETS	SHEET NO.
	09-00049-01 SW	ST. CLAIR	26	26
CONTRACT NO. 97420				
ILLINOIS FED. AID PROJECT				