INDEX OF SHEETS

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LIST OF IDOT STANDARDS

STD. 000001-05 Standard Symbols, Abbreviations and Patterns

STD. 424001-05 Curb Ramps for Sidewalks

STD. 442201-03 Class C and D Patches

STD. 701501-05 Urban Lane Closure, 2L, 2W, Undivided

STD. 701801-04 Lane Closure Multilane 1W or 2W Crosswalk or Sidewalk Closure

STD. 701901-01 Traffic Control Devices

STD. 720001-01 Sign Panel Mount Details

STD. 720006-02Sign Panel Erection Details

STD. 720011-01 Metal Posts for Signs, Markers & Delineators

STD. 729001-01 Applications of Types A & B Metal Posts (For Signs & Markers)

STD. 814001-02 Handholes

UTILITIES

VERIZON NORTH

111 S. MAIN ST.

KEWANEE, IL 61443

AMEREN_CH CO

8420 N. UNIVERSITY ST.


PEORIA, IL 61614

MEDIACOM

609 S. 4TH ST.

CHILLICOTHE, IL 61523

NPDES PERMIT NOT REQUIRED

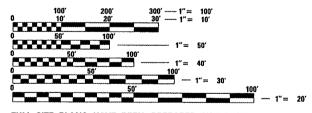

FULL SIZE PLANS HAVE BEEN PREPARED USING STANDARD ENGINEERING SCALES. REDUCED SIZED PLANS WILL NOT CONFORM TO STANDARD SCALES. IN MAKING MEASUREMENTS ON REDUCED PLANS, THE ABOVE SCALES MAY BE USED.

JOINT UTILITY LOCATION INFORMATION FOR EXCAVATION 1-800-892-0123




CHRISTOPHER B. BURKE ENGINEERING LTD.

STATE OF ILLINOIS **DEPARTMENT OF TRANSPORTATION DIVISION OF HIGHWAYS**


PLANS FOR PROPOSED **AMERICAN RECOVERY** AND REINVESTMENT ACT

PROJECT ARA-00D4(102) ITEP # 402205 SECTION 09-00001-00-LT STATE JOB NO. C-94-024-10

DOWNTOWN LIGHTING PROJECT FAS 1375/FAP 643 CITY OF WYOMING **STARK COUNTY**

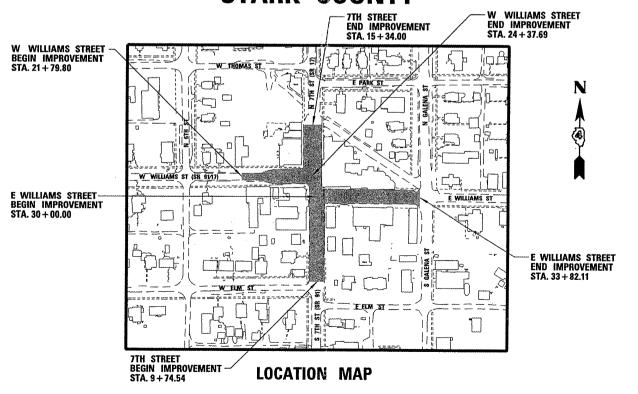

GROSS LENGTH OF IMPROVEMENT: 1199.46 FEET = 0.227 MILES NET LENGTH OF IMPROVEMENT: 1199.46 FEET = 0.227 MILES

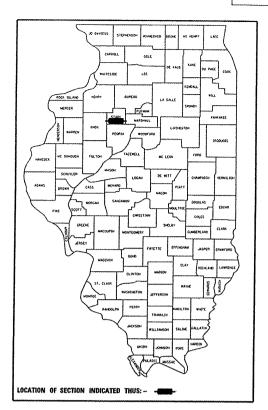

FUNCTIONAL CLASSIFICATION: IL 91 (SEVENTH ST) MAJOR COLLECTOR


IL 17 (SEVENTH ST) MINOR ARTERIAL


IL 91/17 (WILLIAMS ST) MINOR ARTERIAL WILLIAMS ST (NO STATE RTE) LOCAL STREET

DESIGN SPEED: 30 MPH

DESIGN TRAFFIC: 2150 ADT (2007)

DESIGN GUIDELINES: 3R

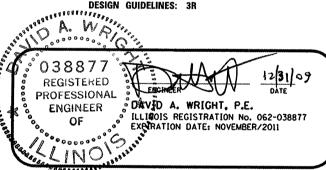

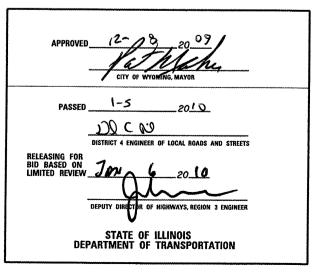

LIGHTING GENERAL NOTES

- THE CONTRACTOR SHALL BE SOLELY RESPONSIBLE FOR JOB SITE SAFETY AS WELL AS SUPERVISION/DIRECTION AND MEANS/METHODS OF CONSTRUCTION.
- 2. ALL POLE HANDHOLES SHALL FACE AWAY FROM TRAFFIC.
- UNIT DUCT SHALL BE SCH 40 HDPE WITH XLP-TYPE USE CABLES, SIZES AS SHOWN ON PLANS.
- LUMINAIRES SHALL BE LEVEL & BE SECURED ON MAST OR TENON ARMS TO THE OWNER'S SATISFACTION. THIS WORK SHALL INCLUDE FIELD ADJUSTING OF THE LUMINAIRE WHICH WILL BE INCLUDED IN THE "LUMINAIRE" OR "ORNAMENTAL LIGHT UNIT COMPLETE" PAY ITEMS.
- ELECTRICAL CONTRACTOR SHALL BE RESPONSIBLE FOR OBTAINING A PERMIT FROM THE CITY OF WYOMING OR STARK COUNTY BEFORE THE START OF WORK, ANY COST FOR PERMIT SHALL BE INCLUDED IN THE TOTAL COST OF THE CONTRACT.
- ALL WORK SHALL BE IN ACCORDANCE WITH THE LATEST EDITION OF THE FOLLOWING SPECIFICATIONS, WHICH ARE HEREBY MADE A PART HEREOF:
 - "STANDARD SPECIFICATIONS FOR ROAD AND BRIDGE CONSTRUCTION IN ILLINOIS", AS PREPARED BY IDOT.
 - "THE NATIONAL ELECTRICAL CODE".
 - C. MUNICIPAL CODES & STANDARDS.
- CONTRACTOR SHALL BE SOLELY RESPONSIBLE FOR JOB SITE SAFETY AS WELL AS SUPERVISION/DIRECTION AND MEANS/METHODS OF CONSTRUCTION.
- THE CONTRACT DRAWINGS AND SPECIFICATIONS ARE NOT INTENDED TO SHOW EVERY AND ALL DETAILS OF WORK TO BE PERFORMED OR EQUIPMENT TO BE SUPPLIED. THE INTENT OF THE CONTRACT DRAWINGS AND SPECIFICATIONS IS TO ILLUSTRATE THE CONCEPTUAL DESIGN AND LAYOUT. THE CONTRACTOR SHALL BE KNOWLEDGEABLE AND REGULARLY ENGAGED IN THE TYPE OF WORK DESCRIBED BY THESE CONTRACT DRAWINGS AND SPECIFICATIONS AND SHALL BE RESPONSIBLE FOR UNDERSTANDING THEIR INTENT. ANY WORK TO BE PERFORMED OR ITEM OF EQUIPMENT TO BE SUPPLIED WHICH IS NOT SPECIFICALLY CALLED FOR BY THESE CONTRACT DRAWINGS AND SPECIFICATIONS, BUT WHICH IS NOT SPECIFICALLY CALLED COMPLETE AND SUCCESSFUL WORKING SYSTEM SHALL BE INCLUDED IN THE CONTRACTOR'S SCOPE OF WORK AT NO ADDITIONAL COST TO THE OWNER.
- NO POLES SHALL BE ERECTED UNTIL THE RESPECTIVE FOUNDATIONS HAVE CURED.
- TO MAINTAIN THE STRUCTURAL INTEGRITY OF LIGHT POLES WITH OR WITHOUT MAST ARMS, THEY SHALL NOT BE ERECTED AND LEFT TO STAND WITHOUT LUMINAIRES. THE CONTRACTOR SHALL NOT BE PAID FOR POLES UNTIL LUMINAIRES ARE INSTALLED. 10.
- NO MATERIALS SHALL BE DELIVERED TO THE JOB SITE UNTIL ALL PERTINENT EQUIPMENT SUBMITTALS HAVE BEEN REVIEWED BY THE OWNER'S REPRESENTATIVE.
- 12. THE EXACT LOCATIONS OF ALL UTILITIES SHALL BE VERIFIED BY THE CONTRACTOR BEFORE THE INSTALLATION OF ANY COMPONENTS OF THE LIGHTING SYSTEM. FOR THE LOCATIONS OF THE UTILITIES, CALL JULIE TOLL FREE AT 1-800-892-0123.
- IT SHALL BE THE CONTRACTOR'S RESPONSIBILITY TO MARK THE PROPOSED LOCATIONS OF ALL LIGHT POLES AND LIGHTING CONTROLLERS FOR EXAMINATION AND CONFIRMATION WITH THE OWNER'S REPRESENTATIVE. ALL UTILITIES SHALL BE LOCATED PRIOR TO MARKING PROPOSED LOCATIONS.
- GROUNDING CONNECTIONS AT THE FOUNDATION SHALL BE MECHANICAL TYPE UL LISTED FOR DIRECT BURIAL USE, AS SPECIFIED, AND SHALL BE REVIEWED BY THE OWNER'S REPRESENTATIVE PRIOR TO POURING CONCRETE OR BACKFILLING, AS APPLICABLE.
- THE INSTALLATION OF BURIED WARNING TAPE, SHALL BE REVIEWED BY THE RESIDENT ENGINEER PRIOR TO BACKFILLING OR DURING PLOWING OPERATIONS. AS APPLICABLE.
- THE CONTRACTOR SHALL BE RESPONSIBLE FOR THE ESTABLISHMENT OF THE TOP OF FOUNDATION ELEVATION WITH THE FINISHED GRADE.
- IT IS THE CONTRACTOR'S RESPONSIBILITY FOR TIMELY NOTIFICATION AND COORDINATION WITH THE ELECTRICAL UTILITY COMPANY FOR SERVICE TO THE PROPOSED LIGHTNG SYSTEM(S).
- THE CONTRACTOR SHALL LABEL ALL WIRES WITH WIRE MARKERS INDICATING THE CIRCUIT ID IN EVERY CONTROLLER, POLE BASE, HAND HOLE AND SPLICE/CONNECTION POINT. WIRE MARKERS SHALL BE MECHANICALLY FASTENED WHITE PLASTIC, TYPE "PLM" AS MANUFACTURED BY PANDUIT OR EQUAL.
- EQUIPMENT GROUND CONDUCTORS SHALL BE SPLICED AND BONDED AT EACH LIGHT POLE OR OTHER PIECE OF EQUIPMENT PER ARTICLE 806 OF THE STANDARD SPECIFICATIONS.
- 20. THE LIGHTING CONTROLLER TOGETHER WITH ALL OF ITS COMPONENTS SHALL BE UL LISTED AS AN
- ALL DISTURBED AREA WHERE RESTORATION IS NOT COVERED BY APPLICABLE SECTIONS OF THE SPECIAL PROVISIONS MUST BE RESTORED TO THE SATISFACTION OF THE OWNER'S REPRESENTATIVE. THE WORK WILL BE CONSIDERED AS INCLUDED IN THE CONTRACT. SEPARATE PAYMENT WILL NOT BE MADE.
- CONTRACTOR SHALL BE RESPONSIBLE FOR ANY DAMAGE TO ALL DISTURBED AREAS WITHIN THE PROJECT LIMITS INCLUDING ALL ABOVE AND BELOW GRADE APPURTENANCES. THE CONTRACTOR SHALL REPAIR ALL DAMAGE TO THE SATISFACTION OF THE OWNER'S REPRESENTATIVE.
- THE WORK PERFORMED UNDER THIS CONTRACT SHALL IN NO WAY INTERFERE WITH THE NORMAL OPERATION OF ANY EXISTING UTILITY SERVICE. THE CONTRACTOR SHALL FURNISH ALL NECESSARY ITEMS OF EQUIPMENT REQUIRED TO MAINTAIN SUCH NORMAL OPERATION AT NO ADDITIONAL COST TO THE OWNER, THE COST ASSOCIATED FOR THIS WORK SHALL BE CONSIDERED AS INCLUDED IN THE COST OF THE CONTRACT. THE COST OF THE CONTRACT.
- 24. THE ELECTRICAL CONTRACTOR SHALL FURNISH TWO SETS OF FULL SIZE RECORD DRAWINGS TO THE OWNER'S REPRESENTATIVE UPON COMPLETION OF THE LIGHTING AND ELECTRICAL IMPROVEMENTS. THE DRAWINGS SHALL SHOW THE INSTALLED LOCATIONS OF ALL LIGHT POLES, UNDERGROUND CONDUITS/WIRING, HANDHOLES, JUNCTION BOXES & CONTROLLER CABINETS. THE DRAWINGS WILL BE REVIEWED BY THE OWNER'S REPRESENTATIVE.
- 25. THE CONTRACTOR SHALL PROVIDE A GUARANTEE FOR ALL MATERIAL AND WORKMANSHIP FOR ONE YEAR AFTER THE DATE OF ACCEPTANCE.
- 26. THE CONTRACTOR SHALL PERFORM ELECTRICAL TESTING IN THE PRESENCE OF THE OWNER'S REPRESENTATIVE. THE ELECTRICAL TESTING SHALL BE IN ACCORDANCE WITH THE STANDARD SPECIFICATIONS.

F.A.P. RTE.	SECTION	COUNTY	TOTAL SHEETS	SHEE T NO.
643	. 09-00001-00-LT	STARK	7	2
		CONTRACT	NO. 8	39564
FED. R	DAD DIST. NO. 4 ILLINOIS FED. A	ID PROJECT		

QUANTITY

-50

0.01

50

5026

4470

25

190 50

228

(1

800 2,550

SUMMARY OF QUANTITIES

			CODE NO.	DESCRIPTION	UNIT
SIDEWALK REMOVAL			***************************************		
STATION	REMOVE	REPLACE	21101625	TOPSOIL FURNISH AND PLACE, 6"	SO YD
SEVENTH ST.	SF SF	SF ·	25000210	SEEDING, CLASS 24	ACRE
9+78 TO 10+13 R	0	143	25000400	NITROGEN FERTILIZER NUTRIENT	. LB
12+25 TO 12+45 R	75	90 75	25000500	PHOSPHORUS FERTILIZER NUTRIENT	LB ·
9+79 L 9+79 R	75	75	25000600	POTASSIUM FERTILIZER NUTRIENT	LB
10+45 L	75	75	25100630	EROSION CONTROL BLANKET	SO YD
10+45 R	75	75	△ •42400420	PORTLAND CEMENT CONCRETE SIDEWALK, 4" SPECIAL	SO FT
11+09 L	75	75	△ 42400800	DETECTABLE WARNINGS	SO FT
11+08 R	75	75			SO FT
11+62 R	75	75	Δ •44000600	SIDEWALK REMOVAL	SQ YD
11+66 L	75	75	△ 44201785	CLASS D PATCHES, TYPE 1, 12 INCH	
12+35 R	75	75	67100100	MOBILIZATION	L SUM
12+72 L	75	75	•70102620	TRAFFIC CONTROL AND PROTECTION, STANDARD 701501	L SUM
14+05 R	75	75	72000100	SIGN PANEL - TYPE 1	SQ FT
14+08 L	75	75	72900110	METAL POST - TYPE A	EACH
14+64 L	. 75	75	80400100	ELECTRIC SERVICE INSTALLATION	EACH
14+64 R	75	75	81018600	CONDUIT PUSHED, 21/2" DIA. GALV. STEEL	FOOT
15+09 L	75	75	81018900	CONDUIT PUSHED, 4" DIA, GALV, STEEL	FOOT
15+09 R	75	75	1		FOOT
15+49 L	75	75	81028030	CONDUIT, BORED AND PULLED, COILABLE NON-METALLIC CONDUIT, 1"	
15+49 R	75	75	81400730	HANDHOLE, COMPOSITE CONCRETE	EACH
WILLIAMS ST. 21+80 L	SF 75	SF 75	82102150	LUMINAIRE, SODIUM VAPOR, HORIZONTAL MOUNT, 150 WATT	EACH
21+98 R	75	75	83600200	LIGHT POLE FOUNDATION, 24" DIAMETER	FOOT
22+56 L	75	75	•X0326654	ORNAMENTAL LIGHT UNIT COMPLETE	EACH
22+56 R	75	75	•x0321766	LIGHT POLE, SPECIAL (DECORATIVE ORNAMENTAL)	EACH
23+24 R	75	75	•XX005560	LIGHT POLE, ALUMINUM, 25 FT. M.H., 6 FT. MAST ARM	EACH
23+32 L	75	75	81603800	UNIT DUCT, 600V. 8-1/C NO. 8, 1/C NO. 8 GROUND, (XLP-TYPE USE), 11/2" DIA. POLYETHYLENE	FOOT
23+93 R	75	75	7 * '	UNIT DUCT, 600V, 6-1/C NO. 8, 1/C NO. 8 GROUND, (XLP-TYPE USE), 1/2" DIA. POLYETHYLENE	FOOT
30+39 L	75	75	81603600	the state of the s	•
31+14 L	. 75	75	82500335	LIGHTING CONTROLLER PEDESTAL MOUNTED 240 VOLT 100 AMP	EACH
31+24 R	75	75] '		•
31+27 TO 33+83 L	2112	2435]	INDICATES SPECIAL PROVISION	
31+90 R	75	75	_	INDICATES THAT ALL UNIT DUCT SHALL BE DIRECTIONALLY BORED AND PULLED. THE COST OF	F THE DIRECTIONAL
32+65 R	75	75].	BORING SHALL BE INCLUDED IN THE UNIT PRICE BID FOR EACH OF THE UNIT DUCT PAY ITEM	S. SEE SHEET *3 OF T
33+40 TO 33+70 R	108	108	1	AND CUEET AC OF 7 FOR CONDUIT SCHEDUIFS	

AND SHEET *6 OF 7 FOR CONDUIT SCHEDULES

△ SPECIALTY ITEMS

SOILS				
	TOPSOIL	SEEDING	FERTILIZER*	EROSION CONTROL BLANKET
STATION	SY	ACRE	LB	SY
22+56 L	25	0.005	0.5	25
23+32 L	25	0.005	0.5	25
TOTAL	50	0.1	1	50
*1/3 NITROGEN 1/3 PI	HOSPHOROUS 1	/3 POTASSIUN	1	

5026

4470

LIGHTING LEGEND

STATION	SF
32+24 L	10

TOTAL

CLASS D PATCHES SCHEDULE					
STATION SY					
10+80 R	3.9				
11+35 R	3.9				
12+48 CROSS	4.7				
13+98 CROSS	5.5				
31+06 R	2.3				
33+65 CROSS	4.7				
TOTAL	25				

PROPOSED 150W HIGH PRESSURE SODIUM COBRA HEAD TYPE LUMINAIRE MOUNTED 25 FT ABOVE GRADE ON A 6' DECORATIVE ARM (REFER TO INTERSECTION LIGHT POLE DETAIL FOR MODEL INFORMATION) PROPOSED 100W HIGH PRESSURE SODIUM ACORN TYPE LUMINAIRE MOUNTED ON A 16 FT DECORATIVE COMPOSITE TYPE LIGHT POLE (REFER TO DECORATIVE LIGHT POLE DETAIL FOR MODEL INFORMATION) PROPOSED LIGHTING CONTROLLER CABINET PROPOSED COMPOSITE CONCRETE HANDHOLE

AS SHOWN ON PLAN RIGID GALVANIZED STEEL (RGS) CONDUIT SLEEVE FOR UNIT DUCT UNDER PAVEMENT

SCALE: N.T.S. SHEET NO. 2 OF 7 SHEETS STA.

WIRE IN SCH 40 HDPE UNIT DUCT.

— 85'-4" RGS-P (P) PUSHED OR (T) TRENCHED PROPOSED RGS ELECTRIC SERVICE CONDUIT

- POLE NUMBER PI3-CKT A - CIRCUIT IDENTIFIER STA. 23+95.0 L --- STATION LOCATION 6.0' B.O.C. OFFSET (FROM BACK OF CURB) EXISTING COBRA HEAD TYPE LUMINAIRE MOUNTED ON A WOOD POLE WITH A 5' ARM, TO REMAIN ~~ EXISTING LIGHT POLE TO BE REMOVED BY ELECTRIC UTILITY COMPANY (CONTRACTOR TO COORDINATE W/CITY AND ELECTRIC SERVICE COMPANY) •> EXISTING AERIAL WIRES TO BE REMOVED BY ELECTRIC UTILITY COMPANY (CONTRACTOR TO COORDINATE W/CITY AND ELECTRIC SERVICE COMPANY) EXISTING SANITARY SEWER EXISTING STORM SEWER EXISTING WATERMAIN


EXISTING GAS LINE


EXISTING OVERHEAD WIRES

DESIGNED GAH REVISED FILE NAME = USER NAME = DWright. :\09519\C:v:1\NOT_090519_02.SHT DRAWN REVISED KBCHECKED AJD REVISED PLOT SCALE = 40' PLOT DATE = 2/1/2010 DATE 11-06-2009 REVISED

STATE OF ILLINOIS **DEPARTMENT OF TRANSPORTATION**

DOWNTOWN LIGHTING PROJECT GENERAL NOTES SCHEDULES AND SUMMARY OF QUANTITIES

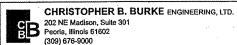


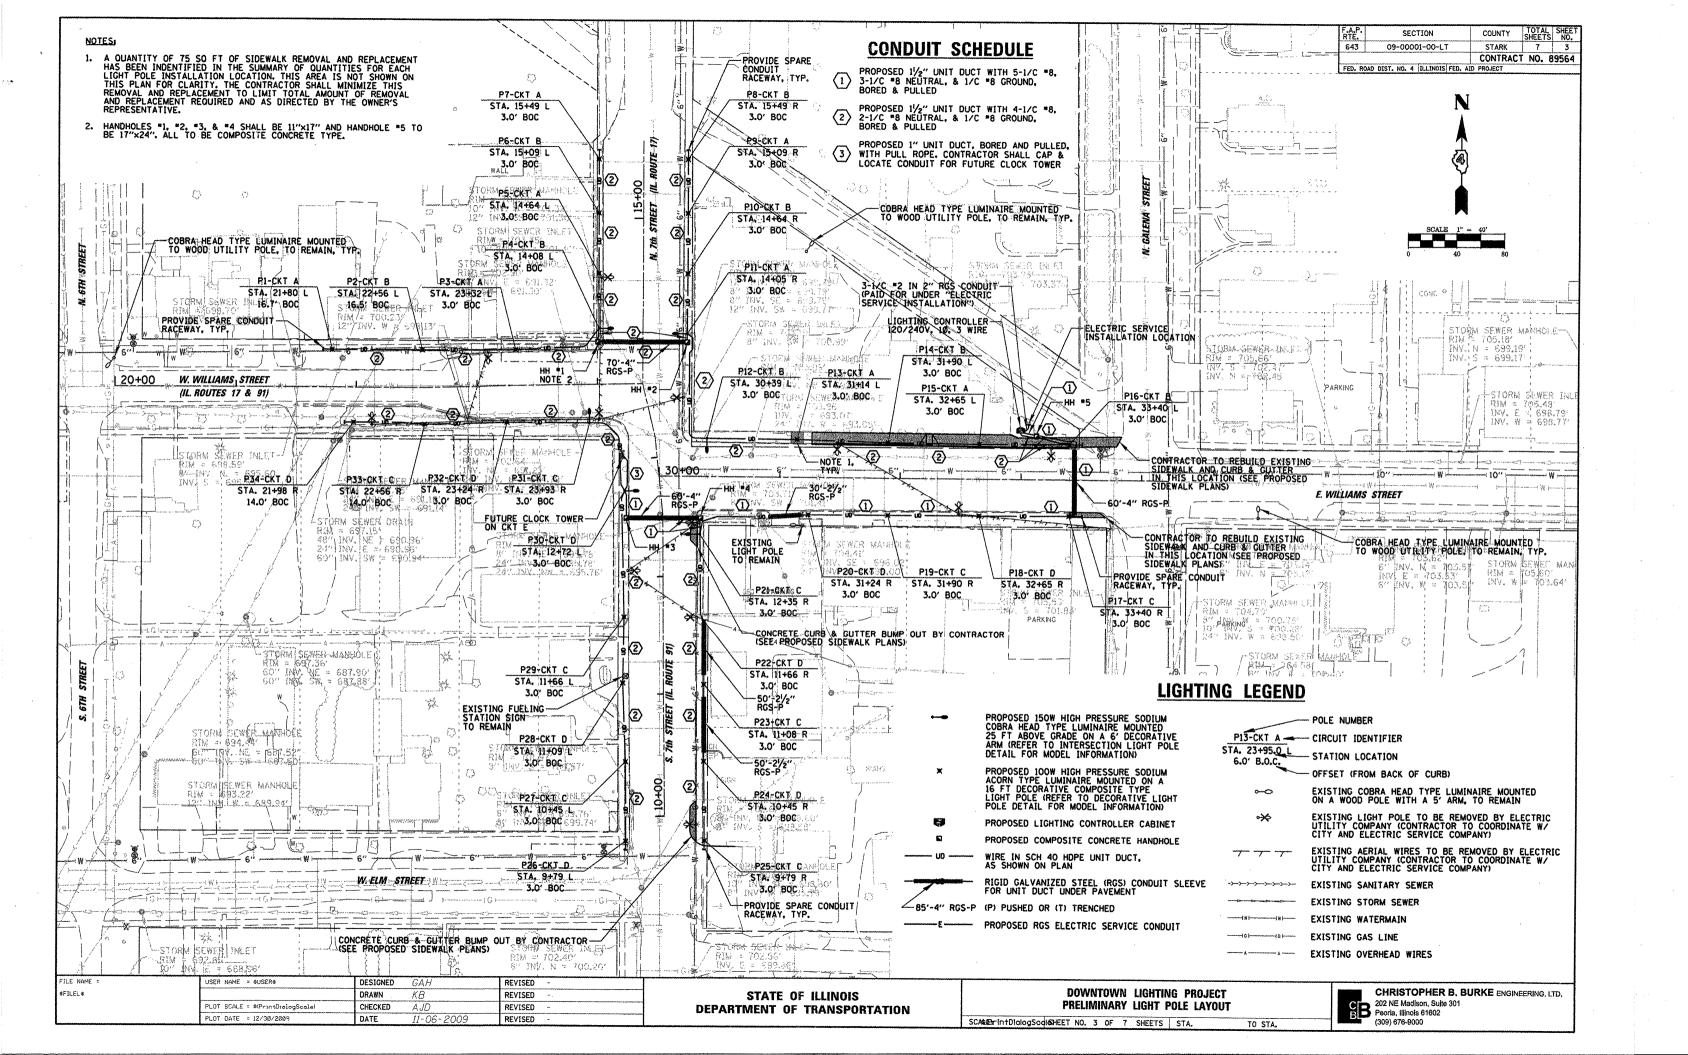

ITEM	COPOLITALITAN	T
	SPECIFICATION	MFG./MODEL NO. OR APPROVED EQUAL
(1) MAIN CIRCUIT BREAKER	100 AMPERE, 2P, 240V SERVICE RATING, 22KAIC	SIEMENS NO. ED42B100
(2) LAMPHOLDER CIRCUIT BREAKER	20 AMPERE, 1P, 120V RATING, 22KAIC	SIEMENS NO. ED41B020
3 PHOTOELECTRIC CONTROL CIRCUIT BREAKER	15 AMPERE, 1P, 120V RATING, 22KAIC	SIEMENS NO. ED41B015
4) NOT USED		
(5) CABINET RECEPTACLE AND BOX	COMMERCIAL GRADE GFCI 20A/120V, MOUNTED IN A WEATHERPROOF CAST ALUMINUM SINGLE GANG BOX WITH WEATHERPROOF COVER	RECEPTACLE: LEVITON NO. 8899, BOX: APPLETON NO. WSM150 COVER: APPLETON NO. WHG1
6 CABINET LIGHT AND BOX	120V WEATHERPROOF LAMPHOLDER MOUNTED IN A CAST ALUMINUM BOX & EXT. GRADE 100W LAMP	LIGHT & BOX: RAB NO. VX100DG
7 CONTACTOR	100 AMPERE, 2 POLE, 120 V COIL, ELEC HELD	SQUARE D NO. 8903 SQG 1 VO2
BRANCH LINE CIRCUIT BREAKERS	6 - 30 AMPERE, 2P, 240V RATING, 22KAIC	SIEMENS NO. ED42B030
POWER DISTRIBUTION BLOCK	600 VOLT, INSULATED, SIZE AS REQUIRED	MARATHON
(10) SERVICE CABLES	3-600V (XLP-TYPE USE) NO. 2	N/A
(1)LAMPHOLDER WIRE	2-600V XLP NO. 12	N/A
(2) CONTROL WIRE	2-600V XLP NO. 12	N/A
(3) SURGE ARRESTOR	10 K AMPERE RATING	SQUARE D NO. SDSA 1175
(4) PHOTOELECTRIC CONTROL WIRE	3-600V XLP NO. 12	N/A
(15) LIGHT SWITCH	20A/12OV, SPST TYPE SWITCH IN 4" BOX W/ COVER	HUBBELL NO. CSB120
(6) HAND-AUTO-OFF CONTROL SWITCH	20A, 3 POS. MTD IN CAST ALUM. ENCLOSURE	SQUARE D NO. 9001 KYK 111
(1) PHOTOCELL	120V, MTD. ON CABINET, DELAY TYPE, SPST-NC	FISHER PIERCE NO. FPFA-105M
(18) BACK PANEL	1/2" THICK SOLID PHENOLIC LAMINATE	ARBORON
19 FUTURE CLOCK CIRCUIT BREAKER	30 AMPERE, 1P, 120V RATING, 22KAIC	SIEMENS NO. ED41B030

- ALL ITEMS LISTED IN LIGHTING CONTROLLER COMPONENT SCHEDULE SHALL BE CONSIDERED INCIDENTAL TO THE PRICE BID FOR "LIGHTING CONTROLLER" INCLUDING CABINET AND FOUNDATION.
- 2. THE LIGHTING CONTROLLER TOGETHER WITH ALL OF ITS COMPONENTS SHALL BE UL LISTED AS AN "ENCLOSED INDUSTRIAL CONTROL PANEL" UNDER UL508A.
- 3. CONNECTION OF SURGE ARRESTOR TO LOAD SIDE OF MAIN CIRCUIT BREAKER SHALL NOT BE "DOUBLE LUGGED."

LIGHTING CONTROLLER COMPONENT SCHEDULE

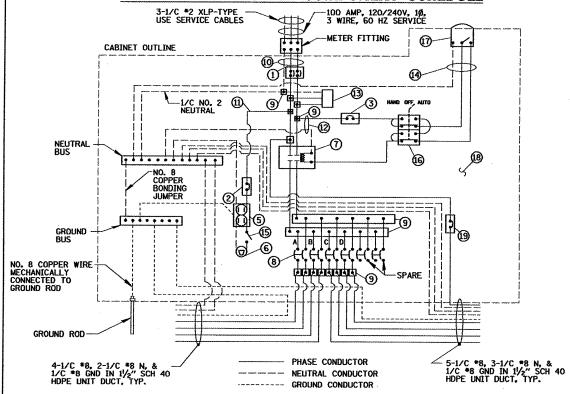

LIGHTING CONTROLLER WIRING DETAIL

	FILE NAME =	USER NAME = CHENN	DESIGNED	GAH	REVISED	-	
1	N:\wyomzng\090519\Mech\LDT_090519_04.SH		DRAWN	KB	REVISED	- ,	
		PLOT SCALE = 20"	CHECKED	AJD	REVISED		
		PLOT DATE = 2/1/2010 .	DATE	11-06-2009	REVISED	-	


100W ORNAMENTAL LUMINAIRE 150W ROADWAY LUMINAIRE RECEPTACLES OR LOAD TOTAL CIRCUIT LOAD CIRCUIT LOAD/FIXT. (WATTS) LOAD/FIXT. LOAD/FIXT (WATTS) QTY. QTY. QTY. (WATTS) AMPS (VOLTS) 195 2587 W 180 10.8A (240V) В 6 136 2 195 8 180 2646 W 11.0A (240V) С 136 2 195 9 180 2962 W 12.3A (240V) D 136 195 180 2903 V 12.1A (240V) Ε N/A N/A N/A N/A 1440 1440 V 12A (120V) TOTAL 6 28 N/A N/A 35 12,538 52.2A (240V)

SECTION 643 STARK 09-00001-00-LT CONTRACT NO. 89564


ALL CONDUCTORS IN THE UNIT DUCT RUNS SHALL HAVE INDIVIDUALLY COLOR CODED INSULATION THROUGHOUT THE ENTIRE LENGTH. OF THE CONDUCTOR. THE COLOR IDENTIFICATION FOR THE SYSTEM GROLIND SHALL BE GREEN. THE IDENTIFICATION FOR THE NEUTRAL SHALL BE WHITE. THE FOUR (4) PHASE CONDUCTORS SHALL BE IN ACCORDANCE WITH LOCAL AND THE I.D.O.T. STANDARD SPECIFICATIONS FOR WIRING MULTI-CONDUCTOR CIRCUITS IN SINGLE UNIT DUCT CONDUCTOR CIRCUITS IN SINGLE UNIT DUCT RUNS.

LIGHTING CONTROLLER CIRCUIT LOADS

LIGHTING CONTROLLER -ENCLOSURE ARRANGED FOR MOUNTING ON PEDESTAL BASE

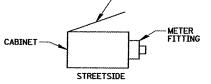

CABINET METER FITTING & DOOR ORIENTATION

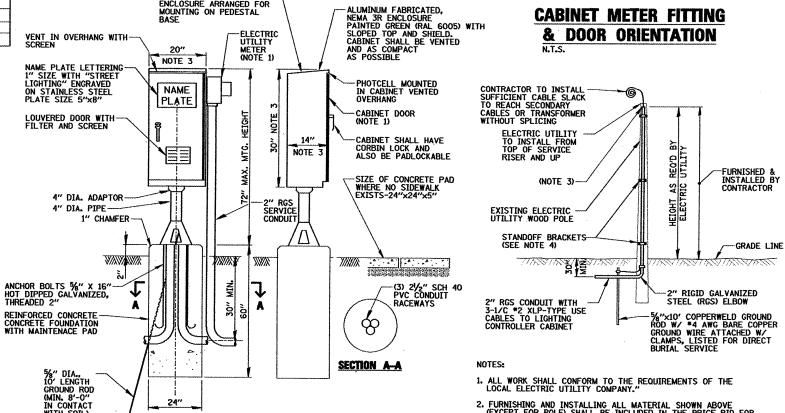

- 2. FURNISHING AND INSTALLING ALL MATERIAL SHOWN ABOVE (EXCEPT FOR POLE) SHALL BE INCLUDED IN THE PRICE BID FOR "ELECTRIC SERVICE INSTALLATION".
- 3. CONTRACTOR TO PROVIDE AN APPROVED WEATHERHEAD OR A CONDUIT BUSHING AND RACEWAY SEAL AT TOP OF RISER.
- 4. AMEREN-CILCO TO INSTALL SERVICE RISER STANDOFF BRACKETS & PROVIDE STRAPS TO CONTRACTOR TO INSTALL. COORDINATE ALL WORK WITH SUSAN SULMONETTI FROM AMEREN-CILCO AT (309) 256-6550.

PROPOSED LIGHTING CONTROLLER **CABINET AND FOUNDATION**

LONGITUDINAL SECTION

3. CABINET DIMENSIONS SHOWN ARE APPROXIMATE, CABINET SHALL BE AS COMPACT AS POSSIBLE, CONTRACTOR TO COORDINATE,

1. SEE DETAIL THIS SHEET FOR CABINET METER FITTING & DOOR ORIENTATION. 2. ALL ITEMS SHOWN ABOVE (INCLUDING FOUNDATION SHALL BE INCLUDED IN THE PRICE BID FOR "LIGHTING CONTROLLER", EXCEPT FOR THE SERVICE CONDUIT/WIRE WHICH WILL BE PAID FOR UNDER "ELECTRIC SERVICE INSTALLATION".

ELECTRIC UTILITY OVERHEAD CONNECTION POLE

DOWNTOWN LIGHTING PROJECT LIGHTING DETAILS (1 OF 3)

CHRISTOPHER B. BURKE ENGINEERING, LTD. 202 NE Medieon, Suite 301 Peorla, Illinois 61602

STATE OF ILLINOIS **DEPARTMENT OF TRANSPORTATION**

WITH SOIL)

SCALE: N.T.S. SHEET NO. 4 OF 7 SHEETS STA.

LUMINAIRE AND POLE SCHEDULE

LIGHT POLE IDENTIFIER		l	UMINAIR		LC	OCATION
	WATTAGE	MTG HT	CKT ID	POLE TYPE	STATION	OFFSET
P1	100	16'	Α	ORNAMENTAL	21+80 L	16.7' B.O.C.
P2	100	16'	В	ORNAMENTAL	22+56 L	16.5' B.O.C.
P3	100	16′	A	ORNAMENTAL	23+32 L	3' B.O.C.
P4	150	25'	В	INTERSECTION	14+08 L	3' B.O.C.
P5	100	16'	Α	ORNAMENTAL	14+64 L	3' B.O.C.
P6	100	16'	В	ORNAMENTAL	15+09 L	3' B.O.C.
P7	100	16'	Α	ORNAMENTAL	15+49 L	3' B.O.C.
P8	100	16'	В	ORNAMENTAL	15+49 R	3' B.O.C.
P9	100	16'	Α	ORNAMENTAL	15+09 R	3' B.O.C.
P10	100	16'	В	ORNAMENTAL	14+64 R	3' B.O.C.
P11	150	25'	Α	INTERSECTION	14+05 R	3' B.O.C.
P12	150	25'	В.	INTERSECTION	30+39 L	3' B.O.C.
P13	100	16'	Α	ORNAMENTAL	31+14 L	3' B.O.C.
P14	100	16'	В	ORNAMENTAL	31+90 L	3' B.O.C.
P15	100	16'	Α	ORNAMENTAL	32+65 L	3' B.O.C.
P16	100	16'	В	ORNAMENTAL	33+40 L	3' B.O.C.
P17	100	16'	С	ORNAMENTAL	33+40 R	3' B.O.C.
P18	100	16'	D	ORNAMENTAL.	32+65 R	3' B.O.C.
P19	100	16'	С	ORNAMENTAL	31+90 R	3' B.O.C.
P20	100	16'	D	ORNAMENTAL	31+24 R	3' B.O.C.
P21	150	25'	С	INTERSECTION	12+35 R	3' B.O.C.
P22	100	16'	D	ORNAMENTAL	11+66 R	3' B.O.C.
P23	100	16'	С	ORNAMENTAL	11+08 R	3' B.O.C.
P24	100	16'	D	ORNAMENTAL	10+45 R	3' B.O.C.
P25	100	16'	С	ORNAMENTAL	9+79 R	3' B.O.C.
P26	100	16'	D	ORNAMENTAL	9+79 L	3' B.O.C.
P27	100	16'	С	ORNAMENTAL	10+45 L	3' B.O.C.
P28	100	16'	D	ORNAMENTAL	11+09 L	3' B.O.C.
P29	100	16'	С	ORNAMENTAL	11+66 L	3' B.O.C.
P30	150	25'	D	INTERSECTION	12+72 L	3' B.O.C.
P31	150	25'	C	INTERSECTION	23+93 R	3' B.O.C.
P32	100	16'	D	ORNAMENTAL	23+24 R	3' B.O.C.
P33	100	16'	С	ORNAMENTAL	22+56 R	14' B.O.C.
P34	100	16'	D	ORNAMENTAL	21+98 R	14' B.O.C.

	150W HIGH PRESSURE SODIUM COBRA HEAD TYPE LUMINAIRE W/ MC III OPTICS AND FACTORY PAINTED BLACK FINISH 6'-0" ALUMINUM DECORATIVE ARM W/ FACTORY PAINTED BLACK FINISH TENON TYPE MOUNTING	
20A-120V GFCI RECEPTAC PAINTED BLACK TO MATC LIGHT POLE WITH A WEATHERPROOF COVER RA FOR IN-USE (MODEL NO. ARLINGTON GOVC)	18" 18"×30" BANNER (BY OTHERS)	


LUMINAIRE MODEL INFORMATION					
M	ANUFACTURER	LUMINAIRE MODEL NO.	IES PHOTOMETRIC CURVE		
A	G.E.	MDCA15SOM12FMC31NU	GE450387.IES		
В	AMERICAN ELECTRIC LIGHTING	31515SMRMT2R3FG4BBK ULNRLCECBLSSPLHPBF	315-15S-R3-FGHP.IES		

	LIGHT	POLE MODEL INFO	RMATION	
M	ANUFACTURER	LIGHT POLE MODEL NO.	DECORATIVE ARM	DECORATIVE BASE
A.	VALMONT	CITY QUARTZ SERIES (CQA816F8LT250P3BK)	PTAAV481LO T3PBK	VALMONT C SERIES
В	HAPCO	A4C25D8-TF0/BA27100	HAPCO	HAPCO ARLEN 8X24X28


NOTES

- 1. LIGHT POLES INCLUDING BANNER ARMS SHALL MEET WIND LOADING & VIBRATION REQUIREMENTS ACCORDING TO THE LATEST AASHTO STANDARDS AND ARTICLE 1069.01 IN STANDARD SPECIFICATIONS FOR ROAD AND BRIDGE CONSTRUCTION. ALL STEEL SHALL BE FROM A DOMESTIC SOURCE.
- 2. THE LIGHT STANDARD SHALL MEET THE ILLUMINATION REQUIREMENTS AS SPECIFIED IN THE LUMINAIRE PERFORMANCE TABLES IN THE SPECIFICATIONS, ALL LUMINAIRES SHALL HAVE A MULTI-TAP BALLAST WIRED FOR 240 VOLTS OPERATION.
- 3. ALL LIGHT STANDARDS SHALL BE FROM THE SAME MANUFACTURER, OR APPROVED EQUAL.
- 4. LIGHT POLE SHALL BE U/L LISTED.
- 5. ALL LUMINAIRES TO BE PROVIDED WITH NON CYCLING LAMPS.


INTERSECTION LIGHT POLE DETAIL

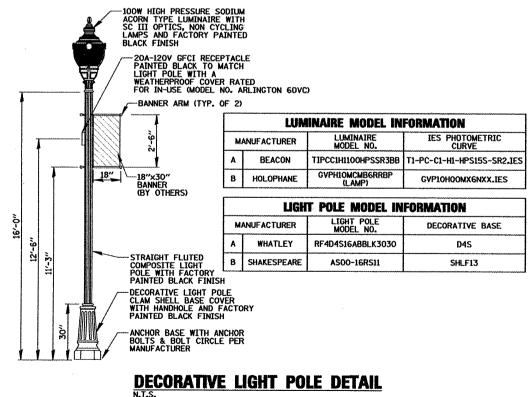

643 09-00001-00-LT STARK 7 5 CONTRACT NO. 89564 FED. ROAD DIST. NO. 4 | ILLINOIS | FED. AUD PROJECT

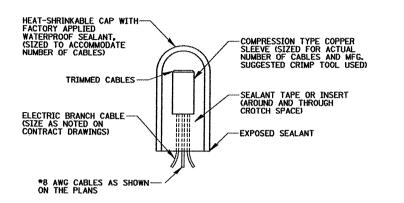

SPLICING ELECTRIC CABLE

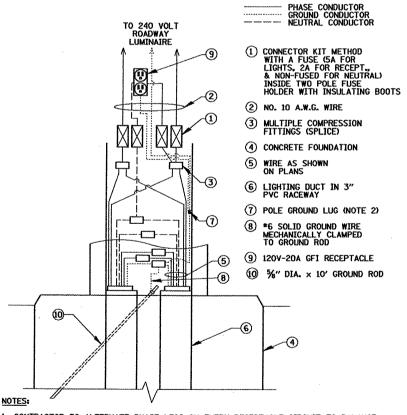

- 1. CONTRACTOR TO ALTERNATE PHASE LEGS ON EVERY RECEPTACLE CIRCUIT TO BALANCE RECEPTACLE LOAD ACCORDINGLY.
- NO POLE GROUND LUGS ARE PROVIDED ON COMPOSITE LIGHT POLES. CONTRACTOR SHALL EXTEND GROUND CONDUCTOR TO LUMINAIRE AT THESE LOCATIONS.

HANDHOLE WIRING DIAGRAM

TO STA.


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wyomzng\090519\Mech\LDT_090519_05.SH1		DRAWN	KB	REVISED	-	STATE
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	PLOT DATE = 2/1/2010	DATE	11-06-2009	REVISED	-	

STATE OF ILLINOIS
DEPARTMENT OF TRANSPORTATION

DOWNTOWN LIGHTING PROJECT LIGHTING DETAILS (2 OF 3)


SCALE: N.T.S. SHEET NO. 5 OF 7 SHEETS STA.

CHRISTOPHER B. BURKE ENGINEERING, LTD.
202 NE Mediaon, Suits 301
Peoria, Minols 61602
(309) 678-9000

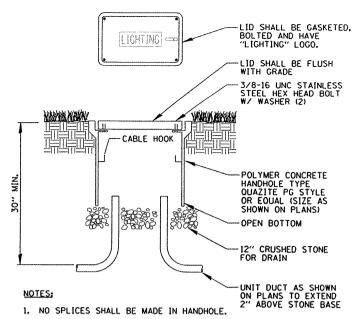

- 2. POLYMER CONCRETE HANDHOLE AND LID SHALL BE GREEN IN LANDSCAPED AREAS AND MATCH COLOR IN CONCRETE/BRICK AREAS.
- 3. BOX & LID SHALL MEET/EXCEED ANSI TIER 15 LOADING REOUIREMENTS AND BE UL LISTED.

POLYMER CONCRETE HANDHOLE

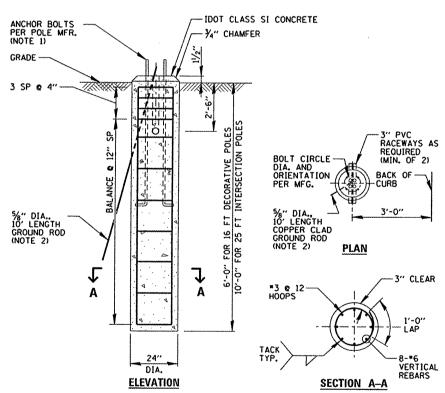

NOTES:

- 1. FOUNDATIONS SHALL NOT PROTRUDE MORE THAN 4" ABOVE FINISHED GRADE, INCLUDING ANCHOR RODS.
- 2. GROUND ROD SHALL BE CAST INTO CONCRETE FOUNDATION WITH 8 FEET IN CONTACT WITH SOIL.
- 3. FOUNDATIONS SHALL BE VIBRATED IN ACCORDANCE WITH IDOT STANDARD PRACTICES.
- 4. ALL ABOVE ITEMS INCLUDING CONCRETE, REINFORCEMENT, RACEWAYS AND FORMWORK SHALL BE INCLUDED IN THE "LIGHT POLE FOUNDATION" PAY ITEM.

CONCRETE FOUNDATION DETAIL

N.T.S.


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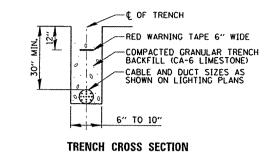
STATE OF ILLINOIS
DEPARTMENT OF TRANSPORTATION

DOWNTOWN LIGHTING PROJECT LIGHTING DETAILS (3 OF 3)

SCALE: N.T.S. SHEET NO. 6 OF 7 SHEETS STA. TO STA.

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Peoria, Illinois 61602



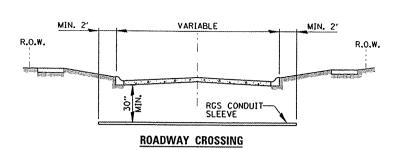

643

SECTION


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COUNTY TOTAL SHEE SHEETS NO.
STARK 7 6

CONTRACT NO. 89564

- ① SLEEVE SHALL BE HEAVY WALL RIGID GALVANIZED STEEL (RGS) CONDUIT.
- 2 SLEEVE SHALL EXTEND A MINIMUM OF 2 FT. BEYOND BACK OF CURB.
- 3 SLEEVE SHALL BE A MINIMUM OF 30" BELOW ROADWAY OR CURB BOTTOM.

ELECTRIC CONDUIT INSTALLATION

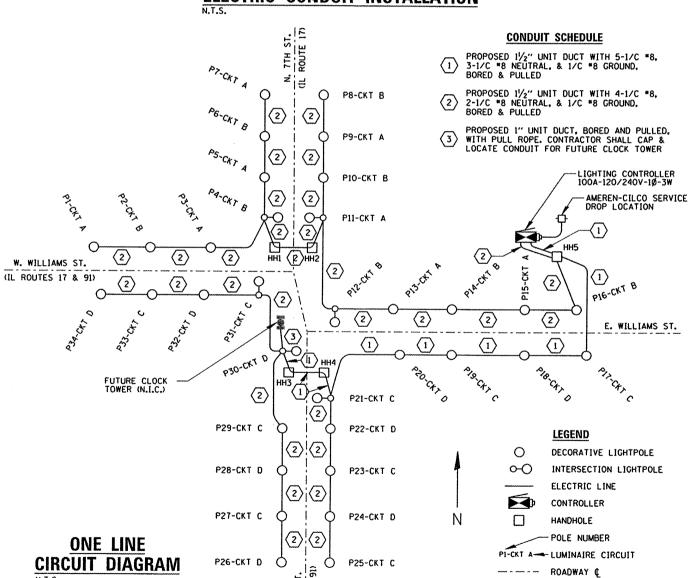

FILE NAME =

\$FILEL\$

