#### **INDEX OF SHEETS**

1 COVER SHEET & HIGHWAY STANDARDS
2 GENERAL NOTES AND TYPICAL SECTION
3 SUMMARY OF QUANTITIES
4 SCHEDULES
5 PLAN & PROFILE
6 GRATE DETAIL
7 GENERAL DETAIL SHEET
8 EXISTING STRUCTURE
9 BOX CULVERT DETAIL
10 BOX CULVERT END SECTION DETAIL
11 CROSS SECTION

#### **STANDARDS**

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STANDARD SYMBOLS, ABBREVIATIONS AND PATTERNS 000001-05 001006 DECIMAL OF AN INCH AND OF A FOOT TEMPORARY EROSION CONTROL SYSTEMS 280001-05 RIGHT-OF-WAY MARKERS 666001-01 PERMANENT SURVEY MARKERS 667101-01 OFF-ROAD OPERATIONS 2L, 2W, MORE THAN 15' (4.5 m) AWAY 701001-02 701006-03 OFF-ROAD OPERATIONS 2L, 2W, 15' (4.5 m) TO 24" (600 mm) FROM PAVEMENT EDGE OFF-ROAD MOVING OPERATIONS 2L, 2W, DAY ONLY 701011-02 LANE CLOSURE, 2L, 2W, DAY ONLY, FOR SPEEDS \*\*e" 45 MPH 701201-03 LANE CLOSURE, 2L, 2W, SHORT TIME OPERATIONS 701301-03 LANE CLOSURE, 2L, 2W, SLOW MOVING OPERATIONS DAY ONLY. 701306-02 FOR SPEEDS \*\*e" 45 MPH 701901-01 TRAFFIC CONTROL DEVICES

TYPICAL APPLICATIONS RAISED REFLECTIVE PAVEMENT MARKERS

0 100' 200' 300' -- 1" = 100'
0 10' 20' 30' -- 1" = 10'
0 50' 100' -- 1" = 50'
0 50' 100' -- 1" = 40'
0 50' 100' -- 1" = 30'
0 50' 100' -- 1" = 20'

TYPICAL PAVEMENT MARKINGS

780001-02

781001-03

FULL SIZE PLANS HAVE BEEN PREPARED USING STANDARD ENGINEERING SCALES. REDUCED SIZED PLANS WILL NOT CONFORM TO STANDARD SCALES. IN MAKING MEASUREMENTS ON REDUCED PLANS, THE ABOVE SCALES MAY BE USED.

J.U.L.I.E. JOINT UTILITY LOCATION INFORMATION FOR EXCAVATION 1–800–892–0123 OR 811

PROJECT ENGINEER: JOE KANNEL UNIT CHIEF: PATRICK BRABOY TOWNSHIP: PILOT CONTRACT NO. 66986

## STATE OF ILLINOIS

# **DEPARTMENT OF TRANSPORTATION**


**DIVISION OF HIGHWAYS** 

# PROPOSED HIGHWAY PLANS

FAS ROUTE 1323 (ILL 115) SECTION (102)I

TYPE of IMPROVEMENT— BOX CULVERT REPLACEMENT KANKAKEE COUNTY


C-93-065-10

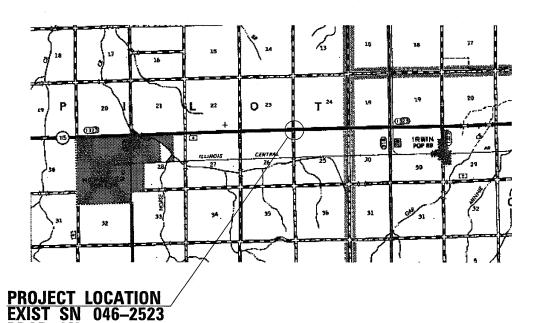

GROSS LENGTH = NET LENGTH = 150 FT. = 0.03 MILE


PROP SN 046-2553

#### P-93-010-10 D-93-026-10

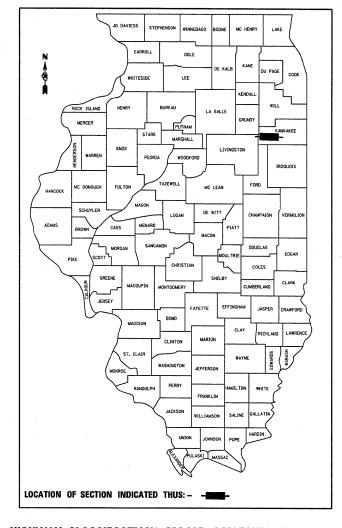

#### HIGHWAY CLASSIFCATIONO MAJOR COLLECTOR (RURAL)

ADT (2009) 2350 P.C. = 85% S.U. = 10% M.U. = 5%

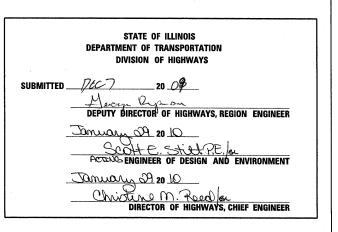

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GENERAL NOTES (Revised May 13, 2009)

THE THICKNESS OF HMA SHOWN ON THE PLANS IS THE NOMINAL THICKNESS. DEVIATIONS FROM THE NOMINAL THICKNESS WILL BE PERMITTED WHEN SUCH DEVIATIONS OCCUR DUE TO IRREGULARITIES IN THE EXISTING SURFACE OR BASE ON WHICH THE HMA IS PLACED.

THE HMA SURFACE OF ALL MAILBOX TURNOUTS, PRIVATE ENTRANCES, COMMERCIAL ENTRANCES, AND SIDE ROADS SHALL BE MADE NEATLY, IN A WORKMANLIKE MANNER, AND SHALL ACCURATELY CONFORM TO THE SHAPES AND DIMENSIONS SHOWN ON THE PLAN DETAILS. IF REQUIRED BY THE ENGINEER, THE CONTRACTOR SHALL BE REQUIRED TO SAW CUT THE HMA SURFACE TO CONFORM TO THE SHAPES AND DIMENSIONS SHOWN ON THE PLAN DETAILS. THIS WORK SHALL BE INCLUDED IN THE COST OF THE HMA SURFACE.

EXCEPT AS NOTED ON THE PLANS, PAVEMENT GRADES SHOWN ARE AT THE TOP OF PAVEMENT SURFACES.

BEFORE ORDERING PIPE CULVERTS OR PIPE DRAINS. THE CONTRACTOR SHALL CONSULT THE ENGINEER FOR EXACT LENGTHS.

THE ENGINEER WILL BE THE SOLE JUDGE CONCERNING CURING TIME FOR THE VARIOUS HMA LIFTS.

FOR STABILIZATION, ALL TYPE III BARRICADES SHALL REQUIRE A MINIMUM OF FOUR SAND BAGS PER BARRICADE.

SEEDING SHALL NOT BE PERMITTED AT ANY TIME WHEN THE GROUND IS FROZEN, WET, OR IN AN UNTILLABLE CONDITION, LOCATIONS TO BE SEEDED WILL BE DETERMINED BY THE ENGINEER.

THE FINISHED EARTHWORK SHALL HAVE A VEGETATION SUSTAINING SOIL COVERING THE TOP FOUR INCHES IN AREAS TO BE SEEDED OR SODDED. THE VEGETATION SUSTAINING SOIL REQUIRED WILL NOT BE PAID FOR SEPARATELY BUT SHALL BE INCLUDED IN THE COST OF SEEDING.

ALL ELEVATIONS REFERRING TO U.S.G.S. MEAN SEA LEVEL DATUM.

ABANDONED UNDERGROUND UTILITIES THAT CONFLICT WITH CONSTRUCTION SHALL BE DISPOSED OF OUTSIDE THE LIMITS OF THE RIGHT OF WAY ACCORDING TO ARTICLE 202.03 OF THE STANDARD SPECIFICATIONS AND AS DIRECTED BY THE ENGINEER. THIS WORK WILL NOT BE PAID FOR SEPARATELY, BUT SHALL BE INCLUDED IN THE COST OF EARTH EXCAVATION.


ANY REFERENCE TO A STANDARD IN THESE PLANS SHALL BE INTERPRETED TO MEAN THE EDITION AS INDICATED BY THE SUBNUMBER SHOWN IN THE LIST OF STANDARDS OR THE COPY INCLUDED IN THESE PLANS.

THE FOLLOWING RATES OF APPLICATION HAVE BEEN USED IN CALCULATING PLAN QUANTITIES:

GRANULAR MATERIALS	2.05	TONS / CU YD
BIT MATERIALS (PRIME COAT)	0.375	GAL / SQ YD
ON AGGREGATE BASES		
FOR ADDITIONAL HMA LIFTS	0.08	GAL / SQ YD
"FOG COAT"		
FOR ADDITIONAL HMA LIFTS	0.05	GAL / SQ YD
"FOG COAT"		
AGGREGATE PRIME COAT	0.002	TONS / SQ YD
HMA RESURFACING	112	LBS / SQ YD / IN
SHORT TERM PAVEMENT MARKING	10	FT /100 FT OF APPLICATION
TEMPORARY DITCH CHECKS	5	TONS AGGREGATE

THE WORK REQUIRED TO CONNECT ANY SEWER TO AN EXISTING DRAINAGE STRUCTURE OR PIPE WILL NOT BE PAID FOR SEPARATELY, BUT SHALL BE CONSIDERED AS INCLUDED IN THE CONTRACT UNIT PRICE BID FOR THE SEWER ITEMS.

THE CONTRACTOR SHALL CONTACT JULIE AT LEAST 48 HOURS PRIOR TO EXCAVATION TO DETERMINE WHICH UTILITIES ARE IN THE AREA.

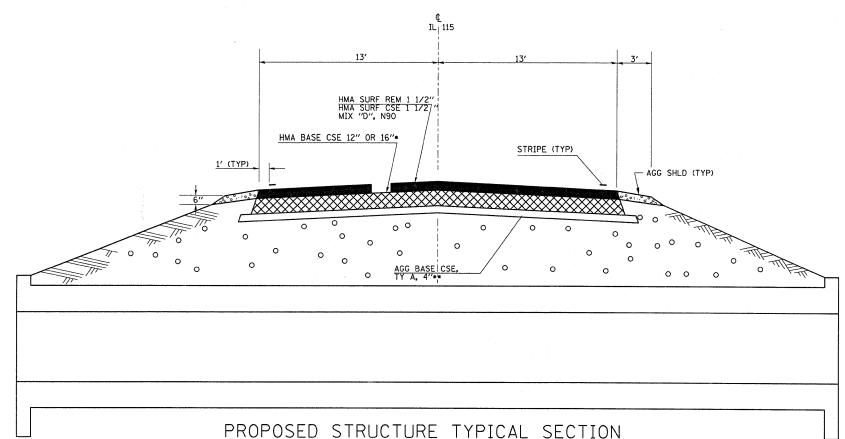

STA 357+98 TO STA 358+12 (@ NEW STRUCTURE) (\*12" HMA BSE CSE \*\*NO AGG BSE CSE) STA 358+23 TO STA 358+37 (@ STRUCTURE REMOVAL) (\*16" HMA BSE CSE \*\*4" AGG BSE CSE)

#### SEQUENCE OF CONSTRUCTION:

- 1. PLACE NEW 8'X3' BOX CULVET
  2. REMOVE EXISTING STRUCTURE
  3. HMA SURF REM 1 1/2", FROM STA 357+50 TO STA 359+00
  (MILL THROUGH HMA BSE CSE 12" OR 16")
- 4. PLACE 1 1/2" SURF CSE

	SURFACE CSE	HMA BINDER (LOWER 4")	HMA BINDER (UPPER 8-12'')
PG GRADE	PG 64-22	PG 58-22	PG 64-22
DESIGN AIR			
VOIDS	4% @ N50	3% @ N30	4% @ N50
MIXTURE	IL 12.5 OR		
COMPOSISION	IL 9.5	IL 19.0	IL 19.0
FRICTION		di d	
AGGREGATE	MIXTURE C		-
DENSITY CONTROL			
LIMITS	CORES	CORES*	CORES

\*MATERIALS SHALL BE COMPACTED TO 93.0-97.4 PERCENT OF THE MAXIMUM THEORETICAL DENSITY, EXCEPT THAT WHEN PLACED AS FIRST LIFT ON AN UNIMPROVED SUBGRADE THE MINIMUM PERCENT COMPACTION SHALL BE 92.0 PERCENT. THE MAXIMUM THEORETICAL DENSITY SHALL BE DETERMINED FROM THE MOVING AVERAGE AS SPECIFIED IN THE QC-QA

\*\* WHEN MORE THAN 20% RAP IS USED, A SOFTER ASPHALT BINDER (PG58-22) MAY BE REQUIRED AS DETERMINED BY THE ENGINEER.

STATE OF ILLINOIS DEPARTMENT OF TRANSPORTATION DISTRICT THREE

Som (

Acting DISTRICT STUDIES & PLANS ENGINEER

DATE:

EXAMINED BY:

DISTRICT CONSTRUCTION ENGINEER DISTRICT MATERIALS ENGINEER

DISTRICT OPERATIONS ENGINEER

ILLINOIS DEPARTMENT OF TRANSPORTATION

**GENERAL NOTES** 

DESIGNED · REVISED FILE NAME = USER NAME = braboupc SECTION COUNTY STATE OF ILLINOIS REVISED **GENERAL NOTES** KANKAKEE 11 2 (102)1 PLOT SCALE = 20.0000 '/ IN. CHECKED REVISED **DEPARTMENT OF TRANSPORTATION** CONTRACT NO. 66986 PLOT DATE = Dec 05, 2009 - 04:00:05 PM DATE REVISED SCALE: SHEET NO. OF SHEETS STA. TO STA. ILLINOIS FED. AID PROJECT

CODE	SUMMARY OF QUAN		TOTAL	CONSTR. TYPE CODE		
NO	ITEM	UNIT	QUANTITY	ROADWAY IOOO	Y007	
20200100	EARTH EXCAVATION	CU YD	44.0	44.0		
20400800	FURNISHED EXCAVATION	CU YD	83.0	83.0		
21400100	GRADING AND SHAPING DITCHES	FOOT	160.0	160.0		
25000300	SEEDING, CLASS 3	ACRE	0.05	0.05		
25000400	NITROGEN FERTILIZER NUTRIENT	POUND	5.0	5.0		
25000500	PHOSPHORUS FERTILIZER NUTRIENT	POUND	5.0	5.0		
25000600	POTASSIUM FERTILIZER NUTRIENT	POUND	5.0	5.0		
25100115	MULCH, METHOD 2	ACRE	0.05	0.05		
28000250	TEMPORARY EROSION CONTROL SEEDING	POUND	15.0	15.0		
28000500	INLET AND PIPE PROTECTION	EACH	2.0	2.0		
28100107	STONE RIPRAP, CLASS A4	SQ YD	40.0	40.0		
28200200	FILTER FABRIC	SQ YD	40.0	40.0		
35100300	AGGREGATE BASE COURSE, TYPE A 4"	SQ YD	52.0	52.0		
35501332	HOT-MIX ASPHALT BASE COURSE, 12"	SQ YD	52.0	52.0		
35501347	HOT-MIX ASPHALT BASE COURSE, 16"	SQ YD	52.0	52.0		
40600100	BITUMINOUS MATERIALS (PRIME COAT)	GALLON	110.0	110.0		
40600300	AGGREGATE (PRIME COAT)	TON	4.0	4.0		
40600990	TEMPORARY RAMP	SQ YD	32.0	32.0		
40603310	HOT-MIX ASPHALT SURFACE COURSE, MIX "C", N50	TON	64.0	64.0		
44000100	PAVEMENT REMOVAL	SQ YD	104.0	104.0		
44000155	HOT-MIX ASPHALT SURFACE REMOVAL, 1 1/2"	SQ YD	714.0	714.0		
48101200	AGGREGATE SHOULDERS, TYPE B	TON	26.0	26.0		
48203029	HOT-MIX ASPHALT SHOULDERS, 8"	SQ YD	16.0	16.0		
50100100	REMOVAL OF EXISTING STRUCTURES	EACH	1.0	1.0		
X0326835	PRECAST CONCRETE BOX CULVERT 8' X 3' (M273), SPECIAL	FOOT	38.0		38.0	
66600105	FURNISHING AND ERECTING RIGHT-OF-WAY MARKERS	EACH	2.0	2.0		
66700095	PERMANENT SURVEY MARKERS	EACH	1.0	1.0		
67100100	MOBILIZATION	L SUM	1.0	1.0		
70100460	TRAFFIC CONTROL AND PROTECTION, STANDARD 701306	L SUM	1.0	1.0		
70300100	SHORT-TERM PAVEMENT MARKING	FOOT	55.0	55.0		
70300220	TEMPORARY PAVEMENT MARKING- LINE 4"	FOOT	330.0	330.0		
70300240	TEMPORARY PAVEMENT MARKING - LINE 6"	FOOT	60.0	60.0		
70301000	WORK ZONE PAVEMENT MARKING REMOVAL	SQ FT	15.0	15.0		
78001110	PAINT PAVEMENT MARKING - LINE 4"	FOOT	330.0	330.0		
78001130	PAINT PAVEMENT MARKING - LINE 6"	FOOT	60.0	60.0		
78300200	RAISED REFLECTIVE PAVEMENT MARKER REMOVAL	EACH	2.0	2.0		
X0324043	GRATING FOR CONCRETE HEADWALL	EACH	2.0		2.0	
X5400900	BOX CULVERT END SECTIONS, SPECIAL	EACH	2.0		2.0	

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STATE OF ILLINOIS
DEPARTMENT OF TRANSPORTATION

		0111		, OF OU	MITITIFO		F.A.S. RTE.	SECTION	COUNTY	TOTAL	SHEET NO.
SUMMARY OF QUANTITIES								(102)I	KANKAKEE	11	3
									CONTRACT	NO. 6	6986
SCALE:	SHEET	NO.	0F	SHEETS	STA.	TO STA.		ILLINOIS FED. A	ID PROJECT		

	MAINLINE												
	LENGTH	НМА	HMA SURF	AGG	TEMP	BIT MATLS	AGG						
LOCATION		SURF	REMOVAL	(PR CT)	RAMP	(PR CT)	SHLD						
LOCATION		CSE	1 1/2"				TY B						
		1 1/2"					,						
STATION	FT	TON	SQ YD	TON	SQ YD	GAL	TON						
STA 357+50 to STA 359+00	150	40.0	434.0	2.0	16.0	60.0	20.0						
9000W SIDEROAD (NORTH SIDE)	40	12.0	140.0	1.0	8.0	25.0	3.0						
9000W SIDEROAD (SOUTH SIDE)	40	12.0	140.0	1.0	8.0	25.0	3.0						
TOTAL		64.0	714.0	4.0	32.0	110.0	26.0						

GRADING AND SI	HAPING DITCH	HES*
LOCATION	LENGTH	GRADING AND SHAPING
		DITCHES
STATION	FEET	FOOT
IL 115		
STA 358+00 To 358+30(LT & RT)	60	60
9000W ROAD		
STA 19+20 TO 19+70 (RT)	50	50
STA 20+30 TO 20+80(RT)	50	50
TOTAL		160

 THIS QUANITY IS TO ASSURE POSITIVE DRAINAGE FOR THE PROPOSED BOX CULVERT

				PREC	AST CONCRET	E BOX CULVER	RT.				
LOCATION	8'X3' PRECAST BOX CULV.	BOX CULVERT END SEC	GRATING FOR CONCRETE	HMA BSE CSE,	HMA BSE CSE,	AGG BSE CSE, TA, 4"	PAVEMENT REMOVAL	FILTER FABRIC	RIPRAP CLASS A4*	FURNISHED EXCAVATION	REMOVE EXISTING STRUCTURE
STATION	M273 SPECIAL LIN FT	SPECIAL EACH	HEADWALL EACH	12'' SQ YD	16" SQ YD	SQ YD	SQ YD	SQ YD	SQ YD	CU YD	SQ YD
STA 358+05	38	2	2	41			41	40	40		30 15
358+30					41	41	41			83	1
TOTAL	38	2	2	41	41	41	82	40	40	83	1

\* SEE PLAN SHEET FOR LOCATION

SEEDING SCHEDULE												
LOCATION	SEEDING	NITROGEN	POTASSIUM	PHOSPHOROUS	MULCH	TEMP	INLET					
	CLASS	FERTILIZER	FERTILIZER	FERTILIZER	METHOD	EROSION	AND					
	3	NUTRIENT	NUTRIENT	NUTRIENT	2	CONTROL	PIPE					
						SEEDING	PROTECTION					
STATION	ACRE	POUND	POUND	POUND	ACRE	POUND	EACH					
STA 358+00 TO 358+50	0.05	5.0	5.0	5.0	0.05	15.0	2.0					
TOTAL	0.05	5.0	5.0	5.0	0.05	15.0	2.0					

EARTH EXC	`Δ \/ Δ Τ Ι Ω	N						
STA TO STA	LT/RT	EARTH EX						
		CU YD						
STA 357+90 TO STA 358+40	RT	15						
STA 357+90 TO STA 358+40	LT	25						
TOTALS		40						

ROW MARKERS					
	ROW				
LOCATION	MARKERS				
LOCATION					
	EACH				
NE QUADRANT	1				
SE QUADRANT	1				
TOTAL	2				

\*PLACE NEAR PROPOSED CULVERT END SECTIONS

	PAVEMENT MARKINGS												
	LENGTH	TEMP	TEMP	PAINT	PAINT	RAISED	SHORT	WORK					
LOCATION		PVMT	PVMT	PVMT	PVMT	REF PVMT	TERM	ZONE					
LOCATION		MARKING	MARKING	MARKING	MARKING	MARKER	PVMT	PVMT					
		4" WHITE	6" YELLOW	4" WHITE	6" YELLOW	REM∗	MARKING	REM					
STATION	FEET	FOOT	FOOT	FOOT	FOOT	EACH	FOOT	SQ FT					
			·										
STA 357+50 to STA 359+00	150	300	40	300	40	2	45	10.0					
9000 W SIDEROAD	100	. 30	20	30	20		10	5.0					
TOTAL		770		770									
TOTAL		330	60	330	60	T	55	15.0					

Н	MA SHOULDER 8"*	
LOCATION	HMA SHLD 8''	EARTH EXCAVATION
STATION	SQ YD	CU YD
357+90 TO 358+18(LT)	7	2
357+90 TO 358+27(RT)	9	2
TOTAL	16	4


\* THIS QUANTITY TO BE PLACED PRIOR TO THE CONSTRUCTION OF BOX CULVERT USE TC&P STD 701306 FOR PLACEMENT


\* NO NEED TO REPLACE RRPM

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STATE OF ILLINOIS
DEPARTMENT OF TRANSPORTATION

						F.A.S. RTE.	SECTION	COUNTY	TOTAL SHEETS	SHEET NO.
SCHEDULES OF QUANTITIES						1323	(102)	KANKAKEE	11	4
	.,							CONTRACT	NO. 66	986
CALE:	SHEET NO.	OF	SHEETS	STA.	TO STA.		ILLINOIS FED. A	ID PROJECT		



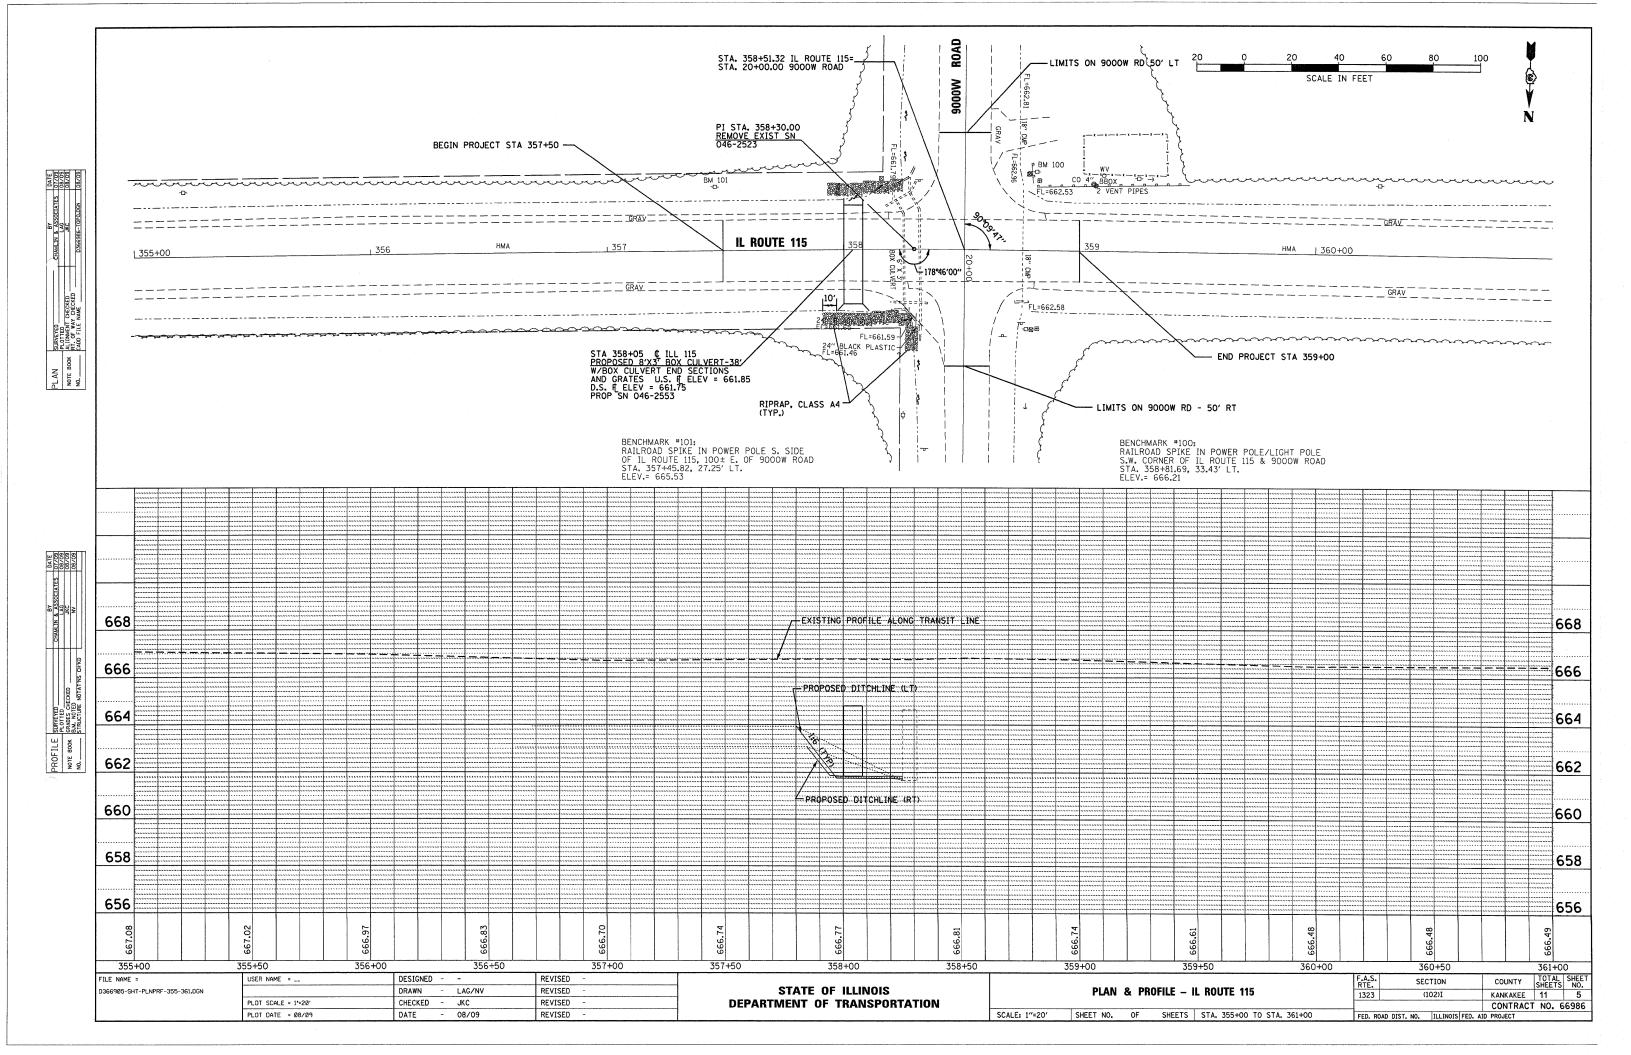
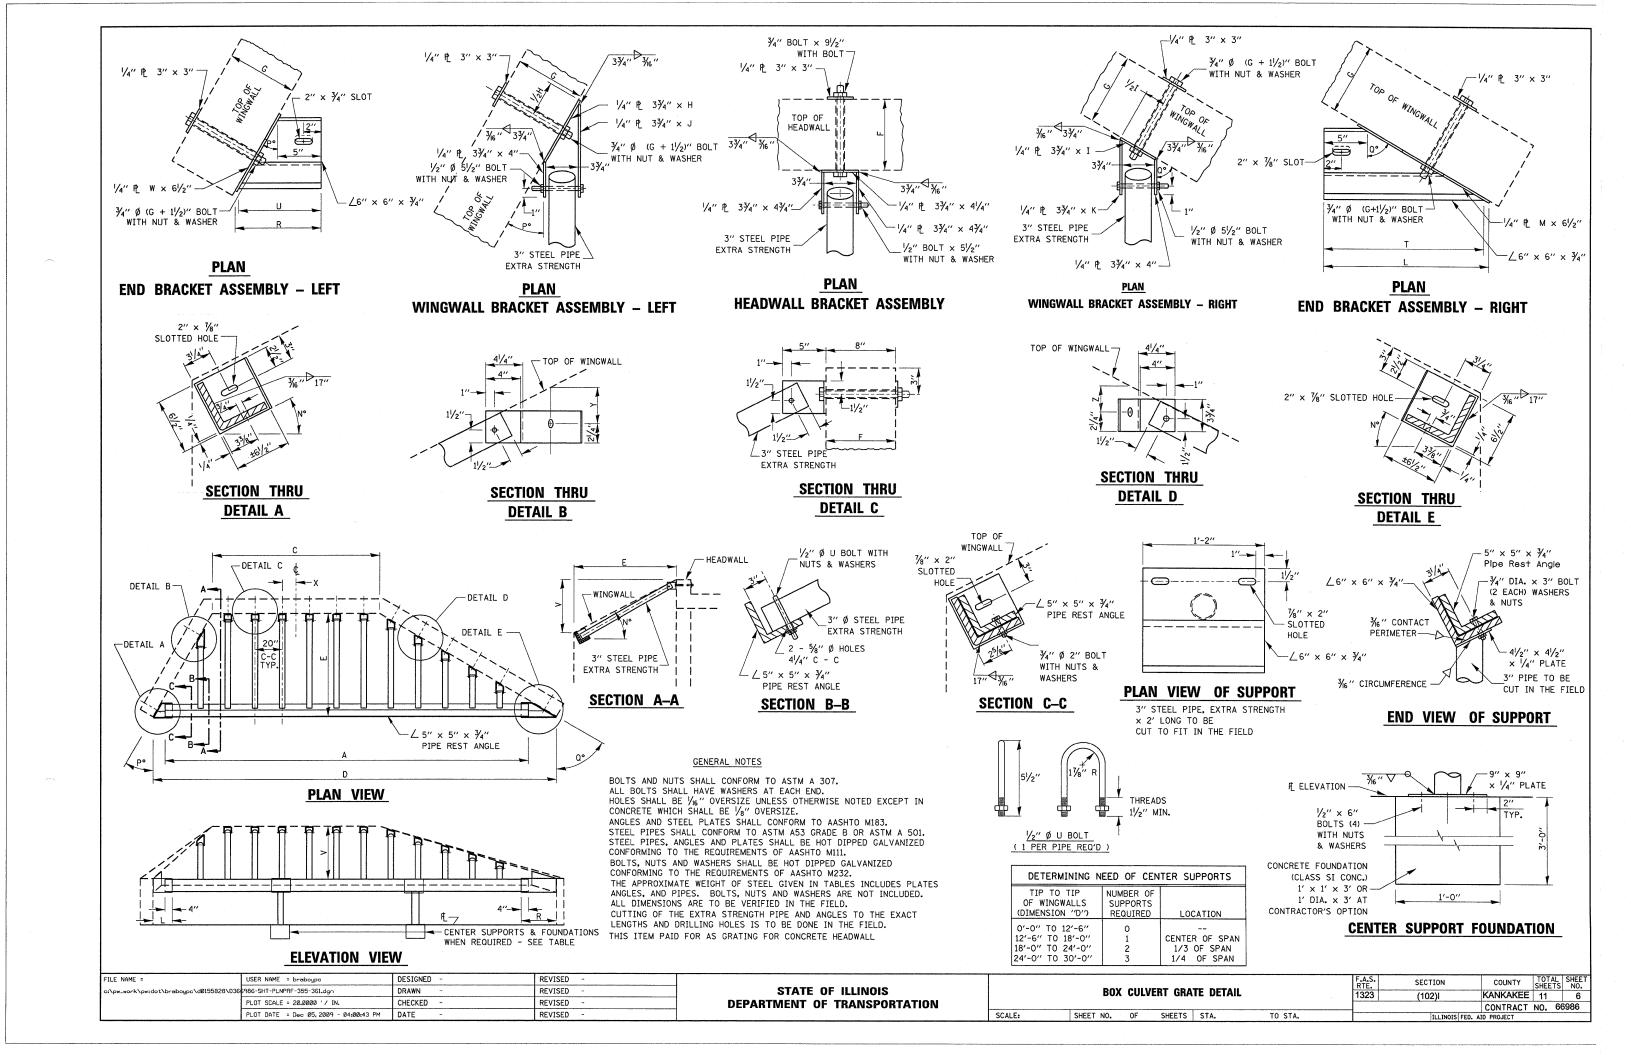
#### WATERWAY INFORMATION TABLE

Route:

FAS 1323 (IL 115)

S.N. (Exist.): 046-2523

County:

(102)I Kankakee IDOT (SAF) S.N. (Prop.): Waterway:

Waterway: Branch of East Branch of Horse Creek

Date: 11/2/2009

Drainage Area =	0.42 Sq Mi	Exist. Low Grade	Exist. Low Grade El. = 666.7 @ Sta. 4+00				Prop. Low Grade El. = 666.7 @ Sta. 4+00					
FLOOD	FREQUENCY	Q	OPENIN	IG - sq. ft.	NAT.	HEAD - ft.		HEADWATER EL.				
	(yr.)	(cfs)	Exist.*	Prop.*	H.W.E.	Exist.	Prop.	Exist.	Prop.			
,,,,,,,,,,,,,,,,,,,,,,,,,,,,,,,,,,,,,,,	10	74	18	24	664.9	0.8	0.5	665.7	665.5			
Design	50	111	18	24	665.1	1.9	1.7	667.0	666.8			
Base	100	125	18	24	665.2	1.9	1.7	667.1	666.9			
Overtopping	N/A	N/A	N/A	N/A	N/A	N/A	N/A	N/A	N/A			
Max. Calc.	500	159	18	24	665.4	1.9	1.8	667.3	667.2			

10-year velocity exist

CHECKED

PLOT SCALE = 20.0000 '/ IN.

PLOT DATE = Dec 05, 2009 - 04:00:54 PM DATE

4.1 fps

10-year velocity prop

3.1 fps

Scope of Work: Total Replacement (Constricted Table)

EXISTING STRUCTURE


Type: Concrete Box Culvert Size: 6' x 3' Length: 57' 6' along centerline U/S Invert El.: 661.6 D/S Invert El.: 661.8 Skew: 6 degrees

REVISED

REVISED

#### PROPOSED STRUCTURE

Type: Concrete Box Culvert Size: 8' x 3' Length: 36' along centerline U/S Inver: El.: 661.85 D/S Inver: El.: 661.75 Skew: 0 degrees

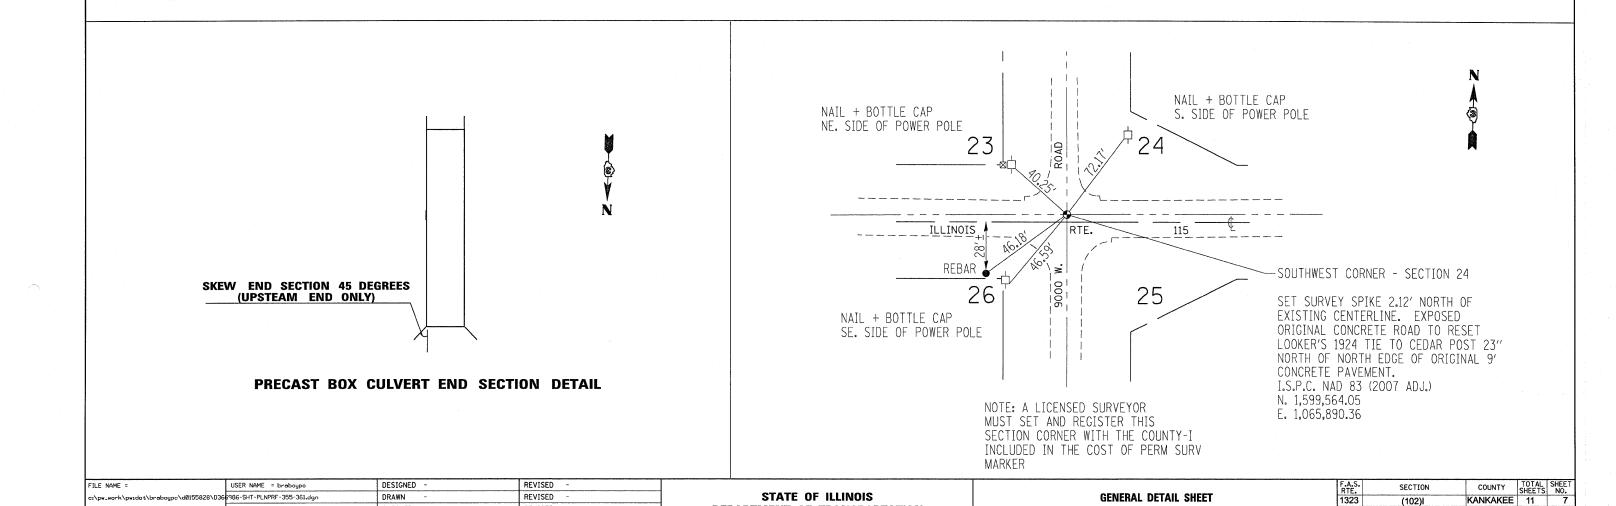

**DEPARTMENT OF TRANSPORTATION** 


SCALE:

SHEET NO. OF SHEETS STA.


TO STA.

CONTRACT NO. 66986



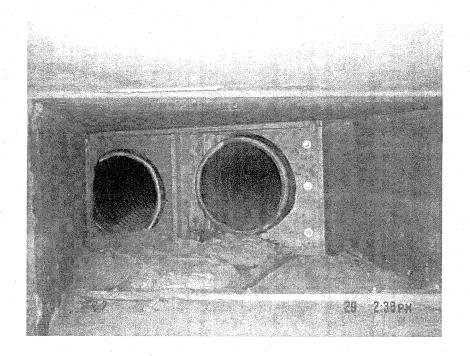


STRUCTURE AS MODIFIED IN 2009

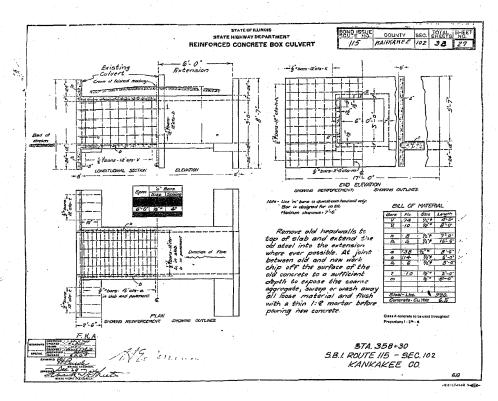


### ORIGINAL STRUCTURE CONSTRUCTED IN 01923 AND WIDENED IN 1928

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FILE NAME =	1.1	USER NAME = braboypc	DESIGNED -	REVISED -	F.A.S. SECTION COUNTY	TOTAL SHEET
c:\pw_work\PWIDO	IDOT\BRABOYPC\dØ155828\D36	6986-SHT-PLNPRF-355-361.dgn	DRAWN -	REVISED -	ORIGINAL CULVERT PLANS 1323 (102) KANKAKEE	SHEETS NO.
		PLOT SCALE = 40.0000 '/ IN.	CHECKED -	REVISED -	CONTRACT	NO 66086
		PLOT DATE = Dec 07, 2009 - 08:31:15 AM	DATE -	REVISED -	SCALE: SHEET NO. OF SHEETS STA. TO STA. ILLINOISIFED AID PROJECT	NO. 00300

FOR INFORMATION ONLY

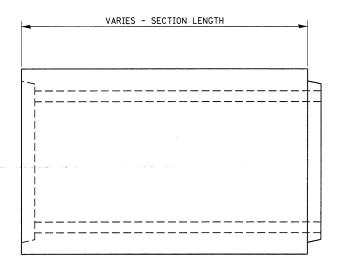

ELEVATION

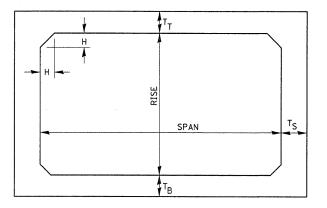

NOTE: THE HAUNCH DIMENSION H, IS EQUAL TO THE WALL THICKNESS  $\mathsf{T}_\mathsf{S}$  .

# TYPICAL BOX SECTION

SPAN,	T <sub>T</sub> , II	NCHES	T <sub>B</sub> , IN	ICHES	T <sub>S</sub> , INCHES		
FEET	м 259	М 273	м 259	M 273	M 259	M 273	
3	4	4 7		4 6		4	
4	5	71/2	5	6	5	5	
5	6	8	6	7	6	6	
6	7	8 7		7	7 7		
7	8	8	8	8	8	8	
8	8	8	8	8	8	8	
9	9	9	9	9	9	9	
10	10	10	10	10	10	10	
11	11	11	11	11	11	11	
12	12	12	12	12	12	12	

GENERAL NOTES:


MINIMUM COVER FOR BOX CULVERTS SHALL BE 6".

TYPICAL THICKNESSES

FILE NAME =	USER NAME = braboypo	DESIGNED -	REVISED -	
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PLOT SCALE = 20.0000 '/ IN.		CHECKED -	REVISED -	
	PLOT DATE = Dec 05, 2009 - 04:01:21 PM	DATE -	REVISED -	

STATE OF ILLINOIS DEPARTMENT OF TRANSPORTATION

_						
	PRESIDE COMORTE POY OFFICE	F.A.S. RTE.	SECTION	COUNTY	TOTAL SHEETS	SHEET NO.
-	PRECAST CONCRETE BOX SECTION	1323	(102)	KANKAKEE	11	9
-				CONTRACT	NO. 66	986
-	SCALE: SHEET NO. OF SHEETS STA. TO STA.	FED. RO	AD DIST. NO. ILLINOIS FED. A	ID PROJECT		

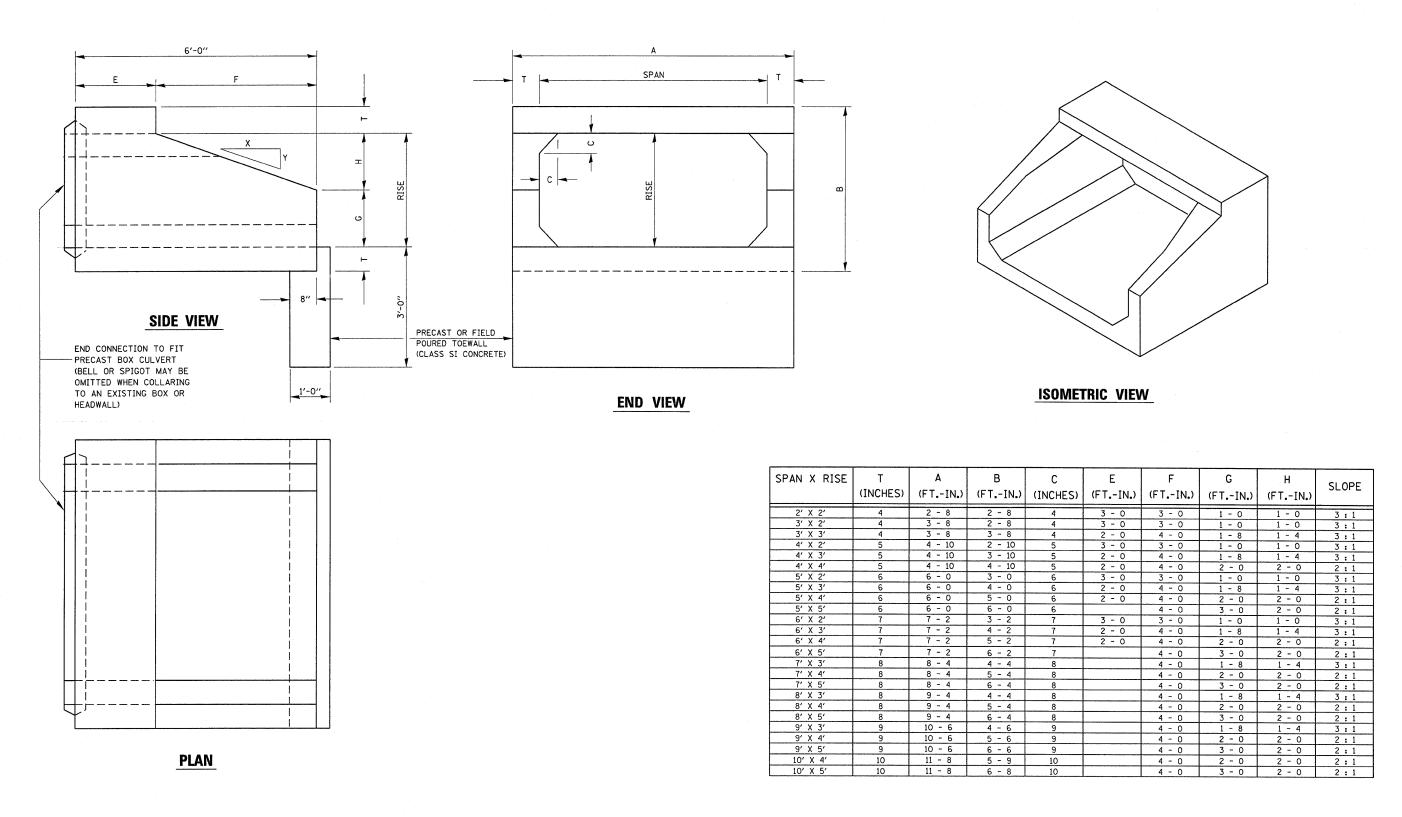

NOTE: THE END SECTION SHALL BE SKEWED 45 DEGREES AS SHOWN ON GENERAL DETAIL SHEET

	FILE NAME =	USER NAME = braboypo		-	REVISED	-	
ļ	c:\pw_work\pw1dot\broboypc\d0155828\D365986-SHT-PLNPRF-355-361.dgn				REVISED	-	
-			CHECKED	×	REVISED	-	
			DATE	-	REVISED	-	1

STATE OF ILLINOIS
DEPARTMENT OF TRANSPORTATION

	PRECAST	COI	NCRETE	BOX	CU	LVERT	END	SECTION
CAL E.	SUEET	NΛ	OE	CHEE	TC	STA		TO STA

