STATE OF ILLINOIS DEPARTMENT OF TRANSPORTATION **DIVISION OF HIGHWAYS**

PLANS FOR PROPOSED FEDERAL AID HIGHWAY

FAP ROUTE 348 (HARLEM AVENUE) 191ST STREET (FAU 3754) TO 159TH STREET (FAP 351) **BEAUTIFICATION - STREETSCAPING**

> **SECTION: 09-00108-00-LS PROJECT NO: ARA-00D1(809)**

> > JOB NO: C-91-137-10

VILLAGE of TINLEY PARK **COOK COUNTY**

DESIGN DESIGNATION - HARLEM AVENUE - ARTERIAL POSTED SPEED LIMIT - 40 mph - 159TH ST TO 175TH ST - 45 mph - 175TH ST TO 191ST ST 159TH ST TO 167TH ST - 45,700 (2007) 167TH ST TO 171ST ST - 40,000 (2007) 171ST ST TO 175TH ST - 37,900 (2007) 175TH ST TO 183RD ST - 34,800 (2007)

- 45,200 (2007)

- 27,100 (2007)


INDEX OF SHEETS


SEE SHEET NO. 2

183RD ST TO 1-80


I-80 TO 191ST ST

HIGHWAY STANDARDS SEE SHEET NO. 2

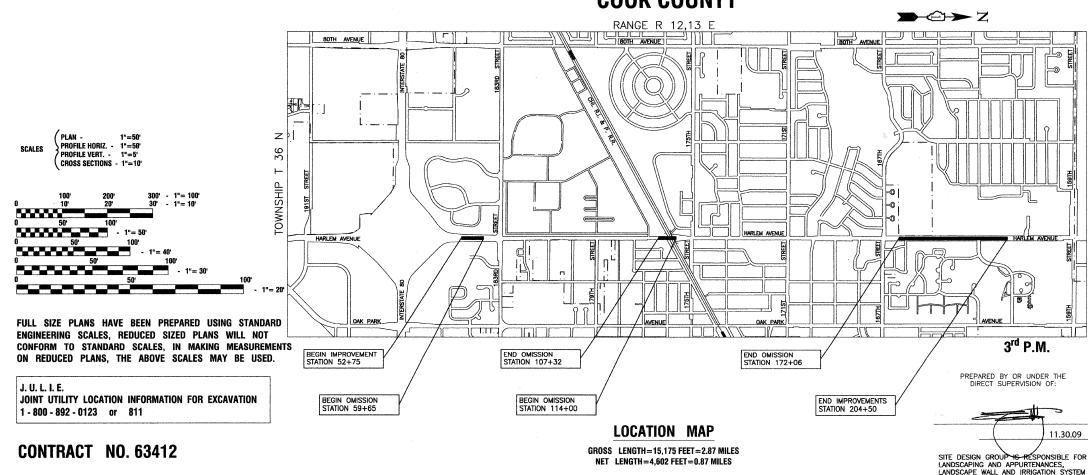

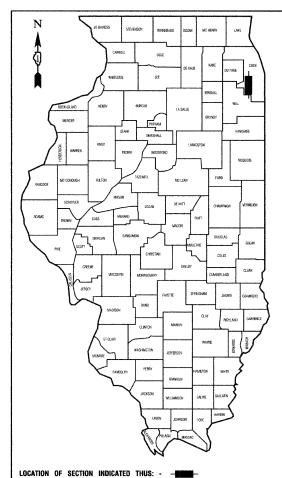


CONTRACT #63412

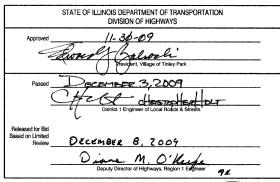

PRINTED BY THE AUTHORITY OF THE STATE OF ILLINOIS



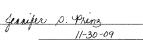

ROBINSON ENGINEERING, LTD IS RESPONSIBLE FOR TOPOGRAPHY, DRAINAGE AND WATER SERVICE PLANS



INDEX OF SHEETS

- COVER SHEET
- 2. INDEX OF SHEETS, STATE STANDARDS, PLANT SCHEDULE, AND HMA MIX CHART 3.-4. SUMMARY OF QUANTITIES
- 5.-14. LANDSCAPING PLAN
- 15.-24. DRAINAGE AND EROSION CONTROL PLAN
- 25.-34. IRRIGATION PLAN
- 35.-38. CONSTRUCTION DETAILS

STATE STANDARDS

00000105	STANDARD SYMBOLS, ABBREVIATIONS AND PATTERNS
28000105	TEMPORARY EROSION CONTROL
442201-03	CLASS C AND D PATCHES
602001-01	CATCH BASIN, TYPE A
604001-03	FRAME AND LIDS TYPE I
604036-02	GRATE, TYPE 8
606001-04	CONCRETE CURB TYPE B AND COMBINATION CONCRETE CURB AND GUTTER
70160106	URBAN LANE CLOSURE, MULTILANE, 1W OR 2W WITH
	NONTRAVERSABLE MEDIAN
70170106	URBAN LANE CLOSURE, MULTILANE INTERSECTION
701801-04	LANE CLOSURE MULTILANE 1W OR 2W CROSSWALK OR
	SIDEWALK CLOSURE
701901-01	TRAFFIC CONTROL DEVICES

HOT-MIX ASPHALT MIXTURE REQUIREMENTS

MIXTURE TYPE	AIR VOIDS • NDES
PAVEMENT PATCHING	
POLYMERIZED HOT MIX ASPHALT SURFACE COURSE, MIX "F", N90 (IL-9.5mm); 1 3/4"	4% 🛭 90 Gyr.
LEVELING BINDER (MACHINE) METHOD, N70 (IL-9.5mm); 3/4"	4% 👁 70 Gyr.

NOTE:
THE UNIT WEIGHT USED TO CALCULATE ALL HOT-MIX ASPHALT SURFACE MIXTURE QUANTITIES IS 112 LBS/SY/IN.
THE "AC-TYPE" FOR POLYMERIZED HMA MIXES SHALL BE "SBS/SBR PG 70-22" AND FOR NON-POLYMERIZED HMA
THE "AC-TYPE" SHALL BE "PG 64-22" UNLESS MODIFIED BY DISTRICT ONE SPECIAL PROVISIONS.
FOR "PERCENT OF RAP" SEE DISTRICT ONE SPECIAL PROVISIONS.

FILE NAME = 09493-INDX-01 - G01	USER NAME =	DESIGNED	REVISED —
		CHECKED — JSP	REVISED
	PLOT SCALE =	DRAWN PS	REVISED —
	PLOT DATE = 11-30-09	CHECKED AG	REVISED

STATE OF ILLINOIS DEPARTMENT OF TRANSPORTATION

DECIDUOUS SHADE TREES

BOTANICAL NAME

CODE QUAN

INDEX OF SHEET		IFICAT	RLEM AVEN TION - STRI RDS, PLAN	EETSCA	PING DULE, AND HMA MIX CHART	F.A.P. RTE. 348
SCALE:	SHEET NO. 2	OF 38	SHEETS	STA.	TO STA.	FED. R

F.A.P. RTE.		SEC.	TON		COU	ΠY	TOTAL SHEETS	
348	094	0010	8-00-LS		COC	ж	38	2
					CONT	ACT I	NO. 6341	2
FED. RO	AD DIST. NO.	1	ILLINOIS	FED. A	D PROJECT	ARA-0	OD1 (809)	

CODE	QUAIN .	DO I ANICAL NAME	COMMON NAME	SIZE	NOOI	VEINVVVO
GT	21	Gleditsia triacanthos 'Skyline'	Skyline Honeylocust	3" cal.	B&B	matching heads
QI	12	Quercus imbricaria	Shingle Oak	3" cal.	B&B	matching heads
ORNAM	IENTAL T	REES		The state of the s		
OV	5	Ostrya virginiana	Ironwood	2-1/2" cal.	B&B	matching heads
PV	30	Prunus virginiana "Canada Red'	Canada Red Cherry	2-1/2" cal.	B&B	matching heads
DECIDU	L JOUS SH	RUBS	<u></u>		<u> </u>	
HK	1494	Hypericum kalmianum 'Ames'	St. Johnswort	2 gal.	pot	24" o.c.
PP	176	Physocarpus opulifolius 'Monlo'	Diabolo™ Eastern Ninebark	30"	B&B	36" o.c.
RA	1030	Rhus aromatic 'Grow Low'	Grow Low Sumac	2 gal.	pot	30" o.c.
VJ	181	Viburnum x juddii	Judd Viburnum	30"	B&B	30" o.c.
PEREN	NIAL PLA	NTS & GRASSES				
CA	630	Calamagrostis x acutiflora 'Karl Foerster'	Feather Reed Grass	gal.	pot	24" o.c.
НА	1616	Hemerocallis 'Chicago Apache'.	Chicago Apache Red Daylily	gal.	pot	12" o.c.
HR	1616	Hemerocallis 'Rosy Returns'.	Rosy Returns Pink Dayliliy	gal.	pot	12" o.c.
HS	1616	Hemerocallis 'Stella d' Oro'	Stella d'Oro Yellow Daylillie	gal.	pot	12" o.c.
LP	1933	Liatris spicata 'Kabold'	Kobold Blazing Star	gal.	pot	12" o.c.
LS	1421	Liriope spicata	Lily Turf	gal.	pot	12" o.c.
LW	758	Liatris spicata 'White'	White Blazing Star	gal.	pot	12" o.c.
MD	361	Monarda didyma 'Marshalls Delight'	Marshalls Delight Monarda	gal.	pot	12" o.c.
MJ	1076	Monarda didyma 'Jacob Cline'	Jacob Cline Monarda	gal.	pot	12" o.c.
PA	2199	Perovskia atriplicifolia 'Little Spire'	Little Spire Russian sage	gal.	pot	12" o.c.
PH	1029	Pennisetum alopecuroides 'Hamlin'	Hamlin Dwarf Fountain Grass	gal.	pot	18" o.c.
PR	385	Pennisetum alopecuroides 'Red Head'	Red Head Fountain Grass	gal.	pot	30" o.c.
RF	628	Rudbeckia fulgida var sullivantii 'Goldsturm'	Goldsturm Rudbeckia	gal.	pot	18" o.c.
SR	404	Solidago Rugosa	Golden rod	gal.	pot	18" o.c.
SS	167	Schizachyrium scoparium	Little Bluestem	3 gal.	Pot	30" o.c.

PLANT SCHEDULE

COMMON NAME

SIZE

ROOT

REMARKS

		SUMMARY OF QUANTITIES		т	1	MARKINGS		LANDSCAPE ISTRUCTION	LIGHTS TYPE CODE	SIGNALS	TRAINING	L	
5.1.	CODE NO.	PAY ITEM	UNIT	QUAN	1000	SFTY-1D	Y002-1C	Y003	Y030-1E	Y031	Y080		T
Ī	20101000	TEMPORARY FENCE	FOOT	3600				3600					Ī
*	20101300	TREE PRUNING (1 TO 10 INCH DIAMETER)	EACH	74				74					
<u> </u>	20200100	EARTH EXCAVATION	CU YD	3165				3165				A	1
	20200410	EARTH EXCAVATION (SPECIAL)	CU YD	500				500					<u> </u>
<u>.</u>	25200110	SODDING, SALT TOLERANT	SQ YD	1500			<u> </u>	1500					1
*	25300500	TOP SOIL FOR PLANTING	CU YD	3200			† · · · · · · · · · · · · · · · · · · ·	3200		l	.		1
*	25300700	TRANSPLANTED SALVAGED SHRUBS	EACH	9				9					
1	28000510	INLET FILTERS	EACH	20		l		20		i			1
1	31200600	STABILIZED SUBBASE - CEMENT AGGREGATE MIXTURE, 4"	SQ YD	136			<u> </u>	136					1
1	35101100	AGGREGATE BASE COURSE, TYPE A 12"	SQ YD	100	100								-
	40600635	LEVELING BINDER (MACHINE METHOD), N70	TON	80	80								1
	40603595	POLYMERIZED HOT-MIX ASPHALT SURFACE COURSE, MIX "F", N90	TON	180	180		l						1
-	44000100	PAVEMENT REMOVAL	SQ YD	100	100								
	44000500	COMBINATION CURB AND GUTTER REMOVAL	FOOT	8100	8100				Mariana da colocida como			and the best above as	
	·	<u> </u>		-									
	44002020	CONCRETE MEDIAN SURFACE REMOVAL	SQ FT	10734	10734								
	44201353	CLASS C PATCHES, TYPE II, 10 INCH	SQ YD	100	100						·····		-
	60100060	CONCRETE HEADWALL FOR PIPE DRAINS	EACH	1] 			and the second of the		
	60107600	PIPE UNDERDRAINS 4"	FOOT	10				10					
	60109510	PIPE UNDERDRAINS, FABRIC LINED TRENCH 4"	FOOT	1525				1525				.	.
	60201005	CATCH BASINS, TYPE A, 4'-DIAMETER, TYPE 10 FRAME AND GRATE	EACH	1				1					
	60250200	CATCH BASINS TO BE ADJUSTED	EACH	10				10					ļ
	60255500	MANHOLES TO BE ADJUSTED	EACH	5				5					
	60260100	INLETS TO BE ADJUSTED	EACH	5				5					
4	60606300	COMBINATION CONCRETE CURB AND GUTTER, TYPE B-9.12 (SPECIAL)	FOOT	8100	8100								
	67100100	MOBILIZATION	L SUM	1				1					
	70102630	TRAFFIC CONTROL AND PROTECTION, STANDARD 701601	L SUM	1	l			1					
	70102635	TRAFFIC CONTROL AND PROTECTION, STANDARD 701701	L SUM	1				1				.	
-	70102640	TRAFFIC CONTROL AND PROTECTION, STANDARD 701801	L SUM	1	!			1					
	78000100	THERMOPLASTIC PAVEMENT MARKING- LETTERS AND SYMBOLS	SQ FT	1000	1000								
	78000200	THERMOPLASTIC PAVEMENT MARKING- LINE 4"	FOOT	8100	8100								
	78000400	THERMOPLASTIC PAVEMENT MARKING-LINE 6"	FOOT	1000	1000								
k	A2005620	TREE, OSTRYA VIRGINIANA (AMERICAN HOPHORNBEAM), 2-1/2" CALIPER, BALLED AND BURLAPPED	EACH	5				5					1
*	C2012136	SHRUB, VIBURNUM X JUDDII (JUDD VIBURNUM) 3' HEIGHT, BALLED AND BURLAPPED	EACH	65				65					Ī
k	K1003680	MULCH	SQ YD	2410				2410					
	X0322903	SAW CUTTING, (FULL DEPTH)	FOOT	8300	8300		1	l		Andrew Control Control Action			
k	X0325775	WET REFLECTIVE TEMPORARY TAPE, TYPE III, 4 INCH	FOOT	8100	8100					<u> </u>			1
k	X0325837	WET REFLECTIVE TEMPORARY TAPE TYPE III, 6 INCH	FOOT	2000	2000	l							
k	X0325842	WET REFLECTIVE TEMPORARY TAPE, TYPE III, LETTERS AND SYMBOLS	SQ FT	2000	2000								T
	Z0017202	DOWEL BARS 1 1/2"	EACH	3000	3000								
1	Z0048665	RAILROAD PROTECTIVE LIABILITY INSURANCE	LSUM	1				1					1
-	Z0075310	TIE BARS 3/4"	EACH	300	300		1						1
. 1	Z0076600	TRAINEES	HOUR	500				.			500		1
k	XX003868	WATER SERVICE CONNECTION, 2" COMPLETE	EACH	1	<u> </u>	,	<u> </u>		L				1
k	XX005206	EXPLORATORY EXCAVATION	FOOT	100			.	100					
	A2006618	TREE, QUERCUS IMBRICARIA (SHINGLE OAK), 2 1/2" CALIPER, BALLED AND BURLAPPED	EACH	12				12					
k	XX005653	AGGREGATE BACKFILL CA-7	CU YD	1703	1			1703	1		<u> </u>		
'	X2800400	PERIMETER EROSION BARRIER, SPECIAL	FOOT	8500			l	8500					

LE NAME = 08489-QUAN-01 - IDOT P01

USER NAME = DESIGNED - REVISED
CHECKED - JSP REVISED
PLOT SCALE = DRAWN - PS REVISED
PLOT DATE = 11-30-09 CHECKED - AG REVISED --


STATE OF ILLINOIS
DEPARTMENT OF TRANSPORTATION


SCALE:


	SUMMARY OF QUANTITIES			PAVEMENT	MARKINGS		LANDSCAPE ISTRUCTION	TYPE CODE	SIGNALS	TRAINING	·····	·
I. CODE NO.	PAY ITEM	UNIT	QUAN	1000	SFTY-1D		Y003	Y030-1E	Y031	Y080		
k XX006769	TREE REMOVAL, (SPECIAL)	EACH	13				13		1	1		
K K0037850 P	ERENNIAL RUDBECKTA RILGIDA (GOLDIFALM BLACK EYED SUSAN), WELL DEVELOPED, 2- GALLON	EACH	584		<u> </u>		584	 				
A2004824	TREE, GLEDITSIA TRIACANTHOS VAR. INERMIS SKYLINE (SKYLINE THORNLESS HONEYLOCUST), 3" CALIPER, BALLED AND BURLAPPED	EACH	20				20					ļ
B2005423	TREE, PRUNUS VIRGINIANA CANADA RED (CANADA RED CHERRY), 2-1/2" CALIPER, TREE FORM, BALLED AND BURLAPPED	EACH	20				20					ļ
	SHRUB, HYPERICUM KALMIANUM 'AMES' (AMES KALM ST. JOHNSWORT), 2—GALLON, CONTAINER	EACH	1352				1352					<u> </u>
C2C03724	SHRUB, PHYSOCARPUS OPULIFOLIUS 'MONLO', (DIABLO NINEBARK), 3' HEIGHT, BALLED AND BURLAPPED	EACH	112				112					-
C2004840	SHRUB, RHUS AROMATICA, 'GRO-LOW', (GRO-LOW SUMAC), CONTAINER GROWN, 2 - GALLON	EACH	882				882	1				
k C2C058G2	HEMEROCALLIS 'CHICAGO APACHE', (CHICAGO APACHE DAYLILIES), 1-GALLON	EACH	1226	!		‡	1226	<u> </u>			2000	
K0040107	AND ADDRESS OF THE AD			!	ļ	.	1226					ļ
K0040119	HEMEROCALLIS 'ROSY RETURNS', (ROSY RETURNS DAYLILIES), 1—GALLON	EACH	1226									ļ
K0040/15	HEMEROCALLIS 'STELLA DE ORO', (STELLA DE ORO DAYLILIES), 1—GALLON	EACH	1226				1226					ļ
K0030082	PERENNIAL LIATRIS SPICATA 'KABOLD' (BLAZING STAR), 1-GALLON	EACH	1913				1913					
K030084	PERENNIAL LIATRIS SPICATA 'WHITE' (WHITE BLAZING STAR), 1-GALLON	EACH	755				755					
K0030184	PERENNIALMONARDA DIDYMA 'MARSHALLS DELIGHT' (MARSHALLS DELIGHT MONARDA), 1-GALLON	EACH	219				219					
k 16030186	PERENNIAL 20 5 MONARDA DIDYMA 'JACOB CLINE' (JACOB CLINE MONARDA), 1-GALLON	EACH	933				933					
K0040312	LIRIOPE SPICATA, LILY TURF (LILY TURF LIR TOPE), 1-GALLON	EACH	1666				1666					
K0030288	PERENNIALPEROVSKIA ATRIPLICIFOLIA 'LITTLE SPIRE', (LITTLE SPIRE RUSSIAN SAGE), 1-GALLON	EACH	1758				1758					
K0030290	PERENNIAL SOLIDAGO RUGOSA (GOLDENROD), 1 GALLON	EACH	415		ļ		415	ļ.,,				
K0039112	CALAMAGROSTIS ACUTIFLORA "KARL FOERSTER" (FEATHER REED GRASS), 1-GALLON	EACH	546				546					<u> </u>
	PENNISETUM ALOPECURO TOES HAMELN (HAMELN FOUNTAIN GRASS), 1 GALLON	EACH	350				350					<u>.</u>
K0040212 F	PENNUTSETUM ALOPECUROTOES REDHEAD (RED HEAD FOUNTAIN GRASS), 1-GALLON	EACH	189				189		l			1
K0030390	SCHIZACHYRIUM SCOPARIUM (LITTLE BLUESTEM), 3-GALLON, 2000 1000 1000 1000 1000 1000 1000 100	EACH	167				167					
XX007907	STAMPED CONCRETE MEDIAN SURFACE, 5 INCH	SQ FT	10734	10734								
K Z0069100	STONE MASONRY WALL	FOOT	600		Ī		600					
k 60108100	PIPE UNDERDRAINS, 4" (SPECIAL)	FOOT	65				65	1	1			
× XX003531	WATER SERVICE CONNECTION, 1"	EACH	2		l	<u> </u>	2					
xx003532	WATER SERVICE CONNECTION, 1.5"	EACH	1		1		1					
× XX003885	IRRIGATION SYSTEM	LSUM	1		1	<u> </u>	1	* Later of the same of				İ
1,11000000					1	i						
		7				<u> </u>	· · · · · · · · · · · · · · · · · · ·					1
		3-0-4	· · · · · · · · · · · · · · · · · · ·									l
								1				l
					‡							ļ
								ļ				<u> </u>
				A service services			,		<u> </u>			
-												ļ
.						<u> </u>						
						ļ				ļ	<u> </u>	ļ
				 						ļ		ļ
										.		
				ļ					ļ			
					<u>.</u>	.						1
									L			
										.		
			1	1	1		1	1				1


* - INDICATES SPECIALTY ITEMS


FILE NAME = 09493-QUAN-01 - IDOT P02	USER NAME ==	DESIGNED	REVISED —			HARLEM AVENUE	F.A.P.	SECTION	COUNTY	TOTAL	SHEET
		CHECKED JSP	REVISED —	STATE OF ILLINOIS		BEAUTIFICATION - STREETSCAPING	348	09-00108-00-LS	соок	38	4
1	PLOT SCALE =	DRAWN — PS	REVISED	DEPARTMENT OF TRANSPORTATION		SUMMARY OF QUANTITIES			CONTRACT	T NO. 634	12
	PLOT DATE = 11-30-09	CHECKED AG	REVISED		SCALE:	SHEET NO. 4 OF 38 SHEETS STA. TO STA.	FED. ROAD D	DIST. NO. 1 ILLINOIS F	ED. AID PROJECT ARA	(-00D1(809)	

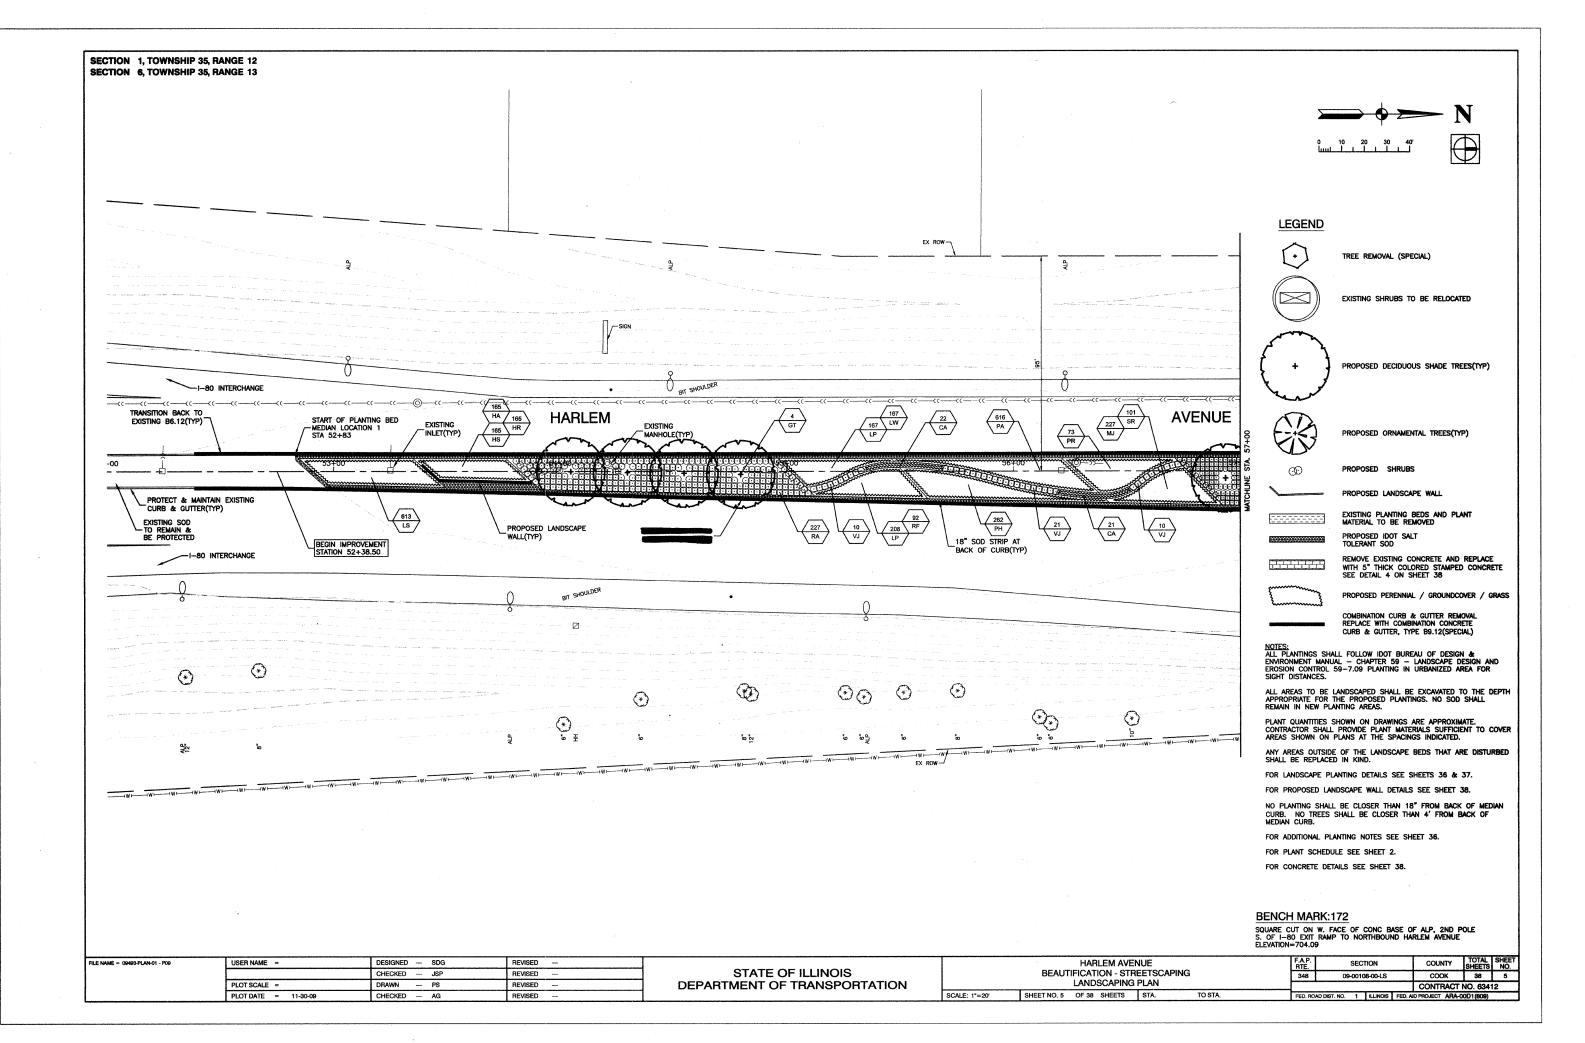


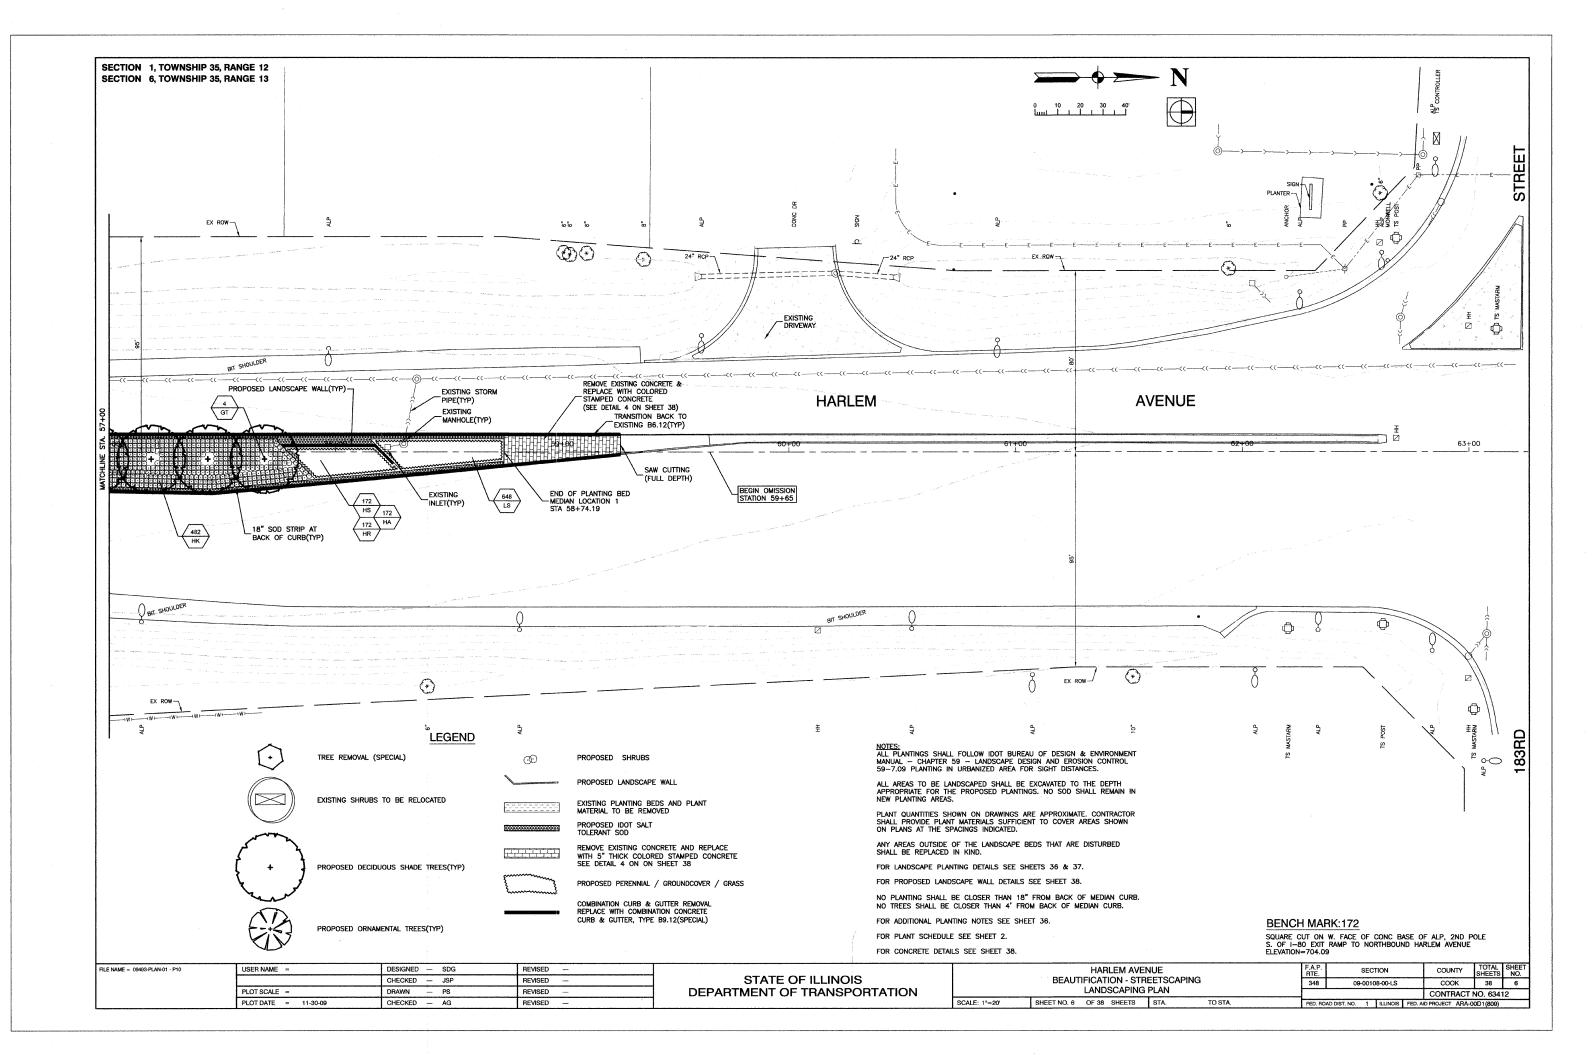

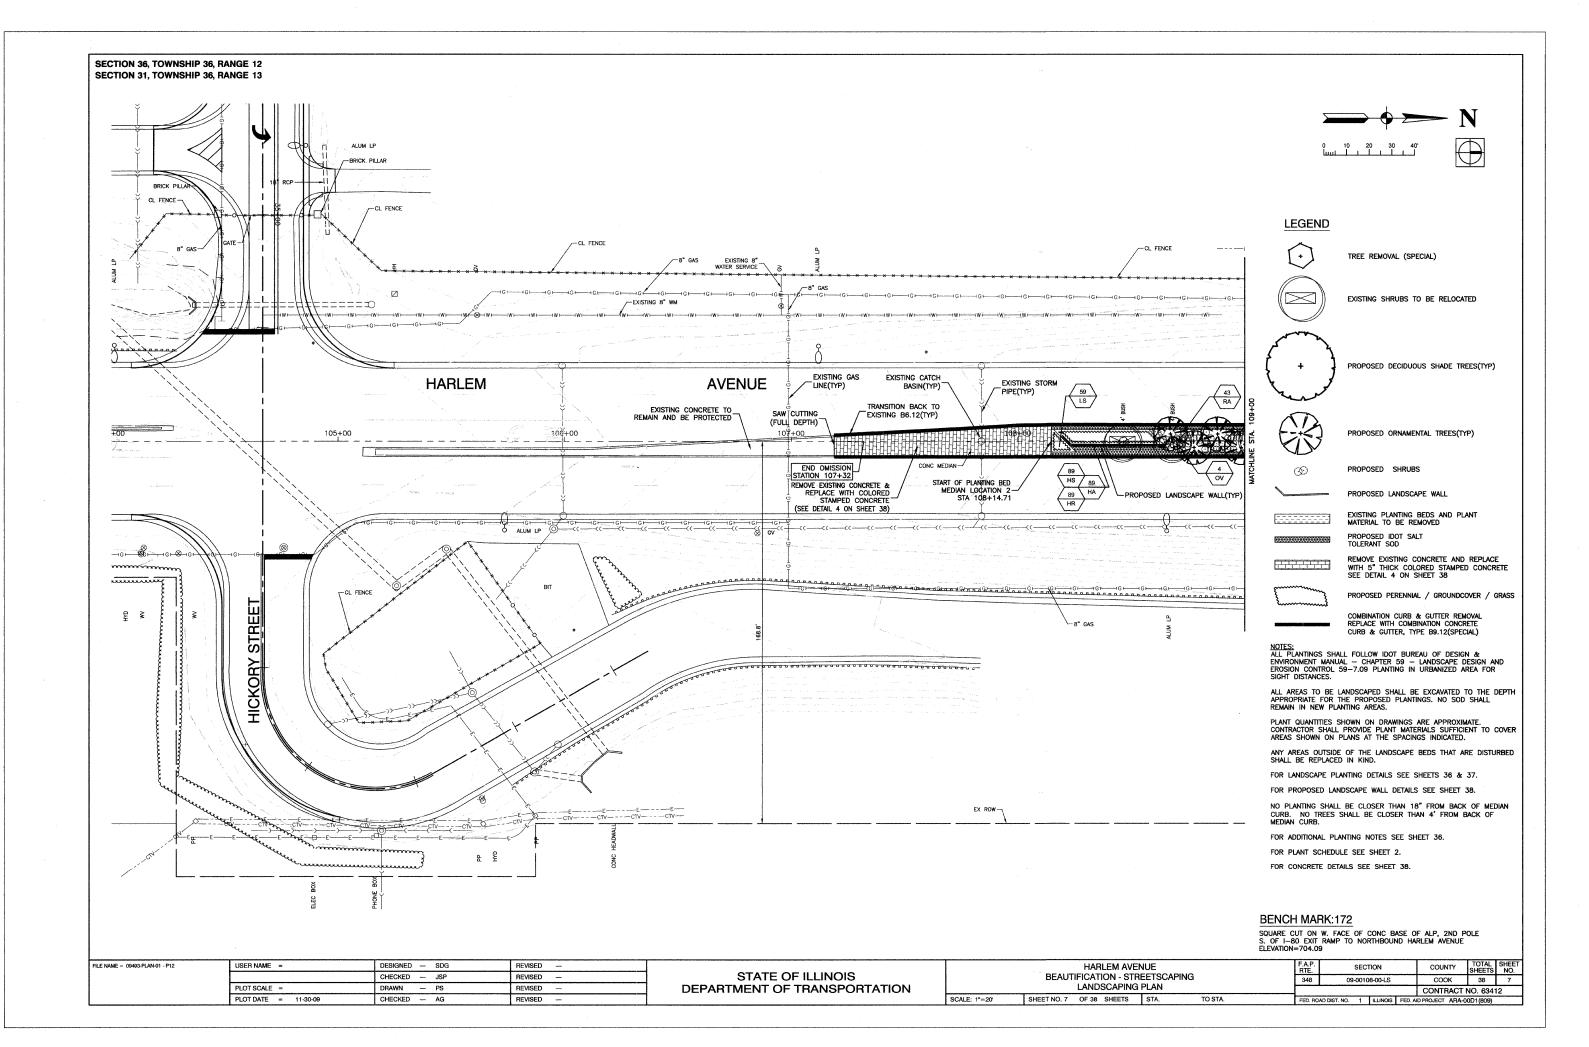

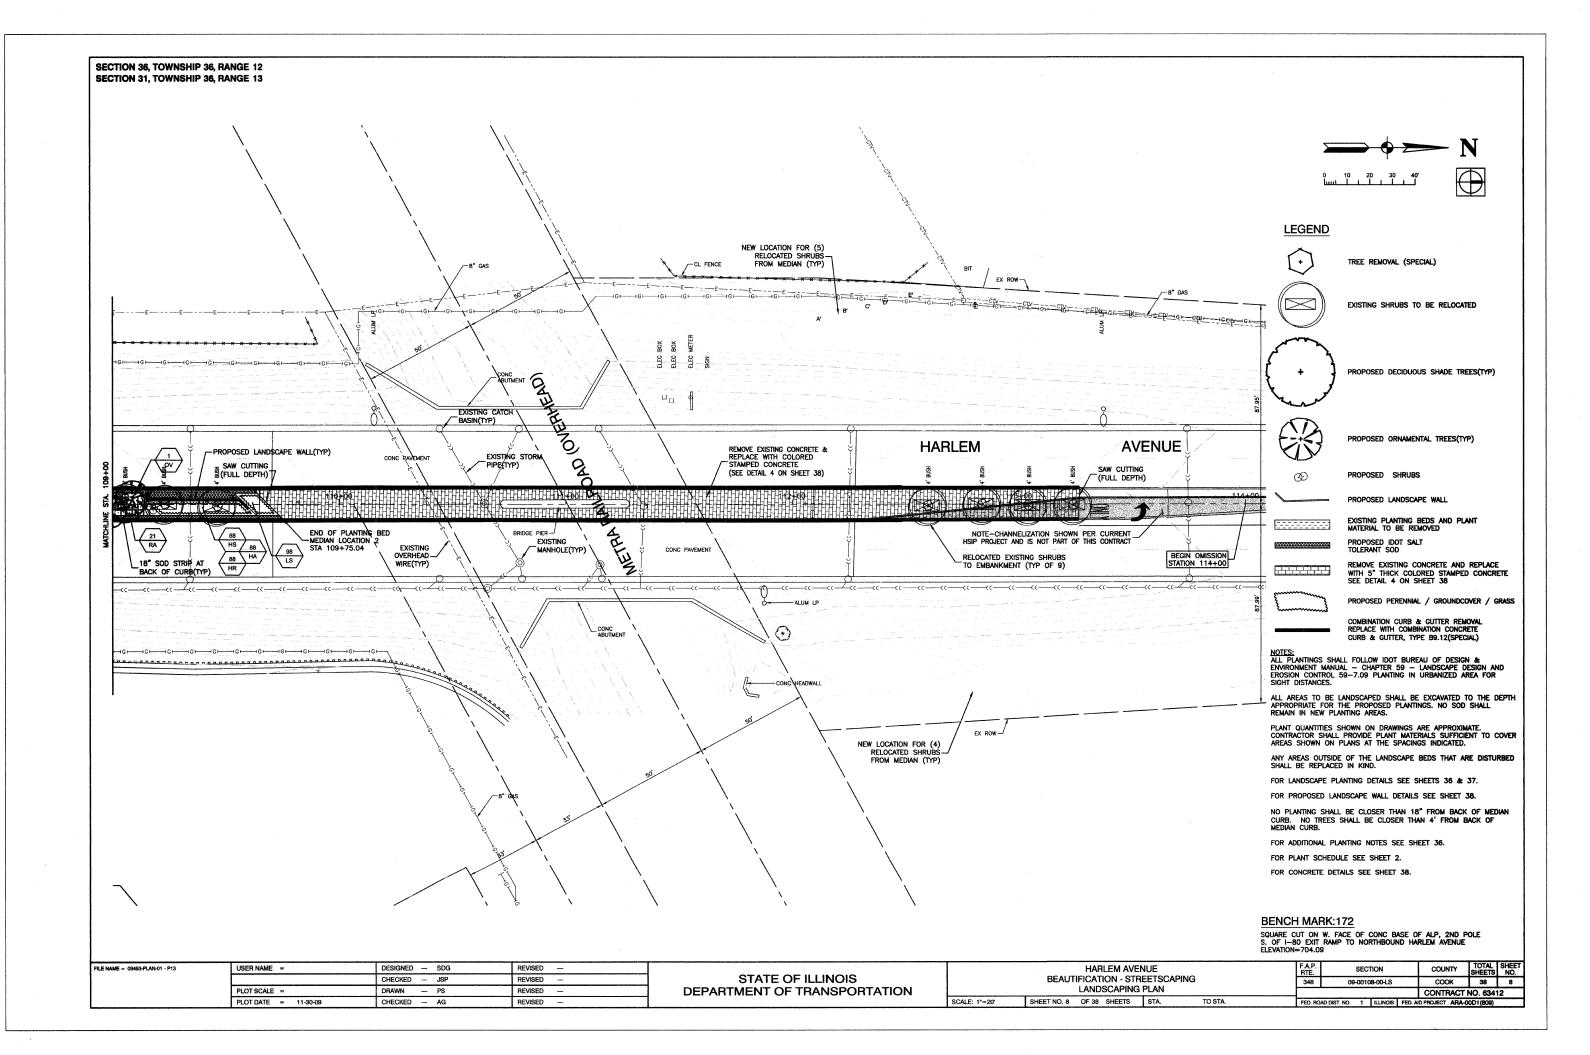

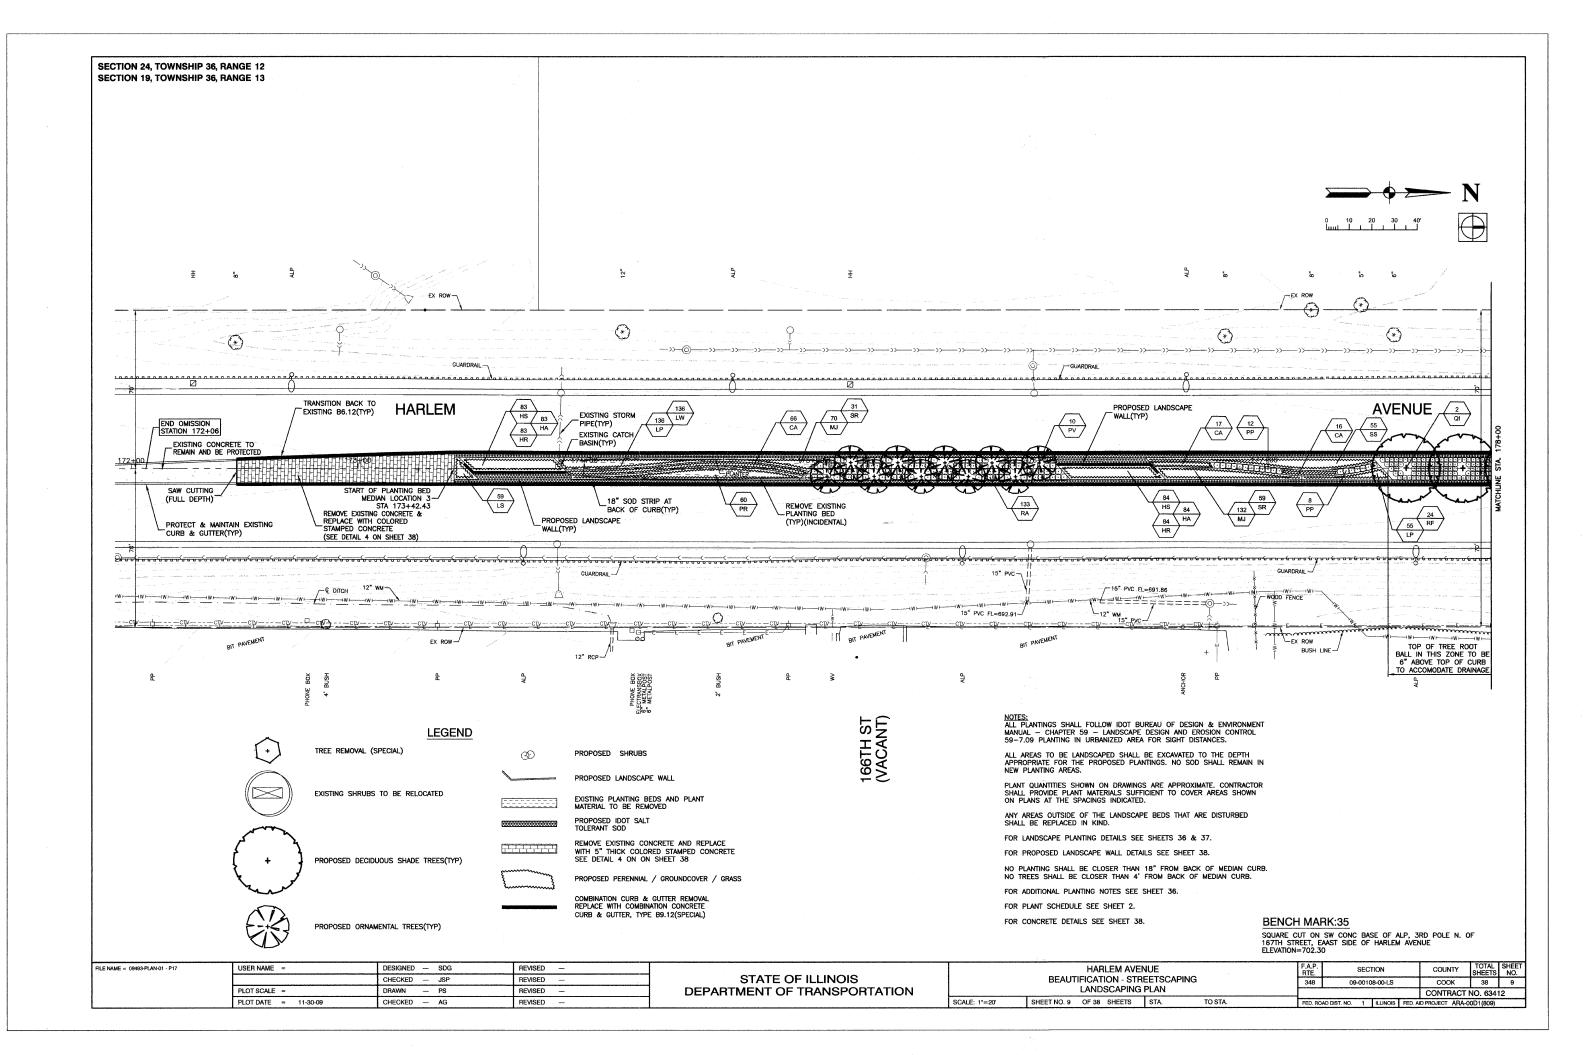

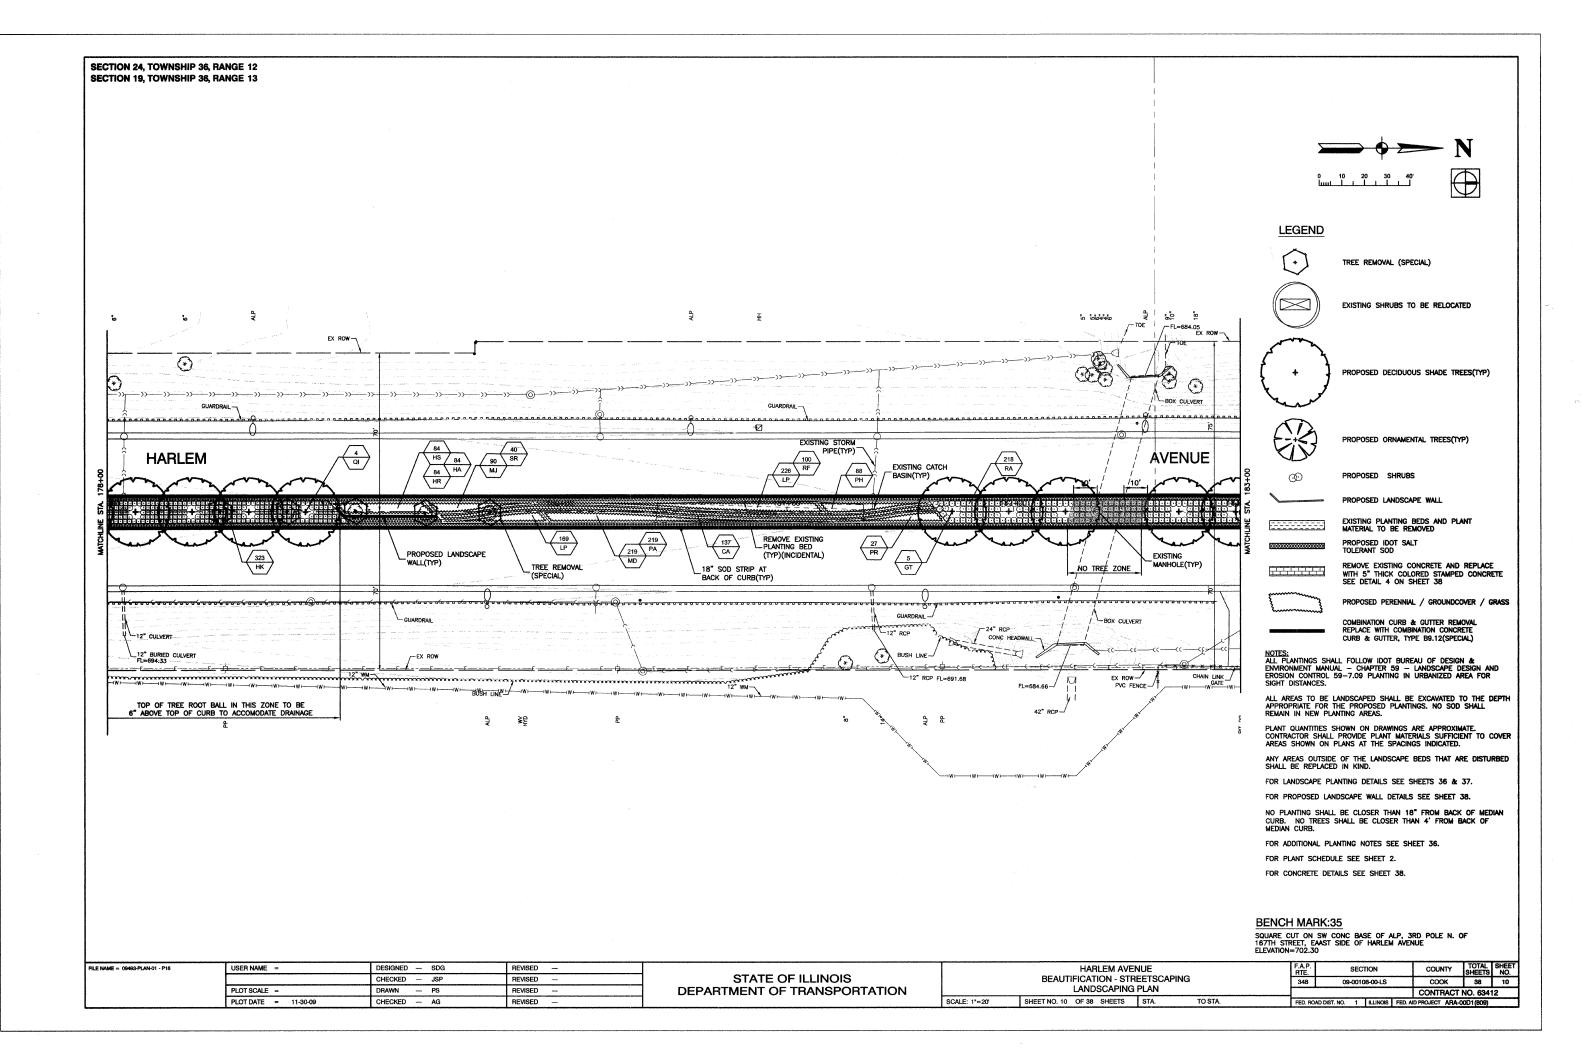

HARLEM

SAW CUTTING (FULL DEPTH)

EX ROW

(*)

0

END OF PLANTING BED

TRANSITION BACK TO


—€ DITCH


(*)

(

REMOVE EXISTING CONCRETE &
REPLACE WITH COLORED
STAMPED CONCRETE
(SEE DETAIL 4 ON SHEET 38)

MEDIAN LOCATION 4-STA 199+38.26

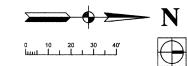

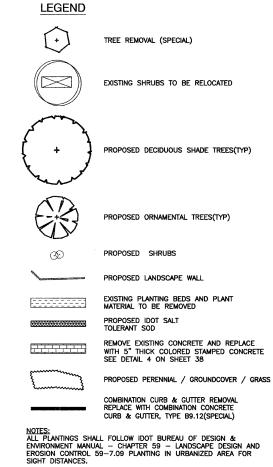

PIPE(TYP)

EXISTING CATC

BASIN(TYP)

 \odot

 \odot

SIGHT DISTANCES.

ALL AREAS TO BE LANDSCAPED SHALL BE EXCAVATED TO THE DEPTH APPROPRIATE FOR THE PROPOSED PLANTINGS. NO SOD SHALL REMAIN IN NEW PLANTING AREAS.

PLANT QUANTITIES SHOWN ON DRAWINGS ARE APPROXIMATE.
CONTRACTOR SHALL PROVIDE PLANT MATERIALS SUFFICIENT TO COVER
AREAS SHOWN ON PLANS AT THE SPACINGS INDICATED.

ARY AREAS OUTSIDE OF THE LANDSCAPE BEDS THAT ARE DISTURBED SHALL BE REPLACED IN KIND.

FOR LANDSCAPE PLANTING DETAILS SEE SHEETS 36 & 37.

OR LANDSCAPE PLANTING DETAILS SEE SHEETS 36 & 37

FOR PROPOSED LANDSCAPE WALL DETAILS SEE SHEET 38.

NO PLANTING SHALL BE CLOSER THAN 18" FROM BACK OF MEDIAN CURB. NO TREES SHALL BE CLOSER THAN 4' FROM BACK OF MEDIAN CURB.

FOR ADDITIONAL PLANTING NOTES SEE SHEET 36.

FOR PLANT SCHEDULE SEE SHEET 2.

FOR CONCRETE DETAILS SEE SHEET 38.

BENCH MARK:35

SQUARE CUT ON SW CONC BASE OF ALP, 3RD POLE N. OF 167TH STREET, EAAST SIDE OF HARLEM AVENUE ELEVATION=702.30

FILE NAME = 09493-PLAN-01 - P22	USER NAME =	DESIGNED - SDG	REVISED —			HARLEM AVENUE		F.A.P.	SECTION	COUNTY	TOTAL	SHEET
		CHECKED JSP	REVISED —	STATE OF ILLINOIS		BEAUTIFICATION - STREETSCAPING	<u> </u>	348	09-00108-00-LS	соок	38	13
	PLOT SCALE =	DRAWN — PS	REVISED —	DEPARTMENT OF TRANSPORTATION		LANDSCAPING PLAN				CONTRAC	T NO. 6341	2
	PLOT DATE ≈ 11-30-09	CHECKED AG	REVISED	1	SCALE: 1"=20'	SHEET NO. 13 OF 38 SHEETS STA. TO STA.		FED. ROAD DIS	ST. NO. 1 ILLINOIS FEE	D. AID PROJECT ARA	4-00D1(809)	

AVENUE

18, SOD STRIP AT

PI ANTER

REMOVE EXISTING

- PLANTING BED (TYP)(INCIDENTAL)

ĕ Ğ ₹

ALPONE

104 RA

(*)

*

手切

(*)


TOP OF TREE ROOT BALL IN THIS ZONE TO BE 6" ABOVE TOP OF CURB TO ACCOMODATE DRAINAGE


BIT PAVEMEN


LS /


PROPOSED LANDSCAPE


WALL(TYP)

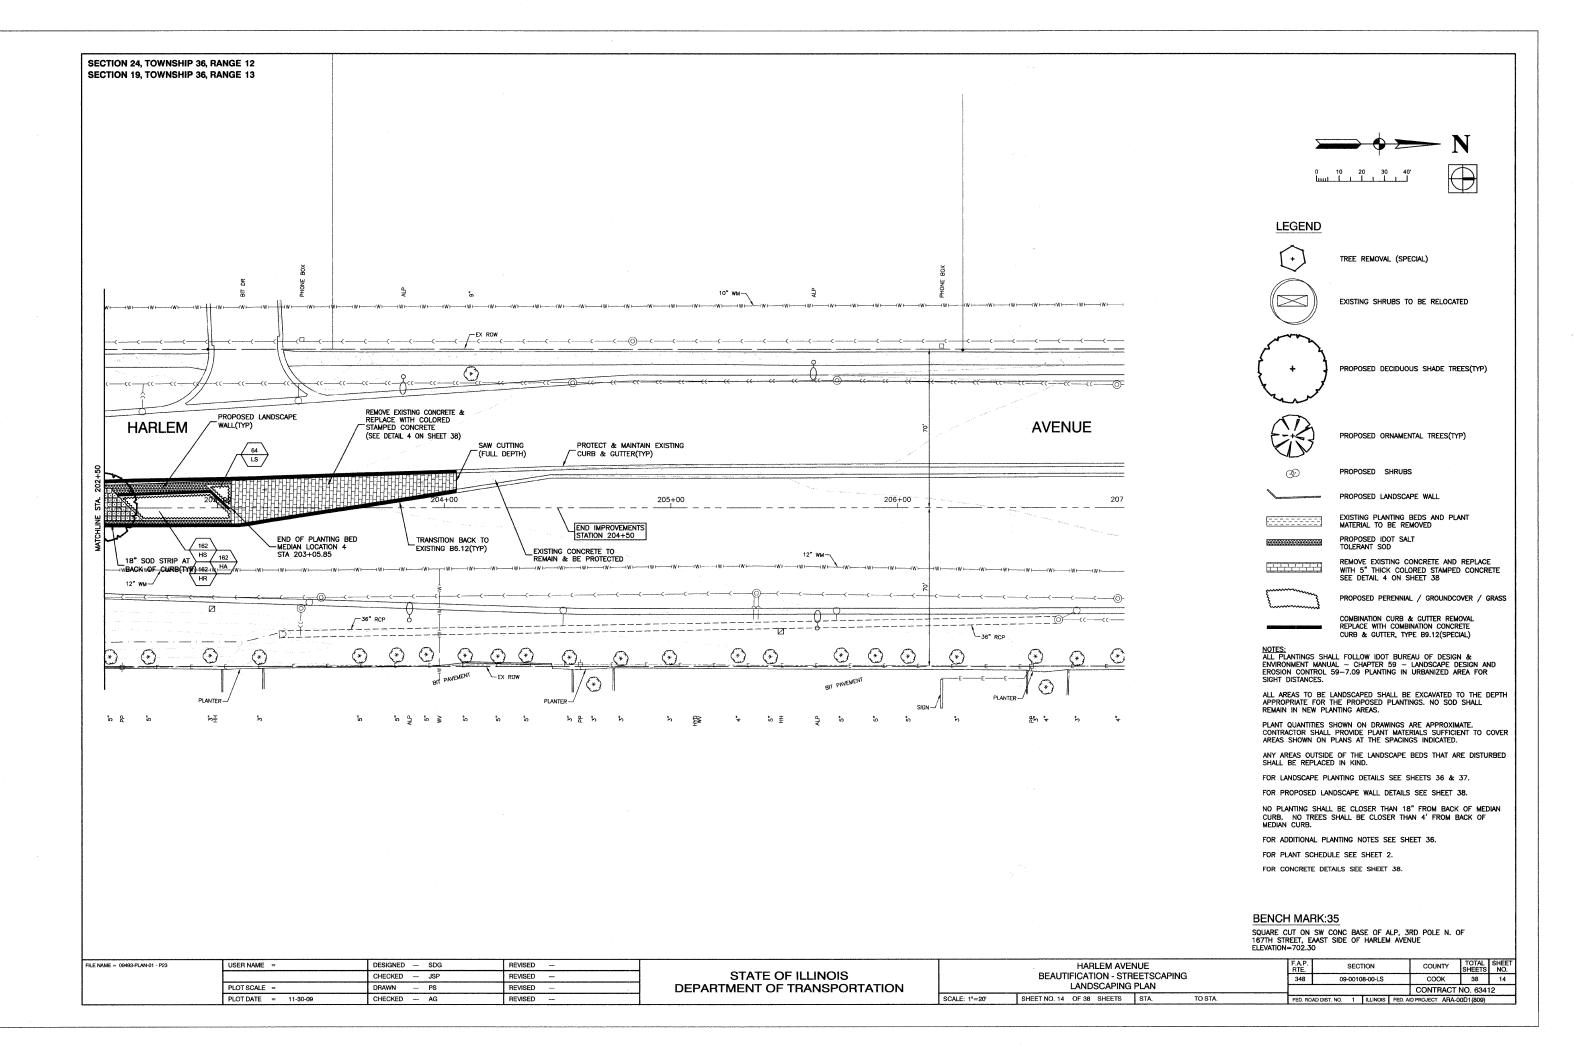


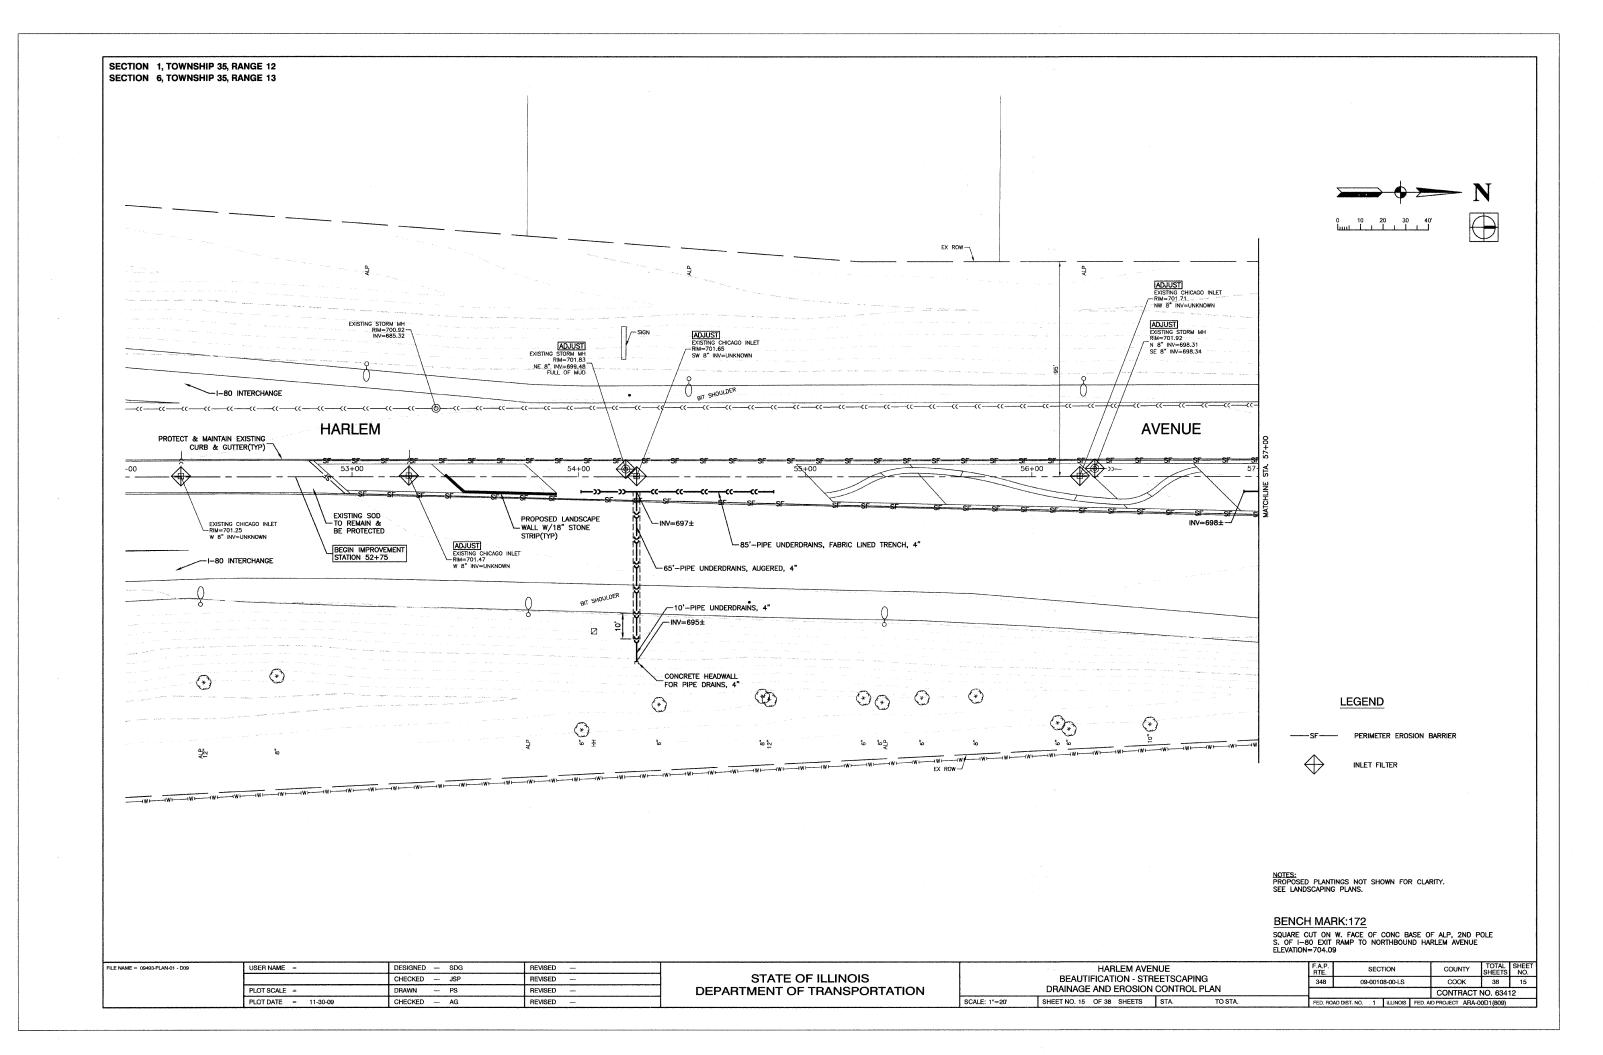


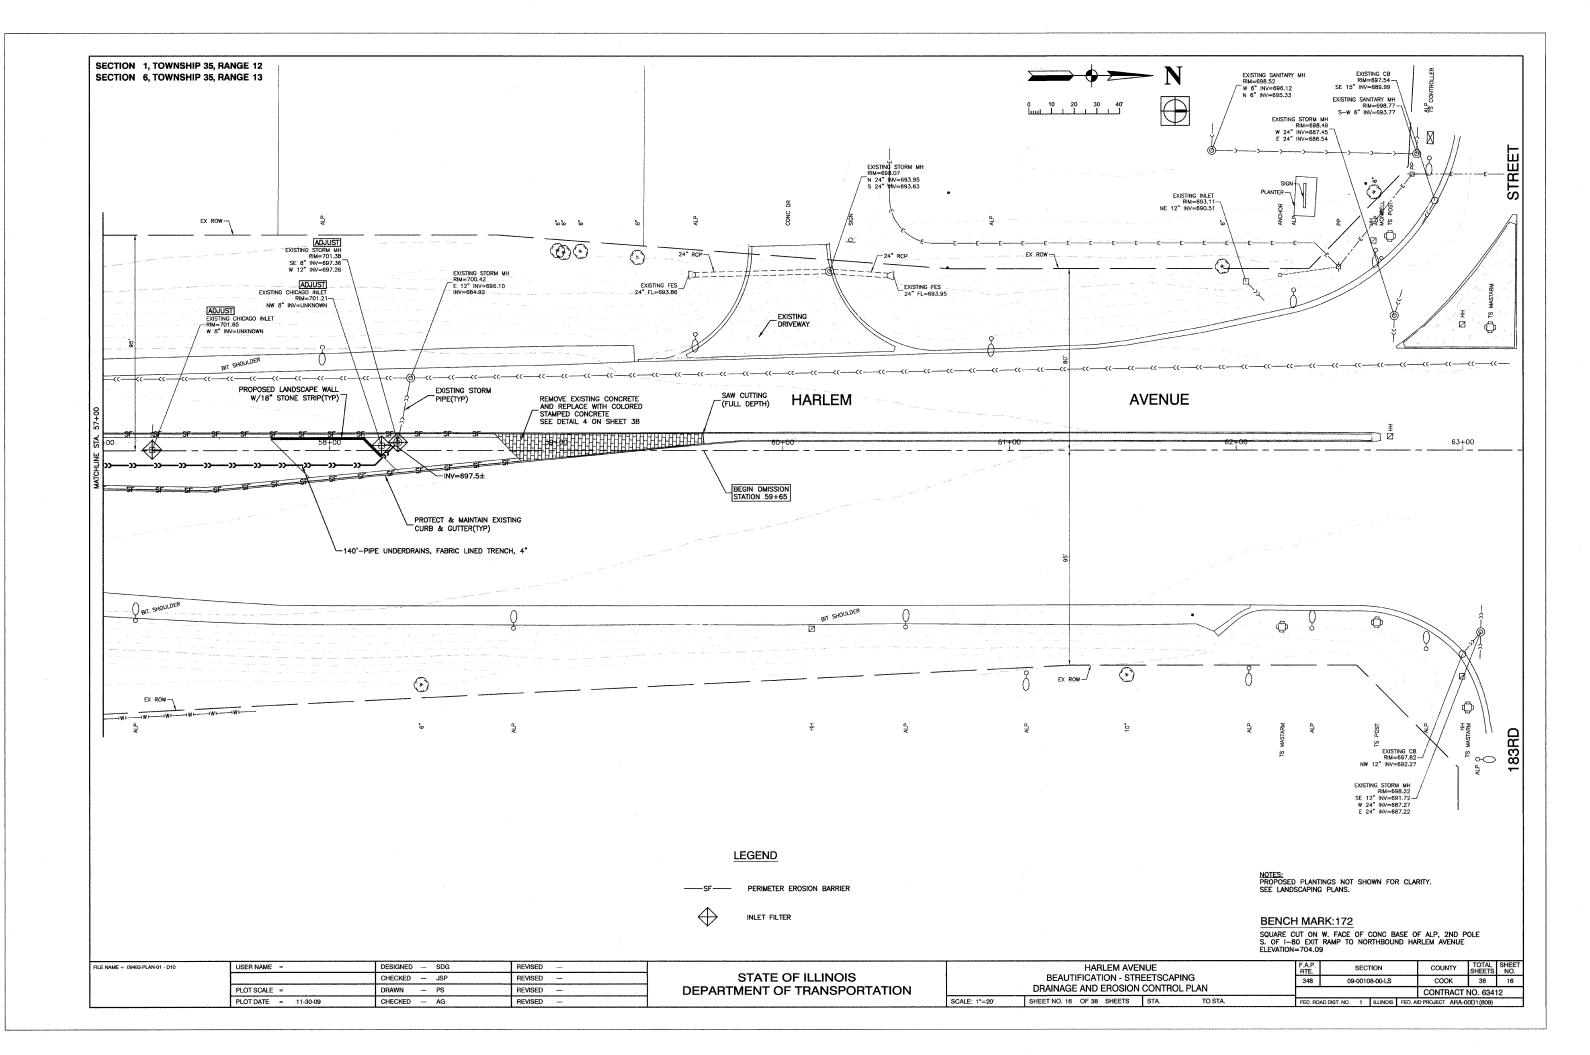


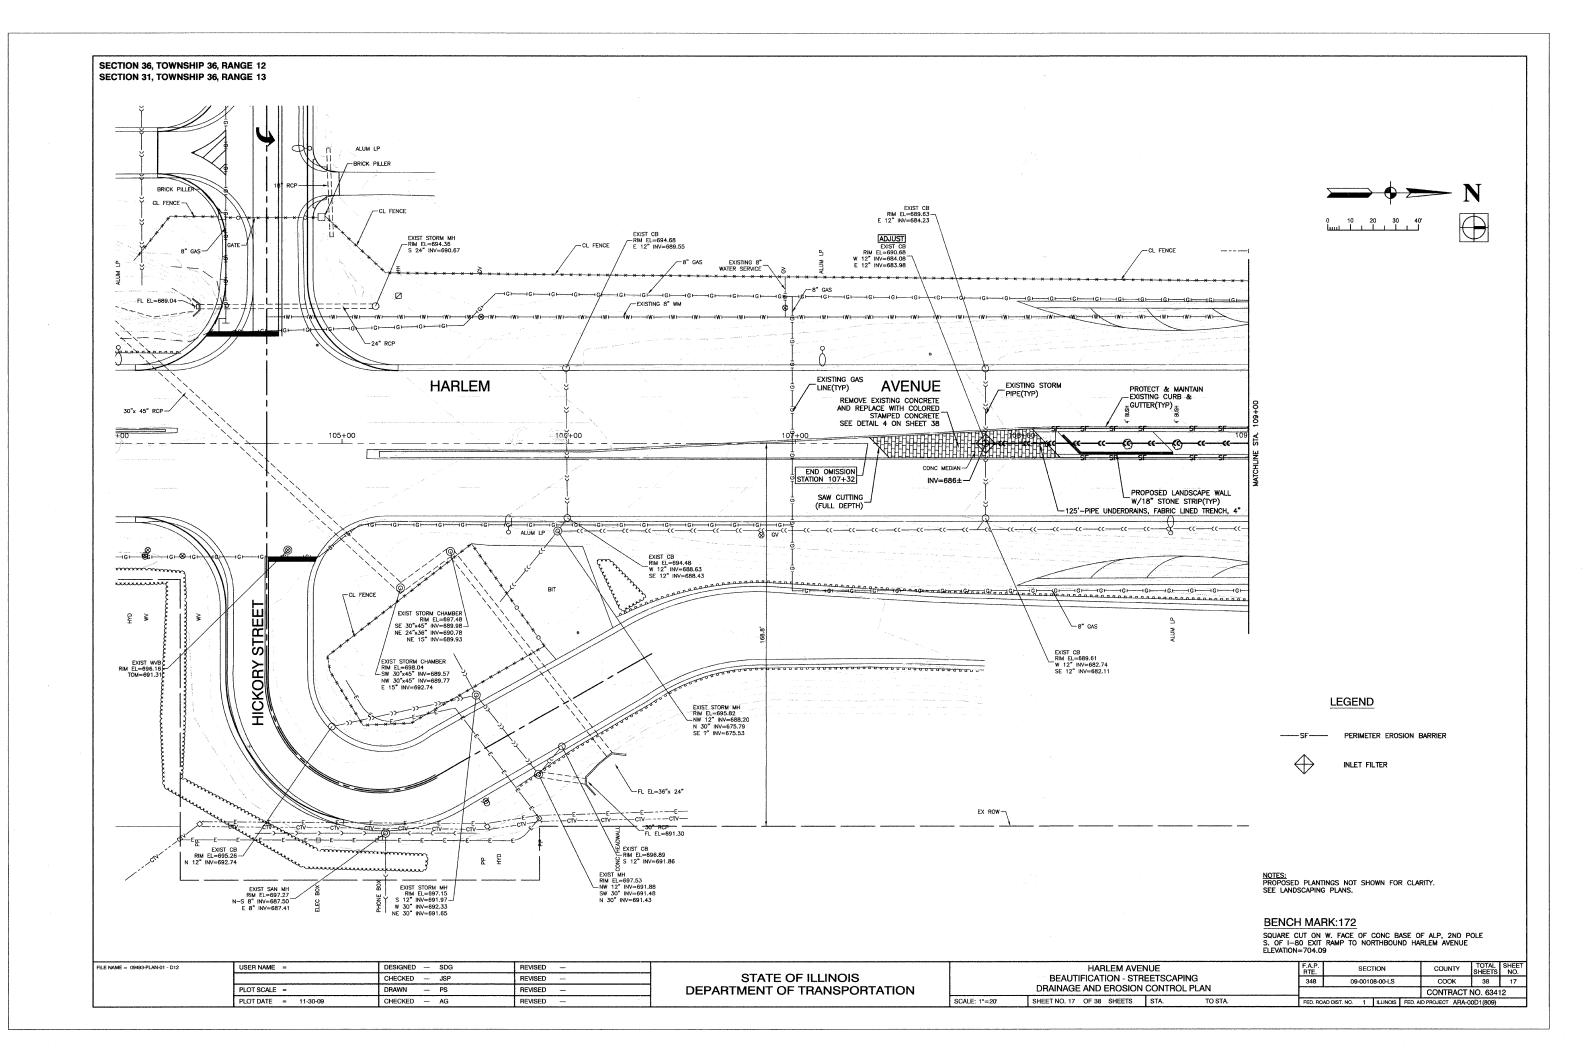


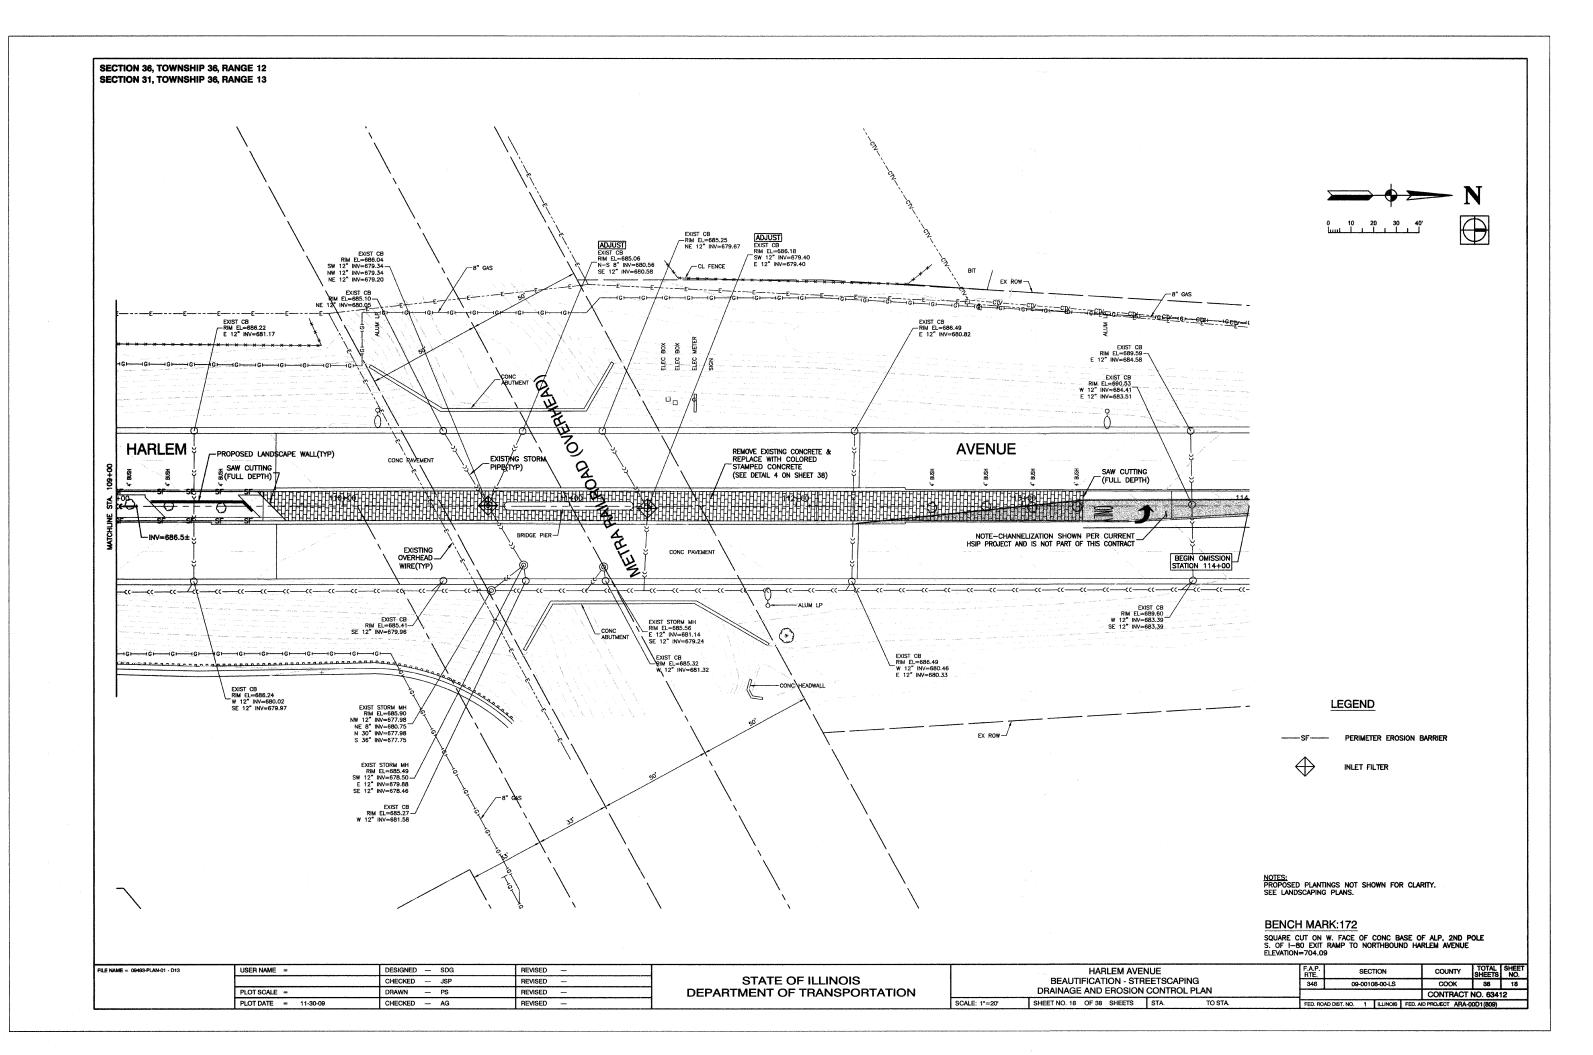


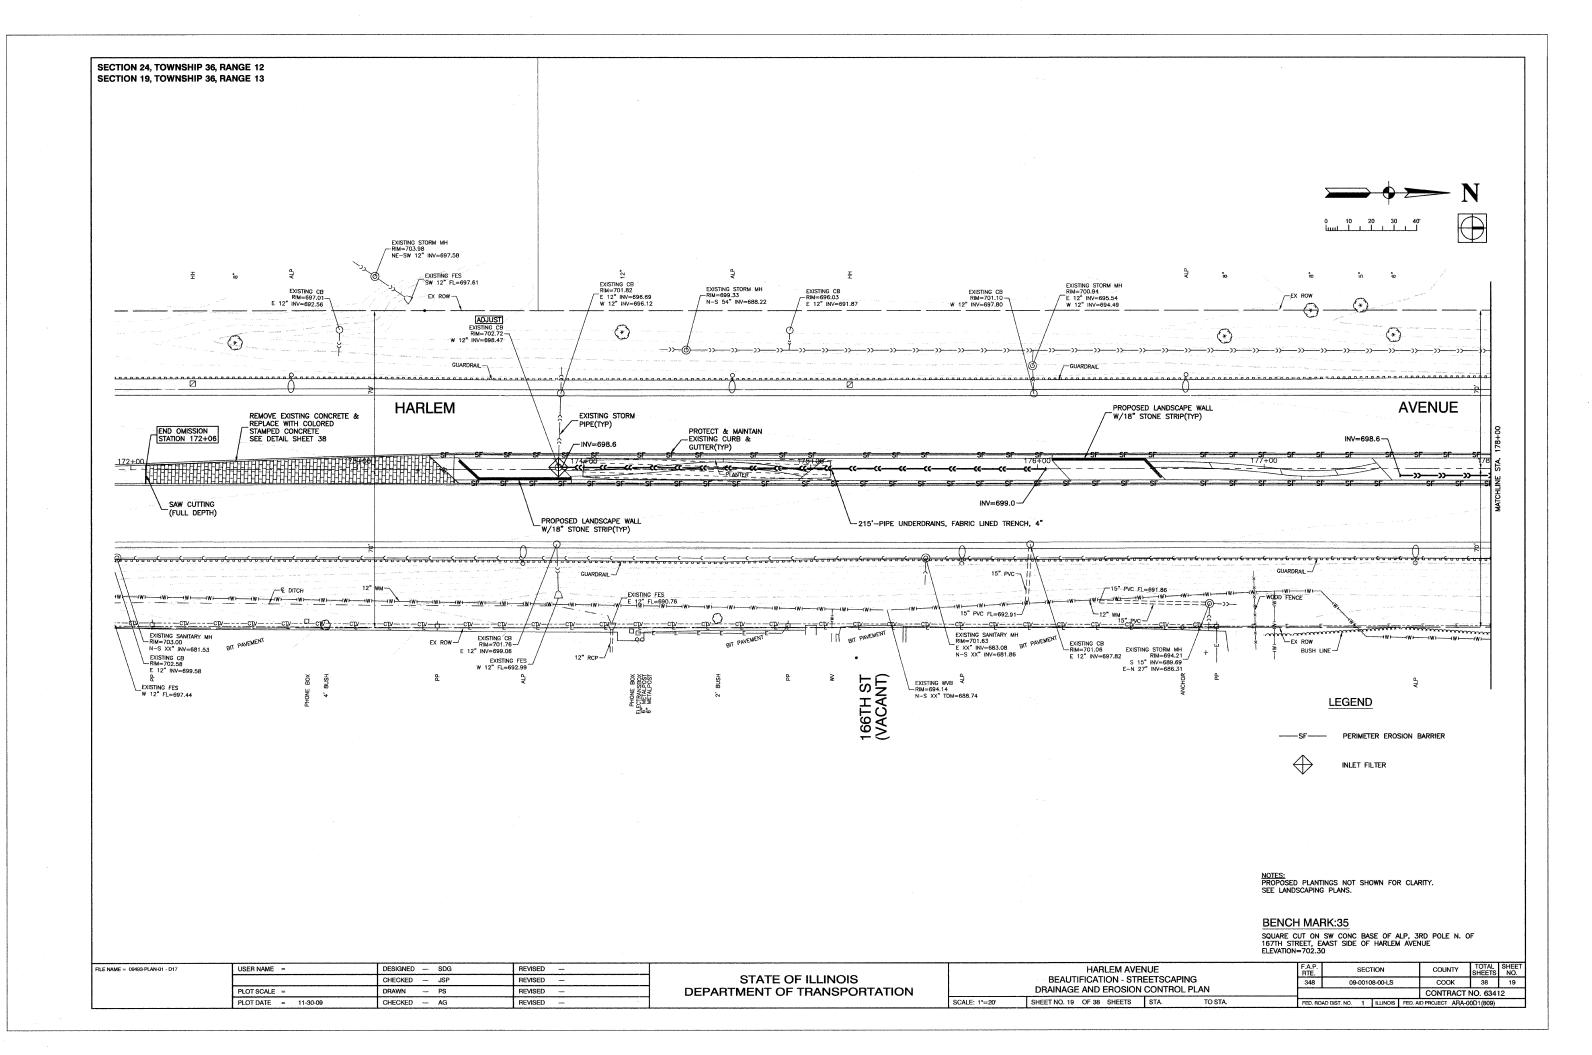

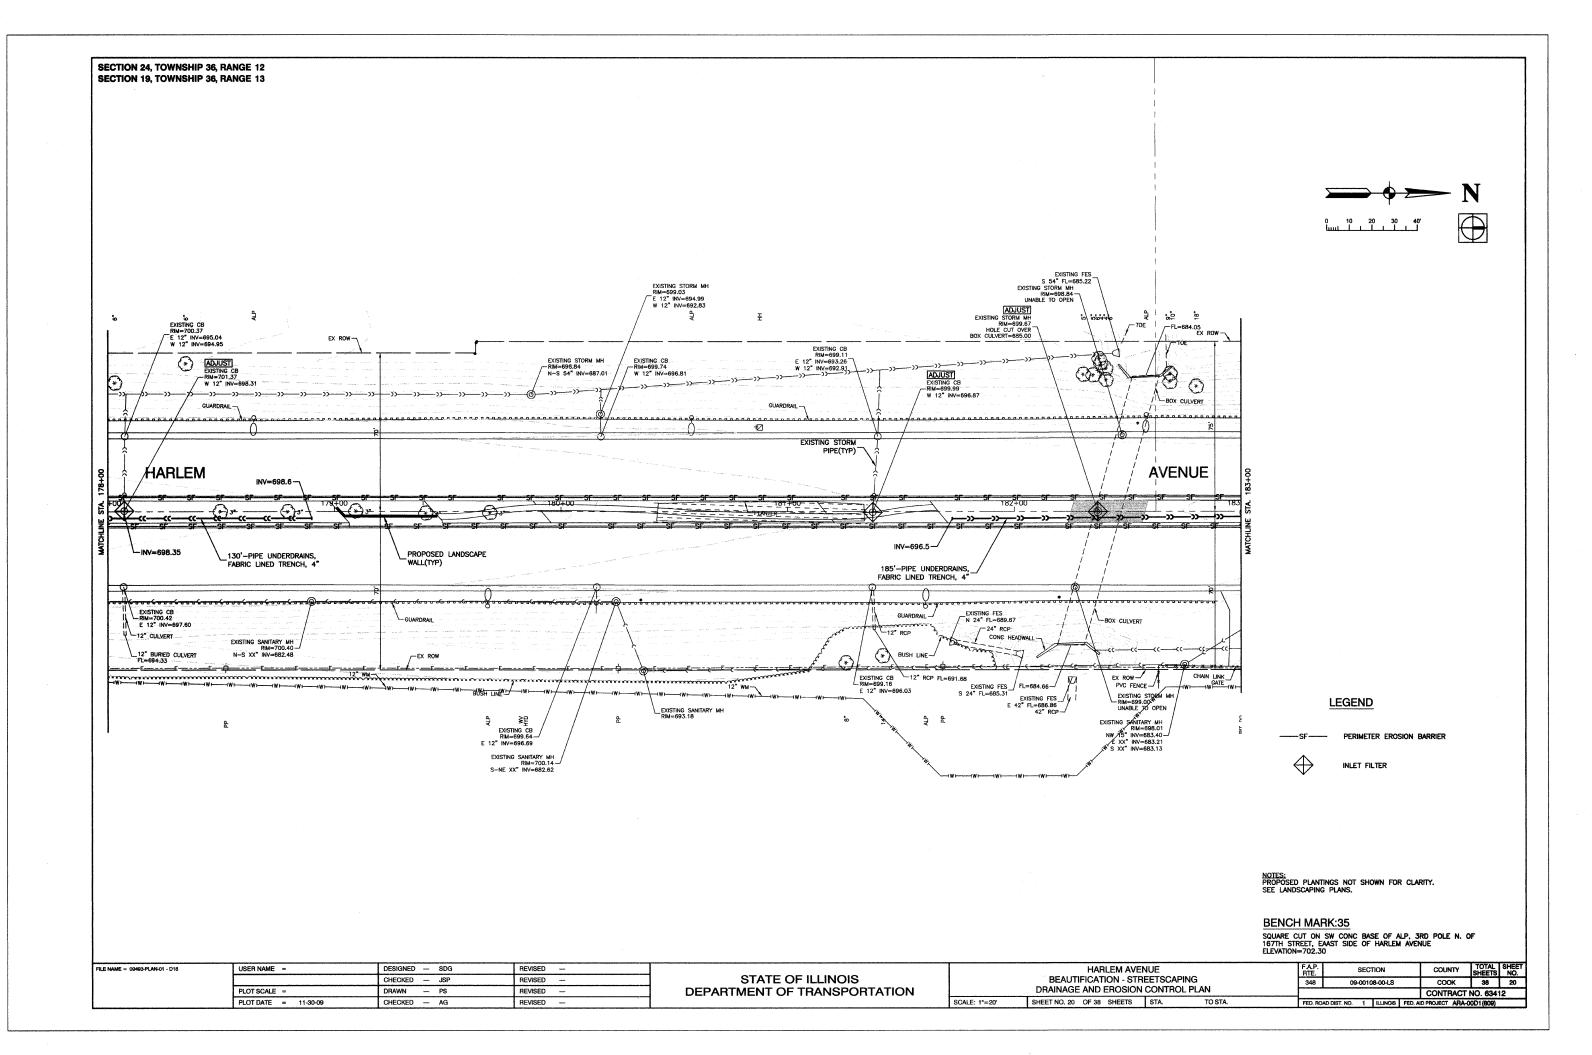

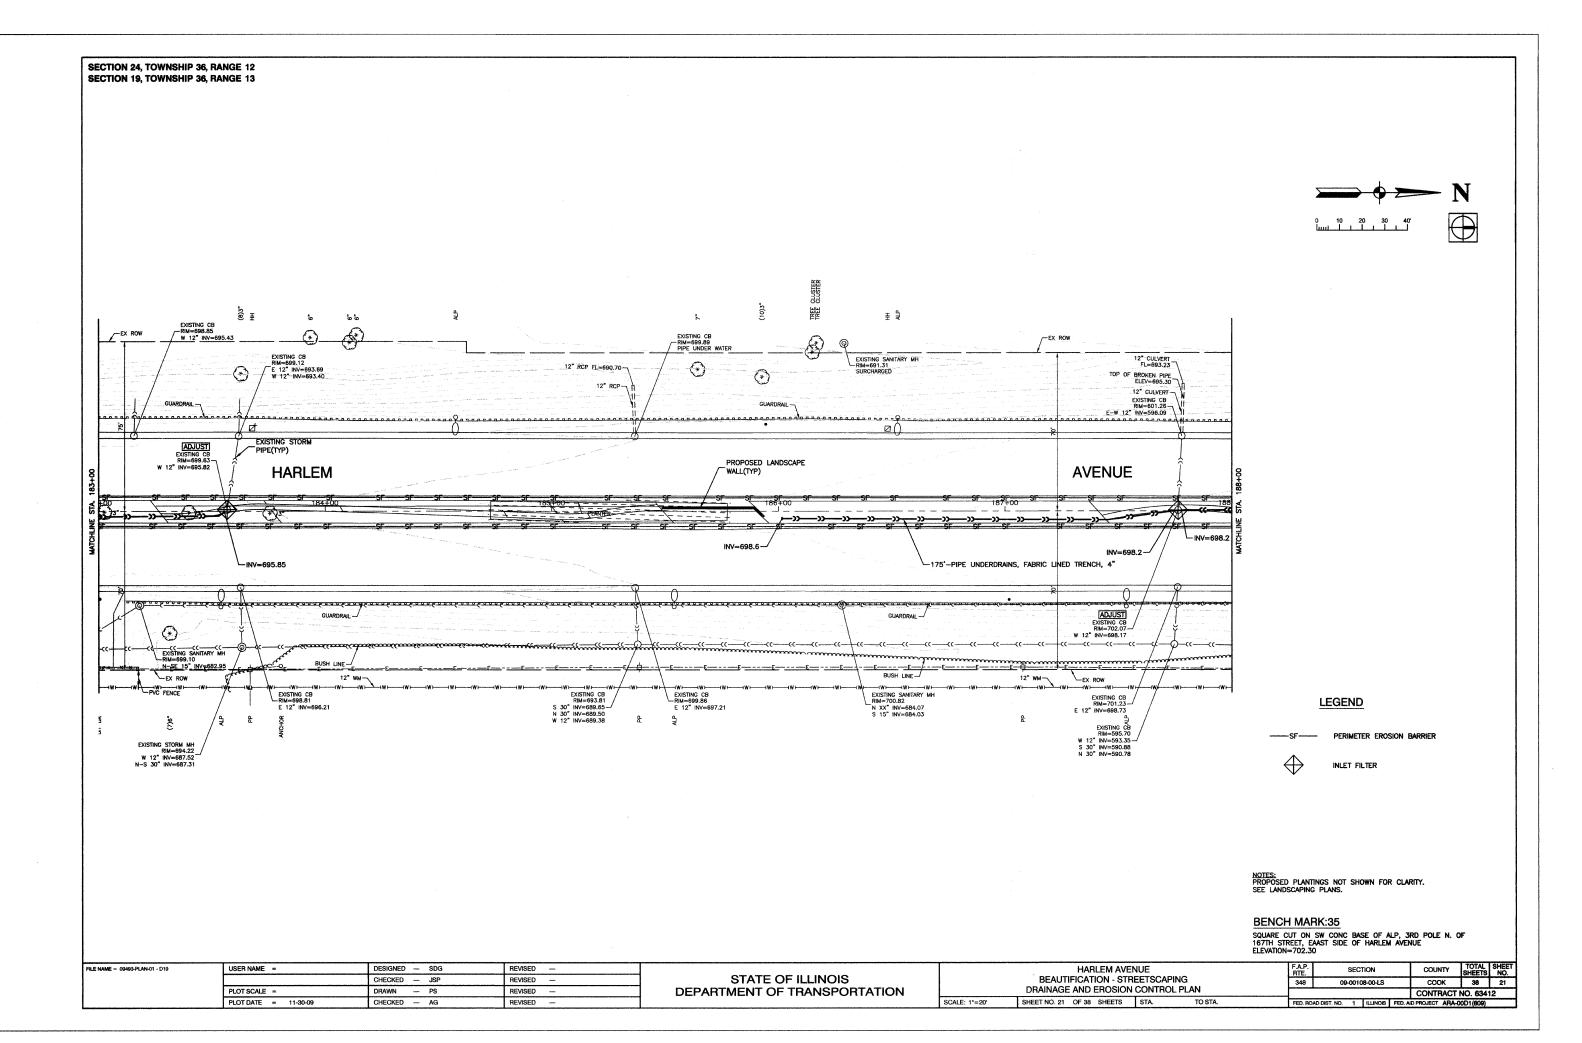

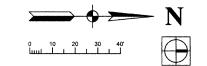

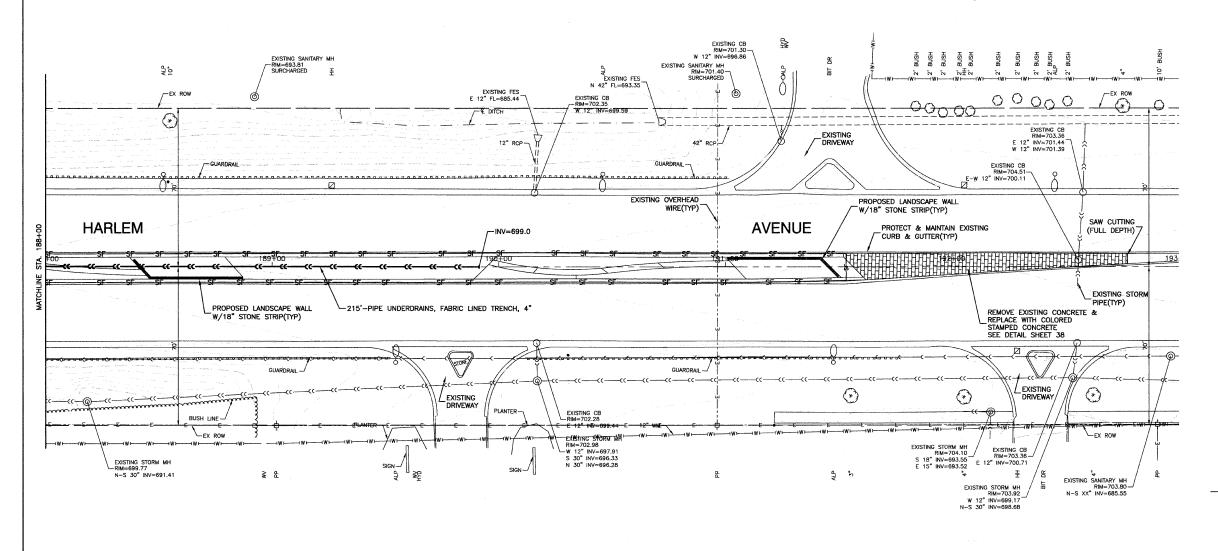

LEGEND

---SF------ PERIMETER EROSION BARRIER

 \bigoplus


INLET FILTER


NOTES: PROPOSED PLANTINGS NOT SHOWN FOR CLARITY. SEE LANDSCAPING PLANS.


BENCH MARK:35


SQUARE CUT ON SW CONC BASE OF ALP, 3RD POLE N. OF 167TH STREET, EAAST SIDE OF HARLEM AVENUE ELEVATION=702.30


FILE NAME = 09493-PLAN-01 - D20	USER NAME =	DESIGNED — SDG	REVISED —			HARLEM AVENUE	F.A.P.	SECTION	COUNTY	TOTAL	SHEET
		CHECKED JSP	REVISED —	STATE OF ILLINOIS		BEAUTIFICATION - STREETSCAPING	348	09-00108-00-LS	соок	38	22
	PLOT SCALE =	DRAWN PS	REVISED	DEPARTMENT OF TRANSPORTATION		DRAINAGE AND EROSION CONTROL PLAN				CT NO. 6341	2
	PLOT DATE = 11-30-09	CHECKED — AG	REVISED		SCALE: 1"=20'	SHEET NO. 22 OF 38 SHEETS STA. TO STA.	FED. ROAD	D DIST. NO. 1 ILLINOIS	FED. AID PROJECT AR	RA-00D1 (809)	

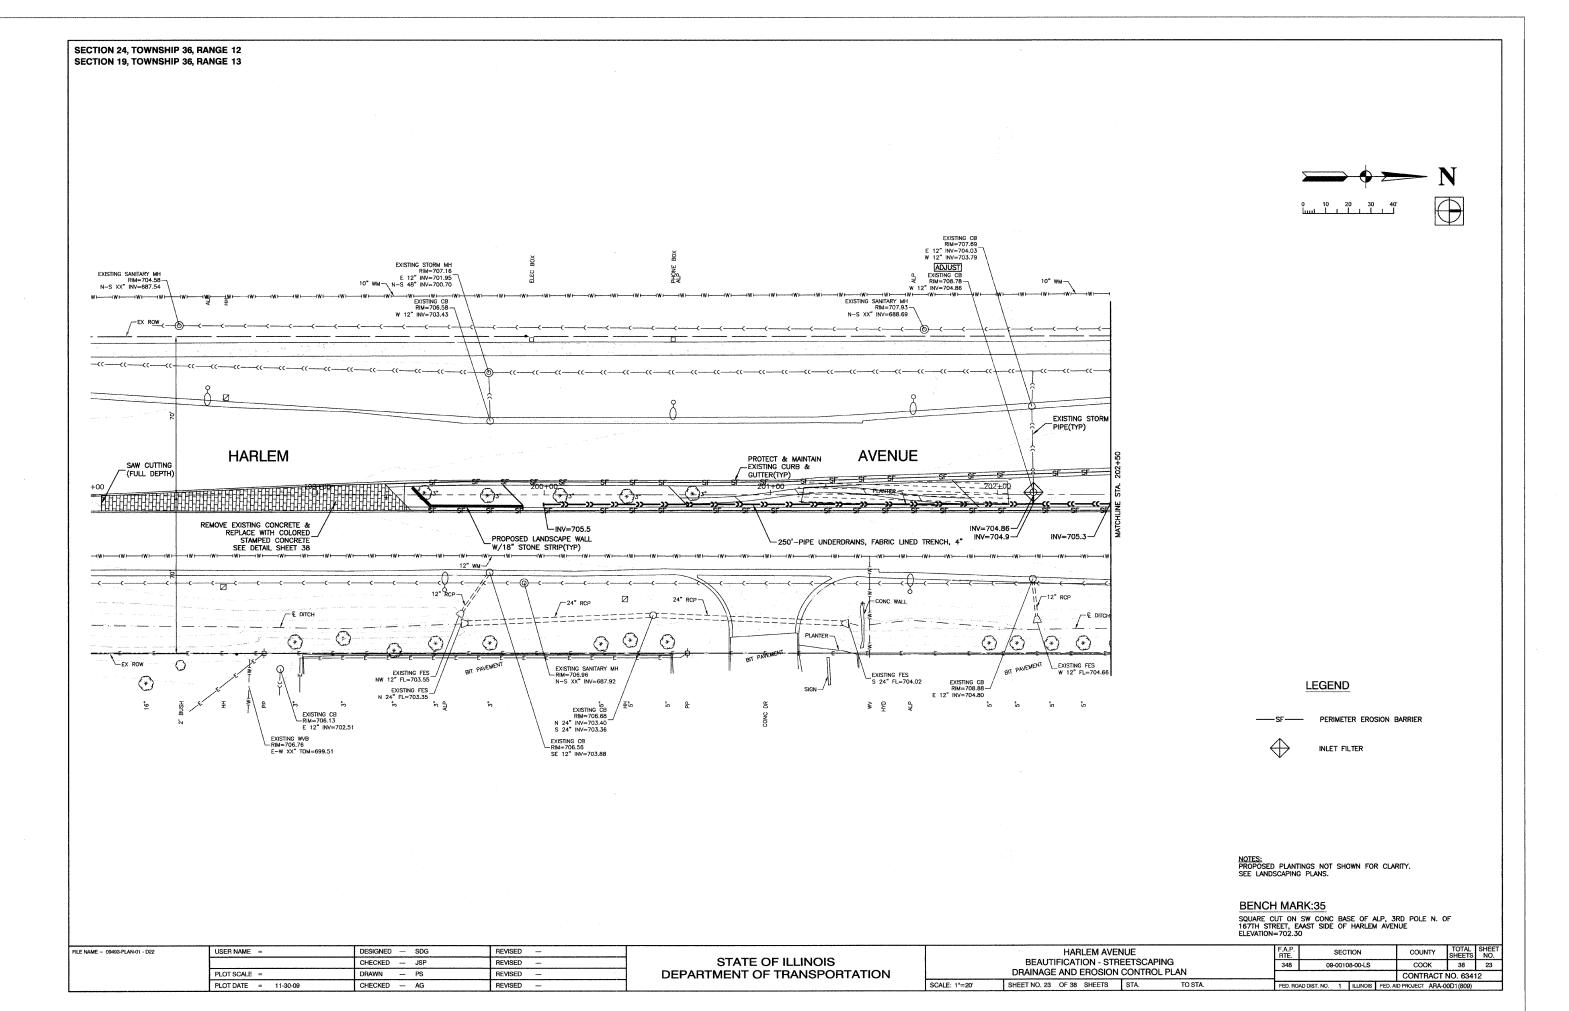


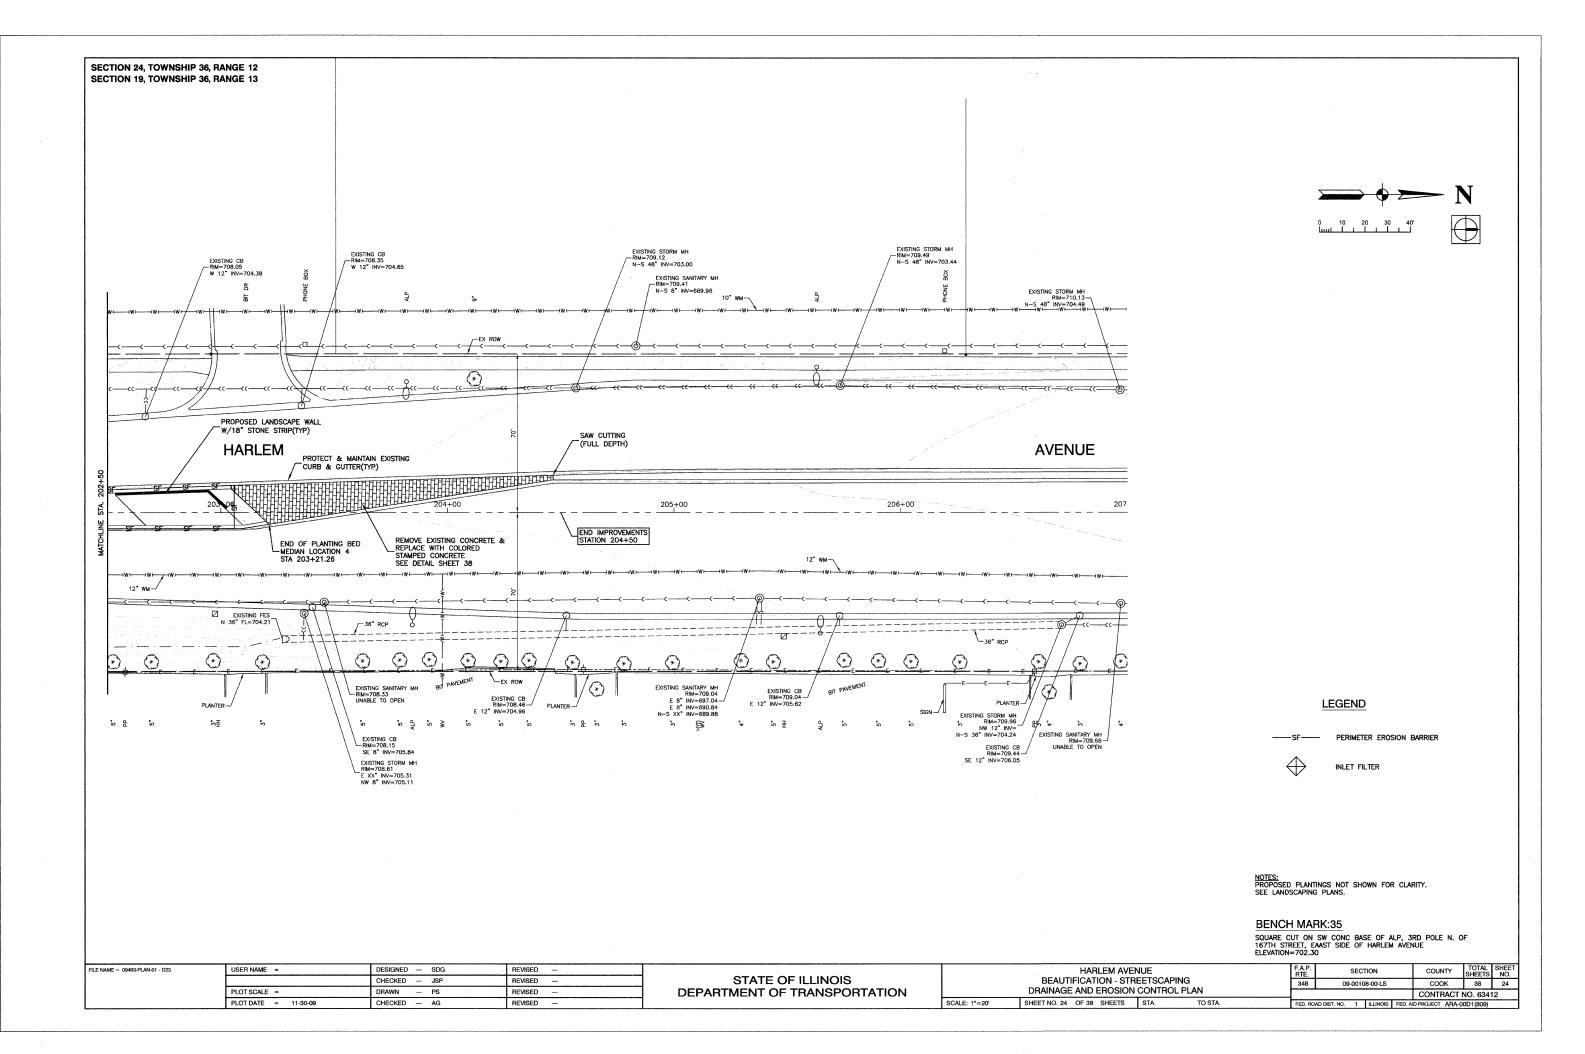


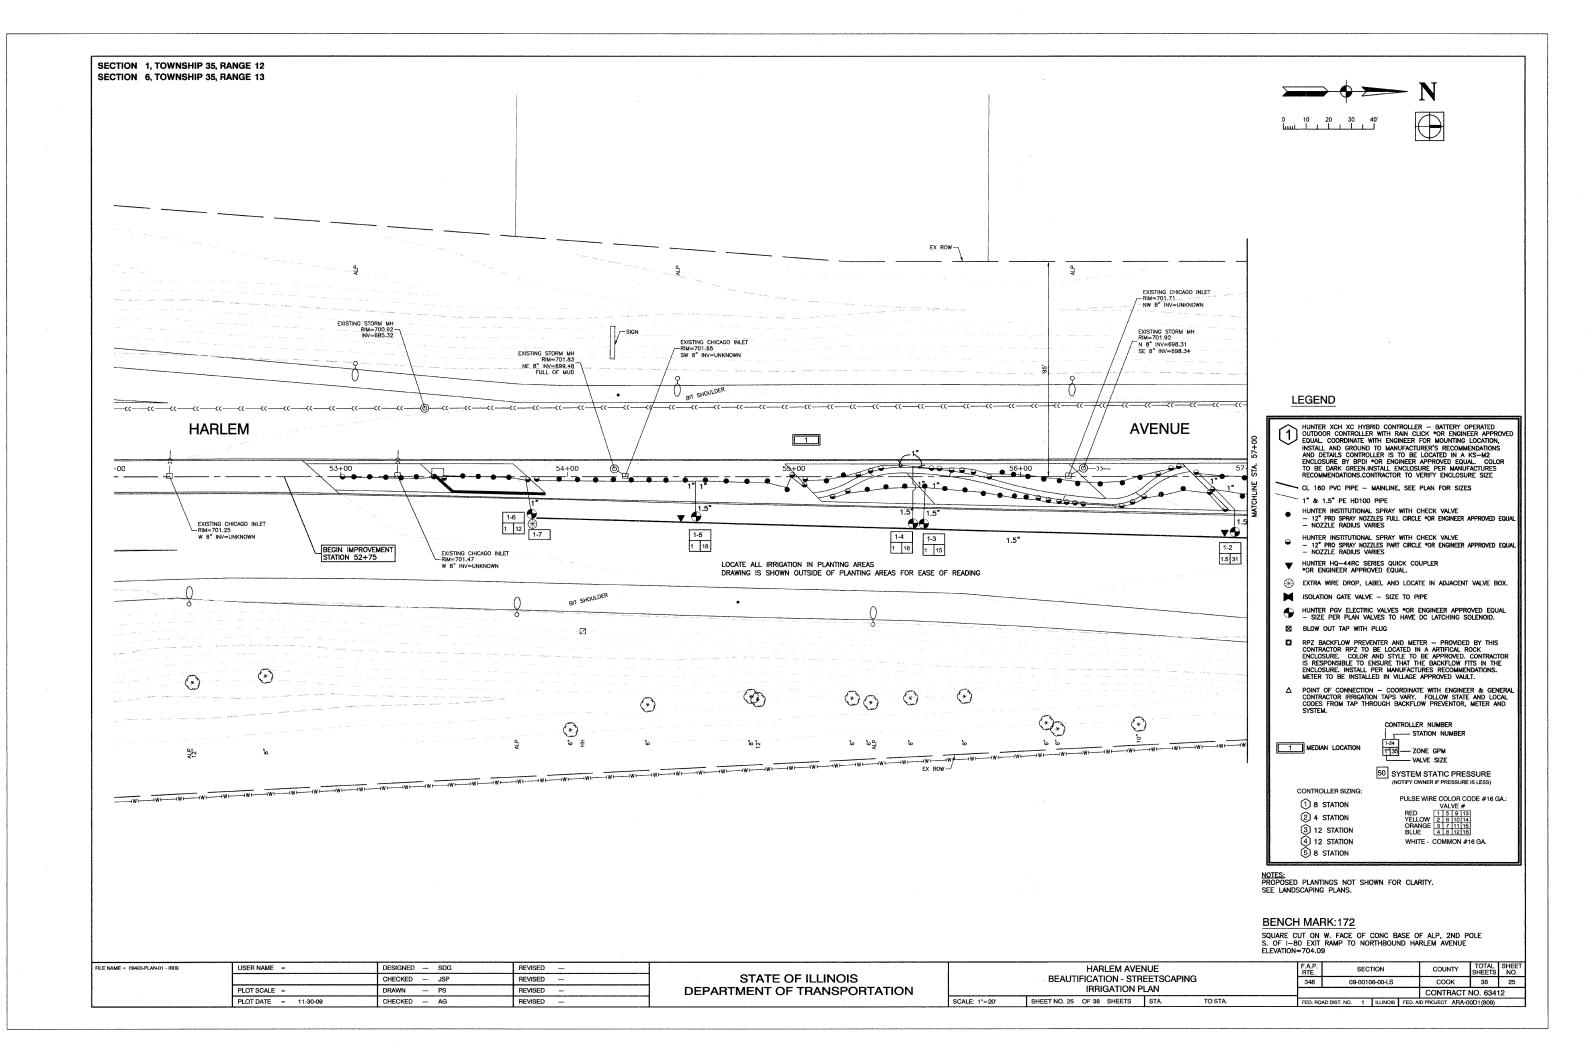


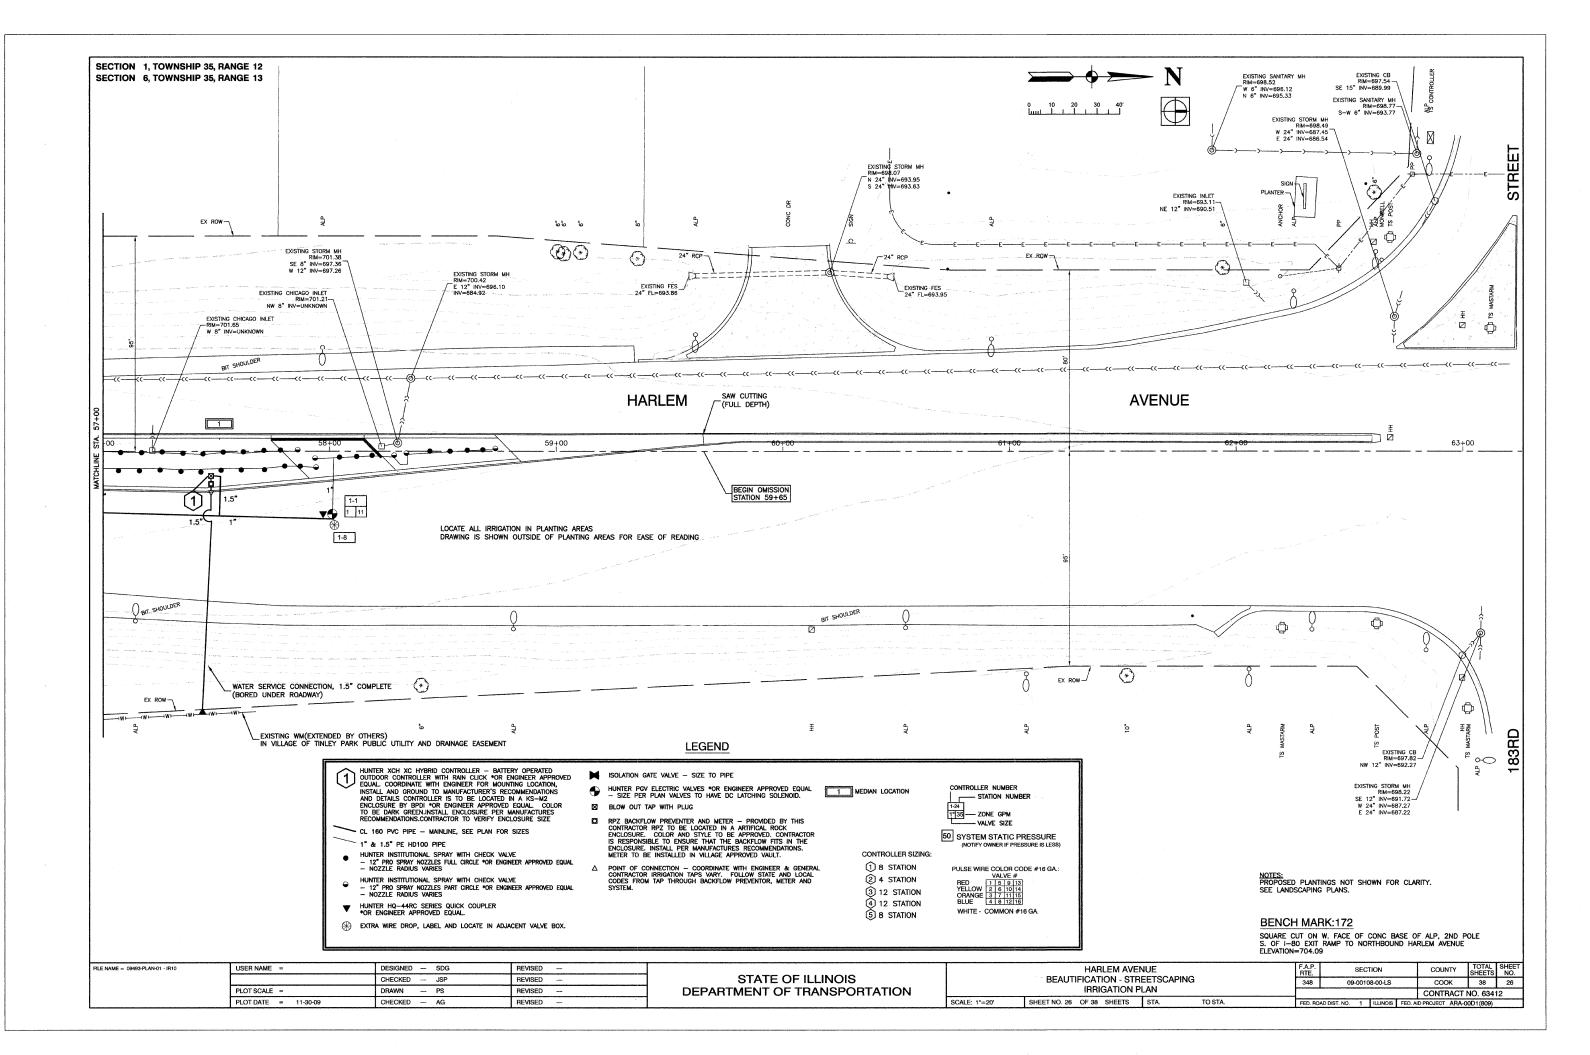

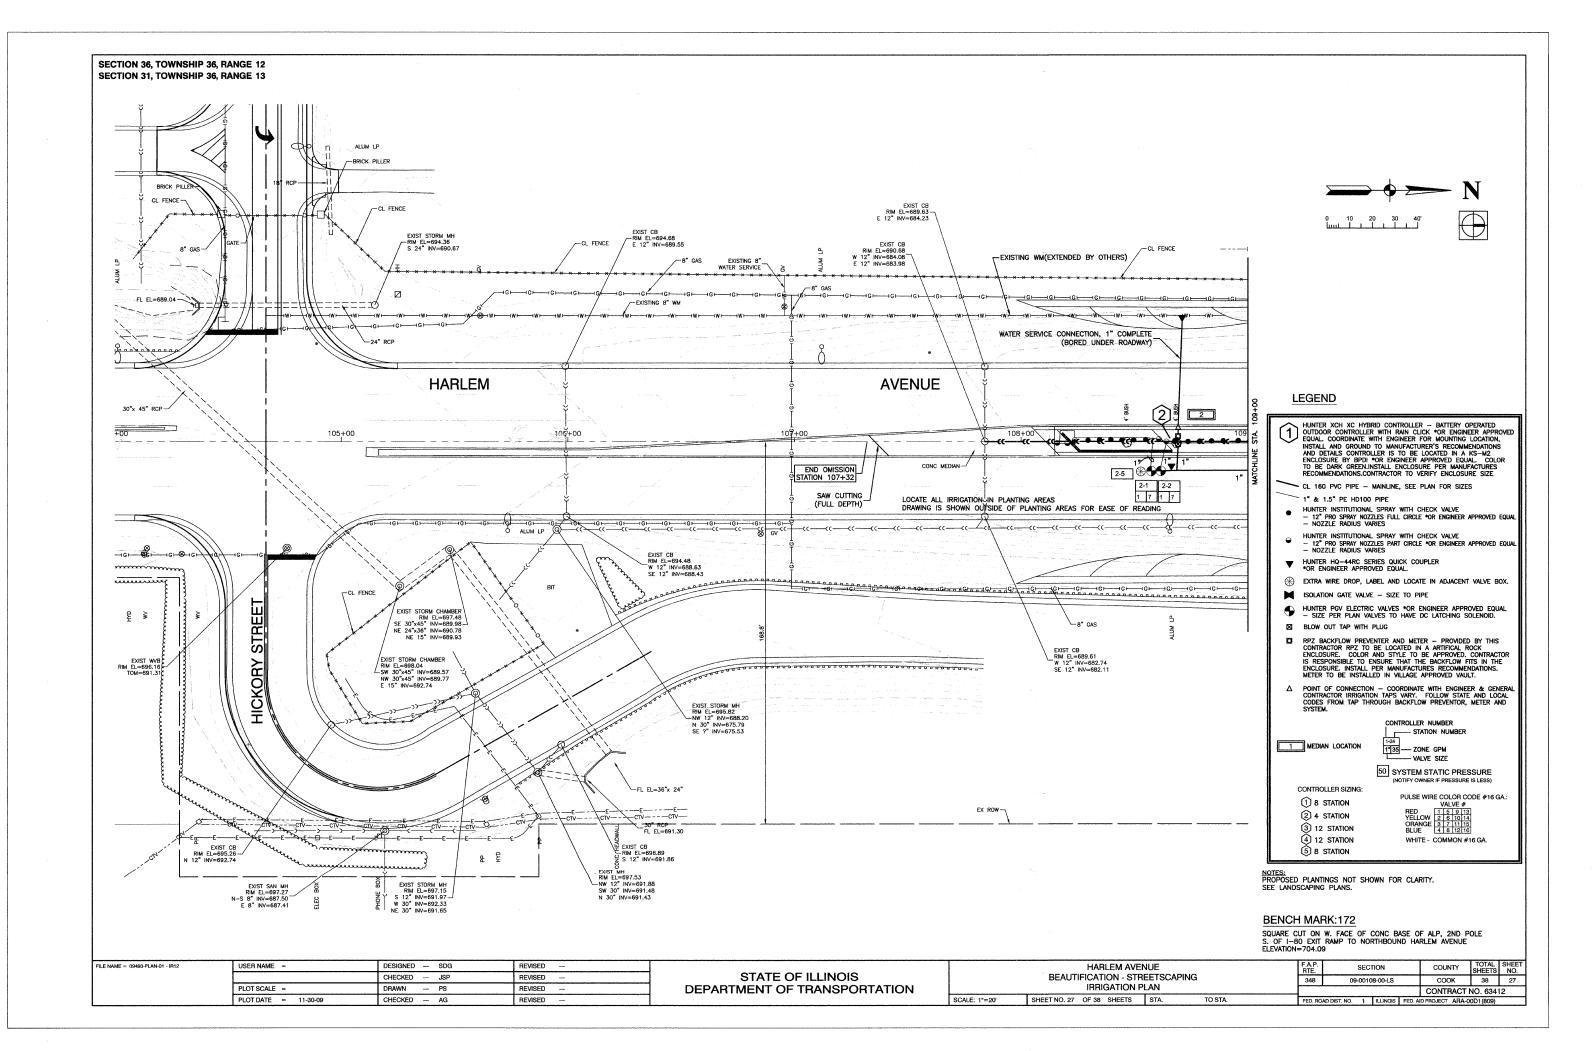

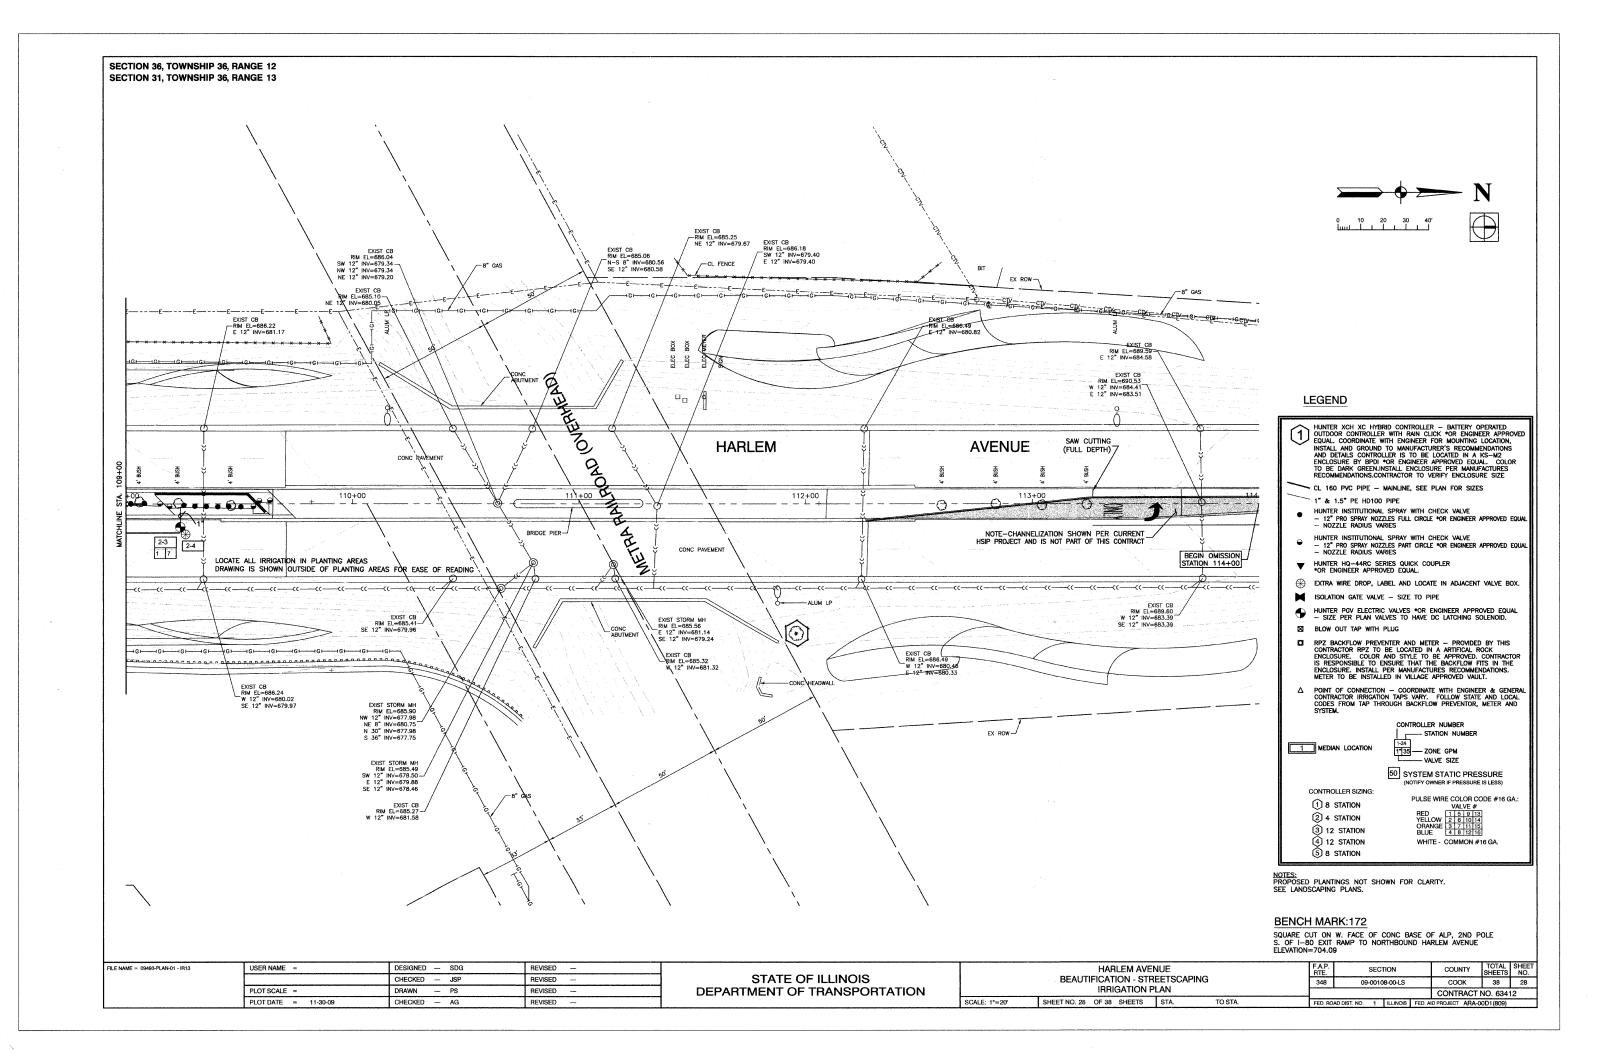

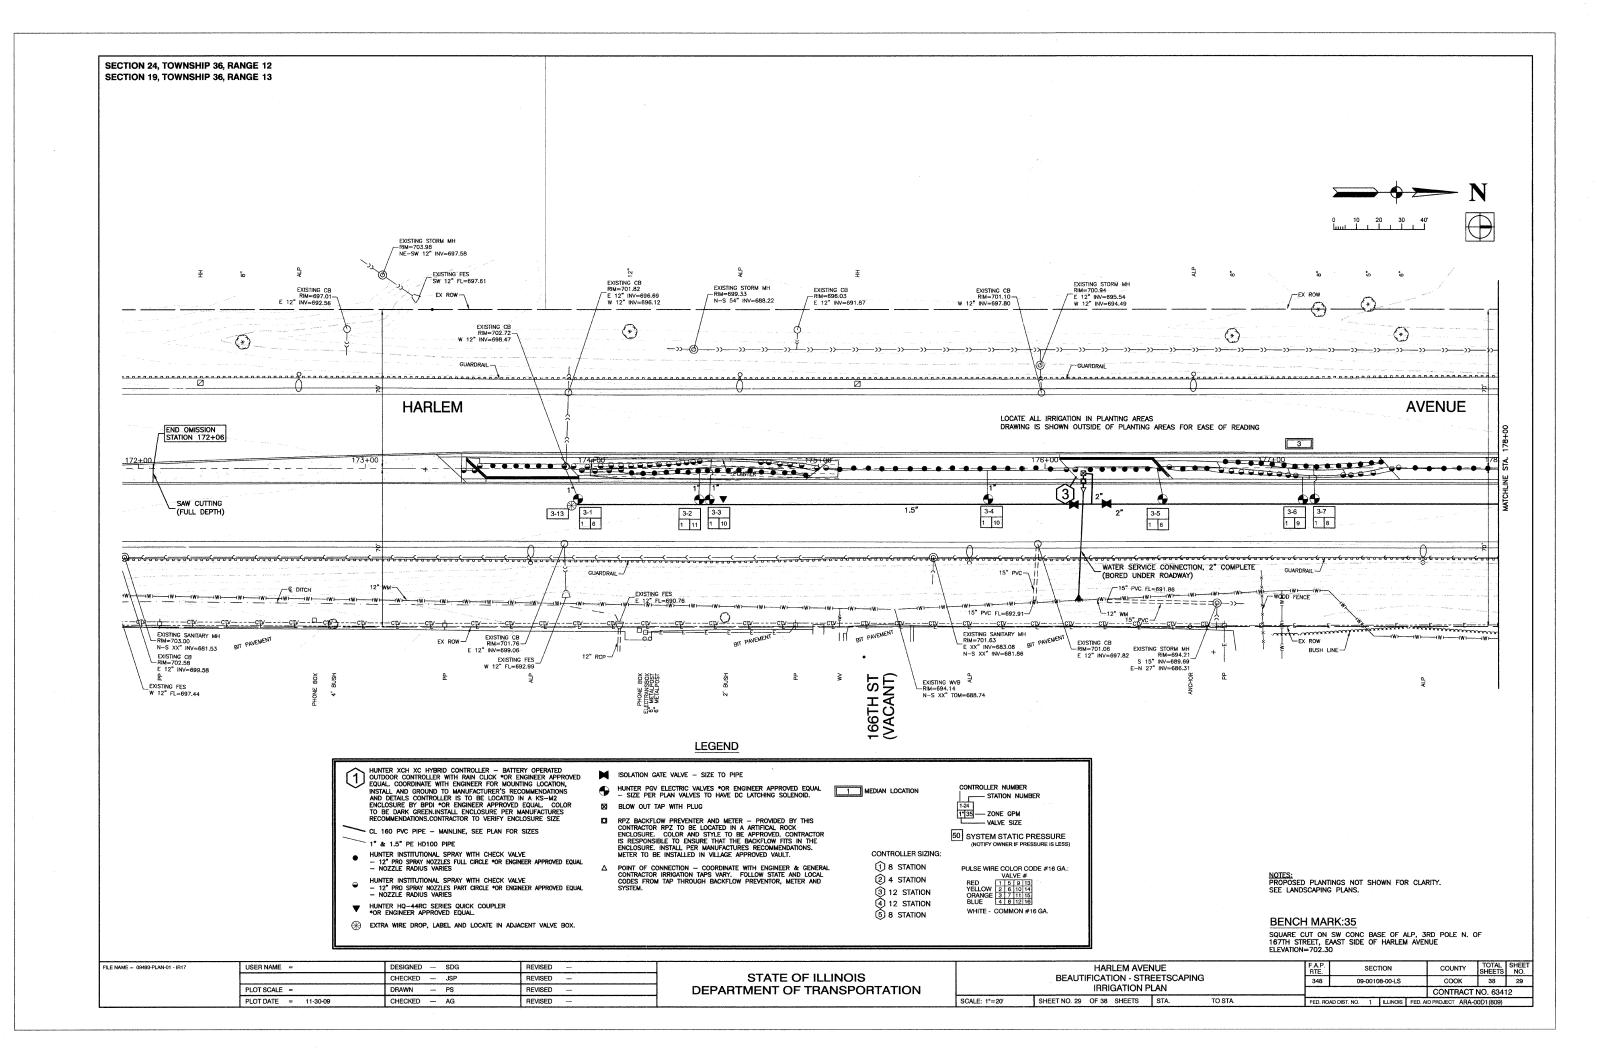

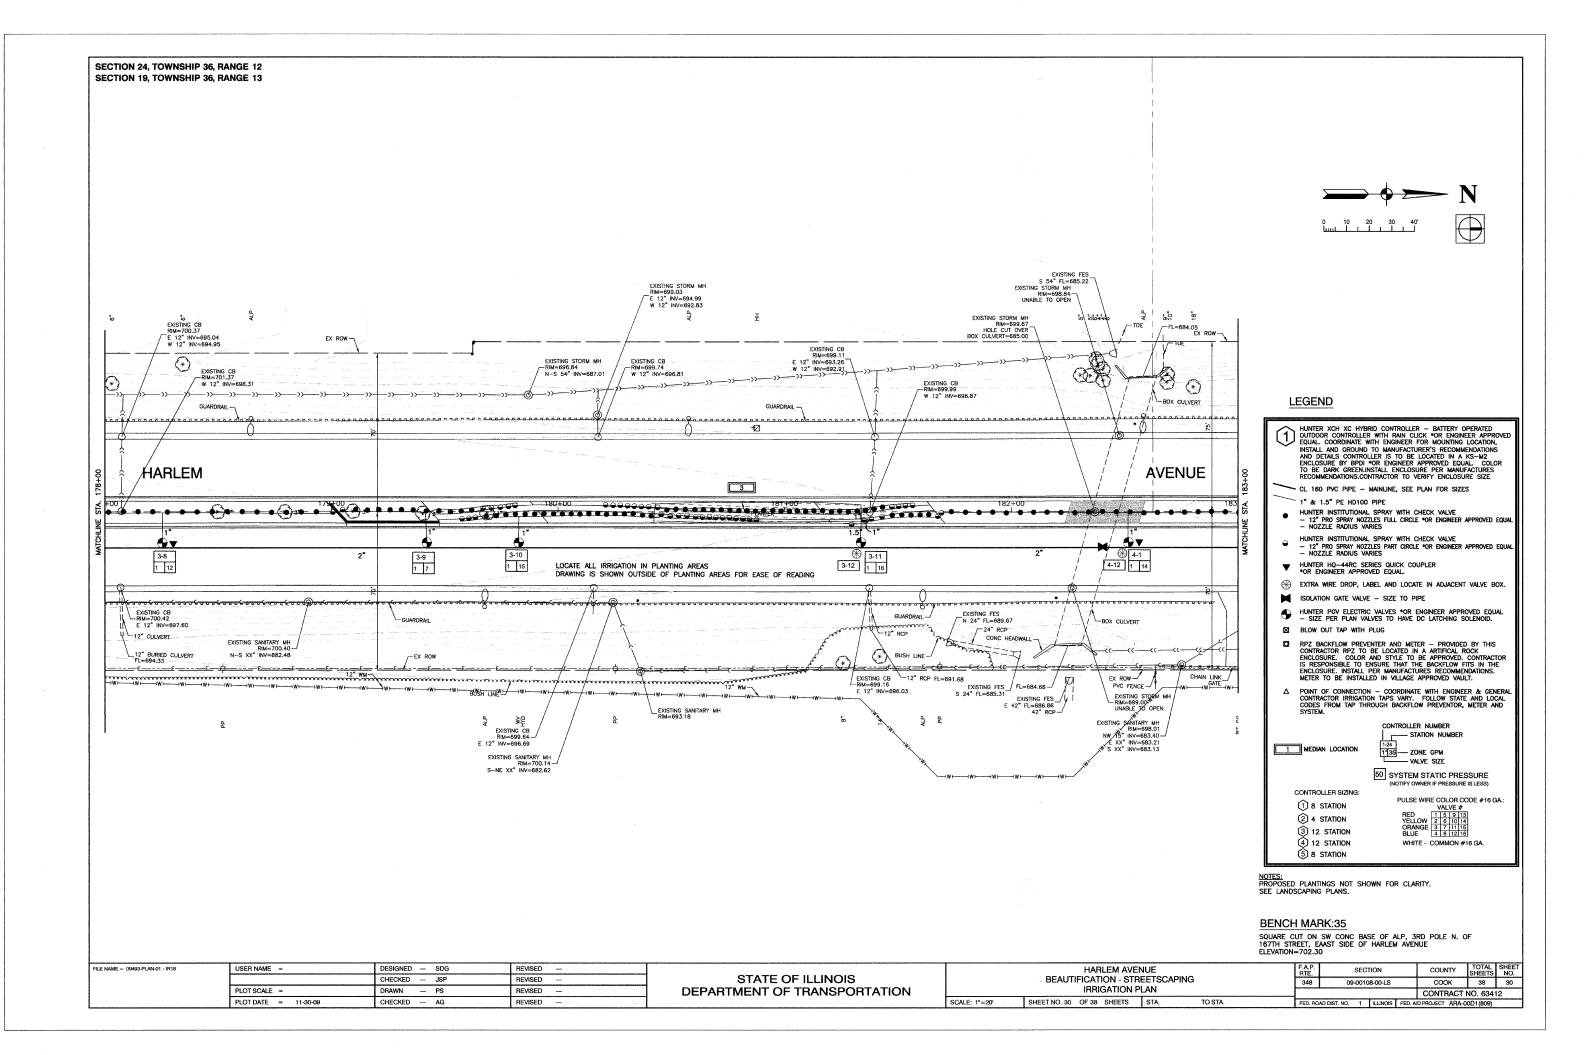

SECTION 24, TOWNSHIP 36, RANGE 12 SECTION 19, TOWNSHIP 36, RANGE 13 TREE ₹₽ °, °, FX ROW 12" CULVERT _ FL=693.23 (*) 12" RCP FL=690.70~ (*) TOP OF BROKEN PIPE ELEV=695.30 12" RCP-12" CULVERT-EXISTING CB RIM=601.26 -E-W 12" INV=596.09 **LEGEND** HUNTER XCH XC HYBRID CONTROLLER — BATTERY OPERATED OUTDOOR CONTROLLER WITH RAIN CLICK *OR ENGINEER APPROVE EQUAL, CORDINATE WITH ENGINEER FOR MOUNTING LOCATION, INSTALL AND GROUND TO MANUFACTURER'S RECOMMENDATIONS AND DETAILS CONTROLLER IS TO BE LOCATED IN A KS-M2 ENCLOSURE BY BPDI *OR ENGINEER APPROVED EQUAL. COLOR TO BE DARK GREEN, INSTALL ENCLOSURE PER MANUFACTURES RECOMMENDATIONS.CONTRACTOR TO VERIFY ENCLOSURE SIZE d EXISTING CB RIM=699.63-W 12" INV=695.82 **HARLEM AVENUE** 3 CL 160 PVC PIPE - MAINLINE, SEE PLAN FOR SIZES 0188 1" & 1.5" PE HD100 PIPE HUNTER INSTITUTIONAL SPRAY WITH CHECK VALVE
-- 12" PRO SPRAY NOZZLES FULL CIRCLE *OR ENGINEER APPROVED EQUI
-- NOZZLE RADIUS VARIES HUNTER INSTITUTIONAL SPRAY WITH CHECK VALVE
-- 12" PRO SPRAY NOZZLES PART CIRCLE *OR ENGINEER APPROVED EQUI
-- NOZZLE RADIUS VARIES 4-3 1.5 18 4-2 1 19 1 9 ▼ HUNTER HQ-44RC SERIES QUICK COUPLER *OR ENGINEER APPROVED EQUAL. LOCATE ALL IRRIGATION IN PLANTING AREAS

DRAWING IS SHOWN OUTSIDE OF PLANTING AREAS FOR EASE OF READING EXTRA WIRE DROP, LABEL AND LOCATE IN ADJACENT VALVE BOX. Charler barre barre HUNTER PGV ELECTRIC VALVES *OR ENGINEER APPROVED EQUAL
- SIZE PER PLAN VALVES TO HAVE DC LATCHING SOLENOID. BLOW OUT TAP WITH PLUG W 12" INV=698.17 PZ BACKFLOW PREVENTER AND METER — PROVIDED BY THIS CONTRACTOR RPZ TO BE LOCATED IN A ARTIFICAL ROCK ENCLOSURE. COLOR AND STYLE TO BE APPROVED. CONTRACTOR IS RESPONSIBLE TO ENSURE THAT THE BACKFLOW FITS IN THE ENCLOSURE. INSTALL PER MANUFACTURES RECOMMENDATIONS. METER TO BE INSTALLED IN VILLAGE APPROVED YAULT. BUSH LINE -EX ROW 12" WM~ 12" WM-EX ROW △ POINT OF CONNECTION — COORDINATE WITH ENGINEER & GENERAL CONTRACTOR IRRIGATION TAPS VARY. FOLLOW STATE AND LOCAL CODES FROM TAP THROUGH BACKFLOW PREVENTIOR, METER AND SYSTEM. EXISTING CB RIM=693.81 S 30" INV=689.65-N 30" INV=689.50 W 12" INV=689.38 EXISTING SANITARY MH RIM=700.82 N XX" INV=684.07 S 15" INV=684.03 CONTROLLER NUMBER STATION NUMBER

1-24
1135 — ZONE GPM
VALVE SIZE W 12" INV=593.35 EXISTING STORM M 1 MEDIAN LOCATION 50 SYSTEM STATIC PRESSURE CONTROLLER SIZING: 1 8 STATION 2 4 STATION 3 12 STATION (4) 12 STATION WHITE - COMMON #16 GA. (5) 8 STATION NOTES: PROPOSED PLANTINGS NOT SHOWN FOR CLARITY. SEE LANDSCAPING PLANS. BENCH MARK:35 SQUARE CUT ON SW CONC BASE OF ALP, 3RD POLE N. OF 167TH STREET, EAAST SIDE OF HARLEM AVENUE ELEVATION=702.30 COUNTY TOTAL SHEET NO.

COOK 38 31 FILE NAME = 09493-PLAN-01 - IR19 USER NAME = DESIGNED - SDG REVISED -HARLEM AVENUE STATE OF ILLINOIS BEAUTIFICATION - STREETSCAPING CHECKED -- JSP REVISED ---IRRIGATION PLAN **DEPARTMENT OF TRANSPORTATION** CONTRACT NO. 63412 PLOT SCALE = DRAWN -- PS BEVISED -PLOT DATE = 11-30-09 CHECKED -- AG REVISED SCALE: 1"=20' SHEET NO. 31 OF 38 SHEETS STA. TO STA.

SECTION 24, TOWNSHIP 36, RANGE 12 **SECTION 19, TOWNSHIP 36, RANGE 13** W 12" INV=696.8 ALP 10. EXISTING FES N 42" FL=693.35 EXISTING FES E 12" FL=685.44 0 0 0 0 0 FEX ROW (*) 12" RCP-LEGEND EXISTING CB RIM=704.51-E-W 12" INV=700.11 HUNTER XCH XC HYBRID CONTROLLER — BATTERY OPERATED OUTDOOR CONTROLLER WITH RAIN CLICK *OR ENGINEER APPROVE EQUAL. COORDINATE WITH ENGINEER FOR MOUNTING LOCATION, INSTALL AND GROUND TO MANUFACTURER'S RECOMMENDATIONS AND DETAILS CONTROLLER IS TO BE LOCATED IN A KS-M2 ENCLOSURE BY BPDI *OR ENGINEER APPROVED EQUAL. COLOR TO BE DARK GREEN, INSTALL ENCLOSURE PER MANUFACTURES RECOMMENDATIONS.CONTRACTOR TO VERIFY ENCLOSURE SIZE SAW CUTTING (FULL DEPTH) HARLEM **AVENUE** 3_ CL 160 PVC PIPE - MAINLINE, SEE PLAN FOR SIZES 1" & 1.5" PE HD100 PIPE 189+00 193 HUNTER INSTITUTIONAL SPRAY WITH CHECK VALVE

— 12" PRO SPRAY NOZZLES FULL CIRCLE *OR ENGINEER APPROVED EQUAL

— NOZZLE RADIUS VARIES HUNTER INSTITUTIONAL SPRAY WITH CHECK VALVE
— 12" PRO SPRAY NOZZLES PART CIRCLE *OR ENGINEER APPROVED EQUAL
— NOZZLE RADIUS VARIES 4-11 4-7 1 10 4-9 1 11 LOCATE ALL IRRIGATION IN PLANTING AREAS DRAWING IS SHOWN OUTSIDE OF PLANTING AREAS FOR EASE OF READING ₩ HUNTER HQ-44RC SERIES QUICK COUPLER *OR ENGINEER APPROVED EQUAL. EXTRA WIRE DROP, LABEL AND LOCATE IN ADJACENT VALVE BOX. HUNTER PGV ELECTRIC VALVES *OR ENGINEER APPROVED EQUAL - SIZE PER PLAN VALVES TO HAVE DC LATCHING SOLENOID. GUARDRAII -BLOW OUT TAP WITH PLUG * \odot * PPZ BACKFLOW PREVENTER AND METER — PROVIDED BY THIS CONTRACTOR RPZ TO BE LOCATED IN A ARTIFICAL ROCK ENCLOSURE. COLOR AND STYLE TO BE APPROVED. CONTRACTOR IS RESPONSIBLE TO ENSURE THAT THE BACKFLOW FITS IN THE ENCLOSURE. INSTALL PER MANUFACTURES RECOMMENDATIONS. METER TO BE INSTALLED IN VILLAGE APPROVED VAULT. PLANTER: BUSH LINE EX ROW EXMENDS SYGRM MA RIM=702.98 W 12" INV=697.91 S 30" INV=696.33 N 30" INV=696.28 V—EX ROW △ POINT OF CONNECTION - COORDINATE WITH ENGINEER & GENERAL CONTRACTOR IRRIGATION TAPS VARY. FOLLOW STATE AND LOCAL CODES FROM TAP THROUGH BACKFLOW PREVENTOR, METER AND SYSTEM. EXISTING STORM MH RIM=704.10 S 18" INV=693.55 E 15" INV=693.52 EXISTING STORM MH -RIM=699.77 N-S 30" INV=691.41 ALP 3* ≩ å 壬 EXISTING SANITARY MH RIM=703.80 N-S XX" INV=685.55 CONTROLLER NUMBER 1-24 1135 — ZONE GPM VALVE SIZE 1 MEDIAN LOCATION 50 SYSTEM STATIC PRESSURE CONTROLLER SIZING: PULSE WIRE COLOR CODE #16 GA.: 1 8 STATION VALVE #

RED 1 5 9 13

YELLOW 2 6 10 14

ORANGE 3 7 11 15

BLUE 4 8 12 16 (2) 4 STATION 3 12 STATION 4 12 STATION WHITE - COMMON #16 GA. (5) 8 STATION NOTES: PROPOSED PLANTINGS NOT SHOWN FOR CLARITY. SEE LANDSCAPING PLANS. BENCH MARK:35 SQUARE CUT ON SW CONC BASE OF ALP, 3RD POLE N. OF 167TH STREET, EAAST SIDE OF HARLEM AVENUE ELEVATION=702.30

STATE OF ILLINOIS

DEPARTMENT OF TRANSPORTATION

USER NAME =

PLOT SCALE =

FILE NAME = 09493-PLAN-01 - IR20

DESIGNED - SDG

CHECKED - JSP

DRAWN -- PS

CHECKED — AG

REVISED -

REVISED ---

REVISED ---

REVISED

COUNTY TOTAL SHEET NO.
COOK 38 32

CONTRACT NO. 63412

348

09-00108-00-LS

HARLEM AVENUE

BEAUTIFICATION - STREETSCAPING

IRRIGATION PLAN

TO STA.

SHEET NO. 32 OF 38 SHEETS STA.

SCALE: 1"=20'

EXISTING STORM MH RIM=707.16 E 12" INV=701.95 10" WM N-S 48" INV=700.70 EXISTING SANITARY MH RIM=704.58-N-S XX" INV=687.54 PHONE EXISTING SANITARY MH RIM=707.93-W 12" INV≈703.43 N-S XX" INV∞688.69 WATER SERVICE CONNECTION, 1" COMPLETE (BORED UNDER ROADWAY) LOCATE ALL IRRIGATION IN PLANTING AREAS DRAWING IS SHOWN OUTSIDE OF PLANTING AREAS FOR EASE OF READING **HARLEM AVENUE** 4 SAW CUTTING (FULL DEPTH) - X----. 🗪 5-4 5-3 1 10 1 11 5-7 5-2 1 9 \square 24" RCP-/- € DITCH (1) **(*)** \odot (*) (*) (*) (*) (*) 0 EXISTING FES_ NW 12" FL=703.55 \odot EXISTING CB RIM=706.68 N 24" INV≈703.40 S 24" INV=703.36 EXISTING CB -RIM=706.56

SECTION 24, TOWNSHIP 36, RANGE 12 SECTION 19, TOWNSHIP 36, RANGE 13

FILE NAME =: 09493-PLAN-01 - IR22

USER NAME =

PLOT SCALE =

PLOT DATE = 11-30-09

DESIGNED - SDG

CHECKED — JSP

CHECKED -- AG


DRAWN

REVISED -

REVISED -

REVISED

REVISED

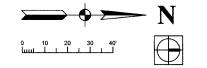

LEGEND

HUNTER XCH XC HYBRID CONTROLLER — BATTERY OPERATED OUTDOOR CONTROLLER WITH RAIN CLICK *OR ENGINEER APPROVED EQUAL COORDINATE WITH ENGINEER FOR MOUNTING LOCATION, INSTALL AND GROUND TO MANUFACTURER'S RECOMMENDATIONS AND DETAILS CONTROLLER IS TO BE LOCATED IN A KS-M2 ENCLOSURE BY BPDI *OR ENGINEER APPROVED EQUAL COLOR TO BE DARK GREENLINSTALL ENCLOSURE PER MANUFACTURES RECOMMENDATIONS.CONTRACTOR TO VERIFY ENCLOSURE SIZE CL 160 PVC PIPE - MAINLINE, SEE PLAN FOR SIZES 1" & 1.5" PE HD100 PIPE

- HUNTER INSTITUTIONAL SPRAY WITH CHECK VALVE
 -- 12" PRO SPRAY NOZZLES FULL CIRCLE *OR ENGINEER APPROVED EQUI-- NOZZLE RADIUS VARIES
- Hunter institutional spray with Check Valve -- 12" pro spray nozzles part circle "or engineer approved equa -- nozzle radius varies
- ▼ HUNTER HQ-44RC SERIES QUICK COUPLER *OR ENGINEER APPROVED EQUAL.
- EXTRA WIRE DROP, LABEL AND LOCATE IN ADJACENT VALVE BOX.
- ISOLATION GATE VALVE SIZE TO PIPE
- HUNTER PGV ELECTRIC VALVES *OR ENGINEER APPROVED EQUAL

 SIZE PER PLAN VALVES TO HAVE DC LATCHING SOLENOID. ☑ BLOW OUT TAP WITH PLUG

- PZ BACKFLOW PREVENTER AND METER PROVIDED BY THIS CONTRACTOR RPZ TO BE LOCATED IN A ARTIFICAL ROCK ENCLOSURE. COLOR AND STYLE TO BE APPROVED. CONTRACTOR IS RESPONSIBLE TO ENSURE THAT THE BACKFLOW FITS IN THE ENCLOSURE. INSTALL PER MANUFACTURES RECOMMENDATIONS. METER TO BE INSTALLED IN VILLAGE APPROVED VAULT.
- POINT OF CONNECTION COORDINATE WITH ENGINEER & GENERA CONTRACTOR IRRIGATION TAPS VARY. FOLLOW STATE AND LOCAL CODES FROM TAP THROUGH BACKFLOW PREVENTOR, METER AND SYSTEM.

	CONTROLLER NUMBER
1 MEDIAN LOCATION	STATION NUMBE

50 SYSTEM STATIC PRESSURE (NOTIFY OWNER IF PRESSURE IS LESS)

CONTROLLER SIZING: (1) 8 STATION 2 4 STATION 3 12 STATION

PULSE WIRE COLOR CODE #16 GA.:

VALVE #

RED
YELLOW
2 6 10 14

ORANGE
3 7 111 15
BLUE
4 8 12 16

4 12 STATION (5) 8 STATION


WHITE - COMMON #16 GA.

NOTES: PROPOSED PLANTINGS NOT SHOWN FOR CLARITY. SEE LANDSCAPING PLANS.

BENCH MARK:35

SQUARE CUT ON SW CONC BASE OF ALP, 3RD POLE N. OF 167TH STREET, EAAST SIDE OF HARLEM AVENUE ELEVATION=702.30

OTATE OF ILLINIOIS	HARLEM AVENUE				F.A.P. RTE.	RTE. SECTION		SHEETS	NO.		
STATE OF ILLINOIS		BEAUTIFICATION - STRI		j .	348	09-00108-00-LS	соок	38	33		
DEPARTMENT OF TRANSPORTATION							CONTRACT NO. 63412				
	SCALE: 1"=20'	SHEET NO. 33 OF 38 SHEETS	STA.	TO STA.	FED. RO	AD DIST. NO. 1 ILLINOIS FED. /	ND PROJECT ARA	-00D1 (809)			

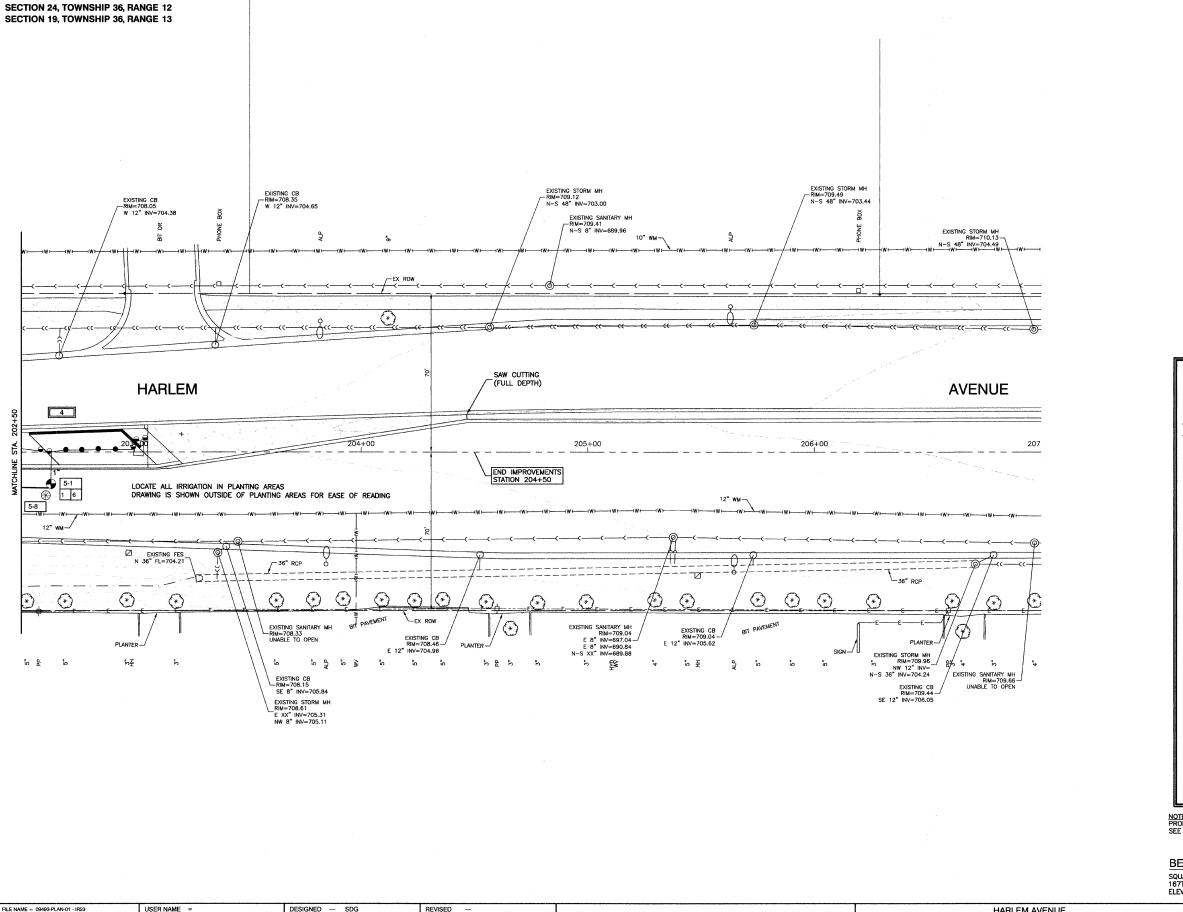

CHECKED - JSP

CHECKED - AG

DRAWN


PLOT SCALE =

PLOT DATE = 11-30-09

REVISED -

REVISED

REVISED

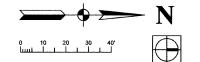

LEGEND

HUNTER XCH XC HYBRID CONTROLLER — BATTERY OPERATED OUTDOOR CONTROLLER WITH RAIN CLICK *OR ENGINEER APPROVED EQUAL COORDINATE WITH ENGINEER FOR MOUNTING LOCATION, INSTALL AND GROUND TO MANUFACTURER'S RECOMMENDATIONS AND DETAILS CONTROLLER IS TO BE LOCATED IN A KS—M2 ENCLOSURE BY BPD *OR ENGINEER APPROVED EQUAL COLOR TO BE DARK GREENLINSTALL ENCLOSURE PER MANUFACTURES RECOMMENDATIONS.CONTRACTOR TO VERIFY ENCLOSURE SIZE

CL 160 PVC PIPE - MAINLINE, SEE PLAN FOR SIZES

1" & 1.5" PE HD100 PIPE

- HUNTER INSTITUTIONAL SPRAY WITH CHECK VALVE
 12" PRO SPRAY NOZZLES FULL CIRCLE *OR ENGINEER APPROVED EQUAL
 NOZZLE RADIUS VARIES
- HUNTER INSTITUTIONAL SPRAY WITH CHECK VALVE

 12" PRO SPRAY NOZZLES PART CIRCLE *OR ENGINEER APPROVED EQUAL

 NOZZLE RADIUS VARIES
- ▼ HUNTER HQ-44RC SERIES QUICK COUPLER *OR ENGINEER APPROVED EQUAL.
- EXTRA WIRE DROP, LABEL AND LOCATE IN ADJACENT VALVE BOX.
- ISOLATION GATE VALVE SIZE TO PIPE
- HUNTER PGV ELECTRIC VALVES *OR ENGINEER APPROVED EQUAL -- SIZE PER PLAN VALVES TO HAVE DC LATCHING SOLENOID. BLOW OUT TAP WITH PLUG
- PRZ BACKFLOW PREVENTER AND METER PROVIDED BY THIS CONTRACTOR RPZ TO BE LOCATED IN A ARTIFICAL ROCK ENCLOSURE. COLOR AND STYLE TO BE APPROVED. CONTRACTOR IS RESPONSIBLE TO ENSURE THAT THE BACKFLOW FITS IN THE ENCLOSURE. INSTALL PER MANUFACTURES RECOMMENDATIONS. METER TO BE INSTALLED IN VILLAGE APPROVED VAULT.
- DOINT OF CONNECTION COORDINATE WITH ENGINEER & GENERAL CONTRACTOR IRRIGATION TAPS VARY. FOLLOW STATE AND LOCAL CODES FROM TAP THROUGH BACKFLOW PREVENTOR, METER AND SYSTEM.

	CONTROLLER NUMBER
	STATION NUMBER
1 MEDIAN LOCATION	1-24 1"35 ZONE GPM
Commence of the Commence of th	المسلوبا
	VALVE SIZE
	50 SYSTEM STATIC PRESSURE
	(NOTIFY OWNER IF PRESSURE IS LESS)
CONTROLLED SIZING:	

(1) 8 STATION

2 4 STATION

3 12 STATION 4 12 STATION (5) 8 STATION


WHITE - COMMON #16 GA.


NOTES: PROPOSED PLANTINGS NOT SHOWN FOR CLARITY. SEE LANDSCAPING PLANS.


BENCH MARK:35

SQUARE CUT ON SW CONC BASE OF ALP, 3RD POLE N. OF 167TH STREET, EAAST SIDE OF HARLEM AVENUE ELEVATION=702.30


OTATE OF HILINIOIS	HARLEM AVENUE BEAUTIFICATION - STREETSCAPING					F.A.P. RTE.	SECTION	COUNTY	SHEETS	NO.
STATE OF ILLINOIS		BEAUTI			NG	348	09-00108-00-LS	соок	38	34
DEPARTMENT OF TRANSPORTATION	IRRIGATION PLAN SCALE: 1"=20" SHEET NO. 34 OF 38 SHEETS STA. TO STA.						CONTRACT NO. 63412		2	
	SCALE: 1"=20'	SHEET NO. 34	OF 38 SHEETS	STA.	TO STA.	FED. RO/	AD DIST. NO. 1 ILLINOIS FED. /	ND PROJECT ARA-C	0D1 (809)	

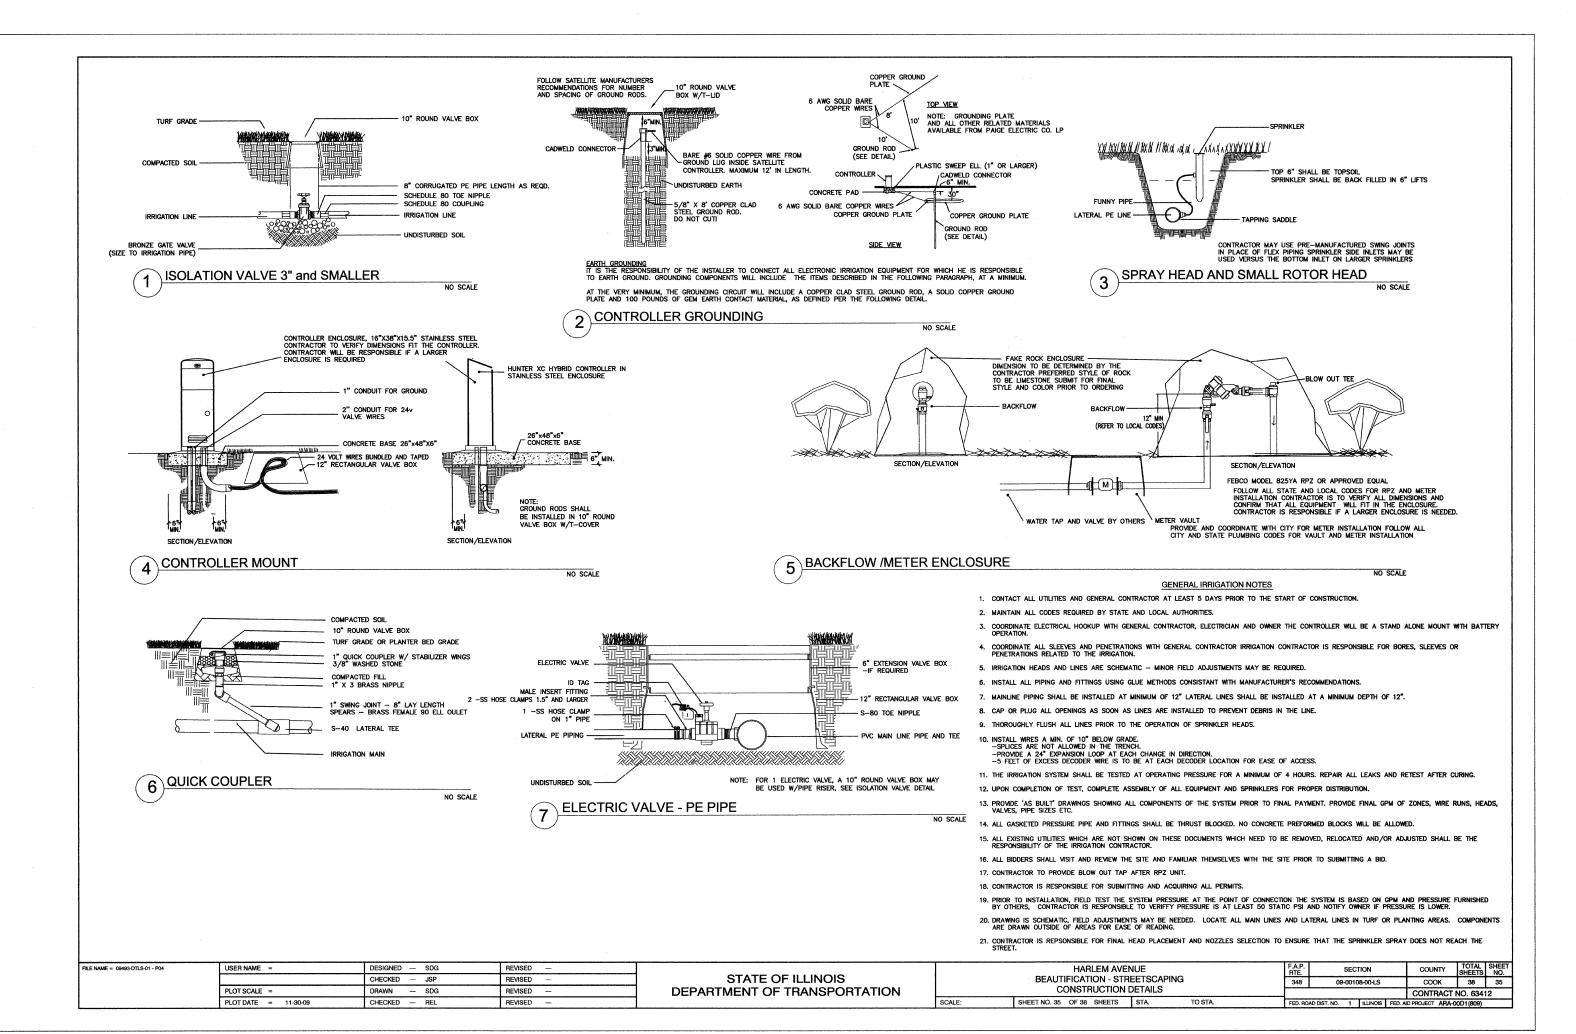

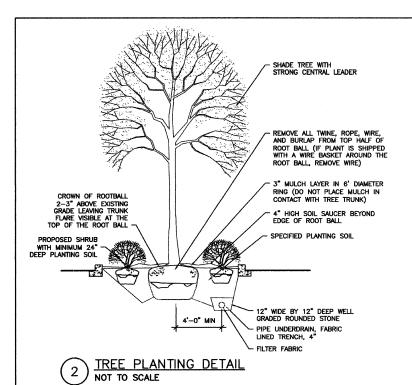


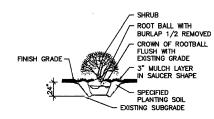

6) STANDARD SHRUB INSTALLATION

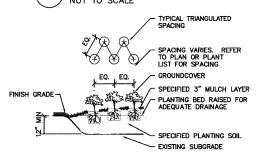

7 GROUNDCOVER/PERENNIAL INSTALLATION NOT TO SCALE

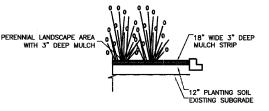


NOTES:
1. FOR PLANT MATERIAL SEE SHEET
2 PLANT SCHEDULE.


 STEEL EDGE BASED ON "BORDER LINE" FOR OTHER ACCEPTABLE MANUFACTURERS — SEE SPECIFICATIONS



3 STAKING & GUYING PLAN NOT TO SCALE

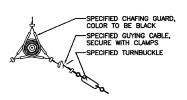


4 GUYING DETAIL NOT TO SCALE

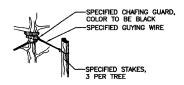


5 STAKING DETAIL
NOT TO SCALE

8 PLANTING BED EDGE DETAIL

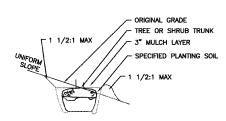

9 TREE PLANTING ON SLOPE DETAIL NOT TO SCALE

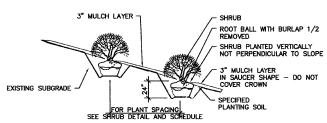



10) SHRUB/PERENNIAL ON SLOPE INSTALLATION DETAIL
NOT TO SCALE


GENERAL PLANTING NOTES


- CONTRACTOR SHALL VERIFY SITE CONDITIONS BEFORE PROCEEDING WITH WORK AND SHALL REPORT ANY CONFLICT TO ENGINEER.
- EXACT LOCATIONS OF ALL UNDERGROUND UTILITIES SHALL BE DETERMINED AND VERIFIED IN THE FIELD BY CONTRACTOR. CONTRACTOR SHALL REPORT ANY CONFLICTS TO ENGINEER PRIOR TO BEGINNING WORK.
- 3. THE CONTRACTOR SHALL COORDINATE THIS WORK WITH OTHER TRADES AND MAINTAIN DRAINAGE DURING CONSTRUCTION.
- 4. CONTRACTOR SHALL KEEP ALL AREAS CLEAN, NEAT AND ORDERLY AT ALL TIMES.
- CONTRACTOR SHALL PROTECT EXISTING VEGETATION OUTSIDE THE LIMITS OF GRADING. ALL EXISTING PARKWAY TREES AND EXISTING INTERIOR TREES SHALL BE PROTECTED WHILE PROJECT IS UNDER CONSTRUCTION AND SHALL BE REPLACED IF DAMAGED BY CONTRACTOR.
- 6. CONTRACTOR SHALL INFORM ENGINEER AS EACH PHASE OF WORK IS UNDERTAKEN.
- 7. SLOPE ALL PLANTING AREAS AWAY FROM BUILDING AT 2% MINIMUM GRADE.
- FINISH GRADE SHALL BE 4" MINIMUM BELOW BUILDING FINISH FLOOR ELEVATION (ADJACENT TO BUILDING SLABS). ALL AREAS SHALL BE RECEIVED BY CONTRACTOR AT +/- 0.1 FOOT TO FINISH GRADE.
- 9. FINISH GRADE SHALL BE 1" BELOW FINISH PAVING SURFACE IN LAWN AREAS AND 2" IN PLANTING AREAS.
- 10. PLANT QUANTITIES SHOWN ON DRAWINGS ARE APPROXIMATE. CONTRACTOR SHALL PROVIDE PLANT MATERIALS SUFFICIENT TO COVER AREAS SHOWN ON PLANS AT THE SPACINGS INDICATED.
- 11. AT LEAST ONE PLANT OF EACH SPECIES DELIVERED TO THE SITE WILL HAVE AN IDENTIFICATION TAG FROM THE SUPPLYING NURSERY SHOWING COMMON AND BOTANICAL PLANT NAMES. ALL PLANTS SHALL BE PROTECTED AGAINST HEAT, SUN, WIND AND FROST DURING TRANSPORTATION TO THE SITE AND WHILE BEING HELD AT THE SITE. DO NOT STORE PLANTS IN TOTAL DARKNESS MORE THAN ONE DAY.
- 12. DO NOT DAMAGE PLANT ROOT BALL DURING TRANSPORTATION OR PLANTING.
- 13. CONTRACTOR SHALL NOTIFY THE ENGINEER AT THE TIME OF DELIVERY OF ANY PLANT MATERIAL THAT IS DAMAGED OR IN POOR CONDITION TO DETERMINE ACCEPTABILITY.
- 14. ALL TREES SHALL BE SINGLE TRUNK STANDARDS UNLESS OTHERWISE NOTED.
- 15. ALL ROCK AND DEBRIS 1" AND LARGER SHALL BE REMOVED FROM PLANTING AREAS AND THEN LEGALLY DISPOSED OF OFF SITE. ALL EXCESS MATERIALS RESULTING FROM CONTRACT WORK SHALL BE LEGALLY DISPOSED OF OFF SITE BY CONTRACTOR.
- 16. ENGINEER RESERVES THE RIGHT TO INSPECT ALL PLANT MATERIALS BEFORE PLANTING. MATERIAL MAY BE REJECTED AT ANY TIME DUE TO CONDITION, FORM OR DAMAGE BEFORE OR AFTER PLANTING. CONTRACTOR SHALL STAKE LOCATION OF ALL TREES, HEDGE LINES AND PLANTING BEDS AND HAVE LAYOUT APPROVED BY ENCINEER PRIOR TO PLANTING.
- 17. THE PLANTING PLANS ARE DIAGRAMMATIC. PLANT MATERIALS SHALL BE SPOTTED APPROXIMATELY AS SHOWN ON THE LANDSCAPE DRAWING AND ARE TO BE APPROVED BY THE ENGINEER BEFORE BEING REMOVED FROM CONTAINERS AND EXCAVATING SOIL FOR PLANTING.
- 18. INSTALL ALL PLANT MATERIAL IN ACCORDANCE WITH DETAILS. ALL FINISH GRADING AND PLANTING OPERATIONS SHALL BE CARRIED OUT IN ACCORDANCE WITH PROJECT SPECIFICATIONS.
- 19. ALL PLANT TYING MATERIAL AND MARKING TAPES SHALL BE REMOVED AT THE TIME OF PLANTING.
- 20. PROVIDE NEW TOPSOIL THAT IS FERTILE, FRIABLE AND NATURAL LOAM SURFACE SOIL, REASONABLY FREE OF SUBSOIL, CLAY, CLAY LUMPS, BRUSH, WEEDS, AND OTHER LITTER AND FREE OF ROOTS, STUMPS, STONES LARGER THAN 2" IN ANY DIMENSION AND OTHER EXTRANEOUS OR TOXIC MATTER HARMFUL TO PLANT GROWTH. OBTAIN TOPSOIL FROM LOCAL SOURCES OR FROM AREAS HAVING SIMILAR SOIL CHARACTERISTICS TO THAT NECESSARY FOR MGOROUS GROWTH OF SPECIFIED PLANTINGS. OBTAIN TOPSOIL THAT OCCURS IN A DEPTH OF NOT LESS THAN 6". DO NOT OBTAIN SOIL FROM BOGS OR MARSHES.
- 21. MIX SPECIFIED SOIL AMENDMENTS AND FERTILIZERS WITH TOPSOIL ON A SITE SPECIFIC BASIS AT RATES APPROPRIATE FOR AREA TREES AND SHRUBS IN ACCORDANCE WITH PROJECT SPECIFICATIONS.
- 22. CONTRACTOR SHALL INSTALL A MIN 3" LAYER OF HARDWOOD BARK MULCH (SEE SPECS.) AROUND ALL TREES AND IN ALL GROUNDCOVER / SHRUB AREAS. CREATE A NATURAL SPADED EDGE WHERE PLANTING REPS MEFET TURE AREAS.
- 23. WATER ALL PLANTS IMMEDIATELY AFTER PLANTING. FLOOD PLANTS TWICE DURING FIRST TWENTY-FOUR HOUR PERIOD OF PLANTING.
- 24. CONTRACTOR SHALL REPAIR TO ITS ORIGINAL CONDITION ANY AREA OR ITEM DAMAGED AS A RESULT OF THEIR WORK. ANY EXISTING LANDSCAPE INDICATED ON THE PLANS THAT IS DAMAGED ON REMOVED DURING DEMOLITION OR CONSTRUCTION SHALL BE REPAIRED AND/OR REPLACED IN KIND AND EQUIVALENT SIZE. CONTRACTOR SHALL REPAIR AND SOD IN KIND ALL TURF AREAS DAMAGED AS A RESULT OF PROJECT CONSTRUCTION.
- 25. CONTRACTOR TO GUY AND STAKE TREES, IF REQUIRED, AS DIRECTED BY A/E, IMMEDIATELY AFTER PLANTING. PROVIDE A MINIMUM OF TWO GUY WIRES PER TREE ON THE UPHILL SIDE OF TREES PLANTED ON SLOPES STEEPER THAN 3:1.
- 26. PROVIDE WIRE TIES AND GUYS OF 2-STRAND, TWISTED, PLIABLE GALVANIZED IRON WIRE, NOT LIGHTER THAN 12 GAGE WITH ZINC-COATED TURNBUCKLES. PROVIDED NOT LESS THAN '%" DIAMETER RUBBER OR PLASTIC HOSE, CUI TO REQUIRED LENGTHS AND OF UNIFORM COLOR, MATERIAL, AND SIZE TO PROTECT TREE TRUNKS FROM DAMAGE BY WIRES.
- 27. CONTRACTOR TO WARRANTY ALL TREES AND SHRUBS AGAINST DEATH AND DEFECTS INCLUDING UNSATISFACTORY GROWTH, EXCEPT FOR DEFECTS RESULTING FROM NEGLECT BY OWNER, ABUSE OR DAMAGE BY OTHERS OR UNUSUAL PHENOMENON OR INCIDENTS WHICH ARE BEYOND THE CONTRACTOR'S CONTROL (SEE SPECS).
- 28. PROTECT SEEDED AREAS AND SLOPES AGAINST EROSION AND SEED LOSS DUE TO BIRDS AND OTHER WILDLIFE BY APPLYING SHORT TERM, BIODEGRADABLE EROSION CONTROL BLANKETS, MATS, AND/OR NETTING AFTER COMPLETION OF SEEDING OPERATIONS. ADHERE TO MANUFACTURER'S SPECIFICATIONS FOR REQUIRED PLACEMENT AND STAKING.
- 29. REMOVE AGGREGRATE FILL TO AN ADEQUATE DEPTH TO ENSURE THAT NO PART OF THE PLANT MATERIAL IS IN CONTACT OR AFFECTED BY THE LIME IN THE AGGREGATE FILL AS APPROVED BY ENGINEER.

FILE NAME = 09493-DTLS-01 - P01	USER NAME =	DESIGNED SDG	REVISED —		HARLEM AVENUE			F.A.P.	SECTION	COUNTY	TOTAL SHEET SHEETS NO.	
		CHECKED — JSP	REVISED —	STATE OF ILLINOIS	BEAUTIFICATION - STREETSCAPING CONSTRUCTION DETAILS					09-00108-00-LS	соок	38 36
	PLOT SCALE =	DRAWN — SDG	REVISED	DEPARTMENT OF TRANSPORTATION							CONTRACT	NO. 63412
	PLOT DATE = 11-30-09	CHECKED — REL	REVISED								AID PROJECT ARA-	

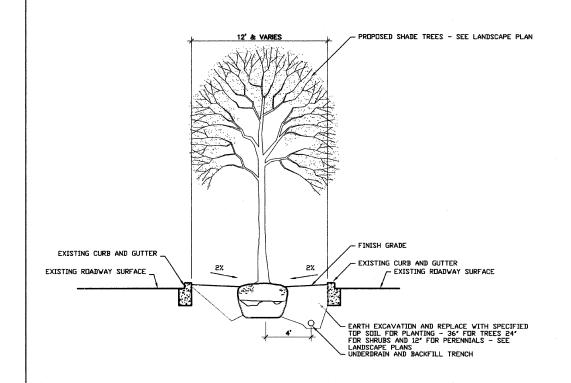


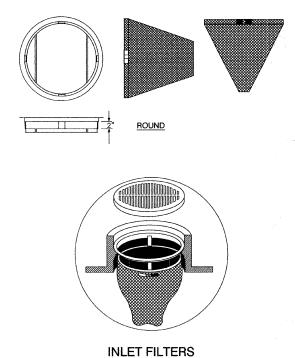

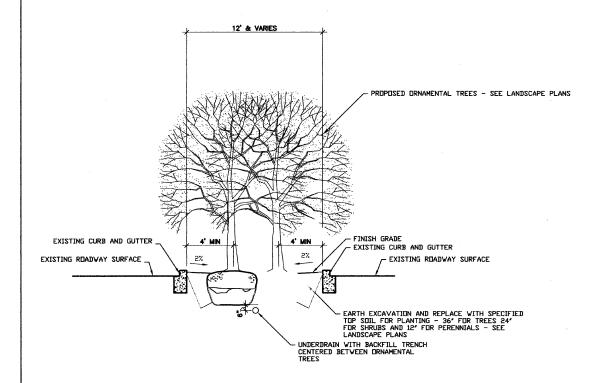

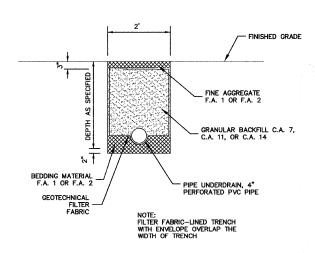

PIPE UNDERDRAINS, FABRIC LINED TRENCH, 4"

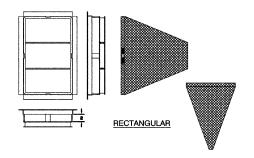

INLET AND PIPE PROTECTION

DESCRIPTION: THIS WORK SHALL CONSIST OF FURNISHING, INSTALLATION, AND REMOVAL OF A DRAINAGE STRUCTURE INLET FILTER ASSEMBLY, CONSISTING OF A FRAME AND FILTER BAG, TO COLLECT SEDIMENT IN SURFACE STORM WATER RUNOFF AT LOCATIONS SHOWN ON THE PLANS OR AS DIRECTED BY THE ENGINEER.

THE CONTRACTOR SHALL INSPECT THE WORKSITE AND REVIEW THE PLANS TO DETERMINE THE NUMBER AND DIMENSIONS OF THE VARIOUS TYPES OF DRAINAGE STRUCTURE FRAMES (CIRCULAR AND RECTANGULAR) INTO WHICH THE INLET FILTERS WILL BE INSTALLED PRIOR TO ORDERING MATERIALS.

THE DRAINAGE STRUCTURE INLET FILTER ASSEMBLY SHALL BE INSTALLED UNDER THE GRATE ON THE LIP OF THE DRAINAGE STRUCTURE FRAME WITH THE FABRIC BAG HANGING DOWN INTO THE DRAINAGE STRUCTURE.

THE DRAINAGE STRUCTURE INLET FILTER ASSEMBLY SHALL REMAIN IN PLACE UNTIL FINAL REMOVAL OF THE ASSEMBLY IS DIRECTED BY THE ENGINEER. THE DRAINAGE STRUCTURE INLET FILTER ASSEMBLY SHALL REMAIN THE PROPERTY OF THE CONTRACTOR.

FINAL REMOVAL OF THE ASSEMBLY SHALL INCLUDE THE DISPOSAL OF DEBRIS OR SILT THAT HAS ACCUMULATED IN THE FILTER BAG AT THE TIME OF FINAL REMOVAL. PERIODIC CLEANING OF THE FILTER IS PAID FOR SEPARATELY.

MATERIALS: THE DRAINAGE STRUCTURE INLET SHALL BE THE (INLET AND PIPE PROTECTION), AS FURNISHED BY MARATHON MATERIALS, INC. 25523 W. SHULTZ ST., PLAINFIELD, IL. 60544, (800) 983—9493, OR APPROVED EQUAL. A DETAILED DRAWING IN THE PLANS DEPICTS THE DRAINAGE STRUCTURE INLET FILTER ASSEMBLY.


THE DRAINAGE STRUCTURE INLET FILTER ASSEMBLY SHALL CONSIST OF A STEEL FRAME WITH A REPLACEABLE GEOTEXTILE FABRIC BAG ATTACHED WITH A STEEL BAND WITH LOCKING CAP THAT IS SUSPENDED FROM THE FRAME. A CLEAN USED BAG AND USED STEEL FRAME IN GOOD CONDITION, MEETING THE APPROVAL OF THE ENGINEER, MAY BE SUBSTITUTED FOR NEW MATERIALS.


THE DRAINAGE STRUCTURE INLET FILTER ASSEMBLY FRAME SHALL BE RIGID STEEL MEETING THE REQUIREMENTS OF ASTM-A36. THE FRAME SHALL INCLUDE AN OVERFLOW FEATURE THAT IS WELDED TO THE FRAMES RING. THE OVERFLOW FEATURE SHALL BE DESIGNED TO ALLOW FULL FLOW OF WATER INTO THE STRUCTURE IF THE FILTER BAG IS FILLED WITH SEDIMENT. THE DIMENSIONS OF THE ASSEMBLY FRAME SHALL ALLOW THE DRAINAGE STRUCTURE GRATE TO FIT INTO THE INLET FILTER ASSEMBLY FRAME OPENING. THE ASSEMBLY FRAME SHALL ALLOW THE DRAINAGE STRUCTURE GRATE TO FIT INTO THE INLET FILTER ASSEMBLY FRAME OPENING. THE ASSEMBLY FRAME SHALL REST ON THE INSIDE LIP OF THE DRAINAGE STRUCTURE FRAME FOR THE FULL VARIETY OF EXISTING AND PROPOSED DRAINAGE STRUCTURE FRAME STRUCTURE

THE DRAINAGE STRUCTURE INLET FILTER ASSEMBLY BAG SHALL BE CONSTRUCTED OF POLYPROPYLENE GEOTEXTILE FABRIC WITH A MINIMUM WEIGHT OF 4 OUNCES PER SQUARE YARD, MINIMUM FLOW RATE OF 145 GALLONS PER MINUTE PER SQUARE FOOT, AND DESIGNED FOR MINIMUM SILT AND DEBRIS CAPACITY OF 2 CUBIC FEET. THE FILTER BAG SHALL BE REINFORCED WITH AN OUTER LAYER OF POLYESTER MESH FABRIC WITH A MINIMUM WEIGHT OF 4 OUNCES PER SQUARE YARD. THE FILTER BAG SHALL BE SUSPENDED FROM THE STEEL FRAME WITH A STAINLESS STEEL BAND AND LOCKING CAP. THE INLET FILTER ASSEMBLY FRAME SHALL NOT CAUSE THE DRAINAGE STRUCTURE GRATE TO EXTEND HIGHER THAN 1/8—INCH ABOVE THE DRAINAGE STRUCTURE FRAME.

BASIS OF PAYMENT: THE WORK WILL BE PAID FOR AT THE CONTRACT UNIT PRICE PER EACH FOR INLET AND PIPE PROTECTION, WHICH PRICE SHALL INCLUDE ALL COST OF LABOR, MATERIALS, EQUIPMENT, AND INCIDENTAL ITEMS NECESSARY TO PERFORM THE WORK.

FILE NAME = 09493-DTLS-01 - P02	USER NAME =	DESIGNED SDG	REVISED —			HARLEM AVENUE		F.A.P.	SECTION	COUNTY	TOTAL	SHEET
		CHECKED — JSP	REVISED —	STATE OF ILLINOIS		BEAUTIFICATION - STREETSC		348	09-00108-00-LS	соок	38	37
	PLOT SCALE =	DRAWN SDG	REVISED	DEPARTMENT OF TRANSPORTATION	1	CONSTRUCTION DETAIL:	LS			CONTRACT	F NO. 6341	12
i	PLOT DATE = 11-30-09	CHECKED - REL	REVISED —	1	SCALE:	SHEET NO. 37 OF 38 SHEETS STA.	TO STA.	FED. BOAD D	NST NO 1 HUNOIS FEE	D AID PROJECT ARA		

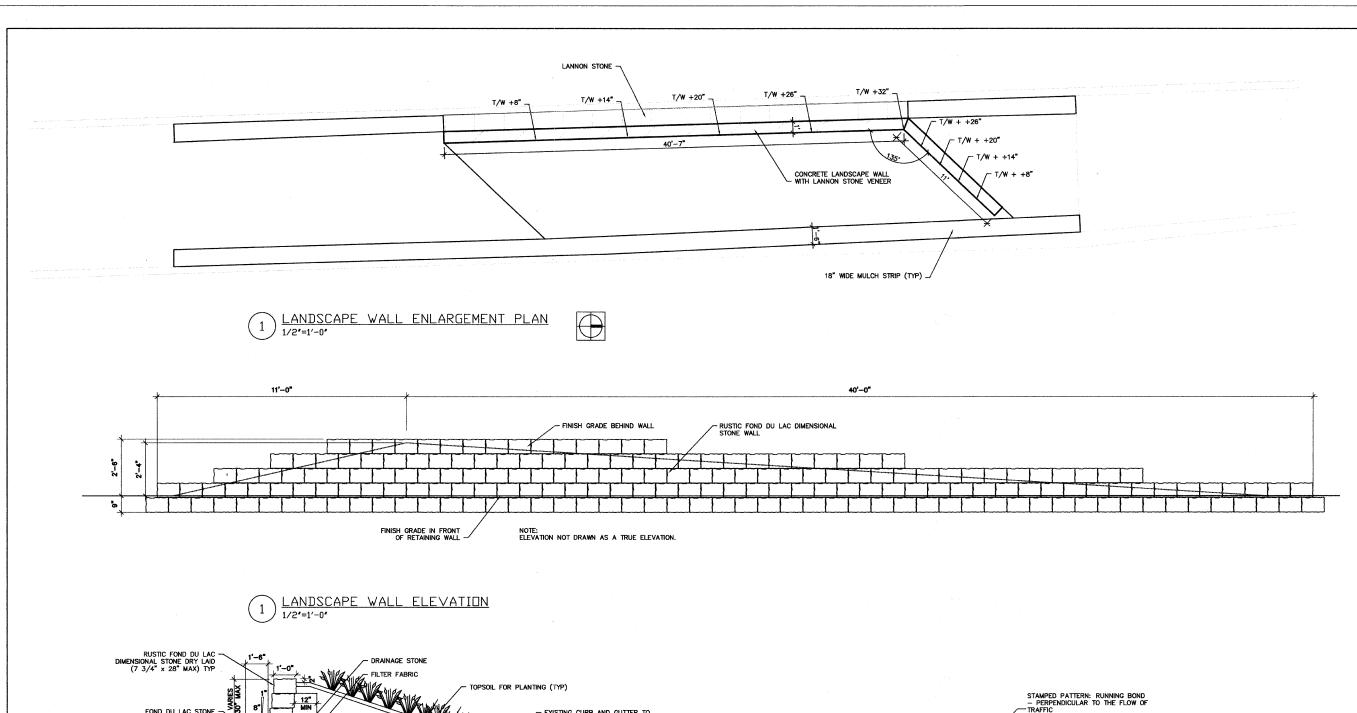

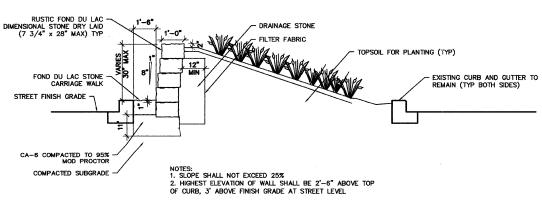

LANDSCAPE WALL SECTION 1 1/2"=1'-0"

STAMPED PATTERN: RUNNING BOND

— PERPENDICULAR TO THE FLOW OF

TRAFFIC -WELDED WIRE FABRIC 5" THICK COLORED CONCRETE COLOR HARDENER: BRICK RED -RELEASE AGENT: SLATE GRAY EXISTING CURB AND GUTTER TO REMAIN AND BE PROTECTED -4" SAND CUSHION COMPACTED SUBGRADE - MATERIAL

NOTES:

1. CONTROL JOINTS EVERY 5'-0" MAX
2. EXPANSION JOINTS EVERY 30'-0" MAX
3. DEMOLISH EXISTING CONCRETE TO FULL DEPTH ARE REPLACE AS SHOWN ON PLANS.
4. MAINTAIN CONSISTENT PATTERN DIRECTION THROUGHOUT PROJECT LIMITS.

5" THICK COLORED STAMPED CONCRETE
1"=1'-0"

FILE NAME = 09493-DTLS-01 - P03	USER NAME =	DESIGNED - SDG	REVISED —		HARLEM AVENUE	F.A.P. SECTION	COUNTY TOTAL SHE
		CHECKED JSP	REVISED —	STATE OF ILLINOIS	BEAUTIFICATION - STREETSCAPING	348 09-00108-00-LS	COOK 38 38
	PLOT SCALE =	DRAWN — SDG	REVISED	DEPARTMENT OF TRANSPORTATION	CONSTRUCTION DETAILS		CONTRACT NO. 63412
	PLOT DATE = 11-30-09	CHECKED — REL	REVISED —		SCALE: AS SHOWN SHEET NO. 38 OF 38 SHEETS STA. TO STA.	FED. ROAD DIST. NO. 1 ILLINOIS FED. A	AID PROJECT ARA-00D1 (809)