COUNTY SECTION

INDEX OF SHEETS

- STANDARDS, GENERAL NOTES, AND APPLICATION RATES
- QUANTITIES
- TYPICAL SECTIONS
- SCHEDULES
- **DETOUR ROUTE**
- PLAN AND PROFILE 6-12
- CROSS SECTIONS
- STANDARD DRAWINGS

LEGEND

	41.12
TRANSPORTATION SURFACE	EDGE OF PAVEMENT
RAILROAD	BACK OF CURB
ABANDONED RAILROAD	FENCE - x x x x
GUARD RAIL non non	ELECTRIC ——E
GUARD POST	WATER
SINGLE POST SIGN	GAS
POWER LINE -□□-	SANITARY SEWER ->>->>
TELEPHONE OR TELEGRAPH -OO-	TRAFFIC SIGNAL CONTROLLER
LIGHT STANDARD 💢	· · · · · · · · · · · · · · · · · · ·
TRAFFIC SIGNAL 🗘	VEGETATION OUTLINE
FIRE HYDRANT &	SINGLE TREE OR BUSH
MANHOLE	STUMP &
INLET =	FENCE -x-x-x-x-
CULVERT I	<u></u>
DISAPPEARING CULVERT	BUILDINGS
DITCH CHECK	MAILBOX P
DITCH-STREAM-SHORELINE	MALLOOA
DISAPPEARING DITCH	
MARSH Julies Julies)
RIGHT OF WAY MARKER ☑	
ABOVE GROUND SPLICE BOX	
HANDHOLE IS	
LOCATED OBJECT O	
TRAFFIC SIGNAL CONTROLLER	

STATE OF ILLINOIS

SURFACE TRANSPORTATION / ENHANCEMENT PROGRAM

PROPOSED BIKE PATH IMPROVEMENT

ROUTE: MARQUETTE DRIVE

LIMITS: STONY ISLAND AVENUE TO RICHARDS DRIVE


SECTION: 01 - P4019 - 05 - BT

FEDERAL PROJECT: TE - 000 (622)

STATE JOB NO.: C - 91 - 206 - 02

CITY OF CHICAGO

COUNTY: COOK

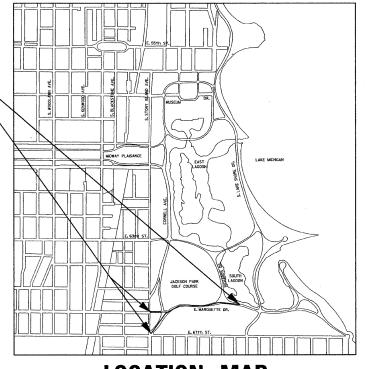



LOCATION MAP

NET LENGTH OF IMPROVEMENT: 0.43 MI GROSS LENGTH OF IMPROVEMENT: 0.43 MI



JACOBS

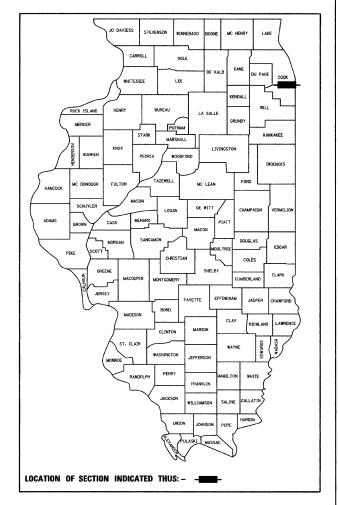


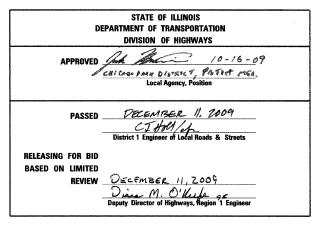

PRINTED BY THE AUTHORITY OF THE STATE OF ILLINOIS

PROJECT LOCATED IN THE CITY OF CHICAGO

PROJECT LIMITS

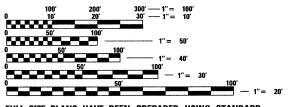

FULL SIZE PLANS HAVE BEEN PREPARED USING STANDARD ENGINEERING SCALES, REDUCED SIZED PLANS WILL NOT CONFORM TO STANDARD SCALES. IN MAKING MEASUREMENTS ON REDUCED PLANS, THE ABOVE SCALES MAY BE USED.

ENGINEER:

(312) 742-4660

JOINT UTILITY LOCATION INFORMATION FOR EXCAVATION 1-800-892-0123

CONTRACT NO. 63184

AMMERICAN ON PLOSED OF THE NAME CANDON

PROFILE	USKSNAPS	A9	DATE
	PLOTTED		
NOTE BOOK	GRADES CHECKED		
	B.M. MOTED		
. Ou	STRUCTURE NOTATING CHIND		

GENERAL NOTES

- 1. UTILITY LOCATIONS SHOWN ON THESE PLANS MAY NOT BE CORRECT OR COMPLETE. THE CONTRACTOR SHALL COORDINATE CONSTRUCTION ACTIVITIES WITH THE RESPECTIVE UTILITY COMPANIES AND THE CITY OF CHICAGO. BEFORE STARTING ANY EXCAVATION, THE CONTRACTOR SHALL CONTACT J.U.L.I.E. AT 1.800.892.0123
- WHERE SECTION AND SUBSECTION MONUMENTS ARE ENCOUNTERED, THE ENGINEER SHALL BE NOTIFIED BEFORE SUCH MONUMENTS ARE REMOVED. THE CONTRACTOR SHALL PROTECT AND CAREFULLY PRESERVE ALL PROPERTY MARKS AND MONUMENTS. THE ENGINEER OR AN AUTHORIZED SURVEYOR AGENT WILL WITNESS OR OTHERWISE REFERENCE AND RESET MONUMENTS AS NECESSARY. ALL PROPERTY CORNERS EXCEPT THOSE WITHIN AREAS WHERE THE SCHEDULE, IF PROVIDED, SHOWS PLACEMENT OF RIGHT OF WAY MARKERS SHALL REMAIN UNDISTURBED.
- 3. THE CONTRACTOR SHALL NOT SET UP A YARD OR FIELD OFFICE ON CHICAGO PARK DISTRICT PROPERTY WITHOUT WRITTEN PERMISSION FROM THE CHICAGO PARK DISTRICT.
- 4. THE CONTRACTOR SHALL TAKE ALL NECESSARY SAFETY PRECAUTIONS TO PROTECT AND PROVIDE ACCESS TO ABUTTING PROPERTY, UTILITIES, PEDESTRIANS, AND VEHICULAR TRAFFIC.
- 5. BARRICADES: THE CONTRACTOR SHALL PROVIDE AND INSTALL TWO WEIGHTED SAND BAGS ON EACH TYPE I OR TYPE II BARRICADE USED (ONE WEIGHTED BAG ACROSS EACH BOTTOM RAIL). ALL TYPE III BARRICADES SHALL REQUIRE A MINIMUM OF FOUR SAND BAGS PER BARRICADE.
- 6. WHEN ARTIFICIAL LIGHTING IS UTILIZED IN NIGHT OPERATIONS. THE CONTRACTOR SHALL EXERCISE THE UTMOST PRECAUTION IN PREVENTING ADVERSE VISIBILITY TO THE MOTORING PUBLIC AND THE ADJOINING COMMERCIAL AND RESIDENTIAL AREAS.
- 7. ALL ELEVATIONS IN THIS PLAN SET REFER TO CITY OF CHICAGO DATUM.
- 8. THE CONTRACTOR SHALL USE CARE IN GRADING OR EXCAVATING NEAR ANY AND ALL EXISTING ITEMS THAT WILL NOT BE REMOVED. ANY DAMAGE DONE TO EXISTING ITEMS BY THE CONTRACTOR SHALL BE REPAIRED BY THE CONTRACTOR AT THE CONTRACTOR'S OWN EXPENSE.
- 9. THE CONTRACTOR SHALL MAINTAIN THE SURFACE DRAINAGE OF ALL ROADWAYS DURING CONSTRUCTION OF THIS PROJECT. WHEN EXISTING DRAINAGE FACILITIES ARE DISTURBED, THE CONTRACTOR SHALL PROVIDE AND MAINTAIN TEMPORARY OUTLETS AND CONNECTORS FOR ALL PRIVATE OR PUBLIC DRAINS, SEWERS, INLETS AND CATCH BASINS. THE CONTRACTOR SHALL PROVIDE FACILITIES TO TAKE IN ALL STORM WATER WHICH WILL BE RECEIVED BY THESE DRAINS AND SEWERS AND DISCHARGE THE SAME. THE CONTRACTOR SHALL PROVIDE AND MAINTAIN A TEMPORARY OUTLET, AND BE PREPARED AT ALL TIMES TO DISPOSE OF THE WATER RECEIVED FROM THESE TEMPORARY CONNECTIONS UNTIL INSTALLATION IS COMPLETE INCLUDING PAVEMENT. THIS WORK SHALL NOT BE PAID FOR DIRECTLY BUT SHALL BE CONSIDERED INCLUDED IN THE CONTRACT.
- 10. ALL STORM SEWER CONNECTIONS WITH PIPES 27 INCH DIAMETER AND SMALLER SHALL BE MADE WITH PRECAST "TEE" OR "WYE" PIPES. FOR PROPOSED STORM SEWER PIPES LARGER THAN 27 INCH DIAMETER, OPENINGS OF THE SPECIFIED DIAMETER SHALL BE MADE IN THE PIPE AT THE SAME TIME IT IS MANUFACTURED. PRECAST "TEE" OR "WYE" PIPE CONNECTIONS FOR THE PROPOSED STORM SEWER WILL NOT BE PAID FOR SEPARATELY BUT WILL BE INCLUDED IN THE COST FOR THE STORM SEWER.
- 11. BUTT JOINTS WILL BE INSTALLED AT THE ENDS OF ALL RESURFACING (WHERE RESURFACING MEETS EXISTING PAVEMENT), IN ACCORDANCE WITH THE "BUTT JOINT AND BITUMINOUS TAPER DETAILS" SHEET INCLUDED IN THE PLANS, UNLESS OTHERWISE SPECIFIED.
- 12. HOT-MIX ASPHALT QUANTITIES ARE BASED ON A UNIT WEIGHT OF 112 LB/SQ YD/IN FOR BINDER AND SURFACE COURSES.
- 13. TEN FOOT TRANSITIONS SHALL BE USED TO MATCH PROPOSED CURB AND GUTTER AND MEDIAN ITEMS OF WORK TO EXISTING CURB AND GUTTERS AND MEDIANS IN THE FIELD, UNLESS OTHERWISE SHOWN. THE TRANSITIONS SHALL BE PAID FOR AT THE CONTRACT UNIT PRICE FOR THE PROPOSED ITEMS OF WORK SPECIFIED.
- 14. THE ENGINEER SHALL BE THE SOLE JUDGE CONCERNING CURING TIME FOR THE VARIOUS HOT-MIX ASPHALT LIFTS.
- 15. BEFORE ORDERING STORM SEWERS, CATCH BASINS, PIPE CULVERTS, PIPE DRAINS, AND MANHOLES, THE CONTRACTOR SHALL CONTACT THE ENGINEER AS TO THE EXACT LENGTH AND QUANTITY REQUIRED.
- 16. AT LEAST (2) TWO WEEKS PRIOR TO PLACING PERMANENT PAVEMENT MARKING, CONTACT WALTER CZARNI, AREA TRAFFIC FIELD ENGINEER AT 773-685-8386
- 17. TEN FOOT TRANSITIONS SHALL BE USED TO MATCH PROPOSED SIDEWALK ITEMS OF WORK TO EXISTING SIDEWALK IN THE FIELD, UNLESS OTHERWISE SHOWN. THE TRANSITIONS SHALL BE PAID FOR AT THE CONTRACT UNIT PRICE FOR THE PROPOSED ITEMS OF WORK SPECIFIED.
- 18. TEMPORARY FENCE SHOULD BE ERECTED ALONG THE DRIP LINE OF EXISTING TREES TO REMAIN WITHIN THE LIMITS OF CONSTRUCTION. AFTER TREES ARE SAFELY FENCED NOTHING IS TO BE STORED, DRIVEN, OR DISTURBED INSIDE THE FENCE. REMOVE PROTECTIVE TEMPORARY FENCE ONLY AFTER ALL CONSTRUCTION WORK HAS BEEN COMPLETED.

- 19. TREE ROOT PRUNING IS TO BE USED ON EXISTING TREES TO PREVENT THE RIPPING UP OF ROOTS WHEN TRENCHING OR EXCAVATION IS WITHIN THE ROOT ZONE OF ADJACENT TREES TO REMAIN. SUPPLEMENTAL WATERING OF TREES SHOULD BEGIN IMMEDIATELY AFTER ROOT PRUNING OF THE TREES HAS OCCURRED.
- 20. EROSION CONTROL ITEMS ARE CONSIDERED TO BE HIGH PRIORITY ITEMS ON THIS CONTRACT. THE ENGINEER WILL IMPLEMENT ALL PROVISIONS OF THE SPECIFICATION NECESSARY TO ASSURE THAT EROSION CONTROL ITEMS ARE CONSTRUCTED AND MAINTAINED IN A TIMELY WAY. ALL EROSION CONTROL MEASURES SHALL BE INSTALLED PRIOR TO BEGINNING ANY CONSTRUCTION ACTIVITIES WHICH WILL POTENTIALLY CREATE ERODIBLE CONDITIONS.
- 21. THE CONTRACTOR WILL BE REQUIRED TO IMPLEMENT AND MAINTAIN SEDIMENT CONTROL PRIOR TO STRIPPING EXISTING VEGETATION.
- 22. WHERE TRANSITIONING FROM A 2% CROSS SLOPE ON TANGENT TO A 2% SUPERELEVATION RATE ON THE HIGH SIDE OF THE CURVE, USE A TRANSITION LENGTH OF 15 FT.

CITY OF CHICAGO NOTES

- ALL CATCH BASINS IN THE CITY OF CHICAGO MUST MEET THE DEPARTMENT OF WATER MANAGEMENT'S STANDARDS.
- 2. PERMITS FROM THE DEPARTMENT OF WATER MANAGEMENT ARE REQUIRED FOR ALL UNDERGROUND STORM, SANITARY OR COMBINED SEWER SYSTEM CONSTRUCTION, AND FOR ALL WORK INVOLVING ADJUSTMENT OF SEWER STRUCTURES. THE DEPARTMENT OF WATER MANAGEMENT'S PERMIT MUST BE OBTAINED BY A LICENSED SEWER DRAIN LAYER PRIOR TO START OF CONSTRUCTION. THE LICENSED SEWER CONTRACTOR/SUBCONTRACTOR MUST SUBMIT TWO SETS OF PLANS APPROVED BY THE DEPARTMENT OF WATER MANAGEMENT FOR THE ISSUE OF THE SEWER PERMIT TO SUITE 410, 333 SOUTH STATE STREET, CHICAGO, ILLINOIS 60604-3971. INSPECTION WILL BE PROVIDED BY THE DEPARTMENT OF WATER MANAGEMENT.
- 3. IF THE SEWER PIPE COVER IS REDUCED TO LESS THAT 3 FEET, CONCRETE ENCASEMENT OF THE SEWER OR REPLACEMENT OF THE SEWER WITH CLASS 52 DUCTILE IRON PIPE WILL BE DEFOLUTION.
- 4. IN CASE DAMAGE TO CITY OF CHICAGO SEWERS, PRIVATE AND PUBLIC DRAINS, SEWER STRUCTURES AND/OR BENCH MONUMENTS, THE CONTRACTOR SHALL IMMEDIATELY CONTACT THE DEPARTMENT OF WATER MANAGEMENT AT (312) 747-7892 OR (312) 747-7893.
- 5. PERFORATED LIDS SHALL BE PLACED ON ALL MANHOLES AND CATCH BASINS.
- 6. ADDITIONAL BENCH MONUMENT LOCATIONS WITHIN THE LIMITS OF THE IMPROVEMENT CAN BE OBTAINED FROM THE DEPARTMENT OF WATER MANAGEMENT AT SUIT 410, 333 SOUTH STATE STREET, CHICAGO, ILLINOIS 60604-3971. THE CONTRACTOR IS RESPONSIBLE FOR REPLACING ANY BENCH MONUMENT DAMAGED OR DESTROYED DURING CONSTRUCTION.
- SIDEWALK ACCESSIBILITY RAMPS SHALL NOT BE CONSTRUCTED DIRECTLY OVER EXISTING OR PROPOSED DRAINAGE STRUCTURES.
- 8. ALL BROKEN, CRACKED, WORN OR OTHERWISE DAMAGED OR BICYCLE UNSAFE FRAMES AND GRATES OR LIDS ON SEWER STRUCTURES WILL BE REPLACED WITH NEW DEPARTMENT OF SEWERS' STANDARD FRAMES AND GRATES OR LIDS. OLD FRAMES AND GRATES OR LIDS SHALL BE DELIVERED TO THE DEPARTMENT OF WATER MANAGEMENT AT 39th STREET AND ASHLAND AVENUE.
- CITY OF CHICAGO WATER VALVE VAULTS AND SEWER STRUCTURES SHALL NOT BE CLOSED, COVERED OR OTHERWISE OBSTRUCTED DURING CONSTRUCTION WITHOUT WRITTEN PERMISSION FROM THE CITY OF CHICAGO DEPARTMENT OF WATER.
- 10. CURB AND GUTTER CONSTRUCTION SHALL PROVIDE A MINIMUM CURB HEIGHT OF 3 INCHES.
- 11. PAVEMENT REPLACEMENT AROUND FRAMES AND GRATES OR LIDS WHERE DRAINAGE, WATER MAIN OR ELECTRICAL STRUCTURES ARE ADJUSTED OR RECONSTRUCTED, SHALL BE CLASS SI CONCRETE.
- 12. ALL PAVEMENT PATCHING SHALL BE CLASS C, UNLESS OTHERWISE NOTED.

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FED. RE	MO DEST. NO.	BLING	S FED. AID	PROJECT		Įō,

LIST OF STANDARDS

000001-05 STANDARD SYMBOLS, ABBREVIATIONS, AND PATTERNS

001006
DECIMAL OF AN INCH AND OF A FOOT
TEMPORARY EROSION CONTROL SYSTEMS
424001-05
CURB RAMPS FOR SIDEWALKS
CONCRETE CURB TYPE B AND COMBINATION CONCRETE CURB AND GUTTER
701001-02
OFF-ROAD OPERATIONS, 2L, 2W, MORE THAN 4,5 m (15') AWAY
701006-03
OFF-ROAD OPERATIONS, 2L, 2W, 4.5 m (15') TO 600 mm (24'') FROM PAVEMENT EDGE
LANE CLOSURE, 2L, 2W, SHORT TIME OPERATIONS
701801-04
LANE CLOSURE, MULTI LANE 1W OR 2W CROSSWALK OR SIDEWALK CLOSURE
701901-01
TRAFFIC CONTROL DEVICES
TYPICAL PAVEMENT MARKINGS

PROJECT COMMITMENTS

NONE

L	REVISIONS		TI	LINOIS DEPARTMENT	OF TRANSPORTATION
	NAME	DATE			
-		ļ			
<u></u>		+	(CHICAGO PARK DISTR	RICT - JACKSON PARK
		 	MΔI	ROUETTE DRIV	E BICYCLE PATH
					L DIGITEL I AIII
<u> </u>					
		-	SCALE	NONE	DRAWN BY: MJP
		 	DATE-	10.45.400	
				10/16/09	CHECKED BY: TB

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		01-P4019-05-BT	COOK	23	3
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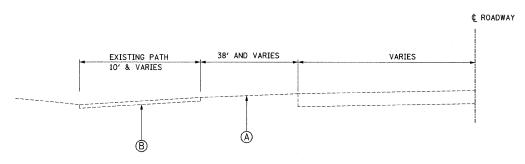
À 25000600	POTASSIUM FERTILIZER NUTRIENT		POUND	74	59.4	14.9	0		
△ 25100630	EROSION CONTROL BLANKET AGGREGATE BASE COURSE, TYPE B 6"		SQ YD	4,723	3778.4	944.6	0		
35101800	BITUMINOUS MATERIALS (PRIME COAT)		SO YD	4,928	3942.6	985.6	0		
40300200			TON	6.1	4.9	1.2	0		
40603310	HOT-MIX ASPHALT SURFACE COURSE, MIX "C", N50		TON	708.0	566.4	141.6	0		
42400200	PORTLAND CEMENT CONCRETE SIDEWALK 5 INCH		SQ FT	1,395	1116.0	279.0	0		
42400800	DETECTABLE WARNINGS		SQ FT	430	344.0	86.0	0		
44000500	COMBINATION CURB AND GUTTER REMOVAL		FOOT	124	99.2	24.8	0	<u> </u>	
60255500	MANHOLES TO BE ADJUSTED		EACH	5	4.0	1.0	0		
60603800	COMBINATION CONCRETE CURB AND GUTTER, TYPE 8-6.12		FOOT	275	220.0	55.0	0		
67100100	MOBILIZATION	•	L SUM	1	0.8	0.2	0		
70101800	TRAFFIC CONTROL AND PROTECTION, (SPECIAL)	•	L SUM	1	0.8	0.2	0		
△ 78000100	THERMOPLASTIC PAVEMENT MARKING - LETTERS AND SYMBOLS		SQ FT	280	224.0	56.0	0		
△ 78000200	THERMOPLASTIC PAVEMENT MARKING - LINE 4"		FOOT	6,899	5519.2	1379.8	0		
△ 78000600	THERMOPLASTIC PAVEMENT MARKING - LINE 12"		FOOT	1,434	1147.2	286.8	0		
△ 78000650	THERMOPLASTIC PAVEMENT MARKING - LINE 24"		FOOT	278	222.4	55.6	0		
78300100	PAVEMENT MARKING REMOVAL		SQ FT	275	220.0	55.0	0		
542A0229	PIPE CULVERTS, CLASS A, TYPE 1 24"		FOOT	55	44.0	11,0	0		
△ A2006716	TREE, QUERCUS MACROCARPA (BUR OAK), 2" CALIPER, BALLED AND BURLAPPED		EACH	3	2.4	0.6	0		
△ 82001666	TREE, CRATAEGUS CRUSGALLI INERMIS (THORN LESS COCKSPUR HAWTHORN), 6' HEIGHT, SHRUB FORM, BALLED AND BURLAPPED		EACH	3	2.4	0.6	0		
△ K0036120	NULCH PLACEMENT 4"	•	SQ YD	93	74,4	18.6	0		
X0321309	CONCRETE PAD	•	SQ YD	7	5.6	1.4	0		
△ X0322453	WEED CONTROL, PRE-EMERGENT	•	POUND	5	4.0	1.0	0		
X0323973	SEDIMENT CONTROL, SILT FENCE	•	FOOT	100	80.0	20.0	0		
14000198	HOT-MIX ASPHALT SURFACE REMOVAL, VARIABLE DEPTH	<u> </u>	sa YD	2402	.1921.6	4,80,4	0		
	BENCHES	•	EACH		0.0	0.0			
X 0444100					i .	•			
X0444100 XX006653	FENCE (SPECIAL)	.	FOOT	121	96.8	24.2	0		

A SPECIALTY ITEMS

ILLINOIS DEPARTMENT OF TRANSPORTATION CHICAGO PARK DISTRICT - JACKSON PARK
MARQUETTE DRIVE BICYCLE PATH

SCALE: 1" = 20'


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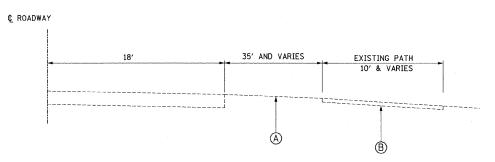
EXISTING TYPICAL SECTION ALONG
MARQUETTE DR AND CORNELL AVE

STA. 0+00 TO STA. 2+50 STA. 100+00 TO STA. 104+70


STA. 9+50 TO STA. 18+00



STA. 2+50 TO STA. 9+50 STA. 18+00 TO STA. 22+47

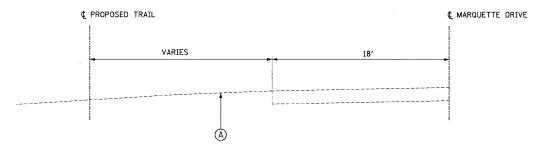

EXISTING TYPICAL SECTION ALONG MARQUETTE DRIVE STA. 50+00 TO STA. 52+34

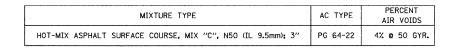

REVISIONS NAME DATE CHICAGO PARK DISTRICT - JACKSON PARK MARQUETTE DRIVE BICYCLE PATH SCALE: 1" = 20' DATE: 10/16/2009 CHECKED BY: TB PRO20019 073 BCodd® Final Plane 10.15.09 BTYPE/CAL de

SECTION

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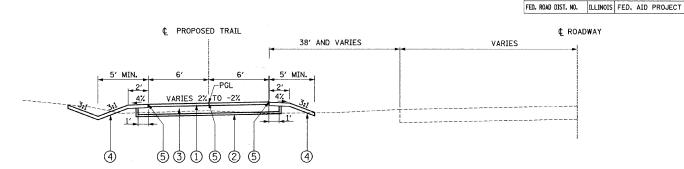
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TO STA.


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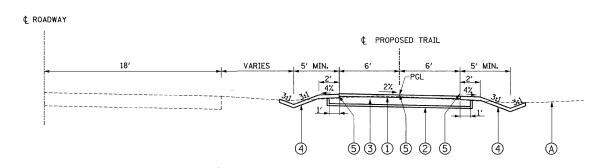
PROPOSED TRAIL TYPICAL SECTION ALONG
MARQUETTE DR AND CORNELL AVE

STA. 0+00 TO STA. 2+50 STA. 100+00 TO STA. 104+70

STA. 9+50 TO STA. 18+00



PROPOSED TRAIL TYPICAL SECTION ALONG MARQUETTE DRIVE STA. 2+50 TO STA. 9+50 STA. 18+00 TO STA. 22+47

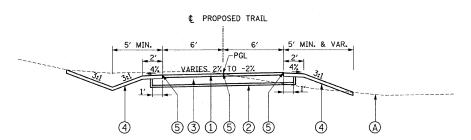

PROPOSED TRAIL TYPICAL SECTION ALONG MARQUETTE DRIVE STA. 50+00 TO STA. 52+34

F	G	F	Ν	D

(A) EXISTING GROUND

(3) 6" AGGREGATE BASE COURSE

B EXISTING BITUMINOUS PAVEMENT

(4) 4" TOPSOIL AND SEEDING

1 3" H.M.A. SURFACE COURSE

(5) PROPOSED PAVEMENT MARKINGS:
- 4" YELLOW 12'-3' CENTER SKIP LINE
- 4" SOLID WHITE EDGE LINE

② GEOTECHNICAL FABRIC

TREE ACTIVITIES / CLEARING SCHEDULE

		TREE REMOVAL	TEMP. FENCE	TREE PRUNING	TREE ROOT PRUNING	MULCH
STATION	SIDE	UNITS	F00T	EACH	EACH	SQ YD
0+00 - 5+00	LT	0	100	1	1	0
0700 - 5700	RT	12, 14	0	0	0	0
5+00 - 10+00	LT	10, 12	200	2	2	93
5+00 - 10+00	RT	10	300	2	2	0
10+00 - 15+00	LT	0	0	0	0	0
10400 - 15400	RT	0	0	0	0	0
15+00 - 20+00	LT	0	0	1	1	0
15+00 - 20+00	RT	0	0	1	1	0
20+00 - 22+47	LT	0	0	0	0	0
20100 - 22141	RT	0	0	1	1	0
50+00 - 52+34	LT	0	0	0	0	0
30700 - 32734	RT	0	0	0	0	0
100+00 - 104+70	LT	0	0	0	0	0
100100 - 104110	RT	0	0	0	0	0
TO	DTAL	58	600	8	8	93

PAVEMENT SCHEDULE

		HMA SURFACE REMOVAL	GEOTECHNICAL	AGGREGATE	BITUMINOUS	HOT-MIX
		VARIABLE	FABRIC	BASE COURSE,	MATERIALS	ASPHALT SURFACE
		DEPTH	FADRIC	TYPE B 6"	(PRIME COAT)	COURSE, MIX C
STATION	SIDE	SQ YD	SQ YD	SQ YD	TON	TON
0+00 - 5+00	LT RT	528	999	878	1.08	121
5+00 - 10+00	LT RT	106	920	804	0.98	121
10+00 - 15+00	LT RT	622	992	873	1.08	121
15+00 - 20+00	LT RT	337	1,051	921	1.13	121
20+00 - 22+47	LT RT	-	399	343	0.41	60.3
50+00 - 52+34	LT RT	291	449	388	0.47	50.9
100+00 - 104+70	LT RT	518	830	721	0.87	112.8
TO	DTAL	2,402	5,639	4,928	6.01	708

FENCE AND SITE FURNISHINGS

			BENCH
		FENCE	INSTALLATION
STATION	SIDE	LF	EACH
0+00 - 5+00	LT	0	0
0+00 - 3+00	RT	0	0
5+00 - 10+00	LT	77	0
3+00 - 10+00	RT	0	0
10+00 - 15+00	LT	44	0
10+00 = 15+00	RT	0	0
15+00 - 20+00	LT	0	0
15+00 - 20+00	RT	0	1
20+00 - 22+47	LT	0	0
20+00 - 22+41	RT	0	0
50+00 - 52+34	LT	0	0
30+00 - 32+34	RT	0	0
100+00 - 104+70	LT	0	0
100+00 - 104+70	RT	0	0
To	OTAL	121	1

SEEDING SCHEDULE

1	
	LAWN
	SEEDING
SIDE	SF
LT	2,334
RT	3,276
LT	3,482
RT	2,640
LT	2,982
RT	3,084
LT	3,709
RT	2,928
LT	1,410
RT	1,533
LT	1,489
RT	1,396
LT	2,832
RT	2,861
TAL	35,956
	LT RT RT RT RT RT


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FED. RO	AD DIST. NO.	ILLINOI	S FED.	AID	PROJECT	•


PAVEMENT MARKING SCHEDULE


	THERMOPLASTIC PAVEMENT MARKING - LINE 4" Solid Yellow	THERMOPLASTIC PAVEMENT MARKING - LINE 4" Solid White	THERMOPLASTIC PAVEMENT MARKING - LINE 4" 12'-3" Yellow Skip	THERMOPLASTIC PAVEMENT MARKING - LINE 12" Solid White	THERMOPLASTIC PAVEMENT MARKING - LINE 24" Solid White
Station	LF	LF	LF	LF	LF
0+00 - 1+00	100	200		30	12
1+00 - 1+84	-	168	15	-	-
1+84 - 2+84	100	287	-	30	12
3+36 - 4+36	100	200		30	12
4+36 - 9+00	-	930	93	-	_
9+00 - 12+00	-	616	60	_	_
12+00 - 17+75	-	1151	115	-	-
17+75 - 18+75	100	290	_	30	12
19+30 - 21+58	228	455	-	60	24
22+13 - 22+47	34	87	-	-	-
50+00 - 51+00	100	200	-	30	12
51+00 - 51+94	_	188	6	-	
51+94 - 52+34	_	SEE 103+50 - 104+64	8	-	-
100+00 - 103+50	-	700	15	-	-
103+50 - 104+64	40	268	45	-	***
TOTAL	802	5740	357	210	84


	THERMOPLASTIC PAVEMENT MARKING - LINE 12" Solid White	THERMOPLASTIC PAVEMENT MARKING - LINE 24" Solid White
Intersection	LF	LF
Marquette Drive and Cornell Avenue	444	74
Marquette Drive Mid-block (Sta. 11+25.00)	168	0
Marquette Drive at Richards Drive (Sta. 19+00.00)	444	60
Marquette Drive at Richards Drive (Sta. 21+88.00)	168	60
TOTAL	1224	194


REVISIONS		ILLINOIS DEPARTM	ENT OF TRANSPORTATION
NAME	DATE		
		CHICAGO PARK DIS	STRICT - JACKSON PARK
		MARQUETTE DR	RIVE BICYCLE PATH
	-	SCALE: 1" = 20'	DRAWN BY: MJP
		DATE: 10/16/2009	CHECKED BY: TB
		P:B020019.073BCaddB_Final Pla	ans_10-15-09@Schedule_of_Quantities.dgn

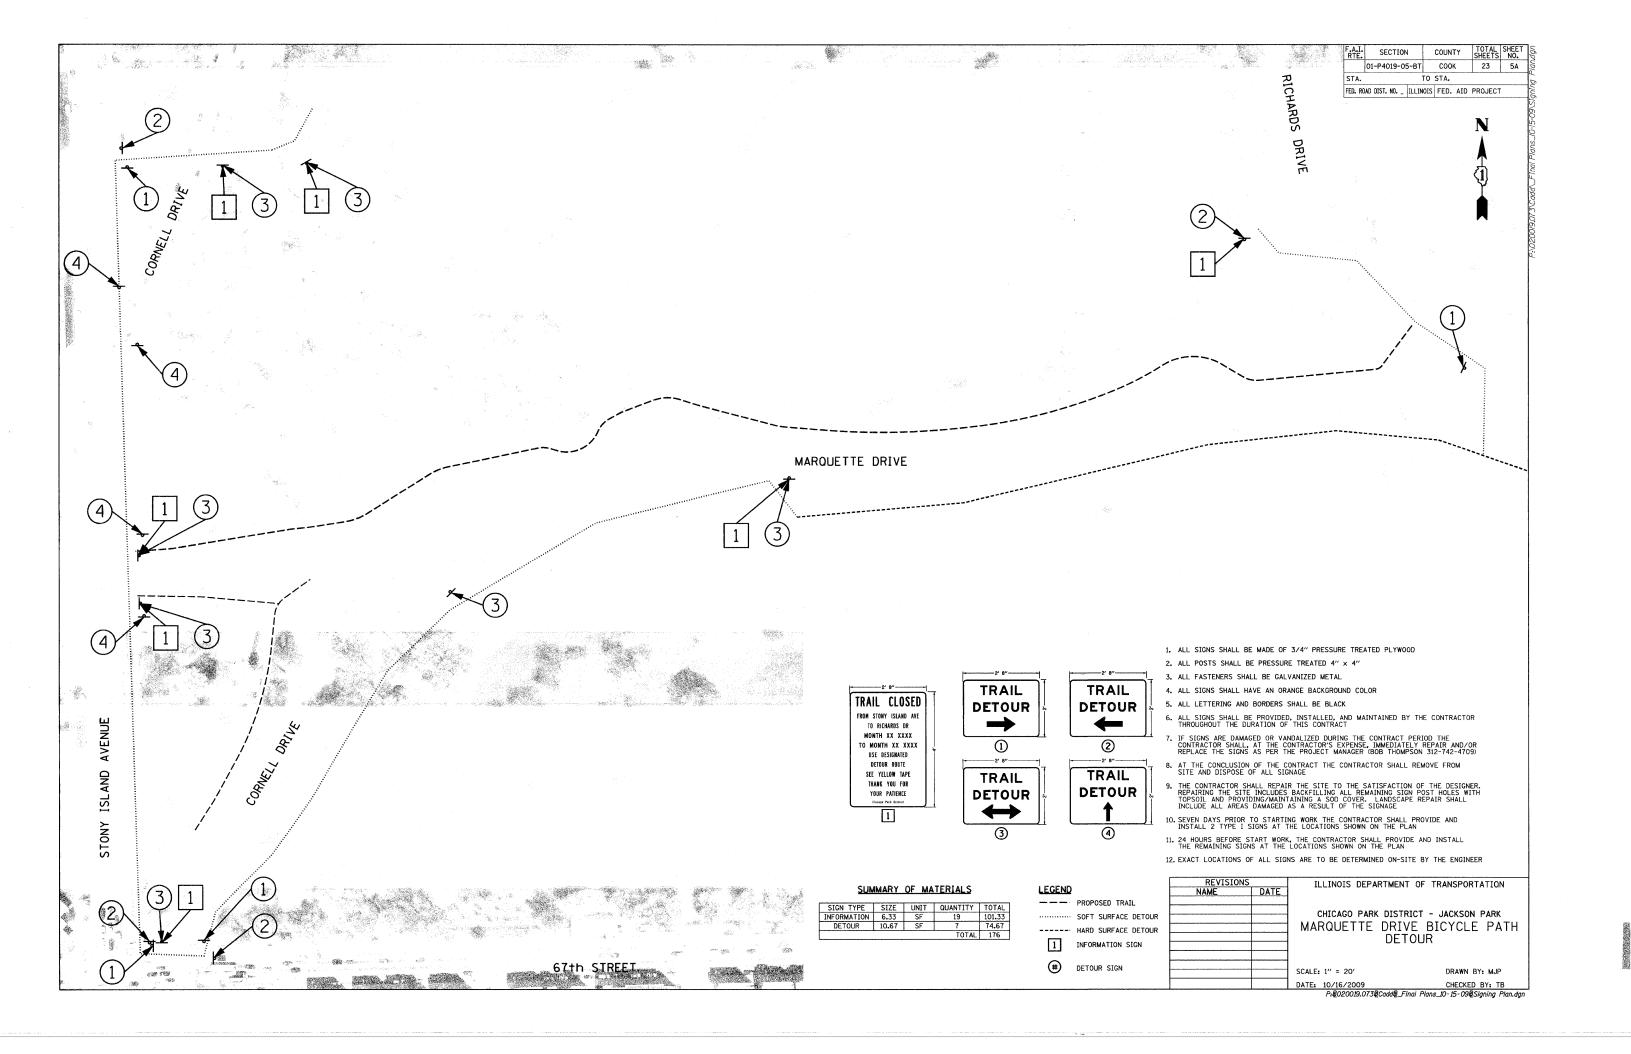


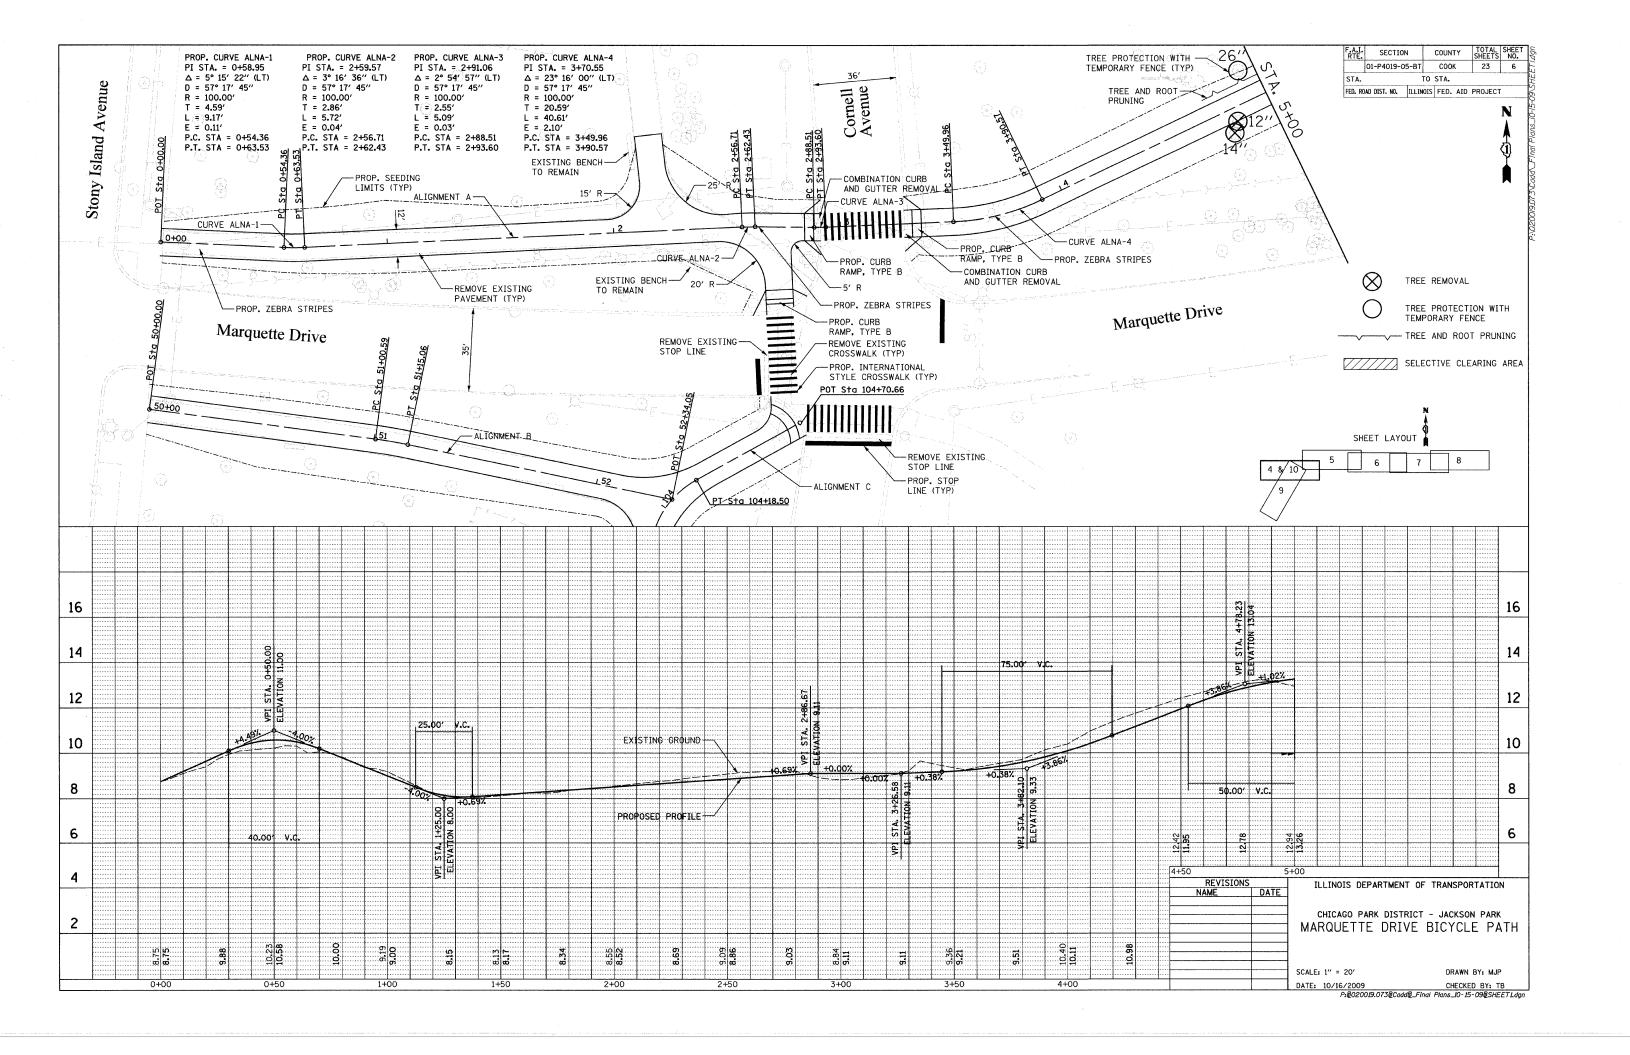


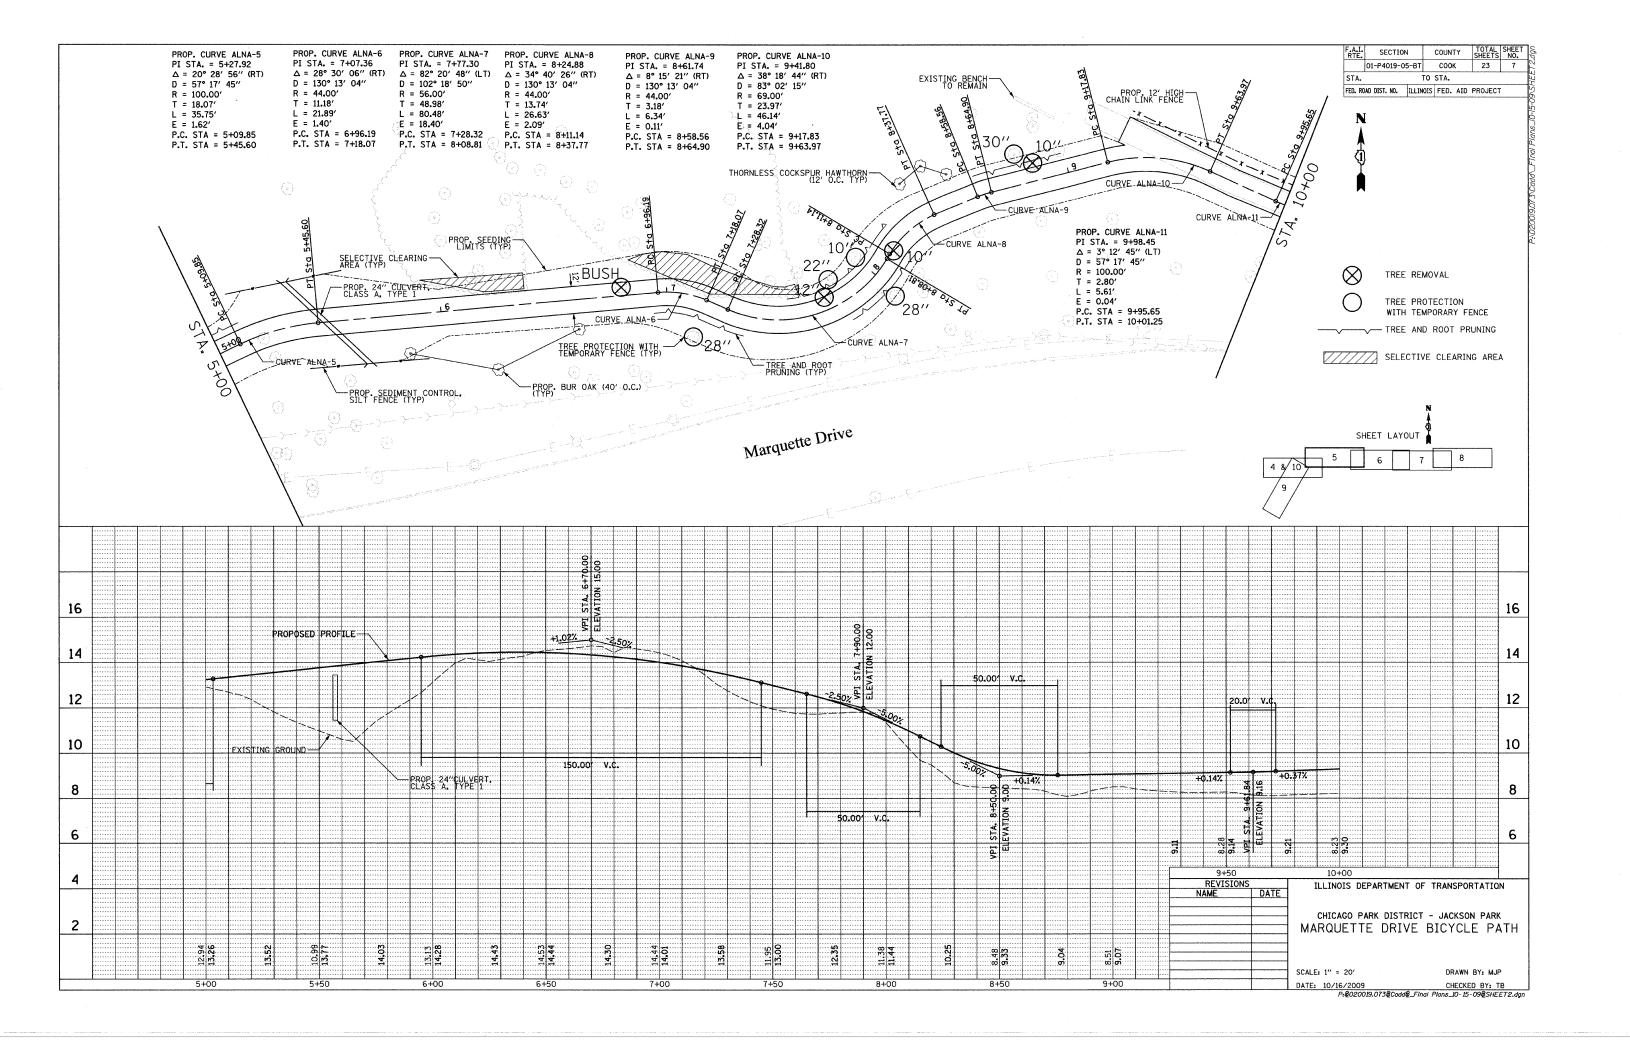


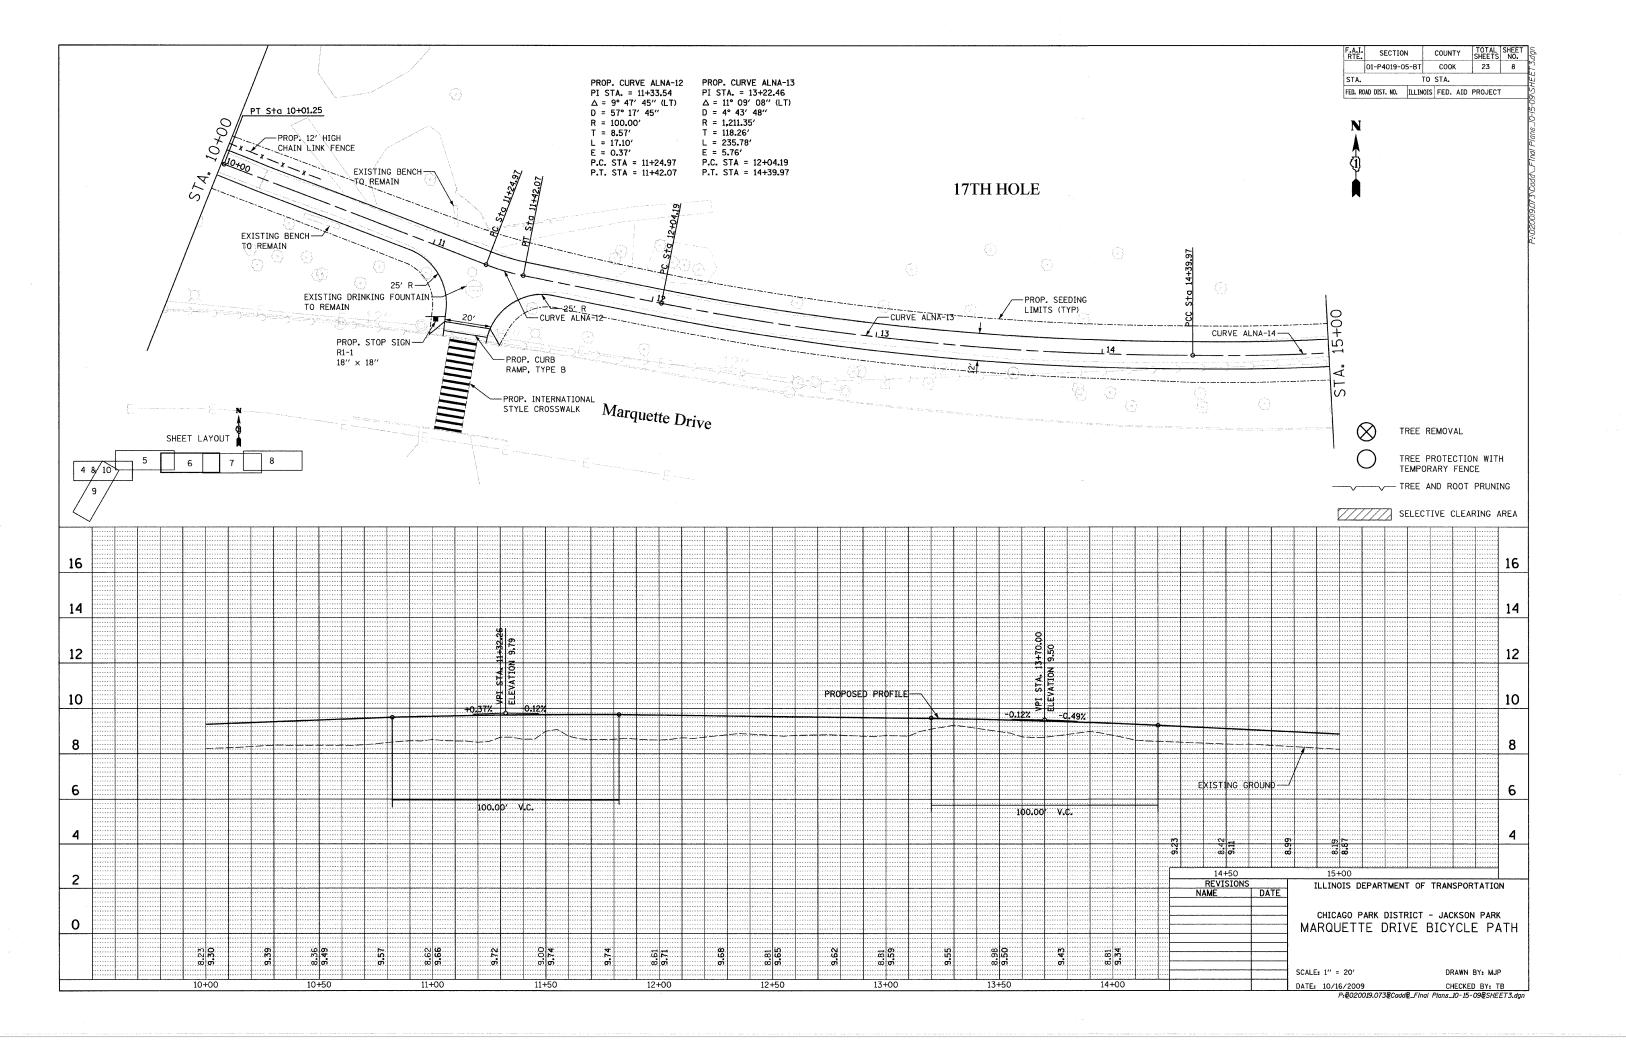

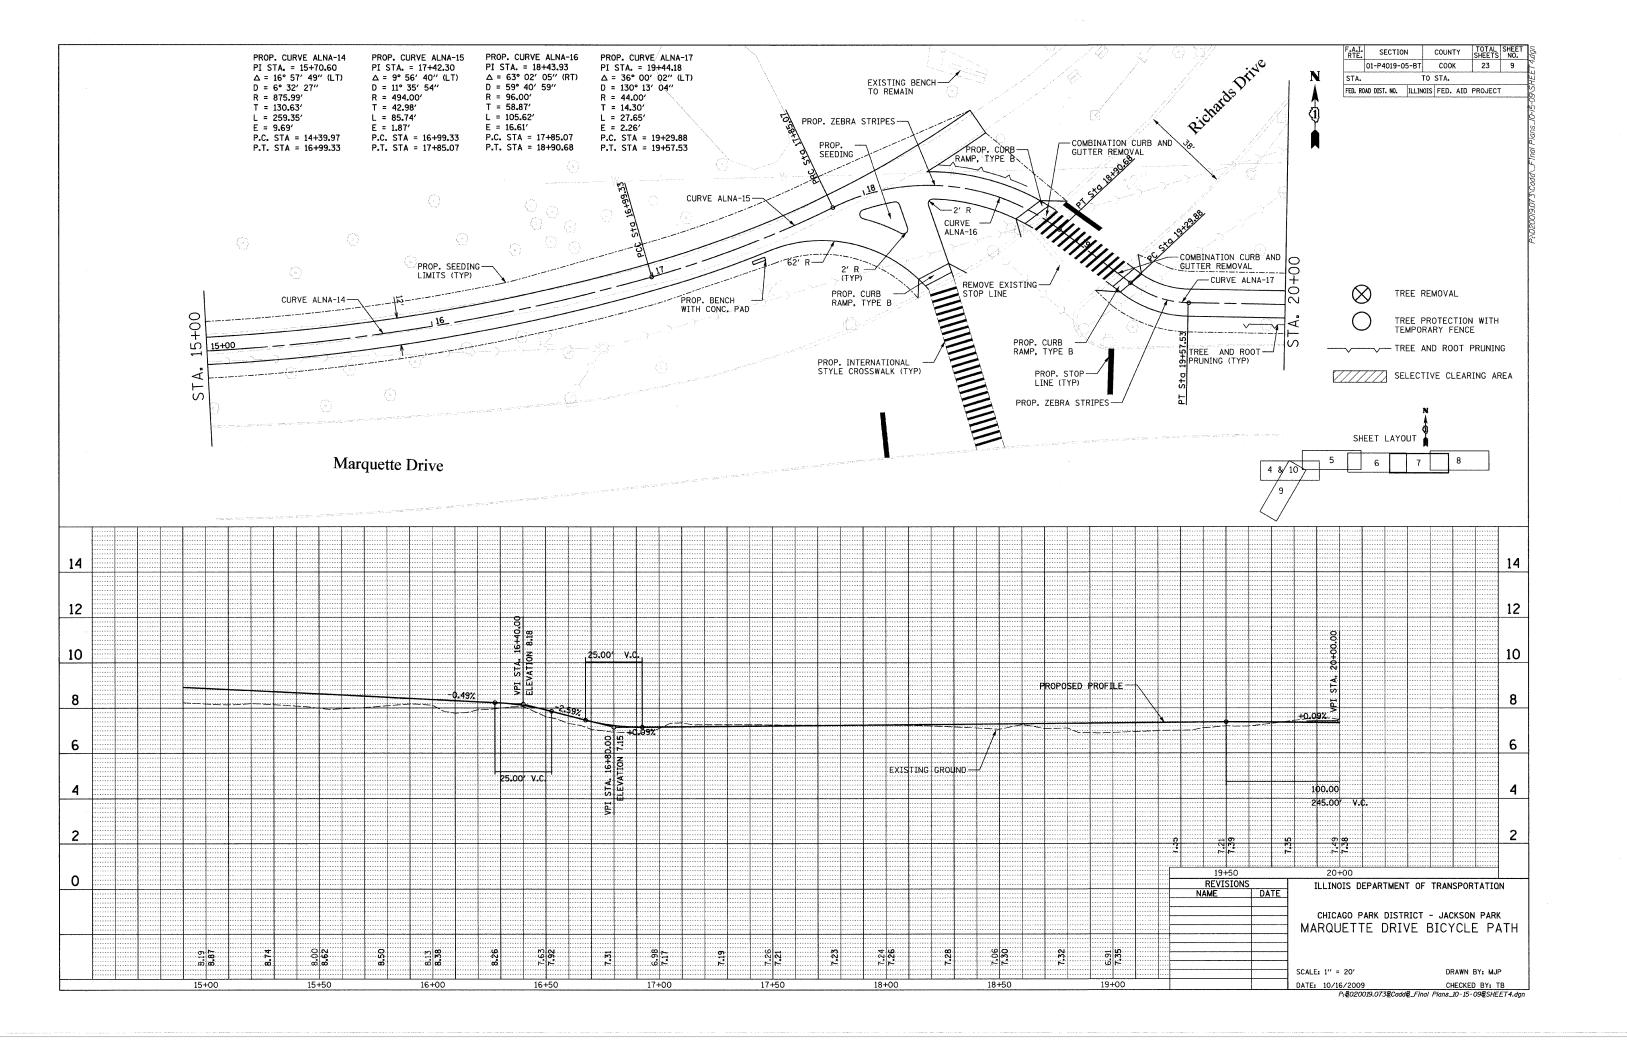


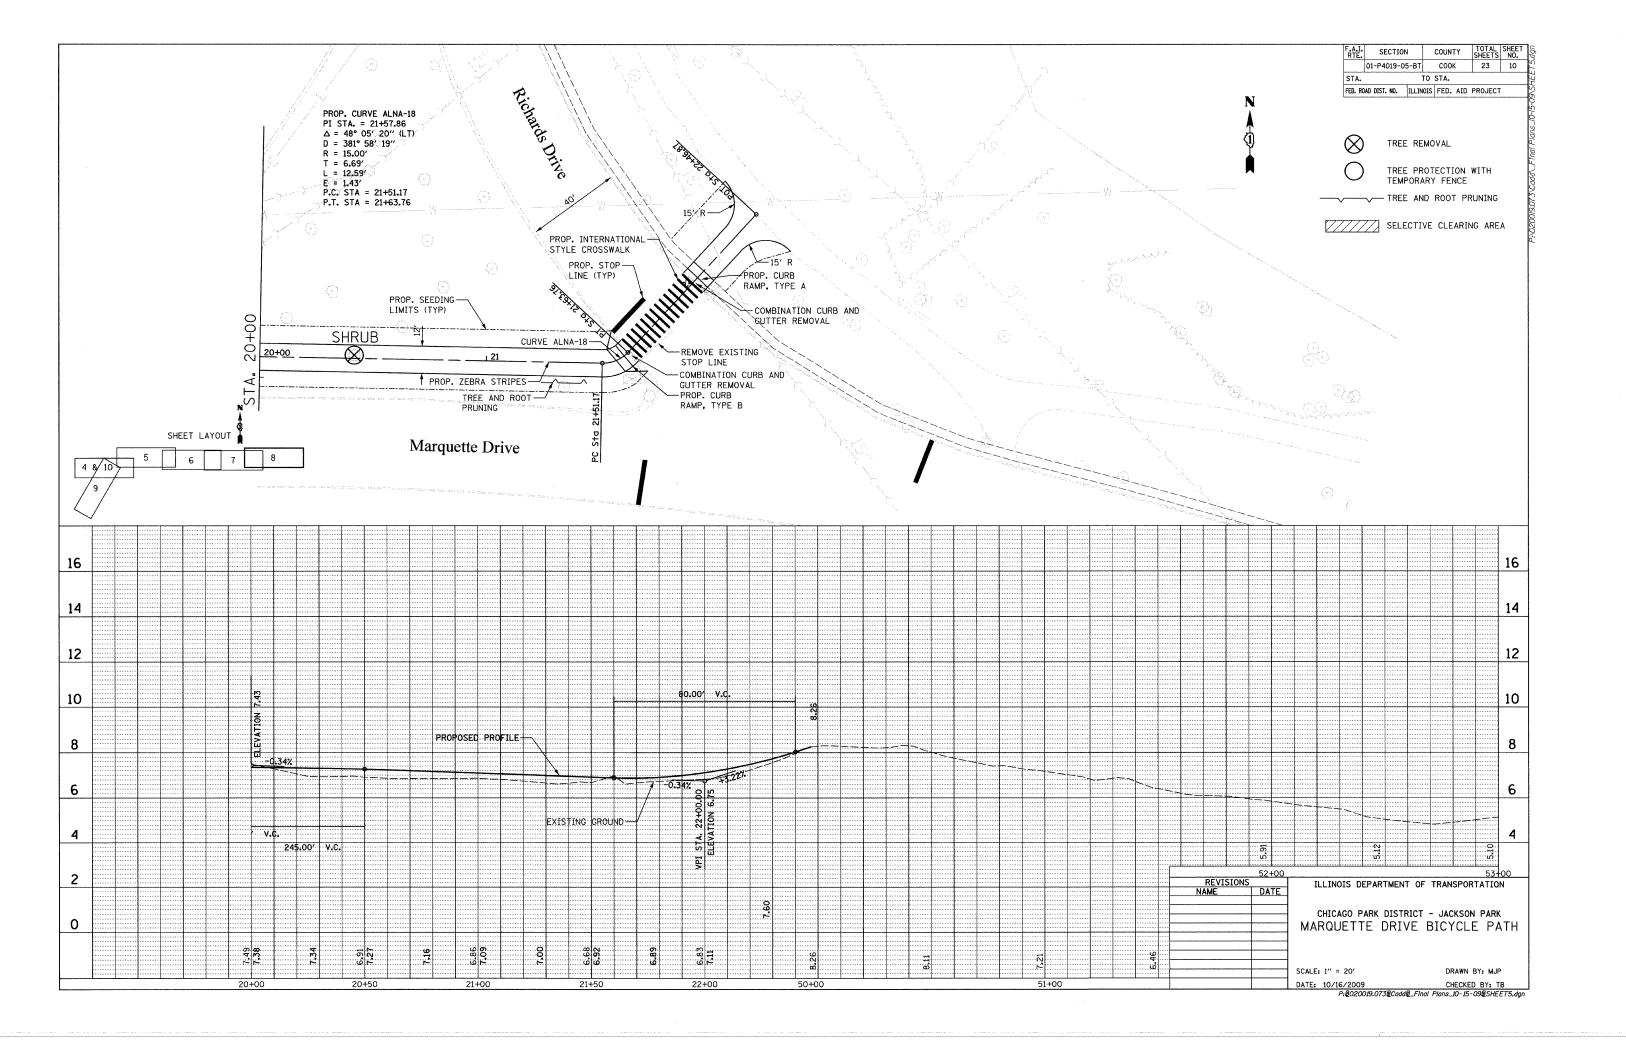


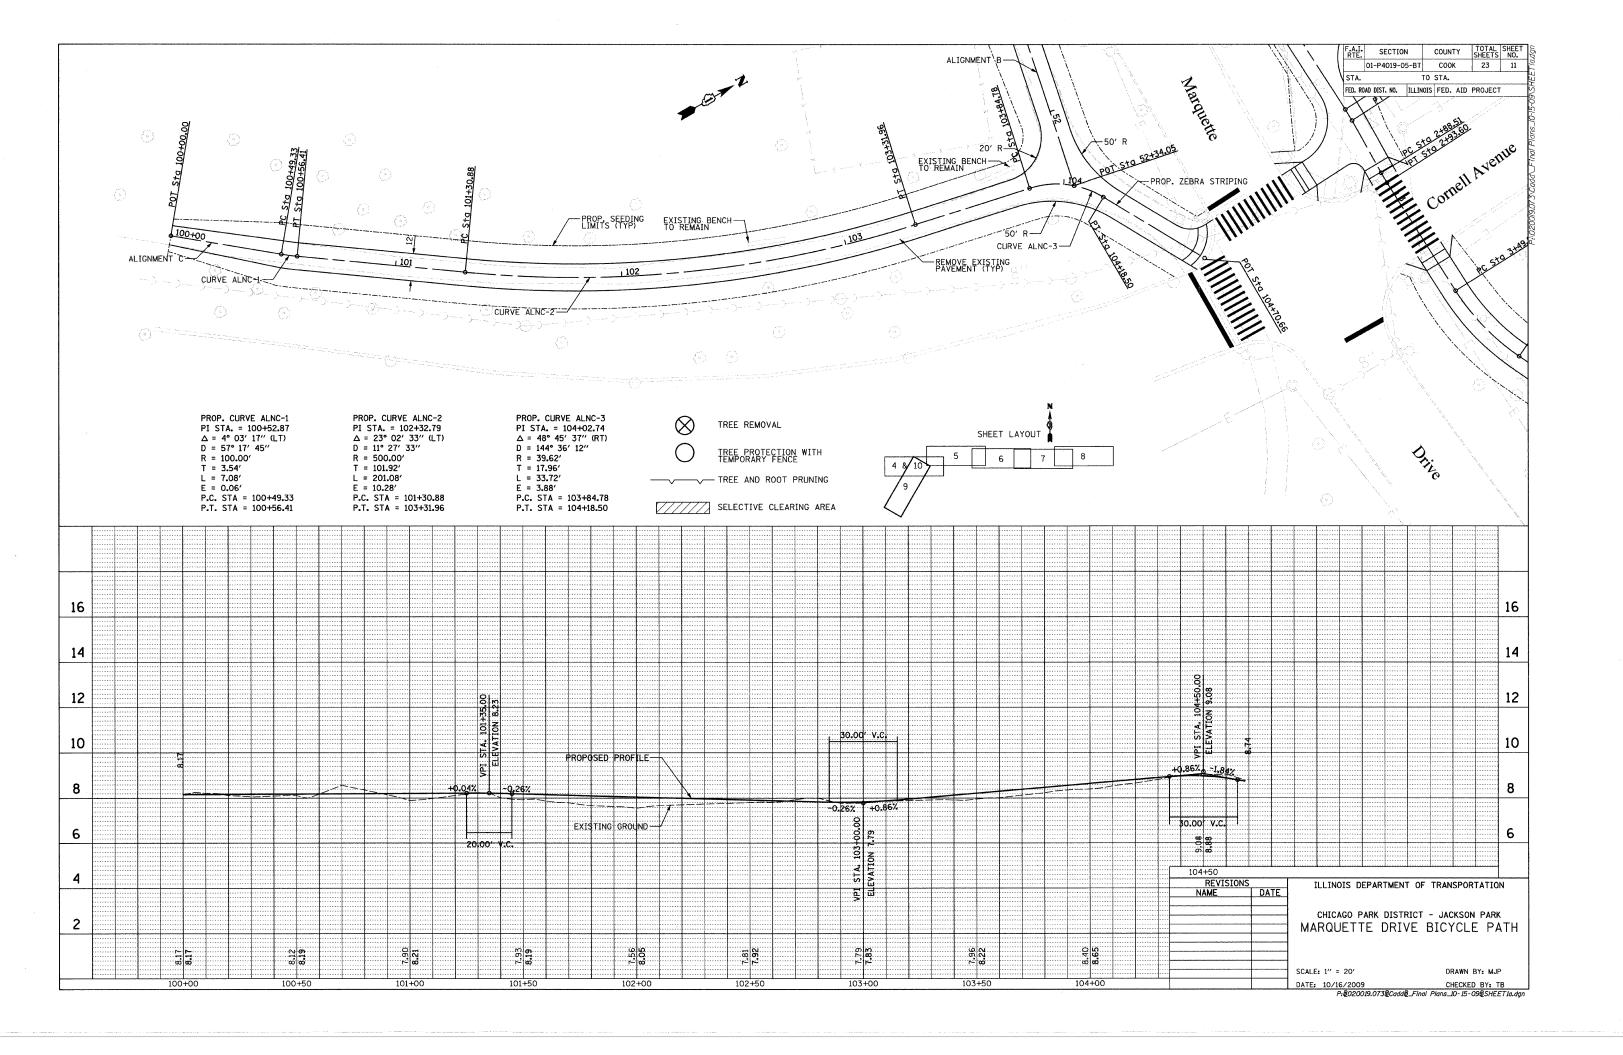

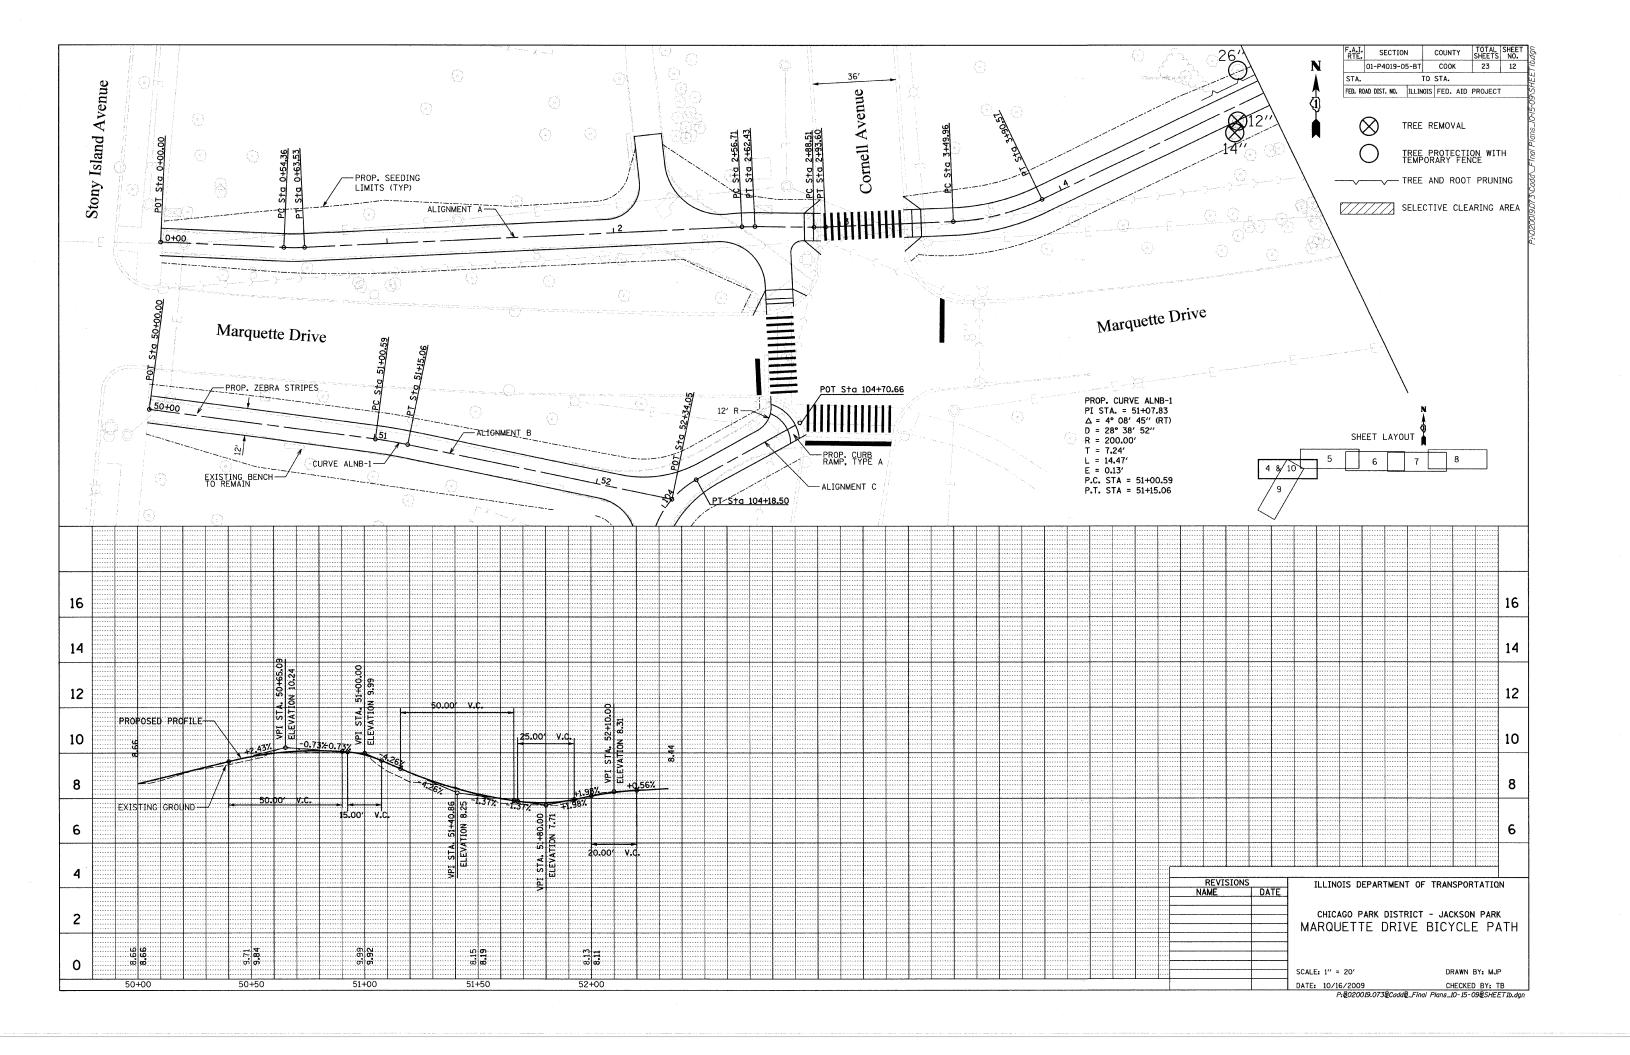



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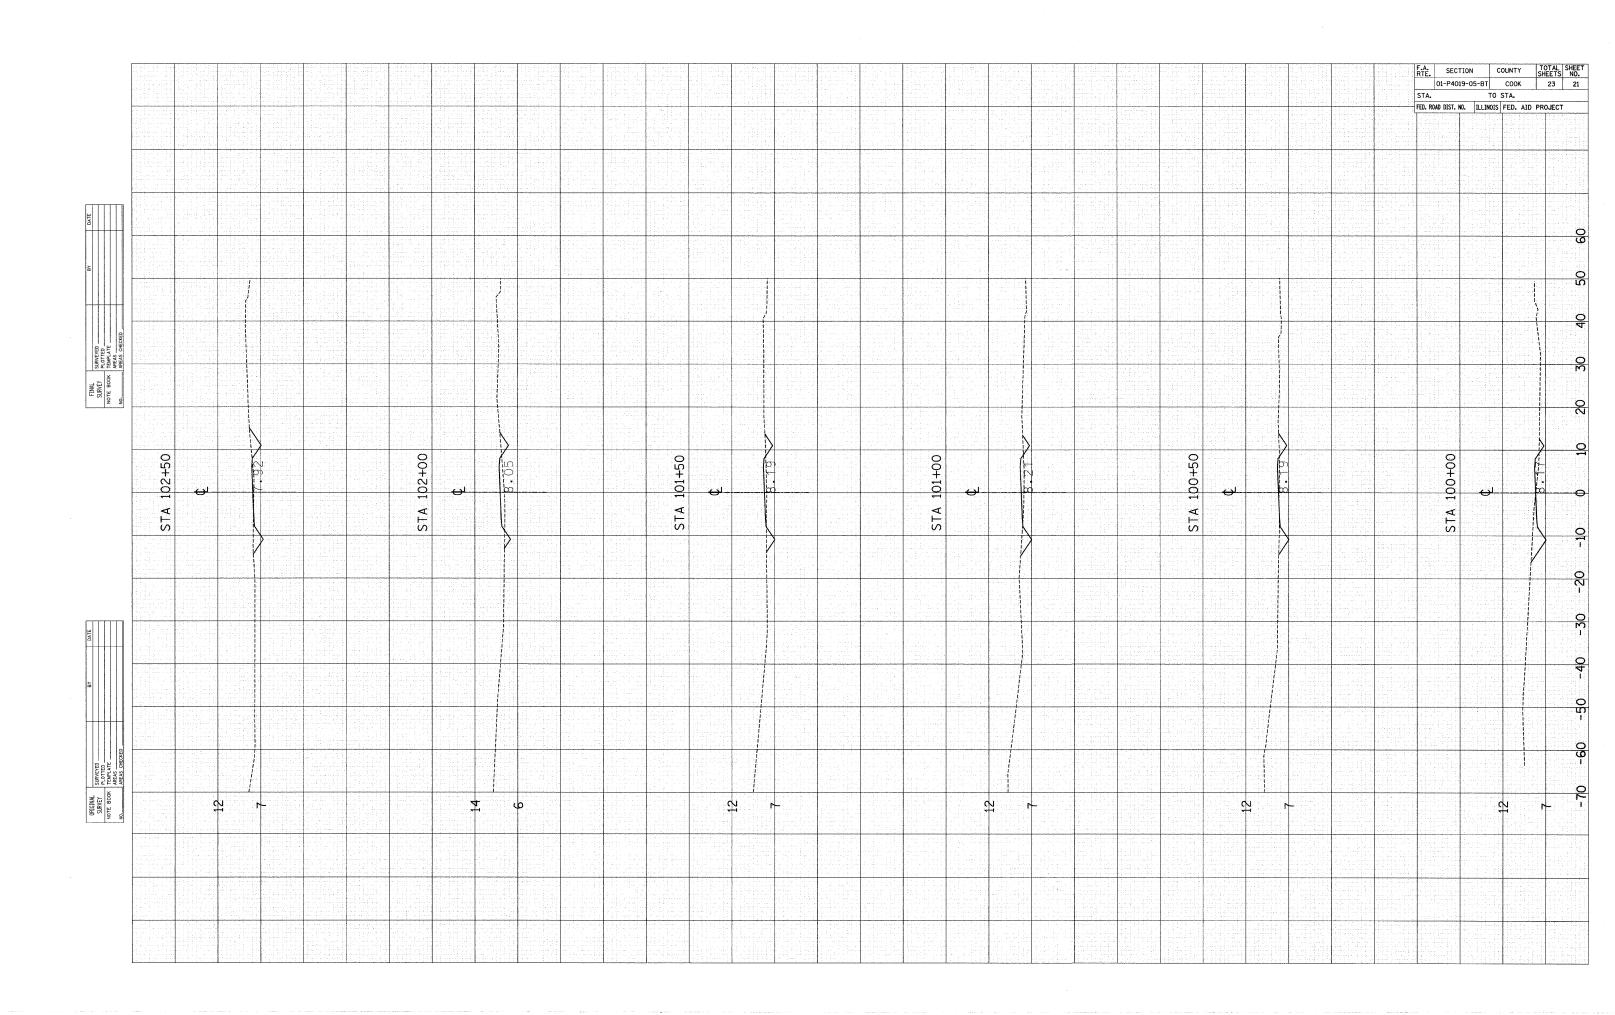
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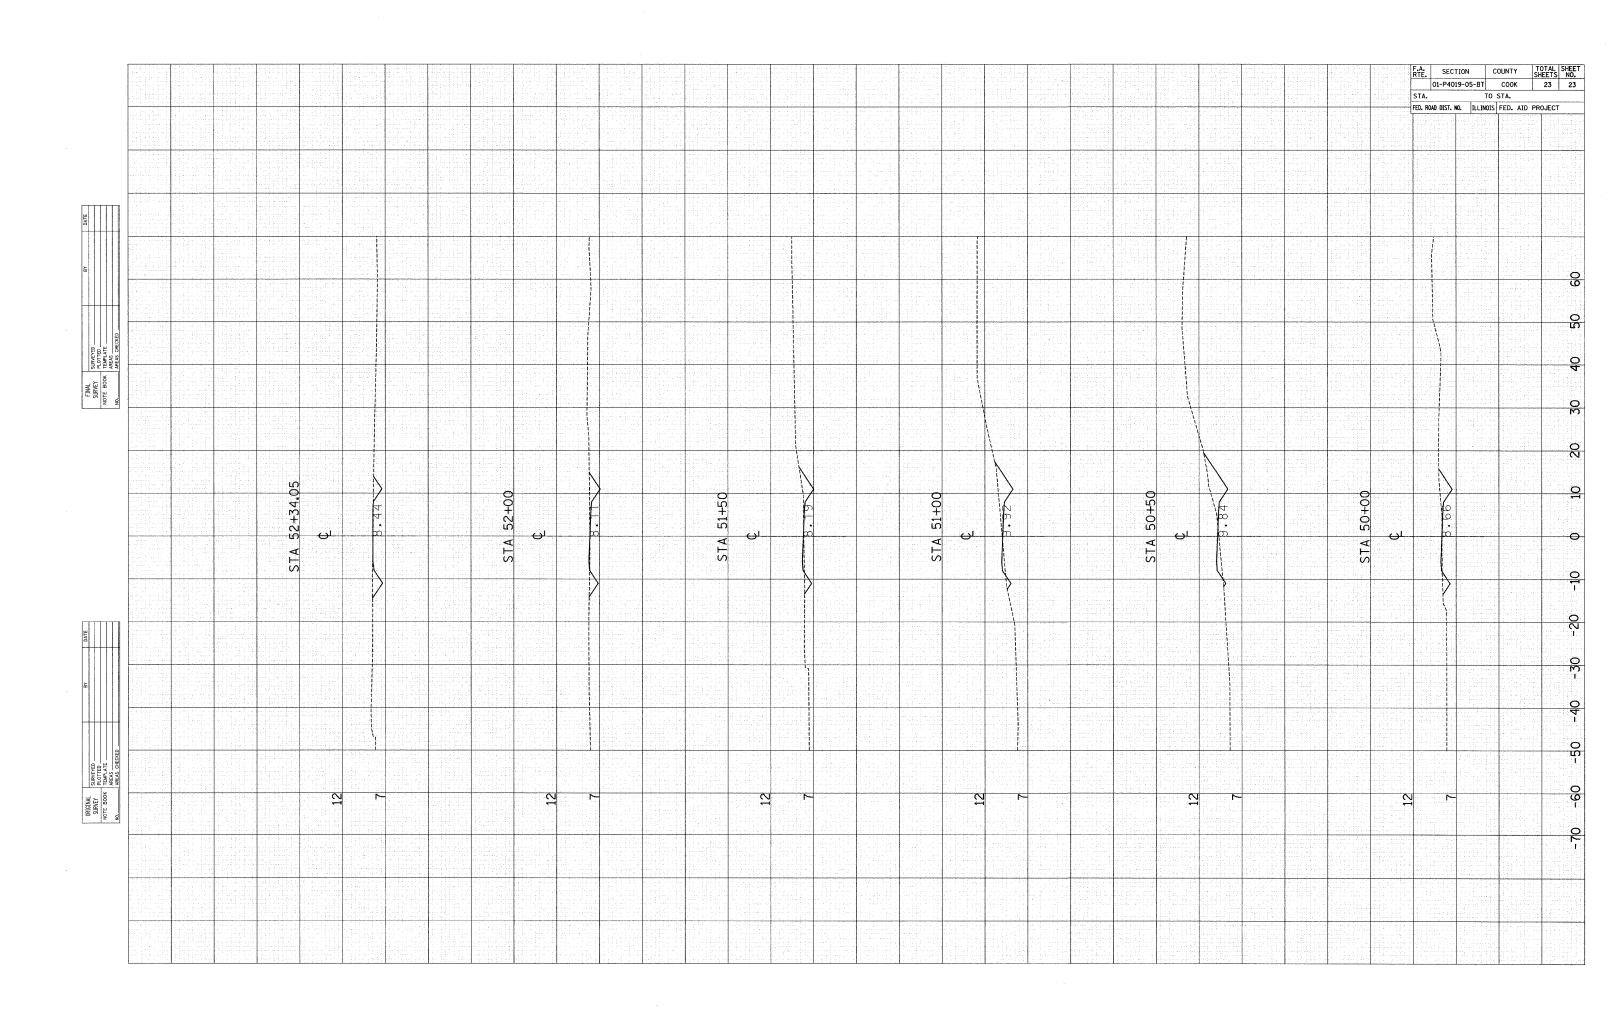

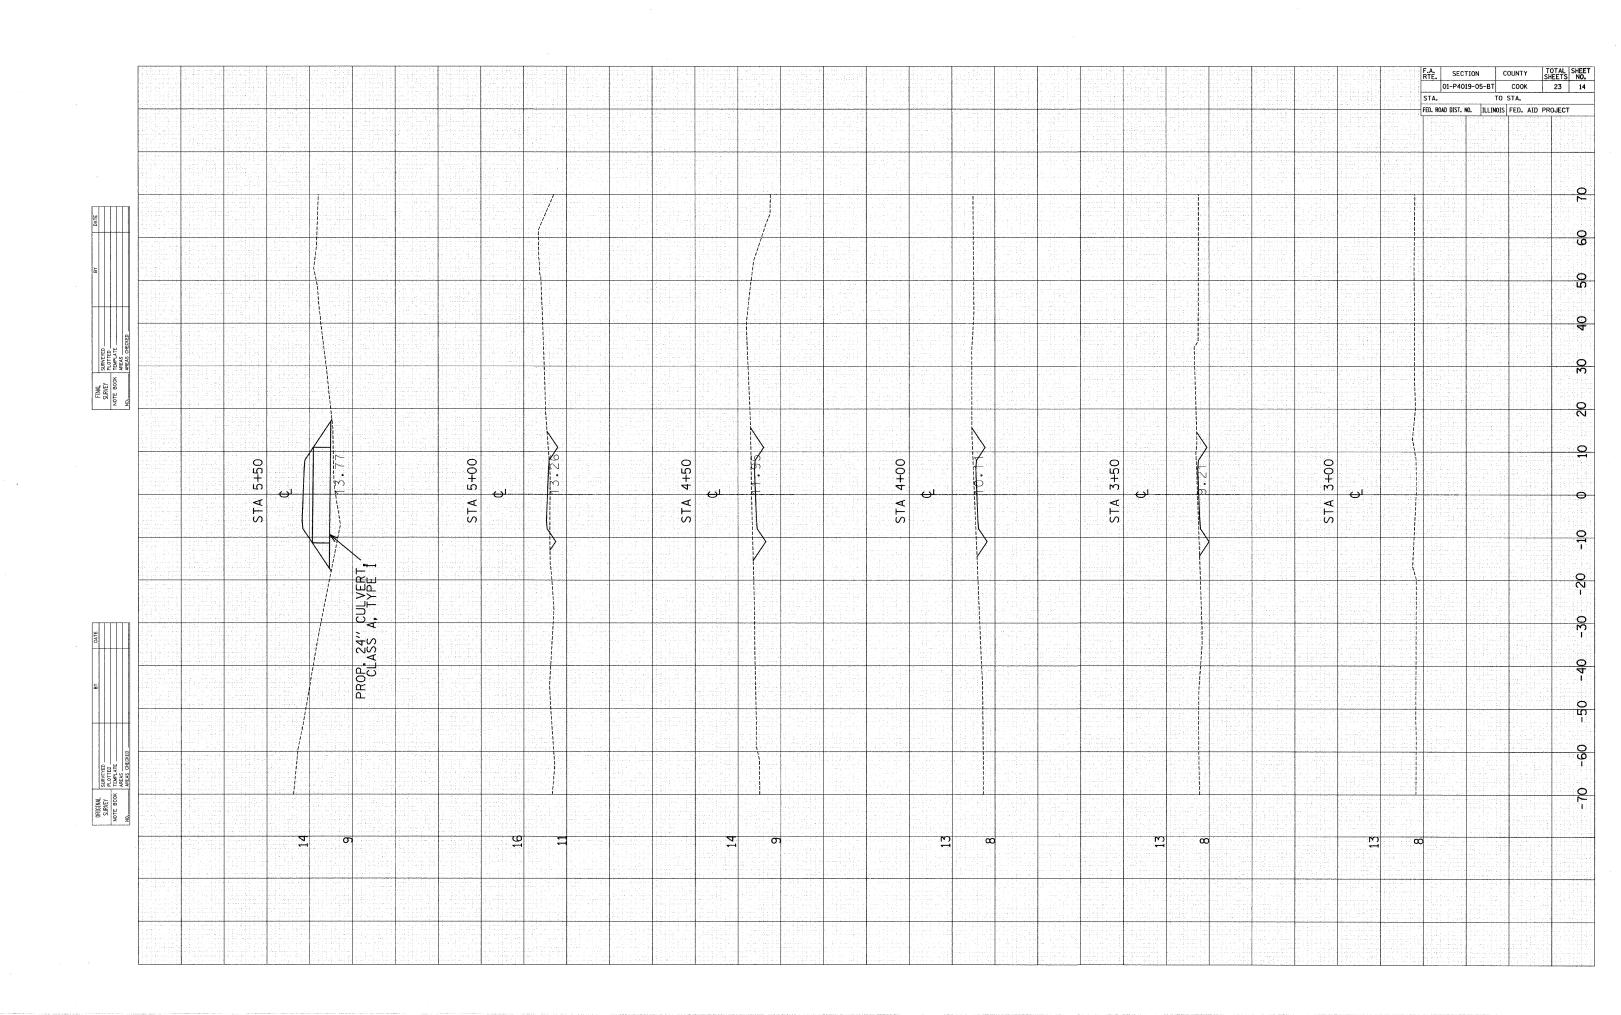
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SEAT HEIGHT MOUNTING 2808-6; 6'0" (1830mm) 2'2" [660mm] 2'10" [865mm] 1'4" [405mm] 2808-8; 7'11" [2415mm] 2'2" [660mm] 2'10" [865mm] 1'4" [405mm] SURFACE* FRAME AND ARMRESTS SURFACE* 9'10" [2995mm] 2'2" [660mm] 2'10" [865mm] 1'4" [405mm]

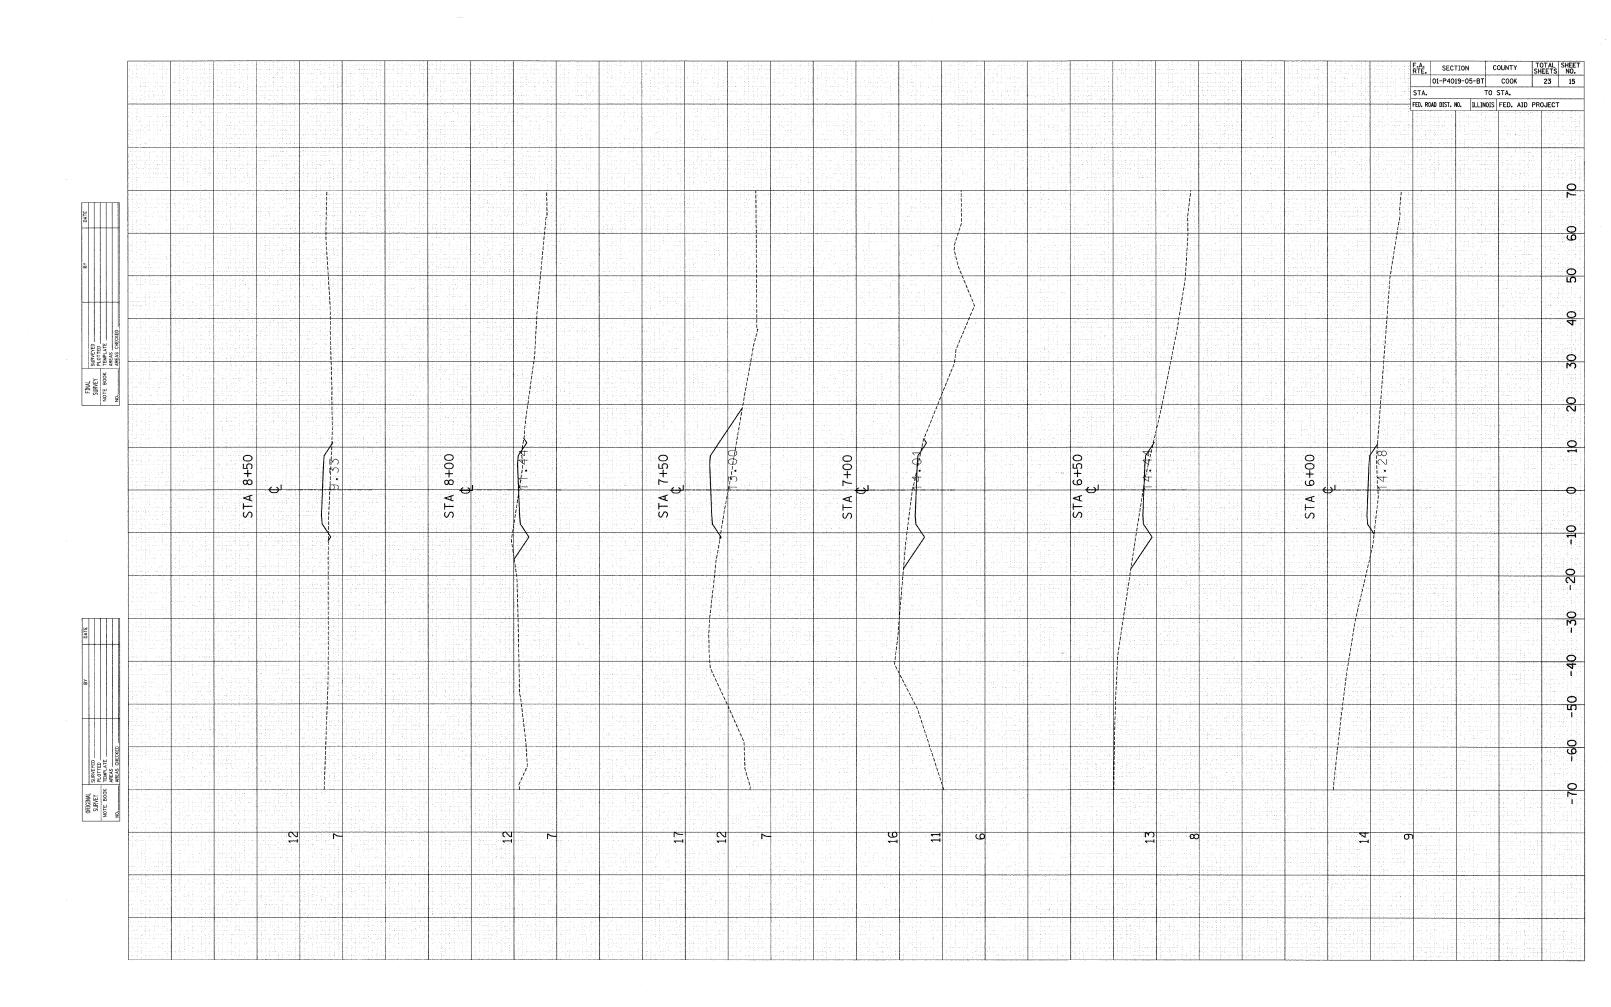MATERIAL: POWDER-COATED STEEL

OPTIONS: POWDER-COATING COLOR

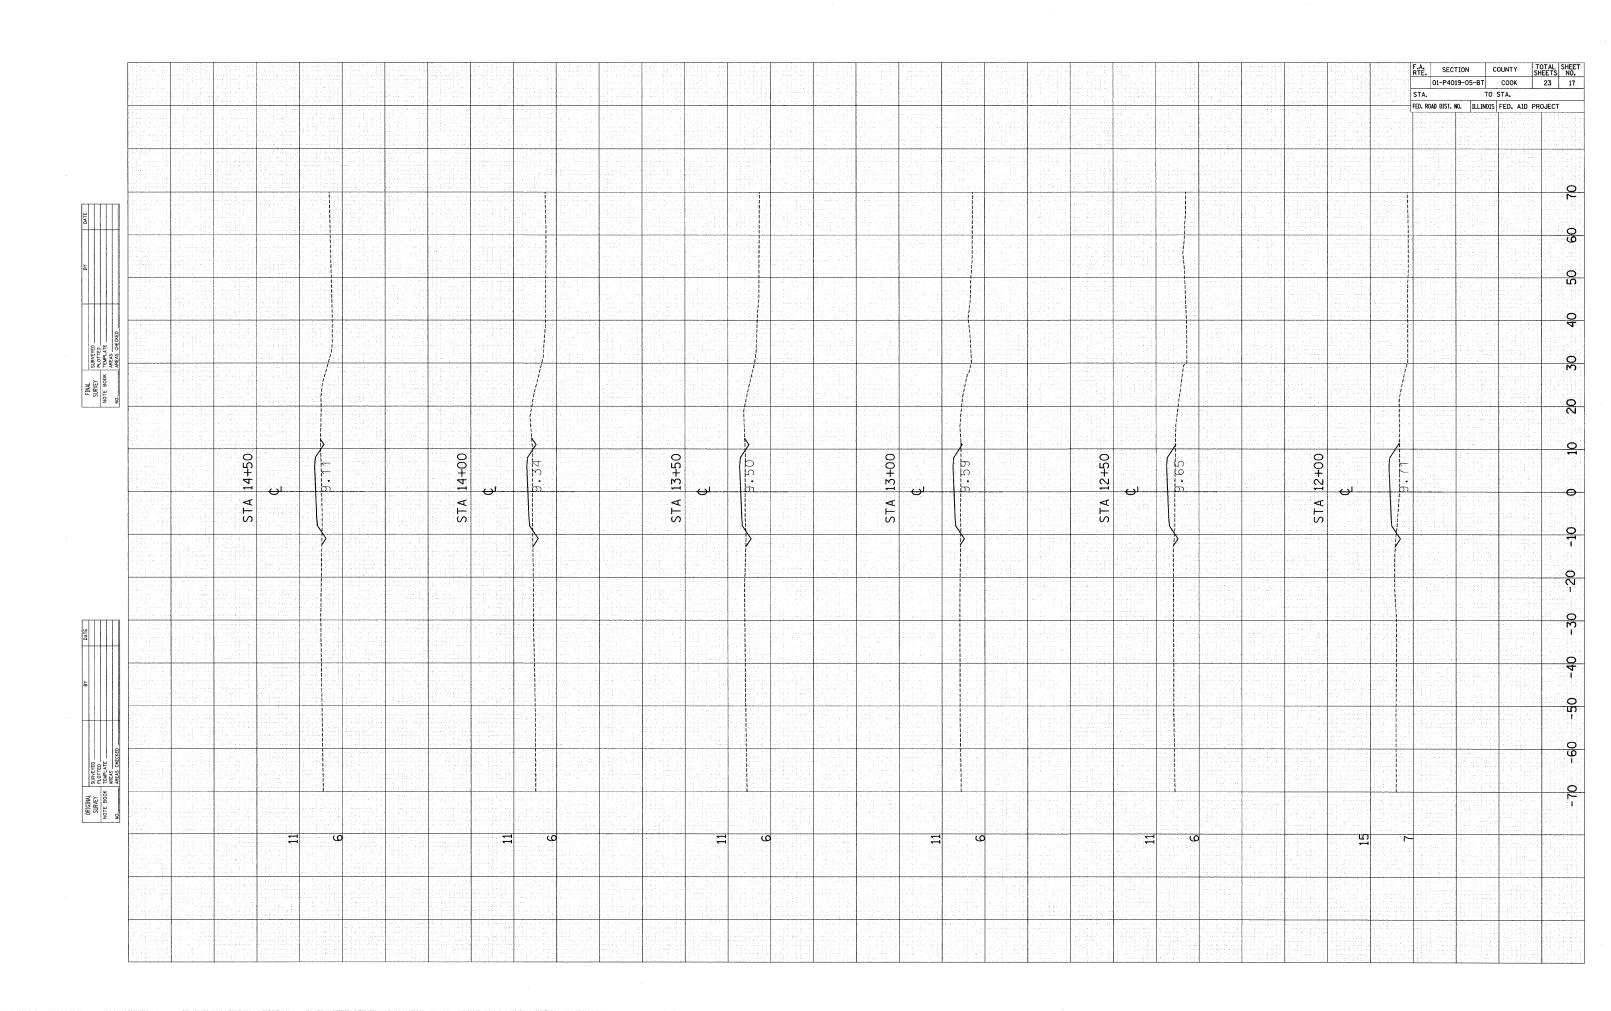
SUGGESTIONS: SPECIFY MATCHING LITTER CONTAINER 2811, 2814, 2815, 1816, OR 2817 AND ASH RECEPTACLE 2812

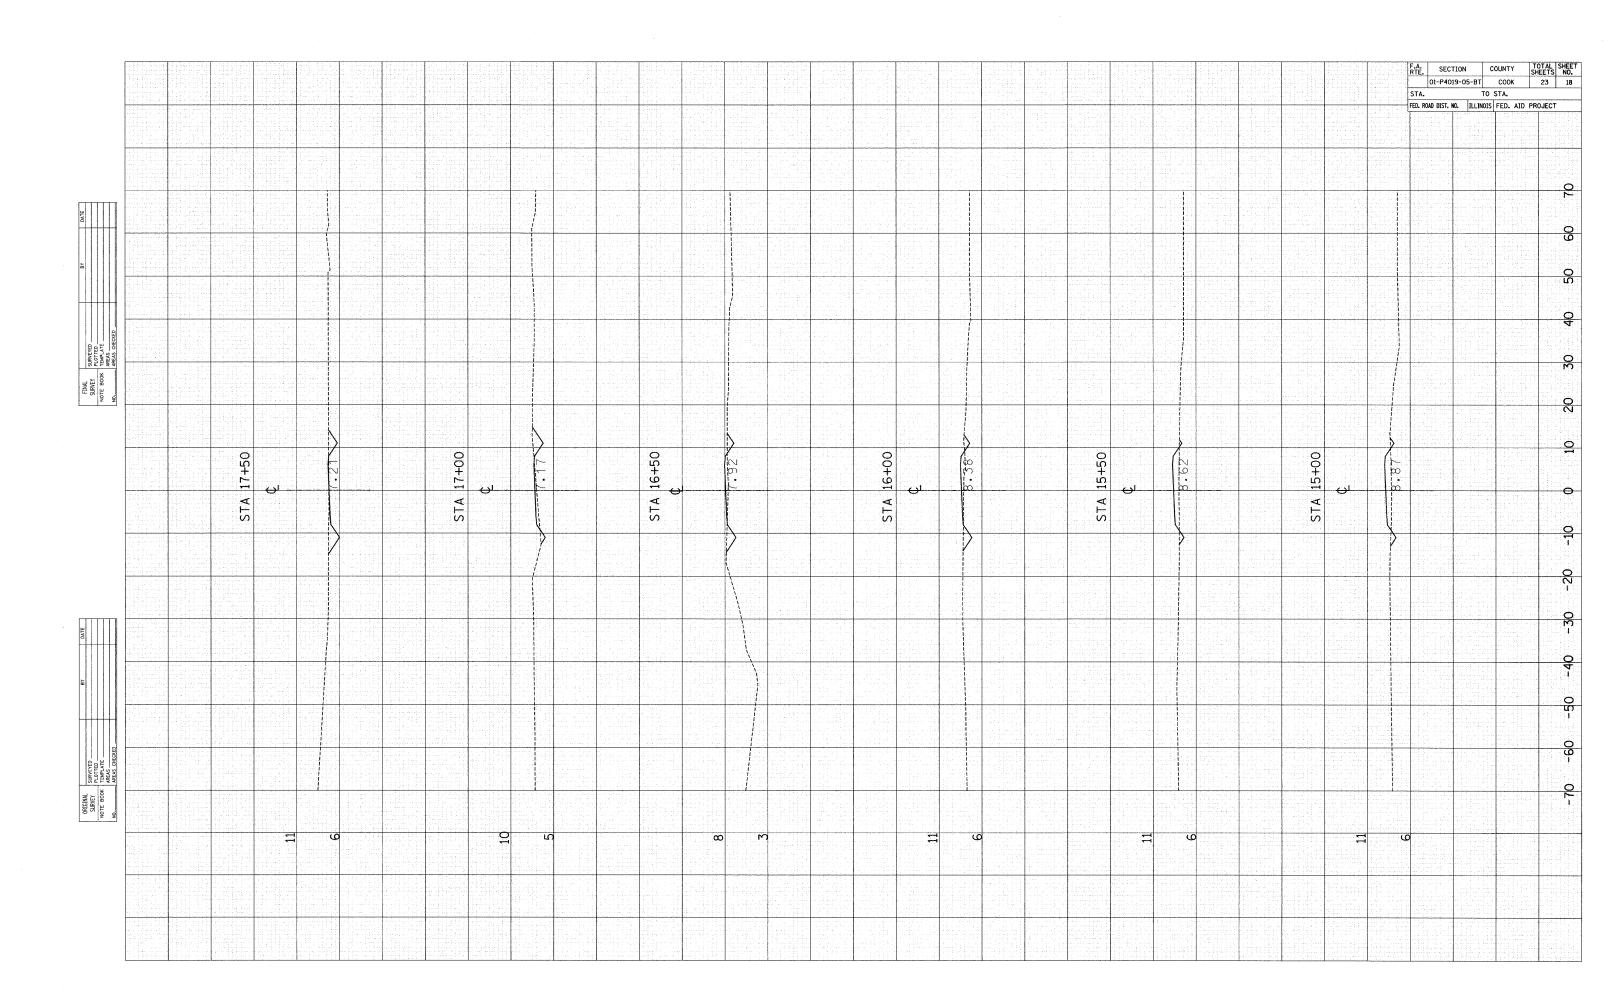
• FOR PERMANENT OR MOVEABLE APPLICATIONS ONLY (ANCHOR BOLTS BY OTHERS)

. INCLUDES TWO INTERMEDIATE FRAMES WITH ARMREST 2 INCLUDES THREE INTERMEDIATE FRAMES WITH ARMREST


3 INCLUDES FOUR INTERMEDIATE FRAMES WITH ARMREST

SITE FURNISHINGS - ALL STEEL BENCH TYPE 1 TIMBERFORM RENAISSANCE MODEL #2808-8 OR MODEL 93 BY DUMOR, INC

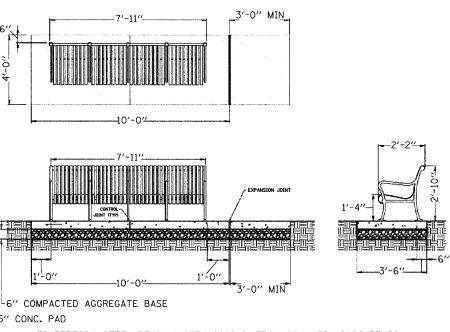

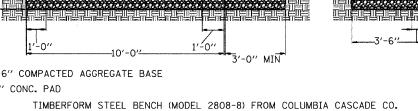


OR DUMOR STEEL BENCH (MODEL #93) FROM NUTOYS

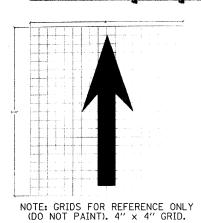

CVILLON

COLDADO

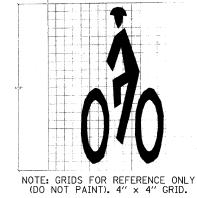

NOTE: GRID LINES ARE FOR REFERENCE ONLY (DO NOT PAINT)

NOTE: GRID LINES ARE FOR REFERENCE ONLY (DO NOT PAINT)

WHITE BANDS

-9" HIGH BLACK LETTERING "CAUTION"

NOTE: CENTERLINE STRIPE IS "OVER"

9" HIGH BLACK LETTERING "CUIDADO"

- WHITE THERMOPLASTIC PAVEMENT MARKING-LINE 12"

-WHITE THERMOPLASTIC

WHITE THERMOPLASTIC


WHITE THERMOPLASTIC PAVEMENT MARKING-LINE 18"

PAVEMENT MARKING-LINE 12"

PAVEMENT MARKING-LINE 12"

ILLINOIS DEPARTMENT OF TRANSPORTATION CHICAGO PARK DISTRICT - JACKSON PARK MARQUETTE DRIVE BICYCLE PATH SCALE: 1" = 20' DRAWN BY: MJP DATE: 10/20/2009 CHECKED BY: TB

P:@020019.073@Cadd@_Final Plans_10-15-09@Park_District_Details.dgn

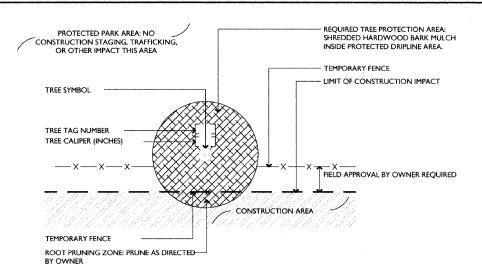

TEMPORARY FENCE INTERSECTS TREE DRIPLINE; 1 ROOTPRUNING REQUIRED N.T.S.

PROTECTED PARK AREA: NO CONSTRUCTION STAGING, TRAFFICKING, OR OTHER IMPACT THIS AREA REQUIRED TREE PROTECTION AREA: SHREDDED HARDWOOD BARK MULCH INSIDE PROTECTED DRIPLINE AREA. TREE SYMBOL TREE TAG NUMBER TREE CALIPER (INCHES)

- LIMIT OF CONSTRUCTION IMPACT DRAWING FIELD APPROVAL BY OWNER REQUIRED CONSTRUCTION AREA


TYPICAL TEMPORARY FENCE FOR TREE AND PARK

2 PROTECTION N.T.S. - EXISTING TREE OR TREES TO BE PROTECTED OUTSIDE OF TREE -TEMPORARY FENCE TREE PROTECTION FENCE MUST BE OUTSIDE
OF TREE ROOT ZONE (DRIPLINE) PER TREE
PROTECTION TABLE, MULCH AREA
ENCLOSED BY FENCE WITH SHREDDED
HARDWOOD BARK MULCH.


TEMPORARY FENCE INTERSECTS TREE DRIPLINE;

3 NO ROOTPRUNING REQUIRED

6 TYPICAL TREE PROTECTION FENCE

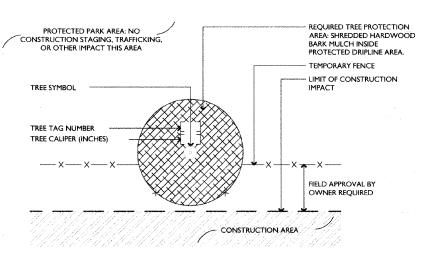



TEMPORARY FENCE INTERSECTS TREE DRIPLINE; NO ROOTPRUNING REQUIRED

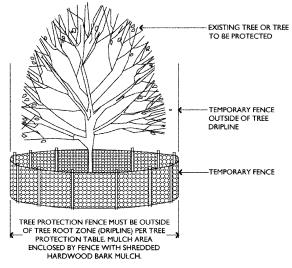


TYPICAL TREE PROTECTION ENTIRELY WITHIN

5 CONSTRUCTION AREA

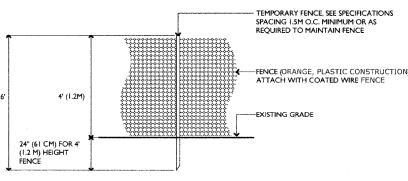

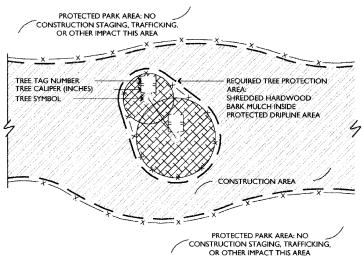

TEMPORARY FENCE PROTECTING TREES ENTIRELY WITHIN 7 CONSTRUCTION AREA

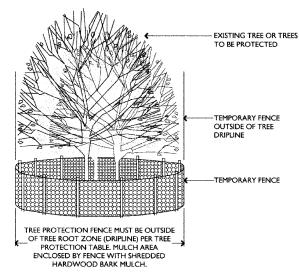

TYPICAL GROUP TREE PROTECTION ENTIRELY WITHIN

8 CONSTRUCTION AREA N.T.S.

TREE PROTECTION	MEASURED TREE CALIPER		MULCH RADIUS UNDEF ENTIRE DRIPLINE
PROTECTED PARK AREA	VARIES	NONE, TREE PROTECTED BY TEMPORARY FENCE AT PROTECTION LIMITS	NONE
TREE WITH THE DRIPLINE INTERSECTING THE TEMPORARY FENCE	0 CM-20.3 CM (0"-8")	MINIMUM 2.44M (8°) OR AS APPROVED BY COMMISSIONER	YES
TREE WITH THE DRIPLINE INTERSECTING THE TEMPORARY FENCE	>20.3 CM-63.5 CM (>8"-25")	0.3048M (i.") RADIUS FENCE FOR EACH 2.54CM (i.") CALIPER OR AS APPROVED BY COMMISSIONER	YES
TREE WITH THE DRIPLINE INTERSECTING THE TEMPORARY FENCE	>63.5 CM (>25")	MINIMUM 2.44M (8°) OR AS APPROVED BY COMMISSIONER	YES
TREE WITH THE DRIPLINE INTERSECTING THE TEMPORARY FENCE, ROOTPRUNED	0 CM-20.3 CM (0°-8")	MINIMUM 2.44M (8") OR AS APPROVED BY COMMISSIONER	YES
TREE WITH THE DRIPLINE INTERSECTING THE TEMPORARY FENCE, ROOTPRUNED	>20.3 CM-63.5 CM (>8"-25")	0.3048M (1") RADIUS FENCE FOR EACH 2.54CM (1") CALIPER OR AS APPROVED BY COMMISSIONER	YES
TREE WITH THE DRIPLINE INTERSECTING THE TEMPORARY FENCE, ROOTPRUNED	>63.5 CM (>25")	MINIMUM 2.44M (8") OR AS APPROVED BY COMMISSIONER	YES
TREE TO BE RELOCATED	0 CM-20.3 CM (0"-8")	NONE, TREE PROTECTED BY TEMPORARY FENCE AT PROTECTION LIMITS	YES, IF PROTECTED
TREE TO BE REMOVED	NONE	TREES MUST BE REMOVED PRIOR TO START C	F NONE

9 TREE PROTECTION NOTES AND TABLE N.T.S.

CHICAGO PARK

DISTRICT

PROJ. MGR.: CHECKED.

SCALE: AS NOTED JOB NO.:


SHEET INFORMATION

CPD STANDARD DRAWING TREE

PARK NO./PROJECT NO. CPD STANDARD DRAWING

ST-872 -L1

DRAWING NO.

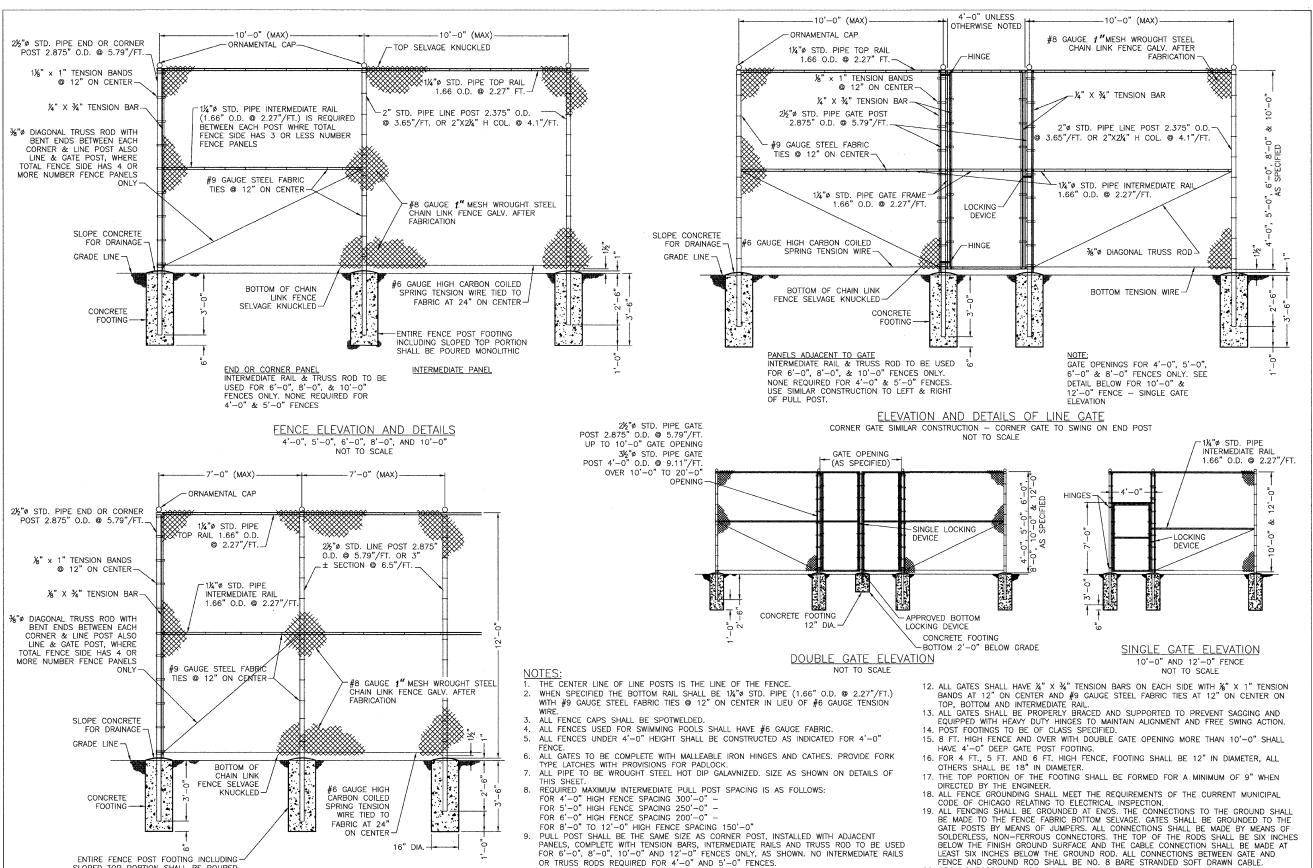

10. TOP RAIL COUPLINGS SHALL BE WROUGHT STEEL GALVANIZED OUTSIDE SLEEVE TYPE. 7"

11. ALL FITTINGS TO BE EQUIPPED WITH NUTS AND BOLTS AS REQUIRED FOR ERECTION, (ALL GALV.) CLAMPS AND CAPS TO BE MALLEABLE IRON, GALVANIZED. BANDS TO BE WROUGHT

AND NUTS TO BE %" GALV. STEEL OF PROPER LENGTH.

LONG SPACED $\ @$ 20'-0" ON CENTER, ONE COUPLING IN EVERY FIVE TO BE OF A TYPE TO TAKE UP EXPANSION AND CONTRACTION OF TOP RAIL.

STEEL GALVANIZED. LOCKING DEVICE TO BE ADAPTABLE FOR PADLOCKING. CARRIAGE BOLTS

ENTIRE FENCE POST FOOTING INCLUDING-

ELEVATION AND DETAILS OF 12'-0" FENCE NOT TO SCALE

SLOPED TOP PORTION SHALL BE POURED

CHICAGO PARK DISTRICT 541 North Fairbanks Court

Chicago, Illinois 60611

REVISIONS DATE

APPROVED ROJ. MGR.: ESIGNER: RAWN: JК CHECKED: CW NONE SCALE:

> 08/2008 DATE: SPEC. NO.:

JOB NO.:

SHEET INFORMATION

LINK FENCING DETAILS

PARK NO./PROJECT NO. ST-686

LEAST SIX INCHES BELOW THE GROUND ROD. ALL CONNECTIONS BETWEEN GATE AND FENCE AND GROUND ROD SHALL BE NO. 8 BARE STRANDED SOFT DRAWN CABLE.

20. GROUND RODS SHALL BE INSTALLED WHERE SHOWN OR REQUIRED AND SHALL BE MADE OF COPPER OR COPPER-CLAD STEEL, NOT LESS THAN 34" DIAMETER AND LENGTH OR

GROUND RODS TO BE INSTALLED VERTICALLY.

NUMBER OF RODS SHALL HAVE A RESISTANCE TO GROUND NOT TO EXCEED 25 OHMS.

EN1-R

DRAWING NO.