03-04-2016 LETTING ITEM 085

FOR INDEX OF SHEETS SEE SHEET NO. 2

TRAFFIC DATA


0

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0

0

CONCORD AVENUE ADT (2014) = 4484SPEED LIMIT = 25 MPH **MAJOR COLLECTOR**

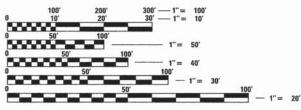

FULL SIZE PLANS HAVE BEEN PREPARED USING STANDARD ENGINEERING SCALES. REDUCED SIZED PLANS WILL NOT CONFORM TO STANDARD SCALES. IN MAKING MEASUREMENTS ON REDUCED PLANS, THE ABOVE SCALES MAY BE USED.


JOINT UTILITY LOCATION INFORMATION FOR EXCAVATION 1-800-892-0123 OR 811

STATE OF ILLINOIS **DEPARTMENT OF TRANSPORTATION DIVISION OF HIGHWAYS**

PLANS FOR PROPOSED FEDERAL AID HIGHWAY

FAU 1680 (CONCORD AVENUE) FAU 1342 (SPRING ST.) TO FAU 3887 (IL RT 31) **RESURFACING** SECTION 15-00046-00-RS PROJECT M-4003(532) **VILLAGE OF SOUTH ELGIN** KANE COUNTY

C-91-375-15 IMPROVEMENT BEGINS R 8 E 3rd PM

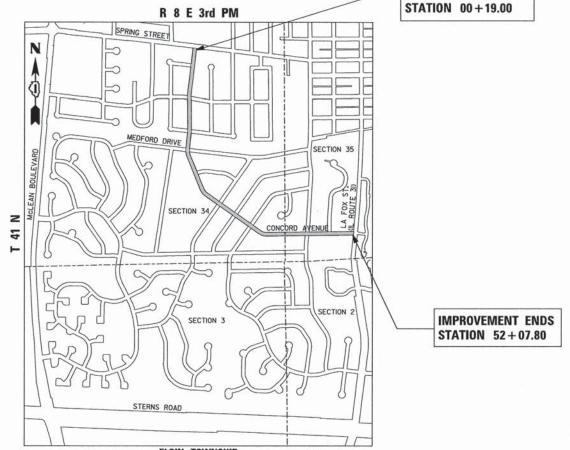

LOCATION MAP - SCALE : 1" = 800' NET AND GROSS LENGTH OF IMPROVEMENTS - CONCORD AVENUE = 5188.80 LINEAL FEET (0.983 MILES)



NOVEMBER 20 20 15 Donafar P. Brownles

DOUGLAS P. BREUNLIN ILLINOIS REG. PROFESSIONAL ENGINEER NO. 062-036608 EXPIRATION DATE 11-30-2017

KANE 15-00046-00-RS FED. ROAD DIST. NO. 1 ILLINOIS CONTRACT NO. 61C20



	STATE OF ILLINOIS DEPARTMENT OF TRANSPORTATION DIVISION OF HIGHWAYS
APPROVED	11-20-15 (0.0120)
PASSED	VILLAGE OF SOUTH ELGIN, DIRECTOR OF PUBLIC WORKS DECEMBER 17, 2015 (DATED)
TAGGED	DISTRICT 1 ENGINEER OF LOCAL ROADS & STREETS
EASING FOR BID SED ON LIMITED REVIEW_	December 17 2015 10ATED
	DEPUTY DIRECTOR OF HIGHWAYS, REGION 1 ENGINEER

PRINTED BY THE AUTHORITY OF THE STATE OF ILLINOIS



CONTRACT NO. 61C20

GENERAL NOTES

- . ALL CONSTRUCTION SHALL BE IN ACCORDANCE WITH THE "STANDARD SPECIFICATIONS FOR ROAD AND BRIDGE CONSTRUCTION",
 ADOPTED JANUARY 1, 2012 (HEREINAFTER REFERRED TO AS THE STANDARD SPECIFICATIONS); THE "SUPPLEMENTAL SPECIFICATIONS
 AND RECURRING SPECIAL PROVISIONS", ADDPTED JANUARY 1, 2015; THE LATEST EDITION OF THE "ILLINOIS MANUAL ON UNIFORM
 TRAFFIC CONTROL DEVICES FOR STREETS AND HIGHWAYS"; THE "STANDARD SPECIFICATIONS FOR TRAFFIC CONTROL ITEMS", THE
 "DETAILS" IN THE PLANS AND THE SPECIAL PROVISIONS INCLUDED IN THE CONTRACT DOCUMENTS.
- 2. ALL REFERENCES TO "ENGINEER" SHALL BE INTERPRETED TO MEAN THE RESIDENT ENGINEER.
- 3. IT IS THE CONTRACTOR'S RESPONSIBILITY TO ASCERTAIN EXISTING FIELD CONDITIONS BEFORE BIDDING ON THIS CONTRACT.
- BEFORE STARTING ALL EXCAVATION, THE CONTRACTOR SHALL CALL "JULIE" (JOINT UTILITY LOCATION INFORMATION FOR EXCAVATION) AT 1-800-892-0123 FOR FIELD LOCATION OF BURIED UTLITIES (48 HOURS NOTIFICATION IS REQUIRED).
- 5. THE CONTRACTOR WILL NOT BE ALLOWED TO SET UP A YARD OR FIELD OFFICE ON STATE OR VILLAGE PROPERTY WITHOUT WRITTEN PERMISSION FROM THE ENGINEER.
- 5. SAW CUTTING OF PAVEMENTS, SIDEWALK, CURB AND GUTTER, ETC. SHALL BE TO FULL DEPTH AND SHALL RESULT IN A CLEAN STRAIGHT EDGE ON THE PORTION REMAINING, ALL SAW CUTTING SHALL BE CONSIDERED INCLUDED IN THE COST OF THE LITEM DEMONAL.
- 7. THE CONTRACTOR SHALL PROTECT AND CAREFULLY PRESERVE ALL SECTION OR SUBSECTION MONUMENTS, PROPERTY CORNERS, AND REFERENCE MARKERS UNTIL THE OWNER, HIS AGENT, OR A PROFESSIONAL LAND SURVEYOR HAS WITNESSED OR OTHERWISE DEFENDED THEIR LOCATIONS.
- 8. OFFSET LOCATIONS GIVEN IN THE PLANS FOR STRUCTURES, EDGE OF PAVEMENT, ETC. ARE FROM THE ROADWAY CENTERLINE.
- . HOT-MIX ASPHALT SURFACE REMOVAL BUTT JOINTS WILL BE INSTALLED AT THE ENDS OF ALL RESURFACING (WHERE RESURFACING MEETS EXISTING PAVEMENT), IN ACCORDANCE WITH THE BUTT JOINT AND HOT-MIX TAPER DETAILS SHEET INCLUDED IN THE PLANS, UNLESS OTHERWISE SPECIFIED.
- 10. ALL PAY ITEMS FOR REMOVAL AND REPLACEMENT MUST BE FIELD MEASURED AND MARKED BY THE ENGIEER PRIOR TO CONSTRUCTION, NO PAYMENT WILL BE MADE FOR ANY ITEMS OF WORK, WHICH HAVE BEEN REMOVED AND/OR REPLACED WITHOUT HAVING BEEN FIELD MEASURED AND MARKED BY THE ENGINEER, NO ADDITIONAL PAYMENT WILL BE MADE FOR REMOVAL AND/OR REPLACEMENT BEYOND FIELD MARKINGS UNLESS SPECIFICALLY AUTHORIZED BY THE ENGINEER.
- 11. BY THE END OF EACH WORKING DAY THE CONTRACTOR AND HIS SUBCONTRACTORS SHALL REMOVE RUBBISH, WASTE MATERIAL AND ACCUMULATIONS FROM THE PREMISES AND SHALL KEEP THE PREMISES CLEAN. THE CONTRACTOR SHALL KEEP THE PREMISES CLEAN DURING CONSTRUCTION TO THE SATISFACTION OF THE ENGINEER. THIS WORK SHALL BE CONSIDERED INCLUDED IN THE COST OF MOBILIZATION.
- 12. ALL EXPOSED CONCRETE INSTALLED UNDER THIS CONTRACT (CURB & GUTTER, SIDEWALK, DRIVEWAY AREAS) SHALL RECEIVE A
 PROTECTIVE SURFACE TREATMENT CONSISTING OF TWO (2) COATS OF BOILED LINSEED OIL AND PETROLEUM SPIRITS MIXTURE,
 FORMULATED AND APPLIED ACCORDING TO ARTICLE 420.18 OF THE STANDARD SPECIFICATIONS. IF THE ENGINEER FOR THE BLOTTER
 MATERIAL REQUIRES AN APPLICATION OF SAND, IT WILL BE INCLUDED IN THE COST OF THE CONCRETE. THE ENGINEER SHALL BE
 NOTIFIED 24 HOURS IN ADVANCE PRIOR TO APPLICATION. THIS WORK SHALL NOT BE PAID FOR SEPARATELY BUT SHALL BE
 CONSIDERED INCLUDED IN THE COST OF THE CONCRETE ITEM PROVIDED.
- 13. THE CONTRACTOR MUST SCHEDULE THE REMOVAL AND REPLACEMENT OF THE CURB AND GUTTER SUCH THAT ONLY ONE SIDE OF A GIVEN STREET WILL BE UNDER CONSTRUCTION AT ANY ONE TIME. ALL HOMEOWNERS SHALL BE GIVEN A MINIMUM 24 HOURS NOTICE PRIOR TO EXCAVATION OF THEIR DRIVEWAY. IN NO CASE SHALL AN OPEN EXCAVATION CAUSED BY REMOVAL OF EXISTING CURBING, WHETHER FORMED OR NOT FORMED, REMAIN OPEN FOR MORE THAN 3 WORKING DAYS.
- 14. DISTURBED PAVEMENT, DRIVEWAY AND PARKWAY AREAS SHALL BE RESTORED IMMEDIATELY FOLLOWING REPLACEMENT OPERATIONS, IN ALL CASES WITHIN 3 WORKING DAYS FROM THE DATE CURB AND GUTTER OR SIDEWALK IS CAST. THE ENGINEER SHALL STOP THE CONTRACTOR FROM FURTHER REMOVAL OPERATIONS AT ANY TIME HE DETERMINES THE RESTORATION IS NOT BEING DONE IN A TIMELY MANNER.
- 15. DURING THE REMOVAL OF MATERIAL AND PREPARATION FOR PLACEMENT OF P.C.C. MATERIAL, A TOLERANCE OF NO MORE THAN TWO FEET OF THE EXISTING LIMITS SHALL BE EXCEEDED FOR RESTORATION, ALL RESTORATION OUTSIDE OF THESE LIMITS SHALL BE INCLUDED IN THE COST OF THE ASSOCIATED CURB AND GUTTER, OR SIDEWALK REMOVAL PAY ITEM.
- 16. THE CONTRACTOR SHALL NOTIFY THE VILLAGE OF SOUTH ELGIN, DIRECTOR OF PUBLIC WORKS, 847-695-2742, 48 HOURS PRIOR TO THE COMMENCEMENT OF WORK.
- 17. WHEN REMOVING PAVEMENT, CURB AND GUTTER, SHOULDER, AND/OR OTHER STRUCTURES, THE USE OF ANY TYPE OF CONCRETE BREAKERS, WHICH MIGHT DAMAGE UNDERGROUND PUBLIC OR PRIVATE UTILITIES, WILL NOT BE PERMITTED. UNDER NO CIRCUMSTANCES WILL THE USE OF A FROST BALL BE PERMITTED. THE CONTRACTOR IS PROHIBITED FROM BREAKING UP CONCRETE BY DROPPING IT ON THE PAVEMENT OR BREAKING IN ANY OTHER MANNER, WHICH IN THE OPINION OF THE ENGINEER MAY DAMAGE EXISTING OR PROPOSED PAVEMENTS OR OTHER ROADWAY BREAKING APPURTENANCES.
- 18. DETECTABLE WARNINGS THE CONTRACTOR SHALL UTILIZE THE VITRIFIED POLYMER COMPOSITE NON-REMOVABLE DETECTABLE TACTILE WARNING SYSTEM IN THE RED COLOR IN CONFORMANCE WITH ADAAG.

STORM SEWERS, WATER MAINS, AND UTILITIES

- THE CONTRACTOR SHALL BE RESPONSIBLE FOR CONTACTING THE OWNERS OF ALL UTILITIES 3 DAYS PRIOR
 TO CONSTRUCTION TO DETERMINE THE LOCATION OF ALL UTILITY EQUIPMENT. THE CONTRACTOR SHALL
 COOPERATE WITH ALL UTILITY OWNERS IN ACCORDANCE WITH THE STANDARD SPECIFICATIONS IF UTILITY
 RELOCATION, ADJUSTMENT, OR PROTECTION IS NECESSARY.
- 2. THE LOCATION OF EXISTING DRAINAGE STRUCTURES, STORM SEWERS, WATER MAINS, SANITARY SEWERS, AND ANY OTHER PUBLIC UTILITIES AS SHOWN ON THE PLANS IS APPROXIMATE AND THEIR EXACT LOCATION IS TO BE DETERMINED IN THE FIELD BY THE CONTRACTOR, THIS WORK SHALL BE CONSIDERED AS INCLUDED IN THE UNIT BID PRICES OF MANHOLES TO BE ADJUSTED, AND NO ADDITIONAL COMPENSATION WILL BE ALLOWED.
- 3. THE CONTRACTOR SHALL BE RESPONSIBLE FOR THE PROTECTION OF ALL UNDERGROUND OR SURFACE UTILITIES EVEN THOUGH THEY ARE NOT SHOWN ON THE PLANS. ANY UTILITY THAT IS DAMAGED DURING CONSTRUCTION SHALL BE REPAIRED TO THE SATISFACTION OF THE ENGINEER OR REPLACED. THIS WORK SHALL BE AT THE CONTRACTOR'S EXPENSE, IN ACCORDANCE WITH ARTICLES 107.20 AND 107.31.
- THE CONTRACTOR SHALL USE ALL NECESSARY PRECAUTIONS AND PROTECTION MEASURES REQUIRED TO MAINTAIN EXISTING UTILITIES, SEWERS, AND APPURTENANCES THAT MUST BE KEPT IN OPERATION.
- THE CONTRACTOR SHALL ENSURE THAT ALL WATER SYSTEMS VALVES, VALVE VAULTS, AND SANITARY SEWER MANHOLES REMAIN READILY ACCESSIBLE TO THE VILLAGE FOR EMERGENCY OPERATIONS. THE LOCATIONS OF ALL WATER AND SANITARY FACILITIES SHALL BE MARKED AND BE READILY VISIBLE AT ALL TIMES.
- 6. THE USE OF VILLAGE OWNED AND OPERATED FIRE HYDRANTS IS PROHIBITED. THE CONTRACTOR SHALL CONTACT THE SOUTH ELGIN PUBLIC WORKS DIRECTOR 847-695-2742, TO COORDINATE USAGE OF VILLAGE HYDRANTS. ALL FINES ASSOCIATED WITH DAMAGE CAUSED BY THE USE OF A VILLAGE FIRE HYDRANT WITHOUT PROPER AUTHORIZATION SHALL BE SOLELY BORNE BY THE CONTRACTOR.
- 7. UNLESS OTHERWISE NOTED IN THE CONTRACT DOCUMENTS, THE EXISTING DRAINAGE FACILITIES SHALL REMAIN IN USE DURING THE PERIOD OF CONSTRUCTION, PRIOR TO COMMENCING WORK THE CONTRACTOR, AT HIS OWN EXPENSE, SHALL DETERMINE THE EXACT LOCATIONS OF EXISTING STRUCTURES THAT ARE WITHIN THE PROPOSED CONSTRUCTION LIMITS. UNLESS RECONSTRUCTION OR ADJUSTMENT OF AN EXISTING MANHOLE, CATCH BASIN, INLET OR ADJUSTMENT TO THE FRAME AND GRATE IS CALLED FOR IN THE CONTRACT DOCUMENTS OR ORDERED BY THE ENGINEER, THE PROPOSED WORK SHALL MEET THE EXISTING ELEVATION OF THESE STRUCTURES. THE CONTRACTOR SHALL TAKE THE NECESSARY PRECAUTIONS WHEN WORKING NEAR OR ABOVE EXISTING SEWERS TO PROTECT THESE SEWERS FROM ANY DAMAGE RESULTING FROM HIS OPERATIONS, ALL WORK AND MATERIAL NECESSARY TO REPAIR ANY EXISTING SEWERS DAMAGED DUE TO NON -COMPLIANCE WITH THIS PROVISION SHALL BE PROVIDED, AS DIRECTED BY THE ENGINEER, IN ACCORDANCE WITH SECTION 550 OF THE STANDARD SPECIFICATIONS, AT THE CONTRACTOR'S EXPENSE WITH NO EXTRA COMPENSATION BEING ALLOWED, IT SHALL BE THE CONTRACTOR'S RESPONSIBILITY TO DIRECT THE WORK AND PROTECT THE FACILITIES FROM DAMAGE DURING CONSTRUCTION, IN ACCORDANCE WITH ARTICLES 107.20 AND 107.31.

SIGNING AND STRIPING

 SEE IDOT STANDARD 780001, DISTRICT ONE DETAIL TC-13 AND PLAN SHEETS FOR PAVEMENT MARKING DETAILS.

TRAFFIC CONTROL

- THE CONTRACTOR SHALL AT ALL TIMES PROVIDE PROTECTION FOR TRAFFIC AS CALLED FOR IN THE SPECIAL PROVISIONS & PLANS.
- THE CONTRACTOR SHALL MAINTAIN EXISTING SIDE STREET ACCESS AND EXISTING DRIVEWAY ACCESS TO ABUTTING PROPERTY AT ALL TIMES DURING CONSTRUCTION OF THIS PROJECT.

SCALE:

- ALL TRAFFIC CONTROL AND OTHER ADVISORY SIGNS NEEDED FOR CONSTRUCTION ARE TO BE FURNISHED BY THE CONTRACTOR IN ACCORDANCE WITH SECTION 107.14 OF THE STANDARD SPECIFICATIONS.
- 4. THE RESIDENT ENGINEER SHALL CONTACT THE TRAFFIC CONTROL SUPERVISOR AT 847-705-4470 A MINIMUM OF 72 HOURS PRIOR TO THE PLACEMENT OF ANY TEMPORARY TRAFFIC CONTROL DEVICES.

INDEX OF SHEETS

SHEET NO.	DESCRIPTION
01 02 03 04 - 05	COVER SHEET GENERAL NOTES SUMMARY OF QUANTITIES TYPICAL SECTIONS
06 - 07 08 - 16	PAVEMENT PLAN DETAILS AND STANDARD DRAWINGS

HIGHWAY STANDARDS	DISTRICT 1 DETAILS
STD. 000001-06	TC-10
STD. 424001-08	TC-13
STD. 424006-02	TC-16
STD. 424021-03	TC-22
STD. 424026-01	BD-22
STD. 606001-06	BD-24
STD. 701006-05	BD-32
STD. 701301-04	
STD. 701311-03	
STD. 701501-06	
STD. 701801-05	
STD. 701901-04	
STD. 780001-05	

USER NAME = bmccrey	DESIGNED - DPB	REVISED - 11-19-15
	DRAWN - BCM	REVISED -
PLOT SCALE = 1:20	CHECKED - DPB	REVISED -
PLOT DATE = 11/18/2015	DATE - 10-08-15	REVISED -

SUMMARY OF QUANTITIES

CONSTRUCTION CODE STU FUNDS

75% FEDERAL 25% CITY

STREET, VILLER STREET	100.020402300 0000 004. W	3.0000000000000000000000000000000000000		25% C				ITY SAFETY LANDSCAPE			
SPECIALTY	SPECIAL	CODE	ITEM	UNIT	TOTAL	ROADWAY 0005	ENVIRONMENT 0020	0021	0031		
ITEM	PROVISION	NO. 21101625	TOPSOIL FURNISH AND PLACE, 6"	SQ YD	QUANTITY 614	URBAN	URBAN	URBAN	URBAN 614		
				SU TU	614				614		
	S	25000110	SEEDING, CLASS 1A	ACRE	0.25				0.25		
		25000400	NITROGEN FERTILIZER NUTRIENT	POUND	12				12		
		25000500	PHOSPHORUS FERTILIZER NUTRIENT	POUND	12				12		
		25000600	POTASSIUM FERTILIZER NUTRIENT	POUND	12				12		
		25100630	EROSION CONTROL BLANKET	SO YD	614		614				
		35101600	AGGREGATE BASE COURSE, TYPE B, 4"	SO YD	665	665					
			BITUMINOUS MATERIALS (PRIME COAT)	POUND	12,598	12,598					
			MIXTURE FOR CRACKS, JOINTS, AND FLANGEWAYS			3					
				TON	3						
		40600625	LEVELING BINDER (MACHINE METHOD), N50	TON	772	772					
	S	40600982	HOT-MIX ASPHALT SURFACE REMOVAL - BUTT JOINT	SO YD	278	278					
		40603335	HOT-MIX ASPHALT SURFACE COURSE, MIX "D", N50	TON	2,090	2,090					
	S	42400200	PORTLAND CEMENT CONCRETE SIDEWALK 5 INCH	SO FT	5,983			5,983			
		42400800	DETECTABLE WARNINGS	SO FT	572			572			
	S	44000159	HOT-MIX ASPHALT SURFACE REMOVAL, 2-1/2"	SO YD	18,386	18,386		Arms in the August Arms and Arms			
		44000600	SIDEWALK REMOVAL	SO FT	5,929	5,929					
		44201717	CLASS D PATCHES, TYPE II, 6 INCH	SO YD	9.2	9.2					
	× × × × × × × × × × × × × × × × × × ×	44201721	CLASS D PATCHES, TYPE III, 6 INCH	SO YD	76.9	76.9					
		50300300	PROTECTIVE COAT	SO YD	938	938					
		60266600	VALVE BOXES TO BE ADJUSTED	EACH	5	5					
		67100100	MOBILIZATION	LSUM	1	1					
41000	S	70102620	TRAFFIC CONTROL AND PROTECTION, STANDARD 701501	LSUM	1	1					
	S		TRAFFIC CONTROL AND PROTECTION, STANDARD 701801	LSUM		1					
	3										
		70300100	SHORT TERM PAVEMENT MARKING	FOOT	2,400			2,400			
		70301000	WORK ZONE PAVEMENT MARKING REMOVAL	SO FT	600			600			
•		78000100	THERMOPLASTIC PAVEMENT MARKING - LETTERS AND SYMBOLS	SO FT	36.4			36.4			
•		78000200	THERMOPLASTIC PAVEMENT MARKING - LINE 4"	FOOT	360			360			
		78000400	THERMOPLASTIC PAVEMENT MARKING - LINE 6"	FOOT	80			80			
		78000600	THERMOPLASTIC PAVEMENT MARKING - LINE 12"	FOOT	78			78			
		78000650	THERMOPLASTIC PAVEMENT MARKING - LINE 24"	FOOT	179			179			
	S	X6025600	MANHOLES TO BE ADJUSTED (SPECIAL)	EACH	21	21					
	S	X6026200	INLETS TO BE ADJUSTED (SPECIAL)	EACH	21	21					
	S		COMBINATION CONCRETE CURB AND GUTTER REMOVAL AND REPLACEMENT	FOOT	1,227	1,227					
	e an a zero e a companyo e e e e e				Apr. C						
¥	S	20013798	CONSTRUCTION LAYOUT	LSUM	1	1					

DESIGNED - DPB WILLS BURKE KELSEY ASSOCIATES LTD. DRAWN - BCM WBK 116 West Main Street, Suite 201 St. Charles, Illinois 60174 PLOT SCALE = 1:1 CHECKED - DPB PLOT DATE = 11/18/2015 DATE - 10-08-15

STATE OF ILLINOIS **DEPARTMENT OF TRANSPORTATION**

REVISED - 11-19-15

REVISED

REVISED

REVISED

SUMMARY OF QUANTITIES CONCORD AVENUE SHEET NO. OF SHEETS STA.

COUNTY TOTAL SHEETS NO.


KANE 16 3

CONTRACT NO. 61C20 SECTION 15-00046-00-RS 1680

SCALE:

TO STA.

ILLINOIS FED. AID PROJECT

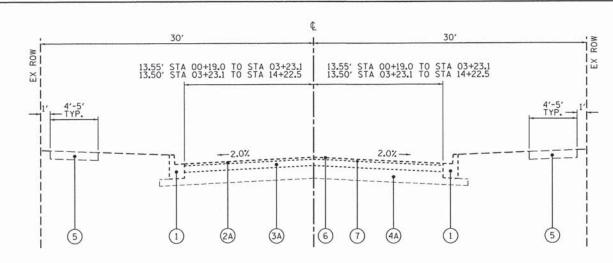


EXISTING TYPICAL SECTION

STA 00+19.0 TO STA 14+22.5 CONCORD AVENUE

LEGEND, EXISTING

- (1) EXISTING COMBINATION CONCRETE CURB AND GUTTER, TYPE B-6.12
- EXISTING HOT-MIX ASPHALT SURFACE COURSE, 31/2" 5"
- (2B) EXISTING HOT-MIX ASPHALT SURFACE COURSE, 1" - 31/2"
- (3A) EXISTING HOT-MIX ASPHALT BINDER COURSE, 0" 2"
- EXISTING HOT-MIX ASPHALT BINDER COURSE, 2" 21/2"

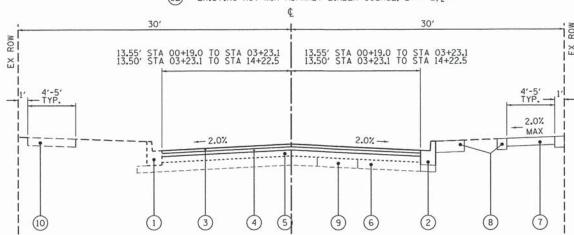

PROPOSED TYPICAL SECTION


STA 00+19.0 TO STA 14+22.5 CONCORD AVENUE

LEGEND, PROPOSED

- 1) EXISTING COMBINATION CONCRETE CURB AND GUTTER, TYPE B-6.12
- PROPOSED COMBINATION CONCRETE CURB & GUTTER, TYPE B-6.12 (LOCATIONS OF CURB & GUTTER OTHER THAN SHOWN ON PLANS WILL BE DETERMINED IN THE FIELD BY THE ENGINEER)
- PROPOSED HOT-MIX ASPHALT SURFACE COURSE, MIX "D", N50, 2"

-19-15


PROPOSED LEVELING BINDER (MACHINE METHOD), N50, 3/4"

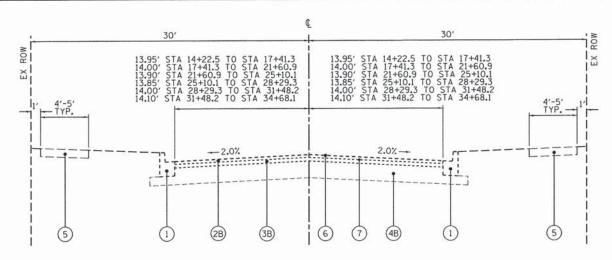

EXISTING TYPICAL SECTION

STA 14+22.5 TO STA 34+68.1 CONCORD AVENUE

- EXISTING AGGREGATE BASE COURSE, 8" 81/2"
- EXISTING AGGREGATE BASE COURSE, 4" 11"
- (5) EXISTING PCC SIDEWALK
- HOT-MIX ASPHALT SURFACE REMOVAL, 21/2"
- EXISTING PETROMAT VARIOUS LOCATIONS

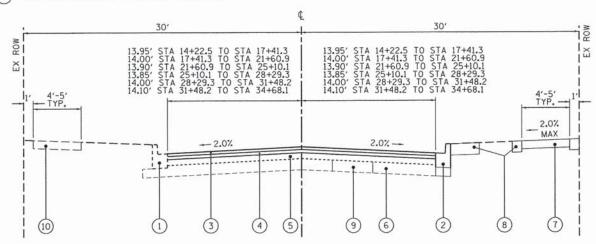

PROPOSED TYPICAL SECTION

STA 14+22.5 TO STA 34+68.1 CONCORD AVENUE

- EXISTING HOT-MIX ASPHALT BINDER COURSE
- EXISTING AGGREGATE BASE COURSE
- PROPOSED PORTLAND CEMENT CONCRETE SIDEWALK, 5" OR 6" THICK AT DRIVEWAYS (LOCATIONS OF SIDEWALKS OTHER THAN SHOWN ON PLANS WILL BE DETERMINED IN THE FIELD BY THE ENGINEER)
- PARKWAY TO BE RESTORED WITH 6" TOPSOIL, SEED AND EROSION CONTROL BLANKET (2' TYP.)
- PROPOSED CLASS D PATCH, TYPE II, 6" OR TYPE III, 6" (LOCATION OF PATCHES WILL BE DETERMINED IN THE FIELD BY THE ENGINEER)
- (10) EXISTING PCC SIDEWALK

SCALE:

EXISTING PAVEMENT NOTES

- INFORMATION FOR HMA SURFACES, HMA BINDER, AND AGGREGATE BASE COURSE WAS TAKEN FROM INFORMATION DOCUMENTED IN THE "PAVEMENT CORE SUMMARY REPORT" DATED JUNE 19, 2015 AS PREPARED BY RUBINO ENGINEERING, INC.
- REFER TO THE "PAVEMENT CORE SUMMARY REPORT" DATED JUNE 19, 2015 AS PREPARED BY RUBINO ENGINEERING, INC. FOR EXISTING PETROMAT INFORMATION.

△ USER NAME = bmccray	DESIGNED - DPB	REVISED - 11-
WILLS BURKE KELSEY ASSOCIATES LTD.	DRAWN - BCM	REVISED -
BK 116 West Mein Street, Suite 201 St. Charles, Illinois 60174 PLOT SCALE = 1:5	CHECKED - DPB	REVISED -
PLOT DATE = 12/1/2015	DATE - 10-08-15	REVISED -


STATE OF ILLINOIS **DEPARTMENT OF TRANSPORTATION**

	TVPI	CAL SECT	IONS		F.A.U. RTE.	SECTION	COUNTY	TOTAL	SHEET NO.
CONCORD AVENUE					1680	15-00046-00-RS	KANE	16	4
CONCOURD AVENUE							CONTRACT	NO. 6	1C20
SHEET NO.	OF	SHEETS	STA.	TO STA.	1	ILLINOIS FED.	AID PROJECT		

EXISTING TYPICAL SECTION STA 34+68.1 TO STA 52+07.8 CONCORD AVENUE

LEGEND, EXISTING

- EXISTING COMBINATION CONCRETE CURB AND GUTTER, TYPE B-6.12
- (2) EXISTING HOT-MIX ASPHALT SURFACE COURSE, 2" - 51/2"
- 3) EXISTING HOT-MIX ASPHALT BINDER COURSE, 0" 41/2"
- EXISTING AGGREGATE BASE COURSE, 4" 6"
- (5) EXISTING PCC SIDEWALK
- HOT-MIX ASPHALT SURFACE REMOVAL, 21/2"
- EXISTING PETROMAT VARIOUS LOCATIONS

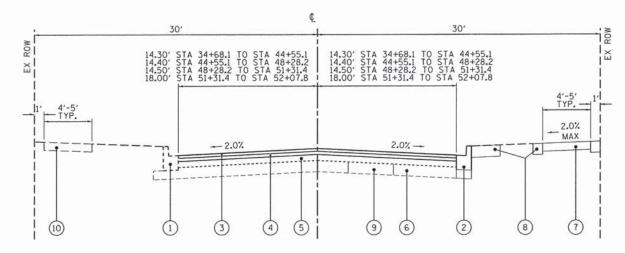

PROPOSED TYPICAL SECTION

STA 34+68.1 TO STA 52+07.8 CONCORD AVENUE

LEGEND, PROPOSED

- EXISTING COMBINATION CONCRETE CURB AND GUTTER, TYPE B-6.12
- PROPOSED COMBINATION CONCRETE CURB & GUTTER, TYPE B-6.12 (LOCATIONS OF CURB & GUTTER OTHER THAN SHOWN ON PLANS WILL BE DETERMINED IN THE FIELD BY THE ENGINEER)
- PROPOSED HOT-MIX ASPHALT SURFACE COURSE, MIX "D", N50, 2"
- PROPOSED LEVELING BINDER (MACHINE METHOD), N50, 3/4"
- EXISTING HOT-MIX ASPHALT BINDER COURSE
- EXISTING AGGREGATE BASE COURSE
- PROPOSED PORTLAND CEMENT CONCRETE SIDEWALK, 5" OR 6" THICK AT DRIVEWAYS (LOCATIONS OF SIDEWALKS OTHER THAN SHOWN ON PLANS WILL BE DETERMINED IN THE FIELD BY THE ENGINEER)
- PARKWAY TO BE RESTORED WITH 6" TOPSOIL, SEED AND EROSION CONTROL BLANKET (2' TYP.)
- PROPOSED CLASS D PATCH, TYPE II, 6" OR TYPE III, 6" (LOCATION OF PATCHES WILL BE DETERMINED IN THE FIELD BY THE ENGINEER)
- (10) EXISTING PCC SIDEWALK

HOT-MIX ASPHALT MIXTURE REQUIREME	ENTS
MIXTURE TYPE	AIR VOIDS @ Ndes
PAVEMENT RESURFACING	
HMA SURFACE COURSE, MIX "D" N50 (IL 9.5 mm)	4% № 50 GYR.
LEVELING BINDER (MACHINE METHOD), N50 (IL 9.5 mm)	4% € 50 GYR.
PATCHING	
CLASS D PATCHES, TYPE II, 6 INCH	4% € 70 GYR.
CLASS D PATCHES, TYPE III, 6 INCH	4% @ 70 GYR.

NOTES:

THE UNIT WEIGHT USED TO CALCULATE ALL HMA SURFACE MIXTURE QUANTITIES IS 112 LBS/SQ YD/IN

THE "AC TYPE" FOR POLYMERIZED HMA MIXES SHALL BE "SBS/SBR PG 76-22" AND FOR NON-POLYMERIZED HMA THE "AC TYPE" SHALL BE " PG 64-22" UNLESS MODIFIED BY DISTRICT ONE SPECIAL PROVISIONS. FOR "PERCENT OF RAP" SEE DISTRICT ONE SPECIAL PROVISIONS.


CONTRACTOR SHALL MILL BEFORE PATCHING.


FOR USE OF RECYCLED MATERIAL, SEE SPECIAL PROVISIONS


EXISTING PAVEMENT NOTES

- 1. INFORMATION FOR HMA SURFACES, HMA BINDER, AND AGGREGATE BASE COURSE WAS TAKEN FROM INFORMATION DOCUMENTED IN THE "PAVEMENT CORE SUMMARY REPORT" DATED JUNE 19, 2015 AS PREPARED BY RUBINO ENGINEERING, INC.
- 2. REFER TO THE "PAVEMENT CORE SUMMARY REPORT" DATED JUNE 19, 2015 AS PREPARED BY RUBINO ENGINEERING, INC. FOR EXISTING PETROMAT INFORMATION.

USER NAME = bmccray				TYPICAL SECTIONS						F.A.U. RTE.	SECTION	COUNTY	TOTAL	SHEET NO.	
WILLS BURKE KELSEY ASSOCIATES LTD.	11 1 1 1 1 1 1 1 1 1 1 1 1 1 1 1 1 1 1	DRAWN - BCM	REVISED -		CONCORD AVENUE		1680	15-00046-00-RS	KANE	16	5				
WBK 116 West Main Street, Suite 201 St. Charles, Illinois 60174	PLOT SCALE = 1:5	CHECKED - DPB	REVISED -	DEPARTMENT OF TRANSPORTATION	CONSOIND AVENSE						CONTRAC	T NO. 61	C20		
	PLOT DATE = 12/1/2015	DATE - 10-08-15	REVISED -		SCALE:	SHEET NO.	OF	SHEETS	STA.	TO STA.		ILLINOIS FED. A	ID PROJECT		

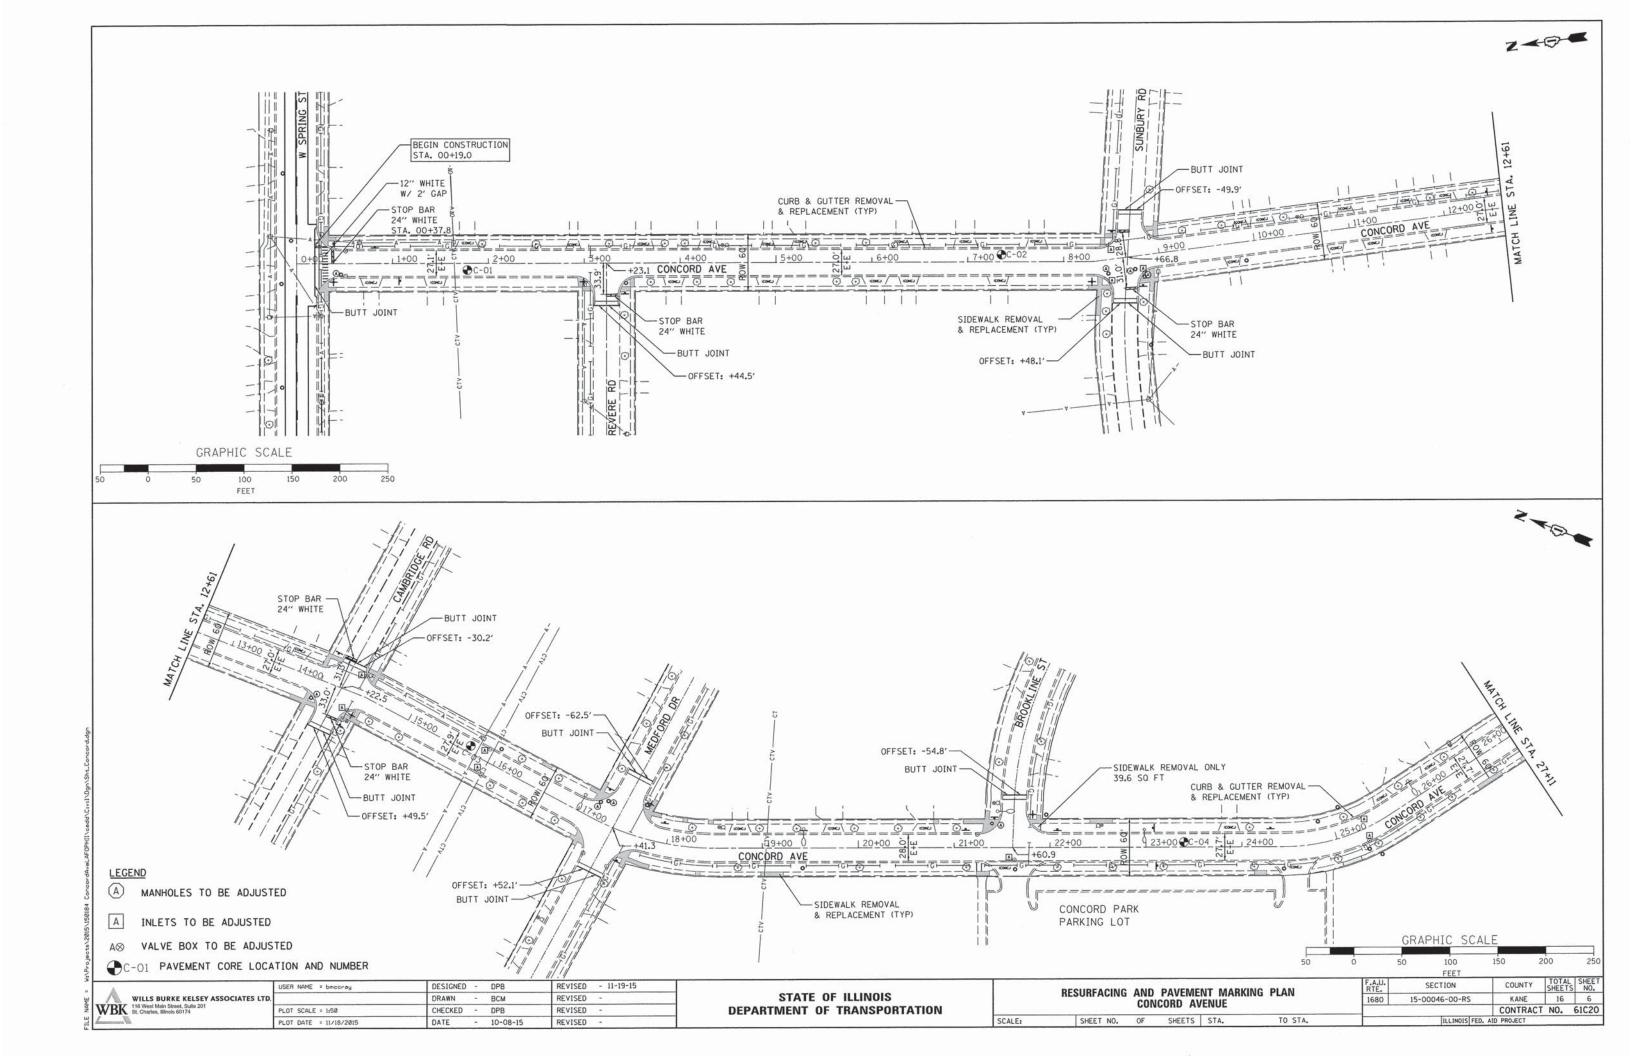

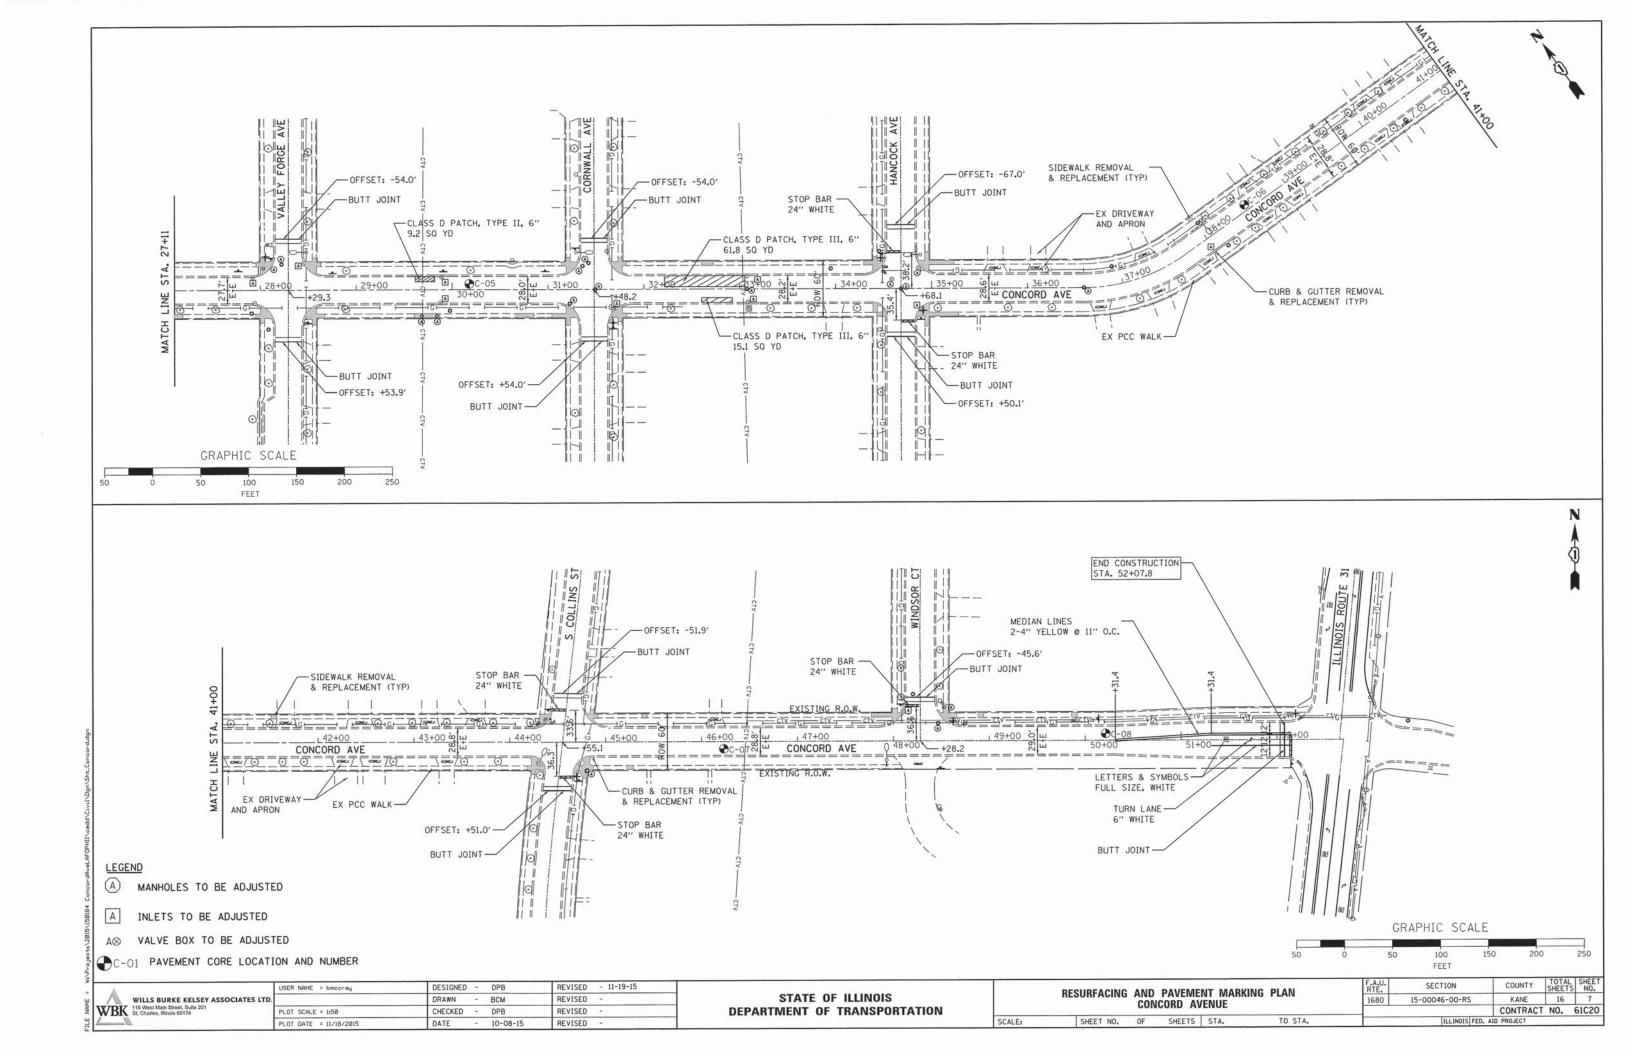

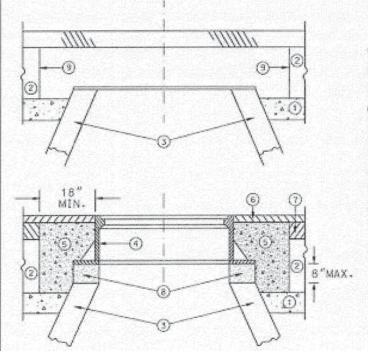

LEGEND

- SUB-BASE GRANULAR MATERIAL
- (2) EXISTING PAVEMENT TO BE REMOVED
- 3 EXISTING STRUCTURE
- (4) FRAME AND LID (SEE NOTES)
- (5) CLASS SI CONCRETE
- PROPOSED HMA SURFACE COURSE
- (7) PROPOSED HMA BINDER COURSE
- PROPOSED MORTAR. STEEL SHIMS & ADJUSTING RINGS 8" MAXIMUM
- (9) FULL DEPTH SAW CUT

CONSTRUCTION PROCEDURES

- STAGE 1 (PRIOR TO PAVEMENT MILLING AND PLACEMENT OF HMA BINDER)
- A) FULL DEPTH SAW CUT 5' X 5' SQUARE OR DIAMOND AROUND CENTER OF FRAME TO BE ADJUSTED
- B) REMOVE FRAME. EXISTING PAVEMENT AND AGGREGATE MATERIAL TO A DEPTH OF 2" BELOW TOP OF MANHOLE STRUCTURE & 2" BELOW BOTTOM OF LOWEST ADJUSTMENT RING.
- C) PLATE AND TEMPORARLILY PATCH WITH HMA UP TO EXISTING SURFACE GRADE.
- STAGE 2 (AFTER PAVEMENT MILLING AND PLACEMENT OF HMA BINDER)
- A) REMOVE TEMPORARY PATCH AND PLATE.
- B) INSTALL FRAME AND LID TO MATCH PROPOSED HMA PAVEMENT SURFACE GRADE USING MORTAR, STEEL SHIMS EMBEDDED IN MORTAR, AND PRECAST CONCRETE ADJUSTING RINGS
- C) COMPACT EXISTING AGGREGATE STONE BASE.
- D) FILL 5'X5' SURROUNDING SPACE WITH IDOT APPROVED CLASS SI CONCRETE TO THE SAME ELEVATION OF THE TOP OF THE BINDER
- El PAVE SURFACE COURSE OVER 5'X 5' CONCRETE COLLAR.

THE PROCEDURE EXPLAINED ABOVE SHALL CONFORM TO THE APPLICABLE PORTIONS OF SECTIONS 353, 406, 602, AND 603 OF THE STANDARD SPECIFICATIONS.

NOT TO SCALE FRAME AND LID **ADJUSTMENT** CONCRETE COLLAR

5" CONCRETE WALK THICKEN TO 6" AND INSTALL 6" X 6" #6 GAGE WELDED WIRE FABRIC THRU 4' - 5' RESIDENTIAL DRIVEWAYS (INCLUDED) MATCH EXIST 2% MAX 4" (6" THRU RESIDENTIAL DRIVEWAYS) COMPACTED AGGREGATE BASE COURSE, TYPE B. (PAID FOR SEPARATELY) - COMPACTED SUBGRADE NOTE: PROVIDE FIBER EXPANSION JOINTS WHERE NEW SIDEWALK MEETS EXISTING AND @ 50' O.C. MAX. AND PROVIDE CONTROL JOINTS @ 5' O.C. P.C.C. SIDEWALK - 5"

P.C.C. SIDEWALK DETAIL


WILLS BURKE KELSEY ASSOCIATES LTD WBK 116 West Main Street, Suite 2 St. Charles, Illinois 60174

DESIGNED - DPB REVISED -ISER NAME = bmccray DRAWN - BCM REVISED LOT SCALE = 1:50 CHECKED - DPB REVISED -PLOT DATE = 11/19/2015 DATE - 10-08-15 REVISED

STATE OF ILLINOIS **DEPARTMENT OF TRANSPORTATION**

SCALE:

COUNTY TOTAL SHEETS NO. SECTION RTE. DETAILS 15-00046-00-RS KANE 1680 CONCORD AVENUE CONTRACT NO. 61C20 SHEET NO. OF SHEETS STA. TO STA.

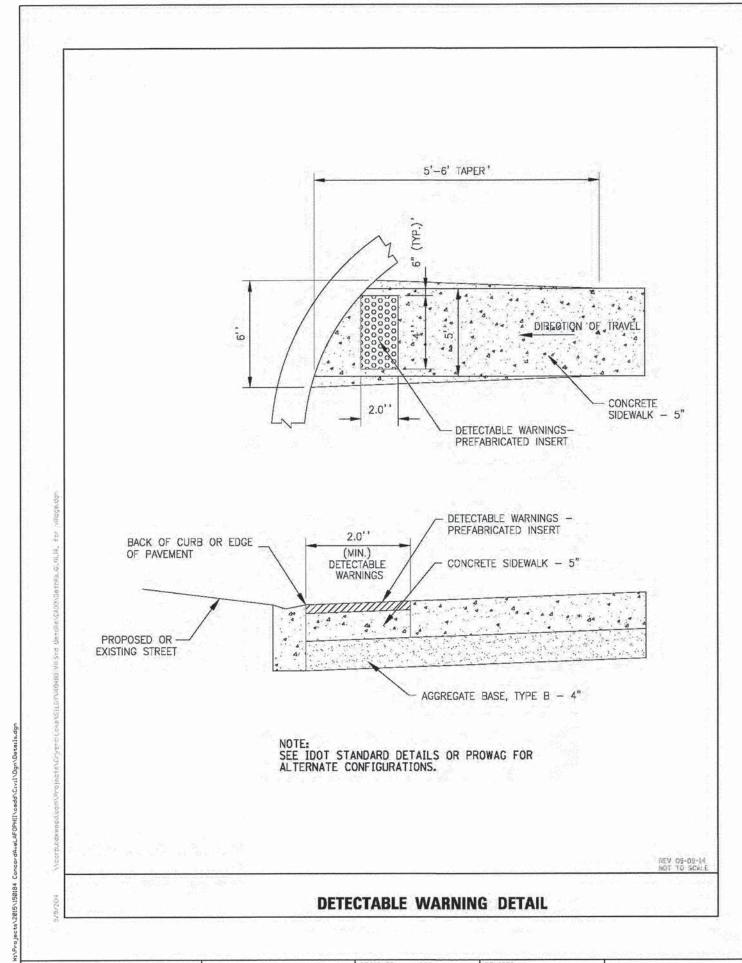


WILLS BURKE KELSEY ASSOCIATES LTD.

116 West Main Street, Suite 201

St. Charles, Illinois 60174

STATE OF ILLINOIS DEPARTMENT OF TRANSPORTATION

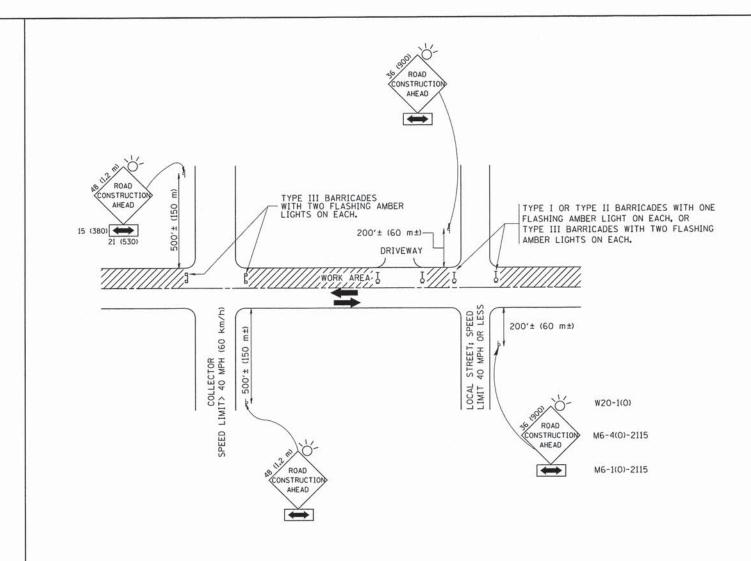

TRAFFIC CONTROL AND PROTECTION FOR SIDE ROADS, INTERSECTIONS, AND DRIVEWAYS

NOTES:

- A. FOR NO LANE RESTRICTION ON THE SIDE ROAD OR DRIVEWAYS
- SIDE ROAD WITH A SPEED LIMIT OF 40 MPH (60 km/h) OR LESS AS SHOWN ON THE DRAWING AND AS DIRECTED BY THE ENGINEER:
- Q) ONE ROAD CONSTRUCTION AHEAD SIGN 36 x 36 (900x900) WITH A FLASHER AND FLAG MOUNTED ON IT APPROXIMATELY 200' (60 m) IN ADVANCE OF THE MAIN ROUTE.
- b) THE CLOSED PORTION OF THE MAIN ROUTE SHALL BE PROTECTED BY BLOCKING WITH TYPE I, TYPE II OR TYPE III BARRICADES, 1/3 OF THE CROSS SECTION OF THE CLOSED PORTION.
- 2. SIDE ROAD WITH A SPEED LIMIT GREATER THAN 40 MPH (60 km/h) AS SHOWN ON THE DRAWING AND AS DIRECTED BY THE ENGINEER:
- O) ONE ROAD CONSTRUCTION AHEAD SIGN 48 × 48 (1.2 m × 1.2 m) WITH A FLASHER MOUNTED ON IT APPROXIMATELY 500" (150 m) IN ADVANCE OF THE MAIN ROLLTE.
- b) THE CLOSED PORTION OF THE MAIN ROUTE SHALL BE PROTECTED BY BLOCKING WITH TYPE III BARRICADES, 1/2 OF THE CROSS SECTION OF THE CLOSED PORTION.
- 3. WHEN THE SIDE ROAD LIES BETWEEN THE BEGINNING OF THE MAINLINE SIGNING AND THE WORK ZONE, A SINGLE HEADED ARROW (MG-1) SHALL BE USED IN LIEU OF THE DOUBLE HEADED ARROW (MG-4).

SCALE: NONE


- B. FOR A LANE CLOSURE ON A SIDE ROAD OR DRIVEWAY:
- USE APPLICABLE PORTIONS OF THE TYPICAL APPLICATION OF TRAFFIC CONTROL DEVICES (STD. 701501, STD. 701606 OR THE APPROPRIATE STANDARD). THE SPACING OF SIGNS AND BARRICADES SHALL BE ADJUSTED FOR FIELD CONDITIONS AS DIRECTED BY THE ENGINEER. THE DIRECTIONAL ARROW SHALL BE COVERED OR REMOVED WHEN NO LONGER CONSISTENT WITH THE SIDE ROAD LANE CLOSURE.
- C. ADVANCE WARNING SIGNS ARE TO BE OMITTED ON DRIVEWAY UNLESS OTHERWISE NOTED.
- D. THE TRAFFIC CONTROL AND PROTECTION FOR SIDE ROADS, INTERSECTIONS, AND DRIVEWAYS SHALL BE INCIDENTAL TO THE COST OF SPECIFIED TRAFFIC CONTROL STANDARDS OR ITEMS.


All dimensions are in millimeters (inches) unless otherwise shown.

FILE NAME =	USER NAME = gaglianobt	DESIGNED - LHA	REVISED - J. OBERLE 10-18-95
Wr\diststd\22x34\tcl0.dgn		DRAWN -	REVISED - A. HOUSEH 03-06-96
The same to see a super-transfer of the supe	PLOT SCALE = 50.000 ' / IN.	CHECKED -	REVISED - A. HOUSEH 10-15-96
	PLOT DATE = 1/4/2008	DATE - 06-89	REVISED -T, RAMMACHER 01-06-00


STATE	OF	ILLINOIS
DEPARTMENT	OF	TRANSPORTATION

TRAFFIC CONTROL AND PROTECTION FOR			F.A RTE.	SECTION	COUNTY	TOTAL	SHEE'		
				1680	15-00046-00-RS	KANE	16	10	
SIDE ROADS, INTERSECTIONS, AND DRIVEWAYS				TC-10	CONTRACT	NO. 61	C20		
SHEET NO.	OF	SHEETS	STA.	TO STA.	FED. ROAD	DIST. NO. 1 ILLINOIS FED.	AID PROJECT		

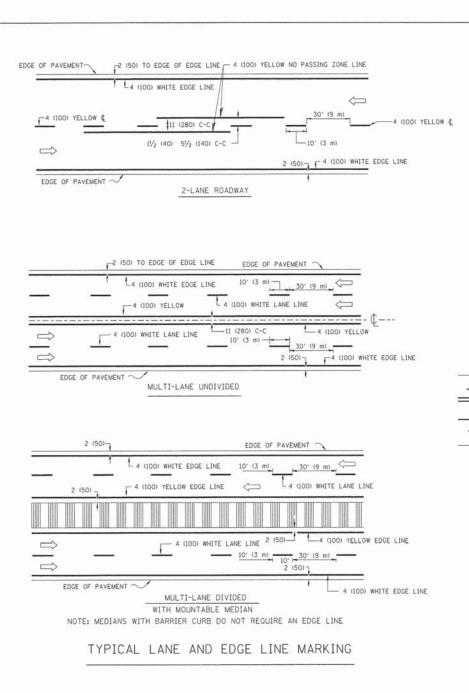


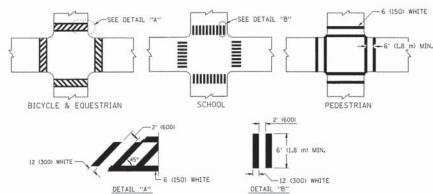

TYPICAL CROSSWALK MARKING

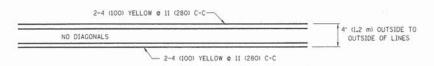


4' (1.2 m) WIDE MEDIANS ONLY

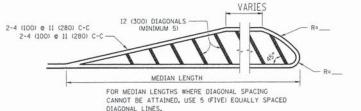

DIAGONAL LINE SPACING: 50' (15 m) C-C (LESS THAN 30MPH (50 km/h))
75' (25 m) C-C 30MPH (50 km/h) T0 45MPH (70 km/h))
150' (45 m) C-C (MORE THAN 45MPH (70 km/h))

MEDIANS OVER 4' (1.2 m) WIDE

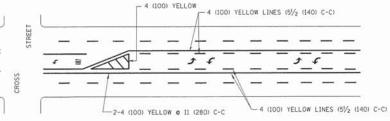


A MINIMUM OF TWO PAIRS OF TURN ARROWS SHALL BE USED, WHITE IN COLOR, ADDITIONAL PAIRS SHALL BE PLACED AT 200' (60 m) TO 300' (90 m) INTERVALS.



MEDIAN WITH TWO-WAY LEFT TURN LANE

TYPICAL PAINTED MEDIAN MARKING

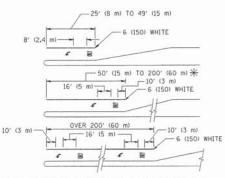


FULL SIZE LETTERS 8' (2.4 m) AND ARROWS SHALL BE USED. \P AREA = 15.6 SO. FT. (1.5 m²) ONLY AREA = 20.8 SO. FT. (1.9 m²)

** TURN LANES IN EXCESS OF 400' (120 m) IN LENGTH MAY HAVE AN ADDITIONAL SET OF ARROW - "ONLY" INSTALLED MIDWAY BETWEEN THE OTHER TWO SETS OF ARROW - "ONLY".

TYPICAL LEFT (OR RIGHT) TURN LANE

TYPICAL TURN LANE MARKING

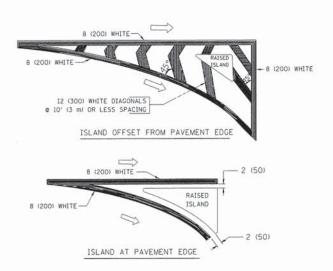

TYPICAL ISLAND MARKING

TYPE OF MARKING	WIDTH OF LINE	PATTERN	COLOR	SPACING / REMARKS
CENTERLINE ON 2 LANE PAVEMENT	4 (100)	SKIP-DASH	YELLOW	10' (3 m) LINE WITH 30' (9 m) SPACE
CENTERLINE ON MULTI-LANE UNDIVIDED PAVEMENT	2 @ 4 (100)	SOLID	YELLOW	11 (280) C-C
NO PASSING ZONE LINES: FOR ONE DIRECTION FOR BOTH DIRECTIONS	4 (100) 2 @ 4 (100)	SOLID SOLID	YELLOW YELLOW	5½ (140) C-C FROM SKIP-DASH CENTERLINE 11 (280) C-C OMIT SKIP-DASH CENTERLINE BETWEEN
LANE LINES	4 (100) 5 (125) ON FREEWAYS	SKIP-DASH SKIP-DASH	WHITE WHITE	10' (3 m) LINE WITH 30' (9 m) SPACE
DOTTED LINES (EXTENSIONS OF CENTER, LANE OR TURN LANE MARKINGS)	SAME AS LINE BEING EXTENDED	SKIP-DASH	SAME AS LINE BEING EXTENDED	2' (600) LINE WITH 6' (J.8 m) SPACE
EDGE LINES	4 (100)	SOLID	YELLOW-LEFT WHITE-RIGHT	OUTLINE MOUNTABLE MEDIANS IN YELLOW: EDGE LINES ARE NOT USED NEXT TO BARRIER CURB
TURN LANE MARKINGS	6 (150) LINE; FULL SIZE LETTERS & SYMBOLS (8' (2.4m))	SOLID	WHITE	SEE TYPICAL TURN LANE MARKING DETAIL
TWO WAY LEFT TURN MARKING	2 @ 4 (100) EACH DIRECTION	SKIP-DASH AND SOLID	YELLOW	10' (3 m) LINE WITH 30' (9 m) SPACE FOR SKIP-DASH; 51/2 (140) C-C BETWEEN SOLID LINE AND SKIP-DASH LINE
	8' (2.4m) LEFT ARROW	IN PAIRS	WHITE	SEE TYPICAL TWO-WAY LEFT TURN MARKING DETAIL
CROSSWALK LINES (PEDESTRIAN) A. DIAGONALS (BIKE & EOUESTRIAN) B. LONGITUDINAL BARS (SCHOOL)	2 @ 6 (150) 12 (300) @ 45° 12 (300) @ 90°	SOLID SOLID SOLID	WHITE WHITE WHITE	NOT LESS THAN 6' (1.8 m) APART 2' (500) APART 2' (600) APART 5EE TYPICAL CROSSWALK MARKING DETAILS.
STOP LINES	24 (600)	SOLID	WHITE	PLACE 4" (1.2 m) IN ADVANCE OF AND PARALLEL TO CROSSWALK, IF PRESENT. OTHERWISE, PLACE AT DESIRED STOPPHO POINT. PARALLEL TO CROSSROAD CENTERLINE, WHERE POSSIBLE
PAINTED MEDIANS	2 @ 4 (100) WITH 12 (300) DIAGONALS @ 45° NO DIAGONALS USED FOR 4' (1,2 m) WIDE MEDIANS	SOLID	YELLOW: TWO WAY TRAFFIC WHITE: ONE WAY TRAFFIC	11 (280) C-C FOR THE DOUBLE LINE SEE TYPICAL PAINTED MEDIAN MARKING.
GORE MARKING AND CHANNELIZING LINES	8 (200) WITH 12 (300) DIAGONALS @ 45°	SOLID	WHITE	DIACONALS: 15' (4,5 m) C-C (LESS THAN 30MPH (50 km/h)) 20' (6 m) C-C 30MPH (50 km/h) TO 45MPH (70 km/h)) 30' (9 m) C-C (OVER 45MPH (70 km/h))
RAILROAD CROSSING	24 (600) TRANSVERSE LINES; "RR" IS 6' (1.8 m) LETTERS; 16 (400) LINE FOR "X"	SOLID	WHITE	SEE STATE STANDARD 780001 AREA OF: "R"=3.6 SO. FT. (0.33 m²) EACH "X"=54.0 SO. FT. (5.0 m²)
SHOULDER DIAGONALS	12 (300) @ 45°	SOLID	WHITE - RIGHT YELLOW - LEFT	50' (15 m) C-C (LESS THAN 30MPH (50 km/h)) 75' (25 m) C-C (30 MPH (50 km/h) TO 45MPH (70 km/h)) 150' (45 m) C-C (0VER 45MPH (70 km/h))


FOR FURTHER DETAILS ON PAVEMENT MARKING REFER TO STANDARD SPECIFICATIONS FOR ROAD AND BRIDGE CONSTRUCTION AND STATE STANDARD 780001.


All dimensions are in inches (millimeters) unless otherwise shown.

FILE NAME =	USER NAME = drivakosgn	DESIGNED - EVERS	REVISED -T. RAMMACHER 10-27-94
c:\pw_work\pwidot\drivakosgn\d0108315\tc	13.dgn	DRAWN -	REVISED -C. JUCIUS 09-09-09
	PLOT SCALE = 50.000 ' / IN.	CHECKED -	REVISED -
	PLOT DATE = 9/9/2009	DATE - 03-19-90	REVISED -


STATE	OF	ILLINOIS
DEPARTMENT	OF	TRANSPORTATION

			-	DISTRICT OF	NF		F.A RTE.	SECTION	COUNTY	TOTAL	SHEET NO.
5		77/			Inches and the contract of the		1680	15-00046-00-RS	KANE	16	11
		IYI	PICAL I	AVENIENT	MARKINGS			TC-13	CONTRACT	NO. 61	C20
SCALE: NONE	SHEET	NO.	OF	SHEETS	STA.	TO STA.	FED. ROAD	DIST. NO. 1 ILLINOIS FED.	AID PROJECT		

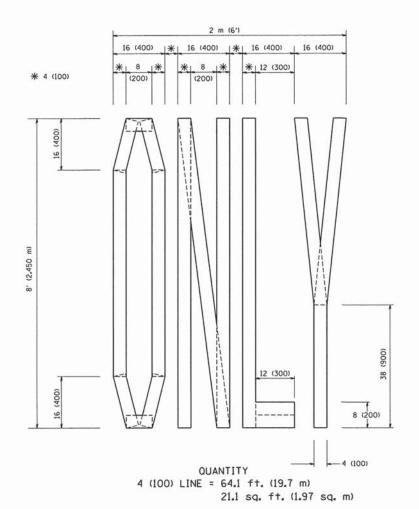

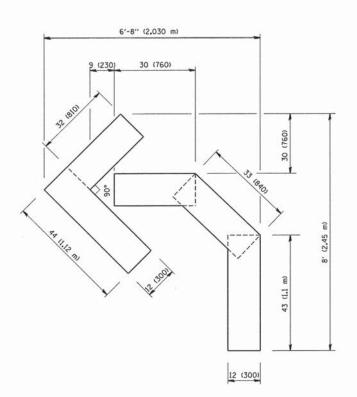


OUANTITY 4 (100) LINE = 45.5 ft. (13.9 m) 15.2 sq. ft. (1.39 sq. m)

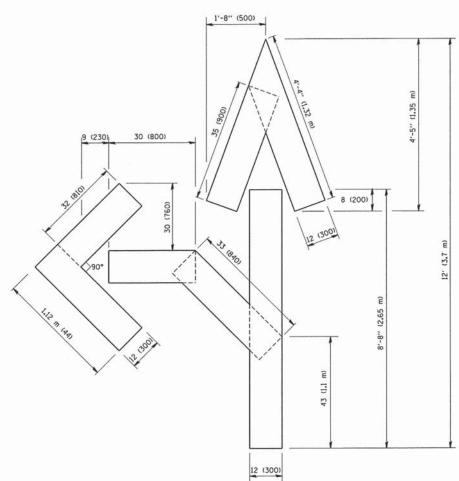

OUANTITY 4 (100) LINE = 82.5 ft. (25.3 m) 27.5 sq. ft. (2.53 sq. m)

All dimensions are in inches (millimeters) unless otherwise shown.

FILE NAME =	USER NAME = gaglianobt	DESIGNED -	REVISED -T. RAMMACHER 06-05-96			PAVEMEN	NT MAR	KING LET	TERS AND S	F.A RTE.	SECTION	COUNTY	SHEET	S NO.	
W:\d:ststd\22x34\tcl6.dgn		DRAWN -	REVISED -T. RAMMACHER 11-04-97	STATE OF ILLINOIS	FOR TRAFFIC STAGING						1680	15-00046-00-RS	KANE	16	12
Just 17 de montre von 1910 de 1900 de 1900 de 1900 de 19	PLOT SCALE = 50.0000 ' / IN.	CHECKED -	REVISED -T. RAMMACHER 03-02-98	DEPARTMENT OF TRANSPORTATION			FUK	IKAFFIC	STAGING			TC-16	CONTRAC	T NO. 6	51C2O
	PLOT DATE = 1/4/2008	DATE - 09-18-94	REVISED -E. GOMEZ 08-28-00		SCALE: NONE	SCALE: NONE SHEET NO. OF SHEETS STA. TO STA.				TO STA.	FED. ROA	D DIST. NO. 1 ILLINOIS FED.	AID PROJECT		

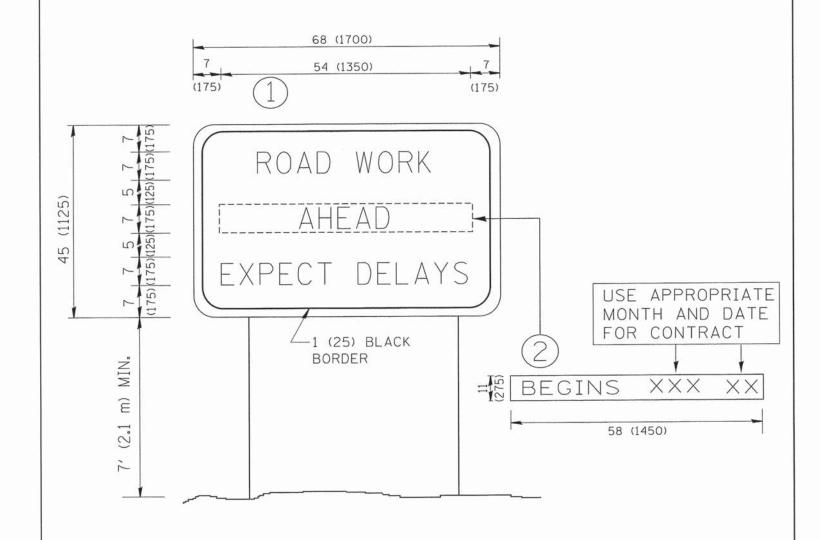


NOTES:

- 1. USE BLACK LETTERING ON ORANGE BACKGROUND.
- 2. ERECT SIGNS IN ADVANCE OF THE LOCATION FOR THE "ROAD CONSTRUCTION AHEAD" SIGN AT LOCATIONS AS DIRECTED BY THE ENGINEER.
- 3. ERECT SIGN (1) WITH INSTALLED PANEL (2) ONE WEEK PRIOR TO THE START OF CONSTRUCTION.
- 4. REMOVE PANEL 2 SOON AFTER THE START OF CONSTRUCTION.
- 5. SEE SPECIAL PROVISION FOR "TEMPORARY INFORMATION SIGNING" FOR ADDITIONAL INFORMATION.
- 6. ONE SIGN ASSEMBLY EQUALS 25.70 SQ. FT. (2.3 SQ. M.)
- 7. SHALL BE PAID FOR AS TEMPORARY INFORMATION SIGNING.

ALL DIMENSIONS ARE IN INCHES (MILLIMETERS)
UNLESS OTHERWISE SHOWN.

FILE NAME =	USER NAME = gaglianobt	DESIGNED -	REVISED - R. MIRS 09-15-97	Property Services Control of Cont			А	RTERIAL	ROAD		F.A RTE.	SECTION	COUNTY	SHEETS	NO.
W:\diststd\22×34\tc22.dgn		DRAWN -	REVISED - R. MIRS 12-11-97	STATE OF ILLINOIS	-	INFORMATION SIGN					1680	15-00046-00-RS	KANE		13
	PLOT SCALE = 50.000 ' / IN.	CHECKED -	REVISED -T. RAMMACHER 02-02-99	DEPARTMENT OF TRANSPORTATION			HVI	100000000000000000000000000000000000000	MEGITTU FIRM			TC-22		CT NO. 610	220
(PLOT DATE = 1/4/2008	DATE -	REVISED - C. JUCIUS 01-31-07		SCALE: NONE	SHEET NO.	OF	SHEETS	STA.	TO STA.	FED. RO	D DIST. NO. 1 ILLINOIS FE	D. AID PROJECT		-

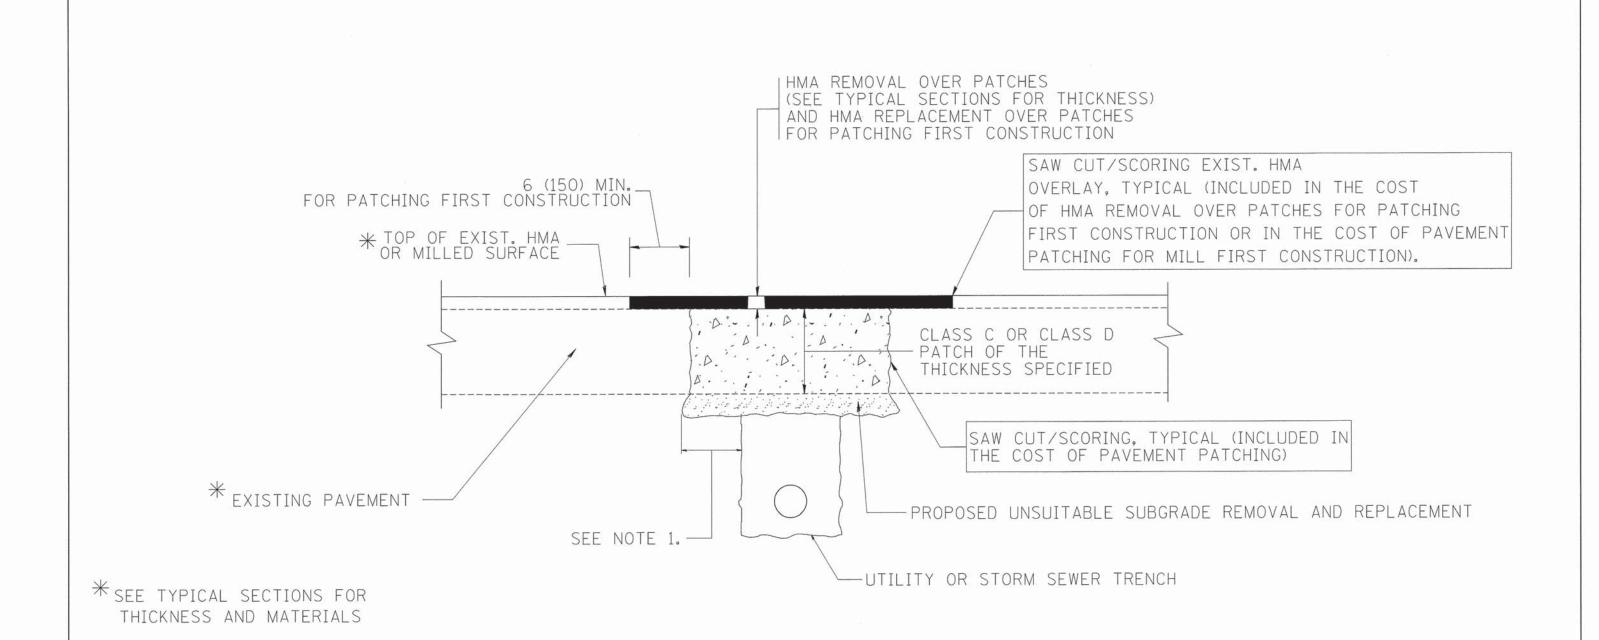

NOTES:

- 1. THE WIDTH OF THE FULL DEPTH PATCH OVER A TRENCH SHALL BE 12 (300) WIDER ON EACH SIDE OF THE TRENCH.
- 2. FOR METHOD OF MEASUREMENT AND BASIS OF PAYMENT, SEE RECURRING SPECIAL PROVISION "PATCHING WITH HOT-MIX ASPHALT OVERLAY REMOVAL".

SEQUENCE OF CONSTRUCTION (PATCHING FIRST)


- 1. REMOVE THE EXISTING HMA MATERIAL OVER THE AREA TO BE PATCHED.
- 2. REMOVE AND REPLACE WITH CLASS C OR D PATCH.
- 3. REPLACE HMA MATERIAL OVER THE AREA TO BE PATCHED.

SEQUENCE OF CONSTRUCTION (MILLING FIRST)

- 1. MILL HMA FIRST IF THERE IS AT LEAST 41/2 INCHES OR MORE OF HMA MATERIAL ON TOP OF THE EXISTING PAVEMENT OR IF THE PAVEMENT IS FULL DEPTH HMA. A MINIMUM OF 2 INCHES OF HMA MATERIAL SHALL BE IN PLACE AFTER MILLING.
- 2. REMOVE AND REPLACE WITH FULL DEPTH CLASS D PATCHES TO TOP OF MILLED SURFACE.

ALL DIMENSIONS ARE IN INCHES (MILLIMETERS) UNLESS OTHERWISE SHOWN.


FILE NAME =	USER NAME = bauerdl	DESIGNED - R. SHAH	REVISED - A. ABBAS 04-27-98	MENANTHAN COLOR OF THE PROPERTY OF THE PROPERT		PAVEMENT PATCH	IING FOR		RTE.	SECTION	COUNTY	SHEETS	NO.
c:\projects\diststd22x34\bd22.dgn		DRAWN -	REVISED - R. BORO 01-01-07	STATE OF ILLINOIS					1680	15-00046-00-RS	KANE	16	14
One of the second	PLOT SCALE = 50.000 ' / IN.	CHECKED -	REVISED - R. BORO 09-04-07	DEPARTMENT OF TRANSPORTATION		HMA SURFACED P	AVEIVIENT			BD400-04 (BD-22)	CONTRAC	CT NO. 61C2	20
	PLOT DATE = 10/27/2008	DATE - 10-25-94	REVISED - K. ENG 10-27-08	- Household Photograph Cab. To the District Market and Stability and Sta	SCALE: NONE	SHEET NO. OF SHEETS	STA.	TO STA.	FED. RO	DAD DIST. NO. 1 ILLINOIS FED.	AID PROJECT		

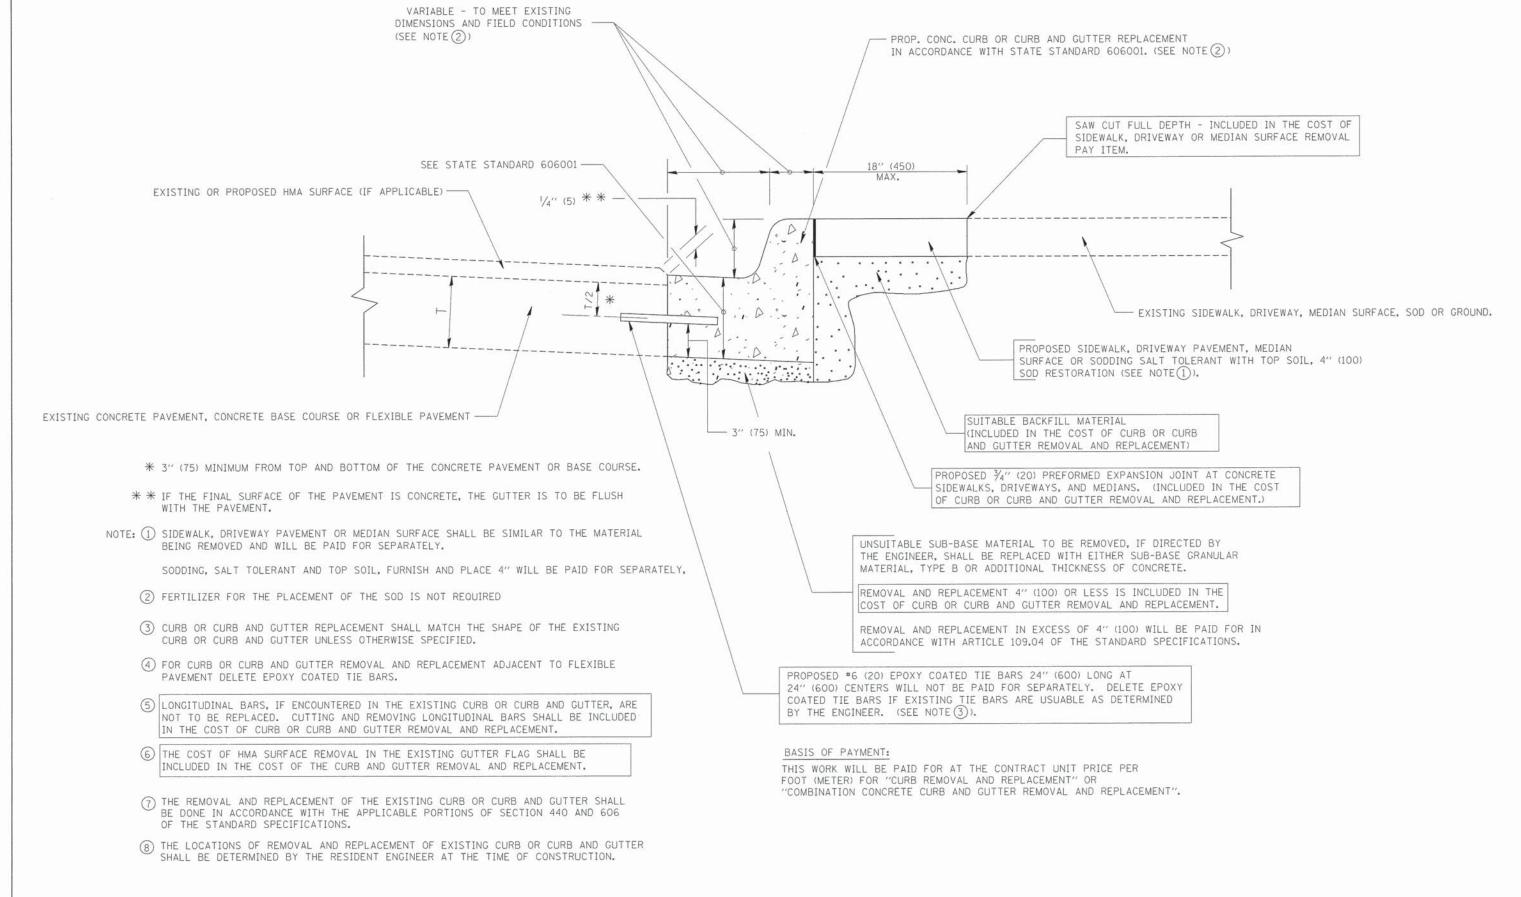


CURB OR CURB AND GUTTER REMOVAL AND REPLACEMENT

ALL DIMENSIONS ARE IN INCHES (MILLIMETERS) UNLESS OTHERWISE SHOWN.

FILE NAME *	USER NAME = drivakasgn	DESIGNED - A. HOUSEH	REVISED - R. SHAH 10-03-96			CURB OR CURB AND	GUTTER	RTE.	SECTION	COUNTY	SHEETS
c:\pw_work\pwidot\drivakosgn\d0108315\bd	24.dgn	DRAWN -	REVISED - A. ABBAS 03-21-97	STATE OF ILLINOIS				1680	15-00046-00-RS	KANE	16
Pr	PLOT SCALE = 50.000 ' / IN.	CHECKED -	REVISED - M. GOMEZ 01-22-01	DEPARTMENT OF TRANSPORTATION		REMOVAL AND REPLA	ACEIVIENT		BD600-06 (BD-24)	CONTRAC	CT NO. 610
	PLOT DATE = 12/15/2009	DATE - 03-11-94	REVISED - R. BORO 12-15-09		SCALE: NONE	SHEET NO. OF SHEETS	STA. TO STA.	FED. R	OAD DIST. NO. 1 ILLINOIS FED.	. AID PROJECT	

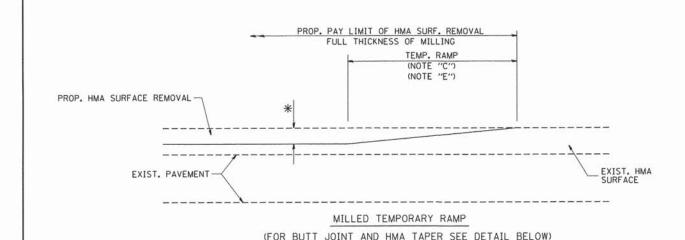


OPTION 1

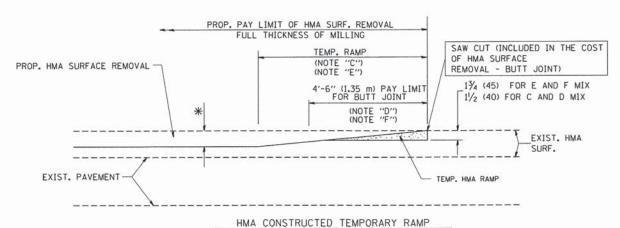


(FOR BUTT JOINT AND HMA TAPER SEE DETAIL BELOW)


OPTION 2

TYPICAL TEMPORARY RAMP

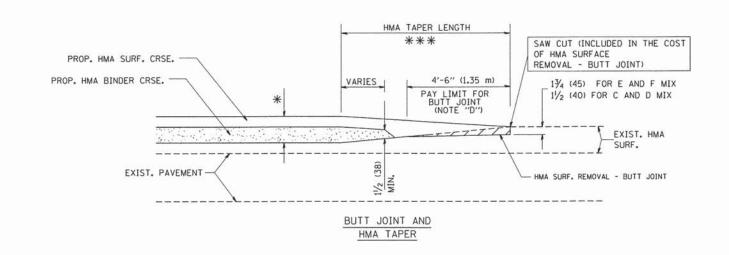

TYPICAL BUTT JOINT AND HMA TAPER FOR MILLING AND RESURFACING

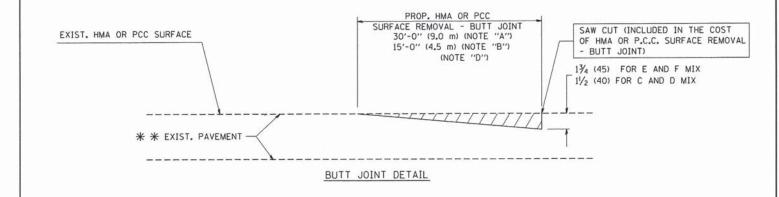

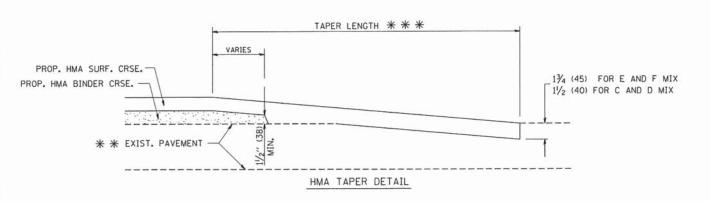

TYPICAL BUTT JOINT AND HMA TAPER FOR RESURFACING ONLY

* * PC CONCRETE, HMA OR HMA RESURFACED PAVEMENT.

NOTES

- A: MAINLINE ROADWAYS AND MAJOR SIDE ROADS.
- B: MINOR SIDE ROADS.
- C: THE TEMP. RAMP SHALL BE CONSTRUCTED IMMEDIATELY UPON REMOVAL OF THE EXISTING HMA SURFACE.
- D: THE BUTT JOINT SHALL BE CONSTRUCTED IMMEDIATELY PRIOR TO PLACING THE PROPOSED HMA COURSES.
- E: TAPER THE TEMP. RAMP AT A RATE OF 3'-0" (900 mm) PER 1 INCH (25 mm) OF MILLING THICKNESS.
- F: INSTALLATION AND REMOVAL OF THE 4'-6" (1.35 m) TEMP. RAMP IS INCLUDED IN COST OF HMA SURFACE REMOVAL BUTT JOINT
- G: SEE ARTICLE 406.08 AND 406.14 OF THE STANDARD SPECIFICATIONS FOR "HMA AND/OR PCC SURFACE REMOVAL, BUTT JOINT".
- * SEE TYPICAL SECTIONS FOR MILLING THICKNESS.
- * * * 20'-0" (6.1 m) PER 1 (25) RESURFACING (NOTE "A") 10'-0" (3.0 m) PER 1 (25) RESURFACING (NOTE "B")

BASIS OF PAYMENT:

THE BUTT JOINT WILL BE PAID FOR AT THE CONTRACT UNIT PRICE PER SQUARE YARD (SQUARE METER) FOR "HOT-MIX ASPHALT SURFACE REMOVAL - BUTT JOINT" OR FOR "PORTLAND CEMENT CONCRETE SURFACE REMOVAL- BUTT JOINT".

ALL DIMENSIONS ARE IN INCHES (MILLIMETERS) UNLESS OTHERWISE SHOWN.

TOTAL CUEE

- 4	FILE NAME =	USER NAME = gaglianobt	DESIGNED - M. DE YONG	REVISED - R. SHAH 10-25-94				RII	TT JOINT	AND		RTE.	SECTION	COUNTY	SHEETS	NO.
	W:\diststd\22x34\bd32.dgn		DRAWN -	REVISED - A. ABBAS 03-21-97	STATE OF ILLINOIS							1680	15-00046-00-RS	KANE	16	16
		PLOT SCALE = 50.0000 ' / IN.	CHECKED -	REVISED - M. GOMEZ 04-06-01	DEPARTMENT OF TRANSPORTATION			HIVIA	TAPER DE	TAILS		1	3D400-05 BD32	CONTRAC	CT NO. 610	20
1	1	PLOT DATE = 1/4/2008	DATE - 06-13-90	REVISED - R. BORO 01-01-07	The state of the s	SCALE: NONE	SHEET NO.	OF	SHEETS	STA.	TO STA.	FED. ROA	D DIST. NO. 1 ILLINOIS FED.	AID PROJECT		