## STATE OF ILLINOIS

DEPARTMENT OF TRANSPORTATION

PLANS FOR PROPOSED FEDERAL-AID HIGHWAY

FOR LIST OF HIGHWAY STANDARDS, SEE SHEET NO. 2

FOR INDEX OF SHEETS, SEE SHEET NO. 2

TRAFFIC DATA:

ADT = 44,200 (2015) IL RT 83

ADT = 26,100 (2012) 63RD STREET

**FULL SIZE PLANS HAVE BEEN PREPARED USING STANDARD** 

CONFORM TO STANDARD SCALES. IN MAKING MEASUREMENTS

**ENGINEERING SCALES. REDUCED SIZED PLANS WILL NOT** 

ON REDUCED PLANS, THE ABOVE SCALES MAY BE USED.

JOINT UTILITY LOCATION INFORMATION FOR EXCAVATION

FUNCTIONAL CLASS = OTHER PRINCIPAL ARTERIAL (IL RT 83)

FUNCTIONAL CLASS = MINOR ARTERIAL (63RD STREET)

POSTED SPEED LIMIT = 45 MPH (IL RT 83)

POSTED SPEED LIMIT = 40 MPH (63RD STREET)

FAP 0344: IL ROUTE 83 AND FAU 1518: 63RD ST. INTERSECTION LIGHTING IMPROVEMENTS **SECTION 16-00023-00-LT** PROJECT M-4003 (743) VILLAGE OF WILLOWBROOK

**DUPAGE COUNTY** PROJECT IL RT 83 C-91-286-16 **END IMPROVEMENT** R 11 E - 3RD PM

STA 216 + 00PROJECT 63RD ST **END IMPROVEMENT** STA 122 + 00PROJECT 63RD ST **BEGIN IMPROVEMENT** STA 101 + 00ONNO DUN ENGINEER PROJECT IL RT 83 BEGIN IMPROVEMENT <sup>©</sup>062-057484 STA 201 + 50ANTHONY J. DeRICCO, P.E

> **GROSS LENGTH = 3,500 FT. = 0.663 MILE NET LENGTH = 3,500 FT. = 0663 MILE**

CHRISTOPHER B. BURKE ENGINEERING, LTD. 9575 W. Higgins Road, Suite 600 Rosement, Illinois 60018

ILLINOIS REGISTRATION No. 062-057484

**EXPIRATION DATE: 11/30/2017** 


PROFESSIONAL DESIGN FIRM NO. 184-001175 **EXPIRATION DATE: 04/30/17** 

LUCATION OF SECTION INDICATED THUS: - -

16-00023-00-LT

DUPAGE

ILLINOIS CONTRACT NO. 61D67

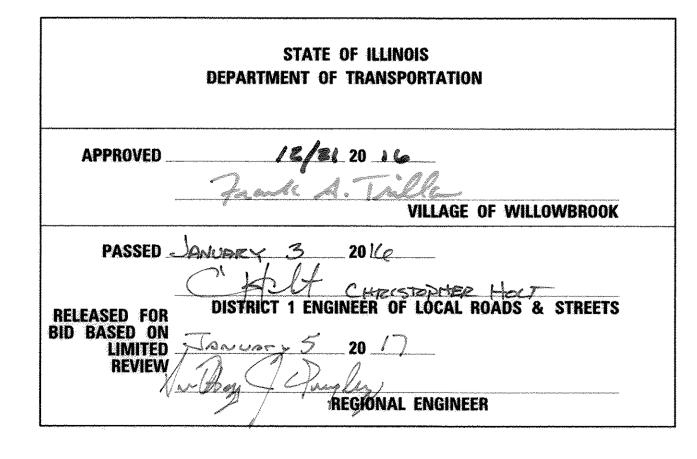

PRINTED BY THE AUTHORITY OF THE STATE OF ILLINOIS

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CONTRACT NO. 61D67

J.U.L.I.E.

OR 811

1-800-892-0123

#### INDEX OF SHEETS

SHEET NO.	DESCRIPTION
1	COVER SHEET
2	INDEX OF SHEETS & GENERAL NOTES
3 - 4	SUMMARY OF QUANTITIES
5 - 10	PROPOSED LIGHTING PLAN
11 - 13	ELECTRICAL DETAILS
14	COMED CORRESPONDENCE
15 - 17	IDOT DISTRICT 1 STANDARDS

#### **HIGHWAY STANDARDS**

STD NO.	DESCRIPTION
000001-06	STANDARD SYMBOLS, ABBREVIATIONS AND PATTERNS
442101-07	CLASS B PATCHES
701426-09	LANE CLOSURE, MULTILANE, INTERMITTANT OR MOVING OPERATION, FOR SPEEDS $\geq$ 45 MPH
701427-05	LANE CLOSURE, MULTILANE, INTERMITTANT OR MOVING OPERATION, FOR SPEEDS & 40 MPH
701601-09	URBAN LANE CLOSURE, MULTILANE, 1W OR 2W WITH NONTRAVERABLE MEDIAN
701701-10	URBAN LANE CLOSURE, MULTILANE INTERSECTION
701801-06	SIDEWALK, CORNER OR CROSSWALK CLOSURE
701901-06	TRAFFIC CONTROL DEVICES
838001	BREAKAWAY DEVICES

ABBRE	VIATIONS
Α	AMPS
CKT	CIRCUIT
CNC	COILABLE NON-METALLIC CONDUIT
DIA	DIAMETER
FT	FOOT
FOC	FACE OF CURB
GFCI	GROUND FAULT CIRCUIT INTERRUPTER
GND	GROUND
HDPE	HIGH DENSITY POLYETHYLENE
НН	HAND HOLE
HPS	HIGH PRESSURE SODIUM
PVC	POLYVINYL CHLORIDE
RGS	RIGID GALVANIZED STEEL CONDUIT
ROW	RIGHT OF WAY
SS	STAINLESS STEEL
STA	STATION
٧	VOLTS
W	WATTS
WR	WEATHER RESISTANT

## LIGHTING GENERAL NOTES

- 1. BEFORE INSTALLING LIGHT STANDARDS NEAR OVERHEAD AND UNDERGROUND ELECTRIC UTILITIES SHALL CALL COM ED FOR LOCATION APPROVAL AND MINIMUM CLEARANCE REQUIREMENTS.
- 2. THE CONTRACTOR SHALL BE SOLELY RESPONSIBLE FOR JOB SITE SAFETY AS WELL AS SUPERVISION/ DIRECTION AND MEANS/METHODS OF CONSTRUCTION.
- 3. ALL WORK SHALL BE IN ACCORDANCE WITH THE LATEST EDITIONS OF THE FOLLOWING SPECIFICATIONS, WHICH ARE HEREBY MADE A PART HEREOF:
  - A. "STANDARD SPECIFICATIONS FOR ROAD AND BRIDGE CONSTRUCTION". AS PREPARED BY IDOT.
  - B. "THE NATIONAL ELECTRICAL CODE".
  - C. MUNICIPAL CODES & STANDARDS.
- 4. NO MATERIALS SHALL BE DELIVERED TO THE JOB SITE UNTIL ALL PERTINENT EQUIPMENT SUBMITTALS HAVE BEEN REVIEWED BY THE ENGINEER.
- 5. ALL UNDERGROUND WIRING SHALL BE COPPER XLP TYPE-USE, EXTRA ABRASION RESISTANCE, 600 VOLTS, INSTALLED IN SCH 40 HDPE CONDUIT A MINIMUM 30 INCHES BELOW FINISHED GRADE, FOLLOWING THE ROADWAY OR SIDEWALK EDGE.
- 6. TO MAINTAIN THE STRUCTURAL INTEGRITY OF LIGHT POLES WITH LUMINAIRE ARMS, THEY SHALL NOT BE ERECTED AND LEFT TO STAND WITHOUT LUMINAIRES.
- 7. ALL POLE HANDHOLES SHALL FACE AWAY FROM TRAFFIC.
- 8. THE ELECTRICAL CONTRACTOR SHALL FURNISH TWO SETS OF FULL SIZE RECORD DRAWINGS TO THE OWNER'S REPRESENTATIVE UPON COMPLETION OF THE LIGHTING AND ELECTRICAL IMPROVEMENTS. THE DRAWINGS SHALL SHOW THE INSTALLED LOCATIONS OF ALL LIGHT POLES, UNDERGROUND CONDUITS/ WIRING, HANDHOLES, JUNCTION BOXES & CONTROLLER CABINETS. THE DRAWINGS WILL BE REVIEWED BY THE ENGINEER.
- UPON COMPLETION OF THE PROPOSED LIGHTING IMPROVEMENTS, THE CONTRACTOR SHALL PERFORM ELECTRICAL TESTING AND VERIFY THAT THE INSTALLATION COMPLIES WITH THE LATEST EDITION OF THE STANDARD SPECIFICATIONS FOR ROAD AND BRIDGE CONSTRUCTION IN ILLINOIS. ALL ELECTRICAL TESTING SHALL BE PERFORMED IN THE PRESENCE OF THE ENGINEER AND THE
- 10. THE CONTRACTOR SHALL MAKE SPECIAL NOTE OF THE REQUIREMENT FOR BURIED WARNING TAPE. SPECIFIED AS PART OF "TRENCH AND BACKFILL FOR ELECTRICAL WORK". THE INSTALLATION OF THE TAPE SHALL BE INSPECTED AND APPROVED BY THE RESIDENT ENGINEER PRIOR TO BACKFILLING OR DURING PLOWING OPERATIONS. AS APPLICABLE.
- 11. THE CONTRACTOR SHALL MAKE SPECIAL NOTE OF THE REQUIREMENTS FOR WIRE MARKERS AND SHALL TAG ALL WIRE ACCORDINGLY.
- 12. EQUIPMENT GROUND CONDUCTORS SHALL BE SPLICED AND BONDED AT EACH LIGHT POLE OR OTHER PIECE OF EQUIPMENT.
- 13. CONDUIT MUST BE POSITIONED IN THE FIELD TO AVOID CONFLICT WITH TREES, BUSHES, DRAINS AND OTHER UTILITIES AND LANDSCAPING.
- 14. THE EXACT LOCATIONS OF ALL UTILITIES SHALL BE VERIFIED BY THE CONTRACTOR BEFORE THE INSTALLATION OF ANY COMPONENTS OF THE LIGHTING SYSTEM. FOR THE LOCATIONS OF THE UTILITIES, CALL JULIE TOLL FREE AT 1-800-892-0123. IT IS THE CONTRACTOR'S RESPONSIBILITY TO LOCATE EXISTING TRAFFIC SIGNAL CABLES AND CONDUITS.
- THE CONTRACTOR SHALL BE RESPONSIBLE FOR TIMELY NOTIFICATION AND ALL COORDINATION WITH COM ED FOR NEW ELECTRIC SERVICE TO THE PROPOSED LIGHTING CONTROLLERS. THE ELECTRIC SERVICE COORDINATION PERFORMED BY THE ENGINEER DURING DESIGN IS INCLUDED IN THE PLANS FOR THE CONTRACTORS INFORMATION.
- 16. THE LIGHT POLE LOCATIONS SHALL COMPLY WITH THE MINIMUM CLEAR WIDTH FOR AN ACCESSIBLE ROUTE FOR SIDEWALKS PER CURRENT AMERICAN WITH DISABILITIES ACT (ADA) REQUIREMENTS.
- 17. PRIOR TO ANY ACTIVITY NEAR THE BP PIPELINE RIGHT-OF-WAY, MARCUS JAMERSON, BP'S DAMAGE PREVENTION SPECIALIST MUST BE CONTACTED TO LOCATE AND FLAG THE PIPELINE. MARCUS JAMERSON CAN BE REACHED AT 312-231-2609.

### IDOT GENERAL NOTE

THE CONTRACTOR SHALL CONTACT THE IDOT TRAFFIC CONTROL SUPERVISOR AT 847-705-4470, 72 HOURS IN ADVANCE OF BEGINNING WORK.

#### **DUPAGE COUNTY D.O.T. GENERAL NOTES FOR 63RD ST**

- 1. ALL CONSTRUCTION WITHIN THE COUNTY'S RIGHT-OF-WAY SHALL BE PERFORMED ACCORDING TO IDOT'S "STANDARD SPECIFICATIONS FOR ROAD AND BRIDGE CONSTRUCTION" (LATEST EDITION) AND THE "SUPPLEMENTAL SPECIFICATIONS AND RECURRING SPECIAL PROVISIONS" (LATEST EDITION).
- DAILY LANE CLOSURES ARE PERMITTED BETWEEN 9:00 AM AND 4:00 PM ONLY. TRAFFIC CONTROL SHALL CONFORM TO IDOT'S HIGHWAY STANDARDS AND THE FHWA'S "MANUAL FOR UNIFORM TRAFFIC CONTROL DEVICES" AND IDOT'S SUPPLEMENT AT ALL TIMES DURING CONSTRUCTION. TRAFFIC CONTROL SHALL INCLUDE USE OF ADVANCE WARNING LANE CLOSURE SIGNAGE, AN ARROW BOARD AND TYPE 1 BARRICADES WITH SANDBAGS.
- 3. LANE CLOSURES ARE NOT PERMITTED ON COUNTY ROADWAYS DURING SNOWFALL OR WITHIN 2 HOURS PRIOR TO PREDICTED SNOWFALL OR PRECIPITATION CONDITIONS BETWEEN NOVEMBER 15 AND APRIL 15 FOR MAINTENANCE OF ROADWAY PAVEMENT BY COUNTY HIGHWAY MAINTENANCE DEPARTMENT STAFF AND EQUIPMENT.
- 4. DISTURBED AREAS OF THE RIGHT-OF-WAY SHALL BE DRESSED WITH A MINIMUM OF 6" TOPSOIL AND CLASS 2A SALT TOLERANT SEED (WITH EROSION CONTROL BLANKET) OR SOD (SALT TOLERANT AND STAKED IN PLACE).
- 5. THE DIVISION OF TRANSPORTATION OPERATES/MAINTAINS TRAFFIC SIGNALS AND RELATED EQUIPMENT WITHIN THE VICINITY OF THE PROJECT. CONTACT THE DIVISION OF TRANSPORTATION A MINIMUM OF 48 HOURS PRIOR TO THE START OF CONSTRUCTION WITHIN THE COUNTY'S RIGHT-OF-WAY AND WITHIN 300' OF ANY COUNTY MAINTAINED SIGNAL TO LOCATE SAID EQUIPMENT. TRAFFIC SIGNALS AND RELATED EQUIPMENT ARE NOT ON THE JULIE SYSTEM.
- 6. EROSION CONTROL MEASURES SHALL COMPLY WITH THE MINIMUM REQUIREMENTS OF THE DUPAGE COUNTY STORMWATER AND FLOODPLAIN ORDINANCE SPECIFICATIONS AT ALL TIMES.
- 7. EQUIPMENT AND MATERIALS SHALL NOT BE STORED WITHIN THE COUNTY'S RIGHT-OF-WAY AT ANY TIME WITHOUT THE EXPRESS WRITTEN PERMISSION OF THE COUNTY'S ENGINEER, OR HIS DULY AUTHORIZED ASSIGN.
- 8. PAVEMENT, CURB/GUTTER AND STORM STRUCTURES WITHIN THE COUNTY'S RIGHT-OF-WAY SHALL BE MAINTAINED FREE OF MUD/DEBRIS AT ALL TIMES AND SHALL BE CLEANED AS REQUIRED AND/OR AS DIRECTED BY DUPAGE COUNTY.
- CONTACT DUPAGE COUNTY (630/407-6900) A MINIMUM OF 48 HOURS PRIOR TO THE START OF CONSTRUCTION TO ARRANGE FOR INSPECTIONS OF AND AT THE COMPLETION OF THE DESCRIBED WORK WITHIN THE COUNTY'S RIGHT-OF-WAY.
- 10. TRENCH BACKFILL FOR NON-PAVED AREAS SHALL BE INSTALLED WITHIN THE COUNTY'S RIGHT-OF-WAY PER DUPAGE COUNTY'S STANDARD.
- 11. TRENCH BACKFILL BELOW EXISTING OR PROPOSED PAVEMENT, CURB/GUTTER AND/OR SIDEWALK SHALL BE INSTALLED WITHIN THE COUNTY'S RIGHT-OF-WAY PER DUPAGE COUNTY'S STANDARD.

#### CAUTION NOTICE TO CONTRACTOR

THE CONTRACTOR IS SPECIFICALLY CAUTIONED THE LOCATION AND/OR ELEVATION OF EXISTING AND PROPOSED UTILITIES AS SHOWN ON THESE PLANS. THE INFORMATION IS NOT TO BE RELIED ON AS BEING EXACT OR COMPLETE. UNDERGROUND PETROLEUM LINES EXISTING ALONG THE EAST AND WEST SIDE OF IL RT 83. THE CONTRACTOR MUST CALL THE LOCAL UTILITY LOCATION CENTER AT LEAST 72 HOURS BEFORE ANY EXCAVATION TO REQUEST EXACT FIELD LOCATIONS OF THE UTILITIES. IT SHALL BE THE RESPONSIBILITY OF THE CONTRACTOR TO INFORM ENGINEER OF ANY EXISTING UTILITIES WHICH CONFLICT WITH THE PROPOSED IMPROVEMENTS.

FILE NAME =	USER NAME = dkerr	DESIGNED - GAH	REVISED -		INDEX OF SHEETS & GENERAL NOTES	F.A.P. SECTION	COUNTY TOTAL SHEET
N:\WILLOWBROOK\150687\Mech\II	INDEX_150687.sht	DRAWN - LRR	REVISED -	STATE OF ILLINOIS	IL RT 83 & 63RD ST	0344 16-00023-00-LT	DUPAGE 17 2
	PLOT SCALE = 20'	CHECKED - AJD	REVISED -	DEPARTMENT OF TRANSPORTATION	, IL NI OO Q DOND OI		CONTRACT NO. 61D67
Default	PLOT DATE = 12/21/2016	DATE - 10/13/2016	REVISED -		SCALE: N.T.S.   SHEET 1 OF 1 SHEETS   STA TO STA	THE INOIS FED.	ATD PROJECT


				CONSTRUCTION TYPE CODE	CONSTRUCTION TYPE CODE				CONSTRUCTION TYPE CODE	CONSTRUCTION TYPE CODE
				0021	0042		·		0021	0042
CODE NO.		ITEM	UNIT	TOTAL QUANTITY	TOTAL QUANTITY	CODE NO.	ITEM	UNIT	TOTAL QUANTITY	TOTAL QUANTITY
20800150 T	TRENCH BACKFILL		CU YD	5		70102630	TRAFFIC CONTROL AND PROTECTION, STANDARD 701601	LSUM	1	
21101625	TOPSOIL FURNISH AND PLACE, 6"		SQ YD	10		70102635	TRAFFIC CONTROL AND PROTECTION, STANDARD 701701	LSUM	1	-
25000210 S	SEEDING, CLASS 2A		ACRE	0.25		70102640	TRAFFIC CONTROL AND PROTECTION, STANDARD 701801	LSUM	1	
25000400 N	NITROGEN FERTILIZER NUTRIENT		POUND	1	****	80400100	ELECTRIC SERVICE INSTALLATION	EACH	1	
25000500 F	PHOSPHORUS FERTILIZER NUTRIENT		POUND	1	-	* 80400200	ELECTRIC UTILITY SERVICE CONNECTION	LSUM	1	***
25000600 F	POTASSIUM FERTILIZER NUTRIENT		POUND	1		81028200	UNDERGROUND CONDUIT, GALVANIZED STEEL, 2" DIA.	FOOT	40	
25100630 F	EROSION CONTROL BLANKET		SQ YD	10		81028210	UNDERGROUND CONDUIT, GALVANIZED STEEL, 2 1/2" DIA.	FOOT	310	
* 42400200 F	PORTLAND CEMENT CONCRETE SIDEWALK 5 INCH		SQ FT	200		81028240	UNDERGROUND CONDUIT, GALVANIZED STEEL, 4" DIA.	FOOT	490	_
* 44000600 5	SIDEWALK REMOVAL		SQ FT	200		81028730	UNDERGROUND CONDUIT, COILABLE NONMETALLIC CONDUIT, 1 1/4" DIA.	, FOOT	7750	
* 44200970 (	CLASS B PATCHES, TYPE II, 10 INCH		SQ YD	40	**************************************	81400730	HANDHOLE, COMPOSITE CONCRETE	EACH	5	
* 44201294 (	CLASS B PATCH - EXPANSION JOINT		FOOT	120	-	81702120	ELECTRIC CABLE IN CONDUIT, 600V (XLP-TYPE USE) 1/C NO. 8	FOOT	38370	
* 44201299 [	DOWEL BARS 1 1/2"		EACH	100		81702150	ELECTRIC CABLE IN CONDUIT, 600V (XLP-TYPE USE) 1/C NO. 2	FOOT	170	
* 66900200 N	NON-SPECIAL WASTE DISPOSAL		CU YD	5		82500335	LIGHTING CONTROLLER, PEDESTAL MOUNTED, 240VOLT, 100AMP	EACH	1	_
* 66900450 S	SPECIAL WASTE PLANS AND REPORTS		LSUM	1	•	83050810	LIGHT POLE, ALUMINUM, 47.5 FT. M.H., 15 FT. MAST ARM	EACH	38	
* 66900530 5	SOIL DISPOSAL ANALYSIS		EACH	1	- Anaer	83050910	LIGHT POLE, ALUMINUM, 47.5 FT. M.H., 2-15 FT. MAST ARMS	EACH	4	- Alan
* SPECIALT  FILE NAME = N:\WILLOWBROOK\150687\Me	USER NAME = dkerr	LRR RE	REVISED – REVISED – REVISED –	Di	STATE OF IL	LINOIS	SUMMARY OF QUANTITIES (1 OF 2) IL RT 83 & 63RD ST	F.A.P. RTE. 0344	SECTION 16-00023-00-LT	COUNTY TOTAL SHE SHEETS N DUPAGE 17 3

ILLINOIS FED. AID PROJECT


			TYPE CODE	CONSTRUCTION TYPE CODE
			0021	0042
CODE NO.	ITEM	UNIT	TOTAL QUANTITY	TOTAL QUANTITY
33600365	LIGHT POLE FOUNDATION, METAL, 15" BOLT CIRCLE, 10" X 8'	EACH	42	
33800205	BREAKAWAY DEVICE, TRANSFORMER BASE, 15 INCH BOLT CIRCLE	EACH	42	
<1400113	LUMINAIRE, LED, HORIZONTAL MOUNT, MEDIUM WATTAGE	EACH	46	
20033020	LUMINAIRE SAFETY CABLE ASSEMBLY	EACH	46	
20076600	TRAINEES	HOUR		500
20076604	TRAINEES TRAINING PROGRAM GRADUATE	HOUR		500
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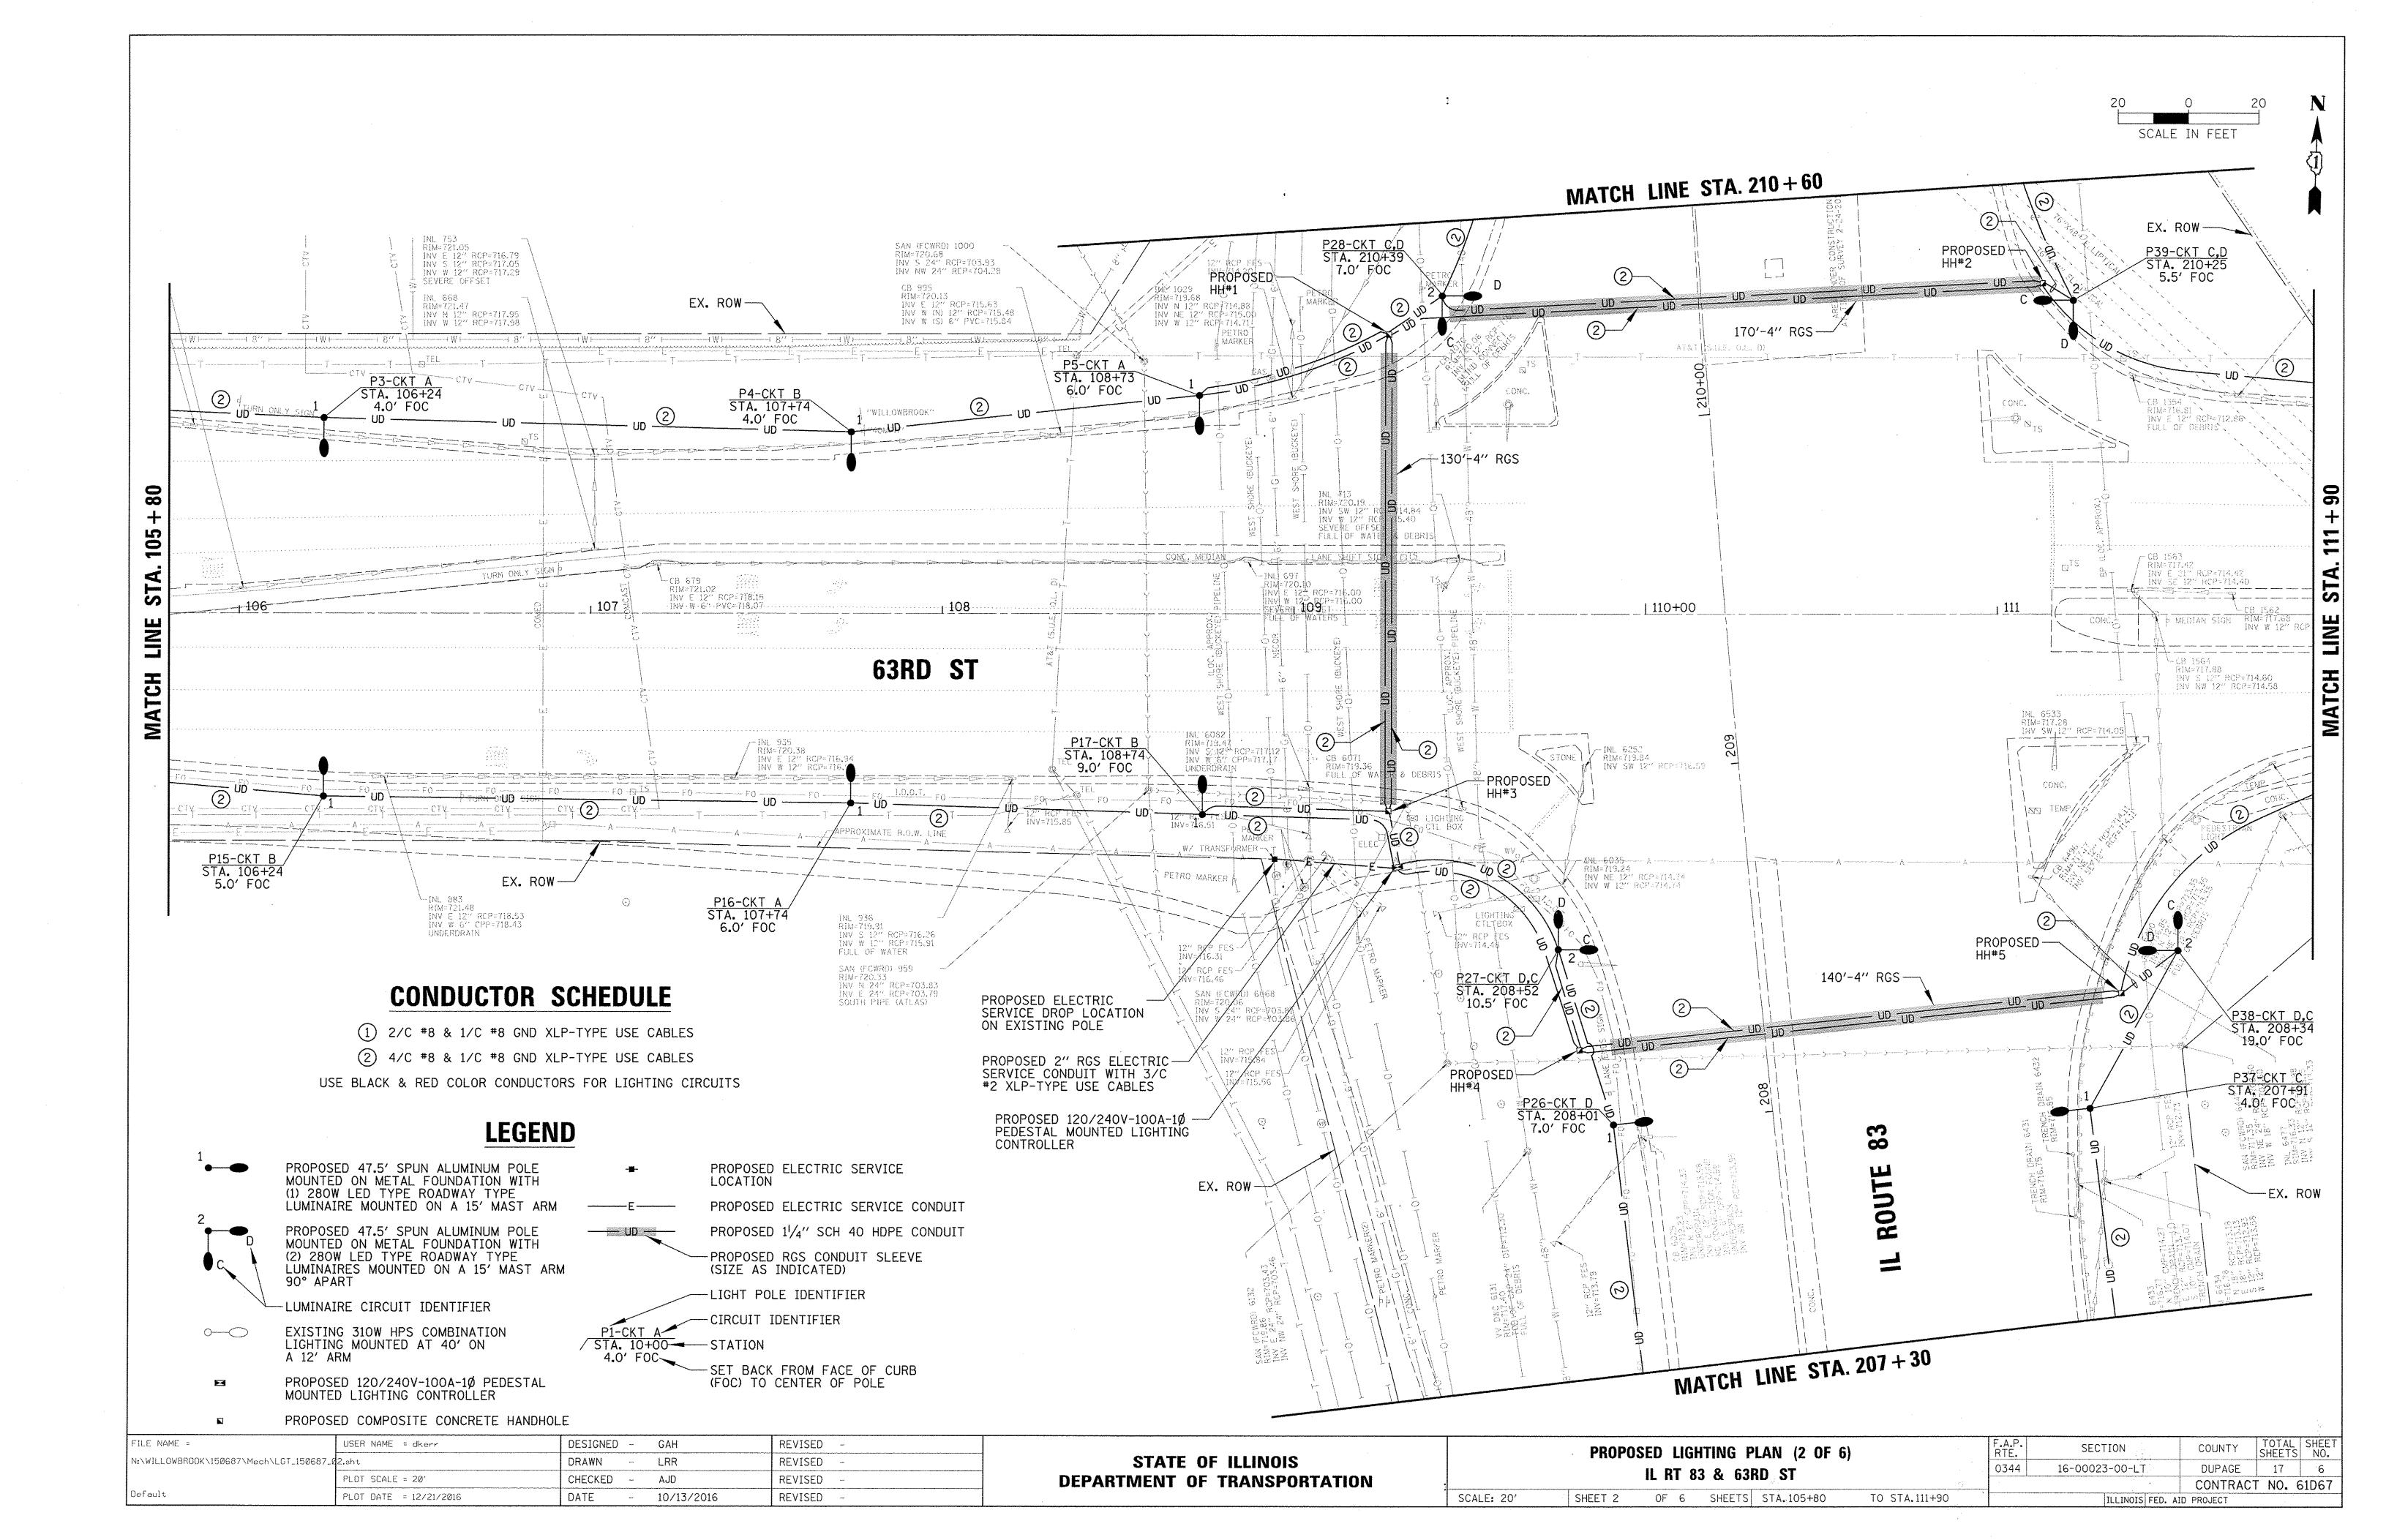
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Default	PLOT DATE = 1/4/2017	DATE	_	10/13/2016	REVISED -


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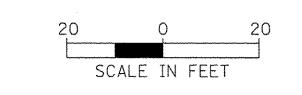


WILLOWBROOK SQUARE CENTRE

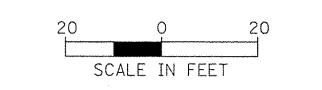




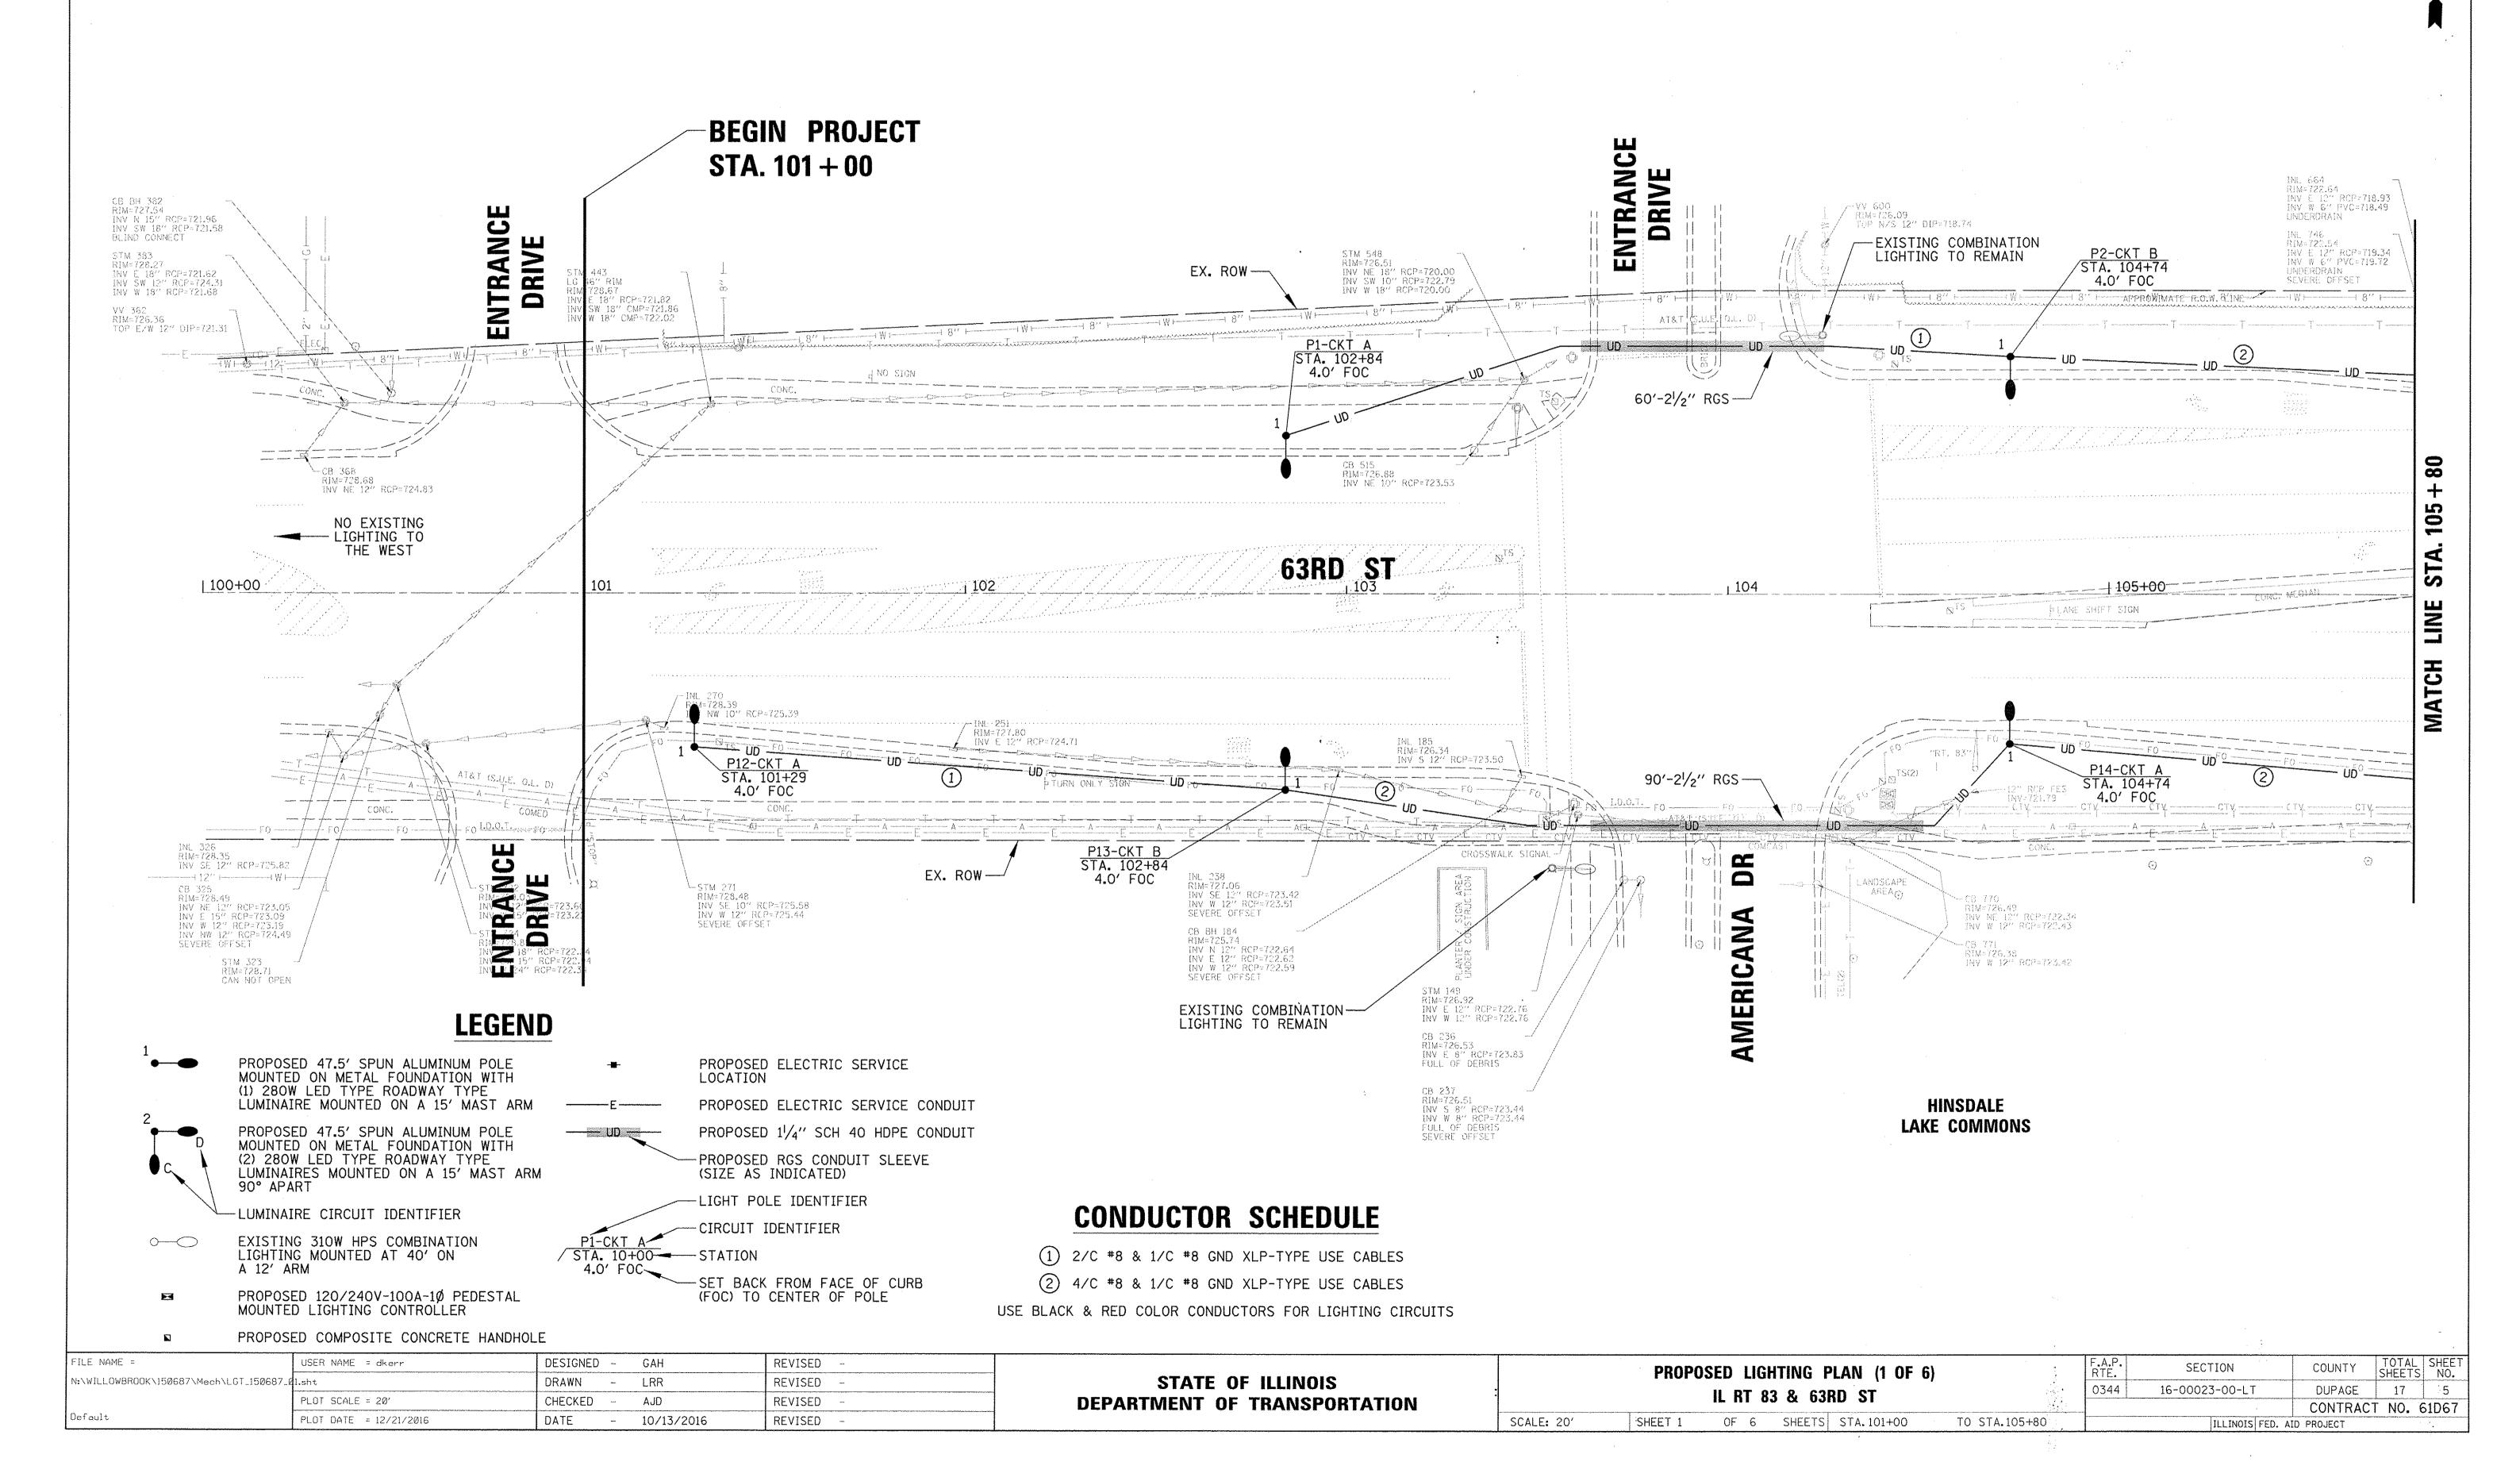


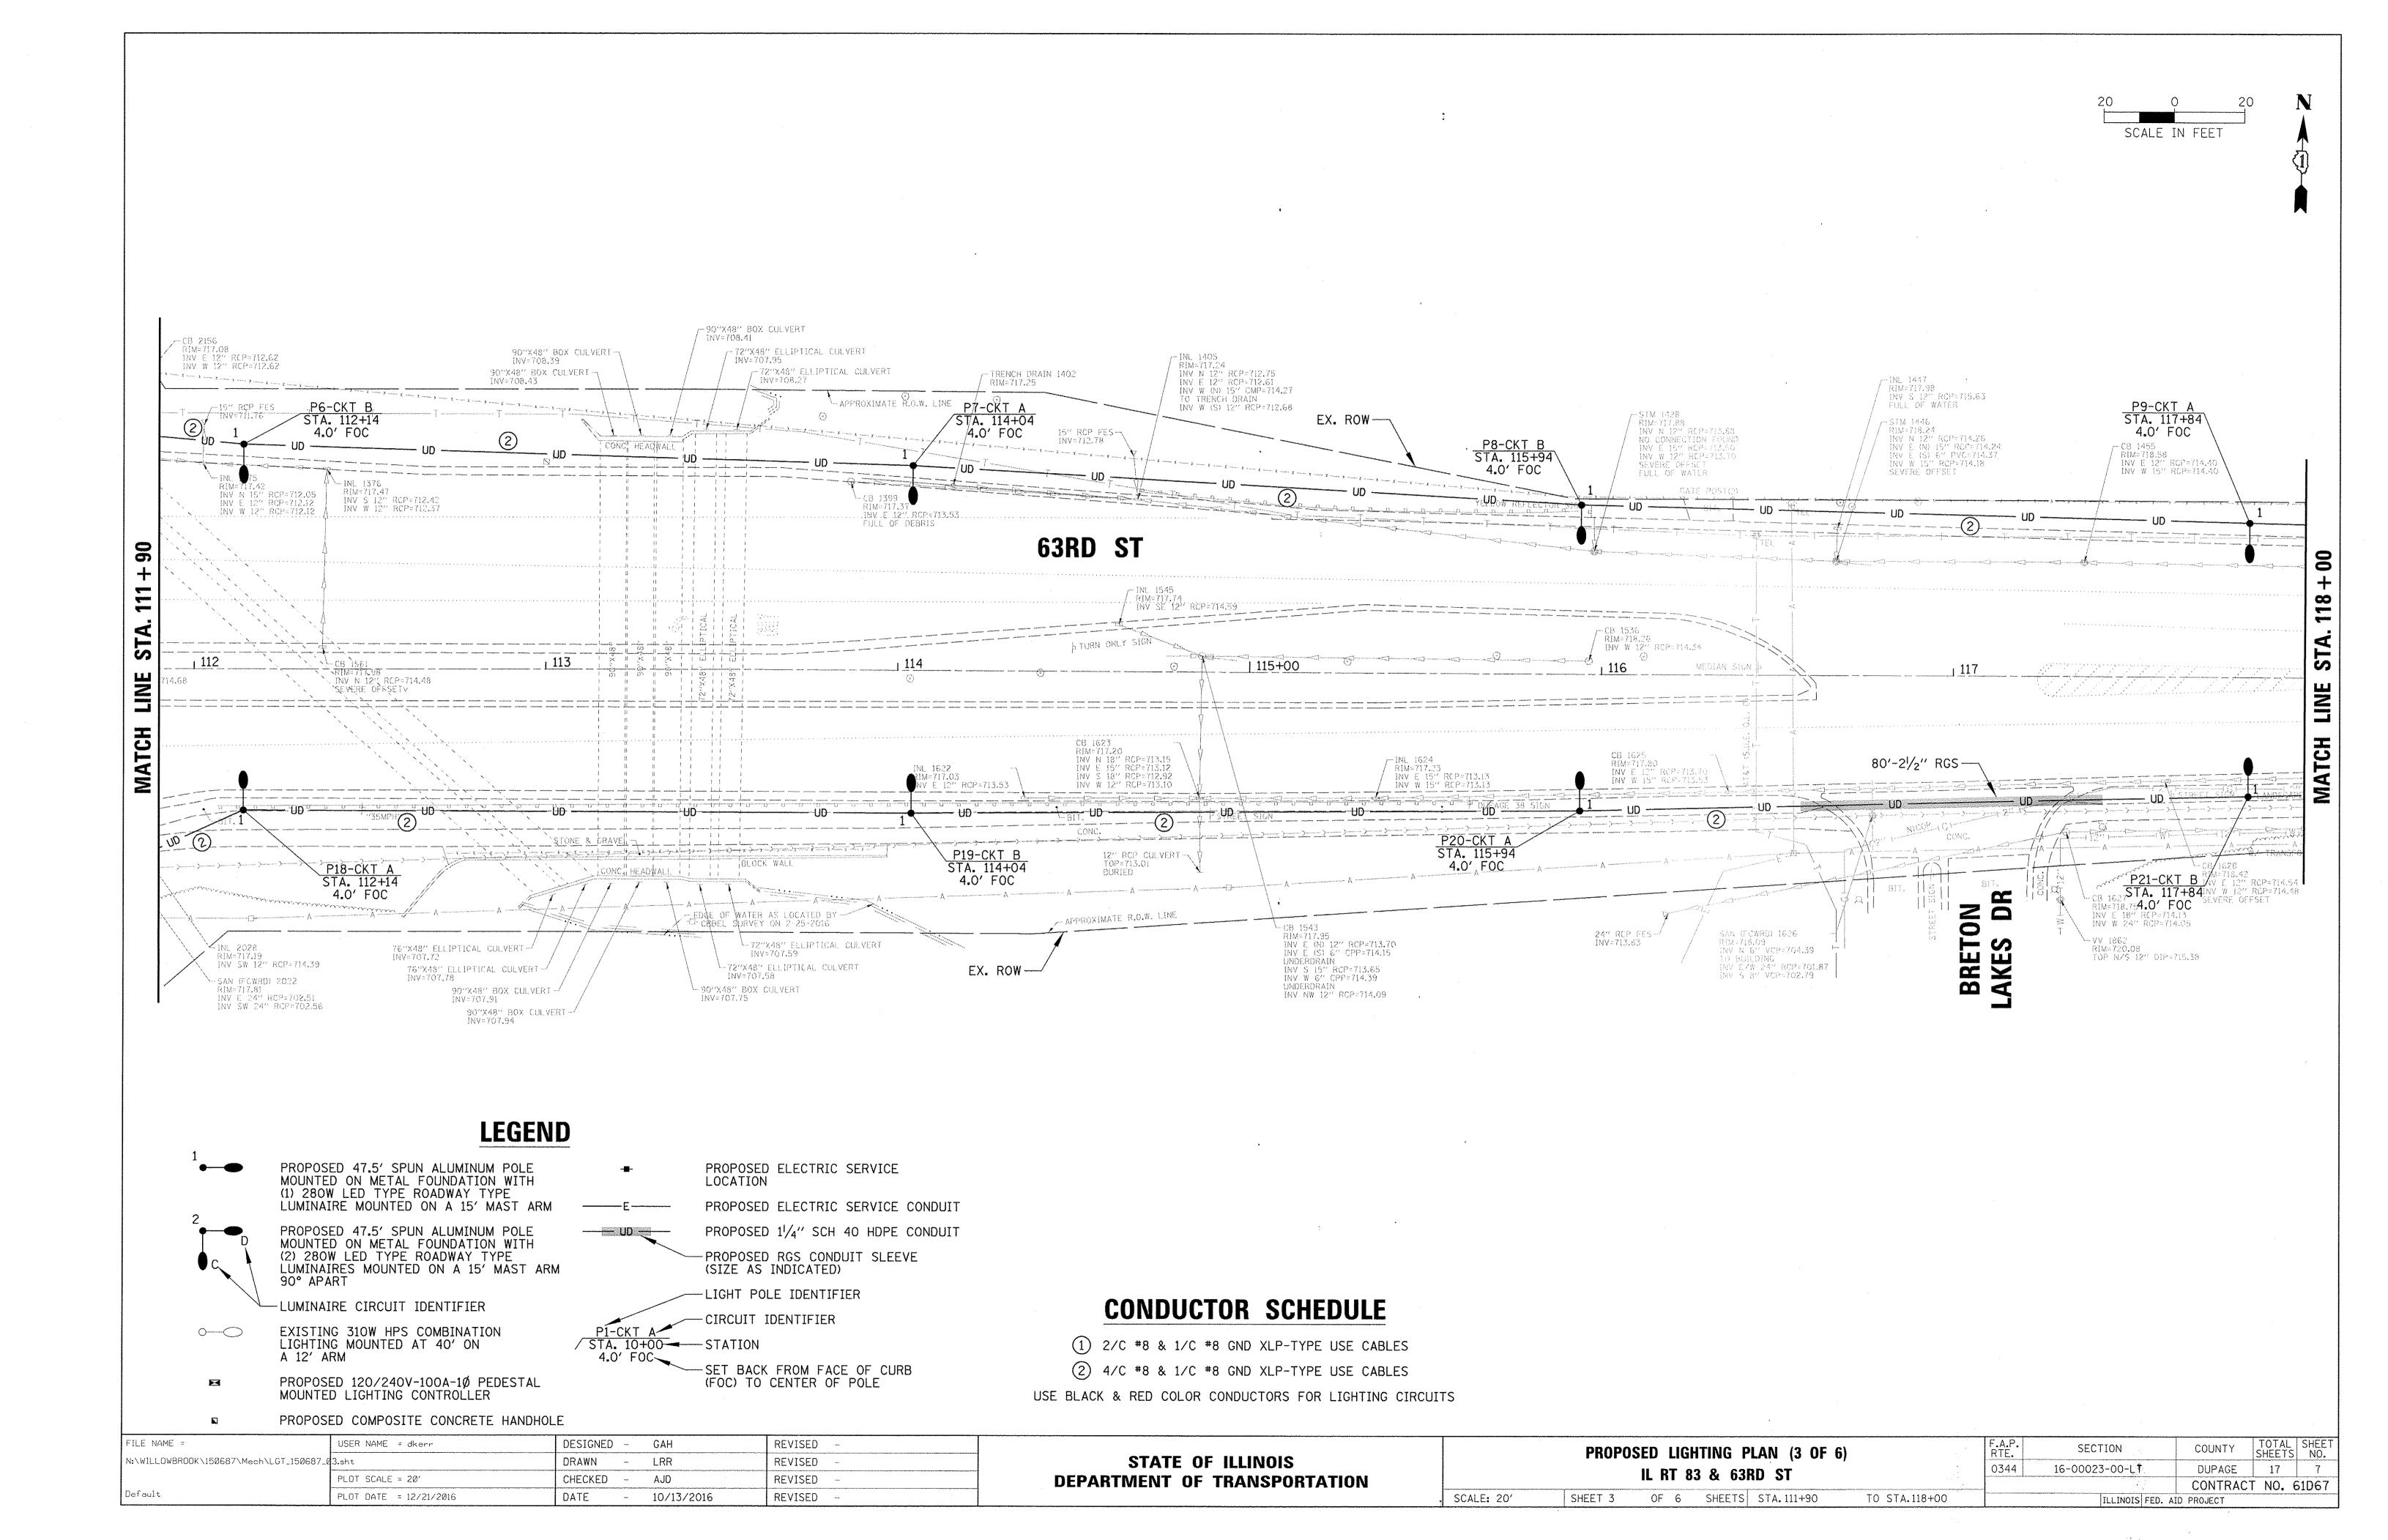



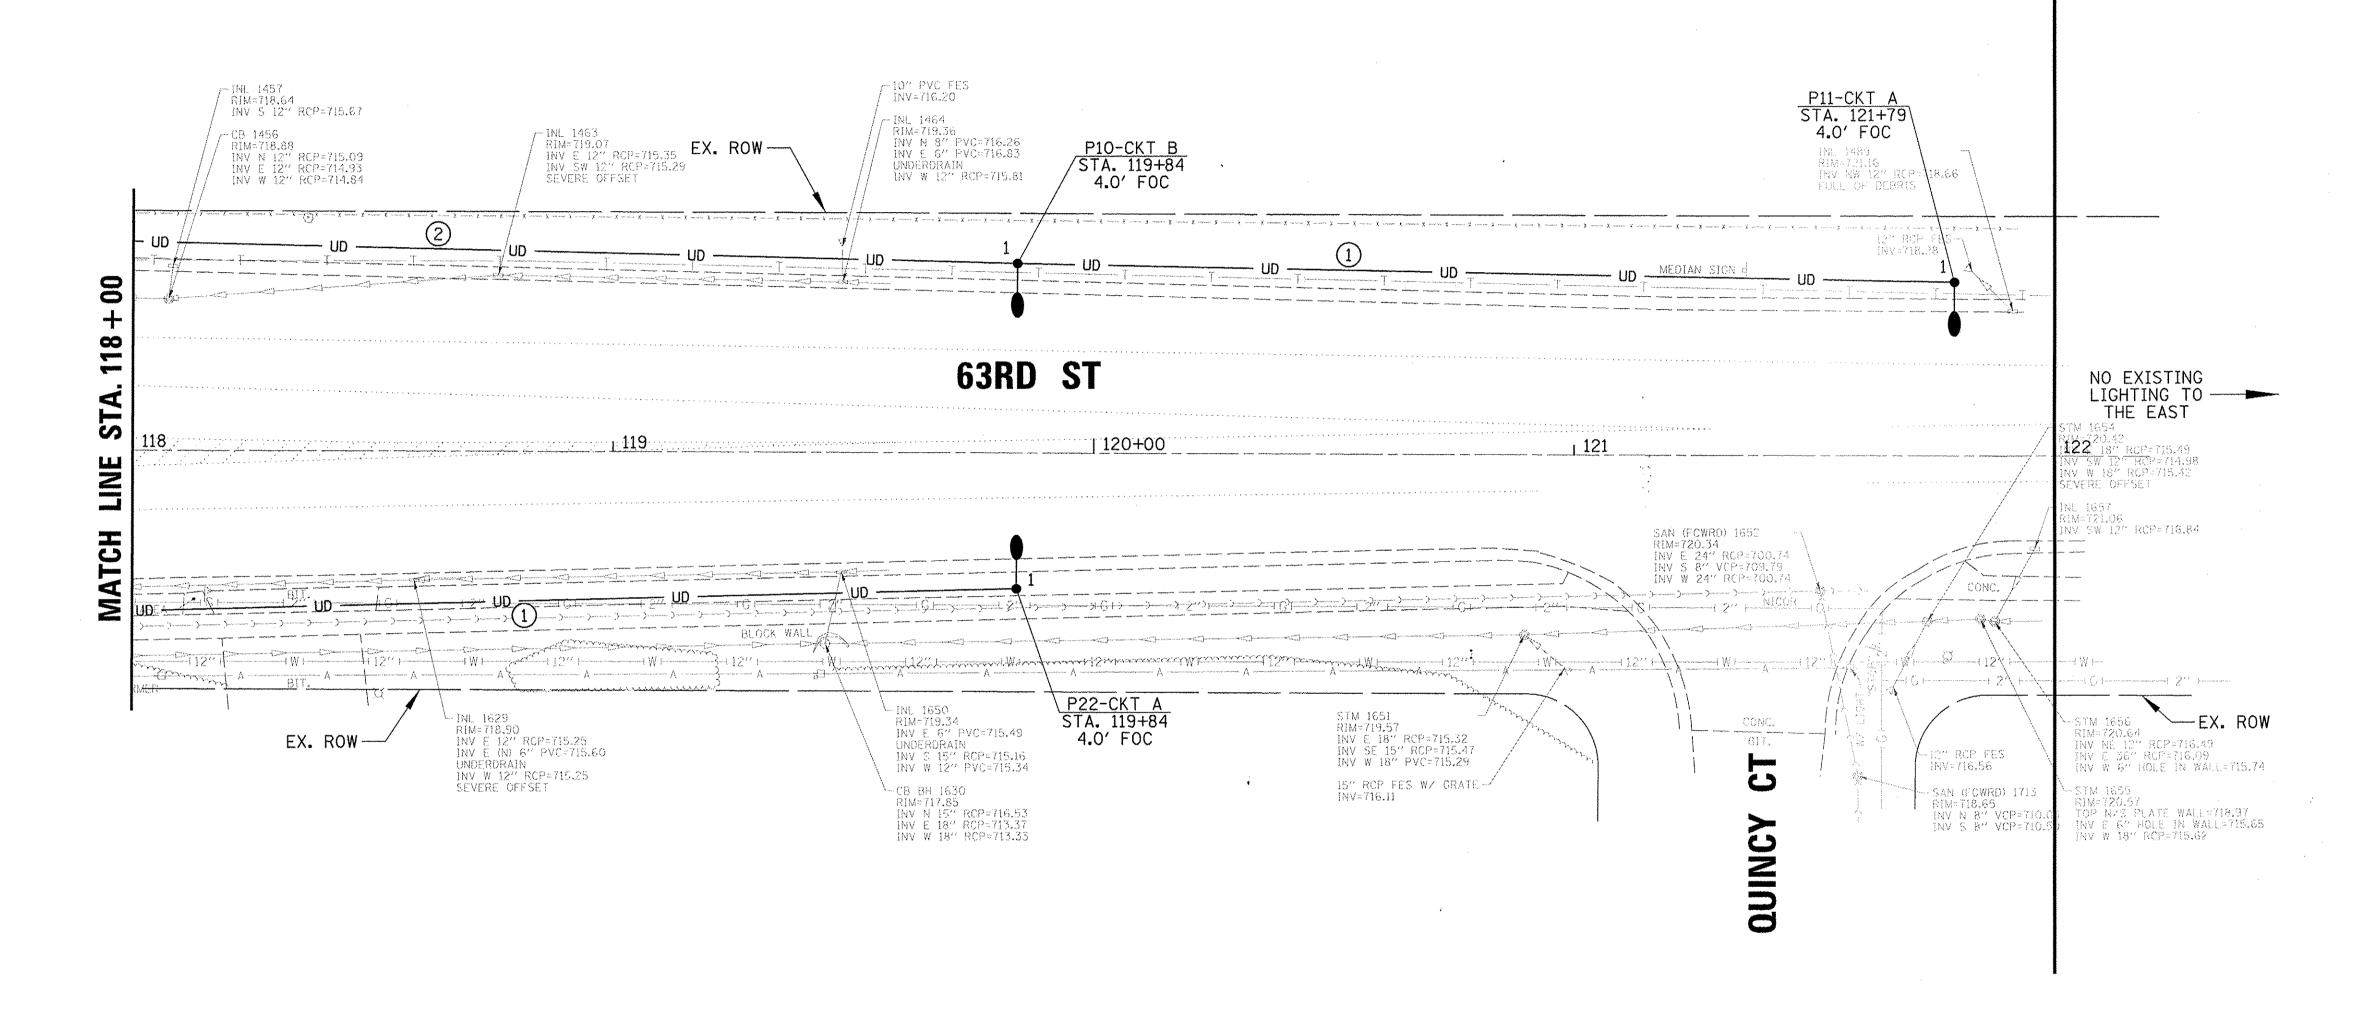

## **LEGEND**

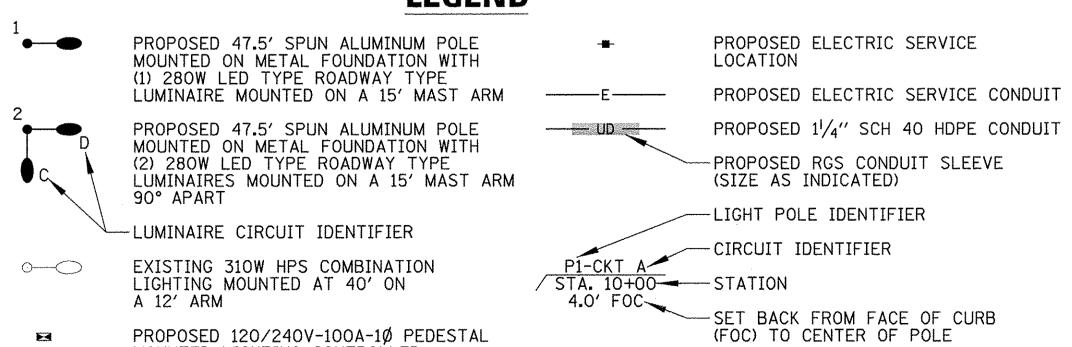

## CONDUCTOR SCHEDULE


- 1 2/C #8 & 1/C #8 GND XLP-TYPE USE CABLES
- 2 4/C #8 & 1/C #8 GND XLP-TYPE USE CABLES


MOUNTED LIGHTING CONTROLLER

PROPOSED COMPOSITE CONCRETE HANDHOLE

OUSE BLACK & RED COLOR CONDUCTORS FOR LIGHTING CIRCUITS

FILE NAME =	USER NAME = dkerr	DESIGNED - GAH	REVISED -		PROPOSED LIGHTING PLAN (4 OF 6)	F.A.P. SECTION	COUNTY TOTAL SHEET SHEETS NO.
N:\WILLOWBROOK\150687\Mech\LGT_150687_	4.sht	DRAWN - LRR	REVISED -	STATE OF ILLINOIS	IL RT 83 & 63RD ST	0344 16-00023-00-ĹT	DUPAGE 17 8
	PLOT SCALE = 20'	CHECKED - AJD	REVISED -	DEPARTMENT OF TRANSPORTATION	IL NI 03 & USND SI		CONTRACT NO. 61D67
Default	PLOT DATE = 12/21/2016	DATE - 10/13/2016	REVISED -		SCALE: 20' SHEET 4 OF 6 SHEETS STA.118+00 TO STA.122+00	ILLINÓIS FED. A	ID PROJECT

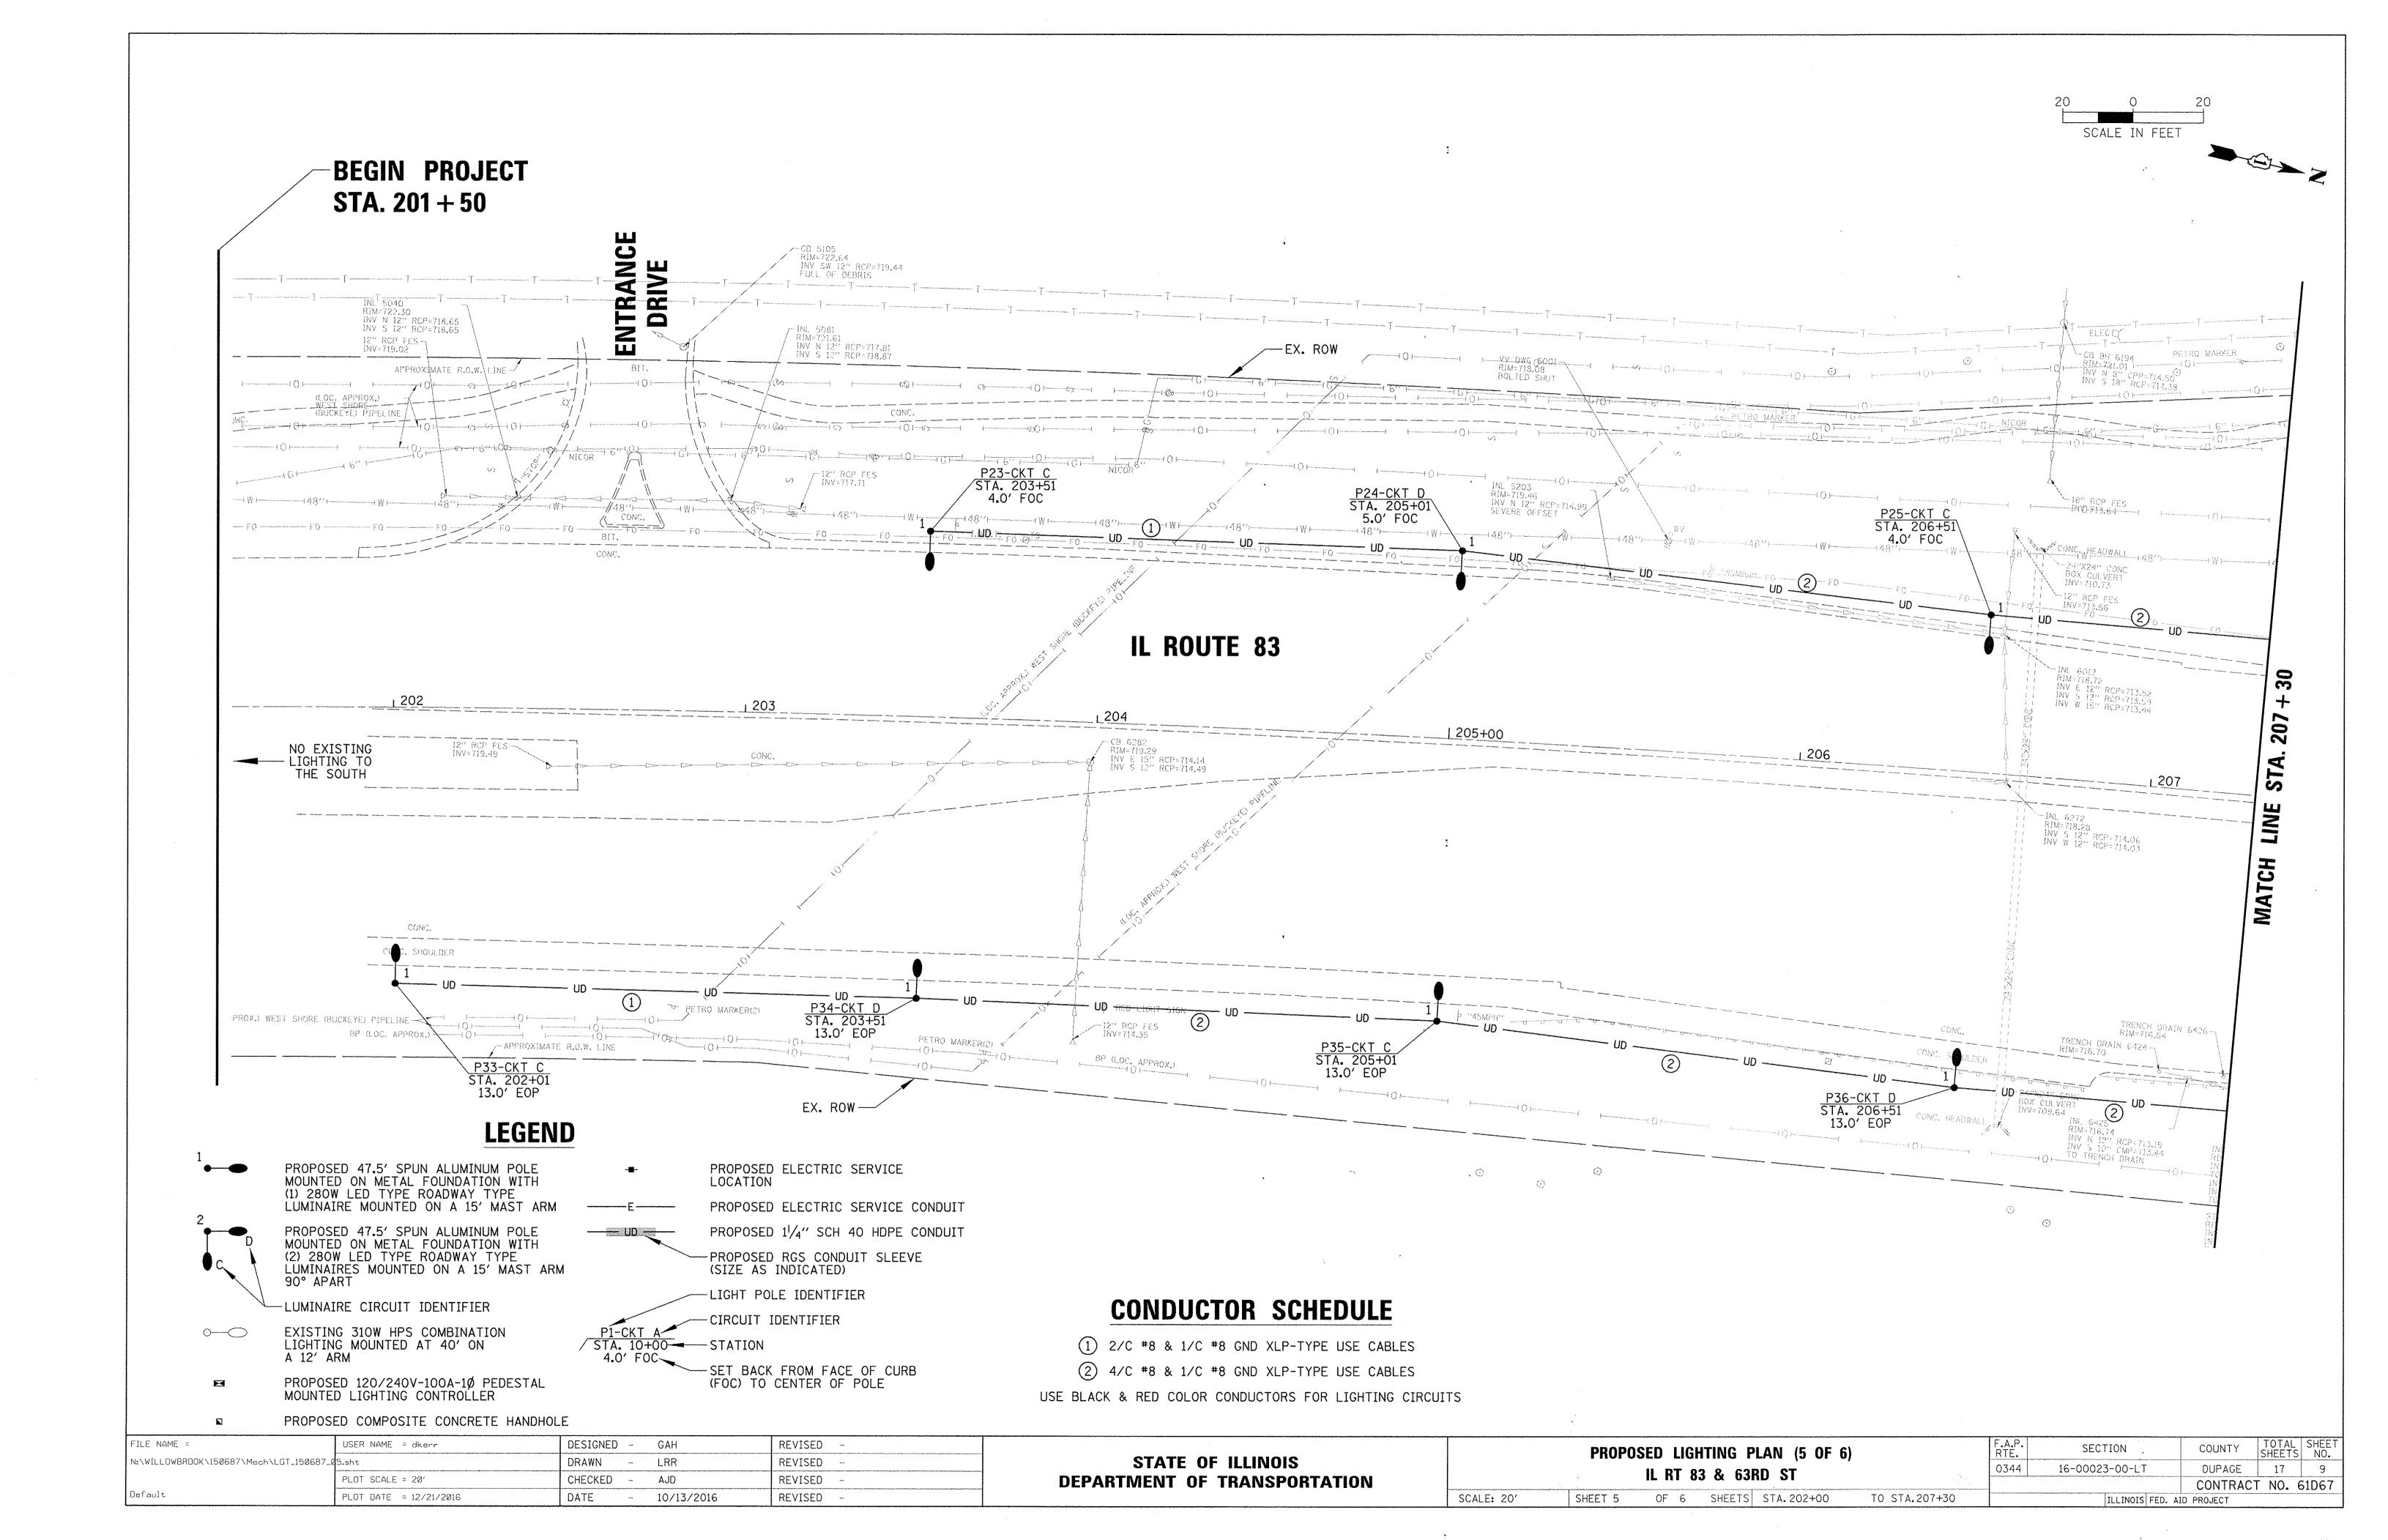

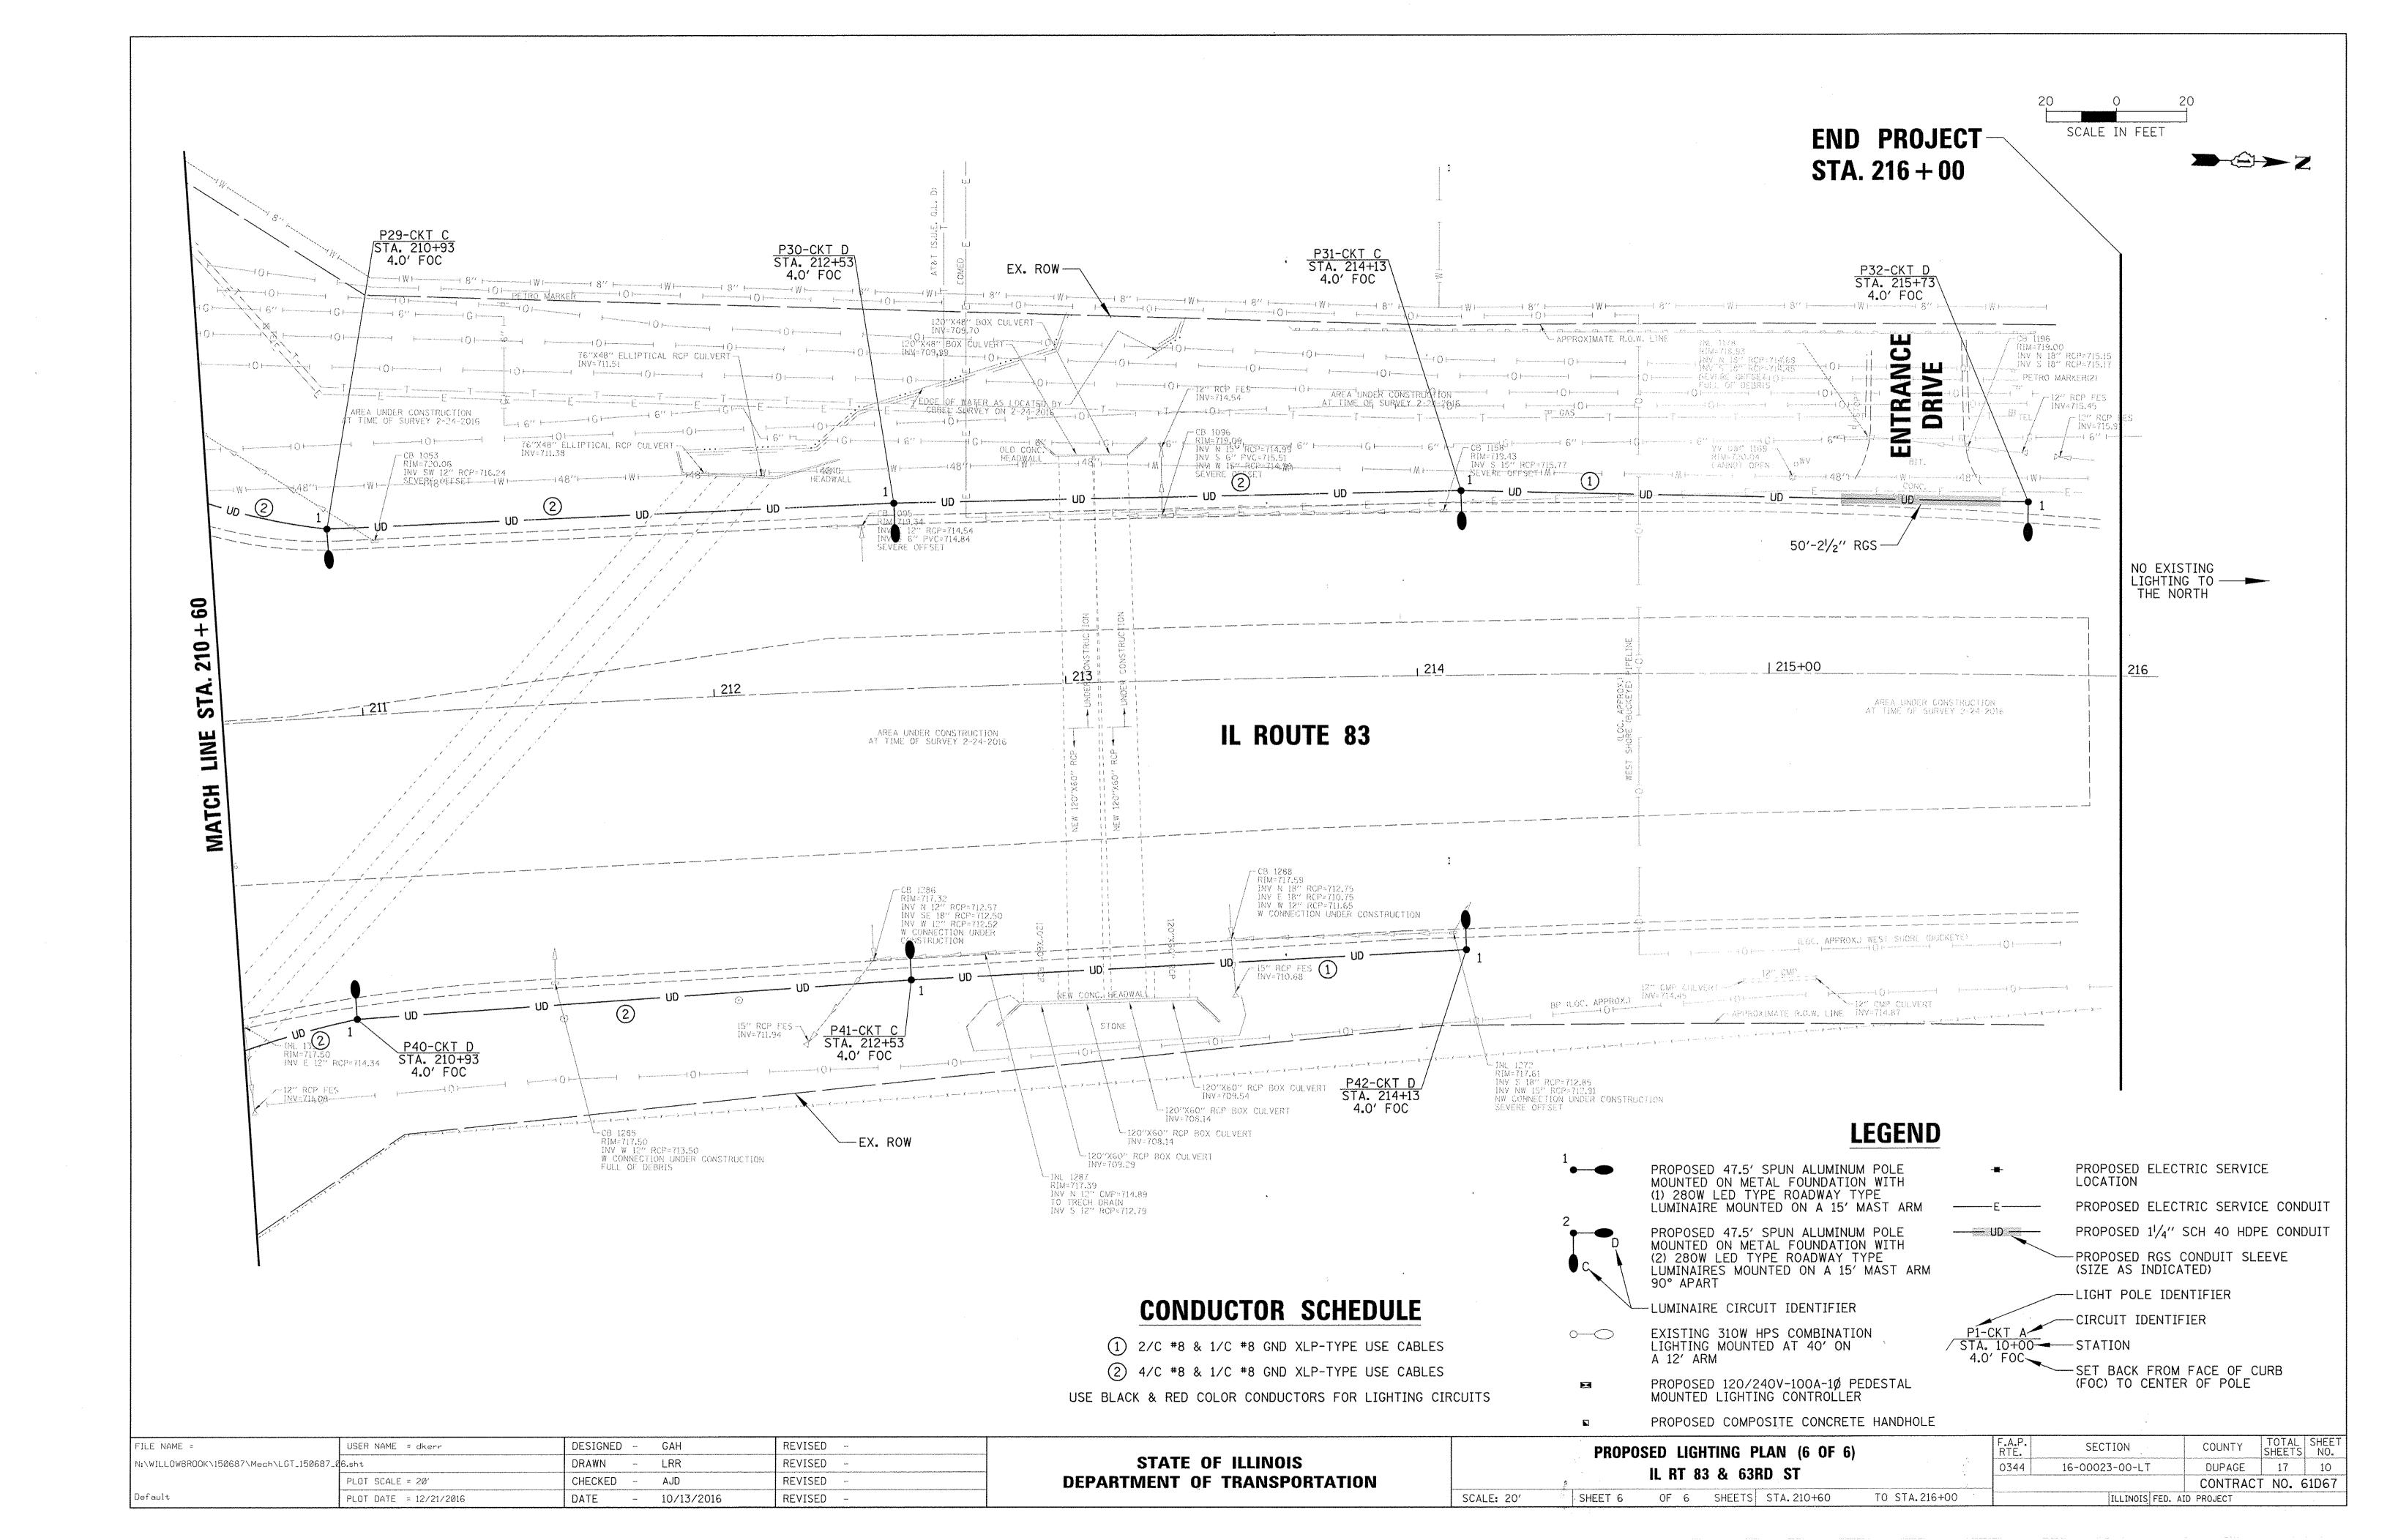

LIGHTING CONTROLLER								
CIRCUIT ID	I .	280W LED LUMINAIRE	TOTAL CIRCUIT LOAD					
CINCUIT ID	QTY.	LOAD/FIXT. (WATTS)	(WATTS)	AMPS (VOLTS)				
Α	12	280 W	3,360 W	14.0A (240V)				
В	10	280 W	2,800 W	11.7A (240V)				
С	12	280 W	3,360 W	14.0A (240V)				
D	12	280 W	3,360 W	14.0A (240V)				
TOTAL	46	N/A	12,880 W	53.7A (240V)				


## PROPOSED ELECTRICAL CIRCUIT LOADS

	CDEOTETO LETON				
ITEM	SPECIFICATION				
(1) MAIN CIRCUIT BREAKER	100 AMPERE, 2P, 240V SERVICE RATING, 10KAIC				
2 LAMPHOLDER CIRCUIT BREAKER	20 AMPERE, 1P, 120V RATING, 10KAIC				
PHOTOELECTRIC CONTROL     CIRCUIT BREAKER	15 AMPERE, 1P, 120V RATING, 10KAIC				
4 AUXILIARY RELAY	120 V OPERATED DPDT 60 HZ COIL 2 NO & 2 NC CONTACTS				
5 CABINET RECEPTACLE AND BOX	COMMERCIAL GRADE GFCI 20A/12OV, MOUNTED IN A WEATHERPROOF CAST ALUMINUM SINGLE GANG BOX WITH WEATHERPROOF COVER				
6 CABINET LIGHT	5 WATT LED STRIP LIGHT, 60K HOUR RATING, 65K COLOR TEMPERATURE, DOOR SWITCH CONTROLLED, FASTENED TO TOP OF CABINET				
7 CONTACTOR	100 AMPERE, 2P, 120V COIL, MECHANICALLY HELD				
8 BRANCH LINE CIRCUIT BREAKERS	(5) 30A, 2P, 240V RATING, 10KAIC				
POWER DISTRIBUTION BLOCK	600 VOLT, INSULATED, SIZE AS REQ'D, 10KAIC				
10 SERVICE CABLES	3-600V (XLP-TYPE USE) NO. #2				
11) LAMPHOLDER WIRE	2-600V XLP NO. 12				
(12) CONTROL WIRE	2-600V XLP NO. 12				
(13) SURGE ARRESTOR	10 K AMPERE RATING				
(14) PHOTOELECTRIC CONTROL WIRE	3-600V XLP NO. 12				
(15) DOOR SWITCH	20A/120V, DOOR MOUNTED SNAP ACTION TYPE PLUNGER SWITCH				
(16) HAND-AUTO-OFF CONTROL SWITCH	20A, 3 POS. MTD IN CAST ALUM. ENCLOSURE				
17 PHOTOCELL	120V, MTD. ON CABINET, DELAY TYPE, SPST-NC				
(18) TERMINAL BLOCK	3 TERMINAL, SCREW TYPE, MAX. #10 WIRE SIZE				
(19) CIRCUIT BREAKER DIST. BLOCKS	30A, 600V, 10 KAIC - WIRE RANGE: LINE SIDE LUG (1) #2/0-#14 AWG, LOAD SIDE LUGS (2) #4-#14 AWG				

#### NOTES:


- 1. ALL ITEMS LISTED IN LIGHTING CONTROLLER COMPONENT SCHEDULE SHALL BE CONSIDERED INCIDENTAL TO THE PRICE BID FOR "LIGHTING CONTROLLER, PEDESTAL MOUNTED, 240 VOLT, 100 AMP" INCLUDING CABINET AND FOUNDATION.
- 2. THE LIGHTING CONTROLLER TOGETHER WITH ALL OF ITS COMPONENTS SHALL BE UL LISTED AS AN "ENCLOSED INDUSTRIAL CONTROL PANEL" UNDER UL508A.
- 3. CONNECTION OF SURGE ARRESTOR TO LINE SIDE OF MAIN CIRCUIT BREAKER SHALL NOT BE "DOUBLE LUGGED."
- 4. THE MAIN CIRCUIT BREAKER SHALL BE LABELED "SERVICE DISCONNECT".
- 5. ALL SWITCHES AND CONTROLS SHALL BE IDENTIFIED USING TWO COLOR ENGRAVED NAMEPLATES.
- 6. THE PANEL MANUFACTURER SHALL LABEL THE CABINET WITH THE APPROPRIATE ARC FLASH WARNING AND PERSONNEL PROTECTION EQUIPMENT REQUIRED FOR SERVICING.
- 7. IN ADDITION TO REQUIRED LABELING, THIS CIRCUIT BREAKER SHALL BE LABELED "SERVICE DISCONNECT", INSTALL RED WARNING PLATE NEXT TO MAIN BREAKER INDICATING "CAUTION LIVE CIRCUITS EVEN WHEN MAIN CIRCUIT BREAKER IS IN THE OFF POSITION".
- 8. ALL EXPOSED BUS BARS SHALL BE INSULATED.
- 9. ALL WIRING SHALL BE COPPER.

## LIGHTING CONTROLLER COMPONENT SCHEDULE

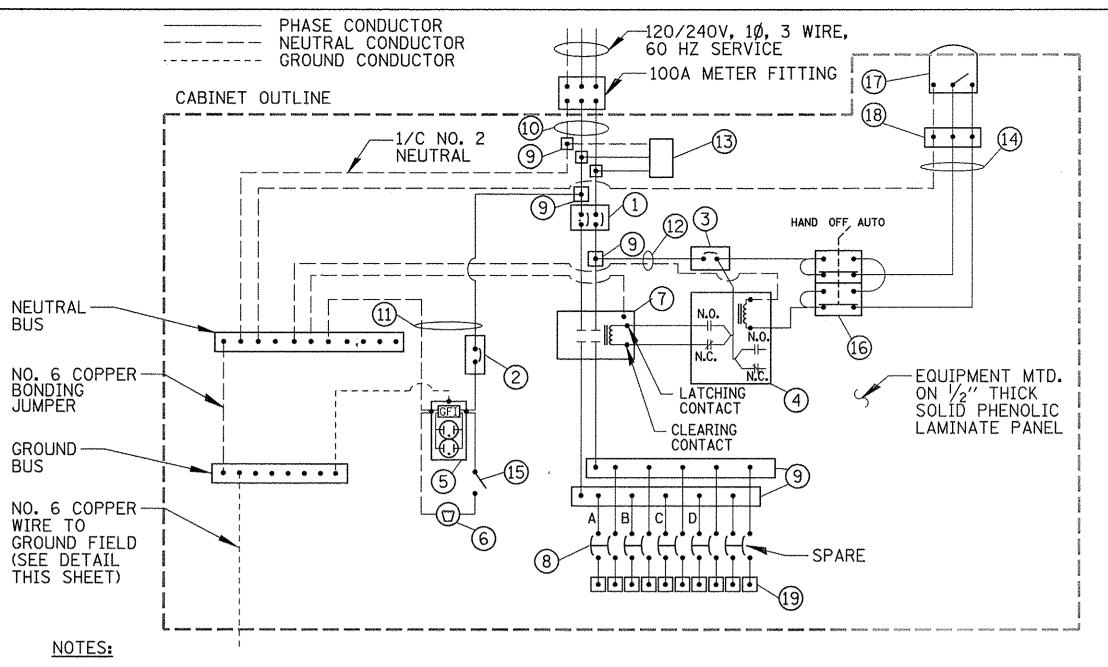


- 1. ALL GROUND CONDUCTORS SHALL BE GREEN AND NEUTRAL CONDUCTORS SHALL BE WHITE. PHASE CONDUCTORS SHALL BE COLOR CODED IN ACCORDANCE WITH SECTION 1066.02 OF THE STANDARD SPECIFICATIONS. CONTRACTOR SHALL ONLY USE SOLID COLOR CODED INSULATIONS. COLOR STRIPPING OF PHASE CONDUCTORS SHALL NOT BE ALLOWED.
- 2. IN ADDITION TO THE TERMINATIONS SHOWN, THE NEUTRAL AND GROUND BUS BARS SHALL EACH ACCOMMODATE A MINIMUM OF 8 ADDITIONAL TERMINATIONS (#2-#14).

## LIGHTING CONTROLLER WIRING DETAIL N.T.S.

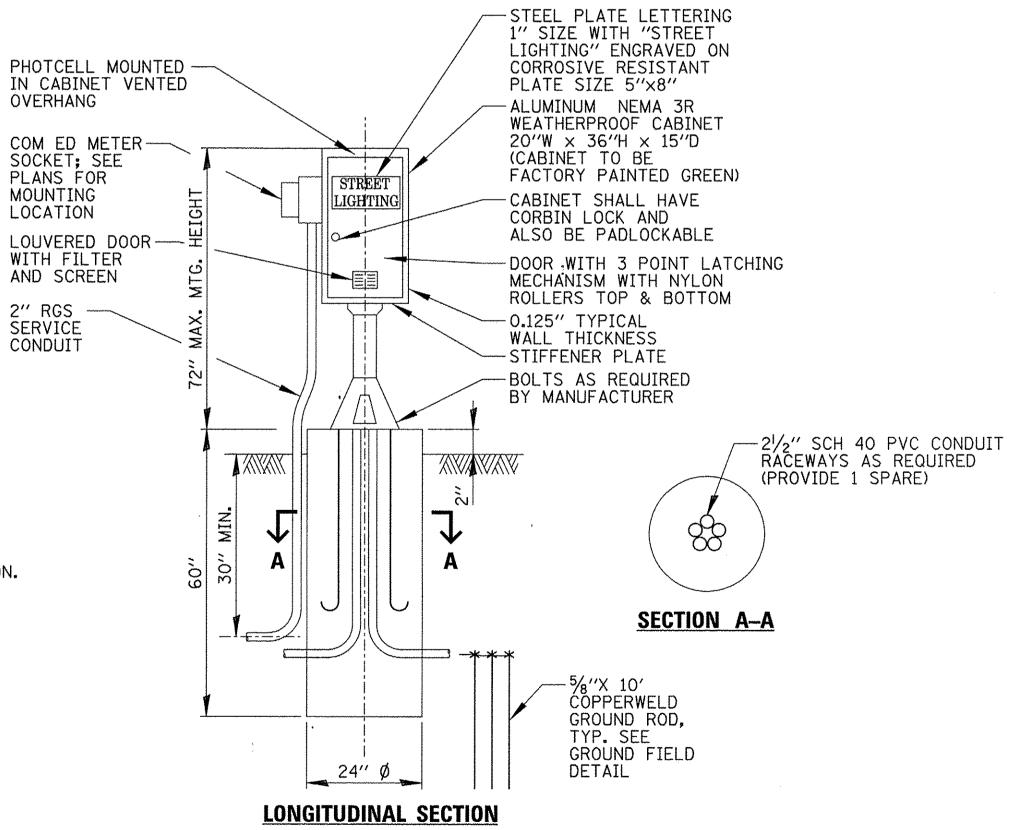


NOTE:
ALL ITEMS SHOWN ABOVE INCLUDING FOUNDATION SHALL BE INCLUDED
IN THE LIGHTING CONTROLLER PAY ITEM EXCEPT FOR THE SERVICE
CONDUIT/CABLES.

## LIGHTING CONTROLLER CABINET & FOUNDATION

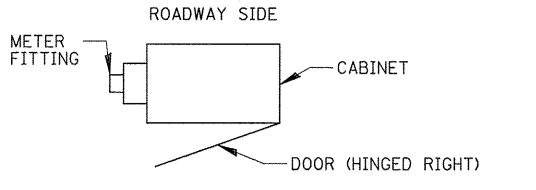


# **CABINET METER FITTING & DOOR ORIENTATION**

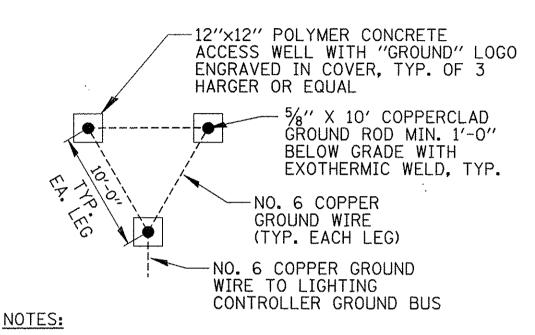

1. ACCESS WELLS SHALL BE INCLUDED IN THE LIGHTING CONTROLLER PAY ITEM.

## GROUND FIELD DETAIL (TYP.)

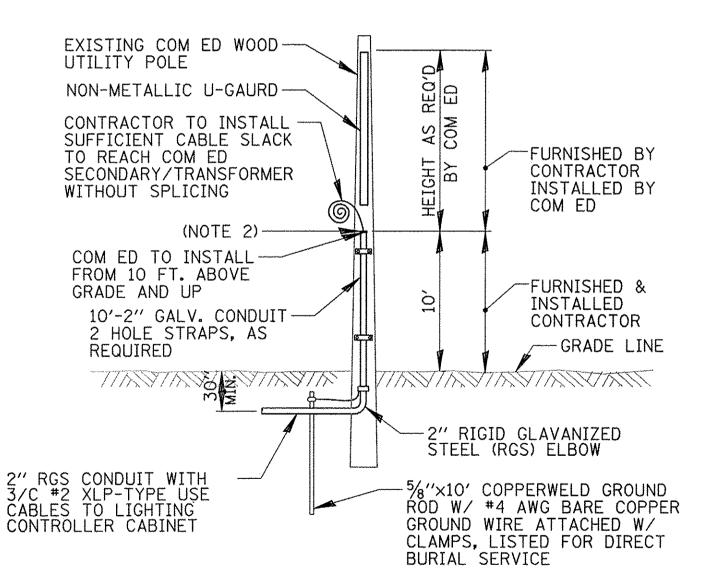


#### NOTES:

- 1. ALL WORK SHALL CONFORM TO COM ED'S BOOK OF "INFORMATION AND REQUIREMENTS FOR THE SUPPLY OF ELECTRIC SERVICE."
- 2. CONTRACTOR SHALL PROVIDE CONDUIT BUSHING AND SEALING COMPOUND AT TOP OF RISER.
- 3. ALL MATERIAL ABOVE (EXCEPT FOR POLE) SHALL BE INCLUDED IN THE PRICE BID FOR "ELECTRIC SERVICE INSTALLATION". THE HORIZONTAL SERVICE CONDUIT AND WIRING FROM POLE TO CONTROLLER SHALL BE PAID FOR SEPERATELY.

## COM ED OVERHEAD CONNECTION POLE

TOTAL SHEET NO. FILE NAME = USER NAME = dkerr - GAH REVISED DESIGNED SECTION COUNTY **ELECTRICAL DETAILS (1 OF 3)** STATE OF ILLINOIS N:\WILLOWBROOK\150687\Mech\LDT\_150687\_ DRAWN LRR REVISED 0344 16-00023-00-LT DUPAGE 17 | 11 IL RT 83 & 63RD ST CHECKED REVISED DEPARTMENT OF TRANSPORTATION PLOT SCALE = 20' AJD CONTRACT NO. 61D67 Default PLOT DATE = 12/21/2016 DATE 10/13/2016 REVISED SCALE: N.T.S. SHEET 1 OF 3 SHEETS STA. -TO STA.-ILLINOIS FED. AID PROJECT

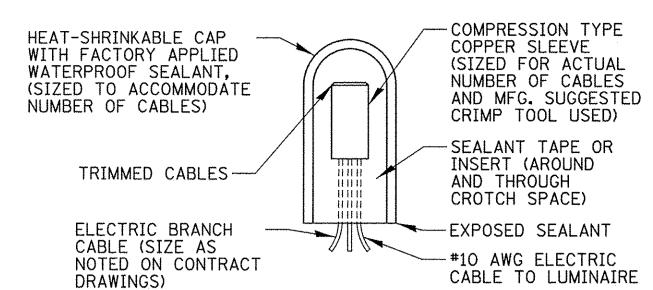

## SPLICING ELECTRIC CABLE N.T.S.

MIN. 2' . 2

R.O.W.

(CONTRACTOR TO

COORDINATE SIZE

CONTRACTOR TO

WITH MFG.)

COORDINATE


**BOLT CIRCLE** 

VARIABLE

1) RGS CONDUIT —

SLEEVE

**ROADWAY CROSSING** 

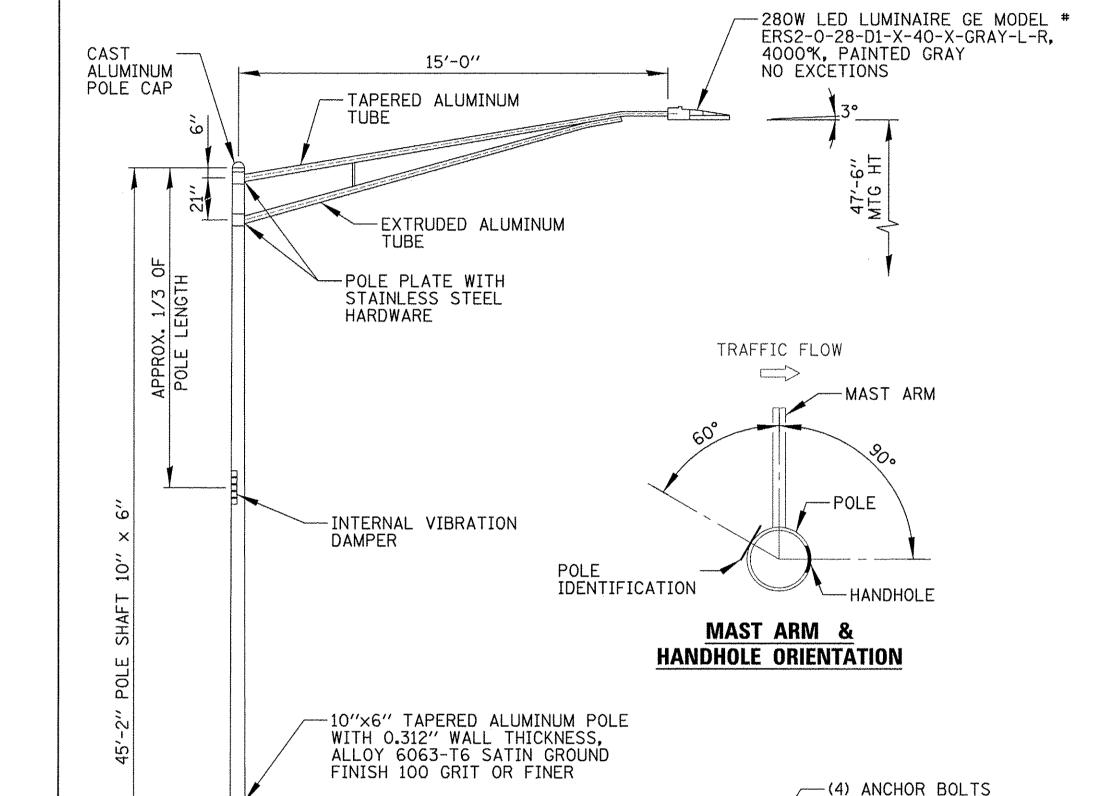

- 1. LIGHT POLES SHALL MEET WIND LOADING & VIBRATION REQUIREMENTS ACCORDING TO THE LATEST AASHTO STANDARDS AND ARTICLE 1069.01 IN STANDARD SPECIFICATIONS FOR ROAD AND BRIDGE CONSTRUCTION.
- 2. POLE HANDHOLE SHALL FACE AWAY FROM TRAFFIC.

- GRADE

(REFER TO PLANS

FOR LOCATIONS)

NOTES:

3. LED LUMINAIRE SHALL BE PAID FOR UNDER "LUMINAIRE, LED, HORIZONTAL MOUNT, MEDIUM WATTAGE"

## LIGHT POLE TYPE 1 DETAIL

-4"x8" HANDHOLE WITH REINFORCING

- ANCHOR BASE ALLOY 356-T6, TAPPED FOR ATTACHING BOLT COVERS WITH

ROUND SLOTTED HD. NYLON STEEL

-SEE METAL HELIX FOUNDATION DETAIL

-CURB &

— SEE BREAKAWAY TRANSFORMER BASE DETAIL

FRAME, COVER AND (2)  $\frac{1}{4}$ "-20


×3/4 LG. STEEL CORE NYLON SCREWS. 3/8"-16 TAP IN FRAME

FOR GRD. CONN.

CORE SCREWS

#### FILE NAME = REVISED USER NAME = dkerr DESIGNED - GAH N:\WILLOWBROOK\150687\Mech\LDT\_150687\_02.sht REVISED DRAWN LRR PLOT SCALE = 20' CHECKED AJD REVISED Default PLOT DATE = 12/21/2016 DATE 10/13/2016 REVISED

# STATE OF ILLINOIS

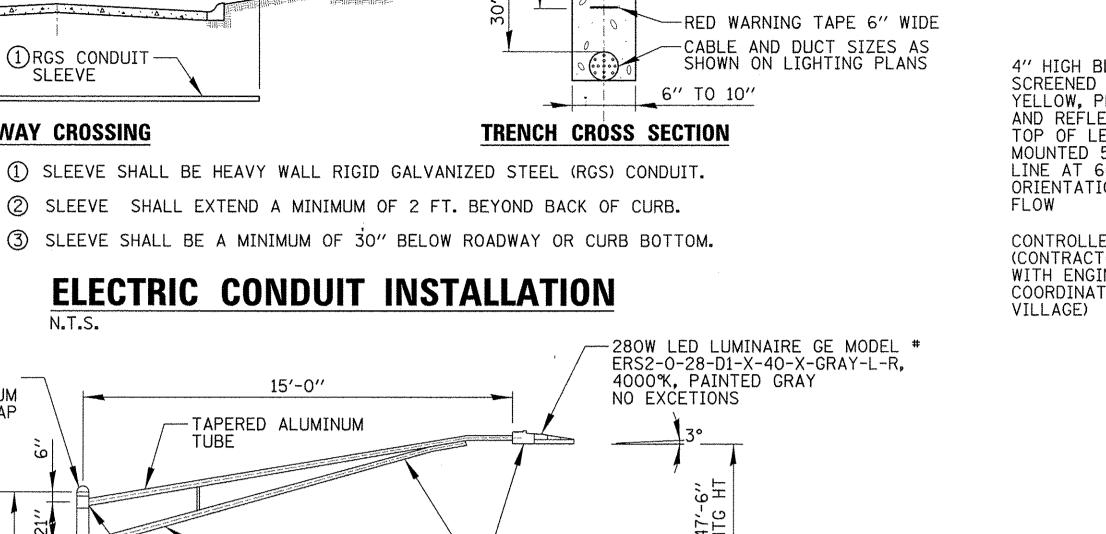


6" TOPSOIL & SEED


COMPACTED GRANULAR TRENCH

BACKFILL (CA-6 LIMESTONE)

OF TRENCH

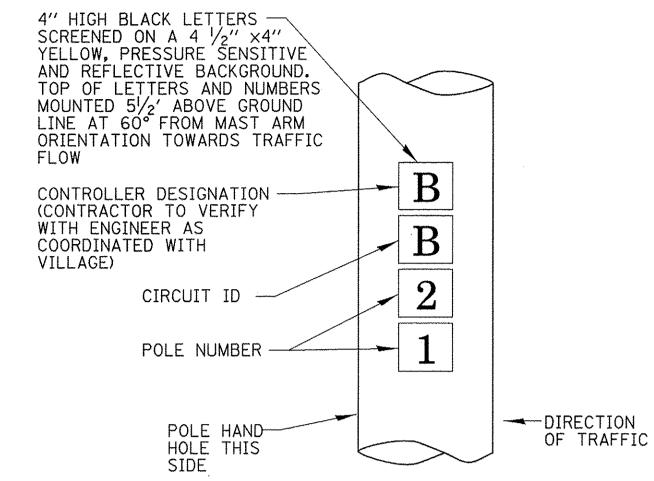

## POLE IDENTIFICATION

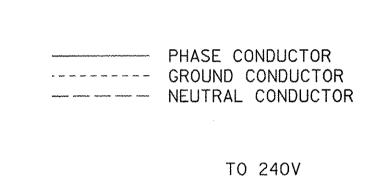

FUSE HOLDER & INSULATING 2 NO. 10 POLE WIRES TO LUMINAIRE COLOR TO MATCH BRANCH WIRING 3 MULTIPLE COMPRESSION FITTINGS (SPLICE), TYP. TO 240V (4) METAL HELIX BASE PLATE LUMINAIRE (2ND HEAD IF (5) WIRE AS SHOWN ON PLANS REQUIRED)

---

0 00 1

LUMINAIRE

- 6 CABLES IN UNIT DUCT AS SHOWN ON PLANS
- (7) POLE GROUND LUG


G-GREEN

(1) 4A TIME-DELAY FUSE

INSIDE A 2-POLE

BREAKAWAY WATERPROOF

8 WIRE COLOR R-RED B=BLACK

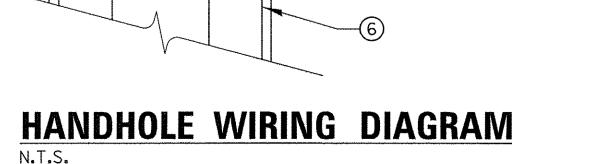

**ELECTRICAL DETAILS (2 OF 3)** IL RT 83 & 63RD ST SHEET 2 OF 3 SHEETS STA. -TO STA.-

TOTAL SHEET NO. SECTION COUNTY 0344 17 12 16-00023-00-LT DUPAGE CONTRACT NO. 61D67 ILLINOIS FED. AID PROJECT

CAST 15'-0" ALUMINUM POLE CAP -TAPERED ALUMINUM -EXTRUDED ALUMINUM POLE HAS TWO APPROX, 1/3 OF POLE LENGTH ARMS/LUMINAIRES -POLE PLATE WITH AT 90° STAINLESS STEEL HARDWARE TRAFFIC FLOW -MAST ARM -INTERNAL VIBRATION DAMPER ---POLE **IDENTIFICATION** MAST ARM --- HANDHOLE TRAFFIC FLOW MAST ARM & **HANDHOLE ORIENTATION** 10"x6" TAPERED ALUMINUM POLE WITH 0.312" WALL THICKNESS, ALLOY 6063-T6 SATIN GROUND FINISH 100 GRIT OR FINER -(4) ANCHOR BOLTS (CONTRACTOR TO COORDINATE SIZE -4"×8" HANDHOLE WITH REINFORCING WITH MFG.) FRAME, COVER AND (2)  $\frac{1}{4}$ "-20 x3/4 LG. STEEL CORE NYLON SCREWS. 3/8"-16 TAP IN FRAME CONTRACTOR TO COORDINATE FOR GRD. CONN. BOLT CIRCLE -ANCHOR BASE ALLOY 356-T6, TAPPED FOR ATTACHING BOLT COVERS WITH ROUND SLOTTED HD. NYLON STEEL CORE SCREWS -SEE BREAKAWAY TRANSFORMER BASE DETAIL -SEE METAL HELIX FOUNDATION DETAIL ---- CURB & GUTTER (REFER TO PLANS

② MIN. 2'

R.O.W.

1. LIGHT POLES SHALL MEET WIND LOADING & VIBRATION REQUIREMENTS ACCORDING TO THE LATEST AASHTO STANDARDS AND ARTICLE 1069.01 IN STANDARD SPECIFICATIONS FOR ROAD AND BRIDGE CONSTRUCTION.

DEPARTMENT OF TRANSPORTATION

2. POLE HANDHOLE SHALL FACE AWAY FROM TRAFFIC.

FOR LOCATIONS)

NOTES:


3. LED LUMINAIRE SHALL BE PAID FOR UNDER "LUMINAIRE, LED, HORIZONTAL MOUNT, MEDIUM WATTAGE"

## LIGHT POLE TYPE 2 DETAIL

SCALE: N.T.S.

## LUMINAIRE AND POLE SCHEDULE

LIGHT POLE IDENTIFIER	POLE TYPE	LUMINAIRE		LC	CATION
IDENTITE!		WATTAGE	CKT ID	STATION	OFFSET
P1	1	280W	A	102+84L	4.0' F.O.C.
P2	1	280W	В	104+74L	4.0' F.O.C.
P3	1	280W	Α	106+24L	4.0' F.O.C.
P4	1	280W	В	107+74L	4.0' F.O.C.
P5	1	280W	Α	108+73L	6.0' F.O.C.
P6	1	280W	В	112+14L	4.0' F.O.C.
P7	1	280W	Α	114+04L	4.0' F.O.C.
P8	1	280W	В	115+94L	4.0' F.O.C.
P9	1	280W	Α	117+84L	4.0' F.O.C.
P10	1	280W	В	119+84L	4.0' F.O.C.
P11	1	280W	Α	121+79L	4.0' F.O.C.
P12	1	280W	А	101+29R	4.0' F.O.C.
P13	1	280W	В	102+84R	4.0' F.O.C.
P14	1	280W	Α	104+74R	4.0' F.O.C.
P15	1	280W	В	106+24R	5.0' F.O.C.
P16	1	280W	Α	107+74R	6.0' F.O.C.
P17	1	280W	В	108+74R	9.0' F.O.C.
P18	1	280W	Α	112+14R	4.0' F.O.C.
P19	1	280W	В	114+04R	4.0' F.O.C.
P20	1	280W	Α	115+94R	4.0' F.O.C.
P21	1	280W	В	117+84R	4.0' F.O.C.
P22	1	280W	Α	119+84R	4.0' F.O.C.
P23	1	280W	С	203+51L	4.0' F.O.C.
P24	1	280W	D	205+01L	5.0' F.O.C.
P25	1	280W	С	206+51L	4.0' F.O.C.
P26	1	280W	D	208+01L	7.0' F.O.C.
P27	2	(2) 280W	D,C	208+52L	10.5' F.O.C.
P28	2	(2) 280W	C,D	210+39L	7.5' F.O.C.
P29	1	280W	С	210+93L	4.0' F.O.C.
P30	11	280W	D	212+53L	4.0' F.O.C.
P31	1	280W	С	214+13L	4.0' F.O.C.
P32	1	280W	D	215+73L	4.0' F.O.C.
P33	1	280W	С		13.0' E.O.P.
P34	1	280W	D	203+51R	13.0' E.O.P.
P35	1	280W	С	<del>}</del>	13.0' E.O.P.
P36	1	280W	D	206+51R	13.0' E.O.P.
P37	1	280W	С	207+91R	4.0' F.O.C.
P38	2	(2) 280W	D,C	208+34R	19.0' F.O.C.
P39	2	(2) 280W	C,D	210+25R	5.5' F.O.C.
P40	1	280W	D	210+93R	4.0' F.O.C.
P41	1	280W	С	212+53R	4.0' F.O.C.
P42	1	280W	D	214+13R	4.0' F.O.C.

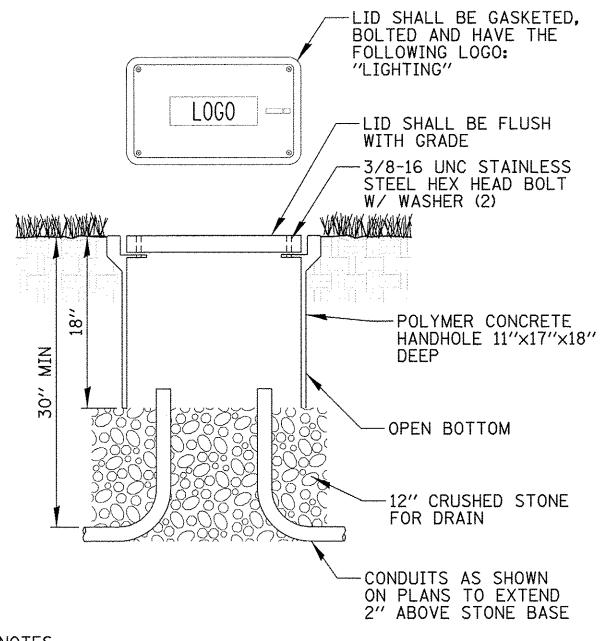


#### NOTES:

- 1. NO SPLICING ALLOWED IN HANDHOLES.
- 2. POLYMER CONCRETE HANDHOLE AND LID SHALL BE GREY.
- 3. BOX & LID SHALL MEET/EXCEED ANSI TIER 15 LOADING REQUIREMENTS, AND BE TESTED IN ACCORDANCE WITH THE LATEST EDITION OF THE ANSI/SCTE 77 "SPECIFICATION FOR UNDERGROUND ENCLOSURE INTEGRITY", AND THE PROVISIONS OF PARAGRAPHS 5.2.3 AND 5.2.4 OF WESTERN UNDERGROUND COMMITTEE GUIDE 3.6.

## COMPOSITE CONCRETE HANDHOLE

## ONE-LINE LEGEND

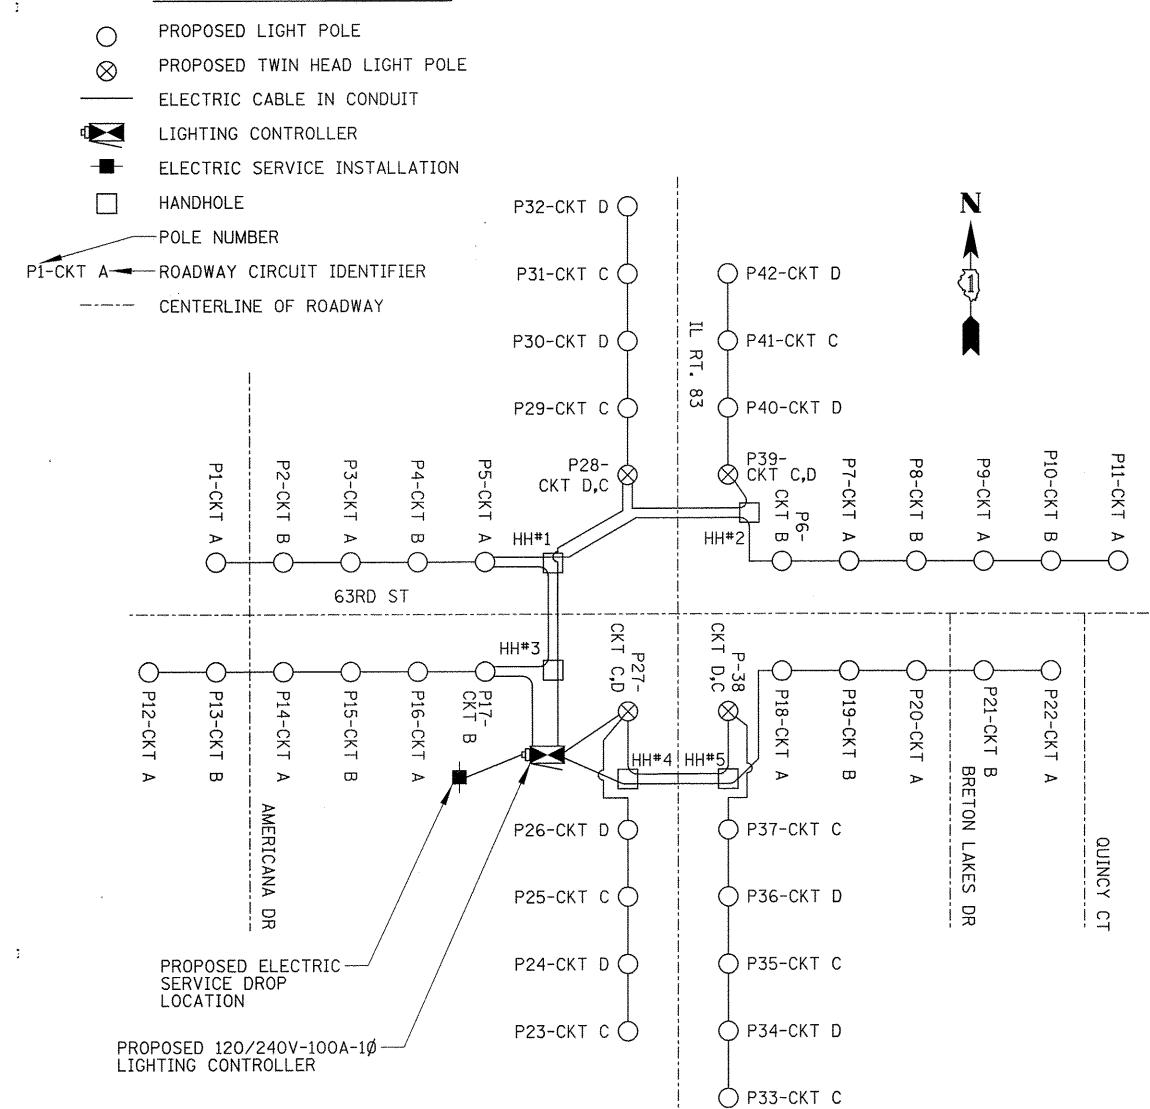

# LIGHTING ONE-LINE DIAGRAM N.T.S.

FILE NAME =	USER NAME = dkerr	DESIGNED -	GAH	REVISED -	, in the second
N:\WILLOWBROOK\150687\Mech\LDT_150687	'_03.sht	DRAWN -	LRR	REVISED -	S
	PLOT SCALE = 20'	CHECKED -	AJD	REVISED -	DEPARTM
Default	PLOT DATE = 12/21/2016	DATE -	10/13/2016	REVISED -	

STATI	E OF	ILLINOIS
DEPARTMENT	OF	TRANSPORTATION

SCALE: N.T.S.

ELEC	CTRICAL DETAILS (3 OF 3)		e Ne	F.A.P. RTE.	SECTION	COUNTY	TOTAL SHEETS	SHEET •ŅO.
IL RT 83 & 63RD ST				0344	16-00023-00-LT	DUPAGE	17	13
	IL NI 03 & USND SI			-		CONTRACT	NO. (	61D67
SHEET 3	OF 3 SHEETS STA	TO STA			ILLINOIS FED. A	D PROJECT	·	

#### **Lewis Reynolds**

From: Sent:

Gardner, David A:(ComEd) <david.gardner@ComEd.com>

Tuesday, October 11, 2016 8:43 AM

To: Cc:

Lewis Reynolds Gerald Hennelly

Subject:

RE: Acct Number: 3131029076 - IL Rt 83 & 63rd St Lighting

Lewis,

I field check the site yesterday...the transformer location you want to go to is good to go. Let me know when you're ready, have the electrical work inspection sign-off, and what wire size for connection.

Any questions please call or email me.

Dave

COMED CONTACT: DAVID GARDNER

847-366-3897 DAVID.GARDNER@COMED.COM

**David Gardner** ComEd Field Engineer **GSR-New Business, Bolingbrook 2** 630-985-4074 office **630-985-4042 fax** ⊠david.gardner@comed.com https://www.comed.com/newbusiness

From: Lewis Reynolds [mailto:lreynolds@cbbel.com] **Sent:** Monday, October 10, 2016 9:37 AM

**To:** Gardner, David A:(ComEd)

Cc: Gerald Hennelly

Subject: RE: Acct Number: 3131029076 - IL Rt 83 & 63rd St Lighting

Great, thank you for your help. Let me know if you have any questions.


Lewis R. Reynolds Mechanical Engineer Christopher B. Burke Engineering, Ltd. 9575 W. Higgins Road, Suite 600 Rosemont, IL 60018 Phone: (847) 823-0500 Fax: (847) 939-5214 E-Mail: <u>Ireynolds@cbbel.com</u>

#### www.cbbel.com



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## ED CORRESPONDENCE

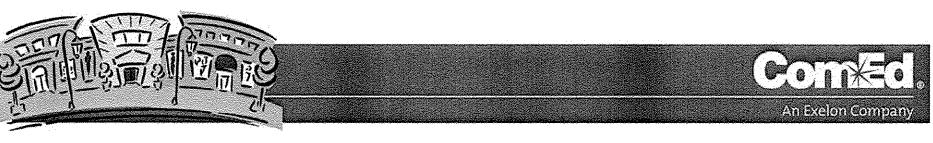

#### **Service and Meter Application Switch and Load Information Sheet**

Please complete a separate sheet for each switch – existing or new:

Project Name: IL Rt 83 & 63rd St. Roadway Lighting Site Address: 0 N. IL Rt. 83, Willowbrook, IL 60527

and Location: Lighting Controller, SW Corner IL Rt 83/63<sup>rd</sup> St.

Switch Name and Location: Lighting	Controller, SW Corner IL Rt 83/63
Service Voltage (check one):  120/240V 1-phase, 3-wire 120/240V 3-phase, 4-wire 120/208V 3-phase, 4-wire Other:	☐ 277/480V 3-phase, 4-wire ☐ 480V 3-phase 3-wire (B-ph ☐ 480V 3-phase 3-wire (Ungr
☐ 4kV ☐ 12kV ☐ 34kV 3-phase, 3- ☐ 4kV ☐ 12kV ☐ 3-phase, 4-wire	-wire

480V 3-phase 3-wire (B-phase Grounded) 480V 3-phase 3-wire (Ungrounded – requires ground detection equip.)

Other Items (check all that apply): New Construction Sq. Ft. Building Addition Sq. Ft. ☐ Relocating Existing Service Entrance ☐ Commercial – No. of units ☐ Hi-Rise/ Vault Service

Overhead Service Residential – No. of units

Sq. Ft. Sq. Ft. Date to Final Grade (est.):

Hours of Operation Per Day: ☐ 8 ☐ 12 ☐ 16 ☐ 24

Date of Ground Breaking (est.): Date to Energize: August 2017 Switch Size (amps): 100 (If switchgear is 1,200 Amps or larger, customer must submit drawings for ComEd approval)

Switch Rating (percentage): 80

□ CU or □ AL


Secondary Conductors: 1 Sets of 3 /C #2 (No. of conductors) (Size) (Number) Total Connected Load Information:

otal Connected Lo	au miornation.						
(KW or HP)	Description:	Connected Load:					
		1-phase	3-phase				
Lighting:	Roadway Lighting	12.9 KW					
VAC:							
Receptacle:							
Process Heat:							
Water Heat:		2					
Space Heat:							
Motors*:							
Welders**:							
TOTAL LOAD:		12.9 KW					

\*Motor Load Detail included above:

Description	Quantity	Size (HP)	Efficiency Rating	Phase / Voltage	Nema Code	Starts Per Hr. or Day	Starting Amps	Use
						***************************************		
					······································			
· · · · · · · · · · · · · · · · · · ·								

\*\*Welder Detail included above: Welds Per Max. Inst. Cycles Per Weld Peak

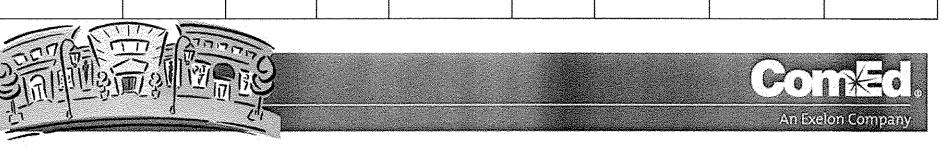

#### **Service and Meter Application Project Information Sheet**

Project Name: IL Rt 83 & 63rd St. Roadway Lighting

Site Address: 0 N. IL Rt. 83 City: Willowbrook

Zip: 60527

Total Number of Service Entrance Locations (meters/switches) Requested: 1

Legal Name of Entity (Electric Consumer): Village of Willowbrook

☐ Corporation ☐ Partnership ☐ Sole Proprietor ☒ Other: Municipality Tax I.D.: Existing Account Number: 3131029076

Principle(s) to Sign Contracts For Service, Easements, Etc.: Phone: 6309202261

Property Owner: Village of Willowbrook **Building Owner:** 

Phone: Phone:

Mailing Address For Contracts:

Building Manager: Tim Halik

Company: Christopher B. Burke Engineering

Fax: 847-939-5214 Phone: 847-823-0500 City: Rosemont Zip: 60018

Fax:

Fax:

Zip:

Zip: 60527

Address: 9575 W. Higgins Rd.

Mailing Address For Electric Bills:

Company: Village of Willowbrook Phone: 6309202261 City: Willowbrook

Address: 835 Midway Dr

Project Contacts: Consulting Engineer: Lewis Reynolds

E-mail: Ireynolds@cbbel.com

Firm Name: Christopher B. Burke Engineering Phone: 847-823-0500 Fax: 847-939-5214 Zip: 60018 City: Rosemont

Address: 9575 W. Higgins Rd. Electrical Contractor:

Consulting Engineer: E-mail: Firm Name:

Phone: City: Address:

Other:

Address:

Consulting Engineer: Firm Name:

E-mail: Phone: Fax: City: Zip:

The Following Documents May Be Required:

1. Plat of Survey with legal description of property (for easement, if required)

2. Site Plan showing building relative to property lines – mark service entrance location(s)

3. Civil drawings (showing water, sewer, gas, phone, electric, pavement, grading, etc.)

4. Complete electrical drawings and/or load detail sheets


**Information** Provided By:


Print Name: Lewis Reynolds Signature:

Date: 10/4/16

## LIGHTING CONTROLLER SERVICE APPLICATION

FILE NAME =	USER NAME = dkerr	DESIGNED - GAH	REVISED -		ELECTRIC SERVICE COORDINATION "FOR INFORMATION ONLY"	F.A.P. RTE.	SECTION	COUNTY TOTAL SHEET SHEETS NO.
N:\WILLOWBROOK\150687\Mech\LDT_150687_	4.sht	DRAWN – LRR	REVISED -	STATE OF ILLINOIS	II DT 02 9. C2DD CT	0344	16-00023-00-LT	DUPAGE 17 14
	PLOT SCALE = 20'	CHECKED - AJD	REVISED -	DEPARTMENT OF TRANSPORTATION	IL NI OO Q UOND OI		» '	CONTRACT NO. 61D67
Default	PLOT DATE = 12/21/2016	DATE - 10/13/2016	REVISED -		SCALE: N.T.S. SHEET 1 OF 1 SHEETS STA TO STA		ILLINOIS FED. A	AID PROJECT

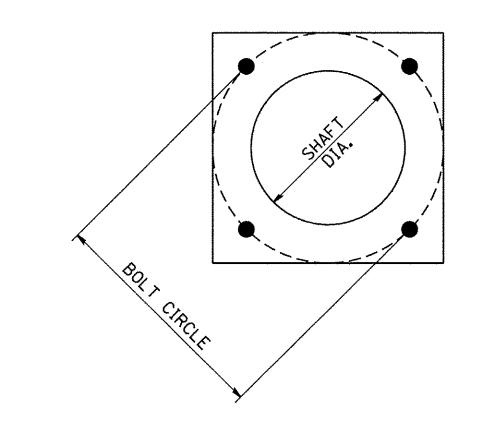

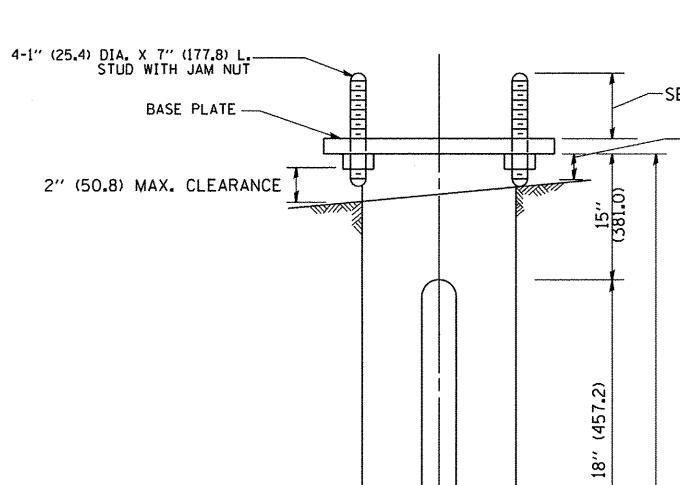


#### HELIX FOUNDATION SIZE

POLE MOUNTING HEIGHT	BOLT CIRCLE	SHAFT DIAMETER	SHAFT LENGTH	BASEPLATE
30 FT.	111/2''	85/8′′	6 FT.	12"×12"×1"
31 FT35 FT.	111/2''	8 <sup>5</sup> /8′′	6 FT.	12''×12''×1''
36 FT40FT.	15"	8 <sup>5</sup> ⁄8′′	6 FT.	15"×15"×1 <sup>1</sup> / <sub>4</sub> "
41 FT45 FT.	15"	85/8′′	6 FT.	15"×15"×1 <sup>1</sup> / <sub>4</sub> "
46 FT50 FT.	15"	10′′	8 FT.	15"×15"×11/4"

#### METAL HELIX FOUNDATION MATERIALS

ITEM	MATERIAL REQUIREMENT
BASEPLATE	AASHTO M 270M, GRADE 36 (M270M, GRADE 250)
SHAFT	ASTM A 252, GRADE 2 (PHOSPHOROUS 0.04% MAXIMUM, SULFUR 0.05% MAXIMUM)
HELIX SCREW	AASHTO M 183 (ASTM A 635)
PILOT POINT	AASHTO M 270 (ASTM A 575)
ANCHOR RODS/STUDS	AASHTO M 314 (ASTM F 1554)
HEXAGON NUTS	AASHTO M 291M (ASTM A 563) GRADE DH, OR AASHTO M 292 (ASTM A 194) GRADE 2H
WASHERS	AASHTO M 293 (ASTM F 436)

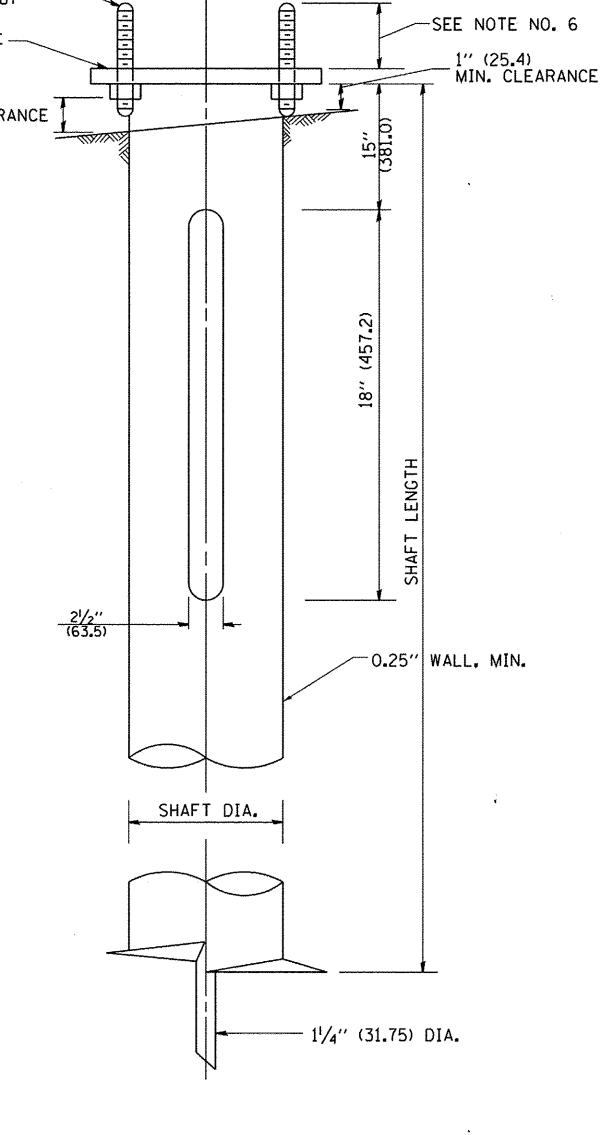


## LIGHT POLE FOUNDATION, METAL


#### NOTES:

- 1. ALL DIMENSION IN INCHES (MILLIMETERS) UNLESS OTHERWISE SHOWN.
- 2. ALL MATERIAL SHALL BE GALVINIZED ACCORDING TO AASHTO M111, UNLESS OTHERWISE SPECIFIED.
- 3. ALL WELDS SHALL BE CONTINUOUS AND NOT LESS THAN  $\frac{1}{4}$ " (6.35 mm) FILLET WELDS. THE WELDED FOUNDATION SHALL BE CAPABLE OF WITHSTANDING 10,000 FT/LBS (13558.18 n.m) OF INSTALLATION TORQUE APPLIED ABOUT THE AXIS OF THE FOUNDATION.
- 4. THE HELIX FOUNDATION SHAFT SHALL BE INSTALLED VERTICAL AND THE BASE PLATE SHALL BE IN LEVEL. THE BREAKAWAY COUPLINGS AND HARDWARE SHALL NOT BE USED TO ALIGN THE POLE INSTALLATION.
- 5. THE CABLE TRENCH SHALL BE BACKFILLED AND FIRMLY COMPACTED BEFORE THE INSTALLATION OF THE LIGHT POLE.
- 6. THE CONTRACTOR SHALL COORDINATE EXTENSION OF ANCHOR BOLTS ABOVE TOP OF THE BASE PLATE WITH THE BREAKAWAY DEVICE MANUFACTURER'S REQUIREMENTS.
- 7. ANY VOIDS WITHIN THE METAL FOUNDATION SHALL BE FILLED WITH FINE AGGREGATE.
- 8. METAL FOUNDATIONS SHALL BE INSTALLED IN UNDISTURBED SOIL. PREDRILLING A PILOT HOLE AND/OR BACKFILLING AROUND THE FOUNDTION IS NOT ALLOWED.
- 9. THE METAL FOUNDATION SHALL NOT BE INSTALLED TO A TORQUE WHICH EXCEEDS THE MANUFACTURER'S MAXIMUM TORQUE RATING NOR SHALL IT BE INSTALLED TO AN INSTALLATION TORQUE VALUE OF LESS THAN 3,500 FT LB (4,750 KNM). METAL FOUNDATIONS THAT ARE NOT INSTALLED TO FULL INSTALLATION DEPTH OR DO NOT ACHIEVE THE MINIMUM INSTALLATION TORQUE SHALL BE REMOVED AND REPLACED WITH A CONCRETE FOUNDATION AT NO ADDITIONAL COST.
- 10. THE BASEPLATE SHALL BE PERPENDICULAR TO THE SHAFT AXIS (± 1°) AND THE HOLE CENTERLINE SHALL BE CONCENTRIC (± 0.188) TO THE SHAFT AXIS.
- 11. THE PILOT POINT AND SHAFT AXIS SHALL BE CONCENTRIC (± 0.125) AND IN LINE (± 2°).
- 12. THE BASEPLATE SHALL BE STAMPED WITH THE MANUFACTURERS NAME AND DATE OF MANUFACTURE.

## **IDOT STANDARD BE-305**

FILE NAME =	USER NAME = dkerr	DESIGNED - GAH	REVISED -		IDOT DISTRICT 1 STANDARD (1 OF 3)	F.A.P. SECTION	COUNTY TOTAL SHEET SHEET NO.
N:\WILLOWBROOK\150687\Mech\STD_15068	7_d1.sht	DRAWN - LRR	REVISED -	STATE OF ILLINOIS		0344 16-00023-00-LT	DUPAGE 17 15
	PLOT SCALE = 20'	CHECKED - AJD	REVISED -	DEPARTMENT OF TRANSPORTATION	IL RT 83 & 63RD ST		CONTRACT NO. 61D67
Default	PLOT DATE = 12/21/2016	DATE - 10/13/2016	REVISED -		SCALE: N.T.S. SHEET 1 OF 3 SHEETS STA TO STA	ILLINOIS FED. AI	D PROJECT

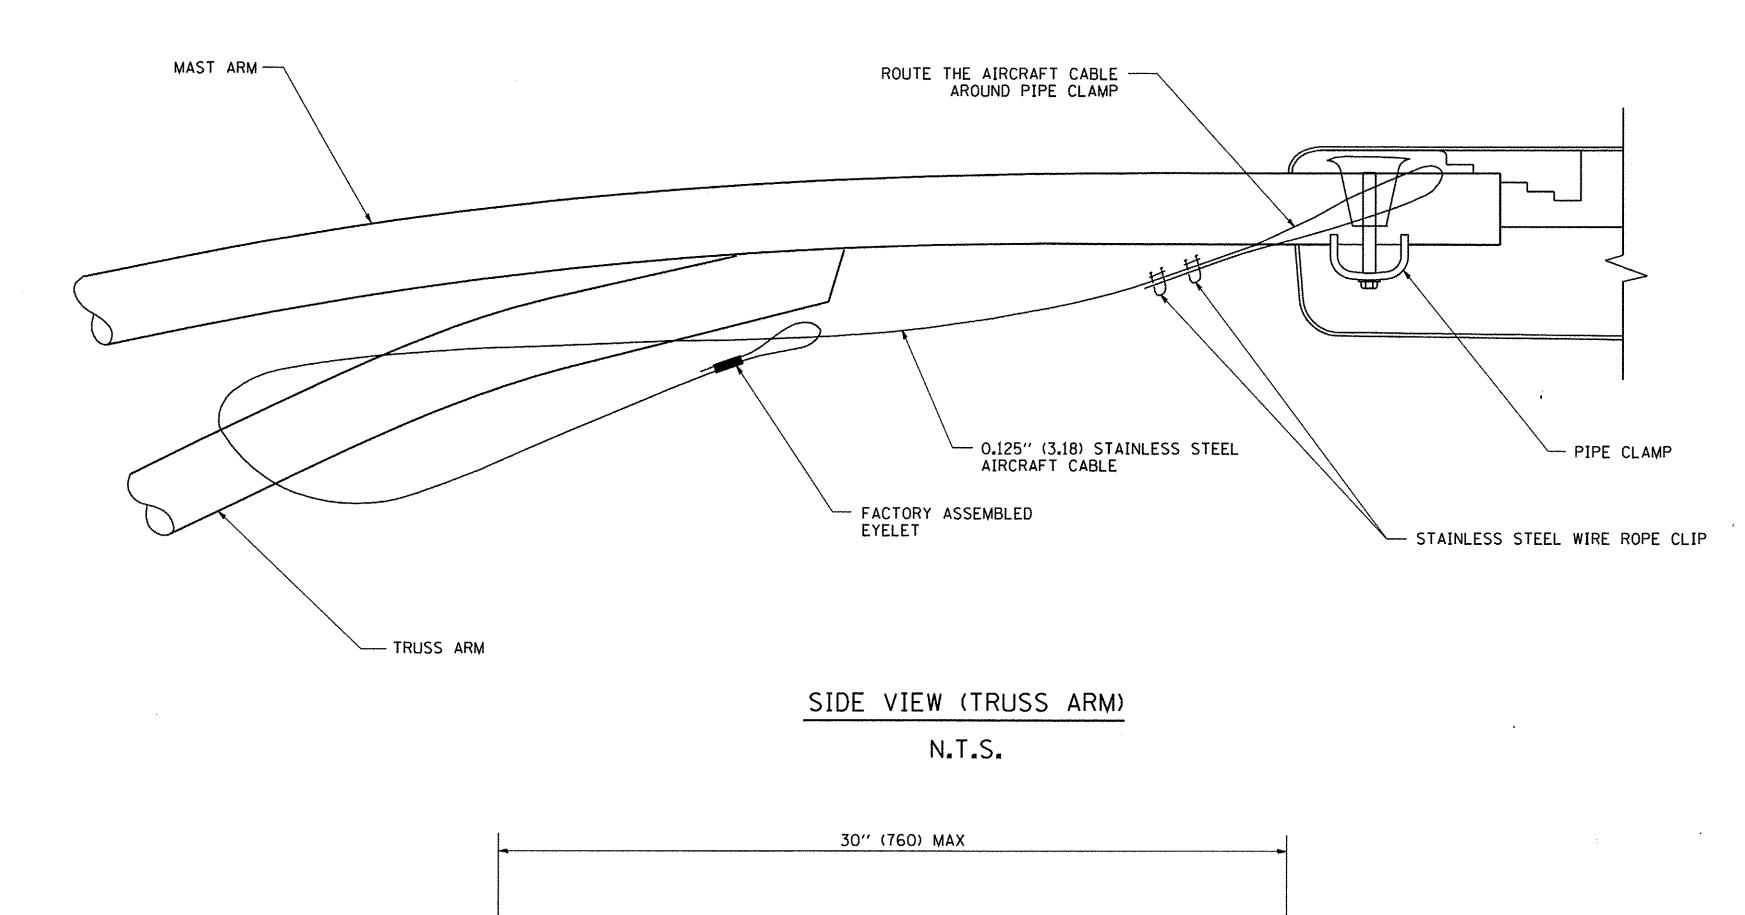

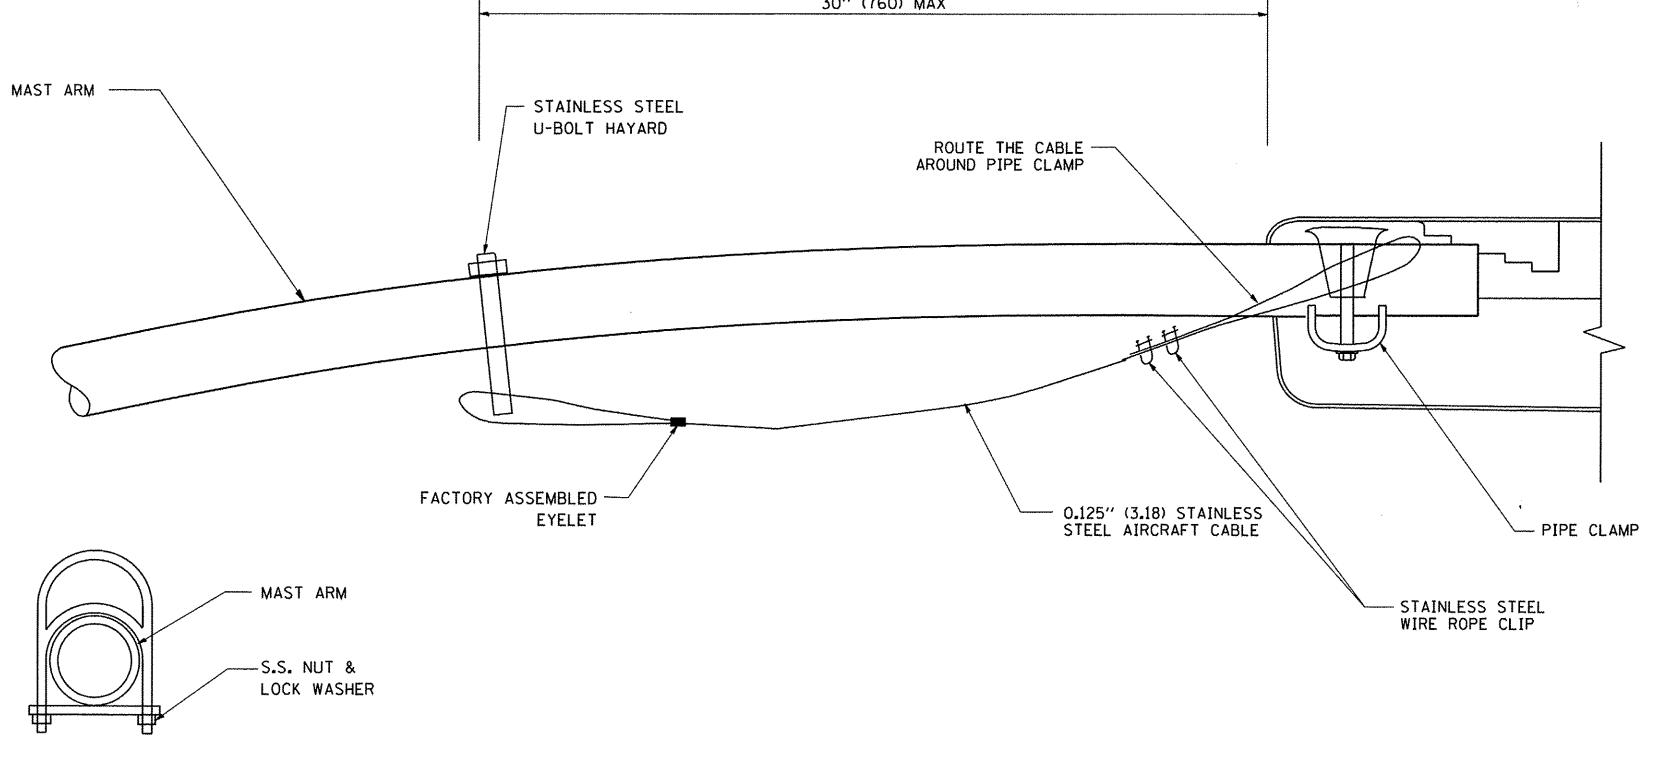

SIDE VIEW (SINGLE MEMBER OR DAVIT ARM)

N.T.S.

# LUMINAIRE SAFETY CABLE ASSEMBLY N.T.S.

FILE NAME = USER NAME = dkerr DESIGNED GAH REVISED STATE OF ILLINOIS - LRR REVISED N:\WILLOWBROOK\150687\Mech\STD\_150687\_02.sht DRAWN REVISED **DEPARTMENT OF TRANSPORTATION** PLOT SCALE = 20' CHECKED AJD Default REVISED PLOT DATE = 12/21/2016 DATE - 10/13/2016

STAINLESS STEEL U-BOLT HAYARD

IDOT DISTRICT 1 STANDARD (2 OF 3)

IL RT 83 & 63RD ST

SHEET 2 OF 3 SHEETS STA. - TO STA. -

SCALE: N.T.S.

O.125" (3.18) STAINLESS — STEEL AIRCRAFT CABLE

F.A.P. SECTION COUNTY TOTAL SHEET NO. 0344 16-00023-00-LT DUPAGE 17 16

CONTRACT NO. 61D67

-STAINLESS STEEL WIRE ROPE CLIP


NOTES:

- 1. ALL DIMENSIONS ARE IN MILLIMETERS (INCHES) UNLESS OTHERWISE SHOWN.
- CONTRACTOR SHALL ADJUST THE WIRE CLIP TO ELIMINATE ANY SLACK FROM THE WIRE ROPE.
- 3. THE 0.125" (3.18) STAINLESS STEEL AIRCRAFT CABLE SHALL REMAIN VISIBLE FROM THE GROUND LEVEL.
- 4. THE BREAKING STRENGTH OF THE CABLE SHALL BE 1700 LBS. MIN.

IDOT STANDARD BE-701 REVISED 8-8-2003

BOTTOM VIEW

N.T.S.

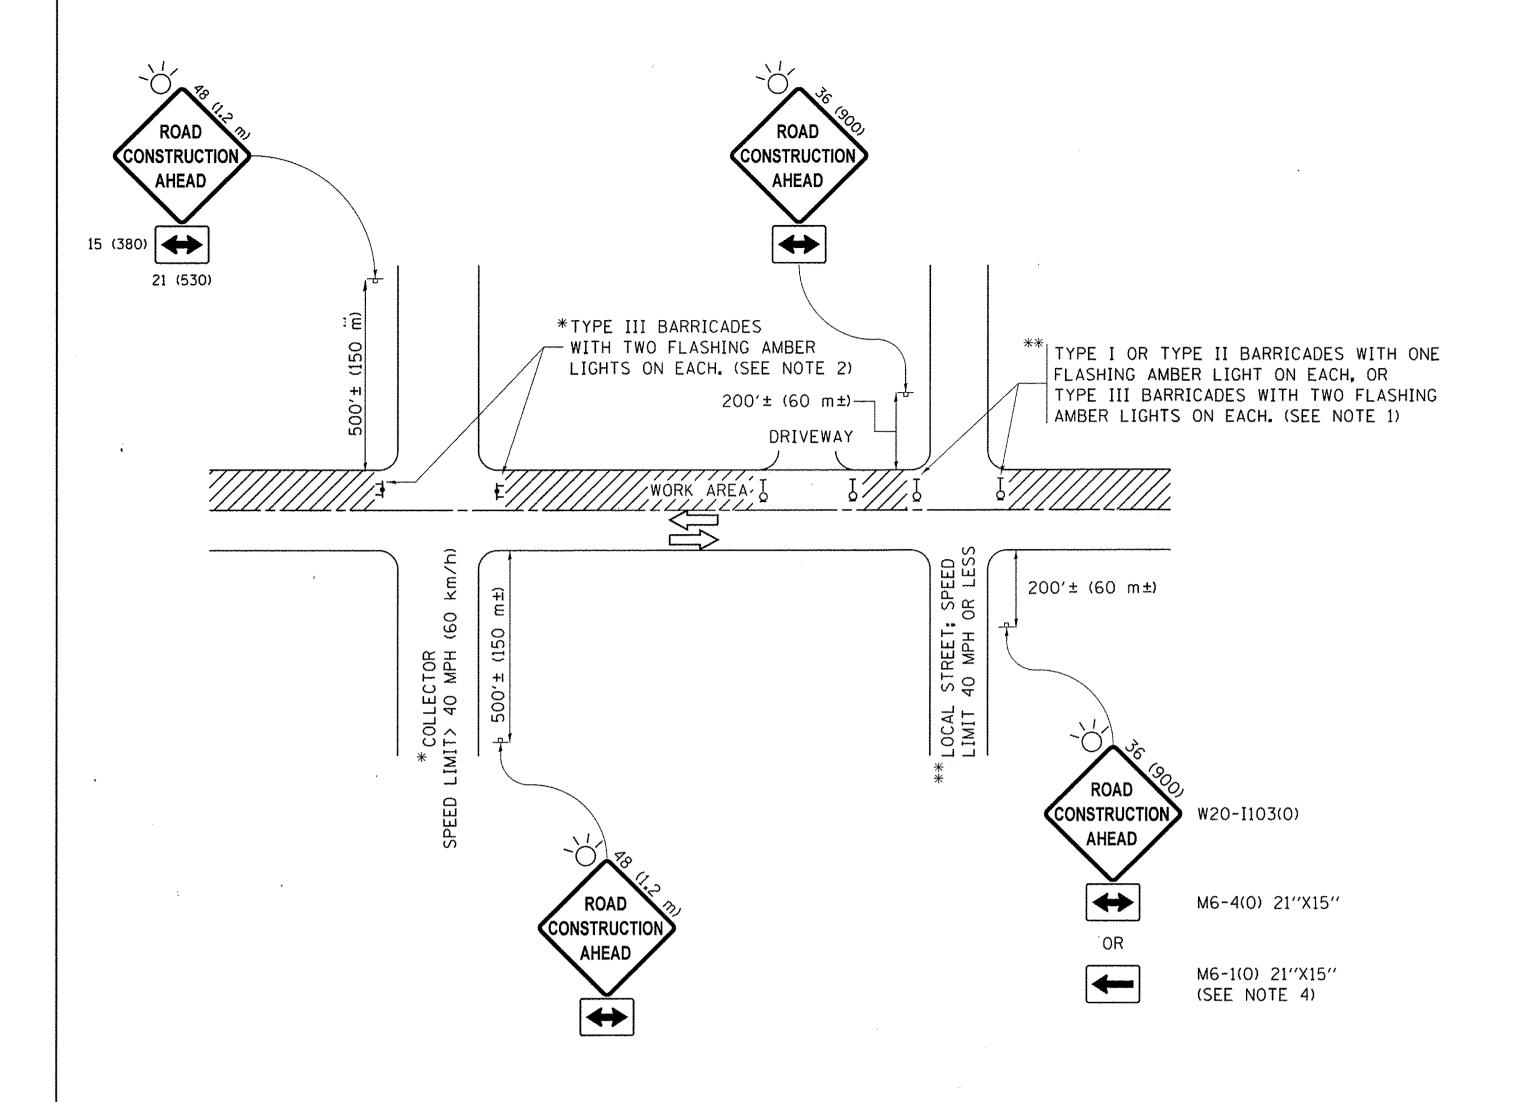

#### **NOTES:**

- 1. SIDE ROAD WITH A SPEED LIMIT OF 40 MPH (60 km/h) OR LESS AS SHOWN ON THE DRAWING AND AS DIRECTED BY THE ENGINEER:
  - a) ONE "ROAD CONSTRUCTION AHEAD" SIGN 36 x 36 (900x900) WITH A FLASHER MOUNTED ON IT APPROXIMATELY 200' (60 m) IN ADVANCE OF THE MAIN ROUTE.
  - b) THE CLOSED PORTION OF THE MAIN ROUTE SHALL BE PROTECTED BY BLOCKING WITH TYPE I. TYPE II OR TYPE III BARRICADES, 1/3 OF THE CROSS SECTION OF THE CLOSED PORTION.
- 2. SIDE ROAD WITH A SPEED LIMIT GREATER THAN 40 MPH (60 km/h) AS SHOWN ON THE DRAWING AND AS DIRECTED BY THE ENGINEER:
  - a) ONE "ROAD CONSTRUCTION AHEAD" SIGN 48  $\times$  48 (1.2 m  $\times$  1.2 m) WITH A FLASHER MOUNTED ON IT APPROXIMATELY 500' (150 m) IN ADVANCE OF THE MAIN ROUTE.
  - b) THE CLOSED PORTION OF THE MAIN ROUTE SHALL BE PROTECTED BY BLOCKING WITH TYPE III BARRICADES, 1/2 OF THE CROSS SECTION OF THE CLOSED PORTION.
- 3. CONES MAY BE SUBSTITUTED FOR BARRICADES OR DRUMS AT HALF THE SPACING DURING DAY OPERATIONS. CONES SHALL BE A MINIMUM OF 28 (710) IN HEIGHT.
- 4. WHEN THE SIDE ROAD LIES BETWEEN THE BEGINNING OF THE MAINLINE SIGNING AND THE WORK ZONE, A SINGLE HEADED ARROW (M6-1) SHALL BE USED IN LIEU OF THE DOUBLE HEADED ARROW (M6-4).

SCALE: N.T.S.

- 5. WHEN WORK IS BEING PERFORMED ON A SIDE ROAD OR DRIVEWAY. FOLLOW THE APPLICABLE STANDARD(S). THE DIRECTIONAL ARROW (M6-1 OR M6-4) SHALL BE COVERED OR REMOVED WHEN NO LONGER CONSISTENT WITH THE TRAFFIC CONTROL SET-UP.
- 6. ADVANCE WARNING SIGNS ARE TO BE OMITTED ON DRIVEWAYS UNLESS OTHERWISE SPECIFIED IN THE PLANS OR BY THE ENGINEER.
- 7. THE TRAFFIC CONTROL AND PROTECTION FOR SIDE ROADS. INTERSECTIONS. AND DRIVEWAYS SHALL BE INCLUDED IN THE COST OF SPECIFIED TRAFFIC CONTROL STANDARDS OR ITEMS.

## IDOT STANDARD TC-10 **REVISED 9–15–2016**

All dimensions are in inches (millimeters) unless otherwise shown.

FILE NAME =	USER NAME = dkerr	DESIGNED	 GAH	REVISED -	
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Default	PLOT DATE = 12/21/2016	DATE	 10/13/2016	REVISED	

STATE	OF	ILLINOIS
DEPARTMENT	OF	<b>TRANSPORTATION</b>

	IDOT	DISTRICT 1	STANDARD	/3 OF	3)
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RTE.	SECTION	COUNTY	TOTAL SHEETS	SHEE NO.
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