INDEX OF SHEETS

SEE SHEET NO. 2

SEE SHEET NO. 2

HIGHWAY STANDARDS

CONTRACT #61D61

FED. ROAD DIST, NO. ILLINOIS FED. AID PROJECT

STATE OF ILLINOIS DEPARTMENT OF TRANSPORTATION

PLANS FOR PROPOSED FEDERAL AID HIGHWAY

MUN 0056 (GRAND BOULEVARD)
WEBER ROAD TO ANNA LANE

RESURFACING


SECTION NO.: 16-00065-00-RS

PROJECT NO.: M-4003(824)

VILLAGE of ROMEOVILLE

WILL COUNTY

C-91-021-17

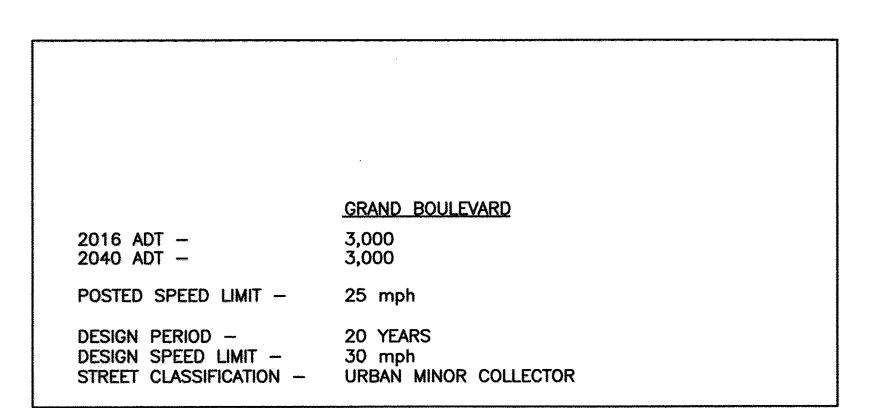

SCALES PLAN - 1"=50'
PROFILE HORIZ. - 1"=50'
PROFILE VERT. - 1"=5'
CROSS SECTIONS - 1"=10'

100' 200' 300' - 1"=100'
10' 20' 30' - 1"=10'

100' 200' 300' - 1"= 100'

100' 20' 30' - 1"= 10'

50' 100'

100'

100'

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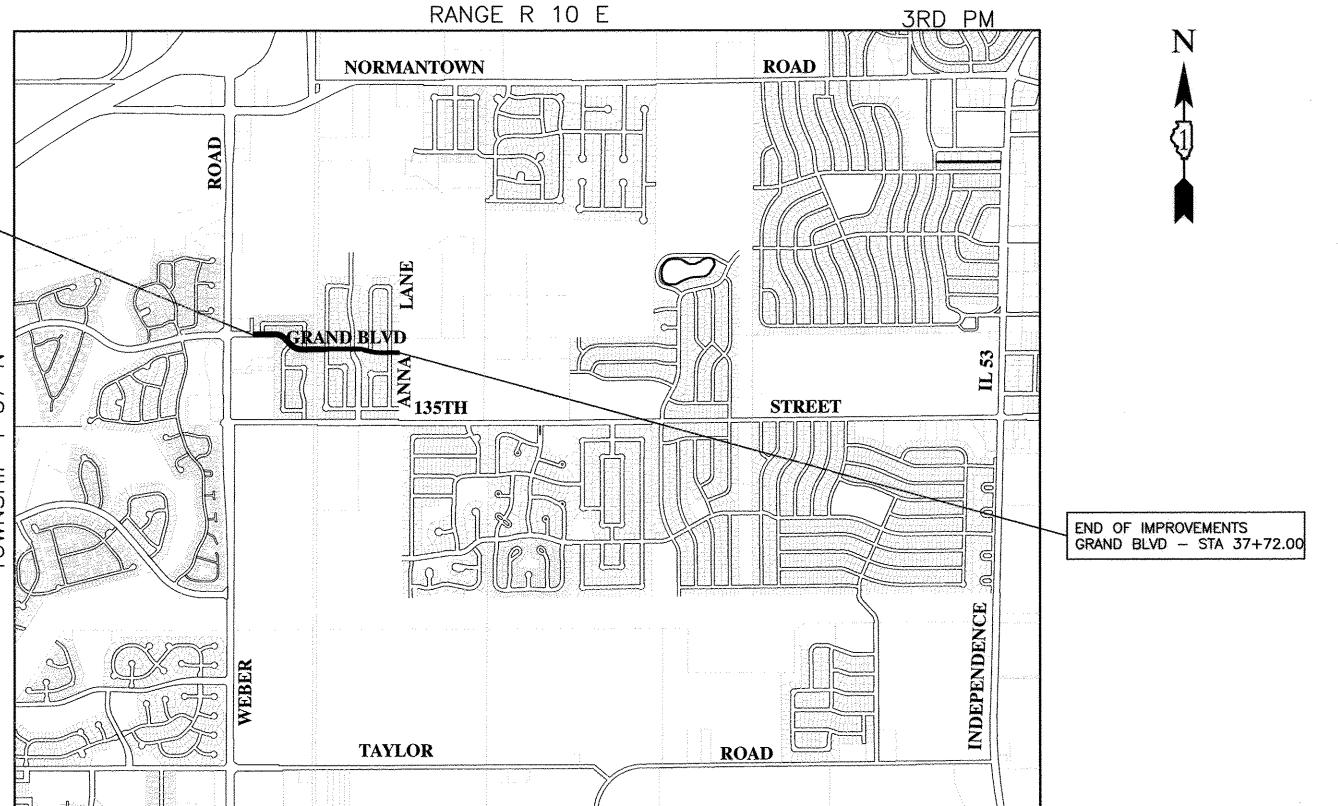
100'

100'

FULL SIZE PLANS HAVE BEEN PREPARED USING STANDARD ENGINEERING SCALES, REDUCED SIZED PLANS WILL NOT CONFORM TO STANDARD SCALES, IN MAKING MEASUREMENTS ON REDUCED PLANS, THE ABOVE SCALES MAY BE USED.


J. U. L. I. E.
JOINT UTILITY LOCATION INFORMATION FOR EXCAVATION
1 - 800 - 892 - 0123 or 811


CONTRACT NO. 61D61



LOCATION MAP

GROSS LENGTH=2375 FEET=0.45 MILES
NET LENGTH=2375 FEET=0.45 MILES

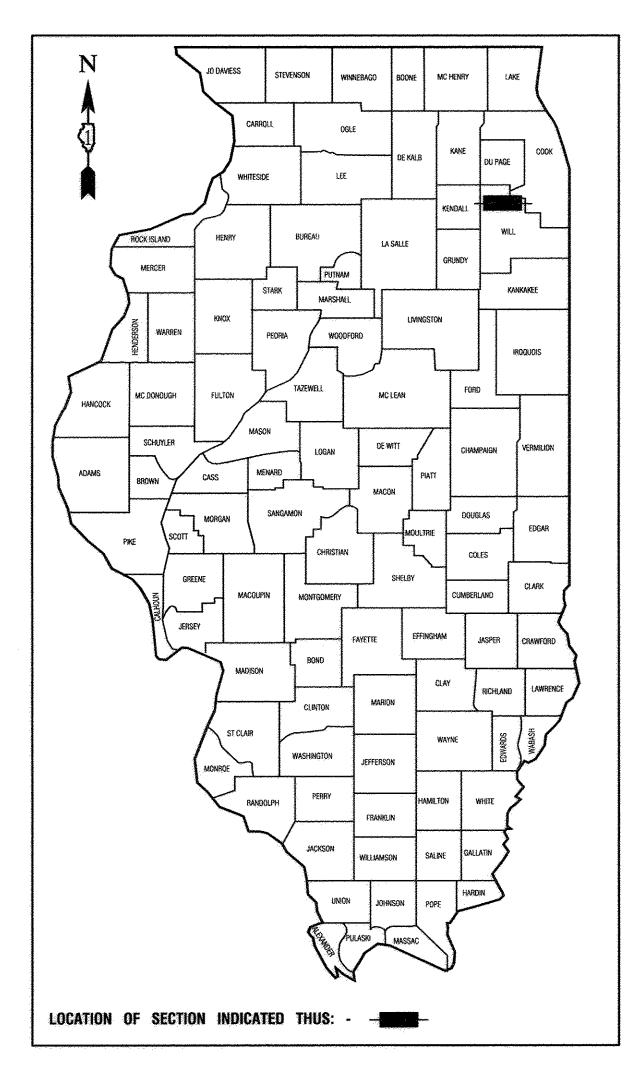

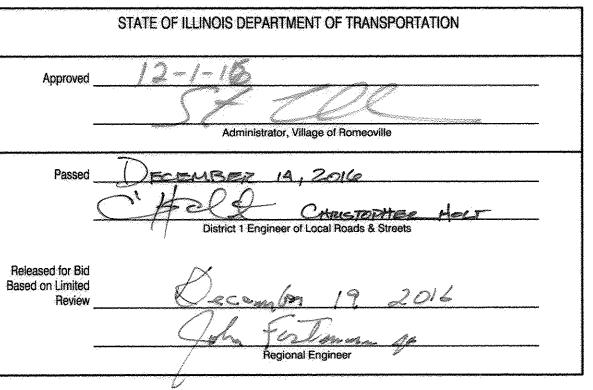


PRINTED BY THE AUTHORITY OF THE STATE OF ILLINOIS

PREPARED BY OR UNDER THE DIRECT SUPERVISION OF:

Description of:

12/5/2016

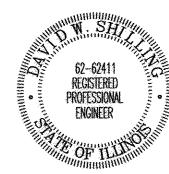

LICENSE EXPIRES: 11/30/17

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. SUMMARY OF QUANTITIES
. TYPICAL SECTIONS
. PROPOSED PLAN
. PAVEMENT MARKING PLAN

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424011-03 CORNER PARALLEL CURB RAMPS FOR SIDEWALKS
424016-03 MID-BLOCK CURB RAMPS FOR SIDEWALKS
424021-03 DEPRESSED CORNER FOR SIDEWALKS
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GENERAL NOTES

- 1. ALL REFERENCES TO "STANDARD SPECIFICATIONS" IN THESE GENERAL NOTES SHALL BE INTERPRETED TO MEAN "STANDARD SPECIFICATIONS FOR ROAD AND BRIDGE CONSTRUCTION" ADOPTED BY THE ILLINOIS DEPARTMENT OF TRANSPORTATION, APRIL 1, 2016.
- 2. ALL REFERENCES TO "ENGINEER" SHALL BE INTERPRETED TO MEAN THE RESIDENT ENGINEER.
- 3. PRIOR TO COMMENCEMENT OF CONSTRUCTION, THE CONTRACTOR SHALL VERIFY ALL DIMENSIONS AND CONDITIONS AFFECTING THEIR WORK WITH THE ACTUAL CONDITIONS AT THE JOB SITE. IN ADDITION, THE CONTRACTOR MUST VERIFY THE ENGINEER'S LINE AND GRADE STAKES. IF THERE ARE ANY DISCREPANCIES FROM WHAT IS SHOWN ON THE CONSTRUCTION PLANS, HE MUST IMMEDIATELY REPORT TO THE ENGINEER BEFORE DOING ANY WORK, OTHERWISE THE CONTRACTOR ASSUMES FULL RESPONSIBILITY. IN THE EVENT OF DISAGREEMENT BETWEEN THE CONSTRUCTION PLANS, STANDARD SPECIFICATIONS AND/OR SPECIAL DETAILS. THE CONTRACTOR SHALL SECURE WRITTEN INSTRUCTION FROM THE ENGINEER PRIOR TO PROCEEDING WITH ANY PART OF THE WORK AFFECTED BY OMISSIONS OR DISCREPANCIES. FAILING TO SECURE SUCH INSTRUCTIONS. THE CONTRACTOR WILL BE CONSIDERED TO HAVE PROCEEDED AT HIS OWN RISK AND EXPENSE IN THE EVENT OF ANY DOUBT OR QUESTION ARISING WITH RESPECT TO THE TRUE MEANING OF THE CONSTRUCTION PLANS OR SPECIFICATIONS. THE DECISION OF THE ENGINEER SHALL BE FINAL AND CONCLUSIVE.
- 4. IT IS THE CONTRACTOR'S RESPONSIBILITY TO ASCERTAIN EXISTING FIELD CONDITIONS PRIOR TO BIDDING ON THE PROJECT.
- 5. BEFORE STARTING ANY EXCAVATION THE CONTRACT SHALL CALL "J.U.L.I.E." AT (800) 892-0123 OR 811 FOR FIELD LOCATIONS OF BURIED UTILITIES (48 HOUR NOTIFICATION REQUIRED).
- 6. THE CONTRACTOR WILL NOT BE ALLOWED TO SETUP A YARD OR FIELD OFFICE ON STATE OR VILLAGE PROPERTY OR RIGHT OF WAY WITHOUT WRITTEN PERMISSION FROM THE ENGINEER.
- 7. SAW CUTTING OF PAVEMENTS. SIDEWALK. ETC. SHALL BE TO FULL DEPTH AND SHALL RESULT IN A CLEAN STRAIGHT EDGE ON THE PORTION REMAINING.
- 8. OFFSET LOCATIONS GIVEN IN THE PLANS FOR STRUCTURES, EDGE OF PAVEMENT, ETC. ARE FROM THE ROADWAY CENTERLINE.
- 9. HOT-MIX ASPHALT SURFACE REMOVAL BUTT JOINTS WILL BE INSTALLED AT THE ENDS OF ALL RESURFACING (WHERE RESURFACING MEETS EXISTING PAVEMENT), IN ACCORDANCE WITH THE BUTT JOINT AND HOT-MIX ASPHALT TAPER DETAILS SHEET INCLUDED IN THE PLANS, UNLESS OTHERWISE SPECIFIED.
- 10. QUANTITIES FOR PATCHING SHALL NOT EXCEED THOSE PROVIDED IN THE SUMMARY OF QUANTITIES UNLESS OTHERWISE APPROVED BY THE ENGINEER. THE ENGINEER WILL VERIFY FINAL PATCH LOCATIONS IN THE FIELD, PRIOR TO REMOVAL.
- 11. THE THICKNESS OF HMA MIXTURE STATED IN THE SPECIFICATIONS IS THE NOMINAL THICKNESS. DEVIATIONS FROM THE NOMINAL THICKNESS WILL BE PERMITTED WHEN SUCH DEVIATIONS OCCUR DUE TO IRREGULARITIES IN THE EXISTING SURFACE OR BASE ON WHICH THE HMA SURFACE IS PLACED.

FILE NAME = 16R0334-NOTS-01 - P01 USER NAME = DESIGNED - DWS REVISED - REVISED - DWS REVISED - DWS

STATE OF ILLINOIS DEPARTMENT OF TRANSPORTATION

UTILITY NOTES

- 1. THE CONTRACTOR SHALL BE RESPONSIBLE FOR CONTACTING THE OWNERS OF ALL UTILITIES PRIOR TO CONSTRUCTION TO DETERMINE THE LOCATION OF ALL UTILITY EQUIPMENT. THE CONTRACTOR SHALL COOPERATE WITH ALL UTILITY OWNERS IN ACCORDANCE WITH THE STANDARD SPECIFICATIONS IF UTILITY RELOCATION, ADJUSTMENT, OR PROTECTION IS NECESSARY.
- 2. THE CONTRACTOR SHALL BE RESPONSIBLE FOR THE PROTECTION OF ALL UNDERGROUND AND SURFACE UTILITIES EVEN THOUGH THEY MAY NOT BE SHOWN ON THE PLANS. ANY UTILITY PROPERTY DAMAGED DURING CONSTRUCTION SHALL BE REPAIRED OR REPLACED TO THE SATISFACTION OF THE ENGINEER IN ACCORDANCE WITH ARTICLES 105.07 AND 107.20.
- 3. ALL UTILITY OWNERS SHALL BE NOTIFIED AT LEAST 3 DAYS PRIOR TO THE START OF CONSTRUCTION.
- 4. THE CONTRACTOR SHALL USE ALL NECESSARY PRECAUTIONS AND PROTECTION MEASURES REQUIRED TO MAINTAIN EXISTING UTILITES, SEWERS, AND APPURTENANCES THAT MUST BE KEPT IN OPERATION.
- 5. THE CONTRACTOR SHALL ENSURE THAT ALL WATER SYSTEM VALVES, VALVE VAULTS, FIRE HYDRANTS, AND SANITARY SEWER MANHOLES REMAIN READILY ACCESSIBLE TO THE VILLAGE FOR EMERGENCY OPERATIONS. THE LOCATIONS OF ALL WATER AND SANITARY FACILITIES SHALL BE MARKED AND READILY VISIBLE AT ALL TIMES.
- 6. ALL LOOSE MATERIAL DEPOSITED IN THE FLOW LINE OF DRAINAGE STRUCTURES, WHICH OBSTRUCTS THE NATURAL FLOW OF WATER SHALL BE REMOVED AT THE CLOSE OF EACH WORKING DAY. PRIOR TO ACCEPTANCE OF THE IMPROVEMENT, ALL DRAINAGE STRUCTURES SHALL BE FREE OF DIRT AND DEBRIS.

MISCELLANEOUS

- 1. MATERIALS RESULTING FROM THE REMOVAL OF CONCRETE SURFACES, UTILITY STRUCTURE ADJUSTMENT, RESTORATION WORK, ETC. SHALL BE REMOVED AT THE END OF EACH DAY TO AN APPROVED SITE.
- 2. THE INDISCRIMINATE USE OF FIRE HYDRANTS, EXISTING STREAMS, CREEKS, OR PONDS IS STRICTLY PROHIBITED. THE CONTRACTOR SHALL PROVIDE A WATER TRUCK AND DRIVER AS REQUIRED TO OBTAIN AND TRANSPORT THIS WATER. THE CONTRACTOR SHALL BE RESPONSIBLE FOR OBTAINING WATER FROM AN APPROVED SOURCE. IF THIS WATER IS FROM A SOURCE OTHER THAN HIS/HER YARD. WRITTEN APPROVAL FROM THE AGENCY HAVING JURISDICTION FOR THE SOURCE OF THE WATER MUST BE RECEIVED BY THE CONTRACTOR PRIOR TO USE OF THE WATER.
- 3. THE CONTRACTOR SHALL BE RESPONSIBLE FOR SWEEPING AND CLEANING STREETS OF ANY DEBRIS AND MATERIAL THAT HAS ACCUMULATED AS A RESULT OF THE CONSTRUCTION ACTIVITY. A MECHANICAL SWEEPER, MECHANICALLY DRIVEN AIR AND HANDWORK WITH SHOVEL AND BROOM SHALL BE UTILIZED TO PROVIDE A CLEAN STREET FOR THE MOTORING PUBLIC. WITHIN 24 HOURS OF PLACING TACK COAT AND THE LAYING OF HMA, THE CONTRACTOR SHALL SWEEP THE PAVEMENT AND REMOVE STANDING WATER, EARTH, WEEDS, LEAVES, DIRT, CONSTRUCTION DEBRIS AND ALL LOOSE MATERIAL.
- 4. IT WILL BE THE CONTRACTOR'S RESPONSIBILITY TO NOTIFY RESIDENTS AND THE VILLAGE WHEN ACCESS TO THEIR DRIVEWAYS WILL BE TEMPORARILY CLOSED DUE TO SIDEWALK REPLACEMENT AND/OR CURB AND GUTTER REPLACEMENT. AT LOCATIONS WHERE THE SIDEWALK OR CURB AND GUTTER IS SCHEDULED TO BE REMOVED. THE CONTRACTOR SHALL CONTACT THE BUSINESS/HOMEOWNER 24 HOURS PRIOR TO REMOVING THE CURB OR SIDEWALK. EVERY EFFORT SHALL BE MADE TO ACCOMMODATE ACCESS TO THESE PROPERTIES. THE CONTRACTOR SHALL NOT BE ALLOWED TO CLOSE A DRIVEWAY FOR MORE THAN 48 HOURS UNDER ANY CIRCUMSTANCE. THE CONTRACTOR SHALL BE RESPONSIBLE FOR MAINTAINING THE BARRICADES TO PREVENT TRAFFIC FROM USING THE DRIVEWAYS DURING THIS PERIOD.
- 5. WHEN REMOVING PAVEMENT, CURB AND GUTTER, SHOULDER, AND/OR AND OTHER STRUCTURES, THE USE OF ANY TYPE OF CONCRETE BREAKERS WHICH MIGHT DAMAGE UNDERGROUND PUBLIC OR PRIVATE UTILITIES AND BUILDING FOUNDATIONS WILL NOT BE PERMITTED. UNDER NO CIRCUMSTANCES WILL THE USE OF A FROST BALL BE PERMITTED.

SIGNING AND STRIPING

1. SEE IDOT STANDARD DETAIL 780001, DISTRICT ONE DETAIL TC-13 AND PLAN SHEETS FOR PAVEMENT MARKING DETAILS.

		SUMMARY OF QUANTITIES		TTOTAL	ROAD CONSTRUCTION TYPE C
S.I.	CODE NO.		UNIT	TOTAL QUANTITY	0005
	35800100	PREPARATION OF BASE	SQ YD	66	6
	35800200	AGGREGATE BASE REPAIR	TON	8	
	40201000	AGGREGATE FOR TEMPORARY ACCESS	TON	46	<u>.</u>
		AGGREGATE I OR TEINI OTARI ACCESS			
	40600290	BITUMINOUS MATERIALS (TACK COAT)	POUND	6770	677
-	40600400	MIXTURE FOR CRACKS, JOINTS, AND FLANGEWAYS	TON	40	
	40600827	POLYMERIZED LEVELING BINDER (MACHINE METHOD), IL-4.75, N50	TON	421	
			ION	721	72
	40600982	HOT-MIX ASPHALT SURFACE REMOVAL - BUTT JOINT	SQ YD	194	19
			And the second s		
	40603335	HOT-MIX ASPHALT SURFACE COURSE, MIX "D", N50	TON	842	84
	42400800	DETECTABLE VALADALINICS	SQ FT	577	
	12 100000	DETECTABLE WARNINGS	JUII	577	J
-	42400200	PORTLAND CEMENT CONCRETE SIDEWALK 5 INCH	SQ FT	2833	283
-			Transport in management of the state of the		
٠.	44000157	HOT-MIX ASPHALT SURFACE REMOVAL, 2"	SQ YD	10029	421 421 194 842 577 2833 10029 222 21
	44000200		SO VD	103	1/
	4-1000200	DRIVEWAY PAVEMENT REMOVAL	SQ YD	102	<u> </u>
	44201717	CLASS D PATCHES, TYPE II, 6 INCH	SQ YD	22	2
	44201721	CLASS D PATCHES, TYPE III, 6 INCH	SQ YD	21	2
	60250200				
	60230200	CATCH BASINS TO BE ADJUSTED	EACH	29	
	60255500	MANHOLES TO BE ADJUSTED	EACH	5	
			Section 100 miles of the section 100 miles of		
	67100100	MOBILIZATION	LSUM	1	
	70102620	TRAFFIC CONTROL AND PROTECTION CTANDARD 701F01			
	70102020	TRAFFIC CONTROL AND PROTECTION, STANDARD 701501	LSUM	1	
. e . e	70102630	TRAFFIC CONTROL AND PROTECTION, STANDARD 701601	LSUM	1	
	70102640	TRAFFIC CONTROL AND PROTECTION, STANDARD 701801	LSUM	1	
	70200100				
	70300100	SHORT TERM PAVEMENT MARKING	FOOT	1484	148
	70300150	SHORT TERM PAVEMENT MARKING REMOVAL	SQ FT	247	24
			Column to the Co		
*	78000200	THERMOPLASTIC PAVEMENT MARKING - LINE 4"	FOOT	1549	154
ر داد	3000000000000000000000000000000000000		termination of the second of t		
*	78000400	THERMOPLASTIC PAVEMENT MARKING - LINE 6"	FOOT	1384	138

	we cover the second of the sec	SUMMARY OF QUANTITIES							
S.I.	CODE NO.	ITEM	UNIT	TOTAL QUANTITY	CONSTRUCTION TYPE CO				
*	78000650	THERMOPLASTIC PAVEMENT MARKING - LINE 24"	FOOT	220	220				
	K1003680	MULCH	SQ YD	11	11				
	X4404700	SIDEWALK REMOVAL (SPECIAL)	SQ FT	2931	2931				
	XX006343	SEEDING (COMPLETE)	SQ YD	388	388				
	Z0004530	HOT-MIX ASPHALT DRIVEWAY PAVEMENT, 8"	SQ YD	102	102				
to construe mandates are effects reconstruent in construent in construen	Z0004562	COMBINATION CONCRETE CURB AND GUTTER REMOVAL AND REPLACEMENT	FOOT	2365	2365				
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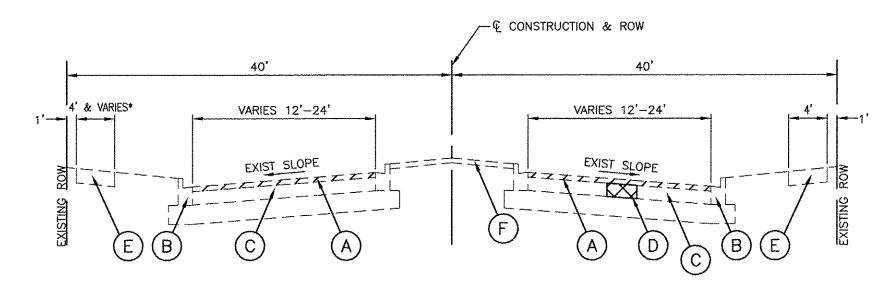
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CHECKED — HLG REVISED —


PLOT SCALE = DRAWN — MED REVISED —

PLOT DATE = 12-01-16 CHECKED — APG REVISED —


STATE OF ILLINOIS DEPARTMENT OF TRANSPORTATION




EXISTING TYPICAL SECTION STA 14+21.00 TO STA 26+25.00, GRAND BOULEVARD

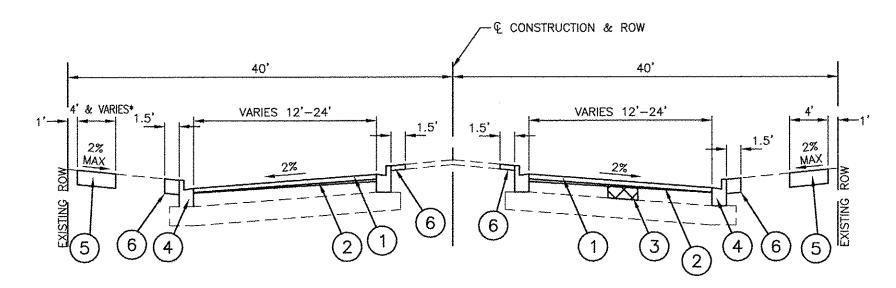

PROPOSED TYPICAL SECTION STA 14+21.00 TO STA 26+25.00, GRAND BOULEVARD

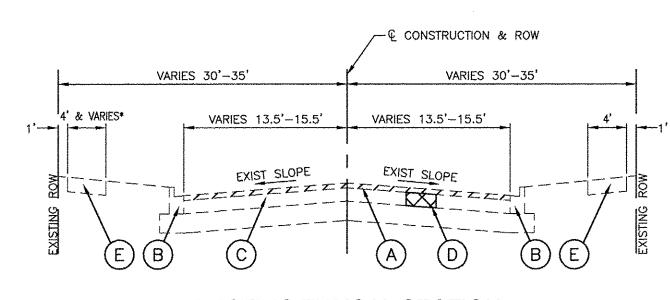

EXISTING TYPICAL SECTION STA 26+25.00 TO STA 37+72.00, GRAND BOULEVARD

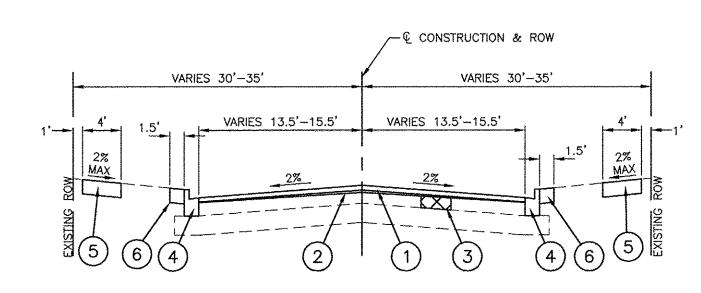

PROPOSED TYPICAL SECTION STA 26+25.00 TO STA 37+72.00, GRAND BOULEVARD

EXISTING LEGEND

- HOT MIX ASPHALT SURFACE REMOVAL, 2"
- EXISTING CURB & GUTTER TO BE REMOVED AT LOCATIONS SHOWN
- ON PLANS OR DIRECTED BY ENGINEER
- EXISTING HOT-MIX ASPHALT PAVEMENT (VARIES 4" TO 4 1/2")
- PAVEMENT REMOVAL FOR CLASS D PATCHES
- EXISTING PCC SIDEWALK TO BE REMOVED AT LOCATIONS SHOWN ON PLANS OR DIRECTED BY ENGINEER
- EXISTING LANDSCAPE MEDIAN

PROPOSED LEGEND

- HOT MIX ASPHALT SURFACE COURSE, MIX "D", N50, 1.5"
- POLYMERIZED LEVELING BINDER (MACHINE METHOD), IL-4.75, N50, 3/4"
- CLASS D PATCH, 6" AT LOCATIONS SHOWN ON PLANS OR DIRECTED BY ENGINEER
- PROPOSED CURB AND GUTTER TO BE INSTALLED AT LOCATIONS SHOWN ON PLAN OR DIRECTED BY ENGINEER (IN KIND)
- PROPOSED PORTLAND CEMENT CONCRETE SIDEWALK 5" (REPLACEMENT AT LOCATIONS DIRECTED BY THE ENGINEER)
- SEEDING (COMPLETE), SPECIAL WITH 4" TOPSOIL AND EROSION CONTROL BLANKET. 1.5' MAXIMUM WIDTH PER BD-24.


HOT-MIX ASPHALT MIXTURE REQUIREMENTS


(CONTRACTOR SHALL MILL BEFORE PATCHING)				
MIXTURE TYPE	AIR VOIDS @ Ndes			
RESURFACING				
HOT-MIX ASPHALT SURFACE COURSE, MIX "D", N50, 1.5"	4% ◎ 50 Gyr.			
POLYMERIZED LEVELING BINDER (MACHINE METHOD), IL-4.75, N50, 3/4"	3.5% © 50 Gyr.			
PATCHING				
CLASS D PATCHES, TYPE I, II, III, IV, (HMA BINDER IL-19.0mm): 6" (IN 3 LIFTS)	4% 🚳 70 Gyr.			
DRIVEWAYS				
HOT-MIX ASPHALT SURFACE COURSE, MIX "D", N50, 2"	4% © 50 Gyr.			
HOT-MIX ASPHALT BINDER COURSE, IL-19.0, N50, 6" (IN 3 LIFTS)	4% @ 50 Gyr.			


- 1. THE UNIT WEIGHT USED TO CALCULATE ALL HMA SURFACE MIXTURE QUANTITIES IS 112 LBS/SQ YD/IN.
- 2. THE "AC TYPE" FOR POLYMERIZED HMA MIXES SHALL BE "SBS/SBR PG 76-22" AND FOR NON-POLYMERIZED HMA THE "AC TYPE" SHALL BE "PG 64-22" UNLESS MODIFIED BY DISTRICT ONE SPECIAL PROVISIONS.
- 3. FOR USE OF RECYCLED MATERIALS SEE SPECIAL PROVISIONS.


NOTE: CLASS D PATCHES, TYPE I, II, III & IV AT APPROXIMATE STATIONS AS SHOWN ON THE PLANS OR AS DIRECTED BY THE ENGINEER.

FILE NAME = 16R0334-TYPX-01 - IDOT P01	USER NAME =	DESIGNED DWS	REVISED —		GRAND BOULEVARD	MUN RTE. SECTION	COUNTY TOTAL SHEET SHEETS NO.
		CHECKED — HLG	REVISED —	STATE OF ILLINOIS	ROADWAY RESURFACING	56 16-00065-00-RS	WILL 13 4
	PLOT SCALE =	DRAWN — RG	REVISED —	DEPARTMENT OF TRANSPORTATION	TYPICAL SECTIONS		CONTRACT NO. 61D61
CACTSAVSO ON TELEVINE ON ECONOM	PLOT DATE = 12-01-16	CHECKED — AG	REVISED —		SCALE: NONE SHEET NO. 4 OF 13 SHEETS STA. TO STA.	FED. ROAD DIST. NO. 1 ILLINOIS	FED. AID PROJECT

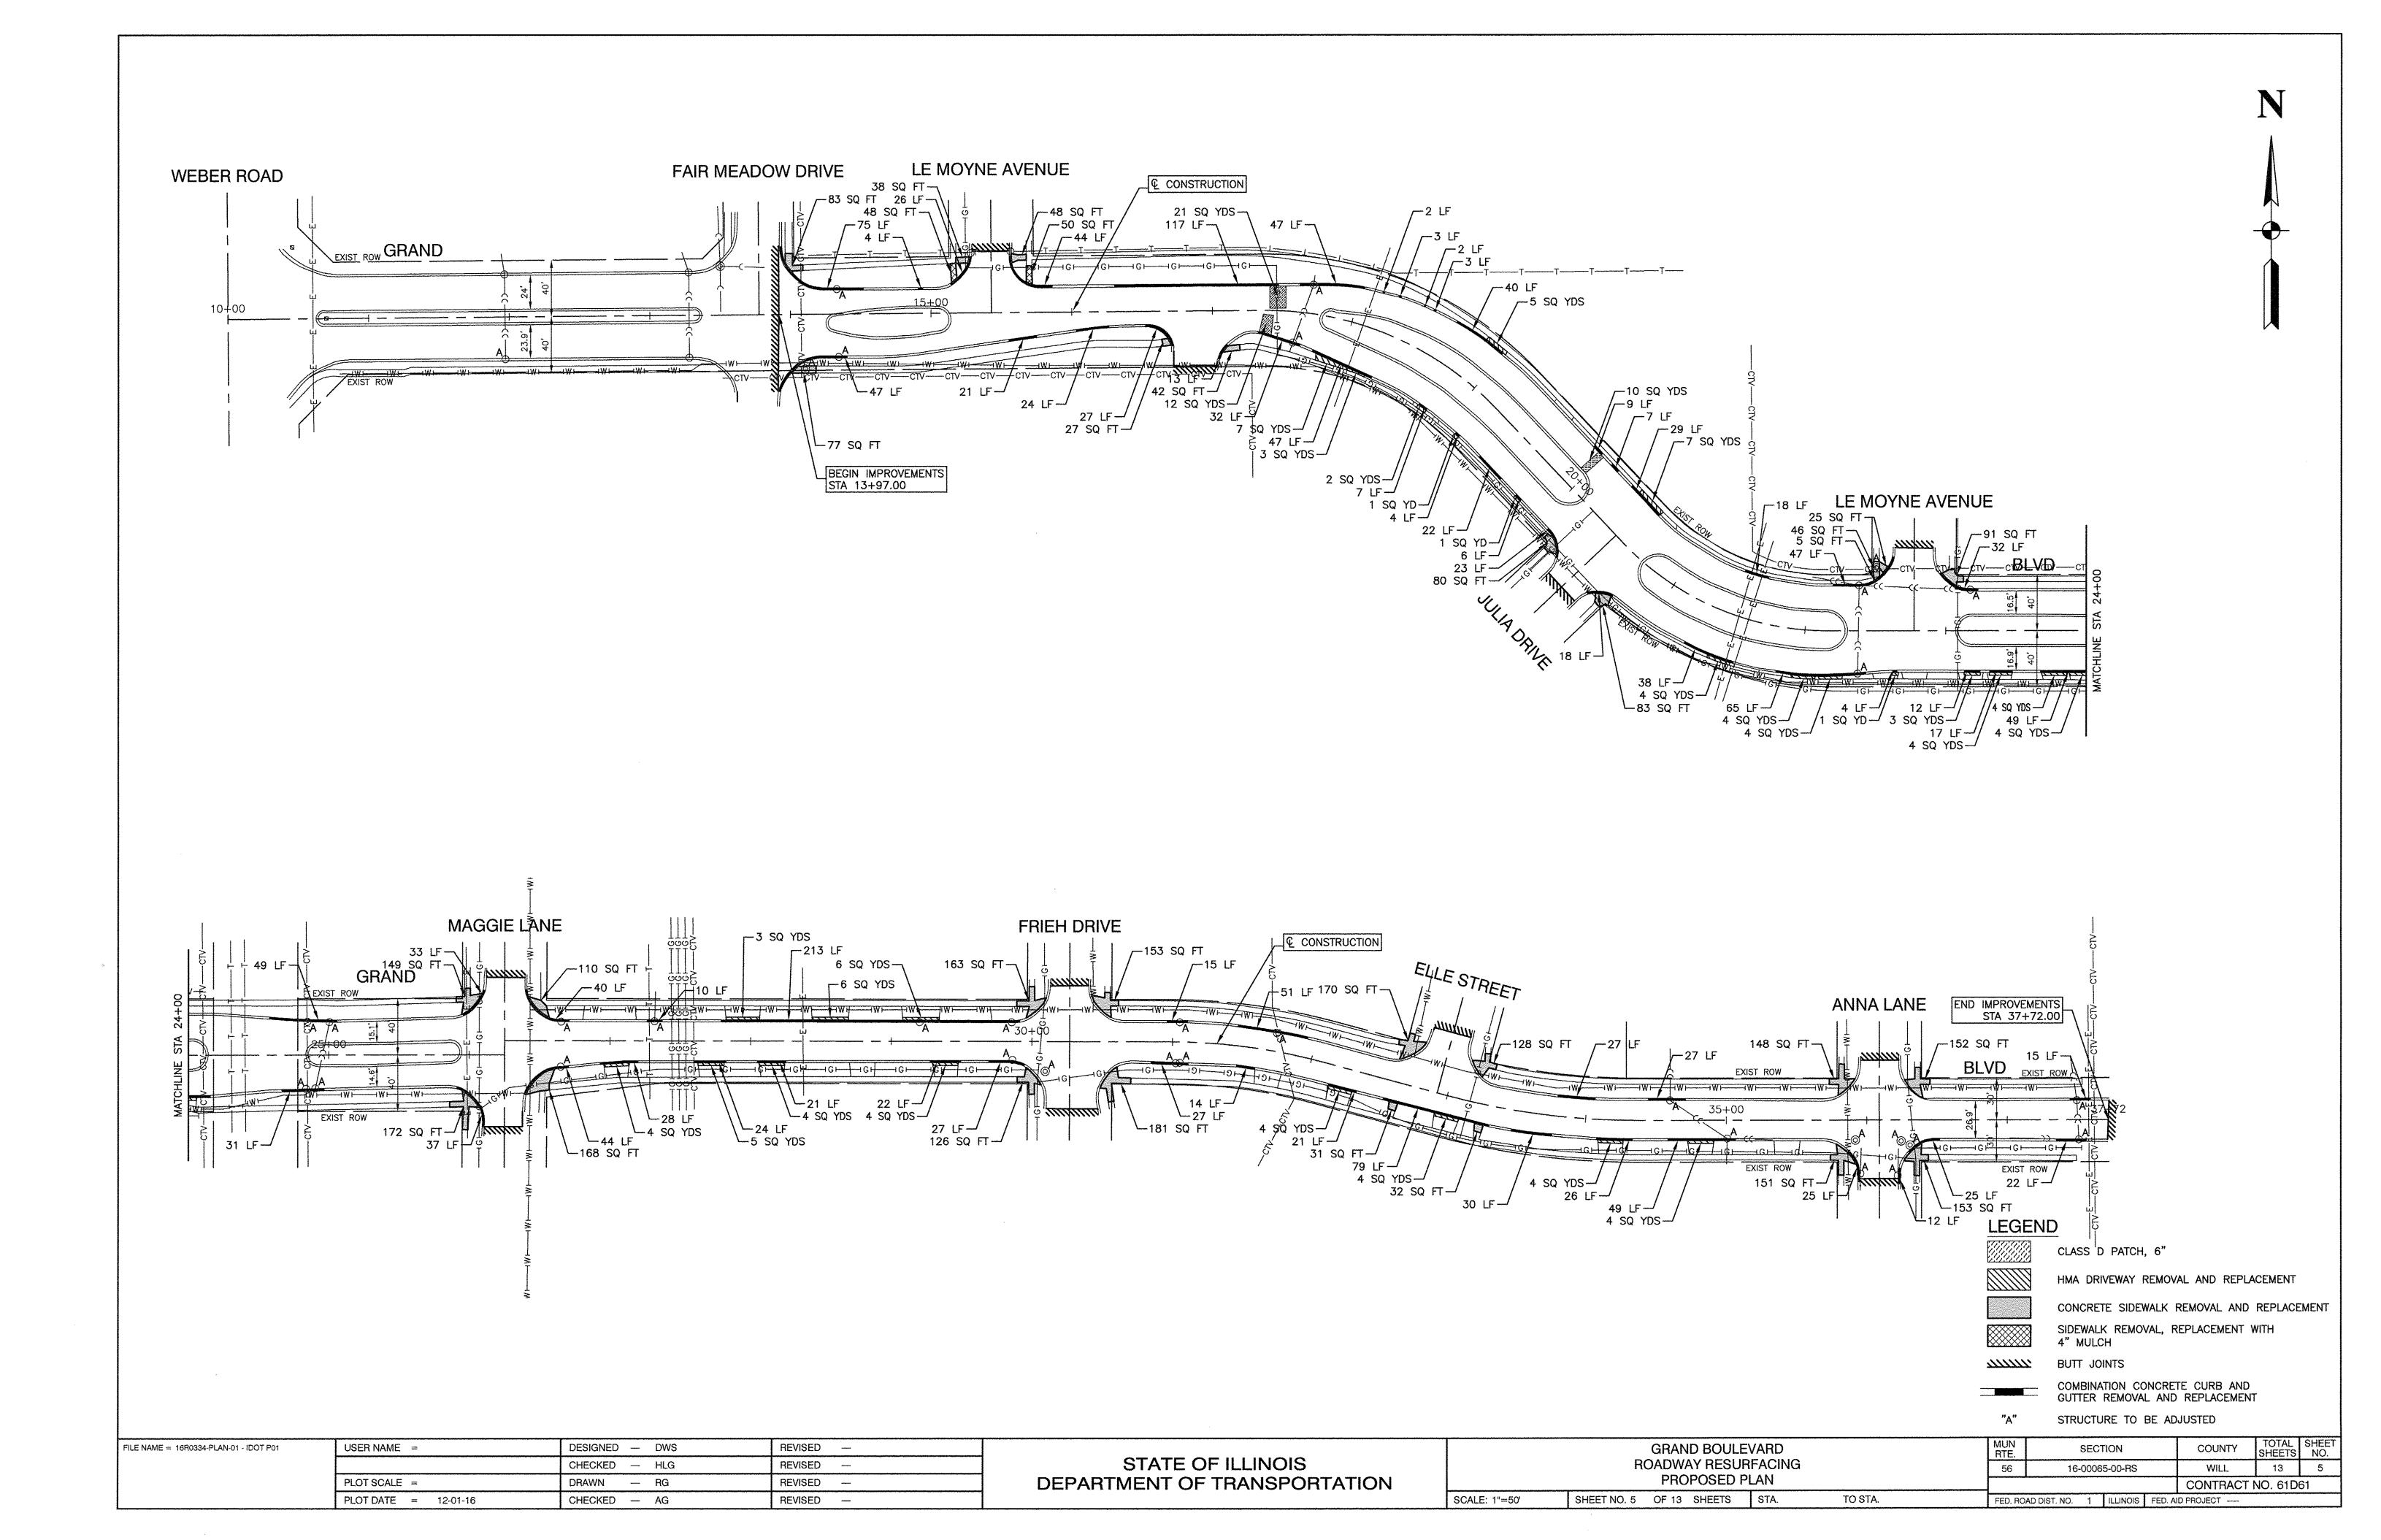

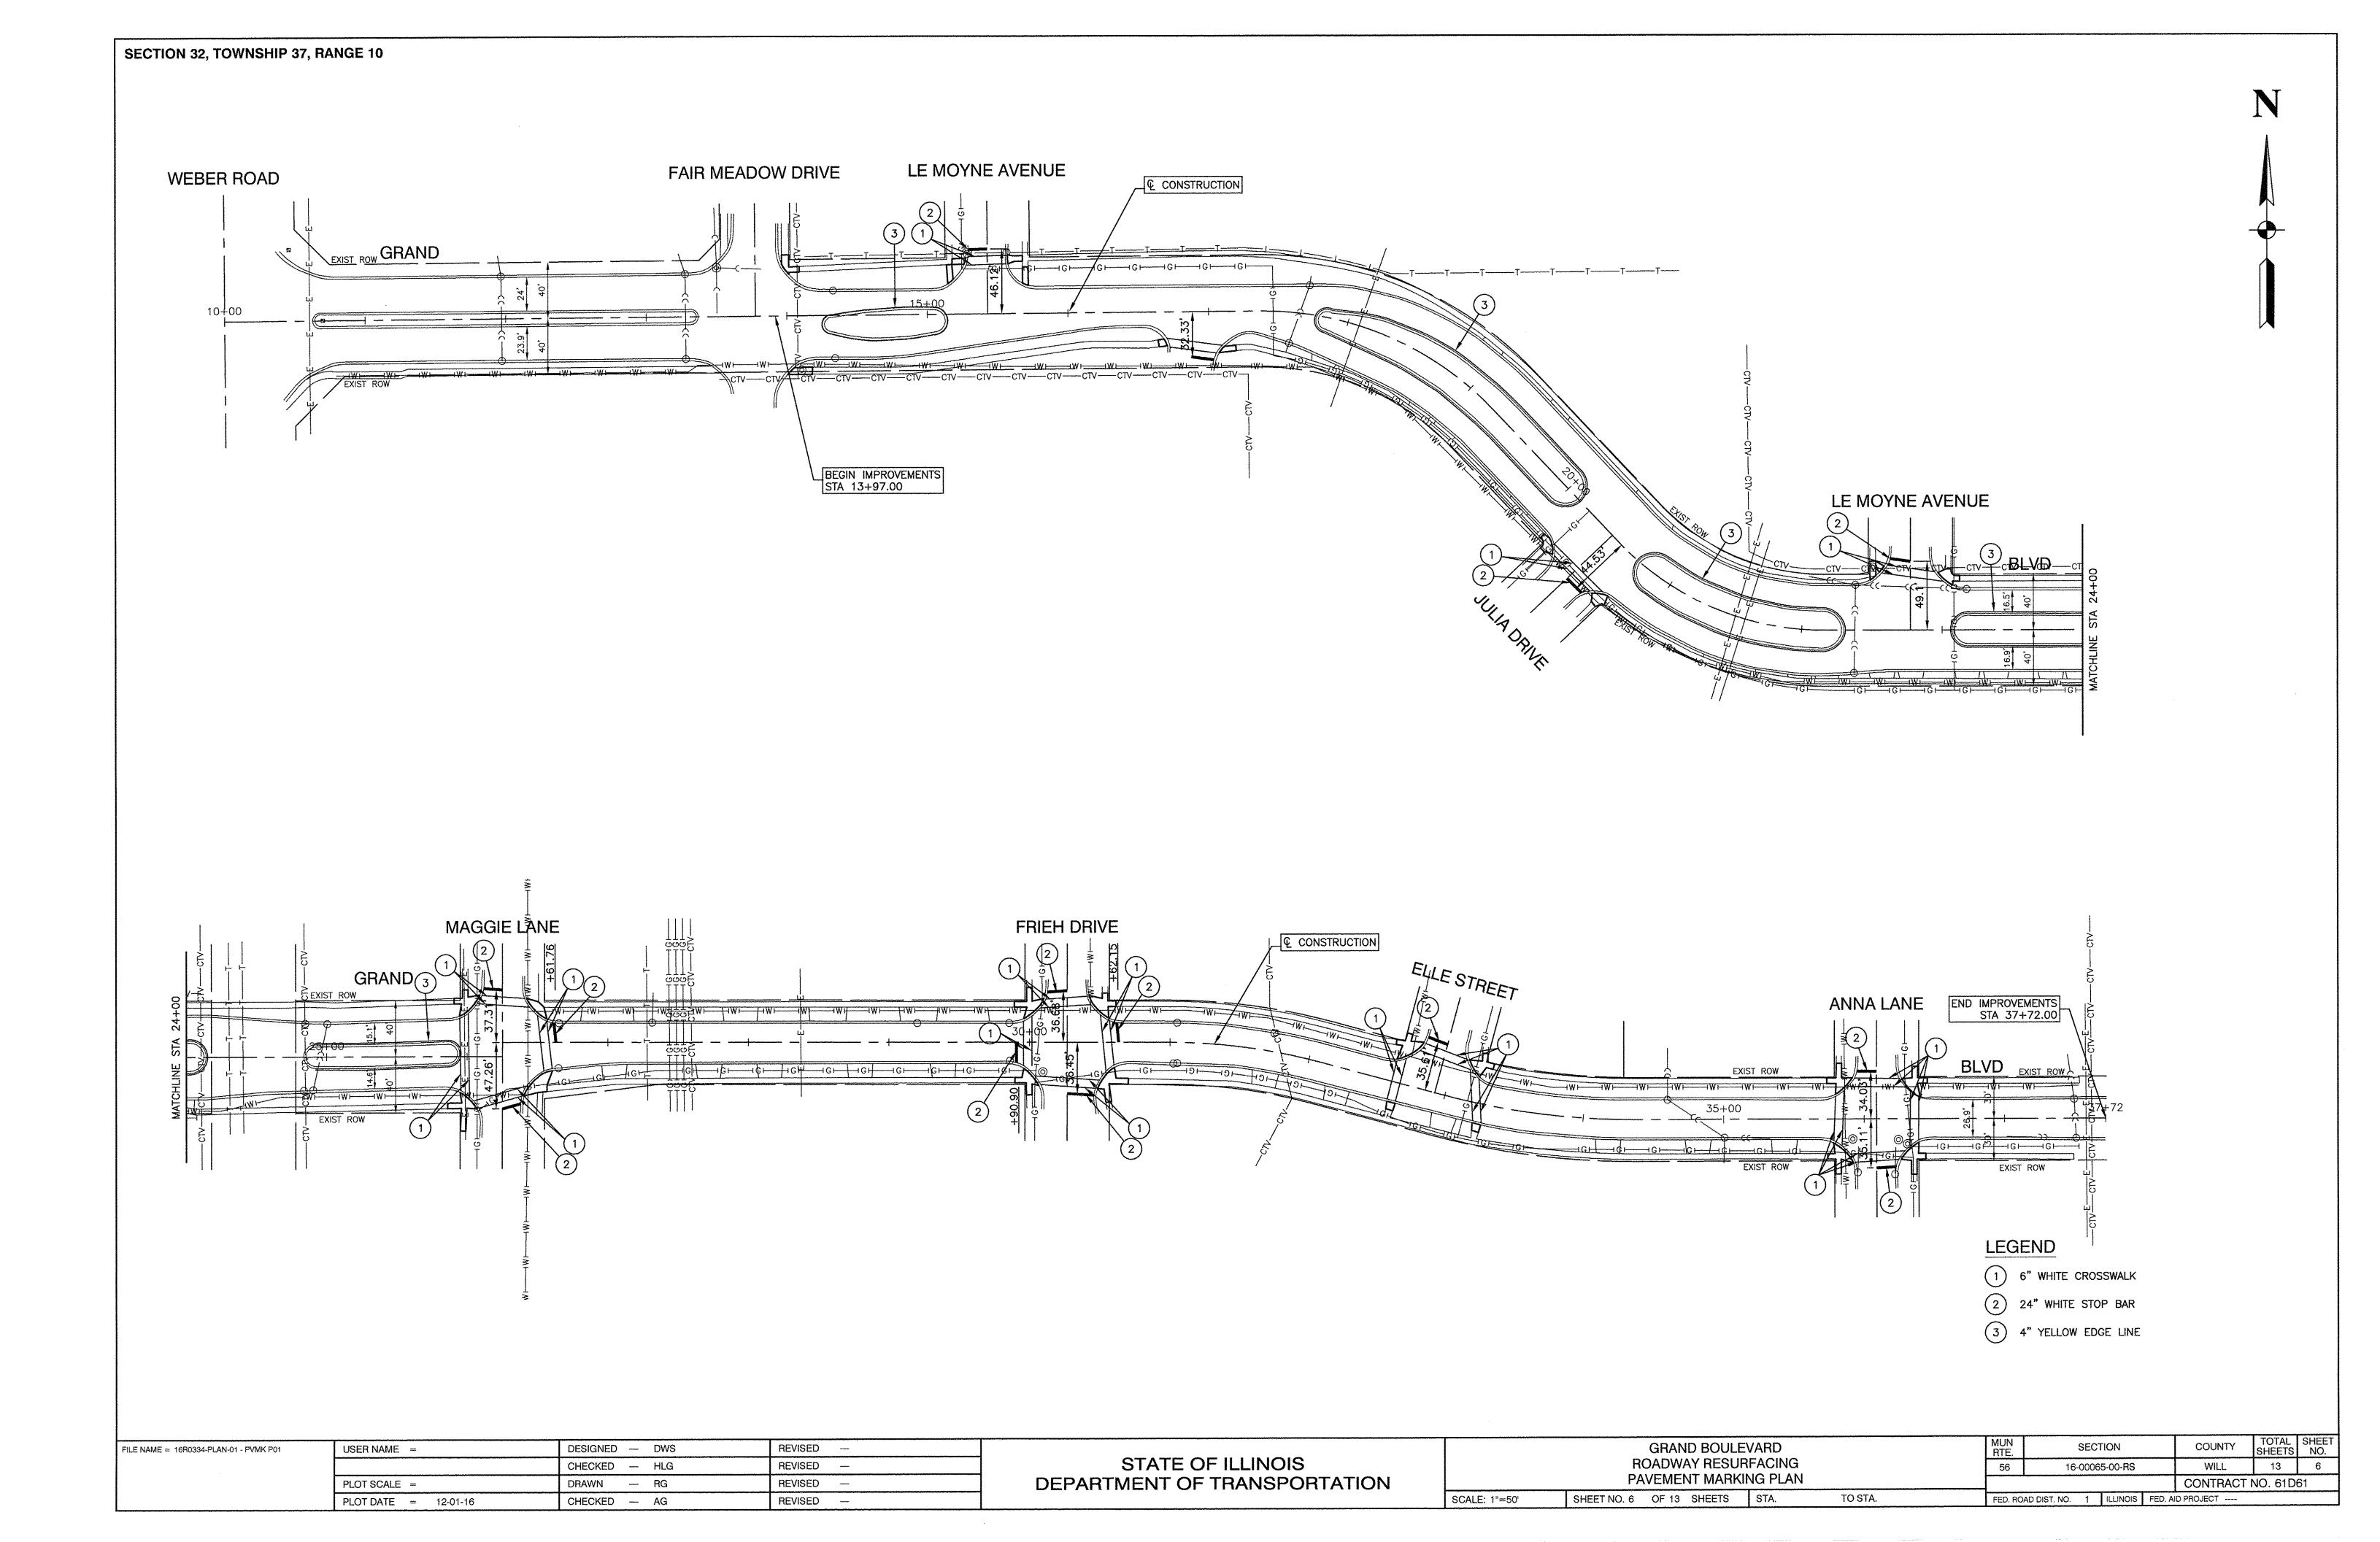

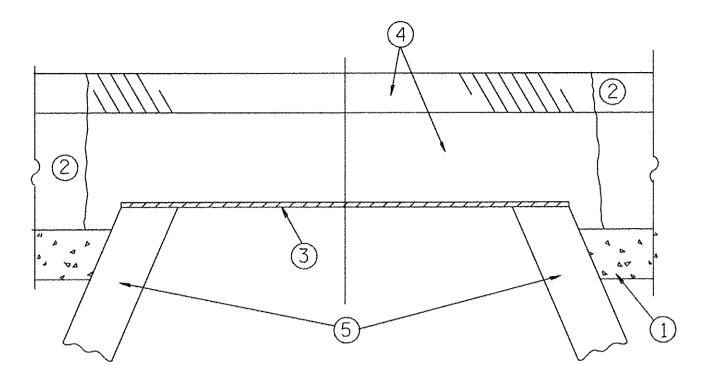

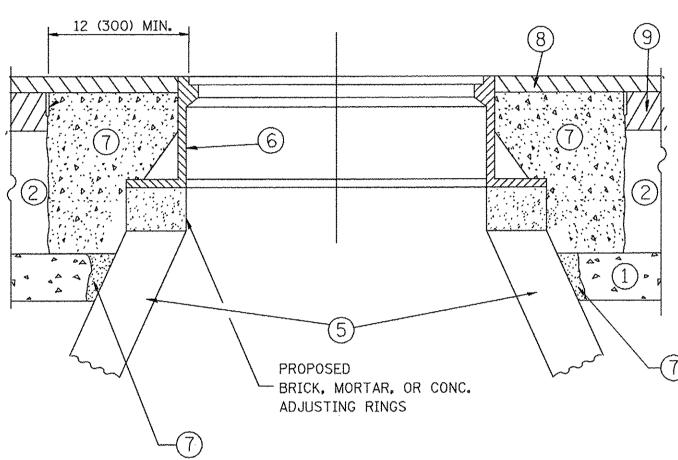

NOTES:

EXISTING BROKEN FRAMES AND LIDS SHALL BE REMOVED AND DISPOSED OF BY THE CONTRACTOR AND SHALL BE REPLACED AS DIRECTED BY THE ENGINEER. REPLACEMENT FRAMES AND LIDS WILL BE PAID FOR IN ACCORDANCE WITH ARTICLE 109.04 OF THE STANDARD SPECIFICATIONS UNLESS A SEPARATE PAY ITEM HAS BEEN PROVIDED.

IF THE EXISTING LIDS ARE OPEN, THE FRAME WILL BE ADJUSTED TO THE ELEVATION OF THE MILLED PAVEMENT SURFACE PRIOR TO THE MILLING OPERATION. THE FRAME WILL NOT BE REMOVED AND COVERED BY THE METAL PLATE.

CITY OF CHICAGO CASTINGS ARE THE PROPERTY OF THE CITY AND THE CONTRACTOR SHALL NOTIFY THE CITY FOR REMOVAL AND DISPOSITION OF THE CASTINGS.

THE METAL PLATE USED TO COVER THE STRUCTURE SHALL REMAIN THE PROPERTY OF THE CONTRACTOR.

SCALE:

WHEN STRUCTURES ARE TO BE ADJUSTED OR RECONSTRUCTED, THE LOWERING AND RAISING OF THE FRAMES AND LIDS WILL NOT BE PAID FOR SEPARATELY BUT WILL BE INCLUDED IN THE COST OF THE CORRESPONDING PAY ITEM.

CONSTRUCTION PROCEDURES

STAGE 1 (BEFORE PAVEMENT MILLING)

- A) REMOVE A MINIMUM OF 12 (300) OF THE PAVEMENT FROM AROUND THE STRUCTURE.
- B) REMOVE THE EXISTING FRAME AND LID FROM THE STRUCTURE.
- C) COVER THE STRUCTURE OPENING WITH A 36 (900) DIAMETER METAL PLATE.
- D) BACKFILL WITH CRUSHED STONE AND A MINIMUM $1\frac{1}{2}$ (40) THICK HMA SURFACE MIX APPROVED BY THE ENGINEER.

STAGE 2 (AFTER PAVEMENT MILLING)

- A) REMOVE THE HMA SURFACE MIX AND CRUSHED STONE.
- B) INSTALL THE FRAME AND LID; ADJUST THE FRAME TO ITS FINAL SURFACE ELEVATION.
- C) THE SURROUNDING SPACE SHALL BE FILLED WITH CLASS PP-1*
 CONCRETE TO THE ELEVATION OF THE SURFACE OF THE EXISTING
 BASE COURSE OR THE BINDER COURSE.
- *UNLESS OTHERWISE SPECIFIED IN THE PLANS.

THE PROCEDURE EXPLAINED ABOVE SHALL CONFORM TO THE APPLICABLE PORTIONS OF SECTIONS 353, 406, 602, AND 603 OF THE STANDARD SPECIFICATIONS EXCEPT THAT "THE CONTRACTOR SHALL ADJUST THE STRUCTURES TO THE FINISHED PAVEMENT ELEVATION NO MORE THAN 5 CALENDAR DAYS PRIOR TO PLACEMENT OF THE FINAL LIFT OF SURFACE UNLESS APPROVED BY THE ENGINEER."

LEGEND

- 1 SUB-BASE GRANULAR MATERIAL
- 6 FRAME AND LID (SEE NOTES)
- 2 EXISTING PAVEMENT
- 7 CLASS PP-1* CONCRETE
- 3 36 (900) DIAMETER METAL PLATE
- 8 PROPOSED HMA SURFACE COURSE
- 4 PROPOSED CRUSHED STONE AND HMA SURFACE MIX

(5) EXISTING STRUCTURE

9 PROPOSED HMA BINDER COURSE

LOCATION OF STRUCTURES:

THE CONTRACTOR WILL BE REQUIRED TO KEEP A RECORD OF THE LOCATIONS OF THE BURIED STRUCTURES ACCORDING TO THE STATION AND DISTANCE LEFT OR RIGHT OF THE CENTERLINE OF PAVEMENT. UPON COMPLETION OF THE WORK, THE CONTRACTOR WILL DELIVER THE RECORD TO THE ENGINEER.

BASIS OF PAYMENT:

REMOVING FRAMES AND LIDS ON DRAINAGE AND UTILITY STRUCTURES IN THE PAVEMENT PRIOR TO MILLING, AND ADJUSTING TO FINAL GRADE PRIOR TO PLACING THE SURFACE COURSE, WILL BE PAID FOR AT THE CONTRACT UNIT PRICE EACH FOR "FRAMES AND LIDS TO BE ADJUSTED (SPECIAL)."

THIS WORK WILL NOT BE PAID FOR WHEN DRAINAGE AND UTILITY STRUCTURES ARE SPECIFIED FOR PAYMENT AS STRUCTURE RECONSTRUCTION.

NEW FRAMES AND LIDS, WHEN SPECIFIED, WILL BE PAID FOR SEPARATELY.

DETAILS FOR FRAMES AND LIDS ADJUSTMENT
WITH MILLING

ALL DIMENSIONS ARE IN INCHES (MILLIMETERS) UNLESS OTHERWISE SHOWN

FILE NAME = 16R0334-DTLS-01 - BD-08

USER NAME = DESIGNED - DWS REVISED - REVISED - REVISED - DRAWN - ACAD REVISED - REVISED - REVISED - REVISED - DRAWN - ACAD REVISED - REVISE


STATE OF ILLINOIS DEPARTMENT OF TRANSPORTATION DETAILS FOR
FRAMES AND LIDS ADJUSTMENT WITH MILLING
SHEET NO. 7 OF 13 SHEETS STA. TO STA.

 MUN RTE.
 SECTION
 COUNTY
 TOTAL SHEETS NO.

 56
 16-00065-00-RS
 WILL
 13
 7

 BD600-03 (BD-8)
 CONTRACT NO. 61 D61

 FED. ROAD DIST. NO. 1
 ILLINOIS
 FED. AID PROJECT

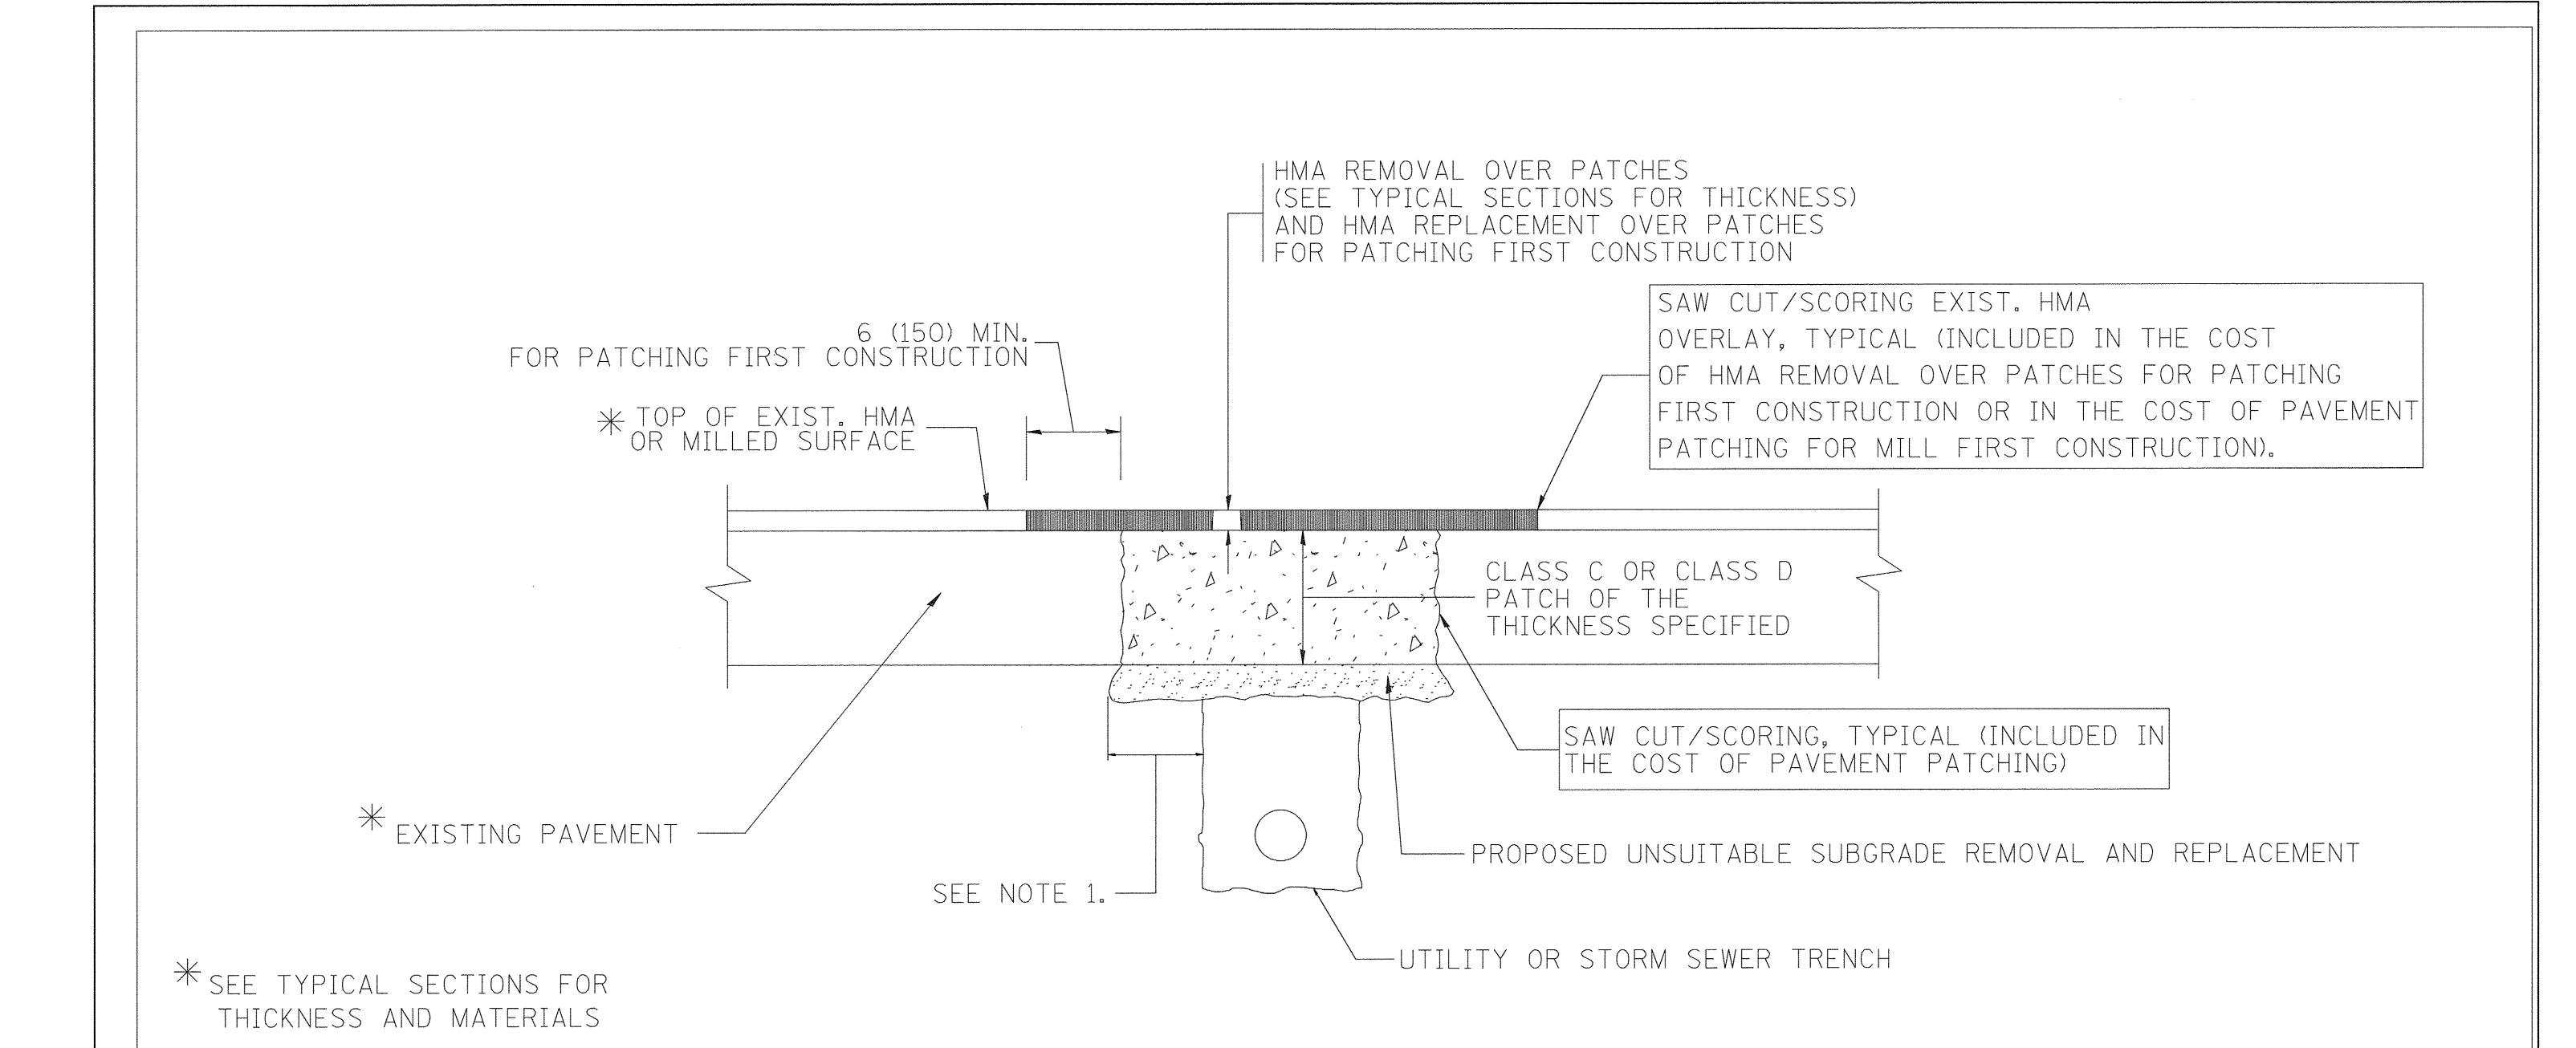

NOTES:

- 1. THE WIDTH OF THE FULL DEPTH PATCH OVER A TRENCH SHALL BE 12 (300) WIDER ON EACH SIDE OF THE TRENCH.
- 2. FOR METHOD OF MEASUREMENT AND BASIS OF PAYMENT, SEE RECURRING SPECIAL PROVISION "PATCHING WITH HOT-MIX ASPHALT OVERLAY REMOVAL".

SEQUENCE OF CONSTRUCTION (PATCHING FIRST)


- 1. REMOVE THE EXISTING HMA MATERIAL OVER THE AREA TO BE PATCHED.
- 2. REMOVE AND REPLACE WITH CLASS C OR D PATCH.
- 3. REPLACE HMA MATERIAL OVER THE AREA TO BE PATCHED.

SEQUENCE OF CONSTRUCTION (MILLING FIRST)

- 1. MILL HMA FIRST IF THERE IS AT LEAST $4\frac{1}{2}$ INCHES OR MORE OF HMA MATERIAL ON TOP OF THE EXISTING PAVEMENT OR IF THE PAVEMENT IS FULL DEPTH HMA. A MINIMUM OF 2 INCHES OF HMA MATERIAL SHALL BE IN PLACE AFTER MILLING.
- 2. REMOVE AND REPLACE WITH FULL DEPTH CLASS D PATCHES TO TOP OF MILLED SURFACE.

ALL DIMENSIONS ARE IN INCHES (MILLIMETERS) UNLESS OTHERWISE SHOWN.


	PLOT DATE = 12-01-16	11-16 CHECKED — ACAD REVISED —	S	SCALE:	SHEET NO. 8 OF 13 SHEETS STA. TO STA.	FED. ROA	AD DIST, NO. 1 ILLINOIS FE	D. AID PROJECT			
	PLOT SCALE =	DRAWN — ACAD	REVISED —	DEPARTMENT OF TRANSPORTATION	HMA SURFACED PAVEMENT			BD400-04 (BD-22)	CONTRACT	NO. 61D61	
		CHECKED — HLG	REVISED —	STATE OF ILLINOIS	HMA SURFACED PAVEMENT		56	16-00065-00-RS	WILL	13	8
FILE NAME = 16R0334-DTLS-01 - BD-22	USER NAME =	DESIGNED — DWS	REVISED —		PAVEMENT PATCHING FOR		MUN RTE.	SECTION	COUNTY	SHEETS SH	EET IO.

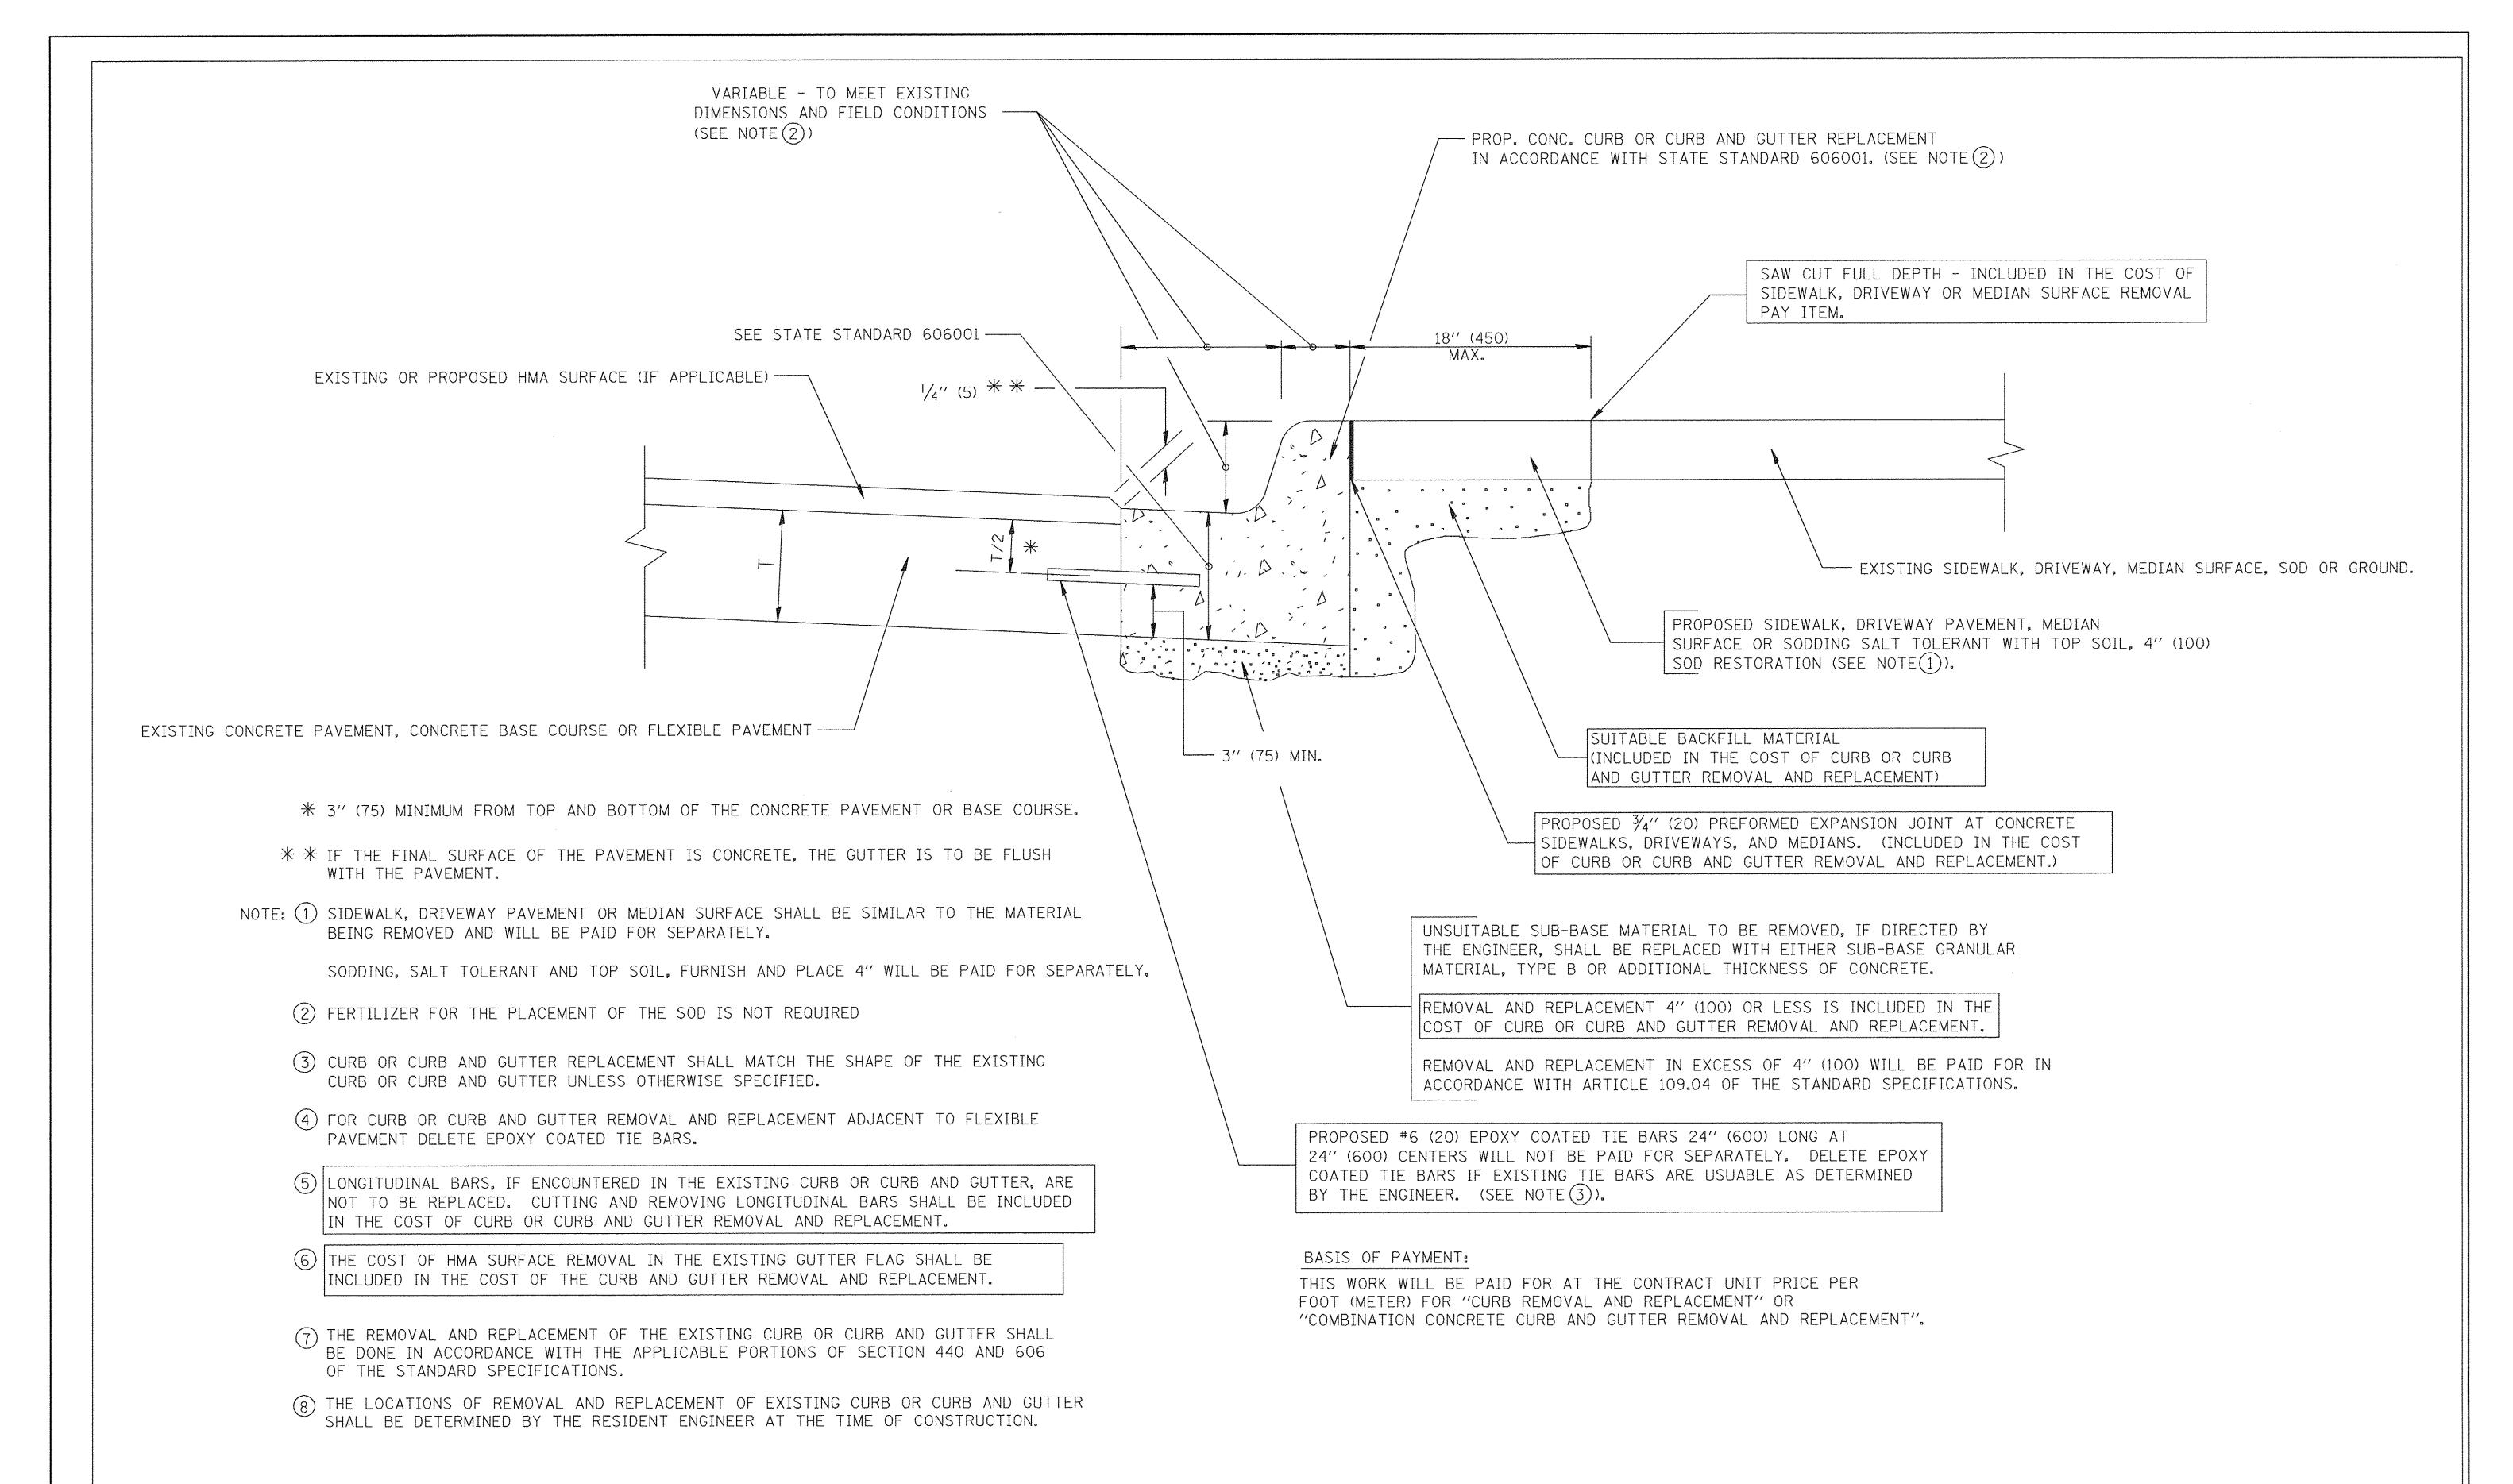


CURB OR CURB AND GUTTER REMOVAL AND REPLACEMENT

ALL DIMENSIONS ARE IN INCHES (MILLIMETERS)
UNLESS OTHERWISE SHOWN.

FILE NAME = 16R0334-DTLS-01 - BD-24	USER NAME =	DESIGNED — DWS	REVISED —			CURB OR CURB AND GUTTER		SECTION	COUNTY	TOTAL SHEET SHEET NO.
		CHECKED — HLG	REVISED —	STATE OF ILLINOIS	REMOVAL AND REPLACEMENT		56	16-00065-00-RS	WILL	13 9
	PLOT SCALE =	DRAWN — ACAD	REVISED —	DEPARTMENT OF TRANSPORTATION				D600-06 (BD-24)	CONTRACT	NO. 61 D61
	PLOT DATE = 12-01-16	CHECKED — ACAD	REVISED		SCALE:	SHEET NO. 9 OF 13 SHEETS STA. TO STA.	FED. ROAD	DIST. NO. 1 ILLINOIS FED.	. AID PROJECT	

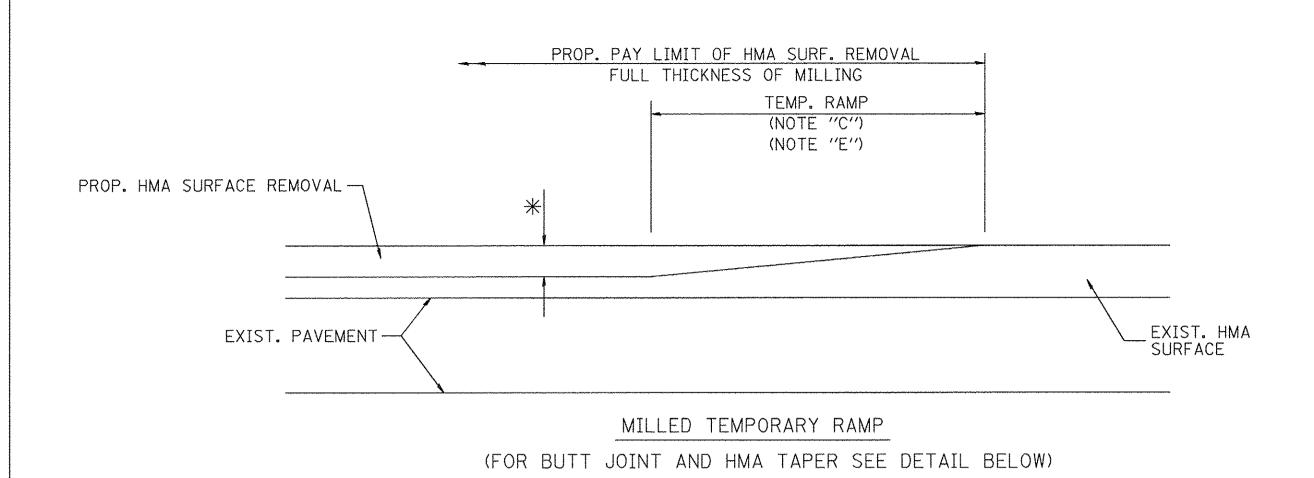

OPTION 1

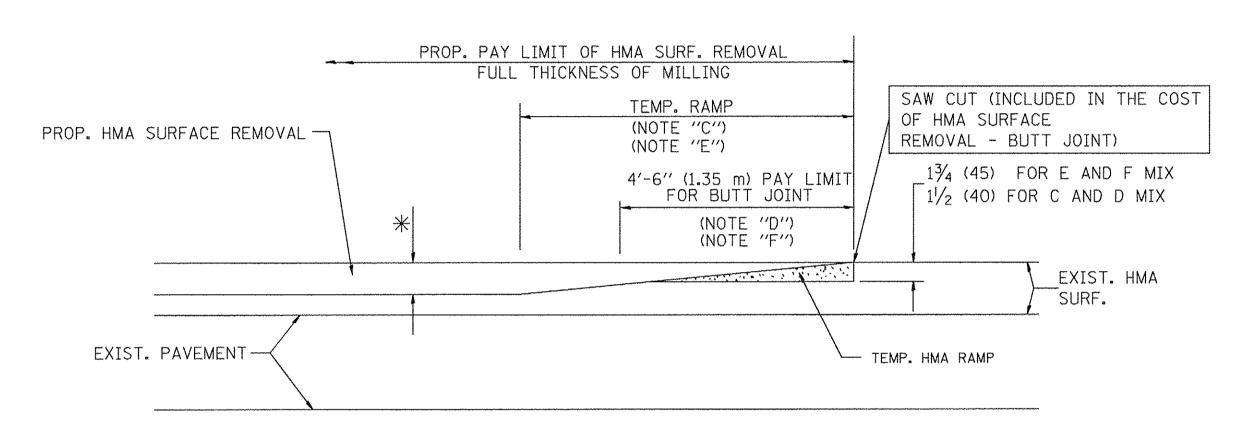


HMA CONSTRUCTED TEMPORARY RAMP


(FOR BUTT JOINT AND HMA TAPER SEE DETAIL BELOW)


OPTION 2

TYPICAL TEMPORARY RAMP

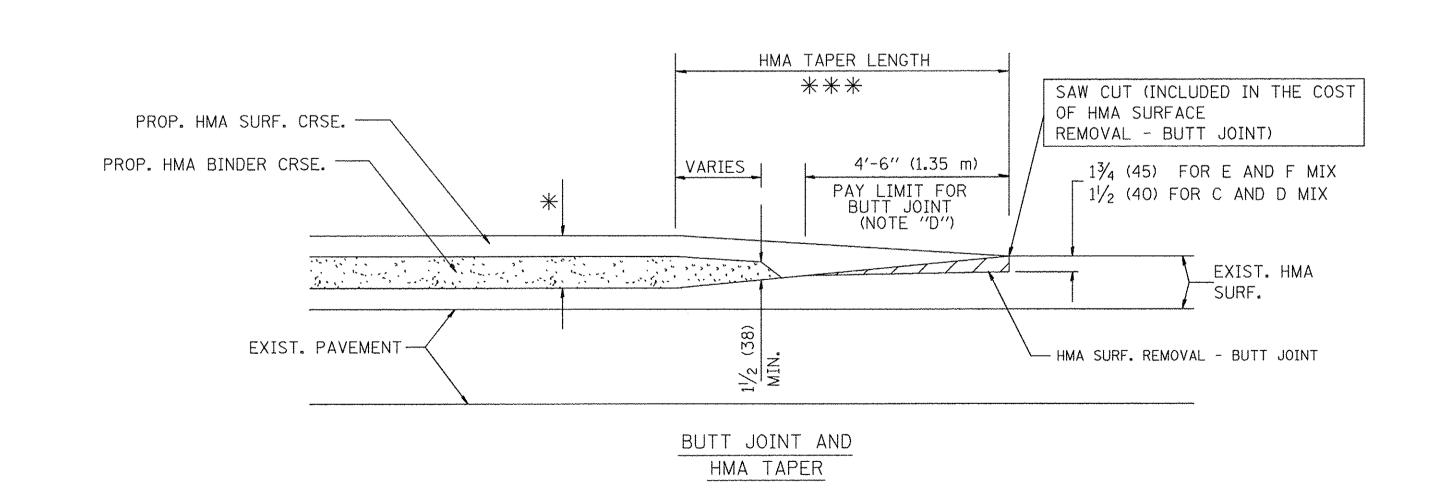

TYPICAL BUTT JOINT AND HMA TAPER FOR MILLING AND RESURFACING

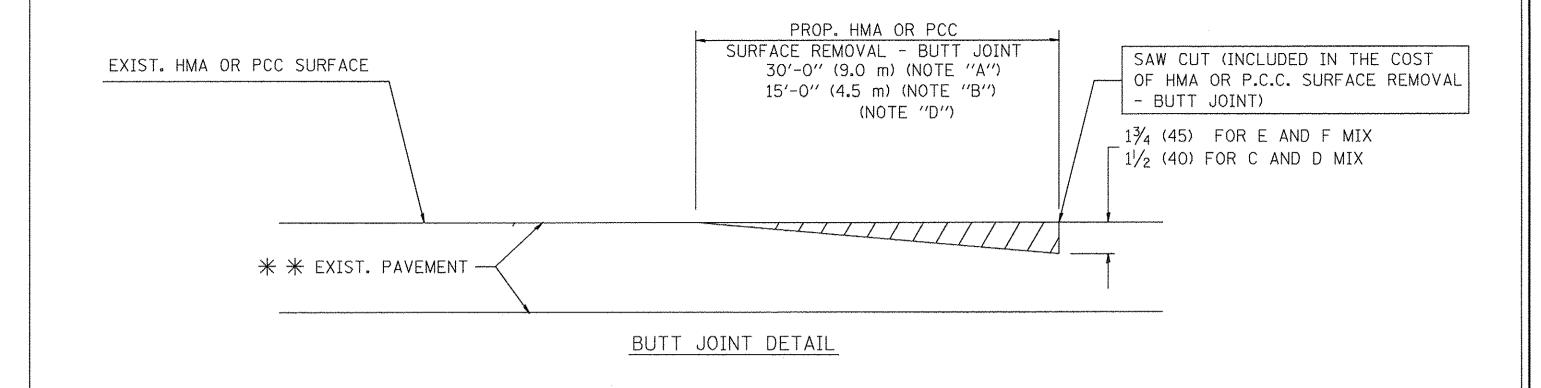

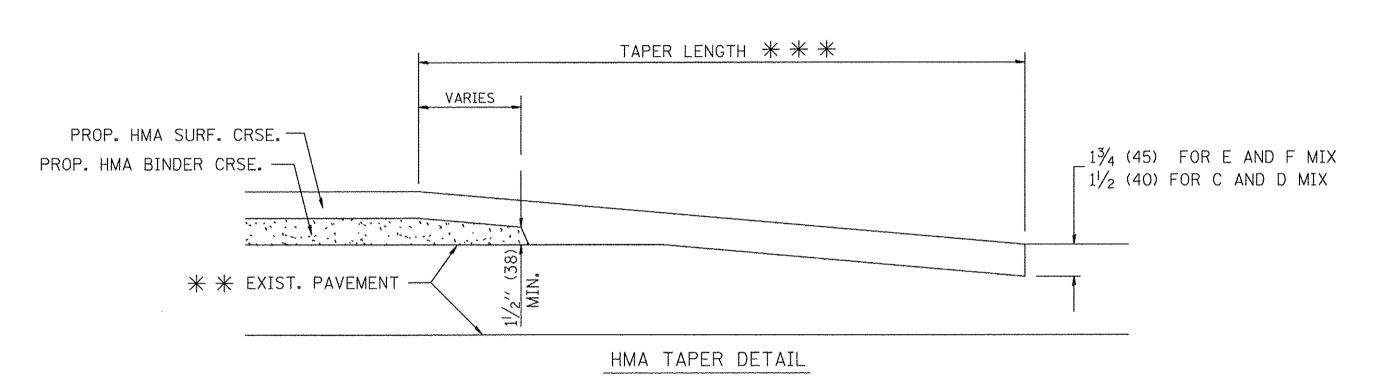

TYPICAL BUTT JOINT AND HMA TAPER FOR RESURFACING ONLY

* * PC CONCRETE, HMA OR HMA RESURFACED PAVEMENT.

NOTES


- A: MAINLINE ROADWAYS AND MAJOR SIDE ROADS.
- B: MINOR SIDE ROADS.
- C: THE TEMP. RAMP SHALL BE CONSTRUCTED IMMEDIATELY UPON REMOVAL OF THE EXISTING HMA SURFACE.
- D: THE BUTT JOINT SHALL BE CONSTRUCTED IMMEDIATELY PRIOR TO PLACING THE PROPOSED HMA COURSES.
- E: TAPER THE TEMP. RAMP AT A RATE OF 3'-0" (900 mm) PER 1 INCH (25 mm) OF MILLING THICKNESS.
- F: INSTALLATION AND REMOVAL OF THE 4'-6" (1.35 m) TEMP. RAMP IS INCLUDED IN COST OF HMA SURFACE REMOVAL BUTT JOINT
- G: SEE ARTICLE 406.08 AND 406.14 OF THE STANDARD SPECIFICATIONS FOR "HMA AND/OR PCC SURFACE REMOVAL, BUTT JOINT".
- * SEE TYPICAL SECTIONS FOR MILLING THICKNESS.
- ** ** ** 20'-0" (6.1 m) PER 1 (25) RESURFACING (NOTE "A") 10'-0" (3.0 m) PER 1 (25) RESURFACING (NOTE "B")

BASIS OF PAYMENT:

- THE BUTT JOINT WILL BE PAID FOR AT THE CONTRACT UNIT PRICE
- PER SQUARE YARD (SQUARE METER)
- FOR "HOT-MIX ASPHALT SURFACE REMOVAL BUTT JOINT" OR FOR "PORTLAND CEMENT CONCRETE SURFACE REMOVAL- BUTT JOINT".

ALL DIMENSIONS ARE IN INCHES (MILLIMETERS) UNLESS OTHERWISE SHOWN.

TOTAL SHEET SHEETS NO. REVISED FILE NAME = 16R0334-DTLS-01 - BD-32 USER NAME = DESIGNED - DWS SECTION **BUTT JOINT AND** STATE OF ILLINOIS REVISED CHECKED - HLG 13 10 16-00065-00-RS WILL HMA TAPER DETAILS DEPARTMENT OF TRANSPORTATION PLOT SCALE = — ACAD REVISED — CONTRACT NO. 61D61 BD400-05 BD32 SHEET NO. 10 OF 13 SHEETS STA. TO STA. SCALE: FED. ROAD DIST. NO. 1 ILLINOIS FED. AID PROJECT ---PLOT DATE = 12-01-16 REVISED — CHECKED — ACAD

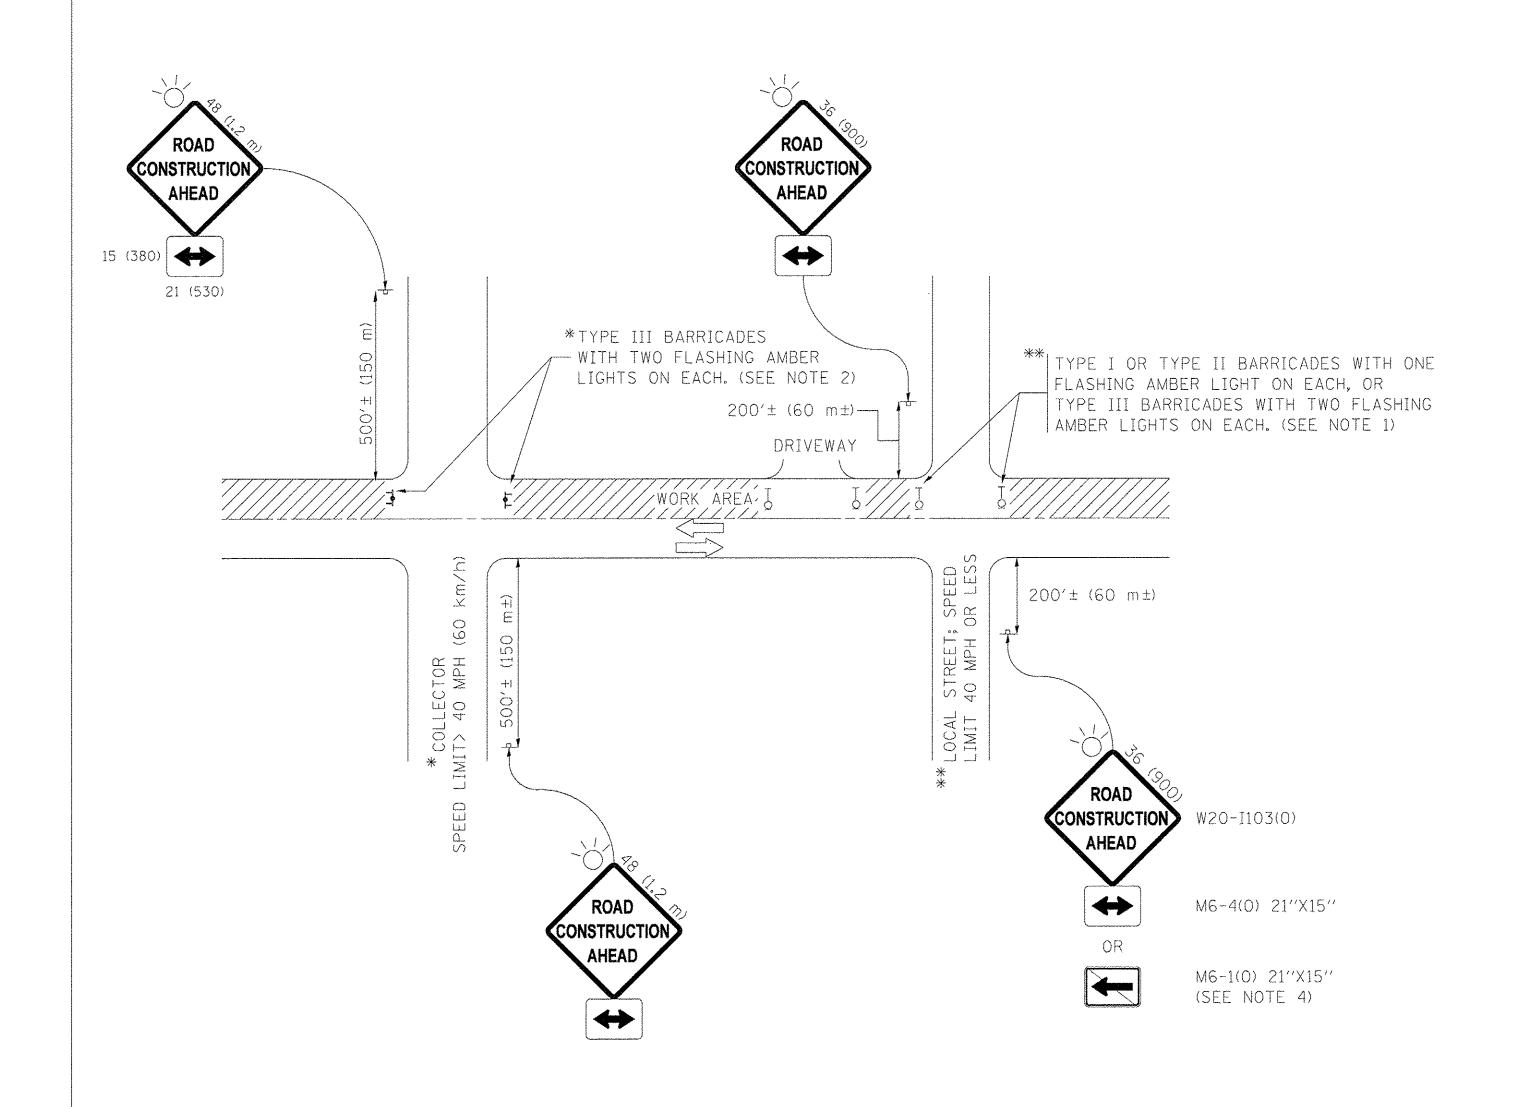

NOTES:

- 1. SIDE ROAD WITH A SPEED LIMIT OF 40 MPH (60 km/h) OR LESS AS SHOWN ON THE DRAWING AND AS DIRECTED BY THE ENGINEER:
 - a) ONE "ROAD CONSTRUCTION AHEAD" SIGN 36 x 36 (900x900) WITH A FLASHER MOUNTED ON IT APPROXIMATELY 200" (60 m) IN ADVANCE OF THE MAIN ROUTE.
 - b) THE CLOSED PORTION OF THE MAIN ROUTE SHALL BE PROTECTED BY BLOCKING WITH TYPE I, TYPE II OR TYPE III BARRICADES, 1/3 OF THE CROSS SECTION OF THE CLOSED PORTION.
- 2. SIDE ROAD WITH A SPEED LIMIT GREATER THAN 40 MPH (60 km/h) AS SHOWN ON THE DRAWING AND AS DIRECTED BY THE ENGINEER:
 - d) ONE "ROAD CONSTRUCTION AHEAD" SIGN 48 \times 48 (1.2 m \times 1.2 m) WITH A FLASHER MOUNTED ON IT APPROXIMATELY 500" (150 m) IN ADVANCE OF THE MAIN ROUTE.
 - b) THE CLOSED PORTION OF THE MAIN ROUTE SHALL BE PROTECTED BY BLOCKING WITH TYPE III BARRICADES, 1/2 OF THE CROSS SECTION OF THE CLOSED PORTION.
- 3. CONES MAY BE SUBSTITUTED FOR BARRICADES OR DRUMS AT HALF THE SPACING DURING DAY OPERATIONS. CONES SHALL BE A MINIMUM OF 28 (710) IN HEIGHT.
- 4. WHEN THE SIDE ROAD LIES BETWEEN THE BEGINNING OF THE MAINLINE SIGNING AND THE WORK ZONE, A SINGLE HEADED ARROW (M6-1) SHALL BE USED IN LIEU OF THE DOUBLE HEADED ARROW (M6-4).

SCALE:

- 5. WHEN WORK IS BEING PERFORMED ON A SIDE ROAD OR DRIVEWAY, FOLLOW THE APPLICABLE STANDARD(S). THE DIRECTIONAL ARROW (M6-1 OR M6-4) SHALL BE COVERED OR REMOVED WHEN NO LONGER CONSISTENT WITH THE TRAFFIC CONTROL SET-UP.
- 6. ADVANCE WARNING SIGNS ARE TO BE OMITTED ON DRIVEWAYS UNLESS OTHERWISE SPECIFIED IN THE PLANS OR BY THE ENGINEER.
- 7. THE TRAFFIC CONTROL AND PROTECTION FOR SIDE ROADS, INTERSECTIONS, AND DRIVEWAYS SHALL BE INCLUDED IN THE COST OF SPECIFIED TRAFFIC CONTROL STANDARDS OR ITEMS.

All dimensions are in inches (millimeters) unless otherwise shown.

FILE NAME = 16R0334-DTLS-01 - TC-10

USER NAME = DESIGNED - DWS

REVISED - A, HOUSEH 10-15-96

CHECKED - HLG

REVISED - A, HOUSEH 10-15-96

DRAWN - ACAD

REVISED - A, SCHUETZE 07-01-13

PLOT DATE = 12-01-16

CHECKED - ACAD

REVISED - A, SCHUETZE 09-15-16

STATE OF ILLINOIS DEPARTMENT OF TRANSPORTATION TRAFFIC CONTROL AND PROTECTION FOR SIDE ROADS, INTERSECTIONS, AND DRIVEWAYS


SHEET NO. 11 OF 13 SHEETS STA. TO STA.

 MUN RTE.
 SECTION
 COUNTY
 TOTAL SHEET NO.

 56
 16-00065-00-RS
 WILL
 13
 11


 TC-10
 CONTRACT NO. 61D61

 FED. ROAD DIST, NO. 1
 ILLINOIS
 FED. AID PROJECT

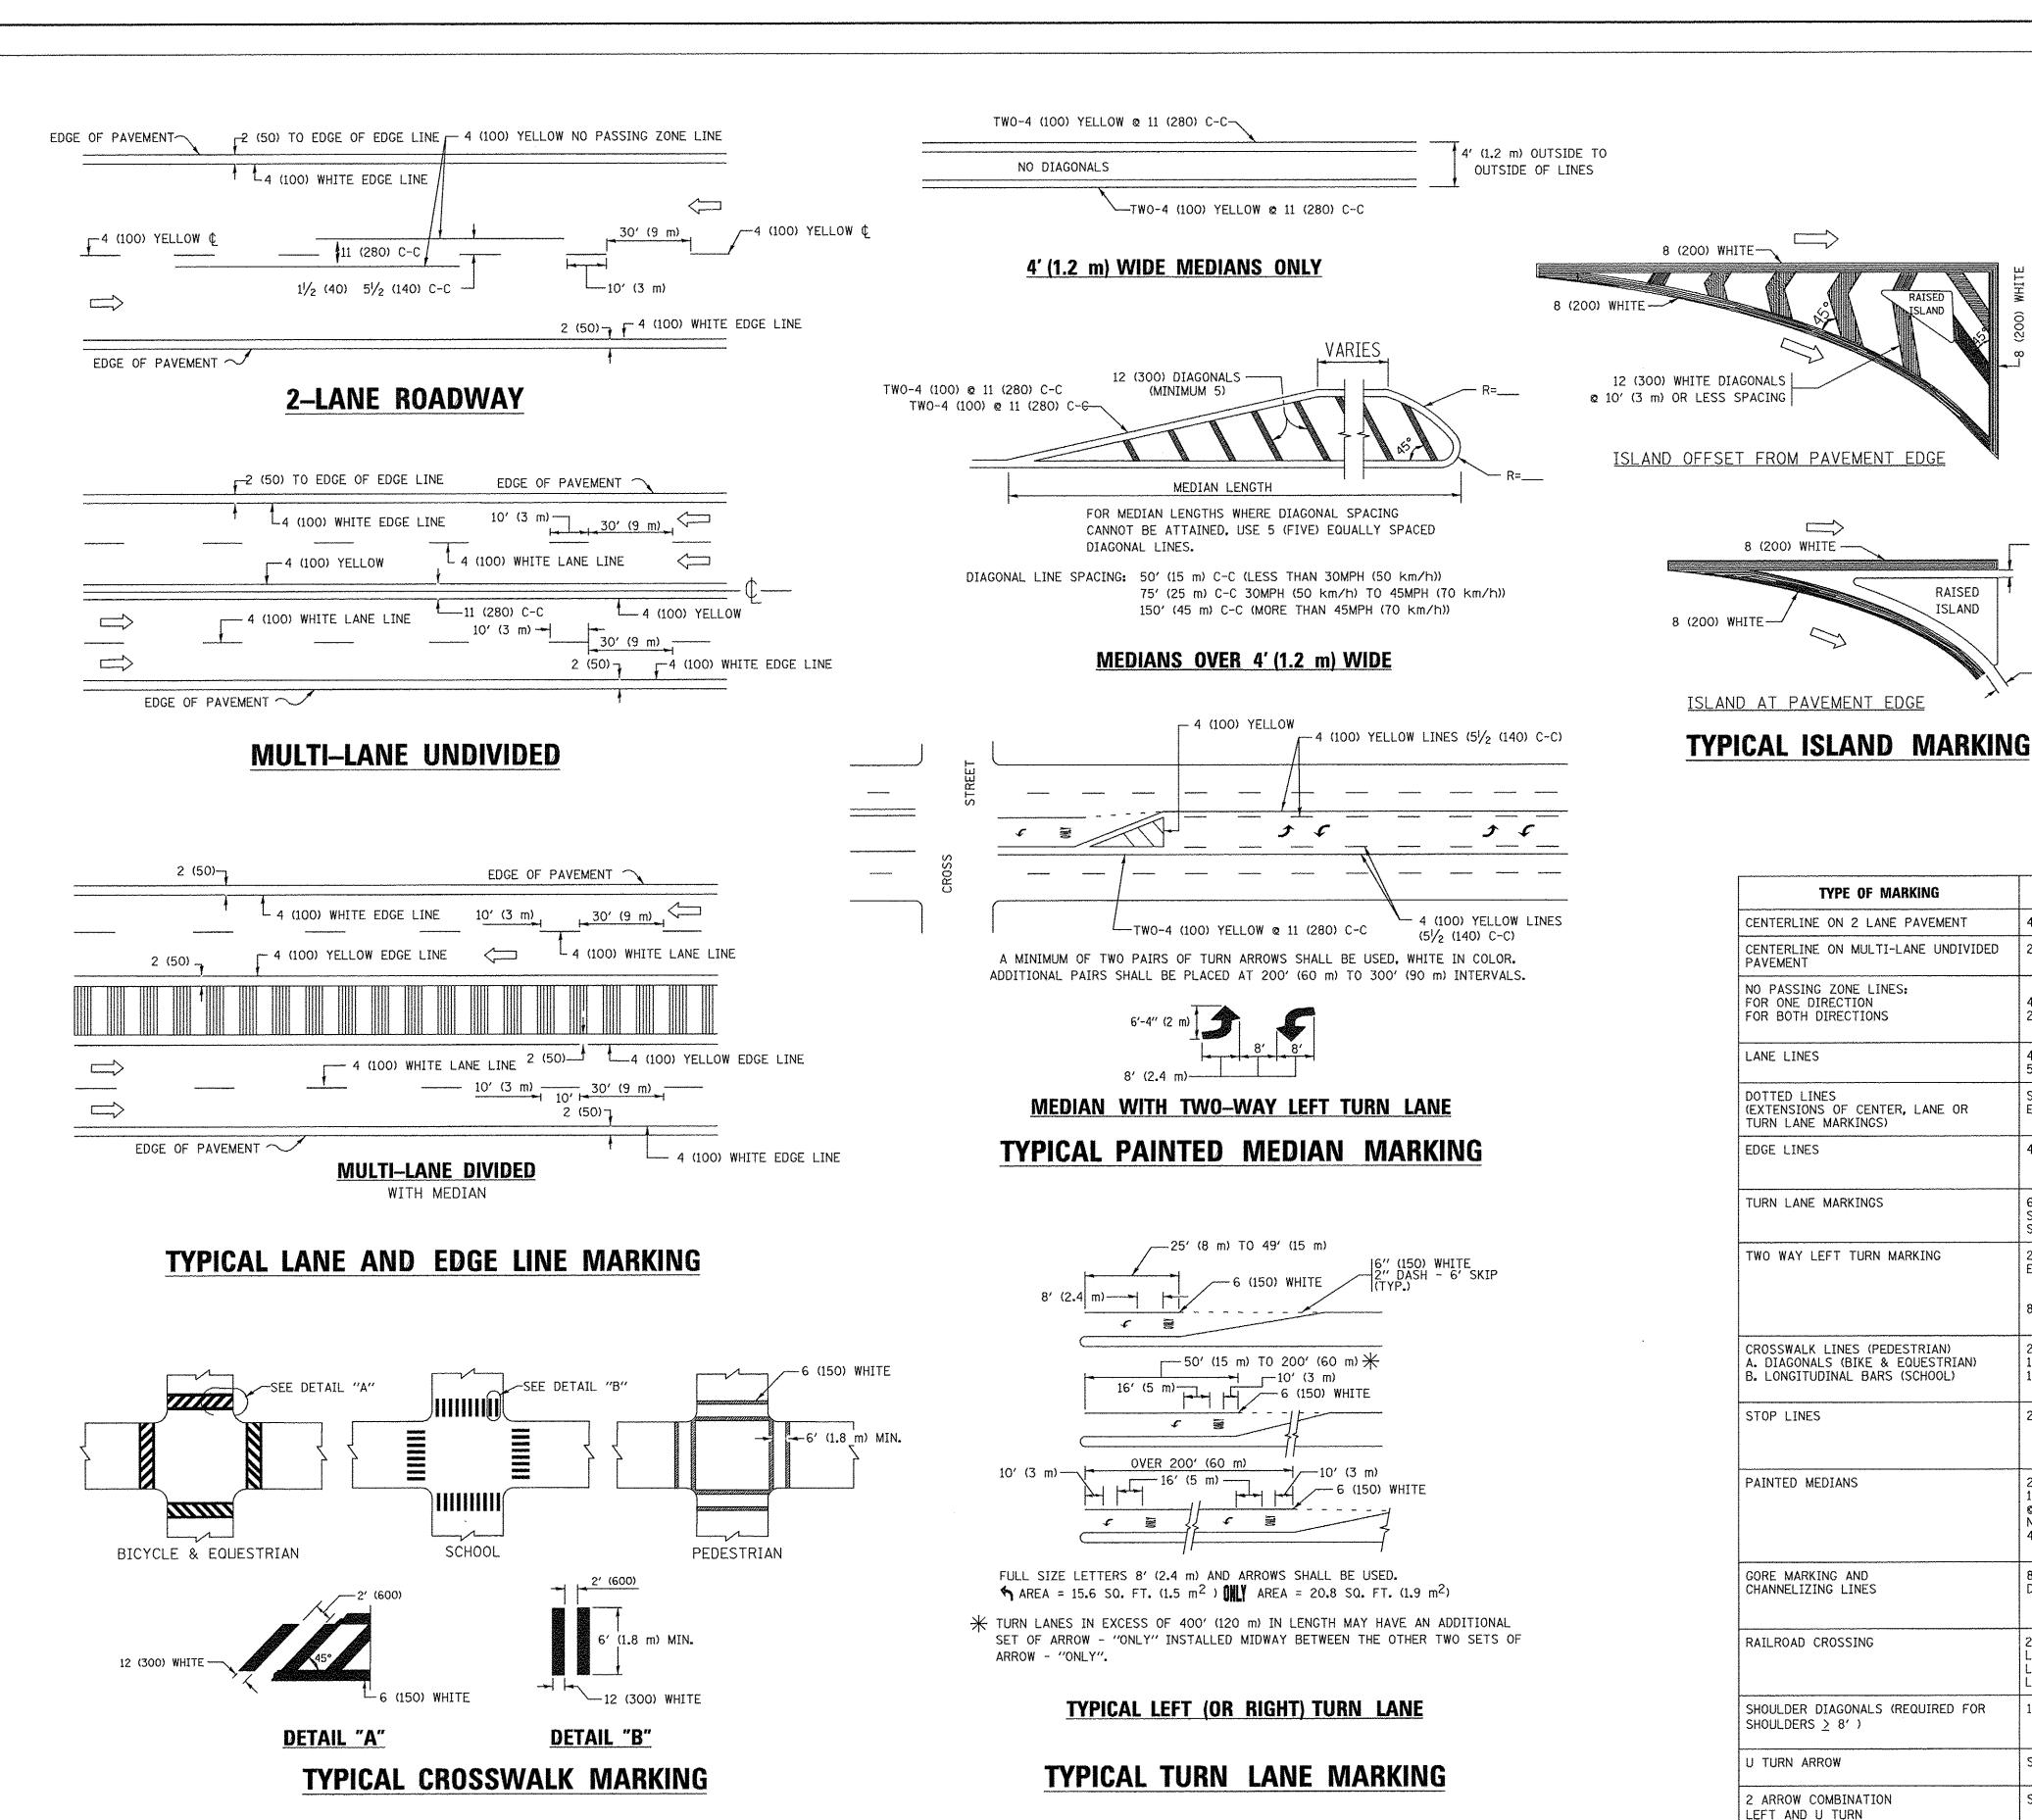

* MARKINGS SHALL BE INSTALLED PARALLEL TO THE CENTERLINE OF

THE ROAD WHICH IT CROSSES

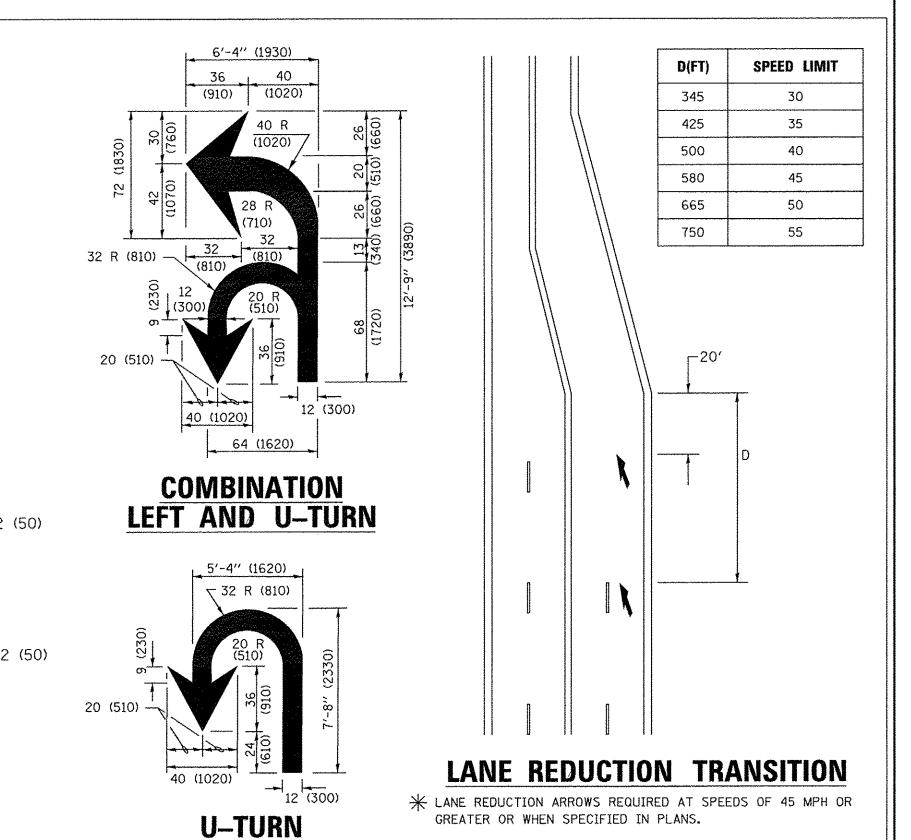

CENTERLINE ON 2 LANE PAVEMENT SKIP-DASH YELLOW 10' (3 m) LINE WITH 30' (9 m) SPACE CENTERLINE ON MULTI-LANE UNDIVIDED 11 (280) C-C 2 @ 4 (100) YELLOW NO PASSING ZONE LINES: 51/2 (140) C-C FROM SKIP-DASH CENTERLINE FOR ONE DIRECTION FOR BOTH DIRECTIONS 2 @ 4 (100) SOLID YELLOW OMIT SKIP-DASH CENTERLINE BETWEEN SKIP-DASH SKIP-DASH 10' (3 m) LINE WITH 30' (9 m) SPACE LANE LINES 5 (125) ON FREEWAYS WHITE SAME AS LINE BEING SAME AS LINE BEING 2' (600) LINE WITH 6' (1.8 m) SPACE (EXTENSIONS OF CENTER, LANE OR TURN LANE MARKINGS) EXTENDED EXTENDED YELLOW-LEFT OUTLINE MEDIANS IN YELLOW WHITE-RIGHT SOLID WHITE SEE TYPICAL TURN LANE MARKING DETAIL TURN LANE MARKINGS 6 (150) LINE; FULL SIZE LETTERS & SYMBOLS (8' (2.4m)) 10' (3 m) LINE WITH 30' (9 m) SPACE FOR SKIP-DASH; 51/2 (140) C-C BETWEEN SOLID LINE AND SKIP-DASH LINE TWO WAY LEFT TURN MARKING 2 @ 4 (100) SKIP-DASH YELLOW EACH DIRECTION AND SOLID IN PAIRS SEE TYPICAL TWO-WAY LEFT TURN
MARKING DETAIL 8' (2.4m) LEFT ARROW CROSSWALK LINES (PEDESTRIAN)
A. DIAGONALS (BIKE & EQUESTRIAN) NOT LESS THAN 6' (1.8 m) APART 2 @ 6 (150) 2' (600) APART SOLID 12 (300) @ 45° WHITE 12 (300) @ 90° SOLID (600) APART B. LONGITUDINAL BARS (SCHOOL) WHITE SEE TYPICAL CROSSWALK MARKING DETAILS. PLACE 4' (1.2 m) IN ADVANCE OF AND STOP LINES 24 (600) SOLID WHITE PARALLEL TO CROSSWALK, IF PRESENT, OTHERWISE, PLACE AT DESIRED STOPPING POINT. PARALLEL TO CROSSROAD CENTERLINE, WHERE SOLID PAINTED MEDIANS 2 @ 4 (100) WITH YELLOW: 1 (280) C-C FOR THE DOUBLE LINE 12 (300) DIAGONALS SEE TYPICAL PAINTED MEDIAN MARKING. TWO WAY TRAFFIC NO DIAGONALS USED FOR ONE WAY TRAFFIC 4' (1.2 m) WIDE MEDIANS SOLID GORE MARKING AND 8 (200) WITH 12 (300) WHITE DIAGONALS @ 45° 15' (4.5 m) C-C (LESS THAN 30MPH (50 km/h)) CHANNELIZING LINES 20' (6 m) C-C 30MPH (50 km/h) TO 45MPH (70 km/h)) 30' (9 m) C-C (OVER 45MPH (70 km/h)) SOLID SEE STATE STANDARD 780001 RAILROAD CROSSING 24 (600) TRANSVERSE WHITE LINES; "RR" IS 6' (1.8 m AREA OF: "R"=3.6 SQ. FT. (0.33 m²) EACH "X"=54.0 SQ. FT. (5.0 m²) LETTERS; 16 (400) LINE FOR "X" SOLID 50' (15 m) C-C (LESS THAN 30MPH (50 km/h)) SHOULDER DIAGONALS (REQUIRED FOR 12 (300) @ 45° YELLOW - LEFT 75' (25 m) C-C (30 MPH (50 km/h) TO 45MPH (70 km/h))

PATTERN

WIDTH OF LINE

TYPE OF MARKING

COLOR

FOR FURTHER DETAILS ON PAVEMENT MARKING REFER TO STANDARD SPECIFICATIONS FOR ROAD AND BRIDGE CONSTRUCTION AND STATE STANDARD 780001.

SEE DETAIL

SEE DETAIL

SOLID

SOLID

WHITE

WHITE

All dimensions are in inches (millimeters) unless otherwise shown.

150' (45 m) C-C (OVER 45MPH (70 km/h))

30.4 SF

SPACING /REMARKS

TOTAL SHEET SHEETS NO. MUN RTE. SECTION COUNTY REVISED FILE NAME = 16R0334-DTLS-01 - TC-13 USER NAME DESIGNED — DWS DISTRICT ONE STATE OF ILLINOIS REVISED CHECKED 13 12 56 16-00065-00-RS WILL TYPICAL PAVEMENT MARKINGS DEPARTMENT OF TRANSPORTATION TC-13 PLOT SCALE = -- ACAD REVISED CONTRACT NO. 61D61 SHEET NO. 12 OF 13 SHEETS STA. TO STA. SCALE: FED. ROAD DIST. NO. 1 ILLINOIS FED. AID PROJECT ---REVISED PLOT DATE = 12-01-16 CHECKED — ACAD

