D-91-229-10

DEPARTMENT OF TRANSPORTATION


DIVISION OF HIGHWAYS

PROPOSED HIGHWAY PLANS

FAU 3512 (US RTE 14 / NORTHWEST HIGHWAY)
AT BROADWAY ST.

SECTION 87-Y-N
PROJECT ACM-3512(013)

TRAFFIC SIGNAL INSTALLATION AND CHANNELIZATION
COOK COUNTY
C-91-229-10

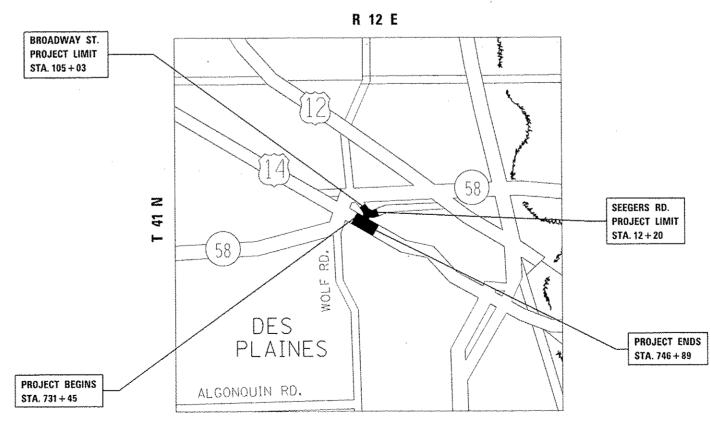

MAINE TOWNSHIP

GROSS LENGTH = 1,544 FT. = 0.29 MILE NET LENGTH = 1,544 FT. = 0.29 MILE

THE CITY OF DES PLAINES

FOR INDEX OF SHEETS, SEE SHEET NO. 2

THE PROJECT IS LOCATED IN

0

0

0

0

TRAFFIC DATA

US 14
2015 ADT = 16,500
POSTED SPEED LIMIT = 40 MPH
BROADWAY ST.
2008 ADT = 3,412
POSTED SPEED LIMIT = 30 MPH

0 100' 200' 300' -- 1" = 100'
0 50' 100' 1" = 50'
0 50' 100' 1" = 40'
0 50' 100' -- 1" = 30'
0 50' 100' -- 1" = 20'

FULL SIZE PLANS HAVE BEEN PREPARED USING STANDARD ENGINEERING SCALES. REDUCED SIZED PLANS WILL NOT CONFORM TO STANDARD SCALES. IN MAKING MEASUREMENTS ON REDUCED PLANS, THE ABOVE SCALES MAY BE USED.

J.U.L.I.E.
JOINT UTILITY LOCATION INFORMATION FOR EXCAVATION
1-800-892-0123
OR 811

PROJECT ENGINEER DAN WILGREEN (847) 705-4240
PROJECT MANAGER FAWAD AQUEEL (847) 705-4247

CONTRACT NO. 60J39

STATE OF ILLINOIS
DEPARTMENT OF TRANSPORTATION

SUBMITTED

OCTOGO 27
20

REGIONAL ENGINEER

PROGRAM DEVELOPMENT

STATE OF ILLINOIS

REGIONAL ENGINEER

PROGRAM DEVELOPMENT

LOCATION OF SECTION INDICATED THUS: --

PRINTED BY THE AUTHORITY OF THE STATE OF ILLINOIS

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TOIIO1-O5 OFF-RD OPERATIONS, MULTILANE, 15' TO 24" FROM PAVEMENT EDGE TOI30\$-04 LANE CLOSURE, 2L, 2W, SHORT TIME OPERATIONS TOI311-O3 LANE CLOSURE, MULTILANE, INTERMITTENT OR MOVING OPER., FOR SPEEDS 40MP TOI501-O6 URBAN LANE CLOSURE, MULTILANE, INTERMITTENT OR MOVING OPER., FOR SPEEDS 40MP TOI501-O6 URBAN SINGLE LANE CLOSURE, MULTILANE, 2W WITH MOUNTABLE MEDIAN TOI601-O1 URBAN HALF ROAD CLOSURE, MULTILANE, 2W WITH MOUNTABLE MEDIAN TOI701-10 URBAN LANE CLOSURE, MULTILANE, 2W WITH MOUNTABLE MEDIAN TOI701-10 URBAN LANE CLOSURE, MULTILANE, 2W WITH MOUNTABLE MEDIAN TOI701-10 URBAN LANE CLOSURE, MULTILANE, 1NTERSECTION TOI801-O6 SIDEWALK, CORNER, OR CROSSWALK CLOSURE TO1901-O6 TRAFFIC CONTROL DEVICES TO4001-O8 TEMPORARY CONCRETE BARRIER T20001-01 SIGN PANEL MOUNTING DETAILS T20001-O1 SIGN PANEL MOUNTING DETAILS T20001-O1 METAL POSTS FOR SIGNS, MARKERS & DELINEATORS T25001-O1 OBJECT AND TERMINAL MARKERS T29001-O1 APPLICATIONS OF TYPES A & B METAL POSTS (FOR SIGNS & MARKERS) TYPICAL PAVEMENT MARKINGS TYPICAL PAVEMENT MARKINGS GUARDRAIL AND BARRIER WALL REFLECTOR MOUNTING DETAILS B14001-O3 HANDHOLES B14001-O3 HANDHOLES LICHTING CONTROLLER PEDESTAL MOUNTED, 240V LIGHT POLE ALUMINUM DAVIT ARM B38001 BREAKAWAY DEVICES B62001-O1 UNINTERUPTABLE POWER SUPPLY (UPS) B77001-O6 STEEL COMB. MAST ARM ASSEMBLY AND POLE 16' THROUGH 55' B78001-10 CONCRETE FOUNDATION DETAILS	630001- <i>11</i>	STEEL PLATE BEAM GUARDRAIL
TOI301-04 LANE CLOSURE, 2L, 2W, SHORT TIME OPERATIONS TOI311-03 LANE CLOSURE 2L, 2W MOVING OPERATIONS- DAY ONLY TOI427-05 LANE CLOSURE, MULTILANE, INTERMITTENT OR MOVING OPER., FOR SPEEDS 4 40MP TOI501-06 URBAN LANE CLOSURE, ZL, 2W, UNDIVIDED TOI606-10 URBAN SINGLE LANE CLOSURE, MULTILANE, 2W WITH MOUNTABLE MEDIAN TOI611-01 URBAN HALF ROAD CLOSURE, MULTILANE, 2W WITH MOUNTABLE MEDIAN TOI701-10 URBAN LANE CLOSURE, MULTILANE INTERSECTION TOI801-06 SIDEWALK, CORNER, OR CROSSWALK CLOSURE TO1901-06 TRAFFIC CONTROL DEVICES TO4001-08 TEMPORARY CONCRETE BARRIER T20001-01 SIGN PANEL MOUNTING DETAILS T20001-01 WETAL POSTS FOR SIGNS, MARKERS & DELINEATORS T2001-01 METAL POSTS FOR SIGNS, MARKERS T29001-01 APPLICATIONS OF TYPES A & B METAL POSTS (FOR SIGNS & MARKERS) T80001-05 TYPICAL PAVEMENT MARKINGS T82006 GUARDRAIL AND BARRIER WALL REFLECTOR MOUNTING DETAILS B14001-03 HANDHOLES B14001-03 HANDHOLES B14001-03 LIGHTING CONTROLLER PEDESTAL MOUNTED, 240V B330006-04 LIGHT POLE ALUMINUM DAVIT ARM B38001 BREAKAWAY DEVICES B62001-01 UNINTERUPTABLE POWER SUPPLY (UPS) B77001-06 STEEL COMB. MAST ARM ASSEMBLY AND POLE 16' THROUGH 55' CONCRETE FOUNDATION DETAILS		
TOI3II-03 LANE CLOSURE 2L. 2W MOVING OPERATIONS- DAY ONLY TOI42T-05 LANE CLOSURE, MULTILANE. INTERMITTENT OR MOVING OPER., FOR SPEEDS & 40MP TOI50I-06 URBAN LANE CLOSURE, 2L. 2W, UNDIVIDED TOI606-10 URBAN SINGLE LANE CLOSURE, MULTILANE. 2W WITH MOUNTABLE MEDIAN TOI6II-01 URBAN HALF ROAD CLOSURE, MULTILANE. 2W WITH MOUNTABLE MEDIAN TOI70I-10 URBAN LANE CLOSURE, MULTILANE INTERSECTION TOI80I-06 SIDEWALK, CORNER, OR CROSSWALK CLOSURE TO400I-08 TEMPORARY CONCRETE BARRIER T2000I-01 SIGN PANEL MOUNTING DETAILS T2000I-01 SIGN PANEL ERECTION DETAILS T200II-01 METAL POSTS FOR SIGNS, MARKERS & DELINEATORS T2500I-01 OBJECT AND TERMINAL MARKERS T2900I-01 APPLICATIONS OF TYPES A & B METAL POSTS (FOR SIGNS & MARKERS) T8000I-05 TYPICAL PAVEMENT MARKINGS T82006 GUARDRAIL AND BARRIER WALL REFLECTOR MOUNTING DETAILS 80500I-01 ELECTRICAL SERVICE INSTALLATION DETAILS 81400I-03 HANDHOLES 81400G-02 DOUBLE HANDHOLES 82110I-07 LIGHTING CONTROLLER PEDESTAL MOUNTED, 240V 83000G-04 LIGHT POLE ALUMINUM DAVIT ARM 838001 BREAKAWAY DEVICES 86200I-01 UNINTERUPTABLE POWER SUPPLY (UPS) 87700I-06 STEEL COMB. MAST ARM ASSEMBLY AND POLE 16' THROUGH 55' 87800I-10 CONCRETE FOUNDATION DETAILS	701101-05	OFF-RD OPERATIONS, MULTILANE, 15' TO 24" FROM PAVEMENT EDGE
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GENERAL NOTES

- BEFORE STARTING ANY EXCAVATION, THE CONTRACTOR SHALL CALL "J.U.L.I.E." AT (800) 892-0123 OR 811 FOR FIELD LOCATIONS OF BURIED ELECTRIC, TELEPHONE AND GAS UTILITIES. 48 HOUR NOTIFICATION IS REQUIRED.
- 2 THE CONTRACTOR SHALL BE RESPONSIBLE FOR PROTECTING UTILITY PROPERTY FROM CONSTRUCTION OPERATIONS AS OUTLINED IN ARTICLE 107.31 OF THE STANDARD SPECIFICATIONS. ANY DAMAGE TO THE UNDERGROUND FACILITIES CAUSED BY THE CONTRACTOR SHALL BE REPAIRED TO THE SATISFACTION OF THE DEPARTMENT AT THE CONTRACTOR'S EXPENSE, INCLUDING TEMPORARY REPAIRS WHICH MAY BE REQUIRED TO KEEP THE FACILITY OPERATIONAL WHILE MATERIAL IS BEING OBTAINED TO MAKE PERMANENT REPAIRS.
- THE LOCATIONS OF THOSE BURIED AND ABOVE GROUND UTILITIES SHOWN ARE APPROXIMATE, ARE SHOWN FOR CONTRACTOR INFORMATIONAL USE ONLY, AND ARE NOT TO BE REFERENCED FOR CONSTRUCTION PURPOSES. THE IMPLIED PRESENCE OR ABSENCE OF UTILITIES IS NOT TO BE CONSTRUED BY THE OWNER, ENGINEER, CONTRACTOR, OR SUBCONTRACTORS TO BE AN ACCURATE AND COMPLETE REPRESENTATION OF UTILITIES THAT MAY OR MAY NOT EXIST ON THE CONSTRUCTION SITE. BURIED AND ABOVE GROUND UTILITY LOCATIONS, IDENTIFICATION, AND MARKING ARE THE SOLE RESPONSIBILITY OF THE CONTRACTOR. REROUTING, DISCONNECTION, PROTECTION, ETC. OF ANY UTILITIES MUST BE COORDINATED BETWEEN CONTRACTOR, UTILITY COMPANY, AND OWNER. SITE SAFETY, INCLUDING THE AVOIDANCE OF HAZARDS ASSOCIATED WITH BURIED AND ABOVE GROUND UTILITES REMAIN THE SOLE RESPONSIBILITY OF THE CONTRACTOR.
- (4) THE CONTRACTOR SHALL COORDINATE CONSTRUCTION ACTIVITIES WITH UTILITY COMPANIES, AND THE CITY OF DES PLAINES.
- (5) A NEW FRAME AND LID WILL BE USED FOR ALL CITY OF DES PLAINES UTILITY ADJUSTMENTS AND RECONSTRUCTIONS. THE NEW FRAME AND LID WILL BE PAID FOR AS FRAMES AND LIDS. SPECIAL
- (6) THE CONTRACTOR SHALL CONTACT THE DISTRICT ONE TRAFFIC CONTROL SUPERVISOR AT (847) 705-4470 A MINIMUM OF 72 HOURS IN ADVANCE OF BEGINNING WORK.
- THE CONTRACTOR SHALL CONTACT RICK WILLMAN, PACE SUBURBAN BUS TRANSPORTATION ENGINEER, AT (847) 228-3584 OR RICHARD.WILLMAN@PACEBUS.COM A MINIMUM OF TEN (10) DAYS PRIOR TO THE BEGINNING OF CONSTRUCTION, SO PACE CAN NOTIFY THEIR OPERATORS, SCHEDULES, AND RIDERS OF THE CONSTRUCTION.
- B) THE CONTRACTOR WILL NOT BE ALLOWED TO SET UP A YARD OR FIELD OFFICE ON STATE PROPERTY WITHOUT WRITTEN PERMISSION FROM THE DEPARTMENT.
- (9) THE CONCONTRACTOR SHALL BE REQUIRED TO PROVIDE ACCESS TO ABUTTING PROPERTY AT ALL TIMES DURING THE CONSTRUCTION OF THIS PROJECT.
- (0) BEFORE BEGINNING ANY WORK, THE CONTRACTOR SHALL RETAIN AND RECORD FOR FUTURE REFERENCE, ALL EXISTING PAVEMENT MARKING LINES (AND RAISED REFLECTIVE PAVEMENT MARKERS) IN ORDER THAT THE LOCATIONS CAN BE RE-ESTABLISED FOR STRIPING. EXACT LOCATIONS OF ALL PAVEMENT MARKINGS SHALL BE AS DIRECTED BY THE ENGINEER.
- 11 IN ADDITION TO FIELD AND AERIAL SURVEYS, PLAN DIMENSIONS AND DETAILS RELATIVE TO THE EXISTING FACILITIES HAVE BEEN TAKEN FROM EXISTING PLANS AND ARE SUBJECT TO CONSTRUCTION VARIATIONS. IT SHALL BE THE CONTRACTOR'S RESPONSIBILITY TO VERIFY SUCH DIMENSIONS AND EXISTING CONDITIONS IN THE FIELD PRIOR TO CONSTRUCTION AND ORDERING MATERIALS. SUCH VARIATIONS SHALL NOT BE A CAUSE FOR ADDITIONAL COMPENSATION DUE TO A CHANGE IN THE SCOPE OF WORK. HOWEVER, THE CONTRACTOR WILL BE PAID FOR THE QUANTITY ACTUALLY FURNISHED AT THE UNIT PRICE BID FOR THE WORK.
- (12) DO NOT SCALE PLANS FOR CONSTRUCTION DIMENSIONS.
- THE CONTRACTOR SHALL TAKE ALL NECESSARY PRECAUTIONS FOR THE PROTECTION OF EXISTING PLANT MATERIAL FOR WHICH THE CONTRACT DOES NOT PROVIDE REMOVAL. THE PROTECTION OF EXISTING PLANT MATERIAL AND THE REPAIR OR REPLACEMENT OF EXISTING PLANT MATERIAL DAMAGED BY THE CONTRACTOR SHALL BE DONE IN ACCORDANCE WITH THE REQUIREMENTS OF SECTION 201 OF THE STANDARD SPECIFICATIONS.
- OVERNIGHT LANE CLOSURES SHALL NOT BE ALLOWED FOR REHABILITATION PROJECTS INVOLVING DAYTIME MILLING AND RESURFACING OPERATIONS AND CLASS D PATCHING UNLESS OTHER CONDITIONS WARRANT EXTENDED LANE CLOSURES AS DETERMINED AND APPROVED IN WRITING BY THE ENGINEER OR AS PROVIDED IN THE CONTRACT SPECIFICATIONS.
- (5) WHERE SECTION OR SUB-SECTION MONUMENTS ARE ENCOUNTERED, THE ENGINEER SHALL BE NOTIFIED BEFORE SUCH MONUMENTS ARE REMOVED. THE CONTRACTOR SHALL PROTECT AND CAREFULLY PRESERVE ALL PROPERTY MARKERS AND MONUMENTS UNTIL THE OWNER, AN AUTHORIZED SURVEYOR, OR AGENT HAS WITNESSED THEIR LOCATION.
- (6) THE EXACT LOCATIONS AND SIZES OF PAVEMENT PATCHES SHALL BE DETERMINED BY THE ENGINEER IN THE FIELD.
- FOR STORM SEWER CONSTRUCTED UNDER THE ROADWAY, BACKFILLING METHODS TWO AND THREE AUTHORIZED UNDER THE PROVISIONS OF ARTICLE 550.07 OF THE STANDARD SPECIFICATIONS WILL NOT BE ALLOWED.
- B) WHEN THE MILLED PAVEMENT IS OPEN TO TRAFFIC THE MAXIMUM GRADE DIFFERENTIAL BETWEEN PASSES OF THE MILLING MACHINE SHALL NOT EXCEED

 1 1/2 INCHES WHERE THE SPEED LIMIT IS 40 MPH OR LESS AND 1 INCH WHERE THE SPEED LIMIT IS GREATER THAN 40 MPH. WITH WRITTEN APPROVAL OF
 THE ENGINEER, A MAXIMUM GRADE DIFFERENTIAL OF 3 INCHES MAY BE ALLOWED IF THE EDGE OF THE MILLING IS SLOPED A MINIMUM 1:3 (V:H) OR A
 NOTCHED LONGITUDINAL WEDGE IS USED.
- (19) ANY PAVEMENT MARKINGS AND RAISED REFLECTIVE PAVEMENT MARKERS OBLITERATED BY MILLING AND RESURFACING OPERATIONS ON SIDE STREETS AND ENTRANCES SHALL BE REPLACED AND PAID FOR IN KIND.
- (2) ALL DAMAGE TO EXISTING PAVEMENT MARKINGS OR RAISED REFLECTIVE PAVEMENT MARKERS OUTSIDE THE REMOVAL LINE SHOWN ON THE PLANS SHALL BE REPLACED AT NO ADDITIONAL COST TO THE DEPARTMENT.
- EXISTING BROKEN FRAMES AND LIDS SHALL BE REMOVED AND DISPOSED OF BY THE CONTRACTOR AND SHALL BE REPLACED AS DIRECTED BY THE ENGINEER.
 REPLACEMENT FRAMES AND LIDS WILL BE PAID FOR ACCORDING TO ARTICLE 109.04 OF THE STANDARD SPECIFICATIONS UNLESS A SEPARATE PAY ITEM HAS BEEN PROVIDED
- 22) FRAMES AND GRATES ADJUSTMENT OF PRIVATE UTILITIES WITHIN THE LIMITS OF THE IMPROVEMENTS SHALL BE DONE BY THEIR RESPECTIVE OWNERS AND ARE NOT PART OF THIS CONTRACT.
- 23 THE NOMINAL THICKNESS FOR HMA BASE AND SURFACE COURSES ARE SHOWN ON THE TYPICAL SECTIONS, STANDARDS, SCHEDULES, OR SPECIAL DETAILS. DEVIATIONS FROM THE NOMINAL THICKNESS WILL BE PERMITTED WHEN SUCH DEVIATIONS OCCUR DUE TO IRREGULARITIES IN THE EXISTING SURFACE OR BASE ON WHICH THE HMA MIXUTRE IS PLACED.
- (24) TEN (10) FOOT TRANSITIONS SHALL BE USED TO MATCH PROPOSED CURB AND GUTTER AND MEDIAN ITEMS OF WORK TO EXISTING CURBS AND GUTTER MEDIANS IN THE FIELD, UNLESS OTHERWISE SHOWN. THE TRANSITIONS SHALL BE PAID FOR AT THE CONTRACT UNIT PRICE FOR THE PROPOSED ITEMS OF WORK SPECIFIED.
- 26) PAVEMENT MARKING TAPE, TYPE III SHALL BE USED FOR SHORT TERM PAVEMENT MARKINGS ON ALL FINAL SURFACES.
- DOUBLE LANE MARKERS ARE TO BE USED AS SHOWN ON THE DISTRICT ONE DETAIL "TYPICAL APPLICATIONS RAISED REFLECTIVE PAVEMENT MARKERS (SNOW-PLOW RESISTANT)" SHOWN IN THE PLANS.
- THE ENGINEER SHALL CONTACT CORY JUCIUS, AREA TRAFFIC FIELD ENGINEER, AT CORY.JUCIUS ILLINOIS.GOV A MINIMUM OF TWO (2) WEEKS PRIOR TO THE PLACEMENT OF PERMANENT PAVEMENT MARKINGS.

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	28000400	PERIMETER EROSION BARRIER	FOOT	3794	3794	-											:						
	28000510	INLET FILTERS	EACH	16	16					and the same of th								<u> </u>					
										1													
	28001100	TEMPORARY EROSION CONTROL BLANKET	SO YD	4680	4680																		
	28100107	STONE RIPRAP, CLASS A4	SO YD	86	86					1			·										
							-		·····	1									PER		***************************************		
	28200200	FILTER FABRIC	SO YD	86	86																An		
																And the second	***************************************						
	30300001	AGGREGATE SUBGRADE IMPROVEMENT	CU YD	150	150					And description of the second					Anna anna anna anna anna anna anna anna	***************************************	***************************************				***************************************		
										A Annual Control of the Control of t			· ···	200		PAAN MISSAANIS SAANIS S	And Andrews						
	30300112	AGGREGATE SUBGRADE IMPROVEMENT 12"	SO YD	798	704					94													
	31101200	SUBBASE GRANULAR MATERIAL, TYPE B 4"	SO YD	427	427		**************************************			The state of the s				***************************************									
	***************************************						-				·········								***************************************				
	35501316	HOT-MIX ASPHALT BASE COURSE, 8"	SO YO	134	134																		
					1			44144	·····				······										
	35600706	T 1/2"	50 YD	798	704					94							namento Administration (American American Americ		***************************************		Anna and an anna and an		
		· · · ·			THE CONTRACTOR OF THE CONTRACT											And the state of t		-		-	Value		
	40600290	BITUMINOUS MATERIALS (TACK COAT)	POUND	7876	7812					64										THE PERSON NAMED IN COLUMN			
					***************************************				-							Printer and Printe							
	40600400	MIXTURE FOR CRACKS, JOINTS, AND FLANGEWAYS	TON	20	20			And the state of t		Angelia de la companya de la company			~~~~~~~~	THE PARTY OF THE P		to the second se							
	Manuscript							Tabalan Fallan F						-									
Ч	Acceptance of the second of th	• SPECIALTY ITEMS						to be desired to the second to						To the state of th									
	FILE NAME : PHAVLOBAEBIOINTEGI	ilnois.gov.P#IDOT\DocumpresvIDOT\Offices\District\NProjects\Pi43909\CADGet\Design\Pi4390\BA			REVISED REVISED	-		<u></u>		TATE OF			***************************************	<u>i</u> U	S. ROUTE 14 /	AT BROADW/		1	F,A.U. RTE. 3512	SECT1		COUNTY SH	OTAL SHEET HEETS NO. 102 5
			CKED - E - 11/	1/2016	REVISED			D	EPARTM	ENT OF T	HANSPOR	ITATION		SCALE: SHE	SOWMAN			TO STA.	FEO. RO			CONTRACT I	

	SUMMARY OF QUANTITIES		T		C	ONSTRUCT!	ON TYPE CO	ODE												~~~···	······		
ļ	COMMINATE OF GOATTITEO	T · · · ·	70741	0004	0021 SIGNALS	0021	0021	0004	0004	0021	0043		1	1		- Average and a second					***************************************	1	
CODE NO	ITEM	UNIT	TOTAL QUANTITIES	ROADWAY ROZ FEDERAL				BUS PAD/FENCE	100% LOCAL	LIGHTING 100% LOCAL	UTILITIES 100% LOCAL	***				***********		}	***		***********	***************************************	
			1	20% STATE	1	100% LOCAL	20% LOCAL	100% EVCAL	SOUN LOCAL	WWW. LOCAL	100% LOCKE			1		detare superior de la constante de la constant			***		*******	VIII-VIII-VIII-VIII-VIII-VIII-VIII-VII	
40600827	POLYMERIZED LEVELING BINDER (MACHINE	TON	587	583		- Anna			4				1										<u> </u>
	METHOD), IL-4.75, N50	- Verein and Arthur											1	-	-								
											<u> </u>		<u> </u>										<u> </u>
40600982	HOT-MIX ASPHALT SURFACE REMOVAL -	SO YD	100	100									-		<u> </u>		<u> </u>				 		
40000362		30 10	100	100					****						-			<u> </u>		1	-	ļ	
	BUTT JOINT	ere e e e e e e e e e e e e e e e e e e		ļ	ļ				THE PERSON NAMED IN COLUMN TO THE PE						-		-				<u> </u>		
			-		<u> </u>					<u> </u>							***************************************				ļ		
40603335	HOT-MIX ASPHALT SURFACE COURSE.	TON	15	15	<u></u>																		
	MIX "D". N50								Andreas and the state of the st			***************************************				***************************************	***************************************		***********		*****	******	
																			Assentanta Assentanta				
40603565	POLYMERIZED HOT-MIX ASPHALT SURFACE	TON	1370	1360			1		10			-						†	***************************************	<u> </u>		 	
	COURSE, MIX "E", N70																						
					 -					<u> </u>				 					and the same of th				
42300400	PORTLAND CEMENT CONCRETE DRIVEWAY	SQ YD	67	67						<u> </u>	-			-				-			<u> </u>		
,2300		34 15	-	-						<u> </u>									-				·/····
	PAVEMENT. 8 INCH	-					ļ	And the state of t													<u> </u>		
		-					ļ				ļ		***			ļ							
42400200	PORTLAND CEMENT CONCRETE SIDEWALK 5 INCH	SQ FT	8130	6862			1268	-															
			***************************************	-				Av-					White the second section of the second secon						**************************************		***		
42400410	PORTLAND CEMENT CONCRETE SIDEWALK 8 INCH	SO FT	1205	1205				red-vertennalra + + + endous	The state of the s														
				· · · · · · · · · · · · · · · · · · ·								Antique de contraction de la c											
42400800	DETECTABLE WARNINGS	SO FT	197	165			32					-								 			
				ARC DESCRIPTION OF THE PROPERTY OF THE PROPERT										 		<u> </u>	***************************************						
44000100	PAVEMENT REMOVAL	SO YD	180	180							-			 					-				
			1					- Average de la constant de la const					And the state of t				<u> </u>		1				
44000150	HOT MAY ASSUMED TO SUBSTACE PERSONAL COLUMN	60 V5		. 3000									Andreas de la constante de la	-									
44000159	HOT-MIX ASPHALT SURFACE REMOVAL, 2 1/2"	SO YD	13266	1 3266			ļ							<u> </u>									
		***************************************	<u> </u>				ļ				ļ			ļ		ļ							
44000200	DRIVEWAY PAVEMENT REMOVAL	SO YD	251	251										ļ									
		***						**************************************		-													
44000300	CURB REMOVAL	FOOT	7	7	***			***************************************		***			TO THE PERSON NAMED IN COLUMN 1			***************************************		***************************************					
44000500	COMBINATION CURB AND GUTTER REMOVAL	FOOT	4562	4562																	***************************************		
	SPECIALTY ITEMS			The second secon									Total de la constantina del constantina de la constantina de la constantina del constantina de la cons	***		-							
FILE NAME =	USER NAME = DOTTONN DE	SIGNED - RM		REVISED		L	<u> </u>			V-Approximately Approximately		<u> </u>	-	,,,,	DOUTE 44 **	T DROAM	AV 070	<u> </u>	F.A.I RTE	J. SE	CTION	COUNTY	TOTAL SHEE SHEETS NO.
PWINLOGHE BIOHTEGI		AN CEGOO - RW ECKED -	18	REVISED REVISED			ı	S Departmi	TATE OF ENT OF T			-			ROUTE 14 A' SUMMARY				35L	2 8	7-Y-N	COOK	102 6
l	PLOT DATE - 11/3/2016 DA	7E - 11,	/1/2016	REVISED			•					Ī	SCALE:	SHEET 1	10. 3 OF 15 SH	EETS ST	١.	TO STA.	FED	ROAD DIST. NO.	ILLINOIS FED. A	CONTRACT	אט. טעו

	SUMMARY OF QUANTITIES				~~~~~~~		ION TYPE C	,		· · · · · · · · · · · · · · · · · · ·	·······	·				~~~~~~~~~~~~~~~~~~~~~~~~~~~~~~~~~~~~~	······································						····
			TOTAL	0004 ROADWAY	OO21 SIGNALS			0004 Bus pad/fence			0043 UTILITIES	***************************************	***	****	**************************************	***************************************							
CODE NO	ITEM	UNIT	QUANTITIES	l	1	100% LOCAL	ł.	100% LOCAL	100% LOCAL	100% LOCAL	100% LOCAL	\$\\\\\\\\\\\\\\\\\\\\\\\\\\\\\\\\\\\\\	**		***************************************	****			and the state of t				***************************************
		1		 	20% STATE		20% LOCAL	and the second s							***************************************			<u> </u>			ļ		
44000600	SIDEWALK REMOVAL	SO FT	7429	7429				and the same of th							***************************************				***************************************				
44		-standard Arastalard	-					war in the dealerst				***	The state of the s	***************************************	11 10 10 10 10 10 10 10 10 10 10 10 10 1				Average Averag				
44003100	MEDIAN REMOVAL	SQ FT	172	172																<u> </u>			_
					The second secon		<u> </u>				 		+	_	 	<u> </u>	-						<u> </u>
		-		ļ	***************************************			Arrandon			ļ		_				-	-			 		
44201827	CLASS D PATCHES, TYPE 11, 15 INCH	SO YD	313	313	***		***				<u> </u>	<u> </u>		_					ļ				
					a voca		-			***************************************			***		***************************************	***************************************			- Alvien Berkelin				***************************************
44201831	CLASS D PATCHES, TYPE III. 15 INCH	SQ YD	358	358			***																
												 					<u> </u>			1			
44201833	CLASS D PATCHES, TYPE IV, 15 INCH	SO YO	2505	2505						-					-	<u> </u>					1		
44201833	CEASS D PATCHES, TIPE IV, 15 INCR	30 10	2505	2303	ļ	-	-				<u> </u>	ļ			-				-				

54213693	PRECAST REINFORCED CONCRETE FLARED END	EACH	1	1					***************************************		-						***						
	SECTIONS 48"	A december of Articles							-							<u></u>			,		-		<u> </u>
		And a				 	<u> </u>						- Andrews		1	-		- 			 	 	<u> </u>
55010740	STORM SEWERS OF ASS 4 TYPE A 100	F00F		746			 					 			-			1	-]	ļ	
550A0340	STORM SEWERS, CLASS A. TYPE 2 12"	FOOT	746	140		ļ					ļ					ļ	-						
							***************************************			And the second			***************************************	***************************************							united Assertional Park		
550A0360	STORM SEWERS. CLASS A. TYPE 2 15"	FOOT	314	314	-		and the second s			MANAGE AND			A Constitution of the Cons								****		
		***			***************************************						-				1		***************************************	1		 	***************************************		
550A0480	STORM SEWERS, CLASS A, TYPE 2 48"	FOOT	460	460					-	hairin Adam	<u> </u>		1	-	-			 					
															<u> </u>	<u> </u>					<u> </u>	ļ	
		-					-												<u> </u>				
550A0780	STORM SEWERS, CLASS A, TYPE 3 48"	FOOT	982	982						Annual Property and a second an	-	destinate of the state of the s	Hannarywanee	**************************************	***************************************			***************************************	***		Antherena	-	
			<u> </u>				of parkers and a second			Antonios de Caracterios de Caracteri	-the insurer challed the character challed the character challed the character charact	Andreas Andrea	Viderarie	***************************************				Water Company					
55100100	STORM SEWER REMOVAL 4"	FOOT	15	15			te de la constante de la const						- Vi						<u> </u>				
<u> </u>							***************************************				***************************************							 					-
						-	***************************************								-						ļ		
55100200	STORM SEWER REMOVAL 6"	FOOT	8	8			uses and a second						and	_									
							Andrew Area and and and and and and and and and an			[[water du director chem		***	557-484-48-48-48-48-48-48-48-48-48-48-48-48		-	700 T T T T T T T T T T T T T T T T T T			***************************************	
55100300	STORM SEWER REMOVAL 8"	FOOT	45	45	talian trade	ļ							- Character of the control of the co	The second secon				And Andrews Andrews				district (Application of the Control	
														****								1	
56100600	WATER MAIN 6"	FOOT	180		 						100			***									
	*		100		<u> </u>						180						 		Annual and annual and annual a				
			<u> </u>												Vinterior Control of C		ļ		***************************************				
56100700	WATER MAIN 8"	FOOT	275					***************************************			275		and the second s	rinierekentunkulumik	**************************************				retronologie				
	SPECIALTY ITEMS							And the second s															
FILE NAME >		SIGNED - RW		REVISED				-			L			1	POUTE CE S	T DROFFIL	AV 070555	<u> </u>	F.A.U RTE.	SE.	TION	COUNTY	TOTAL SHEET SHEETS NO.
pwiNVLOB4E@IQINTEG	Initiad squirPMIDOT Documents viDot Offices Of stital NP10 Jects PN43909-CADDistribestorNetSynP143908 PLOT SCALE * NODDOO */ In	RANGEOPO - RW HECKED -	/B	REVISED REVISED				ST Departmi	TATE OF ENT OF T					U.S.	ROUTE 14 A' SUMMARY				3512	87	-Y-N	COOK	102 7
L		ATE - 11/	/1/2016	REVISEO				/3441411		VI VI			SCALE	SHEET I	10. 4 OF 15 SH			TO STA.	FFD.	BOAD DIST. NO. 1	ILLINOIS FED. A	CONTRACT	NO. 60J39

	SUMMARY OF QUANTITIES					~~~~~~~~~~~~~~~~~~~~~~~~~~~~~~~~~~~~~~	ON TYPE CO				······································												
			TOTAL	OOO4 ROADWAY	OO21 SIGNALS	0021 EVP	0021 SECULOSMED US	0004 Bus pad/fence	0004 Paring laws recou	0021 Lighting	0043 UTILITIES		Acut Acut acut acut acut acut acut acut acut a			İ	}				AAvadesiles la company de la c		
CODE NO	ITEM	UNIT	QUANTITIES				1	100% LOCAL	1	100%, LOCAL	1		**************************************										
		To the second se		20% STATE	20% STATE		20% LOCAL	And the second s			***************************************		varbanire						riste et et en		***************************************		
56100800	WATER MAIN 10"	FOOT	60				**				60												
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56101000	WATER MAIN 16"	FOOT	45				the state of the s				45				***	***************************************	***		***************************************				***************************************
							A CONTRACTOR OF THE CONTRACTOR							***************************************		***							
56400510	FIRE HYDRANTS TO BE REMOVED AND REPLACED	EACH	1				and the second	-			1				-	· · · · · · · · · · · · · · · · · · ·					1		
	CATCH BASINS, TYPE A, 4' DIAMETER,		9	9						ļ					Administration	9000 0000 0000 0000 0000 0000 0000 000		-		 	-	-	
60201205	TYPE 12 FRAME AND GRATE	EACH	7'	1 9							ļ				_	-		<u> </u>	<u> </u>			ļ	
60201330	CATCH BASINS. TYPE A. 4'-DIAMETER, TYPE	EACH	19	19				,						-					:		4444		
	23 FRAME AND GRATE						***	fert embronen		-				of the state of th							***************************************		
																1		1	 	-			
60218400	MANHOLES, TYPE A, 4'-DIAMETER, TYPE 1	F 4011								-		ļ				<u> </u>	<u> </u>	-	1	-		-	
80218400	MANNULES, IFE A, 4 "DIAMCIER, ITE I	EACH	5	5							ļ					<u> </u>		ļ		-			
	FRAME, CLOSED LID							and the second s		***			***************************************			alem verkelini fordesk	***************************************	**************************************	***				
		and was a second			- Adelese - Adel			mrkven met skelen		***************************************					A CONTRACTOR OF THE CONTRACTOR	-berefessionstefens							
60221100	MANHOLES. TYPE A. 5'-DIAMETER, TYPE 1	EACH	1	1		************		- Attended							THE STATE OF THE S	**************************************	<u> </u>	-	***	 		1	
					and the same of th					***************************************				-				****		-	 	<u> </u>	
	FRAME, CLOSED LID				***************************************		ļ				<u></u>							****		<u> </u>		<u> </u>	
					information in the state of the			*******		****	***************************************				e transporter en	Assessant and a second		Av tennishava tenn					
60223800	MANHOLES, TYPE A, 6'-DIAMETER, TYPE 1	EACH	٦	7											***************************************	The state of the s							
	FRAME, CLOSED LID		 												1		 		 		1	-	
		Para William Barrell			-									***************************************		<u> </u>					 	 	
					¥+++++++++++++++++++++++++++++++++++++									***************************************									
60224446	MANHOLES, TYPE A. 7'-DIAMETER, TYPE 1	EACH	4	4	A444		***************************************			district descriptions				*******		}			****	*****			
	FRAME, CLOSED LID		And with the last of the last		Ar Anna and a second		***************************************			mitteliebeterie											<u> </u>		
			Are the second s	***						Western Walter						Antenna		***************************************		ŀ			
				vanisher .								-	-			**************************************		or threaten			<u> </u>		
60224459	MANHOLES. TYPE A, 8'-DIAMETER, TYPE 1	EACH	2	2			ļ	A principal de la constante de								***			<u> </u>		ļ		
	FRAME, CLOSED LID		r.				Ì				****	****		derderkenskerken	***************************************	***				- Annie de la company de la co	***************************************	transfer de la companya de la compan	
60236900	ENLETS, TYPE A, TYPE 12 FRAME AND GRATE	£ACH	-	1							***************************************			- Andrews						***************************************			
60255500	MANHOLES TO BE ADJUSTED	EACH	3	 			 				3		1	North Assessment .	1	<u> </u>	-	-	 			<u> </u>	
30233300		LAVII		ļ				The state of the s			J			***		ļ			1			<u> </u>	_
			A state of the sta											***									
60257900	MANHOLES TO BE RECONSTRUCTED	EACH	Quad				<u> </u>	-			1		-	nite de secución de la constante de la constan			***************************************					off-threshold market and	
														And a					1	 			
60250100	INVETO TO BE ADDICTED	F.60	<u> </u>				-							-				<u> </u>	-		-		
60260100	INLETS TO BE ADJUSTED	EACH	4	4		***************************************												ļ	1		***************************************	ļ	
								***************************************			Annual management			PA-PA-PA-PA-PA-PA-PA-PA-PA-PA-PA-PA-PA-P		i.			***************************************		**************************************		•
	- SPECIALTY ITEMS							TATA A A A A A A A A A A A A A A A A A			· ·			***								**************************************	
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		TE - 11/	/1/2016	REVISED			ı	DEPARTMI	civi Ut T	NANSPO	MIAHUN		SCALE:	SHEET	NO. 5 OF 15 SH			TO STA.			I ILLINOIS FED. A	CONTRACT	NO. 60J39

	SUMMARY OF QUANTITIES				., 	CONSTRUCTIO		DE								······································							
			TOTAL	OOO4 ROADWAY	0021 SIGNALS	0021 EVP	0021 Will/988 015	QOO4 Bus pad/fence	0004 Pardig Lines recon	0021 Lighting	0043 UTILITIES					***************************************	***************************************		A CONTRACTOR OF THE CONTRACTOR		***************************************		
CODE NO	ITEM	UNIT	QUANTITIES								100% LOCAL					valenda e e e e e e e e e e e e e e e e e e e	ease ease	i	A STANSON AND A	Assessational	***************************************		
				20% STATE	20% STATE		20% LOCAL						ļ	1									
60265700	VALVE VAULTS TO BE ADJUSTED	EACH	5	ever til de de la companya de la com				To the state of th			5					A de la constanta de la consta			**************************************				
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60266100	VALVE VAULTS TO BE RECONSTRUCTED	EACH	 		 						1								-			·	
											•					<u> </u>							
			***		<u> </u>								ļ			<u> </u>	<u> </u>		-				
60500060	REMOVING INLETS	EACH	3	3													<u> </u>						
			Avenue de la companya			***										Average			44-03-03-03-03-03-03-03-03-03-03-03-03-03-				
60600605	CONCRETE CURB. TYPE B	FOOT	154	154								·											
			1														<u> </u>						
60603800	COMBINATION CONCRETE CURB AND SUTTER,	FOOT	1529	1300					229				<u> </u>				ļ					·····	-
			1061	,0-0										And the second s		<u> </u>	-	 				···	
	TYPE 8-6,12																ļ	-					
		-									·			***	***************************************						***************************************		
60604400	COMBINATION CONCRETE CURB AND GUTTER.	FOOT	1946	1946									***	no de la companya de	***************************************	**	***************************************						
	TYPE B-6.18	***																	1				
															 	<u> </u>							
60608562	COMBINATION CONCRETE CURB AND GUTTER.	FOOT	328	328										 	<u> </u>	<u> </u>	<u> </u>		<u> </u>				ļ`-
			320	320											-							***************************************	
	TYPE M-4.12						·								and the second				_				
				<u> </u>										A STATE OF THE STA							overlining and a second		
60618300	CONCRETE MEDIAN SURFACE, 4 INCH	SO FT	344	344				Anna mana mana mana mana mana mana mana		a company of the comp				VIIIIVAAAAAAAAA	100 MARKANIA		PH-99-4-99-4-9-4-4-99-4-9-4-4-9-4-4-9-4-4-9-4-4-9-4-4-9-4-4-9-4-4-9-4-4-9-4-4-9-4-4-9-4-4-9-4-4-9-4-4-9-4-4-9			***	ASSESSED AND ASSESSED AND ASSESSED AND ASSESSED AND ASSESSED ASSESSED AND ASSESSED ASSESSED AND ASSESSED NCE ASSESSED NCE ASSESSED ASSESSED ASSESSED ASSESSED ASSESSED ASSESSED ASSESSED ASSESSED ASSESSED ASSESSEDANCE ASSESSEDANCE ASSESSEDANCE ASSE		
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66900200	NOW CRECIAL WASTE DISPOSAL	CII NO							·				-	<u> </u>			ļ			-		······································	ļ
86300200	NON-SPECIAL WASTE DISPOSAL	CU YD	2400	2400											***************************************				-				<u> </u>
			ļ							V design											**************************************		
66900450	SPECIAL WASTE PLANS AND REPORTS	LSUM	1	1	W Company of the Comp	-				-				V Addition V Addition		was a second order of the second order o	**************		***************************************		ve de		
			and the state of t		***************************************																		
66900530	SOIL DISPOSAL ANALYSIS	EACH	6	6													 						+
					FFFF Windowsky Andreas									<u> </u>	 	ļ							-
67000400	ENCINCED C FIELD OFFICE TUDE		4.5														1						-
67000400	ENGINEER'S FIELD OFFICE, TYPE A	CAL MO	15	15																			ļ
			**************************************									· · · · · · · · · · · · · · · · · · ·	Table State				<u> </u>					······	
67100100	MOBILIZATION	LSUM	1	1	p and a second			***************************************			·												
	SPECIALTY ITEMS	The property and the pr	Triving the state of the state	***************************************	-tripperson	KANAMANAAAAAAAAAAAAAAAAAAAAAAAAAAAAAAAA	n e e e e e e e e e e e e e e e e e e e	***************************************	e - Anger property Andread	***************************************								***************************************	A CONTRACTOR OF THE CONTRACTOR	***************************************	***************************************		
FILE NAME & PHAVLOBAEBIDIATECIN	USER NAME = bartoniw Illinols.gov/PWIDDT-Document.svDdf	DESIGNED - RI	RWB RWB	REVISED REVISED				نـــــــــــــــــــــــــــــــــــــ	TATE OF	HIIMOIC		Т		U.S. F	ROUTE 14 A	T BROADW	AY STREET	1	F.A.U. RTE.			COUNTY	TOTAL
		CHECKED -		REVISED			_	EPARTME				1				OF QUANT			3512	87-Y-	N .	COOK	102

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	SUMMARY OF QUANTITIES ITEM CHANGEABLE MESSAGE SIGN	UNIT	TOTAL QUANTITIES	1 1	OO21 Signals 80%, Federal		Į :		OOO4 Paring Lines recon.	0021 Lighting	0043 UTILITIES			edicetoreliselle de la constitución de la constituc	***************************************				***************************************				Ì
70106800		Average de la constant de la constan	QUANTITIES	80% FEDERAL			Į :		l i	3	91101102		1	Ī	1		I		1		1	I	•
	CHANGEABLE MESSAGE SIGN	Average de la constant de la constan	E	1 1	1		OUT FEBRUAL	100% LOCAL	100% LOCAL	100% LOCAL	100% LOCAL			The state of the s				-	and the same of th				i
	CHANGEABLE MESSAGE SIGN	CAL MO		20% STATE	20% STATE		20% LOCAL		Artist designation of the contract of the cont					- Phylotoleum and a contract of the contract o	***************************************		:	<u> </u>	***				į
70700100			45	45		The state of the s			T-H-I-I-I-I-I-I-I-I-I-I-I-I-I-I-I-I-I-I-										***************************************				
70700100						**************************************	-		***************************************					and the state of t	***************************************								i
	SHORT TERM PAVEMENT MARKING	FOOT	14269	14269					-						***								
		1001	1.205																<u> </u>				
		-											ļ		-				<u> </u>				[
70300150	SHORT TERM PAVEMENT MARKING REMOVAL	SQ FT	4752	4752									ļ	nanasary Andrian									,
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70300210	TEMPORARY PAVEMENT MARKING LETTERS AND	SO FT	330	330		<u>.</u>			1					**************************************									
www.	SYMBOLS			***																			
																	***						· · · · · · · · · · · · · · · · · · ·
70300220	TEMPORARY PAVEMENT MARKING - LINE 4"	FOOT	29551	29551									-										
												······											
70300240	TEMPORARY PAVEMENT MARKING - LINE 6"	FOOT	512	512																			
																					-		
70300260	TEMPORARY PAVEMENT MARKING - LINE 12"	FOOT	131	131																			}
70300280	TEMPORARY PAVEMENT MARKING - LINE 24"	FOOT	265	265		And the second s																	
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70400100	TEMPORARY CONCRETE BARRIER	FOOT	723	723						An and an												·	

70400200	RELOCATE TEMPORARY CONCRETE BARRIER	FOOT	101	101		nii saanaa			***************************************													-	
		-			_								The state of the s										
70600260	IMPACT ATTENUATORS, TEMPORARY (FULLY	EACH	8	8											ļ								
	REDIRECTIVE, NARROW), TEST LEVEL 3												-			·····							
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70600332	IMPACT ATTENUATORS, RELOCATE (FULLY	EACH	2	2			_				***		and distributed by the control of th								and the second s		
	REDIRECTIVE, NARROW), TEST LEVEL 3			Avis division of the same of t			-						-										
-				201111111111111111111111111111111111111						TO A A A STATE OF THE STATE OF								1,00					
72000100	SIGN PANEL - TYPE 1	SO FT	151	133	18				And the second s										The control of the co				
				A Administrative A Administrative A	·				es de la la decentra de la constitución de la const	and an artist and a second													
72400100	REMOVE SIGN PANEL ASSEMBLY - TYPE A	EACH	14	14	-				**************************************														
	SPECIALTY ITEMS							The state of the s	Abel distriction and the second							Prince helical heavile conservations when							
FILE NAME 2	USER NAME = bartonnw DE	SIGNED - RW	B	REVISED		<u> </u>						<u> </u>	<u> </u>	17.5	NOUTE 45 CO	- NAA - NA			F.A.U. RTE.	SECT	ION	COUNTY	TOTAL SHEET SHEETS NO.
pw//VILDB4EBIOINT EGJIII/n	OSGONPHIDDT Documents/IDD Offices/District NProjects/P43909CADData/Design:PF4390BR PLOT SCALE = NODDOO */ In. CH	ANDERGO - RW ECKED -	8	REVISED REVISED			_		TATE OF I		TAT:0**				ROUTE 14 AT SUMMARY				3512	87-1	'-N	COOK	102 10
		TE - 11/	/1/2016	REVISED			u	cran i VII	ENT OF TI	naNSPUR	IATION		CALE;		0. 7 OF 15 SHE			TO STA.	FEO. I	ROAD DIST. HO, 1	ILLINOIS FED. AID	CONTRACT	NO. 60J39

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		SUMMARY OF QUANTITIES					ONSTRUCTI	ON TYPE CO	DE					· · · · · · · · · · · · · · · · · · ·		· · · · · · · · · · · · · · · · · · ·		····						
	CODE NO	ITEM	UNIT	TOTAL	ł	OO21 SIGNALS BOX FEDERAL 20% STATE		OC2) SECULIAMED USE 80% FEDERAL 20% LOCAL	1			0043 UTILITIES 100% LOCAL			The state of the s							The state of the s		
•	72400200	REMOVE SIGN PANEL ASSEMBLY - TYPE B	EACH	5	5									A variable to the same of the						West was a series of the serie				
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*	72400310	REMOVE SIGN PANEL - TYPE 1	SO FT	2	2		9																	
	-		-			***************************************							·							***************************************				
*	72400710	RELOCATE SIGN PANEL - TYPE 1	SQ FT	2	2																			
*	72900100	METAL POST - TYPE A									and the second s													
	12300100	METAL POST - TIPE A	FOOT	37	37	A CONTRACTOR OF THE CONTRACTOR							-							***************************************		ļ		
•	72900200	METAL POST - TYPE B	FOOT	198	198				1														***	
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•	78000100	THERMOPLASTIC PAVEMENT MARKING -	SO FT	155	155										***************************************			***************************************						
		LETTERS AND SYMBOLS											·					***************************************						
			ļ											-										
•	78000200	THERMOPLASTIC PAVEMENT MARKING - LINE 4"	FOOT	4838	4593					245														
•	78000400	THERMOPLASTIC PAVEMENT MARKING - LINE 6"	FOOT	913	913			and the second									4 4 4 4 4 4 4 4 4 4 4 4 4 4 4 4 4 4 4							
•	78000500	THERMOPLASTIC PAVEMENT MARKING - LINE 8"	FOOT	138	138																			
											***************************************				-		1000							
•	78000600	THERMOPLASTIC PAVEMENT MARKING - LINE 12"	FOOT	280	262					18		~			 									
•	78000650	THERMOPLASTIC PAVEMENT MARKING - LINE 24"	FOOT	111	111																			
																	1			***************************************				
•	78100100	RAISED REFLECTIVE PAVEMENT MARKER	EACH	76	76		and the second s		-		28 21 10 10 10 10 10 10 10 10 10 10 10 10 10													
	78100200	TEMPORARY RAISED REFLECTIVE PAVEMENT	EACH	55	55									200 mm			44444							
		MARKER						WALL STATE OF THE	***************************************			***************************************					***************************************							-
									The state of the s								-							
	78200011	BARRIER WALL REFLECTORS, TYPE C	EACH	20	20				The state of the s		Athatus								TO A					
N												and the state of t											HARRIST THE STATE OF THE STATE	
		SPECIALTY ITEMS		-				***************************************		naproper production of the control o	***************************************	an property			444 to fulfach for the subsection of the subsect	esservi-v-neinhabon								
ŧ	FÎLE NAME : O W AV <i>LO84EBIONITEGI</i>	USER NAME a bortonny DES USER NAME a bortonny DES Ullinois-gov-PHIDOT-Documents/UDD Offices-District NP10/acts-P143909-CADDels/Design-P14390-CADDels/Design-P14390-CADDels/D	SIGNED - RWI ANDROGO - RWI		REVISED REVISED				£.	ATE OF I	11181010		T	l.	U.S. R	OUTE 14 AT	BROADWA	Y STRFFT	·L	F.A.U. RTE.	5£0	TION	COUNTY	TOTAL SHEET HEETS NO.
		PLOT SCALE . 100,0000 1/ In. CHE	ECKED -		REVISED	_		D	ı د EPARTME	NT OF T	LLINUIS RANSPORT	FATION					OF QUANTIT			3512		-Y-N	COOK	102 11
L	······································	PLOT DATE 4 II/3/2016 DAT	TE - 11/	1/2016	REVISED								S	CALE:			ETS STA.		TO STA.	FED, R	DAD DIST. NO. 1	ILLINOIS FED. AT	CONTRACT PROJECT	NO. 60J39

Ь—		SUMMARY OF QUANTITIES			0004	0021	ONSTRUCTI 0021	0021	0004	0004	0021	0043	·_···	The state of the s	<u> </u>	·				-		***************************************		T
COE	E NO	ITEM	UNIT	TOTAL	ROADWAY 80% FEDERAL	SIGNALS	EVP 100% LOCAL	STATISMED IS	BUS PAD/FENCE	PARIE LACS ROX.	LIGHTING 100% LOCAL	UTILITIES 100% LOCAL		maintainines s s s s s s s s s s s s s s s s s s	ļ		PAPER PROPERTY OF THE PROPERTY	WesternAries shifted seadous shift	**************************************		***************************************	***************************************		
783	00200	RAISED REFLECTIVE PAVEMENT MARKER REMOVAL	EACH	76	76	ZVA STATE	Ve de de la constante de la co	ZVZ LVLAL											***************************************			***************************************	***************************************	
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804	00100	ELECTRIC SERVICE INSTALLATION	EACH	1			and the second s				1								***					
805	00020	SERVICE INSTALLATION - POLE MOUNTED	EACH	1		1	-							-				AND THE PROPERTY OF THE PROPER			***************************************			
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810	28200	UNDERGROUND CONDUIT, GALVANIZED STEEL.	FOOT	WI		571			70											A proprieta de la companya de la com				
		2" DIA.					AAA							Annual Control of the				*******		Territoria del Constitución del Constitu				
810	28210	UNDERGROUND CONDUIT, GALVANIZED STEEL,	FOOT	206		156	**************************************				50			ver de manufacture de constante				***************************************		A Para Para Para Para Para Para Para Par				
		2 1/2" DIA.					***																	
810	28220	UNDERGROUND CONDUIT, GALVANIZED STEEL.	FOOT	104		104								material Advisory and the state of the state			**************************************	***************************************						
		3" DIA.			V		***************************************							real entry of the state of the				BOSELENA AND AND AND AND AND AND AND AND AND A	College of the Colleg	4-00-00-00-00-00-00-00-00-00-00-00-00-00				
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810	-	UNDERGROUND CONDUIT, GALVANIZED STEEL.	FOOT	739		435	A-A-A-A-A-A-A-A-A-A-A-A-A-A-A-A-A-A-A-				304									Managara Amagara				
		4" DIA.					Pennadara Puntura Pan													**************************************				
814	00100	HANDHOLE	EACH	3	-	3	Van de la constanta de la cons							And the second s										
814	100200	HEAVY-DUTY HANDHOLE	EACH	1		1	respectively presentation of the contract of t					-												
			1											A COLUMN TO THE PROPERTY OF TH										ļ
814	00300	DOUBLE HANDHOLE	EACH	2		2	**************************************							The state of the s										
816	603090	UNIT DUCT, 600V, 3-1C NO.4, 1/C NO.6	FOOT	1050			ve e e e e e e e e e e e e e e e e e e				1050					-								
		GROUND, (XLP-TYPE USE), 1 1/4" DIA.		n de la companya del la companya de			***			in the state of th							1							
		POLYETHYLENE		-			read-season variations			TATALOGRAPH AND					***************************************									
817	02160	ELECTRIC CABLE IN CONDUIT, 600V	FOOT	150						A parameter Anna managamenta	150							1						
		(XLP-TYPE USE) 1/C NO. 1/0																						
60.0	WANT -	SPECIALTY ITEMS	cioneo -	1	Domes			1												1.5.				TOP
frict ?	NAME =	USER NAME = bortoonw DE: bitsporPHIDDT Documents/DDT Offices/District NProjects/PH3909CADDstribsign/PH3908R	SIGNED - R		REVISED				\$	TATE OF	PIONITH				U.S. R	OUTE 14 A	T BROADW	AY STREET		F.A.U RTE.	" SE	TION -Y-N	COUNTY	SHEET 102
pw/\VIII	DB4EBIDINTEGJIII:															SUMMARY				3512				

		SUMMARY OF QUANTITIES	,					ON TYPE CO						· · · · · · · · · · · · · · · · · · ·		······		,		·				
	CODE NO	ITEM	UNIT	TOTAL OUANTITIES	1	OO21 SIGNALS 80% FEDERAL 20% STATE		1	OOO4 Bus pad/fence 100% local		3	OO43 UTILITIES 100%, LOCAL										Apariment and a second and a se		
•	82500335	LIGHTING CONTROLLER, PEDESTAL MOUNTED.	EACH	***************************************		27.7	***************************************	201 24012			1									<u> </u>				
		240VOLT, 100AMP		V-10-10-10-10-10-10-10-10-10-10-10-10-10-																			***********	
				THE STREET STREET				Andrews Andrew	Andrews										<u> </u>			<u></u>		
	83050730	LIGHT POLE, ALUMINUM, 47.5 FT, M.H.,	EACH	7				-			7				·	<u> </u>						 		
	***************************************	8 FT. DAVIT ARM	<u> </u>	***************************************	-		***************************************	****						**************************************										
				*******				************											ļ	***************************************				
	83600365	LIGHT POLE FOUNDATION, METAL, 15" BOLT	EACH	7				Action and the second			7													
-		CIRCLE, 10" X 8'	2.00.1	***************************************																				
		Civery 10 × 0		****																				
	83800205	BREAKAWAY DEVICE, TRANSFORMER BASE, 15	EACH	7																				
•	83000203		EAUN	***************************************							7													
		INCH BOLT CIRCLE	-	***************************************																		-		
	05000500	ULLUSTINGS OF CANADANA STATEMENT OF COMME		-											~~~~~	ļ								
•	85000500	MAINTENANCE OF EXISTING FLASHING BEACON	EACH	2		2							· ·							ļ				
	<u> </u>	INSTALLATION																						
							<u></u>						***************************************		The second secon									
•	87301215	ELECTRIC CABLE IN CONDUIT. SIGNAL NO.	FOOT	774	-	774																		
		14 2C	ļ												······									
			ļ																					
•	87301225	ELECTRIC CABLE IN CONDUIT, SIGNAL NO.	F001	1510		1510	eri-						····						***************************************			***************************************		
		14 3C																	***************************************			A A A A A A A A A A A A A A A A A A A		
							A VIII A VA V						**************************************											
•	87301245	ELECTRIC CABLE IN CONDUIT, SIGNAL NO.	FOOT	2503		2503																		
		14 5C								***************************************														
				A Company of the Comp						vertical and verti						and the control of th								
•	87301255	ELECTRIC CABLE IN CONDUIT, SIGNAL NO.	FOOT	1065		1065				***														
		14 7C		Avateur etwa variation etwa variatio																				
				and the same of th																				
•	87301305	ELECTRIC CABLE IN CONDUIT, LEAD-IN, NO.	FOOT	1560		1560																		
		14 1 PAIR			waterware																		L	
<u> </u>										A Company of the Comp	-7		······											
0		SPECIALTY ITEMS								and parties and an area								w						
	FILE NAME =	USER NAME > bortoonw DE:	SIGNED - R		REVISED REVISED			<u> </u>	م	TATE OF	II I INICIC				U.S. F	OUTE 14 A	F BROADWA	Y STREET		F.A.U RTE.	SEC	TION	COUNTY	TOTAL SHEET SHEETS NO.
	PARTICIONE CHOME CO.	PLOY SCALE = 100,0000 1/ In. CHE	CKED - 11	****	REVISED REVISED	-		I	S DEPARTMI	TATE OF ENT OF T		RTATION		SCALE:		SUMMARY 0. 10 OF 15 SE	OF QUANTI	TIES	TO STA.	3512	87-	-Y-N	COOK CONTRACT	102 13 NO. 60J39
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		SUMMARY OF QUANTITIES			2024			ON TYPE CO	~~~~					·	· r · · · · · · · · · · · · · · · · · ·				-r	1	1	1	·	·
Ī	***************************************		<u> </u>	TOTAL	OOO4 ROADWAY	OO21 SIGNALS		OO21	0004 Bus pad/tence	0004 Paring Lines recon	0021 Lighting	0043 UTILITIES			***************************************	***************************************				***************************************		rise standerstand		***************************************
	CODE NO	Mati	UNIT	QUANTITIES		}	100% LOCAL	80% FEDERAL	100% LOCAL	100% LOCAL	100% LOCAL	100% LOCAL				***	Parket de la constant					e Anti-Artistan de Anti	-	
ŀ					20% STATE	20% STATE		20% LOCAL							***************************************			ļ		<u> </u>		<u> </u>		
٠	87301805	ELECTRIC CABLE IN CONDUIT. SERVICE. NO.	FOOT	38		38								derentarion derentarion derentarion derentarion derentarion derentarion derentarion derentarion derentarion de	***************************************				ļ					ļ
		6 2 C		-		diaday.	***************************************							***************************************	AIII		ratio are a decidar a servicio de la constanta						************	
				**************************************											-									
	87301900	ELECTRIC CABLE IN CONDUIT. EQUIPMENT	FOOT	855		855									1900 A				†	1				
		GROUNDING CONDUCTOR, NO. 6 1C														<u> </u>								
ŀ										-				enter the state of	 	-	<u> </u>			***************************************				
	arroncas					_														######################################				
•	87502500	TRAFFIC SIGNAL POST, GALVANIZED STEEL	EACH	3		3	***************************************								ļ		ļ							
		16 FT.									·			ļ	ļ	-				-				
							Andrew Address of the Control of the	-									***************************************							
•	87502520	TRAFFIC SIGNAL POST, GALVANIZED STEEL	EACH	2		2										***************************************								
		18 FT.		***************************************											Andreas de la constitución de la									
ľ												-			-		<u> </u>					 	-	
	87700200	STEEL MAST ARM ASSEMBLY AND POLE, 32 FT.	EACH	1		1									A A A A A A A A A A A A A A A A A A A	<u> </u>				 				
ŀ																 	<u> </u>			<u> </u>				
-	87700330	CTSS: MACT ARM ASSEMBLY AND ROLE 30 FT	F. 600	4							·				Lagrange A.					1				<u> </u>
•	87700230	STEEL MAST ARM ASSEMBLY AND POLE, 38 FT.	EACH	1		1										<u> </u>	<u> </u>					ļ		
																ļ	ļ	-		-	ļ		<u></u>	<u> </u>
•	87800100	CONCRETE FOUNDATION, TYPE A	FOOT	20		20							-							4				
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•	87800150	CONCRETE FOUNDATION, TYPE C	FOOT	4		4																<u> </u>		
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	87800400	CONCRETE FOUNDATION, TYPE E 30-INCH	FOOT	27		27								<u> </u>	 						 		 	
l		DIAMETER												ļ										
ŀ							cherterent de la company de la										<u> </u>			<u> </u>				
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•	88030020	SIGNAL HEAD, LED. 1-FACE, 3-SECTION.	EACH	4		4								ļ		ļ	<u> </u>							
-		MAST-ARM MOUNTED																						
										Average									And the state of t					
•	88030050	SIGNAL HEAD, LED, 1-FACE, 3-SECTION,	EACH	4		4	***************************************			4														
		BRACKET MOUNTED								and the second s						-								
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f												and the second		 	<u></u>	****								
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		SPECIALTY ITEMS	100.00								,									<u> </u>				
1	FILE NAME : PHINLOGHEBIOINTEGIS	indis.gov.PMIDDT\DocumentsvDd* Offices\District i\Projects\P143909\C\DDctv\Dostgis\P143\ OBRA			REVISED REVISED					TATE OF					U.S.	ROUTE 14 A				F.A.U RTE. 3512	SEC A7	TION -Y-N	COUNTY	TOTAL SHEE SHEETS NO 102 14
			CKED -	/1/2016	REVISED REVISED			E	EPARTMI	ENT OF T	RANSPOR	TATION	-	SCALE:	CUEET :	SUMMARY 10. 11 OF 15 SH			TO STA.			ILLINGIS FED. A	CONTRACT	NO. 60J3

	SUMMARY OF QUANTITIES		-	0004	0021	ONSTRUCTI		0004	0004	0021	0043			T	T		1	,	7		······	
***************************************			TOTAL	ROADWAY	SIGNALS		OO21	BUS PAD/FENCE	0004 Parae unes rod.	0021 Lighting	0043 UTILITIES	**************************************								***********		
CODE NO	[TEM	UNIT	QUANTITIES	1	80% FEDERAL 20% STATE	100% LOCAL	80% FEDERAL 20% LOCAL	100% LOCAL	100% LOCAL	1007, LOCAL	100% LOCAL		elementary and the second seco	İ								
8030100	SIGNAL HEAD, LED. 1-FACE, 5-SECTION,	EACH	3		3								<u> </u>			-						
	BRACKET MOUNTED		 						-		 			1								
							The state of the s	<u> </u>														
38030110	SIGNAL HEAD, LED, 1-FACE, 5-SECTION,	EACH	1		1	<u> </u>										2 - 10			A Property Management of the Control			
	MAST-ARM MOUNTED								A-1-1-1-1-1-1-1-1-1-1-1-1-1-1-1-1-1-1-1										The second second			
					Water to the state of the state		***************************************		VAARILITETE A SEE IN CALLED TO THE CALLED TO				ļ									
2				<u> </u>					3:35-144-14-14-14-14-14-14-14-14-14-14-14-14							**************************************						
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99200410	TRACEIC CICAAI RACVRIATE IOUVERED	EACH	5			<u> </u>	***************************************	<u> </u>						****								
88200410	TRAFFIC SIGNAL BACKPLATE, LOUVERED, FORMED PLASTIC	EACH	3	****	5	-	***************************************	ļ											-			
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88500100	INDUCTIVE LOOP DETECTOR	EACH	5		5		****											1	***************************************			
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88600100	DETECTOR LOOP, TYPE I	FOOT	533		533									<u> </u>								
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88700200	LIGHT DETECTOR	EACH	3			3															1000	
88700300	LIGHT DETECTOR AMPLIFIER	EACH	1			1																
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88800100	PEDESTRIAN PUSH-BUTTON	EACH	4		4		<u> </u>		-				cheave the feet of the control of th	***************************************								
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89502400	REMOVE EXISTING FLASHING BEACON	EACH	2		2								***	Annie de la companya			-		***			
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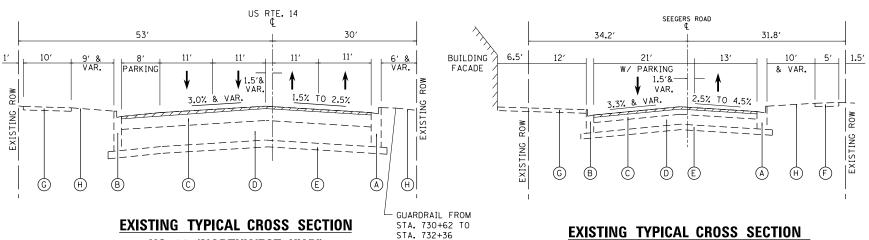
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*	A2004520	TREE, GINKGO BILOBA PRINCETON SENTRY	EACH	3	3															THE STREET STREET				
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•	A2008100	TREE, TILIA CORDATA GLENLEVEN	EACH	2	2															***				
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•	x0324085	EMERGENCY VEHICLE PRIORITY SYSTEM LINE	FOOT	708			708		and the state of t															
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•	X1400107	FULL-ACTUATED CONTROLLER AND TYPE SUPER	EACH	1		1]				
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-	x2080250	TRENCH BACKFILL, SPECIAL	CU YD	465								465						***************************************						
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	X2130010	EXPLORATION TRENCH, SPECIAL	FOOT	105	·							105				-								
ŀ	V402222	TEMPORARY AGORGA SOLUTION STATEMENT	F15.		-										Tentant and the second and the secon		****					and and district the second		
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	X6040205	FRAMES AND LIDS. SPECIAL	EACH	17								17			and the state of t							
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ŀ	V7010216	TRAFFIC CONTROL AND PROTECTION, (SPECIAL)) C19*	*	ļ		<u> </u>			***				 	Andrew An							
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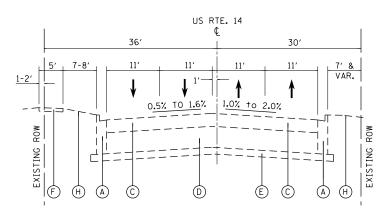


## EXISTING TYPICAL CROSS SECTION SEEGERS ROAD

STA. 11+50 TO STA. 12+20

## EXISTING TYPICAL CROSS SECTION BROADWAY STREET

STA. 102+00 TO STA. 105+03



**US 14 (NORTHWEST HWY)** 

STA. 731+45 TO STA. 740+47.1

### **EXISTING TYPICAL CROSS SECTION**

**US 14 (NORTHWEST HWY)** 

STA. 740+47.1 TO STA. 746+75

#### LEGEND:



21/2" HMA SURFACE REMOVAL

#### **EXISTING LEGEND**

- (A) EXISTING B-6.18 CURB AND GUTTER
- (B) EXISTING B-6.12 CURB AND GUTTER
- (C) EXISTING HOT-MIX ASPHALT PAVEMENT ±7"
- (D) EXISTING P.C.C. PAVEMENT 10"
- (E) EXISTING GRANULAR SUB-BASE 4"
- (F) EXISTING P.C.C. SIDEWALK
- G EXISTING SHARED-USE PATH
- (H) EXISTING LANDSCAPING

NOTES:

THE CONTRACTOR SHALL HAVE THE OPTION TO USE EITHER HMA OR PCC TEMPORARY PAVEMENT. -HMA BINDER COURSE, IL-19.0, N50, 8"

SUBBASE GRANULAR MATERIAL, TYPE B, 4"

-TEMPORARY PCC PAVEMENT, 8"
SUBBASE GRANULAR MATERIAL, TYPE B, 4"


PCC TEMPORARY PAVEMENT SHALL CONSIST OF CLASS PV CONCRETE MEETING THE REQUIREMENTS OF ART. 1020 OF THE STANDARD SPECIFICATIONS. TEMPORARY PCC PAVEMENT DOES NOT REQUIRE DOWEL BARS.

NOTE: THE CONTRACTOR SHALL MILL PRIOR TO PATCHING: PATCHING FOR DRAINAGE ITEMS SHALL BE CONSTRUCTED WHEN DRAINAGE ITEMS ARE INSTALLED.

HOT-MIX ASPHALT MIXTURE REQUIREMENTS		QUALITY
MIXTURE TYPE	PERCENT AIR VOIDS AT Ndes	MANAGEMENT PROGRAM (QMP
HOT-MIX ASPHALT PAVEMENT WIDENING & RESURFACING		
POLYMERIZED HOT-MIX ASPHALT SURFACE COURSE, MIX "E", N70 (IL 9.5 mm), 13/4"	4% ⊚ 70 GYR.	QCP
POLYMERIZED LEVELING BINDER (MACHINE METHOD), IL-4.75, N50,3/4"	3.5% @ 70 GYR.	QC/QA
HOT-MIX ASPHALT BASE COURSE WIDENING, 7 1/2" (HMA BINDER IL 19.0)	4% @ 70 GYR.	QC/QA
PATCHING		
CLASS D PATCH (HMA BINDER IL 19.0)	4% @ 70 GYR.	QC/QA
DRIVEWAY PAVEMENT		
HOT-MIX ASPHALT SURFACE COURSE, MIX "D", N50 (IL 9.5 mm), 2"	4% @ 50 GYR.	QC/QA
HOT-MIX ASPHALT BASE COURSE (HMA BINDER IL-19.0 mm), CE-8"	4% @ 50 GYR.	QC/QA
TEMPORARY PAVEMENT		
HOT-MIX ASPHALT BINDER COURSE, IL-19.0, N50, 8"	4% @ 50 GYR.	QC/QA
OMP DESIGNATION: QUALITY CONTROL/QUALITY ASSURANCE (QC/QA); QUALITY CONTROL	FOR PERFORMANCE (QCP); PAY FOR PERFOR	MANCE (PFP)

- 1. THE UNIT WEIGHT USED TO CALCUALTE ALL HOT-MIX ASPHALT SURFACE MIXTURE QUANTITIES IS 112 LBS/SQ YD/IN
- 2. THE "AC TYPE" FOR POLYMERIZED HMA MIXES SHALL BE "SBS/SBR PG 76-22" AND FOR NON-POLYMERIZED HMA THE "AC TYPE" SHALL BE "PG 64-22" UNLESS MODIFIED BY DISTRICT ONE SPECIAL PROVISIONS. FOR USE OF RECYCLED MATERIALS SEE DISTRICT ONE SPECIAL PROVISIONS.
- 3. QUALITY MANAGEMENT PROGRAM (OMP) IDENTIFIES THE PARTICULAR QUALITY CONTROL SPECIFICATION THAT APPLIES TO THE HMA MIXTURE.

FILE	NAME =	USER NAME = bartonrw	DESIGNED - RWB	REVISED -		TYPICAL SECTIONS	F.A.U.	SECTION	COUNTY	TOTAL SHEET
pw://	\IL084EBIDINTEG.:llinois.gov:PWIDOT\Do	cuments\IDOT Offices\District 1\Projects\P14	39 <b>@RAWN</b> Data\Besign <b>\RWB</b> 3909-sht-typical.dc	REVISED -	STATE OF ILLINOIS	U.S. ROUTE 14 AT BROADWAY STREET	3512	87-Y-N	соок	102 19
		PLOT SCALE = 100.00000 '/ in.	CHECKED -	REVISED -	DEPARTMENT OF TRANSPORTATION	U.S. NUUTE 14 AT DNUADWAT STREET			CONTRACT	NO. 60J39
Defau	oult	PLOT DATE = 11/3/2016	DATE - 10/24/2016	REVISED -		SCALE: NTS SHEET 1 OF 3 SHEETS STA. TO STA.		ILLINOIS FED. A	ID PROJECT	

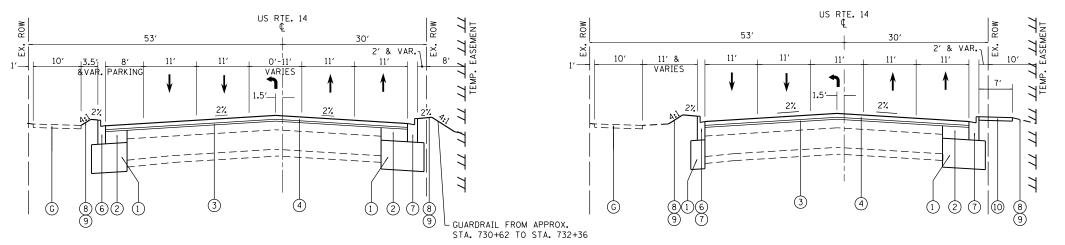

## PROPOSED TYPICAL CROSS SECTION US 14 (NORTHWEST HWY)

STA. 731+45 TO STA. 734+27.8


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# PROPOSED TYPICAL CROSS SECTION US 14 (NORTHWEST HWY)

STA. 734+27.8 TO STA. 735+43.1

# PROPOSED TYPICAL CROSS SECTION US 14 (NORTHWEST HWY)

STA. 736+61.6 TO STA. 737+47.4

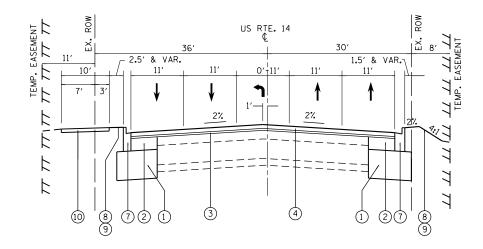

# PROPOSED TYPICAL CROSS SECTION US 14 (NORTHWEST HWY)

STA. 737+47.4 TO STA. 740+47.1

#### **EXISTING LEGEND**

- A EXISTING B-6.18 CURB AND GUTTER
- B) EXISTING B-6.12 CURB AND GUTTER
- © EXISTING HOT-MIX ASPHALT PAVEMENT ±7"
- D EXISTING P.C.C. PAVEMENT 10"
- E EXISTING GRANULAR SUB-BASE 4"
- (F) EXISTING P.C.C. SIDEWALK
- G) EXISTING SHARED-USE PATH
- H EXISTING LANDSCAPING


#### PROPOSED LEGEND

- 1) PROPOSED AGGREGATE SUBGRADE IMPROVEMENT, 12"
- 2) PROPOSED HOT-MIX ASPHALT BASE COURSE WIDENING, 7 1/2"
- $\stackrel{\smile}{\widehat{\text{3}}}$  PROPOSED POLYMERIZED LEVELING BINDER (MACHINE METHOD), IL-4.75, N50, $\stackrel{\checkmark}{\cancel{4}}$ "
- 4) PROPOSED POLYMERIZED HOT-MIX ASPHALT SURFACE COURSE, MIX "E", N70, 1¾"
- PROPOSED COMBINATION CONCRETE CURB AND GUTTER, TYPE M-4.12
- (6) PROPOSED COMBINATION CONCRETE CURB AND GUTTER, TYPE B-6.12
- 7) PROPOSED COMBINATION CONCRETE CURB AND GUTTER, TYPE B-6.18
- 8 PROPOSED TOPSOIL FURNISH AND PLACE, 4"
- 9 PROPOSED SODDING, SALT TOLLERANT
- PROPOSED PORTLAND CEMENT CONCRETE SIDEWALK 5 INCH

#### NOTES:


PROPOSED AGGREGATE SUBGRADE IMPROVEMENT 12" IS TO EXTEND 1' BEHIND THE PROPOSED CONCRETE CURB AND GUTTER.

	FILE NAME =	USER NAME = bartonrw	DESIGNED - RWB	REVISED -		TYPICAL SECTIONS	F.A.U. RTE.	SECTION	COUNTY	TOTAL SHEET SHEETS NO.
	pw:\\IL084EBIDINTEG.:1ll:nois.gov:PWIDOT\Do	cuments\IDOT Offices\District 1\Projects\P14		REVISED -	STATE OF ILLINOIS	U.S. ROUTE 14 AT BROADWAY STREET	3512	87-Y-N	соок	102 20
		PLOT SCALE = 100.0000 ' / in.	CHECKED -	REVISED -	DEPARTMENT OF TRANSPORTATION				CONTRACT	NO. 60J39
- 1	Default	PLOT DATE = 11/3/2016	DATE - 10/11/2016	REVISED -		SCALE: NTS   SHEET 2 OF 3 SHEETS   STA. TO STA.		ILLINOIS FED. AII	D PROJECT	

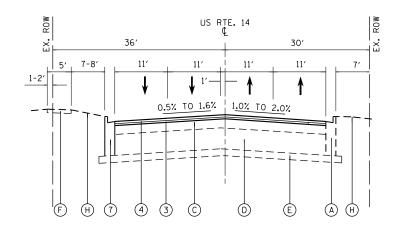


# PROPOSED TYPICAL CROSS SECTION US 14 (NORTHWEST HWY)

STA. 740+47.1 TO STA. 746+89

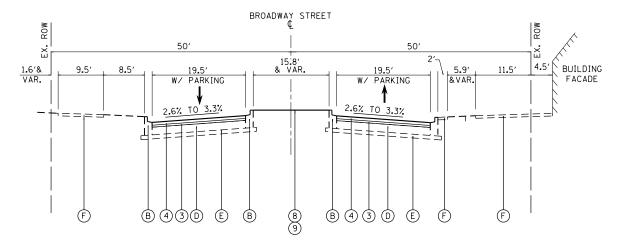

## PROPOSED TYPICAL CROSS SECTION BROADWAY STREET

STA. 102+21 TO STA. 105+03

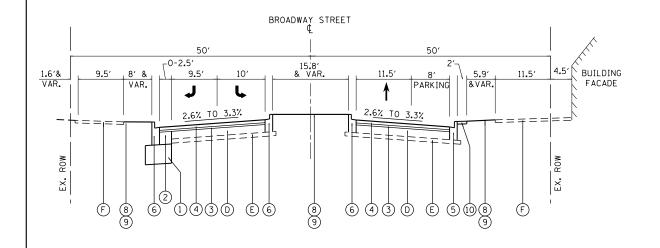

# BUILDING 6.5' 12' 8' 13' 13' 10' 5' 1.5' & VAR. 2.5% TO 4.5% A VAR. 3.3% & VAR. 2.5% TO 4.5% A VAR. X VAR. X VAR.

SEEGERS ROAD

## PROPOSED TYPICAL CROSS SECTION BROADWAY STREET

STA. 102+00 TO STA. 102+21

## PROPOSED TYPICAL CROSS SECTION SEEGERS ROAD

STA. 11+50 TO STA. 12+20

#### NOTES:

PROPOSED AGGREGATE SUBGRADE IMPROVEMENT 12" IS TO EXTEND 1' BEHIND THE PROPOSED CONCRETE CURB AND GUTTER.

Ī	FILE NAME =	USER NAME = bartonrw	DESIGNED - RWB	REVISED -			TYPICAL SECTIONS	F.A.U. RTF.	SECTION	COUNTY	TOTAL	SHEET NO.
	pw:\\IL084EBIDINTEG.ıllınoıs.gov:PWIDOT\Do	cuments\IDOT Offices\District 1\Projects\P143		REVISED -	STATE OF ILLINOIS		U.S. ROUTE 14 AT BROADWAY STREET	3512	87-Y-N	соок	102	21
- 1		PLOT SCALE = 100.0000 ' / in.	CHECKED -	REVISED -	DEPARTMENT OF TRANSPORTATION					CONTRACT	NO. 6	0J39
- 1	Default	PLOT DATE = 11/3/2016	DATE - 10/11/2016	REVISED -		SCALE: NTS	SHEET 3 OF 3 SHEETS STA. TO STA.		ILLINOIS FED. AI	D PROJECT		$\neg$

#### **EXISTING LEGEND**

- A EXISTING B-6.18 CURB AND GUTTER
- (B) EXISTING B-6.12 CURB AND GUTTER
- © EXISTING HOT-MIX ASPHALT PAVEMENT ±7"
- D EXISTING P.C.C. PAVEMENT 10"
- E EXISTING GRANULAR SUB-BASE 4"
- (F) EXISTING P.C.C. SIDEWALK
- G EXISTING SHARED-USE PATH
- H EXISTING LANDSCAPING

#### PROPOSED LEGEND

- 1) PROPOSED AGGREGATE SUBGRADE IMPROVEMENT, 12"
- 2) PROPOSED HOT-MIX ASPHALT BASE COURSE WIDENING, 7 1/2"
- 3 PROPOSED POLYMERIZED LEVELING BINDER (MACHINE METHOD), IL-4.75, N50, 3/4"
- PROPOSED POLYMERIZED HOT-MIX ASPHALT SURFACE COURSE, MIX "E", N70, 1¾"
- (5) PROPOSED COMBINATION CONCRETE CURB AND GUTTER, TYPE M-4.12
- (6) PROPOSED COMBINATION CONCRETE CURB AND GUTTER, TYPE B-6.12
- 7 PROPOSED COMBINATION CONCRETE CURB AND GUTTER, TYPE B-6.18
- (8) PROPOSED TOPSOIL FURNISH AND PLACE, 4"
- 9 PROPOSED SODDING, SALT TOLLERANT
- 10 PROPOSED PORTLAND CEMENT CONCRETE SIDEWALK 5 INCH

## EARTHWORK SCHEDULE - US 14 (NORTHWEST HIGHWAY)

STATION	STATION	EARTH EXCAVATION (20200100)	UNSUITABLE MATERIAL (20201200)	EXCAVATION TO BE USED IN EMBANKMENT ADUJUSTED FOR SHRINKAGE	EMBANKMENT	EARTHWORK BALANCE (+/-) (+)=WASTE (-)=SHORTAGE
		CU YD		CU YD	CU YD	CU YD
731+50.00	732+00.00	9	7	8	0	8
732+00.00	732+50.00	18	10	15	4	11
732+50.00	733+00.00	30	11	26	7	19
733+00.00	733+50.00	40	1 3	34	8	26
733+50.00	734+00.00	48	14	41	9	32
734+00.00	734+50.00	37	1 1	31	10	21
734+50.00	735+00.00	28	9	24	10	14
735+00.00	735+50.00	32	9	27	8	19
737+00.00	737+50.00	46	21	39	16	23
737+50.00	738+00.00	46	20	39	1 7	22
738+00.00	739+00.00	38	13	32	11	21
739+00.00	739+50.00	26	10	22	5	17
739+50.00	740+00.00	17	10	14	2	12
RADIUS WID	ENING (LT)	33	15	28	0	28
RADIUS WID	ENING (RT)	47	20	40	0	40
BROADWAY ST	. ADA RAMPS	24	23	21	6	15
SEEGERS RD.	ADA RAMPS	6	0	5	1	4
US 14 BUS	STOP (EB)	1	1 3	1	20	-19
US 14 BUS	STOP (WB)	1	3	1	0	1
BROADWAY ST. BUS STOP		1	4	1	0	1
BROADWAY ST. ADA RAMPS		1	1	1	0	1
YALE CT. ADA RAMPS		1	0	1	0	1
US 14	TOTAL	531	386*	451	133	318

NOTE: 15% SHRINKAGE FACTOR

NOTE: ASSUME TOP 6" OF TOPSOIL IN UNDISTURBED AREAS TO BE UNSUITABLE

*ADDITIONAL QUANITY IS FOR POSSIBLE UNDERCUTS TO BE DTERMINED IN THE FIELD

FILE NAME =	USER NAME = bartonrw	DESIGNED - RWB	REVISED -
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	PLOT SCALE = 40.0000 '/ in.	CHECKED -	REVISED -
Default	PLOT DATE = 11/3/2016	DATE - 10/13/2016	REVISED -

STATE OF	: ILLINOIS
DEPARTMENT OF	TRANSPORTATION

	S	CHEDULE	OF QU	ANTITIES		F.A.U. RTE.	SECTION	COUNTY	TOTAL SHEETS	SHEET NO.
	II S ROI	ITE 1/1 /	T RRAA	DWAY STRI	FFT	3512	87-Y-N	соок	102	22
		/IL I7 /	i Dilor	DVVAI SIII				CONTRACT	NO. 6	60J39
SCALE:	SHEET 1	OF 3	SHEETS	STA.	TO STA.		ILLINOIS FED. A	ID PROJECT		

## LANDSCAPING SCHEDULE

STATION	TREE REMOVAL (6 TO 15 UNITS DIAMETER) (20100110)	TREE REMOVAL (OVER 15 UNITS DIAMETER) (20100210)	TREE TRUNK PROTECTION (20101100)	TREE GINKGO BILOBA PRINCETON SENTRY ( A2004520)	TREE TILIA CORDATA GLENLEVEN (A2008100)
	UNITS	UNITS	EACH	EACH	EACH
US 14					
732+53	11				
732+95	14				
732+70	8				
733+86			1		
736+05			1		
746+43	10				
BROADWAY ST.				1	
101+85					
102+19		18	1		
102+35					1
102+85				1	
103+35					1
103+85				1	
TOTAL	43	18	3	3	2

FILE NAME =	USER NAME = bartonrw	DESIGNED - RWB	REVISED -
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	PLOT SCALE = 40.0000 '/ in.	CHECKED -	REVISED -
Default	PLOT DATE = 11/3/2016	DATE - 10/24/2016	REVISED -

SCALE:

SCHEDULE OF QUANTITIES		F.A.U. RTE.	SECT	ΓΙΟΝ		COUNTY
U.S. ROUTE 14 AT BROADWAY STREET		3512	87-	Y-N		соок
U.S. HOUTE 14 AT BHOADWAT STILLT						CONTR
SHEET 2 OF 3 SHEETS STA.	TO STA.			ILLINOIS	FED. AII	PROJECT


## CITY OF DES PLAINES UTILITY ADJUSTMENT SCHEDULE


STATION	FIRE HYDRANTS TO BE REMOVED AND REPLACED (56400510)	MANHOLES TO BE ADJUSTED (60255500)	MANHOLES TO BE RECONSTRUCTED (60257900)	VALVE VAULTS TO BE ADJUSTED (60265700)	VALVE VAULTS TO BE RECONSTRUCTED (60266100)	FRAMES AND LIDS TO BE ADJUSTED (SPECIAL) (X6030310)
	EACH	EACH	EACH	EACH	EACH	EACH
STAGE 1						
US 14						
735+58				1		
735+64		1				
736+60						1
BROADWAY ST.						
101+91	1			1		
101+00	· ·			-		
STAGE 2						
US 14						
733+43		1				
736+80				1		
BROADWAY ST.						
101+28			1			
104+32		1				
104+41					1	
STAGE 3						
BROADWAY ST.						
101+81				1		
POST STAGE						
US 14						
735+77						1
735+97						
743+78				1		1
743+87				1		1
745+43						1
SEEGERS RD.						
11+03						1


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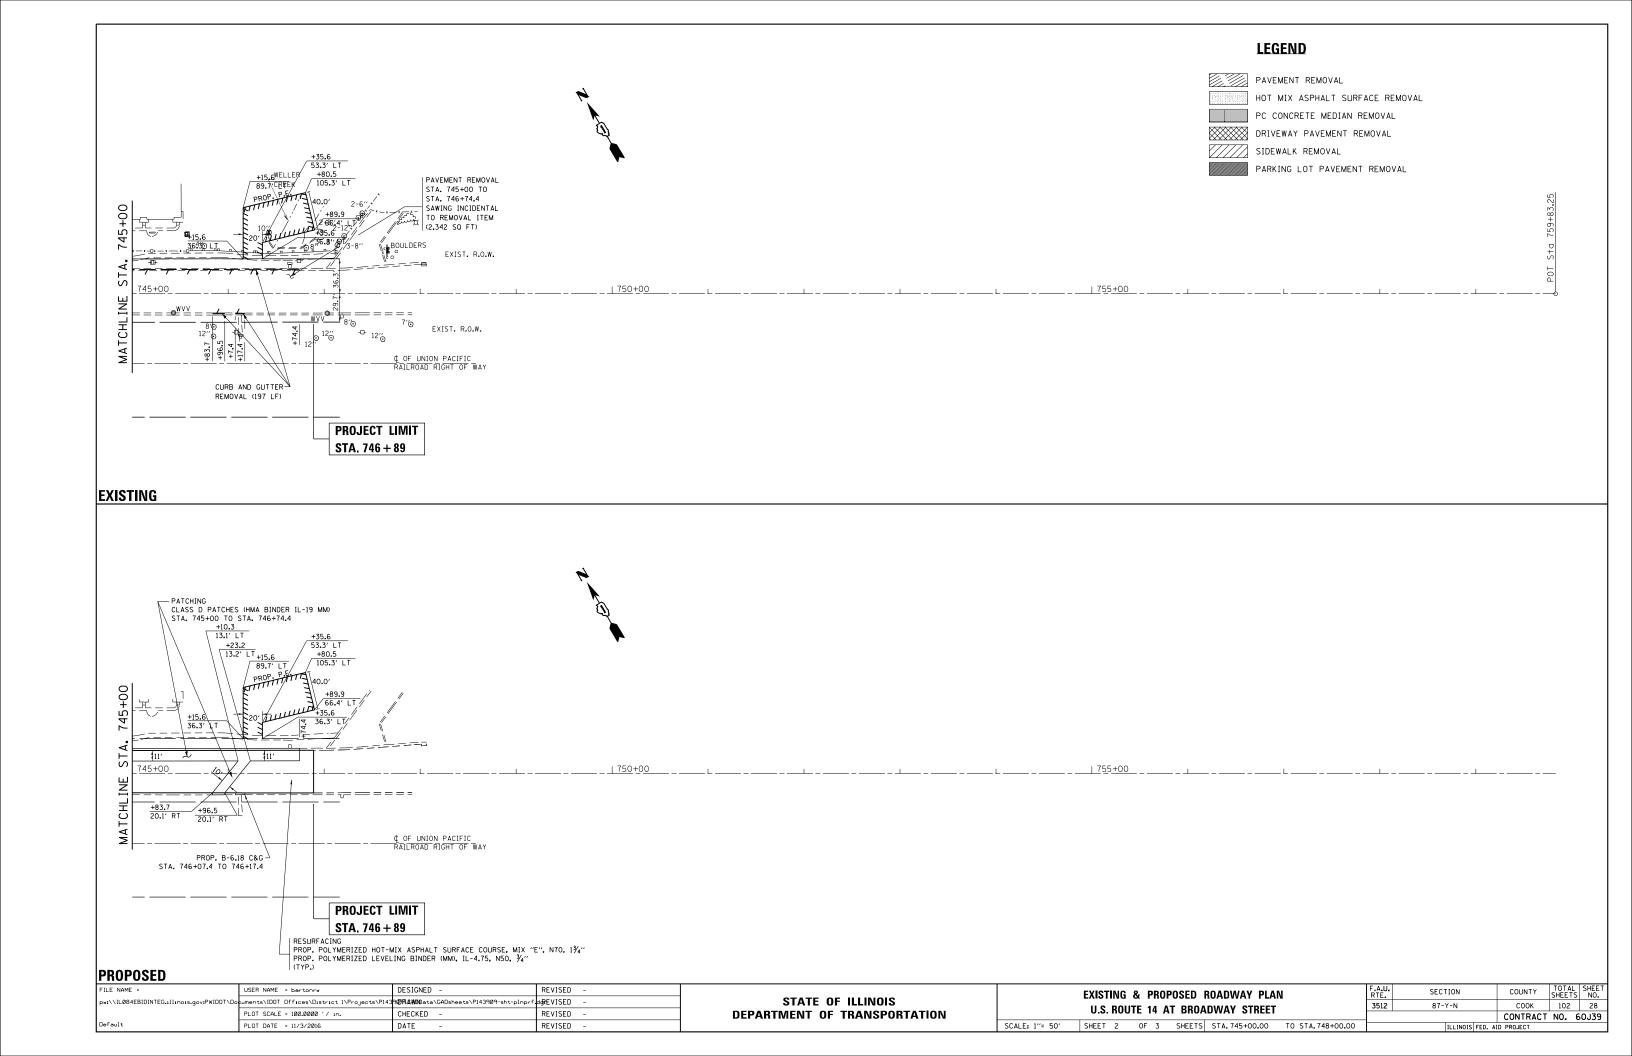
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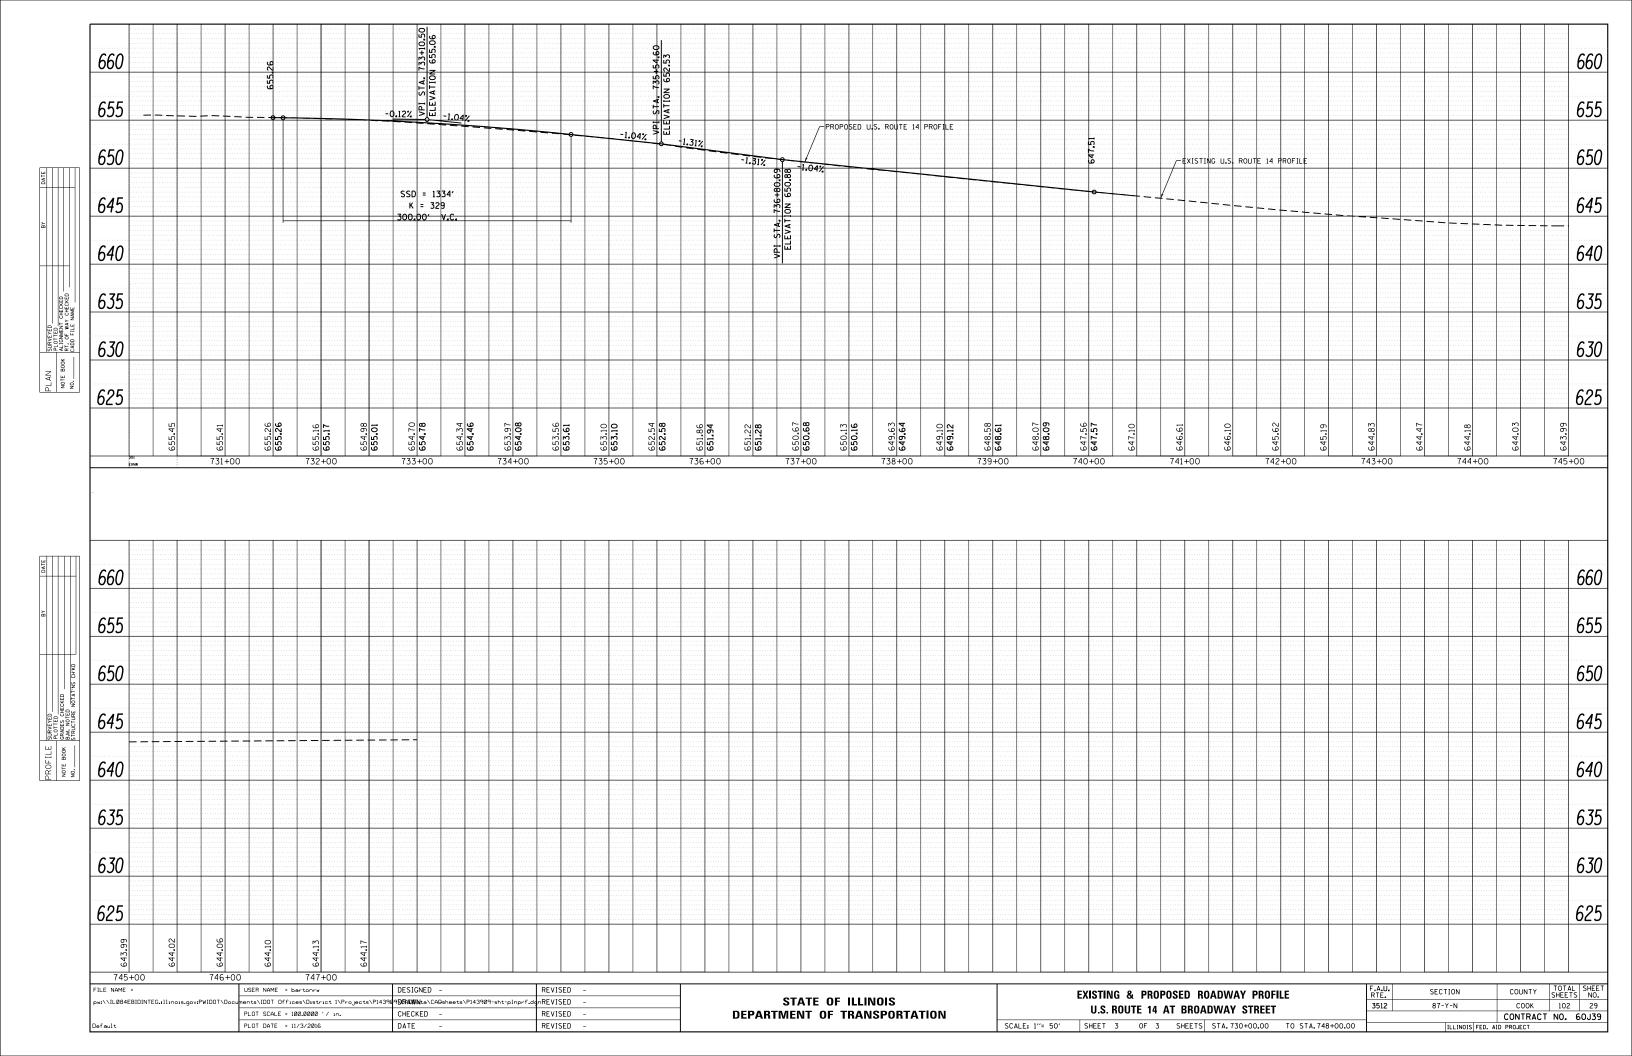
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0.3. 1	1001		7 /	VI DIIO	DVVAI	JIIILLI						CONTRACT	NO. 6	50J
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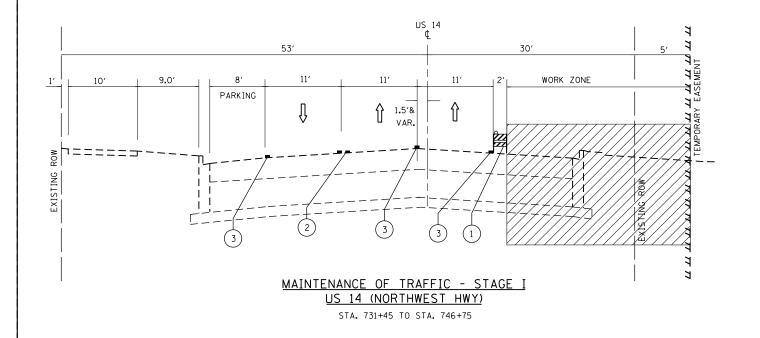








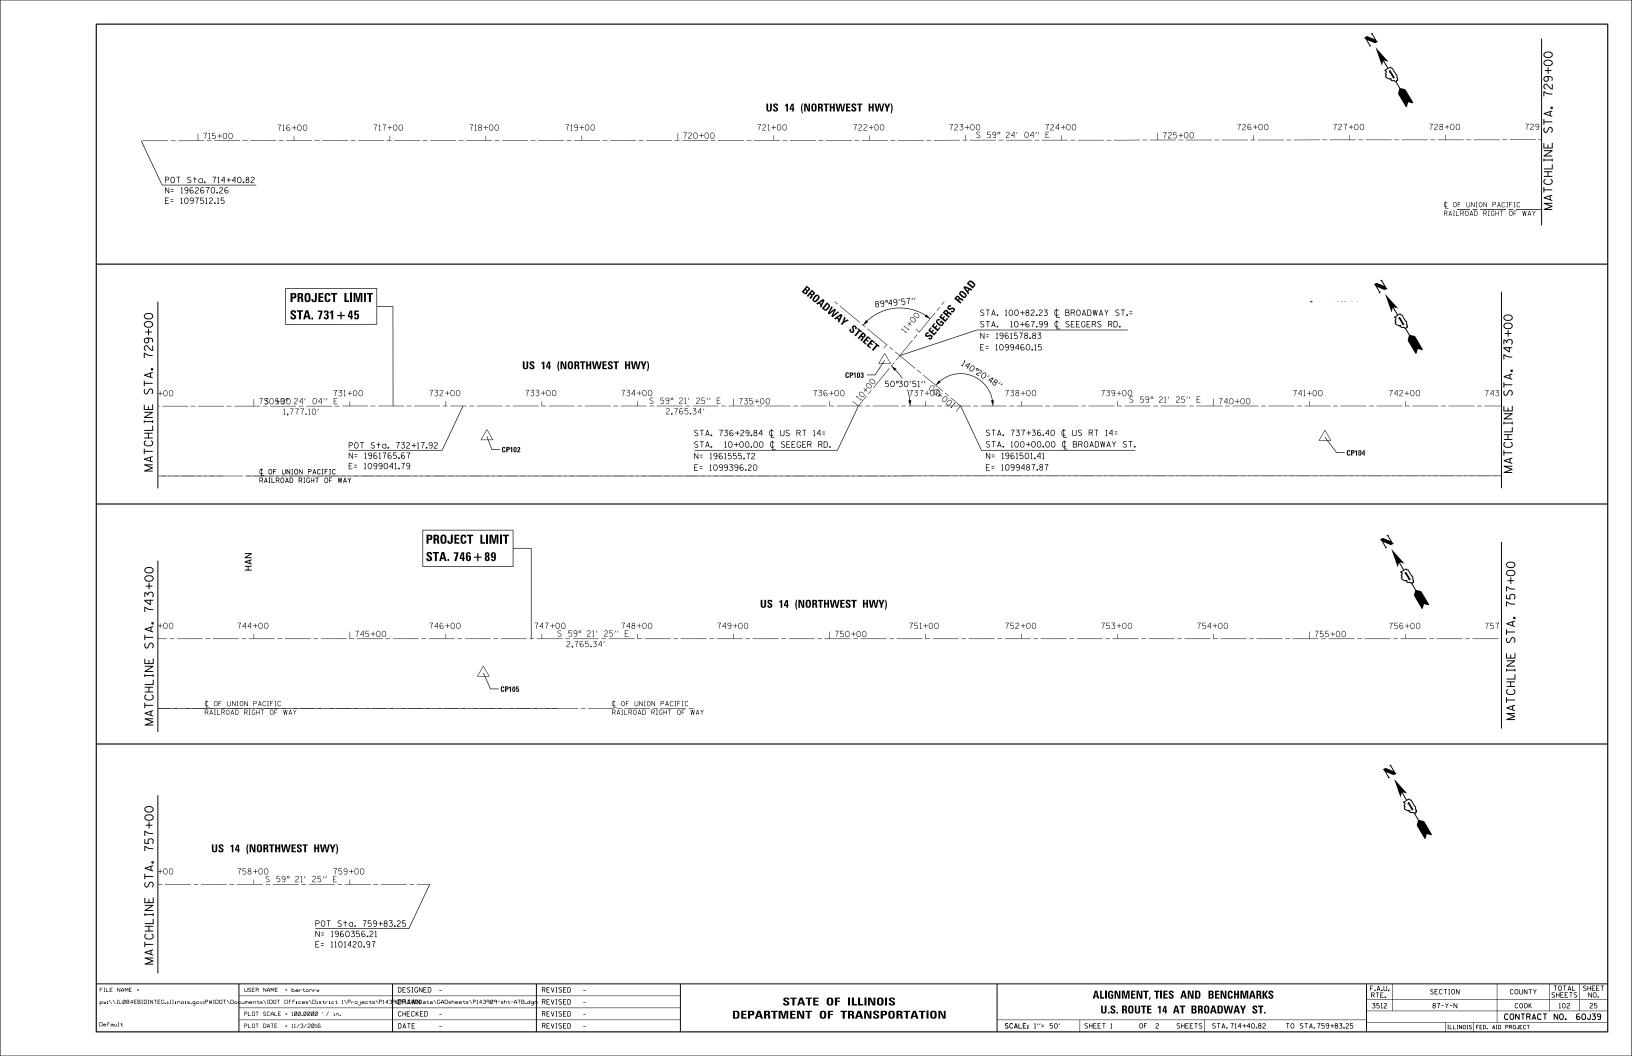

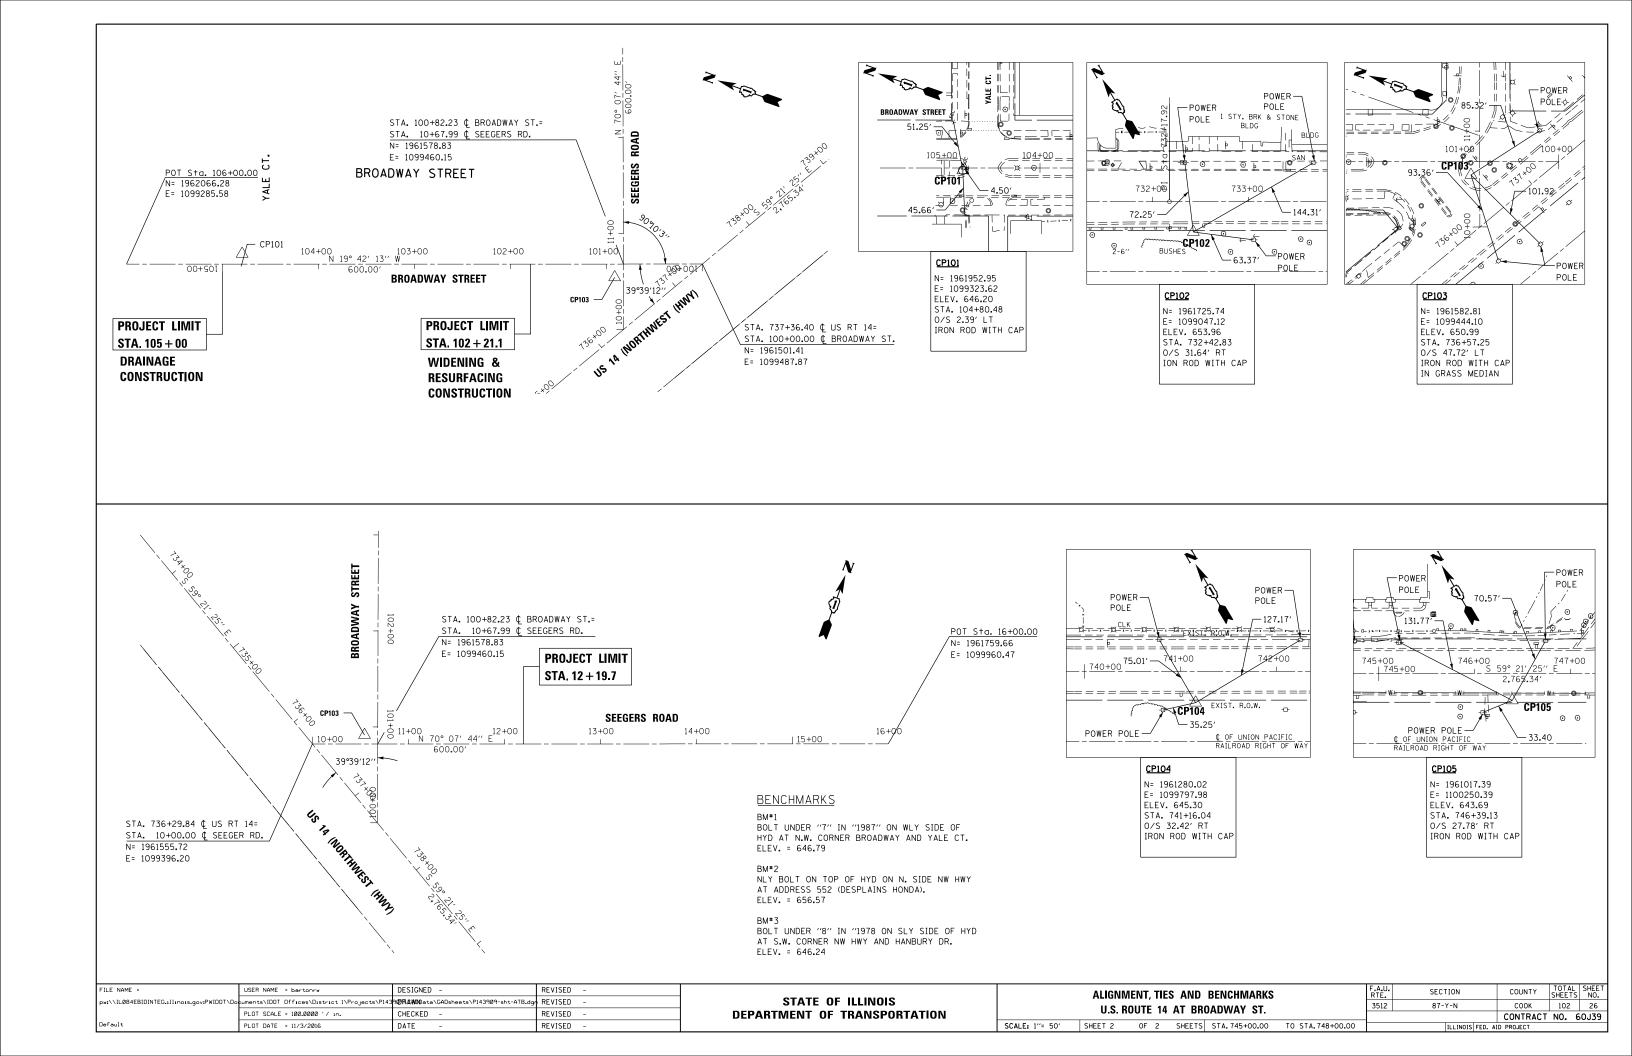


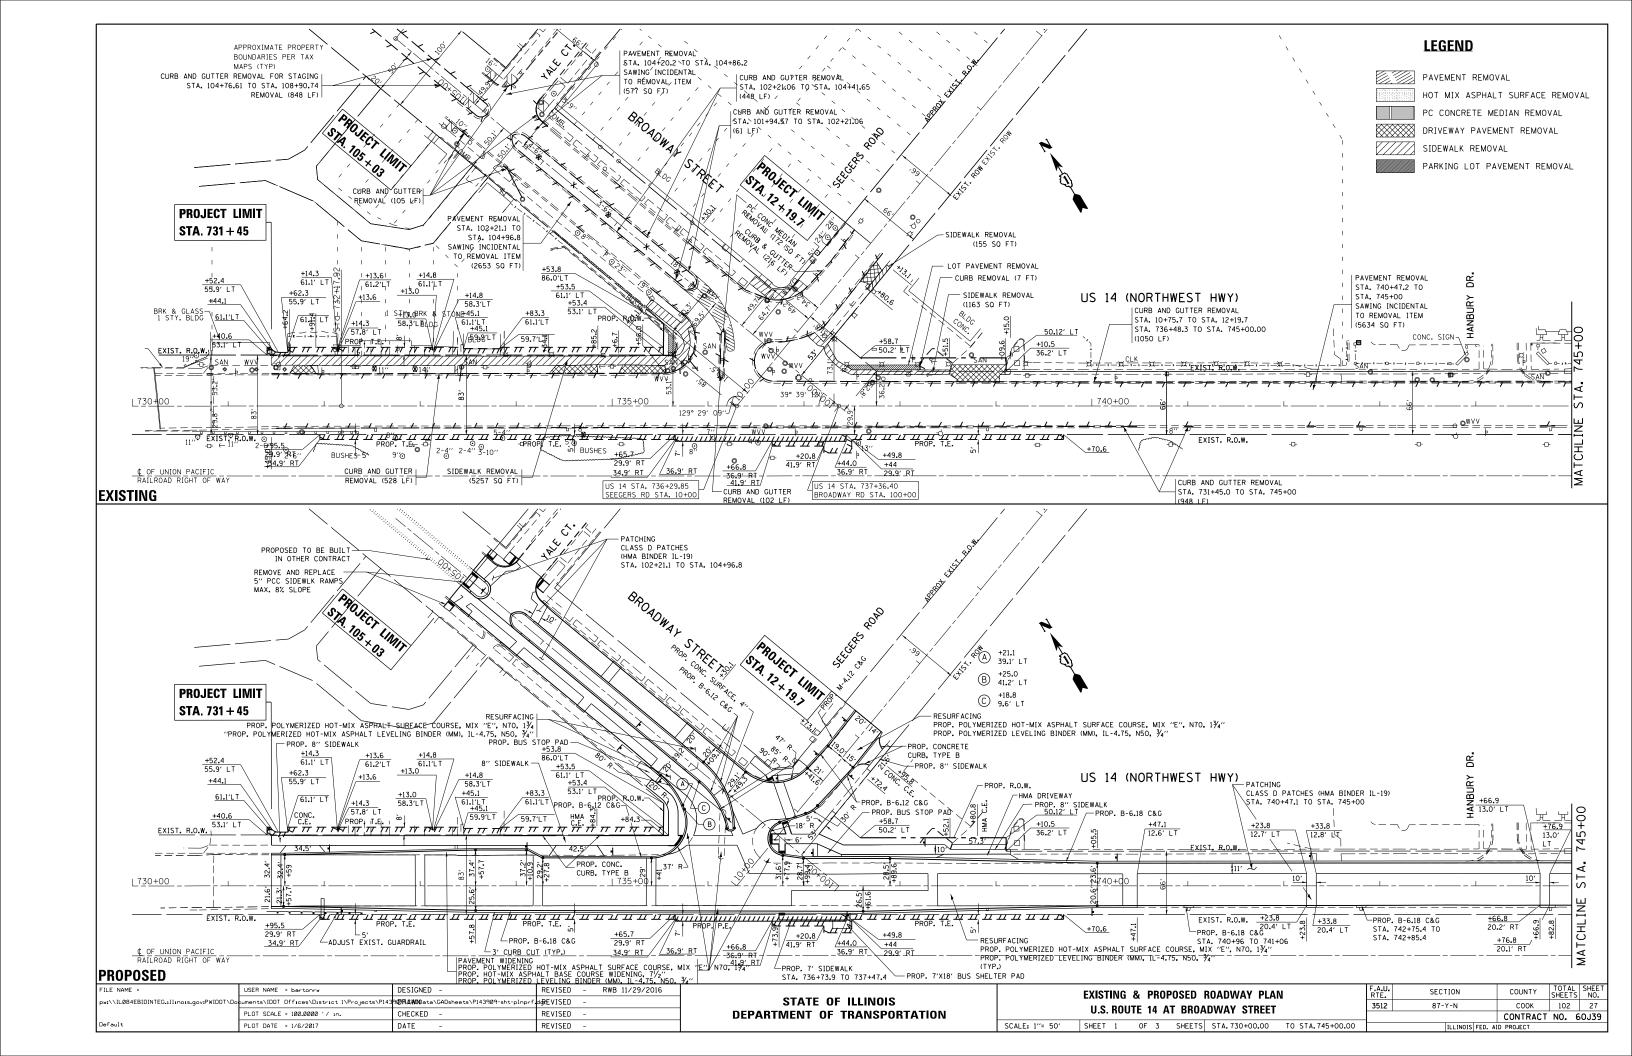

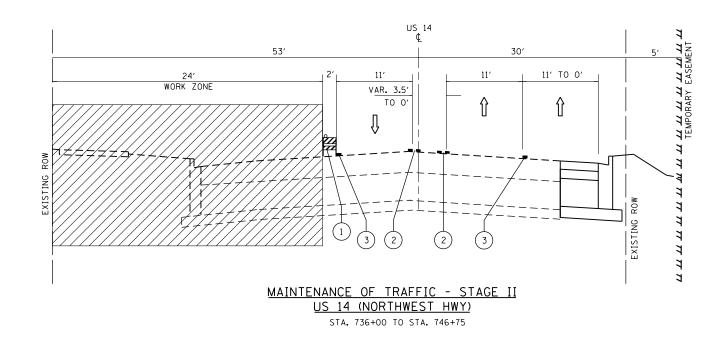

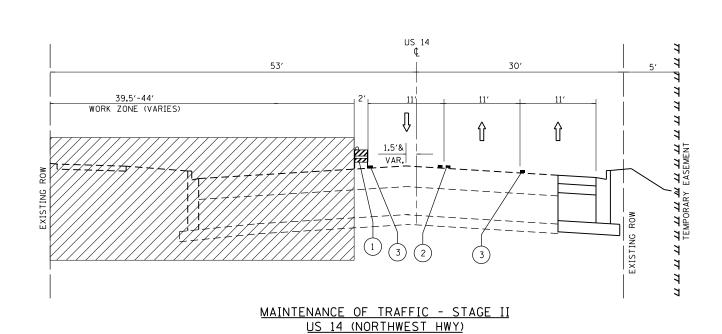


STA. 731+45 TO STA. 736+00

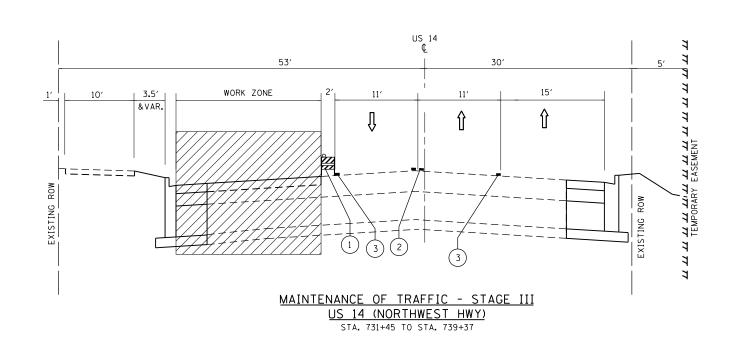


NOTE: SEE SHEET 3 FOR NOTES AND LEGEND

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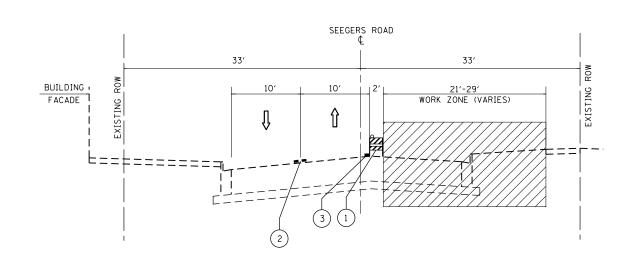
#### MAINTENANCE OF TRAFFIC - STAGE I BROADWAY STREET

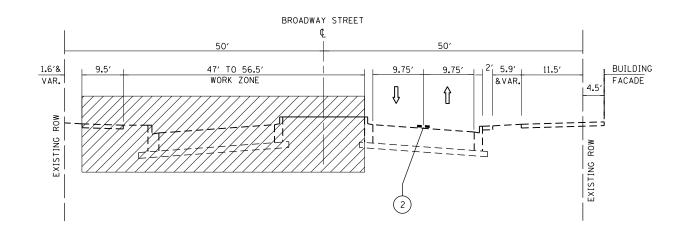STA. 102+00 TO STA. 105+00




#### MAINTENANCE OF TRAFFIC - STAGE II BROADWAY STREET

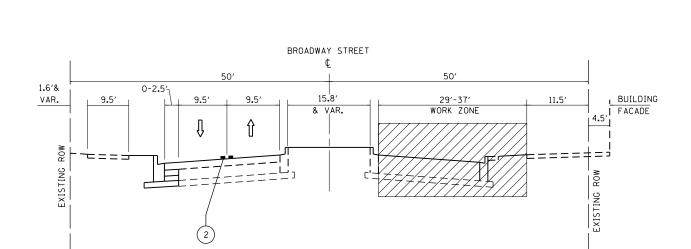STA. 102+00 TO STA. 105+00



#### MAINTENANCE OF TRAFFIC - STAGE I SEEGERS ROAD

STA. 11+50 TO STA. 12+20

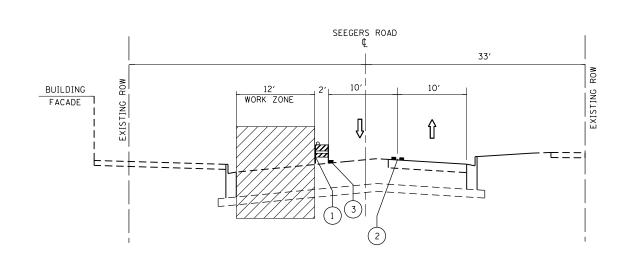


#### MAINTENANCE OF TRAFFIC - STAGE II SEEGERS ROAD

STA. 11+50 TO STA. 12+20

NOTE: SEE SHEET 3 FOR NOTES AND LEGEND

Ī	FILE NAME =	USER NAME = bartonrw	DESIGNED - RWB	REVISED -		MOT TYPICAL SECTIONS – US ROUTE 14 & BROADWAY STREET	F.A.U. RTF.	SECTION	COUNTY TO	OTAL SHEET
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- 1		PLOT SCALE = 100.0000 '/ in.	CHECKED -	REVISED -	DEPARTMENT OF TRANSPORTATION	US NIE 14 (INUNITIVEST TIVIT.) AT BRUADVVAT STREET			CONTRACT NO	0. 60J39
- 1	Default	PLOT DATE = 11/3/2016	DATE - 10/21/2016	REVISED -		SCALE: N.T.S.   SHEET 2 OF 3 SHEETS   STA. TO STA.		ILLINOIS FED. AI	AID PROJECT	

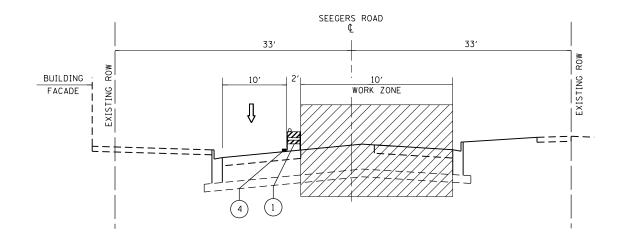

## MAINTENANCE OF TRAFFIC - STAGE III SEEGERS ROAD

STA. 11+50 TO STA. 12+20


#### **LEGEND**


- 1 DRUMS WITH STEADY BURN MONO-DIRECTIONAL LIGHT
- TEMPORARY PAVEMENT MARKING LINE 4" (DOUBLE YELLOW 11"C-C W/ TEMP. RAISED REFLECTIVE PAVEMENT MARKERS)
- (3) TEMPORARY PAVEMENT MARKING LINE 4" (WHITE)
- (4) TEMPORARY PAVEMENT MARKING LINE 4" (YELLOW)
- DIRECTION OF TRAFFIC
- WORK ZONE


#### **NOTES**


- PRIOR TO INSTALLING POST MOUNTED SIGNS, THE CONTRACTOR SHALL CONTACT J.U.L.I.E.
- 2. SEE STAGING PLAN AND STANDARD 701701 FOR ADDITIONAL INFORMATION.
- LOCATION OF "DRIVEWAY ENTRANCE" SIGNS PER STANDARD TC-26 SHALL BE DETERMINED BY THE ENGINEER.


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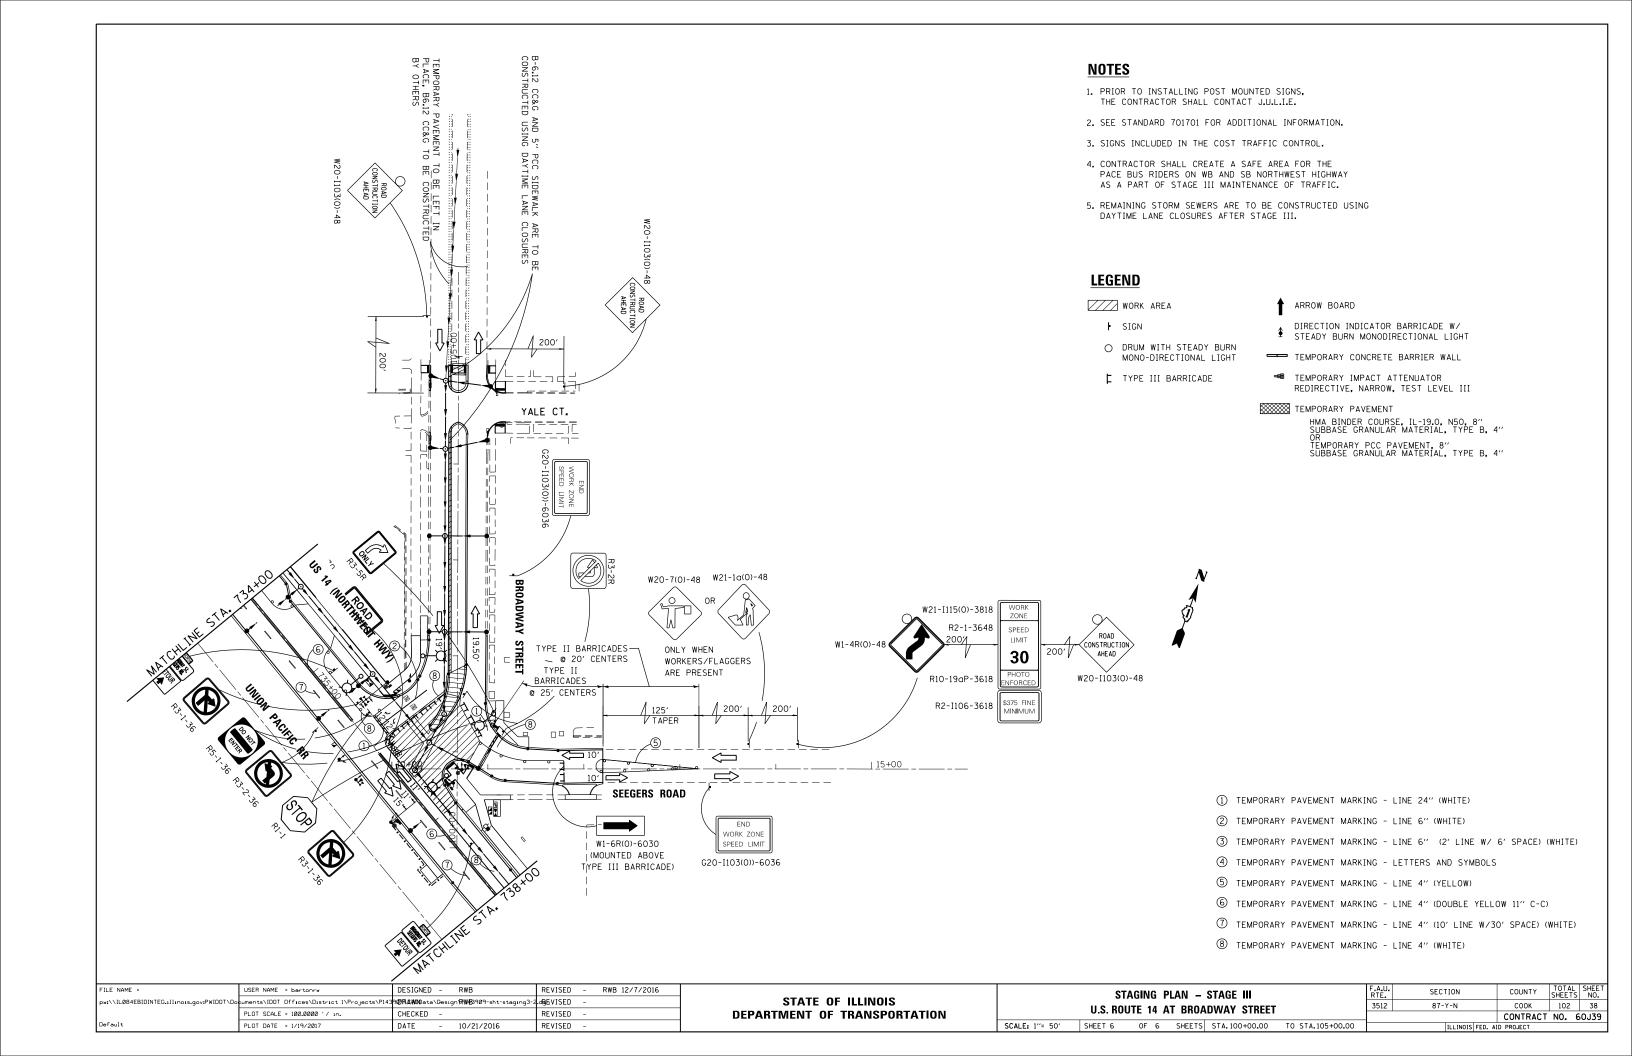


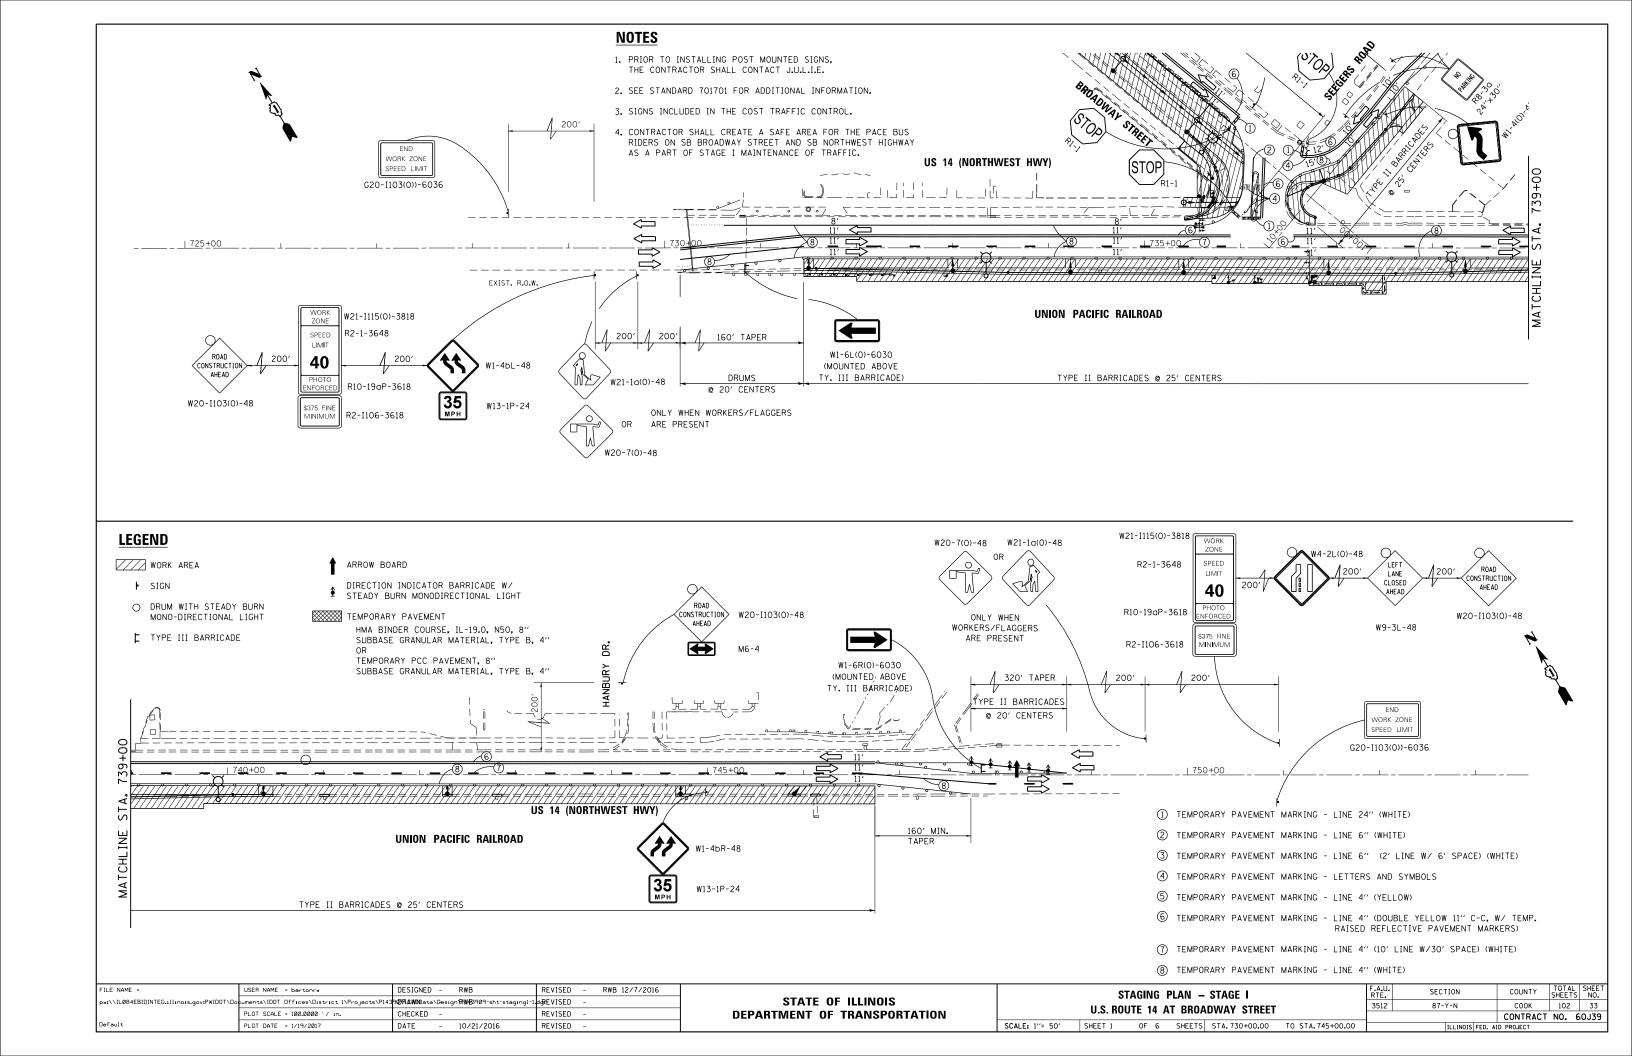


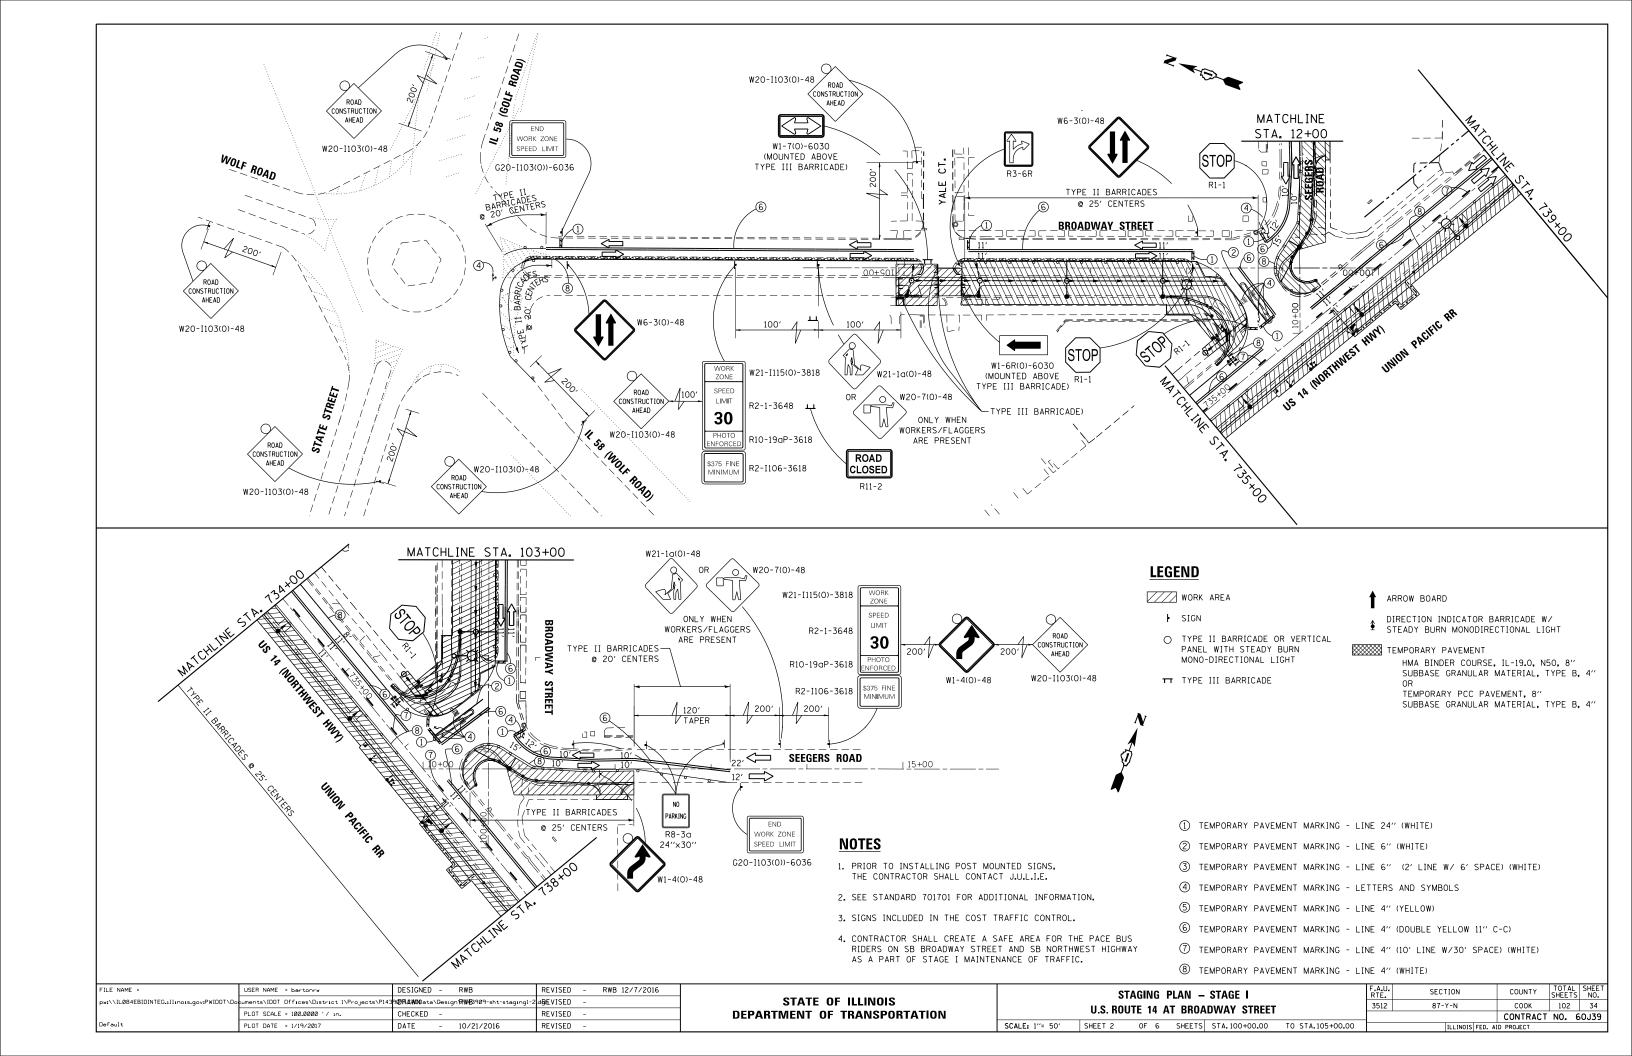

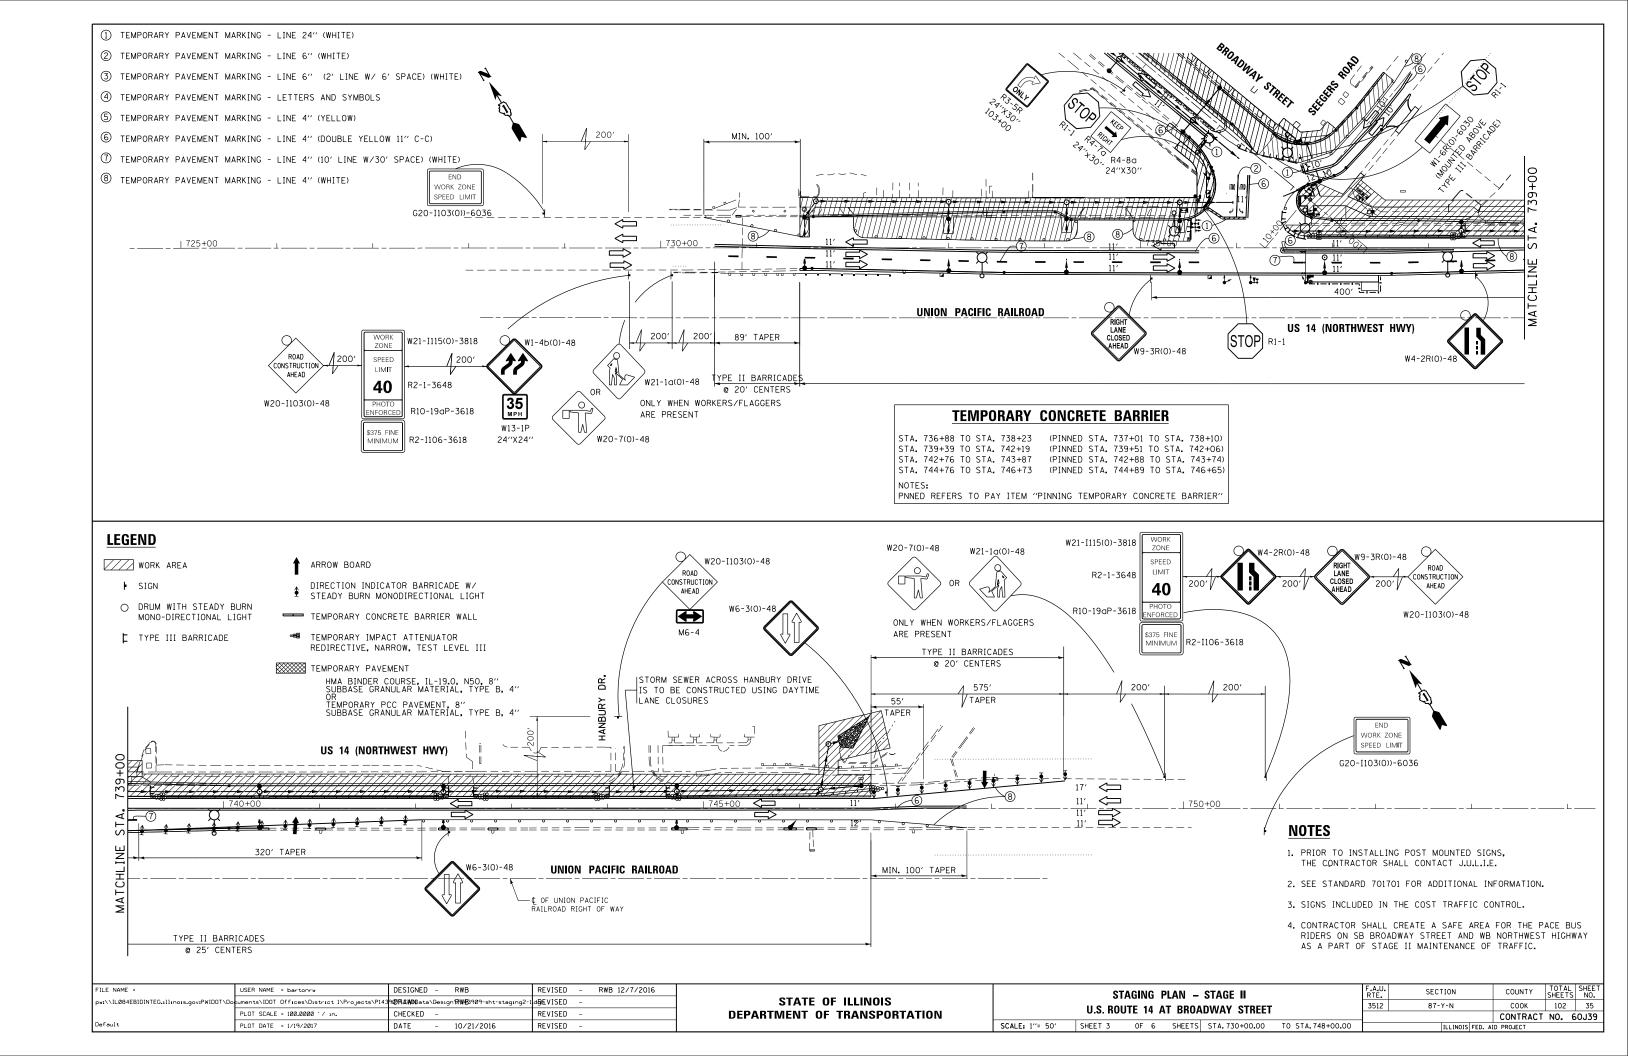

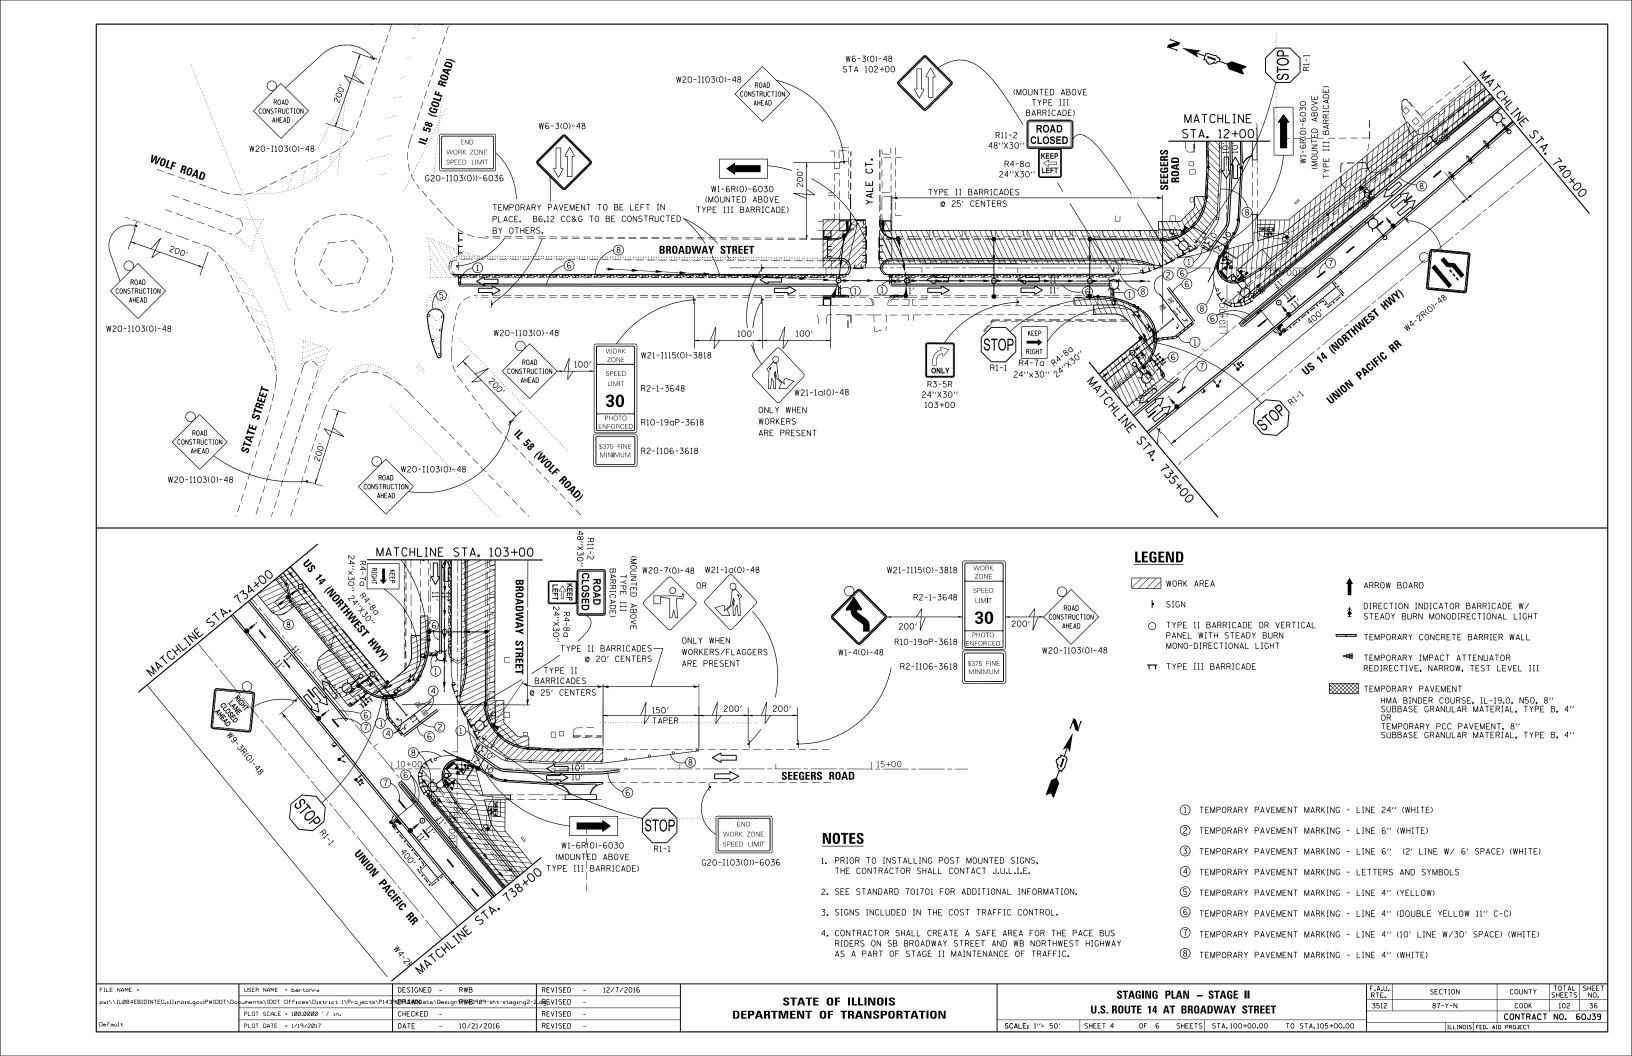

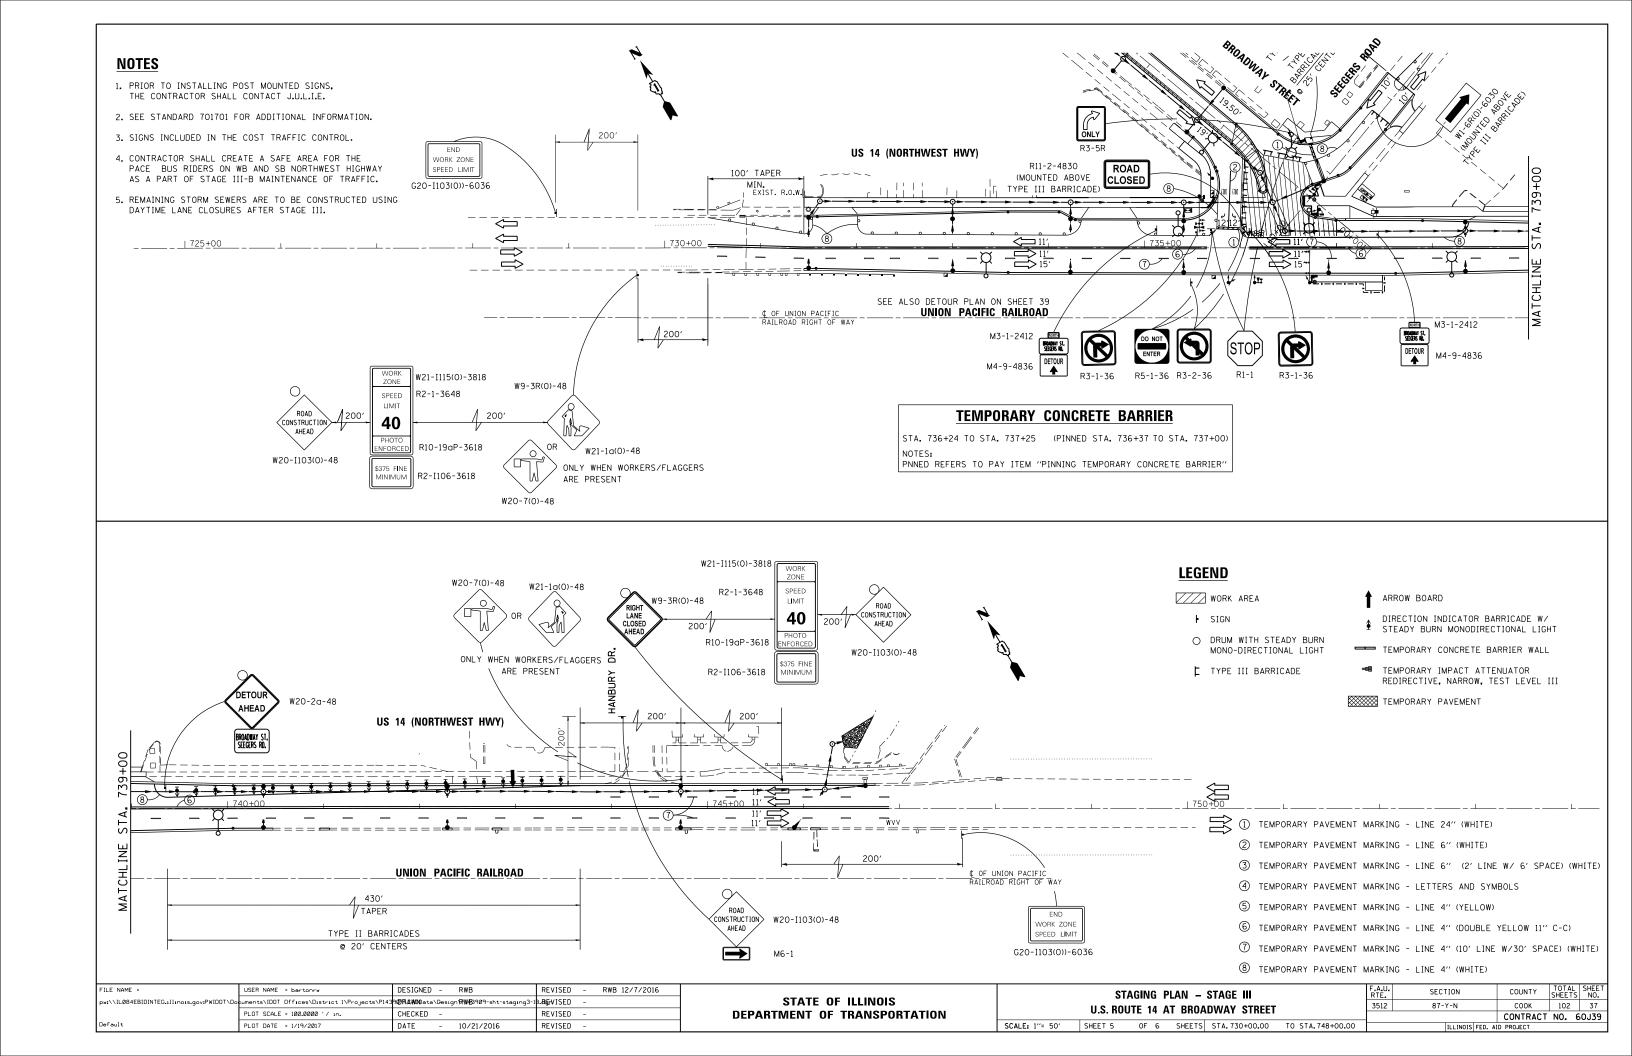

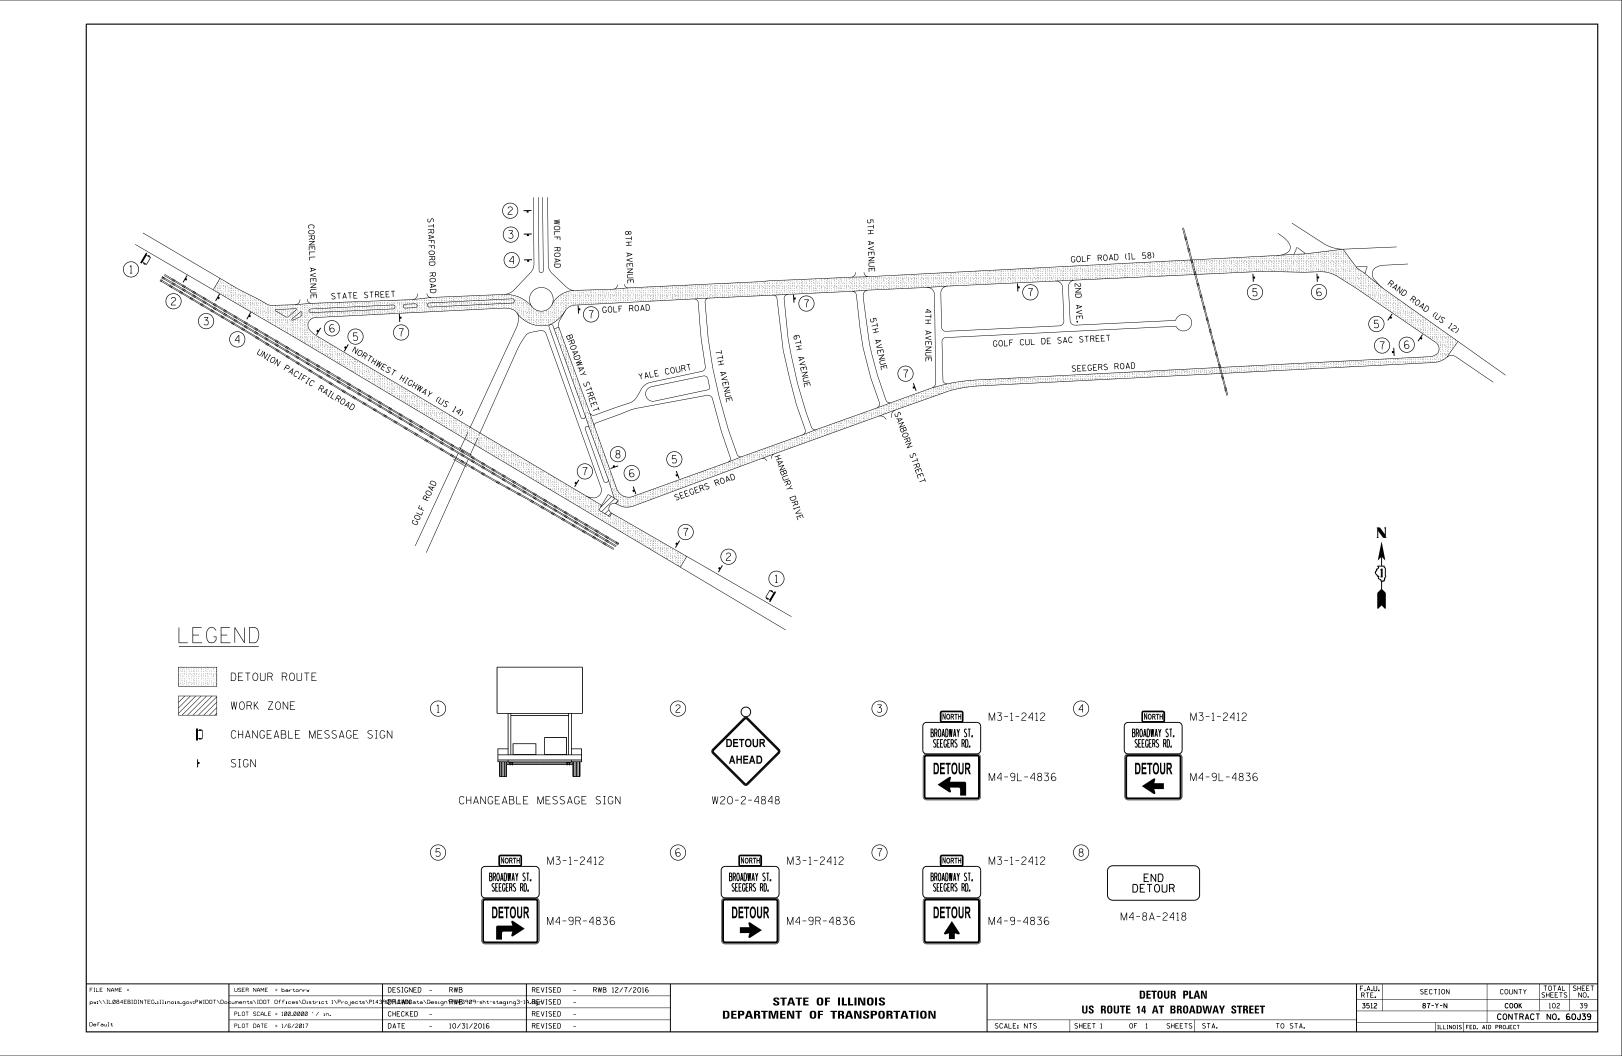

#### **EROSION CONTROL GENERAL NOTES**

- 1. THE CONSTRUCTION LIMITS WILL BE STAKED BY THE ENGINEER PRIOR TO COMMENCING CONSTRUCTION. THE CONSTRUCTION LIMITS MAY BE ADJUSTED BY THE ENGINEER TO PRESERVE TREES AND NO ADDITIONAL COST WILL BE PAID TO THE CONTRACT OR FOR CHANGED CONSTRUCTION LIMITS.
- PERIMETER EROSION BARRIER SHALL BE ERECTED ADJACENT TO THE CONSTRUCTION LIMITS AS INDICATED ON THE EROSION AND SEDIMENT CONTROL PLAN. THE RESIDENT ENGINEER SHALL MAKE THE FINAL DETERMINATION ON THE PLACEMENT AND LOCATION OF THE PERIMETER EROSION BARRIER.
- 3. A COPY OF THE APPROVED EROSION AND SEDIMENT CONTROL PLAN SHALL BE MAINTAINED ON SITE. ALL CHANGES TO THE SOIL EROSION AND SEDIMENT CONTROL PLAN SHALL BE NOTED ON THE SITE PLAN.
- 4. SOIL DISTURBANCE SHALL BE CONDUCTED IN SUCH A MANNER AS TO MINIMIZE EROSION. SOIL STABILIZATION MEASURES SHALL CONSIDER THE TIME OF THE YEAR, SITE CONDITIONS AND THE USE OF TEMPORARY AND PERMANENT MEASURES.
- 5. SOIL EROSION AND SEDIMENT CONTROL FEATURES SHALL BE CONSTRUCTED PRIOR TO THE COMMENCEMENT OF HYDROLOGIC DISTURBANCE OF UPLAND AREAS.
- 6. DISTURBED AREAS SHALL BE STABILIZED WITH TEMPORARY OR PERMANENT MEASURES WITHIN 7 CALENDAR DAYS OF THE END OF ACTIVE HYDROLOGIC DISTURBANCE, OR RE-DISTURBANCE. A QUANTITY OF TEMPORARY EROSION CONTROL SEEDING IS INCLUDED FOR AREAS THAT ARE DISTURBED BUT WILL NOT BE RESTORED WITHIN 14 DAYS.
- 7. ALL STORM SEWERS THAT ARE OR WILL BE FUNCTIONING DURING CONSTRUCTION SHALL BE PROTECTED BY AN APPROPRIATE SEDIMENT CONTROL MEASURE.
- 8. ALL TEMPORARY EROSION AND SEDIMENT CONTROL MEASURES SHALL BE REMOVED WITHIN 30 DAYS AFTER FINAL SITE STABILIZATION IS ACHIEVED OR AFTER THE TEMPORARY MEASURES ARE NO LONGER NEEDED, AS APPROVED BY THE ENGINEER.
- 9. ALL TEMPORARY AND PERMANENT EROSION CONTROL MEASURES MUST BE MAINTAINED AND REPAIRED AS NEEDED. THE PRIME CONTRACTOR SHALL BE ULTIMATELY RESPONSIBLE FOR MAINTENANCE AND REPAIR. THE CONTRACTOR SHALL INSPECT ALL SOIL EROSION CONTROL MEASURE ON A WEEKLY BASIS OR AFTER A ONE-HALF INCH RAINFALL AND REPLACE, REPAIR OR CLEAN THEM ON A TIMELY BASIS. ADDITIONALLY DURING WINTER MONTHS, ALL MEASURES SHOULD BE CHECKED AFTER EACH SIGNIFICANT SNOW MELT. ALL OFF SITE BORROW, WASTE AND USE AREAS ARE PART OF THE CONSTRUCTION SITE AND ARE TO BE INSPECTED AT THE SAME FREQUENCY OF ON SITE INSPECTIONS.
- 10. ANY SEDIMENT OR SOIL REACHING AN IMPROVED PUBLIC RIGHT-OF-WAY, STREET, ALLEY OR PARKING AREA SHALL BE REMOVED BY SCRAPING OR STREET CLEANING AS ACCUMULATIONS WARRANT AND TRANSPORTED TO A CONTROLLED SEDIMENT DISPOSAL AREA. ALL PRECAUTIONS SHALL BE TAKEN TO AVOID TRACKING DURING CONSTRUCTION.
- 11. SOIL STOCKPILES SHALL NOT BE LOCATED IN A FLOOD PRONE AREA OR A DESIGNATED BUFFER PROTECTING WATERS OF THE UNITED STATES. STOCKPILES OR SOIL AND OTHER BUILDING MATERIALS TO REMAIN IN PLACE MORE THAN THREE (3) DAYS SHALL BE FURNISHED WITH EROSION AND SEDIMENT CONTROL MEASURES (I.E. PERIMETER SILT FENCE). STOCKPILES TO REMAIN UNDISTURBED FOR MORE THAN 14 DAYS WILL RECEIVE TEMPORARY SEEDING WITHIN 7 CALENDAR DAYS.
- 12. IF DEWATERING SERVICES ARE USED, ADJOINING PROPERTIES AND DISCHARGE LOCATIONS SHALL BE PROTECTED FROM EROSION. DISCHARGES SHALL BE ROUTED THROUGH AN EFFECTIVE SEDIMENT CONTROL MEASURE (E.G. SEDIMENT TRAP, SEDIMENT BASIN, SILT FILTER BAG (SPECIAL)) OR OTHER APPROPRIATE MEASURE.
- 13. THE EROSION CONTROL MEASURES INDICATED ON THE PLANS ARE THE MINIMUM REQUIREMENTS. ADDITIONAL MEASURES MAY BE REQUIRED, AS DIRECTED BY THE ENGINEER OR GOVERNING AGENCY.
- 14. THE CONDITION OF THE CONSTRUCTION SITE FOR WINTER SHUTDOWN SHALL BE ADDRESSED EARLY IN THE FALL GROWING SEASON SO THAT SLOPES AND OTHER EARTH AREAS MAY BE STABILIZED WITH TEMPORARY AND/OR PERMANENT VEGETATIVE COVER FOR PROPER EROSION AND SEDIMENT CONTROL. ALL OPEN AREAS THAT ARE TO REMAIN IDLE THROUGHOUT THE WINTER SHALL RECEIVE TEMPORARY EROSION CONTROL MEASURES INCLUDING TEMPORARY SEEDING, MULCHING AND/OR EROSION CONTROL BLANKET PRIOR TO THE END OF THE FALL GROWING SEASON. THE AREAS TO BE WORKED BEYOND THE END OF THE GROWING SEASON MUST INCORPORATE SOIL STABILIZATION MEASURES THAT DO NOT RELY ON VEGETATIVE COVER SUCH AS EROSION CONTROL BLANKET AND HEAVY MULCHING.

- 15. UNLESS OTHERWISE INDICATED, ALL VEGETATIVE AND STRUCTURAL EROSION AND SEDIMENT CONTROL PRACTICES WILL BE CONSTRUCTED ACCORDING TO ILLINOIS DEPARTMENT OF TRANSPORTATION STANDARD SPECIFICATIONS FOR ROAD AND BRIDGE CONSTRUCTION, ADOPTED JANUARY 1, 2012.
- 16. THE CONTRACTOR IS RESPONSIBLE FOR INSTALLATION OF ANY ADDITIONAL EROSION CONTROL MEASURES NECESSARY TO PREVENT EROSION AND SEDIMENTATION AS DETERMINED BY THE ENGINEER.
- 17. IT IS THE RESPONSIBILITY OF THE GENERAL CONTRACTOR TO INFORM ANY SUB-CONTRACTORS WHO MAY PERFORM WORK ON THIS PROJECT OF THE REQUIREMENTS IN IMPLEMENTING AND MAINTAINING THESE EROSION CONTROL PLANS AND THE NATIONAL POLLUTANT DISCHARGE ELIMINATION SYSTEM (NPDES) PERMIT REQUIREMENT SET FORTH BY THE ILLINOIS EPA.
- 18. PERMANENT STABILIZATION ON STAGE 1 MUST BE COMPLETED PRIOR TO SWITCHING TRAFFIC THE STAGE 2 CONFIGURATION.


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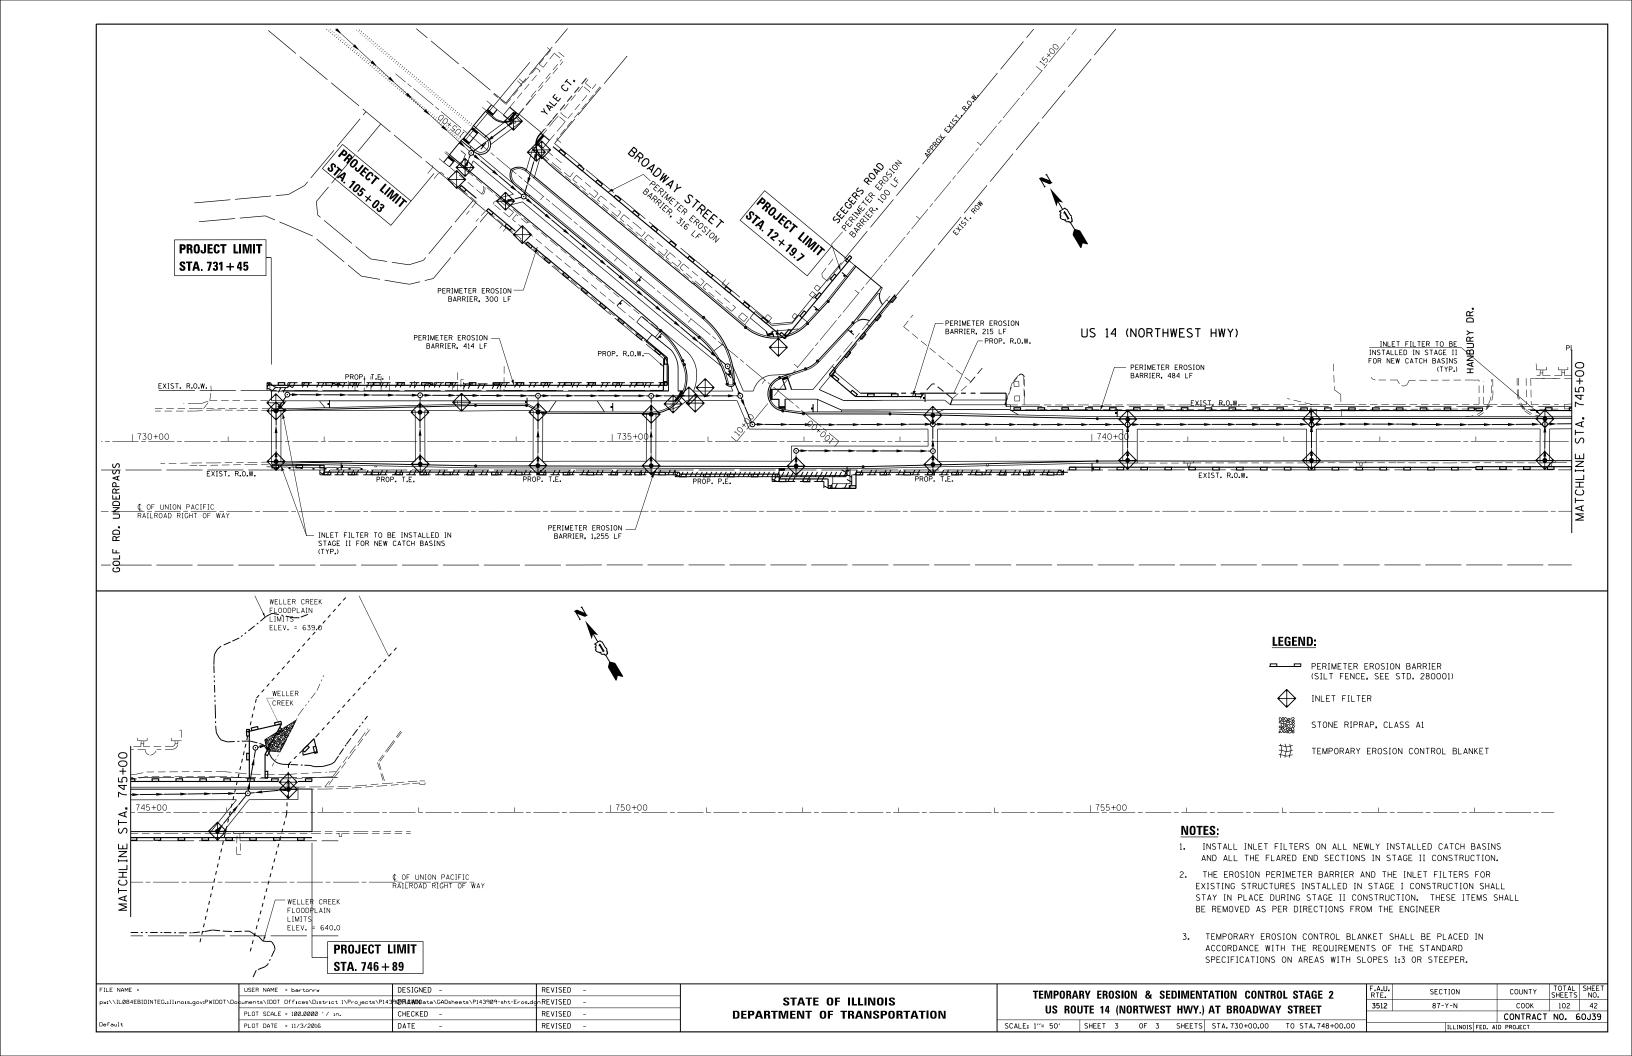
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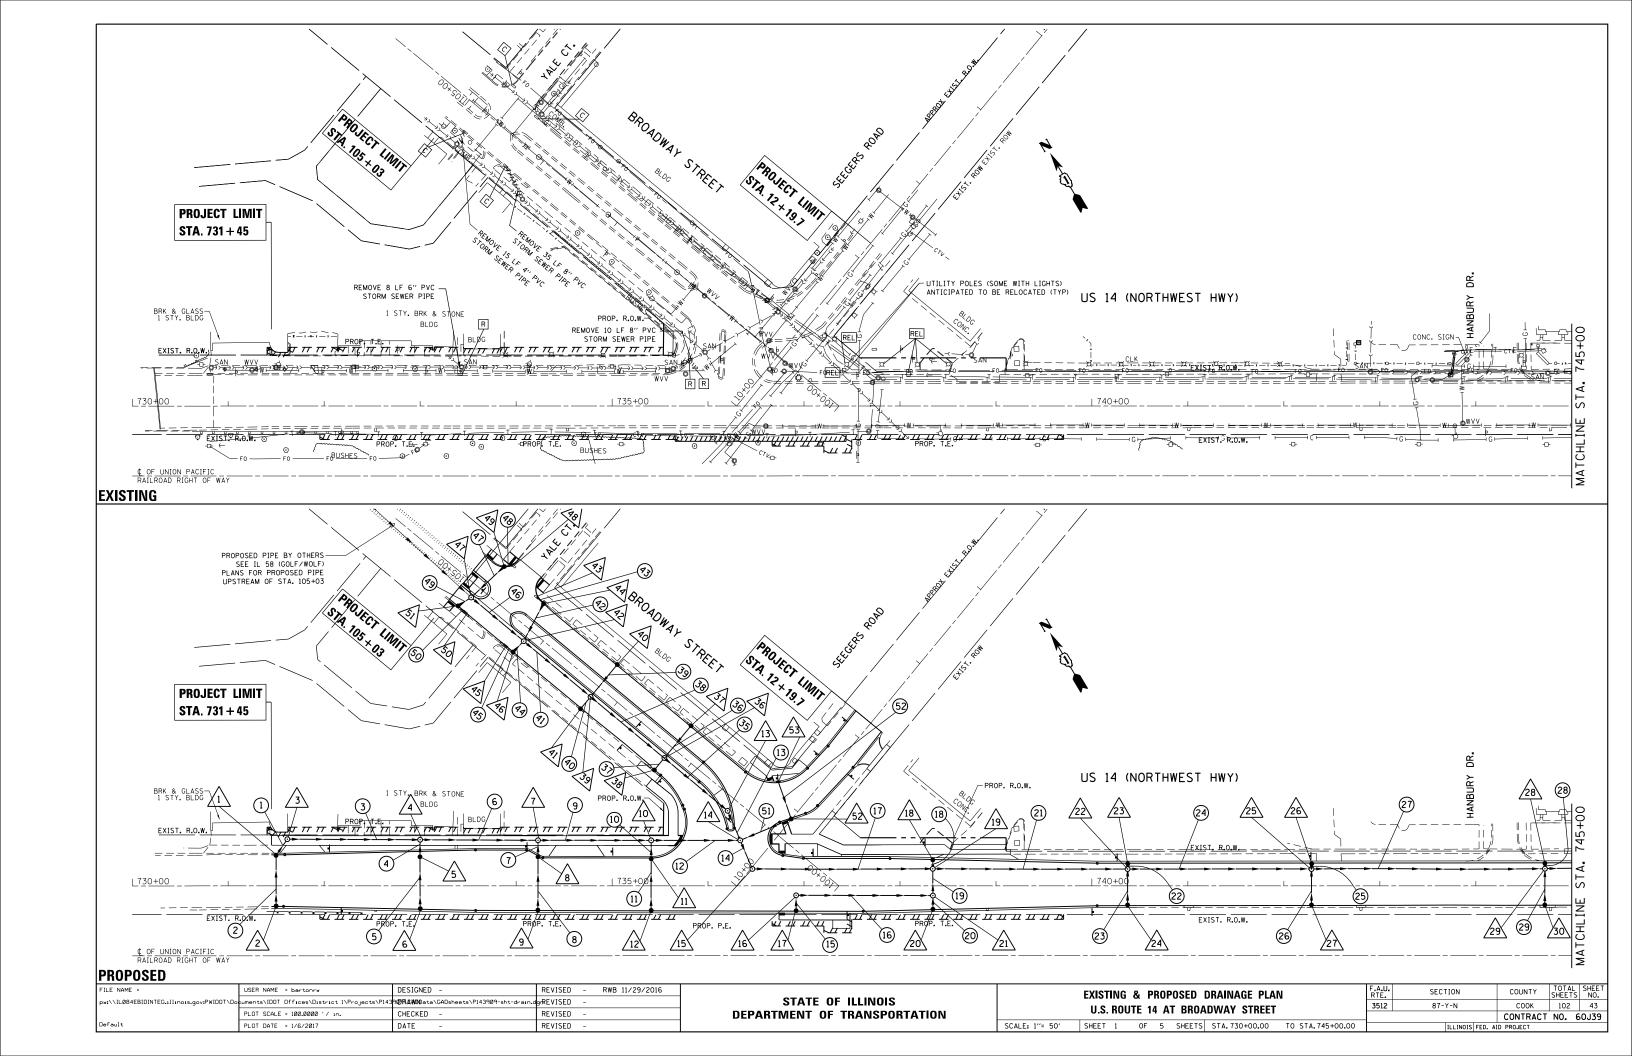
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	03 110	OIL 17 (IV	OITIVVLO			JINLLI			CONTRACT	NO.
ı	SCALE: NA	SHEET 1	OF 3	SHEETS	STA. 730+00.00	TO STA.748+00.00		ILLINOIS FED. A	ID PROJECT	


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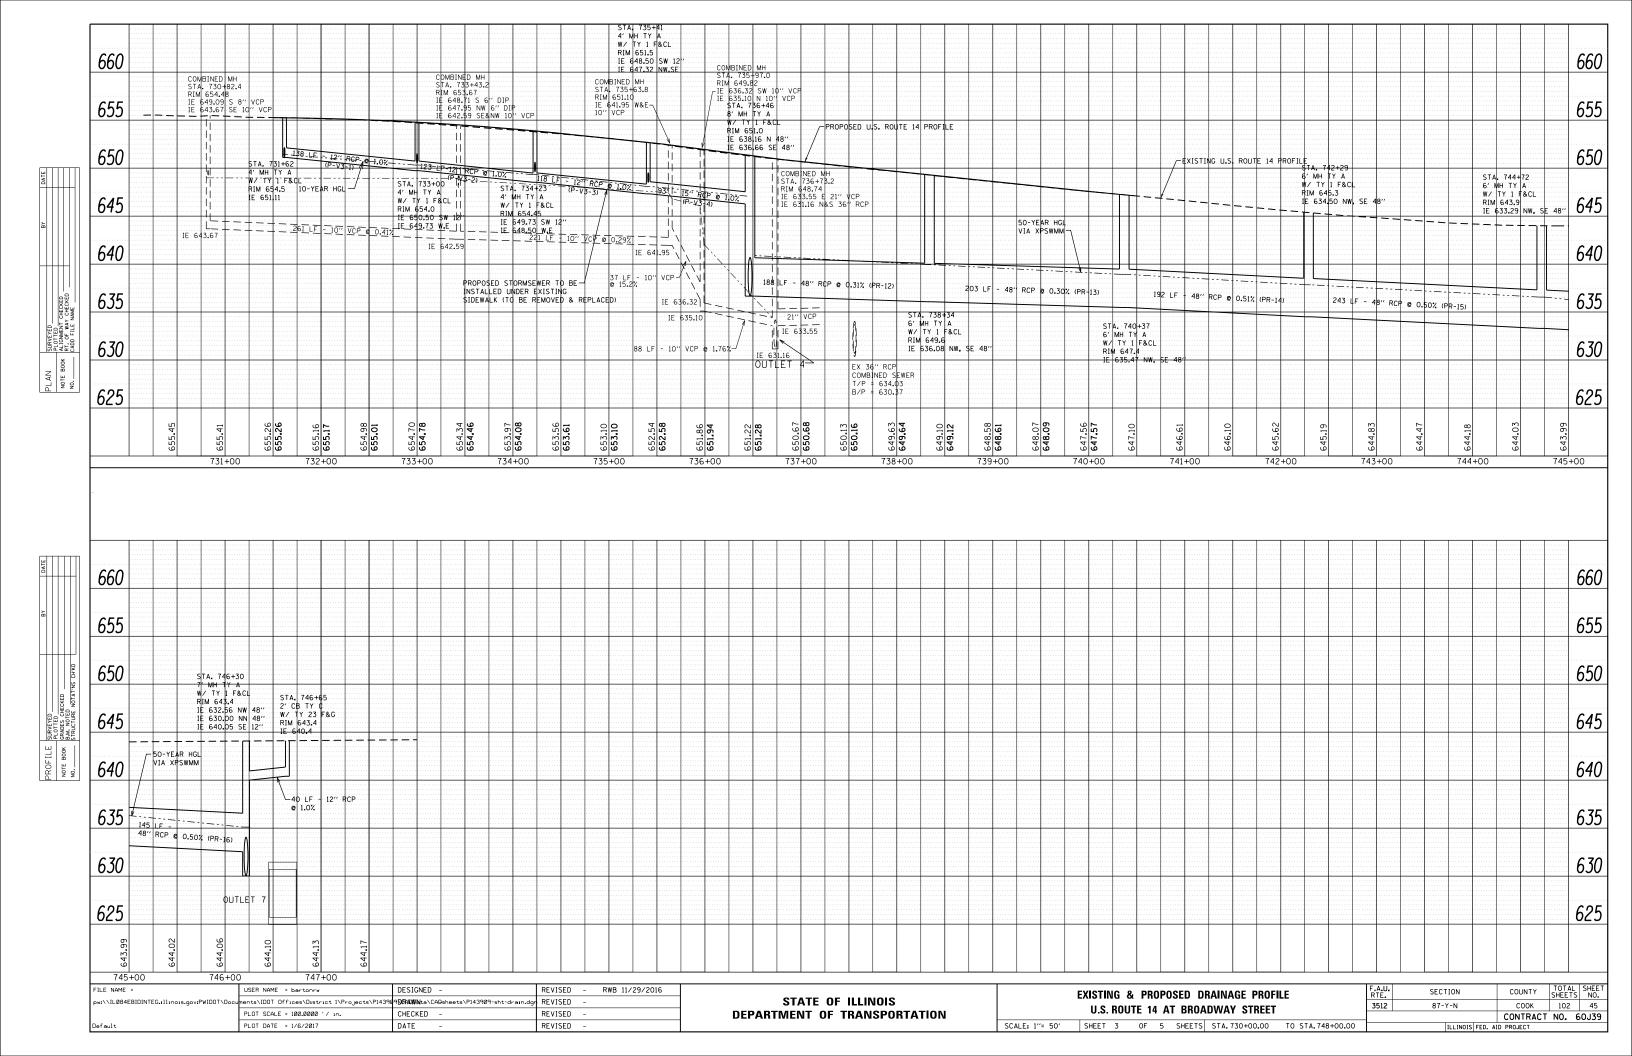
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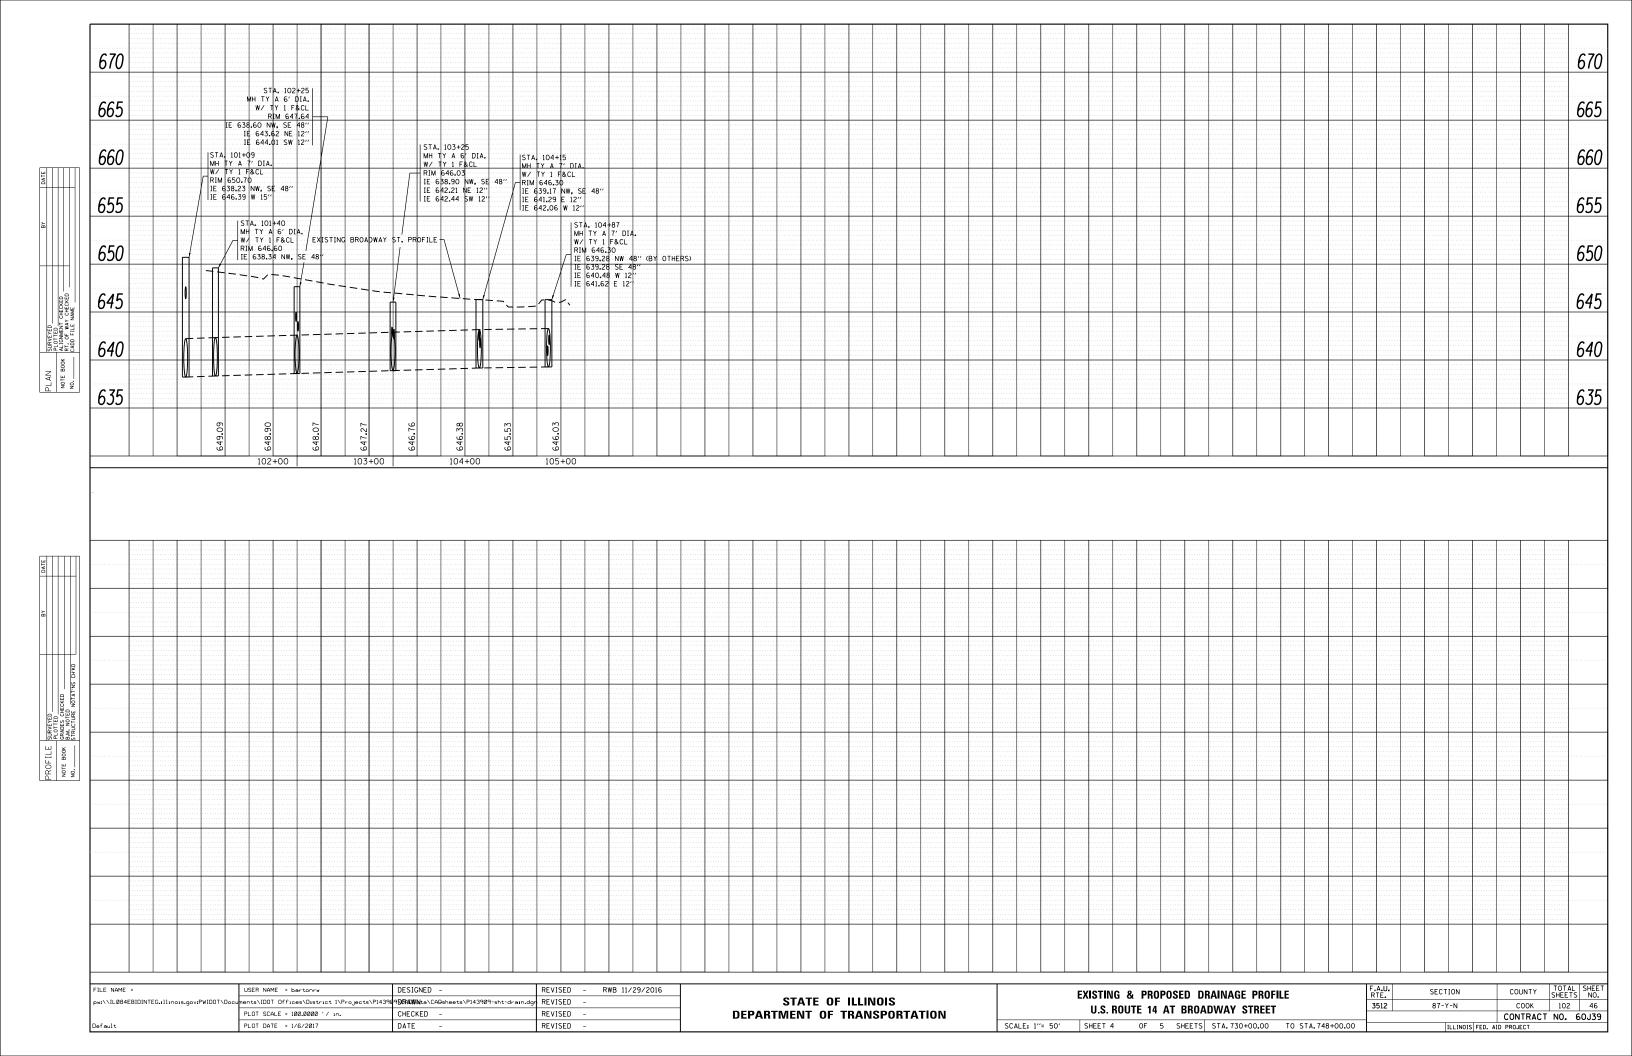









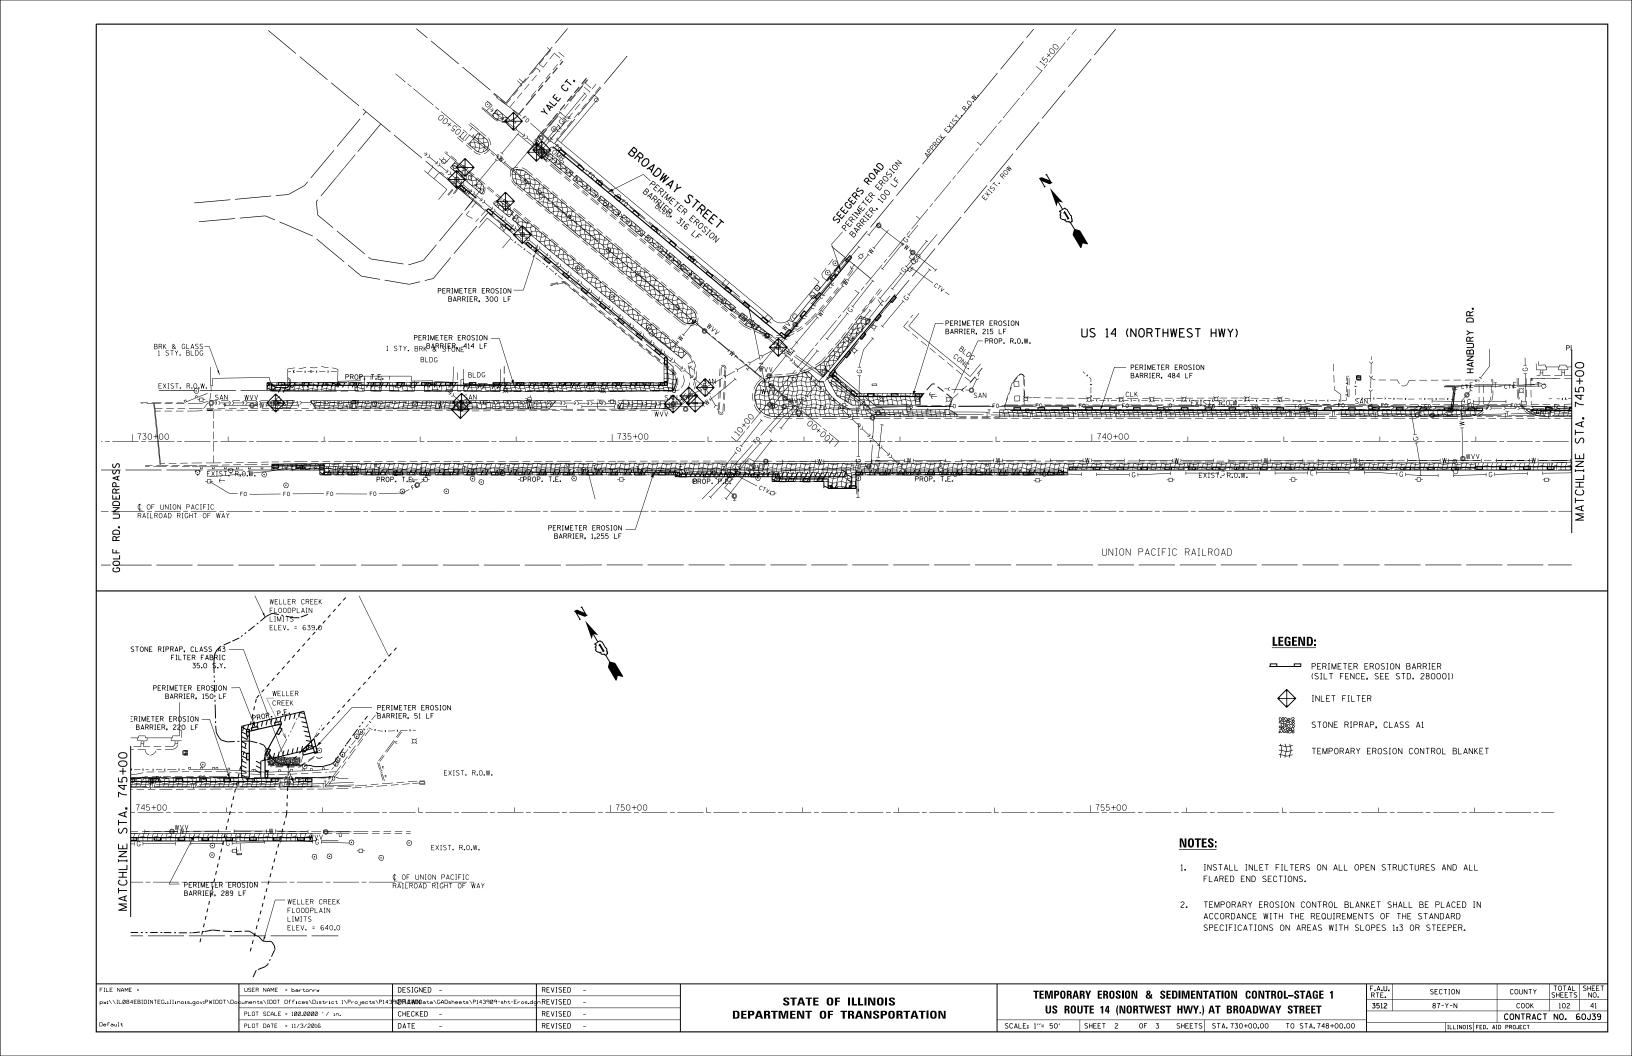

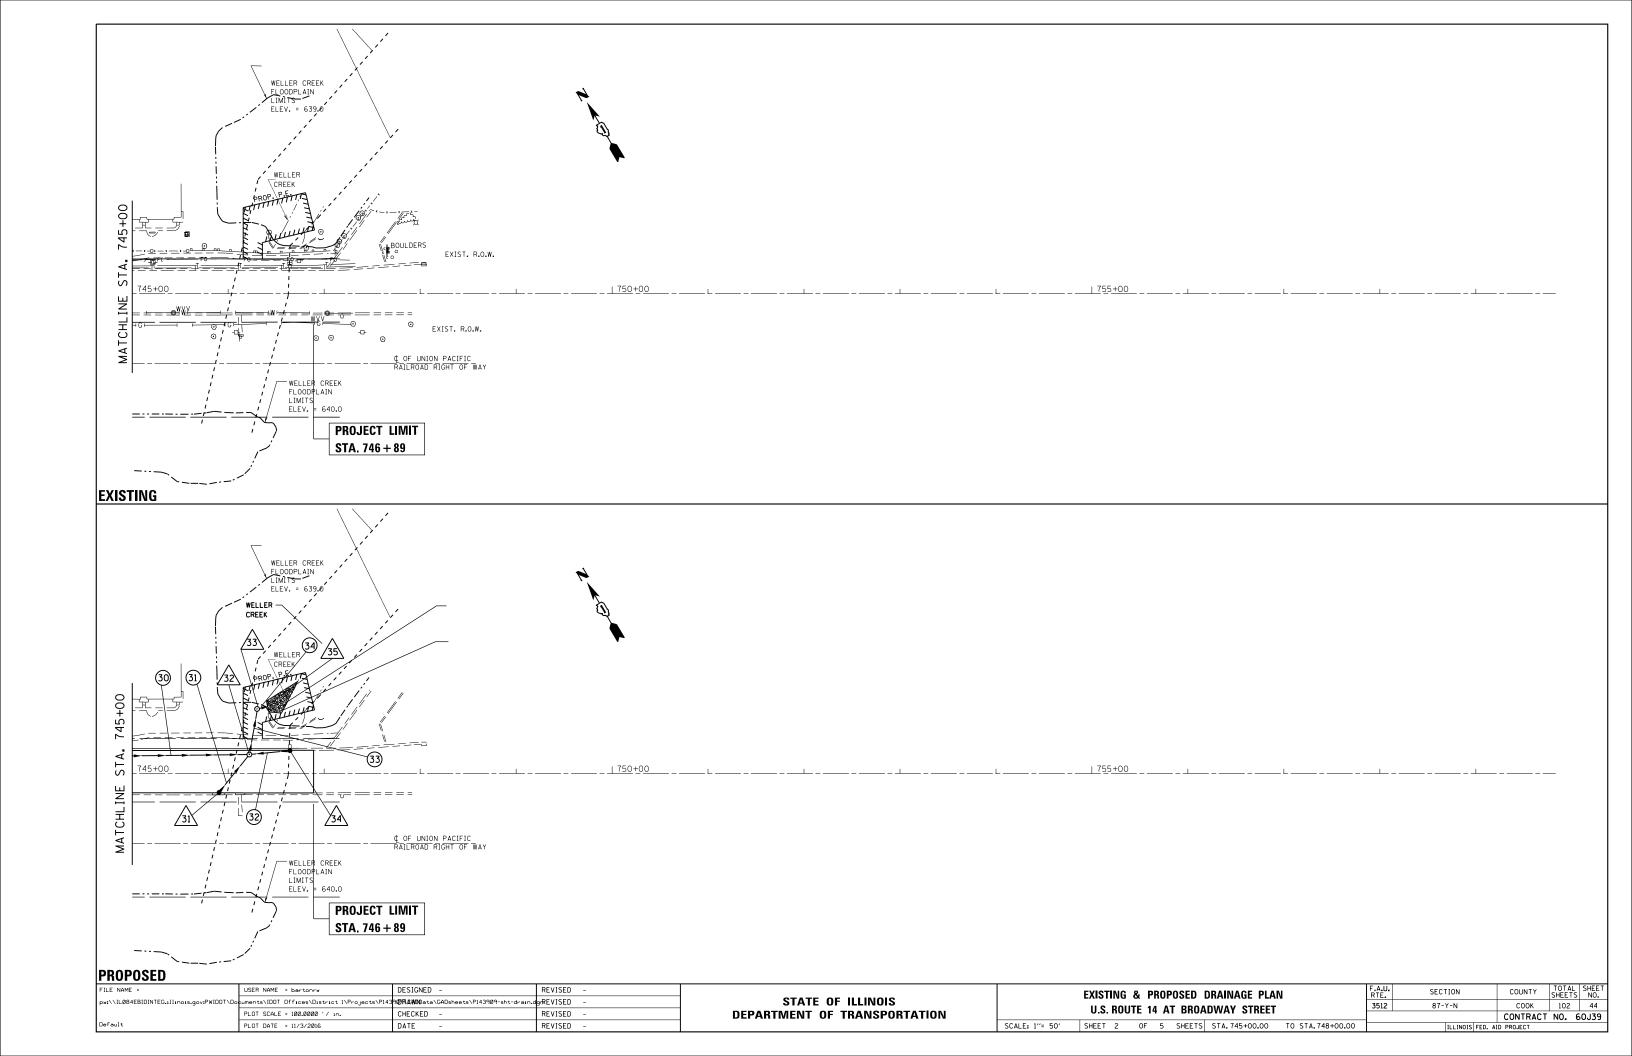

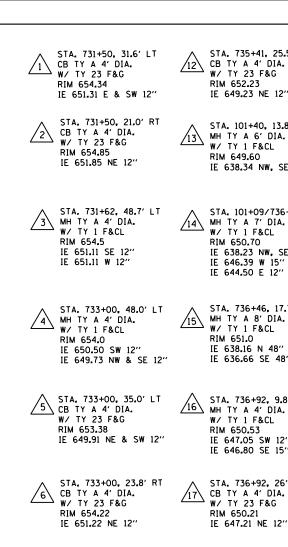

7 STA. (34723, .... MH TY A 4' DIA. STA. 734+23, 47.5' LT

RIM 654.45

STA. 735+41, 28.1' LT

IE 648.67 NE & SW 12"

CB TY A 4' DIA.

W/ TY 23 F&G

RIM 652.23

W/ TY 1 F&CL

IE 649.73 SW 12"



RIM 650.21

STA. 735+41, 25.5' RT

STA. 101+40, 13.8' LT

IE 638.34 NW, SE 48"

STA. 736+46, 17.7' LT

W/ TY 23 F&G

IE 649.23 NE 12"

RIM 652.23

RIM 649.60

IF 646.39 W 15" IE 644.50 E 12"

MH TY A 8' DIA.

IE 638.16 N 48"

IE 636.66 SE 48"

STA. 736+92, 9.8' RT

W/ TY 1 F&CL

IE 647.05 SW 12"


IE 646.80 SE 15"

STA. 736+92, 26' RT

IE 647.21 NE 12"

RIM 650.53

RIM 651.0

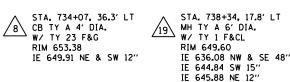



STA. 735+41, 47.4' LT  MH TY A 4' DIA.  W/ TY 1 F&CL  RIM 651.5  IE 648.50 SW 12"  IE 647.32 NW 12"  IE 647.32 SE 15"	STA. 738+34, 10.1'  MH TY A 5' DIA.  W/ TY 1 F&CL  RIM 649.24  IE 645.45 WW 15"  IE 645.17 NW 15"  IE 645.12 NE 15"
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<u>/22</u> \		A. 74 TY TY 4 641		37 <b>,</b> ' D &CL	17. IA.	5′	LT
	ΙE	635.	47	NW	&	SE	48"
	ΙE	643.	35	NE	12'	,	
	ΙE	643.	49	SW	12	,	

<u>/24</u>	STA. 740+37, 20' F CB TY A 4' DIA. W/ TY 23 F&G RIM 646.87	₹T
	IE 643.87 NE 12"	

Λ	STA. 740+37, 20'	RT
2Λ	CB TY A 4' DIA.	
275	W/ TY 23 F&G	
	RIM 646.87	
	IE 643.87 NE 12"	

STA. 101+09/736+34, 29' LT MH TY A 7' DIA. W/ TY 1 F&CL RIM 650.70 IE 638.23 NW, SE 48" IE 646.39 W 15"	STA. 742+29, 17.6' LT MH TY A 6' DIA. W/ TY 1 F&CL RIM 645.3 IE 634.50 NW & SE 48" IE 641.41 NE 12" IE 641.55 SW 12"
------------------------------------------------------------------------------------------------------------------------	----------------------------------------------------------------------------------------------------------------------

STA. 742+29, 23.1' LT

STA. 742+29, 19.8' RT

26 CB TY A 4' DIA. W/ TY 23 F&G

RIM 644.93

27 CB TY A 4' DIA.

RIM 644.93

RIM 643.49

<u>/29\</u>

IE 641.48 NE 12"

W/ TY 23 F&G

IE 641.93 NE 12"

STA. 744+72, 23.6' LT CB TY A 4' DIA. W/ TY 23 F&G

IE 640.17 NE 12"

MH TY A 6' DIA.

IE 639.97 NE 12"

IE 640.11 SW 12"

W/ TY 1 F&CL

RIM 643.9

30 CB TY A 4' DIA.

RIM 643.49

W/ TY 23 F&G

IE 640.49 NE 12"

CB TY A 4' DIA.

IE 640.69 NE 12"

W/ TY 23 F&G

RIM 643.69

32 MH TY A 7' DIA.

RIM 643.4

33 MH TY A 8' DIA.

RIM 639.00

/34 CB TY A 4' DIA.

RIM 643.4

35 PRCFES 48" DIA.

W/ RIPRAP

W/ TY 1 F&CL

IE 627.69 SW 48"

IE 627.69 E 48"

W/ TY 23 F&G

IE 640.4 NW 12"

IE 627.12 W 48'

STA. 746+41, 70' LT

W/ TY 1 F&CL

IE 632.56 NW 48"

IE 630.00 NE 48"

IE 640.00 SE 12'

IF 640-20 SW 12"

STA. 746+30, 67.3' LT

STA. 746+65, 23.8' LT

STA, 744+72, 17,9' LT

IE 633.29 NW & SE 48"

STA. 744+72, 19.8' RT

STA. 745+91, 19.6' RT

STA, 746+30, 29,8' LT

39	STA. 103+25, 13.5' LT MH TY A 6' DIA. W/ TY 1 F&CL
	W/ IY 1 F&CL RIM 646.03
	IE 638.90 NW, SE 48'
	IE 642.21 NE 12"
	IE 642.44 SW 12"

40 CB TY A 4' DIA.

STA. 102+25, 13.5' LT

IF 638-60 NW, SF 48"

STA. 102+25, 30.1' RT

STA. 102+25, 29.8' LT

CB TY A 4' DIA.

IE 644.15 NE. 12"

36 MH TY A 6' DIA.

RIM 647.64

37 CB TY A 4' DIA. W/ TY 12 F&C

RIM 647.03 IE 644.03 SW. 12"

38\ W/ TY 12 F&G

RIM 647-15

W/ TY 1 F&CL

IE 643.62 NE 12" IE 644.01 SW 12"

	W/ TY 12 F&G RIM 645.62 IE 642.62 SW 12"
41	STA. 103+25, 29.8' LT CB TY A 4' DIA. W/ TY 12 F&G RIM 645.58 IE 642.58 NE 12"

STA. 103+25, 30.1' RT

Λ	STA. 104+15, 13.3' LT
/42\	MH TY A 7' DIA.
	W/ TY 1 F&CL
	RIM 646.3
	IE 639.17 NW, SE 48"
	IE 641.25 NE 15"
	IE 642.03 W 15"

43	STA. EXIS	104+ T. INI	·35, LET	30 <b>.</b> 5′	RT
	RIM	644.8	0		
	IE 6	41.77	SE	15′′	

STA. 104+25, 30.

	W/ TY 12 F&G RIM 644.85 IE 641.67 NW, SW 15
45	STA. 104+27, 29' LT EXIST. INLET RIM 644.76

STA. 104+25, 30.0' RT

	IE 642.26 SE 15"	
46	STA. 104+17, 29.0' CB TY A 4' DIA. W/ TY 12 F&G RIM 645.77	L

IE 642.16 NW. E 15"

λ	STA. 104+87, 13.2' LT WH TY A 7' DIA.	
	N/ TY 1 F&CL	
	RIM 646.3	
	(E 639.28 NW 48" (BY OTHERS)	
	E 639.28 SE 48"	
	E 640.48 NE 15"	
	E 641.55 W 15"	


STA. 104+74, 40.3' RT

48 EXIST. INLET

RIM 644.83

IE 641.03 NW 15"

STA. 104+81, 33.6' RT 49 CB TY A 4' DIA. RIM 645.00 IE 640.93 SE, SW 15"

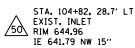

51	STA. 104+92, 28.8' LT CB TY A 4' DIA. W/ TY 12 F&G
	RIM 645.05
	IE 641.69 SE, E 15"

^ 52\	STA. 10+90, 0.5' CB TY A 4' DIA. W/ TY 12 F&G	LT
	RIM 649.76	
	IE 645.05 N 12"	
	IE 645.05 W 12"	

53	STA. 11+11. 35.5' LT INLET TY A W/ TY 12 F&G RIM 648.46 IE 645.46 S 12"

18 LF - 12" SS, TYPE 2, WATER MAIN QUALITY PIPE @ 1.00% TBF= 4.27 C.Y.

$\sim$	
(2)	54 LF - 12" SS RCP
$\cup$	CLASS A. TYPE 2
	€ 1.00% TBF= 12.47 C.Y.

(3)	138 LF - 12" SS RCP
$\overline{}$	CLASS A. TYPE 2
	@ 1.00% TBF= 44.30 C.Y.

<b>(4)</b>	18 LF - 12" SS, TYPE 2,
$\bigcirc$	WATER MAIN QUALITY PIPE
	@ 1.00% TBF= 5.80 C.Y.

- 54 LF 12" SS RCP CLASS A. TYPE 2 @ 1.00% TBF= 13.93 C.Y.
- 123 LF 12" SS RCP CLASS A, TYPE 2 @ 1.00% TBF= 87.58 C.Y.
- 15 LF 12" SS, TYPE 2, WATER MAIN QUALITY PIPE @ 1.00% TBF= 9.72 C.Y.
- 56 LF 12" SS, TYPE 2, WATER MAIN QUALITY PIPE @ 1.00% TBF= 14.45 C.Y.
- 118 LF 12" SS RCP CLASS A. TYPE 2 @ 1.00% TBF= 82.25 C.Y.
- 19 LF 12" SS, TYPE 2, WATER MAIN QUALITY PIPE @ 1.00% TBF= 6.17 C.Y.
- 56 LF 12" SS, TYPE 2, WATER MAIN QUALITY PIPE @ 1.00% TBF= 14.84 C.Y.
- 93 LF 15" SS, TYPE 2. WATER MAIN QUALITY PIPE e 1.00% TBF= 35.15 C.Y.
- 34 LF 48" SS RCP CLASS A. TYPE 3 @ 0.30% TBF= 85.24 C.Y.
- 32 LF 48" SS RCP CLASS A, TYPE 3 @ 0.22% TBF= 87.97 C.Y.
- 16 LF 12" SS, TYPE 2, WATER MAIN QUALITY PIPE @ 1.00% TBF= 4.13 C.Y.
- 142 LF 15" SS RCP CLASS A. TYPE 2 @ 1.00% TBF= 46.72 C.Y.

- 188 LF 48" SS RCP CLASS A. TYPE 3 @ 0.31% TBF= 618.73 C.Y.
- 7 LF 12" SS RCP CLASS A. TYPE 2 @ 1.00% TBF= 2.08 C.Y.
- 27 LF 15" SS RCP CLASS A. TYPE 2 @ 1.00% TBF= 10.77 C.Y.
- 15 LF 12" SS, TYPE 2, WATER MAIN QUALITY PIPE @ 1.00% TBF= 4.17 C.Y.
- 203 LF 48" SS RCP CLASS A. TYPE 3 @ 0.30% TBF= 597.06 C.Y.
- 6 LF 12" SS RCP CLASS A. TYPE 2 @ 1.00% TBF= 1.88 C.Y.
- 37 LF 12" SS RCP CLASS A. TYPE 2 @ 1.00% TBF= 10.47 C.Y.
- 192 LF 48" SS RCP CLASS A. TYPE 3 @ 0.51% TBF= 487.50 C.Y.
- 6 LF 12" SS RCP CLASS A. TYPE 2 @ 1.00% TBF= 1.79 C.Y.
- 37 LF 12" SS RCP CLASS A. TYPE 2 e 1.00% TBF= 10.43 C.Y.
- 243 LF 48" SS RCP CLASS A. TYPE 2 @ 0.50% TBF= 573.50 C.Y.
- 6 LF 12" SS RCP CLASS A. TYPE 2 e 1.00% TBF= 1.76 C.Y.
- 37 LF 12" SS RCP CLASS A. TYPE 2 @ 1.00% TBF= 10.51 C.Y.
- 145 LF 48" SS RCP CLASS A. TYPE 2
- @ 0.50% TBF= 367.16 C.Y. 49 LF - 12" SS RCP
- CLASS A. TYPE 2 € 1.00% TBF= 16.25 C.Y.
- 40 LF 12" SS RCP CLASS A. TYPE 2 @ 1.00% TBF= 8.89 C.Y.

- 44 LF 48" SS RCP CLASS A. TYPE 3 @ 5.00% TBF= 100.77 C.Y.
- 33 LF 48" SS RCP CLASS A. TYPE 3 @ 5.00% TBF= 77.82 C.Y.
  - 86 LF 48" SS RCP CLASS A. TYPE 3 @ 0.30% TBF= 150.41 C.Y.
- 44 LF 12" SS, TYPE 2, WATER MAIN QUALITY PIPE @ 1.00% TBF= 10.77 C.Y.
- 17 LF 12" SS RCP CLASS A. TYPE 2 @ 1.00% TBF= 4.44 C.Y.
- 100 LF 48" SS RCP CLASS A. TYPE 2 @ 0.30% TBF= 174.90 C.Y.
- 44 LF 12" SS, TY 2 WATER MAIN QUALITY PIPE @ 1.00% TBF= 10.77 C.Y.
- 17 LF 12" SS RCP CLASS A. TYPE 2 @ 1.00% TBF= 4.44 C.Y.
- 91 LF 48" SS RCP CLASS A. TYPE 3 @ 0.30% TBF= 159.16 C.Y.
- 45 LF 15" SS, TYPE 2 WATER MAIN QUALITY PIPE
- @ 1.00% TBF= 15.23 C.Y. 10 LF - 15" SS RCP CLASS A, TYPE 2
- @ 1.00% TBF= 2.41 C.Y. 16 LF - 15" SS RCP CLASS A, TYPE 2
- @ 1.00% TBF= 4.38 C.Y. 10 LF - 15" SS RCP (45) CLASS A. TYPE 2
- @ 1.00% TBF= 2.37 C.Y. 72 LF - 48" SS RCP
- CLASS A. TYPE 2 @ 0.17% TBF= 81.72 C.Y. 48 LF - 15" SS, TYPE 2
- WATER MAIN QUALITY PIPE @ 1.00% TBF= 15.94 C.Y.
- 10 LF 15" SS RCP CLASS A. TYPE 2 @ 1.00% TBF= 3.13 C.Y.
- 17 LF 15" SS RCP CLASS A. TYPE 2 @ 1.00% TBF= 11.31 C.Y.
- 10 LF 15" SS RCP CLASS A. TYPE 2 € 1.00% TBF= 2.55 C.Y.
- 58 LF 12" SS, TYPE 2 WATER MAIN QUALITY PIPE @ 1.00% TBF= 40.21 C.Y.
- 41 LF 12" SS, TYPE 2 WATER MAIN QUALITY PIPE e 1.00% TBF= 11.10 C.Y.


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	PLOT SCALE = 100.0000 ' / in.	CHECKED -	REVISED -	•
Default	PLOT DATE = 1/6/2017	DATE -	REVISED -	-


STATE OF ILLINOIS **DEPARTMENT OF TRANSPORTATION** 

PROPOSED DRAINAGE STRUCTURE AND PIPE TABLES U.S. ROUTE 14 AT BROADWAY STREET SCALE: 1"= 50" SHEET 5 OF 5 SHEETS STA. 745+00.00 TO STA. 748+00.00

NOTE: OFFSETS FOR DRAINAGE STRUCTURES ARE TO CENTER OF FRAME.

SECTION COUNTY 3512 87-Y-N COOK 102 47 CONTRACT NO. 60J39 ILLINOIS FED. AID PROJECT

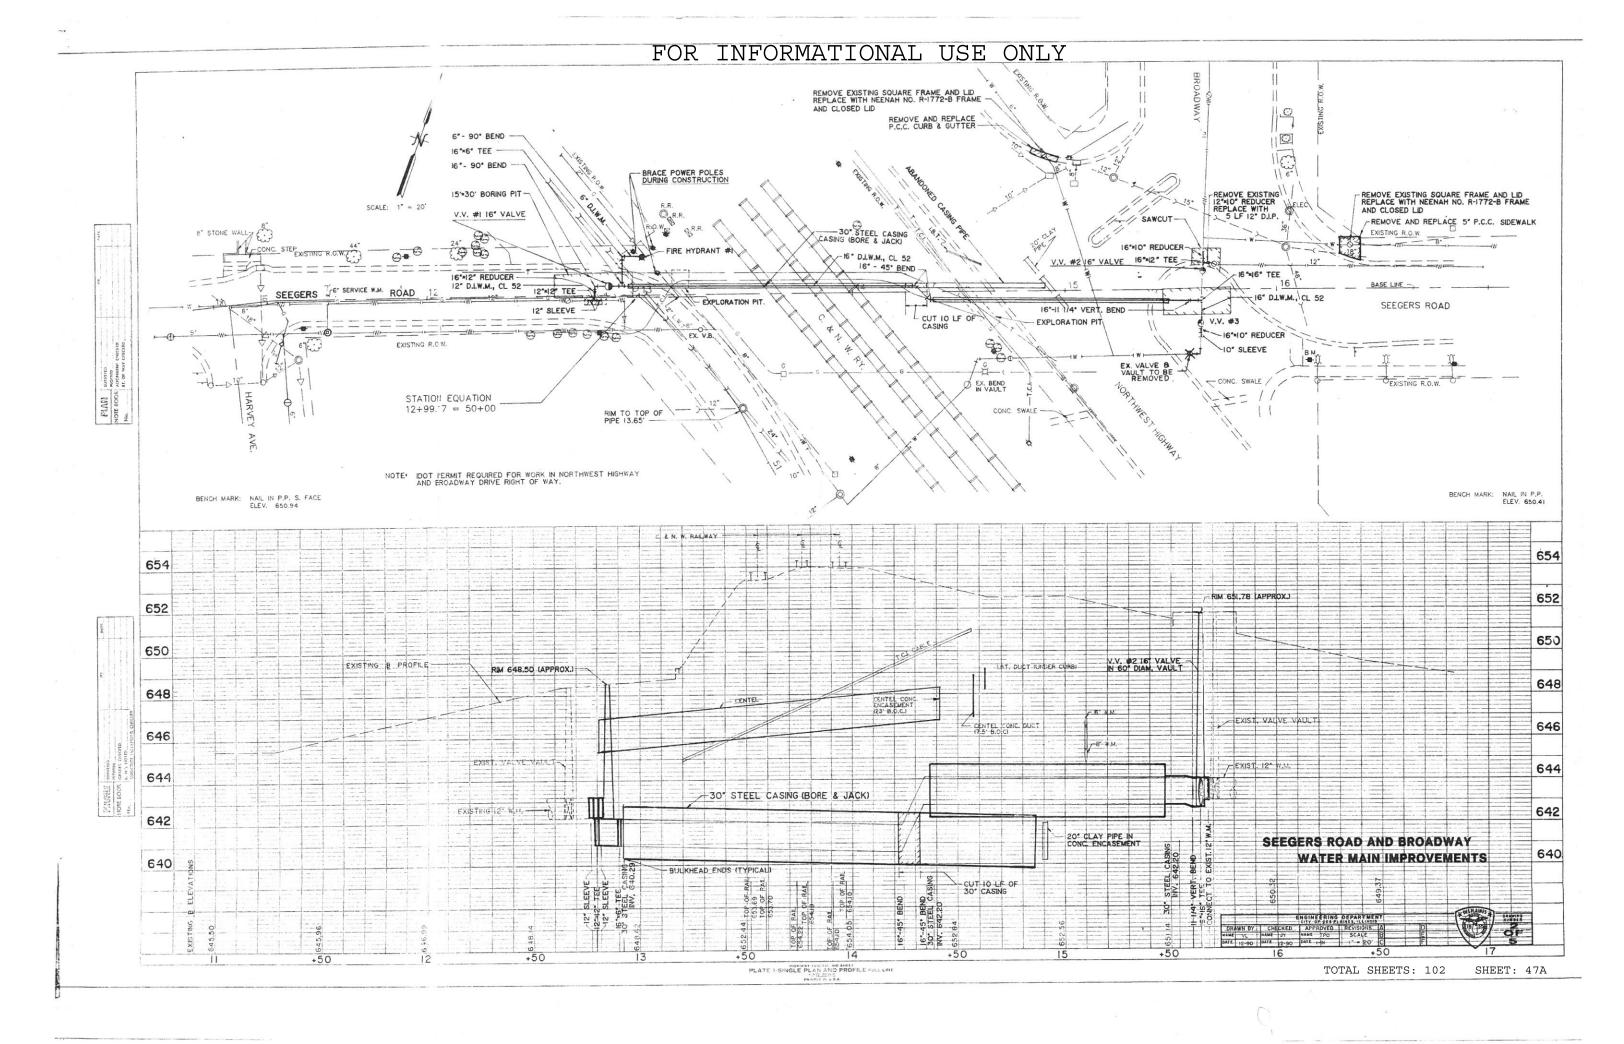

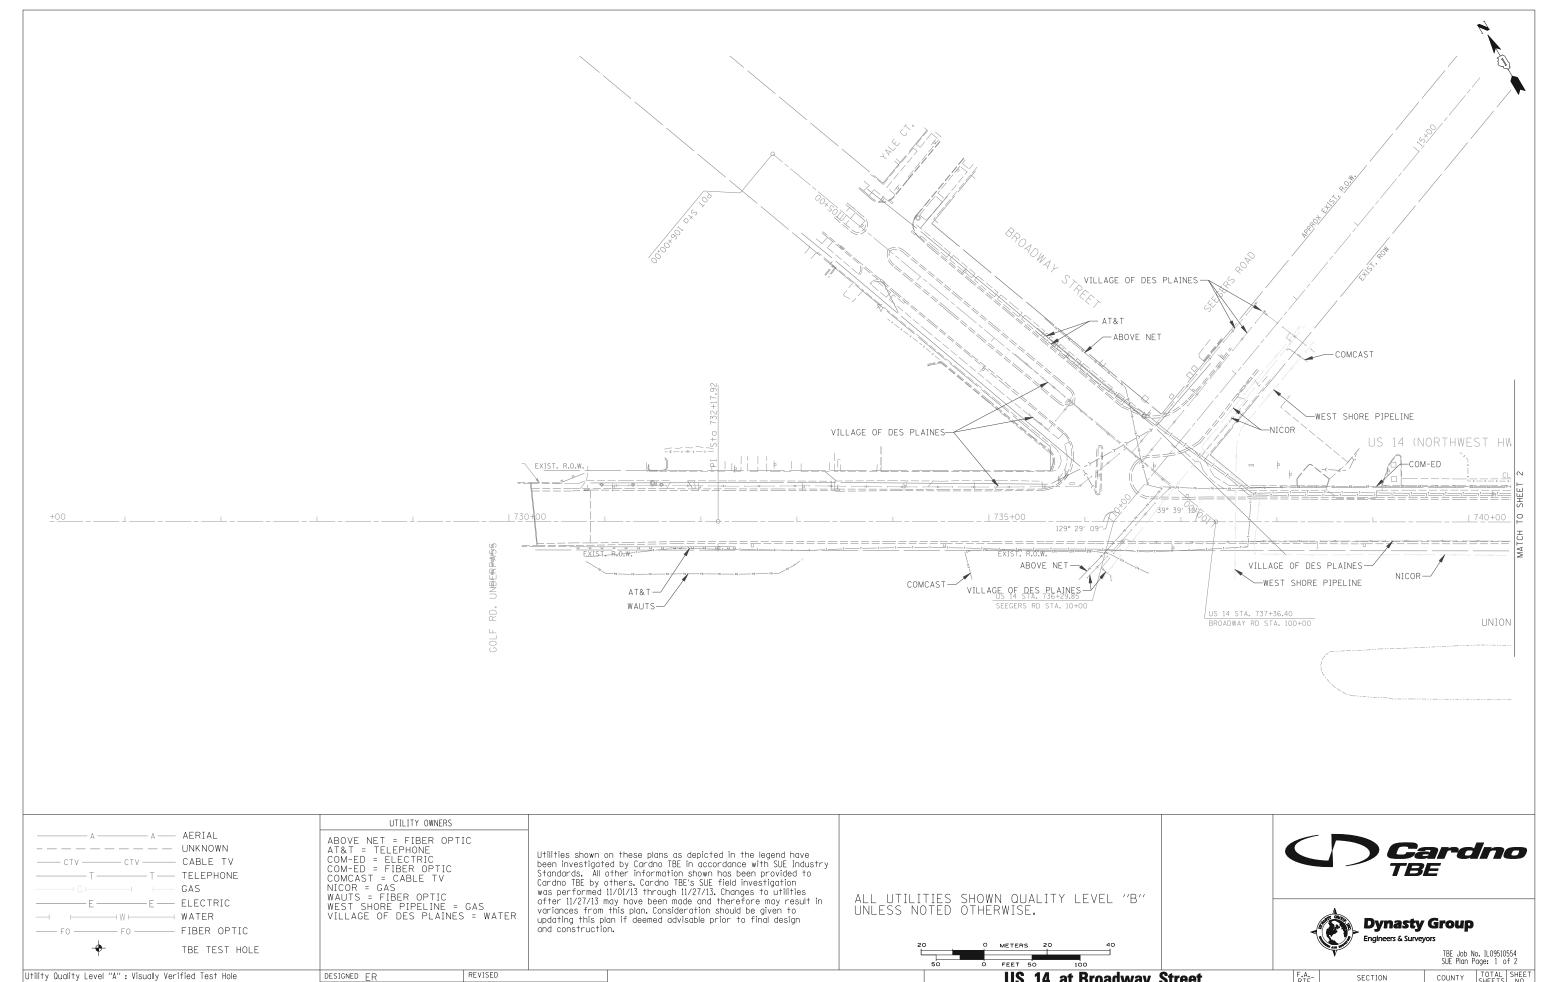

STATE OF ILLINOIS

**DEPARTMENT OF TRANSPORTATION** 

Utility Quality Level "B": Designating/non Visually Verified Test Hole

Utility Quality Level "C": Research with Survey Utility Quality Level "D": Records Research

DRAWN SRK


CHECKED KFS


DATE 12/04/13

REVISED

REVISED

REVISED

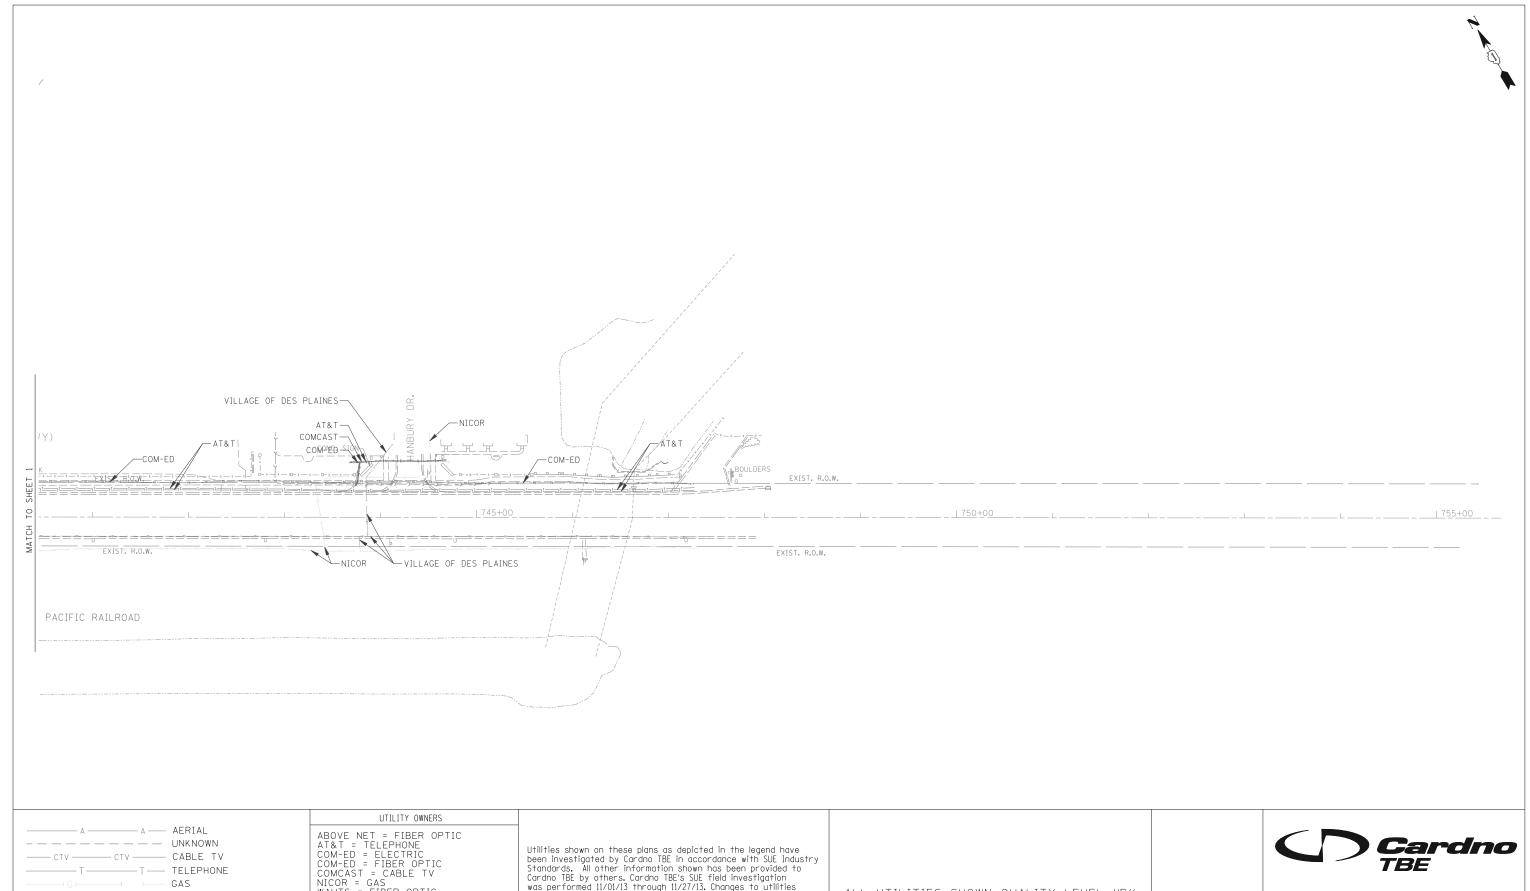

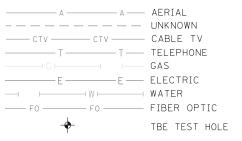

ABOVE NET = FIBER OPTIC
AT&T = TELEPHONE
COM-ED = ELECTRIC
COM-ED = FIBER OPTIC
COMCAST = CABLE TV
NICOR = GAS
WAUTS = FIBER OPTIC
WEST SHORE PIPELINE = GAS
VILLAGE OF DES PLAINES = WATER

Utilities shown on these plans as depicted in the legend have been investigated by Cardno TBE in accordance with SUE Industry Standards. All other information shown has been provided to Cardno TBE by others. Cardno TBE's SUE field investigation was performed 11/01/13 through 11/27/13. Changes to utilities after 11/27/13 may have been made and therefore may result in variances from this plan. Consideration should be given to updating this plan if deemed advisable prior to final design and construction.

ALL UTILITIES SHOWN QUALITY LEVEL "B" UNLESS NOTED OTHERWISE.





TBE Job No. IL09510554 SUE Plan Page: 2 of 2


Utility Quality Level "A": Visually Verified Test Hole Utility Quality Level "B": Designating/non Visually Verified Test Hole Utility Quality Level "C": Research with Survey Utility Quality Level "D": Records Research


DESIGNED ER REVISED DRAWN SRK REVISED CHECKED KFS REVISED DATE 12/04/13 REVISED


STATE OF ILLINOIS **DEPARTMENT OF TRANSPORTATION**  **US 14 at Broadway Street** Des Plaines, IL


COUNTY SHEETS NO.


Cook 102 48A COUNTY N/A Contract No. 60J39 FED. ROAD DIST. NO. _ ILLINOIS IDOT Project No.

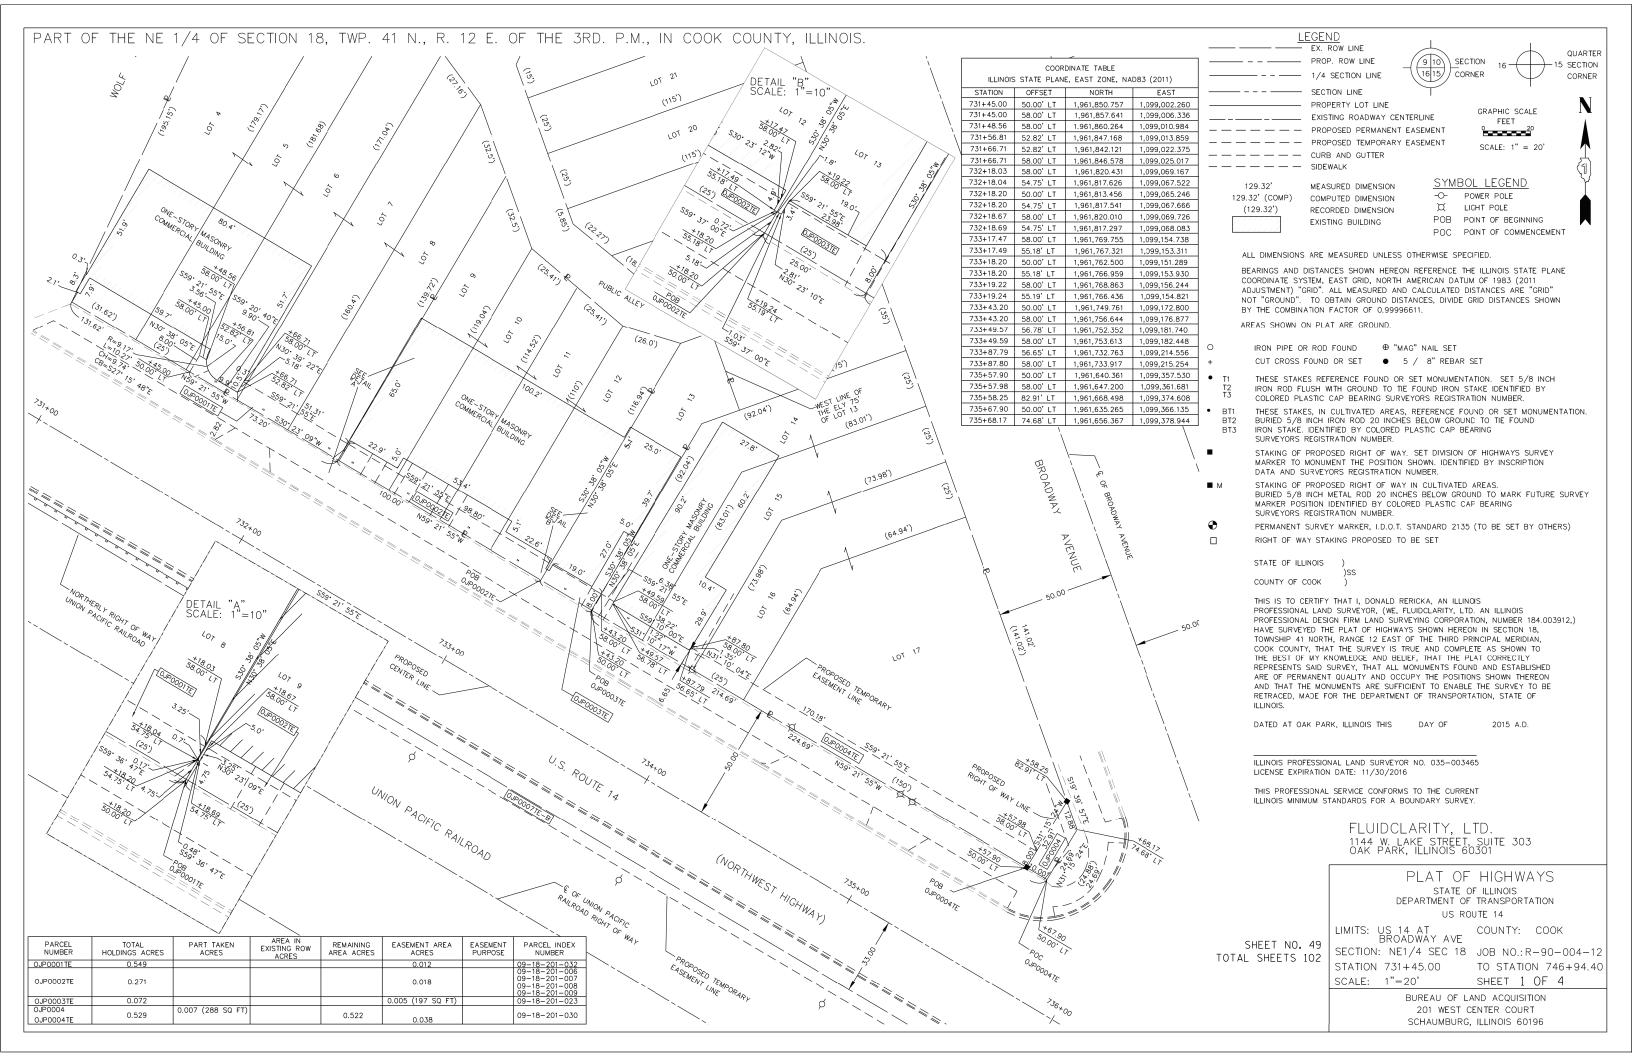


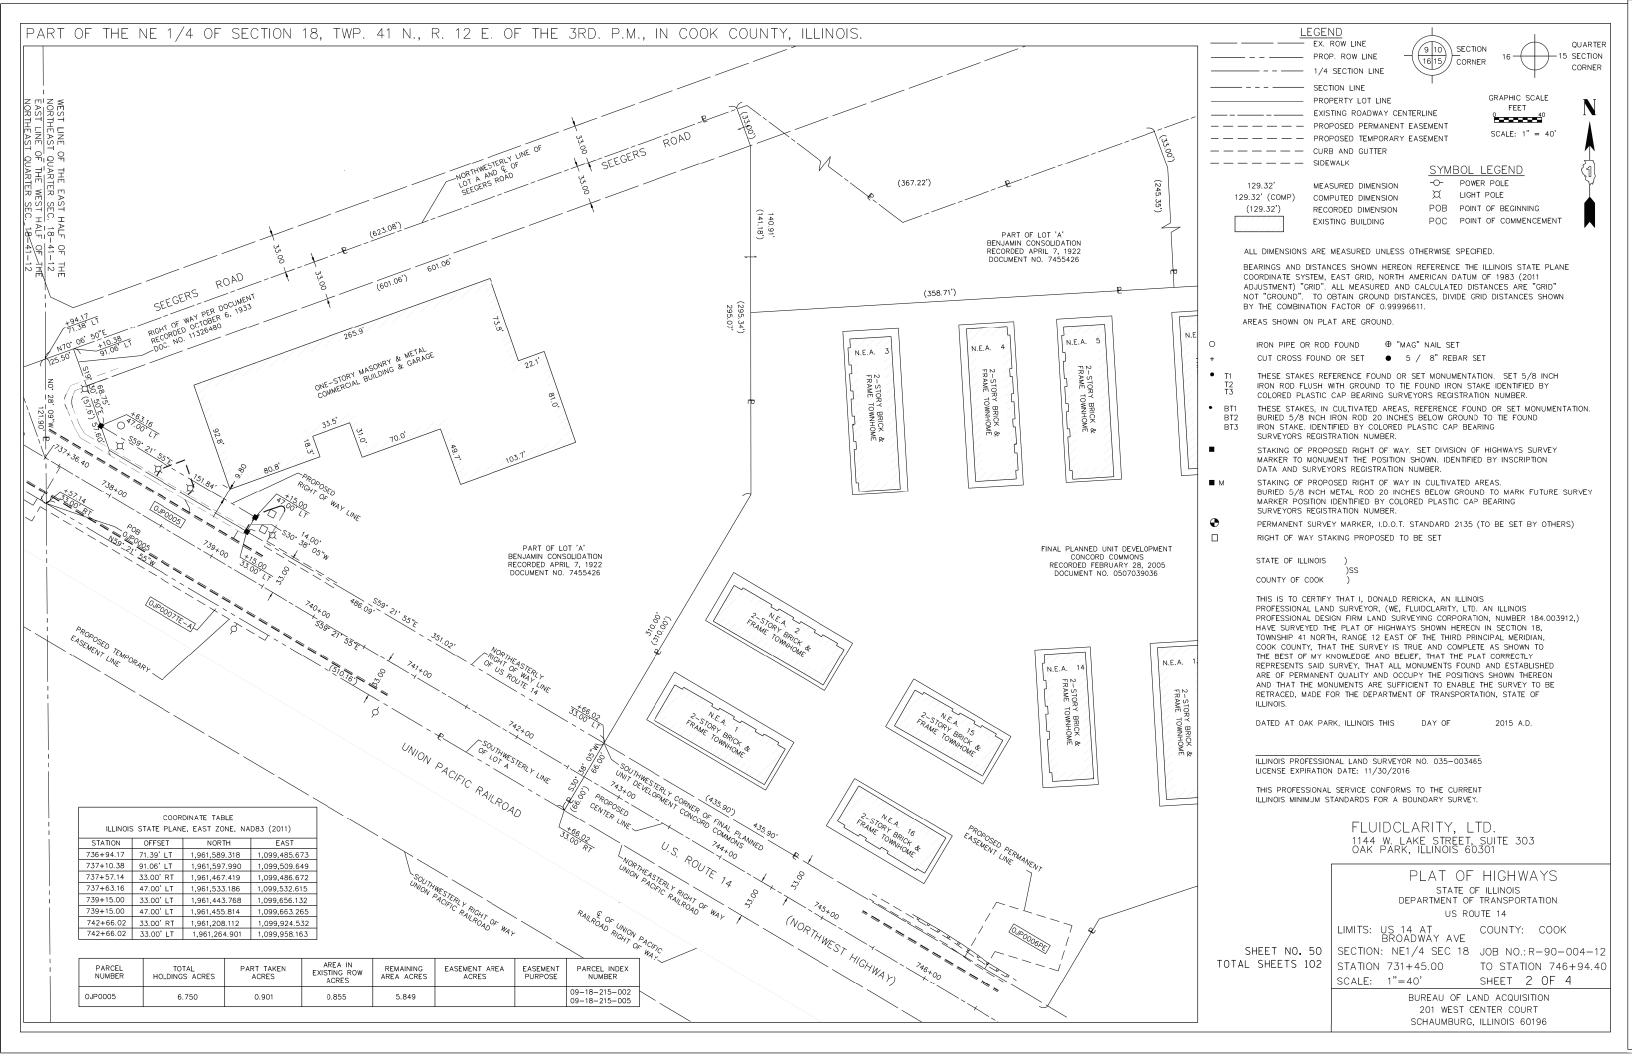


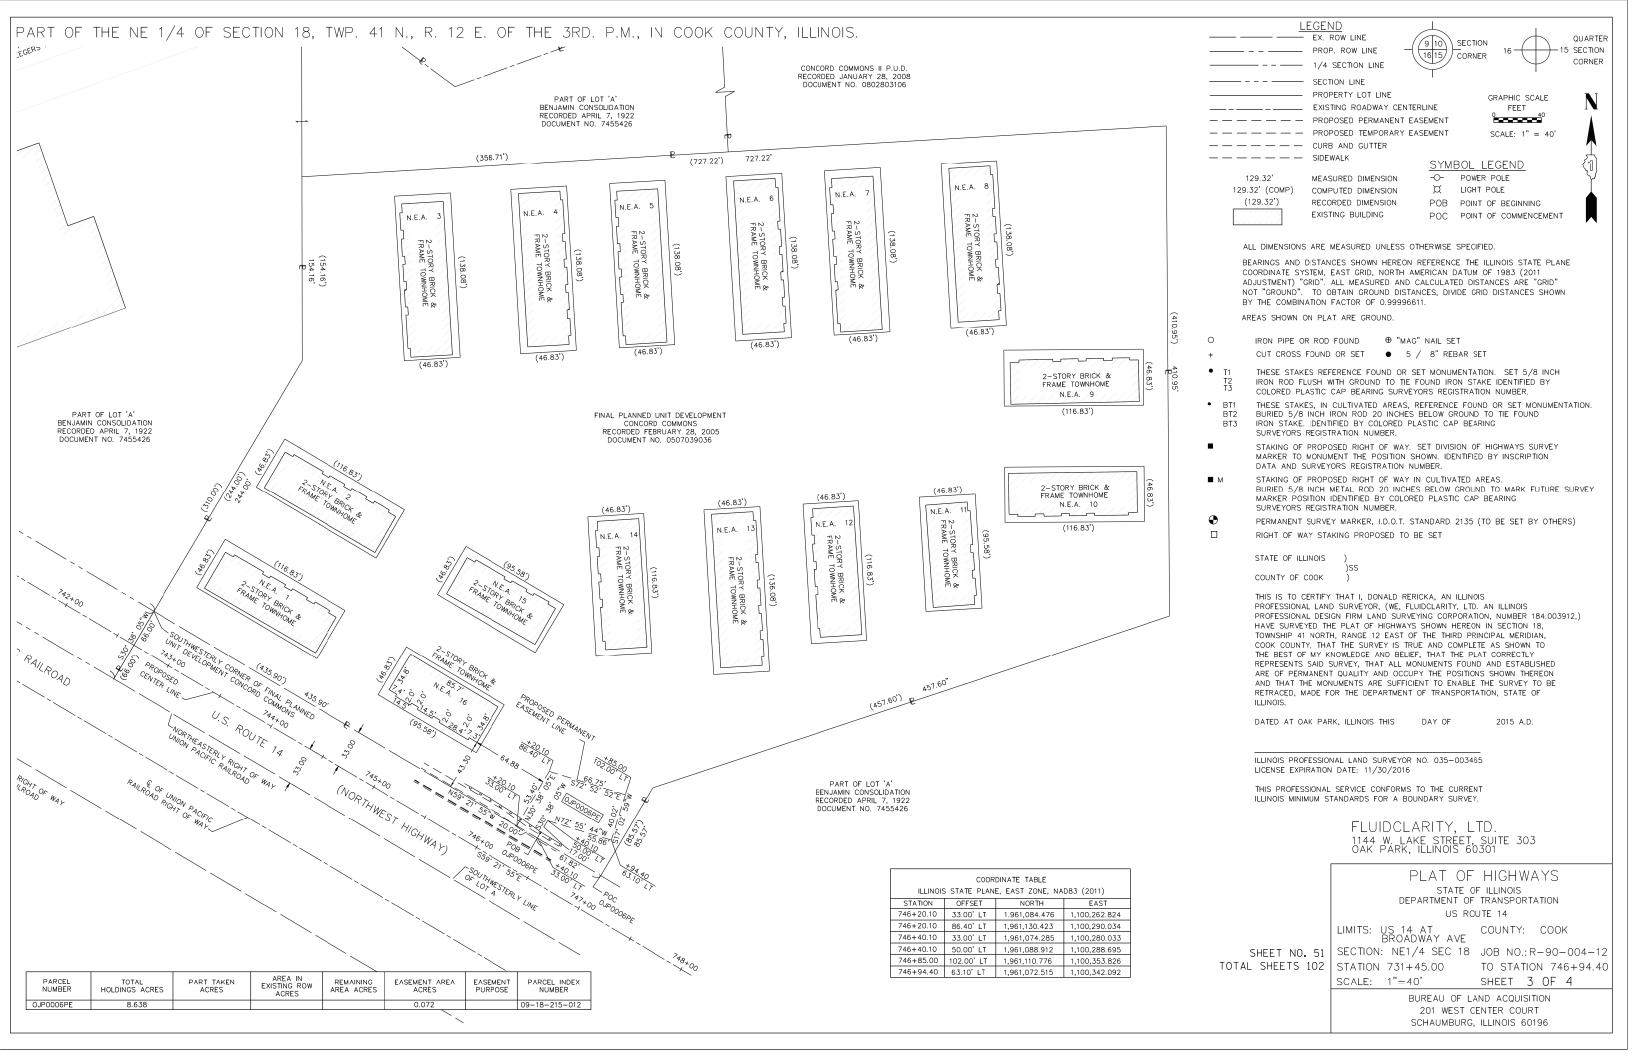


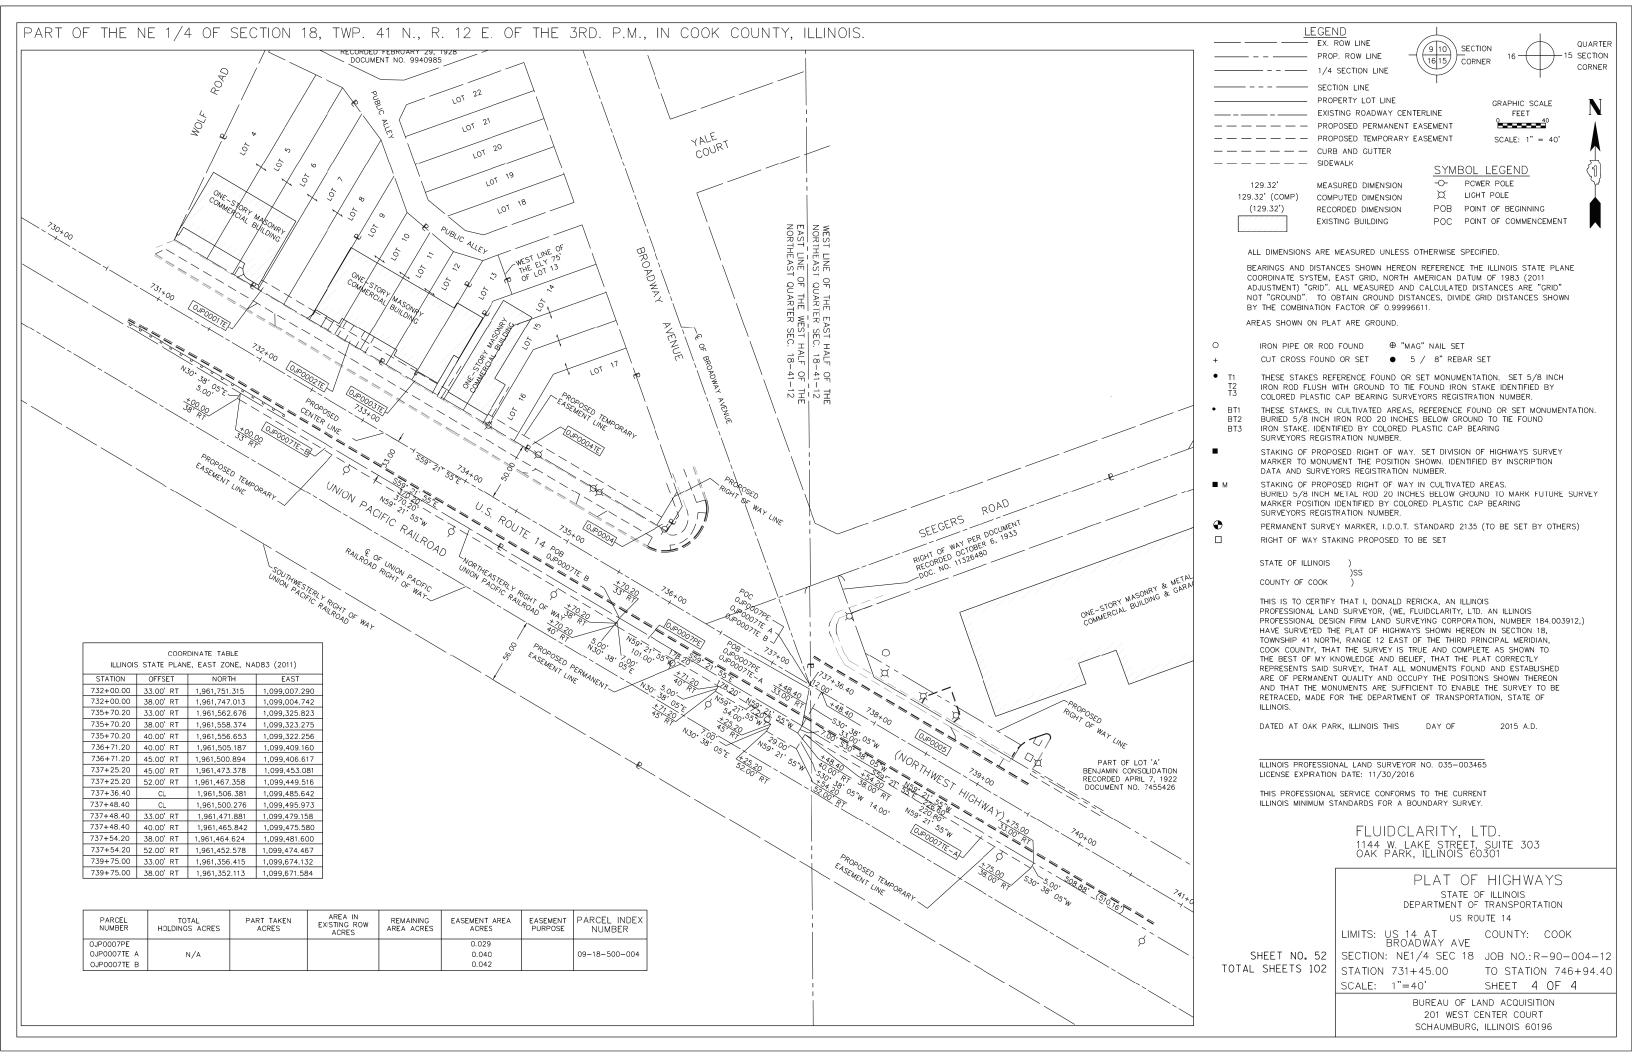

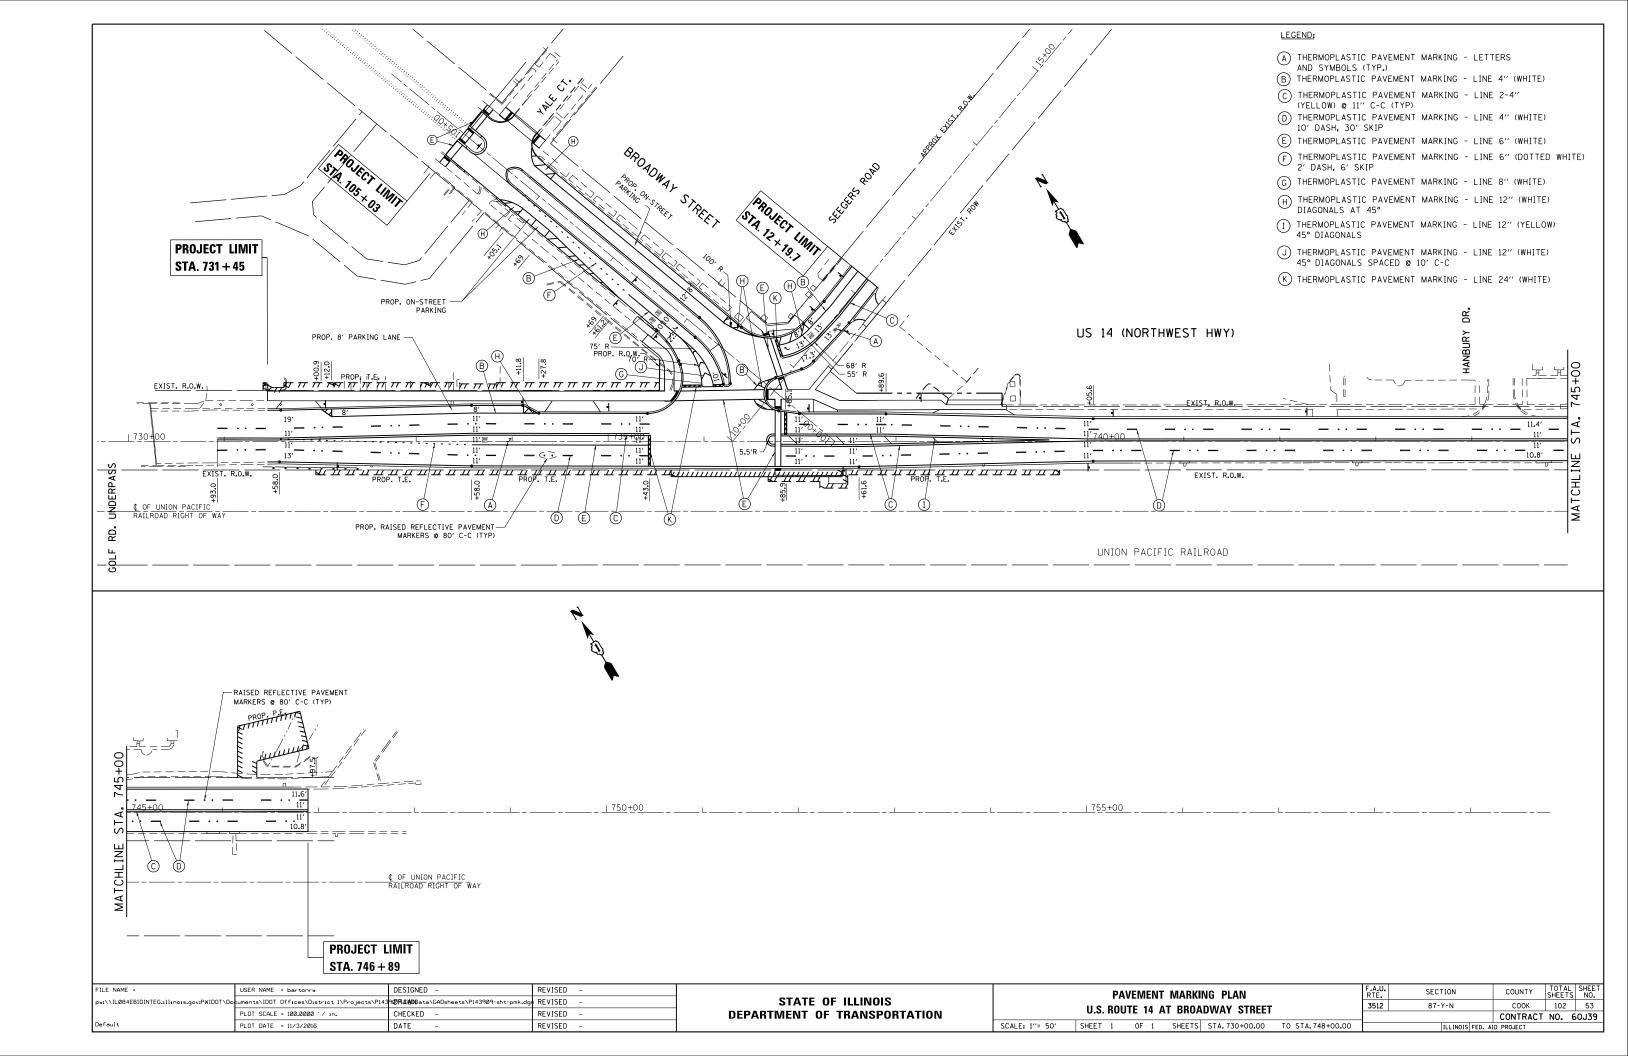

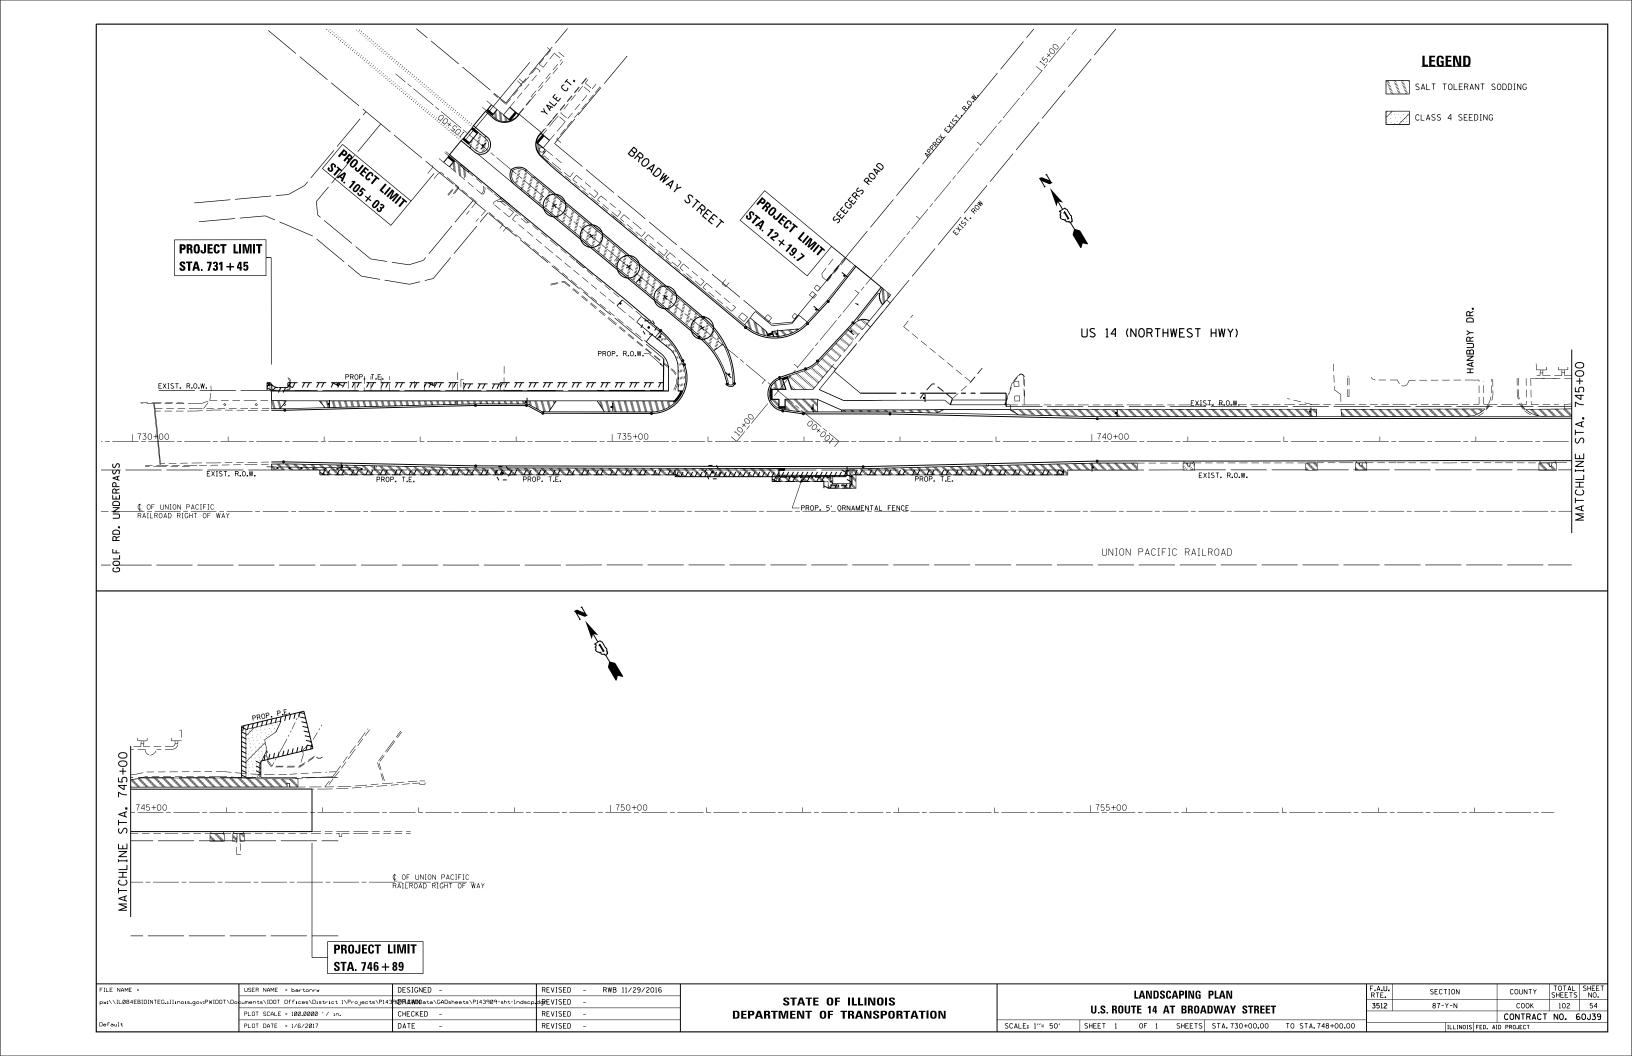

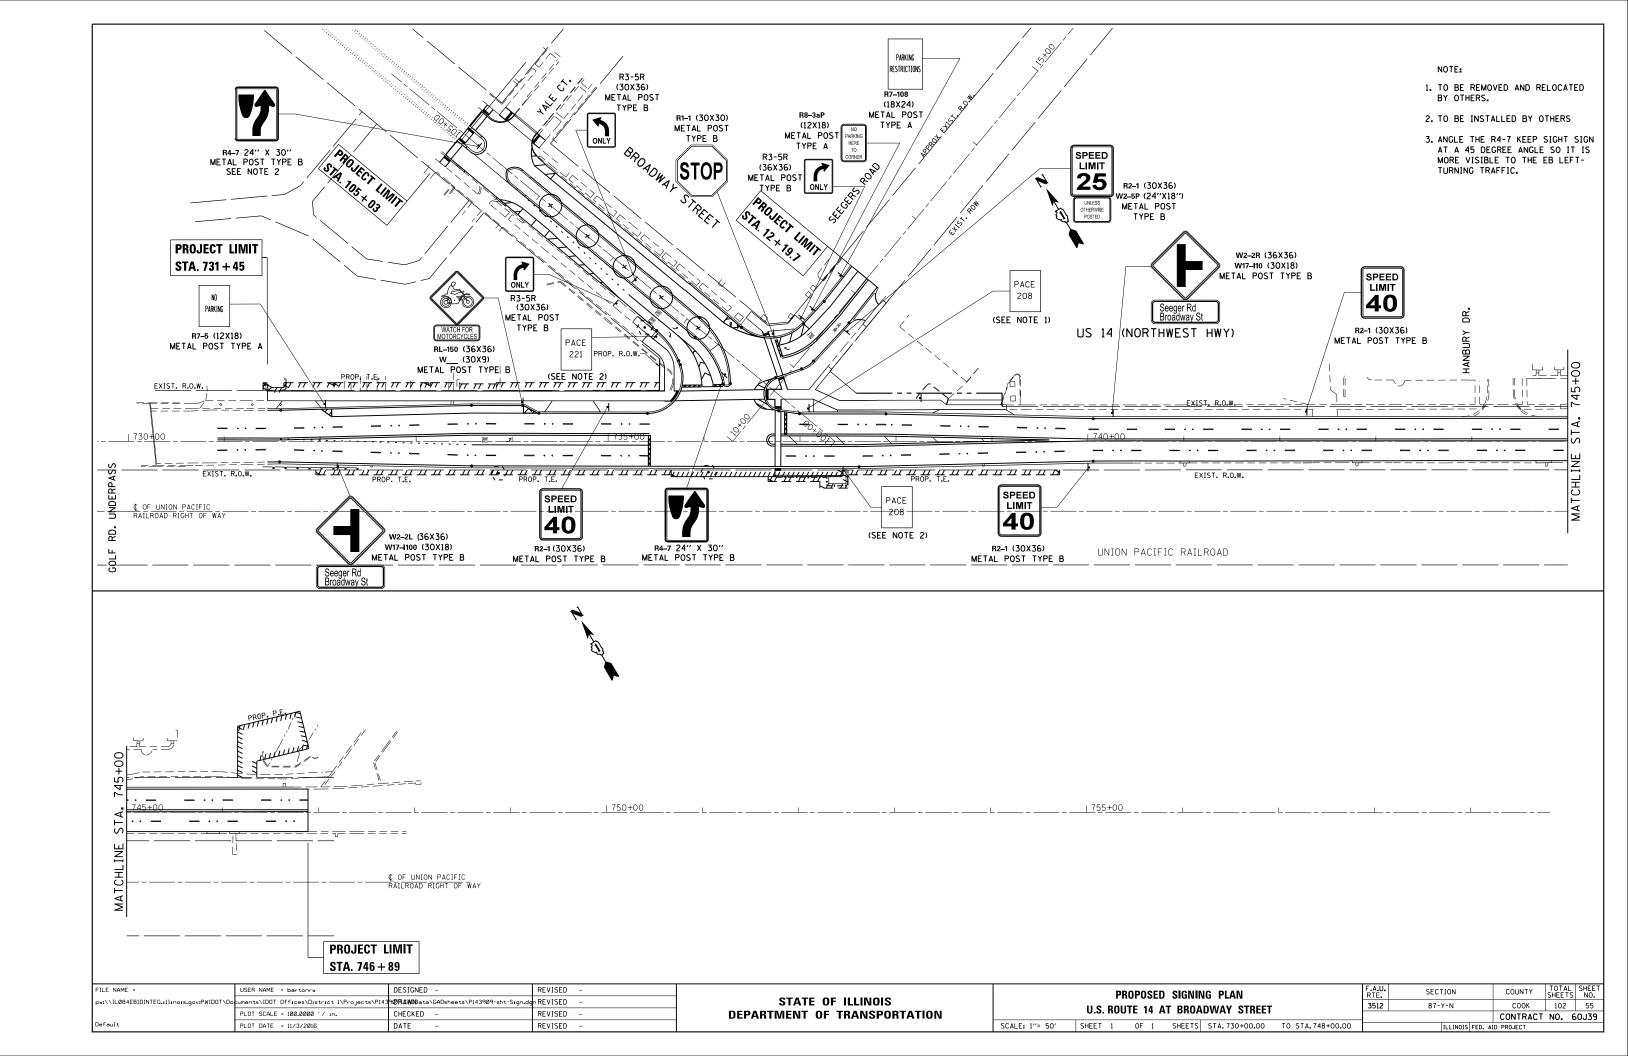

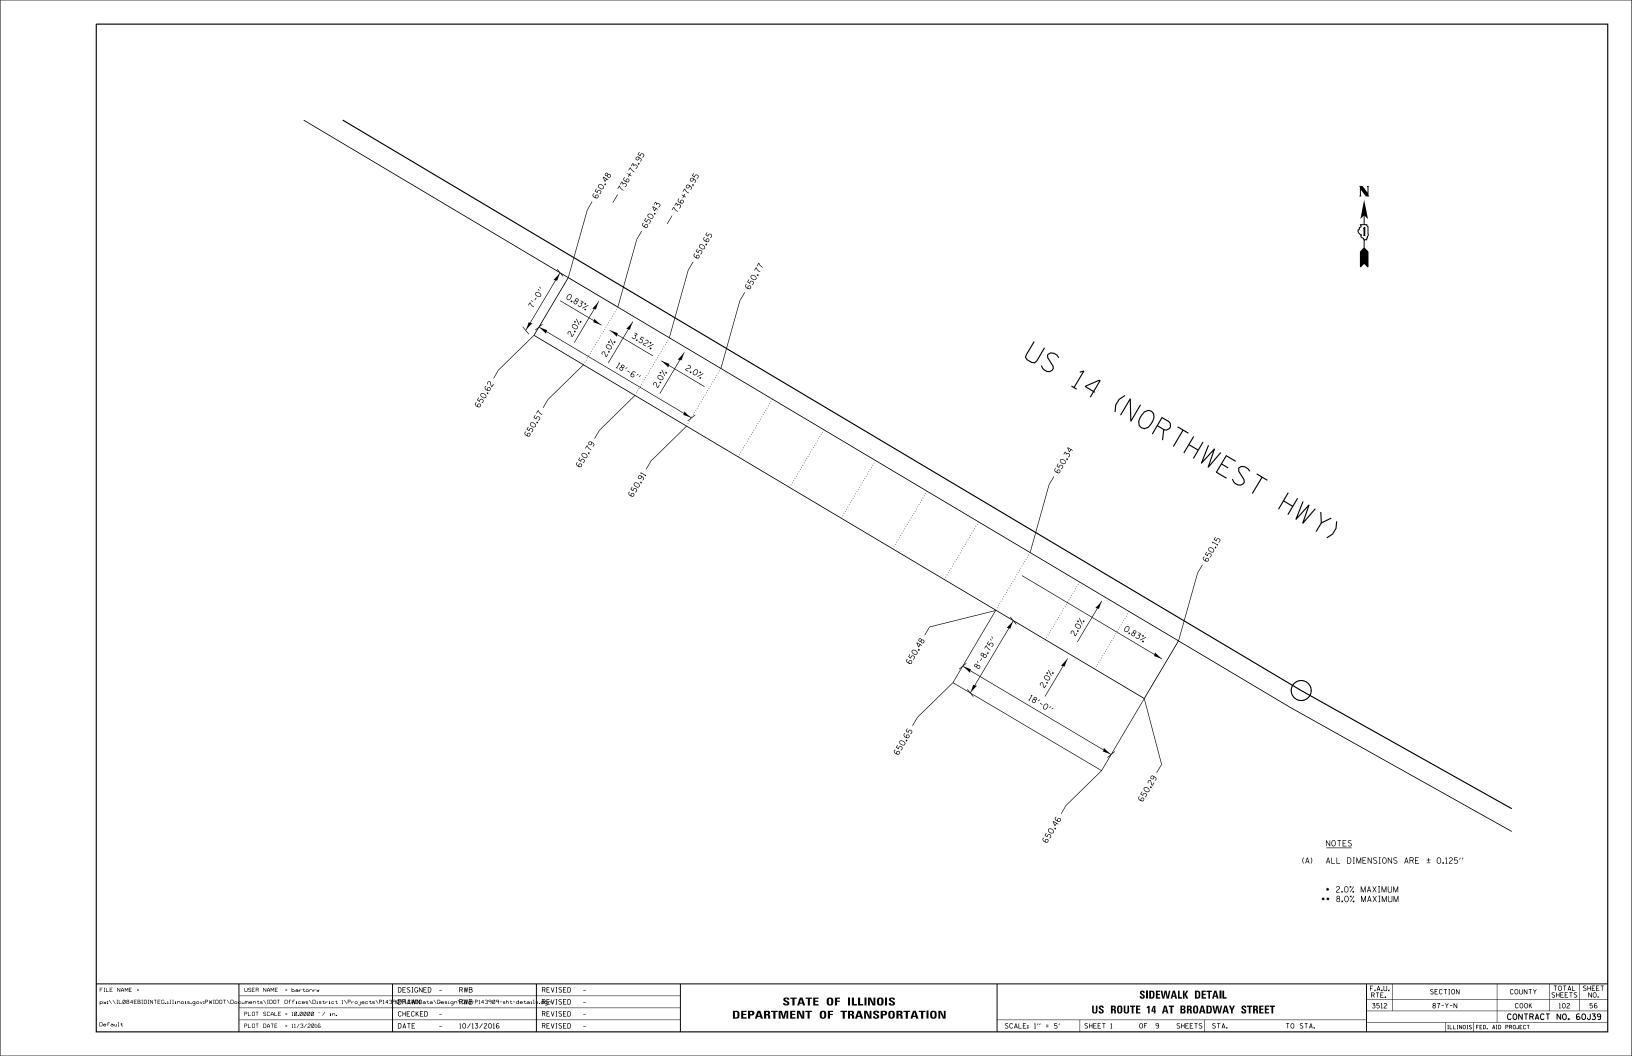

3.0; vi) 650.51 US 14 (NORTHWEST HWY) 650.31


STREET BROADWAY


<u>NOTES</u>


(A) ALL DIMENSIONS ARE ± 0.125"

* 2.0% MAXIMUM ** 8.0% MAXIMUM

F.A.U. RTE. 3512 FILE NAME = DESIGNED - RWB REVISED USER NAME = bartonrw SECTION SIDEWALK DETAIL STATE OF ILLINOIS pw:\\ILØ84EBIDINTEG.:111:no: :uments\IDOT_Offices\District_1\Projects\P143<mark>9@RAWD</mark>ata\Besign**RW&**:P143909-sht-deta: •.<del>R⊈</del>VISED 87-Y-N US ROUTE 14 AT BROADWAY STREET **DEPARTMENT OF TRANSPORTATION** PLOT SCALE = 10.0000 '/ in. CHECKED -REVISED PLOT DATE = 11/3/2016 DATE REVISED SCALE: 1" = 5' SHEET 2 OF 9 SHEETS STA. TO STA. 10/13/2016

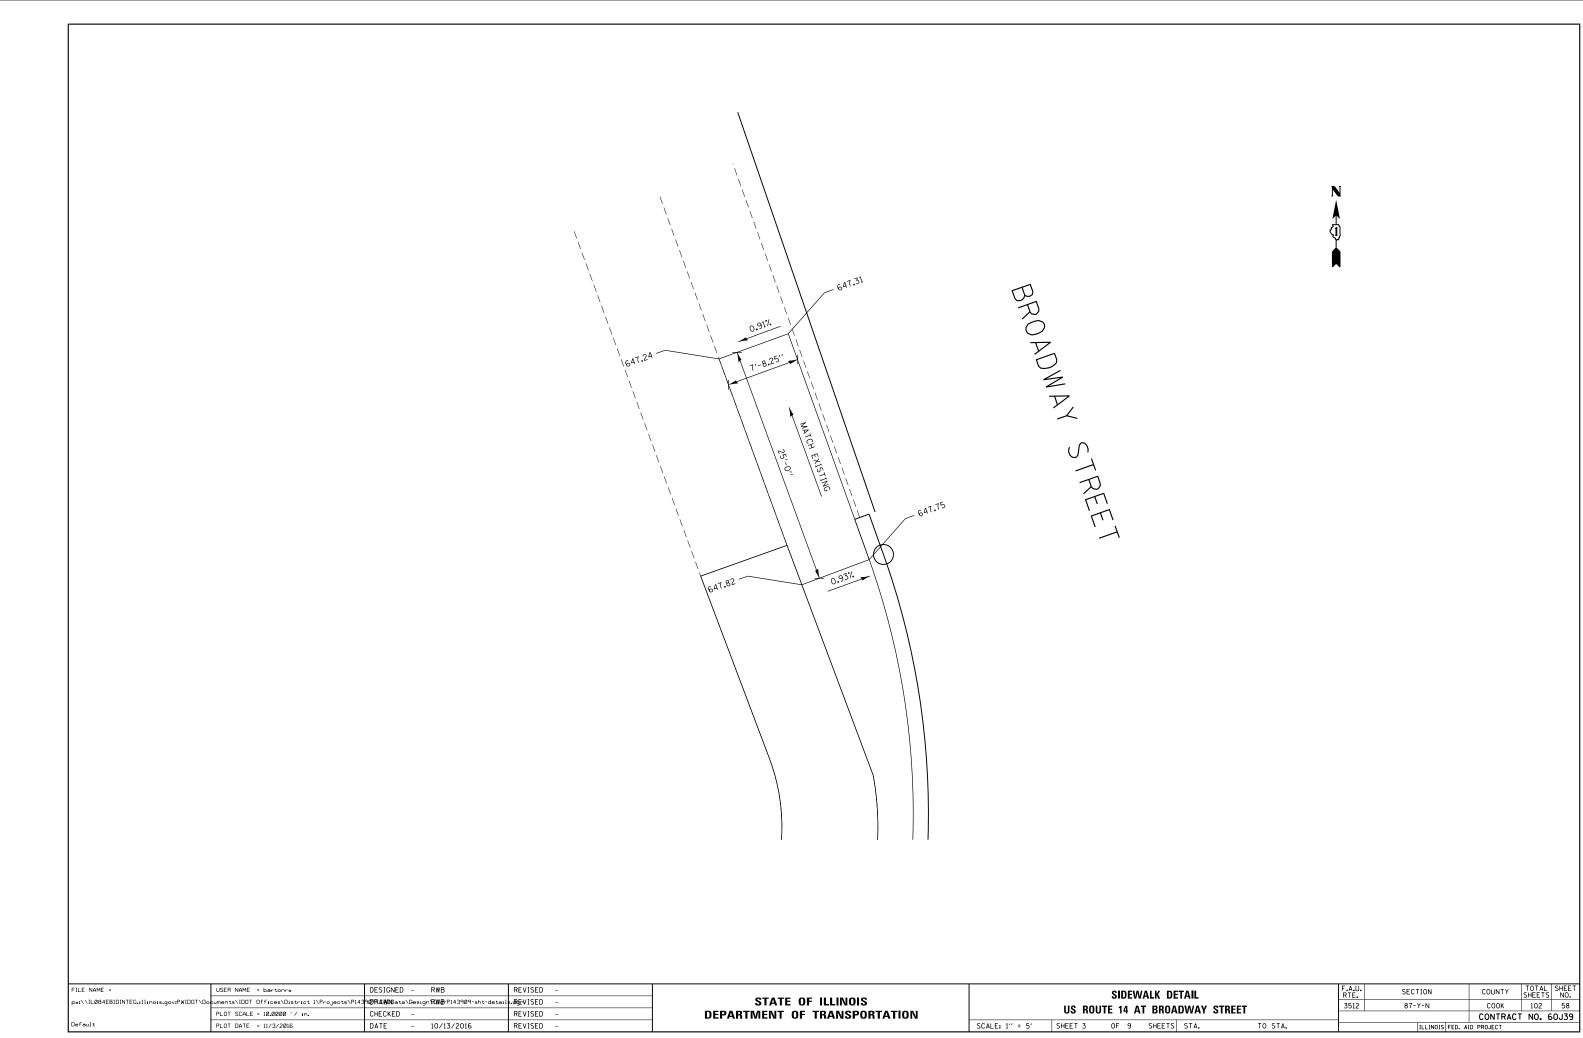

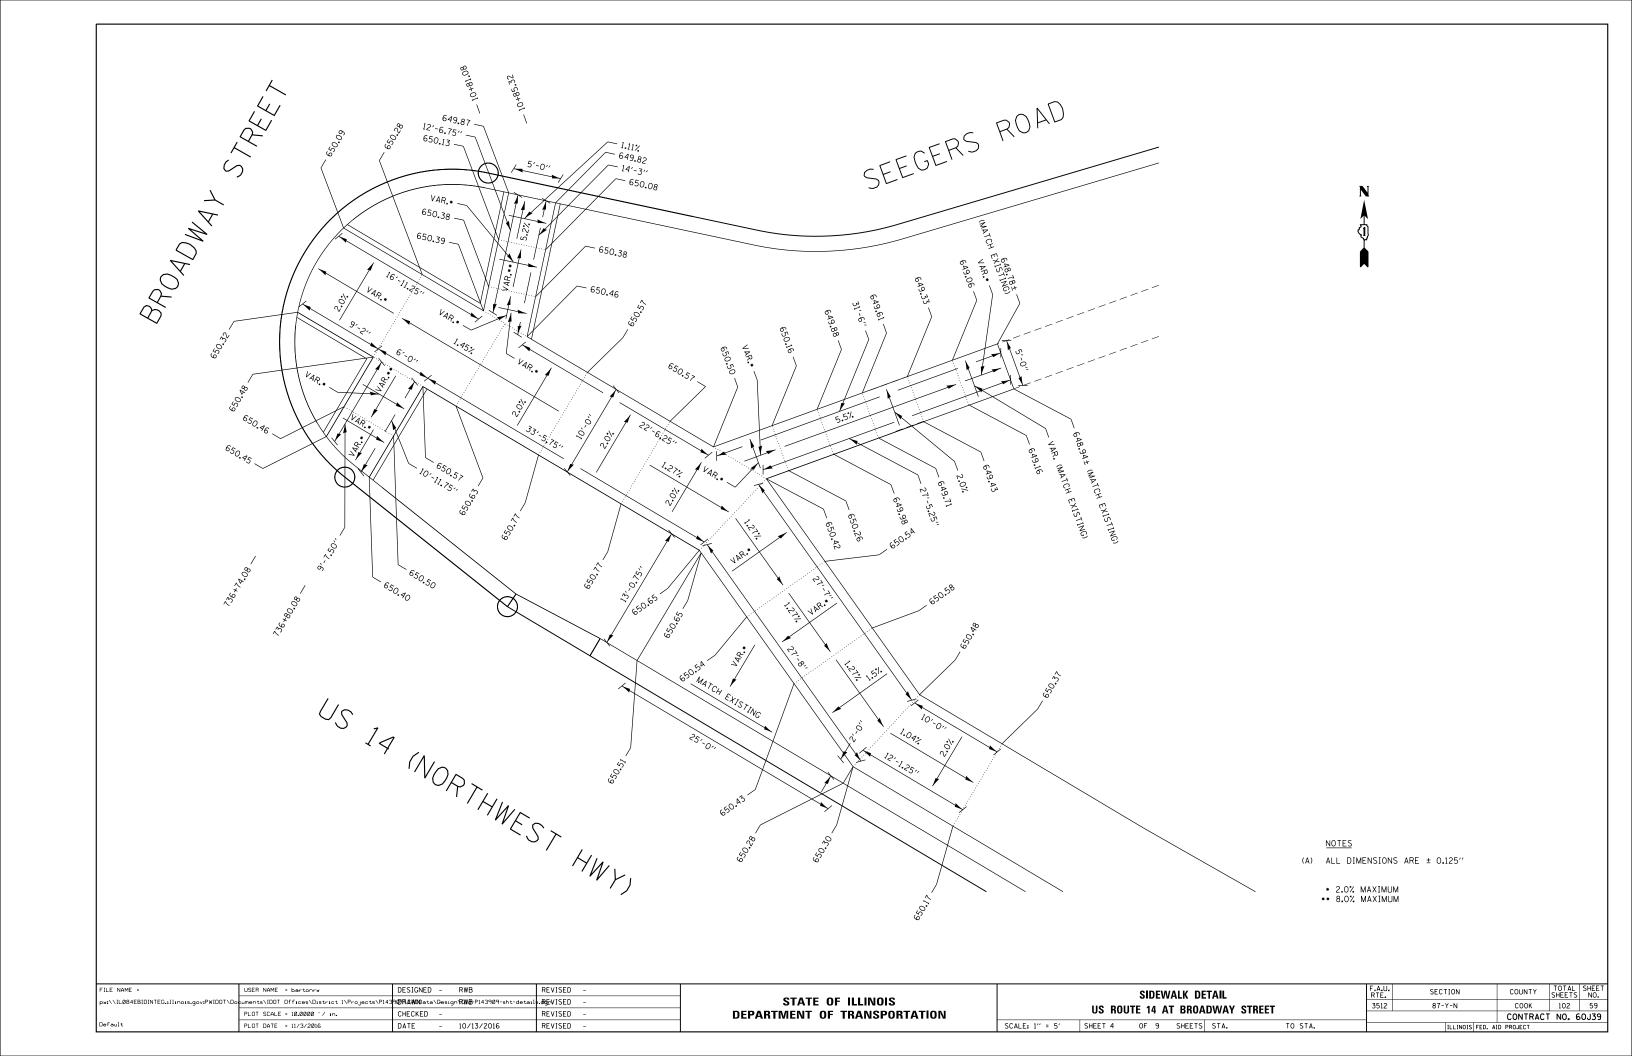

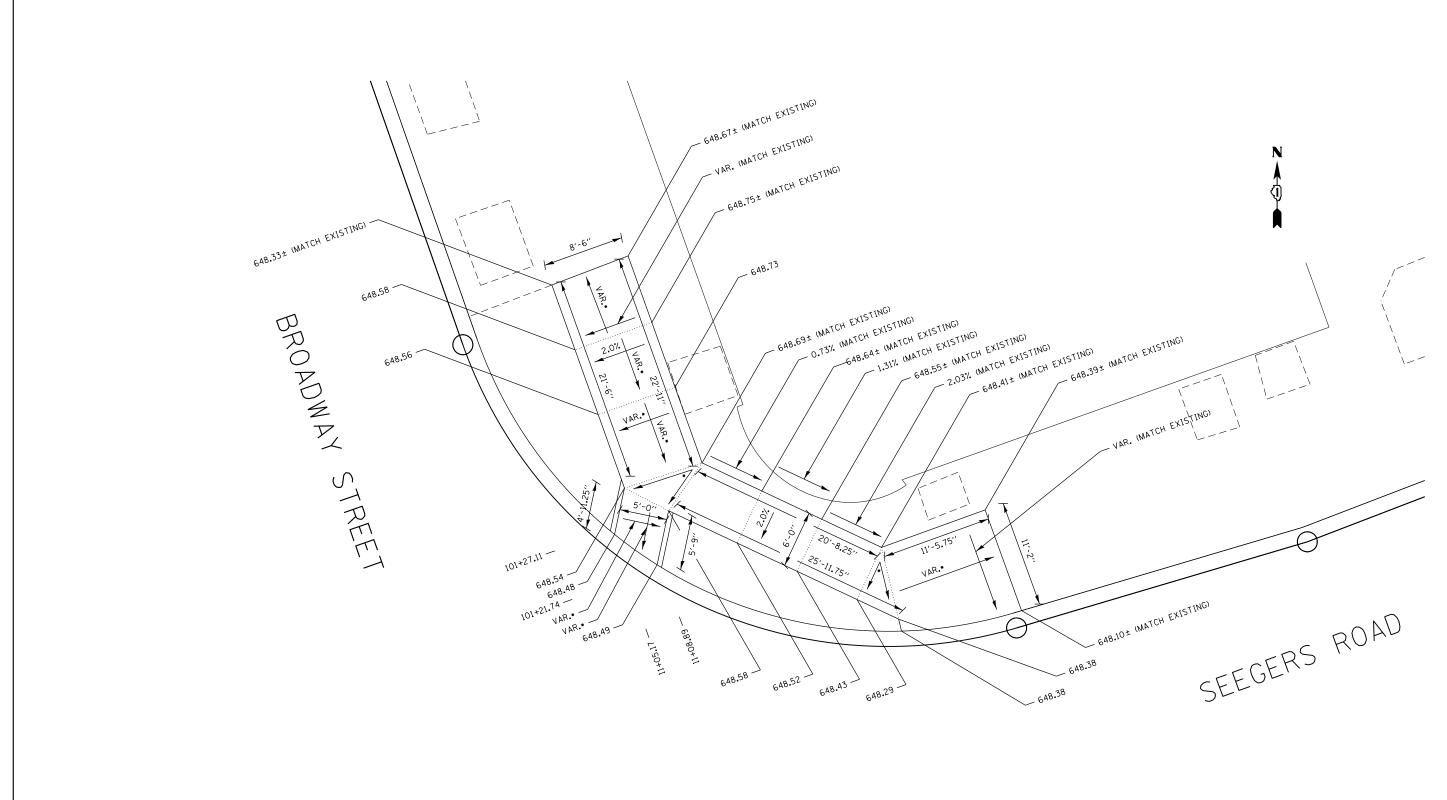


<u>NOTES</u>


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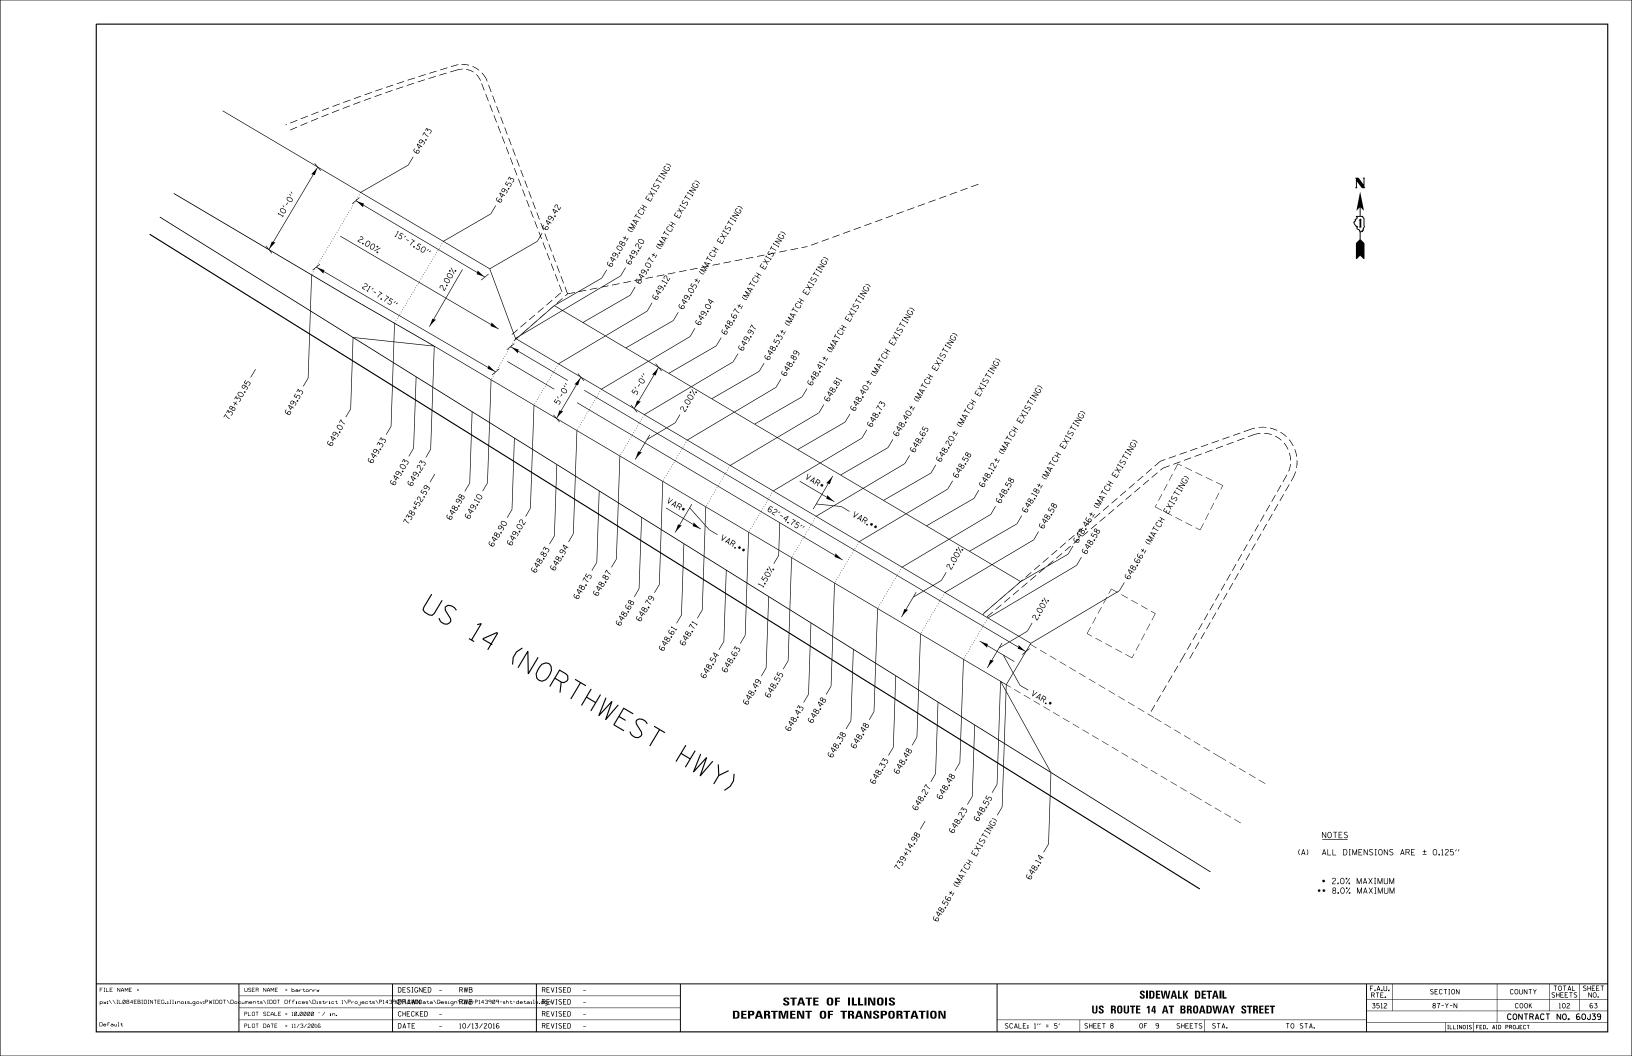
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•• 8.0% MAXIMUM


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	ow:\\IL084EBIDINTEG.:111:no:s.gov:PWIDOT\Do	· · · · · · · · · · · · · · · · · · ·	9 <b>©RAW</b> Dota\Design <b>\RWB</b> -P143909-sht-detai	s.eAg⊑vISED –	STATE OF ILLINOIS	US ROUTE 14 AT BROADWAY STREET	3512	87-Y-N	COOK	102 60
		PLOT SCALE = 10.0000 '/ in.	CHECKED -	REVISED -	DEPARTMENT OF TRANSPORTATION		_		CONTRACT	T NO. 60J39
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F.A.U. RTE. 3512 STATE OF ILLINOIS DEPARTMENT OF TRANSPORTATION pw:\\ILØ84EBIDINTEG.:111:no: :uments\IDOT_Offices\District_1\Projects\P143<mark>9@RAWD</mark>ata\Besign**RW&**:P143909-sht-deta: •.<del>R⊈</del>VISED 87-Y-N US ROUTE 14 AT BROADWAY STREET PLOT SCALE = 10.0000 '/ in. CHECKED -REVISED DATE REVISED SCALE: 1" = 5' SHEET 6 OF 9 SHEETS STA. TO STA. 10/13/2016



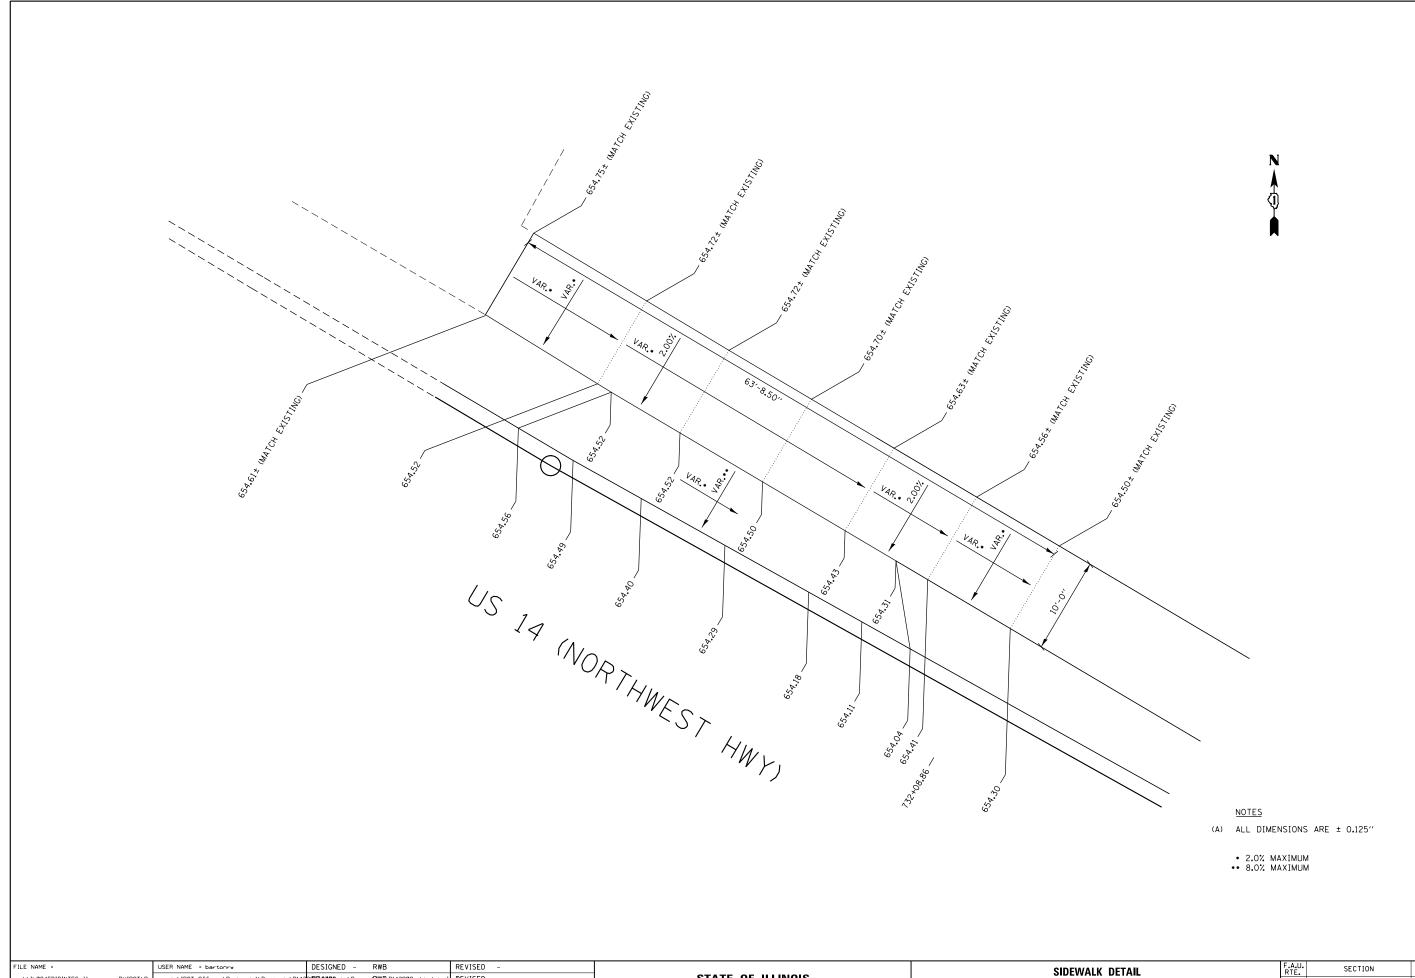

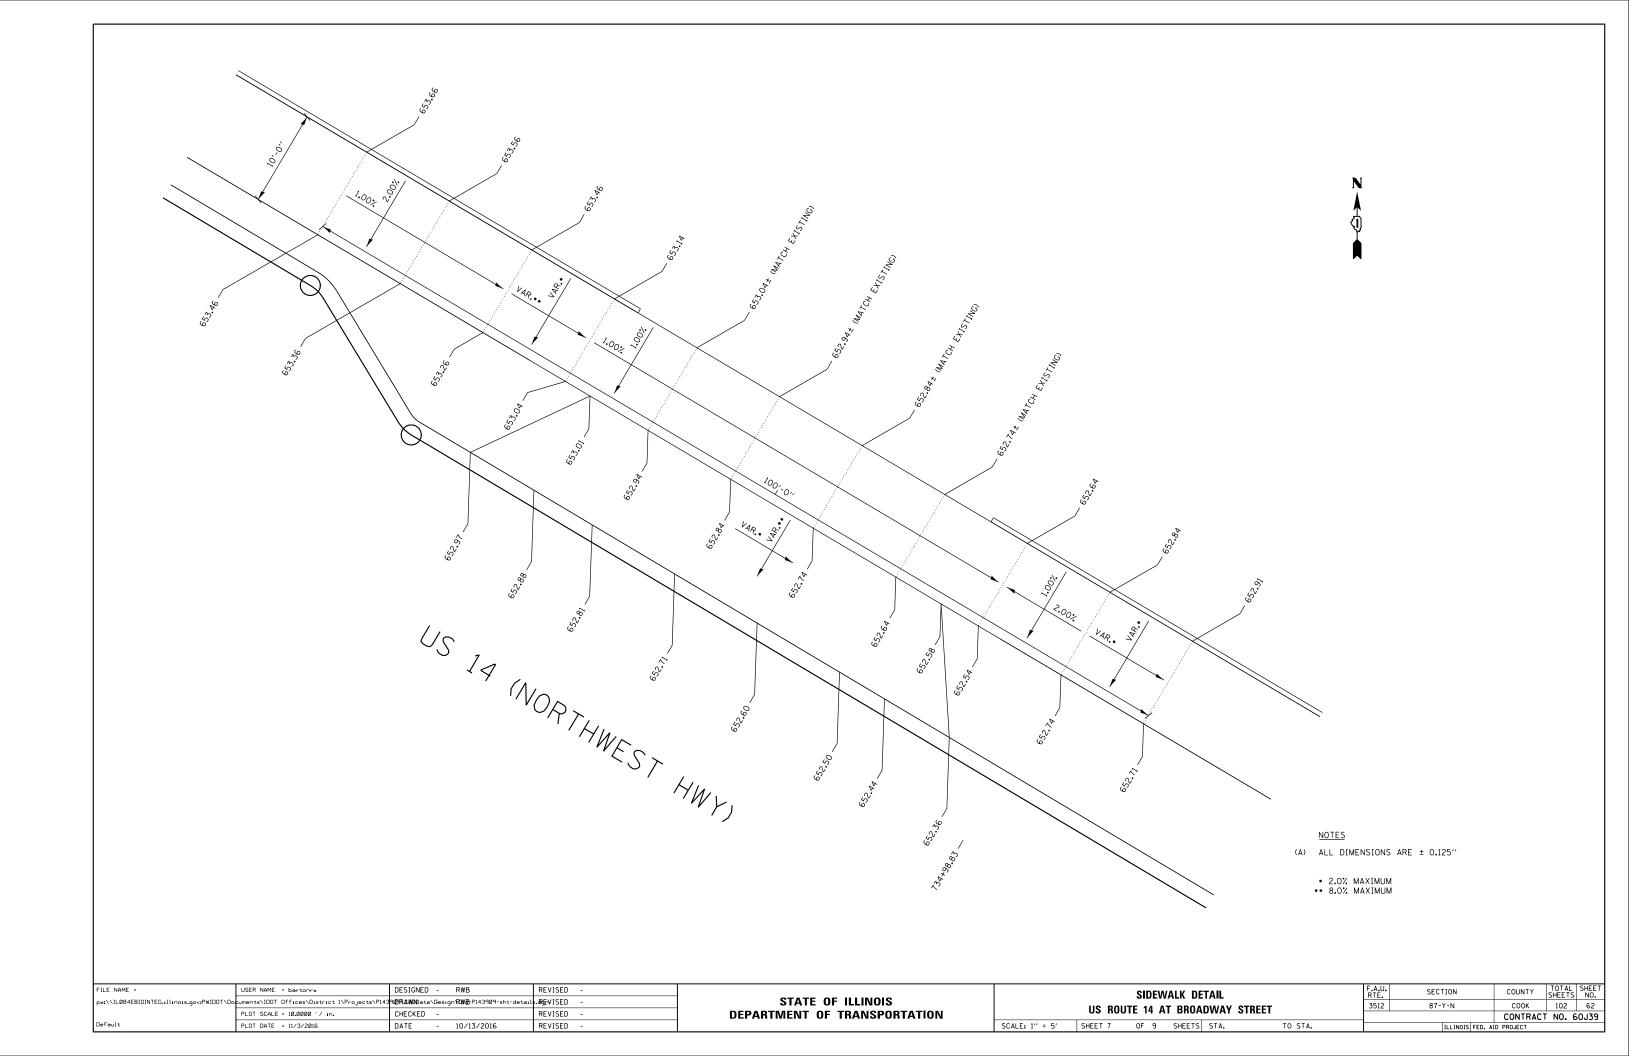



<u>NOTES</u>

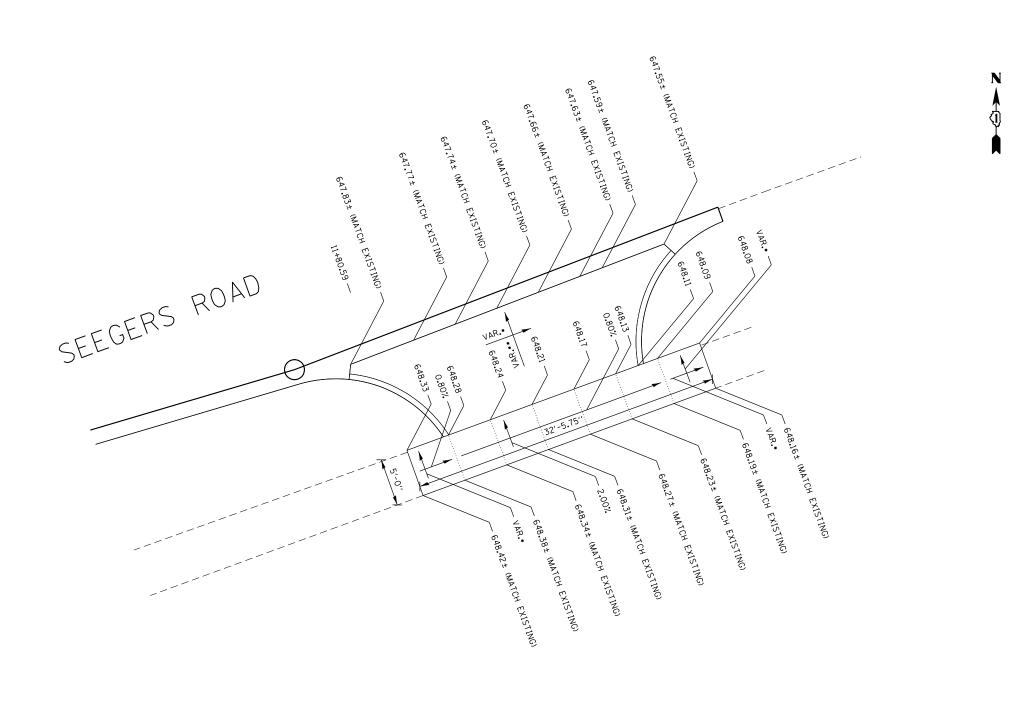(A) ALL DIMENSIONS ARE ± 0.125"

• 2.0% MAXIMUM
•• 8.0% MAXIMUM

FILE N	NAME =	USER NAME = bartonrw	DESIGNED - RWB	REVISED -		SIDEWALK DETAIL	F.A.U. RTF.	SECTION	COUNTY	TOTAL	HEE 1
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	_	PLOT SCALE = 10.00000 '/ in.	CHECKED -	REVISED -	DEPARTMENT OF TRANSPORTATION				CONTRACT	T NO. 6	J39
Defaul	lt	PLOT DATE = 11/3/2016	DATE - 10/13/2016	REVISED -		SCALE: 1" = 5' SHEET 9 OF 9 SHEETS STA. TO STA.		ILLINOIS FED. AI	ID PROJECT		

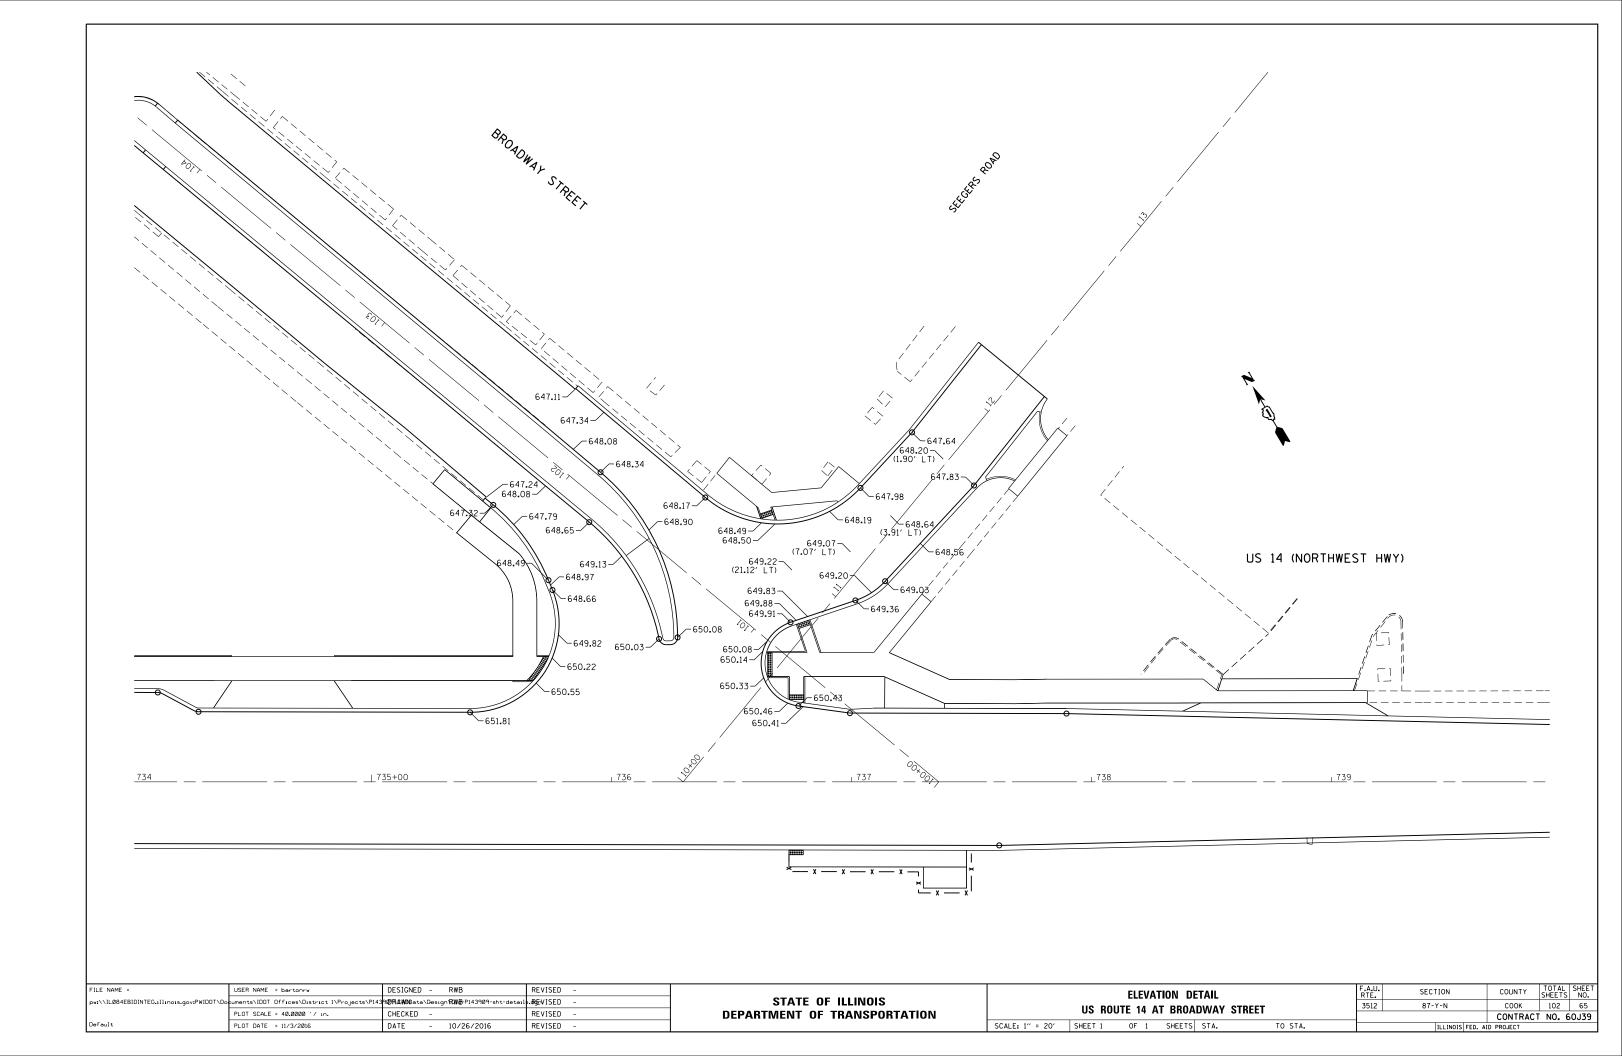


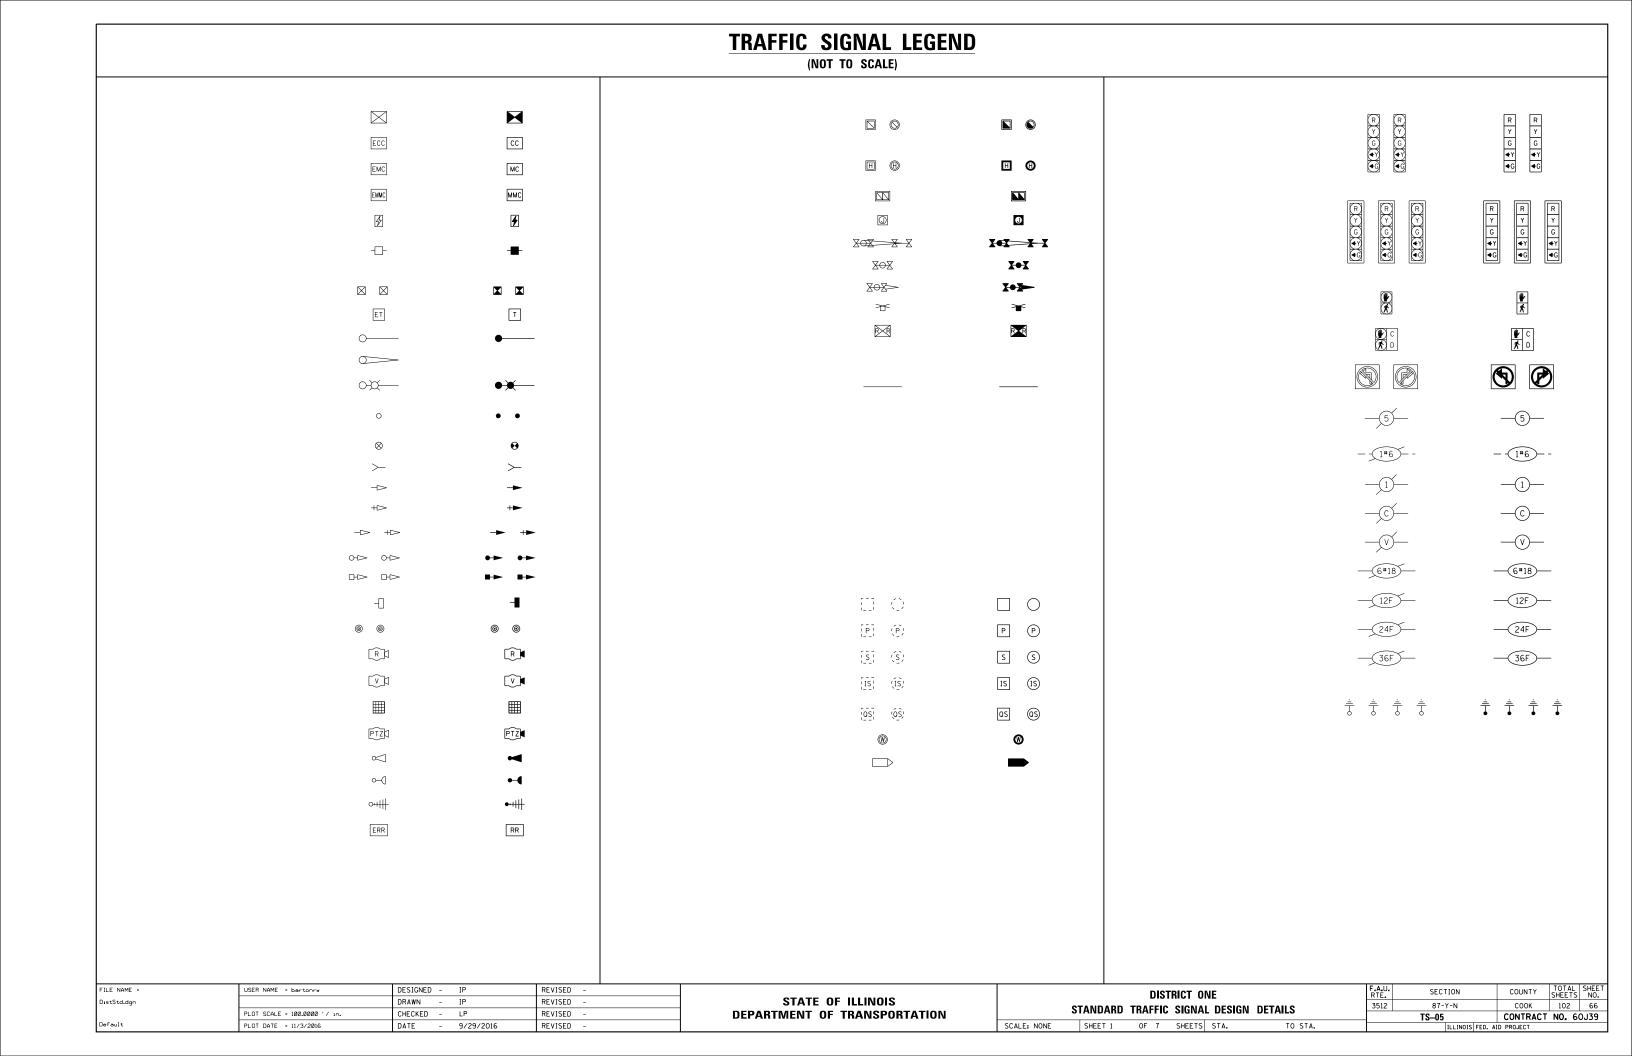


#### **LOOP DETECTOR NOTES**

- 1. EACH PAIR OF LOOP WIRES SHALL BE PLACED IN A SEPARATE EMPTY COILABLE NONMETALLIC CONDUIT FROM THE EDGE OF PAVEMENT TO THE HANDHOLE. SPACING BETWEEN THE HOLES DRILLED IN THE PAVEMENT SHALL NOT BE LESS THAN 6" (150 mm). EMPTY COILABLE NONMETALLIC CONDUIT SHALL BE INCLUDED IN THE COST OF THE LOOP WIRE.
- 2. THE NUMBER OF LOOP TURNS SHALL BE AS RECOMMENDED BY THE AMPLIFIER MANUFACTURER. ALL ADJACENT SIDES OF THE LOOPS SHALL BE INSTALLED IN SUCH A WAY THAT THE CURRENT FLOW IS IN THE SAME DIRECTION TO REINFORCE ITS MAGNETIC FIELDS FOR SMALL VEHICLE DETECTION.
- 3. EACH LOOP LEAD-IN SHALL BE IDENTIFIED AND PERMANENTLY TAGGED IN THE HANDHOLE. EACH LEAD-IN CABLE TAG SHALL INDICATE THE LOCATION OF THE LOOP, LOOP ROTATION (CLOCKWISE/COUNTERCLOCKWISE), LOOP LEAD-IN DIRECTION (IN OR OUT), LOOP CABLE NUMBER AND LOCATION IN CABINET, AND NUMBER OF TURNS IN THE DETECTOR LOOPS IN WATER PROOF INK AS INDICATED ON THE DISTRICT 1 STANDARD TRAFFIC SIGNAL DESIGN DETAIL. THE CONTRACTOR SHALL MARK LOOP LOCATIONS ON RECORD DRAWINGS AND PRESENT TO THE ENGINEER AFTER FINAL INSPECTION. LOOPS SHALL BE MARKED BY LANE AND LOOP NUMBER. SEE DETAIL BELOW.
- 4. ALL LOOP CABLE SHALL BE FASTENED WITH PLASTIC TIE WRAP TO THE HANDHOLE HOOKS.
- 5. IN ASPHALT PAVEMENT, LOOPS SHOULD BE PLACED IN THE BINDER AND DIVEHOLES MARKED AT THE CURB WITH A SAW-CUT. THE SAW-CUT SHALL BE CUT IN ACCORDANCE WITH LOCAL AND E.P.A. DUST CONTROL REQUIREMENTS. DETECTOR LOOP(S) SHALL NOT BE INSTALLED IN WET CONDITIONS AND THE SAW-CUTS MUST BE FREE OF DEBRIS AND RESIDUE SUCH AS DUST AND WATER WHICH IS TO BE ACHIEVED BY THE USE OF COMPRESSED AIR, WIRE BRUSHING AND HEAT DRYING ACCORDING TO SEALANT MANUFACTURER REQUIREMENTS. THE DETECTOR WIRE SHALL BE HELD IN PLACE BY THE USE OF FORM WEDGES. WEDGES SHALL BE SPACED NO MORE THAN 18" (450 mm) APART.
- 6. LOOP SPLICES SHALL BE SOLDERED USING A SOLDERING IRON. BLOW TORCHES OR OTHER DEVICES WHICH OXIDIZE COPPER CABLE SHALL NOT BE ALLOWED FOR SOLDERING OPERATIONS. SEE DETAIL BELOW RIGHT.
- 7. PREFORMED DETECTOR LOOPS SHALL BE USED, AS SHOWN ON THE PLANS, WHERE NEW CONCRETE PAVEMENT IS PROPOSED. THE INSTALLATION OF PREFORMED LOOPS SHALL BE IN ACCORDANCE WITH THE DISTRICT 1 SPECIFICATIONS OR AS DIRECTED BY THE ENGINEER.

#### LOOP LEAD-IN CABLE TAG

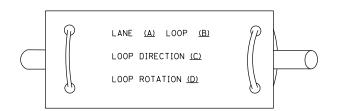



- A. LANE 1 IS THE LANE CLOSEST TO THE CENTERLINE OF THE ROADWAY
- B. LOOP *1 IS THE LOOP IN THE LANE CLOSEST TO THE INTERSECTION.
- C. LABEL LOOP CABLE "IN" OR LOOP CABLE "OUT".
- D. LABEL LOOP CABLE CLOCKWISE OR LOOP CABLE COUNTERCLOCKWISE.

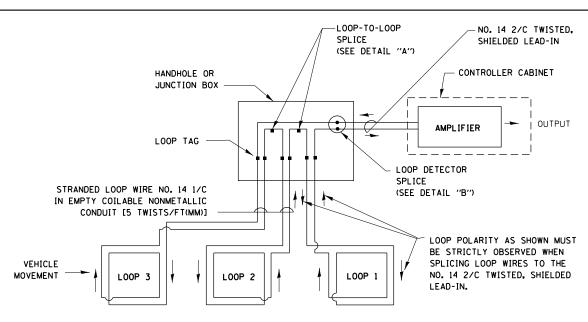

#### **DETECTOR LOOP WIRING SCHEMATIC**

- LOOPS SHALL BE SPLICED IN SERIES.
- SAW-CUTS SHALL BE A MINIMUM WIDTH OF 5/16" (8 mm).
- SAW-CUT DEPTHS SHALL BE 3" (75 mm). IF IN CONCRETE. THE SAW-CUT DEPTH SHALL BE TO THE TOP OF THE REINFORCEMENT.
- LOOP CORNERS SHALL BE DRILLED WITH A 2" (50 mm) DIAMETER CORE.

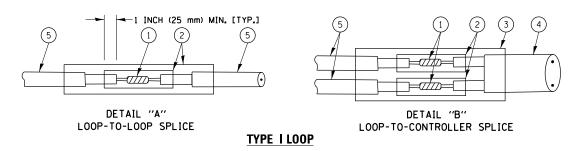

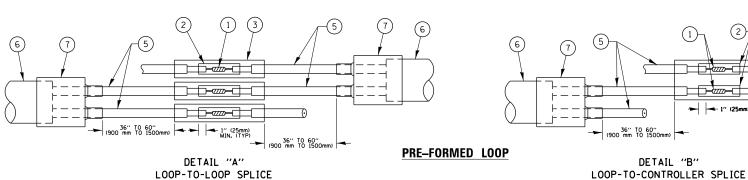

#### LOOP DETECTOR SPLICE


- (1) WESTERN UNION SPLICE SOLDERED WITH ROSIN CORE FLUX. ALL EXPOSED SURFACES OF THE SOLDER SHALL BE SMOOTH. THE WESTERN UNION SPLICES SHALL BE STAGGERED.
- (2) WCSMW 30/100 HEAT SHRINK TUBE, MINIMUM LENGTH 3" (75 mm), UNDERWATER GRADE.
- (3) WCS 200/750 HEAT SHRINK TUBE, MINIMUM LENGHT 6" (150 mm), UNDERWATER GRADE.
- (4) NO. 14 2/C TWISTED, SHIELDED CABLE.

- 5 LOOP CONDUCTOR WITH FLEXIBLE PLASTIC TUBE.
- 6 PRE-FORMED LOOP
- XL POLYOLEFIN 2 CONDUCTOR 7 BREAKOUT SEALS. TYCO CBR-2 OR APPROVED EQUAL

→ 1" (25mm) MIN, (TYP)


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# TRAFFIC SIGNAL MAST ARM AND SIGNAL POST MAST ARM MOUNTED SIGNALS IN EXISTING, PROPOSED OR FUTURE SIDEWALKBICYCLE PATH AREA. INTERSECTION SHOWN WITH PEDESTRIAN SIGNALS AND PEDESTRIAN PUSHBUTTON DETECTORS.

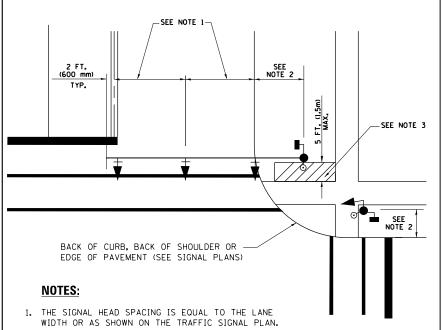


- 2. REFER TO THE TRAFFIC SIGNAL EQUIPMENT OFFSET TABLE.
- 3. PROVIDE A LEVEL ALL-WEATHER SURFACE (CONCRETE SIDEWALK, ASPHALT BICYCLE PATH SURFACE OR MATCHING MATERIAL TO THE ADJACENT SURFACE) UP TO THE MAST ARM SHAFT OR THE SIGNAL POST
- 4. THE FACE OF THE PEDESTRIAN PUSHBUTTON SHALL BE PARALLEL TO THE CROSSWALK TO BE USED.
- 5. THE LOCATIONS AND INSTALLATION OF PEDESTRIAN SIGNAL HEADS AND PEDESTRIAN PUSHBUTTONS SHALL MEET THE REQUIREMENTS OF THE MUTCD AND INFORMATION FOUND IN THE "AMERICANS WITH DISABILITIES ACT ACCESSIBILITY GUIDELINES FOR BUILDINGS AND FACILITIES."

## <u>PEDESTRIAN SIGNAL POST</u> <u>AND</u> PEDESTRIAN PUSH BUTTON POST

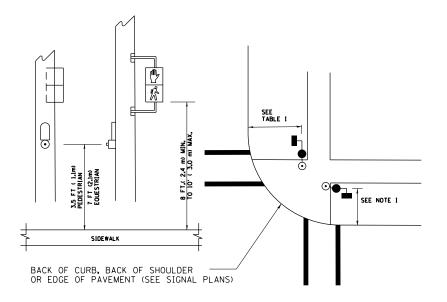

#### NOTES:

- 1. REFER TO THE TRAFFIC SIGNAL EQUIPMENT OFFSET TABLE.
- 2. PROVIDE A LEVEL ALL-WEATHER SURFACE (CONCRETE SIDEWALK, ASPHALT BICYCLE PATH SURFACE OR MATCHING MATERIAL TO THE ADJACENT SURFACE) UP TO THE PEDESTRIAN SIGNAL POST OR THE PEDESTRIAN PUSH BUTTON POST.
- 3. THE FACE OF THE PEDESTRIAN PUSHBUTTON SHALL BE PARALLEL TO THE CROSSWALK TO BE USED.
- 4. THE LOCATIONS AND INSTALLATION OF PEDESTRIAN SIGNAL HEADS AND PEDESTRIAN PUSHBUTTONS SHALL MEET THE REQUIREMENTS OF THE MUTCD AND INFORMATION FOUND IN THE "AMERICANS WITH DISABILITIES ACT ACCESSIBILITY GUIDELINES FOR BUILDINGS AND FACILITIES."

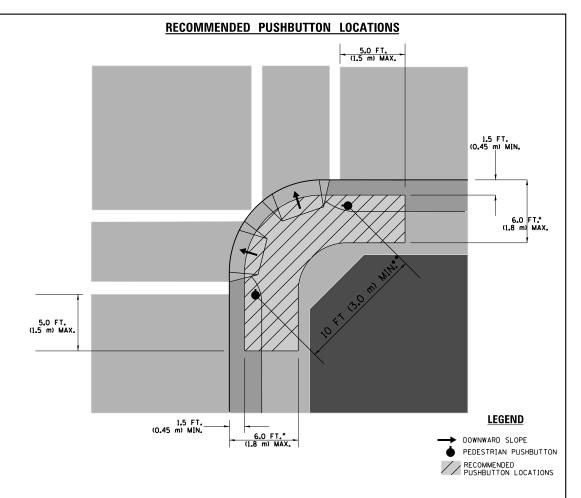

- WHERE THERE ARE CONSTRAINTS THAT MAKE IT IMPRACTICAL TO PLACE THE PEDESTRIAN PUSHBUTTON BETWEEN 1.5 FT (0.45 m) AND 6 FT (1.8 m) FROM THE EDGE OF THE CURB, SHOULDER, OR PAVEMENT, IT SHOULD NOT BE FURTHER THAN 10 FT (3 m) FROM THE EDGE OF CURB, SHOULDER, OR PAVEMENT.
- •• WHERE THERE ARE CONSTRAINTS ON A PARTICULAR CORNER THAT MAKE IT IMPRACTICAL TO PROVIDE THE 10 FT (3 m) SEPERATION BETWEEN THE TWO PEDESTRIAN PUSHBUTTONS, THE PUSHBUTTONS MAY BE PLACED CLOSER TOGETHER OR ON THE SAME POLE.

#### NOTES:

- PEDESTRIAN SIGNAL HEADS SHALL BE MOUNTED WITH THE BOTTOM OF THE SIGNAL HOUSING INCLUDING BRACKETS NOT LESS THAN 8 FT (2.4 m) OR MORE THAN 10 FT (3 m) ABOVE SIDEWALK LEVEL, AND SHALL BE POSITIONED AND ADJUSTED TO PROVIDE MAXIMUM VISIBILITY AT THE BEGINNING OF THE CONTROLLED CROSSWALK.
- 2. THE BOTTOM OF THE SIGNAL HOUSING (INCLUDING BRACKETS) OF A VEHICULAR SIGNAL FACE THAT IS NOT LOCATED OVER A HIGHWAY SHALL BE AT LEAST 8 FT (2.4 m) BUT NOT MORE THAN 19 FT (5.8 m) ABOVE THE SIDEWALK OR, IF THERE IS NO SIDEWALK, ABOVE THE PAVEMENT GRADE AT THE CENTER OF THE ROADWAY.
- 3. THE BOTTOM OF THE SIGNAL HOUSING AND ANY RELATED ATTACHMENTS TO A SIGNAL FACE LOCATED OVER ANY PORTION OF A HIGHWAY SHALL BE ACCORDING TO CURRENT STATE STANDARDS 877001, 877002, 877006, 877011 AND 877012 WITH A MINIMUM OF 16 FT (5.0 m) AND A MAXIMUM OF 18 FT. (5.5 m) FROM THE HIGHEST POINT OF PAVEMENT.
- 4. THE BOTTOM OF THE TEMPORARY SPAN WIRE MOUNTED SIGNAL HOUSING AND ANY RELATED ATTACHMENTS TO A SIGNAL FACE LOCATED OVER ANY PORTION OF A HIGHWAY SHALL BE ACCORDING TO CURRENT STATE STANDARD 880001 WITH A MINIMUM OF 17 FT (5.18 m) FROM THE HIGHEST POINT OF PAVEMENT.
- THE TOP OF THE SIGNAL HOUSING OF A SIGNAL FACE LOCATED OVER ANY PORTION OF A HIGHWAY SHALL NOT BE MORE THAN 25.6 FT (7.8 m) ABOVE THE PAYEMENT.


#### TRAFFIC SIGNAL EQUIPMENT OFFSET


TRAFFIC SIGNAL EQUIPMENT	COMBINATION CONCRETE CURB AND GUTTER (MINIMUM DISTANCE FROM BACK OF CURB TO CENTERLINE OF FOUNDATION)	SHOULDER/NON-CURBED AREA (MINIMUM DISTANCE FROM EDGE OF PAVEMENT TO CENTERLINE OF FOUNDATION)
TRAFFIC SIGNAL MAST ARM POLE	6 FT (1.8m)	SHOULDER WIDTH + 2 FT (0.6m), MINIMUM 10 FT (3.0m)
TRAFFIC SIGNAL POST	4 FT (1.2m)	SHOULDER WIDTH + 2 FT (0.6m), MINIMUM 10 FT (3.0m)
PEDESTRIAN SIGNAL POST	4 FT (1.2m)	SHOULDER WIDTH + 2 FT (0.6m), MINIMUM 10 FT (3.0m)
PEDESTRIAN PUSHBUTTON POST	4 FT (1.2m)	SHOULDER WIDTH + 2 FT (0.6m), MINIMUM 10 FT (3.0m)
TEMPORARY WOOD POLE	6 FT (1.8m)	SHOULDER WIDTH + 2 FT (0.6m), MINIMUM 10 FT (3.0m)
CONTROLLER CABINET	6 FT (1.8m) MINIMUM DISTANCE SEE NOTE 2	SHOULDER WIDTH + 6 FT (1.8m), MINIMUM 16 FT (4.9m) SEE NOTE 3.
SERVICE INSTALLATION, GROUND MOUNT	6 FT (1.8m) MINIMUM DISTANCE SEE NOTE 2	SHOULDER WIDTH + 6 FT (1.8m), MINIMUM 16 FT (4.9m) SEE NOTE 3.


#### NOTES:

- 1. CONTACT THE "AREA TRAFFIC SIGNAL MAINTENANCE AND OPERATIONS ENGINEER" FOR ASSISTANCE IN LOCATING THE TRAFFIC SIGNAL EQUIPMENT WHEN THERE ARE CONFLICTS WITH DITCHES OR THE MINIMUM OFFSET DISTANCES CANNOT BE MET.
- 2. MINIMUM DISTANCE FROM THE BACK OF CURB TO THE ROADWAY SIDE OF THE FOUNDATION.
- 3. MINIMUM DISTANCE FROM THE EDGE OF PAVEMENT TOTHE ROADWAY SIDE OF THE FOUNDATION.
- 4. ANY CHANGES TO THE OFFSETS OF THE FOUNDATIONS, FROM THE MINIMUM DISTANCES LISTED IN THE "TRAFFIC SIGNAL EQUIPMENT OFFSET" CHART AND THE TRAFFIC SIGNAL INSTALLATION PLAN, COULD EFFECT THE PLACEMENT OF THE SIGNAL HEADS, PEDESTRIAN SIGNAL HEADS AND THE PEDESTRIAN PUSHBUTTONS. THE SIGNAL HEAD PLACEMENT ON THE MAST ARMS SHALL REMAIN AS PER THE TRAFFIC SIGNAL INSTALLATION PLAN AND THE "TRAFFIC SIGNAL MAST ARM AND SIGNAL POST" DETAIL ABOVE. THE PROPOSED MAST ARM LENGTHS MAY NEED TO BE REVISED TO MEET THE ABOVE REQUIREMENTS. THE PEDESTRIAN SIGNAL HEADS AND PEDESTRIAN PUSHBUTTONS MUST MEET THE REQUIREMENTS UNDER THE DETAILS ON THIS SHEET.


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**CONTROLLER CABINETS** 

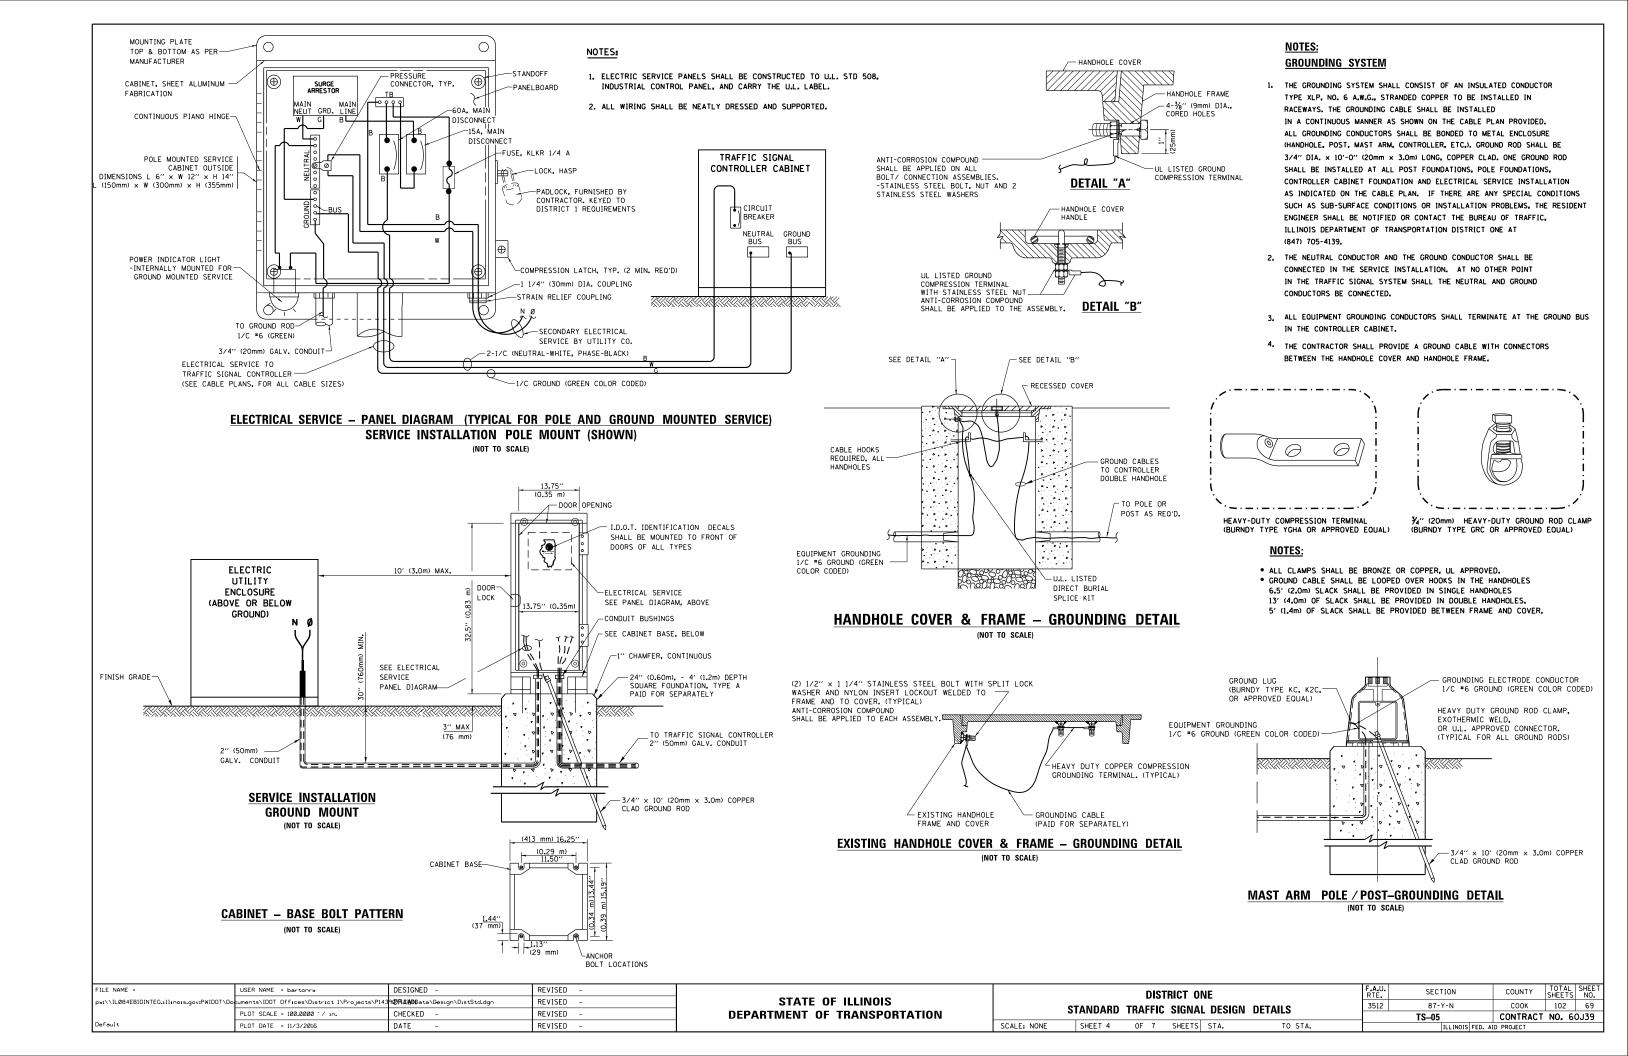

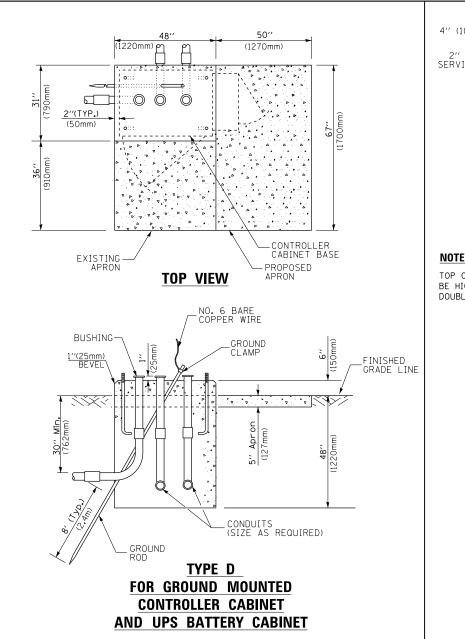- 2. BASED ON UNINTERRUPTIBLE POWER SUPPLY CABINET WITH BASE DIMENSIONS OF 16" x 25" (406mm x 635mm). ADJUST PLATFORM SIZE TO FIT CABINET BASE DIMENSIONS BEING SUPPLIED.
- 3. PLATFORM SIZE FOR CONTROLLER CABINET TYPE IV.
- 4. PLATFORM SIZE FOR CONTROLLER CABINET TYPE IV AND UNINTERRUPTIBLE POWER SUPPLY CABINET.
- 5. DRILLED HOLES THROUGH THE PLATFORM BASE TO MATCH THE CONTROLLER CABINET BOLT TEMPLATE. FASTEN THE CONTROLLER CABINET TO THE PLATFORM WITH CARRIAGE BOLTS, WASHERS AND NUTS.
- 6. FASTEN ALL SUPPORT WOOD FRAMING TO THE WOOD POSTS WITH 2 LAG SCREWS FOR EACH CONNECTION.
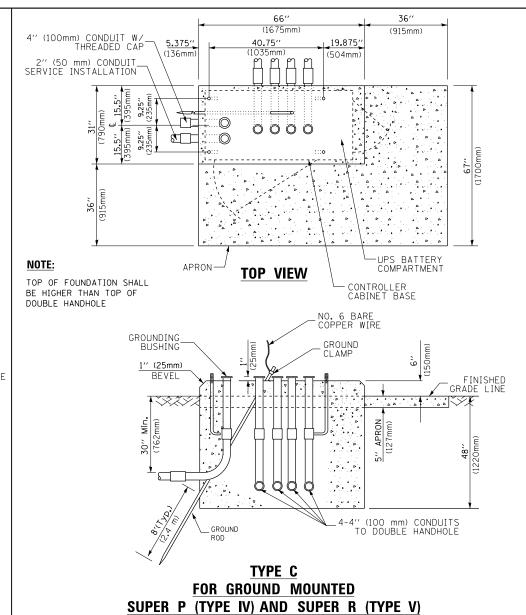
### **TEMPORARY SIGNAL CONTROLLER WOOD SUPPORT PLATFORM**

CABLE SLACK LENGTH	FEET	METER
HANDHOLE	6.5	2.0
DOUBLE HANDHOLE	13.0	4.0
SIGNAL POST	2.0	0.6
MAST ARM	2.0	0.6
CONTROLLER CABINET	1.5	0.5
FIBER OPTIC AT CABINET	13.0	4.0
ELECTRIC SERVICE AT (CABINET OR SERVICE LOCATION)	1.5	0.5
GROUND CABLE (SIGNAL POST, MAST ARM, CABINET)	1.5	0.5
GROUND CABLE (BETWEEN FRAME AND COVER)	5.0	1.6

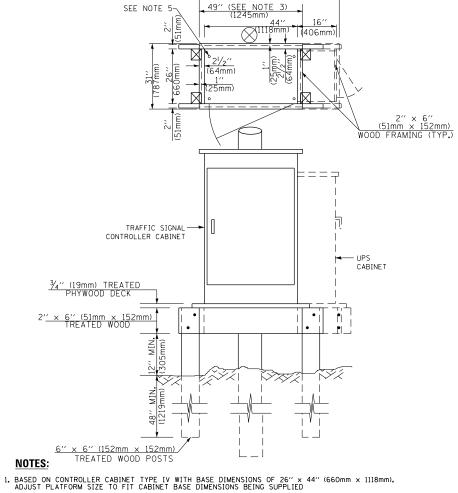**CABLE SLACK** 

VERTICAL CABLE LENGTH	FEET	METER
MAST ARM POLE ( MAST ARM MOUNTED SIGNAL HEAD)		
(L = MAST ARM LENGTH - DISTANCE TO SIGNAL HEAD FROM END OF ARM)	20.0+L	6.0+L
BRACKET MOUNTED (MAST ARM POLE OR SIGNAL POLE)	13.0	4.0
PEDESTRIAN PUSH BUTTON	6.0	2.0
SERVICE INSTALLATION POLE MOUNT TO SERVICE DROP	13.5	4.1
SERVICE INSTALLATION POLE MOUNT TO GROUND	13.5	4.1
SERVICE INSTALLATION GROUND MOUNT	6.0	2.0
FOUNDATION (SIGNAL POST, MAST ARM POLE, CONTROLLER CABINET, SERVICE-GROUND MOUNT)	3.0	1.0

VERTICAL	CABLE	LENGT
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FOUNDATION	DEPTH
TYPE A - Signal Post	4'-0" (1.2m)
TYPE C - CONTROLLER W/ UPS	4'-0" (1.2m)
TYPE D - CONTROLLER	4'-0'' (1.2m)
SERVICE INSTALLATION, GROUND MOUNT, TYPE A - SOUARE	4'-0'' (1.2m)

#### **DEPTH OF FOUNDATION**


Mast Arm Length	① Foundation Depth	Foundation Diameter	Spiral Diameter	Quantity of Rebars	Size of Rebars
Less than 30′ (9.1 m)	10'-0" (3.0 m)	30" (750mm)	24" (600mm)	8	6(19)
Greater than or equal to	13'-6" (4.1 m)	30" (750mm)	24" (600mm)	8	6(19)
30' (9.1 m) and less than 40' (12.2 m)	11'-0'' (3.4 m)	36" (900mm)	30" (750mm)	12	7(22)
Greater than or equal to 40' (12.2 m) and less than 50' (15.2 m)	13'-0'' (4.0 m)	36'' (900mm)	30" (750mm)	12	7(22)
Greater than or equal to 50' (15.2 m) and up to 55' (16.8 m)	15'-0'' (4.6 m)	36'' (900mm)	30'' (750mm)	12	7(22)
Greater than or equal to 56' (16.8 m) and less than 65' (19.8 m)	21'-0'' (6.4 m)	42'' (1060mm)	36'' (900mm)	16	8(25)
Greater than or equal to 65' (19.8 m) and up to 75' (22.9 m)	25'-0" (7.6 m)	42'' (1060mm)	36'' (900mm)	16	8(25)

#### NOTES:

- 1. These foundation depths are for sites which have cohesive soils (clayey silt, sandy clay, etc.) along the length of the shaft, with an average Unconfined Compressive Strength (Ou) > 1.0 tsf (100 kpa). This strength shall be verified by boring data prior to construction or with testing by the Engineer during foundation drilling. The Bureau of Bridges & structures should be contacted for a revised design if other conditions are encountered.
- 2. Combination mast arm assemblies under 55 feet (16.8 m) shall use 36" (900 mm) diameter foundations.
- 3. Combination mast arm assemblies under 56 feet (16.8 m) through 75 feet (22.9 m) shall use 42" (1060 mm) diameter foundations
- 4. For most arm assemblies with dual arms refer to state standard 878001..


### DEPTH OF MAST ARM FOUNDATIONS, TYPE E

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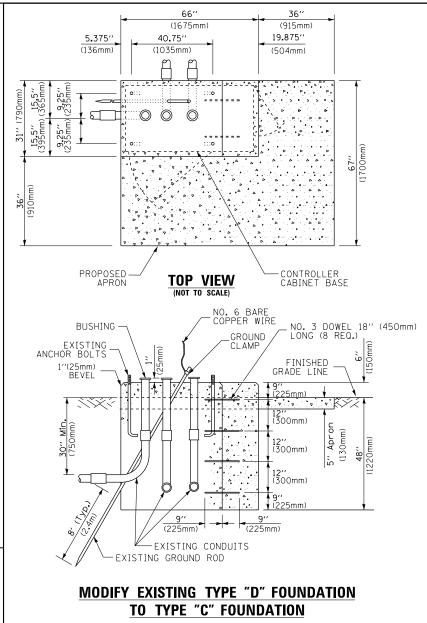
- 1. CONDUIT DEPTH SHALL BE A MINIMUM OF 30" (760mm) BELOW THE BOTTOM OF THE DRAINAGE DITCH OR ANY SLOPING GROUND
- 2. THE MINIMUM CONDUIT DEPTH APPLIES TO ALL CONDUIT PLACED UNDER ROADWAY PAVEMENT, MULTI-USE PATHS, SIDEWALKS AND SOIL SURFACES.
- 3. THE MINIMUM CONDUIT DEPTH APPLIES TO ALL HANDHOLES, HEAVY DUTY HANDHOLES AND DOUBLE HANDHOLES.
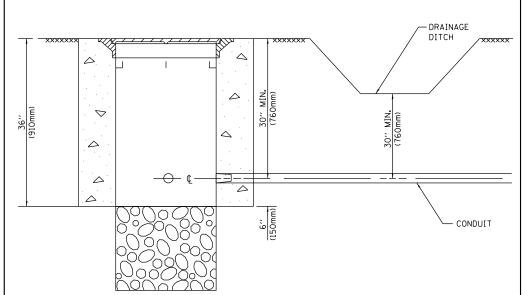
### HANDHOLE WITH MINIMUM CONDUIT DEPTH (NOT TO SCALE)



## EMERGENCY VEHICLE DETECTOR WITH CONFIRMATION BEACON MOUNTING DETAIL

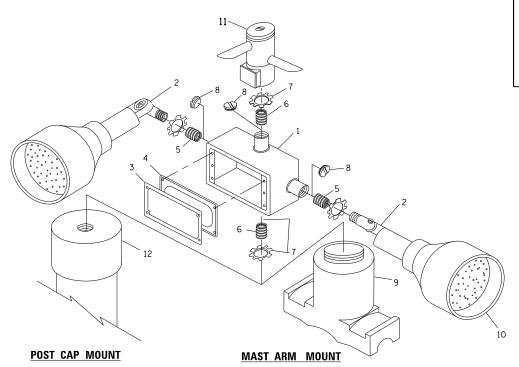- 1					
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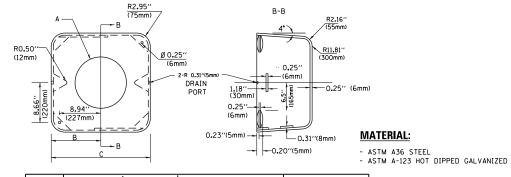
(NOT TO SCALE)

# ITEM NO. IDENTIFICATION 1 OUTLET BOX- GALV. 21 CU.IN. (0.000344 CU-M) 2 LAMP HOLDER AND COVER 3 OUTLET BOX COVER 4 RUBBER COVER GASKET 5 REDUCING BUSHING 6 ¾ (19 mm) CLOSE NIPPLE 7 ¾ (19 mm) LOCKNUT 8 ¾ ¼ (19 mm) HOLE PLUG 9 SADDLE BRACKET - GALV. 10 6 WATT PAR 38 LED FLOOD LAMP 11 DETECTOR UNIT 12 POST CAP [18 FT. (5.4 m) POST MIN.]

#### NOTES:

- ALL ELECTRICAL ITEMS, EXCEPT ITEMS *2 AND *11 SHALL BE ALUMINUM OR GALVANIZED
- 2. ITEM #1- OZ/GEDNEY FSX-1-50 OR EQUIVALENT
  ITEM #2- MULBERRY CON-O-SHADE LAMP SHIELD OR EQUIVALENT
  ITEM #9- "BAND-IT" SADDLE BRACKET OR EQUIVALENT
- 3. WHEN POST MOUNTING IS SPECIFIED, ITEM *9 SHALL NOT BE REQUIRED. THE DETECTION UNIT SHALL BE MOUNTED DIRECTLY ON TOP OF THE CAP BY DRILLING AND TAPPING A 3/4 "(19 mm) HOLE WITH PIPE THREADS. THE POST CAP SHALL EITHER BE SCREWED TO THE TOP OF THE POST OR A MINIMUM OF 3 TIGHTENING SCREWS SHALL BE REQUIRED ON EACH CAP.

STATE OF ILLINOIS
DEPARTMENT OF TRANSPORTATION





Α	В	С	HEIGHT	WEIGHT
VARIES	9.5''(241mm)	19''(483mm)	7" (178mm) - 12" (300mm)	53 lbs (24kg)
VARIES	10.75"(273mm)	21.5"(546mm)	7" (178mm) - 12" (300mm)	68 lbs (31 kg)
VARIES	13.0"(330mm)	26"(660mm)	7" (178mm) - 12" (300mm)	81 lbs (37 kg)
VARIES	18.5′′(470mm)	37''(940mm)	7" (178mm) - 12" (300mm)	126 lbs (57 kg)

#### **SHROUD**

#### NOTES:

- DIMENSION "A" IS EQUAL TO THE DIAMETER OF THE MAST ARM POLE AT THE TOP OF THE SHROUD.
  THE SHROUD SHALL BE TIGHT TO THE MAST ARM POLE.
- 2. THE SUPPLIER SHALL VERIFIED THE ABOVE DIMENSIONS BASED ON MAST ARM REQUIREMENTS.
- 3. THE HEIGHT OF THE SHROUD SHALL COVER THE ANCHOR BOLTS, NUTS AND MAST ARM POLE BASE.

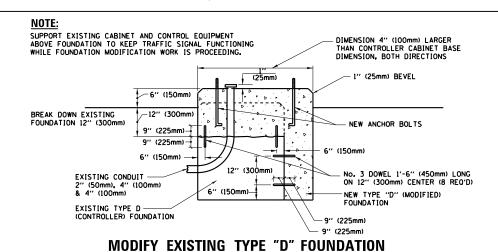

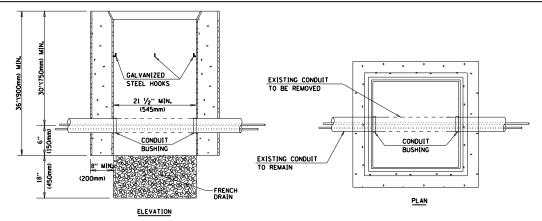


#### NOTES:

SCALE: NONE

- 1. HANDHOLE CONSTRUCTED PER STATE STANDARD 814001.
- 2. REMOVAL OF THE EXISTING CONDUIT FROM THE HANDHOLE AND THE INSTALLATION OF THE CONDUIT BUSHINGS SHALL BE INCLUDED WITH THE COST OF THE HANDHOLE.

#### HANDHOLE TO INTERCEPT EXISTING CONDUIT

DISTRICT ONE		SECTION	COUNTY	TOTAL SHEETS	SHEET NO.
STANDARD TRAFFIC SIGNAL DESIGN DETAILS	3512	87-Y-N	соок	102	71
		TS-05	CONTRACT	NO. 6	OJ39
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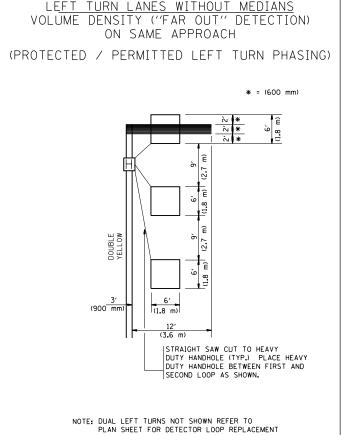

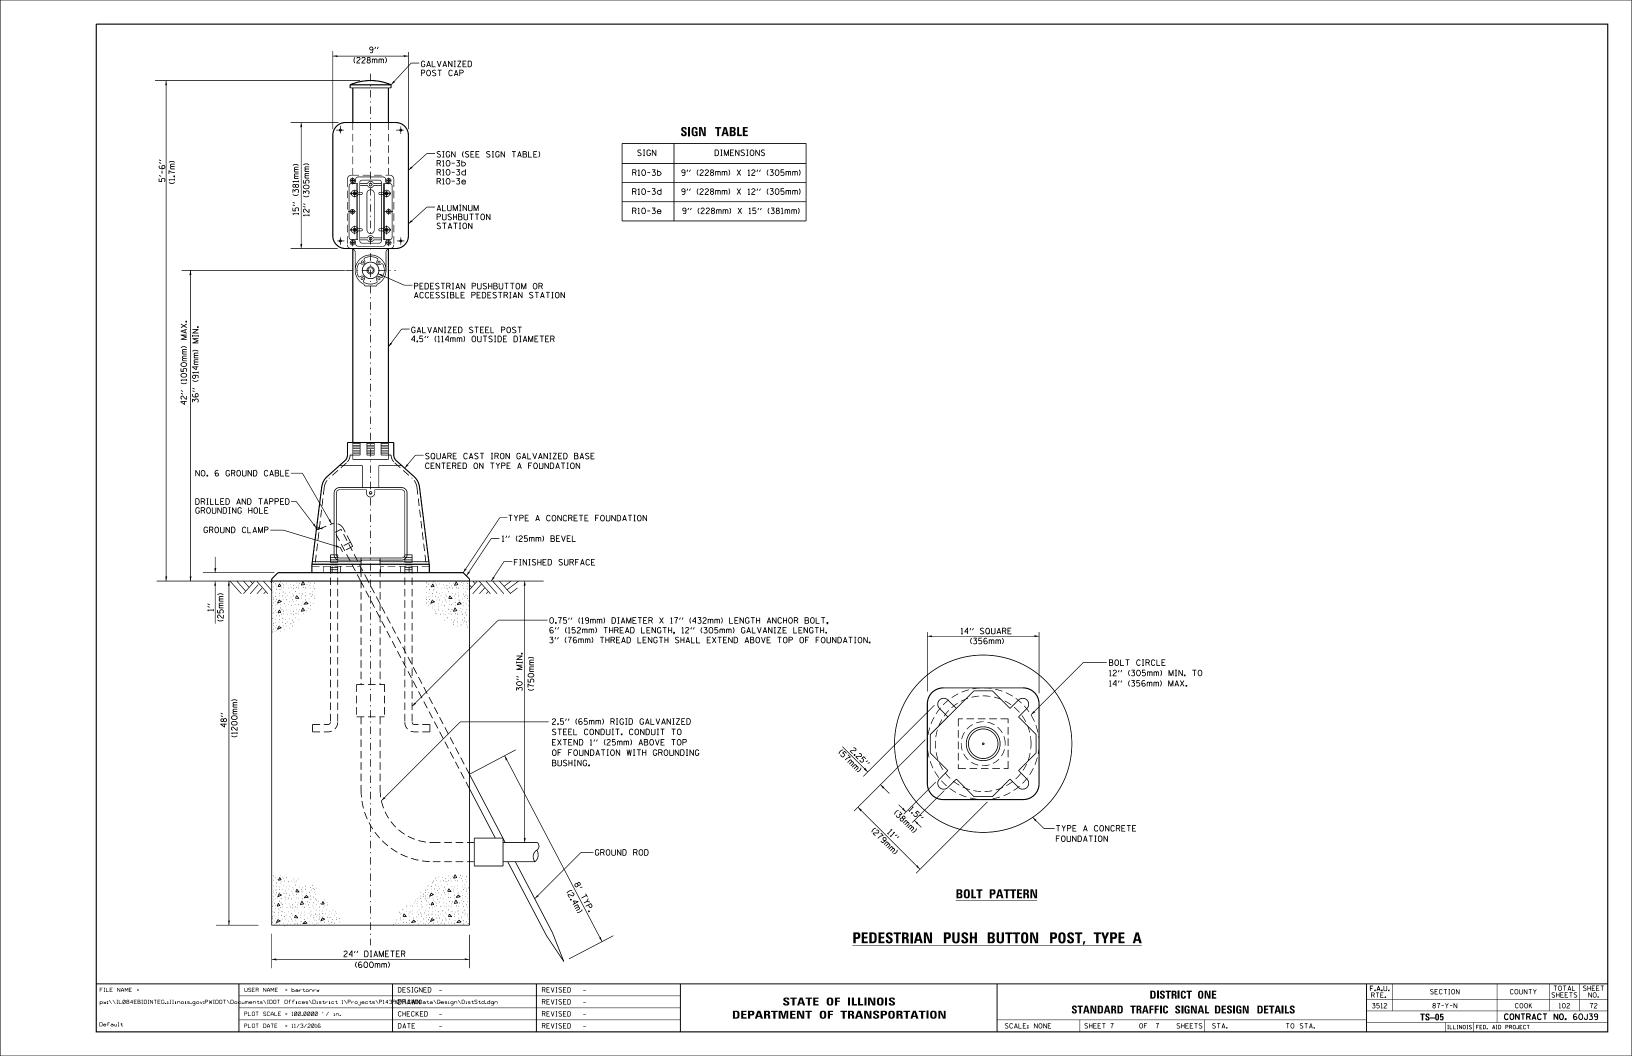
## LOOPS NEXT TO SHOULDERS PROVIDE A PAVEMENT REPLACEMENT NOTE WHICH SHOULD EQUAL 3' (900 mm) X WIDTH OF PAVED SHOULDER. PAVED OR NON-PAVED SHOULDER Ê (1.5 m) (1.8 m) (1.5 m) 1" (25 mm) UNI DUCT-TRENCHED TO E/P •• (3.0 m) (3.0 m) * = (600 mm)* * UNIT DUCT IS TO BE SHOWN ON PLAN SHEETS BUT SHALL NOT BE INCLUDED IN THE PAY ITEMS. ARTERIAL-VOLUME DENSITY ("FAR OUT" DETECTION)

## 

BUT SHALL NOT BE INCLUDED IN THE PAY ITEMS.


NOTE: DUAL LEFT TURNS NOT SHOWN REFER TO



PLAN SHEET FOR DETECTOR LOOP REPLACEMENT

ARTERIAL-VOLUME DENSITY ("FAR OUT" DETECTION)

CROSS STREET-NON VOLUME DENSITY ("UPTIGHT" PRESENCE DETECTION)

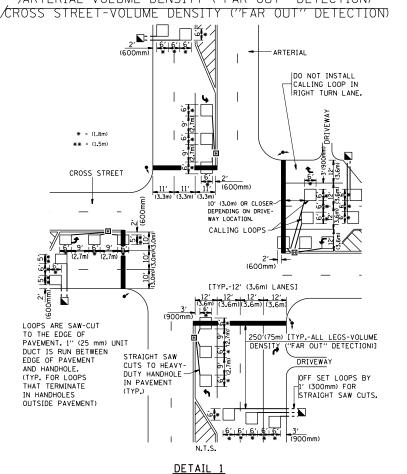

OFFSET LOOPS BY l' (300mm) FOR STRAIGHT SAW CUTS - ARTERIAL THIS DIMENSION MAY BE ADJUSTED FOR DRIVEWAY OR OTHER OBSTRUCTIONS. WHEN ADJUSTMENT IS NORMALLY BE MOVED CLOSER TO THE INTERSECTION. 3'(900mm) UNIT DUCT -CROSS STREET J3'(900mm (3.3m) **3**-6 \( \( \) 6: 9' 6: 2 \( \) -10'(3-0m) PRFFFRRFD-| 6 | 9 | 6 | 9 | 6 | (2.7m) (2.7m) + - THESE DIMENSIONS DRIVEWAY [6' (1.8m) MINIMUM. 25' (7.6 m) MAXIMUM] △ - THESE DIMENSIONS IF "FAR OUT" LOOPS 10' (3.0m) LANE WIDTHS ARE LOCATED IN TAPER OF A RIGHT TURN LANE, DIMENSION THIS LOOP TO COVER TAPER AREA. DO NOT COVER THE LEFT TURN LANE OR LEFT TURN LANE TAPER. DETAIL 2 N.T.S.

SCALE: NONE

#### NOTES

#### VEHICLES LOOP DETECTORS

- * ALL LEAD IN CABLE SHALL BE TWO CONDUCTOR NO. 14 TWISTED, SHIFLDED
- * EACH DETECTOR LOOP SHALL HAVE ITS OWN SAW CUT FROM THE LOOP TO THE EDGE OF PAVEMENT OR TO A HANDHOLE IN THE PAVEMENT.
- * EACH DETECTOR LOOP SHALL HAVE ITS OWN ONE INCH (25 mm) UNIT DUCT BETWEEN THE EDGE OF PAVEMENT AND THE FIRST HANDHOLE OR JUNCTION BOX. EACH UNIT DUCT RUN SHALL BE SHOWN ON THE PLANS BY THE DESIGNER, BUT SHALL NOT BE PAID FOR SEPARATLY. THIS ITEM IS INCIDENTAL TO THE PAY ITEM FOR DETECTOR LOOPS.
- * ONE DIMENSION OF <u>ALL</u> DETECTOR LOOPS SHALL BE SIX FEET (1.8 m)
- * EACH LANE OF NON-LOCKING, PRESENCE DETECTION AND EACH LANE OF A DOUBLE LEFT TURN LANE REQUIRES A SEPARATE INDUCTIVE LOOP DETECTOR AND LEAD IN CABLE.
- * WHEN NON-LOCKING, PRESENCE DETECTION IS USED, MORE THAN ONE LOOP PER LANE IS REQUIRED BEHIND THE STOP BAR (i.e. 1-1/2, 1-3/4, 2).
- * WHEN SYSTEM LOOPS ARE REQUIRED ON AN APPROACH OF AN INTERSECTION, THE LOOPS USED FOR VOLUME DENSITY AND INTERSECTION TIMING SHALL ALSO BE USED AS SYSTEM DETECTORS. EACH ONE OF THESE TYPE OF LOOPS REQUIRES A SEPARATE TWO CONDUCTOR NO. 14 TWISTED SHIELDED CABLE AND A SEPARATE INDUCTIVE LOOP DETECTOR WHEN NEW CONTROLLERS ARE UTILIZED. THE DESIGNER SHALL LABEL THESE TYPES OF LOOPS AS "INTERSECTION AND SAMPLING (SYSTEM) DETECTORS" ON THE SIGNAL LAYOUT, THE INTERCONNECT PLAN AND THE SYSTEM CABLE PLAN. WHEN AN EXISTING CONTROLLER IS UTILIZED FOR THIS TYPE OF DETECTION, THE PAY ITEM "INDUCTIVE LOOP DETECTOR WITH SYSTEM OUTPUT" SHOULD BE USED.

#### PLACEMENT OF DETECTORS

THE FOLLOWING FIGURES REPRESENT THE MOST COMMON DETECTOR LOOP LOCATIONS AND SIZES. ADJUSTMENTS WILL BE NECESSARY FOR SPECIFIC GEOMETRIC CONSIDERATIONS.

LOCATIONS AND DEMENSIONS OF DETECTOR LOOPS ARE REQUIRED ON ALL SIGNAL LAYOUT PLAN SHEETS.

"FAR OUT" DETECTION REFERS TO LOCKING, PRESENCE TYPE DETECTION LOCATED IN THRU LANES, RIGHT TURN LANES, AND RIGHT TURN LANE TAPER AREAS (IF APPLICABLE), USUALLY 250' (75 m) IN ADVANCE OF STOP BARS. "UPTIGHT" DETECTION REFERS TO NON-LOCKING PRESENCE TYPE DETECTION LOCATED IN ALL LANES AND 10'-15' (3.0 m-4.5 m) BEHIND THE CROSSING STREET'S EDGE OF PAVEMENT EXTENDED.

#### JOTE.

ALL DETAILS AND NOTES SHOWN ARE FROM THE I.D.O.T. DISTRICT 1 TRAFFIC SIGNAL DESIGN GUIDELINES DATED JANUARY 1995

THIS DRAWING HAS BEEN PREPARED TO ASSIST THE RESIDENT ENGINEER FOR ALL ROADWAY RESURFACING OR S.M.A.R.T. PROJECTS WHERE THE DIMENSIONS ARE NOT SHOWN ON THE PLANS AND THE FINAL LOCATIONS FOR CROSSWALKS OR STOP BARS ARE NOT DETERMINED.


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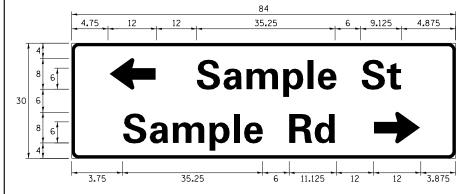
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STATE OF ILLINOIS
DEPARTMENT OF TRANSPORTATION

#### SIGN PANEL – TYPE 1 OR TYPE 2

# 3.75 35.25 6 11.125 3.875 Sample Rd



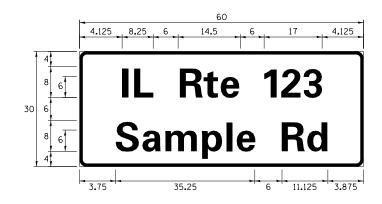

DESIGN	_	SIGN PANEL		QTY.
SERIES	(SQ FT)	TYPE	TYPE	REQUIRED
D OR C	-	1 OR 2	ZZ	-

ALL DIMENSIONS ARE IN INCHES EXCEPT NOTED OTHERWISE

## COMMON STREET NAME ABBREVIATIONS AND WIDTHS

NAME	ABBREVATION	WIDTH (INCH)			
NAME	ADDREVATION	SERIES "C"	SERIES "D"		
AVENUE	Ave	15.000	18.250		
BOULEVARD	Blvd	17.125	20.000		
CIRCLE	Cir	11.125	13.000		
COURT	C†	8.250	9.625		
DRIVE	Dr	8.625	10.125		
HIGHWAY	Hwy	18.375	22.000		
ILLINOIS	ΙL	7.000	8.250		
LANE	Ln	9.125	10.750		
PARKWAY	Pkwy	23.375	27.375		
PLACE	PΙ	7.125	7. 750		
ROAD	Rd	9.625	11.125		
ROUTE	Rte	12.625	14.500		
STREET	S†	8.000	9.125		
TERRACE	Ter	12.625	14.625		
TRAIL	Tr	7. 750	9.125		
UNITED STATES	US	10.375	12.250		

#### **GENERAL NOTES**

- 1. WHERE MAST ARM MOUNTED STREET NAME SIGNS ARE SPECIFIED, THE MAST ARM ASSEMBLY AND POLES SHALL BE DESIGNED TO SUPPORT THE LOADINGS CALLED FOR ON STANDARDS 877001, 877002, 877006, 877011 AND 877012, AS APPLICABLE, PLUS TWO (2) SIGN PANELS 2'-6" x 8'-0" MOUNTED AS SHOWN. THE DESIGN SHALL BE IN ACCORDANCE WITH THE REQUIREMENTS OF THE CURRENT "STANDARD SPECIFICATIONS FOR STRUCTURAL SUPPORTS FOR HIGHWAY SIGNS, LUMINAIRES, AND TRAFFIC SIGNALS" AS PUBLISHED BY THE AMERICAN ASSOCIATION OF STATE HIGHWAY AND TRANSPORTATION OFFICIALS FOR 80 M.P.H. WIND VELOCITY.
- 2. ALL SIGNS SHALL CONSIST OF A WHITE LEGEND AND BORDER (TYPE ZZ SHEETING) ON A GREEN BACKGROUND (TYPE ZZ SHEETING)
- 3. THE SIGN LENGTH SHALL BE IN 6-INCH INCREMENTS, BUT THE OVERALL LENGTH SHALL NOT EXCEED 8'-O". ALL BORDERS SHALL BE ¾" WIDE. CORNER RADIUS SHALL BE 1-7/8". THE SPACING BETWEEN THE WORDS SHOULD BE 6", IF POSSIBLE, BUT MAY BE REDUCED TO 5" WHEN SPACING IS CRITICAL. A MINIMUM OF 2-1/2" SHALL BE INCLUDED BETWEEN THE WORD AND THE RIGHT AND LEFT EDGES OF THE SIGN.
- 4. A PREFERRED METHOD FOR THE SIGN DESIGN IS TO USE SERIES "D" LETTER ON A ONE-LINE SIGN 18" IN HEIGHT AND A MAXIMUM OF 8'-O" IN WIDTH, IF SERIES "D" DOES NOT FIT ON A 8"-O" SIGN, THEN SERIES "C" SHOULD BE TRIED. IF SERIES "C" DOES NOT FIT ON A 8'-O" SIGN, A 30" HIGH TWO-LINE SIGN CAN BE USED. THE CROSSROAD DESIGNATION AS TO STREET, AVENUE, ETC. SHOULD BE SPELLED OUT ON THE SECOND LINE, IF THE ABBREVIATION CANNOT FIT ON THE FIRST LINE.
- 5. LED ILLUMINATED STREET NAME SIGNS CAN BE USED IN PLACE OF REGULAR SIGN PANELS BUT ANY SPECIAL WORDING AND SYMBOLOGY MUST BE APPROVED BY THE DEPARTMENT. GENERAL DESIGN REQUIREMENT AS LISTED ABOVE (COLOR, FONT, SIZE, ETC.) MUST BE FOLLOWED.
- 6. SIGNFIX ALUMINUM CHANNEL FRAMING SYSTEM SHALL BE USED FOR ALL SIGNS ATTACHED TO SIGNAL POLES AND POSTS.

LOCAL SUPPLIERS: PARTS LISTING:


- J.O. HERBERT COMPANY, INC SIGN CHANNEL PART **HPN053 (MED. CHANNEL)
MIDLOTHIAN, VA SIGN SCREWS 1/4" × 14 × 1" H.W.H. **3
SELF TAPPING WITH NEOPRENE WASHER

- WESTERN REMAC, INC. BRACKETS PART *HPN034 (UNIVERSAL)
WOODRIDGE, IL CHANNEL CLAMPS WITH STAINLESS STEEL STRAPPING


OTHER BRANDS OF MOUNTING HARDWARE ARE ACCEPTABLE, BASED UPON THE DEPARTMENT'S APPROVAL AND COMPATIBILITY WITH THE CHANNEL/BRACKET OF THE ABOVE PRODUCT.

#### **MOUNTING LOCATION**

ARM OR POLE MOUNTED

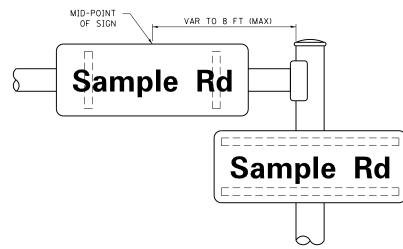

#### **SUPPORTING CHANNELS**

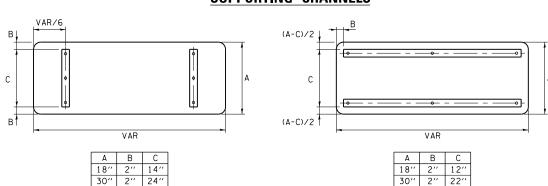

SCALE:

#### STANDARD ALPHABETS SPACING CHART


(8") UPPER CASE AND (6") LOWER CASE

	FHWA SEF	RIES "C"		FHWA SERIES "D"				
	LEFT		RIGHT		LEFT		RIGHT	
CHARACTER	SPACING (INCH)	(INCH)	SPACING (INCH)	CHARACTER	SPACING (INCH)	WIDTH (INCH)	SPACING (INCH)	
Α	0.240	5.122	0.240	Α	0.240	6.804	0.240	
В	0.880	4.482	0.480	В	0.960	5.446	0.400	
С	0.720	4.482	0.720	С	0.800	5.446	0.800	
D	0.880	4.482	0.720	D	0.960	5.446	0.800	
E	0.880	4.082	0.480	E	0.960	4.962	0.400	
F	0.880	4.082	0.240	F	0.960	4.962 5.446	0.240	
G H	0.720 0.880	4.482 4.482	0.720 0.880	G H	0.800 0.960	5.446	0.800	
I	0.880	1.120	0.880	I	0.960	1. 280	0.960	
J	0.240	4.082	0.880	J	0.240	5.122	0.960	
K	0.880	4.482	0.480	K	0.960	5.604	0.400	
L	0.880	4.082	0.240	L	0.960	4.962	0.240	
М	0.880	5.284	0.880	М	0.960	6.244	0.960	
N	0.880	4.482	0.880	N	0.960	5.446	0.960	
0	0.720	4.722	0.720	0	0.800	5.684	0.800	
Р	0.880	4.482	0.720	Р	0.960	5.446	0.240	
0	0.720	4.722	0.720	0	0.800	5.684	0.800	
R	0.880	4.482	0.480	R	0.960	5.446	0.400	
S T	0.480	4.482	0.480	S T	0.400	5.446	0.400	
U	0.240	4.082 4.482	0.240	U	0.240 0.960	4.962 5.446	0.240	
V	0.880	4. 962	0.880	V	0.360	6.084	0.360	
w	0.240	6.084	0.240	w	0.240	7. 124	0.240	
X	0.240	4. 722	0.240	X	0.400	5.446	0.400	
Υ	0.240	5.122	0.240	Y	0.240	6.884	0.240	
Z	0.480	4.482	0.480	Z	0.400	5.446	0.400	
а	0.320	3.842	0.640	a	0.400	4.562	0.720	
b	0.720	4.082	0.480	b	0.800	4.802	0.480	
С	0.480	4.002	0.240	С	0.480	4.722	0.240	
d	0.480	4.082	0.720	d	0.480	4.802	0.800	
е	0.480	4.082	0.320	е	0.480	4.722	0.320	
f	0.320	2.480	0.160	f	0.320	2.882	0.160	
g	0.480	4.082	0.720	g	0.480	4.802	0.800	
h i	0.720	4.082	0.640	h i	0.800	4.722	0.720	
Ī	0.720	1.120 2.320	0.720 0.720	i	0.800	1.280 2.642	0.800	
k	0.720	4. 322	0.160	k	0.800	5. 122	0.160	
ı	0.720	1.120	0.720	1	0.800	1.280	0.800	
m	0.720	6.724	0.640	m	0.800	7. 926	0.720	
n	0.720	4.082	0.640	n	0.800	4.722	0.720	
0	0.480	4.082	0.480	0	0.480	4.882	0.480	
Р	0.720	4.082	0.480	Р	0.800	4.802	0.480	
q	0.480	4.082	0.720	q	0.480	4.802	0.800	
r	0.720	2.642	0.160	r	0.800	3.042	0.160	
S	0.320	3. 362	0.240	S	0.320	3. 762	0.240	
+	0.080	2.882	0.080	+	0.080	3. 202	0.080	
u	0.640	4.082	0.720	u	0.720	4.722	0.800	
V	0.160 0.160	4. 722 7. 524	0.160	V W	0.160 0.160	5.684 9.046	0.160	
×	0.000	5. 202	0.160	×	0.160	6. 244	0.160	
У	0.160	4.962	0.160	у	0.160	6.004	0.160	
Z	0.240	3. 362	0.240	Z	0.240	4.002	0.240	
1	0.720	1.680	0.880	1	0.800	2.000	0.960	
2	0.480	4.482	0.480	2	0.800	5.446	0.800	
3	0.480	4.482	0.480	3	1.440	5.446	0.800	
4	0.240	4.962	0.720	4	0.160	6.004	0.960	
5	0.480	4.482	0.480	5	0.800	5.446	0.800	
6	0.720	4.482	0.720	6	0.800	5.446	0.800	
7	0.240	4.482	0.720	7	0.560	5.446	0.560	
8	0.480	4.482	0.480	8	0.800	5.446	0.800	
9	0.480	4.482	0.480	9	0.800	5.446	0.800	
0 -	0.720 0.240	4. 722 2. 802	0.720	0 -	0.800 0.240	5.684 2.802	0.800	
-	0.240	4.002	0.240		0.240	2.002	0.240	

#### 

STATE (	OF ILLINOIS
DEPARTMENT OF	F TRANSPORTATION

DISTRICT ONE					F.A.U. RTE.	SECTION	COUNTY	TOTAL SHEETS	SHEE'	
MAST ARM MOUNTED STREET NAME SIGNS				AME SIGNS	3512	87-Y-N	соок	102	74	
	IAGI AIIW	IVIOO	NILD 311	ILLI IV			TS-02	CONTRACT	NO. 6	SOJ39
	SHEET	OF	SHEETS	STA.	TO STA.		ILLINOIS FED.	ID PROJECT		

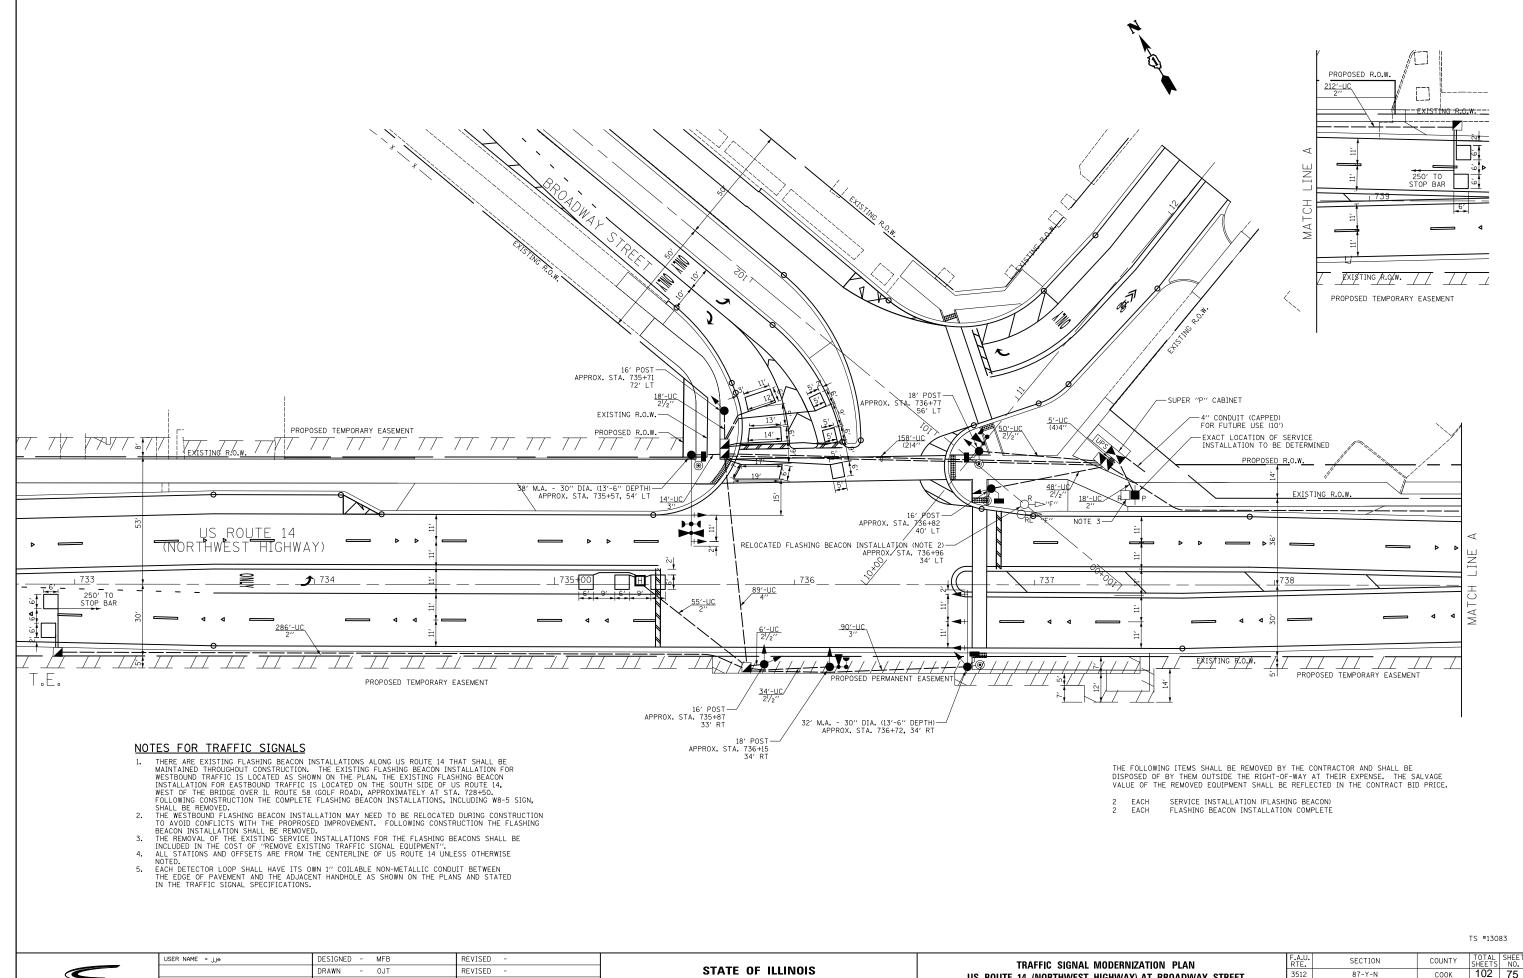

CIVILTECH

LOT SCALE = 20.0000 '/ in. CHECKED JJE REVISED PLOT DATE = 10/26/2016 DATE - 10/26/2016 REVISED


**DEPARTMENT OF TRANSPORTATION** 


US ROUTE 14 (NORTHWEST HIGHWAY) AT BROADWAY STREET SCALE 1" = 20' SHEET NO. 1 OF 1 SHEETS STA.

соок 102 75 CONTRACT NO. 60J39

#### PROPOSED CONTROLLER SEQUENCE

#### PROPOSED EMERGENCY VEHICLE PREEMPTION SEQUENCE

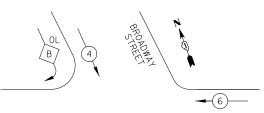

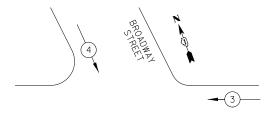




US ROUTE 14 (NORTHWEST HWY)

<u>___3</u>__ US ROUTE 14 (NORTHWEST HWY)

#### LEGEND

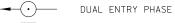





PEDESTRIAN PHASE

NUMBER REFERS TO ASSOCIATED

#### PHASE DESIGNATION DIAGRAM

#### RIGHT TURN OVERLAP PHASE DESIGNATION

OVERLAP P		ERMISSIVE PHASE		PROTECTED PHASE
В	=	4	+	5

DES PLAINES TOWER ACCOUNT NO. 0113100020

	DES	PLAINES TO	WER ACCO	UNI NO.	0113100020			
I.D.O.T. TRAFFIC SIGNAL INSTALLATION ELECTRICAL SERVICE REQUIREMENTS								
TYPE		NO. LAMPS	WAT	TAGE LED	% OPERATION	WATTAGE		
SIGNAL	(RED)	12		17	0.50	102		
	(YELLOW)	12		25	0.25	75		
	(GREEN)	12		15	0.25	45		
ARROW		8		12	0.10	10		
PED. SIG	SNAL	4		25	1.00	100		
CONTRO	LLER	1		100	1.00	100		
FLASHER	₹				0.50			
					TOTAL =	432		

ENERGY COSTS TO: ILLINOIS DEPARTMENT OF TRANSPORTATION
201 WEST CENTER COURT
SCHAUMBURG, IL 60196-1096

ENERGY SUPPLY: CONTACT: ELEANOR SARALLO PHONE: 630-424-5124 COMPANY: COM ED

CABLE PLAN, PHASE DESIGNATION DIAGRAM, AND EMERGENCY VEHICLE PREEMPTION SEQUENCE US ROUTE 14 (NORTHWEST HIGHWAY) AT BROADWAY STREET SHEET NO. 1 OF 1 SHEETS STA.

 
 COUNTY
 TOTAL SHEETS NO.

 COOK
 102
 76

 CONTRACT
 NO.
 60J39
 F.A.U. RTE. 3512 SECTION 87-Y-N

TS #13083

THE END OF THE TRACER CABLE SHALL BE CONTINUOUS AND EXTEND INTO THE CONTROLLER CABINET.

-NUMBER OF CABLES

AS PER PLAN

32

С

**↑ ↑ ○** ≺ **□** 

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↑ ↑ o < ¬ (7)

CABLE PLAN

Я

NOT TO SCALE

## CIVILTECH

USER NAME = JJe DESIGNED - MFB REVISED REVISED DRAWN - OJT PLOT SCALE = 20.0000 '/ in. CHECKED - JJE REVISED PLOT DATE = 10/26/2016 DATE - 10/26/2016 REVISED

STATE OF ILLINOIS **DEPARTMENT OF TRANSPORTATION** 

NO. 20-

US ROUTE 14 (NORTHWEST HIGHWAY)

9


8 x > 0

NO. 6-

#### SCHEDULE OF QUANTITIES

PAY ITEM	UNIT	QNTY.
SIGN PANEL - TYPE 1	SQ FT	18
SERVICE INSTALLATION - POLE MOUNTED	EACH	1
UNDERGROUND CONDUIT, GALVANIZED STEEL, 2" DIA.	FOOT	571
UNDERGROUND CONDUIT, GALVANIZED STEEL, 2 1/2" DIA.	FOOT	156
UNDERGROUND CONDUIT, GALVANIZED STEEL, 3" DIA.	FOOT	104
UNDERGROUND CONDUIT, GALVANIZED STEEL, 4" DIA.	FOOT	435
HANDHOLE	EACH	3
HEAVY-DUTY HANDHOLE	EACH	1
DOUBLE HANDHOLE	EACH	2
MAINTENANCE OF EXISTING FLASING BEACON INSTALLATION	EACH	2
ELECTRIC CABLE IN CONDUIT, SIGNAL NO. 14 2C	FOOT	774
ELECTRIC CABLE IN CONDUIT, SIGNAL NO. 14 3C	FOOT	1510
ELECTRIC CABLE IN CONDUIT, SIGNAL NO. 14 5C	FOOT	2503
ELECTRIC CABLE IN CONDUIT, SIGNAL NO. 14 7C	FOOT	1065
ELECTRIC CABLE IN CONDUIT, LEAD-IN, NO. 14 1 PAIR	FOOT	1560
ELECTRIC CABLE IN CONDUIT, SERVICE, NO. 6 2 C	FOOT	38
ELECTRIC CABLE IN CONDUIT, EQUIPMENT GROUNDING CONDUCTOR, NO. 6 1C	FOOT	855
TRAFFIC SIGNAL POST, GALVANIZED STEEL 16 FT.	EACH	3
TRAFFIC SIGNAL POST, GALVANIZED STEEL 18 FT.	EACH	2
STEEL MAST ARM ASSEMBLY AND POLE 32 FT.	EACH	1
STEEL MAST ARM ASSEMBLY AND POLE 38 FT.	EACH	1
CONCRETE FOUNDATION, TYPE A	FOOT	20
CONCRETE FOUNDATION, TYPE C	FOOT	4
CONCRETE FOUNDATION, TYPE E 30-INCH DIAMETER	FOOT	27
SIGNAL HEAD, LED, 1-FACE, 3-SECTION, MAST-ARM MOUNTED	EACH	4
SIGNAL HEAD, LED, 1-FACE, 3-SECTION, BRACKET MOUNTED	EACH	4
SIGNAL HEAD, LED, 1-FACE, 5-SECTION, BRACKET MOUNTED	EACH	3
SIGNAL HEAD, LED, 1-FACE, 5-SECTION, MAST-ARM MOUNTED	EACH	1
PEDESTRIAN SIGNAL HEAD, LED, 1-FACE, BRACKET MOUNTED WITH COUNTDOWN TIMER	EACH	4
TRAFFIC SIGNAL BACKPLATE, LOUVERED, FORMED PLASTIC	EACH	5
INDUCTIVE LOOP DETECTOR	EACH	5
DETECTOR LOOP, TYPE I	FOOT	533
LIGHT DETECTOR	EACH	3
LIGHT DETECTOR AMPLIFIER	EACH	1
PEDESTRIAN PUSH-BUTTON	EACH	4
RELOCATE EXISTING FLASHING BEACON	EACH	1
REMOVE EXISTING TRAFFIC SIGNAL EQUIPMENT	EACH	1
REMOVE EXISTING FLASHING BEACON INSTALLATION COMPLETE	EACH	2
EMERGENCY VEHICLE PRIORITY SYSTEM LINE SENSOR CABLE, NO. 20 3/C	FOOT	708
FULL-ACTUATED CONTROLLER AND TYPE SUPER P CABINET	EACH	1
UNINTERRUPTABLE POWER SUPPLY, SPECIAL	EACH	1
* 100% COST TO THE CITY OF DES PLAINES		

^{* 100%} COST TO THE CITY OF DES PLAINES

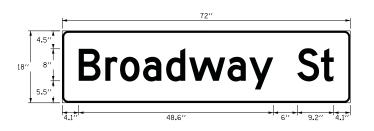

DESIGN	AREA	SIGN PANEL	SHEETING	QTY.
SERIES	(SQ FT)	TYPE	TYPE	REQUIRED
D	9.00	TYPE 1	ZZ	2



USER NAME = JJe	DESIGNED	-	MFB	REVISED	-
	DRAWN	-	OJT	REVISED	-
PLOT SCALE = 20.0000 '/ in.	CHECKED	-	JJE	REVISED	-
PLOT DATE = 10/26/2016	DATE	-	10/26/2016	REVISED	-

			MAST		-					IAME SIGNS	F.A RT
	US	ROU	ΓE 14		_			ULE OF C HIGHWA		BROADWAY STREET	351
SCALE	NONE		SHEET	NO.	1	0F	1	SHEETS	STA.	TO STA.	

SECTION 87-Y-N

#### **GENERAL NOTES:**

- 1. THIS PROJECT INCLUDES THE INSTALLATION OF A NEW LIGHTING SYSTEM AT THE INTERSECTION OF U.S. ROUTE 14 (NORTHWEST HIGHWAY) AND BROADWAY STREET. THE PROPOSED LIGHTING SHALL BE OWNED AND MAINTAINED BY THE CITY OF DES PLAINES.
- 2. THE ONLY TWO EXISTING STREET LIGHTING UNITS LOCATED AT THE INTERSECTION OF US ROUTE 14 AND BROADWAY STREET ARE MOUNTED ON COMED UTILITY WOODEN POLES AND SHALL BE REMOVED AND SALVAGED AFTER THE PROPOSED LIGHTING IS INSTALLED AND OPERATIONAL. THE CONTRACTOR SHALL CONTACT THE LOCAL COMED OFFICE AND THE CITY OF DES PLAINES TO COORDINATE ALL ELECTRIC SERVICE WORK, INCLUDING REMOVAL OF EXISTING LIGHTING UNITS.
- 3. THE QUANTITIES OF RACEWAY WHERE INDICATED IN THESE PLANS ARE APPROXIMATIONS ONLY. THE CONTRACTOR SHALL FIELD VERIFY ALL LENGTHS AND SHALL INSTALL RACEWAYS IN COMPLETE COMPLIANCE WITH THE SPECIFIED REQUIREMENTS.
- 4. THE CONTRACTOR SHALL NOTIFY J.U.L.I.E. TO LOCATE AND MARK/STAKE ALL UNDERGROUND UTILITIES.
- 5. THE CONTRACTOR SHALL VERIFY LOCATIONS OF UNDERGROUND/OVERHEAD UTILITIES PRIOR TO INSTALLATION OF LIGHT POLES AND CONDUITS. IF THERE IS A CONFLICT WITH THE LIGHT POLES/CONDUITS AS SHOWN ON PLANS THE CONTRACTOR SHALL SUGGEST ALTERNATIVE LOCATIONS AND COORDINATE WITH THE ENGINEER PRIOR TO PERFORMING
- 6. TRENCHES FOR LIGHTING RACEWAYS SHALL HAVE A MINIMUM DEPTH OF 30".
- 7. LIGHTING SYSTEM INSTALLATION SHALL CONFORM TO THE LATEST IDOT STANDARDS, NEC
- 8. ALL ELECTRICAL EQUIPMENT AND PRODUCTS SHALL BE U/L LISTED AND LABELED.
- 9. THE CONTRACTOR SHALL TAKE CARE WHEN INSTALLING UNIT DUCTS TO AVOID CONFLICTS WITH EXISTING UNDERGROUND UTILITIES AND TREES. THE CONTRACTOR SHALL BE RESPONSIBLE FOR ANY DAMAGE AS DETERMINED BY THE ENGINEER.
- 10. THE CONTRACTOR SHALL TAKE CARE WHEN INSTALLING LIGHT POLE FOUNDATIONS TO AVOID CONFLICTS WITH UNDERGROUND UTILITIES. WHEN CONFLICTS ARE ENCOUNTERED, THE CONTRACTOR SHALL REQUEST TO RELOCATE THE FOUNDATION. THE NEW LOCATION SHALL BE APPROVED BY THE ENGINEER PRIOR TO INSTALLATION.

#### **BILL OF MATERIALS**

DESCRIPTION	UNIT	QUANTITY
ELECTRIC SERVICE INSTALLATION	EACH	1
ELECTRIC UTILITY SERVICE CONNECTION	L SUM	1
UNDERGROUND CONDUIT, GALVANIZED STEEL, 2 1/2" DIA.	FOOT	50
UNDERGROUND CONDUIT, GALVANIZED STEEL, 4" DIA.	FOOT	304
UNIT DUCT, 600V, 3-1C NO. 4, 1/C NO.6 GROUND, (XLP-TYPE USE), 1 1/4" DIA. POLYETHYLENE	FOOT	1050
ELECTRIC CABLE IN CONDUIT, 600V (XLP-TYPE USE) 1/C NO. 1/0	FOOT	150
LIGHTING CONTROLLER, PEDESTAL MOUNTED, 240 VOLT, 100AMP	EACH	1
LIGHT POLE, ALUMINUM, 47.5 FT.M.H., 8 FT. DAVIT ARM	EACH	7
LIGHT POLE FOUNDATION, METAL, 15" BOLT CIRCLE, 10" X 8'	EACH	7
BREAKAWAY DEVICE, TRANSFORMER BASE, 15 INCH BOLT CIRCLE	EACH	7
LUMINAIRE, LED, HORIZONTAL MOUNT, 285 WATT	EACH	7
LUMINAIRE SAFETY CABLE ASSEMBLY	EACH	7

#### **LEGEND**

E—0—E	EXISTING LIGHTING UNIT TO REMAIN
<b>~</b> □	PROPOSED LIGHTING UNIT: 47.5 FT. MH, 8 FT. DAVIT ARM, 285W, 240V LED LUMINAIRE WITH BREAKAWAY DEVICE
	UNIT DUCT, 600V, 3-1/C #4, 1/C #6 GROUND (XLP-TYPE USE) 1 1/4" DIA. POLYETHYLENE
¢	COMED ELECTRIC SERVICE 240/480V, 1 PHASE 3 WIRE
	PROPOSED LIGHTING CONTROLLER 240/480V, 3 WIRE 100 AMP, PEDESTAL MOUNTED
<b>├</b>	RIGID GALVANIZED STEEL CONDUIT PUSHED AS INDICATED
	ELECTRIC CABLE IN CONDUIT 2 1/2" DIA., 3-1/C NO. 1/0


USER NAME = \$USER\$	DESIGNED -	мв	REVISED -
	DRAWN -	RV	REVISED -
PLOT SCALE = \$SCALE\$	CHECKED -	BL	REVISED -
PLOT DATE = \$DATE\$	DATE -	11-01-16	REVISED -

SCALE: NONE

COUNTY

COOK

CONTRACT NO. 60J39

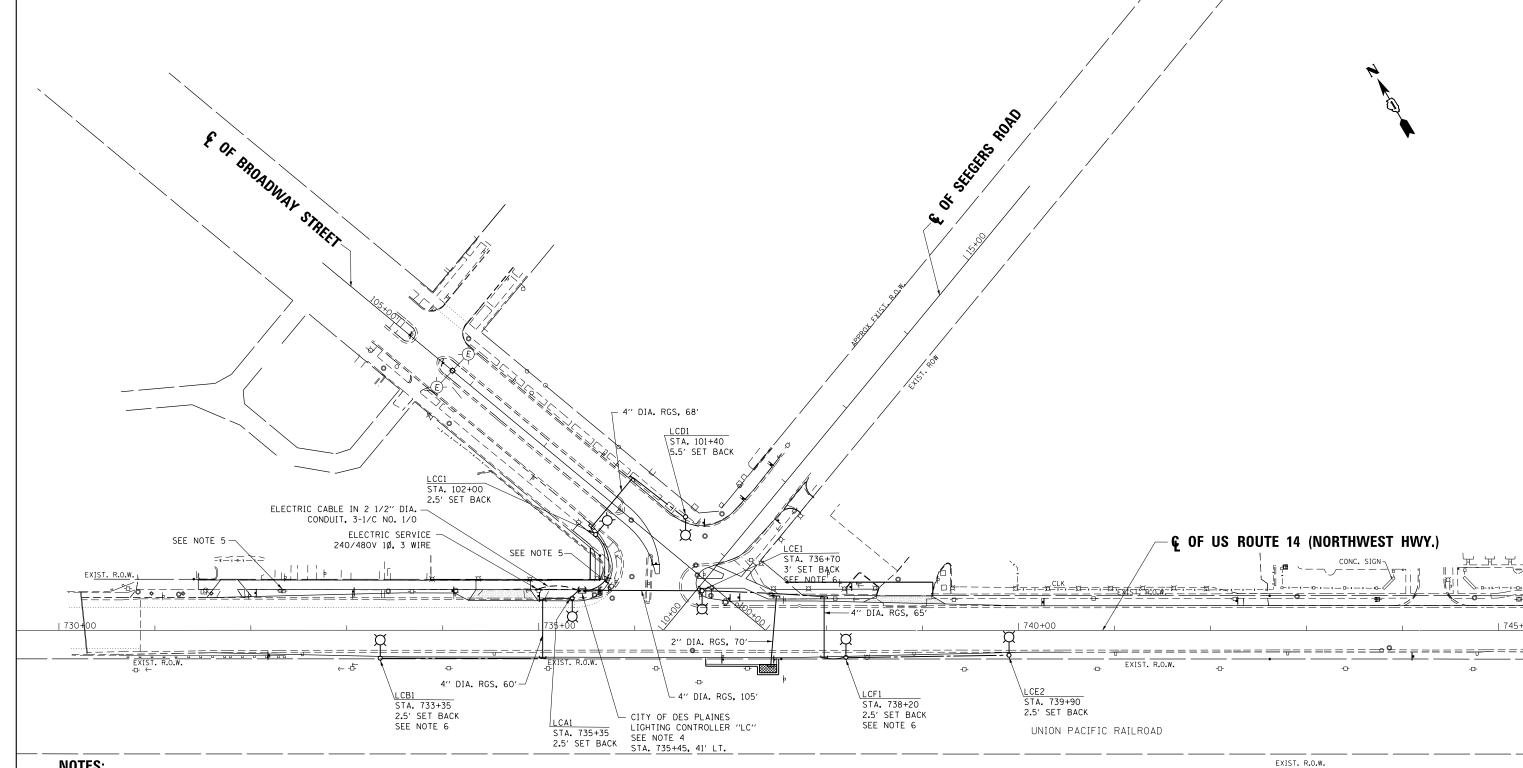


- 1. FOR GENERAL NOTES, LEGEND, AND BILL OF MATERIALS SEE SHEET LT-01.
- LAST POLE OF EACH CIRCUIT SHALL BE PROVIDED WITH 4" DIA. PVC SLEEVE WITH CAP FOR FUTURE EXPANSION OF STREET LIGHTING.
- 3. SETBACKS INDICATED ARE FROM FACE OF CURB TO THE CENTER OF LIGHT POLE.
- 4. THE CONTRACTOR SHALL MARK THE PEDESTAL MOUNTED LIGHTING CONTROLLER LOCATION FOR APPROVAL BY THE ENGINEER PRIOR TO
- 5. EXISTING MAST ARM AND LUMINAIRE TO BE REMOVED FROM COMED POLE.
- 6. THE CONTRACTOR SHALL USE CARE WITH THE POLE INSTALLATION NEAR EXISTING UNDERGROUND UTILITIES.

	SCAL	E IN FE	ΕΤ
0	20	50	100
			I T_02

														LI-UZ
AMES Engineering, Inc.	USER NAME = \$USER\$	DESIGNED - MB	REVISED - 12-07-16			P	ROPOSEC	n Hightii	NG PLAN		F.A.U.	SECTION	COUNTY	TOTAL SHEET SHEETS NO.
CONSULTING ENGINEERS		DRAWN - RV	REVISED -	STATE OF ILLINOIS		_					3512	87-Y-N	соок	102 79
5413 Walnut Avenue, Ste 2	PLOT SCALE = \$SCALE\$	CHECKED - BL	REVISED -	DEPARTMENT OF TRANSPORTATION		U.S. RO	UTE 14 /	AT BROA	DWAY STR	REET				NO. 60J39
Downers Grove, IL 60515	PLOT DATE = \$DATE\$	DATE - 11-01-16	REVISED -		SCALE: 1"-50"	SHEET	OF	SHEETS	STA.	TO STA.		ILLINOIS FED. A	D PROJECT	



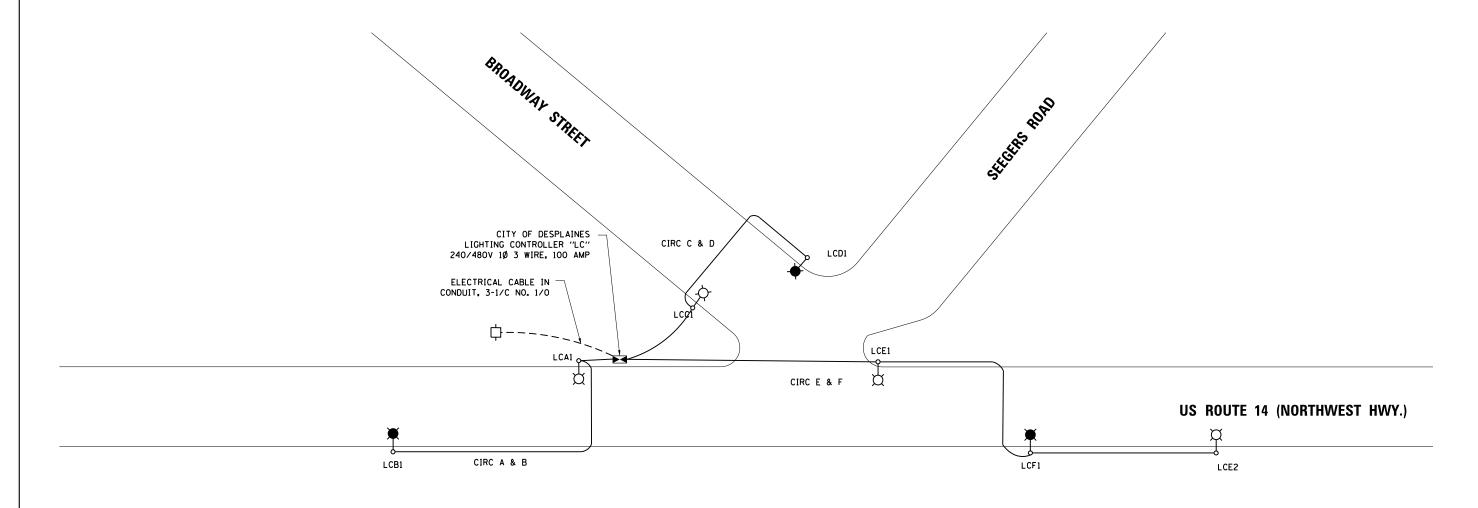

#### **LOAD TABLE**

CIRCUIT	TOTAL AMPS	TOTAL WATTS		
Α	1.0	285		
В	1.0	285		
С	1.0	285		
D	1.0	285		
E	2.0	570		
F	1.0	285		
G	SPARE	SPARE		
Н	SPARE	SPARE		
TOTAL	7.0	1995		

#### **LEGEND**

LED LUMINAIRE, 285W, 240V ON RED CIRCUIT

LED LUMINAIRE, 285W, 240V ON BLACK CIRCUIT

PROPOSED LIGHTING CONTROLLER "LC"


UNIT DUCT, 3-1/C #4, 1/C #6 GROUND

ELECTRIC SERVICE 240/480V, 1Ø, 3 WIRE

LT-03

<b>A</b>	AMES Engineering, Inc.	2
$oldsymbol{\Omega}$	CONSULTING ENGINEERS	
	5413 Walnut Avenue, Ste 2	Ρ
	Downers Grove, IL 60515	Р

	USER NAME = \$USER\$	DESIGNED	-	MB	REVISED -
•		DRAWN	-	RV	REVISED -
-	PLOT SCALE = \$SCALE\$	CHECKED	-	BL	REVISED -
	PLOT DATE = \$DATE\$	DATE	-	11-01-16	REVISED -

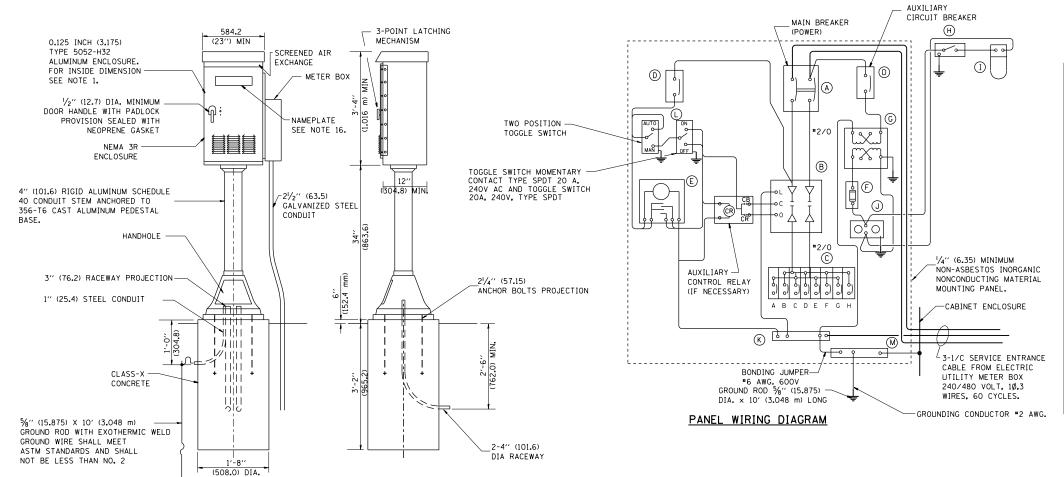

#### PANEL EQUIPMENT

		BILL OF MATERIAL
ITEM	QUANTITY	DESCRIPTION
Α	1	MAIN CIRCUIT BREAKER, 2 POLE, 600 VOLT 100 AMP. FRAME, 100 AMP. NON-INTERCHANGEABLE TRIP INTERRUPTING RATING NEMA-22000 AMP. AT 480 VOLT.
В	1	REMOTE CONTROL SWITCH, ELECTRICALLY OPERATED, MECHANICALLY HELD, 2 POLE, SINGLE THROW, 100 AMP., 600 VOLTS CONTROL CIRCUIT 240 VOLT.
С	8	CIRCUIT BREAKERS, 1 POLE, 277V., 100 AMP., FRAME 50 AMP. NON-INTERCHANGEABLE TRIP INTERRUPTING RATING NEMA-10,000 AMP. AT 240 V.
D	2	CONTROL CIRCUIT-CIRCUIT BREAKER. 1 POLE, 240 V., 100 AMP. FRAME, 15 AMP. NON-INTERCHANGEABLE TRIP INTERRUPTING RATING NEMA-5000 AMP. AT 240 V.
E	1	ASTRONOMIC MICROPROCESSOR-BASED 2-CHANNEL CONTROLLER [TIME SWITCH].
F	1	20 A., 120 V. FUSE.
G	1	1.5 KVA, SINGLE PHASE, ENCAPSULATED TRANSFORMER 240 X 480 / 120 X 240 VOLT, 60 Hz.
Н	1	SPST 20A SWITCH ON DOOR, TO TURN LIGHT ON WHEN DOOR IS OPEN,
I	1	INCANDESCENT LIGHTING FIXTURE ENCLOSED AND GASKETED WITH 60 WATT, 120 V. LAMP.
J	1	20 A., 120 V., DUPLEX RECEPTACLE, GFCI.
К	1	COPPER GROUND BUS $\frac{1}{4}$ " (6.35) X 1" (25.4) X 12" (304.8 mm) LONG MOUNTED ON PANEL WITH LUGS AND 4 SPARE LUGS
L	1	TOGGLE SWITCHES MOUNTED IN 4" (101.6) X 4" (101.6 mm) BOX.
М	1	COPPER GROUND BUS $1/4$ " (6.35) X 1" (25.4) X 12" (304.8 mm) LONG MOUNTED ON PANEL WITH LUGS AND SPARE LUGS

#### FOUNDATION PLAN

<u>FRONT</u>

1/2" (12.7) STEEL CONDUIT -

#### NOTES:

SIDE

CONTROL CABINET

2-4" (101.6) Ø RACEWAY

- ALL DIMENSIONS ARE IN INCHES (MILLIMETERS) UNLESS OTHERWISE SHOWN.
- 2. UNLESS OTHERWISE INDICATED, THE CABINET SHALL BE MOUNTED ATOP A 4-INCH (101.6 mm) RIGID ALUMINUM SCHEDULE 40 CONDUIT STEM ANCHORED TO A CAST ALUMINUM PEDESTAL BASE.
- 3. IN FRONT OF CONTROL CABINET DOOR, REMOVE VEGETATION AND 2" (50.8 mm) TOP SOIL, LEVEL THE AREA AND ON TOP, PLACE LENGTH WISE PARALLEL TO CONTROL CABINET, A CONCRETE PAD 36" (914.4 mm) x 60" (18.288 m) x 4" (101 mm) MIN. SIZE. THE COST OF LABOR AND MATERIALS ARE INCLUDED IN THE COST OF THE CONTROLLER.
- 4. DOOR SHALL BE CONSTRUCTED FROM SAME TYPE OF MATERIAL AND THICKNESS AS CABINET.
- DOOR SHALL BE EQUIPPED WITH THREE POINT LATCHING MECHANISM WITH NYLON ROLLERS AT TOP THE BOTTOM.
- 6. DOOR HINGE SHALL BE A HEAVY GAUGE CONTINUOUS HINGE WITH A 1/4" (6.35 mm) DIA. STAINLESS STEEL HINGE PIN.

- 7. ALL EXTERNAL HARDWARE SHALL BE STAINLESS STEEL.
- 8. CONTROL WIRING TO BE #12 AWG, 600V, TYPE "SIS" GRAY SWITCH BOARD WIRE, STRANDED COPPER.
- METER BOX SHALL BE MOUNTED ON THE SIDE OF CONTROL CABINET, NEAR TO THE SERVICE POLE.
- 10. CABINETS SHALL BE PRIMED AND PAINTED AS SPECIFIED.
- 11. THE HEADS OF CONNECTORS SCREWS SHALL BE PAINTED WHITE FOR NEUTRAL BAR CONNECTION AND GREEN FOR GROUND BAR CONNECTORS.
- 12. ALL WIRING WITHIN THE CABINET SHALL BE COLOR CODED AS INDICATED.


  R = RED BL = BLUE W = WHITE B = BLACK Y = YELLOW G = GREEN
- 13. PROVIDE SEALING GROMMETS FOR ALL OPEN WIRING EXTENDED FROM DEVICES IN BOXES OR CABINETS WITHIN THE CONTROL CABINET.

- 14. ALL WIRING SHALL BE NEATLY DRESSED AND SUPPORTED.
- 15. THE CONTROLLER SHALL BE CONSTRUCTED TO U.L. STD. 508 AND BEAR THE U.L. LABEL "ENCLOSED INDUSTRIAL CONTROL PANEL".
- 16. 12" (304.8) X 16" (406.4 mm) STAINLESS STEEL EXTERIOR NAMEPLATE SHALL BE ENGRAVED TO "STATE OF ILLINOIS LIGHTING CONTROLS" UNLESS OTHERWISE SPECIFIED.

FILE NAME =	USER NAME = bartonrw	DESIGNED -	REVISED - D. DREW 12-02-93
pw:\\ILØ84EBIDINTEG.:111:no:s.gov:PWIDOT\Do	cuments\IDOT Offices\District 1\Projects\P143	P <b>ORAMM</b> ata\Design\DistStd.dgn	REVISED - R. TOMSONS 08-19-04
	PLOT SCALE = 100.0000 '/ in.	CHECKED - R. GUPTA	REVISED -
	PLOT DATE = 11/3/2016	DATE -	REVISED -

STATE OF ILLINOIS
DEPARTMENT OF TRANSPORTATION

LIGHTING CONTROLLER	F.A.U. RTE.	SECTION	COUNTY	TOTAL SHEETS	SHEET NO.	
PEDESTAL MOUNT	3512	87-Y-N	соок	102	81	
		BE-210	CONTRACT	NO. 6	0J39	
SCALE: NONE   SHEET NO. 1 OF 1 SHEETS   STA. TO STA.		FED. RO	DAD DIST, NO. 1 ILLINOIS FED. A	ID PROJECT		

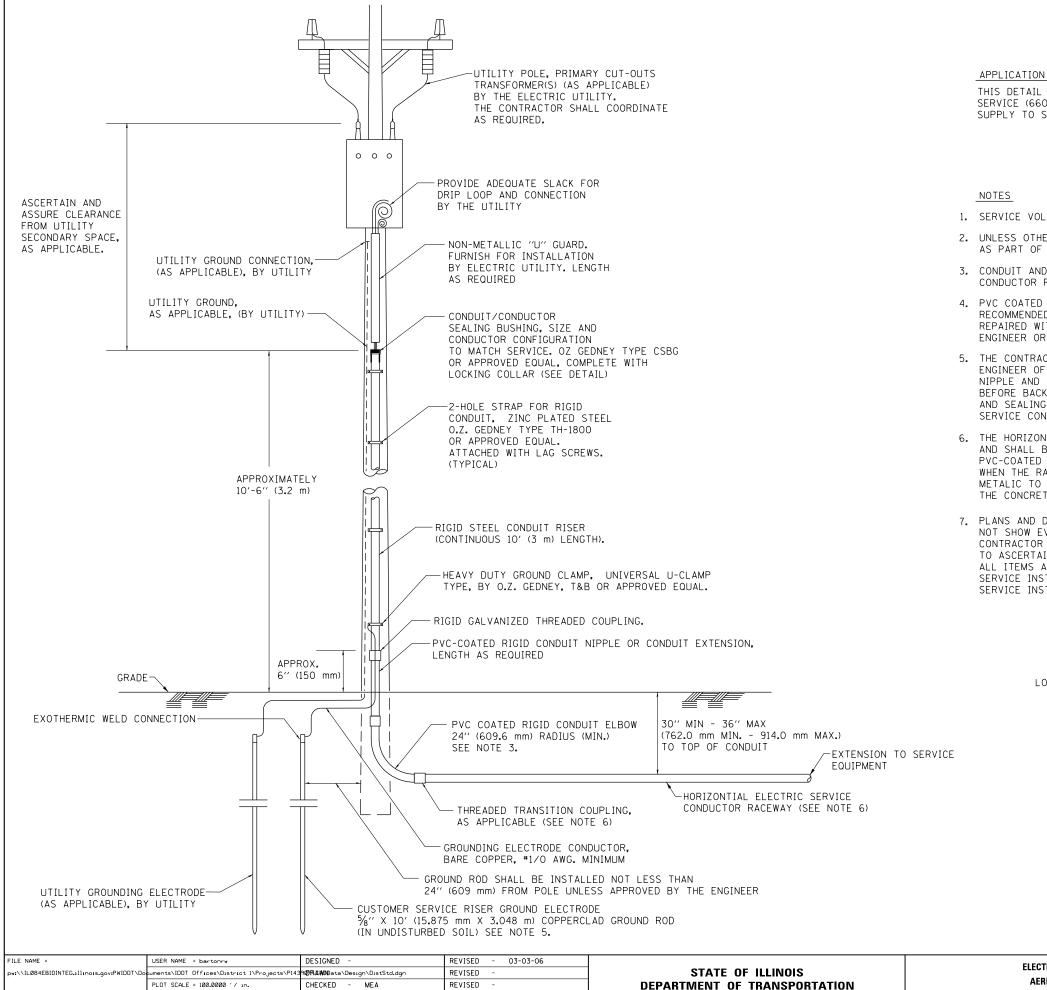


REVISED

SCALE: NONE


THIS DETAIL APPLIES FOR LOW VOLTAGE ELECTRIC SERVICE (660 V OR LESS) FROM AN OVERHEAD UTILITY SUPPLY TO SEPERATLY-MOUNTED SERVICE EQUIPMENT.


- 1. SERVICE VOLTAGE SHALL BE AS INDICATED ELSEWHERE IN THE DRAWINGS.
- 2. UNLESS OTHERWISE INDICATED, ITEMS AND WORK SHALL BE INCLUDED AND PAID AS PART OF THE ELECTRIC UTILITY SERVICE INSTALLATION PAY ITEM.
- 3. CONDUIT AND CONNECTOR DIAMETER SHALL MATCH THE DIAMETER OF THE SERVICE CONDUCTOR RACEWAY AS INDICATED ON THE PLANS.
- 4. PVC COATED RACEWAYS AND ACCESSORIES SHALL BE CAREFULLY INSTALLED WITH MFR RECOMMENDED TOOLS AND PROCEDURES TO AVOID DAMAGE. ANY DAMAGE SHALL BE REPAIRED WITH COMPATIBLE PVC TOUCH-UP MATERIAL TO THE SATISFACTION OF THE ENGINEER OR THE DAMAGED MATERIAL SHALL BE REPLACED AT NO ADDITIONAL COST.
- 5. THE CONTRACTOR SHALL OBTAIN INSPECTION AND APPROVAL BY THE ENGINEER OF SERVICE RISER GROUND ELECTRODE, RISER ELBOW, NIPPLE AND CONNECTION TO SERVICE CONDUCTOR RACEWAY EXTENSION BEFORE BACKFILL AND SHALL ALSO OBTAIN INSPECTION OF SERVICE RISER AND SEALING BUSHING BEFORE UTILITY "U" GUARD INSTALLATION AND SERVICE CONNECTION.
- 6. THE HORIZONTAL ELECTRIC SERVICE CONDUCTOR RACEWAY SHALL BE AS INDICATED AND SHALL BE MEASURED SEPARATELY FOR PAYMENT. WHEN THE RACEWAY IS PVC-COATED RIGID GALVANIZED STEEL, THE COUPLING SHALL BE THE SAME. WHEN THE RACEWAY IS PVC CONDUIT (IN CONCRETE), THE COUPLING SHALL BE A METALIC TO NON METALIC ADAPTER. WHEN THE RACEWAY IS ENCASED IN CONCRETE, THE CONCRETE SHALL EXTEND TO COVER THE COUPLING.
- 7. PLANS AND DETAILS INDICATE THE GENERAL NATURE AND REQUIREMENTS. THEY DO NOT SHOW EVERY ACCESSORY AND ATTACHMENT, AND THEY DO NOT RELIEVE THE CONTRACTOR OF THE REQUIREMENTS OF THE SPECIFICATIONS AND SPECIAL PROVISIONS TO ASCERTAIN UTILITY REQUIREMENTS AND TO COORDINATE ACCORDINGLY, FURNISHING ALL ITEMS AND WORK NOT PROVIDED BY THE UTILITY, BUT NECESSARY FOR A COMPLETE SERVICE INSTALLATION IS REQUIRED AND SHALL BE INCLUDED IN THE ELECTRIC UTILITY SERVICE INSTALLATION PAY ITEM.

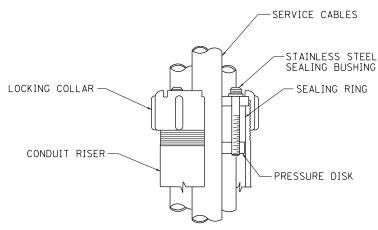

SEALING BUSHING DETAIL

COUNTY **ELECTRIC SERVICE INSTALLATION** 3512 87-Y-N COOK 102 82 **AERIAL, REMOTE DISCONNECT** CONTRACT NO. 60J39 BE-220 SHEET NO. 1 OF 1 SHEETS STA. TO STA. FED. ROAD DIST. NO. 1 | ILLINOIS FED. AID PROJECT

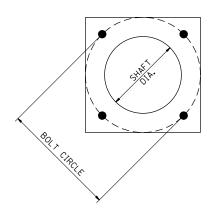

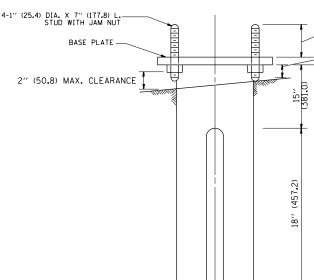


#### HELIX FOUNDATION SIZE

POLE MOUNTING HEIGHT	BOLT CIRCLE	SHAFT DIAMETER	SHAFT LENGTH	BASEPLATE
30 FT.	111/2"	85/8′′	6 FT.	12''×12''×1''
31 FT35 FT.	111/2''	85/8′′	6 FT.	12''×12''×1''
36 FT40FT.	15"	85/8′′	6 FT.	15''×15''×1 ¹ / ₄ ''
41 FT45 FT.	15''	85/8′′	6 FT.	15''×15''×1 ¹ / ₄ ''
46 FT50 FT.	15''	10′′	8 FT.	15''×15''×1 ¹ / ₄ ''

#### METAL HELIX FOUNDATION MATERIALS


ITEM	MATERIAL REQUIREMENT
BASEPLATE	AASHTO M 270M, GRADE 36 (M270M, GRADE 250)
SHAFT	ASTM A 252, GRADE 2 (PHOSPHOROUS 0.04% MAXIMUM, SULFUR 0.05% MAXIMUM)
HELIX SCREW	AASHTO M 183 (ASTM A 635)
PILOT POINT	AASHTO M 270 (ASTM A 575)
ANCHOR RODS/STUDS	AASHTO M 314 (ASTM F 1554)
HEXAGON NUTS	AASHTO M 291M (ASTM A 563) GRADE DH, OR AASHTO M 292 (ASTM A 194) GRADE 2H
WASHERS	AASHTO M 293 (ASTM F 436)

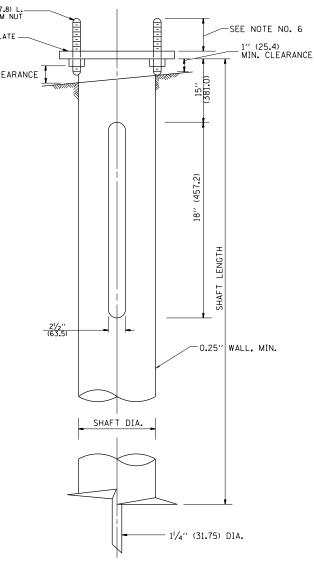

#### NOTES:

- 1. ALL DIMENSION IN INCHES (MILLIMETERS) UNLESS OTHERWISE SHOWN.
- 2. ALL MATERIAL SHALL BE GALVINIZED ACCORDING TO AASHTO M111, UNLESS OTHERWISE SPECIFIED.
- 3. ALL WELDS SHALL BE CONTINUOUS AND NOT LESS THAN  $\frac{1}{4}$ " (6.35 mm) FILLET WELDS. THE WELDED FOUNDATION SHALL BE CAPABLE OF WITHSTANDING 10,000 FT/LBS (13558.18 n.m) OF INSTALLATION TORQUE APPLIED ABOUT THE AXIS OF THE FOUNDATION.
- 4. THE HELIX FOUNDATION SHAFT SHALL BE INSTALLED VERTICAL AND THE BASE PLATE SHALL BE IN LEVEL. THE BREAKAWAY COUPLINGS AND HARDWARE SHALL NOT BE USED TO ALIGN THE POLE INSTALLATION.
- 5. THE CABLE TRENCH SHALL BE BACKFILLED AND FIRMLY COMPACTED BEFORE THE INSTALLATION OF THE LIGHT POLE.
- 6. THE CONTRACTOR SHALL COORDINATE EXTENSION OF ANCHOR BOLTS ABOVE TOP OF THE BASE PLATE WITH THE BREAKAWAY DEVICE MANUFACTURER'S REQUIREMENTS.
- 7. ANY VOIDS WITHIN THE METAL FOUNDATION SHALL BE FILLED WITH FINE AGGREGATE.
- 8. METAL FOUNDATIONS SHALL BE INSTALLED IN UNDISTURBED SOIL. PREDRILLING A PILOT HOLE AND/OR BACKFILLING AROUND THE FOUNDTION IS NOT ALLOWED.
- 9. THE METAL FOUNDATION SHALL NOT BE INSTALLED TO A TORQUE WHICH EXCEEDS THE MANUFACTURER'S MAXIMUM TORQUE RATING NOR SHALL IT BE INSTALLED TO AN INSTALLATION TORQUE VALUE OF LESS THAN 3,500 FT LB (4,750 KNM). METAL FOUNDATIONS THAT ARE NOT INSTALLED TO FULL INSTALLATION DEPTH OR DO NOT ACHIEVE THE MINIMUM INSTALLATION TORQUE SHALL BE REMOVED AND REPLACED WITH A CONCRETE FOUNDATION AT NO ADDITIONAL COST.
- 10. THE BASEPLATE SHALL BE PERPENDICULAR TO THE SHAFT AXIS (± 1°) AND THE HOLE CENTERLINE SHALL BE CONCENTRIC (± 0.188) TO THE SHAFT AXIS.
- 11. THE PILOT POINT AND SHAFT AXIS SHALL BE CONCENTRIC (± 0.125) AND IN LINE (± 2°).
- 12. THE BASEPLATE SHALL BE STAMPED WITH THE MANUFACTURERS NAME AND DATE OF MANUFACTURE.

FILE NAME =	USER NAME = bartonrw	DESIGNED -	REVISED -			LIGHT POLE FOUNDATION, METAL	F.A.U	SECTION	COUNTY TOTAL SHEET
pw:\\IL084EBIDINTEG.:111:no1s.gov:PWIDOT\0	ocuments\IDOT Offices\District 1\Projects\P14	39 <b>@RAWD</b> Data\Design <b>DDB</b> tStd.dgn	REVISED -	STATE OF ILLINOIS		LIGHT FOLE FOUNDATION, WETAL	3512	87-Y-N	COOK 102 83
	PLOT SCALE = 100.0000 '/ in.	CHECKED -	REVISED -	DEPARTMENT OF TRANSPORTATION				BE-305	CONTRACT NO. 60J39
	PLOT DATE = 11/3/2016	DATE - 02-27-07	REVISED -		SCALE: NONE	SHEET NO. 1 OF 1 SHEETS STA. TO STA.	FED.	ROAD DIST. NO. 1   ILLINOIS	FED. AID PROJECT

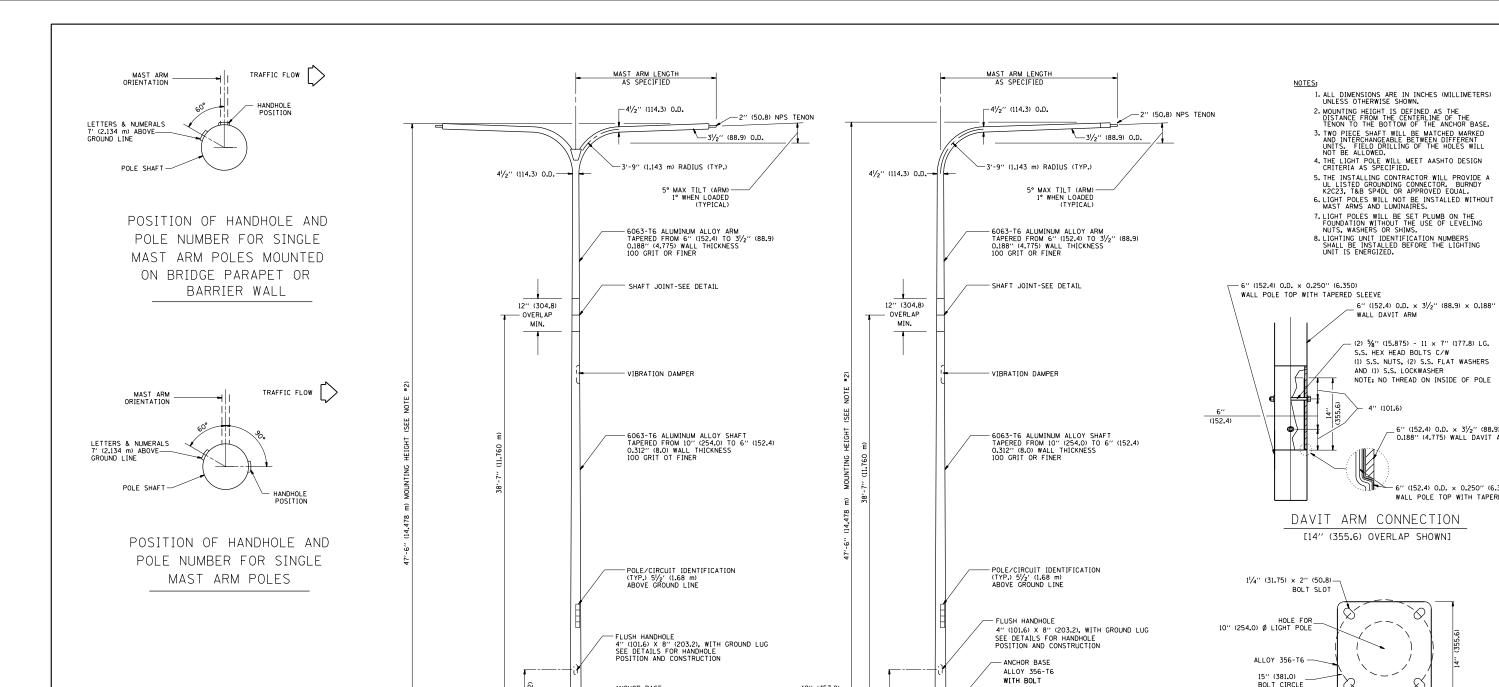

- ANCHOR BASE

ALLOY 356-T6 WITH BOLT

COVERS

TWIN ARM POLE

14" (355.6) LIGHT POLE BASE PLATE DETAIL

(FOR POLE MOUNTED ON 15 INCH (381.0)

BOLT CIRCLE FOUNDATION)

6" (152.4) O.D. × 3½" (88.9) × 0.188" (4.775) WALL DAVIT ARM

(152.4) O.D. x 0.250" (6.350)

WALL POLE TOP WITH TAPERED SLEEVE


NOTE: NO THREAD ON INSIDE OF POLE

WALL DAVIT ARM

- POLE SHAFT 3/4" (9.525)-16 TAPPED BOLT HOLE FOR GROUNDING CONNECTOR 4" (101.6) × 8" (203.2) HAND HOLE HANDHOLE DETAIL (N.T.S.)

SCALE: NONE

COVERS

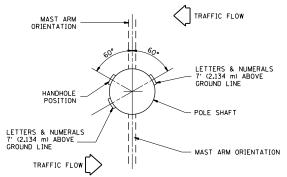

POSITION OF HANDHOLE AND POLE NUMBER FOR TWIN MAST ARM POLES


FILE NAME = DESIGNED REVISED - D. DREW 05-07-92 USER NAME = bartonrw ow:\\IL084EBIDINTEG.:ll:nois.gov:PWIDOT\C ments\IDOT Offices\District 1\Projects\P143966RAMADData\Design\BixstStd.dor REVISED - R. TOMSONS 09-06-00 PLOT SCALE = 100.0000 '/ in. CHECKED REVISED R. TOMSONS 09-02-0 - R. TOMSONS 01-18-13 PLOT DATE = 11/3/2016 DATE REVISED


STATE OF ILLINOIS **DEPARTMENT OF TRANSPORTATION** 

18" (457-2)

SINGLE ARM POLE

	DAVIT LIGHT POLE					SECTION	COUNTY	TOTAL SHEETS	SHEET NO.
47'-6" (14.478 m) MOUNTING HEIGHT					3512	87-Y-N	соок	102	84
						BE-410	CONTRACT	NO. 6	0J39
SHEET	NO 1 OF 1	SHEETS	STA	TO STA	EED DO	AD DICT NO 1 THE INDICE OF AT	D DDO IECT		

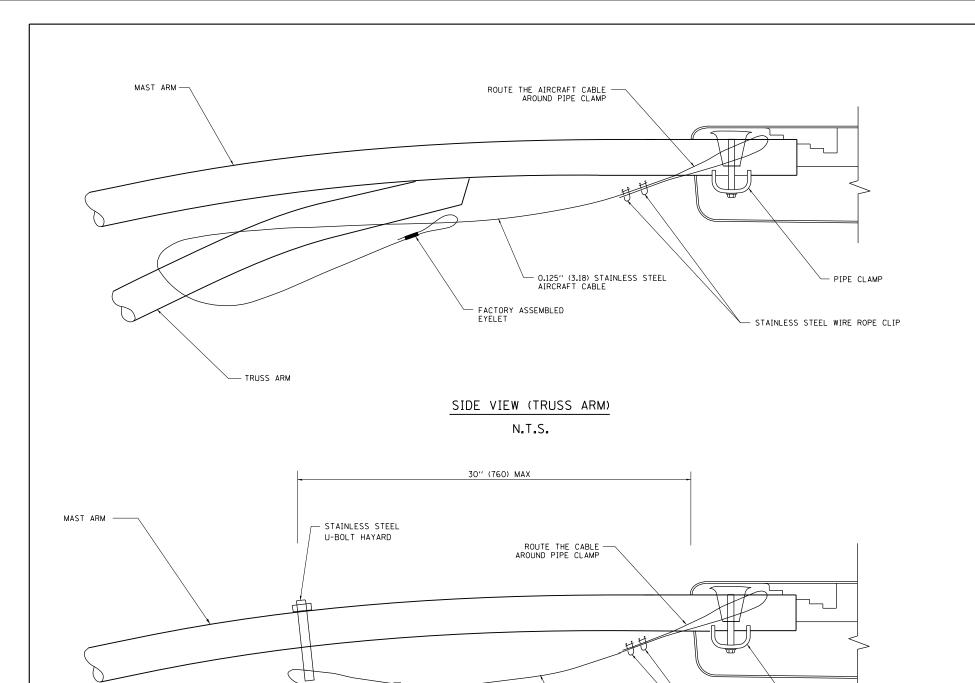

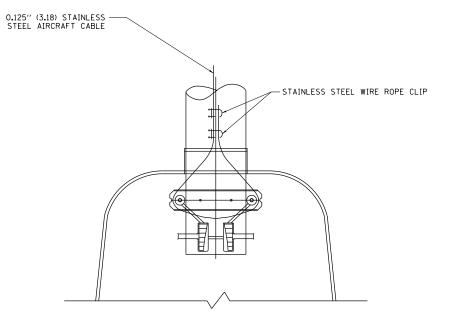

## BOTTOM VIEW N.T.S.

#### NOTES:

- 1. ALL DIMENSIONS ARE IN MILLIMETERS (INCHES) UNLESS OTHERWISE SHOWN.
- 2. CONTRACTOR SHALL ADJUST THE WIRE CLIP TO ELIMINATE ANY SLACK FROM THE WIRE ROPE.
- 3. THE 0.125" (3.18) STAINLESS STEEL AIRCRAFT CABLE SHALL REMAIN VISIBLE FROM THE GROUND LEVEL.
- 4. THE BREAKING STRENGTH OF THE CABLE SHALL BE 1700 LBS. MIN.

#### SIDE VIEW (SINGLE MEMBER OR DAVIT ARM)

FACTORY ASSEMBLED

MAST ARM

-S.S. NUT &

STAINLESS STEEL U-BOLT HAYARD LOCK WASHER

EYELET


N.T.S.


O.125" (3.18) STAINLESS STEEL AIRCRAFT CABLE

FILE NAME =	USER NAME = bartonrw	DESIGNED -	REVISED - 08-08-03			LUMINAIRE SAFETY CABLE ASSEMBLY		F.A.U.	SECTION	COUNTY	TOTAL	SHEET
pw:\\ILØ84EBIDINTEG.:ll:no:s.gov:PWIDOT\Do	cuments\IDOT Offices\District 1\Projects\P14	39 <b>@RAWW</b> ata\Design\DistStd.dgn	REVISED -	STATE OF ILLINOIS		LOWINAINE SAFETT CABLE ASSEMBLE		3512	87-Y-N	соок	102	85
	PLOT SCALE = 100.0000 ' / in.	CHECKED -	REVISED -	DEPARTMENT OF TRANSPORTATION				0012	BE-701	CONTRACT	NO. 60	JJ39
	PLOT DATE = 11/3/2016	DATE -	REVISED -		SCALE: NONE	SHEET NO. 1 OF 1 SHEETS STA.	TO STA.	FED. ROA	D DIST, NO. 1   ILLINOIS FED. A			

- STAINLESS STEEL WIRE ROPE CLIP

— PIPE CLAMP

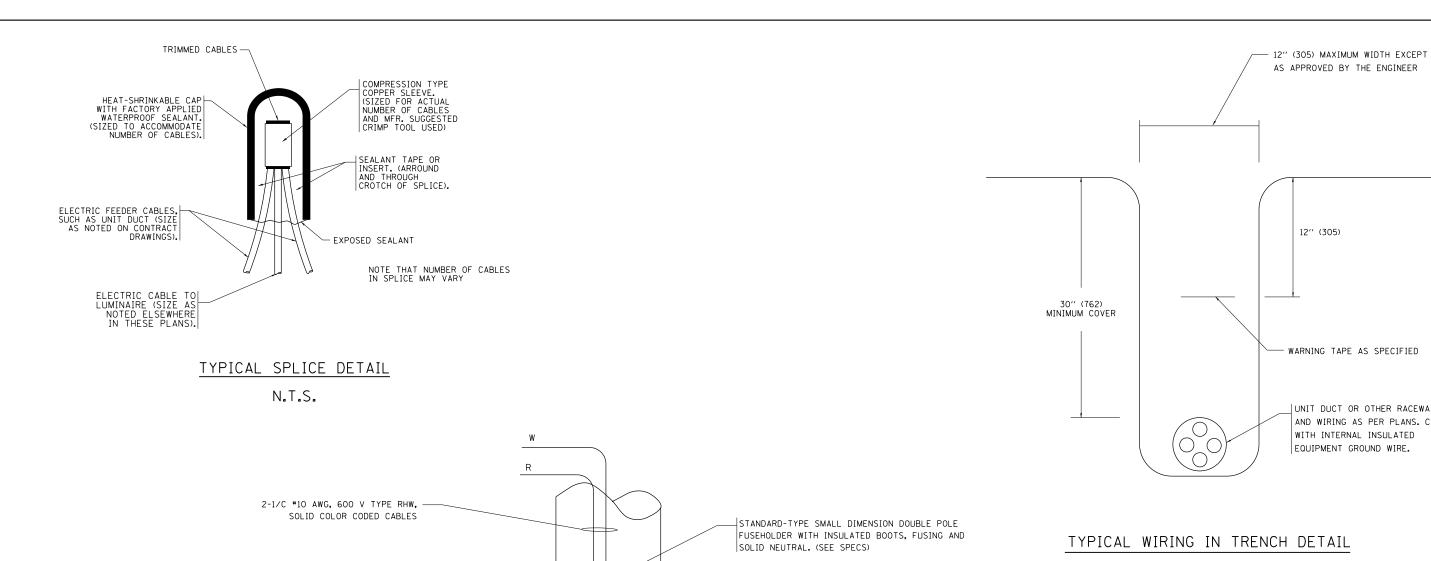

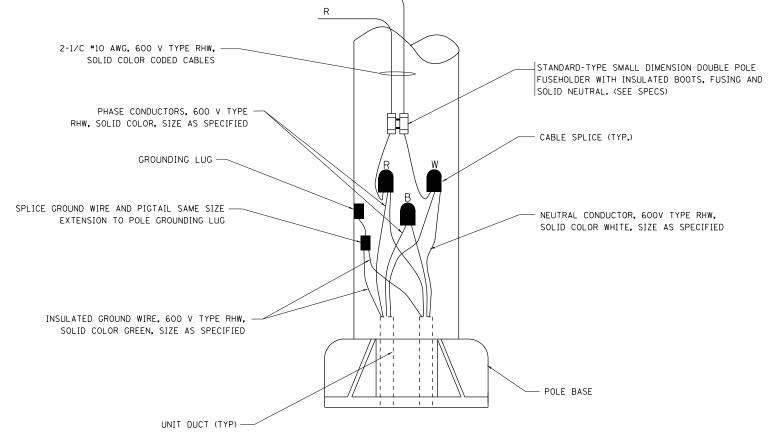

N.T.S.

12" (305)


UNIT DUCT OR OTHER RACEWAY AND WIRING AS PER PLANS. COMPLETE


WITH INTERNAL INSULATED EQUIPMENT GROUND WIRE.


#### POLE WIRING DETAIL

N.T.S.


FILE NAME	=	USER NAME = bartonrw	DESIGNED -	REVISED - 08-08-03		MISC, ELECTRICAL DETAILS		F.A.U.	SECTION	COUNTY	TOTAL SHEET	
pw:\\ILØ84	EBIDINTEG.:111:nois.gov:PWIDOT\Do	cuments\IDOT Offices\District 1\Projects\P	1439 <b>@RAWN</b> Data\Design\DistStd.dgn	REVISED -	STATE OF ILLINOIS				3512	87-Y-N	соок	102 86
		PLOT SCALE = 100.0000 '/ in.	CHECKED -	REVISED -	DEPARTMENT OF TRANSPORTATION	SHEET A SE-702 CONTRAC		CONTRACT	T NO. 60J39			
		PLOT DATE = 11/3/2016	DATE -	REVISED -		SCALE: NONE	SHEET NO. 1 OF 1 SHEETS STA.	TO STA.	FED. ROAD	DIST. NO. 1 ILLINOIS FED. A		

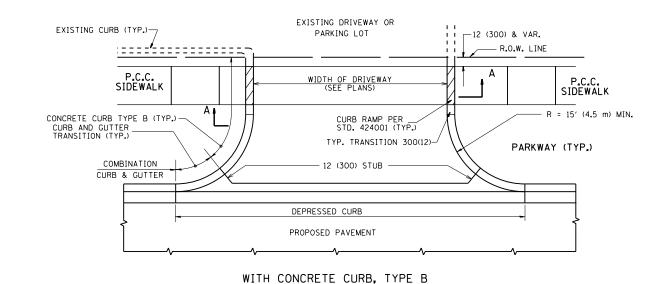


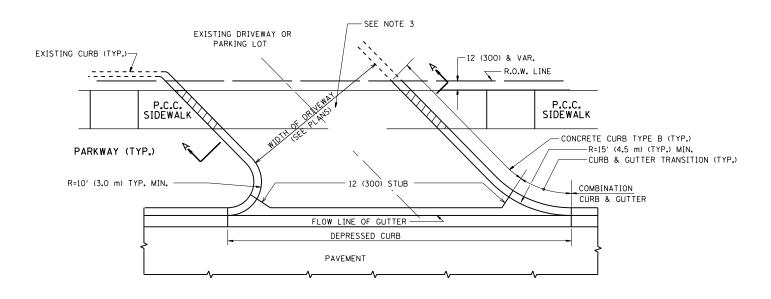

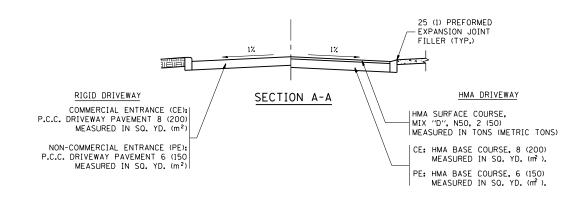

WITH CONCRETE CURB, TYPE B

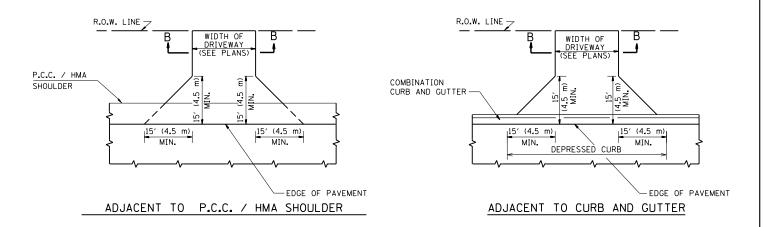

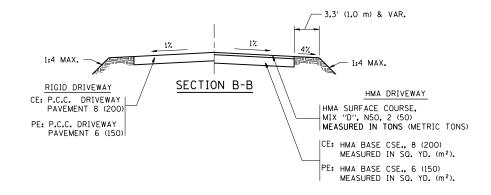

#### RURAL FIELD ENTRANCE (FE)

HMA SURFACE COURSE, MIX "D", N50, 2 (50) MEASURED IN TONS (METRIC TONS)

AGGREGATE BASE CSE., TYPE B, 8 (200) MEASURED IN SQ. YD.  $(m^2)$ .

#### **GENERAL NOTES:**

DRIVEWAY SLOPES, LOCATIONS, & GEOMETRIC LAYOUT SHALL BE IN ACCORDANCE WITH THE LATEST EDITION OF THE "HANDBOOK FOR POLICY ON PERMITS FOR ACCESS DRIVEWAYS TO STATE HIGHWAYS". FOR FURTHER LAYOUT REQUIREMENTS, REFER TO ILLUSTRATIONS IN THE PERMIT HANDBOOK. DRIVEWAYS SHALL BE REPLACED IN KIND, UNLESS OTHERWISE NOTED ON THE PLANS.

COMMERCIAL DRIVEWAYS SHALL BE CONSTRUCTED WITH CONCRETE CURB, TYPE B RETURNS EXCEPT WHEN THE SIDEWALK EDGE IS 4 FEET (1.2 METERS) OR LESS FROM THE BACK OF CURB, CONSTRUCT A FLARE DRIVEWAY WITHOUT CURB.

THE RESIDENT ENGINEER SHALL CONTACT THE TRAFFIC PERMIT OFFICE AT 847/ 705-4131 FOR ANY OUESTIONS ON DRIVEWAYS SHOWN IN THE PLANS; SPECIFICALLY IN REFERENCE TO ADDITIONAL AND/OR RELOCATION/REMOVAL OF A DRIVEWAY.

COMBINATION CONCRETE CURB & GUTTER SHALL BE MEASURED STRAIGHT ACROSS THE DRIVEWAY. NO ADDITIONAL COMPENSATION WILL BE ALLOWED FOR THE CURB & GUTTER TRANSITION.

1 (25) PREFORMED EXPANSION JOINT FILLER WILL NOT BE PAID SEPARATELY, BUT SHALL BE CONSIDERED INCLUDED IN THE COST OF THE P.C.C. DRIVEWAY PAVEMENT OR P.C.C. SIDEWALK.


WHEN THE P.C.C. SIDEWALK EXTENDS THROUGH THE DRIVEWAY, THE THICKNESS OF THE SIDEWALK IN THE DRIVEWAY AREA SHALL BE THE SAME AS THE DRIVEWAY THICKNESS. SIDEWALK WILL BE PAID FOR AS P.C.C. SIDEWALK OF THE THICKNESS SPECIFIED. SIDEWALK CROSS SLOPE THRU DRIVEWAY AREA TO BE A MAXIMUM OF 1:50.


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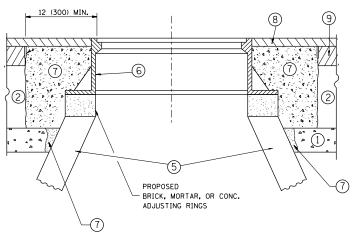
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pw:\\ILØ84EBIDINTEG.:1ll:no:s.gov:PWIDOT\Do	cuments\IDOT Offices\District 1\Projects\P143	9 <b>@RAWN</b> Data\Design\DistStd.dgn	REVISED - R. BORO 01-01-07
	PLOT SCALE = 100.0002 ' / in.	CHECKED -	REVISED - R. BORO 06-11-08
	PLOT DATE = 11/3/2016	DATE - 11-04-95	REVISED - R. BORO 09-06-11

## STATE OF ILLINOIS DEPARTMENT OF TRANSPORTATION

DR	IVEWAY DETAILS – DISTANCE	BETWEEN R.O.	N.	F.A.U. RTE.	SECTION	COUNTY	TOTAL SHEETS	SHEET NO.
AND E	ACE OF CURB & EDGE OF SH	INIII NED 🔍 🗕	15' // 5 m)	3512	87-Y-N	соок	102	87
AND I	ACE OF COMB & EDGE OF SE	IUULDEN / =	13 (4.3 III)		BD0156-07 (BD-01)	CONTRACT	NO. 6	0J39
ΙE	SHEET NO. 1 OF 1 SHEETS	STA.	TO STA.	FED. R	OAD DIST. NO. 1   ILLINOIS FED. A	D PROJECT		



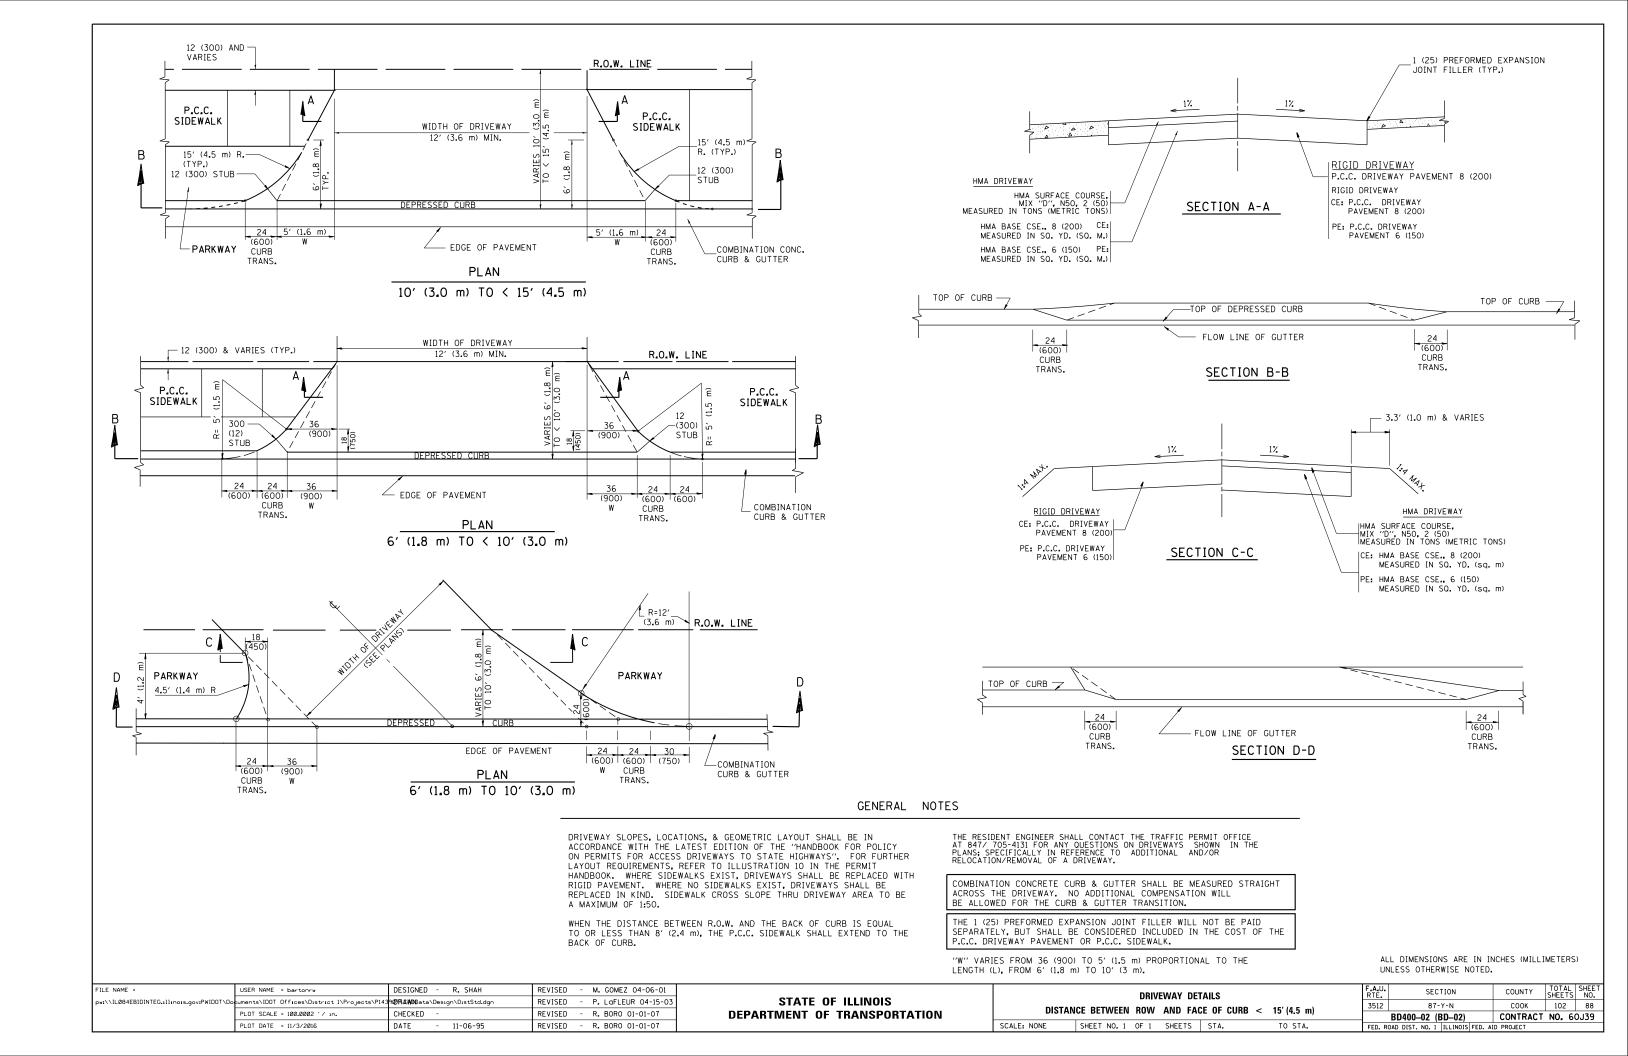

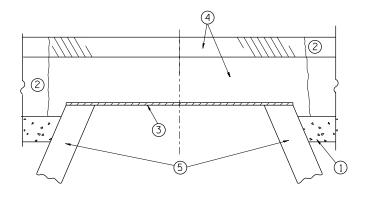

EXISTING BROKEN FRAMES AND LIDS SHALL BE REMOVED AND DISPOSED OF BY THE CONTRACTOR AND SHALL BE REPLACED AS DIRECTED BY THE ENGINEER. REPLACEMENT FRAMES AND LIDS WILL BE PAID FOR IN ACCORDANCE WITH ARTICLE 109,04 OF THE STANDARD SPECIFICATIONS UNLESS A SEPARATE PAY ITEM HAS BEEN PROVIDED.

IF THE EXISTING LIDS ARE OPEN, THE FRAME WILL BE ADJUSTED TO THE ELEVATION OF THE MILLED PAVEMENT SURFACE PRIOR TO THE MILLING OPERATION. THE FRAME WILL NOT BE REMOVED AND COVERED BY THE METAL PLATE.

CITY OF CHICAGO CASTINGS ARE THE PROPERTY OF THE CITY AND THE CONTRACTOR SHALL NOTIFY THE CITY FOR REMOVAL AND DISPOSITION OF THE CASTINGS.

THE METAL PLATE USED TO COVER THE STRUCTURE SHALL REMAIN THE PROPERTY OF THE CONTRACTOR.

WHEN STRUCTURES ARE TO BE ADJUSTED OR RECONSTRUCTED. THE LOWERING AND RAISING OF THE FRAMES AND LIDS WILL NOT BE PAID FOR SEPARATELY BUT WILL BE INCLUDED IN THE COST OF THE CORRESPONDING PAY ITEM.

#### CONSTRUCTION PROCEDURES

#### STAGE 1 (BEFORE PAVEMENT MILLING)

- A) REMOVE A MINIMUM OF 12 (300) OF THE PAVEMENT FROM AROUND THE STRUCTURE.
- B) REMOVE THE EXISTING FRAME AND LID FROM THE STRUCTURE.
- C) COVER THE STRUCTURE OPENING WITH A 36 (900) DIAMETER
- METAL PLATE. D) BACKFILL WITH CRUSHED STONE AND A MINIMUM  $1\frac{1}{2}$  (40) THICK HMA SURFACE MIX APPROVED BY THE ENGINEER.

#### STAGE 2 (AFTER PAVEMENT MILLING)

- A) REMOVE THE HMA SURFACE MIX AND CRUSHED STONE.
- B) INSTALL THE FRAME AND LID; ADJUST THE FRAME TO ITS FINAL SURFACE ELEVATION.
- C) THE SURROUNDING SPACE SHALL BE FILLED WITH CLASS PP-1*
  CONCRETE TO THE ELEVATION OF THE SURFACE OF THE EXISTING
  BASE COURSE OR THE BINDER COURSE.
- * UNLESS OTHERWISE SPECIFIED IN THE PLANS.

THE PROCEDURE EXPLAINED ABOVE SHALL CONFORM TO THE APPLICABLE PORTIONS OF SECTIONS 353, 406, 602, AND 603 OF THE STANDARD SPECIFICATIONS EXCEPT THAT "THE CONTRACTOR SHALL ADJUST THE STRUCTURES TO THE FINISHED PAVEMENT ELEVATION NO MORE THAN 5 CALENDAR DAYS PRIOR TO PLACEMENT OF THE FINAL LIFT OF SURFACE UNLESS APPROVED BY THE FNGINFER."

#### LEGEND

- 1 SUB-BASE GRANULAR MATERIAL
- (6) FRAME AND LID (SEE NOTES)
- 2 EXISTING PAVEMENT

(5) EXISTING STRUCTURE

- (7) CLASS PP-1* CONCRETE
- 3 36 (900) DIAMETER METAL PLATE
- (8) PROPOSED HMA SURFACE COURSE
- PROPOSED CRUSHED STONE AND HMA SURFACE MIX
- (9) PROPOSED HMA BINDER COURSE

#### LOCATION OF STRUCTURES:

THE CONTRACTOR WILL BE REQUIRED TO KEEP A RECORD OF THE LOCATIONS OF THE BURIED STRUCTURES ACCORDING TO THE STATION AND DISTANCE LEFT OR RIGHT OF THE CENTERLINE OF PAVEMENT. UPON COMPLETION OF THE WORK, THE CONTRACTOR WILL DELIVER THE RECORD TO THE ENGINEER.

#### BASIS OF PAYMENT:

REMOVING FRAMES AND LIDS ON DRAINAGE AND UTILITY STRUCTURES IN THE PAVEMENT PRIOR TO MILLING, AND ADJUSTING TO FINAL GRADE PRIOR TO PLACING THE SURFACE COURSE, WILL BE PAID FOR AT THE CONTRACT UNIT PRICE EACH FOR "FRAMES AND LIDS TO BE ADJUSTED (SPECIAL,"

THIS WORK WILL NOT BE PAID FOR WHEN DRAINAGE AND UTILITY STRUCTURES ARE SPECIFIED FOR PAYMENT AS STRUCTURE RECONSTRUCTION.


NEW FRAMES AND LIDS, WHEN SPECIFIED, WILL BE PAID FOR SEPARATELY.

## DETAILS FOR FRAMES AND LIDS ADJUSTMENT WITH MILLING

ALL DIMENSIONS ARE IN INCHES (MILLIMETERS) UNLESS OTHERWISE SHOWN

FILE NAME =	USER NAME = bartonrw	DESIGNED - R. SHAH	REVISED - R. WIEDEMAN 05-14-04					
pw:\\ILØ84EBIDINTEG.:ll:no:s.gov:PWIDOT\Do	cuments\IDOT Offices\District 1\Projects\P143	9 <b>@RAWN</b> Data\Design\DistStd.dgn	REVISED - R. BORO 01-01-07					
	PLOT SCALE = 100.0000 '/ in.	CHECKED -	REVISED - R. BORO 03-09-11					
	PLOT DATE = 11/3/2016	DATE - 10-25-94	REVISED - R. BORO 12-06-11					

DETAILS FOR					F.A.U. RTE.	SECTION	COUNTY	TOTAL SHEETS	SHEE NO.
	FRAMES AND LIDS ADJUSTMENT WITH MILLING				3512	87-Y-N	соок	102	89
TRAINES AND LIDS ADSOSTINENT WITH MILLING					BD600-03 (BD-8)	CONTRACT	NO. 6	0J39	
SCALE: NONE	SHEET NO. 1 OF 1	SHEETS	STA.	TO STA.	FED. R	OAD DIST, NO. 1 ILLINOIS FED. A	D PROJECT		

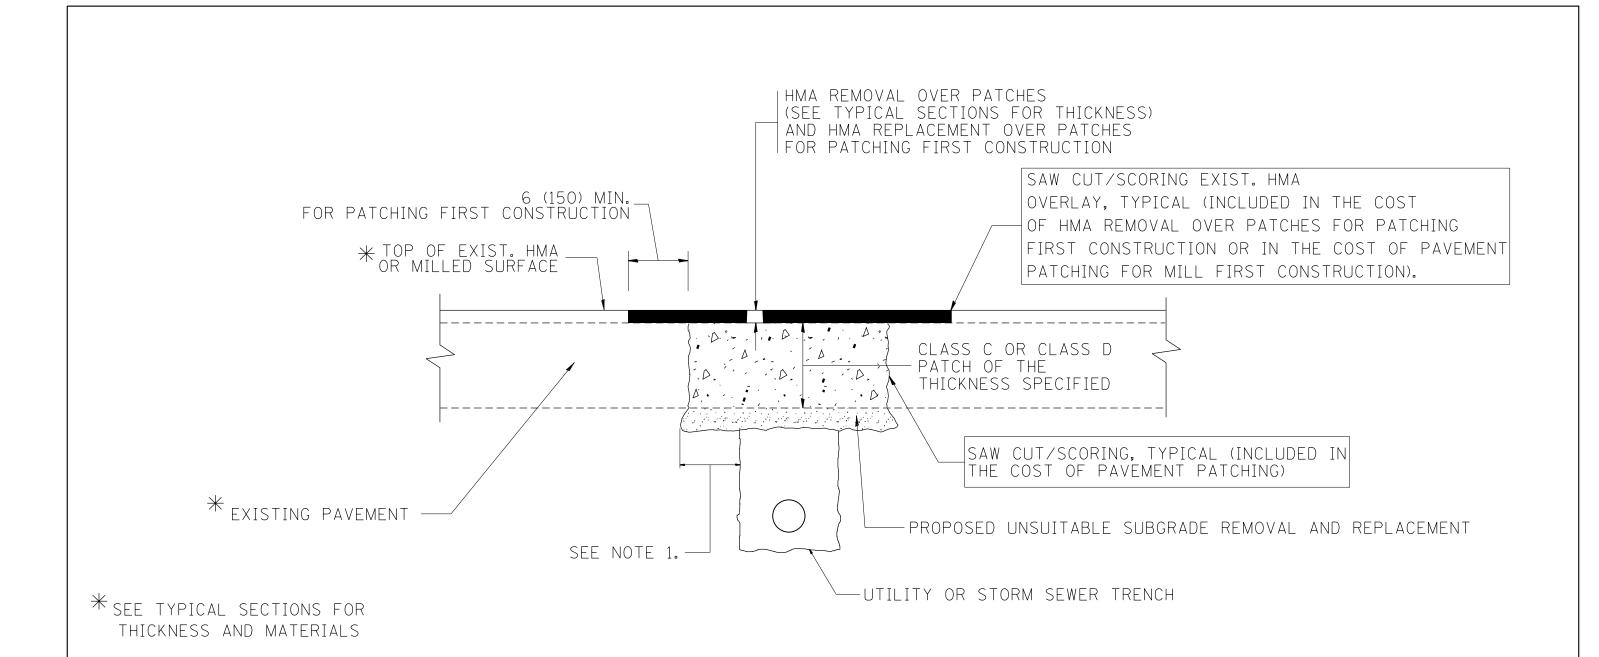

- 1. THE WIDTH OF THE FULL DEPTH PATCH OVER A TRENCH SHALL BE 12 (300) WIDER ON EACH SIDE OF THE TRENCH.
- 2. FOR METHOD OF MEASUREMENT AND BASIS OF PAYMENT, SEE RECURRING SPECIAL PROVISION "PATCHING WITH HOT-MIX ASPHALT OVERLAY REMOVAL".

#### SEQUENCE OF CONSTRUCTION (PATCHING FIRST)


- 1. REMOVE THE EXISTING HMA MATERIAL OVER THE AREA TO BE PATCHED.
- 2. REMOVE AND REPLACE WITH CLASS C OR D PATCH.
- 3. REPLACE HMA MATERIAL OVER THE AREA TO BE PATCHED.

#### SEQUENCE OF CONSTRUCTION (MILLING FIRST)


- 1. MILL HMA FIRST IF THERE IS AT LEAST 41/2 INCHES OR MORE OF HMA MATERIAL ON TOP OF THE EXISTING PAVEMENT OR IF THE PAVEMENT IS FULL DEPTH HMA. A MINIMUM OF 2 INCHES OF HMA MATERIAL SHALL BE IN PLACE AFTER MILLING.
- 2. REMOVE AND REPLACE WITH FULL DEPTH CLASS D PATCHES TO TOP OF MILLED SURFACE.

ALL DIMENSIONS ARE IN INCHES (MILLIMETERS) UNLESS OTHERWISE SHOWN.

Γ	ILE NAME =	USER NAME = bartonrw	DESIGNED - R. SHAH	REVISED -	A. ABBAS 04-27-98			PAVEMENT PATCHING FOR		F.A.U.	SECTION	COUNTY	TOTAL	SHEET NO.
	w:\\ILØ84EBIDINTEG.:111:no1s.gov:PWIDOT\Do	cuments\IDOT Offices\District 1\Projects\P143	9 <b>0RAWN</b> Data\Design\DistStd.dgn	REVISED -	R. BORO 01-01-07	STATE OF ILLINOIS				3512	87-Y-N	соок	102	90
		PLOT SCALE = 100.0000 '/ 10.	CHECKED -	REVISED -	R. BORO 09-04-07	DEPARTMENT OF TRANSPORTATION		HMA SURFACED PAVEMENT		BD4	00-04 (BD-22)	CONTRACT	NO. 60	J39
		PLOT DATE = 11/3/2016	DATE - 10-25-94	REVISED -	K. ENG 10-27-08		SCALE: NONE	SHEET NO. 1 OF 1 SHEETS STA.	TO STA.	FED. ROAD D	ICT NO 1 THE INDICED AT			

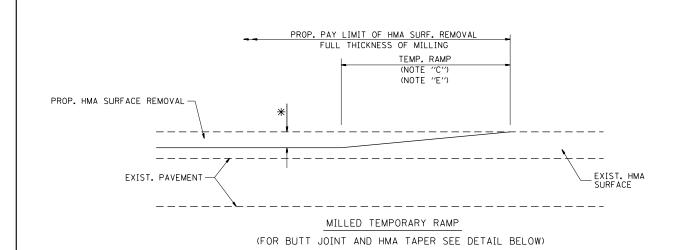


#### OPTION 1

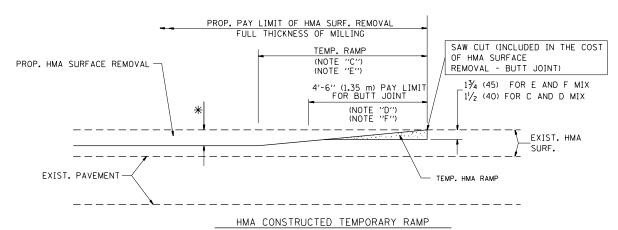


(FOR BUTT JOINT AND HMA TAPER SEE DETAIL BELOW)


## OPTION 2 TYPICAL TEMPORARY RAMP

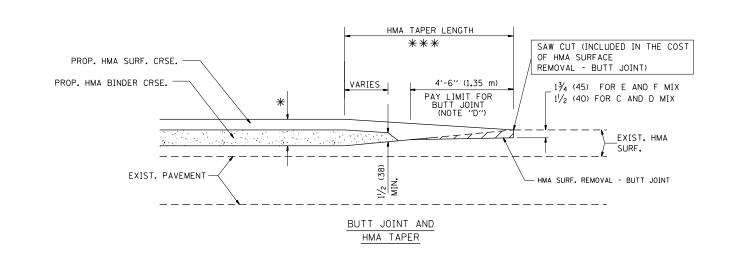

## TYPICAL BUTT JOINT AND HMA TAPER FOR MILLING AND RESURFACING

## STATE OF ILLINOIS DEPARTMENT OF TRANSPORTATION

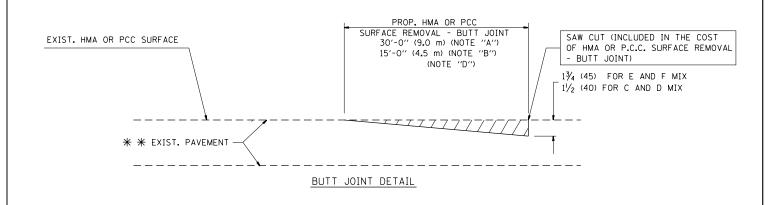

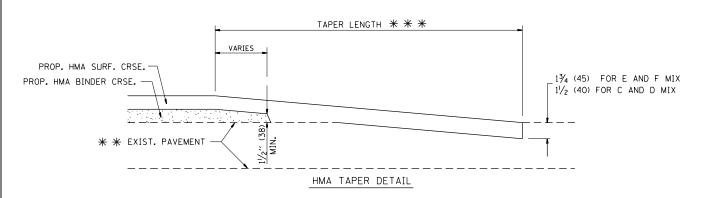

## TYPICAL BUTT JOINT AND HMA TAPER FOR RESURFACING ONLY

* * PC CONCRETE, HMA OR HMA RESURFACED PAVEMENT.


#### NOTES

- A: MAINLINE ROADWAYS AND MAJOR SIDE ROADS.
- MINOR SIDE ROADS.
- C: THE TEMP. RAMP SHALL BE CONSTRUCTED IMMEDIATELY UPON REMOVAL OF THE EXISTING HMA SURFACE.
- D: THE BUTT JOINT SHALL BE CONSTRUCTED IMMEDIATELY PRIOR TO PLACING THE PROPOSED HMA COURSES.
- E: TAPER THE TEMP. RAMP AT A RATE OF 3'-0" (900 mm) PER 1 INCH (25 mm) OF MILLING THICKNESS.
- F: INSTALLATION AND REMOVAL OF THE 4'-6" (1.35 m) TEMP. RAMP IS INCLUDED IN COST OF HMA SURFACE REMOVAL BUTT JOINT
- G: SEE ARTICLE 406.08 AND 406.14 OF THE STANDARD SPECIFICATIONS FOR "HMA AND/OR PCC SURFACE REMOVAL, BUTT JOINT".
- * SEE TYPICAL SECTIONS FOR MILLING THICKNESS.
- ** * 20'-0" (6.1 m) PER 1 (25) RESURFACING (NOTE "A") 10'-0" (3.0 m) PER 1 (25) RESURFACING (NOTE "B")

#### BASIS OF PAYMENT:

THE BUTT JOINT WILL BE PAID FOR AT THE CONTRACT UNIT PRICE PER SQUARE YARD (SQUARE METER) FOR "HOT-MIX ASPHALT SURFACE REMOVAL - BUTT JOINT" OR FOR "PORTLAND CEMENT CONCRETE SURFACE REMOVAL- BUTT JOINT".

ALL DIMENSIONS ARE IN INCHES (MILLIMETERS) UNLESS OTHERWISE SHOWN.

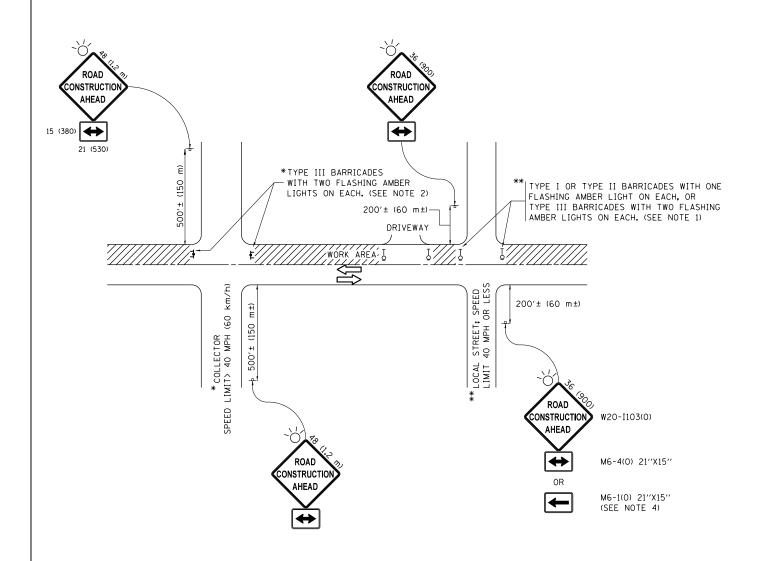

- SIDE ROAD WITH A SPEED LIMIT OF 40 MPH (60 km/h) OR LESS AS SHOWN ON THE DRAWING AND AS DIRECTED BY THE ENGINEER:
  - a) ONE "ROAD CONSTRUCTION AHEAD" SIGN 36 x 36 (900x900) WITH A FLASHER MOUNTED ON IT APPROXIMATELY 200" (60 m) IN ADVANCE OF THE MAIN ROUTE.
  - b) THE CLOSED PORTION OF THE MAIN ROUTE SHALL BE PROTECTED BY BLOCKING WITH TYPE I, TYPE II OR TYPE III BARRICADES, 1/3 OF THE CROSS SECTION OF THE CLOSED PORTION.
- 2. SIDE ROAD WITH A SPEED LIMIT GREATER THAN 40 MPH (60 km/h) AS SHOWN ON THE DRAWING AND AS DIRECTED BY THE ENGINEER:
  - a) ONE "ROAD CONSTRUCTION AHEAD" SIGN 48  $\times$  48 (1.2 m  $\times$  1.2 m) WITH A FLASHER MOUNTED ON IT APPROXIMATELY 500" (150 m) IN ADVANCE OF THE MAIN ROUTE.
  - b) THE CLOSED PORTION OF THE MAIN ROUTE SHALL BE PROTECTED BY BLOCKING WITH TYPE III BARRICADES, 1/2 OF THE CROSS SECTION OF THE CLOSED PORTION.
- 3. CONES MAY BE SUBSTITUTED FOR BARRICADES OR DRUMS AT HALF THE SPACING DURING DAY OPERATIONS. CONES SHALL BE A MINIMUM OF 28 (710) IN HEICHT
- 4. WHEN THE SIDE ROAD LIES BETWEEN THE BEGINNING OF THE MAINLINE SIGNING AND THE WORK ZONE, A SINGLE HEADED ARROW (M6-1) SHALL BE USED IN LIEU OF THE DOUBLE HEADED ARROW (M6-4).

SCALE: NONE

- 5. WHEN WORK IS BEING PERFORMED ON A SIDE ROAD OR DRIVEWAY, FOLLOW THE APPLICABLE STANDARD(S). THE DIRECTIONAL ARROW (M6-1 OR M6-4) SHALL BE COVERED OR REMOVED WHEN NO LONGER CONSISTENT WITH THE TRAFFIC CONTROL SET-UP.
- 6. ADVANCE WARNING SIGNS ARE TO BE OMITTED ON DRIVEWAYS UNLESS OTHERWISE SPECIFIED IN THE PLANS OR BY THE ENGINFER.
- 7. THE TRAFFIC CONTROL AND PROTECTION FOR SIDE ROADS, INTERSECTIONS, AND DRIVEWAYS SHALL BE INCLUDED IN THE COST OF SPECIFIED TRAFFIC CONTROL STANDARDS OR ITEMS.


All dimensions are in inches (millimeters) unless otherwise shown.

FILE NAME =	USER NAME = bartonrw	DESIGNED - L.H.A.	REVISED	- A. HOUSEH 10-15-96
pw:\\ILØ84EBIDINTEG.:ll:no:s.gov:PWIDOT\Do	cuments\IDOT Offices\District 1\Projects\P143	9 <b>@RAWN</b> ata\Besign\DistStd.dgn	REVISED	-T. RAMMACHER 01-06-00
	PLOT SCALE = 100.0000 ' / in.	CHECKED -	REVISED	- A. SCHUETZE 07-01-13
Default	PLOT DATE = 11/3/2016	DATE - 06-89	REVISED	- A. SCHUETZE 09-15-16

STATE OF ILLINOIS	
<b>DEPARTMENT OF TRANSPORTATION</b>	


	TRAFFIC (	CONTR	OL AND F	PROTEC	CTION FOR	F.A.U. RTE.	
CI	DE BUVDS	INTE	RSECTIONS	. AND	DRIVEWAYS	3512	
31	DE HUADS	, IIII L	IIOLUTION	, AIND	DIIIVEVVAIS		TC
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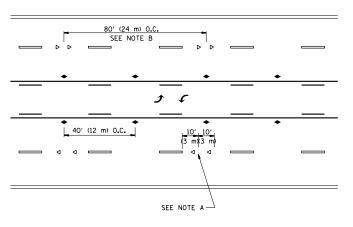
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	TC-10		CONTRACT	NO. 6	0J39
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F.A.U. RTE.	SECTION		COUNTY	TOTAL SHEETS	SHEE NO.

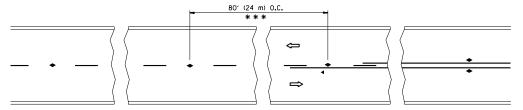


*** REDUCE TO 40' (12 m) O.C. ON CURVES WITH POSTED OR ADVISORY SPEED 45 M.P.H. (70 km/h) OR LESS.

TWO-LANE/TWO-WAY




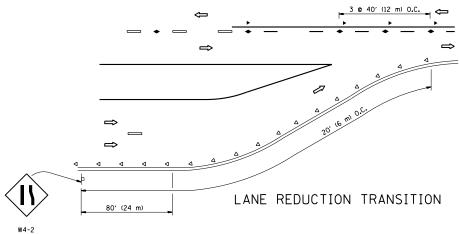

TWO-WAY LEFT TURN

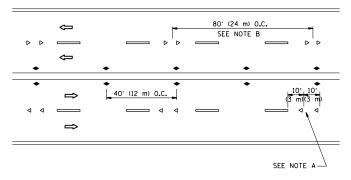

MULTI-LANE/UNDIVIDED

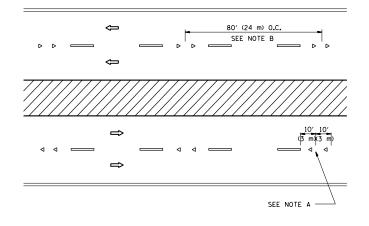

MULTI-LANE/DIVIDED

#### GENERAL NOTES

- MARKERS USED WITH DASHED LINES SHALL BE CENTERED IN THE GAP BETWEEN SEGMENTS.
- 2. MARKERS USED ADJACENT TO SOLID LINES SHALL BE OFFSET 2 TO 3 (50 TO 75) TOWARD TRAFFIC AS SHOWN.
- 3. MARKERS THROUGH TANGENTS LESS THAN 500' (150 m) IN LENGTH BETWEEN CURVES SHALL BE INSTALLED AT THE LESSER OF THE TWO CURVE SPACINGS.

#### LANE MARKER NOTES

A. USE DOUBLE LANE LINE MARKERS SPACED AS SHOWN.

B. REDUCE TO 40' (12 m) O.C. ON CURVES WHERE ADVISORY SPEEDS ARE 10 M.P.H (20 km/h) LOWER THAN POSTED SPEEDS.

#### SYMBOLS

---- YELLOW STRIPE

WHITE STRIPE

- ONE-WAY AMBER MARKER
- ONE-WAY CRYSTAL MARKER (₩/O)
- ◆ TWO-WAY AMBER MARKER

#### DESIGN NOTES

- 1. DOUBLE LANE LINE MARKERS SHALL BE USED UNLESS SPECIFIED OTHERWISE.
- 2. EXCEPT AS SHOWN ON THE LANE REDUCTION TRANSITION AND FREEWAY EXIT RAMP DETAIL, MARKERS ARE NOT TO BE SPECIFIED ON RIGHT EDGE LINES.
- 3. THE EXACT MARKER LIMITS, SPACING, AND COLOR SHALL BE INCLUDED IN THE PLANS WHEN STANDARD SPECIFICATIONS ARE NOT BEING USED.
- 4. MARKERS SHOULD NOT BE USED ALONGSIDE CURBS EXCEPT FOR EXTREMELY SHORT SECTIONS OF CURBS WHERE NOT MORE THAN TWO MARKERS WOULD BE INVOLVED.

MINIMUM OF 3 W
EQUALLY SPACED 3 @ 80' (24 m) O.C. — ___ 3 @ 80' (24 m) O.C. 3 @ 40' (12 m) 3 @ 40' (12 m) 40' (12 m) 0.C. 40' (12 m) 0.C.  $\Rightarrow$  $\Rightarrow$ ◆ 40′ (12 m) 0.C. 40' (12 m) 0.C. * SEE TWO-LANE/TWO-WAY WHERE MARKERS CONTINUE ** WHERE THE MEDIAN WIDTH IS 6' (2 m) OR LESS USE TWO-WAY MARKERS.

LEFT TURN


All dimensions are in inches (millimeters) unless otherwise shown.


FILE NAME =	USER NAME = bartonrw	DESIGNED -	REVISED	-T. RAMMACHER (	09-19-94
pw:\\IL084EBIDINTEG.:1ll:no:s.gov:PWIDOT\Do	cuments\IDOT Offices\District 1\Projects\P143	9 <b>@RAWN</b> Data\Design\DistStd.dgn	REVISED	-T. RAMMACHER (	03-12-99
	PLOT SCALE = 100.0000 ' / in.	CHECKED -	REVISED	-T. RAMMACHER C	01-06-00
	PLOT DATE = 11/3/2016	DATE -	REVISED	- C. JUCIUS C	9-09-09

STATE OF ILLINOIS **DEPARTMENT OF TRANSPORTATION** 

	TYPIC	AL APPLICA	ATIONS		F.A.U. RTE.	SEC.	TION		COUNTY
DAIGED D	EFLECTIVE PAVEME	NIT MADVE	DE JENIONA DIONA	DECICTANT\	3512	87-	Y-N		COOK
NAISLU N	LILLUTIVE PAVEIVIE	INI WANKE	no (SINONA-LEGAN	nL3I3 IANI I		TC-11			CONTRA
SCALE: NONE	SHEET NO. 1 OF 1	SHEETS	STA.	TO STA.	FED. R	OAD DIST. NO. 1	ILLINOIS FE	ED. AI	D PROJECT

SECTION COUNTY соок 3512 87-Y-N 102 93 CONTRACT NO. 60J39 TC-11

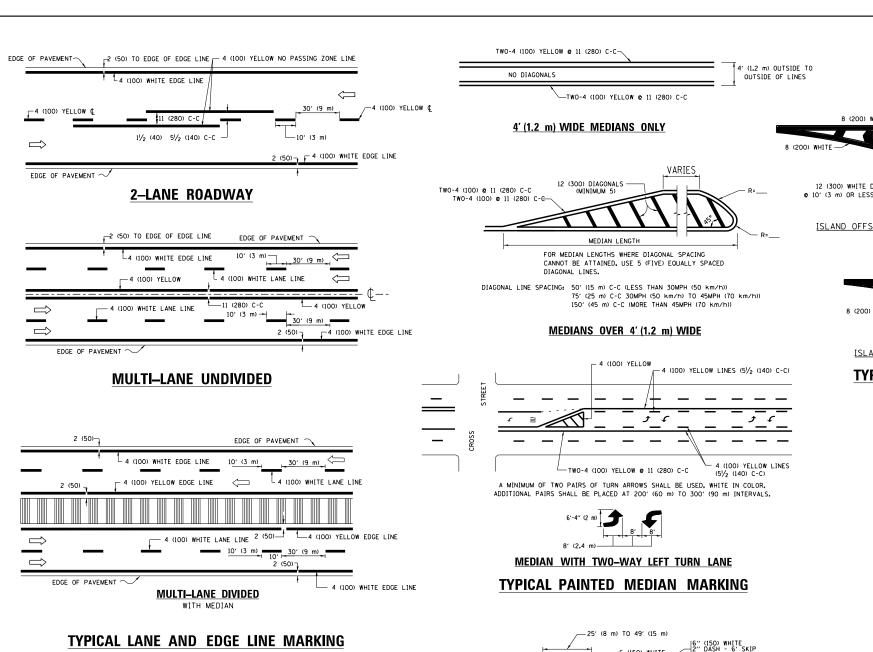

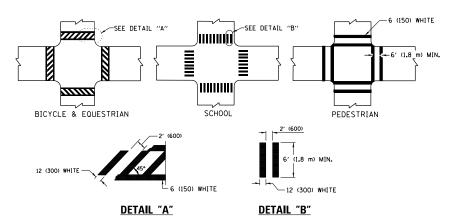

#### TYPICAL CROSSWALK MARKING

* MARKINGS SHALL BE INSTALLED PARALLEL TO THE CENTERLINE OF THE ROAD WHICH IT CROSSES


## −50′ (15 m) TO 200′ (60 m) <del>||</del> OVER 200' (60 m) ____ 6 (150) WHITE


FULL SIZE LETTERS 8' (2.4 m) AND ARROWS SHALL BE USED. AREA = 15.6 SO. FT. (1.5 m² ) (NLY AREA = 20.8 SO. FT. (1.9 m²)


* TURN LANES IN EXCESS OF 400' (120 m) IN LENGTH MAY HAVE AN ADDITIONAL SET OF ARROW - "ONLY" INSTALLED MIDWAY BETWEEN THE OTHER TWO SETS OF ARROW - "ONLY".

TYPICAL LEFT (OR RIGHT) TURN LANE


TYPICAL TURN LANE MARKING

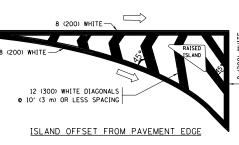

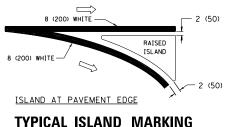

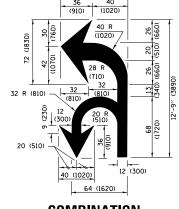

6'-4" (1930)

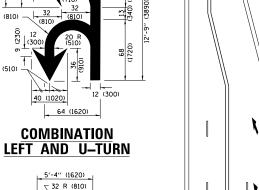

## LANE REDUCTION TRANSITION

D(FT)

345

425

500

580

665

750

**−20**′

SPEED LIMIT

45

50

55

* LANE REDUCTION ARROWS REQUIRED AT SPEEDS OF 45 MPH OR GREATER OR WHEN SPECIFIED IN PLANS.

TYPE OF MARKING	WIDTH OF LINE	PATTERN	COLOR	SPACING /REMARKS
CENTERLINE ON 2 LANE PAVEMENT	4 (100)	SKIP-DASH	YELLOW	10' (3 m) LINE WITH 30' (9 m) SPACE
CENTERLINE ON MULTI-LANE UNDIVIDED PAVEMENT	2 @ 4 (100)	SOLID	YELLOW	11 (280) C-C
NO PASSING ZONE LINES: FOR ONE DIRECTION FOR BOTH DIRECTIONS	4 (100) 2 @ 4 (100)	SOLID SOLID	YELLOW YELLOW	5½ (140) C-C FROM SKIP-DASH CENTERLINE 11 (280) C-C OMIT SKIP-DASH CENTERLINE BETWEEN
LANE LINES	4 (100) 5 (125) ON FREEWAYS	SKIP-DASH SKIP-DASH	WHITE WHITE	10' (3 m) LINE WITH 30' (9 m) SPACE
DOTTED LINES (EXTENSIONS OF CENTER, LANE OR TURN LANE MARKINGS)	SAME AS LINE BEING EXTENDED	SKIP-DASH	SAME AS LINE BEING EXTENDED	2' (600) LINE WITH 6' (1.8 m) SPACE
EDGE LINES	4 (100)	SOLID	YELLOW-LEFT WHITE-RIGHT	OUTLINE MEDIANS IN YELLOW
TURN LANE MARKINGS	6 (150) LINE; FULL SIZE LETTERS & SYMBOLS (8' (2.4m))	SOLID	WHITE	SEE TYPICAL TURN LANE MARKING DETAIL
TWO WAY LEFT TURN MARKING	2 @ 4 (100) EACH DIRECTION 8' (2.4m) LEFT ARROW	SKIP-DASH AND SOLID IN PAIRS	WHITE	10' (3 m) LINE WITH 30' (9 m) SPACE FOR SKIP-DASH: 5½ (140) C-C BETWEEN SOLID LINE AND SKIP-DASH LINE SEE TYPICAL TWO-WAY LEFT TURN MARKING DETAIL
CROSSWALK LINES (PEDESTRIAN) A. DIAGONALS (BIKE & EOUESTRIAN) B. LONGITUDINAL BARS (SCHOOL)	2 @ 6 (150) 12 (300) @ 45° 12 (300) @ 90°	SOLID SOLID SOLID	WHITE WHITE WHITE	NOT LESS THAN 6' (I.8 m) APART 2' (600) APART 2' (600) APART 5' (600) APART SEE TYPICAL CROSSWALK MARKING DETAILS.
STOP LINES	24 (600)	SOLID	WHITE	PLACE 4' (1.2 m) IN ADVANCE OF AND PARALLEL TO CROSSMALK, IF PRESENT. OTHERWISE, PLACE AT DESIRED STOPPING POINT. PARALLEL TO CROSSROAD CENTERLINE, WHERE POSSIBLE
PAINTED MEDIANS	2 @ 4 (100) WITH 12 (300) DIAGONALS @ 45° NO DIAGONALS USED FOR 4' (1.2 m) WIDE MEDIANS	SOLID	YELLOW: TWO WAY TRAFFIC WHITE: ONE WAY TRAFFIC	11 (280) C-C FOR THE DOUBLE LINE SEE TYPICAL PAINTED MEDIAN MARKING.
GORE MARKING AND CHANNELIZING LINES	8 (200) WITH 12 (300) DIAGONALS @ 45°	SOLID	WHITE	DIACONALS: 15' (4,5 m) C-C (LESS THAN 30MPH (50 km/h)) 20' (6 m) C-C 30MPH (50 km/h) TO 45MPH (70 km/h)) 30' (9 m) C-C (OVER 45MPH (70 km/h))
RAILROAD CROSSING	24 (600) TRANSVERSE LINES; "RR" IS 6' (1.8 m) LETTERS; 16 (400) LINE FOR "X"	SOLID	WHITE	SEE STATE STANDARD 780001 AREA OF: "R"=3.6 SO. FT. (0.33 m ² ) EACH "X"=54.0 SO. FT. (5.0 m ² )
SHOULDER DIAGONALS (REQUIRED FOR SHOULDERS > 8')	12 (300) <b>©</b> 45°	SOLID	WHITE - RIGHT YELLOW - LEFT	50' (15 m) C-C (LESS THAN 30MPH (50 km/h)) 75' (25 m) C-C (30 MPH (50 km/h) TO 45MPH (70 km/h) 150' (45 m) C-C (0VER 45MPH (70 km/h))
U TURN ARROW	SEE DETAIL	SOLID	WHITE	16.3 SF
2 ARROW COMBINATION LEFT AND U TURN	SEE DETAIL	SOLID	WHITE	30.4 SF

FOR FURTHER DETAILS ON PAVEMENT MARKING REFER TO STANDARD SPECIFICATIONS FOR ROAD AND BRIDGE CONSTRUCTION AND STATE STANDARD 780001.


All dimensions are in inches (millimeters) unless otherwise shown.

FILE NAME = DESIGNED - EVERS USER NAME = bartonrw REVISED - C. JUCIUS 09-09-09 ow:\\ILØ84EBIDINTEG.:ll:no: ments\IDOT Offices\District 1\Projects\P143868RAMAData\Gesign\DistStd.dar REVISED -C. JUCIUS 07-01-13 CHECKED REVISED C. JUCIUS 12-21-15 PLOT DATE = 11/3/2016 DATE 03-19-90 REVISED -C. JUCIUS 04-12-16

STATE OF ILLINOIS **DEPARTMENT OF TRANSPORTATION** 

DISTRICT ONE	F.A.U. RTE.	SECTION	COUNTY	TOTAL SHEETS	SHEET NO.
TYPICAL PAVEMENT MARKINGS	3512	87-Y-N	соок	102	94
		TC-13	CONTRACT	NO. 6	OJ39
SCALE: NONE   SHEET 1 OF 1 SHEETS   STA. TO STA.		ILLINOIS FED. AI	D PROJECT		

## TURN BAY ENTRANCE AT START OF LANE CLOSURE TAPER

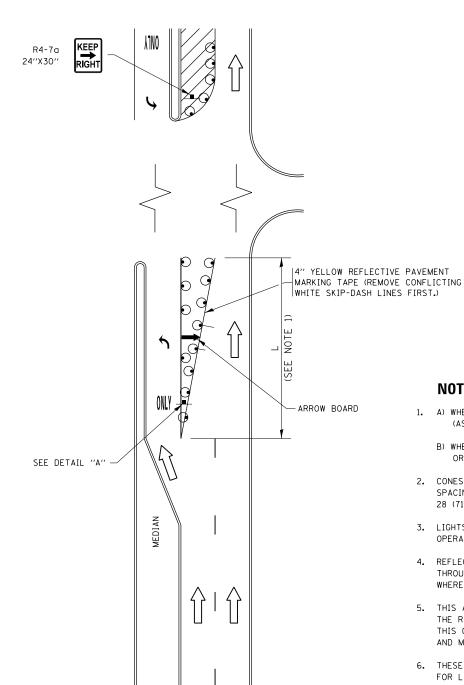

#### FIGURE 1


## **LEGEND** WORK AREA LANE OPEN TO TRAFFIC ARROW BOARD TYPE I OR II BARRICADE OR DRUM WITH STEADY BURN LIGHT DRUM WITH STEADY BURN LIGHT SIGN ASSEMBLY

TYPE I OR II CHECK BARRICADE WITH FLASHING LIGHT

#### NOTES:

- 1. A) WHEN "L" IS < THE STORAGE LENGTH OF THE TURN LANE (AS SHOWN IN FIG. 1), USE FIGURE 1.
  - B) WHEN "L" IS > THE STORAGE LENGTH OF THE TURN LANE OR THE TURN LANE IS WITHIN THE LANE CLOSURE, USE FIGURE 2.
- 2. CONES MAY BE SUBSTITUTED FOR BARRICADES OR DRUMS AT HALF THE SPACING DURING DAY OPERATIONS. CONES SHALL BE A MINIMUM OF 28 (710) IN HEIGHT.
- 3. LIGHTS WILL NOT BE REQUIRED ON BARRICADES OR DRUMS FOR DAY OPERATIONS. ALL LIGHTS SHALL BE MONODIRECTIONAL.
- 4. REFLECTIVE TEMPORARY PAVEMENT MARKINGS SHALL BE PLACED THROUGHOUT THE BARRICADED AREAS OF EACH TURN BAY AS SHOWN WHERE THE CLOSURE TIME IS GREATER THAN FOURTEEN (14) DAYS.
- 5. THIS APPLICATION ALSO APPLIES WHEN WORK IS BEING PERFORMED IN THE RIGHT LANE(S) AND THE RIGHT TURN BAY IS TO REMAIN OPEN. UNDER THIS CONDITION, "RIGHT TURN LANE" R3-I100R 24 x 24 (600 x 600) AND M6-2R 21  $\times$  15 (530  $\times$  380) SHALL BE USED.
- 6. THESE CONTROLS SHALL SUPPLEMENT MAINLINE TRAFFIC CONTROL FOR LANE CLOSURES.
- 7. THE SIGNS SHALL BE MOUNTED ABOVE THE BARRICADES/DRUMS ON SEPARATE SIGN SUPPORTS THAT MEET NCHRP 350 OR MASH PREQUIREMENTS.
- 8. TRAFFIC CONTROL AND PROTECTION AT TURN BAYS (TO REMAIN OPEN TO TRAFFIC) SHALL BE INCLUDED IN THE COST OF SPECIFIED TRAFFIC CONTROL STANDARDS OR ITEMS.

## **TURN BAY ENTRANCE** WITHIN A LANE CLOSURE

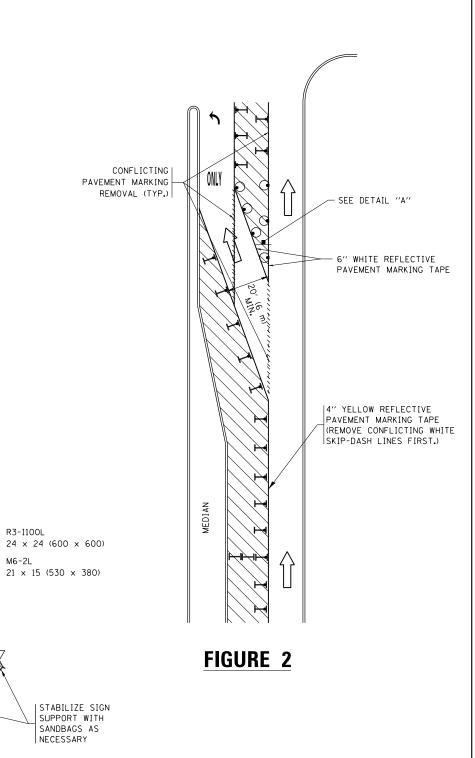


#### **DETAIL A**

TURN


All dimensions are in inches (millimeters) unless otherwise shown.

FILE NAME =		USER NAME = bartonrw	REVISED -T. RAMMACHER 09-08-94 REVISED - R. BORO 09-14		TRAFFIC CONTROL AND PROTECTION AT TURN BAYS	F.A.U.	SECTION	COUNTY	TOTAL SI	IEET NO.
pw:\\ILØ84EBIDINTE	EG.illinois.gov:PWIDOT\Do	cuments\IDOT Offices\District 1\Projects\P1	1439 <b>RREVINDED</b> ta\Design XQis <b>HISU</b> SEHH 11-07-95 REVISED - A. SCHUETZE 07-	STATE OF ILLINOIS	(TO REMAIN OPEN TO TRAFFIC)	3512	87-Y-N	соок	102	95
		PLOT SCALE = 100.0000 '/ in.	REVISED - A. HOUSEH 10-12-96 REVISED - A. SCHUETZE 09-	DEPARTMENT OF TRANSPORTATION	(TO REIVIAIN UPEN TO TRAFFIC)		TC-14	CONTRACT	NO. 60.	39
Default		PLOT DATE = 11/3/2016	REVISED -T. RAMMACHER 01-06-00 REVISED -		SCALE: NONE   SHEET 1 OF 1 SHEETS   STA. TO STA.		ILLINOIS FED. A	ID PROJECT		

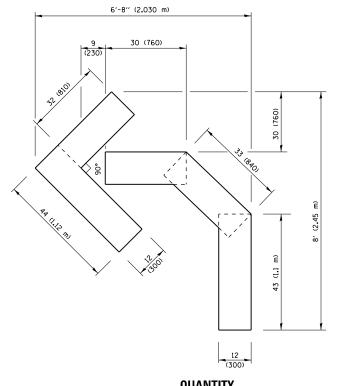


#### **QUANTITY**

4 (100) LINE = 45.5 ft. (13.9 m) 15.2 sq. ft. (1.41 sq. m)

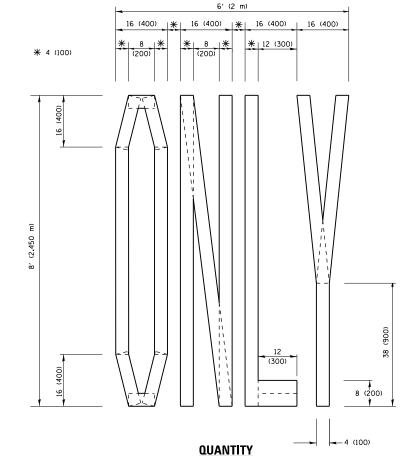

4 (100) LINE = 64.1 ft. (19.5 m) 21.4 sq. ft. (1.99 sq. m)

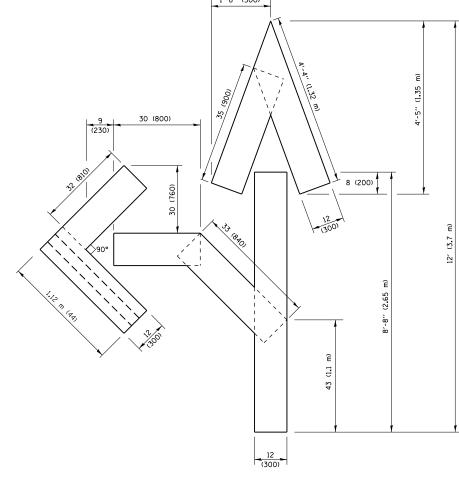


#### QUANTITY

4 (100) LINE = 82.5 ft. (25.1 m) 27.5 sq. ft. (2.53 sq. m)

#### NOTE:

ALL QUANTITIES OF PLACEMENT ARE REPRESENTED IN LINEAR FEET OF 4" LINES TO MATCH THE 4" TEMPORARY TAPE PAY ITEM AND REPRESENTS THE TOTAL QUANTITY OF 4" TAPE REQUIRED.

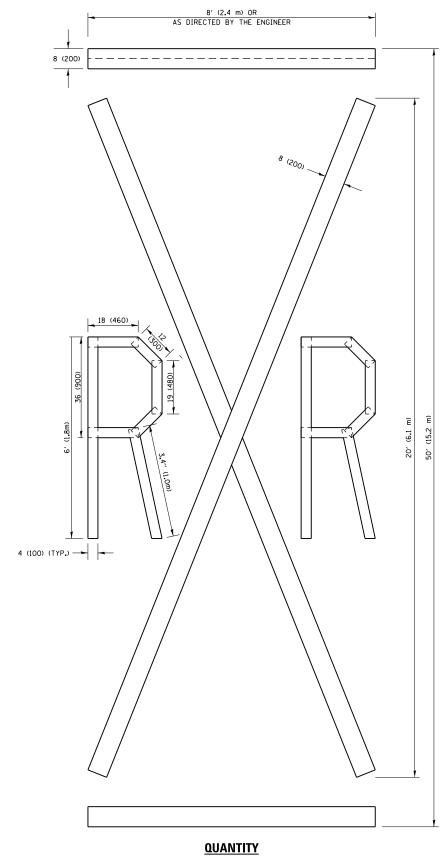


4 (100) LINE = 225.9 ft. (68.9 m) 75.3 sq. ft. (6.99 sq. m)

> All dimensions are in inches (millimeters) unless otherwise shown.

FILE NAME =	USER NAME = bartonrw	DESIGNED -	REVISED	-T. RAMMACHER 03-02-98
pw:\\IL084EBIDINTEG.:111:no:s.gov:PWIDOT\Do	cuments\IDOT Offices\District 1\Projects\P143	9 <b>@RAWN</b> ata\Design\DistStd.dgn	REVISED	-E. GOMEZ 08-28-00
	PLOT SCALE = 100.0000 '/ in.	CHECKED -	REVISED	-E. GOMEZ 08-28-00
	PLOT DATE = 11/3/2016	DATE - 09-18-94	REVISED	- A. SCHUETZE 09-15-16

STATE OF ILLINOIS DEPARTMENT OF TRANSPORTATION


						F.A.L RTE.	SECTION	COUNTY	TOTAL SHEETS	SHEET NO.
SHOR	T TERM PAV	/EMENT	MARKING	LETTERS AND	SYMBOLS	3512	87-Y-N	соок	102	96
							TC-16	CONTRACT	NO. 60	OJ39
SCALE: NONE	SHEET NO. 1	OF 1	SHEETS	STA.	TO STA.	FED	ROAD DIST, NO. 1 ILLINOIS FED. A	ID PROJECT		

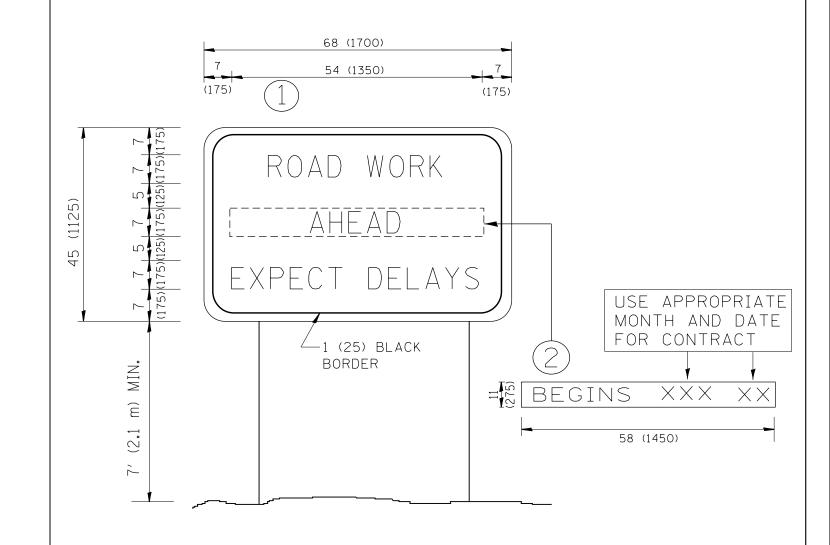

- 1. USE BLACK LETTERING ON ORANGE BACKGROUND.
- 2. ERECT SIGNS IN ADVANCE OF THE LOCATION FOR THE "ROAD CONSTRUCTION AHEAD" SIGN AT LOCATIONS AS DIRECTED BY THE ENGINEER.
- 3. ERECT SIGN (1) WITH INSTALLED PANEL (2) ONE WEEK PRIOR TO THE START OF CONSTRUCTION.
- 4. REMOVE PANEL (2) SOON AFTER THE START OF CONSTRUCTION.
- 5. SEE SPECIAL PROVISION FOR "TEMPORARY INFORMATION SIGNING" FOR ADDITIONAL INFORMATION.
- 6. ONE SIGN ASSEMBLY EQUALS 25.70 SQ. FT. (2.3 SQ. M.)
- 7. SHALL BE PAID FOR AS TEMPORARY INFORMATION SIGNING.

ALL DIMENSIONS ARE IN INCHES (MILLIMETERS) UNLESS OTHERWISE SHOWN.

7	FILE NAME =	USER NAME = bartonrw	DESIGNED -	REVISED - R. MIRS O	9-15-97	·		ARTERIAL RO	NAD.		F.A.U.	SECTION	COUNTY	CHEETS	SHEET
-  ,	ow:\\IL084EBIDINTEG.:111:no:s.gov:PWIDOT\Do	cuments\IDOT Offices\District 1\Projects\P143	9 <b>0RAWN</b> Data\Design\DistStd.dgn	REVISED - R. MIRS 12	2-11-97	STATE OF ILLINOIS					3512	87-Y-N	соок	102	97
		PLOT SCALE = 100.0000 '/ in.	CHECKED -	REVISED -T. RAMMACHER	02-02-99	DEPARTMENT OF TRANSPORTATION		INFORMATION	SIGN			TC-22	CONTRACT	NO. 6	OJ39
		PLOT DATE = 11/3/2016	DATE -	REVISED - C. JUCIUS	01-31-07		SCALE: NONE	SHEET NO. 1 OF 1 SHEETS	STA.	TO STA.	FED. ROAD	DIST. NO. 1   ILLINOIS FED.	AID PROJECT		

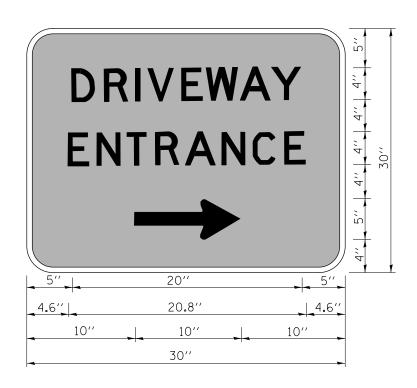

3.0" RADIUS, 0.5" BORDER, WHITE ON GREEN; REFLECTORIZED "DRIVEWAY" D; "ENTRANCE" D; STANDARD ARROW CUSTOM 12.0" x 5.0"

#### NOTES:

- 1. HALF OF THE SIGNS WILL REQUIRE A LEFT HAND FACING ARROW.
- 2. TWO SIGNS SHALL BE USED AT EACH COMMERCIAL ENTRANCE PLACED BACK-TO-BACK: ONE WITH A RIGHT HAND ARROW (SHOWN) SHALL BE PLACED ON THE NEAR RIGHT SIDE THE DRIVEWAY AND ONE WITH A LEFT HAND ARROW SHALL BE PLACED ON THE FAR LEFT SIDE OF THE DRIVEWAY.
- 3. SIGNS TO BE PAID FOR AS ITEM "TEMPORARY INFORMATION SIGNING".

FILE NAME =	USER NAME = bartonrw	DESIGNED -	REVISED	-	C. JUCIUS 02-15-07
pw:\\ILØ84EBIDINTEG.:ll:no:s.gov:PWIDOT\Do	cuments\IDOT Offices\District 1\Projects\P143	9 <b>@RAWN</b> Data\Design\DistStd.dgn	REVISED	-	
	PLOT SCALE = 100.0000 '/ in.	CHECKED -	REVISED	-	
	PLOT DATE = 11/3/2016	DATE -	REVISED	-	

STATE OF ILLINOIS
DEPARTMENT OF TRANSPORTATION

DRIVEWAY ENTRANCE SIGNING					SECTION	COUNTY	TOTAL SHEETS	SHEET NO.		
		3512	87-Y-N	соок	102	98				
			TC-26	CONTRACT	NO. 6	OJ39				
SCALE: NONE	SHEET NO. 1 OF 1 SHEETS	STA.	TO STA.	FED. ROAD DIST. NO. 1   ILLINOIS   FED. AID PROJECT						

