#### INDEX OF SHEETS

SEE SHEET NO. 2

0

 $\circ$ 

0


0

03-03-2017 LETTING ITEM 035

STATE OF ILLINOIS DEPARTMENT OF TRANSPORTATION **DIVISION OF HIGHWAYS** 

## **PROPOSED** FENCING PLANS

**SECTION HSR FENCING SANG. 2017** PROJECT HSR-000V(090) FENCING CONSTRUCTION

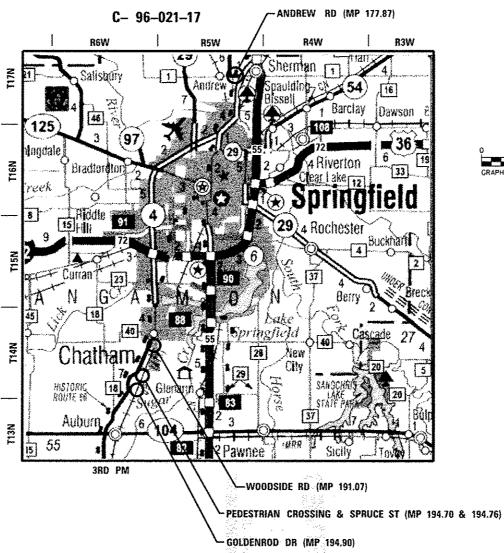

LOCATION MAP

ANDREW RD WOODSIDE RD PEDESTRIAN CROSSING & SPRUCE ST GOLDENROD DR

PROJECT TOTAL

**NET LENGTH** 316.00 FT (0.060 MI) 316.48 FT (0.060 MI)

**GROSS LENGTH** 316.00 FT (0.060 MI) 316.48 FT (0.060 MI) 630.83 FT (0.119 MI)

ARLIN C. WILLIAMS P.E. IL. REG. P.E. NO. 062-058574 EXPIRES: 11-30-2017

DATE:12-08-2016

HSR FENCING SANG. 2017 SANGAMON ILLINOIS CONTRACT NO. 72J59

DOT #294281X DOT #294328R DOT #294335B DOT #440769R MP 177.87 MP 191.07 MP 194.76


D-96-021-17



### **FINAL**

STATE OF ILLINOIS DEPARTMENT OF TRANSPORTATION DIVISION OF HIGHWAYS

> PRINTED BY THE AUTHORITY OF THE STATE OF ILLINOIS

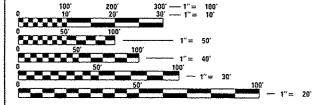

ENGINEERING SCALES. REDUCED SIZED PLANS WILL NOT CONFORM TO STANDARD SCALES, IN MAKING MEASUREMENTS ON REDUCED PLANS, THE ABOVE SCALES MAY BE USED.

JOINT UTILITY LOCATION INFORMATION FOR EXCAVATION 1-800-892-0123 OR 811

DISTRICT 6 NO. (217) 782-7301

PROJECT ENGINEER: KEITH B. DONOVAN, P.E. (217) 782-4761

CONTRACT NO. 72J59 AECOM

345 EAST ASH AVENUE, SUITE B DECATUR, ILLINOIS 62526 PH. 217-875-4800

630.83 FT (0.119 MI) 1174.41 FT (0.222 MI)

1174.41 FT (0.222 MI) 2437.72 FT (0.461 MI)

2437.72 FT (0.461 MI)

District 6 sht-cover.dgn 12/8/2016 3:01:58 PM-

#### **GENERAL NOTES**

- THE CONTRACTOR SHALL BE REQUIRED TO COMPLY WITH STATE REGULATIONS REGARDING AIR, WATER, AND NOISE POLLUTION.
- SEEDING SHALL NOT BE PERMITTED AT ANY TIME WHEN THE GROUND IS FROZEN, WET,
  OR IN AN UNTILLABLE CONDITION. LOCATIONS TO BE SEEDED WILL BE DETERMINED BY
  THE ENCINCER.
- 3. IT SHALL BE THE CONTRACTORS RESPONSIBILITY TO DETERMINE THE ACTUAL LOCATION OF ALL UNDERGROUND UTILITY FACILITIES. THE CONTRACTOR SHALL ALSO OBTAIN FROM THE RESPECTIVE UTILITY COMPANIES DETAILED INFORMATION RELATIVE TO THE LOCATION OF THEIR FACILITIES AND THE WORKING SCHEDULES OF THE UTILITY COMPANIES FOR THEIR MARKING OF THE EXACT LOCATION PRIOR TO CONSTRUCTION.
- 4. ABANDONED UNDERGROUND UTILITIES THAT CONFLICT WITH CONSTRUCTION SHALL BE DISPOSED OF OUTSIDE THE LIMITS OF THE RIGHT OF WAY ACCORDING TO ARTICLE 202.03 OF THE STANDARD SPECIFICATIONS AND AS DIRECTED BY THE ENGINEER. THIS WORK WILL NOT BE PAID FOR SEPARATELY, BUT SHALL BE INCLUDED IN THE COST OF APPLICABLE FENCING.
- 5. THE CONTRACTOR SHALL KEEP EXISTING ADJACENT STREETS CLEAN OF DIRT, MUD, AND OTHER DEBRIS AND, WHEN NECESSARY, CLEAN SAID PAVEMENTS ON A DAILY BASIS OR WHEN DIRECTED BY THE ENGINEER. NO EXTRA COMPENSATION SHALL BE ALLOWED THE CONTRACTOR FOR THIS WORK.
- 6. THE SCALE SHOWN ON THE DRAWINGS APPLIES ONLY TO FULL SIZE PLANS AND NOT TO THE REDUCED SIZE PLANS. REDUCED SIZED PLANS CAN BE PRINTED TO SCALE FOR USE IN THE FIELD.
- 7. BEFORE STARTING ANY EXCAVATION. THE CONTRACTOR SHALL CALL "JULIE" AT 1-800-892-0123 OR 811 FOR FIELD LOCATIONS OF BURIED ELECTRIC, TELEPHONE AND GAS FACILITIES. THE CONTRACTOR SHALL CONTACT THE MUNICIPALITY FOR ANY MUNICIPAL OWNED UTILITIES. (MINIMUM 48 HOURS NOTIFICATION IS REQUIRED). THE CONTRACTOR SHALL CALL THE UNION PACIFIC "CALL BEFORE YOU DIG" OPERATION AT 1-800-336-9193 FOR FIELD LOCATIONS OF BURIED FIBER OPTIC CABLES IN UNION PACIFIC RIGHT OF WAY.
- 8. EXISTING UTILITIES ARE SHOWN ON THE PLANS ACCORDING TO INFORMATION OBTAINED FROM THE LOCAL AGENCIES. OWNERS, AND FIELD SURVEYS. THE ACCURACY AND COMPLETENESS OF SAID INFORMATION IS NOT GUARANTEED. IT SHALL BE THE CONTRACTOR'S RESPONSIBILITY TO VERIFY THE EXISTENCE, NATURE AND EXACT LOCATIONS OF ALL UTILITY LINES AND APPURTENANCES WITHIN THE LIMITS OF THE IMPROVEMENTS.
- 9. MEMBERS OF JULIE KNOWN TO BE WITHIN THE LIMITS OF THE IMPROVEMENT ARE:
  - 1. SPRINT (FO)
  - 2. AMEREN ILLINOIS (G)
  - 3. VILLAGE OF CHATHAM (W). (E).(A).(SANITARY & STORM SEWERS)
  - 4. FRONTIER COMMUNICATIONS (FD)
  - 5. COMCAST (CTV)
  - 6. CITY WATER LIGHT AND POWER "CWLP". (A)
  - 7. AT&T (T)
  - 8. LEVEL 3 COMMUNICATIONS (FO),(T)
  - 9. ZAYO GROUP (FO)
  - 10. CASS CABLE TELEVISION/GREEN COUNTY PARTNERS (CTV)
  - 11. NEW WAVE COMMUNICATIONS (FO)
  - 12. WILLIAMSVILLE WATER AND SEWER (W)
  - 13. VILLAGE OF SHERMAN (SANITARY & STORM SEWER)

NON-JULIE MEMBERS WITHIN THE LIMITS OF IMPROVEMENT ARE:

- 1. UNION PACIFIC RAILROAD COMPANY (UPRR)
- 10. THE CONTRACTOR SHALL COORDINATE WITH THE UPRR SIGNAL DEPARTMENT FOR ITEMS INSTALLED BY THE UPRR SIGNAL DEPARTMENT.
- 11. THE HORIZONTAL SURVEY DATUM IS ILLINOIS STATE PLANE COORDINATES, WEST ZONE NAD 83 (CORS 96). THE SURVEY DATUM USED FOR ELEVATION IS NAVO 88.
- 12. UPRR FLAGGERS SHALL BE PRESENT WHEN WORKING WITHIN UPRR ROW THE CONTRACTOR SHALL COORDINATE DIRECTLY WITH UPRR TO ASSURE FLAGGERS ARE PRESENT DURING CONSTRUCTION. NO ADDITIONAL COMPENSATION WILL BE ALLOWED.

#### COMMITMENTS

NONE. December 08, 2016

- 13. NO WORK WHATSOEVER SHALL BE COMMENCED WITHOUT FIRST NOTIFYING JOHN JEROME, UPRR HSR PROGRAM MANAGER, OFFICE PH 816-399-1760.
- 14. ALL UTILITY FACILITIES THAT REQUIRE RELOCATION WITHIN STATE, CITY OR RAILROAD R.O.W. SHALL BE RELOCATED BY THE UTILITY COMPANY UNLESS OTHERWISE SHOWN ON PLANS.
- 15. THE CONTRACTOR SHALL VERIFY LOCATIONS AND ELEVATIONS OF EXISTING UTILITIES WHETHER KNOWN OR UNKNOWN PRIOR TO BEGINNING CONSTRUCTION.
- 16. ANY DAMAGE TO THE UNDERGROUND FACILITIES CAUSED BY THE CONTRACTOR SHALL BE REPAIRED TO THE SATISFACTION OF THE ENGINEER AT THE CONTRACTOR'S EXPENSE. INCLUDING TEMPORARY REPAIRS WHICH MAY BE REQUIRED TO KEEP THE FACILITY OPERATIONAL WHILE MATERIAL IS BEING OBTAINED TO MAKE PERMANENT REPAIRS.
- 17. ALL UTILITIES, SCHOOL DISTRICTS, LOCAL POLICE, AND FIRE DEPARTMENTS SHALL BE NOTIFIED BY THE CONTRACTOR PRIOR TO THE START OF CONSTRUCTION.
- 18. THE CONTRACTOR SHALL COMPLY WITH ALL FEDERAL, STATE, COUNTY, AND CITY/
  VILLAGE LAWS AND ORDINANCES AND REGULATIONS OF THE DEPARTMENT OF INDUSTRIAL
  RELATIONS, OSHA, NPDES AND INDUSTRIAL ACCIDENT COMMISSION RELATED TO
  THE SAFETY AND CHARACTER OF THE WORK, EQUIPMENT AND LABOR PERSONNEL.
- 19. IN ADDITION TO FIELD SURVEYS AND AERIAL MAPS, PLAN DIMENSIONS AND DETAILS RELATIVE TO EXISTING FACILITIES ARE SUBJECT TO CONSTRUCTION VARIATIONS. IT SHALL BE THE CONTRACTOR'S RESPONSIBILITY TO VERIFY SUCH DIMENSIONS AND DETAILS IN THE FIELD, MINOR VARIATIONS SHALL NOT BE CAUSE FOR ADDITIONAL COMPENSATION. THE CONTRACTOR WILL BE PAID FOR THE QUANTITY ACTUALLY FURNISHED AT THE UNIT PRICE BID FOR THE WORK.
- 20. ANY UNDERGROUND STRUCTURES SUCH AS CESSPOOLS, CISTERNS, MINING SHAFTS, TUNNELS, SEPTIC TANKS, WELLS, AND PIPELINES NOT LOCATED PRIOR TO CONSTRUCTION SHALL BE BROUGHT TO THE ATTENTION OF THE ENGINEER FOR DETERMINATION OF APPROPRIATE ACTION SUCH AS REMOVAL OR TREATMENT IN A MANNER JUDGED SUITABLE TO THE ENGINEER.
- 21. THE CONTRACTOR SHALL COORDINATE LOCATION OF ALL PROPOSED UTILITIES WITH UPRR TO ASSURE ACCURACY OF UTILITY CONNECTIONS AND COMPLIANCE WITH LOCAL CODES.
- 22. ANY REFERENCE WITHIN THESE PLANS TO A STANDARD SHALL BE INTERPRETED TO MEAN THE EDITION INDICATED BY THE SUB-NUMBER LISTED ON THE LIST OF STANDARDS OR THE COPY INCLUDED IN THESE PLANS.
- 23. ANY EXISTING CONDITIONS FOUND TO BE A VARIANCE WITH THESE DRAWINGS SHALL BE IMMEDIATELY REPORTED TO THE ENGINEER.
- 24. THE CONTRACTOR SHALL PERFORM ALL CONSTRUCTION IN SUCH MANNER AS TO PROTECT ADJACENT EXISTING BUILDINGS. AND OTHER SITE ELEMENTS WHICH ARE TO REMAIN IN SERVICE.
- 25. THE CONTRACTOR IS RESPONSIBLE FOR THE PRESERVATION OF ALL SURVEY CONTROL MONUMENTS. IN THE EVENT MONUMENTS ARE DAMAGED OR DESTROYED BY THE CONTRACTOR. THE ENGINEER WILL REPLACE THE MONUMENT SOLELY AT THE CONTRACTOR'S EXPENSE.
- 26. THE CONTRACTOR SHALL PROVIDE AS-BUILT DRAWINGS FOR ALL IMPROVEMENTS.
- 27. NO FIELD CHANGES WILL BE PERMITTED WITHOUT DIRECT WRITTEN AUTHORIZATION FROM THE ENGINEER OR HIS REPRESENTATIVE.
- 28. THE CONTRACTOR SHALL COORDINATE WORK WHICH AFFECTS ADJACENT PROPERTY OWNERS.
  ANY QUESTIONS OR AGREEMENTS BETWEEN ADJACENT PROPERTY OWNERS AND CONTRACTOR
  SHALL BE MADE IN WRITING. A COPY OF SUCH AGREEMENT SHALL BE PROVIDED TO
  THE ENGINEER OR HIS REPRESENTATIVE.
- 29. DISPOSAL OF EXISTING FENCE AND PLACEMENT OF TEMPORARY FENCE SHALL NOT BE PAID FOR SEPARATELY, BUT SHALL BE INCLUDED IN THE COST OF FENCE REMOVAL. CONTRACTOR SHALL REUSE SUCH MATERIALS TO THE EXTENT POSSIBLE TO EXTEND REMAINING PRIVATELY OWNED FENCING INTO NEW RAILROAD R.O.W. FENCING ENSURING THAT ADEQUATE ENCLOSURE OF PRIVATELY OWNED AREAS IS ACCOMPLISHED. ANY NEW FENCING MATERIAL REQUIRED, INCLUDING CONCRETE FOOTING, IS TO BE PROVIDED BY THE CONTRACTOR.
- 30. FINAL CONFIGURATION AND ELEVATION OF FENCING IS SUBJECT TO CHANGE FROM THAT WHICH IS SHOWN OR INDICATED WITHIN THE 100% DESIGN PLAN SET. CONTRACTOR WILL BE PEOUIRED TO ADJUST THE LOCATION, LENGTH AND ELEVATION OF BOTH NEW SIX (6) FOOT HIGH AND NEW THREE (3) FOOT HIGH FENCING AND CATES IN THE VICINITY OF ROADWAYS AND THE FLASHING LIGHT SIGNALS TO ENSURE THAT THE FINAL FENCING AND CATES PROPERLY ADJOINS THE "ASBUILT" ROADWAYS. ESCAPE PADS AND FLASHING LIGHT SIGNALS. IN THE CASE OF THREE (3) FOOT HIGH FENCING ENDING/BEGINNING ADJACENT TO A FLASHING LIGHT SIGNAL, SUCH FENCING MUST END/BEGIN AT A DISTANCE OF SEVEN (7) FOOT FROM THE CENTER OF THE FLASHING LIGHT SIGNAL MAST.
- 31. THE CONTRACTOR SHALL BE REQUIRED TO ADJUST FENCE POST LOCATIONS TO AVOID UNDERGROUND

#### INDEX OF SHEETS

1	COVER SHEET
2	INDEX OF SHEETS, HIGHWAY STANDARDS, COMMITMENTS AND GENERAL NOTES
3-4	SUMMARY OF QUANTITIES
5-6	SCHEDULE OF QUANTITIES
7-11	ALIGNMENTS, TIES AND BENCHMARKS
12	ANDREW RD FENCING PLANS
13	WOODSIDE RD FENCING PLANS
14	PEDESTRIAN CROSSING & SPRUCE ST FENCING PLANS
15	COLDENROD FENCING PLANS
16	ANDREW RD UTILITY PLANS
17	WOODSIDE RD UTILITY PLANS
18	PEDESTRIAN CROSSING & SPRUCE ST UTILITY PLANS
19	GOLDENROD UTILITY PLANS
20-32	FENCING DETAILS

#### HIGHWAY STANDARDS

000001-06 STANDARD SYMBOLS, AGBREVIATIONS AND PATTERNS
001006 DECIMAL OF AN INCH AND OF A FOOT
664001-02 CHAIN LINK FENCE
701001-02 OFF-RD OPERATIONS, 2L, 2W, MORE THAN 15' (4.5 m) AWAY
701006-05 OFF-RD OPERATIONS, 2L, 2W, 15' (4.5 m) TO 24" (600 mm) FROM PAVEMENT EDGE
701901-06 TRAFFIC CONTROL DEVICES

DISTRICT SIX
EXAMINED November 22 nd 20 16  OPERATIONS ENGINEER
EXAMINED November 18 20 16  Ron Changeau  PROJECT IMPLEMENTATION ENGINEER
EXAMINED November 21 20 16

AECOM

	USER NAME : SUSERS	DESIGNED -	MCO	REVISED -
		DRAWN -	SRS	REVISED -
ı	PLOT SCALE : #SCALE*	CHECKED -	JAC	REVISED -
•	PLOT DATE : #DATE#	DATE -	12-08-16	REVISED -

STATE OF ILLINOIS
DEPARTMENT OF TRANSPORTATION

INDEX OF SHEETS, HIGHWAY STANDARDS,

COMMITMENTS AND GENERAL NOTES

SCALE: NTS | SHEET 1 OF 1 SHEETS STA. TO STA.

PPS # 6-00284-1000	
 100 % HSR FUNDING	(FEDERAL)
ROADWAY	
0021	
URBAN	

CODE NO.	ITEM	UNIT	TOTAL QUANTITY	ANDREW ROAD	WOODSIDE ROAD	PEDESTRIAN CROSSING SPRUCE STREET	GOLDENROD DRIVE
					0.00	0.00	0, 25
20100500	TREE REMOVAL, ACRES	ACRE	0.25	0, 00	0.00	0.00	<del></del>
66900200	NON-SPECIAL WASTE DISPOSAL	CU YD	110	27.5	27.5	27.5	27.5
67100100	MOBILIZATION	L SUM	<b>9</b>	0, 25	0. 25	0. 25	0.25
66900450	SPECIAL WASTE PLANS AND REPORTS	L SUM	1	0.26	0.25	0,25	0.25
Z0013798	CONSTRUCTION LAYOUT	L SUM	1	0.25	0.25	0. 25	0. 25
66900530	SOIL DISPOSAL ANALYSIS	EACH	2	0.5	0.5	0.5	0.5
Z0022800	FENCE REMOVAL	FOOT	381	19	0	0	362
20048665	RAILROAD PROTECTIVE LIABILITY INSURANCE	L SUM	1	0. 25	0.25	0. 25	0.25
X220004	CHAIN LINK FENCE, 6' (SPECIAL)	FOOT	74	0	74	0	0
x220000S	DELINEATOR (SPECIAL)	EACH	19	0	0	0	19
X220000 6	FENCE, SPECIAL, 6' WITH SPECIAL LOWER PANEL	FOOT	139	0	0	0	139
<b>X22</b> 00007	FENCE, SPECIAL, 7' SECURITY	FOOT	255	0	0	0	255
X2200008	GATE, SPECIAL, (ESCAPE PAD SWING GATE)	EACH	2	0	0	0	2
x2200009	GATE, SPECIAL, 3' (16'-0" DOUBLE SWING GATE)	EACH	5	1	1	0	3
X2200012	GATE. SPECIAL. 3' (9-7.5") SINGLE SWING GATE)	EACH	3	1	1	0	1
X22,000 /3	GATE, SPECIAL, 6' (9'-7.5") SINGLE SWING GATE)	EACH	1	0	0	i	0
X2200010	ORNAMENTAL FENCE. 3' (SPECIAL)	F00T	276	128	60	0	88

\*SPECIALTY ITEM

DESIGNED - MCD REVISED -USER NAME : #USER# DRAWN - SRS CHECKED - JAC REVISED -PLOT SCALE \* \*SCALE\*
PLOT DATE \* \*DATE\* REVISED -DATE - 12-08-16 REVISED -

STATE OF ILLINOIS DEPARTMENT OF TRANSPORTATION

SUMMARY OF QUANTITIES SCALE: NONE SHEET 1 OF 2 SHEETS STA. TO STA. A.U. SECTION COUNTY TOTAL SHEETS NO.

HSR FENCING SANG. 2017 SANGAMON 32 3

CONTRACT NO. 72J59

[ILLINOIS FEO. AID PROJECT

 PPS # 6-00284-1000	
100 % HSR FUNDING	(PEDERAL)
ROADWAY	
0021	
 URBAN	

				URBAN					
CODE NO.	ITEM	UNIT	TOTAL QUANTITY	ANDREW ROAD	WOODSIDE ROAD	PEDESTRIAN CROSSING SPRUCE STREET	GOLDENROD DRIVE		
Walson II	COMMENTAL STACE OF A SPECIAL Y	F00T	1201	161	155	621	264		
X22008 H	ORNAMENTAL FENCE. 6' (SPECIAL)	. 001	1						
		***************************************		We see that the se					
<u></u>									
		1							
							1		
						-	+		
				-					
***************************************									
to the same of the			Vanish and the same of the sam						
			1	1			F AUT		

	V
<b>AECOM</b>	
ALCUM	P
	۵

USER NAME * BUSERS	DESIGNED - MCD	REVISED -
	ORAWN - SRS	REVISED -
PLOT SCALE . #SCALE.	CHECKED - JAC	REVISED +
PLOT DATE . *DATE*	DATE - 12-08-16	REVISED -

			SU	MM/	RY	OF QUANTITIES	
SCALE:	NONE	SHEET	1	0F	2	SHEETS STA.	TO ST

 F.A.U. RTE.		SECT	ION		Τ	COUNTY	TOTAL SHEETS	SHEE NO.
	HSR	FENCING	SANG.	2017	Т	SANGAMON	32	4
 					T	CONTRACT	NO.	72J59
			ILLINOIS	FED.	AlD	PROJECT		

ANDREW F	ROAD IDOT C	ROSSING NO. 294	281X (MP 177.87)						
POINT	STATION	NORTHERLY	EASTERLY	DESCRIPTION	FENCE REMOVAL	GATE, SPECIAL 3' (9'-7½" SINGLE SWING GATE)	GATE, SPECIAL, 3' (16'-0" DOUBLE SWING GATE)	ORNAMENTAL FENCE, 3' (SPECIAL)	ORNAMENTAL FENCE, 6' (SPECIAL)
					FOOT	EACH	EACH	FOOT	FOOT
1	10+00.00	1,176,384.9795	, ,	BEGIN ORNAMENTAL FENCE 6 SPL					
2	10+88.46	1,176,458.1566		END ORNAMENTAL FENCE 6 SPL AND BEGIN ORNAMENTAL FENCE 3 SPL					88.46
3	11+36.46	1,176,490.7889	, ,	CORNER OF ORNAMENTAL FENCE 3 SPL				48.00	
4	11+44.46	1,176,492.3265		END ORNAMENTAL FENCE 3 SPL AND BEGIN GATE SPL 3 16 DBL SWG GATE				8.00	
5	11+61.33	1,176,495.5697	, ,	END GATE SPL 3 16 DBL SWG GATE AND BEGIN ORNAMENTAL FENCE 3 SPL			1		
6	11+85.33	1,176,500.1823	2,455,358.8202	END ORNAMENTAL FENCE 3 SPL				24.00	
		1,176,399.0960	2,455,243.2340	BEGIN FENCE REMOVAL					
		1,176,416.6790	2,455,250.3210	END FENCE REMOVAL	19				
7	20+00.00	1,176,391.7866	2,455,331.9226	BEGIN ORNAMENTAL FENCE 6 SPL					
8	20+72.38	1,176,451.7397	2,455,372.4660	END ORNAMENTAL FENCE 6 SPL AND BEGIN ORNAMENTAL FENCE 3 SPL					72.38
9	21+20.38	1,176,491.5013	2,455,399.3549	END ORNAMENTAL FENCE 3 SPL AND BEGIN GATE SPL 3 (9'-7½" SGL SWG)				48.00	
10	21+30.67	1,176,500.0627	2,455,393.6435	END GATE SPL 3 (9'-7½" SGL SWG)		1			
	TOTALS				19	1	1	128.00	160.84

WOODSIDE	ROAD IDOT	NO. 294328R (MP	191.07)						
POINT	STATION	NORTHERLY	EASTERLY	DESCRIPTION	CHAIN LINK FENCE, 6' (SPECIAL) FOOT	GATE, SPECIAL 3' (9'-7½" SINGLE SWING GATE) EACH	GATE, SPECIAL, 3' (16'-0" DOUBLE SWING GATE) EACH	ORNAMENTAL FENCE, 3' (SPECIAL) FOOT	ORNAMENTAL FENCE, 6' (SPECIAL) FOOT
1	30+00.00	1,112,237.2662	2,433,549.9432	BEGIN ORNAMENTAL FENCE 6 SPL					
2	30+83.00	1,112,313.5561	2,433,582.6429	END ORNAMENTAL FENCE 6 SPL AND BEGIN ORNAMENTAL FENCE 3 SPL					83.00
3	31+15.00	1,112,334.9665	2,433,606.4251	END ORNAMENTAL FENCE 3 SPL AND BEGIN GATE SPL 3 (9'-7½" SGL SWG)				32.00	
4	31+25.29	1,112,341.8524	2,433,614.0738	END GATE SPL 3 (9'-7½" SGL SWG) AND BEGIN ORNAMENTAL FENCE 3 SPL		1			
5	31+41.29	1,112,352.5576	2,433,625.9649	CORNER OF ORNAMENTAL FENCE 3 SPL				16.00	
6	31+49.29	1,112,359.9185	2,433,629.0984	END ORNAMENTAL FENCE 3 SPL				8.00	
7	40+00.00	1,112,427.1398	2,433,655.7192	BEGIN ORNAMENTAL FENCE 3 SPL					
8	40+04.00	1,112,430.7958	2,433,654.0963	END ORNAMENTAL FENCE 3 SPL AND BEGIN GATE SPL 3 16 DBL SWG GATE				4.00	
9	40+20.88	1,112,446.2195	2,433,647.2498	END GATE SPL 3 16 DBL SWG GATE AND BEGIN ORNAMENTAL FENCE 6 SPL			1		
10	40+93.25	1,112,512.7982	2,433,675.6297	END ORNAMENTAL FENCE 6 SPL AND BEGIN CHAIN LINK FENCE 6 SPL					72.37
11	41+57.19	1,112,571.6142	2,433,700.7006	CORNER OF CHAIN LINK FENCE 6 SPL	63.94				
12	41+67.19	1,112,577.8590	2,433,708.5110	END CHAIN LINK FENCE 6 SPL	10.00				
	TOTALS				73.94	1	1	60.00	155.37

		US
	AECUM	Ρl
		PΙ
İ	District 6, sht-schedules dan 12/7/2016 10:15:20 AM	

USER NAME = \$USER\$	DESIGNED - MCD	REVISED -
	DRAWN - SRS	REVISED -
PLOT SCALE = \$SCALE\$	CHECKED - JAC	REVISED -
PLOT DATE = \$DATE\$	DATE - 12-08-16	REVISED -

Ī	SCHEDULE OF QUANTITIES									F.A.U. RTE.	SECTION	COUNTY	TOTAL SHEETS	SHEET NO.
ı		SCHEDULE OF QUANTITIES									HSR FENCING SANG. 2017	SANGAMON	32	5
l												CONTRACT	NO.	72J59
1	SCALE:	NTS	SHEET	1	OF	2	SHEETS	STA.	TO STA.	ILLINOIS FED. AID PROJECT				

					GATE, SPECIAL 6'	ORNAMENTA
POINT	STATION	NORTHERLY	EASTERLY	DESCRIPTION	(9'-7½" SINGLE	FENCE, 6'
					SWING GATE)	(SPECIAL)
					EACH	FOOT
1	50+00.00	1,094,606.8247	2,426,576.8127	BEGIN ORNAMENTAL FENCE 6 SPL		
2	50+16.08	1,094,622.9066	2,426,577.0290	CORNER OF ORNAMENTAL FENCE 6 SPL		16.08
3	52+86.73	1,094,876.9806	2,426,670.2696	END ORNAMENTAL FENCE 6 SPL		270.65
4	60+00.00	1,094,542,7788	2 426 615 7202	BEGIN ORNAMENTAL FENCE 6 SPL		
5	60+05.00	1,094,547.4727	_,,			5.00
6	60+13.18	1,094,555.1510	2,426,620.2786	BEGIN ORNAMENTAL FENCE 6 SPL		
7	60+29.26	1,094,570.2497	2,426,625.8196	END ORNAMENTAL FENCE 6 SPL AND BEGIN GATE SPL 6 (9'-7½" SGL SWG)		16.08
8	60+39.68	1,094,580.0287	2,426,629.4083	END GATE SPL 6 (9'-7½" SGL SWG) AND BEGIN ORNAMENTAL FENCE 6 SPL	1	
9	62+16.60	1,094,746.1147	2,426,690.3589	CORNER OF ORNAMENTAL FENCE 6 SPL		176.92
10	62+24.64	1,094,753.9500	2,426,692.1691	CORNER OF ORNAMENTAL FENCE 6 SPL		8.04
11	63+44.24	1,094,866.2308	2,426,733.3741	CORNER OF ORNAMENTAL FENCE 6 SPL		119.60
12	63+52.28	1,094,870.2058	2,426,740.3646	END ORNAMENTAL FENCE 6 SPL		8.04
	TOTALS				1	620.41


PEDESTRIAN CROSSING IDOT NO. 294334U (MP 194.70) AND SPRUCE STREET IDOT NO. 294335B (MP 194.76)

2	STATION	NORTHERLY	EASTERLY		LENGE	TREE		LCATE CDECIAL 21	GATE, SPECIAL.	ORNAMENTAL		I EENCE I	EENCE	
1 2	STATION	NORTHERLY	EASTERLY		FENCE		GATE, SPECIAL 3'	'	, ,		ORNAMENTAL	FENCE,	FENCE,	DELINEATO
2				DESCRIPTION	REMOVAL	REMOVAL,	(9'-7½" SINGLE	(16'-0" DOUBLE	(ESCAPE PAD	FENCE, 3'	FENCE, 6'	SPECIAL 6' WITH	SPECIAL, 7'	SPECIAL
2						ACRES	SWING GATE)	SWING GATE)	SWING GATE)	(SPECIAL)	(SPECIAL)	LOWER PANEL	SECURITY	
2					FOOT	ACRE	EACH	FOOT	EACH	FOOT	FOOT	FOOT	FOOT	EACH
		, ,	, ,	BEGIN ORNAMENTAL FENCE 6 SPL										
2				END ORNAMENTAL FENCE 6 SPL AND BEGIN ORNAMENTAL FENCE 3 SPL							160.83			
3				END ORNAMENTAL FENCE 3 SPL AND BEGIN GATE SPL 3 16 DBL SWG GATE						8.00				
4				END GATE SPL 3 16 DBL SWG GATE AND BEGIN ORNAMENTAL FENCE 3 SPL				1						
5				CORNER OF ORNAMENTAL FENCE 3 SPL						8.00				
6	72+09.71	1,093,675.9605	2,426,247.5758	END ORNAMENTAL FENCE 3 SPL						16.00				
				TREE REMOVAL		0.25								
7		, ,	, ,	BEGIN GATE SPL ESC PAD SWG GATE										
8	80+00.00	1,093,750.2264	2,426,262.2577	END GATE SPL ESC PAD SWG GATE AND BEGIN ORNAMENTAL FENCE 3 SPL					1					
9	80+08.00	1,093,757.8954	2,426,264.5350	END ORNAMENTAL FENCE 3 SPL AND BEGIN GATE SPL 3 16 DBL SWG GATE						8.00				T
10	80+24.88	1,093,774.0722	2,426,269.3386	END GATE SPL 3 16 DBL SWG GATE AND BEGIN ORNAMENTAL FENCE 3 SPL				1						T
11	80+32.88	1,093,781.7413	2,426,271.6159	CORNER OF ORNAMENTAL FENCE 3 SPL						8.00				
12	80+40.88	1,093,789.7310	2,426,271.2096	END ORNAMENTAL FENCE 3 SPL AND BEGIN ORNAMENTAL FENCE 6 SPL						8.00				
13	81+36.12	1,093,879.1438	2,426,304.0225	CORNER OF ORNAMENTAL FENCE 6 SPL							95.24			
14	81+44.16	1,093,881.4126	2,426,311.7375	END ORNAMENTAL FENCE 6 SPL							8.04			
				DELINEATOR SPL										10
														1
15	90+00.00	1,093,557.0966	2,426,244,8146	BEGIN FENCE SPL 6 SPL LWR PANEL										1
				CORNER OF FENCE SPL 6 SPL LWR PANEL								15.92		+
17				CORNER OF FENCE SPL 6 SPL LWR PANEL								15.91		+
		, ,	, ,	END FENCE SPL 6 SPL LWR PANEL								106.32		+
19				BEGIN GATE SPL 3 (9'-7½" SGL SWG)										+
20		, ,	, ,	END GATE SPL 3 (9-7½" SGL SWG) AND BEGIN ORNAMENTAL FENCE 3 SPL	1		1							+
21				END ORNAMENTAL FENCE 3 SPL						24.00				+
				BEGIN FENCE REMOVAL										+
+				END FENCE REMOVAL	134									+
<del></del>		1,000,002.0000	2,420,202.0240	END LINE KEMOTTE	104									+
22		1 093 758 2441	2 426 311 5720	BEGIN GATE SPL ESC PAD SWG GATE										+
		, ,		END GATE SPL ESC PAD SWG GATE AND BEGIN ORNAMENTAL FENCE 3 SPL	1				1					+
		, ,	, ,	END ORNAMENTAL FENCE 3 SPL AND BEGIN GATE SPL 3 16 DBL SWG GATE					'	8.00				+
		, ,	, ,	END GATE SPL 3 16 DBL SWG GATE AND BEGIN FENCE SPL 7 SECURITY				1		0.00				+
		, ,	, ,	END FENCE SPL 7 SECURITY	+			<u>'</u>		-			254.85	+
				BEGIN FENCE REMOVAL									204.00	+
		, ,	, ,	END FENCE REMOVAL	228	-		-		1				+
<del></del>		1,094,012.3200	2,420,413.4550	DELINEATOR SPL	220									9
				DELINEATOR OF E	+	-		-		1				+ 9
	TOTALS				362	0.25	1	2	2	88.00	264.11	138.15	254.85	19

	AECUM	
	<i>-</i>	_
ľ	District 6_sht-schedules.dgn 12/7/2016 10:15:50 AM	_

1201 01112	DA1E 12 00 10	. NETISEB
PLOT DATE = \$DATE\$	DATE - 12-08-16	REVISED -
PLOT SCALE = \$SCALE\$	CHECKED - JAC	REVISED -
D	DRAWN - SRS	REVISED -
USER NAME = \$USER\$	DESIGNED - MCD	REVISED -

		RTE.	SECTION	COUNTY	SHEETS	NO.	
	SCHEDULE OF QU		HSR FENCING SANG. 2017	SANGAMON	32	6	
				CONTRAC	T NO. 7	72J59	
SCALE: NTS	SHEET 2 OF 2 SHEETS	STA. TO STA.	ILLINOIS FED. AID PROJECT				

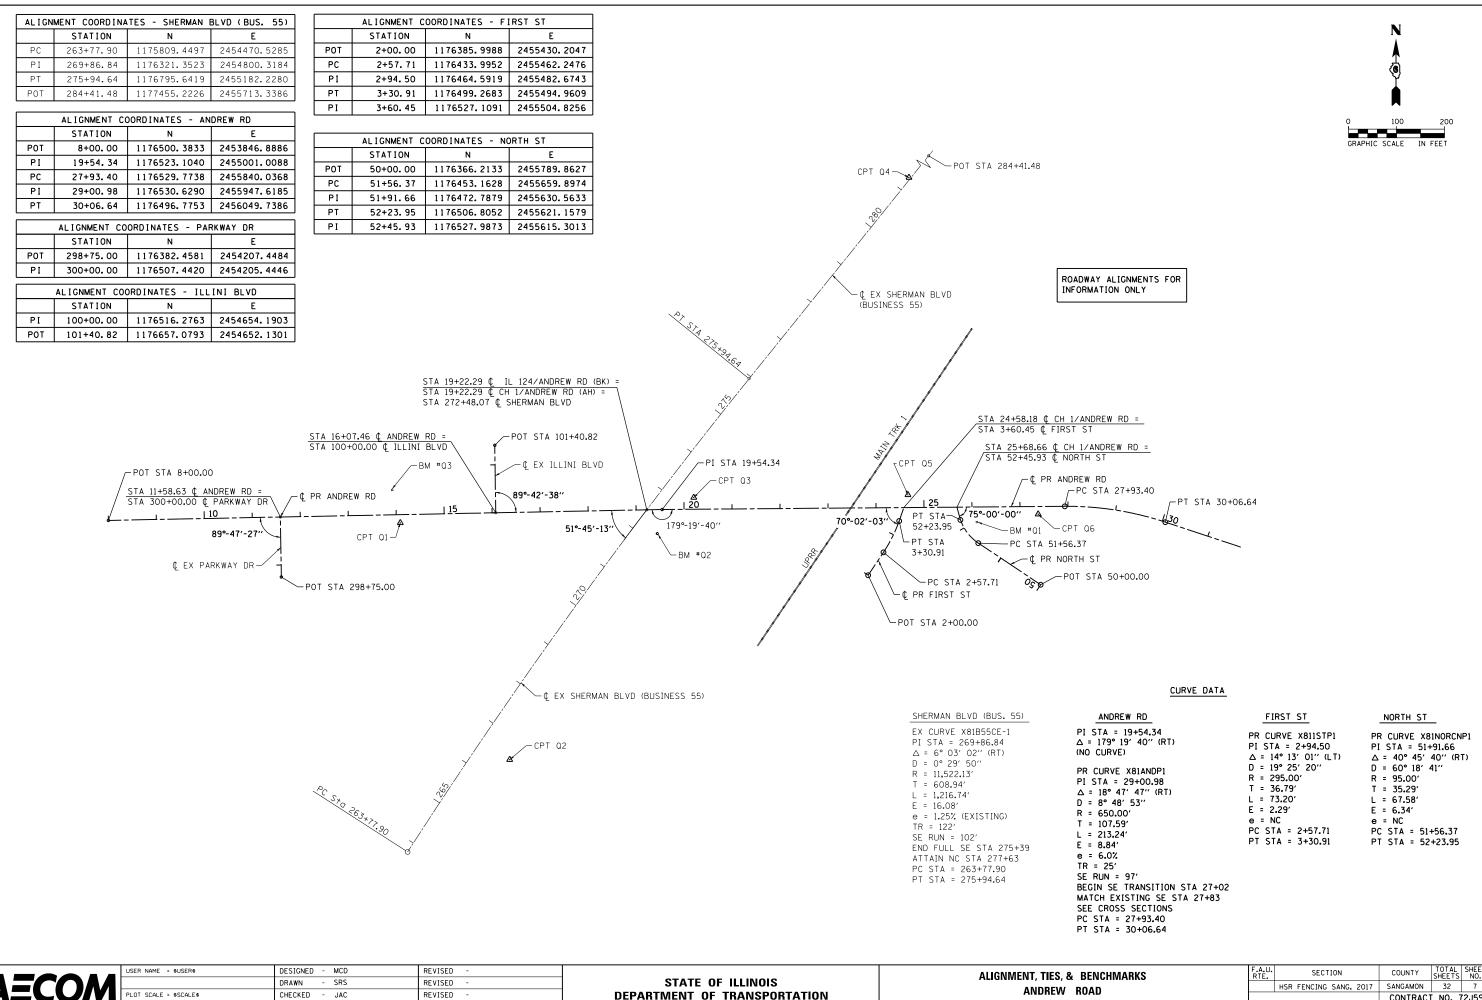

SCALE: 1" = 100' SHEET 1 OF 5 SHEETS STA.

TO STA.


CONTRACT NO. 72J59





DATE


- 12-08-16


REVISED

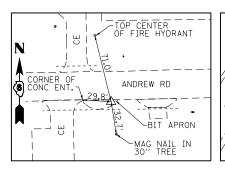


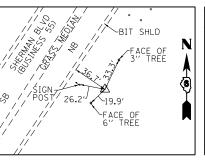

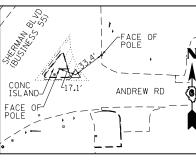

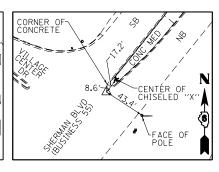

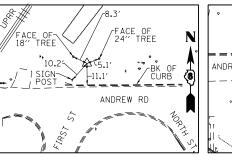

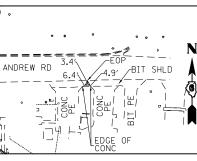

#### CONTROL POINT Q1

SET MAG NAIL IN BIT APRON (500' ± W OF SHERMAN BLVD)

STA 14+08.22, 17.20' RT N 1176495.161 E 2454455.327 ELEV 583.250

#### CONTROL POINT Q2

SET IRON PIN (600'± S OF ANDREW RD)

STA 266+56.54, 71.33' RT N 1176001.767 E 2454683.267 ELEV 580.460

#### **CONTROL POINT Q3**

SET MAG NAIL IN PAVEMENT

STA 20+20.37, 24.37' LT N 1176547.995 E 2455066.836 ELEV 579.720

#### **CONTROL POINT Q4**

SET MAG NAIL IN PAVEMENT (900'± N OF ANDREW RD)

STA 281+30.08, 3.44' LT N 1177214.842 E 2455515.356 ELEV 577.900

#### CONTROL POINT Q5

SET IRON PIN (100'± E OF RR TRACKS)

STA 24+66.86, 26.37' LT N 1176553.546 E 2455513.298 ELEV 577.670

#### **CONTROL POINT Q6**

SET MAG NAIL IN BIT SHLD (350'± E OF RR TRACKS)

STA 27+37.83, 15.88' RT N 1176513.453 E 2455784.593 ELEV 573.310

#### **BENCHMARK**

BM \*01- CHISELED "+" IN E BOLT OF FIRE HYDRANT, SE QUAD OF ANDREW RD & NORTH ST STA 51+97, 29' RT EL 577.99

BM \*02- CHISELED " " SE CORNER OF CONCRETE BASE FOR TRAFFIC SIGNAL (W/O MAST ARM) STA 272+22, 47' RT EL 580.33


BM #03- TOP OF BOLT ON FH BETWEEN "E" & "L" OF MUELLER STA 13+93, 52' LT EL 585.13





USER NAME = \$USER\$	DESIGNED - MCD	REVISED -
	DRAWN - SRS	REVISED -
PLOT SCALE = \$SCALE\$	CHECKED - JAC	REVISED -
PLOT DATE = \$DATE\$	DATE - 12-08-16	REVISED -

SCALE: NTS

AL	ALIGNMENT, TIES, & BENCHMARKS							SECTION	COUNTY	TOTAL SHEETS	SHE
	ANDREW ROAD							HSR FENCING SANG. 2017	SANGAMON	32	8
ANDIEW HOAD									CONTRACT	NO.	72J5
SHEET	2	OF	5	SHEETS	STA.	TO STA.	ILLINOIS FED. AID PROJECT				

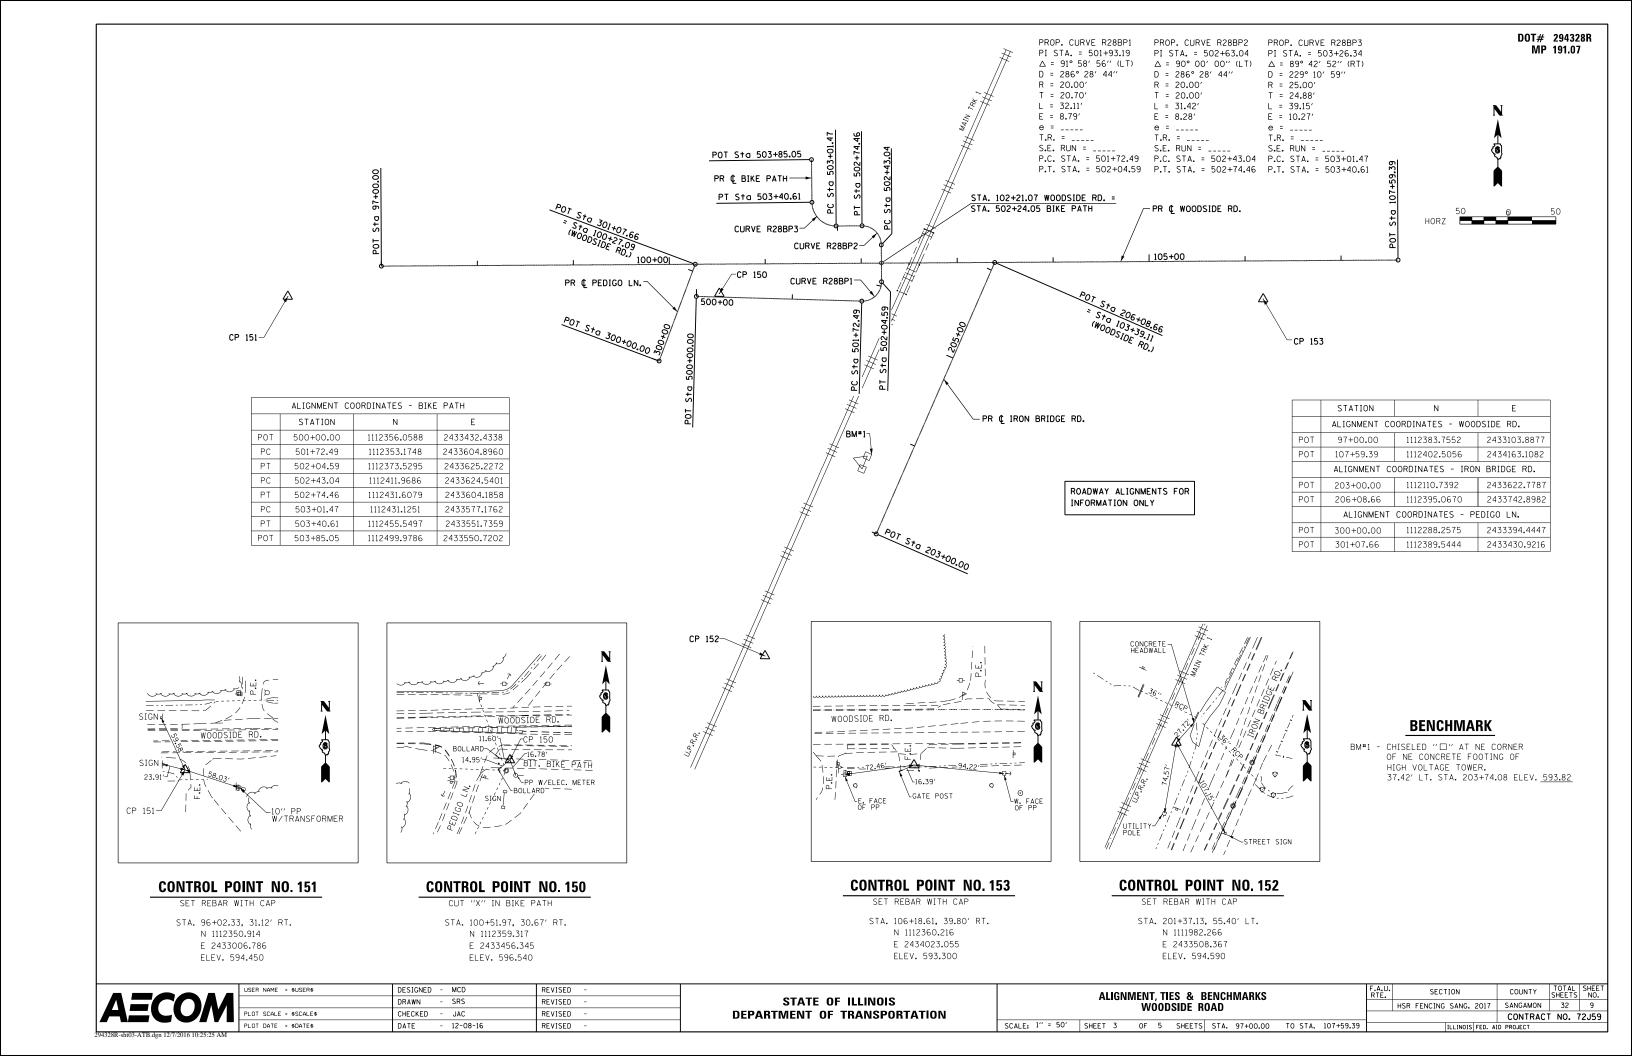


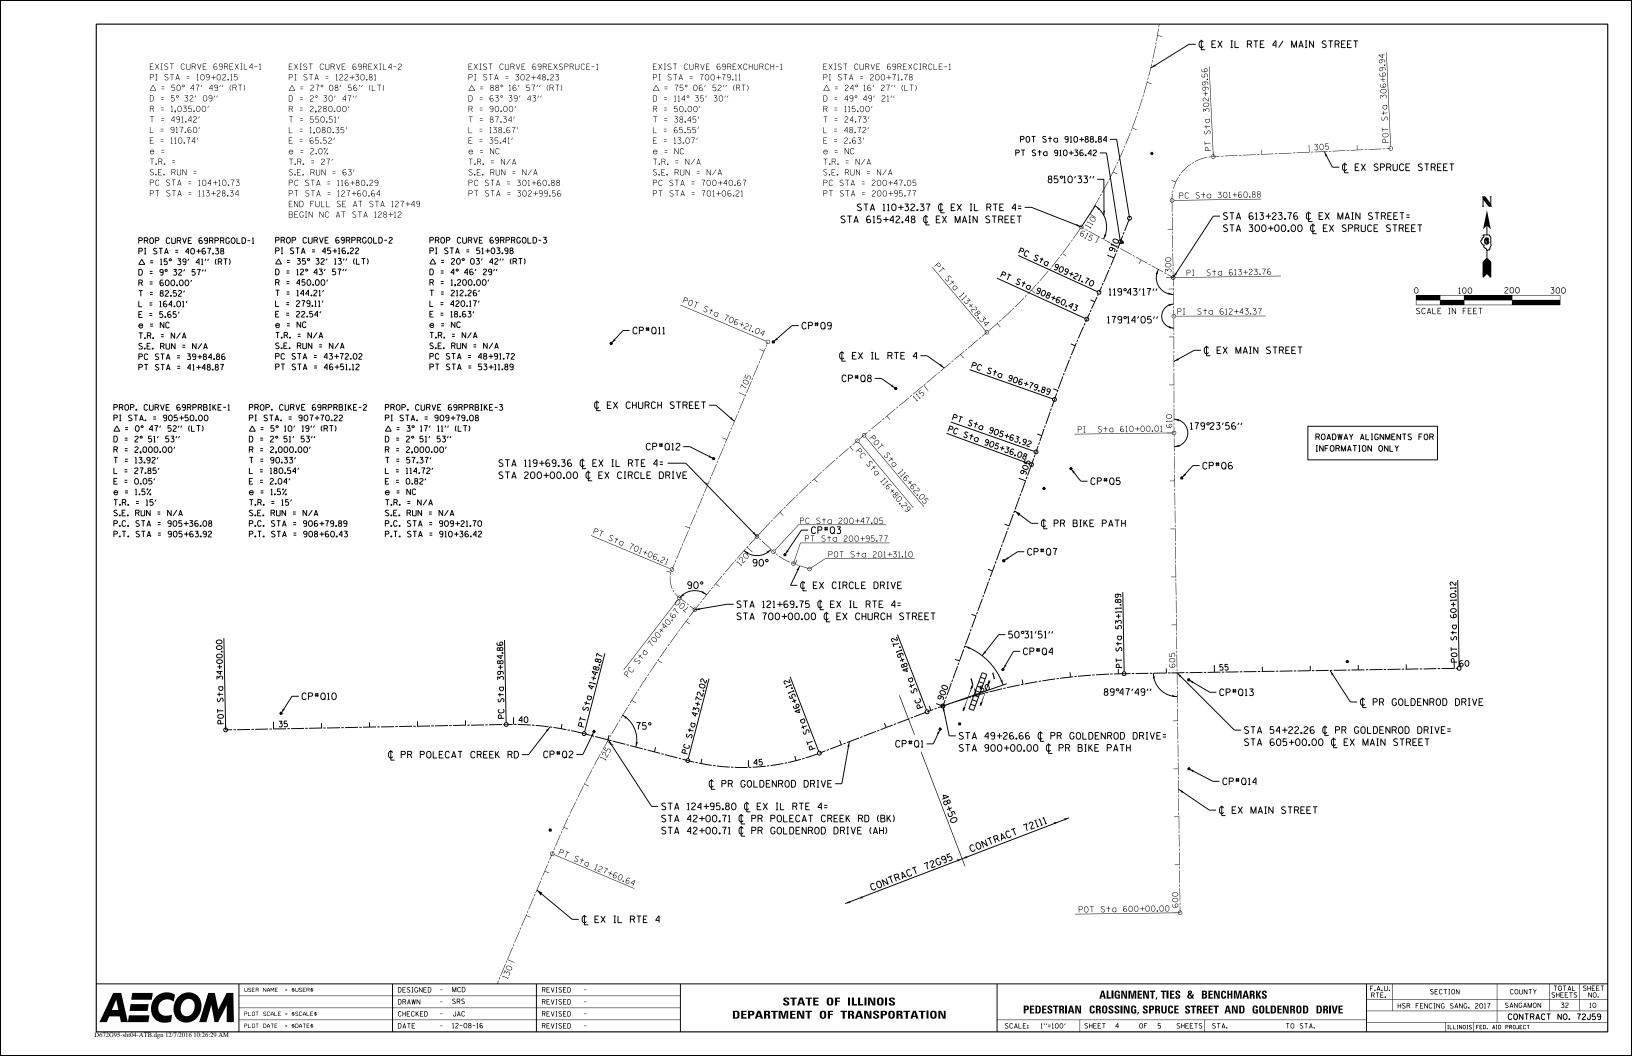

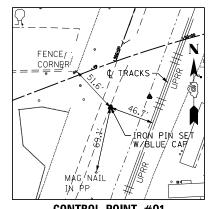


**CONTROL POINT #01** 

SET I.P. W/BLUE CAP STA. 49+04.37, 43.35' RT N 1093640.11 E 2426200.42 ELEV. 603.03

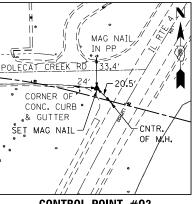


CONTROL POINT #Q2

SET MAG NATI STA, 41+67,64, 9,36' LT N 1093635.10 E 2425479.16 ELEV. 602.60

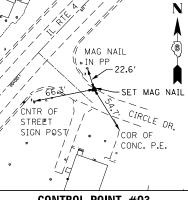


CONTROL POINT #Q3

SET MAG NATI STA. 119+57.49, 68.55' LT N 1094003.67 E 2425876.95 ELEV. 601.92

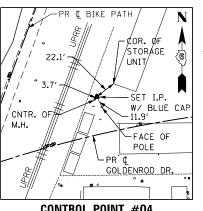


**CONTROL POINT #Q4** 


SET I.P. W/BLUE CAP STA. 50+65.72, 38.82' LT N 1093764.48 E 2426331.38 ELEV. 602.79

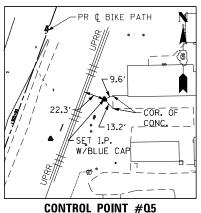

SET I.P. W/BLUE CAP STA. 905+56.61, 80.04' RT N 1094182.92 E 2426473.10 ELEV. 603.28

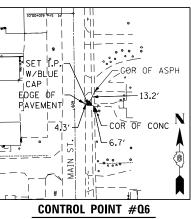


SET I.P. W/BLUE CAP STA. 609+05.91, 14.93' RT N 1094163.55 E 2426704.09 ELEV. 603.03

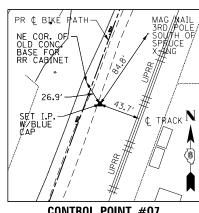


**CONTROL POINT #Q7** 

SET I.P. W/BILLE CAP STA. 903+28.22, 14.70' RT N 1093991.12 E 2426332.94 ELEV. 602.76

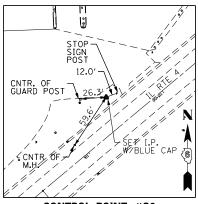


CONTROL POINT #Q8

SET I.P. W/BLUE CAP STA. 115+48.98, 32.45' RT N 1094350.16 E 2426107.86 ELEV. 602.11

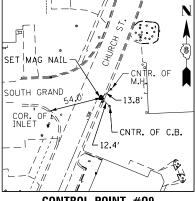

CONTROL POINT #Q9

SET MAG NAIL STA N 1094447.11 E 2425852.93 ELEV 601.30

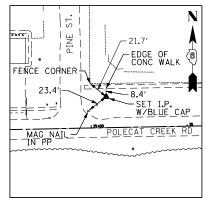


CONTROL POINT #Q10

2426687.9685

2426687.4605


2426686.2191 2426494.6273

SET I.P. W/BLUE CAP STA. 35+16.16, 32.33' LT N 1093673.14 E 2424827.03 ELEV. 603.35

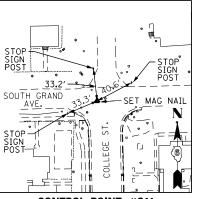


CONTROL POINT #Q11

SET MAG NAIL STA N 1094444.01 E 2425515.01 ELEV. 602.84

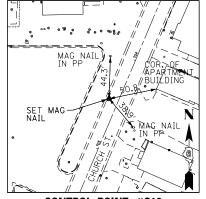


CONTROL POINT #Q12

SET MAG NAIL STA. 703+52.75, 9.81' LT N 1094203.76 E 2425728.43 ELEV. 600.45

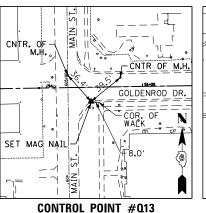

SET MAG NAIL STA. 54+46.12, 14.83' RT N 1093743.04 E 2426718.36

ELEV. 600.77

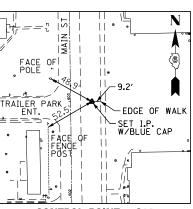

CONTROL POINT #Q14

SET I.P. W/BLUE CAP STA. 602+99.67, 22.13' RT N 1093557.45 E 2426718.91 ELEV. 600.48

#### **BENCHMARK**

STA. 46+86, 67' LT (GOLDENROD DR.) TBMQ1-CHISELED SQUARE SE CORNER CONCRETE PAD ELEV. 602.52

TBMQ2- STA. 295+11, 40' RT (IL RTE 4) TOP CENTER ROW MARKER FLEV. 603.61

STA. 296+80, 95' LT (IL RTE 4) CHISELED "+" SE BOLT ON FH TBMQ3-ELEV. 605.06

> STA. 302+76, 319' LT (IL RTE 4) CHISELED "+" SE BOLT ON FH ELEV. 603.73

TBMQ6- STA 38+94, 26' LT (GOLDENROD DR) CHISELED "+" SE BOLT ON FH ELEV. 606.56

TBMQ7- STA. 609+52, 25' LT (MAIN ST.) CHISELED "+" SE BOLT ON FH ELEV. 604.19

TBM08- STA. 54+75, 19' RT (GOLDENROD DR.) CHISELED "+" SE BOLT ON FH ELEV. 603.03

4NK		
ВМQ9-	STA 298+82, 186' RT (IL RTE 4) CHISELED SQUARE NE CORNER PARKING LOT ELEV. 602.04	

TBM010- STA. 302+86, 44' LT (IL RTE 4) CHISELED SQUARE NW EDGE CONCRETE SIGN BASE FLEV. 602.28

AL	ALIGNMENT COORDINATES - EXISTING CIRCLE DRIVE								
	STATION	N	Ε						
POT	200+00.00	1094041.7930	2425818.7972						
PC	200+47.05	1094009.8360	2425853. 3309						
ΡI	200+71.78	1093993.0384	2425871.4829						
PT	200+95.77	1093985. 1882	2425894.9356						
POT	201+31.10	1093973. 9760	2425928. 4325						
ALIGNMENT COORDINATES - EXISTING MAIN STREET									
STATION N E									
POT	600+00.00	1093257.5258	2426700.5491						

1094257.4530

1094500.8183

1094581.1969

1094686. 6844

ALI	ALIGNMENT COORDINATES - EXISTING CHURCH STREET							
	STATION	N	E					
POT	700+00.00	1093888. 9270	2425689. 3275					
PC	700+40.67	1093913.8200	2425657.1720					
ΡI	700+79.11	1093937. 3545	2425626. 7713					
PT	701+06. 21	1093972. 7807	2425641.7063					
POT	706+21.04	1094447. 1725	2425841.7011					

	ALIGNMENT COORD	NATES - EXISTING	IL ROUTE 4
	STATION	N	E
POT	101+55.61	1095529.0420	2426664.7206
PC	104+10.73	1095273.9395	2426668.0694
ΡI	109+02.15	1094782.5615	2426674.5199
PT	113+28.34	1094466. 9774	2426297.8229
PC	116+80.29	1094240. 9567	2426028.0333
ΡI	122+30.81	1093887.4230	2425606.0378
PT	127+60.64	1093380. 2816	2425391.8554
POT	134+69.99	1092726.8184	2425115.8766

ALIGNMENT COORDINATES - EXISTING SPRUCE STREET						
	STATION	N E				
POT	300+00.00	1094581.1969	2426686. 2191			
PC	301+60.88	1094742.0622	2426683. 7345			
ΡI	302+48.23	1094829. 3936	2426682.3857			
PT	302+99.56	1094833. 3592	2426769.6374			
POT	306+69.94	1094850.1763	2427139.6411			
ALICNMENT COORDINATES - PROPOSED RIKE PATH						

A	ALIGNMENT COORDINATES - PROPOSED BIKE PATH					
	STATION	E				
ΡI	900+00.00	1093688. 3093	2426206. 2942			
PC	905+36.08	1094191.5663	2426390. 9805			
PΙ	905+50.00	1094204.6387	2426395.7778			
PT	905+63.92	1094217.7765	2426400. 3926			
PC	906+79.89	1094327.1916	2426438.8260			
ΡI	907+70.22	1094412. 4159	2426468. 7620			
PT	908+60.43	1094494. 5947	2426506. 2587			
PC	909+21.70	1094550. 3390	2426531.6938			
PΙ	909+79.08	1094602.5363	2426555.5105			
PT	910+36.42	1094656.0130	2426576. 2957			
ΡI	910+88.84	1094704.8750	2426595. 2873			

ALIGNMENT COORDINATES - PROPOSED GOLDENROD DRIVE						
	STATION	N	Ε			
POT	34+00.00	1093638.5618	2424711.5158			
PC	39+84.86	1093649. 8916	2425296. 2695			
ΡI	40+67.38	1093651.4901	2425378.7711			
PT	41+48.87	1093630.7579	2425458.6413			
PC	43+72.02	1093574.6927	2425674.6301			
ΡI	45+16. 22	1093538.4613	2425814.2100			
PT	46+51.12	1093590. 1059	2425948.8507			
PC	48+91.72	1093676. 2712	2426173.4892			
ΡI	51+03.98	1093752. 2870	2426371.6675			
PT	53+11.89	1093755. 7096	2426583.8970			
POT	60+10.12	1093766. 9684	2427282.0355			
,						



USER NAME = \$USER\$	DESIGNED - MCD	REVISED -
	DRAWN - SRS	REVISED -
PLOT SCALE = \$SCALE\$	CHECKED - JAC	REVISED -
PLOT DATE = \$DATE\$	DATE - 12-08-16	REVISED -

610+00.01


612+43.37


613+23.76


615+42.47


	ALIGNMENT, TIES & B	ENCHMARKS	F.A.U. RTE.	_
PEDESTRIAN (	CROSSING, SPRUCE STRE	ET AND GOLDENROD DRIVE		Н
CALE. NTC CL	HEET E OF E SHEETS	CTA TO CTA		_


F.A.U. RTE.	SECTION	COUNTY	TOTAL SHEETS	SHEET NO.
	HSR FENCING SANG. 2017	SANGAMON	32	11
		CONTRACT	NO. 7	72J59
	ILLINOIS FED. AI	D PROJECT		

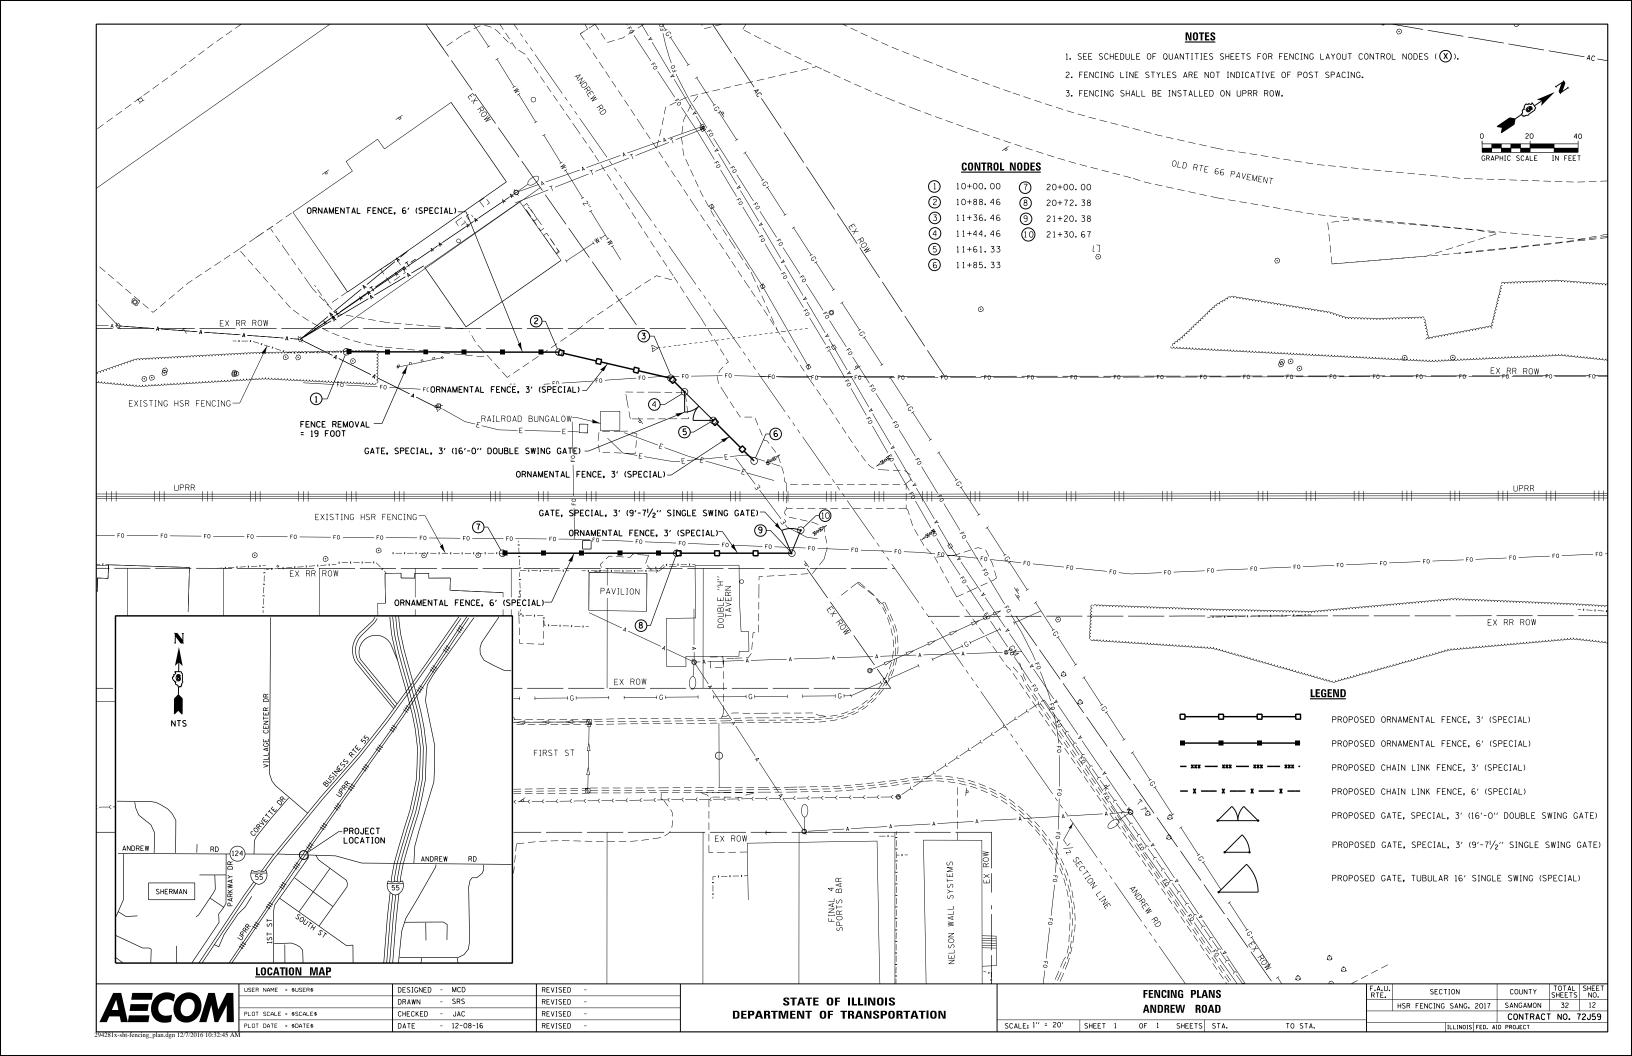


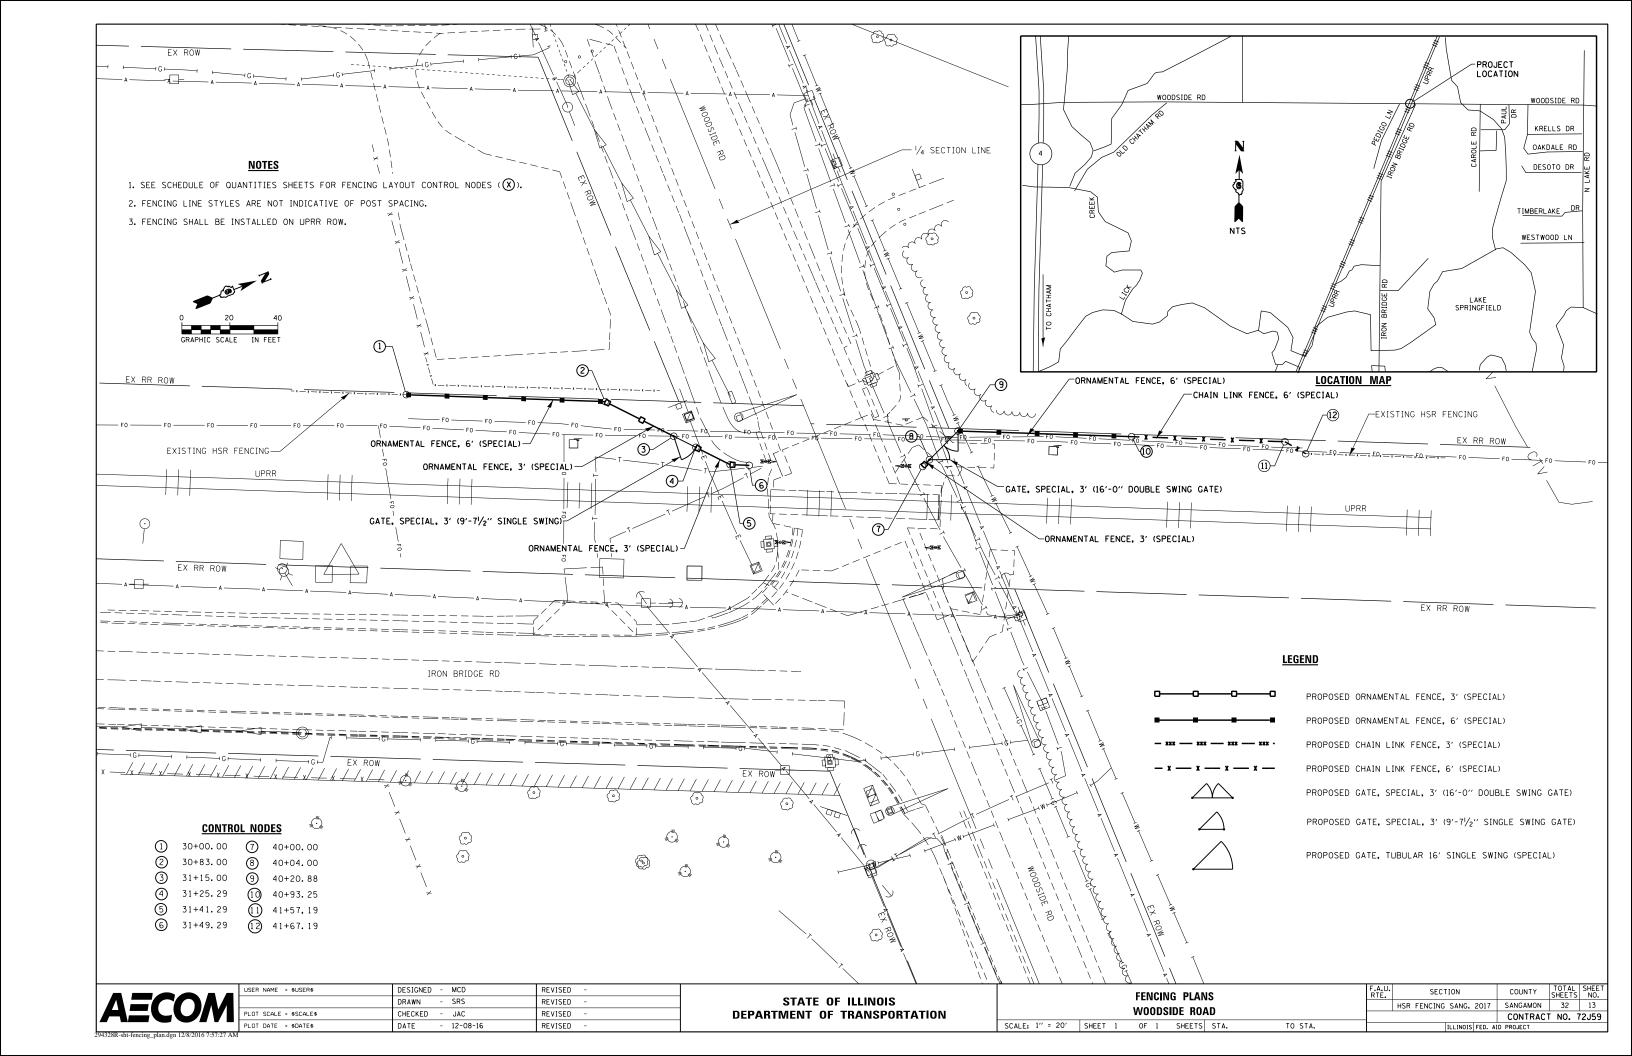


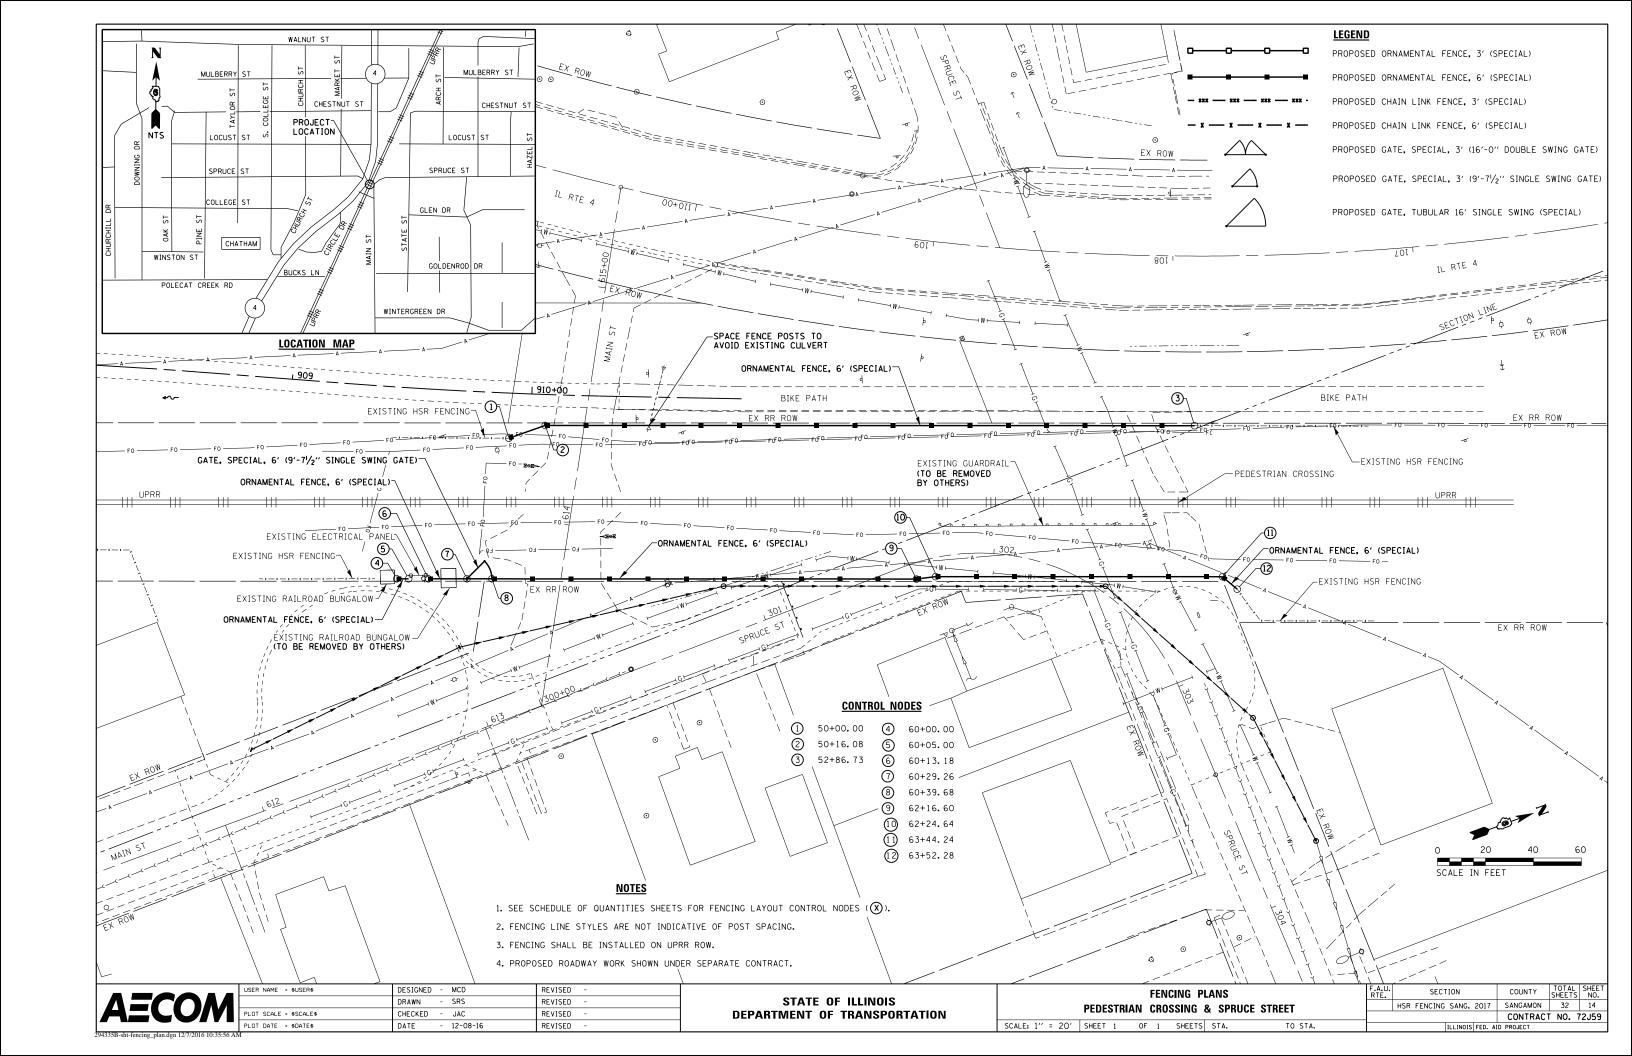


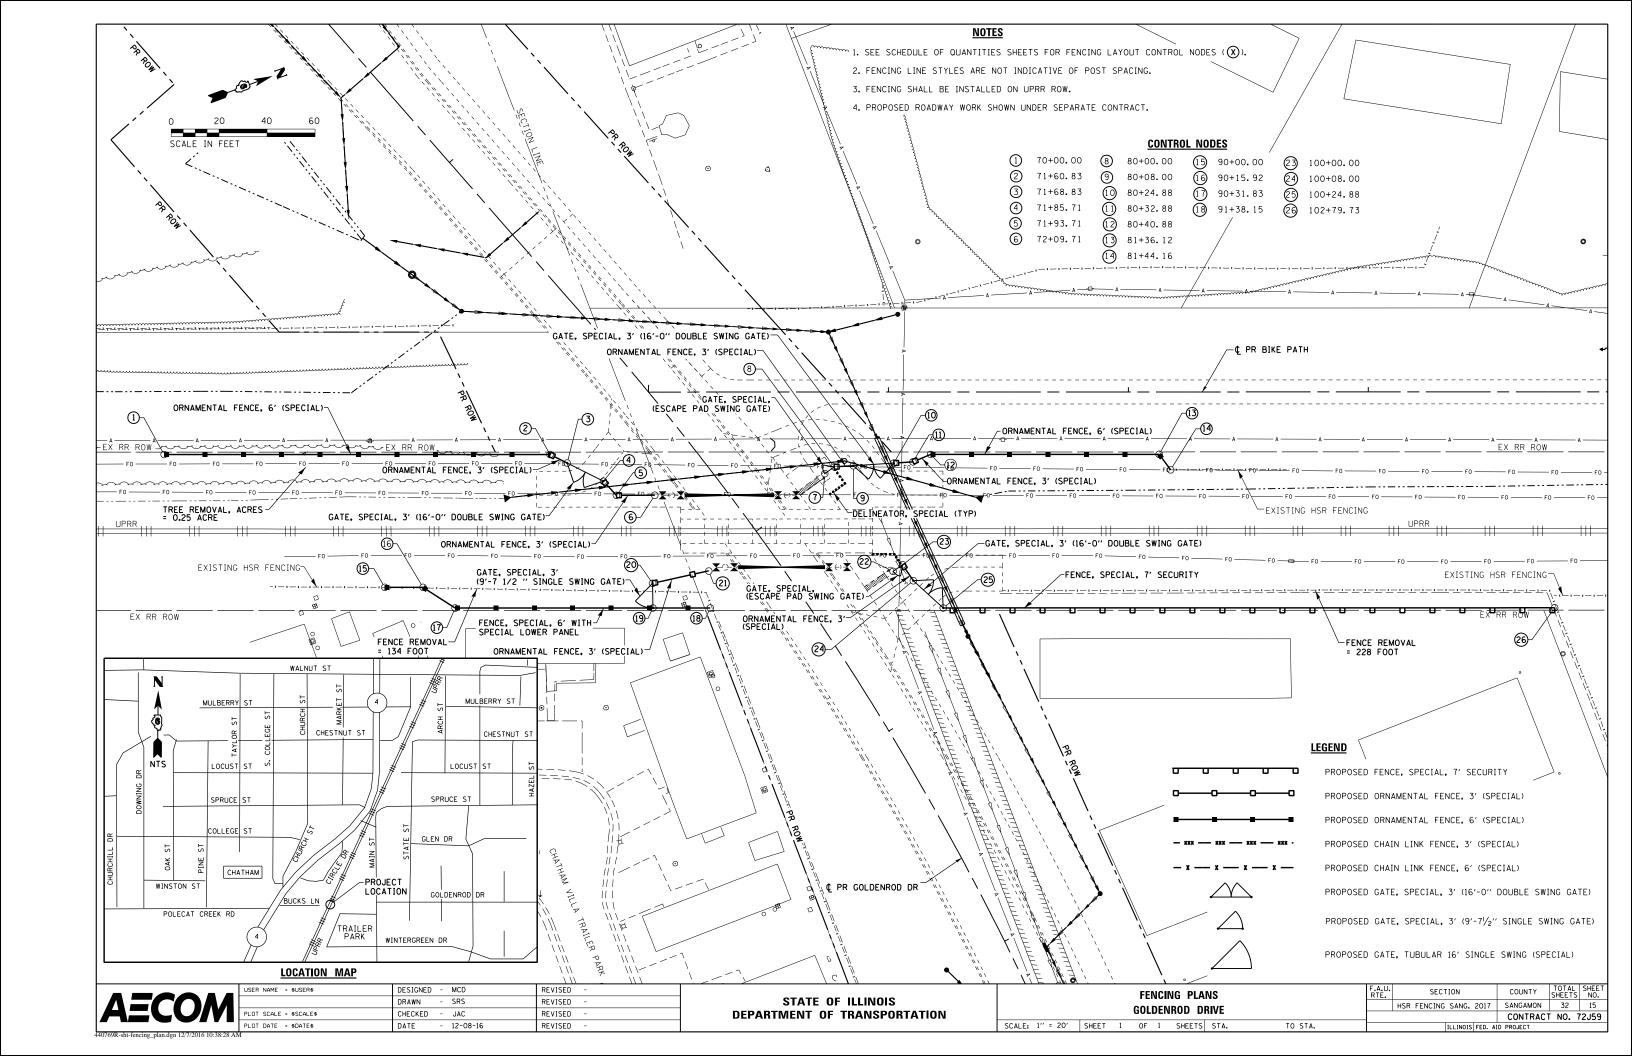


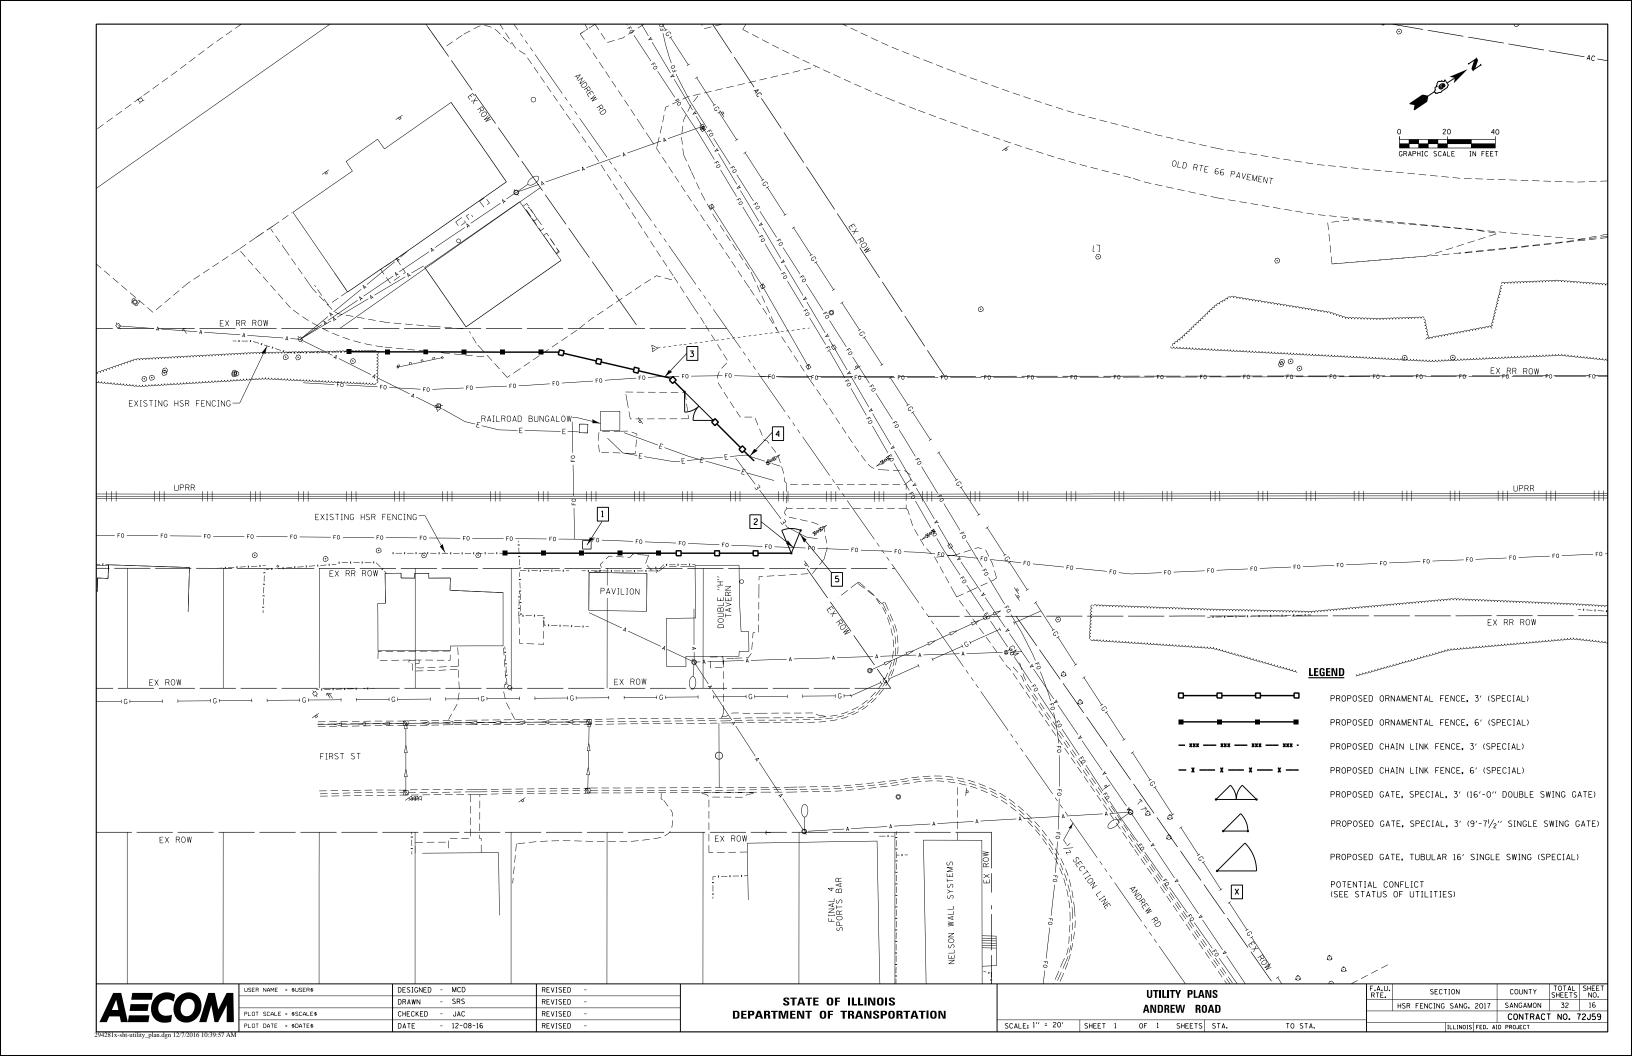


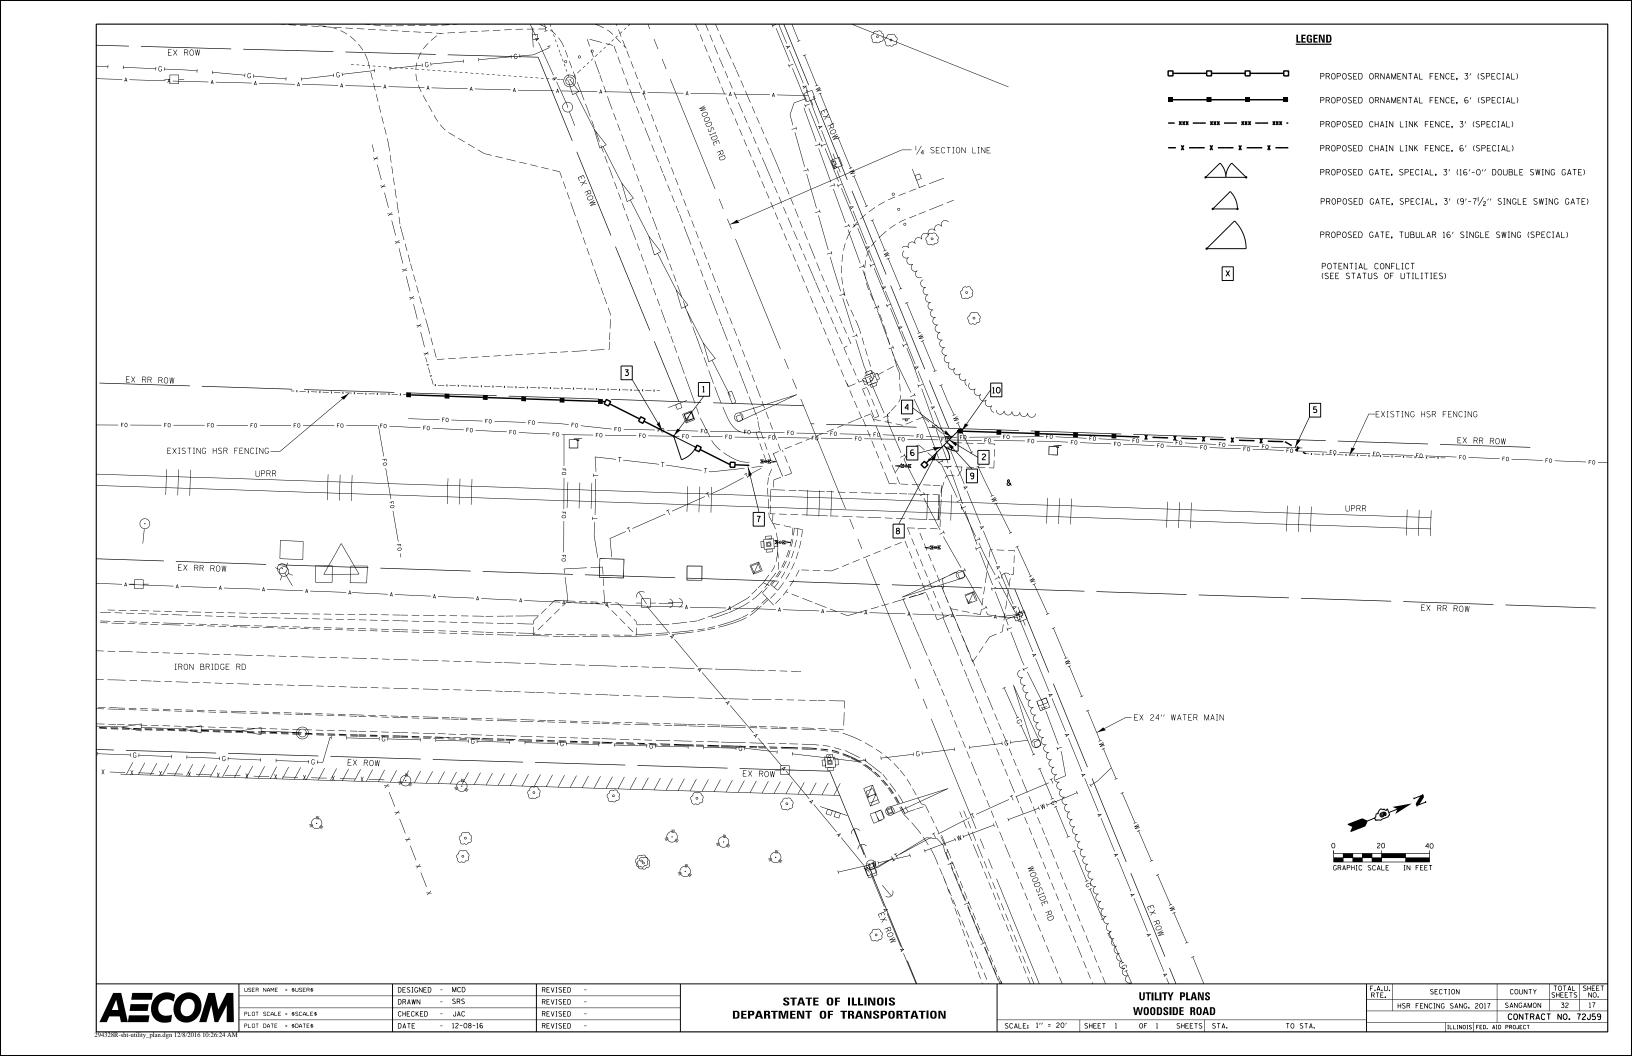

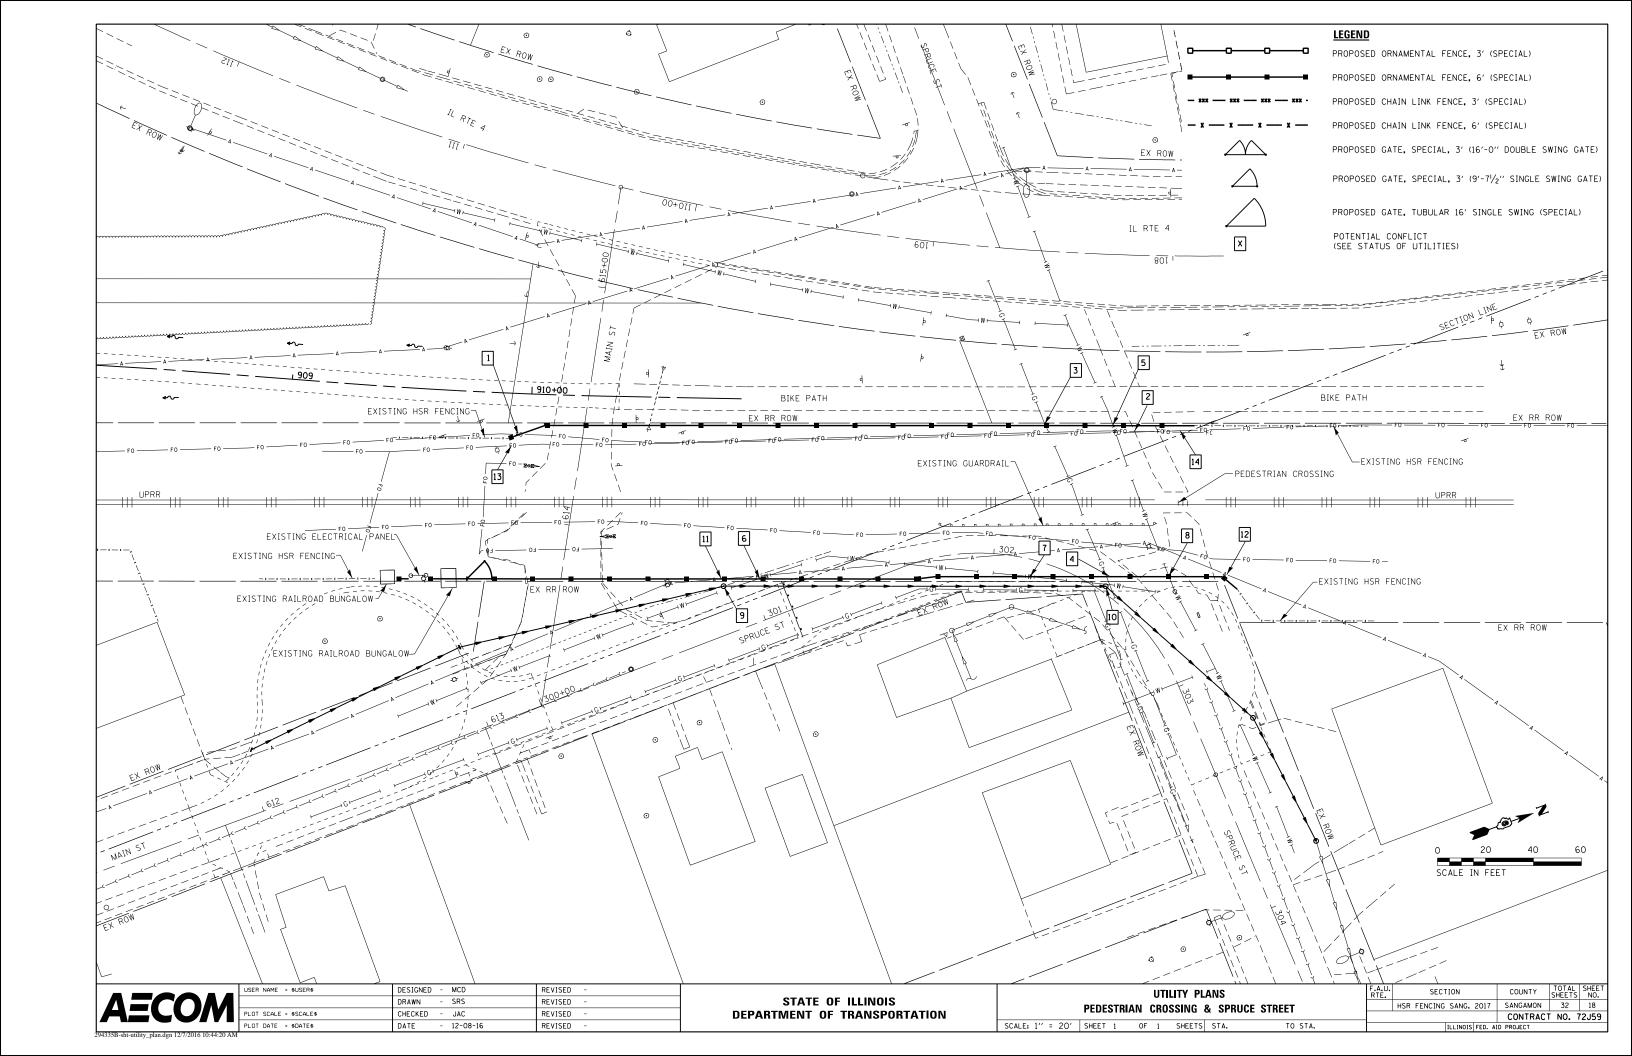

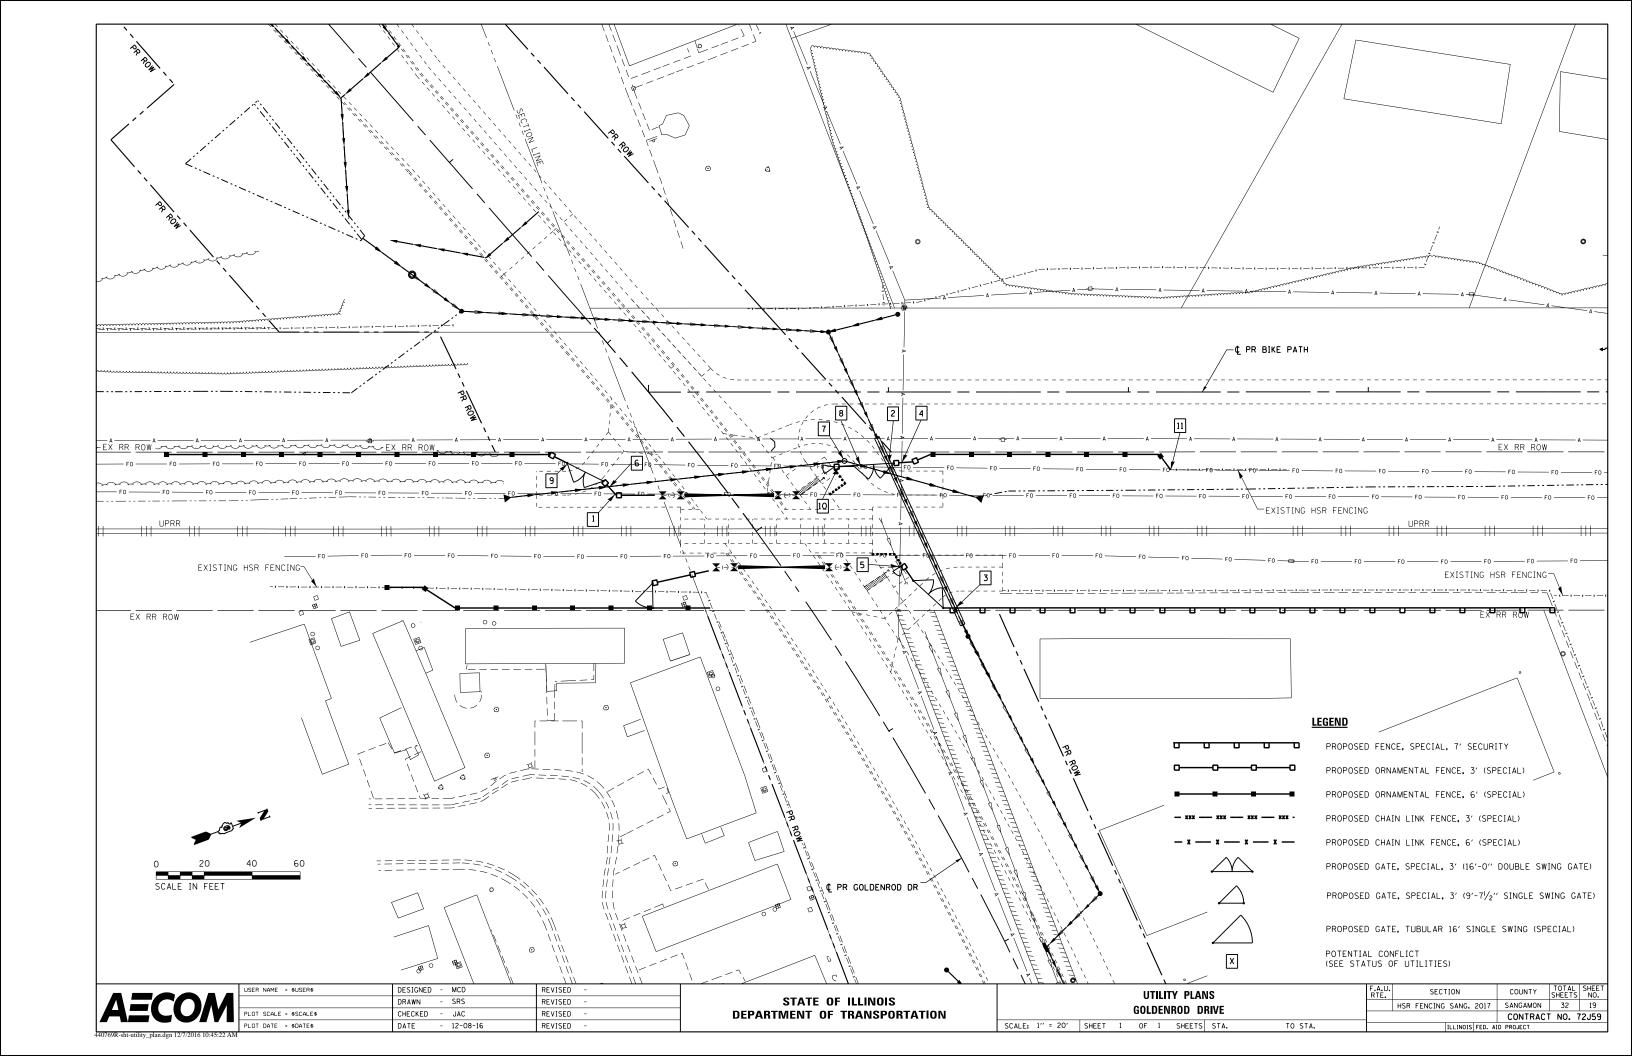

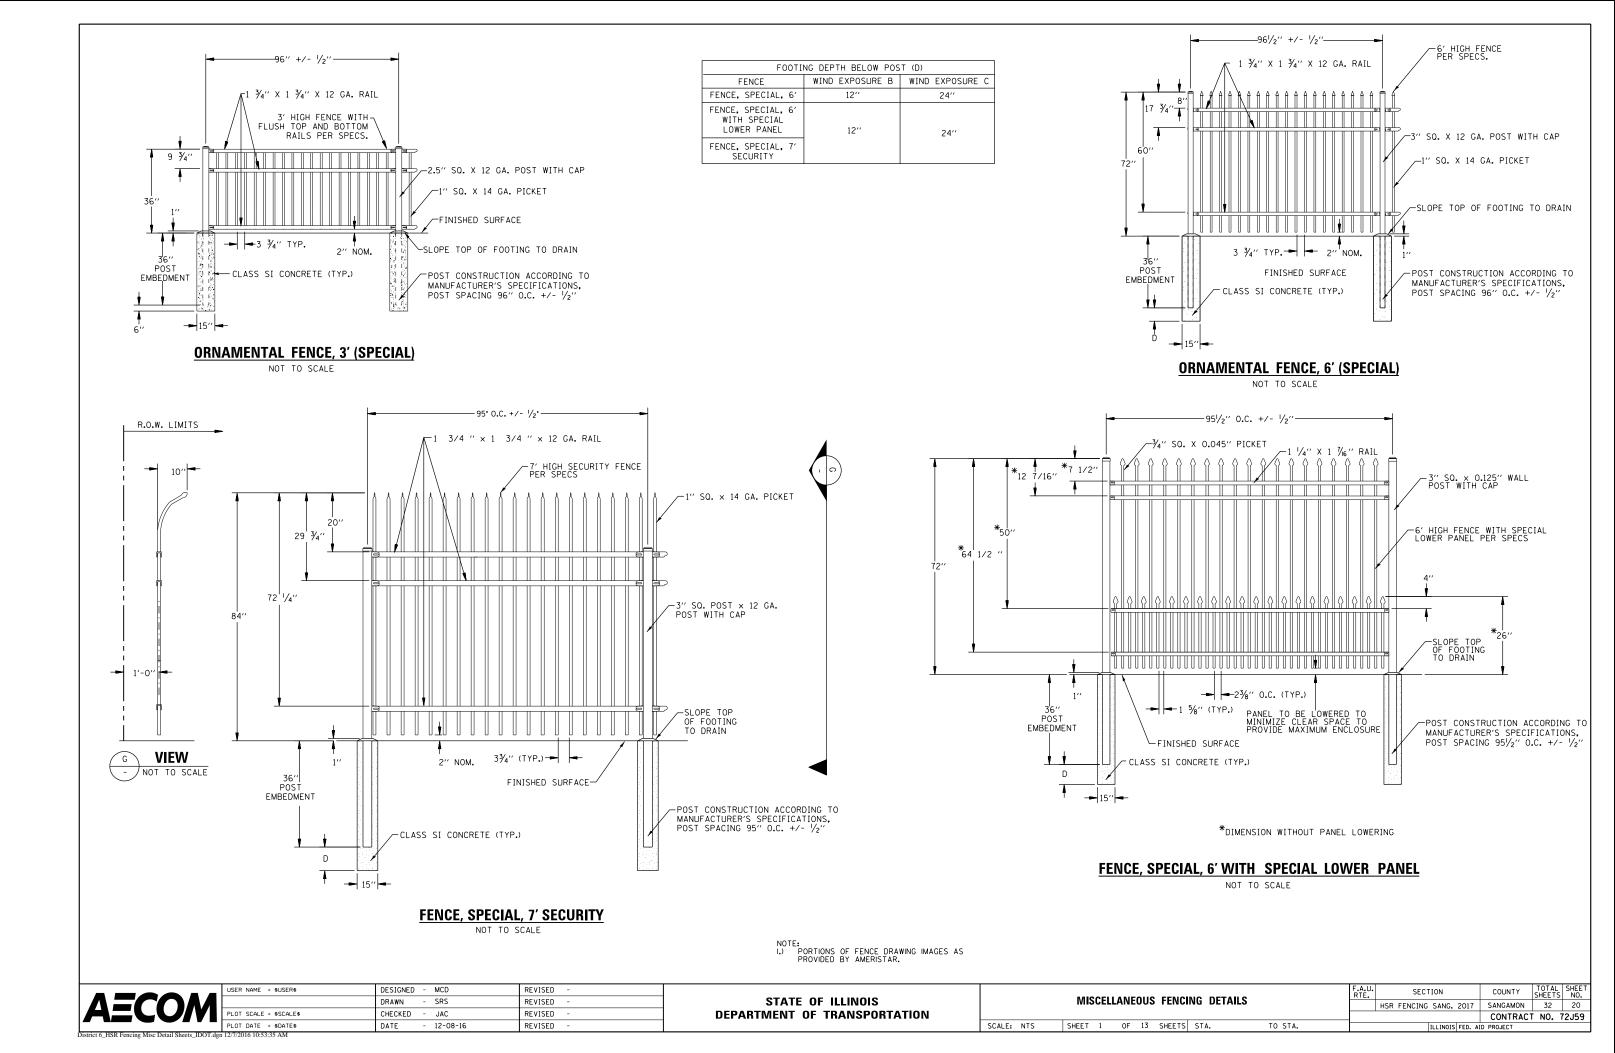


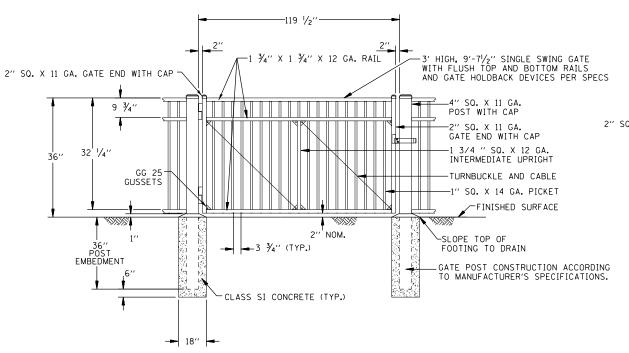

#### GATE, SPECIAL, 3' (9'-7 1/2" SINGLE SWING GATE)

NOT TO SCALE

- NOTE:
  1.) RAILROAD WILL FURNISH PAD LOCK.
  2.) NO DIG GATE HOLDBACK DEVICE (I EACH PER SWING GATE SECTION) TO BE INSTALLED INSIDE FENCE LIMITS. SPECIFIC LOCATIONS FOR GATE HOLDBACK DEVICE AT GATE LOCATIONS WHICH COULD HAVE AN IMPACT ON THE AMOUNT OF HORIZONTAL CLEARANCE TO TRACK CENTERLINE TO BE PROVIDED BY THE ENGINEER IN THE FIELD TO ENSURE PROPER HORIZONTAL CLEARANCE IS PROVIDED TO TRACK CENTERLINE FROM GATE WHEN IN THE OPEN POSITION. MINIMIMIM HORIZONTAL DISTANCE FROM TRACK
  - WHEN IN THE OPEN POSITION. MINIMUM HORIZONTAL DISTANCE FROM TRACK CENTERLINE TO ANY PORTION OF A GATE WHEN IN THE OPEN POSITION IS TEN (10) FOOT.
- ADJUST GRADES AS REQUIRED TO ENSURE A MAXIMUM GAP OF TWELVE (12) INCHES BENEATH ANY PORTION OF GATE AND TO PROVIDE A FULL UNOBSTRUCTED RANGE OF TRAVEL BETWEEN GATE CLOSED AND OPEN POSITION.

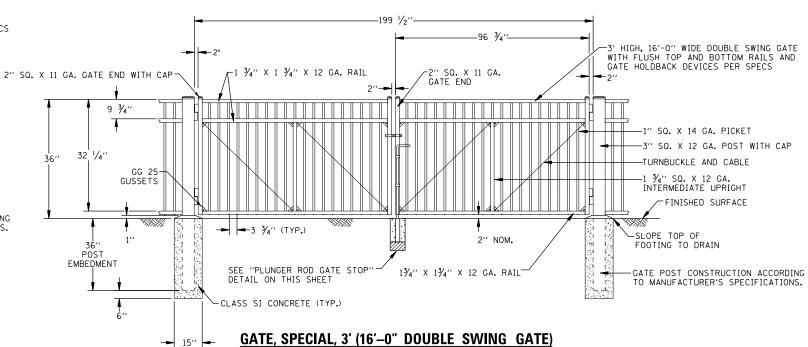


NOT TO SCALE

- NOTE:

  1.) RAILROAD WILL FURNISH PAD LOCK.

  2.) NO DIG GATE HOLDBACK DEVICE (I EACH PER SWING GATE SECTION) TO BE INSTALLED INSIDE FENCE LIMITS. SPECIFIC LOCATIONS FOR GATE HOLDBACK DEVICE AT GATE LOCATIONS WHICH COULD HAVE AN IMPACT ON THE AMOUNT OF HORIZONTAL CLEARANCE TO TRACK CENTERLINE TO BE PROVIDED BY THE ENGINEER IN THE FIELD TO ENSURE PROPER HORIZONTAL CLEARANCE IS PROVIDED TO TRACK CENTERLINE FROM GATE WHEN IN THE OPEN POSITION, MINIMUM HORIZONTAL DISTANCE FROM TRACK CENTERLINE TO ANY PORTION OF A GATE WHEN IN THE OPEN POSITION IS TEN (10) FOOT.
- OPEN POSITION IS TEN (10) FOOT.
  ADJUST GRADES AS REQUIRED TO ENSURE A MAXIMUM GAP OF TWELVE (12) INCHES BENEATH ANY PORTION OF GATE AND TO PROVIDE A FULL UNOBSTRUCTED RANGE OF TRAVEL BETWEEN GATE CLOSED AND OPEN POSITION.

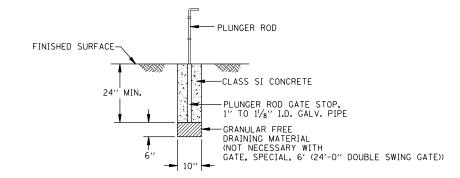

#### **PLUNGER ROD GATE STOP** NOT TO SCALE

PORTIONS OF GATE DRAWING IMAGES AS PROVIDED BY AMERISTAR.


SCALE: NTS



_	USER NAME = \$USER\$	DESIGNED -	- MCD	REVISED -
		DRAWN -	- SRS	REVISED -
	PLOT SCALE = \$SCALE\$	CHECKED -	- JAC	REVISED -
-	PLOT DATE = \$DATE\$	DATE -	12-08-16	REVISED -
3	12/7/2016 10:54:10 AM			

STATE OF ILLINOIS
DEPARTMENT OF TRANSPORTATION

MICCELLANICOLIC FENCING DETAILS			F.A.U. RTE.	SEC	TION		COUNTY	TOTAL SHEETS	SHEET NO.				
MISCELLANEOUS FENCING DETAILS					HSR FENCING	SANG.	2017	SANGAMON	32	21			
											CONTRACT	NO.	72J59
SHEET	2	OF	13	SHEETS	STA.	TO STA.			ILLINOIS	FED. Al	D PROJECT		

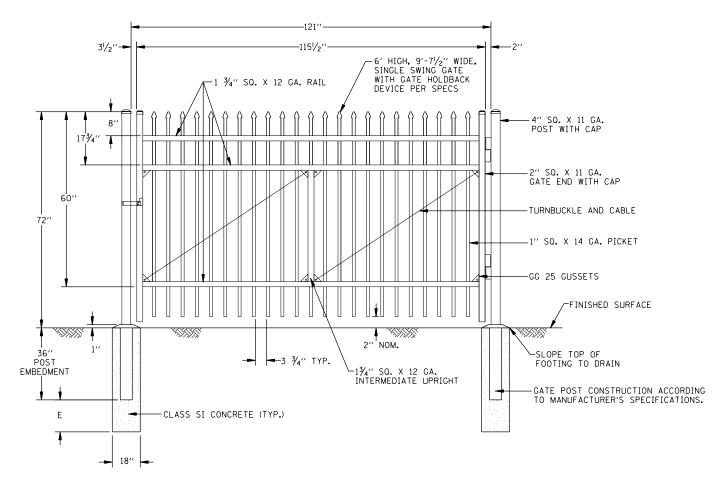

#### GATE, SPECIAL, 6' (9'-7 1/2" SINGLE SWING GATE)

NOT TO SCALE

FOOTING DEPTH BELOW POST (E)											
GATE WIND EXPOSURE B WIND EXPOSURE C											
GATE, SPECIAL, 6' 24" 36"											

- NOTE:

  1.) RAILROAD WILL FURNISH PAD LOCK.

  2.) NO DIG GATE HOLDBACK DEVICE (I EACH PER SWING GATE SECTION) TO BE INSTALLED INSIDE FENCE LIMITS. SPECIFIC LOCATIONS FOR GATE HOLDBACK DEVICE AT GATE LOCATIONS WHICH COULD HAVE AN IMPACT ON THE AMOUNT OF HORIZONTAL CLEARANCE TO TRACK CENTERLINE TO BE PROVIDED BY THE ENGINEER IN THE FIELD TO ENSURE PROPER HORIZONTAL CLEARANCE IS PROVIDED TO TRACK CENTERLINE FROM GATE WHEN IN THE OPEN POSITION. MINIMUM HORIZONTAL DISTANCE FROM TRACK CENTERLINE TO ANY PORTION OF A GATE WHEN IN THE OPEN POSITION IS TEN (10) FOOT.

  3.) ADJUST GRADES AS REQUIRED TO ENSURE A MAXIMUM GAP OF TWELVE (12) INCHES BENEATH ANY PORTION OF GATE AND TO PROVIDE A FULL UNOBSTRUCTED RANGE OF TRAVEL BETWEEN GATE CLOSED AND OPEN POSITION.

NOTE:
1.) PORTIONS OF GATE DRAWING IMAGES AS PROVIDED BY AMERISTAR.


		USER	NAME	=	\$USEF
	AECOM				
		PLOT	SCALE	=	\$SCAL
			DATE		
İ	District 6_HSR Fencing Misc Detail Sheets_IDOT.dgn	12/7/20	16 10:54	1:2	8 AM

	USER NAME = \$USER\$	DESIGNED - MCD	REVISED	-
		DRAWN - SRS	REVISED	-
	PLOT SCALE = \$SCALE\$	CHECKED - JAC	REVISED	-
'	PLOT DATE = \$DATE\$	DATE - 12-08	-16 REVISED	-

#### STATE OF ILLINOIS **DEPARTMENT OF TRANSPORTATION**


SCALE: NTS

	MISCELLANEOUS EENCING DETAILS								SECTION	COUNTY	TOTAL SHEETS	SHEET NO.
	MISCELLANEOUS FENCING DETAILS  SHEET 3 OF 13 SHEETS STA. TO STA.								HSR FENCING SANG. 2017	SANGAMON	32	22
										CONTRACT	NO.	72J59
									ILLINOIS FED. AI	D PROJECT		

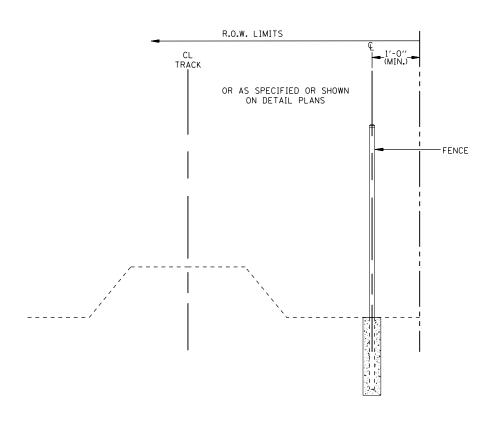


#### FENCE LOCATION ALONG R.O.W. LIMITS

NOT TO SCALE

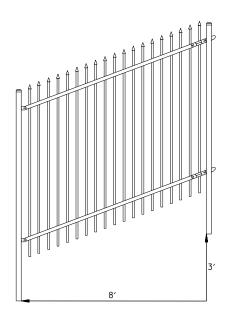


#### **FENCE PANEL FLEXIBILITY**

NOT TO SCALE

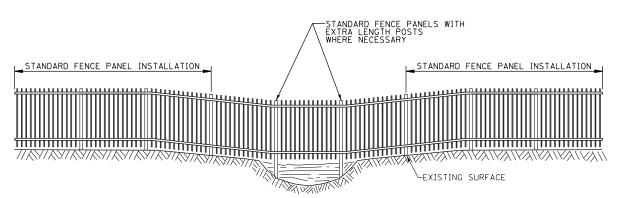

#### **ELEVATION ORNAMENTAL FENCE INSTALLATION OVER SWALE / DITCH**

NOT TO SCALE

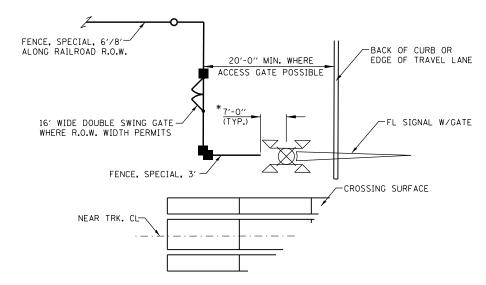

#### PLAN VIEW AT FL SIGNAL WITHOUT SIDEWALK

NOT TO SCALE

\*7'-0" DISTANCE MUST BE MAINTAINED

NOTE: ADJUSTMENTS TO THE FENCE INSTALLATION MAY BE NECESSARY BASED ON SPECIFIC SITE CONDITIONS, BUT IN NO CASE SHALL ANY SECTION OF FENCE OR A FENCE POST BE INSTALLED CLOSER THAN 2.5 FEET FROM ANY PORTION OF THE RAILROAD GATE COUNTERWEIGHT ASSEMBLY WHEN THE GATE IS IN RAISED OR LOWERED POSITION.

NOTE:
1.) PORTIONS OF FENCE DRAWING IMAGE AS PROVIDED BY AMERISTAR.


SCALE: NTS

	USER	NAME	=	\$USEF
AECOM	PLOT	SCALE	=	\$SCAL
		DATE		
District 6_HSR Fencing Misc Detail Sheets_IDOT.dgn	12/7/20	16 10:54	:4:	3 AM


USER NAME = \$USER\$	DESIGNED - MCD	REVISED -
	DRAWN - SRS	REVISED -
PLOT SCALE = \$SCALE\$	CHECKED - JAC	REVISED -
PLOT DATE = \$DATE\$	DATE - 12-08-16	REVISED -
 12/7/2016 10:54:42 AM		

STATI	E OI	FILLINOIS
DEPARTMENT	0F	TRANSPORTATION

MISCELLANEOUS FENCING DETAILS					F.A. RTE		SEC.	TION		COUNTY	TOTAL SHEETS	SHEE NO.		
MISCELLANEOUS FENCING DETAILS				HSF	FENCING	SANG.	2017	SANGAMON	32	23				
												CONTRAC	NO.	72J59
SHEET	4	OF	13	SHEETS	STA.	TO STA.				ILLINOIS	FED. A	ID PROJECT		

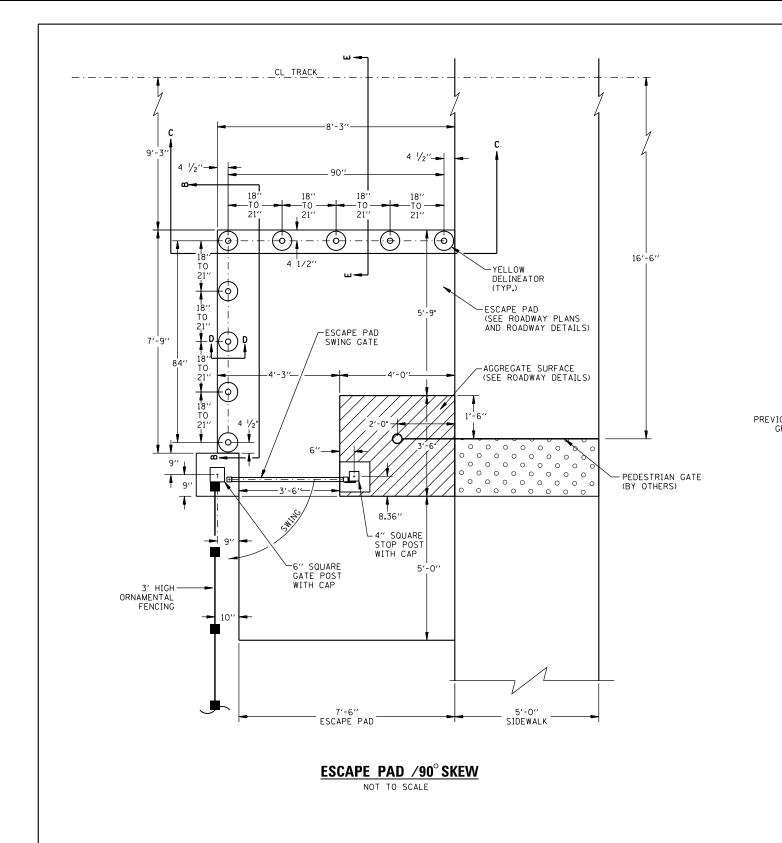


NOTE: AT SKEWED CROSSINGS THE NUMBER OF
DELINEATORS REQUIRED WILL VARY. DELINEATORS
TO BE EQUALLY SPACED ALONG THE OUTSIDE EDGE
OF THE ESCAPE PAD. ENSURE THAT A DELINEATOR
IS LOCATED IN THE CORNER OF THE ESCAPE PAD
AS SHOWN ABOVE. THE REMAINDER OF DELINEATORS
TO BE EQUALLY SPACED BETWEEN THIS CORNER
DELINEATOR AND THE BECINNING AND ENDING DELINEATOR AND THE BEGINNING AND ENDING DELINEATORS, NOT TO EXCEED TWENTY-ONE (21) INCHES.

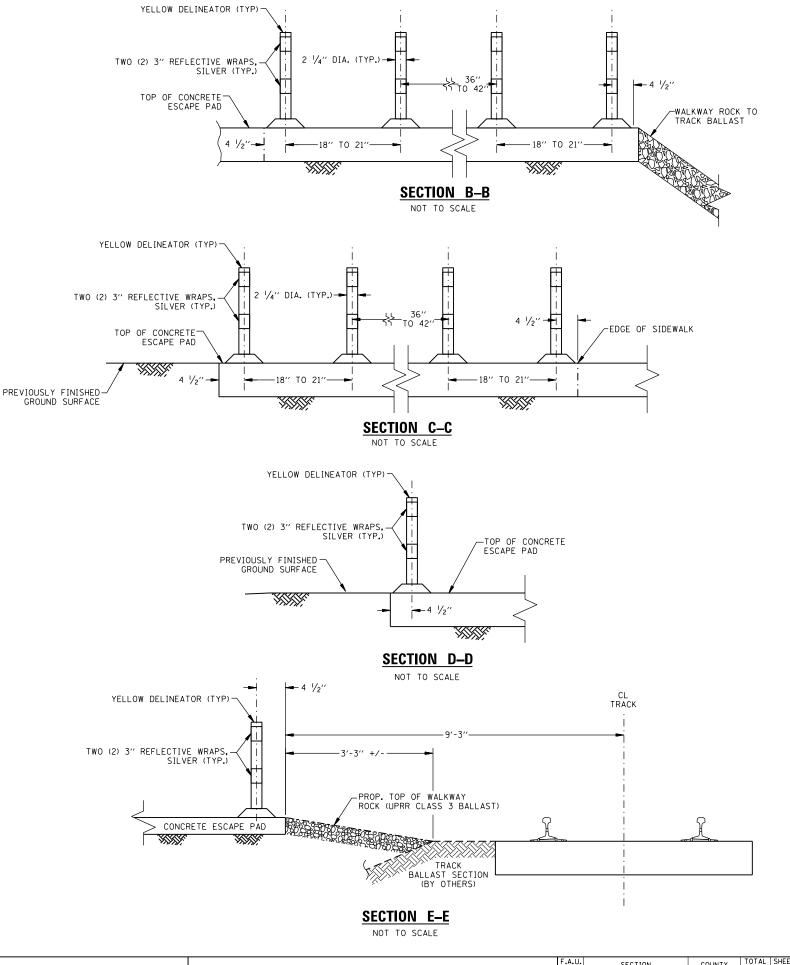


<b>AECOM</b>
--------------


	USER NAME = \$USER\$	DESIGNED - MCD	KENIZED -
		DRAWN - SRS	REVISED -
HECOM	PLOT SCALE = \$SCALE\$	CHECKED - JAC	REVISED -
	PLOT DATE = \$DATE\$	DATE - 12-08-16	REVISED -
District 6_HSR Fencing Misc Detail Sheets_IDOT.dgn	12/7/2016 10:54:57 AM		

					RTE.	SECTION	COUNTY	SHEETS	NO.		
MISCELLANEOUS FENCING DETAILS								HSR FENCING SANG. 2017	SANGAMON	32	24
									CONTRAC	T NO.	72J59
SCALE: NTS SHEET 5 OF 13 SHEETS STA. TO STA.							ILLINOIS FED.	AID PROJECT			

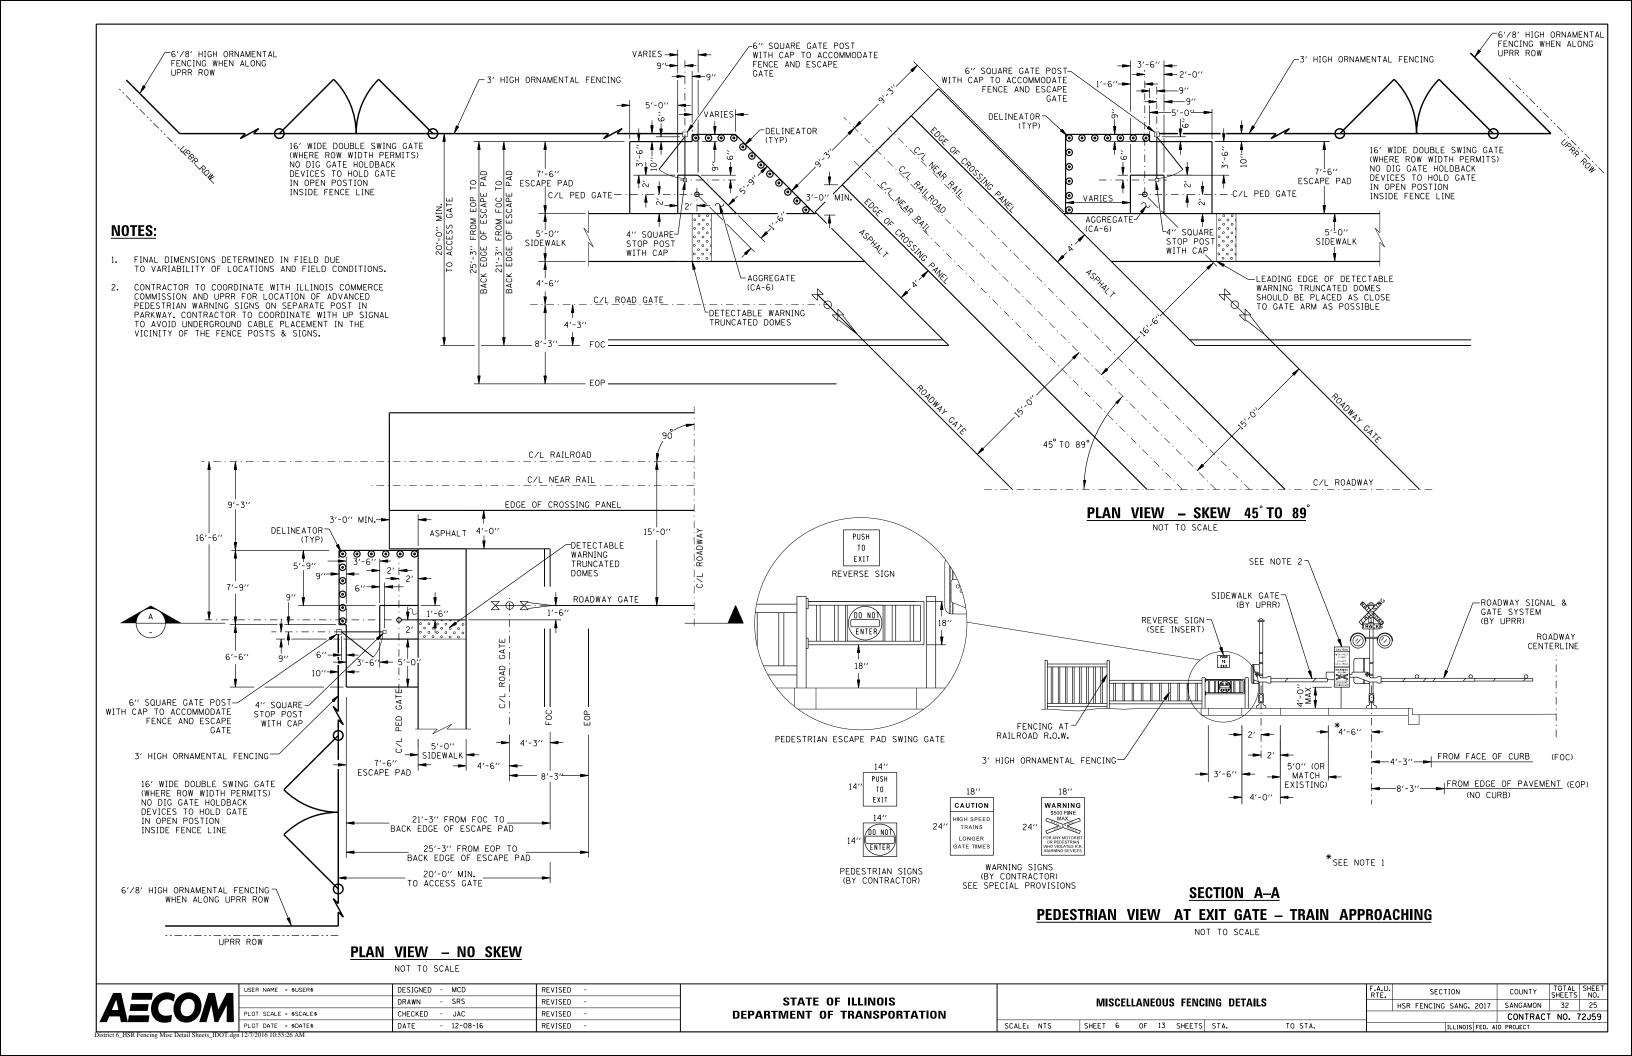

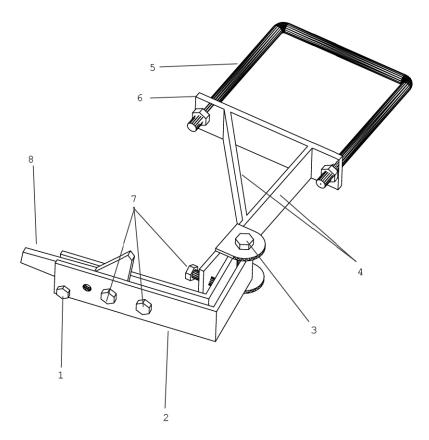

- 1. Bolt-1/4"-20 ASTM A307 zinc plated or galvanized
- 2. Arm -3/16" ASTM A36 hot rolled steel
- 3. Bolt 3/8"-16 ASME B18.2.1 grade 5
- 4. Mount arm 3/16 ASTM A36 hot rolled steel
- 5. U-bolt 3/8"
- 6. Mount 1/4" ASTM A36 hot rolled steel
- 7. Bolt 5/16"-18 ASTM A307 zinc plated or galvanized
- 8. Flapper 1/4" ASTM A36 hot rolled steel

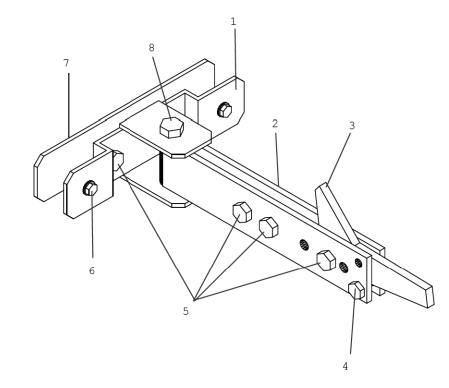

- 1. Mount- 1/8" ASTM A36

  hot rolled steel
- 2. Arm 3/16" ASTM A36
  hot rolled steel
- 3. Flapper 1/4" ASTM A36 hot rolled steel
- 4. Bolt 1/4"-20 ASTM A307 zinc plated or galvanized
- 5. Bolt 5/16-18 ASTM A307 zinc plated or galvanized
- 6. Bolt #10 Self tapping screw
- 7. Pinch plate 1/8" ASTM
  A36 hot rolled steel
- 8. Bolt 3/8"-16 ASMA B18.2.1 grade 5 zinc plated or galvanized

## NO DIG ORNAMENTAL HOLDBACK (AS MANUFACTURED BY CHICAGO SUBURBAN FENCE)


NOT TO SCALE


### NO DIG 180 DEGREE HOLDBACK (AS MANUFACTURED BY CHICAGO SUBURBAN FENCE)

NOT TO SCALE



		F.A.U. RTE.	SECTION	COUNTY	TOTAL SHEETS	SHEET NO.	
	MISCELLANEOUS FENCING DETAILS	5		HSR FENCING SANG. 2017	SANGAMON	32	26
				CONTRACT	T NO. 7	72J59	
SCALE: NTS	SHEET 7 OF 13 SHEETS STA.		ILLINOIS FED. A	D PROJECT			

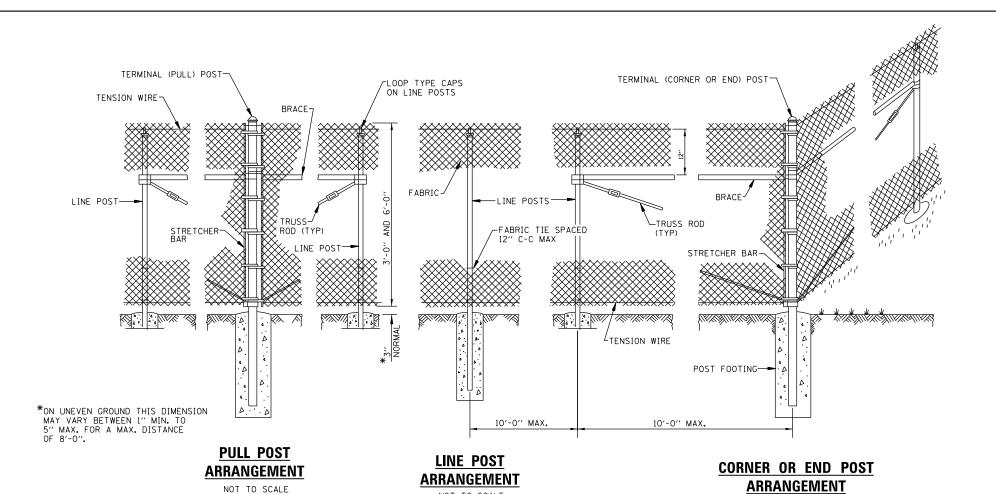

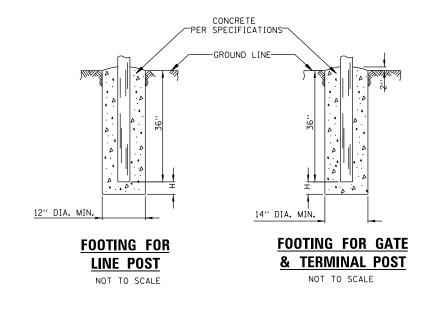

FOOTING DEPTH BELOW POST (H)

FENCE WIND EXPOSURE B WIND EXPOSURE C


CHAIN LINK FENCE, 6' 12" 24"

CHAIN LINK FENCE, 3' 6" 6"


### CHAIN LINK FENCE, 3' AND 6'

NOT TO SCALE

NOT TO SCALE

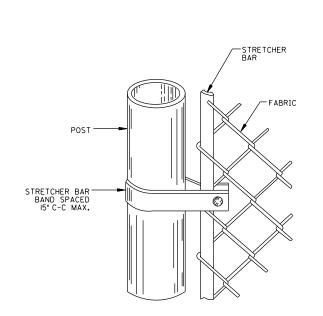



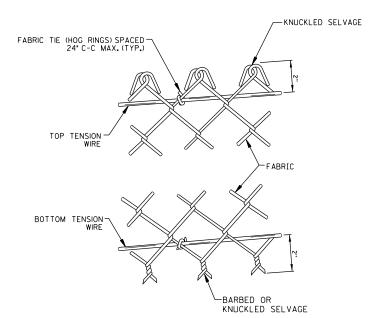

## METHOD OF TYING FABRIC TO TENSION WIRES

NOT TO SCALE


#### **GENERAL NOTES**

PULL POSTS SHALL BE PLACED AT LOCATIONS DETERMINED BY THE ENGINEER, THEY SHALL BE PLACED AT 660' INTERVALS BETWEEN POSTS TO WHICH THE ENDS OF THE FABRIC ARE CLAMPED OR MIDWAY BETWEEN SUCH POSTS WHEN THE DISTANCE IS LESS THAN 1320' AND GREATER THAN 660'.

X + Y SHALL NOT EXCEED 24", 30", OR 36", AS APPLICABLE. WHEN X IS 0" - 9", 15", OR 21", THEN Y = 15" AND THE POST SHALL BE SHORTENED AS REQUIRED. WHEN X EXCEEDS 9", 15", OR 21", THEN Y SHALL BE DECREASED CORRESPONDINGLY.

POST FOOTING CONCRETE TO BE PER SPECIFICATIONS.

ALL DIMENSIONS ARE IN INCHES UNLESS OTHERWISE SHOWN.

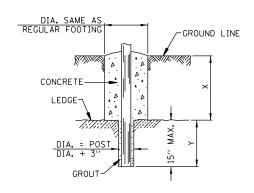


### FOOTING FOR POST IN ROCK LEDGE

NOT TO SCALE

	USER NAME = \$USER\$	DESIGNED - MCD	REVISED -			F.A.U. SECTION COUNTY TOTAL SHEET NO.
<b>AECOM</b>		DRAWN - SRS	REVISED -	STATE OF ILLINOIS	MISCELLANEOUS FENCING DETAILS	HSR FENCING SANG. 2017 SANGAMON 32 27
	PLOT SCALE = \$SCALE\$	CHECKED - JAC	REVISED -	DEPARTMENT OF TRANSPORTATION		CONTRACT NO. 72J59
	PLOT DATE = \$DATE\$	DATE - 12-08-16	REVISED -		SCALE: NTS SHEET 8 OF 13 SHEETS STA. TO STA.	ILLINOIS FED. AID PROJECT

NOT TO SCALE

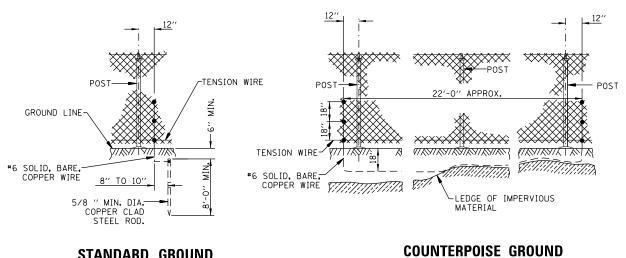


#### STANDARD GROUND NOT TO SCALE


#### (ALTERNATE)


#### PROTECTIVE ELECTRICAL GROUNDS

NOTE: PROTECTIVE ELECTRICAL GROUNDS TYPICAL FOR ORNAMENTAL FENCE.

NOT TO SCALE

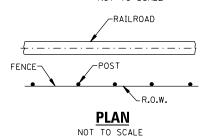

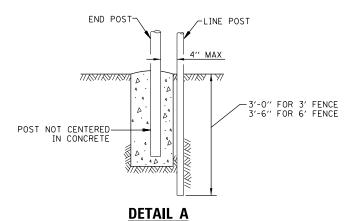

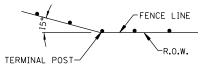

NOT TO SCALE

WHEN FENCE LINE HAS A CHANGE IN DIRECTION OF 15° OR MORE, A TERMINAL POST SHALL BE PLACED AS SHOWN ABOVE.

WHERE ANGLE IS LESS THAN 15° AND EXISTING CONDITIONS REQUIRE A TERMINAL POST, THEY SHALL BE PLACED AS DIRECTED BY THE ENGINEER.


#### **INSTALLATION AT CORNERS**

NOT TO SCALE

Γ	4 - 0 0 1 1	USER NAME = \$USER
	$\Lambda = C \cap AA$	
-1.	AECUM	PLOT SCALE = \$SCAL
Ľ		PLOT DATE = \$DATE
Di	strict 6_HSR Fencing Misc Detail Sheets_IDOT.dgr	12/7/2016 10:56:16 AM


	USER NAME = \$USER\$	DESIGNED	-	MCD	REVISED	-
		DRAWN	-	SRS	REVISED	-
	PLOT SCALE = \$SCALE\$	CHECKED	-	JAC	REVISED	-
'	PLOT DATE = \$DATE\$	DATE	-	12-08-16	REVISED	-

		F.A.U. RTE.	SECTION		COUNTY	TOTAL SHEETS	SHE
	MISCELLANEOUS FENCING DETAILS		HSR FENCING SANG.	2017	SANGAMON	32	28
					CONTRACT	NO.	72J5
	SCALE: NTS   SHEET 9 OF 13 SHEETS STA. TO STA.		ILLINOIS	FED. AI	D PROJECT		

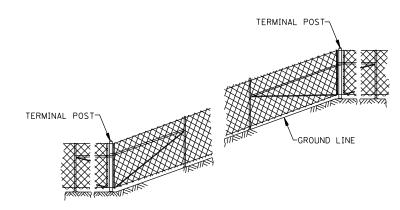


#### **INSTALLATION ON SLOPES**

NOT TO SCALE

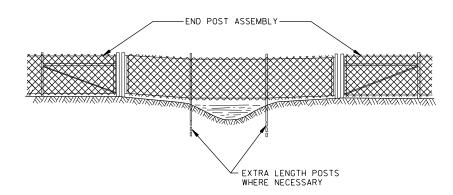

#### **ELEVATION CHAIN LINK FENCE INSTALLATION OVER SWALE / DITCH** NOT TO SCALE

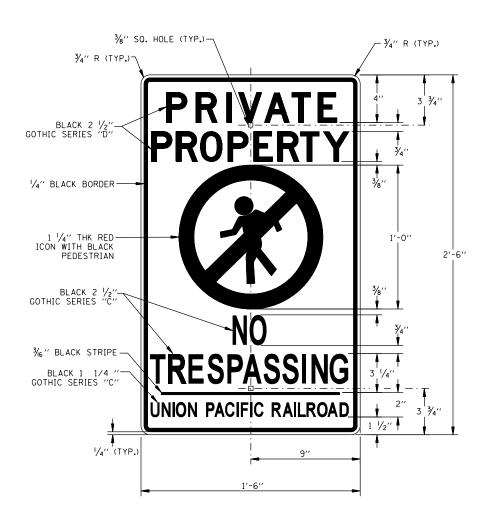

#### UNION PACIFIC NO TRESPASSING SIGN (UP STD. DWG. 0538A) NOT TO SCALE


NOTES: 1.) SIGN TO BE 3290 SILVER 3M ENGINEER GRADE BACKGROUND, ON 0.080" 3105 SHEET ALUMINUM. 2.) SIGN TO BE MOUNTED TO TUBULAR SWING GATE WITH TWO (2) TAMPER-PROOF ONE-WAY FASTENERS.


	USER NAME = \$USER
AECUM	PLOT SCALE = \$SCAL
2	PLOT DATE = \$DATE
District 6_HSR Fencing Misc Detail Sheets_IDOT.dg	n 12/7/2016 11:16:49 AM

USER NAME = \$USER\$	DESIGNED - MCD	REVISED -
	DRAWN - SRS	REVISED -
PLOT SCALE = \$SCALE\$	CHECKED - JAC	REVISED -
PLOT DATE = \$DATE\$	DATE - 12-08-16	REVISED -

STATE 0	F ILLINOIS
<b>DEPARTMENT OF</b>	TRANSPORTATION

MIGOTILIANICOLIO FENICINO DETALLO	F.A.U. RTE.	SECTION	COUNTY	TOTAL SHEETS	SHEET NO.
MISCELLANEOUS FENCING DETAILS		HSR FENCING SANG. 2017	SANGAMON	32	29
			CONTRACT	NO.	72J59
SCALE: NTS   SHEET 10 OF 13 SHEETS STA. TO STA.		ILLINOIS FED. A	D PROJECT		

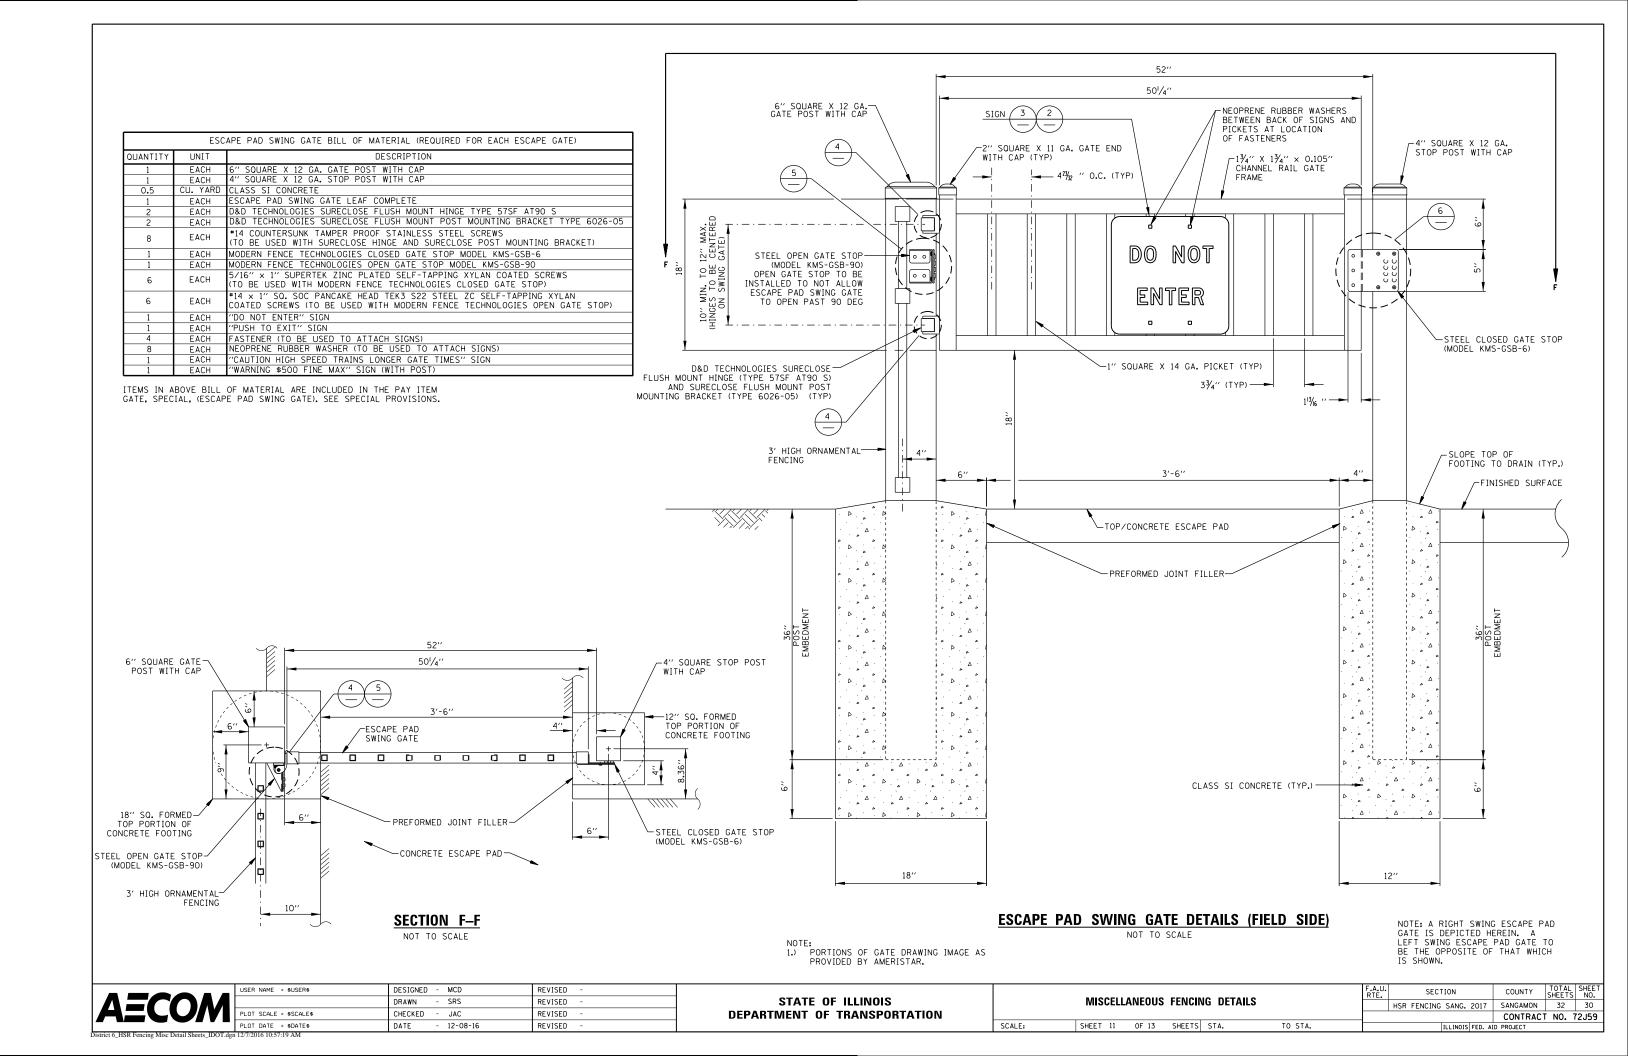


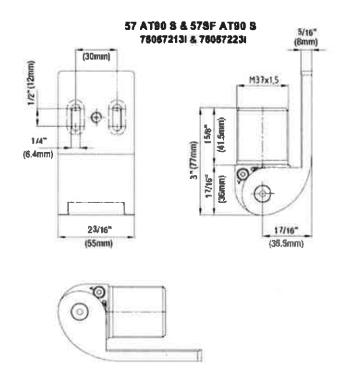


#### SURECLOSE 57 - FLUSH MOUNT HINGE (TYPE 57SF AT90 S AS MANUFACTURED BY D & D TECHNOLOGIES)

NOT TO SCALE

7515 - Bracket Type: 6026-05 Flush Mount

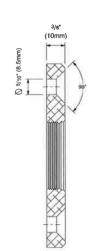


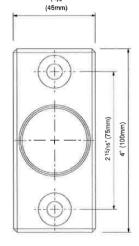



# SURECLOSE POST MOUNTING BRACKET – FLUSH MOUNT (TYPE 6026–05 AS MANUFACTURED BY D & D TECHNOLOGIES)


NOT TO SCALE

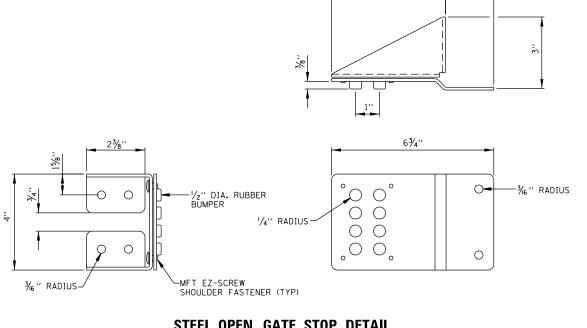

43/4"

#### STEEL OPEN GATE STOP DETAIL (MODEL KMS-GSB-90 AS MANUFACTURED BY MODERN FENCE TECHNOLOGIES)

NOT TO SCALE

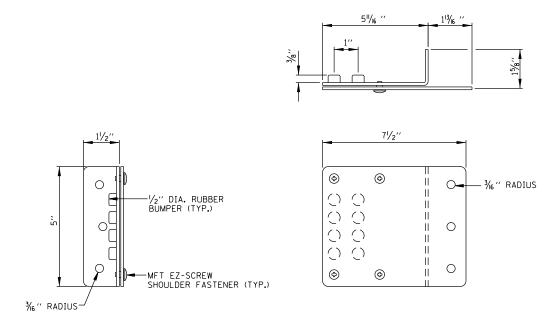

NOTE:
D&D TECHNOLOGIES FLUSH MOUNT SURECLOSE HINGE
AND SURECLOSE FLUSH MOUNT POST MOUNTING BRACKET
TO BE INSTALLED PER MANUFACTURES RECOMMENDATIONS.

CLOSED GATE STOP (MODEL KMS-GSB-6) TO BE FULLY MOUNTED TO GATE ENDS WITH 5\*16" X 1" SUPER-TEK ZINC PLATED SELF-TAPPING SCREWS COATED WITH A XYLAN COATING.

SCALE:


OPEN GATE STOP (MODEL KMS-GSB-90) TO BE FULLY MOUNTED TO GATE POST WITH #14 X 1" SO. SOC PANCAKE HEAD TEK3 SS2 STEEL ZC SELF-TAPPING SCREWS WITH A XYLAN COATING.

#### STEEL CLOSED GATE STOP DETAIL (MODEL KMS-GSB-6 AS MANUFACTURED BY MODERN FENCE TECHNOLOGIES)

NOT TO SCALE

	USER NAME = \$USER\$	DESIGNED - MCD	REVISED -
$\Lambda = C \cap AA$		DRAWN - SRS	REVISED -
HELUM	PLOT SCALE = \$SCALE\$	CHECKED - JAC	REVISED -
	PLOT DATE = \$DATE\$	DATE - 12-08-16	REVISED -

5.714	2051	ANEOU	O FENO	INO DETAILO		F.A.U. RTE.	SECTION	COUNTY	TOTAL SHEETS	SHEET NO.
MISCELLANEOUS FENCING DETAILS				HSR FENCING SANG. 2017	SANGAMON	32	31			
								CONTRACT	NO.	72J59
SHEET	12	OF 13	SHEETS	STA.	TO STA.		ILLINOIS FED. A	D PROJECT		

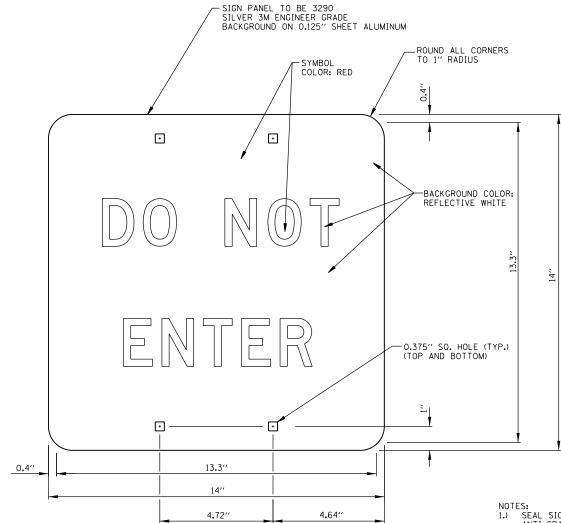

4.72"

4.64"


1.) SEAL SIGNS WITH TRAN ANTI-GRAFFITI FILM

2.) TWO (2) EACH PICKETS DRILLED WITH TWO (2)

REVISED

REVISED REVISED

REVISED

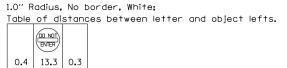

ESCAPE PAD SWING GATE SIGN (FIELD SIDE)


NOT TO SCALE

NOTES: 1.) SEAL SIGNS WITH TRANSPARENT ANTI-GRAFFITI FILM

2.) TWO (2) EACH PICKETS TO BE DRILLED WITH TWO (2) HOLES EACH FOR MOUNTING TAMPER-PROOF FASTENERS. CONTRACTOR TO APPLY ENGINEER APPROVED SURFACE COATING PRODUCT TO DRILLED HOLES.


3.) SIGNS TO BE MOUNTED BACK TO BACK WITH FOUR (4) TAMPER-PROOF STAINLESS STEEL ONE-WAY FASTENERS. ENGINEER APPROVED NEOPRENE WASHERS TO BE PLACED BETWEEN SIGN SURFACES AND PICKETS PRIOR TO INSTALLATION OF FASTENERS.

4.) TYPE ZZ SHEETING IS REQUIRED FOR THE "DO NOT ENTER" SIGN.

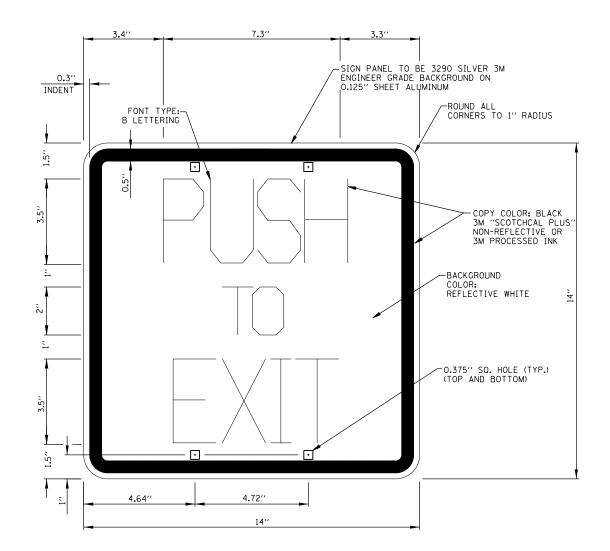

1.0" Radius, 0.5" Border, 0.3" Indent, Black on White; "PUSH" B 75% spacing; "TO" B 75% spacing; "EXIT" B 75% spacing;

Table of distances between letter and object lefts.

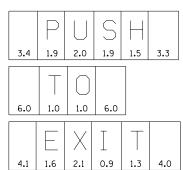

### ESCAPE PAD SWING GATE SIGN (TRACK SIDE)

NOT TO SCALE

	USER NAME = \$USER\$	DESIGNED	-	MCD
		DRAWN	-	SRS
	PLOT SCALE = \$SCALE\$	CHECKED	-	JAC
2	PLOT DATE = \$DATE\$	DATE	-	12-08-16
District 6_HSR Fencing Misc Detail Sheets_IDOT.dgn				

MICOSTILANISONO PETANO	F.A RTI	E. SEC	TION	COUNTY	TOTAL SHEETS	SHEET NO.
MISCELLANEOUS FENCING DETAILS		HSR FENCING	SANG. 2017	SANGAMON	32	32
				CONTRAC	NO. '	72J59
SCALE: SHEET 13 OF 13 SHEETS STA. TO STA.			ILLINOIS FED. A	D PROJECT		