03-03-2017 LETTING ITEM 001

STATE OF ILLINOIS **DEPARTMENT OF TRANSPORTATION**

D-91-507-12

LOCATION OF SECTION INDICATED THUS: - -

STATE OF ILLINOIS DEPARTMENT OF TRANSPORTATION

> PRINTED BY THE AUTHORITY OF THE STATE OF ILLINOIS

PROPOSED HIGHWAY PLANS

FAP ROUTE 347: IL 38 (ROOSEVELT RD)
AT ARDMORE AVENUE SECTION CY-N-1 PROJECT ACCM-0347 (032) WIDENING (RIGHT TURN LANES) **DUPAGE COUNTY**

C-91-507-12


THIS IMPROVEMENT IS LOCATED IN THE VILLAGE OF VILLA PARK & THE CITY OF OAKBROOK TERRACE.

FOR INDEX OF SHEETS, SEE SHEET NO. 2

TRAFFIC DATA

0

2013 ADT = 52300 SPEED LIMIT = 35 MPH

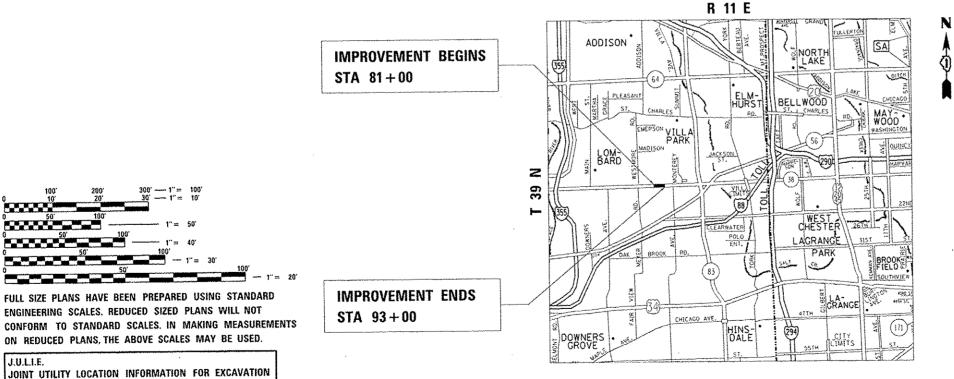

YORK TOWNSHIP

PROJECT ENGINEER: J. ALAIN MIDY (847) 221-3056 PROJECT MANAGER: ISSAM RAYYAN (847) 705-4178

GROSS LENGTH = 1200 FT. = 0.227 MILE NET LENGTH = 1200 FT. = 0.227 MILE

CONTRACT NO. 60V00

1-800-892-0123

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	EDGE GREATER THAN OR EQUAL TO 15' (BD-01)
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000001-06	STANDARD SYMBOLS, ABBREVIATIONS AND PATTERNS
280001-07	TEMPORARY EROSION CONTROL SYSTEM
424001-09	PERPENDICULAR CURB RAMPS FOR SIDEWALKS
442201-03	CLASS C AND D PATCHES
601001-05	PIPE UNDERDRAINS
602001-02	CATCH BASIN TYPE A
602011-02	CATCH BASIN TYPE C
602401-03	MANHOLE TYPE A
604001-04	FRAME AND LIDS TYPE I
604091-03	FRAME AND GRATE TYPE 24
606001-06	CONCRETE CURB TYPE B AND COMBINATION CONCRETE CURB AND GUTTER
606301~04	PC CONCRETE ISLANDS AND MEDIANS
701006-05	OFF-ROAD OPERATIONS. 2L, 2W, 15' TO 24" FROM PAVEMENT EDGE
701101-05	OFF-ROAD OPERATIONS, MULTILANE, 15' TO 24" FROM PAYEMENT EDGE
701427-05	LANE CLOSURE, MULTI LANE, INTERMITTENT OR MOVING OPER, FOR SPEEDS & 40 MPH
701501-06	URBAN LANE CLOSURE, 2L, 2W. UNDIVIDED
701606-10	URBAN SINGLE LANE CLOSURE, MULTILANE, 2W WITH MOUNTABLE MEDIAN
701701-10	URBAN LANE CLOSURE, MULTILANE INTERSECTION
701801-06	SIDEWALK, CORNER OR CROSSWALK CLOSURE
701901-06	TRAFFIC CONTROL DEVICES
720001-01	SIGN PANEL MOUNTING DETAILS
720006-04	SIGN PANEL ERECTION DETAILS
720011-01	METAL POSTS FOR SIGNS, MARKERS & DELINEATORS
729001-01	APPLICATIONS OF TYPES A&B METAL POSTS (FOR SIGNS AND MARKERS)
805001-01	ELECTRICAL SERVICE INSTALLATION DETAILS
814001-03	HANDHOLES
814006-02	DOUBLE HANDHOLES
857001-01	STANDARD PHASE DESIGNATION DIAGRAMS AND PHASE SEQUENCES
862001-01	UNINTERRUPTABLE POWER SUPPLY
873001-02	TRAFFIC SIGNAL GROUNDING & BONDING
877001-06	STEEL MAST ARM ASSEMBLY AND POLE 16' THROUGH 55'
878001-10	CONCRETE FOUNDATION DETAILS
880001-01	SPAN WIRE MOUNTED SIGNALS AND FLASHING BEACON INSTALLATION
880006-01	TRAFFIC SIGNAL MOUNTING DETAILS
886001-01	DETECTOR LOOP INSTALLATIONS
886006-01	TYPICAL LAYOUT FOR DETECTION LOOPS

	USER NAME : dahharr	DESIGNED -	REVISED -		IL ROUTE 38 (ROOSEVELT RD.) AT ARDMORE AVE.	RTE.	SECTION	COUNTY
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GENERAL NOTES

- 1. BEFORE STARTING ANY EXCAVATION, THE CONTRACTOR SHALL CALL "J.U.L.I.E." AT (800) 892-0123 OR 811 FOR FIELD LOCATIONS OF BURIED ELECTRIC, TELEPHONE AND GAS UTILITIES. 48 HOUR NOTIFICATION IS REQUIRED.
- 2. TEN (10) FOOT TRANSITIONS SHALL BE USED TO MATCH PROPOSED CURB AND GUTTER AND MEDIAN ITEMS OF WORK TO EXISTING CURBS AND GUTTER AND MEDIANS IN THE FIELD, UNLESS OTHERWISE SHOWN. THE TRANSITIONS SHALL BE PAID FOR AT THE CONTRACT UNIT PRICE FOR THE PROPOSED ITEMS OF WORK SPECIFIED.
- 3. THE CONTRACTOR SHALL COORDINATE CONSTRUCTION ACTIVITIES WITH UTILITY COMPANIES, AND THE VILLAGE OF VILLA PARK.
- 4. THE CONTRACTOR WILL NOT BE ALLOWED TO SET UP A YARD OR FIELD OFFICE ON STATE PROPERTY WITHOUT WRITTEN PERMISSION FROM THE DEPARTMENT.
- 5. ANY PAVEMENT MARKINGS AND RAISED REFLECTIVE PAVEMENT MARKERS OBLITERATED BY MILLING AND RESURFACING OPERATIONSON SIDE STREETS AND ENTRANCES SHALL BE REPLACED AND PAID FOR IN KIND.
- 6. ALL DAMAGE TO EXISTING PAVEMENT MARKINGS OR RAISED REFLECTIVE PAVEMENT MARKERS OUTSIDE THE REMOVAL LINE SHOWN ON THE PLANS SHALL BE REPLACED AT NO ADDITIONAL COST TO THE DEPARTMENT.
- 7. BEFORE BEGINNING ANY WORK, THE CONTRACTOR SHALL RETAIN AND RECORD FOR FUTURE REFERENCE, ALL EXISTING PAVEMENT MARKING LINES (AND RAISED REFLECTIVE PAVEMENT MARKERS) IN ORDER THAT THESE LOCATIONS CAN BE RE-ESTABLISHED FOR STRIPING, EXACT LOCATIONS OF ALL PAVEMENT MARKINGS SHALL BE AS DIRECTED BY THE ENGINEER.
- 8. ALL PAVEMENT PATCHING LOCATIONS WILL BE DETERMINED IN THE FIELD BY THE ENGINEER.
- 9. LOCATION OF COMBINATION CONCRETE CURB AND GUTTER REMOVAL AND REPLACEMENT FOR COMBINATION CURB AND GUTTER (THE TYPE SPECIFIED ON THE PLANS)], WILL BE DETERMINED IN THE FIELD BY THE ENGINEER.
- 10. DRAINAGE ADJUSTMENT OR RECONSTRUCTION LOCATIONS WILL BE DETERMINED IN THE FIELD BY THE ENGINEER.
- 11. IT SHALL BE THE CONTRACTOR'S RESPONSIBILITY TO VERIFY ALL DIMENSIONS AND CONDITIONS EXISTING IN THE FIELD PRIOR TO CONSTRUCTION AND ORDERING OF MATERIALS.
- 12. FRAMES AND GRATES ADJUSTMENT OF PRIVATE UTILITIES WITHIN THE LIMITS OF THE IMPROVEMENTS SHALL BE DONE BY THEIR RESPECTIVE OWNERS AND ARE NOT PART OF THIS CONTRACT.
- 13. SIDEWALK REMOVAL AND P.C.C. SIDEWALK 5" LOCATIONS SHALL BE DETERMINED BY THE ENGINEER.
- 14. THE CONTRACTOR SHALL CONTACT THE DISTRICT ONE TRAFFIC CONTROL SUPERVISOR AT (847)705-4470 A MINIMUM OF 72 HOURS IN ADVANCE OF BEGINNING WORK.
- 15. THE ENGINEER SHALL CONTACT DON CHIARUGI, AREA TRAFFIC FIELD ENGINEER, AT DON.CHIARUGI@ILLINOIS.GOV A MINIMUM OF TWO (2) WEEKS PRIOR TO THE PLACEMENT OF PERMANENT PAVEMENT MARKINGS.
- 16. THESE PLANS HAVE BEEN PREPARED FROM NOTES RECEIVED FROM THE BUREAU OF CONSTRUCTION.
- 17. THE CONTRACTOR SHALL BE REQUIRED TO PROVIDE ACCESS TO ABUTTING PROPERTY AT ALL TIMES DURINGTHE CONSTRUCTION OF THIS PROJECT.
- 18. FOR STORM SEWER CONSTRUCTED UNDER THE ROADWAY, BACKFILLING METHODS TWO AND THREE AUTHORIZED UNDER THE PROVISIONS OF ARTICLE 550.07 OF THE STANDARD SPECIFICATIONS WILL NOT BE ALLOWED.

- 19. THE CONTRACTOR WILL BE REQUIRED TO KEEP A RECORD OF THE LOCATIONS OF PLATED STRUCTURES BY STATION AND OFFSET LEFT OR RIGHT OF THE CENTERLINE OF PAVEMENT.
- 20. THE CONTRACTOR WILL BE REQUIRED TO KEEP A RECORD OF THE LOCATIONS OF THE BURIED STRUCTURES ACCORDING TO THE STATION AND DISTANCE LEFT OR RIGHT OF THE CENTERLINE OF PAVEMENT. UPON COMPLETION OF THE WORK, THE CONTRACTOR WILL DELIVER THE RECORD TO THE ENGINEER.
- 21. EXISTING BROKEN FRAMES AND LIDS SHALL BE REMOVED AND DISPOSED OF BY THE CONTRACTOR AND SHALL BE REPLACED AS DIRECTED BY THE ENGINEER. REPLACEMENT FRAMES AND LIDS WILL BE PAID FOR ACCORDING TO ARTICLE 109.04 OF THE STANDARD SPECIFICATIONS UNLESS A SEPARATE PAY ITEM HAS BEEN PROVIDED.
- 22. FOR FRAMES AND LIDS ADJUSTMENT WITHOUT MILLING, REUSE EXISTING FRAME AND LID UNLESS OTHERWISE SPECIFIED IN THE PLANS.
- 23. DO NOT SCALE PLANS FOR CONSTRUCTION DIMENSIONS.
- 24. DOUBLE LANE MARKERS ARE TO BE USED AS SHOWN ON THE DISTRICT ONE DETAIL "TYPICAL APPLICATIONS RAISED REFLECTIVE PAVEMENT MARKERS (SNOW-PLOW RESISTANT)" SHOWN IN THE PLANS.
- 25. PAVEMENT MARKING TAPE, TYPE III SHALL BE USED FOR SHORT TERM PAVEMENT MARKINGS ON ALL FINAL SURFACES. THE COST OF THE PAVEMENT MARKING TAPE, TYPE III SHALL BE INCLUDED IN THE COST OF SHORT TERM PAVEMENT MARKING.
- 26. WHEN THE MILLED PAVEMENT IS OPEN TO TRAFFIC THE MAXIMUM GRADE DIFFERENTIAL BETWEENPASSES OF THE MILLING MACHINE SHALL NOT EXCEED 1½INCHES (40 mm) WHERE THE SPEED LIMIT IS 40 MPH (80 km/h) OR LESS AND 1 INCH (25 mm) WHERE THE SPEED LIMIT IS GREATER THAN 40 MPH (80 km/h). WITH WRITTEN APPROVAL OF THE ENGINEER, A MAXIMUM GRADE DIFFERENTIAL OF 3 INCHES (75 mm) MAY BE ALLOWED IF THE EDGE OF THE MILLING IS SLOPED A MINIMUM 1:3 (Y:H) OR A NOTCHED LONGITUDINAL WEDGE IS USED.
- 27. BUTT JOINTS WILL BE INSTALLED AT THE ENDS OF ALL RESURFACING (WHERE RESURFACING MEETS EXISTING PAVEMENT) ACCORDING TO THE "BUTT JOINT AND HOT-MIX ASPHALT TAPER DETAILS" SHEET INCLUDED IN THE PLANS, UNLESS OTHERWISE SPECIFIED.
- 28. OVERNIGHT LANE CLOSURES SHALL NOT BE ALLOWED FOR REHABILITATION PROJECTS INVOLVING DAYTIME MILLING AND RESURFACING OPERATIONS AND CLASS D PATCHING UNLESS OTHER CONDITIONS WARRANT EXTENDED LANE CLOSURES AS DETERMINED AND APPROVED IN WRITING BY THE ENGINEER OR AS PROVIDED FOR IN THE CONTRACT SPECIFICATIONS.
- 29. UNDERBRUSH OR DEBRIS AT PLANTING LOCATIONS SHALL BE REMOVED AND DISPOSED OF ACCORDING TO SECTION 201 OF THE STANDARD SPECIFICATIONS. THIS WORK WILL NOT BE PAID FOR SEPARATELY, BUT THE COSTS SHALL BE CONSIDERED AS INCLUDED IN THE CONTRACT UNIT PRICES FOR THE CONSTRUCTION ITEMS INVOLVED, AND NO ADDITIONAL COMPENSATION WILL BE ALLOWED.
- 30. THE CONTRACTOR SHALL TAKE ALL NECESSARY PRECAUTIONS FOR THE PROTECTION OF EXISTING PLANT MATERIAL FOR WHICH THE CONTRACT DOES NOT PROVIDE REMOVAL. THE PROTECTION OF EXISTING PLANT MATERIAL AND THE REPAIR OR REPLACEMENT OF EXISTING PLANT MATERIAL DAMAGED BY THE CONTRACTOR SHALL BE DONE IN ACCORDANCE WITH THE REQUIREMENTS OF SECTION 201 OF THE STANDARD SPECIFICATIONS.

TOTAL SHEET NO.

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RACT NO. 60000

- 31. SIDEWALKS MAY ONLY BE CLOSED ON ONE SIDE OF THE ROAD AT ANY TIME WHILE THE SIDEWALK ON THE OTHER SIDE MUST BE MAINTAINED OPEN AND ACCESSIBLE.
- 32. TRENCH BACKFILL COMPACTION USING ARTICLE 550.07(C) METHOD 3 WILL BE PROHIBITED.

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	SUMMARY OF QUANTITIES		4.557.10				ON TYPE		VIII LACE	****	SUMMA	RY OF QUANTITIES	· · · · · · · · · · · · · · · · · · ·		DOADWAY	TRAFFIC		ION TYPE	CODE	TURLACE
CODE NO	ITEM	UNIT	TOTAL QUANTITIES	0004	TRAFFIC 0021 FED 80% STATE 10% VILLA- PARK 10%	INTER CONNECT 0021 FED 80% STATE 20%	0021	rrn 00"	VILLAGE WATER 0043 VILLA- PARK 1002	CODE NO		ITEM	UNIT	TOTAL	0004	0021	INTER CONNECT 0021 FED 80% STATE 20%		SIDEWALK 0021 FED 80% VILLA- PARK 20%	
20200100	EARTH EXCAVATION	CU YD	1089.4	1027. 3				62. 1		40600290	BITUMINOUS N	MATERIALS (TACK COAT)	POUND	8931	8931					
20201200	REMOVAL AND DISPOSAL OF UNSUITABLE	CU YD	178-92	176.51			**************************************	2.41		40600827	POLYMER1ZED	LEVELING BINDER (MACHINE	TON	546	546					
1020,200	MATERIAL			**************************************	e manual de la constanta de la					A TOTAL OF THE PROPERTY OF THE	METHOD). IL		***************************************							
					TAMAN				1											
20800150	TRENCH BACKFILL	CU YD	181	181						40600982	JOINT	HALT SURFACE REMOVAL - BUTT	SO YD	125	125			VANANA WALLES		
21001000	GEOTECHNICAL FABRIC FOR GROUND	SQ YD	401	401					1											
	STABILIZATION				maaaaaaaaaaaaaaaaaaaaaaaaaaaaaaaaaaaaa		Annual money			40603335	HOT-MIX ASPI	HALT SURFACE COURSE, MIX	TON	23, 3	23. 3					
21101505	TOPSOIL EXCAVATION AND PLACEMENT	CU YD	149.5	92.65				56.85	A ************************************	100	B , 1130									
		***************************************								40800029	BITUMINOUS I	WATERIALS (TACK COAT)	POUND	47	47					
25200110	SODDING, SALT TOLERANT	SO YD	1021.3)	731. 31	and the same of th	AAAAAAAAAAAAAAAAAAAAAAAAAAAAAAAAAAAAAA	-	290		42300400	PORTLAND CEI	MENT CONCRETE DRIVEWAY	SO YD	77	77	The state of the s				
28000400	PERIMETER EROSION BARRIER	FOOT	568	568	and the second s						PAVEMENT,	8 INCH								
28000510	INLET FILTERS	EACH	20	20	Andrea de la constante de la c				THE PROPERTY OF THE PROPERTY O	42400200	PORTLAND CE	WENT CONCRETE SIDEWALK 5	SO FT	4286	2980				1306	
28000310	THE FACILITY										INCH					***************************************		****		
30300001	AGGREGATE SUBGRADE IMPROVEMENT	CU YD	128	128																
30300112	AGGREGATE SUBGRADE IMPROVEMENT 12"	SO YD	924.7	924.7	Andreas de la constanta de la	444	**************************************			42400410	PORTLAND CEI	WENT CONCRETE SIDEWALK 8	SO FT	765	765					-
													-							
35101600	AGGREGATE BASE COURSE, TYPE B 4"	SO YD	846.4	701.4	<u> </u>			145		42400800	DETECTABLE	WARNINGS	SO FT	282	282			***************************************		
35501316	HOT-MIX ASPHALT BASE COURSE, 8"	SO YD	208	208						44000159	HOT-MIX ASP	HALT SURFACE REMOVAL. 2	SO YD	12574	12574					
75501.00	HOT MAY ACRUM T PAGE COURSE TO A COURSE		CET	***	***************************************	V4 anniminate Administration (American Control of Contr				renimilar (Assault)	1/2"		Haran de la companya	***************************************						
35501334	HOT-MIX ASPHALT BASE COURSE. 12 1/2"	SO YD	657	657	***************************************					44000200	DRIVEWAY PA	VEMENT REMOVAL	SO YD	464.1	464.1			westering and the second of th		
40600275	BITUMINOUS MATERIALS (PRIME COAT)	POUND	1478	1478									The state of the s							
				And Address of the Ad						44000300	CURB REMOVA	L	FOOT	82	82					
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<u> </u>	SHAMADY OF CHANTITIES		-				ION TYPE				CHAMADA	r OF QUANTITIES						ON TYPE (ODE	
	SUMMARY OF QUANTITIES	1:	3 3	ROADWAY 0004	TRAFFIC 0021	INTER CONNECT	TRAFFIC	SIDEWALK 0021	VILLAGE WATER	-	JUMMAR	I VE GUMHITIES	1	TOTAL	ROADWAY 0004	TRAFFIC 0021	INTER CONNECT	TRAFFIC 0021	SIDEWALK 0021	VILLAGE WATER
CODE NO	ITEM	UNIT	TOTAL QUANTITIES		FED 80%	0021	EVD	CED 804	0043 VILLA- PARK 100%	CODE NO		ITEM	UNIT	OUANTITIES	FED 80% STATE 20%	FED 80% STATE 10% VILLA- PARK 10%				
44000500	COMBINATION CURB AND GUTTER REMOVAL	FOOT	1110	1110	(88)					60255500	MANHOLES TO BE	E ADJUSTED	EACH	11	9					2
44000600	SIDEWALK REMOVAL	SQ FT	3045	3045	AND		Market Andreas			60260100	INLETS TO BE	ADJUSTED	EACH	15	15					
44201777	CLASS D PATCHES. TYPE II. 11 INCH	SO YD	21.34	21.34			444.Veritable			60265700	VALVE VAULTS	TO BE ADJUSTED	EACH	5			Annia mana da			5
44201815	CLASS D PATCHES, TYPE II, 14 INCH	SO YD	128	128	Andreanness and the control of the c					60266100	VALVE VAULTS	TO BE RECONSTRUCTED	EACH	2						2
55100500	STORM SEWER REMOVAL 12"	FOOT	33.5	33.5						60266600	VALVE BOXES TO	O BE ADJUSTED	EACH	3						3
55100700	STORM SEWER REMOVAL 15"	FOOT	61	61			we will be seen to be			60300305	FRAMES AND LI	DS TO BE ADJUSTED	EACH	7	7					
56109210	WATER VALVES TO BE ADJUSTED	EACH	1			Charles and Charle			1	60500040	REMOVING MANH	OLES	EACH	2	2					
56400100	FIRE HYDRANTS TO BE MOVED	EACH	2				***		2	60500060	REMOVING INLE	TS	EACH	4	4		A			
60108204	PIPE UNDERDRAINS, TYPE 2, 4"	FOOT	535	535	Andrews					60600605	CONCRETE CURB	. TYPE B	FOOT	120	120		And and annoted the second sec			
60201340	CATCH BASINS. TYPE A. 4'-DIAMETER, TYPE	EACH	1	1					distance of the second	60603800		ONCRETE CURB AND GUTTER,	FOOT	241	241		**************************************			
	24 FRAME AND GRATE										TYPE B-6.12						Accession to the contract access of the contr			
60208240	CATCH BASINS. TYPE C. TYPE 24 FRAME AND GRATE	EACH	2	2						60605000	COMBINATION C	ONCRETE CURB AND GUTTER,	FOOT	762	762					
60218400	MANHOLES, TYPE A, 4'-DIAMETER, TYPE 1	EACH	1	1		and the state of t		water to the state of the state		* 66900200	NON-SPECIAL W	ASTE DISPOSAL	CU YD	822	822					
	FRAME, CLOSED LID	The state of the s						Tarasa da la sangan da la sangan da	лединенентика уплавания макей и политика и	* 66900450	SPECIAL WASTE	PLANS AND REPORTS	LSUM	444	1					
60237470	INLETS, TYPE A, TYPE 24 FRAME AND GRATE	EACH	1	The state of the s						* 66900530	SOIL DISPOSAL	ANALYSIS	EACH	5	5				,,,,	
60255410		EACH	6	6						IC 67000										
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TOTAL COLD	CODE SIDEWALK VILLAG
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Standard Policis Standard Po	
TOURSESS TRAFFIC CONTROL AND PROTECTION. LSW 1	
TODGGS TRAFFIC CONTROL AND PROTECTION	
## FROODLOO THERMOPLASTIC PAYEMENT MARKING - LINE FOOT 4323 4323 100	
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STANDARD 701701	
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STANDARD 701801	
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** T8000600 THERMOPLASTIC PAVEMENT MARKING - LINE FOOT 876 876 876 12" ***T8000600 THERMOPLASTIC PAVEMENT MARKING - LINE FOOT 876 876 876 12" ***T8000650 THERMOPLASTIC PAVEMENT MARKING - LINE FOOT 231 231 231 231 24" ***T8000650 THERMOPLASTIC PAVEMENT MARKING - LINE FOOT 231 231 231 24" ***T8000650 THERMOPLASTIC PAVEMENT MARKING - LINE FOOT 231 231 231 24" ***T8000650 THERMOPLASTIC PAVEMENT MARKING - LINE FOOT 231 231 231 24" ***T8000650 THERMOPLASTIC PAVEMENT MARKING - LINE FOOT 231 231 231 24" ***T8000650 THERMOPLASTIC PAVEMENT MARKING - LINE FOOT 231 231 231 24" ***T8000650 THERMOPLASTIC PAVEMENT MARKING - LINE FOOT 231 231 231 24" ***T8000650 THERMOPLASTIC PAVEMENT MARKING - LINE FOOT 231 231 231 24" ***T8000650 THERMOPLASTIC PAVEMENT MARKING - LINE FOOT 231 231 231 24" ***T8000650 THERMOPLASTIC PAVEMENT MARKING - LINE FOOT 231 231 231 24" ***T8000650 THERMOPLASTIC PAVEMENT MARKING - LINE FOOT 231 231 231 24" ***T8000650 THERMOPLASTIC PAVEMENT MARKING - LINE FOOT 231 231 231 24" ***T8000650 THERMOPLASTIC PAVEMENT MARKING - LINE FOOT 231 231 231 24" ***T8000650 THERMOPLASTIC PAVEMENT MARKING - LINE FOOT 231 231 231 24" ***T8000650 THERMOPLASTIC PAVEMENT MARKING - LINE FOOT 231 231 231 24" ***T8000650 THERMOPLASTIC PAVEMENT MARKING - LINE FOOT 231 231 231 24" ***T8000650 THERMOPLASTIC PAVEMENT MARKING - LINE FOOT 231 231 231 231 24" ***T8000650 THERMOPLASTIC PAVEMENT MARKING - LINE FOOT 231 231 231 231 24" ***T8000650 THERMOPLASTIC PAVEMENT MARKING - LINE FOOT 231 231 231 231 24" ***T8000650 THERMOPLASTIC PAVEMENT MARKING - LINE FOOT 231 231 231 231 231 24" ***T8000650 THERMOPLASTIC PAVEMENT MARKING - LINE FOOT 231 231 231 231 24" ***T8000650 THERMOPLASTIC PAVEMENT MARKING - LINE FOOT 231 231 231 231 24" ***T8000650 THERMOPLASTIC PAVEMENT MARKING - LINE FOOT 231 231 231 231 24" ***T8000650 THERMOPLASTIC PAVEMENT MARKING - LINE FOOT 231 231 231 231 24" ***T8000650 THERMOPLASTIC PAVEMENT MARKING - LINE FOOT 231 231 231 24" ***T8000650 THERMOPLASTIC PAVEMENT MARKING - LINE FOOT 231 231	***************************************
TO300100 SHORT TERM PAVEMENT MARKING FOOT 3225 3225	
TO300150 SHORT TERM PAVEMENT MARKING REMOVAL SO FT 359 359	
24"	
70300210 TEMPORARY PAVEMENT MARKING LETTERS AND SO FT 400.4 400.4	
SYMBOLS # 78100100 RAISED REFLECTIVE PAVEMENT MARKER EACH 106	
TO300220 TEMPORARY PAVEMENT MARKING - LINE 4" FOOT 4323 4323	
70300240 TEMPORARY PAVEMENT MARKING - LINE 6" FOOT 1596 1596	
** 80500020 SERVICE INSTALLATION - POLE MOUNTED EACH 1 1 1	
70300260 TEMPORARY PAVEMENT MARKING - LINE 12" FOOT 876 876	
* 81028200 UNDERGROUND CONDUIT, GALVANIZED STEEL, FOOT 1312 972 340	
70300280 TEMPORARY PAVEMENT MARKING - LINE 24" FOOT 231 231 231 2" DIA. ** SPECIALTY ITEMS	
FILE NAME 2 USER NAME = 66/00/V DESIGNED - REVISED - STATE OF ILLINOIS IL ROUTE 38 (ROOSEVELT RD) AT ARDMORE AVE. F.A.P. SECTION	COUNTY TOTAL SHEETS N
PUNIS DESCRIPTION OF TRANSPORTATION PLOT DATE * IZ/IS/2016 DATE - REVISED - REVISED - DEPARTMENT OF TRANSPORTATION SCALE: SHEET NO. 3 OF 6 SHEETS STA. TO STA. FED. ROAD DIST. NO. 1 ILLINOIS FEI	CONTRACT NO. 60V

3


	SUMMARY OF QUANTITIES					ONSTRUCTI				П		SUMMARY OF QUANTITIES			00.10		ONSTRUCT	ION TYPE	CODE	I WILLIAM
CODE NO	ITEM	UNIT	TOTAL	ROADWAY 0004 FED 80%	0021	INTER CONNECT 0021 FED 80%	0021	SIDEWALK 0021 FED 80%	WAIER		CODE NO	ITEM	UNIT	TOTAL QUANTITIES	0004	TRAFFIC 0021 FED 80% STATE 10%	INTER CONNECT 0021 FED 80%	0021	SIDEWALK 0021 FED 80%	VILLAGE WATER 0043
			QUANTITIES	STATE 20%	VILLA- PARK 10%	STATE 20%	PARK 100%	PARK 20%	PARK 100%				<u> </u>		STATE 20%	PARK 10%	STATE 20%	PARK 100	VILLA- PARK 20%	PARK 100
81028210	UNDERGROUND CONDUIT, GALVANIZED STEEL.	FOOT	63		63					*	87301255	ELECTRIC CABLE IN CONDUIT, SIGNAL NO.	FOOT	2448		2448	_		<u> </u>	
	2 1/2" DIA.	-										14 7C	and a second							
81028220	UNDERGROUND CONDUIT. GALVANIZED STEEL.	FOOT	64		64	A	_		and the same of th	*	87301305	ELECTRIC CABLE IN CONDUIT, LEAD-IN, NO.	FOOT	2125		2125				
	3" DIA.									***************************************		14 1 PAIR								
81028240	UNDERGROUND CONDUIT, GALVANIZED STEEL.	FOOT	514	a a designation of the second	514					*	87301805	ELECTRIC CABLE IN CONDUIT, SERVICE, NO.	FOOT	268	***************************************	268				
01020240	4" DIA.					***************************************					na da caracteria de la	6 2 C				area and an area and a second a				
										£	67701000	ELECTRIC CARLE IN CONSULT FOUNDATION		910		838				
81400100	HANDHOLE	EACH	4		4					7	87301900	GROUNDING CONDUCTOR, NO. 6 1C	FOOT	838		936				
81400200	HEAVY-DUTY HANDHOLE	EACH	4	and the state of t	4						The second secon									
				ļ	Andrews and Andrews					*	87502500	TRAFFIC SIGNAL POST, GALVANIZED STEEL	EACH	4		4		ļ		1
81400300	DOUBLE HANDHOLE	EACH	2	Make and the state of the state	2					***************************************	The same of the sa	16 FT.		***************************************		***************************************				
85000200	MAINTENANCE OF EXISTING TRAFFIC SIGNAL	EACH	2			2				*	87602000	PEDESTRIAN PUSH-BUTTON POST	EACH	3		3				
	INSTALLATION				***************************************		**************************************											Vortes de la Constantina del Constantina de la Constantina de la Constantina de la Constantina de la Constantina del Constantina de la Con		
								***************************************		*	87700210	STEEL MAST ARM ASSEMBLY AND POLE, 34	EACH	1		1	****			
86400100	TRANSCEIVER - FIBER OPTIC	EACH	1		1			And the state of t			A PARAMANA PANAMANA P	FT.								
87300925	ELECTRIC CABLE IN CONDUIT, TRACER, NO.	FOOT	2178	-		2178				*	87700250	STEEL MAST ARM ASSEMBLY AND POLE, 42	EACH	1		1				
	14 10						***************************************					FT.		The state of the s						
87301215	ELECTRIC CABLE IN CONDUIT, SIGNAL NO.	FOOT	1430		1430			errorent de constitue de consti		*	87700270	STEEL MAST ARM ASSEMBLY AND POLE, 46	EACH	**************************************		1				
	14 2C								A THE STATE OF THE		Name of the state	FT.		***************************************						
87301225	ELECTRIC CABLE IN CONDUIT, SIGNAL NO.	FOOT	2121		2121					*	87700280	STEEL MAST ARM ASSEMBLY AND POLE, 48	EACH	The state of the s		1		Anna Anna Anna Anna Anna Anna Anna Anna		
	14 3C							and the state of t				FT.						A CONTRACTOR OF THE CONTRACTOR		
87301245	ELECTRIC CABLE IN CONDUIT, SIGNAL NO.	FOOT	2254		2254		and the state of t	PRODUMENT OF THE PRODUCT OF THE PROD		*	87800100	CONCRETE FOUNDATION, TYPE A	FOOT	24		24	***************************************			Control of the Contro
	14 5C							and the state of t	***************************************	1		* SPECIALTY ITEMS			<u> </u>					****
FILE NAME = ph/\/LO84EBIOINTEGI	ilinolagor/P#I/D0T\Documents\D0T\Offices\D1stild\NPojeds\Pi242i2\CA\Documents\pinPi24a PLGT\SCALE = X000000 ' / In.	DESIGNED - DRAWNS - CHECKED - DATE -		REVISED REVISED REVISED	-				STATE OF		LINOIS Ansporta	TION IL ROUTE 38 (ROOSE SUMMAR SCALE: SHEET NO. 4 OF 6 S	Y OF QUANT	TITIES	IVE.	F.A.F RTE. 347		CTION (-N-1	DUPAGE CONTRACT	TOTAL SHE SHEETS NO 71 7 NO. 60VO

Γ		SUMMARY OF QUANTITIES					ONSTRUCTI						SHIMALIS	RY OF QUANTITIES					ONSTRUCTI	ON TYPE		
ŀ		Sommon of Good Traco	1	TOTAL	ROADWAY 0004	TRAFFIC 0021	INTER CONNECT	TRAFFIC 0021	SIDEWALK 0021	VILLAGE WATER			30///			TOTAL	ROADWAY 0004	TRAFFIC 0021	INTER CONNECT	TRAFFIC 0021	SIDEWALK 0021	VILLAGE WATER
	CODE NO	ITEM	UNIT	CHANTITIES		FED 80%	0021	F.V.P.	FED ROY	0043		CODE NO		ITEM	UNIT	QUANTITIES	EED 80%	FED 80%	0021	E.V.P.	FED 80%	0043
	Company of the Compan				STATE 20%	VILLA-	STATE 20%	VILLA- PARK 100%	VILLA- PARK 20%	VILLA- PARK 100%						QUANTITIES	STATE 20%	VILLA-	STATE 20%	VILLA- PARK 100%	VILLA- PARK 20%	VILLA- PARK 100%
*	87800150	CONCRETE FOUNDATION, TYPE C	FOOT	4		4			The state of the s			88700300	LIGHT DETECT	OR AMPLIFIER	EACH	1		7 4310 104		1		
	and desirable of the state of t														A				444			
*	87800415	CONCRETE FOUNDATION, TYPE E 36-INCH	FOOT	37		37					*	88800100	PEDESTRIAN P	PUSH-BUTTON	EACH	8		8				
	-	DIAMETER		1559444		***************************************																
Ì											*	89000100	TEMPORARY TR	RAFFIC SIGNAL INSTALLATION	EACH	1		1				
*	87900200	DRILL EXISTING HANDHOLE	EACH	5		3	2		1										***************************************			
			***		100 AAAAAAAAAAAAAAAAAAAAAAAAAAAAAAAAAAA						*	89502300	REMOVE ELECT	TRIC CABLE FROM CONDUIT	FOOT	1038			1038			
*	88030020	SIGNAL HEAD, LED, 1-FACE, 3-SECTION,	EACH	8	Andrews Andrews	8					whethermonter						-		**************************************			
		MAST-ARM MOUNTED	***************************************								*	89502375	REMOVE EXIST	ING TRAFFIC SIGNAL	EACH	1		ı				
			- The second sec										EQUIPMENT			Transfer						
*	88030050	SIGNAL HEAD, LED, 1-FACE, 3-SECTION,	EACH	2		2																
		BRACKET MOUNTED									*	89502380	REMOVE EXIST	ING HANDHOLE	EACH	9		9				
				***************************************												AAAA AAAA AAAA AAAAA AAAAA AAAAA AAAAA AAAA						
*	88030100	SIGNAL HEAD. LED. 1-FACE. 5-SECTION.	EACH	6		6					*	89502382	REMOVE EXIST	ING DOUBLE HANDHOLE	EACH	3		3				
		BRACKET MOUNTED		Average by					# ************************************		***************************************					West start Washington						
											*	89502385	REMOVE EXIST	ING CONCRETE FOUNDATION	EACH	8		8				
*	88030110	SIGNAL HEAD, LED, 1-FACE, 5-SECTION,	EACH	6		6										***************************************						
		MAST-ARM MOUNTED	****		****						*	X0323160	VIDEO INSPEC	CTION OF STORM SEWER	FOOT	1679	1679					
*	88102717	PEDESTRIAN SIGNAL HEAD, LED, 1-FACE,	EACH	8		8					*	X0324085	EMERGENCY VE	HICLE PRIORITY SYSTEM LINE	FOOT	618				618		
		BRACKET MOUNTED WITH COUNTDOWN TIMER			***************************************								SENSOR CABLE	. NO. 20 3/C								

*	88200410	TRAFFIC SIGNAL BACKPLATE, LOUVERED,	EACH	14		14					*	x0324599	ROD AND CLEA	AN EXISTING CONDUIT	FOOT	947			947			
		FORMED PLASTIC		A. S. C.				nicket e e e e e e e e e e e e e e e e e e														
				***************************************		,		***************************************			*	X1400081	FULL-ACTUATE	D CONTROLLER AND TYPE SUPER	EACH	1		1				
*	88500100	INDUCTIVE LOOP DETECTOR	EACH	10		10					***************************************		P CABINET (S	PECIAL)								
		ACTION LOOP TWO I	5007	1700		1200		44444400000000000000000000000000000000			***************************************	×4022000	TEMPORARY AC	CCESS (COMMERCIAL ENTRANCE)	F 4 C > 1							
**	88600100	DETECTOR LOOP, TYPE I	FOOT	1209		1209				·		X4022000	TEMPURART AL	CESS (COMMERCIAL ENTRANCE)	EACH	6	6					
*	88700200	LIGHT DETECTOR	EACH	3				3				X4060004	POLYMERIZED	HOT-MIX ASPHALT SURFACE	TON	1297	1297					
12		* SPECIALTY ITEMS	***************************************					AAAA KARII KAR			14		COURSE. STON	E MATRIX ASPHALT, 9.5. N80								
	FILE NAME =		ESIGNED -		REVISED			I	1		لسا			IL ROUTE 38 (ROOSEVI	LT RD) AT	ARDMORF A	VE.	F.A.P RTE.	SEC	TION	COUNTY	TOTAL SHEET SHEETS NO.
	pwXVL084EBIDIHTEGJ	Illinoisgou-PHICOT Documents/DOC Offices-District NProjects-P124212CADOcto-Docton-P124212 PLST SCALE = 100,000 1/ In.	HECKED -		REVISED REVISED			1		TATE OF T		LINOIS Ansporta	TION	SUMMARY				347		N-1	DUPAGE	71 8 NO. 60V00
			ATE -		REVISED									SCALE: SHEET NO, 5 OF 6 SHE	ETS STA	i, T	O STA.	FEO.	ROAD DIST. NO. 1	ILLINOIS FED. AI		.10, 60100

		SUMMARY OF QUANTITIES		1	ROADWAY	TRAFFIC	ONSTRUCTI	TRAFFIC	SIDEWALK	VILLAGE		SUMMARY OF QUANTITIES			ROADWAY	TRAFFIC	ONSTRUCTI INTER CONNECT	ON TYPE C	SIDEWALK	VILLAGE WATER
32.	CODE NO	ITEM	UNIT	TOTAL OUANTITIES	0004 FED 80% STATE 20%	OO21 FED 80% STATE 10% VILLA- PARK 10%	CONNECT 0021 FED 80% STATE 20%	EVE	rcn 90%	0043 VILLA- PARK 100%	CODE NO	ITEM	UNIT	TOTAL	0004 FED 80% STATE 20%	0021 FED 80% STATE 10% VILLA- PARK 10%	0021	0021 E.V.P. VILLA- PARK 100%	0021 FED 80% VILLA- PARK 20%	0043
	X5537800	STORM SEWERS TO BE CLEANED 12"	FOOT	789	789															-
	x5537900	STORM SEWERS TO BE CLEANED 15"	FOOT	773	773															
	X5538000	STORM SEWERS TO BE CLEANED 18"	FOOT	117	117															
	X7030005	TEMPORARY PAVEMENT MARKING REMOVAL	SO FT	3977. 4	3977.4		ALANA AND AND AND AND AND AND AND AND AND													
*	x8620200	UNINTERRUPTABLE POWER SUPPLY. SPECIAL	EACH	1		1		***************************************												
*	X8710024	FIBER OPTIC CABLE IN CONDUIT, NO.	FOOT	2224			2224													
	VI PORTONIA	62.5/125, MM12F SM24F			Anna 1	1		***************************************			***************************************								- A	
	Z0004562	COMBINATION CURB AND GUTTER REMOVAL AND	FOOT	196	196					The state of the s								,		
ŀ	A PARA PARA PARA PARA PARA PARA PARA PA	REPLACEMENT									100								· 	
	Z0013798	CONSTRUCTION LAYOUT	LSUM	1	1														· · · · · · · · · · · · · · · · · · ·	
	Z0030850	TEMPORARY INFORMATION SIGNING	SQ FT	315.3	315. 3	Additional and the state of the														
*	Z0033046	RE-OPTIMIZE TRAFFIC SIGNAL SYSTEM LEVEL 2	EACH	1		are the second s	The state of the s		Anne de la constanta de la con											
	Z0056668	STORM SEWERS, TYPE 2, WATER MAIN	FOOT	8.2	6. 2					2										
		QUALITY PIPE. 12"	may was the strategy of the st	######################################		Manual Ma			and the state of t	**************************************	A CONTRACTOR OF THE PARTY OF TH						velinani di propingi di propin			
	Z0056670	STORM SEWERS. TYPE 2, WATER MAIN OUALITY PIPE. 18"	FOOT	200. 33	150. 33		Annual and a state of the state		AND THE PROPERTY OF THE PROPER	50										
*	20073510	TEMPORARY TRAFFIC SIGNAL TIMING	EACH	t and	and an experience of the control of	1														
3		△ NON PARTICIPATING ITEM		NAME OF THE PROPERTY OF THE PR				es de la constante de la const	And the second s			* SPECIALTY ITEMS								
	FILE NAME = DW/\VLOB4EBIQHTEG	USER NAME = dolhan: DES Illinois gov.PHIDDT Documents/UDF Offloar District NProjects/P1242/2CADOstro.Dasign/P1242/DRAS	SIGNED -	A PARTICIPATION OF THE PARTICI	REVISED REVISED REVISED					STATE OF I	ILLINOIS RANSPORTAT	IL ROUTE 3	B (ROOSEVELT RD) AT SUMMARY OF QUANT 6 OF 6 SHEETS ST.	ITIES	AVE.	F.A.P RTE. 347	SEC	TION -N-1	DUPAGE	TOTAL SHEE SHEETS NO. 71 9 NO. 60V00


ILLINOIS ROUTE 38 (ROOSEVELT ROAD)

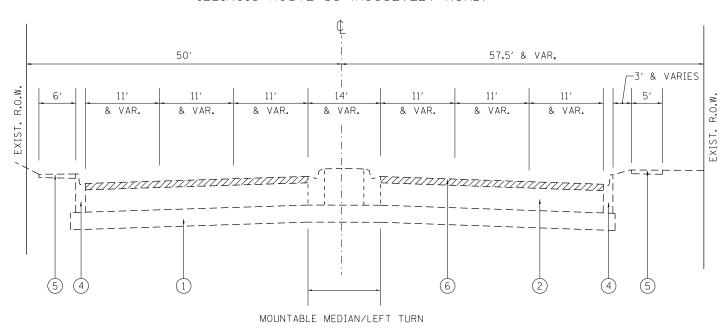

EXISTING TYPICAL SECTION

STA. 81+00 TO STA. 86+60

ILLINOIS ROUTE 38 (ROOSEVELT ROAD)

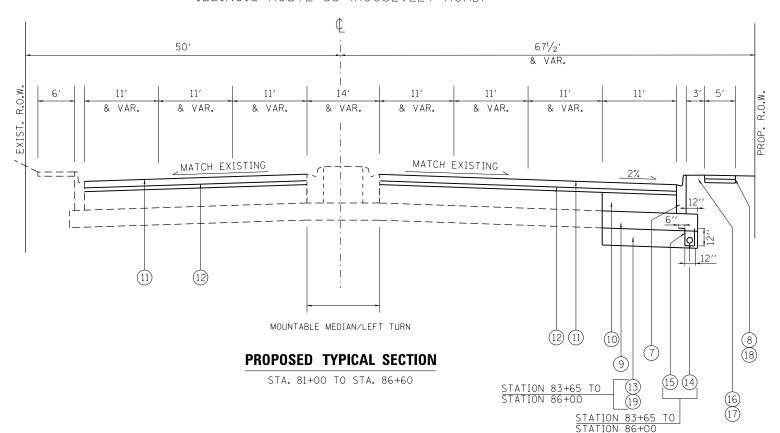

LEGEND

- (1) EXIST. AGGREGATE SUBGRADE, 12"
- (2) EXIST. HMA PAVEMENT AFTER MILLING, 14"±
- (3) EXIST. HMA PAVEMENT AFTER MILLING, 11"±
- 4 EXIST. COMBINATION CONCRETE CURB

& GUTTER, TYPE B 6.24

- EXIST. SIDEWALK
- 6) PROP. HMA SURFACE REMOVAL, 21/2"
- 7 PROP. COMBINATION CONCRETE CURB
 & GUTTER, TYPE B 6.24
- (8) PROP. PCC SIDEWALK, 5"
- 9) PROP. AGGREGATE SUBGRADE IMPROVEMENT, 12"
- (10) PROP. HMA BASE COURSE, 121/2"
- (1) PROP. POLYMERIZED HMA SURFACE COURSE, SMA, N80, 1 3/4 "
- (12) PROP. POLYMERIZED LEVELING BINDER (MACHINE METHOD), IL-4.75, N50, 3/4 "
- 13) REMOVAL AND DISPOSAL OF UNSUITABLE MATERIAL
- 14) PIPE UNDERDRAINS, TYPE 2, 4"

- (15) FILTER FABRIC IS INCLUDED IN THE UNIT COST OF PIPE UNDERDRAINS 4"
- (16) SODDING, SALT TOLERANT
- (17) TOP SOIL FURNISH AND PLACE, 6"
- (18) PROP. AGGREGATE BASE COURSE, TYPE B 4"
- PROP. AGGREGATE SUBGRADE IMPROVEMENT WITH GEOTECHNICAL FABRIC FOR GROUND STABILIZATION.

NOTES:

PIPE UNDERDRAINS TYPE 2 SHALL BE INSTALLED ACCORDING TO SECTION 601 OF THE SSRBC AND STANDARD 601001-05. TOP OF PIPE UNDERDRAINS SHALL BE PLACED 6" BELOW THE SUBGRADE OR UNDERCUT. THE COST OF MAKING PIPE UNDERDRAINS CONNECTIONS TO DRAINAGE STRUCTURES SHALL BE INCLUDED IN THE COST OF THE PIPE UNDERDRAINS.

AGGREGATE SUBGRADE IMPROVEMENT (CU YD) HAS BEEN PROVIDED FOR USE AT THE LOCATIONS INDICATED FOR SOILS THAT TEND TO BE UNSTABLE AND/OR UNSUITABLE. THE ACTUAL NEED FOR REMOVAL AND REPLACEMENT WITH ASI WILL BE DETERMINED IN THE FIELD AT THE TIME OF CONSTRUCTION BY THE GEOTECHNICAL ENGINEER. ALL POTENTIALLY UNSTABLE SOILS SHOULD BE TESTED WITH A STATIC OR DYNAMIC CONE PENETROMETER AND TREATED IN ACCORDANCE WITH ARTICLE 301.04 OF THE SSRBC AND IDOT SUBGRADE STABILITY MANUAL. IF UNSTABLE AND/OR UNSUITABLE SOILS ARE NOT ENCOUNTERED, THEN THE OUANTITY SHALL BE DEDUCTED AND NO ADDITIONAL COMPENSATION WILL BE DUE TO THE CONTRACTOR.


MIXTURE TYPE	AIR VOIDS Ndes	QUALITY MANAGEMENT PROGRAM (QMP)
PAVEMENT WIDENING		
POLYMERIZED HOT-MIX ASPHALT SURFACE COURSE, STONE MATRIX ASPHALT, N80 (IL 9.5 mm)	3.5% @ 80 GYR	ОСР
POLYMERIZED LEVELING BINDER (MACHINE METHOD), IL-4.75, N50	3.5% @ 50 GYR	QC /QA
HOT-MIX ASPHALT BASE COURSE (HMA BINDER-IL 19 mm); 121/2"	4.0% @ 70 GYR	QC /QA
PAVEMENT RESURFACING		
POLYMERIZED HOT-MIX ASPHALT SURFACE COURSE, STONE MATRIX ASPHALT, N80 (IL 9.5 mm)	3.5% @ 80 GYR	QCP
POLYMERIZED LEVELING BINDER (MACHINE METHOD), IL-4.75, N50	3.5% @ 50 GYR	QC /QA
PAVEMENT PATCHING		
CLASS D PATCHES, (HMA BINDER IL-19 mm)	4.0% @ 70 GYR	QC /QA
DRIVEWAY		
HOT-MIX ASPHALT SURFACE COURSE, MIX "D", (IL 9.5 mm), N50; 2"	4.0% @ 50 GYR	QC /QA
HOT-MIX ASPHALT BASE COURSE (HMA BINDER-IL 19 mm); 8 "	4.0% @ 50 GYR	QC /QA

NOTES

- 1.) THE UNIT WEIGHT USED TO CALCULATE ALL HOT-MIX ASPHALT SURFACE MIXTURE QUANTITIES IS 112 LB/SY/IN.
- 2.) THE "AC TYPE" FOR POLYMERIZED HMA MIXES SHALL BE "SBS/SBR PG 76-22" AND FOR NON-POLYMERIZED HMA THE "AC TYPE" SHALL BE "PG 64-22" UNLESS MODIFIED BY DISTRICT ONE SPECIAL PROVISIONS. FOR USE OF RECYCLED MATERIALS SEE SPECIAL PROVISIONS. QUALITY MANAGEMENT PROGRAM (QMP) IDENTIFIES THE PARTICULAR QUALITY CONTROL SPECIFICATION THAT APPLIES TO THE HMA MIXTURE.
- 3.) THE CONTRACTOR SHALL MILL FIRST, BEFORE PATCHING.

FILE NAME =	USER NAME = dahhanr	DESIGNED -	REVISED -			TYPICAL SECTIONS		F.A.P.	SECTION	COUNTY	TOTAL SHEET
pw:\\IL084EBIDINTEG.:1ll:nois.gov:PWIDOT\Doc	uments\IDOT Offices\District 1\Projects\P124	2 12RAANIN ata\D a sign\P124212-sht-typical.dgn	REVISED -	STATE OF ILLINOIS	IL 38 (ROOSEVELT ROAD)			347	CY-N-1	DUPAGE	71 10
	PLOT SCALE = 100.0000 '/ in.	CHECKED -	REVISED -	DEPARTMENT OF TRANSPORTATION		IL 38 (KUUSEVELI KUAD)					T NO. 60V00
Default	PLOT DATE = 12/14/2016	DATE -	REVISED -		SCALE: NTS	SHEET 1 OF 3 SHEETS STA.81+00	TO STA.86+60		ILLINOIS FED. AI		


ILLINOIS ROUTE 38 (ROOSEVELT ROAD)

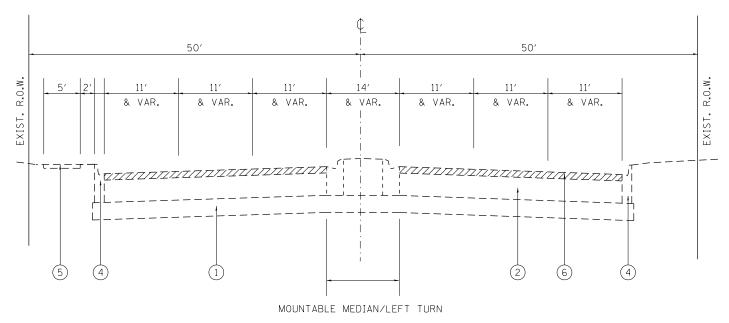

EXISTING TYPICAL SECTION

STA. 86+60 TO STA. 93+00

ILLINOIS ROUTE 38 (ROSEVELT ROAD)

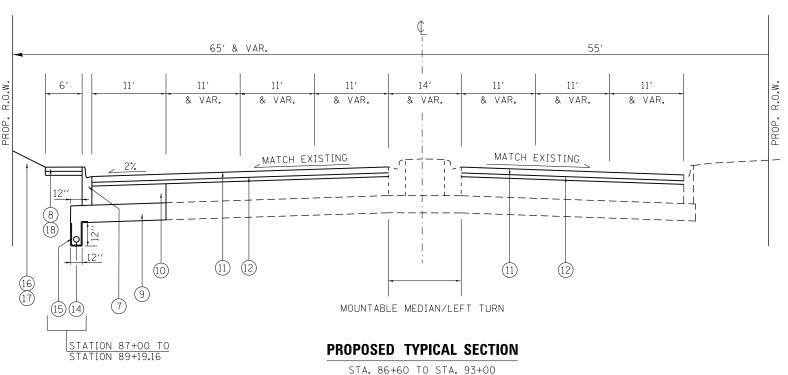

LEGEND

- 1) EXIST. AGGREGATE SUBGRADE, 12"
- (2) EXIST. HMA PAVEMENT AFTER MILLING, 14"±
- (3) EXIST. HMA PAVEMENT AFTER MILLING, 11"±
- (4) EXIST. COMBINATION CONCRETE CURB
 & GUTTER, TYPE B 6.24
- (5) EXIST. SIDEWALK
- (6) PROP. HMA SURFACE REMOVAL, 21/2"
- (7) PROP. COMBINATION CONCRETE CURB

 & GUTTER, TYPE B 6.24
- (8) PROP. PCC SIDEWALK, 5"
- 9) PROP. AGGREGATE SUBGRADE IMPROVEMENT, 12"
- (10) PROP. HMA BASE COURSE, 121/2"
- (11) PROP. POLYMERIZED HMA SURFACE COURSE, SMA, N80, 1 3/4 "
- (12) PROP. POLYMERIZED LEVELING BINDER
 (MACHINE METHOD), IL-4.75, N50, 3/4 "
- (13) REMOVAL AND DISPOSAL OF UNSUITABLE MATERIAL
- (14) PIPE UNDERDRAINS, TYPE 2, 4"
- (15) FILTER FABRIC IS INCLUDED IN THE UNIT COST OF PIPE UNDERDRAINS 4"
- (16) SODDING, SALT TOLERANT

TO STA.93+00

- (17) TOP SOIL FURNISH AND PLACE, 6"
- (18) PROP. AGGREGATE BASE COURSE, TYPE B 4"
- PROP. AGGREGATE SUBGRADE IMPROVEMENT WITH GEOTECHNICAL FABRIC FOR GROUND STABILIZATION.

STATE OF ILLINOIS
DEPARTMENT OF TRANSPORTATION

TYPICAL SECTIONS
IL 38 (ROOSEVELT ROAD)

SHEET 2 OF 3 SHEETS STA.86+60


SCALE: NTS

RTE. SECTION COUNTY TOTAL SHEETS NO.

347 CY-N-1 DUPAGE 71 11

CONTRACT NO. 60V00


ARDMORE AVENUE

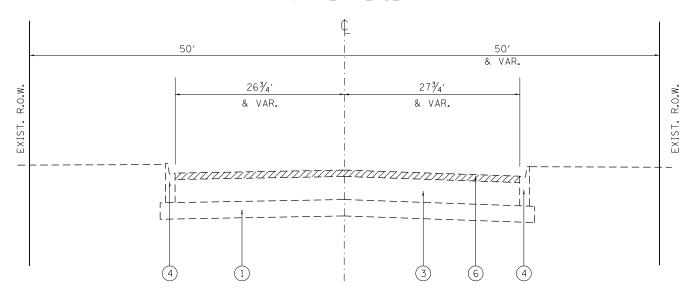

EXISTING TYPICAL SECTION

STA. 497+60 TO STA. 502+80

ARDMORE AVENUE

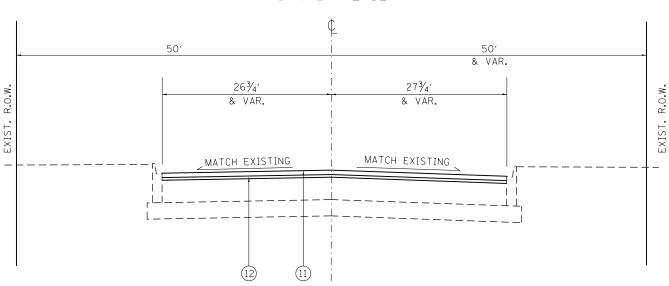

PROPOSED TYPICAL SECTION

STA. 497+60 TO STA. 502+80

FILE NAME = DESIGNED -REVISED COUNTY TOTAL SHEE SHEETS NO. DUPAGE 71 12 USER NAME = dahhanr SECTION TYPICAL SECTIONS STATE OF ILLINOIS ow:\\ILØ84EBIDINTEG.:111:no ments\IDOT Offices\District 1\Projects\P124 21**2R0AWN**ata\Design\P124212-sht-typical.do REVISED CY-N-1 ARDMORE AVENUE CHECKED REVISED **DEPARTMENT OF TRANSPORTATION** CONTRACT NO. 60V00 SCALE: NTS SHEET 3 OF 3 SHEETS STA. 497+60 TO STA.502+80 PLOT DATE = 12/14/2016 DATE REVISED

LEGEND

- 1) EXIST. AGGREGATE SUBGRADE, 12"
- (2) EXIST. HMA PAVEMENT AFTER MILLING, 14"±
- (3) EXIST. HMA PAVEMENT AFTER MILLING, 11"±
- 4 EXIST. COMBINATION CONCRETE CURB
 & GUTTER, TYPE B 6.24
- (5) EXIST. SIDEWALK
- (6) PROP. HMA SURFACE REMOVAL, 21/2"
- 7) PROP. COMBINATION CONCRETE CURB
 & GUTTER, TYPE B 6.24
- 8) PROP. PCC SIDEWALK, 5"
- 9) PROP. AGGREGATE SUBGRADE IMPROVEMENT, 12"
- (10) PROP. HMA BASE COURSE, $12\frac{1}{2}$
- (11) PROP. POLYMERIZED HMA SURFACE COURSE, SMA, N80, 1 3/4 "
- (MACHINE METHOD), IL-4.75, N50, 3/4 "
- (13) REMOVAL AND DISPOSAL OF UNSUITABLE MATERIAL
- (14) PIPE UNDERDRAINS, TYPE 2, 4"
- (15) FILTER FABRIC IS INCLUDED IN THE UNIT COST OF PIPE UNDERDRAINS 4"
- (16) SODDING, SALT TOLERANT
- (17) TOP SOIL FURNISH AND PLACE, 6"
- (18) PROP. AGGREGATE BASE COURSE, TYPE B 4"
- PROP. AGGREGATE SUBGRADE IMPROVEMENT WITH GEOTECHNICAL FABRIC FOR GROUND STABILIZATION.

	PIPE TABLE		
No.	PIPE TYPE	DIA. (IN)	LENGTH (FT)
1	PROPOSED STORM SEWER, CLASS A, TYPE 2, WATERMAIN QUALITY PIPE	12	1.2
2	PROPOSED STORM SEWER, CLASS A, TYPE 2, WATERMAIN QUALITY PIPE	18	39.58
3	PROPOSED STORM SEWER, CLASS A, TYPE 2, WATERMAIN QUALITY PIPE	18	160.75
4	PROPOSED STORM SEWER, CLASS A, TYPE 2, WATERMAIN QUALITY PIPE	12	7

		STRUCTURES							
No.	STRUCTURE TYPE	F & G TYPE	STA.	OFFSET	T.O.G. / E.O.P.	N. PIPE INV.	E. PIPE INV.	S. PIPE INV.	W. PIPE INV.
1	CATCH BASIN, TYPE C	TYPE 24 F&G	83+70.43	41.52 RT	712.70			708.27	
EXISTING	EXISTING MANHOLE		83+70.08	45.69 RT	±713.24	708.25	708.00		
2	CATCH BASIN, TYPE A, 4' DIAMETER WITH PRECAST REINFORCED CONCRETE FLAT TOP	TYPE 24 F&G	84+13.6	45.46 RT	713.26		709.85		708.44
3	INLETS, TYPE A	TYPE 24 F&G	85+77.02	52.15 RT	714.95				712.00
4	CATCH BASIN, TYPE C	TYPE 24 F&G	88+97.59	49.93 LT	715.55			712.82	
5	MANHOLE, TYPE A, 4' DIAMETER WITH PRECAST REINFORCED CONCRETE FLAT TOP	TYPE 1 FRAME, CLOSED LID	88+97.59	40.11 LT	715.77	712.69	±712.61 EXISTING PIPE		

	EARTHWOR	RK SCHEDULE			
EARTHWORK LOCATION	EARTH EXCAVATION (CY)	TOPSOIL EXCAVATION (CY)	TOPSOIL REQUIRED (CY)	TOPSOIL BALANCE *WASTE (+) OR SHORTAGE (-) (CY)	UNSUITABLE MATERIAL (CY)
IL 38 (ROOSEVELT RD)					
STA. 81+00 TO STA. 93+00	1089.4	202.1	149.5	52.6	126.3

* TOPSOIL WASTE REMOVAL SHALL BE PAID AS REMOVAL AND DISPOSAL OF UNSUITABLE MATERIAL

NOTE:


A THICKNESS OF 6 INCHES OF TOPSOIL STRIPPING SHALL BE REUSED WITHIN THE PROJECT LIMITS.


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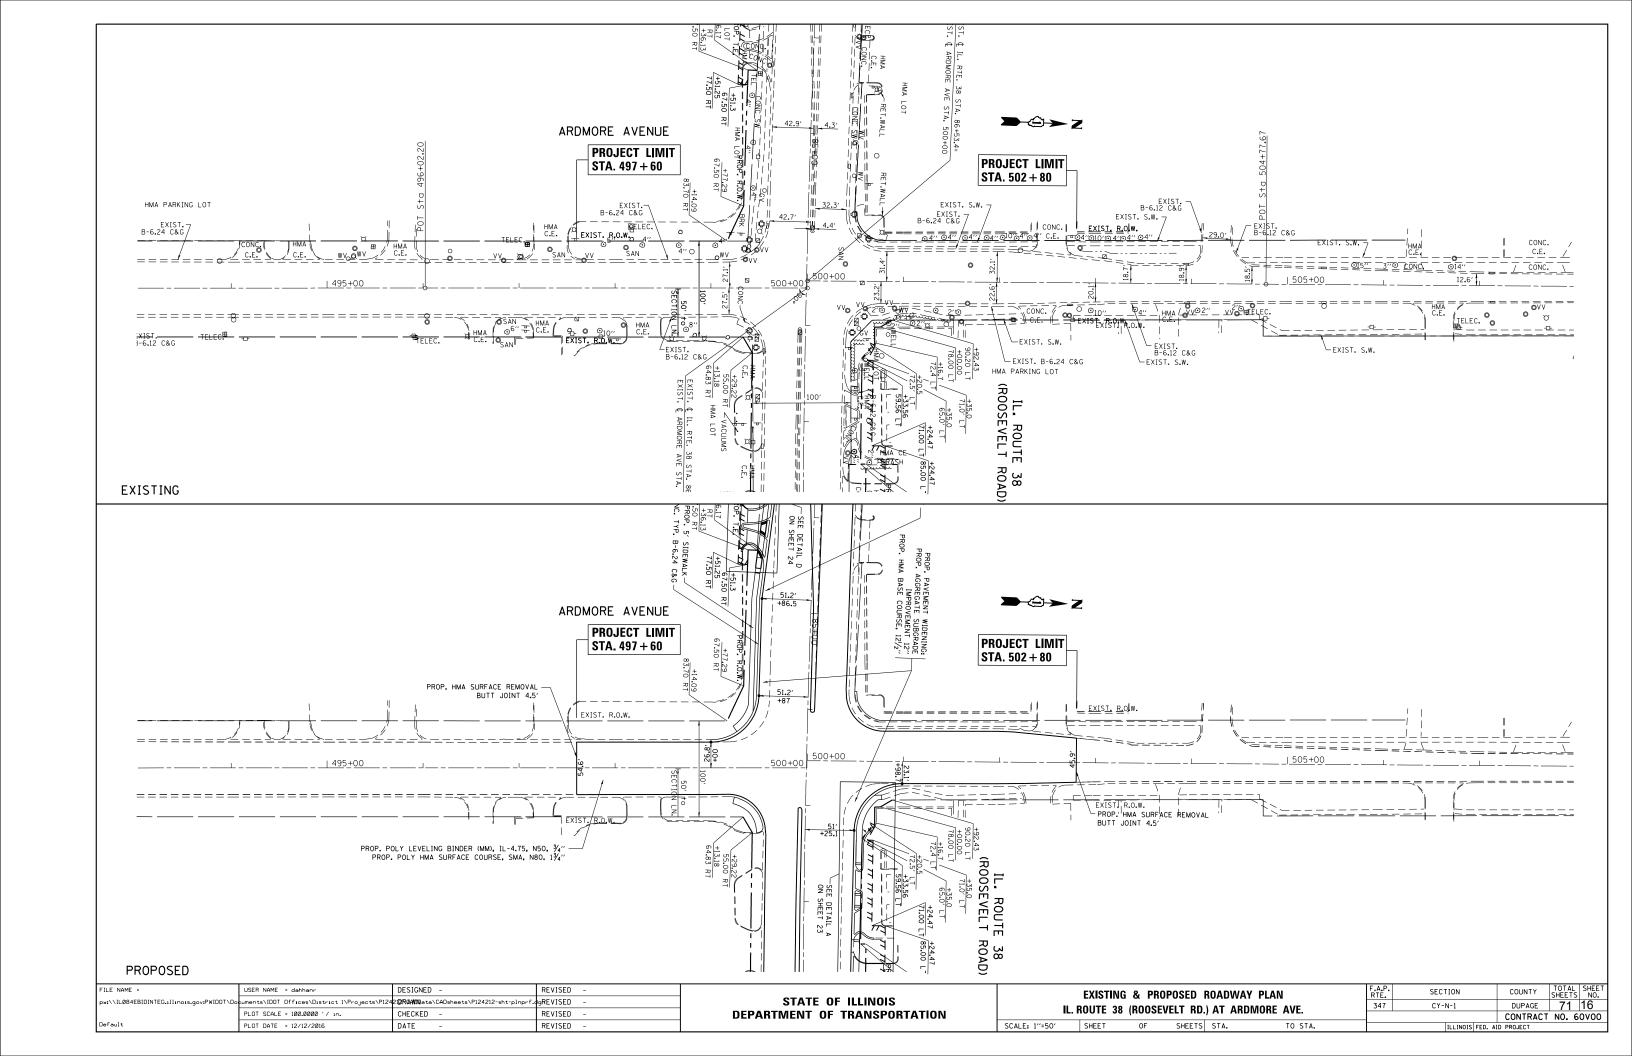
STATE OF ILLINOIS
DEPARTMENT OF TRANSPORTATION


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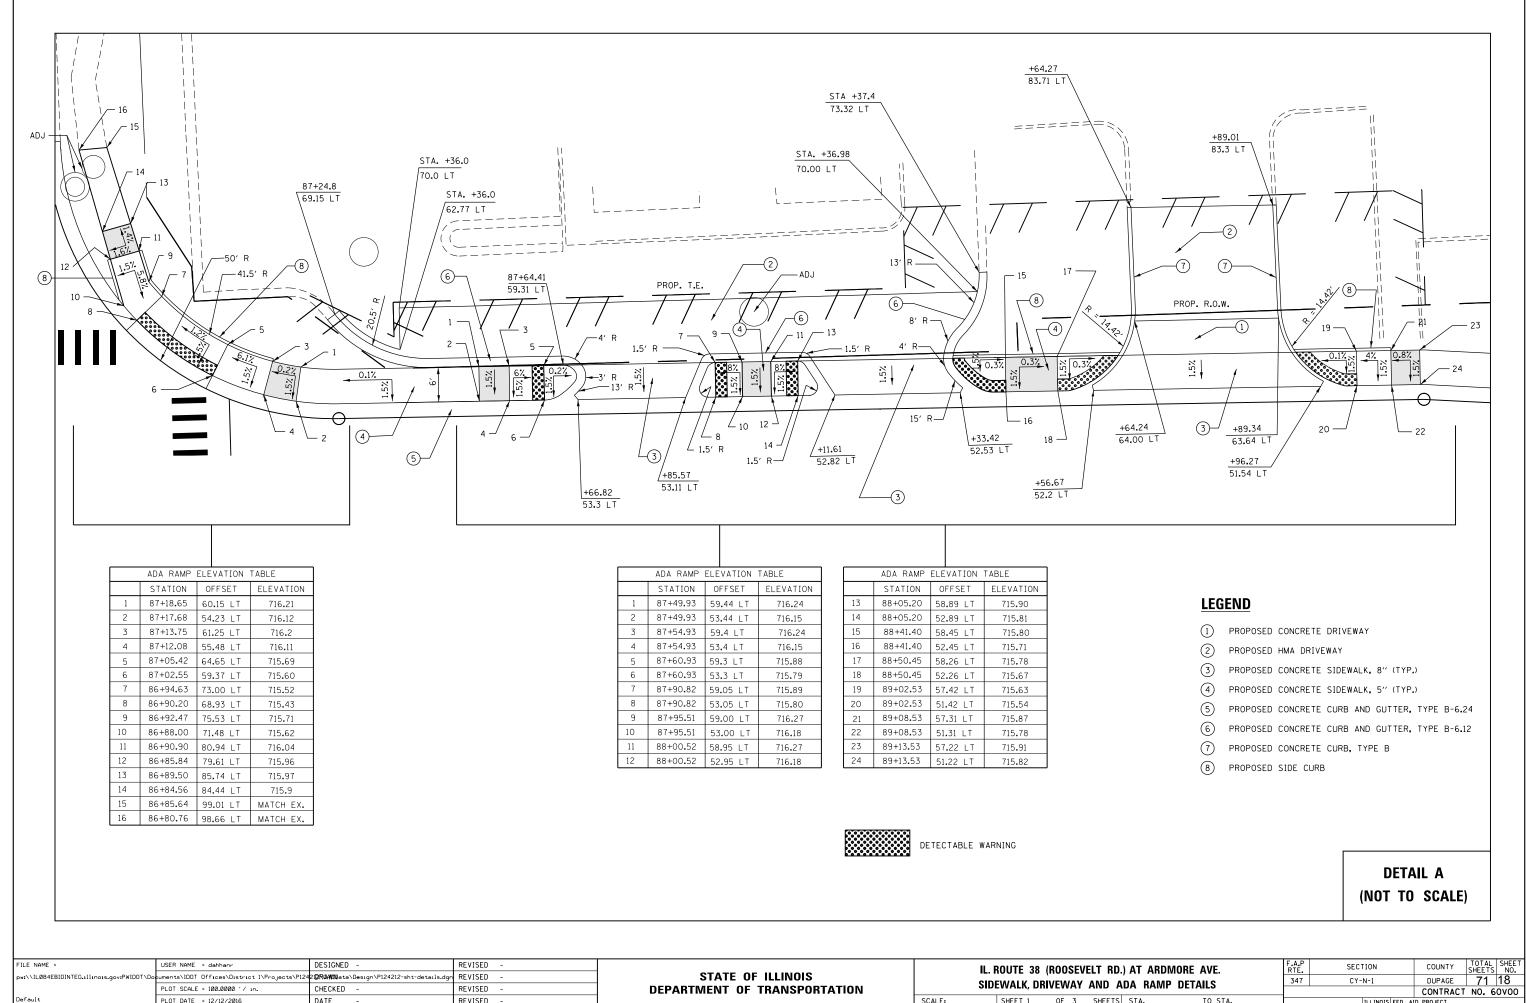
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	II 38 /B	OOSEVELT	L BUVD		347	CY-N-1		DUPAGE	71	13
	IL 30 (II		,					CONTRACT	NO. 6	ovoc
SHEET	OF	SHEETS	STA.	TO STA.		ILLINOIS	FED. A	ID PROJECT		






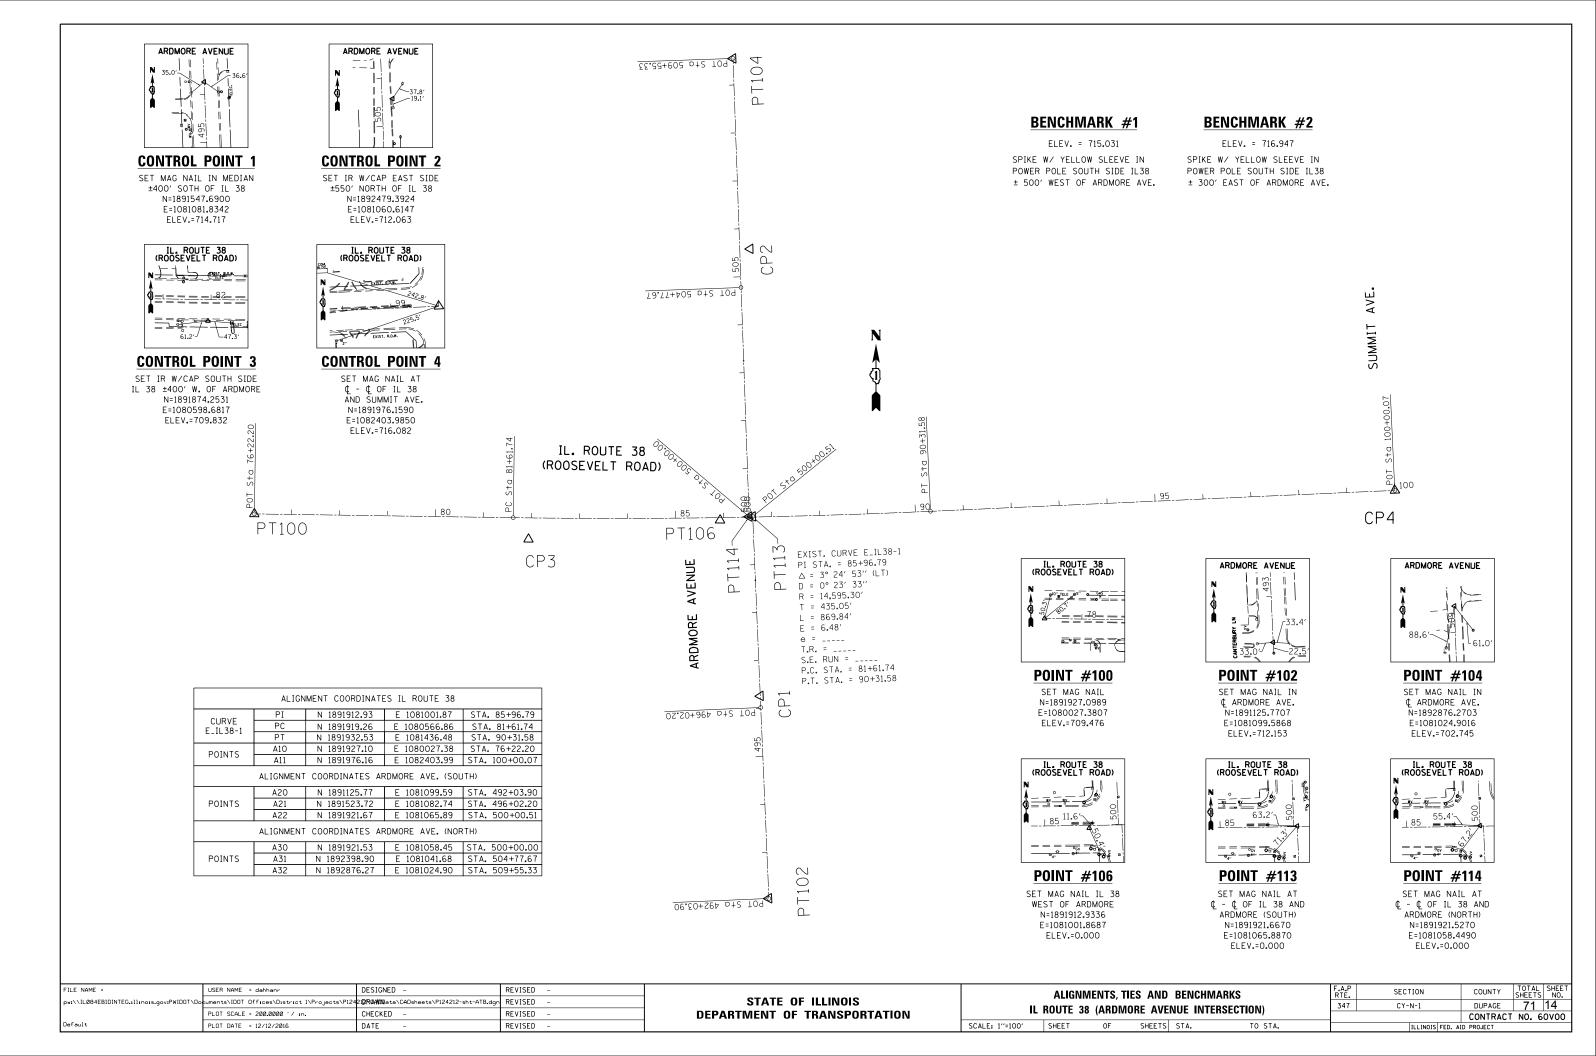


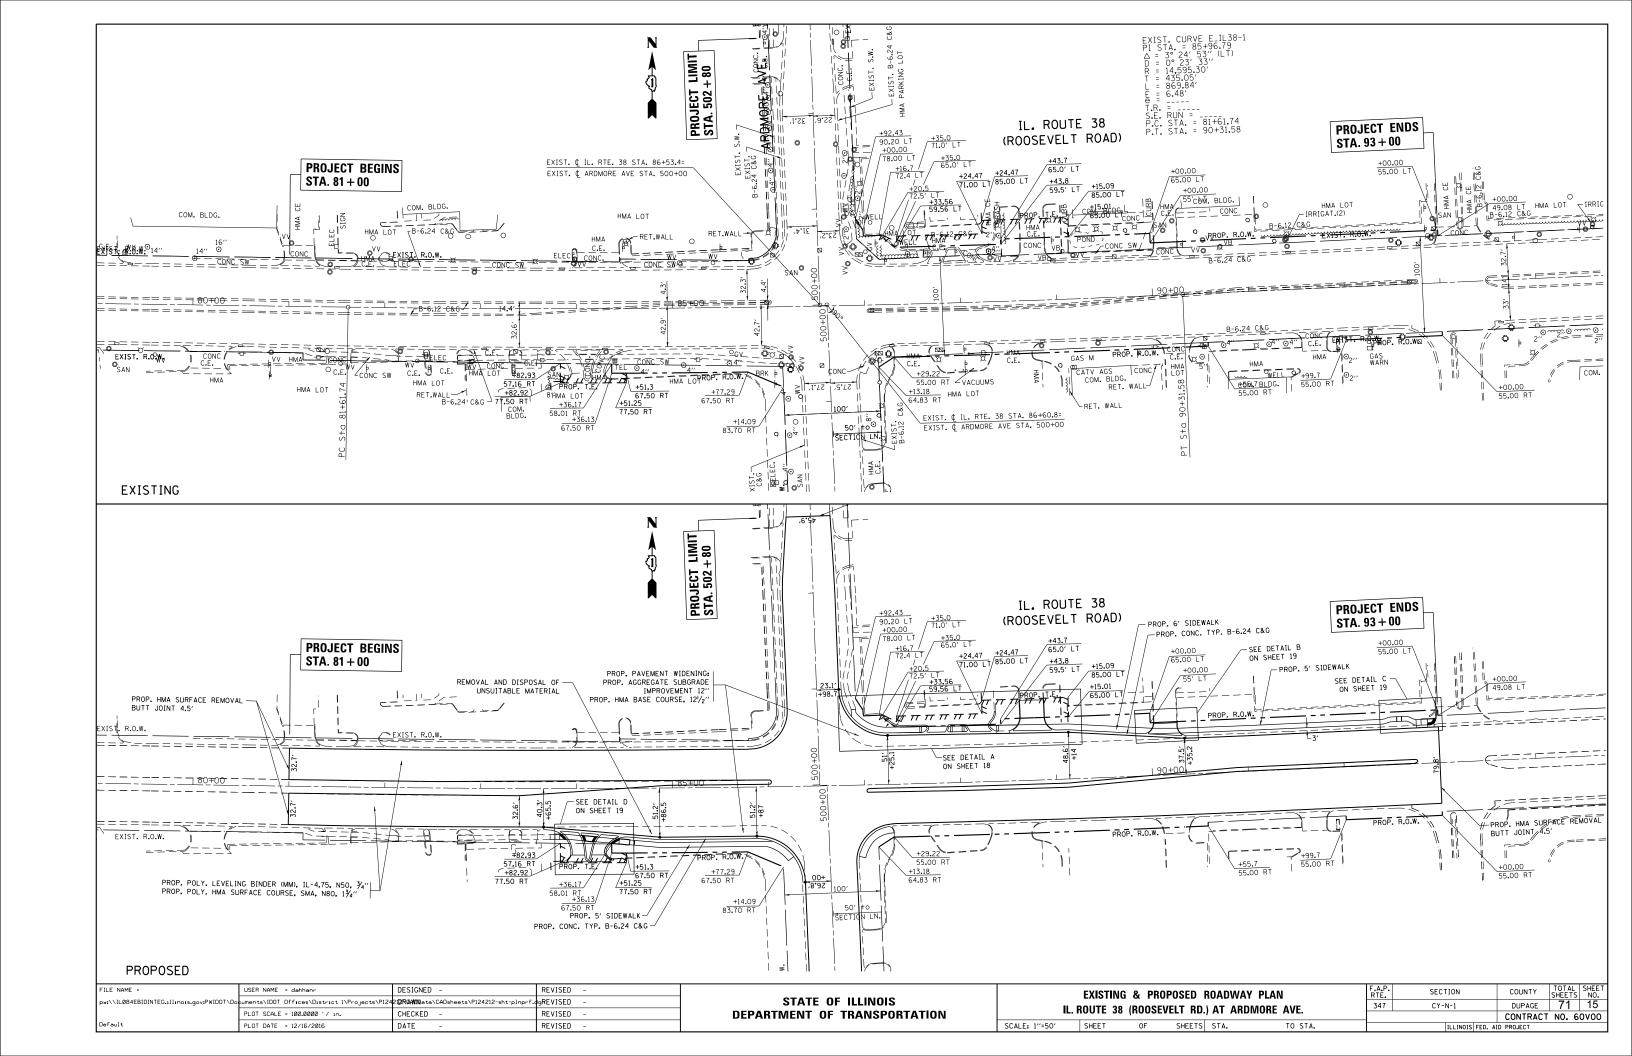


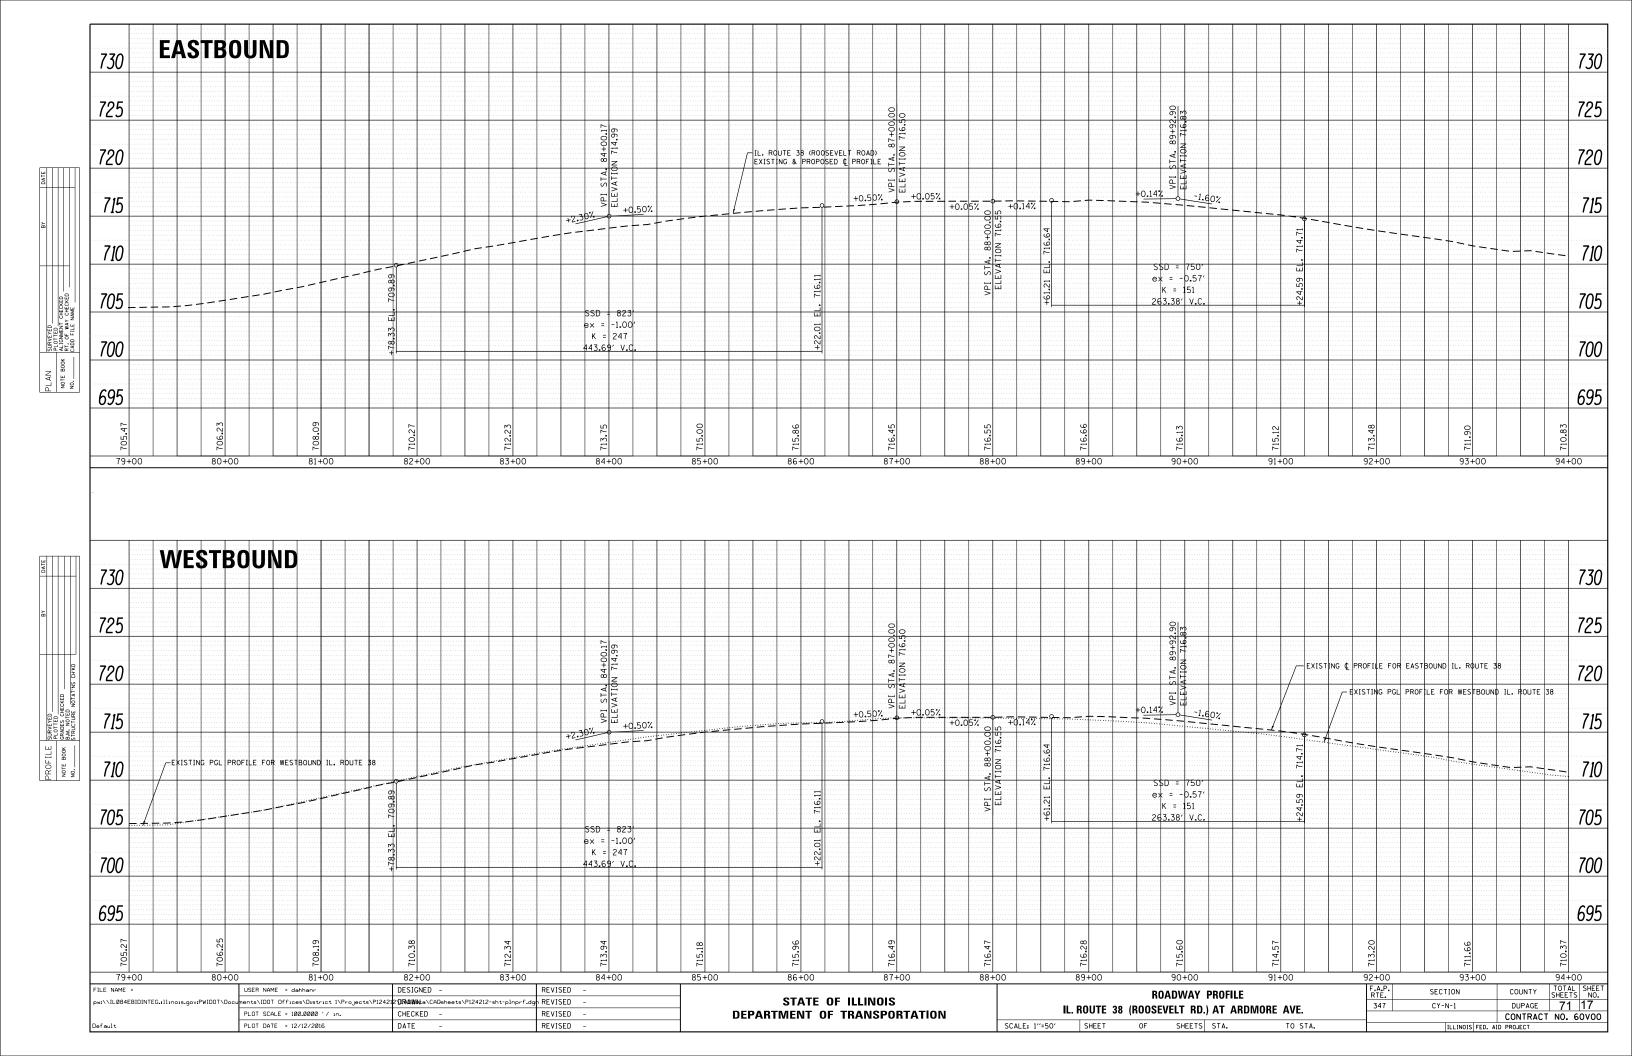

FILE NAME =	USER NAME = dahhanr	DESIGNED -	KEVISED -	\perp	l II I	ROUTE 38 (ROOSEVELT RD.) AT	ARDMORF AVE	RTF	SECTION	COUNTY SHE	FFTS	N
pw:\\ILØ84EBIDINTEG.:111:no:s.gov:PWIDOT\Do	cuments\IDOT Offices\District 1\Projects\P124	2 12RGANDN ata\Design\P124212-sht-details.dgr	REVISED -	STATE OF ILLINOIS		•		347	CY-N-1	DUPAGE 7	71 1	18
	PLOT SCALE = 100.0000 ' / in.	CHECKED -	REVISED -	DEPARTMENT OF TRANSPORTATION	SID	EWALK, DRIVEWAY AND ADA	RAMP DETAILS	•	V	CONTRACT NO	0. 60	. <u></u>
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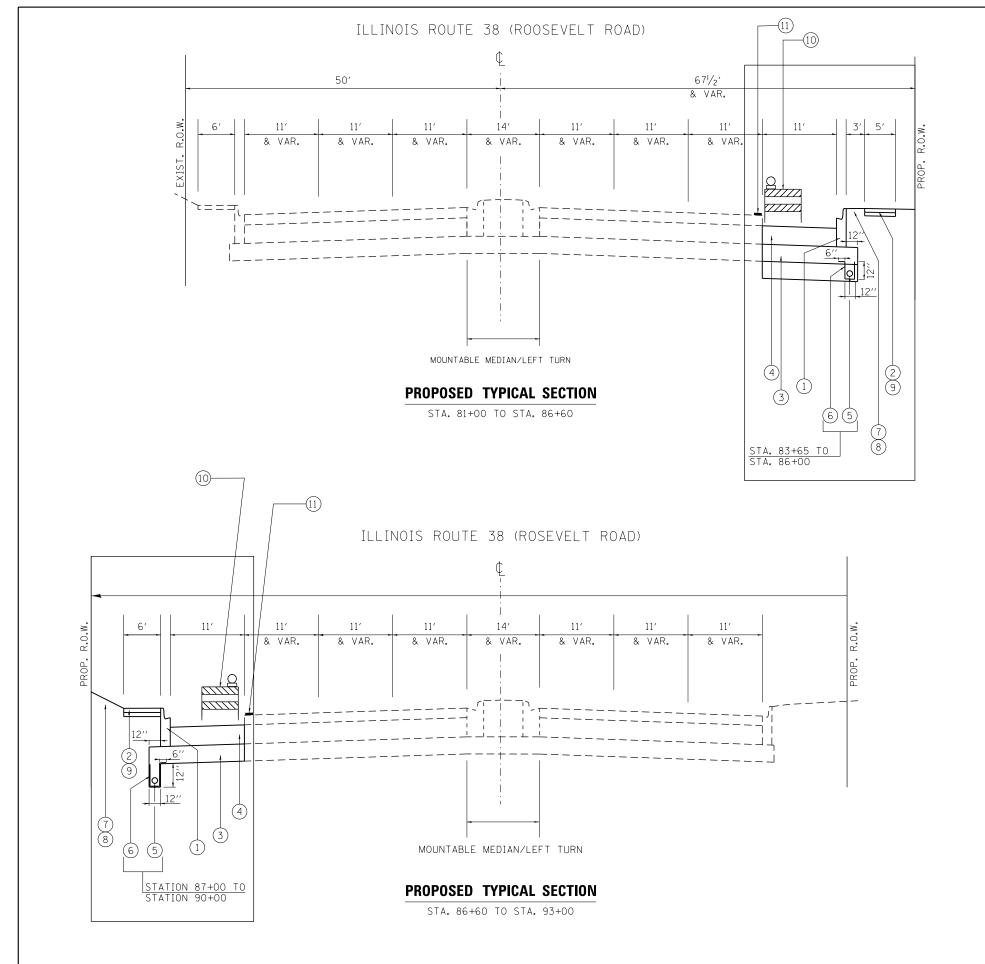


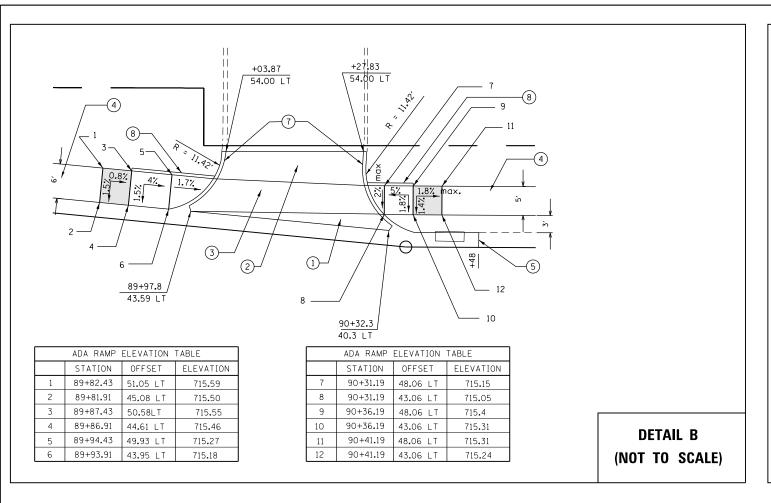

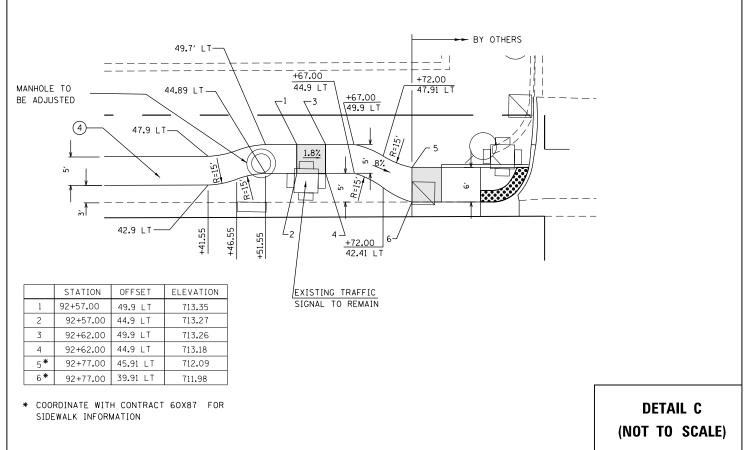LEGEND

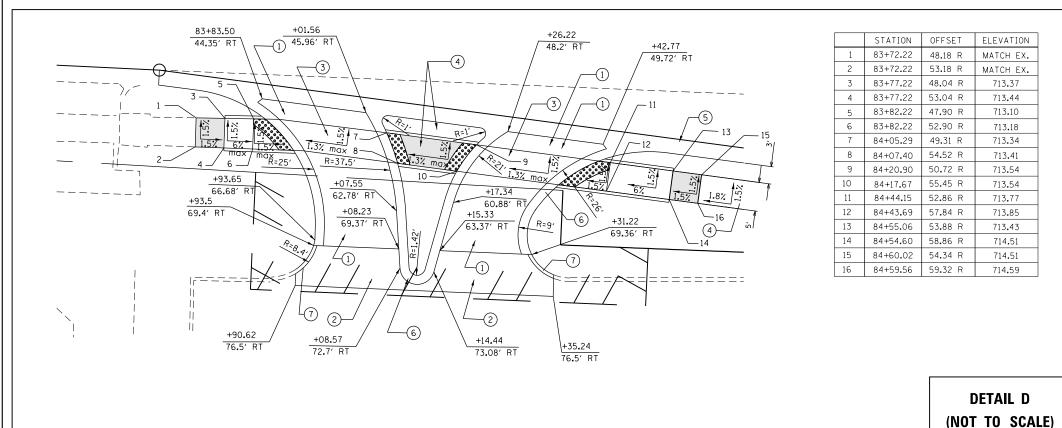- 1 PROPOSED CONCRETE DRIVEWAY
- 2) PROPOSED HMA DRIVEWAY
- 3 PROPOSED CONCRETE SIDEWALK, 8" (TYP.)
- 4 PROPOSED CONCRETE SIDEWALK, 5" (TYP.)
- 5 PROPOSED CONCRETE CURB AND GUTTER, TYPE B-6.24
- 6 PROPOSED CONCRETE CURB AND GUTTER, TYPE B-6.12
- (7) PROPOSED CONCRETE CURB, TYPE B
- 8 PROPOSED SIDE CURB

ILE NAME =	USER NAME = dahhanr	DESIGNED -	REVISED -		11	ROUTE 38 (ROOSEVELT RD.) AT ARDMORE AVE.	F.A.P	SECTION	COUNTY TOTAL SHEET
ow:\\ILØ84EBIDINTEG.:llinois.gov:PWIDOT\Do	cuments\IDOT Offices\District 1\Projects\P124	2 12RAANN ata\D e sign\P124212-sht-details.dgn	REVISED -	STATE OF ILLINOIS	• • •	SIDEWALK DETAILS	347	CY-N-1	DUPAGE 71 19
	PLOT SCALE = 100.0000 ' / in.	CHECKED -	REVISED -	DEPARTMENT OF TRANSPORTATION		SIDEVVALK DETAILS			CONTRACT NO. 60V00
efault	PLOT DATE = 12/12/2016	DATE -	REVISED -		SCALE:	SHEET 2 OF 3 SHEETS STA. TO STA.		ILLINOIS FED. A	AID PROJECT



LEGEND

- 1 PROP. COMBINATION CONCRETE CURB
 & GUTTER, TYPE B 6.24
- (2) PROP. PCC SIDEWALK, 5"
- 3) PROP. AGGREGATE SUBGRADE IMPROVEMENT, 12"
- (4) PROP. HMA BASE COURSE, $12\frac{1}{2}$ "
- (5) PIPE UNDERDRAINS 4"
- (6) FILTER FABRIC IS INCLUDED IN THE UNIT COST OF PIPE UNDERDRAINS 4"
- (7) SODDING, SALT TOLERANT
- TOP SOIL FURNISH AND PLACE, 6"
- 9 PROP. AGGREGATE BASE COURSE, TYPE B 4"
- O) DRUM OR TYPE II BARRICADE WITH EXTENDED LEGS

SECTION

CY-N-1

county SHEETS NO.

DUPAGE 71 20

CONTRACT NO. 60V00


11) TEMPORARY PAVEMENT MARKING - LINE 4", WHITE.


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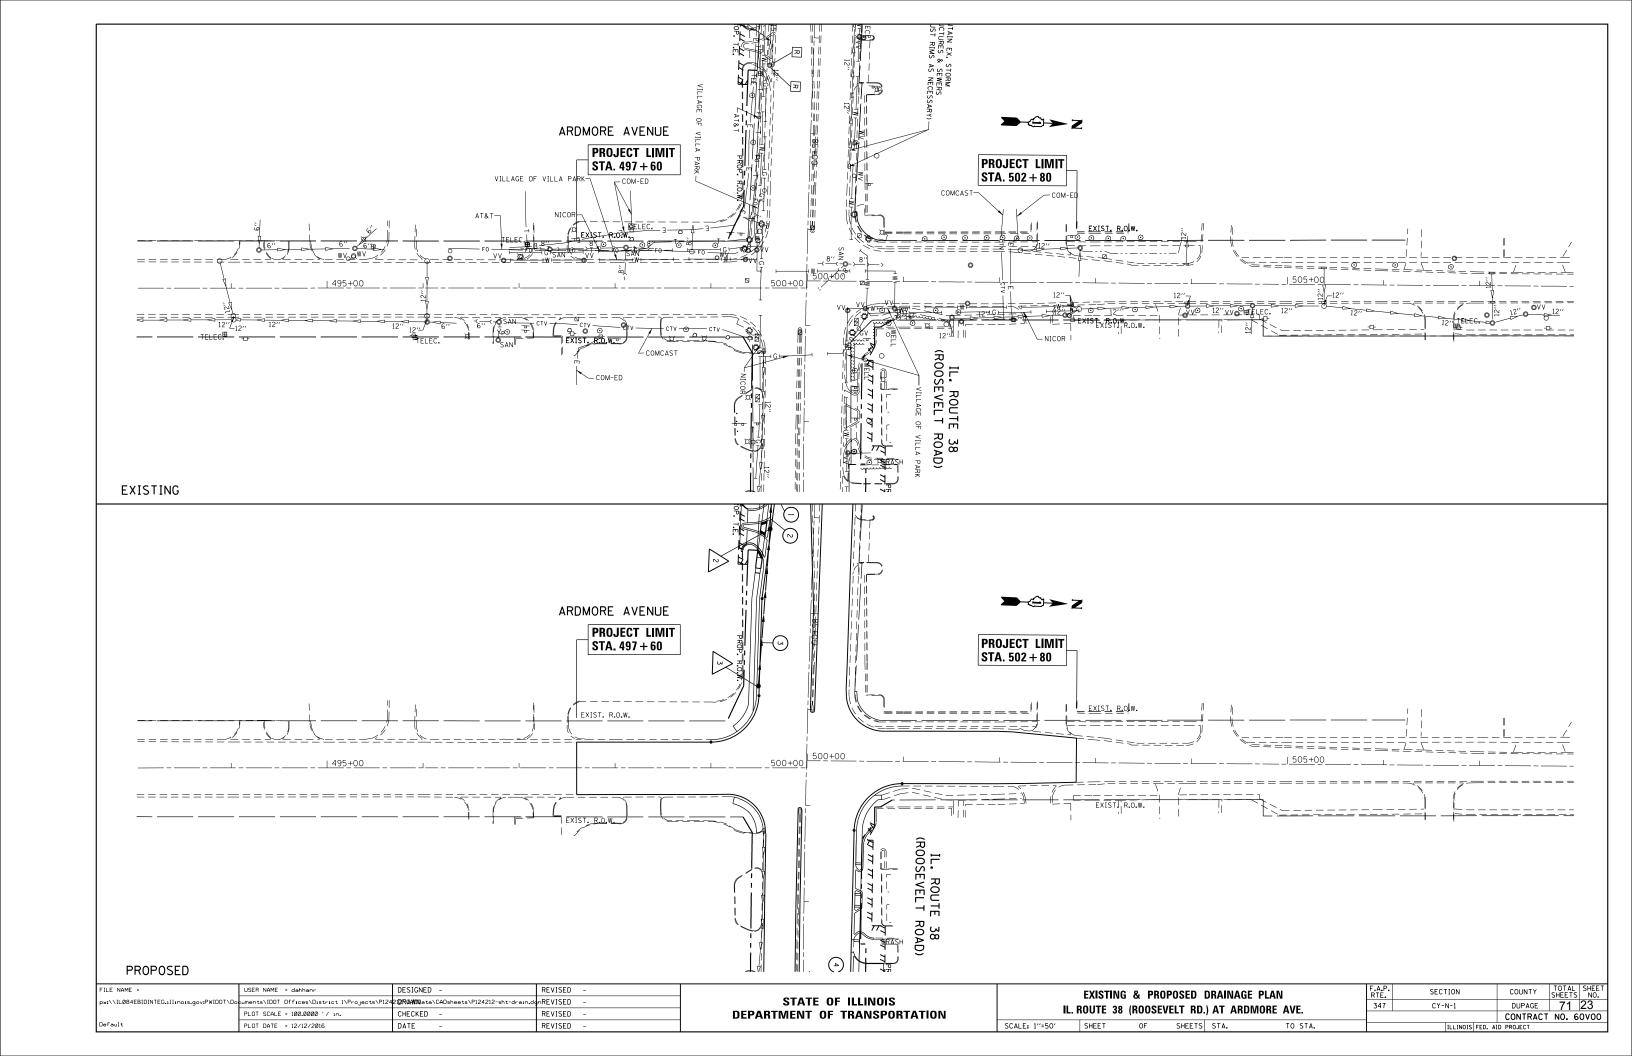
EXCAVATED DEPTH MORE THAN 12" NEAR TRAVELED LANE SHALL NOT EXCEED 48 HOURS


PROVIDE CHANGEABLE MESSAGE SIGNS, 3 TOTAL. PLACE SIGNS ONE IN EACH DIRECTION - WESTBOUND, EASTBOUND AND NORTHBOUND.


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	PLOT SCALE = 100.0000 ' / in.	CHECKED -	REVISED -	DEPARTMENT OF TRANSPORTATION	IL.	RUUIE 38	(KUU2EA	'ELT RD.) AT ARDMO	THE AVE.	
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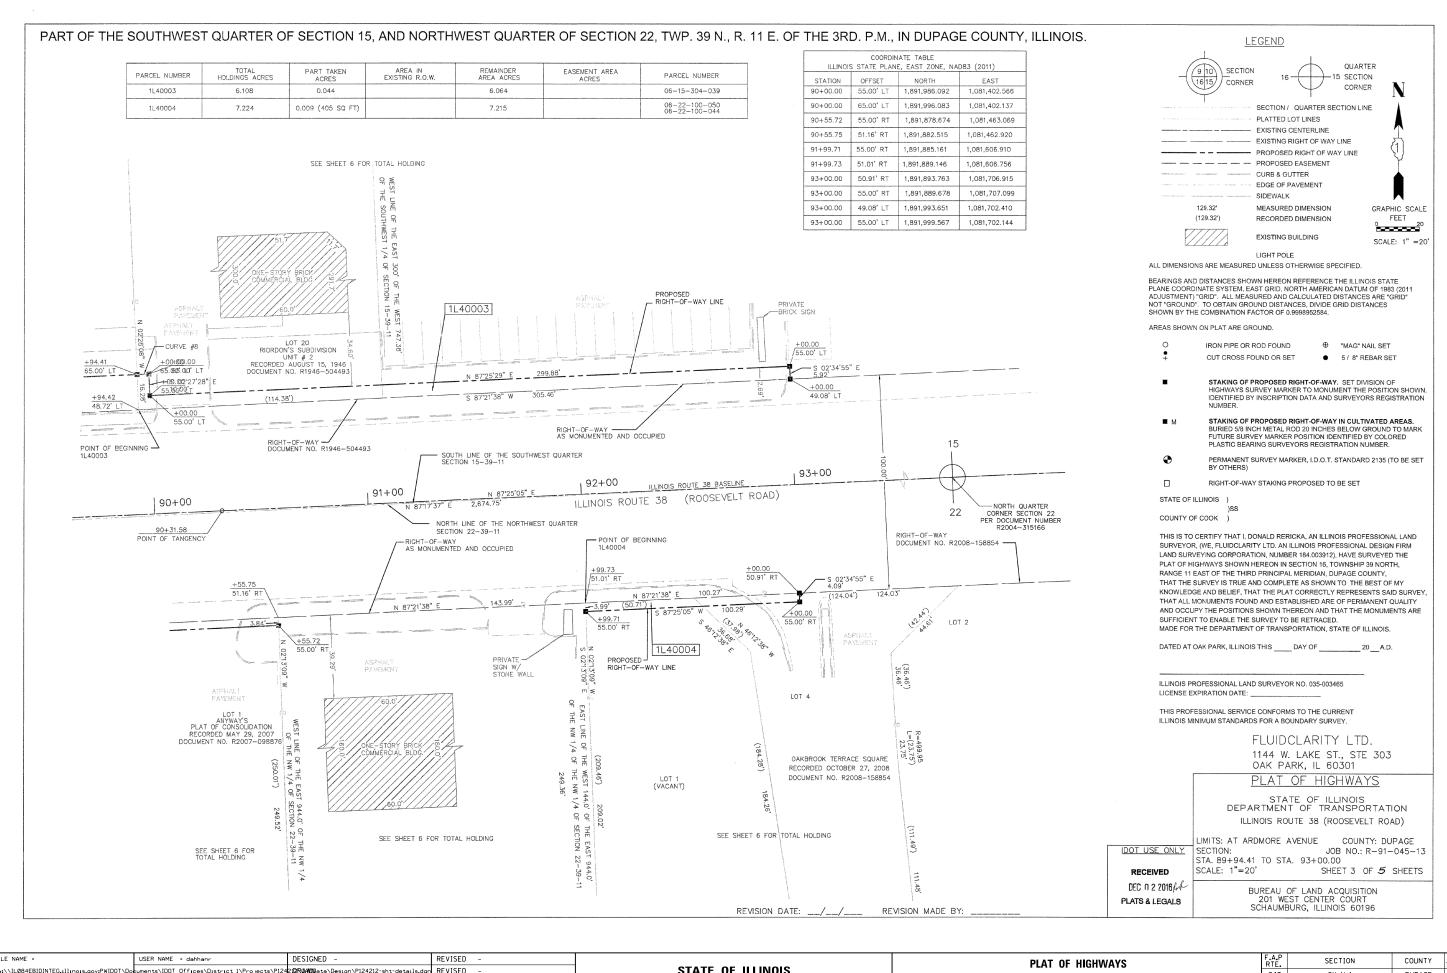




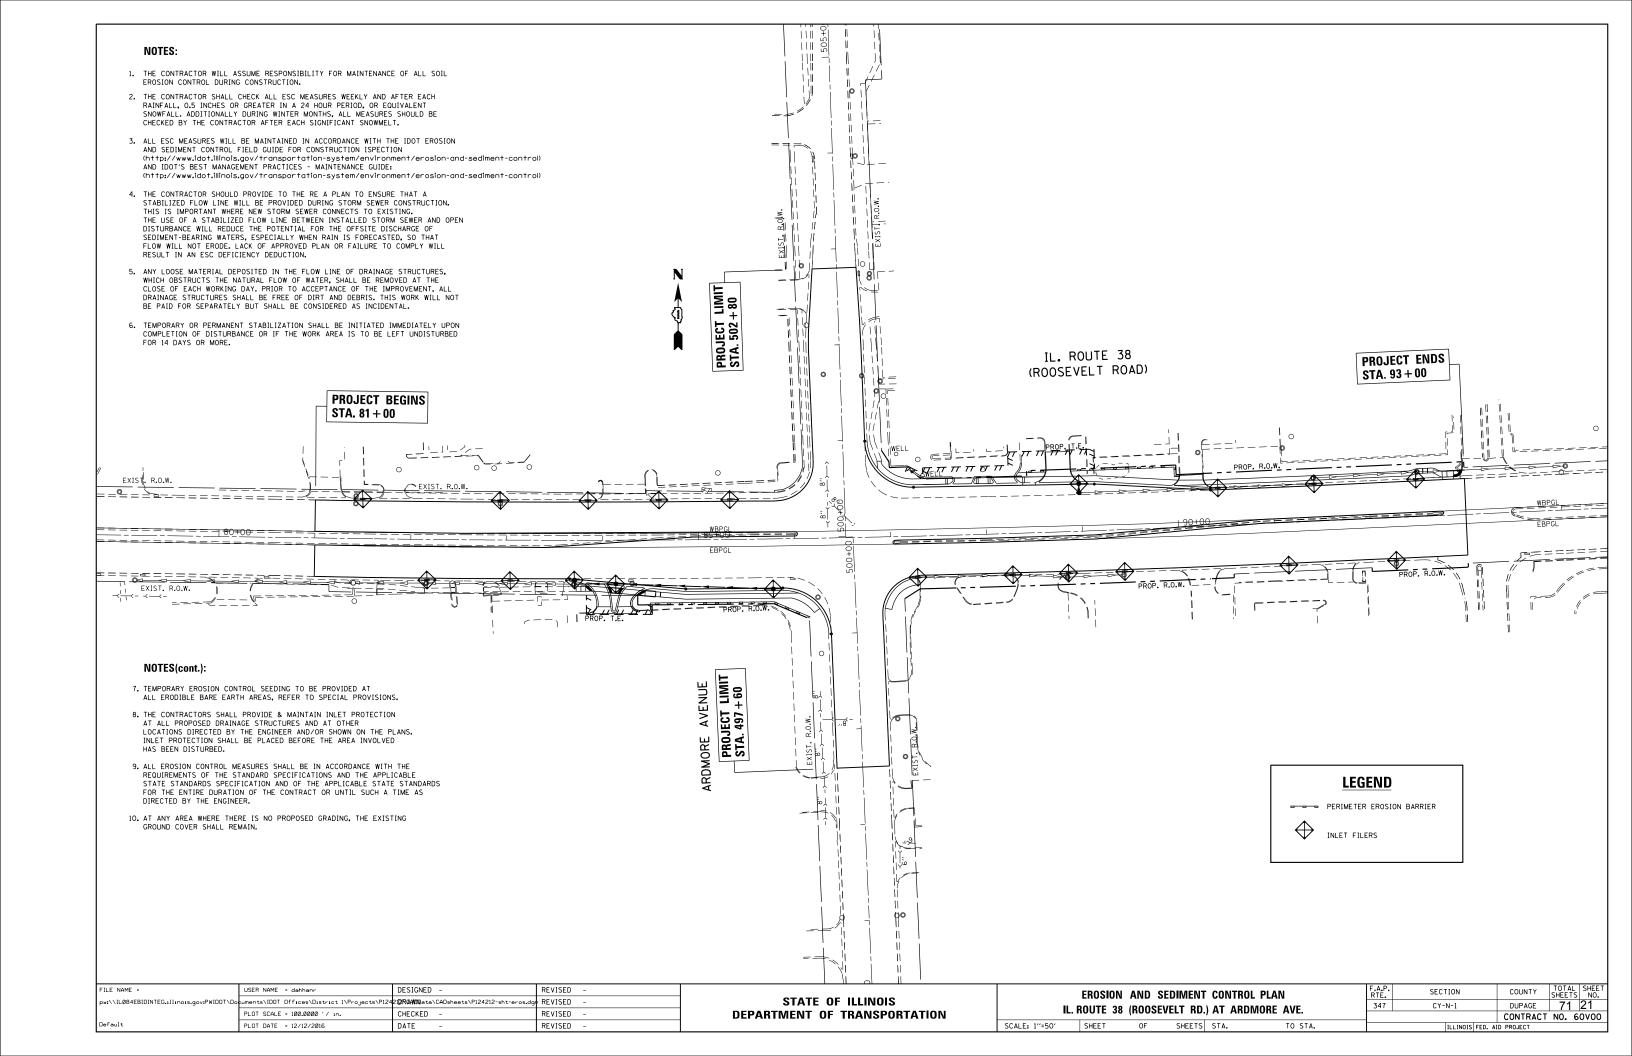


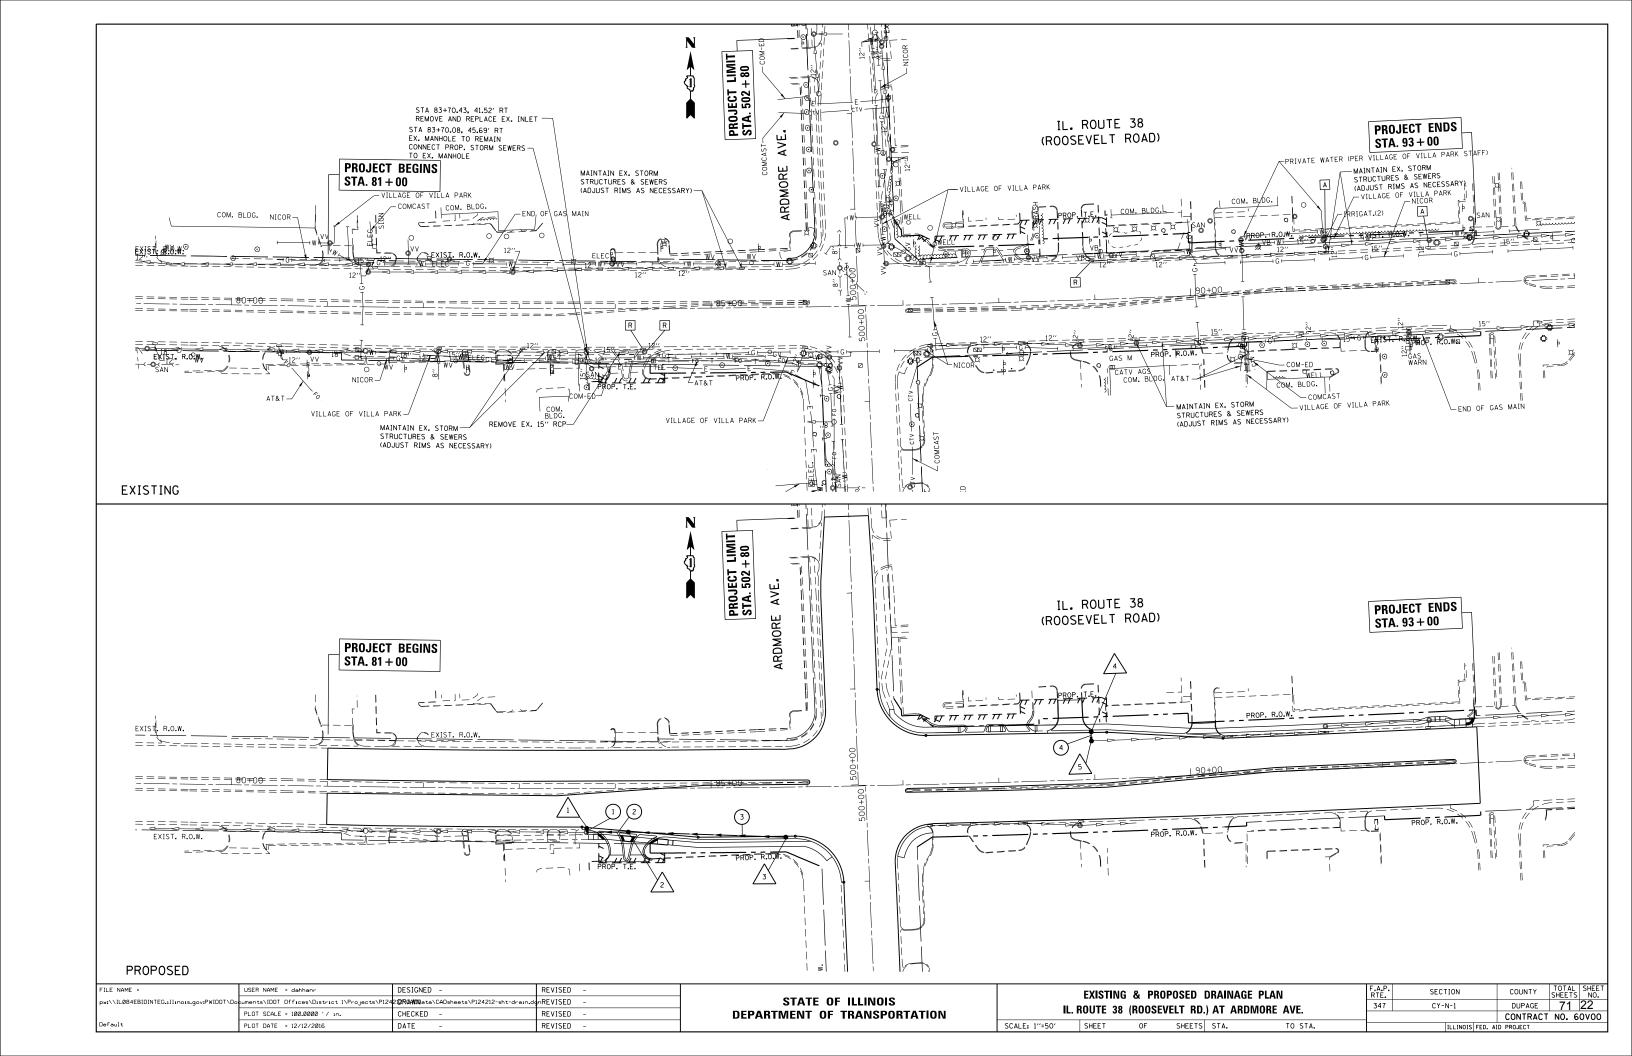

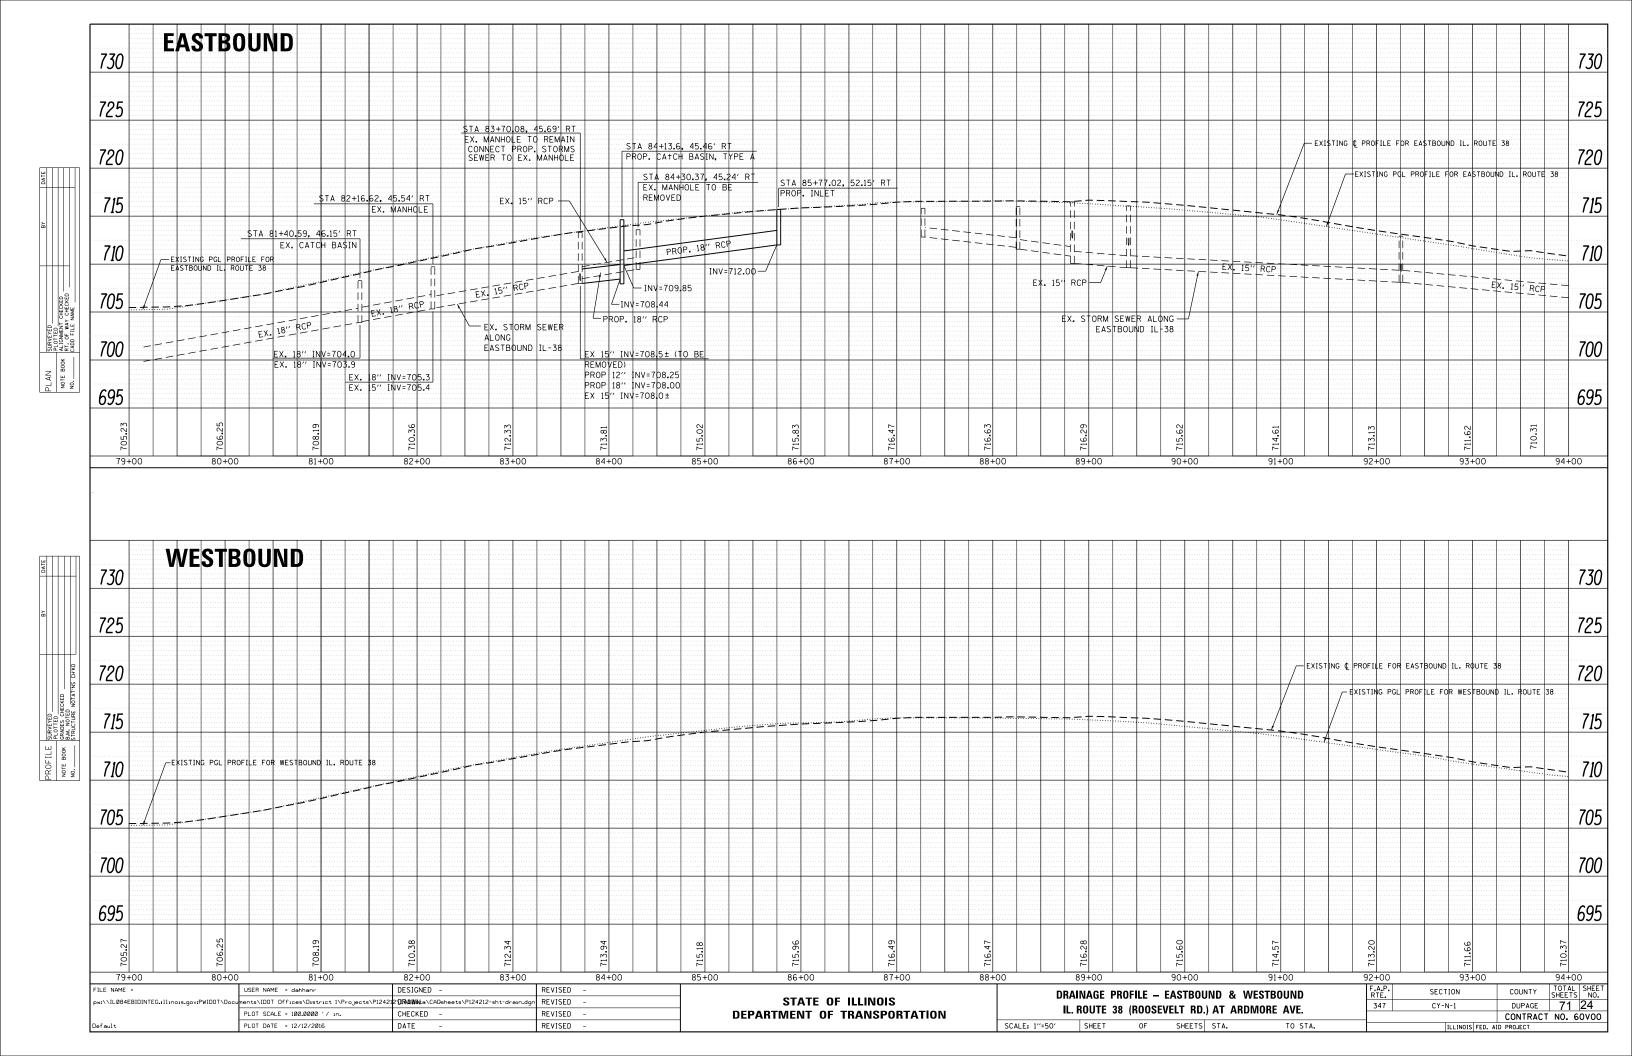
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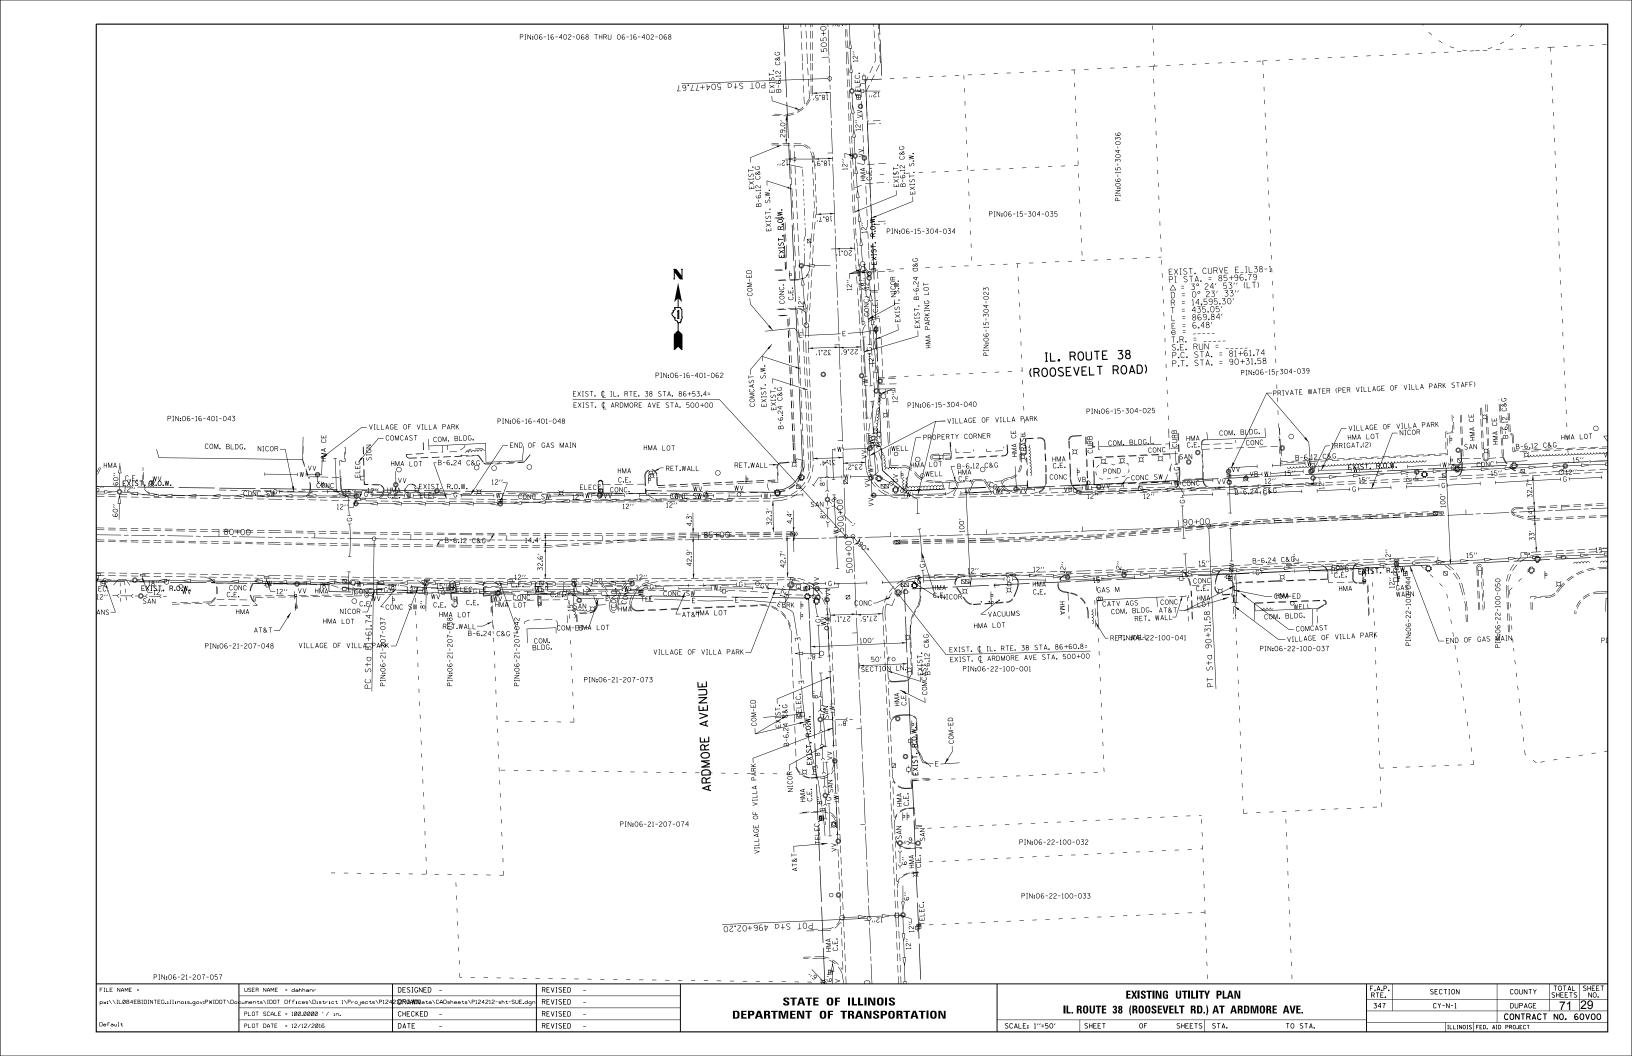
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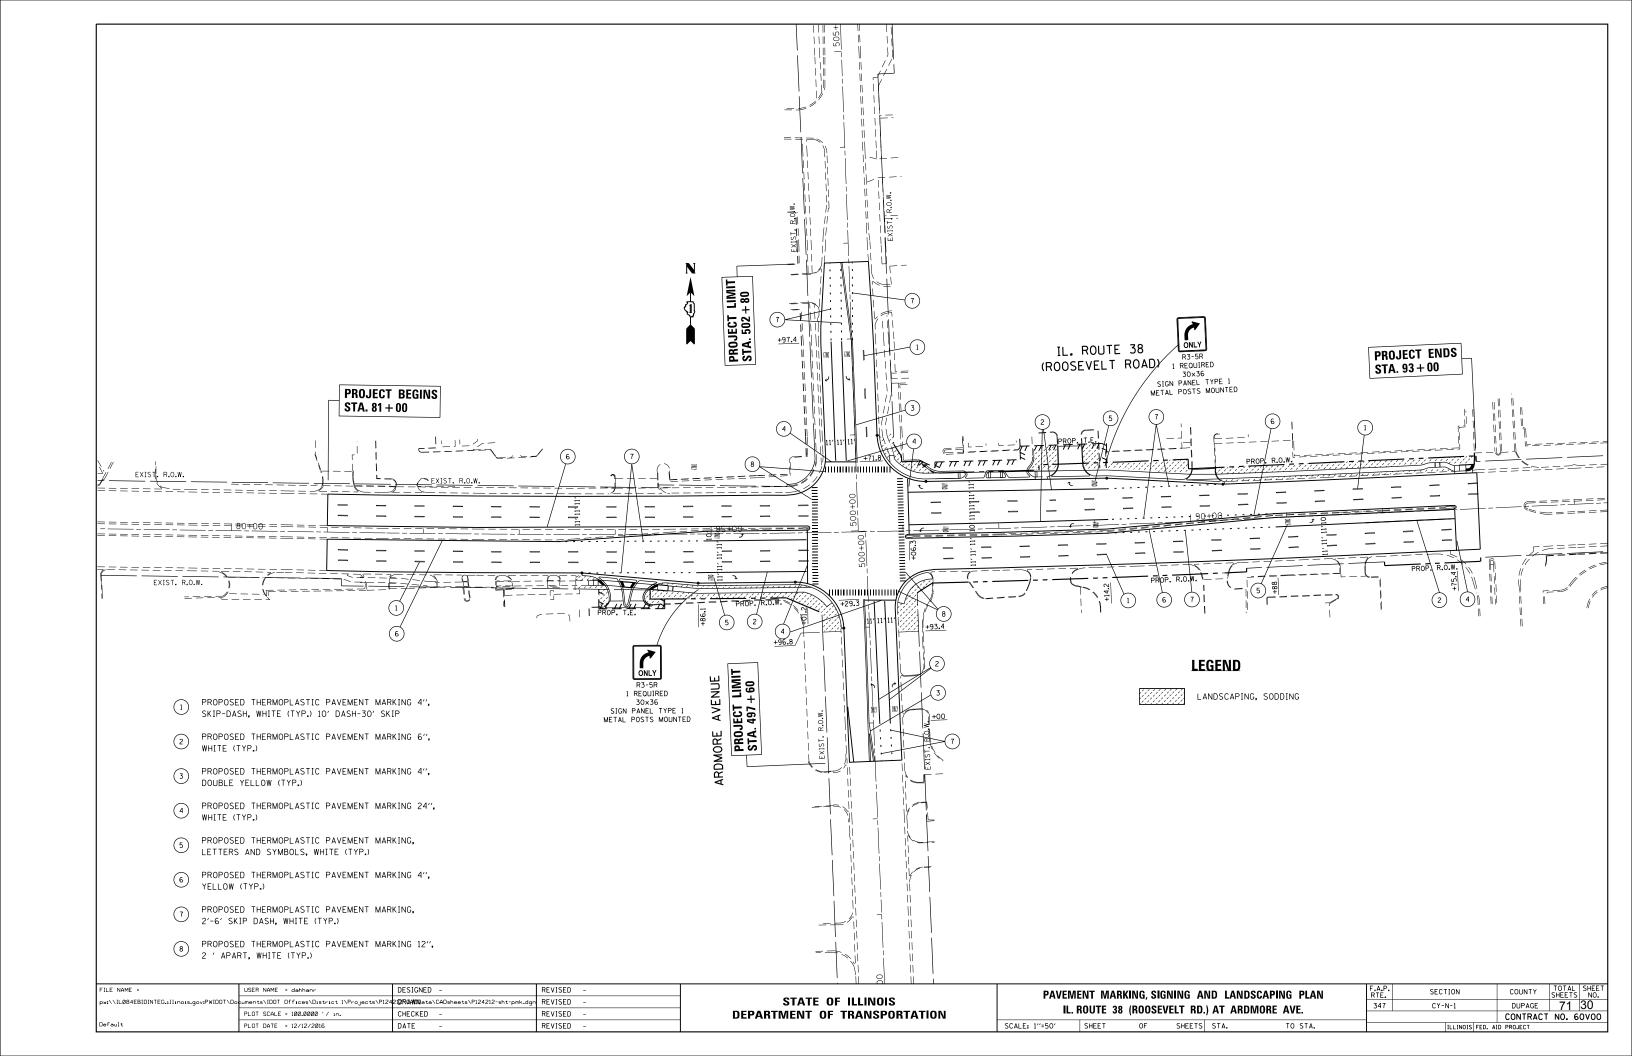


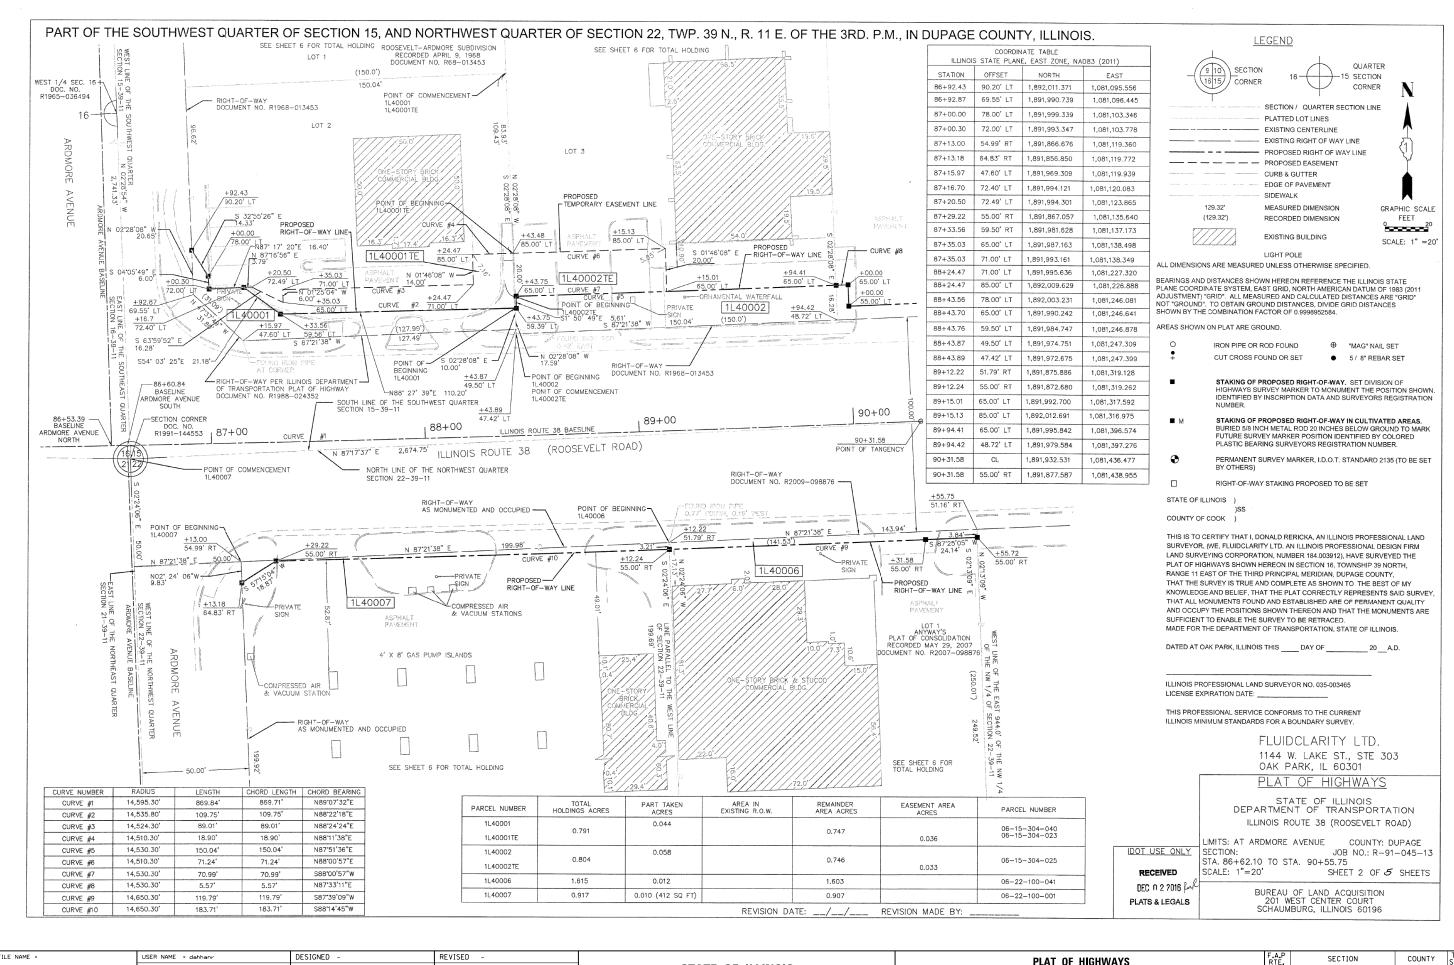PLAT OF HIGHWAYS PHAT OF HIGHWAYS SECTION THE S	
I DOITE 20 (DOOCEVEIT DD) AT ADDMODE AVE	DUPAGE 71 27
PEUT SCHILE - INCOME	CONTRACT NO. 60V00
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	PLOT SCALE = 100.0000 '/ in.	CHECKED -	REVISED -			IL. NOUTE 36 (NOUSEVELT ND.) AT AND	IVIURE AVE.			CONTRACT NO. 6
Default	PLOT DATE = 12/12/2016	DATE -	REVISED -		SCALE:	SHEET 1 OF 4 SHEETS STA.	TO STA.		ILLINOIS FED. AI	D PROJECT



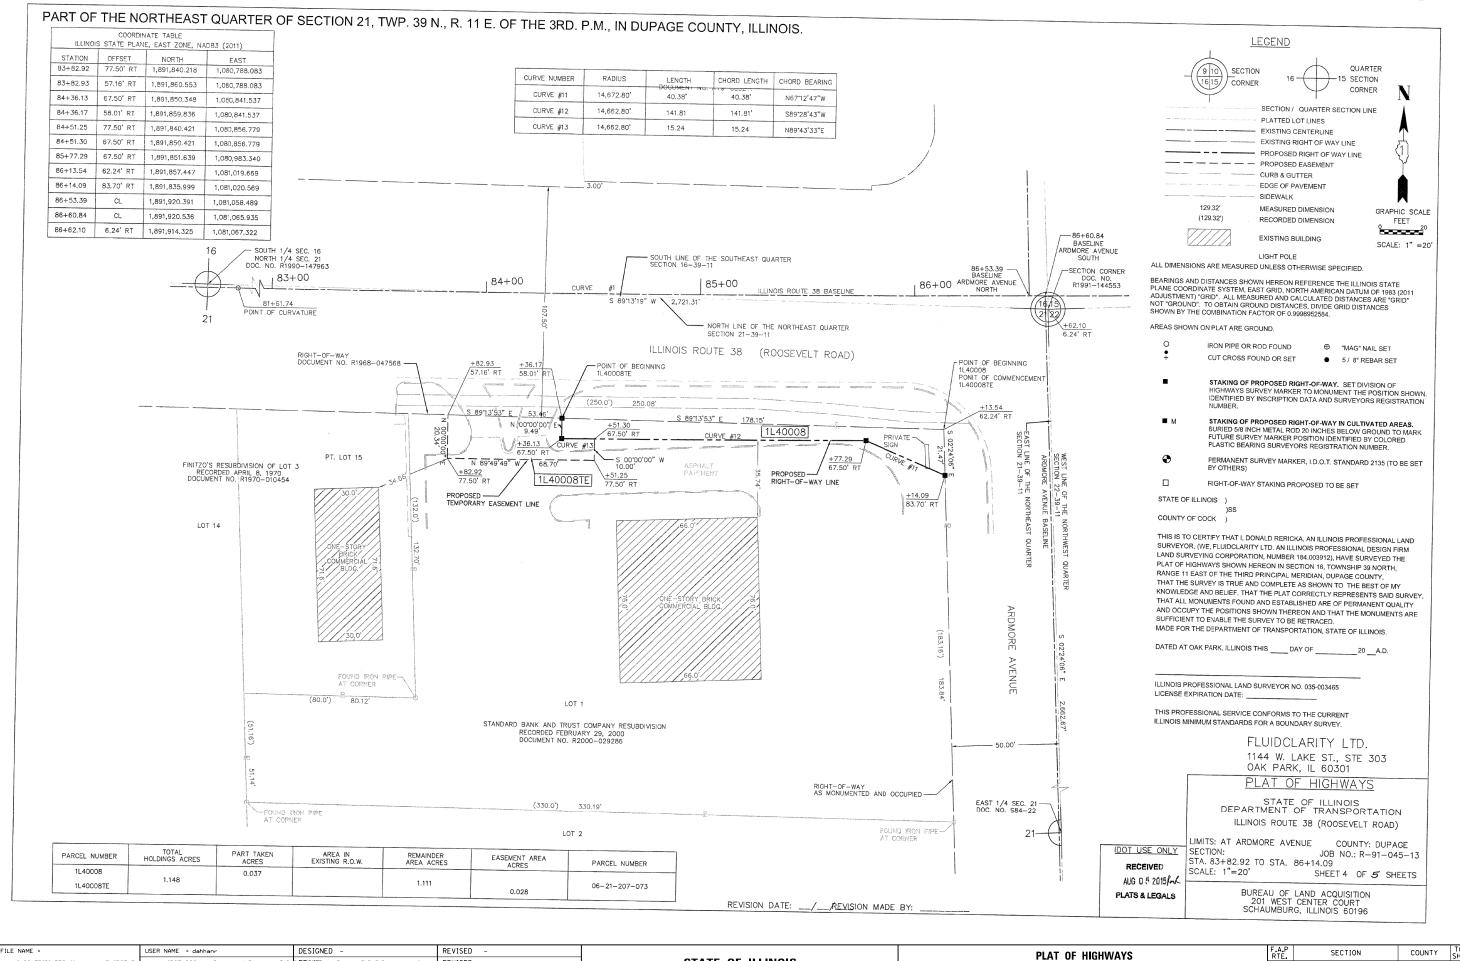

SUMMARY OF QUANTITIES

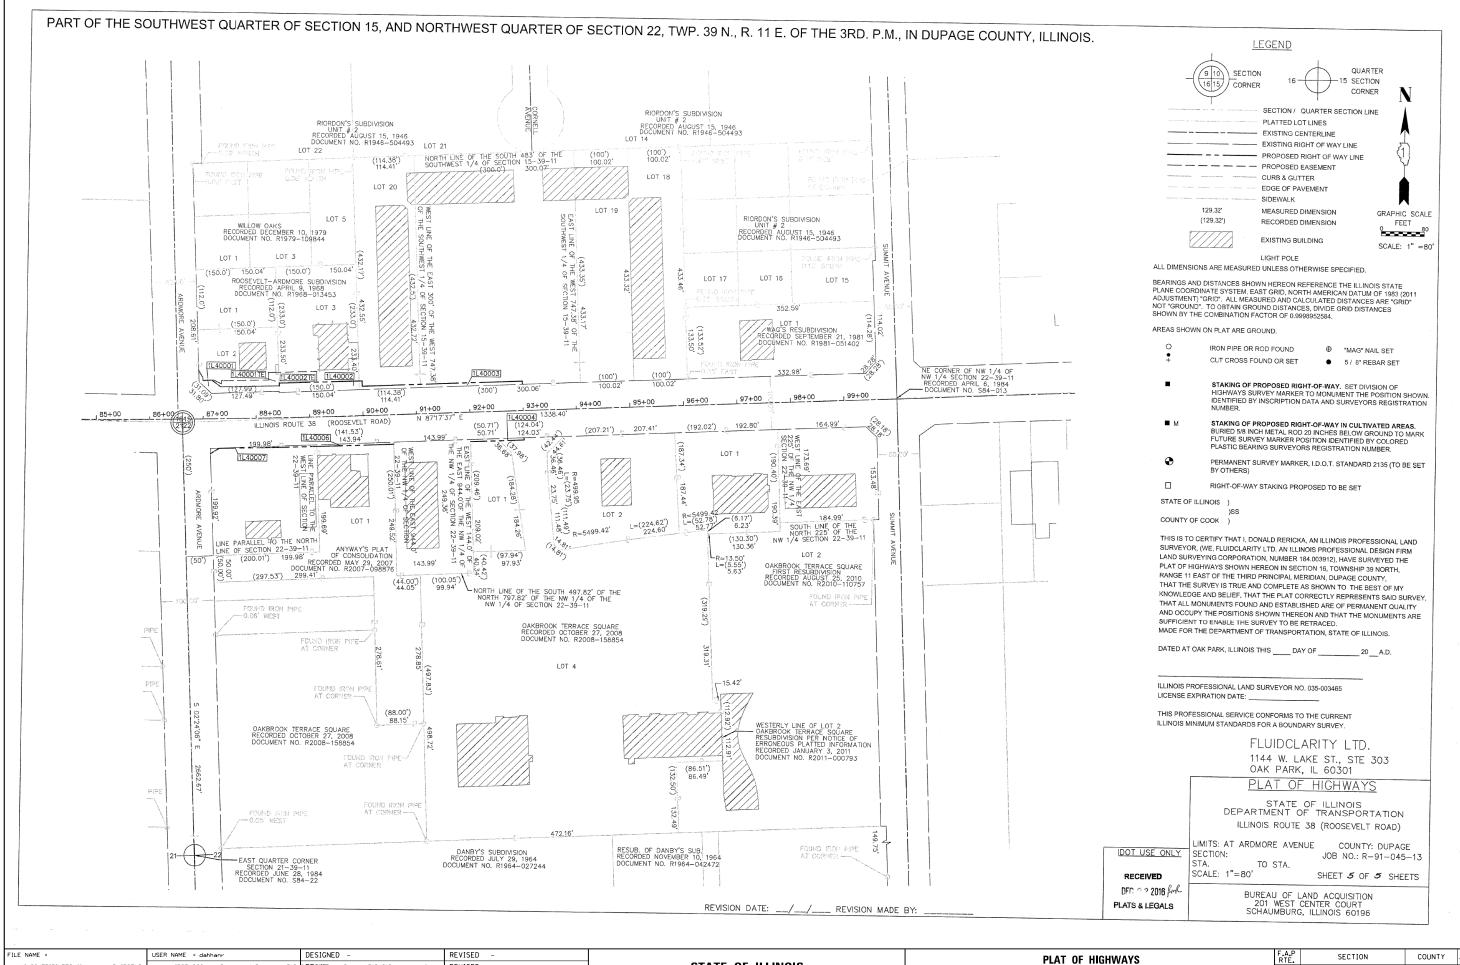			IL 38 (ROOSEVELT RD) @ ARDMORE AVE	INTERCONNECT
LOCATION OF WORK				
	CONSTRUCTION CODE		0021	0021
SUMMARY OF QUANTITIES		GRAND		
CODE NO. ITEM	UNIT	TOTAL		
72000100 SIGN PANEL - TYPE 1	SQ FT	48	48	
72000200 SIGN PANEL - TYPE 2	SQ FT	30	30	
80500020 SERVICE INSTALLATION - POLE MOUNTED	EACH	1	1	
81028200 UNDERGROUND CONDUIT, GALVANIZED STEEL, 2"DIA.	FOOT	1,312	972	340
81028210 UNDERGROUND CONDUIT, GALVANIZED STEEL, 2 1/2"DIA.	FOOT	63	63	
81028220 UNDERGROUND CONDUIT, GALVANIZED STEEL, 3"DIA.	FOOT	64	64	
81028240 UNDERGROUND CONDUIT, GALVANIZED STEEL, 4"DIA.	FOOT	514	514	
81400100 HANDHOLE	EACH	4	4	
81400200 HEAVY-DUTY HANDHOLE	EACH	4	4	
81400300 DOUBLE HANDHOLE	EACH	2	2	
85000200 MAINTENANCE OF EXISTINGTRAFFIC SIGNAL INSTALLATION	EACH	2		2
86400100 TRANSCEIVER - FIBER OPTIC	EACH	1	1	
87300925 ELECTRIC CABLE IN CONDUIT, TRACER, NO. 141C	FOOT	2,178		2178
87301215 ELECTRIC CABLE IN CONDUIT, SIGNAL NO. 142C	FOOT	1,430	1430	
87301225 ELECTRIC CABLE IN CONDUIT, SIGNAL NO. 14 3C	FOOT	2,121	2121	
87301245 ELECTRIC CABLE IN CONDUIT, SIGNAL NO. 145C	FOOT	2,254	2254	
87301255 ELECTRIC CABLE IN CONDUIT, SIGNAL NO. 14 7C	FOOT	2,448	2448	
87301305 ELECTRIC CABLE IN CONDUIT, LEAD-IN, NO. 141 PAIR	FOOT	2,125	2125	
87301805 ELECTRIC CABLE IN CONDUIT, SERVICE, NO. 6 2 C	FOOT	268	268	
87301900 ELECTRIC CABLE IN CONDUIT, EQUIPMENT GROUNDING CONDUCTOR, NO. 6 1C	FOOT	838	838	
87502500 TRAFFIC SIGNAL POST, GALVANIZED STEEL 16 FT.	EACH	4	4	
87602000 PEDESTRIAN PUSH-BUTTON POST	EACH	3	3	
87700210 STEEL MAST ARM ASSEMBLY AND POLE, 34 FT.	EACH	<u> </u>	3	
87700250 STEEL MAST ARM ASSEMBLY AND POLE, 42 FT.	EACH	1	1	
87700270 STEEL MAST ARM ASSEMBLY AND POLE, 46 FT.	EACH	I		
87700280 STEEL MAST ARM ASSEMBLY AND POLE, 48 FT.	EACH	1	1	
87800100 CONCRETE FOUNDATION, TYPE A	FOOT	1	1	
87800150 CONCRETE FOUNDATION, TYPE C	FOOT	24	24	
87800415 CONCRETE FOUNDATION, TITLE C	FOOT	4	4	
	-	37	37.0	
87900200 DRILL EXISTING HANDHOLE	EACH	5	3	2
88030020 SIGNAL HEAD, LED, 1-FACE, 3-SECTION, MAST-ARM MOUNTED	EACH	8	8	
88030050 SIGNAL HEAD, LED, 1-FACE, 3-SECTION, BRACKET MOUNTED	EACH	2	2	
88030100 SIGNAL HEAD, LED, 1-FACE, 5-SECTION, BRACKET MOUNTED	EACH	6	6	
88030110 SIGNAL HEAD, LED, 1-FACE, 5-SECTION, MAST-ARM MOUNTED	EACH	6	6	
88102717 PEDESTRIAN SIGNAL HEAD, LED, 1-FACE, BRACKET MOUNTED WITH COUNTDOWN TIMER	EACH	8	8	
88200410 TRAFFIC SIGNAL BACKPLATE, LOUVERED, FORMED PLASTIC	EACH	14	14	
88500100 INDUCTIVE LOOP DETECTOR	EACH	10	10	
88600100 DETECTOR LOOP, TYPE I	FOOT	1,209	1209	
88700200 LIGHT DETECTOR	EACH	3	3	
88700300 LIGHT DETECTOR AMPLIFIER	EACH	1	1	
88800100 PEDESTRIAN PUSH-BUTTON	EACH	8	8	
89000100 TEMPORARY TRAFFIC SIGNAL INSTALLATION	EACH	1	1	
89502300 REMOVE ELECTRIC CABLE FROM CONDUIT	FOOT	1,038		1038
89502375 REMOVE EXISTING TRAFFIC SIGNAL EQUIPMENT	EACH	1	1	
89502380 REMOVE EXISTING HANDHOLE	EACH	9	9	
89502382 REMOVE EXISTING DOUBLE HANDHOLE	EACH	3	3	
89502385 REMOVE EXISTING CONCRETE FOUNDATION	EACH	8	8	
X0324085 EMERGENCY VEHICLE PRIORITYSYSTEM LINE SENSOR CABLE, NO. 20 3/C	FOOT	618	618	
X0324599 ROD AND CLEAN EXISTING CONDUIT	FOOT	947	0.0	947
X14000081 FULL-ACTUATED CONTROLLER AND TYPE SUPER P CABINET SPECIAL	EACH	1	1	511
X8620200 UNINTERRUPTABLE POWER SUPPLY, SPECIAL	EACH	1	1	
X8710024 FIBER OPTIC CABLE IN CONDUIT, NO. 62,5/125, MM12F SM24F	FOOT	2,224	1	2224
ZOO33046 RE-OPTIMIZE TRAFFIC SIGNAL SYSTEM LEVEL 2	EACH	1		1
		1		

USER NAME = dwiktorzak	DESIGNED -	DW	REVISED	-
	DRAWN -	CDC	REVISED	-
PLOT SCALE = 1.0000 ' / in.	CHECKED -	KMM	REVISED	-
PLOT DATE = 12/12/2016	DATE -	4/1/15	REVISED	-

STATE OF ILLINOIS DEPARTMENT OF TRANSPORTATION

SCALE:

SCHEDULE OF QUANTITIES & GENERAL NOTES F.A.P. RTE. SECTION COUNTY SHEETS NO. TOTAL SHEET NO. SHEET NO. 347 CY-N-1 DUPAGE 71 31 SHEET NO. OF SHEETS STA. TO STA. ILLLINOIS FED. AID PROJECT NO. 60V00

GENERAL NOTES:

- BEFORE STARTING ANY EXCAVATION, THE CONTRACTOR SHALL CALL "J.U.L.I.E." AT (800) 892-0123 OR 811 FOR FIELD LOCATIONS OF BURIED ELECTRIC, TELEPHONE AND GAS UTILITIES. 48 HOUR NOTIFICATION IS REQUIRED.
- 2. CONTRACTOR SHALL CONTACT THE TRAFFIC CONTROL SUPERVISOR AT (847) 705-4470, 72 HOURS IN ADVANCE OF BEGINNING WORK.
- 3. IT SHALL BE THE CONTRACTOR'S RESPONSIBILITY TO VERIFY ALL DIMENSIONS AND CONDITIONS EXISTING IN THE FIELD PRIOR TO ORDERING MATERIALS AND BEGINNING CONSTRUCTION. THIS SHALL INCLUDE LOCATING THE MAST ARM FOUNDATIONS AND VERIFYING THE MAST ARM LENGTHS.
- 4. THE EXACT LOCATION OF ALL UTILITES SHALL BE FIELD VERIFIED BY THE CONTRACTOR BEFORE ORDERING ANY MATERIALS AND STARTING ANY WORK. FOR LOCATIONS OF UTILITIES, LOCALLY OWNED EQUIPMENT, LEASED ENFORCEMENT CAMERA SYSTEM FACILITIES AND IDOT UNDERGROUND FACILITIES, CONTACT THE LOCAL COUNTIES, MUNICIPALITIES AND IDOT FOR LOCATES. THE CONTRACTOR SHALL CALL "JULIE" AT (800) 892-0123 OR 811, IN THE CITY OF CHICAGO CONTACT DIGGER AT (312) 744-7000 FOR FIELD LOCATIONS OF BURIED UTILITIES (48 HOURS NOTIFICATION REQUIRED).
- 5. IF THIS CONTRACT REQUIRES THE SERVICES OF AN ELECTRICAL CONTRACTOR, THE CONTRACTOR SHALL BE RESPONSIBLE AT HIS/HER OWN EXPENSE FOR LOCATING EXISTING IDOT ELECTRICAL FACILITIES PRIOR TO PERFORMING ANY WORK. IF THIS CONTRACT DOES NOT REQUIRE THE SERVICES OF AN ELECTRICAL CONTRACTOR, THE CONTRACTOR MAY REQUEST ONE FREE LOCATE FOR EXISTING IDOT ELECTRICAL FACILITIES FROM THE DISTRICT ONE ELECTRICAL MAINTENANCE CONTRACTOR PRIOR TO THE START OF ANY WORK. ADDITIONAL REQUESTS MAY BE AT THE EXPENSE OF THE CONTRACTOR. THE LOCATION OF UNDERGROUND TRAFFIC FACILITIES DOES NOT RELIEVE THE CONTRACTOR OF THEIR RESPONSIBILITY TO REPAIR ANY FACILITIES DAMAGED DURING CONSTRUCTION AT THEIR EXPENSE.
- 6. CONTRACTOR SHALL CHECK THE PROPOSED TRAFFIC SIGNAL EQUIPMENT LOCATIONS FOR OVERHEAD UTILITY CONFLICTS. THE CONTRACTOR SHALL COORDINATE ANY CONFLICTS WITH THE UTILITY COMPANIES AND THE RESIDENT ENGINEER BEFORE ORDERING MATERIALS.
- THE CONTRACTOR SHALL COORDINATE CONSTRUCTION ACTIVITIES WITH UTILITY COMPANIES, LOCAL GOVERNMENT AGENCIES AND IDOT.
- 8. RESTORATION OF THE TRAFFIC SIGNAL WORK AREA SHALL BE INCLUDED IN THE RELATED PAY ITEM SUCH AS FOUNDATION, CONDUIT, HANDHOLE, ETC., AND NO EXTRA COMPENSATION SHALL BE ALLOWED. ALL ROADWAY SURFACES SUCH AS SHOULDERS, MEDIAN, SIDEWALKS, PAVEMENT ETC. SHALL BE REPLACED IN KIND. ALL DAMAGE TO MOWED LAWNS SHALL BE REPLACED WITH AN APPROVED SOD, AND ALL DAMAGE TO UNMOWED FIELDS SHALL BE SEEDED IN ACCORDANCE WITH STANDARD SPECIFICATIONS 252 AND 250 RESPECTIVELY.

STATE OF ILLINOIS

DEPARTMENT OF TRANSPORTATION

DRAWN

DATE

PLOT DATE = 12/12/2016

CHECKED

CDC

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4/1/15

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DISTRICT ONE

STANDARD TRAFFIC SIGNAL DESIGN DETAILS

SHEET NO. 1 OF 7 SHEETS STA.

SCALE: NONE

DUPAGE 71 32

CONTRACT NO. 60V00

347


CY-N-1

FED. ROAD DIST. NO. 1 | ILLINOIS FED. AID PROJECT


LOOP DETECTOR NOTES

- 1. EACH PAIR OF LOOP WIRES SHALL BE PLACED IN A SEPARATE EMPTY COILABLE NONMETALLIC CONDUIT FROM THE EDGE OF PAVEMENT TO THE HANDHOLE. SPACING BETWEEN THE HOLES DRILLED IN THE PAVEMENT SHALL NOT BE LESS THAN 6" (150 mm). EMPTY COILABLE NONMETALLIC CONDUIT SHALL BE INCLUDED IN THE COST OF THE LOOP WIRE.
- 2. THE NUMBER OF LOOP TURNS SHALL BE AS RECOMMENDED BY THE AMPLIFIER MANUFACTURER. ALL ADJACENT SIDES OF THE LOOPS SHALL BE INSTALLED IN SUCH A WAY THAT THE CURRENT FLOW IS IN THE SAME DIRECTION TO REINFORCE ITS MAGNETIC FIELDS FOR SMALL VEHICLE DETECTION.
- 3. EACH LOOP LEAD-IN SHALL BE IDENTIFIED AND PERMANENTLY TAGGED IN THE HANDHOLE. EACH LEAD-IN CABLE TAG SHALL INDICATE THE LOCATION OF THE LOOP, LOOP ROTATION (CLOCKWISE/COUNTERCLOCKWISE), LOOP LEAD-IN DIRECTION (IN CR OUT), LOOP CABLE NUMBER AND LOCATION IN CABINET, AND NUMBER OF TURNS IN THE DETECTOR LOOPS IN WATER PROOF INK AS INDICATED ON THE DISTRICT 1 STANDARD TRAFFIC SIGNAL DESIGN DETAIL. THE CONTRACTOR SHALL MARK LOOP LOCATIONS ON RECORD DRAWINGS AND PRESENT TO THE ENGINEER AFTER FINAL INSPECTION. LOOPS SHALL BE WARKED BY LANE AND LOOP NUMBER. SEE DETAIL BELOW.
- 4. ALL LOOP CABLE SHALL BE FASTENED WITH PLASTIC TIE WRAP TO THE HANDHOLE HOOKS.
- 5. IN ASPHALT PAVEMENT, LOOPS SHOULD BE PLACED IN THE BINDER AND DIVEHOLES MARKED AT THE CURB WITH A SAW-CUT. THE SAW-CUT SHALL BE CUT IN ACCORDANCE WITH LOCAL AND E.P.A. DUST CONTROL REQUIREMENTS. DETECTOR LOOP(S) SHALL NOT BE INSTALLED IN WET CONDITIONS AND THE SAW-CUTS MUST BE FREE OF DEBRIS AND RESIDUE SUCH AS DUST AND WATER WHICH IS TO BE ACHIEVED BY THE USE OF COMPRESSED AIR, WIRE BRUSHING AND HEAT DRYING ACCORDING TO SEALANT MANUFACTURER REQUIREMENTS. THE DETECTOR WIRE SHALL BE HELD IN PLACE BY THE USE OF FORM WEDGES. WEDGES SHALL BE SPACED NO MORE THAN 18" (450 mm) APART.
- 6. LOOP SPLICES SHALL BE SOLDERED USING A SOLDERING IRON. BLOW TORCHES OR OTHER DEVICES WHICH OXIDIZE COPPER CABLE SHALL NOT BE ALLOWED FOR SOLDERING OPERATIONS. SEE DETAIL BELOW RIGHT.
- 7. PREFORMED DETECTOR LOOPS SHALL BE USED, AS SHOWN ON THE PLANS, WHERE NEW CONCRETE PAVEMENT IS PROPOSED. THE INSTALLATION OF PREFORMED LOOPS SHALL BE IN ACCORDANCE WITH THE DISTRICT 1 SPECIFICATIONS OR AS DIRECTED BY THE ENGINEER.

LOOP LEAD-IN CABLE TAG

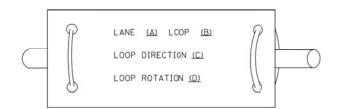



- A. LANE 1 IS THE LANE CLOSEST TO THE CENTERLINE OF THE ROADWAY
- B. LOOP *1 IS THE LOOP IN THE LANE CLOSEST TO THE INTERSECTION.
- C. LABEL LOOP CABLE "IN" OR LOOP CABLE "OUT".
- D. LABEL LOOP CABLE CLOCKWISE OR LOOP CABLE COUNTERCLOCKWISE.

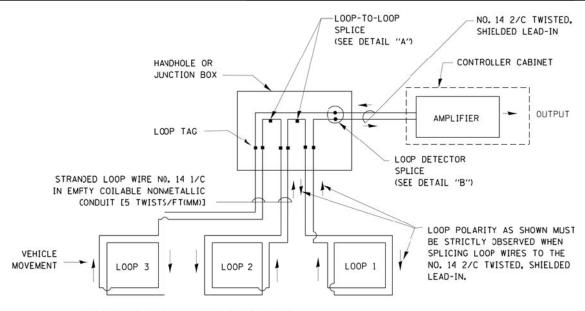

DETECTOR LOOP WIRING SCHEMATIC

- LOOPS SHALL BE SPLICED IN SERIES.
- SAW-CUTS SHALL BE A MINIMUM WIDTH OF 5/16" (8 mm).
- SAW-CUT DEPTHS SHALL BE 3" (75 mm). IF IN CONCRETE,
 THE SAW-CUT DEPTH SHALL BE 10 THE TOP OF THE REINFORCEMENT.
- LOOP CORNERS SHALL BE DRILLED WITH A 2" (50 mm) DIAMETER CORE.

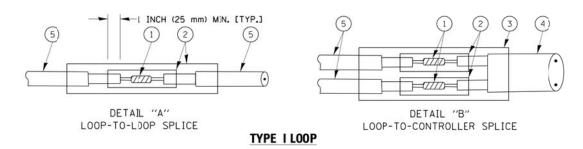

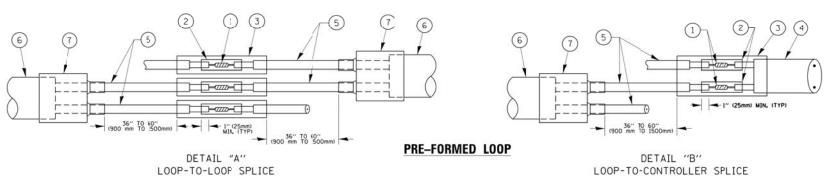

LOOP DETECTOR SPLICE

- 1) WESTERN UNION SPLICE SOLDERED WITH ROSIN CORE FLUX. ALL EXPOSED SURFACES OF THE SOLDER SHALL BE SMOOTH. THE WESTERN UNION SPLICES SHALL BE STAGGERED.
- (2) WCSMW 30/100 HEAT SHRINK TUBE, MINIMUM LENGTH 3" (75 mm), UNDERWATER GRADE.
- 3 WCS 200/750 HEAT SHRINK TUBE, MINIMUM LENGHT 6" (150 mm), UNDERWATER GRADE.

SCALE: NONE


4 NO. 14 2/C TWISTED, SHIELDED CABLE.

- 5 LOOP CONDUCTOR WITH FLEXIBLE PLASTIC TUBE.
- 6 PRE-FORMED LOOP
- 7 XL POLYOLEFIN 2 CONDUCTOR BREAKOUT SEALS. TYCO CBR-2 OR APPROVED EQUAL

USER NAME = dwiktorzak	DESIGNED	-	DW	KE A 12FD	-
	DRAWN	-	CDC	REVISED	-
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PLOT DATE = 12/12/2016	DATE	-	4/1/15	REVISED	-


STATE OF ILLINOIS DEPARTMENT OF TRANSPORTATION

TRAFFIC SIGNAL MAST ARM AND SIGNAL POST MAST ARM MOUNTED SIGNALS IN EXISTING, PROPOSED OR FUTURE SIDEWALK/BICYCLE PATH AREA. INTERSECTION SHOWN WITH PEDESTRIAN SIGNALS AND PEDESTRIAN PUSHBUTTON DETECTORS.

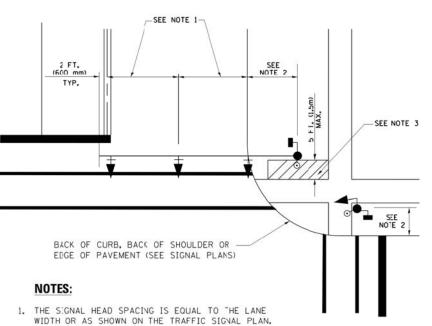


- 2. REFER TO THE TRAFFIC SIGNAL EQUIPMEN OFFSET TABLE.
- 3. PROVIDE A LEVEL ALL-WEATHER SURFACE CONCRETE SIDEWALK, ASPHALT BICYCLE PATH SURFACE OR MATCHING MATERIAL TO THE ADJACENT SURFACE) UP TO THE MAST ARM SHAFT OR THE SIGNAL PAST
- 4. THE FACE OF THE PEDESTRIAN PUSHBUTTON SHALL BE PARALLEL TO THE CROSSWALK TO BE USED.
- 5. THE LOCATIONS AND INSTALLATION OF PEDESTRIAN SIGNAL HEADS AND PEDESTRIAN PUSHBUTTONS SHALL MEET THE REQUIREMENTS OF THE MUTCD AND INFORMATION FOUND IN THE "AMERICANS WITH DISABILITIES ACT ACCESSIBILITY GUIDELINES FOR BUILDINGS AND FACILITIES."

PEDESTRIAN SIGNAL POST AND PEDESTRIAN PUSH BUTTON POST

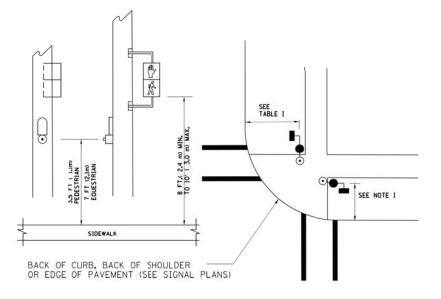

NOTES:

- 1. REFER TO THE TRAFFIC SIGNAL EQUIPMENT OFFSET TABLE.
- PROVIDE A LEVEL ALL-WEATHER SURFACE (CONCRETE SIDEWALK, ASPHALT BICYCLE PATH SURFACE OR MATCHING MATERIAL TO THE ADJACENT SURFACE) UP TO THE PEDESTRIAN SIGNAL POST OR THE PEDESTRIAN PUSH BUTTON POST.
- THE FACE OF THE PEDESTRIAN PUSHBUTTON SHALL BE PARALLEL TO THE CROSSWALK TO BE USED.
- 4. THE LOCATIONS AND INSTALLATION OF PEDESTRIAN SIGNAL HEADS AND PEDESTRIAN PUSHBUTTONS SHALL MEET THE REQUIREMENTS OF THE MUTCD AND INFORMATION FOUND IN THE "AMERICANS WITH DISABILITIES ACT ACCESSIBILITY GUIDELINES FOR BUILDINGS AND FACILITIES."

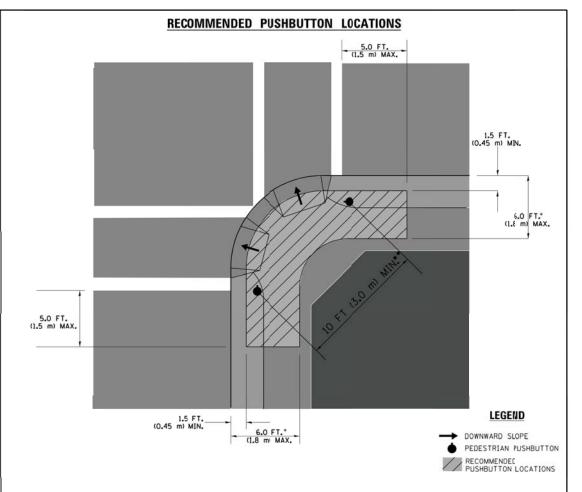

- WHERE THERE ARE CONSTRAINTS THAT MAKE IT IMPRACTICAL TO PLACE THE PEDESTRIAN PUSHBUTTON BETWEEN 1.5 FT (0.45 m) AND 6 FT (1.8 m) FROM THE EDGE OF THE CURB, SHOULDER, OR PAVEMENT, IT SHOULD NOT BE FURTHER THAN 10 FT (3 m) FROM THE EDGE OF CURB, SHOULDER, OR PAVEMENT.
- •• WHERE THERE ARE CONSTRAINTS ON A PARTICULAR CORNER THAT MAKE IT IMPRACTICAL TO PROVIDE THE 10 FT (3 m) SEPERATION BETWEEN THE TWO PEDESTRIAN PUSHBUTTONS, THE PUSHBUTTONS MAY BE PLACED CLOSER TOGETHER OR ON THE SAME POLE.

NOTES:

- PEDESTRIAN SIGNAL HEADS SHALL BE MOUNTED WITH THE BOTTOM OF THE SIGNAL HOUSING INCLUDING BRACKETS NOT LESS THAN 8 FT (2.4 m) OR MORE THAN 10 FT (3 m) ABOVE SIDEWALK LEVEL, AND SHALL BE POSITIONED AND ADJUSTED TO PROVIDE NAXIMUM VISIBILITY AT THE BEGINNING OF THE CONTROLLED CROSSWALK.
- 2. THE BOTTOM OF THE SIGNAL HOUSING (INCLUDING BRACKETS) OF A VEHICULAR SIGNAL FACE THAT IS NOT LOCATED OVER A HIGHWAY SHALL BE AT LEAST 8 FT (2.4 m) BUT NOT MORE THAN 19 FT (5.8 m) ABOVE THE SIDEWALK OR, IF THERE IS NO SIDEWALK, ABOVE THE PAVEMENT GRADE AT THE CENTER OF THE ROADWAY.
- 3. THE BOTTOM OF THE SIGNAL HOUSING AND ANY RELATED ATTACHMENTS TO A SIGNAL FACE LOCATED OVER ANY PORTION OF A HIGHWAY SHALL BE ACCORDING TO CURRENT STATE STANDARDS 877001, 877002, 877006, 877011 AND 877012 WITH A MINIMUM OF 16 FT (5.0 m) AND A MAXIMUM OF 18 FT. (5.5 m) FROM THE HIGHEST POINT OF PAVEMENT.
- 4. THE BOTTOM OF THE TEMPORARY SPAN WIRE MOUNTED SIGNAL HOUSING AND ANY RELATED ATTACHMENTS TO A SIGNAL FACE LOCATED OVER ANY PORTION OF A HIGHWAY SHALL BE ACCORDING TO CURRENT STATE STANDARD 880001 WITH A MINIMUM OF 17 FT (5.18 m) FROM THE HIGHEST POINT OF PAVEMENT.
- 5. THE TOP OF THE SIGNAL HOUSING OF A SIGNAL FACE LOCATED OVER ANY PORTION OF A HIGHWAY SHALL NOT BE MORE THAN 25.6 FT (7.8 m) ABOVE THE PAVEMENT.

TRAFFIC SIGNAL EQUIPMENT OFFSET

TRAFFIC SIGNAL EQUIPMENT	COMBINATION CONCRETE CURB AND GUTTER (MINIMUM DISTANCE FROM BACK OF CURB TO CENTERLINE OF FOUNDATION)	SHOULDER/NON-CURBED AREA (MINIMUM DISTANCE FROM EDGE OF PAVEMENT TO CENTERLINE OF FOUNDATION)						
TRAFFIC SIGNAL MAST ARM POLE	6 FT (1.8m)	SHOULDER WIDTH + 2 FT (0.6m), MINIMUM 10 FT (3.0m)						
TRAFFIC SIGNAL POST	4 FT (1.2m)	SHOULDER WIDTH + 2 FT (0.6m), MINIMUM 10 FT (3.0m)						
PEDESTRIAN SIGNAL POST	4 FT (1.2m)	SHOULDER WIDTH + 2 FT (0.6m), MINIMUM 10 FT (3.0m)						
PEDESTRIAN PUSHBUTTON POST	4 FT (1.2m)	SHOULDER WIDTH + 2 FT (0.6m), MINIMUM 10 FT (3.0m)						
TEMPORARY WOOD POLE	6 FT (1,8m)	SHOULDER WIDTH + 2 FT (0.6m), MINIMUM 10 FT (3.0m)						
CONTROLLER CABINET	6 FT (1.8m) MINIMUM DISTANCE SEE NOTE 2	SHOULDER WIDTH + 6 FT (1.8m), MINIMUM 16 FT (4.9m) SEE NOTE 3.						
SERVICE INSTALLATION, GROUND MCUNT	6 FT (1.8m) MINIMUM DISTANCE SEE NOTE 2	SHOULDER WIDTH + 6 FT (1.8m), MINIMUM 16 FT (4.9m) SEE NOTE 3.						

NOTES:

- 1. CONTACT THE "AREA TRAFFIC SIGNAL MAINTENANCE AND OPERATIONS ENGINEER" FOR ASSISTANCE IN LOCATING THE TRAFFIC SIGNAL EQUIPMENT WHEN THERE ARE CONFLICTS WITH DITCHES OR THE MINIMUM DEFSET DISTANCES CANNOT BE MET.
- 2. MINIMUM DISTANCE FROM THE BACK OF CURB TO THE ROADWAY SIDE OF THE FOUNDATION.
- 3. MINIMUM DISTANCE FROM THE EDGE OF PAVEMENT TOTHE ROADWAY SIDE OF THE FOUNDATION.
- 4. ANY CHANGES TO THE OFFSETS OF THE FOUNDATIONS, FROM THE MINIMUM DISTANCES LISTED IN THE "TRAFFIC SIGNAL EQUIPMENT OFFSET" CHART AND THE TRAFFIC SIGNAL INSTALLATION PLAN, COULD EFFECT THE PLACEMENT OF THE SIGNAL HEADS, PEDESTRIAN SIGNAL HEADS AND THE PEDESTRIAN PUSHBUTTONS. THE SIGNAL HEAD PLACEMENT ON THE MAST ARMS SHALL REMAIN AS PER THE TRAFFIC SIGNAL INSTALLATION PLAN AND THE "TRAFFIC SIGNAL MAST ARM AND SIGNAL POST" DETAIL ABOVE. THE PROPOSED MAST ARM LENGTHS MAY NEED TO BE REVISED TO MEET THE ABOVE REQUIREMENTS. THE PEDESTRIAN SIGNAL HEADS AND PEDESTRIAN PUSHBUTTONS MUST MEET THE REQUIREMENTS UNDER THE DETAILS ON THIS SHEET.


SCALE: NONE

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PLOT DATE = 12/12/2016	DATE	-	4/1/15	REVISED -	

STATE OF ILLINOIS DEPARTMENT OF TRANSPORTATION

	DISTRICT (NE		F.A.P. RTE.	SECTION	COUNTY	TOTAL SHEETS	SHEET NO.
9	TANDARD TRAFFIC SIGNA	I DESIGN	I DETAILS	347	CY-N-1	DUPAGE	71	34
	TANDAND THATTIC SIGNA	L DESIGN	DETAILS			CONTRACT	NO. 6	50V00
ΙE	SHEET NO. 3 OF 7 SHEETS	STA.	TO STA.	FED. ROA	D DIST. NO. 1 ILLINOIS FED. AI	D PROJECT		

MOUNTING PLATE

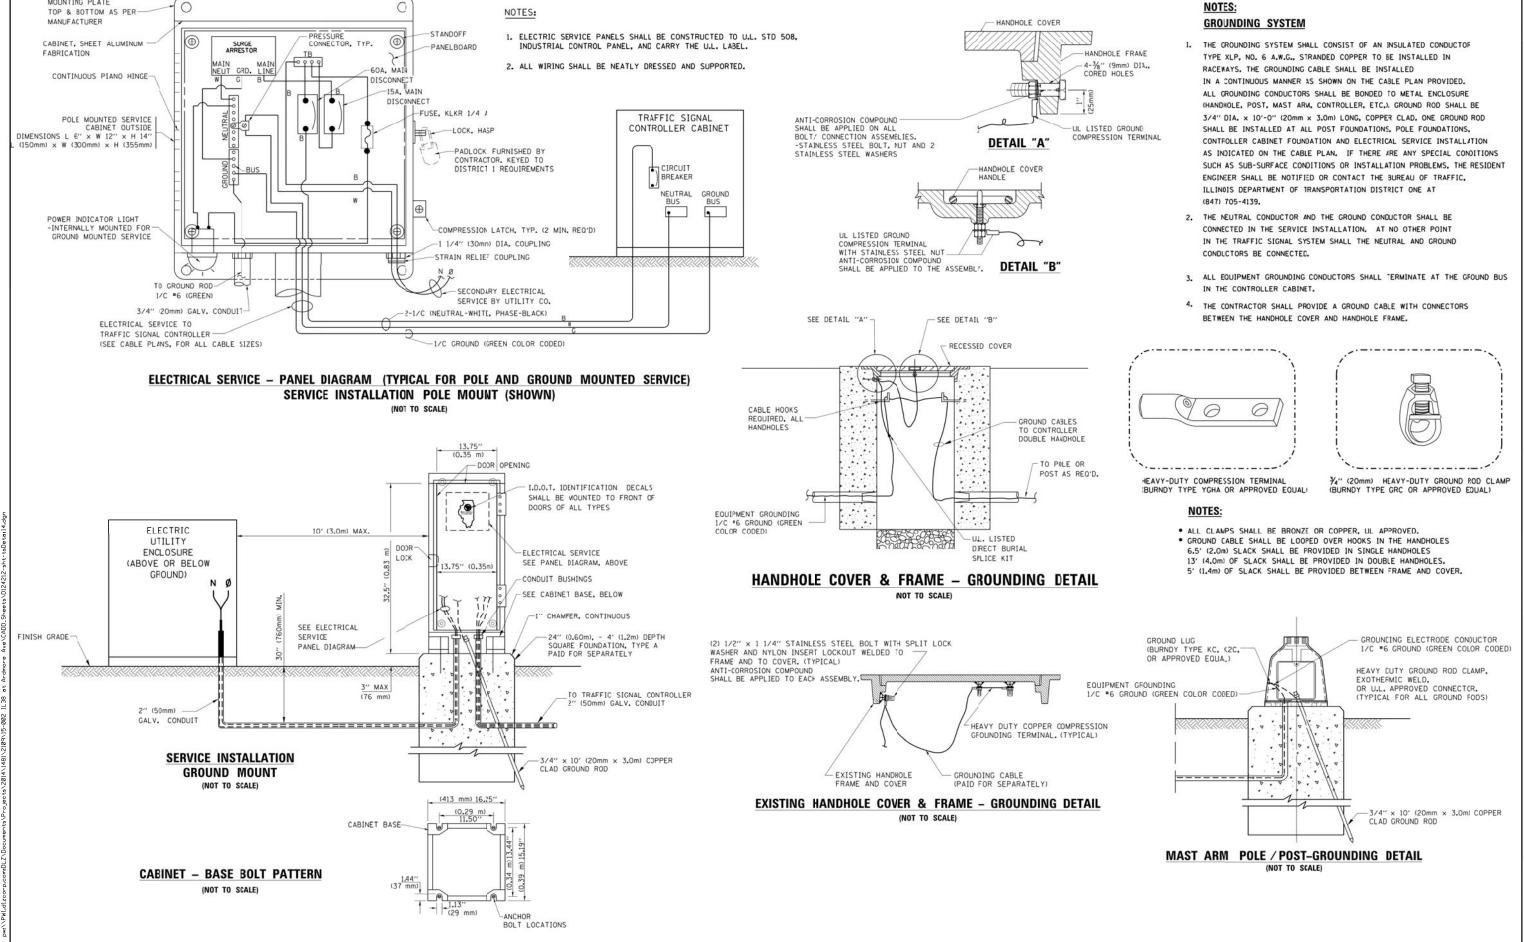

STATE OF ILLINOIS

DEPARTMENT OF TRANSPORTATION

TOTAL SHEET NO. 71 35

CONTRACT NO. 60V00

COUNTY

DUPAGE

SECTION

CY-N-1

FED. ROAD DIST. NO. 1 ILLINOIS FED. AID PROJECT

347

DISTRICT ONE

STANDARD TRAFFIC SIGNAL DESIGN DETAILS

SHEET NO. 4 OF 7 SHEETS STA.

SCALE: NONE

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DESIGNED -

DRAWN

DATE

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USER NAME = dwiktorzak


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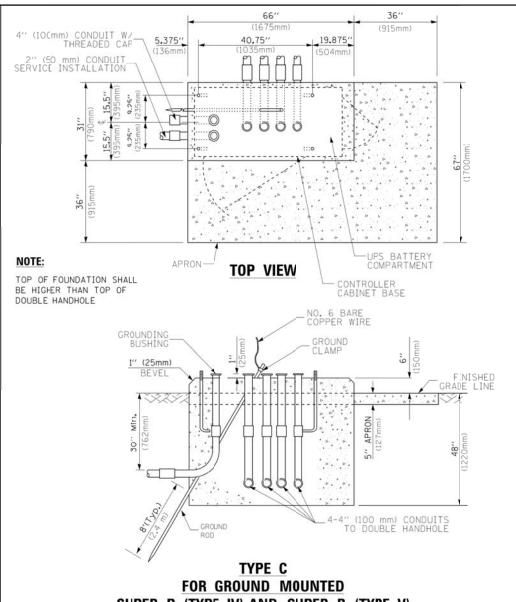
CDC

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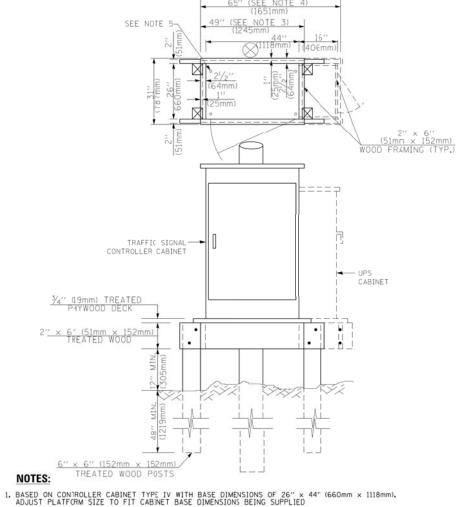
4/1/15



AND UPS BATTERY CABINET

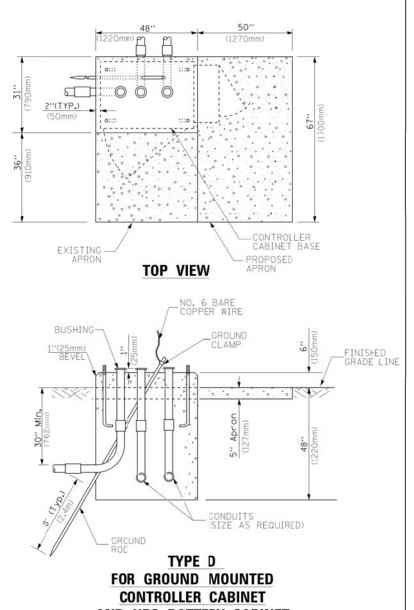

SUPER P (TYPE IV) AND SUPER R (TYPE V) **CONTROLLER CABINETS**



- 2. BASED ON UNINTERRUPTIBLE POWER SUPPLY CABINET WITH BASE DIMENSIONS OF $16^{\prime\prime}$ × $25^{\prime\prime}$ (406mm x 635mm). ADJUST PLATFORM SIZE TO FIT CABINET BASE DIMENSIONS BEING SUPPLIED.
- 3. PLATFORM SIZE FOR CONTROLLER CABINET TYPE IV.
- 4. PLATFORM SIZE FOR CONTROLLER CABINET TYPE IV AND UNINTERRUPTIBLE POWER SUPPLY CABINET.
- 5. DRILLED HOLES THROUGH THE PLATFORM BASE TO MATCH THE CONTROLLER CABINET BOLT TEMPLATE. FASTEN THE CONTROLLER CABINET TO THE PLATFORM WITH CARRIAGE BOLTS, WASHERS AND NUTS.
- 6. FASTEN ALL SUPPORT WOOD FRAMING TO THE WOOD POSTS WITH 2 LAG SCREWS FOR EACH CONNECTION.

TEMPORARY SIGNAL CONTROLLER WOOD SUPPORT PLATFORM

CABLE SLACK LENGTH	FEET	METER
HANDHOLE	6.5	2.0
DOUBLE HANDHOLE	13.0	4.0
SIGNAL POST	2.0	0.6
MAST ARM	2.0	0.6
CONTROLLER CABINET	1.5	0.5
FIBER OPTIC AT CABINET	13.0	4.0
ELECTRIC SERVICE AT (CABINET OR SERVICE LOCATION)	1.5	0.5
GROUND CABLE (SIGNAL POST, MAST ARM, CABINET)	1.5	0.5
GROUND CABLE (BETWEEN FRAME AND COVER)	5.0	1.6

VERTICAL CABLE LENGTH	FEET	METER
MAST ARM POLE (MAST ARW MOUNTED SIGNAL HEAD)		
(L = MAST ARM LENGTH - DISTANCE TO SIGNAL HEAD FROM END OF ARM)	20.0+L	6.0+L
BRACKET MOUNTED (MAST ARM POLE OR SIGNAL POLE)	13.0	4.0
PEDESTRIAN PUSH BUTTON	6.0	2.0
SERVICE INSTALLATION POLE MOUNT TO SERVICE DROP	13.5	4.1
SERVICE INSTALLATION POLE MOUNT TO GROUND	13.5	4.1
SERVICE INSTALLATION GROUND MOUNT	6.0	2.0
FOUNDATION (SIGNAL POST, MAST ARM POLE, CONTROLLER CABINET, SERVICE-GROUND MOUNT)	3.0	1.0

VERTICAL CABLE LENGTH

CABLE	SLACK
OUDEF	OLITOR

FOUNDATION	DEPTH
TYPE A - Signal Post	4'-0" (1.2m)
TYPE C - CONTROLLER W/ UPS	4'-0" (1.2m)
TYPE D - CONTROLLER	4'-0" (1.2m)
SERVICE INSTALLATION, GROUND MOUNT, TYPE A - SQUARE	4'-0" (1.2m)


DEPTH OF FOUNDATION

Wast Arm Length	① Foundation Depth	Foundation Diameter	Spiral Diameter	Quantity of Rebars	Size of Rebars
Less than 30' (9.1 m)	10'-0" (3.0 m)	30" (750mm)	24" (600mm)	8	6(19)
Greater than or equa to	13'-6" (4.1 m)	30" (750mm)	24" (600mm)	8	6(19)
30' (9.1 m) and less than 40' (12.2 m)	11'-0" (3.4 m)	36" (900mm)	30" (750mm)	12	7(22)
Greater than or equa to 40' (12.2 m) and less than 50' (15.2 m)	13'-0" (4.0 m)	36" (900mm)	30" (750mm)	12	7(22)
Greater than or equa to 50 (15.2 m) and up to 55' (16.8 m)	15'-0'' (4.6 m)	36" (900mm)	30" (750mm)	12	7(22)
Greater than or equa to 56' (16.8 m) and less than 65' (19.8 m)	21'-0" (6.4 m)	42" (106(mm)	36" (900mm)	16	8(25)
Greater than or equa to 65 (19.8 m) and up to 75' (22.9 m)	25'-0" (7.6 m)	42" (1060mm)	36" (900mm)	16	8(25)

- 1. These foundation depths are for sites which have cohesive soils (clayey silt, sandy clay, etc.) along the length of the shaft, with an average Unconfined Compressive Strength (Qu) > 1.0 tsf (100 kpa). This strength shall be verified by boring data prior to construction or with testing by the Engineer during foundation drilling. The Bureau of Bridges & structures should be contacted for a revised design if other conditions are encountered.
- 2. Combination mast arm assemblies under 55 feet (16.8 m) shall use 36" (900 mm) diameter foundations.
- 3. Combination most arm assemblies under 56 feet (16.8 m) through 75 feet (22.9 m) shall use 42" (1060 mm) diameter foundations
- 4. For most arm assemblies with dual arms refer to state standard 878001..


DEPTH OF MAST ARM FOUNDATIONS, TYPE E

	USER NAME = dwiktorzak	DESIGNED - DW	REVISED -	STATE OF ILLINOIS DEPARTMENT OF TRANSPORTATION	DISTRICT ONE	F.A.P. SECTION CO	UNTY TOTAL SHEET
		DRAWN - CDC	REVISED -			347 CY-N-1 DU	PAGE 71 36
	PLOT SCALE = 1.00000 '/ in.	CHECKED - KMM	REVISED -		STANDARD TRAFFIC SIGNAL DESIGN DETAILS	CONTRACT NO. 60V00	
	PLOT DATE = 12/12/2016	DATE - 4/1/15	REVISED -		SCALE: NONE SHEET NO. 5 OF 7 SHEETS STA. TO STA.	FED. ROAD DIST. NO. 1 ILLINOIS FED. AID PROJECT	

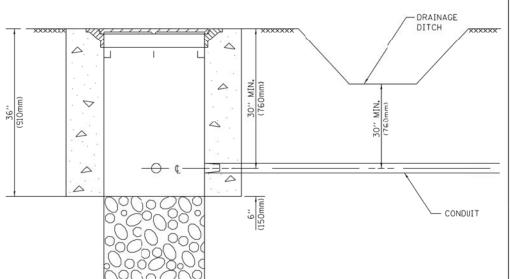

- 1. CONDUIT DEPTH SHALL BE A MINIMUM OF 30" (760mm) BELOW THE BOTTOM OF THE DRAINAGE DITCH OR ANY SLOPING CROUND
- 2. THE MINIMUM CONDUIT DEPTH APPLIES TO ALL CONDUIT PLACED UNDER ROADWAY PAVEMENT, MULTI-USE PATHS, SIDEWALKS AND SOIL SURFACES.
- 3. THE MINIMUM CONDUIT DEPTH APPLIES TO ALL HANDHOLES, HEAVY DUTY HANDHOLES AND DOUBLE HANDHOLES.

HANDHOLE WITH MINIMUM CONDUIT DEPTH NOT TO SCALE)

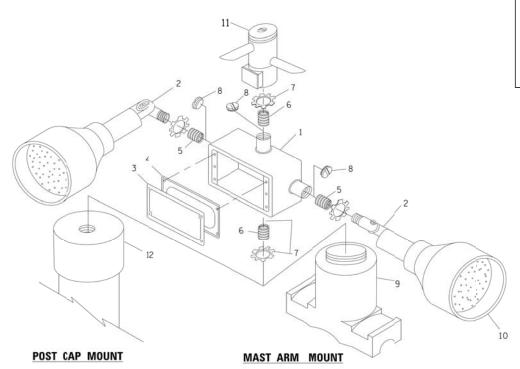

(1675mm) (915mm 19.875" (504mm) -0 -CONTROLLER CABINET BASE **TOP VIEW** NO. 3 DOWEL 18" (450mm) LONG (8 REQ.) BUSHING -ANCHOR BOLTS 1"(25mm) BEVEL -EXISTING CONDUITS EXISTING GROUND ROD MODIFY EXISTING TYPE "D" FOUNDATION


TO TYPE "C" FOUNDATION

(NOT TO SCALE)

IDENTIFICATION OUTLET BOX- GALY. 21 CU.IN. (0.000344 CU-M) LAMP HOLDER AND COVER OUTLET BOX COVER RUBBER COVER GASKET REDUCING BUSHING 3/4"(19 mm) CLOSE NIPPLE 4"(19 mm) LOCKNUT 74 (19 mm) HOLE PLUG SADDLE BRACKET - GALV. 6 WAIT PAR 38 LED FLOOD LAMP DETECTOR UNIT POST CAP [18 FT. (5.4 m) POST MIN.]

NOTES:


- 1. ALL ELECTRICAL ITEMS, EXCEPT ITEMS "2 AND "11 SHALL BE ALUMINUM OR
- 2. ITEM #1- OZ/GEDNEY FSX-1-50 OR EQUIVALENT ITEM #2- MULBERRY CON-O-SHADE LAMP SHIELD OR EQUIVALENT ITEM #9- "BAND-IT" SADDLE BRACKET OR EQUIVALENT
- 3. WHEN POST MOUNTING IS SPECIFIED, ITEM #9 SHALL NOT BE REQUIRED. THE DETECTION UNIT SHALL BE MOUNTED DIRECTLY ON TOP OF THE CAP BY DRILLING AND TAPPING A 3/4 "(19 mm) HOLE WITH PIPE THREADS. THE POST CAP SHALL EITHER BE SCREWED TO THE TOP OF THE POST OR A MINIMUM OF 3 TIGHTENING SCREWS SHALL BE REQUIRED ON EACH CAP. EMERGENCY VEHICLE DETECTOR WITH CONFIRMATION BEACON MOUNTING DETAIL

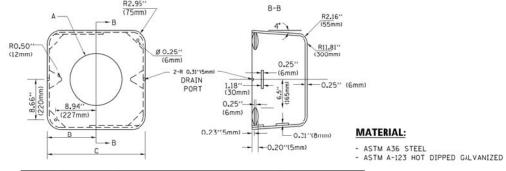


Α	В	С	HEIGHT	WEIGHT		
VARIES	9.5"(241mm)	19"(483mm)	7" (178mm) - 12" (300mm)	53 lbs (24kg)		
VARIES	10.75"(273mm)	21.5"(546mm)	7" (178mm) - 12" (300mm)	68 lbs (31 kg)		
VARIES	13.0"(330mm)	26"(660mm)	7" (178mm) - 12" (300mm)	81 lbs (37 kg)		
VARIES	18.5"(470mm)	37"(940mm)	7" (178mm) - 12" (300mm)	126 lbs (57 kg)		

SHROUD

- 2. THE SUPPLIER SHALL /ERIFIED THE ABOVE DIMENSIONS BASED ON MAST ARM REQUIREMENTS.
- 3. THE HEIGHT OF THE SHROUD SHALL COVER THE ANCHOR BOLTS, NUTS AND MAST ARM FOLE BASE.

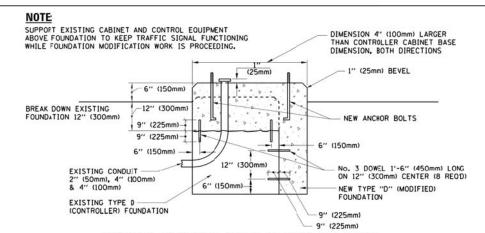

MODIFY EXISTING TYPE "D" FOUNDATION

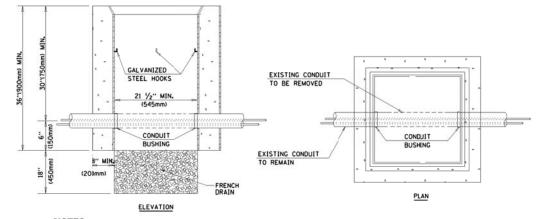

SCALE: NONE


- 1. HANDHOLE CONSTRUCTED PER STATE STANDARD 8:4001.
- 2. REMOVAL OF THE EXISTING CONDUIT FROM THE HANDHOLE AND THE INSTALLATION OF THE CONDUIT BUSHINGS SHALL BE INCLUDED WITH THE COST OF THE HANDHOLE.

HANDHOLE TO INTERCEPT EXISTING CONDUIT

USER NAME = dwiktorzak	DESIGNED -	DW	REVISED -	
	DRAWN -	CDC	REVISED -	
PLOT SCALE = 1.0000 ' / in.	CHECKED -	КММ	REVISED -	
PLOT DATE = 12/12/2016	DATE -	4/1/15	REVISED -	

STATE OF ILLINOIS **DEPARTMENT OF TRANSPORTATION**

				OIS	TRICT O	NE		F.A.P. RTE.	SECTION	COUNTY	TOTAL SHEETS	SHEE NO.
97	ΓΔΝΝΔRN	т	RΔF	FIC	SIGNA	L DESIGN	DETAILS	347	CY-N-1	DUPAGE	71	37
	IANDAND		1171		Oldiva	L DEGIGIA	DETAILO			CONTRACT	NO. 6	ovoc
	SHEET NO.	6	OF	7	SHEETS	STA.	TO STA.	FFD. R	OAD DIST, NO. 1 ILLINOIS FED. A	D PROJECT		

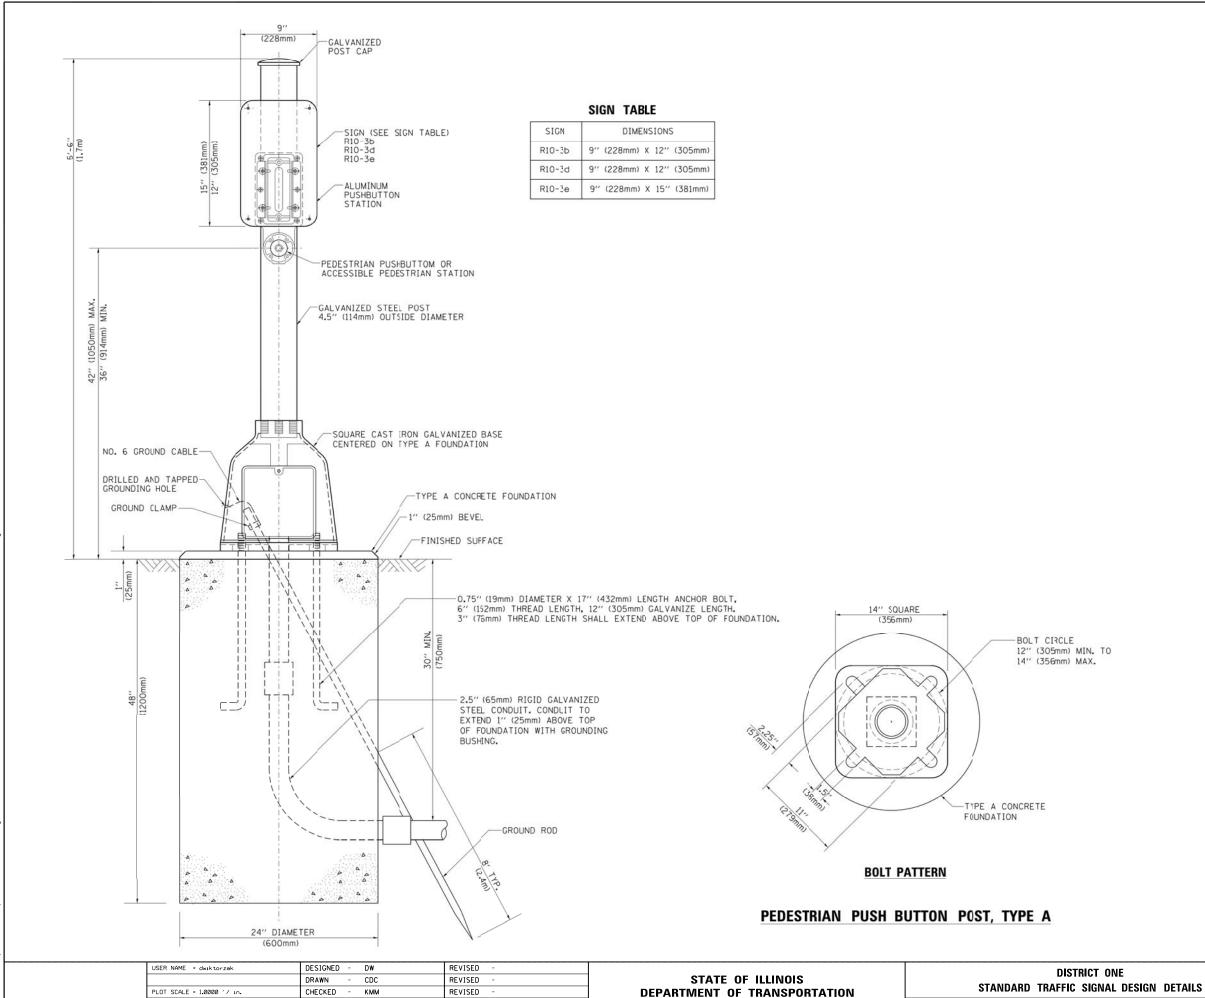

REVISED

COUNTY TOTAL SHEET NO. DUPAGE 71 38

CONTRACT NO. 60V00

SECTION

CY-N-1

FED. ROAD DIST. NO. 1 | ILLINOIS FED. AID PROJECT

347

SCALE: NONE

SHEET NO. 7 OF 7 SHEETS STA.

FILE NAME = pw:\\PWI.dlzcorp.com:[


PLOT DATE = 12/12/2016


DATE

4/1/15

SIGN PANEL - TYPE 1 OR TYPE 2

3.75 35.25 60 11.125 3.875 18 8 Sample Rd

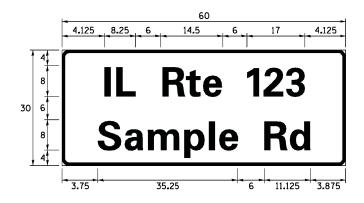

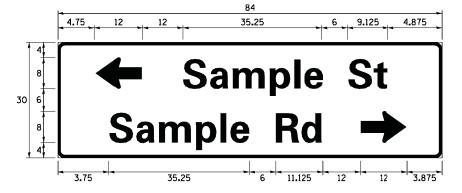

DESIGN	AREA	SIGN PANEL	SHEETING	QTY.
SERIES	(SQ FT)	TYPE	TYPE	REQUIRED
D OR C	-	1 OR 2	ZZ	

COMMON STREET NAME ABBREVIATIONS AND WIDTHS

NAME	ABBREVATION	WIDTH	(INCH)		
INAME	ADDREVATION	SERIES "C"	SERIES "D"		
AVENUE	Ave	15.000	18.250		
BOULEVARD	Blvd	17. 125	20.000		
CIRCLE	Cir	11.125	13.000		
COURT	C†	8. 250	9.625		
DRIVE	Dr	8. 625	10.125		
HIGHWAY	Hwy	18.375	22.000		
ILLINOIS	IL	7. 000	8. 250		
LANE	Ln	9. 125	10.750		
PARKWAY	Pkwy	23. 375	27. 375		
PLACE	PΙ	7. 125	7. 750		
ROAD	Rd	9. 625	11.125		
ROUTE	R†e	12.625	14.500		
STREET	St	8.000	9. 125		
TERRACE	Ter	12.625	14.625		
TRAIL	Tr	7. 750	9. 125		
UNITED STATES	US	10.375	12.250		

GENERAL NOTES

- 1. WHERE MAST ARM MOLINTED STREET NAME SIGNS ARE SPECIFIED, THE MAST ARM ASSEMBLY AND POLES SHALL BE DESIGNED TO SUPPORT THE LOADINGS CALLED FOR ON STANDARDS 877001, 877002, 877006, 877011 AND 877012, AS APPLICABLE, PLUS TWO (2) SIGN PANELS 2'-6" × 8'-0" MOUNTED AS SHOWN. THE DESIGN SHALL BE IN ACCORDANCE WITH THE REQUIREMENTS OF THE CURRENT "STANDARD SPECIFICATIONS FOR STRUCTURAL SUPPORTS FOR HIGHWAY SIGNS, LUMINAIRES, AND TRAFFIC SIGNALS" AS PUBLISHED BY THE AMERICAN ASSOCIATION OF STATE HIGHWAY AND TRANSPORTATION OFFICIALS FOR 80 M.P.H. WIND VELOCITY.
- 2. ALL SIGNS SHALL CONSIST OF A WHITE LEGEND AND BORDER (TYPE ZZ SHEETING) ON A GREEN BACKGROUND (TYPE ZZ SHEETING)
- 3. THE SIGN LENGTH SHALL BE IN 6-INCH INCREMENTS, BUT THE OVERALL LENGTH SHALL NOT EXCEED 8'-0". ALL BORDERS SHALL BE 3/4" WIDE. CORNER RADIUS SHALL BE 1-7/8". THE SPACING BETWEEN THE WORDS SHOULD BE 6", IF POSSIBLE, BUT MAY BE REDUCED TO 5" WHEN SPACING IS CRITICAL. A MINIMUM OF 2-1/2" SHALL BE INCLUDED BETWEEN THE WORD AND THE RIGHT AND LEFT EDGES OF THE SIGN.
- 4. A PREFERRED METHOD FOR THE SIGN DESIGN IS TO USE SERIES "D" LETTER ON A ONE-LINE SIGN 18" IN HEIGHT AND A MAXIMUX OF 8'-O" IN WIDTH. IF SERIES "D" DOES NOT FIT ON A 8"-O" SIGN, THEN SERIES "C" SHOULD BE TRIED. IF SERIES "C" DOES NOT FIT ON A 8'-O" SIGN, A 30" HIGH TWO-LINE SIGN CAN BE USED. THE CROSSROAD DESIGNATION AS TO STREET, AVENUE, ETC. SHOULD BE SPELLED OUT ON THE SECOND LINE, IF THERE IS SPACE AVAILABLE.
- 5. LED ILLUMINATED STREET NAME SIGNS CAN BE USED IN PLACE OF REGULAR SIGN PANELS BUT ANY SPECIAL WORDING AND SYMBOLOGY MUST BE APPROVED BY THE DEPARTMENT. GENERAL DESIGN REQUIREMENT AS LISTED ABOVE (COLOR, FONT, SIZE, ETC.) MUST BE FOLLOWED.
- 6. SIGNFIX ALUMINUM CHANNEL FRAMING SYSTEM SHALL BE USED FOR ALL SIGNS ATTACHED TO SIGNAL POLES AND POSTS.

LOCAL SUPPLIERS: PARTS LISTING:


- J.O. HERBERT COMPANY, INC SIGN CHANNEL PART **HPN053 (MED. CHANNEL)
MIDLOTHIAN, VA SIGN SCREWS 1/4" × 14 × 1" H.W.H. **3
SELF TAPPING WITH NEOPRENE WASHER

- WESTERN REMAC, INC. BRACKETS PART #HPN034 (UNIVERSAL)
WOODRIDGE, IL CHANNEL CLAMPS WITH STAINLESS STEEL STRAPPING


OTHER BRANDS OF MOUNTING HARDWARE ARE ACCEPTABLE, BASED UPON THE DEPARTMENT'S APPROVAL AND COMPATIBILITY WITH THE CHANNEL/BRACKET OF THE ABOVE PRODUCT.

MOUNTING LOCATION

ARM OR POLE MOUNTED

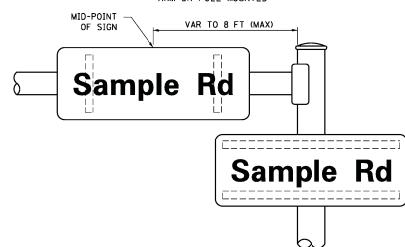

SUPPORTING CHANNELS

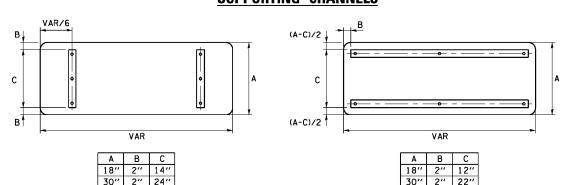

SCALE: NONE

STANDARD ALPHABETS SPACING CHART

(8") UPPER CASE AND (6") LOWER CASE

	FHWA SEF	RIES "C"		FHWA SERIES "D"							
CHARACTER	LEFT SPACING (INCH)	WIDTH (INCH)	RIGHT SPACING (INCH)	CHARACTER	LEFT SPACING (INCH)	WIDTH (INCH)	RIGHT SPACING (INCH)				
Α	0.240	5.122	0.240	Α	0.240	6.804	0.240				
В	0.880	4.482	0.480	В	0.960	5.446	0.400				
С	0.720	4.482	0.720	С	0.800	5.446	0.800				
D	0.880	4.482	0.720	D	0.960	5.446	0.800				
E	0.880	4.082	0.480	E	0.960	4. 962	0.400				
F G	0.880 0.720	4.082	0.240	F G	0.960	4.962	0.240				
H	0. 720	4. 482 4. 482	0.720	Н	0.800 0.960	5. 446 5. 446	0.800				
Ī	0.880	1.120	0.880	I	0. 960	1. 280	0. 960				
J	0. 240	4. 082	0.880	J	0. 240	5. 122	0.960				
K	0.880	4.482	0.480	K	0.960	5.604	0.400				
L	0.880	4.082	0.240	L	0.960	4.962	0.240				
М	0.880	5. 284	0.880	М	0.960	6.244	0.960				
N	0.880	4.482	0.880	N	0.960	5. 446	0.960				
0	0.720	4.722	0.720	0	0.800	5.684	0.800				
P	0.880	4.482	0.720	Р	0.960	5.446	0.240				
<u> </u>	0.720	4. 722	0.720	0	0.800	5.684	0.800				
R	0.880	4.482	0.480	R	0.960	5.446	0.400				
S T	0.480 0.240	4.482 4.082	0.480	S T	0.400 0.240	5.446 4.962	0.400				
U	0. 240	4. 482	0.880	U	0. 240	5.446	0. 960				
V	0. 240	4. 962	0. 240	V	0. 240	6.084	0. 240				
w	0. 240	6. 084	0.240	w	0. 240	7. 124	0. 240				
X	0. 240	4. 722	0.240	X	0.400	5. 446	0.400				
Y	0. 240	5. 122	0.240	Y	0. 240	6. 884	0. 240				
Z	0.480	4.482	0.480	Z	0.400	5.446	0.400				
a	0.320	3.842	0.640	a	0.400	4.562	0.720				
b	0.720	4.082	0.480	b	0.800	4.802	0.480				
С	0.480	4.002	0.240	С	0.480	4.722	0.240				
d	0.480	4.082	0.720	d	0.480	4. 802	0.800				
е	0.480	4.082	0.320	е	0.480	4. 722	0.320				
f	0.320	2.480	0.160	f	0.320	2.882	0.160				
g	0.480	4.082	0.720	g	0.480	4.802	0.800				
h i	0.720 0.720	4.082 1.120	0.640	h	0.800	4. 722 1. 280	0.720				
i	0.000	2. 320	0.720	i	0.000	2.642	0.800				
k	0.720	4. 322	0.160	k	0.800	5. 122	0.160				
i	0. 720	1.120	0.720	i	0.800	1. 280	0.800				
m	0. 720	6. 724	0.640	m	0.800	7. 926	0.720				
n	0.720	4.082	0.640	n	0.800	4.722	0.720				
O	0.480	4.082	0.480	O	0.480	4.882	0.480				
Р	0.720	4.082	0.480	Р	0.800	4.802	0.480				
q	0.480	4.082	0.720	q	0.480	4.802	0.800				
r	0.720	2.642	0.160	r	0.800	3.042	0.160				
s	0.320	3.362	0.240	S	0.320	3. 762	0.240				
†	0.080	2.882	0.080	†	0.080	3. 202	0.080				
u	0.640 0.160	4.082 4.722	0.720	U Y	0.720 0.160	4. 722 5. 684	0.800				
w	0.160	7. 524	0.160	w	0.160	9.046	0.160				
×	0.000	5. 202	0.000	×	0.000	6. 244	0.000				
у	0.160	4. 962	0.160	y	0.160	6.004	0.160				
Z	0. 240	3. 362	0.240	z	0. 240	4.002	0. 240				
1	0.720	1.680	0.880	1	0.800	2.000	0.960				
2	0.480	4.482	0.480	2	0.800	5.446	0.800				
3	0.480	4.482	0.480	3	1.440	5.446	0.800				
4	0.240	4.962	0.720	4	0.160	6.004	0.960				
5	0.480	4.482	0.480	5	0.800	5.446	0.800				
6	0.720	4.482	0.720	6	0.800	5.446	0.800				
7	0.240	4.482	0.720	7	0.560	5.446	0.560				
8	0.480	4.482	0.480	8	0.800	5.446	0.800				
9	0.480	4.482	0.480	9	0.800	5.446	0.800				
0 -	0.720 0.240	4. 722 2. 802	0.720	-	0.800 0.240	5. 684 2. 802	0.800				
	0.270	2.002	0.270		0.270	2.002	0.270				

DRAWN - CDC REVISED -	
PLOT SCALE = 1.0000 '/ In. CHECKED - KMM REVISED -	
PLOT DATE = 1/15/2016 DATE - 4/1/15 REVISED -	

STATE OF ILLINOIS
DEPARTMENT OF TRANSPORTATION

		DIS	STRICT O	VE		F.A.P. RTE.	SECTION	COUNTY	TOTAL SHEETS	SHEE NO.
M	AST ARM	MOUN	ITEN STE	REFT NA	ME SIGNS	347	CY-N-1	DUPAGE	71	39
10	MAST ARM MOUNTED STREET NAME SIGNS							CONTRACT	NO. 6	ovoc
	SHEET NO.	OF	SHEETS	STA.	TO STA.	FED. R	OAD DIST. NO. 1 ILLINOIS FED. AI	D PROJECT		

LOT SCALE = 20.0000 ' / in.

PLOT DATE = 12/13/2016

CHECKED


DATE

КММ

4/1/15

REVISED

REVISED

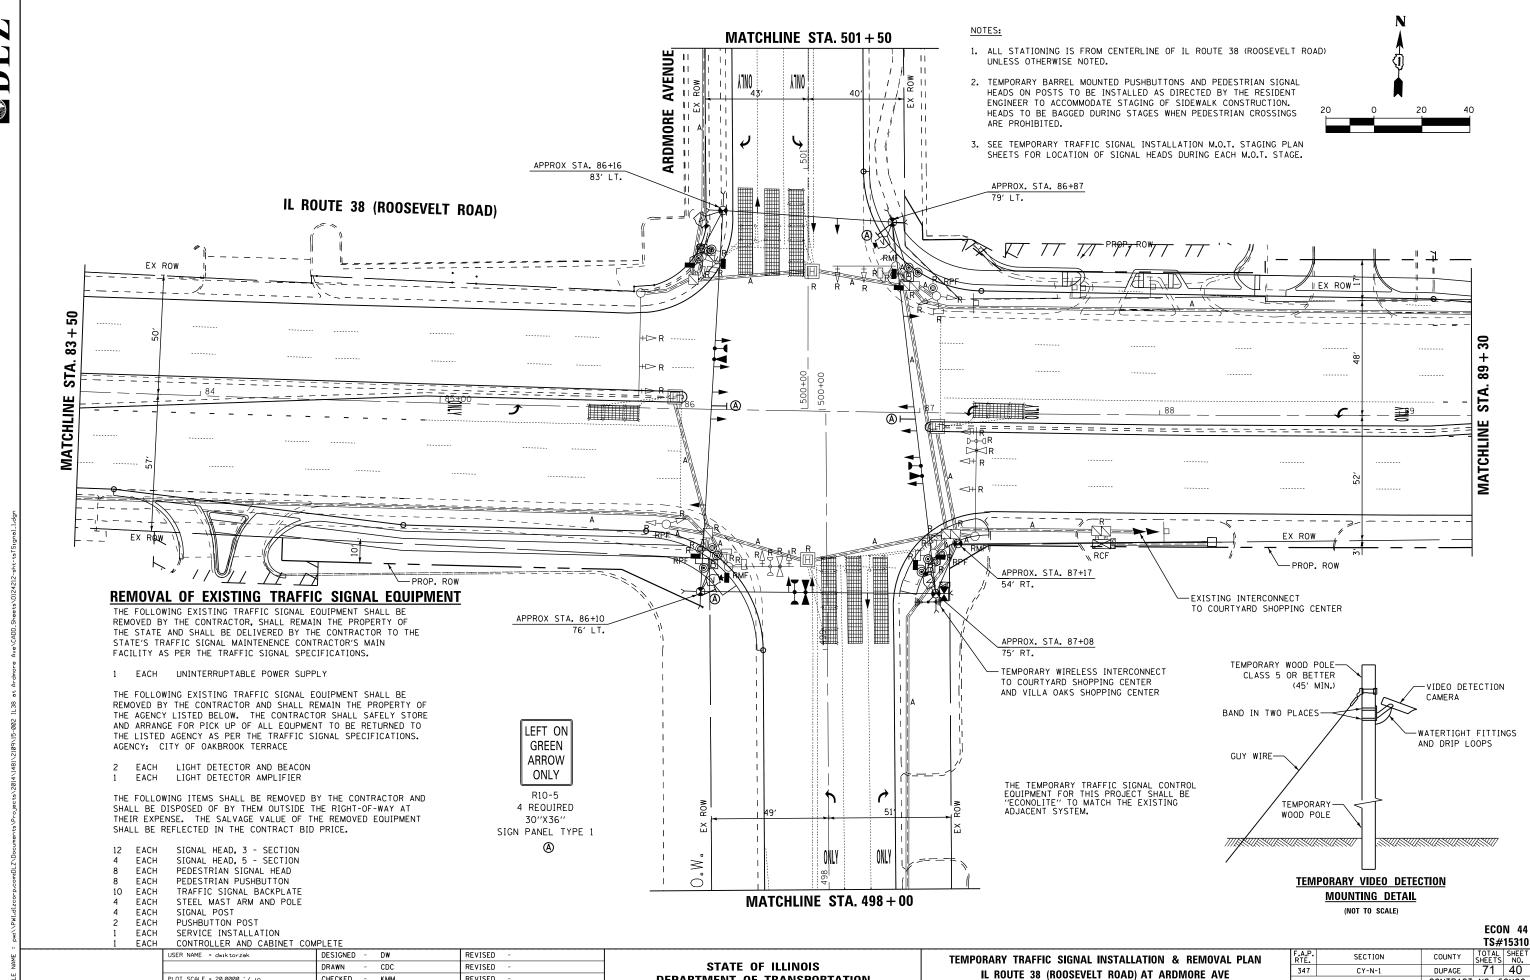



DEPARTMENT OF TRANSPORTATION


SCALE: 1" = 20' SHEET NO. 1 OF 2 SHEETS STA.

CONTRACT NO. 60V00


IL ROUTE 38 (ROOSEVELT RD)

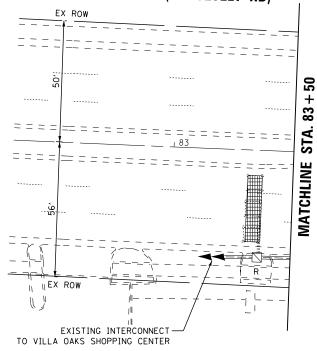

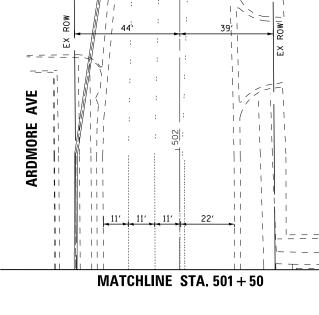

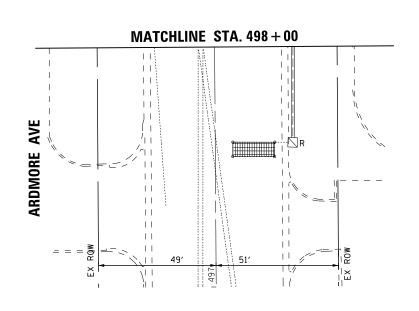


IL ROUTE 38 (ROOSEVELT RD)

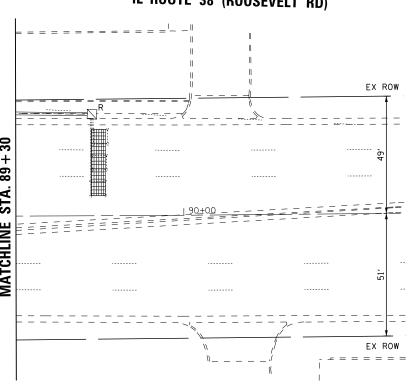

THE TEMPORARY TRAFFIC SIGNAL CONTROL EQUIPMENT FOR THIS PROJECT SHALL BE "ECONOLITE" TO MATCH THE EXISTING ADJACENT SYSTEM.

ECON 44 TS#15310

												.0//	,,,,,
USER NAME = dwiktorzak	DESIGNED - DW	REVISED -			TEMPORARY TRAFFIC SIGNAL INSTALLATION & REMOVAL PLAN			F.A.P.	SECTION	COUNTY	TOTAL	SHEET	
	DRAWN - CDC	REVISED -	STATE OF ILLINOIS						347	CY-N-1	DUPAGE	71	41
PLOT SCALE = 20.0000 ' / in.	CHECKED - KMM	REVISED -	DEPARTMENT OF TRANSPORTATION	IL KU	UTE 38 (ROOSEV	ELI KUAL) AI AKDIV	JURE AVE			CONTRAC	T NO. 6	ovoo
PLOT DATE = 12/12/2016	DATE - 4/1/15	REVISED -	SC	SCALE: 1" = 20"	SHEET NO. 2 OF 2	SHEETS	STA.	TO STA.		ILLINOIS FED.	AID PROJECT		

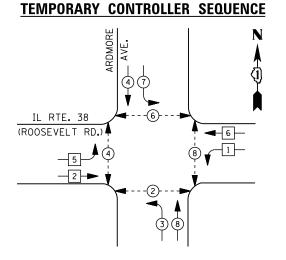


LEGEND


DUAL ENTRY PHASE PEDESTRIAN PHASE SINGLE ENTRY PHASE

OVERLAP

NUMBER REFERS TO ASSOCIATED PHASE

TEMPORARY EMERGENCY VEHICLE PREEMPTION SEQUENCE

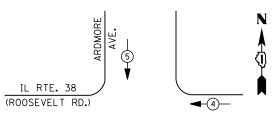

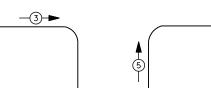

	TRAFFIC S	IGNAL INST	TALLATI ON							
EI	_ECTRI CAL	SERVICE RE	EQUI REMENTS							
	NO. OF	LED	%	TOTAL						
TYPE	LAMPS	WATTAGE	OPERATION	WATTAGE						
SIGNAL (RED)	16	11	50	88						
(YELLOW)	16	20	5	16						
(GREEN)	16	12	45	87						
PERMISSIVE ARROW	8	10	10	8						
PED. SIGNAL	8	20	1 00	160						
CONTROLLER	1	1 00	1 00	100						
UPS	1	25	1 00	25						
VIDEO SYSTEM	1	150	1 00	150						
BLANK-OUT SIGN	-	25	5	-						
FLASHER	-	-	50	-						
STREET NAME SIGN	-	120	50	-						
LUMI NAI RE	-	-	-	-						

ENERGY COSTS TO:

VILLAGE OF VILLA PARK 20 S. ARDMORE AVE. VILLA PARK, IL 60181

TOTAL =

ENERGY SUPPLY -

CONTACT JOE STACHO PHONE

COMPANY COMMONWEALTH EDISON ACCOUNT NUMBER

630-424-5704

DESIGNED - DW REVISED USER NAME = dwiktorzak DRAWN CDC REVISED CHECKED КММ REVISED PLOT DATE = 12/12/2016 DATE REVISED 4/1/15

STATE OF ILLINOIS **DEPARTMENT OF TRANSPORTATION**

TEMPORARY CABLE PLAN, TEMPORARY PHASE DESIGNATION DIAGRAM & TEMPORARY EMERGENCY VEHICLE PREEMPTION SEQUENCE IL ROUTE 38 (ROOSEVELT ROAD) AT ARDMORE AVENUE SCALE: NONE SHEET NO. OF SHEETS STA.

COUNTY TOTAL SHEET NO.

DUPAGE 71 42 SECTION 347 CY-N-1 CONTRACT NO. 60V00

R Y G +Y +G G ←Y ←G **→** • C □ ∩ 1 ∩ D IL RTE. 38 (ROOSEVELT RD.) ت × ش - œ ≻ ∪ **3***20) # **>** 9 **#** } \$ र्ध्यक्री -(5)--(5)-ର **୪** ଅ **-**(5)-**○** | □ | 5 | -(5)-ର ≺ ଅ S ↓ ↑ N N N N N ௱ R Y G TEMPORARY WIRELESS INTERCONNECT— VILLA OAKS SHOPPING CENTER AND COURTYARD SHOPPING CENTER

TEMPORARY CABLE PLAN

THE TEMPORARY TRAFFIC SIGNAL CONTROL EOUIPMENT FOR THIS PROJECT SHALL BE "ECONOLITE" TO MATCH THE EXISTING ADJACENT SYSTEM


ECON 44 TS#15310

DATE


4/1/15


PLOT DATE = 12/12/2016

REVISED

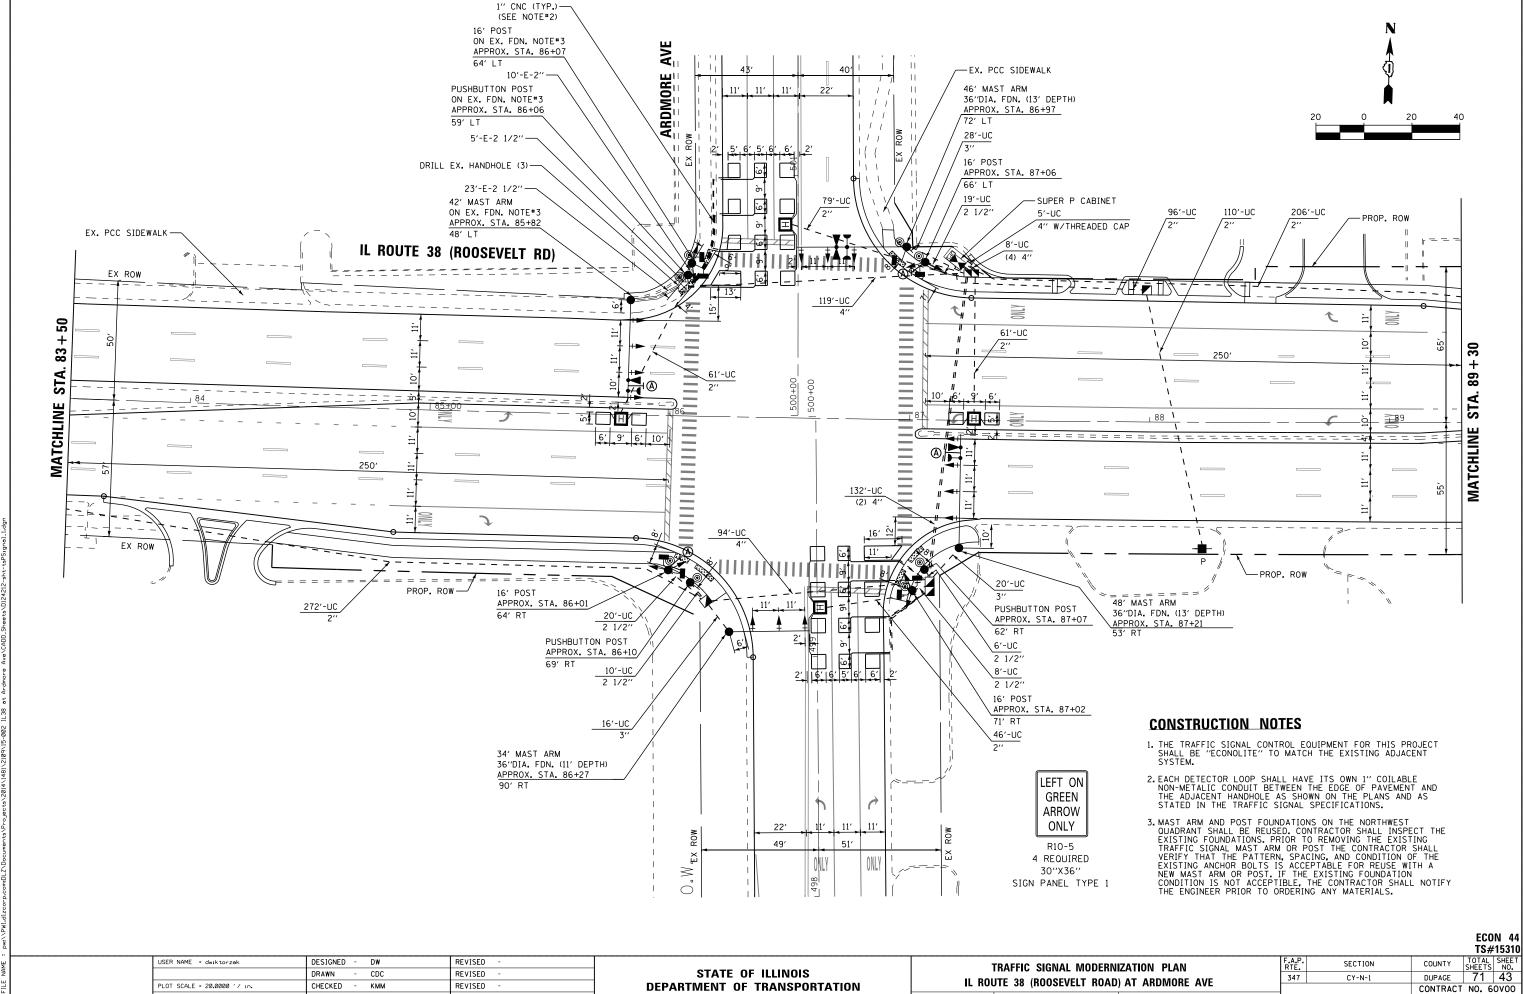

SCALE: 1" = 20' SHEET NO. 1 OF 2 SHEETS STA.

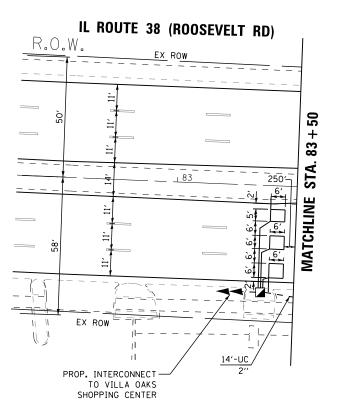

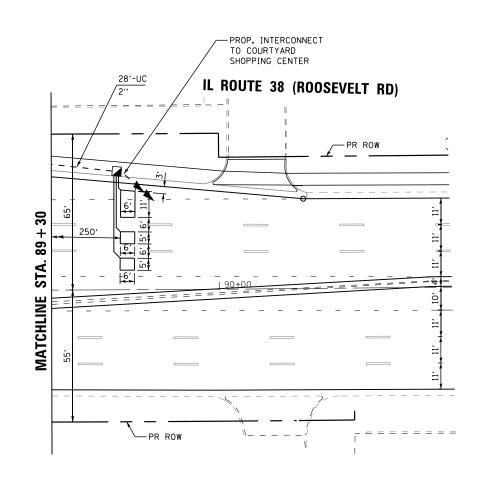


NOTE: EACH DETECTOR LOOP SHALL HAVE ITS OWN 1" COILABLE NON-METALIC CONDUIT BETWEEN THE EDGE OF PAVEMENT AND THE ADJACENT HANDHOLE AS SHOWN ON THE PLANS AND AS STATED IN THE TRAFFIC SIGNAL SPECIFICATIONS.

THE TRAFFIC SIGNAL CONTROL EQUIPMENT FOR THIS PROJECT SHALL BE "ECONOLITE" TO MATCH THE EXISTING ADJACENT SYSTEM.

ECO	N 44
TS#	15310
TOTAL	SHEET

USER NAME = dwiktorzak	DESIGNED - DW	REVISED -		TRAFFIC SIGNAL MODERNIZATION PLAN	F.A.P.	SECTION	COUNTY TOTAL SHEET	
	DRAWN - CDC	REVISED -	STATE OF ILLINOIS		347	CY-N-1	DUPAGE 71 44	
PLOT SCALE = 20.0000 ' / in.	CHECKED - KMM	REVISED -	DEPARTMENT OF TRANSPORTATION	IL ROUTE 38 (ROOSEVELT ROAD) AT ARDMORE AVE			CONTRACT NO. 60V00	
PLOT DATE = 12/12/2016	DATE - 4/1/15	REVISED -		SCALE: 1" = 20' SHEET NO. 2 OF 2 SHEETS STA. TO STA.		ILLINOIS FED. AID PROJECT		

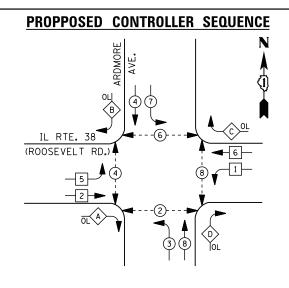


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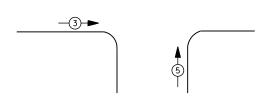
DUAL ENTRY PHASE PEDESTRIAN PHASE SINGLE ENTRY PHASE

NUMBER REFERS TO ASSOCIATED PHASE

RIGHT	TURN	OVERLAP	PHASE	DESIGNATI	<u>0N</u>
OVER	LAP	PERMISS	IVE	PROTECTE)
LETTE	R	PHASE		PHASE	_
Α	=	2	+	3	
В	=	4	+	5	
С	=	6	+	7	

PROPOSED EMERGENCY VEHICLE PREEMPTION SEQUENCE



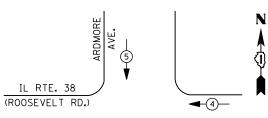

TRAFFIC SIGNAL INSTALLATION								
ELECTRICAL SERVICE REQUIREMENTS								
	NO. OF	LED	7.	TOTAL				
TYPE	LAMPS	WATTAGE	OPERATION	WATTAGE				
SIGNAL (RED)	22	11	50	121				
(YELLOW)	22	20	5	22				
(GREEN)	22	12	45	119				
PERMISSIVE ARROW	24	1 0	10	24				
PED. SIGNAL	8	20	100	160				
CONTROLLER	1	1 00	1 00	100				
UPS	1	25	1 00	25				
VIDEO SYSTEM	-	150	100	-				
BLANK-OUT SIGN	-	25	5	-				

120

ENERGY COSTS TO:

STREET NAME SIGN LUMINAIRE

FLASHER

VILLAGE OF VILLA PARK 20 S. ARDMORE AVE. VILLA PARK, IL 60181

50


50

TOTAL =

ENERGY SUPPLY -

CONTACT JOE STACHO PHONE 630-424-5704

COMPANY COMMONWEALTH EDISON ACCOUNT NUMBER

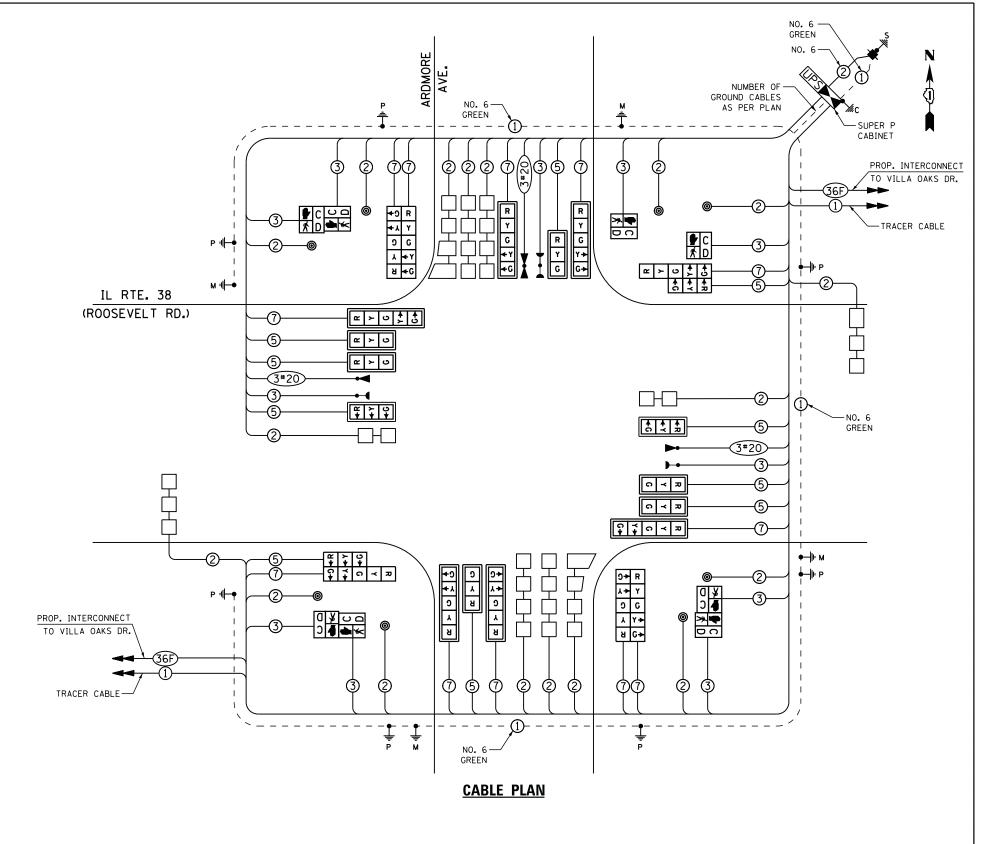


THE TRAFFIC SIGNAL CONTROL EQUIPMENT FOR THIS PROJECT SHALL BE "ECONOLITE" TO MATCH THE EXISTING ADJACENT SYSTEM.

> ECON 44 TS#15310


COUNTY TOTAL SHEET NO. DUPAGE 71 45 DESIGNED - DW REVISED CABLE PLAN, PHASE DESIGNATION DIAGRAM & USER NAME = dwiktorzak SECTION STATE OF ILLINOIS DRAWN CDC REVISED EMERGENCY VEHICLE PREEMPTION SEQUENCE 347 CY-N-1 CHECKED КММ REVISED **DEPARTMENT OF TRANSPORTATION** IL ROUTE 38 (ROOSEVELT ROAD) AT ARDMORE AVENUE CONTRACT NO. 60V00 SHEET NO. OF SHEETS STA. PLOT DATE = 12/12/2016 DATE REVISED 4/1/15

PW1.dlzcorp.com.DLZ\Documents\Projects\2014\1481\2109\15-002 IL38 at Ardmore Ave\CADD_Sheets\D124212-sht-tsPCab

SIGN PANEL – TYPE 1 OR TYPE 2

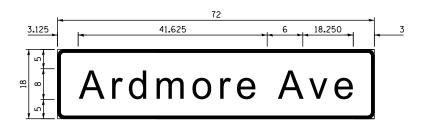

DESIGN	AREA	SIGN PANEL	SHEETING	QTY.
SERIES	(SQ FT)	TYPE	TYPE	REQUIRED
D	9.0	1	ZZ	

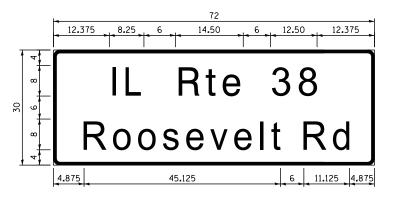

DESIGN	AREA	SIGN PANEL	SHEETING	QTY.
SERIES	(SQ FT)	TYPE	TYPE	REQUIRED
D	15.0	2	ZZ	2

NOTE: FOR ADDITIONAL DESIGN AND INSTALLATION INFORMATION PLEASE SEE DISTRICT ONE MAST ARM MOUNTED STREET NAME SIGNS DETAIL

SCHEDULE OF QUANTITIES

	ITEM DESCRIPTION	UNITS	TOTAL QTY.
SIGN	PANEL - TYPE 1	SQ FT	48
SIGN	PANEL - TYPE 2	SQ FT	30
SERV	ICE INSTALLATION - POLE MOUNTED	EACH	1
UNDE	RGROUND CONDUIT, GALVANIZED STEEL, 2" DIA.	FOOT	972
	RGROUND CONDUIT, GALVANIZED STEEL, 2 1/2" DIA.	FOOT	63
UNDE	RGROUND CONDUIT, GALVANIZED STEEL, 3" DIA.	F00T	64
UNDE	RGROUND CONDUIT, GALVANIZED STEEL, 4" DIA.	FOOT	514
	HOLE	EACH	4
	Y-DUTY HANDHOLE	EACH	4
	BLE HANDHOLE	EACH	2
	ISCEIVER - FIBER OPTIC	EACH	1
	TRICAL CABLE IN CONDUIT, SIGNAL NO. 14 2C	FOOT	1430
	TRICAL CABLE IN CONDUIT, SIGNAL NO. 14 3C	FOOT	2121
	TRICAL CABLE IN CONDUIT, SIGNAL NO. 14 5C	FOOT	2254
	TRICAL CABLE IN CONDUIT, SIGNAL NO. 14 7C	FOOT	2448
	TRICAL CABLE IN CONDUIT, LEAD-IN NO. 14 1 PAIR	FOOT	2125
	TRICAL CABLE IN CONDUIT, SERVICE NO. 6 2 C	FOOT	268
	TRICAL CABLE IN CONDUIT, EQUIPMENT GROUNDING CONDUCTOR, NO. 6 1C	FOOT	838
	FIC SIGNAL POST, GALVANIZED STEEL 16 FT.	EACH	4
	STRIAN PUSH-BUTTON POST	EACH	3
	L MAST ARM ASSEMBLY AND POLE, 34 FT.	EACH	1
	L MAST ARM ASSEMBLY AND POLE, 42 FT.	EACH	1
	L MAST ARM ASSEMBLY AND POLE, 46 FT.	EACH	1
	L MAST ARM ASSEMBLY AND POLE, 48 FT.	EACH	1
	RETE FOUNDATION, TYPE A	FOOT	24
	RETE FOUNDATION, TYPE C	FOOT	4
	RETE FOUNDATION, TYPE E 36-INCH DIAMETER	FOOT	37.0
	L EXISTING HANDHOLE	EACH	3
	AL HEAD, LED, 1-FACE, 3-SECTION, MAST-ARM MOUNTED	EACH	8
	AL HEAD, LED, 1-FACE, 3-SECTION, BRACKET MOUNTED	EACH	2
	AL HEAD, LED, 1-FACE, 5-SECTION, BRACKET MOUNTED	EACH	6
	AL HEAD, LED, 1-FACE, 5-SECTION, MAST-ARM MOUNTED	EACH	6
	STRIAN SIGNAL HEAD, LED, 1-FACE, BRACKET MOUNTED WITH COUNTDOWN TIMER	EACH	8 14
	FIC SIGNAL BACKPLATE, LOUVERED, FORMED PLASTIC	EACH EACH	10
	CTIVE LOOP DETECTOR CTOR LOOP, TYPE I	FOOT	1209
	T DETECTOR	EACH	3
	T DETECTOR AMPLIFIER	EACH	1
	STRIAN PUSH-BUTTON	EACH	8
	PORARY TRAFFIC SIGNAL INSTALLATION	EACH	1
	OVE EXISTING TRAFFIC SIGNAL EQUIPMENT	EACH	1
	OVE EXISTING TRAFFIC SIGNAL EUDIFMENT	EACH	9
	DVE EXISTING MANDHOLE VE EXISTING DOUBLE HANDHOLE	EACH	3
	DVE EXISTING DOUBLE HANDHOLE VE EXISTING CONCRETE FOUNDATION	EACH	8
I LICIVII	GENCY VEHICLE PRIORITY SYSTEM LINE SENSOR CABLE, NO. 20 3/C	FOOT	618
EMER	ACTUATED CONTROLLER AND TYPE SUPER R CARINET SPECIAL	EVCH	1 1
EMER FULL	ACTUATED CONTROLLER AND TYPE SUPER P CABINET, SPECIAL ERRUPTABLE POWER SUPPLY, SPECIAL	EACH EACH	1

ECON 44 TS#15310

COUNTY TOTAL SHEET NO.

DUPAGE 71 46

CONTRACT NO. 60V00

SECTION

CY-N-1

* 100% COST TO THE VILLAGE OF VILLA PARK


MAST ARM MOUNTED STREET NAME SIGNS AND SCHEDULE OF QUANTITIES USER NAME = dwiktorzak DESIGNED - DW REVISED F.A.P. RTE. 347 STATE OF ILLINOIS REVISED DRAWN - CDC IL ROUTE 38 (ROOSEVELT ROAD) AT ARDMORE AVENUE CHECKED - KMM REVISED **DEPARTMENT OF TRANSPORTATION** SHEET NO. OF SHEETS STA. PLOT DATE = 12/12/2016 DATE 4/1/15 REVISED

PLOT DATE = 12/12/2016

DATE

4/1/15

REVISED

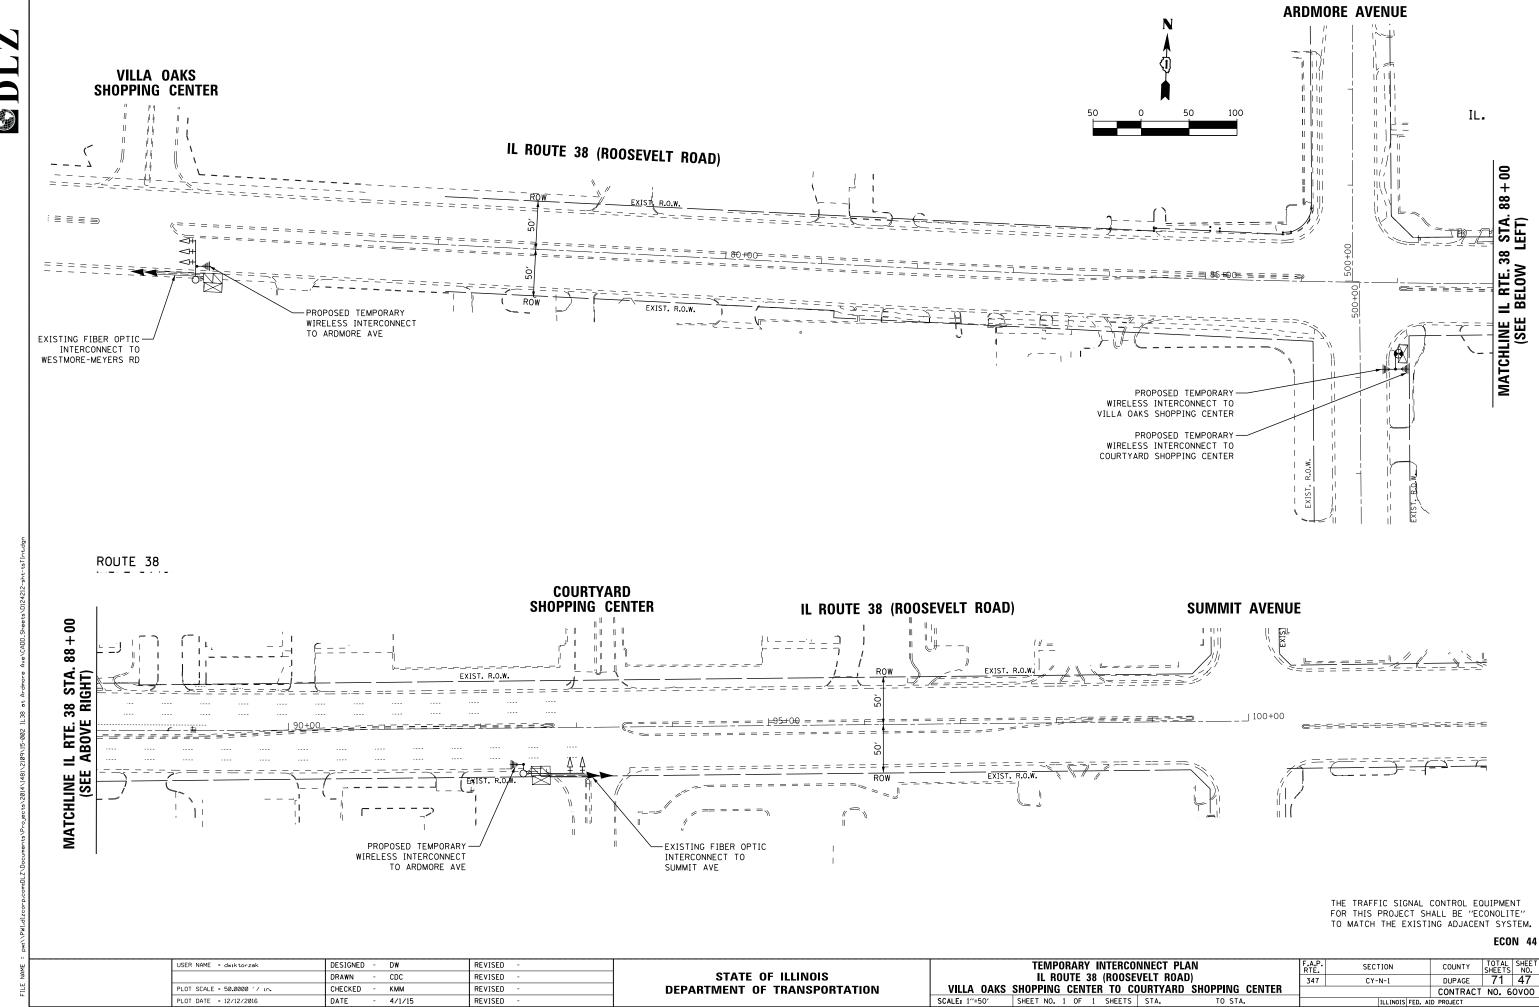

VILLA OAKS SHOPPING CENTER -TEMPORARY WIRELESS INTERCONNECT TO IL RTE. 38/VILLA OAKS SHOPPING CENTER, -TEMPORARY WIRELESS INTERCONNECT TO IL RTE. 38/ARDMORE AVE. AND IL RTE. 38/COURTYARD SHOPPING CENTER TEMPORARY WIRELESS —
INTERCONNECT TO IL RTE. 38/ARDMORE AVE. IL RTE. 38 (ROOSEVELT ROAD) TO WESTMORE
-MEYERS RD 245

THE TRAFFIC SIGNAL CONTROL EQUIPMENT FOR THIS PROJECT SHALL BE "ECONOLITE" TO MATCH THE EXISTING ADJACENT SYSTEM.


ECON 44

PLOT DATE = 12/12/2016

DATE


4/1/15

REVISED

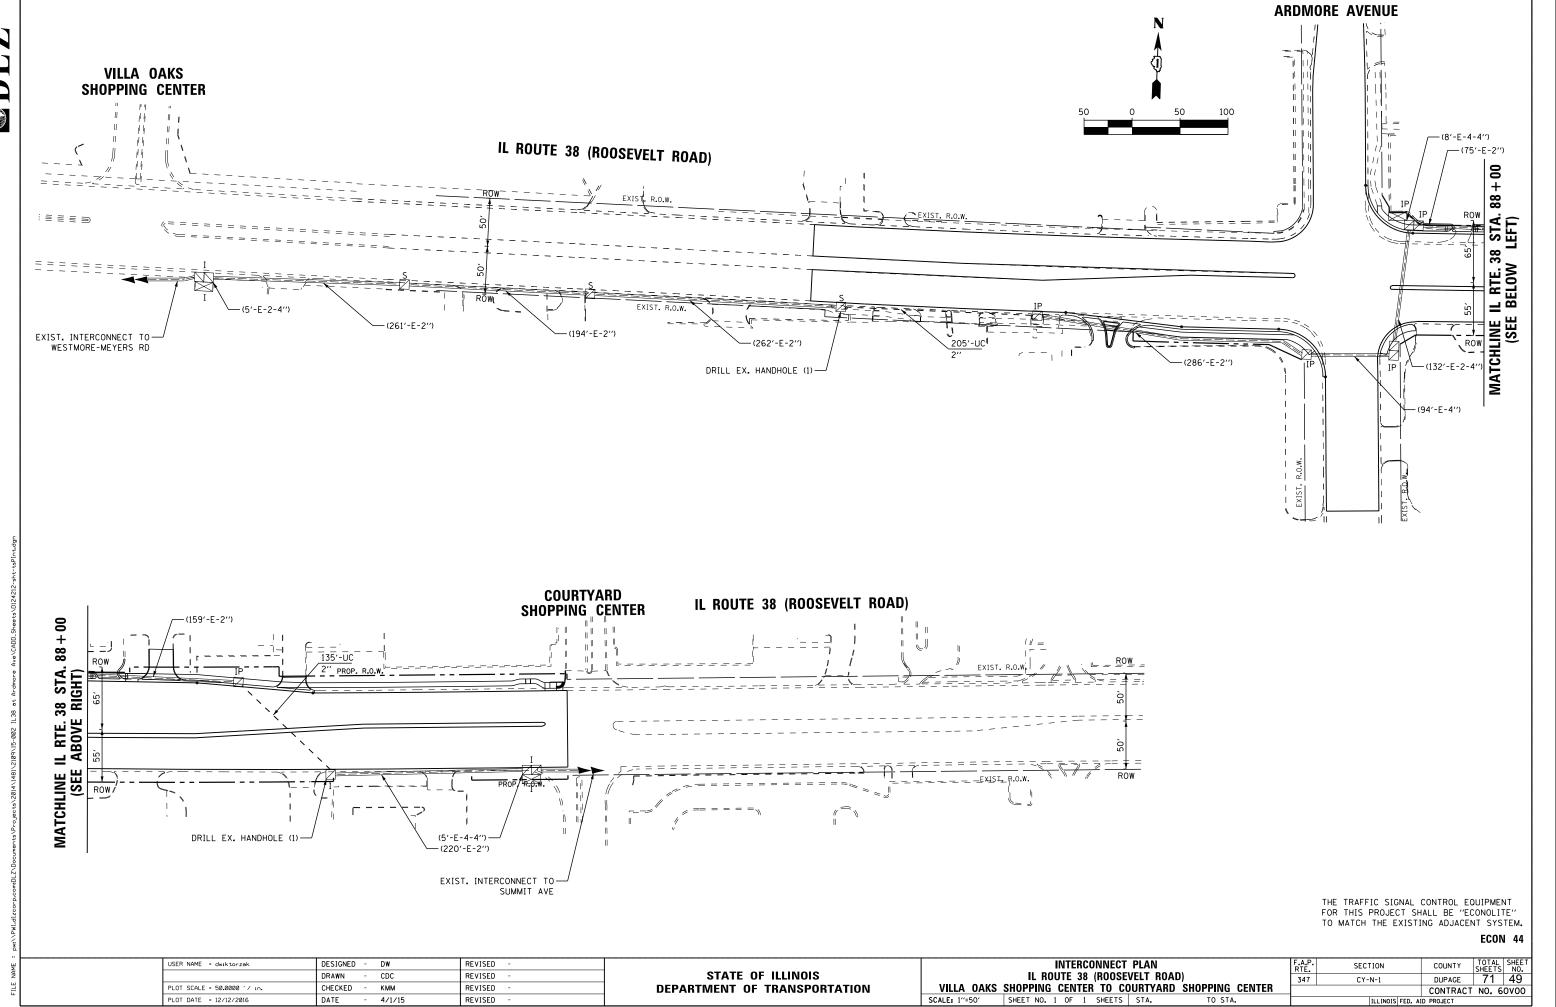

SCHEDULE OF QUANTITIES

ITEM DESCRIPTION	UNITS	TOTAL QTY.
UNDERGROUND CONDUIT, GALVANIZED STEEL, 2" DIA.	FOOT	340
MAINTENANCE OF EXISTING TRAFFIC SIGNAL INSTALLATON	EACH	2
ELECTRIC CABLE IN CONDUIT, TRACER, NO. 14 1C	FOOT	2178
DRILL EXISTING HANDHOLE	EACH	2
REMOVE ELECTRIC CABLE FROM CONDUIT	FOOT	1038
ROD AND CLEAN EXISTING CONDUIT	FOOT	947
FIBER OPTIC CABLE IN CONDUIT, NO. 62.5/125, MM12F SM24F	FOOT	2224
RE-OPTIMIZE TRAFFIC SIGNAL SYSTEM LEVEL 2	EACH	1

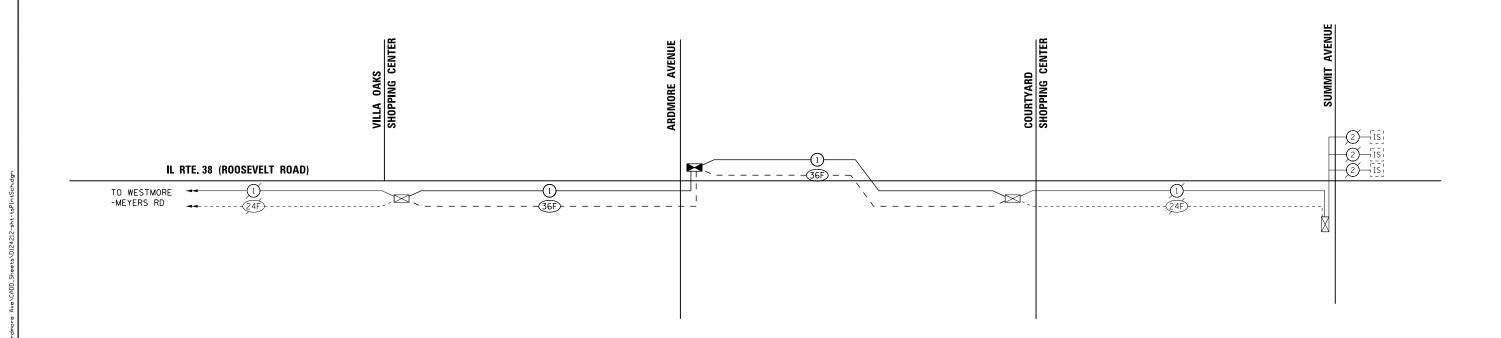

THE TRAFFIC SIGNAL CONTROL EQUIPMENT FOR THIS PROJECT SHALL BE "ECONOLITE" TO MATCH THE EXISTING ADJACENT SYSTEM.

ECON 44

USER NAME = dwiktorzak	DESIGNED -	DW	REVISED -		PROPOSED INTERCONNECT SCHEMATIC - IDOT SYSTEM 44	F.A.P.	SECTION		TOTAL SHEET
	DRAWN -	CDC	REVISED -	STATE OF ILLINOIS	SUMMIT AVE TO VILLA OAKS SHOPPING CENTER	347	CY-N-1	DUPAGE	71 50
PLOT SCALE = 1.0000 '/ in.	CHECKED -	KMM	REVISED -	DEPARTMENT OF TRANSPORTATION	SUMMINI AVE TO VILLA DARS SHUPPING CENTER			CONTRACT I	NO. 60V00
PLOT DATE = 12/12/2016	DATE -	4/1/15	REVISED -		SCALE: SHEET NO. OF SHEETS STA. TO STA.		ILLINOIS FED. A	ID PROJECT	

P	Illinois of Trans	ys	me ior	n
ROUTE	FAP ROUTE 3	47 DE	SCR	P
SECTION	CY-N	<u>l-1</u>	L	.0
COUNTY	Du Page	DRILLING	G ME	TI
STRUCT. No	0		D E	

SOIL BORING LOG

Illinois Route 38

Page <u>1</u> of <u>1</u> Date 7/22/14

LOGGED BW. Esposito Jr.

	SECTION	CY-N-1		1	LOCA	TION	SW 1/	4, SEC. 15, TWP. 39, RI	NG. 11, 3 rd PM		
	COUNTY	Du Page	DRILLING	G ME	THOD)	B-8	0 Mobile Drill Rig	HAMMER TYPE	N/A	
	BORING NO. Station Offset	RB-3 87+25 36.00ft LT. C		D E P T H	B L O W S	U C S Qu (tsf)		Surface Water Elev. Stream Bed Elev. Groundwater Elev.: First Encounter Upon Completion After 24 Hrs.	DRY ft DRY ft		
38 @ ARDMORE AVENUE GP 1 703914	Aggregate Sub-	t Pavement grade and (possible	716.21 714.71 712.21				7 9 9 9	Atter 24 Hrs.	N/A π		
JPAGEWILINOIS ROUTE 38 @ ABDMC	End of Boring		707.21	-10			11				

The Unconfined Compressive Strength (UCS) Failure Mode is indicated by (B-Bulge, S-Shear, P-Penetrometer)
The SPT (N value) is the sum of the last two blow values in each sampling zone (AASHTO T206)
BBS, from 137 (Rev. 8-99)



SOIL BORING LOG

Date __7/22/14

ROUTE FAP ROUTE 347							GED BYM. Esposito
SECTION CY-N-1		LOCA	TION	SW 1	4, SEC. 15, TWP. 39, R	NG. 11, 3 rd PM	
COUNTY Du Page	DRILLING N	METHO		B-8	0 Mobile Drill Rig	HAMMER TYPE	N/A
STRUCT. NO.	D		U	M	Surface Water Elev.	ft	
Station	P	0	C S	0	Stream Bed Elev.	ft	
BORING NO. RB-4 Station 89+21	T	W	Qu	S	Groundwater Elev.:		
Offset 36.00ft LT. CL			-	•	First Encounter Upon Completion	DRY ft	
Ground Surface Elev. 715.7	'3 ft (ft	(/6")	(tsf)	(%)	After Hrs.	N/A ft	
Hot-Mix Asphalt Pavement							
Agreements Carlamenda	714.73	_					
ery Stiff Brown Silty Clay	714.23	-					
rory our brown only oray	ATTENDANCE.	-	1.0	14			
	-	1	4.0	18			
	***************************************				e e e e e e e e e e e e e e e e e e e		
	The Control of the Co	-	3.0	21			
	-		2.5	19			
		2	2.0	15			
			3.5	19			
	700.00	-	4.5	17			
lard Gray Silty Clay	708.23	-	4.5	17			
	0.00						
			4.5	16			
			4.5	16 15			
ote: Strength values obtained	705.73 -10	4	4.5	10			
y pocket penetrometer nd of Boring							
nd of borning				100			
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	7916	- 1					
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							Andrews


The Unconfined Compressive Strength (UCS) Failure Mode is indicated by (B-Bulge, S-Shear, P-Penetrometer)
The SPT (N value) is the sum of the last two blow values in each sampling zone (AASHTO T206)
BBS, from 137 (Rev. 8-99)


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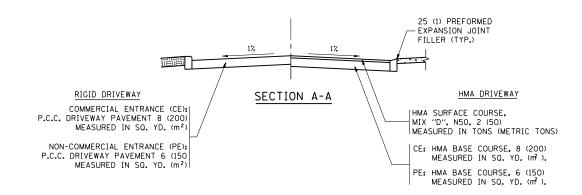
FILE NAME = USER NAME = dehhanr	DESIGNED -	REVISED	=	
pw:\\IL084EBIDINTEG.:111:nois.gov:PWIDOT\Documents\IDOT Offices\District 1\Projects\F	124 212RAMON ata\Design\P124212-sht-details.dgr	REVISED	=	
PLOT SCALE = 100.0000 '/ in.	CHECKED -	REVISED	=	l
Default PLOT DATE = 12/12/2016	DATE -	REVISED	-	


STATE	E OF	ILLINOIS
DEPARTMENT	OF	TRANSPORTATION


SOIL BORING LOG	F.A.P RTE.	SECTION	COUNTY	TOTAL SHEET SHEETS NO.	
IL. ROUTE 38 (ROOSEVELT RD.) AT ARDMORE AVE.	347	CY-N-1	DUPAGE	71 51	
IL HOUTE 30 (HOUSEVEET HD.) AT ANDINONE AVE.			CONTRACT	NO. 60V00	
SHEET 1 OF 1 SHEETS STA. TO STA.	ILLINOIS FED. AID PROJECT				



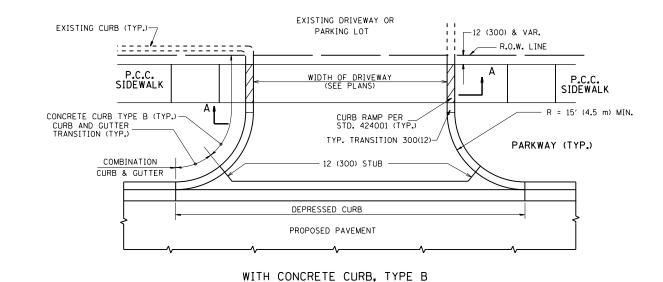

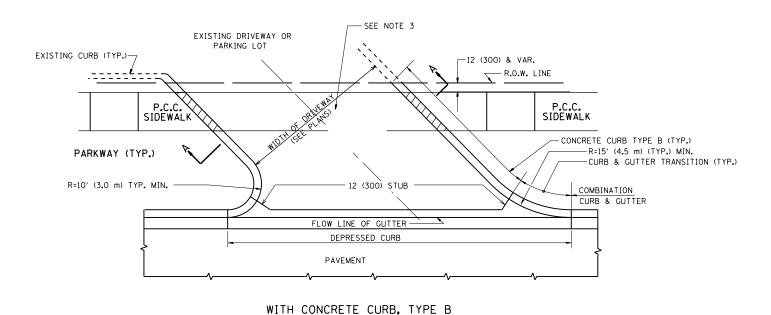

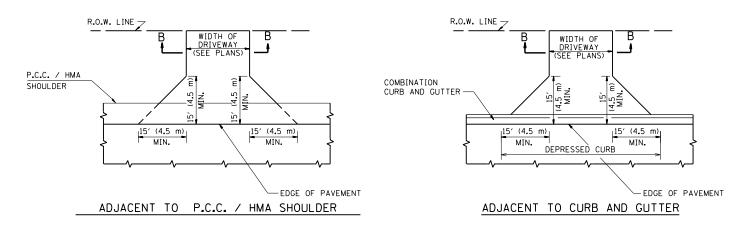

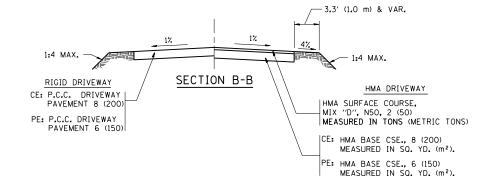

RURAL FIELD ENTRANCE (FE)

HMA SURFACE COURSE, MIX "D", N50, 2 (50) MEASURED IN TONS (METRIC TONS)

AGGREGATE BASE CSE., TYPE B, 8 (200) MEASURED IN SQ. YD. (m^2) .

GENERAL NOTES:

DRIVEWAY SLOPES, LOCATIONS, & GEOMETRIC LAYOUT SHALL BE IN ACCORDANCE WITH THE LATEST EDITION OF THE "HANDBOOK FOR POLICY ON PERMITS FOR ACCESS DRIVEWAYS TO STATE HIGHWAYS". FOR FURTHER LAYOUT REQUIREMENTS, REFER TO ILLUSTRATIONS IN THE PERMIT HANDBOOK. DRIVEWAYS SHALL BE REPLACED IN KIND, UNLESS OTHERWISE NOTED ON THE PLANS.

COMMERCIAL DRIVEWAYS SHALL BE CONSTRUCTED WITH CONCRETE CURB, TYPE B RETURNS EXCEPT WHEN THE SIDEWALK EDGE IS 4 FEET (1.2 METERS) OR LESS FROM THE BACK OF CURB, CONSTRUCT A FLARE DRIVEWAY WITHOUT CURB.

THE RESIDENT ENGINEER SHALL CONTACT THE TRAFFIC PERMIT OFFICE AT 847/ 705-4131 FOR ANY OUESTIONS ON DRIVEWAYS SHOWN IN THE PLANS; SPECIFICALLY IN REFERENCE TO ADDITIONAL AND/OR RELOCATION/REMOVAL OF A DRIVEWAY.

COMBINATION CONCRETE CURB & GUTTER SHALL BE MEASURED STRAIGHT ACROSS THE DRIVEWAY. NO ADDITIONAL COMPENSATION WILL BE ALLOWED FOR THE CURB & GUTTER TRANSITION.

1 (25) PREFORMED EXPANSION JOINT FILLER WILL NOT BE PAID SEPARATELY, BUT SHALL BE CONSIDERED INCLUDED IN THE COST OF THE P.C.C. DRIVEWAY PAVEMENT OR P.C.C. SIDEWALK.


WHEN THE P.C.C. SIDEWALK EXTENDS THROUGH THE DRIVEWAY, THE THICKNESS OF THE SIDEWALK IN THE DRIVEWAY AREA SHALL BE THE SAME AS THE DRIVEWAY THICKNESS. SIDEWALK WILL BE PAID FOR AS P.C.C. SIDEWALK OF THE THICKNESS SPECIFIED. SIDEWALK CROSS SLOPE THRU DRIVEWAY AREA TO BE A MAXIMUM OF 1:50.


SCALE: NONE

FILE NAME =	USER NAME = dahhanr	DESIGNED - R. SHAH	REVISED - P. LaFLUER 04-15-03
pw:\\IL084EBIDINTEG.:: pw:\\IL084EBIDINTEG.: pw:\IL084EBIDINTEG.: pw:\\IL084EBIDINTEG.: pw:\\IL084EBIDINTEG.: pw:\\IL084EBIDINTEG.: pw:\\IL084EBIDINTEG.: pw:\\IL084EBIDINTEG.: pw:\\IL084EBIDINTEG.: pw:\\IL084EBIDINTEG.: pw:\\I		2 12R0AND Nata\Design\DistStd.dgn	REVISED - R. BORO 01-01-07
	PLOT SCALE = 100.0002 ' / in.	CHECKED -	REVISED - R. BORO 06-11-08
	PLOT DATE = 12/14/2016	DATE - 11-04-95	REVISED - R. BORO 09-06-11

STATE OF ILLINOIS DEPARTMENT OF TRANSPORTATION


DRIVEWAY DETAILS - DISTANCE BETWEEN R.O.W. AND FACE OF CURB & EDGE OF SHOULDER >= 15' (4.5 m)					F.A.P. SECTION		COUNTY TOTAL S SHEETS	
					CY-N-1	DUPAGE	71	52
AND I	AND FACE OF COMB & EDGE OF SHOULDEN > = 15 (4.5 III)				BD0156-07 (BD-01)	CONTRACT	NO. 6	0000
ΙE	SHEET NO. 1 OF 1 SHEETS	STA.	TO STA.	FED. RO	DAD DIST. NO. 1 ILLINOIS FED. A	D PROJECT		

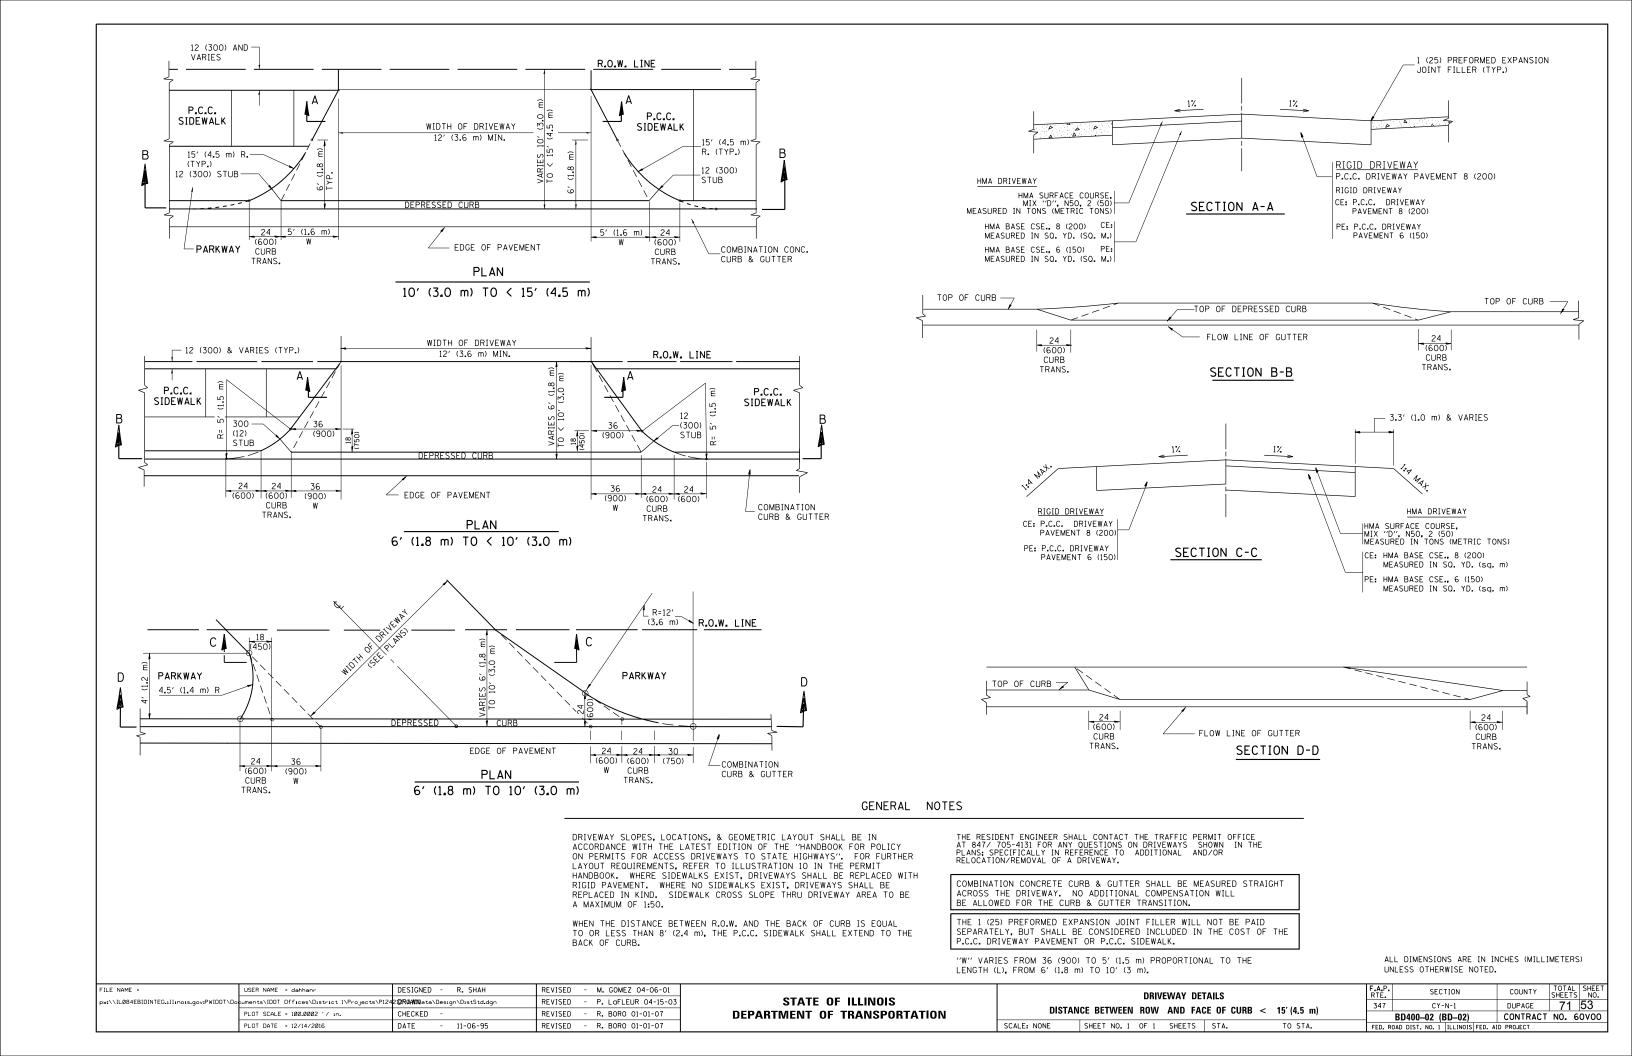


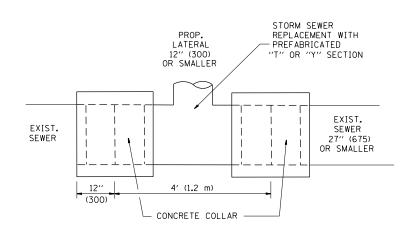


DETAIL "A"

LATERAL CONNECTION TO EXISTING SEWER
OF 27" (675) OR SMALLER

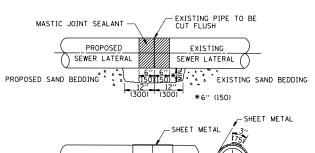

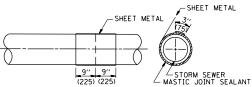

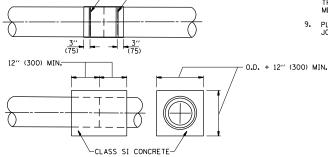

METAL BINDING


<u>DETAIL "B"</u> CLASS SI CONCRETE COLLAR

CONSTRUCTION SEQUENCE

- CUT THE EXISTING END OF THE PIPE SO AS TO PRESENT A FLUSH BUTT JOINT. BRUSH AND CLEAN ALL PIPES.
- 2. APPLY THE MASTIC JOINT SEALANT TO THE FIRST 6" (150) OF EACH PIPE.
- 3. BUTT THE PIPES TOGETHER LEAVING A MINIMUM OF 12' × 6' (300 × 150) DEEP EXCAVATION UNDER AND AROUND EACH PIPE END.
- 4. CUT A PIECE OF SHEET METAL GAGE NO. 19 1.1 (0.0418) 18" (450) WIDE BY THE OUTSIDE CIRCUMFERANCE OF THE PIPE PLUS 3" (75) LONG.
- 5. WRAP THE SHEET METAL AROUND THE PIPES, 9" (225) ON EACH SIDE OF THE JOINT, STARTING AT THE TOP OF THE PIPE.
- 6. LAP THE SHEET METAL AT LEAST 3" (75) AT THE TOP OF THE PIPE AND PLACE THE MASTIC JOINT SEALANT BETWEEN THE LAP.
- 7. PLACE TWO METAL BANDS AROUND THE SHEET METAL AND TIGHTEN.
- 8. WIPE OFF ANY EXCESS MASTIC JOINT SEALANT THAT OOZES OUT FROM BETWEEN THE SHEET METAL AND THE PIPES.
- 9. PLACE CLASS SI CONCRETE AROUND THE JOINT.

OTHERWISE SHOWN.

ALL DIMENSIONS ARE IN INCHES (MILLIMETERS) UNLESS

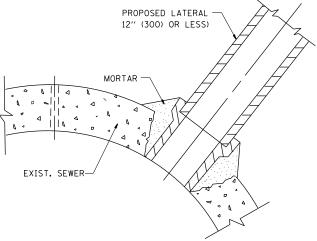

DETAIL "C"

PROPOSED LATERAL
CONNECTION TO EXISTING SEWER
OF 30" (750) OR LARGER

NOTES

MATERIAL

MATERIAL USED FOR THE TEE OR WYE SECTION SHALL BE COMPATIBLE WITH THE EXISTING STORM SEWER OR THE PROPOSED STORM SEWER.

CONSTRUCTION METHODS

- I. THIS WORK SHALL BE CONSTRUCTED IN CONFORMANCE WITH THE APPLICABLE PORTIONS OF SECTION 550 OF THE STANDARD SPECIFICATIONS.
- II. CONNECTION TO AN EXISTING STORM SEWER SHALL BE BY EITHER OF THE FOLLOWING METHODS:

 A) PROPOSED STORM SEWER CONNECTION TO EXISTING SEWER OF 27" (675) OR SMALLER SEE
 - B) PROPOSED STORM SEWER CONNECTION TO EXISTING SEWER OF 30" (750) OR LARGER SEE DETAIL "C".

IF THE EXISTING SEWER PIPE IS CRACKED, BROKEN OR OTHERWISE DAMAGED BY THE CONTRACTOR IN MAKING THE CIRCULAR OPENING, THE CONTRACTOR SHALL REPLACE THAT SECTION OF PIPE WITH PIPE EQUIAL AND SIMILAR IN ALL RESPECTS TO THE PIPE IN THE EXISTING SEWER, IN A CAREFUL WORKMANLIKE MANNER, WITHOUT EXTRA COMPENSATION.

GENERAL

CARE MUST BE TAKEN TO PREVENT DEBRIS FROM ENTERING THE SEWER. ALL DEBRIS WHICH ENTERS THE SEWER MUST BE REMOVED. THE SEWER MUST BE LEFT CLEAN AND UNOBSTRUCTED UPON COMPLETION OF THE CONTRACT.

CARE MUST BE TAKEN TO PREVENT ANY PART OF THE NEW PIPE CONNECTION FROM PROJECTING INTO THE EXISTING SEWER.

BASIS OF PAYMENT

TEE OR WYE CONNECTIONS SHALL BE PAID FOR AT THE CONTRACT UNIT PRICE EACH FOR STORM SEWER TEE OR WYE OF THE TYPE AND SIZE SPECIFIED IN THE PLANS, THIS PRICE SHALL INCLUDE ALL EXCAVATION OF THE TRENCH, REMOVAL OF THE EXISTING STORM SEWER, FURNISHING AND INSTALLING THE SPECIFIED TEE OR WYE SECTION, FURNISHING AND INSTALLING THE REOUIRED CONCRETE COLLAR, AND ALL OTHER MATERIAL NECESSARY TO COMPLETE THIS WORK AS SHOWN AND SPECIFIED.

REMOVAL AND REINSTALLATION OF EXISTING STORM SEWER ADJACENT TO THE PROPOSED TEE OR WYE SECTION, FOR THE PURPOSE OF FACILITATING THE INSTALLATION OF THE TEE OR WYE SECTION, WILL NOT BE PAID FOR SEPARATELY BUT SHALL BE INCLUDED IN THE UNIT PRICE BID FOR THE WORK.

TRENCH BACKFILL, EXCAVATION IN ROCK AND REMOVAL AND REPLACEMENT OF UNSUITABLE MATERIAL BELOW PLAN BEDDING GRADE WILL BE PAID FOR SEPARATELY.


SCALE: NONE

CONCRETE COLLAR FOR CONNECTING A PROPOSED STORM SEWER TO AN EXISTING STORM SEWER WILL NOT BE PAID PAID FOR SEPARATELY BUT SHALL BE INCLUDED IN THE COST OF THE PROPOSED STORM SEWER

FILE NAME =	USER NAME = dahhanr	DESIGNED - M. DE YONG	REVISED	- M. DE YONG 05-08-92
pw:\\ILØ84EBIDINTEG.:ll:nois.gov:PWIDOT\Do	cuments\IDOT Offices\District 1\Projects\P124	2 12R0AMD Qata\Design\DistStd.dgn	REVISED	- R. SHAH 09-09-94
	PLOT SCALE = 100.0000 ' / in.	CHECKED -	REVISED	- R. SHAH 10-25-94
	PLOT DATE = 12/14/2016	DATE - 07-25-90	REVISED	- R. SHAH 06-12-96

STATE OF ILLINOIS DEPARTMENT OF TRANSPORTATION

DETAIL OF STORM		F.A.P. RTE.	SEC	TION	COUNTY	TOTAL SHEETS	SHEET NO.	
CONNECTION TO EXISTI	347	CY-	N-1	DUPAGE	71	54		
CONNECTION TO EXIST		BD500-01 (BD-7)	CONTRACT	NO. 6	0000		
SHEET NO. 1 OF 1 SHEETS	STA.	TO STA.	FED. R	OAD DIST. NO. 1	ILLINOIS FED. AI	D PROJECT		

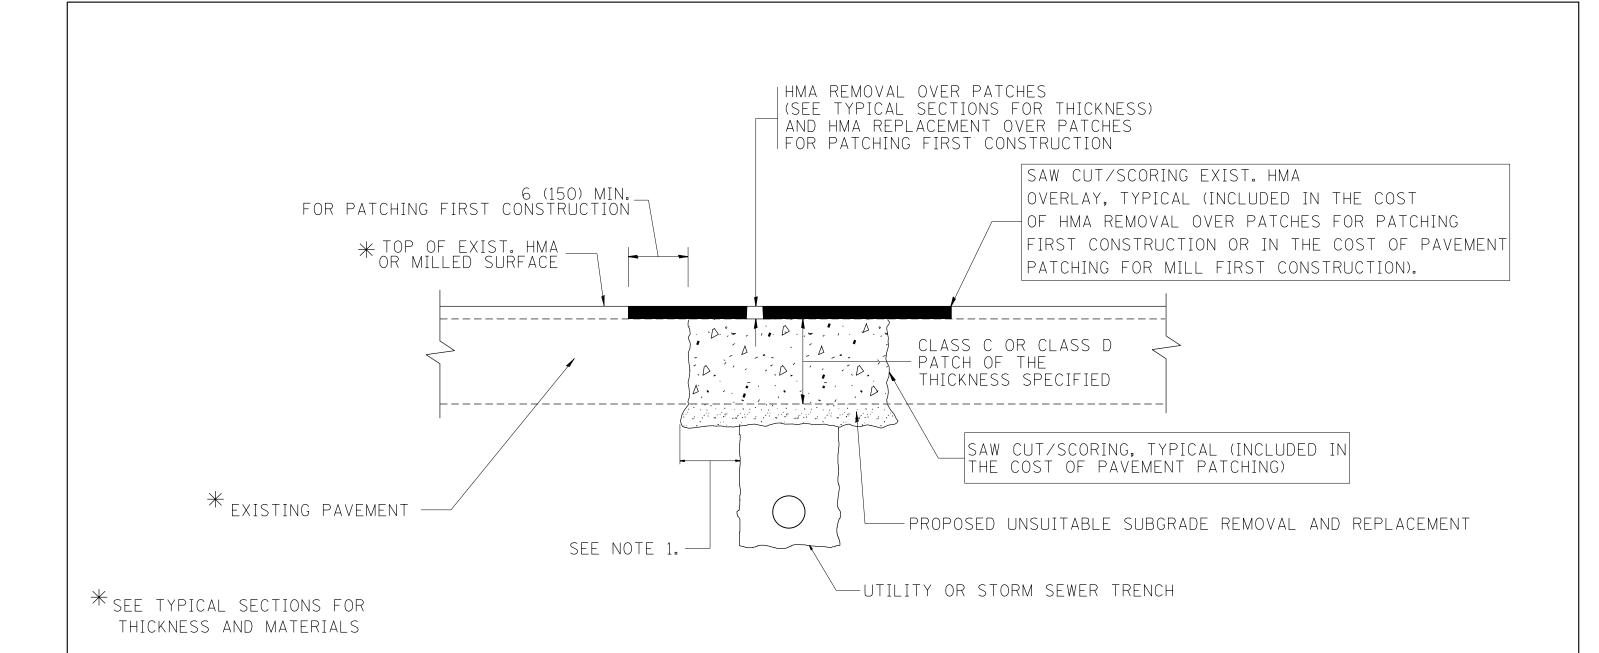

NOTES:

- 1. THE WIDTH OF THE FULL DEPTH PATCH OVER A TRENCH SHALL BE 12 (300) WIDER ON EACH SIDE OF THE TRENCH.
- 2. FOR METHOD OF MEASUREMENT AND BASIS OF PAYMENT, SEE RECURRING SPECIAL PROVISION "PATCHING WITH HOT-MIX ASPHALT OVERLAY REMOVAL".


SEQUENCE OF CONSTRUCTION (PATCHING FIRST)

- 1. REMOVE THE EXISTING HMA MATERIAL OVER THE AREA TO BE PATCHED.
- 2. REMOVE AND REPLACE WITH CLASS C OR D PATCH.
- 3. REPLACE HMA MATERIAL OVER THE AREA TO BE PATCHED.

SEQUENCE OF CONSTRUCTION (MILLING FIRST)


- 1. MILL HMA FIRST IF THERE IS AT LEAST 41/2 INCHES OR MORE OF HMA MATERIAL ON TOP OF THE EXISTING PAVEMENT OR IF THE PAVEMENT IS FULL DEPTH HMA. A MINIMUM OF 2 INCHES OF HMA MATERIAL SHALL BE IN PLACE AFTER MILLING.
- 2. REMOVE AND REPLACE WITH FULL DEPTH CLASS D PATCHES TO TOP OF MILLED SURFACE.

Γ	FILE NAME =	USER NAME = dahhanr	DESIGNED - R. SHAH	REVISED -	A. ABBAS 04-27-98			PAVEMENT PATCHING FOR		F.A.P.	SECTION		OTAL SHEET
	pw:\\IL084EBIDINTEG.:ll:no:s.gov:PWIDOT\Do	cuments\IDOT Offices\District 1\Projects\P124	2 :2RGWIS ata\Design\DistStd.dgn	REVISED -	R. BORO 01-01-07	STATE OF ILLINOIS				347	CY-N-1		71 55
		PLOT SCALE = 100.0000 '/ in.	CHECKED -	REVISED -	R. BORO 09-04-07	DEPARTMENT OF TRANSPORTATION	HMA SURFACED PAVEMENT			BD40	00-04 (BD-22)	CONTRACT NO	o. 60v00
		PLOT DATE = 12/14/2016	DATE - 10-25-94	REVISED -	K. ENG 10-27-08		SCALE: NONE	SHEET NO. 1 OF 1 SHEETS STA.	TO STA.	FED. ROAD DIS	T NO 1 THE INDISPED AT		

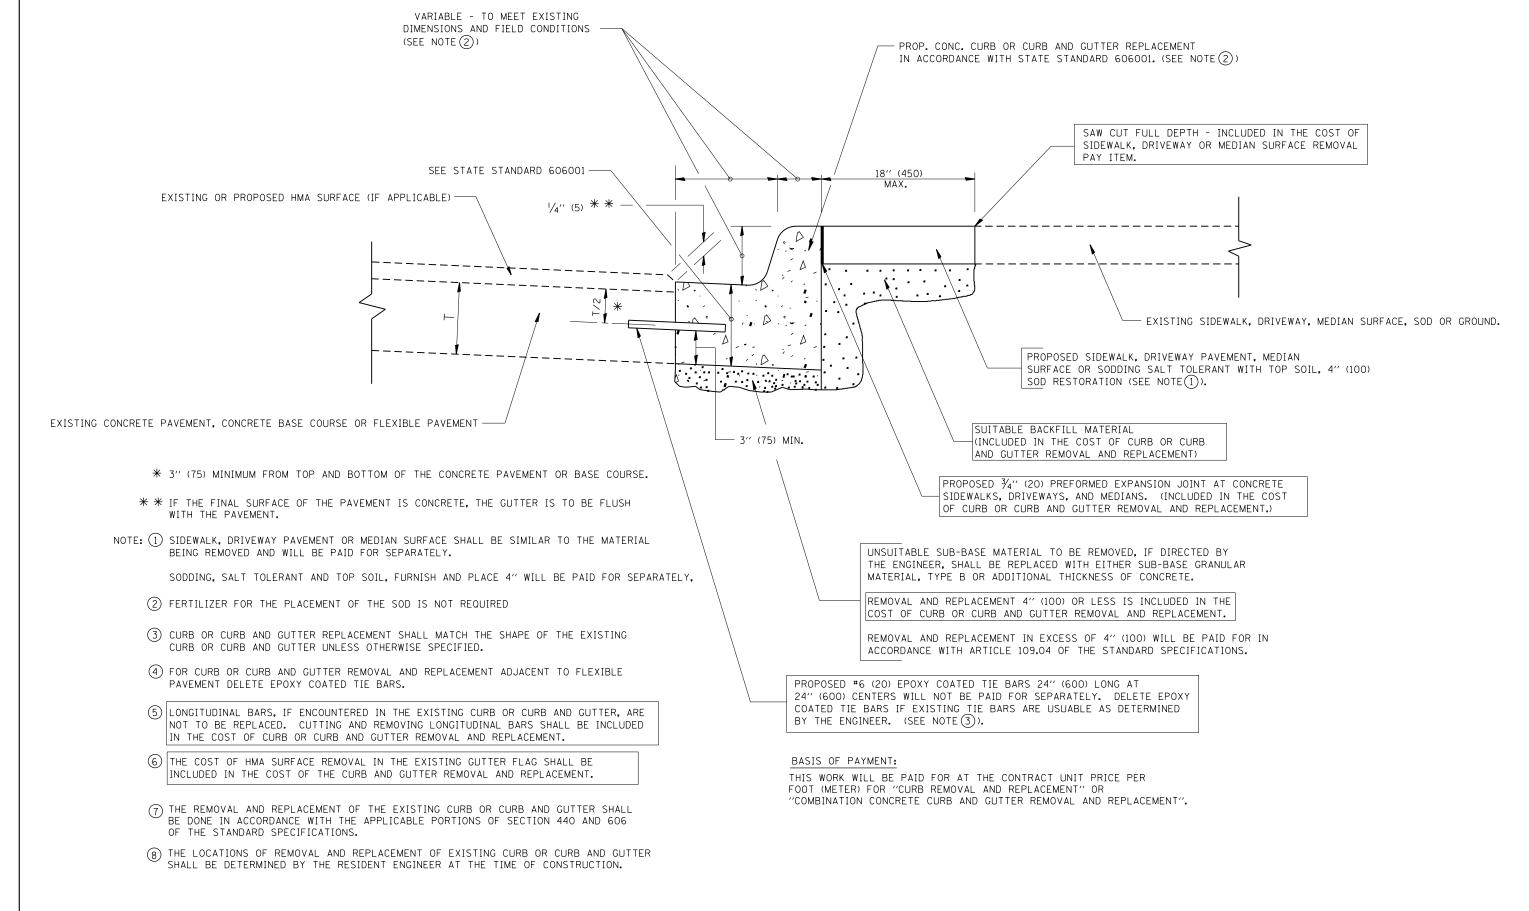


CURB OR CURB AND GUTTER REMOVAL AND REPLACEMENT

FI	ILE NAME =	USER NAME = dahhanr	DESIGNED - A. HOUSEH	REVISED - R. SHAH 10-03-96			CURB OR CURB AND GUTTER	F.A.P. SEC	TION COUNTY	/ TOTAL SHEET
рw	w:\\ILØ84EBIDINTEG.1ll1no1s.gov:PWIDOT\Do	cuments\IDOT Offices\District 1\Projects\P124	21 2RAMON ata\Design\DistStd.dgn	REVISED - A. ABBAS 03-21-97	STATE OF ILLINOIS			347 CY-	·N-1 DUPAGE	71 56
		PLOT SCALE = 100.0000 '/ in.	CHECKED -	REVISED - M. GOMEZ 01-22-01	DEPARTMENT OF TRANSPORTATION		REMOVAL AND REPLACEMENT	BD600-06 (CT NO. 60V00
		PLOT DATE = 12/14/2016	DATE - 03-11-94	REVISED - R. BORO 12-15-09		SCALE: NONE	SHEET NO. 1 OF 1 SHEETS STA. TO STA.	FED. ROAD DIST. NO. 1	ILLINOIS FED. AID PROJECT	

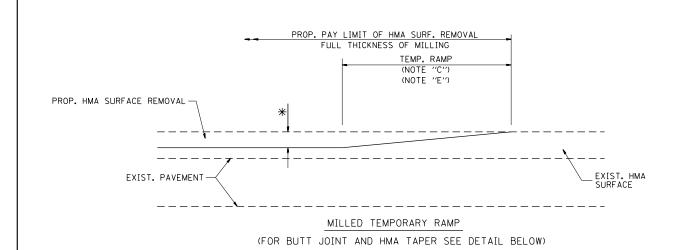


OPTION 1

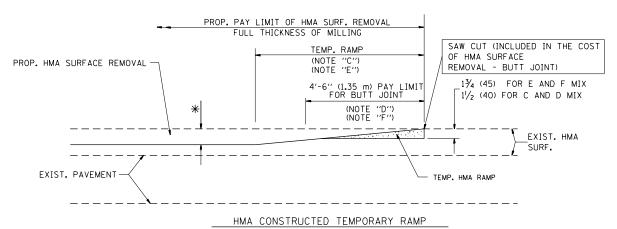

(FOR BUTT JOINT AND HMA TAPER SEE DETAIL BELOW)


OPTION 2


TYPICAL TEMPORARY RAMP

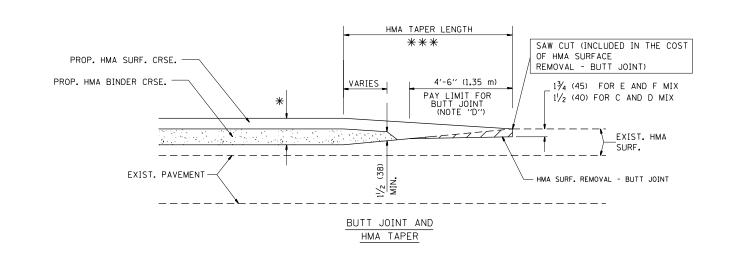

TYPICAL BUTT JOINT AND HMA TAPER FOR MILLING AND RESURFACING

STATE OF ILLINOIS
DEPARTMENT OF TRANSPORTATION

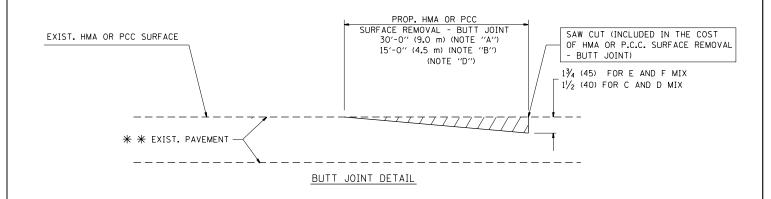

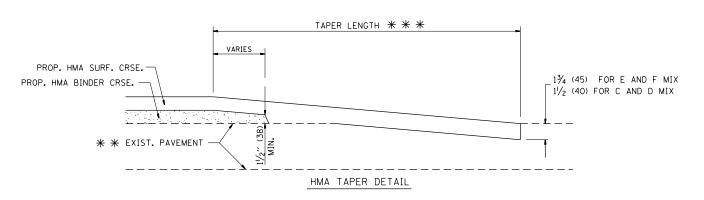

TYPICAL BUTT JOINT AND HMA TAPER FOR RESURFACING ONLY


* * PC CONCRETE, HMA OR HMA RESURFACED PAVEMENT.

NOTES

- A: MAINLINE ROADWAYS AND MAJOR SIDE ROADS.
- MINOR SIDE ROADS.
- C: THE TEMP. RAMP SHALL BE CONSTRUCTED IMMEDIATELY UPON REMOVAL OF THE EXISTING HMA SURFACE.
- D: THE BUTT JOINT SHALL BE CONSTRUCTED IMMEDIATELY PRIOR TO PLACING THE PROPOSED HMA COURSES.
- E: TAPER THE TEMP. RAMP AT A RATE OF 3'-0" (900 mm) PER 1 INCH (25 mm) OF MILLING THICKNESS.
- F: INSTALLATION AND REMOVAL OF THE 4'-6" (1.35 m) TEMP. RAMP IS INCLUDED IN COST OF HMA SURFACE REMOVAL BUTT JOINT
- G: SEE ARTICLE 406.08 AND 406.14 OF THE STANDARD SPECIFICATIONS FOR "HMA AND/OR PCC SURFACE REMOVAL, BUTT JOINT".
- * SEE TYPICAL SECTIONS FOR MILLING THICKNESS.

BASIS OF PAYMENT:

THE BUTT JOINT WILL BE PAID FOR AT THE CONTRACT UNIT PRICE PER SQUARE YARD (SQUARE METER) FOR "HOT-MIX ASPHALT SURFACE REMOVAL - BUTT JOINT" OR FOR "PORTLAND CEMENT CONCRETE SURFACE REMOVAL- BUTT JOINT".

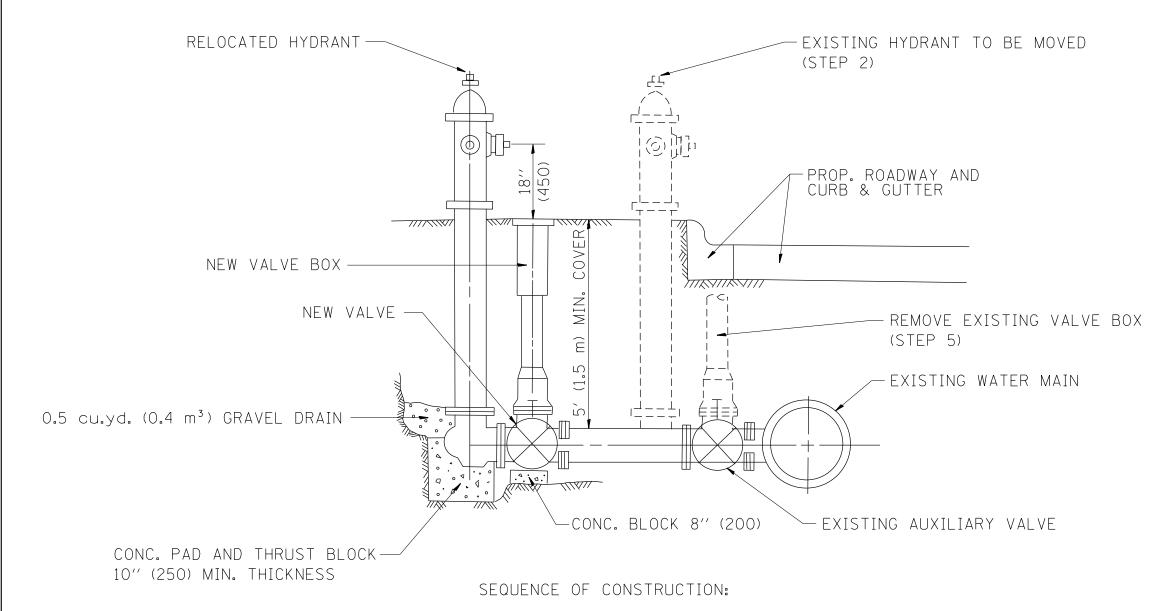


- 1. CLOSE EXISTING VALVE.
- 2. REMOVE EXISTING HYDRANT.
- 3. INSTALL HYDRANT EXTENSION AND NEW VALVE.
- 4. RELOCATE EXISTING HYDRANT.
- 5. OPEN EXISTING VALVE, REMOVE BOX.
- 6. BACKFILL.
- 7. FLUSH AND TEST FOR CHLORIDE RESIDUAL AND PROVIDE TEST.

ALL WORK TO BE DONE IN ACCORDANCE WITH ARTICLE 564 OF THE STANDARD SPECIFICATIONS. NEW VALVE AND BOX SHALL BE SAME MAKE AND MODEL AS EXISTING.

FIRE HYDRANT TO BE MOVED

FILE NAME =	USER NAME = dahhanr	DESIGNED -	REVISED - R. SHAH 09-09-94			FIRE HYDRANT TO BE I	MOVED	RTF	SECTION	COUNTY	SHEETS NO.
pw:\\ILØ84EBIDINTEG.ıllınoıs.gov:PWIDOT\Do	cuments\IDOT Offices\District 1\Projects\P124	2 2R/AWIN ata\Design\DistStd.dgn	REVISED - R. SHAH 10-25-94	STATE OF ILLINOIS		TINE III DIANT TO BE I	WIOVED	347	CY-N-1	DUPAGE	71 58
	PLOT SCALE = 100.0000 '/ in.	CHECKED -	REVISED -	DEPARTMENT OF TRANSPORTATION					BD-36	CONTRACT	T NO. 60V00
	PLOT DATE = 12/14/2016	DATE -	REVISED -		SCALE: NONE	SHEET NO. 1 OF 1 SHEETS ST	TA. TO STA.	FED. ROAD D	DIST. NO. 1 ILLINOIS FED.		

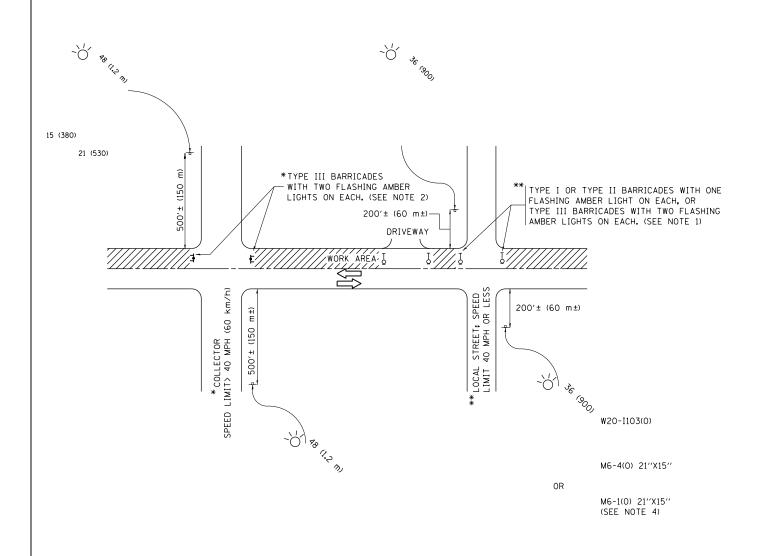

NOTES:

- SIDE ROAD WITH A SPEED LIMIT OF 40 MPH (60 km/h) OR LESS AS SHOWN ON THE DRAWING AND AS DIRECTED BY THE ENGINEER:
 - a) ONE "ROAD CONSTRUCTION AHEAD" SIGN 36 x 36 (900x900) WITH A FLASHER MOUNTED ON IT APPROXIMATELY 200' (60 m) IN ADVANCE OF THE MAIN ROUTE.
 - b) THE CLOSED PORTION OF THE MAIN ROUTE SHALL BE PROTECTED BY BLOCKING WITH TYPE I, TYPE II OR TYPE III BARRICADES, 1/3 OF THE CROSS SECTION OF THE CLOSED PORTION.
- 2. SIDE ROAD WITH A SPEED LIMIT GREATER THAN 40 MPH (60 km/h) AS SHOWN ON THE DRAWING AND AS DIRECTED BY THE ENGINEER:
 - a) ONE "ROAD CONSTRUCTION AHEAD" SIGN 48 \times 48 (1.2 m \times 1.2 m) WITH A FLASHER MOUNTED ON IT APPROXIMATELY 500" (150 m) IN ADVANCE OF THE MAIN ROUTE.
 - b) THE CLOSED PORTION OF THE MAIN ROUTE SHALL BE PROTECTED BY BLOCKING WITH TYPE III BARRICADES, 1/2 OF THE CROSS SECTION OF THE CLOSED PORTION.
- 3. CONES MAY BE SUBSTITUTED FOR BARRICADES OR DRUMS AT HALF THE SPACING DURING DAY OPERATIONS. CONES SHALL BE A MINIMUM OF 28 (710) IN HEIGHT
- 4. WHEN THE SIDE ROAD LIES BETWEEN THE BEGINNING OF THE MAINLINE SIGNING AND THE WORK ZONE, A SINGLE HEADED ARROW (M6-1) SHALL BE USED IN LIEU OF THE DOUBLE HEADED ARROW (M6-4).

SCALE: NONE

- 5. WHEN WORK IS BEING PERFORMED ON A SIDE ROAD OR DRIVEWAY, FOLLOW THE APPLICABLE STANDARD(S). THE DIRECTIONAL ARROW (M6-1 OR M6-4) SHALL BE COVERED OR REMOVED WHEN NO LONGER CONSISTENT WITH THE TRAFFIC CONTROL SET-UP.
- 6. ADVANCE WARNING SIGNS ARE TO BE OMITTED ON DRIVEWAYS UNLESS OTHERWISE SPECIFIED IN THE PLANS OR BY THE ENGINFER.
- 7. THE TRAFFIC CONTROL AND PROTECTION FOR SIDE ROADS, INTERSECTIONS, AND DRIVEWAYS SHALL BE INCLUDED IN THE COST OF SPECIFIED TRAFFIC CONTROL STANDARDS OR ITEMS.


All dimensions are in inches (millimeters) unless otherwise shown.

FILE NAME =	USER NAME = dahhanr	DESIGNED - L.H.A.	REVISED - A. HOUSEH 10-15-96
pw:\\IL084EBIDINTEG.:ll:nois.gov:PWIDOT\Do	cuments\IDOT Offices\District 1\Projects\P124	21 2RAWIN ata\Design\DistStd.dgn	REVISED -T. RAMMACHER 01-06-00
	PLOT SCALE = 100.0000 '/ in.	CHECKED -	REVISED - A. SCHUETZE 07-01-13
Default	PLOT DATE = 12/14/2016	DATE - 06-89	REVISED - A. SCHUETZE 09-15-16

STATE OF ILLINOIS						
DEPARTMENT	0F	TRANSPORTATION				


TRAFFIC CONTROL AND PROTECTION FOR							
SIDE ROADS, INTERSECTIONS, AND DRIVEWAYS							
SIDE NUADS, INTERSECTIONS, AND DRIVEWATS							
	SHEET 1	OF 1	SHEETS	STA.	TO STA.		


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347	CY-N-1	DUPAGE	71	59
F.A.P. RTE.	SECTION	COUNTY	TOTAL SHEETS	SHEE

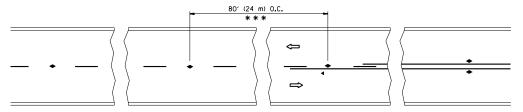


*** REDUCE TO 40' (12 m) O.C. ON CURVES WITH POSTED OR ADVISORY SPEED 45 M.P.H. (70 km/h) OR LESS.

TWO-LANE/TWO-WAY

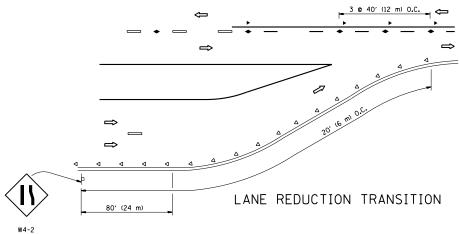


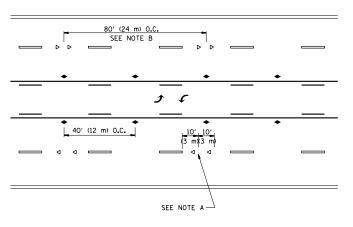

TWO-WAY LEFT TURN

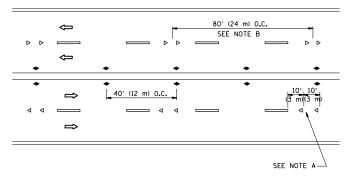

MULTI-LANE/UNDIVIDED

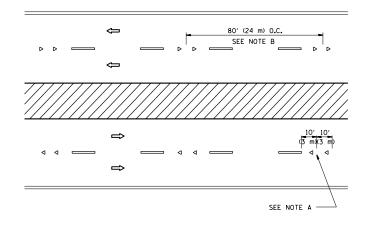

MULTI-LANE/DIVIDED

GENERAL NOTES

- MARKERS USED WITH DASHED LINES SHALL BE CENTERED IN THE GAP BETWEEN SEGMENTS.
- 2. MARKERS USED ADJACENT TO SOLID LINES SHALL BE OFFSET 2 TO 3 (50 TO 75) TOWARD TRAFFIC AS SHOWN.
- 3. MARKERS THROUGH TANGENTS LESS THAN 500' (150 m) IN LENGTH BETWEEN CURVES SHALL BE INSTALLED AT THE LESSER OF THE TWO CURVE SPACINGS.

LANE MARKER NOTES

A. USE DOUBLE LANE LINE MARKERS SPACED AS SHOWN.

B. REDUCE TO 40' (12 m) O.C. ON CURVES WHERE ADVISORY SPEEDS ARE 10 M.P.H (20 km/h) LOWER THAN POSTED SPEEDS.

SYMBOLS

---- YELLOW STRIPE

---- WHITE STRIPE

- ONE-WAY AMBER MARKER
- → ONE-WAY CRYSTAL MARKER (W/O)
- ◆ TWO-WAY AMBER MARKER

DESIGN NOTES

- 1. DOUBLE LANE LINE MARKERS SHALL BE USED UNLESS SPECIFIED OTHERWISE.
- 2. EXCEPT AS SHOWN ON THE LANE REDUCTION TRANSITION AND FREEWAY EXIT RAMP DETAIL, MARKERS ARE NOT TO BE SPECIFIED ON RIGHT EDGE LINES.
- 3. THE EXACT MARKER LIMITS, SPACING, AND COLOR SHALL BE INCLUDED IN THE PLANS WHEN STANDARD SPECIFICATIONS ARE NOT BEING USED.
- 4. MARKERS SHOULD NOT BE USED ALONGSIDE CURBS EXCEPT FOR EXTREMELY SHORT SECTIONS OF CURBS WHERE NOT MORE THAN TWO MARKERS WOULD BE INVOLVED.


LEFT TURN

All dimensions are in inches (millimeters) unless otherwise shown.


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CONTRACT NO. 60V00

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	PLOT DATE = 12/14/2016	DATE -	REVISED	- C. JUCIUS 09-09-09		SCALE: NONE	SHEET	NO. 1 OF	1 SHEETS	STA.	TO STA.	FFD. ROAD	DIST, NO. 1 ILLINOIS FED. AI	ID PROJECT
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l		of Dames	DEWICED		STATE OF ILLINOIS			IYF	PICAL APPLIC	AHUNS		RIE.		
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TYPICAL LANE AND EDGE LINE MARKING

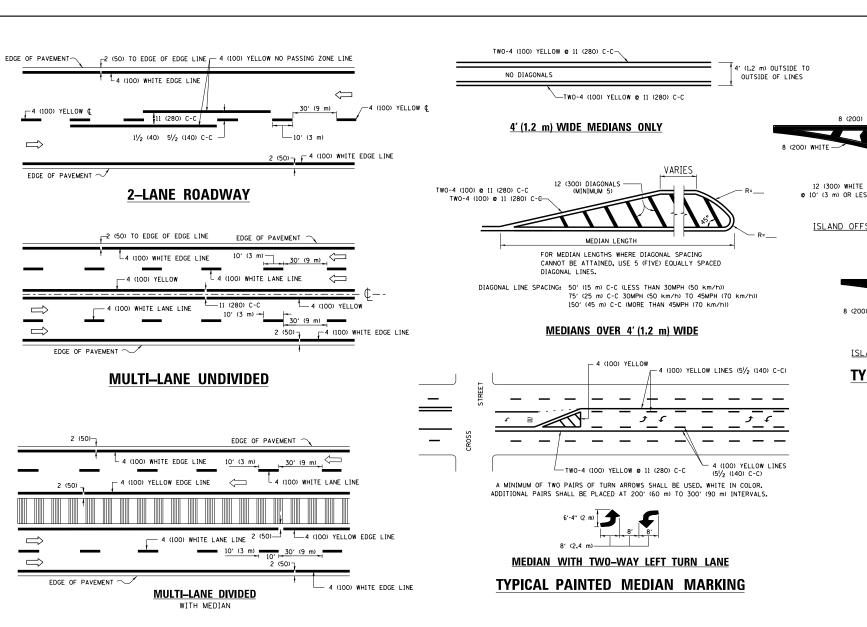

TYPICAL CROSSWALK MARKING

* MARKINGS SHALL BE INSTALLED PARALLEL TO THE CENTERLINE OF THE ROAD WHICH IT CROSSES

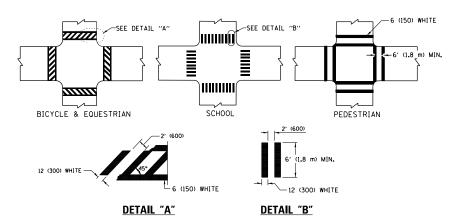−50′ (15 m) TO 200′ (60 m) ||

OVER 200' (60 m)


FULL SIZE LETTERS 8' (2.4 m) AND ARROWS SHALL BE USED.

ARROW - "ONLY".


AREA = 15.6 SO. FT. (1.5 m²) (NLY AREA = 20.8 SO. FT. (1.9 m²) * TURN LANES IN EXCESS OF 400' (120 m) IN LENGTH MAY HAVE AN ADDITIONAL SET OF ARROW - "ONLY" INSTALLED MIDWAY BETWEEN THE OTHER TWO SETS OF

TYPICAL LEFT (OR RIGHT) TURN LANE


TYPICAL TURN LANE MARKING

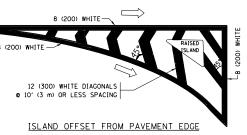




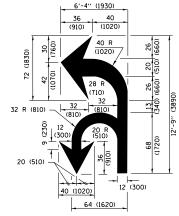

COMBINATION LEFT AND U-TURN

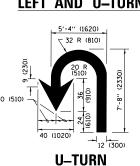

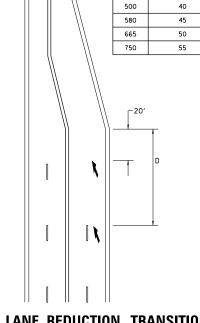

D(FT)

345

425

SPEED LIMIT

LANE REDUCTION TRANSITION

* LANE REDUCTION ARROWS REQUIRED AT SPEEDS OF 45 MPH OR GREATER OR WHEN SPECIFIED IN PLANS.

	T			T
TYPE OF MARKING	WIDTH OF LINE	PATTERN	COLOR	SPACING /REMARKS
CENTERLINE ON 2 LANE PAVEMENT	4 (100)	SKIP-DASH	YELLOW	10' (3 m) LINE WITH 30' (9 m) SPACE
CENTERLINE ON MULTI-LANE UNDIVIDED PAVEMENT	2 @ 4 (100)	SOLID	YELLOW	11 (280) C-C
NO PASSING ZONE LINES: FOR ONE DIRECTION FOR BOTH DIRECTIONS	4 (100) 2 @ 4 (100)	SOLID SOLID	YELLOW YELLOW	5½ (140) C-C FROM SKIP-DASH CENTERLINE 11 (280) C-C OMIT SKIP-DASH CENTERLINE BETWEEN
LANE LINES	4 (100) 5 (125) ON FREEWAYS	SKIP-DASH SKIP-DASH	WHITE WHITE	10' (3 m) LINE WITH 30' (9 m) SPACE
DOTTED LINES (EXTENSIONS OF CENTER, LANE OR TURN LANE MARKINGS)	SAME AS LINE BEING EXTENDED	SKIP-DASH	SAME AS LINE BEING EXTENDED	2' (600) LINE WITH 6' (1.8 m) SPACE
EDGE LINES	4 (100)	SOLID	YELLOW-LEFT WHITE-RIGHT	OUTLINE MEDIANS IN YELLOW
TURN LANE MARKINGS	6 (150) LINE; FULL SIZE LETTERS & SYMBOLS (8' (2.4m))	SOLID	WHITE	SEE TYPICAL TURN LANE MARKING DETAIL
TWO WAY LEFT TURN MARKING	2 @ 4 (100) EACH DIRECTION 8' (2.4m) LEFT ARROW	SKIP-DASH AND SOLID IN PAIRS	YELLOW WHITE	10' (3 m) LINE WITH 30' (9 m) SPACE FOR SKIP-DASH, 5½ (140) C-C BETWEEN SOLID LINE AND SKIP-DASH LINE SEE TYPICAL TWO-WAY LEFT TURN MARKING DETAIL
CROSSWALK LINES (PEDESTRIAN) A. DIAGONALS (BIKE & EOUESTRIAN) B. LONGITUDINAL BARS (SCHOOL)	2 @ 6 (150) 12 (300) @ 45° 12 (300) @ 90°	SOLID SOLID SOLID	WHITE WHITE WHITE	NOT LESS THAN 6' (1.8 m) APART 2' (600) APART 2' (600) APART 5EE TYPICAL CROSSWALK MARKING DETAILS.
STOP LINES	24 (600)	SOLID	WHITE	PLACE 4' (1.2 m) IN ADVANCE OF AND PARALLEL TO CROSSWALK, IF PRESENT. OTHERWISE, PLACE AT DESIRED STOPPING POINT. PARALLEL TO CROSSROAD CENTERLINE, WHERE POSSIBLE
PAINTED MEDIANS	2 @ 4 (100) WITH 12 (300) DIAGONALS @ 45° NO DIAGONALS USED FOR 4' (1.2 m) WIDE MEDIANS	SOLID	YELLOW: TWO WAY TRAFFIC WHITE: ONE WAY TRAFFIC	11 (280) C-C FOR THE DOUBLE LINE SEE TYPICAL PAINTED MEDIAN MARKING.
GORE MARKING AND CHANNELIZING LINES	8 (200) WITH 12 (300) DIAGONALS @ 45°	SOLID	WHITE	DIAGONALS: 15' (4,5 m) C-C (LESS THAN 30MPH (50 km/h)) 20' (6 m) C-C 30MPH (50 km/h) TO 45MPH (70 km/h)) 30' (9 m) C-C (OVER 45MPH (70 km/h))
RAILROAD CROSSING	24 (600) TRANSVERSE LINES; "RR" IS 6' (1.8 m) LETTERS; 16 (400) LINE FOR "X"	SOLID	WHITE	SEE STATE STANDARD 780001 AREA OF: "R"=3.6 SO. FT. (0.33 m²) EACH "X"=54.0 SO. FT. (5.0 m²)
SHOULDER DIAGONALS (REOUIRED FOR SHOULDERS ≥ 8′)	12 (300) © 45°	SOLID	WHITE - RIGHT YELLOW - LEFT	50' (15 m) C-C (LESS THAN 30MPH (50 km/h)) 75' (25 m) C-C (30 MPH (50 km/h) T0 45MPH (70 km/h) 150' (45 m) C-C (0VER 45MPH (70 km/h))
U TURN ARROW	SEE DETAIL	SOLID	WHITE	16.3 SF
2 ARROW COMBINATION LEFT AND U TURN	SEE DETAIL	SOLID	WHITE	30.4 SF

FOR FURTHER DETAILS ON PAVEMENT MARKING REFER TO STANDARD SPECIFICATIONS FOR ROAD AND BRIDGE CONSTRUCTION AND STATE STANDARD 780001.


All dimensions are in inches (millimeters) unless otherwise shown.

FILE NAME = DESIGNED - EVERS USER NAME = dahhanr REVISED - C. JUCIUS 09-09-09 ow:\\ILØ84EBIDINTEG.:ll:no: ments\IDOT Offices\District 1\Projects\P1242**12RGAWIN**ata\Design\DistStd.dgr REVISED -C. JUCIUS 07-01-13 CHECKED REVISED -C. JUCIUS 12-21-15 PLOT DATE = 12/14/2016 DATE 03-19-90 REVISED -C. JUCIUS 04-12-16

STATE OF ILLINOIS **DEPARTMENT OF TRANSPORTATION**

____ 6 (150) WHITE


DISTRICT ONE	F.A.P. RTE.	SECTION	COUNTY	TOTAL S SHEETS	SHEET NO.
TYPICAL PAVEMENT MARKINGS	347	CY-N-1	DUPAGE	71 6	61
		TC-13	CONTRACT	NO. 60	0000
SCALE: NONE SHEET 1 OF 1 SHEETS STA. TO STA.		ILLINOIS FED. A	D PROJECT		

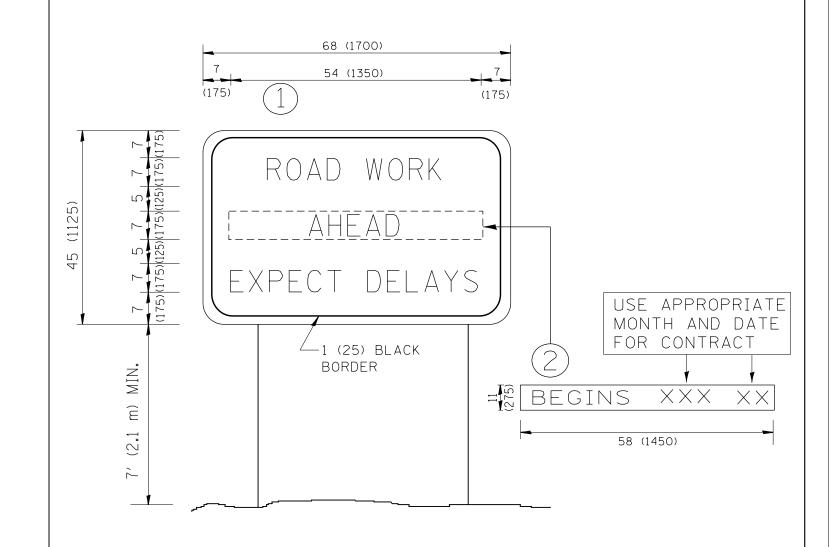

NOTES:

- 1. USE BLACK LETTERING ON ORANGE BACKGROUND.
- 2. ERECT SIGNS IN ADVANCE OF THE LOCATION FOR THE "ROAD CONSTRUCTION AHEAD" SIGN AT LOCATIONS AS DIRECTED BY THE ENGINEER.
- 3. ERECT SIGN (1) WITH INSTALLED PANEL (2) ONE WEEK PRIOR TO THE START OF CONSTRUCTION.
- 4. REMOVE PANEL 2 SOON AFTER THE START OF CONSTRUCTION.
- 5. SEE SPECIAL PROVISION FOR "TEMPORARY INFORMATION SIGNING" FOR ADDITIONAL INFORMATION.
- 6. ONE SIGN ASSEMBLY EQUALS 25.70 SQ. FT. (2.3 SQ. M.)
- 7. SHALL BE PAID FOR AS TEMPORARY INFORMATION SIGNING.

F	ILE NAME =	USER NAME = dahhanr	DESIGNED -	REVISED - R. MIRS 09-15-97			ARTERIAL ROA	AD.	F.A.P.	SECTION	COUNTY TOTAL SHEET
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		PLOT SCALE = 100.0000 '/ in.	CHECKED -	REVISED -T. RAMMACHER 02-02-99	DEPARTMENT OF TRANSPORTATION		INFORMATION	SIGN		TC-22	CONTRACT NO. 60V00
		PLOT DATE = 12/14/2016	DATE -	REVISED - C. JUCIUS 01-31-07		SCALE: NONE	SHEET NO. 1 OF 1 SHEETS	STA. TO STA.	FED. ROAD	DIST. NO. 1 ILLINOIS FED.	AID PROJECT

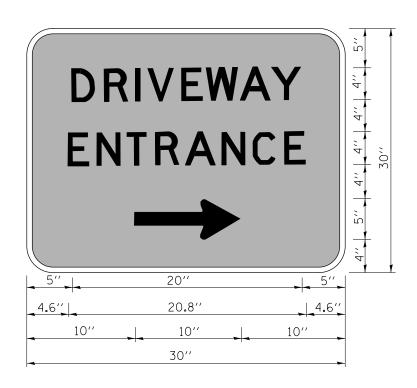

3.0" RADIUS, 0.5" BORDER, WHITE ON GREEN; REFLECTORIZED "DRIVEWAY" D; "ENTRANCE" D; STANDARD ARROW CUSTOM 12.0" x 5.0"

NOTES:


- 1. HALF OF THE SIGNS WILL REQUIRE A LEFT HAND FACING ARROW.
- 2. TWO SIGNS SHALL BE USED AT EACH COMMERCIAL ENTRANCE PLACED BACK-TO-BACK: ONE WITH A RIGHT HAND ARROW (SHOWN) SHALL BE PLACED ON THE NEAR RIGHT SIDE THE DRIVEWAY AND ONE WITH A LEFT HAND ARROW SHALL BE PLACED ON THE FAR LEFT SIDE OF THE DRIVEWAY.
- 3. SIGNS TO BE PAID FOR AS ITEM "TEMPORARY INFORMATION SIGNING".


FILE NAME =	USER NAME = dahhanr	DESIGNED -	REVISED	-	C. JUCIUS 02-15-07
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	PLOT SCALE = 100.0000 '/ in.	CHECKED -	REVISED	-	
	PLOT DATE = 12/14/2016	DATE -	REVISED	-	


STATE OF ILLINOIS	
DEPARTMENT OF TRANSPORTATION	


	DRIVEWAY	ENTRANC	E SIGNING		F.A.P. RTE.	SECTION	COUNTY	TOTAL SHEETS	SHEET NO.
					347	CY-N-1	DUPAGE	71	63
						TC-26	CONTRACT	NO. 6	ovoo
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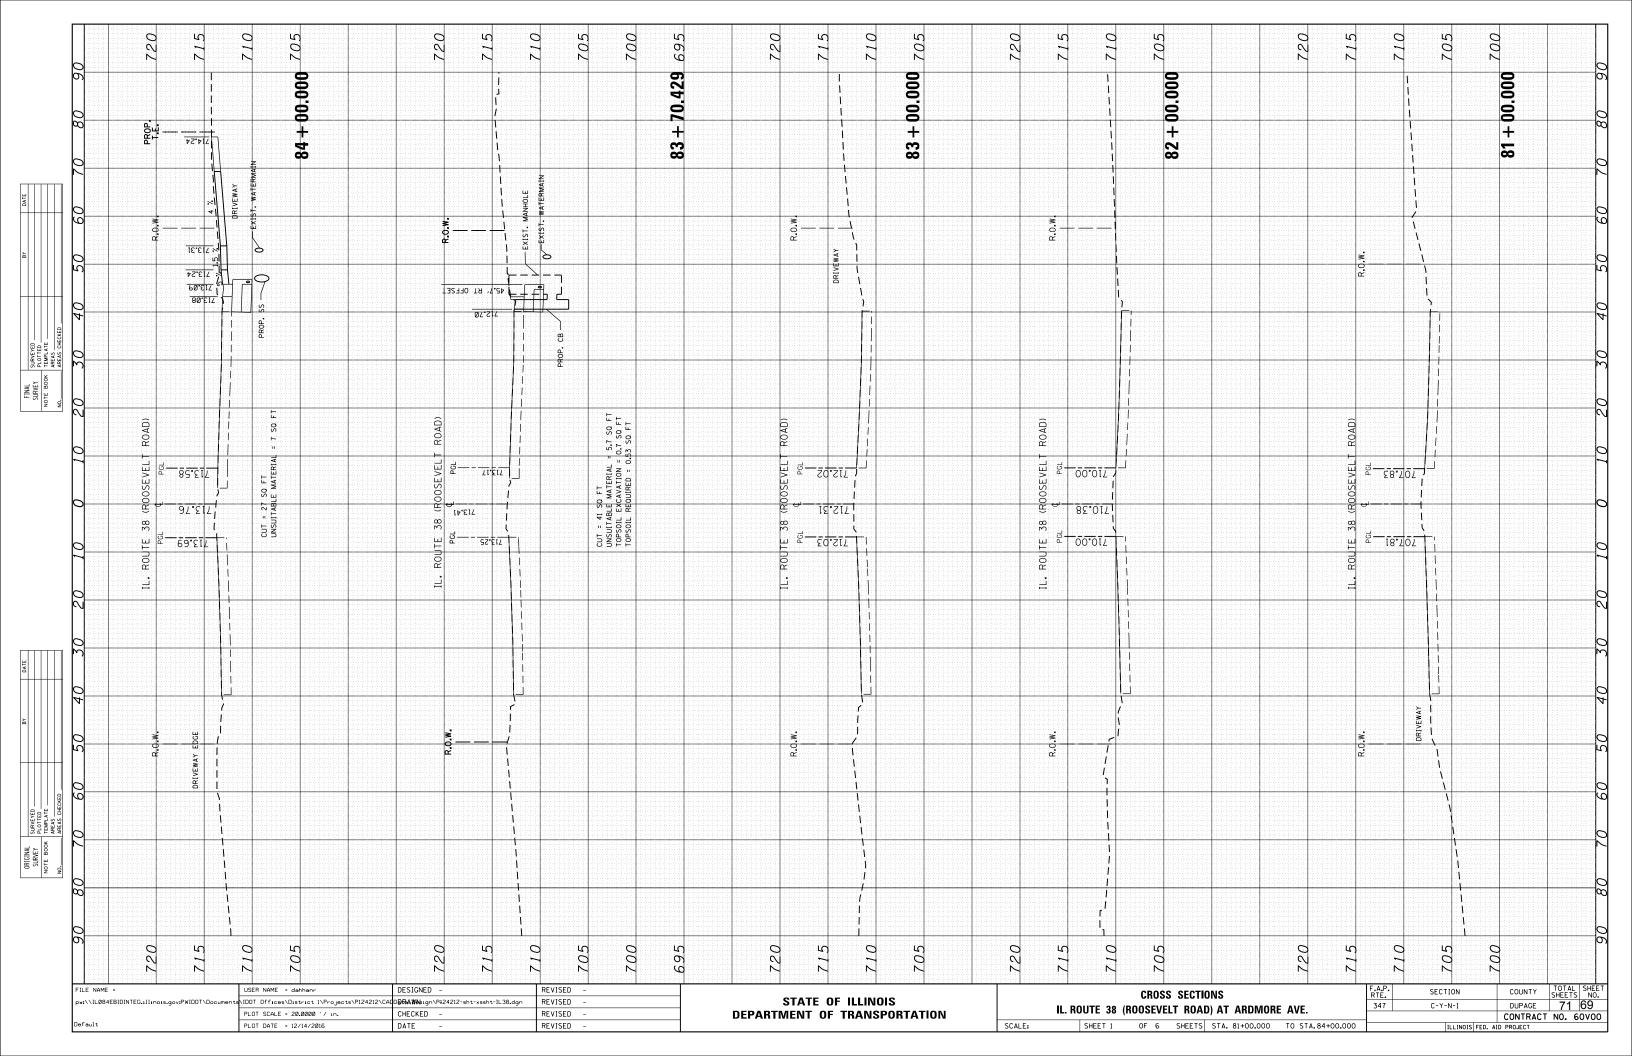
			ORIGINAL SURVEY NOTE BOOK TEMPLATE— NO. AREAS CHEC	XED .	BY DATE				FINAL SURVEYED SURVEYED NOTE BOOK TEMPLATE NO. AREAS OFFICED	Ву	DATE		
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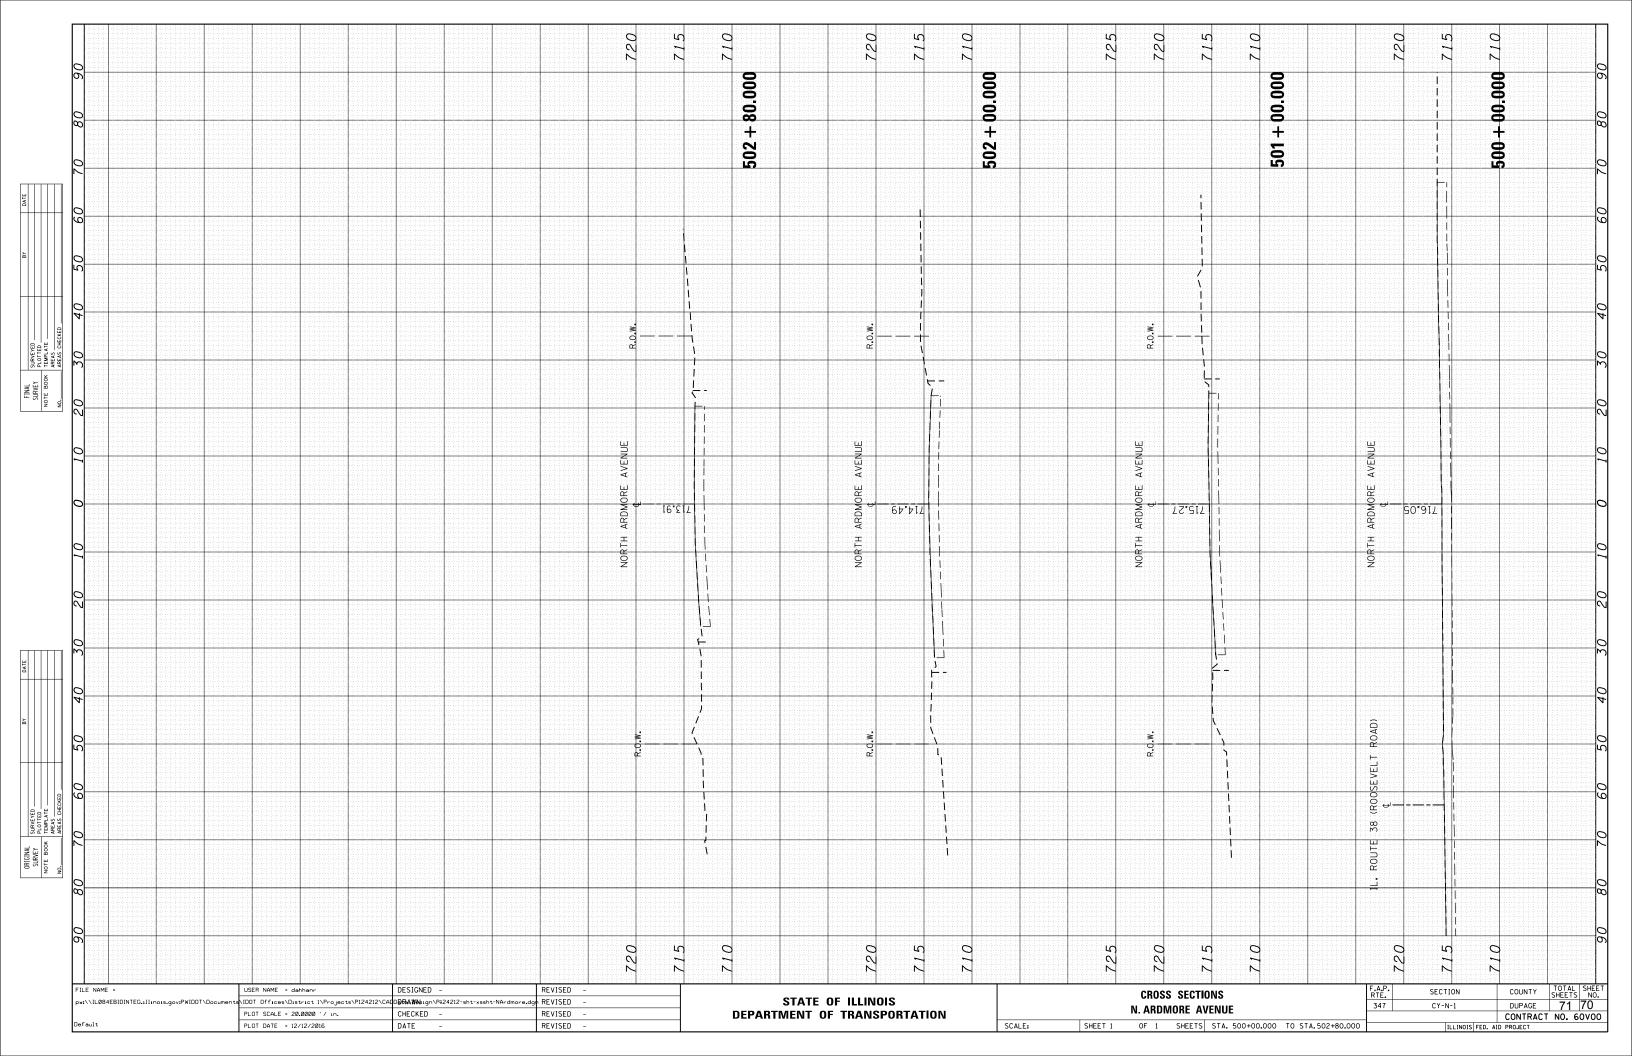




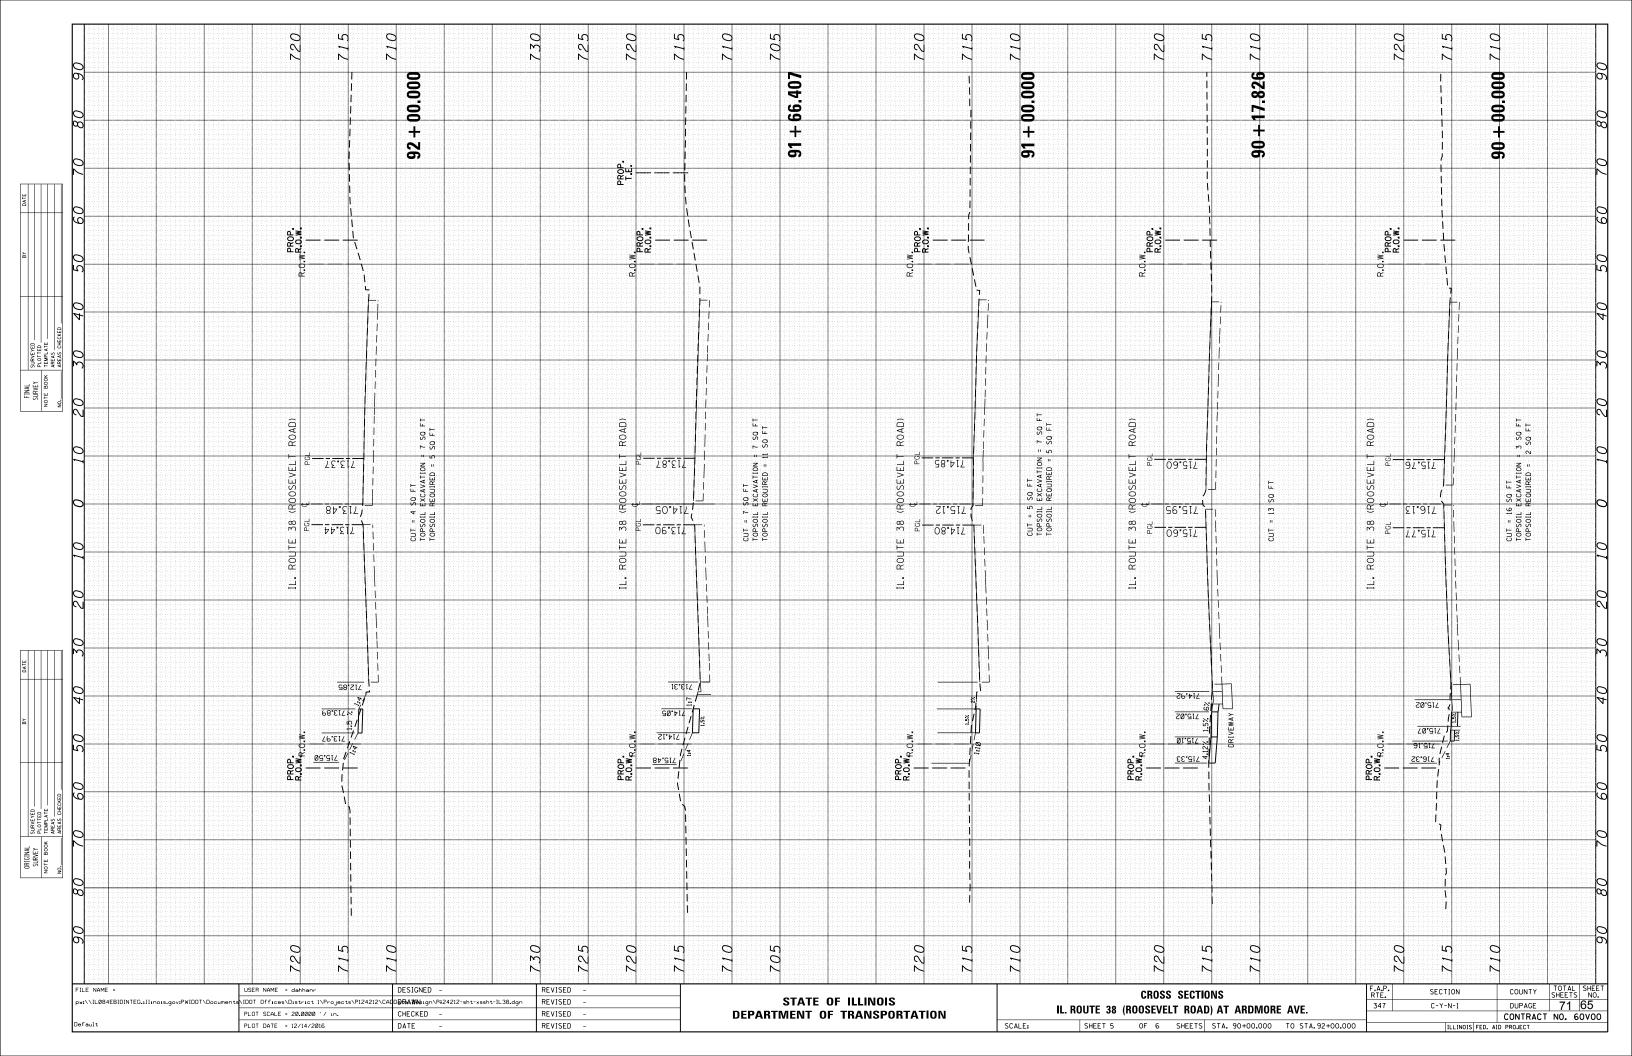

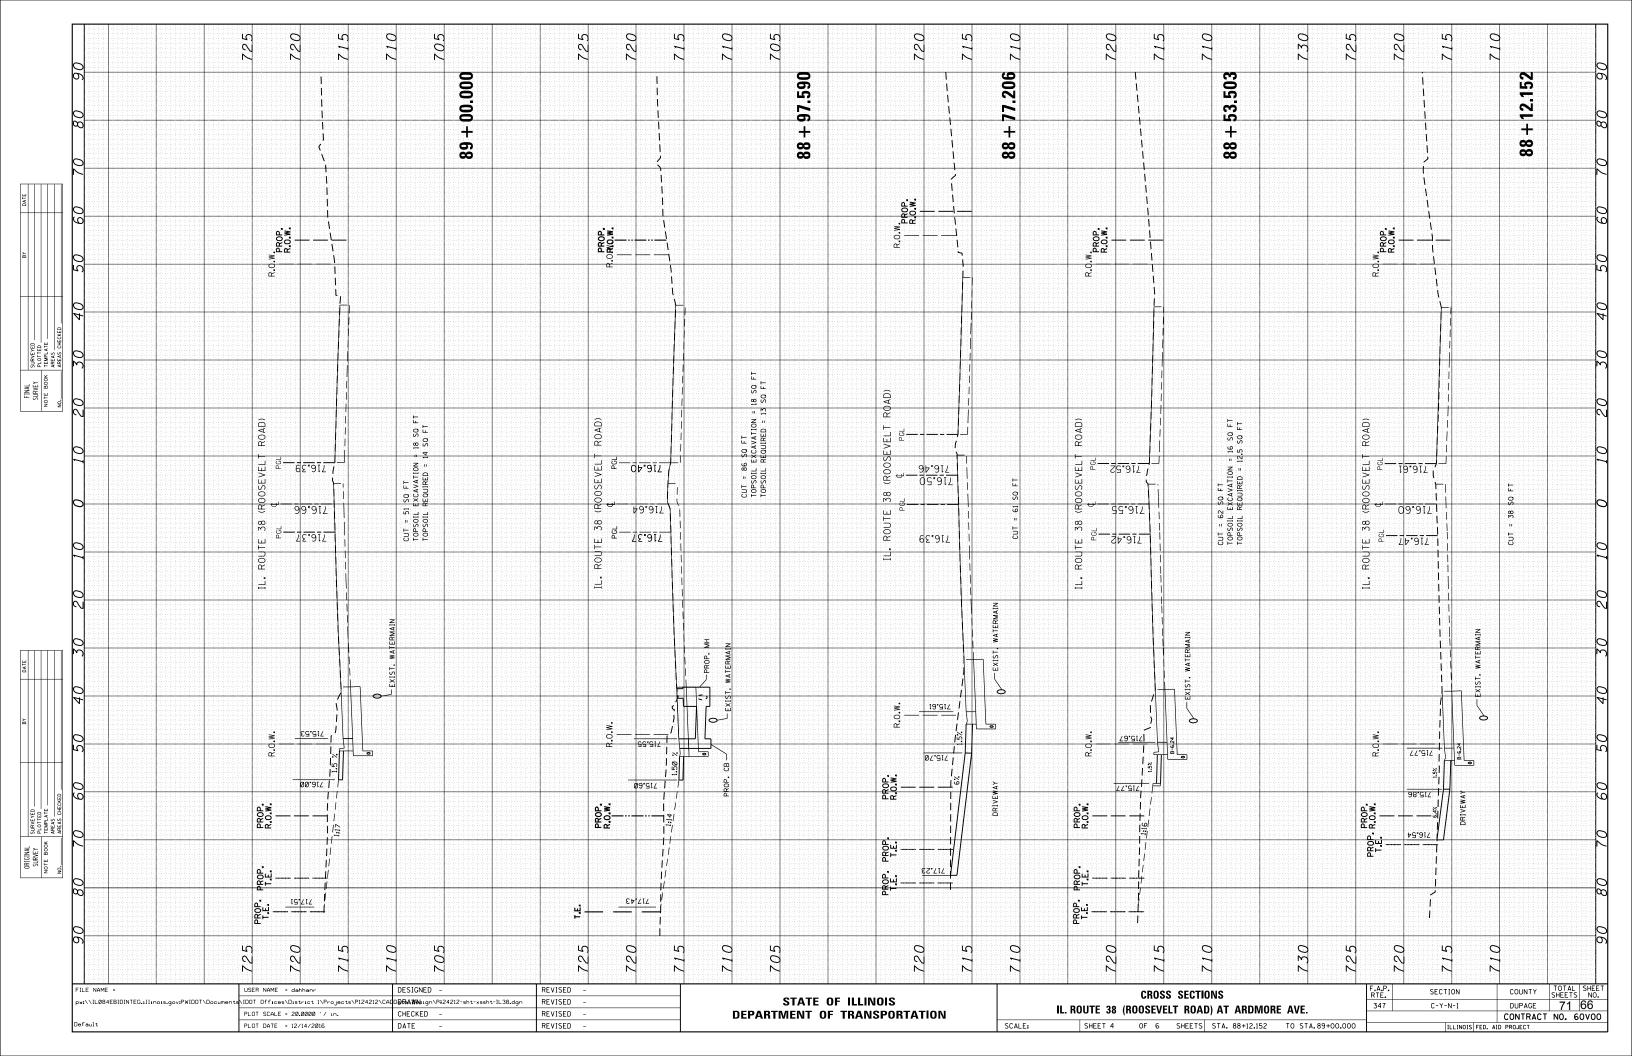

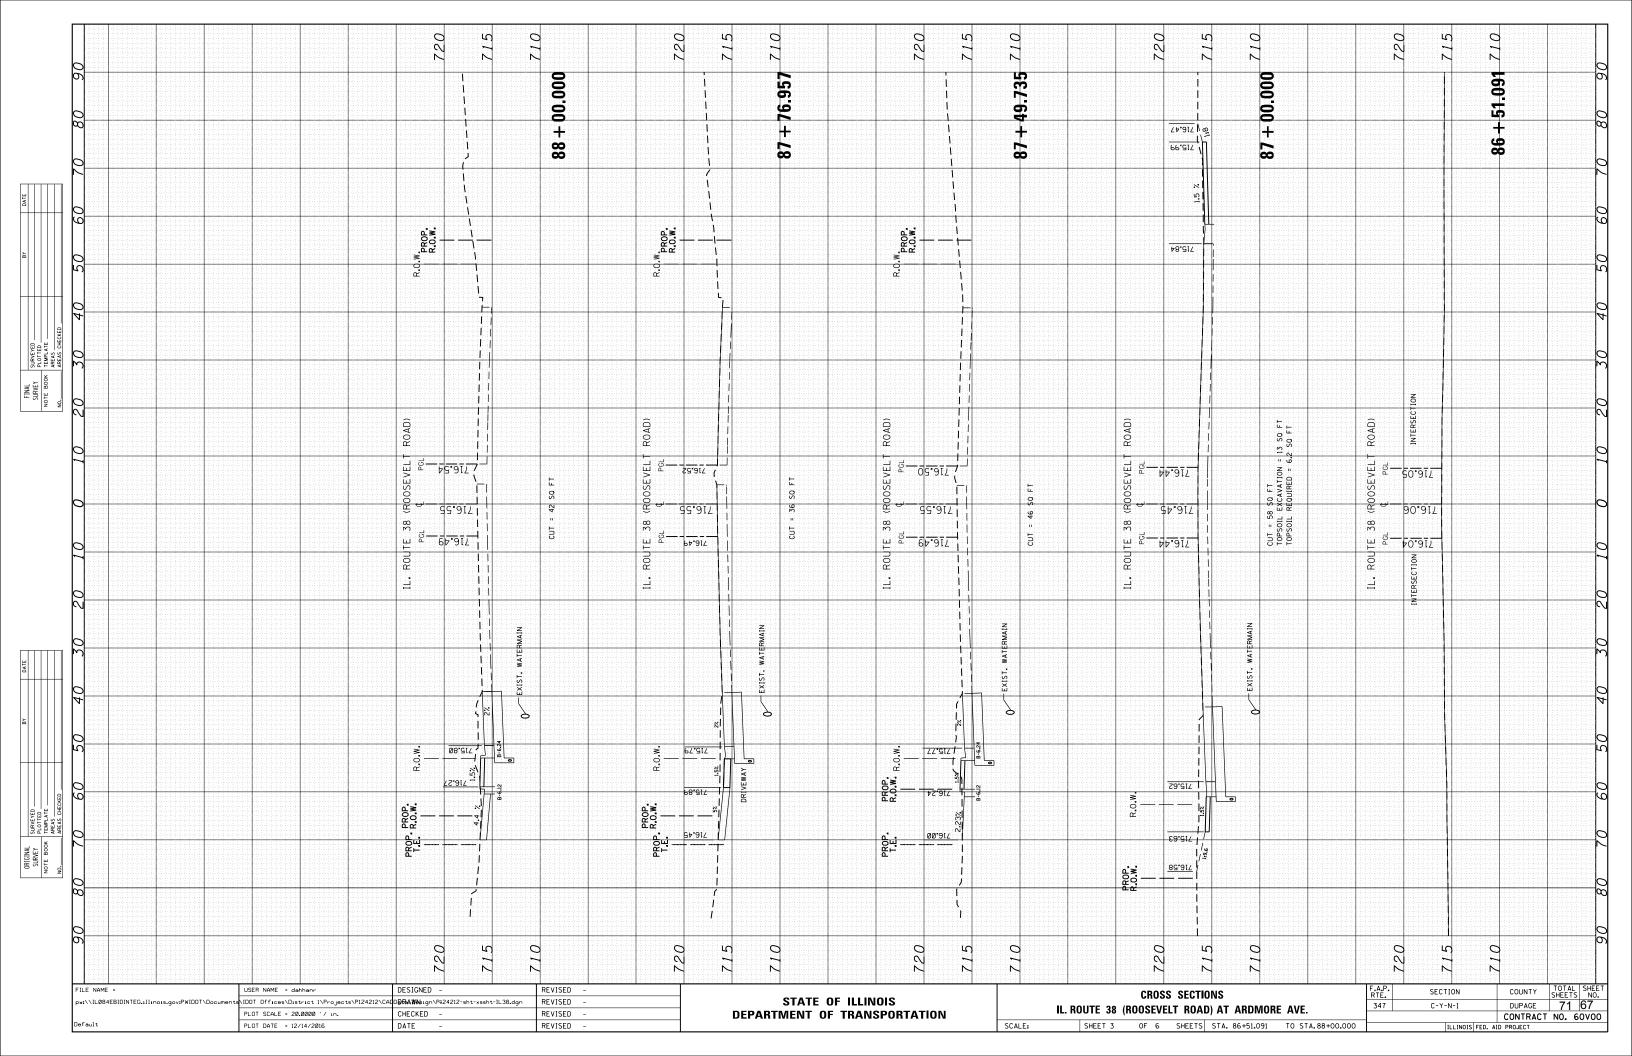

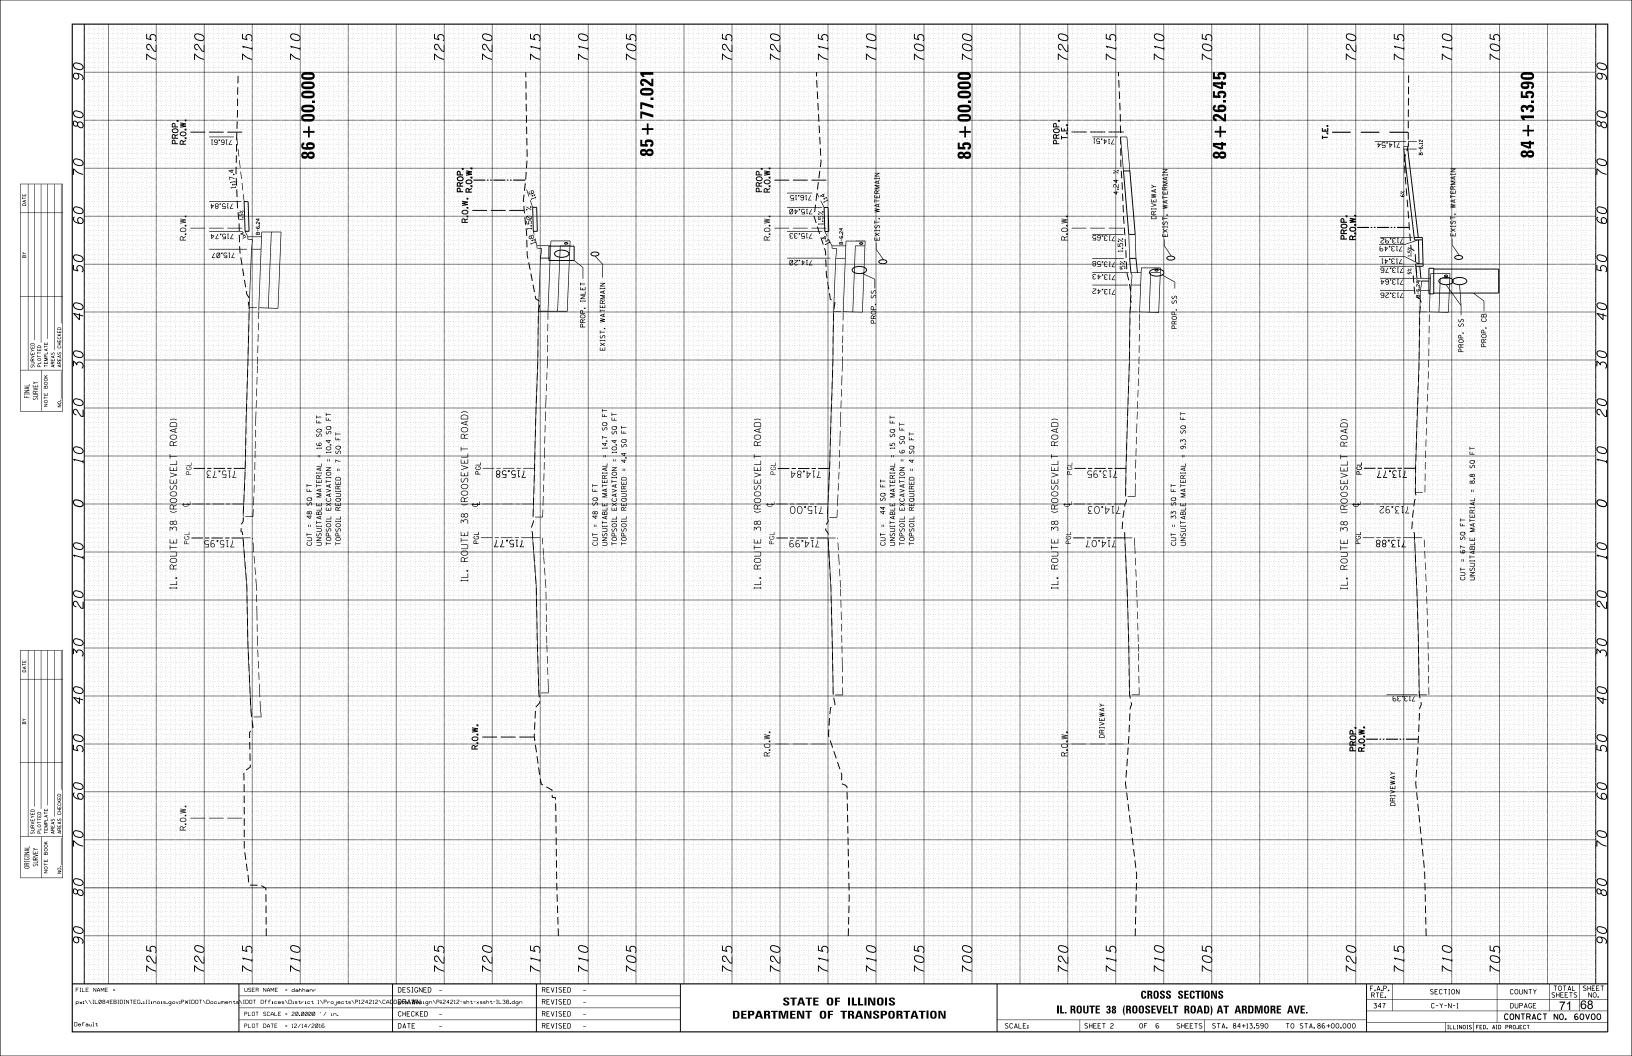

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