INDEX OF SHEETS

5-8

9-13

631032-08

635006-03

635011-02

701006-05

701101-04

701411-08

701427-02

701451-02

701501-06

701701--09

701801-05

701901-03

720011-01

728001--01

ADT = 31.200 (2012)

**COVER SHEET** 

**GENERAL NOTES** 

DETOUR PLAN

**HIGHWAY STANDARDS** 

STRUCTURE PLANS

SUMMARY OF QUANTITIES

SCHEDULE OF QUANTITIES

MAINTENANCE OF PEDESTRIAN TRAFFIC

TRAFFIC CONTROL FOR ROAD CLOSURE (40.1)

TRAFFIC BARRIER TERMINAL, TYPE 6A

RAMP CLOSURE FREEWAY/EXPRESSWAY

TRAFFIC CONTROL DEVICES

TELESCOPING STEEL SIGN SUPPORT

URBAN LANE CLOSURE, 2L, 2W, UNDIVIDED

URBAN LANE CLOSURE, MULTILANE, INTERSECTION

METAL POSTS FOR SIGNS, MARKERS & DELINEATORS

SIDEWALK, CORNER, OR CROSSWALK CLOSURE

APPLICATION OF TYPES A & B METAL POSTS

STANDARD SYMBOLS, ABBREVIATIONS, AND PATTERNS

OFF-RD OPERATIONS, 2L, 2W, 15' (4.5M) TO 24" (600mm) FROM PAVEMENT EDGE

OFF-RD OPERATIONS, MULTILANE, 15' (4.5M) TO 24" (600mm) FROM PAVEMENT EDGI

LANE CLOSURE, MULTILANE, AT ENTRANCE OR EXIT RAMP, FOR SPEEDS > 45MPH

LANE CLOSURE, MULTILANE, DAY OPERATIONS ONLY, FOR SPEEDS > 45MPH TO 55MPH

LANE CLOSURE, MULTILANE, INTERMITTANT OR MOVING OPER., FOR SPEEDS < 40MPH

URBAN LANE CLOSURE, MULTILANE, 1W OR 2W WITH NONTRAVERSABLE MEDIAN

REFLECTOR AND TERMINAL MARKER PLACEMENT

REFLECTOR MARKER AND MOUNTING DETAILS

CHICAGO, STV INCORPORATED PHONE: 312-553-0655; 02-28-14 LETTING ITEM 066

STATE OF ILLINOIS


# DEPARTMENT OF TRANSPORTATION


# **PROPOSED**

F.A.P. ROUTE 308 (US 67) SECTION (3BR)M

**ROCK ISLAND COUNTY** 

## R3E IOWA

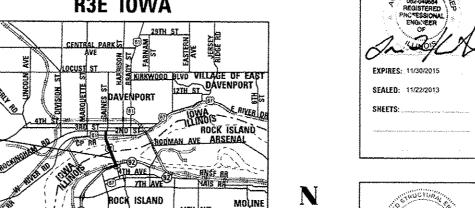

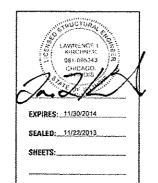

STATE OF ILLINOIS

DEPARTMENT OF TRANSPORTATION

LOCATION OF SECTION INDICATED THUS: -

ROCK ISLAND 7 47 1 ILLINOIS CONTRACT NO. 64H28

D-92-098-11

PLANS PREPARED BY STV Incorporated Chicago, Illinois (312)553-0655

PRINTED BY THE AUTHORITY OF THE STATE OF ILLINOIS

# **DIVISION OF HIGHWAYS**

# HIGHWAY PLANS

TYPE OF IMPROVEMENT: BRIDGE REPAIR C-92-090-12

# **DESCRIPTION OF IMPROVEMENT**

SN # 081-9905

THE IMPROVEMENT CONSISTS OF STRUCTURAL STEEL REPAIRS: BEAMS, BRACKETS, HANGERS. CANOPY AND JOINT REPAIRS, HANDRAIL AND POSTS REPLACEMENT TO STRUCTURE CARRYING US 67 (CENTENNIAL BRIDGE) OVER THE MISSISSIPPI RIVER (S.N. 081-9905).

ENGINEERING SCALES, REDUCED SIZED PLANS WILL NOT CONFORM TO STANDARD SCALES. IN MAKING MEASUREMENTS ON REDUCED PLANS, THE ABOVE SCALES MAY BE USED.

J.U.L.I.E. JOINT UTILITY LOCATION INFORMATION FOR EXCAVATION 1-800-892-0123 OR 811

**ROCK ISLAND TOWNSHIP, SECTIONS: 35, 26** 

**CONTRACT NO. 64H28** 

GROSS LENGTH OF IMPROVEMENT = 3854 FT = 0.730 MILESNET LENGTH OF IMPROVEMENT = 3854 FT = 0.730 MILES


**R2W ILLINOIS** 


**T78N** 

**T18N** 





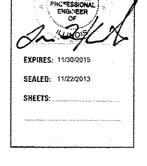

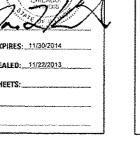



F.A.P. ROUTE 308, SECTION (3BR)M, ROCK ISLAND COUNTY

# GENERAL NOTES

i. THE CONTRACTOR SHALL BE RESPONSIBLE FOR PROTECTING UTILITY PROPERTY DURING CONSTRUCTION OPERATIONS AS OUTLINED IN ARTICLE 107.31 OF THE STANDARD SPECIFICATIONS A MINIMUM OF 48 HOURS ADVANCE NOTICE IS REDUIRED FOR NON-EMERGENCY WORK. THE JULIE NUMBER IS 800-892-0123, FOLLOWING ARE THE KNOWN UTILITIES LOCATED WITHIN THE PROJECT LIMITS OR IMMEDIATELY ADJACENT TO THE PROJECT CONSTRUCTION LIMITS WHICH ARE MEMBERS OF JULIE:

MEMBERS OF JULIE:			
NAME AND ADDRESS OF UTILITY	TYPE OF UTILITY	TELEPHONE	MEMBER OF J.U.L.I.E.
DAVE CREEN AT&T 2800-7TH STREET MOLINE, IL 61265	TELEPHONE	(309) 757-4707	YES
JASON TERRY MIDAMERICAN ENERGY COMPANY 2811-5TH AVENUE ROCK ISLAND, IL 61201	ELECTRIC	(309) 793-3649	YES
ROD HAWK MIDAMERICAN ENERGY COMPANY 2811-5TH AVENUE ROCK ISLAND, IL 61201	GAS	(309) 793-3760	YES
BRENT GIESE CENTURYLINK-OWEST COMMUNICATIONS 3908 UTICA RIDGE ROAD BETTENDORF, IA 52722	TELEPHONE	(563) 355-6402	YES
PAUL BAUMANN WINDSTREAM 1815 S. MEYERS ROAD, SUITE 900 OAKBROOK TERRACE, IL 60181	TELEPHONE	(630) 925-4751	YES
DENNIS JARDING MEDIACOM 3900-26TH AVENUE MOLINE, ILLINOIS 61265	CATV	(309) 743-4750	YES
KEN BAILEY MCI WORLD COM 2400 N. GLENVILLE. DEPT 401103/107 ATTN: INVESTIGATIONS, DEPT. 42864/107 RICHARDSON, TX 75082	TELEPHONE	(972) 729-6016	YES
JIM JOHNSON CITY OF ROCK ISLAND 1309 MILL STREET ROCK ISLAND, ILLINOIS 61201	WATER & SEWER	(309) 732-2238	YES

- A NATIONWIDE 404 PERMIT HAS BEEN ISSUED FOR THIS PROJECT AND THE CONDITIONS OF THAT PERMIT MUST BE ADHERED TO.
- 3. THIS STRUCTURE WILL RETAIN THE SAME NUMBER 081-9905.
- 4. THE CONTRACTOR SHALL SUPPLY THE RESIDENT ENGINEER WITH THE MANUFACTURER'S INSTALLATION REQUIREMENTS FOR THE TYPE OF IMPACT ATTENUATORS (FULLY REDIRECTIVE, NARROW), TEST LEVEL 2.

USER NAME = thompsed	DESIGNED	-	RDT/GC	REVISED	-
	DRAWN	-	RDT	REVISED	
PLOT SCALE = 20.0000 '/ m.	CHECKED	-	JAC	REVISED	•
PLOT DATE = 11/22/22/3	DATE		11-08-2013	REVISED	*

STATE OF ILLINOIS
DEPARTMENT OF TRANSPORTATION

SCALE:

Į.	RTE.	SECTION	COUNTY	TOTAL SHEETS	SHEET NO.
GENERAL NOTES	308	(3BR)M	ROCK ISLAND	47	2
		C-92-090-12	CONTRACT	NO. E	4H28
SHEET NO. 2 OF 47 SHEETS STA. TO STA.		ILLINOIS FED. AL	D PROJECT HSIP	XXXX (XX	X)

	ITEM *	ITEM DESCRIPTION	UNIT	TOTAL OUANTITY	ROADWAY 0004	BRIDGE 0014
_	50102400	CONCRETE REMOVAL	CU YO	10.0		10.
		PROTECTIVE SHIELD	SO YD	357		3
	50300255	CONCRETE SUPERSTRUCTURE	CÚ YĐ	10.0		10
	50500405	FURNISHING AND ERECTING STRUCTURAL STEEL	POUND	29,322		29,32
	50800205	REINFORCEMENT BARS, EPOXY COATED	POUND	1, 240		1, 2
	52000600	FABRIC REINFORCED ELASTOMERIC TROUGH	FOOT	94		
	52100540	ANCHOR BOLTS, 1 1/2"	EACH	4		
*	63100087	TRAFFIC BARRIER TERMINAL, TYPE 6A	EACH	1	1	
		IMPACT ATTENUATORS (FULLY REDIRECTIVE, NARROW), TEST LEVEL 2	EACH		The state of the s	
		ENGINEER'S FIELD OFFICE. TYPE A	CAL MO	3		
		MOBILIZATION	L SUM	1	1	
_		TRAFFIC CONTROL AND PROTECTION, STANDARD 701421	L SUM	1		
~		TRAFFIC CONTROL AND PROTECTION, STANDARD 701411	EACH	4	4	
-		TRAFFIC CONTROL AND PROTECTION, STANDARD 701451	L SUM			
-		TRAFFIC CONTROL AND PROTECTION, STANDARD 701501	L SUM		1	
_		TRAFFIC CONTROL AND PROTECTION, STANDARD 701601	L SUM			
_		TRAFFIC CONTROL AND PROTECTION, STANDARD 701701	L SUM			
_		TRAFFIC CONTROL AND PROTECTION, STANDARD 701801	L SUM		-	
, -		CHANGEABLE MESSAGE SIGN	CAL MO	12	12	
_		NIGHTTIME WORK ZONE LIGHTING	L SUM	1	14	
		TEMPORARY PAVEMENT MARKING - LINE 4"	FOOT	553	553	
-		WORK ZONE PAVEMENT MARKING REMOVAL	SOFT	184	184	
_		GUARDRAIL MARKERS, TYPE A	EACH	4		
-					3	
		CONCRETE PAD	SO YD			14
_		BOLT REPLACEMENT	EACH	105		
		STEEL BRIDGE RAIL POSTS	EACH	ØI		4
		REMOVE AND REINSTALL FINGER PLATE JOINT	EACH	4		
		FURNISH AND INSTALL HANDRAIL	F001	3, 404		3, 4
1 -		TRAFFIC CONTROL AND PROTECTION, (SPECIAL)	L SUM	00.700	1	~~~~~~~~~~~~~~~~~~~~~~~~~~~~~~~~~~~~~~~
_		STRUCTURAL STEEL REMOVAL	POUND	28,769		28,76
		STRUCTURAL STEEL REPAIR	l	49,140		49,14
		BRIDGE HANDRAIL REMOVAL	FOOT	3, 404		3, 4
	1	CLEANING DRAINAGE SYSTEM	L SUM	1		
	20012754	STRUCTURAL REPAIR OF CONCRETE (DEPTH EQUAL TO OR LESS THAN 5 INCHES)	SQ FT	588		Ē
	Z0018800	DRAINAGE SYSTEM	L SUM	1		
	70051955	SILICONE JOINT SEALER	FOOT			
	20048665	RAILROAD PROTECTIVE LIABILITY INSURANCE	L SUM.	1		
	Z0073200	TEMPORARY SHORING AND CRIBBING	EACH EACH	14		
27************************************	X0327943	TEMPORARY SUPPORT SYSTEM CANDPY REPAIR	L SUM	1		
	X0336288	GRINDING AND REMOVAL OF TACK WELDS	EACH	3		

\* SPECIALTY ITEM

1	USER NAME s thempard	DESIGNED	-	RDT/GC	REVISED -	
		DRAWN	-	RDT	REVISED -	
	PLOT SCALE = 28.8888 1/ In.	CHECKED	-	JAC	REVISED -	
	PLOT- DATE = 11/27/2013	DATE	+	11-08-2013	REVISED -	Ĺ

STATE	0F	ILLINOIS
DEPARTMENT O	)F ]	<b>TRANSPORTATION</b>

### 10100420 - TRAFFIC CONTROL AND PROTECTION. STANDARD 701411

LOCATION	EACH
B ON RAMP FROM IL 92 TO US 67	1
8 ON RAMP FROM IL 92 TO US 67	1
B ON RAMP FROM BROWN STREET TO US 67	1

JRAFFIC CONTROL AND PROTECTION. STANDARD 701411. TOTAL: 4

### 70106800 - CHANGEABLE MESSAGE SIGN

LOCATION	CAL MO
DETOUR US ROUTE 67 NORTH BOUND	
AT IL 92 SOUTH OF 1-280	2
AT IL 92 EAST OF 16TH STREET	2
AT INTERSECTION OF US 67 AND 4TH AVENUE	2
DETOUR US ROUTE 67 SOUTH BOUND	
AT W RIVER DRIVE EAST OF SCOTT STREET	
AT 4TH STREET EAST OF WESTERN	2
AT GAINES STREET NORTH OF 4TH STREET	2

CHANGEABLE MESSAGE SIGN. TOTAL= 12
CAL MD

### 78200410 - GUARDRAIL MARKERS, TYPE A

LOCATION					
SW END OF BRIDGE RAILING AT TRAFFIC BARRIER TERMINAL TYPE 6A	4				

GUARDRAIL MARKERS, TYPE A, TOTAL 4 EACH


### WORK ZONE PAVEMENT MARKING


LOCATION	YELLOW SOLID	4" WHITE SKIP DASH	4" WHITE SOLID	4'' DOUBLE YELLOW	WORK ZONE PAVEMENT MARKING REMOVAL
	FOOT	FOOT	FOOT	FOOT	SO FT
NB US ROUTE 67 from 3rd Ave to 2nd Ave	325				108
NB Brown St from 2nd St to US 61/E River Dr		<u> </u>	228		76
Totals	325	0	228	0	184
TO300220 - TEMPORARY PAVEMENT MARKING - LINE 4	R				553
70301000 - WORK ZONE PAVEMENT MARKING REMOVAL					184

	USER NAME a thompsed	DESIGNED - ROT/GC	REVISED -	
		DRAWN - RDT	REVISED -	
į	PLOT SCALE = 20.0000 '/ in,	CHECKED - JAC	REVISED -	
- 3	PLOT CATS * 11/22/2019	DATE - 11-08-2013	REVISED -	

STATE OF ILLINOIS
DEPARTMENT OF TRANSPORTATION

**********	US 67 OVER MISSISSIPPI RIVER STRUCTURE NO. 081-9905  SCHEDULE OF QUANTITIES 1  SCALE: SHEET NO. 4 DF 47 SHEETS STA. TO STA.					SECTION	COUNTY	TOTAL SHEETS	SHEET NO.
ļ						(3BR)M	ROCK ISLAND	47	4
*						C-92-090-12	CONTRACT	NO. E	4H28
-						ILLINOIS FED. A	O PROJECT HSIP	-xxxx (xx	(X)

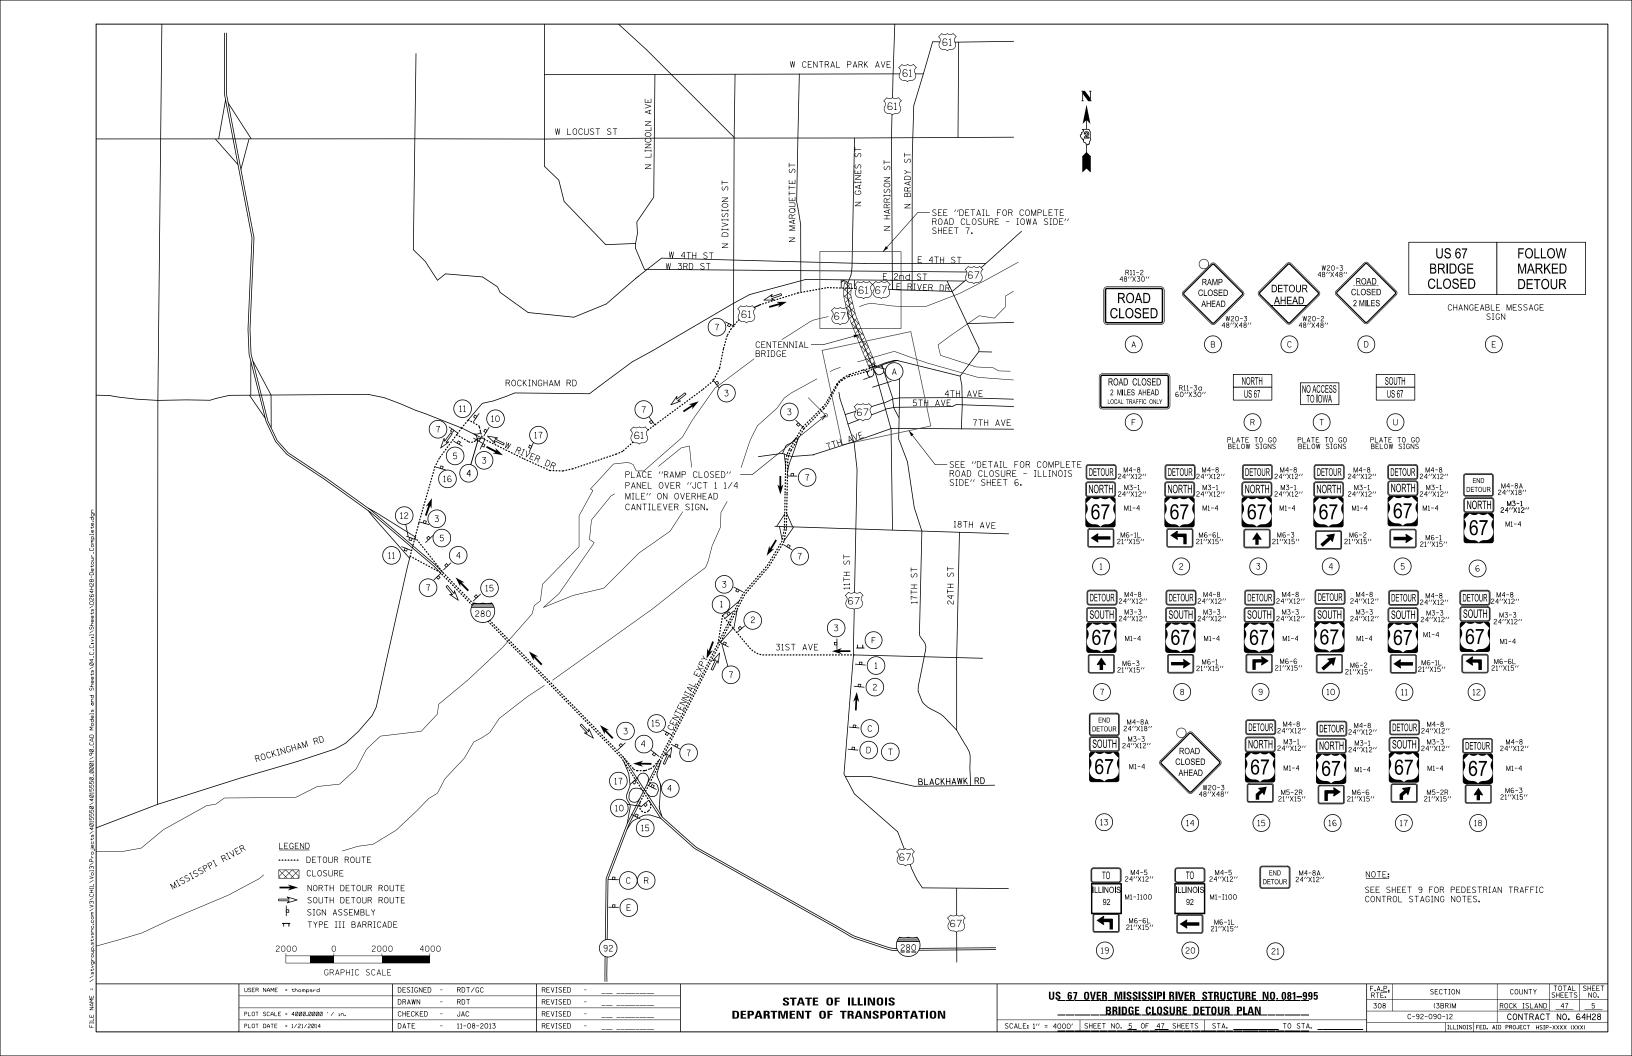

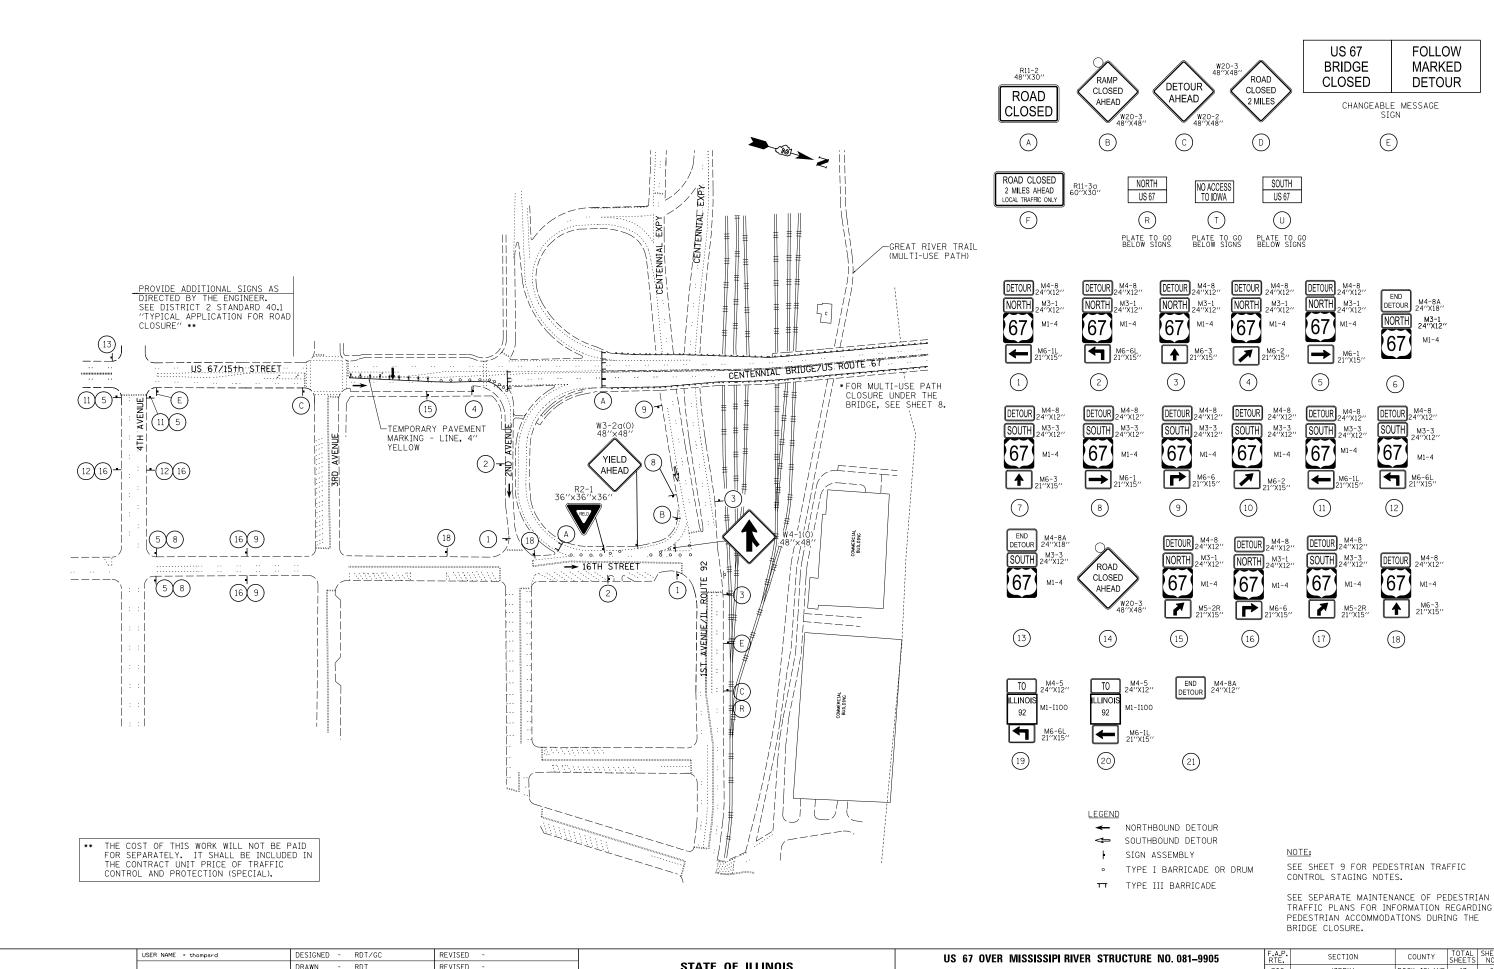

STATE OF ILLINOIS REVISED CHECKED REVISED **DEPARTMENT OF TRANSPORTATION** 11-08-2013 REVISED


PLOT SCALE = 200.0000 '/ in.

DATE

PLOT DATE = 1/21/2014

DETAIL FOR COMPLETE ROAD CLOSURE - ILLINOIS SIDE SCALE: 1" = 100' SHEET NO. 6 OF 47 SHEETS STA.

308 (3BR)M ROCK ISLAND 47 6 C-92-090-12 CONTRACT NO. 64H28

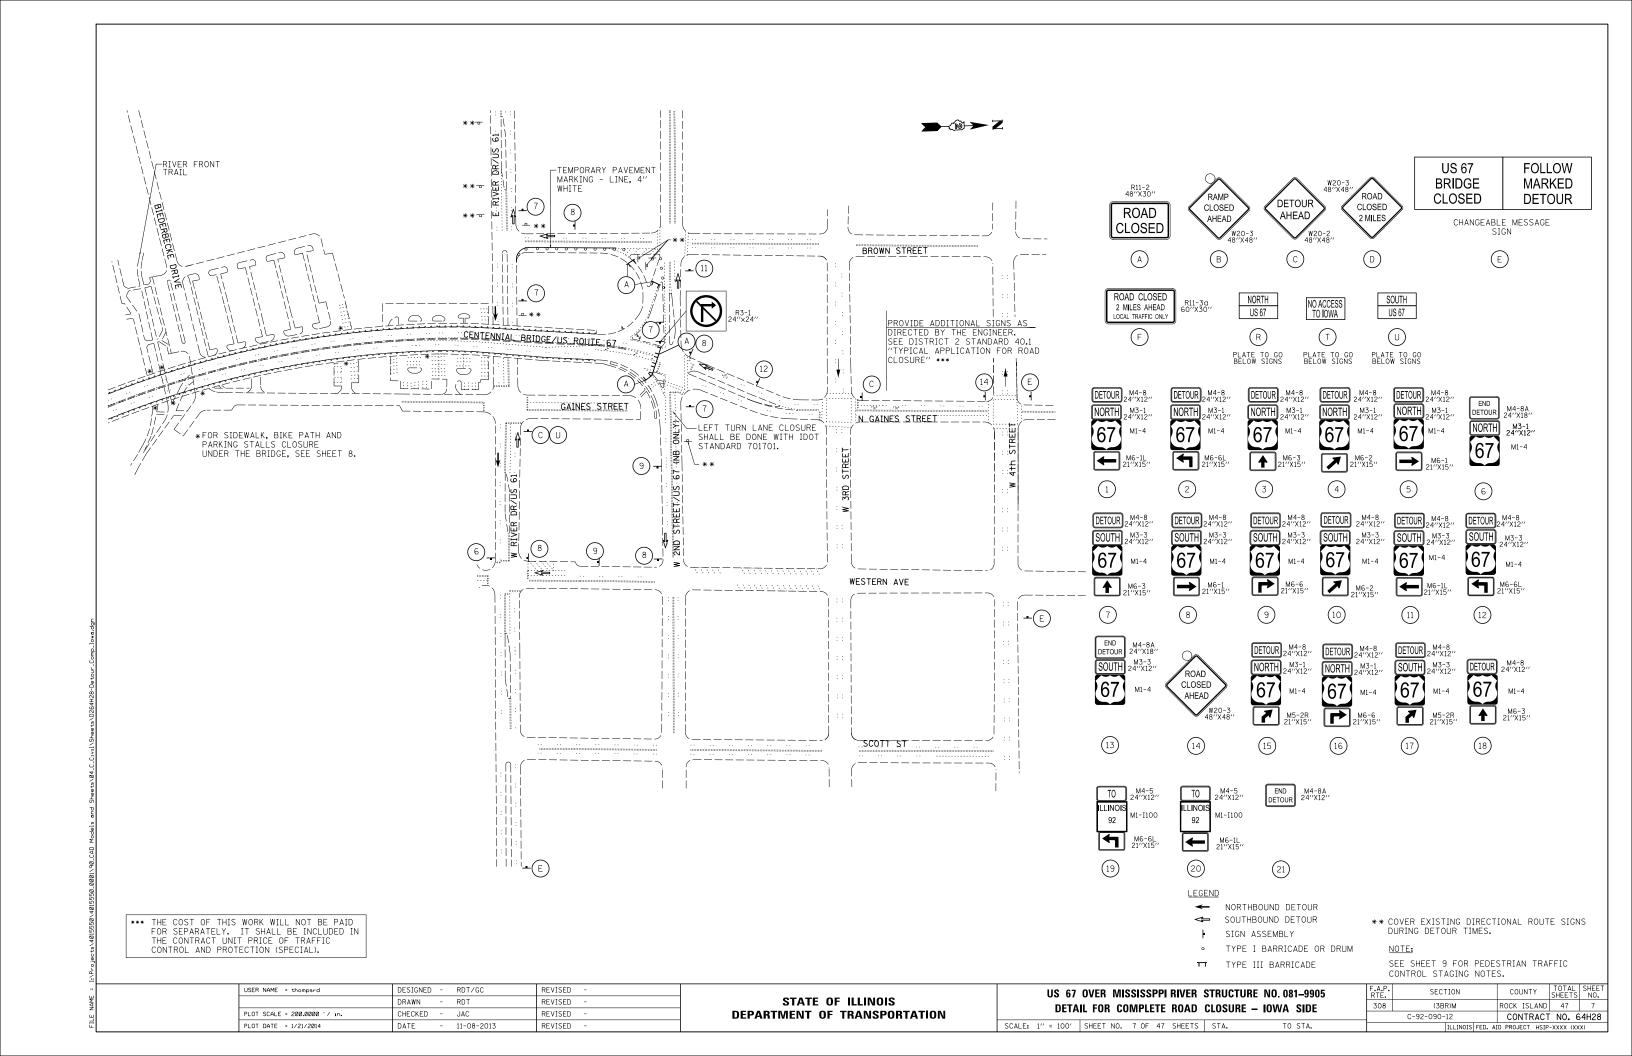

**GREAT RIVER TRAIL DETOUR DETAIL** 

SCALE: 1" = 50"

\*\*TEMPORARY PAVEMENT CONSISTS OF:

2" INCIDENTAL HOT-MIX ASPHALT SURFACING

6" AGGREGATE BASE COURSE, TYPE B PRICE OF TEMPORARY PAVEMENT AND TEMPORARY PAVEMENT REMOVAL SHALL BE INCLUDED IN THE COST OF TRAFFIC


CONTROL AND PROTECTION, STANDARD


701801.

DESIGNED - RDT/GC REVISED USER NAME = thompsrd DRAWN - RDT REVISED PLOT SCALE = 200.0000 '/ in. CHECKED REVISED - 11-08-2013 REVISED PLOT DATE = 1/21/2014 DATE

STATE OF ILLINOIS

**DEPARTMENT OF TRANSPORTATION** 

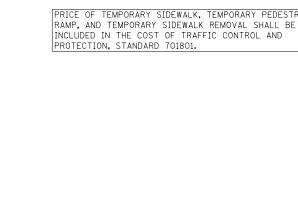

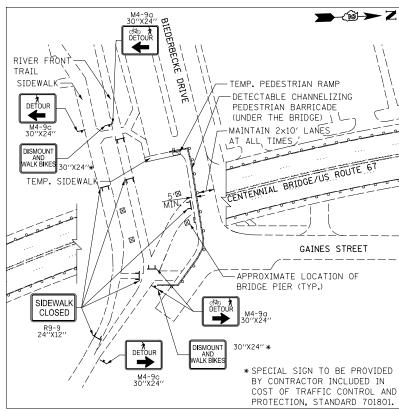


### RIVER FRONT TRAIL AND SIDEWALK DETOUR DETAIL

SCALE: 1" = 50'

PRICE OF TEMPORARY SIDEWALK, TEMPORARY PEDESTRIAN RAMP, AND TEMPORARY SIDEWALK REMOVAL SHALL BE INCLUDED IN THE COST OF TRAFFIC CONTROL AND

US 67 OVER MISSISSIPI RIVER STRUCTURE NO. 081–9905	F.A.P. RTE.	SECTION	COUNTY	TOTAL SHEETS	SHEET NO.
GREAT RIVER TRAIL AND RIVER FRONT TRAIL DETOUR PLAN	308	(3BR)M	ROCK ISLAND	47	8
		C-92-090-12	CONTRACT	. NO. 6	34H28
SCALE: AS SHOWN   SHEET NO. 8 OF 47 SHEETS   STA. TO STA.		ILLINOIS FED. A	ID PROJECT HSTP	-XXXX (XX	(X)

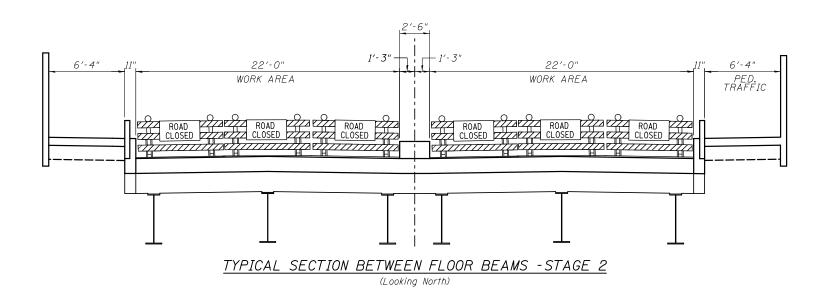

### GENERAL NOTES FOR TRAFFIC CONTROL:

1. The Contractor shall not mount construction traffic control signs on existing signs or supports.

### NARRATIVE FOR PEDESTRIAN TRAFFIC CONTROL STAGES:

Two weeks prior to construction, contractor shall place changeable message boards beyond the northern and southern limits of the project. Message displayed on message boards shall be approved by the Engineer.

Full Bridge Closure

35 calendar days of full bridge closure to replace transfer beam and columns

15 calendar days and replacement and structural steel at Piers 1 & 6, Expansion Joint removal and replacement, and structural steel repairs as shown on plans.

<u>Stage 1 Pedestrian Traffic</u>
The northbound on ramp from 1st Ave. shall be closed. See detour plan for details. Shift pedestrian traffic to the west side of northbound lanes next to the existing median.

<u>Stage 2 Pedestrian Traffic</u>

Maintain existing pedestrian traffic on US Route 67 bridge using existing east sidewalk. The southbound off ramp to 1st Ave. and southbound on ramp from Brown Street/2nd Ave. shall be closed.

NOTES:
Contractor shall provide signage and detectable pedestrian channelizing barricades to facilitate and protect pedestrians when bridge is closed to vehicular traffic.

Use Highway Standard 701601 for Lane Closures at WB IL 92/ 1st Avenue, Highway Standards 701601 and 701701 for Lane Closures at River Road/ US 61, Highway Standard 701421 for Lane Closure at EB IL 92/ 1st Avenue and Highway Standard 701501 for Lane Closures at Gaines Street/ Biederbecke Drive for bridge repairs work.


Single lane closures on US 67 are not allowed from 6 am to 9 am and 3 pm to 6 pm Monday through Friday for preparation work prior to the full bridge closure using Highway Standard 701601. The Contractor shall keep two lanes open on SB Gaines Street between 4th Street and 2nd Street at all times during this preparation work. When there is a SB lane closure on US 67, use Highway Standard 701606 for lane closures.


The Contractor shall protect pedestrians from hazards caused by construction activities at all times. This includes, but is not limited to, flying debris and falling objects from work above.


The Contractor shall move the detectable pedestrian channelizing barricades for access only. They shall be immediately restored to position shown on the standard after the vehicle has cleared the path and a pedestrian flagger shall be present at the opening for the entire time the detectable pedestrian channelizing barricades are out of place.


USER NAME = thompsrd	DESIGNED	-	RDT/GC	REVISED	-
	DRAWN	-	RDT	REVISED	-
PLOT SCALE = 8.0000 '/ in.	CHECKED	-	JAC	REVISED	-
PLOT DATE = 1/27/2014	DATE	-	11-08-2013	REVISED	-

F.A.P. RTE.	SECTION			COI	UNTY	TOTAL SHEETS	SHEE NO
308	(3BR)M			ROCK	ISLAND	47	9
	C-92-090-	12		CON	NTRACT	NO. 6	4H2
		ILLINOIS F	ED. AI	D PROJ	ECT HSIP	-XXXX (X)	(X)

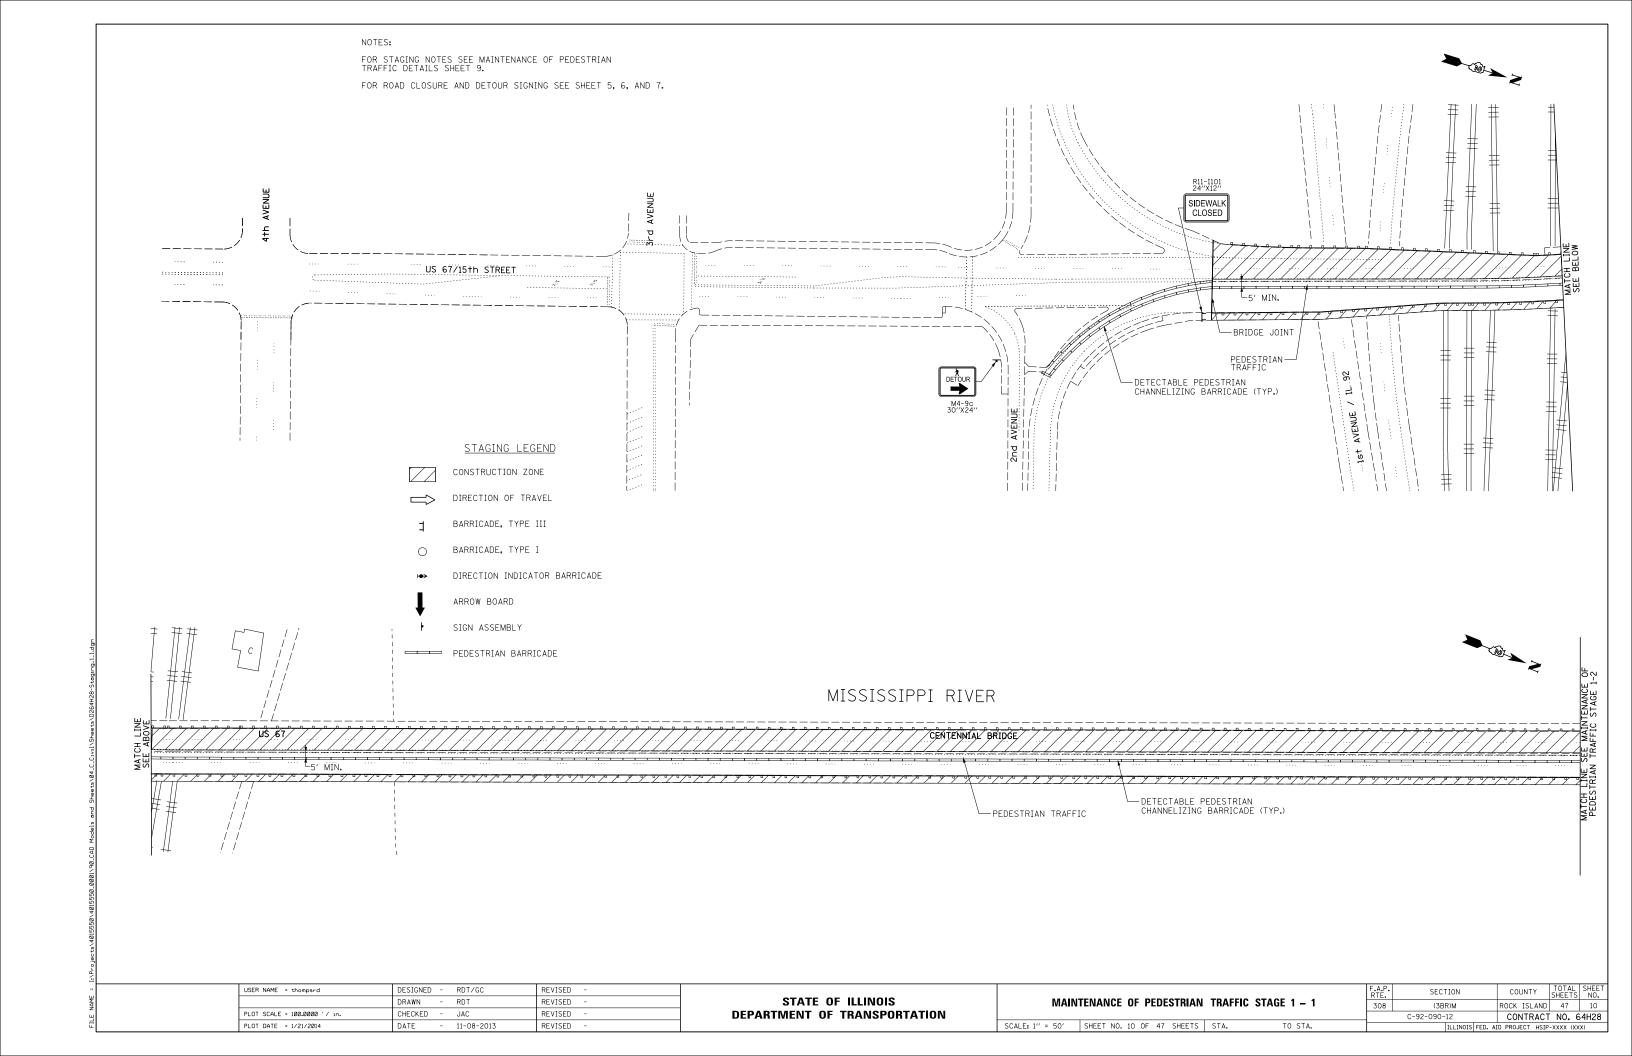


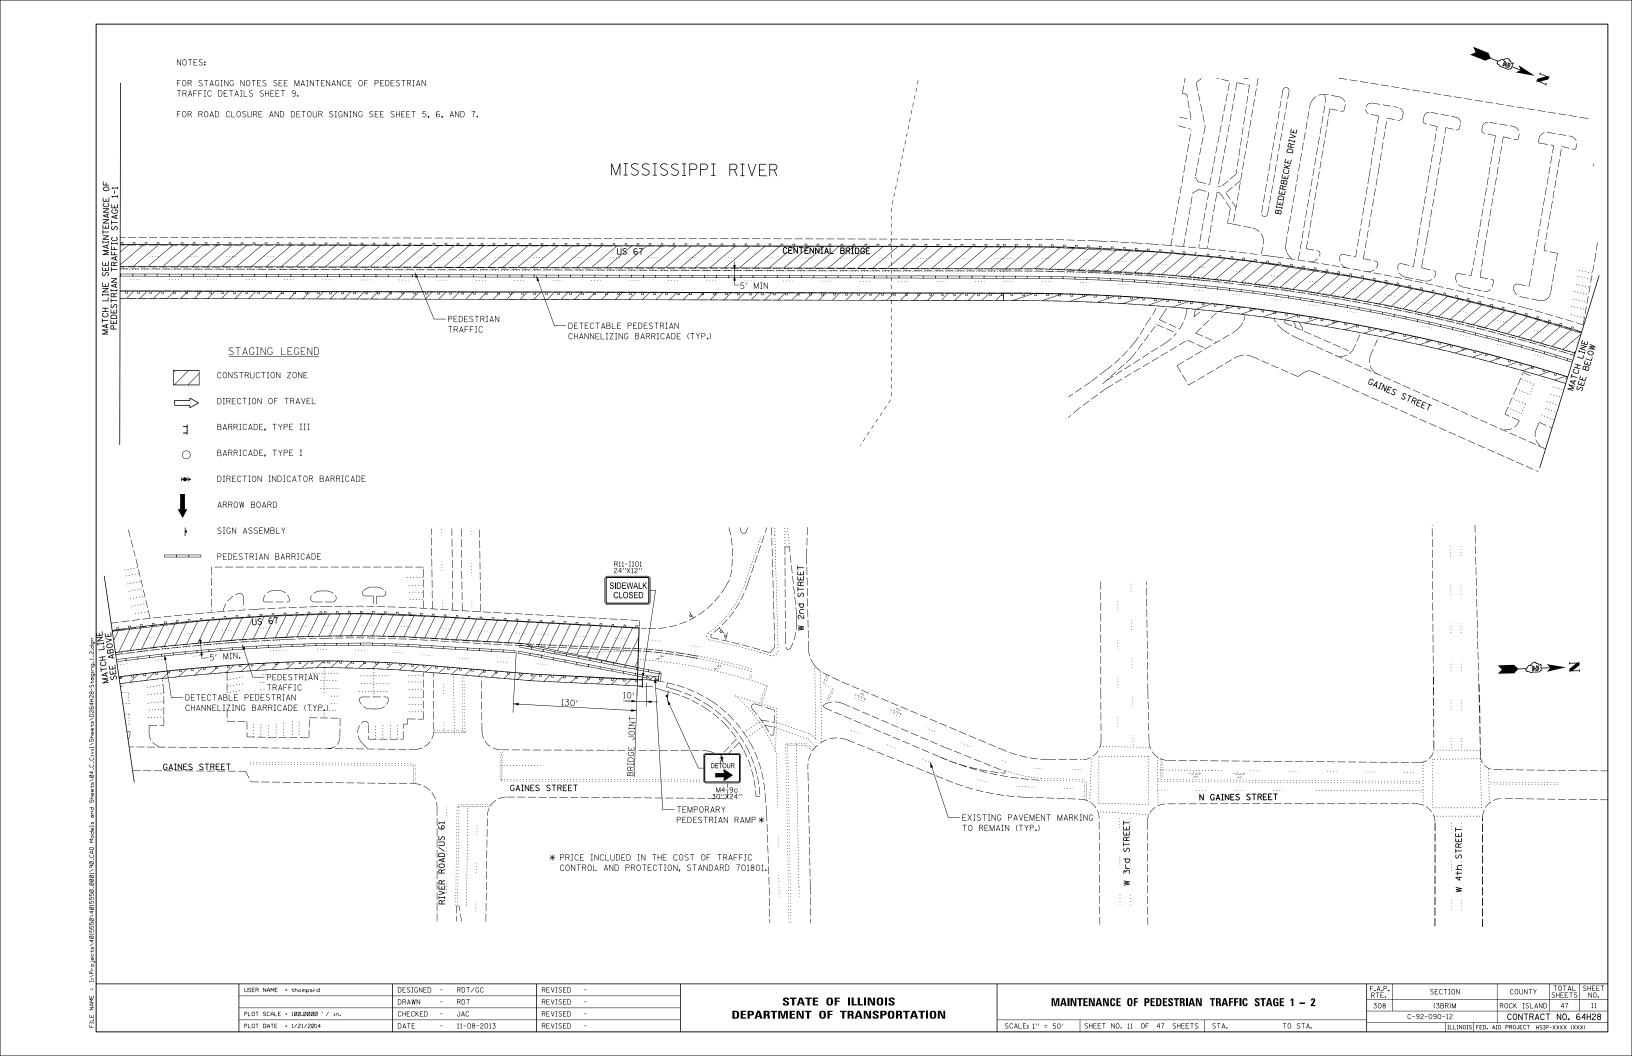


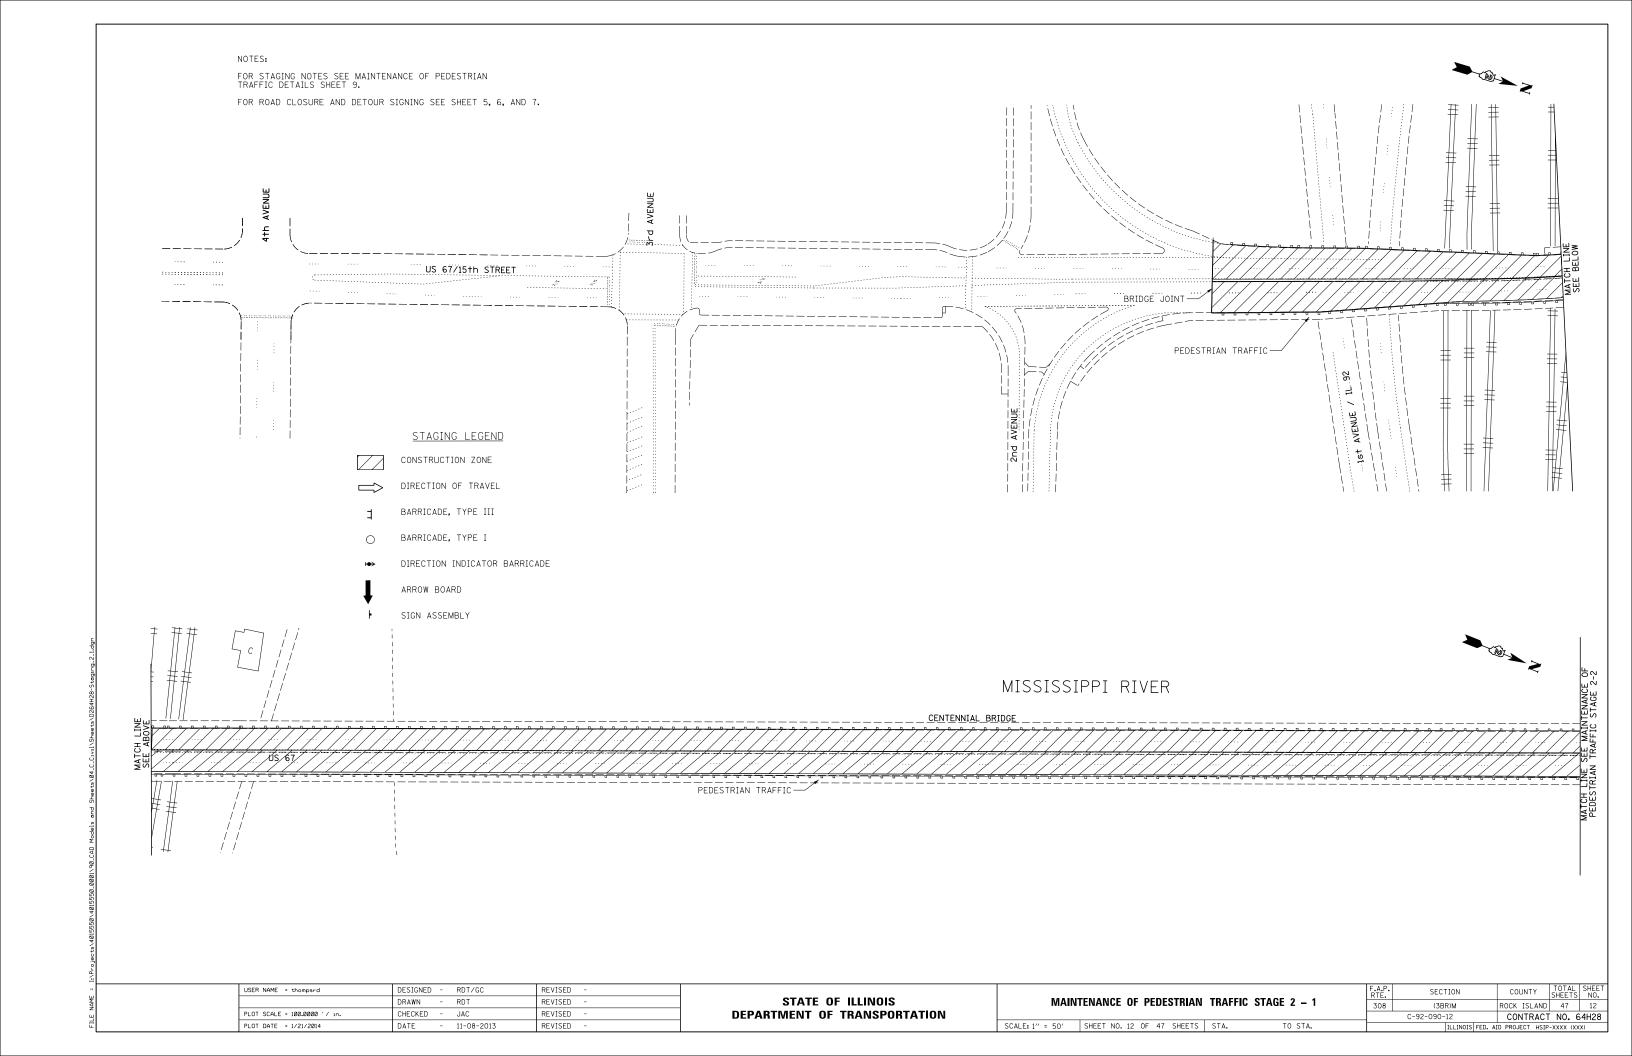


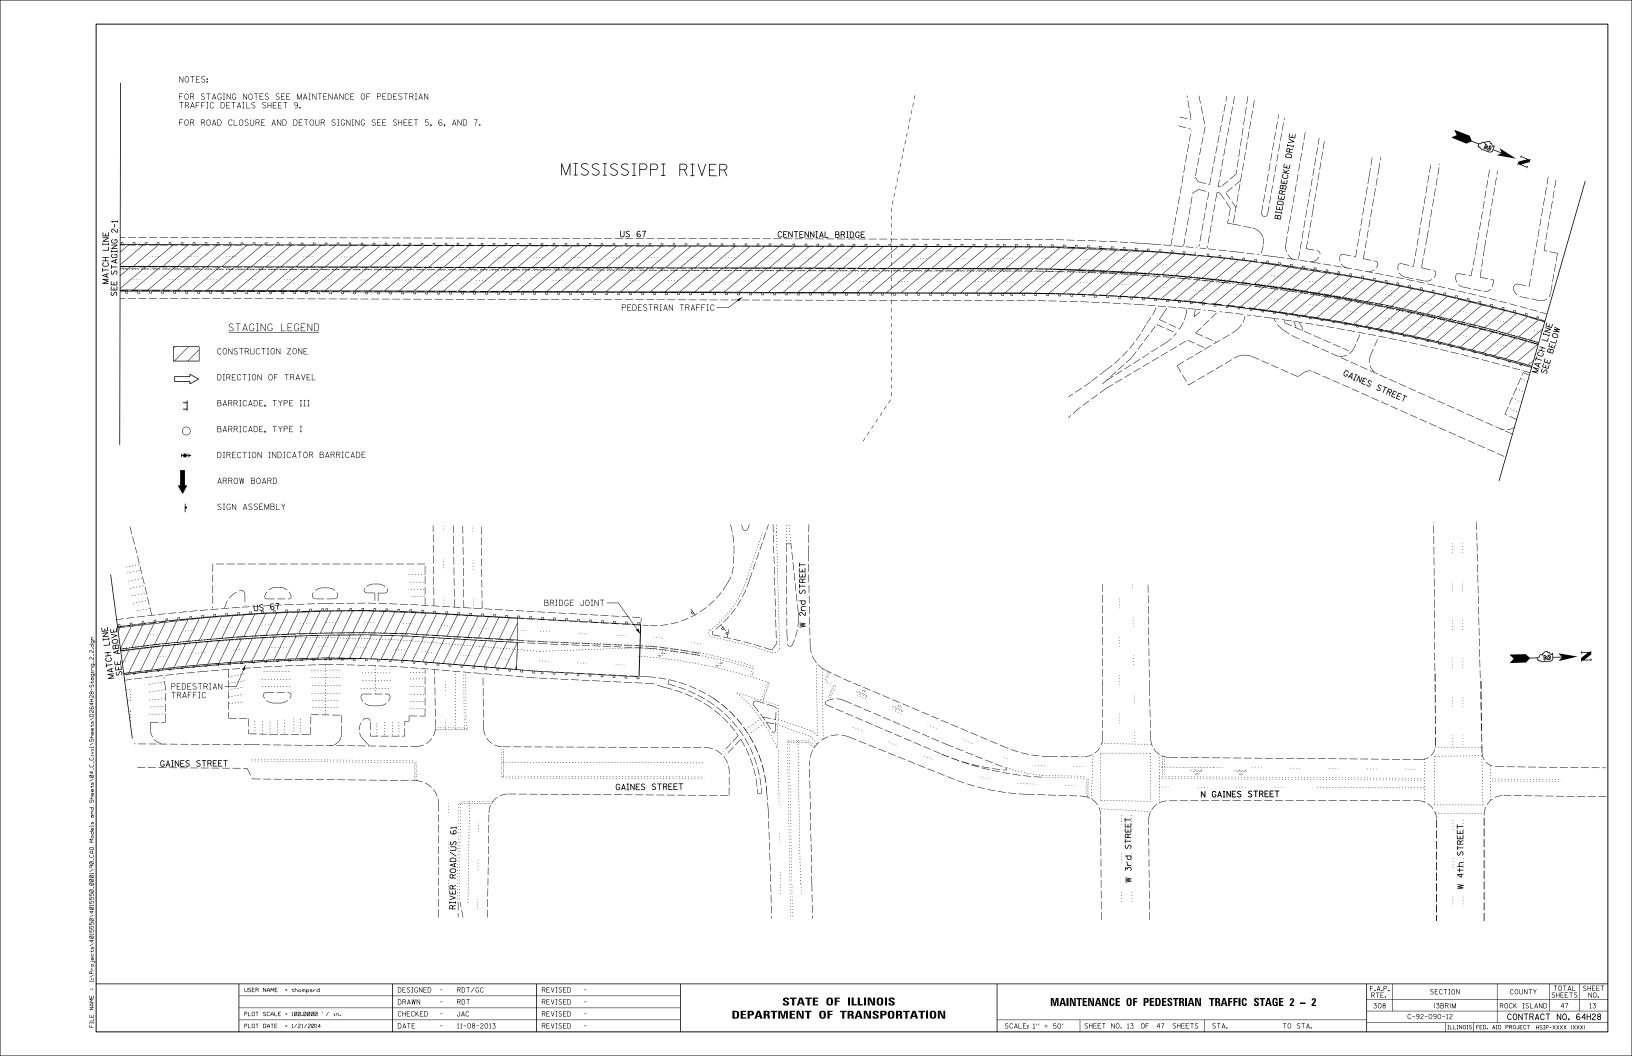

# DESIGN STRESSES NEW CONSTRUCTION f'c = 3,500 psi (Cast in Place Concrete) fy = 60,000 psi (Reinforcing Steel) Fy = 36,000 psi unless otherwise noted (Structural Steel) (M270, Gr. 36) P Bent 21 P Bent 22 N. Abut. F E E E Span # 29 28 27 26 25

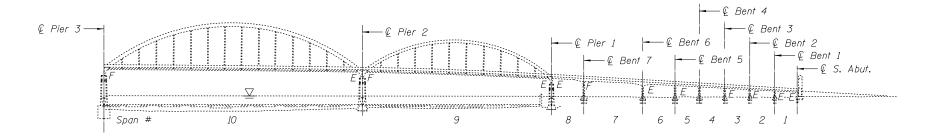

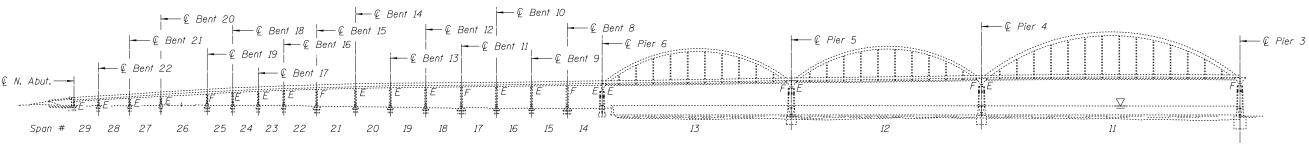

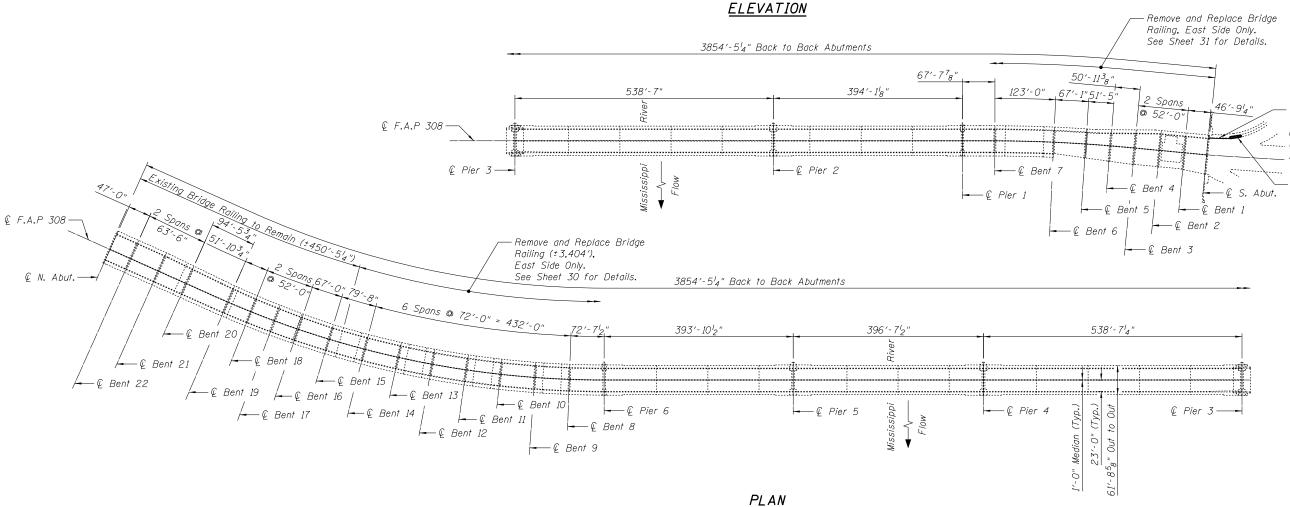

- Traffic Barrier Terminal
Type 6A Std. 631032
(To install guardrail posts core through
existing sidewalk or remove and replace
sidewalk, cost included with
TRAFFIC BARRIER TERMINAL, TYPE 6A)
- Impact Attenuator (Fully Redirective,

Impact Attenuator (Fully Redirective,

© S. Abut. Narrow), Test Level 2 with Concrete Pad

as recommended by manufacturer.

11/2 1/2013

DESIGN SPECIFICATIONS

2002 AASHTO Standard Specifications for Highway Bridges, 17th Edition

•	STV 100	
	- Mears	ı
	. /	_

USER NAME = pattisjm	DESIGNED	-	MJK	REVISED
	CHECKED	-	JAN	REVISED
PLOT SCALE = 200:0.00000 ':' / in.	DRAWN	-	MJK	REVISED
PLOT DATE = 11/26/2013	CHECKED	-	JAN	REVISED
	PLOT SCALE = 200:0.0000 ':' / In.	CHECKED  PLOT SCALE = 200:0.0000 : / in. DRAWN	CHECKED -	CHECKED - JAN PLOT SCALE = 200:0.0000 ': / in. DRAWN - MJK

STATI	OF ILLINOIS	
DEPARTMENT	OF TRANSPORTAT	ION

GENERAL	PLA	₩ W	<b>ELEVATION</b>	
STRUCT	TURE	NO.	081–9905	
SHEET	NO 1	OF 33	SHEETS	

A.P TE.	SECTION COUNTY		UNTY	TOTAL SHEETS	SHEET NO.		
08	08 (3BR)M			ROCK	ISLAND	47	14
C-92-090-12 C					NTRACT	NO. 6	4H28
	I	LLINOIS	FED. AI	D PROJ	ECT		

Fasteners shall be ASTM A325 Type 1, mechanically galvanized bolts. Bolts  $^{7}8$ " $\phi$ , holes  $^{15}16$ " $\phi$ , unless otherwise noted.

Plan dimensions and details relative to existing plans are subject to nominal construction variations. The Contractor shall field verify existing dimensions and details affecting new construction and make necessary approved adjustments prior to construction or ordering of materials. Such variations shall not be cause for additional compensation for a change in scope of the work, however, the Contractor will be paid for the quantity actually furnished at the unit price bid for the work.

The Contractor shall field verify all proposed P dimensions and spacing of holes prior to ordering steel.

The Inorganic Zinc Rich Primer / Acrylic / Acrylic Paint System shall be used for shop and field painting of new structural steel except where otherwise noted. The color of the final finish coat for all interior and exterior steel surfaces shall be Gray, Munsell No. 5B 7/1.

The existing structural steel coating contains lead. The Contractor shall take appropriate precautions to deal with the presence of lead on this project.

Existing structural steel in contact with new structural steel shall only be cleaned and painted as required by the Special Provision "Cleaning and Painting Contact Surface Areas of Existing Steel Structures".

All new structural steel shall conform to AASHTO Classification M-270 GR. 36 unless otherwise noted.

No field welding is permitted except as specified in the contract documents.

The Contractor shall remove and replace existing bolts and nuts in the bridge, bridge rail and bridge handrail satisfying the requirements for corroded or missing bolts and nuts as stated in the special provision BOLT REPLACEMENT. Contractor shall allow for 10 bolt replacements over and above those shown in the plans, the location of which shall be determined by the Contractor to conform with the special provision and/or as determined by the Engineer.

As directed by the Engineer, existing cracked tack welds to the arch ties shall be removed. The weld areas shall be ground flush and inspected for cracks using magnetic particle testing (MT) by qualified personnel approved by the Engineer.

Any cracks that cannot be removed by grinding  $^{l}_{4}$  inch deep shall be identified and reported to the Bureau of Bridges and Structures for further disposition. The cost of removing welds, grinding and inspecting weld areas and grinding cracks will be paid for according to the special provision GRINDING AND REMOVAL OF TACK WELDS.

Use of barges on the Mississippi River or staging repairs from the river will not be allowed.

Reinforcement bars designated (E) shall be epoxy coated.

The Contractor shall not use cranes or any other equipment which would extend past the height of the bridge arch.

All bolts for structural steel repairs shall be included with the item Structural Steel Repair. Replacement of missing rivets with H.S. Bolts shall be included with Bolt Replacement item.

### TOTAL BILL OF MATERIAL

ITEM	UNIT	SUPER	SUB	TOTAL
Concrete Removal	Cu. Yd.	10.0		10.0
Protective Shield	Sq. Yd.	357		357
Concrete Superstructure	Cu. Yd.	10.0		10.0
Furnishing and Erecting Structural Steel	Pound	29,322		29,322
Reinforcement Bars, Epoxy Coated	Pound	1,240		1,240
Fabric Reinforced Elastomeric Trough	Ft.	94		94
Anchor Bolts, 1/2"	Each	4		4
Traffic Barrier Terminal, Type 6A	Each			1
Impact Attenuators (Fully Directive, Narrow) , Test Level 2	Each			1
Concrete Pad	Sq. Yd.			11
Bolt Replacement	Each	<i>1</i> 65		<i>1</i> 65
Steel Bridge Rail Posts	Each	61		61
Remove and Reinstall Finger Plate Joint	Each	2		2
Furnish and Install Handrail	Ft.	3,404		3,404
Structural Steel Removal	Pound	28,769		28,769
Structural Steel Repair	Pound	49,140		49,140
Bridge Handrail Removal	Ft.	3,404		3,404
Cleaning Drainage System	L. Sum			1
Structural Repair of Concrete (Depth Equal to or less than 5 Inches)	Sq. Ft.		588	588
Drainage System	L. Sum	1		1
Silicone Joint Sealer	Ft.	14		14
Railroad Protective Liability Insurance	L. Sum			1
Temporary Support System	Each	2		2
Temporary Shoring and Cribbing	Each	22		22
Canopy Repair	L. Sum	1		1
Grinding and Removal of Tack Welds	Each	3		3

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- General Plan & Elevation
- General Notes, Bill of Material & Index of Sheets
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- 3A. 2012/2013 Inspection Information Tables
- Framing Plan & Repair Locations Spans 29-24
- Framing Plan & Repair Locations Spans 23-18 Framing Plan & Repair Locations Spans 17-14
- Framing Plan & Repair Locations Spans 13 & 12
- Framing Plan & Repair Locations Span 11
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- 11. Framing Plan & Repair Locations Spans 5-1
- 12. Structural Steel Repair Details, Sheet 1
- 13. Structural Steel Repair Details, Sheet 2 14. Structural Steel Repair Details, Sheet 3
- 15. Structural Steel Repair Details, Sheet 4
- 16. Structural Steel Repair Details, Sheet 5
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- 26, Bracket Repair
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- 28. Floor Beam Bracket Repair
- 29. Post Replacements and Railing Repairs
- 30. Handrail Details
- 31. Stiffener Replacement Details
- 32. Stiffener Repair Locations
- 33. Transfer Beam Details

<u>2012 INSPECTION INFORMATION</u>					
REPAIR	07/25/12 NBIS				
DETAIL . NUMBER	INSPECTION DEFICIENCY ITEM NUMBER	LOCATION			
1	68	Span 9, Stringer A at Floorbeam 11, Panel 11			
1	142	Span 11, Stringer F at Floorbeam 10, Panel 10			
1	169	Span 11, Stringer F at Floorbeam 10, Panel 11			
1	<u>143</u> 195/196	Span II, Stringer F at Floorbeam 2, Panel 2 Span 13, Stringer F at Floorbeam 0, Panel 1			
2	121	Span 13, 31 miger 1 at 1 hoorbeam 0, 1 aner 1  Span 2, Beam D, 15'-8 <sup>3</sup> 4'' from Bearing at Bent 2			
2	86	Span 11, Beam E, 480'-4 <sup>1</sup> 2'' from Bearing at Pier 4			
2	145	Span 16, Beam C, 36′-5′′ from Bearing at Bent 10			
2	-	Span 16, Beam C, 2nd Diaphragm from Bent 10			
2	<u>-</u> 147	Span 16, Beam C, 4th Diaphragm from Bent 10 Span 17, Beam A, 36'-0'' from Bearing at Bent 11			
2	148	Span 17, Beam C, 36'-7'' from Bearing at Bent 11			
2	210	Span 17, Beam D, 4th Diaphragm from Bent 11			
2	212	Span 18, Beam C, 4th Diaphragm from Bent 12			
2	- 219	Span 18, Beam D, 4th Diaphragm from Bent 12			
2	219 151	Span 19, Beam A, 4th Diaphragm from Bent 13 Span 20, Beam C, 3rd Diaphragm from Bent 14			
2	230	Span 20, Beam D, 3rd Diaphragm from Bent 14			
2	235	Span 21, Beam C, 4th Diaphragm from Bent 15			
2	-	Span 21, Beam C, 5th Diaphragm from Bent 15			
2	236 117	Span 21, Beam D, 5th Diaphragm from Bent 15 Span 23, Beam D, 3rd Diaphragm from Bent 17			
2	243	Span 23, Beam D, 3rd Diaphragm From Bent 17 Span 24, Beam C, 2nd Diaphragm from Bent 18			
2	-	Span 24, Beam C, 3rd Diaphragm from Bent 18			
2	244	Span 24, Beam D, 3rd Diaphragm from Bent 18			
2	159	Span 27, Beam A, 2nd Diaphragm from Bent 21			
3	72 74	Span 9, Hanger 7E Span 9, Hanger 5E			
3	76	Span 9, Hanger 2W			
3	78	Span 9, Hanger 2E			
4	32	Span 12, Floorbeam 11 at East Tie			
5 6	49 152	Span 21, Beam F, North Pin Span 21, East Sidewalk at 2nd Bracket North of Bent 14			
7	118	Span 25, West Sidewalk, 6' North of Bent 18			
8	126	Span 5, Beam A, Pin near Bent 5			
8	127	Span 5, Beam B, Pin near Bent 5			
<i>8</i>	128 161	Span 5, Beam E, Pin near Bent 5			
9	107	Span 5, Beam F, Pin near Bent 5 Span 18, Beam D at Midspan			
10	64	Span 7, Beam C, 24' North of Bent 6			
10	-	Span 17, Beam B, 16'-10 <sub>2</sub> " North of Bent 10			
10 10	207	Span 17, Beam C, 16'-11'2" North of Bent 10 Span 17, Beam E, 17'-1" North of Bent 10			
10	208 209	Span 17, Beam F, 17'-2" North of Bent 10			
10	223	Span 19, Beam B, $16' \cdot 10^{1}2''$ South of Bent 13			
10	-	Span 23, Beam A, North Side of Bent 16			
10	115	Span 23, Beam B, North Side of Bent 16			
10 10	52 154	Span 23, Beam C, North Side of Bent 16 Span 23, Beam D, North Side of Bent 16			
10	155	Span 23, Beam E, North Side of Bent 16			
10	156	Span 23, Beam F, North Side of Bent 16			
11	122	Span 3, Beam D at Bent 2			
11 12	<u>160</u> 137	Span 27, Beam D at Bent 21 Span 10, Stringer B, 22'-11'4'' South of Floorbeam 2			
12	138	Span 10, Stringer C, 8'-10 $\frac{3}{4}$ '' South of Floorbeam 0			
13	129	Span 6, Beam C, 15' from Bent 5			
13	9	Span 6, Beam D, 6' from Bent 5			
14 15	70 135	Span 9, Floorbeam 8 at Stringer E Span 10, West Bearing at Pier 2			
16	41	Span 13, Sidewalk Support Channel West Side at Pier 6			
17	134	Span 9, 3rd Purlin South of Floorbeam 3			
18	114	Span 23, Diaphragm between Stringers B and C at Bent 16			
19 20	132 16	Span 9, Floorbeam 11 at Stringer F Span 7, Sign Support Channel, E. Side, 6th Bracket from Bent 6			
21	16 75	Span 7, Sign Support Channel, E. Side, 6th Bracket From Bent 6 Span 9, Floorbeam 5 between Stringers D and E			
22	144	Span 13, Stringer E at Floorbeam O			
23	165	Span 10, West Tie at West End of Floorbeam 10			
23 23	170	Span II, West Tie at West End of Floorbeam 9			
23	88 113	Span 11, West Tie at West End of Floorbeam 4 Span 22, Diaphragm between Stringers C and D over Bent 16			
25	77	Span 9, Floorbeam 2 at Stringer D			
26	7	Span 4 & 5, Bent 4 at Beam D			
27	168	Span 10, Lateral Bracing Hanger at Midspan of Panel 4			
28	181	Span 12, Floorbeam O at Stringer F			

### 2012 INSPECTION INFORMATION

REPAIR	07/25/12 NBIS	
DETAIL   NUMBER	INSPECTION DEFICIENCY ITEM NUMBER	LOCATION
29	163	Span 9, Floorbeam 11 at East End
30 30	221 220	Span 19, Beam C, 4th Diaphragm from Bent 13
31	204	Span 19, Beam D, 4th Diaphragm from Bent 13 Span 16, Beam A, at Midspan
31	146	Span 16, Beam D, at Midspan and <sup>1</sup> 4 Point
31	213	Span 18, Beam A, at Midspan
31	116/157	Span 23, Beam C, 26'-6" from Bearing at Bent 17
32	12	Span 7, Beam D, 2'-O" North of Pin and Link
33	211	Span 17, Outer Sidewalk Channel, West Side
<i>33 33</i>	<u>214</u> 218	Span 18, Outer Sidewalk Channel, West Side Span 19, Outer Sidewalk Channel, West Side
33	228	Span 20, Outer Sidewalk Channel, West Side
33	234	Span 21, Outer Sidewalk Channel, West Side
34	229	Span 20, Beam A, 8'-0" from Bearing at Bent 13
35	184	Span 13, Inner Sidewalk Channel, West Side blwn FB 10 & FB 11
36	197	Transfer Beam and Columns at Pier 1
36	198	Transfer Beam and Columns at Pier 6
100 100	5	Span 1, East Side, 3rd Bracket from South Abutment
101	17 123	Span 8, East Side, 2nd Bracket from Bent 7 Span 4, East Side, 1st Bracket from North of Bent 3
102	125	Span 4, 5 at East Bracket at Bent 4
103	130	Span 7, East Side, 6th Bracket from Bent 6
104	11	Span 7, East Side, 4th Bracket from Bent 6
105	42	Span 14, East Side, at Panel 6, 1st Bracket at Pier 6
105	63	Span 6, 7 at Bent 6
106	44	Span 17, West Side, 4th Bracket from Bent 10 at Pin and Link
106 107	205 150	Span 17, West Side, 3rd Bracket from Bent 10 Span 19, West Side, 1st Bracket from South of Bent 13
108	149	Span 19, West Side, 2nd Bracket from South of Bent 13
109	153	Span 23, West Side at Bent 16
110	164	Span 9, Floorbeam 3 at West Cantilevered Bracket
110	166	Span 10, Floorbeam 11 at East Cantilevered Bracket
110	80	Span 10, Floorbeam 10 at East Cantilevered Bracket
110	81	Span 10, Floorbeam 8 at East Cantilevered Bracket
110 110	82	Span 10, Floorbeam 5 at East Cantilevered Bracket
110	167 83	Span 10, Floorbeam 4 at East Cantilevered Bracket Span 10, Floorbeam 1 at East Cantilevered Bracket
110	172	Span 11, Floorbeam 8 at East Cantilevered Bracket
110	173	Span 11, Floorbeam 6 at East Cantilevered Bracket
110	89	Span 12, Floorbeam 10 at East Cantilevered Bracket
110	91	Span 12, Floorbeam 9 at East Cantilevered Bracket
110	92	Span 12, Floorbeam 8 at East Cantilevered Bracket
110	93	Span 12, Floorbeam 7 at East Cantilevered Bracket
110 110	95 96	Span 12, Floorbeam 6 at East Cantilevered Bracket Span 12, Floorbeam 5 at East Cantilevered Bracket
110	97	Span 12, Floorbeam 4 at East Cantilevered Bracket
110	98	Span 12, Floorbeam 2 at East and West Cantilevered Bracket
110	177	Span 12, Floorbeam 1 at East Cantilevered Bracket
110	178	Span 12, Floorbeam 1 at West Cantilevered Bracket
110	185	Span 13, Floorbeam 10 at East Cantilevered Bracket
110	188	Span 13, Floorbeam 7 at East Cantilevered Bracket
110 110	<u>190</u> 191	Span 13, Floorbeam 5 at East Cantilevered Bracket Span 13, Floorbeam 4 at East Cantilevered Bracket
111-114		All spans throughout
115	61	West Sidewalk at Post location 429 and 467
115	187	Span 13 between Floorbeam 7 and 8
120	18	Span 8, Beam D, 6th Stiffener from Bent 7, East Side
121	65	Span 7, Beam D, 15th and 16th Stiffener from Bent 6, E. Side
121	57	Span 26, Beam A, 4th Stiffener South of Bent 20, East Side
122 123	67 66	Span 8, Beam F, 2nd and 3rd Stiffener from Bent 7, W. Side Span 7, Beam F, 3rd Stiffener from Bent 7, West Side
124	00 15	Span 7, Beam F, 19th Stiffener from Bent 6, West Side
125	28	Span 11, Floorbeam 13 between Stringer E and F, Panel 13
125	34	Span 12, Floorbeam 9 between Stringer A and B, Panel 9
125	94	Span 12, Floorbeam 6 between Stringer E and F, Panel 7
125	101	Span 13, Floorbeam 0, 3rd and 4th Stiffener from West Side
126	71	Span 9, Floorbeam 8, Stiffener at Stringer A, North Face
126	133	Span 9, Floorbeam 5, Stiffener at Stringer F, North Face
126 126	<u>87</u> 35	Span 11, FB 8, Stiffener at Stringer A, Panel 8, N. Face Span 12, FB 7, Stiffener below Stringer F, Panel 7, N. Face
126	71	Span 9, Floorbeam 8, Stiffener at Stringer C, Panel 8, N. Face
127	39	Span 13, FB 10, Stiffener below Stringer F, Panel 10, N. Face
128	33	Span 12, FB 9, Stiffener below Stringer A, Panel 9, N. Face
	100	
128	186	Span 13, Floorbeam 9, Stiffener at Stringer F

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CHECKED - MJK REVISED REVISED

STATE OF ILLINOIS **DEPARTMENT OF TRANSPORTATION** 

COUNTY TOTAL SHEETS NO.

ROCK ISLAND 47 16 F.A.P RTE. 308 SECTION 2012 INSPECTION INFORMATION TABLES (3BR)M STRUCTURE NO. 081-9905 C-92-090-12 CONTRACT NO. 64H28
| ILLINOIS FED. AID PROJECT SHEET NO. 3 OF 33 SHEETS

### 2012 INSPECTION INFORMATION (continued)


REPAIR DETAIL NUMBER	07/25/12 NBIS INSPECTION DEFICIENCY ITEM NUMBER	LOCATION
129	180	Span 12, Floorbeam O, Stiffener at Stringer C
129	175	Span 12, Floorbeam 11, Stiffener at Stringer B, C and D
129	183	Span 13, Floorbeam 11, Stiffeners at Stringer B, C and E
130	162	Span 7, Beam A, 3rd and 5th Stiffener from Bent 7, E. Side
131	174	Span 11, Floorbeam O, West Cantilevered Bracket
140	199	Span 14, West Side, 2nd Bracket from Pier 6
Guardrail Bolt Replacement	73	Guardrail throughout (See Table on Sheet 19 for locations)
Bolt Replacement	4	Span 1, Beam C at Midspan
Bolt Replacement	120	Span I, 2 at Diaphragm between Beam E and D at Bent 1
Bolt Replacement	23	Span 10, Lat. Brac. Hangers, Throughout Sp. 10 btwn. Strs. C and D
Bolt Replacement	136	Span 10, 1st Purlin South of Floorbeam 9 at Stringer B
Bolt Replacement	140	Span 11, Floorbeam 14 between Stringers D & E
Bolt Replacement	85	Span 11, Sidewalk Rail, West Side Post #268
Bolt Replacement	90	Span 12, East Arch between U9 and U10
Bolt Replacement	99	Span 12, Elect. Box E. Side 2' Above Deck at P.P. 1
Bolt Replacement	100	Span 12, West Arch, top of arch, 5' North of U2
Bolt Replacement	36	Span 12, West Arch at U2W
Bolt Replacement	40	Span 13 on L5W-U5W
Bolt Replacement	46	Span 17, Beam F, West Side, 7' from Bent 11, Bottom Flange
Bolt Replacement	45	Span 17, Beam A, East Face, 5' from Bent 11
Bolt Replacement	224	Span 19, Beam A, 6' and 12' from Bent 13
Bolt Replacement	109	Span 19, Railpost #396 from South End of bridge, East Side
Bolt Replacement	240	Span 22, Beam A, 4' from Bent 16
Bolt Replacement	54	Span 24, Beam A, 3' from Bent 17
Bolt Replacement	158	Span 27, 2nd Diaphragm North of Bent 20 btwn Beams C & D
Structural Conc. Repair	79	Span 9, 10, Pier 2, Wall and Column
Structural Conc. Repair	84	Span 10, 11, Pier 3, Spandrel and Columns
Structural Conc. Repair	37	Span 12, 13, Pier 5, Cap, Wall and Columns
Structural Conc. Repair	102	Span 13, 14, Pier 6, South & North Face of Wall & Columns
Structural Conc. Repair	225	Span 19, 20, Bent 13, Cap
Structural Conc. Repair	237	Span 21, 22, Bent 15, Cap
Structural Conc. Repair	51	Span 22, 23, Bent 16, South Side of Crash Wall, North Face of Cap
Canopy Repair	139	Span 10, South End of Old Toll Booth Roof over Roadway Centerline
Sidewalk Panel Joint Repair	27	Span 10, 11 Joint, West Sidewalk at Pier 3
Finger Joint Repair	-	Pier 1
Finger Joint Repair	-	Pier 6
Clean Drainage System	194	Span 13, Pier 6


### 2013 INSPECTION INFORMATION

	2013 THSI ECT TON THE ONMATTON			
REPAIR	2013 NBIS INSPECTION			
DETAIL	DEFICIENCY	LOCATION		
NUMBER	ITEM NUMBER	LOCATION		
1	272	Span 10, Stringer F at Floorbeam 11, Panel 12		
1	274	Span 10, Stringer F at Floorbeam 9, Panel 9		
1	281	Span 11, Stringer F at Floorbeam 13, Panel 14		
1	282	Span 11, Stringer F at Floorbeam 13, Panel 13		
3	263	Span 9, Hanger 6E at Bottom of Deck		
3	264	Span 9, Hanger 4E at Bottom of Deck		
3	266	Span 9, Hanger 1E at Bottom of Deck		
3	273	Span 10, Hanger 11W at Bottom of Deck		
3	283	Span 11, Hanger 10E at Bottom of Deck		
3	289	Span 12, Hanger 8E at Bottom of Deck		
10	255	Span 7, Beam A at South Pin & Link, East Side		
15	260	Span 9, East Bearing at Pier 1		
0.0	0.50	Span 7, Sign Support Channel, W. Side, 4th Bracket		
20	256	from Bent 7		
27B	262	Span 9, Lat. Br. Hanger btwn Stringers C & D in Panel 11		
29	286	Span 12, Floorbeam 11 at Lower Panel Point 11, East End		
29B	278	Span 10, Floorbeam 1 at East End		
29B	288	Span 12, Floorbeam 10 at West End		
29B	294	Span 13, Floorbeam 8 at West End		
35	287	Span 12, Inner Sidewalk Channel, W. Side btwn		
	201	Floorbeams 10 & 11		
35	293	Span 13, Inner Sidewalk Channel, E. Side btwn		
		Floorbeams 10 & 11		
35	296	Span 13, Inner Sidewalk Channel, E. Side at Pier 6		
123	253	Span 6, Beam A, 3rd Stiffener South of Bent 6		
126	261	Span 9, Floorbeam 11, Stiffener at Stringer A, N. Face		
129	267	Span 9, Floorbeam 0, Stiffener at Stringer B, C, D & E,		
		N. Face		
Joint Repair	249	Span 1, Joint Repair at South Abutment, E. Side		
Drainage Repair	284	Span 11, 2nd Drain South of Floorbeam 6, E. Side		
Drainage Repair	291	Span 12, 5'-0" North of Floorbeam 4 btwn Stringers C & D		
Bolt Replacement	250	Span 5, Beam F, 1'-0" and 6'-0" from Bent 5		
Bolt Replacement	268	Span 9/10, Joint Trough at Panel 2, btwn Stringers B & C		
Bolt Replacement	279	Span 10, Stringer F, 15′-0" from Floorbeam 0		
Bolt Replacement	280	Span 10, East Arch, 1'-0" Above Deck, East Face		
Bolt Replacement	290	Span 12, East Arch at Upper Panel Point 5, East Side		
Bolt Replacement	295	Span 13, West Arch at Upper Panel Point 7		
Bolt Replacement	299	Span 21, Beam D at 2nd Diaphragm from Bent 14		
Boii Replacement	299	Span ZI, Beam D at 2nd Diaphragm from Bent 14		


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2012 /2013 INSPECTION INFORMATION TABLES STRUCTURE NO. 081–9905  SHEET NO. 3A OF 33 SHEETS	F.A.P RTE.	SECTION	COUNTY	TOT SHEE
	308	(3BR)M	ROCK ISLAND	47
31NOCIONE NO. 001-3303		C-92-090-12	CONTRACT	. N0
SHEET NO. 3A OF 33 SHEETS		ILLINOIS FED. A	AID PROJECT	



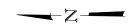
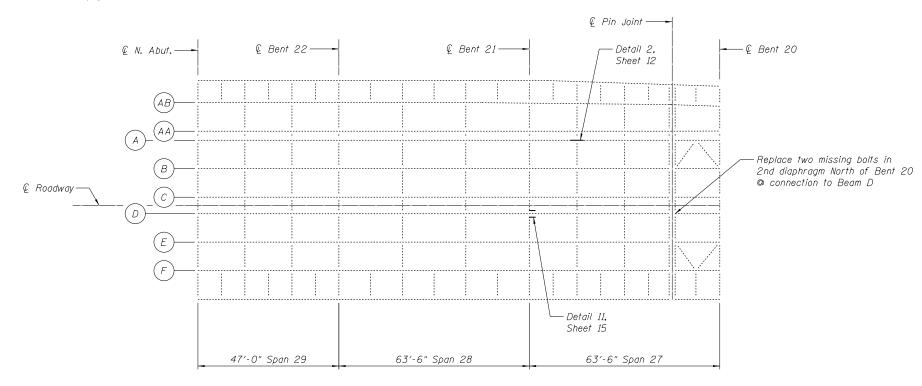
### FRAMING PLAN SPANS 29, 28 AND 27

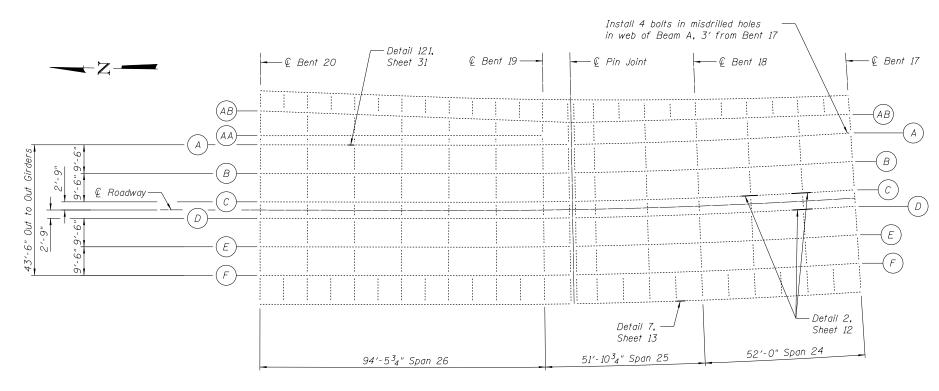

### FRAMING PLAN SPANS 26, 25 AND 24

Handrail post and railing replacement locations not shown for clarity. See Details 111-115, Sheets 29-30.

BILL OF MATERIAL

Bolt Replacement Each
Steel Bridge Rail Posts Each

ITEM

Structural Steel Repair

UNIT TOTAL


Pound 1,637

Guardrail bolt replacement locations not shown for clarity. See Sheet 24.



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F.A.P RTE.	SECTION	COUNTY	TOTAL SHEETS	SHEE NO.
308	(3BR)M	ROCK ISLAND	47	17
C-92-090-12		CONTRACT	NO. 6	4H28
ILLINOIS FED. AID PROJECT				

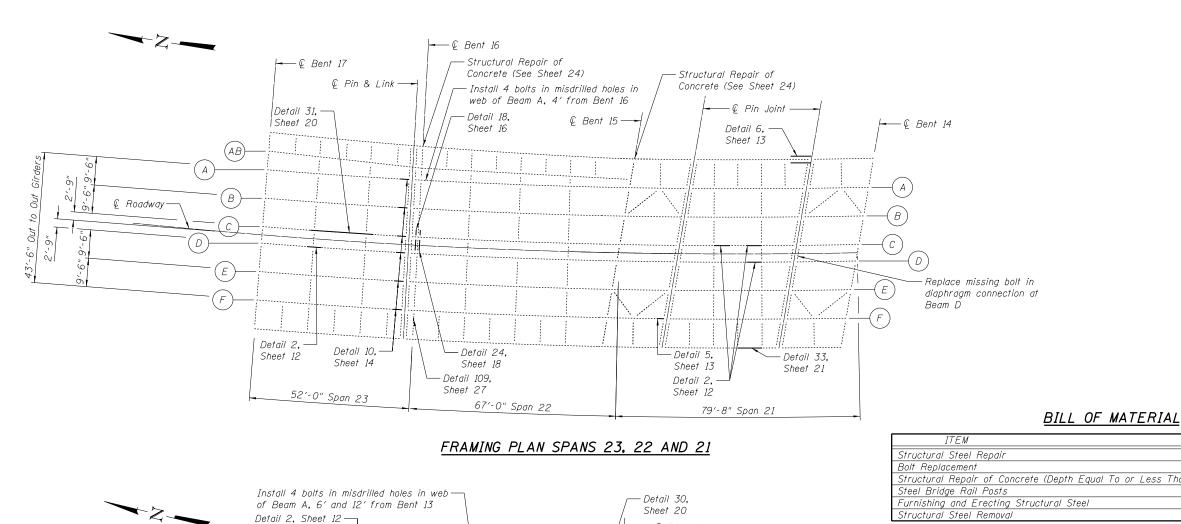

### TOTAL Pound 15,502 Each 21 Sq. Ft. 115 Structural Repair of Concrete (Depth Equal To or Less Than 5 in.) Each Furnishing and Erecting Structural Steel Structural Steel Removal Pound 2,260 Pound 2,260

### Detail 2, Sheet 12 -— € Pin Joint € Bent 11 ---— € Bent 12 --- € Bent 14 € Bent 13 --Pin & Link - Detail 31, Detail 34, Detail 2, — Sheet 20 Sheet 21 Sheet 12 Out to Out - Detail 2, Sheet 12 — Detail 10, Structural Repair of └─ Detail 108, – Detail 9, Concrete (See Sheet 24) Sheet 27 Sheet 14 Sheet 14 - Detail 33, Detail 107, - Detail 33, – Detail 33, Sheet 21 Sheet 21 Sheet 27 Sheet 21 72'-0" Span 20 72′-0" Span 18 72'-0" Span 19

### FRAMING PLAN SPANS 20, 19 AND 18


Handrail post and railing replacement locations not shown for clarity. See Details 111-115, Sheets 29-30.

Guardrail bolt replacement locations not shown for clarity. See Sheet 24.


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		ILLINOIS	FED. A	D PROJ	ECT		
	C-92-0	90-12		COI	NTRACT	NO. 6	4H28
308	(3BR	MG		ROCK	ISLAND	47	18
F.A.P RTE.	SECT	ION		CO	UNTY	SHEETS	NO.



### FRAMING PLAN SPANS 17. 16 AND 15

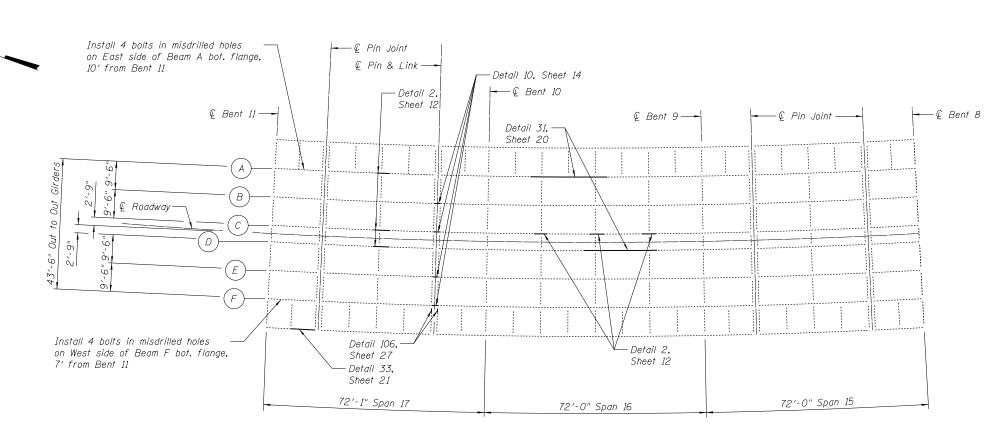

### BILL OF MATERIAL

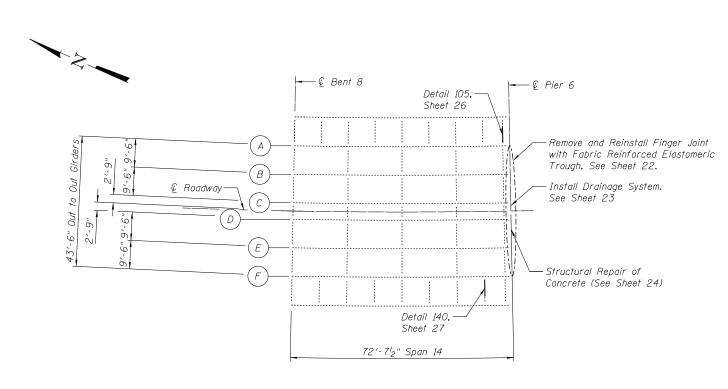ITEM	UNIT	TOTAL
Structural Steel Repair	Pound	9,021
Bolt Replacement	Each	12
Structural Repair of Concrete (Depth Equal To or Less Than 5 in.)	Sq. Ft.	342
Steel Bridge Rail Posts	Each	5
Remove and Reinstall Finger Joint	Each	1
Concrete Removal	Cu. Yd.	5
Concrete Superstructure	Cu. Yd.	5
Fabric Reinforced Elastomeric Trough	Ft.	47
Furnishing and Erecting Structural Steel	Pound	445
Structural Steel Removal	Pound	445

### FRAMING PLAN SPAN 14

Notes:

Handrail post and railing replacement locations not shown for clarity. See Details 111-115, Sheets 29-30.

Guardrail bolt replacement locations not shown for clarity. See Sheet 24.



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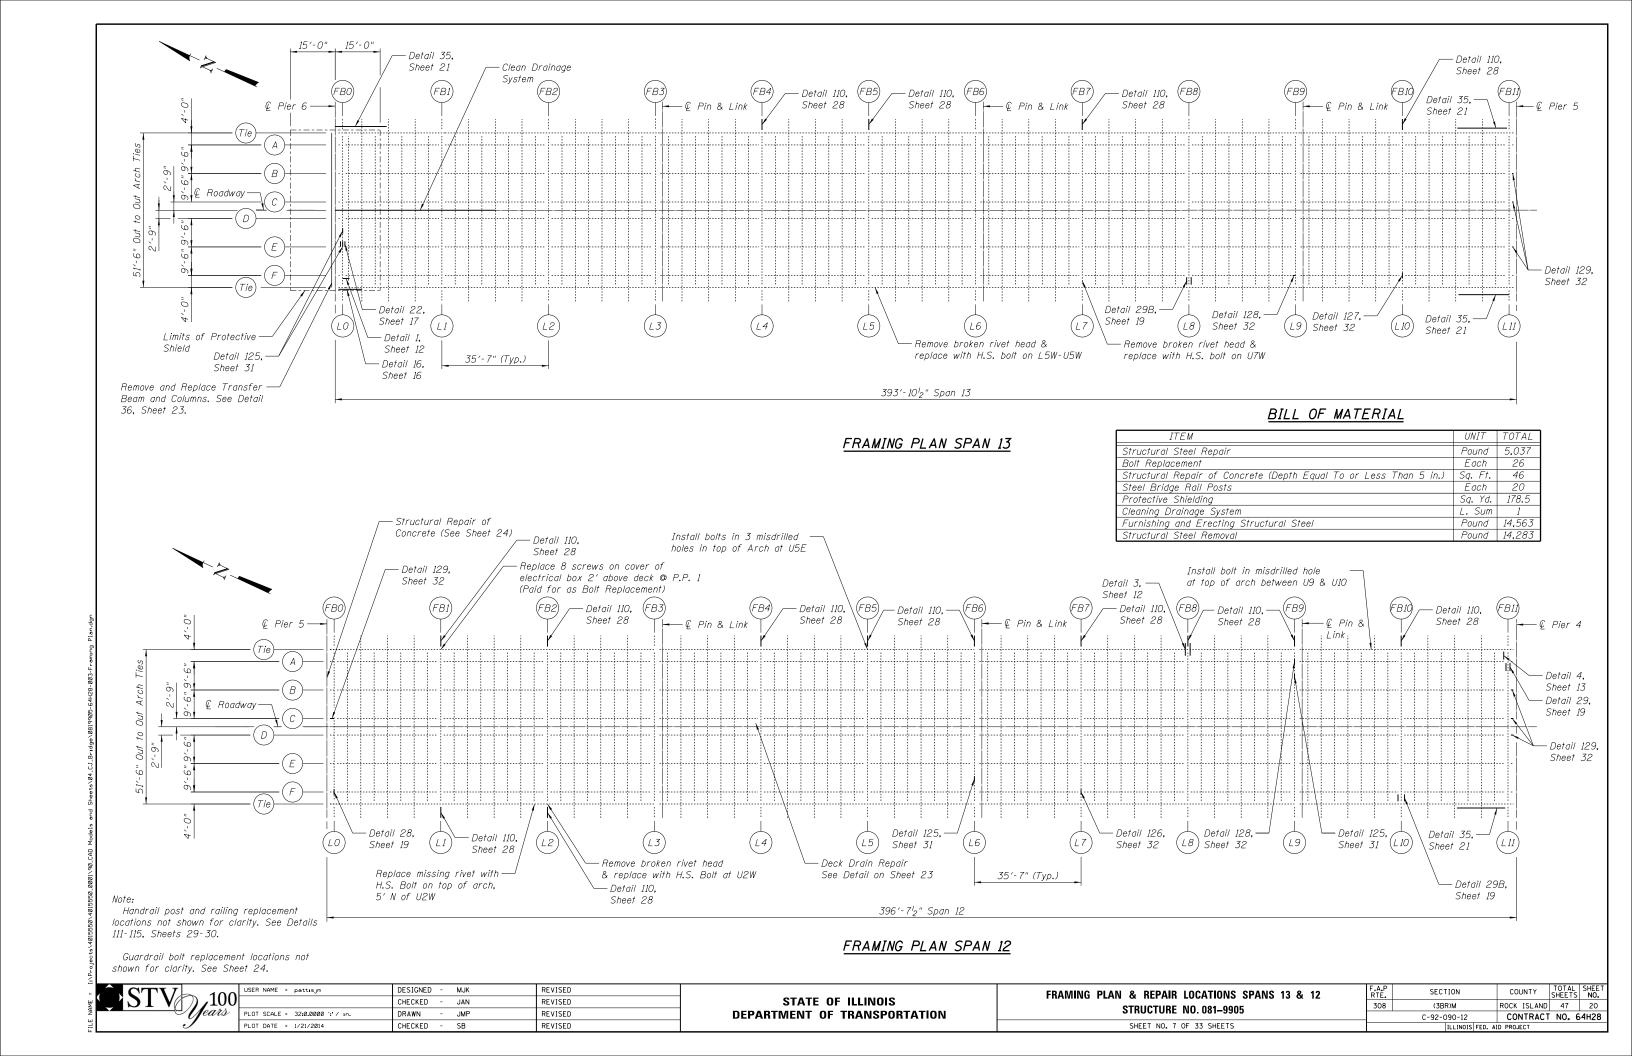
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 PLOT DATE = 1/21/2014
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 REVISED

STATE OF ILLINOIS
DEPARTMENT OF TRANSPORTATION

FRAMING PLAN & REPAIR LOCATIONS SPANS 17–14
STRUCTURE NO. 081–9905

SHEET NO. 6 OF 33 SHEETS



### <u>BILL OF MATERIAL</u>

ITEM	UNIT	TOTAL
Structural Steel Repair	Pound	3,150
Bolt Replacement	Each	9
Structural Repair of Concrete (Depth Equal To or Less Than 5 in.)	Sq. Ft.	42
Silicone Joint Sealer	Ft.	7
Grinding and Removal of Tack Welds	Each	2

SECTION

(3BR)M

C-92-090-12

308

FRAMING PLAN & REPAIR LOCATIONS SPAN 11


STRUCTURE NO. 081-9905

SHEET NO. 8 OF 33 SHEETS


COUNTY

ROCK ISLAND 47 21

CONTRACT NO. 64H28

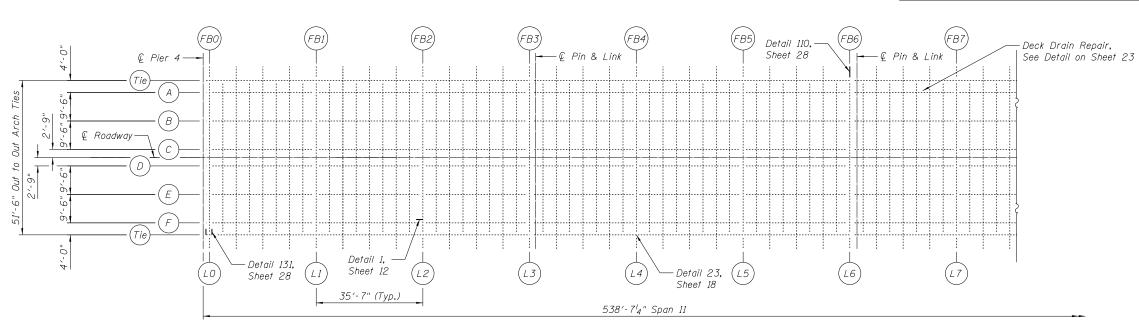

### FRAMING PLAN SPAN 11

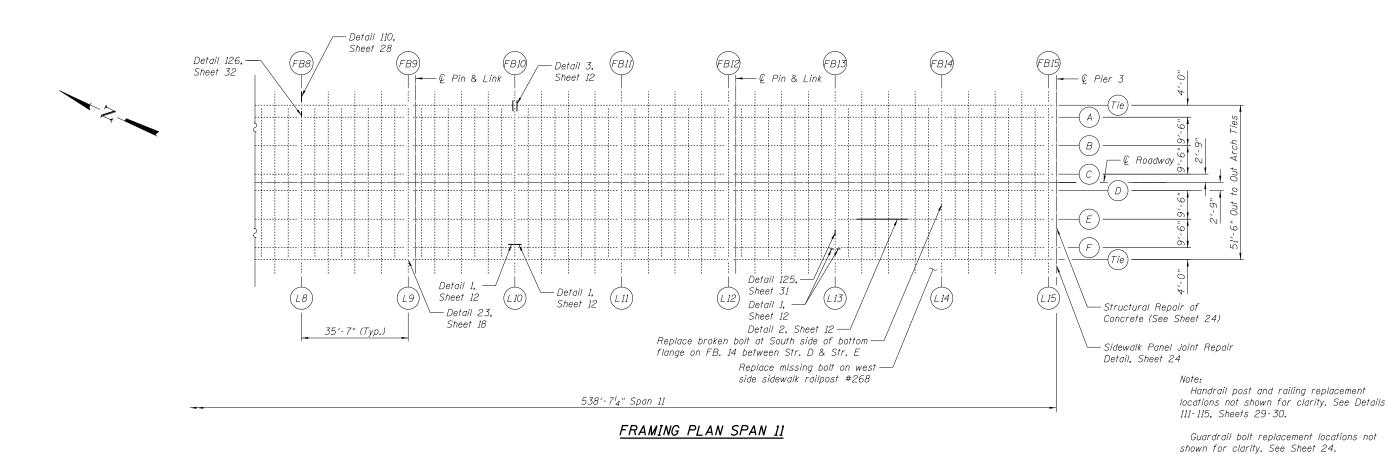

STATE OF ILLINOIS

**DEPARTMENT OF TRANSPORTATION** 

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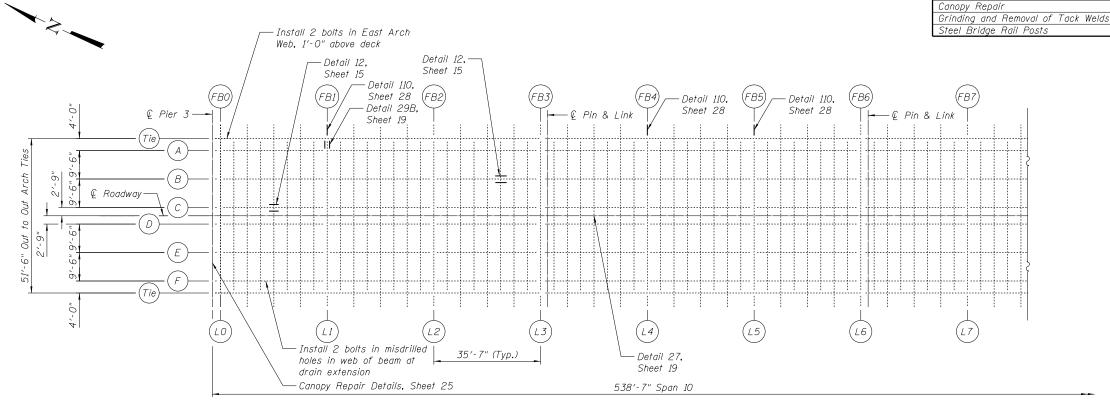
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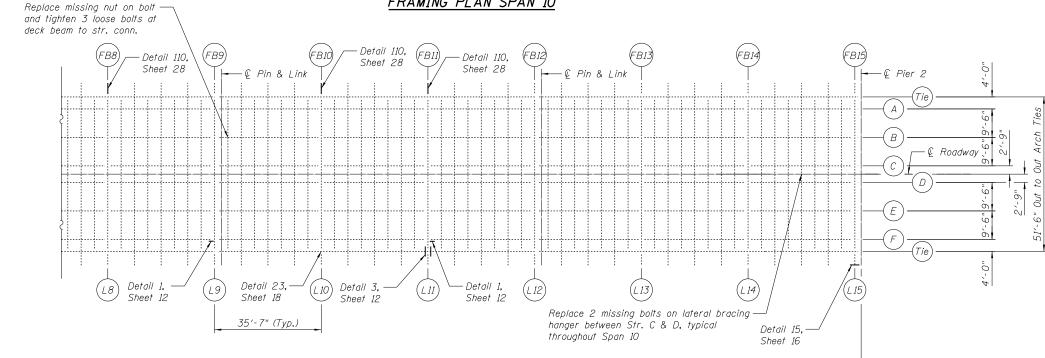
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### BILL OF MATERIAL

ITEM	UNIT	TOTAL
Structural Steel Repair	Pound	2,472
Bolt Replacement	Each	49
Canopy Repair	L. Sum	1
Grinding and Removal of Tack Welds	Each	1
Steel Bridge Rail Posts	Each	5



### FRAMING PLAN SPAN 10



### FRAMING PLAN SPAN 10

Handrail post and railing replacement locations not shown for clarity. See Details 111-115, Sheets 29-30

Guardrail bolt replacement locations not shown for clarity. See Sheet 24.




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538′-7" Span 10


FRAMING	PLAN	&	REP	AIR	LOCATIONS	SPAN	10	
STRUCTURE NO. 081-9905								
	CUE	CT .		OF :	77 CHEETC			

	ILLINOIS FED. A	ID PROJECT		
	C-92-090-12	CONTRACT	NO. 6	4H2
308	(3BR)M	ROCK ISLAND	47	22
F.A.P RTE.	SECTION	COUNTY	TOTAL SHEETS	SHE!

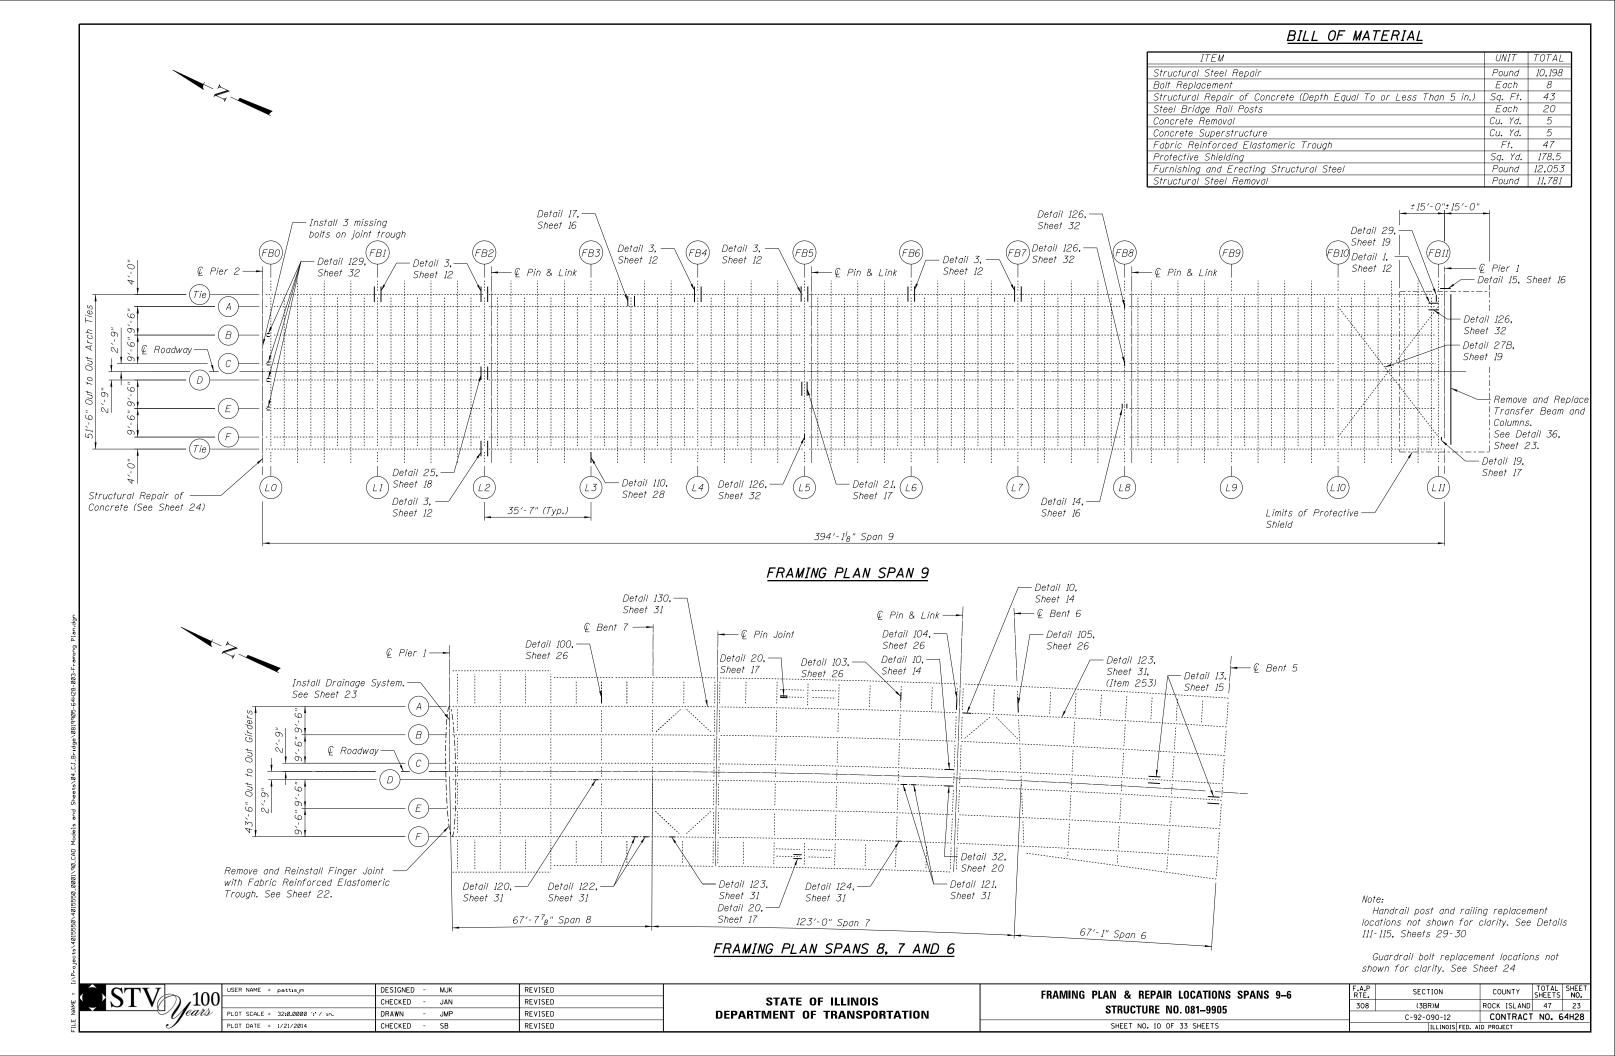


### BILL OF MATERIAL

ITEM	UNIT	TOTAL
Structural Steel Repair	Pound	2,122
Bolt Replacement	Each	23
Anchor Bolts, 1 1/2"	Each	4
Silicone Joint Sealer	Ft	7

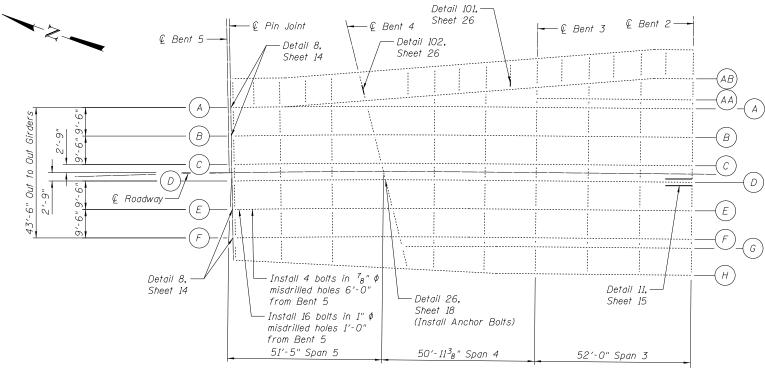

### FRAMING PLAN SPANS 5, 4 AND 3

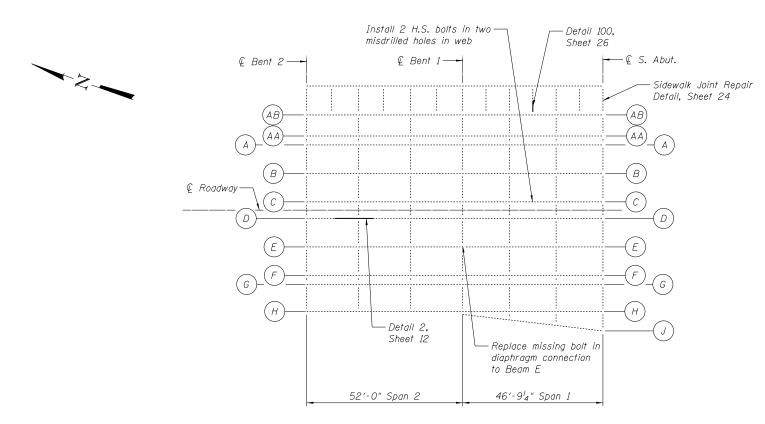

### FRAMING PLAN SPANS 2 AND 1

Notes:

Handrail post and railing replacement locations not shown for clarity. See Details 111-115, Sheets 29-30.
Guardrail bolt replacement locations not

shown for clarity. See Sheet 24.



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### DETAIL 1

Span 9 Str. A © FB. 11, Panel 11 (Looking West)

Span 10 Str. F © FB. 9, Panel 9 (Looking West - Opp Hand)

Span 10 Str. F © FB. 11, Panel 12 (Looking East)

Span 11 Str. F © FB. 10, Panel 10 (Looking West)

Span 11 Str. F © FB. 10, Panel 11 (Looking West - Opposite Hand)

Span 11 Str. F © FB. 2, Panel 2 (Looking West)

Span 11 Str. F © FB. 13, Panel 13 (Looking West - Opp Hand)


Span 11 Str. F © FB. 13, Panel 14 (Looking East)

Span 13 Str. F © FB. 0, Panel 1 (Looking East)

### <u>Notes</u>


Contractor shall temporarily support stringer while connection is removed.

Dead load reactions provided for temporary shoring and cribbing. Contractor to add construction live loads. All work associated with temporarily supporting girder shall be paid for as Temporary Shoring and Cribbing, Type 2. See Special Provisions.

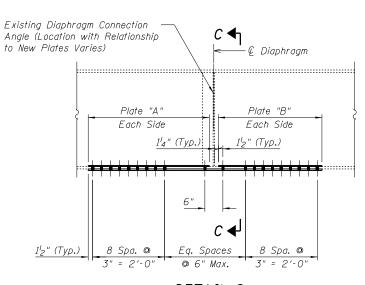

### DETAIL 2

See Table for Locations and Plate Dimensions

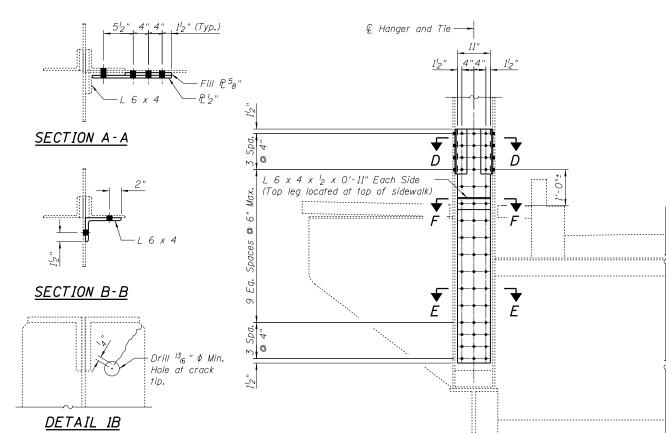

# Span 9, Str. A @ FB. 11, Panel 11 Only

Note:
Locate crack tip using liquid dye penetrant or magnetic particle testing. Drill <sup>13</sup><sub>16</sub> " min.  $\Phi$  Crack Arrestor hole at the crack tip. After crack arrestor hole has been drilled, dye penetrant or magnetic particle testing shall be used to verify that the drilled hole has captured the crack tip. Cost shall be included in the cost of "Furnishing and Erecting Structural Steel".


### DETAIL 1 - DEAD LOAD REACTIONS

SPAN	BEAM	DEAD LOAD REACTIONS (KIPS)
9	A, F	26
10	A, F	26
11	A, F	26
13	A, F	26


### DETAIL 3

Span 9, Hanger 7E
Span 9, Hanger 5E
Span 9, Hanger 5E
Span 9, Hanger 5E
Span 9, Hanger 2W
Span 10, Hanger 11W
Span 9, Hanger 2E
Span 11, Hanger 10E
Span 9, Hanger 6E
Span 12, Hanger 8E
(Looking South Typ.)
(Looking North Span 9, Hanger 2W)


(Looking North Span 10, Hanger 11W)

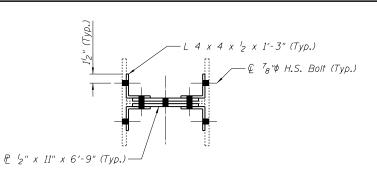

### SECTION D-D

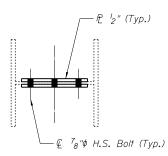


### SECTION E-E

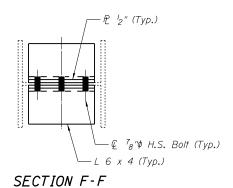

### DETAIL 2 - LOCATION AND PLATE SIZE SUMMARY

SPAN	BEAM	REPAIR LOCATION	PLATE "A"	PLATE "B"	PLATE "C"
2	D	2nd Diaphragm From Bent 2	P 2" x 42" x 6'-44"	P 2" x 42" x 6'-44"	P2" x 11 <sup>1</sup> 2" x 12'-11"
11	Ε	€ Repair at 15′-8" From CL FB13	(2)-Top P 2" x	4 <sup>1</sup> 2" x 17′-0"	P2" x 11'2" x 17'-0"
16	С	3rd Diaphragm From Bent 10	P 2" x 4 2" x 2'-1034"	P '2" x 4'2" x 6'-4 <sup>3</sup> 4"	P2" x 11 <sup>3</sup> 4" x 9'-6"
16	С	2nd Diaphragm From Bent 10	P 2" x 42" x 3'-234"	P 2" x 42" x 2'-3"	PC 12" x 11 <sup>3</sup> 4" x 5'-814"
16	С	4th Diaphragm From Bent 10	P 2" x 42" x 2'-3"	P 2" x 42" x 2'-1034"	P '2" x 11 <sup>3</sup> 4" x 5'-4'4"
17	Α	4th Diaphragm From Bent 11	P 2" x 42" x 2'-34"	P 2" x 42" x 2'-34"	P2" x 12" x 4'-9"
17	С	4th Diaphragm From Bent 11	P 2" x 42" x 2'-64"	P 2" x 42" x 2'-64"	P '2" x 11'2" x 5'-3"
17	D	4th Diaphragm From Bent 11	P 2" x 4 2" x 3'-1034"	P 12" x 412" x 5'-1034"	P2" x 11½" x 10'-0"
18	С	4th Diaphragm From Bent 12	P 2" x 4 2" x 2'-1034"	P 2" x 42" x 4'-1034"	P '2" x 11 <sup>3</sup> 4" x 8'-0"
18	D	4th Diaphragm From Bent 12	P 2" x 4 2" x 2'-1034"	P 2" x 42" x 4'-1034"	P '2" x 11 <sup>3</sup> 4" x 8'-0"
19	Α	4th Diaphragm From Bent 13	P 2" x 4 <sup>1</sup> 2" x 5'-10 <sup>3</sup> 4"	P 2" x 42" x 3'-1034"	P2
20	С	3rd Diaphragm From Bent 14	P 2" x 4 2" x 3'-1034"	P 2" x 42" x 6'-1034"	PC 12" x 11 <sup>3</sup> 4" x 11'-0"
20	D	3rd Diaphragm From Bent 14	P 2" x 42" x 12'-1034"	P 2" x 42" x 3'-1034"	PC 12" x 11 <sup>3</sup> 4" x 17'-0"
21	С	4th Diaphragm From Bent 15	P 2" x 4 2" x 4'-1034"	P 2" x 42" x 3'-1034"	PC 12" x 11 <sup>3</sup> 4" x 9'-0"
21	С	5th Diaphragm From Bent 15	P 2" x 4 2" x 4'-1034"	P 2" x 42" x 3'-1034"	₽ ½" x 11½" x 9′-0"
21	D	5th Diaphragm From Bent 15	P 2" x 4 <sup>1</sup> 2" x 5'-10 <sup>3</sup> 4"	P 2" x 42" x 5'-1034"	P2" x 11'2" x 12'-0"
23	D	2nd Diaphragm From Bent 17	P 2" x 42" x 2'-34"	P 2" x 42" x 2'-34"	P 2" x 112" x 4'-9"
24	С	2nd Diaphragm From Bent 18	P 2" x 42" x 3'-104"	P 2" x 42" x 3'-114"	P2" x 11'2" x 8'-0"
24	С	3rd Diaphragm From Bent 18	P 2" x 42" x 4'-434"	P 2" x 42" x 3'-1034"	P2" x 11'2" x 8'-6"
24	D	3rd Diaphragm From Bent 18	P 2" x 42" x 4'-434"	P 2" x 42" x 3'-1034"	£ ½" x 11½" x 8′-6"
27	Α	2nd Diaphragm From Bent 21	R 2" x 42" x 2'-34"	PC 12" x 412" x 2'-314"	PC 12" x 11 <sup>3</sup> 4" x 4'-9"

Note: For this table, in referencing diaphragms, the first shall be on the pier or abutment.

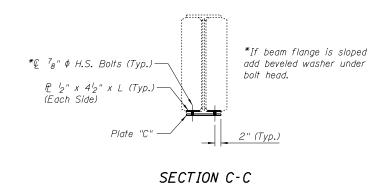

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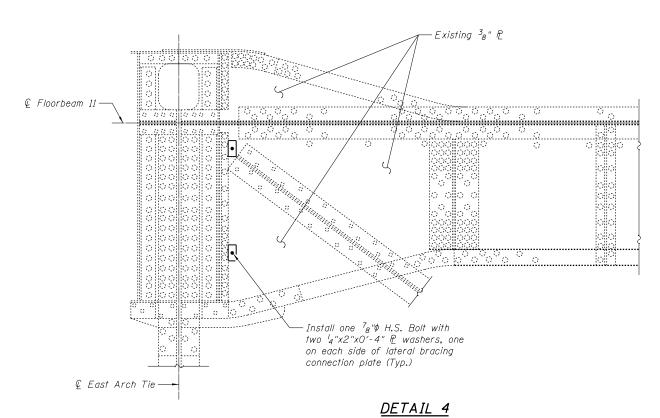
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STATE OF ILLINOIS DEPARTMENT OF TRANSPORTATION 
 STRUCTURAL STEEL REPAIR DETAILS, SHEET 1
 F,A,P RTE.
 SECTION

 STRUCTURE NO. 081–9905
 308
 (3BR)M

 SHEET NO. 12 OF 33 SHEETS
 C-92-090-12



Span 12 Floorbeam 11 @ East Tie (Plan View)


1<sup>7</sup>8" (Typ.

Existing handrail

 $P_{2}^{l_{2}''} \times 9^{3}_{4}'' \times 18''$ 


new plates.

post (Typ.)

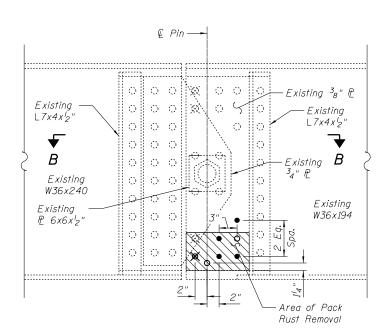

### DETAIL 5

Span 21, Beam F North Pin, West Face

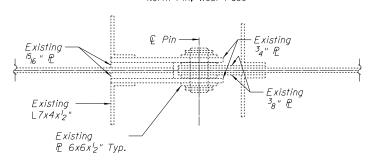


### REPAIR SEQUENCE:

- 1. Drill out and remove designated flattened rivets.
- 2. Remove pack rust from between  $\frac{3}{8}$ " bearing plates and web of W36x194 using hand tool or power tool methods.
- 3. Clean out bolt holes and tap threads in plates and web of W36x194 at location where threaded rod will be installed.
- 4. Install new  $^{7}_{8}$ " $\phi$  A325SC Bolts and Tighten to bring  $^{3}_{8}$ " plates into contact with web of W36x194.
- 5. Install new 1"\$\phi\$ H.S. threaded rod. Threaded rod should be cut short to allow for 18" of exposed threads on each  $\frac{3}{8}$ " bearing plate.
- 6. Mar exposed threads on each  ${}^{3}_{8}$ " bearing plate to prevent threaded rod from rotating out of hole.

### LEGEND:

- Existing Rivet
- Existing Flattened Rivet to be replaced with New 78" \$\phi\$ Hex Head Bolt
- **⊠** Existing Flattened Rivet to be replaced with New 1" \$\phi\$ H.S. Threaded Rod
- to Remain
- O New 78" \$\phi\$ A325SC Hex Head Bolt

### SECTION B-B

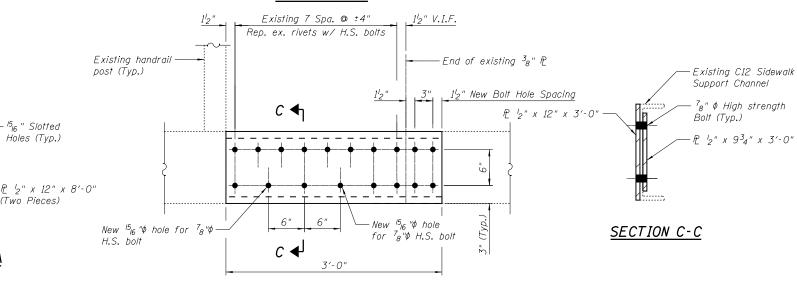

### DETAIL 7

Span 25 West Sidewalk, 6' North from Bent 18 (Looking East) Contractor to ensure support of sidewalk channel during splice plate exchange

STV Jears

New <sup>15</sup>16 "\$\phi\$ hole

for 78"\$ H.S. bolt

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Typ.)

 $A \blacktriangleleft \downarrow$ 

*V.I.F.* 

 $P_2$  'z" x 12" x 8'-0" V.I.F. (Outside face)

(Install in Two Pieces with  $I_2$ " Expansion Gap)

P '2" x 934"

DETAIL 6

Span 21 East Sidewalk @ 2nd Bracket North from Bent 14

(Looking East)

Contractor to ensure support of sidewalk channel during splice plate exchange

Match existing rivet holes

15<sub>16</sub> "x1<sup>1</sup>8" Slotted Hole in <sup>1</sup>2"

Plate Only. <sup>7</sup><sub>8</sub>" Bolts Hand Tightened with Double Nuts.

STATE OF ILLINOIS **DEPARTMENT OF TRANSPORTATION** 

<sup>15</sup>16 " Slotted

Holes (Typ.)

(Two Pieces)

SECTION A-A


Remove existing 1/2"x12" plate. Cut off 8'-0" section at expansion

ioint, Replace remainder of

existing plate and add Detail 6

STRUCTURAL STEEL REPAIR DETAILS, SHEET 2	F.A.P RTE.	SECTION
STRUCTURE NO. 081-9905	308	(3BR)M
31NUCTURE NO. 001-3303		C-92-090-12
CHEET NO. 17 OF 77 CHEETC		

COUNTY ROCK ISLAND 47 26 CONTRACT NO. 64H28

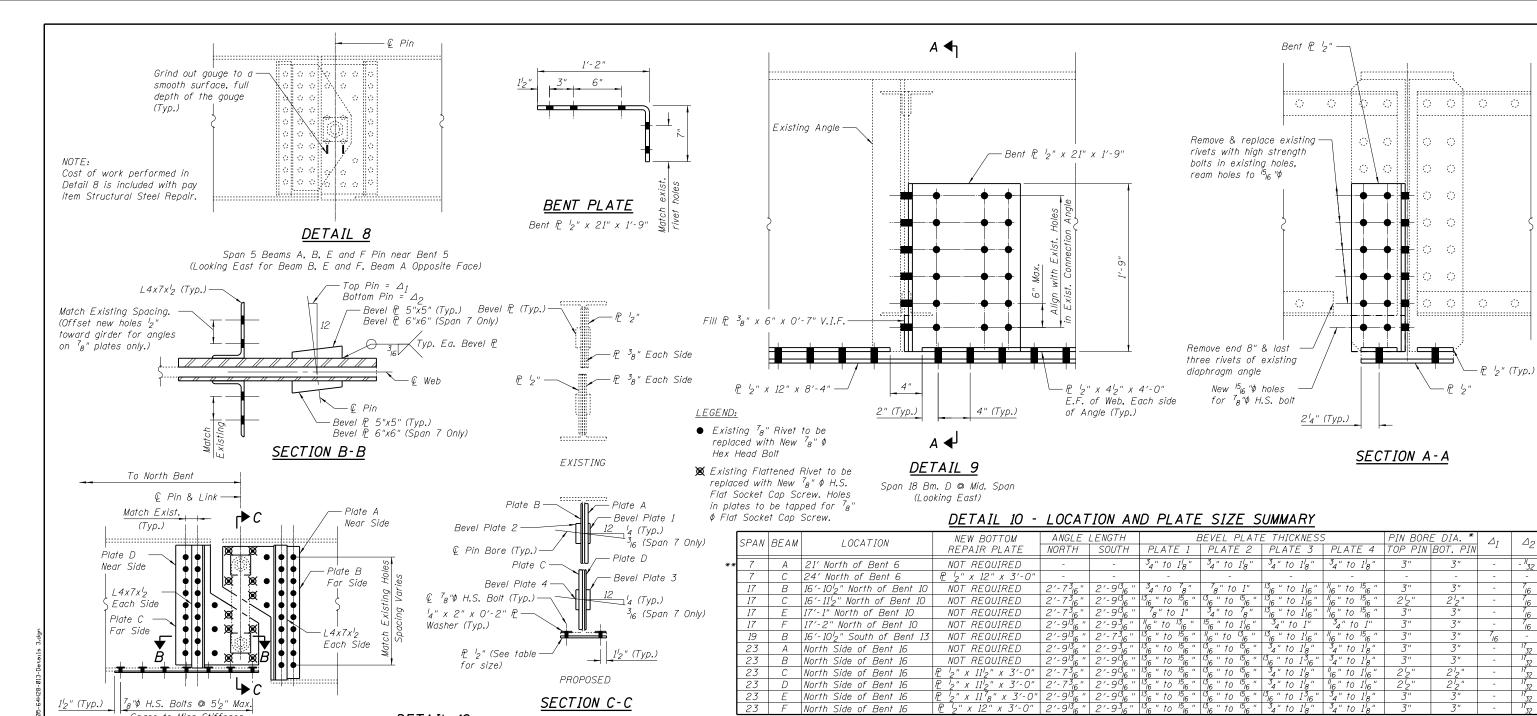

Space to Miss Stiffener DETAIL 10 See Plate A & B Detail, Plate C & D Detail, and Table for Plate Sizes and Locations. Repair at Span 19, Beam B is similar and opposite.


 $^{7}8$ "  $\phi$  H.S. Flat Socket Cap Screw shall be installed from Plate A side on South Girder and Plate C side on North Girder. In the locations shown, Plates A and C shall have beveled holes to match the  $^{7}_{8}$ "  $\phi$  H.S. Flat Socket Cap Screws.

Contractor to provide Flat Socket Cap Screws such that  $\frac{1}{4}$ " of threads are exposed. Mar exposed threads to prevent screw from rotating out of hole.

Existing teflon bushing shall be replaced. New bushing thickness shall match existing. Bushings shall be a self lubricating filament wound epoxy matrix backed Duralon Bearing, metal backed Fiber Glide Bearing, or equivalent. No primer or grease shall be allowed on bushings. Bushings shall be suitable for dynamic loads of 20,000 psi. Teflon bushing replacement shall be included in Structural Steel Repair pay item.

Immediately before reinstalling existing link plates, apply  $^38$ " bead of Silicone Sealant to face of the web reinforcing plates approximately  $^12$ " from bushing. Place sealant around nuts after installation. Sealant shall be suitable for prolonged exterior exposure without losing flexibility or adhesion to painted steel surfaces. Proposed products shall be subject to Department's acceptance based on deocumented testing or other evidence. Silicone Sealant shall be included in Structural Steel Repair pay item.

Contractor shall temporarily support girder while performing repairs at Pin and Link joints. Dead load reactions provided for temporary shoring and cribbing. Contractor to add construction live loads. All work associated with temporarily supporting girder shall be paid for as Temporary Shoring and Cribbing. See Special Provisions.

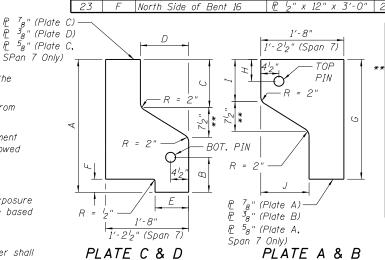

DETAIL

9 10	1	10 10		10	. 0 10	4 .	- 0	4 .0 10			•	JZ
SPAN	BEAM		PLATE	E C & E	DIMEN	SIONS		PLATE	. A & E	B DIME!	SIONS	DEAD LOAD REACTIONS
		Α	В	С	D	Ε	F	G	Н	I	J	(KIPS)
7	Α	2'-04"	8 <sup>3</sup> 8"	N/A	1'-0'8"	N/A	N/A	2'-04"	8 <sup>3</sup> 8"	1'-0 <sup>9</sup> 16"	1'-08"	61
7	С	-	-	-	-	-	-	-	-	-	-	39
17	В	2'-6'2"	53 <sub>8</sub> "	1'-0 <sup>5</sup> 8"	1'-0"	N/A	N/A	2'-9"	54"	10 <sup>3</sup> 4"	1'-0"	25
17	С	2'-6'2"	53 <sub>8</sub> "	1'-0 <sup>5</sup> 8"	1'-0"	N/A	N/A	2'-9"	5½"	11"	1'-0"	22
17	Ε	2'-6'2"	53 <sub>8</sub> "	1'-0 <sup>5</sup> 8"	1'-0"	N/A	N/A	2'-9"	5¼"	10 34"	1'-0"	25
17	F	3'-0"	8½"	1'-2"	1'-0"	9"	2"	2'-812"	5¼"	1'-04"	1'-0"	34
19	В	2'-612"	51/8"	1'-0 <sup>5</sup> 8"	1'-012"	N/A	N/A	2'-9"	5¼"	10 <sup>3</sup> 4"	1'-034"	25
23	Α	2'-11 <sup>7</sup> 8"	84"	1'-2"	11'4"	9"	134"	2'-812"	5%"	1'-08"	1'-04"	36
23	В	2'-9"	3 <sup>3</sup> 4"	1'-2"	114"	N/A	N/A	2'-9"	5¼"	1'-0"	1'-04"	32
23	С	2'-6 <sup>3</sup> 8"	5"	1'-0 <sup>5</sup> 8"	114"	N/A	N/A	2'-9"	5½"	11"	1'-04"	27
23	D	2'-6 <sup>3</sup> 8"	5"	1'-0 <sup>5</sup> 8"	114"	N/A	N/A	2'-9"	5½"	11"	1'-04"	27
23	Ε	2'-9"	33 <sub>4</sub> "	1'-2"	114"	N/A	N/A	2'-9"	5¼"	1'-0"	1'-04"	32
23	F	2'-11 <sup>7</sup> 8"	84"	1'-2"	114"	9"	1 <sup>3</sup> 4"	2'-812"	51/8"	1'-08"	1'-04"	36
/erifv	all dim	ensions .	in field	prior to	orderii	na steel						

\* Contractor shall increase given pin bore diameters by the thickness of the new teflon bushing.

Thickness of new teflon bushing shall match existing.

\*\* Replace  $^{5}8$ " web plates at pins only. Plate dimensions provided for Span 7 Beam A repair are estimates only. Contractor shall verify dimensions prior to ordering steel.


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STATE OF ILLINOIS **DEPARTMENT OF TRANSPORTATION** 

DETAIL

COUNTY TOTAL SHEET NO. ROCK ISLAND 47 27 STRUCTURAL STEEL REPAIR DETAILS, SHEET 3 308 (3BR)M **STRUCTURE NO. 081-9905** C-92-090-12 CONTRACT NO. 64H28 SHEET NO. 14 OF 33 SHEETS




### DETAIL 13 - LOCATION AND PLATE SUMMARY

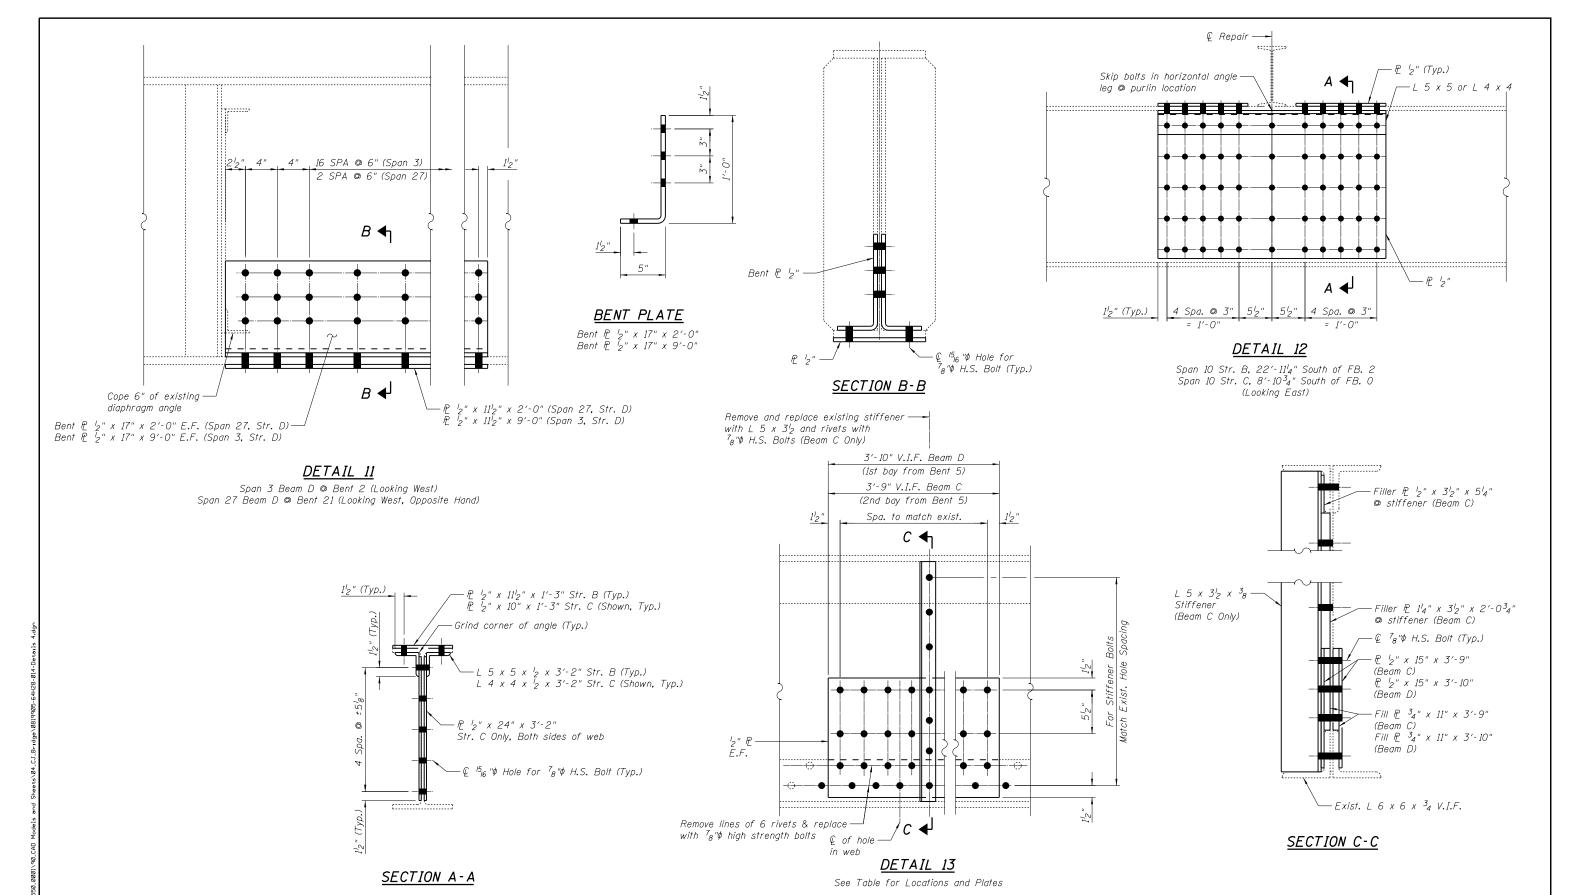6 C 15' from Bent 5 $\frac{1}{2}$ " x 15" x 3'-9" L 5" x $\frac{3}{2}$ " x $\frac{3}{8}$ " x 2'-11" $\frac{1}{4}$ " x $\frac{3}{2}$ " x 2'-0 $\frac{3}{4}$ " x 11" x 3'-9"	FILL PLATE
	2" x 3½" x 5¼"
$\begin{bmatrix} 6 & D & 6' \text{ from Bent 5} & \frac{1}{2}" \times 15" \times 3'-10" & N/A & N/A & N/A & \frac{3}{4}" \times 11" \times 3'-10 & N/A & $	N/A



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STRUCTURAL STEEL REPAIR DETAILS, SHEET 4	F.A.P RTE.	SECTION
STRUCTURE NO. 081-9905	308	(3BR)M
3111001011L NO. 001-3303		C-92-090-12
CHEET NO 15 OF 77 CHEETS		

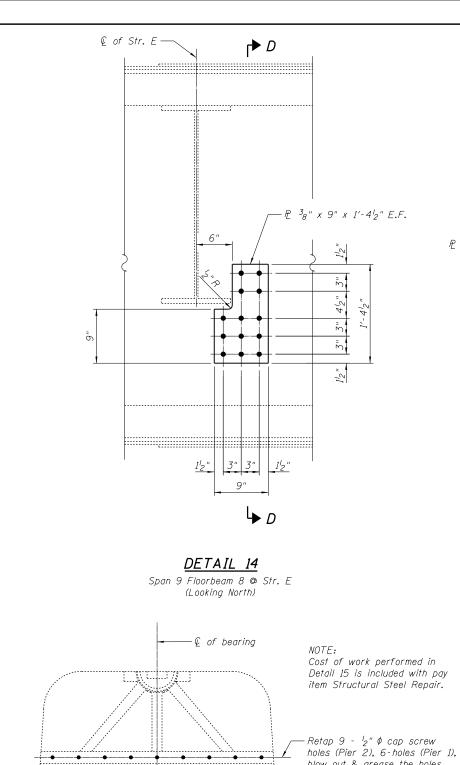

Cost of work performed in Detail 15 is included with pay item Structural Steel Repair.


blow out & grease the holes

Reattach  $\frac{3}{16}$ " dust guard plate with  $\frac{1}{2}$ "  $\phi$ cap screws with  $1_{16}'' \phi \times 0.177''$  thick washers


Provide new  $^{3}_{l6}$ " dust guard plate with  $^{l}_{2}$ "  $\phi$  cap screws with  $^{l}_{l6}$ "  $\phi$  x 0.177" thick washers.

### DETAIL 15

Span 10, West Bearing @ Pier 2 (Looking East) Span 9, East Bearing @ Pier 1 (Looking East)

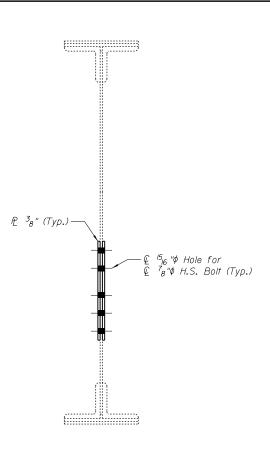


### SECTION D-D

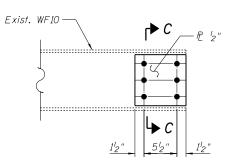


### DETAIL 17

Span 9, 3rd Purlin South of Floorbeam 3 (Looking North)

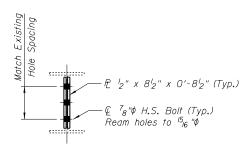


SECTION C-C

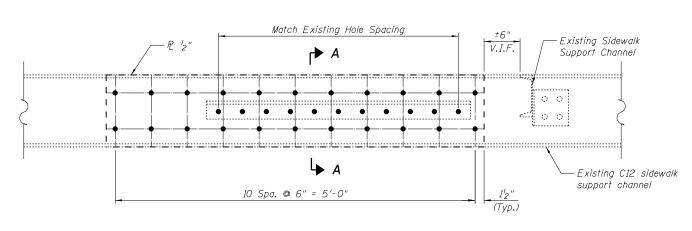


### DETAIL 16

Span 13 Sidewalk Support Channel, West Side @ Pier 6 (Looking East)

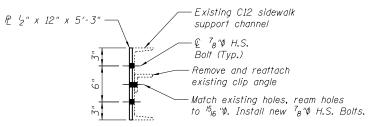

### SECTION A-A

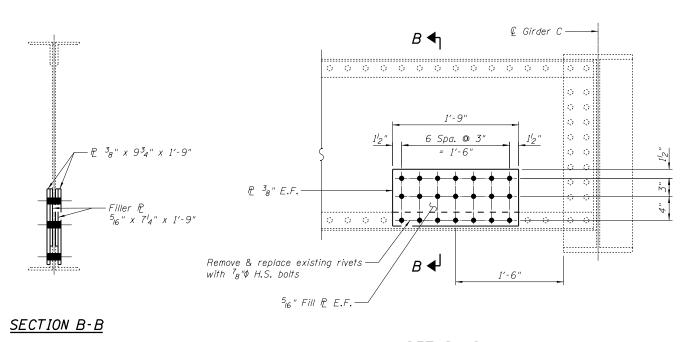

### DETAIL 18


Span 23 Diaphragm Between Str. B & Str. C @ Bent 16 (Looking South)



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STATE OF ILLINOIS **DEPARTMENT OF TRANSPORTATION**  STRUCTURAL STEEL REPAIR DETAILS, SHEET 5 STRUCTURE NO. 081-9905 SHEET NO. 16 OF 33 SHEETS

COUNTY TOTAL SHEETS NO. ROCK ISLAND 47 29 SECTION 308 (3BR)M CONTRACT NO. 64H28 C-92-090-12

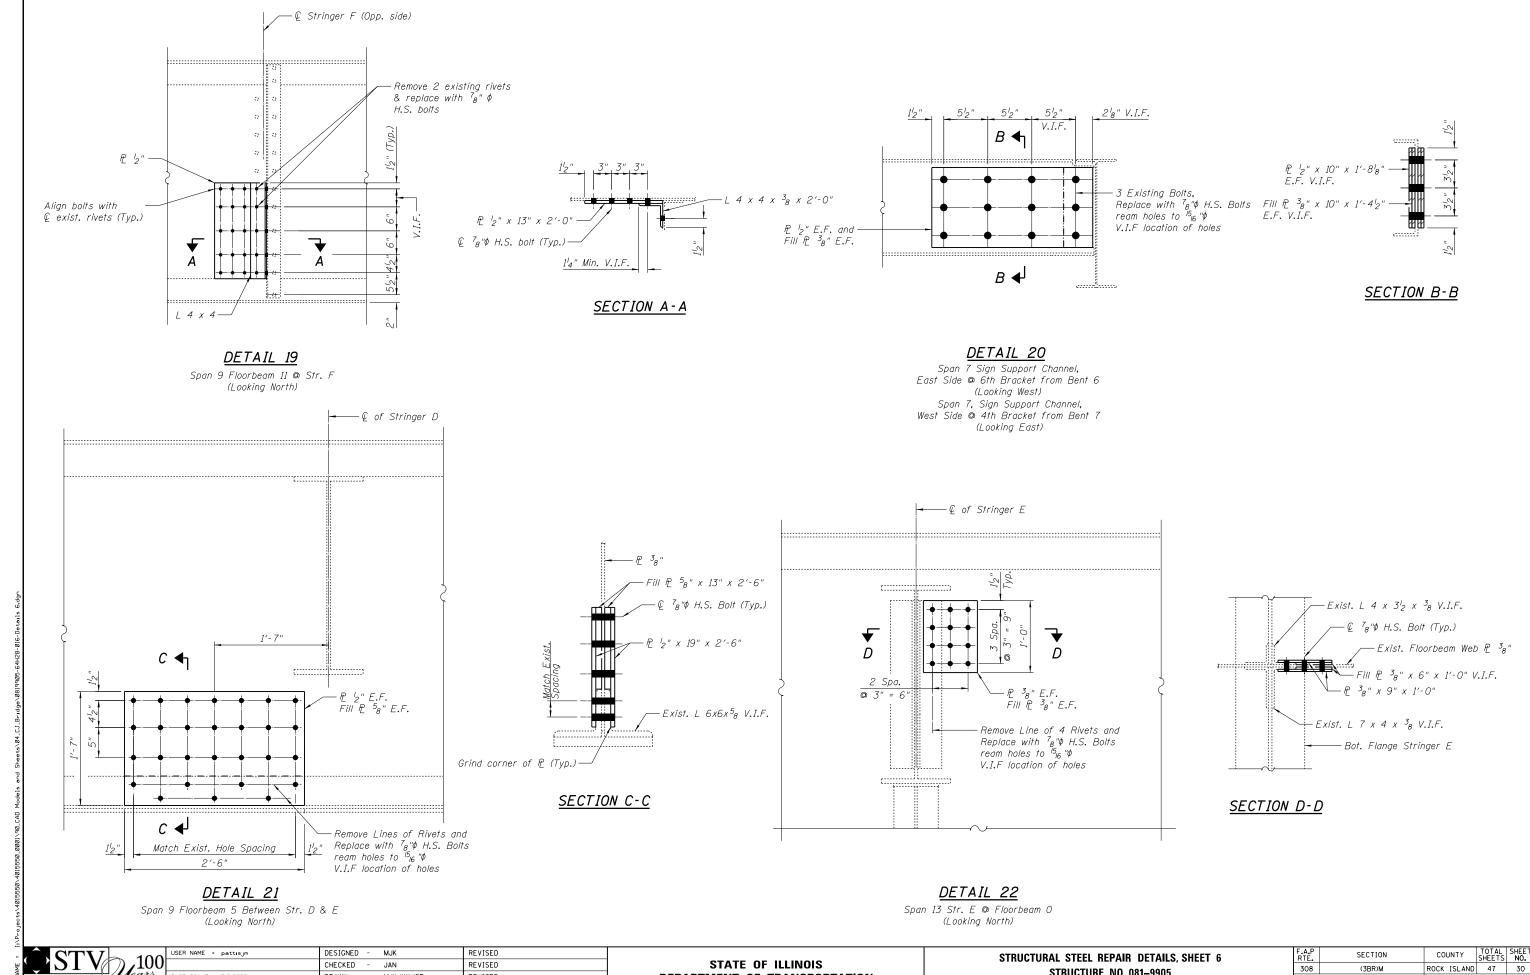

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**DEPARTMENT OF TRANSPORTATION** 

SECTION

(3BR)M

C-92-090-12

CONTRACT NO. 64H28

308

STRUCTURAL STEEL REPAIR DETAILS, SHEET 6

STRUCTURE NO. 081-9905

SHEET NO. 17 OF 33 SHEETS

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JAN


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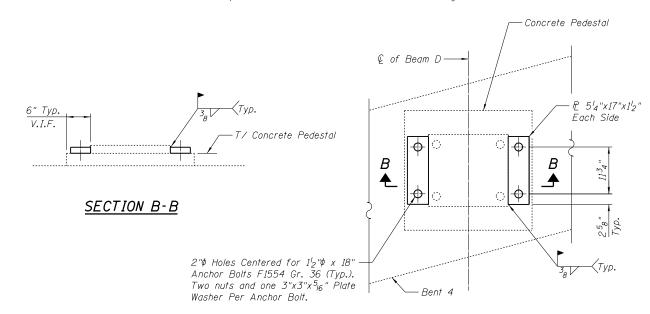
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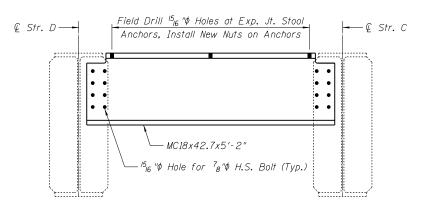


### DETAIL 23

Span 10 West Tie © West End of FB. 10 (Looking South - Opposite Hand)
Span 11 West Tie © West End of FB. 9 (Looking North)
Span 11 West Tie © West End of FB. 4 (Looking North)



<u>DETAIL 26</u> Bent 4 @ Beam D

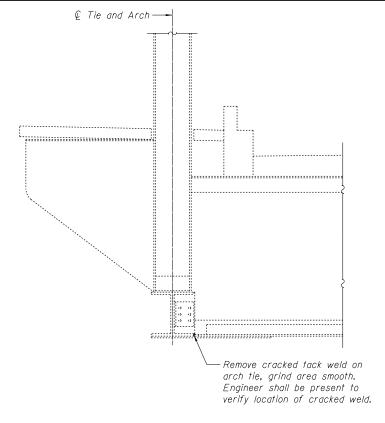


### DIAPHRAGM END DETAIL

Fill PC 58" x 27'8" x 2'-5'4"

### DETAIL 24

Span 22 Diaphragm Between Str. C & Str. D Over Bent 16 (Looking North)

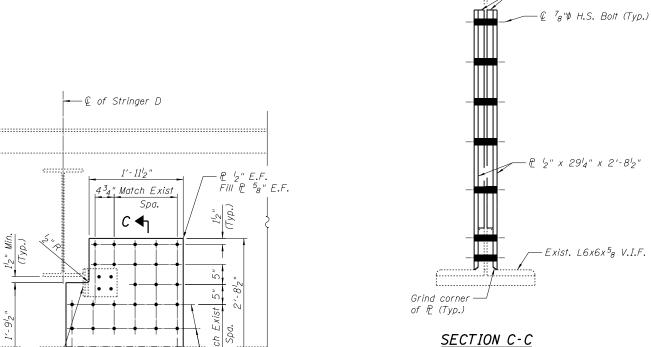

-Remove exist. bolts and exist. repair æs Replace with <sup>7</sup>8"\$ H.S. bolts and new æs, ream

holes to 15<sub>16</sub> "\$

1<sup>1</sup><sub>2</sub>" Min (Typ.) V.I.F.

### SECTION C-C

DETAIL 25

Match Exist Spacing

2'-54"

Span 9 Floorbeam 2 @ Str. D (Looking North)





$\overline{}$	USER NAME = pattisjm	DESIGNED	-	MJK	REVISED
J		CHECKED	-	JAN	REVISED
	PLOT SCALE = 2:0.00000 ':' / in.	DRAWN	-	MJK/KK	REVISED
	PLOT DATE = 1/21/2014	CHECKED	-	JAN	REVISED

Remove and reinstall existing wind shear


device. Replace exist.

bolts with  $^{'}7_{8}$ " $\phi$  H.S. bolts, ream holes to

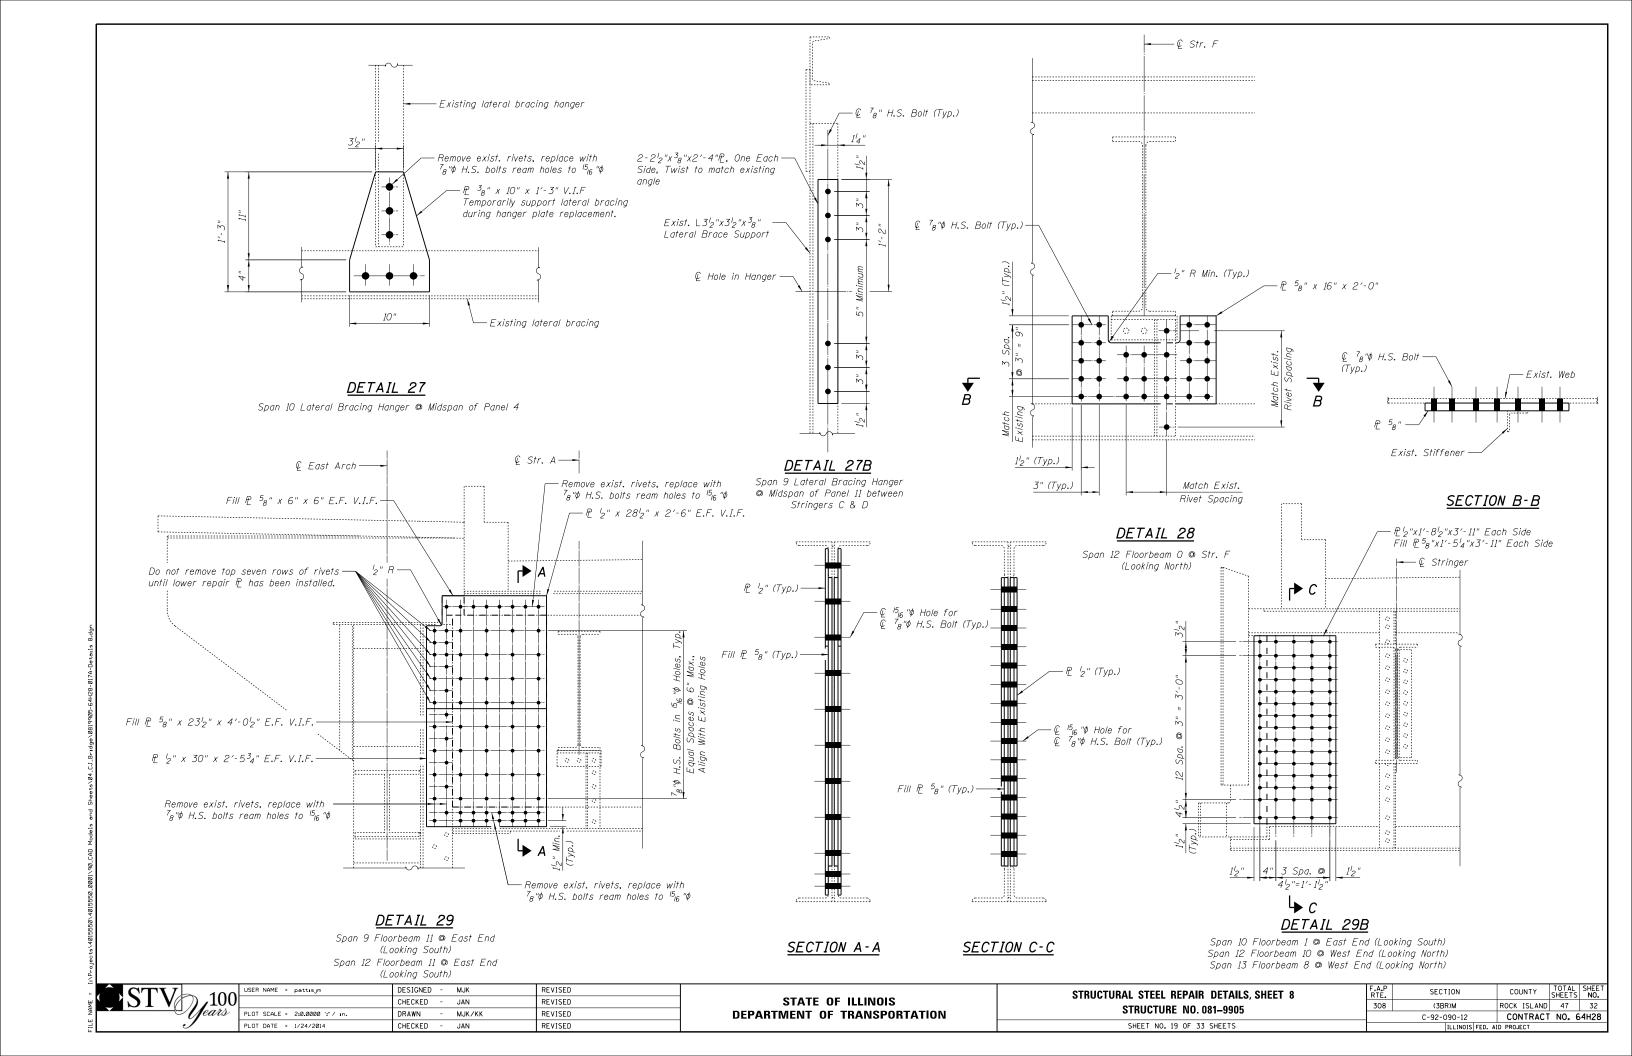

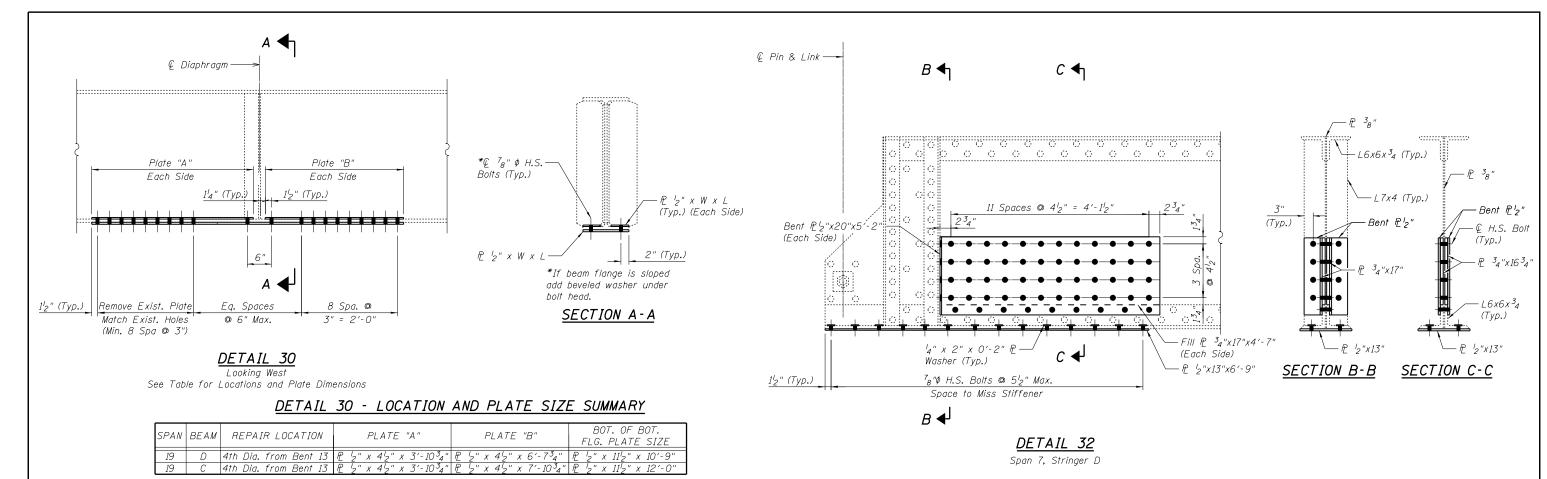

Note: For this table, in referencing diaphragms, the first shall be on the pier or abutment.

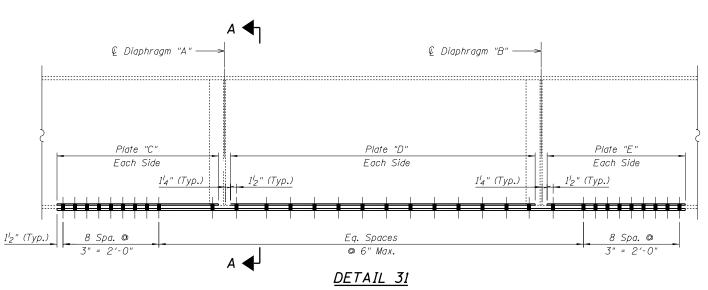

See Table for Locations and Plate Dimensions


### DETAIL 31 - LOCATION AND PLATE SIZE SUMMARY


SPAN	BEAM	DIAPHRAGM "A"	DIAPHRAGM "A"	PLATE "C"	PLATE "D"	PLATE "E"	BOT. OF BOT. FLG. PLATE SIZE
16	D	3rd Dia. from Bent 10	4th Dia. from Bent 10	P 12" x 412" x 4'-434"	P '2" x 4'2" x 17'-934"	P 12" x 412" x 3'-234"	R '2" x 1134" x 25'-10'4"
16	Α	2nd Dia. from Bent 10	3rd Dia. from Bent 10	P '2" x 6 '2" x 13'-119 <sub>16</sub> "	P '2" x 6'2" x 17'-7'8"	P 12" x 612" x 9'-034"	PL 12" x 16" x 41'-0716"
18	Α	3rd Dia. from Bent 12	4th Dia. from Bent 12	P '2" x 6'2" x 8'-6 <sup>3</sup> 4"			
23	С	2nd Dia. from Bent 17	3rd Dia. from Bent 17	P 2" x 42" x 2'-3"	P 2" x 412" x 17'-118"	P 12" x 412" x 2'-434"	PL 12" x 1112" x 22'-178"


Note: For this table, in referencing diaphragms, the first shall be on the pier or abutment.


CTV 100	USER NAME = pattisjm	DESIGNED - MJK	REVISED	
$\sim 21 \text{ A} \sim 100$		CHECKED - JAN	REVISED	
ears	PLOT SCALE = 2:0.0000 ':' / in.	DRAWN - JMP	REVISED	
./	PLOT DATE - 1/21/2014	CHECKED - CB	DEVISED	ı

| STRUCTURE NO. 081–9905 | F.A.P | SECTION | COUNTY | STRUCTURE NO. 081–9905 | SHEET NO. 20 OF 33 SHEETS | SHEETS | SHEET NO. 20 OF 33 SHEETS | SHE

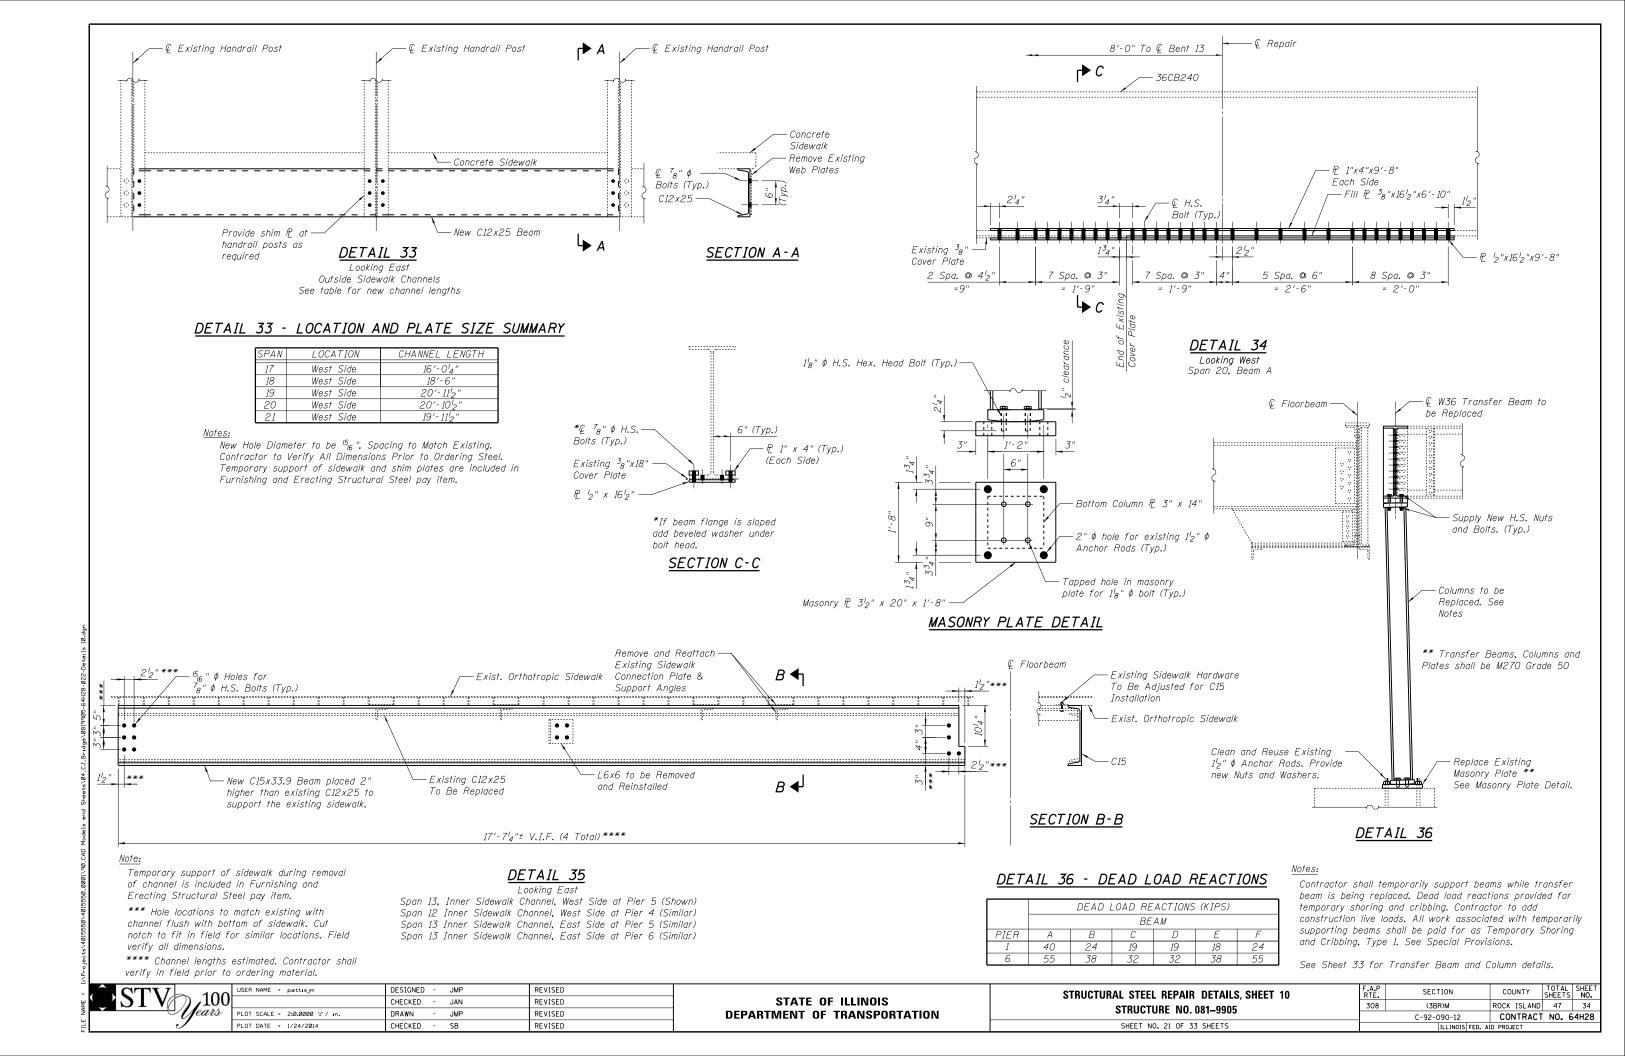

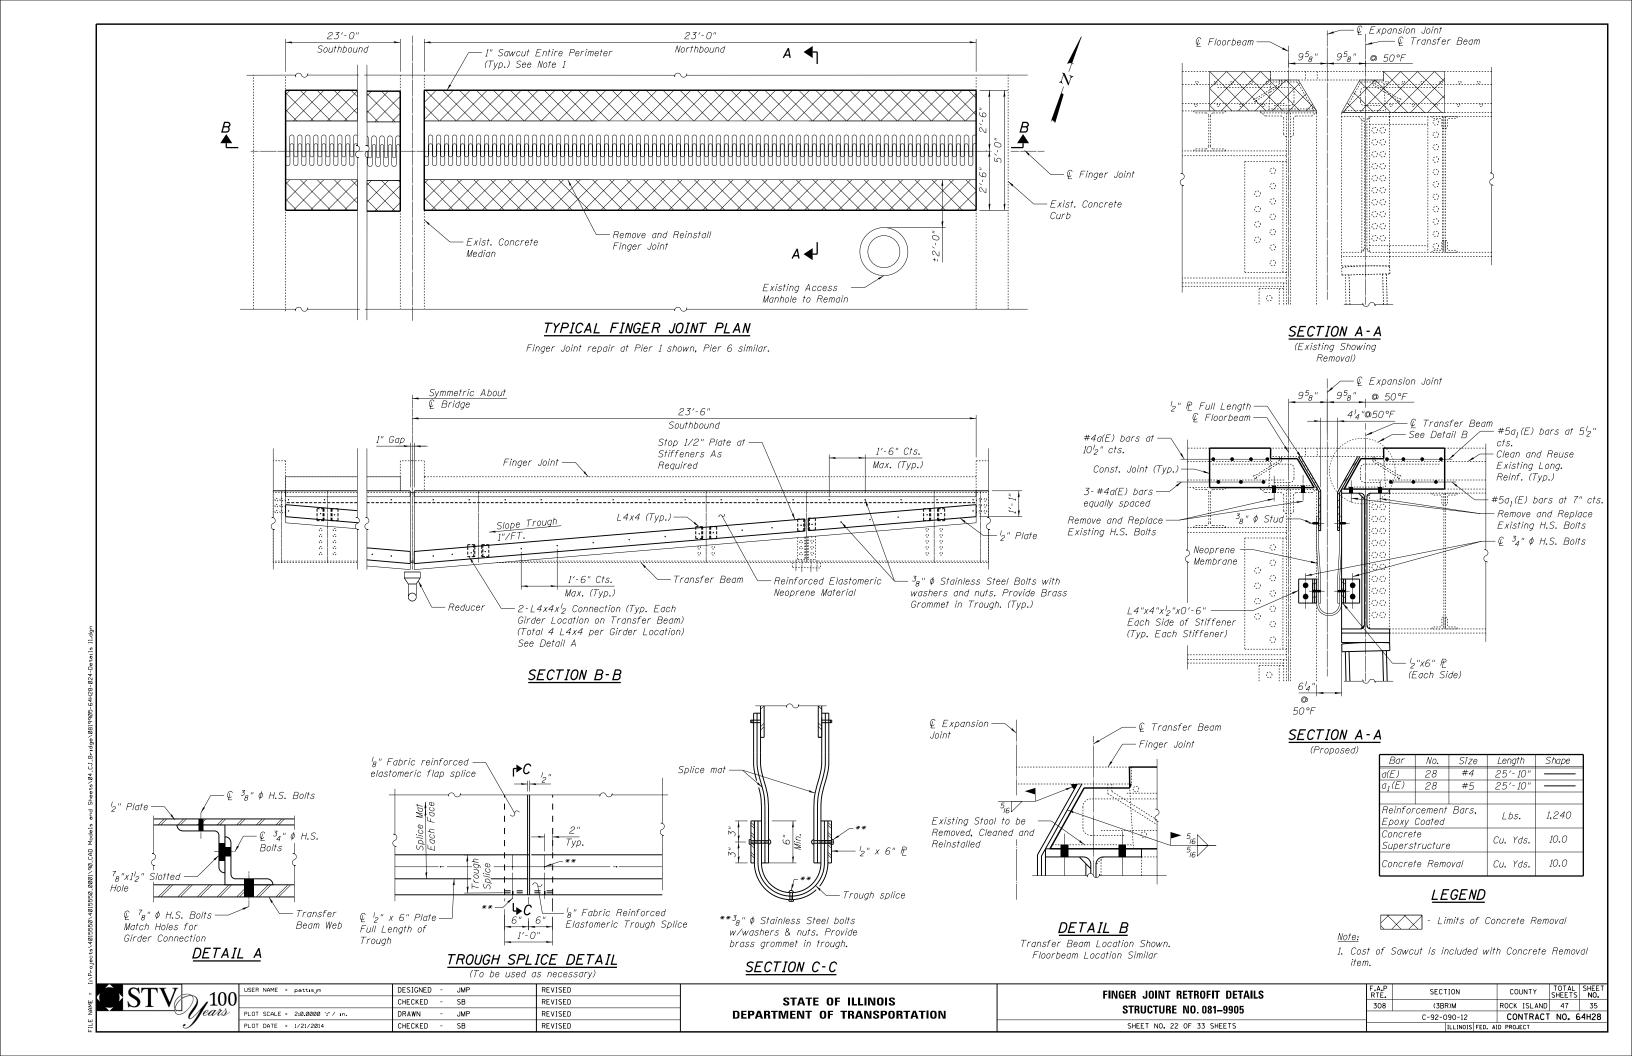

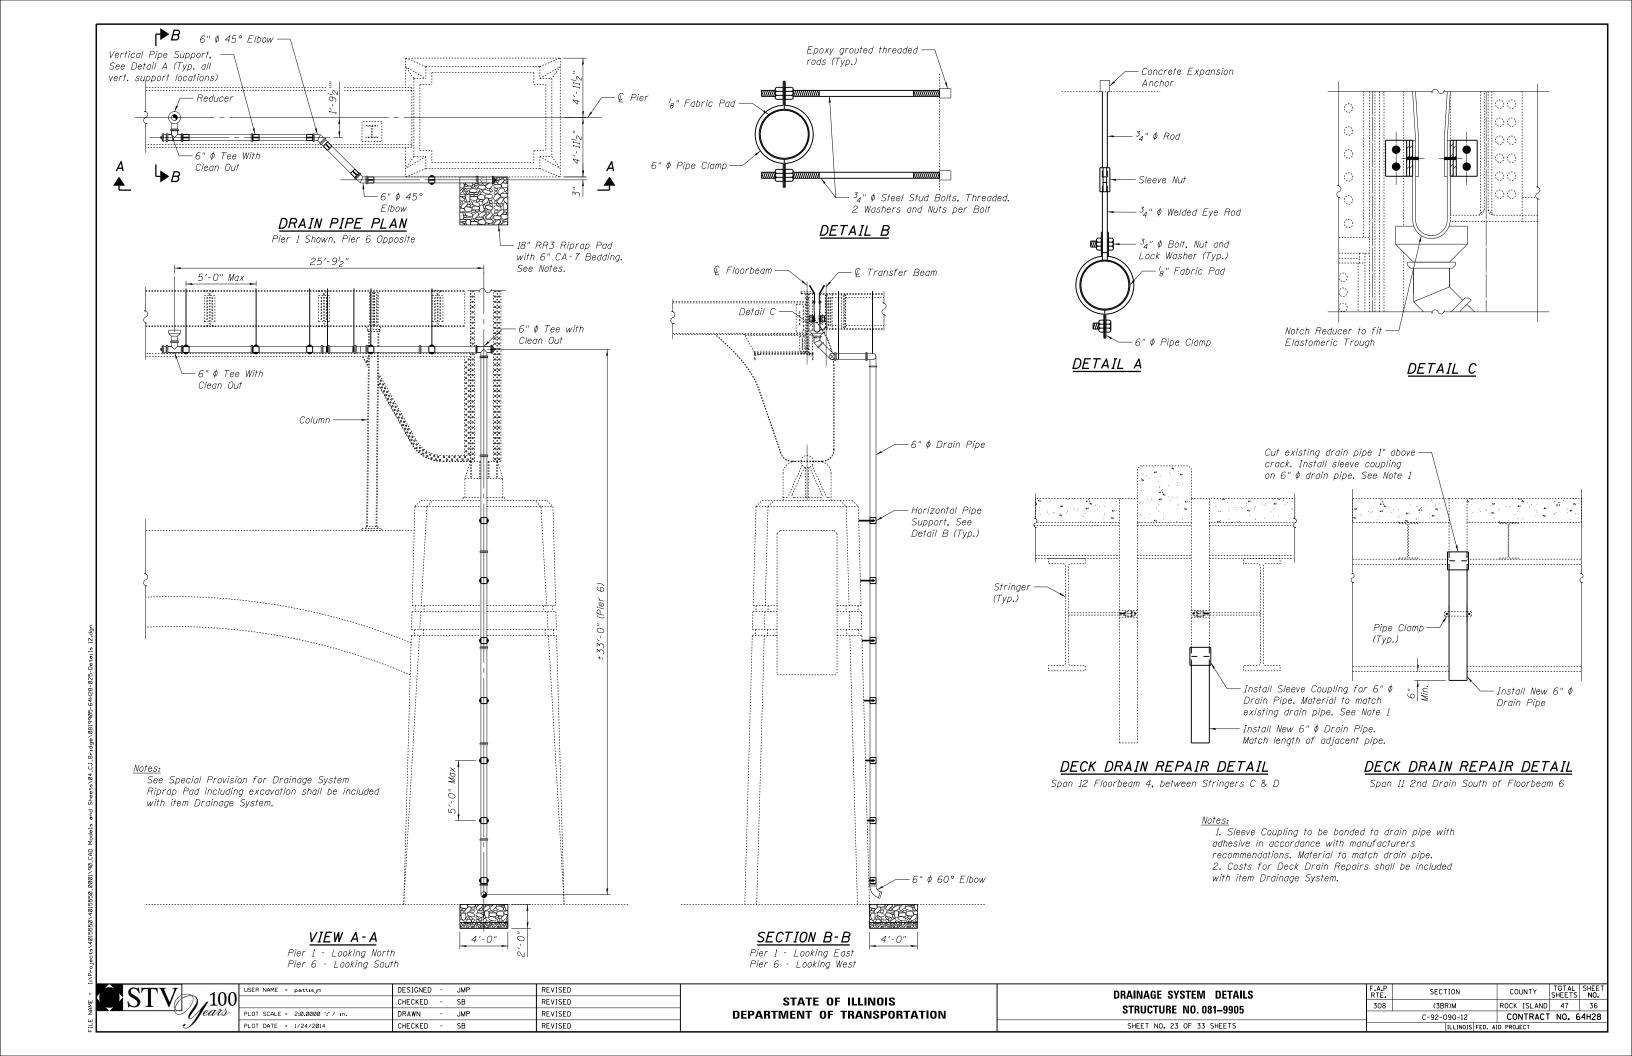

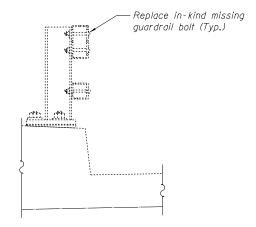


#### TYPICAL SECTION THROUGH GUARDRAIL

See Table for Locations

# GUARDRAIL BOLT REPLACEMENT LOCATION SUMMARY

SPAN	SIDE	LOCATION	BOLTS MISSING	TOTAL/SPAN
9	East	P.P. 7 - P.P. 6	2	5
9	West	P.P. 7 - P.P. 6	3	5
10	West	P.P. 8 - P.P. 7	1	
10	East	P.P. 8 - P.P. 7	1	
10	West	P.P. 7 - P.P. 6	1	
10	East	P.P. 6 - P.P. 5	2	11
10	East	P.P. 4 - P.P. 3	2	
10	East	P.P. 4 - P.P. 3	2	
10	East	P.P. 4 - P.P. 3	2	
11	East	P.P. 13 - P.P. 12	1	
11	East	P.P. 12 - P.P. 11	1	
11	East	P.P. 11 - P.P. 10	1	
11	East	P.P. 3 - P.P. 2	1	7
11	West	10' N OF B6	1	
11	West	3' S OF B6	1	
11	West	3' N OF JT.	1	
12	West	P.P. 11 - P.P. 10	3	
12	West	P.P. 3 - P.P. 2	3	8
12	West	13' S OF B2	1	0
12	West	P.P. 2 - P.P. 1	1	
13	West	P.P. 8 - P.P. 7	2	2
14	West	25' S of B8	2	2
<i>1</i> 5	East	6' S of B9	1	1
17	East	6' N of B10	1	1
19	West	6' N of B12	2	
19	West	9' N of B12	2	
19	East	24' N of B12	1	8
19	East	40' N of B12	1	
19	East	20' S of B13	2	
21	West	3' N of B14	1	3
21	East	9' N of B14	2	J
24	West	5′ S OF B18	1	1
			TOTAL	49

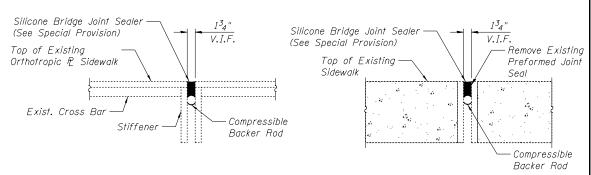


## SIDEWALK PANEL JOINT REPAIR DETAIL

Span 10,11 West Sidewalk Joint @ Pier 3

#### SIDEWALK JOINT REPAIR DETAIL

Span 1, East Sidewalk Joint @ S. Abutment

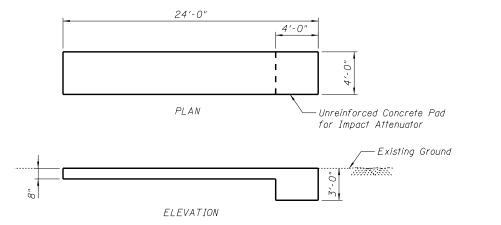


#### CONCRETE PAD DETAIL

<u>Notes:</u>
Concrete Pad per Manufacturer Recommendation fc' = 4,000 psi

# STRUCTURAL REPAIR OF CONCRETE LOCATION SUMMARY


SPAN	MEMBER	LOCATION	AREA (SQ. FT.)
9.10	Pier 2	Wall	31
9,10	riei Z	Column	12
10,11	Pier 3	Wall	12
10,11	i iei J	Column	30
		Сар	6
12,13	Pier 5	Wall	30
		Column	10
		Сар	62
13,14	Pier 6	Column	80
		Wall	200
19,20	Bent 13	Сар	40
21,22	Bent 15	Сар	25
22.23	Bent 16	Wall	25
22,23	Deill 10	Сар	25

Paid for as: Structural Repair of Concrete (Depth Equal To or Less Than 5 in.)

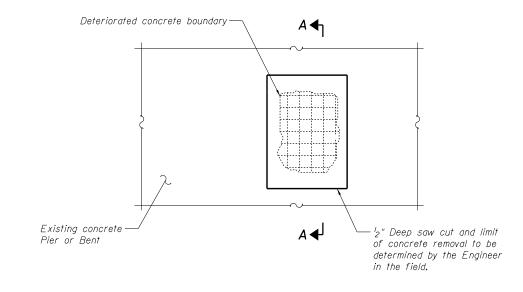

# STRUCTURAL REPAIR OF CONCRETE DETAIL

(Depth Equal To or Less Than 5 in.) See Table for Locations

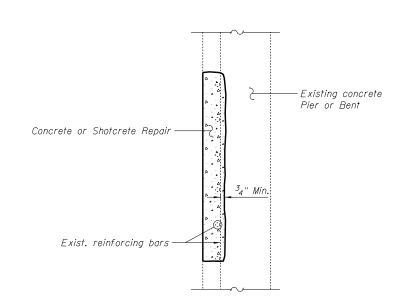


# SECTION A-A



USER NAME = pattisjm	DESIGNED - MJK	REVISED
	CHECKED - JAN	REVISED
PLOT SCALE = 2:0.0000 ':' / in.	DRAWN - JMP	REVISED
PLOT DATE = 1/21/2014	CHECKED - SB	REVISED

MISCELLANEOUS REPAIR DETAILS	F.A.P RTE.	SECTION	COUNTY	TOTAL SHEETS	SHEE NO.
STRUCTURE NO. 081-9905	308	(3BR)M	ROCK ISLAND	47	37
21KOCIOKE NO. 081-9903		C-92-090-12	CONTRACT	NO.	64H28
SHEET NO. 24 OF 33 SHEETS		ILLINOIS FED. A	D PROJECT		

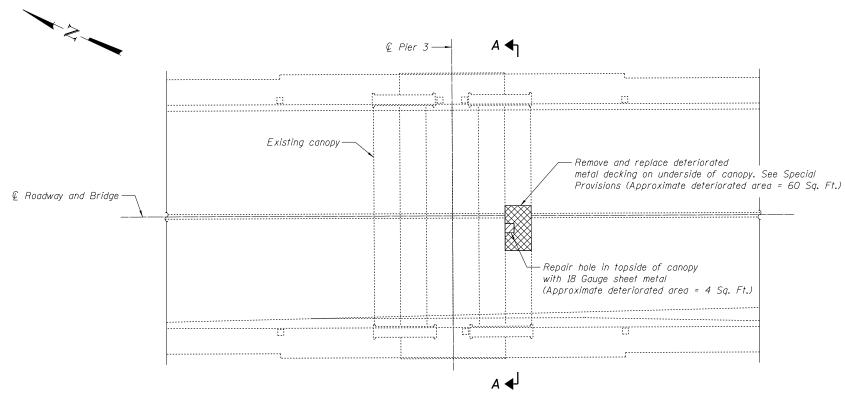

V.I.F. Install 18 Ga Sheet metal roof repair with  $^3$ 32 " $\phi$  sealing blind rivets @  $^1$ 2" Spa. and seal with weather resistant sealant. Limits of deterioration-6" Min. Overlap

#### TOP SIDE OF CANOPY REPAIR DETAIL

(Plan View)


## LEGEND

Repair location on topside of canopy


Repair location on underside of canopy

# CANOPY PLAN

Span 10, 11

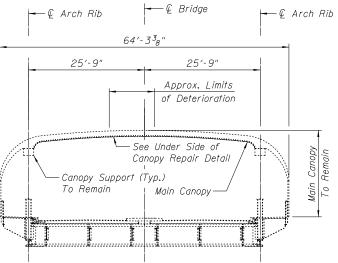

SECTION A-A

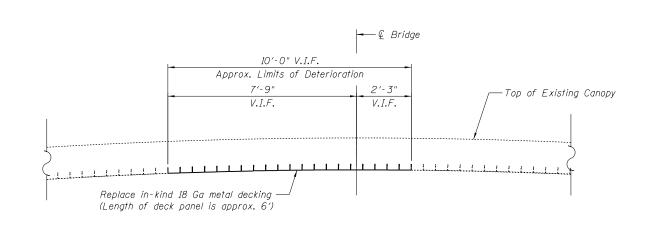



# UNDER SIDE OF CANOPY REPAIR DETAIL

(Section View)

$\sim$	USER NAME = pattisjm	DESIGNED -	MJK	REVISED
U		CHECKED -	JAN	REVISED
,	PLOT SCALE = 21:4.00000 ':" / in.	DRAWN -	MJK	REVISED
	PLOT DATE = 1/21/2014	CHECKED -	JAN	REVISED

CANOPY REPAIR DETAILS		SECTION	COUNTY	TOTAL SHEETS	SHEET NO.
STRUCTURE NO. 081-9905	308	(3BR)M	ROCK ISLAND	47	38
31NOCIONE NO. 001-3303		C-92-090-12	CONTRACT	NO. 6	4H28
SHEET NO. 25 OF 33 SHEETS		ILLINOIS FED. A	ID PROJECT		

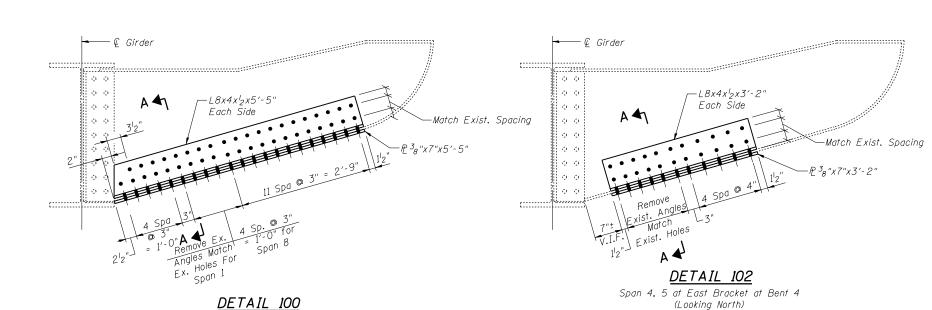


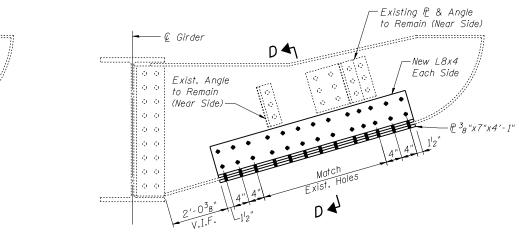

DETAIL 103

Span 7, East Side, 5th Bracket from Bent 6

(Looking North)

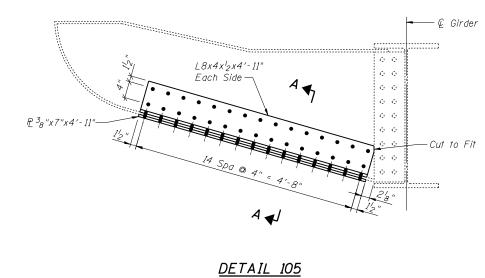

 $B \blacktriangleleft_1$ 

1'-0"

P 1/2"x1'-0"x2'-31/8" Each Side (Cut to Fit) -2 Spa @ 4½"

DETAIL 104

Span 7, East Side, 4th Bracket from Bent 6

(Looking South)

P2 1/2"x9"x1'-2"

3'-3"


- @ Girder

– Fill ₽ ½"x7"x9"

-Match Exist.

**→** Spacing


Remove Rivets Install New P and Bolts

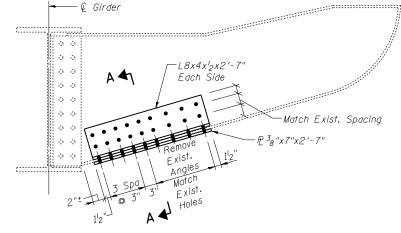



Span 1, East Side, Third Bracket from South Abutment (Looking North) Span 8, East Side, Second Bracket from Bent 7 (Looking North)

DETAIL 101


Span 4, East Side, First Bracket from North of Bent 3 (Looking North)

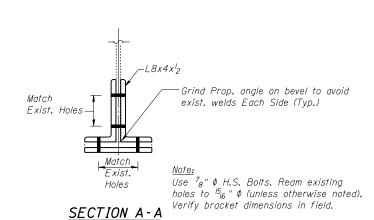

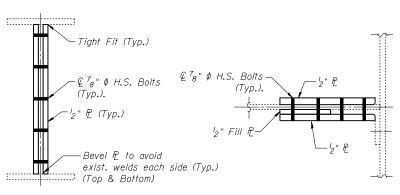

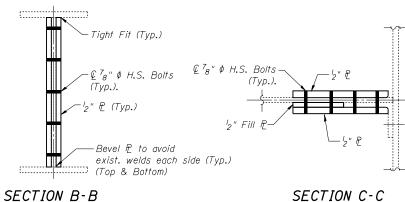

SECTION C-C Detail 107 Opposite Hand

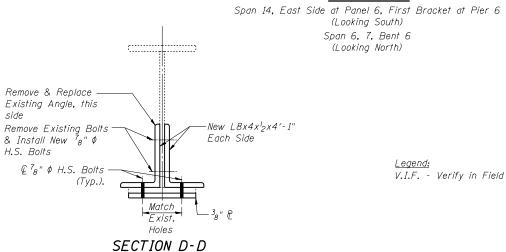


Work this sheet with Sheet 27




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		CHECKED - OAO	REVISED
<u>D</u>	PLOT SCALE = 2.0000004 '/ in	DRAWN - JL	REVISED
m	PLOT DATE = 1/24/2014	CHECKED - LRT	REVISED

STATE OF ILLINOIS **DEPARTMENT OF TRANSPORTATION** 

BRACKET REPAIR STRUCTURE NO. 081-9905 SHEET NO. 26 OF 33 SHEETS	F.A.P RTE.	SECTION	COUNTY	TOTAL SHEETS	SHEE NO.
	308	(3BR)M	ROCK ISLAND	47	39
0111001011E 140: 001-3303		C-92-090-12	CONTRACT	NO. 6	54H28
SHEET NO. 26 OF 33 SHEETS		ILLINOIS FED. A	D PROJECT		

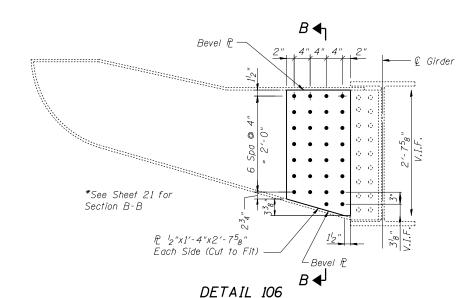


Span 17, West Side, 4th Bracket from Bent 10 at Pin and Link (Looking North) Span 17, West Side, 3rd Bracket from Bent 10 (Looking North)

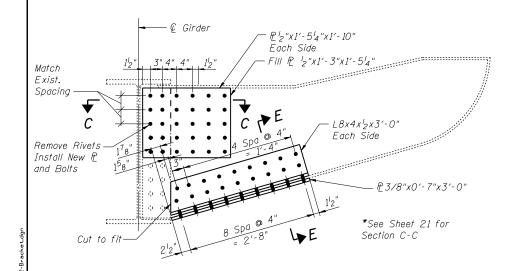


#### DETAIL 107

Span 19, West Side, First Bracket from South of Bent 13 (Looking South)

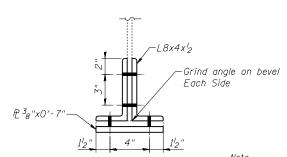


SECTION E-E

Note: Use  $^{7}8''$   $\phi$  H.S. Bolts. Ream existing holes to  $^{15}_{16}''$   $\phi$  (unless otherwise noted). Verify bracket dimensions in field.

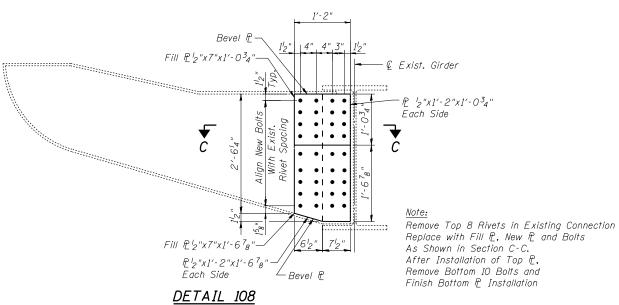


Span 19, West Side, 2nd Bracket from South of Bent 13 (Looking North)

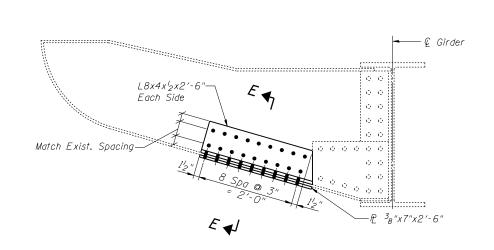


# <u>DETAIL 109</u>

Span 23, West Side at Bent 16 (Looking North)

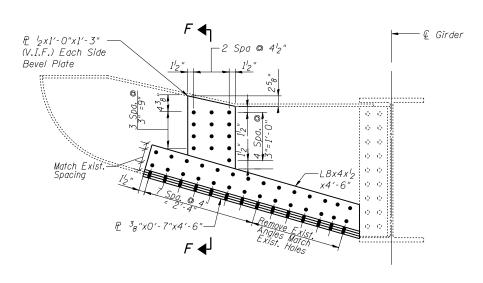

# DETAIL 140

Span 14, West Side, 2nd Bracket from Pier 6 (Looking South)

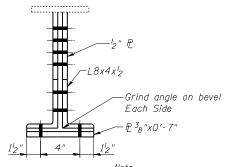

<u>Legend:</u> V.I.F. - Verify in Field


Notes: Section C-C is on Sheet 26. Verify bracket dimensions in field.

Section B-B is on Sheet 26.


STRUCTURE DESIGNS, INCORPORATED
ARCHITECTS & ENGINEERS
PH: 01/2 551-9780 \*\*vv.structuredesignsinc.com

STATE OF ILLINOIS
DEPARTMENT OF TRANSPORTATION


BRACKET REPAIR
STRUCTURE NO. 081-9905
SHEET NO. 27 OF 33 SHEETS

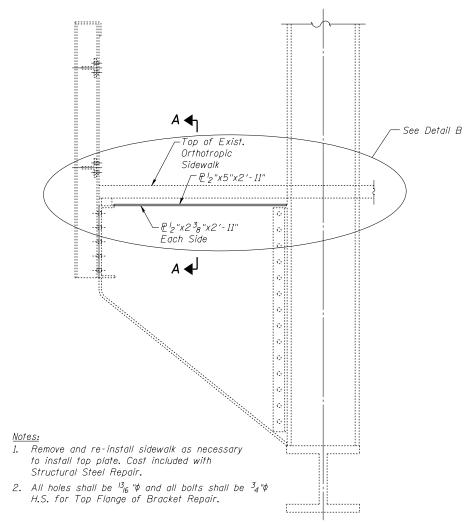

<u>DETAIL 110</u> See Table for Locations

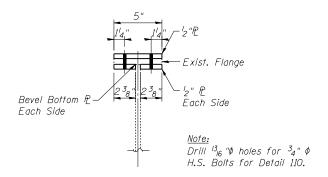


SECTION A-A

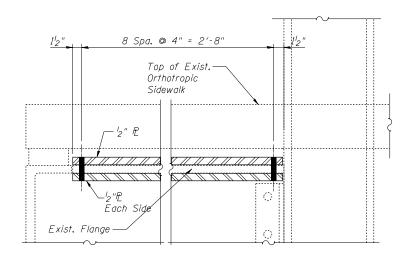

<u>DETAIL B</u> TOP FLANGE REPAIR ELEVATION


## <u>DETAIL 110 - LOCATION SUMMARY</u>

SPAN	MEMBER	LOCATION
9	FB 3	West Cantilevered Bracket
10	FB 11	East Cantilevered Bracket
10	FB 10	East Cantilevered Bracket
10	FB 8	East Cantilevered Bracket
10	FB 5	East Cantilevered Bracket
10	FB 4	East Cantilevered Bracket
10	FB 1	East Cantilevered Bracket
11	FB 8	East Cantilevered Bracket
11	FB 6	East Cantilevered Bracket
12	FB 10	East Cantilevered Bracket
12	FB 9	East Cantilevered Bracket
12	FB 8	East Cantilevered Bracket
12	FB 7	East Cantilevered Bracket
12	FB 6	East Cantilevered Bracket
12	FB 5	East Cantilevered Bracket
12	FB 4	East Cantilevered Bracket
12	FB 2	East Cantilevered Bracket
12	FB 2	West Cantilevered Bracket
12	FB 1	East Cantilevered Bracket
12	FB 1	West Cantilevered Bracket
13	FB 10	East Cantilevered Bracket
13	FB 7	East Cantilevered Bracket
13	FB 5	East Cantilevered Bracket
13	FB 4	East Cantilevered Bracket

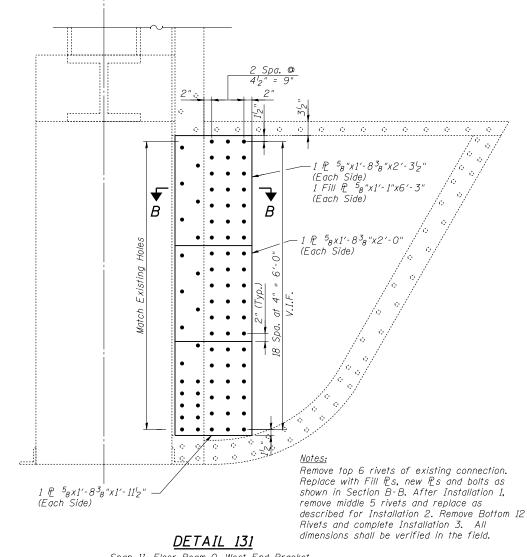

€ West Arch\_

Span 11, Floor Beam 0, West End Bracket Above Bearing at Pier 4

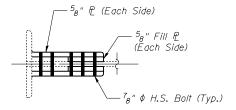



SECTION B-B



USER NAME =	pattısjm	DESIGNED	-	LRT	REVISED
		CHECKED	-	0A0	REVISED
PLOT SCALE =	2:0 ':" / in.	DRAWN	-	JL	REVISED
PLOT DATE =	1/21/2014	CHECKED	-	LRT	REVISED

FLOOR BEAM BRACKET REPAIR STRUCTURE NO. 081–9905		SECTION	COUNTY	TOTAL SHEETS	SHEE NO.
		(3BR)M	ROCK ISLAND	47	41
		C-92-090-12	CONTRACT	NO.	64H28
SHEET NO. 28 OF 33 SHEETS		ILLINOIS FED. A	D PROJECT		

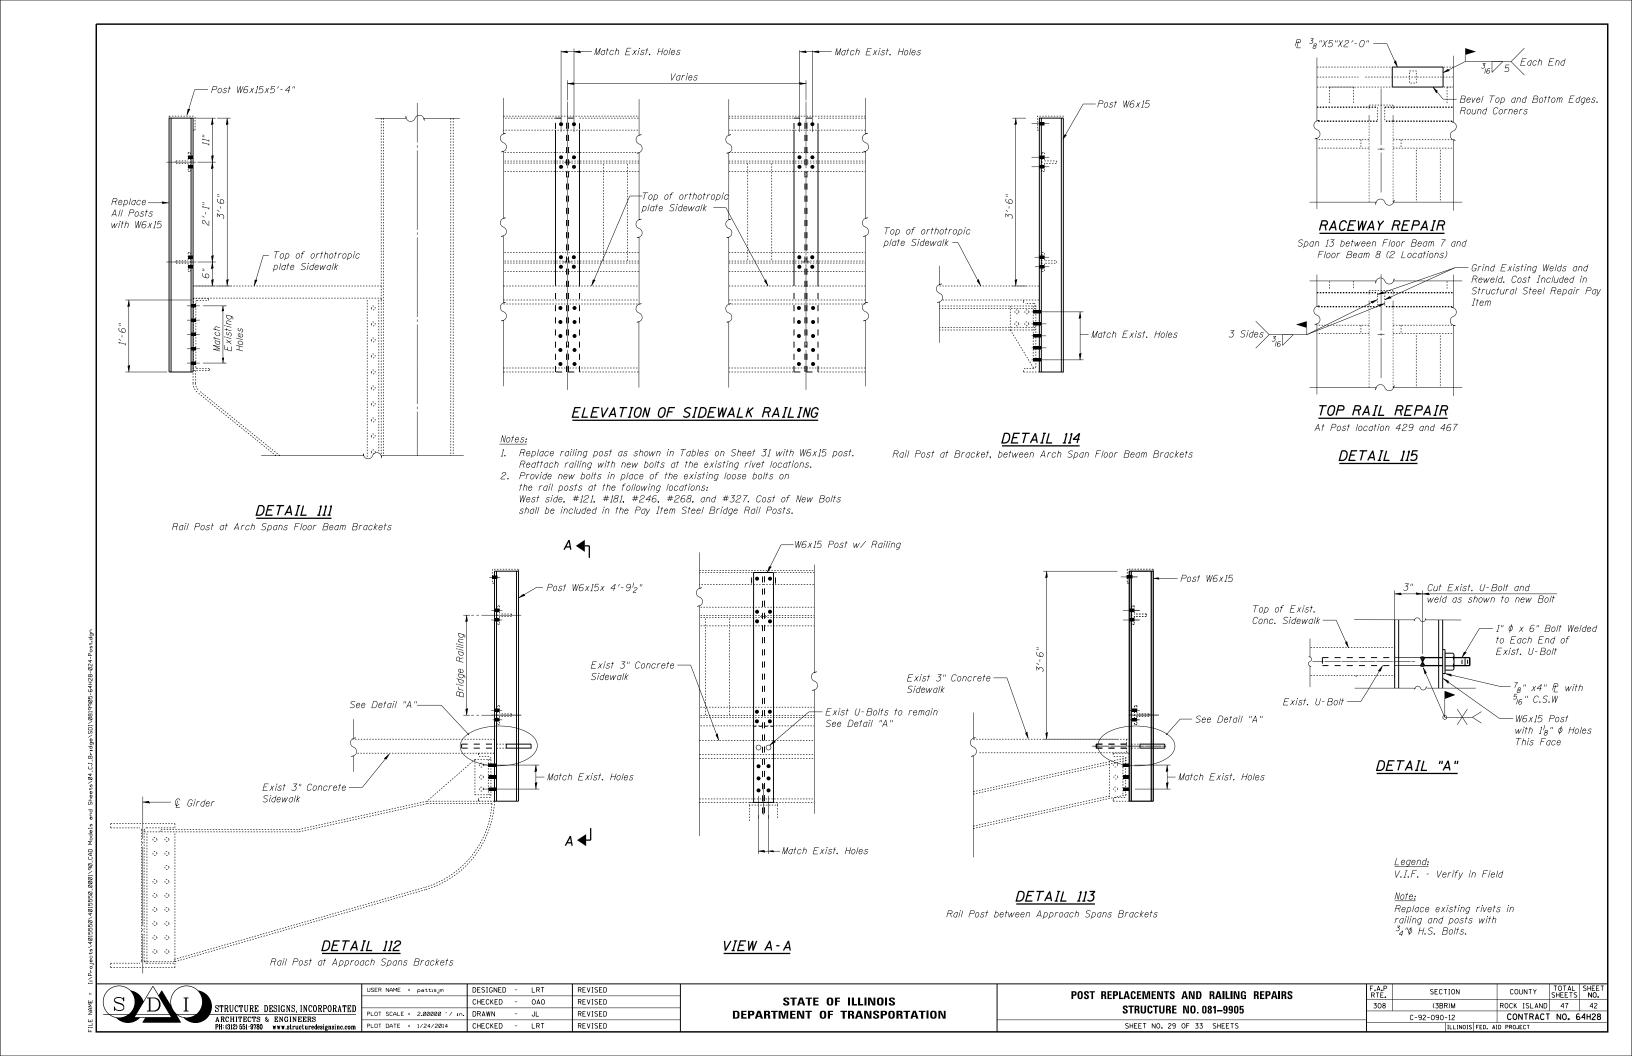

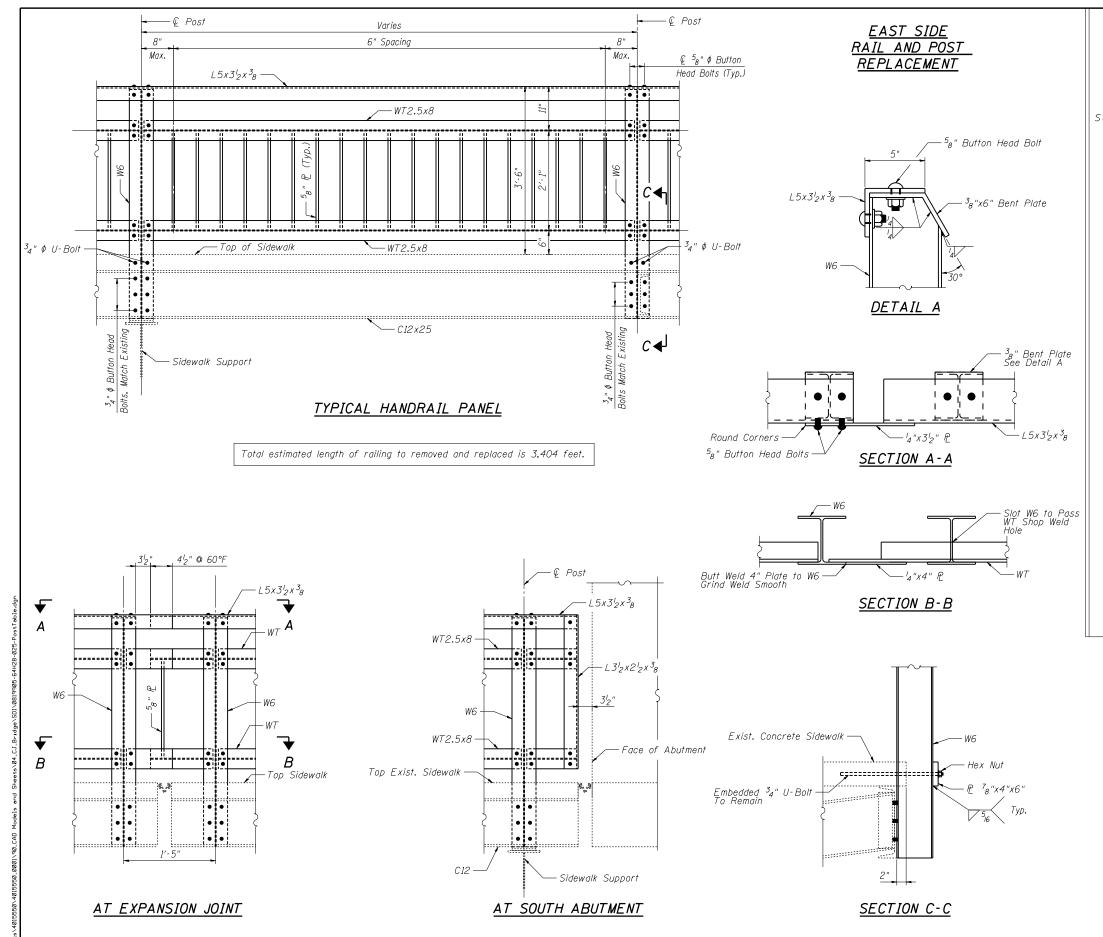

#### <u>WEST SIDE</u> <u>POST REPLACEMENT LOCATIONS</u>

South End

WEST SIDE				
SPAN No.	POST No.	DETAIL No.		
	64	113		
	65	113		
	67	112		
7	69	112		
	70	113		
	71	112		
	72	113		
	73	112		
	74	113		
7-8	<i>7</i> 5	112		
8	78	113		
0	79	112		
9-1	93	114		
<i>J</i> 1	96	9 112 3 114 6 111 3 114 7 114 8 111		
	103	114		
9-2	107			
	108	111		
	117	114		
9-3	118	114		
	119	114		
0-5	137	111		
0-6	152	114		
O-7	159	114		
0-9	191	114		
	192	114		
	262	114		
12 - 1	266	114		
	267	114		
	271	114		
2-2	272	114		
ے ک	275	114		
	278	114	l	

WEST SIDE							
SPAN No.	POST No.	DETAIL No.					
10. 7	283	114					
12 - 3	285	111					
12 - 4	295	114					
12 - 4	297	111					
13-1	321	114					
	329	114					
	333	114					
13-2	335	114					
	337	114					
	338	114					
	342	114					
13-3	345	114					
	346	114					
	353	112					
14	361	113					
15	366	112					
15	370	112					
16	373	113					
18	390	113					
19	399	112					
19-20	404	112					
20	405	113					
21	416	113					
22	422	112					
<i>८८</i>	424	112					
23	428	112					
24	441	112					
26	458	113					
29	474	113					

North End

Notes:

The posts are defined with span numbers, overall post numbers and detail numbers.

Post replacements shall be paid as Pay Item "Steel Bridge Rail Post". See Special Provisions

<u>Notes</u>


The finish coat of the railing shall match existing railing to remain.

New handrail panel lengths to match existing. See Special Provisions.

Work this Sheet with Sheet 29




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	PLOT DATE = 1/21/2014	CHECKED		LRT	REVISED
ED	PLOT SCALE = 2.00000 '/ in.	DRAWN	-	JL	REVISED
, n		CHECKED	-	OAO	REVISED
	USER NAME = pattisjm	DESIGNED	-	LRT	REVISED

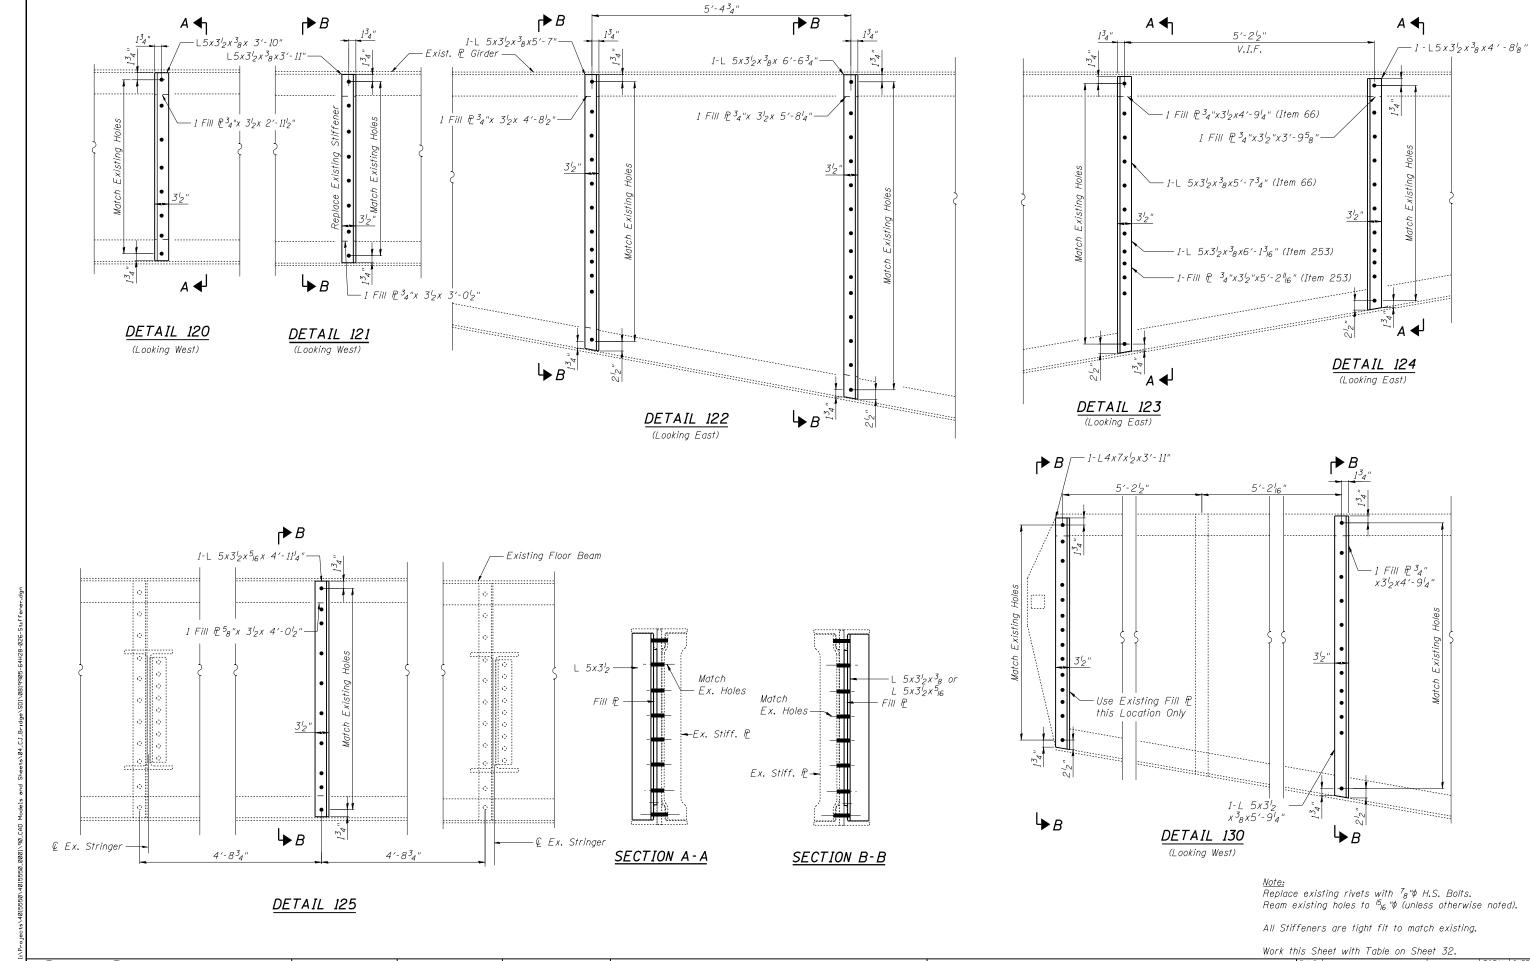


STRUCTURE DESIGNS, INCORPORATED
ARCHITECTS & ENGINEERS
PH: (312) 551-9780 www.structuredesignsinc.com

STATE OF ILLINOIS DEPARTMENT OF TRANSPORTATION STIFFENER REPLACEMENT DETAILS
STRUCTURE NO. 081-9905
SHEET NO. 31 OF 33 SHEETS

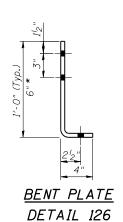



Bent P2'z"x6"x1'-4"

\* - Span 9 FB. II Only.
Omit 2nd bolt hole and hold
1'z" edge distance.

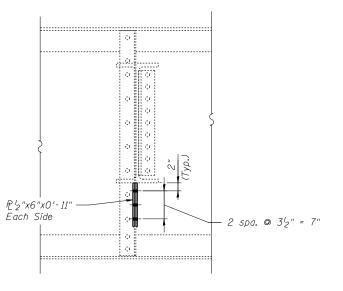

DETAIL 127
Stiffener Repair © Stringer "F" on Floorbeam 10, Span 13

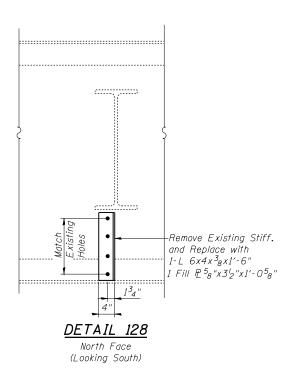

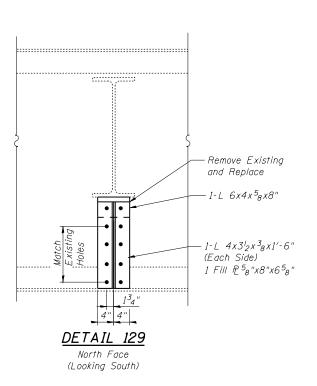

#### STIFFENER REPAIR LOCATIONS

DETAIL	SPAN	MEMBER	LOCATION
120	8	BEAM "D"	6th Stiffener from Bent 7, East Side
	7	BEAM "D"	15th and 16th Stiffener from Bent 6, East Side
121	26	BEAM "A"	4th Stiffener South of Bent 20, East Side
122	8	BEAM "F"	2nd & 3rd Stiffener from Bent 7, West Side
123	6	BEAM "A"	3rd Stiffener South Bent 6, East Side
123	7	BEAM "F"	3rd Stiffener from Bent 7, West Side
124	7	BEAM "F"	19th Stiffener from Bent 6, West Side
125	11	FLOOR BEAM "13"	Between Stringer "E" and Stringer "F"-Panel 13
	12	FLOOR BEAM "9"	Between Stringer "A" and Stringer "B"- Panel 9
	12	FLOOR BEAM "6"	Between Stringer "E" and Stringer "F"-Panel 7
	13	FLOOR BEAM "O"	3rd, 4th and 8th Stiffener from West Side
126	9	FLOOR BEAM "8"	Stiffener @ Stringer "A" North Face
	9	FLOOR BEAM "8"	Stiffener © Stringer "C" Panel 8, North Face
	9	FLOOR BEAM "5"	Stiffener © Stringer "F" North Face
	9	FLOOR BEAM "11"	Stiffener © Stringer "A" Panel 11
	11	FLOOR BEAM "8"	Stiffener @ Stringer "A" Panel 8, North Face
	12	FLOOR BEAM "7"	Stiffener Below Stringer "F" Panel 7, North Face
127	13	FLOOR BEAM "10"	Stiffener Below Stringer "F" Panel 10, North Face
128	12	FLOOR BEAM "9"	Stiffener Below Stringer "A" Panel 9, North Face
	13	FLOOR BEAM "9"	Stiffener @ Stringer "F"
129	9	FLOOR BEAM "O"	N. Face, Stiffener © Stringers "B", "C", "D", & "E"
	12	FLOOR BEAM "O"	Stiffener @ Stringer "C"
	12	FLOOR BEAM "11"	Stiffeners © Stringer "B". Stringer "C" and Stringer "D", Backside of Floor Beam
	13	FLOOR BEAM "11"	Stiffeners © Stringer "B", Stringer "C" and Stringer "E" Below Joint
130	7	BEAM "A"	3rd and 5th Stiffener from Bent 7, East Side

#### General Notes:

When referencing stiffeners, the first shall be on the pier or abutment.

Verify dimensions in field.

Work this Sheet with Sheet 31




USER NAME =	pattısjm	DESIGNED	-	LRT	REVISED
		CHECKED	-	OAO	REVISED
PLOT SCALE =	2.00000 ′/ in.	DRAWN	-	JL	REVISED
PLOT DATE =	1/21/2014	CHECKED	-	LRT	REVISED


STATE OF ILLINOIS
DEPARTMENT OF TRANSPORTATION

STIFFENER REPAIR LOCATIONS	
STRUCTURE NO. 081-9905	
SHEET NO 32 OF 33 SHEETS	


F.A.P RTE.	SECTION	COUNTY	TOTAL SHEETS	SHEE NO.
308	(3BR)M	ROCK ISLAND	47	45
	C-92-090-12	CONTRACT	NO. 6	4H28
	THE TWO IC FED. AT	ID DDO IECT		

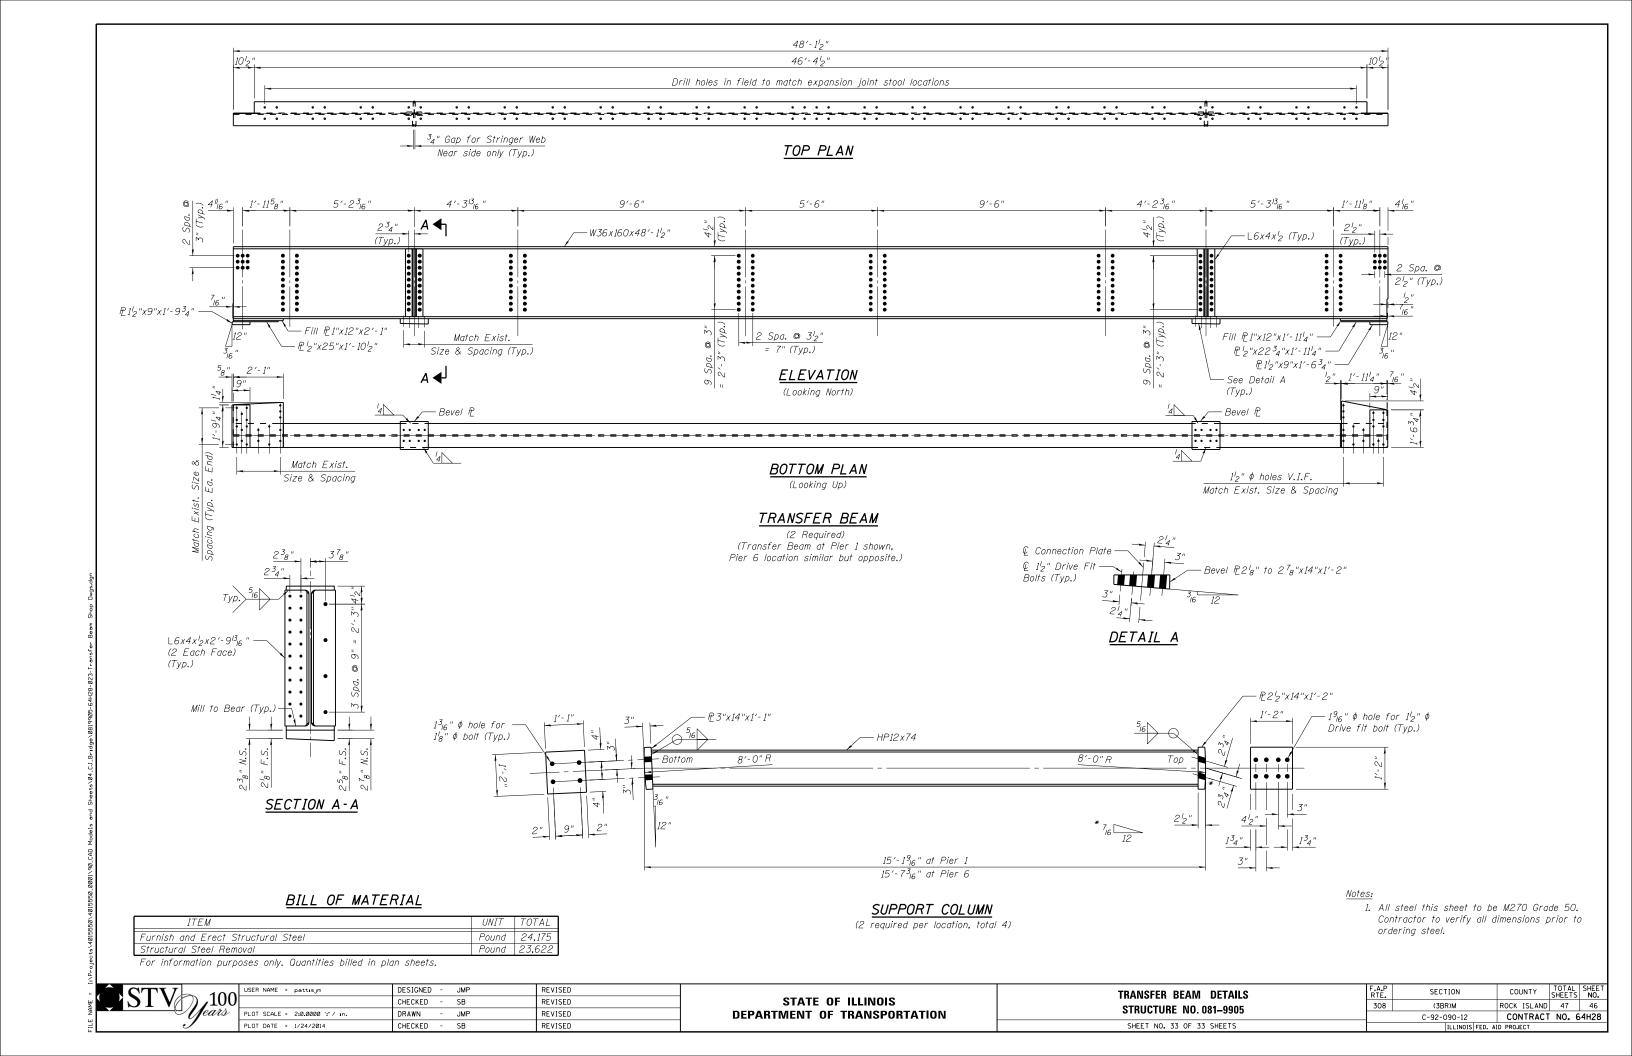


# TRAFFIC CONTROL FOR ROAD CLOSURE

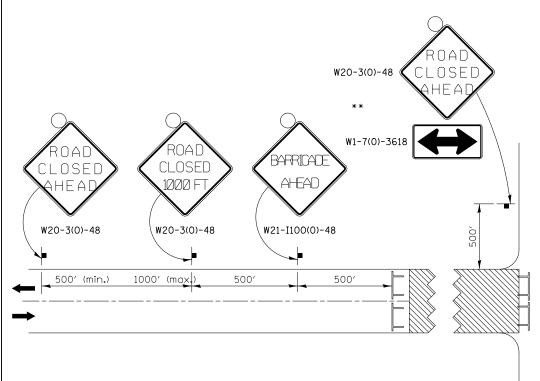

#### ROAD CLOSED TO THRU TRAFFIC BARRICADE SET UP

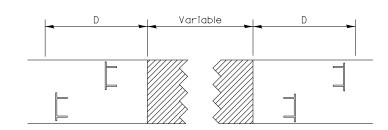

Type III Barricades and R11-4-4830 signs shall be as shown in "Road Closed To Thru Traffic" detail on Highway Standard 701901. If the distance "D" exceeds 2000' an additional set of barricades and R11-4-4830 shall be placed at each end of the work area.

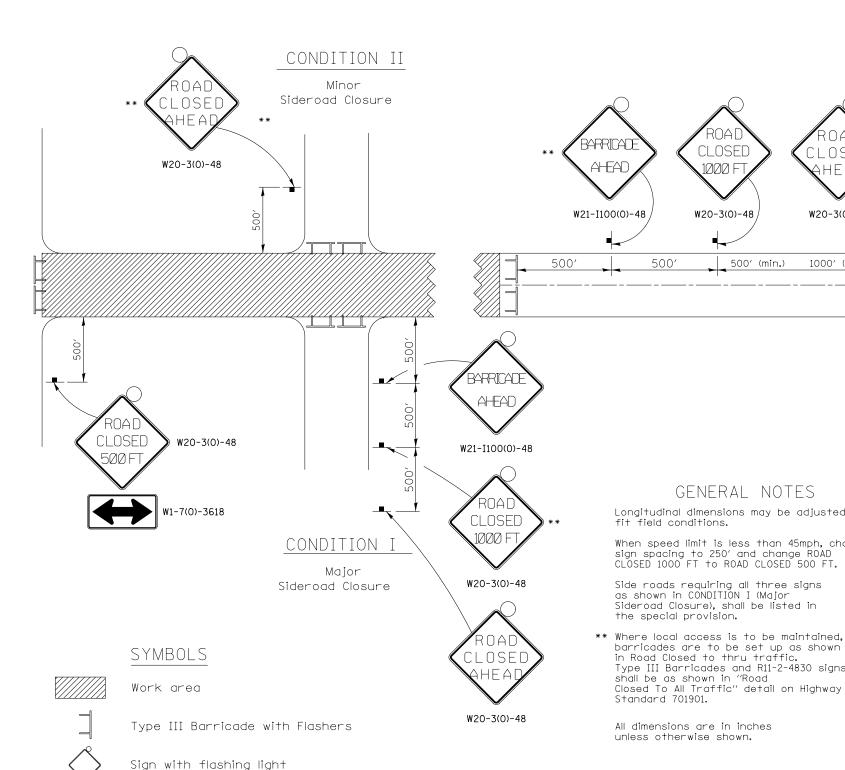

# TYPICAL APPLICATION FOR ROAD CLOSURE

CLOSED

1000 F

W20-3(0)-48

GENERAL NOTES

Longitudinal dimensions may be adjusted to

When speed limit is less than 45mph, change sign spacing to 250' and change ROAD CLOSED 1000 FT to ROAD CLOSED 500 FT.

Side roads requiring all three signs as shown in CONDITION I (Major

Sideroad Closure), shall be listed in

in Road Closed to thru traffic. Type III Barricades and R11-2-4830 signs shall be as shown in "Road Closed To All Traffic" detail on Highway

All dimensions are in inches

unless otherwise shown.

barricades are to be set up as shown

fit field conditions.

the special provision.

Standard 701901.


CLOSE

W20-3(0)-48

1000' (max.


FILE NAME = USER NAME = thompsrd DESIGNED REVISED - 8-27-13 STATE OF ILLINOIS REGION 2 / DISTRICT 2 STANDARD odels and Sheets\04\_C\_Civil\Sheets\D264H28 REVISED 10-17-11 **DEPARTMENT OF TRANSPORTATION** PLOT SCALE = 103.5000 '/ in. CHECKED REVISED SHEET NO. 47 OF 47 SHEETS STA. PLOT DATE = 1/21/2014 DATE REVISED SCALE:

# INFORMATIONAL WARNING SIGN (FOR NARROW TRAVEL LANES)

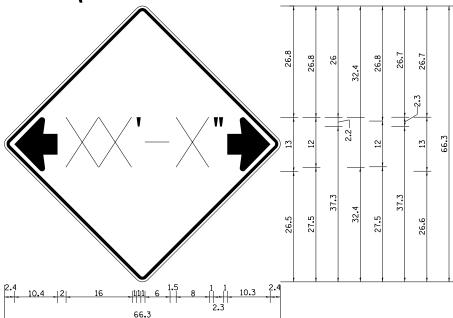

#### NOTES

W12-2 - Horizontal Clearance Sign 48.0" across sides, 1.9" Radius, 0.8" Border, 0.5" Indent, Black on Orange; Standard Arrow Custom 10.4" X 8.1" 180° Black 11 Inch D Series Lettering; Standard Arrow Custom 10.4" X 8.1" 0°

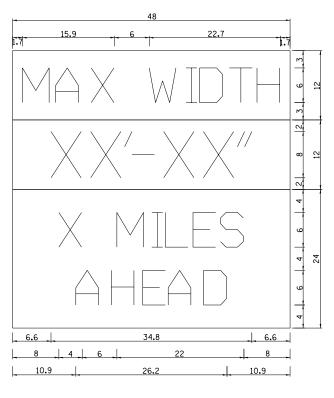

W12-I103 (Width is 8D); No border, Black on White; [MAX WIDTH] D;

No border, Black on Orange; [XX'-XX''] D;

No border, Black on White; [X MILES] D; [AHEAD] D;

All work to furnish and install these signs shall be included in the cost of the Traffic Control Standards and shall not be paid for separately.

ALL DIMENSIONS ARE IN INCHES UNLESS OTHERWISE NOTED.

REVISED - 5-15-09

# INFORMATIONAL WARNING SIGNS (FOR NARROW TRAVEL LANES) 39.2

USER NAME = thompsrd	DESIGNED	-	RDT/GC	REVISED	-
	DRAWN	-	RDT	REVISED	-
PLOT SCALE = 100.0000 ' / in.	CHECKED	-	JAC	REVISED	-
PLOT DATE = 1/27/2014	DATE	-	11-08-2013	REVISED	-

STATE OF ILLINOIS
DEPARTMENT OF TRANSPORTATION

SCALE:

REGION 2 / DISTRICT 2 STANDARD		F.A.P. RTE.	SECTION	COUNTY	TOTAL SHEETS	SHEET NO.		
		308	(3BR)M	ROCK ISLAND	47	47A		
			C-92-090-12	CONTRACT	NO. 6	4H28		
	SHEET NO 474 OF 47 SHEETS STA TO STA			THE THOTO CODE	D DDO IECT LICED	WWW 1977		