



TEMPORARY PAVEMENT



EROSION CONTROL BLANKET AND
TEMPORARY EROSION CONTROL SEEDING



MULCH, METHOD 2 AND
TEMPORARY EROSION CONTROL SEEDING

LEGEND




PERIMETER EROSION BARRIER PLACED
AROUND OPEN GRATE STRUCTURE AND
END SECTION IN ACCORDANCE WITH 280001-05



INLET FILTERS




TEMPORARY DITCH CHECKS

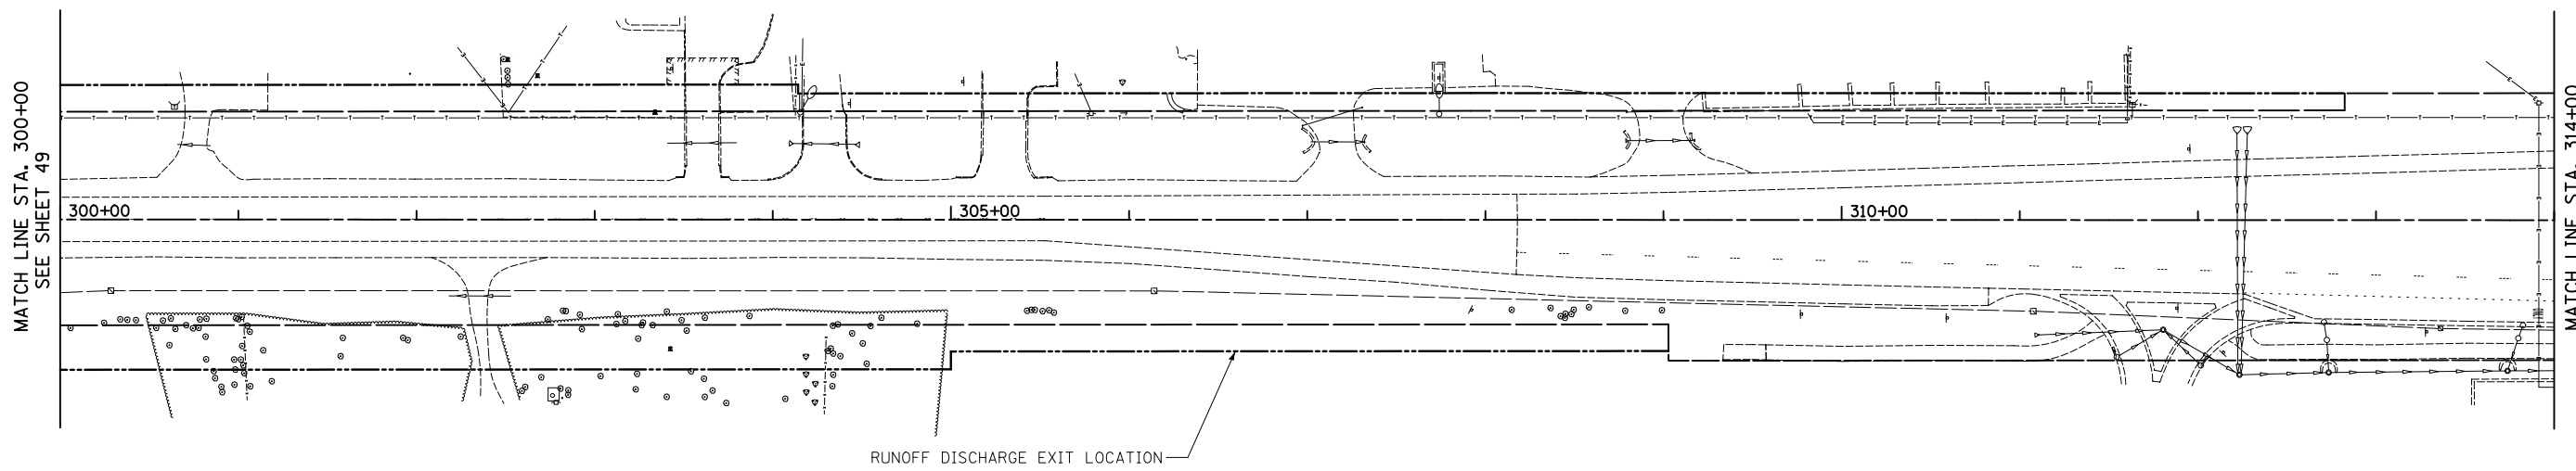

MATCH LINE STA. 300+00
SEE SHEET 49


MATCH LINE STA. 314+00

RUNOFF DISCHARGE EXIT LOCATION

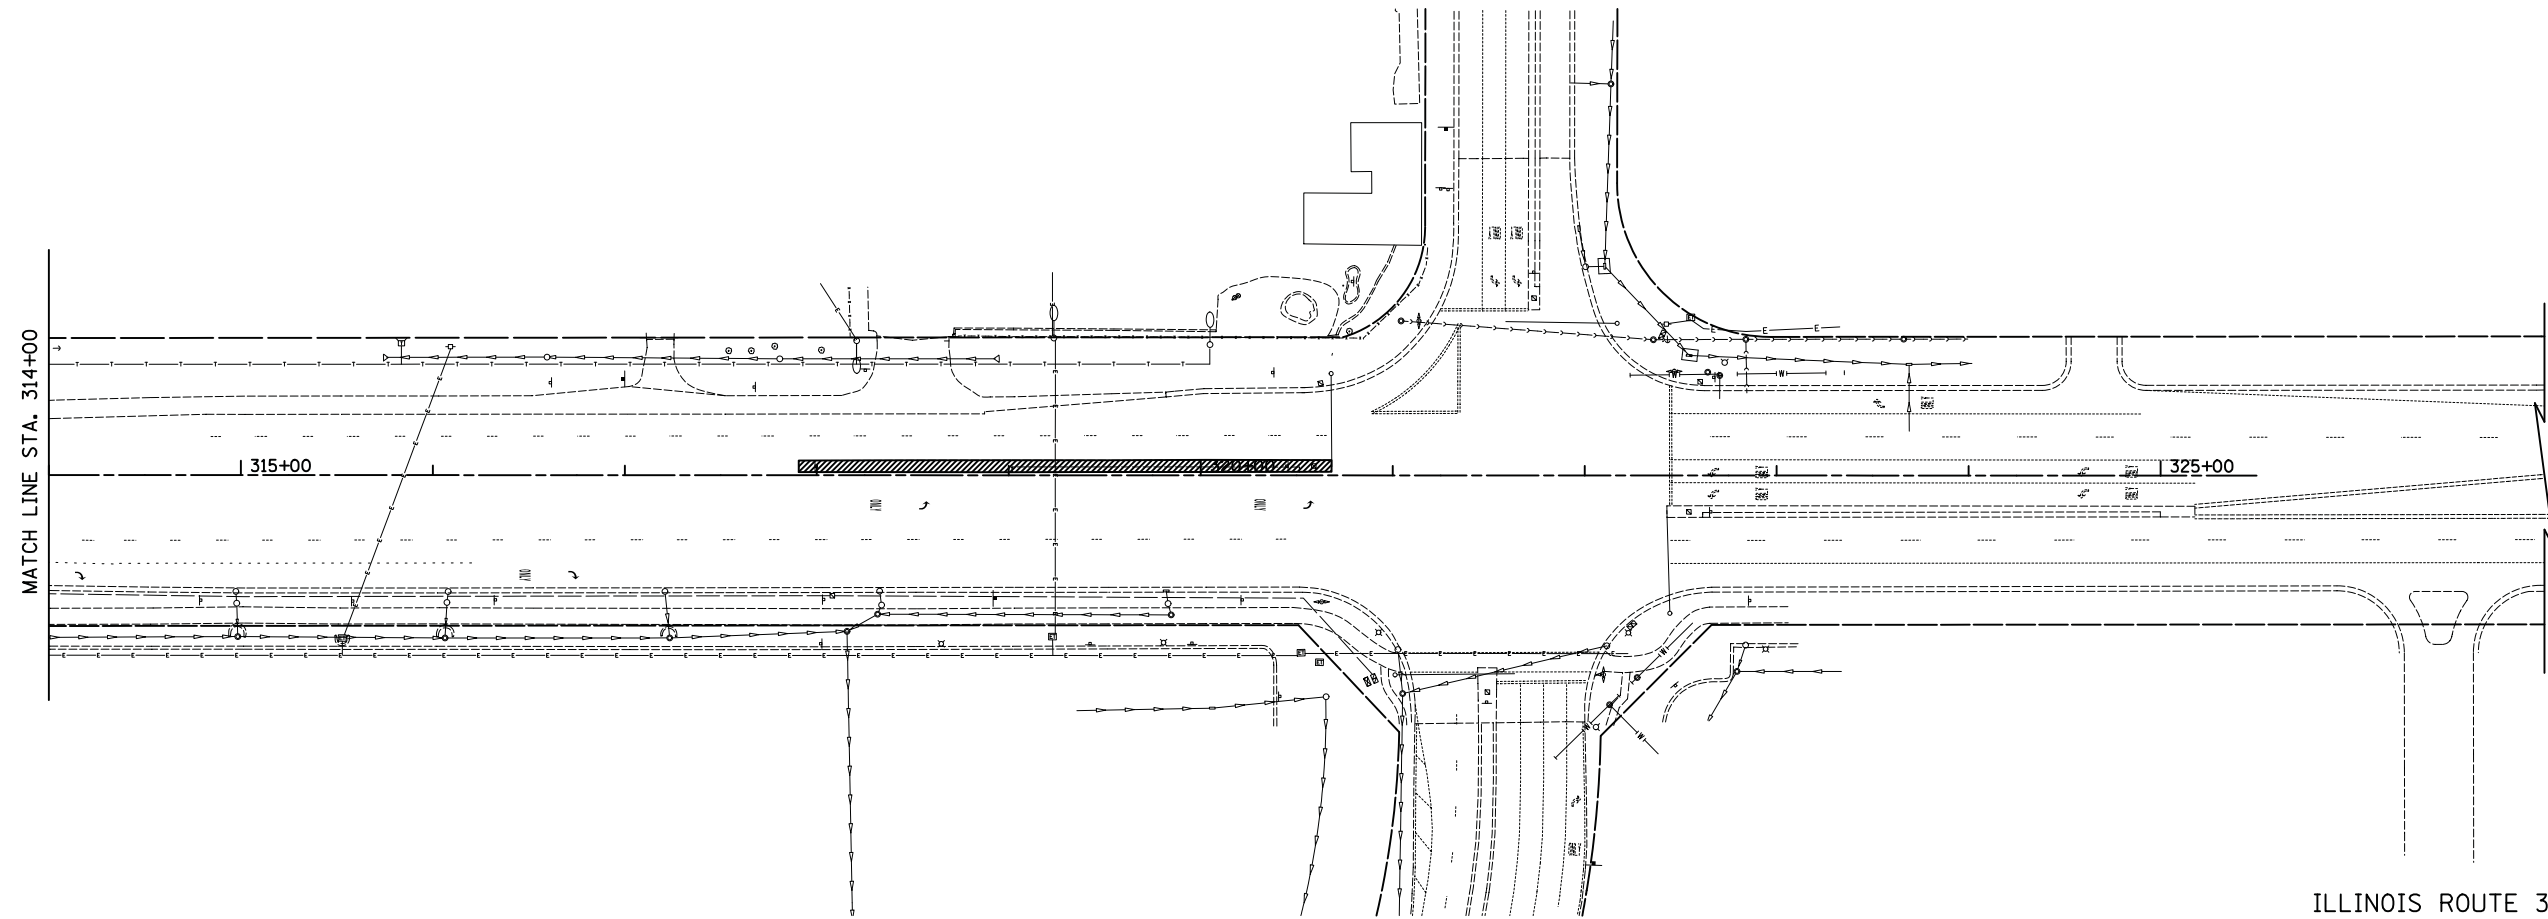

MATCH LINE STA. 314+00

ILLINOIS ROUTE 31

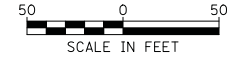

FILE NAME =
...\\2278NG.ERO_PRE.S1.02.dgn

USER NAME = kwh
PLOT SCALE = 50.0000' / in.
PLOT DATE = 8/5/2013

DESIGNED - KWH
DRAWN - PML
CHECKED - GAB
DATE - 06/24/2013

REVISED -
REVISED -
REVISED -
REVISED -

STATE OF ILLINOIS
DEPARTMENT OF TRANSPORTATION

EROSION AND SEDIMENT CONTROL - PRESTAGE 1

SCALE: 1" = 50' SHEET NO. 2 OF 6 SHEETS STA. 300+00 TO STA. 320+82.66

F.A.P. RTE.	SECTION	COUNTY	TOTAL SHEETS	SHEET NO.
3887	18W&RS-5 (12)	MCHENRY	151	49
CONTRACT NO. 60V72				
FED. ROAD DIST. NO. 1 ILLINOIS FED. AID PROJECT				