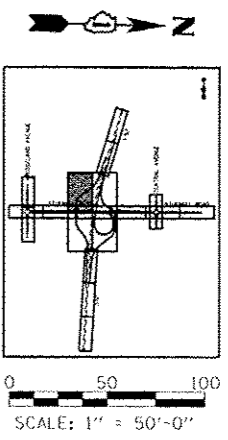
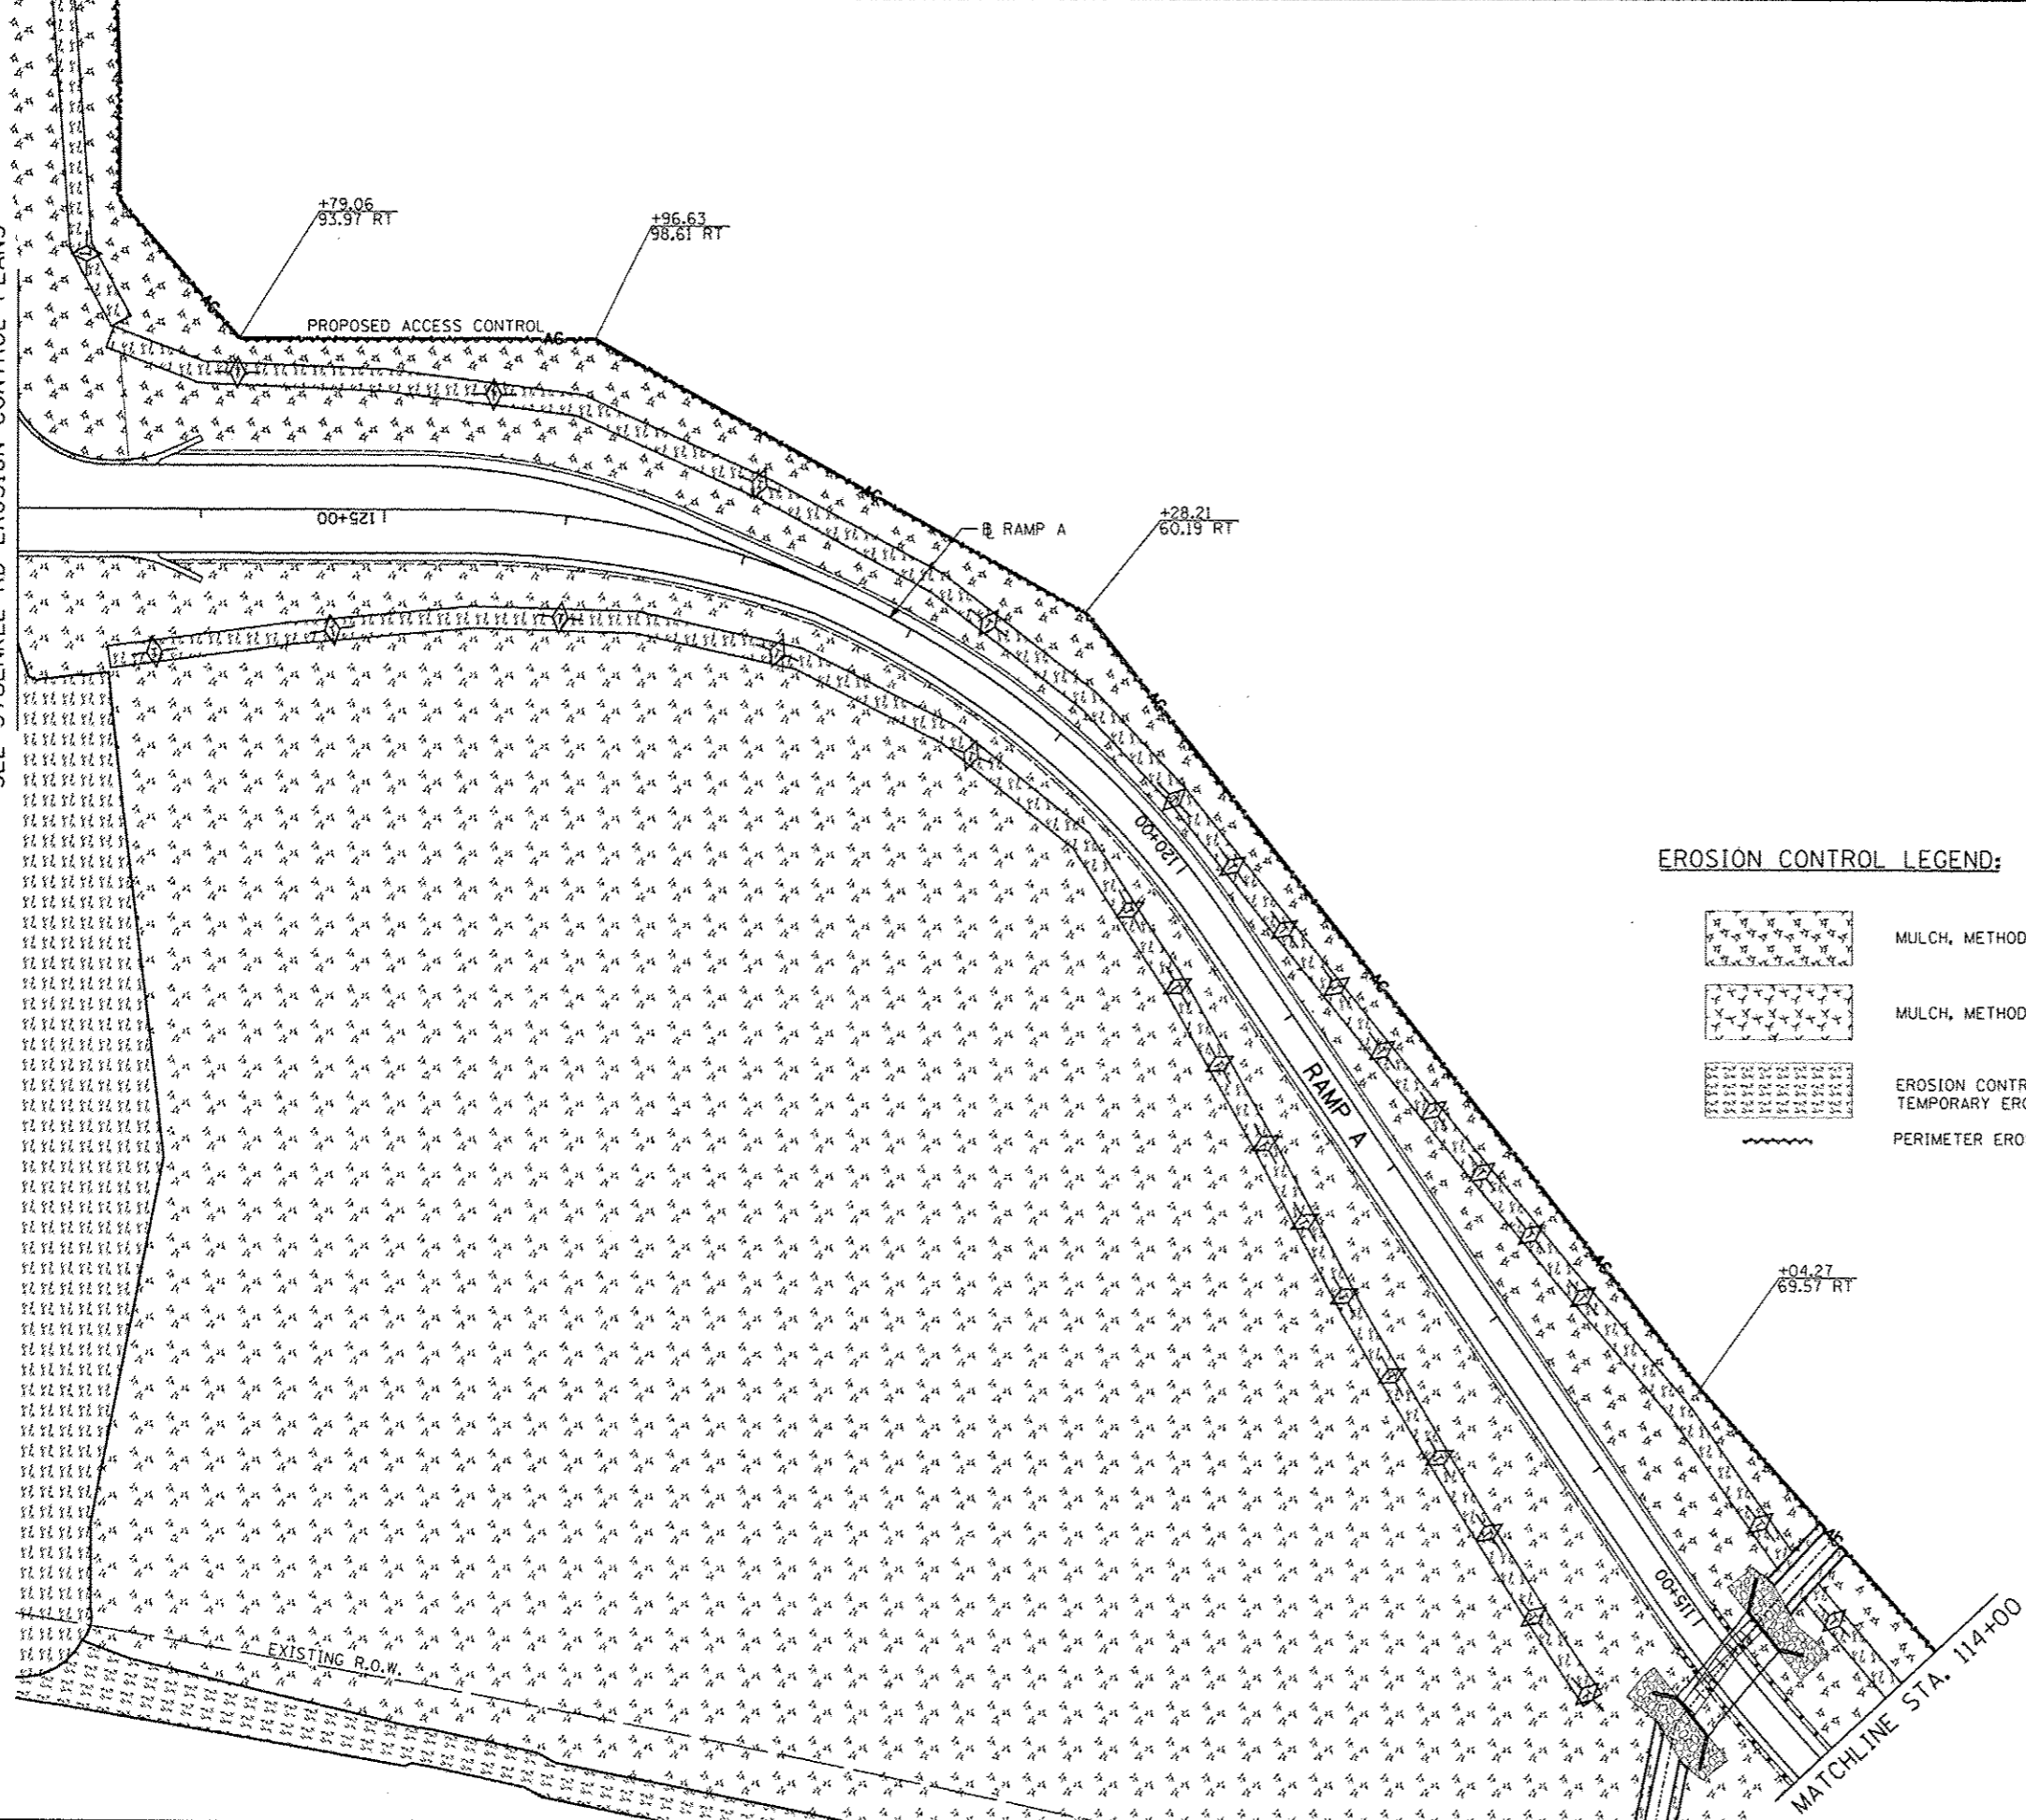

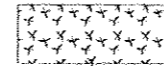
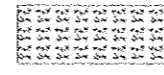

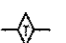




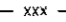


SEE STUENKEL RD EROSION CONTROL PLANS



**EROSION CONTROL LEGEND:**

-  MULCH, METHOD 2
-  MULCH, METHOD 4
-  EROSION CONTROL BLANKET (MODIFIED)  
TEMPORARY EROSION CONTROL SEEDING
-  PERIMETER EROSION BARRIER
-  TEMPORARY DITCH CHECK
-  PIPE CULVERT OUTLET
-  "PROTECTED WETLAND-NO INTRUSION"  
(FURNISHED BY IDOT RESIDENT ENGINEER)
-  INLET FILTERS
-  SEDIMENTATION BASIN
-  - xxx - xxx - TEMPORARY FENCE

**TYLIN INTERNATIONAL**

|             |                   |           |
|-------------|-------------------|-----------|
| USER NAME   | DESIGNED - PP     | REVISED - |
| PLANT SCALE | DRAWN - DPS       | REVISED - |
| PLANT DATE  | CHECKED - JPM     | REVISED - |
|             | DATE - 05/10/2013 | REVISED - |

**STATE OF ILLINOIS  
DEPARTMENT OF TRANSPORTATION**

**STUENKEL ROAD AT I-57 RIDGELAND AVENUE TO CENTRAL AVENUE  
RAMP A EROSION CONTROL PLAN**

SCALE: 1" = 50' SHEET 10 OF 12 SHEETS STA. 114+00 TO STA. 127+00

|                           |                    |              |                    |                |
|---------------------------|--------------------|--------------|--------------------|----------------|
| F.A.I. RYE: 57            | SECTION: 99-1MB-R1 | COUNTY: WILL | TOTAL SHEETS: 679  | SHEET NO.: 157 |
| ILLINOIS FED. AID PROJECT |                    |              | CONTRACT NO. 60L69 |                |

P:\602632\1-57 Stuenkel\Road\NE\_31\storcharge\NE3\_5\stuenkel\_110510.dwg