FOR LIST OF HIGHWAY STANDARDS, SEE SHEET 2

STATE OF ILLINOIS 01-30-15 LETTING ITEM 055 **DEPARTMENT OF TRANSPORTATION DIVISION OF HIGHWAYS**

SECTION COUNTY 09-00372-01-PW MCHENRY 358 3860 ILLINOIS CONTRACT NO. 63892 FED. ROAD DIST. NO.

KANKAKEE

TRAFFIC DATA

0

0

CHARLES J. MILLER ROAD ILLINOIS ROUTE 31 GREEN STREET/BARREVILLE ROAD

20,700 VPD (2009) 20,700 VPD (2009)

ROADWAY

BULL VALLEY ROAD CHARLES J. MILLER ROAD ILLINOIS ROUTE 31

POSTED SPEED 50 MPH (EXISTING) 45 MPH (EXISTING/PROPOSED) 45 MPH (EXISTING/PROPOSED) DESIGN SPEED 45 MPH

DESIGN DESIGNATION

FAU 3860 (BULL VALLEY ROAD/CHARLES J. MILLER ROAD) - URBAN MINOR ARTERIAL FAP 0336 (ILLINOIS ROUTE 31/FRONT STREET) - OTHER PRINCIPAL ARTERIAL


VOLUME I OF II

PROJECT LOCATED IN THE CITY OF MCHENRY

PLANS FOR PROPOSED FEDERAL-AID HIGHWAY

FAU 3860 (CHARLES J. MILLER ROAD)
FAP 336 (ILLINOIS ROUTE 31) TO EAST OF
FAU 0087 (GREEN STREET) RECONSTRUCTION

> SECTION: 09-00372-01-PW PROJ TECMM-M-4003(020) MCHENRY COUNTY JOB: C-91-425-12

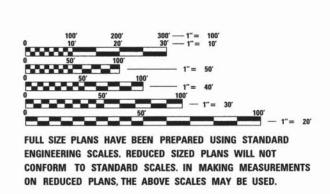

J.U.L.I.E. JOINT UTILITY LOCATION INFORMATION FOR **EXCAVATION CALL 811**






420 NORTH FRONT STREET, SUITE 100 | McHENRY, ILLINOIS 60050 Phone: 815,385,1778 | Toll Free: 800,728,7805 | Fax: 815,385,1781 | HRGreen.com ILLINOIS PROFESSIONAL DESIGN FIRM #184-001322

PROJECT MANAGER: J. PISHA

CONTRACT NO. 63892

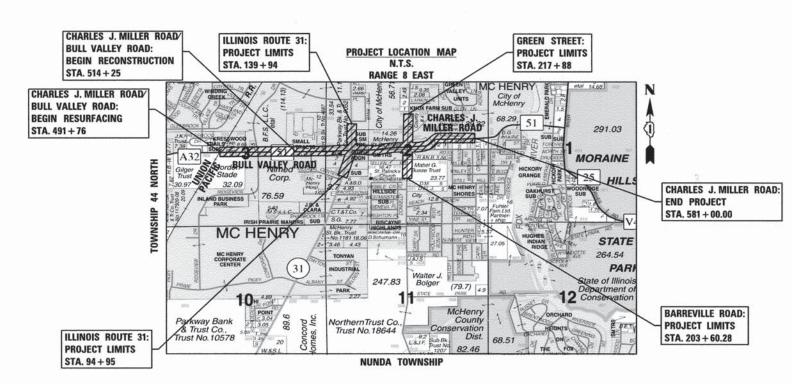

PROJECT LENGTH

NET LENGTH OF PROJECT (CHARLES J. MILLER ROAD) = GROSS LENGTH OF PROJECT = 8,924 (1.690 MI)

PRINTED BY THE AUTHORITY OF THE STATE OF ILLINOIS

STATE OF ILLINOIS

DEPARTMENT OF TRANSPORTATION

DIVISION OF HIGHWAYS

COUNTY ENGINEER, MCHENRY COUNTY

Joseph R Korpelski JR-

DISTRICT ONE ENGINEER OF LOCAL ROADS AND STREETS

November 13 20 14

DEPUTY DIRECTOR OF HIGHWAYS, REGION ONE ENGINEER

LOCATION OF SECTION INDICATED THUS: -

APPROVED OCTOBER 16 20 14

PASSED NOVEMBER 132014

PROFESSIONAL ENGINEER'S SIGN & SEAL 062-05498 JEFFREY L. PISHA, P.E. EXPIRES: 11-30-15 SEAL

PROFESSIONAL ENGINEER'S SIGN & SEAL FOR STRUCTURAL SHEET(S): SA-1 THRU SA-9 Paker &

ROBERT G. DAVIES, P.E., S.E. EXPIRES: 11-30-16



PROFESSIONAL ENGINEER'S SIGN & SEAL FOR LIGHTING SHEET(S): LTG-01 thry LTG-09

BRENDA D. LOWERY, P.E. EXPIRES: 11-30-15



0

11	ND	EX	OF SHEETS	INDEX
VOLL	JME	J	VC	LUME II
1			COVER CUEST	17
2			TURES OF CUEENS INC. FOR AS ARISE OF THE COLUMN TO SECOND TO SECON	18
3			GENERAL NOTES 2	19 - 23
		10		33 - 23
		17		36 - 30
		25	A TOWNER TIES AND DENOMINEUS	06 - 35
26 32	-	31	ALIGNMENT, TIES AND BENCHMARKS SUPERELEVATION TABLES	52 - 35
	- 2	39	ROADWAY PLAN AND PROFILE - BULL VALLEY/CHARLES J. MILLER ROAD	
		42	ROADWAY PLAN AND PROFILE - IL ROUTE 31	
43			ROADWAY PLAN AND PROFILE - GREEN STREET/BARREVILLE ROAD	DISTI
44			SUGGESTED MAINTENANCE OF TRAFFIC PLAN - GENERAL NOTES	BD-01
45	-	55	SUGGESTED MAINTENANCE OF TRAFFIC PLAN - TYPICAL SECTIONS	
56			SUGGESTED MAINTENANCE OF TRAFFIC PLAN - TEMPORARY SIGN DETAILS	BD-02
		60	SUGGESTED MAINTENANCE OF TRAFFIC - STAGE 1 - BULL VALLEY/CHARLES J. MILLER ROAD	
	-	62	SUGGESTED MAINTENANCE OF TRAFFIC - STAGE 1 - IL ROUTE 31	BD-03
63		67	SUGGESTED MAINTENANCE OF TRAFFIC - STAGE 1 - GREEN STREET/BARREVILLE ROAD	BD-34
68		67	SUGGESTED MAINTENANCE OF TRAFFIC - STAGE 2 - BULL VALLEY/CHARLES J. MILLER ROAD SUGGESTED MAINTENANCE OF TRAFFIC - STAGE 2 - IL ROUTE 31	
70		03	SUGGESTED MAINTENANCE OF TRAFFIC - STAGE 2 - GREEN STREET/BARREVILLE ROAD	BD-07
	1	74	SUGGESTED MAINTENANCE OF TRAFFIC - STAGE 3 - BULL VALLEY/CHARLES J. MILLER ROAD	BD-08
75			SUGGESTED MAINTENANCE OF TRAFFIC - STAGE 3 - IL ROUTE 31	BD-22
77			SUGGESTED MAINTENANCE OF TRAFFIC - STAGE 3 - GREEN STREET	BD-32
78	-	82	SUGGESTED MAINTENANCE OF TRAFFIC - CHARLES J. MILLER ROAD AT GREEN STREET/BARREVILLE ROAD	TC-10
83	-	89	SUGGESTED MAINTENANCE OF TRAFFIC - BULL VALLEY/CHARLES J. MILLER ROAD AT IL ROUTE 31	
90	_	92	EROSION CONTROL PLAN - BULL VALLEY/CHARLES J. MILLER ROAD	TC-11
	-	94	EROSION CONTROL PLAN - IL ROUTE 31	TC-13
95			EROSION CONTROL PLAN - GREEN STREET/BARREVILLE ROAD	TC-14
96			EROSION CONTROL DETAILS	TO 10
102		101	DRAINAGE AND UTILITY REMOVAL PLAN - BULL VALLEY/CHARLES J. MILLER ROAD	TC-16
104		103	DRAINAGE AND UTILITY REMOVAL PLAN - IL ROUTE 31 DRAINAGE AND UTILITY REMOVAL PLAN - GREEN STREET/BARREVILLE ROAD	TC-22
105	-	108	DRAINAGE AND UTILITY PLAN AND PROFILE - BULL VALLEY/CHARLES J. MILLER ROAD	TC-26
109			DRAINAGE AND UTILITY PLAN AND PROFILE - IL ROUTE 31	
112			DRAINAGE AND UTILITY PLAN AND PROFILE - GREEN STREET/BARREVILLE ROAD	
113			RIPRAP DETAILS	
114	-	121	DRAINAGE SCHEDULE OF QUANTITIES	
122			WATERMAIN PLAN & PROFILE - BULL VALLEY/CHARLES J. MILLER ROAD	
126	7	128	WATERMAIN PLAN & PROFILE - IL ROUTE 31	
129		171	WATERMAIN PLAN & PROFILE - GREEN STREET/BARREVILLE ROAD	
130 132	7	131	DETENSION BASIN 1 GRADING PLAN DETENSION BASIN 2 GRADING PLAN	
133		152	PLAT OF HIGHWAYS	
153		102	PROPOSED PAVEMENT JOINTING AND ELEVATION PLAN - BULL VALLEY/CHARLES J. MILLER ROAD AT IL RTE 31	
154			PROPOSED INTERSECTION ELEVATION PLAN - CHARLES J. MILLER ROAD AT LAWRENCE PARKWAY AND OLD BULL VALLEY ROAD	
155			PROPOSED INTERSECTION ELEVATION PLAN - CHARLES J. MILLER ROAD AT GREEN STREET/BARREVILLE ROAD	
156			PROPOSED INTERSECTION ELEVATION PLAN - CHARLES J. MILLER ROAD AT ACCESS DRIVE	
157			PROPOSED INTERSECTION ELEVATION PLAN - IL RTE 31 AT MERCY DRIVE AND W MEDICAL CENTER DRIVE	
158			PROPOSED INTERSECTION ELEVATION PLAN - GREEN STREET/BARREVILLE ROAD AT BANK DRIVE AND W ELLEN ROAD	
	-	162	PAVEMENT MARKING, SIGNING, AND LANDSCAPING PLAN - BULL VALLEY/CHARLES J. MILLER ROAD	
163 164			PAVEMENT MARKING, SIGNING, AND LANDSCAPING PLAN - IL ROUTE 31 PAVEMENT MARKING, SIGNING, AND LANDSCAPING PLAN - IL ROUTE 31 AND GREEN STREET/BARREVILLE ROAD	
165			SIGNING LEGEND	
166			SIGN DETAILS	
167	្ន	175	DISTRICT 1 STANDARD TRAFFIC SIGNAL DESIGN DETAILS	
176	-	181	TEMPORARY TRAFFIC SIGNAL PLAN - CHARLES J. MILLER ROAD AT IL ROUTE 31	
182	-	186	TRAFFIC SIGNAL INSTALLATION PLAN - CHARLES J. MILLER ROAD AND IL ROUTE 31	
187	7	190	TEMPORARY TRAFFIC SIGNAL PLAN - CHARLES J. MILLER ROAD AT GREEN STREET	
191	-	194	TRAFFIC SIGNAL INSTALLATION PLAN - CHARLES J. MILLER ROAD AND GREEN STREET	
195			TEMPORARY INTERCONNECT PLAN - CHARLES J. MILLER ROAD AND IL ROUTE 31	
196			TEMPORARY INTERCONNECT SCHEMATIC - CHARLES J. MILLER ROAD AND IL ROUTE 31	
197 198			INTERCONNECT PLAN - CHARLES J. MILLER ROAD AND IL ROUTE 31 INTERCONNECT SCHEMATIC - CHARLES J. MILLER ROAD AND IL ROUTE 31	
199			LIGHTING PLAN - GENERAL NOTES, SCHEDULE OF QUANTITIES AND LEGEND	
200			LIGHTING PLAN - GENERAL NOTES, SCHEDOLE OF GOARTITIES AND LEGEND	
201			LIGHTING PLAN - CHARLES J. MILLER ROAD/GREEN STREET PLAN EXISTING/REMOVAL PLAN	
202			LIGHTING PLAN - WIRING DIAGRAM	
203			LIGHTING PLAN - ELECTRIC SERVICE INSTALLATION ABOVE GROUND (BE-220)	
204			LIGHTING PLAN - ALUMINUM LIGHT POLE 40'-0" MOUNTING HEIGHT	
205			LIGHTING PLAN - MISCELLANEOUS ELECTRICAL DETAILS	
206			LIGHTING PLAN - LIGHT POLE FOUNDATION, METAL	
207		216	LIGHTING PLAN - LIGHTING CONTROLLER	
208	= 1	210	STRUCTURAL PLAN - CHARLES J. MILLER ROAD RETAINING WALL #1	

INDEX OF SHEETS (CONTINUED) STATE STANDARDS

			STATE STANDA	ANDS
	DLUME II		STANDARD NO.	LIST OF DESCRIPTION
	17	COVER SHEET		
	18	INDEX OF SHEETS AND LIST OF STATE STANDARDS	000001-06	STANDARD SYMBOLS, ABBREVIATIONS AND PATTERNS
	19 - 232 33 - 235		001006	DECIMAL OF AN INCH AND OF A FOOT
	36 - 305		202001-01 280001-07	EARTH MEDIAN DITCH CHECK
	06 - 351	이 그는 아이들은 이렇게 되었다면 가장 그리는 이 그리는 이번에 가장 가장 가장 가장 가장 하나 하나 하나 하는 것이 없는데 그렇게 되었다면 하는데	420001-08	TEMPORARY EROSION CONTROL SYSTEMS
	52 - 358		420106-05	PAVEMENT JOINTS 36' (10.8M) JOINTED PCC PAVEMENT
35			424001-08	PERPENDICULAR CURB RAMPS FOR SIDEWALKS
			424006-02	DIAGONAL CURB RAMPS FOR SIDEWALKS
	DISTR	ICT ONE DETAILS	424011-02	CORNER PARALLEL CURB RAMPS FOR SIDEWALKS
	DIOTIL	IOT ONE DETAILS	424016-02	MID-BLOCK CURB RAMPS FOR SIDEWALKS
	BD-01	DRIVEWAY DETAILS - DISTANCE BETWEEN ROW	424021-03	DEPRESSED CORNER FOR SIDEWALKS
		AND FACE OF CURB & EDGE OF SHOULDER >= 15'(4.5 m)	442201-03	CLASS C AND D PATCHES
	BD-02	DRIVEWAY DETAILS - DISTANCE BETWEEN ROW	482001-02	HMA SHOULDER ADJACENT TO FLEXIBLE PAVEMENT
		AND FACE OF CURB < 15'(4.5 m)	542301-03	PRECAST REINFORCED CONCRETE FLARED END SECTION
		OUTLET FOR CONCRETE CURB AND GUTTER	601001-04	SUB-SURFACE DRAINS
		DETAILS FOR DEPRESSED CURB & GUTTER SHOULDER	601101-01	CONCRETE HEADWALL FOR PIPE DRAIN
		TREATMENT AT THE TY 1 SPL.	602001-02	CATCH BASIN TYPE A
		DETAIL OF STORM SEWER CONNECTION TO EXISTING SEWER FRAMES AND LIDS ADJUSTMENT WITH MILLING; AND FRAMES	602011-02	CATCH BASIN, TYPE C
		AND LIDS ADJUSTMENT WITH MILLING; AND FRAMES	602301-04	INLET, TYPE A
		PAVEMENT PATCHING FOR HMA SURFACED PAVEMENT	602401-03	MANHOLE, TYPE A
		BUTT JOINT AND HMA TAPER DETAILS	602411-04 602416-04	MANHOLE, TYPA A, 7' (2.1 M) DIAMETER
		TRAFFIC CONTROL AND PROTECTION FOR SIDE ROADS,	602601-03	MANHOLE, TYPE A, 8' (2.4 M) DIAMETER
		INTERSECTIONS, AND DRIVEWAYS	602701-02	PRECAST REINFORCED CONCRETE FLAT SLAB TOP MANHOLE STEPS
		RAISED REFLECTIVE PAVEMENT MARKERS (SNOW PLOW RESISTANT)	604001-04	FRAME AND LIDS. TYPE 1
		DISTRICT ONE TYPICAL PAVEMENT MARKINGS	604036-03	GRATE TYPE 8
		TRAFFIC CONTROL AND PROTECTION AT TURN BAYS,	604051-04	FRAME AND GRATE TYPE 11
		(TO REMAIN OPEN TO TRAFFIC)	604091-03	FRAME AND GRATE TYPE 24
	TC-16	PAVEMENT MARKING LETTERS AND SYMBOLS	606001-06	CONCRETE CURB TYPE B AND COMBINATION CONCRETE CURB AND GUTTER
		FOR TRAFFIC STAGING	606301-04	PC CONCRETE ISLANDS AND MEDIANS
		ARTERIAL ROAD INFORMATION SIGN	606306-03	CORRUGATED PC CONCRETE MEDIANS
	TC-26	DRIVEWAY ENTRANCE SIGNING	630001-10	STEEL PLATE BEAM GUARDRAIL
			630201-06	PCC/HMA SHOULDER STABILIZATION AT STEEL PLATE BEAM GUARDRAIL
			630301-06	SHOULDER WIDENING FOR TYPE 1 (SPECIAL) GUARDRAIL TERMINALS
			631011-09	TRAFFIC BARRIER TERMINAL, TYPE 2
			635006-03	REFLECTOR AND TERMINAL MARKER PLACEMENT
			635011-02	REFLECTOR MARKER AND MOUNTING DETAILS
			701006-05	OFF-ROAD OPERATIONS, 2L, 2W, 15' (4.5 m) TO 24" (600 mm) FROM PAVEMENT EDGE
			701011-04	OFF-ROAD MOVING OPERATIONS, 2L, 2W, DAY ONLY
			701101-04	OFF-ROAD OPERATIONS, MULTILANE, 15' (4.5 m) TO 24" (600 mm) FROM PAVEMENT EDGE
			701301-04	LANE CLOSURE, 2L, 2W, SHORT TIME OPERATIONS
			701311-03	LANE CLOSURE, 2L, 2W, MOVING OPERATIONS - DAY ONLY
AD			701426-06 701427-0 3	LANE CLOSURE, MULTILANE, INTERMITTENT OR MOVING OPERATION, FOR SPEEDS • 45 MPH
			701501-06	LANE CLOSURE, MULTILANE, INTERMITTENT OR MOVING OPERATION, FOR SPEEDS • 40 MPH URBAN LANE CLOSURE, 2L, 2W, UNDIVIDED
			701601-09	URBAN LANE CLOSURE, MULTILANE, 1W OR 2W WITH NONTRAVERSABLE MEDIAN
			701602-07	URBAN LANE CLOSURE, MULTILANE, 2W WITH BIDIRECTIONAL LEFT TURN LANE
			701701-09	URBAN LANE CLOSURE, MULTILANE INTERSECTION
			701801-05	SIDEWALK, CORNER OR CROSSWALK CLOSURE
			701901-04	TRAFFIC CONTROL DEVICES
			720001-01	SIGN PANEL MOUNTING DETAILS
			720006-04 720011-01	SIGN PANEL ERECTION DETAILS
			728001-01	METAL POSTS FOR SIGNS, MARKERS & DELINEATORS TELESCOPING STEEL SIGN SUPPORT
			729001-01	APPLICATIONS OF TYPES A AND B METAL POSTS (FOR SIGNS & MARKERS)
			731001-01	BASE FOR TELESCOPING STEEL SIGN SUPPORT
			780001-05	TYPICAL PAVEMENT MARKINGS
			781001-03	TYPICAL APPLICATIONS RAISED REFLECTIVE PAVEMENT MARKERS
			805001-01	ELECTRICAL SERVICE INSTALLATION DETAILS
			814001-03 814006-02	HANDHOLES DOUBLE HANDHOLES
			836001-02	LIGHT POLE FOUNDATION
			862001-01	UNINTERRUPTABLE POWER SUPPLY (UPS)
			873001-02	TRAFFIC SIGNAL GROUNDING & BONDING
			876001-03	PEDESTRIAN PUSH BUTTON POST
			877001-05	STEEL MAST ARM ASSEMBLY AND POLE 16' THROUGH 55'
			878001-10 880001-01	CONCRETE FOUNDATION DETAILS
			880001-01	SPAN WIRE MOUNTED SIGNALS AND FLASHING BEACON INSTALLATION TRAFFIC SIGNAL MOUNTING DETAILS
			886001-01	DETECTOR LOOP INSTALLATIONS
			886006-01	TYPICAL LAYOUT FOR DETECTION LOOPS

USER NAME = tyelton	DESIGNED	-	JPA	REVISED -	
FILE NAME = 090071-gen-01.dgn	DRAWN	-	SVJ	REVISED -	
PLOT SCALE = N.T.S.	CHECKED	-	JLP	REVISED -	
PLOT DATE = 12/4/2014	DATE	-	12/5/14	REVISED -	

STATE OF ILLINOIS

СНО			STANDARDS IMPROVEMENTS
SCALE: N.T.S.	 -	EETS STA.	TO STA.

		CONTRACT	NO.	6389
3860	09-00372-01-PW	MCHENRY	358	2
RTE.	SECTION	COUNTY	SHEETS	SHEE NO.

GENERAL NOTES

- ALL REFERENCES TO "STANDARD SPECIFICATIONS" IN THESE GENERAL NOTES SHALL BE INTERPRETED TO MEAN "STANDARD SPECIFICATIONS FOR ROAD AND BRIDGE CONSTRUCTION" ADOPTED BY THE ILLINOIS DEPARTMENT OF TRANSPORTATION, JANUARY 1, 2012. ALL WORK TO BE COMPLETED IN ACCORDANCE WITH THE STANDARD SPECIFICATIONS.
- 2. ALL REFERENCES TO "ENGINEER" SHALL BE INTERPRETED TO MEAN THE RESIDENT ENGINEER.
- 3. PRIOR TO COMMENCEMENT OF CONSTRUCTION, THE CONTRACTOR SHALL VERIFY ALL DIMENSIONS AND CONDITIONS AFFECTING THEIR WORK WITH THE ACTUAL CONDITIONS AT THE JOB SITE. IF THERE ARE ANY DISCREPANCIES FROM WHAT IS SHOWN ON THE CONSTRUCTION PLANS, HE MUST IMMEDIATELY REPORT SAME TO THE ENGINEER BEFORE DOING ANY WORK, OTHERWISE THE CONTRACTOR ASSUMES FULL RESPONSIBILITY. IN THE EVENT OF DISAGREEMENT BETWEEN THE CONSTRUCTION PLANS, STANDARD SPECIFICATIONS AND/OR SPECIAL DETAILS, THE CONTRACTOR SHALL SECURE WRITTEN INSTRUCTIONS FROM THE ENGINEER PRIOR TO PROCEEDING WITH ANY PART OF THE WORK AFFECTED BY OMISSIONS OR DISCREPANCIES. FAILING TO SECURE SUCH INSTRUCTIONS, THE CONTRACTOR WILL BE CONSIDERED TO HAVE PROCEEDED AT HIS OWN RISK AND EXPENSE. IN THE EVENT OF ANY DOUBT OR QUESTION ARISING WITH RESPECT TO THE TRUE MEANING OF THE CONSTRUCTION PLANS OR SPECIFICATIONS, THE DECISION OF THE ENGINEER SHALL BE FINAL AND CONCLUSIVE.
- 4. IT IS THE CONTRACTOR'S RESPONSIBILITY TO ASCERTAIN EXISTING FIELD CONDITIONS PRIOR TO
- 5. BEFORE STARTING ANY EXCAVATION, THE CONTRACTOR SHALL CALL "JULIE" (JOINT UTILITY LOCATION INFORMATION FOR EXCAVATION) AT 8-1-1, THE CITY OF MCHENRY AT (815) 363-2100, AND MCDOT AT (815) 334-4960 FOR FIELD LOCATIONS OF BURIED UTILITIES (48 HOURS NOTIFICATION IS BEOLURED).
- 6. ALL ELEVATIONS SHOWN ON THE PLANS ARE ON THE USGS DATUM.
- 7. ALL RADII FOR PROPOSED CURB AND GUTTER ARE TO THE EDGE OF PAVEMENT, UNLESS OTHERWISE NOTED. CURB AND GUTTER ELEVATIONS SHOWN ALONG RETURNS AND AT POINTS OF CURVATURE, ETC. ARE TO THE EDGE OF PAVEMENT UNLESS OTHERWISE NOTED.
- 8. OFFSET LOCATIONS GIVEN IN THE PLANS FOR STRUCTURES, EDGE OF PAVEMENT, ETC. ARE FROM THE ROADWAY CENTERLINE.
- THE BITUMINOUS MATERIAL PRIME COAT QUANTITIES HAVE BEEN DETERMINED USING A RATE OF 0.1 GALLONS / SQ YD.
- SAW CUTTING OF PAVEMENTS, SIDEWALK, ETC. SHALL BE TO FULL DEPTH AND SHALL RESULT IN A CLEAN STRAIGHT EDGE ON THE PORTION REMAINING. ALL SAW CUTTING SHALL BE CONSIDERED INCLUDED IN THE ITEM REMOVED.
- 11. DRIVEWAYS ARE TO BE CONSTRUCTED TO THE R.O.W. OR UNLESS OTHERWISE NOTED.
- 12. REMOVAL OF EXISTING COMBINATION CURB AND GUTTER, REGARDLESS OF CURB AND GUTTER TYPE, SHALL BE PAID FOR AS "COMBINATION CURB AND GUTTER REMOVAL".
- 13. ALL CONSTRUCTION PERSONNEL WILL BE REQUIRED TO WEAR VESTS AT ALL TIMES THAT MEET THE ANSI 207 STANDARD WHILE ON THE CONSTRUCTION SITE. COMPLIANCE WITH THIS REQUIREMENT SHALL BE CONSIDERED INCLUDED IN THE CONTRACT.
- 14. ALL PROPOSED COMMERCIAL ENTRANCES ARE COMPRISED OF 6 INCHES OF HOT-MIX ASPHALT, BASE COURSE, AND 2 INCHES OF HOT-MIX ASPHALT, SURFACE COURSE, UNLESS OTHERWISE NOTED ON THE PLANS. PRIVATE DRIVEWAYS ARE COMPRISED OF 4 INCHES OF HOT-MIX ASPHALT, BASE COURSE, AND 2 INCHES OF HOT-MIX ASPHALT, SURFACE COURSE.
- 15. THE CURB & GUTTER SHALL BE DEPRESSED THROUGH DRIVEWAYS AND PAID FOR AS COMBINATION CONCRETE CURB & GUTTER AS NOTED ON THE PLANS.
- 16. AGGREGATE SUBGRADE IMPROVEMENT (ASI) IN CUBIC YARDS, HAS BEEN PROVIDED FOR GENERAL USE. THE ACTUAL NEED FOR REMOVAL OF UNSUITABLE AND UNSTABLE SOILS AND REPLACEMENT WITH ASI WILL BE DETERMINED IN THE FIELD AT THE TIME OF CONSTRUCTION BY THE ENGINEER. ALL POTENTIALLY UNSTABLE SOILS SHOULD BE TESTED WITH A STATIC CONE PENETROMETER AND TREATED IN ACCORDANCE WITH AATICLE 301 AND THE UNDERCUT GUIDELINES IN THE IDOT SUBGRADE STABILITY MANUAL. IF UNSTABLE AND/OR UNSUITABLE MATERIAL IS ENCOUNTERED, THE SOIL SHALL BE REMOVED BY THE CONTRACTOR AT THE DIRECTION OF THE ENGINEER. IF UNSTABLE AND/OR UNSUITABLE MATERIAL IS NOT ENCOUNTERED, THEN THE QUANTITY SHALL BE DEDUCTED FROM THE CONTRACT, AND NO ADDITIONAL COMPENSATION WILL BE DUE TOWARDS THE CONTRACTOR. IN THE AREAS WHERE ASI IS PLACED, A GEOTEXTILE GROUND STABILIZATION FABRIC WILL BE PLACED UNDER THE ASI.
- 17. THE THICKNESSES OF HOT MIX ASPHALT MIXTURES SHOWN IN THE PLANS ARE NOMINAL. DEVIATIONS MAY OCCUR DUE TO IRREGULARITIES IN THE SURFACES OR BASES ON WHICH THE HOT MIX ASPHALT MIXTURES ARE TO BE PLACED.
- 18. WHERE NEW WORK MEETS EXISTING FEATURES TO REMAIN, FIELD CHECK ALL DIMENSIONS AND ELEVATIONS BEFORE PROCEEDING WITH CONSTRUCTION, NOTIFY ENGINEER IMMEDIATELY OF ANY DISCREPANCIES.
- 19. THE INDISCRIMINATE USE OF FIRE HYDRANTS OR EXISTING STREAMS, CREEKS, WETLANDS OR PONDS IS STRICTLY PROHIBITED. THE CONTRACTOR SHALL PROVIDE A WATER TRUCK AND DRIVER AS REQUIRED TO OBTAIN AND TRANSPORT THIS WATER. THE CONTRACTOR SHALL BE RESPONSIBLE FOR OBTAINING WATER FROM AN APPROVED SOURCE. IF THIS WATER IS FROM A SOURCE OTHER THAN HIS YARD, WRITTEN APPROVAL FROM THE AGENCY HAVING JURISDICTION FOR THE SOURCE OF THE WATER MUST BE RECEIVED BY THE ENGINEER PRIOR TO USE OF THE WATER.
- 20. ALL REFERENCES IN THE HIGHWAY STANDARDS AND STANDARD SPECIFICATIONS FOR REINFORCEMENT, DOWEL BARS AND TIE BARS IN PAVEMENT, SHOULDERS, CURB, GUTTER, COMBINATION CURB AND GUTTER AND MEDIAN, AND CHAIR SUPPORTS FOR CRC PAVEMENT, SHALL BE EPOXY COATED, UNLESS NOTED ON THE PLAN.
- 21. RAMPED NOSE ADJACENT TO GRASS MEDIAN SHALL BE PAID FOR AS COMBINATION CONCRETE CURB AND CUTTER, TYPE B-6.12. RAMPED NOSE ADJACENT TO CONCRETE MEDIAN SURFACE SHALL BE PAID FOR AS CONCRETE MEDIAN, TYPE SB-6.12.
- 22. TEMPORARY FENCE SHALL BE USED FOR TREE PROTECTION. ALL TREE PROTECTION SHALL BE PAID FOR AS TEMPORARY FENCE.
- 23. THE EXISTING PATH ALONG THE SOUTH SIDE OF MILLER ROAD WILL BE CLOSED DURING CONSTRUCTION UNLESS OTHERWISE AUTHORIZED BY THE MCHENRY COUNTY DIVISION OF TRANSPORTATION.
- 24. CONTRACTOR SHALL ABIDE BY ACCESSIBLE PUBLIC RIGHT-OF-WAY REQUIREMENTS.
- 25. IT IS THE CONTRACTOR'S SOLE RESPONSIBILITY TO COORDINATE WITH THE UNION PACIFIC RAILROAD WHENEVER CONSTRUCTION ACTIVITY IS WITHIN 25 FEET OF THE RAILROAD ROW. THE CONTRACTOR SHALL RETAIN FLAGMEN EMPLOYED AND DESIGNATED BY THE UNION PACIFIC RAILROAD TO MONITOR ONCOMING TRAIN TRAFFIC, AND ADVISE CONTRACTOR PERSONNEL WHEN ACTIVITY ON OR NEAR THE RAILROAD RIGHT-OF-WAY MAY PROCEED. THIS ITEM WILL BE PAID FOR ACCORDING TO ARTICLE 107.12 AND WILL BE REIMBURSED ACCORDING TO ARTICLE 109.05.

- 26. IN ACCORDANCE WITH ARTICLE 107.20 OF THE STANDARD SPECIFICATIONS, ALL MAILBOXES SHALL BE REMOVED, MAINTAINED, AND REINSTALLED UPON CONCLUSION OF CONSTRUCTION. THIS WORK SHALL BE CONSIDERED AS INCLUDED IN THE UNIT BID PRICES OF THE CONTRACT.
- 27. ALL PROPOSED SIDEWALK THAT CONTINUES THROUGH PROPOSED DRIVEWAYS SHALL MATCH THE THICKNESS OF THE ENTRANCE, BUT SHALL BE PAID FOR AS PORTLAND CEMENT CONCRETE SIDEWALK, 5".

ORM SEWERS, WATER MAINS, AND UTILITIES

- THE CONTRACTOR SHALL BE RESPONSIBLE FOR CONTACTING THE OWNERS OF ALL UTILITIES PRIOR TO CONSTRUCTION TO DETERMINE THE LOCATION OF ALL UTILITY EQUIPMENT. THE CONTRACTOR SHALL COOPERATE WITH ALL UTILITY OWNERS IN ACCORDANCE WITH THE STANDARD SPECIFICATIONS IF UTILITY RELOCATION, ADJUSTMENT, OR PROTECTION IS NECESSARY.
- 2. THE LOCATION OF EXISTING DRAINAGE STRUCTURES, STORM SEWERS, WATER MAINS, SANITARY SEWERS, AND ANY OTHER PUBLIC OR PRIVATE UTILITIES AS SHOWN ON THE PLANS IS APPROXIMATE AND THEIR EXACT LOCATION IS TO BE DETERMINED IN THE FIELD BY THE CONTRACTOR. THIS WORK SHALL BE CONSIDERED AS INCLUDED IN THE UNIT BID PRICES OF THE CONTRACT, AND NO ADDITIONAL COMPENSATION WILL BE ALLOWED.
- 3. THE CONTRACTOR SHALL BE RESPONSIBLE FOR THE PROTECTION OF ALL UNDERGROUND AND SURFACE UTILITIES EVEN THOUGH THEY MIGHT NOT BE SHOWN ON THE PLANS. ANY UTILITY PROPERTY DAMAGED DURING CONSTRUCTION SHALL BE REPAIRED OR REPLACED TO THE SATISFACTION OF THE ENGINEER AT THE CONTRACTOR'S EXPENSE.
- ALL UTILITY COMPANIES SHALL BE NOTIFIED AT LEAST 3 DAYS PRIOR TO THE START OF CONSTRUCTION.
- 5. THE CONTRACTOR SHALL PROTECT EXISTING OR NEW UTILITIES WHEN CONSIDERED NECESSARY BY METHODS APPROVED BY THE ENGINEER, AND HE SHALL BRACE AND SUPPORT THE UTILITIES PROPERLY TO PREVENT SETTLEMENT, DISPLACEMENT, OR DAMAGE TO THE UTILITIES. THE PROTECTION OF THE UTILITIES SPECIFIED HEREIN WILL NOT BE PAID FOR SEPARATELY, BUT THE COST THEREOF SHALL BE CONSIDERED AS INCLUDED IN THE CONTRACT.
- 6. UNLESS OTHERWISE NOTED OFFSETS FOR DRAINAGE STRUCTURES LOCATED IN CURB AND GUTTER ARE TO THE EDGE OF PAVEMENT AND OFFSETS FOR DRAINAGE STRUCTURES NOT LOCATED IN THE CURB AND GUTTER ARE TO THE CENTER OF THE STRUCTURE.
- 7. ANY LOOSE MATERIAL DEPOSITED IN THE FLOW LINE OF DRAINAGE STRUCTURES, WHICH OBSTRUCTS THE NATURAL FLOW OF WATER SHALL BE REMOVED AT THE CLOSE OF EACH WORKING DAY, PRIOR TO ACCEPTANCE OF THE IMPROVEMENT, ALL DRAINAGE STRUCTURES SHALL BE FREE OF DIRT AND DEBRIS. THIS WORK WILL NOT BE PAID FOR SEPARATELY, BUT SHALL BE CONSIDERED AS INCLUDED IN THE UNIT BID PRICES OF THE CONTRACT.
- 8. WHEN EXISTING DRAINAGE FACILITIES ARE DISTURBED, THE CONTRACTOR SHALL PROVIDE AND MAINTAIN, IN AN OPERATING CONDITION, TEMPORARY OUTLETS AND CONNECTIONS FOR ALL DRAINS, SEWERS, AND CATCH BASINS. THE CONTRACTOR SHALL PROVIDE FACILITIES WHICH HAVE THE CAPACITY TO RECEIVE AND DISCHARGE THE STORM WATER FLOW RATES NORMALLY ACCEPTED AND RELEASED BY THE EXISTING DRAINAGE FACILITIES. THIS WORK WILL NOT BE PAID FOR SEPARATELY, BUT SHALL BE CONSIDERED AS INCLUDED IN THE UNIT BID PRICES OF THE CONTRACT.
- 9. ALL FRAMES, GRATES, LIDS, AND BOXES SCHEDULED TO BE REMOVED FROM EXISTING STRUCTURES ON BULL VALLEY/CHARLES J. MILLER ROAD SHALL REMAIN THE PROPERTY OF AND BE DELIVERED TO THE MCHENRY COUNTY DIVISION OF TRANSPORTATION AT 16111 NELSON ROAD, WOODSTOCK, IL 60098. THESE ITEMS TO BE REMOVED FROM IL ROUTE 31 AND GREEN STREET/BARREVILLE ROAD WILL NOT BE SALVAGED.
- 10. ANY ITEMS DAMAGED DURING REMOVAL OPERATIONS SHALL BE REPLACED BY THE CONTRACTOR AT HIS EXPENSE. THE COST OF SALVAGING EXISTING FRAMES, GRATES, LIDS, OR BOXES AND/OR STOCKPILING THEM ON THE JOB SITE FOR DELIVERY TO THE APPLICABLE AGENCY, AS APPLICABLE SHALL BE CONSIDERED AS INCLUDED IN THE UNIT BID PRICES OF THE CONTRACT, AND NO ADDITIONAL COMPENSATION WILL BE ALLOWED.
- 11. ALL FRAMES WITH CLOSED LIDS TO BE FURNISHED AS PART OF THE CONTRACT FOR CONSTRUCTION, ADJUSTMENT OR RECONSTRUCTION OF ANY MANHOLE, CATCH BASIN, INLET, VALVE VAULT OR METER VAULT SHALL HAVE CAST INTO THE LID ONE OF THE FOLLOWING WORDS: ALL LIDS TO BE USED ON STORM SEWER STRUCTURES SHALL BEAR THE WORD "STORM." ALL LIDS TO BE USED ON SANITARY SYSTEM STRUCTURES SHALL BEAR THE WORD "SANITARY." ANY ADDITIONAL COST FOR THIS REQUIREMENT WILL NOT BE PAID FOR SEPARATELY, BUT SHALL BE CONSIDERED AS INCLUDED IN THE UNIT BID PRICES OF THE FRAMES AND CLOSED LIDS PROVIDED.
- 12. FRAME ELEVATIONS GIVEN ON THE PLANS ARE ONLY TO ASSIST THE CONTRACTOR IN DETERMINING THE APPROXIMATE OVERALL HEIGHT OF THE STRUCTURE. FRAMES ON ALL NEW, ADJUSTED OR RECONSTRUCTED STRUCTURES WILL BE ADJUSTED TO THE FINAL ELEVATION OF THE AREA IN WHICH THEY ARE LOCATED AS PART OF THE STRUCTURE, ADJUSTMENT OR RECONSTRUCTION COST.
- 13. ALL STORM SEWER SHALL BE REINFORCED CONCRETE PIPE WITH FLEXIBLE GASKET MEETING THE REQUIREMENTS OF ASTM C361. THIS ITEM WILL NOT BE PAID FOR SEPARATELY, BUT SHALL BE INCLUDED IN THE PRICE OF STORM SEWER.
- 14. ONLY PRECAST CONCRETE ADJUSTMENT RINGS, MAXIMUM OF 12" IN HEIGHT, WILL BE ALLOWED IN THE ADJUSTMENT OR RECONSTRUCTION OF CATCH BASIN, MANHOLE, INLET AND VALVE VAULT STRUCTURES. COMMON BRICK WILL NOT BE ALLOWED. THE RINGS SHALL BE INCLUDED IN THE COST OF WORK BEING PERFORMED.

BACKFILL

- 1. STORM SEWER SHALL BE BACK FILLED IN ACCORDANCE WITH ARTICLE 550.07, METHOD 1 ONLY.
- 2. PROVIDE TRENCH BACKFILL FOR ALL UTILITY LINES WITHIN 2' OF PAVED AREAS. ALL TRENCH BACKFILL QUANTITIES FOR STORM SEWER HAVE BEEN COMPUTED AND SHALL BE PAID FOR IN ACCORDANCE WITH THE STATE OF ILLINOIS DEPARTMENT OF TRANSPORTATION DIVISION OF HIGHWAYS BUREAU OF CONSTRUCTION TRENCH BACKFILL TABLE, BASED ON PIPE SIZE AND INVERT DEPTH FROM SUBGRADE.

SIGNING AND STRIPING

- 1. SEE IDOT STANDARD DETAIL 780001, DISTRICT ONE DETAIL AND PLAN SHEETS FOR PAVEMENT MARKING DETAILS.
- 2. SIGNS SHALL NOT BE MOVED OR COVERED UNTIL PROGRESS OF WORK NECESSITATES IT.
- 3. THE CONTRACTOR WILL BE REQUIRED TO TEMPORARILY RESET ALL SUCH SIGNS THAT INTERFERE WITH HIS CONSTRUCTION OPERATIONS. ALL SUCH SIGNS MUST BE MAINTAINED STRAIGHT AND CLEAN FOR THE DURATION OF THE TEMPORARY SETTING AND MUST BE RE-ERECTED AT A TEMPORARY LOCATION IN A WORKMANLIKE MANNER AND BE VISIBLE TO THE TRAFFIC FOR WHICH IT IS INTENDED. THIS WORK WILL NOT BE PAID FOR SEPARATELY, BUT SHALL BE INCLUDED IN THE UNIT BID PRICES OF THE CONTRACT.

- ALL SIGNS SHALL BE INSTALLED OR RELOCATED IN PERMANENT LOCATIONS AS THE ROADWAY IS COMPLETED. THIS WORK SHALL BE PAID FOR USING THE APPROPRIATE PAY ITEMS.
- 5. ALL SIGNS TO BE REMOVED ALONG BULL VALLEY/CHARLES J. MILLER ROAD SHALL REMAIN THE PROPERTY OF THE MCDOT AND SHALL BE RETURNED TO MCDOT AT 16111 NELSON ROAD, WOODSTOCK, IL 60098 UPON REMOVAL. ALL SIGNS TO BE REMOVED ALONG IL ROUTE 31 SHALL REMAIN THE PROPERTY OF 100T. THE CONTRACTOR SHALL CONTACT MCHENRY COUNTY ARTERIAL FIELD ENGINEER WALTER CZARNY (847-438-2300) PRIOR TO SIGN REMOVAL TO DETERMINE A LOCATION FOR DELIVERY OF SALVAGED SIGNS TO 100T. SIGNS TO BE REMOVED ALONG GREEN STREET/BARREVILLE ROAD WILL NOT BE SALVAGED.
- 6. LONGER POSTS MAY BE REQUIRED AT SOME TEMPORARY OR PERMANENT SIGN LOCATIONS TO MAINTAIN PROPER SIGN ELEVATIONS. THIS WORK SHALL BE PAID FOR AS TELESCOPING STEEL SIGN SUPPORT, SPECIAL

EROSION CONTROL PLANS

1. SEE EROSION CONTROL PLANS FOR GENERAL NOTES CONCERNING EROSION CONTROL.

TRAFFIC CONTROL

SEE TRAFFIC CONTROL PLANS FOR GENERAL NOTES CONCERNING TRAFFIC CONTROL AND PROTECTION.

EARTHWORK

- PRIOR TO ANY EMBANKMENT PLACEMENT ALL VEGETATION AND UNSTABLE MATERIAL SHOULD BE REMOVED TO DEPTH ENCOUNTERED AND REPLACED WITH SUITABLE EMBANKMENT MATERIAL AS APPROVED BY THE ENCOUNTER.
- EXISTING TOPSOIL IS ASSUMED TO BE 6 INCHES IN THICKNESS AND IS REMOVED UNDER THE PAY ITEM, REMOVAL AND DISPOSAL OF UNSUITABLE MATERIAL.

STRUCTURAL PLANS

1. SEE STRUCTURAL PLANS FOR GENERAL NOTES CONCERNING STRUCTURAL DESIGN.

LIGHTING PLANS

1. SEE LIGHTING PLANS FOR GENERAL NOTES CONCERNING LIGHTING DESIGN.

SCALE: N.T.S.

MCHENRY 358

CONTRACT NO. 63892

SUMMARY OF QUANTITIES

PAYCODE ITEM DESCRIPTION 20101000 TEMPORARY FENCE	UNIT T	TOTAL	ROADWAY 80% FEDERAL 20% LOCAL 0003 1,120	RETAINING WALL 80% FEDERAL 20% LOCAL 0040	SIGNALS - IL RTE 31 80% FEDERAL 20% LOCAL 0021	SIGNALS - GREEN ST 80% FEDERAL 20% LOCAL 0021	SIGNALS - INTERCONNECT 80% FEDERAL 20% LOCAL 0021	LIGHTING 80% FEDERAL 20% LOCAL 0021	LOCAL 0% FEDERAL 100% LOCAL 0043	Multi-Use Pat 80% FED 20% LOCA 0028
		1,120								
20200100 EARTH EXCAVATION	CU YD 3	-1	35,555					,		-
20201200 REMOVAL AND DISPOSAL OF UNSUITABLE MATERIAL	CU YD 3	227	35,235	110						-
20800150 TRENCH BACKFILL	CU YD 5	5,434	5,434							
21001000 GEOTECHNICAL FABRIC FOR GROUND STABILIZATION	SQ YD 8	32,880	82,880							
21101615 TOPSOIL FURNISH AND PLACE, 4"	SQ YD 7	71,440	71,440							
21101685 TOPSOIL FURNISH AND PLACE, 24"	SQ YD 5	5,570	5,570					THE VELLEY		
25000210 SEEDING, CLASS 2A	ACRE	11	11							-
25000312 SEEDING, CLASS 4A	ACRE	4	4							
25000400 NITROGEN FERTILIZER NUTRIENT	POUND 1	1,401	1,401							
25000500 PHOSPHORUS FERTILIZER NUTRIENT	POUND 1	1,401	1,401							
25000600 POTASSIUM FERTILIZER NUTRIENT	POUND 1	1,401	1,401							-
25100635 HEAVY DUTY EROSION CONTROL BLANKET	SO YD 13	3,880	13,880							
25100900 TURF REINFORCEMENT MAT	SO YD		100	***************************************						
25200110 SODDING, SALT TOLERANT	SO YD 5		5,140							
25200200 SUPPLEMENTAL WATERING		257	257							
BOO0250 TEMPORARY EROSION CONTROL SEEDING	POUND 1		1,592							
8000305 TEMPORARY DITCH CHECKS										
8000400 PERIMETER EROSION BARRIER	F00T 1	and the same	1,210							}
	F00T 19	111111111111111111111111111111111111111	19,000							
28000500 INLET AND PIPE PROTECTION		35	35							-
28000510 INLET FILTERS		182	182		1					
28001100 TEMPORARY EROSION CONTROL BLANKET	SQ YD 5	7,565	57,565							
28100101 STONE RIPRAP, CLASS A1	SQ YD	35	35		i i					
28100105 STONE RIPRAP, CLASS A3	SQ YD	165	165							-
28100107 STONE RIPRAP, CLASS A4	SQ YD	45	45							
28100109 STONE RIPRAP, CLASS A5	SQ YD	25	25							
28100709 STONE DUMPED RIPRAP, CLASS A5	SQ YD	75		75						-
8200200 FILTER FABRIC	SQ YD	270	270		1					-
0300001 AGGREGATE SUBGRADE IMPROVEMENT	CU YD 5	5,390	5,390							
30300112 AGGREGATE SUBGRADE IMPROVEMENT 12"	SQ YD 9	95,105	95,105							
31101400 SUBBASE GRANULAR MATERIAL, TYPE B 6"	SO YD 5		2,966							2 (14
10600275 BITUMINOUS MATERIALS (PRIME COAT)	POUND 5	100000	57,582							2,614
0600827 POLYMERIZED LEVELING BINDER (MACHINE METHOD), IL-4.75, N50		Acres de la constitución de la c								
10600982 HOT-MIX ASPHALT SURFACE REMOVAL - BUTT JOINT	TON 2		2,193							
0600990 TEMPORARY RAMP	SO YD	D V 17	598							
	SQ YD		250					21/4		
10603080 HOT-MIX ASPHALT BINDER COURSE, IL-19.0, N50	TON		1 21	in the second se	1					602
0603335 HOT-MIX ASPHALT SURFACE COURSE, MIX "D", N50	TON									301
0603595 POLYMERIZED HOT-MIX ASPHALT SURFACE COURSE, MIX "F", N90	TON 2		2,767							
40701841 HOT-MIX ASPHALT PAVEMENT (FULL-DEPTH), 8"	SQ YD 4	4,550	4,550							
40701961 HOT-MIX ASPHALT PAVEMENT (FULL-DEPTH), 14"	SQ YD 4	11,251	41,251							
12000416 PORTLAND CEMENT CONCRETE PAVEMENT 9 3/4" (JOINTED)	SO YD 28	8,476	28,476							
2001300 PROTECTIVE COAT	SQ YD 40	0,093	40,093					100		

SPECIALTY ITEM
 CONSTRUCTION TYPE CODE 0042

HRGreen.com illinois Professional Desig HRGreen

) esion Firm	-
osegu ram	
	Γ

Ī	USER NAME = tyelton	DESIGNED - JPA	REVISED -
	FILE NAME = 090071-sum.dgn	DRAWN - SVJ	REVISED -
	PLOT SCALE = N.T.S.	CHECKED - JLP	REVISED -
	PLOT DATE = 12/4/2014	DATE - 12/5/14	REVISED -

	STATE	OF	ILLINOIS	
DEPART	MENT	OF	TRANSPORTATION	

		S	U	MIN	ARY	OF QU	ANTIT	IES
СНА	RLES J	. MI	LLI	ER	RO/	D ROA	DWAY	IMPROVEMENTS
SCALE: N.T.S.	SHEET	NO.	1	OF	7	SHEETS	STA.	TO STA.

RTE.	SE	CTION		COUNTY	TOTAL	SHEE
3860 09-00372-01-PW			1	MCHENRY	358	4
				CONTRACT	NO.	6389
FED. ROAD	DIST. NO.	ILLINOIS	FED. AID	PROJECT		

PAYCODE 42400200	ITEM DESCRIPTION PORTLAND CEMENT CONCRETE SIDEWALK 5 INCH	UNIT SQ FT	TOTAL 26,690	ROADWAY 80% FEDERAL 20% LOCAL 0003 26,690	RETAINING WALL 80% FEDERAL 20% LOCAL 0040	SIGNALS - IL RTE 31 80% FEDERAL 20% LOCAL 0021	SIGNALS - GREEN ST 80% FEDERAL 20% LOCAL 0021	SIGNALS - INTERCONNECT 80% FEDERAL 20% LOCAL 0021	LIGHTING 80% FEDERAL 20% LOCAL 0021	LOCAL 0% FEDERAL 100% LOCAL 0043
42400800	DETECTABLE WARNINGS	S0 FT	600	600						
44000100	PAVEMENT REMOVAL	SQ YD	79,602	79,602						
44000157	HOT-MIX ASPHALT SURFACE REMOVAL, 2"	SQ YD	5,991	5,991		20				
44000166	HOT-MIX ASPHALT SURFACE REMOVAL, 4 1/4"	SQ YD	16,651	16,651						
44000200	DRIVEWAY PAVEMENT REMOVAL	SQ YD	4,018	4,018						
44000500	COMBINATION CURB AND GUTTER REMOVAL	FOOT	15,684	15,684						
44000600	SIDEWALK REMOVAL	SQ FT	11,658	11,658						
44004000	PAVED DITCH REMOVAL	FOOT	538	538						
44004250	PAVED SHOULDER REMOVAL	SQ YD	3,370	3,370						
44201745	CLASS D PATCHES, TYPE III, 8 INCH	SQ YD	158	158						
44201747	CLASS D PATCHES, TYPE IV, 8 INCH	SQ YD	754	754						
48101500	AGGREGATE SHOULDERS, TYPE B 6"	SQ YD	2,808	2,808						
48203029	HOT-MIX ASPHALT SHOULDERS, 8"	SQ YD	54	54						
50200100	STRUCTURE EXCAVATION	CU YD	1,995		1,995					
50300225	CONCRETE STRUCTURES	CU YD	714.7		714.7					
50800205	REINFORCEMENT BARS, EPOXY COATED	POUND	74,270		74,270					
542A0213	PIPE CULVERTS, CLASS A, TYPE 1 8"	FOOT	53	53						
542A0217	PIPE CULVERTS, CLASS A, TYPE 1 12"	FOOT	26	26			, ,			
54213657	PRECAST REINFORCED CONCRETE FLARED END SECTIONS 12"	EACH	16	16						
54213660	PRECAST REINFORCED CONCRETE FLARED END SECTIONS 15"	EACH	2	2						
54213663	PRECAST REINFORCED CONCRETE FLARED END SECTIONS 18"	EACH	9	9						
54213666	PRECAST REINFORCED CONCRETE FLARED END SECTIONS 21"	EACH	1	1						
54214509	PRECAST REINFORCED CONCRETE FLARED END SECTIONS, EQUIVALENT ROUND-SIZE 24"	EACH	4	4						
54214521	PRECAST REINFORCED CONCRETE FLARED END SECTIONS, EQUIVALENT ROUND-SIZE 36"	EACH	2	2						
54214539	PRECAST REINFORCED CONCRETE FLARED END SECTIONS, EQUIVALENT ROUND-SIZE 54"	EACH	1	1						
550A0340	STORM SEWERS, CLASS A, TYPE 2 12"	FOOT	3,943	3,943						
550A0360	STORM SEWERS, CLASS A, TYPE 2 15"	FOOT		576						
550A0380	STORM SEWERS, CLASS A, TYPE 2 18"	FOOT	2,112	2,112						
550A0400	STORM SEWERS, CLASS A, TYPE 2 21"	FOOT		22						
550A0410	STORM SEWERS, CLASS A, TYPE 2 24"	FOOT	1,266	1,266		1				
550A0450	STORM SEWERS, CLASS A, TYPE 2 36"	FOOT		172						
550A0480	STORM SEWERS, CLASS A, TYPE 2 48"	FOOT	- 1 3 M	209						
	STORM SEWERS, CLASS A, TYPE 2 60"		245	245						
550A4100	STORM SEWERS, CLASS A, TYPE 1 EQUIVALENT ROUND-SIZE 24"	FOOT		46						
	STORM SEWERS, CLASS A, TYPE 1 EQUIVALENT ROUND-SIZE 36"	FOOT		210						
200000000000000000000000000000000000000	STORM SEWERS, CLASS A, TYPE 1 EQUIVALENT ROUND-SIZE 54"	FOOT		78						
55100300	STORM SEWER REMOVAL 8"	FOOT	13	30						
	STORM SEWER REMOVAL 10"	FOOT		55						
	STORM SEWER REMOVAL 12"		3,389	3,389						
	STORM SEWER REMOVAL 15"		3,671	3,671						
	STORM SEWER REMOVAL 18"	FOOT	24.56	897						
3010000		17001	031	031						

* SPECIALTY ITEM
X CONSTRUCTION TYPE CODE 0042

USER NAME = tyelton	DESIGNED - JPA	REVISE
FILE NAME = 090071-sum.dgn	DRAWN - SVJ	REVISE
PLOT SCALE = N.T.S.	CHECKED - JLP	REVISE
PLOT DATE = 12/4/2014	DATE - 12/5/14	REVISE

			S	UN	IΜ	ARY	OF QU	ANTIT	IES
	CHARLES	J.	MI	LLE	ER	ROA	D ROA	DWAY	IMPROVEMENTS
SCALE: N.T.S.	SHE	ET	NO.	2	OF	7	SHEETS	STA.	TO STA.

F.A.U. RTE.	SE	CTION		COUNTY	TOTAL	SHEE NO.
3860	09-00372-01-PW	1	MCHENRY	358	5	
				CONTRACT	NO.	6389
FED. ROAD	DIST. NO.	ILLINOIS	FED. AI	D PROJECT		

PAYCODE 55101100	ITEM DESCRIPTION STORM SEWER REMOVAL 21"	UNIT	TOTAL 218	ROADWAY 80% FEDERAL 20% LOCAL 0003 218	RETAINING WALL 80% FEDERAL 20% LOCAL 0040	SIGNALS - IL RTE 31 80% FEDERAL 20% LOCAL 0021	SIGNALS - GREEN ST 80% FEDERAL 20% LOCAL 0021	SIGNALS - INTERCONNECT 80% FEDERAL 20% LOCAL 0021	LIGHTING 80% FEDERAL 20% LOCAL 0021	LOCAL OX FEDERAL 100% LOCAL 0043
	STORM SEWER REMOVAL 24"	FOOT		1,116						
	STORM SEWER REMOVAL 30"	FOOT		117						
	DUCTILE IRON WATER MAIN REDUCER, 12" X 10"	EACH	117	111						
	DUCTILE IRON WATER MAIN REBUCER, 12 × 10		1							1
	DUCTILE IRON WATER MAIN 10	FOOT	-							6
	ADJUSTING WATER MAIN 12"	FOOT								835
Account to the second			350							350
	FIRE HYDRANTS TO BE REMOVED	EACH	9							9
	FIRE HYDRANT WITH AUXILIARY VALVE AND VALVE BOX	EACH	7							7
	GEOCOMPOSITE WALL DRAIN		652		652					
	PIPE UNDERDRAINS, FABRIC LINED TRENCH 4"	FOOT		492						
	CATCH BASINS, TYPE A, 4'-DIAMETER, TYPE 1 FRAME, OPEN LID	EACH	3	3						
	CATCH BASINS, TYPE A, 4'-DIAMETER, TYPE 8 GRATE	EACH	2	2						
	CATCH BASINS, TYPE A, 4'-DIAMETER, TYPE 11 FRAME AND GRATE	EACH		44						
60201340	CATCH BASINS, TYPE A, 4'-DIAMETER, TYPE 24 FRAME AND GRATE	EACH	54	54						
60204505	CATCH BASINS, TYPE A, 5'-DIAMETER, TYPE 8 GRATE	EACH	1	1						
60207605	CATCH BASINS, TYPE C, TYPE 8 GRATE	EACH	12	12						
60207905	CATCH BASINS, TYPE C, TYPE 11 FRAME AND GRATE	EACH	3	3						
60208240	CATCH BASINS, TYPE C, TYPE 24 FRAME AND GRATE	EACH	11	11						
60218300	MANHOLES, TYPE A, 4'-DIAMETER, TYPE 1 FRAME, OPEN LID	EACH	2	2						
60218400	MANHOLES, TYPE A, 4'-DIAMETER, TYPE 1 FRAME, CLOSED LID	EACH	20	20				PART -		
60221000	MANHOLES, TYPE A, 5'-DIAMETER, TYPE 1 FRAME, OPEN LID	EACH	11	1						
60221100	MANHOLES, TYPE A, 5'-DIAMETER, TYPE 1 FRAME, CLOSED LID	EACH	11	11						
60223800	MANHOLES, TYPE A, 6'-DIAMETER, TYPE 1 FRAME, CLOSED LID	EACH	2	2						
60224005	MANHOLES, TYPE A, 6'-DIAMETER, TYPE 8 GRATE	EACH	1	1						
60224446	MANHOLES, TYPE A, 7'-DIAMETER, TYPE 1 FRAME, CLOSED LID	EACH	4	4						
60224448	MANHOLES, TYPE A, 7'-DIAMETER, TYPE 8 GRATE	EACH	1	1						
60224458	MANHOLES, TYPE A, 8'-DIAMETER, TYPE 8 GRATE	EACH	2	2						
60224459	MANHOLES, TYPE A, 8'-DIAMETER, TYPE 1 FRAME, CLOSED LID	EACH	1	1						
60234200	INLETS, TYPE A, TYPE 1 FRAME, OPEN LID	EACH	1	1						
60236800	INLETS, TYPE A, TYPE 11 FRAME AND GRATE	EACH	35	35						
	INLETS, TYPE A, TYPE 24 FRAME AND GRATE	EACH		20						
60256400	MANHOLES TO BE ADJUSTED WITH NEW TYPE 8 GRATE	EACH	1	1						
	REMOVING MANHOLES	EACH		20		-				
	REMOVING CATCH BASINS	EACH		18						
	REMOVING INLETS	EACH		55						
	CLASS SI CONCRETE (OUTLET)	Gentalen	3.5	3.5						
	CONCRETE CURB, TYPE B		369	369						
	COMBINATION CONCRETE CURB AND GUTTER, TYPE B-6.12	District Control								
	COMBINATION CONCRETE CURB AND GUTTER, TYPE B-6.12	1	9,010	9,010						
			183	183						
	COMBINATION CONCRETE CURB AND GUTTER, TYPE B-6.24	least the second	18,734	18,734						
60618300	CONCRETE MEDIAN SURFACE, 4 INCH	SQ FT	454	454						

SPECIALTY ITEM
 CONSTRUCTION TYPE CODE 0042



USER NAME = tyelton	DESIGNED	PA	REVISED -
FILE NAME = 898871-sum-dgn		VJ	REVISED -
PLOT SCALE = N.T.S.	CHECKED -	LP	REVISED -
PLOT DATE = 11/11/2014	DATE - 1	1/12/14	REVISED -

SUMMARY OF QUANTITIES CHARLES J. MILLER ROAD ROADWAY IMPROVEMENTS							
CHA	RLES J. M	ILL	ER	RO/	AD ROA	DWAY	IMPROVEMENTS
SCALE: N.T.S.	SHEET NO	. 3	OF	7	SHEETS	STA.	TO STA.

F.A.U. RTE.	SE	CTION		COUNTY	TOTAL	SHEET NO.
3860	09-003	72-01-PW	,	MCHENRY	358	6
		- 0 - 1		CONTRACT	NO.	63892
FED. ROA	D DIST. NO.	ILLINOIS	FED. AI	D PROJECT		

				ROADWAY 80% FEDERAL 20% LOCAL	RETAINING WALL 80% FEDERAL 20% LOCAL	80% FEDERAL 20% LOCAL	SIGNALS - GREEN ST 80% FEDERAL 20% LOCAL	SIGNALS - INTERCONNECT 80% FEDERAL 20% LOCAL	LIGHTING 80% FEDERAL 20% LOCAL	LOCAL 0% FEDERAL 100% LOCAL
60619600	ITEM DESCRIPTION CONCRETE MEDIAN, TYPE SB-6.12	SQ FT	14,716	0003 14,716	0040	0021	0021	0021	0021	0043
	STEEL PLATE BEAM GUARDRAIL, TYPE A, 6 FOOT POSTS	FOOT	775	775						
• 63000003	STEEL PLATE BEAM GUARDRAIL, TYPE A, 9 FOOT POSTS	FOOT	312.5	312.5						
• 63100045	TRAFFIC BARRIER TERMINAL, TYPE 2	EACH		2						
63100167	TRAFFIC BARRIER TERMINAL, TYPE 1 (SPECIAL) TANGENT	EACH	1	1						
	REMOVE AND REERECT STEEL PLATE BEAM GUARDRAIL, TYPE A	FOOT	62.5	62.5						
* 66900200	NON-SPECIAL WASTE DISPOSAL	CU YD	10,000	10,000						
* 66900450	SPECIAL WASTE PLANS AND REPORTS	L SUM	1	1						
* 66900530	SOIL DISPOSAL ANALYSIS	EACH	5	5						
67000400	ENGINEER'S FIELD OFFICE, TYPE A	CAL MO	17	17						
67100100	MOBILIZATION	L SUM	1	1						
70103815	TRAFFIC CONTROL SURVEILLANCE		415	415						
	CHANGEABLE MESSAGE SIGN	CAL MO		96						
	SHORT TERM PAVEMENT MARKING		14,310	14,310						
70300210	TEMPORARY PAVEMENT MARKING LETTERS AND SYMBOLS	Atomasei	895	895						
70300220	TEMPORARY PAVEMENT MARKING - LINE 4"		70,015	70,015						
	TEMPORARY PAVEMENT MARKING - LINE 6"		3,980	3,980						
	TEMPORARY PAVEMENT MARKING - LINE 12"	September 1	945	945						
	TEMPORARY PAVEMENT MARKING - LINE 24"		285	285						
	PAVEMENT MARKING TAPE, TYPE III - LETTERS AND SYMBOLS	1000	2117	2117						
	PAVEMENT MARKING TAPE, TYPE III 4"		60,240	60,240						
	PAVEMENT MARKING TAPE, TYPE III 6"	100.700	8,355	8,355						
	PAVEMENT MARKING TAPE, TYPE III 12"		220	220						
	PAVEMENT MARKING TAPE, TYPE III 24"		370	370						
	WORK ZONE PAVEMENT MARKING REMOVAL		71,126	71,126						
	TEMPORARY CONCRETE BARRIER	200	6,775	6,775						
	RELOCATE TEMPORARY CONCRETE BARRIER		6,937.5	6,937.5						
	IMPACT ATTENUATORS, TEMPORARY (FULLY REDIRECTIVE, NARROW), TEST LEVEL 3	EACH	Sec. 1	11						
	IMPACT ATTENUATORS, RELOCATE (FULL YREDIRECTIVE, NARROW), TEST LEVEL 3	EACH		15						
	SIGN PANEL - TYPE 1		765	660		90	16			
	SIGN PANEL - TYPE 2					30	15			
a processor	THERMOPLASTIC PAVEMENT MARKING - LETTERS AND SYMBOLS		660	660						
	THERMOPLASTIC PAVEMENT MARKING - LINE 4"	ža senius s	31,575	31,575						
TO SECTION AND ASSESSMENT	THERMOPLASTIC PAVEMENT MARKING - LINE 6"	TOO KE LOO	lond Standard							
	THERMOPLASTIC PAVEMENT MARKING - LINE 12"	CONTRACTOR AND CO.	3,080 655	3,080 655						
Contraction of the Contraction o	THERMOPLASTIC PAVEMENT MARKING - LINE 12" THERMOPLASTIC PAVEMENT MARKING - LINE 24"	25500		250						
	POLYUREA PAVEMENT MARKING - LINE 24 POLYUREA PAVEMENT MARKING TYPE I - LETTERS AND SYMBOLS	1.5	250							
			1,045	1,045						
	POLYUREA PAVEMENT MARKING TYPE I - LINE 4"		8,210	8,210						
PC. MAY CO. M. L. WILLIAM	POLYUREA PAVEMENT MARKING TYPE I - LINE 6"	-1	5,050	5,050						
	POLYUREA PAVEMENT MARKING TYPE I - LINE 8"		730	730						
	POLYUREA PAVEMENT MARKING TYPE I - LINE 12"		555	555						
78008270	POLYUREA PAVEMENT MARKING TYPE I - LINE 24"	FOOT	235	235						

SPECIALTY ITEM
 CONSTRUCTION TYPE CODE 0042



USER NAME = tyelton	DESIGNED - JPA	REVISED -
FILE NAME = 898871-sum.dgn	DRAWN - SVJ	REVISED -
PLOT SCALE = N.T.S.	CHECKED - JLP	REVISED -
PLOT DATE = 11/11/2014	DATE - 11/12/14	REVISED -

	S	UMN	IARY	OF QU	ANTIT	ES
CHA	RLES J. MII	LLER	ROA	D ROA	DWAY	IMPROVEMENTS
SCALE: N.T.S.	SHEET NO.	4 0	7	SHEETS	STA.	TO STA.

FED. ROA	D DIST. NO.	ILLINOIS FED. A	AID PROJECT		
			CONTRACT	NO.	63892
3860	09-003	72-01-PW	MCHENRY	358	7
RTE.	SEC	CTION	COUNTY	SHEETS	SHEET NO.

DAYCODE	INTEL OFFICE INTEREST	UNIT	TOTAL	ROADWAY 80% FEDERAL 20% LOCAL 0003	RETAINING WALL 80% FEDERAL 20% LOCAL 0040	SIGNALS - IL RTE 31 80% FEDERAL 20% LOCAL 0021	SIGNALS - GREEN ST 80% FEDERAL 20% LOCAL 0021	SIGNALS - INTERCONNECT 80% FEDERAL 20% LOCAL 0021	LIGHTING 80% FEDERAL 20% LOCAL 0021	LOCAL 0% FEDERAL 100% LOCAL 0043
78100100	ITEM DESCRIPTION RAISED REFLECTIVE PAVEMENT MARKER	EACH		365	0040	0021	0021	0021	0021	0013
78200410	CUARDRAIL MARKERS, TYPE A	EACH	14	14						
78200530	BARRIER WALL MARKERS, TYPE C	EACH	546	546						
78300100	PAVEMENT MARKING REMOVAL	SQ FT	22,570	22,570						
78300200	RAISED REFLECTIVE PAVEMENT MARKER REMOVAL	EACH	441	441						
80400100	ELECTRIC SERVICE INSTALLATION	EACH	1						1	- 1000 -
80400200	ELECTRIC UTILITY SERVICE CONNECTION	L SUM	1						1	
80500020	SERVICE INSTALLATION - POLE MOUNTED	EACH	2			1	1			
81028200	UNDERGROUND CONDUIT, GALVANIZED STEEL, 2" DIA.	FOOT	3,530			1,680	43	1,757	50	
81028210	UNDERGROUND CONDUIT, GALVANIZED STEEL, 2 1/2" DIA.	FOOT	228			171	57			
81028220	UNDERGROUND CONDUIT, GALVANIZED STEEL, 3" DIA.	FOOT	128			84	44			
81028240	UNDERGROUND CONDUIT, GALVANIZED STEEL, 4" DIA.	FOOT	1,387			655	501		231	
81400100	HANDHOLE	EACH	11			6	2	3		
	HEAVY-DUTY HANDHOLE	EACH	4			4				
	DOUBLE HANDHOLE	EACH	4			2	2			
	UNIT DUCT, 600V, 3-1C NO.6, 1/C NO.8 GROUND, (XLP-TYPE USE), 1" DIA. POLYETHYLENE	FOOT	1,235						1,235	
	ELECTRIC CABLE IN CONDUIT, 600V (XLP-TYPE USE) 1/C NO. 1/0	FOOT							150	
	LUMINAIRE, SODIUM VAPOR, HORIZONTAL MOUNT, 310 WATT	EACH	12						12	
	LIGHTING CONTROLLER, BASE MOUNTED, 240VOLT, 100AMP	EACH	1						1	
	LIGHT POLE, ALUMINUM, 40 FT. M.H., 12 FT. MAST ARM	EACH	8						8	
Tarres on the second	LIGHT POLE FOUNDATION, METAL, 15" BOLT CIRCLE, 8" X 6"	EACH	8						8	
	BREAKAWAY DEVICE, TRANSFORMER BASE, 15 INCH BOLT CIRCLE	EACH	8						8	
		EACH	2						2	
	REMOVAL OF LIGHTING UNIT, SALVAGE	EACH	2						2	
	REMOVAL OF POLE FOUNDATION	EACH	7						3	
	RELOCATE EXISTING LIGHTING UNIT	EACH	3					•	3	
1	TRANSCEIVER - FIBER OPTIC		7 705					2,550	1,235	
F DISENTINE	ELECTRIC CABLE IN CONDUIT, TRACER, NO. 14 1C		3,785			1.770	449	2,550	1,233	
	ELECTRIC CABLE IN CONDUIT, SIGNAL NO. 14 2C		2,219			1,770				
	ELECTRIC CABLE IN CONDUIT, SIGNAL NO. 14 3C		5,630			3,993	1,637			
	ELECTRIC CABLE IN CONDUIT, SIGNAL NO. 14 5C		5,397			3,235	2,162			
	ELECTRIC CABLE IN CONDUIT, SIGNAL NO. 14 7C		4,537			2,038	2,499			
	ELECTRIC CABLE IN CONDUIT, SIGNAL NO. 18 3C	FOOT					908			
A STATE OF THE PARTY OF THE PAR	ELECTRIC CABLE IN CONDUIT, LEAD-IN, NO. 14 1 PAIR	FOOT				5,588				
10000000	ELECTRIC CABLE IN CONDUIT, SERVICE, NO. 6 2 C	FOOT				165	122			
	ELECTRIC CABLE IN CONDUIT, EQUIPMENT GROUNDING CONDUCTOR, NO. 6 1C	FOOT	1,632			1,014	618			
122	TRAFFIC SIGNAL POST, GALVANIZED STEEL 10 FT.	EACH	3			3				
	TRAFFIC SIGNAL POST, GALVANIZED STEEL 16 FT.	EACH	8			4	4			
34.7	STEEL MAST ARM ASSEMBLY AND POLE, 48 FT.	EACH	1			1				
• 87700300	STEEL MAST ARM ASSEMBLY AND POLE, 52 FT.	EACH	1			1				
• 87700320	STEEL MAST ARM ASSEMBLY AND POLE, 55 FT.	EACH	1			1				
• 87700340	STEEL MAST ARM ASSEMBLY AND POLE, 58 FT.	EACH	11			1				
87702985	STEEL COMBINATION MAST ARM ASSEMBLY AND POLE 52 FT.	EACH	1				1			

USER NAME = tyelton	DESIGNED - JPA	REVISED -	
FILE NAME = 890071-sum.dgn	DRAWN - SVJ	REVISED -	
PLOT SCALE = N.T.S.	CHECKED - JLP	REVISED -	
PLOT DATE = 11/14/2014	DATE - 11/14/14	REVISED -	

STATE	OF	ILLINOIS	
DEPARTMENT	OF	TRANSPORTATION	

			S	UN	IM	ARY	OF	QU	ANTIT	IES	
	CHA	RLES J.	MI	LLE	R	ROA	AD F	ROA	DWAY	IMPROVEMENT	S
SCALE:	N.T.S.	SHEET	NO.	5	OF	7	SHEE	TS	STA.	TO STA	

FED. ROAD	DIST. NO.	ILLINOIS	FED. AI	PROJECT		
		- Marie		CONTRACT	NO.	6389
3860	09-003	72-01-PW		MCHENRY	358	8
F.A.U. RTE.	SE		COUNTY	TOTAL	SHEE NO.	

SPECIALTY ITEM
 CONSTRUCTION TYPE CODE 0042

PAYCODE 87703000	ITEM DESCRIPTION STEEL COMBINATION MAST ARM ASSEMBLY AND POLE 55 FT.	UNIT EACH	TOTAL	ROADWAY 80% FEDERAL 20% LOCAL 0003	RETAINING WALL 80% FEDERAL 20% LOCAL 0040	SIGNALS - IL RTE 31 80% FEDERAL 20% LOCAL 0021	SIGNALS - GREEN ST 80% FEDERAL 20% LOCAL 0021	SIGNALS - INTERCONNECT 80% FEDERAL 20% LOCAL 0021	LIGHTING 80% FEDERAL 20% LOCAL 0021	LOCAL 0% FEDERAL 100% LOCAL 0043
	CONCRETE FOUNDATION, TYPE A	FOOT	44			28	16			
ETTOTION CONCE	CONCRETE FOUNDATION, TYPE C	FOOT	8			4	16			
	CONCRETE FOUNDATION, TYPE C 36-INCH DIAMETER	FOOT	99	2002		43	56			
	CONCRETE FOUNDATION, TYPE E 30 INCH DIAMETER	FOOT	21			21	26			
	DRILL EXISTING HANDHOLE	EACH	21			21				
	SIGNAL HEAD, LED, 1-FACE, 3-SECTION, MAST-ARM MOUNTED	EACH	16			8	0	1		
	SIGNAL HEAD, LED, 1-FACE, 5-SECTION, MAST-ARM MOUNTED	EACH	10			4	8			
	SIGNAL HEAD, LED, 2-FACE, 5-SECTION, BRACKET MOUNTED	EACH	2			1	6			
	SIGNAL HEAD, LED, 2-FACE, 1-3 SECTION, 1-5 SECTION, BRACKET MOUNTED	EACH	6			1	2			
	PEDESTRIAN SIGNAL HEAD, LED, 1-FACE, BRACKET MOUNTED WITH COUNTDOWN TIMER	EACH	10			4	2			
	PEDESTRIAN SIGNAL HEAD, LED, 2-FACE, BRACKET MOUNTED WITH COUNTDOWN TIMER	EACH	10			8	2			
	TRAFFIC SIGNAL BACKPLATE, LOUVERED		26			12	1			
		EACH	26			12	14			
Carried Annual Carried Control	INDUCTIVE LOOP DETECTOR	EACH	16			16				
La constant de la companya della companya della companya de la companya della com	DETECTOR LOOP, TYPE I	FOOT	446			446				
	PREFORMED DETECTOR LOOP	FOOT	463			463			A. ///1980 - 2019/199	
	LIGHT DETECTOR	EACH	6			4	2			
	LIGHT DETECTOR AMPLIFIER	EACH	2			1	1			
	PEDESTRIAN PUSH-BUTTON	EACH	12			8	4			
	TEMPORARY TRAFFIC SIGNAL INSTALLATION	EACH	2			1	1			
A SANSAN AND AND AND AND AND AND AND AND AND A	REMOVE ELECTRIC CABLE FROM CONDUIT	FOOT	800					800		
- And the Annual	REMOVE EXISTING TRAFFIC SIGNAL EQUIPMENT	EACH	2			1	- 1			
	REMOVE EXISTING HANDHOLE	EACH	26			10	12	4		
89502382	REMOVE EXISTING DOUBLE HANDHOLE	EACH	2	mak remarka		1	1			
89502385	REMOVE EXISTING CONCRETE FOUNDATION	EACH	15			8	7			
X0323868	DRAINAGE RESTRICTOR	EACH	5	- 5						
X0324085	EMERGENCY VEHICLE PRIORITY SYSTEM LINE SENSOR CABLE, NO. 20 3/C	FOOT	233			123	110			
X0327698 X0426200	LED INTERNALLY ILLUMINATED STREET NAME SIGN DEWATERING	EACH L SUM	8	1		4	4			
X4021000	TEMPORARY ACCESS (PRIVATE ENTRANCE)	EACH	7	Ť						
X4022000	TEMPORARY ACCESS (COMMERCIAL ENTRANCE)	EACH	23	23						
X4024100	TEMPORARY ACCESS (WINTERIZE)	SO YD	3,735	3,735						
X5610662	WATER MAIN TO BE ABANDONED, 12"	FOOT	666							666
X5610752	WATER MAIN LINE STOP 12"	EACH	1							1
X5630012	CUT AND CAP EXISTING 12" WATER MAIN	EACH	1	×	-chaptania - nasa					1
CONTRACTOR OF CASE	CONNECTION TO EXISTING WATER MAIN 12"	EACH	2							2
X5860110	GRANULAR BACKFILL FOR STRUCTURES	CU YD	2,740		2,740					
X6020296	MANHOLES, TYPE A, 8'-DIAMETER, WITH SPECIAL FRAME AND GRATE	EACH	1	1						
X6022712	CATCH BASINS, TYPE A, 4'-DIAMETER, WITH SPECIAL FRAME AND GRATE	EACH	1	1						
X6025620	CATCH BASINS, TYPE A, 5'-DIAMETER, WITH SPECIAL FRAME AND GRATE	EACH	1	1						
X6026622	VALVE VAULTS TO BE REMOVED	EACH	1							1
X6030310	FRAMES AND LIDS TO BE ADJUSTED (SPECIAL)	EACH	7	7						
X7010216	TRAFFIC CONTROL AND PROTECTION, (SPECIAL)	L SUM	1	1						

* SPECIALTY ITEM
X CONSTRUCTION TYPE CODE 0042

HRGreen.com
Illinois Profinsional Design Firm
HRGreen
HRGreen

USER NAME = tyelton	DESIGNED - JPA	REVISED -
FILE NAME = 090071-sum.dgn	DRAWN - SVJ	REVISED -
PLOT SCALE = N.T.S.	CHECKED - JLP	REVISED -
PLOT DATE = 12/4/2014	DATE - 12/5/14	REVISED -

		S	UN	/M	ARY	OF QU	JANTITI	ES
CHA	RLES J.	MII	LE	R	RO/	AD ROA	DWAY	IMPROVEMENTS
SCALE: N.T.S.	SHEET	NO.	6	OF	7	SHEETS	STA.	TO STA.

F.A.U. RTE.	SEC	CTION			COUNTY	TOTAL	SHEE NO.
3860	09-003	72-01-PW	1	T	MCHENRY	358	9
				T	CONTRACT	NO.	6389
FED. ROAD	DIST. NO.	ILLINOIS	FED.	AID	PROJECT		

PAYCODE ITEM DESCRIPTION	UNIT	TOTAL	ROADWAY 80% FEDERAL 20% LOCAL 0003	RETAINING WALL 80% FEDERAL 20% LOCAL 0040	SIGNALS - IL RTE 31 80% FEDERAL 20% LOCAL 0021	SIGNALS - GREEN ST 80% FEDERAL 20% LOCAL 0021	SIGNALS - INTERCONNECT 80% FEDERAL 20% LOCAL 0021	LIGHTING 80% FEDERAL 20% LOCAL 0021	LOCAL 0% FEDERAL 100% LOCAL 0043
X7040125 PINNING TEMPORARY CONCRETE BARRIER	EACH		2,718						
X7280105 TELESCOPING STEEL SIGN SUPPORT (SPECIAL)	FOOT		1,500						
X7830060 GROOVING FOR RECESSED PAVEMENT MARKING, LETTERS AND SYMBOLS		1,475	1,475						
X7830070 GROOVING FOR RECESSED PAVEMENT MARKING 5"		18,925	18,925						
X7830074 GROOVING FOR RECESSED PAVEMENT MARKING 7"	FOOT		6,530						
X7830076 GROOVING FOR RECESSED PAVEMENT MARKING 9"	FOOT		95						
X7830078 GROOVING FOR RECESSED PAVEMENT MARKING 13"	FOOT		1,360						
X7830090 GROOVING FOR RECESSED PAVEMENT MARKING 25"	FOOT	460	460						
X8570226 FULL-ACTUATED CONTROLLER AND TYPE IV CABINET, SPECIAL	EACH	2			1	1			
X8620200 UNINTERRUPTABLE POWER SUPPLY, SPECIAL	EACH	2			1	1			
X8710024 FIBER OPTIC CABLE IN CONDUIT, NO. 62.5/125, MM12F SM24F	FOOT	2,550					2,550		
XX004907 GATE VALVE 12" WITH VAULT, 5" DIAMETER	EACH	11							1
XX005230 VIDEO DETECTION SYSTEM COMPLETE INTERSECTION	L SUM	1				1			
XX006852 EXPLORATION TRENCH, SPECIAL	CU YD	100	100						
XX008698 WET REFLECTIVE PREFORMED PLASTIC MARKINGS-LETTERS AND SYMBOLS	SQ FT	1,475							1,475
XX008699 WET REFLECTIVE PREFORMED PLASTIC MARKINGS, 4 INCH	FOOT	18,925							18,925
XX008700 WET REFLECTIVE PREFORMED PLASTIC MARKINGS, 6 INCH	FOOT	6,530							6,530
XX008701 WET REFLECTIVE PREFORMED PLASTIC MARKINGS, 8 INCH	FOOT	95							95
XX008702 WET REFLECTIVE PREFORMED PLASTIC MARKINGS, 12 INCH	FOOT	1,360							1,360
XX008703 WET REFLECTIVE PREFORMED PLASTIC MARKINGS, 24 INCH	FOOT	460							460
Z0013302 SEGMENTAL CONCRETE BLOCK WALL	SQ FT	50	50						
Z0013798 CONSTRUCTION LAYOUT	L SUM	1	1						
Z0018400 DRAINAGE STRUCTURES TO BE ADJUSTED	EACH	20	20						
Z0018600 DRAINAGE STRUCTURES TO BE RECONSTRUCTED	EACH	2	2						
Z0022800 FENCE REMOVAL	FOOT	71	71				~		
Z0030850 TEMPORARY INFORMATION SIGNING	SQ FT	870	870						
Z0033046 RE-OPTIMIZE TRAFFIC SIGNAL SYSTEM LEVEL 2	EACH	1			F 15-		1		
Z0034105 MATERIAL TRANSFER DEVICE	TON	2,767							2,767
ZOO48665 RAILROAD PROTECTIVE LIABILITY INSURANCE	L SUM	1	1						2,101
Z0056608 STORM SEWER (WATER MAIN REQUIREMENTS) 12 INCH	FOOT		930						
Z0056612 STORM SEWER (WATER MAIN REQUIREMENTS) 18 INCH	FOOT		231						
Z0056616 STORM SEWER (WATER MAIN REQUIREMENTS) 24 INCH	FOOT		633						
Z0062456 TEMPORARY PAVEMENT		10,104	10,104						
Z0066400 STABILIZED DRIVEWAYS 6"		758	758						
Z0066600 STABILIZED DRIVEWAYS 8"		2,403	2,403						
Z0073510 TEMPORARY TRAFFIC SIGNAL TIMING	EACH		2,103			,			
Z0076600 TRAINEES		1,500				1			
Z0076604 TRAINEES TRAINING PROGRAM GRADUATE									
TAUURAN WANDUNG PRODUNG PRODUCTS	HOUR	1,500							

* SPECIALTY ITEM
X CONSTRUCTION TYPE CODE 0042




com	Г
nal Design Firm	L
	Г
	H
	ı

USER NAME = tyelton	DESIGNED - JPA	REVISED -	8.0
FILE NAME = 090071-sum.dgn	DRAWN - SVJ	REVISED -	
PLOT SCALE = N.T.S.	CHECKED - JLP	REVISED -	
PLOT DATE = 12/4/2014	DATE - 12/5/1	4 REVISED -	

		5	SUN	M	ARY	OF QU	ANTIT	IES
CHA	ARLES .	J. MI	LLE	R	ROA	D ROA	DWAY	IMPROVEMENTS
SCALE: N.T.S.	SHEE	T NO.	7	0F	7	SHEETS	STA.	TO STA.

F.A.U. RTE. 3860	SECTION 09-00372-01-PW		TOTAL	-
3000	09-00312-01-PW	MCHENRY	358	10
		CONTRACT	NO.	63892

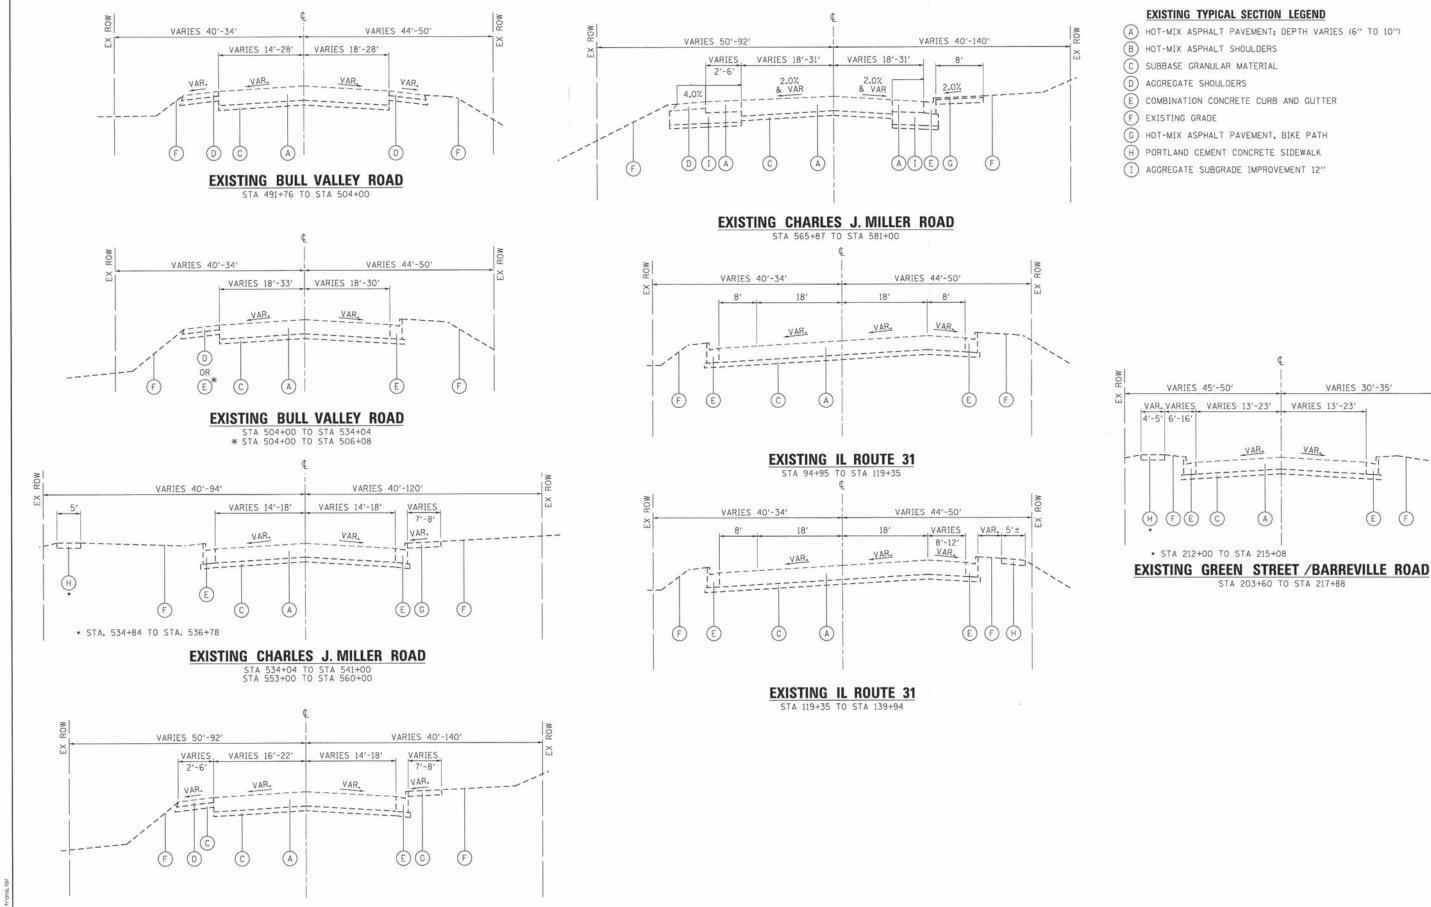

HRGreen.com

JSER NAME = tyelton DESIGNED - JPA REVISED SVJ REVISED FILE NAME = 090071-typ-01.dgn DRAWN PLOT SCALE = N.T.S. CHECKED - JLP REVISED

EXISTING CHARLES J. MILLER ROAD STA 541+00 TO STA 553+00 STA 560+00 TO STA 565+87

> STATE OF ILLINOIS **DEPARTMENT OF TRANSPORTATION**

EXISTING TYPICAL SECTIONS CHARLES J. MILLER ROAD ROADWAY IMPROVEMENTS SCALE: N.T.S. | SHEET NO. 1 OF 7 SHEETS | STA.

SECTION 09-00372-01-PW MCHENRY 358 CONTRACT NO. 63892

VARIES 30'-35'


E

VAR.

VARIES 40'-34' VARIES 44'-50' VARIES 18'-33' VARIES 18'-28' VAR. 12


PROPOSED BULL VALLEY ROAD

- STA 491+76 TO STA 514+25 STA 504+00 TO STA 506+80 •• STA 503+90 TO STA 514+25

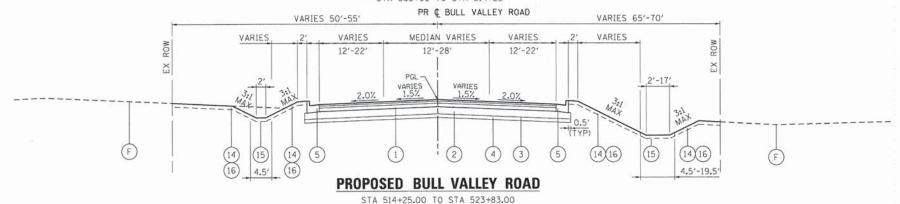

PR & BULL VALLEY ROAD VARIES 63'-111' VARIES 69'-101' VARIES 55'-70' VARIES 65'-85' VARIES 2'-12' 22'-33' VARIES 22' 0'-11' 2'-12' LANE LANE PGL LT--PGL RT 2.0% (TYP (14)(16) (14)(16) (15) (14)(16) (15)

> PROPOSED BULL VALLEY ROAD STA 523+83.00 TO STA 532+60.00

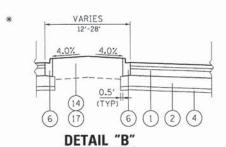

4.5'

*GRASS MEDIAN STA 523+83 TO STA 528+43

STRUCTURAL D	ESIGN TRAFFIC	:	YEAR:	202	2	
	PV =	23,232	SU =	1,848	MU =	1,320
ROAD/STREET	CLASSIFICATIO	N:	URBAN MINOR	ART.	CLASS	I
PERCENT OF S	TRUCTURAL DES	SIGN TRAF	FIC IN DESIGN L	ANE:		
	P =	88%	S =	7%	M =	5%
TRAFFIC FACT	OR:		ACTUAL TF =	7.96	AC TYPE =	20
			MINIMUM TF	3.56	T S	
PG GRADE:	BINDER =	64-28	Allega Market Color Color	SURFACE =	64-28	
SUBGRADE SUF	PPORT RATING:			-		
	SSR =	POOR	(STA.	514+25.00	TO	594+61.34
	SSR =	POOR	(STA.	601+16.01	TO	606+03.80

4.5'-15'

*THE UNIT WEIGHT TO CALCULATE ALL HMA SURFACE MIXTURE QUATITIES IS 112 LBS/SQ YD/IN THE "AC TYPE" FOR POLYMERIZED HMA MIXES SHALL BE "SBS/SBR PG 76-22" AND FOR NON-POLYMERIZED HMA THE "AC TYPE" SHALL BE "PG 64-22" UNLESS MODIFIED BY DISTRICT ONE SPECIAL PROVISIONS. FOR HMA FULL DEPTH "AC TYPE" SEE SPECIAL PROVISIONS. FOR USE OF RECYCLED MATERIALS SEE SPECIAL PROVISIONS.

. NOTE: CONTRACTOR SHALL MILL BEFORE PATCHING

PROPOSED TYPICAL SECTION LEGEND

- HOT-MIX ASPHALT PAVEMENT (FULL-DEPTH), 14"
- AGGREGATE SUBGRADE IMPROVEMENT, 12" (SQ YD)
- GEOTECHNICAL FABRIC FOR GROUND STABILIZATION (AS DETERMINED BY THE ENGINEER DURING CONSTRUCTION)
- AGGREGRATE SUBGRADE IMPROVEMENT (CU YD) (AS DETERMINED BY THE ENGINEER DURING CONSTRUCTION)
- (5) COMBINATION CONCRETE CURB AND GUTTER, TYPE B-6.24
- (6) COMBINATION CONCRETE CURB AND GUTTER, TYPE B-6.12
 - PORTLAND CEMENT CONCRETE PAVEMENT 9 3/4" (JOINTED)
- (8) CONCRETE MEDIAN, TYPE SB-6.12
- 9) HOT-MIX ASPHALT SURFACE COURSE, MIX "D", N50, 2"
- (10) HOT-MIX ASPHALT BINDER COURSE, IL 19.0, N50, 4"
- (11) SUB-BASE GRANULAR MATERIAL, TYPE B 6"
- (12) POLYMERIZED HOT-MIX ASPHALT SURFACE, MIX "F", N90, 2"
- (13) POLYMERIZED LEVELING BINDER (MACHINE METHOD), IL-4.75, N50, 2 1/4"
- (14) SEEDING, CLASS 2A
- (15) SODDING, SALT TOLERANT
- (16) TOPSOIL FURNISH AND PLACE, 4"
- (17) TOPSOIL, FURNISH AND PLACE, 24"
- (18) PORTLAND CEMENT CONCRETE SIDEWALK, 5"
- (19) AGGREGATE SHOULDERS, TYPE B 6"
- (20) STEEL PLATE BEAM GUARDRAIL, TYPE A
- (21) HOT-MIX ASPHALT PAVEMENT (FULL-DEPTH), 8"
- (22) SEEDING, CLASS 4A

EXISTING TYPICAL SECTION LEGEND

- (A) HOT-MIX ASPHALT PAVEMENT; DEPTH VARIES (6" TO 10")
- B) HOT-MIX ASPHALT SHOULDERS
- (C) SUBBASE GRANULAR MATERIAL
- (D) AGGREGATE SHOULDERS
- (E) COMBINATION CONCRETE CURB AND GUTTER
- (F) EXISTING GRADE
- (G) HOT-MIX ASPHALT PAVEMENT, BIKE PATH
- (H) PORTLAND CEMENT CONCRETE SIDEWALK
- (I) AGGREGATE SUBGRADE IMPROVEMENT 12"

HOT-MIX ASPHALT MIXTURE REQUIREMENTS	HOT-MIX ASPHALT MIXTURE REQUIREMENTS							
MIXTURE TYPE	AIR VOIDS							
FULL DEPTH PAVEMENT - BULL VALLEY/CHARLES J. MILLER ROAD								
POLYMERIZED HMA SURFACE COURSE, MIX "F", N90 (IL 9.5mm); 2"	4% @ 90 GYR.							
POLYMERIZED HMA BINDER COURSE, IL-19.0, N90; 2 1/2"	4% @ 90 GYR.							
HMA BASE COURSE (HMA BINDER IL-19 mm); 9 1/2" (3 LIFTS)	4% @ 90 GYR.							
FULL DEPTH PAVEMENT - BULL VALLEY ROAD								
HMA SURFACE COURSE, MIX "D", N50 (IL-9.5mm); 2"	4% @ 50 GYR.							
HMA BASE COURSE (HMA BINDER IL-19 mm); 6" (2 LIFTS)	4% @ 50 GYR.							
RESURFACING								
POLYMERIZED HMA SURFACE COURSE, MIX "F", N90 (IL-9.5mm); 2"	4% @ 90 GYR.							
POLYMERIZED LEVELING BINDER (MACHINE METHOD), IL-4.75, N50	3.5% @ 50 GYF							
DRIVEWAYS								
HMA SURFACE COURSE, MIX "D", N50 (IL-9.5mm); 2"	4% @ 50 GYR.							
HMA BASE COURSE (HMA BINDER IL-19 mm); PE - 6", CE - 8" (3 LIFTS)	4% @ 50 GYR.							
SHOULDERS								
HMA SHOULDER (HMA BINDER IL-19 mm); 8" (3 LIFTS)	4% @ 50 GYR.							
SHARED-USE PATH								
HMA SURFACE COURSE, MIX "D", N50 (IL 9.5mm); 2"	4% @ 50 GYR.							
HMA BINDER COURSE, IL-19.0, N50, 4"	4% @ 50 GYR.							
TEMPORARY PAVEMENT								
HMA SURFACE COURSE, MIX "D", N50 (IL 9.5mm); 2"	4% @ 50 GYR.							
TEMP PAVEMENT (HMA BINDER IL-19mm); 6"	4% @ 50 GYR.							
PATCHING								
CLASS D PATCH (HMA BINDER IL-19 mm)	4% @ 70 GYR.							


COUNTY TOTAL SHEET NO. MCHENRY 358 12

CONTRACT NO. 63892

HRGreen

USER NAME = tyelton	DESIGNED -	JPA	REVISED -	
FILE NAME = 090071-typ-02.dgn	DRAWN -	SVJ	REVISED -	27.25
PLOT SCALE = N.T.S.	CHECKED -	JLP	REVISED -	
PLOT DATE = 11/11/2014	DATE -	11/12/14	REVISED -	

	PROPOSED T	YPICAL SECTIONS	}	F.A.U. RTE.	SEC	CTION	COUNTY
CHV	RLES J. MILLER ROA		3860	09-003	72-01-PW	MCHENRY	
UIIA	IIILLO O. WIILLEII IIOA	D HOADWAT IIVII	HOVEINIEITO				CONTRA
ALE: N.T.S.	SHEET NO. 2 OF 7	SHEETS STA.	TO STA.	FED. ROAD	DIST. NO.	ILLINOIS FED.	AID PROJECT

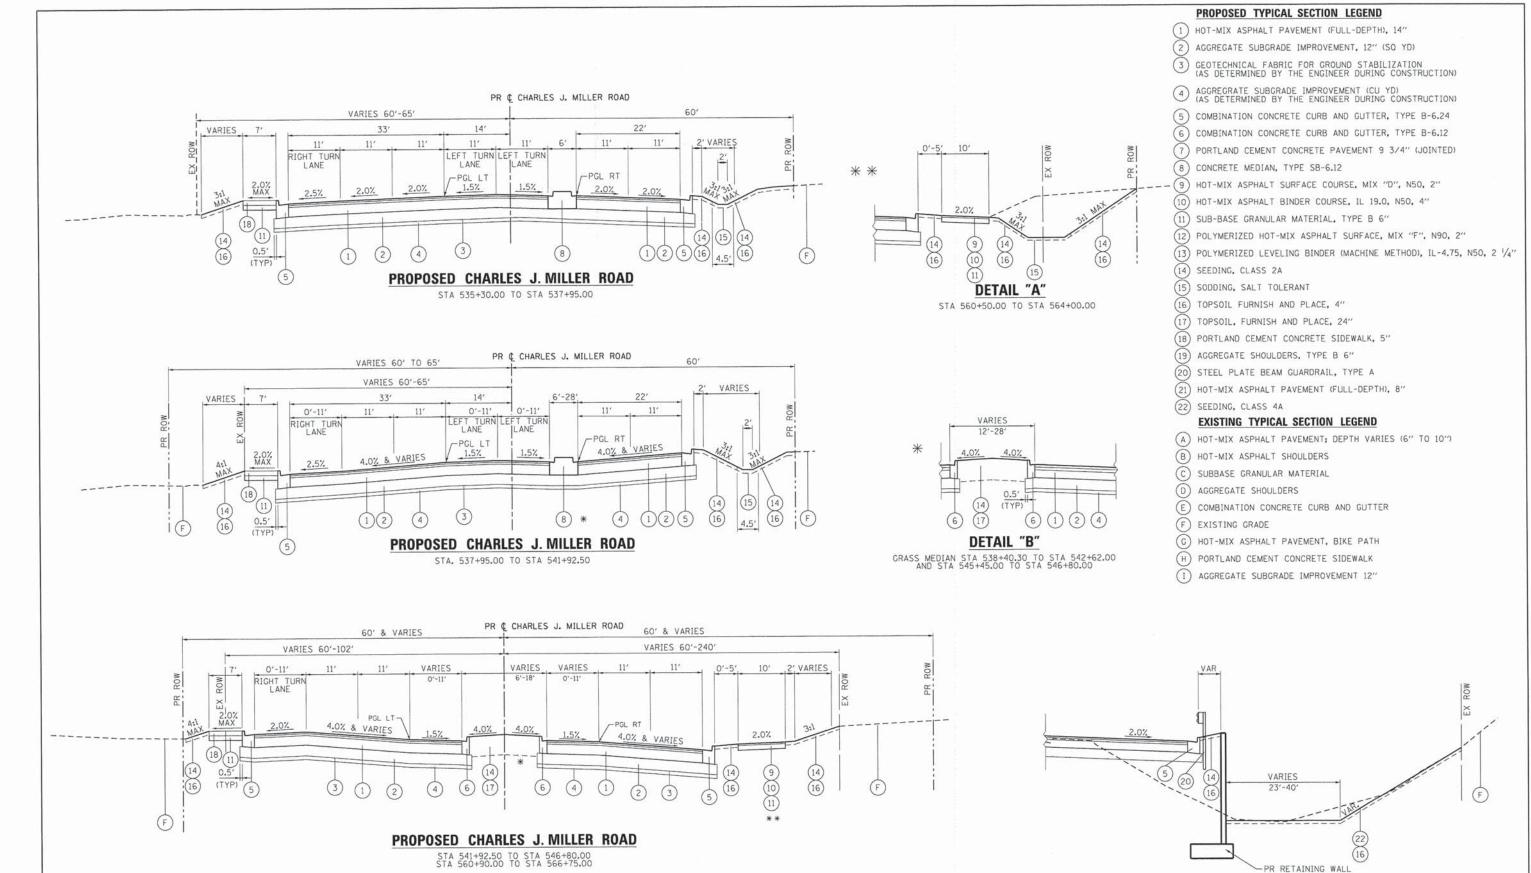

HRGreen

JPA REVISED DESIGNED -JSER NAME = tyelton REVISED DRAWN SVJ FILE NAME = 090071-tup-03.dgr CHECKED JII P REVISED REVISED PLOT DATE = 11/11/2014

• CONCRETE MEDIAN, TYPE SB-6.12; STA 543+55 TO STA 545+45; STA 562+78 TO STA 564+94

STATE OF ILLINOIS **DEPARTMENT OF TRANSPORTATION**

PROPOSED TYPICAL SECTIONS CHARLES J. MILLER ROAD ROADWAY IMPROVEMENTS


RETAINING WALL DETAIL STA 544+25.00 TO STA 551+20.90

> COUNTY TOTAL SHEET NO. SECTION MCHENRY 09-00372-01-PW

(SEE STRUCTURE PLANS)

SHEET NO. 3 OF 7 SHEETS STA. SCALE: N.T.S.

CONTRACT NO. 63892 FED. ROAD DIST. NO. | ILLINOIS FED. AID PROJECT

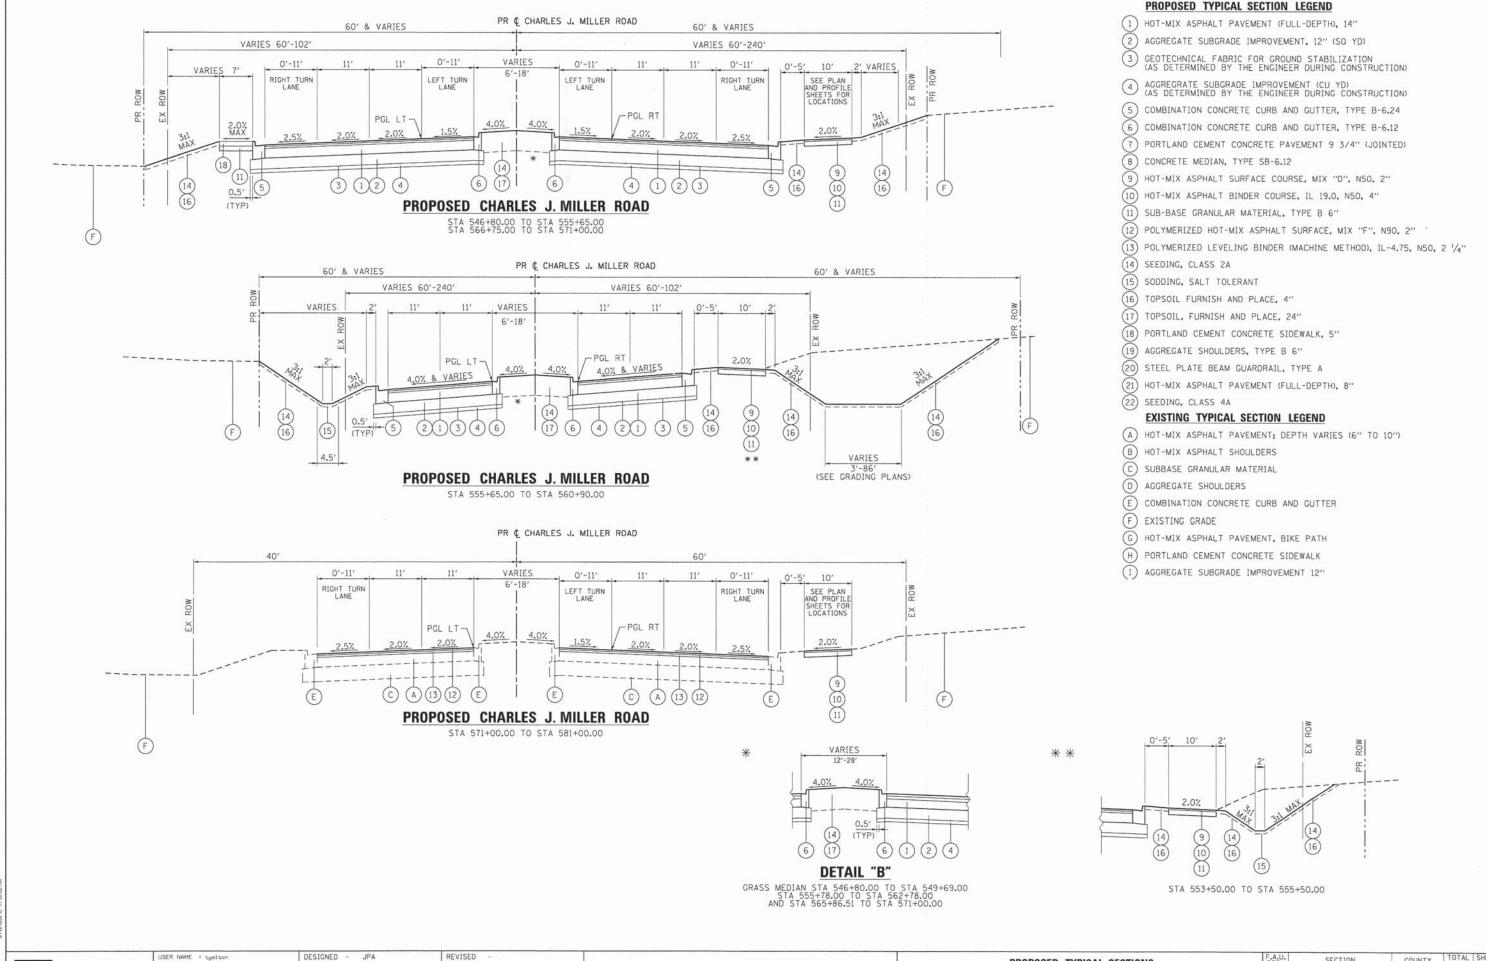

NAT.

E PLOTTED: 11/71/2014 10

NAME: 090071-179-0


T DRIVER: pdf.pft

TABLE: sfandord-17

HRGreen.com
Illinois Professional Design Firm
#184-001322


STATE OF ILLINOIS
DEPARTMENT OF TRANSPORTATION


PROPOSED TYPICAL SECTIONS
CHARLES J. MILLER ROAD ROADWAY IMPROVEMENTS
S. SHEET NO. 4 OF 7 SHEETS STA. TO STA.

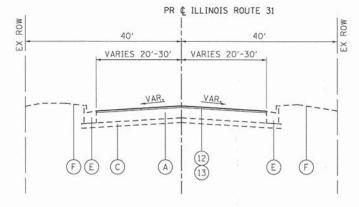

PROPOSED IL ROUTE 31

STA 94+95 TO STA 99+25 STA 136+76 TO STA 139+94

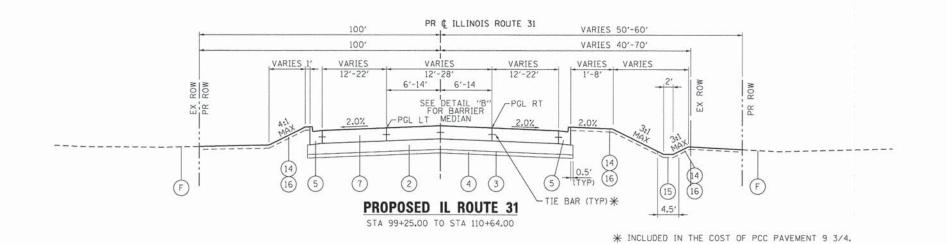

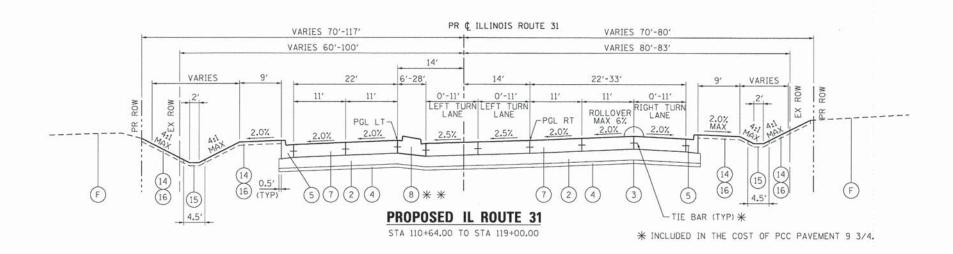


PROPOSED TYPICAL SECTION LEGEND

- (1) HOT-MIX ASPHALT PAVEMENT (FULL-DEPTH), 14"
- AGGREGATE SUBGRADE IMPROVEMENT, 12" (SO YD)
- GEOTECHNICAL FABRIC FOR GROUND STABILIZATION (AS DETERMINED BY THE ENGINEER DURING CONSTRUCTION)
- 4 AGGREGRATE SUBGRADE IMPROVEMENT (CU YD)
 (AS DETERMINED BY THE ENGINEER DURING CONSTRUCTION)
- (5) COMBINATION CONCRETE CURB AND GUTTER, TYPE B-6.24
- (6) COMBINATION CONCRETE CURB AND GUTTER, TYPE B-6.12
- 7) PORTLAND CEMENT CONCRETE PAVEMENT 9 3/4" (JOINTED)
- (8) CONCRETE MEDIAN, TYPE SB-6.12
- (9) HOT-MIX ASPHALT SURFACE COURSE, MIX "D", N50, 2"
- (10) HOT-MIX ASPHALT BINDER COURSE, IL 19.0, N50, 4"
- (11) SUB-BASE GRANULAR MATERIAL, TYPE B 6"
- (12) POLYMERIZED HOT-MIX ASPHALT SURFACE, MIX "F", N90, 2"
- (13) POLYMERIZED LEVELING BINDER (MACHINE METHOD), IL-4.75, N50, 2 1/4"
- (14) SEEDING, CLASS 2A
- (15) SODDING, SALT TOLERANT
- (16) TOPSOIL FURNISH AND PLACE, 4"
- (17) TOPSOIL, FURNISH AND PLACE, 24"
- (18) PORTLAND CEMENT CONCRETE SIDEWALK, 5"
- (19) AGGREGATE SHOULDERS, TYPE B 6"
- (20) STEEL PLATE BEAM GUARDRAIL, TYPE A
- (21) HOT-MIX ASPHALT PAVEMENT (FULL-DEPTH), 8"
- (22) SEEDING, CLASS 4A

EXISTING TYPICAL SECTION LEGEND

- (A) HOT-MIX ASPHALT PAVEMENT; DEPTH VARIES (6" TO 10")
- (B) HOT-MIX ASPHALT SHOULDERS
- C) SUBBASE GRANULAR MATERIAL
- D AGGREGATE SHOULDERS
- (E) COMBINATION CONCRETE CURB AND GUTTER
- (F) EXISTING GRADE
- (G) HOT-MIX ASPHALT PAVEMENT, BIKE PATH
- (H) PORTLAND CEMENT CONCRETE SIDEWALK
- (I) AGGREGATE SUBGRADE IMPROVEMENT 12"

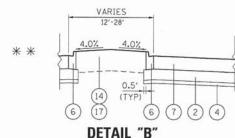

GRASS MEDIAN STA 107+33 TO STA 114+24

TO STA.

HRGreen

USER NAME = tyelton	DESIGNED	-	JPA	REVISED -
FILE NAME = 090071-typ-05.dgn	DRAWN	•	SVJ	REVISED -
PLOT SCALE # N.T.S.	CHECKED		JLP	REVISED -
PLOT DATE = 11/11/2014	DATE	-	11/12/14	REVISED -


STATE OF ILLINOIS **DEPARTMENT OF TRANSPORTATION**

	PROPOS	ED TY	PICAL SECT	TONS
ARLES	J. MILLER	ROAD	ROADWAY	IMPROVEMENTS


SHEET NO. 5 OF 7 SHEETS STA.

SCALE: N.T.S.

F.A.U. RTE.	RTE. SECTION				TOTAL	SHE	
3860	09-003	72-01-PV	1	MCHENRY	358	15	
				CONTRACT	NO.	6389	
FED. ROAD	DIST. NO.	ILLINOIS	FED. AID	PROJECT			

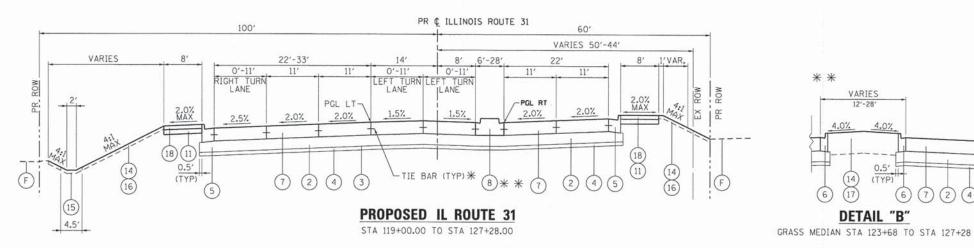

* INCLUDED IN THE COST OF PCC PAVEMENT 9 3/4.

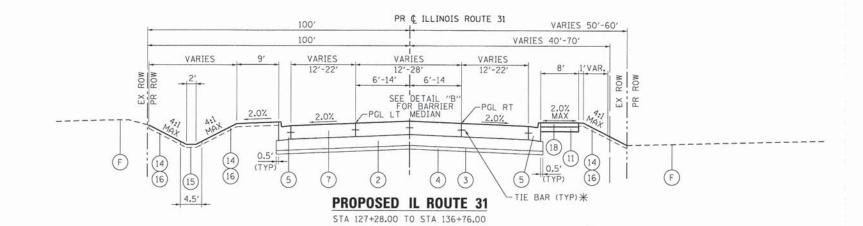

PROPOSED TYPICAL SECTION LEGEND

HOT-MIX ASPHALT PAVEMENT (FULL-DEPTH), 14"

AGGREGATE SUBGRADE IMPROVEMENT, 12" (SQ YD)

GEOTECHNICAL FABRIC FOR GROUND STABILIZATION (AS DETERMINED BY THE ENGINEER DURING CONSTRUCTION)

4 AGGREGRATE SUBGRADE IMPROVEMENT (CU YD)
(AS DETERMINED BY THE ENGINEER DURING CONSTRUCTION)

(5) COMBINATION CONCRETE CURB AND GUTTER, TYPE B-6.24

(6) COMBINATION CONCRETE CURB AND GUTTER, TYPE B-6.12

7) PORTLAND CEMENT CONCRETE PAVEMENT 9 3/4" (JOINTED)

(8) CONCRETE MEDIAN, TYPE SB-6.12

(9) HOT-MIX ASPHALT SURFACE COURSE, MIX "D", N50, 2"

(10) HOT-MIX ASPHALT BINDER COURSE, IL 19.0, N50, 4"

(11) SUB-BASE GRANULAR MATERIAL, TYPE B 6"

(12) POLYMERIZED HOT-MIX ASPHALT SURFACE, MIX "F". N90, 2"

(13) POLYMERIZED LEVELING BINDER (MACHINE METHOD), IL-4.75, N50, 2 1/4"

(14) SEEDING, CLASS 2A

VARIES

12'-28'

(14)

(TYP)

DETAIL "B"

(15) SODDING, SALT TOLERANT

(16) TOPSOIL FURNISH AND PLACE, 4"

TOPSOIL, FURNISH AND PLACE, 24"

(18) PORTLAND CEMENT CONCRETE SIDEWALK, 5"

(19) AGGREGATE SHOULDERS, TYPE B 6"

(20) STEEL PLATE BEAM GUARDRAIL, TYPE A

(21) HOT-MIX ASPHALT PAVEMENT (FULL-DEPTH), 8"

(22) SEEDING, CLASS 4A

EXISTING TYPICAL SECTION LEGEND

(A) HOT-MIX ASPHALT PAVEMENT; DEPTH VARIES (6" TO 10")

(B) HOT-MIX ASPHALT SHOULDERS

SUBBASE GRANULAR MATERIAL

AGGREGATE SHOULDERS

(E) COMBINATION CONCRETE CURB AND GUTTER

(F) EXISTING GRADE


(G) HOT-MIX ASPHALT PAVEMENT, BIKE PATH

(H) PORTLAND CEMENT CONCRETE SIDEWALK

AGGREGATE SUBGRADE IMPROVEMENT 12"




* INCLUDED IN THE COST OF PCC PAVEMENT 9 3/4.

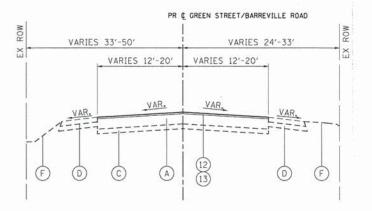


PROPOSED GREEN STREET /BARREVILLE ROAD

STA 204+00 TO STA 205+55 STA 215+08 TO STA 217+88

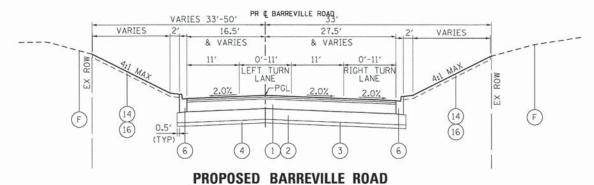

STA 205+55.00 TO STA 211+00.00

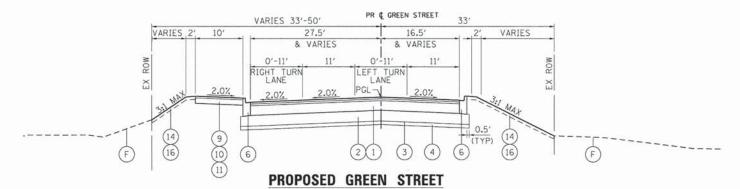


STA 211+00.00 TO STA 215+08.00

PROPOSED TYPICAL SECTION LEGEND

- 1) HOT-MIX ASPHALT PAVEMENT (FULL-DEPTH), 14"
- 2 AGGREGATE SUBGRADE IMPROVEMENT, 12" (SO YD)
- GEOTECHNICAL FABRIC FOR GROUND STABILIZATION (AS DETERMINED BY THE ENGINEER DURING CONSTRUCTION)
- 4 AGGREGRATE SUBGRADE IMPROVEMENT (CU YD)
 (AS DETERMINED BY THE ENGINEER DURING CONSTRUCTION)
- (5) COMBINATION CONCRETE CURB AND GUTTER, TYPE B-6.24
- (6) COMBINATION CONCRETE CURB AND GUTTER, TYPE B-6.12
- 7) PORTLAND CEMENT CONCRETE PAVEMENT 9 3/4" (JOINTED)
- (8) CONCRETE MEDIAN, TYPE SB-6.12
- (9) HOT-MIX ASPHALT SURFACE COURSE, MIX "D", N50, 2"
- (10) HOT-MIX ASPHALT BINDER COURSE, IL 19.0, N50, 4"
- (11) SUB-BASE GRANULAR MATERIAL, TYPE B 6"
- (12) POLYMERIZED HOT-MIX ASPHALT SURFACE, MIX "F", N90, 2"
- (13) POLYMERIZED LEVELING BINDER (MACHINE METHOD), IL-4.75, N50, 2 1/4"
- (14) SEEDING, CLASS 2A
- (15) SODDING, SALT TOLERANT
- (16) TOPSOIL FURNISH AND PLACE, 4"
- (17) TOPSOIL, FURNISH AND PLACE, 24"
- (18) PORTLAND CEMENT CONCRETE SIDEWALK, 5"
- (19) AGGREGATE SHOULDERS, TYPE B 6"
- (20) STEEL PLATE BEAM GUARDRAIL, TYPE A
- (21) HOT-MIX ASPHALT PAVEMENT (FULL-DEPTH), 8"
- (22) SEEDING, CLASS 4A

EXISTING TYPICAL SECTION LEGEND

- (A) HOT-MIX ASPHALT PAVEMENT; DEPTH VARIES (6" TO 10")
- (B) HOT-MIX ASPHALT SHOULDERS
- (C) SUBBASE GRANULAR MATERIAL
- (D) AGGREGATE SHOULDERS
- (E) COMBINATION CONCRETE CURB AND GUTTER
- (F) EXISTING GRADE
- G HOT-MIX ASPHALT PAVEMENT, BIKE PATH
- (H) PORTLAND CEMENT CONCRETE SIDEWALK
- I AGGREGATE SUBGRADE IMPROVEMENT 12"

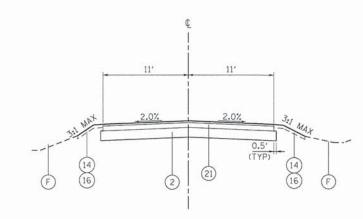

PROPOSED BULL VALLEY ROAD

CHARLES J. MILLER ROAD STA 544+25 TO STA 550+90 RT

11/11/2014 10:23:51 AM 090071-typ-07.dgn pdf.plt standard-trans.tbl

PROJECT CONTACT:
PROJECT CONTACT:
CLENT:
DATE PLOTTED: 11/
FILE NAME: 09
PLOT ORNVER: po

HRGreer

ı	HRGreen.com
ı	Illinois Professional Design Firm # 184-001322
1	

USER NAME = tyelton	DESIGNED - JPA	REVISED -	
FILE NAME = 090071-typ-07.dgn	DRAWN - SVJ	REVISED -	
PLOT SCALE = N.T.S.	CHECKED - JLP	REVISED -	
PLOT DATE = 11/11/2014	DATE - 11/12/14	REVISED -	

PROPOSED TYPICAL SECTIONS								
CHA	ARLES J	. MI	LLE	R	ROA	D ROA	DWAY	IMPROVEMENTS
SCALE: N.T.S.	SHEET	NO.	7	OF	7	SHEETS	STA.	TO STA.

	F.A.U. RTE.	SEC	CTION	COUNTY	TOTAL	SHEET NO.
	3860	09-003	72-01-PW	MCHENRY	358	17
_			we constituted	CONTRACT	NO.	63892
	FED. ROAD	DIST. NO.	ILLINOIS FED.	AID PROJECT		-0

EARTHWORK - CHARLES J. MILLER ROAD

PMILL		STAGE 1	(CU YD)			STAGE 2	(CU YD)			STAGE 3	(CU YD)		EARTHWORK BALAN	NCE WASTE (+) OR SHO SHRINKAGE	RTAGE (-) WITH 15%
STATION	REMOVAL AND DISPOSAL OF UNSUITABLE MATERIAL	EARTH EXCAVATION	EMBANKMENT	AGGREGATE SUBGRADE IMPROVEMENT	REMOVAL AND DISPOSAL OF UNSUITABLE MATERIAL	EARTH EXCAVATION	EMBANKMENT	AGGREGATE SUBGRADE IMPROVEMENT	REMOVAL AND DISPOSAL OF UNSUITABLE MATERIAL	EARTH EXCAVATION	EMBANKMENT	AGGREGATE SUBGRADE IMPROVEMENT	PRE-STAGE 1	STAGE 2	STAGE 3
514+25.00									1				0.0	0.0	0.0
514+50.00	2.8	29.9	0.7	0.0	4.7	18.9	1.3	0.0	0.0	16.0	0.0	0.0	24.6	14.7	13.6
515+00.00	7.7	61.9	2.7	0.0	16.9	43.3	2.5	0.0	0.0	30.3	0.0	0.0	50.0	34.3	25.7
515+13.67	2.1	18.3	0.5	0.0	12.0	12.9	0.3	0.0	0.0	7.6	0.0	0.0	15.0	10.6	6.5
515+50.00	12.3	56.7	0.9	7.9	52.9	60.4	2.7	5.8	3.8	25.1	0.0	3,8	47.3	48.7	21.3
516+00.00	43.3	99.4	4.4	21.8	66.9	95.4	16.8	16.2	10.5	41.6	0.0	10.5	80.0	64.3	35.3
516+38.40	47.7	85.3	4.7	16.6	47.6	56.5	12.8	12.9	8.1	35.2	0.0	8.1	67.8	35.2	29.9
516+50.00	15.2	25.6	1.4	5.0	11.5	17.1	1.1	4.0	2.4	10.6	0.0	2.4	20.3	13.5	9.0
517+00.00	63.6	112.8	9.2	21.6	40.4	88.0	6.6	17.6	10.6	45.4	0.0	10.6	86.7	68.2	38.6
517+43.17	54.8	108.6	11.6	18.5	52.1	80.4	5.8	15.8	9.2	39.7	0.0	9.2	80.8	62.6	33.7
517+50.00	8.9	18.3	2.4	3.0	9.8	11.7	0.4	2.6	1.5	5.9	0.0	1.5	13.1	9.6	5.0
518+00.00	90.0	155.1	11.9	23.4	60.1	85.5	4.4	19.1	10.7	42.1	0.0	10.7	120.0	68.2	35.8
518+50.00	115.1	159.6	11.4	26.5	55.6	89.1	10.1	19.8	10.7	39.7	0.0	10.7	124.3	65.6	33.8
518+69.35	38.6	48.9	7.5	5.4	25.9	36.7	3.1	3.9	2.1	12.9	0.0	2.1	34.1	28.0	11.0
519+00.00	54.3	70.6	16.4	0.0	35.8	56.3	3.3	0.0	0.0	17.4	0.0	0.0	43.6	44.5	14.8
519+50.00	90.6	123.3	27.8	0.0	58.5	93.4	5.2	0.0	0.0	28.9	0.0	0.0	77.1	74.2	24.6
520+00.00	87.2	127.9	21.5	0.0	70.5	99.4	1.3	0.0	0.0	29.6	0.0	0.0	87.2	83,2	25.2
520+05.69	9.6	14.3	2.5	0.0	8.0	11.3	0.1	0.0	0.0	3.4	0.0	0.0	9.7	9,5	2.9
520+50.00	71.2	119.9	12.9	0.0	55.6	87.2	3.2	0.0	0.0	27.2	0.0	0,0	89.0	70.9	23.2
521+00.00	65.1	123.7	3.4	0.0	48.5	94.9	4.3	0.0	0.0	32.3	0.0	0.0	101.7	76.4	27.5
521+14.83	29.8	34.7	0.3	0.0	12.9	26.9	1.2	0.0	0.0	10.1	0.0	0.0	29.2	21.7	8.6
521+50.00	63.6	85.4	1.8	0.0	39.7	69.4	6.8	0.0	0.0	26.8	0.0	0.0	70.8	52.2	22.8
521+63.81	9.6	26.6	1.3	0.0	19.4	30.9	2.5	0.0	0.0	11.6	0.0	0.0	21.3	23.8	9.9
522+00.00	30.0	59.7	4.6	0.0	49.7	80.0	2.7	0.0	0.0	32.8	0.0	0.0	46.1	65.3	27.9
522+50.00	78.1	98.6	16.8	0.0	64.1	122.5	3.4	0.0	0.0	51.4	0.0	0.0	67.1	100.7	43.7
523+00.00	114.0	156.9	25.7	0.0	58.1	142.8	2.4	0.0	0.0	62.6	0.0	0.0	107.6	119.0	53.2
523+50.00	117.8	197,5	32.0	0.0	53.2	125.3	3,1	0.0	0.0	80.0	0.0	0.0	135.8	103.4	68.0
524+00.00	119.4	195.4	35.6	0.0	57.0	120.2	2.5	0.0	0.0	114.4	0.0	0.0	130.5	99.7	97.3
524+50.00	121.6	208.0	28.0	0.0	59.9	120.6	1.9	0.0	0.0	140.4	0.0	0.0	148.8	100.5	119.3
525+00.00	123.4	218.9	23.5	0.0	57.1	92.8	3.4	0.0	0.0	141.6	0.0	0.0	162.5	75.4	120.3
525+50.00	125.2	224.5	21.2	0.0	53.0	65.9	19.7	0.0	0.0	131.7	0.0	0.0	169.7	36.3	111.9
526+00.00	125.6	241.1	12.6	0.0	53.3	62.3	39.4	0.0	0.0	114.2	0.1	0.0	192.4	13.5	96.9
526+12.78	32.3	65.1	1.6	0.0	14.6	18.5	5.9	0.0	30.9	22.8	23.9	0.0	53.7	9.8	-4.5
526+50.00	95.3	196,5	14.8	0.0	42.4	53.6	24.1	0.0	90.4	62.1	69.5	0.0	152.3	21.4	-16.7
527+00.00	137.8	261.4	21.2	11.5	65.6	82.2	49.3	11.8	9.4	95.5	0.0	7,5	201.0	20.6	81.1
527+50.00	138.9	214.1	9.5	23.5	76.4	97.2	27.6	23.5	20.6	98.9	0.0	16.4	172.4	55.0	84.1
528+00.00	123.0	138.1	12.0	25.2	75.4	108.0	29.1	23.5	25.9	108.5	0.0	19.4	105.3	62.7	92.2
528+50.00	117.5	108.3	9.2	27.5	73.2	114.7	35.2	23.5	32.1	111.0	0.0	23.5	82.9	62.3	94,4
529+00.00	120.1	111.1	3.0	29.8	74.4	118.1	25.2	23.5	36.4	106.9	0.0	25.9	91.5	75.2	90.8
529+50.00	121.2	107.9	3.8	32.0	76.3	122.2	19.3	23.5	37.9	99.8	0.0	25.9	87.9	84.6	84.8
530+00.00	123.1	112.9	9.8	33.2	76.1	118.8	19.0	23.5	39.1	92.6	0.0	25.8	86.1	82.0	78.7
530+50.00	125.0	145.4	8.7	33.2	73.5	118.3	21.6	23.5	40.2	98.6	0.0	25.8	114.9	79.0	83.8
531+00.00	135.4	208.3	2.8	41.4	73.5	123.9	20.2	29.4	47.3	105.4	0.0	32.4	174.3	85.1	89.6
531+50.00	145.9	266.6	1.4	49.6	76,6	121.6	15.6	35.2	53.7	108.6	0.0	39.0	225.2	87.8	92.3
532+00.00	149.2	308.8	1.4	49.7	78.1	115.6	20.0	37.4	49.9	97.8	0.0	39.0	261.1	78.3	83.1
532+50.00	151.4	312.2	2.8	49.8	95.4	116.4	32.1	43.8	42.6	71.1	0.0	38.9	262.6	66.8	60.4
532+73.00	68.5	123.3	1.3	23.0	51.9	49.3	19.3	22.9	17.9	23.4	0.0	17.9	103.5	22.6	19.9
533+00.00	81.9	131.6	2.3	28.4	60.3	49.0	22.7	27.9	21.0	21.9	0.0	21.0	109.5	19.0	18.6
533+50.00	215.5	194.0	79.0	55.8	142.4	91.8	54.2	63.8	38.9	36.6	0.0	38,9	85.9	23.8	31.1

090071-sch-01.dgn pdf.pit standard-trans,tbl

COMPAY NAME:
PROJECT CONTACT:
DATE PLOTTED: 11/11/2
FILE NAME: 090071
PLOT DRIVER: poff.pri
PEN TABLE: stond

HRGreen.com
#ilnois Professional Design Firm
#184-001322

USER NAME = tyelton	DESIGNED - JPA	REVISED -	
FILE NAME = 090071-sch-01.dgn	DRAWN - SVJ	REVISED -	
PLOT SCALE = N.T.S.	CHECKED - JLP	REVISED -	
PLOT DATE = 11/11/2014	DATE - 11/12/14	REVISED -	

	SCHEDULE OF QUANTITIES								
CHA	RLES .	J. MII	LLEF	RO	AD ROA	DWAY	IMPROVEMENTS		
SCALE: N.T.S.	SHEE	T NO.	1 (OF 8	SHEETS	STA.	TO STA.		

F.A.U. RTE.	SE	CTION		COUNTY	TOTAL	SHEET NO.
3860	09-003	72-01-PW		MCHENRY	358	18
				CONTRACT	NO.	63892
FED. ROAD	DIST. NO.	ILLINOIS F	FED. AID	PROJECT		

EARTHWORK - CHARLES J. MILLER ROAD (CONT.)

PMILL		STAGE 1	(CU YD)			STAGE 2	(CU YD)			STAGE 3	(CU YD)		EARTHWORK BALAN	NCE WASTE (+) OR SHO SHRINKAGE	RTAGE (-) WITH 15%
STATION	REMOVAL AND DISPOSAL OF UNSUITABLE MATERIAL	EARTH EXCAVATION	EMBANKMENT	AGGREGATE SUBGRADE IMPROVEMENT	REMOVAL AND DISPOSAL OF UNSUITABLE MATERIAL	EARTH EXCAVATION	EMBANKMENT	AGGREGATE SUBGRADE IMPROVEMENT	REMOVAL AND DISPOSAL OF UNSUITABLE MATERIAL	EARTH EXCAVATION	EMBANKMENT	AGGREGATE SUBGRADE IMPROVEMENT	PRE-STAGE 1	STAGE 2	STAGE 3
534+00.00	203.2	112.4	100.6	45.5	104.9	80.6	38.1	55.5	49.9	54.3	0.0	38.9	-5.1	30.3	46.1
534+50.00	151.3	301.2	60.4	62.0	121.4	129.4	69.7	45.7	49.9	102.3	0.0	38.9	195,7	40.3	87.0
535+00.00	151.4	324.7	39.8	70.4	144.9	228.6	70.3	57.3	38.9	141.2	0.0	38.9	236.2	124.0	120.0
535+25.00	64.5	63.3	2.6	25.6	39.1	118.0	3.6	27,2	22.6	71,3	0.0	19.4	51.2	96.7	60.6
535+50.00	63.0	61.5	1.6	24.6	39.1	98.6	6.3	25.3	25.9	63.8	0.0	19.4	50.7	77.4	54.2
536+00.00	124.6	135.4	3.1	42.9	82.5	173.1	23.0	50.6	50.7	113.1	0.0	38.8	112.0	124.2	96.1
536+50.00	118.5	109.2	7.3	36.7	82.7	159.1	21.5	50.5	49.1	103.0	0.0	38.9	85.5	113.7	87.5
537+00.00	110.6	79.0	7.9	34.6	82.7	156.0	19.7	50.5	48.9	95.7	0.0	38.9	59.3	112,9	81.4
537+50.00	98.9	102.1	3.2	34.5	83.2	157.0	17.9	50.6	50.4	96.0	0.0	38.9	83.6	115.6	81.6
537+89.70	71.3	95.7	2.4	27.3	93.7	118.5	7,9	39.0	40.3	79.1	0.0	30.9	78.9	92.8	67.2
538+00.00	18.5	25.7	0.6	7.1	31.4	28.3	2.1	9.8	10.3	20.3	0.0	8.0	21.2	21.9	17.3
538+50.00	72.9	112.1	2.5	17.2	89.4	106.7	11.9	23.5	31.6	88.4	0.0	19.4	92.8	78.8	75.2
538+81.28	39.2	52.7	3.4	0.0	16.0	46.8	6.6	0.0	8.2	49.4	0.0	0.0	41.4	33.2	41.9
539+00.00	24.2	25.0	2.0	0.0	12.8	28.6	2.9	0.0	3.5	30.1	0.0	0.0	19.2	21.5	25.6
539+21.97	30.0	30.4	1.6	0.0	22.2	28.9	4.7	0.0	4.6	34.2	0.0	0.0	24.3	19.9	29.1
539+50.00	39.7	34.5	8.1	0.0	29.1	28.0	14.2	0.0	4.5	43.9	0.0	0.0	21.2	9.6	37.3
540+00.00	65.1	72.1	16.7	0.0	64.3	48.6	36.9	0.0	0.0	85.7	0.0	0.0	44.6	4.4	72.9
540+50.00	67.0	152.1	5.9	0.0	66.1	40.4	22.4	0.0	0.0	89.2	0.0	0.0	123.4	11.9	75.8
541+00.00	58.1	186.9	2.3	0.0	75.9	33.4	20.7	0.0	0.0	90.3	0.0	0.0	156.5	7.7	76.7
541+50.00	36.2	155.1	2.1	0.0	97.0	25.5	49.4	0.0	1.9	89.1	0.6	0.0	129.7	-27.7	75.1
542+00.00	28.8	138.3	2.4	0.0	92.5	14.6	69.4	0.0	6.2	89.8	5.4	0.0	115.2	-57.0	71.0
542+50.00	20.8	130.6	2.8	0.0	93.9	10.6	80.9	0.0	8.4	77.8	4.7	0.0	108.2	-71.9	61.4
543+00.00	4.3	160.5	1.6	0.0	98.1	9.9	100.1	0.0	5.6	61.9	0.0	0.0	134.8	-91.7	52.7
543+35.00	0.6	196.6	0.2	0.0	69.9	10.4	104.5	0.0	1.0	45.6	0.0	0.0	166.9	-95.7	38.7
543+50.00	17.9	112.6	0.4	0.0	29.3	6.4	53.5	0.0	0.0	20.4	0.0	0.0	95.3	-48.1	17.4
544+00.00	59.5	225.0	1.7	0.0	90.6	31.0	172.8	0.0	0.0	60.7	0.0	0.0	189.6	-146.4	51.6
544+50.00	38.2	74.7	11.8	0.0	78.9	44.4	166.7	0.0	0.0	48.1	0.0	0.0	51.8	-129.0	40.9
545+00.00	81.0	67.9	38.7	0.0	66.6	52.2	141.4	0.0	0.0	35.7	0.0	0.0	19.0	- 97.0	30.4
545+50.00	118.5	66.5	69.6	0.0	50.0	58.5	92.4	0.0	0.0	30.6	0.9	0.0	-13.1	-42.7	25.0
546+00.00	132.1	92.7	88.6	0.0	33.5	64.3	47.6	0.0	0.0	30.5	2.0	0.0	-9.8	7.0	23.9
546+50.00	115.2	139.2	85.6	0.0	23.1	70.8	26.0	0.0	0.0	37.0	1.7	0.0	32.6	34.2	29.8
547+00.00	120.5	205.1	73.0	0.0	19.4	84.4	18.1	0.0	0.0	54.4	0.6	0.0	101.4	53.6	45.7
547+50.00	117.5	246.5	54.9	0.0	28.1	92.1	32.2	0.0	0.0	66.3	0.0	0.0	154,6	46.1	56.4
548+00.00	55.3	677.0	21.5	0.0	39.5	86.6	58.7	0.0	0.0	68.0	0.0	0.0	554.0	14.9	57.8
548+50.00	69.7	718.6	18.7	0.0	42.6	78.9	71.4	0.0	0.0	61.6	0.0	0.0	592.1	-4.3	52.3
549+00.00	123.6	197.2	97.1	0.0	43.2	75.1	73.7	0.0	0.0	51.0	0.0	0.0	70.5	-9.9	43.4
549+50.00	111.4	57.3	174.0	0.0	43.4	66.9	76.4	0.0	0.0	40.6	0.1	0.0	-125.3	-19.5	34.4
550+00.00	116.8	52.4	220.1	0.0	71.9	66.0	123.5	0.0	0.0	26.9	0.1	0.0	-175.5	-67.4	22.8
550+50.00	122.9	46.9	278.9	0.0	101.9	70.6	163.3	0.0	0.0	17.6	0.0	0.0	-239.0	-103.3	15.0
551+00.00	184.2	63.7	279.1	0.0	105.5	68.1	175.2	0.0	0.0	15,9	0.0	0.0	-224.9	-117,3	13.5
551+50.00	253.8	95.1	138.9	0.0	88.1	58.8	184.1	0.0	0.0	16.5	0.0	0.0	-58.1	-134.1	14.0
551+68.21	92.2	44.4	10.1	0.0	24.9	17.9	61.4	0.0	0.0	6.1	0.0	0.0	27.7	-46.1	5.2
552+00.00	105.2	99.0	10.0	0.0	43.9	30.4	113.0	0.0	0.0	11.3	0.0	0.0	74.1	-87.2	9.6
552+50.00	93.0	254.0	2.7	0.0	78.6	38.6	186.3	0.0	0.0	18.4	0.0	0.0	213.2	-153.5	15.7
553+00.00	109.4	281.8	8.7	0.0	68.5	22.1	91.3	0.0	1.2	19.5	0.0	0.0	230.8	-72,5	16.6
553+50.00	114.1	246.8	9.1	0.0	46.6	23.3	33.1	0.0	1.2	22.1	0.0	0.0	200.7	-13.3	18.8
554+00.00	97.9	247.2	2.4	0.0	46.9	35.4	65.3	0.0	0.0	21.3	0.0	0.0	207.7	-35.2	18.1
554+50.00	93.7	235.7	2.4	0.0	50.9	42.9	67.5	0.0	0.0	18.1	0.0	0.0	198.0	-31.1	15.4
555+00.00	97.2	234.0	2.4	0.0	50.6	48.7	64.9	0.0	0.0	23.3	0.0	0.0	196.5	-23.5	19.8

H33 RGreen	Paris 122 (1920) (1920)	USER NAME = tyelton	DESIGNED - JPA	REVISED -
	HRGreen.com Blinois Professional Design Firm # 184-001322	FILE NAME = 090071-sch-02.dgn	DRAWN - SVJ	REVISED -
		PLOT SCALE = N.T.S.	CHECKED - JLP	REVISED -
		PLOT DATE = 11/11/2014	DATE - 11/12/14	REVISED -

SCHEDULE OF QUANTITIES								
CHA	RLES J.	MI.	LLE	ER	ROA	D ROA	DWAY	IMPROVEMENTS
SCALE: N.T.S.	SHEET	NO.	2	OF	8	SHEETS	STA.	TO STA.

F.A.U. RTE.	SE	CTION		COUNTY	TOTAL	SHEET NO.
3860	09-003	72-01-PW	1	MCHENRY	358	19
				CONTRACT	NO.	63892
FED. ROAD	DIST. NO.	ILLINOIS	FED. A	ID PROJECT		

EARTHWORK - CHARLES J. MILLER ROAD (CONT.)

PMILL		STAGE 1	(CU YD)		<u></u>	STAGE 2	(CU YD)			STAGE 3	(CU YD)		EARTHWORK BALAN	CE WASTE (+) OR SHO SHRINKAGE	RTAGE (-) WITH 15%
STATION	REMOVAL AND DISPOSAL OF UNSULTABLE MATERIAL	EARTH EXCAVATION	EMBANKMENT	AGGREGATE SUBGRADE IMPROVEMENT	REMOVAL AND DISPOSAL OF UNSUITABLE MATERIAL	EARTH EXCAVATION	EMBANKMENT	AGGREGATE SUBGRADE IMPROVEMENT	REMOVAL AND DISPOSAL OF UNSUITABLE MATERIAL	EARTH EXCAVATION	EMBANKMENT	AGGREGATE SUBGRADE IMPROVEMENT	PRE-STAGE 1	STAGE 2	STAGE 3
555+50.00	100.6	205.6	4.4	0.0	51.2	50.9	64.9	0.0	0.0	31.4	0.0	0,0	170.4	-21.6	26.7
556+00.00	56.8	321.0	8.4	0.0	51,9	51.9	54.2	0.0	0.0	41.2	0.0	0.0	264.4	-10.0	35.0
556+50.00	55.8	267.5	81.0	0.0	44.1	48.3	34.6	0.0	0.0	51.7	0.0	0.0	146.4	6.5	43.9
557+00.00	105.6	71.9	147.0	0.0	35.5	43.2	28.7	0.0	0.0	55.2	0.0	0.0	-85.9	8.1	46.9
557+50.00	113.1	74.5	126.0	0.0	29.9	39.8	26.5	0.0	0.0	58.0	0.0	0.0	-62.7	7.4	49.3
558+00.00	149.6	230.3	114.1	0.0	20.3	34.4	18.7	0.0	0.0	61.2	0.1	0.0	81.7	10.5	51.9
558+50.00	202.4	479.0	141.2	0.0	17.9	30.0	19.4	0.0	0.0	63.6	0.2	0.0	265.9	6.1	53.9
559+00.00	248.1	647.1	246.9	0.0	18.1	28.3	21.2	0.0	0.0	63.7	0.3	0.0	303.2	2.9	53.9
559+50.00	299.0	707.2	310.6	0.0	15.5	33.7	14.4	0.0	0.0	62.4	0.6	0.0	290.6	14.2	52.4
560+00.00	311.0	485.7	253.2	0.0	7.6	38.2	11.0	0.0	0.0	59.6	1.4	0.0	159.6	21.5	49.3
560+50.00	197.4	149,2	155.6	0.0	0.0	40.0	8.1	0.0	0.0	57.4	3.6	0.0	-28.8	25.9	45.2
561+00.00	99.3	34.5	62.0	0.0	0.0	40.3	5.2	0.0	0.0	54.0	7.3	0.0	-32.7	29.1	38.6
561+50.00	105.7	87.5	15.9	0.0	0,0	42.9	6.1	0.0	0.0	48.0	10.2	0.0	58.4	30.3	30.6
562+00.00	110.0	213.6	3.1	0.0	0.0	47.9	3.9	0.0	0.0	39.4	8.4	0.0	178.5	36.8	25.1
562+50.00	111.4	370.5	2.4	0.0	3.1	53.4	4.5	0.0	0.0	31.4	3.2	0.0	312.5	40.9	23.4
563+00.00	107.3	431.9	2.3	0.0	9.5	65.8	7.9	0.0	0.0	31.9	0.4	0.0	364.8	48.1	26.8
563+50.00	96.2	384.9	2.2	0.0	16.3	74.6	7.0	0.0	0.0	38.0	0.0	0.0	324.9	56.4	32.3
564+00.00	80.6	288.3	2.2	0.0	24.1	79.3	6.5	0.0	0.0	46.0	0.0	0.0	242.9	60.9	39.1
564+50.00	56.9	159.5	3.7	0.0	35.9	81.4	16.1	0.0	0.0	55.2	0.0	0.0	131.9	53.1	46.9
565+00.00	36.6	98.1	4.6	0.0	44.9	74.4	33,1	0.0	0.0	60.8	0.0	0.0	78.8	30.1	51.7
565+32.45	79.9	75.6	44.0	0.0	33.8	22.0	32.0	0.0	1.9	50.1	0.0	0.0	20.3	-13.3	42.5
565+50.00	43.1	55.8	28.5	0.0	10.1	0.0	10.1	0.0	8.5	37.3	11.6	0.0	19.0	-10.1	20.1
566+00.00	62.5	172.7	29.7	0.0	0.0	0.0	0.0	0.0	85.1	111.9	79.6	0.0	117.1	0.0	15.5
566+50.00	97.8	163.8	22.9	0.0	0.0	0.0	0.0	0.0	128.7	88.0	96.4	0.0	116.4	0.0	-21.6
567+00.00	106.7	187.9	18.3	0.0	0.0	0.0	0.0	0,0	129.6	123.1	85.6	0.0	141.4	0.0	19.1
567+50.00	119.5	234.9	20.9	0.0	0.0	0.0	0.0	0.0	134.6	164.3	80.1	0.0	178.7	0.0	59.5
568+00.00	128.9	274.6	27.3	0.0	0.0	0.0	0.0	0.0	139.6	147.8	95.6	0.0	206.1	0.0	30.1
568+50.00	130.7	249.5	54.8	0.0	0.0	0.0	0.0	0.0	142.6	142.2	120.2	0,0	157.3	0.0	0.7
569+00.00	121.9	178.1	70.3	0.0	0.0	0.0	0.0	0.0	151.8	139.4	142.7	0.0	81.1	0.0	-24.2
569+50.00	109.0	134.3	37.6	0.0	0.0	0.0	0.0	0.0	169.1	135.2	134.3	0.0	76.5	0.0	-19.4
570+00.00	99.9	101.0	31.6	0.0	0.0	0.0	0.0	0.0	178.0	120.7	144.1	0.0	54.3	0.0	-41.4
570+50.00	90.6	69.0	45.4	0.0	0.0	0.0	0.0	0.0	172.8	97.5	159.1	0.0	13.3	0.0	-76.2
571+00.00	122.9	71.8	84.9	0.0	94.4	28.0	73.1	0.0	85.6	102.5	75.8	0.0	-23.9	-49.4	11.3
						-									
TOTALS:	12280.6	21628.2	4726.1	1092.0	6200.4	8080.2	4286.7	1039.8	2746.1	7877.4	1370.3	836.2	13657.9	2581.4	5325.5

PAYCODE		TOTAL (CU YD)
20200100	EARTH EXCAVATION	21564.8
20201200	REMOVAL AND DISPOSAL OF UNSUITABLE MATERIAL	21227.2
30300001	AGGREGATE SUBGRADE IMPROVEMENT	2967.9

-33	HERE	USER NAME = tyelton	DESIGNED	-	JP
	HRGreen.com Illinois Professional Design Firm # 184-001322	FILE NAME = 090071-sch-03.dgn	DRAWN	ā.	SV
		PLOT SCALE = N.T.S.	CHECKED	-	JL
Green		PLOT DATE = 11/11/2014	DATE	-	11/

USER NAME = tyelton	DESIGNED - JPA	REVISED -
FILE NAME = 090071-sch-03.dgn	DRAWN - SVJ	REVISED -
PLOT SCALE = N.T.S.	CHECKED - JLP	REVISED -
PLOT DATE = 11/11/2014	DATE - 11/12/14	REVISED -

STATI	E OF	ILLINOIS	
DEPARTMENT	OF	TRANSPORTATION	

		S	CH	IED	ULE	: 01	au	ANTITI	ES	
CHA	RLES J.	MI	LLE	R	RO	AD	ROA	DWAY	IMPROVEMI	ENTS
SCALE: N.T.S.	SHEET	NO.	3	OF	8	SHE	EETS	STA.	ТО	STA.

	F.A.U. RTE.	SE	CTION		COUNTY	TOTAL	SHEET NO.
	3860	09-003	72-01-PW		MCHENRY	358	20
- 10					CONTRACT	NO.	63892
	FED. ROAD	DIST. NO.	ILLINOIS	FED. AIC	PROJECT		

EARTHWORK - ILLINOIS ROUTE 31

P31		STAGE 1	(CU YD)			STAGE 2	(CU YD)			STAGE 3	(CU YD)		EARTHWORK BALANCE WASTE (+) OR SHORTAGE (-) WITH 15%			
STATION	REMOVAL AND DISPOSAL OF UNSUITABLE MATERIAL	EARTH EXCAVATION	EMBANKMENT	AGGREGATE SUBGRADE IMPROVEMENT	REMOVAL AND DISPOSAL OF UNSUITABLE MATERIAL	EARTH EXCAVATION	EMBANKMENT	AGGREGATE SUBGRADE IMPROVEMENT	REMOVAL AND DISPOSAL OF UNSUITABLE MATERIAL	EARTH EXCAVATION	EMBANKMENT	AGGREGATE SUBGRADE IMPROVEMENT	PRE-STAGE 1	STAGE 2	STAGE 3	
99+25.00													0.0	0.0	0.0	
99+50.00	2.4	9.8	1.2	0.0	17,7	12.0	24.4	0.0	0.0	3.8	0.0	0.0	7.2	-14.2	3.2	
100+00.00	13.4	22.9	9.4	0.0	125.2	27.6	133.1	0.0	0.0	3.1	0.0	0.0	10.0	-109.6	2.7	
100+50.00	19.4	25.9	18.6	0.0	118.2	29.6	126.3	0.0	0.0	1.9	0.0	0.0	3,4	-101.1	1.7	
101+00.00	12.7	31.3	13.9	0.0	30.4	30.3	29.7	0.0	0.0	1.9	0.0	0.0	12.7	-4.0	1.7	
101+31.14	3.5	23.2	2.9	0.0	35.3	19.3	15.2	0.0	0.0	1.2	0.0	0.0	16.9	1.3	1.0	
101+50.00	1.6	15.0	0.8	0.0	25.1	13.2	10,2	0.0	0.0	1.1	0.0	0.0	12.0	1.0	0.9	
102+00.00	4.5	46.9	2.3	0.0	44.4	50.6	36.3	0.0	0.0	5.6	0.0	0.0	37.6	6.8	4.8	
102+50.00	19.5	57.8	5.5	0.0	37.9	67.9	16.5	0.0	0.0	8.5	0.0	0.0	43.6	41.2	7.2	
102+54.91	3.4	6.2	0.8	0.0	4.2	8.0	0.4	0.0	0.0	0.9	0.0	0.0	4.4	6.4	0.8	
102+88.42	17.4	45.7	3.4	0.0	61.9	99.8	1.4	0.0	0.0	6.5	0.0	0.0	35.5	83.4	5.5	
103+00.00	2.4	16.9	0.5	0.0	32.0	47.9	0.2	0.0	0.0	2.4	0.0	0.0	13.8	40.5	2.0	
103+50.00	6.6	74.1	2.3	0.0	99.2	147.1	4.0	0.0	0.0	10.5	0.0	0.0	60.6	121.1	8.9	
104+00.00	11.3	76.1	2.2	0.0	60.6	88.7	8.6	0.0	0.0	10.5	0.0	0.0	62.5	66.8	8.9	
104+50.00	17.8	83.3	3.0	0.0	56.6	95.6	7.1	0.0	0.0	9.2	0.0	0.0	67.9	74.1	7.8	
105+00.00	28.1	96.7	5.2	0.0	56.9	128.3	3.2	0.0	0.0	5.9	0.0	0.0	77.0	105.8	5.0	
105+50.00	35.4	109.6	5.7	0.0	54.4	136.3	3.0	0.0	0.0	2.8	0.0	0.0	87.4	112.9	2.4	
106+00.00	33.5	115.1	4.6	0.0	47.7	111.4	3.3	0.0	0.0	2.2	0.0	0.0	93.2	91.3	1.9	
106+50.00	22.6	108.1	3.7	0.0	43.9	97.3	3.2	0.0	0.0	2.4	0.0	0.0	88.1	79.5	2.0	
107+00.00	37.1	115.5	6.3	0.0	41.7	91.1	3.1	0.0	0.0	2.2	0.0	0.0	91.8	74.4	1.9	
107+50.00	67.9	141.8	8.6	0.0	43.3	90.3	2.5	0.0	0.0	2.6	0.0	0.0	111.9	74.2	2.2	
108+00.00	59.8	156.1	13.9	0.0	45.9	88.6	2.5	0.0	0.0	3.9	0.0	0.0	118.8	72.8	3.3	
108+50.00	79.5	205.6	10.9	0.0	54.0	81.5	7.5	0.0	0.0	7.5	0.0	0.0	163.9	61.8	6.4	
109+00.00	107.1	217.5	20.6	12.6	75.1	84.1	20.5	11,5	1.1	13.4	0.0	1.1	164.3	51.0	11.4	
109+50.00	102.1	184.7	47.2	25.2	94,8	98.1	20,6	23.0	2.2	17.3	0.0	2.2	109.8	62.9	14.7	
109+74.70	51.4	93.4	23.5	12.4	50.7	48.9	3.7	11.3	1.1	9.0	0.0	1.1	56.0	37.9	7.7	
110+00.00	50.6	94.4	24.3	12.7	50.9	50.2	3.2	11.6	1.1	9.6	0.0	1.1	55.9	39.4	8.1	
110+50.00	101.2	182.2	55.2	25.2	90.2	99.4	7.7	23.0	2.2	18.8	0.0	2.2	99.7	76.8	16.0	
111+00.00	96.0	171.1	63.9	12.6	70.3	76.7	4.4	11.5	1.1	12.6	0.0	1.1	81.6	60.8	10.7	
111+50.00	93.7	163.3	70.7	0.0	59.5	73.7	3.1	0.0	0.0	5.1	0.0	0.0	68.1	59.6	4.3	
112+00.00	96.3	158.6	65.9	0.0	44.9	71.8	4.1	0.0	0.0	2.8	0.0	0.0	68.9	56.9	2.4	
112+26.98	51.2	83.8	25.5	0.0	29.4	31.5	5.1	0.0	0.0	0.8	0.0	0.0	45.8	21.7	0.7	
112+50.00	43.2	80.1	8.4	0.0	26.6	30.7	3.5	0.0	0.0	0.5	0.0	0.0	59.7	22.6	0.4	
113+00.00	96.4	211.3	4.4	0.0	47.5	86.5	2.0	0.0	0.0	1.9	0.0	0.0	175.3	71.5	1.7	
113+50.00	102.6	242.4	2.5	0.0	60.6	90.9	6.8	0.0	0.0	1.9	0.0	0.0	203.5	70.5	1.6	
114+00.00	104.9	241.7	3.1	0.0	59.9	95.3	7.4	0.0	0.0	1.1	0.0	0.0	202.4	73.6	0.9	
114+50.00	111.6	251.9	3.1	0.0	45.8	83.3	2.3	0.0	0.0	8.0	0.0	0.0	210.9	68.5	0.7	
114+61.07	27.0	60.2	0.6	0.0	9.8	12.4	0.4	0.0	0.0	0,2	0.0	0.0	50.6	10.1	0.1	
115+00.00	98.3	223.2	1.9	0.0	39.7	52.1	3.5	0.0	0.0	0.5	0.0	0.0	187.8	40.8	0.4	
115+46.76	121.3	294.8	1.6	0.0	45.3	64.3	7.7	0.0	0.0	0.4	0.0	0.0	249.0	47.0	0.4	
115+50.00	8.7	20.8	0.1	0.0	3.2	3.6	0.7	0.0	0.0	0.0	0.0	0.0	17.6	2.4	0.0	
116+00.00	135.6	313.8	1.9	0.0	39.4	55.1	17.5	0.0	0.0	0.4	0.0	0.0	264.9	29.3	0.3	
116+50.00	136.1	346.1	3.2	0.0	30.7	57.7	25.5	0.0	0.0	0.5	0.0	0.0	291.0	23.6	0.4	
116+88.96	106.0	305.3	2.3	0.0	28.6	42.4	11.4	0.0	0.0	0.4	0.0	0.0	257.2	24.6	0.4	
117+00.00	29.7	89.0	0.4	0.0	8.9	10.1	0.7	0.0	0.0	0.1	0.0	0.0	75.3	7.9	0.1	
117+50.00	140.7	434.0	1.5	0.0	34.9	55.5	11.8	0.0	0.0	0.3	0.0	0.0	367.4	35.4	0.2	
118+00.00	153.9	419.1	1.8	0.0	31.3	48.8	15.7	0.0	0.0	0.1	0.0	0.0	354.5	25.7	0.1	
118+50.00	157.7	280.4	3.4	0.0	26.5	36.9	19.8	0.0	0.0	0.0	0.0	0.0	234.9	11.5	0.0	
119+00.00	117.0	96.8	44.1	0.0	49.4	50.5	94.3	0.0	0.0	0.1	0.0	0.0	38.2	-51.4	0.1	

090071-sch-04.dgn pdf.plt standard-trans.tbl

MODERATE NAME:
ROJECT CONTACT:
LENT:
ATE PLOTTED: 11/11/
ATE NAME: 09001
LOT DRIVER: pdf.p

#RGreen.com
#184-001322

#RGreen

184-01322

#RGreen

184-01322

#RGreen

184-01322

#RGreen

184-01322

USER NAME = tyelton	DESIGNED - JPA	REVISED -
FILE NAME = 090071-sch-04.dgn	DRAWN - SVJ	REVISED -
PLOT SCALE = N.T.S.	CHECKED - JLP	REVISED -
PLOT DATE = 11/11/2014	DATE - 11/12/14	REVISED -

			S	CH	IED	ULE	OF QU	ANTITI	ES
	CHARLES	J.	MII	LLE	R	ROA	D ROA	DWAY	IMPROVEMENTS
SCALE: N.T.	S. SH	EET	NO.	4	OF	8	SHEETS	STA.	TO STA.

F.A.U. RTE.	SEC	CTION	COUNTY	TOTAL	SHEE NO.
3860	09-003	72-01-PW	MCHENRY	358	21
			CONTRACT	NO.	6389
FED. ROAD	DIST. NO.	ILLINOIS FEO.	AID PROJECT		No.

EARTHWORK - ILLINOIS ROUTE 31 (CONT.)

P31		STAGE 1	(CU YD)			STAGE 2	(CU YD)			STAGE 3	(CU YD)		EARTHWORK BALAN	NCE WASTE (+) OR SHO	ORTAGE (-) WITH 15%
STATION	REMOVAL AND DISPOSAL OF UNSUITABLE MATERIAL	EARTH EXCAVATION	EMBANKMENT	AGGREGATE SUBGRADE IMPROVEMENT	REMOVAL AND DISPOSAL OF UNSUITABLE MATERIAL	EARTH EXCAVATION	EMBANKMENT	AGGREGATE SUBGRADE IMPROVEMENT	REMOVAL AND DISPOSAL OF UNSULTABLE MATERIAL	EARTH EXCAVATION	EMBANKMENT	AGGREGATE SUBGRADE IMPROVEMENT	PRE-STAGE 1	STAGE 2	STAGE 3
119+50.00	79.1	58.6	42.3	39.5	79.6	53.7	89.8	32.2	0.3	0.6	0.0	0.3	7.5	-44.2	0.5
120+00.00	141.7	89.7	20.6	72.0	71.3	102.8	11.0	63.1	0.5	0.8	0.0	0.5	55.7	76.3	0.7
120+50.00	210.2	63.2	74.7	64.9	46.1	120.0	6.6	45.9	0.5	1.0	0.0	0.5	-21.0	95.4	0.9
121+00.00	215.8	64.6	145.0	64.0	26.1	75.5	10.4	25.9	0.6	1.4	0.0	0.6	-90.1	53.8	1.2
121+41.10	178.7	60.1	155.7	51.9	25.3	62.1	4.8	16.6	0.5	1.4	0.0	0.5	-104.6	48.0	1.2
121+50.00	39.1	14.0	35.6	11.2	8.0	15.2	0.3	3.4	0.1	0.3	0.0	0.1	-23.7	12.7	0.2
122+00.00	221.7	82.8	215.6	63.1	34.4	75.4	7.7	19.0	0.4	1.1	0.0	0.4	-145.3	56.4	0.9
122+50.00	192.9	77.8	262.6	31.6	9.4	57.5	14.2	9.4	0.2	1.7	0.0	0.2	-196.5	34.7	1.4
123+00.00	160.6	76.9	284.7	0.0	0.0	54.5	10.6	0.0	0.0	1.6	0.0	0.0	-219.3	35.7	1.3
123+50.00	223.1	132.0	228.3	60.6	26.8	87.6	7.8	21.5	0.5	1.8	0.0	0.5	-116.1	66.7	1.5
123+96.03	261.4	183.6	142.0	110.0	60.4	121.0	4.8	40.8	1.0	2.8	0.0	1.0	14.1	98.0	2.4
124+00.00	21.8	16.1	10.2	9.4	6.1	11.6	0.1	3,6	0.1	0.3	0.0	0.1	3.5	9.8	0.3
124+50.00	264.1	211.3	95.4	115.9	70.5	152.7	2.4	47.9	1.3	4.4	0.0	1.3	84.2	127.4	3.7
125+00.00	249.4	274.9	47.1	105.4	69.4	175.3	3.7	50.2	0.5	3.7	0.0	0.5	186.5	145.3	3.1
125+50.00	228.4	325.6	25.4	91.7	81.2	167.3	2.9	48.0	2.3	27.6	0.0	2.3	251.4	139.3	23.5
125+57.25	31.4	48.9	2.4	12.5	12.7	20.6	0.3	6.6	0.7	7.6	0.0	0.7	39.2	17.3	6.5
126+00.00	176.3	285.9	12.2	69.3	74.3	119.5	9.7	39.0	4.0	48.8	0.0	4.0	230.8	91.8	41.5
126+50.00	155.2	274.3	15.3	38.3	61.8	104.1	20.0	22.9	2.3	60.3	0.0	2.3	217.8	68.5	51.2
127+00.00	106.5	189.3	29.8	0.0	36.9	63.1	20.5	0.0	0.0	56.2	0.0	0.0	131.1	33.1	47.8
127+50.00	97.7	152.4	41.9	0.0	33.8	50.8	24.4	0.0	0.0	48.9	0.0	0.0	87.6	18.9	41.6
128+00.00	93.9	173.1	26.8	0.0	18.3	46.8	14.6	0.0	0.0	39.4	0.0	0.0	120.3	25.1	33.4
128+50.00	90.2	210.3	6.3	0.0	21.8	73.5	10.2	0.0	0.0	17.8	0.0	0.0	172.4	52.3	15.1
128+91.27	68.3	177.9	2.1	0.0	77.6	165.5	7.8	0.0	0.0	1,5	0.0	0.0	149.1	132.9	1.3
129+00.00	13.4	37.0	0.4	0.0	26.0	53.5	0.2	0.0	0.0	0.3	0.0	0.0	31.0	45.3	0.3
129+50.00	84.0	255.9	2.8	0.0	93.7	221.8	1.9	0.0	0.0	1.2	0.0	0.0	214.8	186.6	1.0
130+00.00	101.2	377.5	3.0	0.0	36.5	124.2	3.1	0.0	0.0	1.7	0.0	0.0	317.9	102.5	1.4
130+50.00	115.2	503.2	2.9	0.0	37.4	110.3	6.6	0.0	0.0	1.9	0.0	0.0	424.9	87.2	1.6
131+00.00	119.5	571.9	2.5	0.0	34.0	96.3	6.5	0.0	0.0	1.1	0.0	0.0	483.7	75.4	0.9
131+50.00	117.1	672.2	2.2	0.0	26.1	82.2	2.2	0.0	0.0	1.3	0.0	0.0	569.2	67.7	1.1
132+00.00	112.9	665.8	2.0	0.0	23.8	67.1	1.3	0.0	0.0	1.5	0.0	0.0	563.9	55.8	1.3
132+50.00	107.1	479.7	2.1	0.0	23.2	47.5	3.0	0.0	0.0	1.3	0.0	0.0	405.6	37.4	1.1
133+00.00	94.4	243.9	6.9	0.0	23.2	32.0	5.6	0.0	0.0	0.9	0.0	0.0	200.5	21.7	0.8
133+50.00	85.1	86.4	31.2	0.0	23.0	25.1	6.4	0.0	0.0	0.5	0.0	0.0	42.2	14.9	0.4
134+00.00	90.0	57.9	110.4	0.0	23.0	24.6	6.4	0.0	0.0	0.4	0.0	0.0	-61.2	14.5	0.3
134+50.00	99.4	53.6	193.7	0.0	22.8	24.3	7.3	0.0	0.0	0.4	0.0	0.0	-148.1	13.3	0.3
135+00.00	109.6	58.6	244.7	0.0	22.6	22.2	9.4	0.0	0.0	0.6	0.0	0.0	-194,9	9.5	0.5
135+50.00	107.6	53.9	308.6	0.0	22.4	21.7	11.0	0.0	0.0	1.2	0.0	0.0	-262.8	7.4	1.0
136+00.00	96.3	46.1	315.6	0.0	16.8	22.7	7.7	0.0	0.0	2.4	0.0	0.0	-276.5	11.6	2.0
136+50.00	92.8	44.4	311.1	0.0	9,5	26.9	3.7	0.0	0.0	4.3	0.0	0.0	-273.3	19.2	3.6
136+76.00	32.5	18.7	95.1	0.0	3.1	17.0	1.6	0.0	0.0	5.2	0.0	0.0	-79.2	12.9	4.5
TOTALS:	8025.7	14314.0	4164.2	1112.1	3709.4	6068.1	1112.8	587.8	24.5	552.2	0.0	24.5	8002.7	4045.1	469.4

PAYCODE		TOTAL (CU YD)
20200100	EARTH EXCAVATION	12517.1
20201200	REMOVAL AND DISPOSAL OF UNSUITABLE MATERIAL	11759.6
30300001	AGGREGATE SUBGRADE IMPROVEMENT	1724.4

11/11/2014 10:24:08 AM 090071-sch-05.dgn pdf.plt standard-trans.tbl

PLOT URIVER; po

_		USER NAME	-	1
3	HRGreen.com Illinois Professional Design Firm	FILE NAME	2	0
1_/1	# 184-001322	PLOT SCALE	1	1
reen		PLOT DATE		1

USER NAME = tyelton	DESIGNED - JPA	REVISED -	
FILE NAME = 090071-sch-05.dgn	DRAWN - SVJ	REVISED -	
PLOT SCALE = N.T.S.	CHECKED - JLP	REVISED -	
PLOT DATE = 11/11/2014	DATE - 11/12/14	REVISED -	

		S	CH	IED	ULE	OF QU	ANTITI	ES	
CHA	RLES J	. MI	LLI	ER	RO/	AD ROA	DWAY	IMPROVEMEN	ΓS
SCALE: N.T.S.	SHEET	NO.	5	OF	8	SHEETS	STA.	TO ST	Α.

F.A.U. RTE.	SE	CTION	COUNTY	TOTAL	SHEE NO.
3860	09-003	372-01-PW	MCHENRY	358	22
		·	CONTRACT	NO.	6389
FED. ROAD	DIST. NO.	ILLINOIS FED	. AID PROJECT		

EARTHWORK - GREEN STREET/BARREVILLE ROAD

PGREEN		STAGE 1	CU YD)	į		STAGE 2	(CU YD)		EARTHWORK BALANCE WASTE (+) OR SHORTAGE (-) WITH 15% SHRINKAGE	EARTHWORK BALAN WASTE (+) OR SHORTAGE (-) WIT 15% SHRINKAGE
STATION	REMOVAL AND DISPOSAL OF UNSUITABLE MATERIAL	EARTH EXCAVATION	EMBANKMENT	AGGREGATE SUBGRADE IMPROVEMENT	REMOVAL AND DISPOSAL OF UNSUITABLE MATERIAL	EARTH EXCAVATION	EMBANKMENT	AGGREGATE SUBGRADE IMPROVEMENT	STAGE 1	STAGE 2
205+55.00									0.0	0.0
206+00.00	8.6	14.5	4.3	0.0	24.6	75.6	2.8	0.0	8.0	61.4
206+39.19	18.7	11.5	2.0	0.0	21.1	68.7	0.8	0.0	7.8	57.6
206+50.00	7.4	3.5	0.3	0.0	1.0	13.2	0.2	0.0	2.6	11.0
207+00.00	29.2	22.9	2.9	0.0	6.1	60.8	1.5	0.0	16.6	50.2
207+27.25	14.8	12.6	2.1	0.0	13.1	32.3	1.8	0.0	8.6	25.6
207+50.00	11.3	12.0	1.2	0.0	17.8	28.7	1.8	0.0	9.0	22.6
208+00.00	15.6	31.3	4.3	0.0	23.4	64.5	4.5	0.0	22.3	50.3
208+50.00	20.9	40.6	7.9	7.3	21.4	75.7	3.9	15.7	26.6	60.5
209+00.00	32.2	63.1	6.0	17.9	32.8	93.6	1.5	30.8	47.6	78.1
209+50.00	43.2	93.1	1.9	25.0	32.8	101.6	1.5	30.2	77.2	84.9
210+00.00	52.6	111.5	2.2	29.2	35.8	110.3	1.5	31.2	92.5	92.3
210+50.00	54.4	109.1	2.9	30.2	65.9	154.1	1.9	38.7	89.8	129.1
211+00.00	129.5	191.9	1.5	64.4	104.9	195.8	1.4	56.5	161.7	165.1
211+50.00	292.2	201.1	133.0	49.0	226.6	158.3	114.2	33.9	38.0	20.4
212+00.00	196.0	66.6	144.1	0.0	195.1	71.4	145.1	0.0	-87.5	-84.4
212+50.00	20.9	18.8	28.2	9.0	56.2	29.9	53.6	13.3	-12.3	-28.2
213+00.00	30.7	33.4	34.3	18.0	59.3	42.7	42.4	26.7	-5.8	-6.1
213+50.00	32.0	41.7	31.9	18.0	64.3	56.6	44.4	26.7	3.5	3.7
214+00.00	33.6	50.8	27.1	18.1	60.6	64.3	40.1	25.2	16.1	14.5
214+50.00	33.1	57.9	25.4	18.1	44.9	66.7	24.4	22.8	23.8	32.2
215+00.00	26,6	59.5	13.7	17.1	36.8	70.2	11.6	21.4	36.9	48.1
TOTALS:	1103.6	1247.4	477.1	321.3	1144.5	1634.9	500.8	373.1	583.1	888.9

PAYCODE		TOTAL (CU YD)
20200100	EARTH EXCAVATION	1472.0
20201200	REMOVAL AND DISPOSAL OF UNSUITABLE MATERIAL	2248.1
30300001	AGGREGATE SUBGRADE IMPROVEMENT	694.4

EARTHWORK SUMMARY

			CROSS SECTION BASED					
ITEM NO.	CODE	DESCRIPTION	MILLER	IL 31	GREEN	TOTAL		
1	20200100	EARTH EXCAVATION	21,564.8	12,517.1	1,472.0	35,553.9		
2	20201200	REMOVAL AND DISPOSAL OF UNSUITABLE MATERIAL	21,227.2	11,759.6	2,248.1	35,234.9		
3	30300001	AGGREGATE SUBGRADE IMPROVEMENT	2,967,9	1,724.4	694.4	5,386.6		

1111/2014 10:24:11 AM 09:0071-sch-06.dgn pdf.plf standard-trans.tbf

DATE PLOTTED: 11/1
FILE NAME: 090
PLOT DRIVER: pdf
PEN TABLE: 510

	HRGreen.com
ス	Blinols Professional Design Firm # 184-001322
een	

USER NAME = tyelton	DESIGNED	-	JPA	REVISED	1+	
FILE NAME = 090071-sch-06.dgn	DRAWN	7.	SVJ	REVISED		
PLOT SCALE = N.T.S.	CHECKED	-	JLP	REVISED	+	
PLOT DATE = 11/11/2014	DATE	+	11/12/14	REVISED	-	

	SCHEDULE OF QUANTITIES							
CH	IARLES	J. I	VIILL	ER	RO/	AD ROA	DWAY	IMPROVEMENTS
SCALE: N.T.S.	SHE	ET N	10. 6	OF	8	SHEETS	STA.	TO STA.

FED. ROAL	DIST. NO.	ILLINOIS F				
				CONTRACT	NO.	63892
3860	09-00372-01-PW			MCHENRY	358	23
F.A.U. RTE.	SE	CTION		COUNTY	TOTAL SHEETS	SHEET NO.

(42400200) PORTLAND CEMENT CONCRETE SIDEWALK 5 INCH

	BULL V	ALLEY ROAD	
STA	TO STA	OFF	SQ FT
533+02	533+27	RT	258
533+05	533+27	LT	530

SUBTOTAL	788	SO F

	CHARLES	MILLER ROAD	
STA	TO STA	OFF	SQ FT
534+45	535+04	RT	548
534+83	540+14	LT	3631
540+99	552+35	LT	8095
552+20	552+40	RT	162

SUBTOTAL	12436	SQ FT

	IL R	OUTE 31	
STA	TO STA	OFF	SQ FT
120+18	128+72	RT	7188
129+12	136+76	RT	6278

SUBTOTAL 13466 SQ FT

	GREEN STREET	/BARREVILLE R	OAD
STA	TO STA	OFF	SQ FT

SUBTOTAL

GRAND TOTAL 26690 S0 FT

(60600605) CONCRETE CURB TYPE B

		BULL VALLEY I	10.10	
STA	OFF	TO STA	OFF	FOOT
317	UI I	I O SIM		

SUBTOTAL

	(HARLES J MILLE	R ROAD	
STA	OFF	TO STA	OFF	FOOT
37+92			LT	113

SUBTOTAL 1	113	FO
------------	-----	----

		IL ROUTE 3	11	
STA	OFF	TO STA	OFF	FOOT
109+71			RT	78
115+46			RT	42
116+89			RT	55
121+41			RT	81

SUBTOTAL	256	FO

	GREEN	STREET/BARRE	VILLE ROAD	
STA	OFF	TO STA	OFF	FOOT

SUBTOTAL FOOT

GRAND TOTAL

(63100167) TRAFFIC BARRIER TERMINAL, TYPE 1 (SPECIAL) TANGENT BULL VALLEY ROAD

	SUBTOTAL	0	EACH
CHARLES J M	TILER ROAD		

STA	OFF	TO STA	OFF	EACH
57+04	50.6	557+51	50.6	1

SUBTOTAL EACH

CTA	OFF	TO STA	DEE	EACH
314	Ort	IU SIA	OFF	CAGE

SUBTOTAL EACH

	GREEN	N STREET/BARRE	VILLE ROAD	
STA	OFF	TO STA	OFF	EACH

GRAND TOTAL 1 EACH

(60603800) COMBINATION CONCRETE CURB AND GUTTER, TYPE B-6.12

BULL VALLEY ROAD				
STA	OFF	TO STA	OFF	FOOT
521+11	RT		RT	112
523+82	LT/RT	528+43	LT/RT	944

SUBTOTAL	1056	FOOT
SUBTUTAL	1036	1001

	C	HARLES J MILLE	ER ROAD	
STA	OFF	TO STA	OFF	FOOT
538+40	LT/RT	542+56	LT/RT	847
540+50	LT		LT	112
545+44	LT/RT	549+69	LT/RT	851
555+78	LT/RT	562+78	LT/RT	1403
565+50	LT		LT	13
565+98	LT/RT	571+00	LT/RT	1011

SUBTOTAL 4237 FOOT

		IL ROUTE	31	
STA	OFF	TO STA	OFF	FOOT
103+07	RT		RT	31
107+34	LT/RT	114+24	LT/RT	1380
108+50	LT		LT	4
123+68	LT/RT	128+28	LT/RT	921
125+54	RT		RT	46
129+00	RT		RT	9

SUBTOTAL	2391	FOOT

		N STREET/BARRE	TO SHARE WAS A SHA	_
STA	OFF	TO STA	OFF	FOOT
206+09	LT	209+75	LT	379
206+20	RT	210+36	RT	482
212+32	LT	215+08	LT	277
212+34	RT	215+08	RT	188

SUBTOTAL 1326 FOOT GRAND TOTAL 9010 F00T

(60604400) COMBINATION CONCRETE CURB AND GUTTER, TYPE B-6.18

		BULL VALLEY	ROAD	
STA	STA	TO STA	OFF	FOOT

SUBTOTAL 0 F00T

		HARLES J MILLE	N NUAU	Al-
TA	STA	TO STA	OFF	FOOT

SUBTOTAL 0 F00T

		IL ROUTE 3	1	
STA	STA	TO STA	OFF	FOOT
112+06	RT	112+45	RT	68
114+44	RT	114+80	RT	61
123+73	RT	124+20	RT	54

SUBTOTAL	183	FOOT

TA	OFF	TO STA	OFF	FOOT
-		1		

FOOT SUBTOTAL GRAND TOTAL FOOT

(60605000) COMBINATION CONCRETE CURB AND GUTTER, TYPE B-6,24

	BULL VALLEY ROAD					
STA	OFF	TO STA	OFF	FOOT		
514+25	RT	520+96	RT	708		
514+50	LT	533+66	LT	1935		
521+33	RT	533+30	RT	1263		

SUBTOTAL	3906	FOO

	(CHARLES J MILLE	R ROAD	
STA	OFF	TO STA	OFF	FOOT
534+43	RT	543+11	RT	938
534+75	LT	540+36	LT	612
540+72	LT	552+66	LT	1276
543+58	RT	552+67	RT	1051
553+13	LT	565+17	LT	1276
553+15	RT	555+76	RT	343
556+41	RT	571+00	RT	1541
565+57	1.7	571+00	1.T	564

SUBTOTAL

		IL ROUTE 3	1	
STA	OFF	TO STA	OFF	FOOT
99+25	RT	102+89	RT	384
99+25	LT	108+25	LT	940
103+25	RT	118+53	RT	1572
108+62	LT	118+26	LT	994
120+37	RT	128+72	RT	880
120+19	LT	136+76	LT	1651
129+10	RT	136+76	RT	806

SUBTOTAL 7227 FOOT

STA	OFF	TO STA	OFF	FOOT
Distance of				

SUBTOTAL FOOT

GRAND TOTAL 18734 FOOT

(60619600) CONCRETE MEDIAN, TYPE SB-6.12

	BULL V	ALLEY ROAD	
STA	TO STA	OFF	SQ FT
528+43	532+75	MED	2566

SUBTOTAL 2566 S0 FT

	CHARLES	MILLER ROAD	
STA	TO STA	OFF	SO FT
535+23	538+40	MED	1878
543+51	545+44	MED	1234
549+69	552+21	MED	1722
553+61	555+78	MED	1478
562+78	564+97	MED	1542

SUBTOTAL 7854 SQ FT

	IL R	OUTE 31	
STA	TO STA	OFF	SQ FT
114+24	118+26	MED	2384
120+46	123+68	MED	1912

	GREEN STREET	/BARREVILLE R	DAD
STA	TO STA	OFF	SQ FT
12255		- 10-10-10-10-10-10-10-10-10-10-10-10-10-1	10 miles 10 miles 10 miles

SUBTOTAL SQ FT GRAND TOTAL 14716 S0 FT

(63000001) STEEL PLATE BEAM GUARDRAIL, TYPE A. 6 FOOT POSTS

		BULL VALLEY	ROAD	
STA	OFF	TO STA	OFF	FOOT

SUBTOTAL 0.0

	0	HARLES J MILLE	R ROAD	
STA	OFF	TO STA	OFF	FOOT
543+61	74.1	551+14	44.6	775.0

SUBTOTAL 775.0 FOOT

		IL ROUTE 3	1	
ATA	OFF	TO STA	OFF	FOOT

SUBTOTAL 0.0 FOOT

	ONLL	N STREET/BARRE	VILLE NOAD	
STA	OFF	TO STA	OFF	FOOT

SUBTOTAL 0.0 FOOT

FOOT GRAND TOTAL 775.0

(63000003) STEEL PLATE BEAM GUARDRAIL, TYPE A, 9 FOOT POSTS

STA	OFF	TO STA	OFF	FOOT
1.74	OFF	10 314	ULL	1.001

SUBTOTAL 0.0 F00T

	C	HARLES J MILLE	R ROAD	
STA	OFF	TO STA	OFF	FOOT
557+51	50.6	560+48	50.6	312.5

SUBTOTAL 312.5 FOOT

7.4	OFF	TOCTA	OFF	FOOT
1A	OFF	IUSIA	UFF	FOOT

SUBTOTAL FOOT 0.0

		7		
STA	OFF	TO STA	OFF	FOOT
~	OI I	10.014	OLI	1 00

SUBTOTAL 0.0 FOOT

GRAND TOTAL 312.5 FOOT

(63100045) TRAFFIC BARRIER TERMINAL, TYPE 2

STA	OFF	TO STA	OFF	FACH
-	011	100111	01.1	2001

SUBTOTAL

	C	HARLES J MILLE	R ROAD	
STA	OFF	TO STA	OFF	EACH
543+70	83.8	543+61	74.1	1
551+14	44.6	551+26	44.6	- 1

SUBTOTAL 2 EACH

	and the state of t	IL ROUTE 3		
ATA	OFF	TO STA	OFF	FACH
174	OL 1	10 31A	OFF	LACII


SUBTOTAL O EACH

	GREEN	STREET/BARRE	VILLE ROAD	
STA	OFF	TO STA	OFF	EACH
		1		

SUBTOTAL

GRAND TOTAL EACH

HRGreen.com

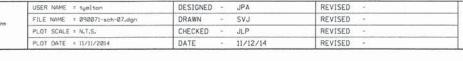

			SCI	HED	ULE	OF QU	ANTITI	ES
CHA	ARLES .	J. MI	LLI	ER	ROA	D ROA	DWAY	IMPROVEMENTS
SCALE: N.T.S.	SHEET	T NO.	7	OF	8	SHEETS	STA.	TO STA.

RTE.	SE	CTION			COUNTY	SHEETS	NO.
3860	09-003	72-01-PV	V	T	MCHENRY	358	24
				T	CONTRACT	NO.	6389
FED. ROA	DIST. NO.	ILLINOIS	FED.	AID	PROJECT		-
		1111	/				

ALIGN	MOT STAGE	STA	TO STA	LT/RT	TEMPORARY CONCRETE BARRIER	PINNED Y/N	PINNING TEMPORARY CONCRETE BARRIER	IMPACT ATTENUATORS, TEMPORARY (FULLY REDIRECTIVE, NARROW), TEST LEVEL 3	RELOCATE TEMPORARY CONCRETE BARRIER	IMPACT ATTENUATORS, RELOCATE (FULLY REDIRECTIVE, NARROW), TEST LEVEL 3
			4		(F00T) 70400100		(EACH) X7040125	(EACH) 70600260	(F00T) 70400200	(EACH) 70600332
PMILL	1	514+00		RT		N/A		1		PARAMETER STATE OF THE STATE OF
PMILL	1	514+00	520+62	RT	662.5	Y	153			
PMILL	1	522+06		RT		N/A		1		
PMILL	1	522+06	533+06	RT	1100	Υ	258			
PMILL	1	535+54		RŢ	71	N/A		1		
PMILL	1	535+54	536+91	RT	137.5	N				
PMILL	1	537+53		RT		N/A		1		
PMILL	1	537+53	538+53	RT	100	N				
PMILL	1	539+41		RT		N/A	Indiana and a second	1	13000	
PMILL	1	539+41	542+42	RT	300	N				
PMILL	1	544+17	E 40 . CC	RT	427.5	N/A		1		
PMILL	1	544+17	548+66	RT	437.5	N	174			
PMILL	1	548+66	552+74	RT	750	Y	174	1		
PMILL	1	553+07 553+07	EEE 71	RT	700	N/A		1		
PMILL	1		555+31	RT RT	300	Y	66	1		
PMILL PMILL	1	556+77 556+77	562+28	RT	550	N/A N		1		
PMILL	1	562+28	571+16	RT	887.5	Y	207			
PMILL	1	566+05	571+17	LT	512.5	Y	117			
PMILL	1	571+17	511111	LT	212.2	N/A	111	1		
PGREEN	1	206+32	206+82	LT	50	Y	6			
PGREEN	1	206+82	200.02	LT	30	N/A		1		
PGREEN	1	211+77	215+21	LT	375	Y	84			
PGREEN	1	215+21	210 - 21	LT		N/A		1		
FR	ROM STAG	E 1 TO BE	USED IN	STAGE 2:					6162.5	9
	U-1								A-132416-C-413-C-4	
		STA	AGE 1 SUB	-TOTALS:	6162.5		1065	11	6162.5	9
PMILL	2	514+25	514+86	LT/RT	1862.5	Y	441			
PMILL	2	514+86		LT		N/A		1		
PMILL	2	535+08	552+68	LT	1800	Υ	426			
PMILL	2	552+68		LT		N/A		1		
PMILL	2	553+09	564+89	LT	1262.5	Y	297			
PMILL	2	564+89		LT		N/A		1		
PMILL	2	566+15	570+02	LT	387.5	N				and the second s
PMILL	2	570+02		LT		N/A		1		
PGREEN	2	205+37		RT		N/A		1		
PGREEN	2	205+37	210+12	RT	475	Y	108			
PGREEN	2	205+43	210+17	LT	475	Y	108			
PGREEN	2	210+17		LT		N/A		1		
PGREEN	2	212+20	215.00	RT	207.5	N/A	63	1		
PGREEN PGREEN	2	212+20	215+08	RT LT	287.5	Y	63			
PGREEN	2		214+47		225	N/A	48	1		
PGREEN	2	214+47	214741	LT LT	225	Y N/A	48	1		
ONLEN		214441		LI		IN/ A		1		
		RELOCA	TED FROM	STAGE 1	6162.5			9		
		,,	. 20 . 110101	J. HOL II	010210					
FR	OM STAG	E 2 TO BE	USED IN	STAGE 3:					775	6
			NUS RELO				1491	0		
STAGE	200-10	TALS WIT	100 NELO	VM 10113/1	012.3		1431			h
PGREEN	3	205+43		RT		N/A		1		T
PGREEN	3		206+18	RT	75	Y	12			
PGREEN	3	206+74		RT		N/A		1		
PGREEN	3		206+99	RT	25	Y				
PGREEN	3	207+74		RT		N/A		1		
PGREEN	3		210+49	RT	275	Y	60			
PGREEN	3	210+49		RT		N/A		1		
PGREEN	3	211+70		RT		N/A		1		
PGREEN	3	211+70	215+21	RT	400	Y	90			
PGREEN	3	215+21		RT		N/A		1		
		RELOCAT	TED FROM	STAGE 2:	775			6		Tarabaya I
	2 6115 5	T. 1. E								
STAGE	3 SUB-TO	IALS (MIN	NUS RELO	LATIONS):	0		162	0		
				TOTALC	C77F		2710	11	6077 5	15
				TOTALS:	6775		2718	11	6937.5	15

090071-sch-08.dgn pdf.plt standard-trans.tbl


COMPANY NAME;
PROJECT CONTACT;
DATE PLOTTED;
11/11
DATE NAME;
PLOT DRIVER;
PEN TABLE;
1


HRGreen.com
Illinois Professional Design Firm
#164-001322


USER NAME = tyelton	DESIGNED - JPA	REVISED -	
FILE NAME = 090071-sch-08.dgn	DRAWN - SVJ	REVISED -	1,000
PLOT SCALE = N.T.S.	CHECKED - JLP	REVISED -	
PLOT DATE = 11/11/2014	DATE - 11/12/14	REVISED -	

	SCHEDULE OF QUANTITIES							
C	HARLES	J. MI	LLER	ROAD	ROA	DWAY	IMPROVEME	ENTS
SCALE: N.T.S.	SHE	ET NO.	8 OF	8 SH	HEETS	STA.	TO	STA.

RIE.		CTION		COUNTY	TOTAL	SHEET NO.
3860	09-003	72-01-PW		MCHENRY	358	25
				CONTRACT	NO.	63892
FED. ROAD	DIST. NO.	ILLINOIS	FED. AID	PROJECT		

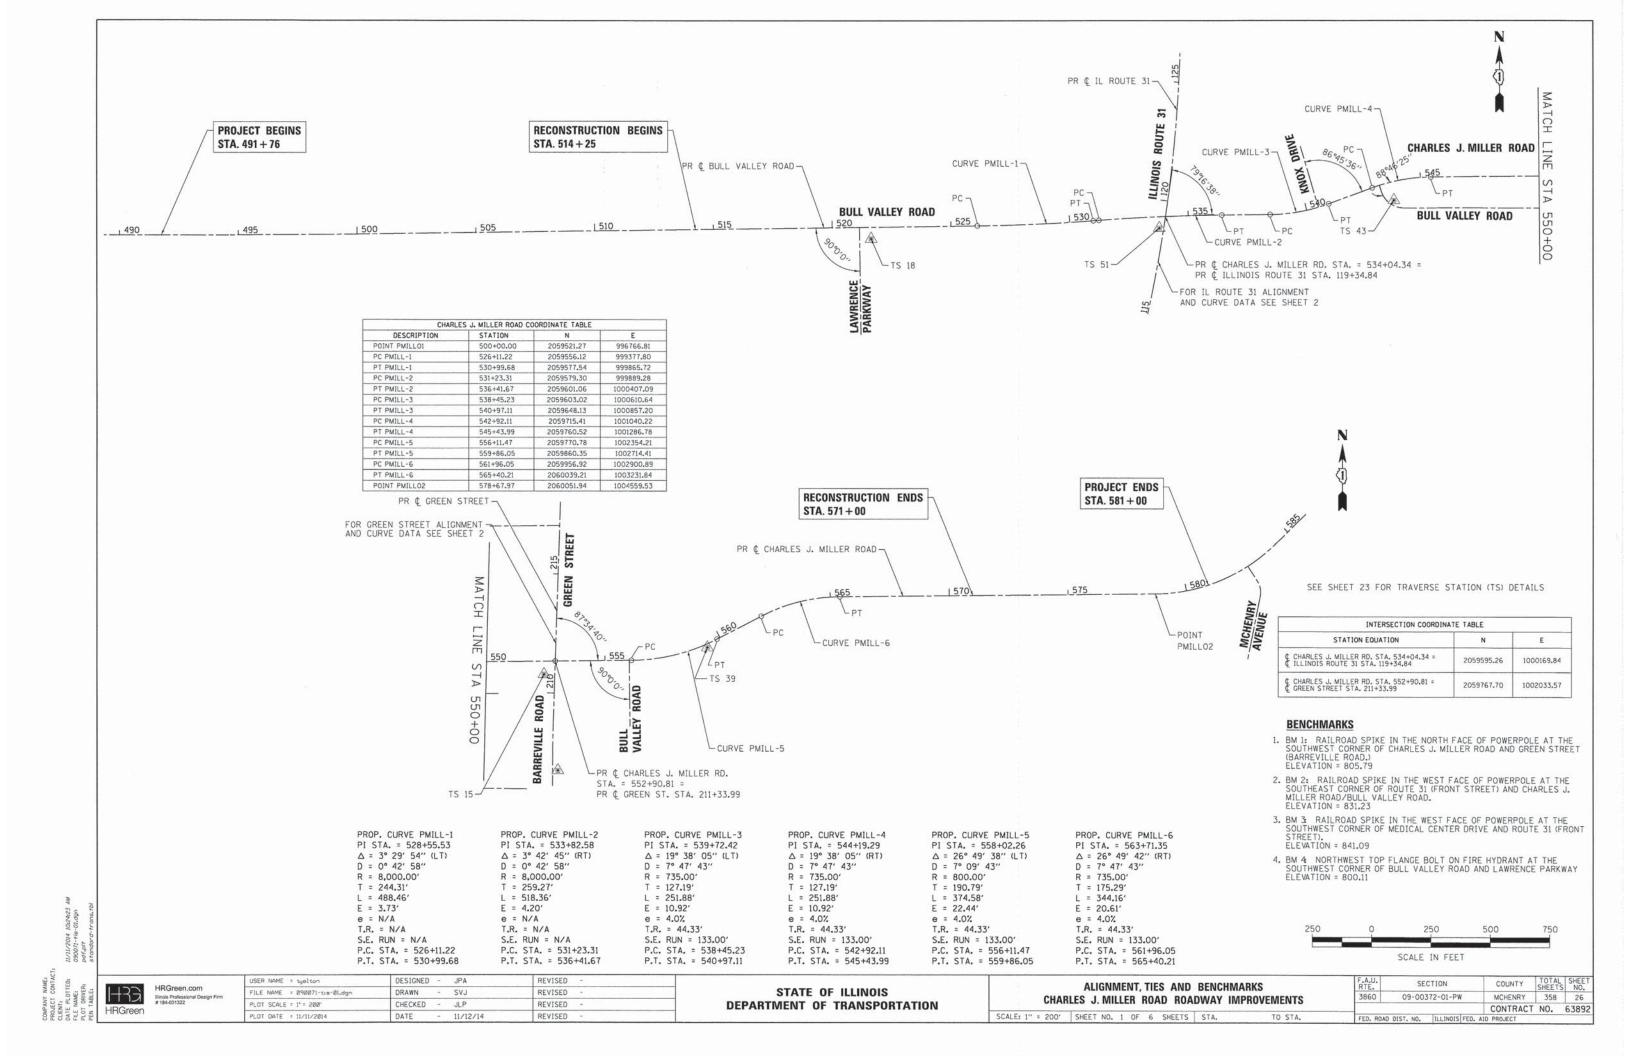

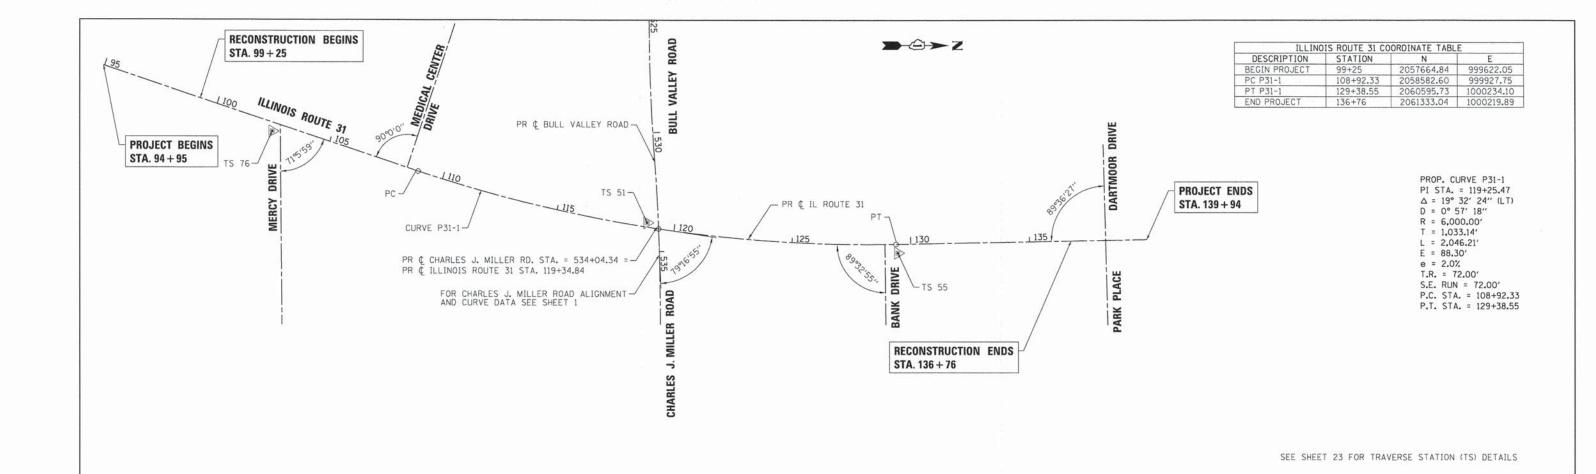

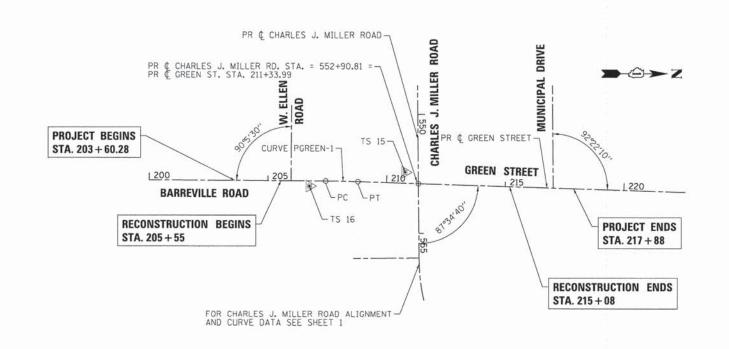

DESCRIPTION	STATION	N	E
BEGIN PROJECT	205+55	2059188.87	1002021.62
PC PGREEN-1	207+43.49	2059377.36	1002022.66
PT PGREEN-1	208+79.28	2059513.12	1002025.25
END PROJECT	215+08	2060141.51	1002045.78

PI STA. = 208+11.39 Δ = 1° 33′ 22″ (RT) D = 1° 08′ 45″ R = 5.000.00' T = 67.90' L = 135.79' E = 0.46' e = N/A

PROP. CURVE PGREEN-1

T.R. = N/A S.E. RUN = N/A P.C. STA. = 207+43.49 P.T. STA. = 208+79.28

SCALE IN FEET


HRGreen

HRGreen.com

USER NAME = tyelton	DESIGNED -	JPA	REVISED 1 - 10/30/2012	
FILE NAME = 090071-tie-02.dgn	DRAWN -	SVJ	REVISED -	
PLOT SCALE = 1* = 200'	CHECKED -	JLP	REVISED -	
PLOT DATE = 11/11/2014	DATE -	11/12/14	REVISED -	

	CHARI				0.00				HMARKS IMPROVEMENTS
SCALE: 1" =	200'	SHEET	NO.	2	OF	6	SHEETS	STA.	TO STA.

F.A.U. RTE.	SE	CTION	COUNTY	TOTAL	SHEET NO.
3860	09-003	372-01-PW	MCHENRY	358	27
			CONTRACT	NO.	63892
FED. ROA	AD DIST. NO.	ILLINOIS FED.	AID PROJECT		

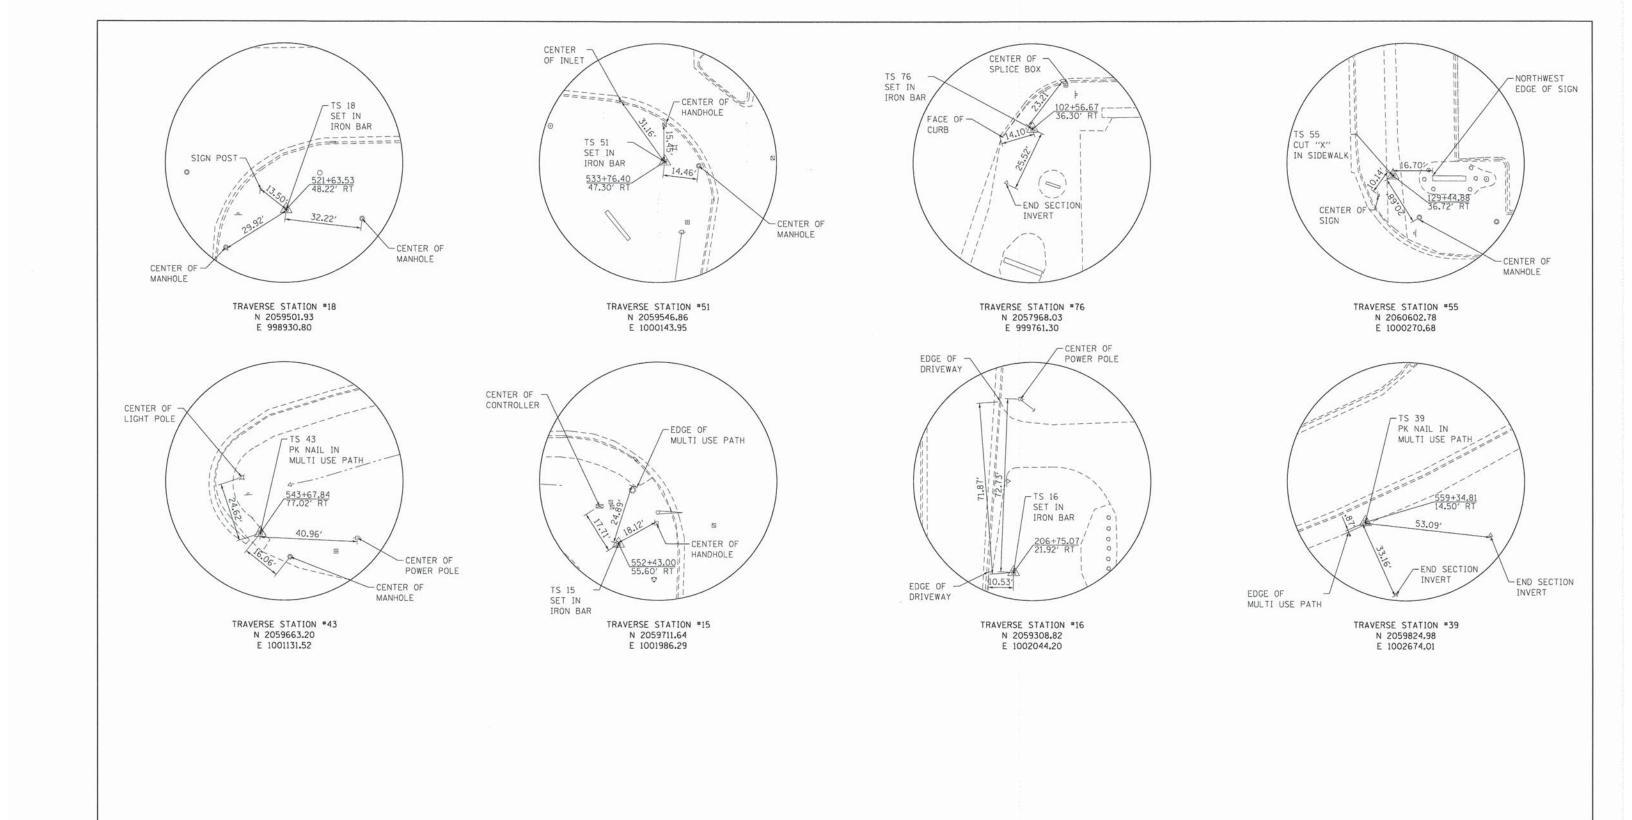

11/11/2014 10:24:39 AM 090071-+1e-03:49n pdf.pl+ standard-+rans.tbl

FILE NAMES


PLOT ORIVER: po

HRGreen.com Itinols Professional Design Firm # 184-001322

USER NAME = tyelton	DESIGNED - JPA	REVISED -	
FILE NAME = 090071-tie-03.dgn	DRAWN - SVJ	REVISED -	
PLOT SCALE = N.T.S.	CHECKED - JLP	REVISED -	
PLOT DATE = 11/11/2014	DATE - 11/12/	14 REVISED -	


ALIGNMENT, TIES AND BENCHMARKS							
C	HARLES	J. MII	LLER	ROAD	ROA	DWAY	IMPROVEMENTS
SCALE: N.T.S.	SHEE	ET NO.	3 OF	6 5	HEETS	STA.	TO STA.

F.A.U. SEC		CTION	COUNTY	TOTAL	
3860	09-003	372-01-PW	MCHENRY	358	28
			CONTRACT	NO.	63892
FED. ROAL	DIST. NO.	ILLINOIS FED.	AID PROJECT		

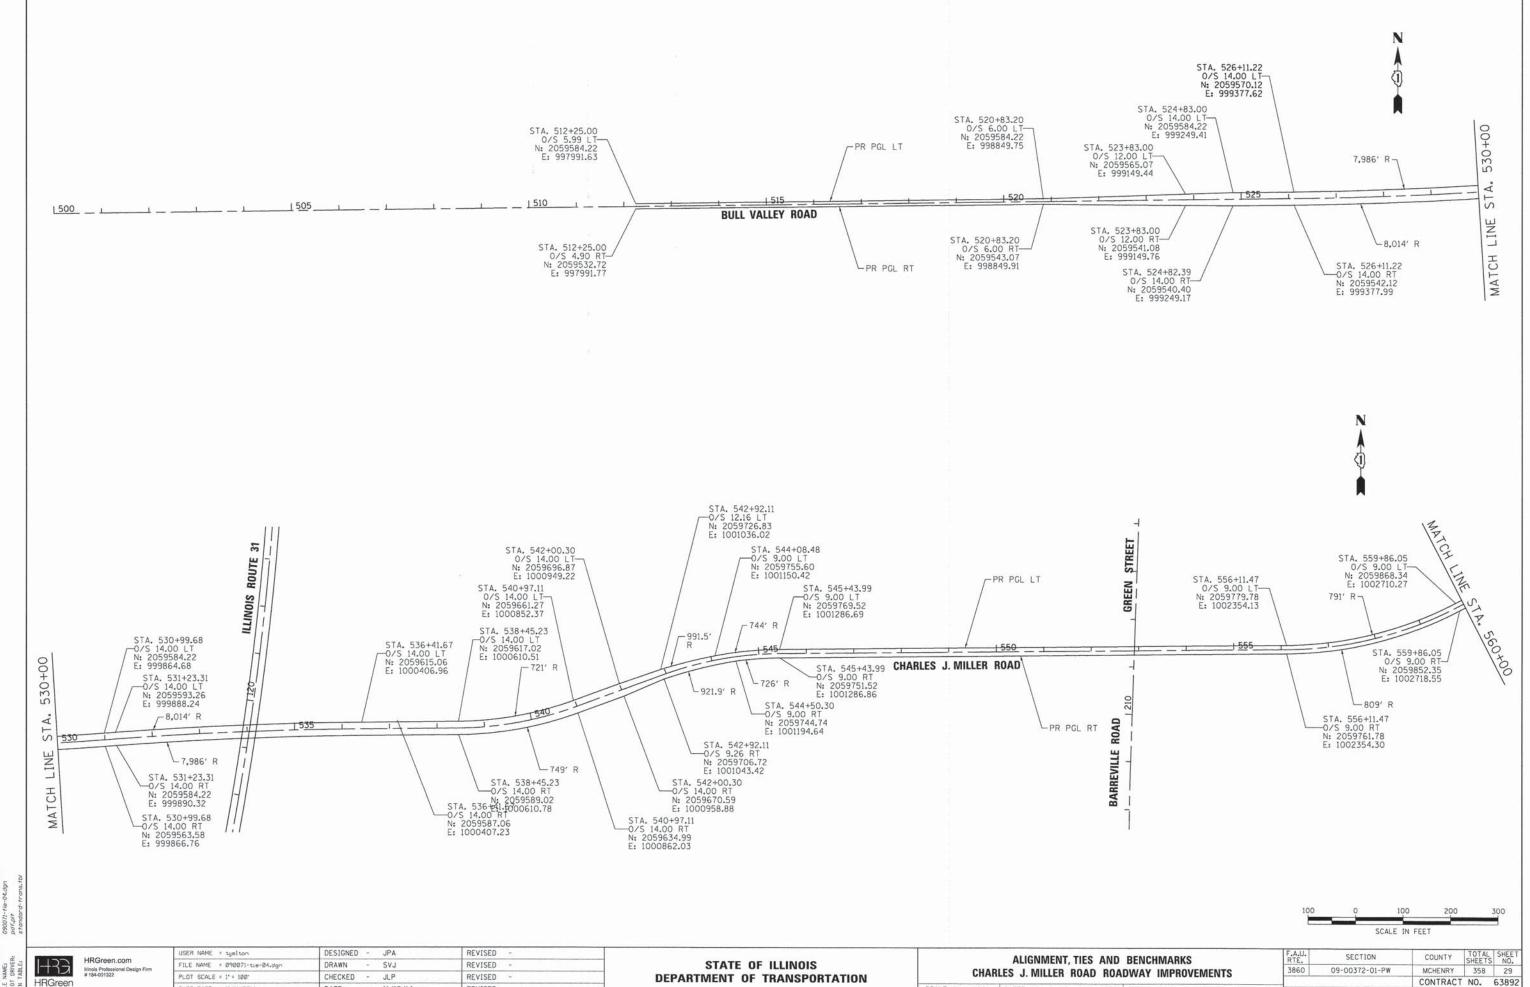

PLOT DATE = 11/11/2014 11/12/14 REVISED

SCALE: 1" = 100' SHEET NO. 4 OF 6 SHEETS STA. TO STA. CONTRACT NO. 63892

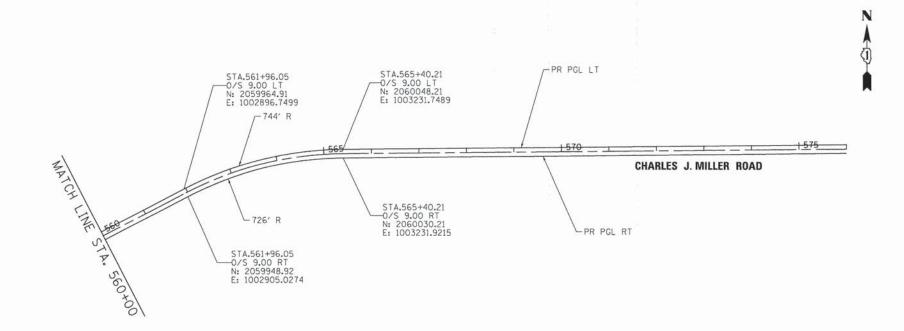

100 0 100 200 300 SCALE IN FEET


COMPANY NAME:
PROJECT CONTACT:
CLENT:
ATE PLOTTED:
TE NAME:
OF
TEL NAM

HRGreen.com
Illnois Professional Design Firm
#184-001322

4	USER NAME = tyelton	DESIGNED - JPA	REVISED -	
	FILE NAME = 090071-tie-05.dgn	DRAWN - SVJ	REVISED -	
	PLOT SCALE = 1* = 100"	CHECKED - JLP	REVISED -	
	PLOT DATE = 11/11/2014	DATE - 11/12/14	REVISED -	

ALIGNMENT, TIES AND BENCHMARKS	F.A.U. RTE.	SE	CTION	
CHARLES J. MILLER ROAD ROADWAY IMPROVEMENTS	3860	09-003	09-00372-01-P1	
SCALE: 1" = 100' SHEET NO. 5 OF 6 SHEETS STA. TO STA.	FED. ROAD	DIST. NO.	ILLINOIS	

	F.A.U. RTE.	SECTION	COUNTY	TOTAL	SHEET NO.
	3860	09-00372-01-PW	MCHENRY	358	30
_			CONTRACT	NO.	63892
	EED DOLG	name vo la tropic men	IN DOCKER		

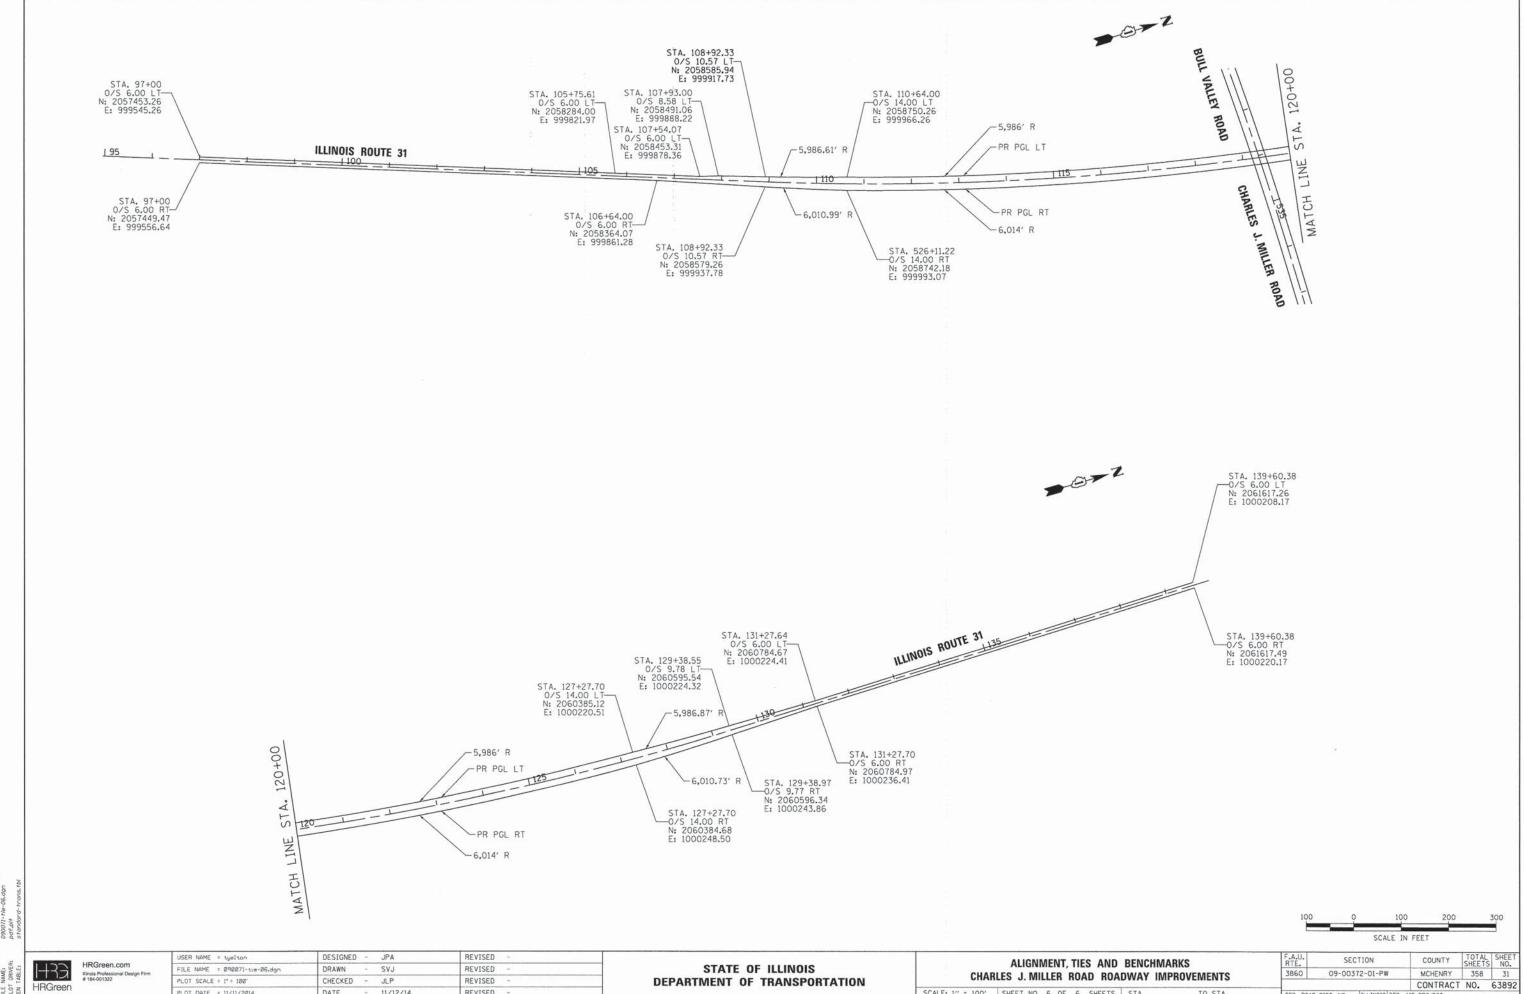

REVISED PLOT DATE = 11/11/2014 DATE 11/12/14

SCALE: 1" = 100' SHEET NO. 6 OF 6 SHEETS STA. TO STA.

SUPERELEVATION TABLES

LT EOP	PGL ELEV.	X-SLOPE	PR & STATION	X-SLOPE	PGL ELEV.	RT EOP
824.73	825.61	-2.00% (NC)	537+11.23	-2.00% (NC)	825.61	825.17
823.56	824.21	-2.00% (NC)	537+56.23	0.00% (ZG)	824.21	824.21
822.44	823.05	-2.00% (NC)	538+00.56	2.00% (RC)	823.05	823.49
821.37	822.12	-2.67% (SE)	538+45.23 (PC)	2.67% (SE)	822.12	822.71
820.36	821.4	-4.00% (SE)	538+90.23	4.00% (SE)	821.4	822.28
817.37	818.25	-4.00% (SE)	540+52.11	4.00% (SE)	818.25	819.13
816.40	816.99	-2.67% (SE)	540+97.11 (PT)	2.67% (SE)	816.99	817.58
815.15	815.59	-2.00% (NC)	541+41.78	2.00% (RC)	815,59	816.03
813.72	814.16	-2.00% (NC)	541+86.11	0.00% (ZG)	814.16	814.16
812.26	812.7	-2.00% (NC)	542+31.11	-2.00% (NC)	812.7	812.26

LT EOP	PGL ELEV.	X-SLOPE	PR & STATION	X-SLOPE	PGL ELEV.	RT EOF
814.82	815.26	-2.00% (NC)	541+58.11	-2.00% (NC)	815.26	814.82
813.60	813.60	0.00% (ZG)	542+03.11	-2.00% (NC)	813.60	813.16
812.61	812.17	2.00% (RC)	542+47.44	-2.00% (NC)	812.17	811.73
811.31	810.72	2.67% (SE)	542+92.11 (PC)	-2.67% (SE)	810.72	810.13
810.16	809.28	4.00% (SE)	543+37.11	-4.00% (SE)	809.28	808.40
808.43	807.55	4.00% (SE)	544+98.99	-4.00% (SE)	807.55	806.67
805.50	804.91	2.67% (SE)	545+43.99 (PT)	-2.67% (SE)	804.91	804.32
804.93	804.49	2.00% (RC)	545+88.66	-2.00% (NC)	804.49	804.05
804.26	804.26	0.00% (ZG)	546+32.99	-2.00% (NC)	804.26	803,82
803.78	804.22	-2.00% (NC)	546+77.99	-2.00% (NC)	804.22	803.78

LT EOP	PGL ELEV.	X-SLOPE	PR ¢ STATION	X-SLOPE	PGL ELEV.	RT EOP
796.56	797.22	-2.00% (NC)	554+77.47	-2.00% (NC)	797.22	796.78
795.64	796.30	-2.00% (NC)	555+22.47	0.00% (ZG)	796.30	796.30
794.59	795.25	-2.00% (NC)	555+66.80	2.00% (RC)	795.25	795.69
793.22	794.05	-2.67% (SE)	556+11.47 (PC)	2.67% (SE)	794.05	794.64
791.56	792.72	-4.00% (SE)	556+56.47	4.00% (SE)	792.72	793.60
784.68	785.56	-4.00% (SE)	559+41.05	4.00% (SE)	785.56	786.44
784.46	785.05	-2.67% (SE)	559+86.05 (PT)	2.67% (SE)	785.05	785.64
784.32	784.76	-2.00% (NC)	560+30.72	2.00% (RC)	784.76	785.20
784.23	784.67	-2.00% (NC)	560+75.05	0.00% (ZG)	784.67	784.67
784.34	784.78	-2.00% (NC)	561+20.05	-2.00% (NC)	784.78	784.34

PROJECTED ELEVATION AT PROPOSED INTERSECTION

LT EOP	PGL ELEV.	X-SLOPE	PR & STATION	X-SLOPE	PGL ELEV.	RT EOF
784.23	784.67	-2.00% (NC)	560+62.05	-2.00% (NC)	784.67	784.23
784.73	784.73	0.00% (ZG)	561+07.05	-2.00% (NC)	784.73	784.29
785.42	784.98	2.00% (RC)	561+51.38	-2.00% (NC)	784.98	784.54
786.03	785.44	2.67% (SE)	561+96.05 (PC)	-2.67% (SE)	785.44	784.85
787.00	786.12	4.00% (SE)	562+41.05	-4.00% (SE)	786.12	785.24
790.27	789.39	4.00% (SE)	564+95.21	-4.00% (SE)	789.39	788.51
789.81	789.22	2.67% (SE)	565+40.21 (PT)	-2.67% (SE)	789.22	788.63
789.27	788.83	2.00% (RC)	565+84.88	-2.00% (NC)	788.83	788.39
788.20	788.20	0.00% (ZG)	566+29,21	-2.00% (NC)	788.20	787.76
786.66	787.32	-2.00% (NC)	566+74.21	-2.00% (NC)	787.32	786.88

PROJECTED ELEVATION AT PROPOSED INTERSECTION


			SUPERELEVATION	ON TRANSITIONS A	T CURVE P31-1		
	LT EOP	PGL ELEV.	X-SLOPE	PR & STATION	X-SLOPE	PGL ELEV.	RT EOP
Ī	839.81	840.33	-2.00% (NC)	107+72.33	-2.00% (NC)	840.33	839.81
	839.37	839.89	-2.00% (NC)	108+44.33	0.00% (ZG)	839.89	839.89
Ì	838.76	839.28	-2.00% (NC)	109+68.33	2.00% (RC)	839.28	839.80
Ī	838.96	839.48	-2.00% (SE)	108+92.33 (PC)	2.00% (SE)	839.48	840.00
Ì	819.83	820.56	-2.00% (SE)	129+14.55	2.00% (SE)	820,56	821.27
İ	819.36	820.08	-2.00% (SE)	129+38.55	2.00% (SE)	820.08	820.79
Ì	819.83	820.56	-2.00% (NC)	129+86.55 (PT)	2.00% (RC)	820.56	821.27
Ì	816.43	817.09	-2.00% (NC)	130+58.55	-2.00% (NC)	817.09	816.43

PROJECTED ELEVATION AT PROPOSED INTERSECTION

11/11/2014 10:25:00 AM 090071-tle-07.dgn pdf.p/t standard-trans.tbl

CLOWS AND TO AND THE PROJECT CONTACT:
CLENT:
DATE PLOTTED:
11/11/2
DATE NOTHER:
PLOT ORIVER:
PEN TABLE:
STORM

HRGreen	
HKGreen	i.com
# 184-001322	sional Design Firm

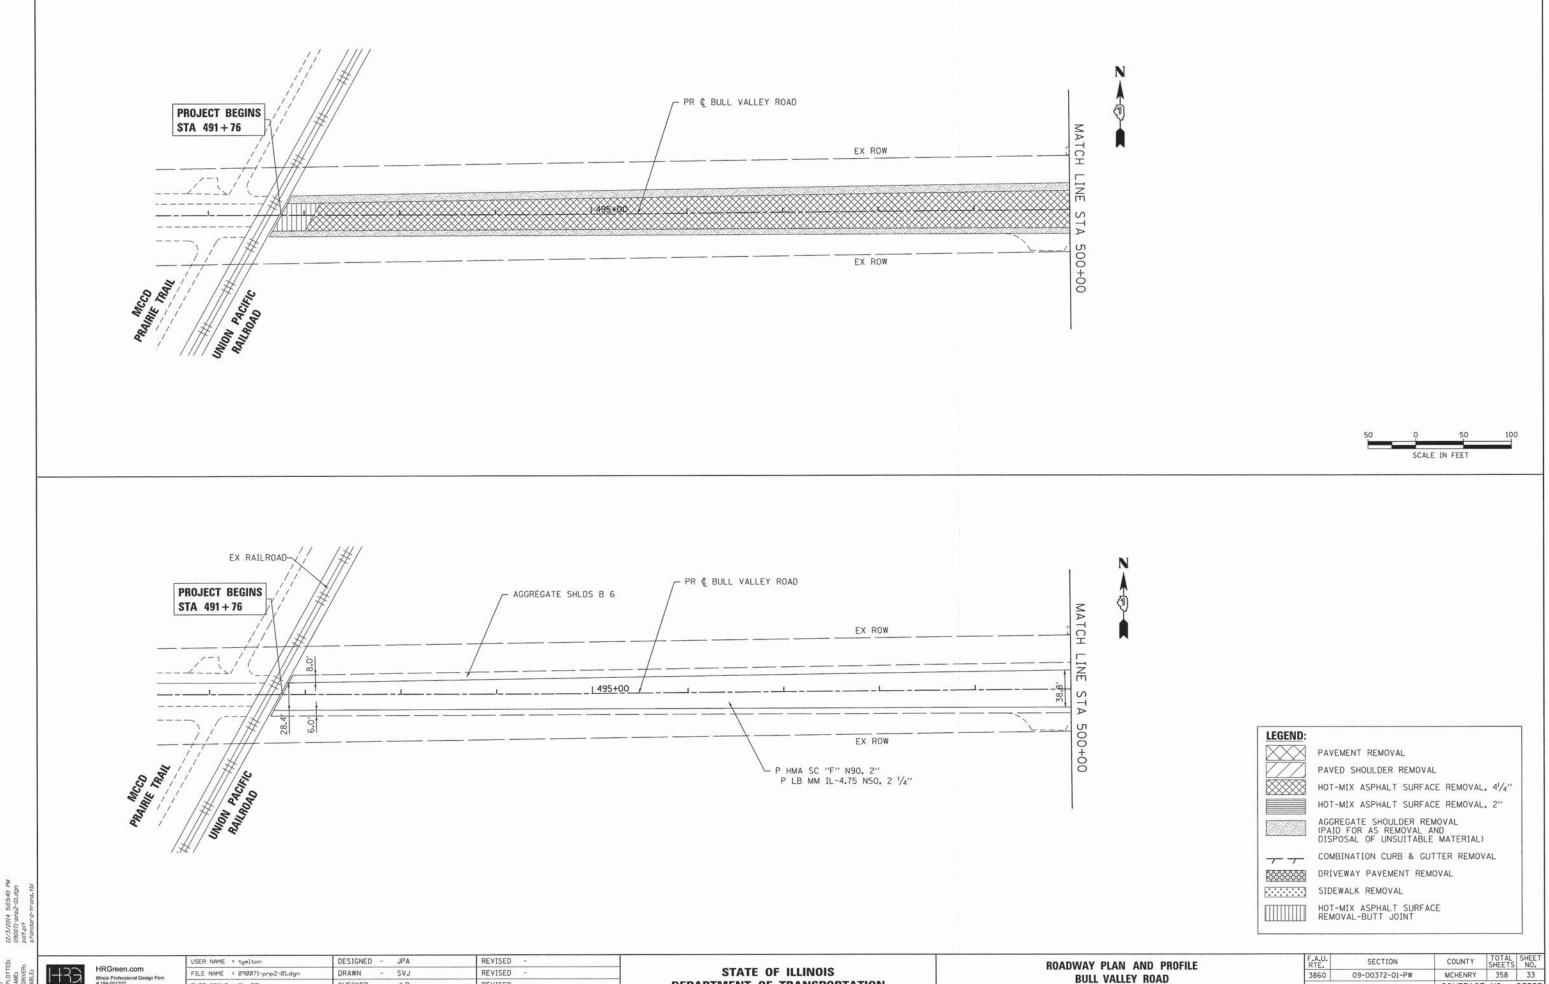



HRGreen


FILE NAME = 090071-pnp2-01.dgn PLOT SCALE = I' = 50' CHECKED - JLP REVISED PLOT DATE = 12/3/2014


DEPARTMENT OF TRANSPORTATION


BULL VALLEY ROAD SCALE: 1" = 50' SHEET NO. 1 OF 11 SHEETS STA. 491+76 TO STA. 500+00 09-00372-01-PW CONTRACT NO. 63892

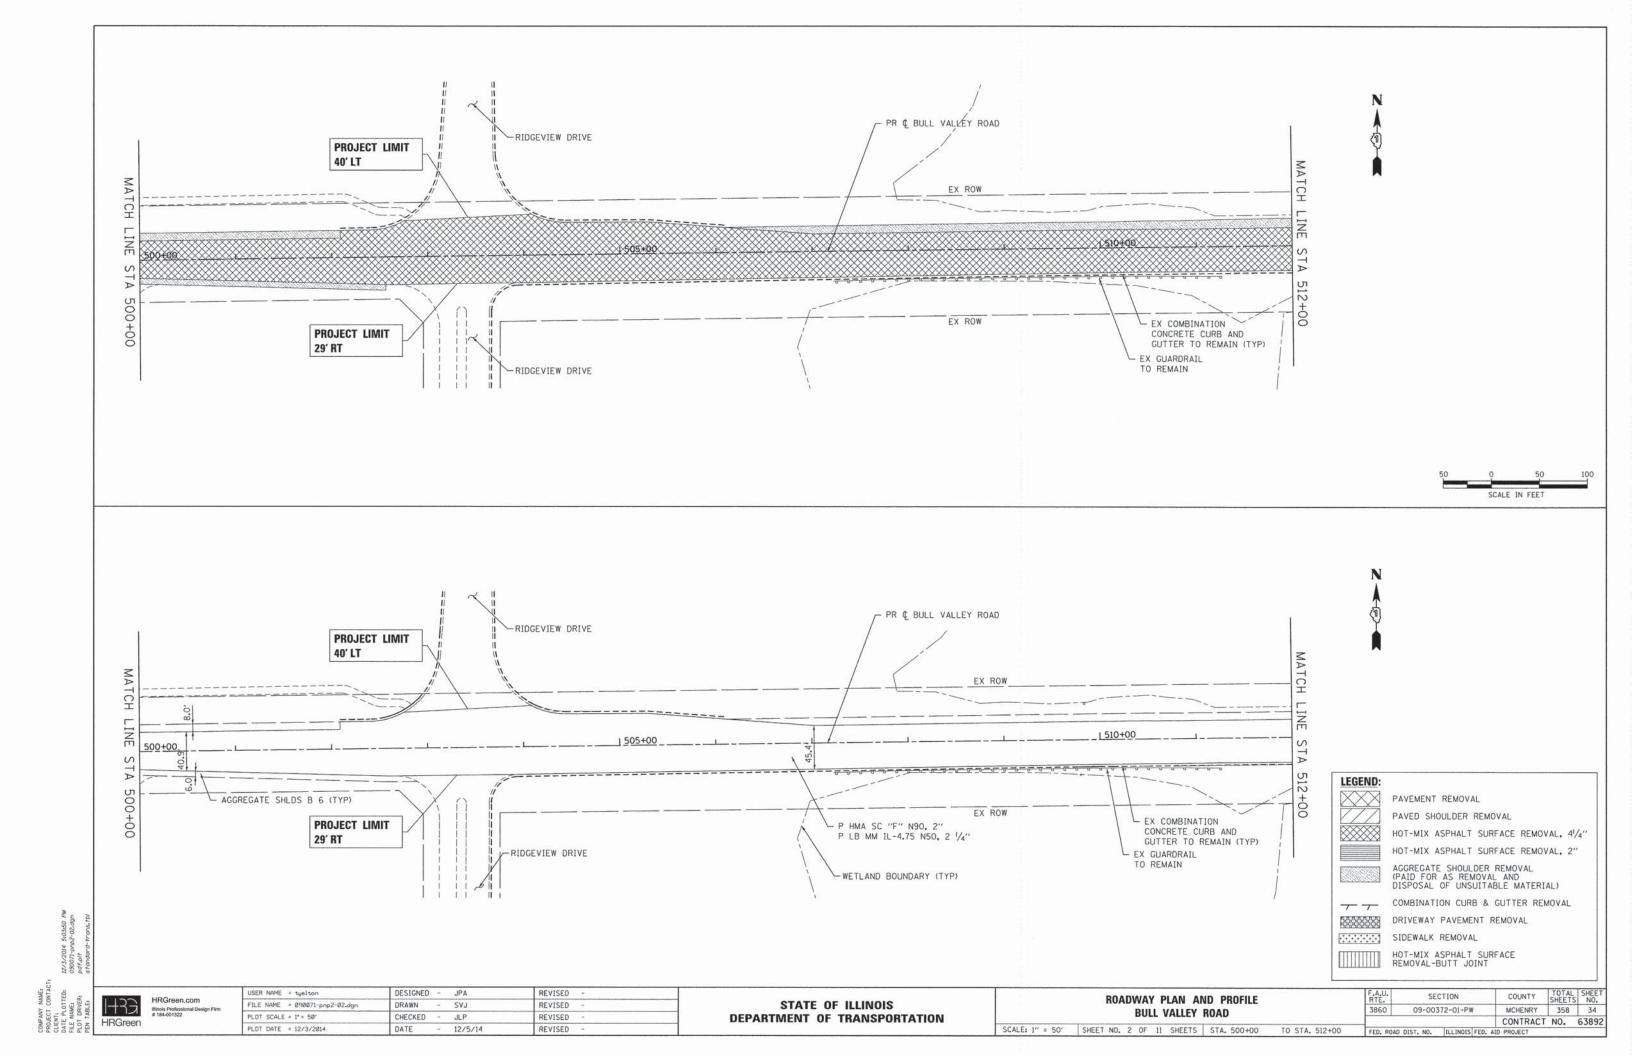


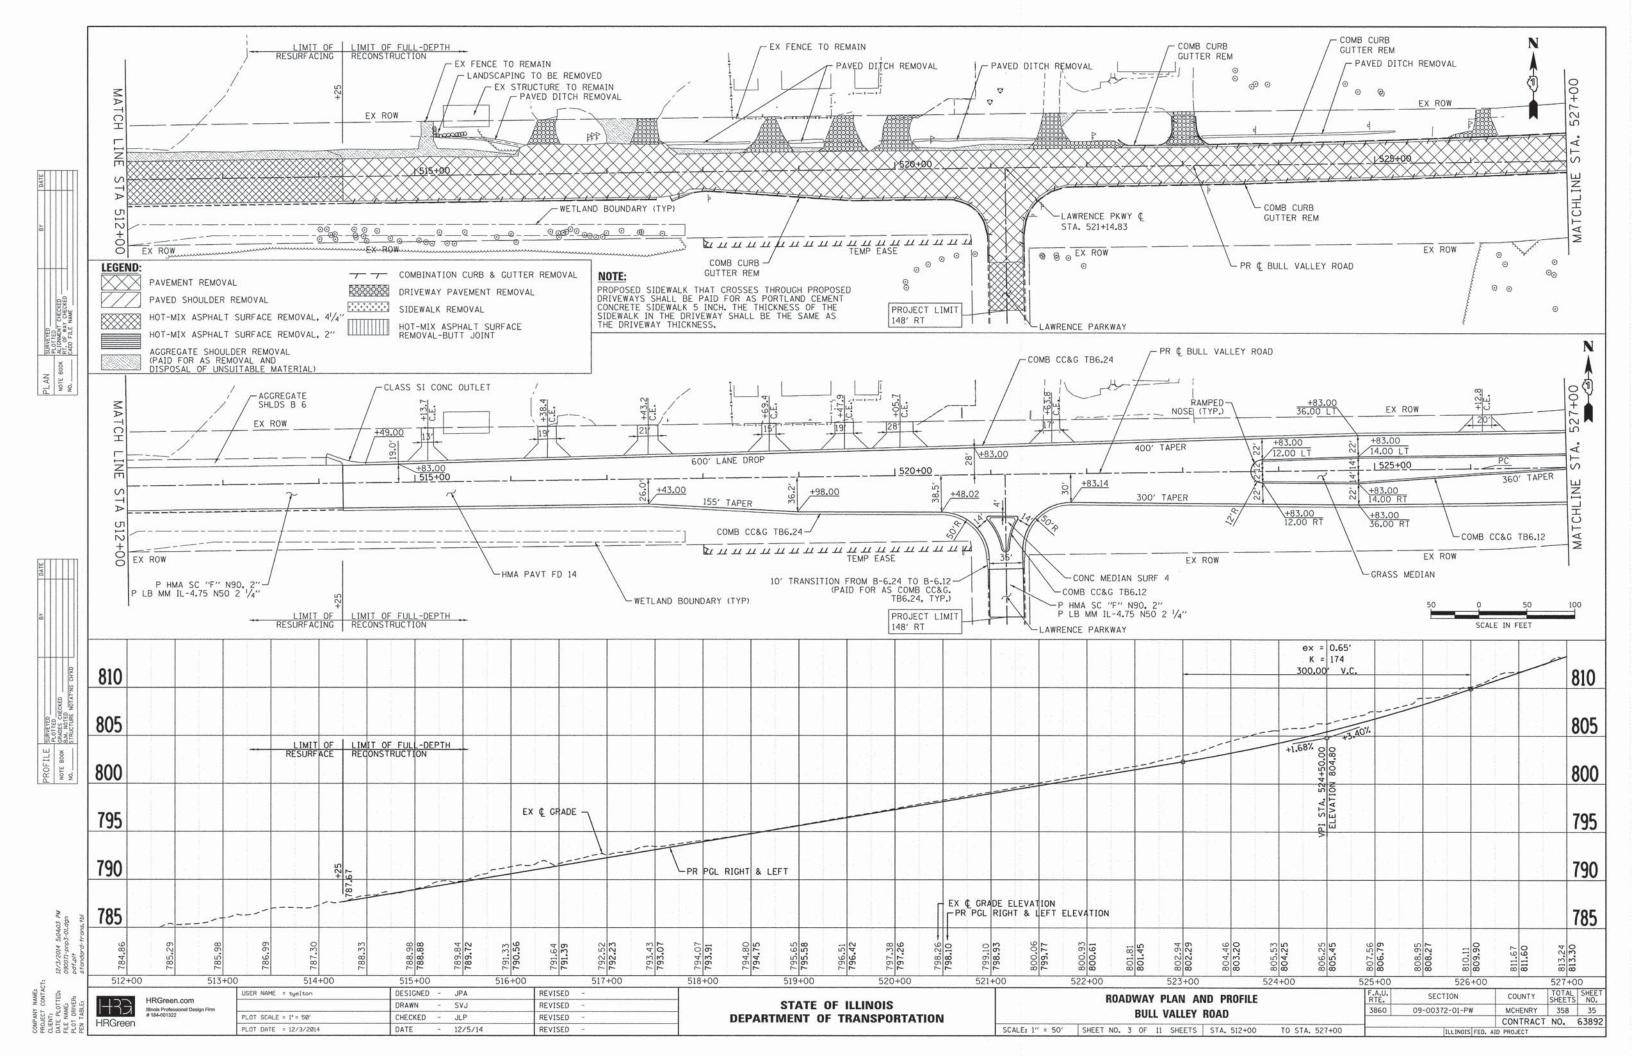


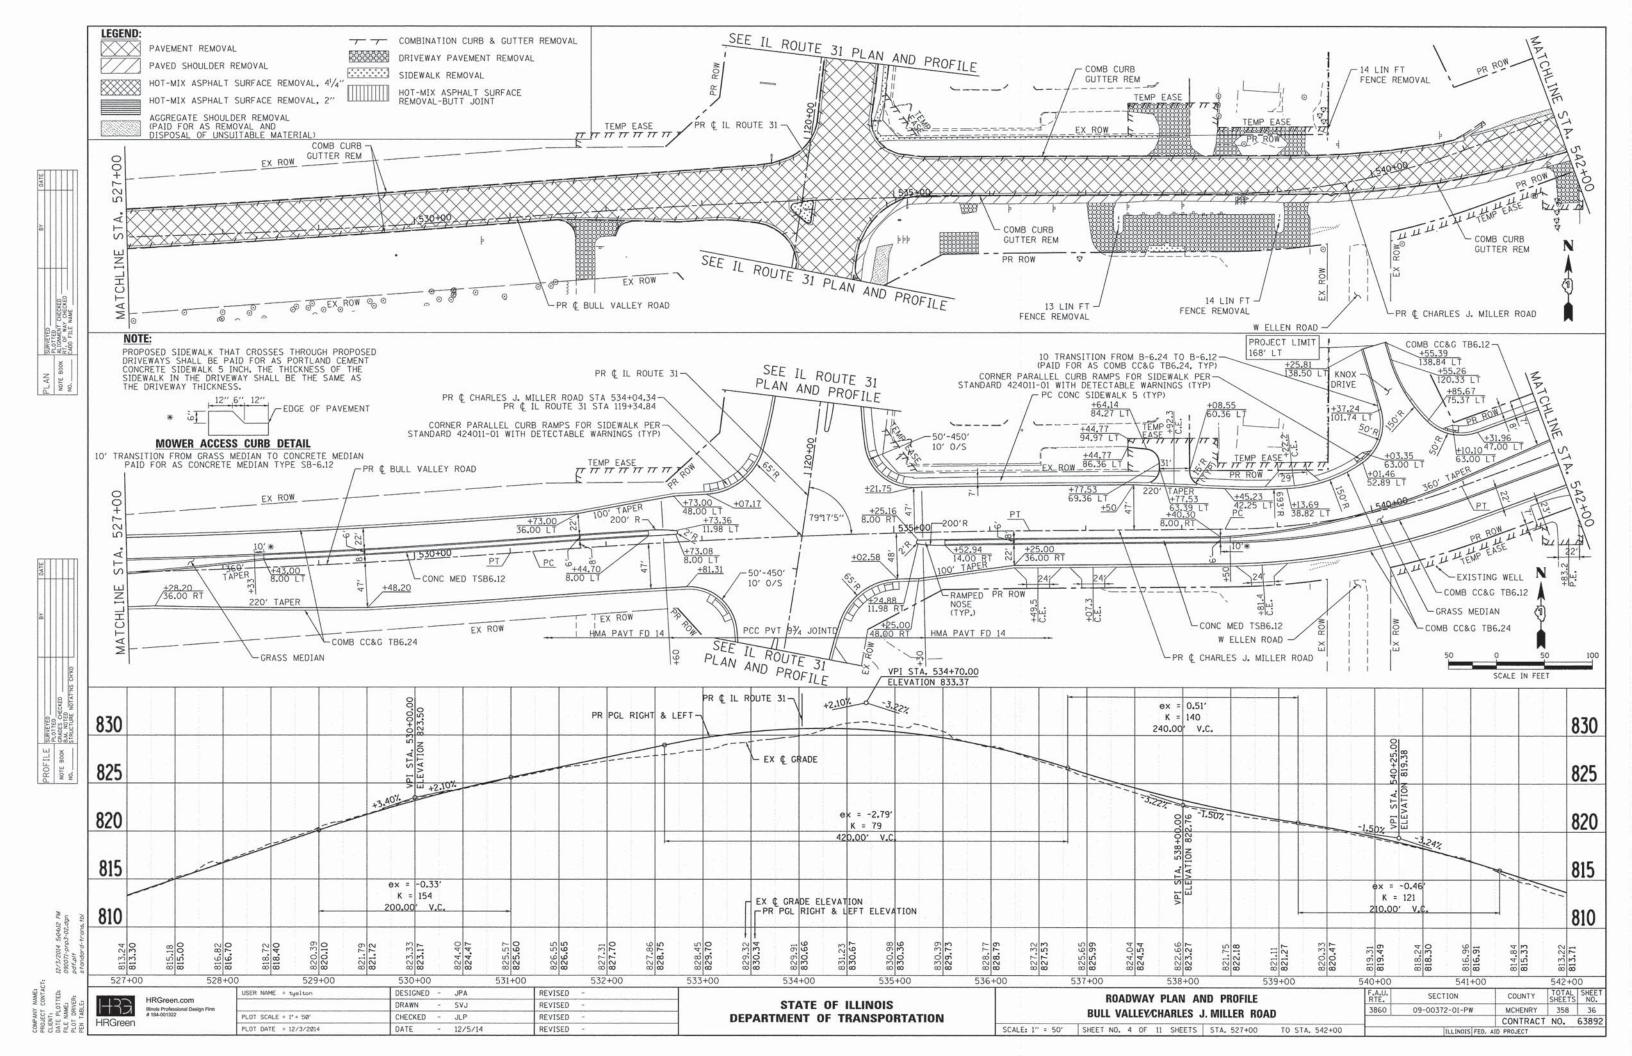


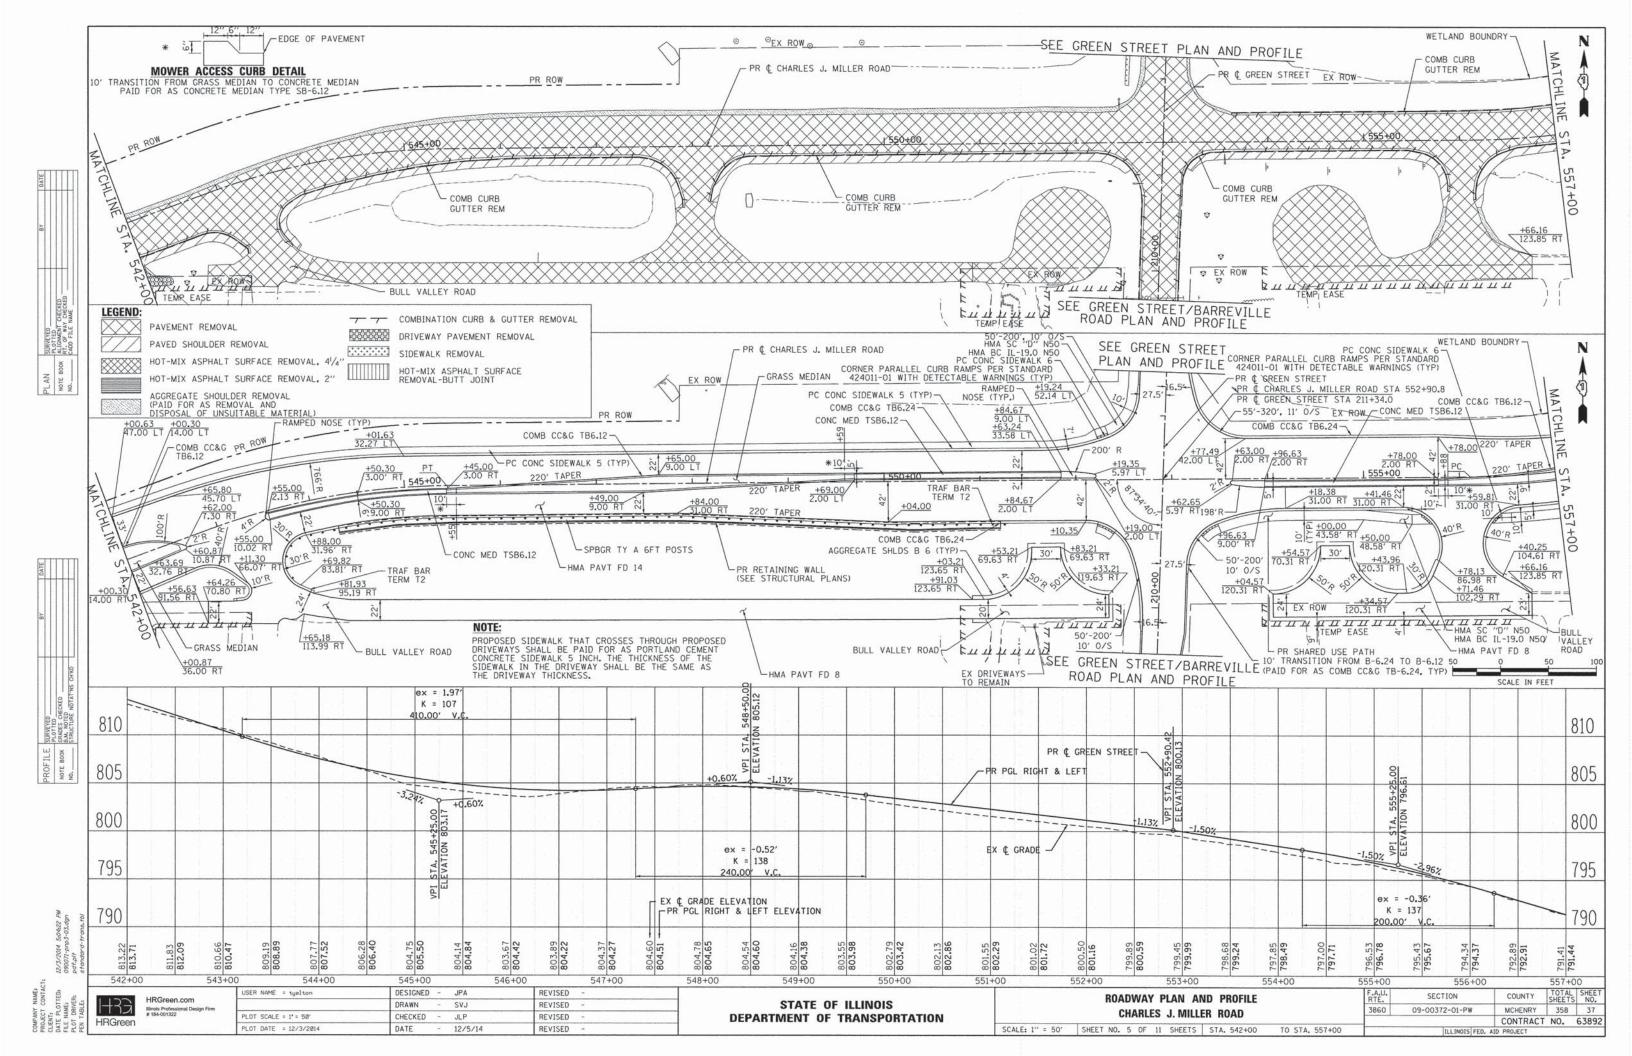


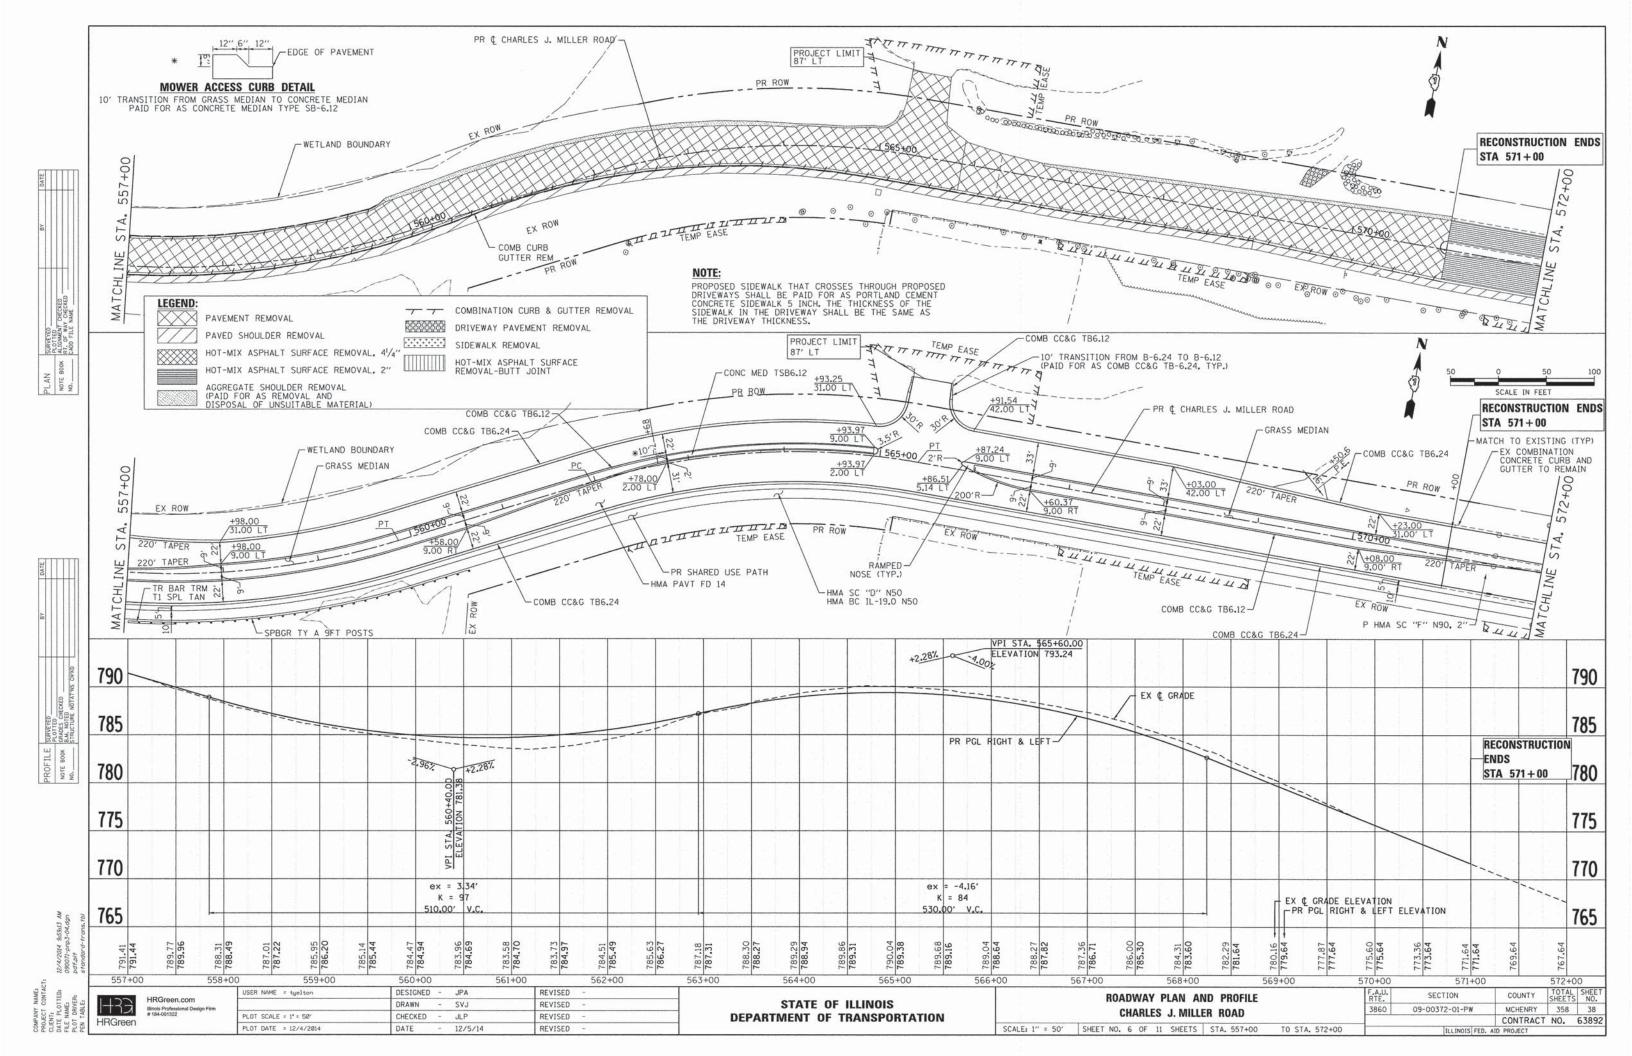


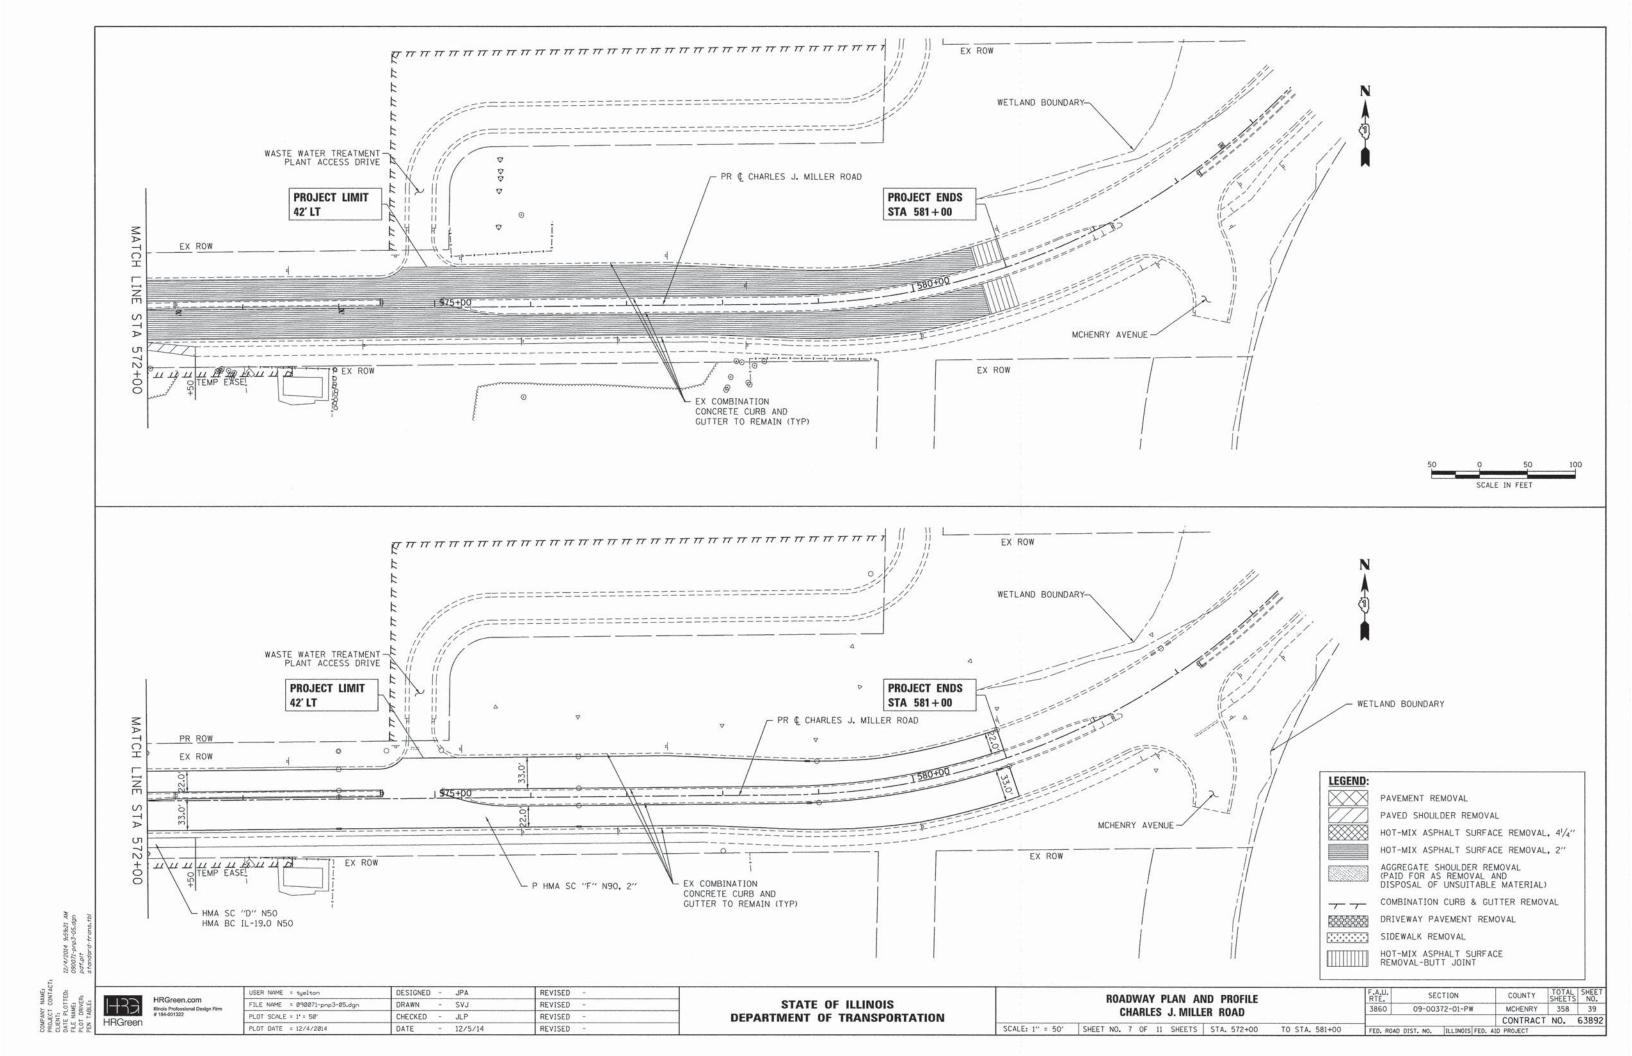

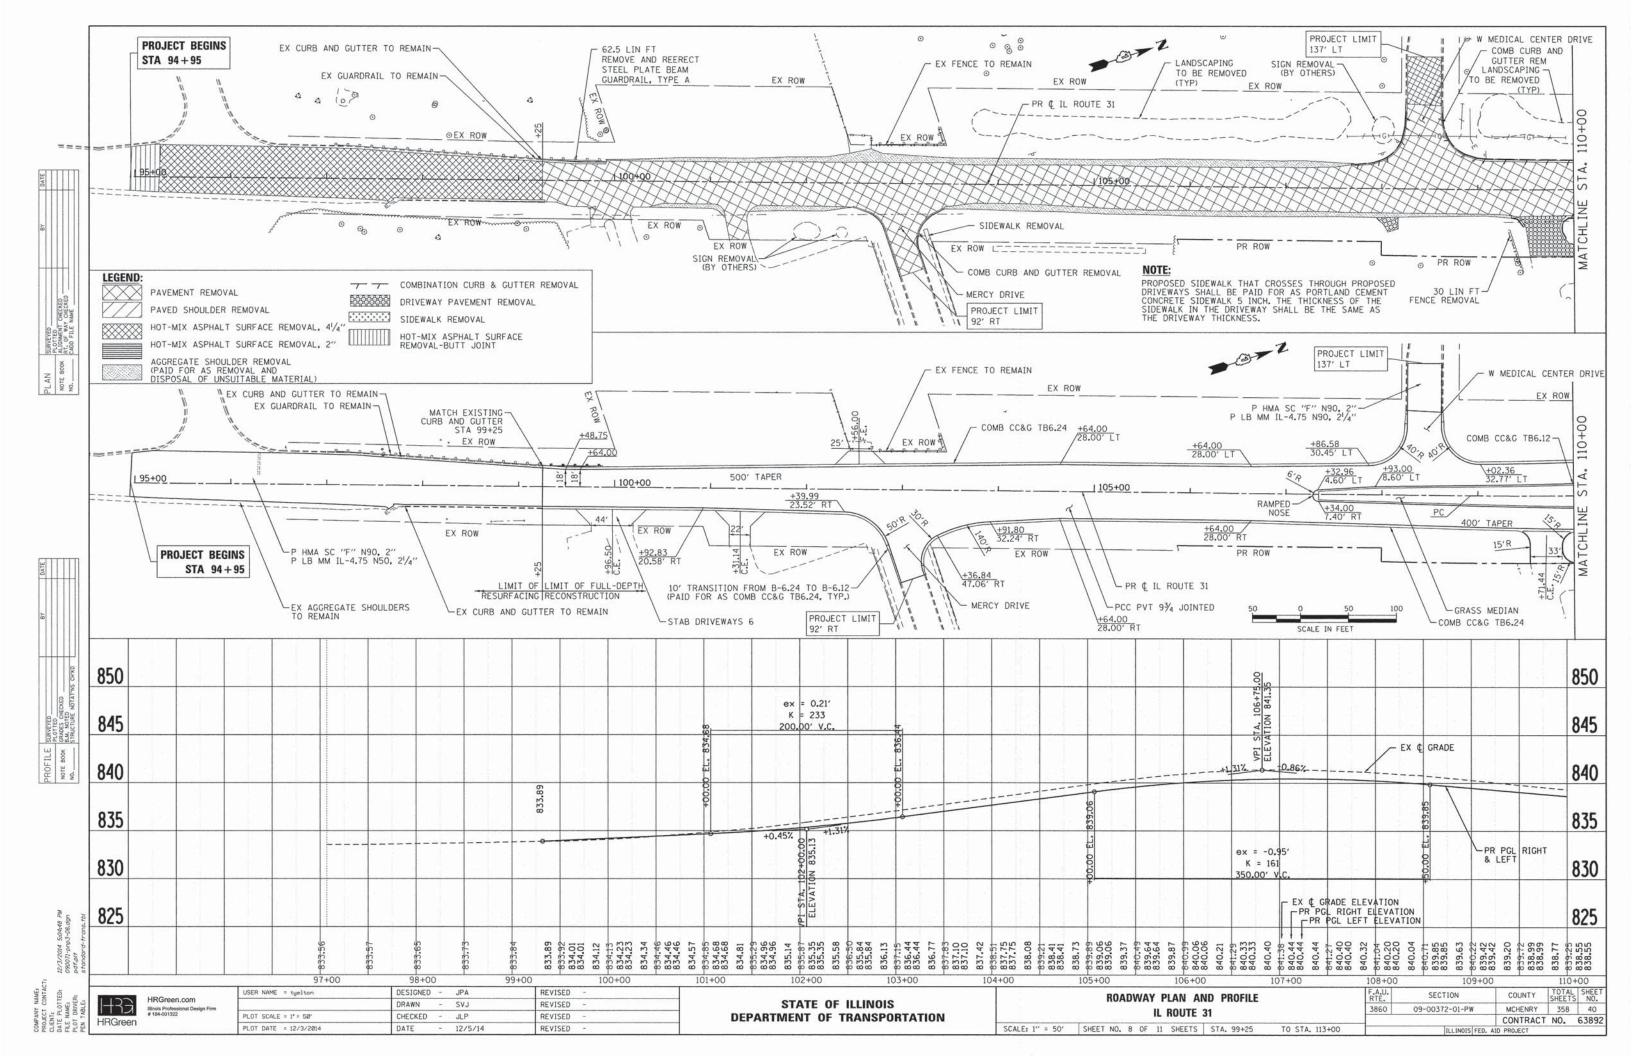

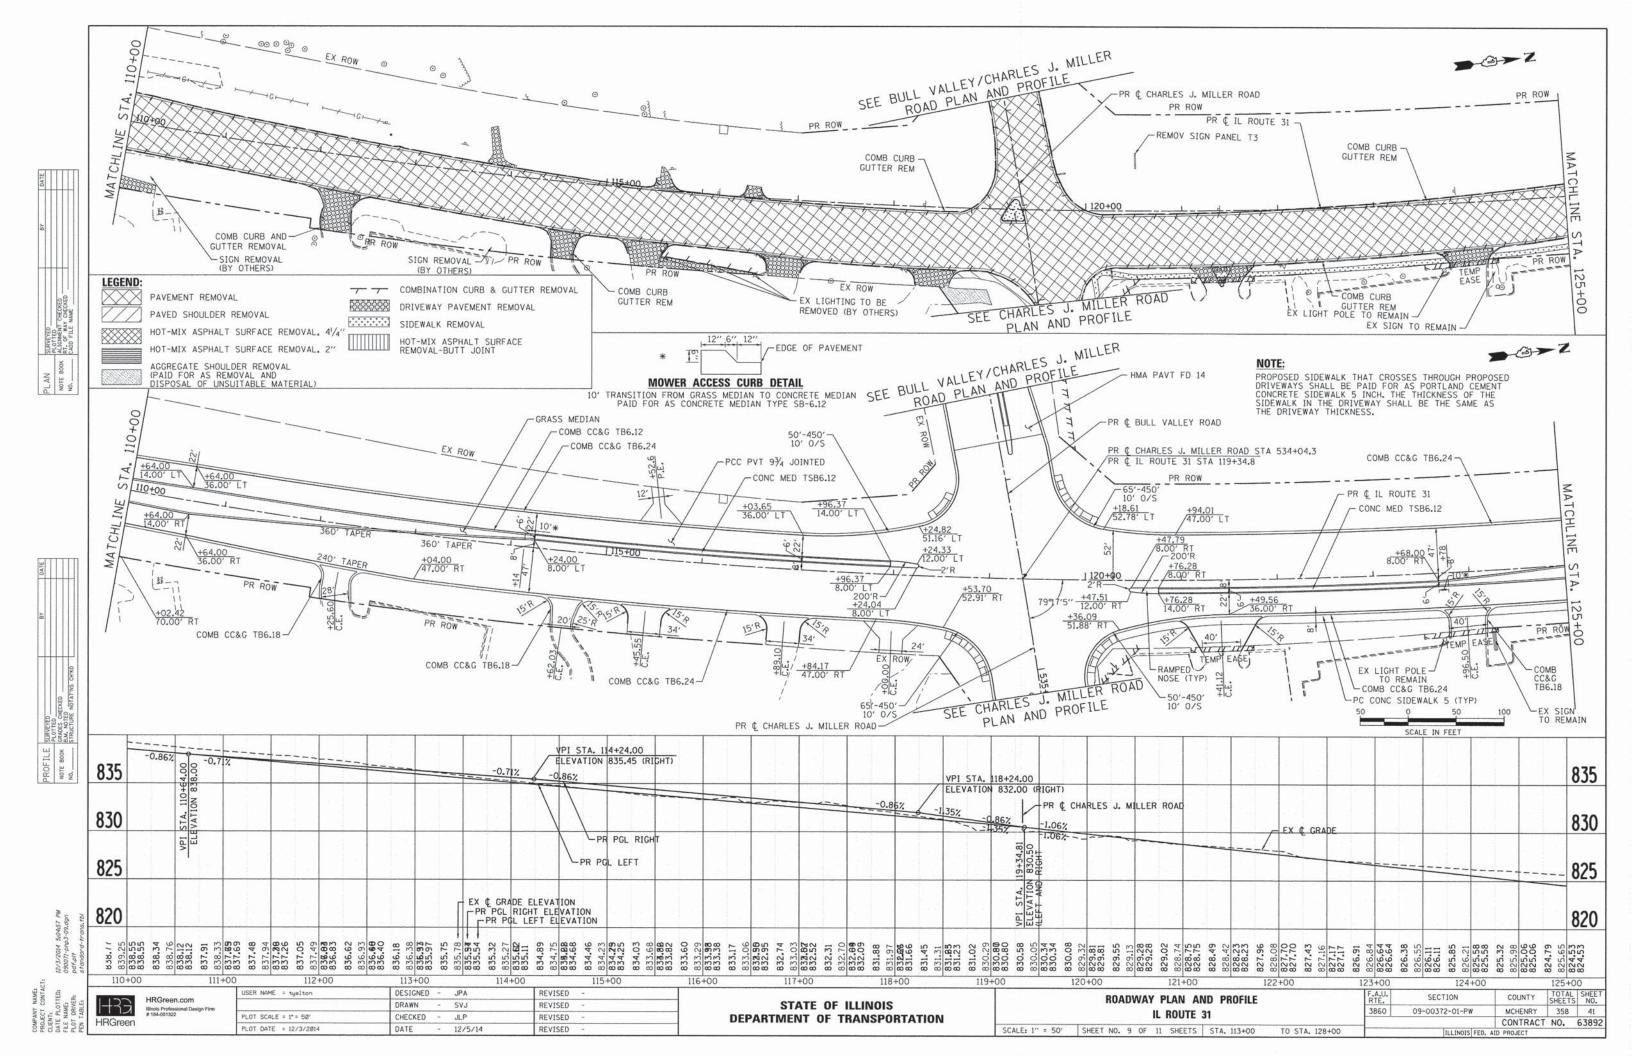

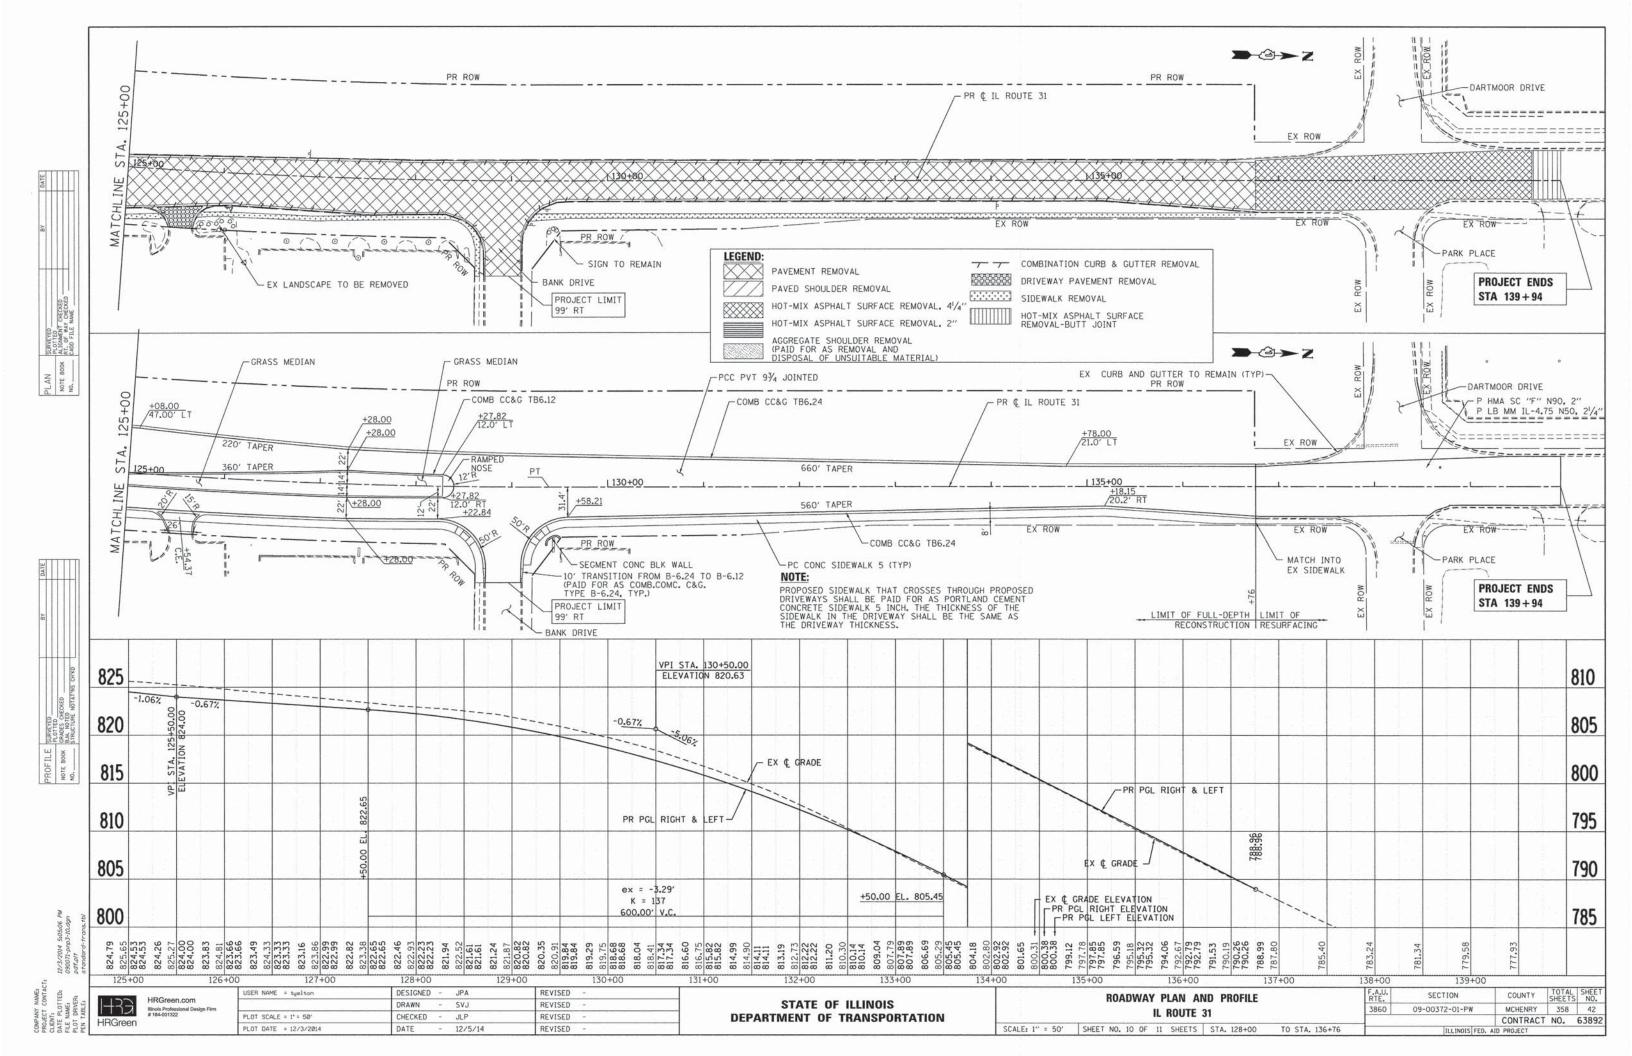

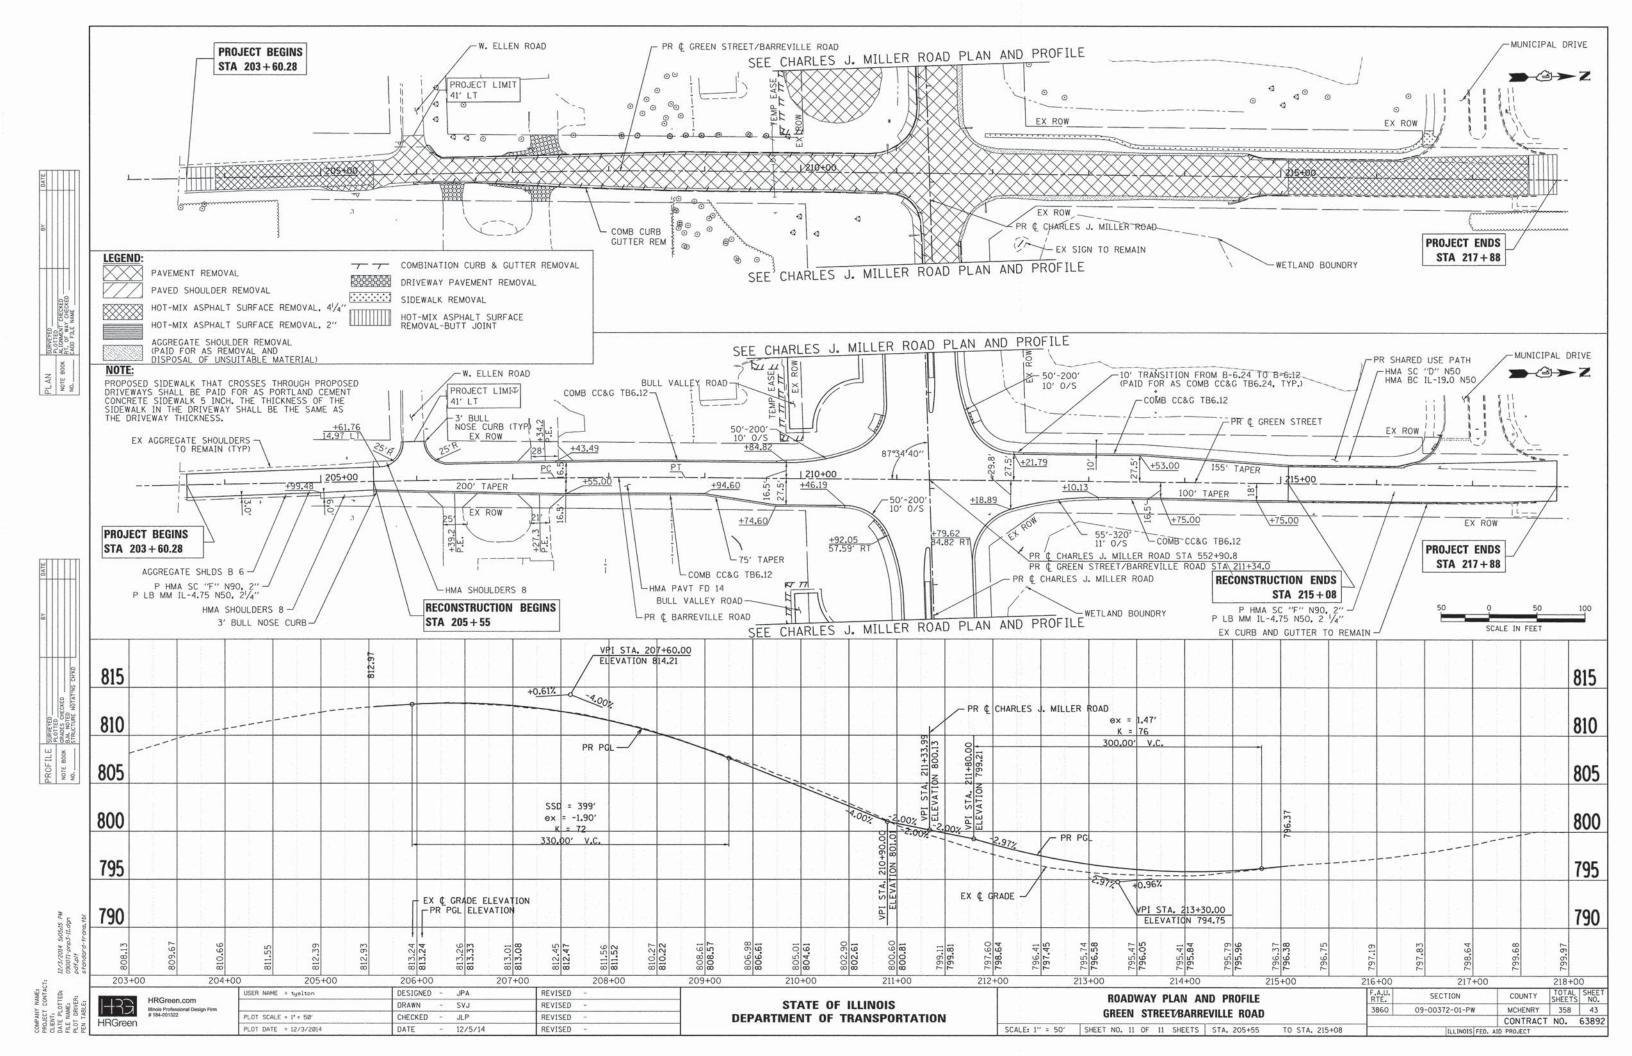

GENERAL NOTES

- 1. THE TRAFFIC CONTROL PLANS SHALL SERVE AS A GUIDE FOR SAFE DIVERSION OF TRAFFIC DURING EXECUTION OF THIS CONTRACT. HOWEVER, THE CONTRACTOR MAY MODIFY THE TRAFFIC CONTROL PLANS TO MEET CONSTRUCTION NEEDS BUT NOT AT THE EXPENSE OF PUBLIC SAFETY OR CONVENIENCE. ANY CHANGES TO THE TRAFFIC CONTROL PLAN SHALL BE SUBMITTED TO THE ENGINEER AND THE COUNTY FOR APPROVAL, AND TO THE STATE FOR APPROVAL ON IL 31
- 2. THE RESIDENT ENGINEER SHALL BE INFORMED 72 HOURS IN ADVANCE OF ANY CHANGE TO THE STAGING
- 3. THE CONTRACTOR SHALL CONTACT THE IDOT TRAFFIC CONTROL SUPERVISOR AT (847) 705-4470 A MINIMUM OF 72 HOURS IN ADVANCE OF BEGINNING WORK.
- 4. CONTRACTOR SHALL MAINTAIN A MINIMUM OF ONE THROUGH LANE IN EACH DIRECTION THROUGHOUT
- 5. TRAFFIC CONDITIONS, ACCIDENTS, AND OTHER UNFORESEEN EMERGENCY CONDITIONS MAY REQUIRE THE ENGINEER TO RESTRICT, MODIFY, OR REMOVE LANE CLOSURES OR CHANNELIZATION SHOWN IN THE PLANS. THE CONTRACTOR SHALL MAKE THE NECESSARY ADJUSTMENTS AS DIRECTED BY THE ENGINEER WITHOUT DELAY. THE CONTRACTOR SHALL RESPOND TO ANY REQUEST MADE BY THE ENGINEER FOR CORRECTION WITHIN TWO HOURS FROM THE TIME OF NOTIFICATION.
- 6. ALL OF THE TRAFFIC CONTROL DEVICES SHALL BE IN PLACE BEFORE CONSTRUCTION IS STARTED. ALL TEMPORARY PAVEMENT MARKINGS & TRAFFIC CONTROL DEVICES SHALL BE IN PLACE AT THE BEGINNING OF EACH STAGE, AND SHALL BE MAINTAINED FOR THE DURATION OF THAT STAGE UNLESS
- 7. THE CONTRACTOR SHALL BE REQUIRED TO MAINTAIN ACCESS TO ENTRANCES AND APPROACHES AS INDICATED ON THE PLANS WITHIN THE PROJECT LIMITS. THIS WORK IS TO BE PAID FOR AT THE CONTRACT UNIT PRICE PER EACH FOR TEMPORARY ACCESS (PRIVATE ENTRANCE), OR TEMPORARY ACCESS (COMMERCIAL ENTRANCE), OR TEMPORARY ACCESS (ROAD).
- 8. A WORK ZONE SPEED LIMIT OF 45 MPH ON BULL VALLEY/CHARLES J. MILLER ROAD AND ILLINOIS ROUTE 31, AND 30 MPH ON GREEN STREET/BARREVILLE ROAD, OR AS DIRECTED BY THE ENGINEER SHALL BE IN PLACE JUST PRIOR TO PRE-STAGE CONSTRUCTION.

- 1. TRAFFIC CONTROL DEPICTED ON THE MAINTENANCE OF TRAFFIC PLANS IS THE MINIMUM REQUIREMENT. OTHER WORK OR SIGNING MAY BE REQUIRED BY THE ENGINEER.
- 2. ALL EXISTING SIGNS THAT CONFLICT WITH THE TRAFFIC CONTROL PLAN SHALL BE COVERED OR REMOVED IN ACCORDANCE WITH ARTICLE 107.25 OF THE STANDARD SPECIFICATIONS.
- 3. THE CONTRACTOR SHALL PROVIDE, INSTALL, MAINTAIN AND REMOVE ALL SIGNS AND SIGN SUPPORTS REQUIRED FOR TRAFFIC CONTROL AND PROTECTION. THIS WORK SHALL NOT BE PAID FOR SEPARATELY BUT SHALL BE INCLUDED IN THE CONTRACT UNIT LUMP SUM PRICES PER THE TRAFFIC CONTROL AND
- 4. THE CONTRACTOR SHALL PLACE "CAUTION NEW LANES OPEN" SIGNS AT EVERY ENTRANCE AND SIDE ROADS AT THE TIME OF OPENING NEW LANES TO TRAFFIC AND/OR AS DIRECTED BY THE ENGINEER. SEE TEMPORARY INFORMATION SIGN DETAIL FOR FURTHER INFORMATION.
- 5. THE CONTRACTOR SHALL PLACE "DRIVEWAY ENTRANCE" SIGNS AT ALL COMMERCIAL ENTRANCES WITHIN THE PROJECT LIMITS WHERE ENTRANCE IS OBSTRUCTED DUE TO CONSTRUCTION AND/OR AS DIRECTED BY THE ENGINEER. ACCESS SHALL BE MAINTAINED TO ALL PROPERTIES DURING CONSTRUCTION OPERATIONS WITH THE USE OF AGGREGATE FOR TEMPORARY ACCESS AND/OR BY CONSTRUCTION OPERATIONS WITH THE USE OF AGGREGATE FOR TEMPORARY INFORMATION SIGNS DETAIL TC-26 FOR FURTHER INFORMATION.
- 6. TEMPORARY SIGNING, AS SHOWN, SHALL CONFORM TO THE APPLICABLE STANDARDS INCLUDED IN THE SPECIAL PROVISIONS AND CONTRACT PLANS OR AS DIRECTED BY THE ENGINEER, ALL TEMPORARY INFORMATION SIGNS SHALL BE PAID FOR SEPARATELY AT THE UNIT PER SQUARE FOOT FOR TEMPORARY INFORMATION SIGNING".
- 7. THE CONTRACTOR SHALL PLACE FOUR CHANGEABLE MESSAGE SIGNS, ONE AT THE BEGINNING OF THE PROJECT ON BULL VALLEY ROAD, THE NORTH AND SOUTH LEGS OF IL ROUTE 31, AND AT THE EAST END OF THE PROJECT ON CHARLES J. MILLER ROAD. THE MESSAGE SIGNS WITH THE APPROPRIATE INFORMATION SHALL BE IN PLACE TWO WEEKS BEFORE START OF CONSTRUCTION ACTIVITY. THIS WORK IS TO BE PAID FOR AT THE CONTRACT UNIT PRICE PER CALENDAR MONTH FOR "CHANGEABLE MESSAGE
- 8. THE BIKE PATH TEMPORARY INFORMATION SIGNING IS TO BE PLACED AT THE EXIT OF THE MORAINE HILLS STATE PARK BIKE PATH.

BARRICADES

- 1. EXISTING TRAFFIC CONTROL DEVICES WITHIN THE LIMITS OF CONSTRUCTION ARE TO BE PROTECTED FROM DAMAGE BY THE CONTRACTOR. ANY DAMAGED SIGNS CAUSED BY HIS WORK SHALL BE REPLACED BY THE CONTRACTOR.
- 2. CHANNELIZING DEVICES ARE TO BE PLACED AT SAME LEVEL AS TRAVELING LANE OR SHOULDER
- 3. CHANNELIZING DEVICES MAY BE PLACED AT THE DROP-OFF ELEVATION TO PRESERVE LAVE WIDTH. THE REFLECTIVE AREA AND WARNING LIGHT SHALL BE RAISED TO THE ELEVATION ABOVE THE TRAVELING LANE OR SHOULDER PROFILE AS REQUIRED BY STANDARD 701901. THE CONTRACTOR SHALL USE LEG EXTENSIONS FOR TYPE II BARRICADES OR PROVIDE A 2 FT WIDTH EARTH FILL PAD FOR DRUMS TO MEET MINIMUM BARRICADE HEIGHT (SEE STAGING TYPICAL CROSS SECTION SHEETS). THIS WORK SHALL NOT BE PAID FOR SEPARATELY BUT SHALL BE INCLUDED IN THE CONTRACT UNIT LUMP SUM PRICE FOR TRAFFIC CONTROL AND PROTECTION, (SPECIAL)
- ALL TEMPORARY CONCRETE BARRIERS SHALL BE EQUIPPED WITH A 6 IN. PAINTED STRIPE AND A STEADY BURNING LIGHT. THIS WORK SHALL NOT BE PAID FOR SEPARATELY BUT SHALL BE INCLUDED IN THE CONTRACT UNIT PRICE PER FOOT FOR "TEMPORARY CONCRETE BARRIER".

- 1. ALL TEMPORARY PAVEMENT MARKINGS PROPOSED WITHIN THE WORK AREA SHALL BE COMPLETED PRIOR TO THE CONSTRUCTION PHASE CHANGE.
- 2. THE REMOVAL OF ALL PAVEMENT MARKING ON IL ROUTE 31 PCC PAVEMENT MUST BE DONE USING WATER BLASTING WITH VACUUM RECOVERY, AND IT WILL BE PAID AS "PAVEMENT MARKING REMOVAL."
- 3. ALL PAVEMENT MARKINGS CONFLICTING WITH REVISED TRAFFIC PATTERNS SHALL BE REMOVED. TYPE III MARKING TAPE SHALL BE USED ON THE FINAL WEARING SURFACE OR ON THE EXISTING PAVEMENT TO REMAIN WHEN THE TEMPORARY PAVEMENT MARKING WILL CONFLICT WITH THE PERMANENT PAVEMENT MARKING SUCH AS ON TAPERS OR LANE SHIFTS.

PAVEMENT MARKING (CONTINUED)

4. ALL STAGE 1 PAVEMENT MARKINGS SHALL BE TEMPORARY PAVEMENT MARKING, ALL STAGE 2 PAVEMENT MARKINGS ON HMA SHALL BE THERMOPLASTIC AND TEMPORARY PAVEMENT MARKING ON PCC. ALL STAGE 3 PAVEMENT MARKINGS SHALL BE PAVEMENT MARKING TAPE, TYPE III.

- WHEN ARTIFICIAL LIGHTING IS USED IN NIGHT OPERATIONS THE CONTRACTOR SHALL EXERCISE THE UTMOST PRECAUTIONS IN PREVENTING ADVERSE VISIBILITY TO THE MOTORING PUBLIC AND ADJOINING RESIDENTIAL AREAS.
- 2. ANY SAWCUTTING OF THE EXISTING PAVEMENT FOR STAGE CONSTRUCTION SHALL BE INCLUDED IN THE CONTRACT UNIT PRICE PER SQUARE YARD FOR "PAVEMENT REMOVAL".
- 3. ALL DRAINAGE STRUCTURES THAT ARE REQUIRED TO BE INSTALLED WITHIN TEMPORAY PAVEMENT OR AT A TEMPORARY ELEVATION NECESSARY TO MAINTAIN TRAFFIC AND DRAINAGE ARE REQUIRED TO BE ADJUSTED TO THE PROPOSED TEMPORARY ELEVATION WITH A TYPE 1 FRAME OPEN LID AND THEN ADJUSTED TO FINAL GRADE WITH THE PROPOSED FRAME AND GRATE. THIS WORK SHALL NOT BE PAID FOR SEPARATELY BUT SHALL BE INCLUDED IN THE CONTRACT UNIT PRICE FOR THE DRAIANGE
- 4. ANY PAVEMENT DROP-OFFS GREATER THAN 3 INCHES IMMEDIATELY ADJACENT TO TRAFFIC SHALL NOT BE LEFT OVERNIGHT. DROP-OFFS GREATER THAN 18 INCHES SHALL NOT BE EXPOSED TO TRAFFIC FOR GREATER THAN 48 HOURS. THIS WORK SHALL NOT BE PAID FOR SEPARATELY BUT SHALL BE INCLUDED IN THE CONTRACT UNIT LUMP SUM PRICE FOR TRAFFIC CONTROL AND PROTECTION, (SPECIAL).
- 5. THE CONTRACTOR SHALL PROVIDE TEMPORARY HMA RAMPS TO TRANSITION THE DIFFERENTIAL ELEVATIONS CAUSED BY STAGED CONSTRUCTION BETWEEN THE NEW CONSTRUCTION AND EXISTING PAVEMENT. THIS WORK WILL BE PAID FOR AT THE CONTRACT UNIT PRICE PER SQUARE YARD FOR TEMPORARY RAMP.
- 6. END OF TEMPORARY CONCRETE BARRIER WALL MUST BE TAPERED 8:1 (12:1 IF POSTED SPEED LIMIT IS >40 MPH) AWAY FROM TRAFFIC.

NORMAL DROP-OFF HEIGHT

7. THE FOLLOWING DROP-OFF POLICY TABLE PROVIDES THE MINIMUM RECOMMENDED TREATMENT FOR DROP-OFFS. THE RECOMMENDED TREATMENT HAS BEEN DEPICTED ON THE MAINTENANCE OF TRAFFIC PLAN SHEETS.

DROP-OFF LOCATION	POSTED SPEED	AND TYPE (INCHES)	TREATMENT REQUIRED
	A1.1	<= 1	NONE
	ALL	> 1, <= 3 IN	LOW SHOULDER SIGNS (2 MILE SPACING)
	< 45	> 3, <= 18 IN	PLACE CHANNELIZING DEVICES AT 50 FT SPACING
	>= 45	> 3, <=12 IN	PLACE CHANNELIZING DEVICES AT 100 FT SPACING
	< 45	> 18, <=24 IN FOR < 0.5 MILE OR <48 HOURS (6)	PLACE CHANNELIZING DEVICES AT 50 FT SPACING
=< 3 FT (3,4)	>= 45	> 12. <= 18 IN FOR < 0.5 MILE OR < 48 HOURS.	PLACE CHANNELIZING DEVICES AT 100 FT SPACING
	>= 45	> 12, <= 24 IN FOR > 0.5 MILE OR > 48 HOURS	CLOSURE USING TEMPORARY TRAFFIC BARRIER
	< 45	> 18, <= 24 IN	CLOSURE USING TEMPORARY TRAFFIC BARRIER
	>= 45	> 18, <= 24 IN FOR < 0.5 MILE OR < 48 HOURS.	CLOSURE USING TEMPORARY TRAFFIC BARRIER
	ALL	> 24 IN	CLOSURE USING TEMPORARY TRAFFIC BARRIER
	ALL	<= 1 IN	NONE
	ALL	> 1. <=3 IN	LOW SHOULDER SIGNS (2 MILE SPACING)
> 3 FT =< 8 FT (5)	< 45	> 3, <= 24 IN (6)	PLACE CHANNELIZING DEVICES AT 50 FT SPACING
	>= 45	> 3, <= 24 IN	PLACE CHANNELIZING DEVICES AT 100 FT SPACING
	ALL	> 24 IN	CLOSURE USING TEMPORARY TRAFFIC BARRIER
> 8_FT_TO_	< 45	> 12, <= 24 IN (6)	PLACE CHANNELIZING DEVICES AT 50 FT SPACING
WORK ZONE CLEAR ZONE	>= 45	> 12, <= 24 IN	PLACE CHANNELIZING DEVICES AT 100 FT SPACING
(5)	ALL	> 24 IN	CLOSURE USING TEMPORARY TRAFFIC BARRIER

- (1) FOR LOCAL ROADS LESS THAN OR EQUAL TO 400 ADT, BARRICADES MAY BE SUBSTITUTED FOR TEMPORARY TRAFFIC BARRIER BASED ON ENGINEERING JUDGMENT
- (2) SPOT LOCATIONS FOR TWO LANE, TWO WAY HIGHWAYS WITH CONTINUOUS FLAGGING OR TRAFFIC SIGNALS MAY OMIT BARRIER FOR UP TO 96 HOURS.
- (3) CHANNELIZING DEVICES AND TEMPORARY BARRIER ARE TO BE PLACED AT SAME LEVEL AS TRAVELING LANE OR SHOULDER PROFILE.
- (4) CHANNELIZING DEVICES MAY BE PLACED AT THE DROP-OFF ELEVATION TO PRESERVE LANE WIDTH. THE REFLECTIVE AREA AND WARNING LIGHT (IF REQUIRED) SHALL BE RAISED TO THE ELEVATION ABOVE TRAVELING LANE OR SHOULDER PROFILE AS REQUIRED BY STANDARD 701901.
- (5) CHANNELIZING DEVICES AND TEMPORARY BARRIER ARE TO BE PLACED AT SAME LEVEL AS SIDE SLOPE PROFILE TO BE FULLY VISIBLE.
- (6) LENGTH AND DURATION MAY BE EXCEEDED FOR URBAN AREAS WHEN ENGINEERING JUDGEMENT INDICATES SIGHT DISTANCE WILL BE ADVERSELY AFFECTED BY TEMPORARY BARRIER.

SEQUENCE OF CONSTRUCTION

PRE-STAGE

- CONSTRUCTION

 1. PREPARE THE TEMPORARY SIGNALS AT THE INTERSECTIONS OF ILLINOIS ROUTE 31 AND GREEN STREET/BARREVILLE ROAD PER THE TEMPORARY SIGNAL PLANS.

 2. PREPARE THE ROADWAYS AND INTERSECTIONS FOR STAGE 1 TRAFFIC WITH TEMPORARY PAVEMENT. SEE MAINTENANCE OF TRAFFIC PLAN SHEETS FOR LOCATIONS.

 3. CONSTRUCT TEMPORARY PAVEMENT AT LOCATIONS SHOWN IN THE PLANS.
- 4. REMOVE CONFLICTING EXISTING SIGNS LOCATED ALONG THE MAINLINE. RELOCATE EXISTING SIGNS AS
- 5. REMOVE ALL EXISTING RAISED PAVEMENT MARKERS AND PAVEMENT MARKINGS IN CONFLICT WITH MAINTENANCE OF TRAFFIC STRIPING.

MAINTENANCE OF TRAFFIC

1. MAINTAIN THE EXISTING TRAFFIC CONFIGURATION.

STAGE 1

- CONSTRUCTION

 1. PLACE STAGE 1 TRAFFIC CONTROL DEVICES AND TEMPORARY PAVEMENT MARKINGS. SET TRAFFIC AND ACTIVATE SIGNAL HEADS FOR THE TEMPORARY TRAFFIC SIGNALS AT THE INTERSECTIONS OF ILLINOIS ROUTE 31 AND GREEN STREET/BARREVILLE ROAD PER THE TEMPORARY SIGNAL PLANS.
- 2. CONSTRUCT THE CURB AND GUTTER WITHIN THE WORK ZONE FOR STAGE 1 AT LOCTATIONS SHOWN.
 CONSTRUCT THE PROPOSED PAVEMENT UP TO THE BINDER COURSE OR SURFACE OF PCC JOINTED
 PAVEMENT. PREPARE THE MAINLINE AND INTERSECTIONS FOR STAGE 2 TRAFFIC WITH TEMPORARY
 PAVEMENT. SEE MAINTENANCE OF TRAFFIC PLAN SHEETS FOR LOCATIONS OF STAGE 2 TEMPORARY PAVEMENT
- 3. CONSTRUCT DRAINAGE STRUCTURES AND STORM SEWER AT LOCATIONS SHOWN IN THE PLANS.

MAINTENANCE OF TRAFFIC

- 1. A MINIMUM OF ONE LANE OF TRAFFIC IN EACH DIRECTION SHALL BE MAINTAINED AT ALL TIMES, AS SHOWN ON THE PLANS.
 2. TRAFFIC WILL BE SHOTTED FOR STAGE 1 CONSTRUCTION AND WILL UTILIZE THE EXISTING PAVEMENT AND
- TEMPORARY PAVEMENT.

STAGE 2

- CONSTRUCTION

 1. INSTALL STAGE 2 TRAFFIC CONTROL DEVICES AND TEMPORARY PAVEMENT MARKINGS. SET TRAFFIC SIGNAL HEADS FOR THE TEMPORARY TRAFFIC SIGNALS AT THE INTERSECTIONS OF ILLINOIS ROUTE 31 AND GREEN STREET/BARREVILLE ROAD PER THE TEMPORARY SIGNAL PLANS.

 2. CONSTRUCT THE CURB AND GUTTER WITHIN THE WORK ZONE FOR STAGE 2. CONSTRUCT THE PROPOSED PAVEMENT UP TO THE BINDER COURSE OR SURFACE OF PCC JOINTED PAVEMENT. PREPARE THE MAINLINE AND INTERSECTIONS FOR STAGE 3 TRAFFIC WITH TEMPORARY PAVEMENT. SEE MAINTENANCE OF TRAFFIC PLAN SHEETS FOR LOCATIONS OF STAGE 3 TEMPORARY PAVEMENT.
- 3. CONSTRUCT DRAINAGE STRUCTURES AND STORM SEWER AT LOCATIONS SHOWN IN THE PLANS.

MAINTENANCE OF TRAFFIC

- 1. A MINIMUM OF ONE LANE OF TRAFFIC IN EACH DIRECTION SHALL BE MAINTAINED AT ALL TIMES, AS SHOWN
- ON THE PLANS.

 2. TRAFFIC WILL BE SHIFTED FOR STAGE 2 CONSTRUCTION AND WILL UTILIZE NEWLY CONSTRUCTED PAVEMENT AND TEMPORARY PAVEMENT.

STAGE 3

- CONSTRUCTION

 PLACE STAGE 3 TRAFFIC CONTROL DEVICES AND TEMPORARY PAVEMENT MARKINGS. SET TRAFFIC SIGNAL HEADS FOR THE TEMPORARY TRAFFIC SIGNALS AT THE INTERSECTIONS OF ILLINOIS ROUTE 31 AND GREEN STREET/BARREVILLE ROAD PER THE TEMPORARY SIGNAL PLANS.

 CONSTRUCT THE REMAINING PAVEMENTS UP TO THE BINDER COURSE. CONSTRUCT THE CURB AND GUTTER ALONG MEDIANS AND MEDIAN SURFACES.
- 3. CONSTRUCT DRAINAGE AND PARKWAY IMPROVEMENTS ALONG CHARLES J. MILLER ROAD AT LOCATIONS SHOWN IN THE PLANS. MAINTENANCE OF TRAFFIC

A MINIMUM OF ONE LANE OF TRAFFIC IN EACH DIRECTION SHALL BE MAINTAINED AT ALL TIMES, AS SHOWN ON THE PLANS.

STAGE 4 (Not Illustrated)

- CONSTRUCTION
 1. PLACE THE HOT MIX ASPHALT SURFACE COURSES.
 2. COMPLETE REMAINING RESTORATION AND LANDSCAPING.
- 3. COMPLETE INSTALLATION OF TRAFFIC SIGNALS AT ILLINOIS ROUTE 31 AND GREEN STREET/BARREVILLE
- 4. REMOVE TEMPORAY TRAFFIC SIGNALS.
 5. INSTALL PERMANENT PAVEMENT MARKINGS AND RAISED REFLECTIVE PAVEMENT MARKINGS.

MAINTENANCE OF TRAFFIC

1. A MINIMUM OF ONE LANE OF TRAFFIC IN EACH DIRECTION SHALL BE MAINTAINED AT ALL TIMES.

HRGreen.com HRGreen


USER NAME = tuelton DESIGNED - JPA REVISED DRAWN SVJ REVISED PLOT SCALE = N.T.S. CHECKED JLP REVISED PLOT DATE = 11/11/2014 DATE 11/12/14 REVISED


STATE OF ILLINOIS DEPARTMENT OF TRANSPORTATION SUGGESTED MAINTENANCE OF TRAFFIC - GENERAL NOTES CHARLES J. MILLER ROAD ROADWAY IMPROVEMENTS


SHEET NO. 1 OF 46 SHEETS STA.


SCALE: N.T.S.

SHEETS NO. SECTION COUNTY MCHENRY 358 3860 09-00372-01-PW CONTRACT NO. 63892 FED. ROAD DIST. NO. | ILLINOIS FED. AID PROJECT

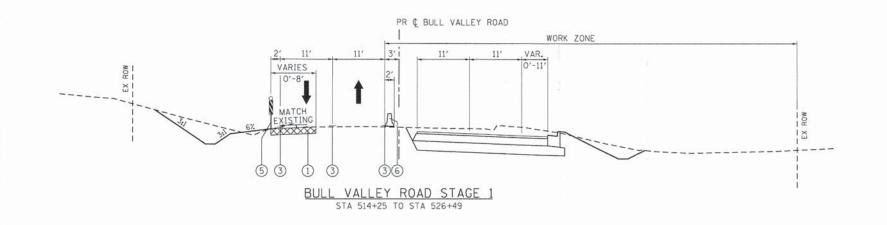

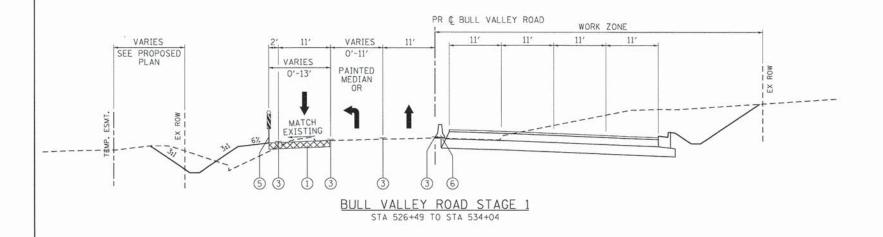

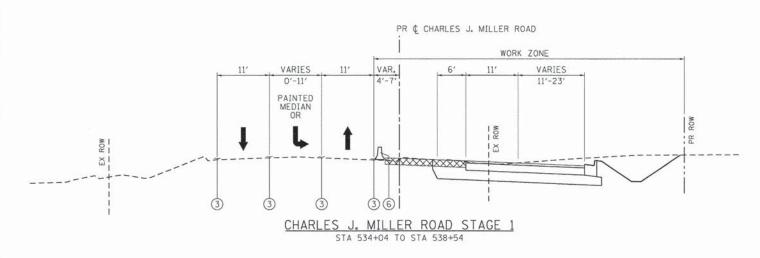

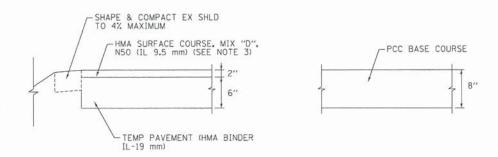

TEMPORARY PAVEMENT DETAILS



- 1 TEMPORARY PAVEMENT, 8" (SEE NOTE 2)
- ② TYPE II BARRICADES OR DRUMS
 WITH STEADY BURNING BI-DIRECTIONAL LIGHTS
 @ 50 FT CENTERS ALONG ROADWAY TANGENTS,
 20 FT CENTERS ALONG TAPERS, AND
 12 FT CENTERS ALONG RADII
- 3 PAVEMENT MARKING (SEE NOTE 1)
- EXISTING PAVEMENT MARKING
- DOUBLE VERTICAL PANELS WITH STEADY

 BURNING BI-DIRECTIONAL LIGHTS

 50 FT CENTERS ALONG ROADWAY TANGENTS,
 20 FT CENTERS ALONG TAPERS, AND
 12 FT CENTERS ALONG RADII
- 6 TEMPORARY CONCRETE BARRIER (SEE NOTE 4)
- → DIRECTION OF TRAFFIC

TEMPORARY PAVEMENT

 SEE MAINTENANCE OF TRAFFIC PLAN SHEETS FOR LOCATIONS AND TYPE OF PAVEMENT MARKING.

MAINTENANCE OF TRAFFIC NOTES:

- SEE MAINTENANCE OF TRAFFIC PLAN SHEETS FOR TEMPORARY PAVEMENT CONSTRUCTION STAGING.
- 3. THE CONTRACTOR HAS THE OPTION OF USING HMA OR PCC SECTION FOR TEMPORARY PAVEMENT.
- 4. TEMPORARY CONCRETE BARRIER WALL SHALL BE PINNED WHEN A 3.5' CLEAR ZONE CANNOT BE PROVIDED FROM BEHIND THE WALL.

11/11/2014 10:26:42 AM 090071-motgn-02.dgn pdf.plt standard-trans.tbl

PROJECT CONTACT:
CLENT:
DATE PLOTTED:
II/I
FILE NAME:
PLOT DRIVER:
PEN TABLE:
570

HRGreen


HRGreen

n.com ssional Design Firm	USER NAME = tyelton	DESIGNED -	JPA	REVISED -	
	FILE NAME = 090071-motgn-02.dgn	DRAWN -	SVJ	REVISED -	
2	PLOT SCALE = N.T.S.	CHECKED -	JLP	REVISED -	
	PLOT DATE = 11/11/2014	DATE -	11/12/14	REVISED -	

STATE OF ILLINOIS
DEPARTMENT OF TRANSPORTATION

								TYPICAL SECTIONS AD STAGE 1
SCALE: N.T.S.	SHE	ET NO	. 2	OF	46	SHEETS	STA.	TO STA.

F.A.U. RTE.	SE	CTION	COUNTY	TOTAL	SHEET NO.	
3860	09-003	72-01-PW	MCHENRY	358	45	
			CONTRACT	NO.	63892	
FED. ROAD	DIST. NO.	ILLINOIS FED.	AID PROJECT			

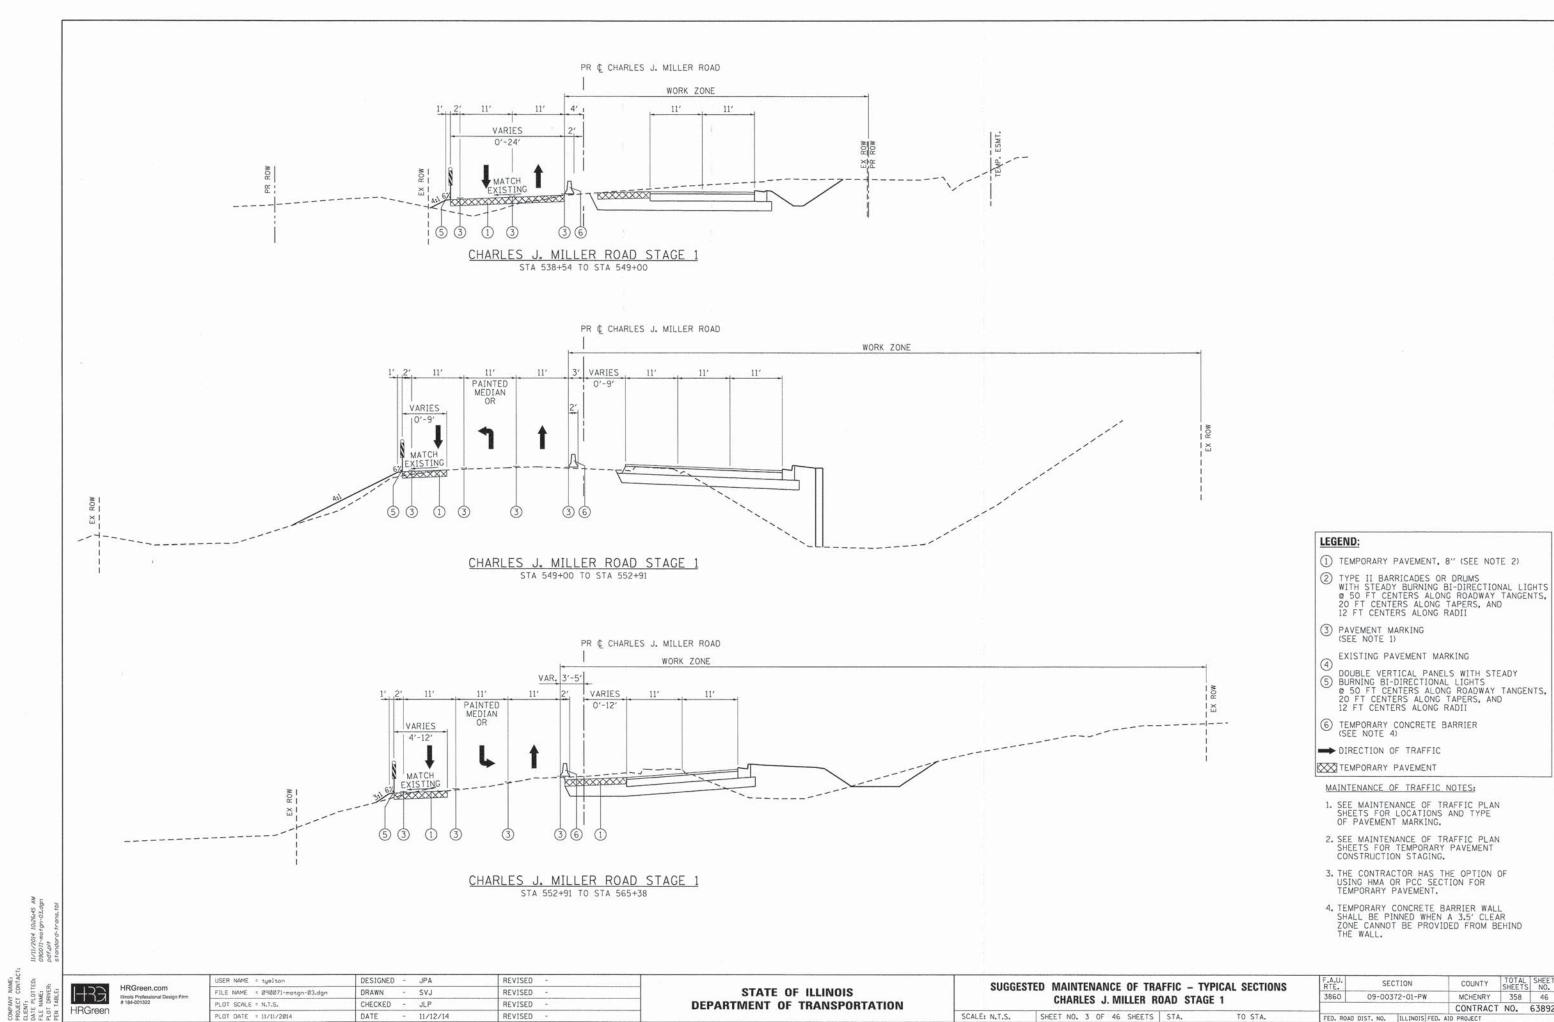


EXISTING PAVEMENT MARKING

SECTION

09-00372-01-PW

COUNTY TOTAL SHEETS NO. MCHENRY 358 46

CONTRACT NO. 63892

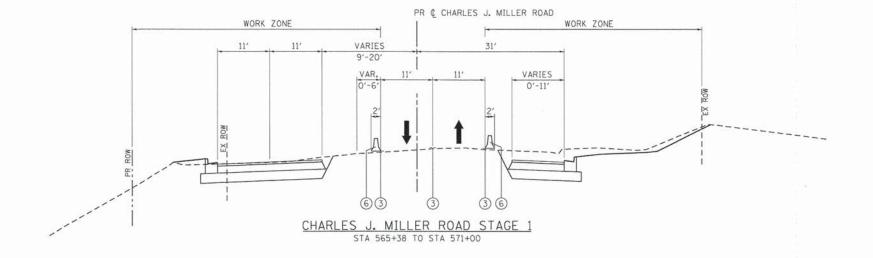

- 1 TEMPORARY PAVEMENT, 8" (SEE NOTE 2)
- 2 TYPE II BARRICADES OR DRUMS
 WITH STEADY BURNING BI-DIRECTIONAL LIGHTS
 © 50 FT CENTERS ALONG ROADWAY TANGENTS,
 20 FT CENTERS ALONG TAPERS, AND
 12 FT CENTERS ALONG RADII
- 3 PAVEMENT MARKING (SEE NOTE 1)
- EXISTING PAVEMENT MARKING

 DOUBLE VERTICAL PANELS WITH STEADY
 BURNING BI-DIRECTIONAL LIGHTS

 0 50 FT CENTERS ALONG ROADWAY TANGENTS,
 20 FT CENTERS ALONG TAPERS, AND
 12 FT CENTERS ALONG RADII
- 6 TEMPORARY CONCRETE BARRIER (SEE NOTE 4)
- → DIRECTION OF TRAFFIC

TEMPORARY PAVEMENT

MAINTENANCE OF TRAFFIC NOTES;

- 1. SEE MAINTENANCE OF TRAFFIC PLAN SHEETS FOR LOCATIONS AND TYPE OF PAVEMENT MARKING.
- 2. SEE MAINTENANCE OF TRAFFIC PLAN SHEETS FOR TEMPORARY PAVEMENT CONSTRUCTION STAGING.
- 3. THE CONTRACTOR HAS THE OPTION OF USING HMA OR PCC SECTION FOR TEMPORARY PAVEMENT.
- 4. TEMPORARY CONCRETE BARRIER WALL SHALL BE PINNED WHEN A 3.5' CLEAR ZONE CANNOT BE PROVIDED FROM BEHIND THE WALL.


HRGreen.com HRGreen


500000000							
FILE	NAME = 090071-motgn-04.dgn	DRAWN	-	SVJ	REVISED	(#1)	
PLOT	SCALE = N.T.S.	CHECKED	*	JLP	REVISED		
PLOT	DATE = 11/11/2014	DATE	-	11/12/14	REVISED	-	


STATE OF ILLINOIS DEPARTMENT OF TRANSPORTATION

SUGGESTED MAINTENANCE OF TRAFFIC - TYPICAL SECTIONS CHARLES J. MILLER ROAD STAGE 1 SHEET NO. 4 OF 46 SHEETS STA. SCALE: N.T.S. TO STA.

550 5015	n nist wo lili i wois een	CONTRACT	NO.	6389
3860	09-00372-01-PW	MCHENRY	358	47
F.A.U. RTE.	SECTION	COUNTY	TOTAL	SHE

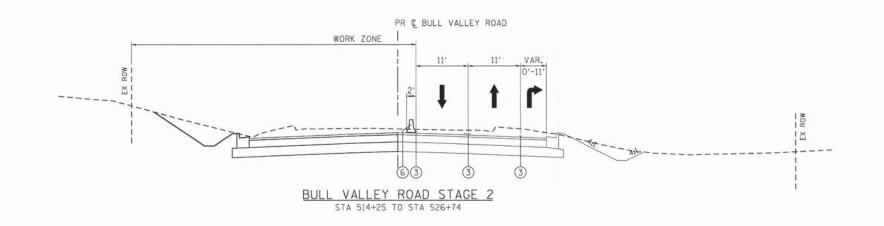

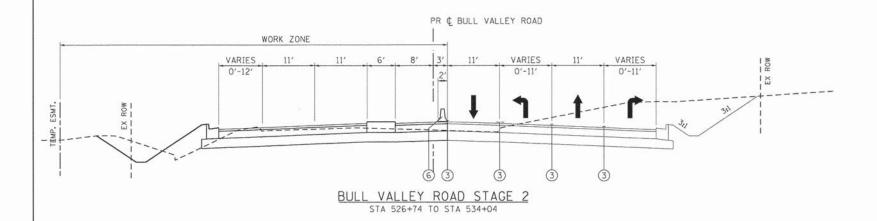

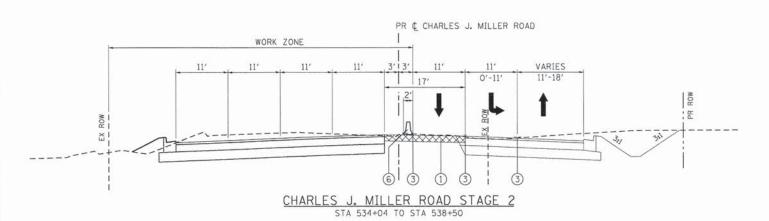

- 1 TEMPORARY PAVEMENT, 8" (SEE NOTE 2)
- 2) TYPE II BARRICADES OR DRUMS
 WITH STEADY BURNING BI-DIRECTIONAL LIGHTS
 © 50 FT CENTERS ALONG ROADWAY TANGENTS,
 20 FT CENTERS ALONG TAPERS, AND
 12 FT CENTERS ALONG RADII
- 3 PAVEMENT MARKING (SEE NOTE 1)
- EXISTING PAVEMENT MARKING
- OUBLE VERTICAL PANELS WITH STEADY

 BURNING BI-DIRECTIONAL LIGHTS

 50 FT CENTERS ALONG ROADWAY TANGENTS,
 20 FT CENTERS ALONG TAPERS, AND
 12 FT CENTERS ALONG RADII
- 6 TEMPORARY CONCRETE BARRIER (SEE NOTE 4)
- → DIRECTION OF TRAFFIC

TEMPORARY PAVEMENT

MAINTENANCE OF TRAFFIC NOTES:

- SEE MAINTENANCE OF TRAFFIC PLAN SHEETS FOR LOCATIONS AND TYPE OF PAVEMENT MARKING.
- 2. SEE MAINTENANCE OF TRAFFIC PLAN SHEETS FOR TEMPORARY PAVEMENT CONSTRUCTION STAGING.
- 3. THE CONTRACTOR HAS THE OPTION OF USING HMA OR PCC SECTION FOR TEMPORARY PAVEMENT.
- 4. TEMPORARY CONCRETE BARRIER WALL SHALL BE PINNED WHEN A 3.5' CLEAR ZONE CANNOT BE PROVIDED FROM BEHIND THE WALL.

11/11/2014 10:26:52 AM 090071-motgn-06.dgn pdf.plt standard-trans.tbl

COMPANT NAME:
PROJECT CONTACT:
CLENIE
DATE PLOTTED: 11/17
FILE NAME: 099
PLOT DRIVER: pdf

HRGreen.com
Illinois Professional Design Fir
#184-001322


STATE OF ILLINOIS
DEPARTMENT OF TRANSPORTATION

SUGGESTED MAINTENANCE OF TRAFFIC - TYPICAL SECTIONS
BULL VALLEY/CHARLES J. MILLER ROAD STAGE 2

.U. SECTION COUNTY TOTAL SHEET NO. 60 09-00372-01-PW MCHENRY 358 48

E: N.T.S. SHEET NO. 5 OF 46 SHEETS STA. TO ST.

FED. ROAD DIST. NO. | ILLINOIS FED. AID PROJECT

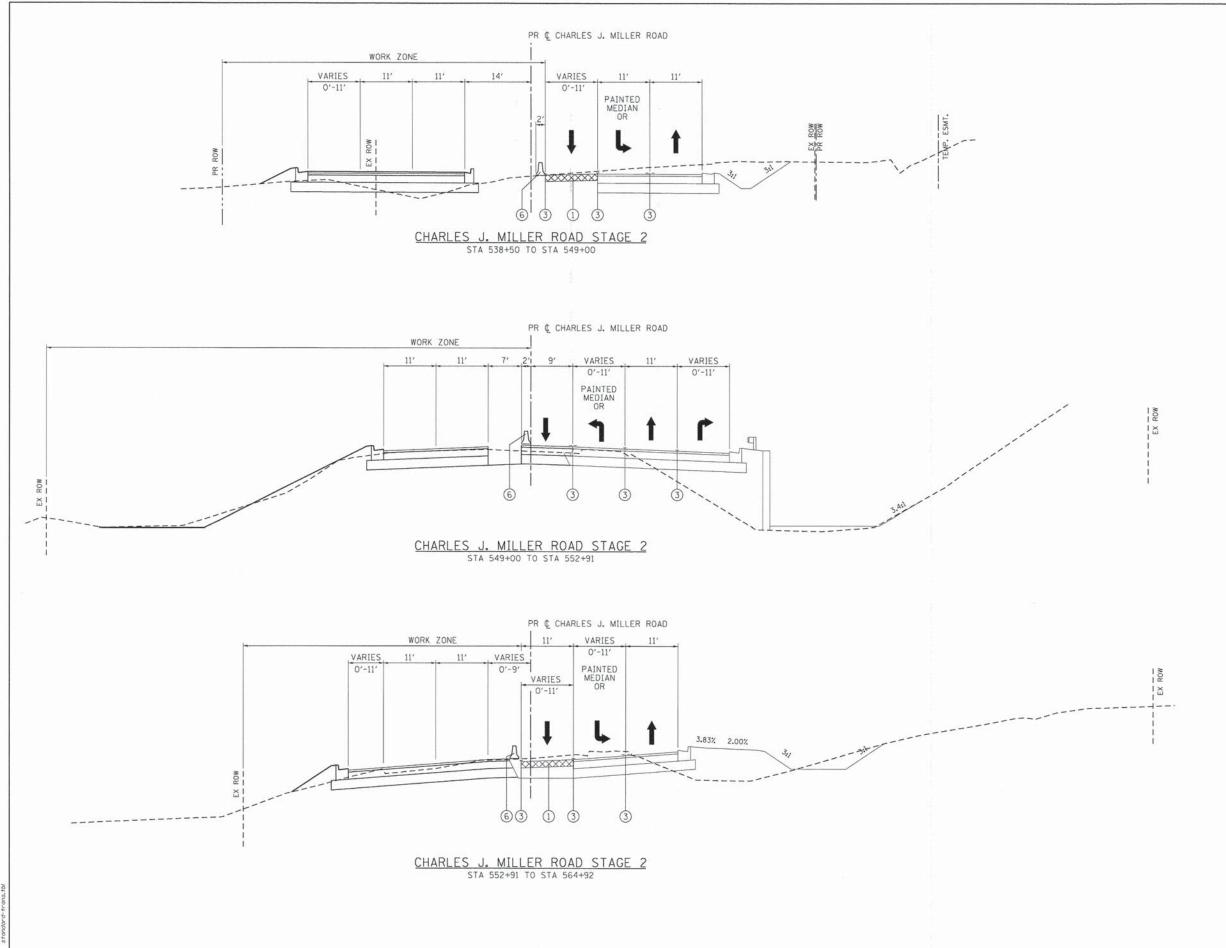

- 1 TEMPORARY PAVEMENT, 8" (SEE NOTE 2)
- 2 TYPE II BARRICADES OR DRUMS
 WITH STEADY BURNING BI-DIRECTIONAL LIGHTS
 © 50 FT CENTERS ALONG ROADWAY TANGENTS,
 20 FT CENTERS ALONG TAPERS, AND
 12 FT CENTERS ALONG RADII
- 3 PAVEMENT MARKING (SEE NOTE 1)
 - EXISTING PAVEMENT MARKING
- (4)
 DOUBLE VERTICAL PANELS WITH STEADY

 (5) BURNING BI-DIRECTIONAL LIGHTS
 (6) 50 FT CENTERS ALONG ROADWAY TANGENTS,
 (20) FT CENTERS ALONG TAPERS, AND
 (12) FT CENTERS ALONG RADII
- 6 TEMPORARY CONCRETE BARRIER (SEE NOTE 4)
- DIRECTION OF TRAFFIC
- TEMPORARY PAVEMENT

MAINTENANCE OF TRAFFIC NOTES:

- 1. SEE MAINTENANCE OF TRAFFIC PLAN SHEETS FOR LOCATIONS AND TYPE OF PAVEMENT MARKING.
- 2. SEE MAINTENANCE OF TRAFFIC PLAN SHEETS FOR TEMPORARY PAVEMENT CONSTRUCTION STAGING.
- 3. THE CONTRACTOR HAS THE OPTION OF USING HMA OR PCC SECTION FOR TEMPORARY PAVEMENT.
- 4. TEMPORARY CONCRETE BARRIER WALL SHALL BE PINNED WHEN A 3.5' CLEAR ZONE CANNOT BE PROVIDED FROM BEHIND THE WALL.


HRGreen.com **HRGreen**

USER NAME = tyelton	DESIGNED	8	JPA	REVISED		П
FILE NAME = 090071-motgn-07.dgn	DRAWN	-	SVJ	REVISED	+	
PLOT SCALE = N.T.S.	CHECKED	-	JLP	REVISED		
PLOT DATE = 11/11/2014	DATE	-	11/12/14	REVISED	-	

STATE OF ILLINOIS DEPARTMENT OF TRANSPORTATION

SUGGESTED MAINTENANCE OF TRAFFIC - TYPICAL SECTIONS CHARLES J. MILLER ROAD STAGE 2 SCALE: N.T.S. SHEET NO. 6 OF 46 SHEETS STA. TO STA.

SECTION COUNTY 09-00372-01-PW MCHENRY 358 CONTRACT NO. 63892 FED. ROAD DIST. NO. | ILLINOIS FED. AID PROJECT

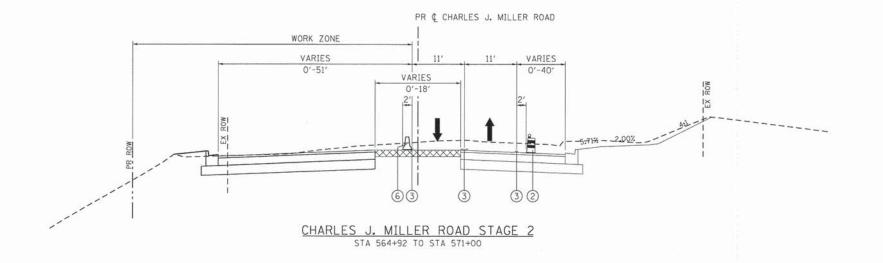

- 1 TEMPORARY PAVEMENT, 8" (SEE NOTE 2)
- ② TYPE II BARRICADES OR DRUMS
 WITH STEADY BURNING BI-DIRECTIONAL LIGHTS
 © 50 FT CENTERS ALONG ROADWAY TANGENTS,
 20 FT CENTERS ALONG TAPERS, AND
 12 FT CENTERS ALONG RADII
- 3 PAVEMENT MARKING (SEE NOTE 1)
- EXISTING PAVEMENT MARKING
- (4) DOUBLE VERTICAL PANELS WITH STEADY
 (5) BURNING BI-DIRECTIONAL LIGHTS
 (6) 50 FT CENTERS ALONG ROADWAY TANGENTS,
 (7) FT CENTERS ALONG TAPERS, AND
 (12) FT CENTERS ALONG RADII
- 6 TEMPORARY CONCRETE BARRIER (SEE NOTE 4)
- → DIRECTION OF TRAFFIC
- TEMPORARY PAVEMENT

MAINTENANCE OF TRAFFIC NOTES:

- 1. SEE MAINTENANCE OF TRAFFIC PLAN SHEETS FOR LOCATIONS AND TYPE OF PAVEMENT MARKING.
- 2. SEE MAINTENANCE OF TRAFFIC PLAN SHEETS FOR TEMPORARY PAVEMENT CONSTRUCTION STAGING.
- 3. THE CONTRACTOR HAS THE OPTION OF USING HMA OR PCC SECTION FOR TEMPORARY PAVEMENT.
- 4. TEMPORARY CONCRETE BARRIER WALL SHALL BE PINNED WHEN A 3.5' CLEAR ZONE CANNOT BE PROVIDED FROM BEHIND THE WALL.

11/11/2014 10:27:00 AM 090071:motgn-08.dgn pdf.plt standard-trans.tbl

CLENT:
DATE PLOTTED: 11
FILE NAME: 0:
PLOT DRIVER: pc


177	HRGreen.com
Green	Illinois Professional Design Fit # 184-001322

USER NAME = tyelton	DESIGNED - JPA	REVISED -	
FILE NAME = 090071-motgn-08.dgn	DRAWN - SVJ	REVISED -	
PLOT SCALE = N.T.S.	CHECKED - JLP	REVISED -	
PLOT DATE = 11/11/2014	DATE - 11/12/14	REVISED -	

STATI	E 01	F ILLINOIS
DEPARTMENT	0F	TRANSPORTATION

SUGGES								– TYPICAL STAGE 2	SECTIONS
SCALE: N.T.S.	SHE	T NO.	7	OF	46	SHEE	TS STA.	8	TO STA.

F.A.U. RTE.	SE	CTION	COUNTY	TOTAL	SHEE NO.	
3860	09-003	72-01-PW	MCHENRY	358		
			CONTRACT	NO.	6389	
FED. ROAD	DIST. NO.	ILLINOIS FED.	AID PROJECT			

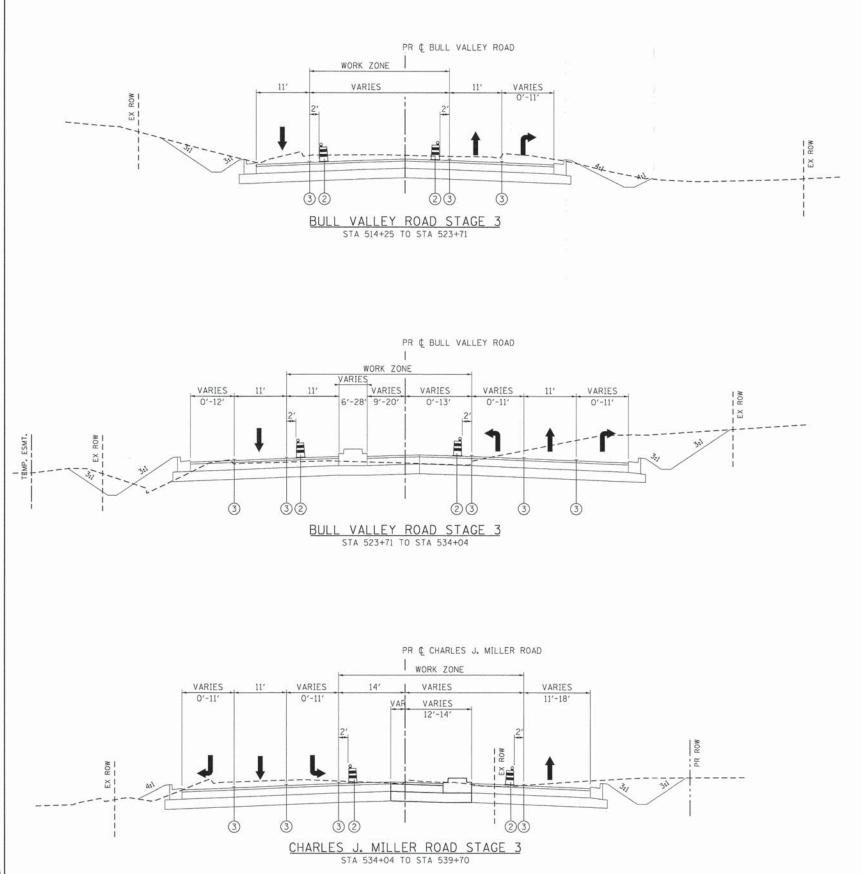

- 1 TEMPORARY PAVEMENT, 8" (SEE NOTE 2)
- 2 TYPE II BARRICADES OR DRUMS
 WITH STEADY BURNING BI-DIRECTIONAL LIGHTS
 © 50 FT CENTERS ALONG ROADWAY TANGENTS,
 20 FT CENTERS ALONG TAPERS, AND
 12 FT CENTERS ALONG RADII
- 3 PAVEMENT MARKING (SEE NOTE 1)
- EXISTING PAVEMENT MARKING
- DOUBLE VERTICAL PANELS WITH STEADY

 (5) BURNING BI-DIRECTIONAL LIGHTS

 © 50 FT CENTERS ALONG ROADWAY TANGENTS,
 20 FT CENTERS ALONG TAPERS, AND
 12 FT CENTERS ALONG RADII
- 6 TEMPORARY CONCRETE BARRIER (SEE NOTE 4)
- → DIRECTION OF TRAFFIC

TEMPORARY PAVEMENT

MAINTENANCE OF TRAFFIC NOTES:

- SEE MAINTENANCE OF TRAFFIC PLAN SHEETS FOR LOCATIONS AND TYPE OF PAVEMENT MARKING.
- SEE MAINTENANCE OF TRAFFIC PLAN SHEETS FOR TEMPORARY PAVEMENT CONSTRUCTION STAGING.
- 3. THE CONTRACTOR HAS THE OPTION OF USING HMA OR PCC SECTION FOR TEMPORARY PAVEMENT.
- 4. TEMPORARY CONCRETE BARRIER WALL SHALL BE PINNED WHEN A 3.5' CLEAR ZONE CANNOT BE PROVIDED FROM BEHIND THE WALL.

SUGGESTED MAINTENANCE OF TRAFFIC - TYPICAL SECTIONS
BULL VALLEY/CHARLES J. MILLER ROAD STAGE 3

TO STA.


SHEET NO. 8 OF 46 SHEETS STA.

SCALE: N.T.S.

11/11/2014 10:27:04 AM 09/071-motgn-10.dgn pdf.pit standard-trans.tbi

HRGreen.
tilnois Professio
#184-001322

STATE OF ILLINOIS
DEPARTMENT OF TRANSPORTATION

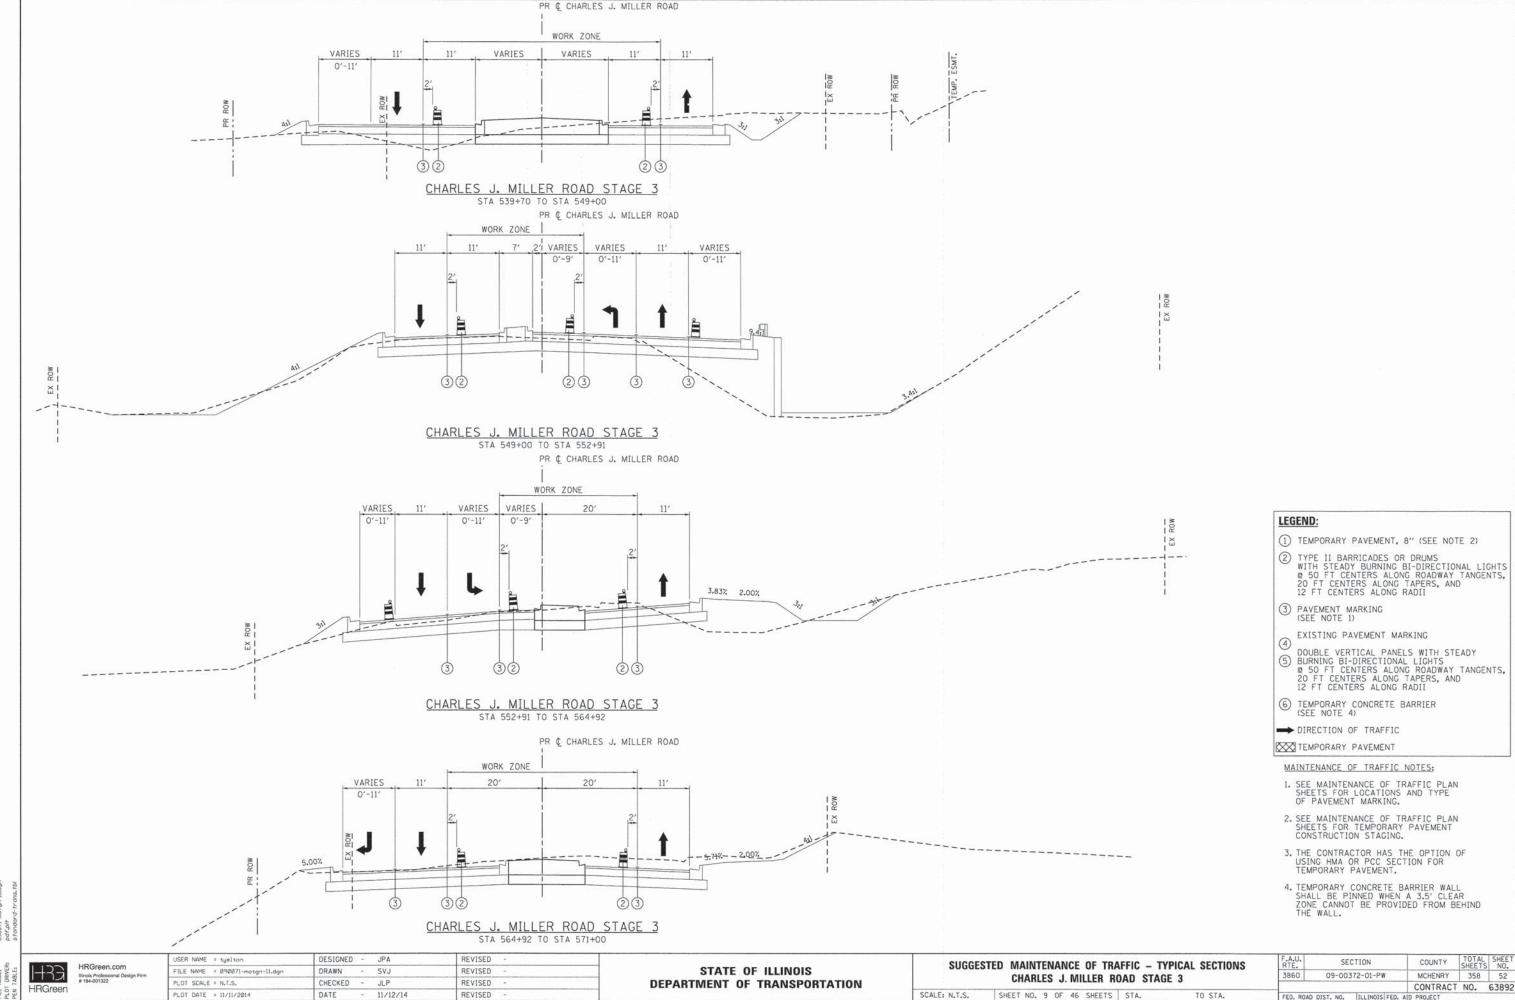

OJECT CONTACT:


ENT:


ITE PLOTTED: 11/11/22014 10


EN NAME: 090071-morg

DOT DRIVER: pdf.pft

N TABLE: stondord-tr

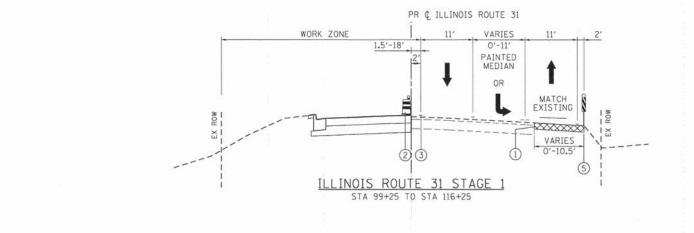

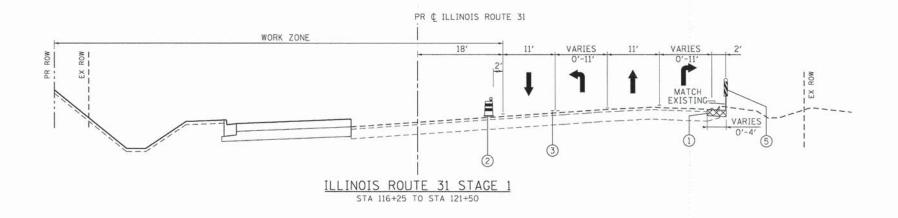

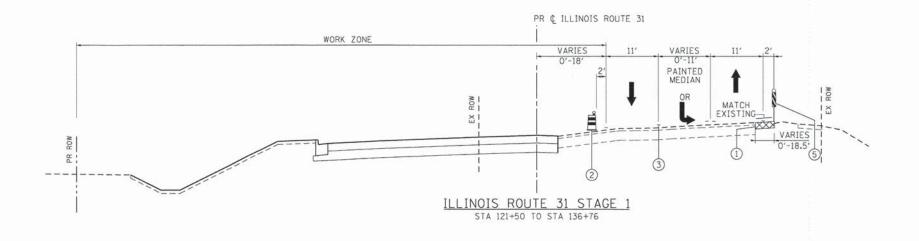

- 1 TEMPORARY PAVEMENT, 8" (SEE NOTE 2)
- 2 TYPE II BARRICADES OR DRUMS
 WITH STEADY BURNING BI-DIRECTIONAL LIGHTS
 0 50 FT CENTERS ALONG ROADWAY TANGENTS,
 20 FT CENTERS ALONG TAPERS, AND
 12 FT CENTERS ALONG RADII
- 3 PAVEMENT MARKING (SEE NOTE 1)
- EXISTING PAVEMENT MARKING
- (4)
 DOUBLE VERTICAL PANELS WITH STEADY

 (5) BURNING BI-DIRECTIONAL LIGHTS
 (9 50 FT CENTERS ALONG ROADWAY TANGENTS,
 20 FT CENTERS ALONG TAPERS, AND
 12 FT CENTERS ALONG RADII
- 6 TEMPORARY CONCRETE BARRIER (SEE NOTE 4)
- → DIRECTION OF TRAFFIC

TEMPORARY PAVEMENT

MAINTENANCE OF TRAFFIC NOTES:

- 1. SEE MAINTENANCE OF TRAFFIC PLAN SHEETS FOR LOCATIONS AND TYPE OF PAVEMENT MARKING.
- SEE MAINTENANCE OF TRAFFIC PLAN SHEETS FOR TEMPORARY PAVEMENT CONSTRUCTION STAGING.
- 3. THE CONTRACTOR HAS THE OPTION OF USING HMA OR PCC SECTION FOR TEMPORARY PAVEMENT.
- 4. TEMPORARY CONCRETE BARRIER WALL SHALL BE PINNED WHEN A 3.5' CLEAR ZONE CANNOT BE PROVIDED FROM BEHIND THE WALL.

11/11/2014 10:27:13 AM 090071-motgn-12.dgn pdf.pit standard-trans.tbl

PROJECT CONTACT;
CLENT;
DATE PLOTTED; 11/71
FILE NAME; 09/0
PLUT DRIVER; pdf;
PEN TABLE; sto.


H33 RGreen	HRGreen.com Illinois Professional Design Firm # 184-001322	

USER NAME = tyelton	DESIGNED	-	JPA	REVISED -	
FILE NAME = 090071-motgn-12.dgn	DRAWN	-	SVJ	REVISED -	
PLOT SCALE = N.T.S.	CHECKED	-	JLP	REVISED -	
PLOT DATE = 11/11/2014	DATE	-	11/12/14	REVISED -	

STATE OF ILLINOIS
DEPARTMENT OF TRANSPORTATION

	SUGGESTE) M	AINT			RAFFIC	SECTIONS
SCALE:	N.T.S.	SHEET	NO.	101001	 	 TS STA.	 TO STA.

F.A.U. RTE.	SE	CTION	COUNTY	TOTAL	SHEE	
3860	09-003	72-01-PW		MCHENRY	358	53
				CONTRACT	NO.	6389
FED. ROAD	DIST. NO.	ILLINOIS	FED. A	D PROJECT		

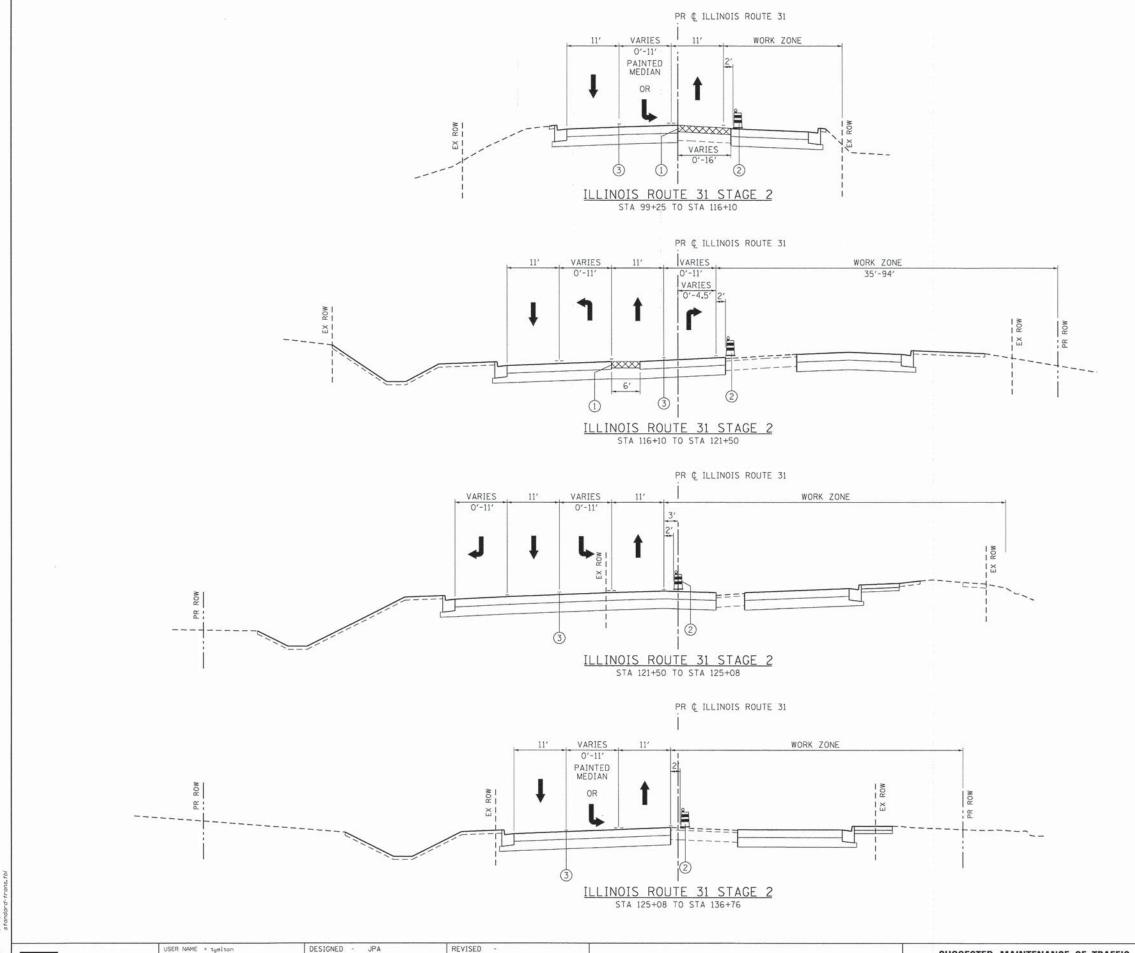

- 1 TEMPORARY PAVEMENT, 8" (SEE NOTE 2)
- 2 TYPE II BARRICADES OR DRUMS
 WITH STEADY BURNING BI-DIRECTIONAL LIGHTS

 50 FT CENTERS ALONG ROADWAY TANGENTS,
 20 FT CENTERS ALONG TAPERS, AND
 12 FT CENTERS ALONG RADII
- 3 PAVEMENT MARKING (SEE NOTE 1)
- EXISTING PAVEMENT MARKING
- (4)
 DOUBLE VERTICAL PANELS WITH STEADY

 (5) BURNING BI-DIRECTIONAL LIGHTS
 (6) 50 FT CENTERS ALONG ROADWAY TANGENTS,
 20 FT CENTERS ALONG TAPERS, AND
 12 FT CENTERS ALONG RADII
- 6 TEMPORARY CONCRETE BARRIER (SEE NOTE 4)
- → DIRECTION OF TRAFFIC
- TEMPORARY PAVEMENT

MAINTENANCE OF TRAFFIC NOTES:

- SEE MAINTENANCE OF TRAFFIC PLAN SHEETS FOR LOCATIONS AND TYPE OF PAVEMENT MARKING.
- SEE MAINTENANCE OF TRAFFIC PLAN SHEETS FOR TEMPORARY PAVEMENT CONSTRUCTION STAGING.
- 3. THE CONTRACTOR HAS THE OPTION OF USING HMA OR PCC SECTION FOR TEMPORARY PAVEMENT.
- 4. TEMPORARY CONCRETE BARRIER WALL SHALL BE PINNED WHEN A 3.5' CLEAR ZONE CANNOT BE PROVIDED FROM BEHIND THE WALL.

ZONE CANNOT BE PROVIDED FROM BEHIND
THE WALL.

A.U. SECTION COUNTY TOTAL
E. SECTION COUNTY SHEETS

OT DRIVER: po


HRGreen.com
Illinois Professional Design Fit
HRGreen

USER NAME = tyelton	DESIGNED -	JPA	REVISED -	
FILE NAME = 090071-motgn-13.dgn	DRAWN -	SVJ	REVISED -	
PLOT SCALE = N.T.S.	CHECKED -	JLP	REVISED -	
PLOT DATE = 11/11/2014	DATE -	11/12/14	REVISED -	

STATE OF ILLINOIS
DEPARTMENT OF TRANSPORTATION

	SUGGESTED MAINTENANCE OF TRAFFIC – TYPICAL SECTIONS IL ROUTE 31 STAGE 2								S					
CALE:	N.T.S.	SHE	ET	NO.	11	OF	46	SHEE	TS	STA.			TO STA.	

RTE.	SE	CTION		COUNTY	SHEETS	SHEET NO.
3860	09-003	72-01-PV	(MCHENRY	358	54
				CONTRACT	NO.	63892
FED. ROAD	DIST. NO.	ILLINOIS	FED. AI	D PROJECT		

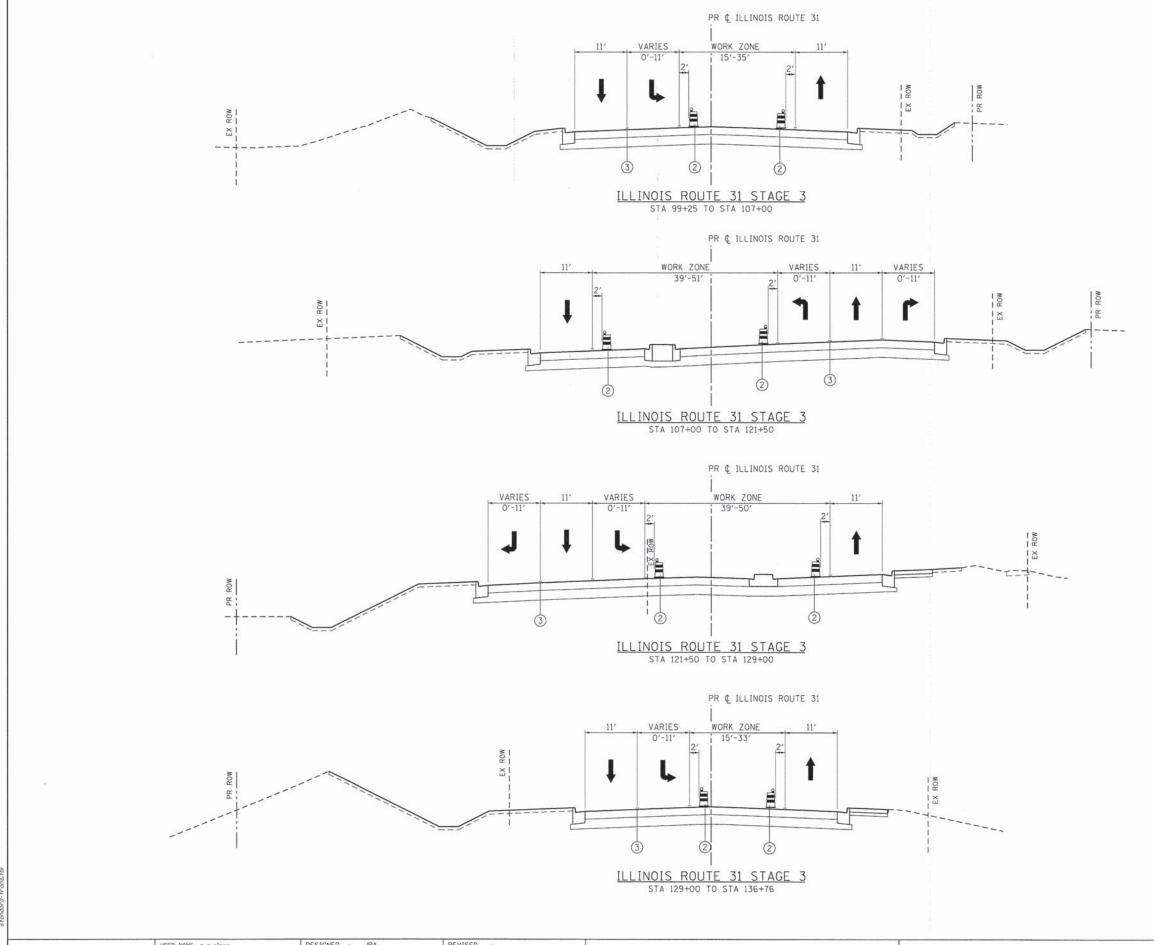

- 1 TEMPORARY PAVEMENT, 8" (SEE NOTE 2)
- 2) TYPE II BARRICADES OR DRUMS
 WITH STEADY BURNING BI-DIRECTIONAL LIGHTS
 © 50 FT CENTERS ALONG ROADWAY TANGENTS,
 20 FT CENTERS ALONG TAPERS, AND
 12 FT CENTERS ALONG RADII
- 3 PAVEMENT MARKING (SEE NOTE 1)
- EXISTING PAVEMENT MARKING
- (4)
 DOUBLE VERTICAL PANELS WITH STEADY
 (5) BURNING BI-DIRECTIONAL LIGHTS
 (9) 50 FT CENTERS ALONG ROADWAY TANGENTS,
 20 FT CENTERS ALONG TAPERS, AND
 12 FT CENTERS ALONG RADII
- (SEE NOTE 4)
- → DIRECTION OF TRAFFIC

TEMPORARY PAVEMENT

MAINTENANCE OF TRAFFIC NOTES:

- SEE MAINTENANCE OF TRAFFIC PLAN SHEETS FOR LOCATIONS AND TYPE OF PAVEMENT MARKING.
- SEE MAINTENANCE OF TRAFFIC PLAN SHEETS FOR TEMPORARY PAVEMENT CONSTRUCTION STAGING.
- 3. THE CONTRACTOR HAS THE OPTION OF USING HMA OR PCC SECTION FOR TEMPORARY PAVEMENT.
- 4. TEMPORARY CONCRETE BARRIER WALL SHALL BE PINNED WHEN A 3.5' CLEAR ZONE CANNOT BE PROVIDED FROM BEHIND THE WALL.

HRGreen.com HRGreen


USER NAME = tyelton	DESIGNED - JPA	REVISED -	
FILE NAME = 090071-motgn-14.dgn	DRAWN - SVJ	REVISED -	
PLOT SCALE = N.T.S.	CHECKED - JLP	REVISED -	
PLOT DATE = 11/11/2014	DATE - 11/12/14	REVISED -	

STATE OF ILLINOIS **DEPARTMENT OF TRANSPORTATION**

SUGGESTED MAINTENANCE OF TRAFFIC - TYPICAL SECTIONS IL ROUTE 31 STAGE 3 SCALE: N.T.S. SHEET NO. 12 OF 46 SHEETS STA.

COUNTY TOTAL SHEET NO.

MCHENRY 358 55 SECTION 3860 09-00372-01-PW CONTRACT NO. 63892 FED. ROAD DIST. NO. ILLINOIS FED. AID PROJECT

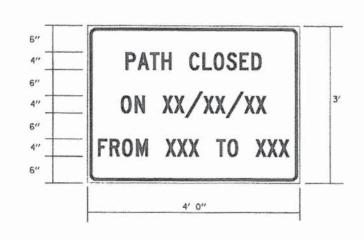


S" CAUTION S" NEW LANES OPEN "" O" A TO O"

AT ENDS OF PROJECT

NOTE: ABOVE SIGN SHALL BE BLACK ON ORANGE REFLECTIVE BACKGROUND

BIKE PATH TEMPORARY INFORMATION SIGNING

NOTE: ABOVE SIGN SHALL BE BLACK ON ORANGE REFLECTIVE BACKGROUND

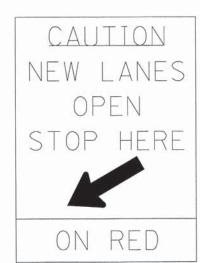

(1)

TO BE USED ONLY AT SIGNALIZED INTERSECTIONS




3

0

AT COMMERCIAL ENTRANCES

NOTE: SEE DISTRICT ONE DETAIL TC-26

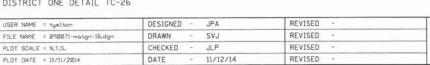

STATE OF ILLINOIS
DEPARTMENT OF TRANSPORTATION

0

SIDE ROAD

WORK ZONE

NEW LANES OPEN

C.E.

SUGGESTED MAINTENANCE OF TRAFFIC - TEMPORARY SIGNING DETAIL RTE.

MILLER ROAD ROADWAY IMPROVEMENTS

SCALE: N.T.S. SHEET NO. 13 OF 46 SHEETS STA. TO STA.

FED. RC
FED. RC

NOTE: ALL SIGNS ON THIS SHEET ARE TO BE PAID FOR AS "TEMPORARY INFORMATION SIGNING".

11/11/2014 10:27:23 AM 090071-motgn-16.dgn pdf.plt standard-trans.tbl

HRGreen

HRGreen.com Illinois Professional Design Firm #184-001322


F TRANSPORTATION


TYPICAL LOCATION OF TEMPORARY INFORMATION SIGNING


1


P.E.


C.E.

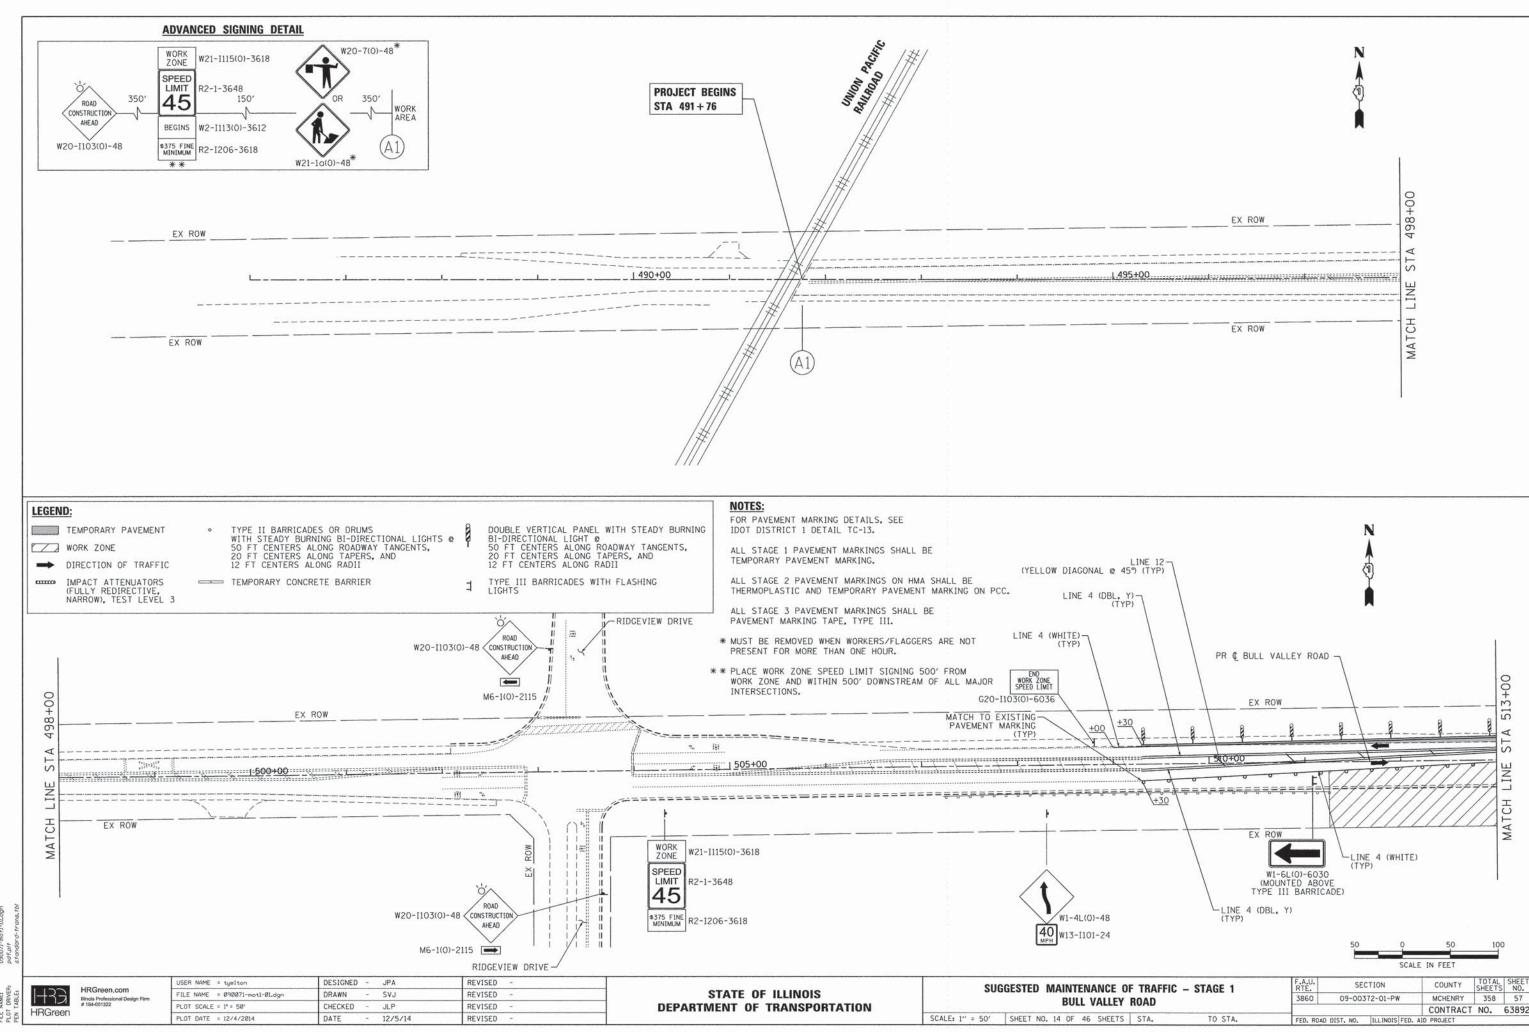

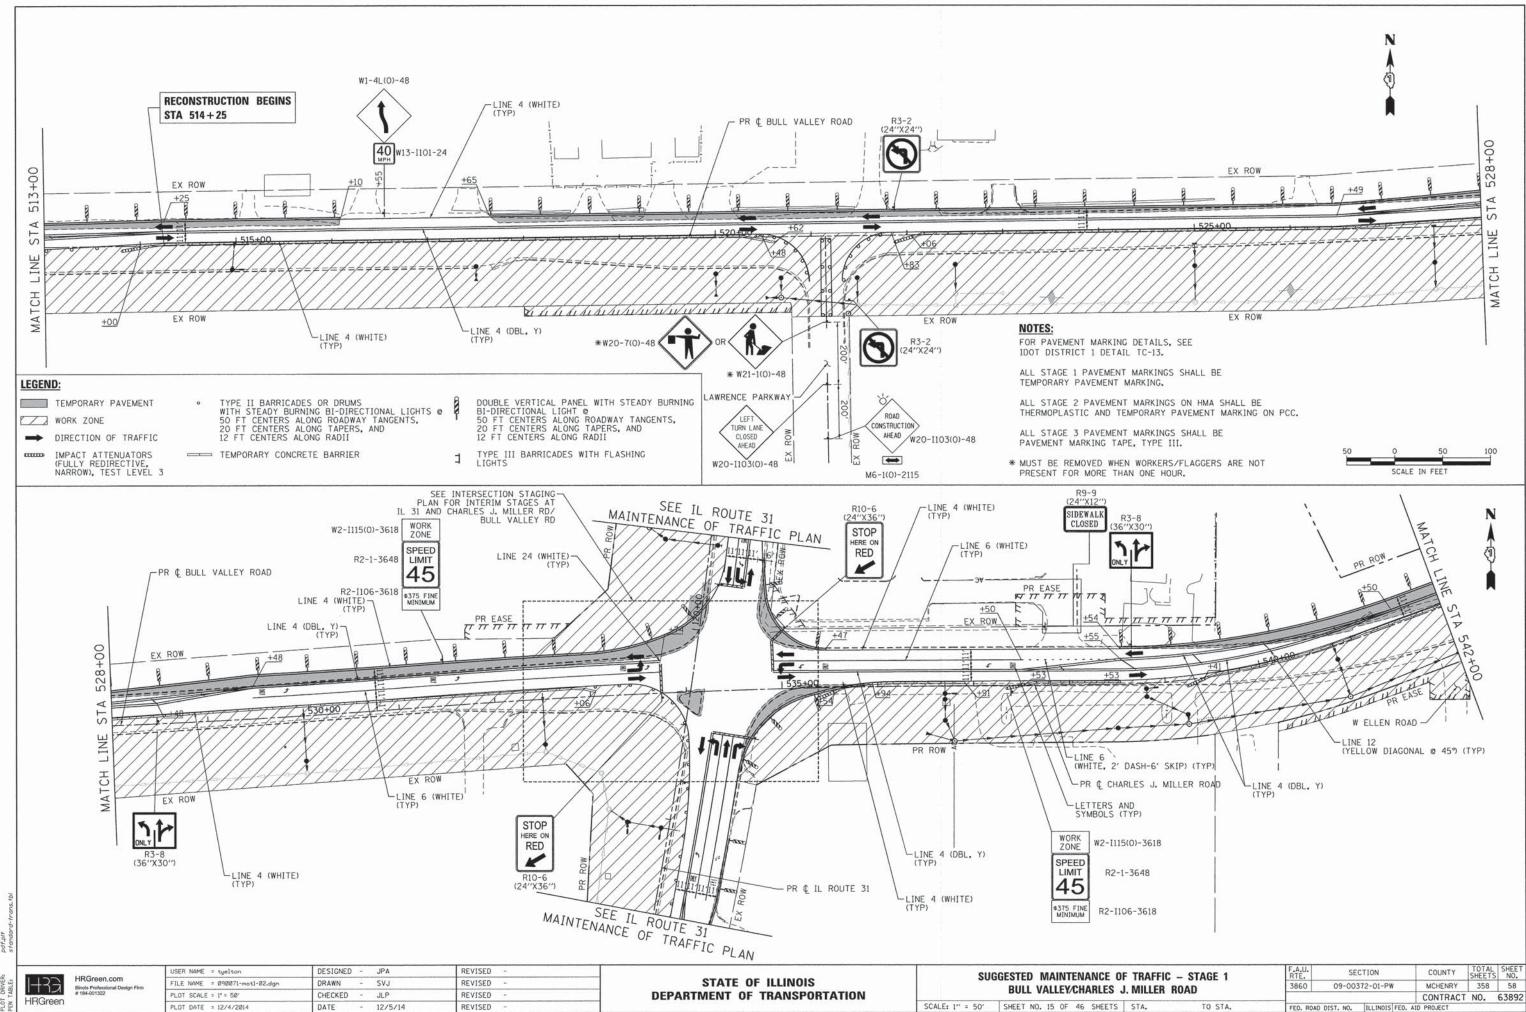


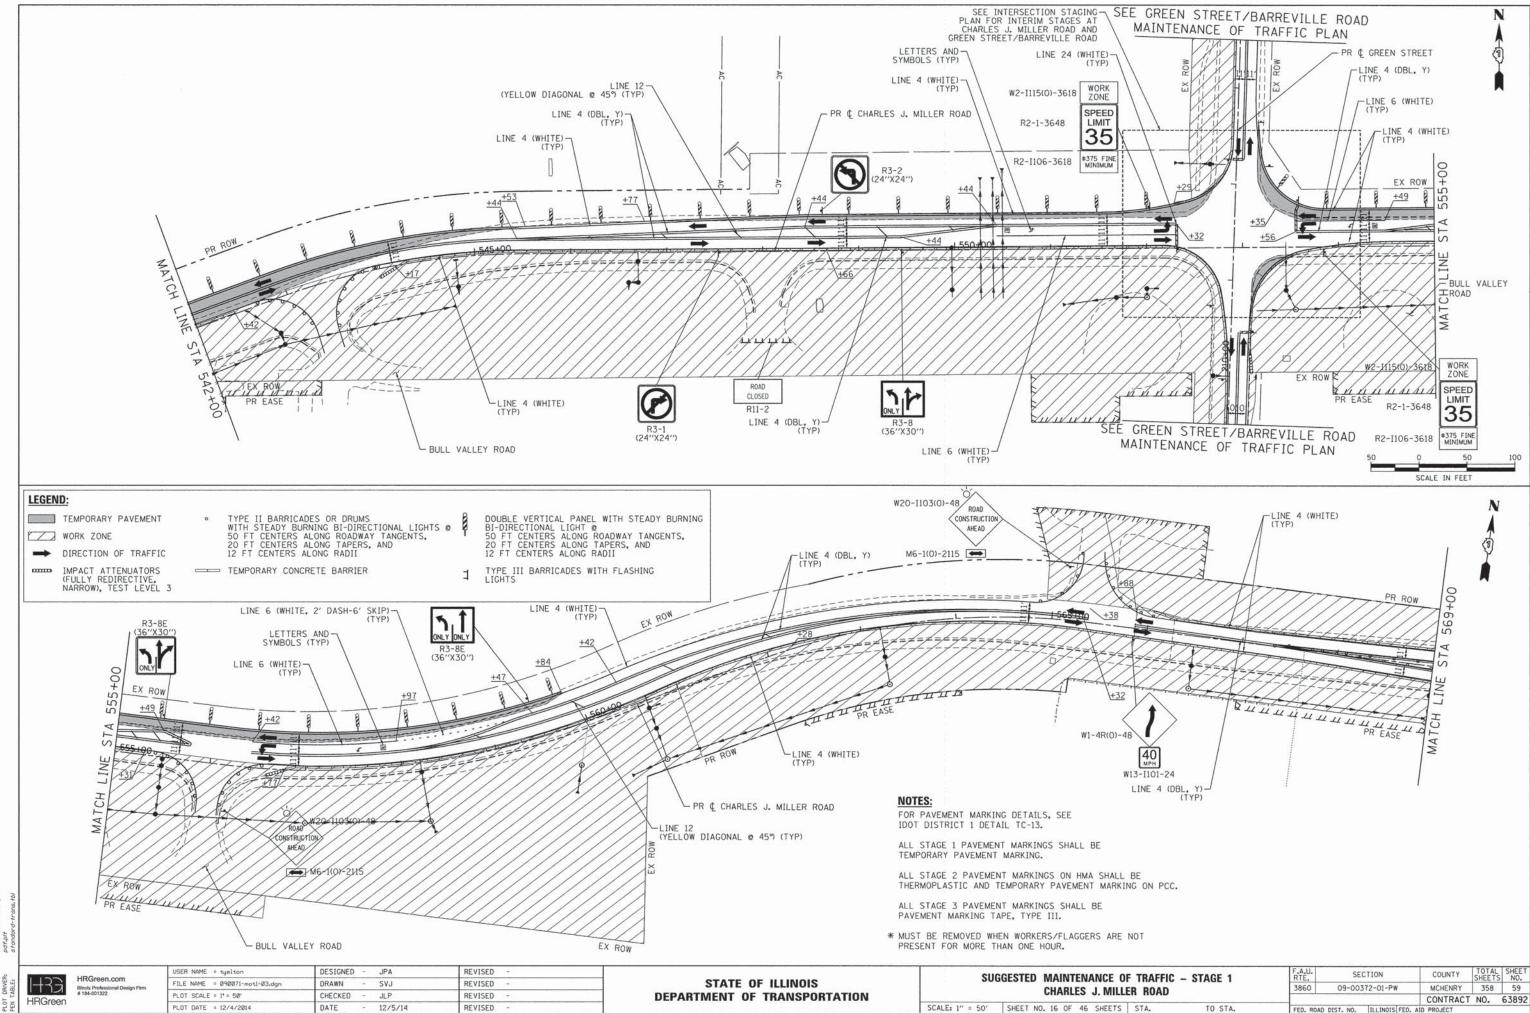

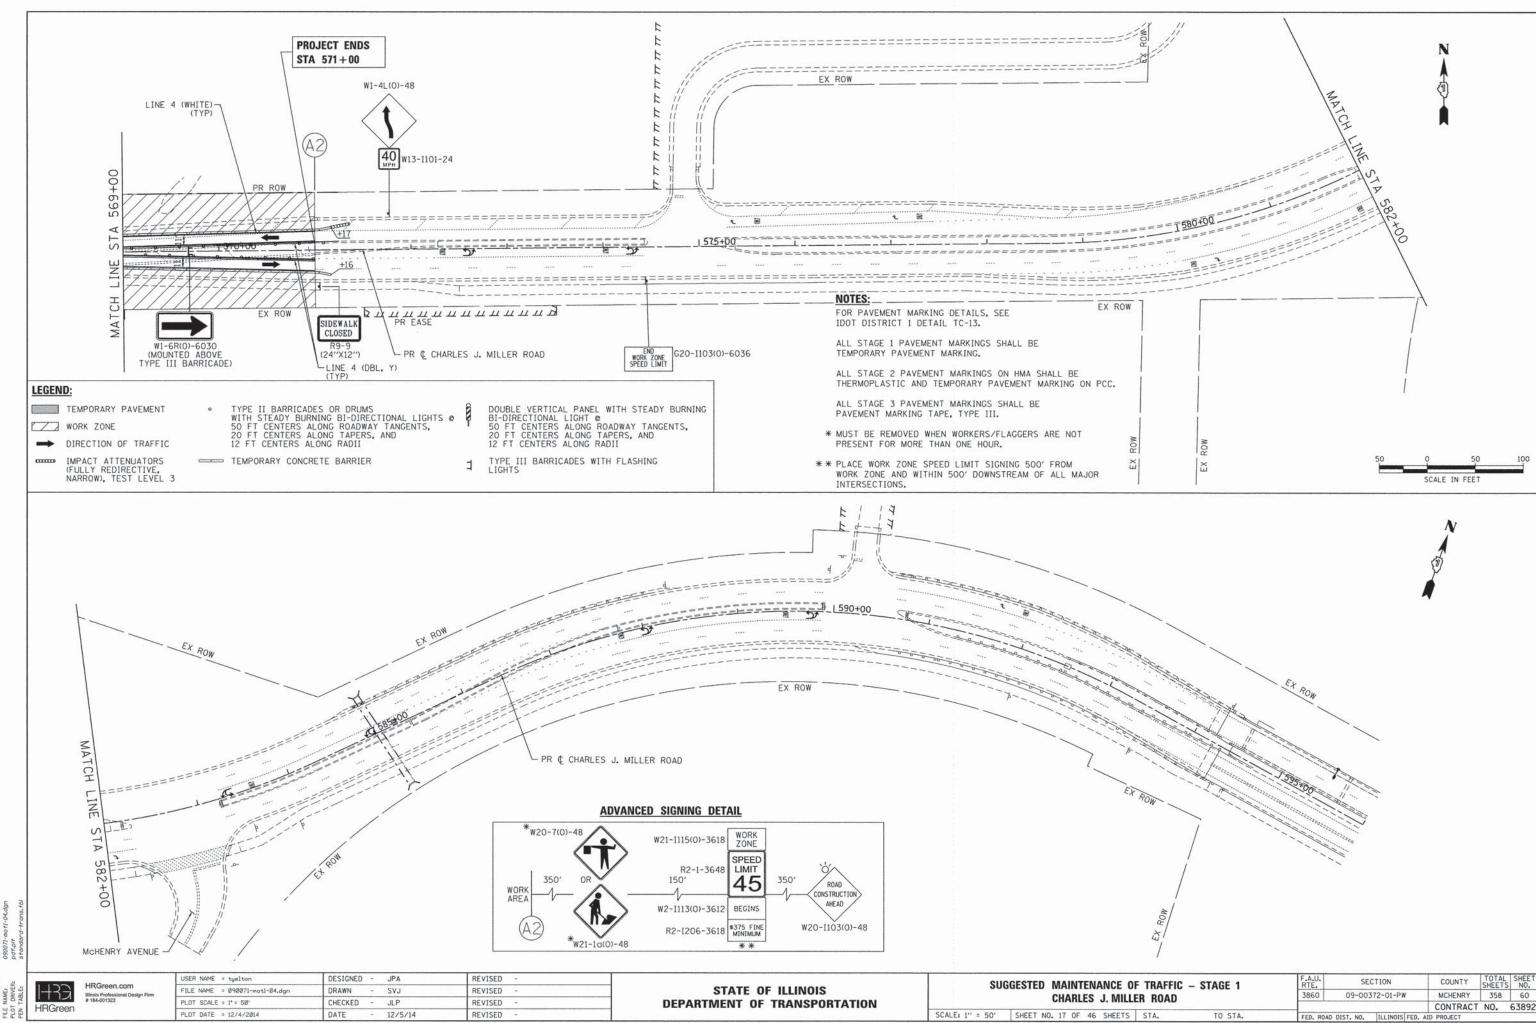


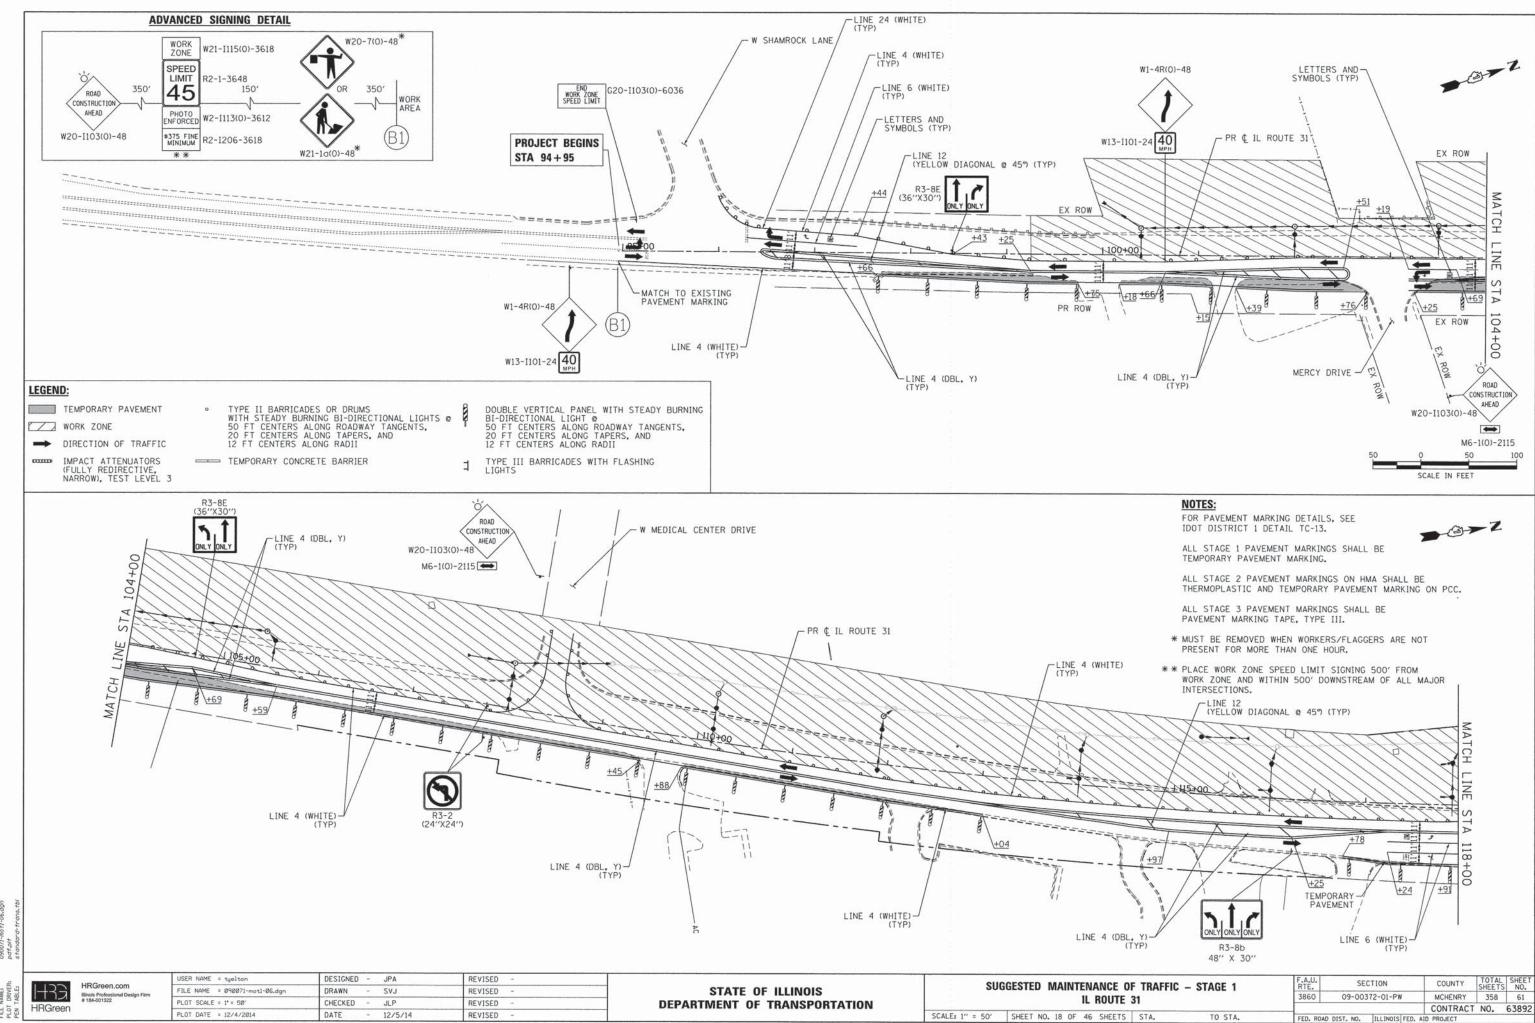

COMPART RAME:
COUNTACT:
CLENT:
DATE PLOTTED: 12/4/2014 St.
FUE NAME:
PLOT DRIVER: pdf.pdf.
PLOT DRIVER: pdf.pdf.

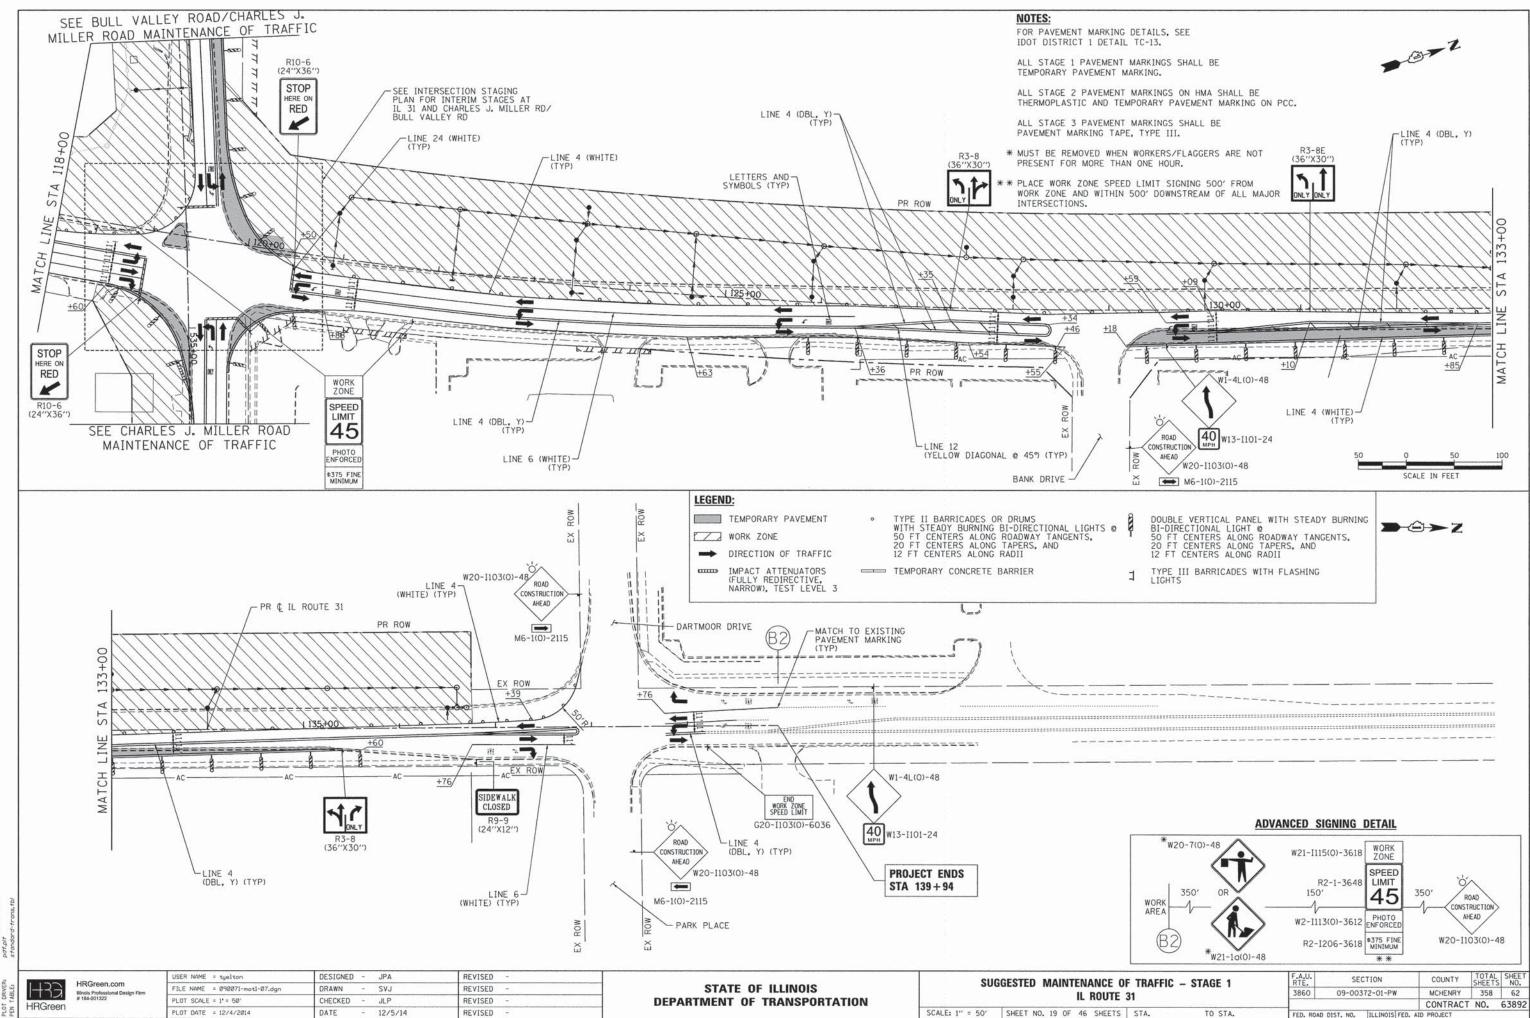


COMPANY NAME:
PROJECT CONTACT:
CLENT:
DATE PLOTTED: 1274/2014 S
FILE NAME: 050071-mot P
LOT DRIVER: off-cit

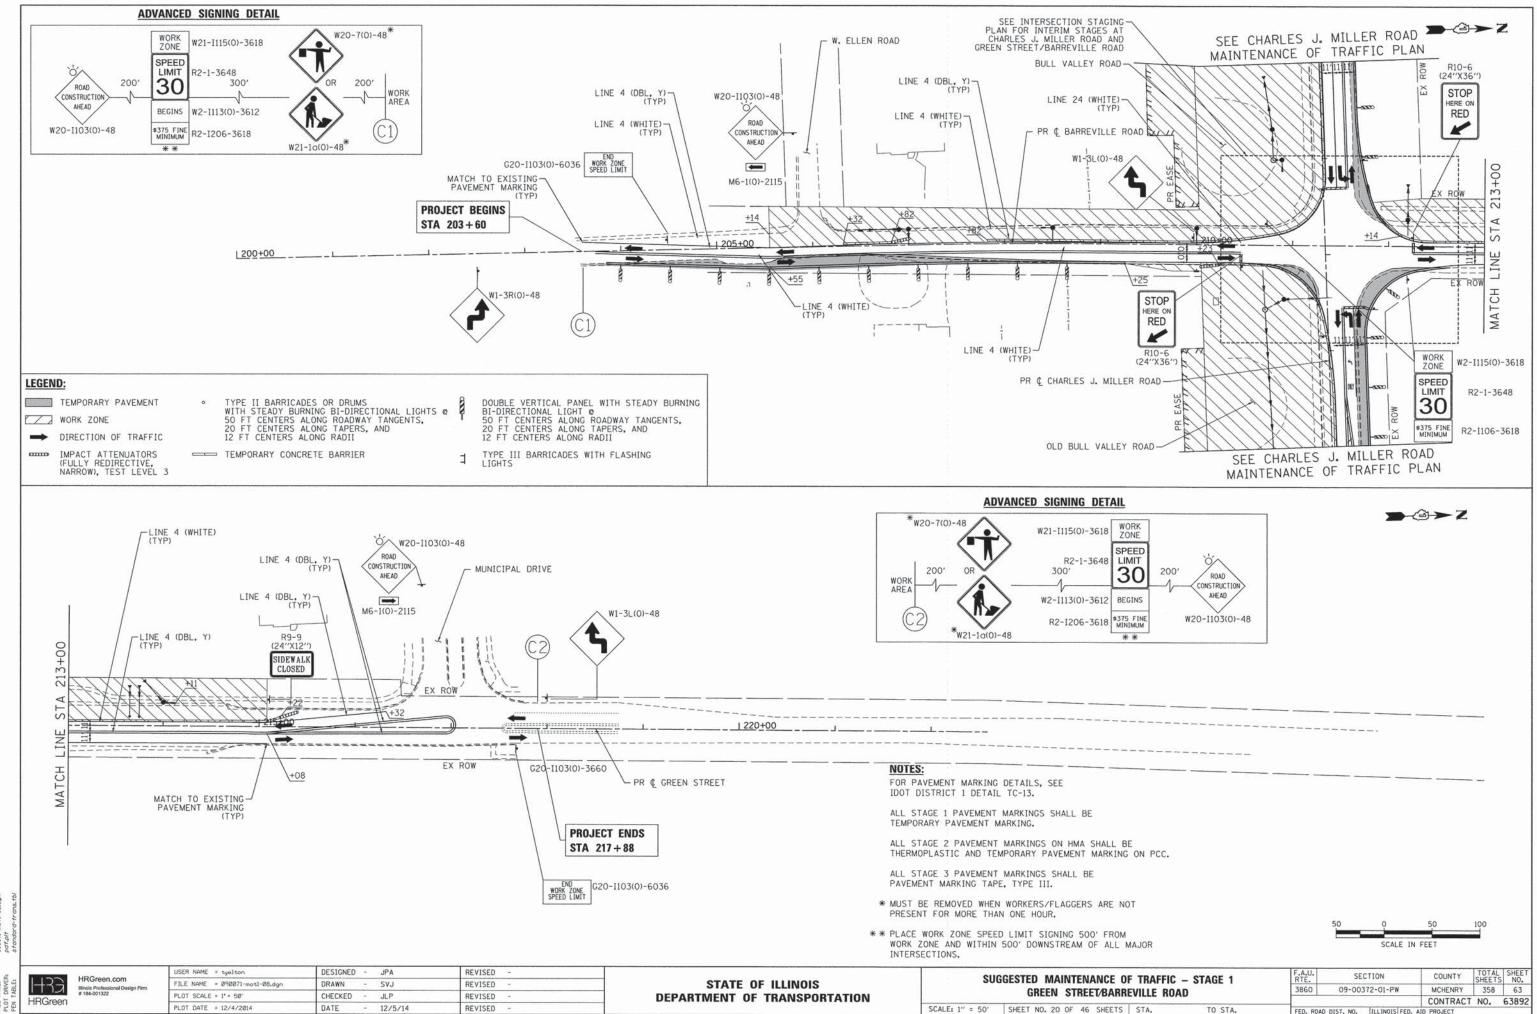



PLOT DATE = 12/4/2014 DATE REVISED 12/5/14


FED. ROAD DIST. NO. | ILLINOIS FED. AID PROJECT

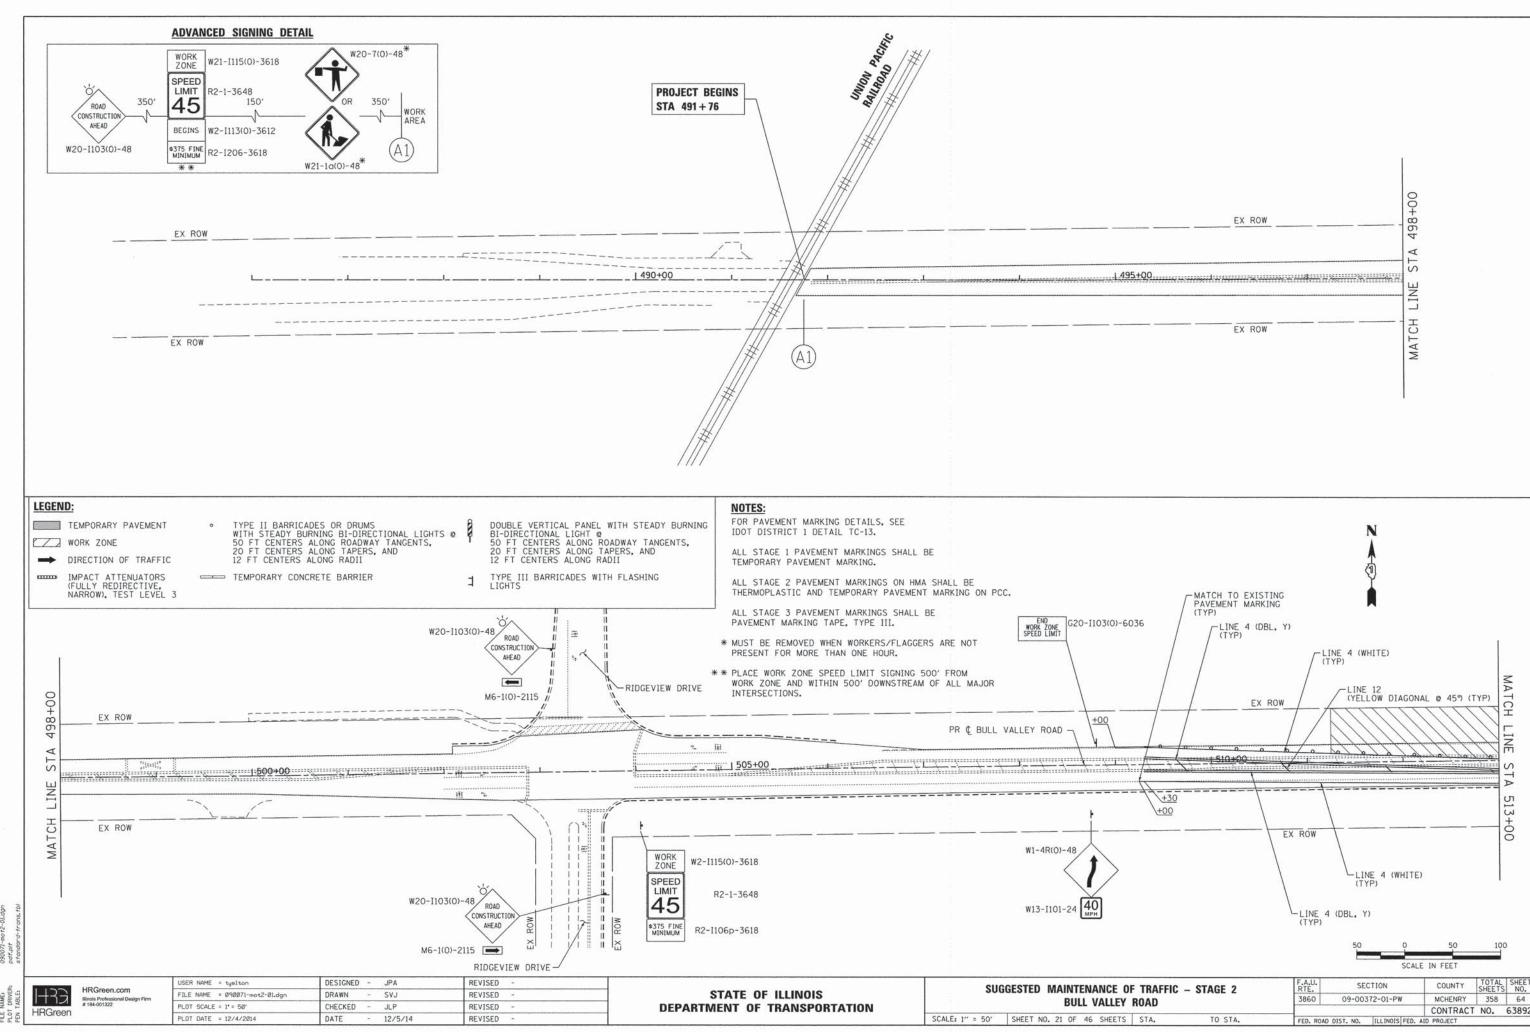


CONTRACT NO. 63892

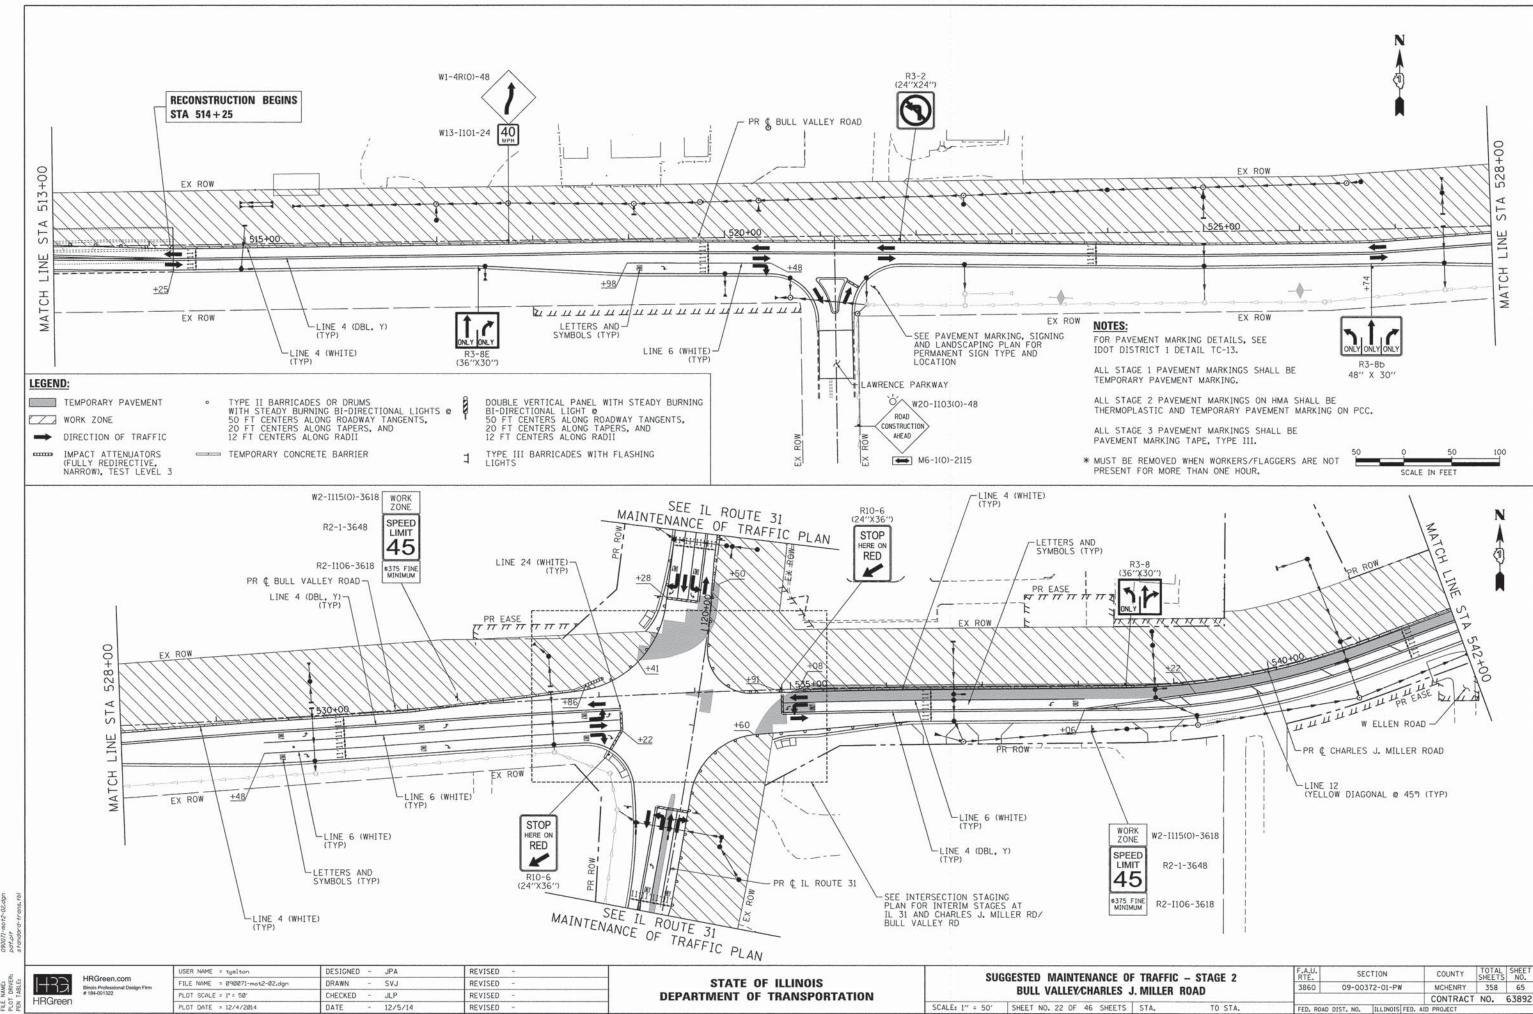

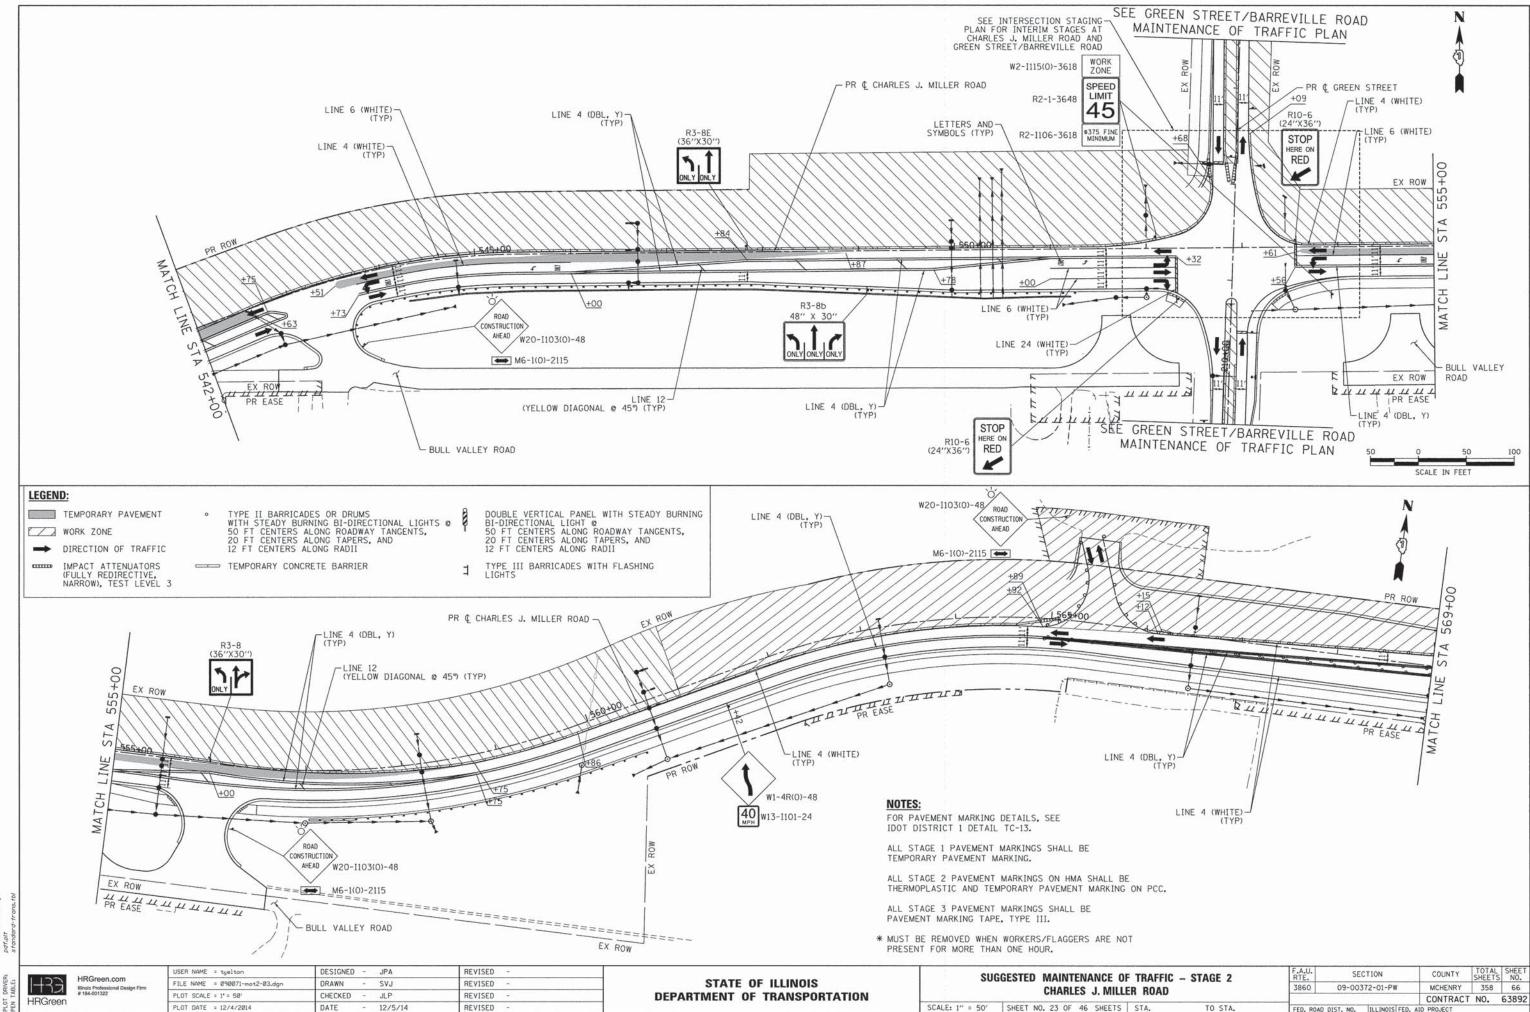


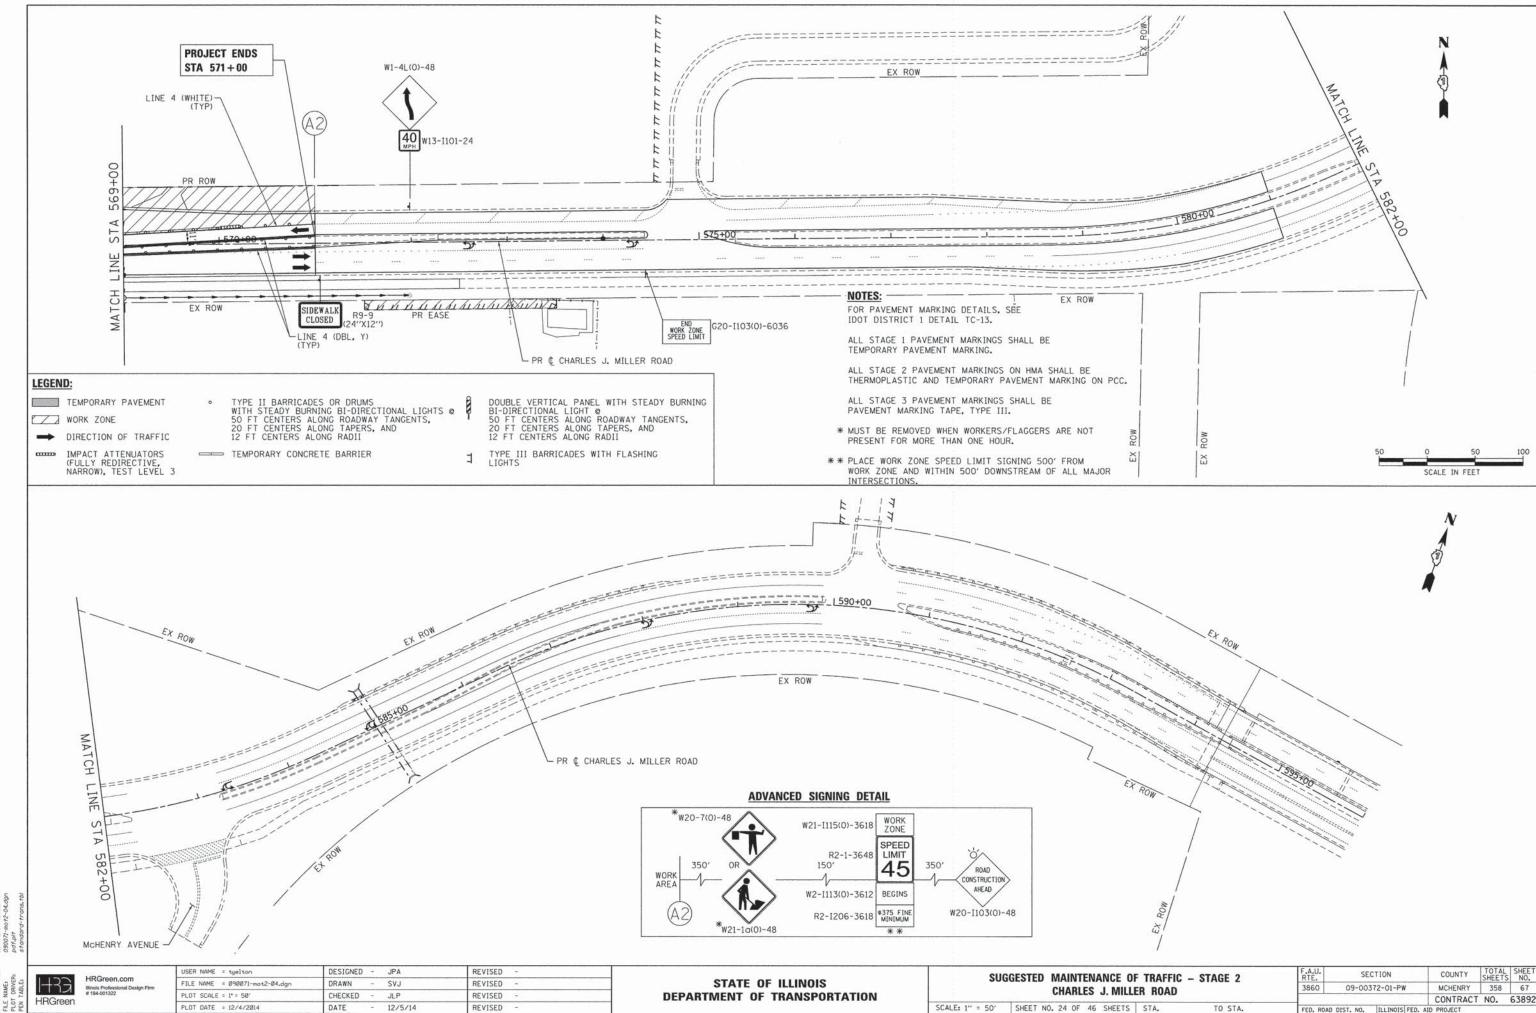


PROJECT CONTACT:
CLENT:
CLENT:
DATE PLOTTED: 12/4/2014 9;
FLLE NAME: 090071-mort2
PLGT DRIVER: pdf.ptt

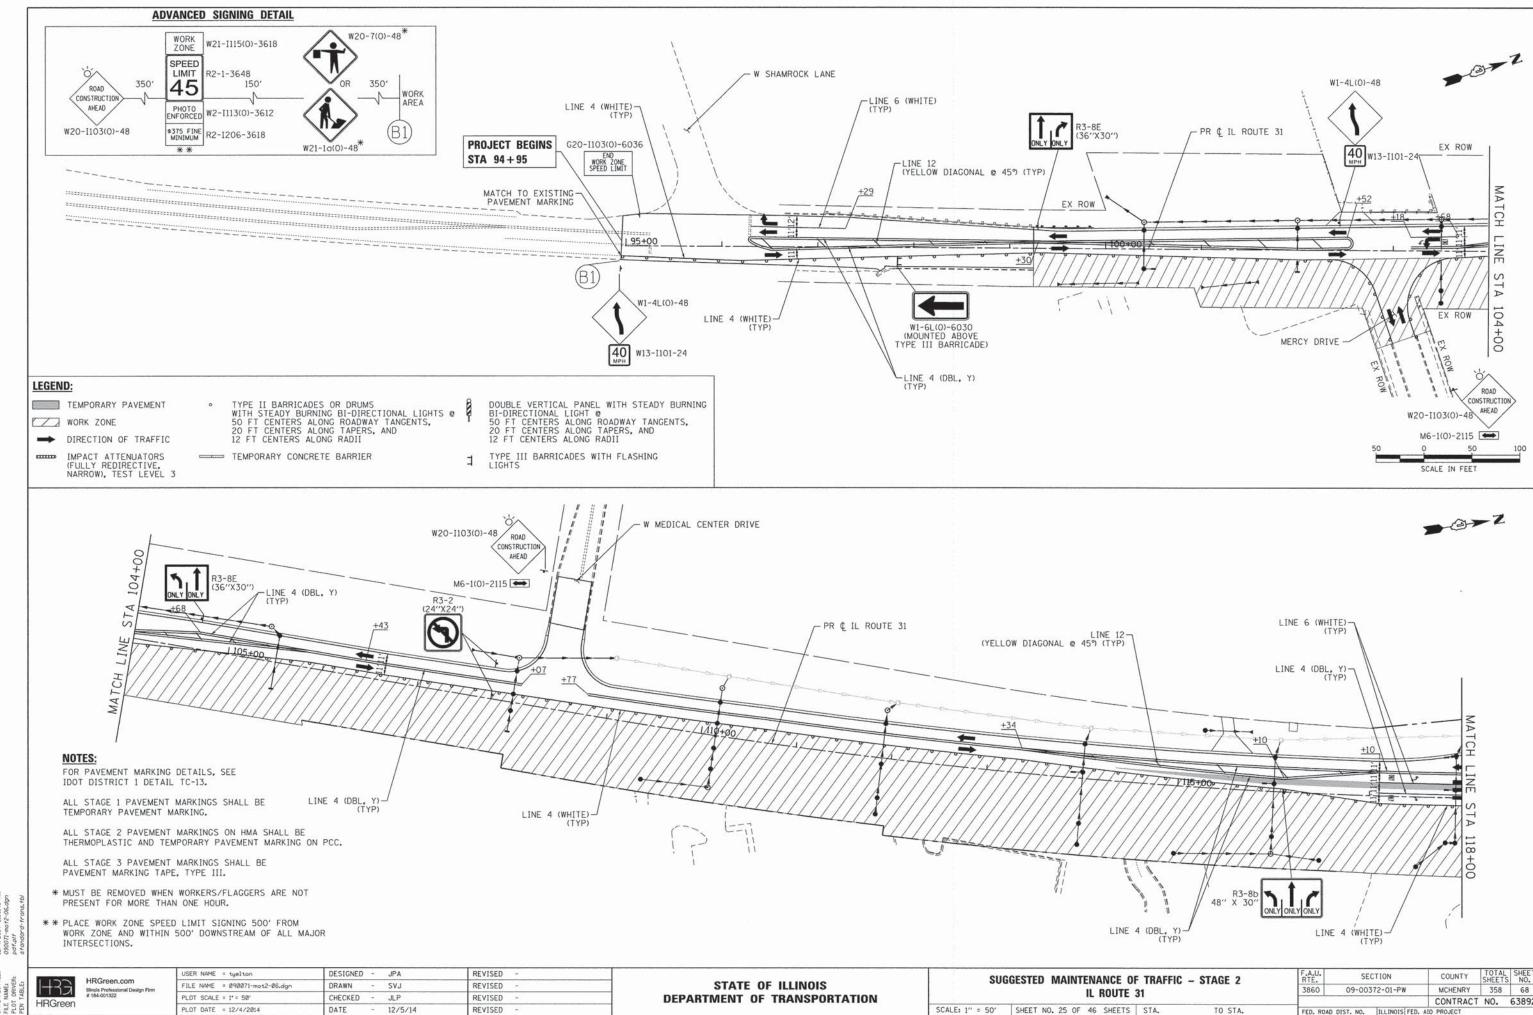


MCHENRY 358 68 CONTRACT NO. 63892

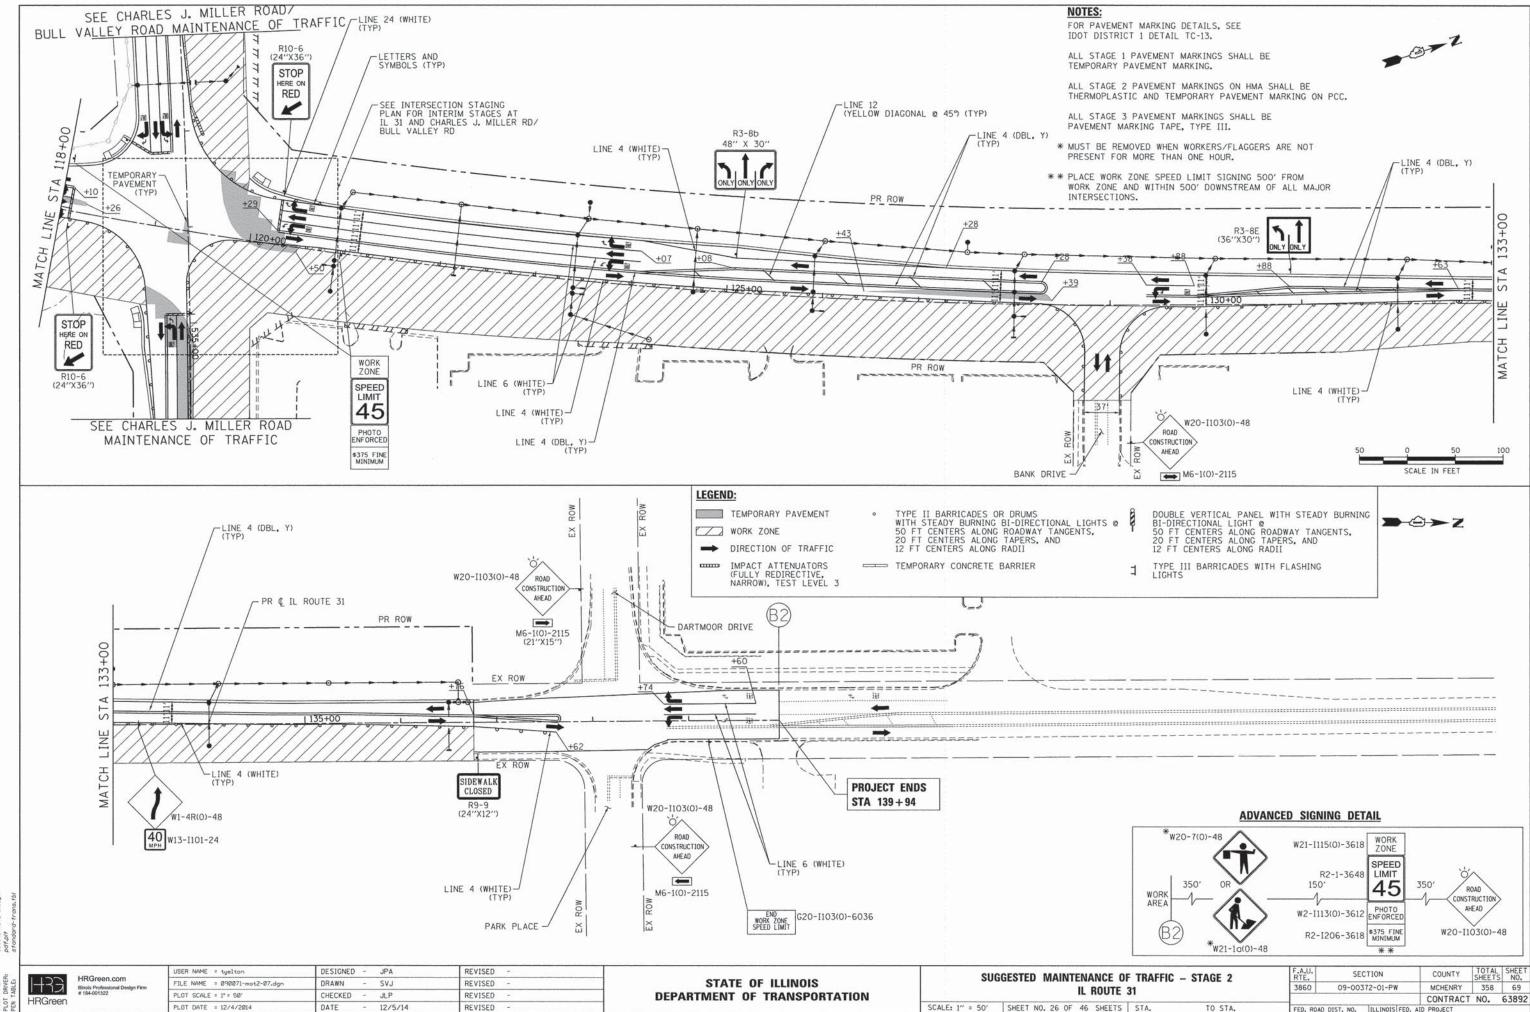



12/5/14 REVISED

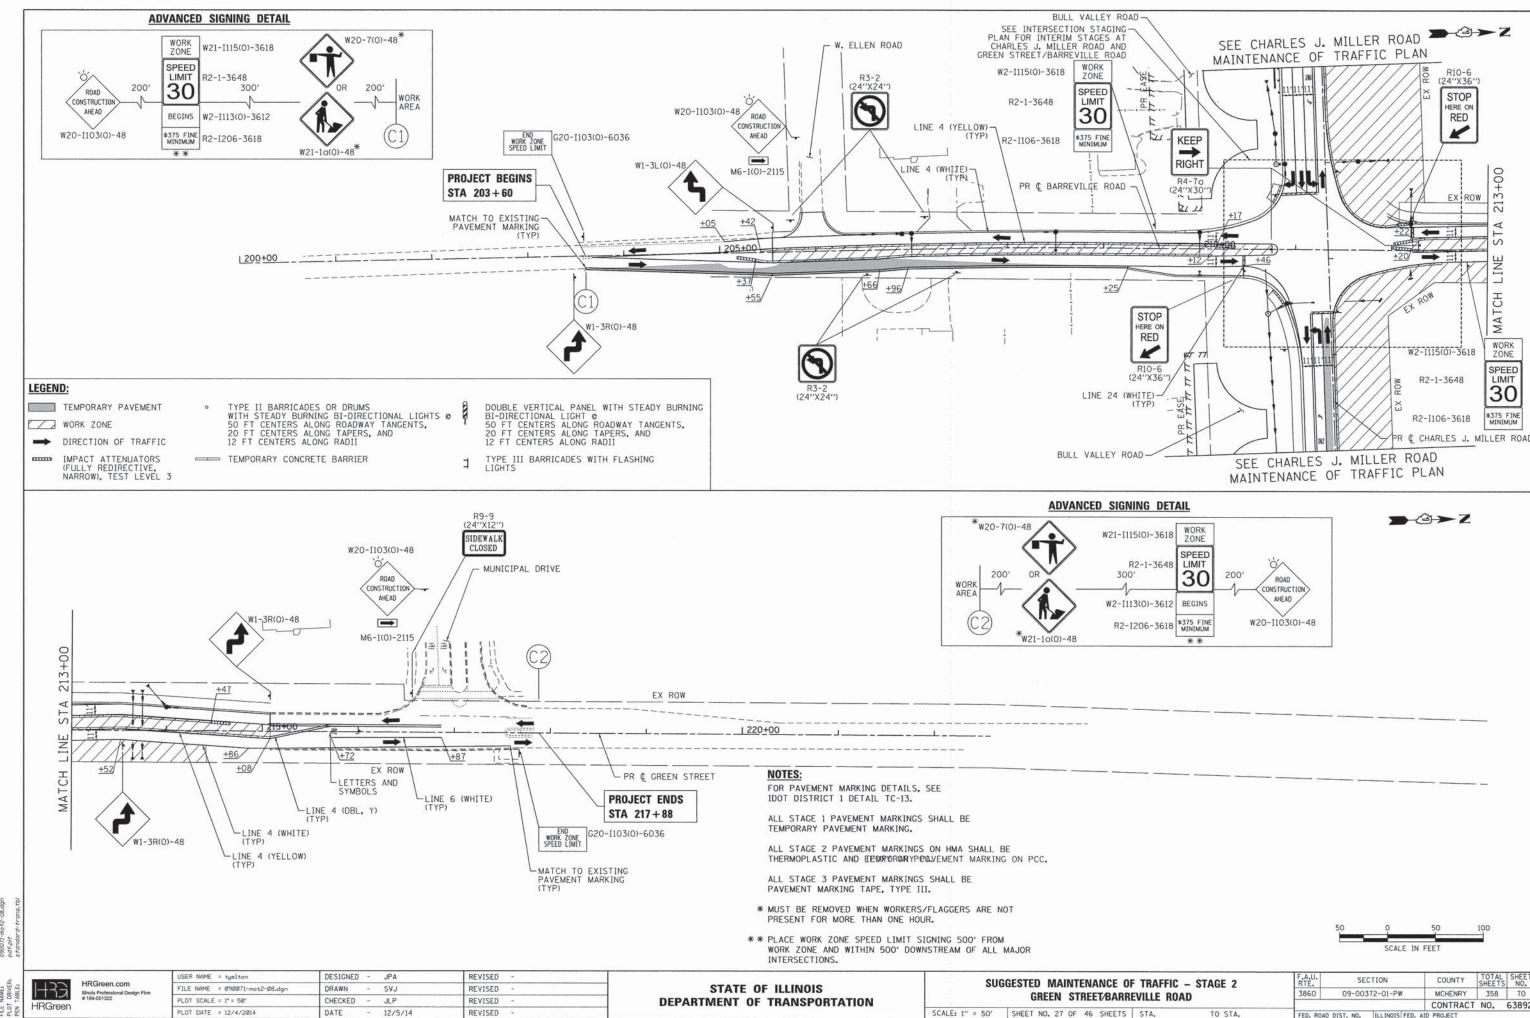


DATE 12/5/14 REVISED CONTRACT NO. 63892

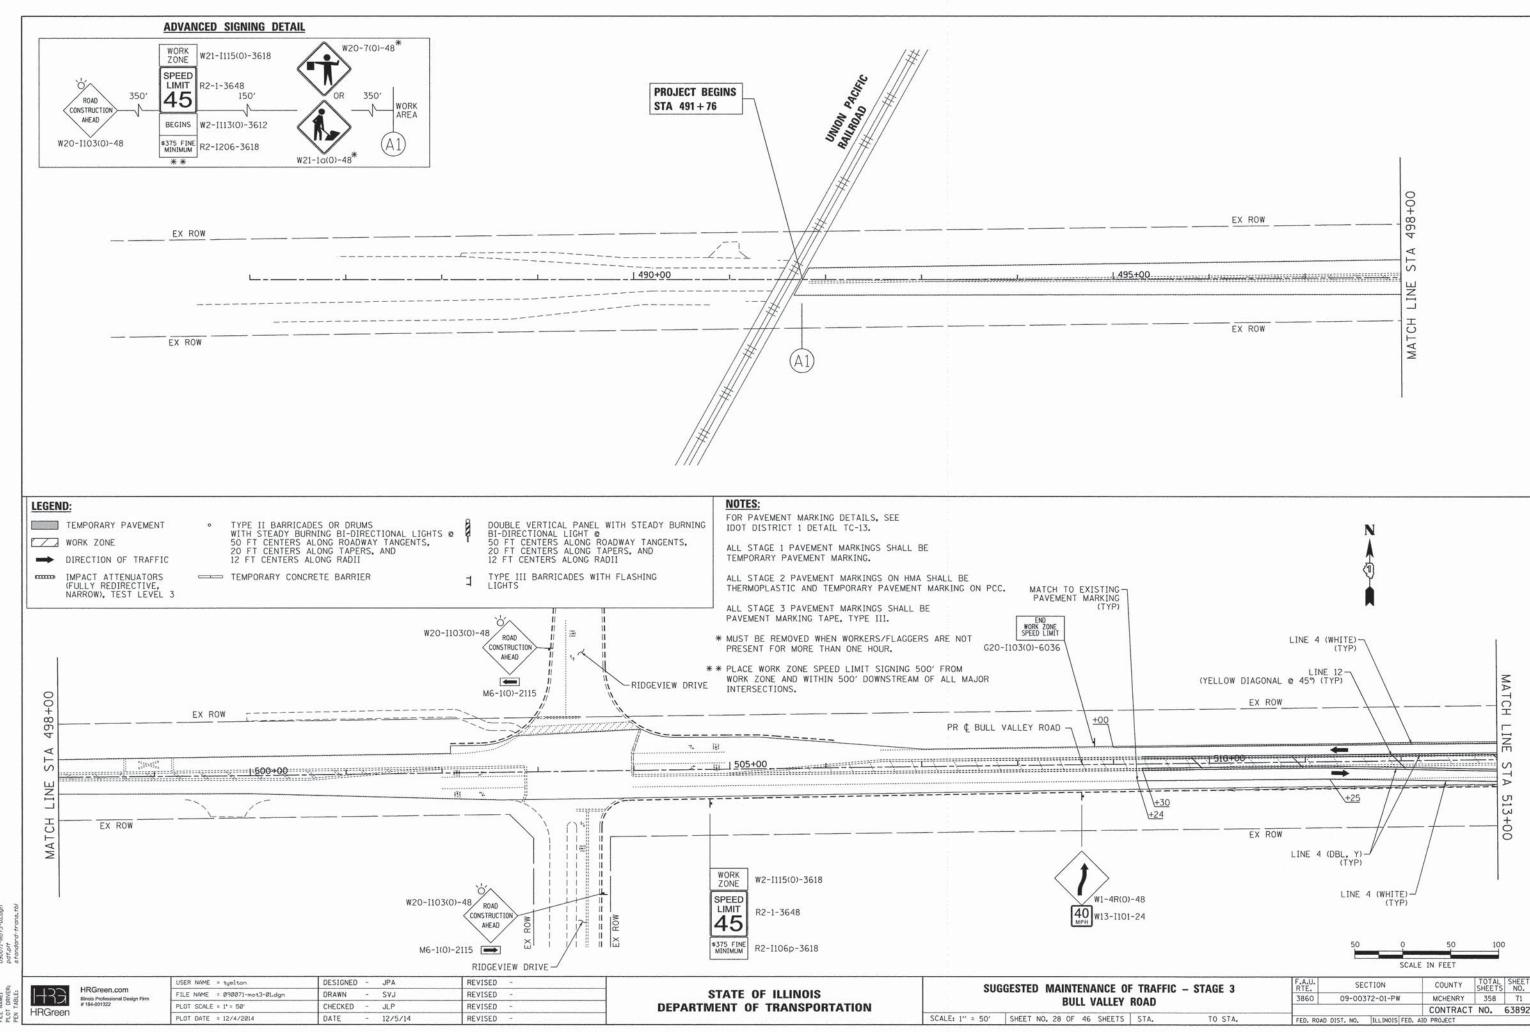


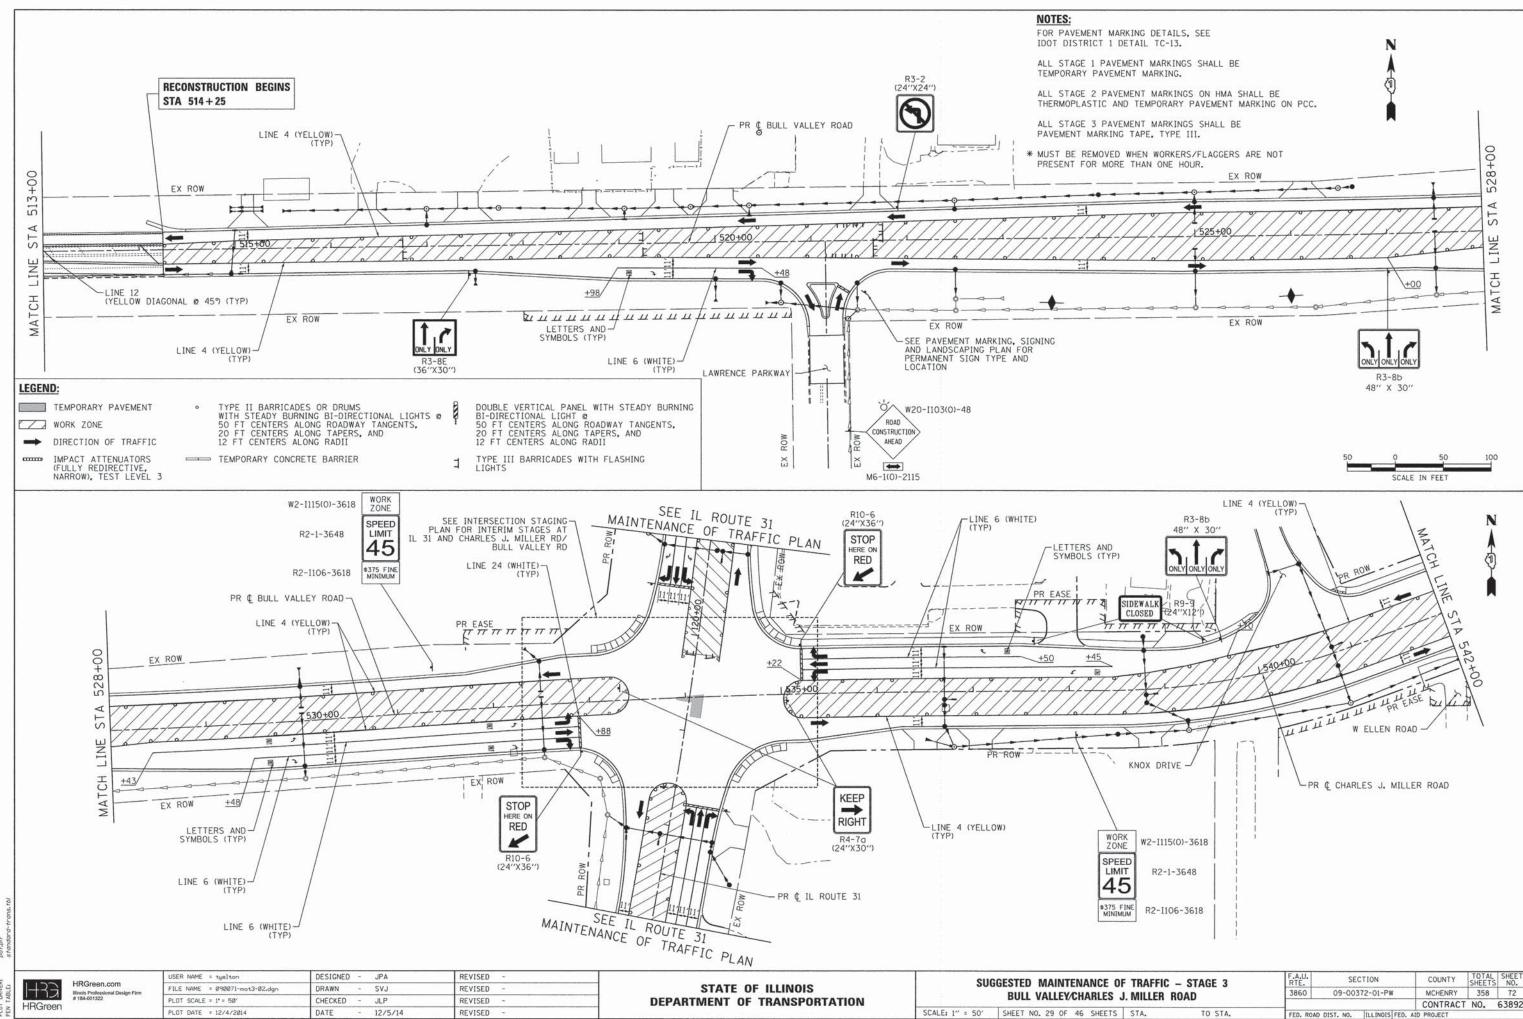

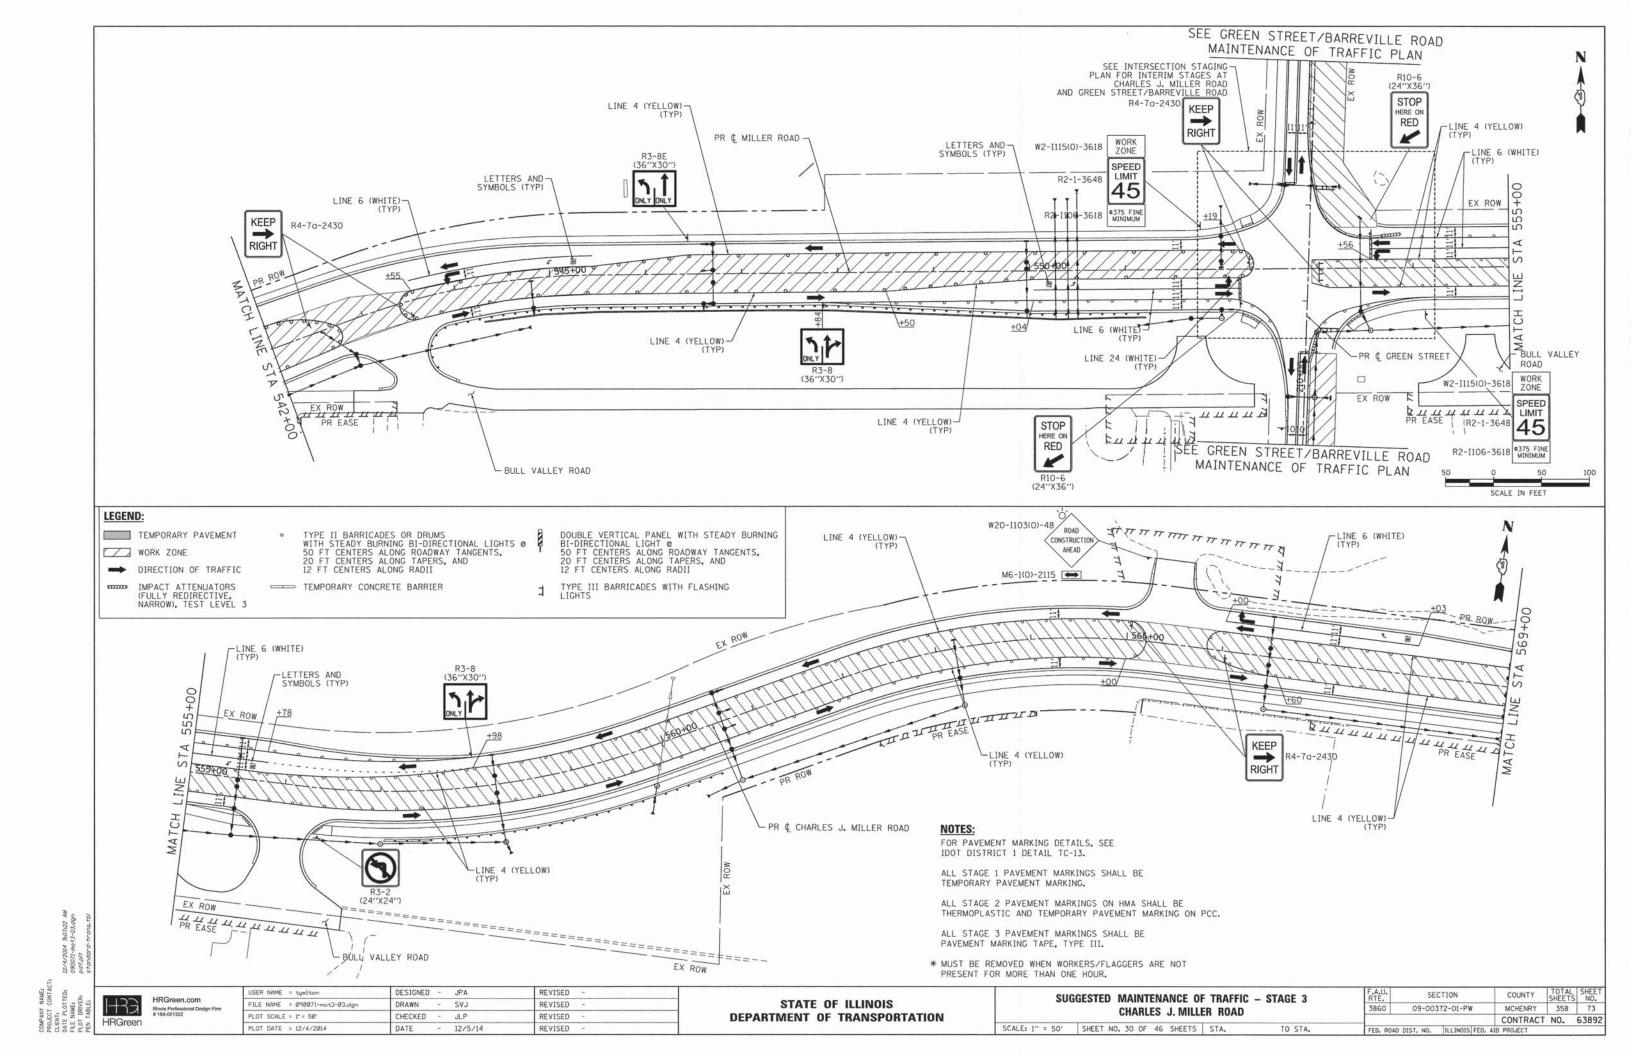


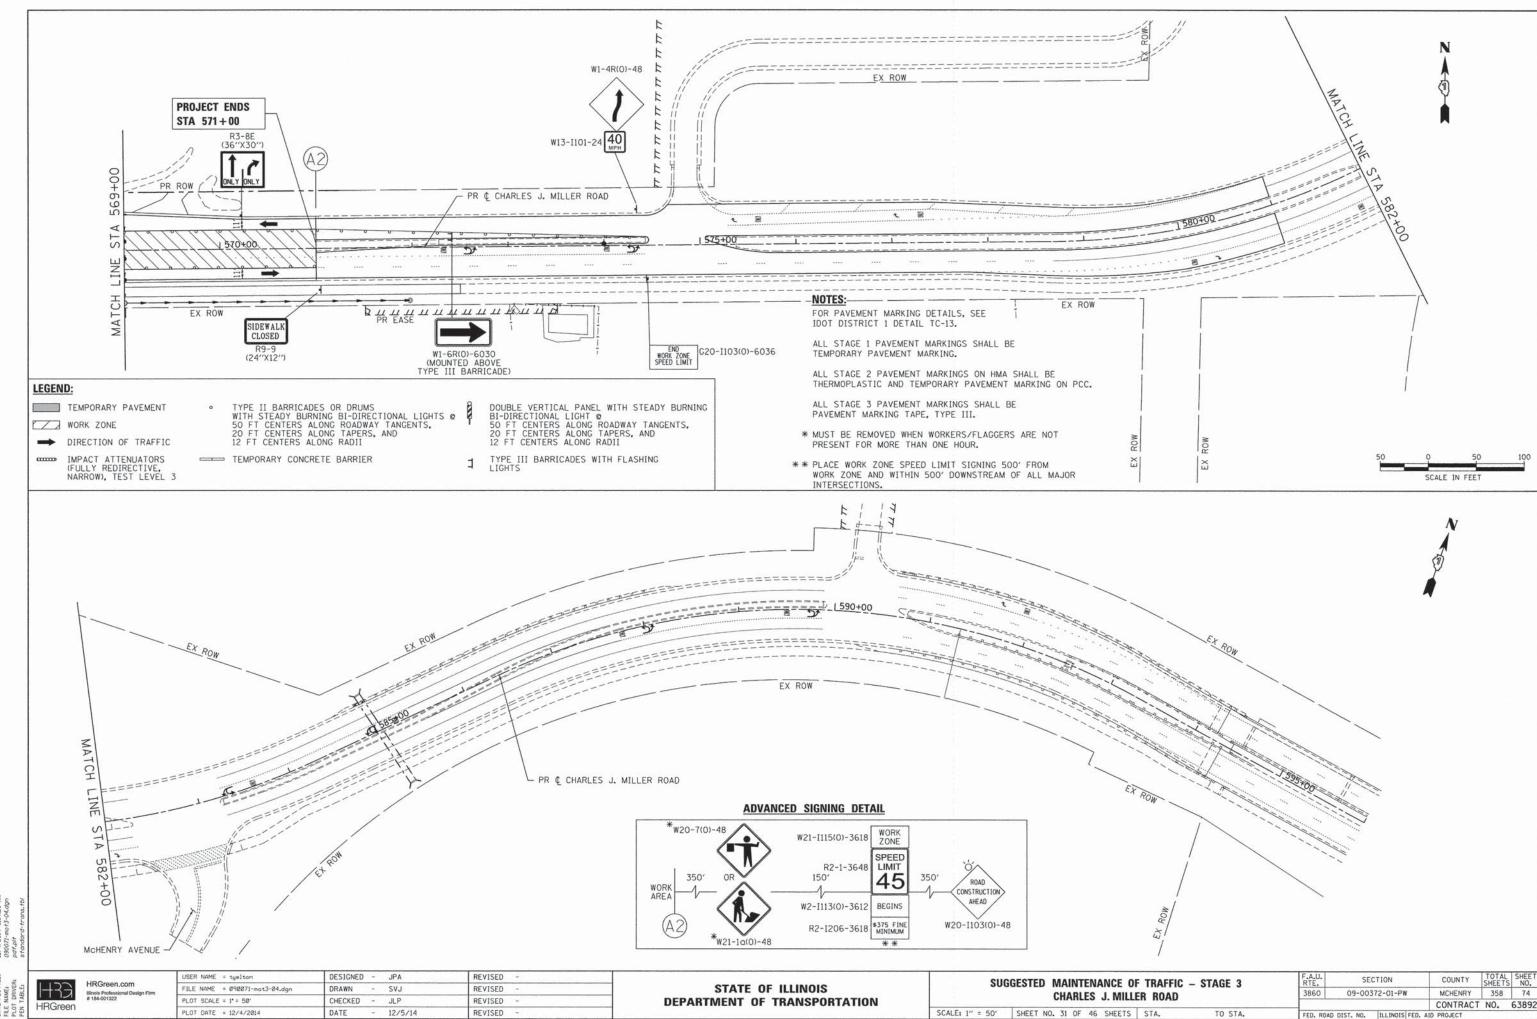


NROJECT CONTACT:
LLENT:
12/4/2014 9:07:29 /
30071-mo13-04.dgr
ille NAME:
10 PRIVER:
10 PRIVER:
10 PRIVER:

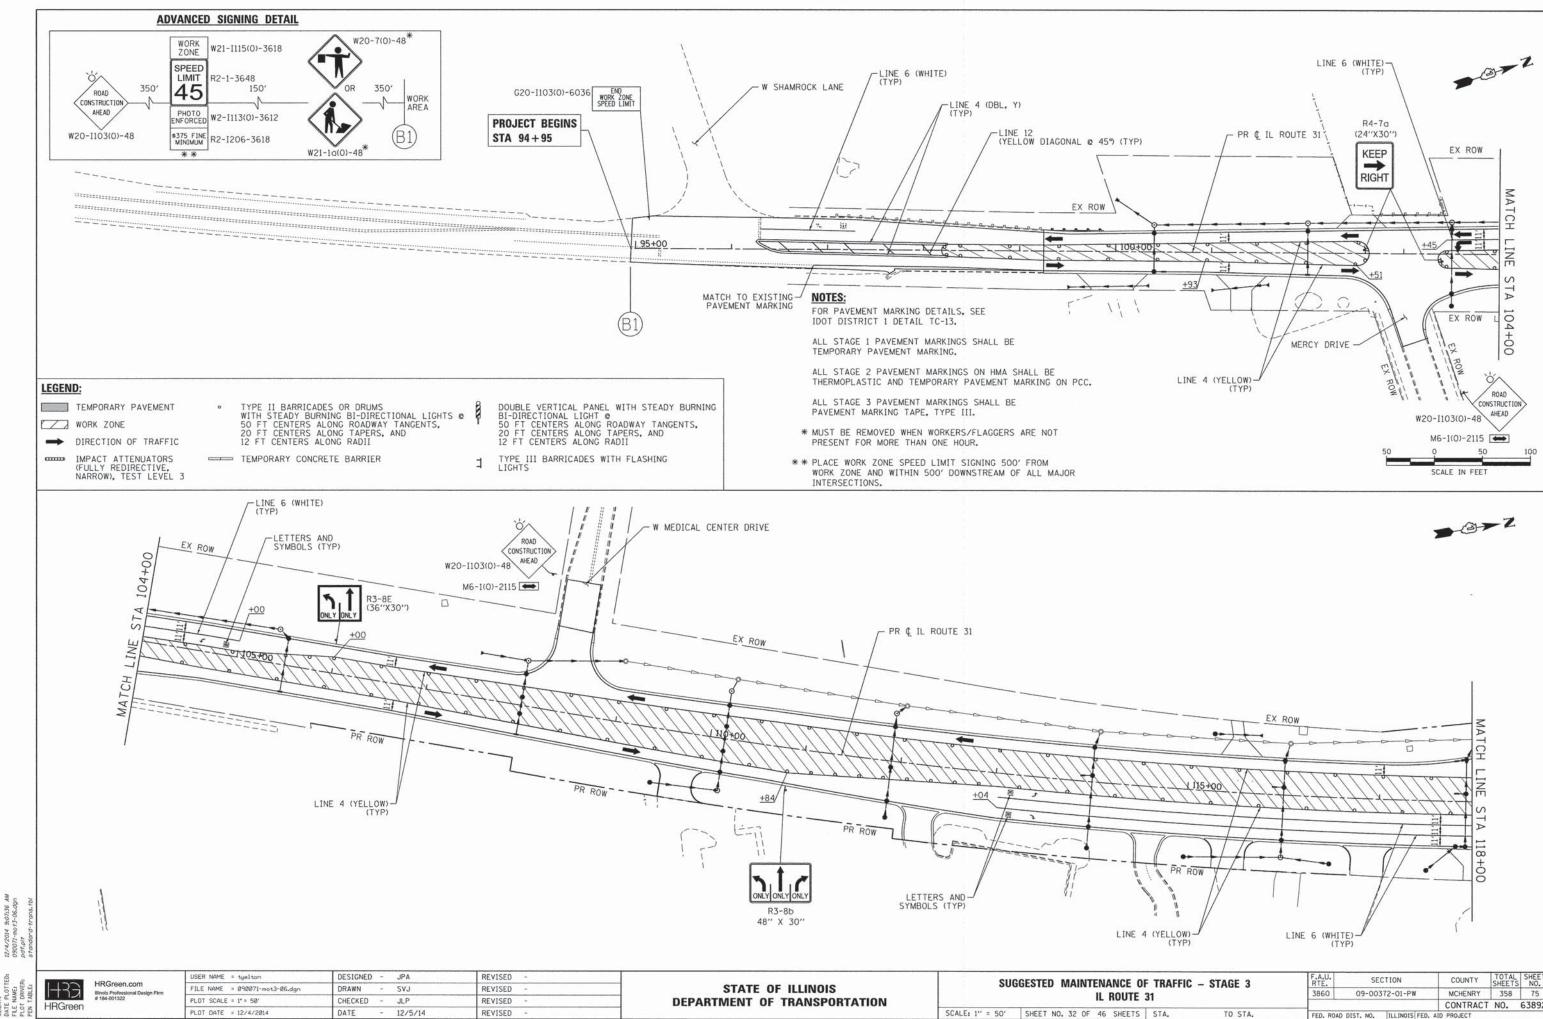



CONTRACT NO. 63892

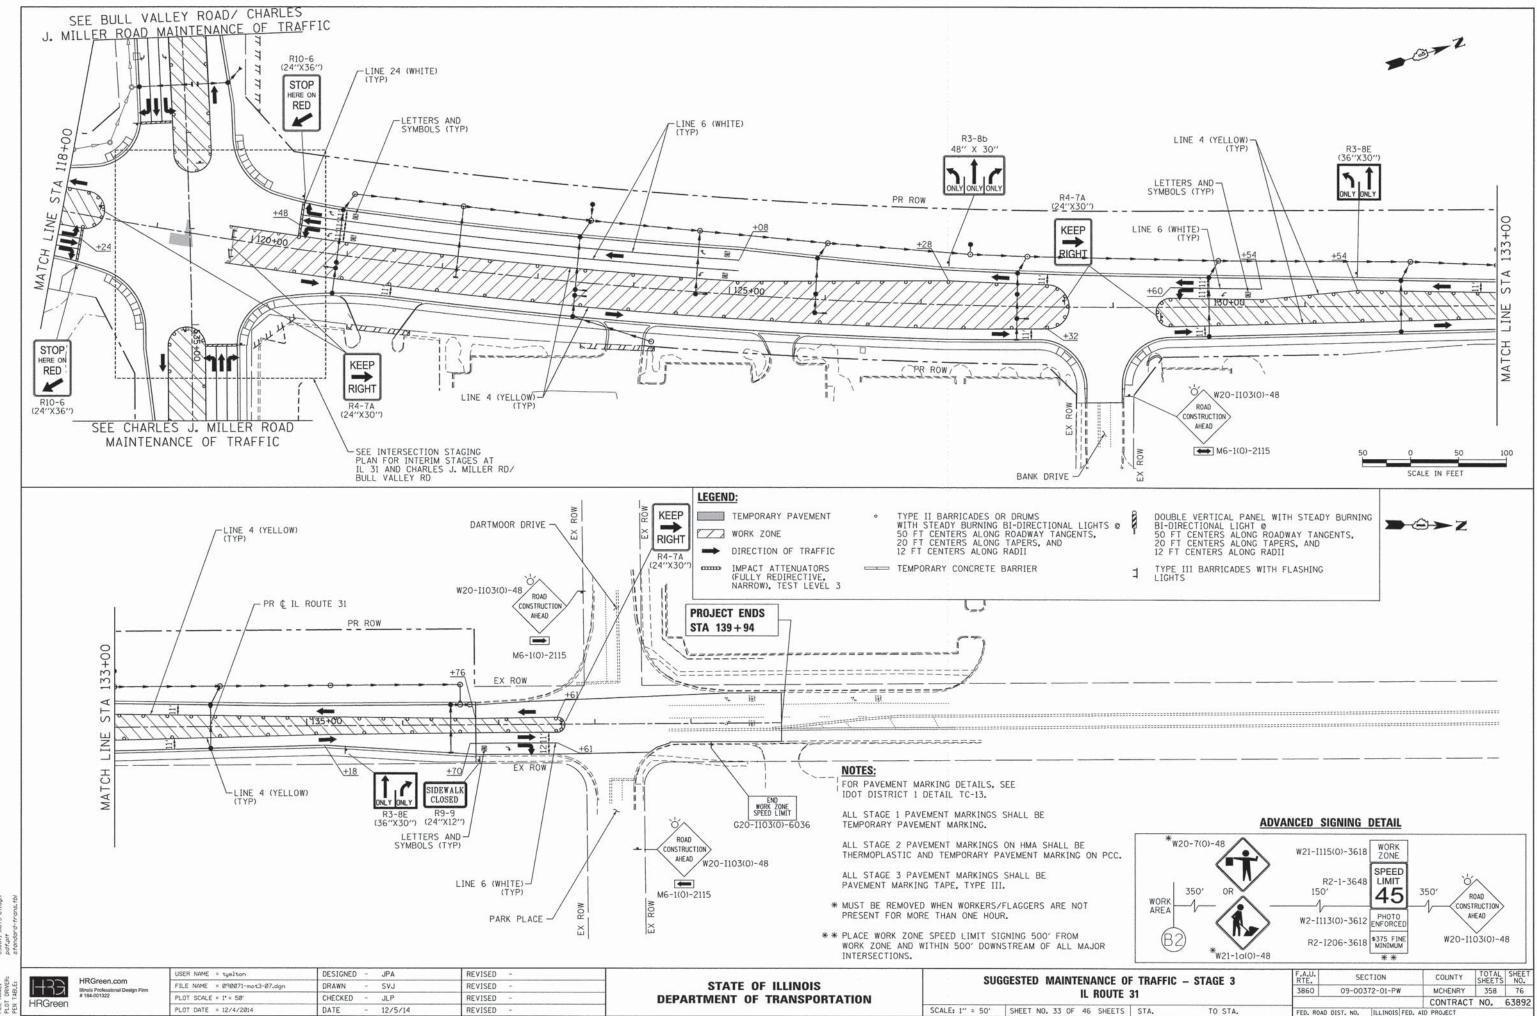


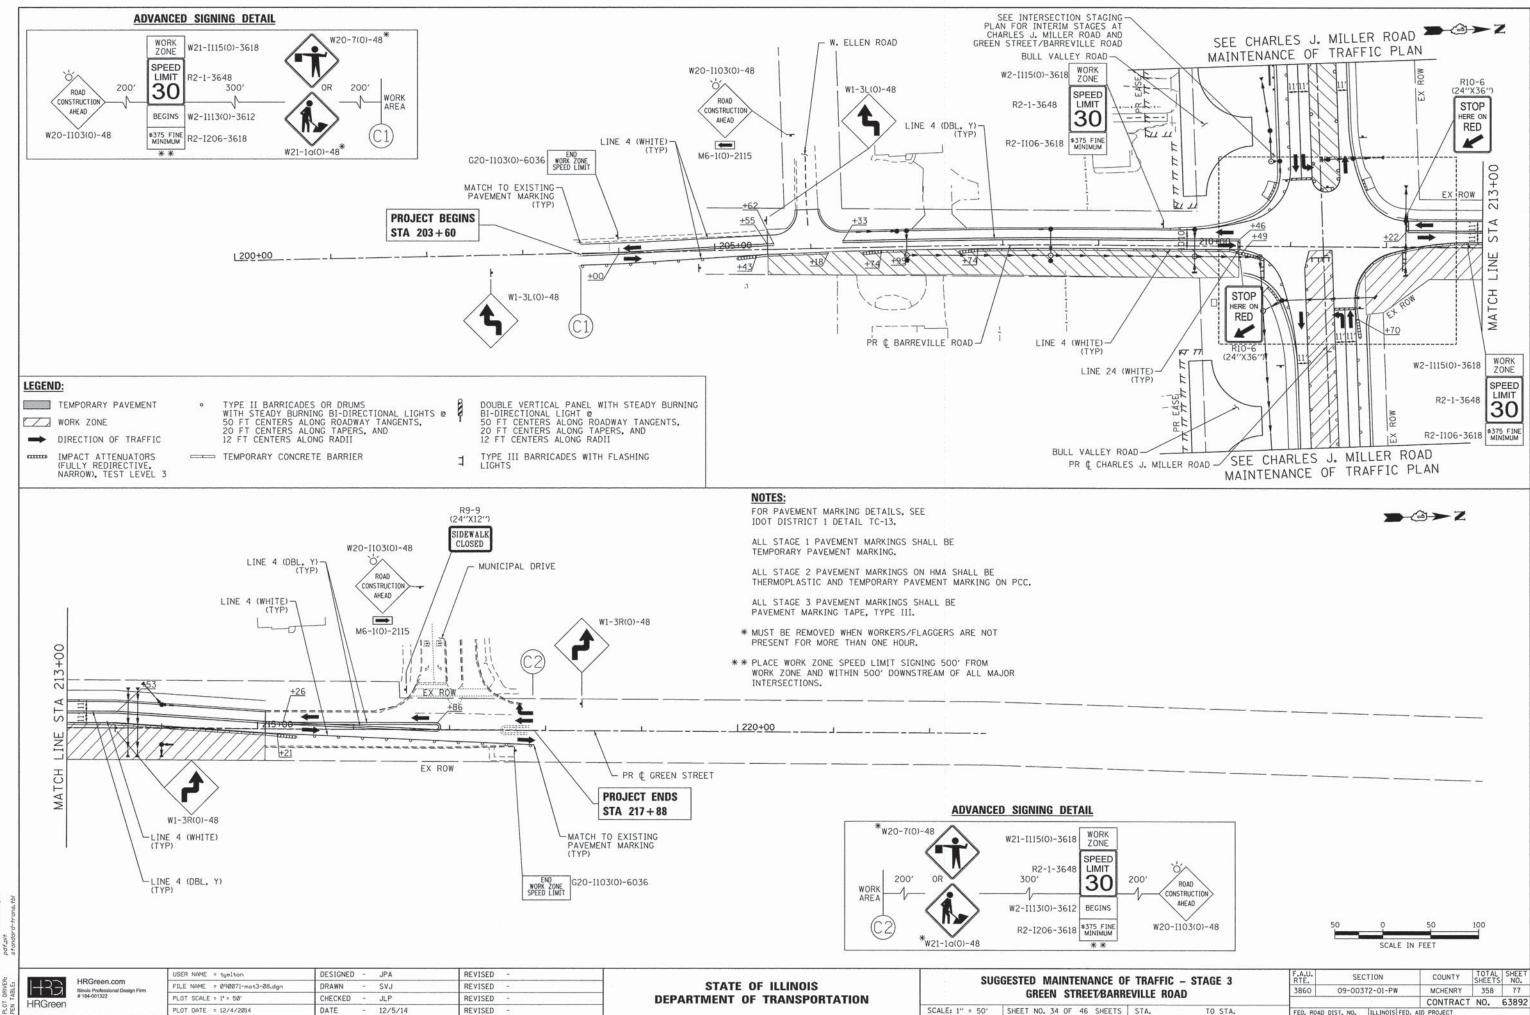

PLOT DATE = 12/4/2014 DATE 12/5/14 REVISED

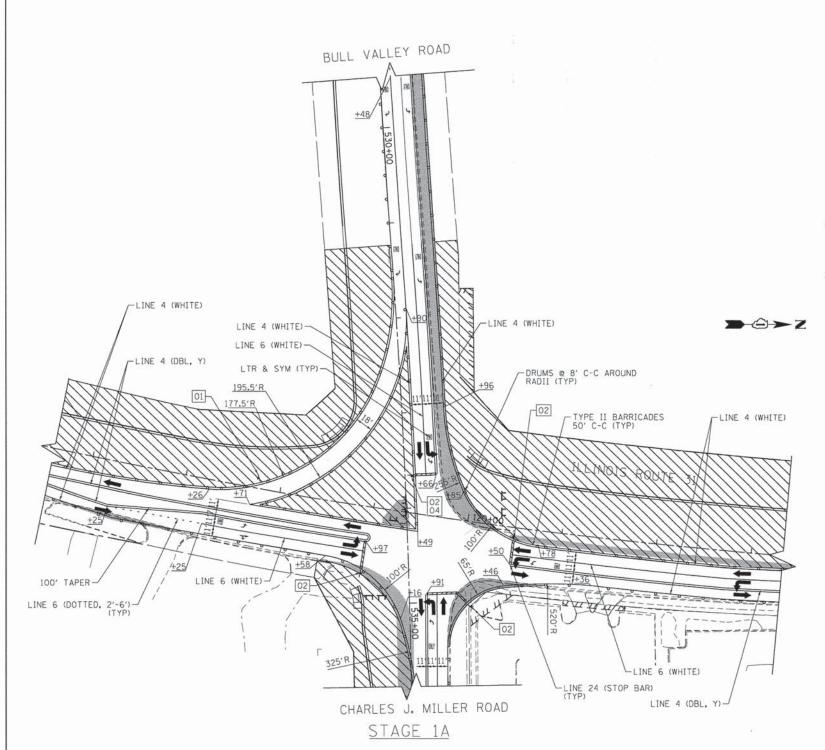

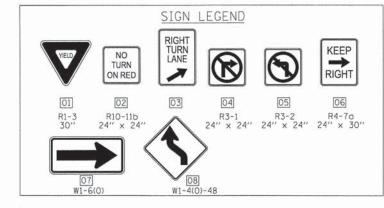

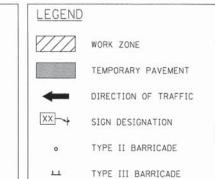

STAGE 1A CONSTRUCTION NOTES

- TRAFFIC PATTERNS FOR BULL VALLEY RD./CHARLES J. MILLER RD. AND ILLINOIS ROUTE 31 SHALL REMAIN THE SAME AS SHOWN IN STAGE 1 EXCEPT AS FOLLOWS:

 -THE EASTBOUND TO SOUTHBOUND RIGHT TURN LANE WILL BE SHIFTED AS SHOWN
 -THE SOUTH LEG NORTHBOUND LANES WILL BE SHIFTED 7' TO THE EAST TO PROVIDE A PAINTED MEDIAN.
- GRIND EXISTING PAVEMENT WITHIN THE INTERSECTION FLUSH WITH PROPOSED PAVEMENT OR PLACE TEMPORARY RAMPING AS DIRECTED BY THE ENGINEER TO PROVIDE A SMOOTH TRANSITION FOR VEHICLES TRAVELLING BETWEEN EXISTING PAVEMENT AND NEW PAVEMENT, THIS WORK SHALL NOT BE MEASURED FOR PAVEMENT BUT SHALL BE INCLUDED IN TRAFFIC CONTROL AND PROTECTION, (SPECIAL).



100	11/11/2014 10:30:3	090071-mot_int-0	pdf.plf	standard-trans.
2011	160:		ď	111


S AM 1.dgn

177	HRGreen.com	
コイン RGreen	Illinois Professional Design Firm # 184-001322	

USER NAME = tyelton	DESIGNED - JPA	REVISED -	
FILE NAME = 090071-mot_int-01.dgn	DRAWN - SVJ	REVISED -	
PLOT SCALE = 1° = 58'	CHECKED - JLP	REVISED -	
PLOT DATE = 11/11/2014	DATE - 11/12/14	REVISED -	

		SUGGES	TED N	MAINTENAN	ICE OF	TRAFFIC		
	BULL	VALLEY/CH	ARLES	J. MILLER	ROAD	AT IL ROUTE 31		
SCALE: 1"	= 50'	SHEET NO.	35 OF	46 SHEETS	STA.	TO STA.		

F.A.U. RTE.	SE	CTION	COUNTY	TOTAL	SHEET NO.
3860	09-003	72-01-PW	MCHENRY	358	78
			CONTRACT	NO.	63892
 FED. ROAD	DIST. NO.	ILLINOIS FED.	AID PROJECT		

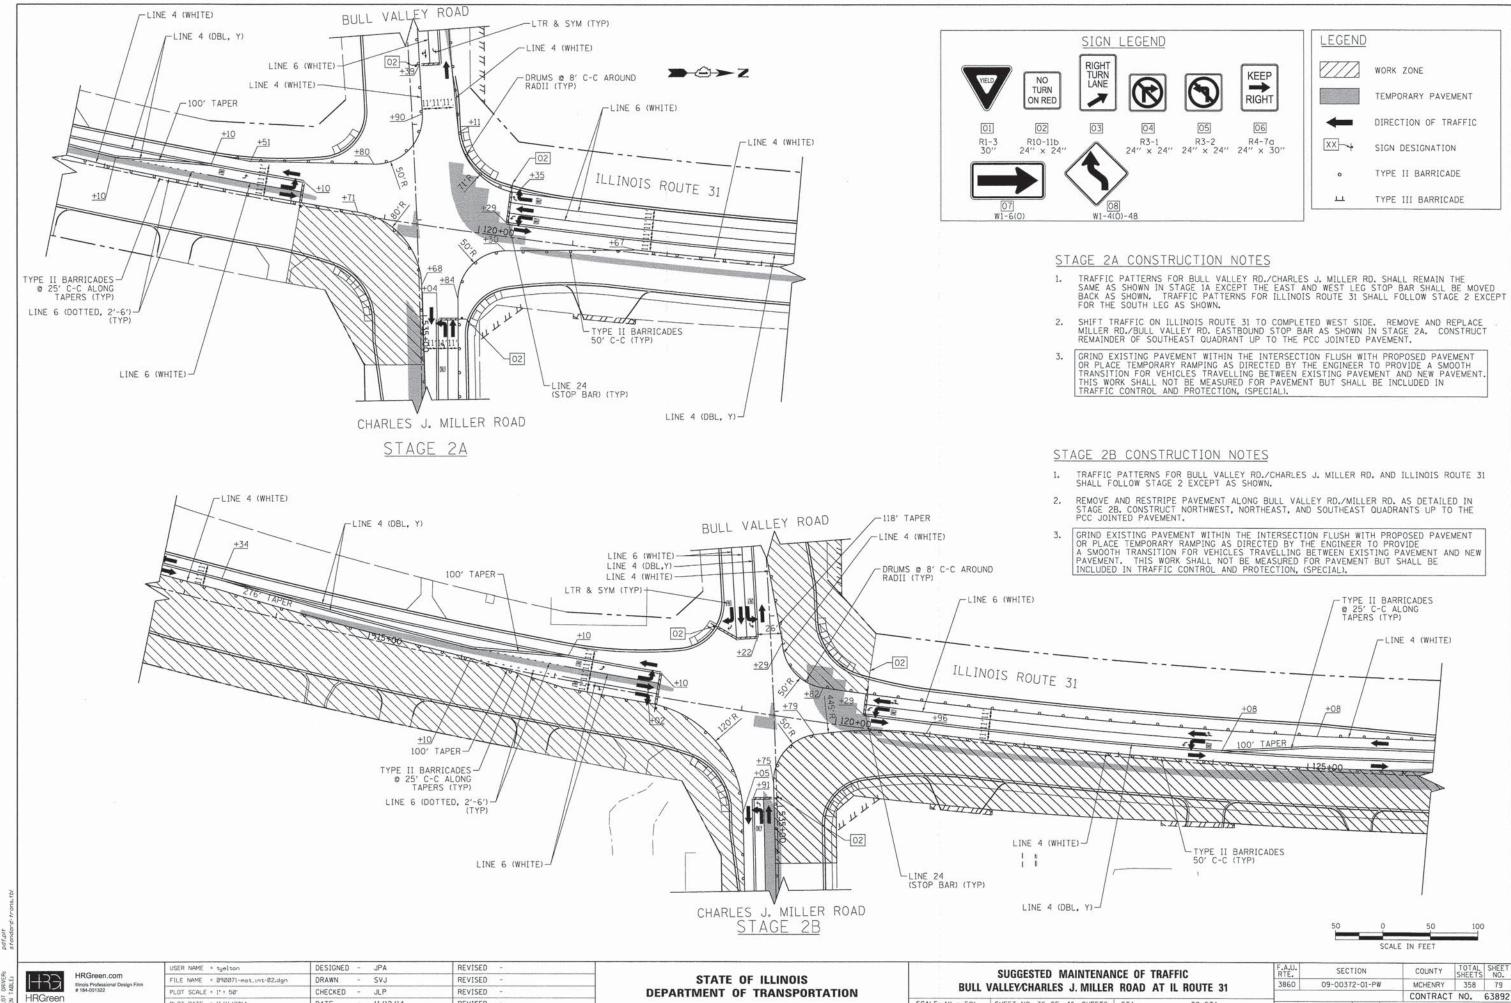



REVISED PLOT DATE = 11/11/2014 DATE 11/12/14


DEPARTMENT OF TRANSPORTATION


SCALE: 1" = 50' SHEET NO. 36 OF 46 SHEETS STA. TO STA.

CONTRACT NO. 63892 FED. ROAD DIST. NO. | ILLINOIS FED. AID PROJECT

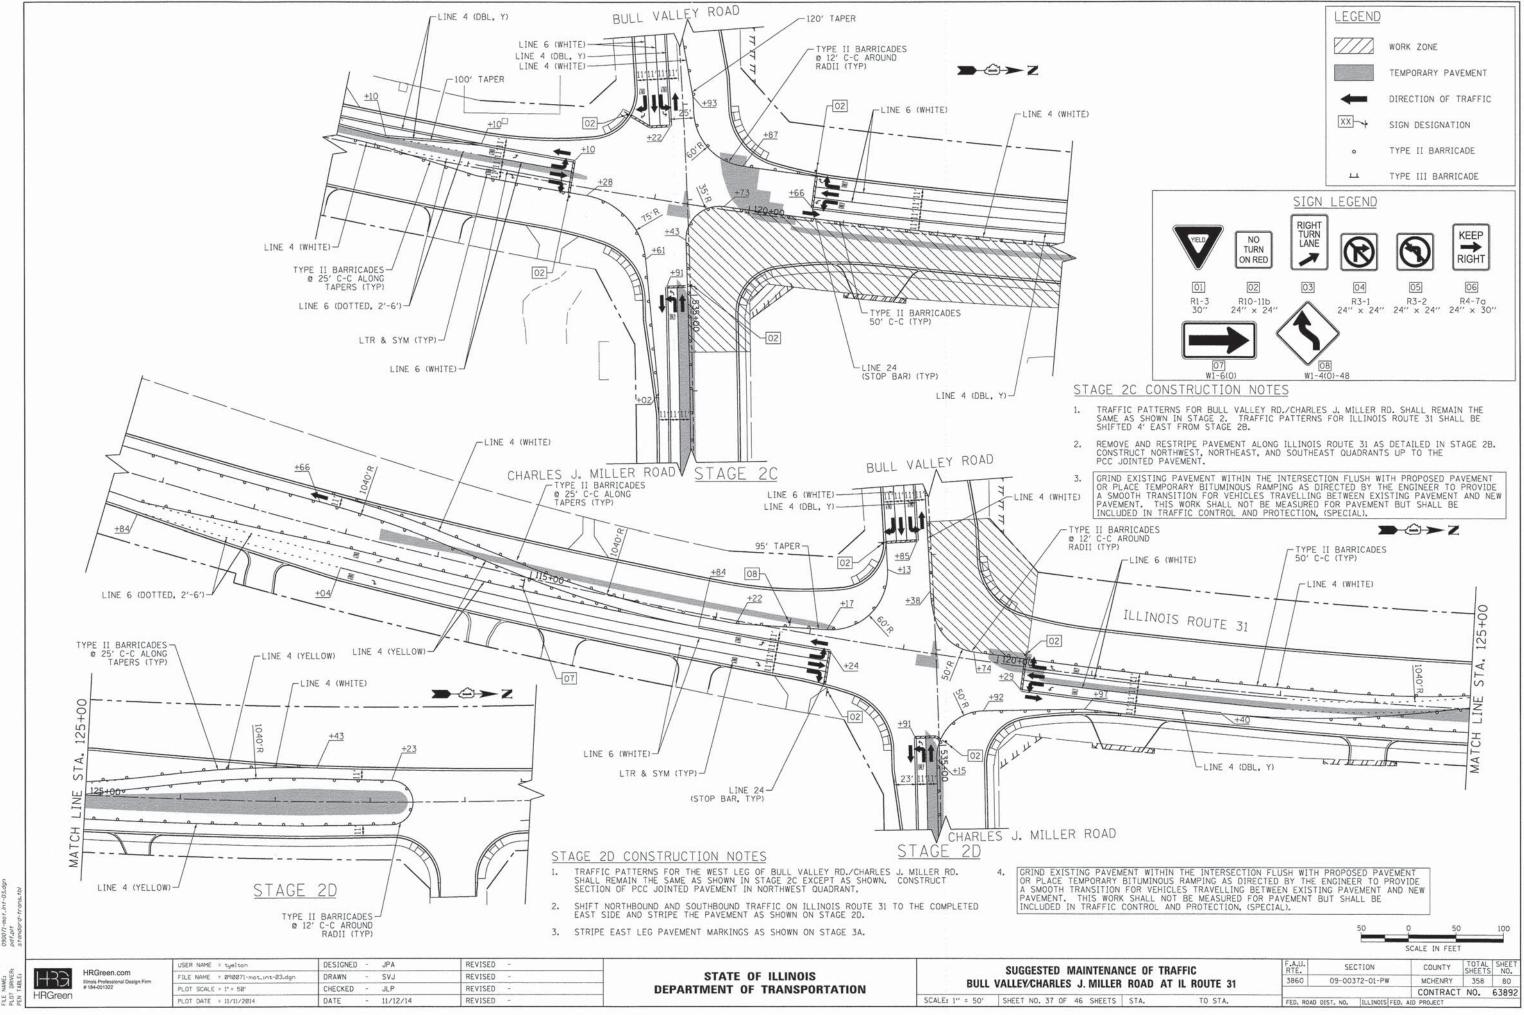

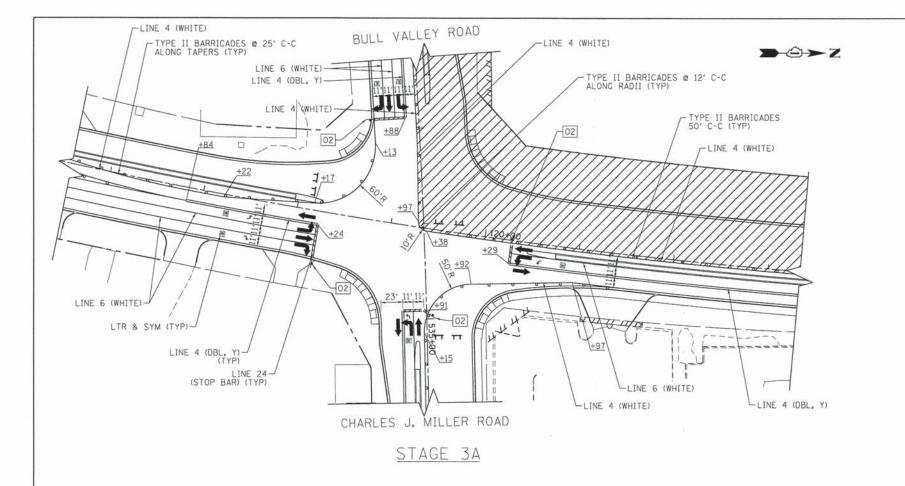

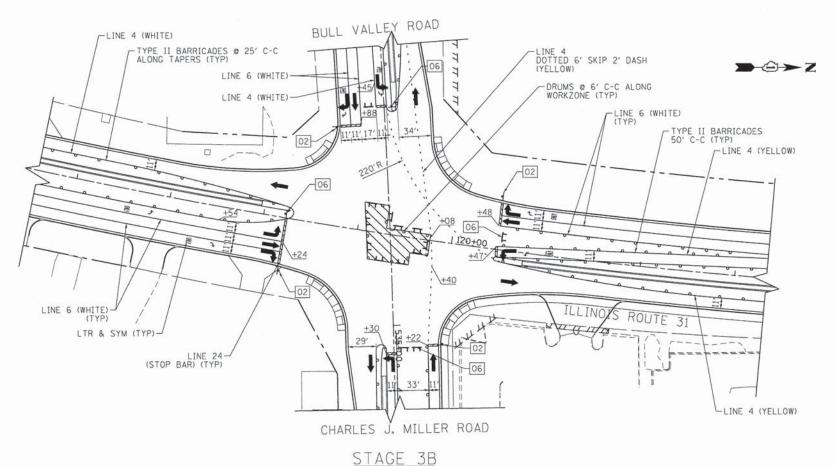

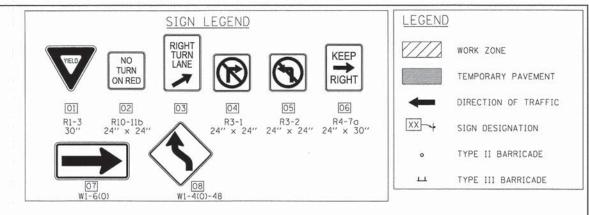

STAGE 3A CONSTRUCTION NOTES

- TRAFFIC PATTERNS FOR THE WEST LEG OF BULL VALLEY RD./CHARLES J. MILLER RD. AND THE SOUTH LEG OF ILLINOIS ROUTE 31 SHALL REMAIN THE SAME AS SHOWN IN STAGE 2D.
- SPLIT SOUTHBOUND THROUGH TRAFFIC AND THE SOUTHBOUND TO WESTBOUND RIGHT TRAFFIC AS DETAILED IN STAGE 3A. CONSTRUCT SECTION OF PCC JOINTED PAVEMENT IN NORTHWEST QUADRANT.
- GRIND EXISTING PAVEMENT WITHIN THE INTERSECTION FLUSH WITH PROPOSED PAVEMENT OR PLACE TEMPORARY BITUMINOUS RAMPING AS DIRECTED BY THE ENGINEER TO PROVIDE A SMOOTH TRANSITION FOR VEHICLES TRAVELLING BETWEEN EXISTING PAVEMENT AND NEW PAVEMENT. THIS WORK SHALL NOT BE MEASURED FOR PAVEMENT BUT SHALL BE INCLUDED IN TRAFFIC CONTROL AND PROTECTION, (SPECIAL).

STAGE 3B CONSTRUCTION NOTES

- TRAFFIC PATTERNS FOR BULL VALLEY RD. AND ILLINOIS ROUTE 31 SHALL REMAIN THE SAME AS SHOWN IN STAGE 3 EXCEPT AT NOTED BELOW.
- RESTRIPE THE LEFT TURN LANES, AND RESTRIPE THE WESTBOUND RIGHT AND THROUGH FOR CHARLES J. MILLER ROAD. CONSTRUCT INTERSECTION CENTER UP TO THE PCC JOINTED PAVEMENT.
- GRIND EXISTING PAVEMENT WITHIN THE INTERSECTION FLUSH WITH PROPOSED PAVEMENT OR PLACE TEMPORARY BITUMINOUS RAMPING AS DIRECTED BY THE ENGINEER TO PROVIDE A SMOOTH TRANSITION FOR VEHICLES TRAVELLING BETWEEN EXISTING PAVEMENT AND NEW PAVEMENT. THIS WORK SHALL NOT BE MEASURED FOR PAVEMENT BUT SHALL BE INCLUDED IN TRAFFIC CONTROL AND PROTECTION, (SPECIAL).



HRGreen

JSER NAME = tyelton DESIGNED -JPA REVISED REVISED FILE NAME = 890071-mot_int-04.dgn DRAWN SVJ PLOT SCALE = 1° = 58° CHECKED JLP REVISED 11/12/14 REVISED


STATE OF ILLINOIS **DEPARTMENT OF TRANSPORTATION**

SUGGESTED MAINTENANCE OF TRAFFIC BULL VALLEY/CHARLES J. MILLER ROAD AT IL ROUTE 31


COUNTY TOTAL SHEE SHEETS NO. SECTION MCHENRY 358 81 3860 09-00372-01-PW CONTRACT NO. 63892 FED. ROAD DIST. NO. ILLINOIS FED. AID PROJECT

SCALE: 1" = 50' | SHEET NO. 38 OF 46 SHEETS | STA.

TO STA.

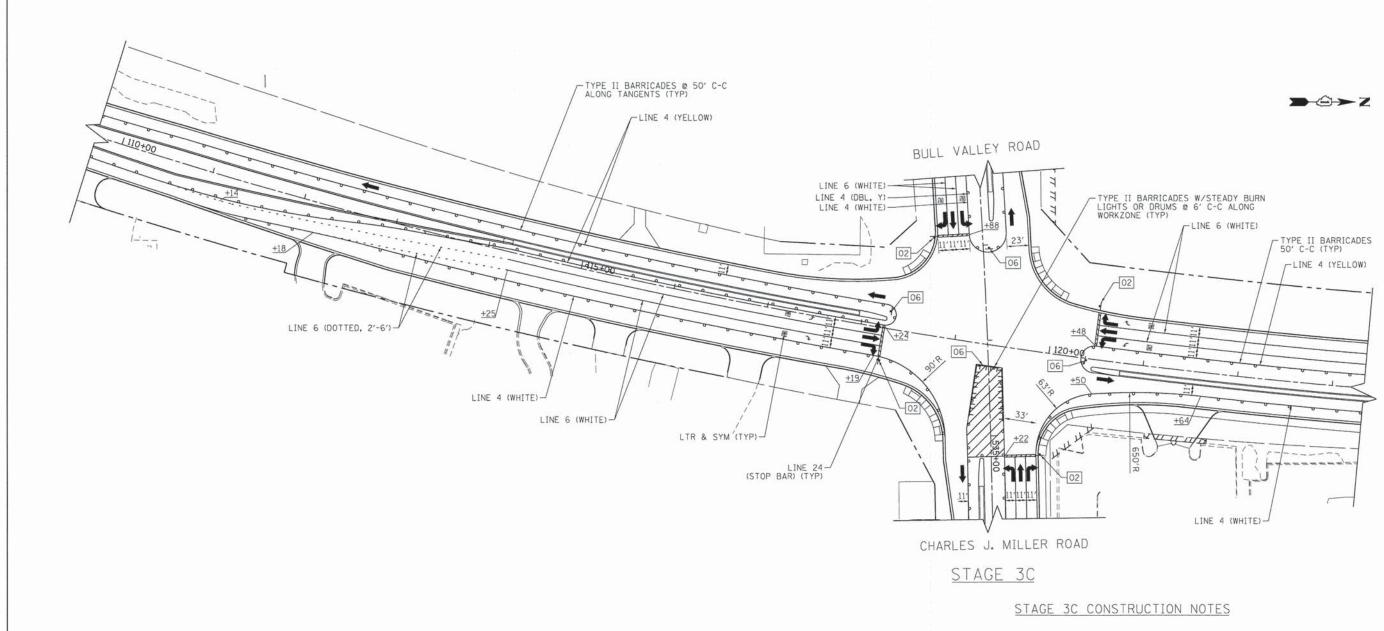

- TRAFFIC PATTERNS FOR BULL VALLEY RD./CHARLES J. MILLER RD. AND THE SOUTH LEG OF ILLINOIS ROUTE 31 SHALL REMAIN THE SAME AS SHOWN IN STAGE 3B.
- SHIFT NORTHBOUND TRAFFIC TO EASTERN EDGE OF BARRIER MEDIAN, AS SHOWN ON STAGE 3C. CONSTRUCT REMAINDER OF INTERSECTION CENTER UP TO THE PCC JOINTED PAVEMENT.

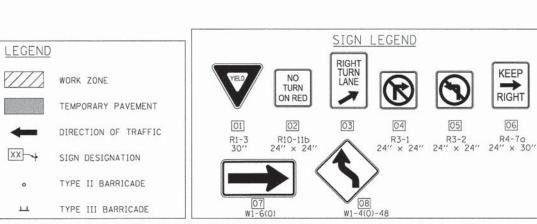


50 0 50 100 SCALE IN FEET

LE NAME: 09001 090

USER NAME = tyelton	DESIGNED - JPA	REVISED -	
FILE NAME = 090071-mot.int-05.dgn	DRAWN - SVJ	REVISED -	
PLOT SCALE = 1' = 50'	CHECKED - JLP	REVISED -	
PLOT DATE = 11/11/2014	DATE - 11/12/14	REVISED -	

	SUGGESTED	MAINTENANCE OF	TRAFFIC	
BULL	VALLEY/CHARLE	S J. MILLER ROAD	AT IL ROUTE 31	
SCALE: 1" = 50'	SHEET NO. 39 OF	46 SHEETS STA.	TO STA.	

F.A.U. RTE.	SEC	CTION			COUNTY	TOTAL	SHEET NO.
3860	09-003	72-01-PW	1	7	MCHENRY	358	82
					CONTRACT	NO.	63892
FED. ROAL	DIST. NO.	ILLINOIS	FED.	AID	PROJECT		*******

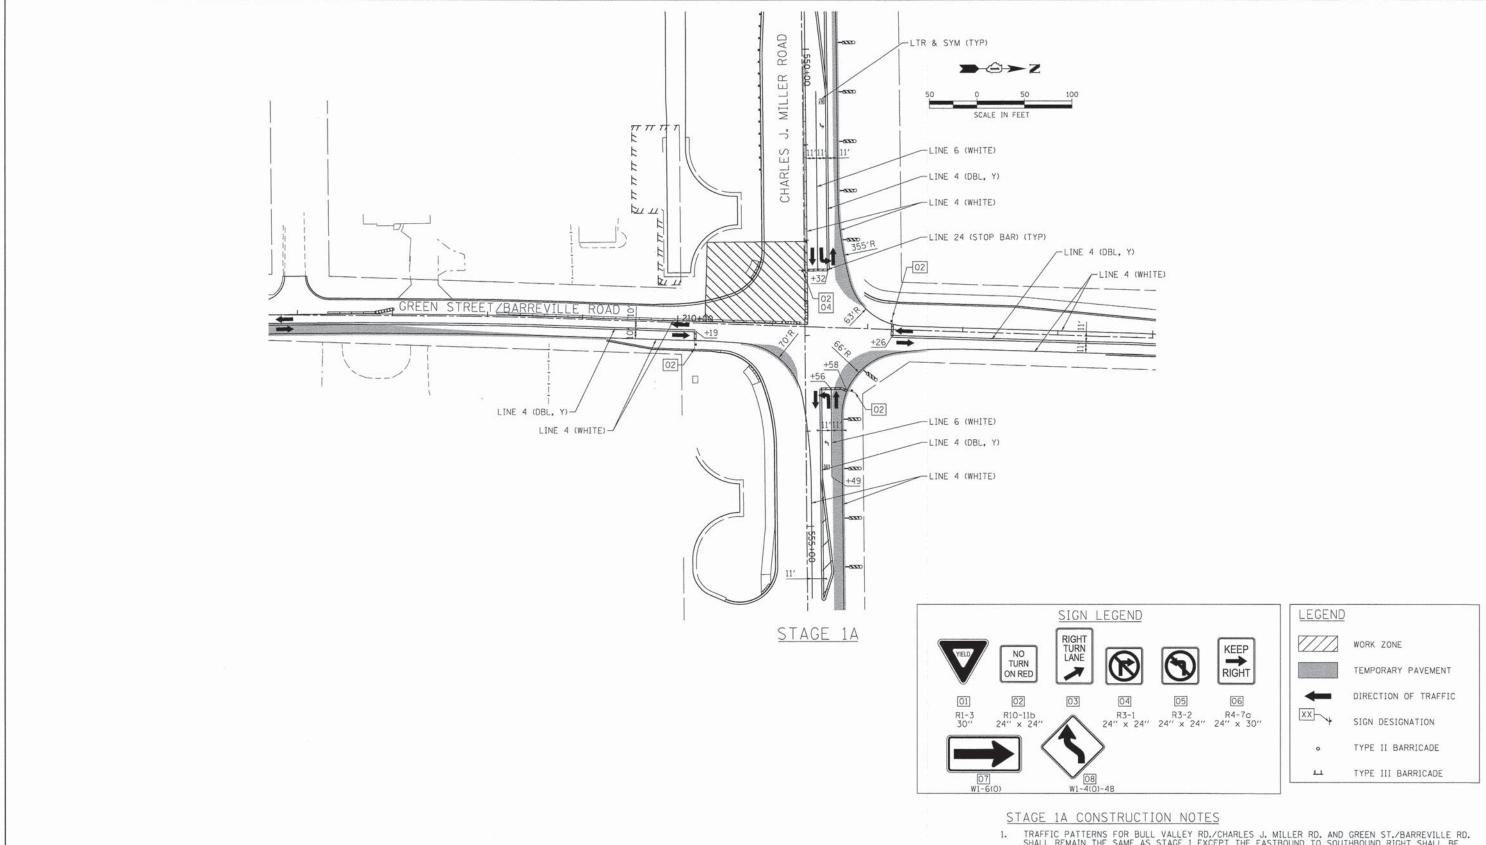


- TRAFFIC PATTERNS FOR BULL VALLEY RD./CHARLES J. MILLER RD. AND GREEN ST./BARREVILLE RD. SHALL REMAIN THE SAME AS STAGE 1 EXCEPT THE EASTBOUND TO SOUTHBOUND RIGHT SHALL BE PROHIBITED TO BUILD THE SOUTHWEST QUADRANT.
- 2. GRIND EXISTING PAVEMENT WITHIN THE INTERSECTION FLUSH WITH PROPOSED PAVEMENT OR PLACE TEMPORARY RAMPING AS DIRECTED BY THE ENGINEER TO PROVIDE A SMOOTH TRANSITION FOR VEHICLES TRAVELLING BETWEEN EXISTING PAVEMENT AND NEW PAVEMENT. THIS WORK SHALL BE PAID FOR AS TEMPORARY RAMP.

ETT E NA							
LIFE MM	ME = 090071-mot_int-01_green.dgn	DRAWN	+	SVJ	REVISED		
PLOT SC	CALE * 1* = 50*	CHECKED	-	JLP	REVISED	•	
PLOT DA	ATE = 11/11/2014	DATE	-	11/12/14	REVISED	-	


SUGGESTED MAINTENANCE OF TRAFFIC						
CHARL	ES J. MILLER	ROAD AT	GREEN ST/BARREVILLE RD			
SCALE: 1" = 50'	SHEET NO. 40	OF 46 SHEETS	STA. TO STA.			


	F.A.U. SECTION				COUNTY	TOTAL	SHEET NO.
1	3860	09-003	V	MCHENRY	358	83	
Į	3000-00-0				CONTRACT	NO.	63892
	FED. ROA	D DIST. NO.	ILLINOIS	FED. A	D PROJECT		

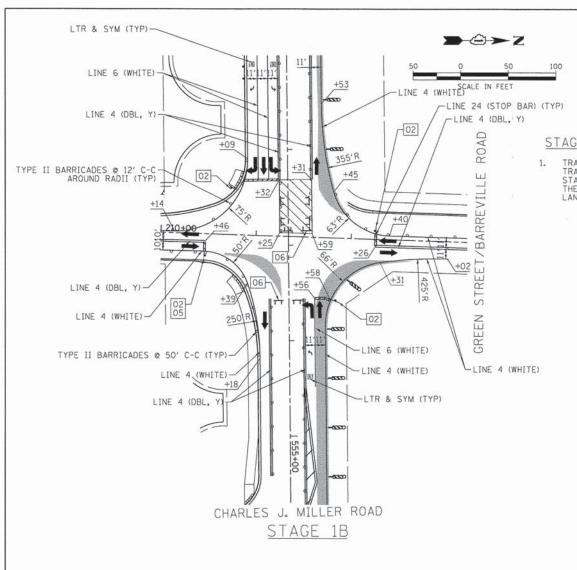


STAGE 1B CONSTRUCTION NOTES

TRAFFIC PATTERNS FOR GREEN ST./BARREVILLE RD. SHALL REMAIN THE SAME AS STAGE 1B. TRAFFIC PATTERNS FOR BULL VALLEY RD./CHARLES J. MILLER RD. WILL REMAIN THE SAME AS STAGE 1B EXCEPT THE WEST LEG LANES WILL BE SHIFTED SOUTH ONTO THE NEW PAVEMENT AND THE NORTHBOUND TO WESTBOUND LEFT TURN MOVEMENT WILL BE PROHIBITED. LANES WILL BE STRIPPED AS SHOWN.

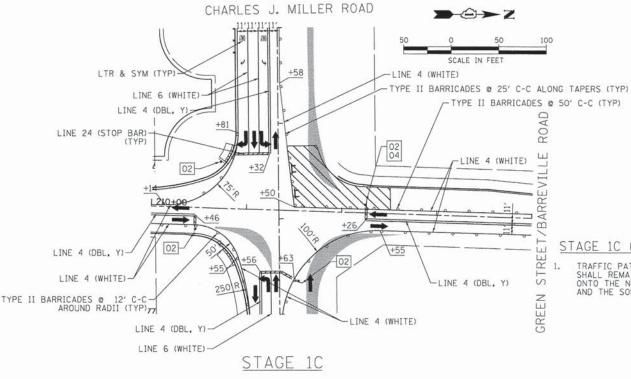

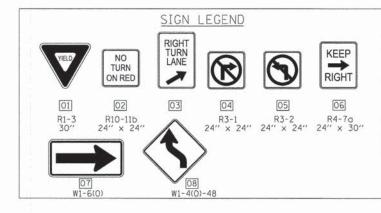

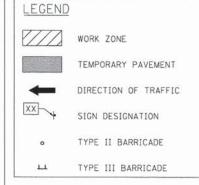

STAGE 1C CONSTRUCTION NOTES

TRAFFIC PATTERNS FOR BULL VALLEY RD./CHARLES J. MILLER RD. AND GREEN ST./BARREVILLE RD. SHALL REMAIN THE SAME AS AS STAGE IB EXCEPT AS FOLLOWS: THE EAST LEG TRAFFIC SHALL BE SHIFTED SOUTH ONTO THE NEW PAVEMENT, THE NORTHBOUND TO WESTBOUND LEFT TURN MOVEMENT WILL BE PERMITTED, AND THE SOUTHBOUND TO WESTBOUND RIGHT TURN MOVEMENT WILL BE PROHIBITED.


HRGreen


HRGreen.com

USER NAME = tyelton	DESIGNED	-	JPA	REVISED -	
FILE NAME = 090071-mot.int-02.green.dgr	DRAWN	-	SVJ	REVISED -	
PLOT SCALE = 1° = 50°	CHECKED	-	JLP	REVISED -	
PLOT DATE = 11/11/2014	DATE	2	11/12/14	REVISED -	


		SUGGESTE	D MAII	NTENANCE	OF TRAFFIC
	CHARL	ES J. MILLEI	ROAD	AT GREEN	ST/BARREVILLE RD
SCALE: 1"	= 50'	SHEET NO. 41	OF 46	SHEETS STA	. TO STA.

	FED. ROAL	D DIST. NO.	ILLINOIS FED.	AID PROJECT		
-				CONTRACT	NO.	63892
ı	3860	09-003	72-01-PW	MCHENRY	358	84
	F.A.U. RTE.	SE	CTION	COUNTY	TOTAL	SHEET NO.

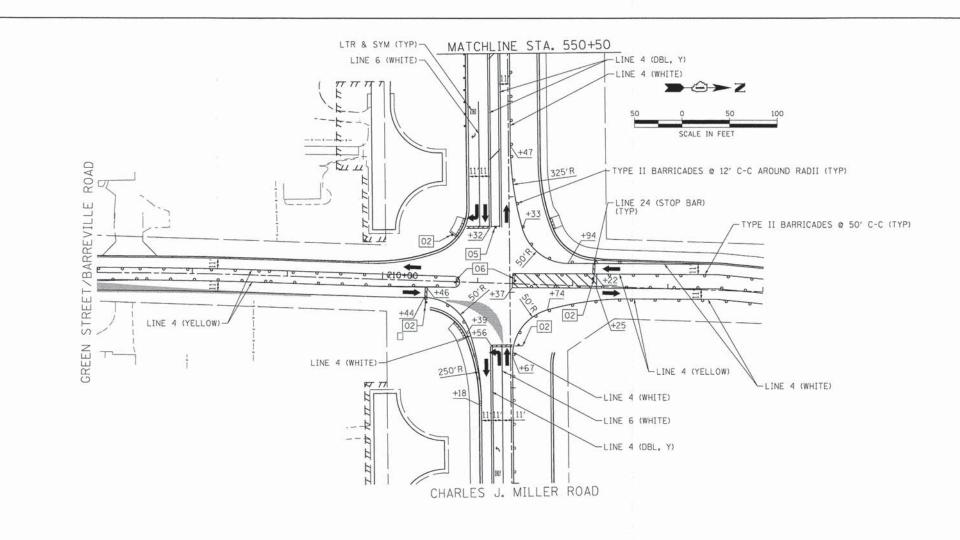

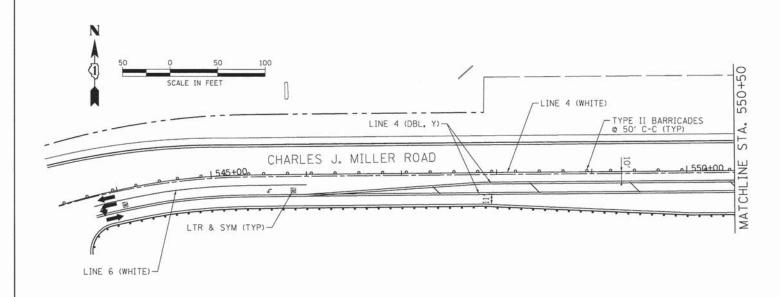



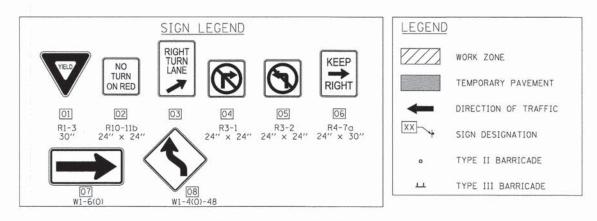

STAGE 2A CONSTRUCTION NOTES

 TRAFFIC PATTERNS FOR BULL VALLEY RD./CHARLES J. MILLER RD. AND GREEN ST./BARREVILLE RD. AS STAGE 2 EXCEPT THE EASTBOUND TO NORTHBOUND LEFT TURN MOVEMENT WILL BE PROHIBITED.

11/11/2014 10:31:19 AM 090011-mot_int-03_green.dgn pdf.plt stondard-trans.tbl

PROJECT CONTACT:
CLENT:
DATE PLOTTED: 11/71/
FLE NAME: 0900/
PLOT DRIVER: pdf.p

HRGreen.com


Ilinois Professional Design


HRGreen

USER NAME = tyelton	DESIGNED	-	JPA	REVISED -	Т
FILE NAME = 090071-mot_int-03_green.dgn	DRAWN	-	SVJ	REVISED -	1
PLOT SCALE = 1° = 50°	CHECKED		JLP	REVISED -	
PLOT DATE = 11/11/2014	DATE	-	11/12/14	REVISED -	


SUGGESTED MAINTENANCE OF TRAFFIC								
CHAR	LES J. MILLER	ROAD AT G	REEN ST/E	ARREVILLE RD				
SCALE: 1" = 50'	SHEET NO. 42 C	OF 46 SHEETS	STA.	TO STA.				

F.A.U. RTE.	SE	CTION		COUNTY	TOTAL	SHEET NO.
3860	09-003	72-01-PV	MCHENRY	358	85	
				CONTRACT	NO.	63892
FED. RO	AD DIST. NO.	ILLINOIS	FED. A	ID PROJECT		

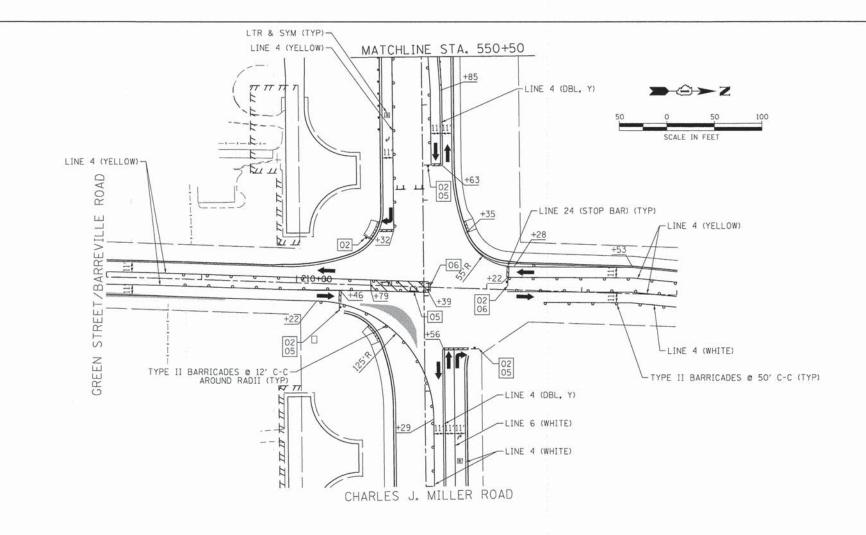

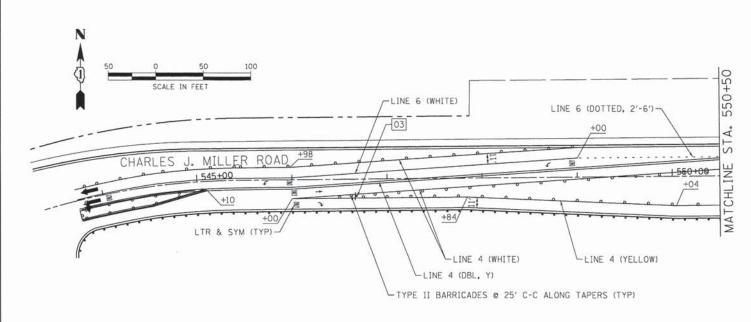



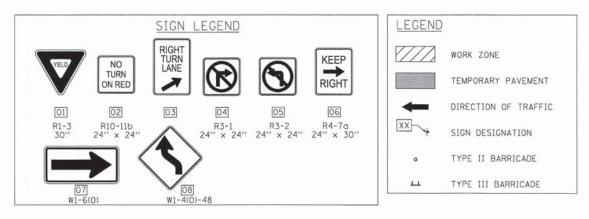

STAGE 2B CONSTRUCTION NOTES

1. TRAFFIC PATTERNS FOR BULL VALLEY RD./CHARLES J. MILLER RD. AND GREEN ST./BARREVILLE RD. SHALL REMAIN THE SAME AS SHOWN IN STAGE 2A EXCEPT AS FOLLOWS:
THE WEST LEG TRAFFIC SHALL BE SHIFTED NORTH ONTO THE NEW PAVEMENT. THE EASTBOUND THROUGH LAME SHALL BE SHIFTED NORTH, THE WESTBOUND TO SOUTHBOUND LEFT AND NORTHBOUND TO WESTBOUND LEFT TURN MOVEMENTS SHALL BE PROHIBITED.

11/11/2014 10:31:24 AM 090071-mot_int-04_green.dgn pdf.plt standard-trans,tbl

FILE NAME: 00 PLOT DRIVER; po PEN TABLE: s

HRGreen.com


Ilinois Professional Design

HRGreen

USER NAME = tyelton	DESIGNED		JPA	REVISED -	
FILE NAME = 090071-mot.int-04_green.dgn	DRAWN	-	SVJ	REVISED -	
PLOT SCALE = 1" = 50"	CHECKED	-	JLP	REVISED -	
PLOT DATE = 11/11/2014	DATE	-	11/12/14	REVISED -	


SUGGESTED MAINTENANCE OF TRAFFIC									
	CHARLE	S J.	MILI	ER	ROA	D AT	GREEN	N ST/BARREVILL	E RD
SCALE: 1"	= 50'	SHEET	NO.	43	OF 46	SHEE	TS ST	A. TO 5	STA.


RTE. SECTION						COUNTY	SHEET NO.	
3860		09-00	372-01-PW	٧ .		MCHENRY	358	86
						CONTRACT	NO.	63892
FED. R	OAD D	IST. NO.	ILLINOIS	FED.	AID	PROJECT		

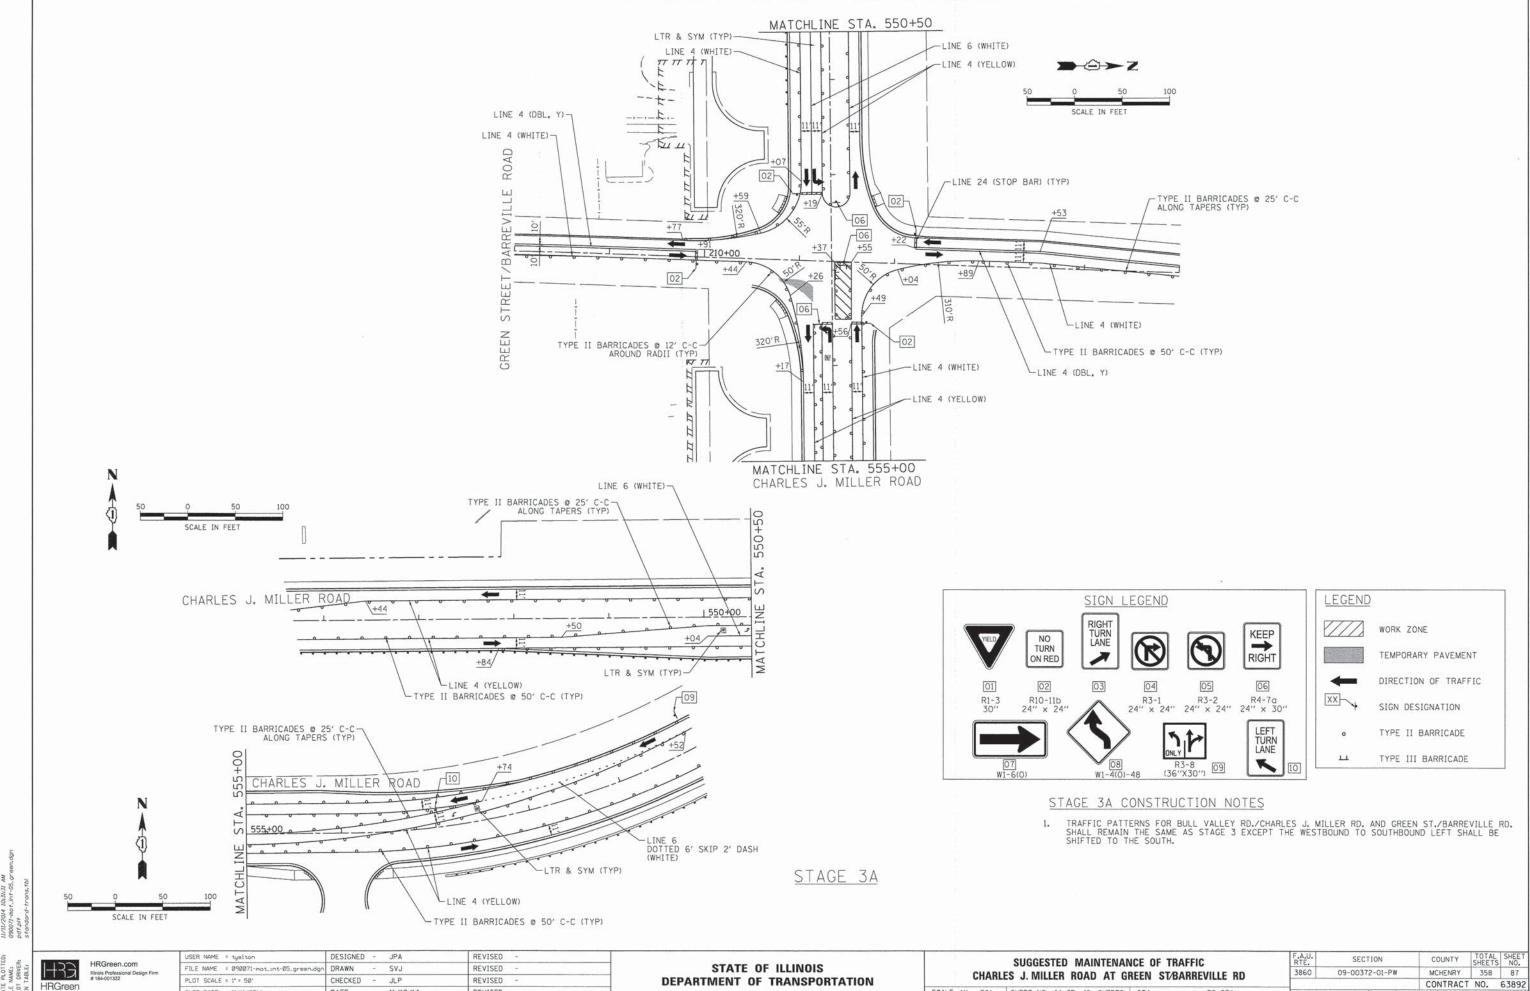

PLOT DATE = 11/11/2014 DATE - 11/12/14 REVISED


SCALE: 1" = 50' SHEET NO. 44 OF 46 SHEETS STA. TO STA. CONTRACT NO. 63892

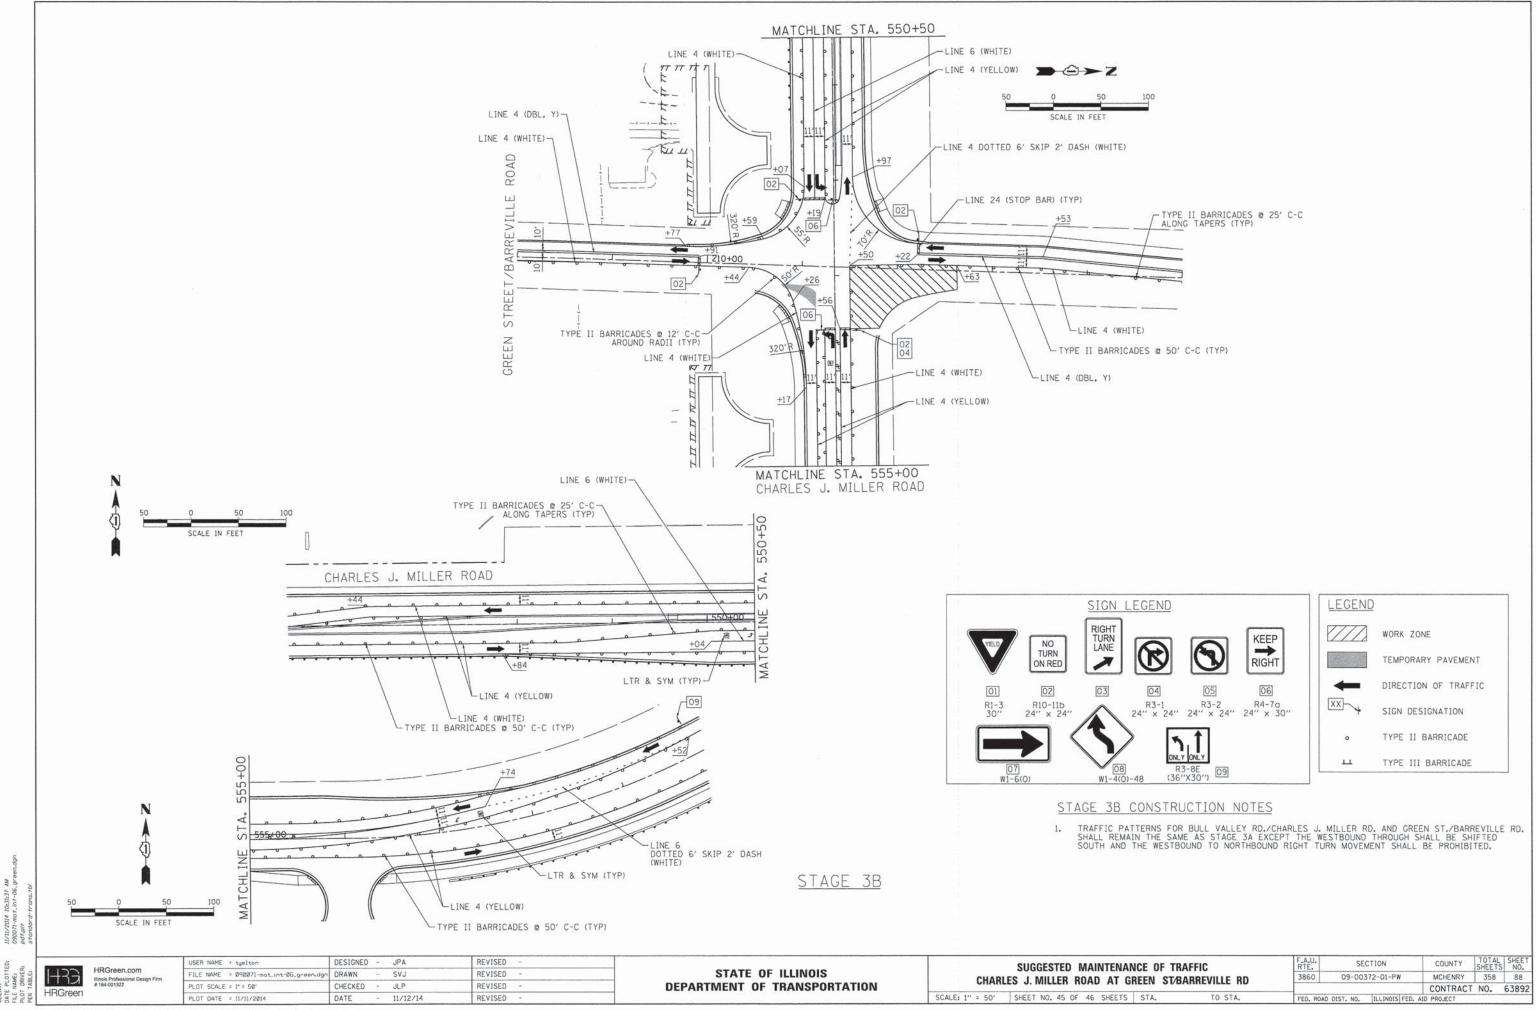


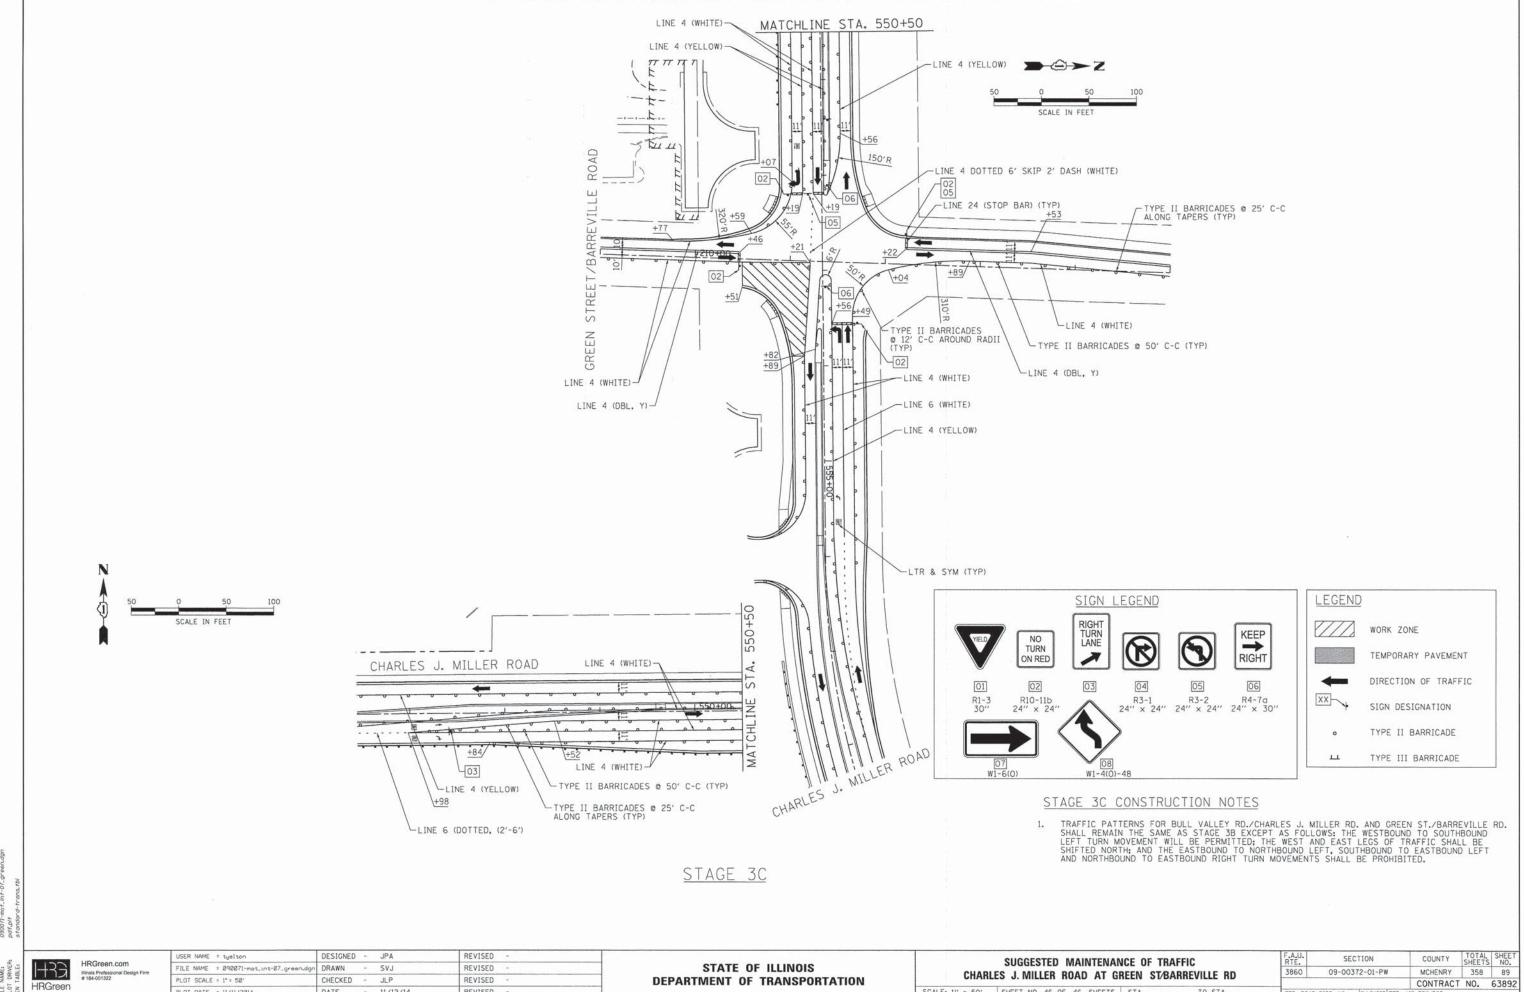


REVISED DATE - 11/12/14 PLOT DATE = 11/11/2014

SCALE: 1" = 50' SHEET NO. 46 OF 46 SHEETS STA. TO STA.

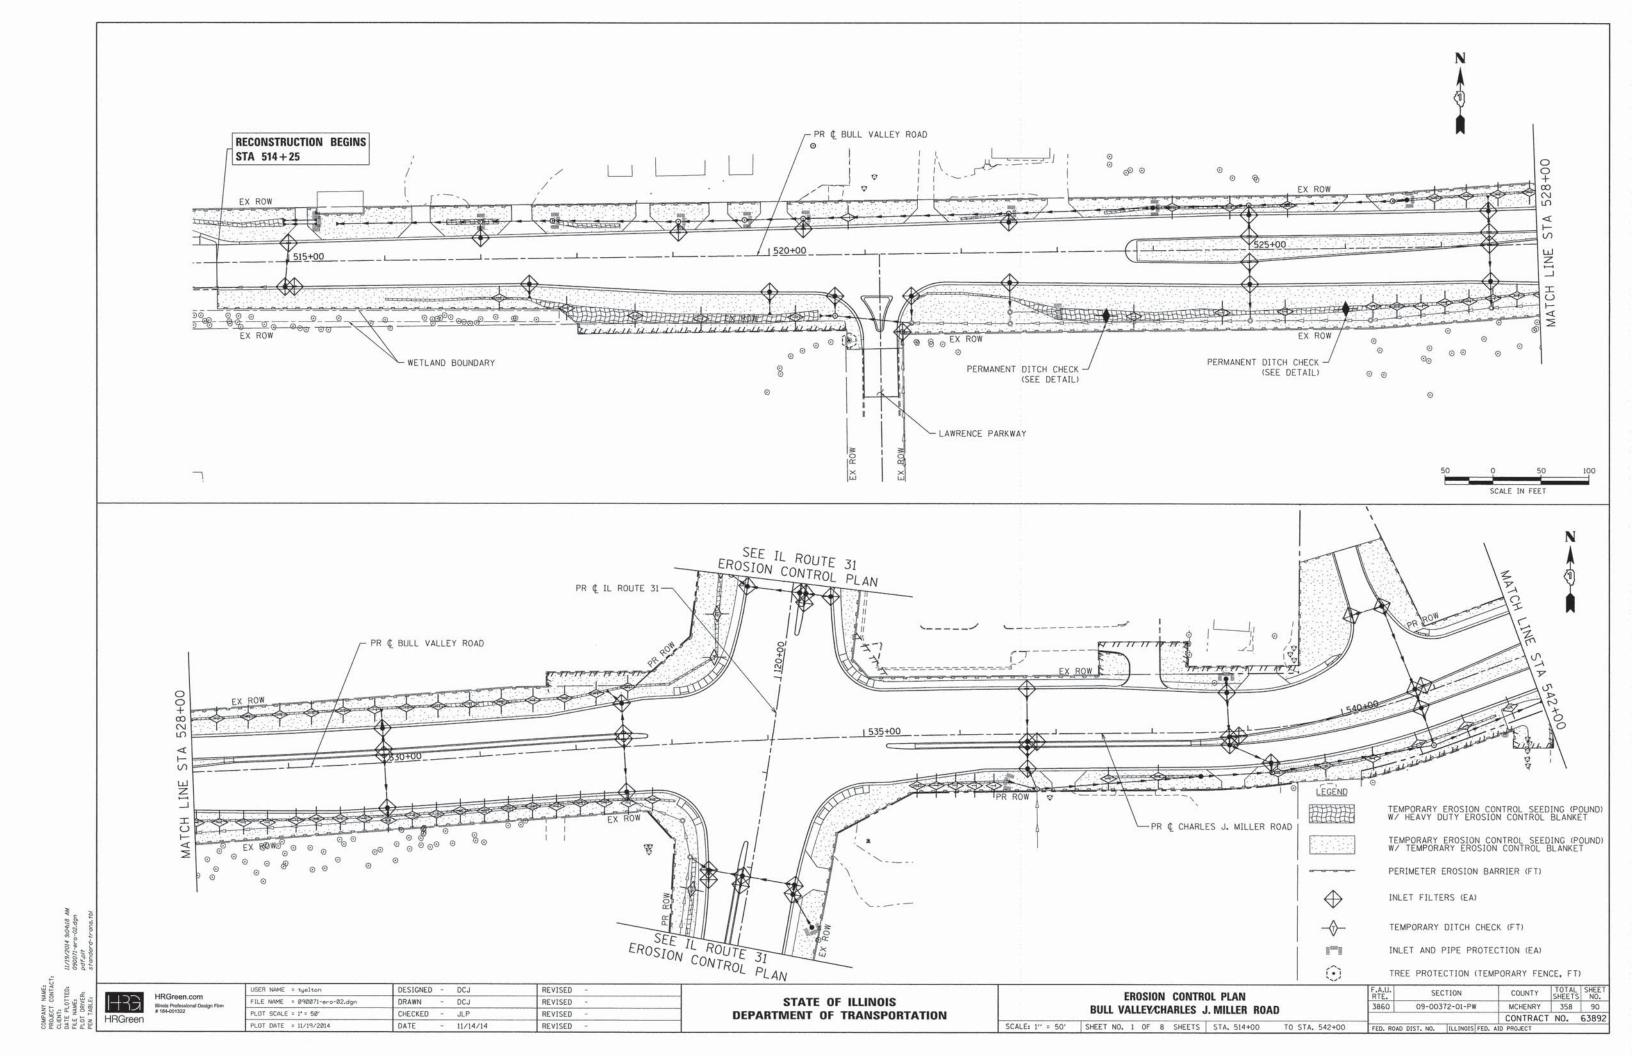

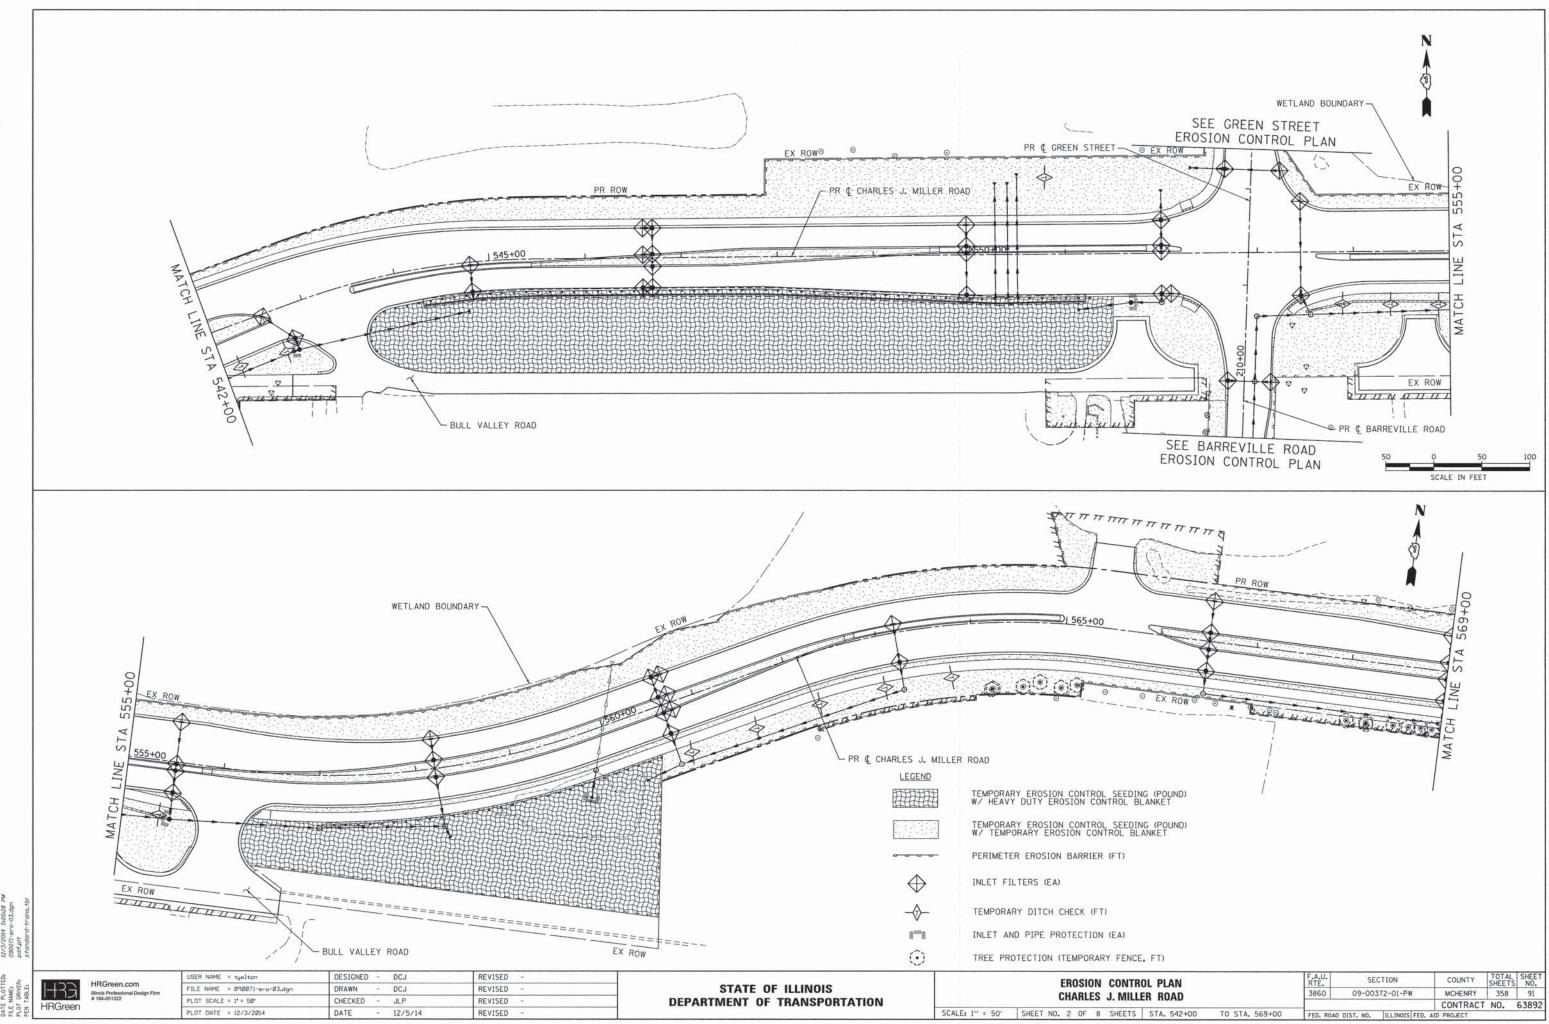

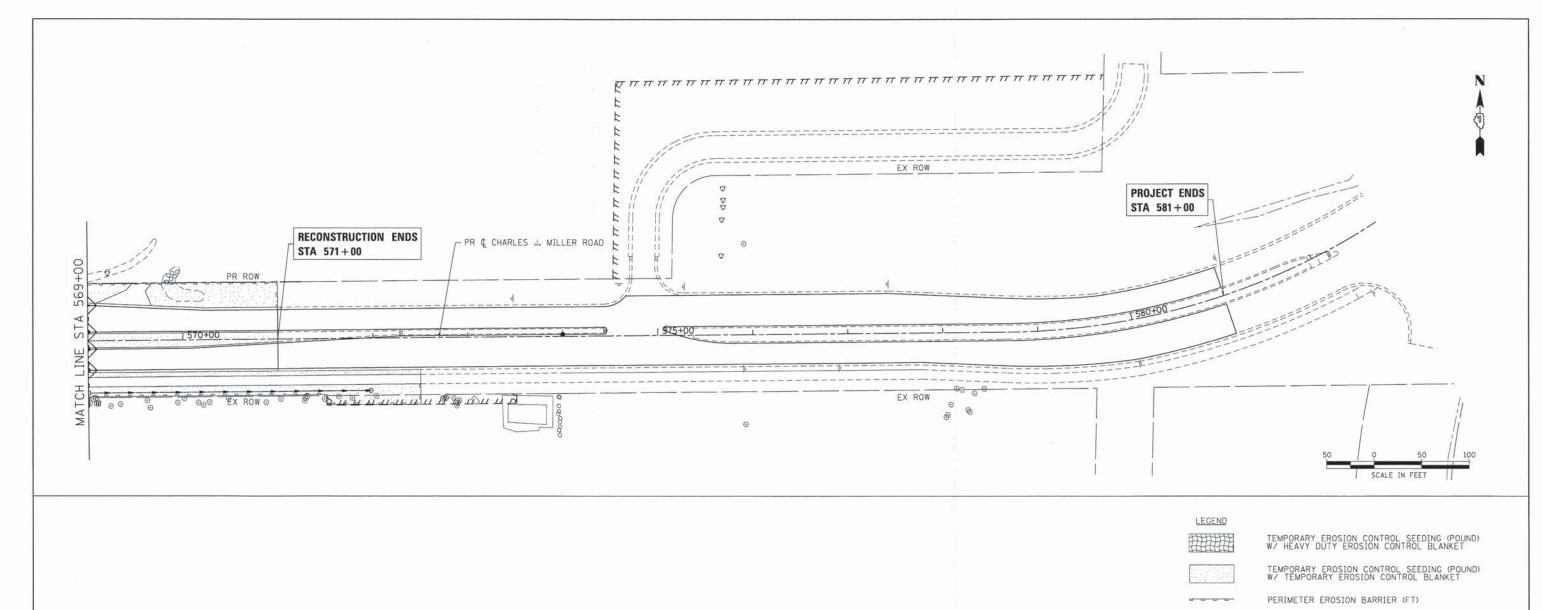

 \bigoplus

 $\rightarrow \bigcirc$

INLET FILTERS (EA)

TEMPORARY DITCH CHECK (FT)

INLET AND PIPE PROTECTION (EA)

 \odot

TREE PROTECTION (TEMPORARY FENCE, FT)

11/11/2014 10:32:08 AM 090071-ero-04.dgn pdf.plt stondord-trons.tbl


PLOT ORIVER:

HRGreen
HRGreen
HRGreen


,	USER NAME = tyelton	DESIGNED - DCJ	REVISED -	
	FILE NAME = 890071-ero-84.dgn	DRAWN - DCJ	REVISED -	
	PLOT SCALE = 1° = 50°	CHECKED - JLP	REVISED -	
	PLOT DATE = 11/11/2014	DATE - 11/12/	14 REVISED -	

		EROSIC	ON CONT	ROL PLAN	
		CHARL	ES J. MIL	LER ROAD	
SCALE: 1" = 50'	SHEET NO). 3 OF	8 SHEETS	STA. 569+00	TO STA. 572+50


	F.A.U. RTE.	SE	CTION	COUNTY	TOTAL	SHEET NO.
	3860	09-003	372-01-PW	MCHENRY	358	92
_				CONTRAC	T NO.	63892
	FED. ROAD	DIST. NO.	ILLINOIS FED.	AID PROJECT		-

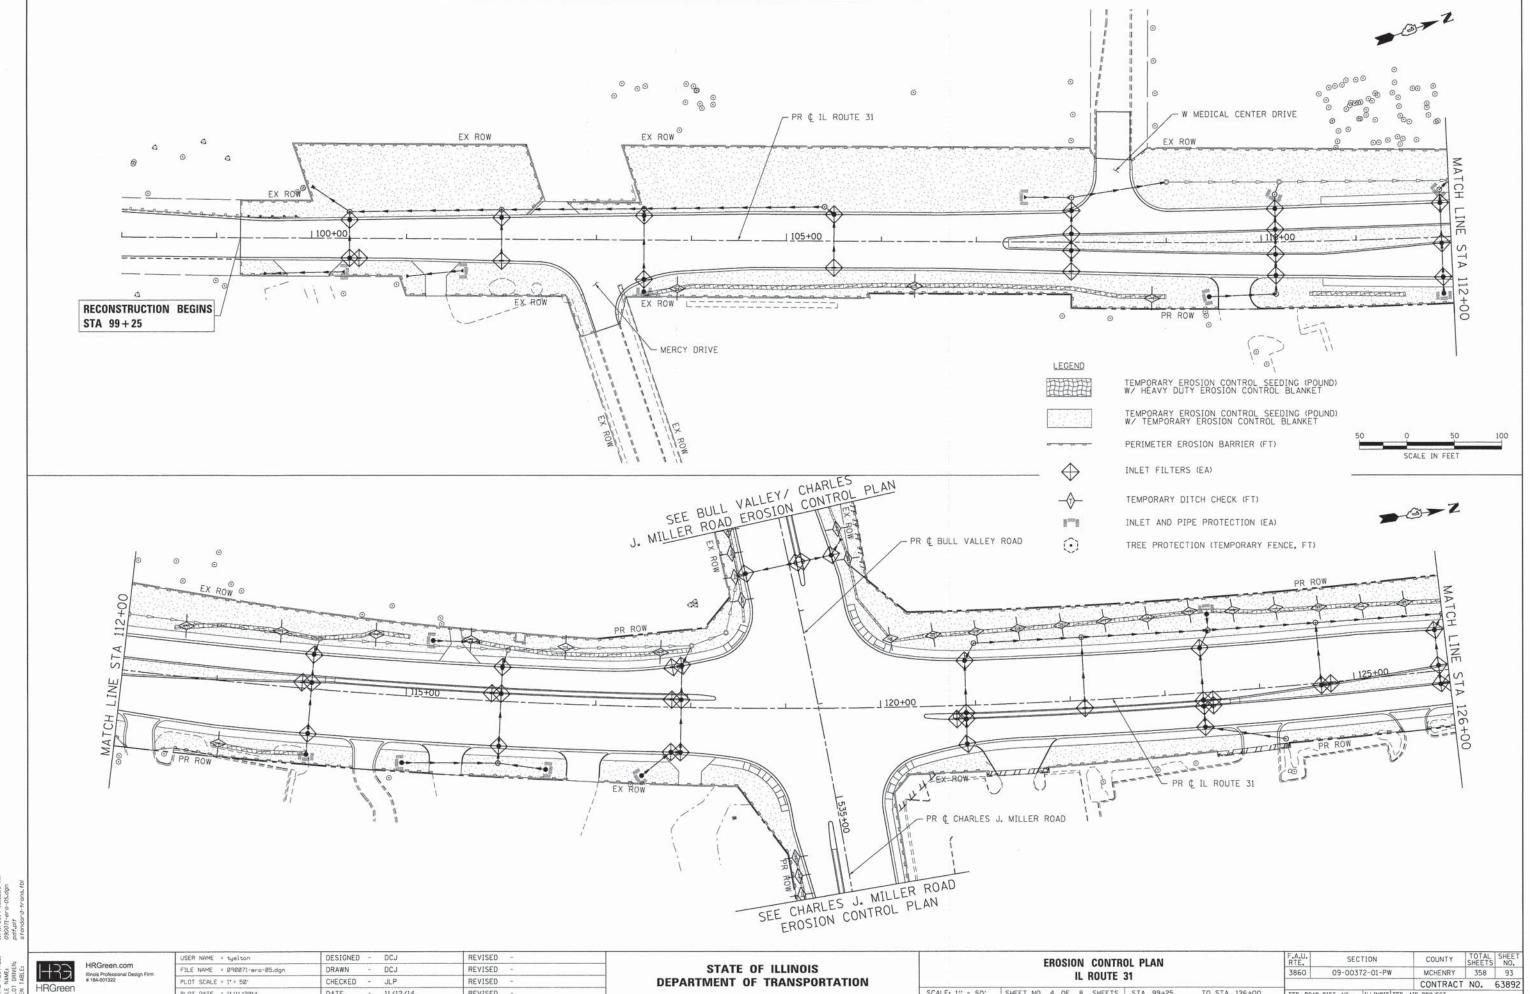

PLOT DATE = 11/11/2014 DATE - 11/12/14 REVISED SCALE: 1" = 50' SHEET NO. 4 OF 8 SHEETS STA. 99+25 TO STA. 126+00

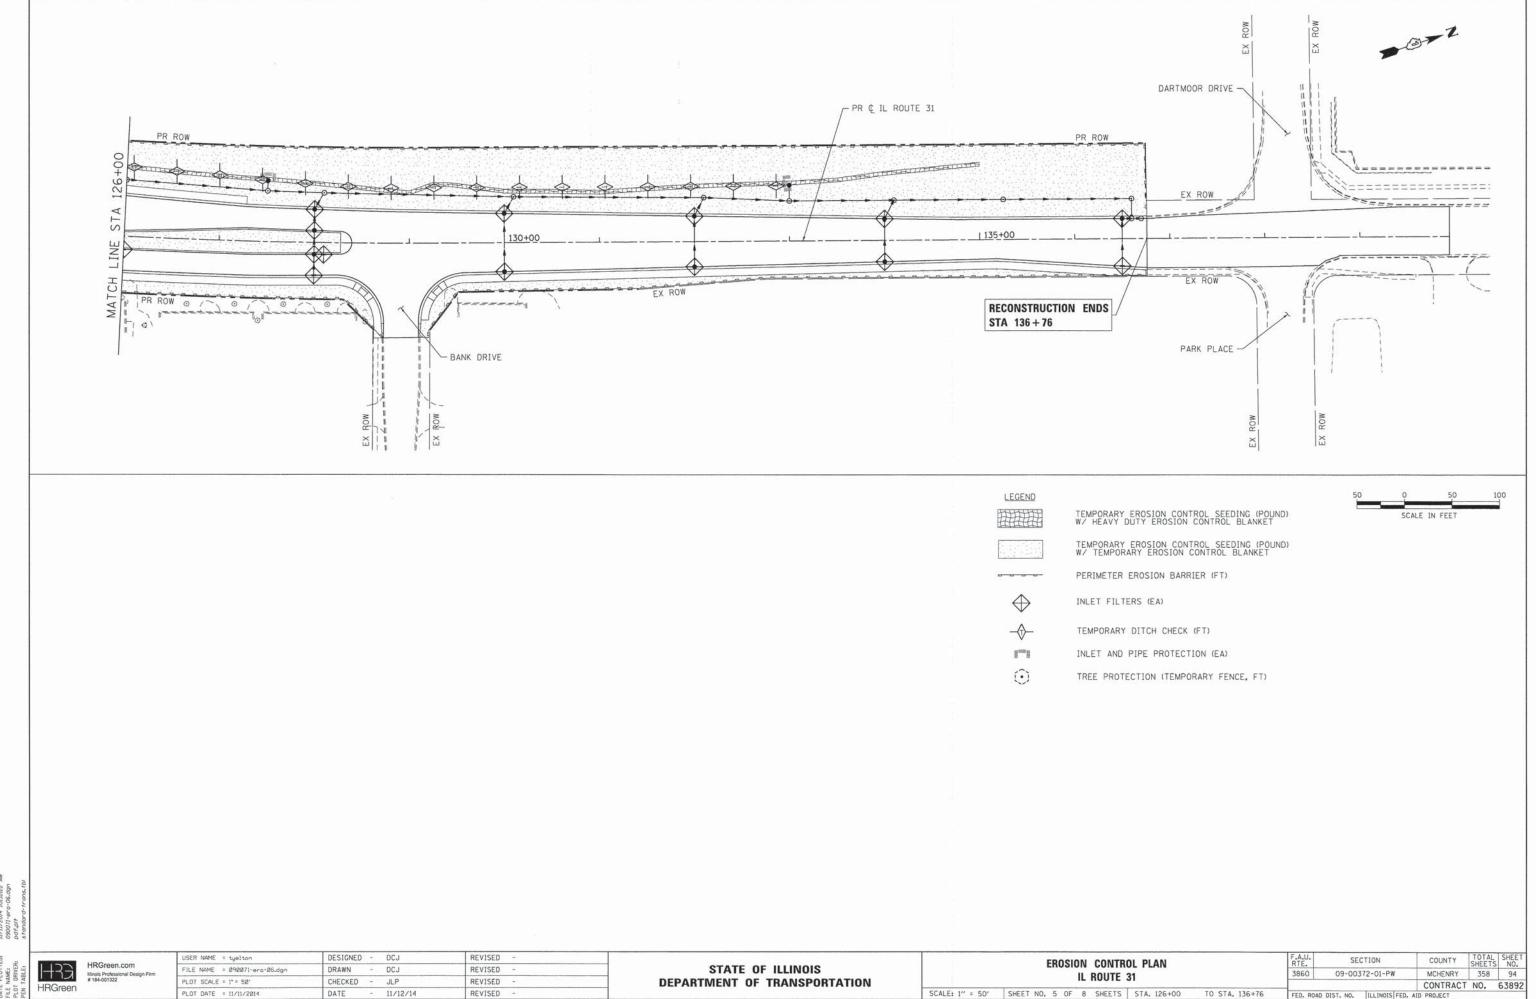

PLOT DATE = 11/11/2014 REVISED DATE - 11/12/14

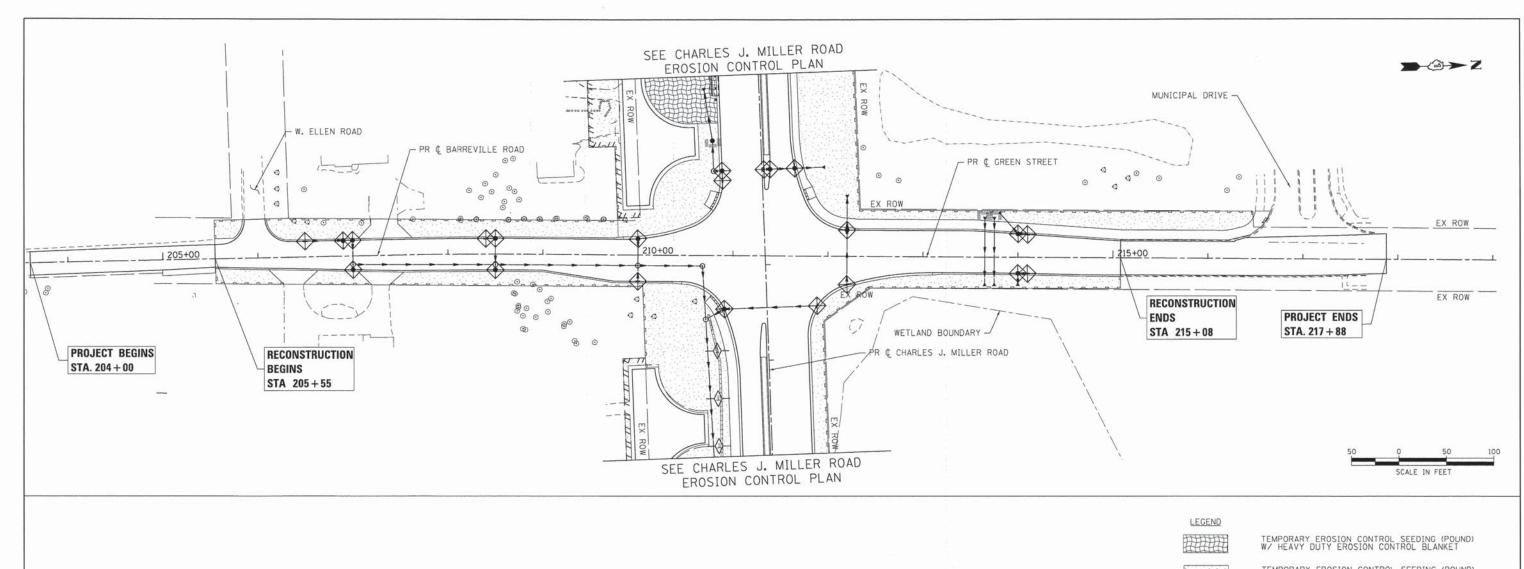

TEMPORARY EROSION CONTROL SEEDING (POUND) W/ TEMPORARY EROSION CONTROL BLANKET

PERIMETER EROSION BARRIER (FT)

 \oplus

INLET FILTERS (EA)



TEMPORARY DITCH CHECK (FT)

Ham H

INLET AND PIPE PROTECTION (EA)

(i)

TREE PROTECTION (TEMPORARY FENCE, FT)

HRGreen

HRGreen.com

USER NAME = tyelton	DESIGNED - DCJ	REVISED -	
FILE NAME = 090071-ero-07.dgn	DRAWN - DCJ	REVISED -	
PLOT SCALE = 1° = 50°	CHECKED - JLP	REVISED -	
PLOT DATE = 11/11/2014	DATE - 11/12/14	REVISED -	

EROSION CONTROL PLAN								
	GREEN	STRE	ET/BARRI	EVILLE ROAD				
SCALE: 1" = 50"	SHEET NO. 6	OF 8	SHEETS	STA. 205+55	TO STA. 215+08			

F.A.U. RTE.	SEC	CTION	COUNTY	TOTAL	SHEE NO.
3860	09-003	72-01-PW	MCHENRY	358	95
			CONTRACT	NO.	6389
FED. ROA	D DIST. NO.	ILLINOIS FED. AID PROJECT			

EROSION CONTROL NOTES:

1. ALL WORK SHALL BE DONE IN ACCORDANCE WITH THE MCHENRY COUNTY AND CITY OF MCHENRY STORMWATER ORDINANCES. ALL CONSTRUCTION ACTIVITIES WILL BE IN ACCORDANCE WITH THE NATIONAL POLLUTANT DISCHARGE ELIMINATION SYSTEM STORM WATER

2. EROSION CONTROL SHALL BE PROVIDED IN ACCORDANCE WITH THE SEQUENCE OF STAGED CONSTRUCTION. THE CONTRACTOR SHALL SUBMIT A DETAILED SCHEDULE FOR APPROVAL.

3. SEDIMENT AND EROSION CONTROL DEVICES SHALL BE FUNCTIONAL BEFORE THE PROJECT SITE IS OTHERWISE DISTURBED.

4. ALL DISTURBED AREAS SHALL BE SEEDED OR SODDED AS SOON AS PRACTICAL AFTER CONSTRUCTION ACTIVITIES IN THAT AREA HAVE CONCLUDED. THE SURFACE OF STRIPPED AREAS SHALL BE PERMANENTLY OR TEMPORARILY PROTECTED FROM SOIL EROSION WITHIN 14 DAYS AFTER FINAL GRADE IS REACHED. STRIPPED AREAS THAT WILL REMAIN UNDISTURBED FOR MORE THAN 15 DAYS AFTER INITIAL DISTURBANCE SHALL BE PROTECTED FROM EROSION. TEMPORARY SEDIMENT AND EROSION CONTROL MEASURES SHALL BE MAINTAINED CONTINUOUSLY UNTIL PERMANENT COVER IS ESTABLISHED.

5. IF A TOPSOIL STOCKPILE IS TO REMAIN IN PLACE FOR MORE THAN 3 DAYS, EROSION CONTROL MEASURES WILL BE PROVIDED. SOIL STOCKPILES MUST NOT BE LOCATED WITHIN ANY SPECIAL MANAGEMENT AREAS. SPECIAL MANAGEMENT AREAS INCLUDE JURISDICTIONAL WETLANDS AND ADJACENT OFF-SITE WETLANDS.

6. THE CONTRACTOR SHALL TAKE ALL PRECAUTIONS TO PROTECT WETLANDS TO REMAIN FROM DAMAGE BY SEDIMENT, CONSTRUCTION EOUIPMENT OR BY HIS WORK CREWS. THE CONTRACTOR SHALL ASSURE THAT DEBRIS OR ANY CONSTRUCTION MATERIAL IS NOT DISPOSED OF IN WETLANDS.

7. WATER PUMPED OR OTHERWISE DISCHARGED FROM THE SITE DURING CONSTRUCTION DEWATERING SHALL BE FILTERED.

8. WHEN TEMPORARY DRAINAGE IS ESTABLISHED, EROSION CONTROL MEASURES MAY BE REQUIRED BY THE ENGINEER.

9. GRAVEL ROADS, ACCESS DRIVES, PARKING AREAS OF SUFFICIENT WIDTH AND LENGTH, AND VEHICLE WASH DOWN FACILITIES IF NECESSARY, SHALL BE PROVIDED TO PREVENT SOIL FROM BEING TRACKED ONTO PUBLIC OR PRIVATE ROADWAYS, ANY SOIL REACHING A PUBLIC OR PRIVATE ROADWAY SHALL BE REMOVED BEFORE THE END OF EACH WORKDAY AND AS NEEDED.

10. CLEANING OF VEHICLES AND EQUIPMENT, INCLUDING CONCRETE MIXERS, SHALL BE PERFORMED IN A MANNER TO REDUCE THE AMOUNT OF POLLUTANTS TRIBUTARY TO STORM SEWERS AND OPEN WATERS TO THE MAXIMUM EXTENT PRACTICAL.

11. ALL NECESSARY MEASURES SHALL BE TAKEN TO CONTAIN ANY FUEL OR POLLUTION RUNOFF, LEAKING EQUIPMENT OR SUPPLIES SHALL BE IMMEDIATELY REPAIRED OR REMOVED FROM THE SITE.

12. SEDIMENT COLLECTED DURING CONSTRUCTION BY THE VARIOUS TEMPORARY EROSION CONTROL SYSTEMS SHALL BE DISPOSED OF ON THE SITE ON A REGULAR BASIS. SEDIMENT SHALL BE REMOVED FROM EROSION CONTROL SYSTEMS WHEN THE HEIGHT OF THE SEDIMENT EXCEEDS ONE-HALF OF THE HEIGHT OF THE FILTER DEVICE.

13. THE ENGINEER SHALL INSPECT EROSION CONTROL MEASURES PERIODICALLY AND WITHIN 24 HOURS OF ANY STORM EXCEEDING 59/64 INCH PRECIPITATION. DAMAGED AND INEFFECTIVE EROSION CONTROL MEASURES SHALL BE REPAIRED OR REPLACED WITHIN 72 HOURS. EROSION CONTROL SYSTEMS REPLACED DUE TO SEDIMENT LOADING WILL BE PAID FOR AT THE CONTRACT UNIT PRICE FOR THE APPLICABLE EROSION CONTROL ITEM.

14. ALL SEDIMENT AND EROSION CONTROL MEASURES WILL BE PAID FOR IN ACCORDANCE WITH SECTION 280 OF THE STANDARD SPECIFICATIONS, EXCEPT WHERE OTHERWISE NOTED IN THE CONTRACT SPECIAL PROVISIONS

15. THE COST OF REPAIRING OR REMOVING SEDIMENT FROM EROSION CONTROL SYSTEMS SHALL BE INCLUDED IN THE CONTRACT UNIT PRICE FOR THE APPLICABLE EROSION CONTROL ITEM.

16. ALL EROSION CONTROL MEASURES SHALL BE KEPT OPERATIONAL AND MAINTAINED CONTINUOUSLY THROUGHOUT THE PERIOD OF LAND DISTURBANCE UNTIL PERMANENT SEDIMENT AND EROSION CONTROL MEASURES ARE OPERATIONAL.

17. TREES TO BE PROTECTED DURING CONSTRUCTION SHOULD BE IDENTIFIED BY THE ENGINEER AND BE IN ACCORDANCE TO THE DETAILS PROVIDED IN THE PLANS, AND SHALL BE PAID FOR AS TEMPORARY

MCHENRY COUNTY STORMWATER PERMIT REQUIREMENTS:

1. SOIL DISTURBANCE SHALL BE CONDUCTED IN SUCH A MANNER AS TO MINIMIZE EROSION. AREAS OF THE DEVELOPMENT SITE THAT ARE NOT TO BE GRADED SHALL BE PROTECTED FROM CONSTRUCTION TRAFFIC OR OTHER DISTURBANCE UNTIL FINAL SEEDING IS PREFORMED.

2. PROPERTIES AND CHANNELS ADJOINING THE DEVELOPMENT SITE SHALL BE PROTECTED FROM EROSION AND SEDIMENTATION.

3. SOIL EROSION AND SEDIMENT CONTROL FEATURES SHALL BE CONSTRUCTED PRIOR TO THE COMMENCEMENT OF HYDROLOGIC DISTURBANCE OF UPLAND AREAS.

4. DISTURBED AREAS SHALL BE STABILIZED WITH TEMPORARY OR PERMANENT MEASURES WITHIN SEVEN (7) CALENDAR DAYS FOLLOWING THE END OF ACTIVE HYDROLOGIC DISTURBANCE.

5. ALL STORM SEWERS THAT ARE OR WILL BE FUNCTIONING DURING CONSTRUCTION SHALL BE PROTECTED BY AN APPROPRIATE SEDIMENT CONTROL MEASURE.

6. IF DEWATERING SERVICES ARE USED, ADJOINING PROPERTIES AND DISCHARGE LOCATIONS SHALL BE PROTECTED FROM EROSION. DISCHARGES SHALL BE ROUTED THROUGH AN EFFECTIVE SEDIMENT CONTROL MEASURE (E.G., SEDIMENT TRAP, SEDIMENT BASIN, OR OTHER APPROPRIATE MEASURES).

7. ALL TEMPORARY SOIL EROSION AND SEDIMENT CONTROL MEASURES SHALL BE REMOVED WITHIN THIRTY (30) DAYS AFTER FINAL SITE STABILIZATION IS ACHIEVED OR AFTER THE TEMPORARY MEASURES ARE NO LONGER NEEDED. TRAPPED SEDIMENT AND OTHER DISTURBED SOIL AREAS SHALL BE PERMANENTLY STABILIZED.


8. A STABILIZED MAT OF AGGREGATE UNDERLAIN WITH FILTER CLOTH (OR OTHER APPROPRIATE MEASURES) SHALL BE LOCATED AT ANY POINT WHERE TRAFFIC WILL BE ENTERING OR LEAVING A CONSTRUCTION-SITE OF A MAJOR DEVELOPMENT TO OR FROM A PUBLIC RIGHT-OF-WAY, STREET ALLEY, OR PARKING AREA. ANY SEDIMENT OR SOIL REACHING AN IMPROVED PUBLIC RIGHT OF WAY, STREET, ALLEY OR PARKING AREA SHALL BE SCRAPED OR STREET CLEANED AS ACCUMULATIONS WARRANT AND BE TRANSPORTED TO A CONTROLLED SEDIMENT DISPOSAL AREA.

9. SOIL STOCKPILES SHALL NOT BE LOCATED IN A FLOOD-PRONE AREA OR A DESIGNATED BUFFER PROTECTING WATERS OF THE UNITED STATES OR ISOLATED WATERS OF MCHENRY COUNTY.

10. THE CONTRACTOR SHALL PROVIDE ADEQUATE RECEPTACLES FOR THE DESPOSITION OF ALL CONSTRUCTION MATERIAL DEBRIS GENERATED DURING THE DEVELOPMENT PROCESS. THE CONTRACTOR SHALL NOT CAUSE OR PERMIT THE DUMPING, DEPOSITING, DROPPING, THROWING, DISCARDING OR LEAVING OF CONSTRUCTION MATERIAL DEBRIS UPON OR INTO ANY DEVELOPMENT SITE, CHANNEL, WATERS OF THE U.S. OR ISOLATED WATERS OF MCHENRY COUNTY. THE CONTRACTOR SHALL MAINTAIN THE DEVELOPMENT SITE FREE OF CONSTRUCTION MATERIAL DEBRIS.

11. ALL TEMPORARY AND PERMANENT EROSION AND SEDIMENT CONTROL MEASURES SHALL BE MAINTAINED IN AN EFFECTIVE WORKING CONDITION.

12. DRAIN TILE SYSTEMS DISTURBED DURING DEVELOPMENT MUST BE RECONNECTED BY THOSE RESPONSIBLE FOR THEIR DISTURBANCE UNLESS THE APPROVED ENGINEERING PLANS INDICATE HOW THE DRAIN TILE SYSTEM IS TO BE CONNECTED TO THE PROPOSED STORWWATER MANAGEMENT SYSTEM. ALL ABANDONED DRAIN TILES SHALL BE REMOVED IN THEIR ENTIRETY.

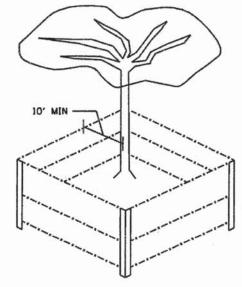

TREE PROTECTION
(PAID FOR AS TEMPORARY FENCE)

II/II/2014 849441 AM 090071-erode+01.dgn pdf_0E1-Tiff,plt standard-trans.tbl

COMPANY NAME:
PROJECT CONTACT;
CLIENT,
DATE PLOTTED,
FILE NAME:
PLOT DRIVER;
FENTABLE:

HRGreen

HRGreen.com Illinois Professional Design Firm # 184-001322


Firm File (


USER NAME = tyelton	DESIGNED	- DCJ	REVISED -	
FILE NAME = 090071-erodet01.dgn	DRAWN	- DCJ	REVISED -	
PLOT SCALE = N.T.S.	CHECKED	- JLP	REVISED -	
PLOT DATE = 11/11/2014	DATE	- 11/12/14	REVISED -	


STATE OF ILLINOIS
DEPARTMENT OF TRANSPORTATION


EROSION CONTROL DETAILS
CHARLES J. MILLER ROAD ROADWAY IMPROVEMENTS


SCALE: N.T.S. SHEET NO. 7 OF 8 SHEETS STA. TO STA. FEO. ROAD DIST. NO. | ILLINOIS FED. AID R

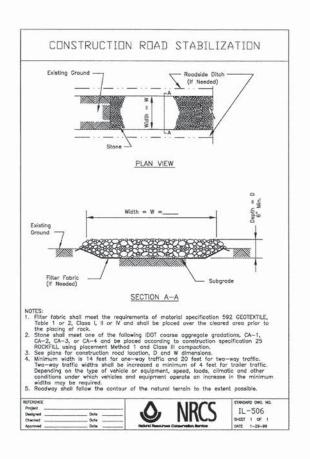


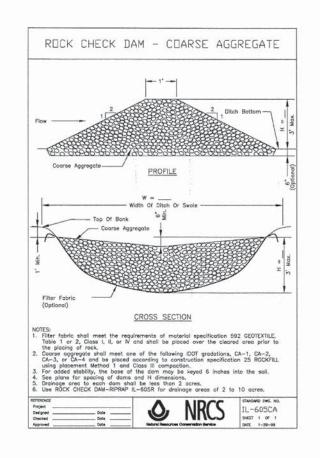

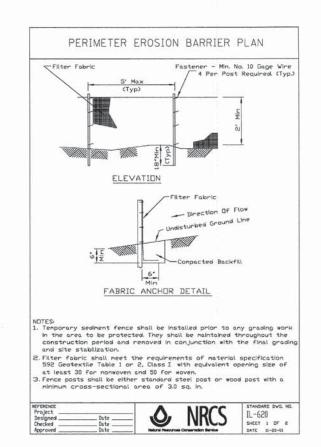

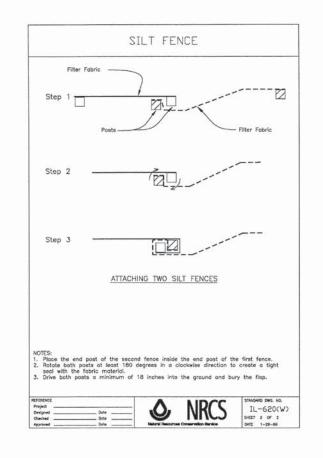

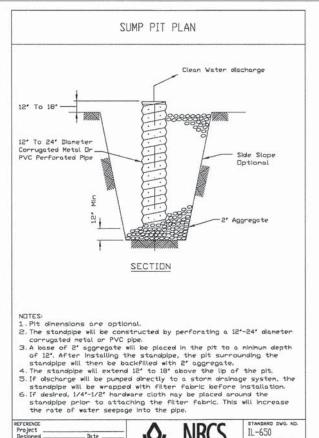

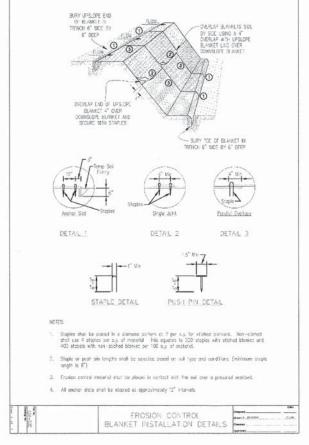



HRGreen

HRGreen.com
| Illinois Professional Design Firm | FII | PL

USER NAME = tyelton	DESIGNED -	DCJ	REVISED -	- 1
FILE NAME = 090071-erodet02.dgn	DRAWN -	DCJ	REVISED -	
PLOT SCALE = N.T.S.	CHECKED -	JLP	REVISED -	
PLOT DATE = 11/11/2014	DATE -	11/12/14	REVISED -	

EROSION CONTROL DETAILS										
CHAI	RLES J	. MI	LLE	R	ROA	D	ROA	DWAY	IMPROVEMI	ENTS
.T.S.	SHEET	NO.	8	OF	8	SHE	ETS	STA.	TO	STA.

F.A.U. RTE.	SE	CTION	COUNTY	TOTAL	SHEET NO.		
3860	09-00372-01-PW			MCHENRY	358	97	
				CONTRACT	NO.	63892	
FED. ROAD	DIST. NO.	ILLINOIS	FED. Al	D PROJECT			

