ADT: MILWAUKEE AVE.. 36,400 VPD (2007) 38,000 VPD (2030)

DESIGN SPEED

40 MPH (PROPOSED)

FOR INDEX OF SHEETS, SEE SHEET NO. 2 FOR LIST OF HIGHWAY STANDARDS SEE SHEET NO. 2

STATE OF ILLINOIS **DEPARTMENT OF TRANSPORTATION DIVISION OF HIGHWAYS** 

# PLANS FOR PROPOSED FEDERAL AID HIGHWAY

FAP 374 (ILLINOIS ROUTE 21 - MILWAUKEE AVENUE) **OAKTON STREET TO MONROE STREET** 

> STREETSCAPE IMPROVEMENTS SECTION NO.: 13-00117-00-LS PROJECT NO.: TE-00D1(993) VILLAGE OF NILES **COOK COUNTY** C-91-102-15

**DESIGN DESIGNATION** 

ARTERIAL


TRAFFIC DATA

0

0

J.U.L.I.E. JOINT UTILITY LOCATION INFORMATION FOR **EXCAVATION CALL 811** 



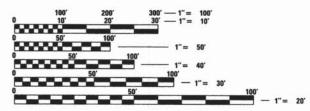

**ENGINEERING SCALES. REDUCED SIZED PLANS WILL NOT** CONFORM TO STANDARD SCALES. IN MAKING MEASUREMENTS ON REDUCED PLANS, THE ABOVE SCALES MAY BE USED.

PROJECT LOCATED IN THE **VILLAGE OF NILES** 



420 NORTH FRONT STREET, SUITE 100 | McHENRY, ILLINOIS 60050
Phone: 815.385.1778 | Toll Free: 800.728.7805 | Fax: 815.385.1781 | HRGreen.c
ILLINOIS PROFESSIONAL DESIGN FIRM #184-001322

PROJECT ENGINEER: J. STRZALKA PROJECT MANAGER: A. CHAUDHRY

CONTRACT NO. 61A93

**RANGE 12 EAST** PROJECT ENDS STA. 231 + 60.5 43 PROJECT BEGINS STA. 218 + 22.7 PROJECT LOCATION MAP

PROJECT LENGTH

NET AND GROSS LENGTH OF PROJECT = 1,337.8 FT (0.25 MI)

COOK 31 1 13-00117-00-LS FED. ROAD DIST. NO. ILLINOIS CONTRACT NO. 61A93



STATE OF ILLINOIS DEPARTMENT OF TRANSPORTATION **DIVISION OF HIGHWAYS** APPROVED OCTOBER PASSED DISTRICT ONE ENGINEER OF LOCAL ROADS AND STREETS DEPUTY DIRECTOR OF HIGHWAYS, REGION ONE ENGINEER

PROFESSIONAL ENGINEER'S SIGN & SEAL 062-036735 Albam Chauch M. AKRAM CHAUDHRY, P.E. EXPIRES: 11-30-15

> PRINTED BY THE AUTHORITY OF THE STATE OF ILLINOIS

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### INDEX OF SHEETS

GENERAL NOTES, SPECIFICATIONS, & STATE STANDARDS

SUMMARY OF QUANTITIES 4-5 TYPICAL SECTIONS

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7-9 STREETSCAPE PLANS

10-12 ELEVATION AND LANDSCAPE PLANS IRRIGATION PLANS

16-21 LANDSCAPE DETAILS SIDEWALK RAMP DETAILS 22-24

DETAILS AND DISTRICT ONE STANDARDS 25-31

### LIST OF STATE STANDARDS

STANDARD NO.	DESCRIPTION
000001-06	STANDARD SYMBOLS, ABBREVIATIONS AND PATTERS
280001-07	TEMPORARY EROSION CONTROL SYSTEMS
424001-08	PERPENDICULAR CURB RAMPS FOR SIDEWALKS
606001-06	CONCRETE CURB TYPE B AND COMBINATION CURB AND GUTTER
701006-05	OFF-ROAD OPERATIONS, 2L, 2W, 15' TO 24" FROM PAVEMENT EDGE
701101-04	OFF-ROAD OPERATIONS, MULTILANE, 15' TO 24" FROM PAVEMENT EDGE
701301-04	LANE CLOSURE, 2L, 2W, SHORT TIME OPERATIONS
701311-03 ·	LANE CLOSURE, 2L, 2W, MOVING OPERATIONS- DAY ONLY
701427-03	LANE CLOSURE, MULTILANE, INTERMITTENT OR MOVING OPERATIONS, FOR SPEEDS , 40 MPH
701606-10	URBAN LANE CLÓSURE, MULTILANE, 2W WITH MOUNTABLE MEDIAN
701701-09	URBAN LANE CLOSURE, MULTILANE INTERSECTION
701801-05	SIDEWALK, CORNER OR CROSSWALK CLOSURE
701901-04	TRAFFIC CONTROL DEVICES

### LIST OF DISTRICT DETAILS

STANDARD NO. BD-01	DESCRIPTION  DRIVEWAY DETAILS - DISTANCE BETWEEN R.O.W. AND FACE OF CURB & EDGE OF SHOULDER >= 15' (4.5m)
BD-02	DRIVEWAY DETAILS - DISTANCE BETWEEN R.O.W. AND FACE OF CURB $\langle \mathtt{=15'} \; (4.5 \mathrm{m}) \rangle$
BD-36	FIRE HYDRANT TO BE MOVED
TC-10	TRAFFIC CONTROL AND PROTECTION FOR SIDE ROADS. INTERSECTIONS, AND DRIVEWAYS
TC-13	DISTRICT ONE TYPICAL PAVEMENT MARKINGS
TC-22	ARTERIAL ROAD INFORMATION SIGN
TC-26	DRIVEWAY ENTRANCE SIGNING

### **GENERAL NOTES**

- 1. ALL REFERENCES TO "STANDARD SPECIFICATIONS" IN THESE GENERAL NOTES SHALL BE INTERPRETED TO MEAN "STANDARD SPECIFICATIONS FOR ROAD AND BRIDGE CONSTRUCTION" ADOPTED BY THE ILLINOIS DEPARTMENT OF TRANSPORTATION, JANUARY 1, 2012
- 2. ALL REFERENCES TO "ENGINEER" SHALL BE INTERPRETED TO MEAN THE RESIDENT ENGINEER.
- 3. PRIOR TO COMMENCEMENT OF CONSTRUCTION, THE CONTRACTOR SHALL VERIFY ALL DIMENSIONS AND CONDITIONS AFFECTING THEIR WORK WITH THE ACTUAL CONDITIONS AT THE JOB SITE. IN ADDITION, THE CONTRACTOR MUST VERIFY THE ENGINEER'S LINE AND GRADE STAKES. IF THERE ARE ANY DISCREPANCIES FROM WHAT IS SHOWN ON THE CONSTRUCTION PLANS, HE MUST IMMEDIATELY REPORT SAME TO THE ENGINEER BEFORE DOING ANY WORK, OTHERWISE THE CONTRACTOR ASSUMES FULL RESPONSIBILITY. IN THE EVENT OF DISAGREEMENT BETWEEN THE CONSTRUCTION PLANS, STANDARD SPECIFICATIONS AND/OR SPECIAL DETAILS, THE CONTRACTOR SHALL SECURE WRITTEN INSTRUCTIONS FROM THE ENGINEER PRIOR TO PROCEEDING WITH ANY PART OF THE WORK AFFECTED BY OMISSIONS OR DISCREPANCIES. FAILING TO SECURE SUCH INSTRUCTIONS, THE CONTRACTOR WILL BE CONSIDERED TO HAVE PROCEEDED AT HIS OWN RISK AND EXPENSE. IN THE EVENT OF ANY DOUBT OR QUESTION ARISING WITH RESPECT TO THE TRUE MEANING OF THE CONSTRUCTION PLANS OR SPECIFICATIONS, THE DECISION OF THE ENGINEER SHALL BE FINAL AND CONCLUSIVE.
- 4. IT IS THE CONTRACTOR'S RESPONSIBILITY TO ASCERTAIN EXISTING FIELD CONDITIONS PRIOR TO BIDDING ON THE PROJECT.
- 5. BEFORE STARTING ANY EXCAVATION, THE CONTRACTOR SHALL CALL "JULIE" (JOINT UTILITY LOCATION INFORMATION FOR EXCAVATION) AT (800) 892-0123 AND THE VILLAGE OF NILES AT (847) 588-7926 FOR FIELD LOCATIONS OF BURIED UTILITIES (48 HOURS NOTIFICATION IS REQUIRED).
- 6. AT LOCATIONS WHERE PROPOSED SIDEWALK IS TO BE PLACED ADJACENT TO EXISTING CONCRETE PAVEMENT, THE LIMIT OF REMOVAL SHALL BE SAW CUT TO PRODUCE A SMOOTH EDGE FOR AN EXPANSION JOINT AND PROPOSED CONCRETE TO BE PLACED ADJACENT TO. AT LOCATIONS WHERE PROPOSED SIDEWALK IS TO BE PLACED ADJACENT TO EXISTING HMA DRIVEWAYS OR PARKING LOTS, THE LIMIT OF REMOVAL SHALL BE EXTENDED 1 FOOT BEYOND THE PROPOSED SIDEWALK TO ALLOW FOR FORMS TO BE USED IN THE SIDEWALK CONSTRUCTION.
- 7. THE CONTRACTOR WILL NOT BE ALLOWED TO SET UP A YARD OR FIELD OFFICE ON STATE OR VILLAGE PROPERTY WITHOUT WRITTEN PERMISSION FROM THE DEPARTMENT.
- 8. ALL ELEVATIONS SHOWN ON THE PLANS ARE ON THE USGS DATUM.
- 9. THE CONTRACTOR SHALL PROTECT AND CAREFULLY PRESERVE ALL SECTION OR SUBSECTION MONUMENTS, PROPERTY CORNERS, AND REFERENCE MARKERS UNTIL THE ENGINEER, HIS AGENT, OR AN AUTHORIZED SURVEYOR HAS WITNESSED OR OTHERWISE REFERENCED THEIR LOCATIONS.
- 10. ALL RADII FOR PROPOSED CURB AND GUTTER ARE TO THE EDGE OF PAVEMENT, UNLESS OTHERWISE NOTED. CURB AND GUTTER ELEVATIONS SHOWN ALONG RETURNS AND AT POINTS OF CURVATURE, ETC. ARE TO THE EDGE OF PAVEMENT UNLESS OTHERWISE NOTED.
- 11. OFFSET LOCATIONS GIVEN IN THE PLANS FOR STRUCTURES, EDGE OF PAVEMENT, ETC. ARE FROM THE ROADWAY CENTERLINE.
- 12. SAW CUTTING OF PAVEMENTS, SIDEWALK, ETC. SHALL BE TO FULL DEPTH AND SHALL RESULT IN A CLEAN STRAIGHT EDGE ON THE PORTION REMAINING. ALL SAWCUTTING SHALL BE CONSIDERED INCLUDED IN THE ITEM REMOVED
- 13. IN ADDITION TO THE REQUIREMENTS OF SECTION 107.01 OF THE STANDARD SPECIFICATIONS, THE CONTRACTOR SHALL BE RESPONSIBLE FOR THE PROPER REMOVAL AND DISPOSAL OF EXCAVATED MATERIALS FROM THE PROJECT SITE. THE CONTRACTOR WILL MEET ALL REQUIREMENTS SET FORTH BY THE IEPA AND PUBLIC ACT 96-1416 IN REGARDS TO CLEAN CONSTRUCTION AND DEMOLITION DEBRIS WHICH MAY INCLUDE, BUT NOT LIMITED TO, FIELD AND LABORATORY ANALYSIS, CERTIFICATION FROM A LICENSED PROFESSIONAL ENGINEER, DUMPING FEES AND DOCUMENTATION, THIS WORK SHALL NOT BE PAID FOR SEPARATELY, BUT WILL BE INCLUDED IN THE COST OF THE ITEM BEING REMOVED. NO ADDITIONAL COMPENSATION WILL BE PROVIDED.
- 14. REMOVAL OF EXISTING COMBINATION CURB AND GUTTER, REGARDLESS OF CURB AND GUTTER TYPE, SHALL BE PAID FOR AS "COMBINATION CURB AND GUTTER REMOVAL".
- 15. THE ELEVATIONS SHOWN ON THE PLANS ARE FINISHED GRADES OF PROPOSED PAVEMENT, UNLESS OTHERWISE NOTED.
- 16. THE CONTRACTOR SHALL CONTACT THE DISTRICT ONE TRAFFIC CONTROL SUPERVISOR AT (847)705-4470 A MINIMUM OF 72 HOURS IN ADVANCE OF BEGINNING WORK.

- 17. WHEN NECESSARY, LANE CLOSURES ON ILLINOIS ROUTE 21 WILL ONLY BE PERMITTED BETWEEN THE HOURS OF 9am TO 3pm.
- 18. SIDEWALK PLACED ADJACENT TO BRICK PAVER BANDING SHALL INCLUDE A 3" WIDE SMOOTH TROWEL SURFACE, 3/16" DEEP ON THE ADJACENT EDGE. THIS WORK SHALL BE CONSIDERED AS INCLUDED IN THE SIDEWALK UNIT BID PRICES, AND NO ADDITIONAL COMPENSATION WILL BE ALLOWED. SEE BRICK PAVER BANDING DETAIL FOR ADDITIONAL INFORMATION.
- 19. PROPOSED TREES SHALL BE SPACED AT APPROXIMATELY 45 FEET APART AS SHOWN ON THE PLANS OR AS DIRECTED BY THE ENGINEER.

- 1. THE CONTRACTOR SHALL BE RESPONSIBLE FOR CONTACTING THE OWNERS OF ALL UTILITIES PRIOR TO CONSTRUCTION TO DETERMINE THE LOCATION OF ALL UTILITY EQUIPMENT. THE CONTRACTOR SHALL COOPERATE WITH ALL UTILITY OWNERS IN ACCORDANCE WITH THE STANDARD SPECIFICATIONS IF UTILITY RELOCATION, ADJUSTMENT, OR PROTECTION IS NECESSARY.
- 2. THE LOCATION OF EXISTING DRAINAGE STRUCTURES, STORM SEWERS, WATER MAINS, SANITARY SEWERS, AND ANY OTHER PUBLIC OR PRIVATE UTILITIES AS SHOWN ON THE PLANS IS APPROXIMATE AND THEIR EXACT LOCATION IS TO BE DETERMINED IN THE FIELD BY THE CONTRACTOR. THIS WORK SHALL BE CONSIDERED AS INCLUDED IN THE UNIT BID PRICES OF THE CONTRACT, AND NO ADDITIONAL COMPENSATION WILL BE ALLOWED.
- 3. THE CONTRACTOR SHALL BE RESPONSIBLE FOR THE PROTECTION OF ALL UNDERGROUND AND SURFACE UTILITIES EVEN THOUGH THEY MIGHT NOT BE SHOWN ON THE PLANS. ANY UTILITY PROPERTY DAMAGED DURING CONSTRUCTION SHALL BE REPAIRED OR REPLACED TO THE SATISFACTION OF THE OWNER AT THE CONTRACTOR'S EXPENSE.
- 4. THE CONTRACTOR SHALL USE ALL NECESSARY PRECAUTIONS AND PROTECTION MEASURES REQUIRED TO MAINTAIN EXISTING UTILITIES, SEWERS, AND APPURTENANCES THAT MUST BE KEPT IN OPERATION.
- 5. ANY LOOSE MATERIAL DEPOSITED IN THE FLOWLINE OF DRAINAGE STRUCTURES, WHICH OBSTRUCTS THE NATURAL FLOW OF WATER SHALL BE REMOVED AT THE CLOSE OF EACH WORKING DAY. PRIOR TO ACCEPTANCE OF THE IMPROVEMENT, ALL DRAINAGE STRUCTURES SHALL BE FREE OF DIRT AND DEBRIS. THIS WORK WILL NOT BE PAID FOR SEPARATELY, BUT SHALL BE CONSIDERED AS INCLUDED IN THE UNIT BID PRICES OF THE CONTRACT.
- 6. WHEN EXISTING DRAINAGE FACILITIES ARE DISTURBED, THE CONTRACTOR SHALL PROVIDE AND MAINTAIN, IN AN OPERATING CONDITION, TEMPORARY OUTLETS AND CONNECTIONS FOR ALL DRAINS,
- 7. ANY ITEMS DAMAGED DURING REMOVAL OPERATIONS SHALL BE REPLACED BY THE CONTRACTOR AT HIS EXPENSE. THE COST OF SALVAGING EXISTING FRAMES, GRATES, LIDS, OR BOXES AND/OR STOCKPILING THEM ON THE JOB SITE FOR DELIVERY TO THE STATE OR VILLAGE MAINTENANCE YARD SHALL BE CONSIDERED AS INCLUDED IN THE UNIT BID PRICES OF THE CONTRACT, AND NO ADDITIONAL COMPENSATION WILL BE ALLOWED.
- 8. THE CONTRACTOR SHALL TAKE PRECAUTION EXCAVATING AND REMOVING MATERIALS IN THE VICINITY OF LIGHTING EQUIPMENT AND CONDUIT. ANY DAMAGED ITEMS WILL BE REPLACED AT NO ADDITIONAL COST BY THE CONTRACTOR.

#### SIGNING AND STRIPING

- 1. ALL EXISTING SIGNS LOCATED ON UTILITY/LIGHT POLES TO REMAIN THAT DO NOT CONFLICT WITH THE IMPROVEMENTS SHALL REMAIN IN PLACE UNLESS DIRECTED BY THE ENGINEER.
- 2. SIGNS SHALL NOT BE MOVED OR COVERED UNTIL PROGRESS OF WORK NECESSITATES IT.
- 3. THE CONTRACTOR WILL BE REQUIRED TO TEMPORARILY RESET ALL SUCH SIGNS THAT INTERFERE WITH HIS CONSTRUCTION OPERATIONS. ALL SUCH SIGNS MUST BE MAINTAINED STRAIGHT AND CLEAN FOR THE DURATION OF THE TEMPORARY SETTING AND MUST BE RE-ERECTED AT A TEMPORARY LOCATION IN A WORKMANLIKE MANNER AND BE VISIBLE TO THE TRAFFIC FOR WHICH IT IS INTENDED. THIS WORK WILL NOT BE PAID FOR SEPARATELY, BUT SHALL BE INCLUDED IN THE UNIT BID PRICES OF THE CONTRACT.
- 4. THE RESIDENT ENGINEER SHALL CONTACT THE NORTH COOK AREA TRAFFIC FIELD ENGINEER AT (773) 685-8386 AT A MINIMUM OF TWO (2) WEEKS PRIOR TO PLACEMENT OF PERMANENT PAVEMENT MARKING.
- 5. PROPOSED PAVEMENT MARKING SHALL BE IN ACCORDANCE WITH DISTRICT ONE TYPICAL PAVEMENT MARKINGS UNLESS OTHERWISE NOTED.

HRGreen

HRGreen.com

ER NAME = jstrzal PLOT SCALE = N.T.S. PLOT DATE = 10/23/2014

DESIGNED -REVISED JJS WH REVISED CHECKED - AC REVISED DATE REVISED

STATE OF ILLINOIS DEPARTMENT OF TRANSPORTATION

NDEX OF	SHEETS					NDARDS STREET	GENERAL	NOTES	
ALE: N.T.S.	SHE	ET NO.	1 (	OF 1	SHEETS	STA. NA	TO STA.	NA	+

COUNTY TOTAL SHEE NO. 13-00117-00-LS COOK 31 2 374 CONTRACT NO. 61A93 FED. ROAD DIST. NO. | ILLINOIS FED. AID PROJECT


# SUMMARY OF QUANTITIES


PROV.	LITY					LANDSCAPING ITEP
SP. P	SPECIALITY	557.57556				CONSTRUCTION
•	S	CODE NUMBER	ITEM DESCRIPTON	UNIT	QUANTITY	CODE
	Н	20100110	TREE REMOVAL (6 TO 15 UNITS DIAMETER)	UNIT	40	40
		20100210	TREE REMOVAL (OVER 15 UNITS DIAMETER)	UNIT	20	20
	H	20101000	TEMPORARY FENCE	FOOT	120	120
	†	21101625	TOPSOIL FURNISH AND PLACE, 6"	SQ YD	900	900
	+	25000400	NITROGEN FERTILIZER NUTRIENT	POUND	17	17
	†	25000500	PHOSPHORUS FERTILIZER NUTRIENT	POUND	17	17
	+	25000600	POTASSIUM FERTILIZER NUTRIENT	POUND	17	17
	†	25200110	SODDING, SALT TOLERANT	SO YD	900	900
•	+	25200200	SUPPLEMENTAL WATERING	UNIT	79	79
	H	28000510	INLET FILTERS	EACH	36	36
	H	31101200	SUBBASE GRANULAR MATERIAL, TYPE B 4"	SO YD	1.710	1.710
	H	31101400	SUBBASE GRANULAR MATERIAL, TYPE B 6"	SO YD	870	870
	H	40201000	AGGREGATE FOR TEMPORARY ACCESS	TON	324	324
	+	40600275	BITUMINOUS MATERIALS (PRIME COAT)	POUND	198	198
	Ŧ	40603335	HOT-MIX ASPHALT SURFACE COURSE, MIX "D", N50	TON	675	675
		42300400	PORTLAND CEMENT CONCRETE DRIVEWAY PAVEMENT. 8 INCH	SO YD	495	495
	Н	42400200	PORTLAND CEMENT CONCRETE SIDEWALK 5 INCH	SQ FT	4,635.0	4,635.0
		42400800	DETECTABLE WARNINGS	SQ FT	64	64
		44000100	PAVEMENT REMOVAL	SO YD	1.485	1,485
	+	44000161	HOT-MIX ASPHALT SURFACE REMOVAL, 3"	SQ YD	2,930	2,930
	Н	44000200	DRIVEWAY PAVEMENT REMOVAL	SQ YD	1,950	1,950
	Н	44000500	COMBINATION CURB AND GUTTER REMOVAL	FOOT	2,845	2,845
	$\mathbb{H}$	44000600	SIDEWALK REMOVAL	SQ FT	7,255,0	7,255,0
	+	56400800	FIRE HYDRANT AND VALVE TO BE MOVED	EACH	1	1
	+	56500600	DOMESTIC WATER SERVICE BOXES TO BE ADJUSTED	EACH	10	10
	Н	60300305	FRAMES AND LIDS TO BE ADJUSTED	EACH	27	27
	H	60406000	FRAMES AND LIDS, TYPE 1, OPEN LID	EACH	9	9
-	H		FRAMES AND LIDS, TYPE 1, CLOSED LID	EACH	,	,
7	$\Box$		COMBINATION CONCRETE CURB AND GUTTER, TYPE B-6.12		2 711	2,711
1	7		MOBILIZATION	FOOT	2,711	2,111
1	7	70102625	TRAFFIC CONTROL AND PROTECTION, STANDARD 701606	L SUM		
1			TRAFFIC CONTROL AND PROTECTION, STANDARD 701701	L SUM	1	
			TRAFFIC CONTROL AND PROTECTION, STANDARD TOTAL	L SUM	1	
				L SUM	1	
			RELOCATE SIGN PANEL - TYPE 1	SQ FT	22.5	22.5
	†		THERMOPLASTIC PAVEMENT MARKING - LINE 6"	FOOT	190	190
1	+	78000650	THERMOPLASTIC PAVEMENT MARKING - LINE 24"	FOOT	55	55
	+	A2004820	TREE, GLEDITSIA TRIACANTHOS INERMIS SKYLINE (SKYLINE THORNLESS COMMON HONEYLOCUST), 2-1/2" CALIPER, BALLED AND BURLAPPED	EACH	4	4
-	+	A2006720	TREE, QUERCUS MACROCARPA (BUR OAK), 2-1/2" CALIPER, BALLED AND BURLAPPED	EACH	5	5
7	+	C20058G5	SHRUB, RHUS AROMATICA GRO-LOW (GRO-LOW FRAGRANT SUMAC), 5-GALLON	EACH	42	42
	+	C2C06318	SHRUB, RIBES ALPINUM GREEN MOUND (GREEN MOUND ALPINE CURRANT), 18" WIDTH, CONTAINER	EACH	21	21
1	+	K0012990	PERENNIAL PLANTS, ORNAMENTAL TYPE, GALLON POT	UNIT	10	10
1	t	K0013020	PERENNIAL PLANTS, PRAIRIE TYPE, GALLON POT	UNIT	3	3
	†	K1001988	IRRIGATION SYSTEM SPECIAL	L SUM	1	1
	+	K1005481	SHREDDED BARK MULCH 3"		355	355

SP. PROV.	SPECIALITY	CODE NUMBE <b>R</b>	ITEM DESCRIPTON	UNIT	QUANTITY	LANDSCAPING ITEP CONSTRUCTION CODE 0031
٠	Ŧ	X0300635	PLANTER	EACH	3	3
•		X0327301	RELOCATE EXISTING MAILBOX	EACH	2	2
•		X0327426	BRICK PAVER BANDING	SQ FT	7,055.0	7,055.0
•	+	X0327808	PLANTING SOIL MIX FURNISH AND PLACE, 18"	SQ YD	355	355
•		<b>X03</b> 50810	BOLLARD REMOVAL	EACH	23	23
•	Ŧ	X0539700	TREE FRAME AND GRATE	EACH	3	3
•		X2130010	EXPLORATION TRENCH, SPECIAL	FOOT	100	100
•		X6060714	CONCRETE MEDIAN (SPECIAL)	SQ FT	7,055.0	7,055.0
•	#	X6061005	CONCRETE CURB, TYPE B (SPECIAL)	FOOT	2,102	2,102
•	Ŧ	X8140115	HANDHOLE TO BE ADJUSTED	EACH	1	1
•		XX000959	TRASH RECEPTACLES	EACH	3	3
•		Z0003850	BENCHES	EACH	3	3
•	1	Z0013798	CONSTRUCTION LAYOUT	L SUM	1	1
•	1	Z0022800	FENCE REMOVAL	FOOT	73	73
•	1	Z0030850	TEMPORARY INFORMATION SIGNING	SQ FT	214	214
•	Ŧ	20033028	MAINTENANCE OF LIGHTING SYSTEM	CAL MO	6	6
	+	A2007208	TREE, QUERCUS X WAREI 'NADLER', (KNIDRED SPIRIT HYBRID OAK), 2-1/2" CALIPER, BALLED AND BURLAPPED	EACH	4	4
•	+	XX001249	ORNAMENTAL FENCE	FOOT	159	159

USER NAME = jstrzal	DESIGNED - JJS	REVISED -	
	DRAWN - WH	REVISED -	
PLOT SCALE = N.T.S.	CHECKED - AC	REVISED -	
PLOT DATE = 10/24/2014	DATE -	REVISED -	

<sup>+</sup> SPECIALTY ITEM
\* SPECIAL PROVISION

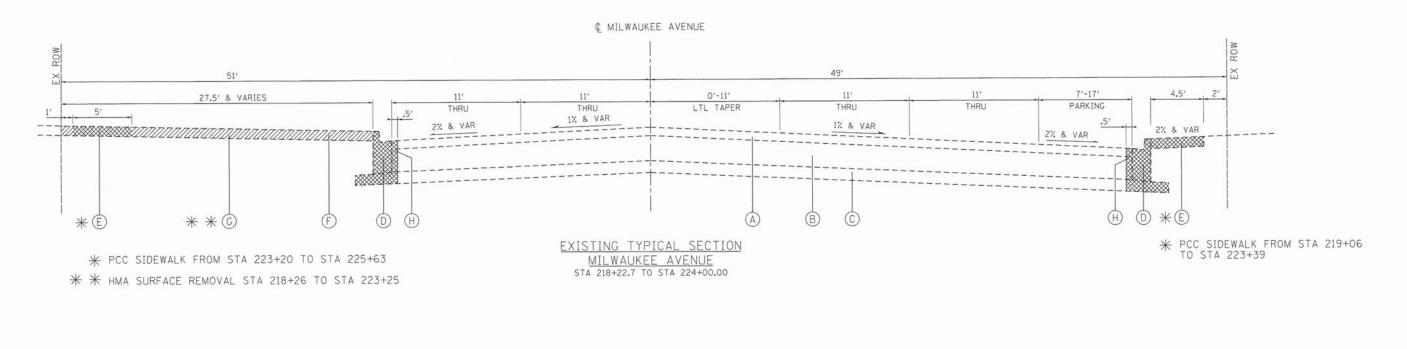

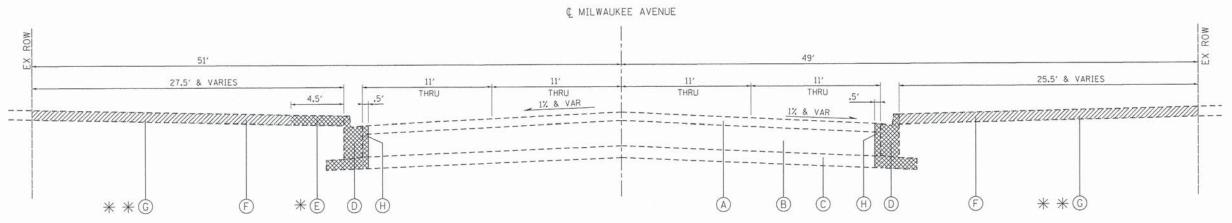

\* PCC SIDEWALK FROM STA 226+85 TO STA 228+03 STA 228+28 TO STA 229+78 STA 230+04 to STA 230+14

\* \* HMA SURFACE REMOVAL STA 226+60 TO STA 230+09

EXISTING TYPICAL SECTION MILWAUKEE AVENUE STA 224+00.00 TO STA 231+60.5

\* \* HMA SURFACE REMOVAL STA 224+01 TO STA 226+49 STA 227+29 TO STA 229+99 STA 230+23 TO STA 230+89

### EXISTING LEGEND

- HOT-MIX ASPHALT SURFACE AND BINDER COURSE; 4" & VARIES
- PORTLAND CEMENT CONCRETE PAVEMENT: 9" & VARIES
- SUB-BASE GRANULAR MATERIAL
- COMBINATION CONCRETE CURB & GUTTER TYPE B-6.12 (MOD) (VARIABLE HEIGHT) TO BE REMOVED
- PORTLAND CEMENT CONCRETE SIDEWALK TO BE REMOVED
- HOT-MIX ASPHALT DRIVEWAY PAVEMENT (SEE STREETSCAPE PLAN FOR REMOVAL LIMITS)
- HOT-MIX ASPHALT SURFACE REMOVAL, 3"
- FULL-DEPTH SAWCUT AND PAVEMENT REMOVAL REQUIRED FOR INSTALLATION OF FRONT FACE FORM OR SLIPFORM MACHINE. SEE CONSTRUCTION DETAILS. (INCLUDED IN THE COST OF COMBINATION CURB AND GUTTER REMOVAL)

INDICATES REMOVAL ITEM

INDICATES HOT-MIX ASPHALT SURFACE REMOVAL

SCALE: N.T.S.


HRGreen.com

DESIGNED - JJS JSER NAME = jstrzal REVISED DRAWN LOT SCALE = N.T.S. CHECKED REVISED PLOT DATE = 10/23/2014

STATE OF ILLINOIS DEPARTMENT OF TRANSPORTATION

**EXISTING TYPICAL SECTIONS** MILWAUKEE AVENUE STREETSCAPE

COUNTY TOTAL SHEE COOK 31 4 374 13-00117-00-LS CONTRACT NO. 61A93 SHEET NO. 1 OF 2 SHEETS STA. 218+22.7 TO STA. 231+60.5 FED. ROAD DIST. NO. | ILLINOIS FED. AID PROJECT

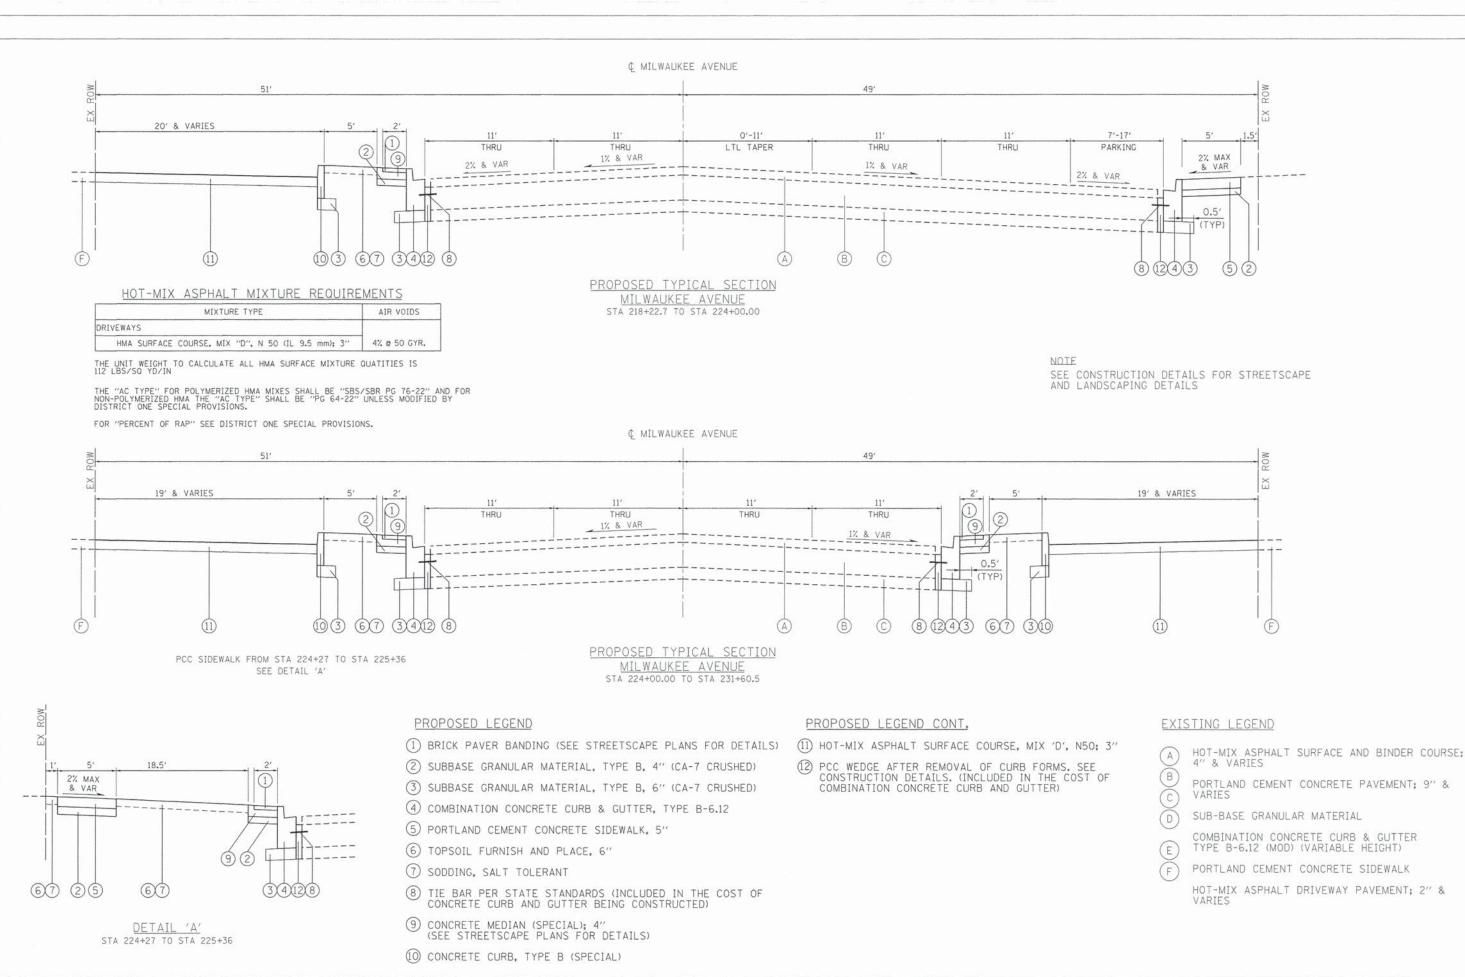


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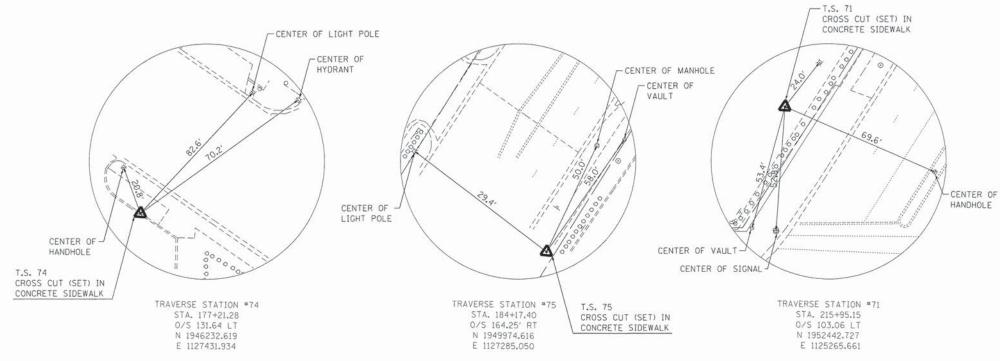
DESIGNED - JJS DRAWN - WH REVISED CHECKED LOT SCALE = N.T.S. REVISED PLOT DATE = 10/23/2014 DATE REVISED

STATE OF ILLINOIS **DEPARTMENT OF TRANSPORTATION** 

PROPOSED TYPICAL SECTIONS MILWAUKEE AVENUE STREETSCAPE SCALE: N.T.S.

TOTAL SHEE SHEETS NO. SECTION COUNTY 13-00117-00-LS COOK 31 5 SHEET NO. 2 OF 2 SHEETS STA. 218+22.7 TO STA. 231+60.5 FED. ROAD DIST. NO. | ILLINOIS | FED. AID PROJECT



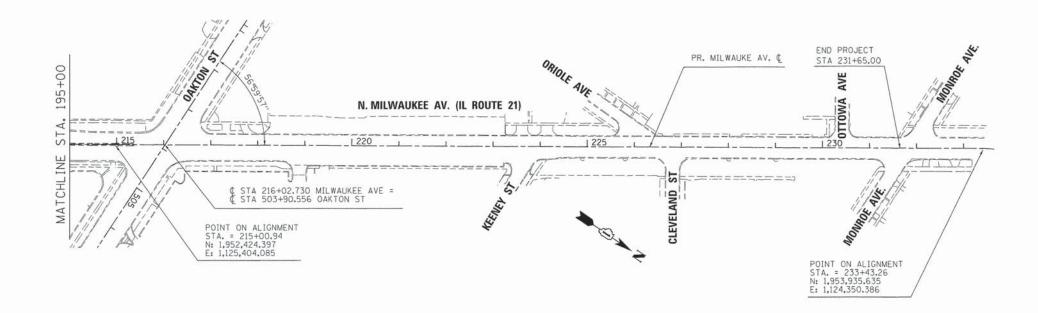

BENCHMARKS
CUT CROSS IN CONCRETE SIDEWALK APPROXIMATELY
27 FEET EAST/NORTHEAST OF THE CENTERLINE OF MILWAUKEE
AVENUE AND 52 FEET SOUTH OF THE CENTERLINE OF
BIRCHWOOD AVENUE. ELEVATION = 641.62

BM "2: TAG BOLT LOCATED ON THE SOUTHWEST CORNER OF THE UPPER FLANGE OF THE FIREHYDRANT LOCATED ON THE SOUTHEAST CORNER OF MILWAUKEE AVE. AND MONROE AVE. ELEV=650.38


HRGreen


	USER NAME = jstrzel	DESIGNED - JJS	REVISED -	
lirm.		DRAWN - WH	REVISED -	
****	PLOT SCALE = 1" = 100"	CHECKED - AC	REVISED -	
	PLOT DATE = 10/23/2014	DATE -	REVISED -	


STATE OF ILLINOIS DEPARTMENT OF TRANSPORTATION

ALIGNMENT, TIE & BENCHMARKS	
MILWAUKEE AVENUE STREETSCAPE	

COUNTY TOTAL SHEET NO. 374 13-00117-00-LS SCALE: 1" = 100' SHEET NO. 1 OF 1 SHEETS STA. 218+22.7 TO STA. 231+60.5 FED. ROAD DIST. NO. | ILLINOIS FED. AID PROJECT |

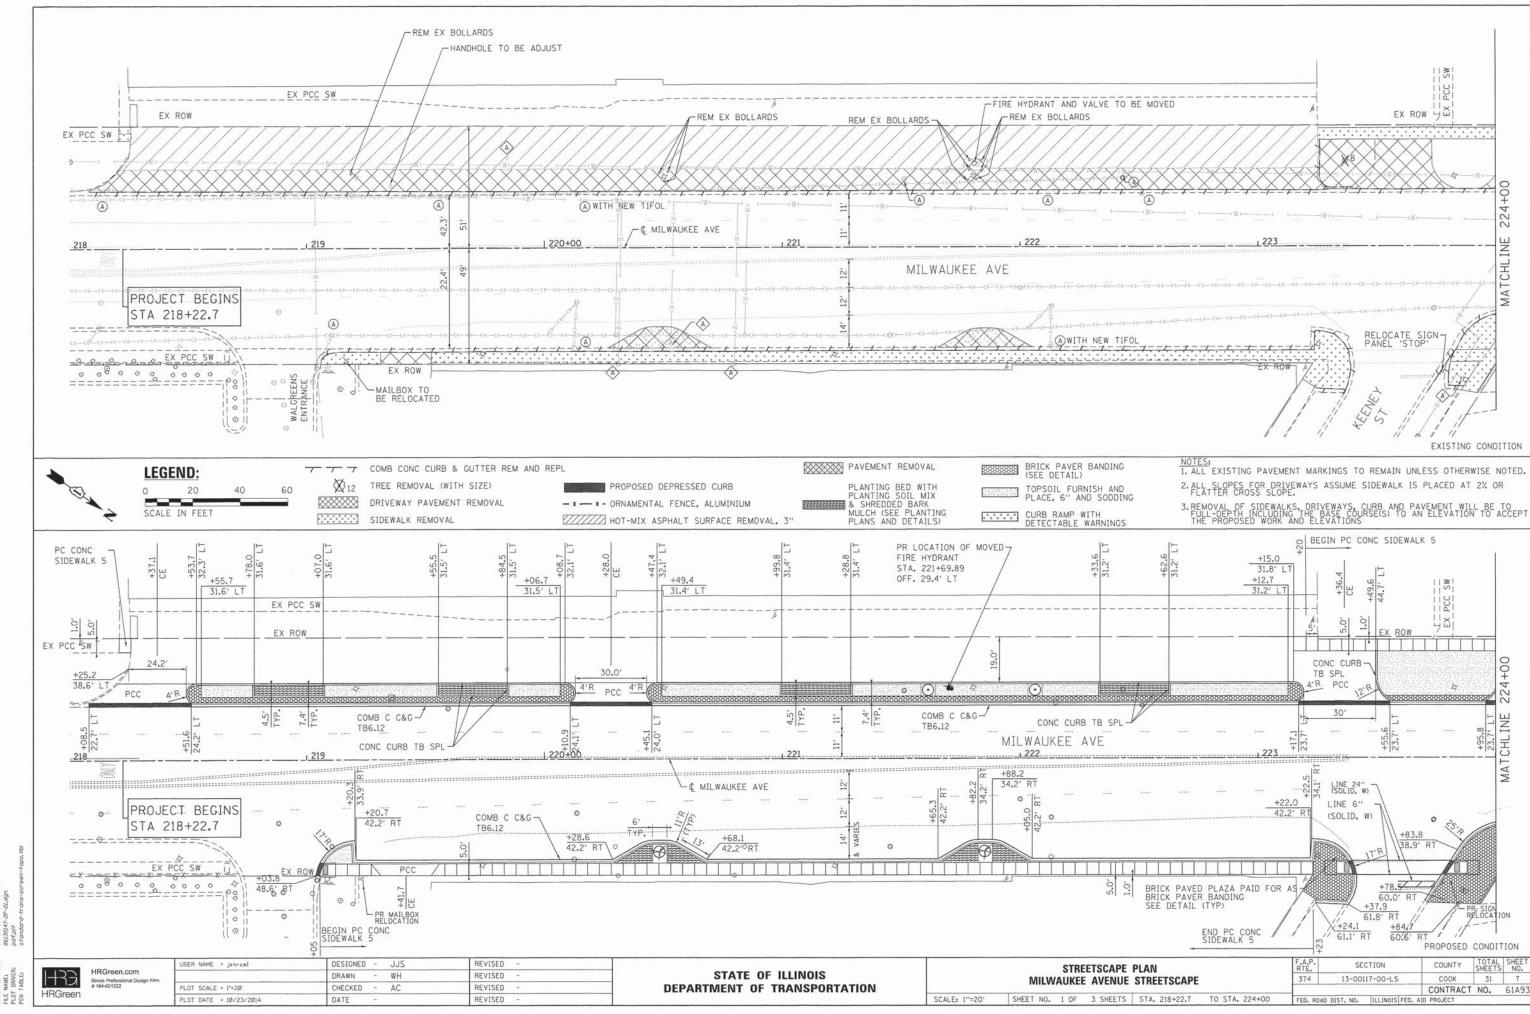

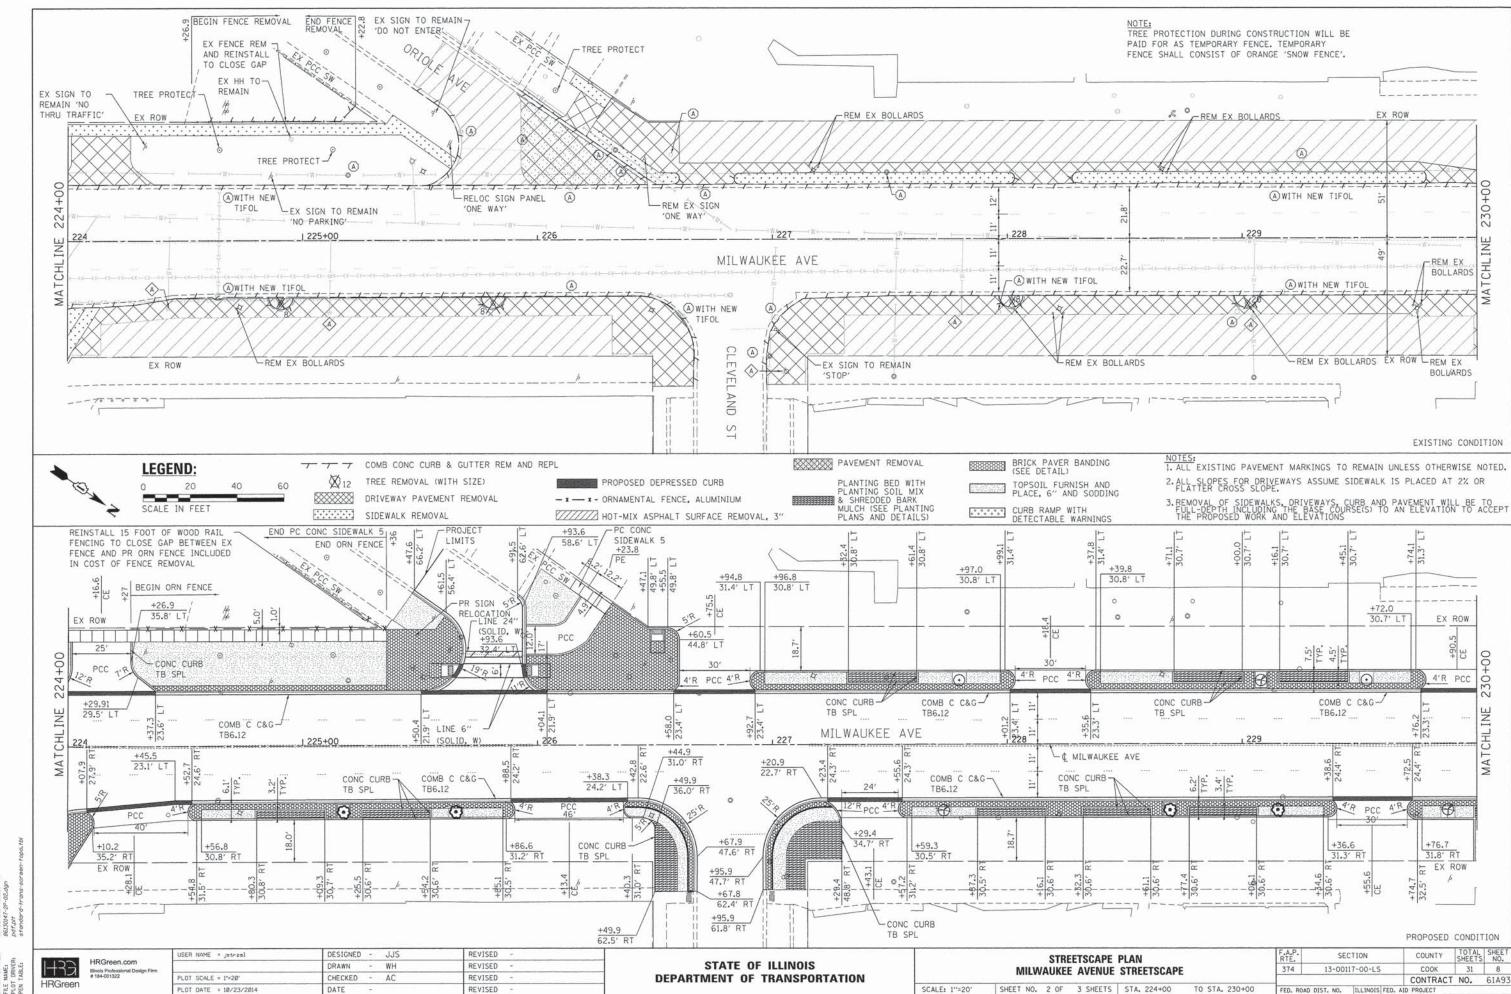

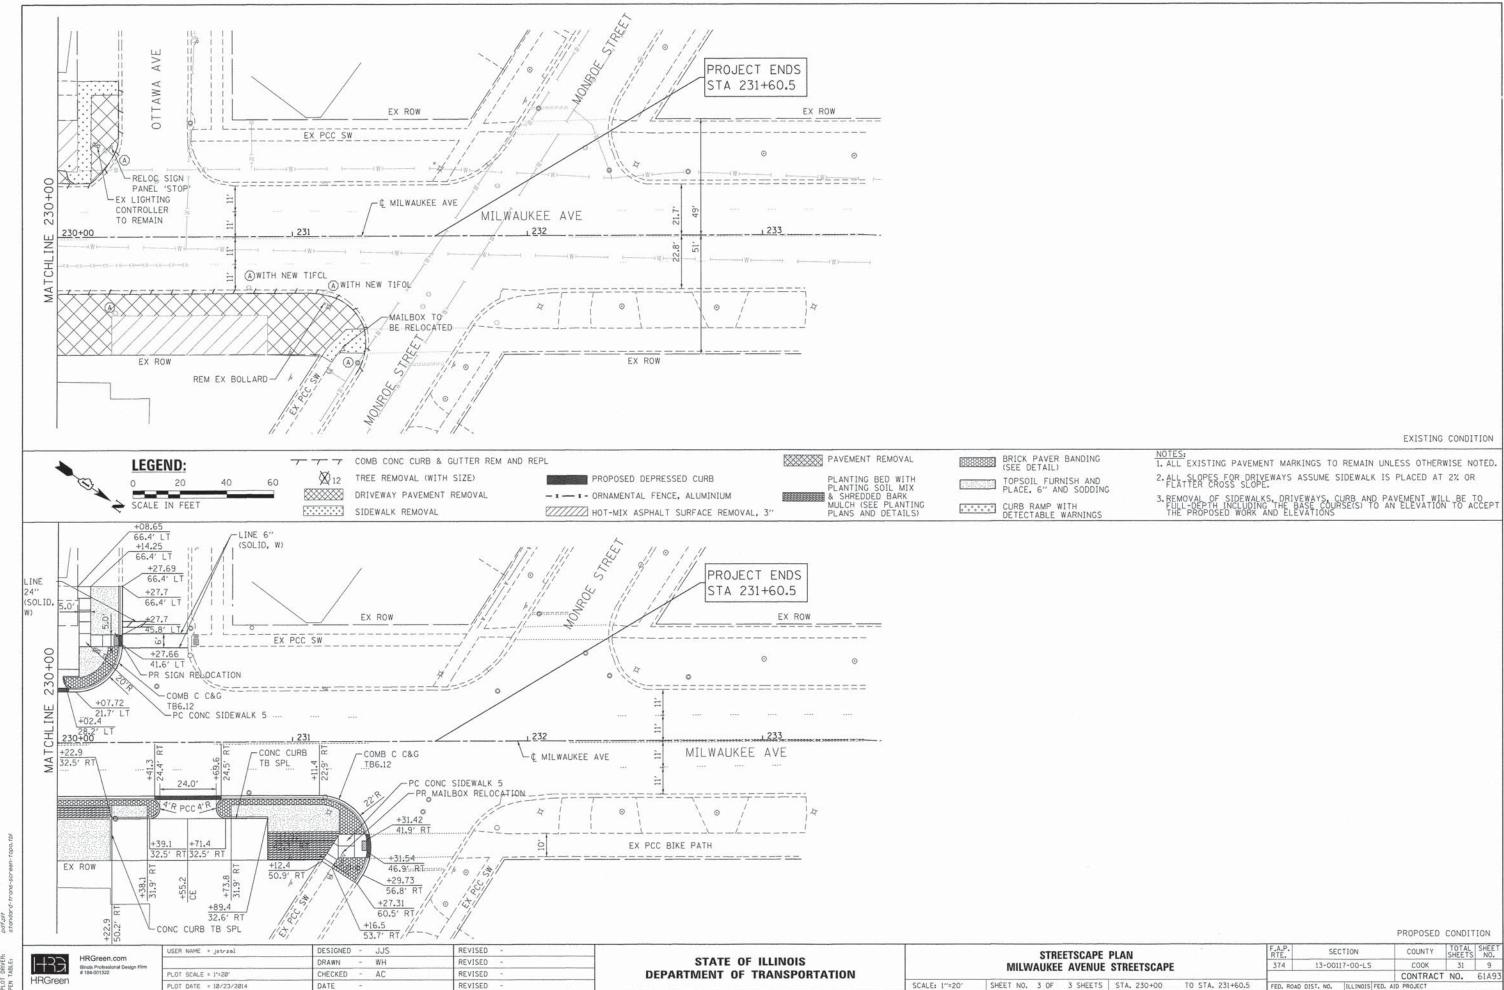

0; 10/23/20144:25:42 PM 86130147-2P-03.dgn pdf.pt standard-trans-screen-topo.tbl

PROJECT CONTACT:
CLIENT:
CALENT:
DATE PLOTTED: 10/23,
FILE NAME: 861301
PLOT ORRVER: pdf.pd
PEN TABLE: stortal

### **LEGEND**


- TREE, OUERCUS X WAREI 'NADLER', (KINDRED SPIRIT HYBRID OAK), 2-1/2" CALIPER, BALLED AND BURLAPPED
- TREE, GLEDITSIA TRIACANTHOS INERMIS SKYLINE (SKYLINE THORNLESS COMMON HONEYLOCUST), 2-1/2" CALIPER, BALLED AND BURLAPPED
- TREE, OUERCUS MACROCARPA (BUR OAK), 2-1/2" CALIPER, BALLED AND BURLAPPED 8
- PERENNIAL PLANTS, PRAIRIE TYPE, GALLON POT (SEE PERENNIAL PLANTING SCHEDULE) (8)
- PERENNIAL PLANTS, ORNAMENTAL TYPE. GALLON POT (SEE PERENNIAL PLANTING SCHEDULE)
- SHRUB, RIBES ALPINUM GREEN MOUND (GREEN MOUND ALPINE CURRANT),  $18^{\prime\prime}$  WIDTH, CONTAINER

SHRUB, RHUS AROMATICA GRO-LOW (GRO-LOW FRAGRANT SUMAC), 5-GALLON

T/C TOP OF CURB

B/C BOTTOM OF CURB

# PLANTING SCHEDULE KEY

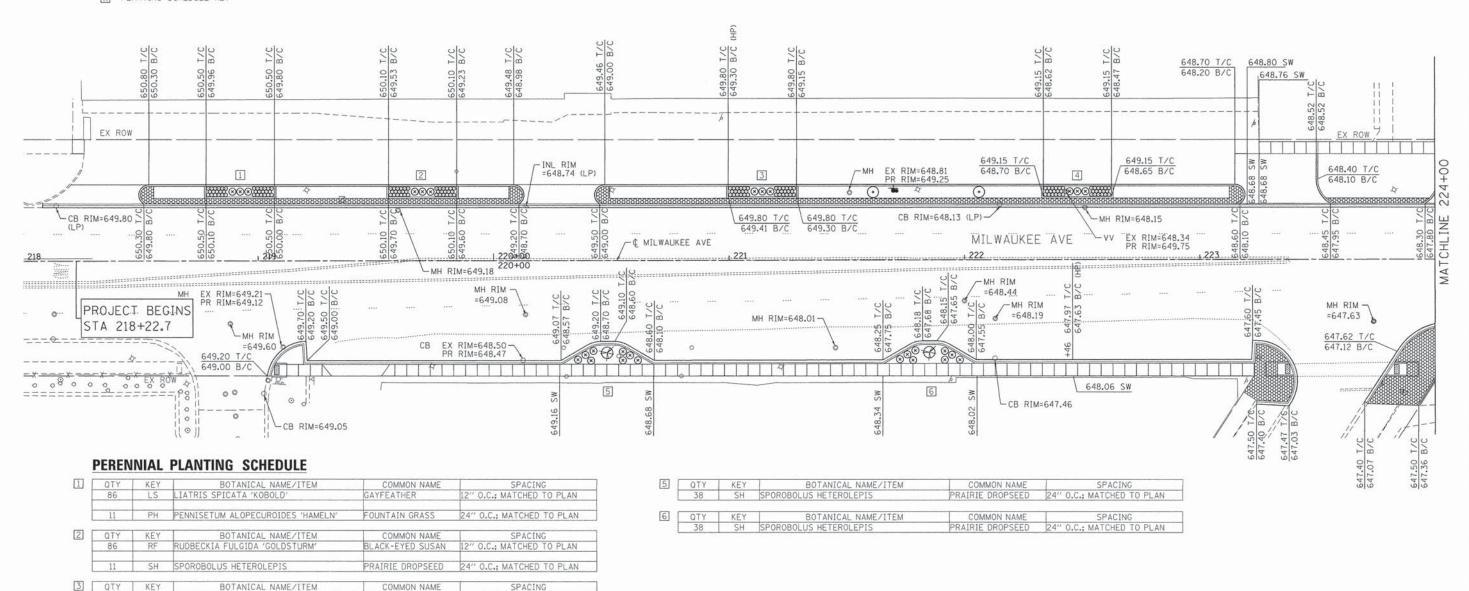

HRGreen

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USER NAME = jstrzal	DESIGNED - JJS	REVISED -	
	DRAWN - WH	REVISED -	
PLOT SCALE = 1'=20'	CHECKED - AC	REVISED -	
PLOT DATE = 10/23/2014	DATE -	REVISED -	

COREOPSIS 'JETHRO TULL

SH SPOROBOLUS HETEROLEPIS

BOTANICAL NAME/ITEM

COMMON NAME

COMMON NAME CONEFLOWER

PRAIRIE DROPSEED

FOUNTAIN GRASS

" O.C.; MATCHED TO PLAN

4" O.C.; MATCHED TO PLAN


O.C.; MATCHED TO PLAN

24" O.C.: MATCHED TO PLAN

STATE OF ILLINOIS **DEPARTMENT OF TRANSPORTATION** 

**ELEVATION AND LANDSCAPE PLAN** MILWAUKEE AVENUE STREETSCAPE SCALE: 1"=20" SHEET NO. 1 OF 3 SHEETS STA. 218+22.7 TO STA. 224+00


SECTION 374 13-00117-00-LS COOK 31 10 CONTRACT NO. 61A93

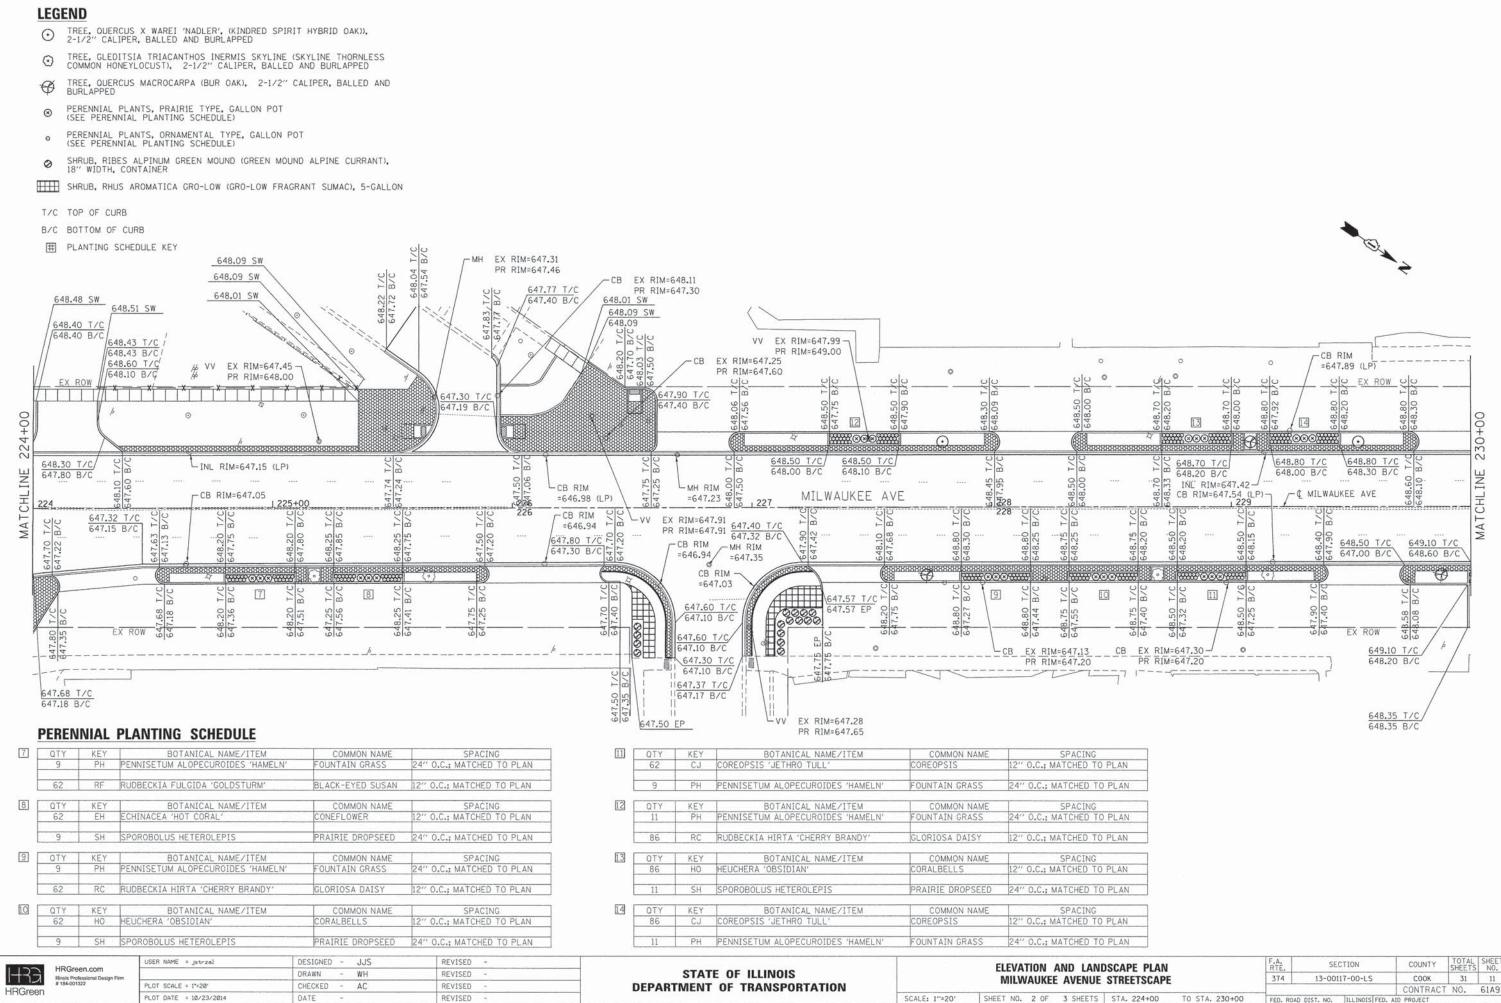

REVISED

SHEET NO. 2 OF 3 SHEETS STA. 224+00 TO STA. 230+00

CONTRACT NO. 61A93 FED. ROAD DIST. NO. | ILLINOIS FED. AID PROJECT

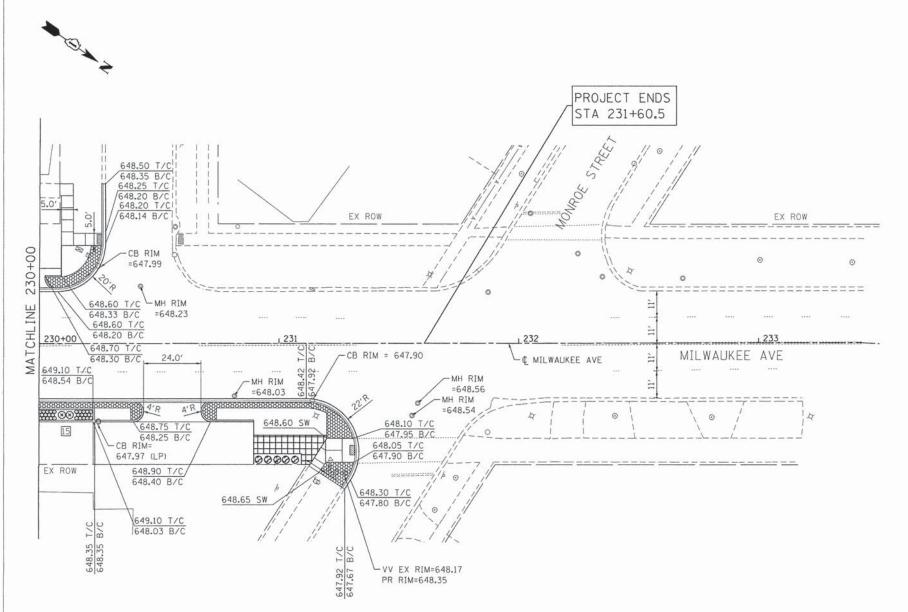

REVISED

REVISED

REVISED

REVISED

### LEGEND

- TREE, OUERCUS X WAREI 'NADLER', (KINDRED SPIRIT HYBRID OAK), 2-1/2" CALIPER, BALLED AND BURLAPPED
- TREE, GLEDITSIA TRIACANTHOS INERMIS SKYLINE (SKYLINE THORNLESS COMMON HONEYLOCUST), 2-1/2" CALIPER, BALLED AND BURLAPPED
- TREE, OUERCUS MACROCARPA (BUR OAK), 2-1/2" CALIPER, BALLED AND BURLAPPED
- ⊗ PERENNIAL PLANTS, PRAIRIE TYPE, GALLON POT (SEE PERENNIAL PLANTING SCHEDULE)
- PERENNIAL PLANTS, ORNAMENTAL TYPE, GALLON POT (SEE PERENNIAL PLANTING SCHEDULE)
- SHRUB, RIBES ALPINUM GREEN MOUND (GREEN MOUND ALPINE CURRANT), 18" WIDTH, CONTAINER

SHRUB, RHUS AROMATICA GRO-LOW (GRO-LOW FRAGRANT SUMAC), 5-GALLON

T/C TOP OF CURB

B/C BOTTOM OF CURB

# PLANTING SCHEDULE KEY

### PERENNIAL PLANTING SCHEDULE

15	QTY	KEY	BOTANICAL NAME/ITEM	COMMON NAME	SPACING
-	68	EH	ECHINACEA 'HOT CORAL'	CONEFLOWER	12" O.C.; MATCHED TO PLAN
	9	SH	SPOROBOLUS HETEROLEPIS	PRAIRIE DROPSEED	24" O.C.: MATCHED TO PLAN

TO STA. 231+60.5

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**HRGreen** 


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STATE OF ILLINOIS
DEPARTMENT OF TRANSPORTATION


ELEVATION AND LANDSCAPE PLAN MILWAUKEE AVENUE STREETSCAPE

SHEET NO. 3 OF 3 SHEETS STA. 230+00

16130147 16130147-elev-03.dgr

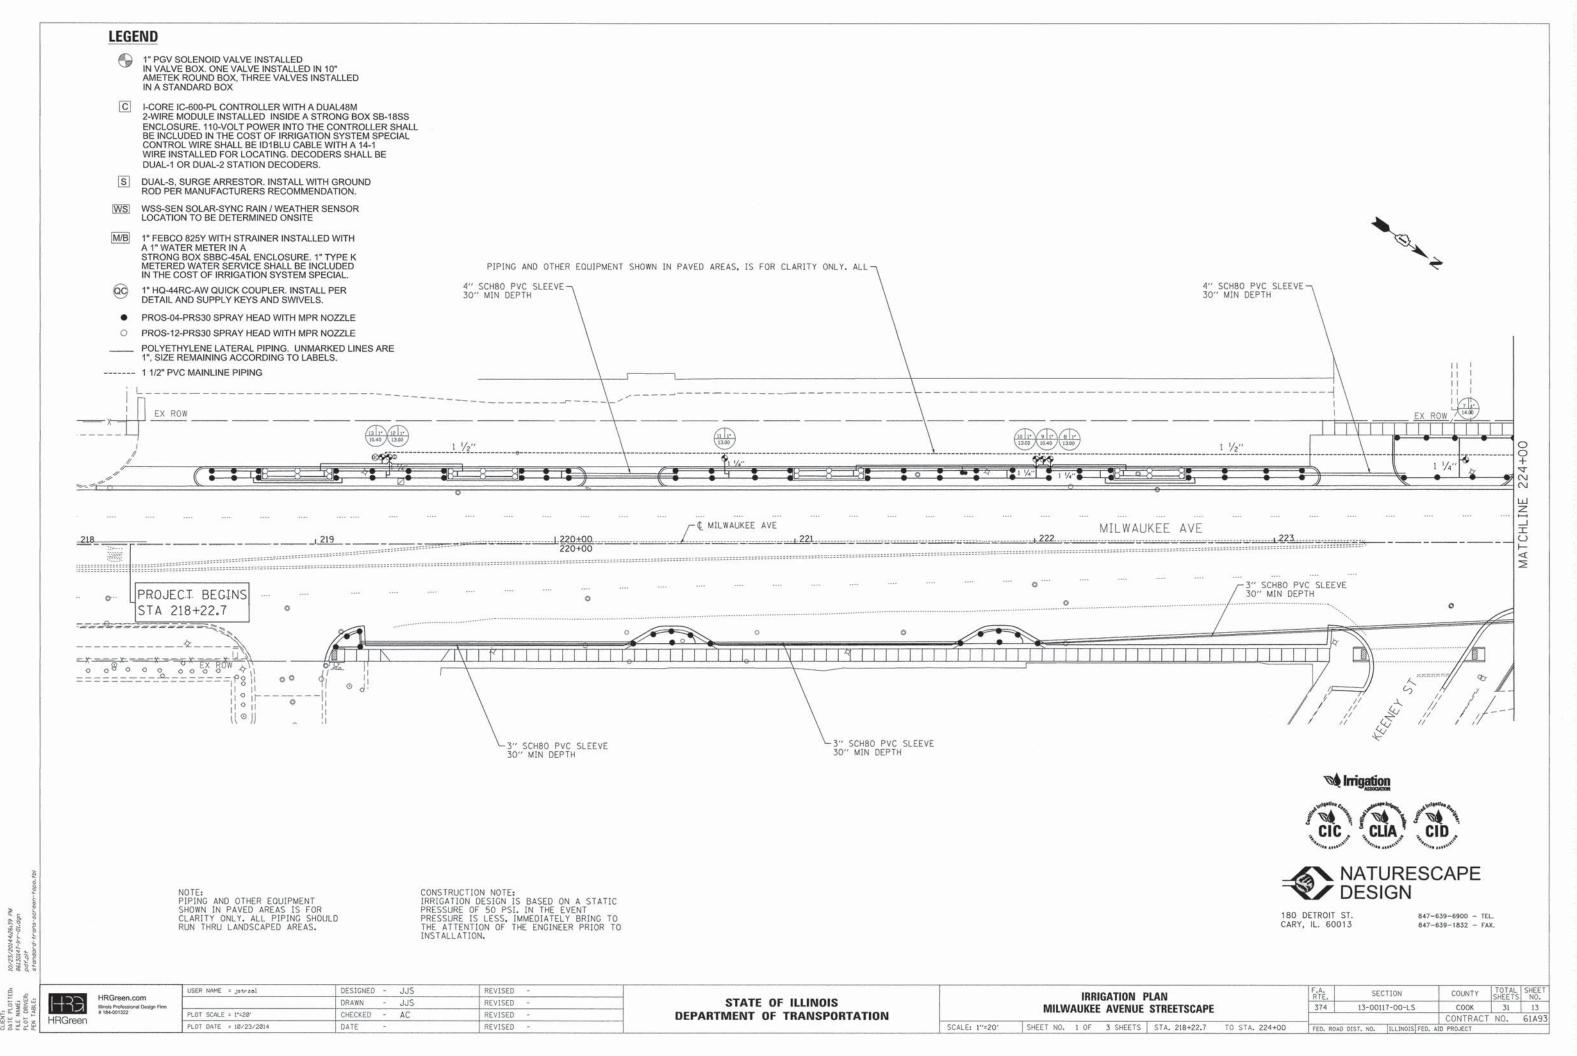


16130147 16130147-hrr-01.dgn

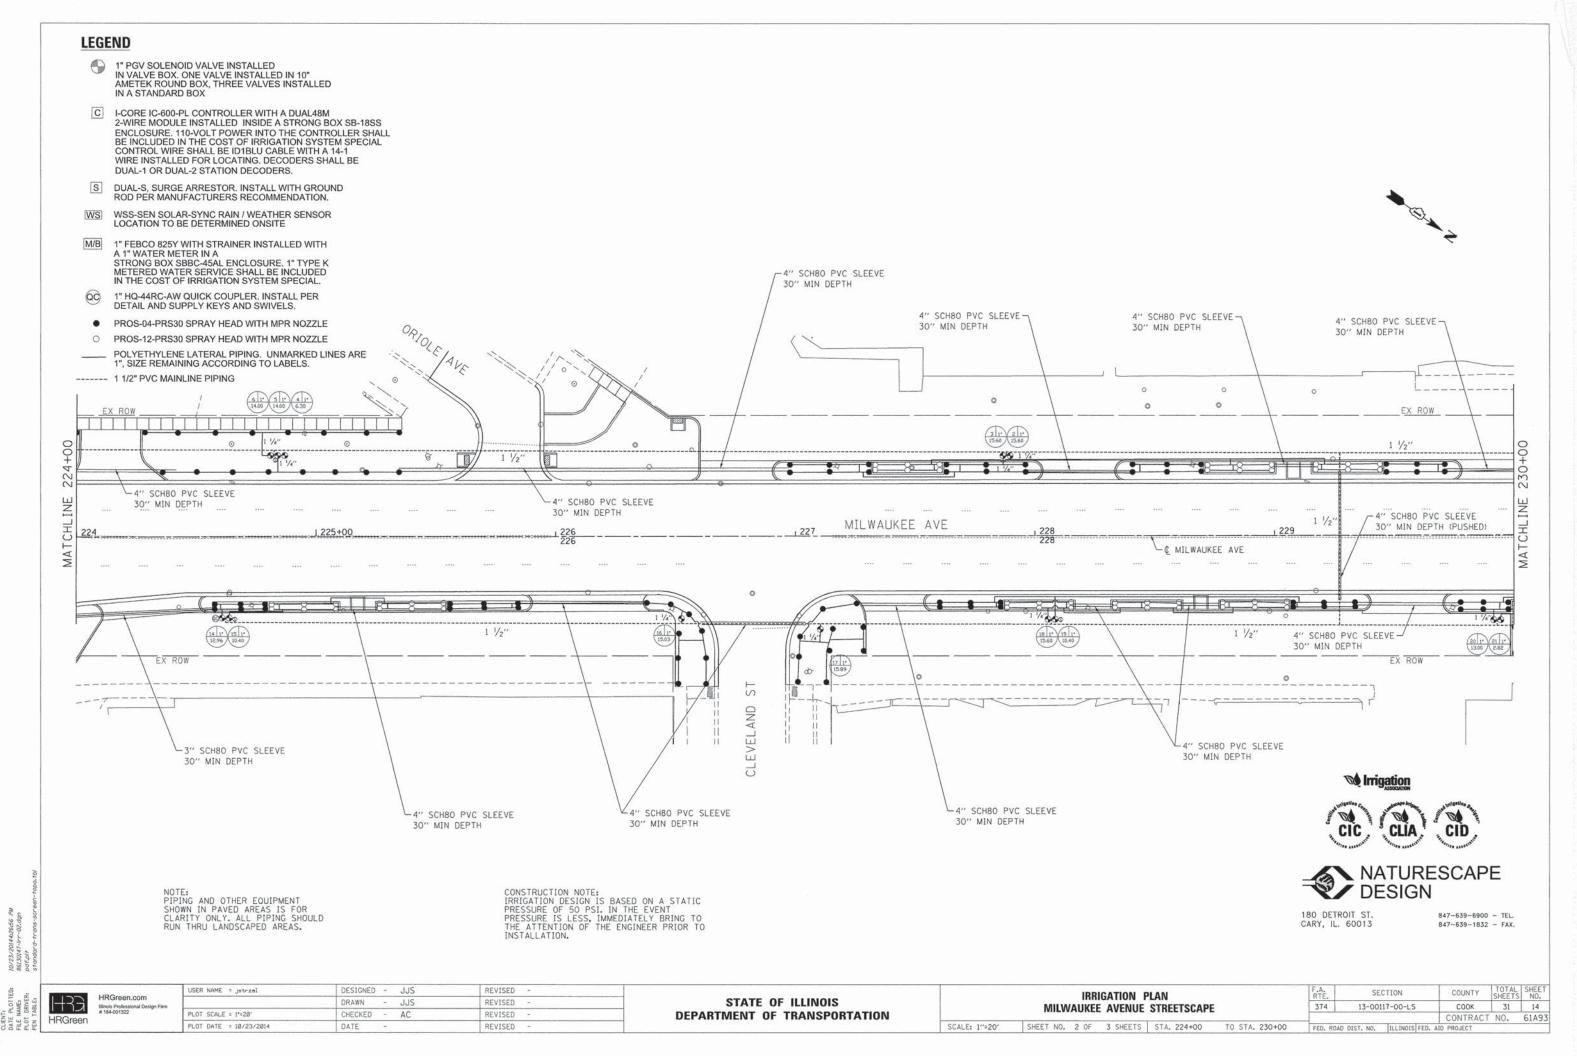

16130147 16130147-irr-02.dgn



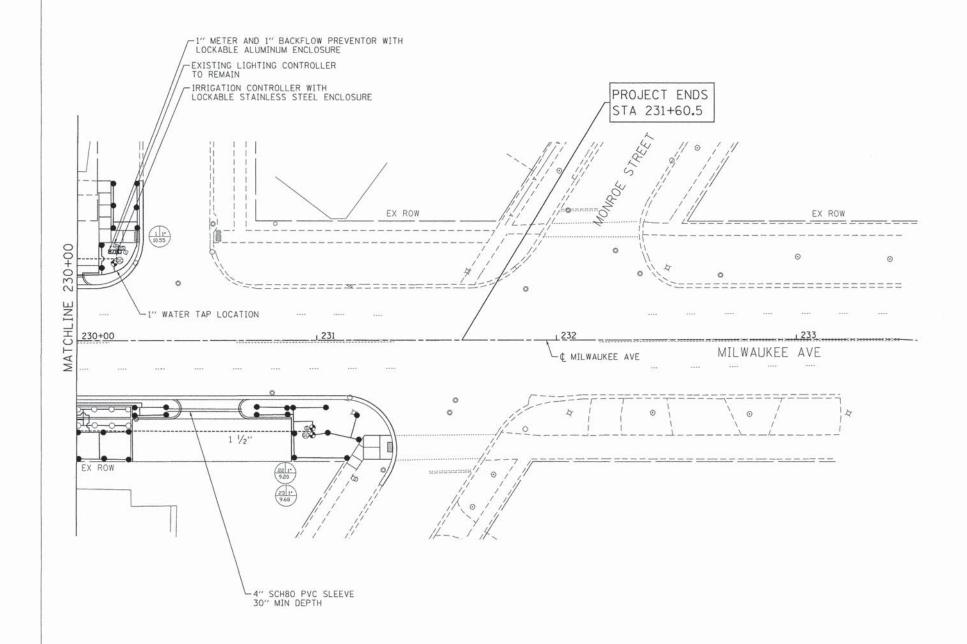

NOTE: PIPING AND OTHER EQUIPMENT SHOWN IN PAYED AREAS IS FOR CLARITY ONLY. ALL PIPING SHOULD RUN THRU LANDSCAPED AREAS. CONSTRUCTION NOTE:
IRRIGATION DESIGN IS BASED ON A STATIC
PRESSURE OF 50 PSI. IN THE EVENT
PRESSURE IS LESS, IMMEDIATELY BRING TO
THE ATTENTION OF THE ENGINEER PRIOR TO
INSTALLATION.

-d-trans-scr

PROJECT CONTACT:
CLENT:
DATE PLOTED: 86/30
FILE NAME: 86/30
PLOT DRIVER: pdf.p
PEN TABLE: store

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#linois Professional Design I
#184-001322

USER NAME = jetrzel	DESIGNED - JJS	REVISED -	
	DRAWN - JJS	REVISED -	
PLOT SCALE = 1*=20"	CHECKED - AC	REVISED -	
PLOT DATE = 10/23/2014	DATE -	REVISED -	

STATE OF ILLINOIS
DEPARTMENT OF TRANSPORTATION

IRRIGATION PLAN
MILWAUKEE AVENUE STREETSCAPE

SHEET NO. 3 OF 3 SHEETS STA. 230+00

### LEGEND

- 1" PGV SOLENOID VALVE INSTALLED IN 10"
  IN VALVE BOX. ONE VALVE INSTALLED IN 10"
  AMETEK ROUND BOX, THREE VALVES INSTALLED IN A STANDARD BOX
- C I-CORE IC-600-PL CONTROLLER WITH A DUAL48M
  2-WIRE MODULE INSTALLED INSIDE A STRONG BOX SB-18SS
  ENCLOSURE. 110-VOLT POWER INTO THE CONTROLLER SHALL
  BE INCLUDED IN THE COST OF IRRIGATION SYSTEM SPECIAL
  CONTROL WIRE SHALL BE ID1BLU CABLE WITH A 14-1
  WIRE INSTALLED FOR LOCATING. DECODERS SHALL BE
  DUAL-1 OR DUAL-2 STATION DECODERS.
- S DUAL-S, SURGE ARRESTOR. INSTALL WITH GROUND ROD PER MANUFACTURERS RECOMMENDATION.
- WS WSS-SEN SOLAR-SYNC RAIN / WEATHER SENSOR LOCATION TO BE DETERMINED ONSITE
- M/B

  1" FEBCO 825Y WITH STRAINER INSTALLED WITH
  A 1" WATER METER IN A
  STRONG BOX SBBC-45AL ENCLOSURE. 1" TYPE K
  METERED WATER SERVICE SHALL BE INCLUDED
  IN THE COST OF IRRIGATION SYSTEM SPECIAL.
- © 1" HQ-44RC-AW QUICK COUPLER. INSTALL PER DETAIL AND SUPPLY KEYS AND SWIVELS.
- PROS-04-PRS30 SPRAY HEAD WITH MPR NOZZLE
- O PROS-12-PRS30 SPRAY HEAD WITH MPR NOZZLE
- POLYETHYLENE LATERAL PIPING. UNMARKED LINES ARE 1", SIZE REMAINING ACCORDING TO LABELS.

----- 1 1/2" PVC MAINLINE PIPING

**Imigation** 








180 DETROIT ST. CARY, IL. 60013


847-639-1832 - FAX.

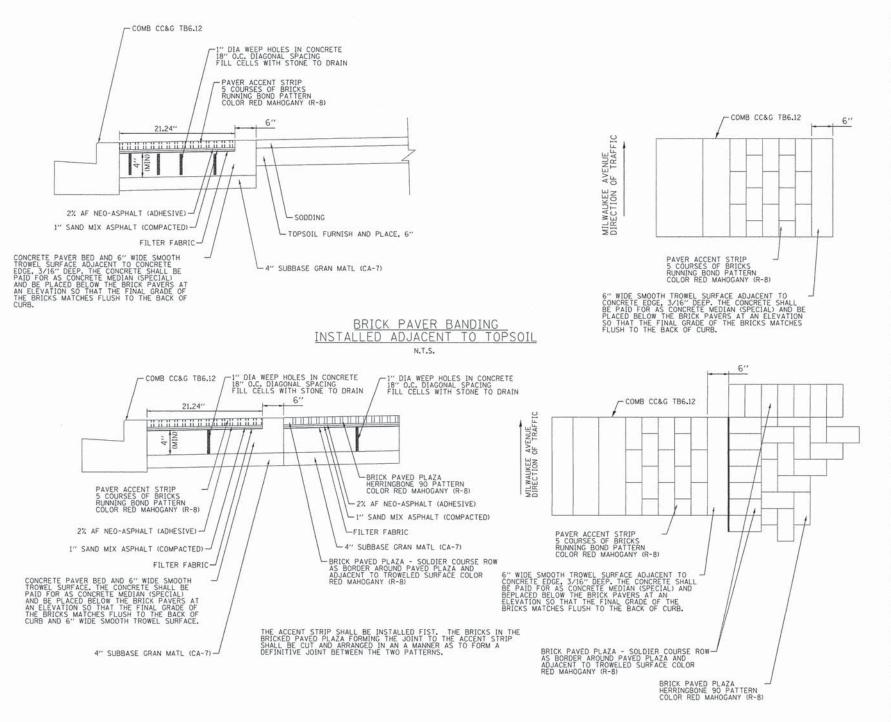

BRICK PAVER BANDING AND BRICK PAVED PLAZA INSTALLATION
N.T.S.

### INSTALLATION NOTES

- 1. BRICK DIMENSIONS 8.40" X 4.19" X 2.38" (PAVELOC PAVERS)
- 2. PAVERS SHALL BE INSTALLED ON TOP OF THE SAND MIX/NEO-ASPHALT (ADHESIVE), INSTALLING ALL FULL STONES POSSIBLE FIRST. SMALL CUT PIECES WILL THEN BE INSTALLED.
- 3. CONTRACTOR SHALL COMPACT PAVING STONES INTO THE SAND MIX/NEO-ASPHALT (ADHESIVE) COURSE WITH A MECHNICAL PLATE COMPACTOR WITH A FORCE OF 2500-3500 LBS.
- 4. POLYMERIC SAND IS THEN SWEPT INTO THE JOINTS AND VIBRATED UNTIL THE JOINT ARE FULL.
- 5. THE PAVERS SHALL BE PLACED ACCORDING TO MANUFACTURER SPECIFICATIONS AND INTERLOCKING CONCRETE PAVEMENT INSTITUTE SPECIFICATIONS.

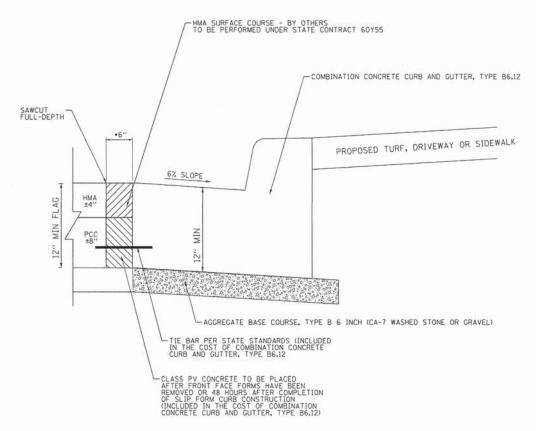

\*NOTE SAWCUT AND PAVEMENT REMOVAL 6" MAXIMUM WIDTH (INCLUDED IN THE COST OF COMBINATION CURB AND GUTTER REMOVAL)

\*CONSTRUCTION NOTE
IF THE CONDITION OF THE
EXISTING PAVEMENT TO REMAIN IS
DETERIORATED TO THE EXTENT
THAT DRILLING FOR INSTALLATION
OF TIE BARS IS NOT FEASIBLE,
THEN TIE BARS MAY BE OMITTED
FOR THAT LOCATION.

COMBINATION CONCRETE CURB AND GUTTER, TYPE B6.12


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#184-001322


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m		DRAWN - WH	REVISED -	
	PLOT SCALE = NTS	CHECKED - AC	REVISED -	
	PLOT DATE = 10/23/2014	DATE -	REVISED -	~

STATE OF ILLINOIS
DEPARTMENT OF TRANSPORTATION

SCALE: NTS

	LANDSCAPE DETAILS MILWAUKEE AVENUE STREETSCAPE				F.A. RTE.	SECTION	COUNTY	TOTAL	SHEET NO.
				374	13-00117-00-LS	COOK	31	16	
	MILITAGREE AVERGE OTHERTOON E					///	CONTRACT	NO.	61A93
	SHEET NO. 1 OF	6 SHEETS	STA. NA	TO STA. NA	FED. ROAD	DIST. NO. ILLINOIS FED.	AID PROJECT		

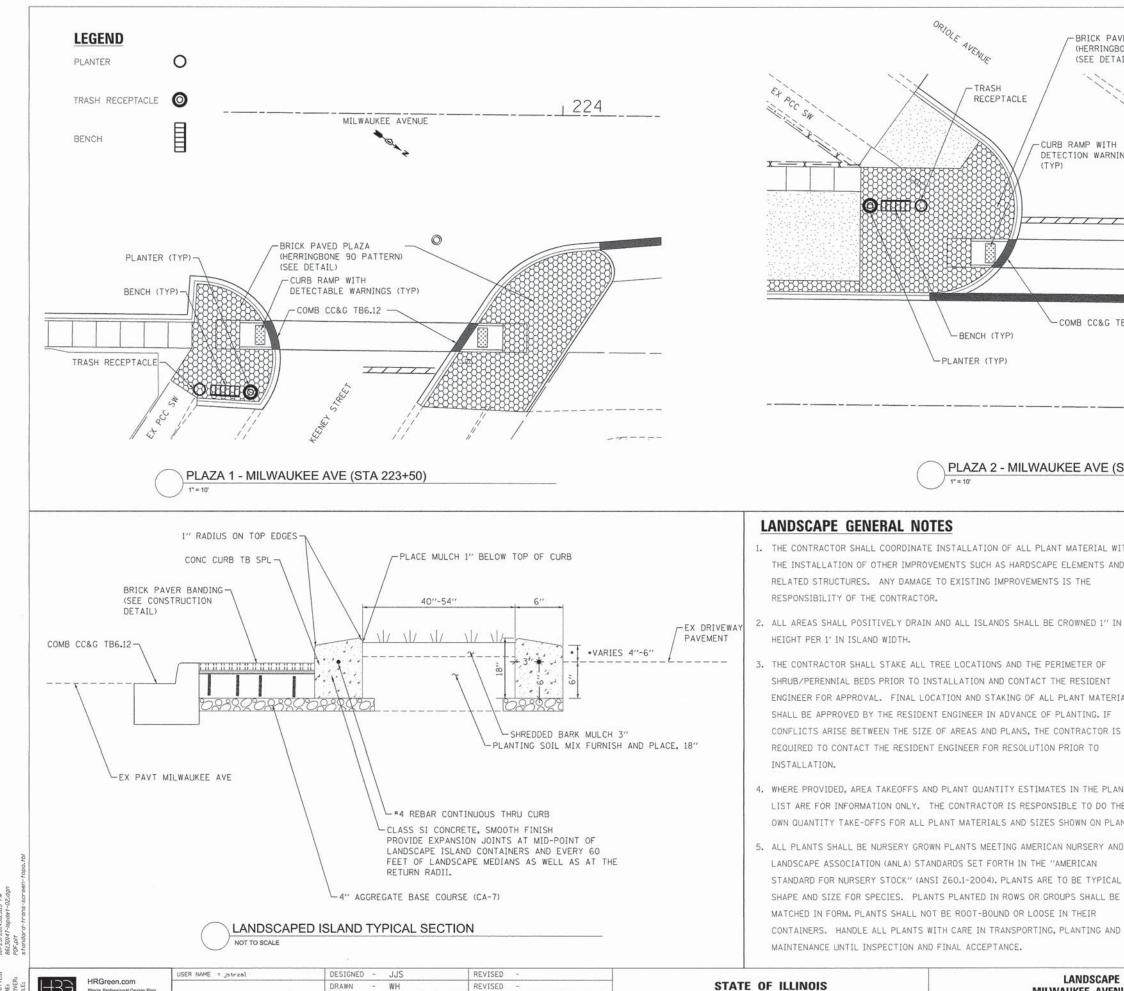

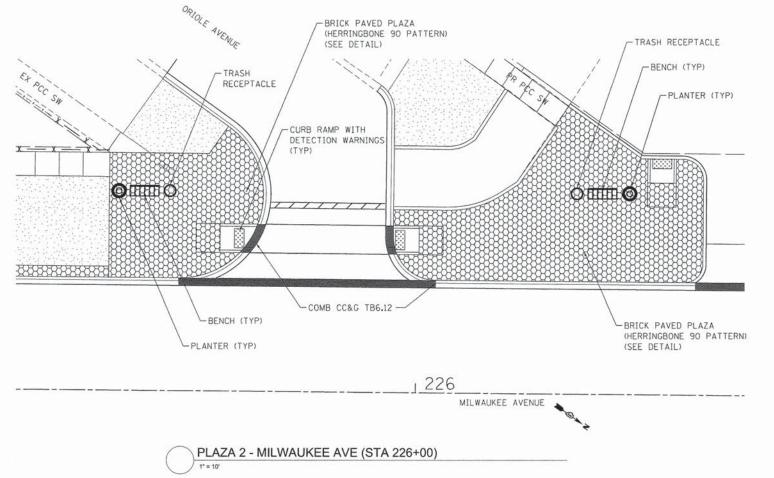

- 1. THE CONTRACTOR SHALL COORDINATE INSTALLATION OF ALL PLANT MATERIAL WITH THE INSTALLATION OF OTHER IMPROVEMENTS SUCH AS HARDSCAPE ELEMENTS AND
- SHRUB/PERENNIAL BEDS PRIOR TO INSTALLATION AND CONTACT THE RESIDENT ENGINEER FOR APPROVAL. FINAL LOCATION AND STAKING OF ALL PLANT MATERIALS SHALL BE APPROVED BY THE RESIDENT ENGINEER IN ADVANCE OF PLANTING, IF CONFLICTS ARISE BETWEEN THE SIZE OF AREAS AND PLANS, THE CONTRACTOR IS REQUIRED TO CONTACT THE RESIDENT ENGINEER FOR RESOLUTION PRIOR TO
- 4. WHERE PROVIDED, AREA TAKEOFFS AND PLANT QUANTITY ESTIMATES IN THE PLANT LIST ARE FOR INFORMATION ONLY. THE CONTRACTOR IS RESPONSIBLE TO DO THEIR OWN QUANTITY TAKE-OFFS FOR ALL PLANT MATERIALS AND SIZES SHOWN ON PLANS.
- 5. ALL PLANTS SHALL BE NURSERY GROWN PLANTS MEETING AMERICAN NURSERY AND LANDSCAPE ASSOCIATION (ANLA) STANDARDS SET FORTH IN THE "AMERICAN STANDARD FOR NURSERY STOCK" (ANSI Z60.1-2004). PLANTS ARE TO BE TYPICAL IN SHAPE AND SIZE FOR SPECIES. PLANTS PLANTED IN ROWS OR GROUPS SHALL BE MATCHED IN FORM, PLANTS SHALL NOT BE ROOT-BOUND OR LOOSE IN THEIR CONTAINERS. HANDLE ALL PLANTS WITH CARE IN TRANSPORTING, PLANTING AND

SCALE: NTS

- 6. PROVIDE STRONGLY ROOTED SOD, NOT LESS THAN 2 YEARS OLD AND FREE OF WEEDS AND UNDESIRABLE NATIVE GRASSES. PROVIDE ONLY SOD CAPABLE OF GROWTH AND DEVELOPMENT WHEN PLANTED (VIABLE, NOT DORMANT).
- 7. THE FIRST ROW OF TURFGRASS SOD SHALL BE LAID IN A STRAIGHT LINE, WITH SUBSEQUENT ROWS PLACED PARALLEL TO AND TIGHTLY AGAINST EACH OTHER. LATERAL JOINTS SHALL BE STAGGERED TO PROMOTE MORE UNIFORM GROWTH AND STRENGTH. CARE SHALL BE EXERCISED TO INSURE THAT THE PIECES ARE NOT STRETCHED OR OVERLAPPED AND THAT ALL JOINTS ARE BUTTED TIGHTLY TO PREVENT VOIDS THAT WOULD CAUSE AIR DRYING OF THE ROOTS. EDGES SHOULD BE PINNED TO AVOID THE EDGES OF SOD FROM CURLING ALONG PAVEMENT AREAS.
- 8. THE INSTALLATION CONTRACTOR SHALL WATER THE TURF GRASS SOD IMMEDIATELY AFTER TRANSPLANTING TO PREVENT EXCESSIVE DRYING DURING PROGRESS OF THE WORK. AS SODDING IS COMPLETED IN ANY ONE SECTION, THE ENTIRE AREA SHALL BE LIGHTLY ROLLED. IT SHALL THEN BE THOROUGHLY WATERED TO A DEPTH SUFFICIENT THAT THE UNDERSIDE OF THE NEW SOD PAD AND SOIL IMMEDIATELY BELOW THE PAD ARE THOROUGHLY WET. THE GENERAL CONTRACTOR SHALL BE RESPONSIBLE FOR HAVING ADEQUATE WATER AVAILABLE AT THE SITE PRIOR TO AND DURING INSTALLATION.
- 9. MOWING, TRIMMING AND REMOVAL OF GRASS CLIPPINGS IN TURF AREAS SHALL BE THE RESPONSIBILITY OF THE CONTRACTOR UNTIL ACCEPTANCE OF THE TURF. DURING THIS TIME, CONTRACTOR SHALL MOW TURF AREAS AT REGULAR INTERVALS TO MAINTAIN AT A MAXIMUM HEIGHT OF 2-1/2 INCHES. DO NOT CUT MORE THAN 1/3 OF GRASS BLADE AT ANY ONE MOWING. CONTRACTOR SHALL ALSO NEATLY TRIM EDGES WHERE NECESSARY AND REMOVE CLIPPINGS AFTER MOWING AND TRIMMING.


**HRGreer** 

USER NAME = jstrzel	DESIGNED - JJS	REVISED -	
	DRAWN - WH	REVISED -	
PLOT SCALE = NTS	CHECKED - AC	REVISED -	
PLOT DATE = 10/23/2014	DATE -	REVISED -	
	PLOT SCALE = NTS	PLOT SCALE = NTS CHECKED - AC	DRAWN         -         WH         REVISED         -           PLOT SCALE = NTS         CHECKED         -         AC         REVISED         -

DEPARTMENT OF TRANSPORTATION


LANDSCAPE DETAILS MILWAUKEE AVENUE STREETSCAPE								
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COUNTY 374 13-00117-00-LS COOK 31 17 CONTRACT NO. 61A93

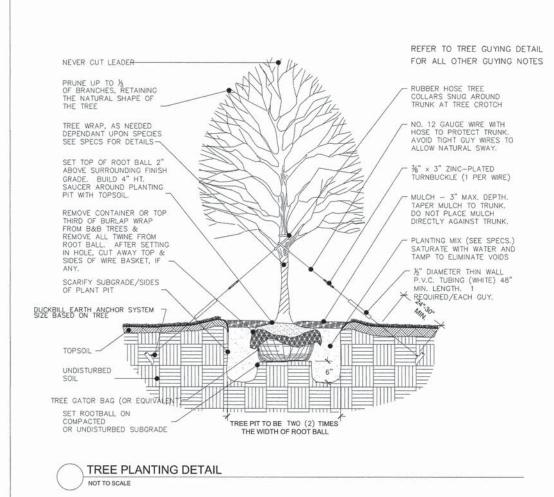

STAKING DETAIL **GUYING DETAIL** OF RUBBER HOSE PER TREE TWO GUY WIRES PER TREE STEEL TREE

\*APPLIES TO SINGLE TRUNK DECIDUOUS TREES 3" CAL. AND LESS & EVERGREEN TREES 8" HT. AND LESS & ALL MULTI-STEM TREES

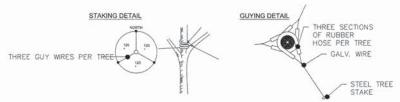

\*APPLIES TO SINGLE TRUNK DECIDUOUS TREES GREATER THAN 3" CAL. & EVERGREEN TREES GREATER THAN 8" HT.

TREE GUYING DETAIL

NOT TO SCALE

PREPARE ENTIRE PLANTING BED TO A 12" MINIMUM DEPTH WITH PLANTING MIX (SEE SPECS.) SATURATE WITH WATER AND TAMP TO ELIMINATE VOIDS. - MULCH — 3" MAX. DEPTH. TAPER MULCH TO TRUNK. DO NOT PLACE MULCH DIRECTLY AGAINST TRUNK. LIMIT PRUNING TO DEAD AND BROKEN BRANCHES REMOVE CONTAINER OR TOP THIRD OF BURLAP WRAP FROM B&B SHRUBS & REMOVE ALL TWINE FROM ROOT BALL. PRINE DAMAGED OR DESICCATED ROOTS. - SET TOP OF ROOTBALL LEVEL TO SURROUNDING FINISH GRADE SPACING PER PLANTING PLAN - SPADE EDGE WHERE BED AREAS ARE ADJACENT TO TURF - FINISH GRADE - TOPSOIL SET ROOTBALL ON COMPACTED OR UNDISTURBED SUBGRADE SCARIFY ENTIRE SHRUB BED TO A MINIMUM DEPTH OF 12" UNDISTURBED SOIL THRUB PIT T

\*WHEN PLANTING MASSES OF SHRUBS, GROUNDCOVER, PERENNIALS, AND ANNUALS, THIS DIAGRAM SHALL BE FOLLOWED. SET PLANTS AT SAME LEVEL AS GROWN IN CONTAINER MULCH - 3" MAX. DEPTH.
TAPER MULCH TO PLANT
STEM. DO NOT PLACE
MULCH DIRECTLY AGAINST
PLANT STEM. EQUAL SPACING BETWEEN ALL PLANTS - EDGE OF PLANTING BED - TYPICAL STAGGERED ROWS - PREPARE ENTIRE PLANTING BED TO A 18" MINIMUM DEPTH WITH PLANTING MIX (SEE SPECS.) SPADE EDGE WHERE BED AREAS ARE ADJACENT TO TURF SPACING PER PLANTING PLAN - FINISH GRADE - TOPSOIL 4" SPADE EDGE

SHRUB PLANTING DETAIL NOT TO SCALE

PERENNIAL PLANTING DETAIL NOT TO SCALE

BRICK BANDING 9933

SCALE: NTS

UNDISTURBED SOIL

CONCRETE ANCHOR BOLT (BY INSTALLER) TREE GRATE -I" THICK X 2" STEEL TAB SLOTTED 76" X 2"
FOR CONCRETE
ANCHOR SHOP
WELDED TO FRAM
(TYP. 24" OC - AGGREGATE BASE 23-

REFER TO TYPICAL TREE PLANTING DETAIL FOR OTHER NOTES

TREE GRATE / TREE PLANTING DETAIL

72"x72" TREE GRATE EXPANDABLE

PEA GRAVEL MULCH (FILL TO BOTTOM OF GRATE AND TAPPER TO BASE OF TREE

TRUNK) INCLUDED IN THE COST OF THE TREE GRATE

ACCRECATE BASE 3' BELOW SOIL

**DETAIL A** 

EFHI **HRGreen** 


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DESIGNED -REVISED DRAWN REVISED LOT SCALE = NTS CHECKED - AC REVISED PLOT DATE = 10/23/2014 DATE REVISED


STATE OF ILLINOIS **DEPARTMENT OF TRANSPORTATION** 


LANDSCAPE DETAILS MILWAUKEE AVENUE STREETSCAPE SHEET NO. 3 OF 6 SHEETS STA. NA

COUNTY TOTAL SHEET NO. SECTION COOK 31 18 374 13-00117-00-LS CONTRACT NO. 61A93




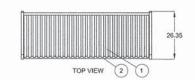


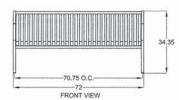


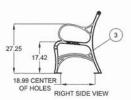




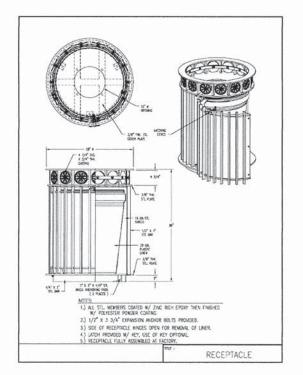

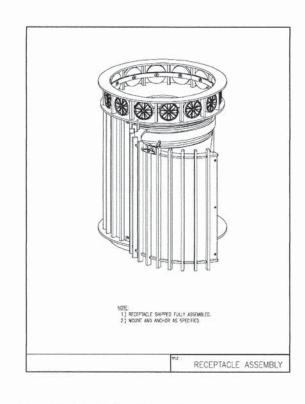

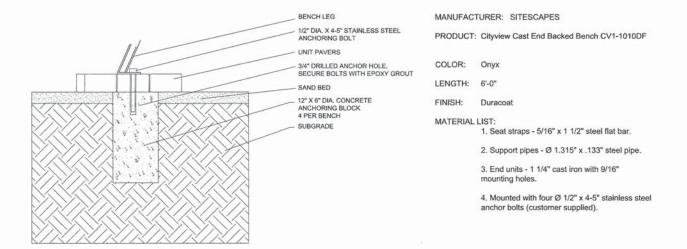

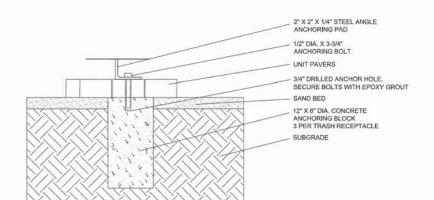

MANUFACTURER: DuMor, Inc.

PRODUCT: Receptacle 102-32SH-FTO

COLOR: Black

SIZE: 32 Gallon

FINISH: Powder Coat

BENCH AND TRASH RECEPTACLE ANCHOR DETAIL

TRASH RECEPTACLE DETAIL NOT TO SCALE

**HRGreen** 

USER NAME = jstrzel	DESIGNED - JJS	REVISED -
	DRAWN - WH	REVISED -
PLOT SCALE = NTS	CHECKED - AC	REVISED -
PLOT DATE = 10/23/2014	DATE -	REVISED -

STATE OF ILLINOIS DEPARTMENT OF TRANSPORTATION

LANDS	SCAPE DE	TAILS
MILWAUKEE	<b>AVENUE</b>	STREETSCAPE

F.A. RTE.	SE	CTION		COUNTY	TOTAL	SHE
374 13-00117-00-LS		COOK	31	15		
				CONTRACT	NO.	614
FED. ROA	D DIST. NO.	ILLINOIS	FED. All	D PROJECT		

SHEET NO. 4 OF 6 SHEETS STA. NA

7'-8 3/4" [2356MM] FACE TO FACE INDUSTRIAL DRIVE RIVET-POST CAP SQUARE POST — 3/4" [19MM] SQUARE, 16 GAUGE — [0.060" (1.65MM)] PICKET 1 3/8" [35MM] X 1 1/2" [38MM] U-CHANNEL RAIL INDUSTRIAL DRIVE RIVET-\_\_\_6" [152MM] POST CAP OPTIONS 3 13/16" [97MM] - (2) ENDS 3 15/16" [100MM] -- -L2" [51MM] NOM MIN DEPTH IN: 36" 4'-0" [1219MM] MM: 914 5'-0" [1524MM] WIDTH IN:

MANUFACTURER: MASTER HALCO

PRODUCT: I COLONIAL ALUMINUM Nom 8' Section Length - 3/4" PLUS

COLOR: Black

HEIGHT: 3'-0"

POST: Flat

MATERIAL: ALUMINUM

FINISH: Powder Coat

1. Metric dimensions are nominal equivalents to U.S. dimensions.

2. Footing width to be (4)x post width.

3. See panel & post selection sheet for available post sizes.

4. For installation on concrete see post detail.


### ORNAMENTAL FENCE, ALUMINUM TYPICAL DETAIL

NOT TO SCALE

### PLANT LIST - PLANTER CONTAINER

KEY	COMMON NAME	BOTANICAL NAME
CAKF	Feather Reed Grass	Calamagrostis acutiflora 'Karl Foerster'
STAJ	Sedum-Autumn Joy	Sedum telephium 'Autumn Joy'
HSDO	Daylily	Hemerocallis 'Stella de Oro'

 $\frac{\text{NOTE:}}{\text{FURNISHING AND INSTALLING PLANTS IN PLANT BED IS INCLUDED IN THE COST OF PLANTER}$ 

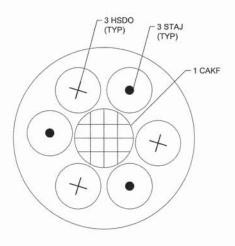

### PLANTER DETAIL - PLAN VIEW

NOT TO SCALE



MANUFACTURER: Custom Design Precast

PRODUCT: CDP3046

Autumn Brown SIZE: 36" Dia. x 24" H

FINISH: NaturaStone

### PLANTER DETAIL - PROFILE VIEW

NOT TO SCALE

- 1	
OT DRIVER: N TABLE:	HRGreen
4 4	

HRGreen.com Illinois Professional Design Fin # 184-001322

DESIGNED - JJS REVISED DRAWN - WH REVISED PLOT SCALE = NTS CHECKED - AC REVISED PLOT DATE = 10/23/2014 REVISED

STATE OF ILLINOIS DEPARTMENT OF TRANSPORTATION


LANDSCAPE DETAILS MILWAUKEE AVENUE STREETSCAPE

COUNTY SHEETS NO.


COOK 31 20

CONTRACT NO. 61A93 F.A. RTE. 374 SECTION 13-00117-00-LS


SCALE: NTS SHEET NO. 5 OF 6 SHEETS STA. NA

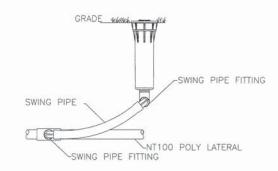



A PROS-04-PRS30 4" SPRAY HEAD

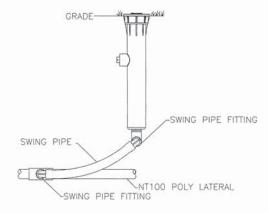


C PROS-12-PRS30 12" SPRAY HEAD

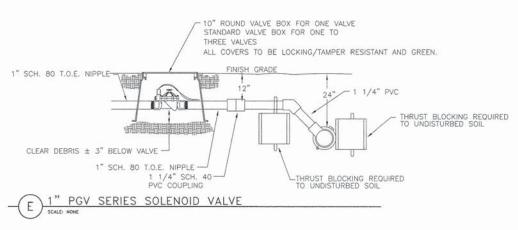


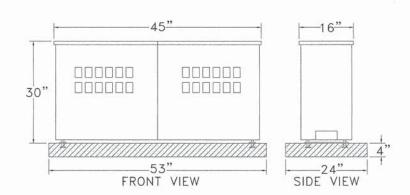

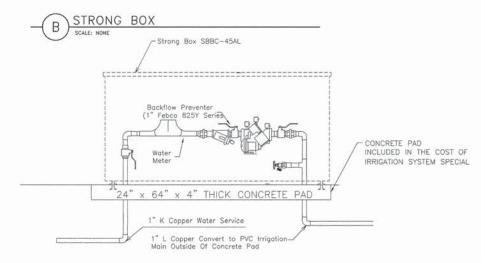

## 1" METER AND RPZ INSTALLED IN ENCLOSURE

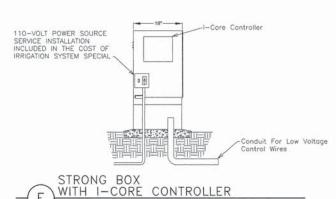

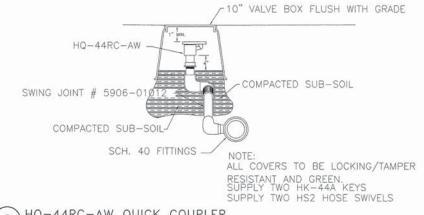

-G HQ-44RC-AW QUICK COUPLER

SCALE: NONE

PEN TABLE:	HRGreen	HRGreen. Illinois Professio II 184-001322
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en.com lessional Design Firm 122	USER NAME = jstrzel	DESIGNED - JJS	REVISED -	
		DRAWN - WH	REVISED -	
	PLOT SCALE = NTS	CHECKED - AC	REVISED -	
	PLOT DATE = 10/23/2014	DATE -	REVISED -	


STATI	E 01	ILLINOIS
DEPARTMENT	OF	TRANSPORTATION

SCALE: NTS

SCALE: NONE

IRRIGATION DETAILS		F.A. RTE.	SECTION	COUNTY	TOTAL	SHEE NO.	
	MILWAUKEE AVENUE STREETSCAPE		374	13-00117-00-LS	соок	31	21
THE THORE IN LINE OF THE LOOP LE					CONTRACT	NO.	61A
	SHEET NO. 6 OF 6 SHEETS STA. NA	TO STA. NA	FED. ROAD	DIST, NO. ILLINOIS FED.	AID PROJECT		

16130147

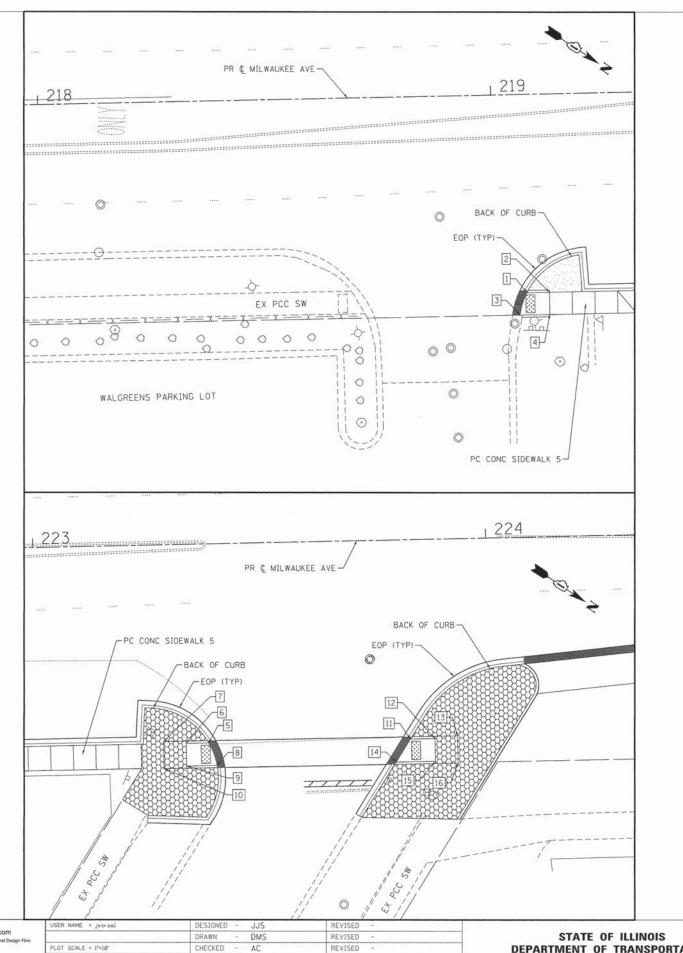



SIDEWALK	
POINT #	ELEVATION (FT)
1	649.15
2	649.35
3	649.10
4	649.35
5	647.25
6	647.45
7	647.47
8	647.20
9	647.45
10	647.47
11	647.10
12	647.32
13	647.37
14	647.10
15	647.32
16	647.37

NOTE: FOR CURB ELEVATIONS SEE ELEVATION AND LANDSCAPE PLAN.

**LEGEND** 

POINT

DETECTABLE WARNINGS

CURB DEPRESSION

COUNTY | TOTAL SHEET NO. | COOK | 31 | 22 | CONTRACT NO. | 61A93 F.A. RTE. 374 SECTION 13-00117-00-LS


HRGreen

CHECKED - AC REVISED -PLOT DATE = 10/23/2014

DEPARTMENT OF TRANSPORTATION

SCALE: 1"=10"

SIDEWALK RAMP DETAILS MILWAUKEE AVENUE STREETSCAPE SHEET NO. 1 OF 3 SHEETS STA.

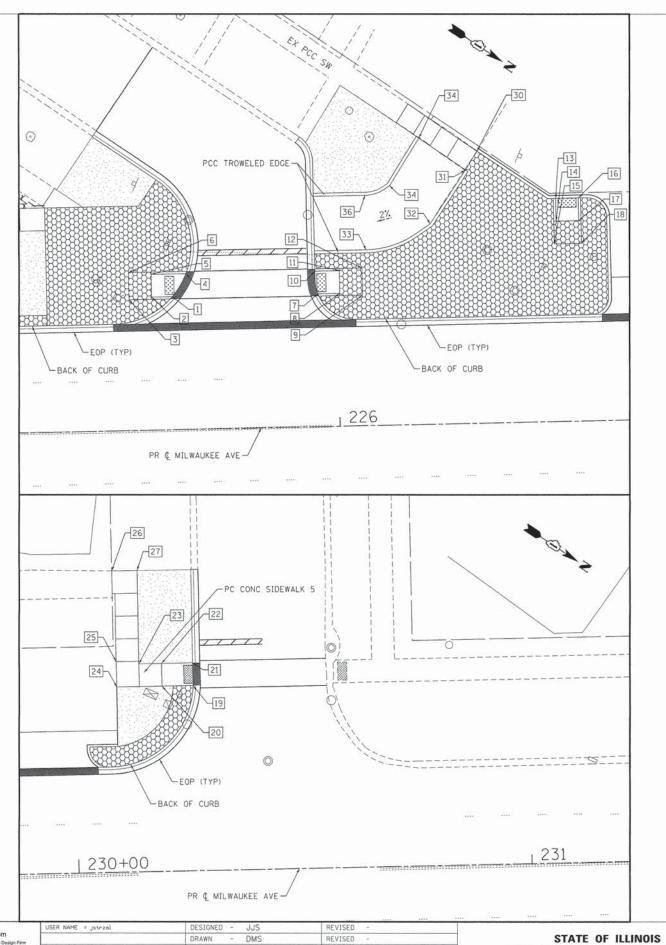



SIDEWALK	
POINT #	ELEVATION (FT)
	647.37
2	647.60
3	647.65
4	647.40
5	647.65
6	647.67
7	647.17
8	647.40
9	647.40
10	647.20
11	647.40
12	647.40
13	647.54
14	647.76
15	647.76
16	647.54
17	647.76
18	647.76
19	648.20
20	648.54
21	648.25
22	648.54
23	648.59
24	648.69
25	648.69
26	649.52
27	649,42
30	648.09
31	648.01
32	647.73
33	647.42
34	648.25
35	648.00
36	647.88

NOTE: FOR CURB ELEVATIONS SEE ELEVATION AND LANDSCAPE PLAN.

### **LEGEND**

POINT

DETECTABLE WARNINGS

CURB DEPRESSION

HRGreen

REVISED REVISED PLOT SCALE = 1\*=10" CHECKED - AC PLOT DATE = 10/23/2014

DEPARTMENT OF TRANSPORTATION


SIDEWALK RAMP DETAILS
MILWAUKEE AVENUE STREETSCAPE SCALE: 1"=10" SHEET NO. 2 OF 3 SHEETS STA.

COUNTY TOTAL SHEET NO.

COOK 31 23

CONTRACT NO. 61A93 F.A. RTE. SECTION 13-00117-00-LS



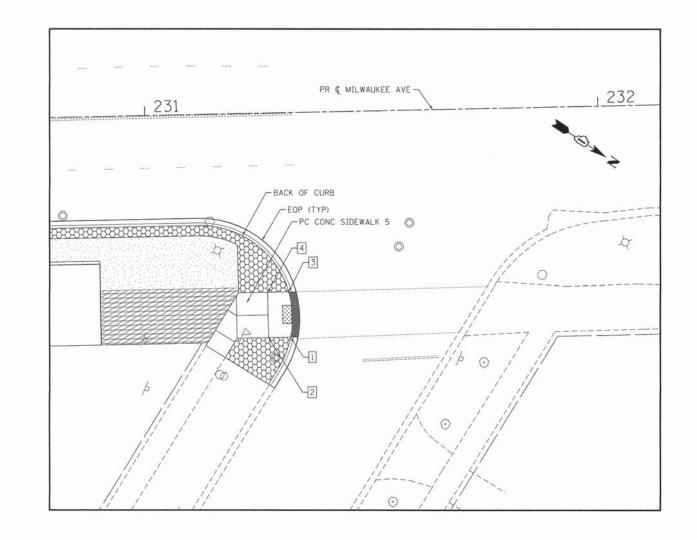

SIDEWALK POINT # ELEVATION (FT) 647.90 648.00 647.85 647.95

NOTE: FOR CURB ELEVATIONS SEE ELEVATION AND LANDSCAPE PLAN.


**LEGEND** 

POINT

DETECTABLE WARNINGS


CURB DEPRESSION




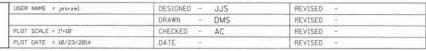


STATE OF ILLINOIS
DEPARTMENT OF TRANSPORTATION


	SIDEWALK RAMP DETAILS							
	MILW	AUKE	<b>AVENUE</b>	STREETSC	APE	374	13	
CALE: 1"=10"	SHEET NO.	3 OF	3 SHEETS	STA	TO STA	EED DOAD	DICT .	

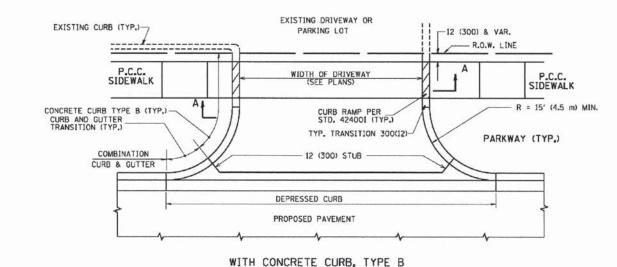


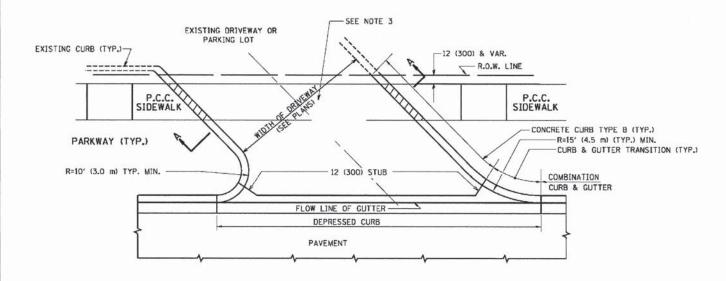

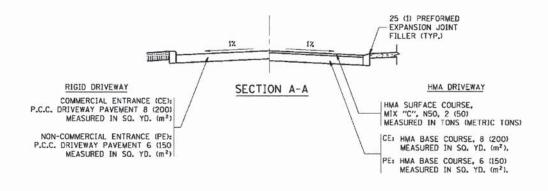

WITH CONCRETE CURB, TYPE B

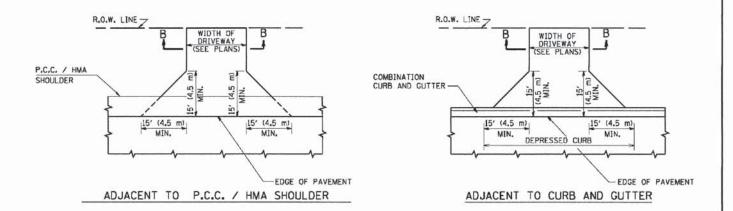

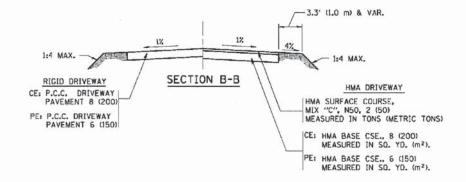

### RURAL FIELD ENTRANCE (FE)

HMA SURFACE COURSE, MIX "C", N50, 2 (50) MEASURED IN TONS (METRIC TONS)

AGGREGATE BASE CSE., TYPE B, 8 (200) MEASURED IN SO, YD, (m²),

### GENERAL NOTES:

DRIVEWAY SLOPES, LOCATIONS, & GEOMETRIC LAYOUT SHALL BE IN ACCORDANCE WITH THE LATEST EDITION OF THE "HANDBOOK FOR POLICY ON PERMITS FOR ACCESS DRIVEWAYS TO STATE HIGHWAYS". FOR FURTHER LAYOUT REQUIREMENTS, REFER TO ILLUSTRATIONS IN THE PERMIT HANDBOOK. DRIVEWAYS SHALL BE REPLACED IN KIND, UNLESS OTHERWISE NOTED ON THE PLANS.

COMMERCIAL DRIVEWAYS SHALL BE CONSTRUCTED WITH CONCRETE CURB, TYPE B RETURNS EXCEPT WHEN THE SIDEWALK EDGE IS 4 FEET (1.2 METERS) OR LESS FROM THE BACK OF CURB, CONSTRUCT A FLARE DRIVEWAY WITHOUT CURB.

THE RESIDENT ENGINEER SHALL CONTACT THE TRAFFIC PERMIT OFFICE AT 847/ 705-4131 FOR ANY DUESTIONS ON DRIVEWAYS SHOWN IN THE PLANS; SPECIFICALLY IN REFERENCE TO ADDITIONAL AND/OR RELOCATION/REMOVAL OF A DRIVEWAY.

COMBINATION CONCRETE CURB & GUTTER SHALL BE MEASURED STRAIGHT ACROSS THE DRIVEWAY. NO ADDITIONAL COMPENSATION WILL BE ALLOWED FOR THE CURB & GUTTER TRANSITION.


1 (25) PREFORMED EXPANSION JOINT FILLER WILL NOT BE PAID SEPARATELY, BUT SHALL BE CONSIDERED INCLUDED IN THE COST OF THE P.C.C. DRIVEWAY PAVEMENT OR P.C.C. SIDEWALK.


WHEN THE P.C.C. SIDEWALK EXTENDS THROUGH THE DRIVEWAY, THE THICKNESS OF THE SIDEWALK IN THE DRIVEWAY AREA SHALL BE THE SAME AS THE DRIVEWAY THICKNESS. SIDEWALK WILL BE PAID FOR AS P.C.C. SIDEWALK OF THE THICKNESS SPECIFIED. SIDEWALK CROSS SLOPE THRU DRIVEWAY AREA TO BE A MAXIMUM OF 1:50.

	FILE NAME =	USER NAME = beuerdl	DESIGNED - R. SHAH	REVISED - M. GOMEZ 04-06-01
SLE:	o:\projeots\diststd22x34\bd81.dgn		DRAWN -	REVISED - P. LOFLUER 04-15-03
TA		PLOT SCALE = 49.9999 '/ IN.	CHECKED -	REVISED - R. BORO 01-01-07
NE N		PLOT DATE = 6/12/2008	DATE - 11-04-95	REVISED - R. BORO 06-11-08

STATE	OF	ILLINOIS
DEPARTMENT	OF '	TRANSPORTATION

DR	IVEWAY DETA	ILS -	DISTANCE	BETWEEN	R.O.W.	F.A RTE.	SECTION	COUNTY	TOTAL	SHEET NO.
AND	FACE OF CUID	0. 1	DOE OF S	HAIH DED	> = 15' (4.5 m)	374	13-00117-00-LS	COOK	31	25
ANU	TAGE OF COR	0 0 1	DGE OF 3	HOULDER .	> = 15 (4.5 m)		BD0156-07 (BD-01)	CONTRACT	NO.	61A93
SCALE: NONE	SHEET NO. 1	OF 1	SHEETS	STA.	TO STA.	FED. RO	DAD DIST. NO. 1   ILLINOIS FED.	AID PROJECT		

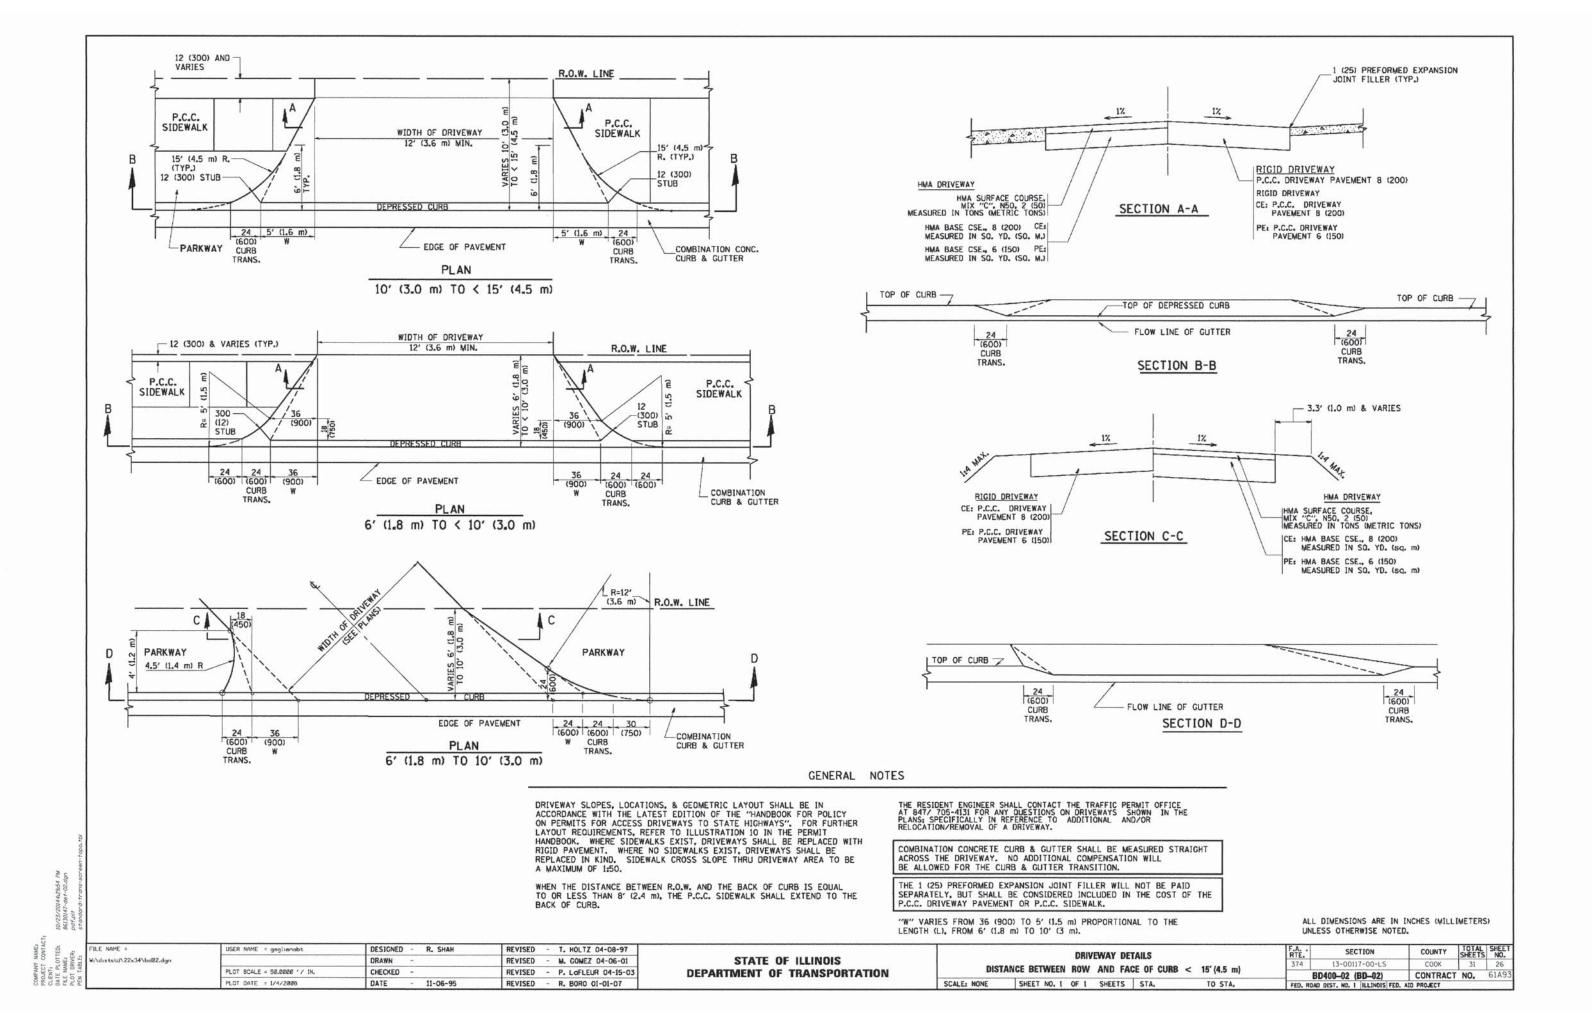

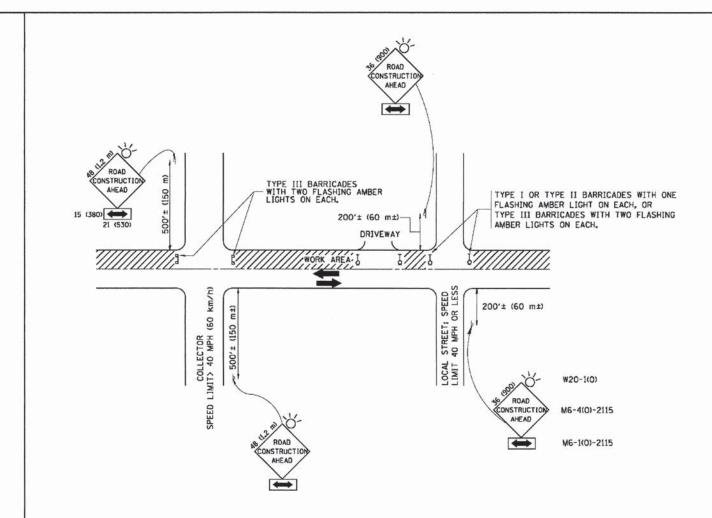

TRAFFIC CONTROL AND PROTECTION FOR SIDE ROADS, INTERSECTIONS, AND DRIVEWAYS

### NOTES:

- A. FOR NO LANE RESTRICTION ON THE SIDE ROAD OR DRIVEWAYS
- L SIDE ROAD WITH A SPEED LIMIT OF 40 MPH (60 km/h) OR LESS AS SHOWN ON THE DRAWING AND AS DIRECTED BY THE ENGINEERS
- O) ONE ROAD CONSTRUCTION AHEAD SIGN 36 x 36 (900x900) WITH A FLASHER AND FLAG MOUNTED ON IT APPROXIMATELY 200' (60 m) IN ADVANCE OF THE MAIN ROUTE.
- b) THE CLOSED PORTION OF THE MAIN ROUTE SHALL BE PROTECTED BY BLOCKING WITH TYPE 1, TYPE II OR TYPE III BARRICADES, 1/3 OF THE CROSS SECTION OF THE CLOSED PORTION.
- 2. SIDE ROAD WITH A SPEED LIMIT GREATER THAN 40 MPH (60 km/h) AS SHOWN ON THE DRAWING AND AS DIRECTED BY THE ENGINEER:
- O) ONE ROAD CONSTRUCTION AHEAD SIGN 48 x 48 (1.2 m x 1.2 m) WITH A FLASHER MOUNTED ON IT APPROXIMATELY 500' (150 m) IN ADVANCE OF THE MAIN ROUTE.
- b) THE CLOSED PORTION OF THE MAIN ROUTE SHALL BE PROTECTED BY BLOCKING WITH TYPE III BARRICADES, 1/2 OF THE CROSS SECTION OF THE CLOSED PORTION.
- 3. WHEN THE SIDE ROAD LIES BETWEEN THE BEGINNING OF THE MAINLINE SIGNING AND THE WORK ZONE, A SINGLE HEADED ARROW (MG-1) SHALL BE USED IN LIEU OF THE DOUBLE HEADED ARROW (M6-4).

- B. FOR A LANE CLOSURE ON A SIDE ROAD OR DRIVEWAY:
- USE APPLICABLE PORTIONS OF THE TYPICAL APPLICATION OF TRAFFIC CONTROL DEVICES (STD. 701501, STD. 701606 OR THE APPROPRIATE STANDARD). THE SPACING OF SIGNS AND BARRICADES SHALL BE ADJUSTED FOR FIELD CONDITIONS AS DIRECTED BY THE ENGINEER. THE DIRECTIONAL ARROW SHALL BE COVERED OR REMOVED WHEN NO LONGER CONSISTENT WITH THE SIDE ROAD LANE CLOSURE.
- C. ADVANCE WARNING SIGNS ARE TO BE OMITTED ON DRIVEWAY UNLESS
- D. THE TRAFFIC CONTROL AND PROTECTION FOR SIDE ROADS, INTERSECTIONS, AND DRIVEWAYS SHALL BE INCIDENTAL TO THE COST OF SPECIFIED TRAFFIC CONTROL STANDARDS OR ITEMS.


All dimensions are in millimeters (inches) unless otherwise shown.

DESIGNED - LHA REVISED - J. OBERLE 10-18-95 USER NAME = gaglianobt /:\dietstd\22x34\tol@.dgn DRAWN REVISED - A. HOUSEH 03-06-96 PLOT SCALE = 58.000 '/ IN. CHECKED REVISED - A. HOUSEH 10-15-96 DATE REVISED -T. RAMMACHER 01-06-00


STATE OF ILLINOIS DEPARTMENT OF TRANSPORTATION

	TRAFFIC CONTROL AN	PROTECTION	FOR	F.A RTE.	SECTION	COUNTY	TOTAL	SHEET NO.
	SIDE ROADS, INTERSECTION			374	13-00117-00-LS	COOK	31	27
	SIDE RUADS, INTERSECTION		TC-10	CONTRACT	NO.	61A9		
SCALE: NONE	SHEET NO. 1 OF 1 SHEET	S STA.	TO STA.	FED. ROAD	DIST, NO. 1 ILLINOIS FED.	AID PROJECT		


FILE NAME =

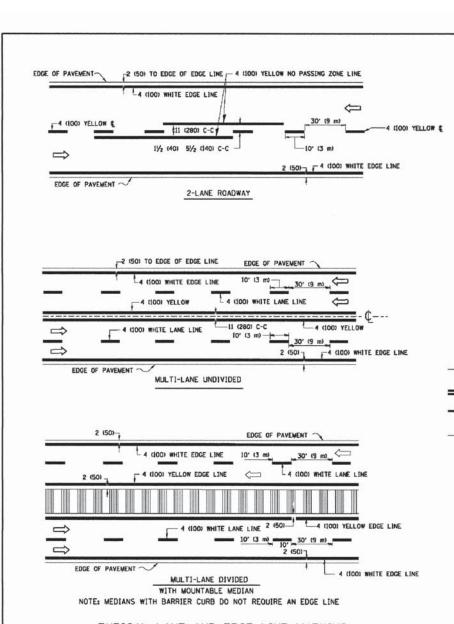


### TYPICAL LANE AND EDGE LINE MARKING

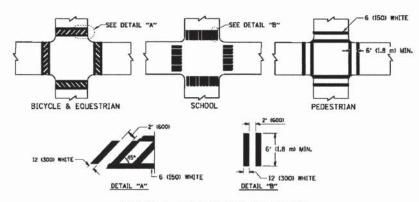

TYPICAL CROSSWALK MARKING

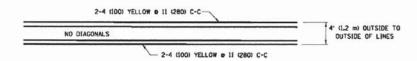


#### 4' (1.2 m) WIDE MEDIANS ONLY

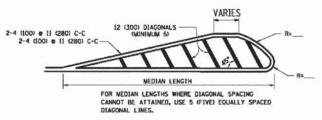

DIAGONAL LINE SPACING: 50' (15 m) C-C (LESS THAN 30MPH (50 km/h)) 75' (25 m) C-C 30MPH (50 km/h) TO 45MPH (70 km/h)) 150' (45 m) C-C (MORE THAN 45MPH (70 km/h))

#### MEDIANS OVER 4' (1.2 m) WIDE

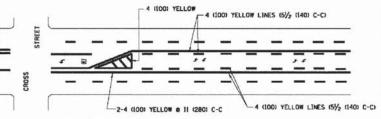


A MINIMUM OF TWO PAIRS OF TURN ARROWS SHALL BE USED, WHITE IN COLOR, ADDITIONAL PAIRS SHALL BE PLACED AT 200' (60 m) TO 300' (90 m) INTERVALS.



MEDIAN WITH TWO-WAY LEFT TURN LANE

### TYPICAL PAINTED MEDIAN MARKING

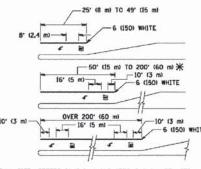


FULL SIZE LETTERS 8° (2.4 m) AND ARROWS SHALL BE USED.  $\P$  AREA = 15.6 SO. FT. (1.5 m²)  $\P$  AREA = 20.8 SO. FT. (1.9 m²)

\* TURN LAMES IN EXCESS OF 400' (120 m) IN LENGTH MAY HAVE AN ADDITIONAL SET OF ARROW - "ONLY" INSTALLED MIDWAY BETWEEN THE OTHER TWO SETS OF ARROW - "ONLY".

TYPICAL LEFT (OR RIGHT) TURN LANE

### TYPICAL TURN LANE MARKING

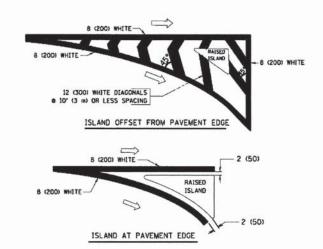

### TYPICAL ISLAND MARKING

TYPE OF MARKING	WIDTH OF LINE	PATTERN	COLOR	SPACING / REMARKS
CENTERLINE ON 2 LANE PAVENET	4 (100)	SKIP-DASH	YELLOW	10' (3 m) LINE WITH 30' (9 m) SPACE
CENTERLINE ON MULTI-LANE LINDIVEDED PAYEMENT	2 a 4 (100)	SOLID	YELLOW	11 (280) C-C
NO PASSING ZONE LINES: FOR ONE DIRECTION FOR BOTH DIRECTIONS	4 (100) 2 a 4 (100)	SOL 10 SOL 10	YELLOW YELLOW	5½ (140) C-C FROM SKIP-DASH CENTERLINE 11 (280) C-C DMIT SKIP-DASH CENTERLINE BETWEEN
LANE LINES	4 (100) 5 (125) ON FREEWAYS	SKIP-DASH SKIP-DASH	WHITE WHITE	10' (3 m) LINE WITH 30' (9 m) SPACE
DOTTED LINES (EXTENSIONS OF CENTER, LANE OR TURN LANE MARKINGS)	SAME AS LINE BEING EXTENDED	SKIP-DASH	SAME AS LINE BEING EXTENDED	2' (600) LINE WITH 6' (L8 m) SPACE
EDGE LINES	4 (100)	SOLID	YELLOW-LEFT WHITE-RIGHT	OUTLINE MOUNTABLE MEDIANS IN YELLOW, EDGE LINES ARE NOT USED NEXT TO BARRIER CURB
TURN LANE MARKINGS	6 ((50) LINE; FULL SIZE LETTERS & SYMBOLS (8' (2,4m))	SOLID	WHITE	SEE TYPICAL TURN LANE MARKING DETAIL
TWO WAY LEFT TURN MARKING	2 8 4 (100) EACH DIRECTION	SKIP-DASH AND SOLID	YELLO#	10' (3 m) LINE WITH 30' (9 m) SPACE FOR SKIP-DASH; 5/2 (140) C-C BETWEEN SOLID LINE AND SKIP-DASH LINE
	8' (2.4m) LEFT ARROW	IN PAIRS	WHITE	SEE TYPICAL TWO-WAY LEFT TURN MARKING DETAIL
CROSSWALK LINES (PEDESTRIAN) A. DIAGONALS (BIKE & EQUESTRIAN) B. LONGITUDINAL BARS (SCHOOL)	2 to 6 (150) 12 (300) to 45° 12 (300) to 90°	SOLID SOLID SOLID	WHITE WHITE WHITE	NOT LESS THAN 6' (LB m) APART 2' (500) APART 2' (600) APART SEE TYPICAL CROSSWALK MARKING DETAILS.
STOP LINES	24 (600)	SOLID	WHITE	PLACE 4" (1.2 m) IN ADVANCE OF AND PARALLEL TO CROSSWALK, IF PRESENT. OTHERWISE, PLACE AT OSSIRED STOPPING POINT. PARALLEL TO CROSSROAD CENTERLINE, WHERE POSSIBLE
PAINTED MEDIANS	2 m 4 (100) WITH 12 (300) DIAGONALS e 45" NO DIAGONALS USED FOR 4' (1,2 m) WIDE MEDIANS	SOLID	YELLOW: TWO WAY TRAFFIC WHITE: ONE WAY TRAFFIC	11 (280) C-C FOR THE DOUBLE LINE SEE TYPICAL PAINTED MEDIAN MARKING.
GORE MARKING AND CHANNELIZING LINES	8 (200) WITH 12 (300) DIAGONALS @ 45°	SOLID	WHITE	DIAGONALS: 15' 14,5 m) C-C (LESS THAN 30MPH (50 km/h)) 20' (6 m) C-C 30MPH (50 km/h) TO 45MPH (70 km/h)) 30' (9 m) C-C (OVER 45MPH (70 km/h))
RAILROAD CROSSING	24 (600) TRANSVERSE LINES; "RR" [S 6' (1.8 m) LETTERS; [6 (400) LINE FOR "X"	SOLID	WHITE.	SEE STATE STANDARD 78000! AREA OF: "R"-3,6 SO, FT, (0,33 m²) EACH "X"-54,0 SO, FT, (5,0 m²)
SHOULDER DIAGONALS	12 (300) o 45°	SOLID	WHITE - RIGHT YELLOW - LEFT	50' (15 m) C-C (LESS THAN 30MPH (50 km/h)) 75' (25 m) C-C (30 MPH (50 km/h) T0 45MPH (70 km/h) 150' (45 m) C-C (0VER 45MPH (70 km/h))


FOR FURTHER DETAILS ON PAVEMENT MARKING REFER TO STANDARD SPECIFICATIONS FOR ROAD AND BRIDGE CONSTRUCTION AND STATE STANDARD 780001.

All dimensions are in inches (millimeters) unless otherwise shown.

FILE NAME =	USER NAME = geglionobt	DESIGNED - EVERS	REVISED -T. RAMMACHER 10-27-9
พื่:\diststd\22x34\tcl3.dgn		DRAWN -	REVISED -A. HOUSEH 10-09-96
Z.	PLOT SCALE = 50.000 '/ IN.	CHECKED -	REVISED -A. HOUSEH 10-17-96
PEN	PLOT DATE = 1/4/2008	DATE - 03-19-90	REVISED - T. RAMMACHER 01-06-0

STATE OF ILLINOIS
DEPARTMENT OF TRANSPORTATION

				ISTRICT O	NE		F.A RTÉ.	SECTION	COUNTY	TOTAL	SHEET NO.
1		TVD	ICAL E	AVERSENT	MARKINGS		374	13-00117-00-LS	COOK	31	28
		III	ICAL I	AVENIENI	MANKINGS			TC-13	CONTRACT	NO.	61A93
SCALE: NONE	SHEET	NO. 1	OF 1	SHEETS	STA.	TO STA.	FED. ROAD	DIST. NO. 1 ILLINOIS FED.	AID PROJECT		

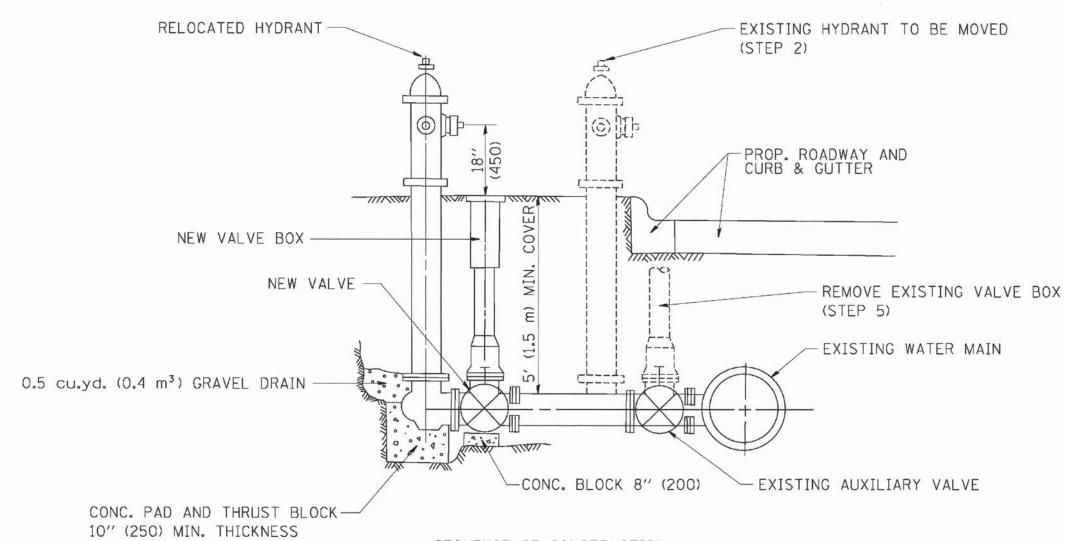

SEQUENCE OF CONSTRUCTION:

- 1. CLOSE EXISTING VALVE.
- 2. REMOVE EXISTING HYDRANT.
- 3. INSTALL HYDRANT EXTENSION AND NEW VALVE.
- 4. RELOCATE EXISTING HYDRANT.
- 5. OPEN EXISTING VALVE, REMOVE BOX.
- 6. BACKFILL.
- 7. FLUSH AND TEST FOR CHLORIDE RESIDUAL AND PROVIDE TEST.

ALL WORK TO BE DONE IN ACCORDANCE WITH ARTICLE 564 OF THE STANDARD SPECIFICATIONS. NEW VALVE AND BOX SHALL BE SAME MAKE AND MODEL AS EXISTING.

### FIRE HYDRANT TO BE MOVED

ALL DIMENSIONS ARE IN INCHES (MILLIMETERS) UNLESS OTHERWISE SHOWN.

DESIGNED -REVISED - R. SHAH 09-09-94 USER NAME = geglionabt SECTION COUNTY TOTAL SHEET NO. FIRE HYDRANT TO BE MOVED W:\d:ststd\22×34\bd36.dgn DRAWN STATE OF ILLINOIS REVISED - R. SHAH 10-25-94 13-00117-00-LS PLOT SCALE = 50.0000 '/ IN. CHECKED REVISED **DEPARTMENT OF TRANSPORTATION** CONTRACT NO. 61A9 REVISED SCALE: NONE SHEET NO. 1 OF 1 SHEETS STA. TO STA.

ED: 10/23/20144:3042 PM 86j30147-de+-06.dgn ; pdf.plt



3.0" RADIUS, 0.5" BORDER, WHITE ON GREEN; REFLECTORIZED "DRIVEWAY" D; "ENTRANCE" D; STANDARD ARROW CUSTOM 12.0" x 5.0"


### NOTES:

- 1. HALF OF THE SIGNS WILL REQUIRE A LEFT HAND FACING ARROW.
- 2. TWO SIGNS SHALL BE USED AT EACH COMMERCIAL ENTRANCE PLACED BACK-TO-BACK: ONE WITH A RIGHT HAND ARROW (SHOWN) SHALL BE PLACED ON THE NEAR RIGHT SIDE THE DRIVEWAY AND ONE WITH A LEFT HAND ARROW SHALL BE PLACED ON THE FAR LEFT SIDE OF THE DRIVEWAY.
- 3. SIGNS TO BE PAID FOR AS ITEM "TEMPORARY INFORMATION SIGNING".

10/23/20146;30;58 PM 86130147-det-07,dgn pdf\_plt stendord-trons-screen-food,tb

STATE OF ILLINOIS
DEPARTMENT OF TRANSPORTATION

	DI	RIVEWAY	ENTRANC	E SIGNING	F.A RTE.	SECTION	COUNTY	TOTAL	SHEET NO.	
							13-00117-00-LS	COOK	31	30
							TC-26	CONTRACT	NO.	61A93
ALE: NONE	SHEET NO.	1 OF 1	SHEETS	STA.	TO STA.	FED. ROAD	DIST. NO. 1 ILLINOIS FED.	AID PROJECT		- 00 ( )

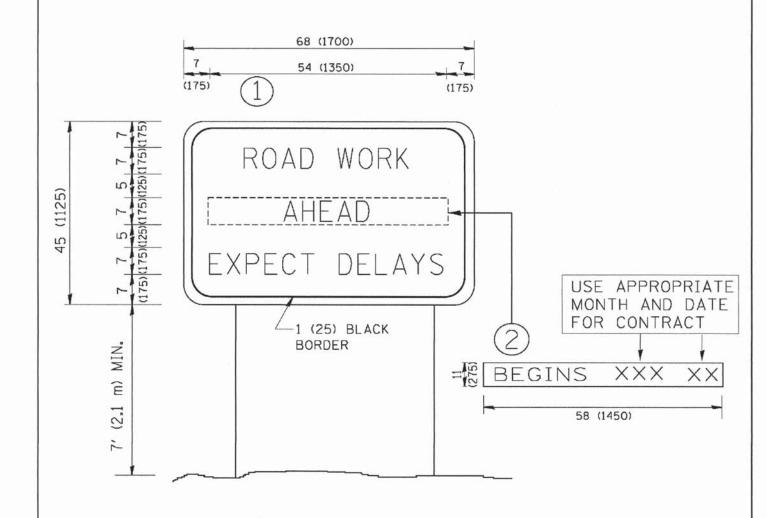

### NOTES:

- 1. USE BLACK LETTERING ON ORANGE BACKGROUND.
- 2. ERECT SIGNS IN ADVANCE OF THE LOCATION FOR THE "ROAD CONSTRUCTION AHEAD" SIGN AT LOCATIONS AS DIRECTED BY THE ENGINEER.
- 3. ERECT SIGN (1) WITH INSTALLED PANEL (2) ONE WEEK PRIOR TO THE START OF CONSTRUCTION.
- 4. REMOVE PANEL 2 SOON AFTER THE START OF CONSTRUCTION.
- 5. SEE SPECIAL PROVISION FOR "TEMPORARY INFORMATION SIGNING" FOR ADDITIONAL INFORMATION.
- 6. ONE SIGN ASSEMBLY EQUALS 25.70 SQ. FT. (2.3 SQ. M.)
- 7. SHALL BE PAID FOR AS TEMPORARY INFORMATION SIGNING.

ALL DIMENSIONS ARE IN INCHES (MILLIMETERS) UNLESS OTHERWISE SHOWN.

FILE NAME = USER NAME = goglianobt DESIGNED - REVISED - R. MIRS 09-15-97

DRAWN - REVISED - R. MIRS 09-15-97

PLOT SCALE = 66.000 '/ IN. CHECKED - REVISED - T. RAWMACHER 02-02-99

PLOT DATE = 1/4/2008 DATE - REVISED - C. JUCIUS 01-31-07

STATE OF ILLINOIS
DEPARTMENT OF TRANSPORTATION

	ARTERIAL ROAD							
		INFO	DRMATION	SIGN		374		
ALE: NONE	SHEET NO. 1	OF 1	SHEETS	STA.	TO STA.	FFD. ROAD		

10/23/20144;32:05 PM 86130147-det-08.dgn pdf.plf