01-30-15 LETTING ITEM 008

INDEX OF SHEETS ON SHEET 2

STATE OF ILLINOIS **DEPARTMENT OF TRANSPORTATION**

DIVISION OF HIGHWAYS

PLANS FOR PROPOSED **FEDERAL AID HIGHWAY**

FAU 3512 (US ROUTE 14) (NORTHWEST HIGHWAY)

FOREST AVENUE TO ALBERT STREET STREETSCAPE IMPROVEMENTS

SECTION 13-00160-00-SW

PROJECT TE-00D1(940)

VILLAGE OF MOUNT PROSPECT

COOK COUNTY C-91-031-14

OMISSION BEGINS

TRAFFIC DATA

2012 ADT = 13,100 POSTED SPEED LIMIT: 35/40 MPH DESIGN SPEED LIMIT: 35/40 MPH MINOR ARTERIAL

PROJECT LOCATED IN THE VILLAGE OF MOUNT PROSPECT

SCALE: 1" = 50' SCALE: 1" = 40'

FULL SIZE PLANS HAVE BEEN PREPARED USING STANDARD ENGINEERING SCALES. REDUCED SIZED PLANS WILL NOT CONFORM TO STANDARD SCALES. IN MAKING MEASUREMENTS ON REDUCED PLANS, THE ABOVE SCALES MAY BE USED.



Know what's **below**. **Call** before you dig.

IMPROVEMENT REGIN ORTHWEST HIGHWA STATION 1+00

CONTRACT NO. 61A23

LOCATION MAP RANGE 11 EAST, 3RD PRINCIPAL MERIDIAN PRINTED BY THE AUTHORITY OF THE STATE OF ILLINOIS OWEN STREET IMPROVEMEN **OMISSION BEGINS** GEORGE STREET IMPROVEMEN NORTHWEST HIGHWAY ALBERT STREET IMPROVEMENT **OMISSION ENDS** IMPROVEMENT ENDS MAP SCALE: NONE

WHEELING AND ELK GROVE TOWNSHIPS

- AREA OF IMPROVEMENT GROSS LENGTH OF PROJECT =8,284 FT. = 1.569 MI. NET LENGTH OF PROJECT = 3,849 FT. = 0.729 MI.

FIANCOCK CIVIL Engineers

Municipal Consu
ENGINEERING Established 1911

EDWIN HANCOCK ENGINEERING COMPANY 9933 ROOSEVELT ROAD PHONE: (708)865-0300 WESTCHESTER, ILLINOIS 60154

4-8-14

3512 13-00160-00-SW

ILLINOIS PROJECT

LOCATION OF SECTION

INDICATED THUS:

STATE OF ILLINOIS ILLINOIS DEPARTMENT OF TRANSPORTATION **DIVISION OF HIGHWAYS**

DISTRICT | ENGINEER OF LOCAL ROADS & STREETS

fortmens as

(NOT TO SCALE)

соок

LICENSE EXPIRES :11-30-15

E.H.E. NO. 555-13-148

INDEX OF SHEETS

SHEET NO.	DESCRIPTION
1	TITLE SHEET, LOCATION MAP
2	INDEX OF SHEETS, LEGEND OF SYMBOLS, HIGHWAY STANDARDS, AND BENCHMARKS
3	GENERAL NOTES
4-5	SUMMARY OF QUANTITIES
6-9	EXISTING TYPICAL SECTIONS
10-13	PROPOSED TYPICAL SECTIONS
14-24	PAVING PLANS
25-26	ROADWAY DETAILS
27-28	EROSION CONTROL PLAN
29-39	IRRIGATION AND UTILITIES PLAN
40-41	DRAINAGE AND UTILITIES DETAILS
42-45	LANDSCAPE PLAN
46	TRAFFIC CONTROL AND PROTECTION FOR SIDE ROADS, INTERSECTIONS, AND DRIVEWAYS (TC-10)
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48	ARTERIAL ROAD INFORMATION SIGN (TC-22)
49	DRIVEWAY ENTRANCE SIGNING (TC-26)
50	BUTT JOINT AND HMA TAPER DETAILS (BD-32)

I.D.O.T. STANDARD DRAWINGS

STANDARD NO.	TITLE OR DESCRIPTION
000001-06	STANDARD SYMBOLS, ABBREVIATIONS AND PATTERNS
280001-07	TEMPORARY EROSION CONTROL SYSTEMS
424001-08	PERPENDICULAR CURB RAMPS FOR SIDEWALKS
424026-01	ENTRANCE/ALLEY PEDESTRIAN CROSSINGS
602601-03	PRECAST REINFORCED CONCRETE FLAT SLAB TOP
701006-05	OFF-RD OPERATIONS, 2L, 2W, 15' (4.5 m) TO 24" (600 mm) FROM PAVEMENT EDGE
701101-04	OFF-RD OPERATIONS, MULTILANE, 15' (4.5 m) TO 24" (600 mm) FROM PAVEMENT EDGE
701301-04	LANE CLOSURE, 2L, 2W, SHORT TIME OPERATIONS
701427-02	LANE CLOSURE, MULTILANE, INTERMITTENT OR MOVING OPER., FOR SPEEDS <40MPH
701501-06	URBAN LANE CLOSURE, 2L, 2W, UNDIVIDED
701606-10	URBAN LANE CLOSURE, MULTILANE, 2W WITH MOUNTABLE MEDIAN
701701-09	URBAN LANE CLOSURE, MULTILANE INTERSECTION
701801-05	SIDEWALK, CORNER OF CROSSWALK CLOSURE
701901-04	TRAFFIC CONTROL DEVICES
720001-01	SIGN PANEL MOUNTING DETAILS
720006-04	SIGN PANEL ERECTION DETAILS
720011-01	METAL POSTS FOR SIGNS, MARKERS & DELINEATORS

LEGEND OF SYMBOLS

(TO BE USED IN CONJUNCTION WITH I.D.O.T. STANDARD 000001-06)

EXISTING	PROPOSED	DESCRIPTION	EXISTING	PROPOSED	DESCRIPTION
Ø		POWER POLE		\longrightarrow	STORM SEWER PIPE
Δ		GAS VALVE	—— <c——< td=""><td></td><td>COMBINATION SEWER PIPE</td></c——<>		COMBINATION SEWER PIPE
-\$>>		STREET LIGHT POLE			SANITARY SEWER PIPE
0		WATER MAIN BUFFALO BOX		s	IRRIGATION PIPE
\otimes	Θ	WATER MAIN VALVE BOX	E	———E———	ELECTRIC LINE
	\blacksquare	RPZ VALVE	G		GAS LINE
(\$)		SPRINKLER	——т—		TELEPHONE LINE
	-	WATER MAIN VALVE VAULT	W		WATER MAIN PIPE
0	0	STORM SEWER MANHOLE			CURB AND GUTTER
0	•	STORM CATCH BASIN			DIRECTION OF FLOW
	-	STORM INLET		- \$- -	DRAINAGE SUMMIT
Я	A	FIRE HYDRANT			
$igotimes_{RM}$		EXISTING STRUCTURE TO BE REMOVED	627.75	627.75 620.50	WATER MAIN VALVE VAULT RIM AND TOP OF PIPE ELEVATION
⊗ _F		EXISTING STRUCTURE TO BE FILLED			
		TREE TO BE REMOVED	627.75 620.50	627.75	COMBINATION MANHOLE RIM AND INVERT ELEVATION
0		BUSH	627.75 620.50	627.75	STORM SEWER MANHOLE/CATCHBASIN
\odot	\odot	TREE	620.50	620.50	RIM AND INVERT ELEVATION
******		EXISTING CURB AND GUTTER TO BE REMOVED		Α	STRUCTURE TO BE ADJUSTED
		BRICK REMOVAL		1C	TYPE 1 FRAME & CLOSED LID
//////		EXISTING CONCRETE SIDEWALK TO BE REMOVED		1P	TYPE 1 FRAME & OPEN LID
		EXISTING CONCRETE DRIVEWAY TO BE REMOVED		RC	RECONSTRUCT EXISTING STRUCTURE
		PAVEMENT REMOVAL	643.90 ×	632.25 _×	GROUND ELEVATIONS
		BASE COURSE, 10"		CB-OL	CATCH BASINS, TYPE A, 4' DIAMETER, TYPE 1 FRAME, OPEN LID
		BASE COURSE, 8"		CB-CL	CATCH BASINS, TYPE A, 4' DIAMETER, TYPE 1 FRAME, CLOSED LID
		PLANTER AREA		INL-OL	INLETS, TYPE A, TYPE 1 FRAME, OPEN LID
		PAVING BRICK SIDEWALK		INL-CL	INLETS, TYPE A, TYPE 1 FRAME, CLOSED LID
	BENCH	NAPKS		МН	MANHOLES, TYPE A, TYPE I FRAME, CLOSED LID
	DATUM IS				

DATUM IS - NAV 8

BM NO.	DESCRIPTION	ELEVATION
1	NORTH SIDE OF LIGHT POLE FOUNDATION ON WEST SIDE OF NORTHWEST HIGHWAY AT SCHOOL STREET	660.11
2	NORTH SIDE OF LIGHT POLE FOUNDATION ON WEST SIDE OF NORTHWEST HIGHWAY AT OWEN STREET	659.28
3	NORTH SIDE OF LIGHT POLE FOUNDATION ON WEST SIDE OF NORTHWEST HIGHWAY AT 716 NORTHWEST HIGHWAY	658.21
4	NORTH SIDE OF LIGHT POLE FOUNDATION ON WEST SIDE OF NORTHWEST HIGHWAY AT 950 NORTHWEST HIGHWAY	660.04

THANCOC	K
◆ Civil Engineers ◆ Municipal Consultants	VG 9933 Koo Weeksheeker, Elfenin
♦ Established 1911	Flore: 1 Fest 3

USER NAME - XX	DESIGNED - JGG	REVISED - XX
	DRAWN - MK, DMM	REVISED - XX
PLOT SCALE - XX	CHECKED - MDL	REVISED - XX
PLOT DATE - XX	DATE - 05-14-14	REVISED - XX

STATE OF ILLINOIS
DEPARTMENT OF TRANSPORTATION

					OF SYMBOLS	
SCALE: NO	ET NO.	OF	S. S. Carlotter	EETS STA	BENCHMAR	20000

	FED. ROAD I	DIST. NO. 1	ILLINOIS FED	. AID PROJECT		
_				CONTRAC	T NO. 61A	23
	3612	13-00	160-00-SW	соок	50	:
	F.A.U. RTE.	SE	CTION	COUNTY	TOTAL	SH

ACCESS

THE CONTRACTOR WILL BE REQUIRED TO MAINTAIN INGRESS AND EGRESS FOR EMERGENCY VEHICLES AT ALL TIMES DURING THE CONSTRUCTION PERIOD. DURING CONSTRUCTION, GARBAGE TRUCKS MUST BE PERMITTED ACCESS TO THE WORK ZONE IN ORDER TO PICK UP COMMERCIAL GARBAGE FOR THOSE PROPERTIES IMPACTED BY CONSTRUCTION. IF GARBAGE TRUCK ACCESS IS NOT PROVIDED, THE CONTRACTOR WILL BE REQUIRED TO MOVE TRASH CONTAINERS TO AN ACCESSIBLE LOCATION.

UNDERGROUND UTILITIES

THE LOCATIONS OF THE UNDERGROUND UTILITIES AS SHOWN ON THE PLANS HAVE BEEN OBTAINED BY FIELD SURVEYS AND SEARCHES OF AVAILABLE RECORDS. IT IS BELIEVED THAT THE DATA IS ESSENTIALLY CORRECT, BUT THE VILLAGE OF MOUNT PROSPECT, THE ILLINOIS DEPARTMENT OF TRANSPORTATION AND/OR OTHER OFFICES AND AGENCIES ASSOCIATED WITH THE DEVELOPMENT OF THESE PLANS DO NOT GUARANTEE THEIR ACCURACY OR COMPLETENESS. THE CONTRACTOR WILL BE REQUIRED TO VERIFY THE LOCATION OF EACH FACILITY WITH THE UTILITY COMPANY, AND SHALL TAKE DUE CARE IN ALL PHASES OF THE CONSTRUCTION TO PROTECT ANY SUCH FACILITIES WHICH MAY BE AFFECTED BY THE WORK. ANY DAMAGE TO EXISTING UTILITIES SHALL BE REPAIRED IN ACCORDANCE WITH ARTICLE LR 105.

ADJUSTMENTS REQUIRED BY UTILITY COMPANIES WILL BE PERFORMED BY THE COMPANY INVOLVED OR ITS CONTRACTOR, BUT WILL BE COORDINATED BY GENERAL CONTRACTOR.

COORDINATION OF ALL UTILITY WORK INVOLVED IN THE CONSTRUCTION AREA WILL BE DISCUSSED AT A PRE-CONSTRUCTION CONFERENCE.

THE CONTRACTOR SHALL USE EXTREME CAUTION IN THE REMOVAL OF ABANDONED EXISTING GAS LINES SINCE RESIDUAL MATERIALS CONTAINED THEREIN ARE HIGHLY EXPLOSIVE, FLAMMABLE, AND TOXIC. ONCE THE MAINS ARE ABANDONED BY THE OWNER, THE CONTRACTOR SHALL ASSUME ALL RESPONSIBILITY FOR ANY DAMAGE AND/OR INJURY OCCURRING ON THE PROJECT DUE TO HIS OPERATIONS NEXT TO THE MAINS AND/OR THE METHOD OF REMOVAL OF THE ABANDONED MAINS.

STORM SEWER

THE VERTICAL AND HORIZONTAL CLEARANCES BETWEEN WATER MAINS AND PROPOSED OR EXISTING STORM SEWERS SHALL CONFORM TO THE REQUIREMENTS OF SECTIONS 41-1.02A THROUGH 41-1.02D OF THE "STANDARD SPECIFICATIONS FOR WATER & SEWER MAIN CONSTRUCTION IN ILLINOIS".

FRAMES AND GRATES

THE TYPE OF FRAMES AND GRATES REQUIRED FOR ALL CATCH BASINS AND MANHOLES LISTED IN THE SUMMARY OF QUANTITIES MAY BE FOUND ON THE PLANS AT THEIR RESPECTIVE LOCATIONS. WHERE LIDS ARE CALLED FOR ON THE PLANS, THEY SHALL BE IN ACCORDANCE WITH ARTICLE 604.01 OF THE STANDARD SPECIFICATIONS AND THE TERM LID IS USED IN LIEU OF GRATE.

ALL OPEN LIDS SHALL HAVE A TYPE D GRATE. ALL CLOSED LIDS SHALL BE SELF-SEALING WITH CONCEALED PICK HOLES.

FORMS FOR CONCRETE SIDEWALKS, DRIVEWAYS, **PAVEMENT. AND GUTTER FLAGS**

A 2" X 6" BOARD WILL BE USED AS A FORM FOR ALL SIDEWALKS TO BE INSTALLED FIVE INCHES (5") IN THICKNESS. A 2" X 8" BOARD WILL BE USED AS A FORM FOR ALL DRIVEWAYS TO BE INSTALLED SEVEN INCHES (7") IN THICKNESS, A 2" X 10" BOARD WILL BE USED AS THE FORM FOR ALL DRIVEWAYS TO BE INSTALLED EIGHT INCHES (8") IN THICKNESS. A 2" X 12" BOARD WILL BE USED AS THE FORM FOR THE FACE OF THE GUTTER FLAGS TO BE INSTALLED TEN INCHES (10") IN THICKNESS. ALL FORMS MUST BE OF A MINIMUM HEIGHT OF THE

PROPOSED THICKNESS OF THE RESPECTIVE CONCRETE ITEMS TO BE INSTALLED.

OPEN EXCAVATION

THE CONTRACTOR WILL NOT BE ALLOWED TO LEAVE EXCAVATIONS OPEN OVERNIGHT.
THE CONTRACTOR WILL BE RESPONSIBLE FOR COMPLETELY BACKFILLING OR PLATING OVER OF ALL EXCAVATIONS AT THE END OF EACH DAY. IF THE EXCAVATIONS ARE BACKFILLED THEY SHALL BE FILLED WITH AN AGGREGATE MEETING THE GRADATION OF CA-6. THE MATERIAL WILL BE COMPACTED SUFFICIENTLY TO PREVENT RUTTING OR SETTLEMENT OF MATERIAL UNDER TRAFFIC LOADS. IF PLATES ARE USED THEY SHALL BE OF SUFFICIENT THICKNESS TO SUPPORT VEHICULAR LOADS. ADDITIONALLY THEY SHALL EXTEND A MINIMUM OF NINE INCHES (9") BEYOND THE LIMITS OF THE EXCAVATION ON ALL SIDES. IF THE PLATES ARE TO BE LEFT OVER THE WEEKEND, THE EDGES OF THE PLATES SHALL BE CUSHIONED WITH A BITUMINOUS MIXTURE IN AREAS WHERE VEHICULAR TRAFFIC WILL CROSS THE PLATES.

THE COSTS FOR PROVIDING THE AGGREGATE, PLATES AND BITUMINOUS MIXTURE WILL NOT BE PAID FOR DIRECTLY BUT SHALL BE INCLUDED IN THE VARIOUS CONTRACT ITEMS.

THE CONTRACTOR SHALL NOTIFY THE IDOT TRAFFIC CONTROL SUPERVISOR AT (847) 705-4470 A MINIMUM OF 72 HOURS IN ADVANCE OF BEGINNING WORK. THE RESIDENT ENGINEER SHALL CONTACT THE NORTH COOK AREA FIELD ENGINEER AT (773) 685-8386 AT LEAST (2) WEEKS PRIOR TO PLACING PERMANENT PAVEMENT MARKINGS.

BACKFILLING SEWERS UNDER ROADWAY

FOR SEWERS UNDER THE ROADWAY, BACKFILLING METHODS TWO AND THREE (JETTING) AS DESCRIBED IN ARTICLE 550.07 WILL NOT BE ALLOWED.

MAINTENANCE OF SEWER FLOWS

THE CONTRACTOR SHALL CONDUCT HIS OPERATIONS SO AS TO MAINTAIN AT ALL TIMES FLOWS THROUGH EXISTING STORM AND SANITARY SEWER SYSTEMS. HE SHALL ALSO PROVIDE AND MAINTAIN AN EFFICIENT PUMPING PLANT IF NECESSARY AND A TEMPORARY OUTLET AND BE PREPARED AT ALL TIMES TO DISPOSE OF THE WATER COLLECTED IN A SAFE MANNER WITHOUT DAMAGE OF ANY KIND TO ADJACENT PROPERTIES. THE ENDS OF EXISTING DRAINAGE LINES WHICH ARE NOT TO BE INCORPORATED INTO THE PROJECT ARE TO BE SEALED AS SPECIFIED IN THE SPECIAL PROVISIONS. THE COST OF ALL THE PREVIOUSLY MENTIONED WORK SHALL BE INCLUDED IN THE RESPECTIVE SEWER PAY ITEMS. ALL ACCUMULATION OF MATERIAL IN THE STRUCTURE DUE TO CONSTRUCTION OPERATIONS AS WELL AS MATERIAL EXISTING BEFORE CONSTRUCTION, SHALL BE REMOVED BY THE CONTRACTOR AT HIS EXPENSE.

EXISTING STRUCTURE MODIFICATIONS

ALL KNOWN EXISTING STRUCTURES IN THE PAVEMENT OR ADJACENT AREAS WHICH ARE INVOLVED IN THE CONSTRUCTION HAVE BEEN SHOWN ON THE PLANS AND NOTED AS TO BE REMOVED, FILLED, RECONSTRUCTED, OR ADJUSTED BY THE CONTRACTOR EXCEPT THOSE OF AMERITECH, COMED, AND THE NICOR GAS COMPANY, WHICH ARE TO BE ADJUSTED BY THE APPROPRIATE UTILITY FORCE. WHERE EXISTING STRUCTURES ARE TO BE REMOVED OR FILLED, OR THE EXISTING CASTING REPLACED, THE CASTINGS REMOVED FROM THE STRUCTURE ARE TO REMAIN THE PROPERTY OF THE VILLAGE AND BE SALVAGED. THE CONTRACTOR IS TO DELIVER FRAMES AND LIDS TO THE VILLAGE'S PUBLIC WORKS YARD LOCATED AT 1700 W CENTRAL RD, MT PROSPECT, IL 60056.

SHEETING OR SHORING

SHEETING OR SHORING REQUIRED FOR THE STORM SEWER INSTALLATION OR OTHER CONSTRUCTION ELEMENTS REQUIRING RELATIVELY DEEP EXCAVATIONS, SHALL BE INCLUDED IN THE PARTICULAR PAYMENT ITEM AND NO ADDITIONAL COMPENSATION WILL BE ALLOWED FOR ANY SUPPLEMENTAL WORK ASSOCIATED WITH THE MAINTENANCE OF TRENCH SIDES OR OTHER EXCAVATED AREAS.

MAINTENANCE OF EXISTING DRAINAGE STRUCTURES

LOOSE MATERIAL THAT IS DEPOSITED IN THE FLOW LINE OF GUTTERS OR DRAINAGE STRUCTURE THAT INHIBITS THE NATURAL FLOW OF WATER SHALL BE REMOVED AT THE CLOSE OF EACH WORKING DAY. AT THE CONCLUSION OF THE CONSTRUCTION OPERATIONS, ALL DRAINAGE FACILITIES SHALL BE CLEAN AND FREE OF ALL OBSTRUCTIONS. THE COST OF THIS WORK SHALL BE INCLUDED IN THE RESPECTIVE SEWER PAY ITEMS.

SAW CUTTING

THE CONTRACTOR SHALL SAW CUT ASPHALT PAVEMENT AND CONCRETE PAVEMENT AS INDICATED ON THE PLANS OR AS DIRECTED BY THE ENGINEER, TO SEPARATE THE EXISTING PAVEMENT TO BE REMOVED BY MEANS OF AN APPROVED CONCRETE SAW TO A DEPTH AS DIRECTED BY THE ENGINEER. SUITABLE GUIDELINES OR DEVICES SHALL BE USED TO ASSURE CUTTING A NEAT, STRAIGHT LINE AS SHOWN ON THE PLANS. CARE SHALL BE TAKEN BY THE CONTRACTOR SO AS NOT TO DAMAGE THE REMAINING PAVEMENT DIRECTLY ADJACENT TO THE PAVEMENT TO BE REMOVED. ANY DAMAGE TO THE EXISTING PAVEMENT RESULTING FROM PAVEMENT REMOVAL OPERATIONS SHALL BE REPAIRED AT THE CONTRACTOR'S EXPENSE. THE PRICE OF SAW CUTTING, AS NOTED ABOVE, SHALL BE INCLUDED IN THE PARTICULAR PAY ITEMS.

PROPOSED STRUCTURES

THE CONTRACTOR SHALL NOT ORDER PROPOSED STRUCTURES UNTIL A JULIE REQUEST HAS BEEN EXECUTED AND THE ENGINEER HAS BEEN NOTIFIED BY THE CONTRACTOR WHETHER ANY CONFLICTS EXISTS.

ITEMS TO BE SALVAGED

WHERE SPECIFIED ON THE PLANS OR AS DIRECTED BY THE ENGINEER, EXISTING SEWER FRAMES AND LIDS, VALVE BOXES, DOMESTIC WATER SERVICE BOXES, FIRE HYDRANTS AND OTHER CASTINGS ARE TO BE REMOVED BY THE CONTRACTOR. ADDITIONALLY, ALL EXISTING SIGNAGE SCHEDULED FOR REMOVAL WILL ALSO BE APPROPRIATED BY THE CONTRACTOR. THESE ITEMS WILL REMAIN THE PROPERTY OF THE VILLAGE, AND SHALL BE DELIVERED TO THE OWNER AT ITS PUBLIC WORKS FACILITY LOCATED AT 1700 W CENTRAL RD, MT PROSPECT, IL 60056.

NOTIFICATION OF RESIDENTS

THE CONTRACTOR WILL BE RESPONSIBLE FOR PROVIDING WRITTEN NOTICE TO ALL RESIDENCES AND/OR PLACES OF BUSINESS IN THE WORK ZONE AT LEAST ONE (1) WORKING DAY PRIOR TO PERFORMING ANY CONSTRUCTION ACTIVITY THAT WILL IMPACT ACCESS TO THEIR PROPERTY. THE WRITTEN NOTICE SHALL BE APPROVED BY THE ENGINEER/VILLAGE AND COORDINATED WITH THE VILLAGE PRIOR TO THE BEGINNING OF

TRAFFIC PROTECTION

WHEN WORK COMMENCES, THE CONTRACTOR SHALL ASSUME THE MAINTENANCE OF ALL PAVEMENT, SHOULDERS, DRAINAGE FACILITIES, TRAFFIC CONTROL SIGNS, PAVEMENT MARKINGS, AND OTHER APPURTENANCES ON ROADWAYS WITHIN THE LIMITS OF THE CONTRACT WHICH ARE TO BE USED BY THE PUBLIC DURING CONSTRUCTION AND TO RETAIN THIS MAINTENANCE RESPONSIBILITY UNTIL PROJECT COMPLETION. NEED FOR SNOW AND ICE CONTROL DURING THE CONSTRUCTION PERIOD SHALL BE ACCOMMODATED FOR BY OTHERS. ALL UNBALLASTED TYPE I & TYPE II BARRICADES SHALL HAVE TWO SANDBAGS ONE ACROSS EACH BOTTOM RAIL.

PLUGGING EXISTING SEWERS AND DRAINS

UNLESS OTHERWISE SPECIFIED, ABANDONED SEWERS AND DRAINS, AS DESIGNATED BY THE ENGINEER, SHALL BE PLUGGED AT BOTH ENDS WITH A MINIMUM OF TWO (2) FOOT LONG NON-SHRINK/MORTAR PLUG. THIS WORK SHALL NOT BE PAID FOR SEPARATELY, BUT SHALL BE INCLUDED IN THE PAY ITEMS FOR REMOVING AND/OR FILLING THE VARIOUS TYPES OF STRUCTURES.

STORM SEWER STRUCTURES

PRE-CAST REINFORCED CONCRETE SECTIONS FABRICATED IN ACCORDANCE WITH ASTM C-478 WILL BE USED ON ALL STRUCTURES AND RECONSTRUCTED STRUCTURES. FINAL ADJUSTMENT SHALL BE MADE USING PRE-CAST ADJUSTING RINGS. A MAXIMUM OF 6" OF ADJUSTING RINGS WILL BE PERMITTED. THE WORK DESCRIBED WITHIN THE SPECIAL PROVISION FOR FRAMES AND LIDS TO BE ADJUSTED (SPECIAL) SHALL BE PERFORMED WHEN INSTALLING A NEW STORM SEWER STRUCTURE. THIS ITEM WILL NOT BE PAID FOR SEPARATELY BUT WILL BE INCLUDED IN THE UNIT PRICE FOR THE VARIOUS PROPOSED STORM SEWER STRUCTURES IN THE CONTRACT.

FRAMES WITH CLOSED LIDS

ALL FRAMES WITH CLOSED LIDS TO BE FURNISHED AS PART OF THIS CONTRACT FOR CONSTRUCTION, ADJUSTMENT, OR RECONSTRUCTION OF ANY MANHOLE, CATCH BASIN, INLET, OR VALVE VAULT SHALL HAVE THE WORD "WATER", "SANITARY", OR "STORM" CAST INTO THE LID. THE WORDS "VILLAGE OF MOUNT PROSPECT" SHALL ALSO BE CAST INTO ALL CLOSED LIDS.

CONCRETE BREAKERS

WHEN REMOVING PAVEMENT, CURB AND GUTTER, SHOULDER, AND/OR ANY OTHER STRUCTURES, THE USE OF ANY TYPE OF CONCRETE BREAKERS SUCH AS DROP HAMMERS, WHICH MIGHT DAMAGE UNDERGROUND PUBLIC OR PRIVATE UTILITIES, WILL NOT BE PERMITTED, UNDER NO CIRCUMSTANCES WILL THE USE OF A FROST BALL BE PERMITTED.

COMMERCIAL PROPERTY ACCESS

THE CONTRACTOR SHALL MAINTAIN ACCESS TO COMMERCIAL PROPERTIES AT ALL TIMES AS DIRECTED BY THE ENGINEER. THIS CAN INVOLVE THE STAGING OF SIDEWALK OR DRIVEWAY REMOVAL AND REPLACEMENT, CURB AND GUTTER REMOVAL AND REPLACEMENT, AND THE REPLACEMENT OF BRICK PAVERS. IT MAY ALSO NECESSITATE THE USE OF TEMPORARY STONE FOR ACCESS. PAYMENT WILL NOT BE MADE SEPARATELY, BUT WILL BE INCLUDED IN THE UNIT PRICE FOR THE RESPECTIVE PAY ITEMS IN THE CONTRACT

STREET SIGNS

IF ANY STREET SIGNS ARE DAMAGED DURING CONSTRUCTION THEY SHALL BE REPLACED AT THE CONTRACTOR'S EXPENSE.

CONCRETE PROTECTION

AFTER THE CONCRETE HAS BEEN FINISHED AND THE WATER SHEEN HAS DISAPPEARED FROM THE SURFACE OF THE CONCRETE, THE SURFACE SHALL BE SEALED WITH MEMBRANE CURING COMPOUND OF A TYPE APPROVED BY THE ENGINEER. THE SEAL SHALL BE MAINTAINED FOR THE SPECIFIED CURING PERIOD. THE EDGES OF THE CONCRETE SHALL ALSO BE SEALED IMMEDIATELY AFTER THE FORMS ARE REMOVED. IN ADDITION, ALL CONCRETE PLACED AFTER OCTOBER 15TH, SHALL BE PROTECTED IN ACCORDANCE WITH ARTICLE 1020.13 OF THE STANDARD SPECIFICATIONS. THIS WORK SHALL BE CONSIDERED INCLUDED IN THE COST OF THE VARIOUS CONCRETE ITEMS IN THE CONTRACT. PROTECTIVE COAT SHALL BE PAID FOR ACCORDING TO SECTION 420.

THE WORK SHALL BE UNDER THE CHARGE AND CARE OF THE CONTRACTOR UNTIL FINAL ACCEPTANCE BY THE ENGINEER. THE CONTRACTOR SHALL ASSUME ALL RESPONSIBILITY FOR ANY INJURY OR DAMAGE TO THE WORK FROM ANY CAUSE WHATSOEVER AND HE SHALL REBUILD, REPAIR OR RESTORE THE DAMAGED WORK AT HIS OWN EXPENSE. THE EXPOSED FACES OF CONCRETE OF ANY ITEMS THAT ARE DEFACED SHALL BE REPLACED BY THE CONTRACTOR AT HIS OWN EXPENSE.

TREE PROTECTION

THE CONTRACTOR SHALL BE RESPONSIBLE FOR BEING FAMILIAR WITH AND COMPLYING WITH ALL ASPECTS OF THE VILLAGE OF MOUNT PROSPECT TREE PROTECTION ORDINANCES AND ARBORICULTURAL STANDARDS MANUAL

TTANCOCK	USER NAME -	XX	DESIGNED -	JGG	REVISED -	XX
ENGINEERING			DRAWN -	MK	REVISED -	XX
♦ Civil Engineers Washington, Etnoh 6015-2700	PLOT SCALE -	xx	CHECKED -	MDL	REVISED -	XX
♦ Municipal Consultants Page: 708/86-9700 ♦ Established 1911 Fac: 708/86-9701	PLOT DATE -	XX	DATE -	03-19-14	REVISED -	XX

STATE OF ILLINOIS **DEPARTMENT OF TRANSPORTATION**

Ī				F.A.U. RTE.	SECTION	COUNTY	TOTAL	SHEE NO.				
		G	EN	ΙEΙ	RAL NO	DTES		3612	13-00160-00-SW	соок	50	3
										CONTRAC	T NO. 61A	23
	SHEET NO.	1	OF	1	SHEETS	STA.	TO STA.	FED. ROAD I	DIST. NO. 1 ILLINOIS FED	AID PROJECT		

SUMMARY OF QUANTITIES

	CODE NO.	ITEM	UNIT	TOTAL QUANTITY	CONSTRUCTION TYPE CODE ITEP 0031 80% FEDERAL 20% LOCAL
	00400440				
-	20100110	TREE REMOVAL (6 TO 15 UNITS DIAMETER)	UNIT	150	150
	20100210	TREE REMOVAL (OVER 15 UNITS DIAMETER)	UNIT	200	200
~	20101000	TEMPORARY FENCE	FOOT	550	550
	20200100	EARTH EXCAVATION	CU YD	800	800
		No.			
~	20800150	TRENCH BACKFILL	CUYD	125	125
~	21101615	TOPSOIL FURNISH AND PLACE, 4*	SQYD	1,400	1,400
	25000400	NITROGEN FERTILIZER NUTRIENT	POUND	30	30
	25000500	PHOSPHORUS FERTILIZER NUTRIENT	POUND	30	30
	25000600	POTASSIUM PERTILIZER NUTRIENT	POUND	30	30
-	25200100	SODDING	SQYD	1,400	1,400
	25200200	SUPPLEMENTAL WATERING	UNIT	10	10
~	28000510	INLET FILTERS	EACH	17	17
~	35101800	AGGREGATE BASE COURSE, TYPE B 6"	SQYD	1,800	1,800
~	35102200	AGGREGATE BASE COURSE, TYPE B 10"	SQYD	375	375
-	35300300	PORTLAND CEMENT CONCRETE BASE COURSE 8*	SQYD	500	500
~	35300500	PORTLAND CEMENT CONCRETE BASE COURSE 10"	SQYD	140	140
					140
+-	40201000	AGGREGATE FOR TEMPORARY ACCESS	TON	250	250
	-406 00 275	BITUMINOUS MATERIALS (PRIME COAT)	POUND	480	480
	40600625	LEVELING BINDER (MACHINE METHOD), N50	TON	60	60
	40603335	HOT-MIX ASPHALT SURFACE COURSE, MIX "D", N50	TON	120	120
	40603340	HOT-MIX ASPHALT SURFACE COURSE, MIX "D", N70	TON	180	180
-	40800050	INCIDENTAL HOT-MIX ASPHALT SURFACING	TON	20	20
			TON	20	20
~	42101300	PROTECTIVE COAT	SQ YD	3,625	3,625

		CODE NO.	ITEM	UNIT	TOTAL QUANTITY	TYPE CODE ITEP 0031 80% FEDERAL 20% LOCAL
~		42300400	PORTLAND CEMENT CONCRETE DRIVEWAY PAVEMENT, 8 INCH	SQYD	950	950
~		42400200	PORTLAND CEMENT CONCRETE SIDEWALK 5 INCH	SQFT	17,000	17,000
2		42400800	DETECTABLE WARNINGS	SQFT	040	040
		-	DETECTABLE WANTINGS	SQFI	242	242
~		44000100	PAVEMENT REMOVAL	SQYD	780	780
~		44000200	DRIVEWAY PAVEMENT REMOVAL	SQYD	945	945
~		44000500	COMBINATION CURB AND GUTTER REMOVAL	FOOT	3,620	3,620
~		44000600	SIDEWALK REMOVAL	SQFT	25,000	25,000
~		44213204	TIE BARS 3/4*	EACH	725	725
~	*	56400100	FIRE HYDRANTS TO BE MOVED	EACH	3	3
~	*	56500600	DOMESTIC WATER SERVICE BOXES TO BE ADJUSTED	EACH	30	30
~	*	56500800	DOMESTIC WATER SERVICE BOXES	EACH	5	5
~		60300305	FRAMES AND LIDS TO BE ADJUSTED	EACH	15	15
~		60406100	FRAMES AND LIDS, TYPE 1, CLOSED LID	EACH	14	14
~		60602800	CONCRETE CURB, TYPE B	FOOT	120	120
~		60604100	COMBINATION CONCRETE CURB AND GUTTER, TYPE B-6.12 (MODIFIED)	FOOT	420	420
~		60604700	COMBINATION CONCRETE CURB AND GUTTER, TYPE B-6.18 (MODIFIED)	FOOT	900	900
		67100100	MOBILIZATION	L SUM	1	1
	*	66900200	NON-SPECIAL WASTE DISPOSAL	CU YD	550	550
	*	66900450	SPECIAL WASTE PLANS AND REPORTS	L SUM	1	1
	*	66900530	SOIL DISPOSAL ANALYSIS	EACH	5	5
						T

- ~ DENOTES SPECIAL PROVISION HAS BEEN PROVIDED * DENOTES SPECIALTY ITEM

HANCO	
◆ Civil Engineers	Wast
♦ Municipal Consultants	
◆ Established 1911	

	USER NAME - XX	DESIGNED -	JGG	REVISED -	XX	
		DRAWN -	MK, DMM	REVISED -	XX	
=	PLOT SCALE - XX	CHECKED -	MDL	REVISED -	XX	
111	PLOT DATE - XX	DATE -	05-14-14	REVISED -	XX	

SCALE: NONE	SHEET NO. 1 OF 2 SHEETS	TO STA.	CONTRACT NO.				23
	SUMMART OF QU	3612	13-00160-00-SW	COOK 50		4	
100	SUMMARY OF QU	F.A.U. RTE.	SECTION	COUNTY	TOTAL	SHEET NO.	

- 3
- 2
- 5
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- 1

		CODE NO.	ITEM	UNIT	TOTAL QUANTITY	CONSTRUCTION TYPE CODE ITEP 0031 80% FEDERAL 20% LOCAL
		70102620	TRAFFIC CONTROL AND PROTECTION, STANDARD 701501	L SUM	1	1
		70102625	TRAFFIC CONTROL AND PROTECTION, STANDARD 701606	L SUM	1	1
		7012635	TRAFFIC CONTROL AND PROTECTION, STANDARD 701701	L SUM	1	1
		70102640	TRAFFIC CONTROL AND PROTECTION, STANDARD 701801	L SUM	1	1
~	-	72000100	SIGN PANEL - TYPE 1	SQFT	60	60
		72900100	METAL POST - TYPE A	FOOT	45	45
		72900200	METAL POST - TYPE B	FOOT	120	120
	•	78000400	THERMOPLASTIC PAVEMENT MARKING - LINE 6"	FOOT	850	850
		78000650	THERMOPLASTIC PAVEMENT MARKING - LINE 24"	FOOT	175	175
		78001100	PAINT PAVEMENT MARKING - LETTERS AND SYMBOLS	SQFT	40	40
		78300100	PAVEMENT MARKING REMOVAL	SQ FT	775	775
		A2004524	TREE, GINKGO BILOBA PRINCETON SENTRY (PRINCETON SENTRY GINKGO),	EACH	9	9
			3" CALIPER, BALLED AND BURLAPPED			
	•	A2005024	TREE, GYMNOCLADUS DIOICIUS (KENTUCKY COFFEETREE), 3" CALIPER, BALLED AND BURLAPPED	EACH	3	3
~		K0012990	PERENNIAL PLANTS, ORNAMENTAL TYPE, GALLON POT	UNIT	13.55	13.55
~		K1001988	IRRIGATION SYSTEM SPECIAL	L SUM	1	1
~		LR430040	PAVING BRICK SIDEWALK	SQ YD	1,800	1,860
~		X0322463	CONNECTION TO EXISTING SEWER	EACH	1	1
~		X0323389	STORM SEWER CONNECTION	EACH	1	1
~		X4240800	DETECTABLE WARNINGS (SPECIAL)	SQ FT	100	100
~	*	X4400196	HOT-MIX ASPHALT SURFACE REMOVAL, SPECIAL	SQ YD	1,400	1,400

		CODE NO.	ITEM	UNIT	TOTAL QUANTITY	TYPE CODE ITEP 0031 80% FEDERAL 20% LOCAL
~	*	X5620122	WATER SERVICE REMOVAL	EACH	2	2
~		X6022805	CATCH BASINS, TYPE A, 4' DIAMETER, TYPE 1 FRAME, OPEN LID, SPECIAL	EACH	5	5
~		X6022900	CATCH BASINS TO BE RECONSTRUCTED (SPECIAL)	EACH	2	2
~		X6022905	CATCH BASINS, TYPE A, 4' DIAMETER, TYPE 1 FRAME, CLOSED LID, SPECIAL	EACH	3	3
~		X6023203	INLETS, WITH TYPE 1 FRAME, CLOSED LID, SPECIAL	EACH	3	3
-		X6026620	VALVE VAULTS TO BE RECONSTRUCTED (SPECIAL)	EACH	1	1
~		X6028000	MANHOLES TO BE RECONSTRUCTED (SPECIAL)	EACH	3	3
_		X6061700	COMBINATION CONCRETE CURB AND GUTTER, TYPE B (SPECIAL)	FOOT	1,325	1,325
				1001	1,020	1,020
~		XX003308	TRENCH DRAIN	FOOT	190	190
~	•	- XX004533	SOIL PLANTING MIXTURE	CU YD	225	225
~		XX000541	EXPLORATORY EXCAVATION	CU YD	50	50
~		XX005735	PLANTER CURB	FOOT	1,550	1,550
~	*	XX007001	ROOT BARRIER	EACH	12	12
~		XX007413	CONCRETE EDGE RESTRAINT	FOOT	1,750	1,750
~		XX008931	8" X 8" CATCH BASIN TRAP	EACH	5	5
		Z0018700	DRAINAGE STRUCTURE TO BE REMOVED	EACH	5	5
~		Z0030850	TEMPORARY INFORMATION SIGNING	SQFT		
		2000000	TEMPORART INFORMATION SIGNING	SQFI	240	240
~		Z0042500	POST, SPECIAL	EACH	200	200
-		Z0056642	STORM SEWERS, TYPE 1, WATER MAIN QUALITY PIPE, 6"	FOOT	93	93
~		Z0056644	STORM SEWERS, TYPE 1, WATER MAIN QUALITY PIPE, 8"	FOOT	255	255


~ DENOTES SPECIAL PROVISION HAS BEEN PROVIDED * DENOTES SPECIALTY ITEM

HANCO ENGINEE	
◆ Municipal Consultant	Wateles
A Established 1911	

	USER NAME -	xx	DESIGNED -	JGG	REVISED -	XX	
			DRAWN -	MK, DMM	REVISED -	XX	
1	PLOT SCALE -	xx	CHECKED -	MDL	REVISED -	XX	
113	PLOT DATE -	xx	DATE -	05-14-14	REVISED -	XX	


STATE OF ILLINOIS	
DEPARTMENT OF TRANSPORTATION	l

3612 13-00160-00-5W COOK 50 5 CONTRACT NO. 61A23		SUMMARY OF QUANTITIES					JANTITII	ES	F.A.U. RTE. 3612	SECTION 13-00160-00-SW	COUNTY	TOTAL SHEETS 50	NO.
	3±00 20 10 10 10 10 10 10 10 10 10 10 10 10 10							3012	13-00100-00-344			3	
		SHEET NO.	2	OF	2	SHEETS	STA.	TO STA.	FED. ROAD I	IST. NO. 1 ILLINOIS FED	. AID PROJECT		

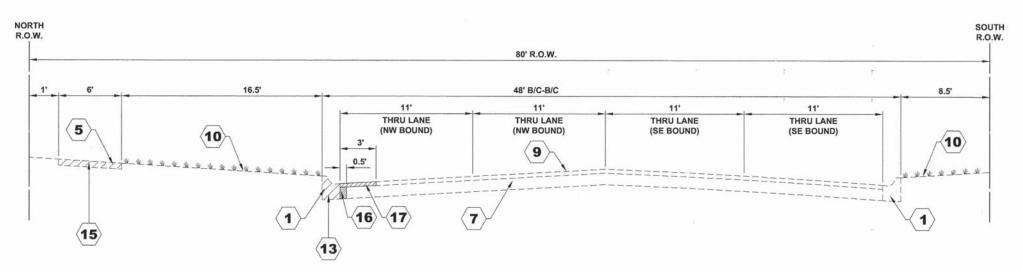

EXISTING TYPICAL SECTION

NORTHWEST HIGHWAY FOREST AVENUE TO FAIRVIEW AVENUE (STATION 1+00 TO STATION 4+90)

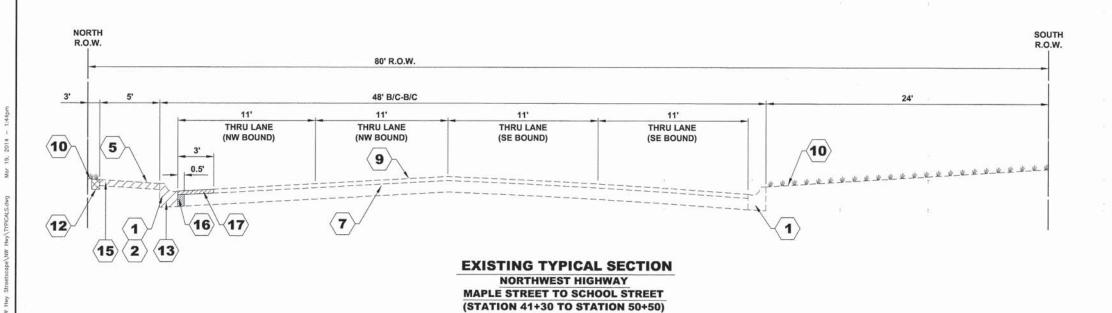

SYMBOL **DESCRIPTION** $\langle \mathbf{1} \rangle$ COMBINATION CONCRETE CURB AND GUTTER, TYPE B-6.18 $\langle \mathbf{2} angle$ COMBINATION CONCRETE CURB AND GUTTER, TYPE B-6.12 (3) COMBINATION CONCRETE CURB AND GUTTER, TYPE M-3.12 CONCRETE CURB, TYPE B **(5**) PORTLAND CEMENT CONCRETE SIDEWALK **(6**) BRICK PAVER SIDEWALK $\overline{7}$ PORTLAND CEMENT CONCRETE BASE COURSE, ± 10" **8** PORTLAND CEMENT CONCRETE BASE COURSE, ± 8" 9 HOT-MIX ASPHALT BINDER & SURFACE COURSE, 2" - 4" (10) **GRASS PARKWAY** 11 PLANTER **12 EARTH EXCAVATION** COMBINATION CURB AND GUTTER REMOVAL (ONLY CERTAIN DETERIORATED (13) SECTIONS OF COMBINATION CURB AND GUTTER WILL BE REPLACED) 14 COMBINATION CURB AND GUTTER REMOVAL **15** SIDEWALK REMOVAL (16) PAVEMENT REMOVAL

HOT-MIX ASPHALT SURFACE REMOVAL, SPECIAL

REVISED -DRAWN -MK REVISED -XX PLOT SCALE - XX CHECKED -MDL REVISED -XX DATE -03-19-14 REVISED -

STATE OF ILLINOIS **DEPARTMENT OF TRANSPORTATION**

SCALE: NONE


SECTION RTE. **EXISTING TYPICAL SECTIONS** 3612 13-00160-00-SW SHEET NO. 1 OF 4 SHEETS STA. FED. ROAD DIST. NO. 1 ILLINOIS FED. AID PROJECT


COOK 50 6

CONTRACT NO. 61A23

COUNTY


TOTAL SHEET NO.

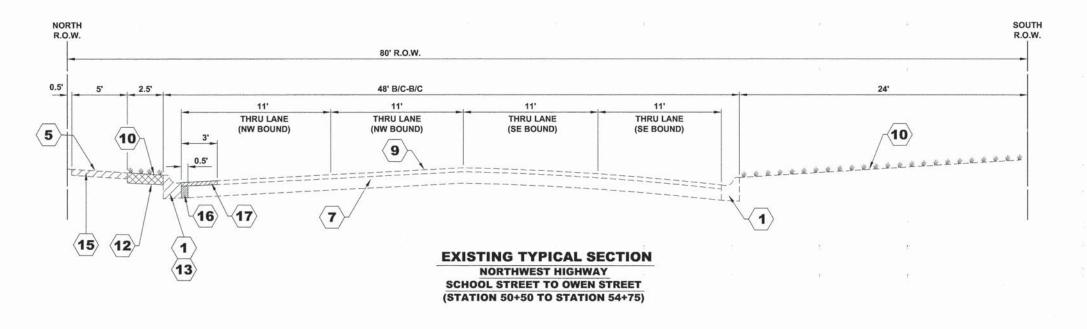


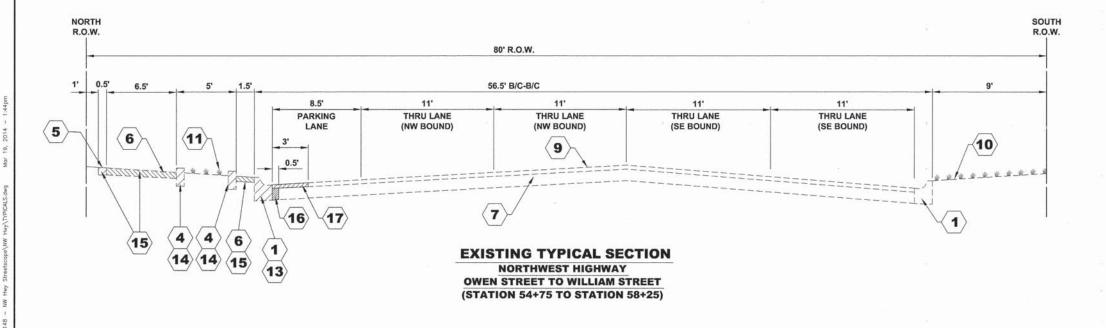

SYMBOL	DESCRIPTION
1	COMBINATION CONCRETE CURB AND GUTTER, TYPE B-6.18
(2)	COMBINATION CONCRETE CURB AND GUTTER, TYPE B-6.12
3	COMBINATION CONCRETE CURB AND GUTTER, TYPE M-3.12
(4)	CONCRETE CURB, TYPE B
(5)	PORTLAND CEMENT CONCRETE SIDEWALK
6	BRICK PAVER SIDEWALK
(7)	PORTLAND CEMENT CONCRETE BASE COURSE, ± 10"
8	PORTLAND CEMENT CONCRETE BASE COURSE, ± 8"
9	HOT-MIX ASPHALT BINDER & SURFACE COURSE, 2" - 4"
10	GRASS PARKWAY
11	PLANTER
12	EARTH EXCAVATION
13	COMBINATION CURB AND GUTTER REMOVAL (ONLY CERTAIN DETERIORATED SECTIONS OF COMBINATION CURB AND GUTTER WILL BE REPLACED)
14	COMBINATION CURB AND GUTTER REMOVAL
15	SIDEWALK REMOVAL

HOT-MIX ASPHALT SURFACE REMOVAL, SPECIAL

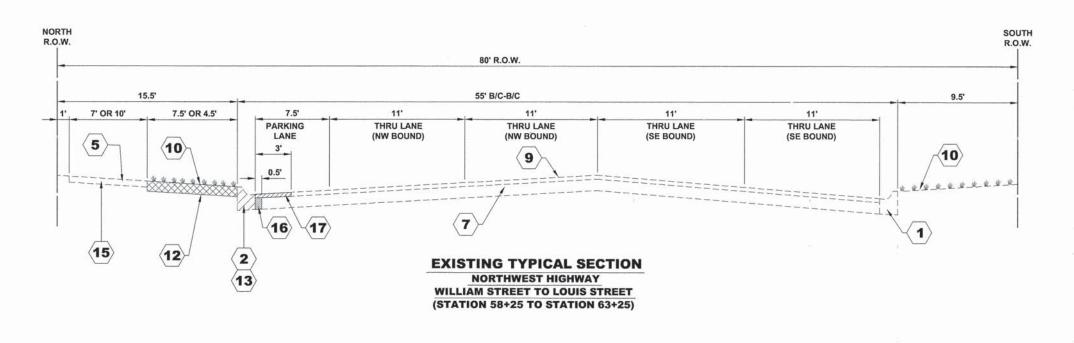

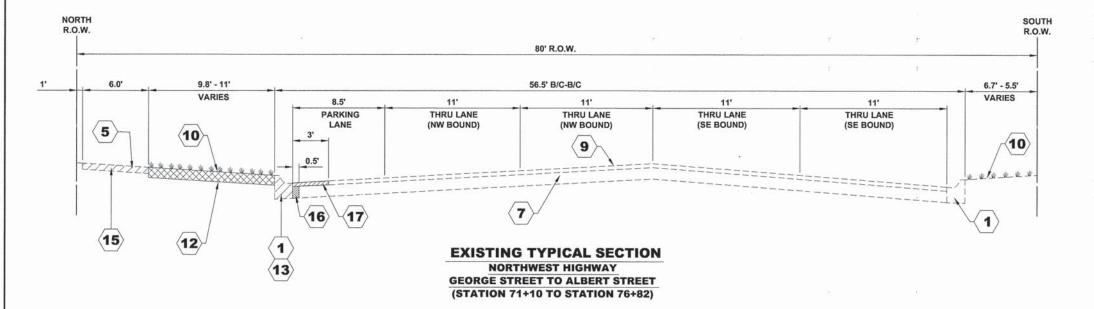

SYMBOL	DESCRIPTION
1	COMBINATION CONCRETE CURB AND GUTTER, TYPE B-6.18
(2)	COMBINATION CONCRETE CURB AND GUTTER, TYPE B-6.12
3	COMBINATION CONCRETE CURB AND GUTTER, TYPE M-3.12
(4)	CONCRETE CURB, TYPE B
(5)	PORTLAND CEMENT CONCRETE SIDEWALK
6	BRICK PAVER SIDEWALK
(7)	PORTLAND CEMENT CONCRETE BASE COURSE, ± 10"
8	PORTLAND CEMENT CONCRETE BASE COURSE, ± 8"
9	HOT-MIX ASPHALT BINDER & SURFACE COURSE, 2" - 4"
(10)	GRASS PARKWAY
11	PLANTER
12	EARTH EXCAVATION
13	COMBINATION CURB AND GUTTER REMOVAL (ONLY CERTAIN DETERIORATED SECTIONS OF COMBINATION CURB AND GUTTER WILL BE REPLACED)
14	COMBINATION CURB AND GUTTER REMOVAL
15	SIDEWALK REMOVAL

SCALE: NONE


PAVEMENT REMOVAL


HOT-MIX ASPHALT SURFACE REMOVAL, SPECIAL


(16)

COOK

TOTAL SHEET NO.

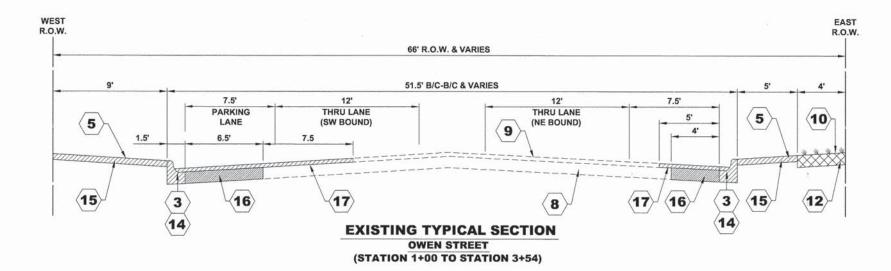

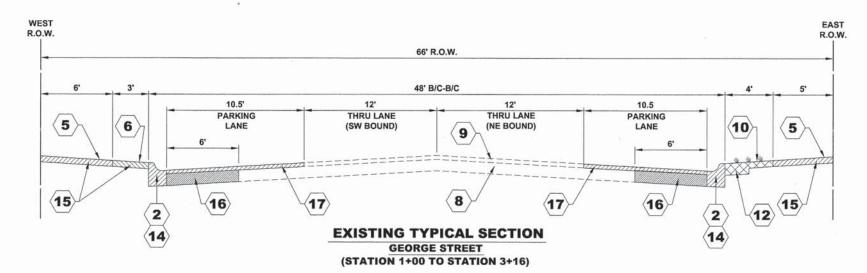

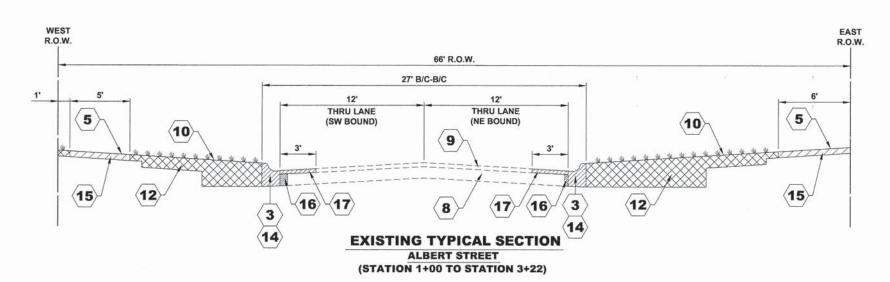


SYMBOL	DESCRIPTION
1	COMBINATION CONCRETE CURB AND GUTTER, TYPE B-6.18
(2)	COMBINATION CONCRETE CURB AND GUTTER, TYPE B-6.12
$\langle 3 \rangle$	COMBINATION CONCRETE CURB AND GUTTER, TYPE M-3.12
4	CONCRETE CURB, TYPE B
(5)	PORTLAND CEMENT CONCRETE SIDEWALK
6	BRICK PAVER SIDEWALK
(7)	PORTLAND CEMENT CONCRETE BASE COURSE, ± 10"
8	PORTLAND CEMENT CONCRETE BASE COURSE, ± 8"
9	HOT-MIX ASPHALT BINDER & SURFACE COURSE, 2" - 4"
10	GRASS PARKWAY
11	PLANTER
12	EARTH EXCAVATION
13	COMBINATION CURB AND GUTTER REMOVAL (ONLY CERTAIN DETERIORATED SECTIONS OF COMBINATION CURB AND GUTTER WILL BE REPLACED)
14	COMBINATION CURB AND GUTTER REMOVAL
15	SIDEWALK REMOVAL
16	PAVEMENT REMOVAL
17	HOT-MIX ASPHALT SURFACE REMOVAL, SPECIAL

STATE OF ILLINOIS
DEPARTMENT OF TRANSPORTATION

EXISTING TYPICAL SECTIONS


SHEET NO. 4 OF 4 SHEETS STA. TO STA.

SCALE: NONE

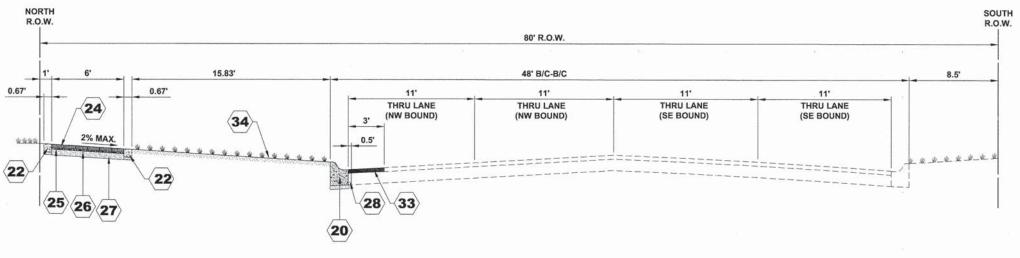

PROPOSED TYPICAL SECTION

NORTHWEST HIGHWAY FOREST AVENUE TO FAIRVIEW AVENUE (STATION 1+00 TO STATION 4+90)

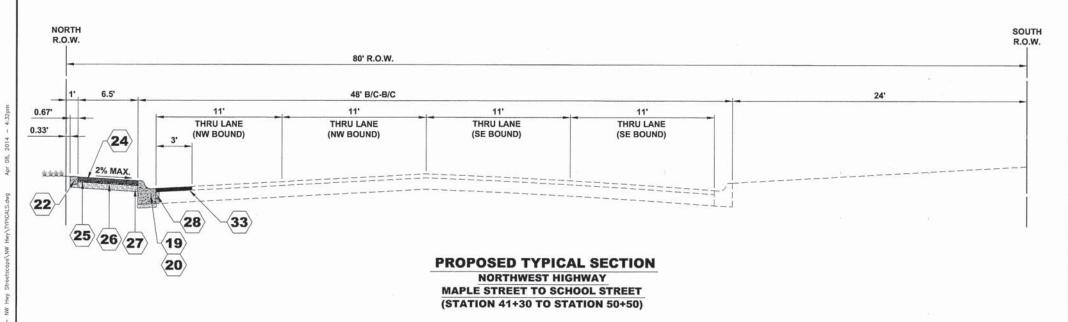

SYMBOL	DESCRIPTION
18	COMBINATION CONCRETE CURB AND GUTTER, TYPE B (SPECIAL)
19	COMBINATION CONCRETE CURB AND GUTTER, TYPE B-6.12 (MODIFIED)
20	COMBINATION CONCRETE CURB AND GUTTER, TYPE B-6.18 (MODIFIED)
21	PLANTER CURB
22	CONCRETE EDGE RESTRAINT
23	PORTLAND CEMENT CONCRETE SIDEWALK, 5"
24	PAVING BRICK SIDEWALK
25	SAND CUSHION, 1" (INCLUDED IN THE COST FOR PAVING BRICK SIDEWALK)
26	FILTER FABRIC (INCLUDED IN THE COST FOR PAVING BRICK SIDEWALK)
27	AGGREGATE BASE COURSE, TYPE B, 6"
28	PORTLAND CEMENT CONCRETE BASE COURSE 10"
29	PORTLAND CEMENT CONCRETE BASE COURSE 8"
30	TIE BARS 3/4" (EPOXY COATED, 3/4" DIA., 18" LONG DEFORMED TIE BARS @ 24" O.C.)
31	LEVELING BINDER (MACHINE METHOD), N50
32	HOT-MIX ASPHALT SURFACE COURSE, MIX "D", N50
33	HOT-MIX ASPHALT SURFACE COURSE, MIX "D", N70
34	TOPSOIL FURNISH AND PLACE, 4" SODDING
35	SOIL PLANTING MIXTURE

ITEM	AIR VOIDS	QUALITY MANAGEMENT PROGRAM (QMP)
RESURFACING		
HOT-MIX ASPHALT SURFACE COURSE, MIX "D", N50, (IL - 9.5 mm)	4% @ 50 GYR	Qc/Qa
HOT-MIX ASPHALT SURFACE COURSE, MIX "D", N70, (IL - 9.5 mm)	4% @ 50 GYR	Qc/Qa
LEVELING BINDER (MACHINE METHOD), N50	4% @ 50 GYR	Qc/Qa
INCIDENTAL HOT-MIX ASPHALT SURFACING (HOT-MIX ASPHALT SURFACE COURSE, MIX "D", N50, (IL-9.5mm))	4% @ 50 GYR	Qc/Qa

THE UNIT WEIGHT USED TO CALCULATE ALL HMA SURFACE MIXTURE QUANTITIES = 112 LBS/SQYD/IN.

THE "AC TYPE" FOR POLYMERIZED HMA MIXES SHALL BE "SBS/SBR PG 76-22" AND FOR NON-POLYMERIZED HMA THE "AC TYPE" SHALL BE "PG 64-22" UNLESS MODIFIED BY DISTRICT ONE SPECIAL PROVISIONS.

FOR HMA FULL DEPTH "AC TYPE" SEE SPECIAL PROVISIONS.

FOR USE OF RECYCLED MATERIALS SEE SPECIAL PROVISIONS.

QUALITY MANAGEMENT PROGRAM (QMP) IDENTIFIES THE PARTICULAR QUALITY CONTROL SPECIFICATION THAT APPLIES TO THE HMA MIXTURE.

HANCOCK	<u> </u>
◆ Civil Engineers	G 9933 Rose Wassbester, Ellecte 6
◆ Municipal Consultants ◆ Established 1911	Fhose: 70 Fat: 70

	USER NAME -	XX	DESIGNED -	JGG	REVISED -	XX
			DRAWN -	MK	REVISED -	XX
Road 2760	PLOT SCALE -	xx	CHECKED -	MDL	REVISED -	XX
-0300 -0212	PLOT DATE -	xx	DATE -	03-19-14	REVISED -	XX


STATE OF ILLINO	IS
DEPARTMENT OF TRANSP	ORTATION

SCALE: NONE

PROPOSED TYPICAL SECTIONS			RTE. 3612	13-00160-00-SW	COOK 50		10				
						CONTRAC	T NO. 61A	23			
SHEET NO.	1	OF	4	SHEETS	STA.	TO STA.	FED. ROAD I	DIST. NO. 1 ILLINOIS FED	. AID PROJECT		

TOTAL SHEET NO.

50 10

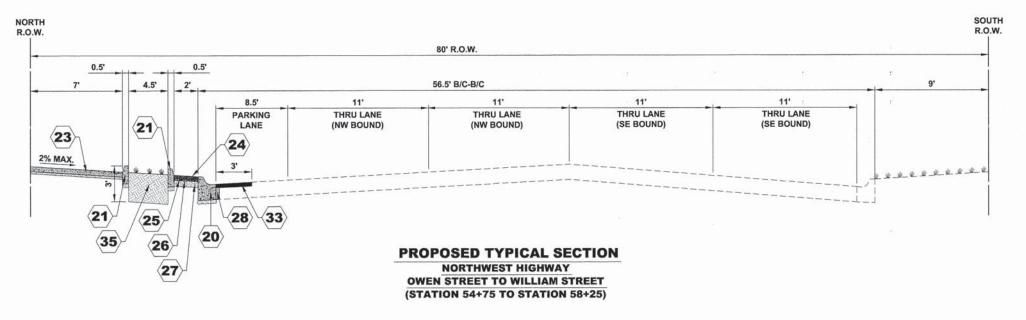

18	COMBINATION CONCRETE CURB AND GUTTER, TYPE B (SPECIAL)
19	COMBINATION CONCRETE CURB AND GUTTER, TYPE B-6.12 (MODIFIED)
20	COMBINATION CONCRETE CURB AND GUTTER, TYPE B-6.18 (MODIFIED)
21	PLANTER CURB
22	CONCRETE EDGE RESTRAINT
23	PORTLAND CEMENT CONCRETE SIDEWALK, 5"
24	PAVING BRICK SIDEWALK
25	SAND CUSHION, 1" (INCLUDED IN THE COST FOR PAVING BRICK SIDEWALK)
26	FILTER FABRIC (INCLUDED IN THE COST FOR PAVING BRICK SIDEWALK)
27	AGGREGATE BASE COURSE, TYPE B, 6"
28	PORTLAND CEMENT CONCRETE BASE COURSE 10"
29	PORTLAND CEMENT CONCRETE BASE COURSE 8"
30	TIE BARS 3/4" (EPOXY COATED, 3/4" DIA., 18" LONG DEFORMED TIE BARS @ 24" O.C.)
31	LEVELING BINDER (MACHINE METHOD), N50
32	HOT-MIX ASPHALT SURFACE COURSE, MIX "D", N50
33	HOT-MIX ASPHALT SURFACE COURSE, MIX "D", N70
34	TOPSOIL FURNISH AND PLACE, 4" SODDING
35	SOIL PLANTING MIXTURE

DESCRIPTION

ITEM	AIR VOIDS	QUALITY MANAGEMENT PROGRAM (QMP)
RESURFACING		
HOT-MIX ASPHALT SURFACE COURSE, MIX "D", N50, (IL - 9.5 mm)	4% @ 50 GYR	Qc/Qa
HOT-MIX ASPHALT SURFACE COURSE, MIX "D", N70, (IL - 9.5 mm)	4% @ 50 GYR	Qc/Qa
LEVELING BINDER (MACHINE METHOD), N50	4% @ 50 GYR	Qc/Qa
INCIDENTAL HOT-MIX ASPHALT SURFACING (HOT-MIX ASPHALT SURFACE COURSE, MIX "D", N50, (IL-9.5mm))	4% @ 50 GYR	Qc/Qa

THE UNIT WEIGHT USED TO CALCULATE ALL HMA SURFACE MIXTURE QUANTITIES = 112 LBS/SQYD/IN.

THE "AC TYPE" FOR POLYMERIZED HMA MIXES SHALL BE "SBS/SBR PG 76-22" AND FOR NON-POLYMERIZED HMA THE "AC TYPE" SHALL BE "PG 64-22" UNLESS MODIFIED BY DISTRICT ONE SPECIAL PROVISIONS.

FOR HMA FULL DEPTH "AC TYPE" SEE SPECIAL PROVISIONS.

SYMBOL

FOR USE OF RECYCLED MATERIALS SEE SPECIAL PROVISIONS.


QUALITY MANAGEMENT PROGRAM (QMP) IDENTIFIES THE PARTICULAR QUALITY CONTROL SPECIFICATION THAT APPLIES TO THE HMA MIXTURE.

ETTANCOC	
◆ Civil Engineers	ING
 ◆ Municipal Consultants ◆ Established 1911 	Floor Fee

	USER NAME - XX	DESIGNED -	JGG	REVISED -	XX	
		DRAWN -	MK	REVISED -	xx	
1154-2160 1154-2160	PLOT SCALE - XX	CHECKED -	MDL	REVISED -	XX	
VM65-0300 VM65-1212	PLOT DATE - XX	DATE -	03-19-14	REVISED -	XX	

STATE OF ILLINOIS
DEPARTMENT OF TRANSPORTATION

	F.A.U. RTE.	SECTION	COUNTY	TOTAL	SHEET NO.
PROPOSED TYPICAL SECTIONS	3612	13-00160-00-SW	соок	50	11
			CONTRAC	T NO. 61A	23
SHEET NO. 2 OF 4 SHEETS STA. TO STA.	FED. ROAD I	DIST. NO. 1 ILLINOIS FED	. AID PROJECT		

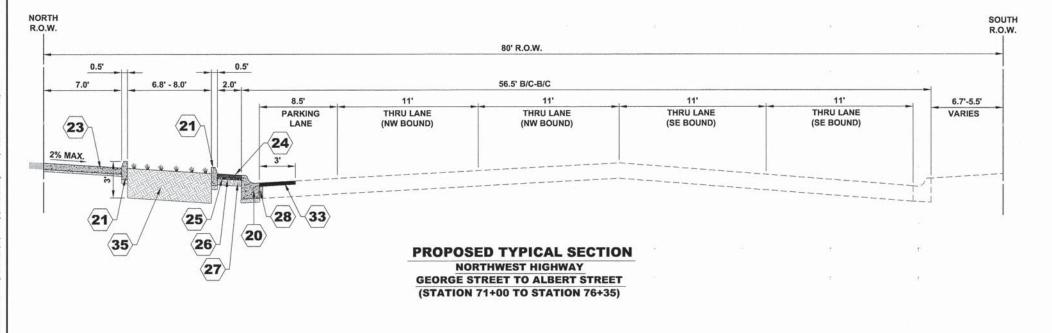

SYMBOL	DESCRIPTION
18	COMBINATION CONCRETE CURB AND GUTTER, TYPE B (SPECIAL)
19	COMBINATION CONCRETE CURB AND GUTTER, TYPE B-6.12 (MODIFIED)
20	COMBINATION CONCRETE CURB AND GUTTER, TYPE B-6.18 (MODIFIED)
21	PLANTER CURB
22	CONCRETE EDGE RESTRAINT
23	PORTLAND CEMENT CONCRETE SIDEWALK, 5"
24	PAVING BRICK SIDEWALK
25	SAND CUSHION, 1" (INCLUDED IN THE COST FOR PAVING BRICK SIDEWALK)
26	FILTER FABRIC (INCLUDED IN THE COST FOR PAVING BRICK SIDEWALK)
27	AGGREGATE BASE COURSE, TYPE B, 6"
28	PORTLAND CEMENT CONCRETE BASE COURSE 10"
29	PORTLAND CEMENT CONCRETE BASE COURSE 8"
30	TIE BARS 3/4" (EPOXY COATED, 3/4" DIA., 18" LONG DEFORMED TIE BARS @ 24" O.C.)
31	LEVELING BINDER (MACHINE METHOD), N50
32	HOT-MIX ASPHALT SURFACE COURSE, MIX "D", N50
33	HOT-MIX ASPHALT SURFACE COURSE, MIX "D", N70
34	TOPSOIL FURNISH AND PLACE, 4" SODDING
35	SOIL PLANTING MIXTURE

ITEM	AIR VOIDS	QUALITY MANAGEMENT PROGRAM (QMP
RESURFACING		
HOT-MIX ASPHALT SURFACE COURSE, MIX "D", N50, (IL - 9.5 mm)	4% @ 50 GYR	Qc/Qa
HOT-MIX ASPHALT SURFACE COURSE, MIX "D", N70, (IL - 9.5 mm)	4% @ 50 GYR	Qc/Qa
LEVELING BINDER (MACHINE METHOD), N50	4% @ 50 GYR	Qc/Qa
INCIDENTAL HOT-MIX ASPHALT SURFACING (HOT-MIX ASPHALT SURFACE COURSE, MIX "D", N50, (IL-9.5mm))	4% @ 50 GYR	Qc/Qa

THE UNIT WEIGHT USED TO CALCULATE ALL HMA SURFACE MIXTURE QUANTITIES = 112 LBS/SQYD/IN.

THE "AC TYPE" FOR POLYMERIZED HMA MIXES SHALL BE "SBS/SBR PG 76-22" AND FOR NON-POLYMERIZED HMA THE "AC TYPE" SHALL BE "PG 64-22" UNLESS MODIFIED BY DISTRICT ONE SPECIAL PROVISIONS.

FOR HMA FULL DEPTH "AC TYPE" SEE SPECIAL PROVISIONS.

FOR USE OF RECYCLED MATERIALS SEE SPECIAL PROVISIONS.


QUALITY MANAGEMENT PROGRAM (QMP) IDENTIFIES THE PARTICULAR QUALITY CONTROL SPECIFICATION THAT APPLIES TO THE HMA MIXTURE.


HANCOC	K NG
◆ Civil Engineers	9933 Reserved Ros Wastelester, Educal 60154-278
♠ Municipal Consultants	Fines 706/965-030
♦ Established 1911	Fat: 106565-121

USER NAME - XX	DESIGNED -	JGG	REVISED -	XX
	DRAWN -	MK	REVISED -	XX
PLOT SCALE - XX	CHECKED -	MDL	REVISED -	XX
PLOT DATE - XX	DATE -	03-19-14	REVISED -	XX

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DEPARTMENT	OF TRAN	ISPORTATION

222			_				RTE.	SECTION
PROP	JS	ED		YPICA	L SECT	IONS	3612	13-00160-00-SW
SHEET NO	3	OF	4	CHEETC	STA	TOSTA		

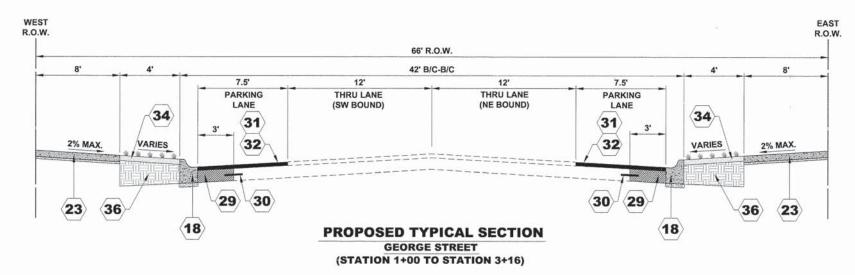

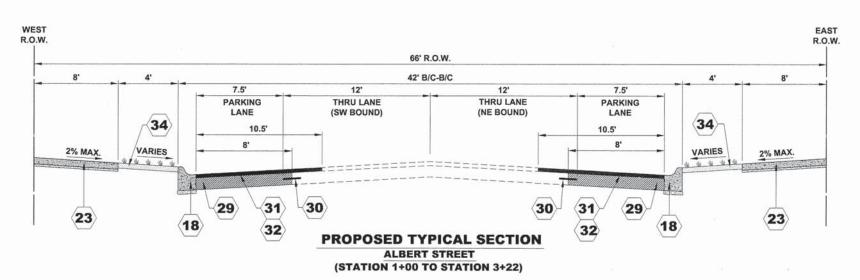

SYMBOL	DESCRIPTION
18	COMBINATION CONCRETE CURB AND GUTTER, TYPE B (SPECIAL)
19	COMBINATION CONCRETE CURB AND GUTTER, TYPE B-6.12 (MODIFIED)
20	COMBINATION CONCRETE CURB AND GUTTER, TYPE B-6.18 (MODIFIED)
(21)	PLANTER CURB
22	CONCRETE EDGE RESTRAINT
23	PORTLAND CEMENT CONCRETE SIDEWALK, 5"
24	PAVING BRICK SIDEWALK
25	SAND CUSHION, 1" (INCLUDED IN THE COST FOR PAVING BRICK SIDEWALK)
26	FILTER FABRIC (INCLUDED IN THE COST FOR PAVING BRICK SIDEWALK)
27	AGGREGATE BASE COURSE, TYPE B, 6"
28	PORTLAND CEMENT CONCRETE BASE COURSE 10"
29	PORTLAND CEMENT CONCRETE BASE COURSE 8"
30	TIE BARS 3/4" (EPOXY COATED, 3/4" DIA., 18" LONG DEFORMED TIE BARS @ 24" O.C.)
31	LEVELING BINDER (MACHINE METHOD), N50
32	HOT-MIX ASPHALT SURFACE COURSE, MIX "D", N50
33	HOT-MIX ASPHALT SURFACE COURSE, MIX "D", N70
34	TOPSOIL FURNISH AND PLACE, 4" SODDING
35	SOIL PLANTING MIXTURE
36	AREA OF STREET NARROWING TO BE FILLED WITH EARTH EXCAVATION FROM PROJECT

DESCRIPTION

HOT-MIX ASPHALT (HMA) MIXTURE REQU	IREMENTS
ITEM	AIR VOIDS @ Ndes
RESURFACING	
HOT-MIX ASPHALT SURFACE COURSE, MIX "D", N50, (IL - 9.5 mm), 2"	4% @ 50 GYR
HOT-MIX ASPHALT SURFACE COURSE, MIX "D", N70, (IL - 9.5 mm), 3" (2 LIFTS)	4% @ 70 GYR
LEVELING BINDER (MACHINE METHOD), N50, 1"	4% @ 50 GYR
INCIDENTAL HOT-MIX ASPHALT SURFACING (HOT-MIX ASPHALT SURFACE COURSE, MIX "D", N50, (IL-9.5mm)), 3" (2 LIFTS)	4% @ 50 GYR

THE UNIT WEIGHT USED TO CALCULATE ALL HMA SURFACE MIXTURE QUANTITIES = 112 LBS/SQYD/IN.

THE "AC TYPE" FOR POLYMERIZED HMA MIXES SHALL BE "SBS/SBR PG 76-22" AND FOR NON-POLYMERIZED HMA THE "AC TYPE" SHALL BE "PG 64-22" UNLESS MODIFIED BY DISTRICT ONE SPECIAL PROVISIONS.

FOR HMA FULL DEPTH "AC TYPE" SEE SPECIAL PROVISIONS.

CVMDOL

FOR USE OF RECYCLED MATERIALS SEE SPECIAL PROVISIONS.

ANCOCK	USER NAME -	xx	DESIGNED -	JGG	REVISED -	XX	
ENGINEERING			DRAWN -	MK, DMM	REVISED -	XX	S
♦ Civil Engineers 9931 Roserell Road Watchook, Ellow 60154-2780	PLOT SCALE -	xx	CHECKED -	MDL	REVISED -	XX	DEPARTM
◆ Municipal Consultants Phone: 710,005-0300 ◆ Established 1911 Per: 710,005-1312	PLOT DATE -	xx	DATE -	05-14-14	REVISED -	XX	


STATE OF ILLINOIS	
DEPARTMENT OF TRANSPORTA	ATION

SCALE: NONE

			F.A.U. RTE.	SE	CTION	COUNTY	
PROPOSED 1	YPICA	L SECTI	ONS	3612	13-00	160-00-SW	соок
							CONTRA
SHEET NO. 4 OF 4	SHEETS	STA.	TO STA.	FED, ROAD D	IST. NO. 1	ILLINOIS FED.	AID PROJECT

CONTRACT NO. 61A23

50 13

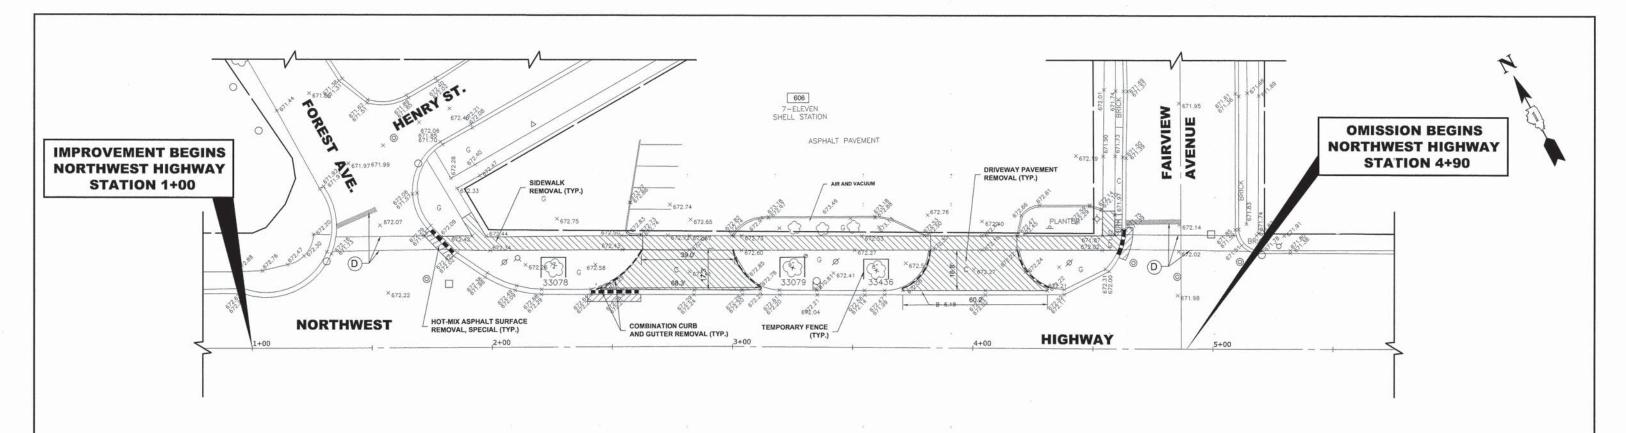

UNITID	BOTNAME	DBH
		Dia. (IN)
17408	GLTR1	24
33078	MA1DW	7
33079	MA1DW	9
33436	MA1DW	8

PLOT SCALE - XX

PLOT DATE - XX

SEE LEGEND ON SHEET 2 FOR SYMBOL DESCRIPTION.

CHECKED .

DATE -

MDL

03-19-14

COMMERCIAL PROPERTY ACCESS:
THE CONTRACTOR SHALL MAINTAIN ACCESS TO COMMERCIAL PROPERTIES AT ALL TIMES AS DIRECTED BY THE ENGINEER. THIS CAN INVOLVE THE STAGING OF SIDEWALK OR DRIVEWAY REMOVAL AND REPLACEMENT, CURB AND GUTTER REMOVAL AND REPLACEMENT, AND THE REPLACEMENT OF BRICK PAVERS. IT MAY ALSO NECESSITATE THE USE OF TEMPORARY STONE FOR ACCESS. PAYMENT WILL NOT BE MADE SEPARATELY, BUT WILL BE INCLUDED IN THE UNIT PRICE FOR THE RESPECTIVE PAY ITEMS IN THE CONTRACT.

REVISED -

REVISED .

REVISED -

XX

XX

SIGNING PLAN **LEGEND OF SYMBOLS**

A.	TYPE A POST
B	TYPE B POST
s	STOP SIGN, R1-1, 30"X30" REFLECTIVE SIGN POST PANEL, R1-1, 60"X3"
R	EXISTING SIGN PANELS TO BE RELOCATED TO PROPOSED POST (INCLUDED IN COST OF POST)
RM	EXISTING SIGN PANELS TO BE REMOVED (INCLUDED IN COST OF POST)

PAVEMENT MARKING LEGEND THERMOPLASTIC PAVEMENT MARKING LINE 6", CROSS WALK, WHITE THERMOPLASTIC PAVEMENT MARKING LINE 24", STOP BAR, WHITE PAINT PAVEMENT MARKING, LETTERS AND SYMBOLS, WHITE

PAVING PLAN

TO STA. 4+90


SHEET NO. 1 OF 11 SHEETS STA. 1+00

* EXISTING PAVEMENT MARKINGS TO BE REMOVED AS NECESSARY.

PAVEMENT MARKING REMOVAL

SCALE: 1"=20"


EXISTING TOPOGRAPHY

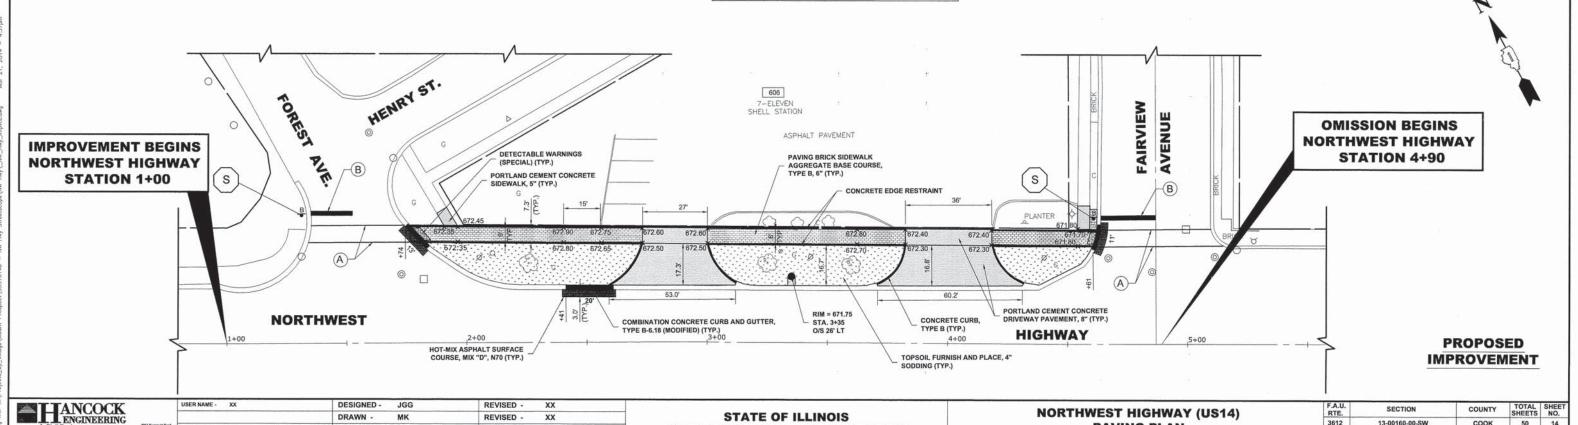


DEPARTMENT OF TRANSPORTATION

соок

13-00160-00-SW

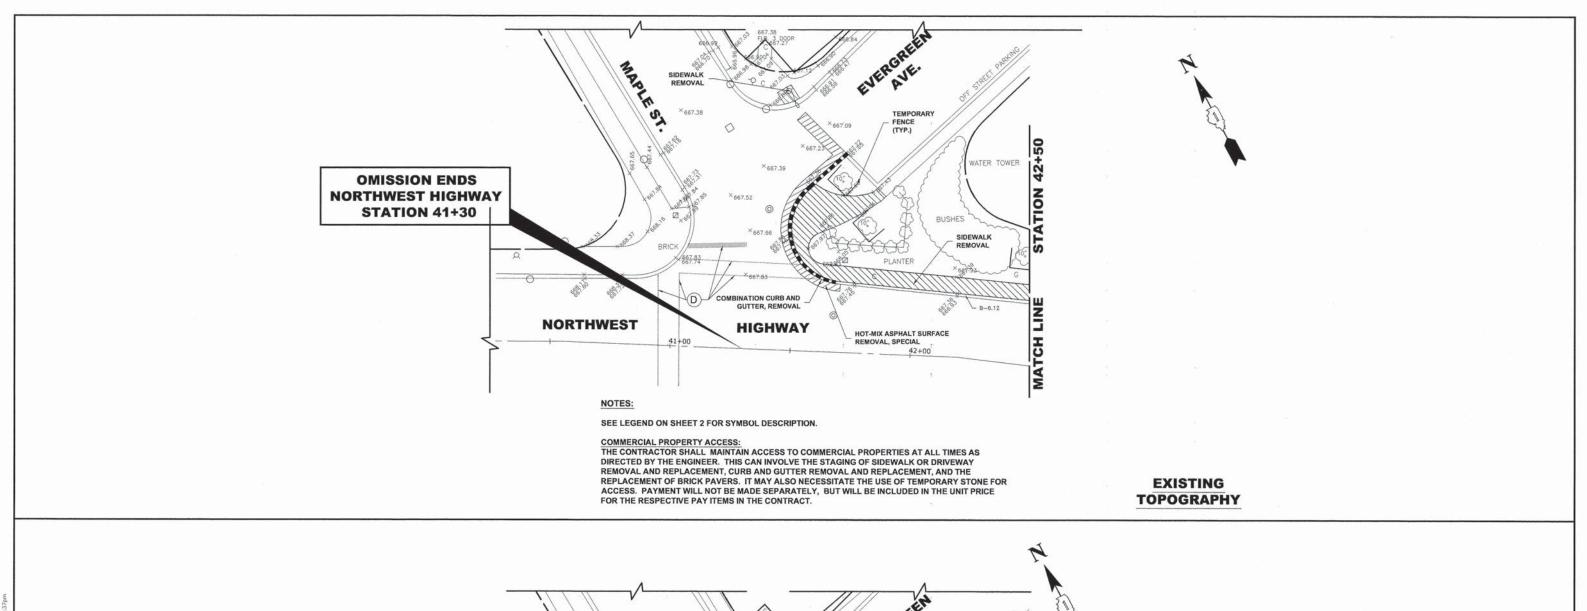

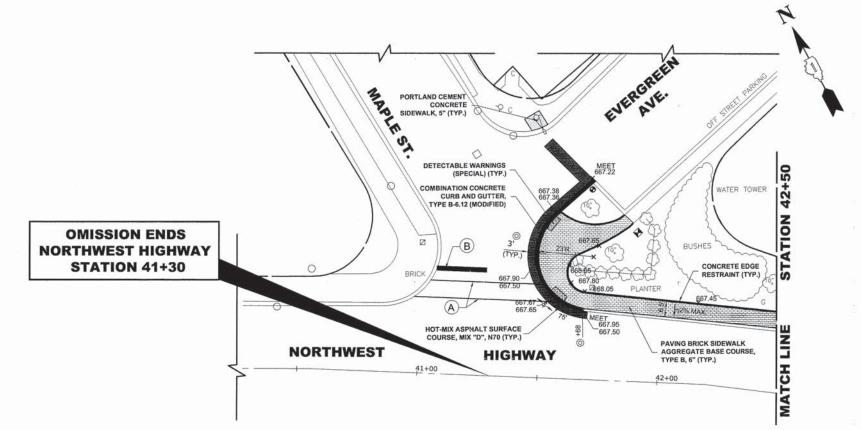

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PAVEMENT MARKING LEGEND						
ITEM DESCRIPTION	SYMBOL					
THERMOPLASTIC PAVEMENT MARKING LINE 6", CROSS WALK, WHITE	(A)					
THERMOPLASTIC PAVEMENT MARKING LINE 24", STOP BAR, WHITE	B					
PAINT PAVEMENT MARKING, LETTERS AND SYMBOLS, WHITE	©					
PAVEMENT MARKING REMOVAL	(D)					

^{*} EXISTING PAVEMENT MARKINGS TO BE REMOVED AS NECESSARY.

PROPOSED IMPROVEMENT

HANCOC	K
◆ Civil Engineers	
 Municipal Consultants 	Ph.
◆ Established 1911	


	USER NAME - XX	DESIGNED -	JGG	REVISED -
		DRAWN -	MK	REVISED -
151 Blood 154 2780	PLOT SCALE - XX	CHECKED -	MDL	REVISED -
NIS-0300 NIS-1212	PLOT DATE - XX	DATE -	03-19-14	REVISED -


STATE OF ILLINOIS
DEPARTMENT OF TRANSPORTATION

NORTHWEST HIGHWAY (US14)

PAVING PLAN

SCALE: 1"=20' SHEET NO. 2 OF 11 SHEETS STA. 40+50 TO STA. 42+50

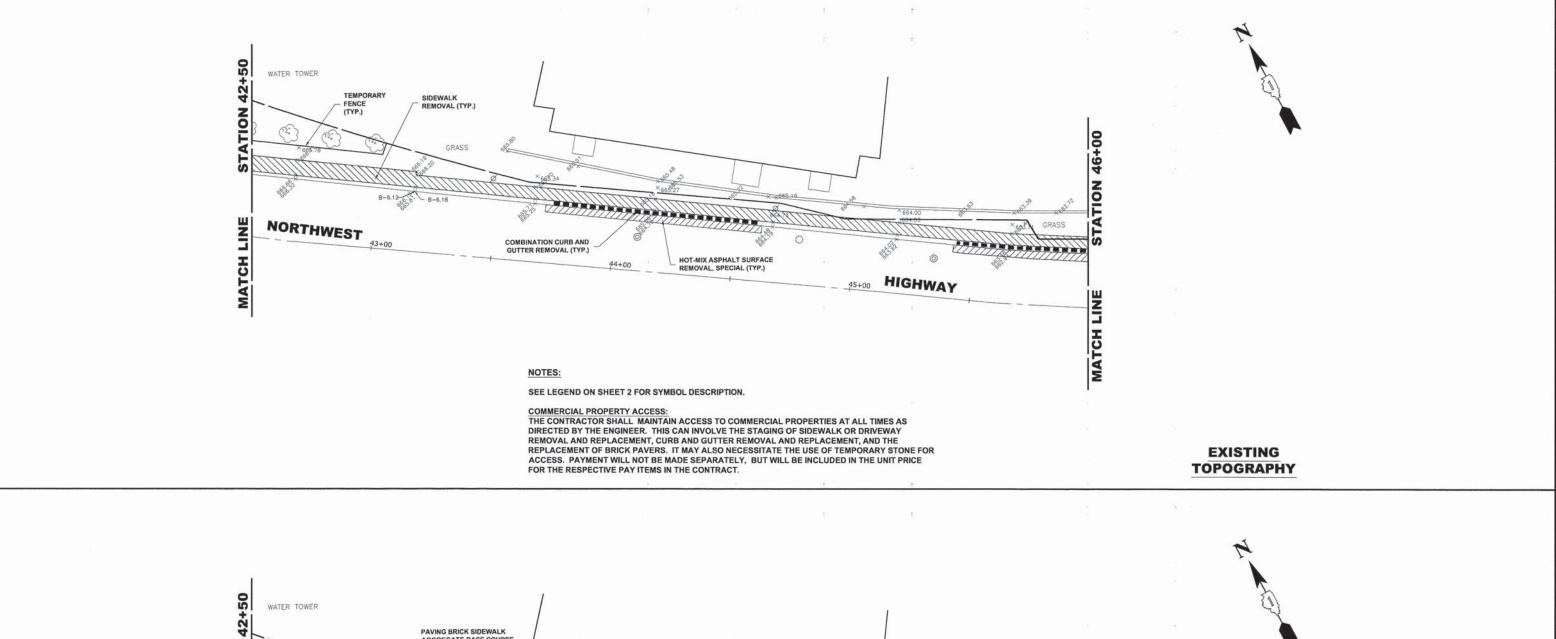

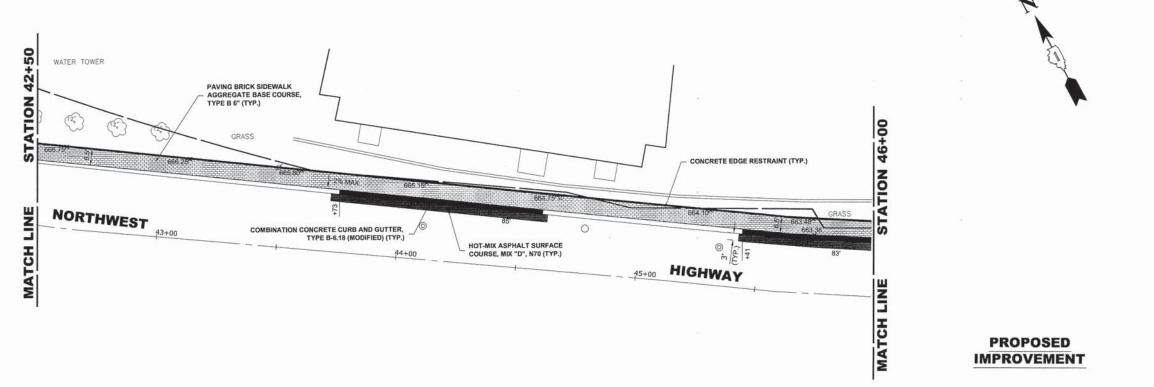

HANCOCK DESIGNED -JGG REVISED -**NORTHWEST HIGHWAY (US14)** STATE OF ILLINOIS DRAWN -MK REVISED -XX 3612 **PAVING PLAN** PLOT SCALE - XX CHECKED -MDL REVISED -XX **DEPARTMENT OF TRANSPORTATION** Phone: 708/05-000 PLOT DATE - XX SHEET NO. 3 OF 11 SHEETS STA. 42+50 TO STA. 46+00 03-19-14 SCALE: 1"=20" REVISED -


50

COUNTY

соок

SECTION


13-00160-00-SW

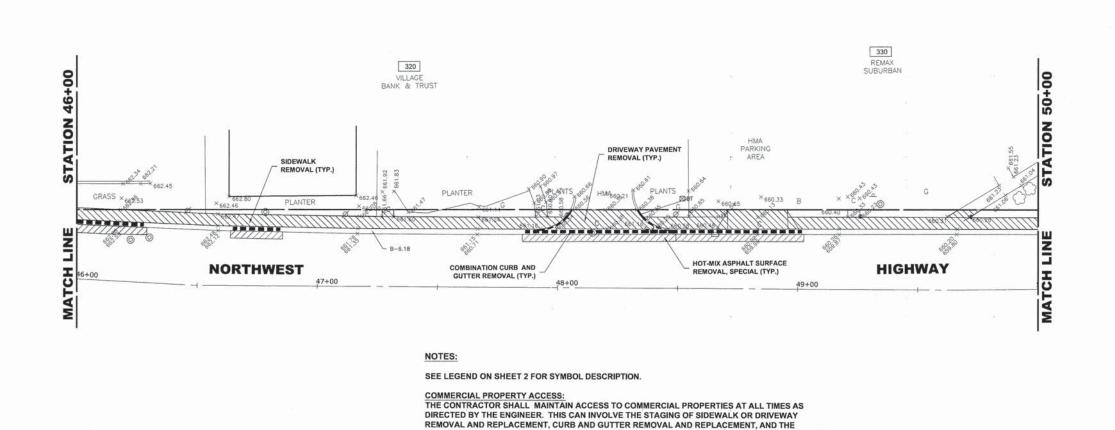

FOR THE RESPECTIVE PAY ITEMS IN THE CONTRACT.

REPLACEMENT OF BRICK PAVERS. IT MAY ALSO NECESSITATE THE USE OF TEMPORARY STONE FOR ACCESS. PAYMENT WILL NOT BE MADE SEPARATELY, BUT WILL BE INCLUDED IN THE UNIT PRICE

EXISTING TOPOGRAPHY

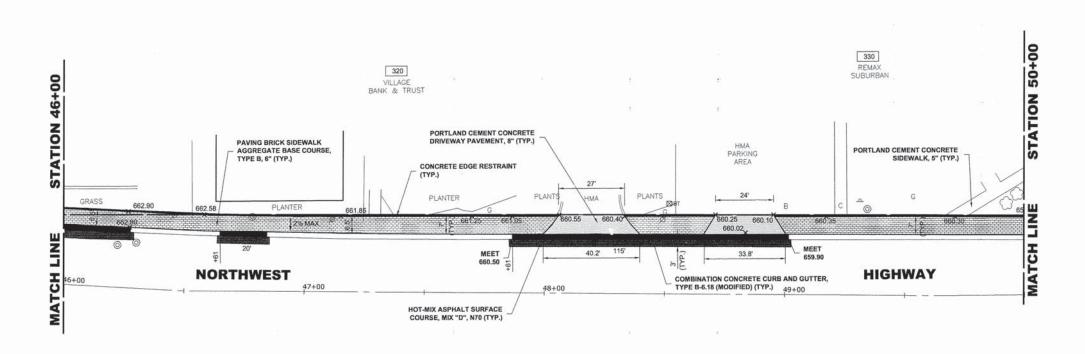

PROPOSED IMPROVEMENT

TTANCOCK		USER NAME -	xx	DESIGNED - JGG REVISED - XX				NORTHWEST HIGHWAY (11644)	F.A.U.	SECTION	COUNTY	TOTAL SHEET		
ENGINEERIN	Ğ			DRAWN -	MK	REVISED -	XX	X STATE OF ILLINOIS		NORTHWEST HIGHWAY (US14)			соок	SHEETS NO.
 ◆ Civil Engineers ◆ Municipal Consultants 	9933 Rosewell Road Westchester, Edward 60154-2780 Flores: 708/865-2100	PLOT SCALE -	XX	CHECKED -	MDL	REVISED -	XX	DEPARTMENT OF TRANSPORTATION	PAVING PLAN		3612	13-00100-00-344		NO 61422
♦ Established 1911	Fee: 708-865-1212	PLOT DATE -	xx	DATE -	03-19-14	REVISED -	XX		SCALE: 1"=20"	SHEET NO. 4 OF 11 SHEETS STA. 46+00 TO STA. 50+00	FED. ROAD DIST, NO. 1 ILLINOIS FED.		CONTRACT NO. 61A23	
							ALC: A PART OF THE							

UNITID	BOTNAME	DBH
		Dia. (IN)
23948	FRAM	13
23949	FRAM	18

NOTES:

SEE LEGEND ON SHEET 2 FOR SYMBOL DESCRIPTION.

COMMERCIAL PROPERTY ACCESS:
THE CONTRACTOR SHALL MAINTAIN ACCESS TO COMMERCIAL PROPERTIES AT ALL TIMES AS DIRECTED BY THE ENGINEER. THIS CAN INVOLVE THE STAGING OF SIDEWALK OR DRIVEWAY REMOVAL AND REPLACEMENT, CURB AND GUTTER REMOVAL AND REPLACEMENT, AND THE REPLACEMENT OF BRICK PAVERS. IT MAY ALSO NECESSITATE THE USE OF TEMPORARY STONE FOR ACCESS. PAYMENT WILL NOT BE MADE SEPARATELY, BUT WILL BE INCLUDED IN THE UNIT PRICE FOR THE RESPECTIVE PAY ITEMS IN THE CONTRACT.

SIGNING PLAN **LEGEND OF SYMBOLS**

A	TYPE A POST	PAV
В	. TYPE B POST	
1	STOP SIGN, R1-1, 30"X30"	THERMOPLASTIC PAY
(8	REFLECTIVE SIGN POST PANEL, R1-1, 60"X3"	THERMOPLASTIC PAV
-		PAINT PAVEMENT MA
F	EXISTING SIGN PANELS TO BE RELOCATED TO PROPOSED POST (INCLUDED IN COST OF POST)	PAVEMENT MARKING
R	EXISTING SIGN PANELS TO BE REMOVED (INCLUDED IN COST OF POST)	* EXISTING PAVEMEN


VEMENT MARKING LEGEND

ITEM DESCRIPTION	SYMBOL
THERMOPLASTIC PAVEMENT MARKING LINE 6", CROSS WALK, WHITE	A
THERMOPLASTIC PAVEMENT MARKING LINE 24", STOP BAR, WHITE	B
PAINT PAVEMENT MARKING, LETTERS AND SYMBOLS, WHITE	©
PAVEMENT MARKING REMOVAL	(D)

ENT MARKINGS TO BE REMOVED AS NECESSARY.

EXISTING TOPOGRAPHY



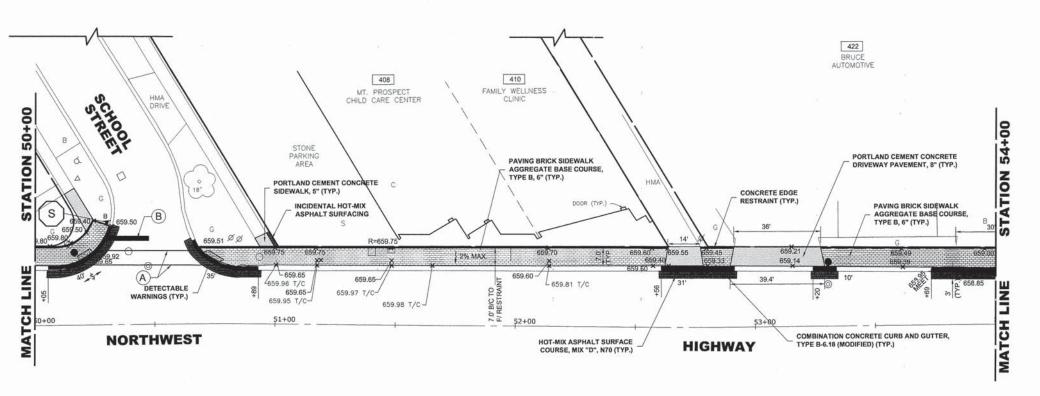

PROPOSED IMPROVEMENT


HANCOC	K
◆ Civil Engineers	9903 Rosemelt Ro Westchneter, Effects 60154-27
 Municipal Consultants 	Fhore: 706/905-01
♦ Established 1911	Fax: 706/NG-03

	USER NAME -	xx	DESIGNED -	JGG	REVISED -	XX	
			DRAWN -	MK	REVISED -	XX	
md 50	PLOT SCALE -	xx	CHECKED -	MDL	REVISED -	XX	
113	PLOT DATE -	xx	DATE -	03-19-14	REVISED -	XX	

STATE OF ILLINOIS **DEPARTMENT OF TRANSPORTATION**

	NORT	Н١		HIGH	•	14)	
SCALE: 1"=20"	SHEET NO.	5			 50+00	TO STA.	54+00

F.A.U. RTE.	SECTION	COUNTY	TOTAL	SHEE NO.	
3612	13-00160-00-SW	соок	50	18	
		CONTRAC	T NO. 61A	23	
EED BOAD I	DIST NO 1 II I INOIS FED	AID PROJECT	-		

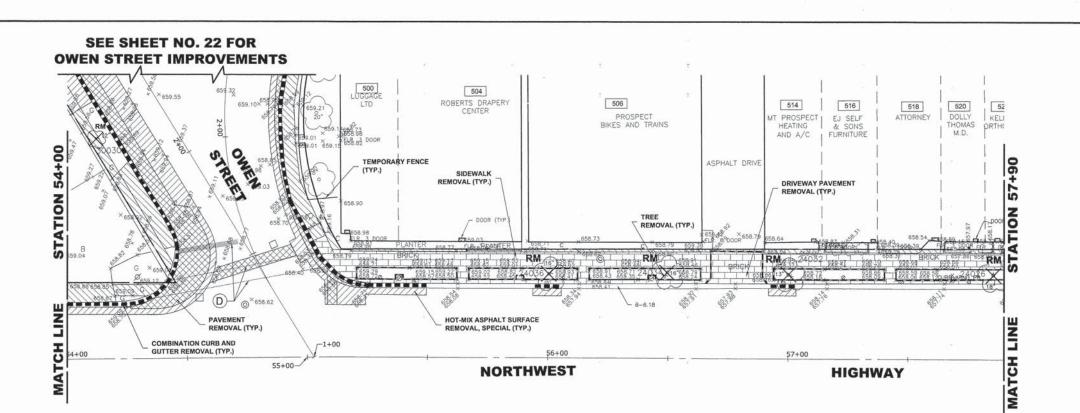

UNITID	BOTNAME	DBH
		Dia. (IN)
24026	PYCA	18
24032	PYCA	13
24034	PYCA	16
24036	PYCA	16

NOTES:

SEE LEGEND ON SHEET 2 FOR SYMBOL DESCRIPTION.

COMMERCIAL PROPERTY ACCESS:
THE CONTRACTOR SHALL MAINTAIN ACCESS TO COMMERCIAL PROPERTIES AT ALL TIMES AS DIRECTED BY THE ENGINEER. THIS CAN INVOLVE THE STAGING OF SIDEWALK OR DRIVEWAY REMOVAL AND REPLACEMENT, CURB AND GUTTER REMOVAL AND REPLACEMENT, AND THE REPLACEMENT OF BRICK PAVERS. IT MAY ALSO NECESSITATE THE USE OF TEMPORARY STONE FOR ACCESS. PAYMENT WILL NOT BE MADE SEPARATELY, BUT WILL BE INCLUDED IN THE UNIT PRICE FOR THE RESPECTIVE PAY ITEMS IN THE CONTRACT.

SIGNING PLAN **LEGEND OF SYMBOLS**

A	TYPE A POST
B	TYPE B POST
s	STOP SIGN, R1-1, 30"X30" REFLECTIVE SIGN POST PANEL, R1-1, 60"X3"
R	EXISTING SIGN PANELS TO BE RELOCATED TO PROPOSED POST (INCLUDED IN COST OF POST)
RM	EXISTING SIGN PANELS TO BE REMOVED (INCLUDED IN COST OF POST)

PAVEMENT MARKING REMOVAL * EXISTING PAVEMENT MARKINGS TO BE REMOVED AS NECESSARY.

THERMOPLASTIC PAVEMENT MARKING LINE 6", CROSS WALK, WHITE

THERMOPLASTIC PAVEMENT MARKING LINE 24", STOP BAR, WHITE

PAINT PAVEMENT MARKING, LETTERS AND SYMBOLS, WHITE

PAVEMENT MARKING LEGEND


ITEM DESCRIPTION

SYMBOL

EXISTING TOPOGRAPHY



SEE SHEET NO. 22 FOR

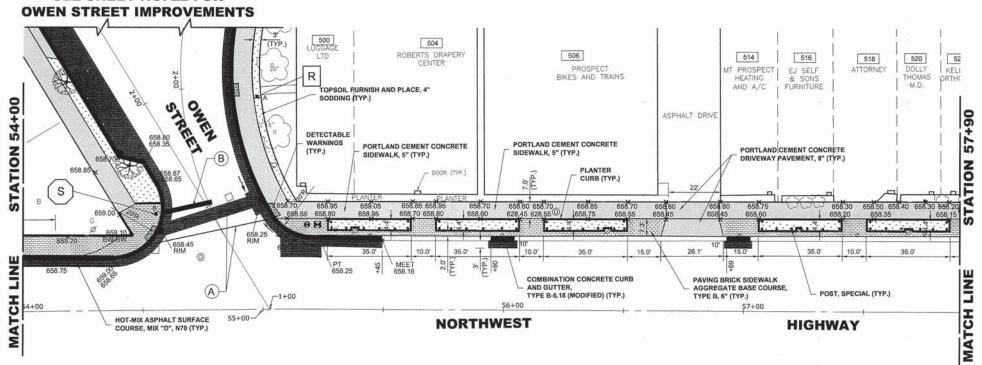

PROPOSED IMPROVEMENT


HANCOC	K NG
◆ Civil Engineers	Washbarr, Eth
♦ Municipal Consultants	Phone
◆ Established 1911	Fee

	USER NAME - XX	DESIGNED -	JGG	REVISED -	XX	
		DRAWN -	MK	REVISED -	XX	
1154-2780	PLOT SCALE - XX	CHECKED -	MDL	REVISED -	XX	
1965-1212 1965-1212	PLOT DATE - XX	DATE -	03-19-14	REVISED -	XX	

STATE OF ILLINOIS **DEPARTMENT OF TRANSPORTATION**

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			P	AV	ING P	LAN			
SCALE: 1"=20'	SHEET NO.	6	OF	11	SHEETS	STA.	54+00	TO STA.	57+90

111	F.A.U. RTE.	SE	CTION	COUNTY	TOTAL	SHE	
	3612	13-00	160-00-SW	соок	50	1	
	CONTRACT NO. 61A23						
	FED. ROAD D	IST. NO. 1	ILLINOIS FED	. AID PROJECT		-	

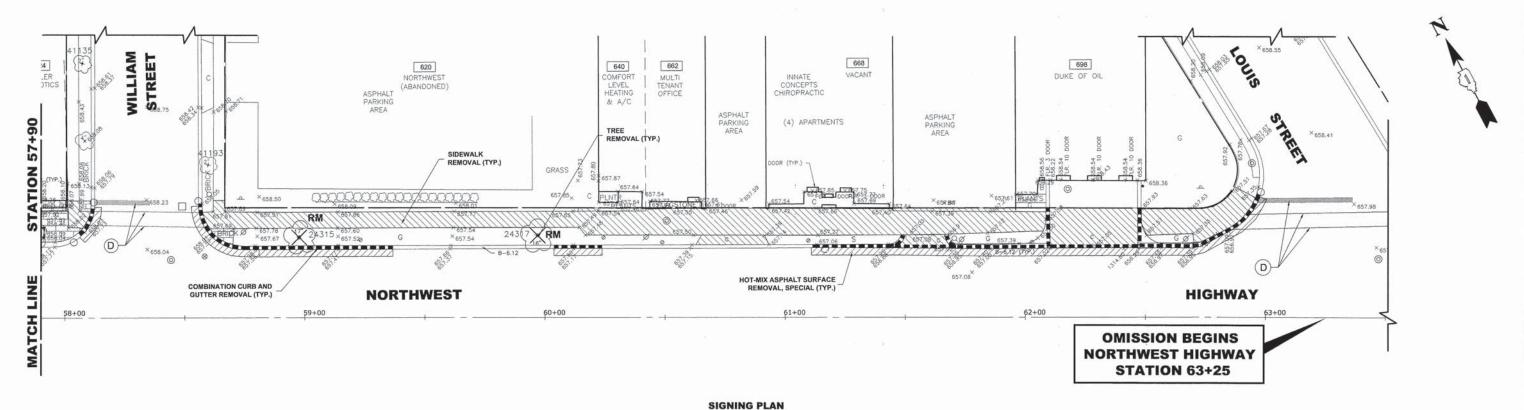

ı	UNITID	BOTNAME	DBH
			Dia. (IN)
	24315	PYCA	17
	24317	PYCA	16
	41135	SYREIV	2
	41193	CEOC	2

NOTES:

SEE LEGEND ON SHEET 2 FOR SYMBOL DESCRIPTION

COMMERCIAL PROPERTY ACCESS:
THE CONTRACTOR SHALL MAINTAIN ACCESS TO COMMERCIAL PROPERTIES AT ALL TIMES AS DIRECTED BY THE ENGINEER. THIS CAN INVOLVE THE STAGING OF SIDEWALK OR DRIVEWAY REMOVAL AND REPLACEMENT, CURB AND GUTTER REMOVAL AND REPLACEMENT, AND THE REPLACEMENT OF BRICK PAVERS. IT MAY ALSO NECESSITATE THE USE OF TEMPORARY STONE FOR ACCESS. PAYMENT WILL NOT BE MADE SEPARATELY, BUT WILL BE INCLUDED IN THE UNIT PRICE FOR THE RESPECTIVE PAY ITEMS IN THE CONTRACT.

LEGEND OF SYMBOLS


A	TYPE A POST
₽.	TYPE B POST
s	STOP SIGN, R1-1, 30"X30" REFLECTIVE SIGN POST PANEL, R1-1, 60"X3"
R	EXISTING SIGN PANELS TO BE RELOCATED TO PROPOSED POST (INCLUDED IN COST OF POST)
RM	EXISTING SIGN PANELS TO BE REMOVED (INCLUDED IN COST OF POST)

PAVEMENT MARKING LEGEND

ITEM DESCRIPTION	SYMBOL
THERMOPLASTIC PAVEMENT MARKING LINE 6", CROSS WALK, WHITE	A
THERMOPLASTIC PAVEMENT MARKING LINE 24", STOP BAR, WHITE	B
PAINT PAVEMENT MARKING, LETTERS AND SYMBOLS, WHITE	C
PAVEMENT MARKING REMOVAL	(D)

* EXISTING PAVEMENT MARKINGS TO BE REMOVED AS NECESSARY.

EXISTING TOPOGRAPHY

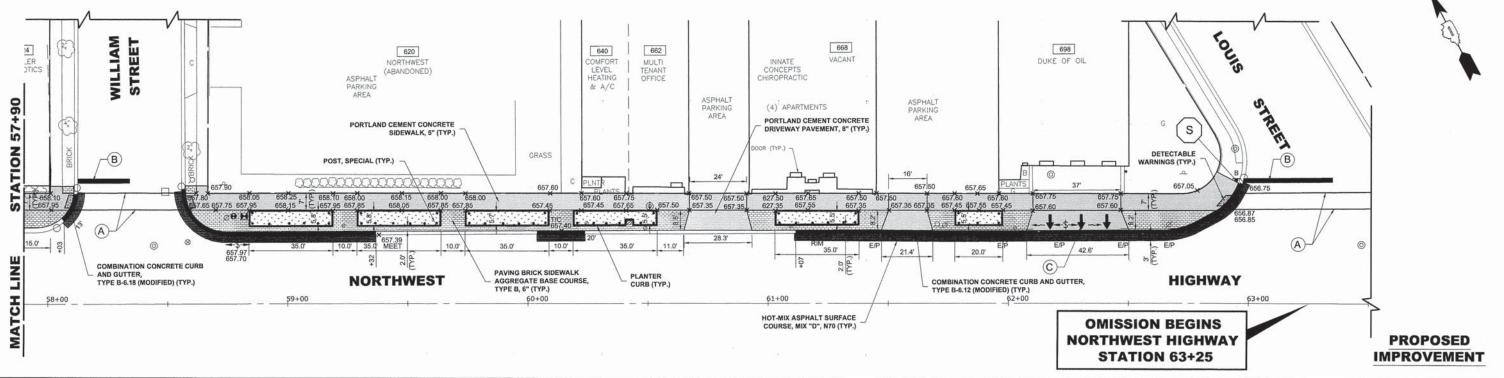

HANCOCK ENGINEERING

USER NAME - XX DESIGNED - JGG REVISED -XX REVISED . XX PLOT SCALE - XX CHECKED -MDL REVISED XX REVISED -


STATE OF ILLINOIS **DEPARTMENT OF TRANSPORTATION**


NORTHWEST HIGHWAY (US14) PAVING PLAN SHEET NO. 7 OF 11 SHEETS STA. 57+90 TO STA. 63+25


SCALE: 1"=20"


SECTION 3612 13-00160-00-SW соок 50 CONTRACT NO. 61A23

E.H.E. PROJECT NO. 555-13-14801

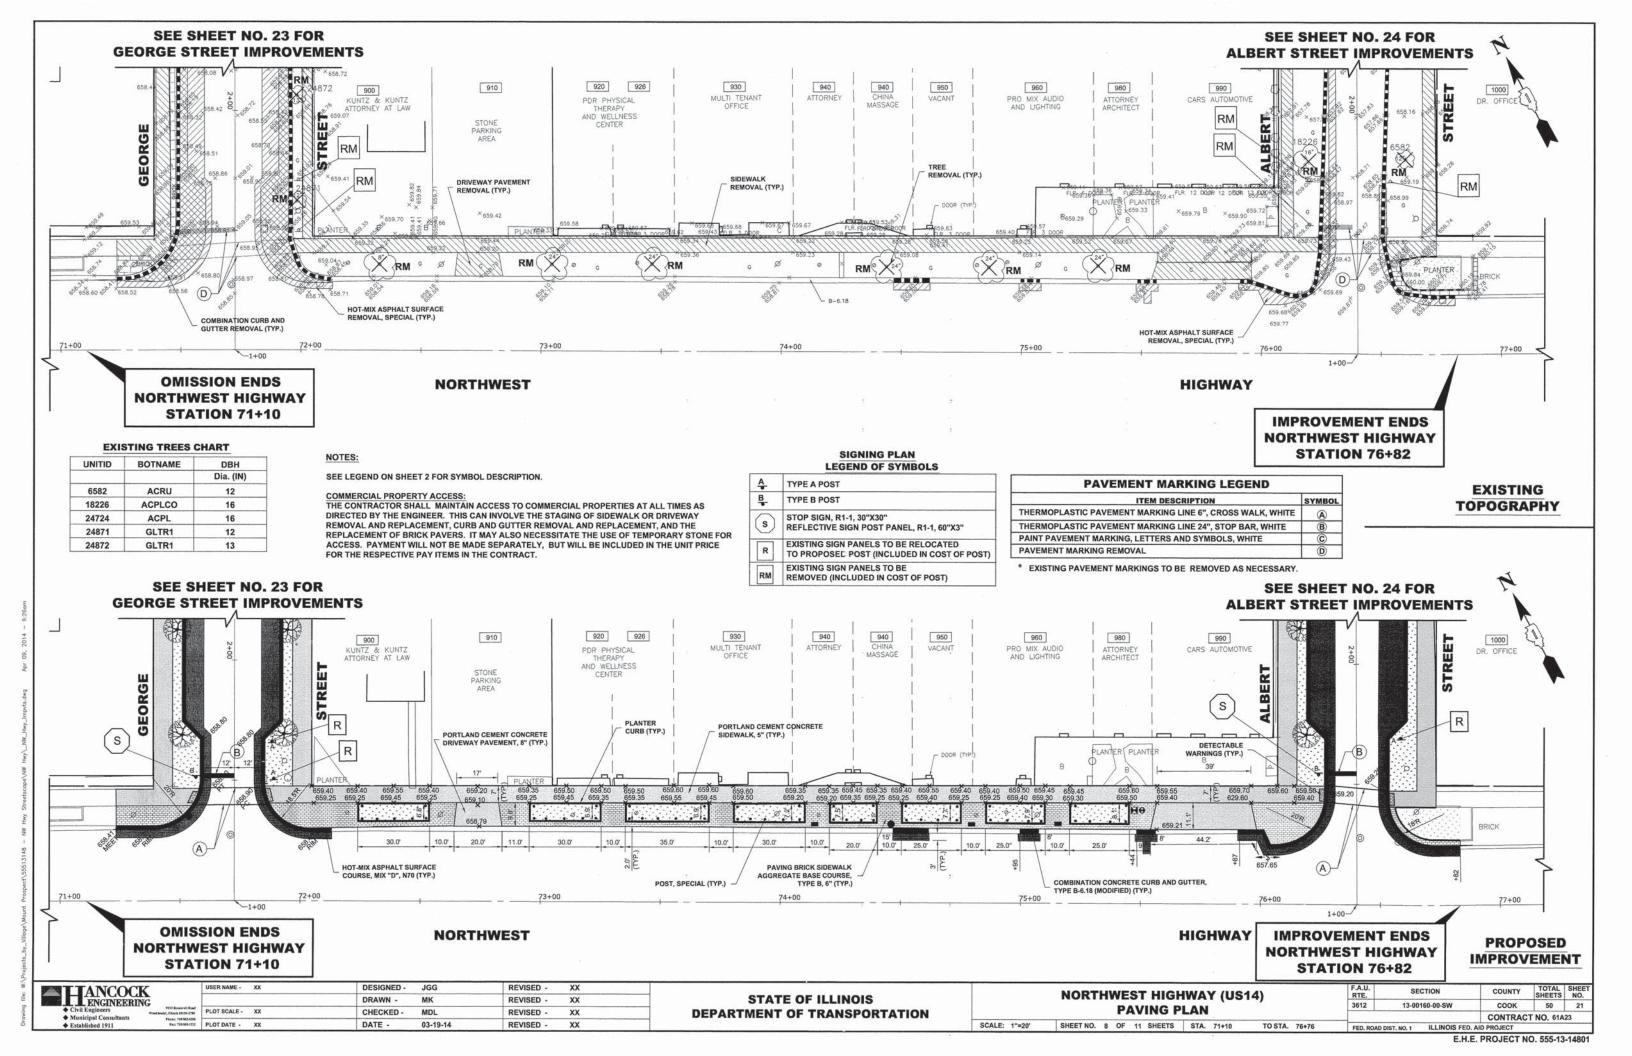

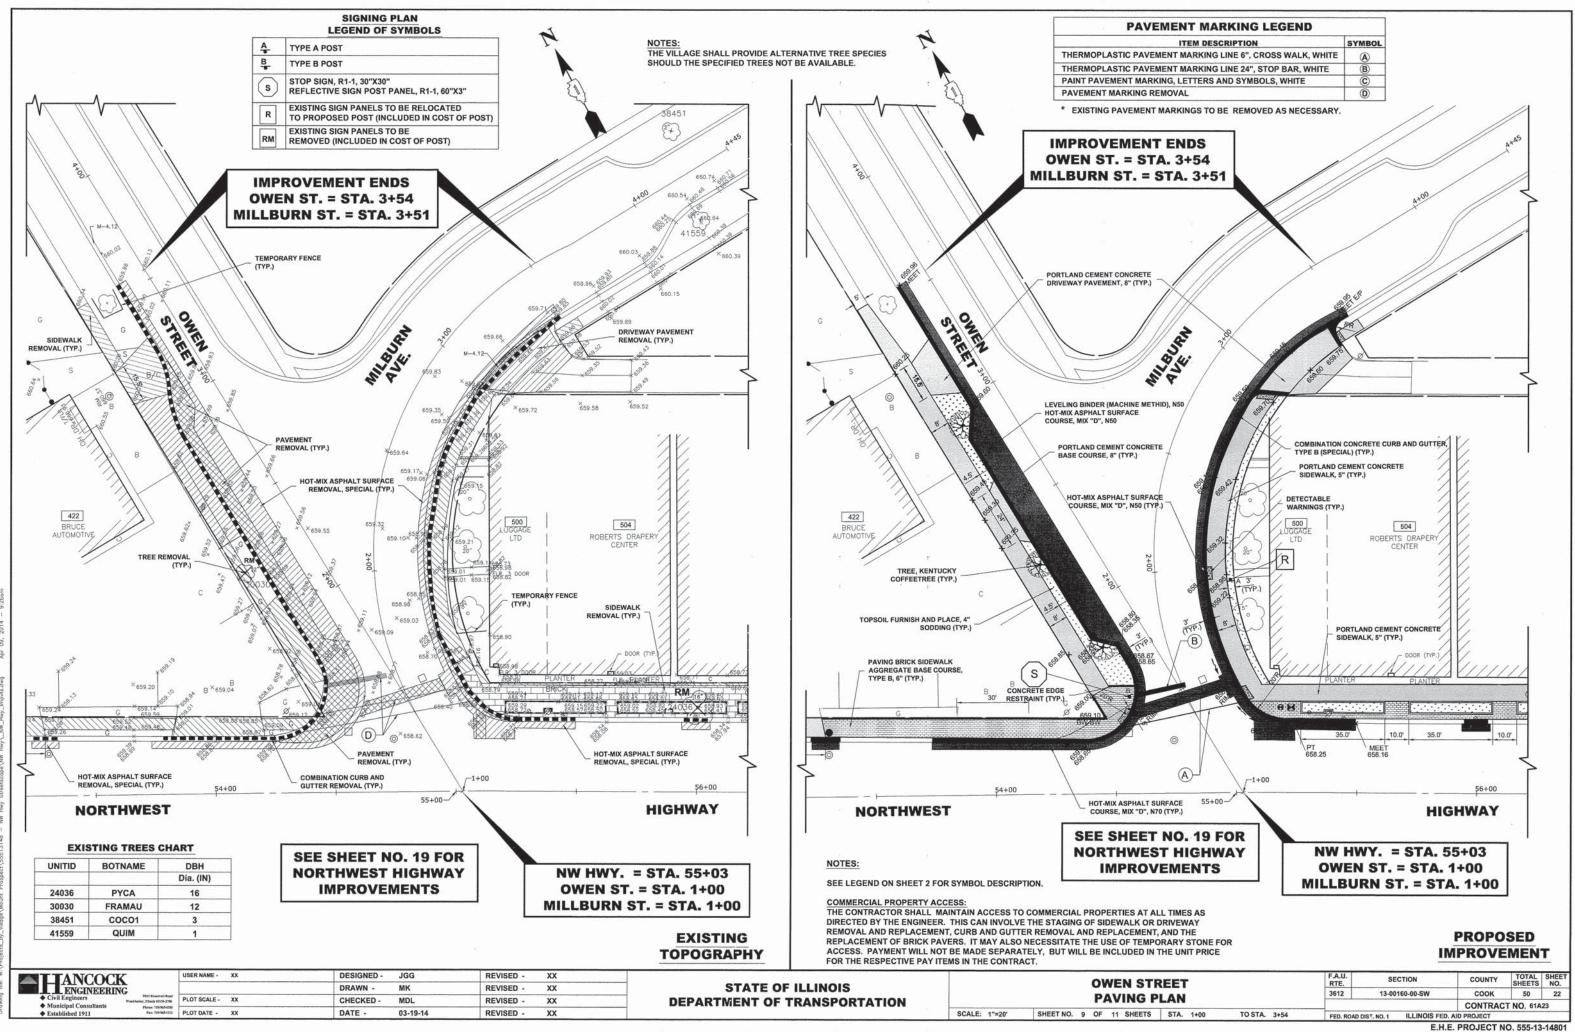

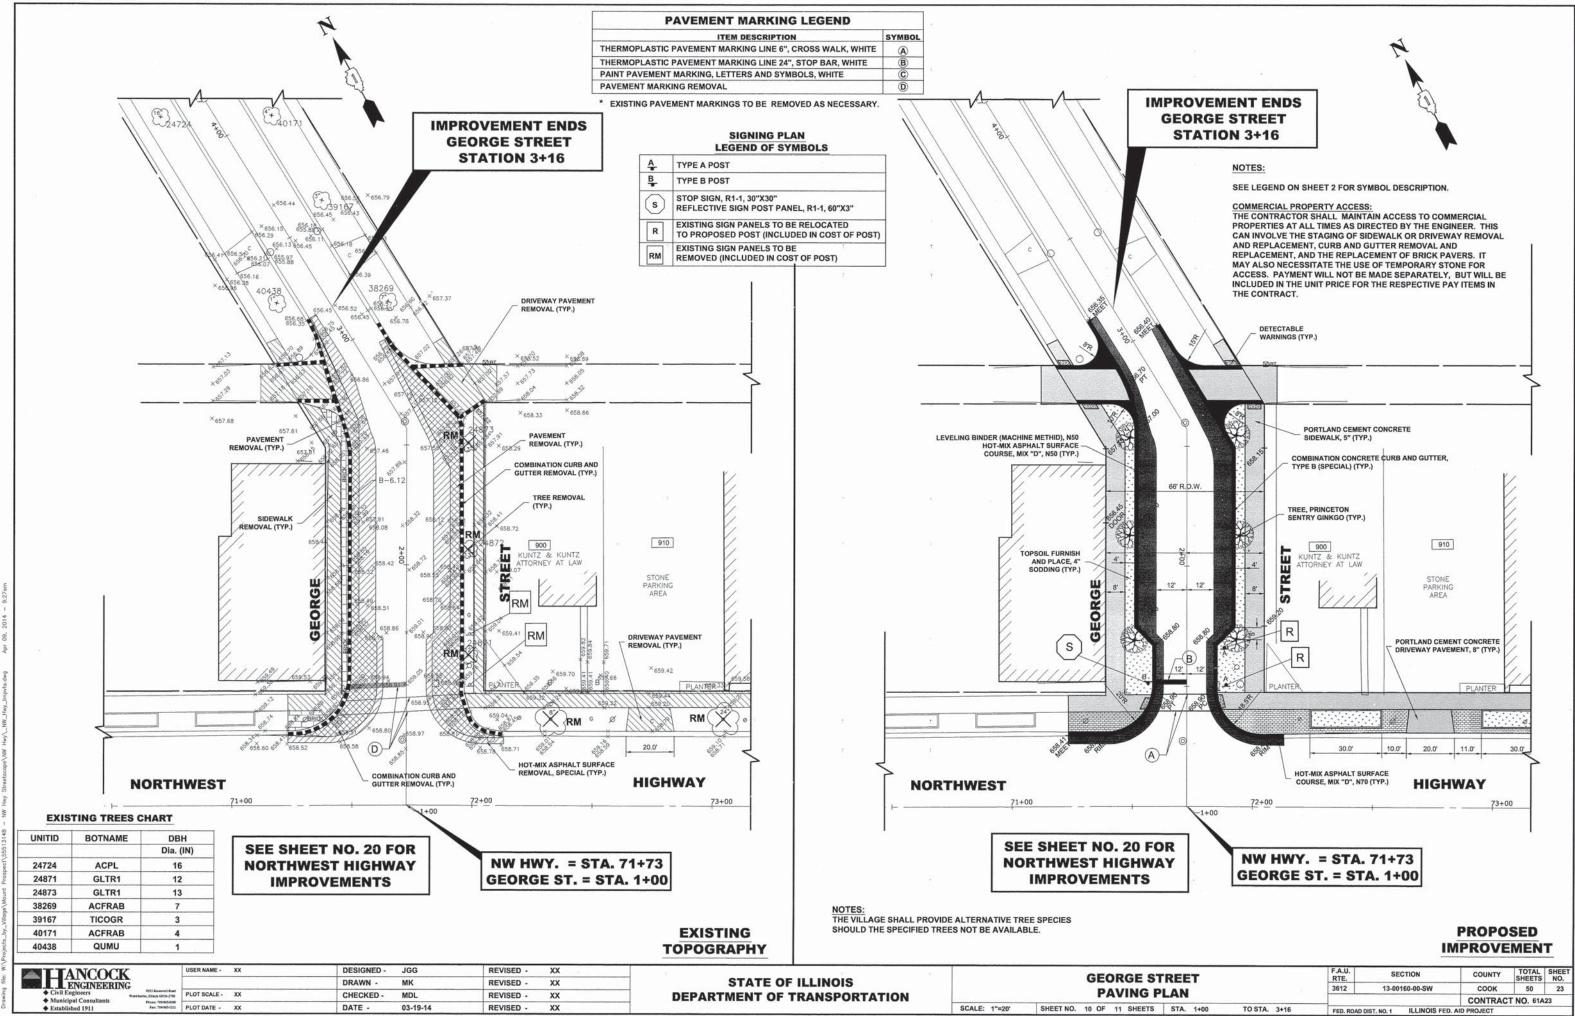


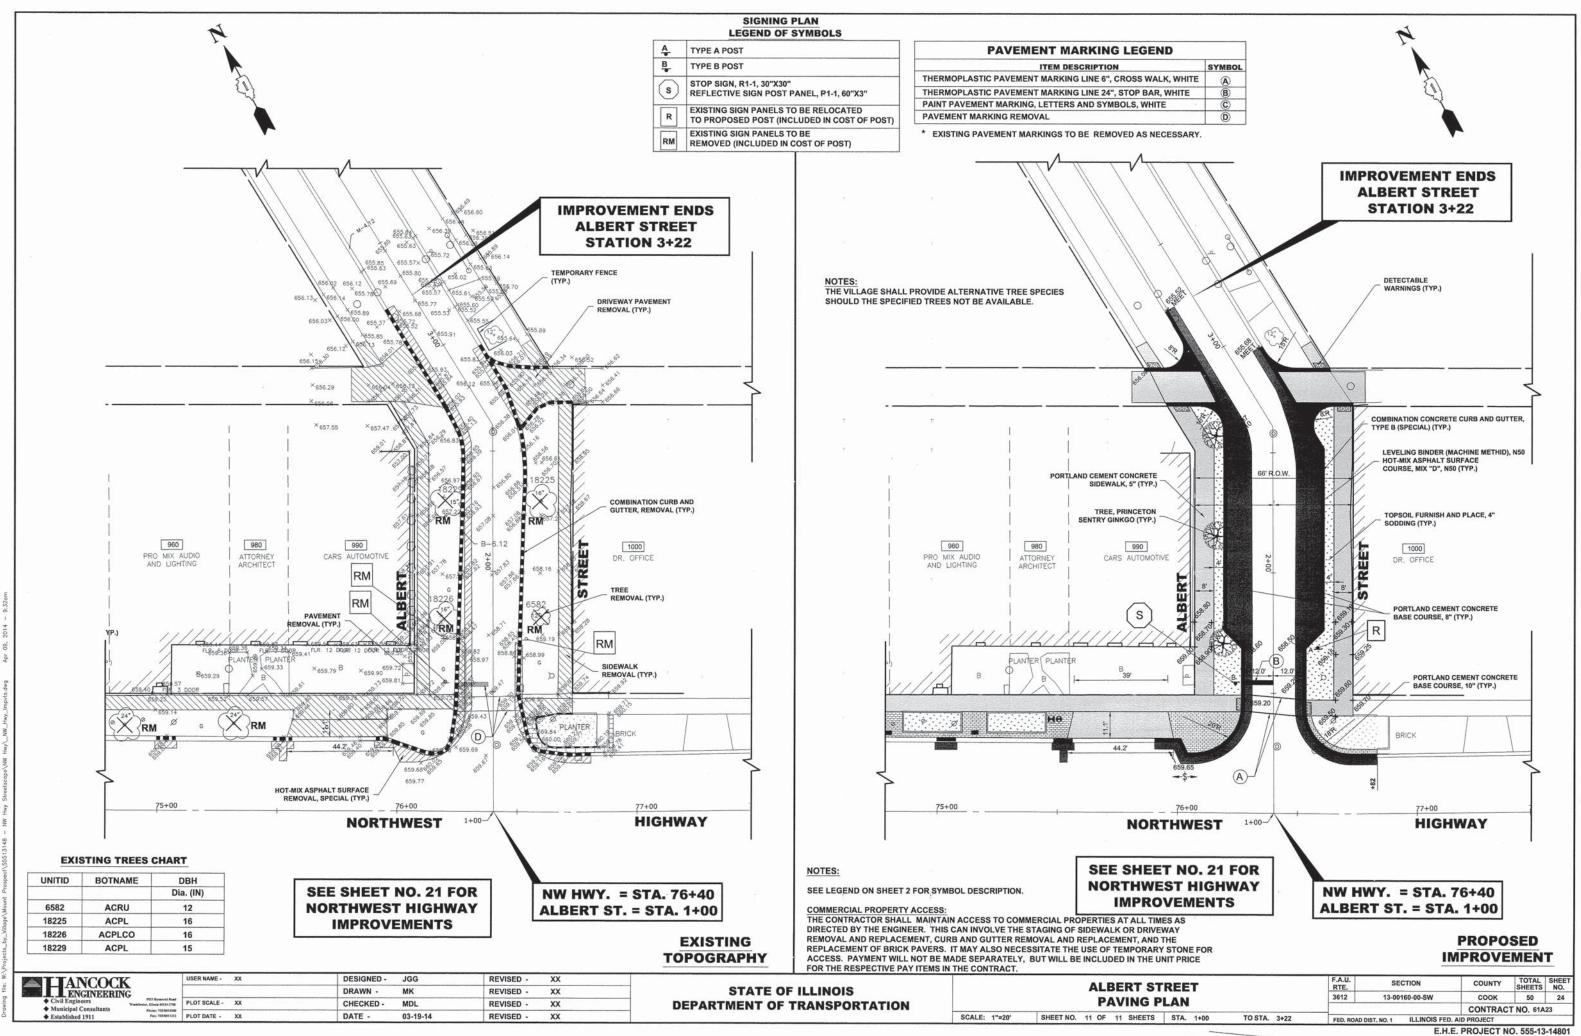

R.O.W. -MATCH EXISTING PROPOSED CONCRETE SIDEWALI PORTLAND CEMENT CONCRETE DRIVEWAY PAVEMENT, 8 INCH, WITH 2" CRUSHED STONE BEDDING (INCLUDED IN COST OF DRIVEWAY) DEPRESSED CURB AND GUTTER CURB AND GUTTER TRANSITION (TYP.)


DRIVEWAY DETAIL


TYPICAL CURB AND GUTTER **EXPANSION JOINT**

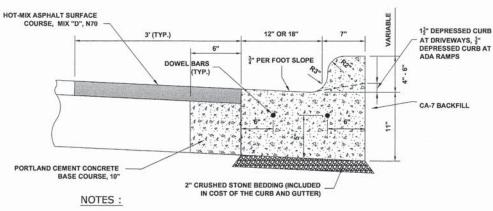

- PROVIDE 2 3/4" DIAMETER, 18" LONG EPOXY COATED SMOOTH DOWEL BARS WITH PLASTIC EXPANSION CAPS AT EACH EXPANSION JOINT.
- CONTRACTION JOINT 2" DEEP CONTRACTION JOINTS SHALL BE SAWED AT EQUAL SPACES (NOT EXCEEDING 15 FEET) BETWEEN NORMAL EXPANSION JOINTS, IN THE UPPER 1/3 OF CURB & GUTTERS WITHIN 24 HOURS OF PLACEMENT.
- THE NEW CURB AND GUTTER SHALL BE BACKFILLED FOR THE FULL-DEPTH OF THE CURB WITH CA-7 OR OTHER STONE APPROVED BY ENGINEER.
- THE COST OF THE ABOVE SHALL BE INCLUDED IN THE COST OF THE CURB

COMBINATION CONCRETE CURB & GUTTER, TYPE B-6.12 OR B-6.18 (MODIFIED)

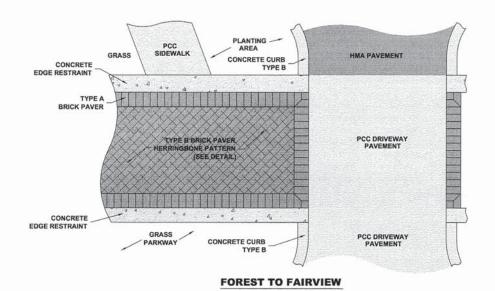

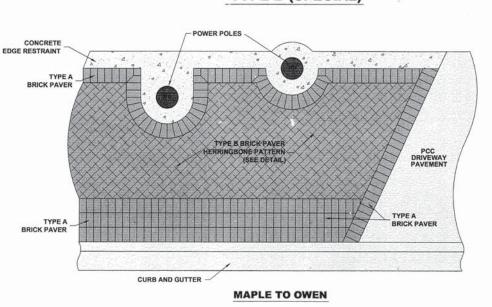

HMA SURFACE COURSE MIX "D" N50 LEVELING BINDER AT DRIVEWAYS, 3" **ADA RAMPS** (18" LONG EPOXY COATED DOWEL BARS 8. DEFORMED TIE BAR @ 24" O.C.) CA-7 BACKFILL PORTLAND CEMENT CONCRETE BASE COURSE, 8" 2" CRUSHED STONE BEDDING (INCLUDED IN COST OF THE CURB AND GUTTER)

- PROVIDE 2 3/4" DIAMETER, 18" LONG EPOXY COATED SMOOTH DOWEL BARS WITH PLASTIC EXPANSION CAPS AT EACH EXPANSION JOINT.
- CONTRACTION JOINT 2" DEEP CONTRACTION JOINTS SHALL BE SAWED AT EQUAL SPACES (NOT EXCEEDING 15 FEET) BETWEEN NORMAL EXPANSION JOINTS, IN THE UPPER 1/3 OF CURB & GUTTERS WITHIN 24 HOURS OF PLACEMENT.
- THE NEW CURB AND GUTTER SHALL BE BACKFILLED FOR THE FULL-DEPTH OF THE CURB WITH CA-7 OR OTHER STONE APPROVED BY ENGINEER.
- THE COST OF THE ABOVE SHALL BE INCLUDED IN THE COST OF THE CURB

COMBINATION CONCRETE CURB & GUTTER, TYPE B (SPECIAL)

DEPRESSED CURBS - THE TOP OF CURBS SHALL BE DEPRESSED WHERE THE CURB AND GUTTER IS CONSTRUCTED AT HANDICAP ACCESSIBLE SIDEWALK RAMPS AT ALLEY RETURNS AND STREET INTERSECTIONS, AND FOR PRIVATE AND COMMERCIAL DRIVES AND AS DIRECTED BY THE ENGINEER DRAINAGE OPENINGS - AT ALL LOCATIONS WHERE CASTINGS ARE TO BE INCORPORATED IN THE CURB AND GUTTER, A 3/4" EXPANSION JOINT SHALL BE INSTALLED IN THE CURB AND GUTTER A DISTANCE OF 5 FT. FROM EACH SIDE OF THE CASTING. 2-NO. 4 RE-BARS, 9' IN LENGTH, SHALL BE INCORPORATED IN THE CONTINUOUS PORTION OF CONCRETE CURB BEHIND THE CASTING.

<u>DETECTABLE WARNINGS</u> - DETECTABLE WARNINGS SHALL BE INSTALLED AT HANDICAP ACCESSIBLE SIDEWALK RAMPS, AT ALLEY RETURNS, AND STREET INTERSECTIONS. THESE SHALL BE CONSTRUCTED IN ACCORDANCE WITH THE APPLICABLE IDOT STANDARDS.

SLIPFORM CONSTRUCTION - VERTICAL FACES MAY BE BATTERED AT THE RATE OF 3/4" PER FOOT OF HEIGHT TO AID IN SLIPFORM OPERATIONS. THE PROPOSED CURB HEIGHT IS VARIABLE.


 $\frac{\text{DEPRESSED CURB HEIGHT}}{\text{SEE IDOT STANDARD 424001-05 FOR HEIGHT AT SIDEWALK RAMP.}}$

BITUMINOUS EXPANSION JOINTS - THREE QUARTER INCH (3/4") BITUMINOUS PREMOLDED INORGANIC FIBER EXPANSION JOINTS SHALL BE INSTALLED WHERE NEW SIDEWALK OR CURB AND GUTTER OR DRIVEWAY PAVEMENT ABUTS AN EXISTING CONCRETE WALK, DRIVE, OR CURB WHICH IS TO REMAIN IN PLACE, AND AT NOT LESS THAN NINETY FOOT (90') INTERVALS AT LOCATIONS WHERE CURB REPLACEMENT IS IN EXCESS OF NINETY FEET (90'); AT RADIUS POINTS, AT BOTH SIDES OF FRAMES AND GRATES WHICH FALL IN THE CURB; AND AS DIRECTED BY THE ENGINEER.


ALL EXPANSION JOINTS LOCATED IN THE CURB AND GUTTER SHALL HAVE TWO (2) THREE QUARTER INCH (3/4") DIAMETER, SMOOTH, ROUND, EPOXY COATED DOWEL BARS, EIGHTEEN INCHES (18") IN LENGTH, WITH GREASED PLASTIC END CAPS INSERTED TO ALLOW THE CURB AND GUTTER TO EXPAND AND CONTRACT LATERALLY. CONTRACTION JOINTS SHALL BE TOOLED INTO THE CURB AND GUTTER AT INTERVALS NOT TO EXCEED FIFTEEN FEET (15'). THESE CONTRACTION JOINTS SHALL BE SAW CUT TO A DEPTH OF TWO INCHES (2") WITHIN TWENTY-FOUR (24) HOURS OF CONCRETE PLACEMENT AND CAULKED WITHIN SEVEN (7) DAYS. THE COST OF THE ABOVE WORK SHALL BE INCLUDED IN THE RESPECTIVE ITEMS FOR CONCRETE INSTALLATION.


THE COSTS FOR REMOVAL OF ANY ASPHALT OVERLAY THAT EXTENDS INTO THE GUTTER PORTION OF THE CURB AND GUTTER WILL BE INCLUDED IN THE PRICE FOR COMBINATION CURB AND GUTTER REMOVAL

THE EDWIN HANCOCK ENGINEERING COMPANY AND THE VILLAGE PUBLIC WORKS DEPARTMENT SHALL BE NOTIFIED AT LEAST TWO (2) WORKING DAYS PRIOR TO ANY CONSTRUCTION ACTIVITY.

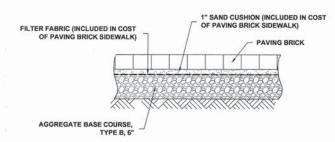

PAVING BRICK SIDEWALK

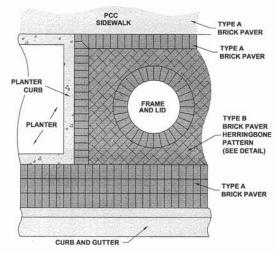

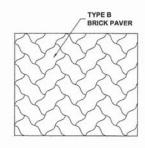

TYPE B BRICK PAVER HERRINGBONE PATTERN DETAIL

OWEN TO ALBERT

TYPE A BRICK PAVER HOLLAND PREMIER SOLID GREY (CUSTOM) - UNILOCK'S UNDURACOLOR LINE TYPE B PRICK PAVER: UNISTONE PREMIER RED - UNILOCK'S ENDURACOLOR LINE

PAVING BRICK SIDEWALK PATTERN DETAIL


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Civil Engineers Municipal Consultants	NG 9933 Roservelt Road Warkshorter, Elisade 401 54-2130	-
Established 1911	Fbsse: 708/965-0202 Fes: 708/965-0212	1


	USER NAME -	xx	DESIGNED -	JGG	REVISED -	XX
			DRAWN -	MK	REVISED -	XX
Road - 2790	PLOT SCALE -	xx	CHECKED -	MDL	REVISED -	XX
5-1312 5-1312	PLOT DATE -	XX	DATE -	03-19-14	REVISED -	XX


STATE OF ILLINOIS **DEPARTMENT OF TRANSPORTATION**


ROADWAY DETAILS							
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F.A.U. RTE.	SECTION	COUNTY	TOTAL SHE		
3612	13-00160-00-SW	соок	50	25	
		CONTRAC	CONTRACT NO. 61A23		



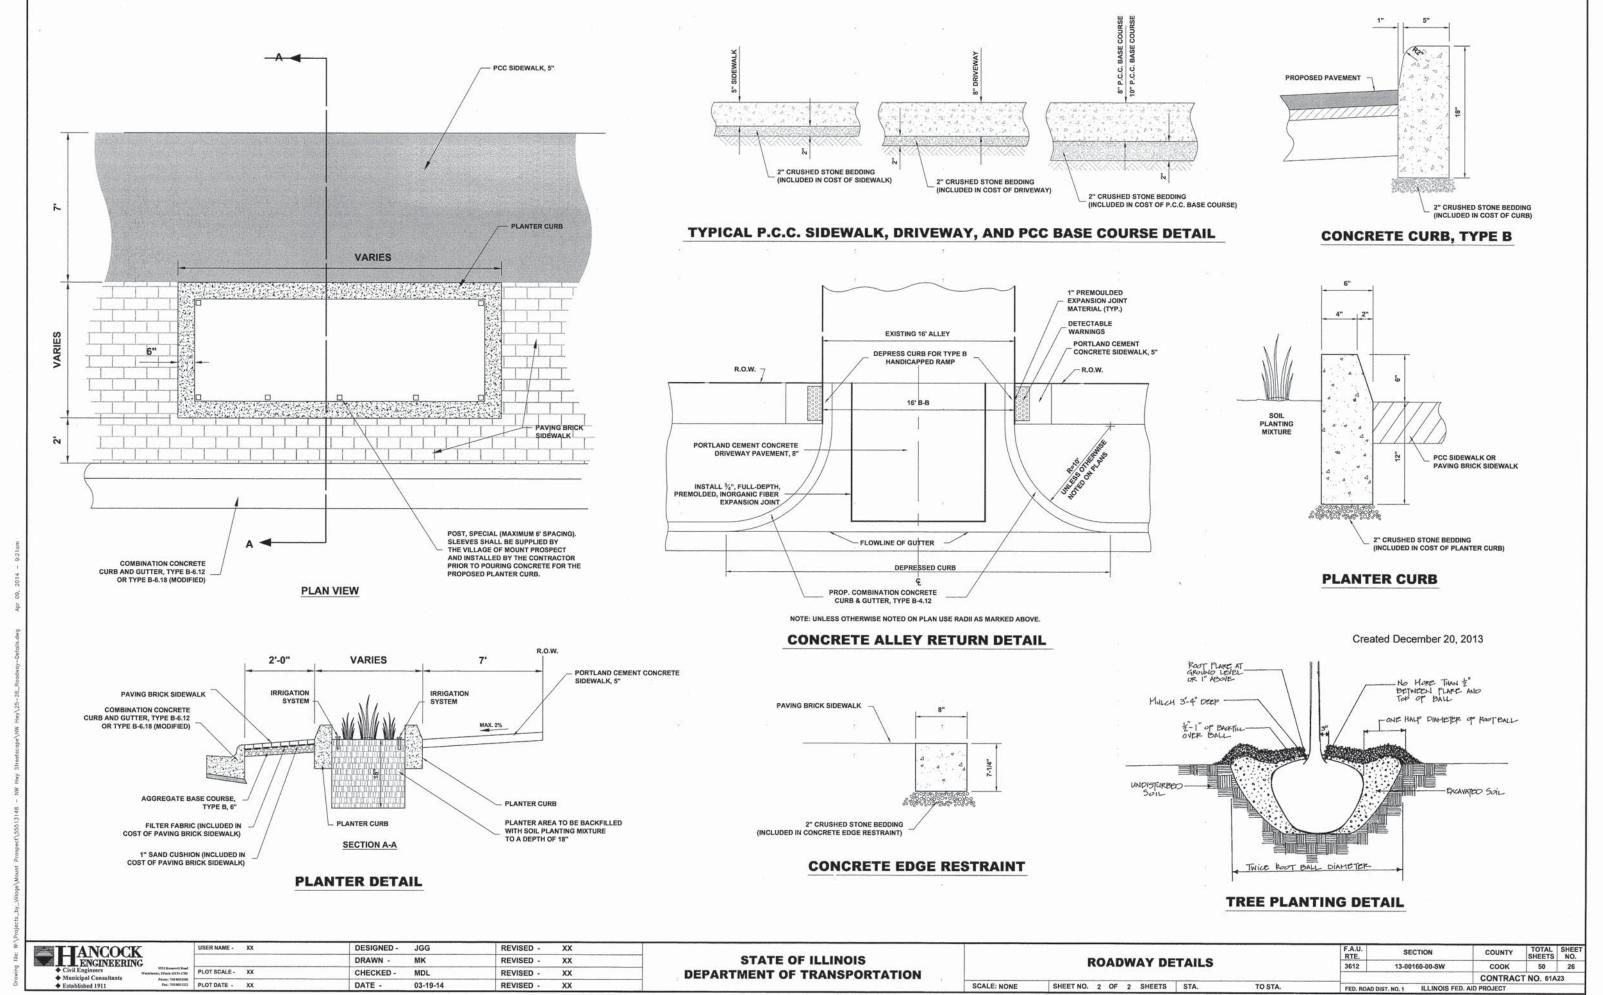

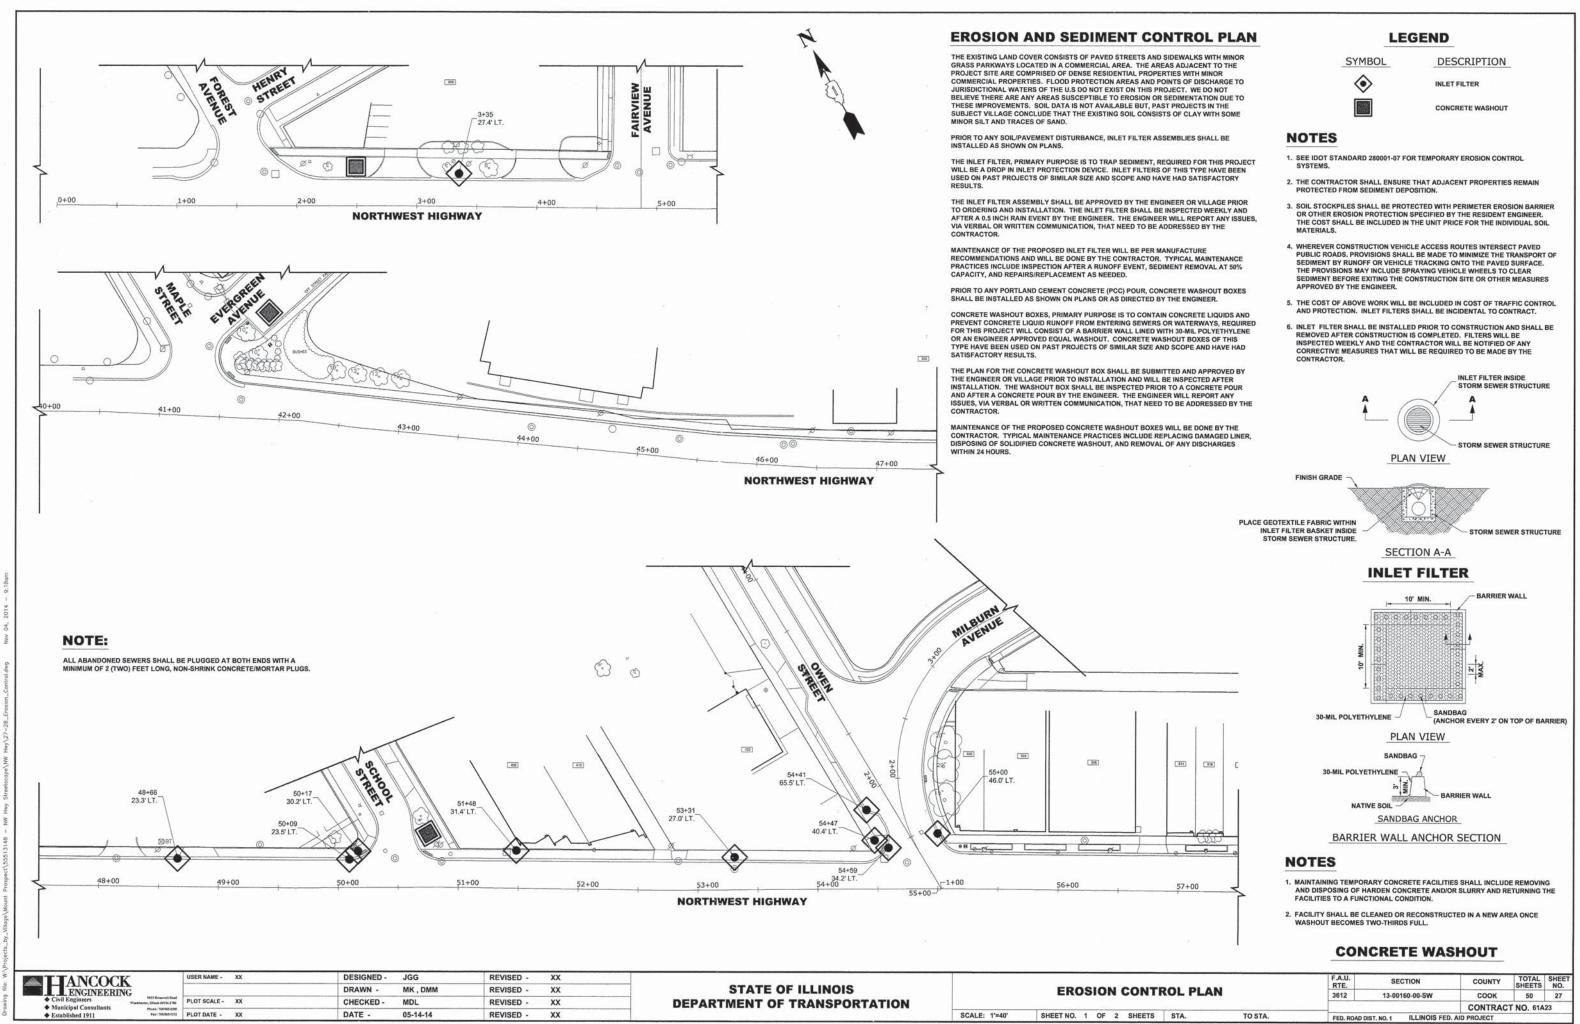

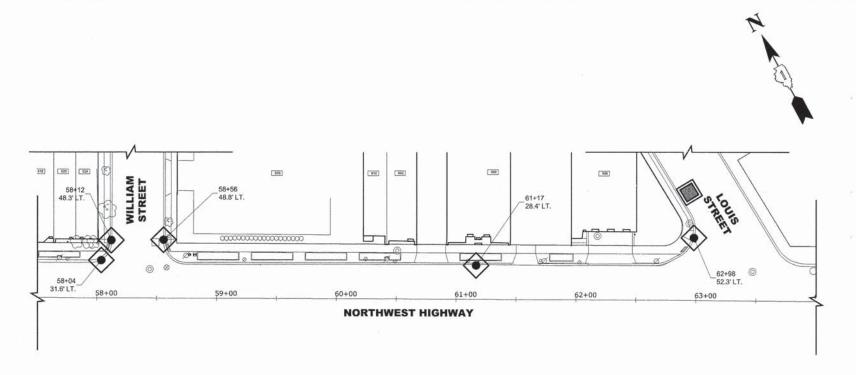

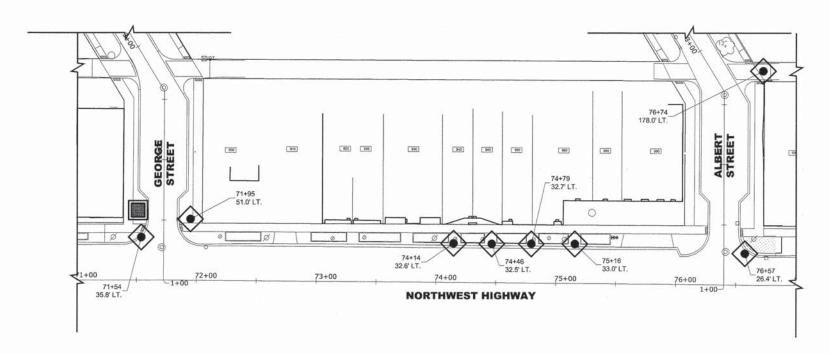NOTE

ALL ABANDONED SEWERS SHALL BE PLUGGED AT BOTH ENDS WITH A MINIMUM OF 2 (TWO) FEET LONG, NON-SHRINK CONCRETE/MORTAR PLUGS.

EROSION AND SEDIMENT CONTROL PLAN

THE EXISTING LAND COVER CONSISTS OF PAVED STREETS AND SIDEWALKS WITH MINOR GRASS PARKWAYS LOCATED IN A COMMERCIAL AREA. THE AREAS ADJACENT TO THE PROJECT SITE ARE COMPRISED OF DENSE RESIDENTIAL PROPERTIES WITH MINOR COMMERCIAL PROPERTIES. FLOOD PROTECTION AREAS AND POINTS OF DISCHARGE TO JURISDICTIONAL WATERS OF THE U.S DO NOT EXIST ON THIS PROJECT. WE DO NOT BELIEVE THERE ARE ANY AREAS SUSCEPTIBLE TO EROSION OR SEDIMENTATION DUE TO THESE IMPROVEMENTS. SOIL DATA IS NOT AVAILABLE BUT, PAST PROJECTS IN THE SUBJECT VILLAGE CONCLUDE THAT THE EXISTING SOIL CONSISTS OF CLAY WITH SOME MINOR SILT AND TRACES OF SAND.

PRIOR TO ANY SOIL/PAVEMENT DISTURBANCE, INLET FILTER ASSEMBLIES SHALL BE INSTALLED AS SHOWN ON PLANS.

THE INLET FILTER, PRIMARY PURPOSE IS TO TRAP SEDIMENT, REQUIRED FOR THIS PROJECT WILL BE A DROP IN INLET PROTECTION DEVICE. INLET FILTERS OF THIS TYPE HAVE BEEN USED ON PAST PROJECTS OF SIMILAR SIZE AND SCOPE AND HAVE HAD SATISFACTORY RESULTS.

THE INLET FILTER ASSEMBLY SHALL BE APPROVED BY THE ENGINEER OR VILLAGE PRIOR TO ORDERING AND INSTALLATION. THE INLET FILTER SHALL BE INSPECTED WEEKLY AND AFTER A 0.5 INCH RAIN EVENT BY THE ENGINEER. THE ENGINEER WILL REPORT ANY ISSUES, VIA VERBAL OR WRITTEN COMMUNICATION, THAT NEED TO BE ADDRESSED BY THE CONTRACTOR.

MAINTENANCE OF THE PROPOSED INLET FILTER WILL BE PER MANUFACTURE RECOMMENDATIONS AND WILL BE DONE BY THE CONTRACTOR. TYPICAL MAINTENANCE PRACTICES INCLUDE INSPECTION AFTER A RUNOFF EVENT, SEDIMENT REMOVAL AT 50% CAPACITY, AND REPAIRS/REPLACEMENT AS NEEDED.

PRIOR TO ANY PORTLAND CEMENT CONCRETE (PCC) POUR, CONCRETE WASHOUT BOXES SHALL BE INSTALLED AS SHOWN ON PLANS OR AS DIRECTED BY THE ENGINEER.

CONCRETE WASHOUT BOXES, PRIMARY PURPOSE IS TO CONTAIN CONCRETE LIQUIDS AND PREVENT CONCRETE LIQUID RUNOFF FROM ENTERING SEWERS OR WATERWAYS, REQUIRED FOR THIS PROJECT WILL CONSIST OF A BARRIER WALL LINED WITH 30-MIL POLYETHYLENE OR AN ENGINEER APPROVED EQUAL WASHOUT. CONCRETE WASHOUT BOXES OF THIS TYPE HAVE BEEN USED ON PAST PROJECTS OF SIMILAR SIZE AND SCOPE AND HAVE HAD SATISFACTORY RESULTS.

THE PLAN FOR THE CONCRETE WASHOUT BOX SHALL BE SUBMITTED AND APPROVED BY THE ENGINEER OR VILLAGE PRIOR TO INSTALLATION AND WILL BE INSPECTED AFTER INSTALLATION. THE WASHOUT BOX SHALL BE INSPECTED PRIOR TO A CONCRETE POUR AND AFTER A CONCRETE POUR BY THE ENGINEER. THE ENGINEER WILL REPORT ANY ISSUES, VIA VERBAL OR WRITTEN COMMUNICATION, THAT NEED TO BE ADDRESSED BY THE CONTRACTOR.

MAINTENANCE OF THE PROPOSED CONCRETE WASHOUT BOXES WILL BE DONE BY THE CONTRACTOR. TYPICAL MAINTENANCE PRACTICES INCLUDE REPLACING DAMAGED LINER, DISPOSING OF SOLIDIFIED CONCRETE WASHOUT, AND REMOVAL OF ANY DISCHARGES WITHIN 24 HOURS.

LEGEND

SYMBOL DESCRIPTION




INLET FILTER




CONCRETE WASHOUT

NOTES


- 1. SEE IDOT STANDARD 280001-07 FOR TEMPORARY EROSION CONTROL SYSTEMS.
- 2. THE CONTRACTOR SHALL ENSURE THAT ADJACENT PROPERTIES REMAIN PROTECTED FROM SEDIMENT DEPOSITION.
- 3. SOIL STOCKPILES SHALL BE PROTECTED WITH PERIMETER EROSION BARRIER OR OTHER EROSION PROTECTION SPECIFIED BY THE RESIDENT ENGINEER. THE COST SHALL BE INCLUDED IN THE UNIT PRICE FOR THE INDIVIDUAL SOIL MATERIALS.
- 4. WHEREVER CONSTRUCTION VEHICLE ACCESS ROUTES INTERSECT PAVED PUBLIC ROADS, PROVISIONS SHALL BE MADE TO MINIMIZE THE TRANSPORT OF SEDIMENT BY RUNOFF OR VEHICLE TRACKING ONTO THE PAVED SURFACE. THE PROVISIONS MAY INCLUDE SPRAYING VEHICLE WHEELS TO CLEAR SEDIMENT BEFORE EXITING THE CONSTRUCTION SITE OR OTHER MEASURES APPROVED BY THE ENGINEER.
- THE COST OF ABOVE WORK WILL BE INCLUDED IN COST OF TRAFFIC CONTROL AND PROTECTION. INLET FILTERS SHALL BE INCIDENTAL TO CONTRACT.
- 6. INLET FILTER SHALL BE INSTALLED PRIOR TO CONSTRUCTION AND SHALL BE REMOVED AFTER CONSTRUCTION IS COMPLETED. FILTERS WILL BE INSPECTED WEEKLY AND THE CONTRACTOR WILL BE NOTIFIED OF ANY CORRECTIVE MEASURES THAT WILL BE REQUIRED TO BE MADE BY THE CONTRACTOR.

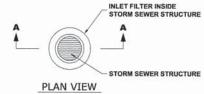

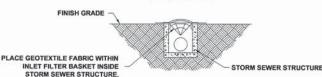

SECTION A-A

INLET FILTER

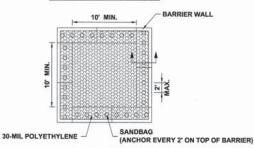

PLAN VIEW



SANDBAG ANCHOR
BARRIER WALL ANCHOR SECTION

NOTES

- MAINTAINING TEMPORARY CONCRETE FACILITIES SHALL INCLUDE REMOVING AND DISPOSING OF HARDEN CONCRETE AND/OR SLURRY AND RETURNING THE FACILITIES TO A FUNCTIONAL CONDITION.
- 2. FACILITY SHALL BE CLEANED OR RECONSTRUCTED IN A NEW AREA ONCE WASHOUT BECOMES TWO-THIRDS FULL.

CONCRETE WASHOUT

► Civil Engineers

Municipal Consultants

Www.bash.


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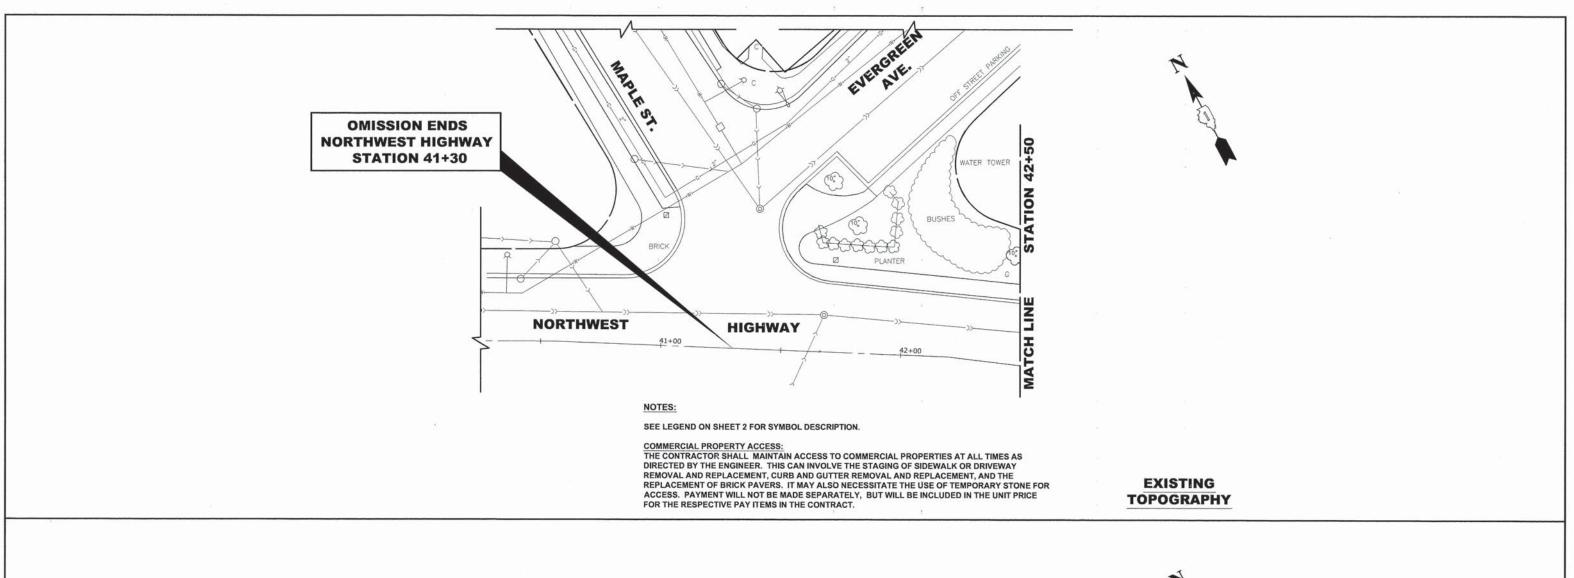
STATE OF ILLINOIS
DEPARTMENT OF TRANSPORTATION


EROSION CONTROL PLAN


SHEET NO. 2 OF 2 SHEETS STA.

E.H.E. PROJECT NO. 555-13-14801



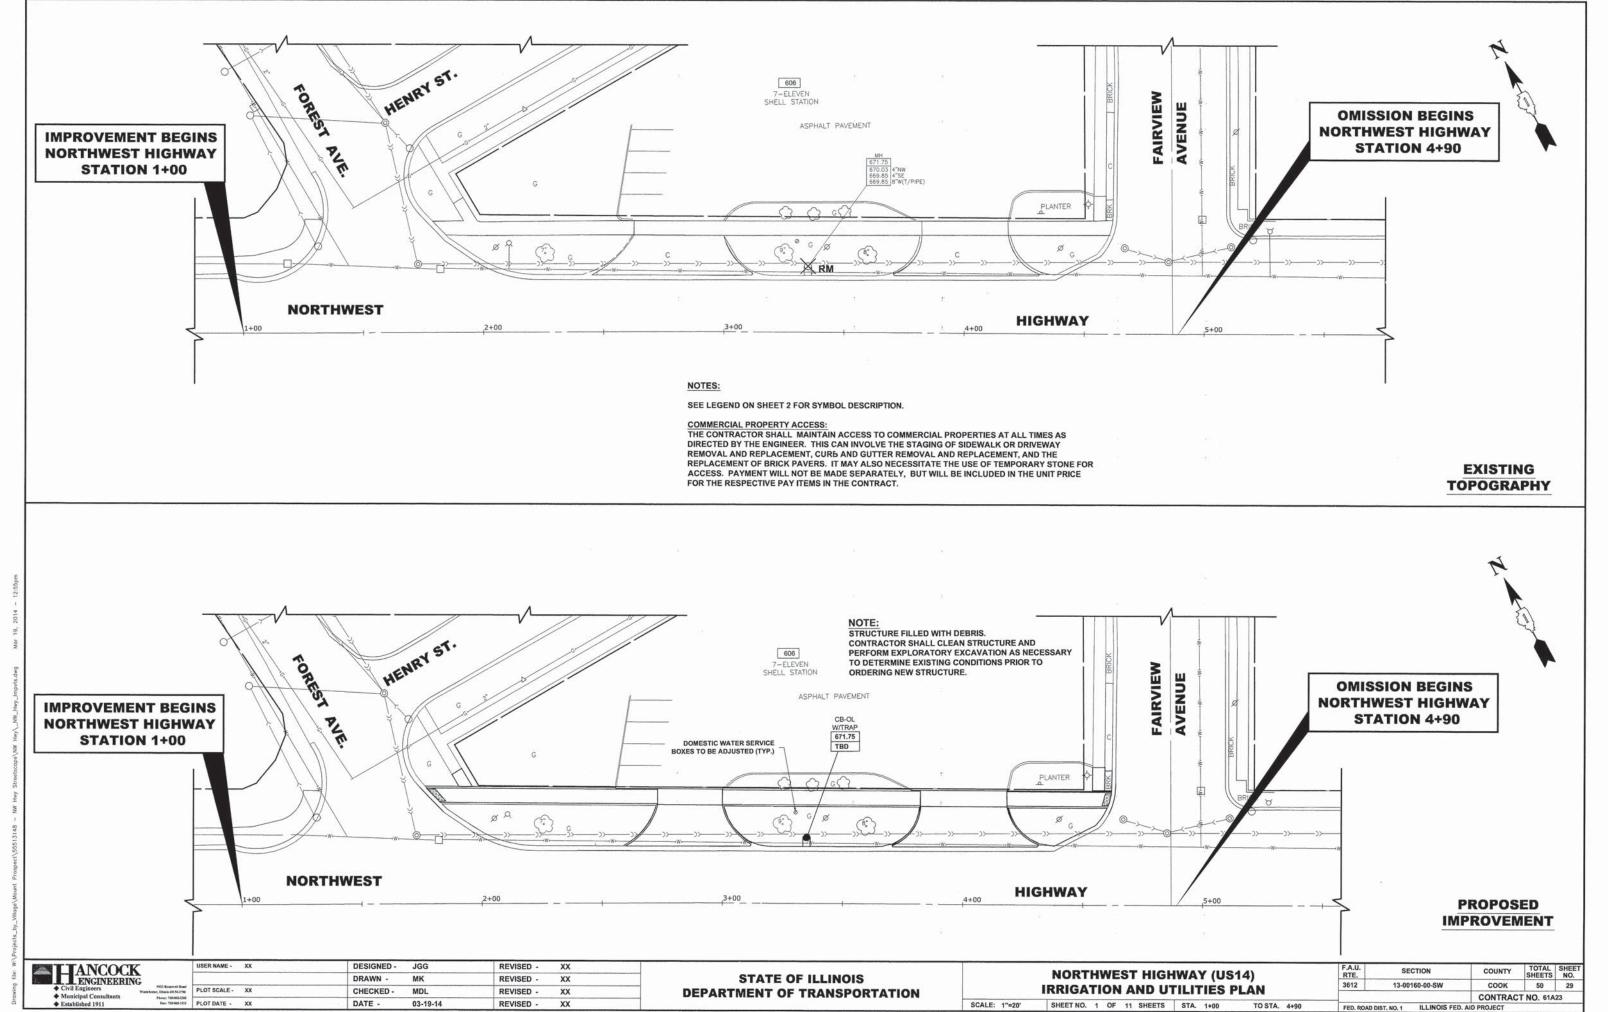

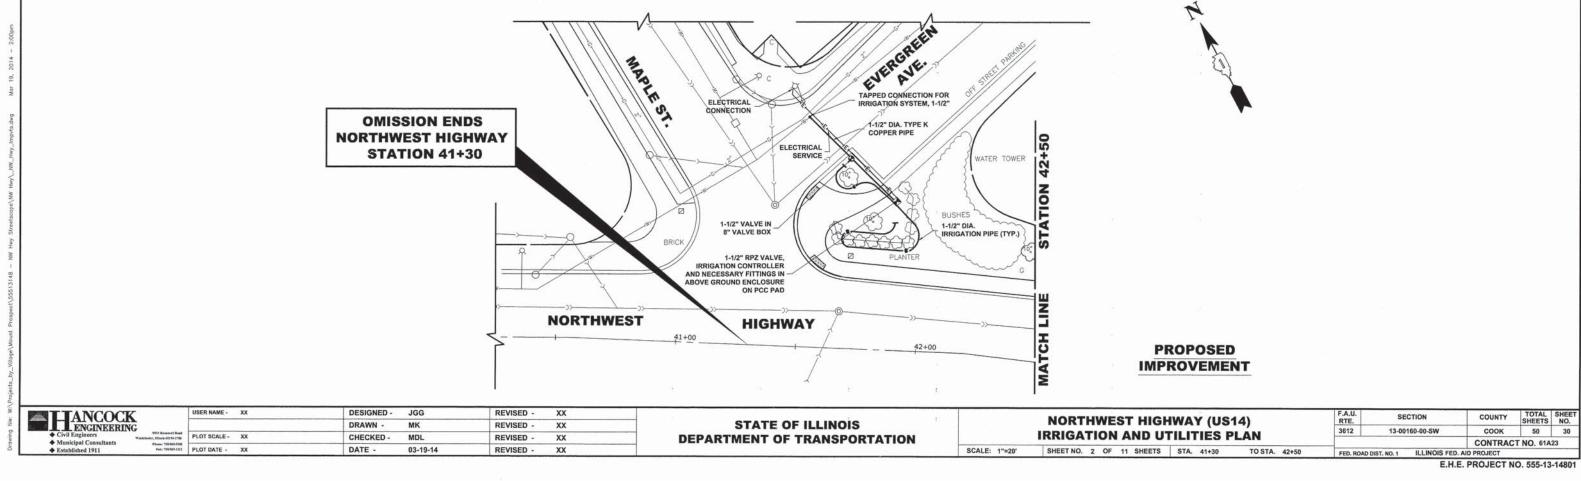

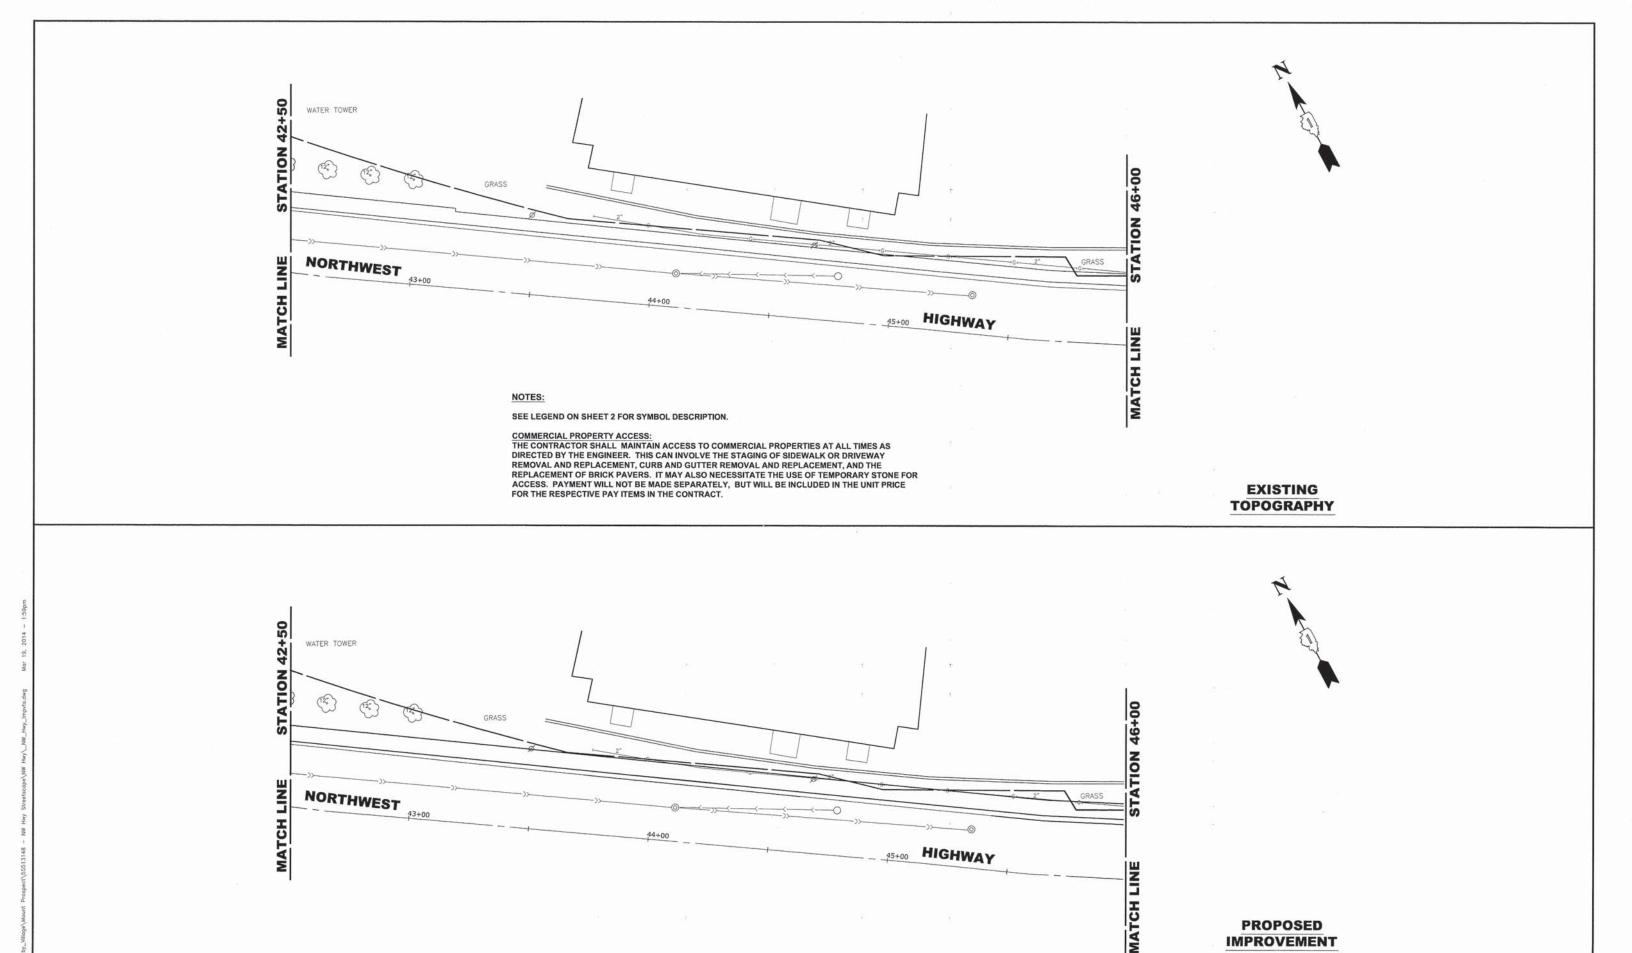

TTANCOCK	USER NAME -	XX	DESIGNED -	JGG	REVISED -	XX		NORTHWEST HIGHWAY (US14) IRRIGATION AND UTILITIES PLAN		
ENGINEERING			DRAWN -	MK	REVISED -	XX	STATE OF ILLINOIS DEPARTMENT OF TRANSPORTATION			
♦ Civil Engineers ♦ Municipal Consultants Washester, Dispa 6054-278	PLOT SCALE -	xx	CHECKED -	MDL	REVISED -	XX				
	PLOT DATE -	XX	DATE -	03-19-14	REVISED -	XX		SCALE: 1"=20"	SHEET NO. 3 OF 8 SHEETS STA. 42+50 TO STA. 464	


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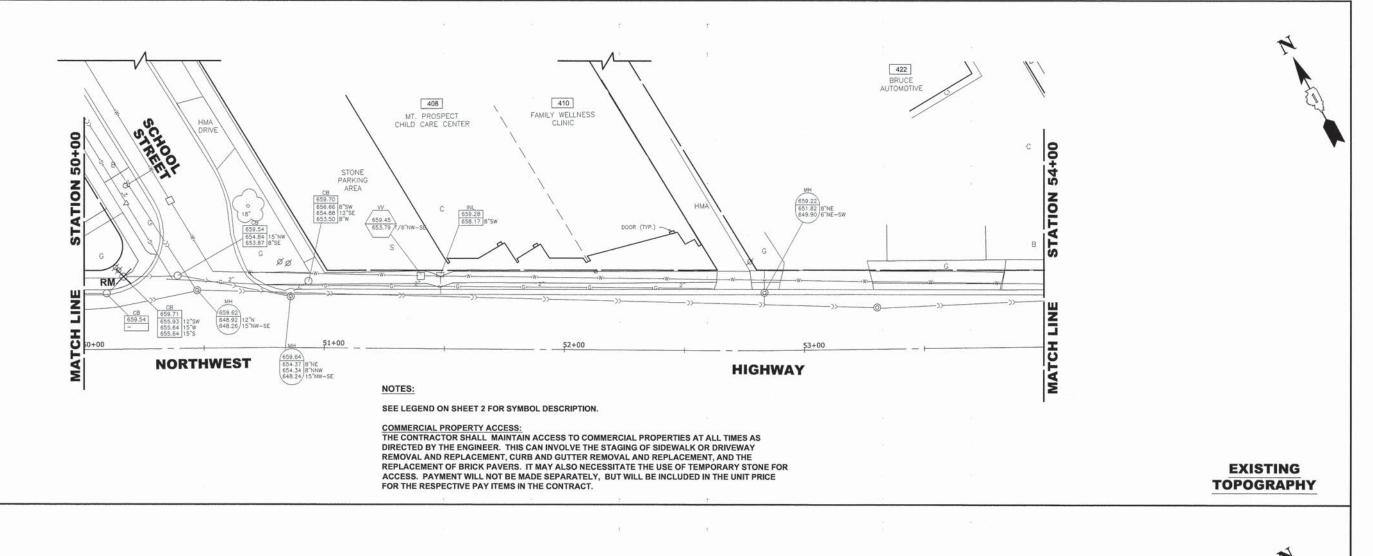
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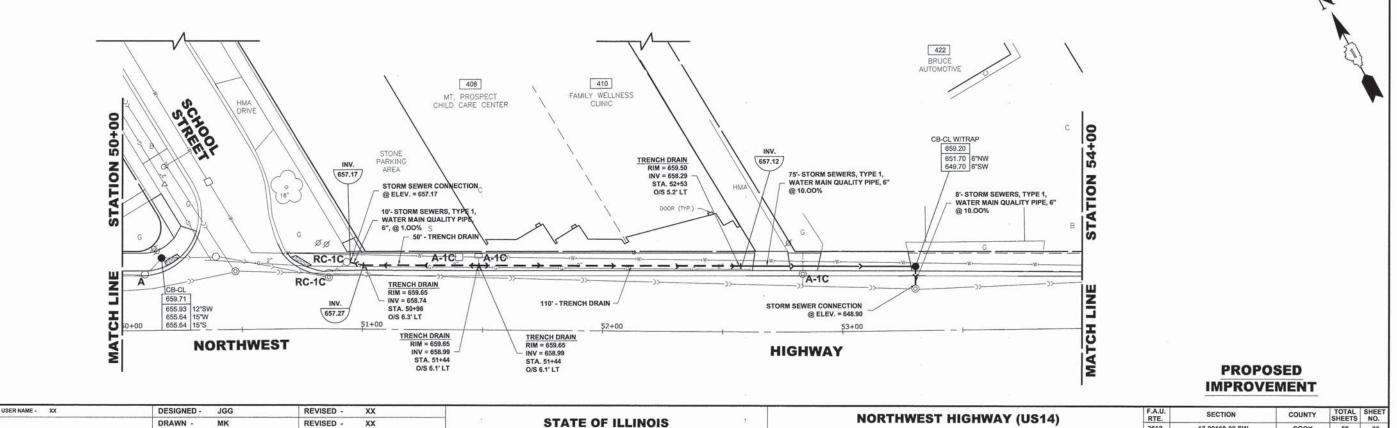
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PROPOSED IMPROVEMENT







SCALE: 1"=20"

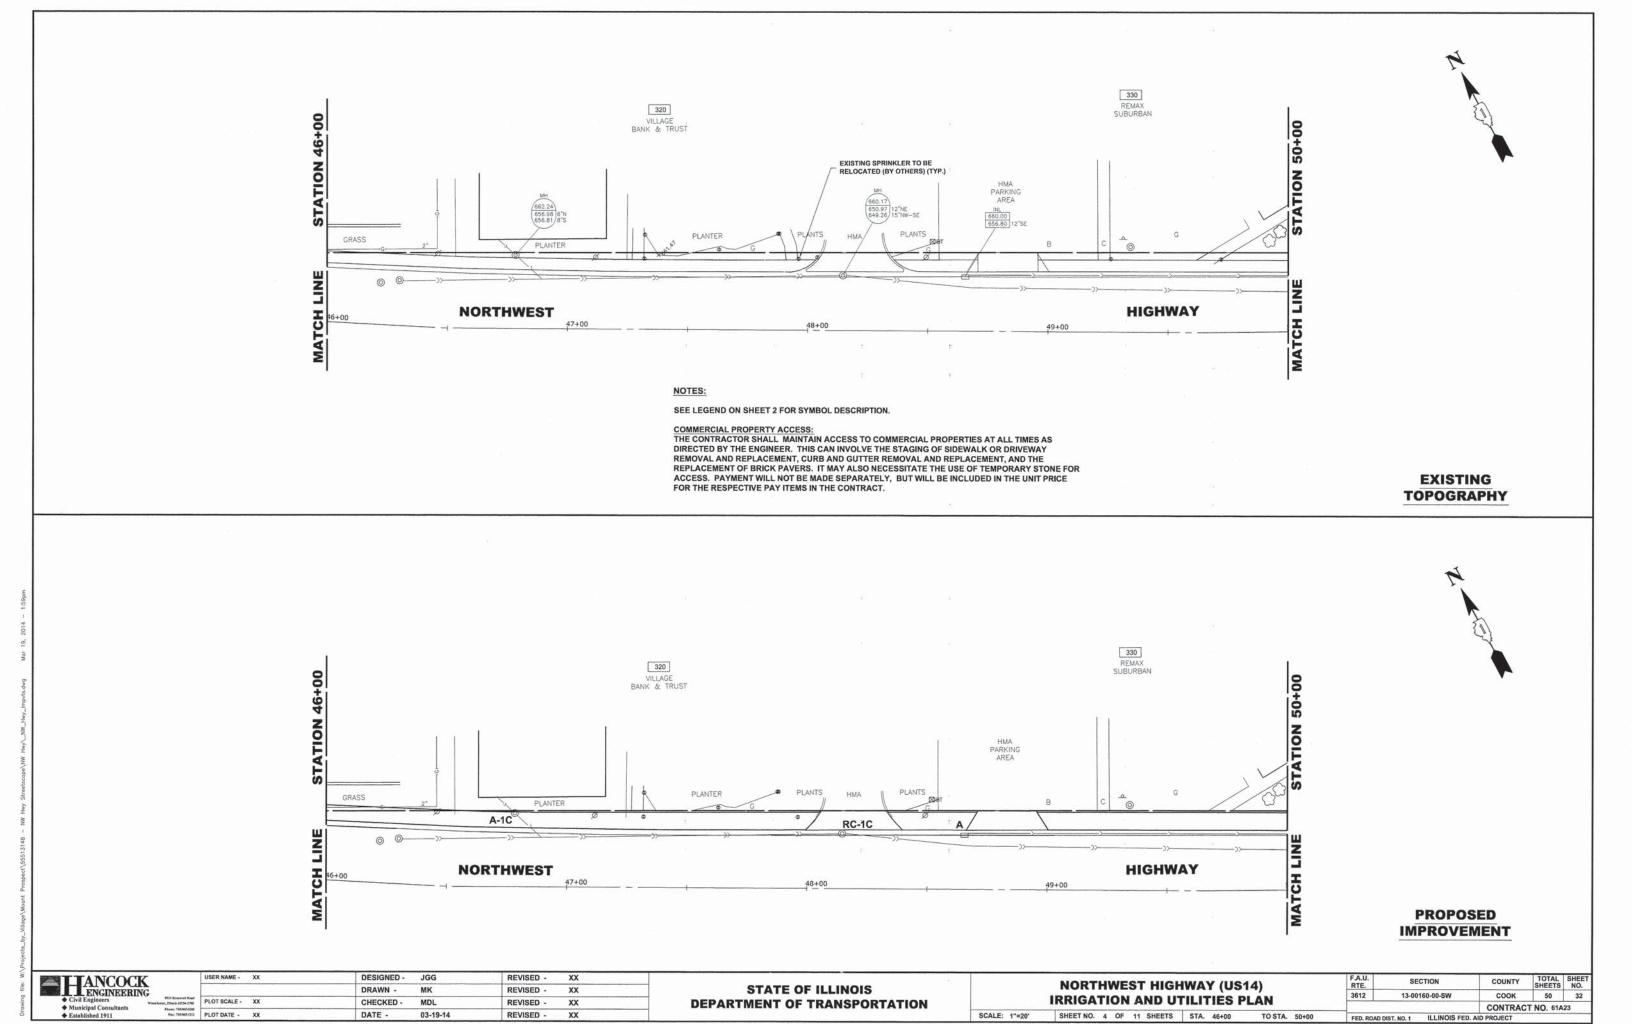DEPARTMENT OF TRANSPORTATION

HANCOCK

PLOT SCALE - XX

FAIR THE MINISTERS PLOT DATE - XX

CHECKED .

DATE -

MDL

03-19-14

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CONTRACT NO. 61A23


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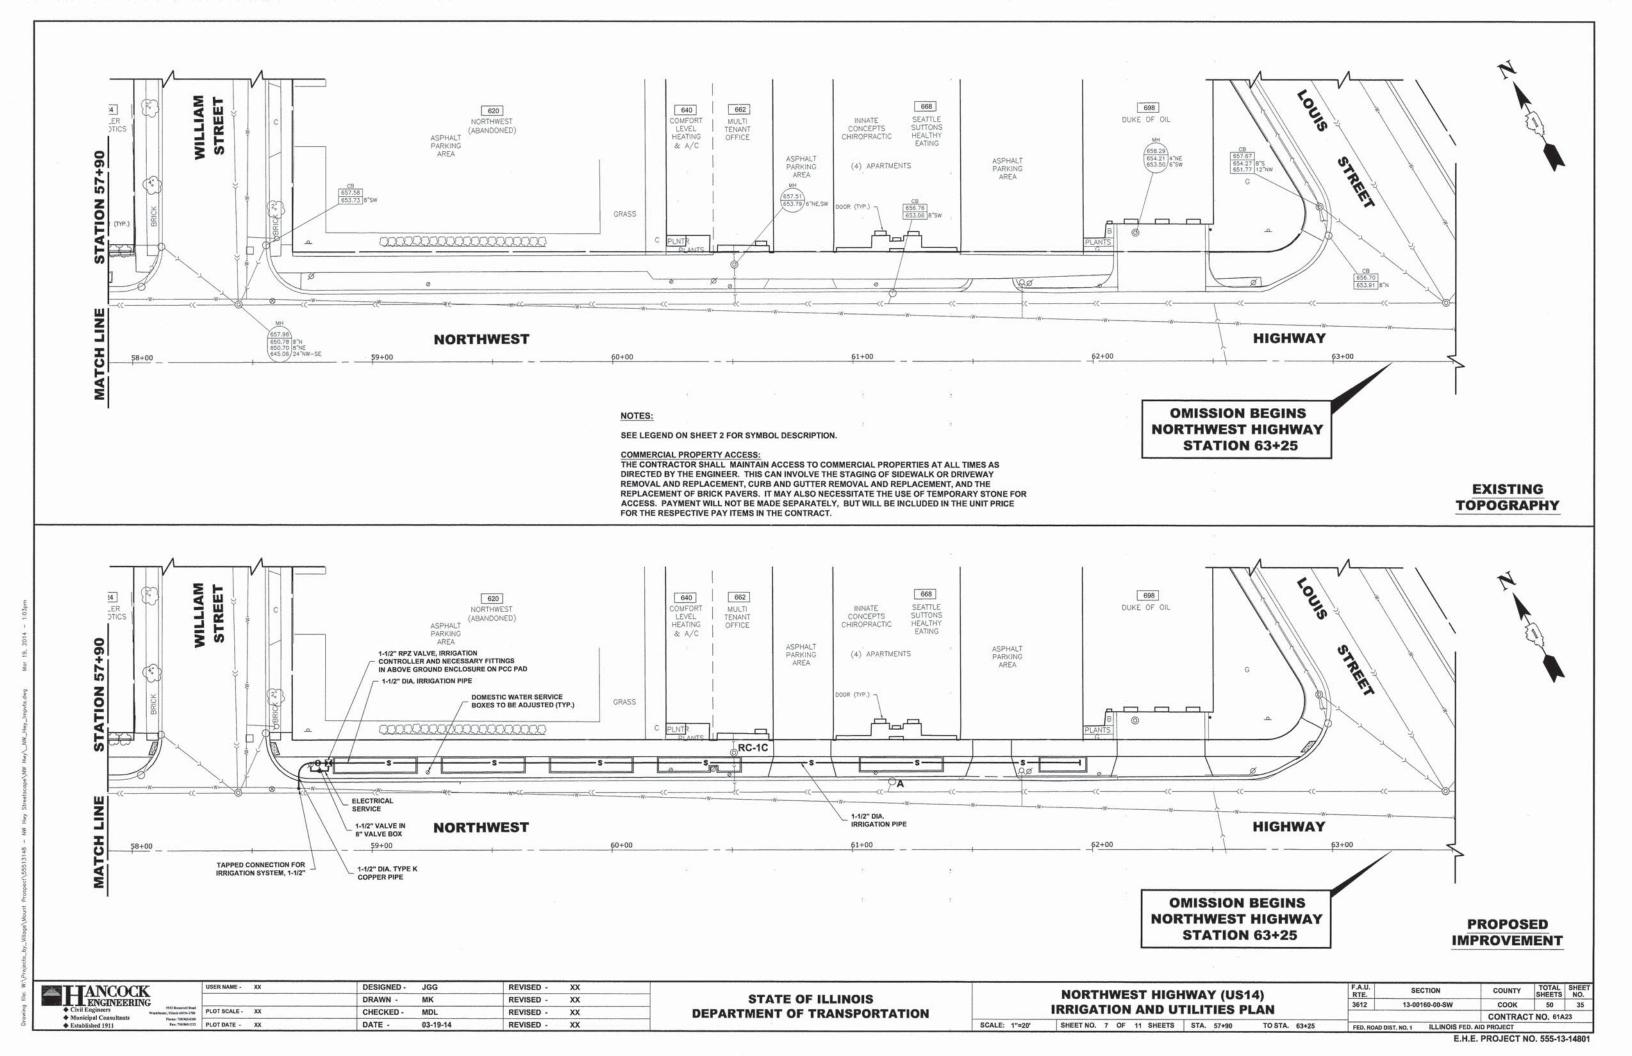
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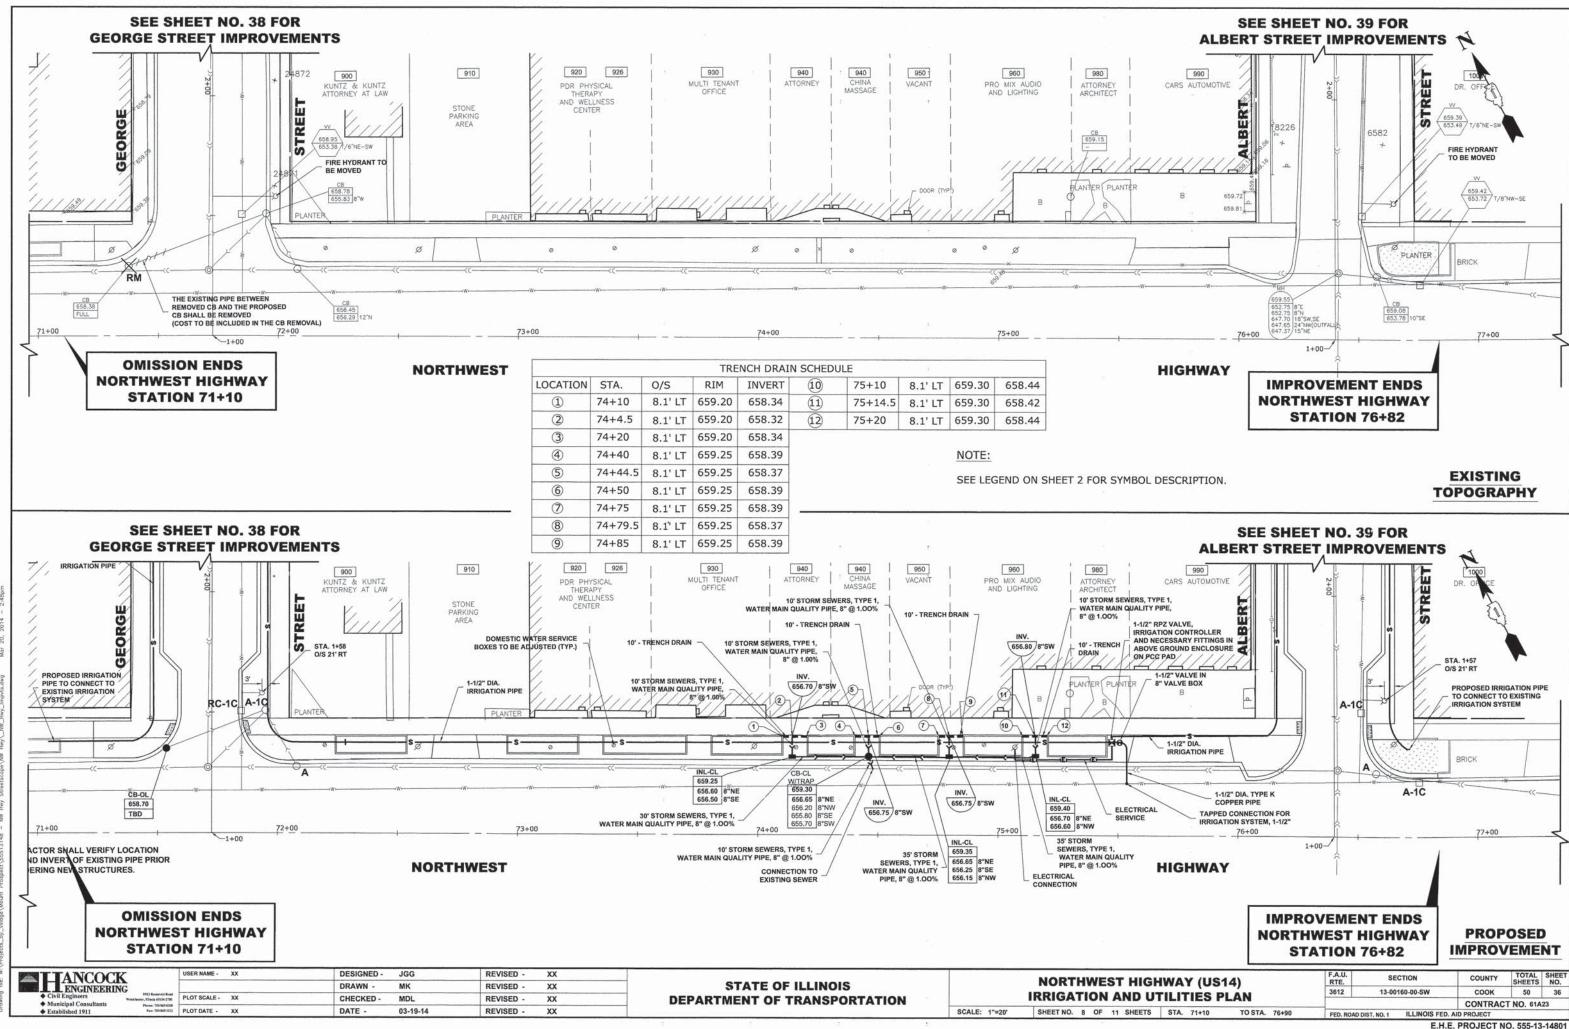
IRRIGATION AND UTILITIES PLAN


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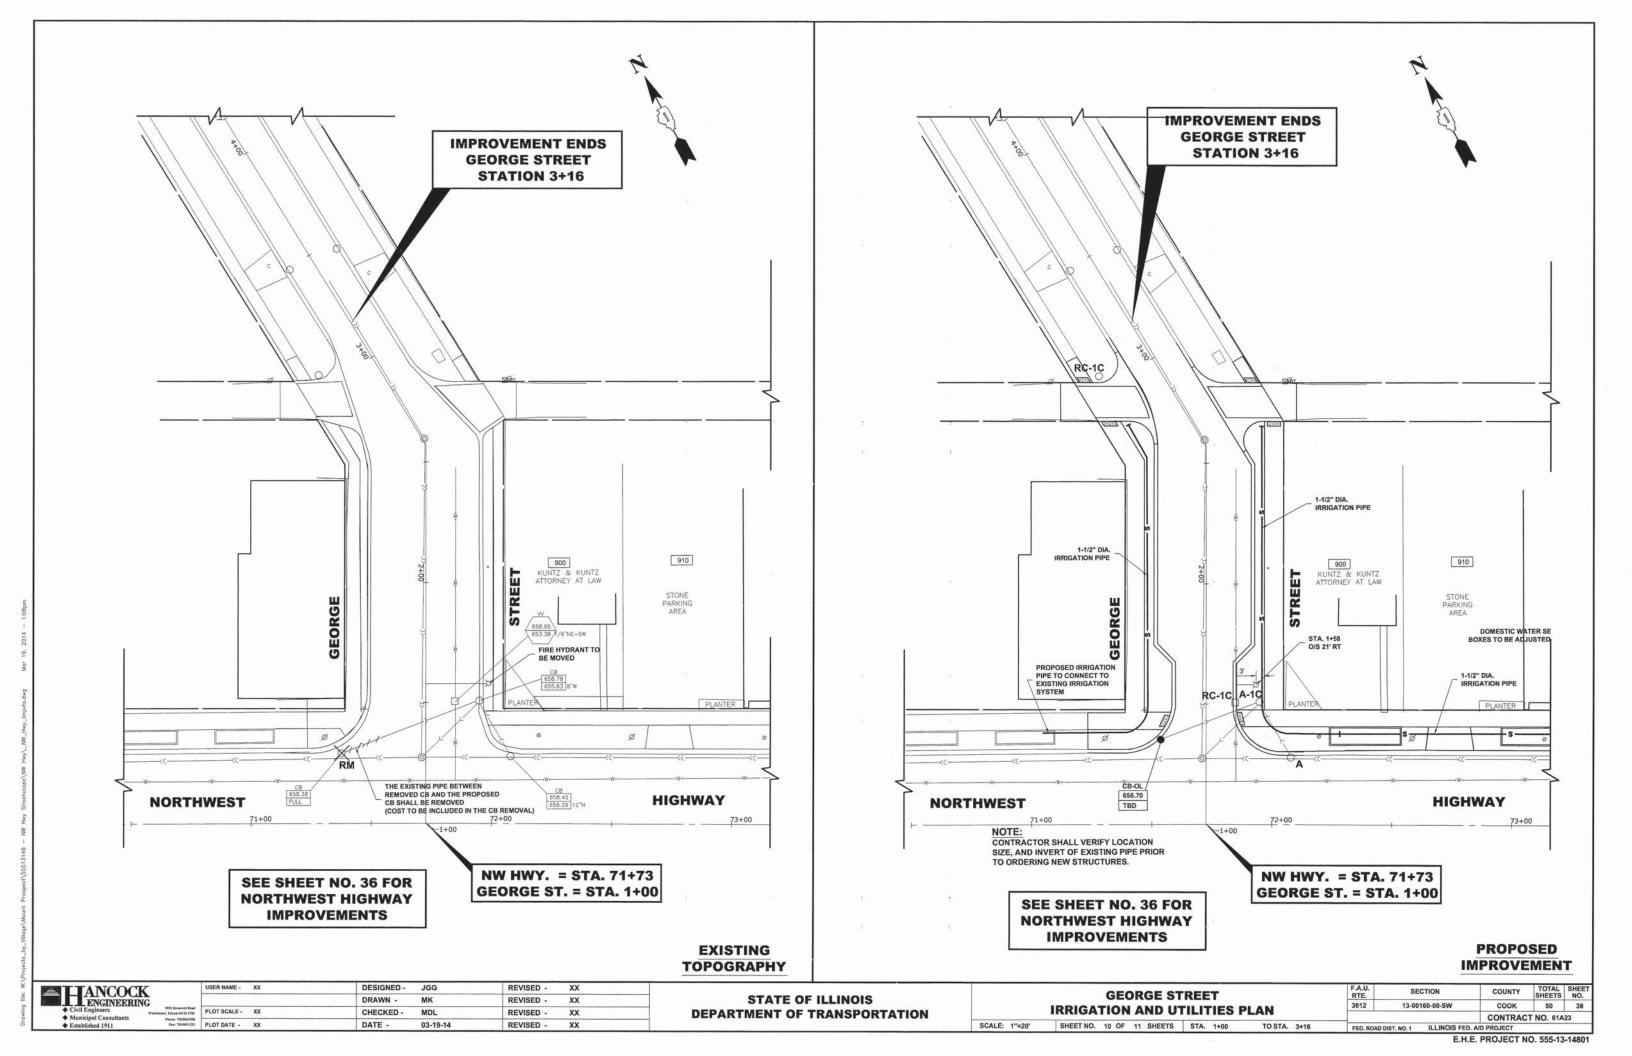
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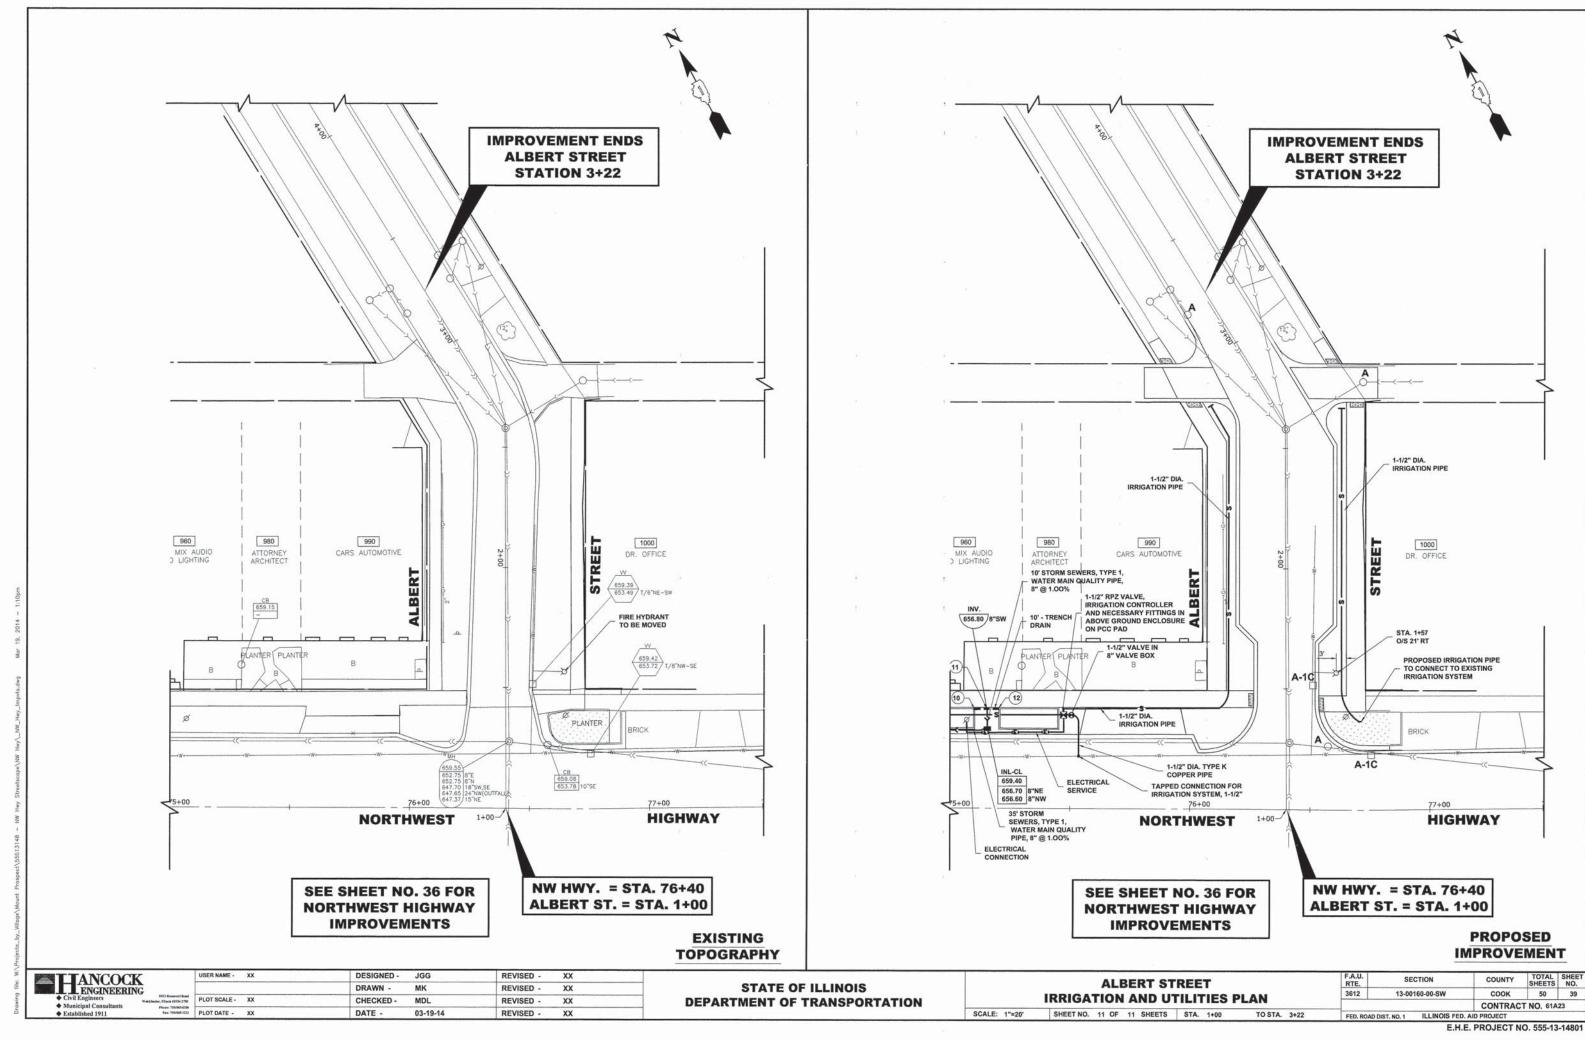









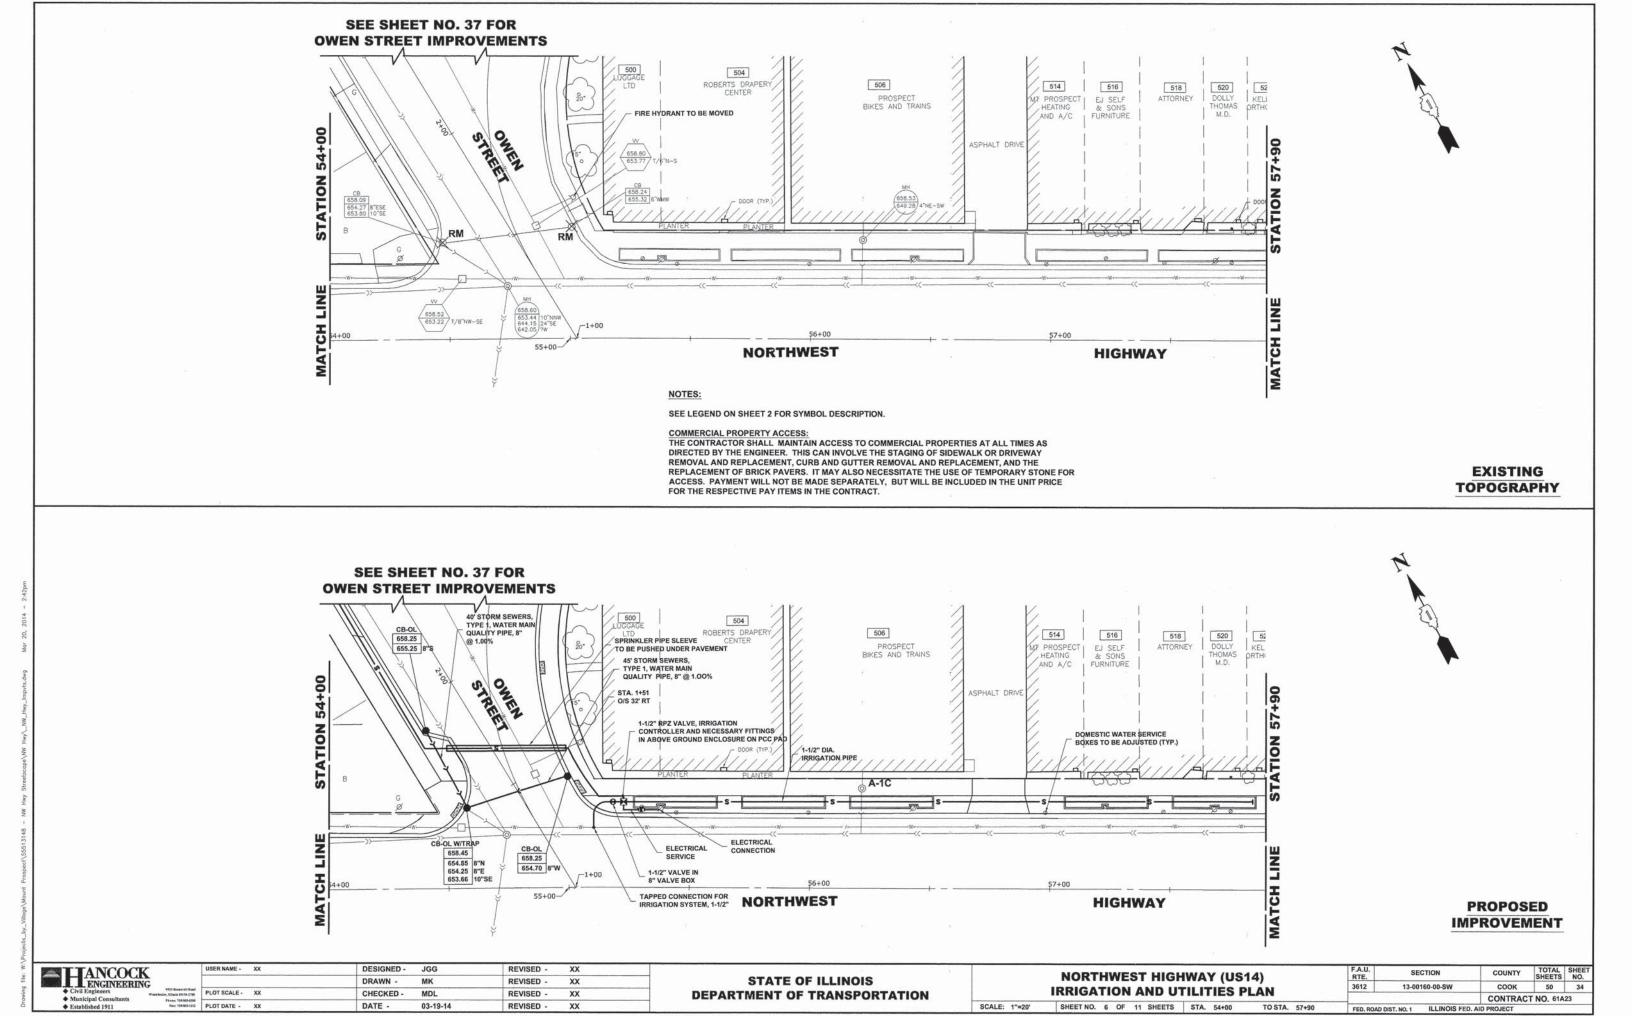

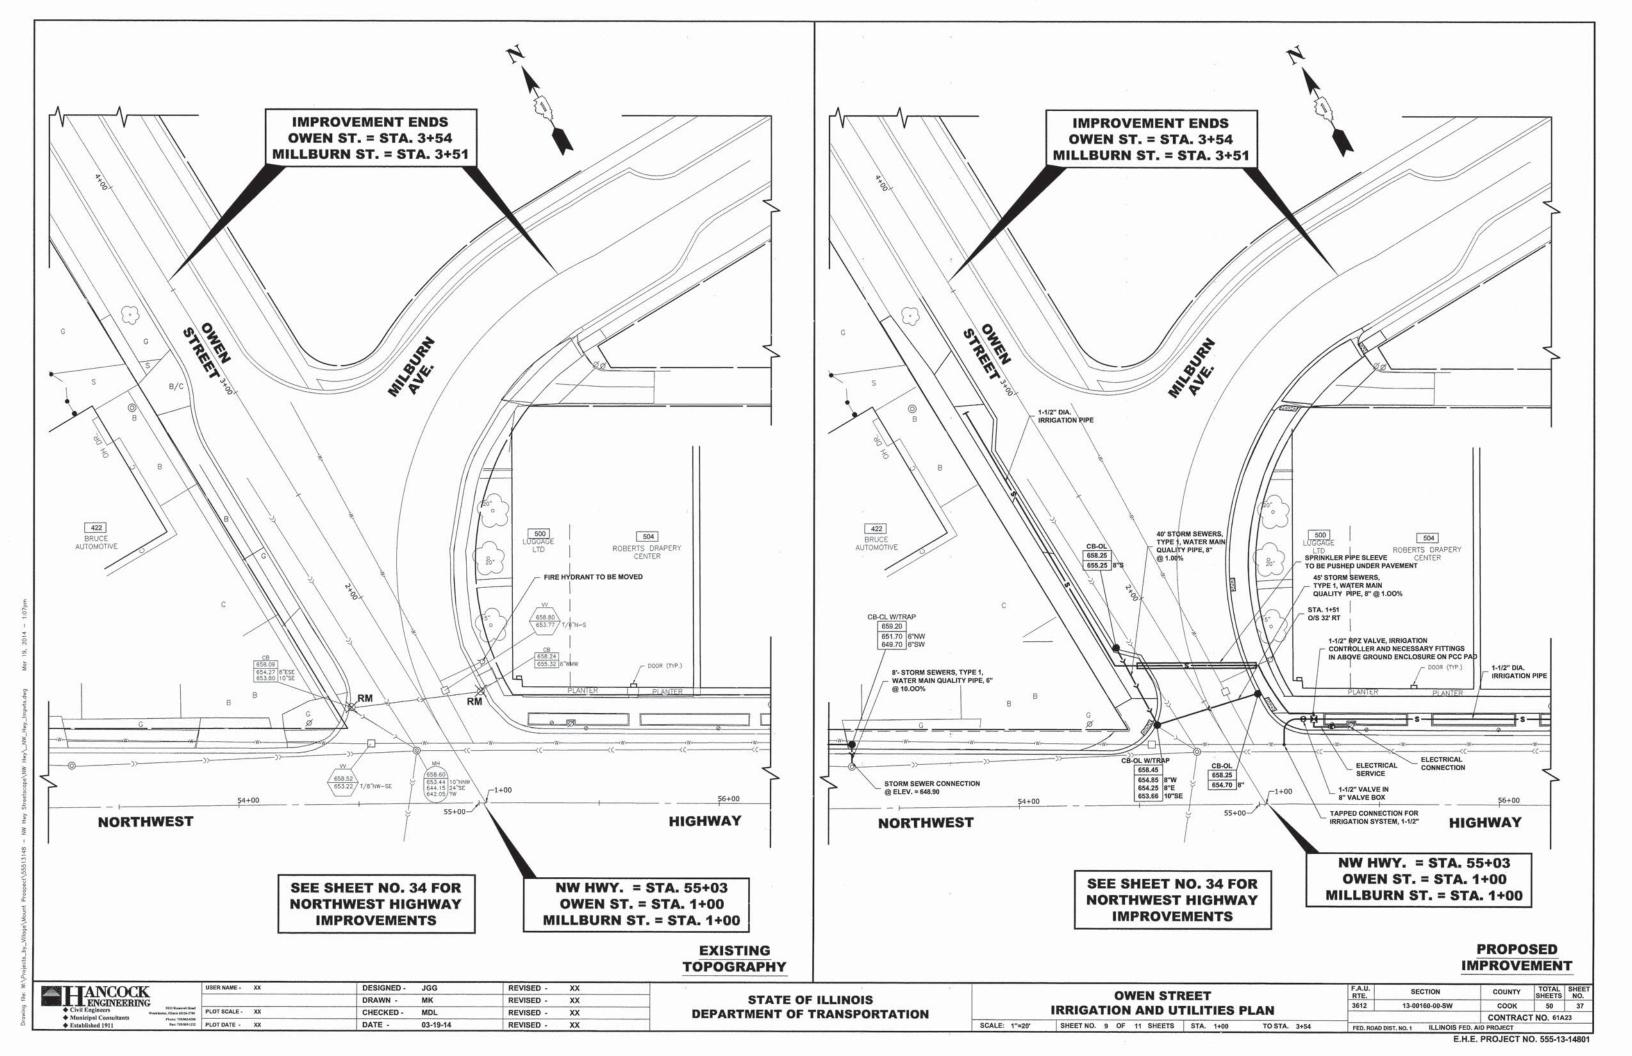


IN NON-EXCAVATED PAVED AREAS, REPLACE

IN LANDSCAPED AREAS.

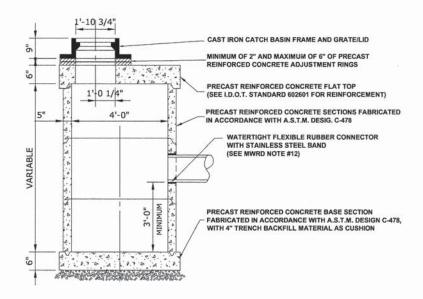

CATCH BASINS, TYPE A. 4' DIAMETER, TYPE 1 FRAME, SPECIAL

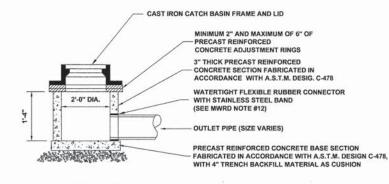

INLET, TYPE A, SPECIAL

M.W.R.D.G.C. GENERAL NOTES

- THE MWRD SEWER SYSTEMS SECTION FIELD OFFICE MUST BE NOTIFIED AT LEAST TWO (2) WORKING DAYS PRIOR TO THE COMMENCEMENT OF WORK AT (708) 588-4055.
 FLEVATION DATIM IS ILS G.S.
- 3. ALL FLOOR DRAINS SHALL DISCHARGE TO THE SANITARY SEWER SYSTEM (NO FLOOR DRAINS PROPOSED)
- 4. ALL DOWNSPOUTS AND FOOTING DRAINS SHALL DISCHARGE INTO THE STORM SEWER SYSTEM (NO DOWNSPOUTS AND FOOTING DRAINS PROPOSED)...
- ALL PVC STORM, COMBINED, AND SANITARY SEWER PIPE JOINTS SHALL CONFORM TO ASTM D-3139. ALL PVC SEWER PIPE 12" IN DIAMETER OR LESS SHALL CONFORM TO ASTM D-2241 (WATER QUALITY PIPE). ALL PVC SEWER PIPE 15" OR GREATER SHALL CONFORM TO ASTM D-3034. ALL PVC SEWER PIPE SHALL BE SDR 26.
- 6. ALL SANITARY SEWER CONSTRUCTION, AND ALSO STORM SEWER CONSTRUCTION IN COMBINED SEWER AREAS, REQUIRES STONE BEDDING 1/4" TO 1" IN SIZE, WITH A MINIMUM THICKNESS EQUAL TO 1/4 THE OUTSIDE DIAMETER OF THE SEWER PIPE, BUT NOT LESS THAN FOUR INCHES (4") NOR MORE THAN EIGHT INCHES (8"). MATERIAL SHALL BE CA-11 OR CA-13 AND SHALL BE EXTENDED AT LEAST 12" ABOVE THE TOP OF THE PIPE WHEN USING PVC PIPE
- NON-SHEAR FLEXIBLE-TYPE COUPLINGS SHALL BE USED IN THE CONNECTION OF SEWER PIPE OF DISSIMILAR MATERIALS.
- WHEN CONNECTING TO AN EXISTING SEWER MAIN BY MEANS OTHER THAN AN EXISTING WYE, TEE, OR AN EXISTING MANHOLE, ONE OF THE FOLLOWING METHODS SHALL BE USED:
 - CIRCULAR SAW-CUT OF SEWER MAIN BY MECHANICAL CORING MACHINE, AND PROPER INSTALLATION OF HUB-WYE SADDLE OR HUB-TEE SADDLE, IN ACCORDANCE WITH THE MANUFACTURE'S RECOMMENDATIONS.
 - 2) REMOVE AN ENTIRE SECTION OF PIPE (BREAKING ONLY THE TOP OF ONE BELL) AND REPLACE WITH A WYE OR TEE BRANCH SECTION. AFTER THE WYE OR TEE BRANCH IS INSERTED, CONCRETE SHALL BE PLACED OVER THE BROKEN AREA TO A MINIMUM THICKNESS OF 4" AND TO A DIMENSION OF 8" IN ALL DIRECTIONS.
 - 3) USING PIPE CUTTER, NEATLY AND ACCURATELY CUT OUT DESIRED LENGTH OF PIPE FOR INSERTION OF PROPER FITTING. USE "BAND SEAL" OR SIMILAR COUPLINGS TO HOLD FIRMLY IN PLACE. FOLLOW MANUFACTURER'S RECOMMENDATIONS FOR THE INSTALL ATION
- 9. WHEREVER A SANITARY/COMBINED SEWER CROSSES UNDER A WATER MAIN, THE MINIMUM VERTICAL DISTANCE FROM THE TOP OF THE SEWER TO THE BOTTOM OF THE WATERMAIN SHALL BE 18 INCHES, FURTHERMORE, A MINIMUM HORIZONTAL DISTANCE OF 10 FEET BETWEEN SANITARY/COMBINED SEWERS AND WATERMAINS SHALL BE MAINTAINED UNLESS: THE SEWER IS LAID IN A SEPARATE TRENCH, KEEPING A MINIMUM 18" VERTICAL SEPARATION; OR THE SEWER IS LAID IN THE SAME TRENCH WITH THE WATERMAIN LOCATED AT THE OPPOSITE SIDE ON BENCH OF UNDISTURBED EARTH, KEEPING A MINIMUM 18" VERTICAL SEPARATION. IF EITHER THE VERTICAL OR HORIZONTAL DISTANCES DESCRIBED ABOVE CANNOT BE MAINTAINED, OR THE SEWER CROSSES ABOVE THE WATERMAIN, THE SEWER SHALL BE CONSTRUCTED WATERMAIN STANDARDS.
- ALL SANITARY MANHOLES, (AND STORM MANHOLES IN COMBINED SEWER AREAS), SHALL
 HAVE A MINIMUM INSIDE DIAMETER OF 48 INCHES, AND SHALL BE CAST IN PLACE OR
 PRE-CAST REINFORCED CONCRETE.
- 11. ALL ABANDONED SANITARY SEWERS SHALL BE PLUGGED AT BOTH ENDS WITH A MINIMUM OF TWO (2) FEET LONG CONCRETE/MORTAR PLUG.
- 12. ALL INELT AND OUTLET PIPES OF SANITARY SEWER MANHOLES AND OTHER UNDERGROUND STRUCTURES (IN COMBINED SEWER AREAS, ALSO INCLUDED ARE ALL COMBINED/STORM SEWER MANHOLES, CATCH BASINS, INLETS, AND UNDERGROUND DETENTION STORAGE STRUCTURES) SHALL BE JOINED WITH WATERTIGHT FLEXIBLE RUBBER CONNECTORS CONFORMING TO ASTM C-443 AND C-923 WITH STAINLESS STEEL BAND.
- 13. THE MAXIMUM ALLOWABLE INFILTRATION OR EX-FILTRATION IS 100 GAL/DAY/MILE/INCH DIA. OF SEWER PIPE.
- 14. EXCEPT FOR FOUNDATION/FOOTING DRAINS PROVIDED TO PROTECT BUILDINGS, DRAIN TILES/FIELD TILES/UNDERDRAINS/PERFORATED PIPES ARE NOT ALLOWED TO BE CONNECTED TO OR TRIBUTARY TO COMBINED SEWERS, SANITARY SEWERS, OR STORM SEWERS TRIBUTARY TO COMBINED SEWERS IN COMBINED SEWERED AREAS. CONSTRUCTION OF NEW FACILITIES OF THIS TYPE IS PROHIBITED; AND ALL EXISTING DRAIN TILES AND PERFORATED PIPES ENCOUNTERED WITHIN THE PROJECT AREA SHALL BE PLUGGED OR REMOVED, AND SHALL NOT BE CONNECTED TO COMBINED SEWERS, SANITARY SEWERS, OR STORM SEWERS TRIBUTARY TO COMBINED SEWERS.

DRAINAGE AND UTILITIES NOTES

THE LOCATIONS OF EXISTING DRAINAGE STRUCTURES, STORM SEWERS, COMBINED SEWERS, TELEPHONE LINES, COMMUNICATION LINES, ELECTRIC LINES, GAS MAINS, AND WATER SERVICES ARE APPROXIMATE AND THEIR SPECIFIC LOCATIONS ARE TO BE DETERMINED IN THE FIELD AT NO COMPENSATION TO THE CONTRACTOR.

COORDINATION OF ALL UTILITY WORK INVOLVED WITHIN THE CONSTRUCTION AREAS SHALL BE SUBJECT TO DISCUSSION AND CLARIFICATION AT A PRECONSTRUCTION MEETING.

WHEN EXISTING DRAINAGE FACILITIES ARE DISTURBED, THE CONTRACTOR SHALL PROVIDE AND MAINTAIN TEMPORARY OUTLETS AND CONNECTIONS FOR ALL PRIVATE OR PUBLIC DRAINAGE STRUCTURES OR SEWERS UNTIL PERMANENT CONNECTIONS TO SEWERS ARE BUILT AND IN SERVICE. THIS WORK SHALL BE PAID FOR AS TEMPORARY DRAINAGE CONNECTIONS.

IF, DURING CONSTRUCTION OPERATIONS, ANY LOOSE MATERIALS ARE DEPOSITED IN THE FLOW LINES OF GUTTERS OR DRAINAGE STRUCTURES SO THAT THE NATURAL FLOW OF WATER IS OBSTRUCTED, THE OBSTRUCTING MATERIALS SHALL BE REMOVED AT THE CLOSE OF EACH WORK DAY. AT THE CONCLUSION OF THE CONSTRUCTION OPERATIONS, ALL DRAINAGE STRUCTURES ARE TO BE FREE OF ALL DIRT, DEBRIS, AND OBSTRUCTING MATERIALS. THE WORK SPECIFIED ABOVE WILL NOT BE PAID FOR SEPARATELY, BUT SHALL BE CONSIDERED AS INCIDENTAL TO THE CONTRACT.

ALL COSTS INVOLVED IN CONNECTING PROPOSED STORM SEWERS AND STORM STRUCTURES TO EXISTING STORM SEWERS OR PROPOSED STORM SEWERS SHALL BE CONSIDERED INCLUDED IN THE COST OF PROPOSED ITEMS BEING CONSTRUCTED.

THE CONTRACTOR SHALL VERIFY THE TYPE OF ANY WATER MAIN HARDWARE INCLUDING VALVES, FIRE HYDRANTS, VALVE BOXES, CORPORATION STOPS, CURB STOPS, AND WATER SERVICES BOXES WITH THE UTILITY SUPERINTENDENT PRIOR TO ORDERING SUCH MATERIAL.

THE TYPE OF FRAMES AND GRATES REQUIRED FOR ALL CATCH BASINS AND MANHOLES LISTED IN THE SUMMARY OF QUANTITIES MAY BE FOUND ON THE PLANS AT THEIR RESPECTIVE LOCATIONS. WHERE LIDS ARE CALLED FOR ON THE PLANS, THEY SHALL BE IN ACCORDANCE WITH ARTICLE 604.01 OF THE STANDARD SPECIFICATIONS AND THE TERM LID IS USED IN LIEU OF GRATE.

ON ALL IMPROVEMENTS, THE FRAMES AND LIDS OF EXISTING CATCH BASINS, INLETS, MANHOLES, AND VALVE VAULTS WHICH ARE TO BE ABANDONED DUE TO CONSTRUCTION OF THIS IMPROVEMENT ARE TO REMAIN THE PROPERTY OF THE VILLAGE OF MOUNT PROSPECT AND BE SALVAGED. THE CONTRACTOR IS TO DELIVER FRAMES AND LIDS TO THE VILLAGE'S PUBLIC WORKS YARD.

ANY COSTS FOR SHEETING OR SHORING REQUIRED FOR THE STORM SEWER INSTALLATION OR OTHER CONSTRUCTION ELEMENTS REQUIRING RELATIVELY DEEP EXCAVATIONS SHALL BE INCLUDED IN THE PARTICULAR PAYMENT ITEM AND NO ADDITIONAL COMPENSATION WILL BE ALLOWED FOR ANY SUPPLEMENTAL WORK ASSOCIATED WITH THE MAINTENANCE OF TRENCH SIDES OR OTHER EXCAVATED AREAS.

UNLESS OTHERWISE SPECIFIED, ABANDONED SEWERS AND DRAINS, AS DESIGNATED BY THE ENGINEER, SHALL BE PLUGGED WITH CLASS "SI" CONCRETE OR BRICK AND SUITABLE MORTAR TO THE SATISFACTION OF THE ENGINEER. THIS WORK SHALL NOT BE PAID FOR SEPARATELY, BUT SHALL BE INCLUDED IN THE PAY ITEMS FOR REMOVING AND/OR FILLING THE VARIOUS TYPES OF STRUCTURES.


SEWER PIPE INSTALLED ON THIS PROJECT SHALL CONFORM TO THE FOLLOWING STANDARD:

TYPE OF PIPE MATERIAL STANDARD JOINT STANDARD

REINFORCED CONCRETE PIPE ASTM C-76 ASTM C-443
POLYVINYLCHLORIDE PIPE, SDR 26 ASTM D-2241 ASTM D-3139
DUCTILE IRON PIPE, CLASS 52 ASTM A-21.51 ASTM A-21.11

PVC PIPE SPECIFICATIONS

- ALL PVC SEWER PIPE 12" DIAMETER OR LESS SHALL HAVE A MINIMUM STANDARD DIMENSION RATIO (SDR) OF 26 AND SHALL CONFORM TO ASTM DESIGNATION D-2241 (WATER QUALITY PIPE)
- 2. THE JOINTS SHALL BE RUBBER GASKET AND CONFORM TO ASTM DESIGNATIONS D-3139 AND F-447.

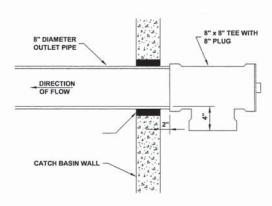

8" x 8" CATCH BASIN TRAP

TO STA.

JSER NAME - XX **DESIGNED** -JGG REVISED -XX TANCOCK MK . DMM XX ENGINEERING DRAWN REVISED CHECKED MDL REVISED XX PLOT DATE - XX DATE 05-14-14 REVISED -XX


STATE OF ILLINOIS
DEPARTMENT OF TRANSPORTATION

DRAINAGE AND UTILITIES DETAILS


SHEET NO. 1 OF 2 SHEETS STA.

SCALE: NONE


TRENCH DRAIN **ADJACENT TO PAVING BRICK SIDEWALK**

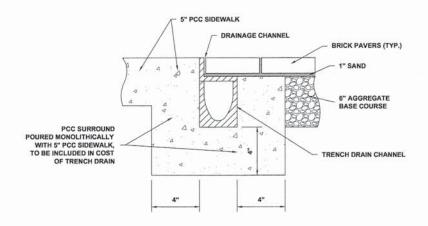


TRENCH DRAIN ADJACENT TO PCC SIDEWALK

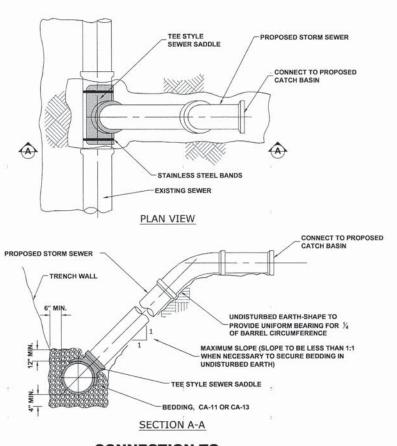


CONNECTION TO EXISTING SEWER

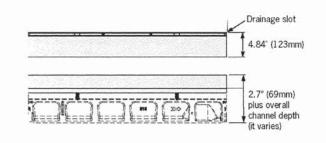


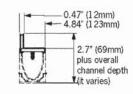

Access unit (must be used with catch basin and can also be used with channels)

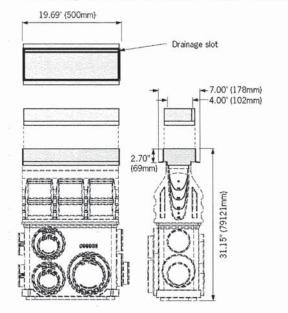

TRENCH DRAIN

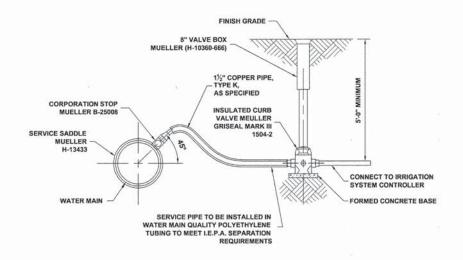

WATER SERVICE TAP FOR IRRIGATION SYSTEM

TTANCOCK	USER NAME -	xx	DESIGNED -	JGG	REVISED -	XX
ENGINEERING			DRAWN -	MK	REVISED -	XX
♦ Civil Engineers 9933 Roservelt Road Watchester, Ultrain 60154-2780	PLOT SCALE -	XX	CHECKED -	MDL	REVISED -	XX
◆ Municipal Consultants Phone TORMOS 47000 ◆ Established 1911 Par: TORMOS 47000	PLOT DATE -	xx	DATE -	03-19-14	REVISED -	XX

STATE OF ILLINOIS **DEPARTMENT OF TRANSPORTATION**


SECTION **DRAINAGE AND UTILITIES DETAILS** 3612 13-00160-00-SW SCALE: NONE SHEET NO. 2 OF 2 SHEETS STA. FED. ROAD DIST. NO. 1 ILLINOIS FED. AID PROJECT


COUNTY

TOTAL SHEET NO.

COOK 50 41

CONTRACT NO. 61A23

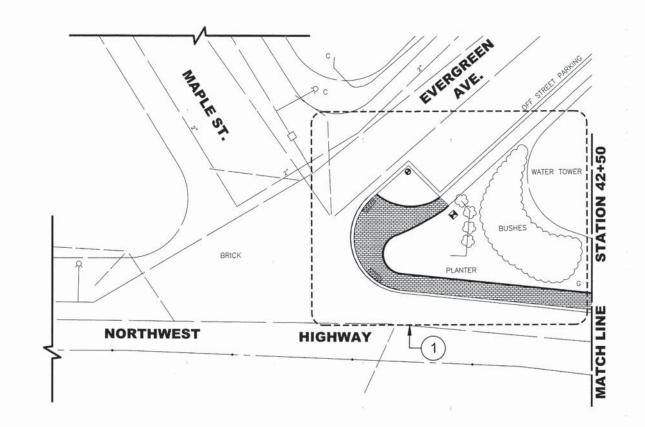

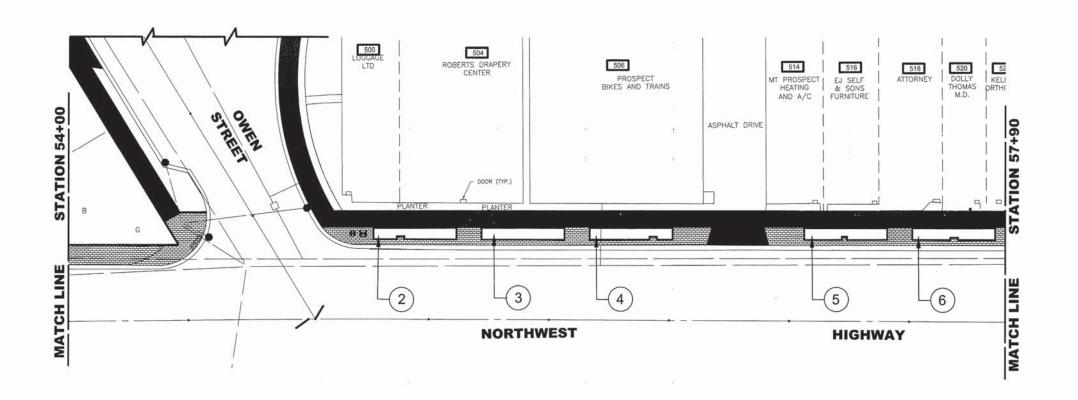



HITCHCOCK DESIGN GROUP 1-19-1 180 N. Wacker Drive Sulie (03) Chicago, R. 60660 T 312,554,200 P 312,554,200 hichcock designoup con


0' 20' 40' 60'


♦ Civil Engineers Wanters (State Plant Plant SCALE - XX	
♦ Municipal Consultants Phone Number 4300	_
♦ Established 1911 Fact 706/04-1272 PLOT DATE - XX	


	USER NAME - XX	DESIGNED -	TCK	REVISED -	XX	
		DRAWN -	SMM, JLP	REVISED -	STATE OF ILL	□ inois
H#48 6-2788	PLOT SCALE - XX	CHECKED -	TCK	REVISED -	XX	DEPARTMENT OF TRANSPORTATION
5-6300 5-6313	PLOT DATE - XX	DATE -	03-24-14	REVISED -	XX	


	NORTH		T HIGHV SCAPE		•)		
SCALE: 1" = 20'	SHEET NO.	OF	SHEETS	STA.	42+50	TO STA.	57+90	-


	F.A.U. RTE.	SECTION	COUNTY	TOTAL SHEETS	SHEET NO.
	3612	13-00160-00-SW	соок	50	42
_			CONTRAC	T NO. 61A	23
	FED. ROAD D	DIST. NO. 1 ILLINOIS FE	D. AID PROJECT		

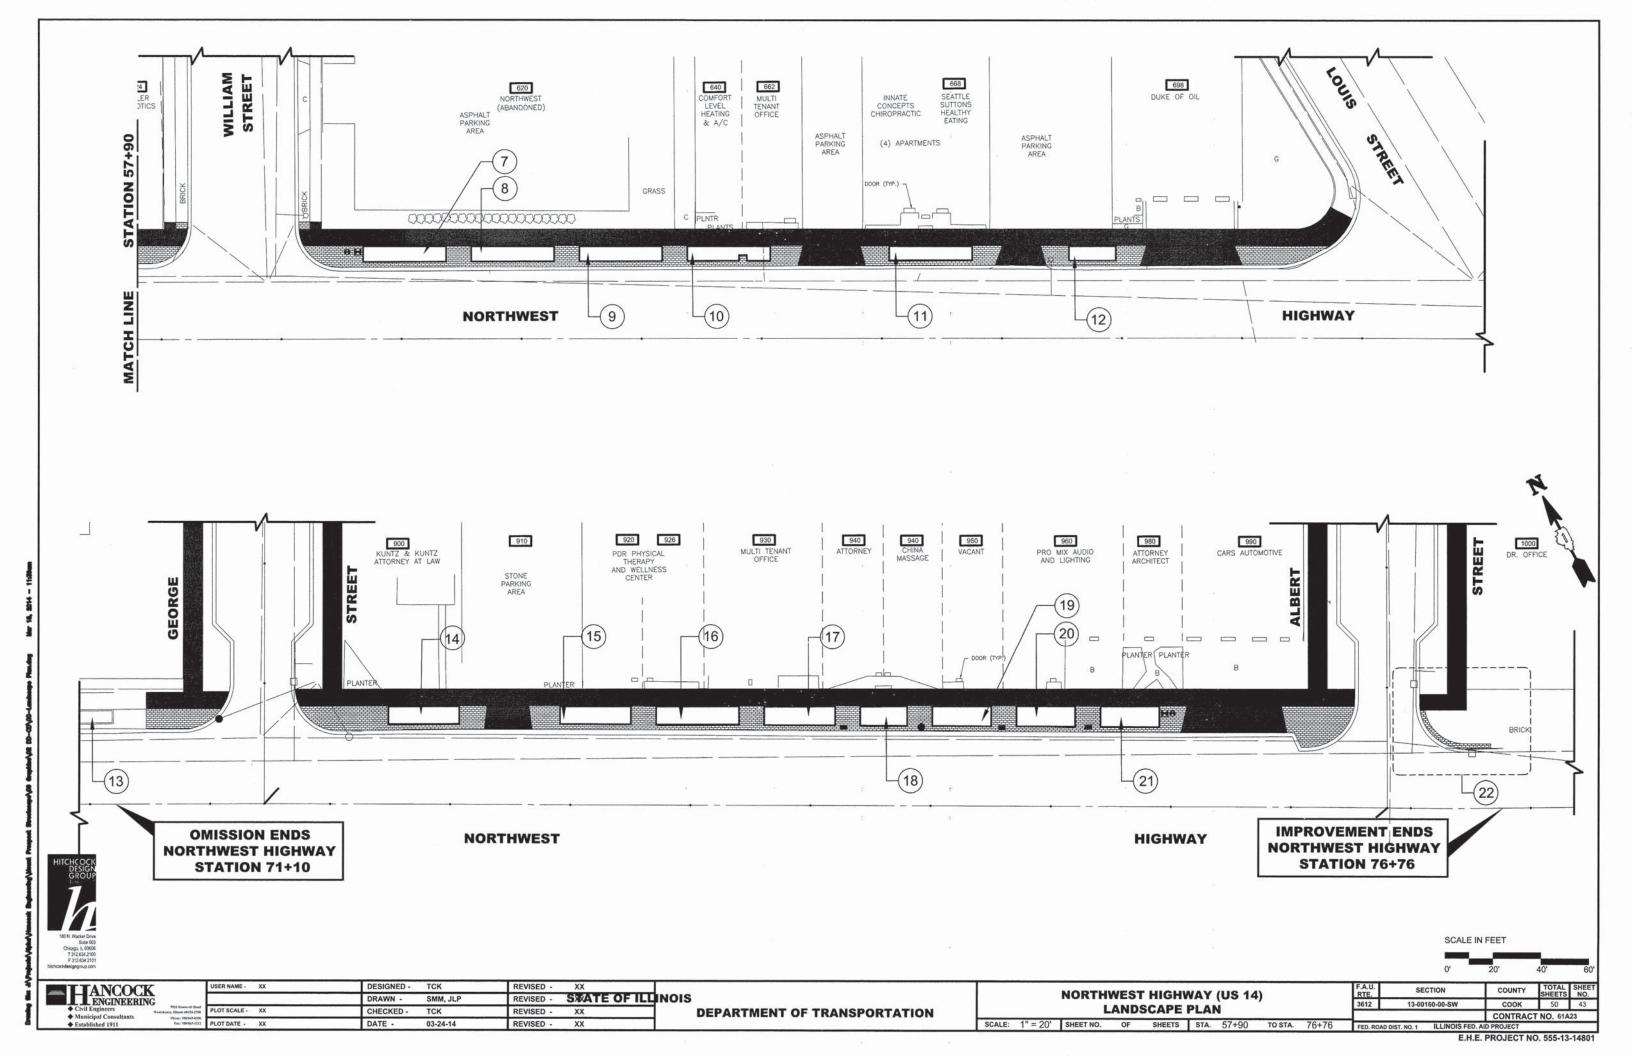


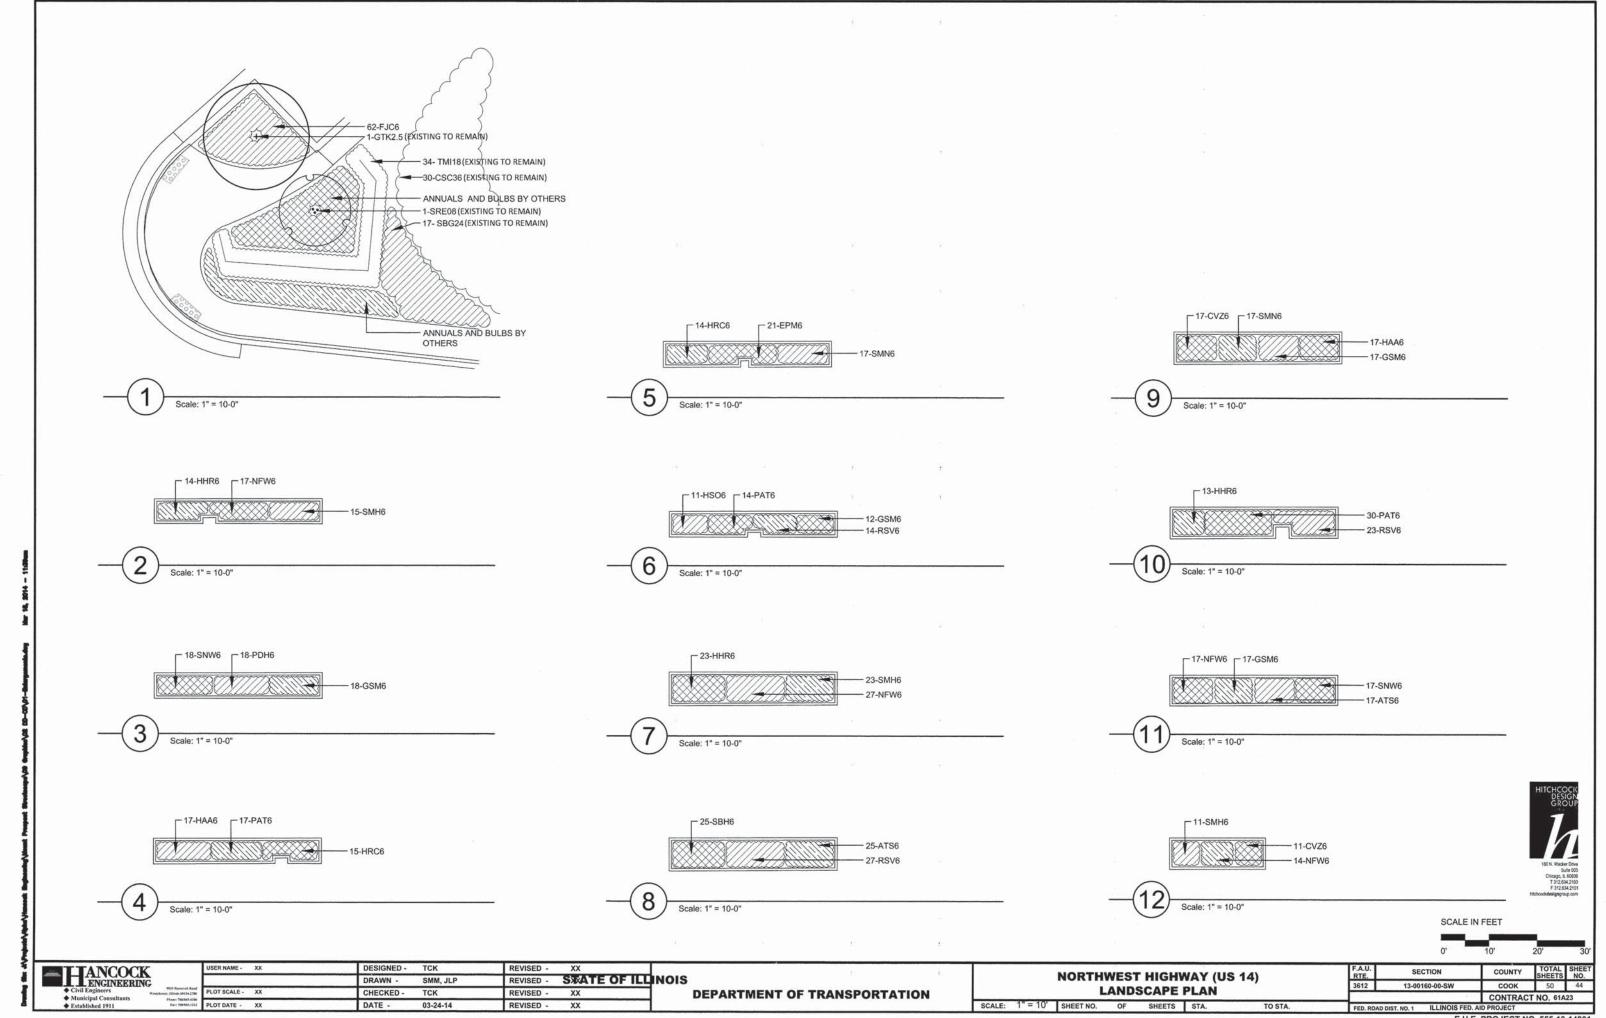


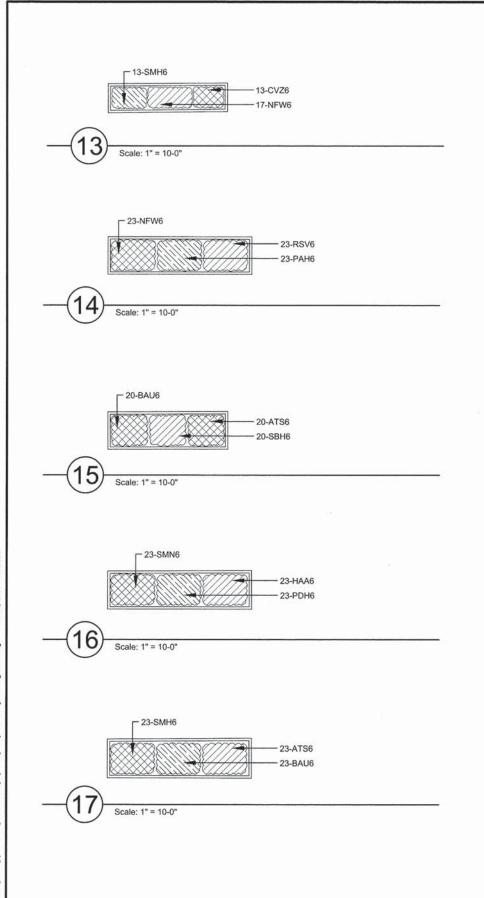


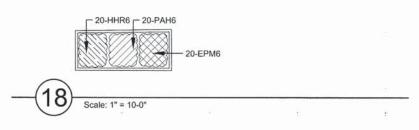

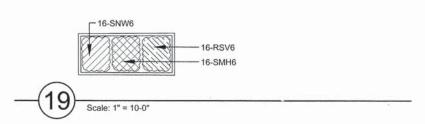

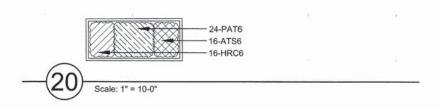

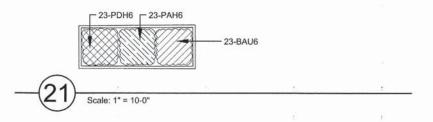

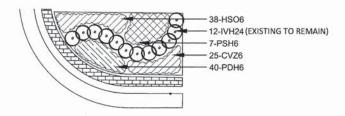



PLANT MATERIALS LIST

CODE			SIZE	QTY
SHADE	TREES (EXISTING)			
GTK2.5	GLEDITSIA TRIACANTHOS VAR. INERMIS 'SKYLINE'	SKYLINE THORNLESS HONEYLOCUST	- 2 1/2" C	-1-
INTERMI	EDIATE TREES (EXISTING)			
SRE.08	SYRINGA RETICULATA IVORY SILK'	IVORY SILK JAPANESE TREE LILAC	- 8' HT	-1-
			231177	1 -0-1
DECIDO	US TREES (EXISTING)			
DECIDO:	US TREES (EXISTING)	CARDINAL REDOSIER DOGWOOD	- 36" HT	- 30-
		CARDINAL REDOSIER DOGWOOD HENRY'S GT.VIRGINIA SWEETSPIRE	36" HT	- 30 - 12

EVERGREEN TREES (EXISTING)

TMI18	TAXUS XMEDIA 'HICKSII'	HICKS ANGLOJAP YEW	18" HT-	-34
PERENN	HAL C			
ATS6	ALLIUM TANGUTICUM 'SUMMER BEAUTY'	SUMMER BEAUTY ORNAMENTAL CHIVE	I1 GAL	101
BAU6	BAPTISIA AUSTRALIS "	BLUE FALSE INDIGO	1 GAL	66
CVZ6	COREOPSIS VERTICILLATA 'ZAGREB'	ZAGREB THREADLEAF COREOPSIS	1 GAL	66
EPM6	ECHINACEA PURPUREA 'MAGNUS'	MAGNUS PURPLE CONEFLOWER	1 GAL	41
FJC6	FALLOPIA JAPONICA	JAPENESE FLEECE FLOWER	1 GAL	62
GSM6	GERANIUM SANGUINEUM MAX FREI'	MAX FREI BLOODY CRANESBILL	1 GAL	64
HAA6	HEMEROCALLIS 'CHICAGO APACHE'	CHICAGO APACHE DAYLILY	1 GAL	57
HHR6	HEMEROCALLIS 'HAPPY RETURNS'	HAPPY RETURNS DAYLILY	1 GAL	70
HRC6	HEMEROCALLIS 'ROCKET CITY'	ROCKET CITY DWARF DAYLILY	1 GAL	45
HSO6	HEMEROCALLIS 'STELLA DE ORO'	STELLA DE ORO DWARF DAYLILY	1 GAL	49
NFW6	NEPETA X FAASSENII WALKER'S LOW'	WALKER'S LOW CATMINT	1 GAL	115
PSH6	PANICUM VIRGATUM 'SHENANDOAH'	SHENANDOAH SWITCH GRASS	1 GAL	7
PAH6	PENNISETUM ALOPECUROIDES 'HAMELIN'	HAMELIN DWARF FOUNTAIN GRASS	1 GAL	66
PDH6	PENSTEMON DIGITALIS 'HUSKER RED'	HUSKER RED BEARD TONGUE	1 GAL	104
PAT6	PEROVSKIA ATRIPLICIFOLIA *	RUSSIAN SAGE	1 GAL	85
RSV6	RUDBECKIA SPECIOSA VIETTE'S LITTLE SUZY'	VIETTE'S LITTLE SUZY BLACK-EYED SUSAN	1 GAL	103
SNW6	SALVIA NEMOROSA WESUWE'	WESUWE SALVIA	1 GAL	51
SBH6	SALVIA X SYLVESTRIS 'BLUE HILL'	BLUE HILL SALVIA	1 GAL	45
SMN6	SALVIA X SYLVESTRIS MAINACHT	MAY NIGHT SALVIA	1 GAL	57
SMH6	STACHYS MONNIERI 'HUMMELO'	HUMMELO BETONY	1 GAL	101

PERENNIAL TOTAL 1355

TOTAL UNITS: 13.55

EXISTING TREES TO REMAIN AND SHALL BE PROTECTED FROM DAMAGE DURING CONSTRUCTION

ALL PERENNIALS TO BE PAID FOR AS PERENNIAL PLANTS, ORNAMENTAL TYPE, GALLON POT (1 UNIT = 100 PLANTS)

ALL PERENNIALS TO BE PLANTED 18 INCHES ON CENTER.

ANNUALS AND BULBS BY OTHERS



SCALE IN FEET

0'	10'	20'	30	
N	COUNTY	TOTAL	SHEE NO.	

HANCOC	K NG
◆ Civil Engineers	9933 Romerolt Road
 Municipal Consultants 	Phone: 708/905-0300
◆ Established 1911	Fec: 768/665-1212


	USER NAME - XX	DESIGNED - TCK	REVISED - XX
		DRAWN - SMM, JL	P REVISED - STATE OF ILLINO
	PLOT SCALE - XX	CHECKED - TCK	REVISED - XX
1312	PLOT DATE - XX	DATE - 03-24-14	REVISED - XX

OIS **DEPARTMENT OF TRANSPORTATION**

NORTHWEST HIGHWAY (US 14) LANDSCAPE PLAN SCALE: 1" = 10' SHEET NO. OF SHEETS STA.

SECTION COOK 50 45 CONTRACT NO. 61A23



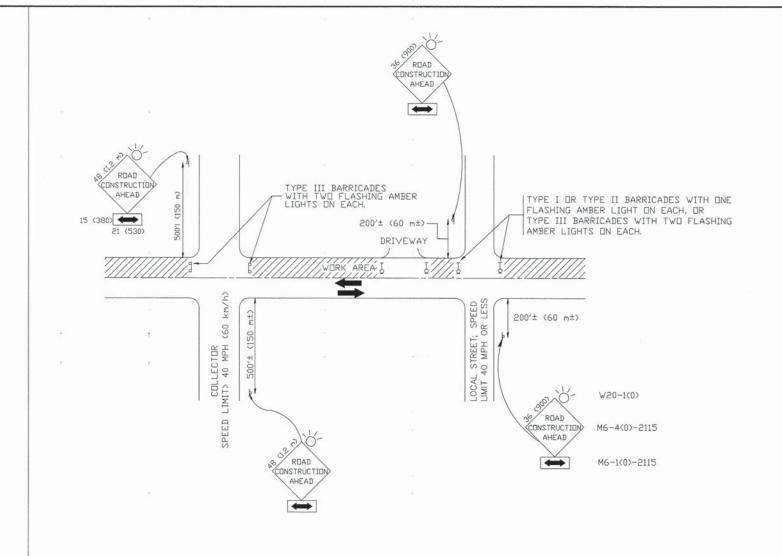

TRAFFIC CONTROL AND PROTECTION FOR SIDE ROADS, INTERSECTIONS, AND DRIVEWAYS

NOTES:

- A. FOR NO LANE RESTRICTION ON THE SIDE ROAD OR DRIVEWAYS
- 1. SIDE ROAD WITH A SPEED LIMIT OF 40 MPH (60 km/h) OR LESS AS SHOWN ON THE DRAWING AND AS DIRECTED BY THE ENGINEER:
- DNE ROAD CONSTRUCTION AHEASIGN 36 x 36 (900x900) WITH A FLASHER AND FLAG MOUNTED ON IT APPROXIMATELY 200' (60 m) IN ADVANCE OF THE MAIN ROUTE.
- b)THE CLOSED PORTION OF THE MAIN ROUTE SHALL BE PROTECTED BY BLOCKING WITH TYPE I, TYPE II OR TYPE III BARRICADES, 1/3 OF THE CROSS SECTION OF THE CLOSED PORTION.
- 2. SIDE ROAD WITH A SPEED LIMIT GREATER THAN 40 MPH (60 km/h) AS SHOWN ON THE DRAWING AND AS DIRECTED BY THE ENGINEER:
- © DNE ROAD CONSTRUCTION AHEABIGN 48 × 48 (1.2 m × 1.2 m) WITH A FLASHER MOUNTED ON IT APPROXIMATELY 500' (150 m) IN ADVANCE OF THE MAIN POLITE
- b) THE CLOSED PORTION OF THE MAIN ROUTE SHALL BE PROTECTED BY BLOCKING WITH TYPE III BARRICADES, 1/2 OF THE CROSS SECTION OF THE CLOSED PORTION.
- WHEN THE SIDE ROAD LIES BETWEEN THE BEGINNING OF THE MAINLINE SIGNING AND THE WORK ZONE, A SINGLE HEADED ARROW (M6-1) SHALL BE USED IN LIEU OF THE DOUBLE HEADED ARROW (M6-4).

- B. FOR A LANE CLOSURE ON A SIDE ROAD OR DRIVEWAY:
- USE APPLICABLE PURTIONS OF THE TYPICAL APPLICATION OF TRAFFIC CONTROL DEVICES (STD. 701501, STD. 701606 OR THE APPROPRIATE STANDARD). THE SPACING OF SIGNS AND BARRICADES SHALL BE ADJUSTED FOR FIELD CONDITIONS AS DIRECTED BY THE ENGINEER. THE DIRECTIONAL ARROW SHALL BE COVERED OR REMOVED WHEN NO LONGER CONSISTENT WITH THE SIDE ROAD LANE CLOSURE.
- C. ADVANCE WARNING SIGNS ARE TO BE OMITTED ON DRIVEWAY UNLESS OTHERWISE NOTED.
- D. THE TRAFFIC CONTROL AND PROTECTION FOR SIDE ROADS, INTERSECTIONS, AND DRIVEWAYS SHALL BE INCIDENTAL TO THE COST OF SPECIFIED TRAFFIC CONTROL STANDARDS OR ITEMS.


All dimensions are in millimeters (inches) unless otherwise shown.

STATE OF ILLINOIS
DEPARTMENT OF TRANSPORTATION


TRAFFIC CONTROL AND PROTECTION FOR SIDE ROADS, INTERSECTIONS, AND DRIVEWAYS

SHEET NO. 1 OF 1 SHEETS STA. TO ST

E.H.E. PROJECT NO. 555-13-14801

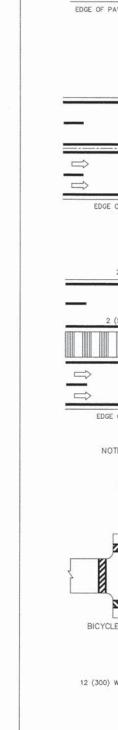


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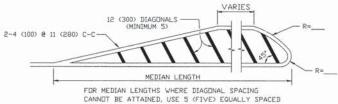


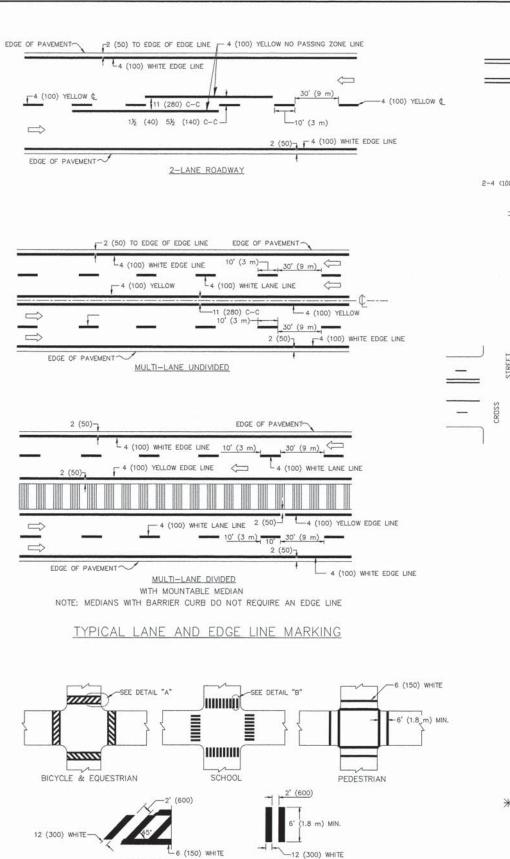

DETAIL "A"

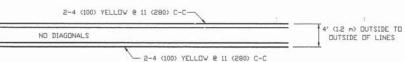


4' (1.2 m) WIDE MEDIANS ONLY




DIAGDNAL LINE SPACING 50' (15 n) C-C (LESS THAN 30MPH (50 km/h)) 75' (25 m) C-C 30MPH (50 km/h) TD 45MPH (70 km/h)) 150' (45 m) C-C (MDRE THAN 45MPH (70 km/h))

MEDIANS OVER 4' (1.2 m) WIDE

DIAGONAL LINES.

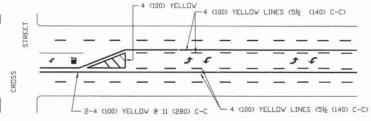


A MINIMUM OF TWO PAIRS OF TURN ARROWS SHALL BE USED, WHITE IN COLOR. ADDITIONAL PAIRS SHALL BE PLACED AT 200' (60 m) TO 300' (90 m) INTERVALS.

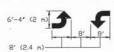

MEDIAN WITH TWO-WAY LEFT TURN LANE

TYPICAL PAINTED MEDIAN MARKING

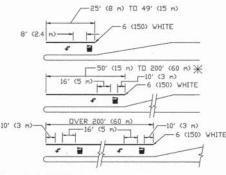


FULL SIZE LETTERS 8' (2.4 m) AND ARROWS SHALL BE USED. \P AREA = 15.6 SQ. FT. (1.5 m²) \P AREA = 20.8 SQ. FT. (1.9 m²)

* TURN LANES IN EXCESS OF 400' (120 m) IN LENGTH MAY HAVE AN ADDITIONAL SET OF ARROW - "ONLY" INSTALLED MIDWAY BETWEEN THE OTHER TWO SETS OF ARROW - "ONLY".

TYPICAL LEFT (OR RIGHT) TURN LANE

TYPICAL TURN LANE MARKING

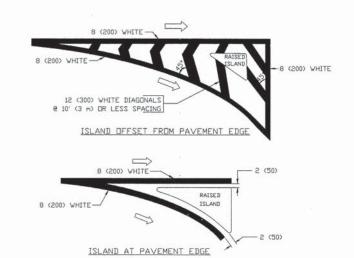

TYPICAL ISLAND MARKING

TYPE DF MARKING	WIDTH OF LINE	PATTERN	COLOR	SPACING / REMARKS
CENTERLINE ON 2 LANE PAVEMENT	4 (100)	SKIP-DASH	YELLOW	10' (3 m) LINE WITH 30' (9 m) SPACE
CENTERLINE ON MULTI-LANE UNDIVIDED PAVEMENT	2 @ 4 (100)	SOLID	YELLOW	11 (280) C-C
NO PASSING ZONE LINES: FOR ONE DIRECTION FOR BOTH DIRECTIONS	4 (100) 2 @ 4 (100)	SOLID SOLID	YELLOW YELLOW	5 1/2 (140) C-C FROM SKIP-DASH CENTERLINE 11 (280) C-C DMIT SKIP-DASH CENTERLINE BETWEEN
LANE LINES	5 (125) DN FREEWAYS	SKIP-DASH SKIP-DASH	WHITE WHITE	10' (3 m) LINE WITH 30' (9 m) SPACE
DOTTED LINES (EXTENSIONS OF CENTER, LANE OR TURN LANE MARKINGS)	SAME AS LINE BEING EXTENDED	SKIP-DASH	SAME AS LINE BEING EXTENDED	2' (600) LINE WITH 6' (1.8 m) SPACE
EDGE LINES	4 (100)	SOLID	YELLOW-LEFT WHITE-RIGHT	DUTLINE MOUNTABLE MEDIANS IN YELLOW; EDGE LINES ARE NOT USED NEXT TO BARRIER CURB
TURN LANE MARKINGS	6 (150) LINE; FULL SIZE LETTERS & SYMBOLS (8' (2.4m))	SOLID	WHITE	SEE TYPICAL TURN LANE MARKING DETAIL
TWO WAY LEFT TURN MARKING	2 @ 4 (100) EACH DIRECTION	SKIP-DASH AND SOLID	YELLOW	10' (3 m) LINE WITH 30' (9 m) SPACE FOR SKIP-DASH, 5 1/2 (140) C-C BETWEEN SOLID LINE AND SKIP-DASH LINE
	8' (2.4m) LEFT ARROW	IN PAIRS	WHITE	SEE TYPICAL TWD-WAY LEFT TURN MARKING DETAIL
CROSSWALK LINES (PEDESTRIAN) A. DIAGONALS (BIKE & EQUESTRIAN) B. LONGITUDINAL BARS (SCHOOL)	2 @ 6 (150) 12 (300) @ 45* 12 (300) @ 90*	SOLID SOLID SOLID	WHITE WHITE WHITE	NOT LESS THAN 6' (1.8 m) APART 2' (600) APART 2' (600) APART SEE TYPICAL CROSSWALK MARKING DETAILS.
STOP LINES	24 (600)	SOLID	WHITE	PLACE 4' (1.2 m) IN ADVANCE OF AND PARALLEL TO CROSSWALK, IF PRESENT. UTHERWISE, PLACE AT DESIRED STOPPING POINT. PARALLEL TO CROSSROAD CENTERLINE, WHERE POSSIBLE
PAINTED MEDIANS	2 @ 4 (100) WITH 12 (300) DIAGONALS @ 45* ND DIAGONALS USED FOR 4' (1.2 m) WIDE MEDIANS	SOLID	YELLOW: TWO WAY TRAFFIC WHITE: ONE WAY TRAFFIC	11 (280) C-C FOR THE DOUBLE LINE SEE TYPICAL PAINTED MEDIAN MARKING.
GORE MARKING AND CHANNELIZING LINES	8 (200) WITH 12 (300) DIAGUNALS @ 45*	SOLID	WHITE	DIAGUNALS: 15' (4.5 m) C-C (LESS THAN 30MPH (50 km/h)) 20' (6 m) C-C 30MPH (50 km/h) TU 45MPH (70 km/h)) 30' (9 m) C-C (UVER 45MPH (70 km/h))
	24 (600) TRANSVERSE LINES; 'RR' IS 6' (1.8 m) LETTERS; 16 (400) LINE FOR 'X'	SOLID	WHITE	SEE STATE STANDARD 780001 AREA DF: "X"=3.6 SQ. FT. (0.33 m²) EACH "X"=54.0 SQ. FT. (5.0 m²)
SHOULDER DIAGONALS	12 (300) € 45*	SOLID	WHITE - RIGHT YELLOW - LEFT	50' (15 m) C-C (LESS THAN 30MPH (50 km/h)) 75' (25 m) C-C (30 MPH (50 km/h) TO 45MPH (70 km/h)! 150' (45 m) C-C (DVER 45MPH (70 km/h))

FOR FURTHER DETAILS ON PAVEMENT MARKING REFER TO STANDARD SPECIFICATIONS FOR ROAD AND BRIDGE CONSTRUCTION AND STATE STANDARD 780001.

All dimensions are in inches (millimeters) unless otherwise shown.


USER NAME =	drivakosgn	DESIGNED	- EVERS	REVISED - T	RAMMACHER 10-27-94
		DRAWN	<u></u>	REVISED - C	. JUCIUS 09-09-09
PLOT SCALE =	50.000° / IN.	CHECKED	T.	REVISED -	
PLOT DATE = 1	9/9/2009	DATE	- 03-19-90	REVISED -	

STATE OF ILLINOIS **DEPARTMENT OF TRANSPORTATION**

		F.A.U. SECTION				COUNTY	TOTAL	L SHEE			
TYPICAL PAVEMENT MARKINGS					3612 13-00160-00-SW				COOK 5		47
		TC-13				CONTRACT NO. 61A23					
	SCALE: NONE	SHEET NO. 1 OF 1 SHEETS	STA.	TO STA.	FED. ROAD	DIST. NO. 1	ILLINOIS	FED. A	ID PROJECT	TE-00D1	(940)

E.H.E. PROJECT NO. 555-13-14801



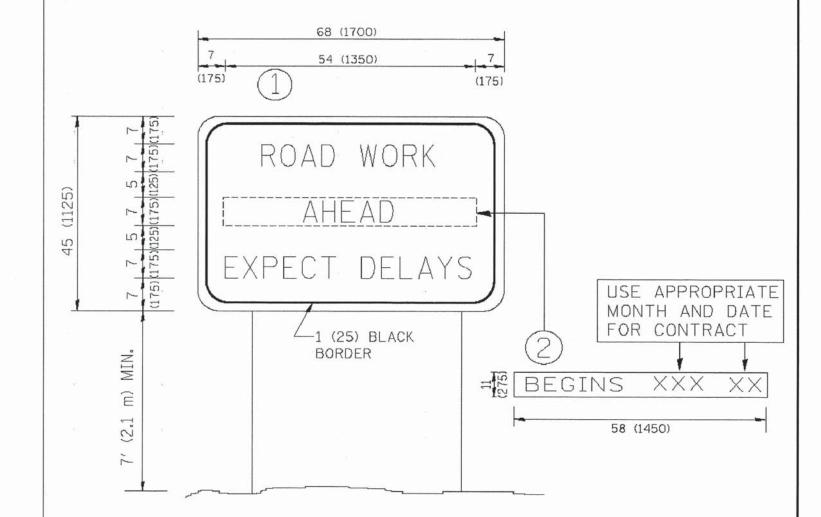

NOTES:

- 1. USE BLACK LETTERING ON ORANGE BACKGROUND.
 - 2. ERECT SIGNS IN ADVANCE OF THE LOCATION FOR THE "ROAD CONSTRUCTION AHEAD" SIGN AT LOCATIONS AS DIRECTED BY THE ENGINEER.
 - 3. ERECT SIGN (1) WITH INSTALLED PANEL (2) ONE WEEK PRIOR TO THE START OF CONSTRUCTION.
 - 4. REMOVE PANEL (2) SOON AFTER THE START OF CONSTRUCTION.
 - 5. SEE SPECIAL PROVISION FOR "TEMPORARY INFORMATION SIGNING" FOR ADDITIONAL INFORMATION.
 - 6. ONE SIGN ASSEMBLY EQUALS 25.70 SQ. FT. (2.3 SQ. M.)
 - 7. SHALL BE PAID FOR AS TEMPORARY INFORMATION SIGNING.

ALL DIMENSIONS ARE IN INCHES (MILLIMETERS) UNLESS OTHERWISE SHOWN.

FILE NAME =	USER NAME = geglaenobt	DESIGNED -	REVISED - R. MIRS 09-15-97		ADDRESS BAAD		F.A.U.	SECTION	COUNTY	TOTAL SHEE	
Wi\dastatd\22k34\ta22.dgn		DRAWN - F	REVISED - R. MIRS 12-11-97	STATE OF ILLINOIS DEPARTMENT OF TRANSPORTATION	ARTERIAL ROAD INFORMATION SIGN			RICA		соок	SHEETS NO.
	PLOT SCALE = 58.080 '/ IN.	CHECKED -	REVISED -T. RAMMACHER 02-02-99					3012	13-00160-00-SW	CONTRACT NO. 61A23	
	PLOT DATE = 1/4/2008	DATE -	REVISED - C. JUCIUS 01-31-07		SCALE: NONE	SHEET NO. 1 OF 1 SHEETS STA.	TO STA.	FEG. ROAD	DIST. NO. 1 ILLINOIS FED		TE-00D1(940)




3.0" RADIUS, 0.5" BORDER, WHITE ON GREEN; REFLECTORIZED "DRIVEWAY" D; "ENTRANCE" D; STANDARD ARROW CUSTOM 12.0" x 5.0"

NOTES:

- 1. HALF OF THE SIGNS WILL REQUIRE A LEFT HAND FACING ARROW.
- 2. TWO SIGNS SHALL BE USED AT EACH COMMERCIAL ENTRANCE PLACED BACK-TO-BACK: ONE WITH A RIGHT HAND ARROW (SHOWN) SHALL BE PLACED ON THE NEAR RIGHT SIDE THE DRIVEWAY AND ONE WITH A LEFT HAND ARROW SHALL BE PLACED ON THE FAR LEFT SIDE OF THE DRIVEWAY.
- 3. SIGNS TO BE PAID FOR AS ITEM "TEMPORARY INFORMATION SIGNING".


FILE NAME = DESIGNED -REVISED - C. JUCIUS 02-15-07 JSER NAME = gaglianobt DRIVEWAY ENTRANCE SIGNING DRAWN REVISED STATE OF ILLINOIS 3612 13-00160-00-SW **DEPARTMENT OF TRANSPORTATION** PLOT SCALE = 50,000 1/ 10 CHECKED REVISED TC-26 CONTRACT NO. 61A23 PLOT DATE = 12/13/2012 SHEET NO. 1 OF 1 SHEETS STA.

COOK 50 49

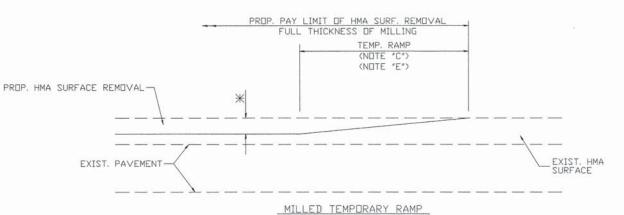

(FOR BUTT JOINT AND HMA TAPER SEE DETAIL BELOW)


OPTION 1

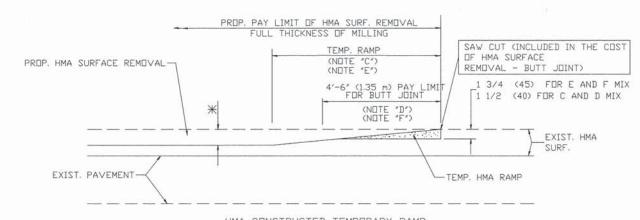


HMA CONSTRUCTED TEMPORARY RAMP (FOR BUTT JOINT AND HMA TAPER SEE DETAIL BELOW)


OPTION 2

TYPICAL TEMPORARY RAMP

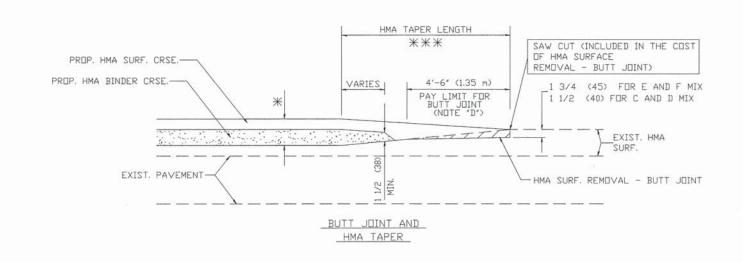

TYPICAL BUTT JOINT AND HMA TAPER FOR MILLING AND RESURFACING

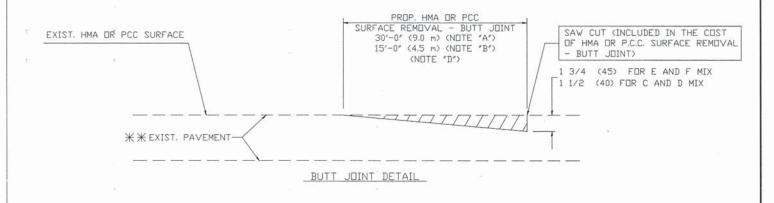

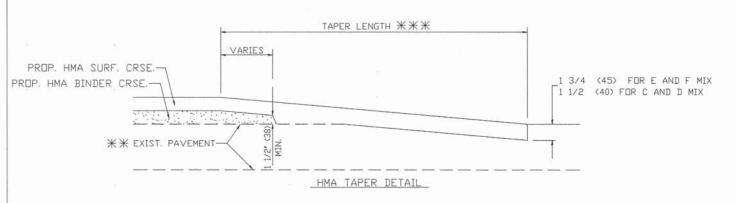

TYPICAL BUTT JOINT AND HMA TAPER FOR RESURFACING ONLY

** PC CONCRETE, HMA OR HMA RESURFACED PAVEMENT.

NOTES

- A: MAINLINE ROADWAYS AND MAJOR SIDE ROADS.
- B: MINOR SIDE ROADS.
- C: THE TEMP. RAMP SHALL BE CONSTRUCTED IMMEDIATELY UPON REMOVAL OF THE EXISTING HMA SURFACE.
- D: THE BUTT JOINT SHALL BE CONSTRUCTED IMMEDIATELY PRIOR TO PLACING THE PROPOSED HMA COURSES.
- E: TAPER THE TEMP, RAMP AT A RATE OF 3'-0" (900 mm) PER 1 INCH (25 mm) OF MILLING THICKNESS,
- F: INSTALLATION AND REMOVAL OF THE 4'-6" (1.35 m) TEMP. RAMP IS INCLUDED IN COST OF HMA SURFACE REMOVAL - BUTT JOINT
- G: SEE ARTICLE 406.08 AND 406.14 OF THE STANDARD SPECIFICATIONS FOR "HMA AND/OR PCC SURFACE REMOVAL, BUTT JOINT".
- * SEE TYPICAL SECTIONS FOR MILLING THICKNESS.
- ₩ ※ 20'-0" (6.1 m) PER 1 (25) RESURFACING (NDTE "A") 10'-0" (3.0 m) PER 1 (25) RESURFACING (NDTE "B")

BASIS OF PAYMENT

THE BUTT JUINT WILL BE PAID FOR AT THE CONTRACT UNIT PRICE PER SQUARE YARD (SQUARE METER)
FOR "HOT-MIX ASPHALT SURFACE REMOVAL - BUTT JOINT" OR FOR "PORTLAND CEMENT CONCRETE SURFACE REMOVAL - BUTT JOINT".

SCALE: NONE

ALL DIMENSIONS ARE IN INCHES (MILLIMETERS) UNLESS OTHERWISE SHOWN

USER NAME =	DESIGNED - M. DE YONG	REVISED - R. SHAH 10-25-94
	DRAWN -	REVISED - A. ABBAS 03-21-97
PLOT SCALE =	CHECKED -	REVISED - M. GOMEZ 04-06-01
PLOT DATE =	DATE - 06-13-90	REVISED - R. BORO 01-01-07

STATE OF ILLINOIS **DEPARTMENT OF TRANSPORTATION**

BUTT JOINT AND			FAU SECTION		CTION	COUNTY		TOTAL	SHE
HMA TAF	3612	13-0016	0-00-SW		соок	50	50		
			B	D400-05	(BD-32)	CONTRACT	NO. 61	A23
SHEET NO. 1 OF 1	SHEETS STA.	TO STA.	FED. ROAD	DIST. NO. 1	ILLINOIS	FED. AL	D PROJECT	TE-00D1	(940)

E.H.E. PROJECT NO. 555-13-14801