


PLAN	SURVEYED	BY	DATE
	PLOTTED		
NOTE BOOK NO.	ALIGNMENT CHECKED		
	CAD FILE NAME		

PROFILE	SURVEYED	BY	DATE
	PLOTTED		
NOTE BOOK NO.	GRADES CHECKED		
	STRUCTURE NOTATIONS CHWD		

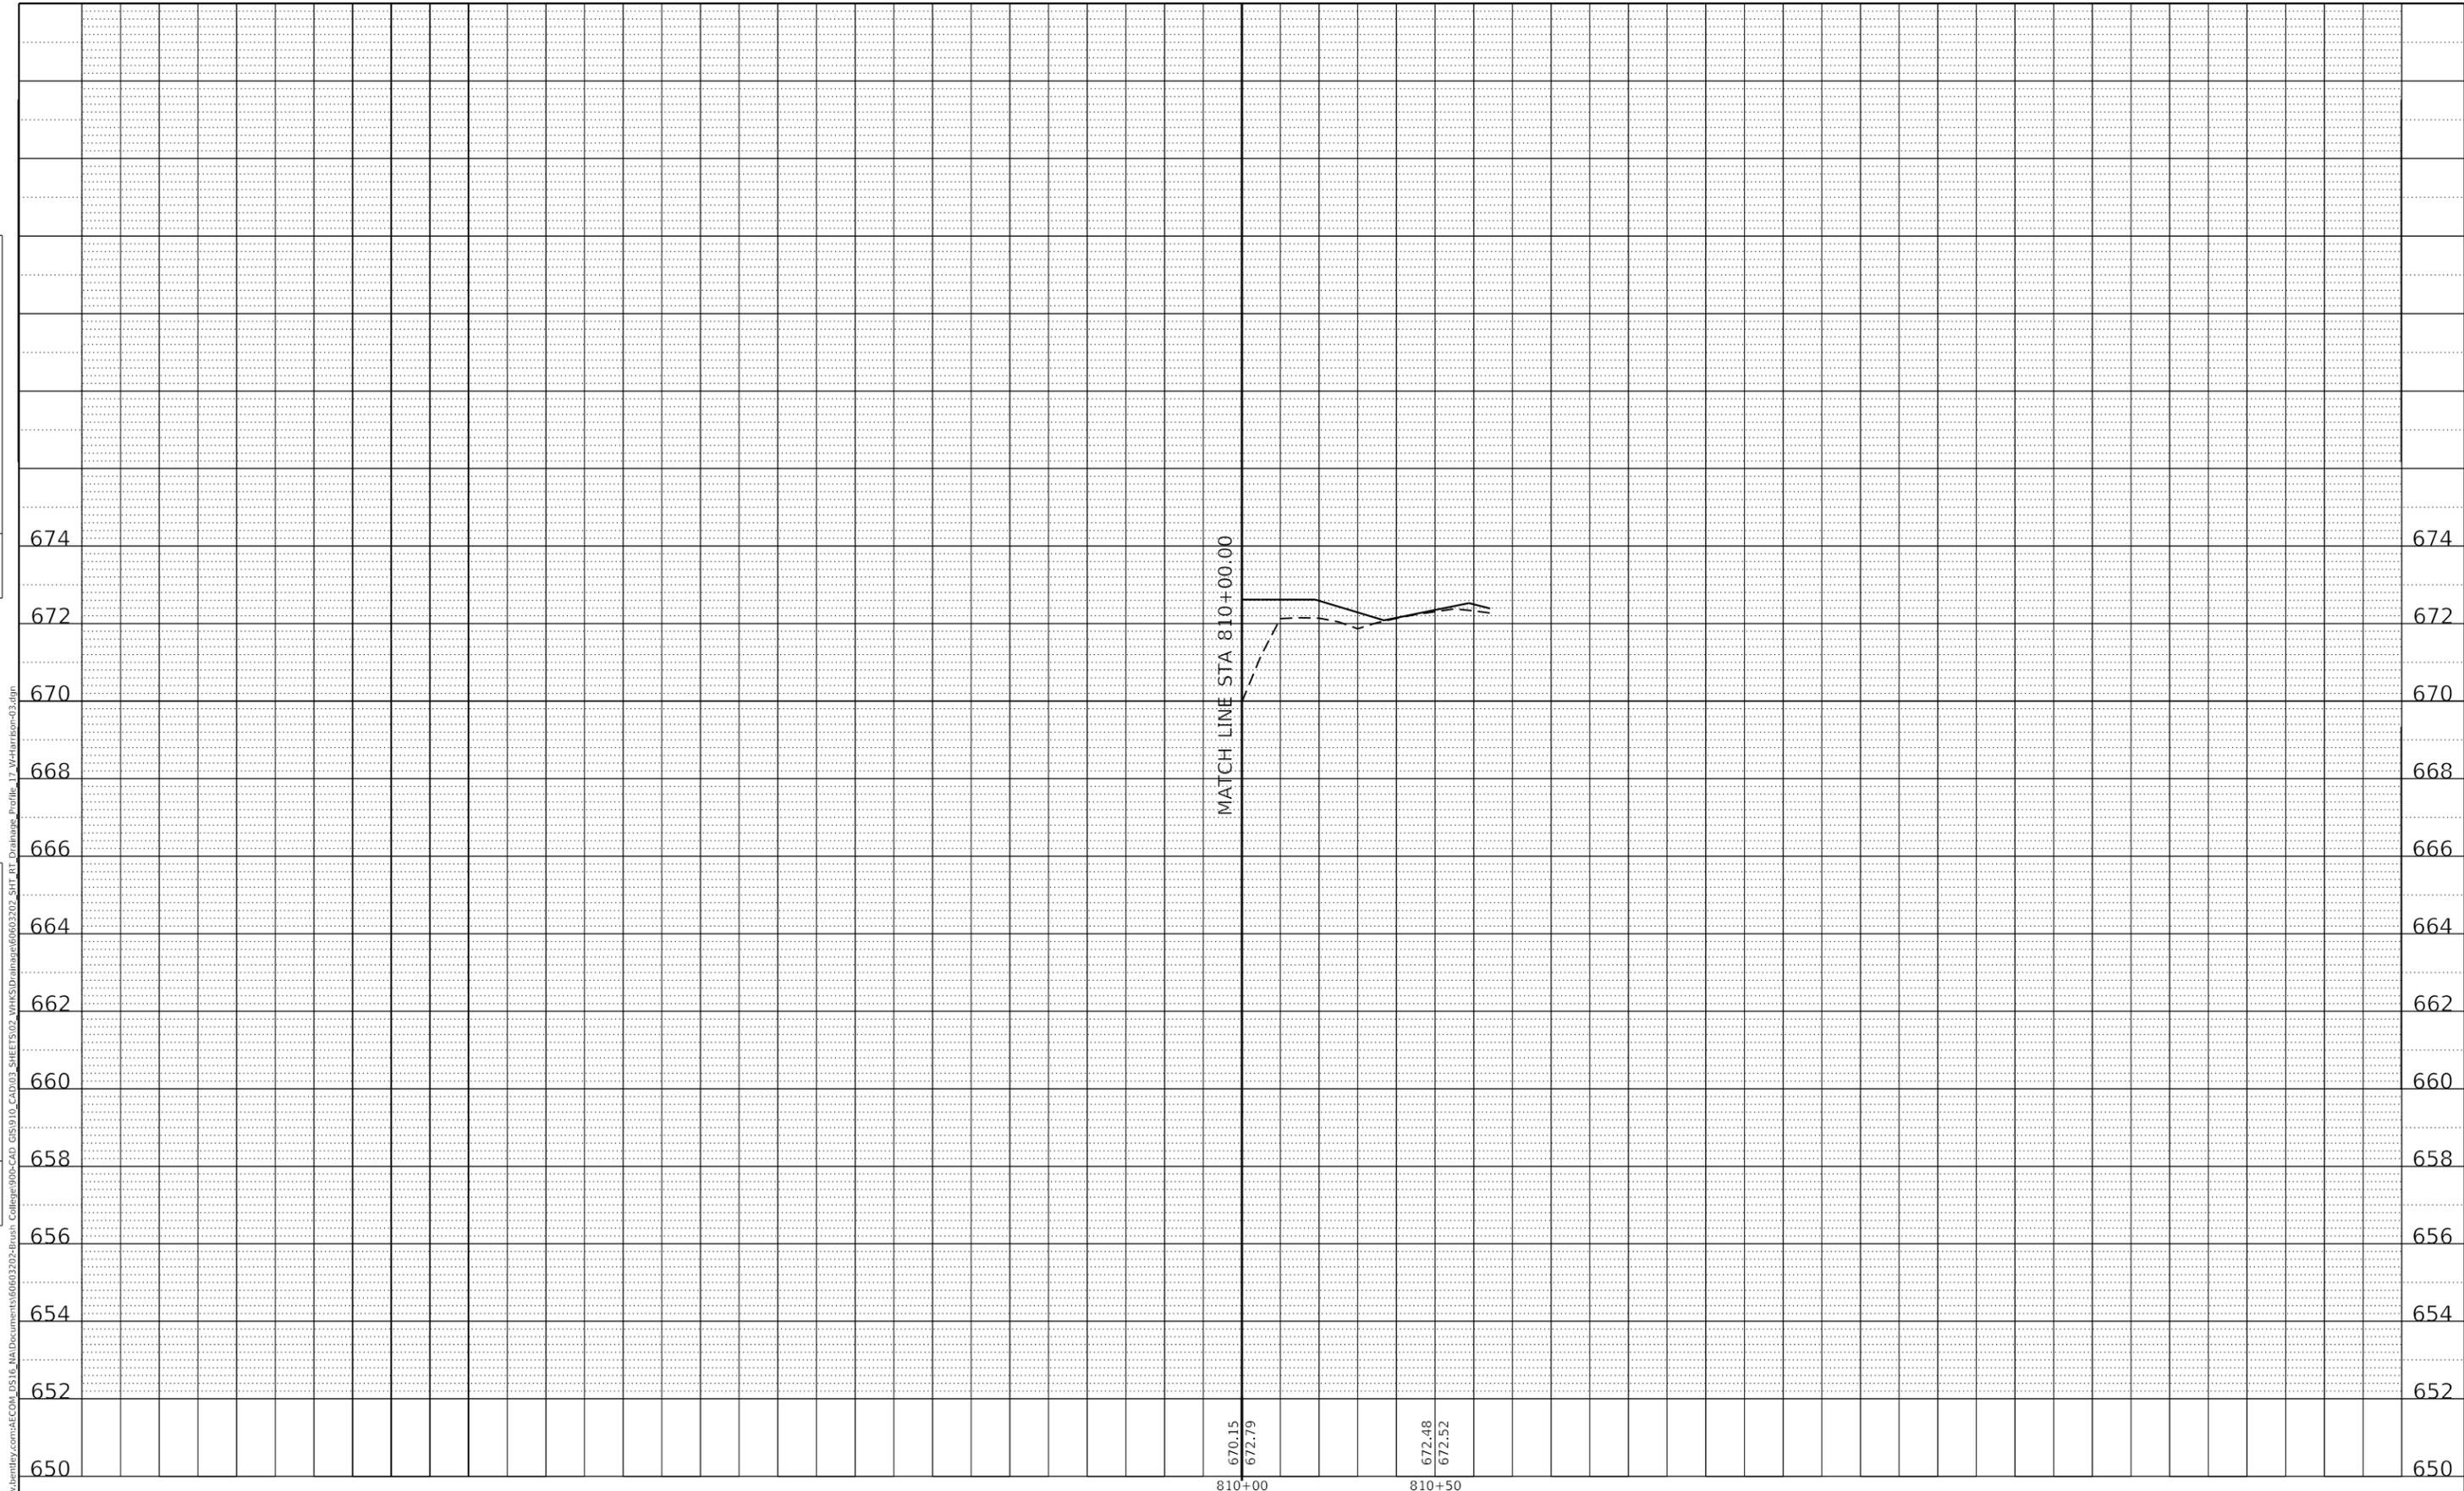

650 652 654 656 658 660 662 664 666 668 670 672 674

810+00 810+50

670.15  
672.79

672.48  
672.52



USER NAME = gjameson	DESIGNED - TJB	REVISED -
PLOT SCALE = 40.0000' / in.	DRAWN - GSJ	REVISED -
PLOT DATE = 4/27/2021	CHECKED - CWC	REVISED -
	DATE - 4/30/2021	REVISED -

**STATE OF ILLINOIS  
DEPARTMENT OF TRANSPORTATION**

**E HARRISON AVENUE (WEST LEG)  
PROPOSED DRAINAGE PROFILES RIGHTSIDE**


SCALE: 1"=10' V SHEET 23 OF 27 SHEETS STA. 804+50.00 TO STA. 810+20.00

F.A.U. RTE.	SECTION	COUNTY	TOTAL SHEETS	SHEET NO.
7448	09-00933-01-BR	MACON	1019	501
CONTRACT NO. 95893				
ILLINOIS FED. AID PROJECT				

PLAN	SURVEYED	BY	DATE
	PLOTTED		
NOTE BOOK NO.	ALIGNMENT CHECKED		
	GRADE CHECKED		
	STRUCTURE NOTATION		
	CAD FILE NAME		

PROFILE	SURVEYED	BY	DATE
	PLOTTED		
NOTE BOOK NO.	GRADES CHECKED		
	STRUCTURE NOTATION		

MODEL: Default  
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700+00      700+50      701+00

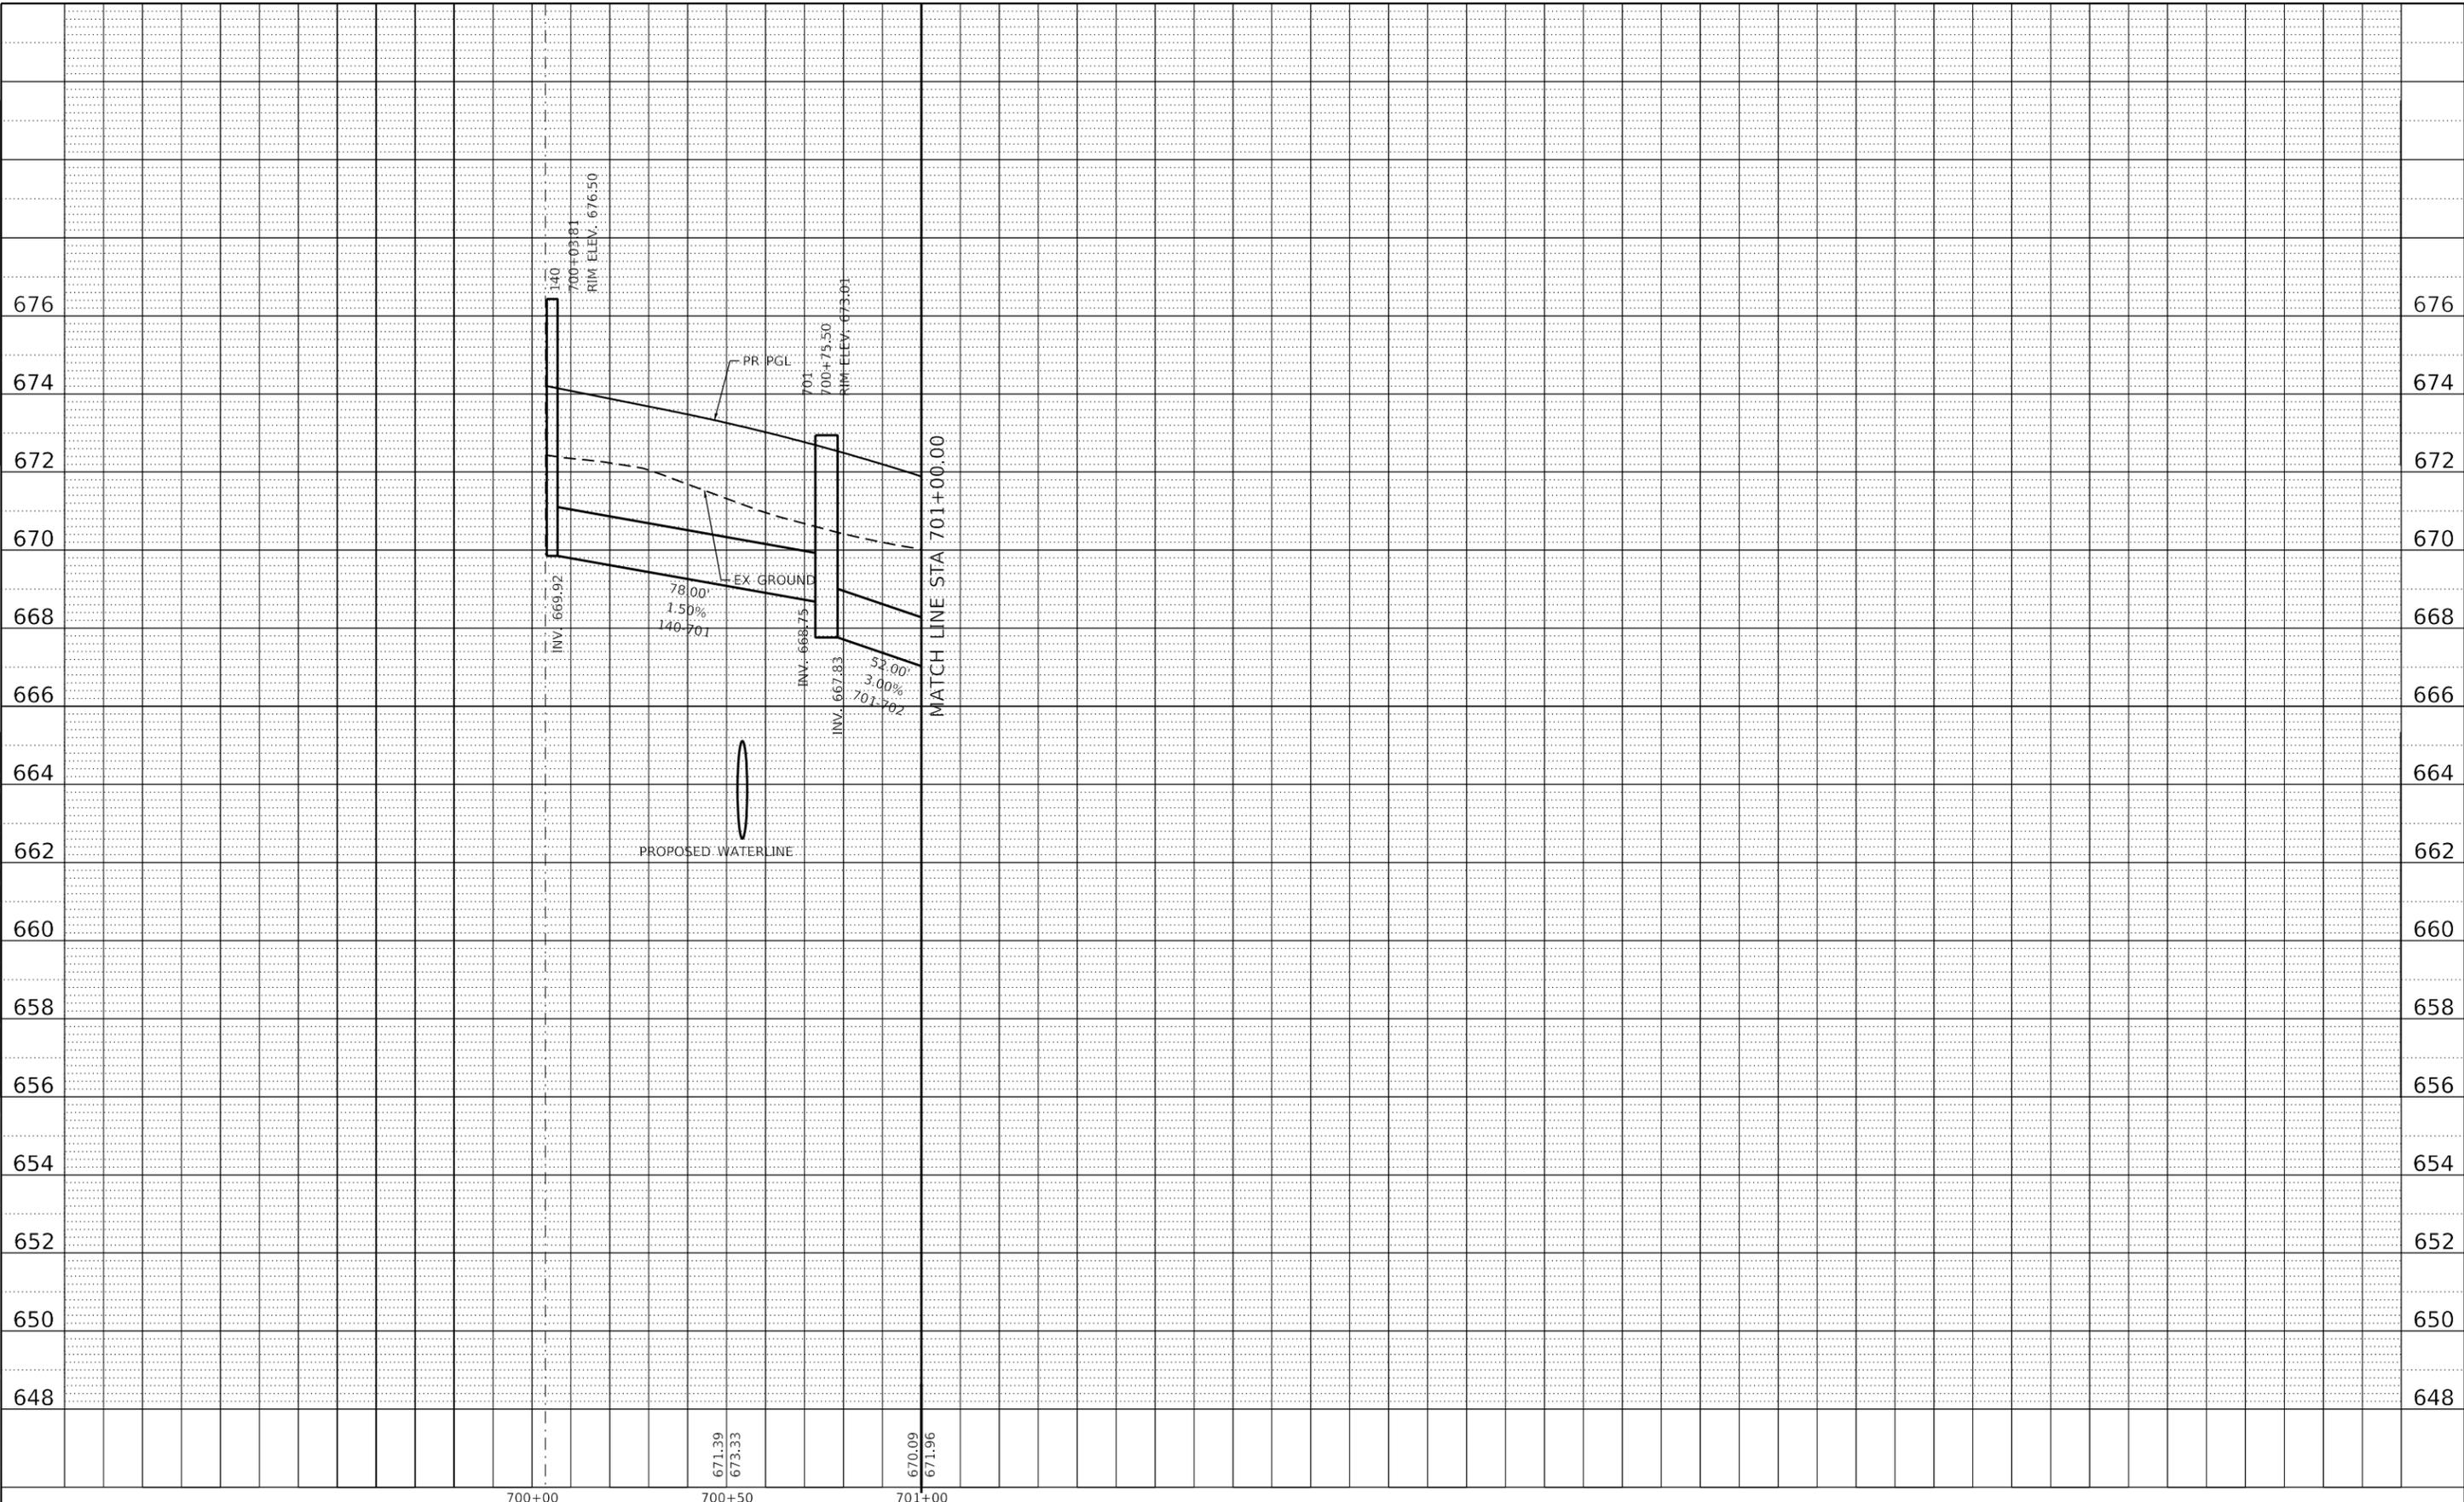671.39  
673.33

670.09  
671.96



USER NAME = gjameson	DESIGNED - TJB	REVISED -
PLOT SCALE = 40.0000' / in.	DRAWN - GSJ	REVISED -
PLOT DATE = 4/27/2021	CHECKED - CWC	REVISED -
	DATE - 4/30/2021	REVISED -

**STATE OF ILLINOIS  
DEPARTMENT OF TRANSPORTATION**

**E HARRISON AVENUE (EAST LEG)  
PROPOSED DRAINAGE PROFILES RIGHTSIDE**


SCALE: 1"=10' V    SHEET 24 OF 27 SHEETS    STA. 700+00.00 TO STA. 705+00.00

F.A.U. RTE.	SECTION	COUNTY	TOTAL SHEETS	SHEET NO.
7448	09-00933-01-BR	MACON	1019	502
CONTRACT NO. 95893				
ILLINOIS FED. AID PROJECT				

PLAN	SURVEYED	BY	DATE
	PLOTTED		
NOTE BOOK NO.	ALIGNMENT CHECKED		
	GRADE CHECKED		
	STRUCTURE NOTATION		
	CAD FILE NAME		

PROFILE	SURVEYED	BY	DATE
	PLOTTED		
NOTE BOOK NO.	GRADES CHECKED		
	STRUCTURE NOTATION		

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USER NAME = gjameson	DESIGNED - TJB	REVISED -
PLOT SCALE = 40.0000' / in.	DRAWN - GSJ	REVISED -
PLOT DATE = 4/27/2021	CHECKED - CWC	REVISED -
	DATE - 4/30/2021	REVISED -

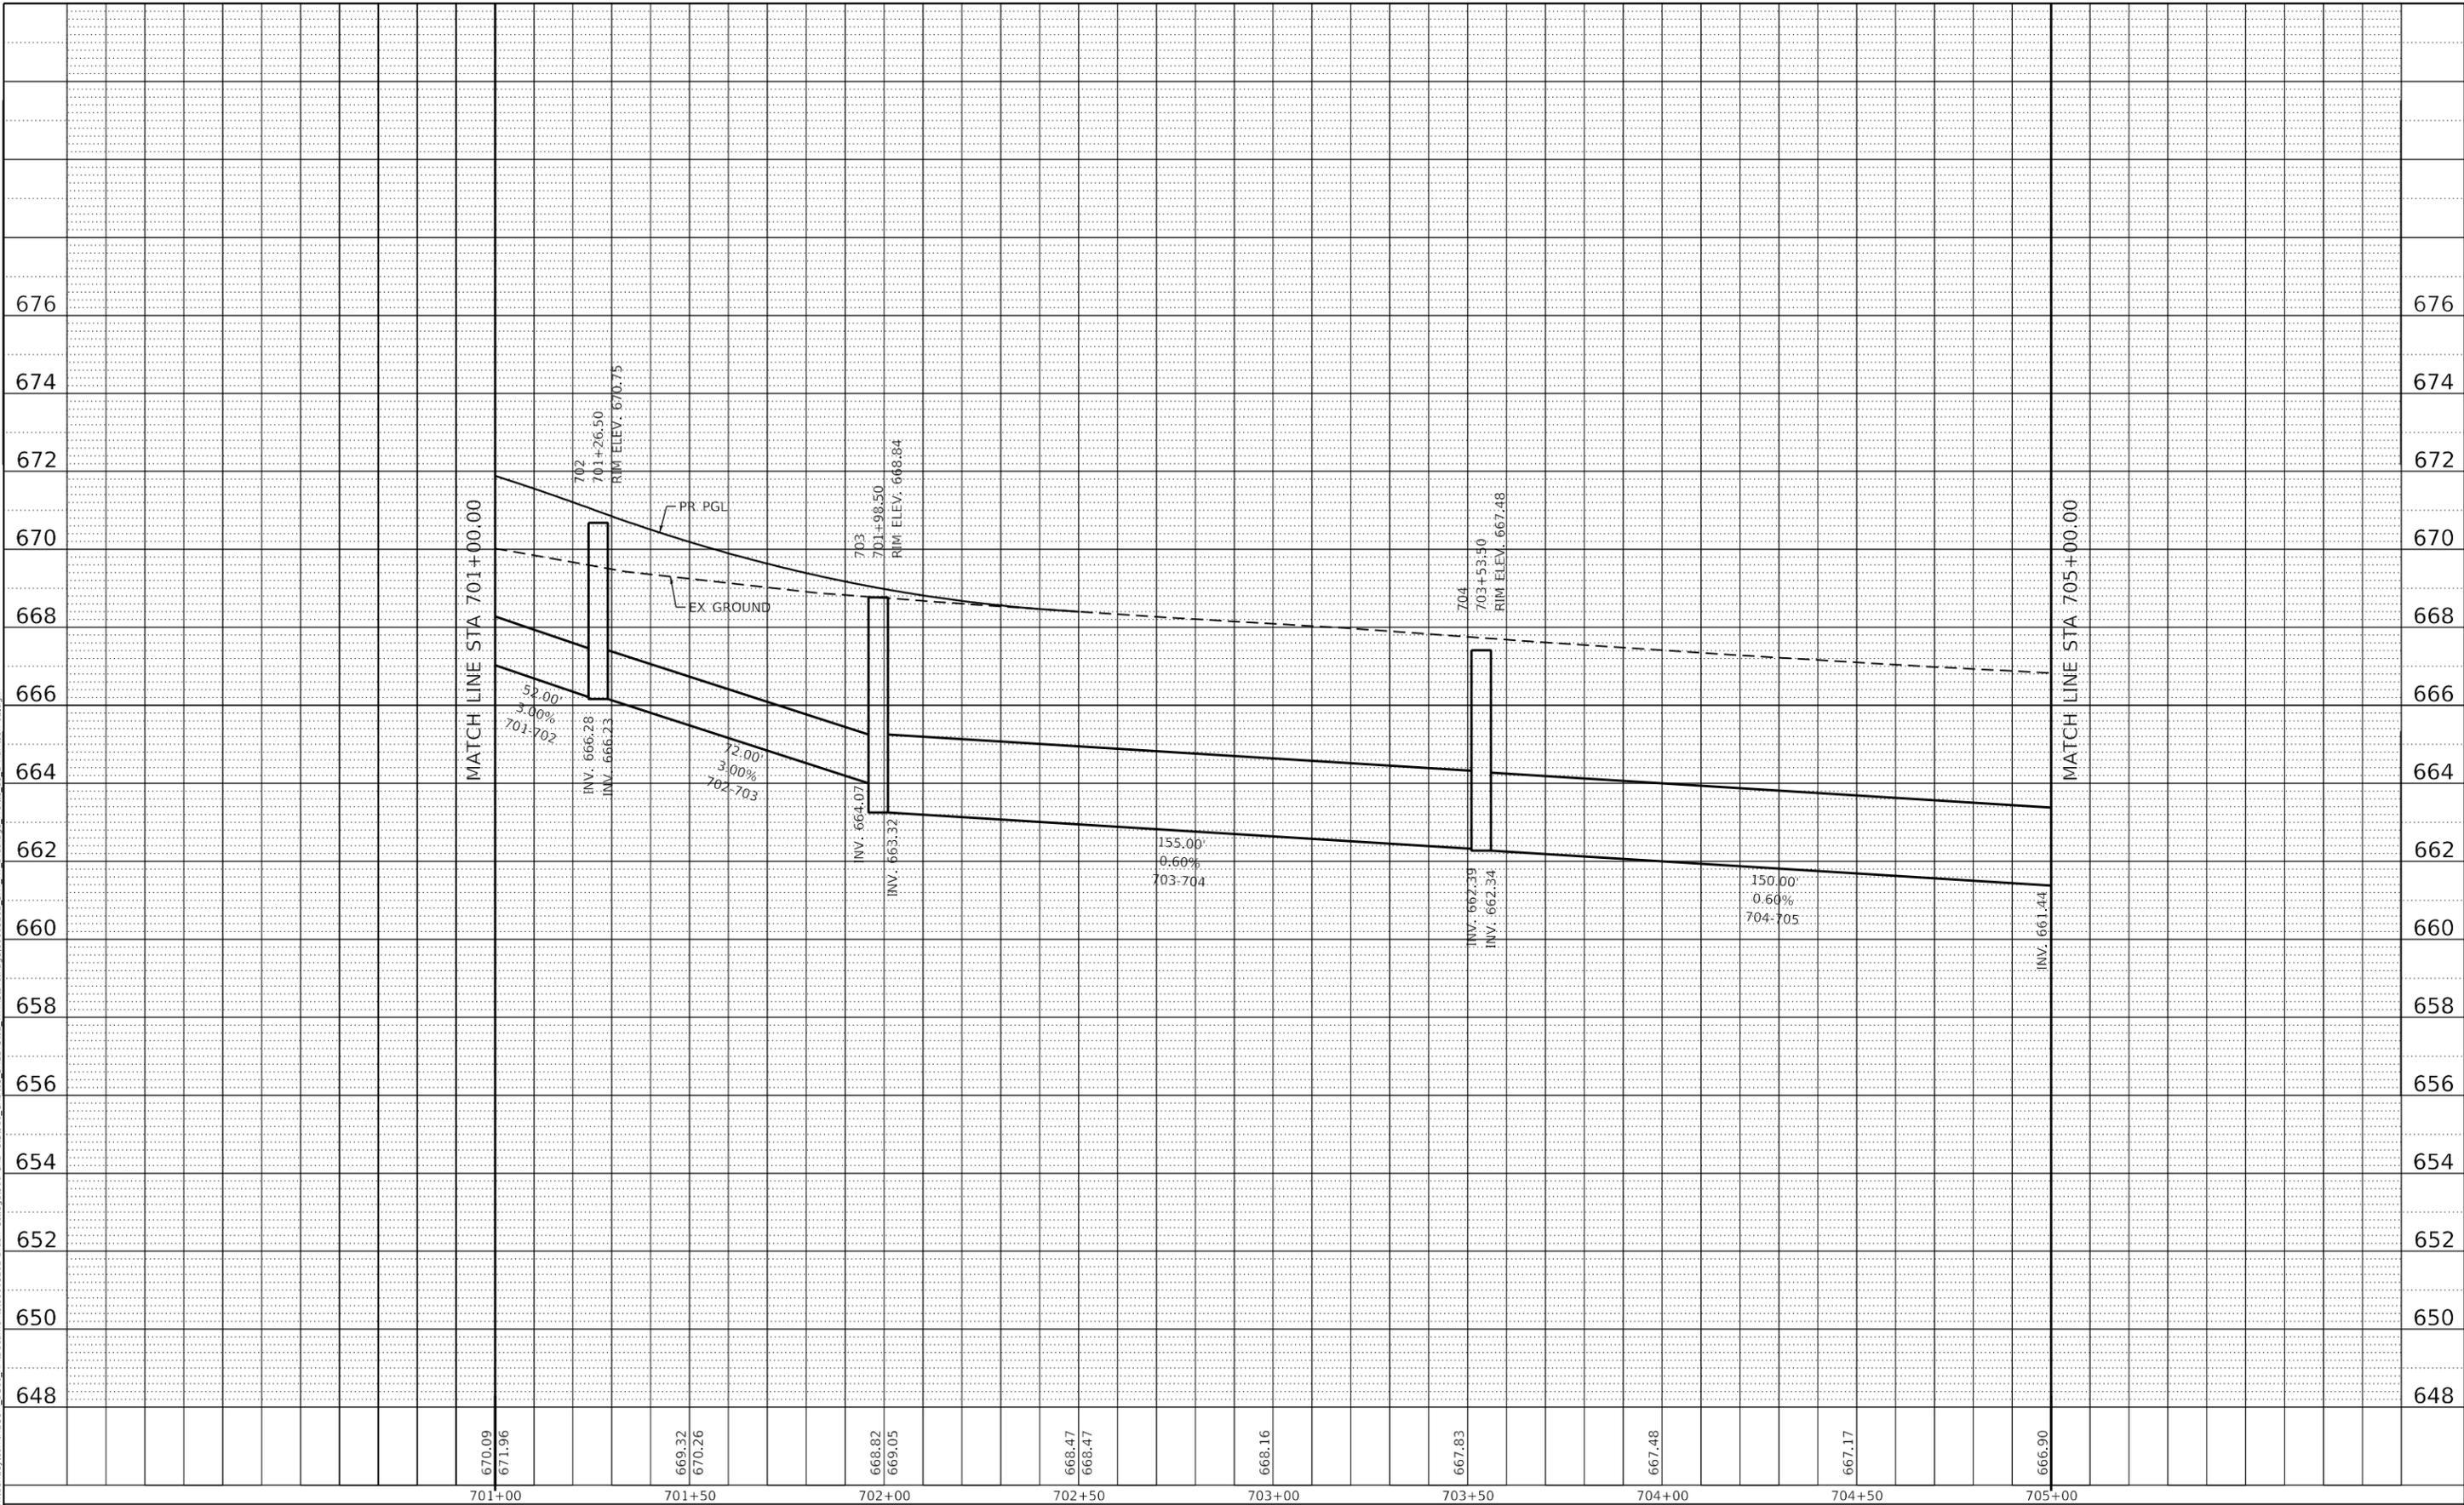**STATE OF ILLINOIS  
 DEPARTMENT OF TRANSPORTATION**


<b>E HARRISON AVENUE (EAST LEG)    PROPOSED DRAINAGE PROFILES RIGHTSIDE</b>			
SCALE: 1"=10' V	SHEET 25	OF 27 SHEETS	STA. 700+00.00 TO STA. 705+00.00

F.A.U. RTE. 7448	SECTION 09-00933-01-BR	COUNTY MACON	TOTAL SHEETS 1019	SHEET NO. 503
CONTRACT NO. 95893				
ILLINOIS FED. AID PROJECT				

PLAN	SURVEYED	BY	DATE
NO.	PLOTTED		
	ALIGNED		
	CHECKED		
	CAD FILE NAME		

PROFILE	SURVEYED	BY	DATE
NO.	PLOTTED		
	GRADES CHECKED		
	STRUCTURE NOTATIONS CHECKED		

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design firm  
 no. 184001036  
**whks**  
 engineers + planners + land surveyors

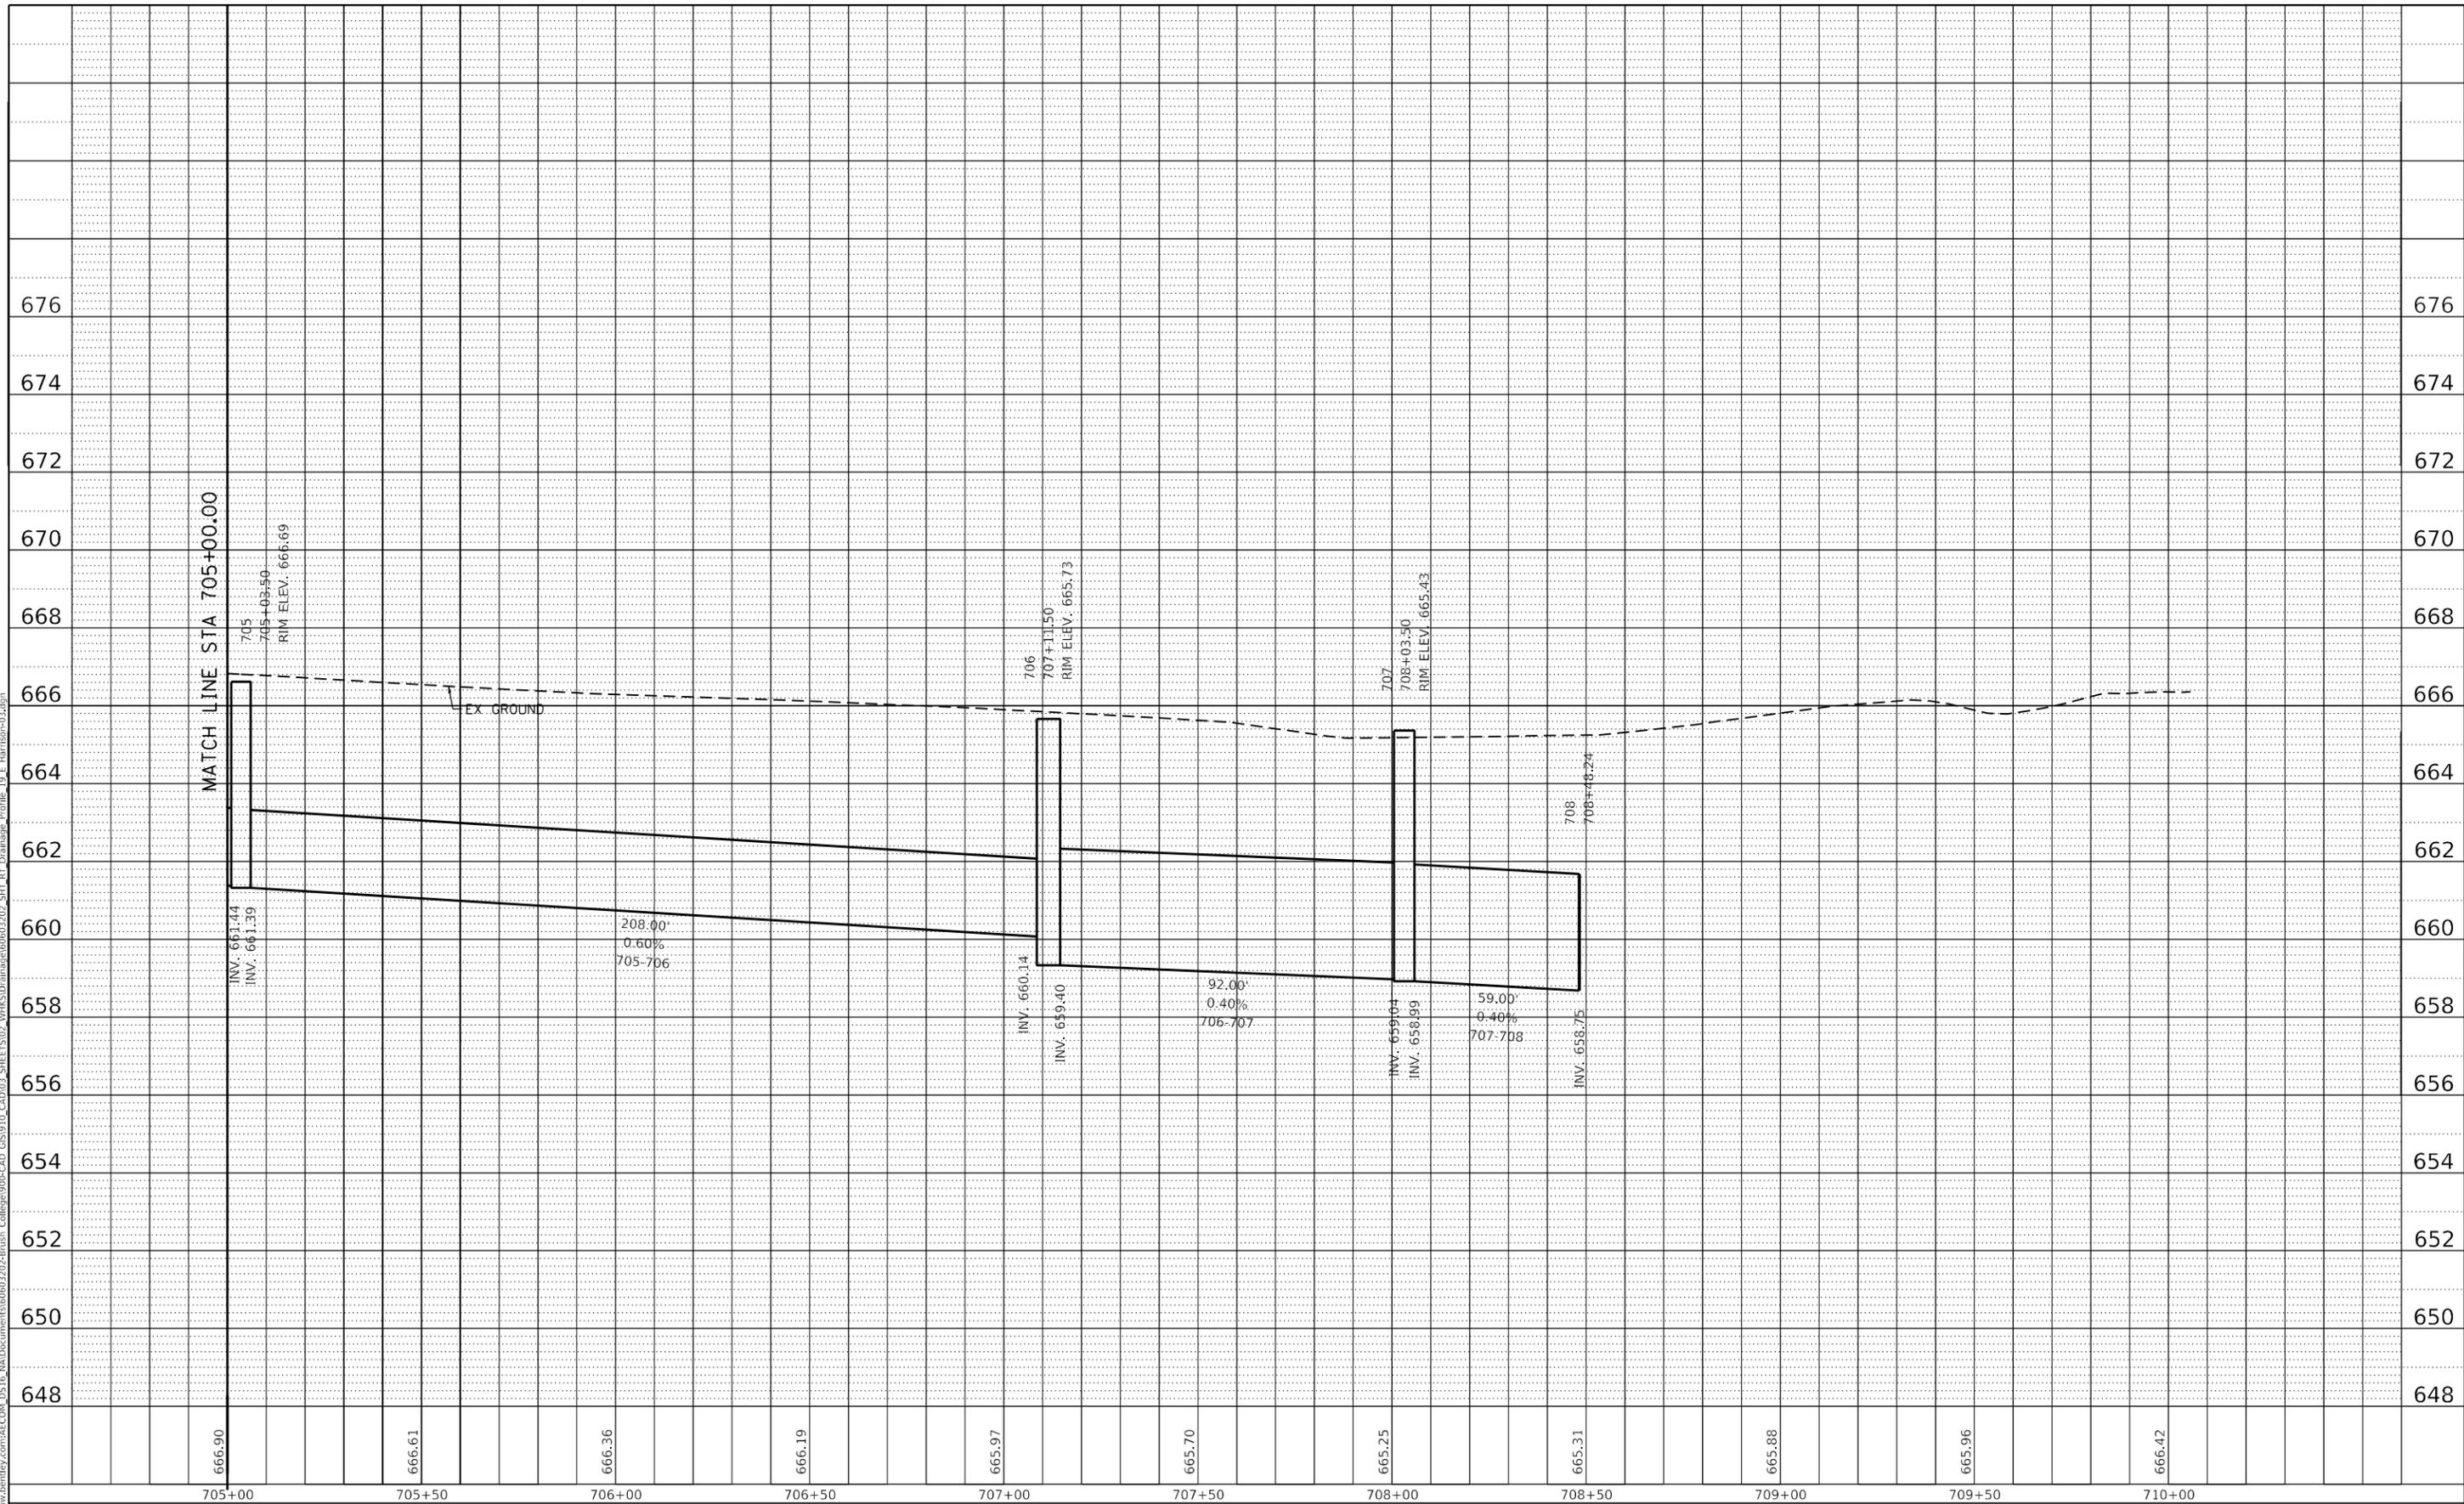USER NAME = gjameson	DESIGNED - TJB	REVISED -
PLOT SCALE = 40.0000' / in.	DRAWN - GSJ	REVISED -
PLOT DATE = 4/27/2021	CHECKED - CWC	REVISED -
	DATE - 4/30/2021	REVISED -

**STATE OF ILLINOIS  
 DEPARTMENT OF TRANSPORTATION**


**E HARRISON AVENUE (EAST LEG)  
 PROPOSED DRAINAGE PROFILES RIGHTSIDE**  
 SCALE: 1"=10' V SHEET 26 OF 27 SHEETS STA. 705+00.00 TO STA. 710+00.00

F.A.U. RTE.	SECTION	COUNTY	TOTAL SHEETS	SHEET NO.
7448	09-00933-01-BR	MACON	1019	504
CONTRACT NO. 95893				
ILLINOIS FED. AID PROJECT				

PLAN	SURVEYED	BY	DATE
	PLOTTED		
NOTE BOOK NO.	ALIGNMENT CHECKED		
	CAD FILE NAME		

PROFILE	SURVEYED	BY	DATE
	PLOTTED		
NOTE BOOK NO.	GRADES CHECKED		
	STRUCTURE NOTATIONS		

MODEL: Default  
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design firm  
 no. 184001036  
**whks**  
 engineers + planners + land surveyors

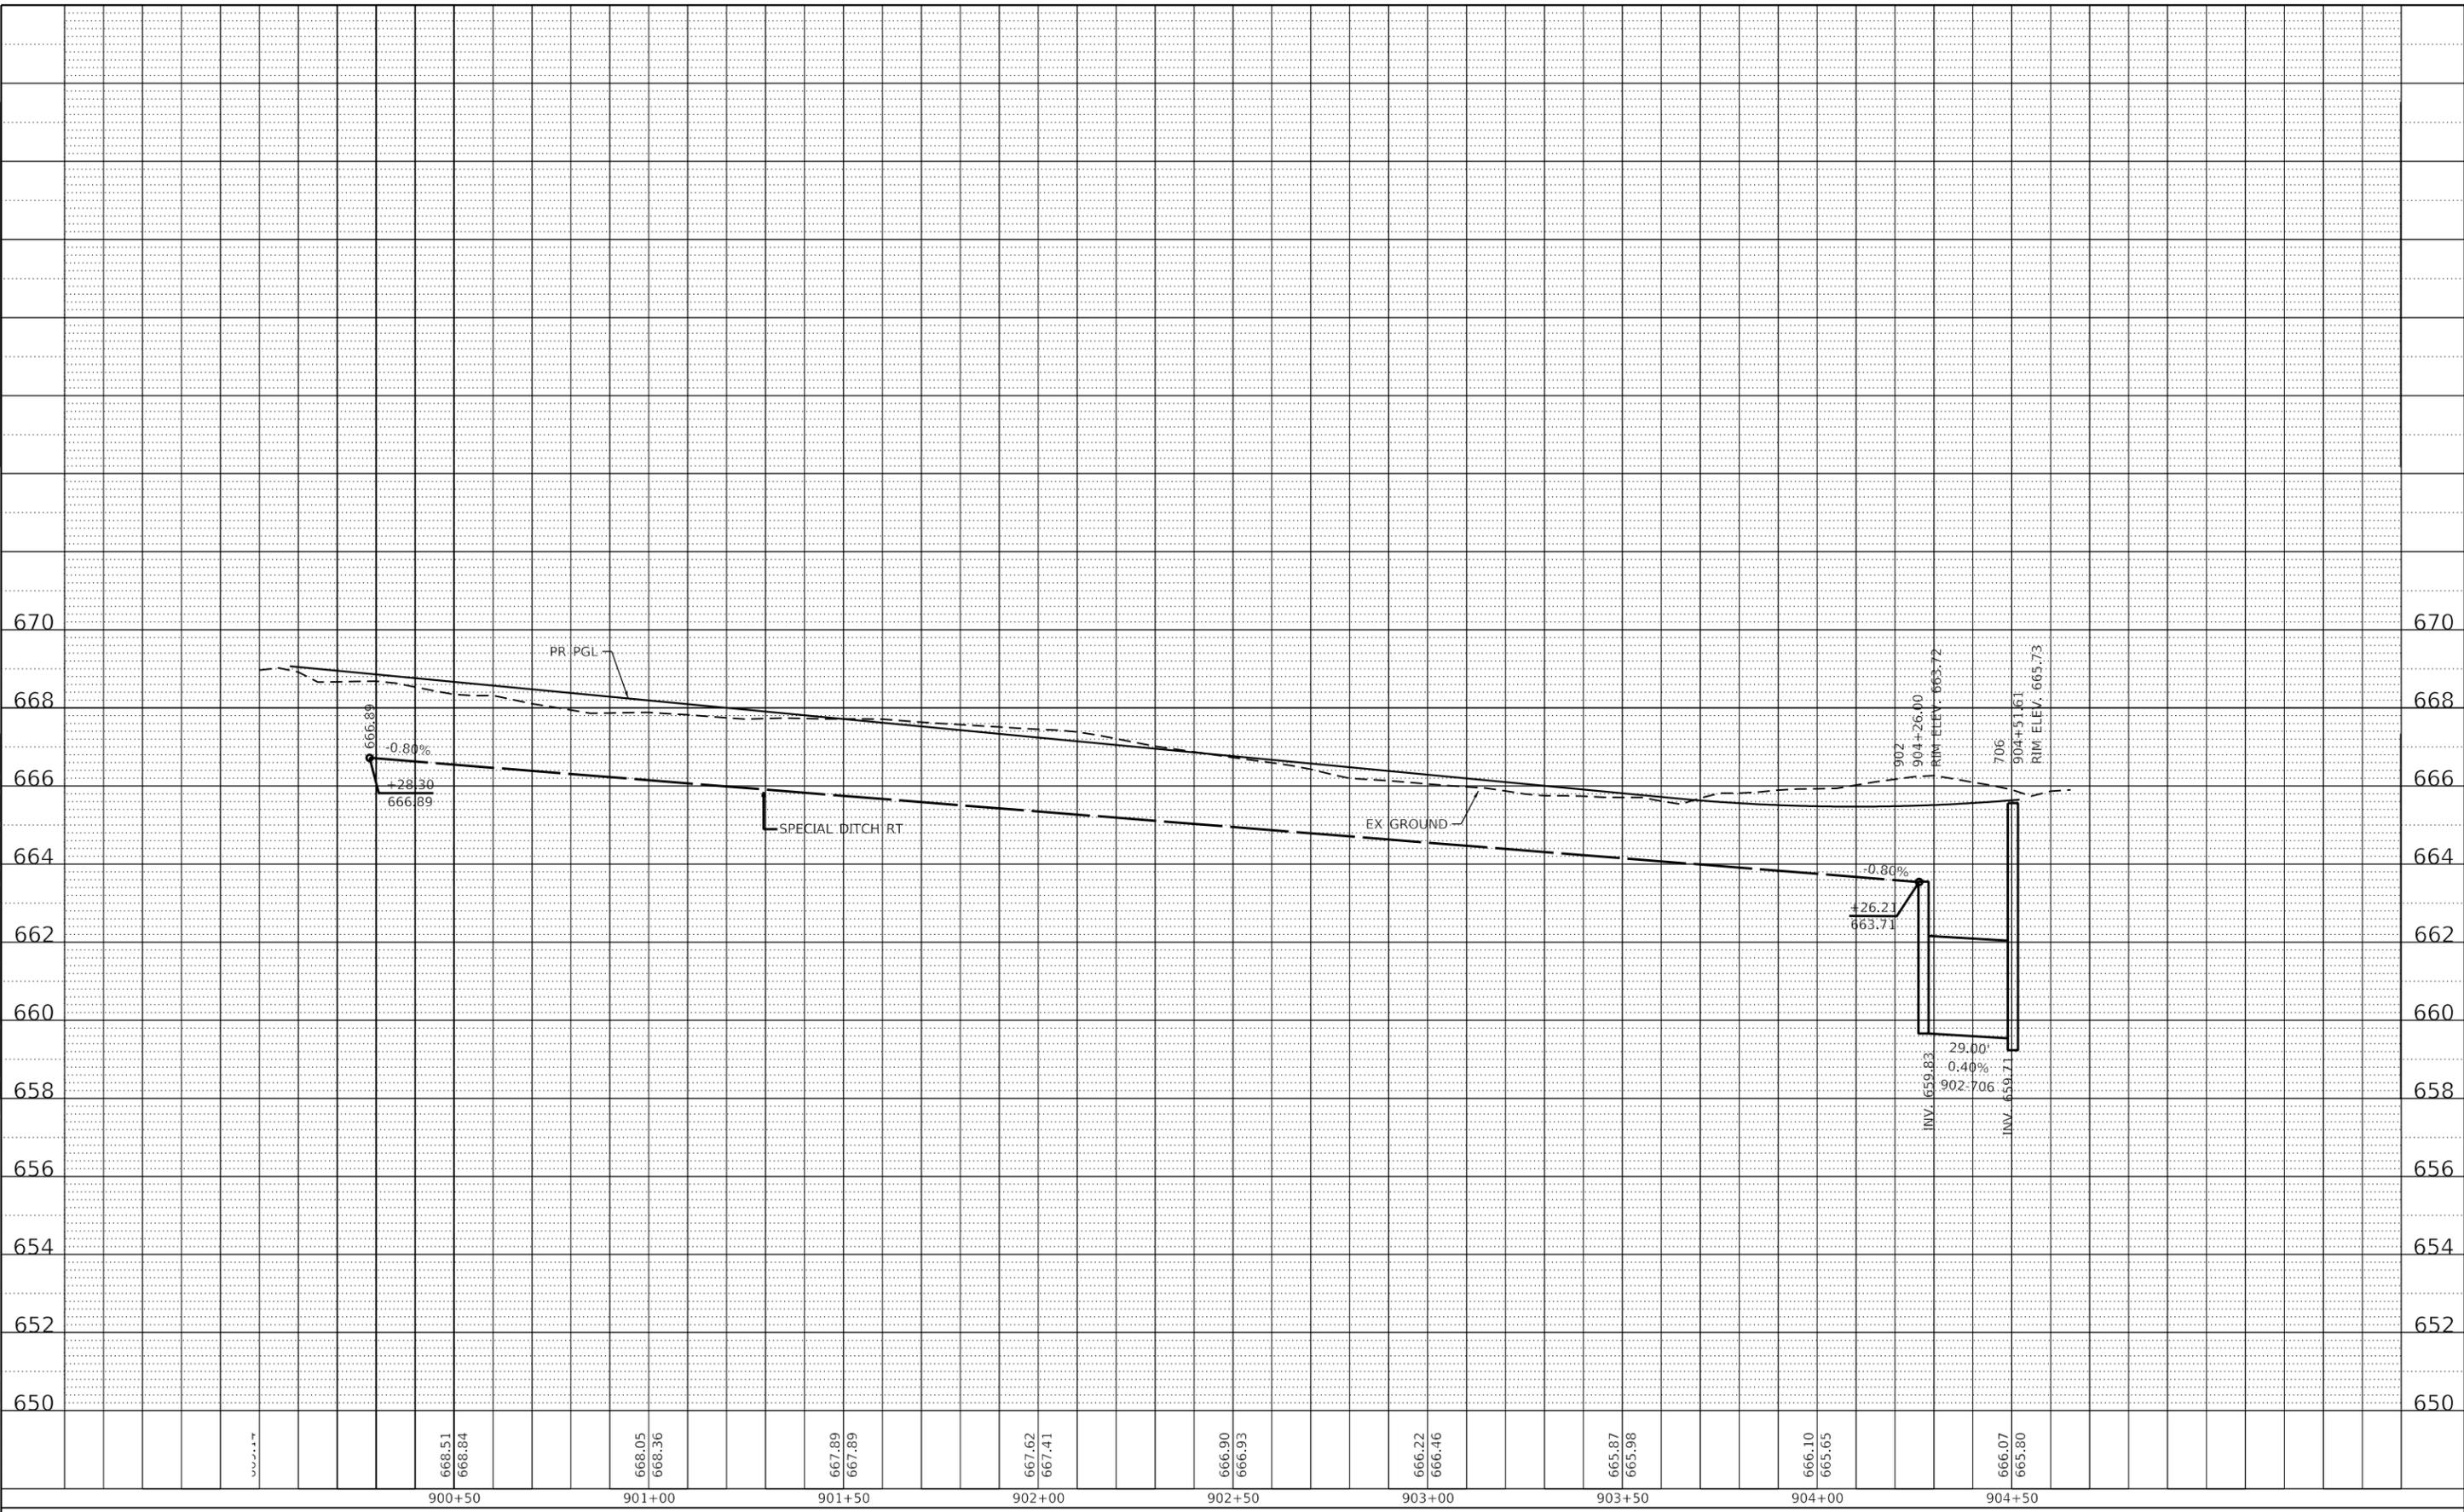
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PLOT DATE = 4/27/2021	CHECKED - CWC	REVISED -
	DATE - 4/30/2021	REVISED -

**STATE OF ILLINOIS  
 DEPARTMENT OF TRANSPORTATION**


**CEMETERY ACCESS  
 PROPOSED DRAINAGE PROFILES RIGHTSIDE**

SCALE: 1"=10' V SHEET 27 OF 27 SHEETS STA. 900+00.00 TO STA. 904+66.28


F.A.U. RTE.	SECTION	COUNTY	TOTAL SHEETS	SHEET NO.
7448	09-00933-01-BR	MACON	1019	505
CONTRACT NO. 95893				
ILLINOIS FED. AID PROJECT				

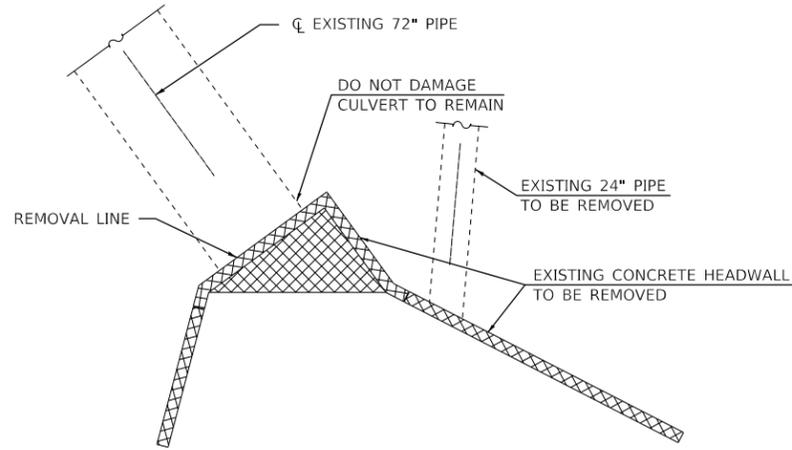


**REMOVAL PLAN**  
FARIES ROAD (STA. 226+62)

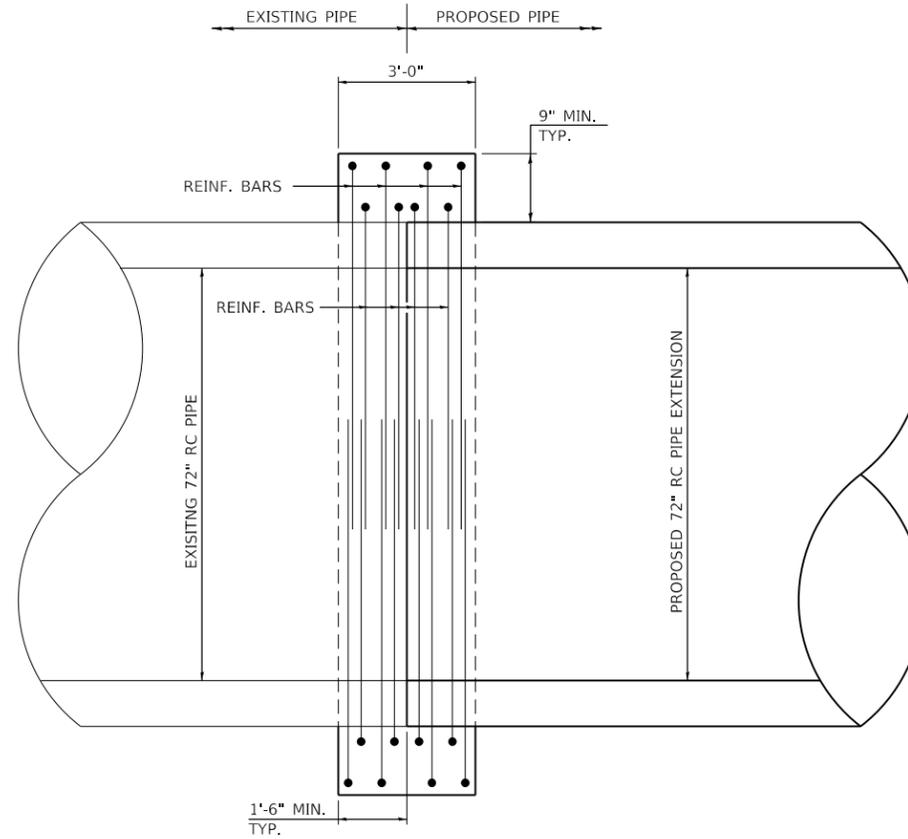

**COLLAR SECTION**  
PIPE END TO PIPE END EXTENSION

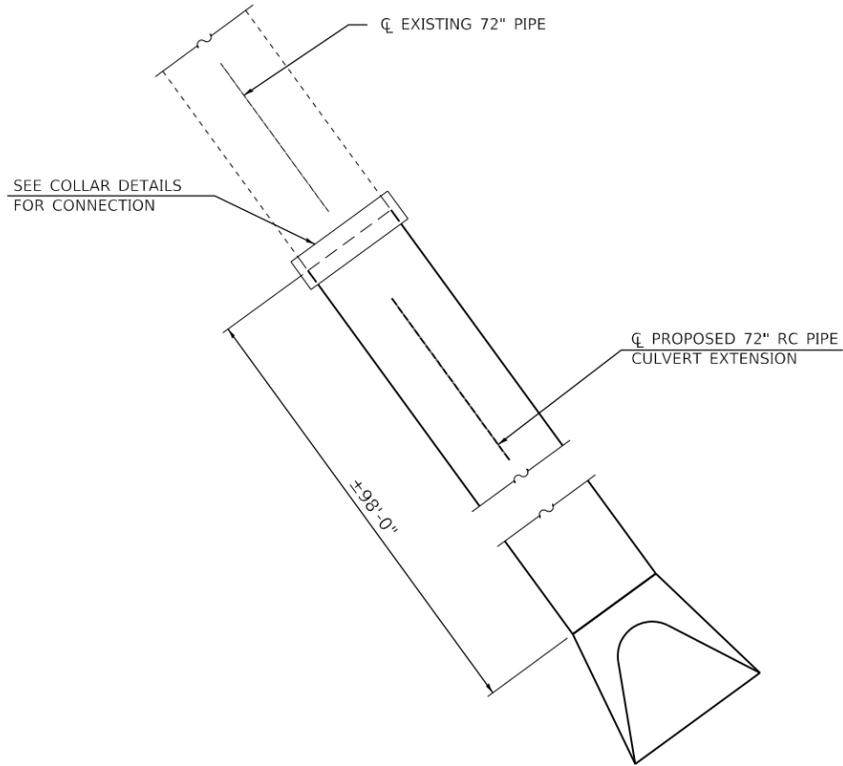


**PROPOSED PLAN**  
FARIES ROAD (STA. 226+62)

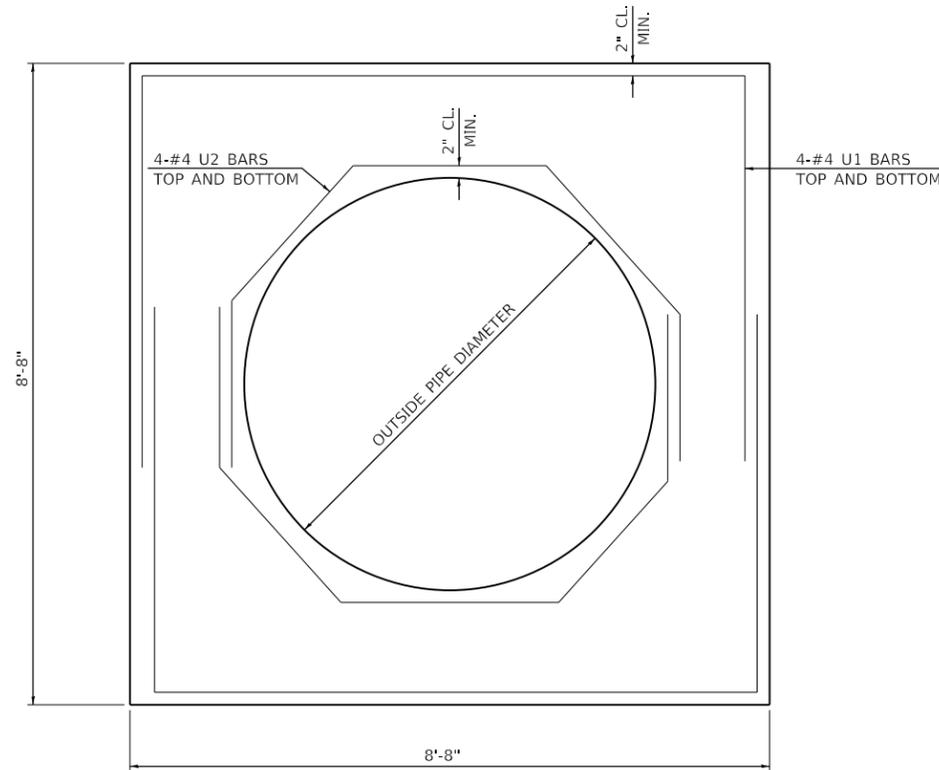

**END SECTION**

**GENERAL NOTES**

1. THE COLLAR SHALL BE CONSTRUCTED OF CLASS SI CONCRETE IN ACCORDANCE WITH THE APPLICABLE PORTIONS OF SECTION 503 OF THE STANDARD SPECIFICATIONS. REINFORCEMENT BARS SHALL CONFORM TO SECTION 508.
2. THIS WORK SHALL BE PAID FOR BY THE CUBIC YARD FOR CONCRETE COLLAR WHICH SHALL INCLUDE THE COST OF THE REINFORCEMENT SHOWN.
3. DETAILS ARE NOT TO SCALE.
4. SEE DRAINAGE PLANS FOR ADDITIONAL DETAILS.

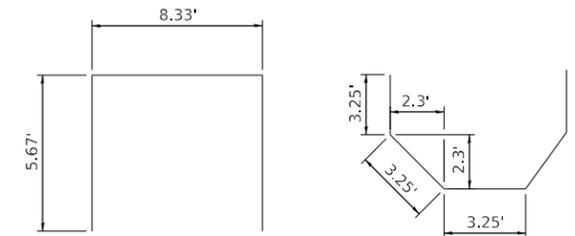

**U1 BAR**

**U2 BAR**

**BILL OF MATERIAL**

ITEM	UNIT	TOTAL
CONCRETE COLLAR	CU. YD.	6.2

IF NEEDED FOR CONNECTION, A COLLAR SIMILAR TO ABOVE SHALL BE USED TO CONNECT PROPOSED 36" S5 NEAR STR 809. A ESTIMATED QUANTITY OF 2.3 CU YD OF CONCRETE COLLAR HAS BEEN ADDED TO TOTAL QUANTITY.

MODEL SHEET  
FILE NAME: p:\mcom-pw-bentley.com\AECOM\_0516\_MIA\Documents\60603202-Brush\College\006-202-Culvert\_Ext\_Collar\_Details\_Sheet 1



USER NAME = gjameson	DESIGNED - CWC	REVISED -
PLOT SCALE = 0.167' / in.	DRAWN - DLH	REVISED -
PLOT DATE = 4/27/2021	CHECKED - CWC	REVISED -
	DATE - 4/30/2021	REVISED -

**STATE OF ILLINOIS  
DEPARTMENT OF TRANSPORTATION**


**DRAINAGE DETAILS  
CONCRETE PIPE EXTENSION AND COLLAR DETAILS**

SCALE: SHEET 1 OF 7 SHEETS STA. 207+98 TO STA. 209+82


F.A.U. RTE. 7448	SECTION 09-00933-01-BR	COUNTY MACON	TOTAL SHEETS 1019	SHEET NO. 506
CONTRACT NO. 95893				
ILLINOIS FED. AID PROJECT				





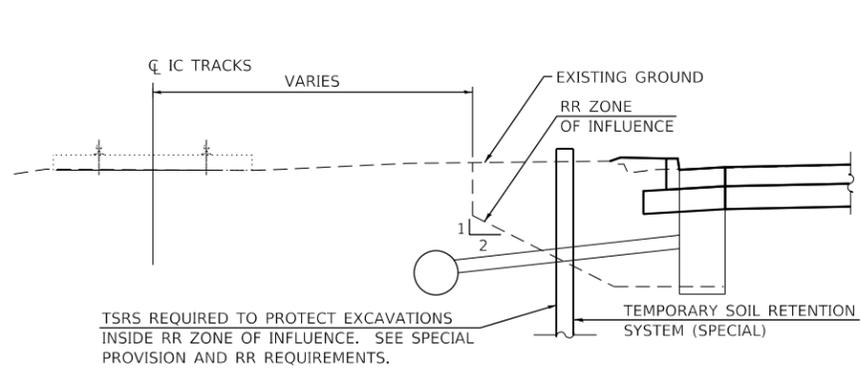


**TYPICAL SECTION**

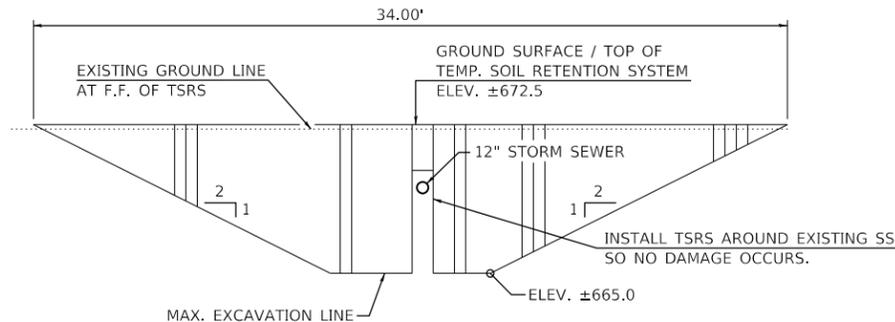

**TYPICAL ELEVATION (LOCATIONS 1-5)**

(LOOKING WEST)  
AT 5 LOCATIONS (SEE PLAN)  
ELEVATIONS VARY

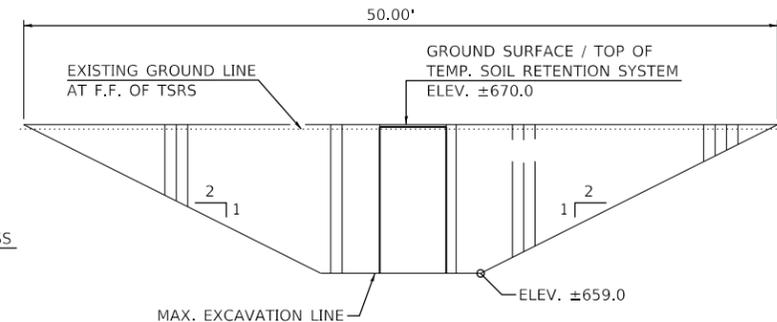

**ELEVATION (LOCATION 6)**


(STA. 72+40)  
(LOOKING EAST)

**NOTES:**

1. A CANTILEVERED SHEET PILING DESIGN DOES NOT APPEAR FEASIBLE AND ADDITIONAL MEMBERS OR OTHER RETENTION SYSTEMS MAY BE NECESSARY. THE CONTRACTOR SHALL SUBMIT A TEMPORARY SOIL RETENTION SYSTEM DESIGN INCLUDING PLAN DETAILS AND CALCULATIONS FOR REVIEW AND ACCEPTANCE BY THE ENGINEER.
2. HORIZONTAL DIMENSIONS AND GROUNDS SLOPES ARE SHOWN ALONG THE TEMPORARY SOIL RETENTION SYSTEM UNLESS NOTED OTHERWISE.
3. THE CONTRACTOR IS ALERTED TO THE PRESENCE OF UNDERGROUND STORM SEWER, SANITARY SEWERS AND OTHER UTILITIES. THESE SEWERS AND UTILITIES IN THE VICINITY AND UNDER THE PROPOSED TEMPORARY SOIL RETENTION SYSTEM NEED TO BE KEPT IN SERVICE DURING CONSTRUCTION. SEE DRAINAGE AND UTILITY PLANS.
4. TEMPORARY SOIL RETENTION SYSTEM IS PAID FOR AS TEMPORARY SOIL RETENTION SYSTEM (SPECIAL). SEE SPECIAL PROVISIONS.
5. DIMENSIONS AND OFFSETS ARE APPROXIMATE AND MAY NEED TO BE ADJUSTED BASED ON ACTUAL DEPTHS OF STRUCTURES AND THE CONTRACTOR'S MEANS AND METHODS.

**BILL OF MATERIAL**

ITEM	UNIT	TOTAL
TEMPORARY SOIL RETENTION SYSTEM (SPECIAL)	SQ. FT.	1023

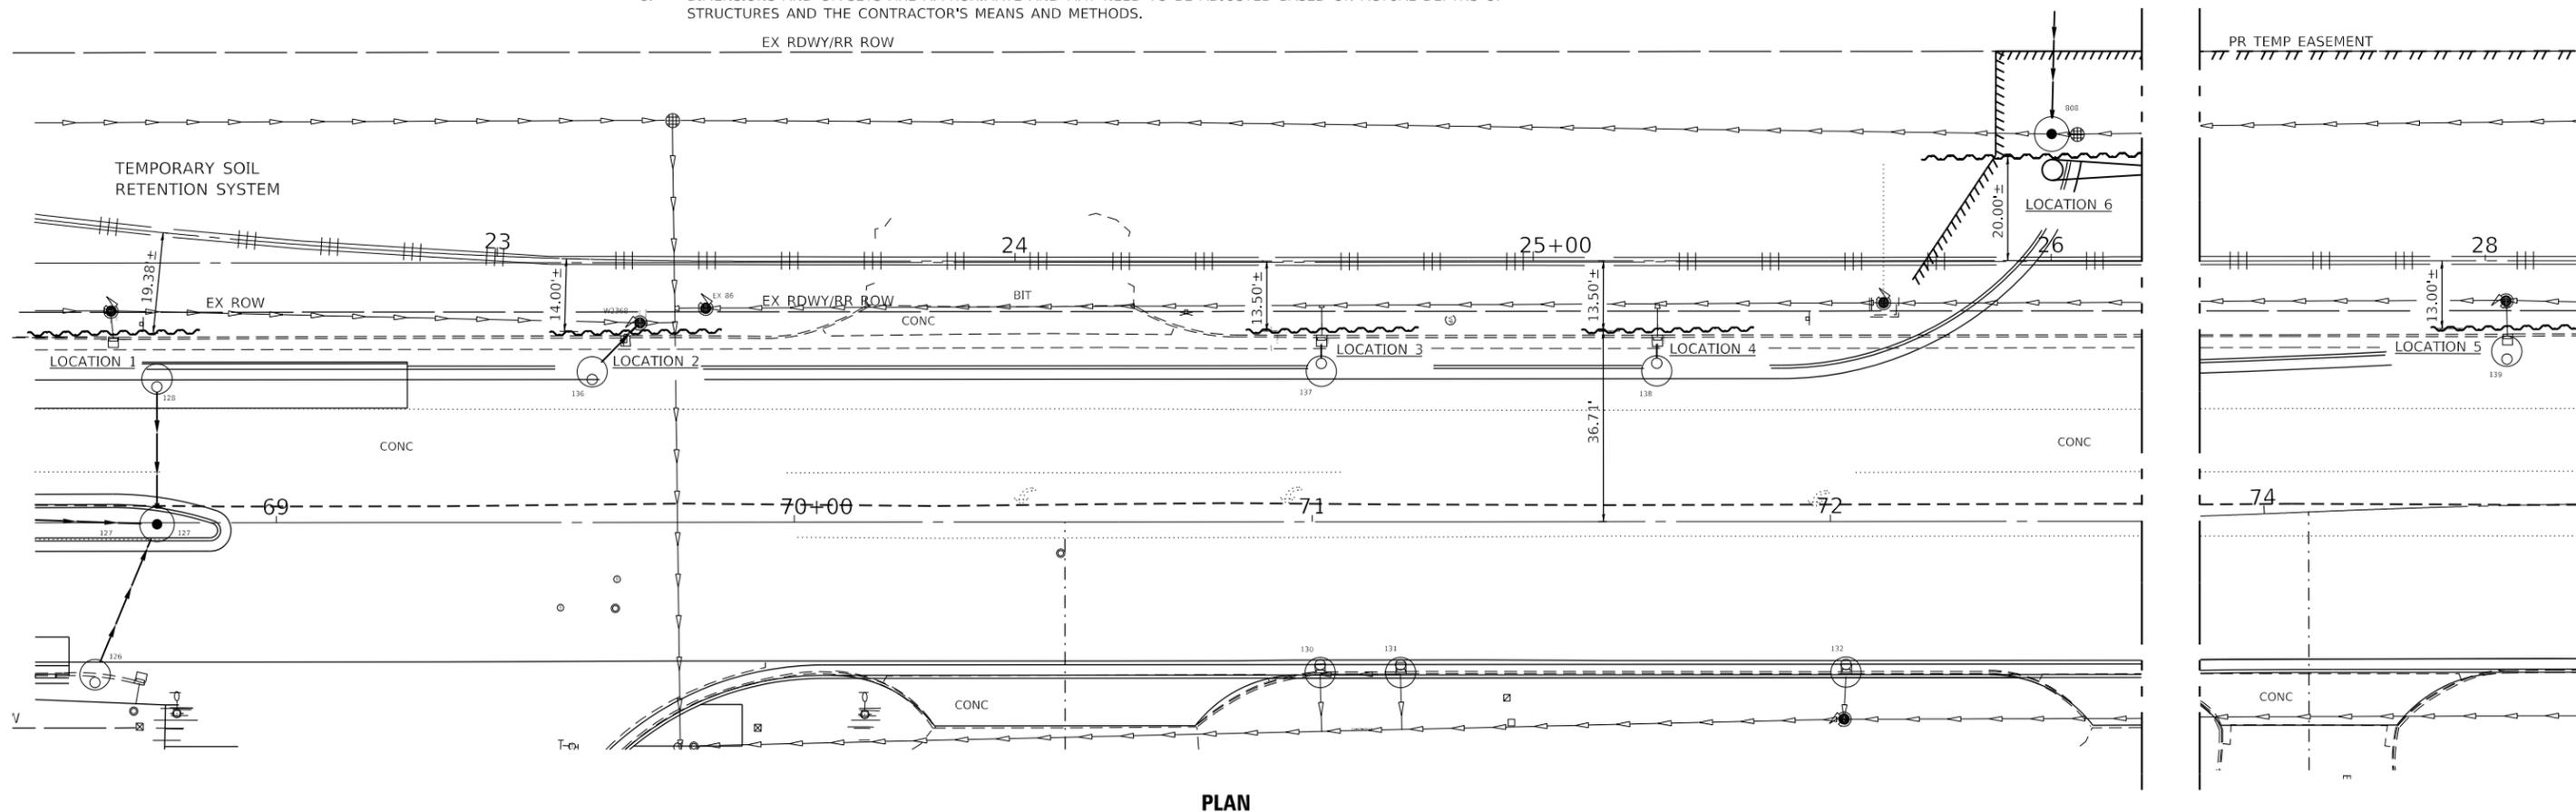

**PLAN**

MODEL: Drainage Details  
FILE NAME: p:\w\com\pw\henderly.com\AECOM\_051\_M\Documents\60603202-Brush\_College\006-CAD GIS\010\_CAD\013\_SHEETS\02\_VHKS\Drainage Details\60603202\_Drainage Details\_Sheet\_4.dgn

design firm  
no. 184001036  
**whks**  
engineers + planners + land surveyors


USER NAME = gjameson	DESIGNED - CWC	REVISED -
PLOT SCALE = 0.1667' / in.	DRAWN - DLH	REVISED -
PLOT DATE = 4/27/2021	CHECKED - CWC	REVISED -
	DATE - 4/30/2021	REVISED -

**STATE OF ILLINOIS  
DEPARTMENT OF TRANSPORTATION**


**DRAINAGE DETAILS  
TEMPORARY SOIL RETENTION SYSTEM**

SCALE: SHEET 4 OF 7 SHEETS STA. TO STA.


F.A.U. RTE.	SECTION	COUNTY	TOTAL SHEETS	SHEET NO.
7448	09-00933-01-BR	MACON	1019	509
CONTRACT NO. 95893				
ILLINOIS FED. AID PROJECT				

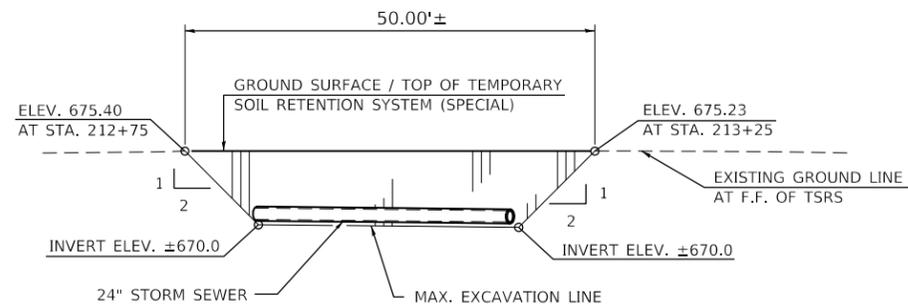

**ELEVATION**  
(LOOKING NORTH)

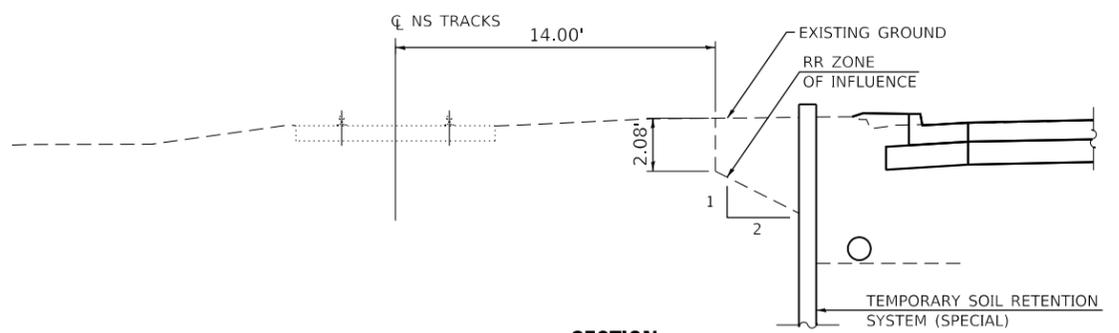

**SECTION**  
STA. ±212+75 TO ±213+25

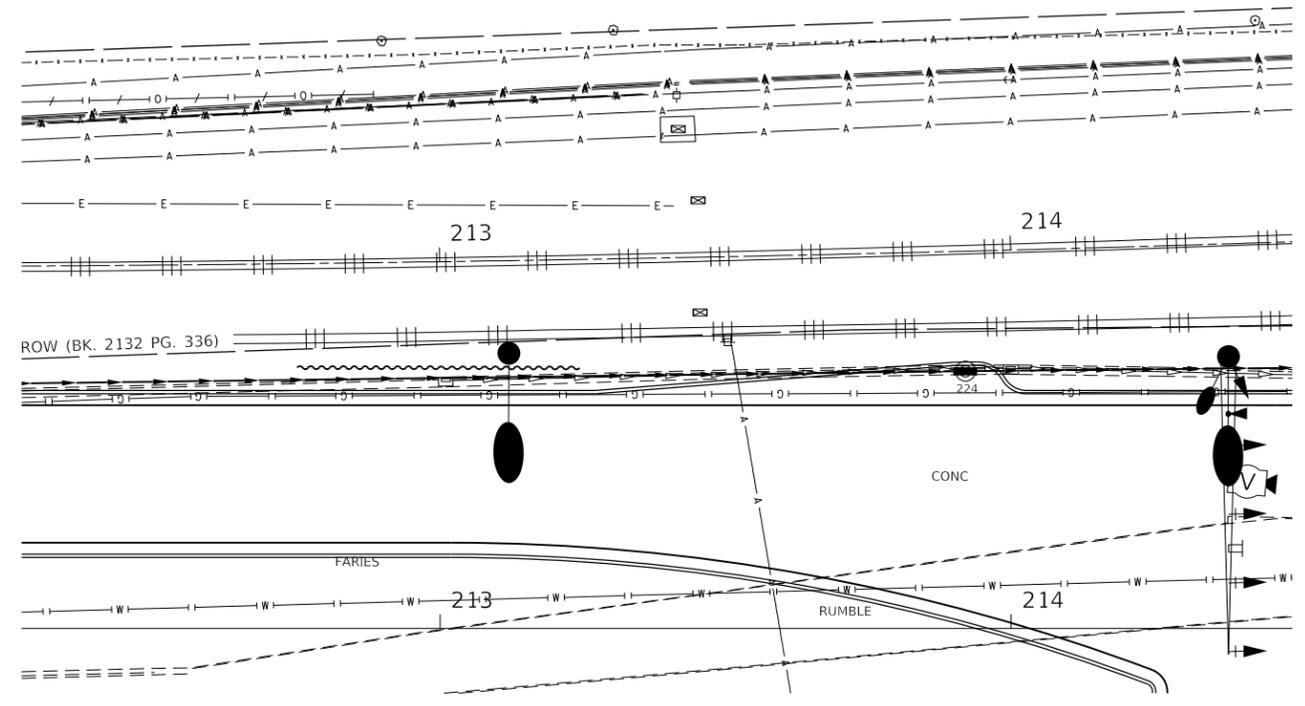

**PLAN**

**NOTES:**

1. A CANTILEVERED SHEET PILING DESIGN DOES NOT APPEAR FEASIBLE AND ADDITIONAL MEMBERS OR OTHER RETENTION SYSTEMS MAY BE NECESSARY. THE CONTRACTOR SHALL SUBMIT A TEMPORARY SOIL RETENTION SYSTEM DESIGN INCLUDING PLAN DETAILS AND CALCULATIONS FOR REVIEW AND ACCEPTANCE BY THE ENGINEER.
2. HORIZONTAL DIMENSIONS AND GROUNDS SLOPES ARE SHOWN ALONG THE TEMPORARY SOIL RETENTION SYSTEM UNLESS NOTED OTHERWISE.
3. THE CONTRACTOR IS ALERTED TO THE PRESENCE OF UNDERGROUND STORM SEWER, SANITARY SEWERS AND OTHER UTILITIES. THESE SEWERS AND UTILITIES IN THE VICINITY AND UNDER THE PROPOSED TEMPORARY SOIL RETENTION SYSTEM NEED TO BE KEPT IN SERVICE DURING CONSTRUCTION. SEE DRAINAGE AND UTILITY PLANS.
4. TEMPORARY SOIL RETENTION SYSTEM IS PAID FOR AS TEMPORARY SOIL RETENTION SYSTEM (SPECIAL). SEE SPECIAL PROVISIONS.
5. DIMENSIONS AND OFFSETS ARE APPROXIMATE AND MAY NEED TO BE ADJUSTED BASED ON ACTUAL DEPTHS OF STRUCTURES AND THE CONTRACTOR'S MEANS AND METHODS.
6. TSRS INSTALLATION SHALL BE COORDINATED WITH INSTALLATION OF TRAFFIC SIGNAL AND LIGHT FOUNDATIONS.

**BILL OF MATERIAL**

ITEM	UNIT	TOTAL
TEMPORARY SOIL RETENTION SYSTEM (SPECIAL)	SQ. FT.	209

MODEL: Drainage Details  
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design firm  
no. 184001036  
**whks**  
engineers + planners + land surveyors



USER NAME = gjameson	DESIGNED - CWC	REVISED -
PLOT SCALE = 0.1667' / in.	DRAWN - DLH	REVISED -
PLOT DATE = 4/27/2021	CHECKED - CWC	REVISED -
	DATE - 4/30/2021	REVISED -

**STATE OF ILLINOIS  
DEPARTMENT OF TRANSPORTATION**

**DRAINAGE DETAILS  
TEMPORARY SOIL RETENTION SYSTEM**

SCALE: SHEET 5 OF 7 SHEETS STA. TO STA.

F.A.U. RTE.	SECTION	COUNTY	TOTAL SHEETS	SHEET NO.
7448	09-00933-01-BR	MACON	1019	510
CONTRACT NO. 95893				
ILLINOIS FED. AID PROJECT				

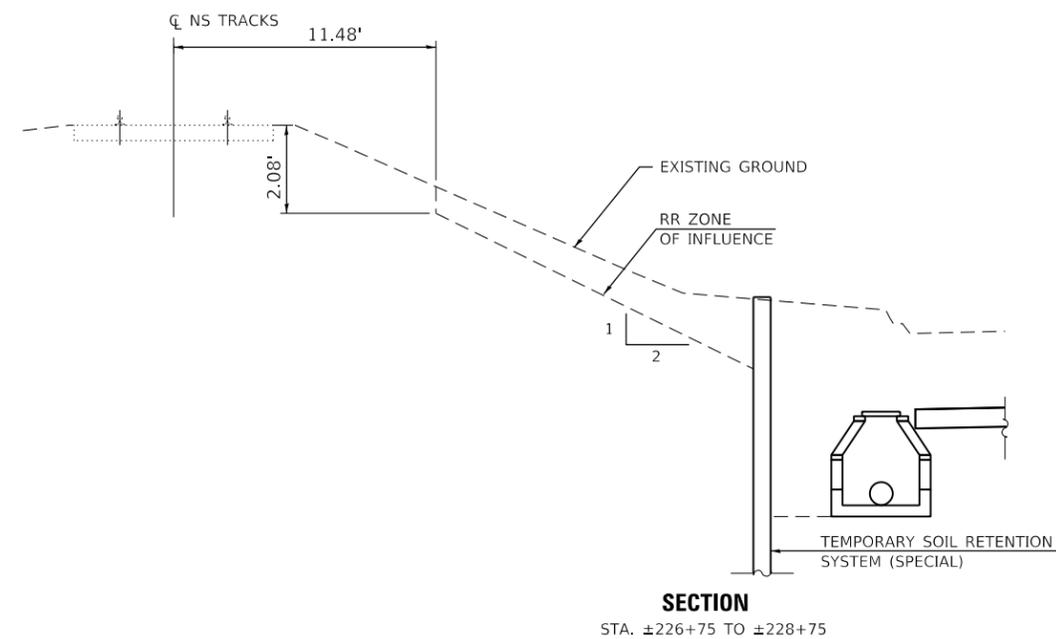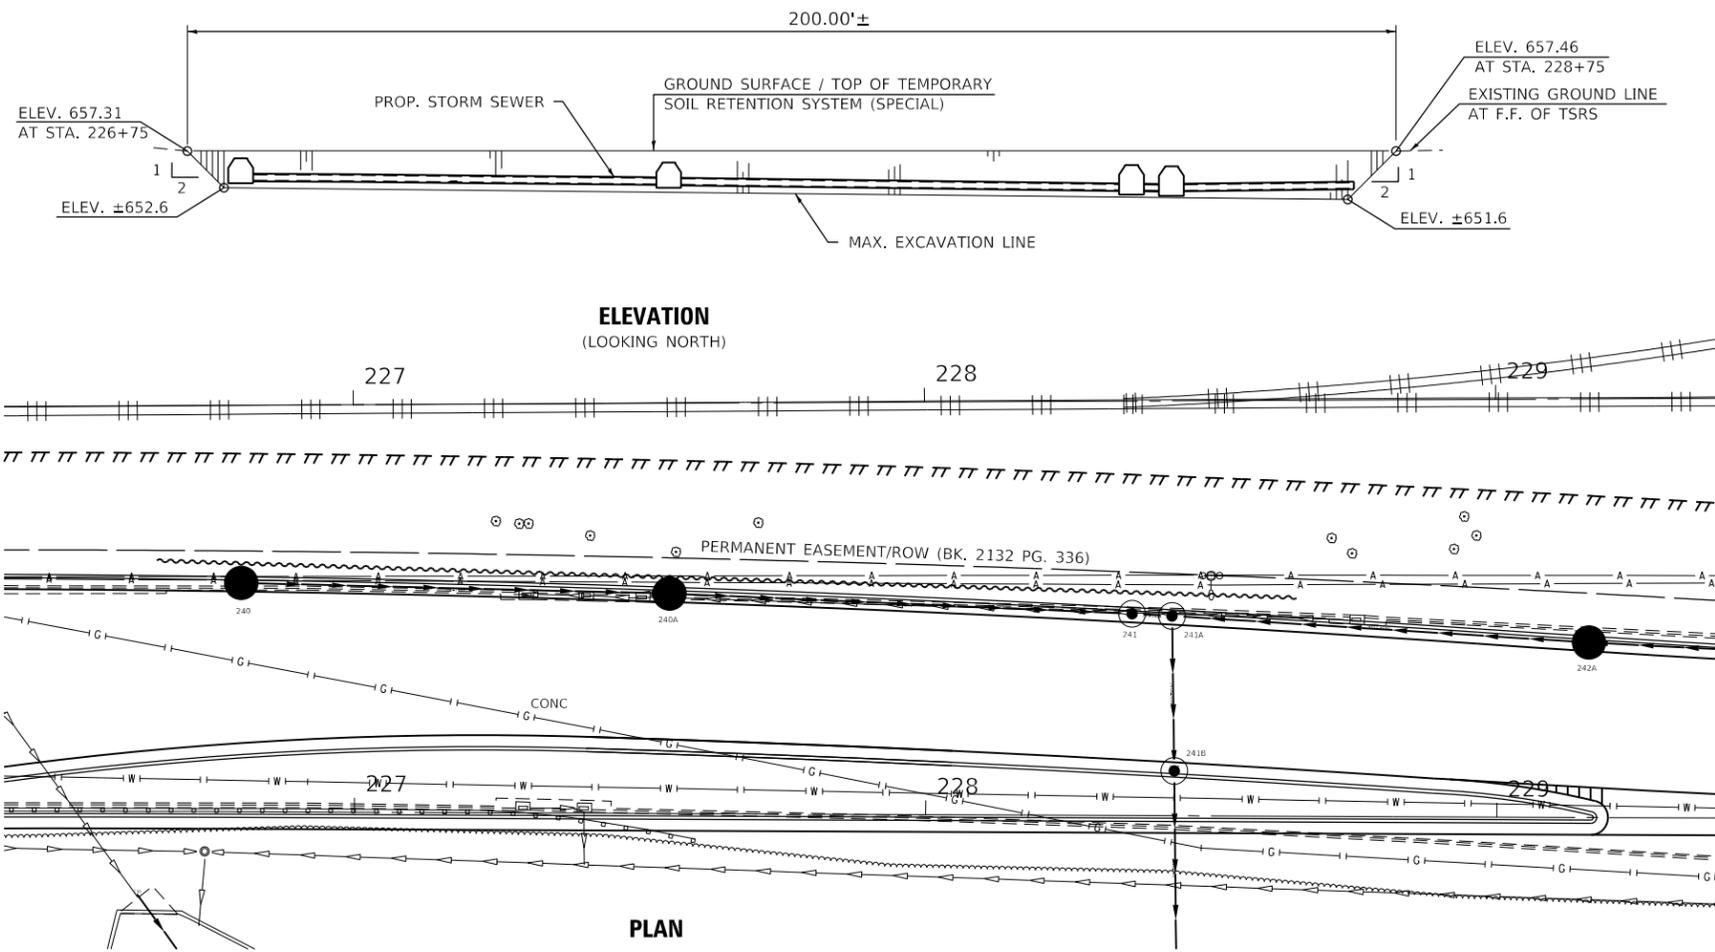

**NOTES:**

1. A CANTILEVERED SHEET PILING DESIGN DOES NOT APPEAR FEASIBLE AND ADDITIONAL MEMBERS OR OTHER RETENTION SYSTEMS MAY BE NECESSARY. THE CONTRACTOR SHALL SUBMIT A TEMPORARY SOIL RETENTION SYSTEM DESIGN INCLUDING PLAN DETAILS AND CALCULATIONS FOR REVIEW AND ACCEPTANCE BY THE ENGINEER.
2. HORIZONTAL DIMENSIONS AND GROUNDS SLOPES ARE SHOWN ALONG THE TEMPORARY SOIL RETENTION SYSTEM UNLESS NOTED OTHERWISE.
3. THE CONTRACTOR IS ALERTED TO THE PRESENCE OF UNDERGROUND STORM SEWER, SANITARY SEWERS AND OTHER UTILITIES. THESE SEWERS AND UTILITIES IN THE VICINITY AND UNDER THE PROPOSED TEMPORARY SOIL RETENTION SYSTEM NEED TO BE KEPT IN SERVICE DURING CONSTRUCTION. SEE DRAINAGE AND UTILITY PLANS.
4. TEMPORARY SOIL RETENTION SYSTEM IS PAID FOR AS TEMPORARY SOIL RETENTION SYSTEM (SPECIAL). SEE SPECIAL PROVISIONS.
5. DIMENSIONS AND OFFSETS ARE APPROXIMATE AND MAY NEED TO BE ADJUSTED BASED ON ACTUAL DEPTHS OF STRUCTURES AND THE CONTRACTOR'S MEANS AND METHODS.

**BILL OF MATERIAL**

ITEM	UNIT	TOTAL
TEMPORARY SOIL RETENTION SYSTEM (SPECIAL)	SQ. FT.	992

MODEL: Drainage Details  
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design firm  
no. 184001036

engineers + planners + land surveyors


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PLOT SCALE = 0.1667' / in.	DRAWN -	REVISED -
PLOT DATE = 4/27/2021	CHECKED -	REVISED -
	DATE - 4/30/2021	REVISED -

**STATE OF ILLINOIS  
DEPARTMENT OF TRANSPORTATION**


**DRAINAGE DETAILS  
TEMPORARY SOIL RETENTION SYSTEM**

SCALE: SHEET 6 OF 7 SHEETS STA. TO STA.

F.A.U. RTE.	SECTION	COUNTY	TOTAL SHEETS	SHEET NO.
7448	09-00933-01-BR	MACON	1019	511
CONTRACT NO. 95893				
ILLINOIS FED. AID PROJECT				

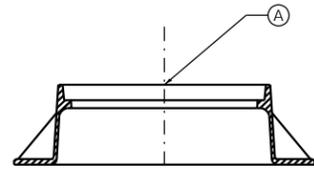


TYPE 1

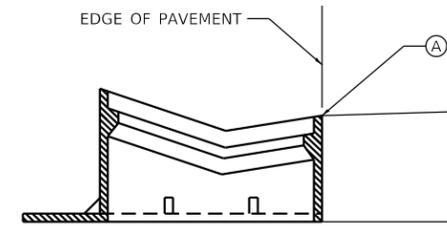


TYPE 10

NOTE: EXCEPT FOR STRUCTURES 100, 103, 105, AND 107 WHICH ARE LOCATED BEHIND RETAINING WALL AND OFFSETS ARE GIVEN TO CENTER OF STRUCTURE AND ELEVATIONS TO FLOW LINE OF GUTTER.

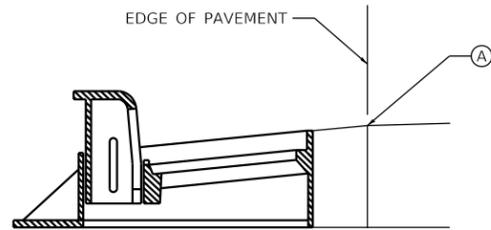


TYPE 3 / TYPE 11 / TYPE 6


EOP TO CASTING AND STRUCTURE VARIES AT CURB FLARES.

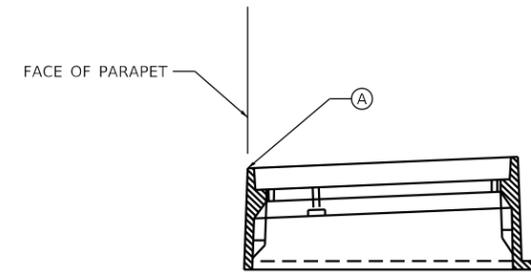


TYPE 20

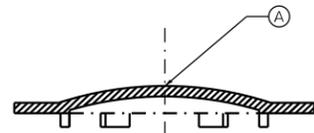

TYPE 8

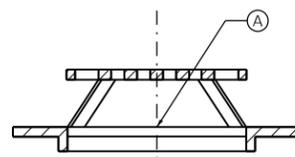

SPECIAL FRAME AND GRATE  
(CITY STD. 3044)

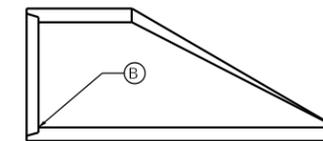

PRECAST REINFORCED CONCRETE FLARED END SECTION

**DRAINAGE CASTING LOCATIONS**

**NOTES**

CONTRACTOR TO COORDINATE WITH ROADWAY PLANS AT CURB FLARES TO DETERMINE EXACT STRUCTURE LOCATION FROM EOP OFFSETS GIVEN.

- (A) LOCATION OF STATION, OFFSET, & RIM ELEVATION OF DRAINAGE CASTING AS NOTED ON THE DRAINAGE PLANS AND SCHEDULES.
- (B) WORKING POINT STATION, OFFSET & INVERT LOCATION AS NOTED ON THE DRAINAGE PLANS AND SCHEDULES.

MODEL: Grate\_Detail  
FILE NAME: p:\mecom\m-pw\hennley.com\AECOM\_0516\_M\Documents\60603202-Brush\_College\006-CAD\_GIS\010\_CAD\013\_SHEETS\02\_VHKSDrainage\_Details\60603202\_Drainage\_Details\_Sheet\_7.dgn

design firm  
no. 184001036

engineers • planners • land surveyors

USER NAME = gjameson	DESIGNED - CWC	REVISED -
PLOT SCALE = 2,000' / in.	DRAWN - DLH	REVISED -
PLOT DATE = 4/27/2021	CHECKED - CWC	REVISED -
	DATE - 4/30/2021	REVISED -

**STATE OF ILLINOIS  
DEPARTMENT OF TRANSPORTATION**

**DRAINAGE DETAILS**

SCALE: SHEET 7 OF 7 SHEETS STA. TO STA.


F.A.U. RTE.	SECTION	COUNTY	TOTAL SHEETS	SHEET NO.
7448	09-00933-01-BR	MACON	1019	512
CONTRACT NO. 95893				
ILLINOIS FED. AID PROJECT				

**WATER MAIN & SANITARY SEWER GENERAL NOTES**

- THE LOCATION OF EXISTING DRAINAGE STRUCTURES, STORM SEWERS, WATER MAINS, SANITARY SEWERS AND ANY OTHER PUBLIC OR PRIVATE UTILITIES AS SHOWN ON THE PLANS IS APPROXIMATE AND THEIR EXACT LOCATION IS TO BE DETERMINED IN THE FIELD BY THE CONTRACTOR. THIS WORK SHALL BE CONSIDERED INCLUDED IN THE COST OF THE CONTRACT.
- PROFILE VIEW LOCATIONS OF THE EXISTING UTILITIES ARE BASED ON ASSUMED DEPTH. ACTUAL DEPTHS OF SUCH EXISTING UTILITIES MAY BE SHALLOWER OR DEEPER THAN SHOWN.
- WATER MAIN AND SERVICE PIPES SHALL HAVE A MINIMUM COVER OF 3.5 FEET FROM GROUND SURFACE AND 6 FEET FROM TRAIN TRACKS, UNLESS OTHERWISE SHOWN IN THE PLANS.
- ANY SHEETING, SHORING OR TEMPORARY SOIL RETENTION SYSTEM USED FOR WATER MAIN AND/OR SANITARY SEWER WORK SHALL BE INCLUDED IN THE COST OF THE ITEM BEING INSTALLED, REMOVED, ADJUSTED, OR ABANDONED AND SHALL NOT BE PAID SEPARATELY.
- THE CONTRACTOR SHALL BE RESPONSIBLE FOR INSTALLING THE PROPOSED WATER MAIN AND SANITARY SEWER SO THAT THERE ARE NOT ANY CONFLICTS WITH THE REQUIRED CLEARANCES FROM EXISTING OR PROPOSED UTILITIES. SEE ROADWAY DRAINAGE AND UTILITY SHEETS FOR PROPOSED STORM SEWER INFORMATION.
- PRIOR TO STARTING ANY CONSTRUCTION A FIVE (5) WORKING DAY NOTIFICATION IS REQUIRED. NOTIFY THE CITY OF DECATUR PUBLIC WORKS AND ENGINEERING, (217) 424-2747 TO ARRANGE FOR REQUIRED INSPECTION.
- ALL MATERIAL INCORPORATED INTO THIS PUBLIC WATER MAIN IMPROVEMENT REQUIRES INSPECTION AND APPROVAL PRIOR TO ANY CONSTRUCTION.
- THE SEPARATION REQUIREMENTS BETWEEN WATER MAIN AND SEWERS SHALL BE IN ACCORDANCE WITH 35 IL ADMINISTRATIVE CODE, SUBTITLE F, SECTION 653.119.
- WATER MAIN SHUTDOWNS: COORDINATE SHUTDOWN OF EXISTING WATER MAINS WITH THE CITY OF DECATUR AND ENGINEER. CONTRACTOR SHALL NOT OPERATE EXISTING VALVES AND HYDRANTS ON THE CITY'S EXISTING WATER SYSTEM. CONTRACTOR SHALL SCHEDULE WITH THE CITY OF DECATUR A MINIMUM OF 48 HOURS PRIOR TO THE REQUIRED SHUTDOWN OF EXISTING WATER MAINS.
- WATER MAIN FITTINGS AND CONNECTIONS: INCLUDE ALL NECESSARY PIPING, FITTINGS AND ADAPTERS FOR A COMPLETE INSTALLATION, CONTRACTOR SHALL ALSO VERIFY EXACT LOCATION, DEPTH, MATERIAL, AND SIZE OF EXISTING WATER MAIN AND PIPING BEFORE ORDERING NEW MATERIALS. THE CONTRACTOR SHALL CONNECT TO EXISTING WATER MAINS, REGARDLESS OF LOCATION, DEPTH, AND MATERIAL, AT NO ADDITIONAL COST. TEES AND FITTINGS SHALL BE ROLLED AS NEEDED FOR CONSTRUCTION TO ACCOMODATE CONNECTIONS, AVOID UTILITY CONFLICTS, ETC. THE COST SHALL BE INCLUDED IN THE COST OF THE FITTING OR TEE BEING INSTALLED.
- EXISTING UTILITY LOCATIONS (JULIE REQUESTS):
  - THREE (3) WORKING DAYS PRIOR TO BEGINNING THE WORK, IT SHALL BE THE CONTRACTOR'S RESPONSIBILITY TO CONTACT JULIE TO VERIFY THE LOCATION OF ALL EXISTING UTILITIES. THE CONTRACTOR SHALL ASSUME RESPONSIBILITY FOR THE PROTECTION OF ALL EXISTING UTILITIES DURING CONSTRUCTION.
  - ALL UTILITIES ARE TO BE MAINTAINED IN SERVICE AT ALL TIMES UNLESS PRIOR WRITTEN AUTHORIZATION IS GRANTED FROM THE RESPECTIVE UTILITY FOR A PLANNED SERVICE INTERRUPTION NECESSARY FOR THE COMPLETION OF THIS WORK.
  - UTILITIES AND OBSTRUCTIONS SHOWN ON THE PLANS WERE DERIVED FROM THE BEST AVAILABLE INFORMATION THROUGH CONTACT MADE WITH VARIOUS UTILITIES AND AGENCIES KNOWN TO HAVE STRUCTURES IN THE AREA. THE LOCATION MATERIAL AND DIMENSIONS OF THE EXISTING OBSTRUCTIONS ARE BASED ON AVAILABLE RECORDS BUT MUST NOT BE CONSTRUED AS BEING ACCURATE, CORRECT OR COMPLETE. CONTRACTOR SHALL NOTIFY THE ENGINEER OF ANY DISCREPANCIES.
  - ALL STRUCTURES ABOVE OR BELOW GROUND ENCOUNTERED DURING CONSTRUCTION SHALL BE PROPERLY SUPPORTED AND MAINTAINED. THE CONTRACTOR SHALL MAKE ARRANGEMENTS WITH THE OWNER/ENGINEER OF SUCH STRUCTURES FOR SHIFTING, SUPPORT, TEMPORARY RELOCATION AND PROTECTION WHERE NECESSARY. IF DAMAGED DURING CONSTRUCTION, THE CONTRACTOR SHALL MAKE OR PAY TO HAVE MADE ALL REPAIRS TO THE STRUCTURE TO THE SATISFACTION OF THE OWNER OF THE STRUCTURE. NO EXTRA PAYMENT WILL BE MADE FOR SUCH REPAIRS.

- UTILITY SEPARATION: WHERE THE PROPOSED WATER MAINS CROSS OVER AND LESS THAN 18-INCHES ABOVE OR UNDER SANITARY/STORM SEWER LINES, THE SEWER SHALL BE REPLACED WITH WATER MAIN QUALITY PIPE FOR A DISTANCE OF 10 FEET ON BOTH SIDES OF THE PROPOSED WATER MAIN WHEN ORDERED IN WRITING BY THE ENGINEER. FOR NON-PARALLEL STORM SEWER CROSSINGS, CONTRACTOR IS PERMITTED TO UTILIZE REINFORCED CONCRETE PIPE WITH JOINT FLEXIBLE GASKET JOINT MEETING ASTM C361 OR ASTM C443.
- UNLESS OTHERWISE NOTED, THE CONTRACTOR SHALL MAINTAIN IN SERVICE ALL EXISTING WATER MAINS, SANITARY SEWERS, STORM SEWERS, CULVERTS, DITCHES, DRAINS, MANHOLES, AND CATCH BASINS DURING CONSTRUCTION. THIS INCLUDES, BUT IS NOT LIMITED TO, BYPASS PUMPING. REFER ALSO TO THE DRAINAGE SHEETS FOR ADDITIONAL DETAIL.
- REFER TO SPECIAL PROVISIONS FOR WATER MAIN RECORD DRAWING AND SURVEY REQUIREMENTS WHICH INCLUDES PROVIDING AS-BUILT WATER MAIN FACILITY INFORMATION TO THE CITY IN AN ELECTRONIC FORMAT COMPATIBLE WITH THE CITY'S GIS.
- ALL FRAMES, GRATES, LIDS, FIRE HYDRANTS AND BOXES SCHEDULED TO BE REMOVED FROM EXISTING STRUCTURES SHALL REMAIN THE PROPERTY OF THE CITY, AND ITEMS DAMAGED DURING REMOVAL SHALL BE REPLACED BY THE CONTRACTOR AT HIS/HER EXPENSE. THE COST OF SALVAGING EXISTING FRAMES, GRATES, LIDS, HYDRANTS OR BOXES AND/OR STOCKPILING THEM ON THE JOB SITE FOR PICK-UP BY THE CITY OR DELIVERY TO THE CITY YARD SHALL BE CONSIDERED INCLUDED IN THE COST OF THE ITEM BEING REMOVED, ABANDONED, OR FILLED. ANY REJECTED ITEMS SHALL BE DISPOSED OF BY THE CONTRACTOR AT NO ADDITIONAL COST TO THE CONTRACT.
- ALL REFERENCES IN THE DRAWINGS AND SPECIAL PROVISIONS TO STANDARDS (E.G. AWWA, ASTM, IDOT, ETC.) SHALL BE ASSUMED TO BE THE LATEST VERSION/ADDITION OF THE STANDARD BEING REFERENCED.
- UNLESS OTHERWISE SPECIFIED HEREIN, PERFORM ALL WORK IN ACCORDANCE WITH THE STANDARD SPECIFICATIONS FOR WATER MAIN CONSTRUCTION IN ILLINOIS AND THE CITY OF DECATUR STANDARD SPECIFICATIONS FOR WATER MAIN CONSTRUCTION (INCLUDING CONSTRUCTION DETAILS), LATEST EDITIONS. CITY OF DECATUR STANDARD SPECIFICATIONS FOR WATER MAIN CONSTRUCTION (INCLUDING CONSTRUCTION DETAILS) CAN BE PROVIDED UPON REQUEST.
- WHETHER TEMPORARY OR PERMANENT, ALL VALVES, PIPING, FITTINGS, SLEEVES, AND APPURTENANCES SHALL HAVE A MINIMUM RATING OF 150 PSI.
- JACKING PITS TO BE DESIGNED BY THE CONTRACTOR. LIMITS SHOWN ARE APPROXIMATE.
- THE FOLLOWING PAY ITEMS ARE INCLUDED IN THE SPECIAL PROVISIONS, BUT ARE NOT CURRENTLY SHOWN IN THE WATER MAIN RELOCATION PLANS:
  - PRESSURE CONNECTION, 16" X 16", 12" X 12", 16" X 6" (1 EACH FOR THE PAY ITEMS LISTED)
  - WATER MAIN LINE STOP, 6", 8", 12" (1 EACH FOR THE PAY ITEMS LISTED)
  - REMOVE AND RELOCATE WATER MAIN, 6", 8", 12", 16", 24", 30" (20 FT FOR EACH PAY ITEM LISTED)
  - WATER SERVICE LINE RELOCATED (20 FT)
  - FIRE HYDRANT EXTENSION (10 FT)
  - MANHOLES, SANITARY, 4'-DIAMETER, TYPE 1 FRAME, CLOSED LID (2 EACH)
  - SANITARY SEWER REMOVAL AND REPLACEMENT 8" (390 FT)
  - SPECIAL EXCAVATION (SHOWN IN PLANS BUT AN ADDITIONAL 10 CY IS INCLUDED IN THE SOQ)
  - SANITARY SERVICE TO BE ADJUSTED, 1 EACH
 THESE ITEMS SHALL ONLY BE USED TO ADDRESS UNFORESEEN CONDITIONS WHEN ORDERED BY THE ENGINEER IN WRITING.
- THE CONTRACTOR'S ATTENTION IS CALLED TO SECTION 106 OF IDOT'S STANDARD SPECIFICATION, SPECIFICALLY THE DOMESTIC IRON AND STEEL REQUIREMENTS. THE CONTRACTOR IS REQUIRED TO FOLLOW ALL IDOT REQUIREMENTS AND SPECIFICATIONS REGARDING DOMESTIC PRODUCTION, FABRICATION, ETC.

**WATER MAIN & SANITARY SEWER SYMBOLS**

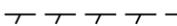-  PROPOSED WATER VALVE WITH BOX
-  PROPOSED WATER VALVE AND BYPASS WITH BOXES
-  PROPOSED LINE STOP
-  PROPOSED FIRE HYDRANT AUXILIARY VALVE
-  PROPOSED FIRE HYDRANT
-  PROPOSED COMMUNICATIONS VAULT
-  PROPOSED WATER MAIN
-  PROPOSED WATER MAIN IN STEEL CASING PIPE
-  UTILITY TO BE ABANDONED
-  UTILITY TO BE REMOVED
-  UTILITY TO BE ABANDONED
-  PROPOSED UNDERGROUND CONDUIT
-  PROPOSED WATER MAIN FITTING, REDUCER
-  PROPOSED CAP OR PLUG FOR EXISTING WATER MAIN
-  PROPOSED WATER MAIN FITTING, TEE
-  PROPOSED WATER MAIN FITTING, 90 DEGREE BEND
-  PROPOSED WATER MAIN FITTING, 45 DEGREE BEND
-  PROPOSED WATER MAIN FITTING, 22.5 DEGREE BEND
-  PROPOSED WATER MAIN FITTING, 11.25 DEGREE BEND
-  PROPOSED WATER MAIN FITTING, CAP OR PLUG
-  PROPOSED WATER MAIN FITTING, SOLID SLEEVE

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USER NAME = brooke.henry	DESIGNED - BNH	REVISED -
PLOT SCALE = 40.0000 ' / in.	DRAWN - BNH	REVISED -
PLOT DATE = 10/27/2021	CHECKED - RB	REVISED -
	DATE - 10/22/2021	REVISED -

**STATE OF ILLINOIS  
DEPARTMENT OF TRANSPORTATION**

<b>WATER MAIN RELOCATION PLAN AND SANITARY SEWER ADJUSTMENTS</b>		F.A.U. RTE.	SECTION	COUNTY	TOTAL SHEETS	SHEET NO.
GENERAL NOTES AND SYMBOLS		7448	09-00933-01-BR	MACON	1019	513
SCALE: NTS		SHEET 1 OF 31 SHEETS		STA. N/A	TO STA. N/A	
ILLINOIS FED. AID PROJECT						

CONTRACT NO. 95893	
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PROPOSED STRUCTURES							
ROAD	SHEET	STRUCTURE TYPE	WM STATION	ROADWAY STATION OFFSET	IDOT PAY ITEM NAME	EXST. GROUND EL. (FT.)	PR. GROUND EL. (FT.)
BRUSH COLLEGE	5	WATER VALVE AND BOX	10+04	47+10, RT 2.3	PRESSURE CONNECTION 24" X 24"	-	-
	5				VALVE BOX*	653.0	653.1
	5				VALVE BOXES TO BE ADJUSTED*	653.0	653.1
	5	WATER VALVE AND BOX	13+52, RT 5.1	49+68, RT 84.7	WATER VALVES 24"	-	-
	5				VALVE BOX*	673.1	-
	5				VALVE BOXES TO BE ADJUSTED*	673.1	-
	5	FIRE HYDRANT	13+45, RT 11.8	49+61, RT 77.0	FIRE HYDRANT WITH AUXILIARY VALVE AND VALVE BOX	673.0	-
	6	WATER VALVE AND BOX	16+08, RT 7.5	52+22, RT 103.1	WATER VALVES 8"	-	-
	6				VALVE BOX	674.9	674.7
	6				VALVE BOXES TO BE ADJUSTED	674.9	674.7
	6	FIRE HYDRANT	16+09, RT 49.4	52+16, RT 144.3	FIRE HYDRANT WITH AUXILIARY VALVE AND VALVE BOX	675.6	-
	7	WATER VALVE AND BOX	24+25	60+18, RT 118.8	WATER VALVES 24"	-	-
	7				VALVE BOX*	676.4	675.1
	7				VALVE BOXES TO BE ADJUSTED*	676.4	675.1
	7	FIRE HYDRANT	24+68, RT 27.9	60+76, RT 124.1	FIRE HYDRANT WITH AUXILIARY VALVE AND VALVE BOX	675.6	675.1
	7	COMMUNICATIONS VAULT	24+32, LT 4.6	60.22, RT 112.7	COMMUNICATIONS VAULT	676.4	674.9
	7	COMMUNICATIONS VAULT	26+61, LT 1.6	62+47, RT 43.0	COMMUNICATIONS VAULT	675.1	-
	9	WATER VALVE AND BOX	29+15	64+98, RT 61.6	WATER VALVES 30"	-	-
	9				VALVE BOX*	674.2	-
	9				VALVE BOXES TO BE ADJUSTED*	674.2	-
	9	FIRE HYDRANT	29+32, LT 18.0	65+24, RT 59.6	FIRE HYDRANT WITH AUXILIARY VALVE AND VALVE BOX	673.9	-
	9	WATER VALVE AND BOX	30+54, RT 3.6	66+36, RT 82.0	WATER VALVES 8"	-	-
	9				VALVE BOX	670.2	-
	9				VALVE BOXES TO BE ADJUSTED	670.2	-
	9	COMMUNICATIONS VAULT	30+53, LT 2.2	66+34, RT 76.5	COMMUNICATIONS VAULT	670.3	-
	10	WATER VALVE AND BOX	34+00, RT 3.6	69+54, 31.0	WATER VALVES 12"	-	-
	10				VALVE BOX	672.0	673.2
	10				VALVE BOXES TO BE ADJUSTED	672.0	673.2
10	FIRE HYDRANT	34+22, RT 24.6	69+76, RT 43.0	FIRE HYDRANT WITH AUXILIARY VALVE AND VALVE BOX	671.7	-	
10	WATER VALVE AND BOX	34+45, RT 5.3	69+95, RT 15.5	WATER VALVES 16"	-	-	
10				VALVE BOX	672.2	672.7	
10				VALVE BOXES TO BE ADJUSTED	672.2	672.7	
10	WATER VALVE AND BOX	34+78	69+89, LT 17.4	PRESSURE CONNECTION 24" X 24"	-	-	
10				VALVE BOX*	672.3	672.6	
10				VALVE BOXES TO BE ADJUSTED*	672.3	672.6	
JUG HANDLE	6, 18	WATER VALVE AND BOX	40+08	302+04, LT 128.8	WATER VALVES 8"	-	-
	6, 18				VALVE BOX	675.3	675.4
	6, 18				VALVE BOXES TO BE ADJUSTED	675.3	675.4
18	FIRE HYDRANT	43+44, LT 7.2	304+59, RT 112.8	FIRE HYDRANT WITH AUXILIARY VALVE AND VALVE BOX	678.1	678.2	
FARIES	7, 13	WATER VALVE AND BOX	50+41	61+33, RT 96.6	WATER VALVES 16"	-	-
	7, 13				VALVE BOX	675.2	675.8
	7, 13				VALVE BOXES TO BE ADJUSTED	675.2	675.8
	7, 13	WATER VALVE AND BOX	61+66	61+38, LT 104.3	WATER VALVES 16"	-	-
	7, 13				VALVE BOX	675.3	675.2
	7, 13				VALVE BOXES TO BE ADJUSTED	675.3	675.2
	14	FIRE HYDRANT	-	216+12, LT 43.7	FIRE HYDRANT WITH AUXILIARY VALVE AND VALVE BOX	673.6	673.2
17	FIRE HYDRANT	-	231+36, LT 24.4	FIRE HYDRANT WITH AUXILIARY VALVE AND VALVE BOX	661.3	660.6	
LOGAN	19	N/A					
JAMES	20	N/A					
HARRISON	21-25	N/A					
CEMETERY	25	N/A					

\* PROPOSED STRUCTURE HAS TWO VALVE BOXES, REFER ALSO TO NOTE 1.

## NOTES

- FOR VALVES WITH TWO (2) BOXES (I.E. VALVES WITH A BYPASS) IN THE PROPOSED STRUCTURE SCHEDULE. THE PROPOSED GROUND ELEVATION LISTED IS FOR THE BYPASS VALVE BOX. THE CONTRACTOR IS RESPONSIBLE FOR COORDINATING AND CONFIRMING THE FINAL ELEVATION OF THE VALVE BOX FOR THE MAIN VALVE. UNLESS OTHERWISE NOTED, NO ADDITIONAL PAYMENT WILL BE MADE FOR ANY VALVE BOXES TO BE ADJUSTED.
- FOR FIRE HYDRANT WITH AUXILIARY VALVE AND VALVE BOX IN THE PROPOSED STRUCTURE SCHEDULE, THE PROPOSED GROUND ELEVATION LISTED IS FOR THE HYDRANT. THE CONTRACTOR IS RESPONSIBLE FOR COORDINATING AND CONFIRMING THE FINAL GROUND ELEVATION FOR THE PROPOSED AUXILIARY VALVE. UNLESS OTHERWISE NOTED, NO ADDITIONAL PAYMENT WILL BE MADE FOR ANY VALVE BOXES TO BE ADJUSTED.



USER NAME = brooke.henry  
 PLOT SCALE = 40.0000' / in.  
 PLOT DATE = 10/27/2021

DESIGNED - BNH  
 DRAWN - BNH  
 CHECKED - RB  
 DATE - 10/22/2021

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STATE OF ILLINOIS  
 DEPARTMENT OF TRANSPORTATION

WATER MAIN RELOCATION PLAN AND SANITARY SEWER ADJUSTMENTS  
 STRUCTURE SCHEDULE

SCALE: NTS SHEET 2 OF 31 SHEETS STA. N/A TO STA. N/A

F.A.U. RTE.	SECTION	COUNTY	TOTAL SHEETS	SHEET NO.
7448	09-00933-01-BR	MACON	1019	514
CONTRACT NO. 95893				
ILLINOIS FED. AID PROJECT				

MODEL: Default  
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EXISTING STRUCTURES							
ROAD	SHEET	STRUCTURE TYPE	WM STATION	ROADWAY STATION OFFSET	IDOT PAY ITEM NAME	EXST. GROUND EL. (FT.)	PR. GROUND EL. (FT.)
BRUSH COLLEGE	6	FIRE HYDRANT	-	57+10, RT 37.8	FIRE HYDRANT TO BE REMOVED & SALVAGED	674.9	
	7	FIRE HYDRANT	-	62+38, LT 73.3	FIRE HYDRANT TO BE REMOVED & SALVAGED	673.9	
	10	VALVE BOX	-	70+63, LT 22.8	VALVE BOXES TO BE ADJUSTED	671.9	671.6
	11	VALVE BOX	-	73+64, RT 20.3	VALVE BOXES TO BE ADJUSTED	672.0	672.3
	11	VALVE BOX	-	75+41, LT 24.2	VALVE BOXES TO BE ADJUSTED	671.6	671.7
JUG HANDLE	18	N/A	-				
FARIES	14	FIRE HYDRANT	-	215+89, RT 17.5	FIRE HYDRANT TO BE REMOVED & SALVAGED	673.5	-
	15	VALVE BOX	-	221+30, LT 6.9	VALVE BOXES TO BE ADJUSTED	668.3	668.6
	15	VALVE BOX	-	221+62, LT 5.4	VALVE BOXES TO BE ADJUSTED	668.0	668.8
	15	VALVE BOX	-	221+68, LT 9.6	VALVE BOXES TO BE ADJUSTED	668.0	668.2
	15	VALVE VAULT	-	221+68, LT 4.7	VALVE VAULTS TO BE ADJUSTED	667.6	668.7
	15	MANHOLE	-	221+70, RT 3.5	SANITARY MANHOLES TO BE RECONSTRUCTED WITH NEW TYPE 1 FRAME, CLOSED LID	668.7	668.3
	15	FIRE HYDRANT	-	221+61, RT 36.2	FIRE HYDRANTS TO BE REMOVED AND REPLACED	668.8	668.2
	16	VALVE BOX	-	225+47, LT 5.8	VALVE BOXES TO BE ADJUSTED	659.5	660.7
	16	FIRE HYDRANT	-	225+46, RT 31.8	FIRE HYDRANTS TO BE REMOVED AND REPLACED	662.0	660.7
	16	MANHOLE	-	225+64, LT 0.1	SANITARY MANHOLES TO BE ADJUSTED	659.2	660.9
	16	MANHOLE	-	228+14, RT 69.1	SANITARY MANHOLES TO BE ADJUSTED	647.5	648.8
	16	MANHOLE	-	225+79, RT 34.4	SANITARY MANHOLES TO BE RECONSTRUCTED WITH NEW TYPE 1 FRAME, CLOSED LID	654.0	660.0
	16	MANHOLE	-	229+75, RT 41.2	SANITARY MANHOLES TO BE RECONSTRUCTED WITH NEW TYPE 1 FRAME, CLOSED LID	645.1	657.8
	17	VALVE BOX	-	232+22, RT 2.4	VALVE BOXES TO BE ADJUSTED	662.5	662.6
	17	VALVE VAULT	-	232+22, LT 2.8	VALVE VAULTS TO BE ADJUSTED	662.5	662.6
	17	FIRE HYDRANT	-	232+16, LT 22.7	FIRE HYDRANT TO BE REMOVED & SALVAGED	663.5	-
	17	VALVE BOX	-	234+71, LT 1.7	VALVE BOXES TO BE ADJUSTED	665.7	666.1
	LOGAN	19	N/A				
JAMES	20	N/A					
W. HARRISON	21-22	N/A					
E. HARRISON	10	FIRE HYDRANT	-	700.47, LT 43.7	FIRE HYDRANT TO BE REMOVED & SALVAGED	671.7	-
CEMETERY	25	N/A					

EXISTING STRUCTURES TO BE REMOVED OR ABANDONED					
ROAD	SHEET	STRUCTURE TYPE	ROADWAY STATION OFFSET	IDOT PAY ITEM NAME	EX. GROUND EL. (FT.)
BRUSH COLLEGE	6	VALVE VAULT	51+77, LT 35.2	VALVE VAULTS TO BE ABANDONED	671.9
	6	VALVE VAULT	54+55, LT 1.8	VALVE VAULTS TO BE ABANDONED	674.1
	6	VALVE BOX	52+22, RT 7.6	WATER VALVE BOXES TO BE ABANDONED	673.3
	6	VALVE BOX	54+55, LT 3.5	WATER VALVE BOXES TO BE ABANDONED	674.2
	6	VALVE BOX	57.14, RT 11.9	WATER VALVE BOXES TO BE ABANDONED	673.9
	7	MANHOLE	58+89, RT 45.5	SANITARY MANHOLES TO BE REMOVED	675.8
	7	VALVE BOX	60+47, RT 5.7	VALVE BOXES TO BE REMOVED	674.1
	7	VALVE BOX	62+43, RT 44.3	VALVE BOXES TO BE REMOVED	675.1
	7	VALVE VAULT	63+02, RT 43.8	VAULTS TO BE REMOVED	674.8
	7, 13	VALVE BOX	61+22, RT 45.0	WATER VALVE BOXES TO BE ABANDONED	674.8
	7, 13	VALVE BOX	61+29, RT 54.6	WATER VALVE BOXES TO BE ABANDONED	674.9
	8	VALVE BOX	65+85, RT 0.0	WATER VALVE BOXES TO BE ABANDONED	673.7
	8	VALVE BOX	66+31, RT 32.2	WATER VALVE BOXES TO BE ABANDONED	673.4
	9	VALVE VAULT	69+65, RT 20.0	VALVE VAULTS TO BE ABANDONED	672.1
9	VALVE BOX	69+54, RT 19.9	WATER VALVE BOXES TO BE ABANDONED	672.1	
9	VALVE BOX	69+65, RT 4.4	WATER VALVE BOXES TO BE ABANDONED	672.2	
JUG HANDLE	18	MANHOLE	301+66, RT 53.5	SANITARY MANHOLES TO BE REMOVED	685.1
FARIES	13	VALVE BOX	209+02, RT 3.4	VALVE BOXES TO BE REMOVED	674.4
	14	MANHOLE	215+22, RT 62.9	SANITARY MANHOLES TO BE REMOVED	677.4
LOGAN	19	N/A			
JAMES	20	N/A			
W. HARRISON	21-22	N/A			
E. HARRISON	23-24	N/A			
CEMETERY	25	N/A			



USER NAME = brooke,henry	DESIGNED - BNH	REVISED -
DRAWN - BNH	REVISIONS -	
PLOT SCALE = 40.0000 ' / in.	CHECKED - RB	REVISED -
PLOT DATE = 10/27/2021	DATE - 10/22/2021	REVISED -



**STATE OF ILLINOIS**  
**DEPARTMENT OF TRANSPORTATION**

**WATER MAIN RELOCATION PLAN AND SANITARY SEWER ADJUSTMENTS**  
**STRUCTURE SCHEDULE**

SCALE: NTS    SHEET 3 OF 31 SHEETS    STA. N/A TO STA. N/A

F.A.U. RTE. 7448	SECTION 09-00933-01-BR	COUNTY MACON	TOTAL SHEETS 1019	SHEET NO. 515
CONTRACT NO. 95893				
ILLINOIS FED. AID PROJECT				

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**NOTES**

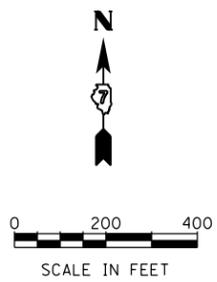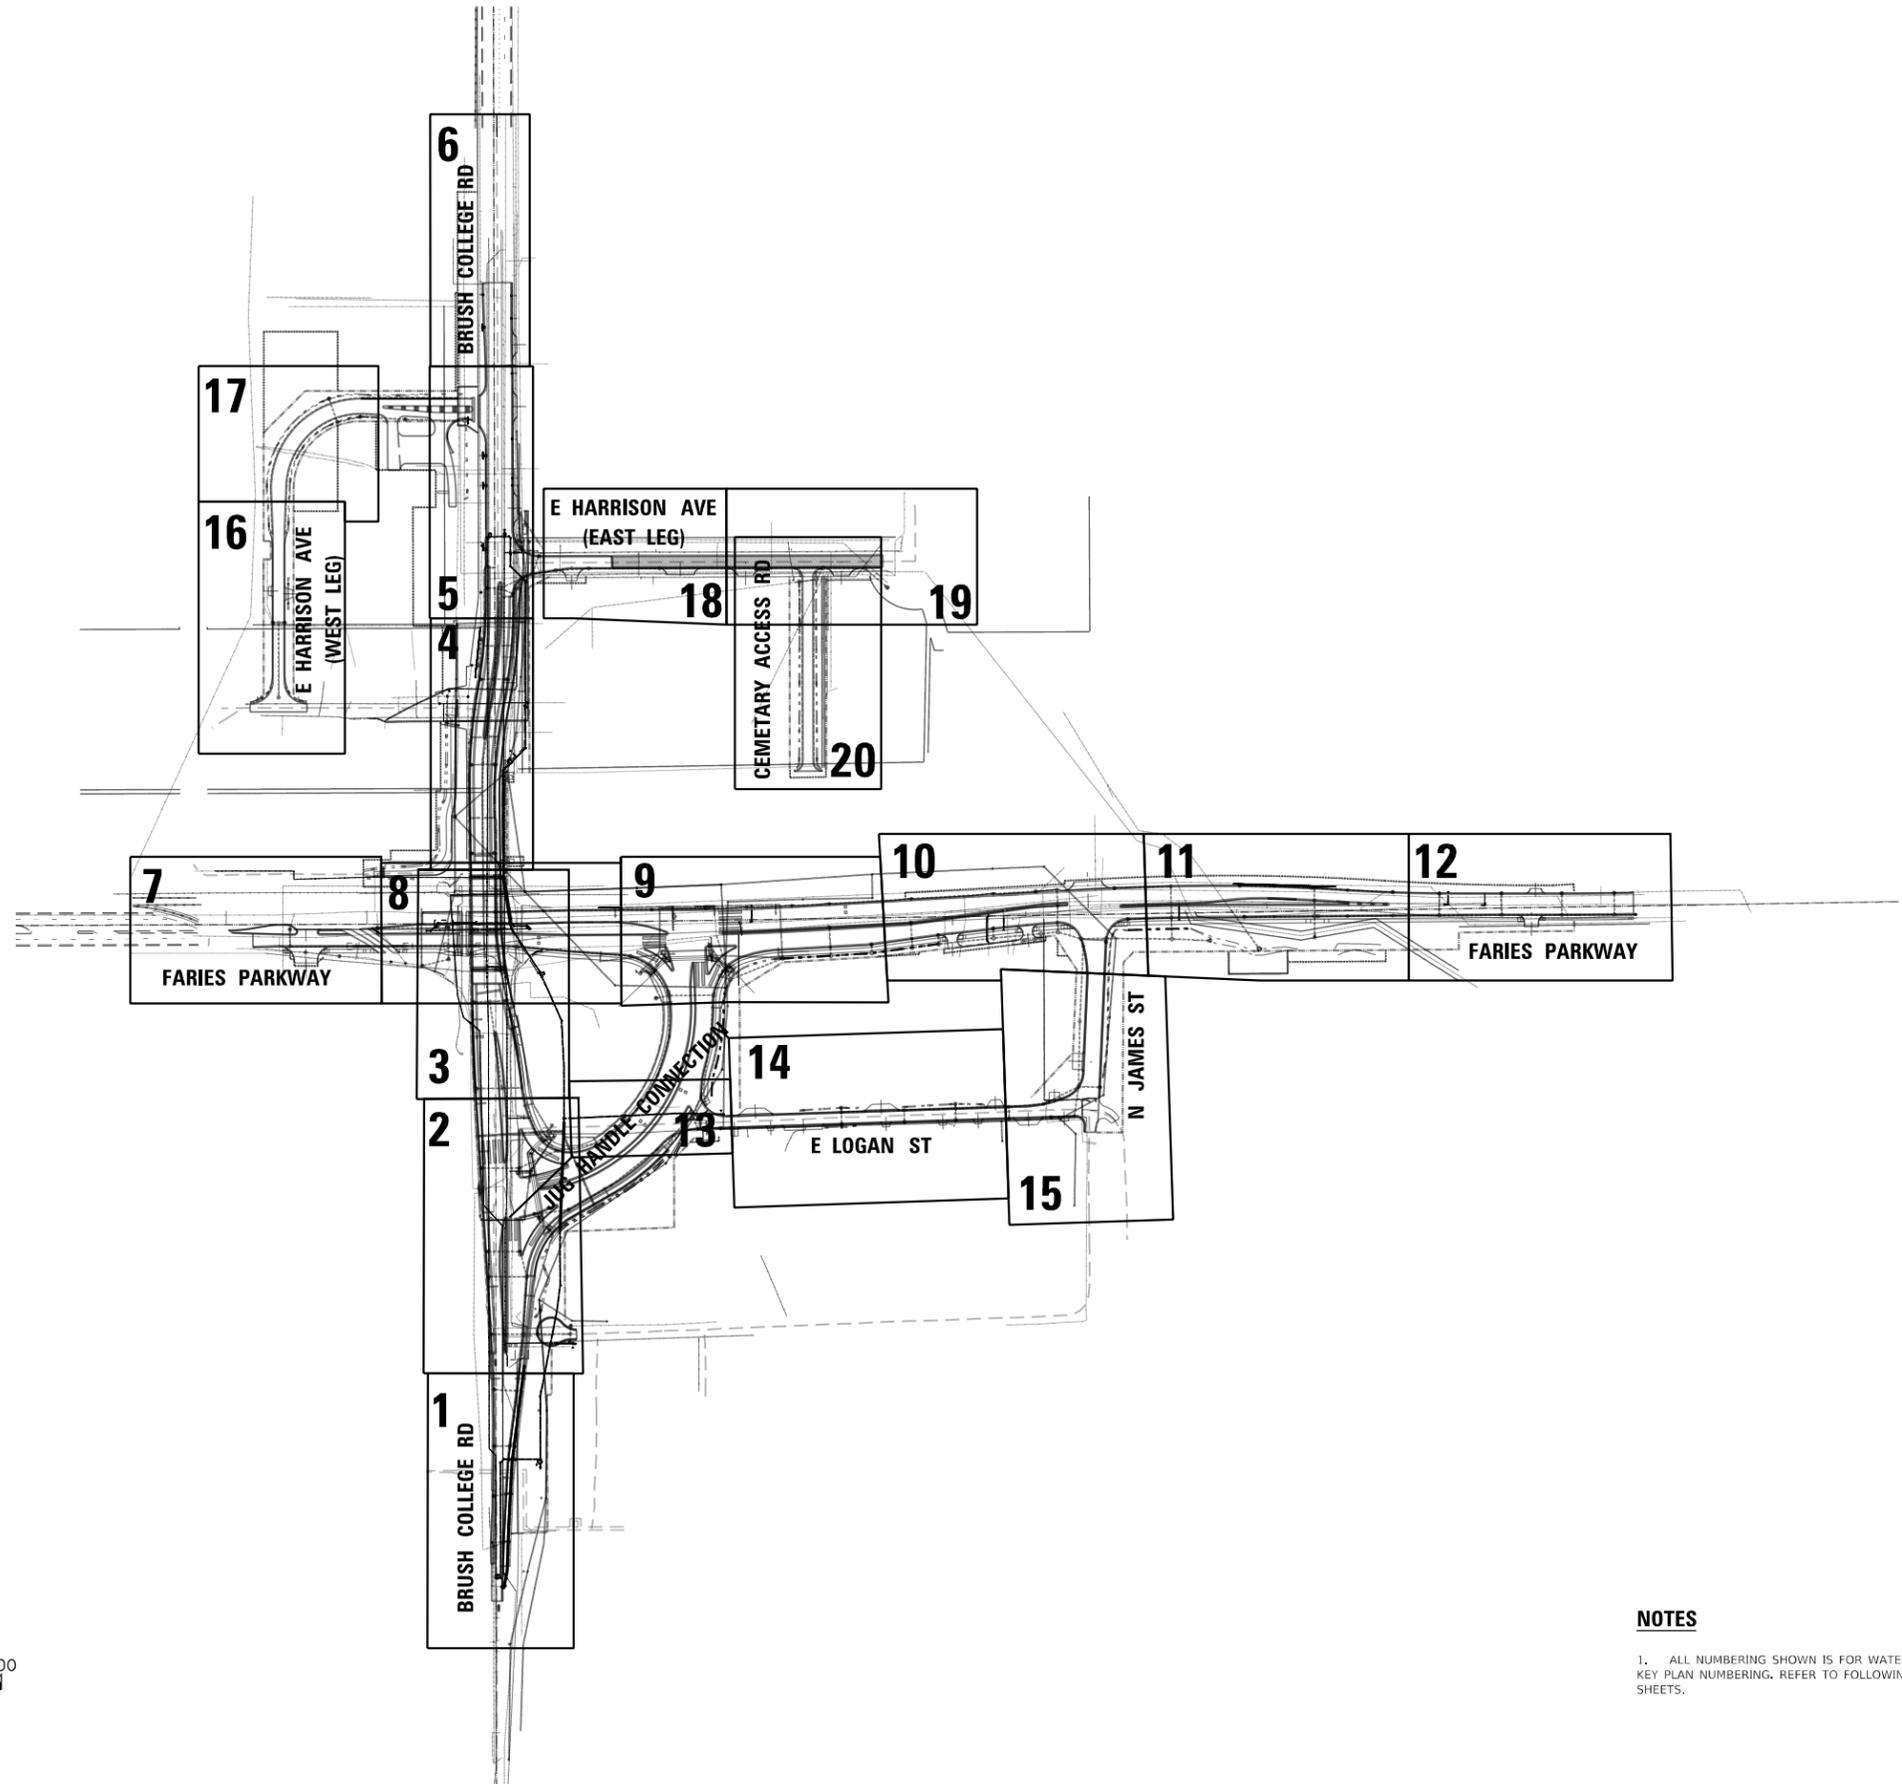1. ALL NUMBERING SHOWN IS FOR WATER MAIN KEY PLAN NUMBERING. REFER TO FOLLOWING SHEETS.



USER NAME = brooke.henry	DESIGNED - BNH	REVISED - XXX
	DRAWN - BNH	REVISED - XXX
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PLOT DATE = 10/27/2021	DATE - 10/22/2021	REVISED -

**STATE OF ILLINOIS  
 DEPARTMENT OF TRANSPORTATION**

**WATER MAIN RELOCATION PLAN AND SANITARY SEWER ADJUSTMENTS  
 WATER MAIN KEY PLAN MAP**

SCALE: 1"=200' SHEET 4 OF 31 SHEETS STA. N/A TO STA. N/A

F.A.U. RTE.	SECTION	COUNTY	TOTAL SHEETS	SHEET NO.
7448	09-00933-01-BR	MACON	1019	516
CONTRACT NO. 95893				
		ILLINOIS	FED. AID PROJECT	




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	PLOTTED	
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	NOTE BOOK	
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	FILE NAME	
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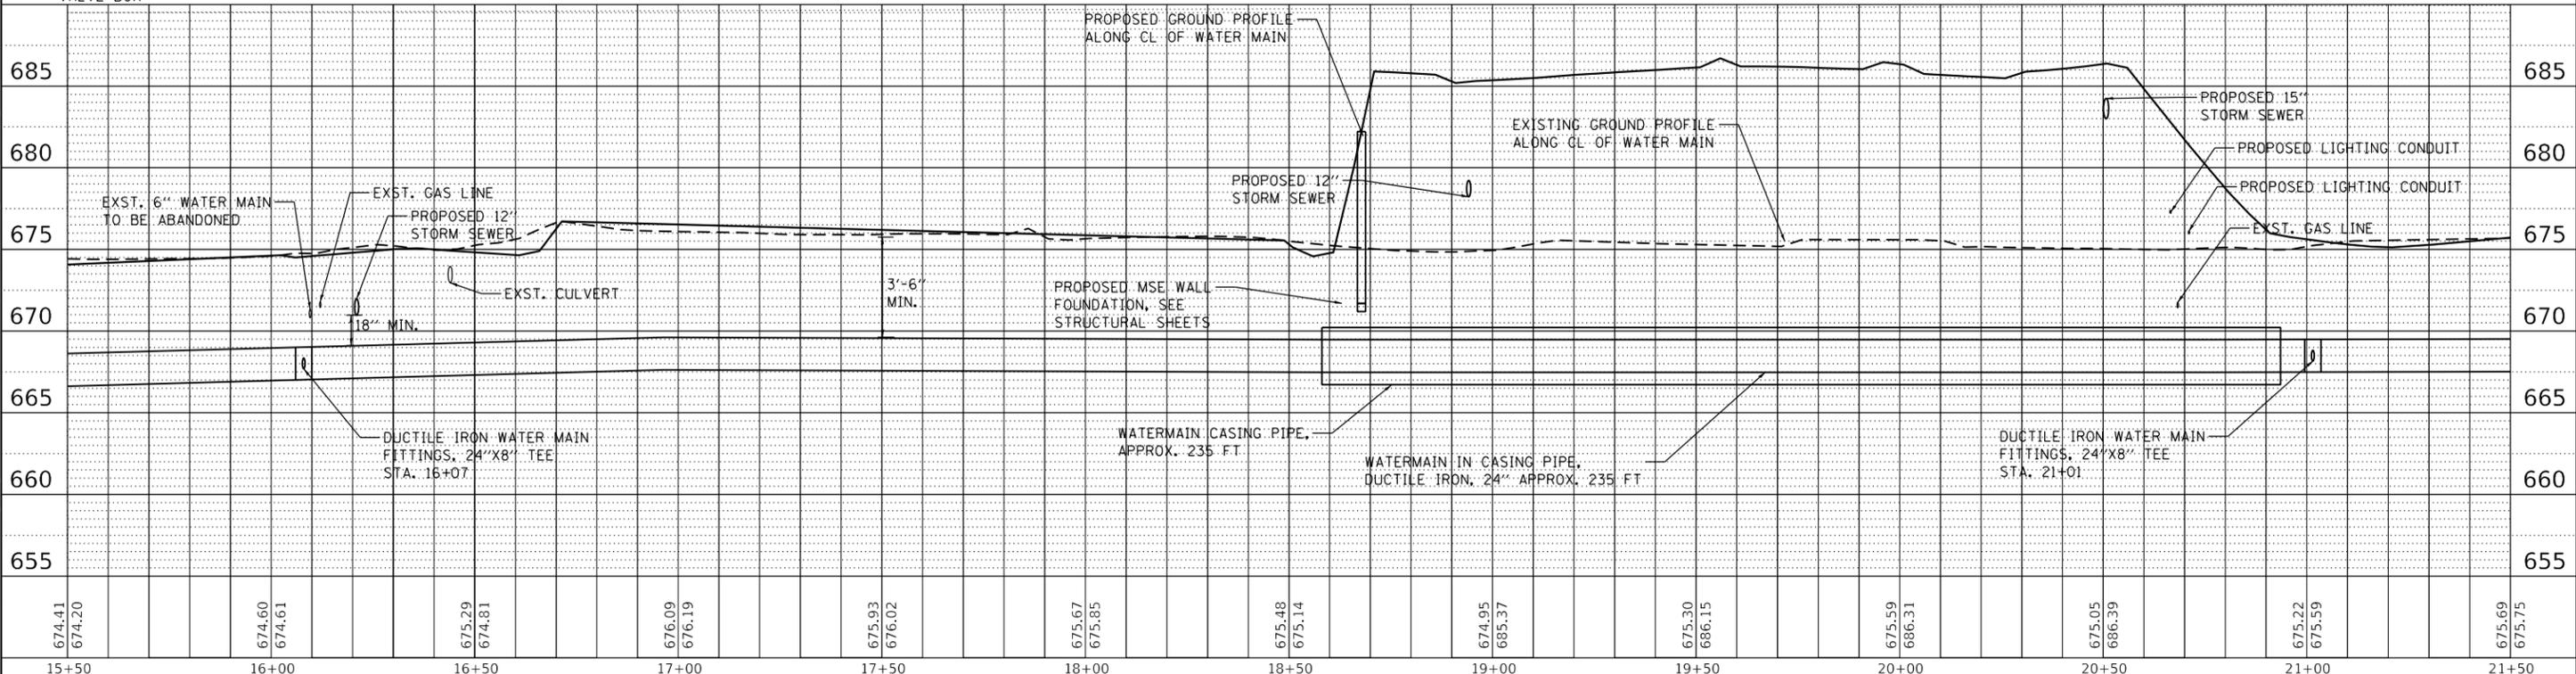
MATCH LINE STA. 15+50 (WATER) STA. 51+68 (ROADWAY)  
 SEE WATER MAIN KEY MAP PLAN VIEW NO. 1

MATCH LINE STA. 21+50 (WATER) STA. 57+53 (ROADWAY)  
 SEE WATER MAIN KEY MAP PLAN VIEW NO. 3



WATER MAIN KEY MAP PLAN VIEW NO. 2

SEE WATER MAIN KEY MAP PLAN VIEW NO. 13

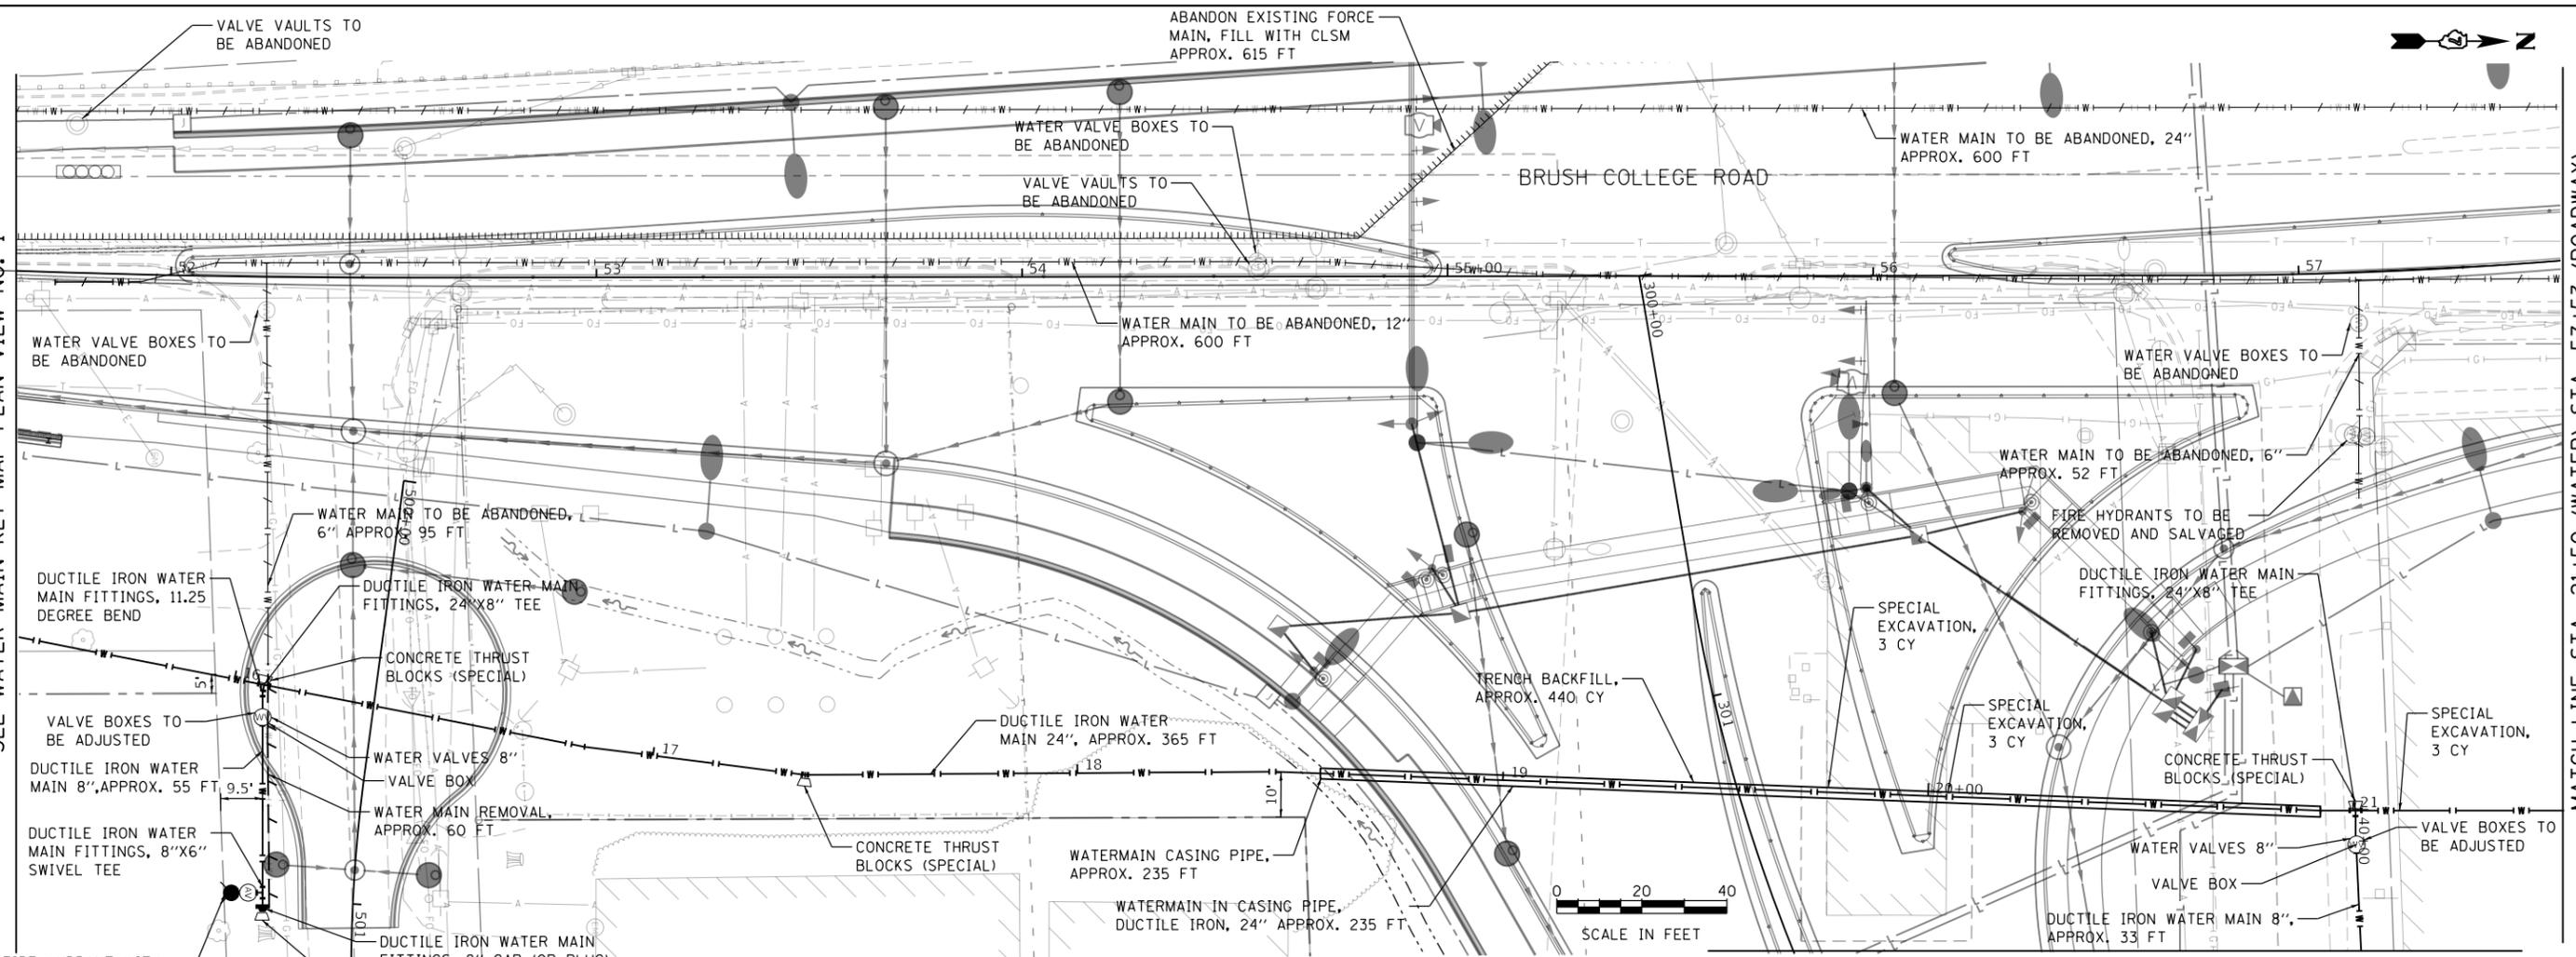

674.41	674.20	674.60	674.61	675.29	674.81	676.09	676.19	675.93	676.02	675.67	675.85	675.48	675.14	674.95	685.37	675.30	686.15	675.59	686.31	675.05	686.39	675.22	675.59	675.69	675.75	
15+50	16+00	16+50	17+00	17+50	18+00	18+50	19+00	19+50	20+00	20+50	21+00	21+50														



USER NAME = brooke.henry	DESIGNED - BNH	REVISED -
	DRAWN - BNH	REVISED -
	CHECKED - PSA	REVISED -
PLOT SCALE = 40,0000' / in.	DATE - 10/22/2021	REVISED -

STATE OF ILLINOIS  
 DEPARTMENT OF TRANSPORTATION


WATER MAIN RELOCATION PLAN AND SANITARY SEWER ADJUSTMENTS  
 WATER MAIN PLAN AND PROFILE  
 SCALE: 1"=20' SHEET 6 OF 31 SHEETS STA. 15+50 TO STA. 21+50

F.A.U. RTE. 7448	SECTION 09-00933-01-BR	COUNTY MACON	TOTAL SHEETS 1019	SHEET NO. 518
CONTRACT NO. 95893				
ILLINOIS FED. AID PROJECT				




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	PLOTTED	
NOTE BOOK	GRADES CHECKED	
	STRUCTURE NOTATION	
NO.	FILE NAME	

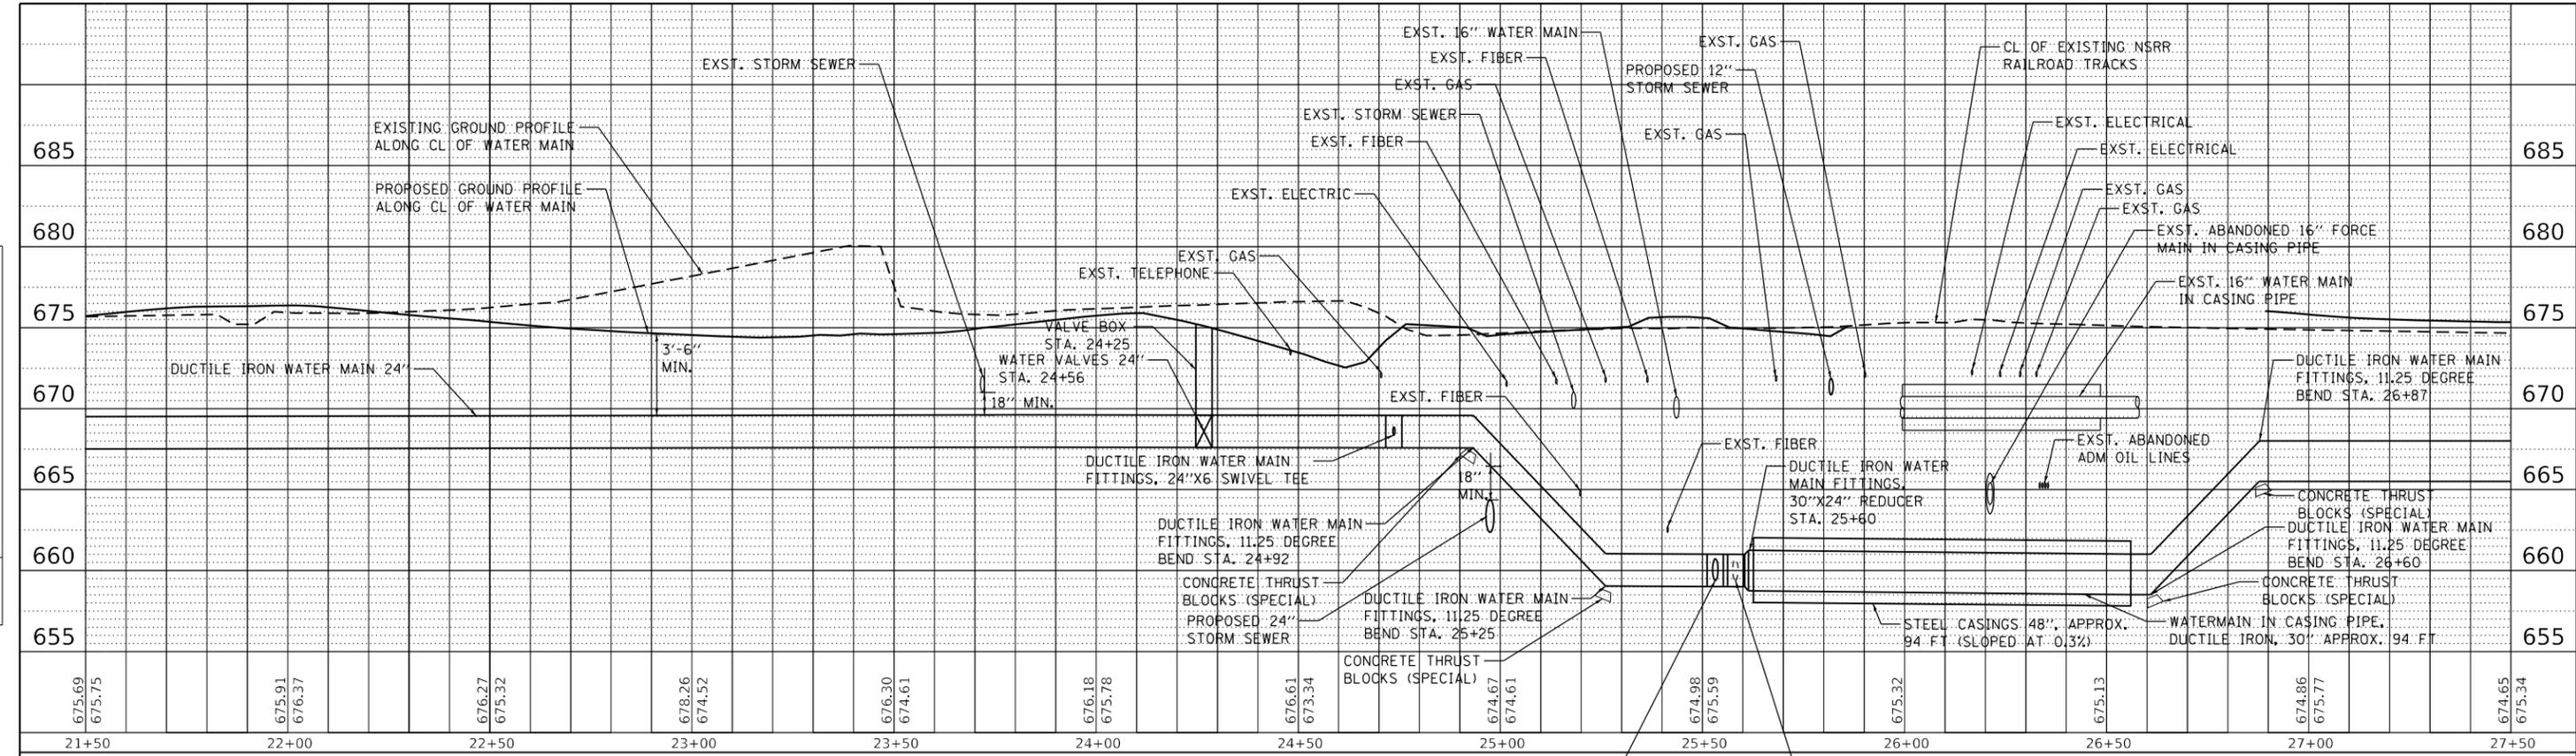

**NOTES**

- FOR CLARITY, PR UNDERGROUND CONDUIT, HDPE, 4" DIA. IS NOT SHOWN IN THE PROFILE. THE CONTRACTORS ATTENTION IS ESPECIALLY CALLED TO THE PROPOSED GRADING CHANGES BETWEEN STA. 24+10 AND 24+75. CONTRACTOR SHALL MAINTAIN A BURIED CONDUIT DEPTH OF 30"-36" ( TO THE TOP OF THE CONDUIT) WITH THE PROPOSED GRADING IN THIS AREA.
- WHERE WATER MAIN IS PROPOSED TO HAVE LESS THAN 42" OF COVER BETWEEN APPROX. STA. 24+55 AND 24+70, CONTRACTOR SHALL INSTALL INSULATION AROUND THE ENTIRE 24-INCH DIA. WATER MAIN, FITTING, AND VALVE. INSULATION SHALL BE FOAMGLAS (WITH PITWRAP JACKETING) OR ENGINEER APPROVED EQUAL.

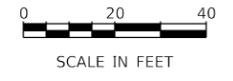

USER NAME = brooke.henry  
 PLOT SCALE = 40.0000' / in.  
 PLOT DATE = 10/27/2021

DESIGNED - BNH  
 DRAWN - BNH  
 CHECKED - PSA  
 DATE - 10/22/2021

REVISED -  
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 REVISED -

**STATE OF ILLINOIS  
 DEPARTMENT OF TRANSPORTATION**

**WATER MAIN RELOCATION PLAN AND SANITARY SEWER ADJUSTMENTS  
 WATER MAIN PROFILE**

SCALE: 1"=20' SHEET 8 OF 31 SHEETS STA. 21+50 TO STA. 27+50


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7448	09-00933-01-BR	MACON	1019	520
CONTRACT NO. 95893				
ILLINOIS FED. AID PROJECT				

PLAN	SURVEYED	DATE
	PLOTTED	
	ALIGNED	
	CHECKED	
	FILED	
	NO.	
	BY	

PROFILE	SURVEYED	DATE
	PLOTTED	
	GRADES	
	CHECKED	
	STRUCTURE	
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	BY	

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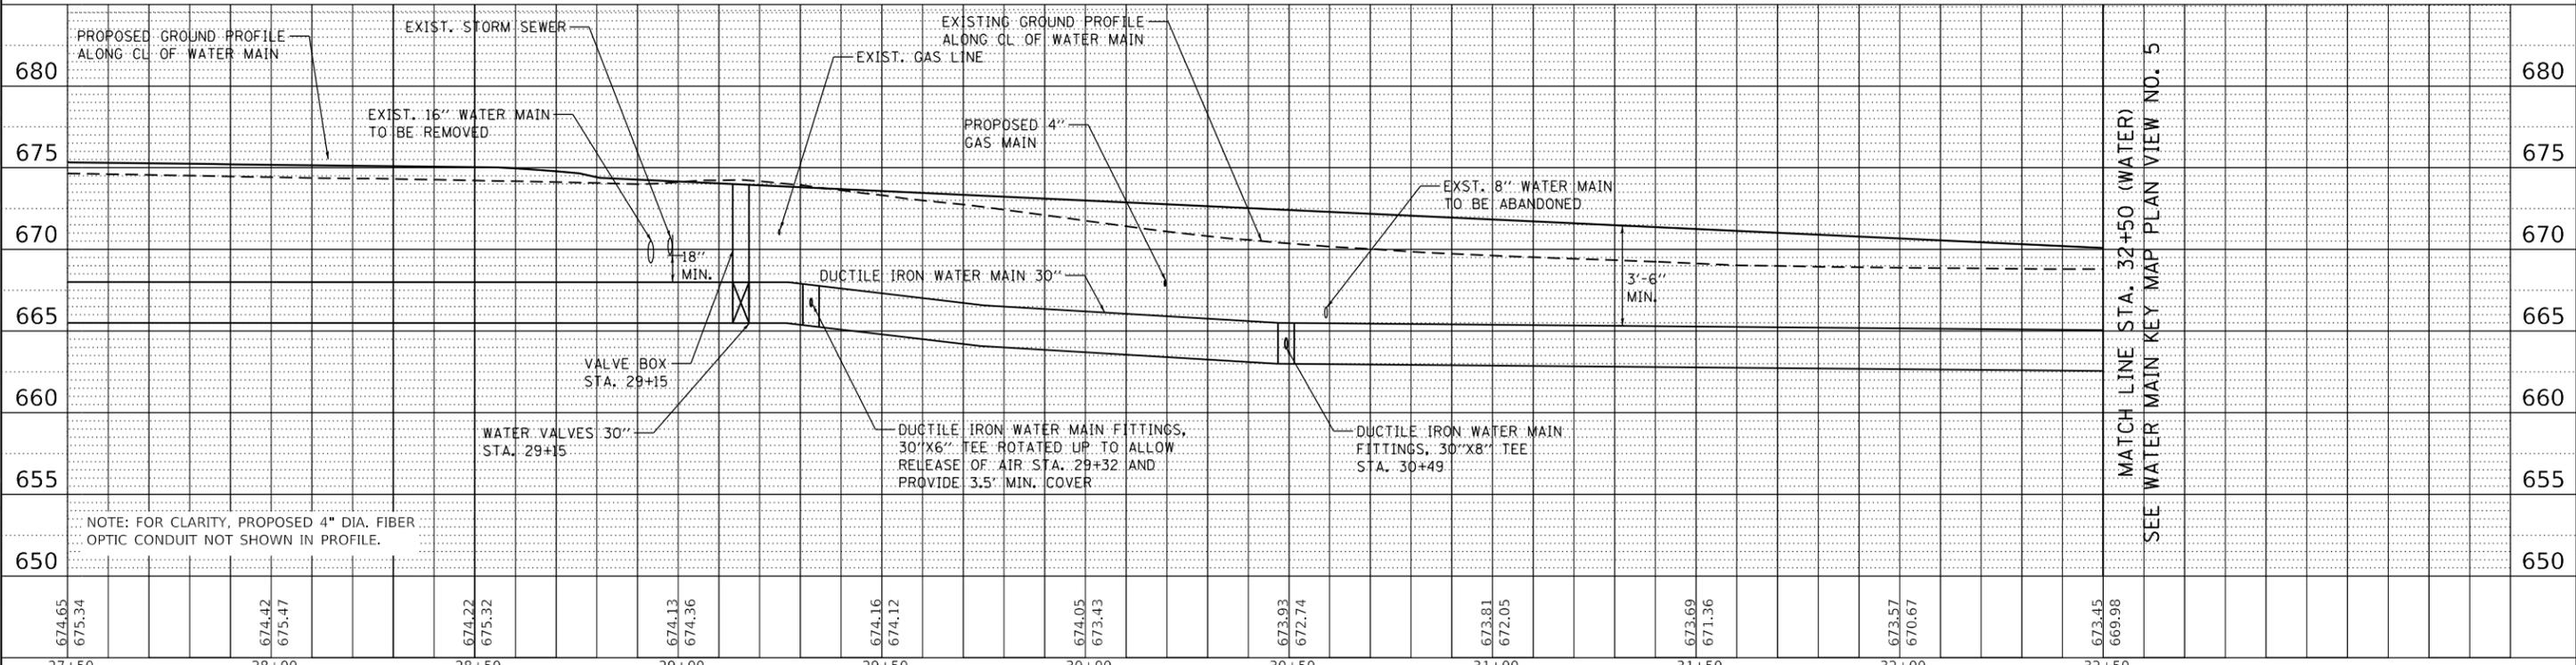
MATCH LINE STA. 27+50 (WATER), STA. 63+35 (ROADWAY)  
 SEE WATER MAIN KEY MAP PLAN VIEW NO. 3

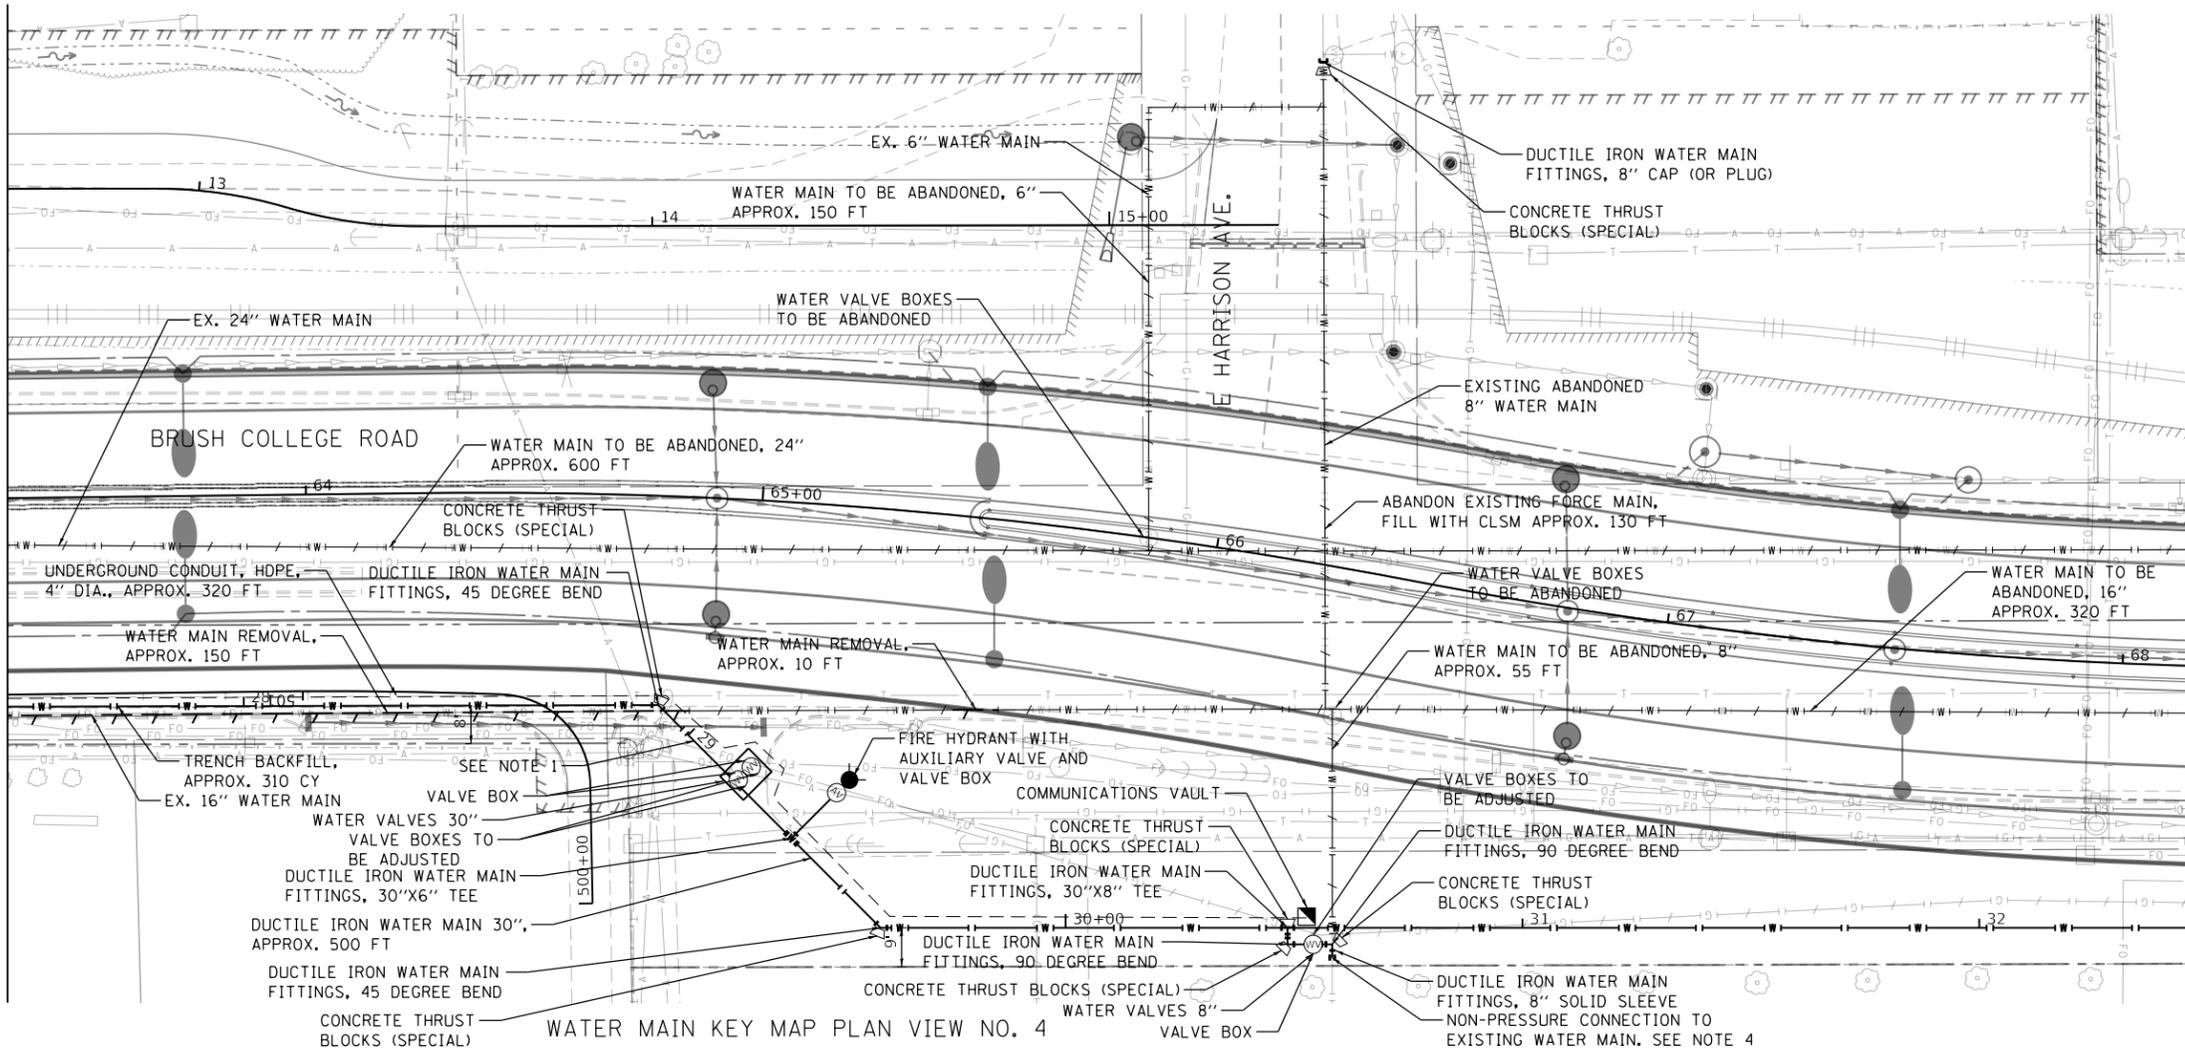

MATCH LINE STA. 32+50 (WATER), STA. 68+17 (ROADWAY)  
 SEE WATER MAIN KEY MAP PLAN VIEW NO. 5

**NOTES**

1. USE FLUOROELASTOMER (VITON) GASKETS FOR ALL WATER MAIN JOINTS FROM STA. 28+80 TO STA. 32+00.
2. FIBER OPTIC CONDUIT FOR FUTURE USE IS TO BE INSTALLED WITH A MINIMUM 20" BENDING RADIUS. CONDUIT TERMINATING IN COMMUNICATION VAULTS SHALL BE CAPPED FOR FUTURE USE.
3. COMMUNICATIONS VAULTS AND INSTALLED CONDUIT SHALL BE STAKED IN THE FIELD AND APPROVED BY THE ENGINEER PRIOR TO INSTALLATION. SEE WATER MAIN DETAIL SHEETS FOR COMMUNICATIONS VAULT DETAIL.
4. REFER TO ADVANCE CUSTOMER COORDINATION NOTES ON THE WATER MAIN PHASING PLAN SHEETS.



MATCH LINE STA. 32+50 (WATER)  
 SEE WATER MAIN KEY MAP PLAN VIEW NO. 5



USER NAME = brooke.henry	DESIGNED - BNH	REVISED -
	DRAWN - BNH	REVISED -
	CHECKED - PSA	REVISED -
	DATE - 10/22/2021	REVISED -

STATE OF ILLINOIS  
 DEPARTMENT OF TRANSPORTATION

WATER MAIN RELOCATION PLAN AND SANITARY SEWER ADJUSTMENTS	
WATER MAIN PLAN AND PROFILE	
SCALE: 1"=20'	SHEET 9 OF 31 SHEETS
STA. 27+50	TO STA. 32+50


F.A.U. RTE. 7448	SECTION 09-00933-01-BR	COUNTY MACON	TOTAL SHEETS 1019	SHEET NO. 521
CONTRACT NO. 95893				
ILLINOIS FED. AID PROJECT				

PLAN	SURVEYED	DATE
	PLOTTED	
	ALIGNED	
	CHECKED	
	FILED	
	NO.	
	BY	

PROFILE	SURVEYED	DATE
	PLOTTED	
	GRADES	
	CHECKED	
	FILED	
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	BY	

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MATCH LINE STA. 32+50 (WATER), STA. 68+17 (ROADWAY)  
 SEE WATER MAIN KEY MAP PLAN VIEW NO. 4

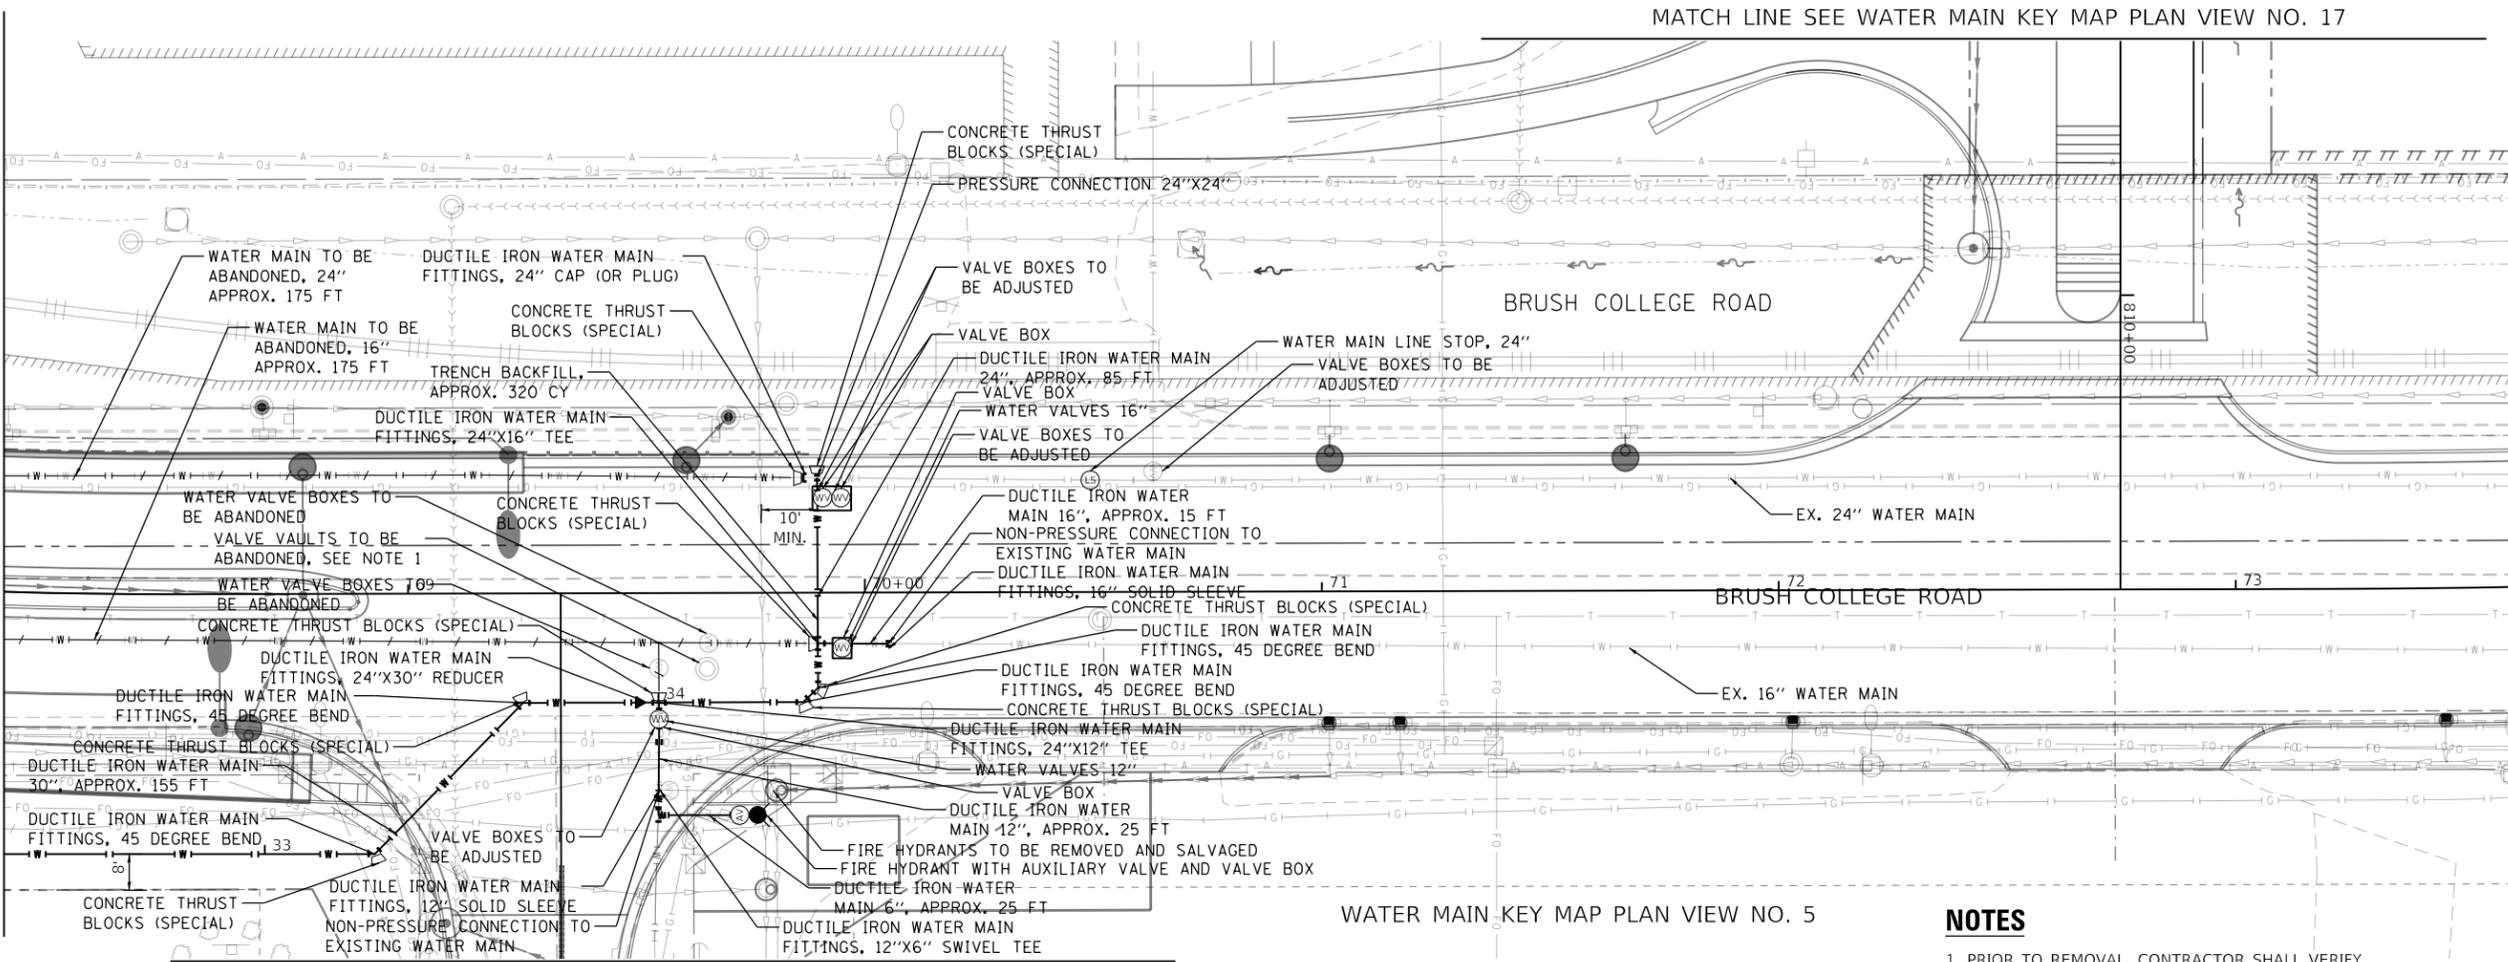


MATCH LINE SEE WATER MAIN KEY MAP PLAN VIEW NO. 18

WATER MAIN KEY MAP PLAN VIEW NO. 5

**NOTES**

1. PRIOR TO REMOVAL, CONTRACTOR SHALL VERIFY WITH THE ENGINEER THAT THIS VAULT IS CONNECTED TO THE EXISTING WATER MAIN SYSTEM THAT IS PROPOSED TO BE ABANDONED.

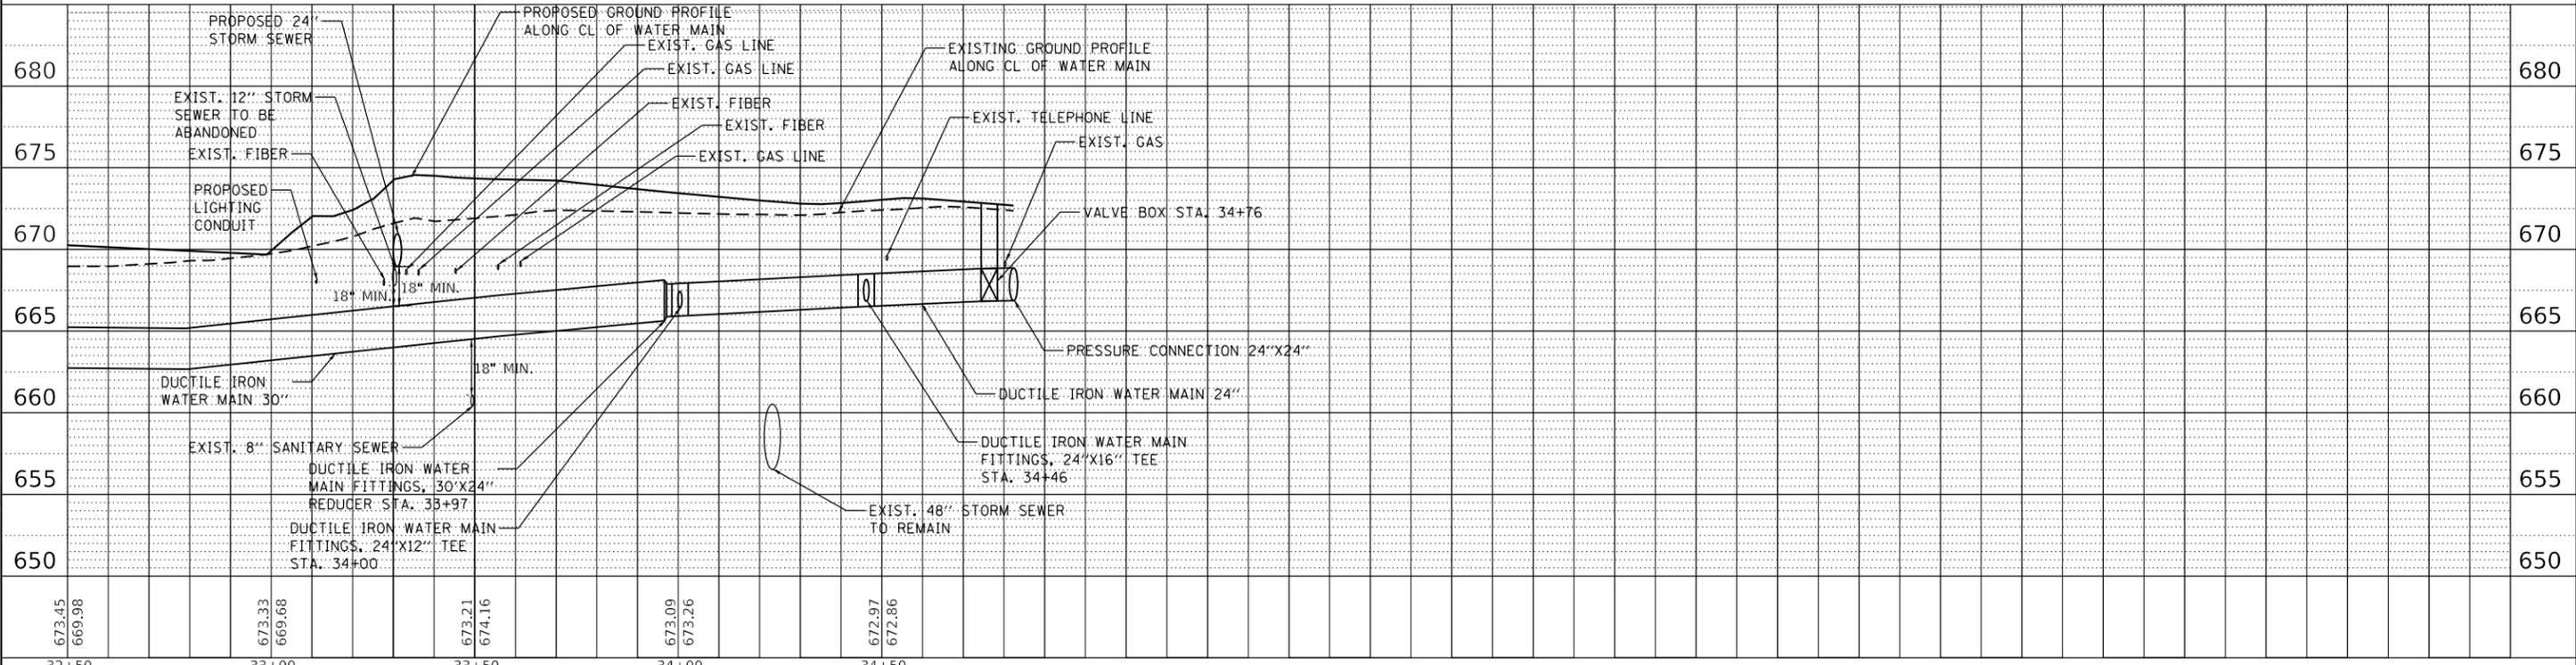

USER NAME	= brooke.henry	DESIGNED -	BNH	REVISED -	
		DRAWN -	BNH	REVISED -	
PLOT SCALE	= 40.0000' / in.	CHECKED -	PSA	REVISED -	
PLOT DATE	= 10/22/2021	DATE	= 10/22/2021	REVISED -	

STATE OF ILLINOIS  
 DEPARTMENT OF TRANSPORTATION


WATER MAIN RELOCATION PLAN AND SANITARY SEWER ADJUSTMENTS  
 WATER MAIN PLAN AND PROFILE

SCALE: 1"=20' SHEET 10 OF 31 SHEETS STA. 32+50 TO STA. 32+82

F.A.U. RTE.	SECTION	COUNTY	TOTAL SHEETS	SHEET NO.
7448	09-00933-01-BR	MACON	1019	522
CONTRACT NO. 95893				
ILLINOIS FED. AID PROJECT				



MATCH LINE STA 73+61 (ROADWAY)  
SEE WATER MAIN KEY MAP PLAN VIEW NO. 5

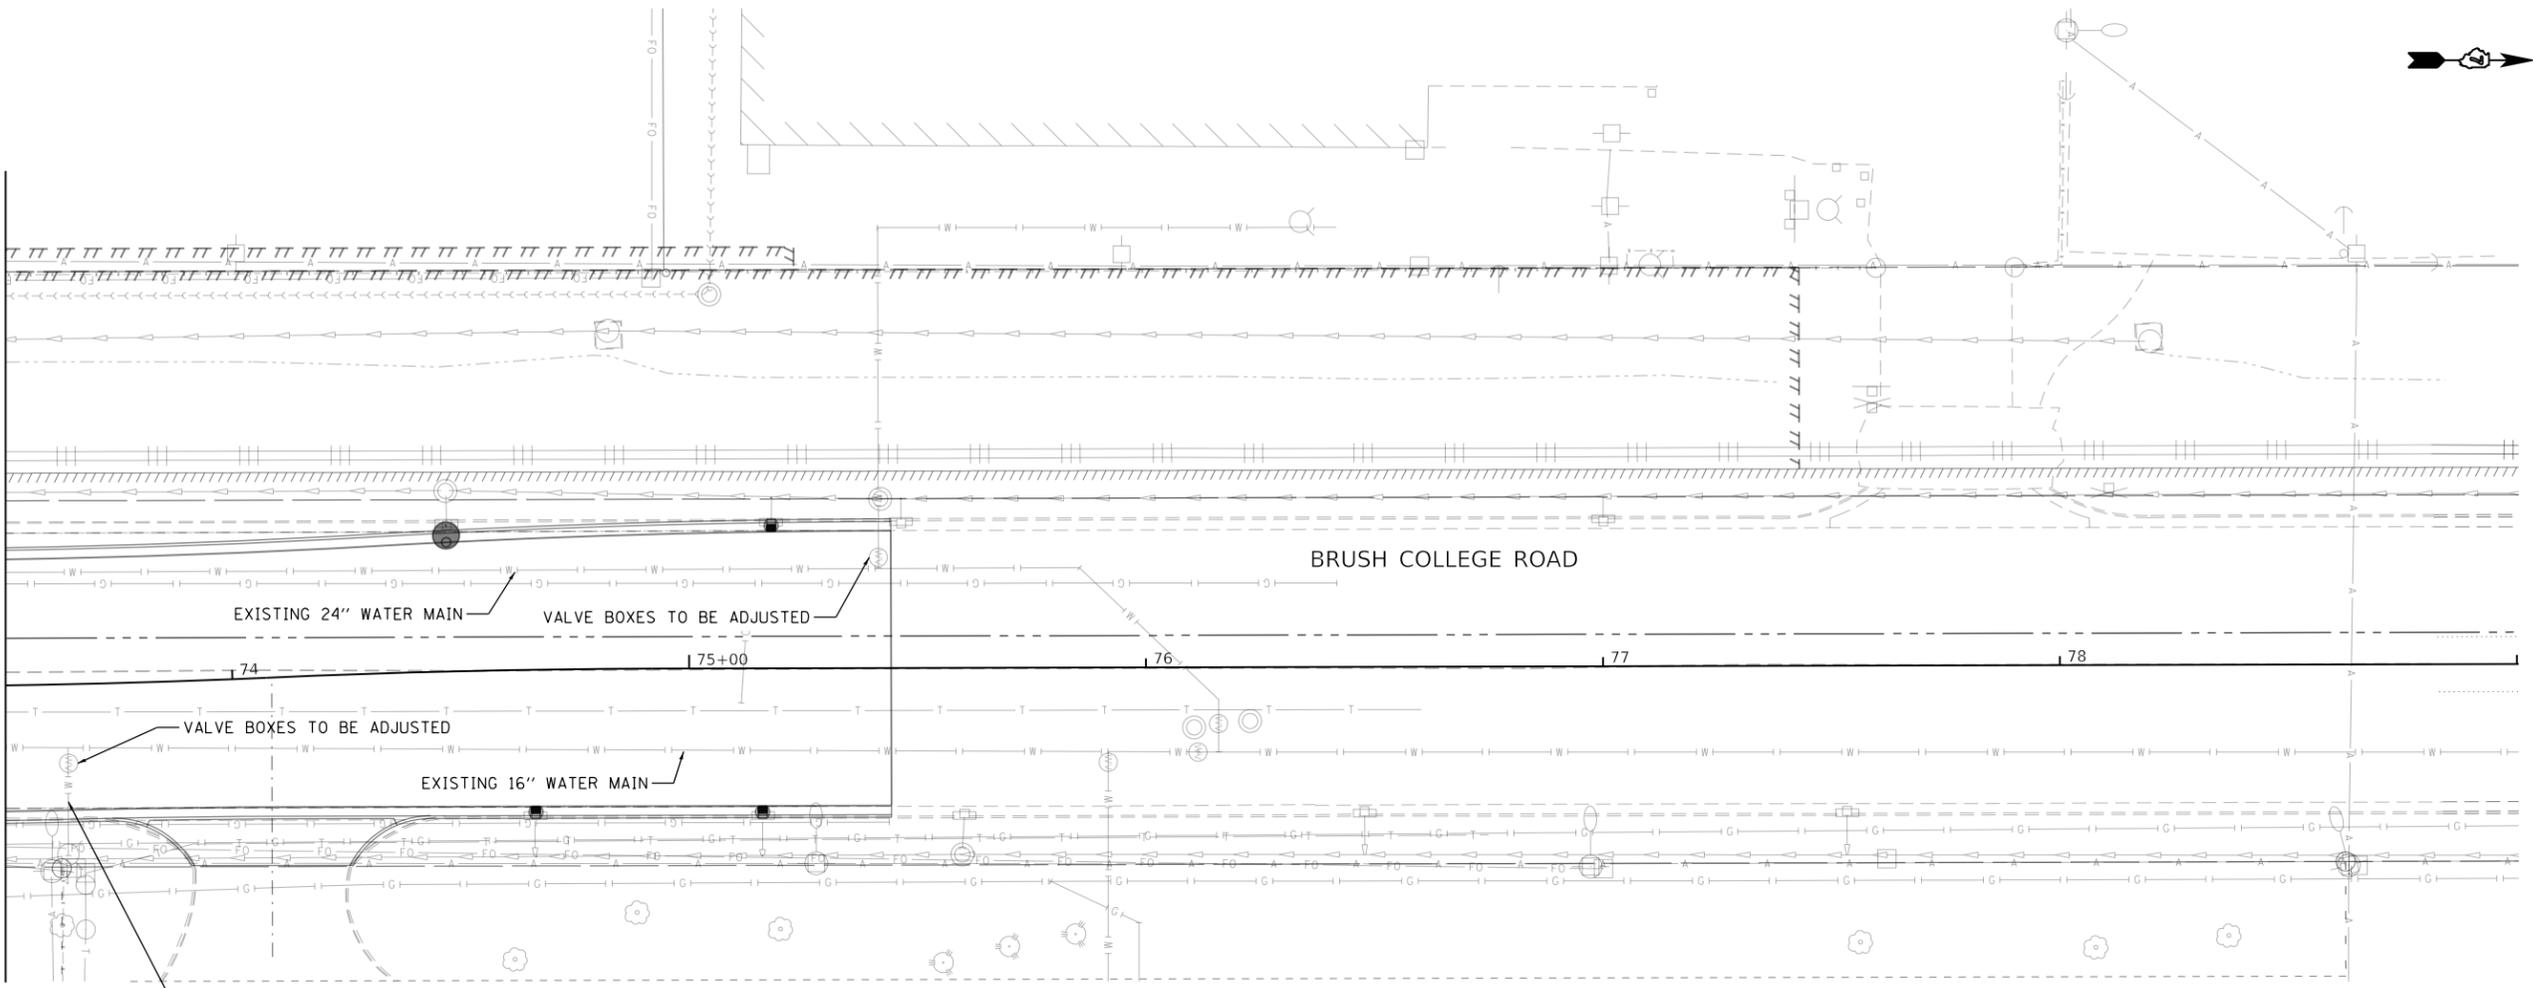

REFER TO ADVANCE CUSTOMER  
COORDINATION NOTES ON THE  
WATER MAIN PHASING PLAN  
SHEETS

WATER MAIN KEY MAP PLAN VIEW NO. 6



MODEL: Default  
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PLOT DATE = 10/27/2021


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DRAWN - BNH  
CHECKED - PSA  
DATE - 10/22/2021

REVISED -  
REVISED -  
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REVISED -

STATE OF ILLINOIS  
DEPARTMENT OF TRANSPORTATION


WATER MAIN RELOCATION PLAN AND SANITARY SEWER ADJUSTMENTS  
WATER MAIN PLAN  
SCALE: 1"=20' SHEET 11 OF 31 SHEETS STA. 73+61 TO STA.

F.A.U. RTE. 7448	SECTION 09-00933-01-BR	COUNTY MACON	TOTAL SHEETS 1019	SHEET NO. 523
CONTRACT NO. 95893				
ILLINOIS FED. AID PROJECT				

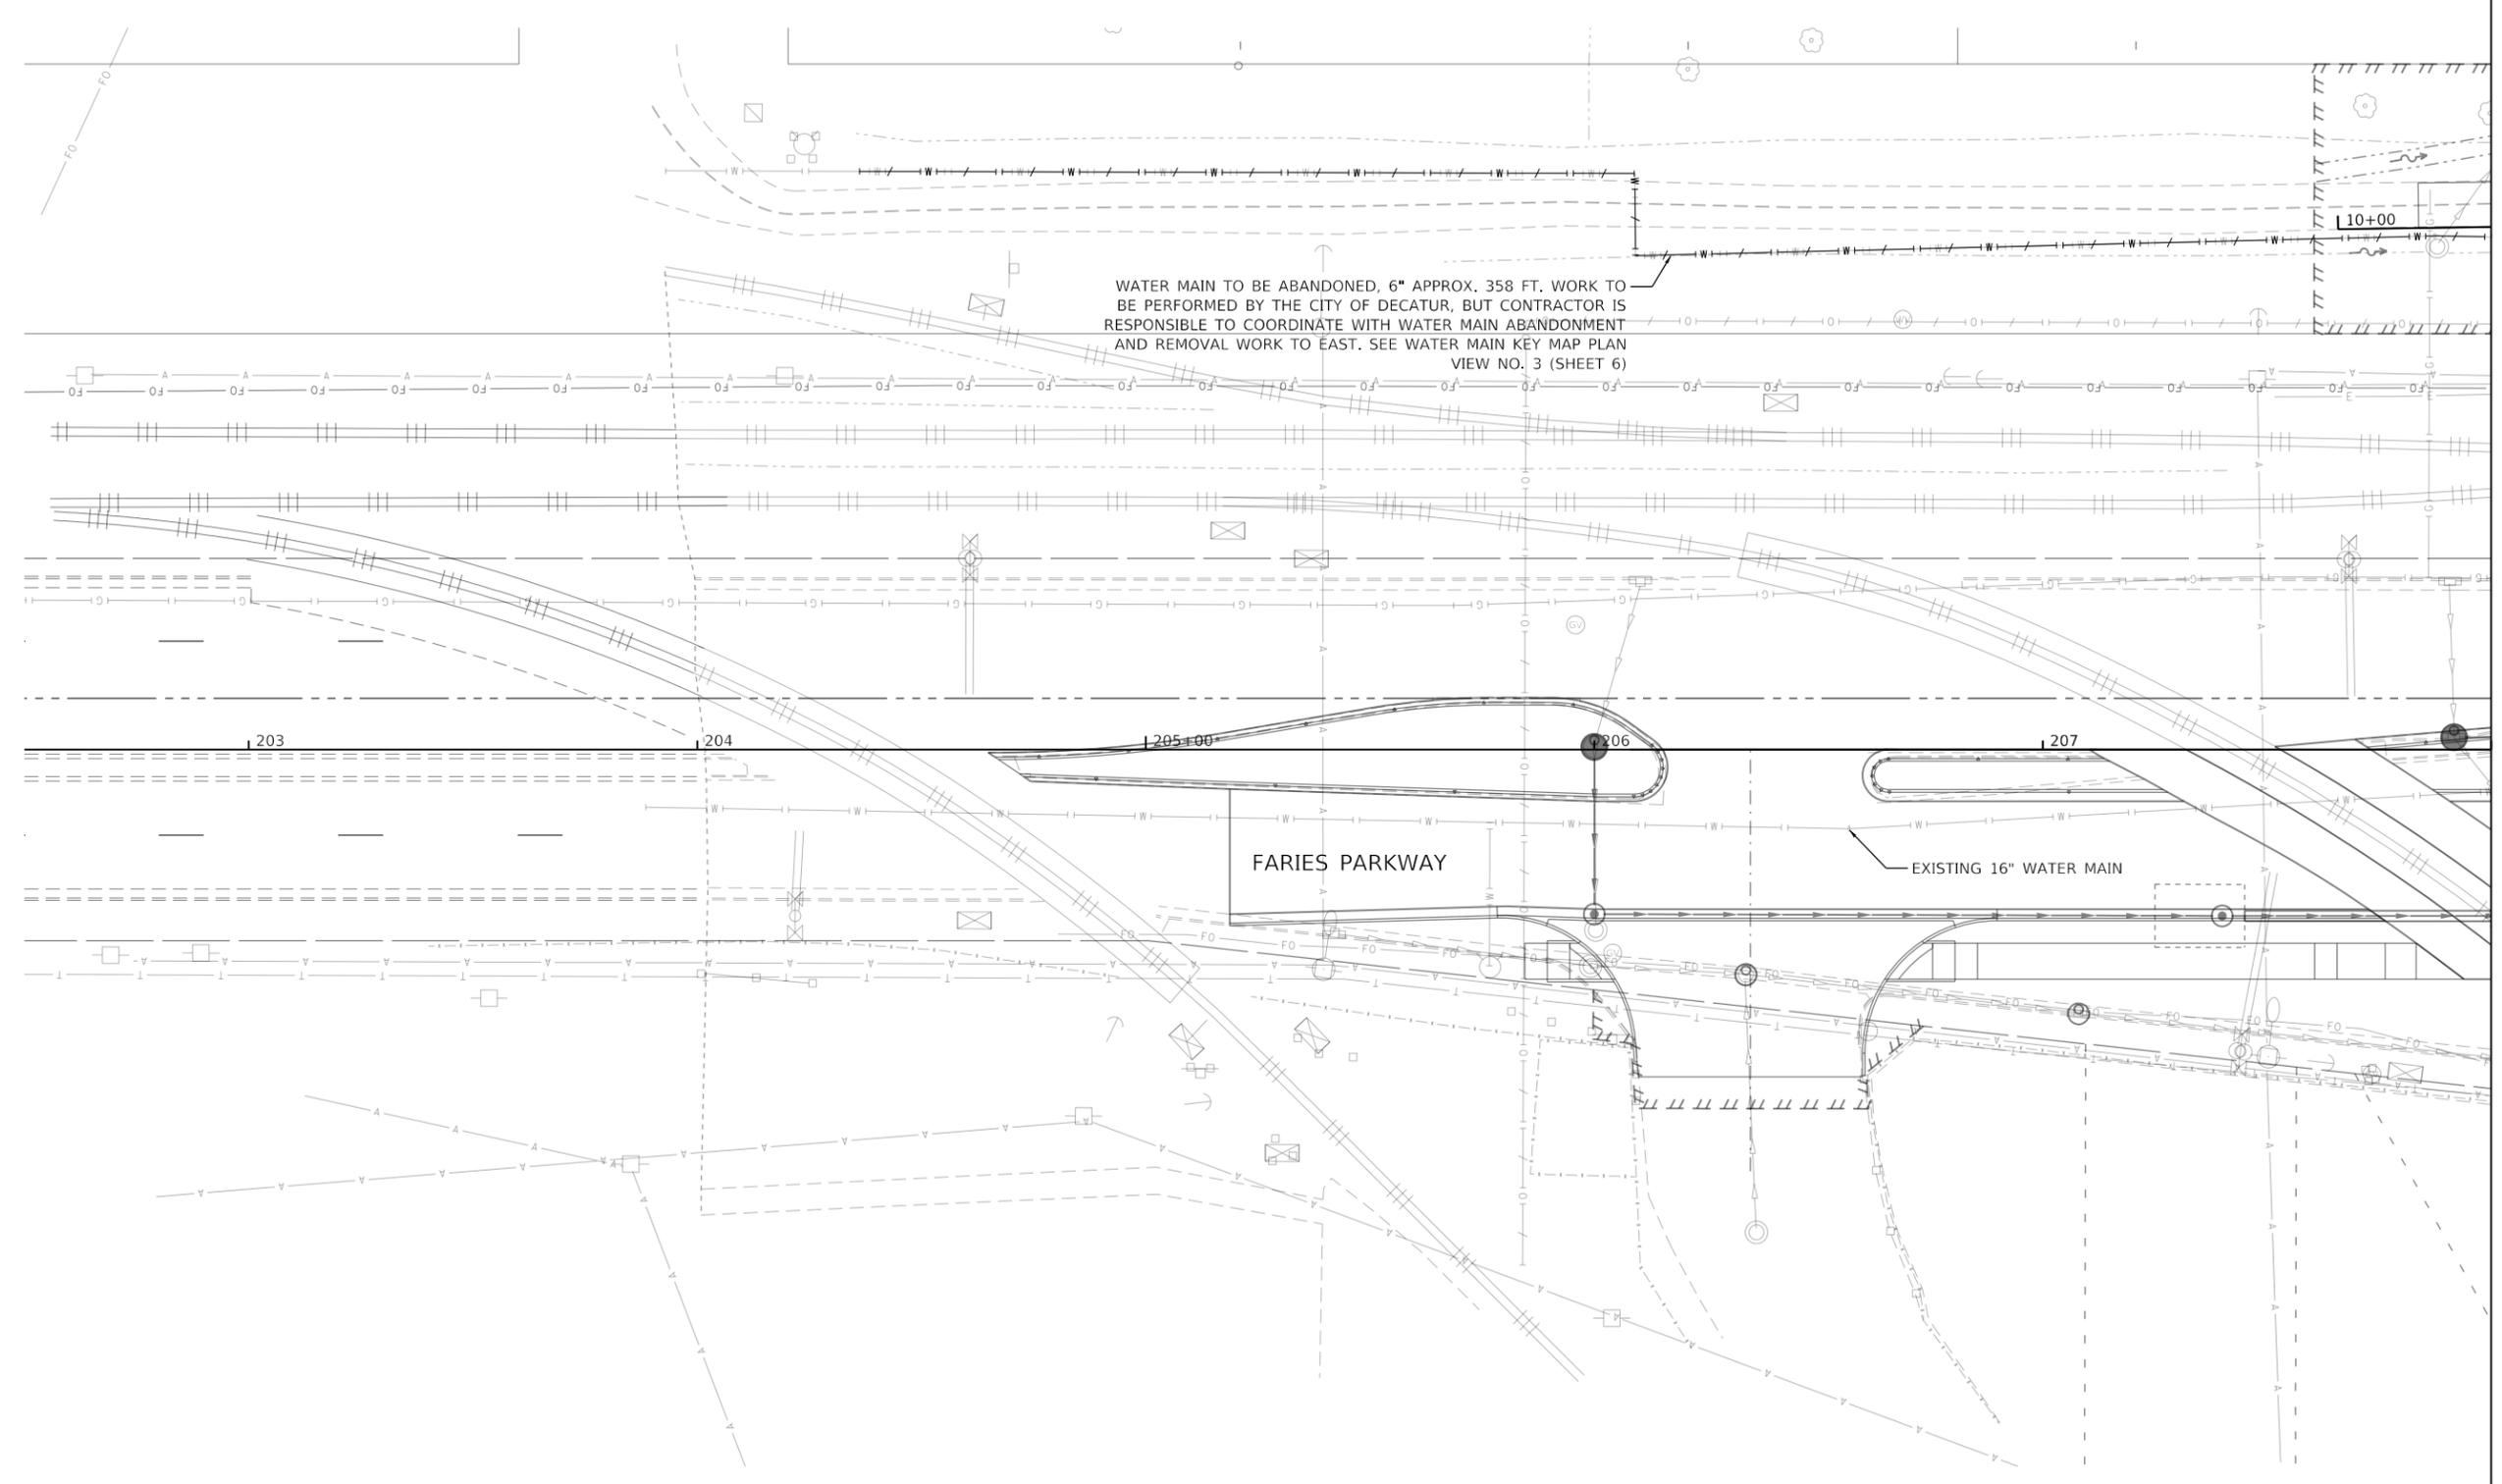

MATCH LINE STA 208+00 (ROADWAY)  
SEE WATER MAIN KEY MAP PLAN VIEW NO. 8

WATER MAIN KEY MAP PLAN VIEW NO. 7

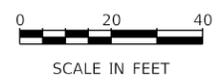

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USER NAME = brooke,henry
PLOT SCALE = 40.0000' / in.
PLOT DATE = 10/27/2021

DESIGNED - BNH	REVISOR -
DRAWN - BNH	REVISION -
CHECKED - PSA	REVISION -
DATE - 10/22/2021	REVISION -

STATE OF ILLINOIS  
DEPARTMENT OF TRANSPORTATION

WATER MAIN RELOCATION PLAN AND SANITARY SEWER ADJUSTMENTS  
WATER MAIN PLAN

SCALE: 1"=20' SHEET 12 OF 31 SHEETS STA. 202+50 TO STA. 208+00


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7448	09-00933-01-BR	MACON	1019	524
CONTRACT NO. 95893				
ILLINOIS FED. AID PROJECT				

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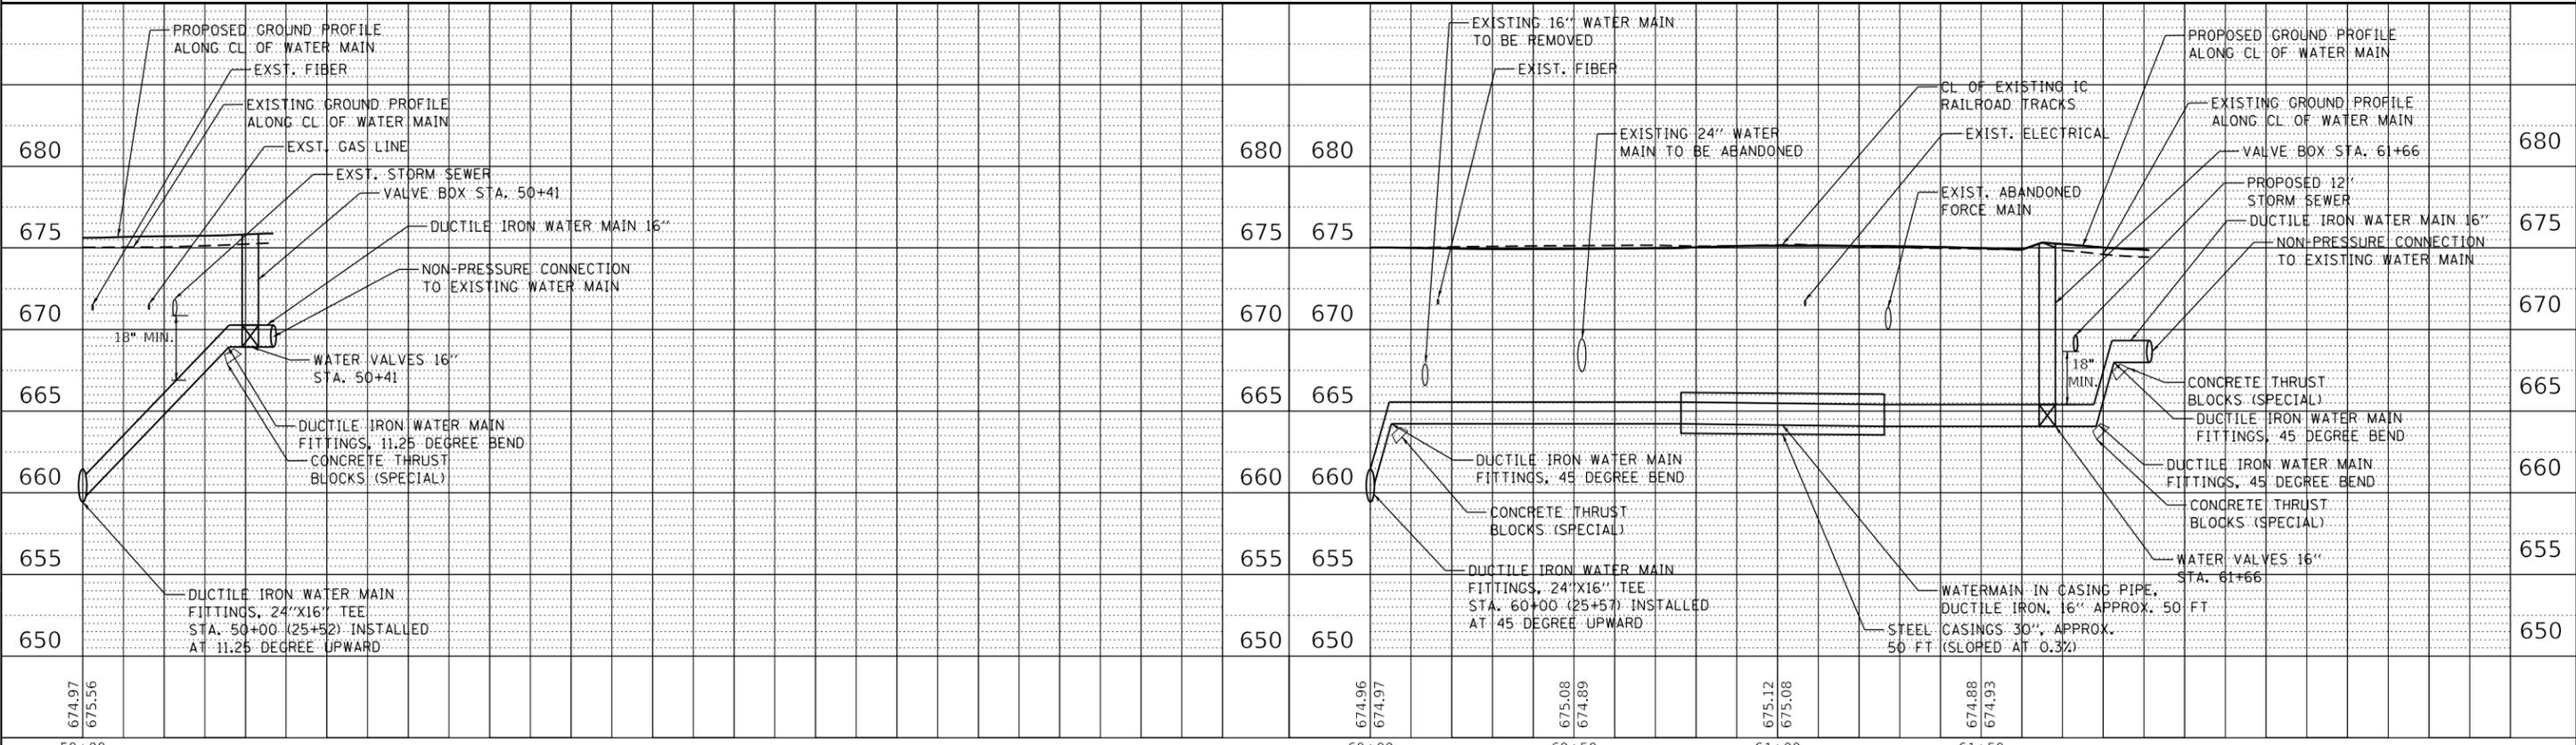
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	BY	
	DATE	

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MATCH LINE STA 208+00 (ROADWAY)  
 SEE WATER MAIN KEY MAP PLAN VIEW NO. 7



MATCH LINE STA 213+25 (ROADWAY)  
 SEE WATER MAIN KEY MAP PLAN VIEW NO. 9

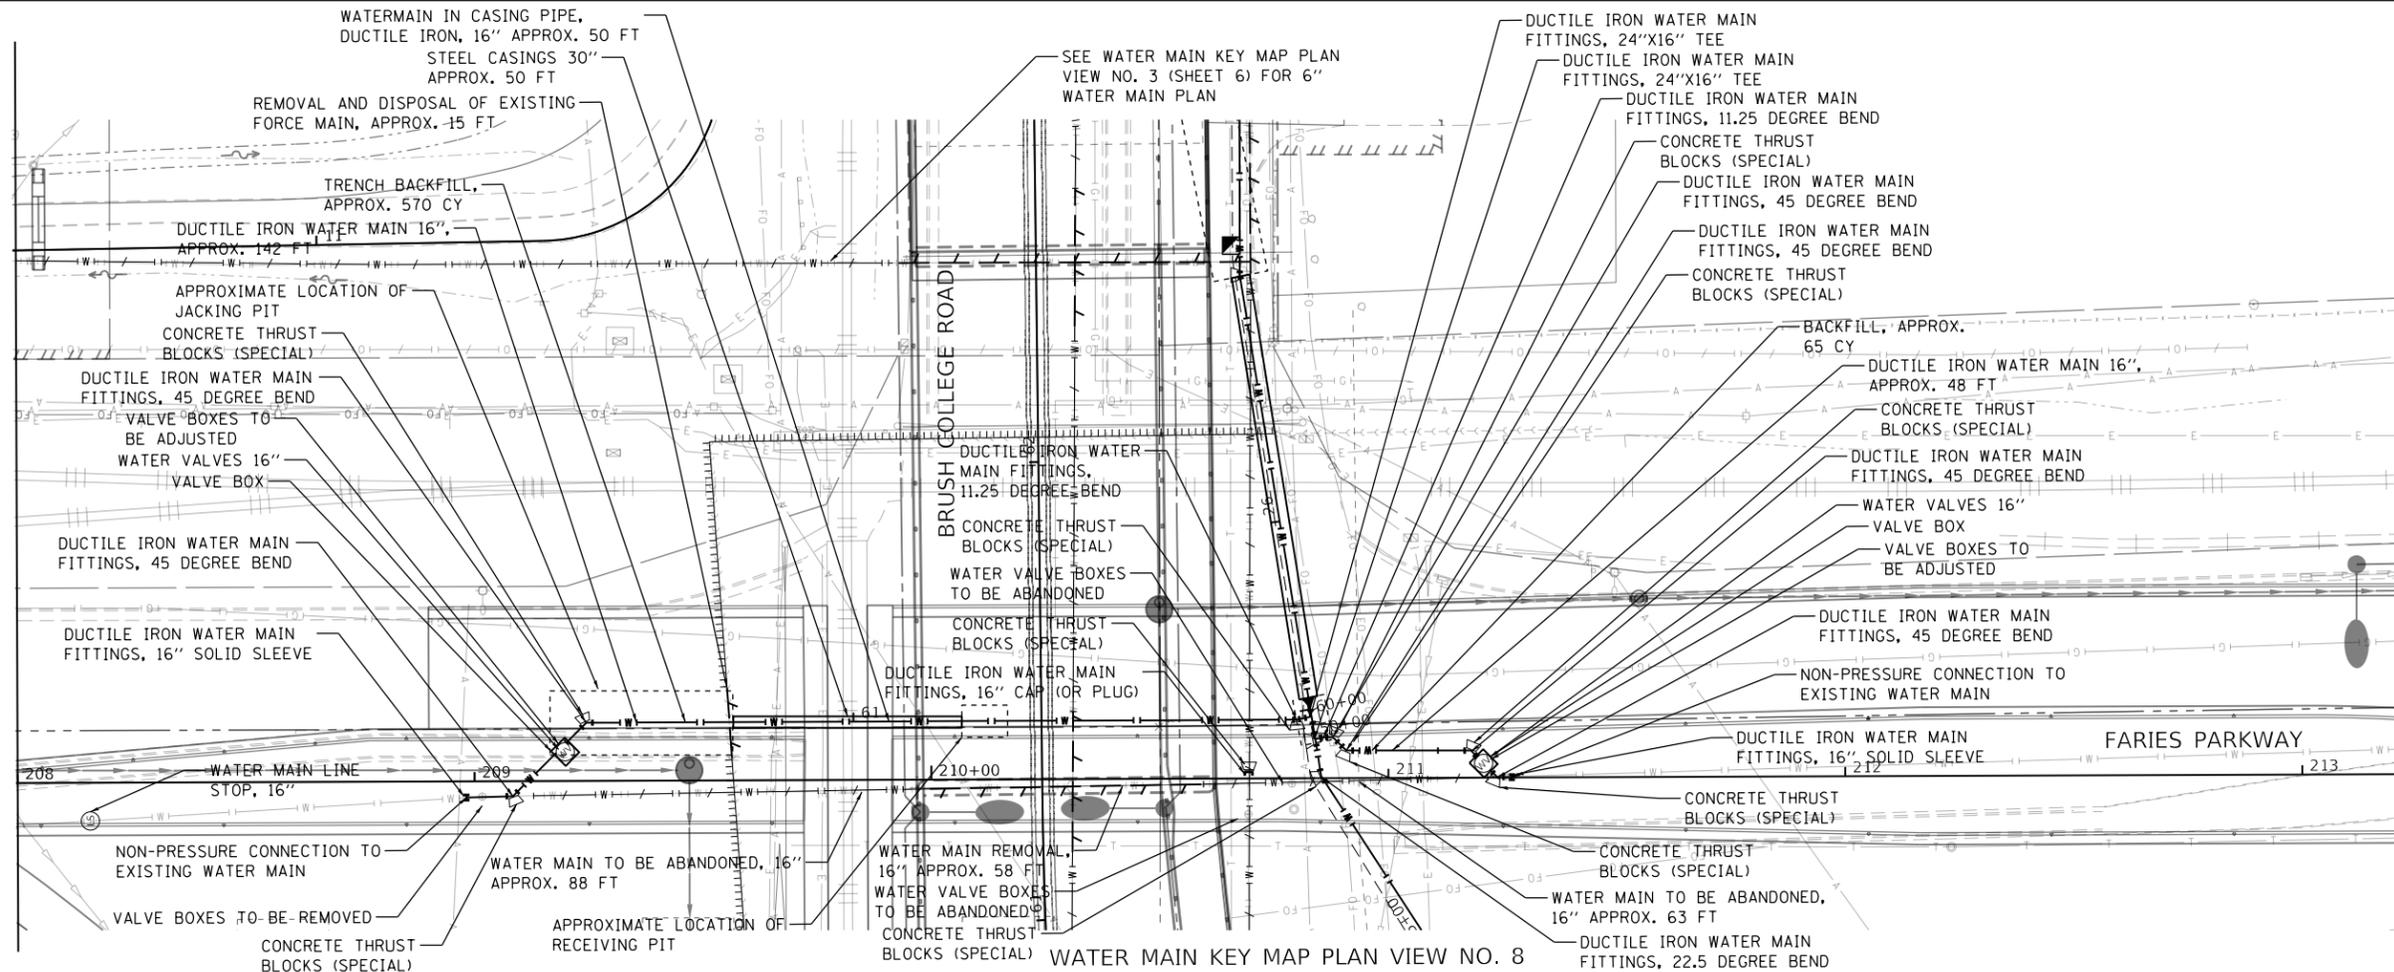

USER NAME	= monica.crinion
DESIGNED	- BNH
REVISD	-
DRAWN	- BNH
REVISD	-
PLOT SCALE	= 40,0000' / in.
CHECKED	- PSA
REVISD	-
PLOT DATE	= 10/29/2021
DATE	= 10/22/2021
REVISD	-

STATE OF ILLINOIS  
 DEPARTMENT OF TRANSPORTATION


WATER MAIN RELOCATION PLAN AND SANITARY SEWER ADJUSTMENTS  
 WATER MAIN PLAN AND PROFILE  
 SCALE: 1"=20' SHEET 13 OF 31 SHEETS STA. 208+00 TO STA. 213+25

F.A.U. RTE.	SECTION	COUNTY	TOTAL SHEETS	SHEET NO.
7448	09-00933-01-BR	MACON	1019	525
CONTRACT NO. 95893				
ILLINOIS FED. AID PROJECT				



MATCH LINE STA 213+25 (ROADWAY)  
SEE WATER MAIN KEY MAP PLAN VIEW NO. 8


MATCH LINE STA 219+00 (ROADWAY)  
SEE WATER MAIN KEY MAP PLAN VIEW NO. 10

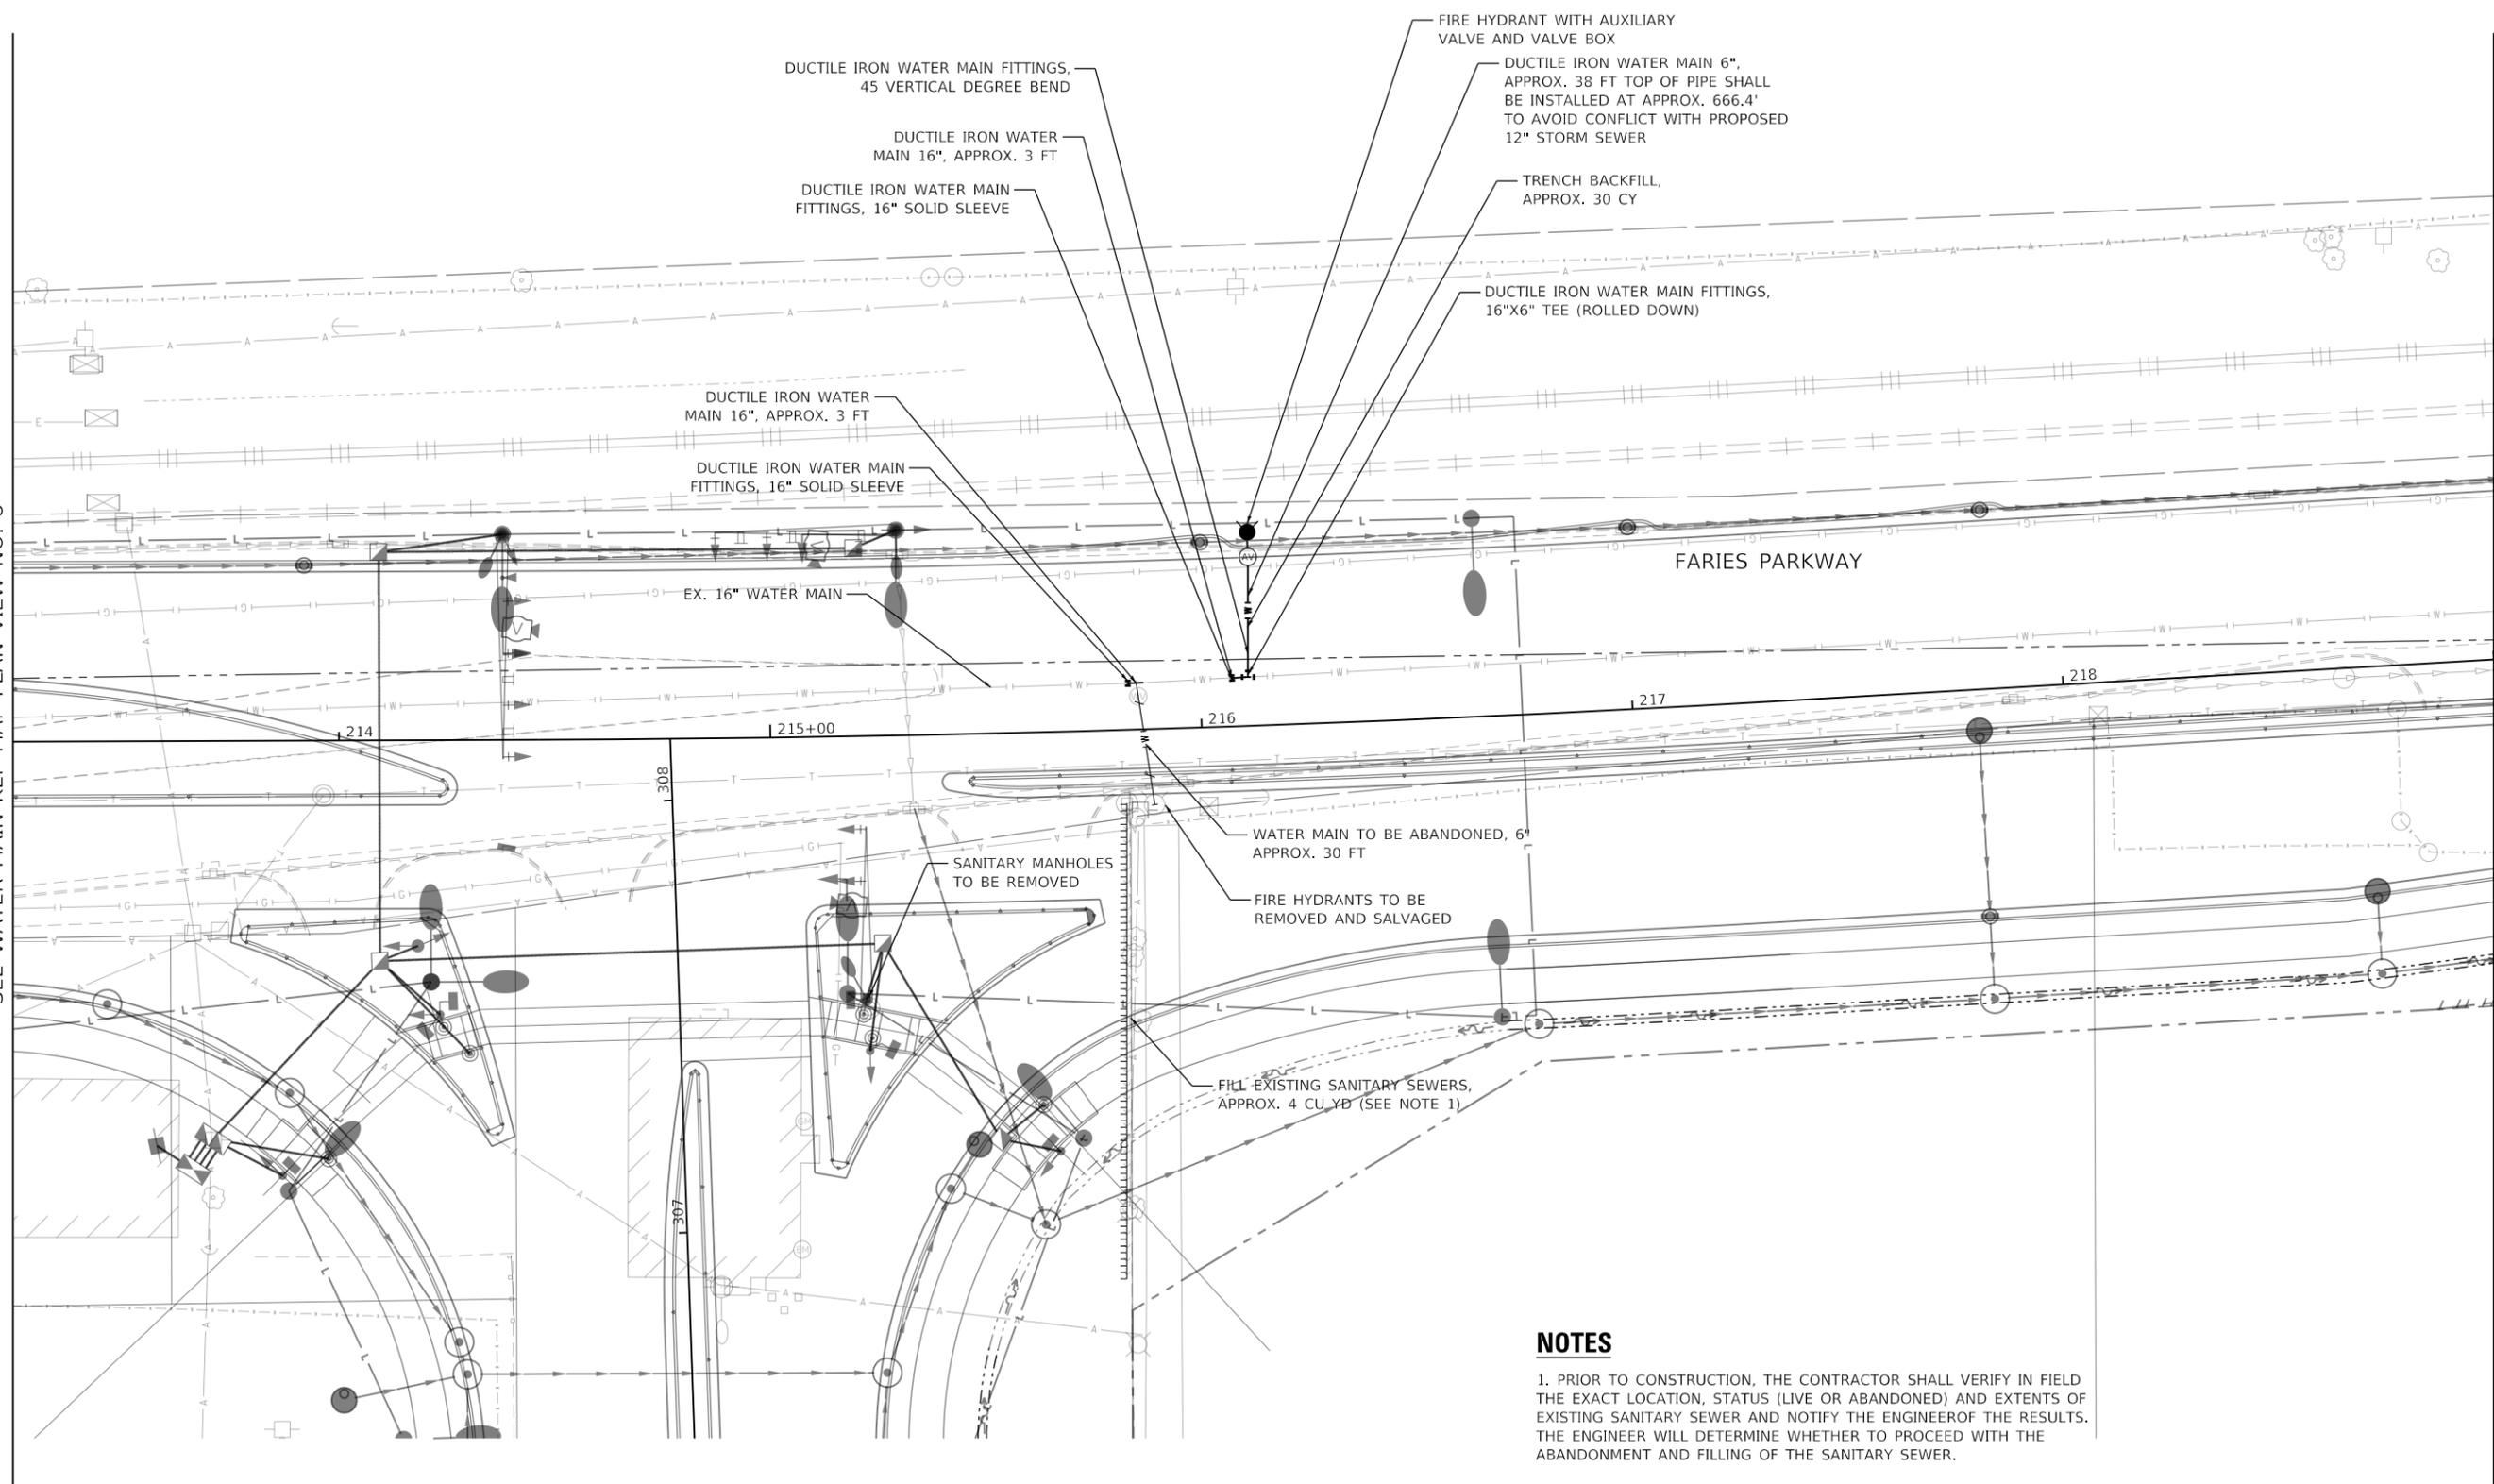

**NOTES**

1. PRIOR TO CONSTRUCTION, THE CONTRACTOR SHALL VERIFY IN FIELD THE EXACT LOCATION, STATUS (LIVE OR ABANDONED) AND EXTENTS OF EXISTING SANITARY SEWER AND NOTIFY THE ENGINEER OF THE RESULTS. THE ENGINEER WILL DETERMINE WHETHER TO PROCEED WITH THE ABANDONMENT AND FILLING OF THE SANITARY SEWER.

WATER MAIN KEY MAP PLAN VIEW NO. 9

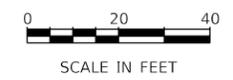

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USER NAME = brooke.henry  
PLOT SCALE = 40.0000 ' / in.  
PLOT DATE = 10/27/2021

DESIGNED - BNH  
DRAWN - BNH  
CHECKED - PSA  
DATE - 10/22/2021

REVISED -  
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REVISED -

**STATE OF ILLINOIS  
DEPARTMENT OF TRANSPORTATION**

**WATER MAIN RELOCATION PLAN AND SANITARY SEWER ADJUSTMENTS**  
**WATER MAIN PLAN**  
SCALE: 1"=20' SHEET 14 OF 31 SHEETS STA. 213+25 TO STA. 219+00


F.A.U. RTE.	SECTION	COUNTY	TOTAL SHEETS	SHEET NO.
7448	09-00933-01-BR	MACON	1019	526
CONTRACT NO. 95893				
ILLINOIS FED. AID PROJECT				

**NOTES**


1. EXISTING SANITARY MANHOLE IS BURIED UNDER EXISTING CONCRETE SLAB. REFER TO SPECIAL PROVISION FOR ADDITIONAL DETAILS. CONTRACTOR SHALL REMOVE THE SLAB AND FIELD VERIFY EXISTING SANITARY MANHOLE INVERT ELEVATIONS.
2. CONFIRM ELEVATION OF EXISTING SANITARY SEWER SERVICE LATERAL. IF THE SEWER CROWN IS NOT LOCATED A MINIMUM OF 18" BELOW THE PROPOSED HYDRANT LEAD INVERT, THEN CONTRACTOR SHALL PERFORM SANITARY SEWER TO BE ADJUSTED WORK (1 EACH) TO MEET IEPA WATER/SEWER SEPARATION REQUIREMENTS. PAYMENT WILL BE IN ACCORDANCE WITH THE SPECIAL PROVISIONS.
3. THE EXACT ELEVATION OF THE EXISTING 4" DIAMETER WATER SERVICE MAIN IS UNKNOWN. HOWEVER, AS A RESULT OF THE PROPOSED GRADING CHANGES OVER THE EXISTING PIPE, IT IS ASSUMED THAT MINIMUM BURY DEPTH REQUIREMENTS CANNOT BE MET (I.E. 3.5' OF COVER), AND THEREFORE THE PIPE WILL NEED TO BE RELOCATED IN ORDER TO ACHIEVE THE SPECIFIED BURY DEPTH. HOWEVER, A MINIMUM OF 2 WEEKS PRIOR TO ANY PROPOSED WORK, THE CONTRACTOR SHALL CONFIRM THE NEED AND EXACT LIMITS OF CONSTRUCTION WITH THE ENGINEER. REFER ALSO TO ADVANCE CUSTOMER COORDINATION NOTES ON THE WATER MAIN PHASING PLAN SHEETS.
4. CONTRACTOR SHALL FIELD VERIFY THE ELEVATION OF EXISTING 8" DIAMETER SANITARY SEWER TO DETERMINE IF A CONFLICT EXISTS WITH THE PROPOSED STORM SEWER. THE CONTRACTOR SHALL NOTIFY THE ENGINEER OF THE RESULTS A MINIMUM OF 4 WEEKS IN ADVANCE OF CONSTRUCTION. AT THE ENGINEER'S DIRECTION AND IF REQUIRED FOR CONSTRUCTION, THE CONTRACTOR MAY BE DIRECTED TO UTILIZE THE FOLLOWING SPECIAL PROVISIONS IN ORDER TO AVOID A CONFLICT.  
 -SANITARY SEWER REMOVAL AND REPLACEMENT 8"  
 -MANHOLES, SANITARY, 4'-DIAMETER, TYPE 1 FRAME, CLOSED LID

MATCH LINE STA 219+00 (ROADWAY)  
SEE WATER MAIN KEY MAP PLAN VIEW NO. 9

MATCH LINE STA 224+75 (ROADWAY)  
SEE WATER MAIN KEY MAP PLAN VIEW NO. 11

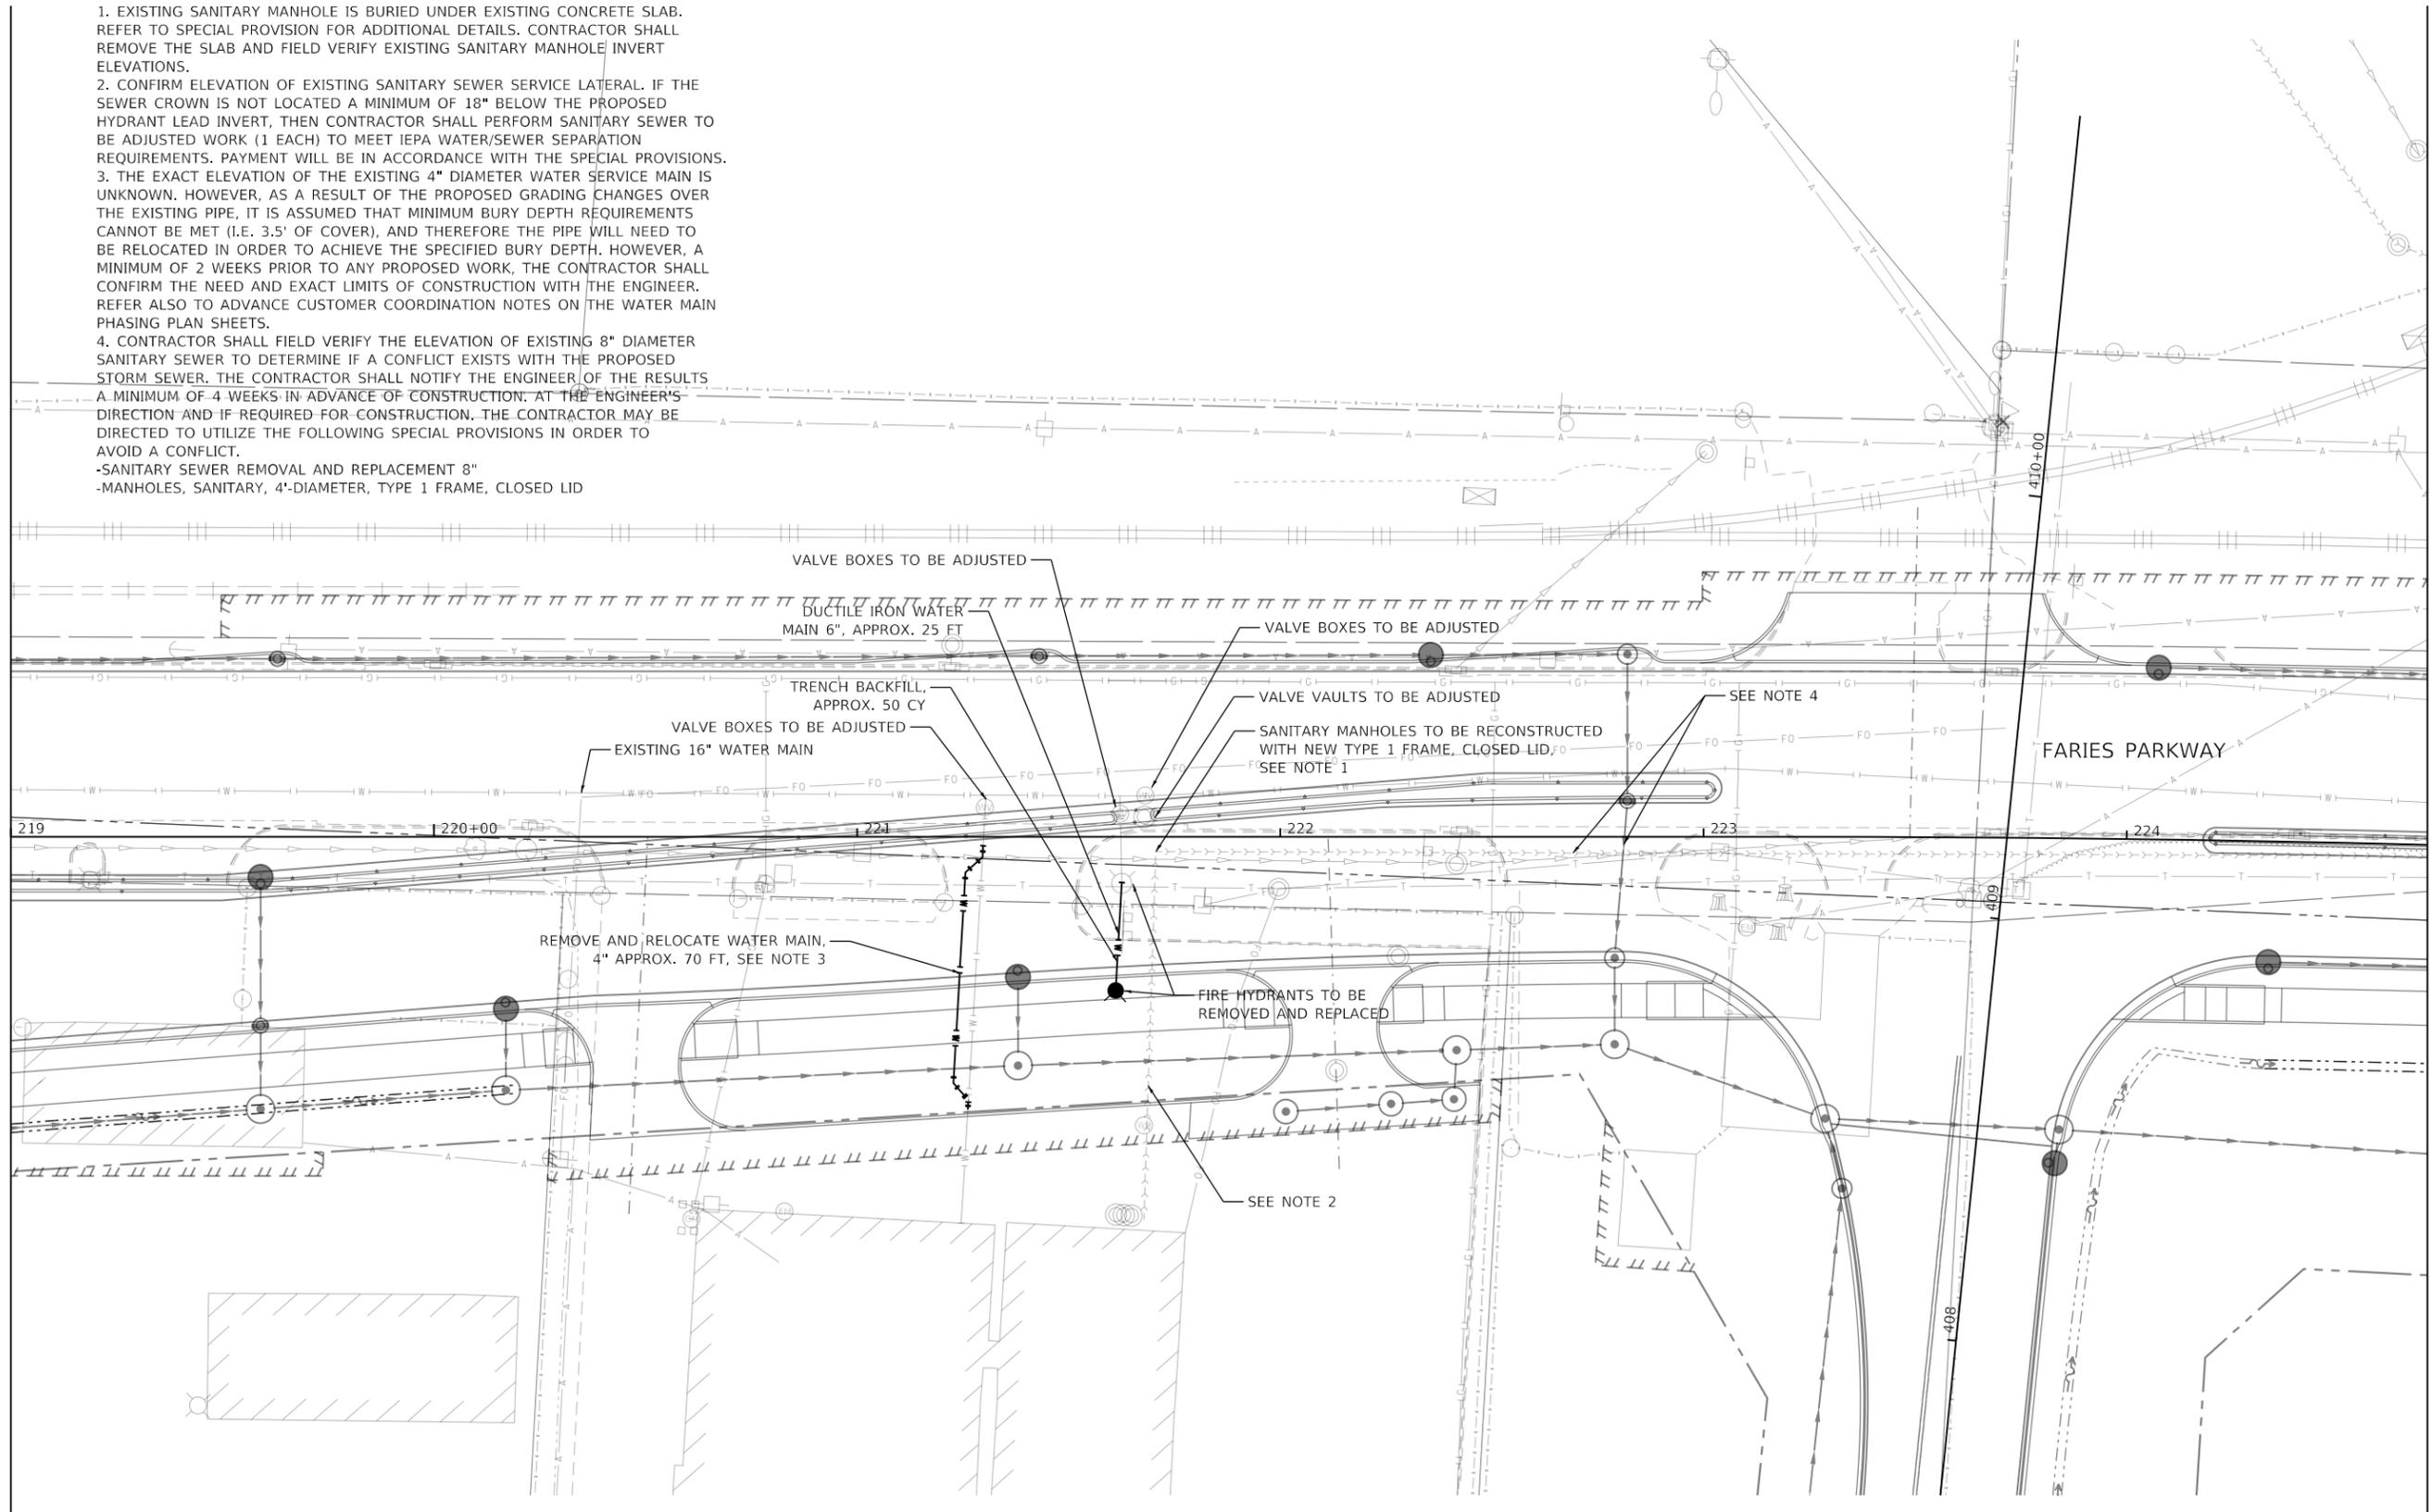

WATER MAIN KEY MAP PLAN VIEW NO. 10

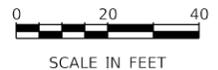

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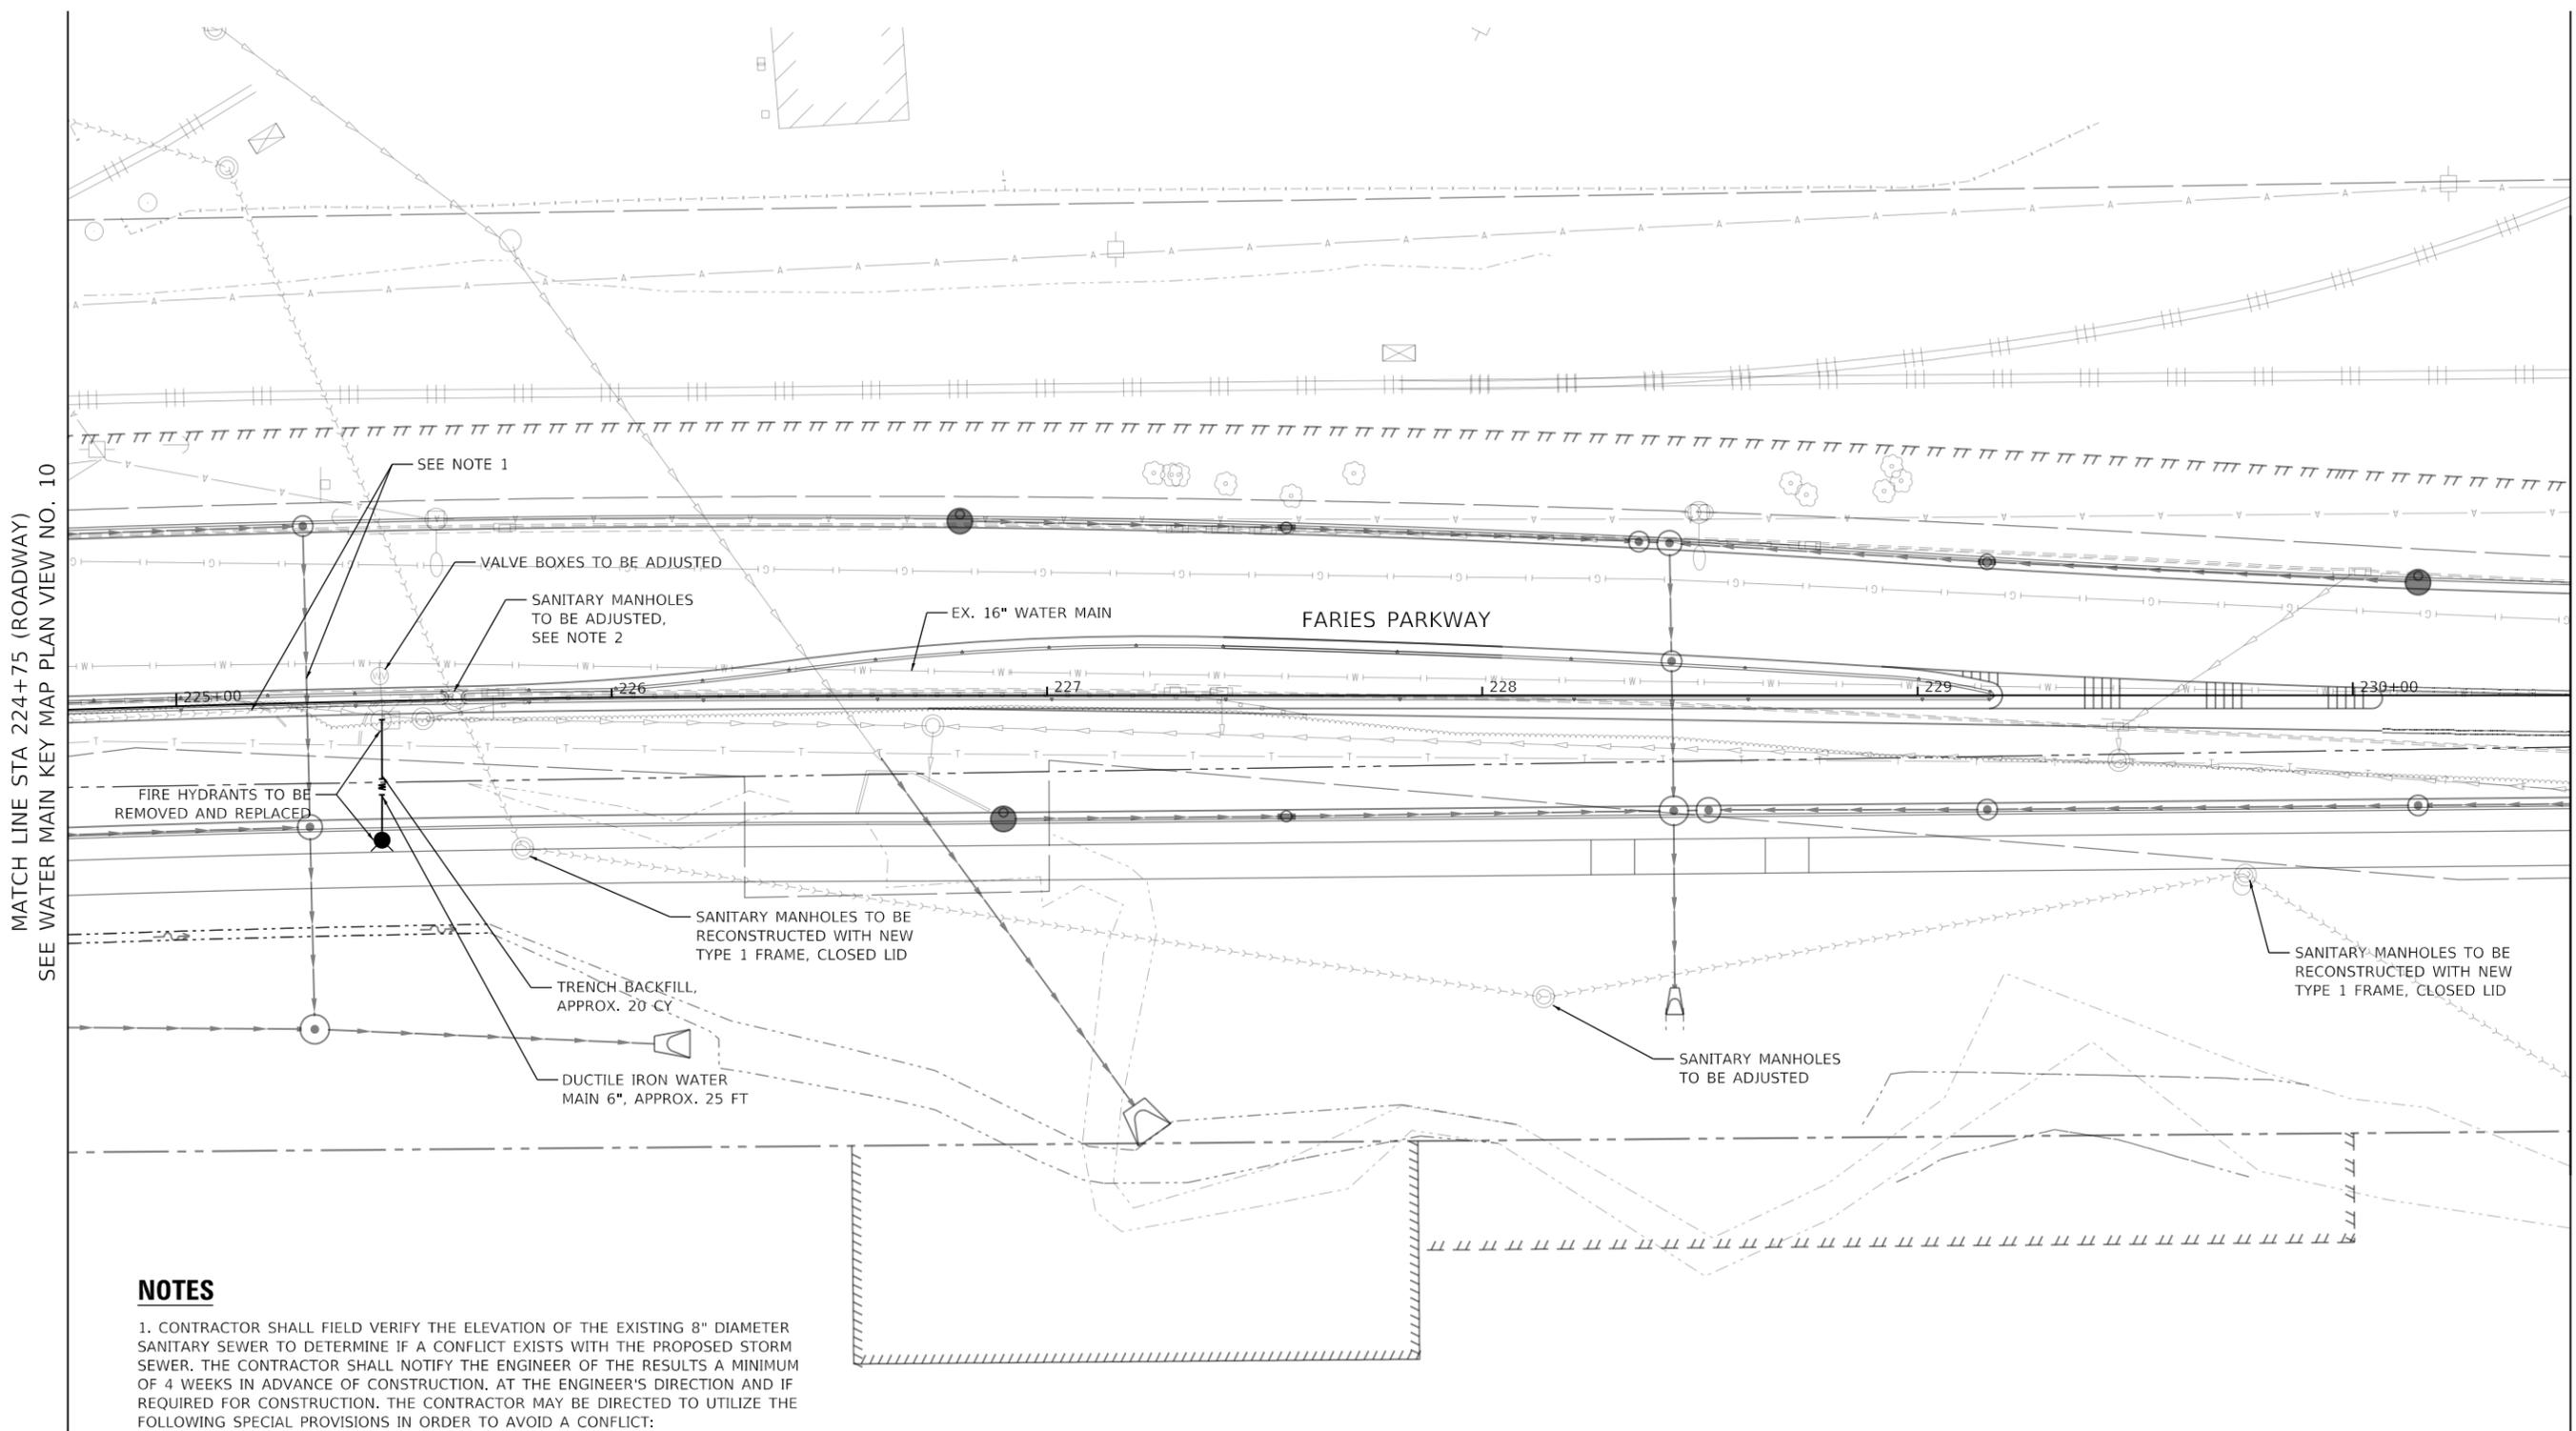


USER NAME = brooke,henry	DESIGNED - BNH	REVISED -
PLOT SCALE = 40,0000 ' / in.	DRAWN - BNH	REVISED -
PLOT DATE = 10/27/2021	CHECKED - PSA	REVISED -
	DATE - 10/22/2021	REVISED -

**STATE OF ILLINOIS  
DEPARTMENT OF TRANSPORTATION**

**WATER MAIN RELOCATION PLAN AND SANITARY SEWER ADJUSTMENTS**  
**WATER MAIN PLAN**  
 SCALE: 1"=20' SHEET 15 OF 31 SHEETS STA. 219+00 TO STA. 224+75

F.A.U. RTE. 7448	SECTION 09-00933-01-BR	COUNTY MACON	TOTAL SHEETS 1019	SHEET NO. 527
CONTRACT NO. 95893				
ILLINOIS FED. AID PROJECT				




MATCH LINE STA 224+75 (ROADWAY)  
SEE WATER MAIN KEY MAP PLAN VIEW NO. 10

MATCH LINE STA 230+50 (ROADWAY)  
SEE WATER MAIN KEY MAP PLAN VIEW NO. 12

**NOTES**

1. CONTRACTOR SHALL FIELD VERIFY THE ELEVATION OF THE EXISTING 8" DIAMETER SANITARY SEWER TO DETERMINE IF A CONFLICT EXISTS WITH THE PROPOSED STORM SEWER. THE CONTRACTOR SHALL NOTIFY THE ENGINEER OF THE RESULTS A MINIMUM OF 4 WEEKS IN ADVANCE OF CONSTRUCTION. AT THE ENGINEER'S DIRECTION AND IF REQUIRED FOR CONSTRUCTION, THE CONTRACTOR MAY BE DIRECTED TO UTILIZE THE FOLLOWING SPECIAL PROVISIONS IN ORDER TO AVOID A CONFLICT:
  - SANITARY SEWER REMOVAL AND REPLACEMENT
  - MANHOLES, SANITARY, 4'-DIAMETER, TYPE 1 FRAME, CLOSED LID
2. EXISTING SANITARY MANHOLE RIM ELEVATION = 659.21' (APPROX.)  
EXISTING 8" SANITARY INVERT ELEVATION TO WEST = 652.57' (APPROX.)

WATER MAIN KEY MAP PLAN VIEW NO. 11

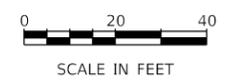

MODEL: Default  
FILE NAME: p:\aecom\m-pw-bentley.com\AECOM\_051\A\Documents\60603202-Brush\College006-CAD GIS09\_10\_CAD\03\_SHEETS\10\_LA\AECOM\Watermain\60603202\_WW\_KEYMAP\_SEC\_11




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PLOT SCALE = 40.0000 ' / in.	DRAWN - BNH	REVISED -
PLOT DATE = 10/27/2021	CHECKED - PSA	REVISED -
	DATE - 10/22/2021	REVISED -

**STATE OF ILLINOIS  
DEPARTMENT OF TRANSPORTATION**

**WATER MAIN RELOCATION PLAN AND SANITARY SEWER ADJUSTMENTS  
WATER MAIN AND SANITARY SEWER PLAN**

SCALE: 1"=20'    SHEET 16 OF 31 SHEETS    STA. 224+75 TO STA. 230+50

F.A.U. RTE.	SECTION	COUNTY	TOTAL SHEETS	SHEET NO.
7448	09-00933-01-BR	MACON	1019	528
CONTRACT NO. 95893				
ILLINOIS FED. AID PROJECT				

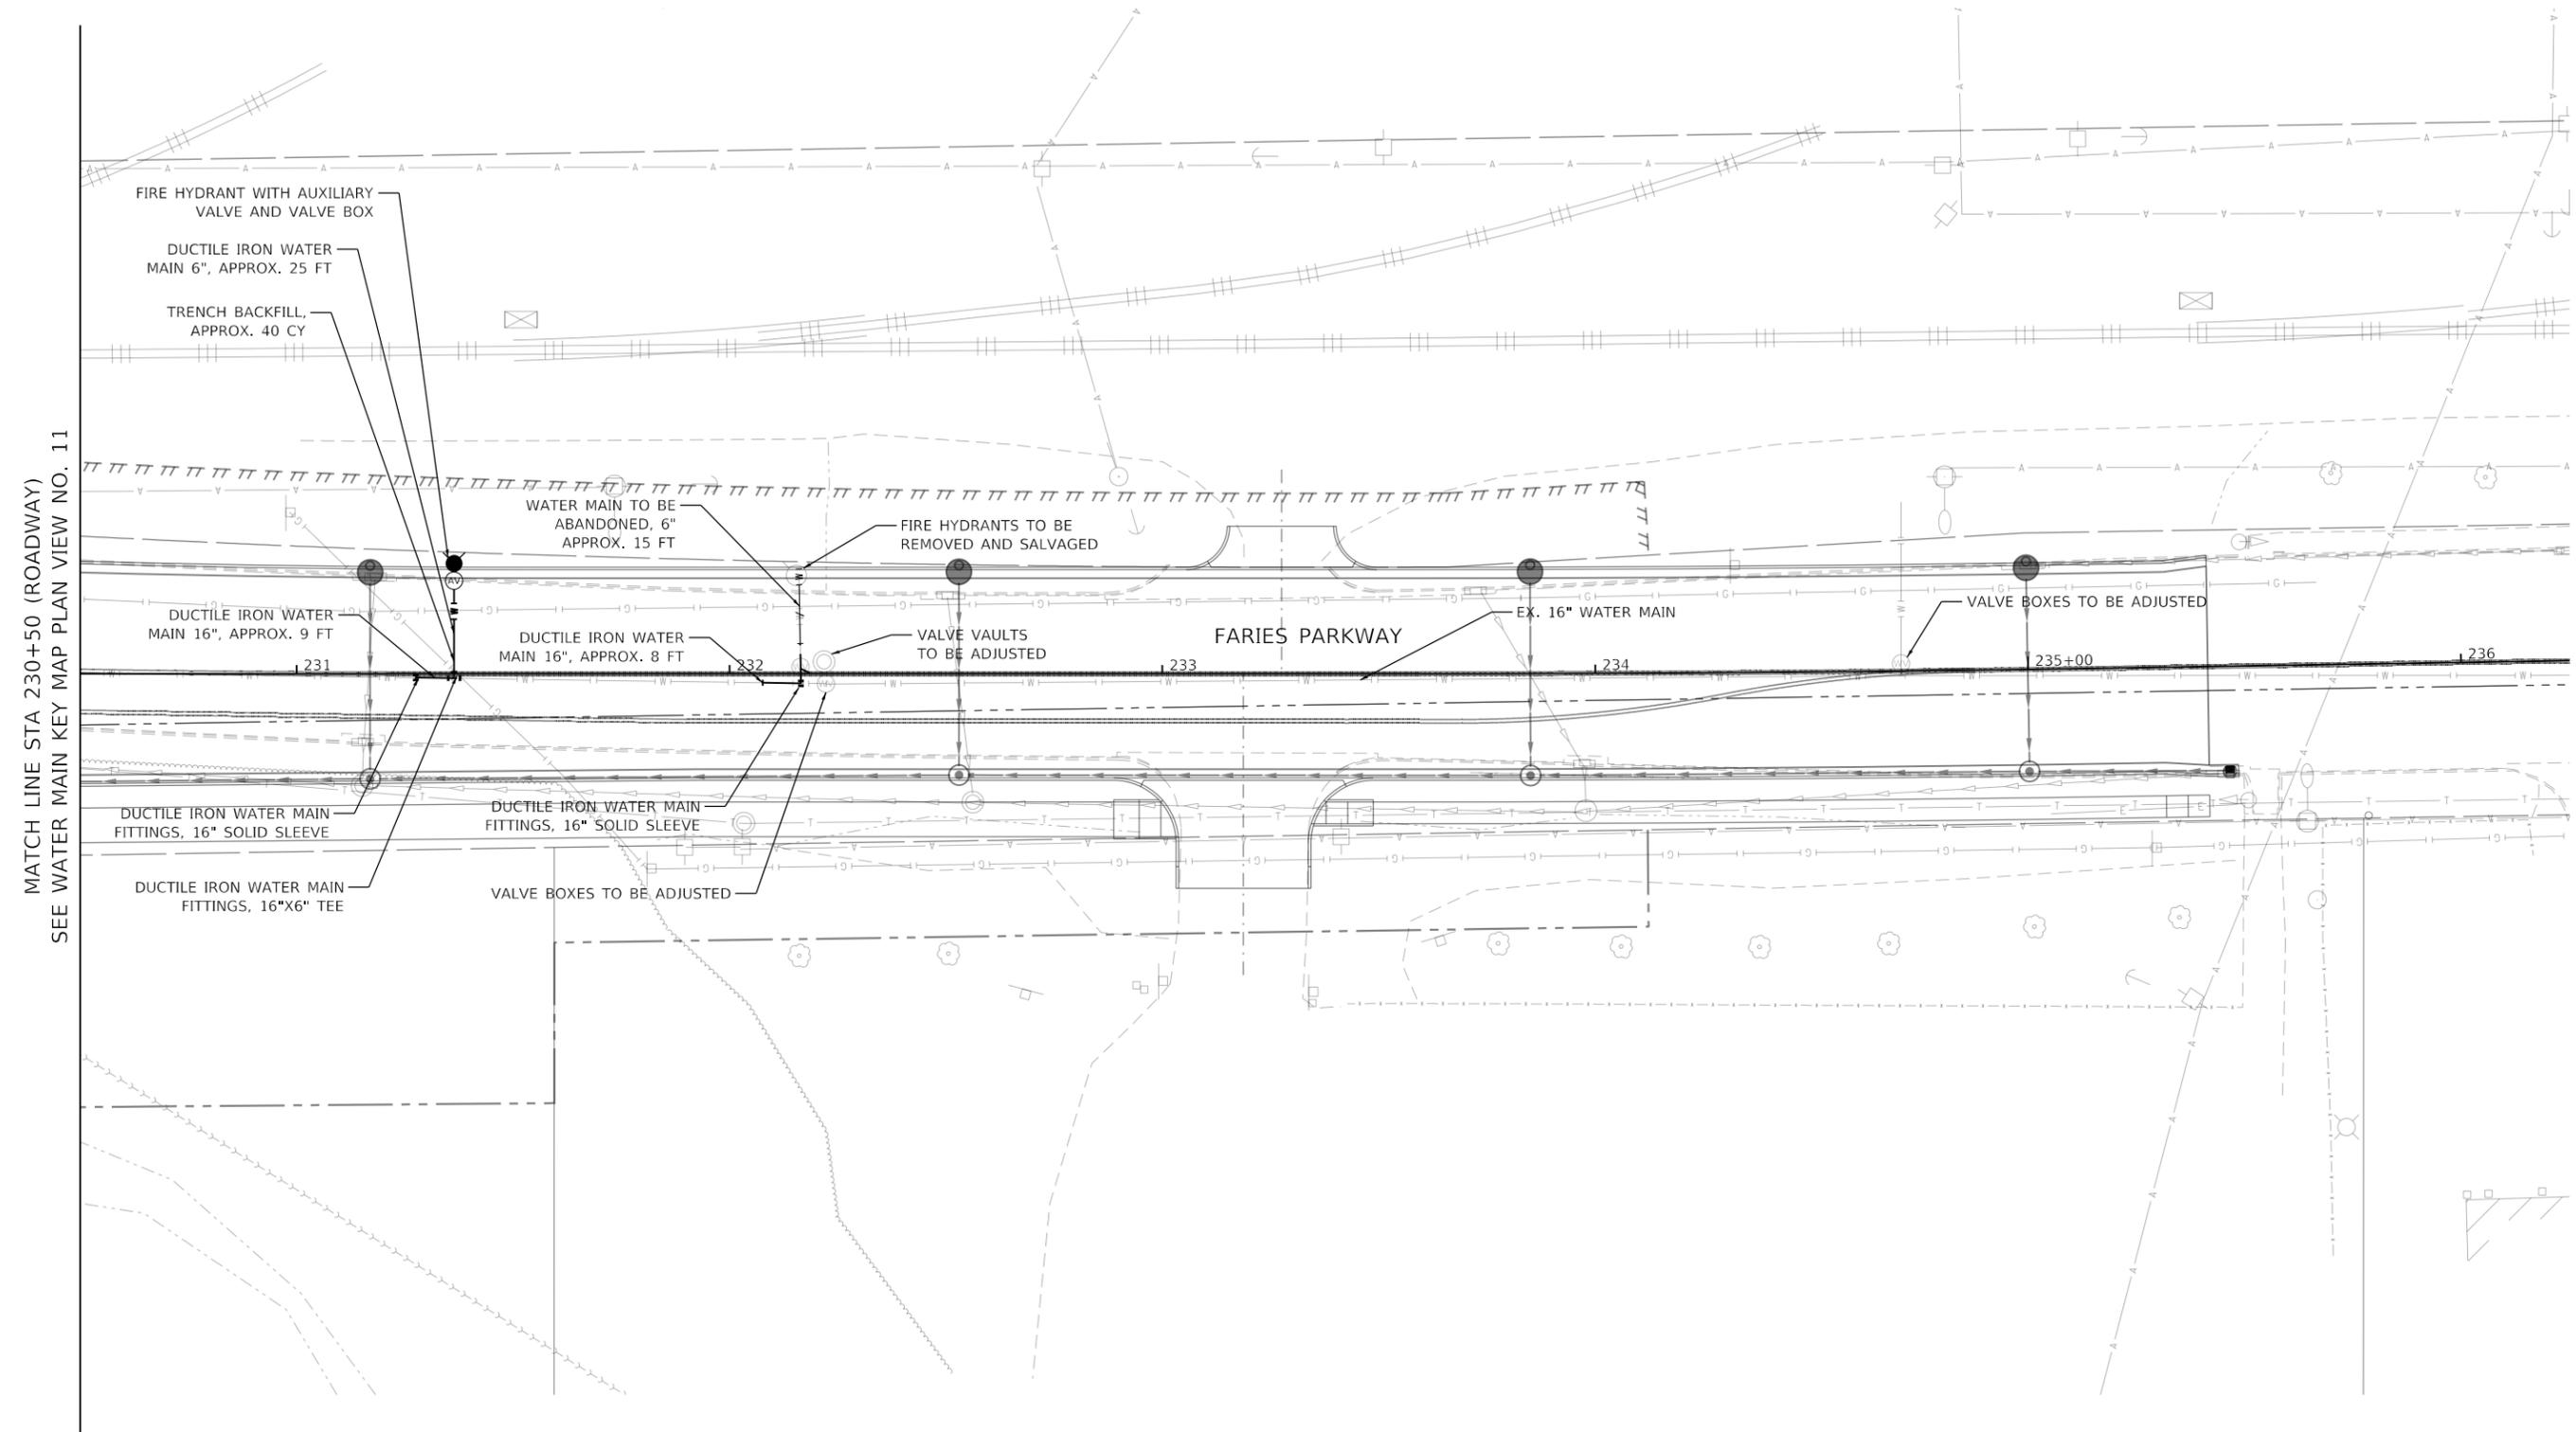

MATCH LINE STA 230+50 (ROADWAY)  
SEE WATER MAIN KEY MAP PLAN VIEW NO. 11

WATER MAIN KEY MAP PLAN VIEW NO. 12



MODEL: Default  
FILE NAME: p:\aecom\m-pw\henley.com\AECOM\_0516\_M\Documents\60603202-Brush\_College\006-CAD\_GIS\910\_CAD\03\_SHEETS\10\_L4\AECOM\Watermain\60603202\_WW\_KEYMAP\_SEC\_12



USER NAME = brooke.henry
PLOT SCALE = 40.0000 ' / in.
PLOT DATE = 10/27/2021

DESIGNED - BNH	REVISED -
DRAWN - BNH	REVISED -
CHECKED - PSA	REVISED -
DATE - 10/22/2021	REVISED -

**STATE OF ILLINOIS  
DEPARTMENT OF TRANSPORTATION**


**WATER MAIN RELOCATION PLAN AND SANITARY SEWER ADJUSTMENTS**  
**WATER MAIN PLAN**

SCALE: 1"=20'    SHEET 17 OF 31 SHEETS    STA. 230+50 TO STA. 236+25

F.A.U. RTE.	SECTION	COUNTY	TOTAL SHEETS	SHEET NO.
7448	09-00933-01-BR	MACON	1019	529
CONTRACT NO. 95893				
ILLINOIS FED. AID PROJECT				



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MATCH LINE STA 601+50 (ROADWAY)  
 SEE WATER MAIN KEY MAP PLAN VIEW NO. 13

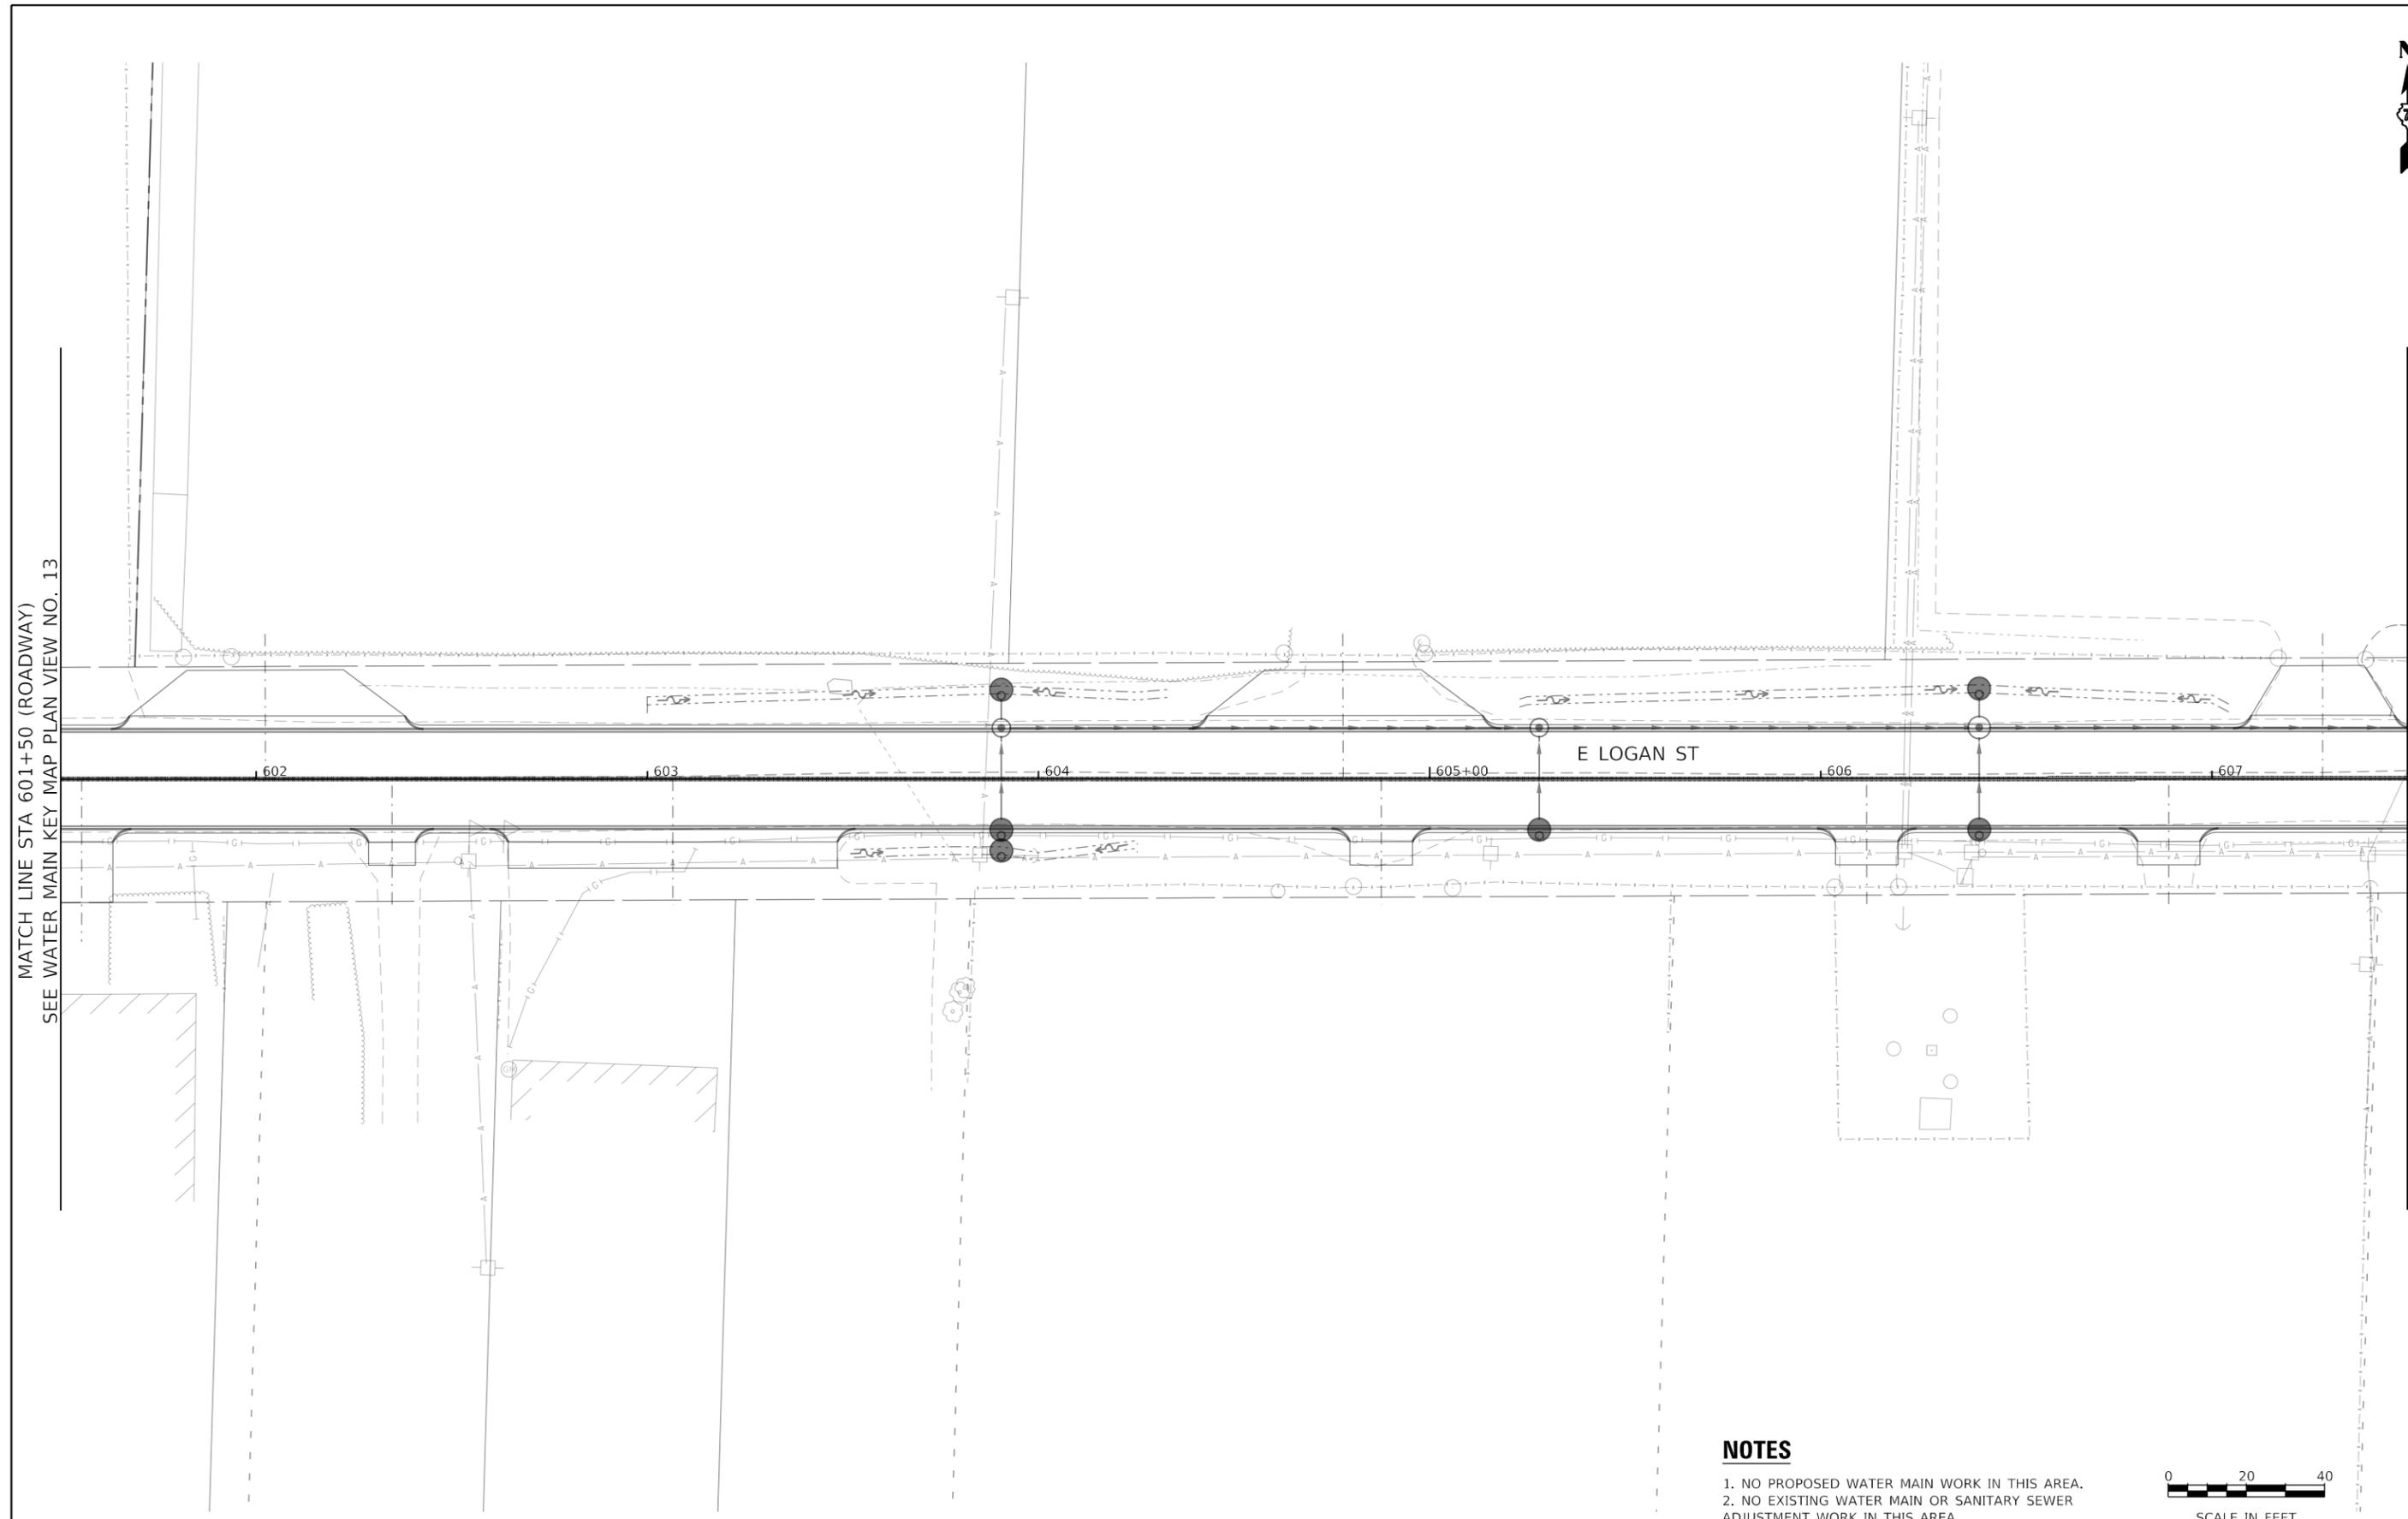MATCH LINE STA 607+50 (ROADWAY)  
 SEE WATER MAIN KEY MAP PLAN VIEW NO. 15



WATER MAIN KEY MAP PLAN VIEW NO. 14

**NOTES**

1. NO PROPOSED WATER MAIN WORK IN THIS AREA.
2. NO EXISTING WATER MAIN OR SANITARY SEWER ADJUSTMENT WORK IN THIS AREA.



USER NAME = brooke.henry	DESIGNED - XXX	REVISED -
DRAWN - XXX	CHECKED - XXX	REVISED -
PLOT SCALE = 40.0000' / in.	DATE - 10/22/2021	REVISED -
PLOT DATE = 10/27/2021		


**STATE OF ILLINOIS  
 DEPARTMENT OF TRANSPORTATION**

**WATER MAIN RELOCATION PLAN AND SANITARY SEWER ADJUSTMENTS  
 EXISTING UTILITY PLAN**

SCALE: 1"=20'    SHEET 19 OF 31 SHEETS    STA. 601+50 TO STA. 607+50

F.A.U. RTE.	SECTION	COUNTY	TOTAL SHEETS	SHEET NO.
7448	09-00933-01-BR	MACON	1019	531
CONTRACT NO. 95893				
ILLINOIS FED. AID PROJECT				

MATCH LINE STA 607+50 (ROADWAY)  
SEE WATER MAIN KEY MAP PLAN VIEW NO. 14

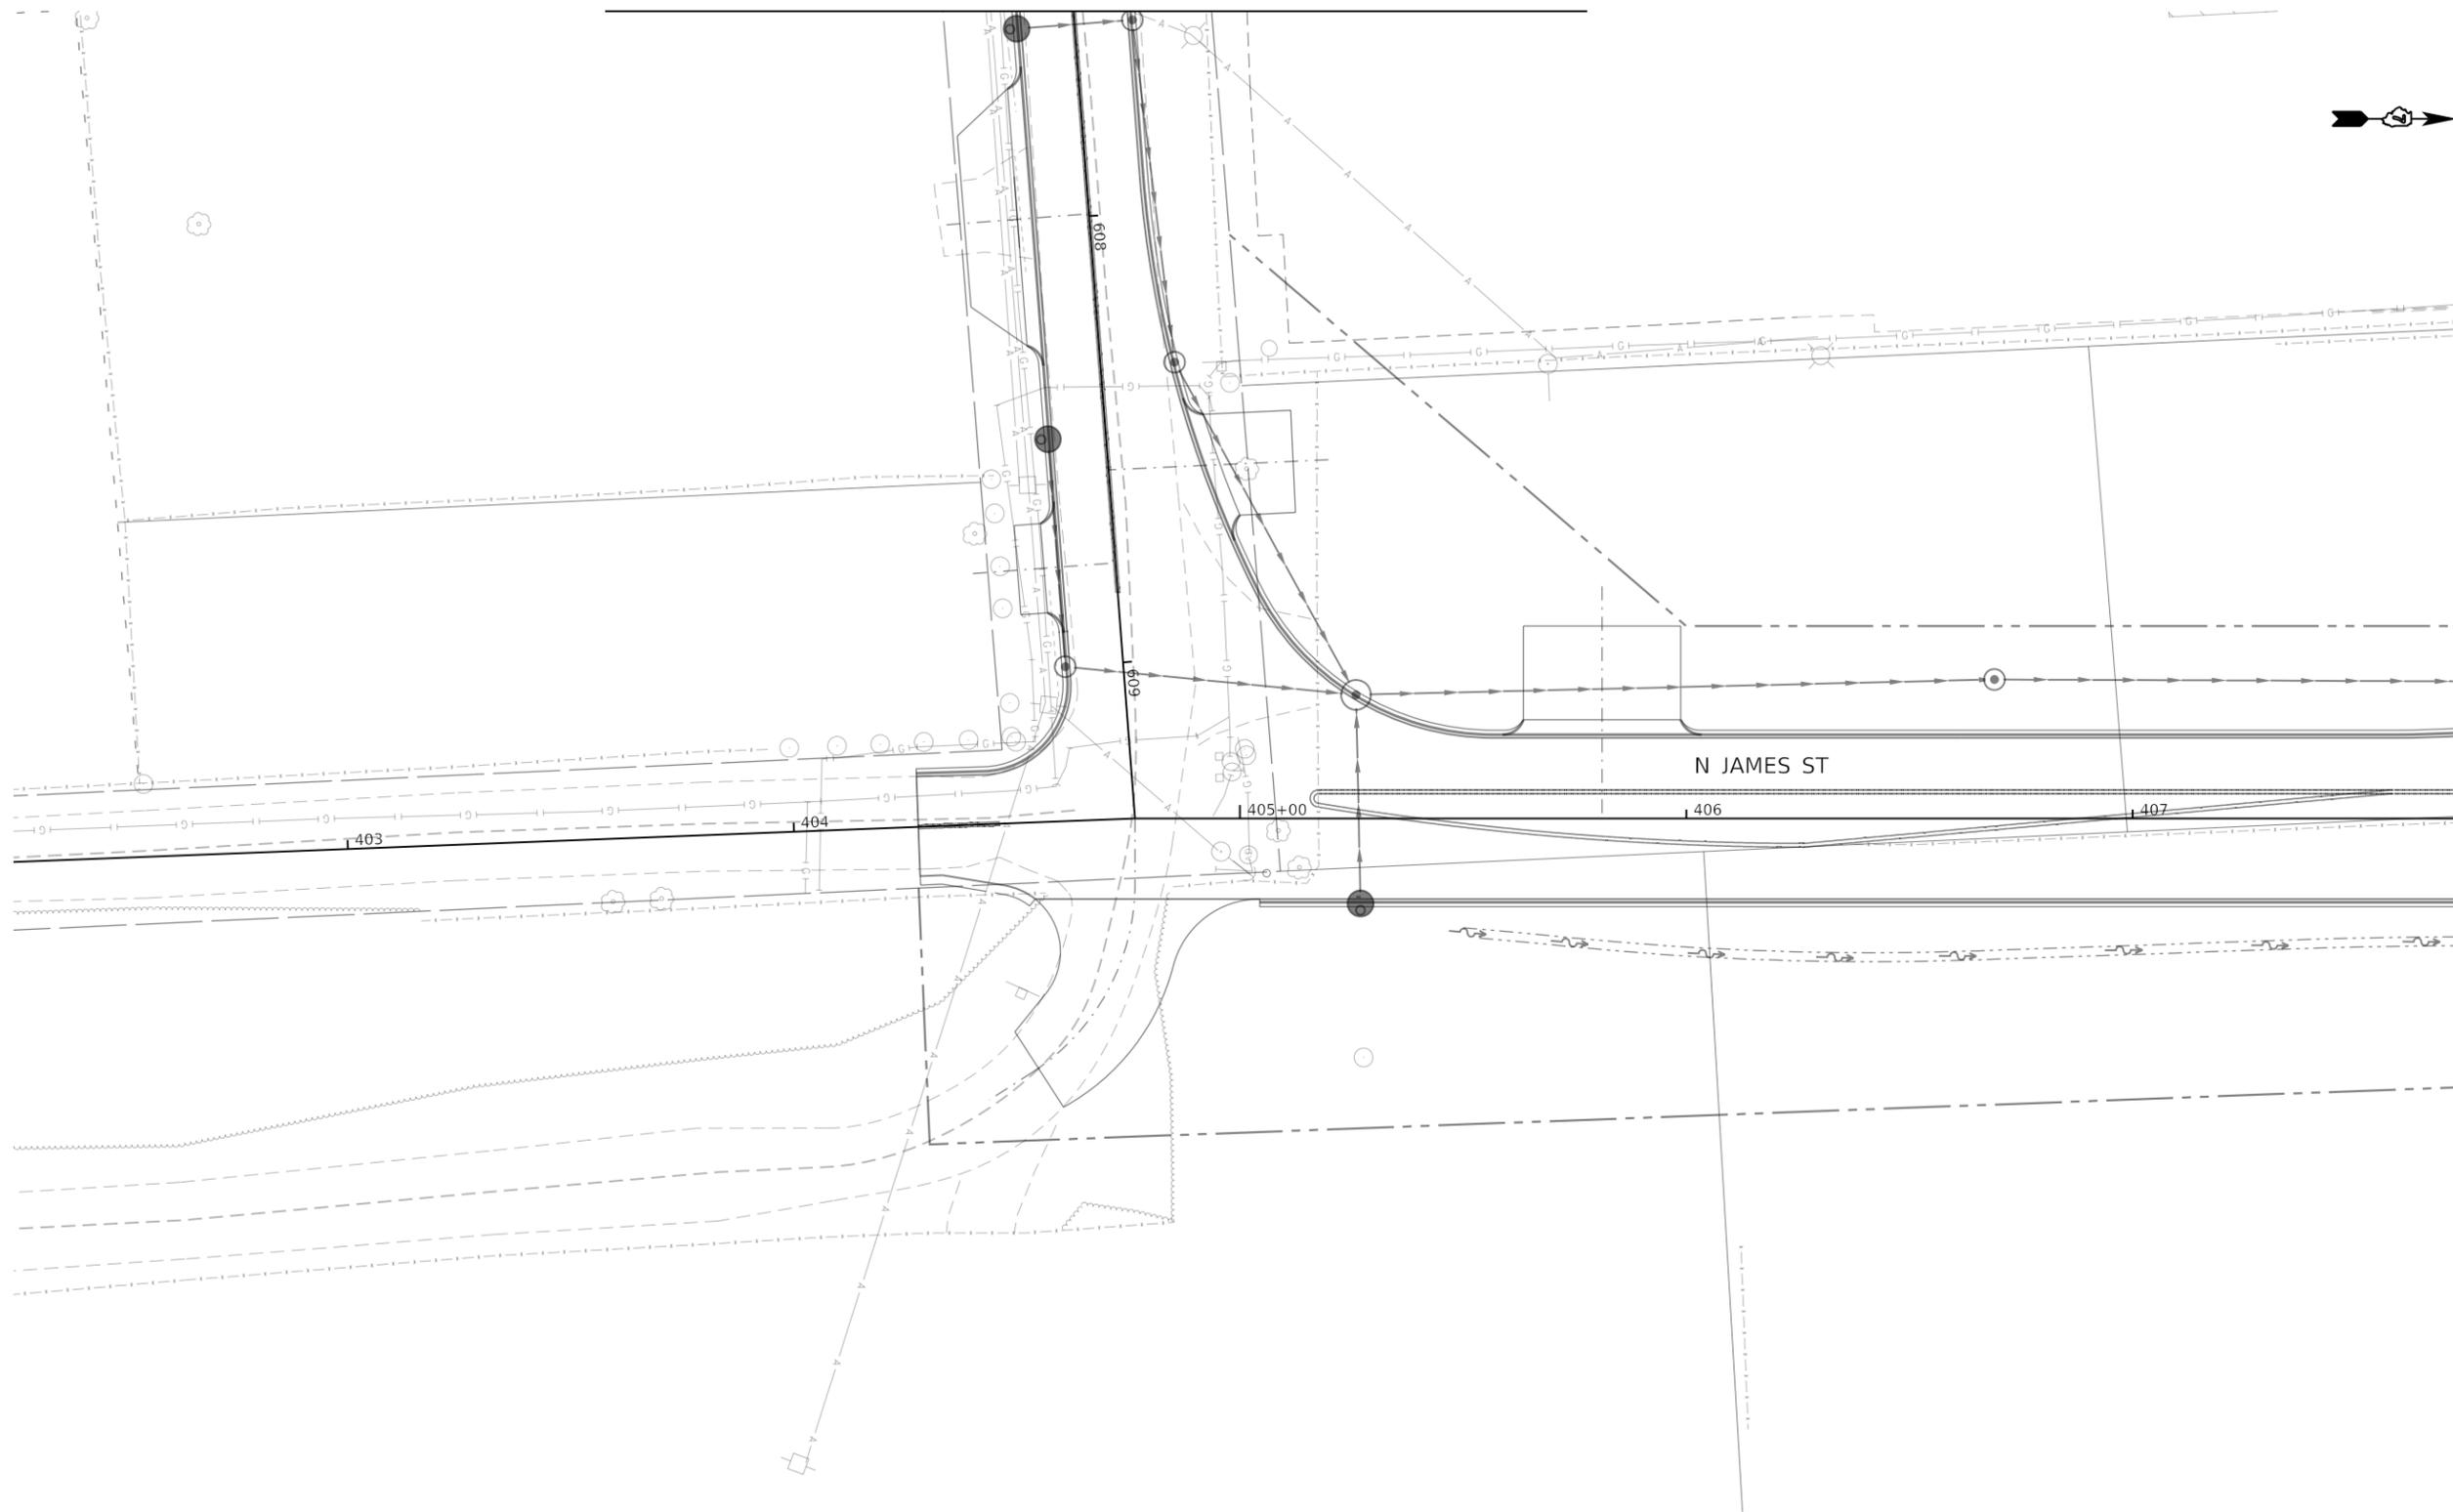


MATCH LINE STA 407+50 (ROADWAY)  
SEE WATER MAIN KEY MAP PLAN VIEW NO. 10

WATER MAIN KEY MAP PLAN VIEW NO. 15

**NOTES**

1. NO PROPOSED WATER MAIN WORK IN THIS AREA.
2. NO EXISTING WATER MAIN OR SANITARY SEWER ADJUSTMENT WORK IN THIS AREA.

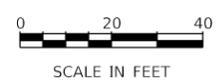

MODEL: Default  
FILE NAME: p:\aecom\pw\henley.com\AECOM\_0516\_NA\Documents\60603202-Brush\_College\006-CAD\_GIS\010\_CAD\013\_SHEETS\014\_AECOM\Watermain\60603202\_WW\_KEYMAP\_SEC\_15





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PLOT SCALE = 40.0000 ' / in.	DRAWN - BNH	REVISED -
PLOT DATE = 10/27/2021	CHECKED - PSA	REVISED -
	DATE - 10/22/2021	REVISED -

**STATE OF ILLINOIS  
DEPARTMENT OF TRANSPORTATION**

**WATER MAIN RELOCATION PLAN AND SANITARY SEWER ADJUSTMENTS**  
**EXISTING UTILITY PLAN**

SCALE: 1"=20'    SHEET 20 OF 31 SHEETS    STA. 402+50 TO STA. 407+75

F.A.U. RTE.	SECTION	COUNTY	TOTAL SHEETS	SHEET NO.
7448	09-00933-01-BR	MACON	1019	532
CONTRACT NO. 95893				
ILLINOIS FED. AID PROJECT				

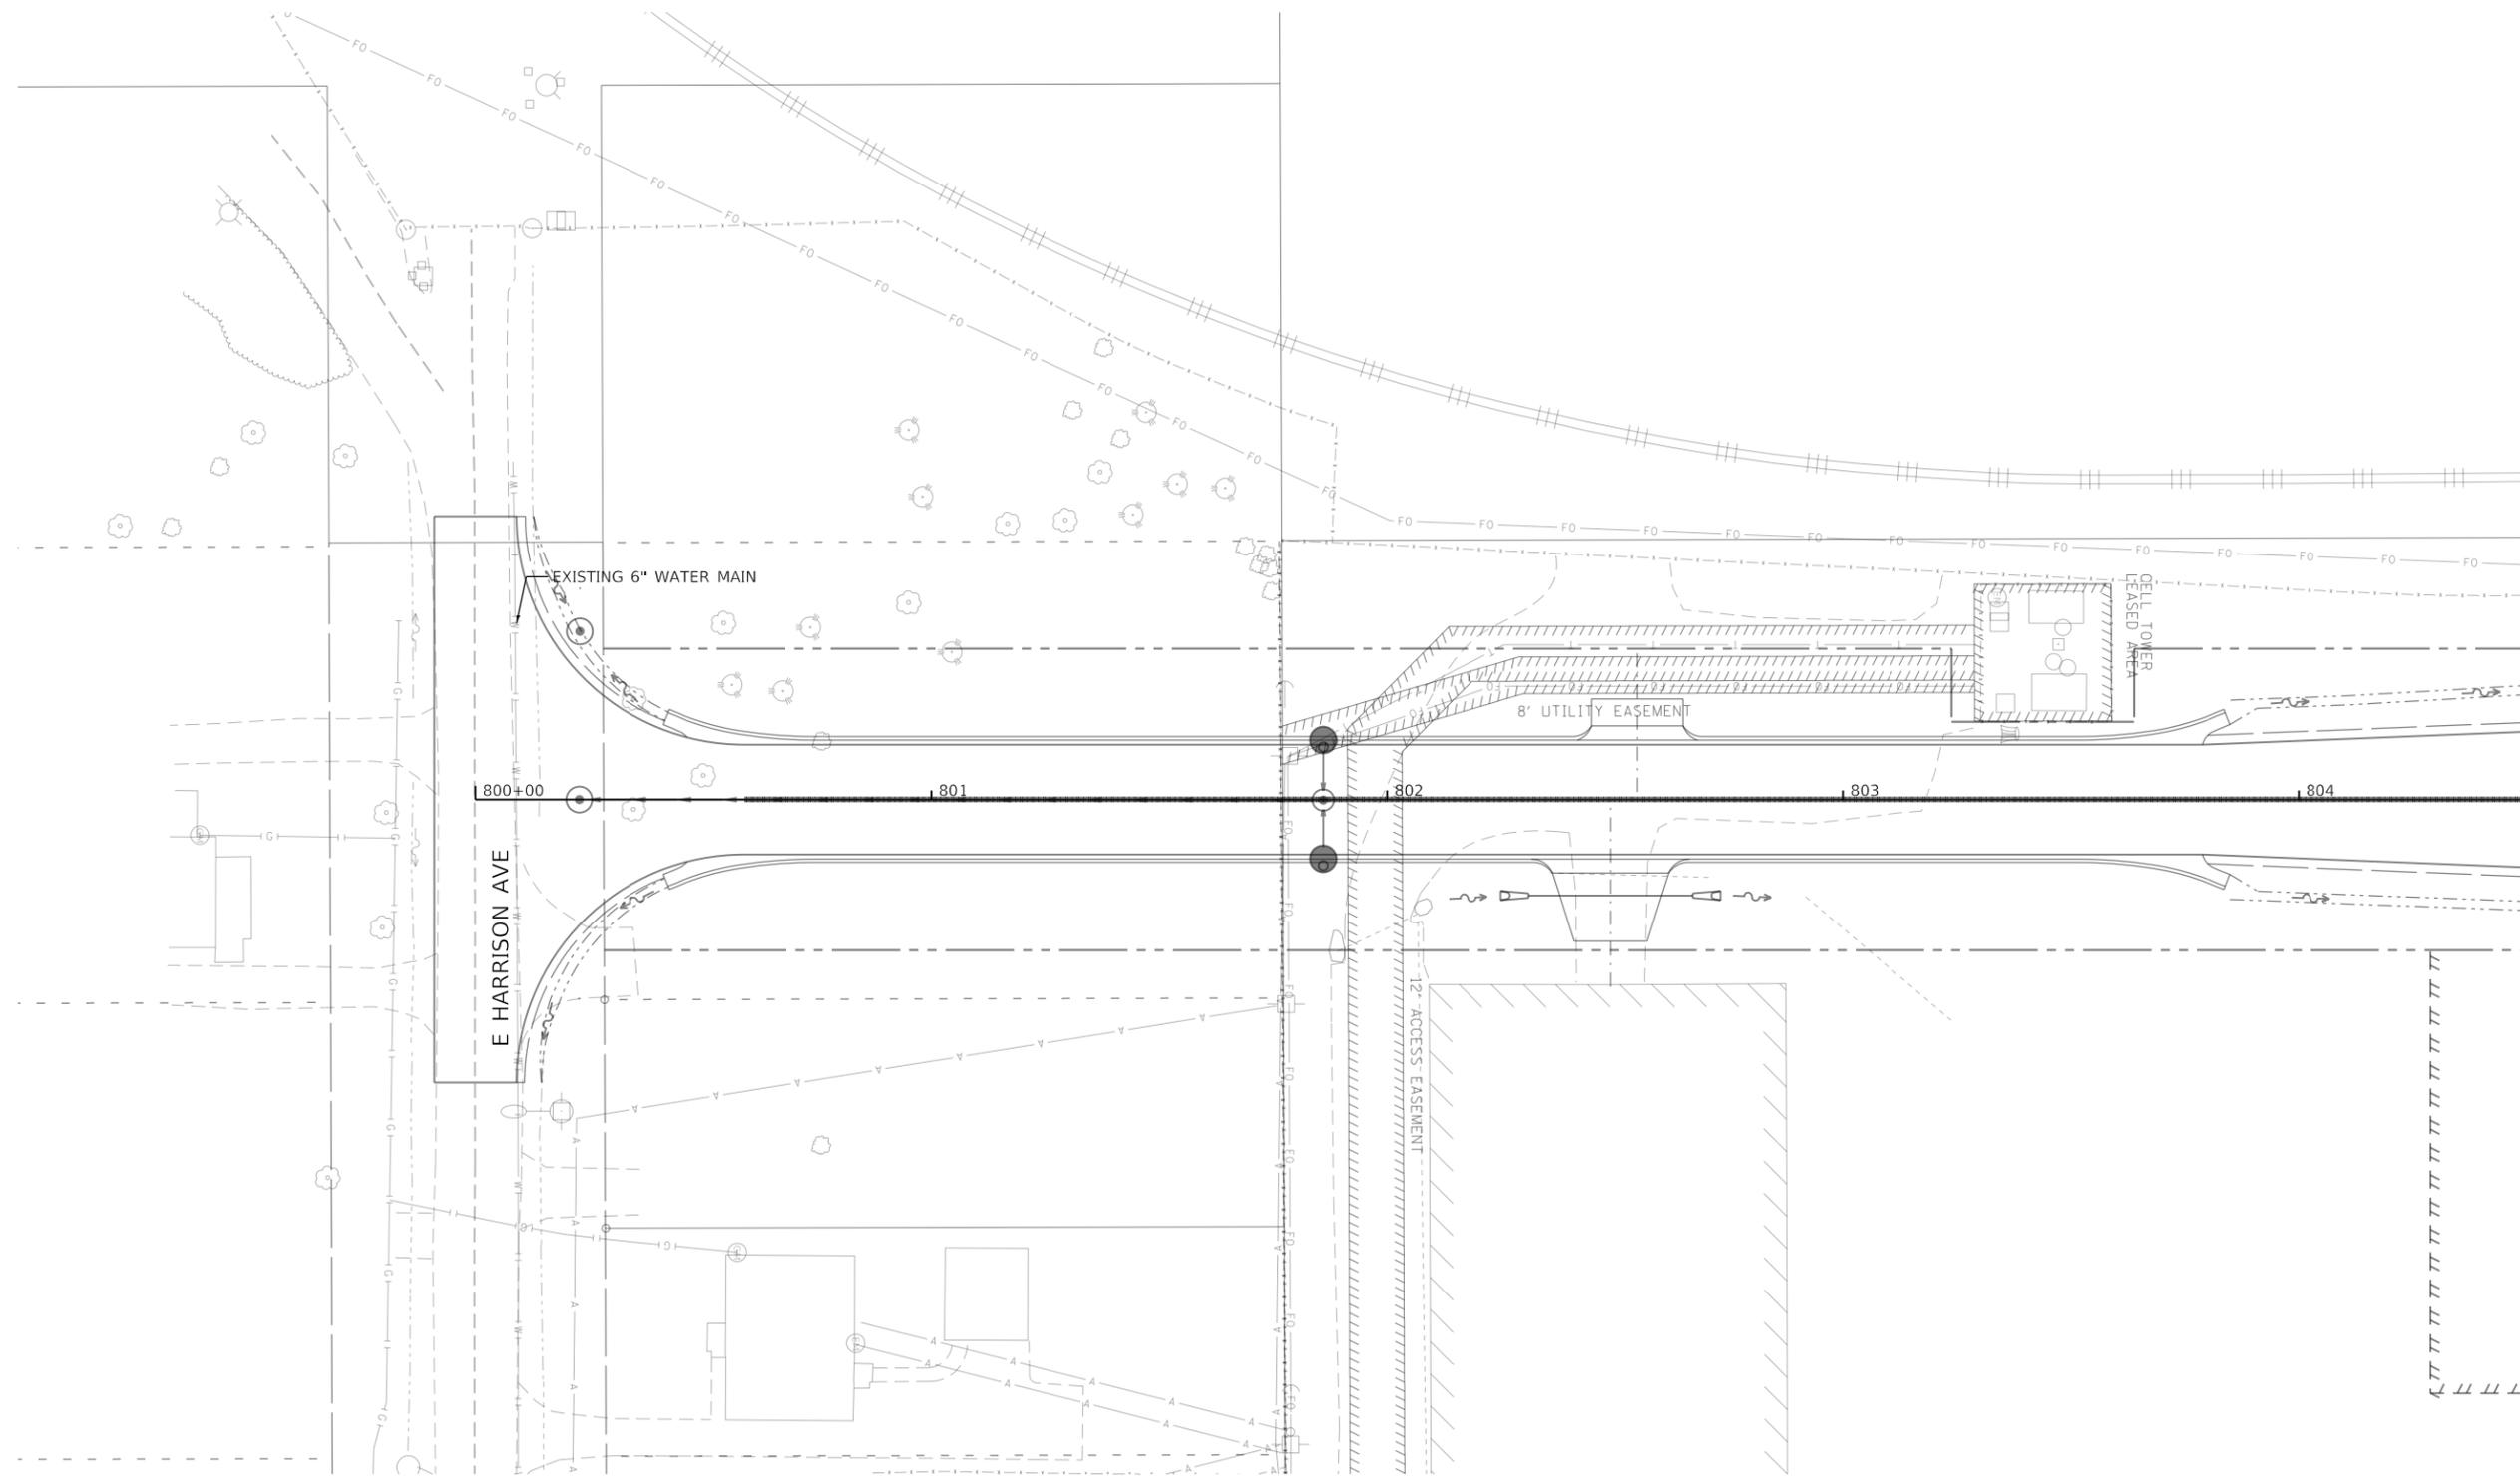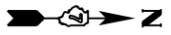


WATER MAIN KEY MAP PLAN VIEW NO. 16

MATCH LINE STA 804+50 (ROADWAY)  
SEE WATER MAIN KEY MAP PLAN VIEW NO. 17

**NOTES**

1. NO PROPOSED WATER MAIN WORK IN THIS AREA.
2. NO EXISTING WATER MAIN OR SANITARY SEWER ADJUSTMENT WORK IN THIS AREA.

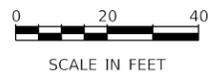

MODEL: Default  
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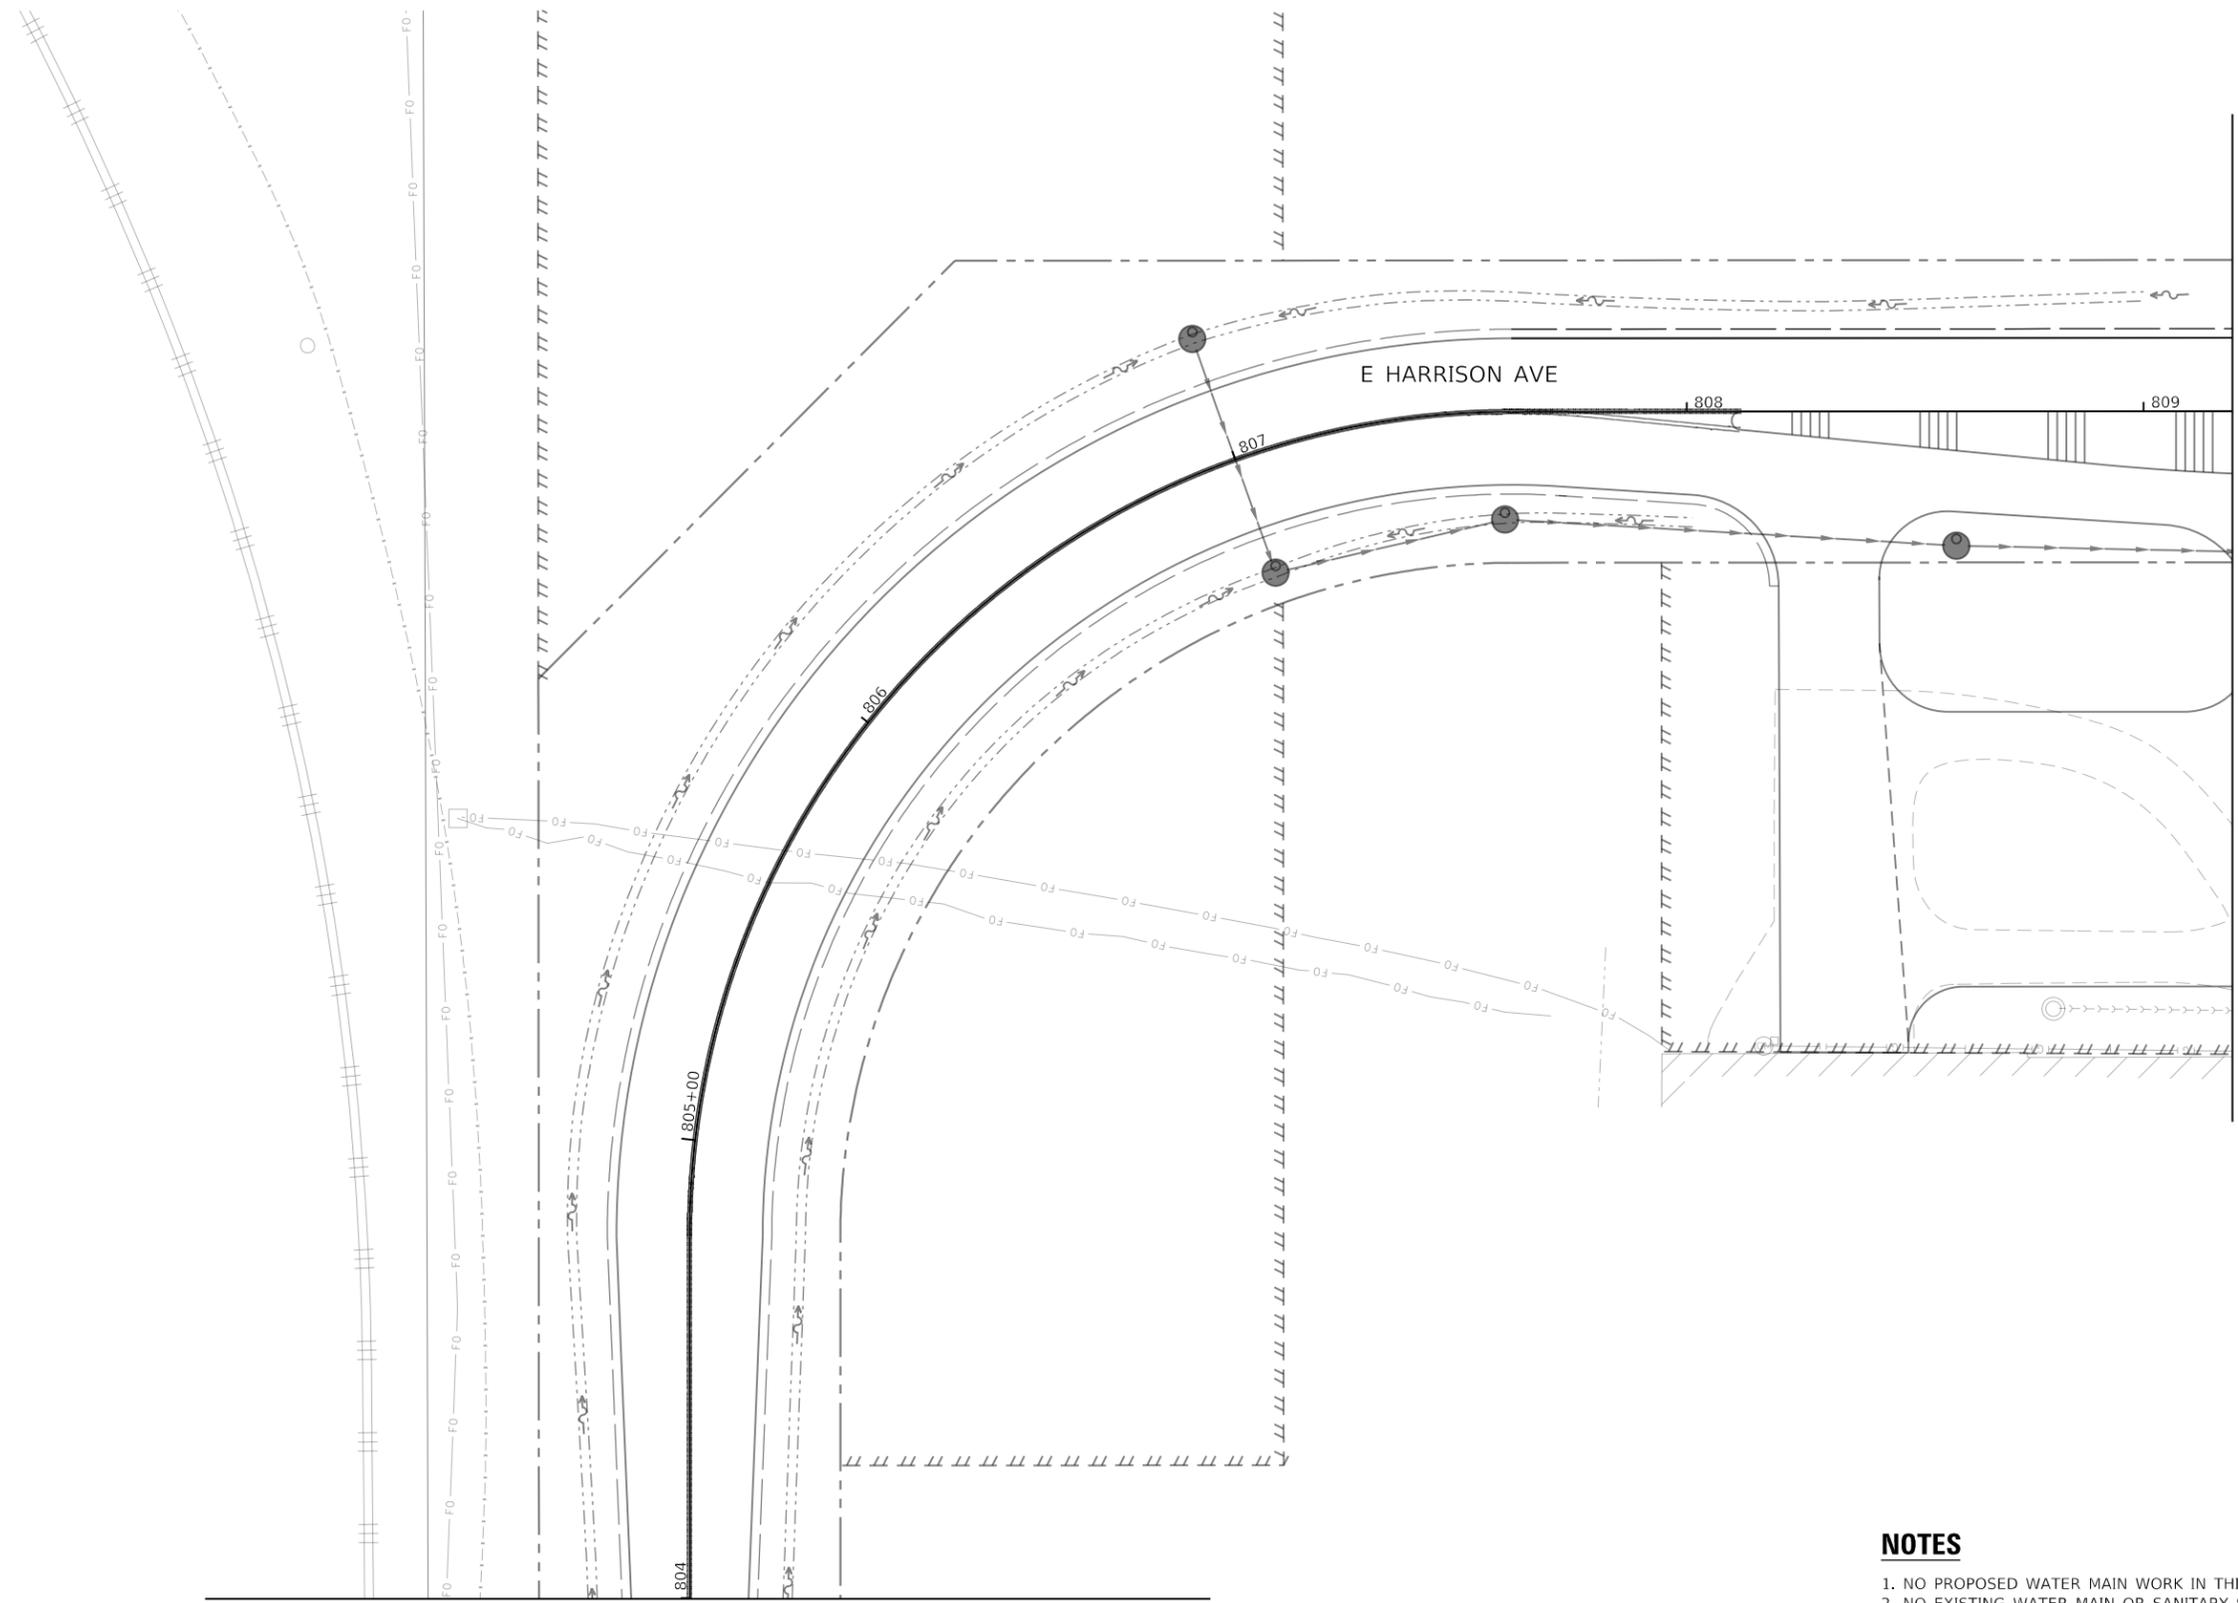
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PLOT DATE = 10/27/2021	DATE - 10/22/2021	REVISED -

DRAWN - BNH	REVISED -
CHECKED - PSA	REVISED -
DATE - 10/22/2021	REVISED -

**STATE OF ILLINOIS  
DEPARTMENT OF TRANSPORTATION**

<b>WATER MAIN RELOCATION PLAN AND SANITARY SEWER ADJUSTMENTS</b>	
<b>EXISTING UTILITY PLAN</b>	
SCALE: 1"=20'	SHEET 21 OF 31 SHEETS
STA. 800+00 TO STA. 804+50	

F.A.U. RTE.	SECTION	COUNTY	TOTAL SHEETS	SHEET NO.
7448	09-00933-01-BR	MACON	1019	533
CONTRACT NO. 95893				
ILLINOIS FED. AID PROJECT				



SEE WATER MAIN KEY MAP PLAN VIEW NO. 5

MATCH LINE STA 804+00 (ROADWAY)  
SEE WATER MAIN KEY MAP PLAN VIEW NO. 16

WATER MAIN KEY MAP PLAN VIEW NO. 17

**NOTES**

1. NO PROPOSED WATER MAIN WORK IN THIS AREA.
2. NO EXISTING WATER MAIN OR SANITARY SEWER ADJUSTMENT WORK IN THIS AREA.



MODEL: Default  
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USER NAME = brooke,henry	DESIGNED - BNH	REVISED -
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PLOT DATE = 10/27/2021	DATE - 10/22/2021	REVISED -

**STATE OF ILLINOIS  
DEPARTMENT OF TRANSPORTATION**

**WATER MAIN RELOCATION PLAN AND SANITARY SEWER ADJUSTMENTS**  
**EXISTING UTILITY PLAN**


SCALE: 1"=20'    SHEET 22 OF 31 SHEETS    STA. 804+00 TO STA. 808+00

F.A.U. RTE. 7448	SECTION 09-00933-01-BR	COUNTY MACON	TOTAL SHEETS 1019	SHEET NO. 534
CONTRACT NO. 95893				
ILLINOIS FED. AID PROJECT				



MATCH LINE STA 701+00 (ROADWAY)  
SEE WATER MAIN KEY MAP PLAN VIEW NO. 5

MATCH LINE STA 705+00 (ROADWAY)  
SEE WATER MAIN KEY MAP PLAN VIEW NO. 19

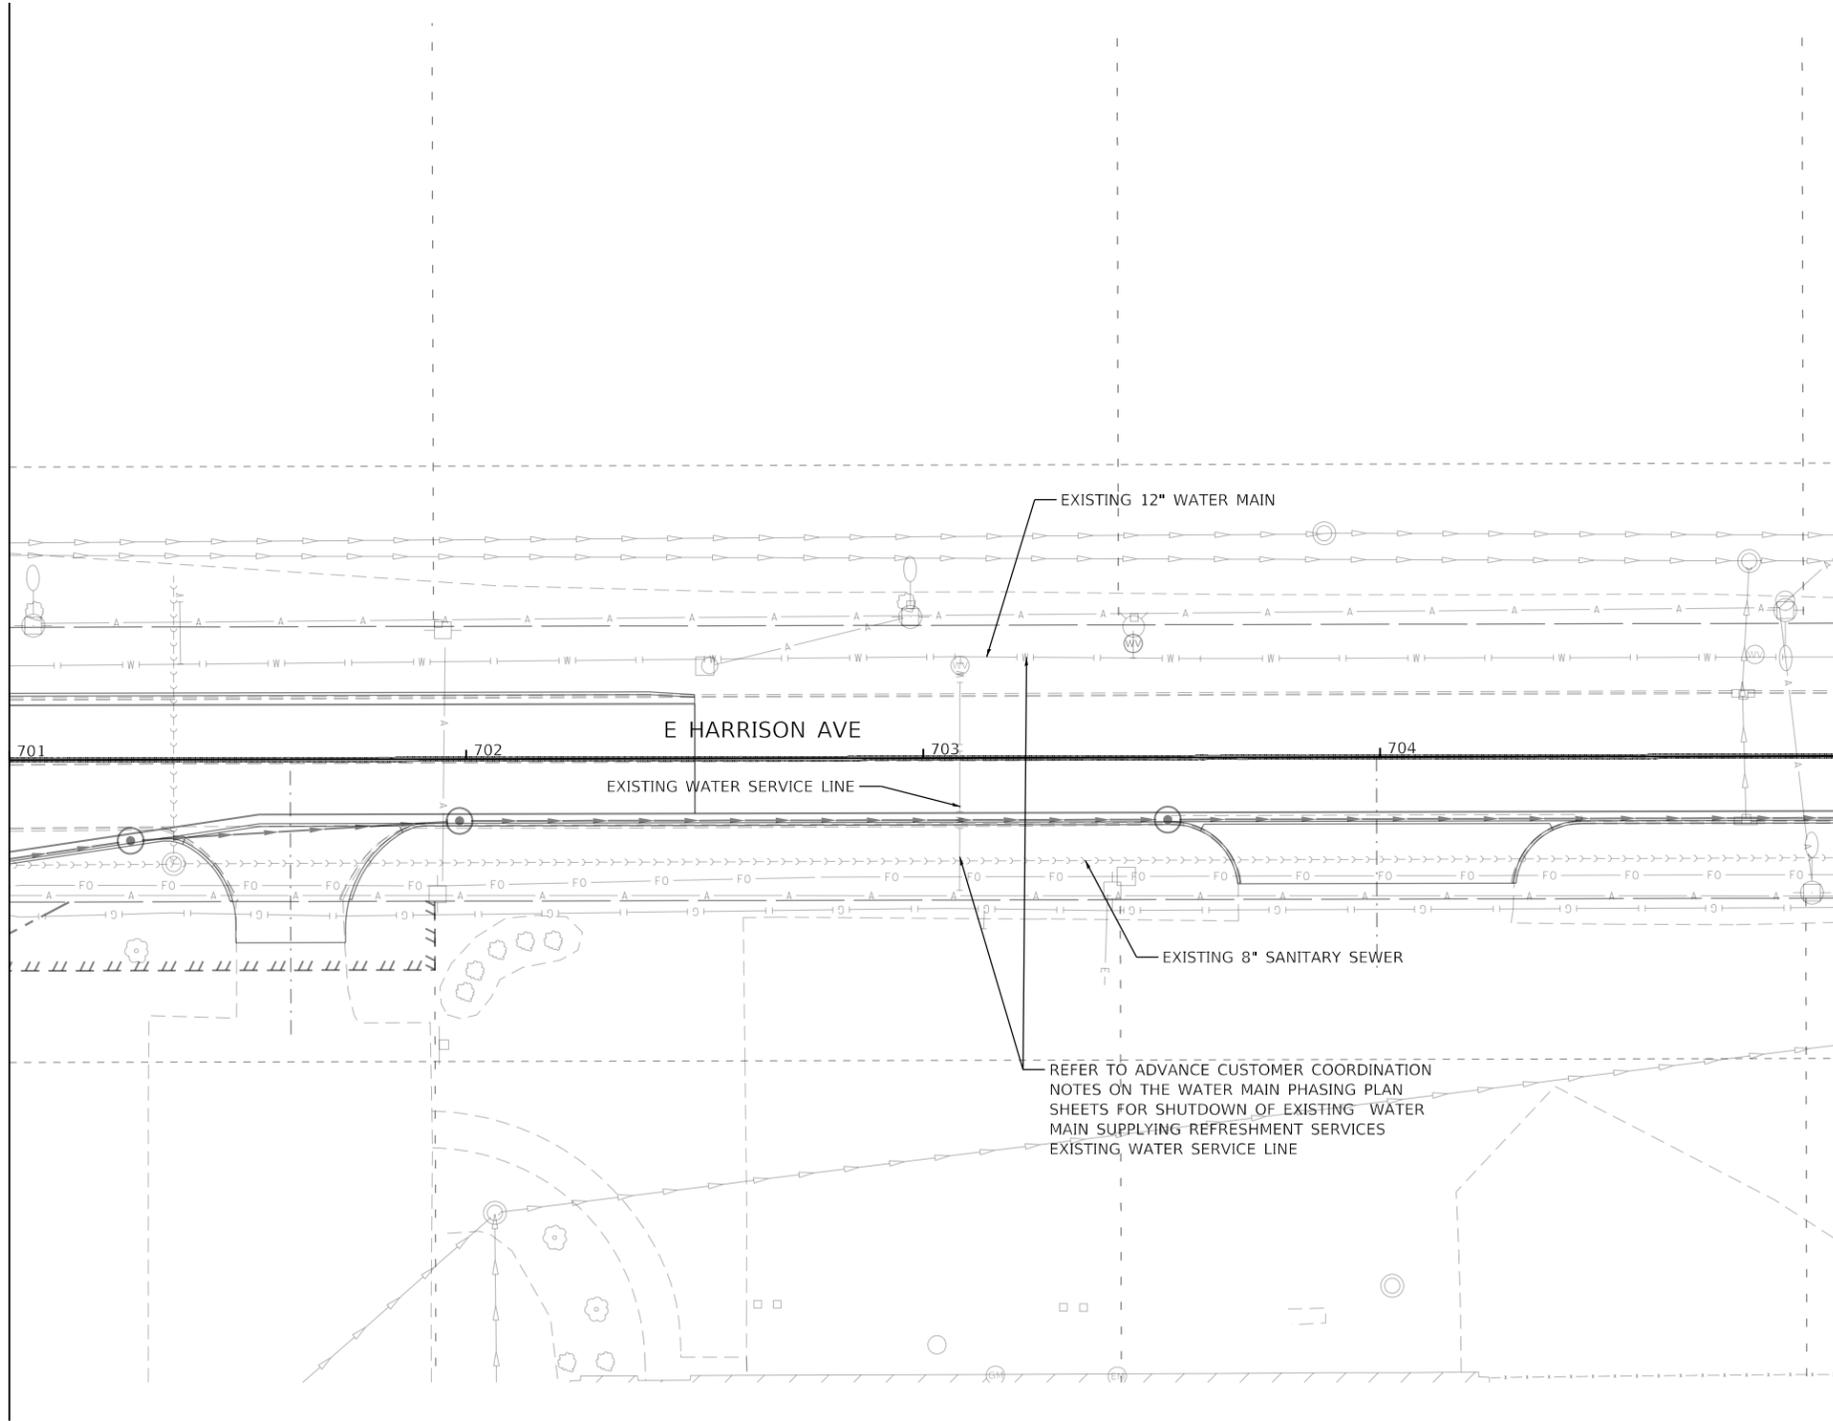

REFER TO ADVANCE CUSTOMER COORDINATION  
NOTES ON THE WATER MAIN PHASING PLAN  
SHEETS FOR SHUTDOWN OF EXISTING WATER  
MAIN SUPPLYING REFRESHMENT SERVICES  
EXISTING WATER SERVICE LINE

WATER MAIN KEY MAP PLAN VIEW NO. 18

**NOTES**

1. NO PROPOSED WATER MAIN WORK IN THIS AREA.
2. NO EXISTING WATER MAIN OR SANITARY SEWER ADJUSTMENT WORK IN THIS AREA.



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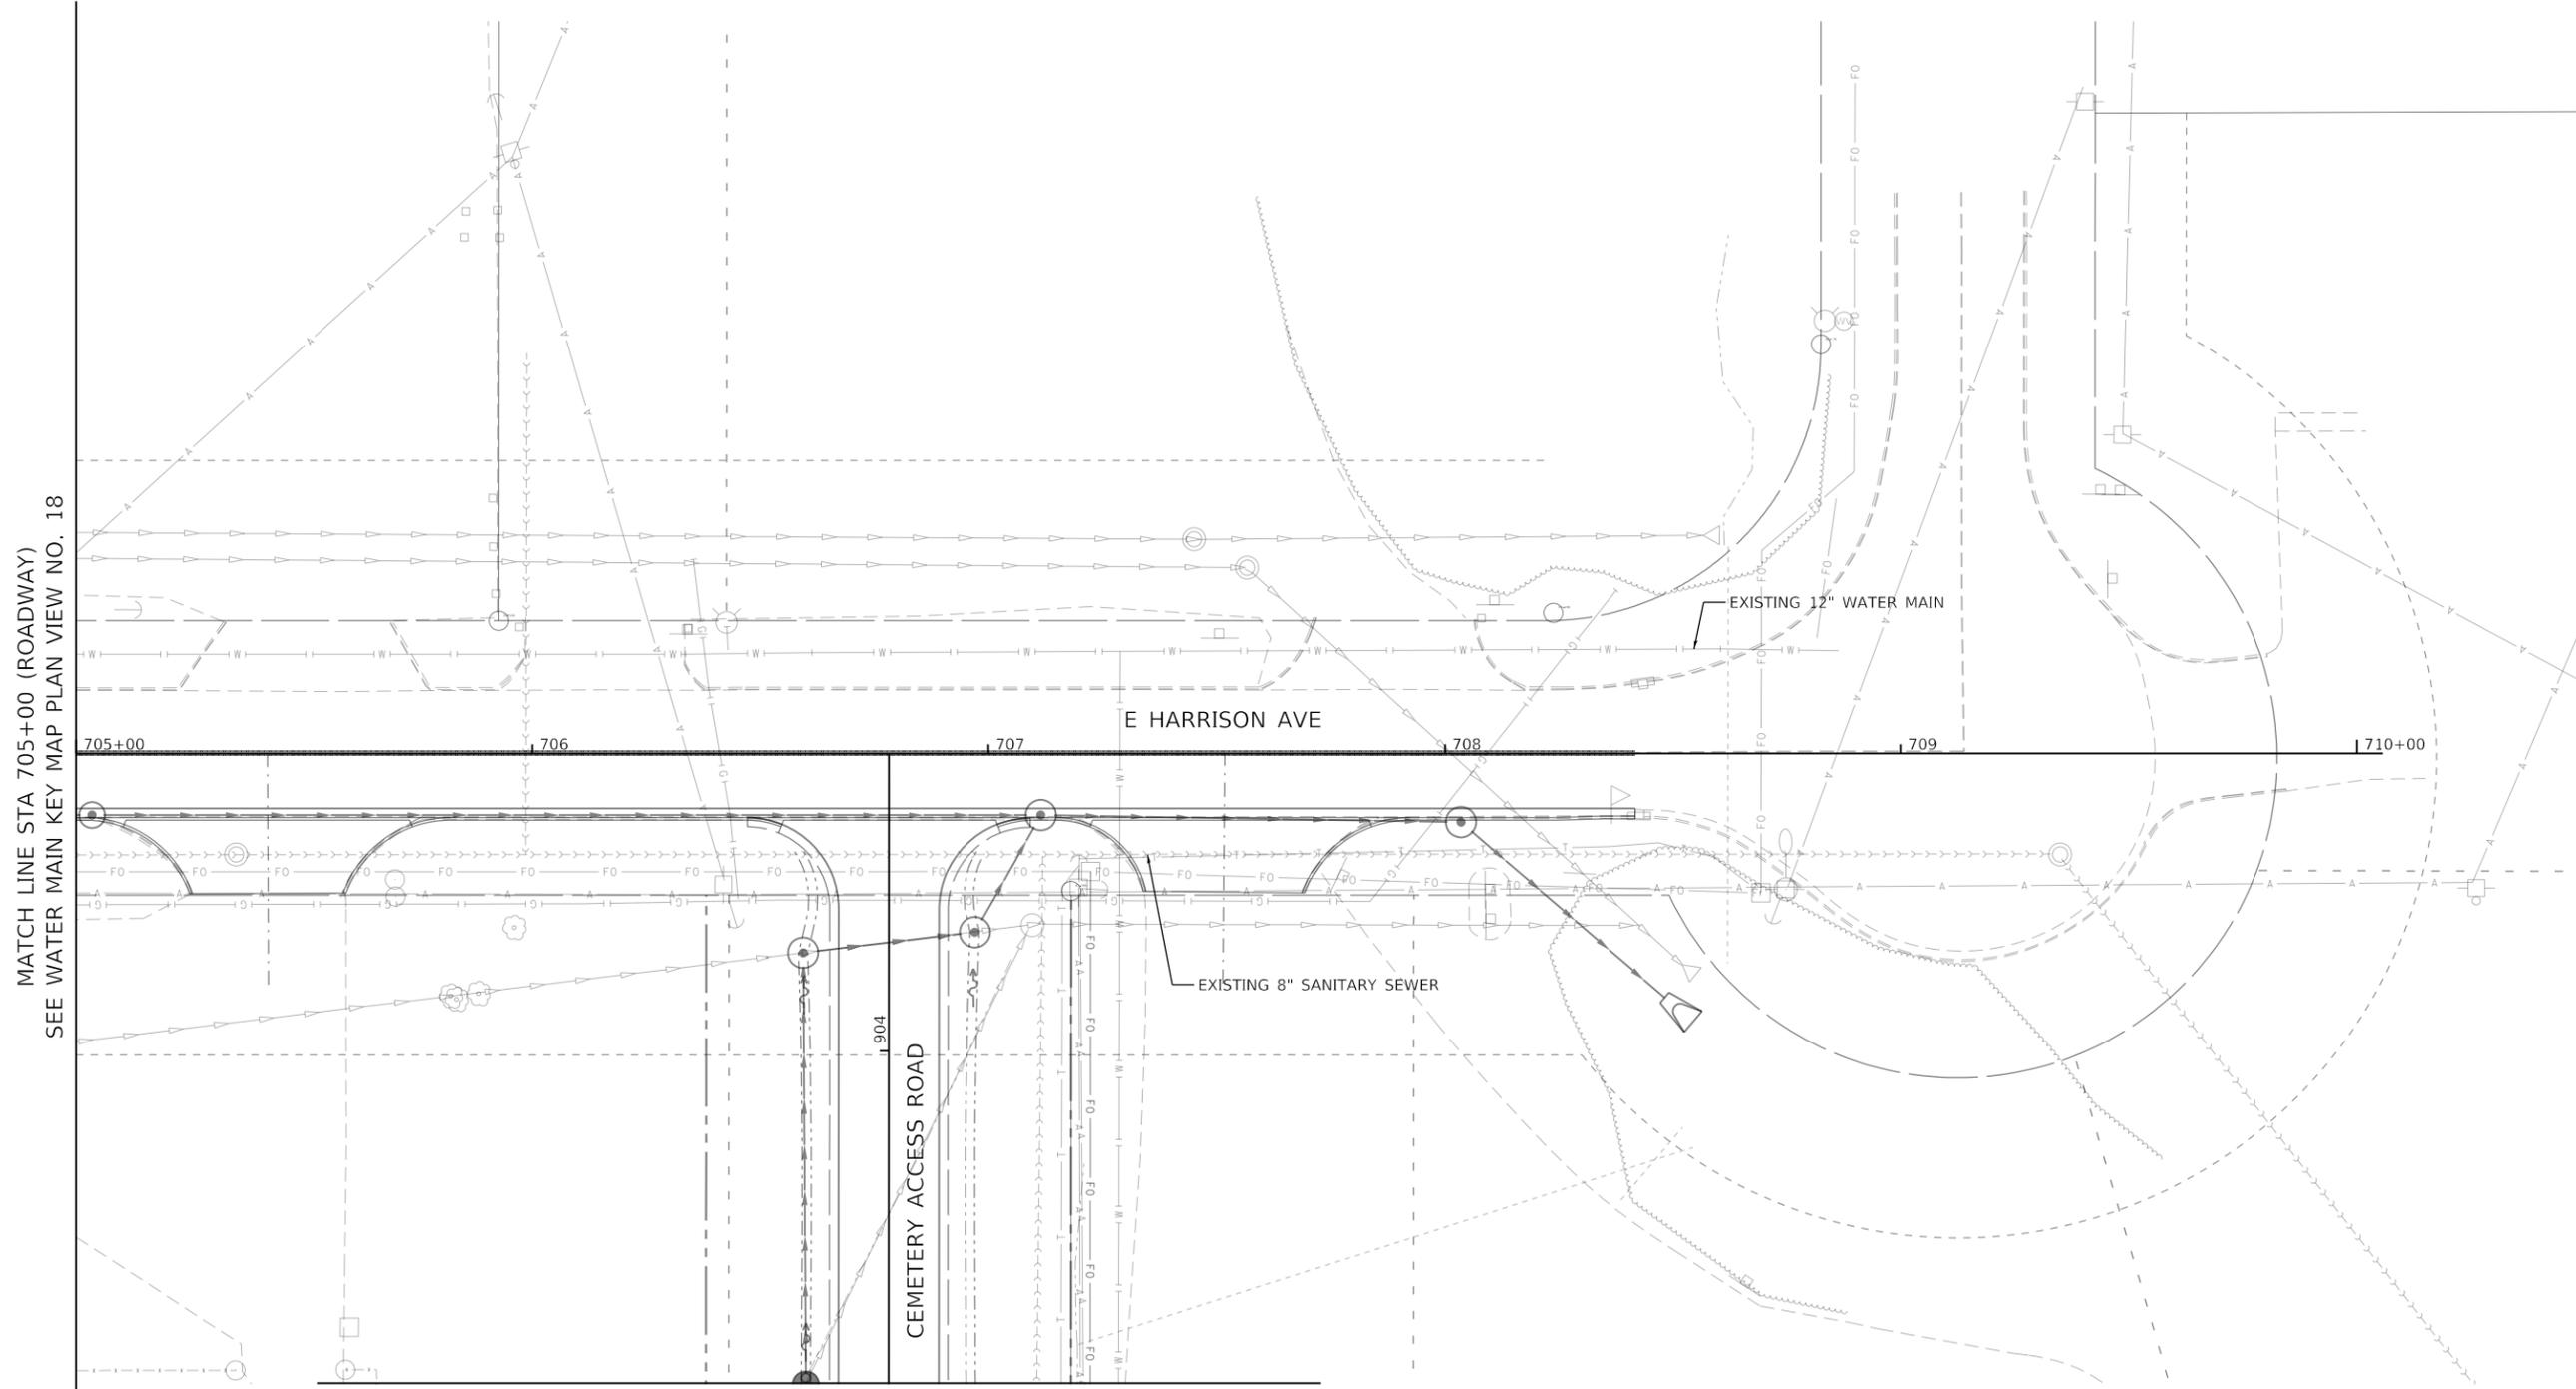


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PLOT SCALE = 40.0000 ' / in.	DRAWN - XXX	REVISED -
PLOT DATE = 10/27/2021	CHECKED - XXX	REVISED -
	DATE - 10/22/2021	REVISED -

**STATE OF ILLINOIS  
DEPARTMENT OF TRANSPORTATION**

<b>WATER MAIN RELOCATION PLAN AND SANITARY SEWER ADJUSTMENTS</b>	
<b>EXISTING UTILITY PLAN</b>	
SCALE: 1"=20'	SHEET 23 OF 31 SHEETS
STA. 701+00	TO STA. 705+00

F.A.U. RTE.	SECTION	COUNTY	TOTAL SHEETS	SHEET NO.
7448	09-00933-01-BR	MACON	1019	535
CONTRACT NO. 95893				
ILLINOIS FED. AID PROJECT				




MATCH LINE STA 705+00 (ROADWAY)  
SEE WATER MAIN KEY MAP PLAN VIEW NO. 18

MATCH LINE STA 904+75 (ROADWAY)  
SEE WATER MAIN KEY MAP PLAN VIEW NO. 20

WATER MAIN KEY MAP PLAN VIEW NO. 19

**NOTES**

1. NO PROPOSED WATER MAIN WORK IN THIS AREA.
2. NO EXISTING WATER MAIN OR SANITARY SEWER ADJUSTMENT WORK IN THIS AREA.

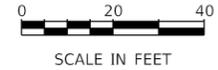

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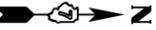


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PLOT DATE = 10/27/2021	DATE - 10/22/2021	REVISED -


**STATE OF ILLINOIS  
DEPARTMENT OF TRANSPORTATION**

<b>WATER MAIN RELOCATION PLAN AND SANITARY SEWER ADJUSTMENTS</b>			
<b>EXISTING UTILITY PLAN</b>			
SCALE: 1"=20'	SHEET 24 OF 31 SHEETS	STA. 705+00 TO STA. 710+00	

F.A.U. RTE.	SECTION	COUNTY	TOTAL SHEETS	SHEET NO.
7448	09-00933-01-BR	MACON	1019	536
CONTRACT NO. 95893				
ILLINOIS FED. AID PROJECT				




MATCH LINE STA 705+00 (ROADWAY)  
SEE WATER MAIN KEY MAP PLAN VIEW NO. 18 & 19

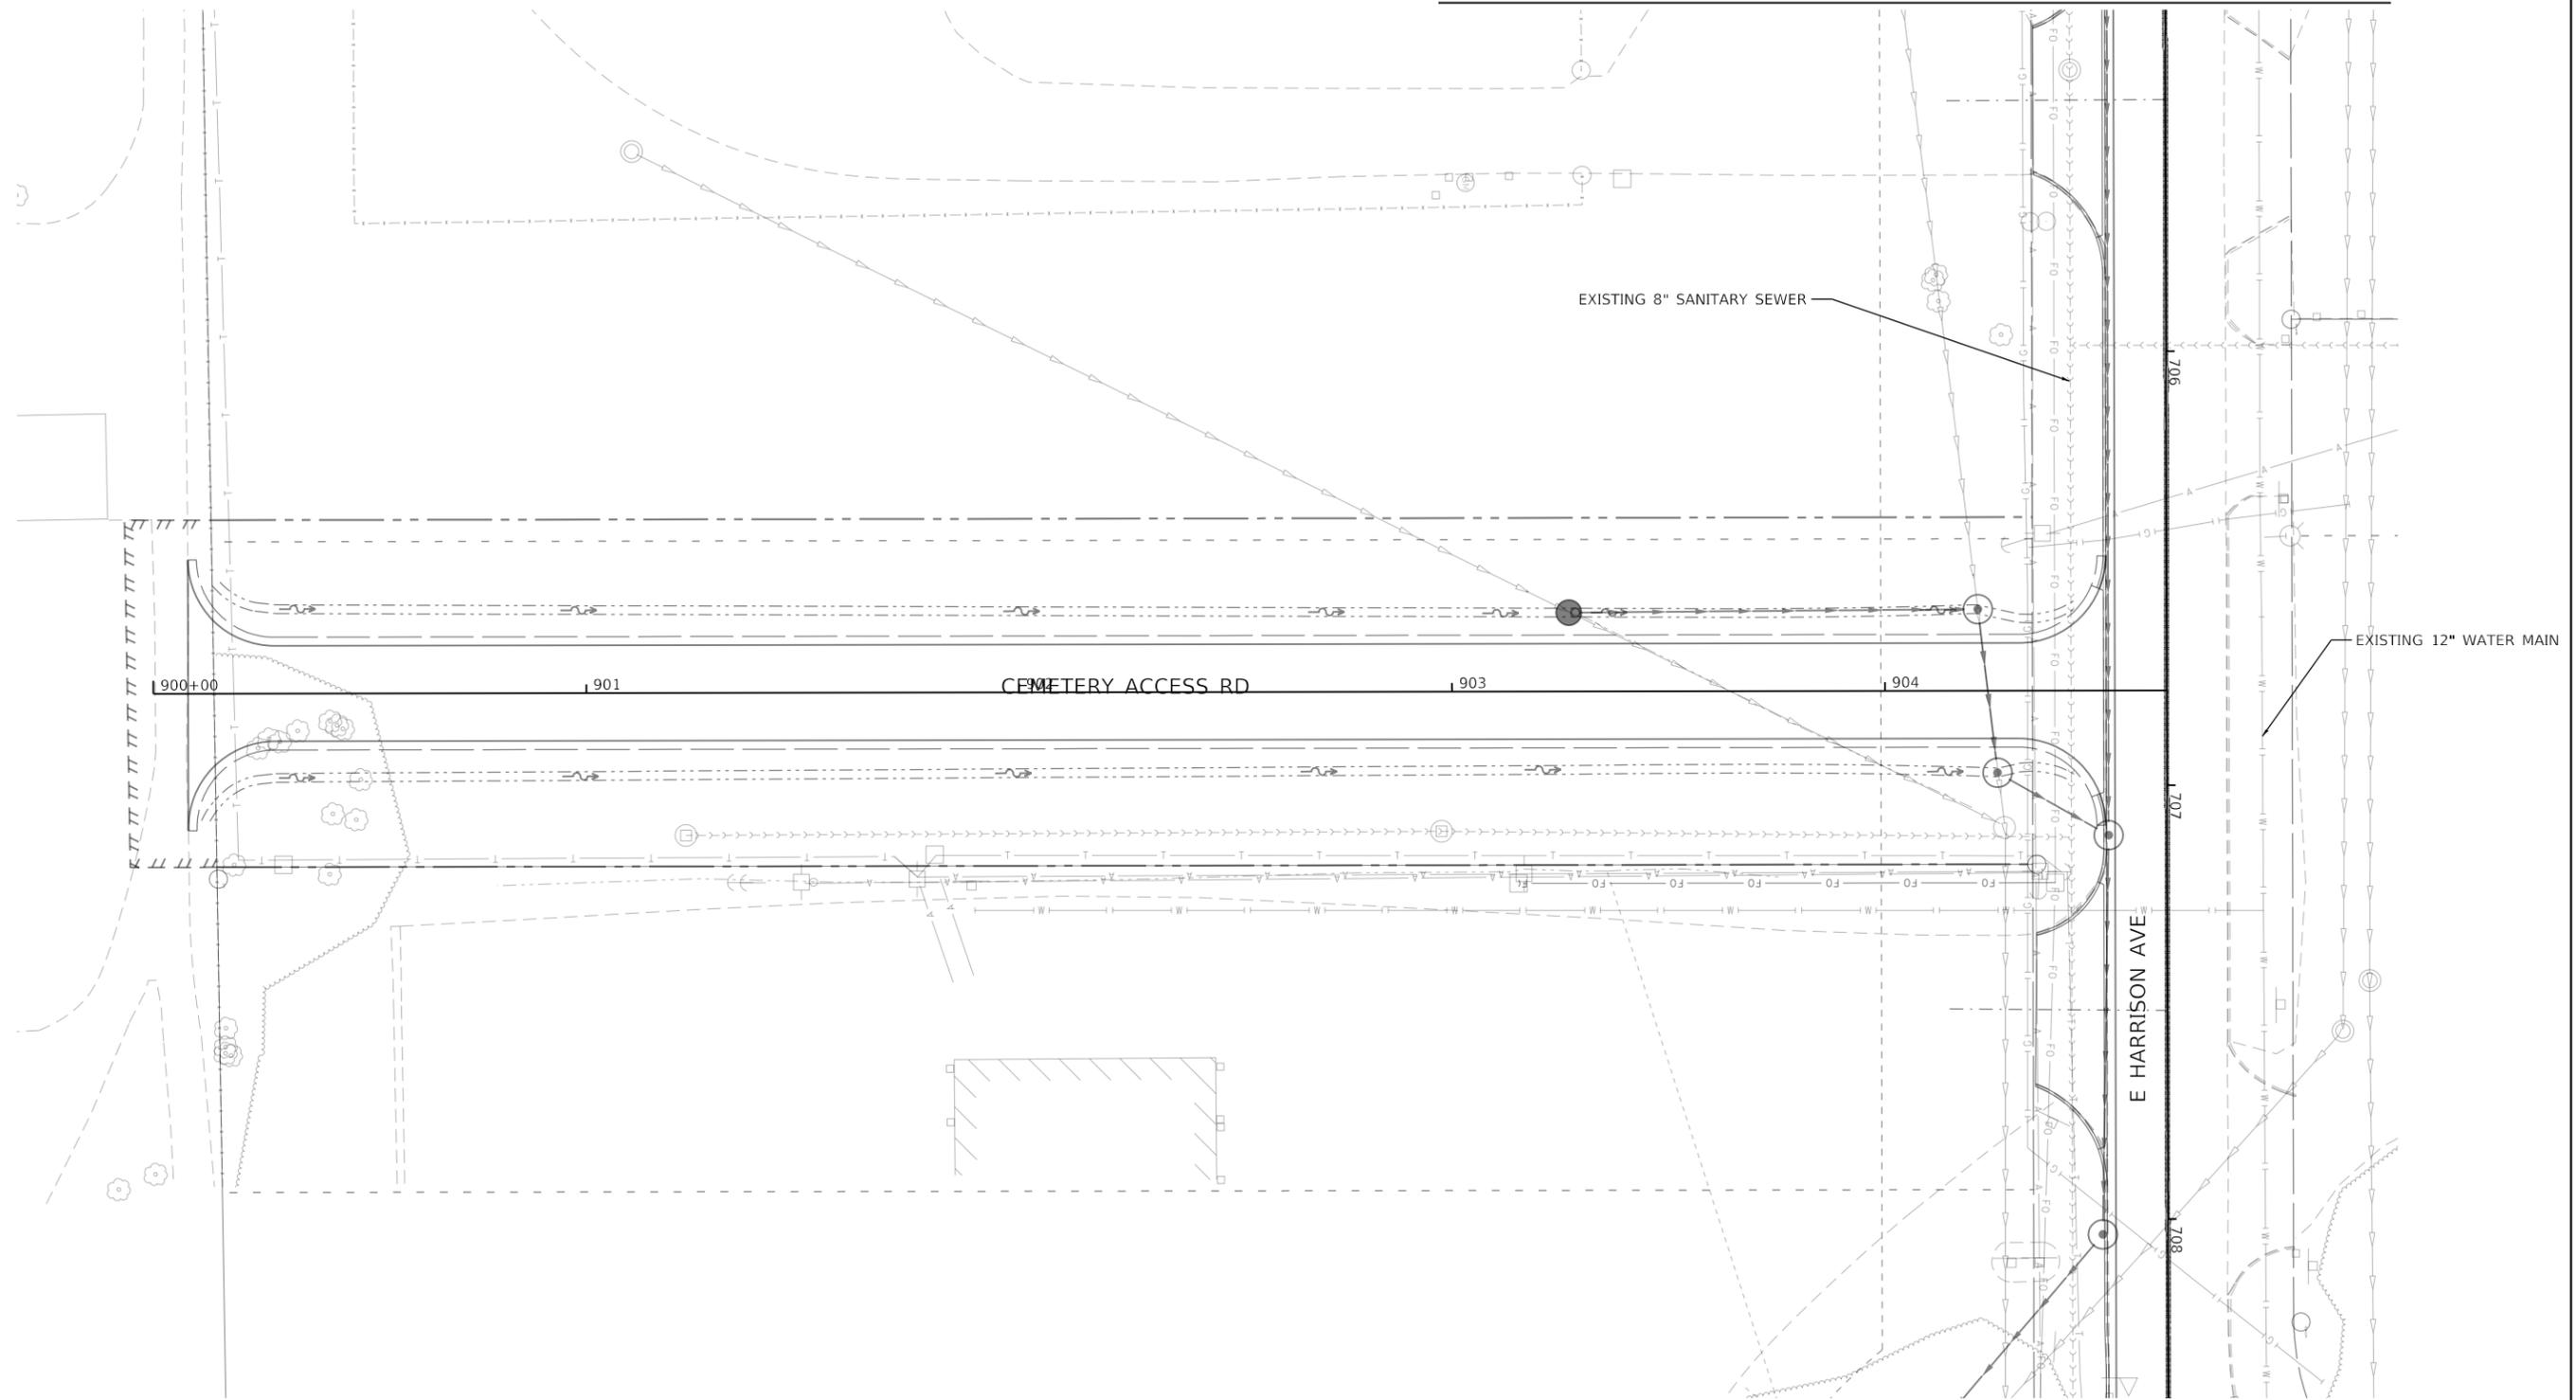

WATER MAIN KEY MAP PLAN VIEW NO. 20

**NOTES**

1. NO PROPOSED WATER MAIN WORK IN THIS AREA.
2. NO EXISTING WATER MAIN OR SANITARY SEWER ADJUSTMENT WORK IN THIS AREA.

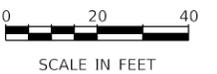

MODEL: Default  
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USER NAME = brooke.henry
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PLOT DATE = 10/27/2021

DESIGNED - BNH	REVISED -
DRAWN - BNH	REVISED -
CHECKED - PSA	REVISED -
DATE - 10/22/2021	REVISED -

**STATE OF ILLINOIS  
DEPARTMENT OF TRANSPORTATION**

**WATER MAIN RELOCATION PLAN AND SANITARY SEWER ADJUSTMENTS  
EXISTING UTILITY PLAN**

SCALE: 1"=20' SHEET 25 OF 31 SHEETS STA. 900+00 TO STA. 904+60


F.A.U. RTE.	SECTION	COUNTY	TOTAL SHEETS	SHEET NO.
7448	09-00933-01-BR	MACON	1019	537
CONTRACT NO. 95893				
ILLINOIS FED. AID PROJECT				

**GENERAL NOTES**

- WATER MAIN CONSTRUCTION PHASES 1 THROUGH 3B SHALL BE PERFORMED DURING ROADWAY CONSTRUCTION PRE-STAGES A THROUGH H. WATER MAIN CONSTRUCTION PHASES 4 THROUGH 5 SHALL BE PERFORMED DURING ROADWAY CONSTRUCTION STAGE 1. PHASE 6 SHALL BE PERFORMED AS NEEDED FOR CONSTRUCTION.
- WATER MAIN ABANDONMENT AND REMOVAL IS NOT REQUIRED TO BE PERFORMED AT ANY SPECIFIC POINT DURING THE WATER MAIN PHASING AND SEQUENCING BUT IS THE RESPONSIBILITY OF THE CONTRACTOR AND MUST BE PERFORMED AS NEEDED FOR CONSTRUCTION. ADDITIONALLY, EXISTING WATER MAINS IN CONFLICT WITH THE PROPOSED PIER FOOTING AND/OR OTHER ROADWAY AND BRIDGE CONSTRUCTION MUST BE REMOVED AS DETAILED IN THE PLANS.
- ALL WORK REQUIRES A COORDINATION MEETING WITH THE CITY A MINIMUM OF 48 HOURS IN ADVANCE.
- MAXIMUM ALLOWABLE DURATION FOR EACH SHUT DOWN IS 6 HOURS UNLESS OTHERWISE NOTED. ALL SHUT DOWNS MUST BE COORDINATED WITH THE CITY OF DECATUR AND THE CUSTOMERS BEING AFFECTED. CONTRACTOR SHALL PERFORM SHUTDOWNS AT A TIME THAT IS APPROVED BY THE CITY AND BY THE CUSTOMER BEING AFFECTED. THIS MAY REQUIRE THAT WORK BE PERFORMED DURING NON STANDARD WORKING HOURS, SUCH AS OVERNIGHT OR ON THE WEEKEND. ALL WORK, REGARDLESS OF THE TIME AND DAY SHALL BE PERFORMED AT NO ADDITIONAL COST TO THE CONTRACT. THE ENGINEER HAS PERFORMED SOME ADVANCE COORDINATION WITH CUSTOMERS. SEE NOTES IN THE UPPER RIGHT OF THIS SHEET.
- CONTRACTOR IS NOT ALLOWED TO OPERATE EXISTING VALVES AND HYDRANTS. EXISTING VALVES AND HYDRANTS ARE ONLY TO BE OPERATED BY THE CITY OF DECATUR.
- THE SEQUENCING PLAN DETAILED HEREIN IS THE ENGINEER'S GENERAL RECOMMENDED APPROACH, WHICH MAY NEED TO BE REVISED BASED ON FIELD CONDITIONS, EXISTING VALVE OPERABILITY, ETC. CONTRACTOR REQUESTED CHANGES TO THE SEQUENCING MAY BE CONSIDERED BUT MUST BE SUBMITTED IN ADVANCE TO THE CITY AND THE ENGINEER FOR APPROVAL. ANY CHANGES TO THE SEQUENCING SHALL BE AT NO ADDITIONAL COST TO THE CONTRACT.
- ALL PREPARATION WORK, INCLUDING, BUT NOT LIMITED TO, EXCAVATION, THRUST BLOCKS, PIPE CLEANING, TEST SHUTDOWNS, ETC. SHALL BE DONE IN ADVANCE OF CONSTRUCTING THE PROPOSED CONNECTIONS TO REDUCE SHUT DOWN TIMES. ALL PROPOSED FITTINGS, VALVES, AND HYDRANTS SHALL BE LOCATED ON-SITE, IN ADVANCE OF CONSTRUCTION TO PROVIDE SUFFICIENT OPPORTUNITY FOR THE PROPOSED APPURTENANCES TO BE INSPECTED.
- PROVIDE ALL TEMPORARY AND PERMANENT BRACING/ THRUST BLOCKING REQUIRED FOR ALL PRESSURIZED PIPING AND SYSTEMS.
- THE STATION LOCATIONS IN THE PHASING NOTES REFERENCE THE PROPOSED WATER MAIN BASELINE.
- FLUSHING, DISINFECTION, AND DE CHLORINATION OF WATER MAIN SYSTEM, INCLUDING BOTH THE BRANCH CONNECTIONS (E.G. THE 12" WATER MAIN IN E. HARRISON AVENUE) AND THE MAIN LINES SHALL BE PERFORMED IN ACCORDANCE WITH AWWA REQUIREMENTS. THE CONTRACTOR SHALL SUBMIT A DETAILED PLAN AND SCHEDULE FOR THESE OPERATIONS TO THE CITY AND THE ENGINEER A MINIMUM OF 7 DAYS IN ADVANCE FOR REVIEW AND APPROVAL.
- A MINIMUM OF TWO (2) WEEKS IN ADVANCE OF BEGINNING CONSTRUCTION, CONTRACTOR SHALL FIELD VERIFY ALL EXISTING WATER MAIN ELEVATIONS. ALL STATIONING IS APPROXIMATE.

**PHASE 1**

- GENERALLY, INSTALL PIPE AND FITTINGS SOUTH TO NORTH FROM STA. 29+15 TO 34+82 AS SHOWN ON THE PLANS.
- INSTALL 30" VALVE AT STA. 29+15.
- SET TEE AND FIRE HYDRANT AT STA. 29+32.
- SET 30"x8" TEE, 8" VALVE, AND TEMPORARY CAP AT STA. 30+49.
  - THIS WORK IS IN PREPARATION FOR CONNECTION NO. 4, WHICH WILL BE COMPLETED AT THE END OF PHASE 1 (8" CONNECTION FOR REFRESHMENT SERVICES AT 2112 BRUSH COLLEGE ROAD).

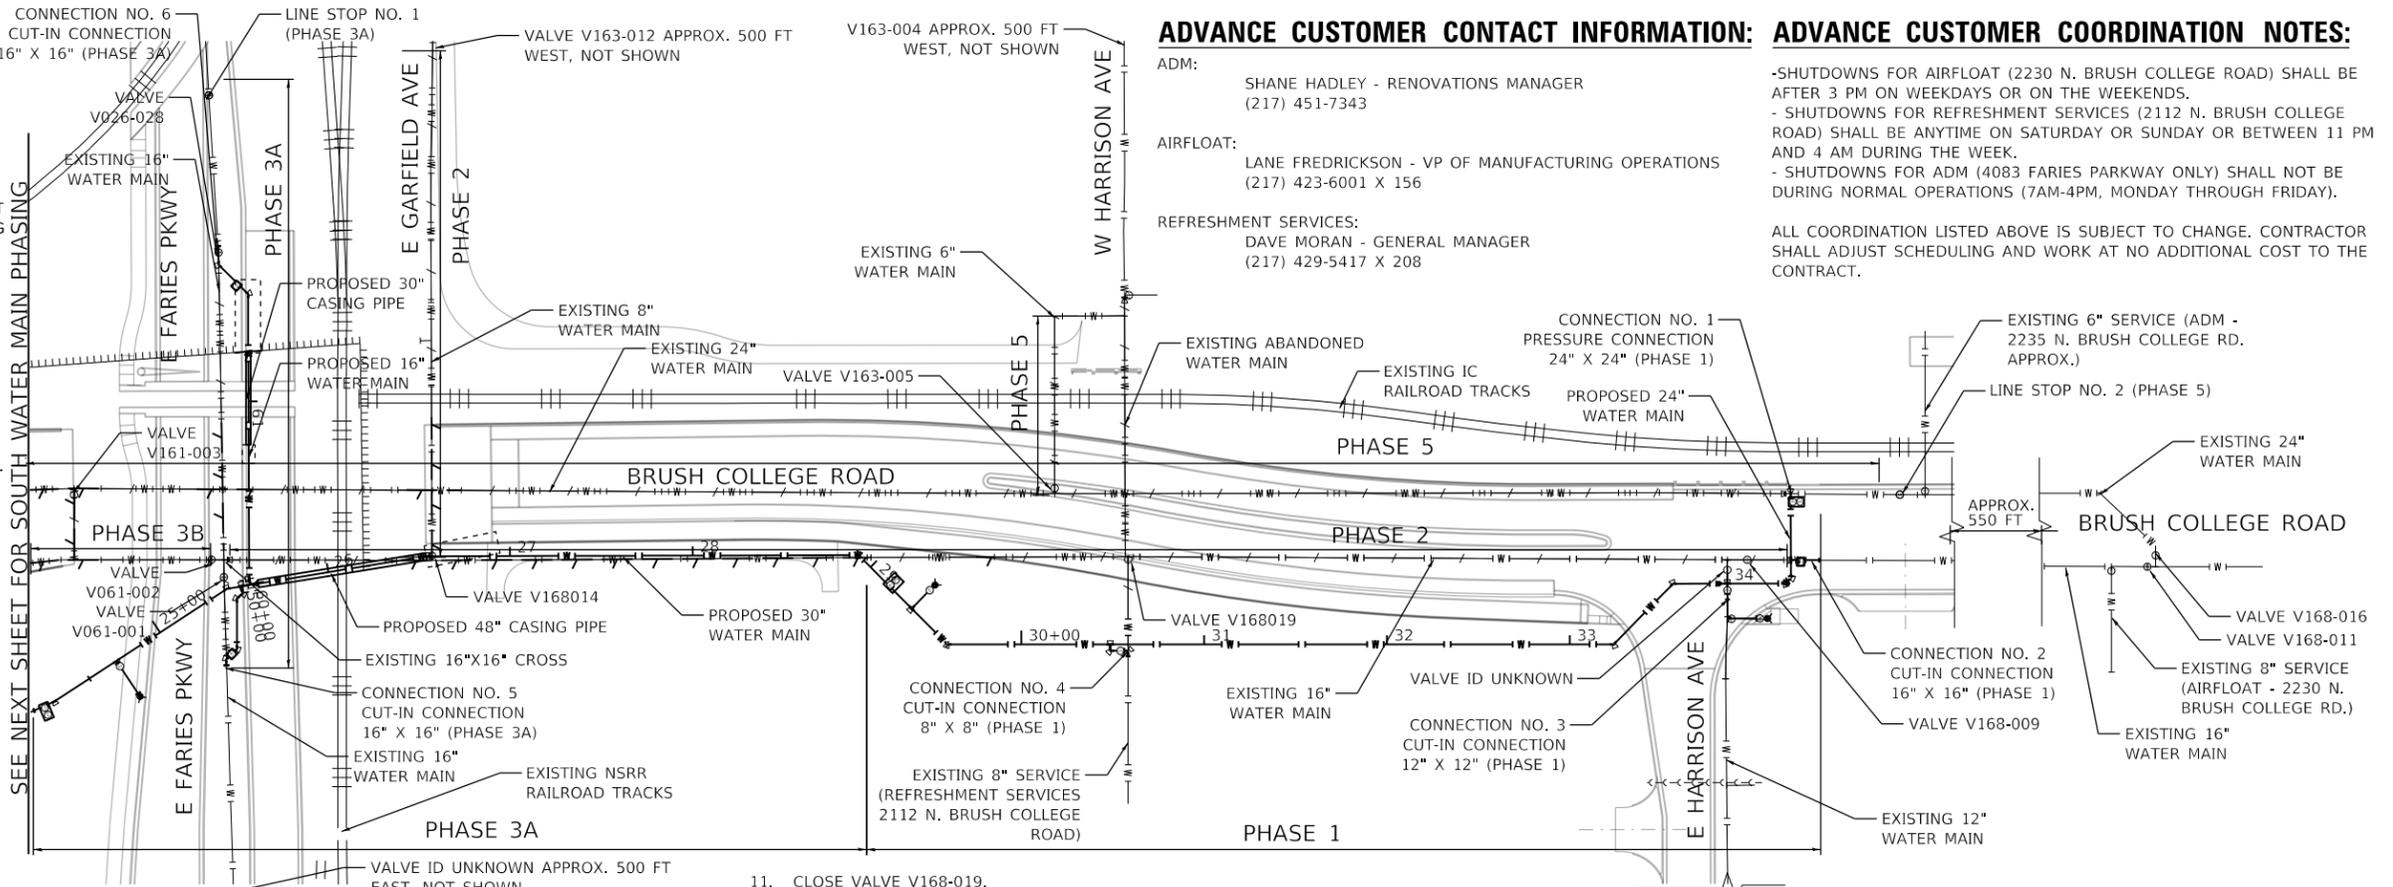

- CLOSE EXISTING VALVE V168-008 AND THE EXISTING VALVE (UNKNOWN ID) AT BRUSH COLLEGE ROAD AND E. HARRISON AVENUE.
  - INSTALL PERMANENT CAP ON EXISTING 12" WATER MAIN TO WEST OF FUTURE CONNECTION POINT.
  - INSTALL TEMPORARY CAP ON EXISTING 12" WATER MAIN TO EAST OF FUTURE CONNECTION POINT.
  - OPEN VALVE V168-008 TO PLACE 12" WATER MAIN BACK INTO SERVICE.
  - INSTALL 24"x12" TEE, VALVE, PIPING AND APPURTENANCES AT STA. 34+00 INCLUDING A TEMPORARY CAP AND THE PROPOSED HYDRANT ASSEMBLY AT THE NORTHEAST CORNER OF BRUSH COLLEGE ROAD AND E. HARRISON AVENUE.
- CLOSE EXISTING VALVES V168-011, V168-009, AND THE 8" SERVICE VALVE FOR AIRFLOAT (2230 N. BRUSH COLLEGE ROAD).
  - INSTALL PERMANENT CAP ON EXISTING 16" WATER MAIN TO THE SOUTH OF FUTURE CONNECTION POINT.
  - INSTALL TEMPORARY CAP ON EXISTING 16" WATER MAIN TO THE NORTH OF FUTURE CONNECTION POINT.
  - OPEN EXISTING VALVES V168-011 AND THE 8" SERVICE VALVE FOR AIRFLOAT (2230 N. BRUSH COLLEGE ROAD) TO PLACE THE 16" WATER MAIN AND AIRFLOAT BACK INTO SERVICE.
  - INSTALL 24"x16" TEE, VALVE, PIPING, AND APPURTENANCES AT STA. 34+46, INCLUDING A TEMPORARY CAP.
- INSTALL CONNECTION NO. 1 (PRESSURE CONNECTION) ON THE EXISTING 24" WATER MAIN AT STA. 34+82.
- FLUSH, PRESSURE TEST, DISINFECT, AND PLACE THE PHASE 1 WATER MAIN INTO SERVICE.
  - WATER MAIN SHALL BE FLUSHED TO BRUSH COLLEGE ROAD OR OTHER SUITABLE LOCATION. PROVIDE TRAFFIC CONTROL ON BRUSH COLLEGE ROAD AND E. HARRISON AVENUE AS NEEDED FOR THE FLUSHING OPERATION AND TO MAINTAIN TRAFFIC OPERATIONS. PROVIDE ALL TEMPORARY PIPING, VALVES, AND APPURTENANCES NEEDED TO PERFORM THIS FLUSHING OPERATION.
  - TEMPORARY FLUSHING PIPING SHALL BE 30" DIAMETER MINIMUM.
  - THE CONTRACTOR'S ATTENTION IS CALLED TO THE CITY'S REQUIREMENT FOR UTILIZING PIGS FOR THE FLUSHING OPERATIONS. REFER TO SPECIAL PROVISIONS FOR ADDITIONAL DETAILS.
- CLOSE VALVES V168-011 AND THE EXISTING 8" SERVICE VALVE FOR AIRFLOAT (2230 N. BRUSH COLLEGE ROAD).
  - REMOVE TEMPORARY CAPS AND INSTALL CONNECTION NO. 2 (CUT-IN) AT STA. 34+46, RT 15.5 FT.
  - OPEN VALVE V168-011, 8" SERVICE VALVE FOR AIRFLOAT (2230 N. BRUSH COLLEGE ROAD), AND THE PROPOSED 16" VALVE AT STA. 34+46, RT 5.3 FT.
- CLOSE VALVE V168-008.
  - REMOVE TEMPORARY CAPS AND INSTALL CONNECTION NO. 3 (CUT-IN) AT STA. 34+00, RT. 8.6 FT.
  - OPEN VALVE V168-008 AND THE PROPOSED 12" VALVE AT STA. 31+51, RT 3.6 FT.

**PHASE 2**

- CLOSE VALVES V163-012, V061-002, V061-001 AND V026-028.
- INSTALL TWO (2) PERMANENT CAPS ON THE EXISTING 16" WATER MAIN JUST NORTH OF THE EXISTING 16"x16" CROSS AT FARIES AND BRUSH COLLEGE ROAD INTERSECTION.
- OPEN VALVES V061-001, V061-002 AND V026-028, WHICH WILL PLACE THE EXISTING 16" FARIES PKWY WATER MAIN BACK INTO SERVICE.
- THE CITY OF DECATUR WILL ABANDON IN PLACE THE EXISTING 6" WATER MAIN WEST OF BRUSH COLLEGE ROAD IN E. GARFIELD AVENUE BEGINNING JUST EAST OF THE FIRE HYDRANT (TO BE MAINTAINED IN SERVICE) AT FARIES PARKWAY APPROX. STA. 204+22, LT 136' AND EXTEND TO JUST WEST OF THE FIRE HYDRANT (TO BE REMOVED BY THE CONTRACTOR) AT FARIES PARKWAY APPROX. STA. 209+50, LT 110'. THE CITY WILL PROVIDE A PERMANENT PLUG/CAP AND THRUST BLOCK FOR THE EXISTING WATER MAIN TO BE MAINTAINED IN SERVICE AT APPROX. STA. 204+22, LT 136'. WHEN THE CONTRACTOR REMOVES THE HYDRANT AT APPROX. STA. 209+50, LT 110', THE CONTRACTOR SHALL ALSO PLUG THE EXISTING 6" WATER MAIN EAST AND WEST OF THE HYDRANT. THIS WILL ALLOW THE CITY TO ABANDON THE WATER MAIN WEST OF THIS LOCATION AND ALLOW THE CONTRACTOR TO ABANDON THE WATER MAIN EAST OF THIS LOCATION.
- OPEN VALVE V163-012.
- ABANDON THE FOLLOWING WATER MAINS:
  - EXISTING 16" WATER MAIN ALONG BRUSH COLLEGE ROAD, BETWEEN E. FARIES PKWY AND E. HARRISON AVE.
  - EXISTING 6" WATER MAIN ALONG GARFIELD AVE. FROM BRUSH COLLEGE RD. TO EXISTING FIRE HYDRANT AT FARIES PARKWAY APPROX. STA. 209+50, LT 110'.

**PHASE 3A**

- INSTALL 48" CASING PIPE BY JACK AND BORE ALONG BRUSH COLLEGE ROAD UNDER NSRR TRACKS BETWEEN STA. 25+66 AND STA. 26+40.
- INSTALL 30" CASING PIPE BY JACK AND BORE ALONG FARIES PKWY UNDER IC RR TRACKS BETWEEN STA. 60+76 AND STA. 61+26.
- GENERALLY, INSTALL PIPE AND FITTINGS FROM NORTH TO SOUTH FROM STA. 29+15 TO STA. 24+25 AS SHOWN ON THE PLANS. FOR THE FOLLOWING WORK ITEMS. SEQUENCE WATER MAIN WORK AS REQUIRED FOR CONSTRUCTION IN ORDER TO MEET THE SUGGESTED STAGES OF CONSTRUCTION AND TRAFFIC CONTROL PLAN (SEE ESPECIALLY PRE STAGES A THROUGH H).
  - SET 30"x24" REDUCER AT STA. 26+60.
  - SET 24"x16" TEE AT STA. 25+57. LAY 16" PIPE AND FITTINGS TO THE WEST ALONG FARIES PKWY. INSTALL 16" VALVE AT STA. 61+66 AND TEMPORARILY CAP.
  - SET 24"x16" TEE AT STA. 25+52. LAY 16" PIPE AND FITTINGS TO THE EAST ALONG FARIES PKWY. INSTALL 16" VALVE AT STA. 50+41 AND TEMPORARILY CAP.
  - SET 24"x6" TEE AND FIRE HYDRANT AT STA. 24+72.
  - INSTALL 24" VALVE AT STA. 24+25.
  - OPEN PROPOSED 30" VALVE AT STA. 29+15.

**ADVANCE CUSTOMER CONTACT INFORMATION: ADVANCE CUSTOMER COORDINATION NOTES:**

ADM: SHANE HADLEY - RENOVATIONS MANAGER (217) 451-7343

AIRFLOAT: LANE FREDRICKSON - VP OF MANUFACTURING OPERATIONS (217) 423-6001 X 156

REFRESHMENT SERVICES: DAVE MORAN - GENERAL MANAGER (217) 429-5417 X 208

-SHUTDOWNS FOR AIRFLOAT (2230 N. BRUSH COLLEGE ROAD) SHALL BE AFTER 3 PM ON WEEKDAYS OR ON THE WEEKENDS.

- SHUTDOWNS FOR REFRESHMENT SERVICES (2112 N. BRUSH COLLEGE ROAD) SHALL BE ANYTIME ON SATURDAY OR SUNDAY OR BETWEEN 11 PM AND 4 AM DURING THE WEEK.

- SHUTDOWNS FOR ADM (4083 FARIES PARKWAY ONLY) SHALL NOT BE DURING NORMAL OPERATIONS (7AM-4PM, MONDAY THROUGH FRIDAY).


ALL COORDINATION LISTED ABOVE IS SUBJECT TO CHANGE. CONTRACTOR SHALL ADJUST SCHEDULING AND WORK AT NO ADDITIONAL COST TO THE CONTRACT.

**PHASE 3A**

- FLUSH, PRESSURE TEST, DISINFECT, AND PLACE THE PHASE 3A WATER MAIN INTO SERVICE.
  - WATER MAIN SHALL BE FLUSHED TO THE PROPOSED STORM SEWER DRAIN SYSTEM LOCATED IN FARIES PARKWAY (STRUCTURE I.D. 205, 208, 209, OR OTHER SUITABLE LOCATION). REFER TO DRAINAGE SHEETS FOR ADDITIONAL DETAIL. PROVIDE TRAFFIC CONTROL ON FARIES PARKWAY AS NEEDED FOR FLUSHING OPERATION AND TO MAINTAIN TRAFFIC OPERATIONS. PROVIDE ALL TEMPORARY PIPING, VALVES, AND APPURTENANCES NEEDED TO PERFORM THIS FLUSHING OPERATION.
  - TEMPORARY FLUSHING PIPING SHALL BE THE SAME SIZE AS THE WATER MAIN BEING FLUSHED.
  - THE CONTRACTOR'S ATTENTION IS CALLED TO THE CITY'S REQUIREMENT FOR UTILIZING PIGS FOR THE FLUSHING OPERATIONS. REFER TO SPECIAL PROVISIONS FOR ADDITIONAL DETAILS.
- CLOSE VALVES V061-001 AND UNKNOWN VALVE EAST ON FARIES (NOT SHOWN).
  - INSTALL PERMANENT CAP ON EXISTING 16" WATER MAIN AT STA. 50+25, RT 2.4 FT.
  - INSTALL CONNECTION NO. 5 (CUT-IN) AT STA. 50+47.
  - OPEN THE PROPOSED 16" VALVE JUST EAST OF THE PROPOSED 24" WATER MAIN AND THE UNKNOWN VALVE EAST ON FARIES (NOT SHOWN). THIS WILL PLACE THE EASTERN SEGMENT OF THE 16" FARIES PKWY WATER MAIN BACK INTO SERVICE.
  - VALVE V061-001 WILL REMAIN CLOSED.
- INSTALL LINE STOP NO. 1 IN FARIES PKWY, JUST WEST OF BRUSH COLLEGE RD. CLOSE VALVE V061-002.
  - INSTALL PERMANENT CAP ON EXISTING 16" WATER MAIN AT STA. 61+78, LT 3.1 FT.
  - INSTALL CONNECTION NO. 6 (CUT-IN) AT STA. 61+91.
  - OPEN THE PROPOSED 16" VALVE AT STA. 61+66 AND REMOVE LINE STOP NO. 1. THIS WILL PLACE THE 16" FARIES PKWY WATER MAIN SYSTEM BACK INTO SERVICE.
  - VALVE V061-002 WILL REMAIN CLOSED.
- ABANDON 16" WATER MAIN ALONG FARIES PKWY AS SHOWN ON THE PLANS.

**PHASE 3B**

- CLOSE VALVE V161-003, JUST SOUTH OF FARIES PKWY IN BRUSH COLLEGE RD.
- INSTALL ALL PERMANENT CAPS AS NEEDED TO ABANDON THE EXISTING 12" WATER MAIN ALONG BRUSH COLLEGE RD., SOUTH OF FARIES PKWY. ABANDON EXISTING 8" WATER MAIN STUBS.

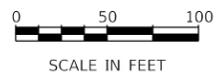

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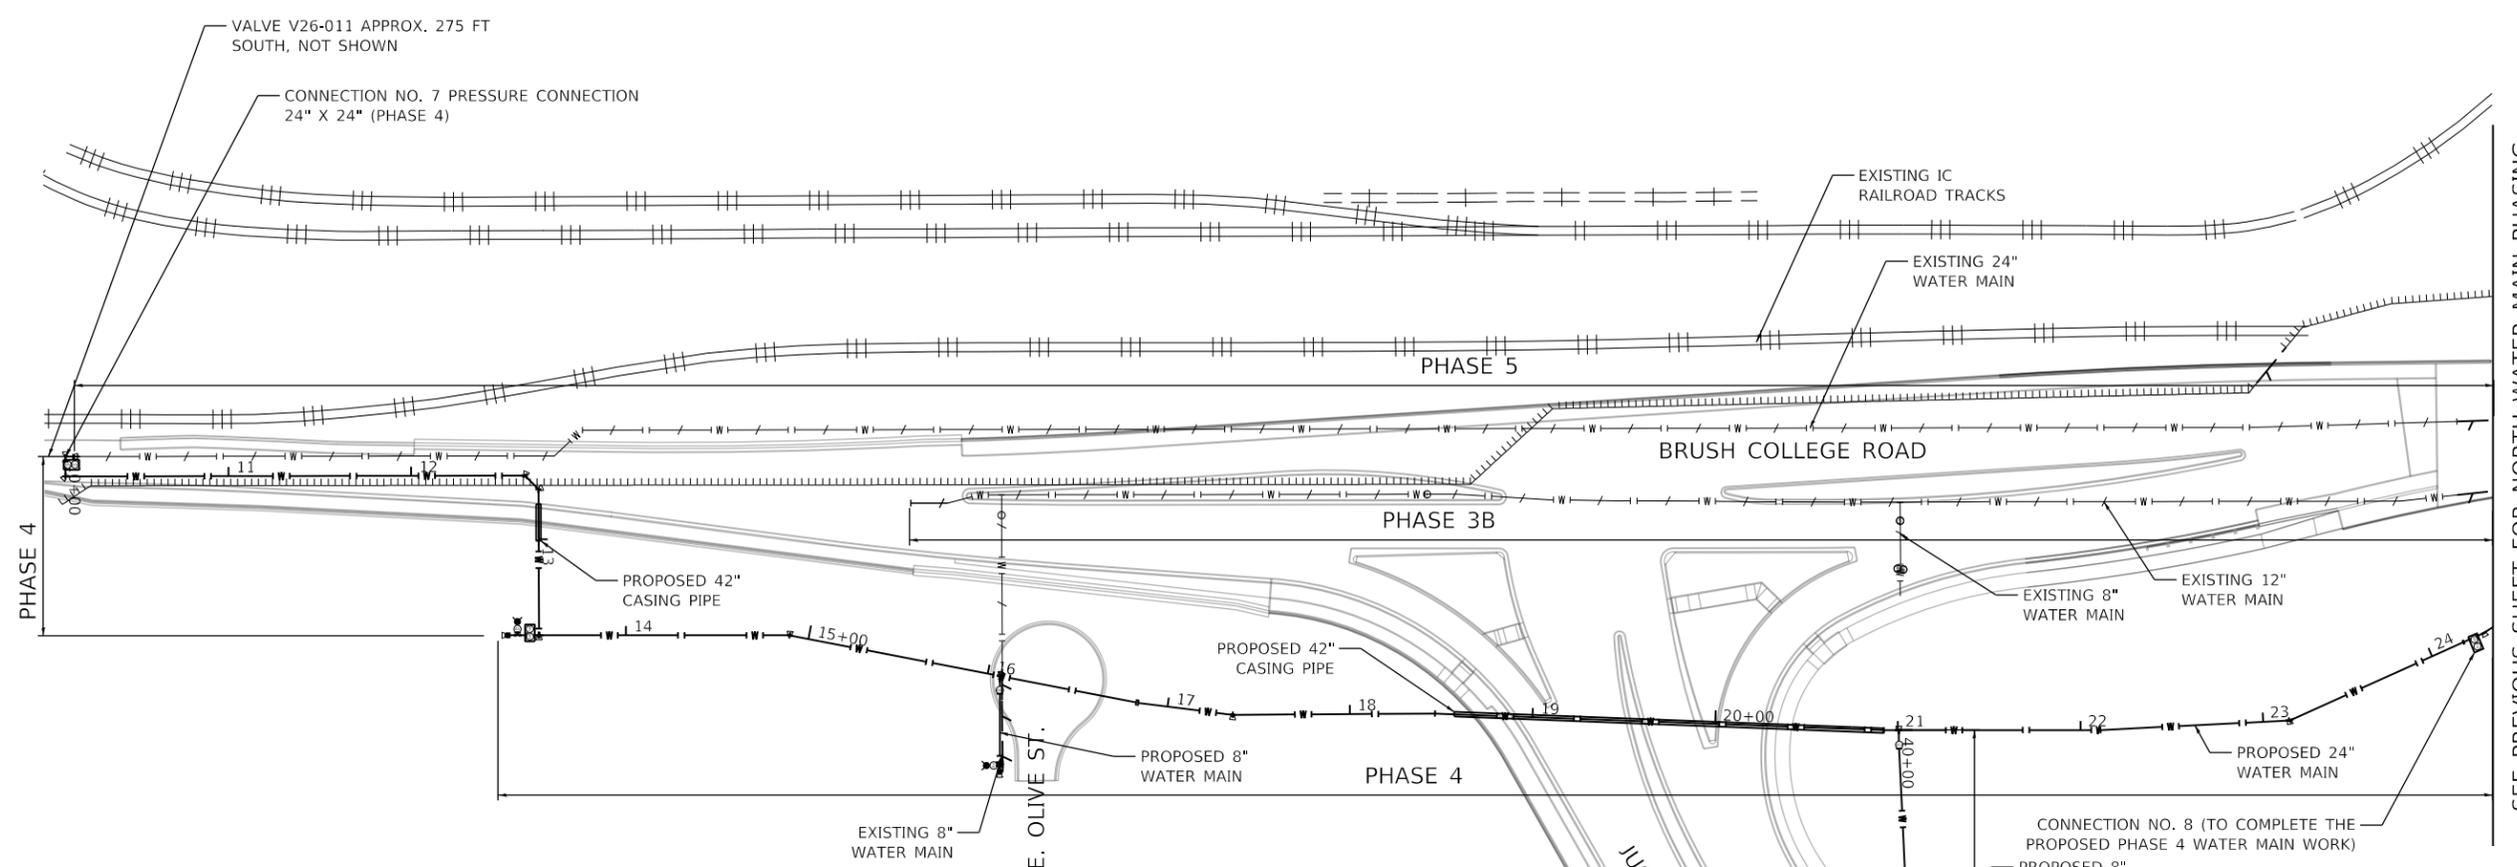
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	DATE - 10/22/2021	REVISED -

**STATE OF ILLINOIS  
DEPARTMENT OF TRANSPORTATION**

**WATER MAIN RELOCATION PLAN AND SANITARY SEWER ADJUSTMENTS**  
**WATER MAIN PHASING PLAN NORTH**

SCALE: 1"=50' SHEET 26 OF 31 SHEETS STA. N/A TO STA. N/A

F.A.U. RTE.	SECTION	COUNTY	TOTAL SHEETS	SHEET NO.
7448	09-00933-01-BR	MACON	1019	538
CONTRACT NO. 95893				
ILLINOIS FED. AID PROJECT				



SEE PREVIOUS SHEET FOR NORTH WATER MAIN PHASING

**PHASE 4**

1. GENERALLY, INSTALL PIPE AND FITTINGS FROM NORTH TO SOUTH FROM STA. 24+25 TO STA. 10+00 AS SHOWN ON THE PLANS.
  - A. CONTRACTOR IS RECOMMENDED TO DELAY THE CONNECTION TO THE PROPOSED WATER MAIN AT STA. 24+25. UTILIZING THIS APPROACH, THE PHASE 4 WATER MAIN CAN BE USED TO FLUSH FROM SOUTH TO NORTH AND THEN USING TEMPORARY PIPING TO DISCHARGE INTO STRUCTURE I.D. 209. AFTER PRELIMINARY FLUSHING AND BEFORE DISINFECTION, CONTRACTOR CAN MAKE THE CONNECTION AT STA. 24+25.
2. SET 24"x8" TEE AT STA. 21+00 (E. LOGAN ST. EXTENDED).
  - A. INSTALL 8" VALVE, PIPING AND HYDRANT TO THE EAST FROM STA. 40+00 TO STA. 43+48.
  - B. SET 8"x6" TEE AND FIRE HYDRANT AT STA. 43+44.
  - C. INSTALL 8" PLUG IN EAST RUN OF TEE.
3. INSTALL 42" CASING PIPE BY OPEN CUT UNDER THE PROPOSED JUG HANDLE ROAD FROM STA. 18+57 TO STA. 20+92.
4. SET 24"x8" TEE AT STA. 16+07 (E. OLIVE ST.).
  - A. INSTALL 8" PIPING AND HYDRANT TO THE EAST.
  - B. SET 8"x6" TEE AND FIRE HYDRANT 40.5 FT.
  - C. INSTALL 8" PLUG IN EAST RUN OF TEE.
5. SET 24"x24" TEE AT STA. 13+52.
6. INSTALL 42" CASING PIPE BY OPEN CUT UNDER PROPOSED RETAINING WALL.
7. INSTALL 24" VALVE AT STA. 13+52, RT 5.1 FT.
8. SET 24"x6" TEE AT STA. 13+52, RT 11.8 FT AND INSTALL 6" VALVE AND FIRE HYDRANT.
9. INSTALL PERMANENT CAP AT STA. 13+52, RT 16.9 FT.
10. LAY 24" PIPE AND FITTINGS TO THE WEST.
11. INSTALL PIPING AND FITTINGS BETWEEN STA. 13+52 AND 10+00, INCLUDING INSTALLATION OF CONNECTION NO. 7 (PRESSURE CONNECTION WITH EXISTING 24" WATER MAIN)
12. FLUSH, PRESSURE TEST AND DISINFECT.
  - A. 24" WATER MAIN SHALL BE FLUSHED TO THE PROPOSED STORM SEWER DRAIN SYSTEM LOCATED ON FARIES PARKWAY (STRUCTURE I.D. 209 OR OTHER SUITABLE LOCATION). REFER TO DRAINAGE SHEETS FOR ADDITIONAL DETAIL. PROVIDE TRAFFIC CONTROL ON FARIES PARKWAY AS NEEDED FOR THE FLUSHING OPERATION AND TO MAINTAIN TRAFFIC OPERATIONS. PROVIDE ALL TEMPORARY PIPING, VALVES, AND APPURTENANCES NEEDED TO PERFORM THIS FLUSHING OPERATION. FOR FLUSHING THE 8" LOGAN STREET WATER MAIN, CONTRACTOR SHALL INSTALL TEMPORARY PIPING AND FLUSH TO THE PROPOSED E. FARIES PARKWAY DRAINAGE SYSTEM TO THE NORTH. FOR FLUSHING THE 8" OLIVE STREET WATER MAIN, CONTRACTOR SHALL UTILIZE THE EXISTING GREEN SPACE TO THE SOUTH OF OLIVE STREET, BUT SHALL PROVIDE ENERGY DISSIPATION, TEMPORARY TANKS, AND/OR SILT FENCE AS NEEDED TO PREVENT FLOODING.
  - B. TEMPORARY FLUSHING PIPING SHALL BE THE SAME SIZE AS THE WATER MAIN BEING FLUSHED.
  - C. THE CONTRACTOR'S ATTENTION IS CALLED TO THE CITY'S REQUIREMENT FOR UTILIZING PIGS FOR THE FLUSHING OPERATIONS. REFER TO THE SPECIAL PROVISIONS FOR ADDITIONAL DETAILS.


13. INSTALL CONNECTION NO. 8 (SLEEVED CONNECTION) TO THE PROPOSED VALVE AT STA. 24+25.
14. OPEN THE FOLLOWING VALVES TO PLACE THE WATER DISTRIBUTION SYSTEM BACK INTO COMPLETE SERVICE.
  - A. V026-011
  - B. PROPOSED VALVE AT STA. 24+25
  - C. PROPOSED VALVE AT STA. 34+82

**PHASE 5**

1. CLOSE VALVES V163-004 AND V163-005
  - A. INSTALL TWO (2) PERMANENT CAPS ON EXISTING 8" WATER MAIN IN W. HARRISON AVE. (WEST OF BRUSH COLLEGE RD.), JUST EAST OF EXISTING FIRE HYDRANT.
  - B. ABANDON EXISTING 8" WATER MAIN ALONG WEST HARRISON AVE.
  - C. OPEN VALVE V163-004.
  - D. THIS 8" WATER MAIN ABANDONMENT WORK CAN BE PERFORMED AT ANY POINT DURING THE CONSTRUCTION SEQUENCING.
2. INSTALL LINE STOP NO. 2 IN BRUSH COLLEGE RD., JUST NORTH OF E. HARRISON AVE. (SEE WATER MAIN KEY MAP PLAN VIEW NO. 5 FOR LOCATION). THE EXISTING 24" WATER MAIN SHALL NOT BE SHUT DOWN FOR LONGER THAN 12 HOURS. ALL WORK SHALL BE COORDINATED WITH THE CITY OF DECATUR AND PERFORMED ONLY AT APPROVED TIMES, WHICH MAY INCLUDE WEEKENDS AND/OR OVERNIGHT WORK.
  - A. CLOSE VALVE V026-011.
  - B. CLOSE THE PROPOSED VALVE AT STA. 34+82.
  - C. CLOSE THE PROPOSED VALVE (I.E. FOR THE PRESSURE CONNECTION) AT STA. 10+00.
  - D. WITHIN THE SAME SHUT DOWN PERIOD, INSTALL A PERMANENT CAP ON THE EXISTING 24" WATER MAIN BOTH JUST NORTH OF CONNECTION NO. 7 AND JUST SOUTH OF CONNECTION NO. 1.
  - E. ABANDON EXISTING 24" WATER MAIN ALONG BRUSH COLLEGE RD.
3. OPEN PREVIOUSLY CLOSED VALVES. REMOVE LINE STOP AND PLACE WATER DISTRIBUTION SYSTEM BACK INTO COMPLETE SERVICE.

**PHASE 6**

1. FIRE HYDRANT RELOCATIONS ALONG FARIES PARKWAY (NOT SHOWN IN THE WATER MAIN PHASING PLAN SHEETS) SHALL BE PERFORMED IN CONJUNCTION WITH ROADWAY CONSTRUCTION WORK OR AS NEEDED FOR CONSTRUCTION.

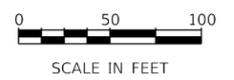

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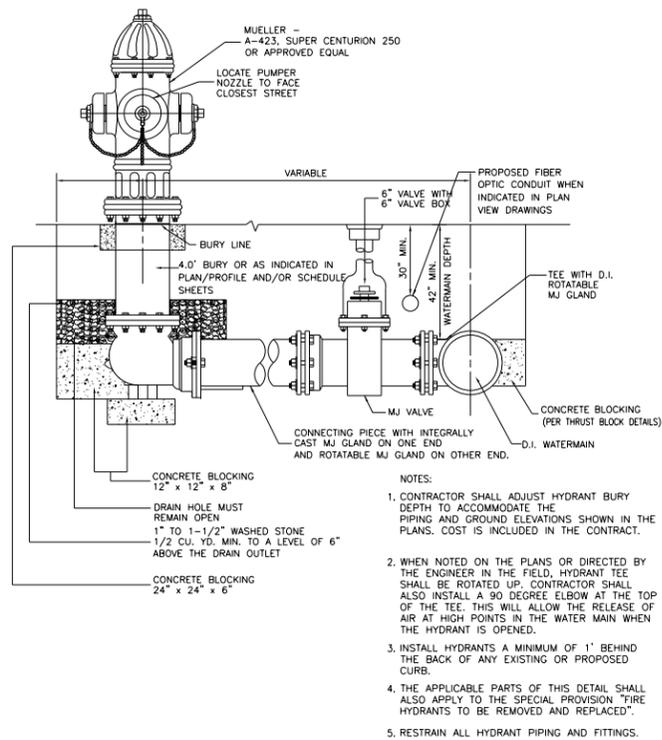
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**STATE OF ILLINOIS  
DEPARTMENT OF TRANSPORTATION**


<b>WATER MAIN RELOCATION PLAN AND SANITARY SEWER ADJUSTMENTS</b>	
<b>WATER MAIN PHASING PLAN SOUTH</b>	
SCALE: 1"=50'	SHEET 27 OF 31 SHEETS STA. N/A TO STA. N/A

F.A.U. RTE. 7448	SECTION 09-00933-01-BR	COUNTY MACON	TOTAL SHEETS 1019	SHEET NO. 539
CONTRACT NO. 95893				
ILLINOIS FED. AID PROJECT				


**FIRE HYDRANT WITH AUXILIARY VALVE AND VALVE BOX**




**CONCRETE THRUST BLOCKS (SPECIAL) - 4" TO 10"**

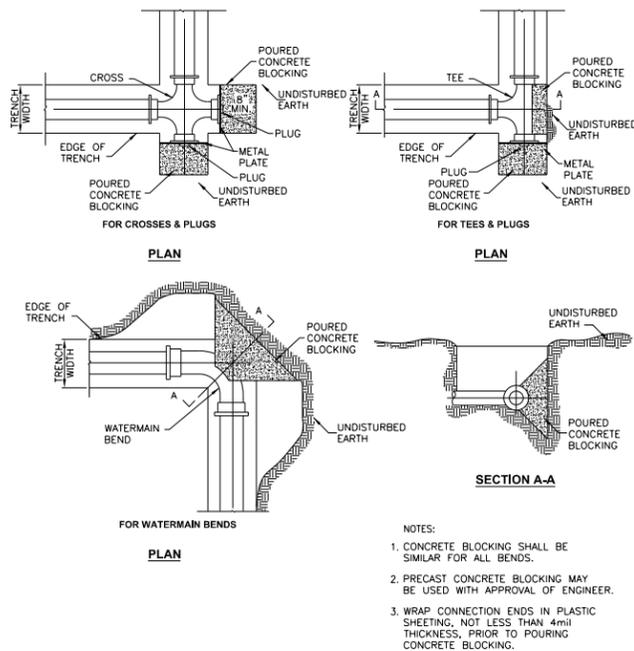



**CONCRETE THRUST BLOCKS (SPECIAL) - 12" TO 42"**

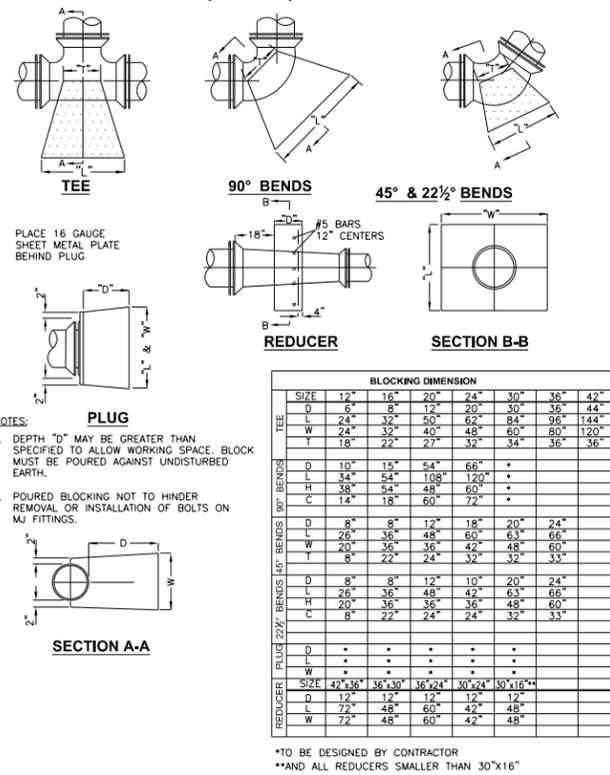

**WATER VALVES AND VALVE BOX 12" AND SMALLER**

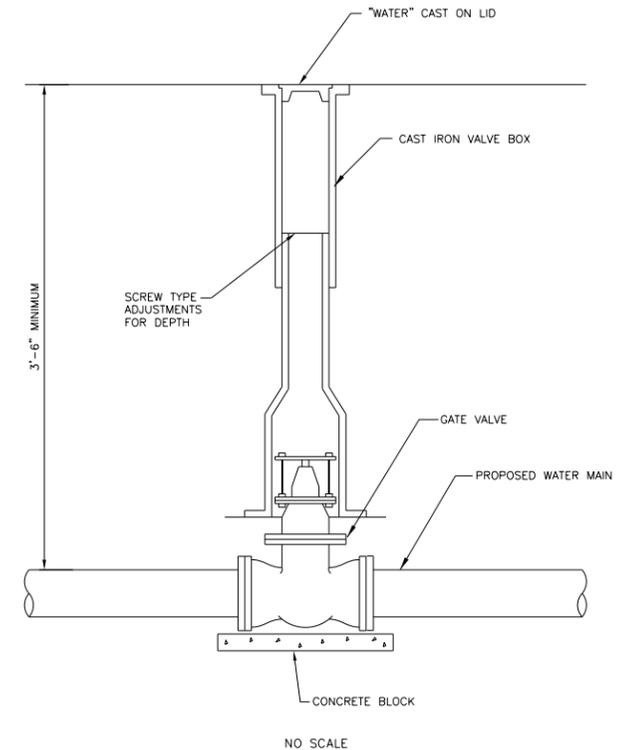

**WATER VALVES AND VALVE BOX 16" AND LARGER**

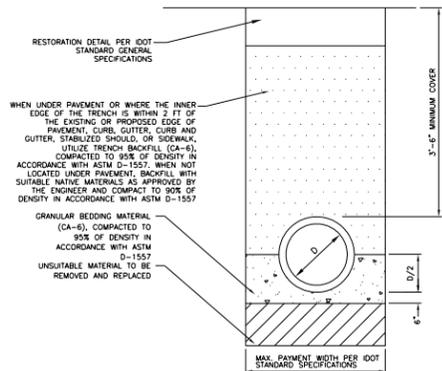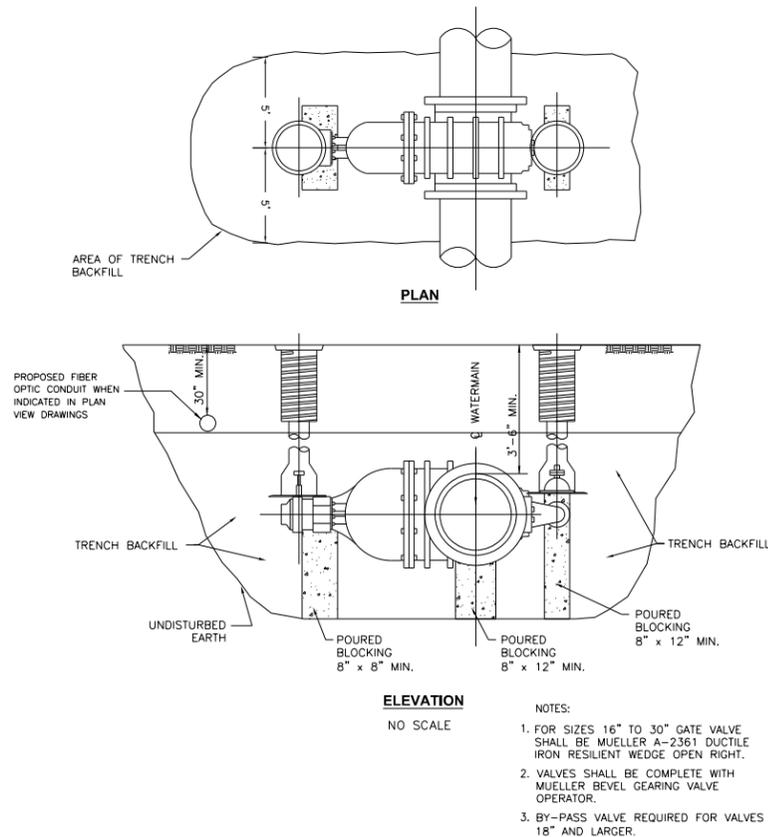


**TYPICAL WATER MAIN TRENCH CROSS SECTION**

**NO SCALE**

**NOTES:**

- TYPICAL WATER MAIN TRENCH CROSS SECTION SHALL APPLY TO DUCTILE IRON WATER MAIN AND OPEN CUT STEEL CASINGS.
- BETWEEN STA. 24+30 AND 30+55 (APPROX.), INSTALL FIBER OPTIC CONDUIT A MIN. HORIZONTAL DISTANCE OF 18" FROM THE PROPOSED 24" DIA. AND 30" DIA. WATER MAINS (AS MEASURED FROM OD TO OD). STANDARD BURY DEPTH SHALL BE 30"-36", AND SHALL BE A MINIMUM OF 6" ABOVE THE TOP OF THE PROPOSED 24" AND 30" DIA. WATER MAINS. THE FOLLOWING EXCEPTIONS SHALL APPLY:
  - WHEN INSTALLED INSIDE THE PROPOSED 48" DIAMETER CASING PIPE.
  - WHEN THE PROPOSED WATER MAIN HAS ONLY 36-INCHES OF BURY DEPTH (SEE WATER MAIN STATION 24+55 TO 24+70, APPROX.), IN WHICH CASE THE 4" HDPE CONDUIT IS PERMITTED TO BE INSTALLED AT APPROXIMATELY THE SAME ELEVATION AS THE PROPOSED WATER MAIN.

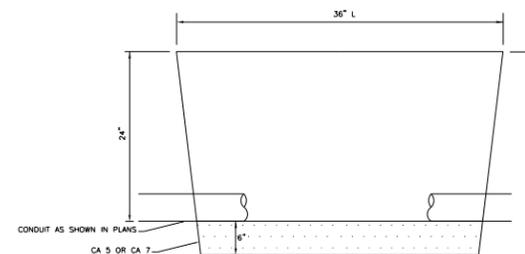

**COMMUNICATIONS VAULT**

**NO SCALE**

**NOTES:**

- TYPICAL WATER MAIN TRENCH CROSS SECTION SHALL APPLY TO DUCTILE IRON WATER MAIN AND OPEN CUT STEEL CASINGS.
- BETWEEN STA. 24+30 AND 30+55 (APPROX.), INSTALL FIBER OPTIC CONDUIT A MIN. HORIZONTAL DISTANCE OF 18" FROM THE PROPOSED 24" DIA. AND 30" DIA. WATER MAINS (AS MEASURED FROM OD TO OD). STANDARD BURY DEPTH SHALL BE 30"-36", AND SHALL BE A MINIMUM OF 6" ABOVE THE TOP OF THE PROPOSED 24" AND 30" DIA. WATER MAINS. THE FOLLOWING EXCEPTIONS SHALL APPLY:
  - WHEN INSTALLED INSIDE THE PROPOSED 48" DIAMETER CASING PIPE.
  - WHEN THE PROPOSED WATER MAIN HAS ONLY 36-INCHES OF BURY DEPTH (SEE WATER MAIN STATION 24+55 TO 24+70, APPROX.), IN WHICH CASE THE 4" HDPE CONDUIT IS PERMITTED TO BE INSTALLED AT APPROXIMATELY THE SAME ELEVATION AS THE PROPOSED WATER MAIN.

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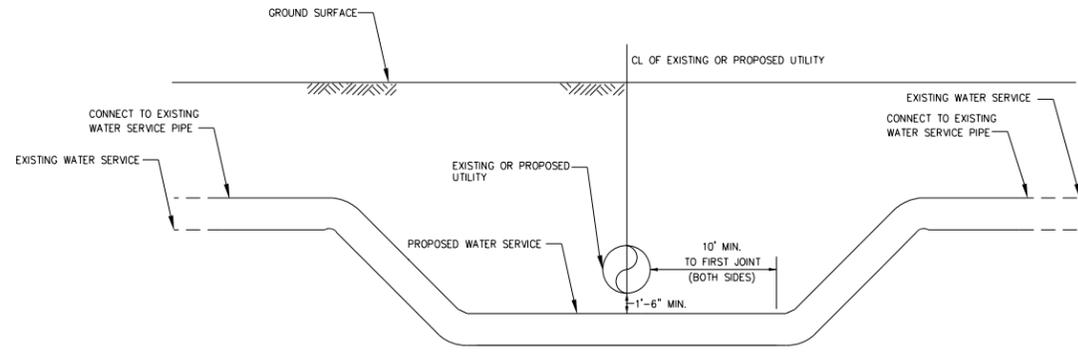
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	DATE - 10/22/2021	REVISED -

**STATE OF ILLINOIS  
DEPARTMENT OF TRANSPORTATION**

**WATER MAIN RELOCATION PLAN AND SANITARY SEWER ADJUSTMENTS  
DETAIL SHEET 1**


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F.A.U. RTE.	SECTION	COUNTY	TOTAL SHEETS	SHEET NO.
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CONTRACT NO. 95893				
ILLINOIS FED. AID PROJECT				





**WATER SERVICE LINE RELOCATED**  
NTS

NOTES:  
1. SEWER SHALL BE WATER MAIN QUALITY PIPE MATERIAL (OR RCP PIPE WITH GASKETS MEETING ASTM C361 OR C443), ALL IN ACCORDANCE WITH IEPA WATER/SEWER SEPARATION REQUIREMENTS.  
2. PROVIDE ALL REQUIRED COUPLINGS, UNIONS, BENDS, FITTINGS, REDUCERS, AND APPURTENANCES REQUIRED FOR CONSTRUCTION.

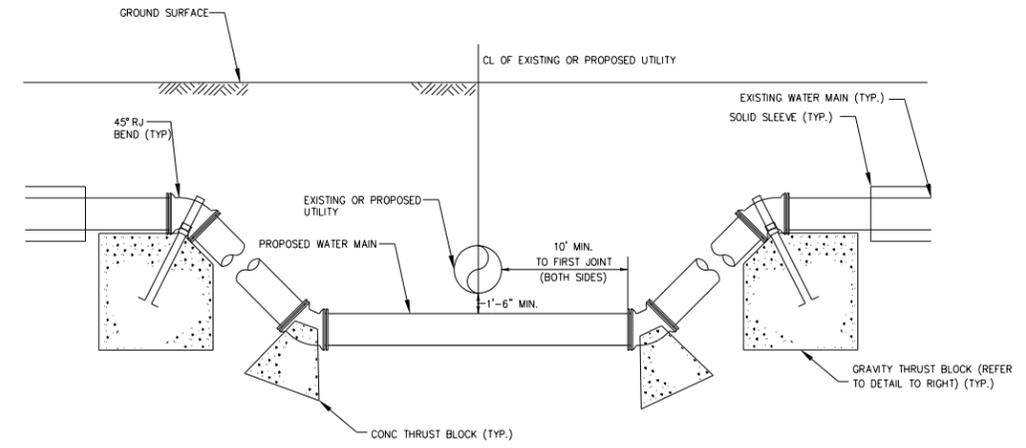


**REMOVE AND RELOCATE WATER MAIN**  
NTS

NOTES:  
1. SEWER SHALL BE WATER MAIN QUALITY PIPE MATERIAL (OR RCP PIPE WITH GASKETS MEETING ASTM C361 OR C443), ALL IN ACCORDANCE WITH IEPA WATER/SEWER SEPARATION REQUIREMENTS.

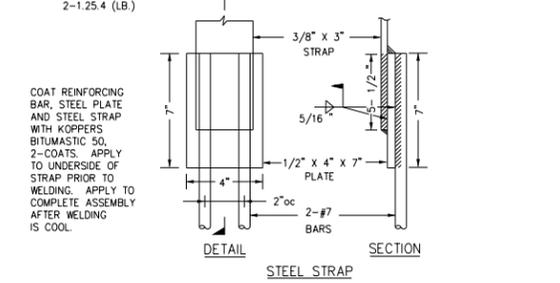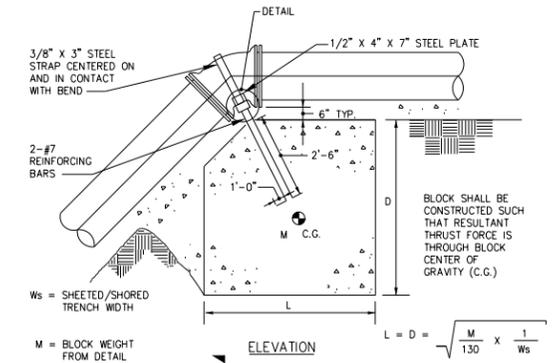


**CONCRETE GRAVITY THRUST BLOCK**  
NTS

**MANHOLES, SANITARY, 4' DIAMETER, TYPE 1 FRAME, CLOSED LID**

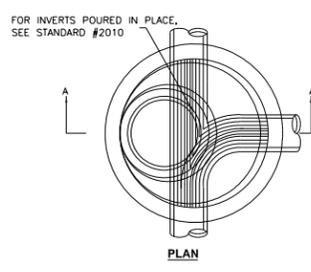

PLAN

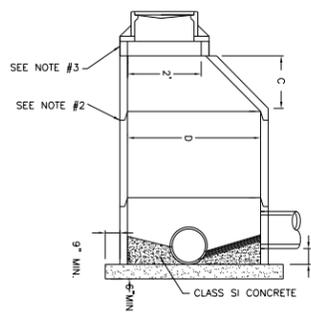


SECTION A-A

- SANITARY SEWER NOTES:**
- FOR VERTICAL SEPARATIONS GREATER THAN 2' USE DROP STACK, STANDARD 2030.
- GENERAL NOTES:**
- PRECAST MANHOLE SECTIONS ARE REQUIRED. POURED IN PLACE MANHOLES MUST BE APPROVED IN WRITING BY THE CITY ENGINEER.
  - ALL MASONRY JOINTS IN THE STRUCTURE SHALL BE SEALED USING PERMAGUM ROPE MASTIC OR APPROVED EQUAL. ADJUSTING RINGS AND THE CASTING SHALL BE SEALED USING 2 LOOPS OF 3/4\"/>

ALTERNATE MATERIALS FOR WALLS	D	C*	T (MIN.)
PRECAST REINFORCED CONCRETE RISERS	4'-0"	2'-6"	4"
	5'-0"	3'-9"	5"
MONOLITHIC CONCRETE	4'-0"	2'-6"	6"
	5'-0"	3'-9"	6"

\*WHEN USING PRECAST REINFORCED CONCRETE RISERS, DIMENSION "C" MAY VARY FROM THAT GIVEN TO PLUS 6 INCHES.


**SANITARY FRAME AND LIDS TYPE 1**

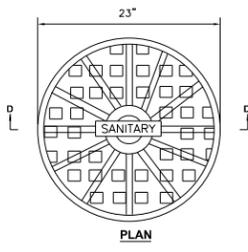


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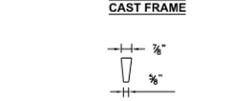
SECTION D-D



PLAN

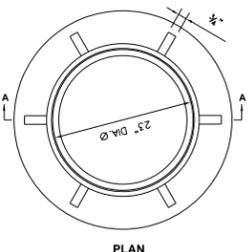


SECTION A-A

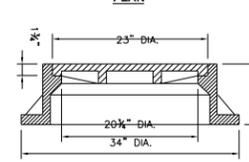


SECTION C-C

- NOTES:**
- THE OPEN AND CLOSED LIDS MAY BE MADE OF EITHER GRAY IRON OR DUCTILE IRON.
  - CLOSED LID SHALL HAVE CONCEALED PICKHOLE.
  - CLOSED LID SHALL BE GASKETED IF INSTALLATION IS FOR A SEPARATE SANITARY SEWER.
  - THE LID SHALL BE CAST "STORM" IF INSTALLATION IS FOR A SEPARATE STORM SEWER.
  - THE LID SHALL BE CAST "SANITARY" IF INSTALLATION IS FOR A SEPARATE SANITARY SEWER OR COMBINATION SEWERS, UNLESS OTHERWISE SPECIFIED OR NOTED.
  - THE LID SHALL BE CAST "COMBINED" IF INSTALLATION IS FOR A COMBINED SEWER.


**DROP STACK MANHOLE**

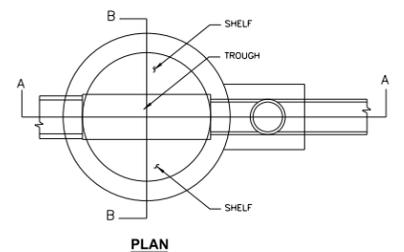

PLAN

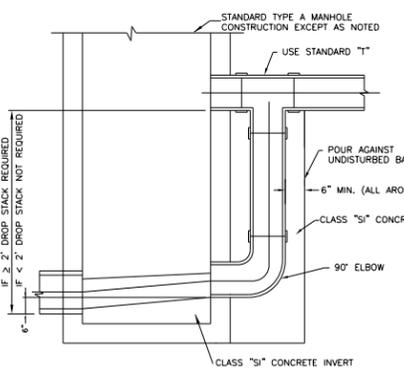

SECTION A-A

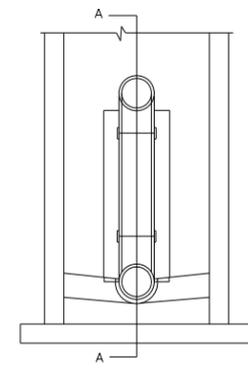

SECTION B-B

- NOTES:**
- ENTIRE EXCAVATION TO BE BACKFILLED WITH TRENCH BACKFILL MATERIAL, IF ANY EDGE OF EXCAVATION IS WITHIN 2' OF ANY PAVED SURFACE.
  - BACKFILL AROUND PIPE SHALL BE IN ACCORDANCE (DOT STANDARDS).
  - POURED CONCRETE AROUND DROP STACK PIPE WILL NOT BE REQUIRED IF DROP STACK IS PRECAST WITH MANHOLE.
  - TO BE USED IN PLACE OF SANITARY MANHOLE WHERE SEWER ENTERS 2'-0" OR MORE ABOVE LOWEST INVERT. NOT TO BE USED FOR INLET OR CATCH BASIN CONNECTIONS.
  - THIS DETAIL APPLIES TO INCOMING SEWER OF 18" DIAMETER OR LESS.
  - FOR INCOMING SEWER SMALLER THAN 12" USE VERTICAL PIPE OF SAME DIAMETER. FOR INCOMING SEWER 12" OR GREATER, USE 12" VERTICAL PIPE.

**VERTICAL BEND CONCRETE GRAVITY BLOCKS**  
TABLE OF MINIMUM BLOCK WEIGHTS IN POUNDS

PIPE SIZE	BEND	PRESSURE 150 psi
4"/6"	45°	4,300
	22 1/2°	2,300
8"	45°	7,500
	22 1/2°	3,900
12"	45°	16,300
	22 1/2°	8,600
16"	45°	28,800
	22 1/2°	15,200
20"	45°	44,800
	22 1/2°	23,700

- NOTES:**
- FOR PIPES EQUAL TO OR GREATER THAN 24", CONTRACTOR SHALL DESIGN AND INSTALL THRUST RESTRAINT AND THRUST RESTRAINT SYSTEM.
  - BLOCK WEIGHTS ARE VALID ONLY FOR GRAVITY BLOCKS WHICH ARE ALWAYS ABOVE THE GROUND WATER LEVEL.
  - USE BLOCK WEIGHT FOR 22 1/2° BEND FOR FITTINGS LESS THAN 22 1/2° VERTICAL.

**STRUCTURAL NOTES**

- FOR ALL WATER MAIN AND SANITARY SEWER SPECIAL PROVISIONS, CONTRACTOR SHALL MEET OR EXCEED THE FOLLOWING REQUIREMENTS:
- ALL EXCAVATION FOR STRUCTURES SHALL BE KEPT DEWATERED DURING CONSTRUCTION OPERATIONS UNTIL BACKFILL IS IN PLACE. PROVISIONS SHALL BE MADE TO PREVENT THE BOTTOM OF ALL EXCAVATIONS FROM FREEZING OR FLOODING AT ALL TIMES.
  - ALL CONCRETE SLABS SUPPORTED ON SOIL SHALL BE PROTECTED AGAINST FROST ACTION AND DANGER FROM HEAVING BY INSULATING THE SLAB WITH A LAYER OF INSULATING MATERIAL THICK ENOUGH TO PREVENT FROST PENETRATION.
  - BACKFILL MATERIAL, PLACING AND COMPACTION OF BACKFILL SHALL BE IN ACCORDANCE WITH THE CONTRACT DRAWINGS AND SPECIFICATIONS. PLACE BACKFILL EQUALLY ON BOTH SIDES OF FOUNDATION WALLS AND STRUCTURES.
  - ALL DIMENSIONS AND ELEVATIONS SHOWN TO EXISTING CONSTRUCTION AND ALL EXISTING CONDITIONS SHALL BE ASSUMED TO BE (±) AND SHALL BE VERIFIED BY THE CONTRACTOR PRIOR TO FABRICATION OF MATERIAL. THE CONTRACTOR SHALL VISIT THE SITE AND FAMILIARIZE HIMSELF WITH ALL EXISTING CONDITIONS PRIOR TO BIDDING THE WORK.
  - CONTRACTOR SHALL BE RESPONSIBLE FOR THE DESIGN AND INSTALLATION OF ALL TEMPORARY CONSTRUCTION REQUIRED FOR, BUT NOT LIMITED TO, SHEETING, SHORING, UNDERPINNING, NEEDLING AND BRACING, FOR THE PROTECTION OF THE EXISTING STRUCTURES, UTILITIES AND ROADWAYS TO REMAIN WHETHER OR NOT SHOWN ON THE CONTRACT DRAWINGS. THE CONTRACTOR SHALL PROVIDE ALL MEASURES AND PRECAUTIONS NECESSARY TO PREVENT DAMAGE, SETTLEMENT OR MOVEMENT OF EXISTING AND NEW CONSTRUCTION INSIDE AND OUTSIDE OF THE PROJECT LIMITS DURING EXCAVATION AND CONSTRUCTION. ANY DAMAGE TO NEW OR EXISTING CONSTRUCTION INSIDE OR OUTSIDE OF THE PROJECT LIMITS, CAUSED BY CONSTRUCTION TECHNIQUES OR MOVEMENTS OF THE SOIL OR STRUCTURE RETENTION SYSTEM, IS THE RESPONSIBILITY OF THE CONTRACTOR. CONTRACTOR SHALL ALSO PROVIDE ALL NECESSARY MATERIALS, LABOR, AND EQUIPMENT TO MEET RAILROAD REQUIREMENTS FOR SHEETING AND/OR SHORING.
  - (\*) - DIMENSIONS NOTED THUS INDICATE DIMENSIONS TO BE DETERMINED BY EQUIPMENT MANUFACTURER OR DIMENSIONS TO BE VERIFIED IN FIELD BASED ON EXISTING CONSTRUCTION.

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PLOT SCALE = 40.0000 ' / in.	DRAWN - BNH	REVISED -
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	DATE - 10/22/2021	REVISED -

**STATE OF ILLINOIS  
DEPARTMENT OF TRANSPORTATION**



**WATER MAIN RELOCATION PLAN AND SANITARY SEWER ADJUSTMENTS**

**DETAIL SHEET 2**

SCALE: NTS SHEET 29 OF 31 SHEETS STA. N/A TO STA. N/A

F.A.U. RTE.	SECTION	COUNTY	TOTAL SHEETS	SHEET NO.
7448	09-00933-01-BR	MACON	1019	541
CONTRACT NO. 95893				
		ILLINOIS	FED. AID PROJECT	

MODEL: Default  
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DETAIL OF PIPE INSTALLED IN CASING PIPE UNDER RAILROAD (INSTALLED BY JACKING AND BORING)  
 NTS

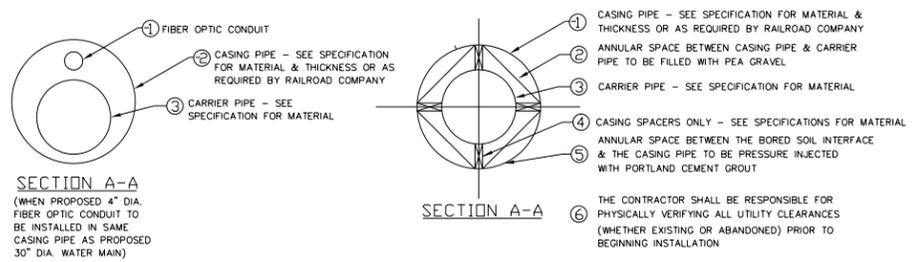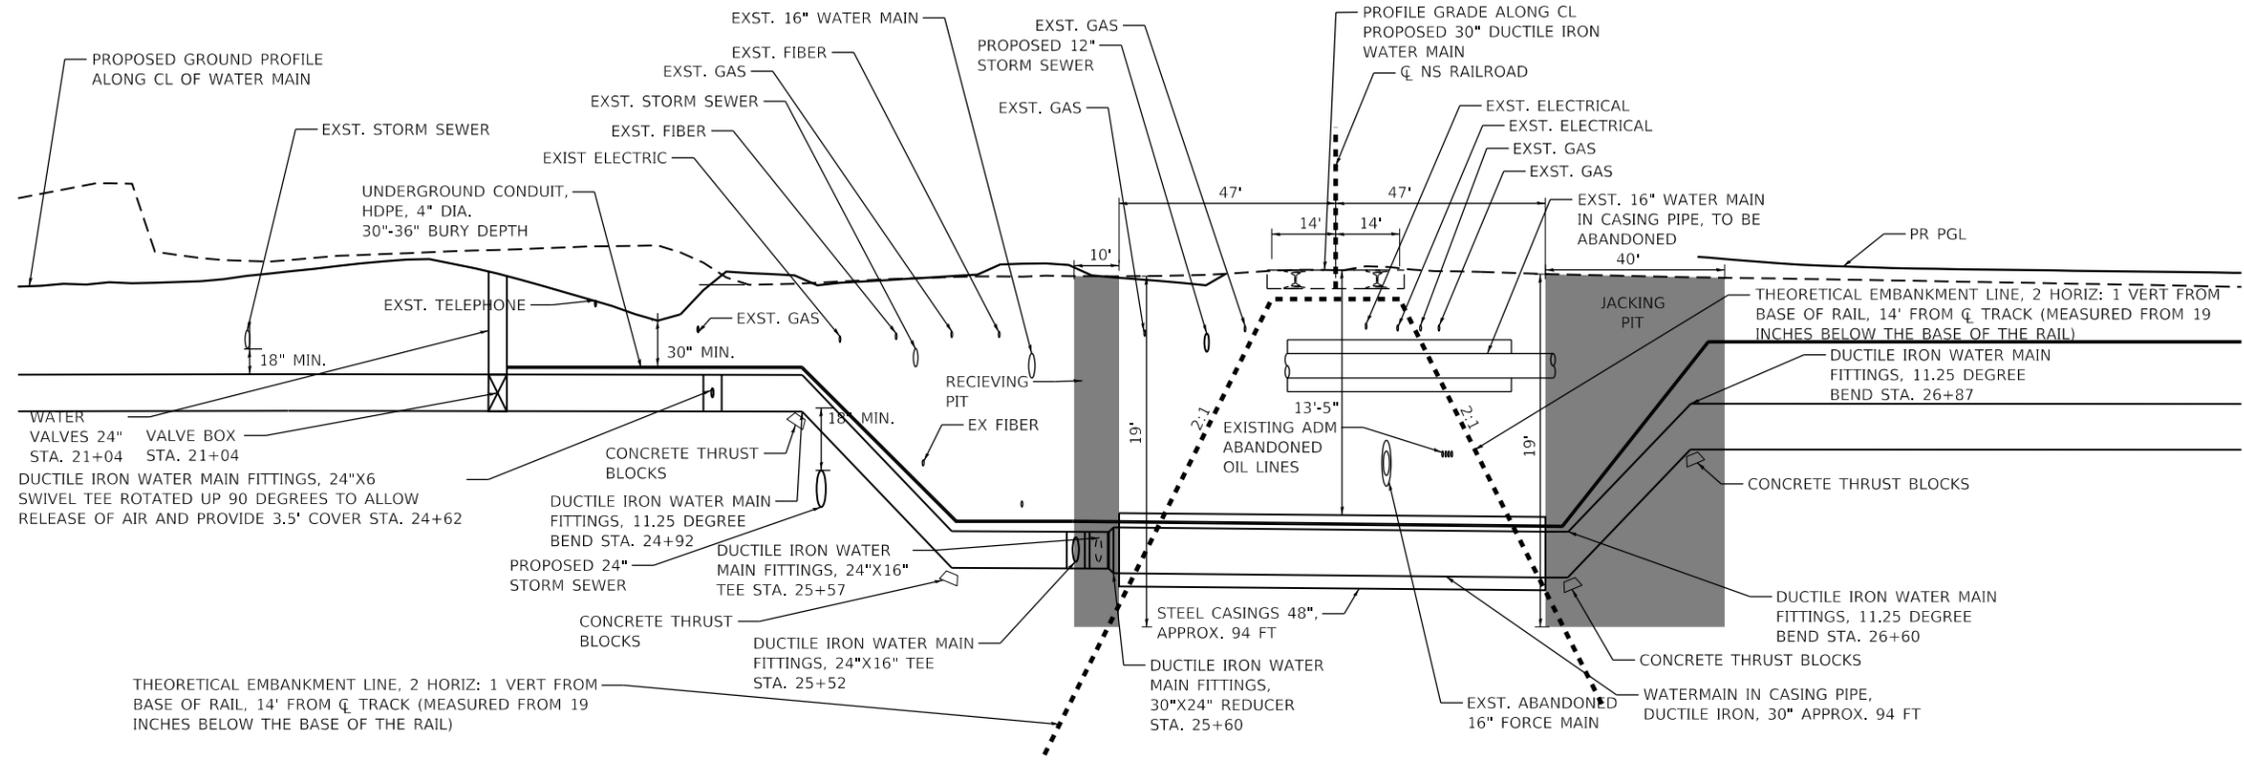

USER NAME = brooke,henry	DESIGNED - BNH	REVISED -
DRAWN - BNH	REVISED -	
PLOT SCALE = 40.0000 ' / in.	CHECKED - RB	REVISED -
PLOT DATE = 10/27/2021	DATE - 10/22/2021	REVISED -


STATE OF ILLINOIS  
 DEPARTMENT OF TRANSPORTATION

WATER MAIN RELOCATION PLAN AND SANITARY SEWER ADJUSTMENTS  
 DETAIL SHEET 3 - NS RAILROAD CROSSING  
 SCALE: NTS SHEET 30 OF 31 SHEETS STA. N/A TO STA. N/A

F.A.U. RTE. 7448	SECTION 09-00933-01-BR	COUNTY MACON	TOTAL SHEETS 1019	SHEET NO. 542
CONTRACT NO. 95893				
ILLINOIS FED. AID PROJECT				

**NOTES**



1. CARRIER PIPE WILL BE HELD CLEAR OF THE CASING PIPE BY SUPPORTS (STAINLESS STEEL SPACER AS SPECIFIED IN THE SPECIAL PROVISIONS).
2. CASING WILL BE SEALED WITH CONCRETE BRICK AND MORTAR.
3. INSTALL UTILITY WARNING MARKER ON NORTH SIDE OF FARRIES IN PARKWAY (SEE DETAIL BELOW).
4. MAXIMUM TEST PRESSURE OF WATER MAIN (CARRIER PIPE) IS 110 PSI.
5. SLOPE CASING PIPE AT 0.3%.
6. ABANDON EXISTING 16" WATER MAIN IN CASING PIPE UNDER ICRR TRACKS BY COMPLETELY FILLING WITH CLSM.

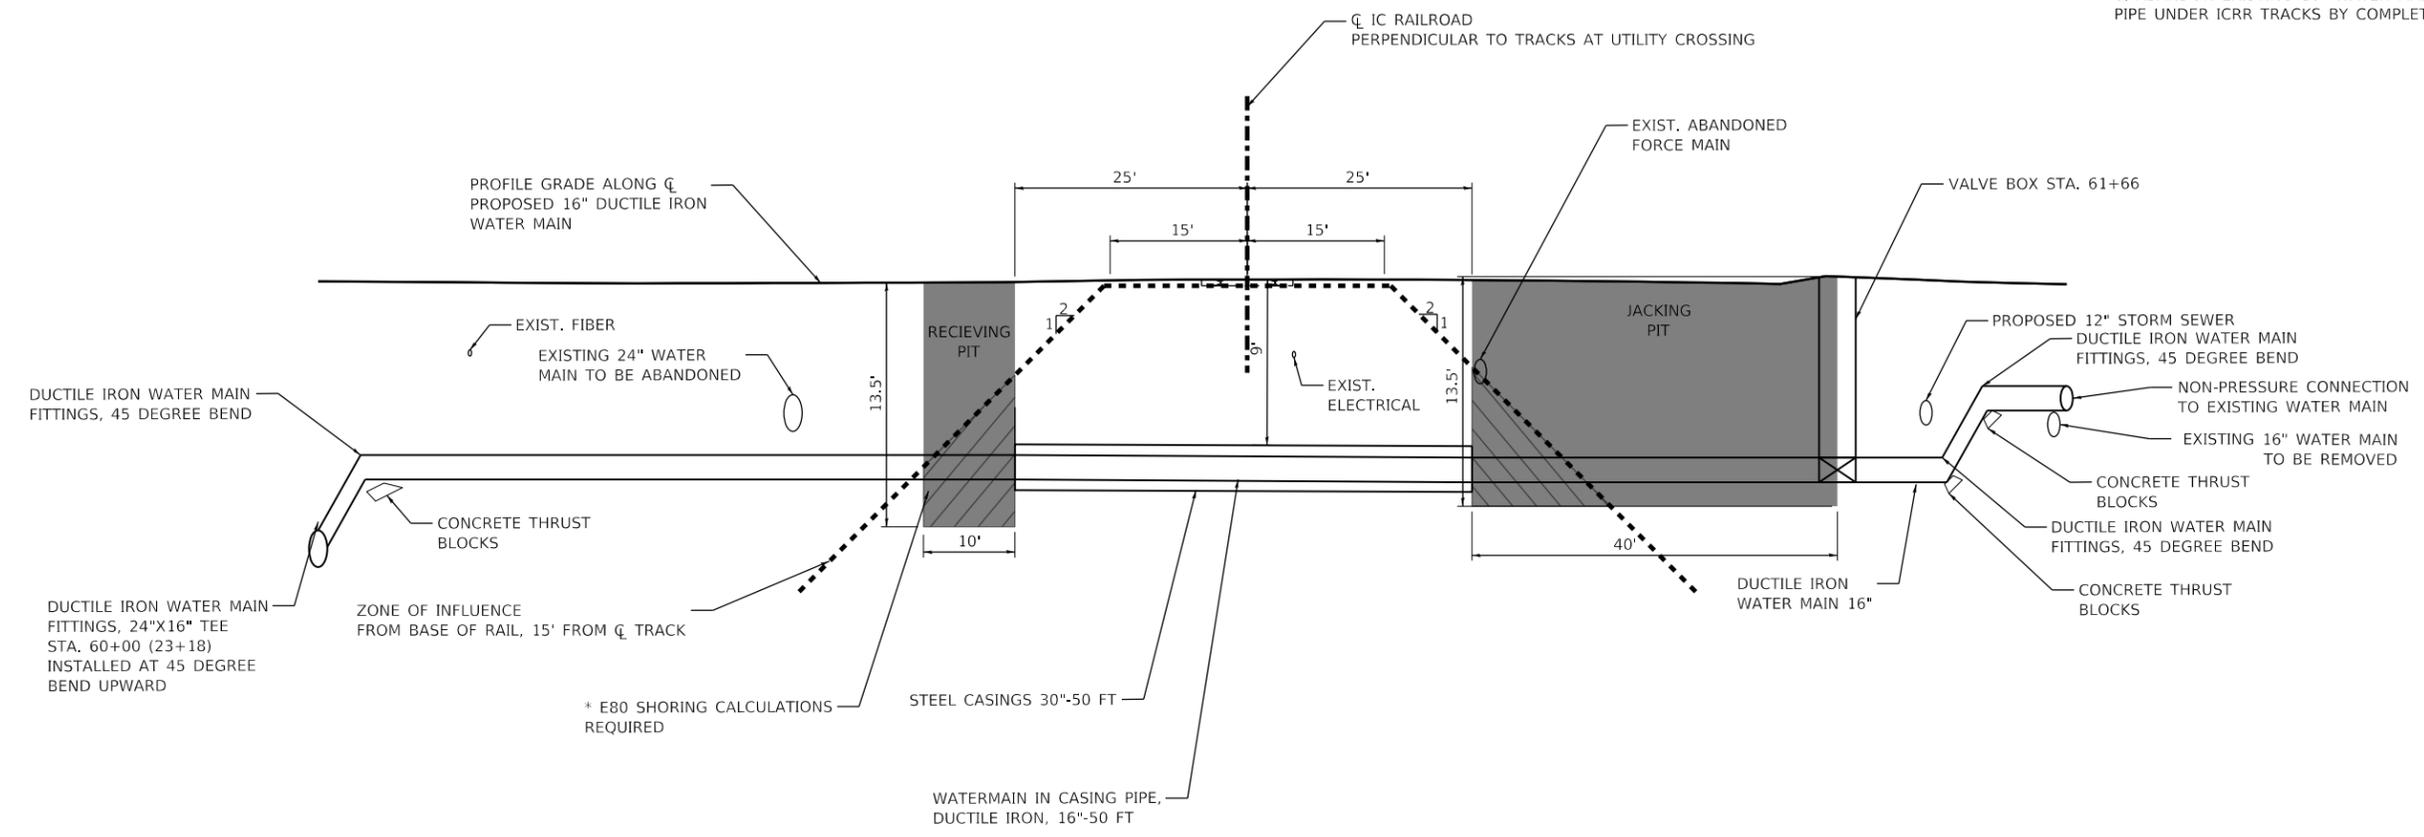

**SECTION A-A**  
LOOKING SOUTH

**RAILROAD CROSSING PROFILE DETAILS**

**DETAIL OF CASING PIPE INSTALLED BY DRY JACK AND BORING UNDER RAILROAD TRACKS**  
NTS

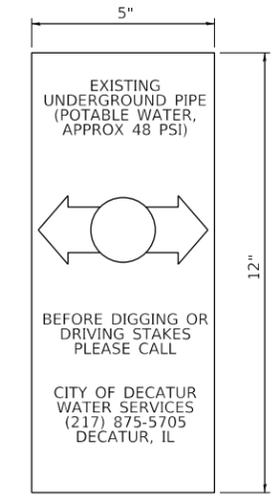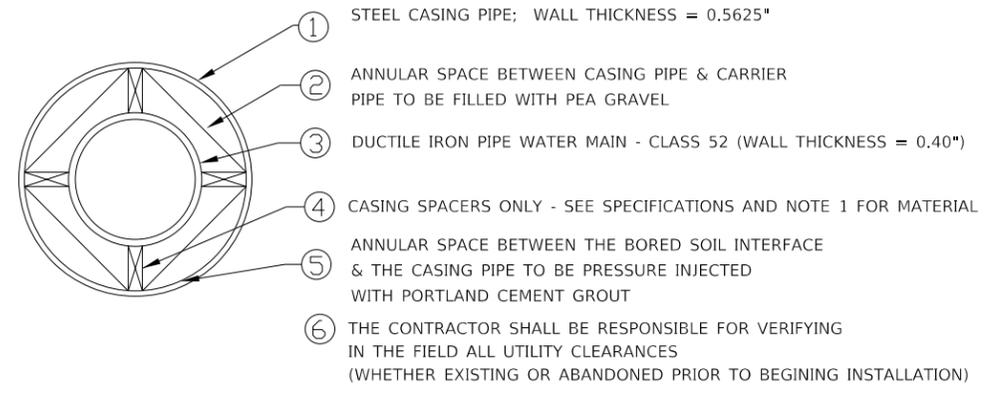

CABLE ROUTE MUST BE MARKED AT EDGE OF RIGHT OF WAY WHERE CABLE ENTERS OR LEAVES RAILROAD PROPERTY. IN CASES OF PARALLEL CABLE ROUTE, SIGNS AS INDICATED IN FIGURE 1 ON THIS EXHIBIT WILL BE PLACED APPROXIMATELY EVERY 200 FEET. SIGNS TO BE OF A PERMANENT VERTICAL TYPE, NOT SMALLER THAN 5 INCHES WIDE BE 12 INCHES HEIGHT. YELLOW BACKGROUND WITH BOLD BLACK LETTERING, SIGNS TO BE MOUNTED ON METAL POSTS OR AS OTHERWISE AGREED TO AT A HEIGHT OF 3 FEET ABOVE GROUND LEVEL.

**MARKING OF UTILITIES ON RAILROAD RIGHT-OF-WAY**  
NTS

MODEL: Default  
FILE NAME: p:\aecom\m-pw\henley.com\AECOM\_0516\_NA\Documents\60603202-Brush\_College\006-CAD\_GIS\910\_CAD\03\_SHEETS\01\_AECOM\Watermain\60603202\_SHT\_Detail\_Sheets\_ICRR.dgn



USER NAME = brooke.henry	DESIGNED - BNH	REVISED -
PLOT SCALE = 20.0000 ' / in.	DRAWN - BNH	REVISED -
PLOT DATE = 10/27/2021	CHECKED - RB	REVISED -
	DATE - 10/22/2021	REVISED -

**STATE OF ILLINOIS**  
**DEPARTMENT OF TRANSPORTATION**

**WATER MAIN RELOCATION PLAN AND SANITARY SEWER ADJUSTMENTS**  
**DETAIL SHEET 4 - IC RAILROAD CROSSING**

F.A.U. RTE.	SECTION	COUNTY	TOTAL SHEETS	SHEET NO.
7448	09-00933-01-BR	MACON	1019	543
CONTRACT NO. 95893				
ILLINOIS FED. AID PROJECT				

SCALE: 1"=10' SHEET 31 OF 31 SHEETS STA. N/A TO STA. N/A

**PAVEMENT MARKING SCHEDULE**

SHEET	ROAD	STATION	STATION	SQ FT	FOOT	FOOT	FOOT	FOOT	FOOT	EACH	EACH	FOOT	COMMENTS	
				MOD URETH PM LTR-SYM	MOD URETH PM LINE 4	MOD URETH PM LINE 6	MOD URETH PM LINE 8	MOD URETH PM LINE 12	MOD URETH PM LINE 24	RAISED REFL PAVT MKR	CURB REFLECTORS	PAINT CURB		
1	BRUSH	46+59.44	52+00.00	2,082	38			41		35				
2		52+00.00	57+75.00	110	1,504	812	206	37	72	19	33	287		
3		57+75.00	62+50.00	73	2,463	643			98		22	14	52	
4		62+50.00	68+00.00		2,800	276			101		42	15	52	
5		68+00.00	73+50.00		63	1,289	269		240		28	7	63	
6		73+50.00	75+44.21		32	485	97				16			
6		75+44.21	84+56.00	110	1,814	624				69			REPLACEMENT STRIPING FOR MOT IMPACTED AREAS	
7 & 8	FARES	200+32.00	208+90.03		457	563				22			REPLACEMENT STRIPING FOR MOT IMPACTED AREAS	
7		205+18.73	208+00.00		474	59				3	30	129	205+18.73 RT & 208+90.03 LT	
8		208+00.00	213+25.00	282	1,012	284	4		144	11	30	53		
9		213+25.00	219+00.00	146	936	1,476	168	51	88	30	36	170		
10		219+00.00	224+75.00	146	932	688				17	47	95		
11		224+75.00	230+50.00	120	1,237	328		28		23	32	78		
12		230+50.00	235+41.47	37	1,859	177		283		58				
12		235+41.47	239+99.00	73	1,068	305		128		26			REPLACEMENT STRIPING FOR MOT IMPACTED AREAS	
13	JUG	301+75.00	306+50.00	401	1,340	1,291	377	1,122	98	21	174	985	INCLUDES BRUSH COLLEGE RD & FARES PKWY INTERSECTIONS	
14	LOGAN	601+50.00	607+50.00		1,654	128		22	28		18	112	INCLUDES CONNECTOR RD & N JAMES ST INTERSECTIONS	
15	JAMES	404+27.90	407+75.00	37	1,228	143		421	70				INCLUDES FARES PKWY INTERSECTION	
16	HARRISON W	800+00.00	804+50.00		782									
17		804+50.00	808+00.00	62	1,512				73				INCLUDES BRUSH COLLEGE RD INTERSECTION & BUSINESS DRIVES	
18	HARRISON E	701+00.00	705+00.00		874				19				INCLUDES BRUSH COLLEGE RD INTERSECTION	
19		705+00.00	708+41.73		684									
19	CEMETERY	900+00.00	904+52.12						25					
TOTAL				1,692	28,486	8,201	755	2,572	617	442	436	2,077		

**SIGNING SCHEDULE**

SHEET	ROAD	STATION	STATION	STA	LOC	TYPE	DESCRIPTION	W (INCH)	H (INCH)	SQ FT	SQ FT	FOOT	COMMENTS	
										SIGN PANEL T1	SIGN PANEL T2	TELES STL SIN SUPPORT		
1	BRUSH	46+59.44	52+00.00	51+95.0	RT	D3-2	ADVANCE STREET NAMES (2 LINES)	60	30	-	12.5	31.0	FARES PKWY NEXT RIGHT - TWO POSTS	
2		52+00.00	57+75.00	54+33.6	RT	D1-1d	CIRCULAR INTERSECTION DESTINATION (1 LINE)	78	18	-	9.8	32.0	FARES PKWY (RIGHT ARROW) - TWO POSTS	
					54+94.5	LT	R3-24	ALL TURNS (RIGHT ARROW)	72	18	9.0	-		
					56+24.2	LT	R4-7	KEEP RIGHT	24	30	5.0	-	16.0	
							R3-8	MODIFIED	30	30	6.3	-		DUAL LEFT TURN ONLY (BACK TO BACK)
							R4-7	KEEP RIGHT	24	30	5.0	-		
3			57+75.00	62+50.00	58+03.2	LT	R3-8	MODIFIED	30	30	6.3	-	34.0	DUAL LEFT TURN ONLY - TWO POSTS
							D1-1d	CIRCULAR INTERSECTION DESTINATION (1 LINE)	78	18	-	9.8		FARES PKWY (LEFT ARROW)
					59+00.0	RT	W4-2	LANE ENDS	36	36	9.0	-	18.0	
4			62+50.00	68+00.00	65+95.7	LT	OM4-2	OBJECT MARKER	18	18	2.3	-	16.0	AT THE END OF OLD E HARRISON AVE AND RR TRACK
					66+03.1	LT	R11-H100	ROAD ENDS	36	30	7.5	-	16.0	AT THE END OF OLD E HARRISON AVE AND RR TRACK
					66+10.6	LT	OM4-2	OBJECT MARKER	18	18	2.3	-	16.0	AT THE END OF OLD E HARRISON AVE AND RR TRACK
					68+83.1	LT	R4-7	KEEP RIGHT	24	30	5.0	-	16.0	
					69+40.0	LT	W1-7	TWO-DIRECTION	48	24	8.0	-	30.0	TWO POSTS
5			68+00.00	73+50.00	71+68.9	RT	M1-6	COUNTY ROUTE SIGN	24	24	4.0	-		MACON CO 1
							R5-H101	BEGIN CLASS II TRUCK ROUTE	24	30	5.0	-	18.0	
					71+90.0	LT	R2-1	SPEED LIMIT	30	36	RELOC	-	16.0	RELOCATE - SPEED LIMIT, 35 MPH
					73+16.0	LT	D3-1	STREET NAME	60	9	3.8	-	15.0	N BRUSH COLLEGE RD
							D3-1	STREET NAME	48	9	3.0	-		E HARRISON AVE
6			73+50.00	76+25.97										
SUB-TOTAL										81.3	32.0	290.0		

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USER NAME = rjo	DESIGNED - LDC	REVISED -
PLOT SCALE = 2,000' / in.	DRAWN - RJO	REVISED -
PLOT DATE = 4/28/2021	CHECKED - LDC	REVISED -
	DATE - 4/30/2021	REVISED -

**STATE OF ILLINOIS  
DEPARTMENT OF TRANSPORTATION**

**BRUSH COLLEGE ROAD & FARES PARKWAY  
PAVEMENT MARKING & SIGNING SCHEDULES**

SCALE: SHEET 1 OF 3 SHEETS STA. TO STA.

F.A.U. RTE.	SECTION	COUNTY	TOTAL SHEETS	SHEET NO.
7448	09-00933-01-BR	MACON	1019	544
CONTRACT NO. 95893				
ILLINOIS FED. AID PROJECT				

**SIGNING SCHEDULE**

SHEET	ROAD	STATION	STATION	STA	LOC	TYPE	DESCRIPTION	W (INCH)	H (INCH)	SQ FT	SQ FT	FOOT	COMMENTS	
7		205+18.73	208+00.00	-	-	-	-	-	-	-	-	-		
8	FARIES	208+00.00	213+25.00	208+51.2	RT	W10-1	GRADE CROSSING ADVANCE WARNING	36 DIA.	-	7.1	-	16.0	RAILROAD	
				209+56.0	RT	R8-10a	STOP HERE WHEN FLASHING	24	30	5.0	-	16.0		
				210+05.0	LT	R8-10a	STOP HERE WHEN FLASHING	24	30	5.0	-	16.0		
				210+75.8	RT	D3-2	ADVANCE STREET NAMES (2 LINES)	78	30	-	16.3	31.0	BRUSH COLLEGE RD NEXT RIGHT - TWO POSTS	
				211+52.9	LT	W10-1	GRADE CROSSING ADVANCE WARNING	36 DIA.	-	7.1	-	16.0	RAILROAD	
9	FARIES	213+25.00	219+00.00	213+95.6	RT	D1-1c	CIRCULAR INTERSECTION DESTINATION (1 LINE)	96	18	-	12.0	32.0	BRUSH COLLEGE RD (RIGHT ARROW) - TWO POSTS	
				214+23.3	RT	R4-7	KEEP RIGHT	24	30	5.0	-	16.0		
				215+59.3	RT	R3-8	MODIFIED	30	30	6.3	-	16.0	DUAL LEFT TURN ONLY (BACK TO BACK)	
				218+42.4	RT	W4-2	LANE ENDS	36	36	9.0	-	18.0		
				219+74.6	LT	R3-8	MODIFIED	60	30	-	12.5	34.0	DUAL LEFT TURN ONLY & DUAL THRU LANE - TWO POSTS	
10	FARIES	219+00.00	224+75.00	222+50.0	LT	D1-1c	CIRCULAR INTERSECTION DESTINATION (1 LINE)	96	18	-	12.0	34.0	BRUSH COLLEGE RD (LEFT ARROW)	
				223+00.0	LT	R2-1	SPEED LIMIT, 35 MPH	30	36	7.5	-	16.0		
				224+26.1	LT	R3-5L	LEFT TURN ONLY	30	36	7.5	-	16.0	BACK TO BACK	
				224+26.1	LT	R4-7	KEEP RIGHT	24	30	5.0	-	16.0	BACK TO BACK	
				224+26.1	LT	R3-5L	LEFT TURN ONLY	30	36	7.5	-	16.0	BACK TO BACK	
11		224+75.00	230+50.00	226+40.0	LT	W9-1	LEFT LANE ENDS	36	36	9.0	-	18.0		
12		230+50.00	235+41.47	234+00.0	LT	R8-3	NO PARKING	30	30	6.3	-	16.0		
13	JUG	301+75.00	306+50.00	300+84.0	LT	R4-7	KEEP RIGHT	24	30	5.0	-	16.0		
				302+00.0	RT	D3-2	ADVANCE STREET NAMES (2 LINES)	48	30	-	10.0	31.0	LOGAN ST NEXT RIGHT - TWO POSTS	
				303+00.0	LT	R3-7R	RIGHT LANE MUST TURN RIGHT	36	36	9.0	-	16.0		
				303+00.0	CENTER	R3-8	MODIFIED	30	30	6.3	-	16.0	DUAL LEFT TURN ONLY	
				304+25.0	RT	D1-1c	CIRCULAR INTERSECTION DESTINATION (1 LINE)	60	18	7.5	-	29.0	LOGAN ST (RIGHT ARROW) - TWO POSTS	
				304+56.7	CENTER	R6-1R	ONE WAY	54	18	6.8	-	29.0	TWO POSTS	
				305+24.2	CENTER	R3-8	MODIFIED	30	30	6.3	-	16.0	DUAL LEFT TURN ONLY	
				305+24.2	RT	R3-7R	RIGHT LANE MUST TURN RIGHT	36	36	9.0	-	16.0		
				307+26.5	RT	R3-8	MODIFIED	30	30	6.3	-	16.0	DUAL LEFT TURN ONLY (BACK TO BACK)	
				307+26.5	RT	R4-7	KEEP RIGHT	24	30	5.0	-	16.0		
14	LOGAN	601+50.00	607+50.00	600+48.3	LT	R3-2	NO LEFT TURN	36	36	9.0	-	16.0		
				600+90.0	LT	R1-1	STOP SIGN	36	36	7.0	-	19.0		
				601+50.0	LT	R3-5R	RIGHT TURN ONLY	30	36	7.5	-	19.0		
				601+50.0	LT	W11-2	PEDESTRIAN	36	36	9.0	-	19.0		
				608+91.9	RT	W16-9P	AHEAD	24	12	2.0	-	17.0		
15	JAMES	607+50.00	407+75.00	404+41.5	RT	R1-1	STOP SIGN	36	36	7.0	-	17.0		
				404+41.5	RT	R1-3P	ALL WAY	18	6	0.8	-	17.0		
				405+21.2	LT	D3-1	STREET NAME	36	9	2.3	-	19.0	N JAMES ST	
				405+21.2	LT	D3-1	STREET NAME	36	9	2.3	-	19.0	E LOGAN ST	
				405+21.2	LT	R1-1	STOP SIGN	36	36	7.0	-	19.0		
				405+21.2	LT	R1-3P	ALL WAY	18	6	0.8	-	19.0		
				408+66.2	RT	D-3	STREET NAME	36	9	2.3	-	19.0	N JAMES ST	
				408+66.2	RT	D-3	STREET NAME	42	9	2.6	-	19.0	E FARIES PKWY	
				408+66.2	RT	R1-1	STOP SIGN	36	36	7.0	-	19.0		
				408+66.2	RT	W4-4P	CROSS TRAFFIC DOES NOT STOP	24	12	2.0	-	19.0		
16		800+00.00	804+50.00	799+83.0	RT	W14-1	DEAD END	30	30	6.3	-	17.0		
17	HARRISON W	804+50.00	808+00.00	809+63.9	RT	R1-1	STOP SIGN	36	36	7.0	-	16.0		
				809+83.0	RT	R1-1	STOP SIGN	36	36	7.0	-	16.0		
18	HARRISON E	701+00.00	705+00.00	700+66.9	LT	R1-1	STOP SIGN	36	36	7.0	-	19.0		
							W4-4P	CROSS TRAFFIC DOES NOT STOP	24	12	2.0	-	19.0	
							D3-1	STREET NAME	60	9	3.8	-	19.0	N BRUSH COLLEGE RD
							D3-1	STREET NAME	48	9	3.0	-	19.0	E HARRISON AVE
							702+00.0	LT	W11-2	PEDESTRIAN	36	36	9.0	-
19		705+00.00	708+41.73	-	-	-	-	-	-	-	-			
20	CEMETERY	900+00.00	904+52.12	900+24.8	LT	R1-1	STOP SIGN	36	36	7.0	-	16.0		
				904+37.9	RT	R1-1	STOP SIGN	36	36	7.0	-	16.0		

SUB-TOTAL	304.5	62.8	723.0
SUB-TOTAL PAGE 1	81.3	32.0	290.0
TOTAL	386	95	1013

NOTES: 1. ALL STATIONS ARE APPROXIMATE. SIGNS SHALL BE ERECTED ACCORDING TO HIGHWAY STANDARD 720006.

MODEL: Default  
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USER NAME = rjo  
 DESIGNED - LDC  
 DRAWN - RJO  
 PLOT SCALE = 2,000' / in.  
 PLOT DATE = 4/28/2021

REVISOR -  
 REVISIONS -  
 CHECKED - LDC  
 DATE - 4/30/2021

REVISOR -  
 REVISIONS -  
 REVISOR -  
 REVISIONS -

STATE OF ILLINOIS  
 DEPARTMENT OF TRANSPORTATION

BRUSH COLLEGE ROAD & FARIES PARKWAY  
 PAVEMENT MARKING & SIGNING SCHEDULES

SCALE: SHEET 2 OF 3 SHEETS STA. TO STA.

F.A.U. RTE.	SECTION	COUNTY	TOTAL SHEETS	SHEET NO.
7448	09-00933-01-BR	MACON	1019	545
CONTRACT NO. 95893				
ILLINOIS FED. AID PROJECT				

**SIGNING REMOVAL SCHEDULE**

SHEET	ROAD	STATION	STATION	STA	LOC	TYPE	DESCRIPTION	SIGN REMOVAL EACH	COMMENTS
2		52+00.00	57+75.00	52+60	RT	R1-1	STOP SIGN	1	
				52+64	RT	D3-1	STREET NAME	1	OLIVE ST
						D3-1	STREET NAME		BRUSH COLLEGE RD
				57-14	RT	R8-3	NO PARKING	1	
3	BRUSH	57+75.00	62+50.00	57+18	RT	D3-1	STREET NAME	1	LOGAN ST
						R1-1	STOP SIGN		BRUSH COLLEGE RD
				59+12	LT	W4-2R	LANE ENDS	1	
				60+78	RT	R15-1	GRADE CROSSING (CROSS BUCK)	1	MOUNTED ON SIGNAL POST
						D3-1	STREET NAME		BRUSH COLLEGE RD - MOUNTED ON SIGNAL MAST ARM
				60+78	LT	R15-1	GRADE CROSSING (CROSS BUCK)	1	MOUNTED ON SIGNAL TRUSS POST
						R15-1	GRADE CROSSING (CROSS BUCK)		MOUNTED ON SIGNAL TRUSS
						R15-1	GRADE CROSSING (CROSS BUCK)		MOUNTED ON SIGNAL TRUSS
						R15-1	GRADE CROSSING (CROSS BUCK)		MOUNTED ON SIGNAL TRUSS
						R-SPECIAL	WATCH FOR TRAIN WHEN FLASHING		MOUNTED ON SIGNAL TRUSS
				60+81	LT	R10-11a	NO TURN ON RED	1	MOUNTED ON SIGNAL POST
						D3-1	STREET NAME		FARIES PKWY - MOUNTED ON SIGNAL MAST ARM
				61+80	RT	R15-1	GRADE CROSSING (CROSS BUCK)	1	MOUNTED ON SIGNAL POST
				61+83	LT	R-SPECIAL	WATCH FOR TRAIN WHEN FLASHING	1	MOUNTED ON SIGNAL TRUSS
						R15-1	GRADE CROSSING (CROSS BUCK)		MOUNTED ON SIGNAL TRUSS
						R15-1	GRADE CROSSING (CROSS BUCK)		MOUNTED ON SIGNAL TRUSS
		D3-1	STREET NAME		MOUNTED ON SIGNAL TRUSS				
62+08	RT	D3-1	EMERGENCY - CALL NUMBERS	1	MOUNTED ON SIGNAL POST				
			STREET NAME		MOUNTED ON SIGNAL TRUSS				
		R15-1	GRADE CROSSING (CROSS BUCK)		MOUNTED ON SIGNAL TRUSS				
		R15-1	GRADE CROSSING (CROSS BUCK)		MOUNTED ON SIGNAL TRUSS				
		R-SPECIAL	WATCH FOR TRAIN WHEN FLASHING		MOUNTED ON SIGNAL TRUSS				
62+08	LT	R-SPECIAL	EMERGENCY - CALL NUMBERS	1	MOUNTED ON SIGNAL POST				
			WATCH FOR TRAIN WHEN FLASHING		MOUNTED ON SIGNAL TRUSS				
		R15-1	GRADE CROSSING (CROSS BUCK)		MOUNTED ON SIGNAL TRUSS				
		R15-1	GRADE CROSSING (CROSS BUCK)		MOUNTED ON SIGNAL TRUSS				
		R15-1	GRADE CROSSING (CROSS BUCK)		MOUNTED ON SIGNAL TRUSS POST				
			EMERGENCY - CALL NUMBERS		MOUNTED ON SIGNAL POST				
4		62+50.00	68+00.00	63+87	RT	R5-1101	BEGIN TRUCK ROUTE	1	
						M1-6	COUNTY ROUTE SIGN		
				64+48	LT	W10-1	GRADE CROSSING ADVANCE WARNING	1	
				64+71	RT	W10-3L	GRADE CROSSING AND INTERSECTION ADVANCE WARNING	1	
						R3-9dP	END		
				65+44	LT	R3-9b	TWO-WAY LEFT TURN ONLY (POST MOUNTED)	1	
				65+80	LT	R15-1	GRADE CROSSING (CROSS BUCK)	1	
				65+83	LT	R1-1	STOP SIGN	1	
				66+22	LT	W14-2	NO OUTLET	1	
				66+35	LT	R15-1	GRADE CROSSING (CROSS BUCK)	1	
							YIELD		
				66+39	LT	D3-1	STREET NAME	1	E HARRISON AV
	STREET NAME		N BRUSH COLLEGE RD						
66+57	RT	R3-9cP	BEGIN	1					
			TWO-WAY LEFT TURN ONLY (POST MOUNTED)						
67+22	LT	W10-3R	GRADE CROSSING AND INTERSECTION ADVANCE WARNING	1					
5		68+00.00	73+50.00	68+45	RT		UNKNOWN	1	
				68+74	LT	R3-9b	TWO-WAY LEFT TURN ONLY (POST MOUNTED)	1	
				69+65	RT	R1-1	STOP SIGN	1	
				69+69	RT	D3-1	STREET NAME	1	E HARRISON AV
							STREET NAME		N BRUSH COLLEGE RD
				70+08	LT	R15-1	GRADE CROSSING (CROSS BUCK)	1	
						R1-2	YIELD		
70+63	LT	R15-1	GRADE CROSSING (CROSS BUCK)	1					
71+96	LT	R2-1	SPEED LIMIT	1	35 MPH				
9	FARIES	213+25.00	219+00.00	215+83	RT	W4-2R	LANE ENDS	1	
219+00.00		224+75.00	222+34	RT	R4-1	DO NOT PASS	1		
			222+63	LT	R2-1	SPEED LIMIT	1	35 MPH - MOUNTED ON UTILITY POLE	
230+50.00		235+41.47	234+32	LT	R7-#	NO PARKING	1		
TOTAL								34	

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USER NAME = rjo  
DESIGNED - LDC  
DRAWN - RJO  
CHECKED - LDC  
DATE - 4/30/2021  
PLOT SCALE = 2,000' / in.  
PLOT DATE = 4/28/2021

REVISED -  
REVISED -  
REVISED -  
REVISED -

**STATE OF ILLINOIS  
DEPARTMENT OF TRANSPORTATION**


**BRUSH COLLEGE ROAD & FARIES PARKWAY  
PAVEMENT MARKING & SIGNING SCHEDULES**

SCALE: SHEET 3 OF 3 SHEETS STA. TO STA.

F.A.U. RTE.	SECTION	COUNTY	TOTAL SHEETS	SHEET NO.
7448	09-00933-01-BR	MACON	1019	546
CONTRACT NO. 95893				
ILLINOIS FED. AID PROJECT				

**PAVEMENT MARKING & SIGNING NOTES**

1. ALL PAVEMENT MARKINGS SHALL BE OF THE TYPE AND COLOR AS SPECIFIED IN THE PLANS AND SHALL BE PLACED PER DISTRICT 7 STANDARD 78000001 AND IDOT STANDARD 780001-05.
2. RAISED REFLECTIVE PAVEMENT MARKERS SHALL BE PLACED PER DISTRICT 7 STANDARD 78000001.
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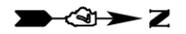


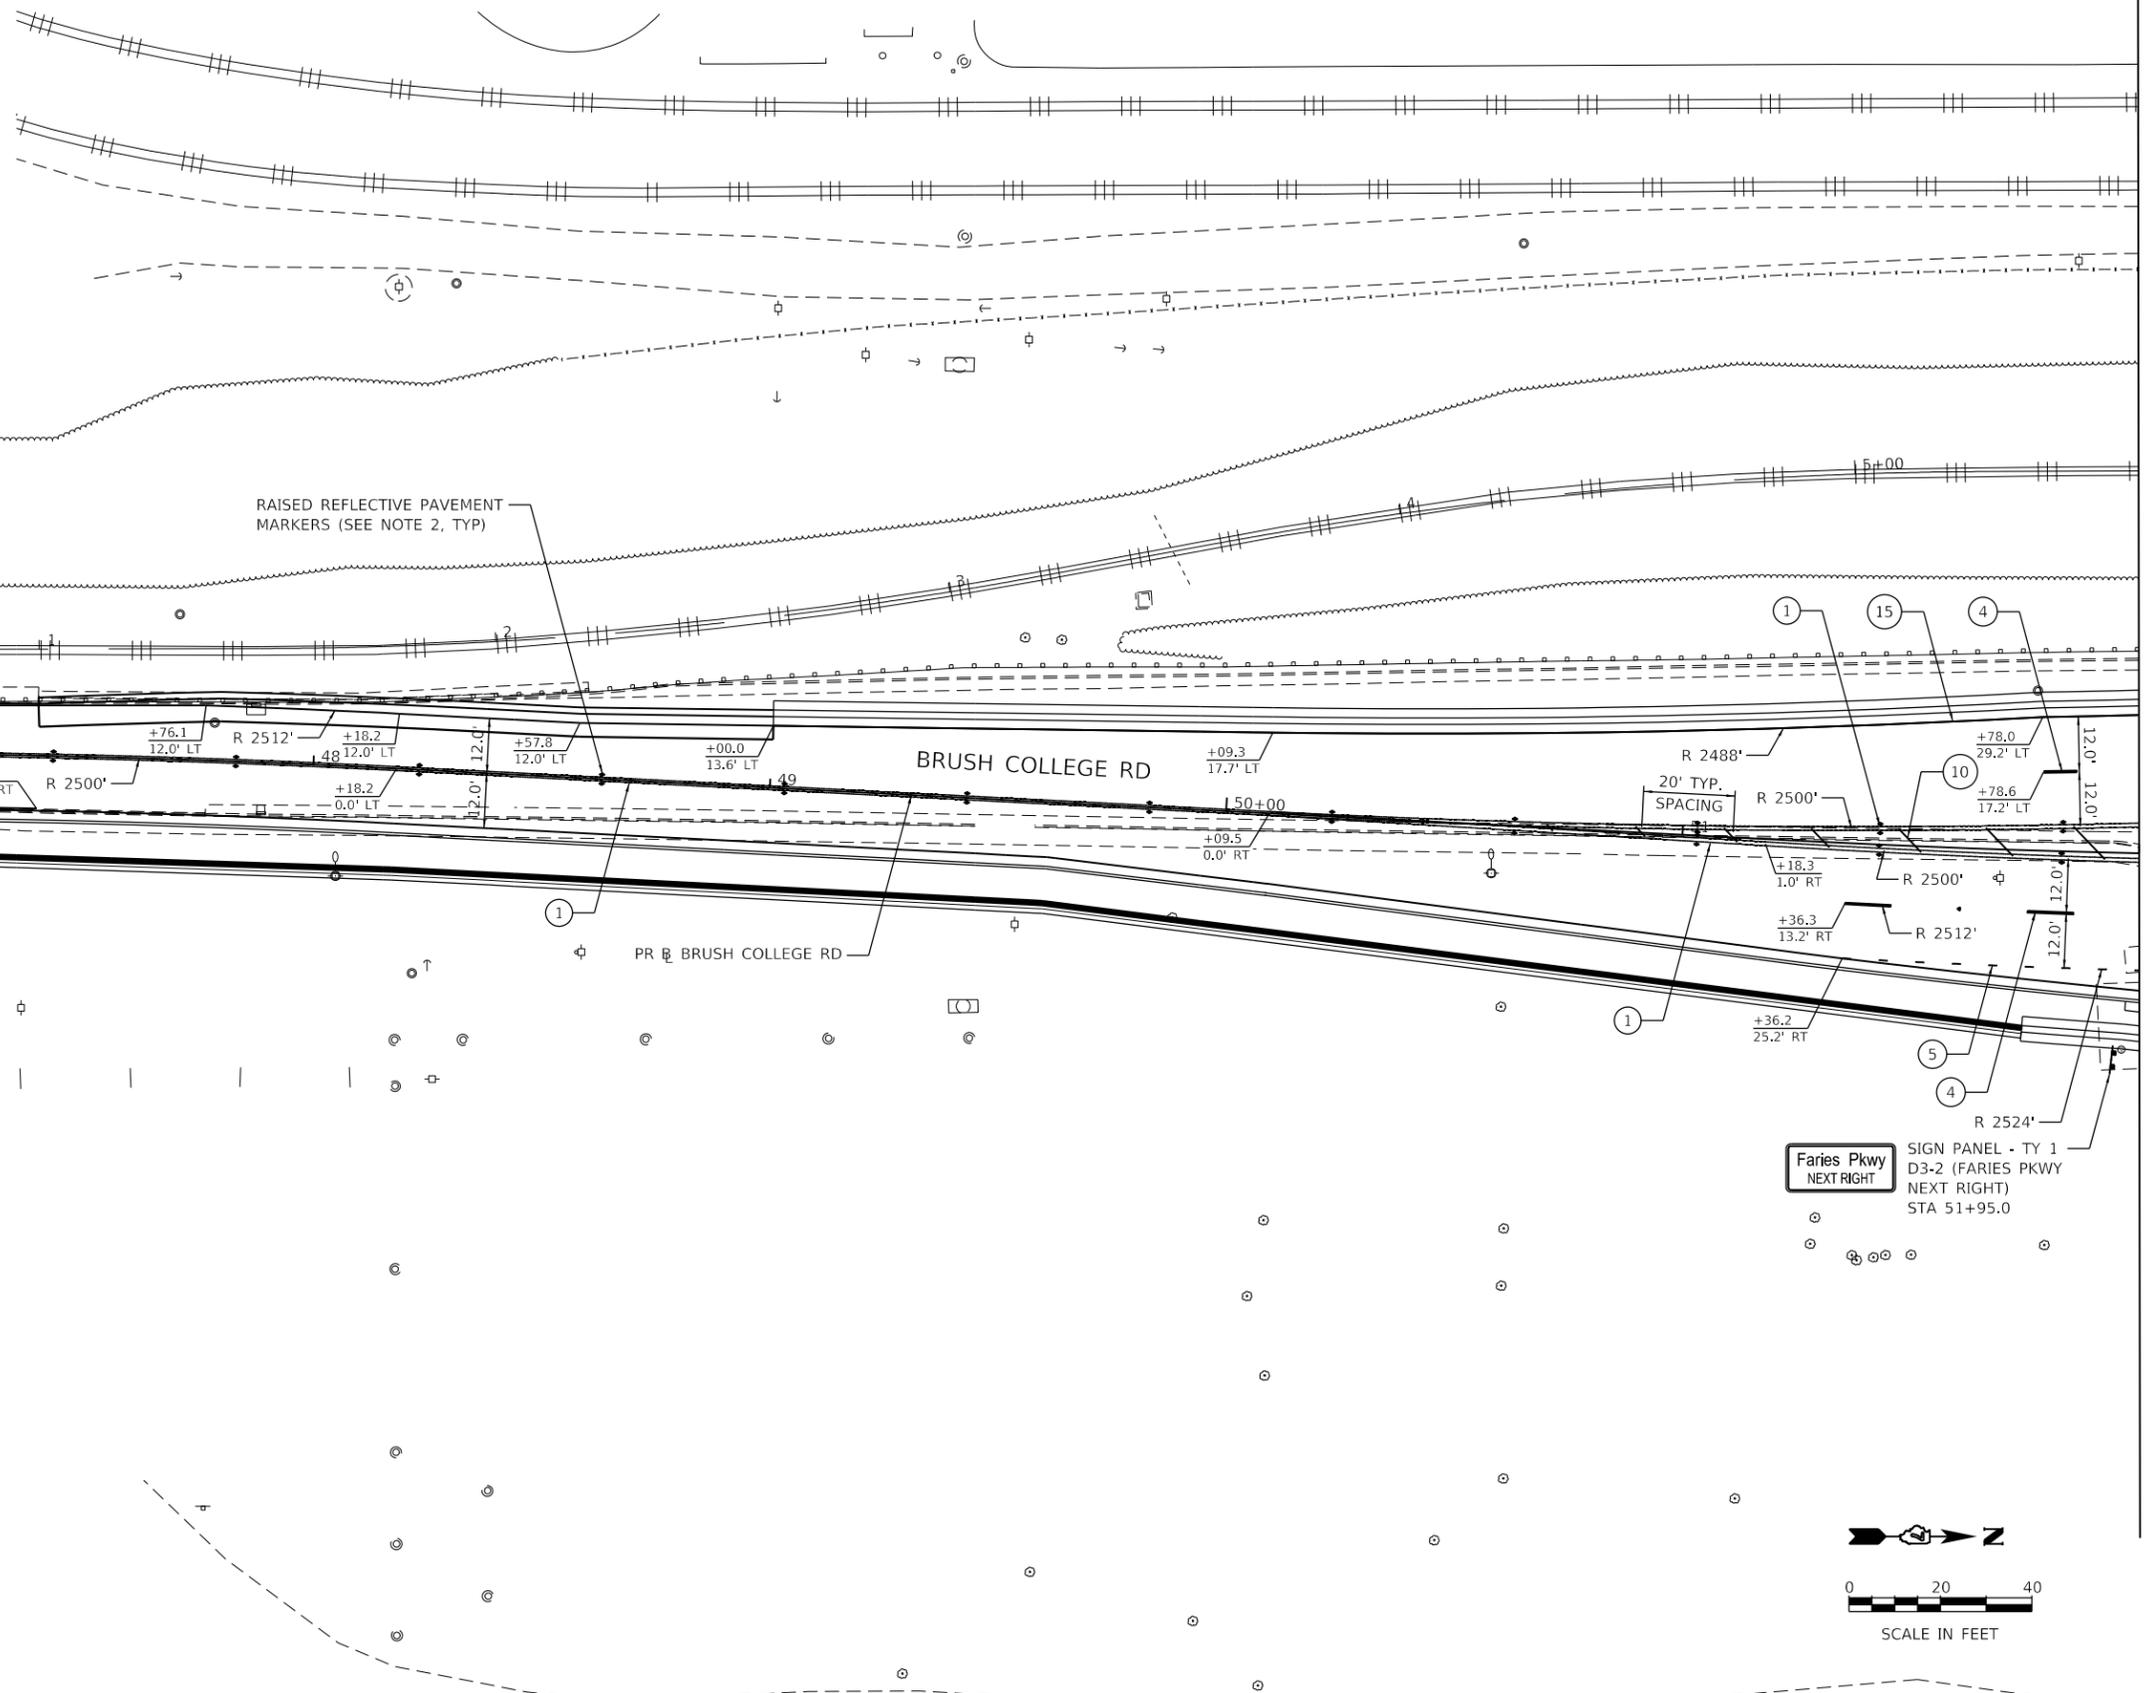MATCH LINE STA 52+00.00 (PR BRUSH)

**PAVEMENT MARKING LEGEND**

- ① MOD URETH PM LINE 4 (SOLID YELLOW, DOUBLE CENTERLINE, 11" C-C)
- ④ MOD URETH PM LINE 6 (WHITE, 10' DASH - 30' SKIP)
- ⑤ MOD URETH PM LINE 6 (WHITE, 2' DASH - 6' SKIP)
- ⑩ MOD URETH PM LINE 12 (SOLID YELLOW)
- ⑮ MOD URETH PM LINE 4 (SOLID WHITE)

**Faries Pkwy**  
NEXT RIGHT  
SIGN PANEL - TY 1  
D3-2 (FARIES PKWY  
NEXT RIGHT)  
STA 51+95.0



SCALE IN FEET

MODEL: Default  
FILE NAME: p:\lsc\com-nw-bentley.com\AECOM\_051\MA\Documents\60603202-Brush\_College\006-CAD GIS\010\_CAD\013\_SHEETS\04-KASKASKIA\PAVEMENT MARKING Plans\60603202\_S11\_PMKSign\_01\_Brush01.dgn



USER NAME = rjo	DESIGNED - NDP	REVISED -
PLOT SCALE = 40.0000 ' / in.	DRAWN - NDP	REVISED -
PLOT DATE = 4/28/2021	CHECKED - LDC	REVISED -
	DATE - 4/30/2021	REVISED -


**STATE OF ILLINOIS  
DEPARTMENT OF TRANSPORTATION**

<b>BRUSH COLLEGE ROAD PAVEMENT MARKING &amp; SIGNING PLAN</b>	
SCALE: 1"=20'	SHEET 1 OF 20 SHEETS
STA. 46+59.44 TO STA. 52+00.00	

F.A.U. RTE. 7448	SECTION 09-00933-01-BR	COUNTY MACON	TOTAL SHEETS 1019	SHEET NO. 547
CONTRACT NO. 95893				
ILLINOIS FED. AID PROJECT				


**PAVEMENT MARKING & SIGNING NOTES**

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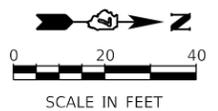
MATCH LINE STA 52+00.00 (PR BRUSH)

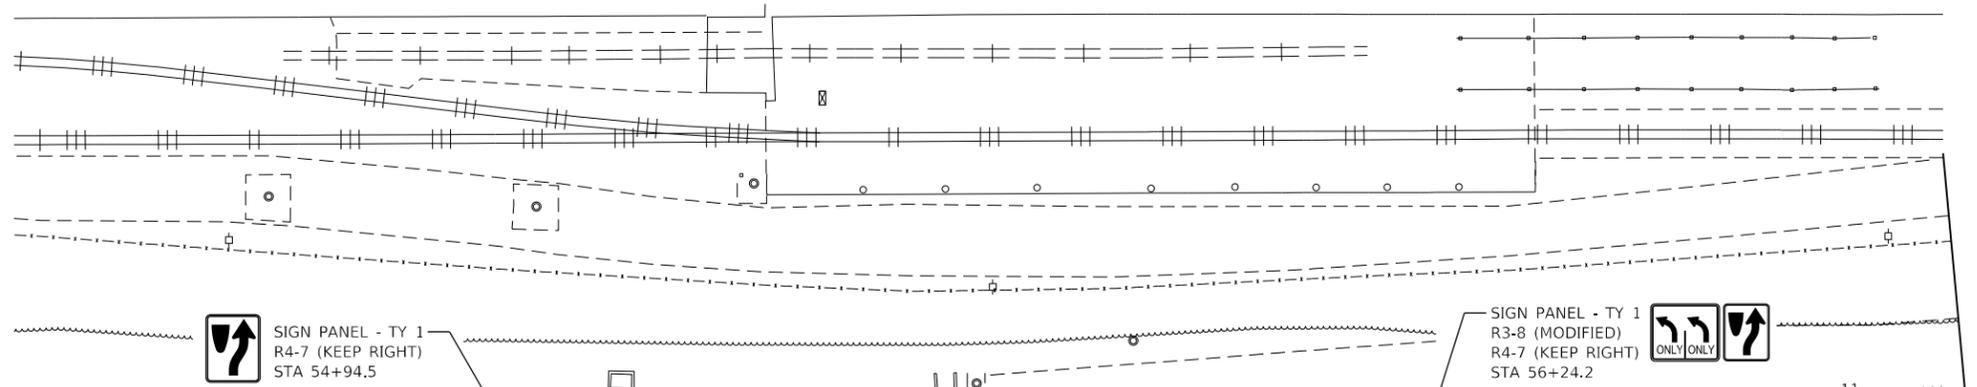MATCH LINE STA 57+75.00 (PR BRUSH)



**PAVEMENT MARKING LEGEND**

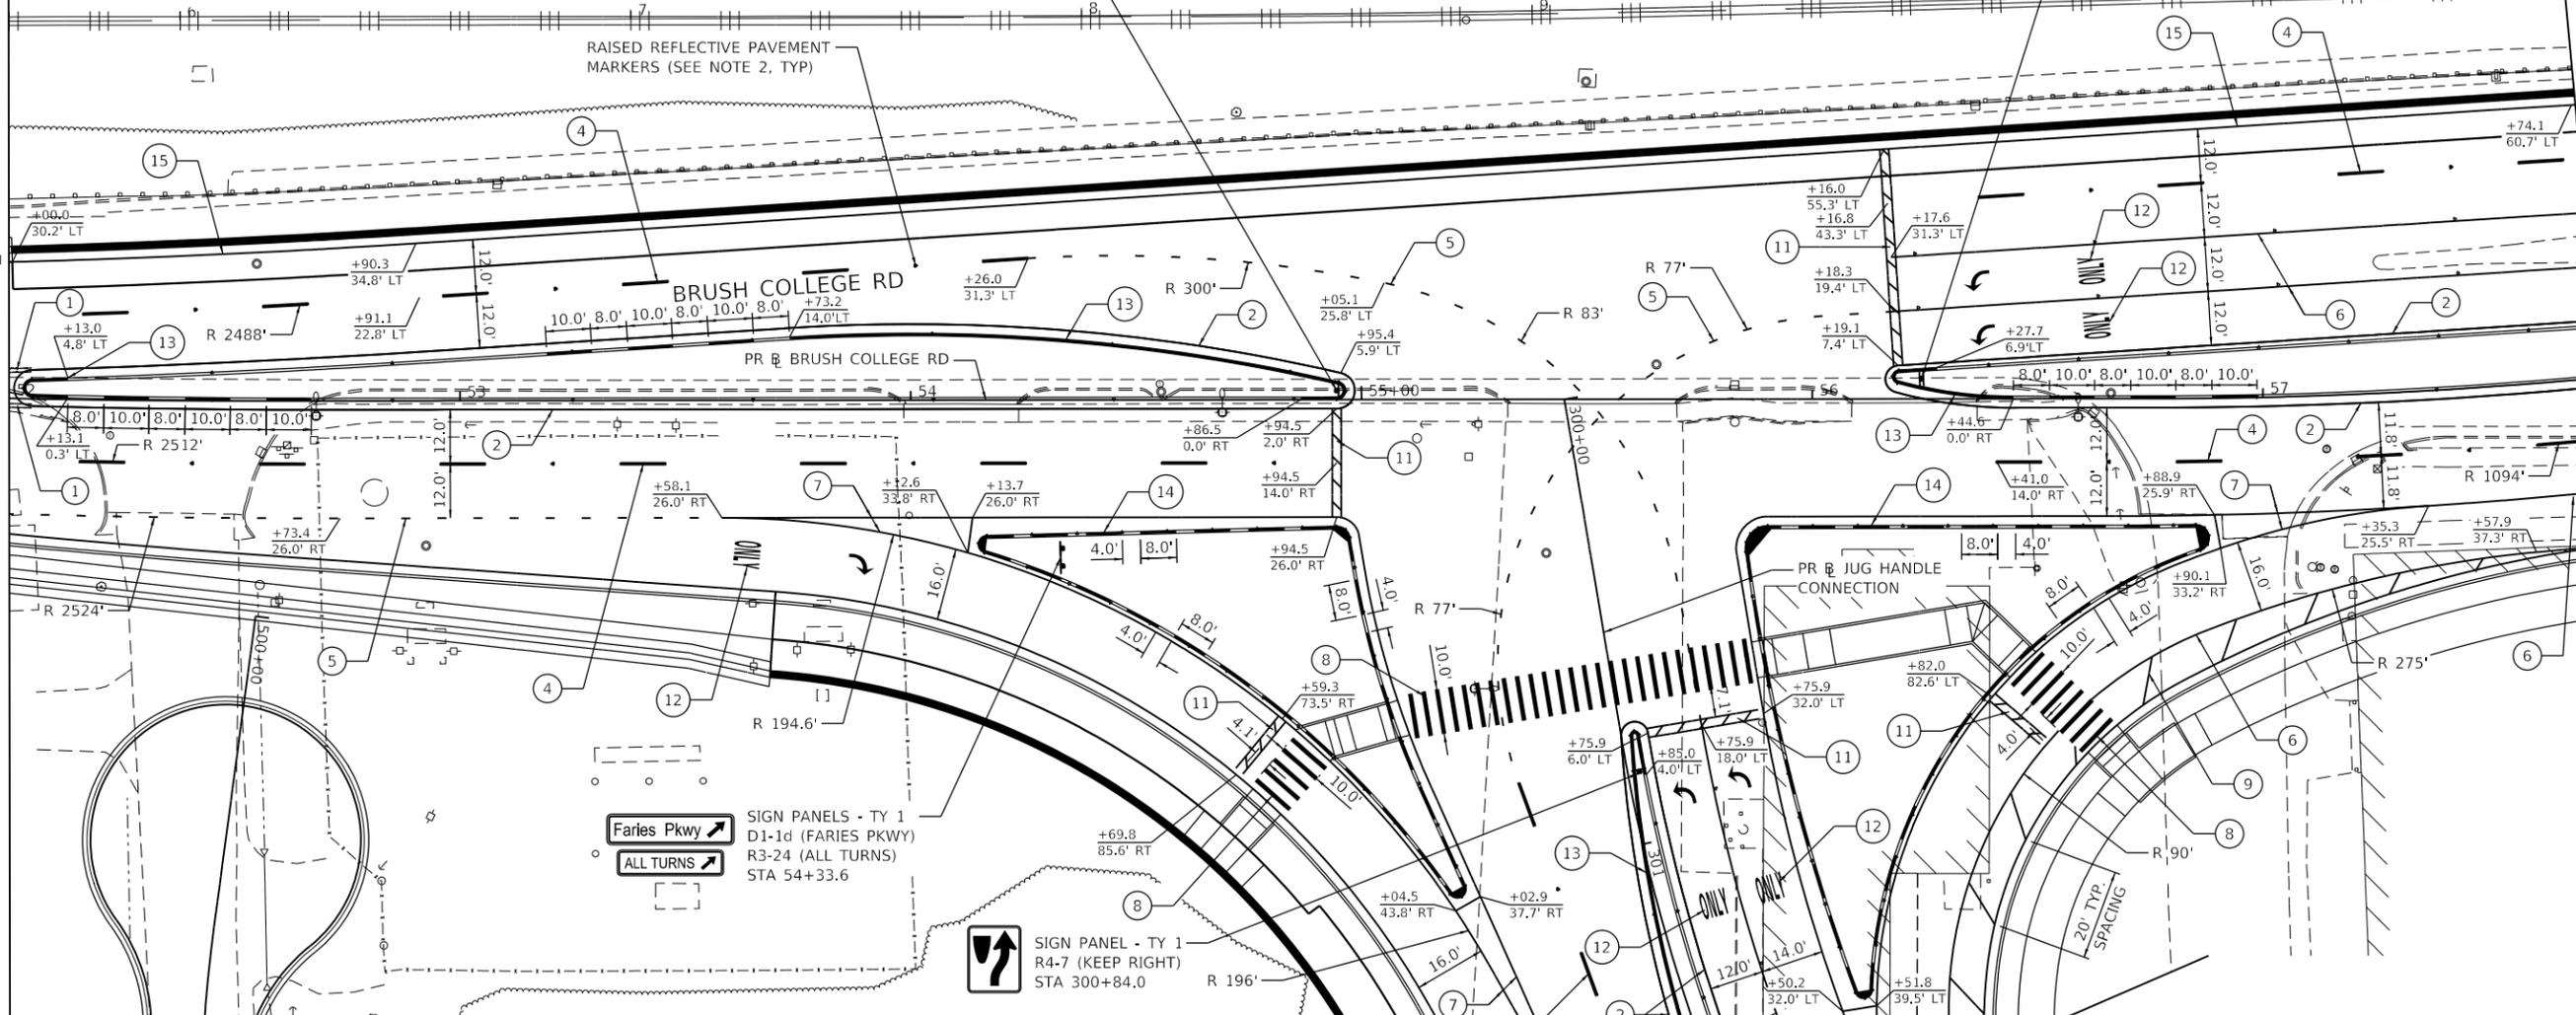- |  |  |
|--|--|
| ① MOD URETH PM LINE 4 (SOLID YELLOW, DOUBLE CENTERLINE, 11" C-C) | ⑧ MOD URETH PM LINE 12 (SOLID WHITE, CROSS WALK) |
| ② MOD URETH PM LINE 4 (SOLID YELLOW)                             | ⑨ MOD URETH PM LINE 12 (SOLID WHITE)             |
| ④ MOD URETH PM LINE 6 (WHITE, 10' DASH - 30' SKIP)               | ⑪ MOD URETH PM LINE 24 (SOLID WHITE, STOP BAR)   |
| ⑤ MOD URETH PM LINE 6 (WHITE, 2' DASH - 6' SKIP)                 | ⑫ MOD URETH PM LTR-SYM                           |
| ⑥ MOD URETH PM LINE 6 (SOLID WHITE)                              | ⑬ PAINT PVT MARK CURB (YELLOW)                   |
| ⑦ MOD URETH PM LINE 8 (SOLID WHITE)                              | ⑭ PAINT PVT MARK CURB (WHITE)                    |
|  | ⑮ MOD URETH PM LINE 4 (SOLID WHITE)              |



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USER NAME = rjo	DESIGNED - NDP	REVISED -
PLOT SCALE = 40.0000' / in.	DRAWN - NDP	REVISED -
PLOT DATE = 4/28/2021	CHECKED - LDC	REVISED -
	DATE - 4/30/2021	REVISED -


**STATE OF ILLINOIS  
DEPARTMENT OF TRANSPORTATION**

<b>BRUSH COLLEGE ROAD PAVEMENT MARKING &amp; SIGNING PLAN</b>	
SCALE: 1"=20'	SHEET 2 OF 20 SHEETS
STA. 52+00.00	TO STA. 57+75.00

F.A.U. RTE.	SECTION	COUNTY	TOTAL SHEETS	SHEET NO.
7448	09-00933-01-BR	MACON	1019	548
CONTRACT NO. 95893				
ILLINOIS FED. AID PROJECT				

**PAVEMENT MARKING & SIGNING NOTES**


1. ALL PAVEMENT MARKINGS SHALL BE OF THE TYPE AND COLOR AS SPECIFIED IN THE PLANS AND SHALL BE PLACED PER DISTRICT 7 STANDARD 78000001 AND IDOT STANDARD 780001-05.
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**PAVEMENT MARKING LEGEND**

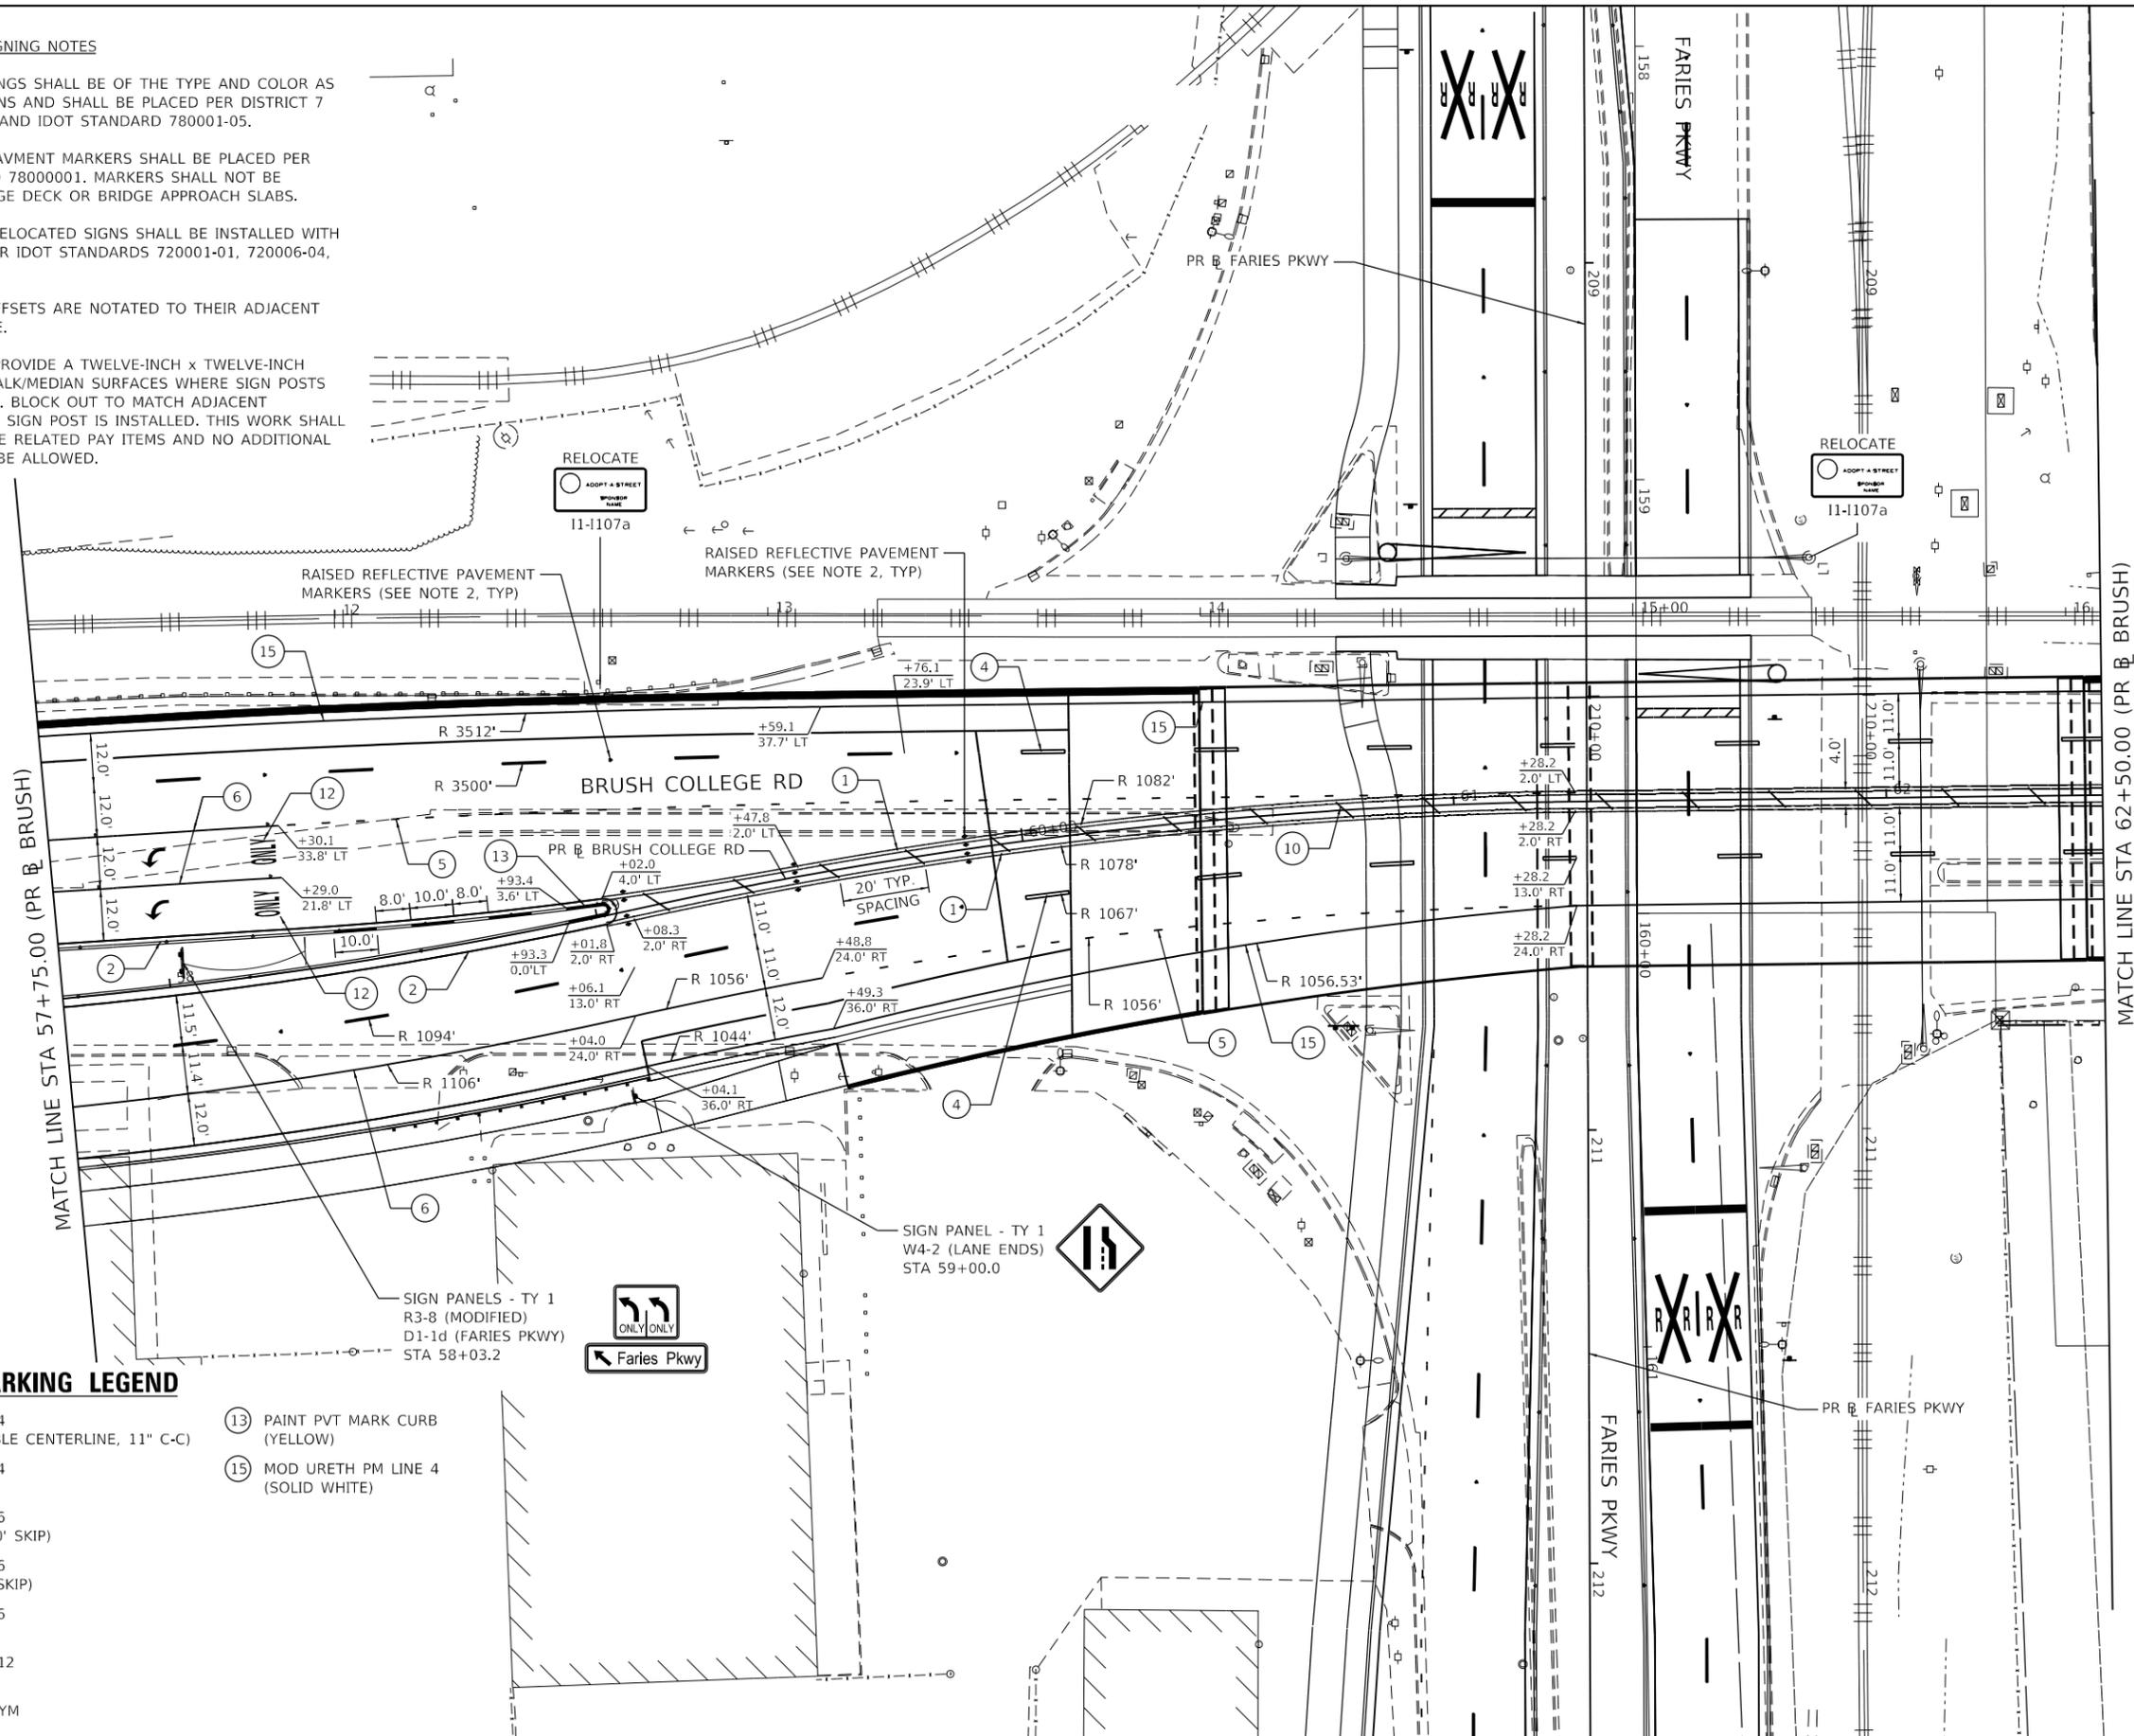- |  |                                     |
|--|-------------------------------------|
| ① MOD URETH PM LINE 4 (SOLID YELLOW, DOUBLE CENTERLINE, 11" C-C) | ⑬ PAINT PVT MARK CURB (YELLOW)      |
| ② MOD URETH PM LINE 4 (SOLID YELLOW)                             | ⑮ MOD URETH PM LINE 4 (SOLID WHITE) |
| ④ MOD URETH PM LINE 6 (WHITE, 10' DASH - 30' SKIP)               |                                     |
| ⑤ MOD URETH PM LINE 6 (WHITE, 2' DASH - 6' SKIP)                 |                                     |
| ⑥ MOD URETH PM LINE 6 (SOLID WHITE)                              |                                     |
| ⑩ MOD URETH PM LINE 12 (SOLID YELLOW)                            |                                     |
| ⑫ MOD URETH PM LTR-SYM   |                                     |

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USER NAME = rjo	DESIGNED - NDP	REVISED -
PLOT SCALE = 40.0000' / in.	DRAWN - NDP	REVISED -
PLOT DATE = 4/28/2021	CHECKED - LDC	REVISED -
	DATE - 4/30/2021	REVISED -

**STATE OF ILLINOIS  
DEPARTMENT OF TRANSPORTATION**


**BRUSH COLLEGE ROAD  
PAVEMENT MARKING & SIGNING PLAN**

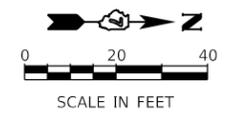SCALE: 1"=20'    SHEET 3 OF 20 SHEETS    STA. 57+75.00 TO STA. 62+50.00

F.A.U. RTE. 7448	SECTION 09-00933-01-BR	COUNTY MACON	TOTAL SHEETS 1019	SHEET NO. 549
CONTRACT NO. 95893				
ILLINOIS FED. AID PROJECT				


**PAVEMENT MARKING & SIGNING NOTES**

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**PAVEMENT MARKING LEGEND**

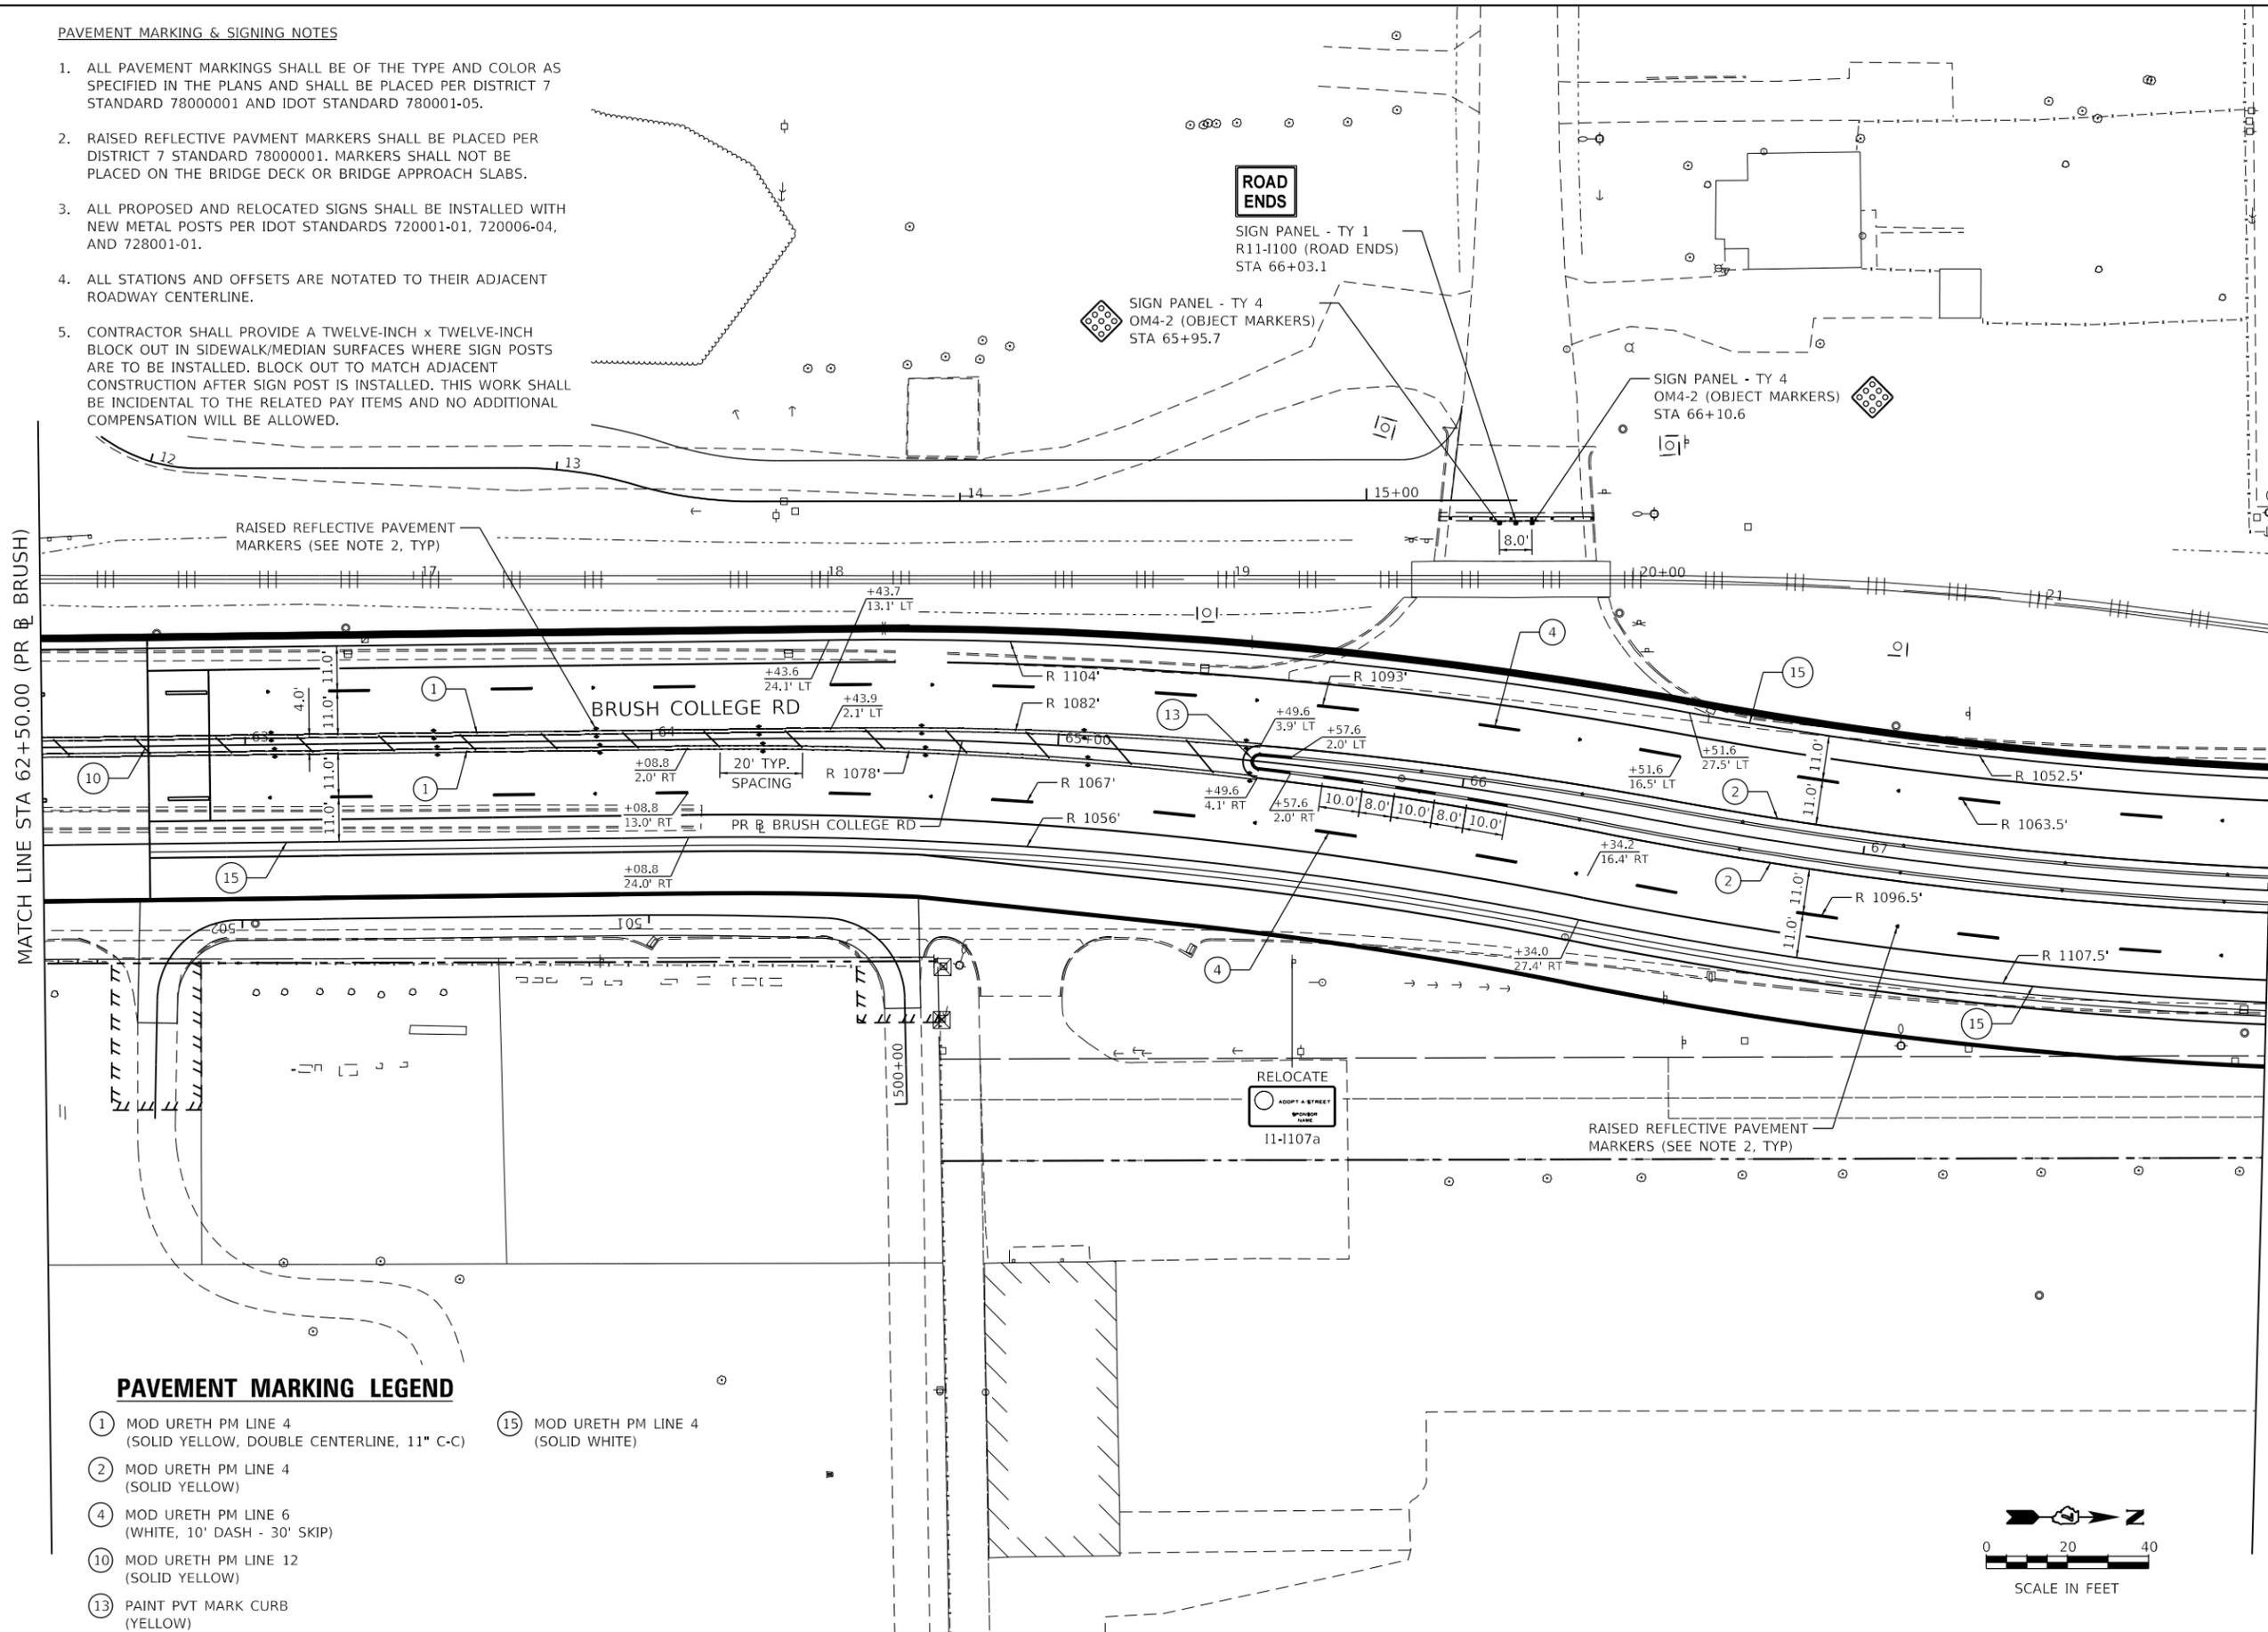- ① MOD URETH PM LINE 4 (SOLID YELLOW, DOUBLE CENTERLINE, 11" C-C)
- ② MOD URETH PM LINE 4 (SOLID YELLOW)
- ④ MOD URETH PM LINE 6 (WHITE, 10" DASH - 30" SKIP)
- ⑩ MOD URETH PM LINE 12 (SOLID YELLOW)
- ⑬ PAINT PVT MARK CURB (YELLOW)
- ⑮ MOD URETH PM LINE 4 (SOLID WHITE)



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**Kaskaskia**  
 Engineering Group, LLC  
PROFESSIONAL REGISTERED ENGINEERS  
 Illinois Professional Design Firm  
 Professional Engineering Group

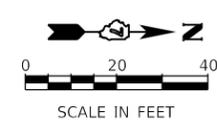USER NAME = rjo	DESIGNED - NDP	REVISED -
PLOT SCALE = 40.0000' / in.	DRAWN - NDP	REVISED -
PLOT DATE = 10/21/2021	CHECKED - LDC	REVISED -
	DATE - 10/22/2021	REVISED -

**STATE OF ILLINOIS**  
**DEPARTMENT OF TRANSPORTATION**

**BRUSH COLLEGE ROAD**  
**PAVEMENT MARKING & SIGNING PLAN**

SCALE: 1"=20'  
 SHEET 4 OF 20 SHEETS  
 STA. 62+50.0 TO STA. 68+00.00


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7448	09-00933-01-BR	MACON	1019	550
CONTRACT NO. 95893				
ILLINOIS FED. AID PROJECT				

**PAVEMENT MARKING & SIGNING NOTES**

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**PAVEMENT MARKING LEGEND**

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- ② MOD URETH PM LINE 4 (SOLID YELLOW)
- ③ MOD URETH PM LINE 4 (YELLOW, 10' DASH - 30' SKIP)
- ④ MOD URETH PM LINE 6 (WHITE, 10' DASH - 30' SKIP)
- ⑤ MOD URETH PM LINE 6 (WHITE, 2' DASH - 6' SKIP)
- ⑥ MOD URETH PM LINE 6 (SOLID WHITE)
- ⑧ MOD URETH PM LINE 12 (SOLID WHITE, CROSS WALK)
- ⑪ MOD URETH PM LINE 24 (SOLID WHITE, STOP BAR)
- ⑫ MOD URETH PM LTR-SYM
- ⑬ PAINT PVT MARK CURB (YELLOW)
- ⑮ MOD URETH PM LINE 4 (SOLID WHITE)

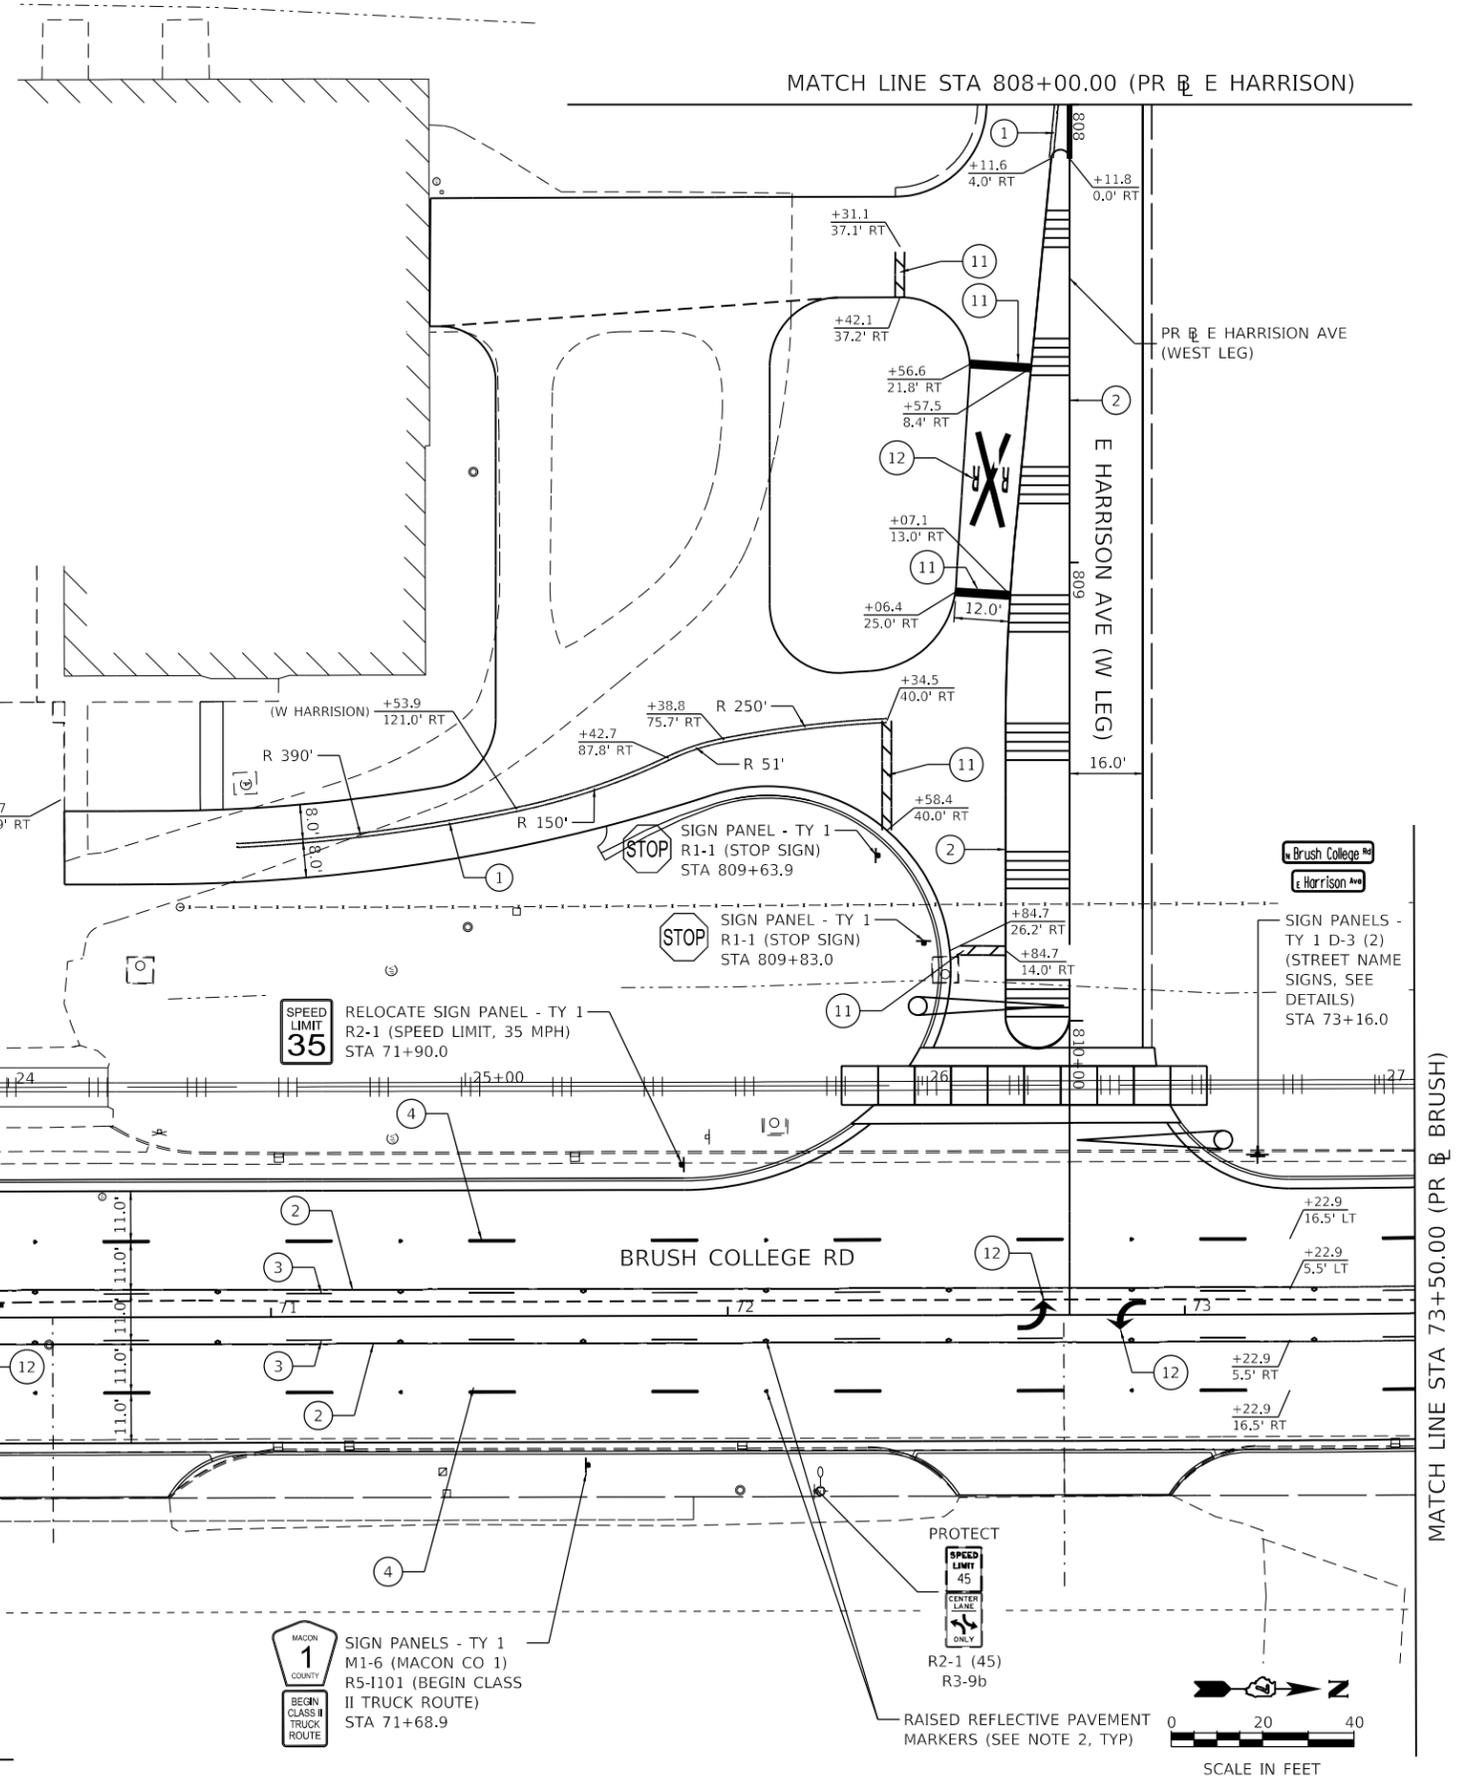

SIGN PANEL - TY 1  
W1-7 (TWO-DIRECTION)  
STA 69+40.0

SIGN PANEL - TY 1  
R4-7 (KEEP RIGHT)  
STA 68+83.1

SPEED LIMIT 35  
RELOCATE SIGN PANEL - TY 1  
R2-1 (SPEED LIMIT, 35 MPH)  
STA 71+90.0

SIGN PANEL - TY 1  
R1-1 (STOP SIGN)  
STA 809+63.9

SIGN PANEL - TY 1  
R1-1 (STOP SIGN)  
STA 809+83.0

Brush College Rd  
E Harrison Ave


SIGN PANELS - TY 1 D-3 (2)  
(STREET NAME SIGNS, SEE DETAILS)  
STA 73+16.0

SIGN PANELS - TY 1  
D-3 (2) (STREET NAME SIGNS, SEE DETAILS)  
R1-1 (STOP SIGN)  
R4-4P (CROSS TRAFFIC DOES NOT STOP)  
STA 700+66.9

MACON COUNTY  
1  
BEGIN CLASS II TRUCK ROUTE  
SIGN PANELS - TY 1  
M1-6 (MACON CO 1)  
R5-1101 (BEGIN CLASS II TRUCK ROUTE)  
STA 71+68.9

PROTECT  
SPEED LIMIT 45  
CENTER LINE ONLY  
R2-1 (45)  
R3-9b

RAISED REFLECTIVE PAVEMENT MARKERS (SEE NOTE 2, TYP)

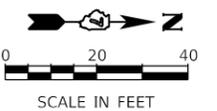

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**Kaskaskia**  
Engineering Group, LLC  
PROFESSIONAL DESIGN FIRMS  
Illinois Professional Design Firm  
Professional Engineering Group

USER NAME = rjo	DESIGNED - NDP	REVISED -
PLOT SCALE = 40.0000' / in.	DRAWN - NDP	REVISED -
PLOT DATE = 4/28/2021	CHECKED - LDC	REVISED -
	DATE - 4/30/2021	REVISED -

**STATE OF ILLINOIS  
DEPARTMENT OF TRANSPORTATION**

**BRUSH COLLEGE ROAD  
PAVEMENT MARKING & SIGNING PLAN**


SCALE: 1"=20'

SHEET 5 OF 20 SHEETS STA. 68+00.00 TO STA. 73+50.00

F.A.U. RTE. 7448	SECTION 09-00933-01-BR	COUNTY MACON	TOTAL SHEETS 1019	SHEET NO. 551
CONTRACT NO. 95893				
ILLINOIS FED. AID PROJECT				



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**PAVEMENT MARKING LEGEND**

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- ② MOD URETH PM LINE 4 (SOLID YELLOW)
- ③ MOD URETH PM LINE 4 (YELLOW, 10' DASH - 30' SKIP)
- ④ MOD URETH PM LINE 6 (WHITE, 10' DASH - 30' SKIP)
- ⑤ MOD URETH PM LINE 6 (WHITE, 2' DASH - 6' SKIP)
- ⑥ MOD URETH PM LINE 6 (SOLID WHITE)
- ⑫ MOD URETH PM LTR-SYM

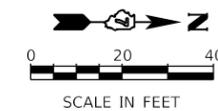

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**Kaskaskia**  
Engineering Group, LLC  
PROFESSIONAL DESIGN FIRM  
ILLINOIS PROFESSIONAL DESIGN FIRM  
Professional Engineering Group  
184.004773  
20-5080586

USER NAME = rjo	DESIGNED - NDP	REVISED -
PLOT SCALE = 40.0000' / in.	DRAWN - NDP	REVISED -
PLOT DATE = 4/28/2021	CHECKED - LDC	REVISED -
	DATE - 4/30/2021	REVISED -

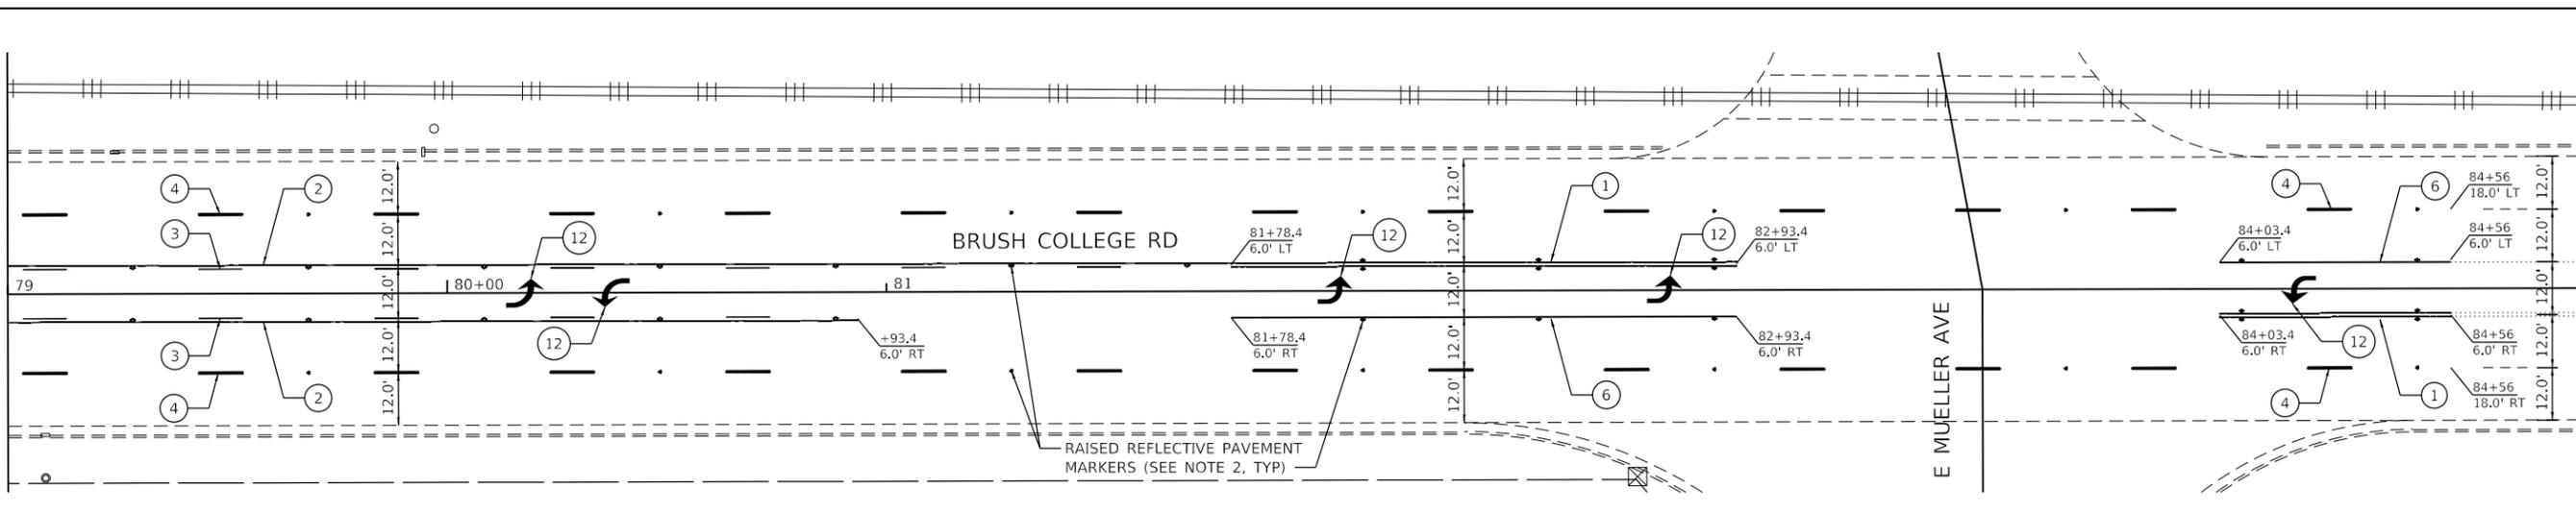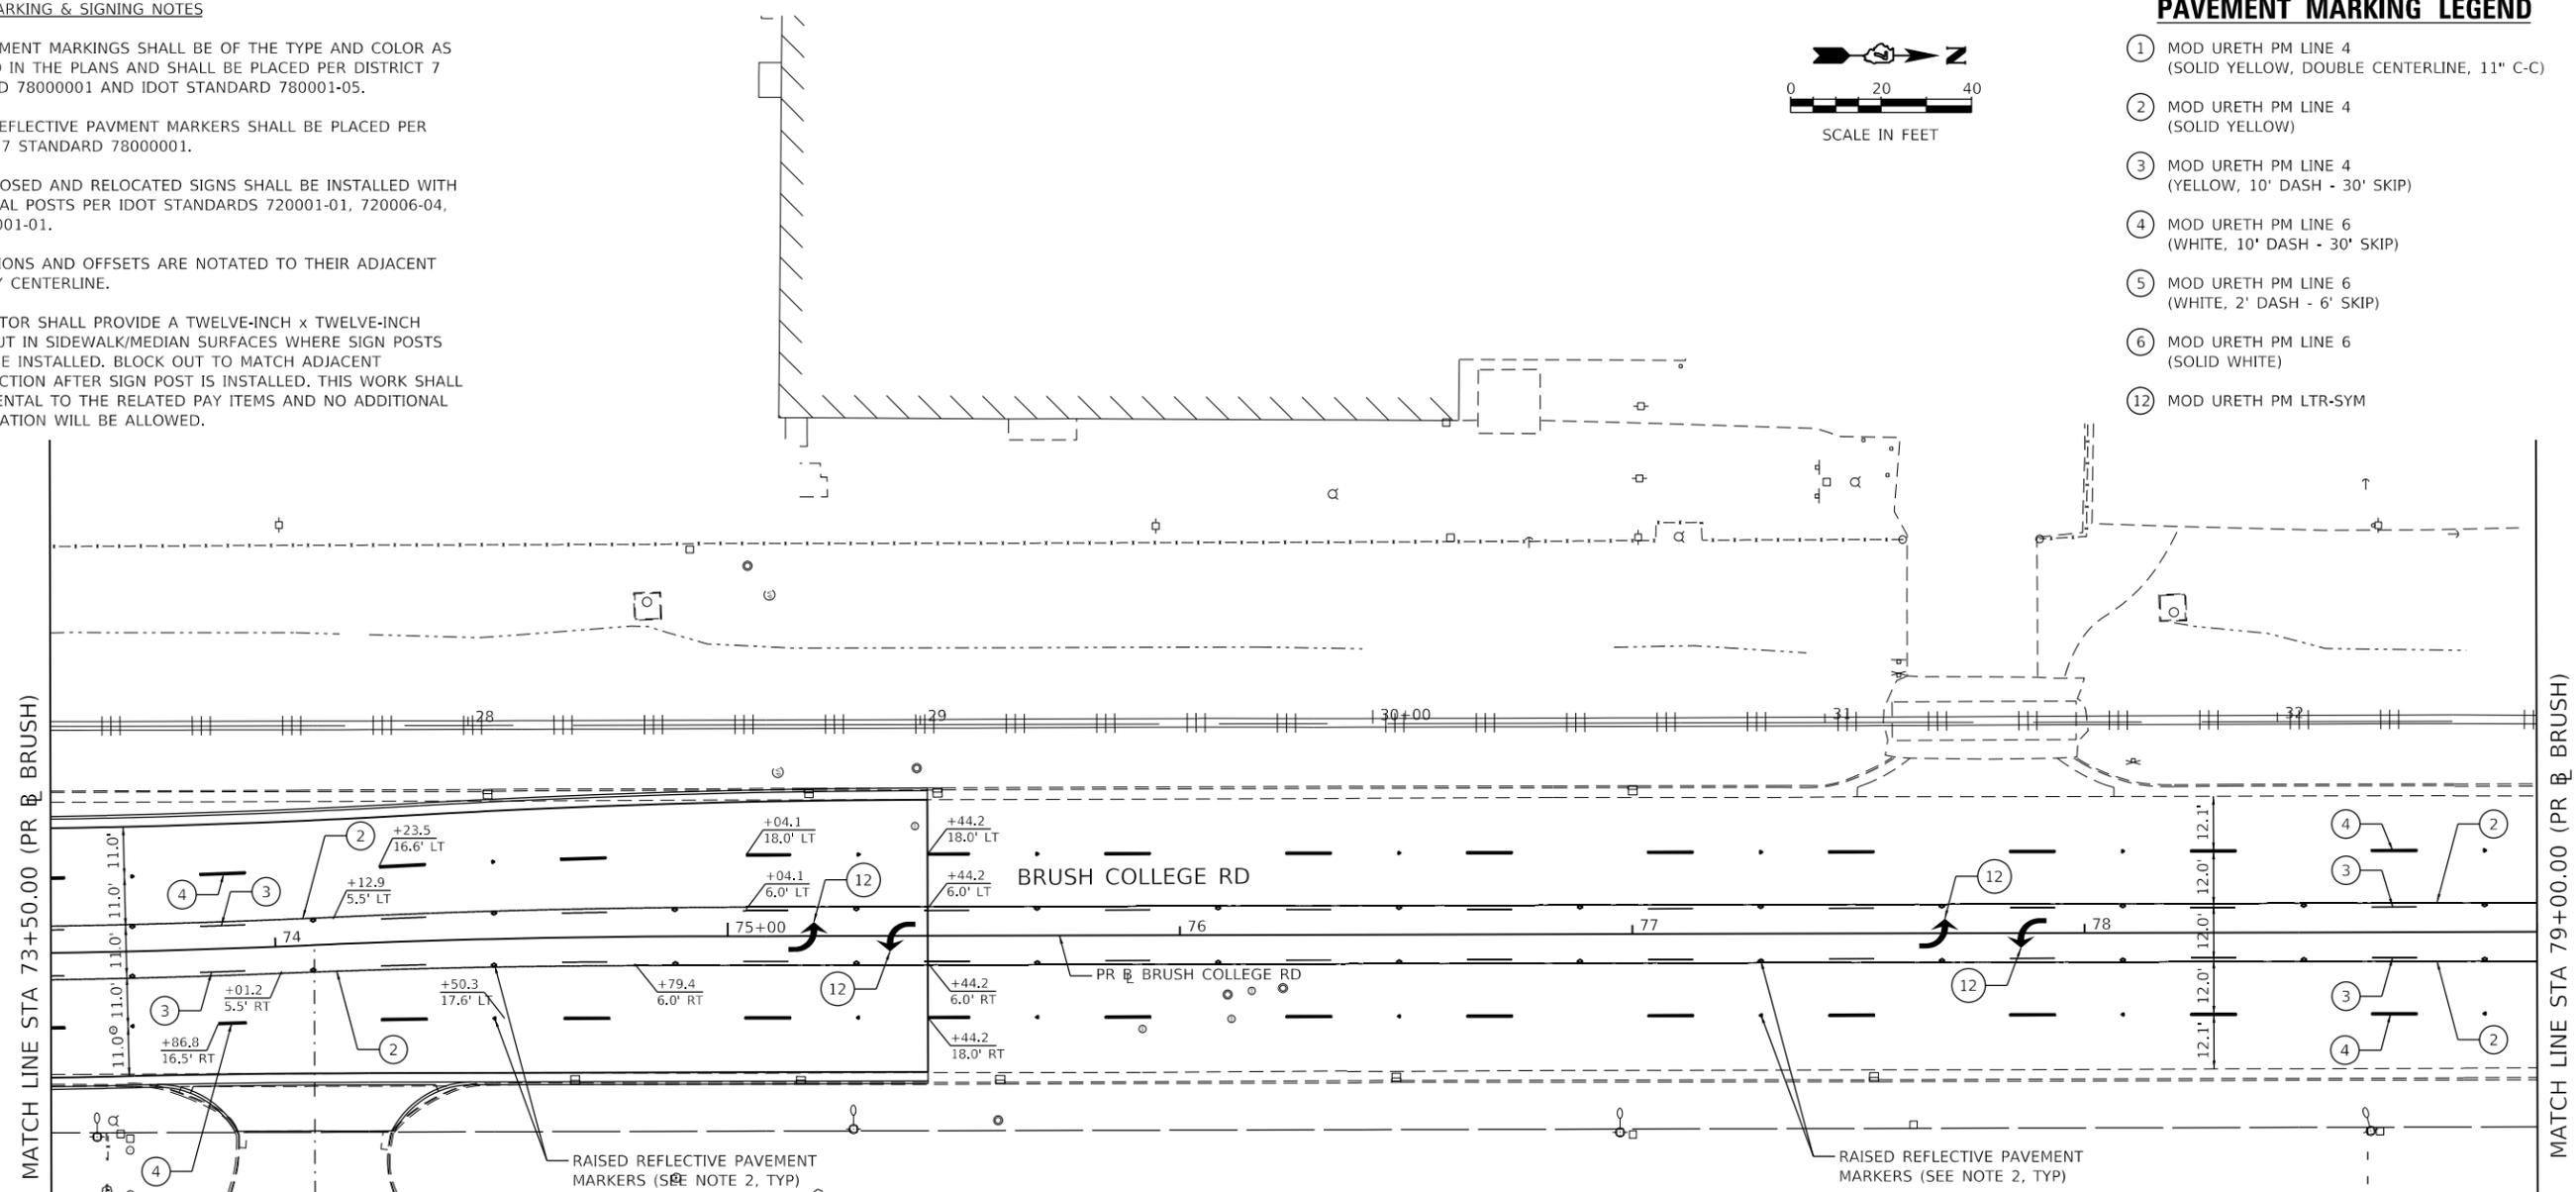**STATE OF ILLINOIS  
DEPARTMENT OF TRANSPORTATION**

**BRUSH COLLEGE ROAD  
PAVEMENT MARKING & SIGNING PLAN**

SCALE: 1"=20'    SHEET 6 OF 20 SHEETS    STA. 73+50.00 TO STA.


F.A.U. RTE. 7448	SECTION 09-00933-01-BR	COUNTY MACON	TOTAL SHEETS 1019	SHEET NO. 552
CONTRACT NO. 95893				
ILLINOIS FED. AID PROJECT				

**PAVEMENT MARKING & SIGNING NOTES**

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**PAVEMENT MARKING LEGEND**

- ② MOD URETH PM LINE 4 (SOLID YELLOW)
- ④ MOD URETH PM LINE 6 (WHITE, 10' DASH - 30' SKIP)
- ⑥ MOD URETH PM LINE 6 (SOLID WHITE)
- ⑬ PAINT PVT MARK CURB (YELLOW)

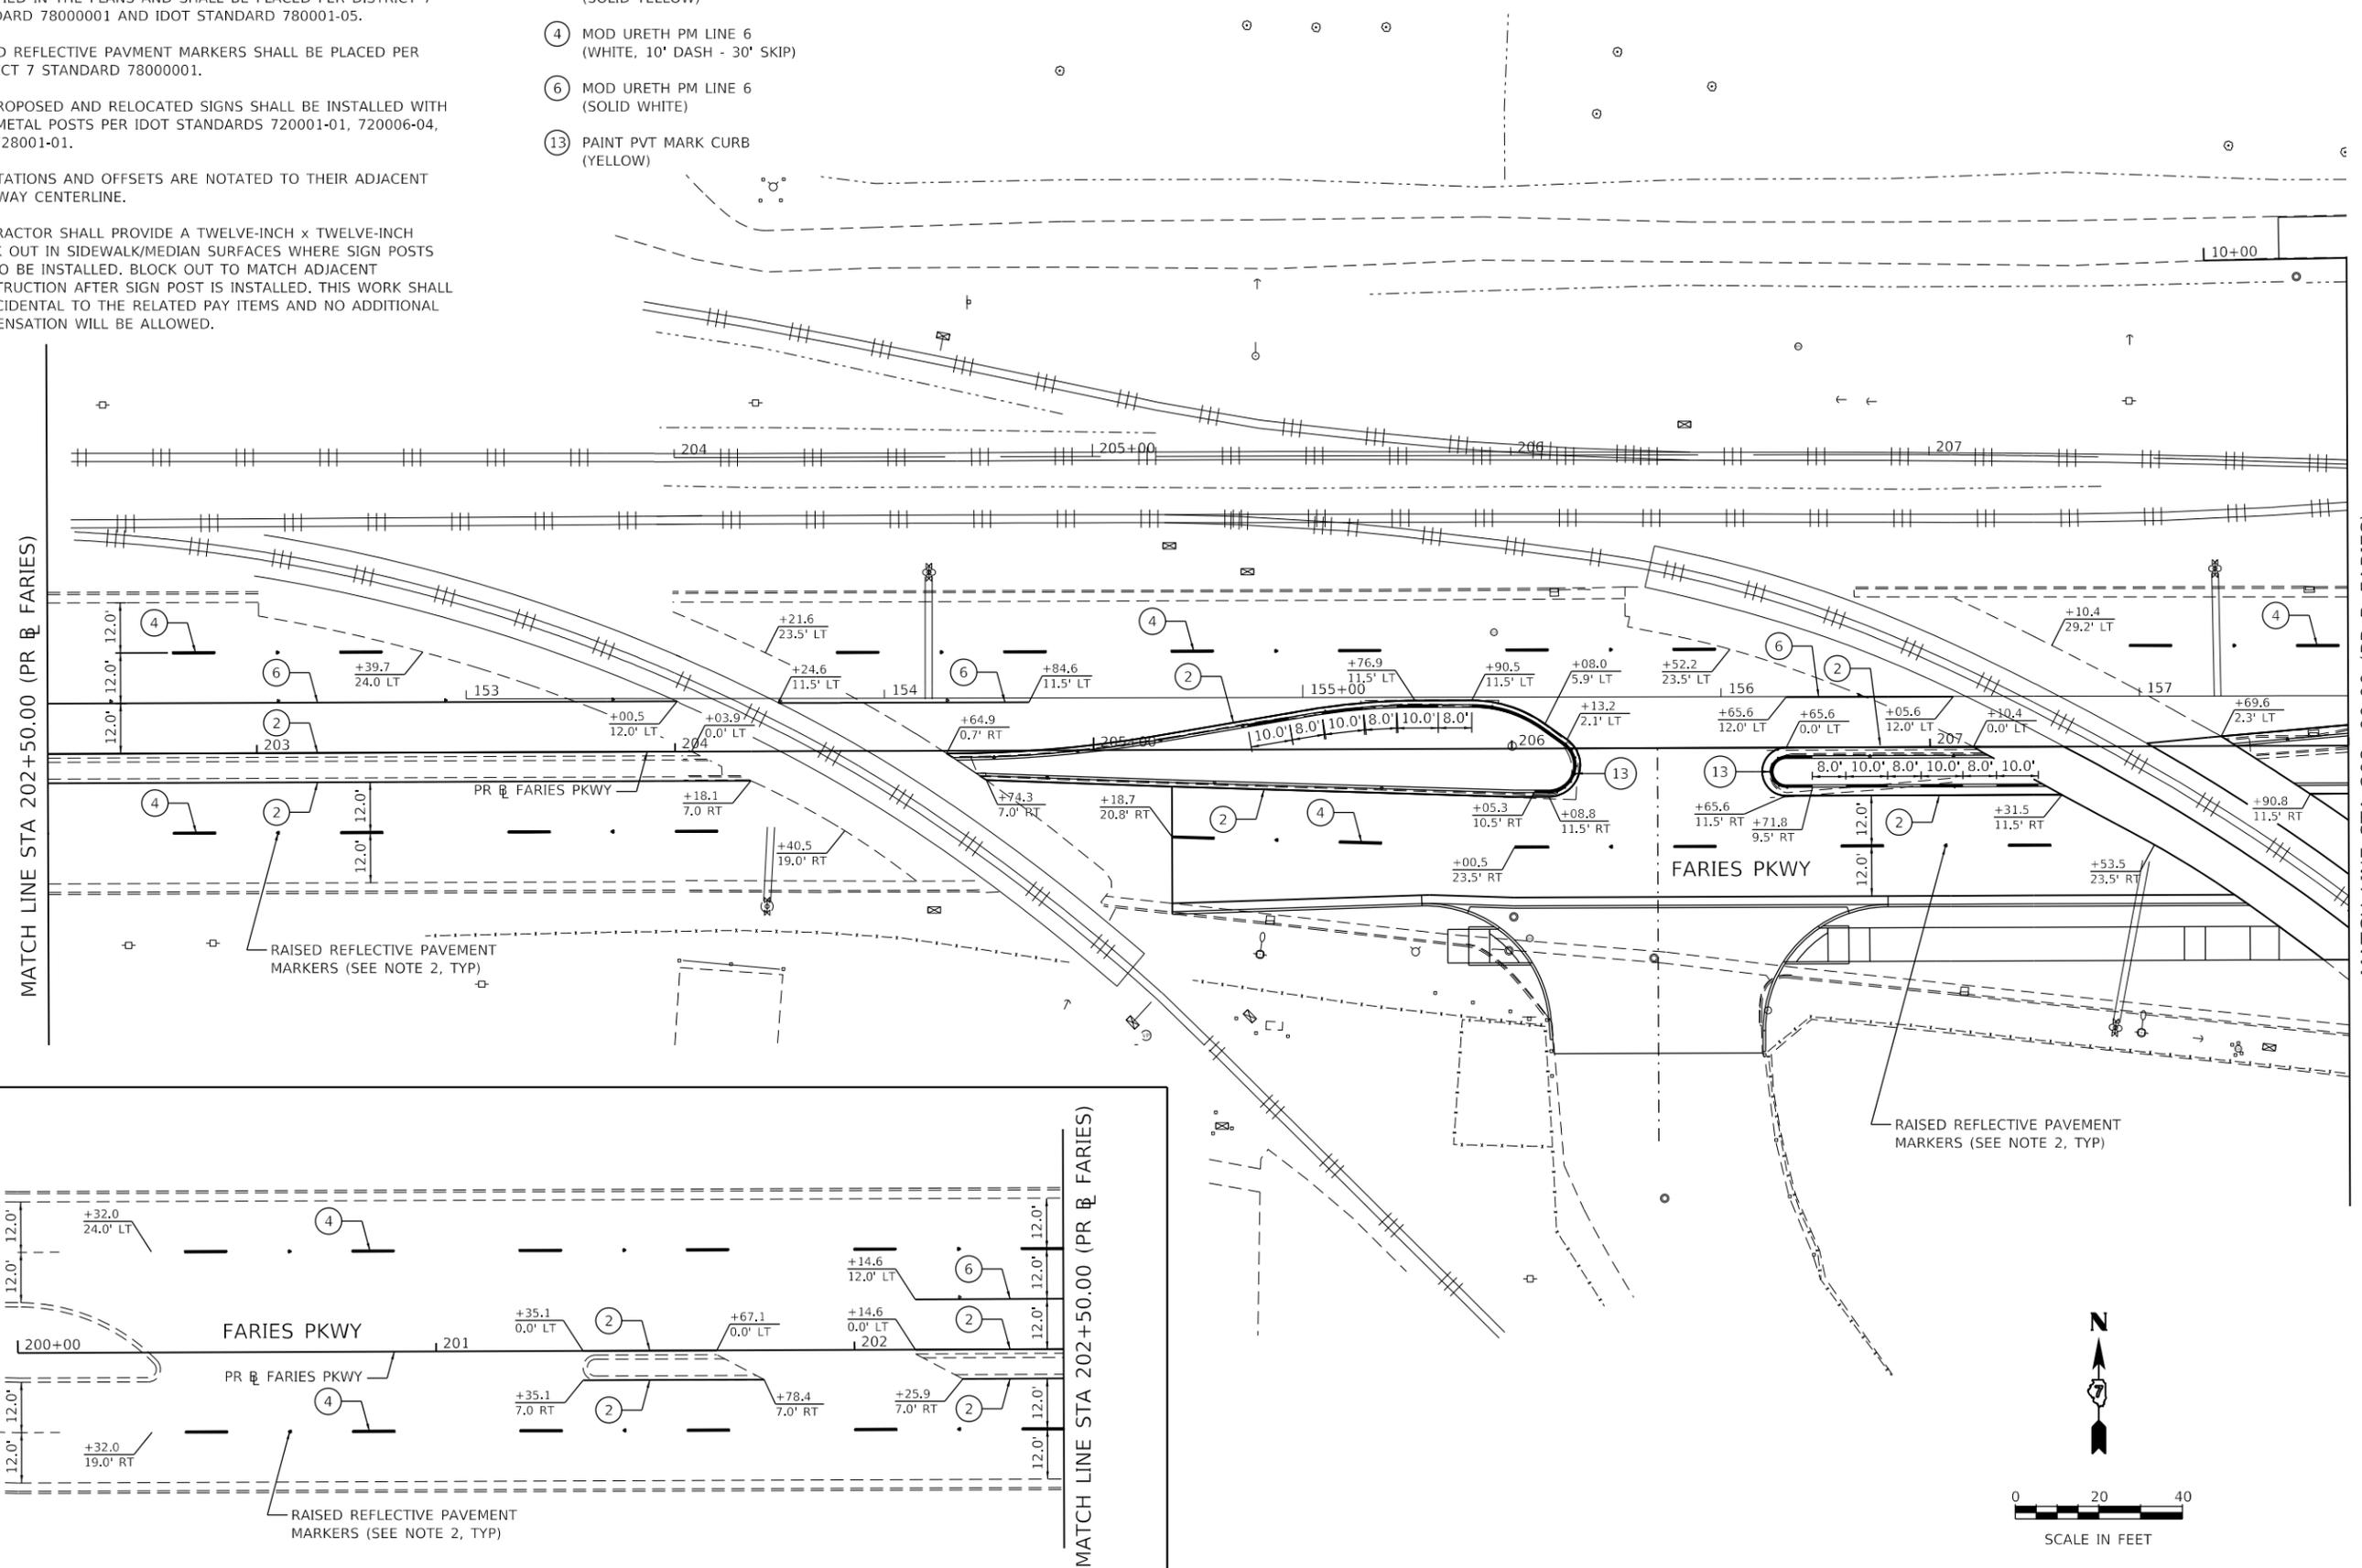

MATCH LINE STA 202+50.00 (PR FARIES)

MATCH LINE STA 208+00.00 (PR FARIES)

RAISED REFLECTIVE PAVEMENT MARKERS (SEE NOTE 2, TYP)

RAISED REFLECTIVE PAVEMENT MARKERS (SEE NOTE 2, TYP)

RAISED REFLECTIVE PAVEMENT MARKERS (SEE NOTE 2, TYP)

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USER NAME = rjo	DESIGNED - NDP	REVISED -
PLOT SCALE = 40.0000' / in.	DRAWN - NDP	REVISED -
PLOT DATE = 4/28/2021	CHECKED - LDC	REVISED -
	DATE - 4/30/2021	REVISED -

**STATE OF ILLINOIS  
DEPARTMENT OF TRANSPORTATION**


**FARIES PARKWAY  
PAVEMENT MARKING & SIGNING PLAN**

SCALE: 1"=20'  
SHEET 7 OF 20 SHEETS  
STA. 205+18.77 TO STA. 208+00.00

F.A.U. RTE. 7448	SECTION 09-00933-01-BR	COUNTY MACON	TOTAL SHEETS 1019	SHEET NO. 553
CONTRACT NO. 95893				
ILLINOIS FED. AID PROJECT				

**PAVEMENT MARKING & SIGNING NOTES**

1. ALL PAVEMENT MARKINGS SHALL BE OF THE TYPE AND COLOR AS SPECIFIED IN THE PLANS AND SHALL BE PLACED PER DISTRICT 7 STANDARD 78000001 AND IDOT STANDARD 780001-05.
2. RAISED REFLECTIVE PAVMENT MARKERS SHALL BE PLACED PER DISTRICT 7 STANDARD 78000001.
3. ALL PROPOSED AND RELOCATED SIGNS SHALL BE INSTALLED WITH NEW METAL POSTS PER IDOT STANDARDS 720001-01, 720006-04, AND 728001-01.
4. ALL STATIONS AND OFFSETS ARE NOTATED TO THEIR ADJACENT ROADWAY CENTERLINE.
5. CONTRACTOR SHALL PROVIDE A TWELVE-INCH x TWELVE-INCH BLOCK OUT IN SIDEWALK/MEDIAN SURFACES WHERE SIGN POSTS ARE TO BE INSTALLED. BLOCK OUT TO MATCH ADJACENT CONSTRUCTION AFTER SIGN POST IS INSTALLED. THIS WORK SHALL BE INCIDENTAL TO THE RELATED PAY ITEMS AND NO ADDITIONAL COMPENSATION WILL BE ALLOWED.

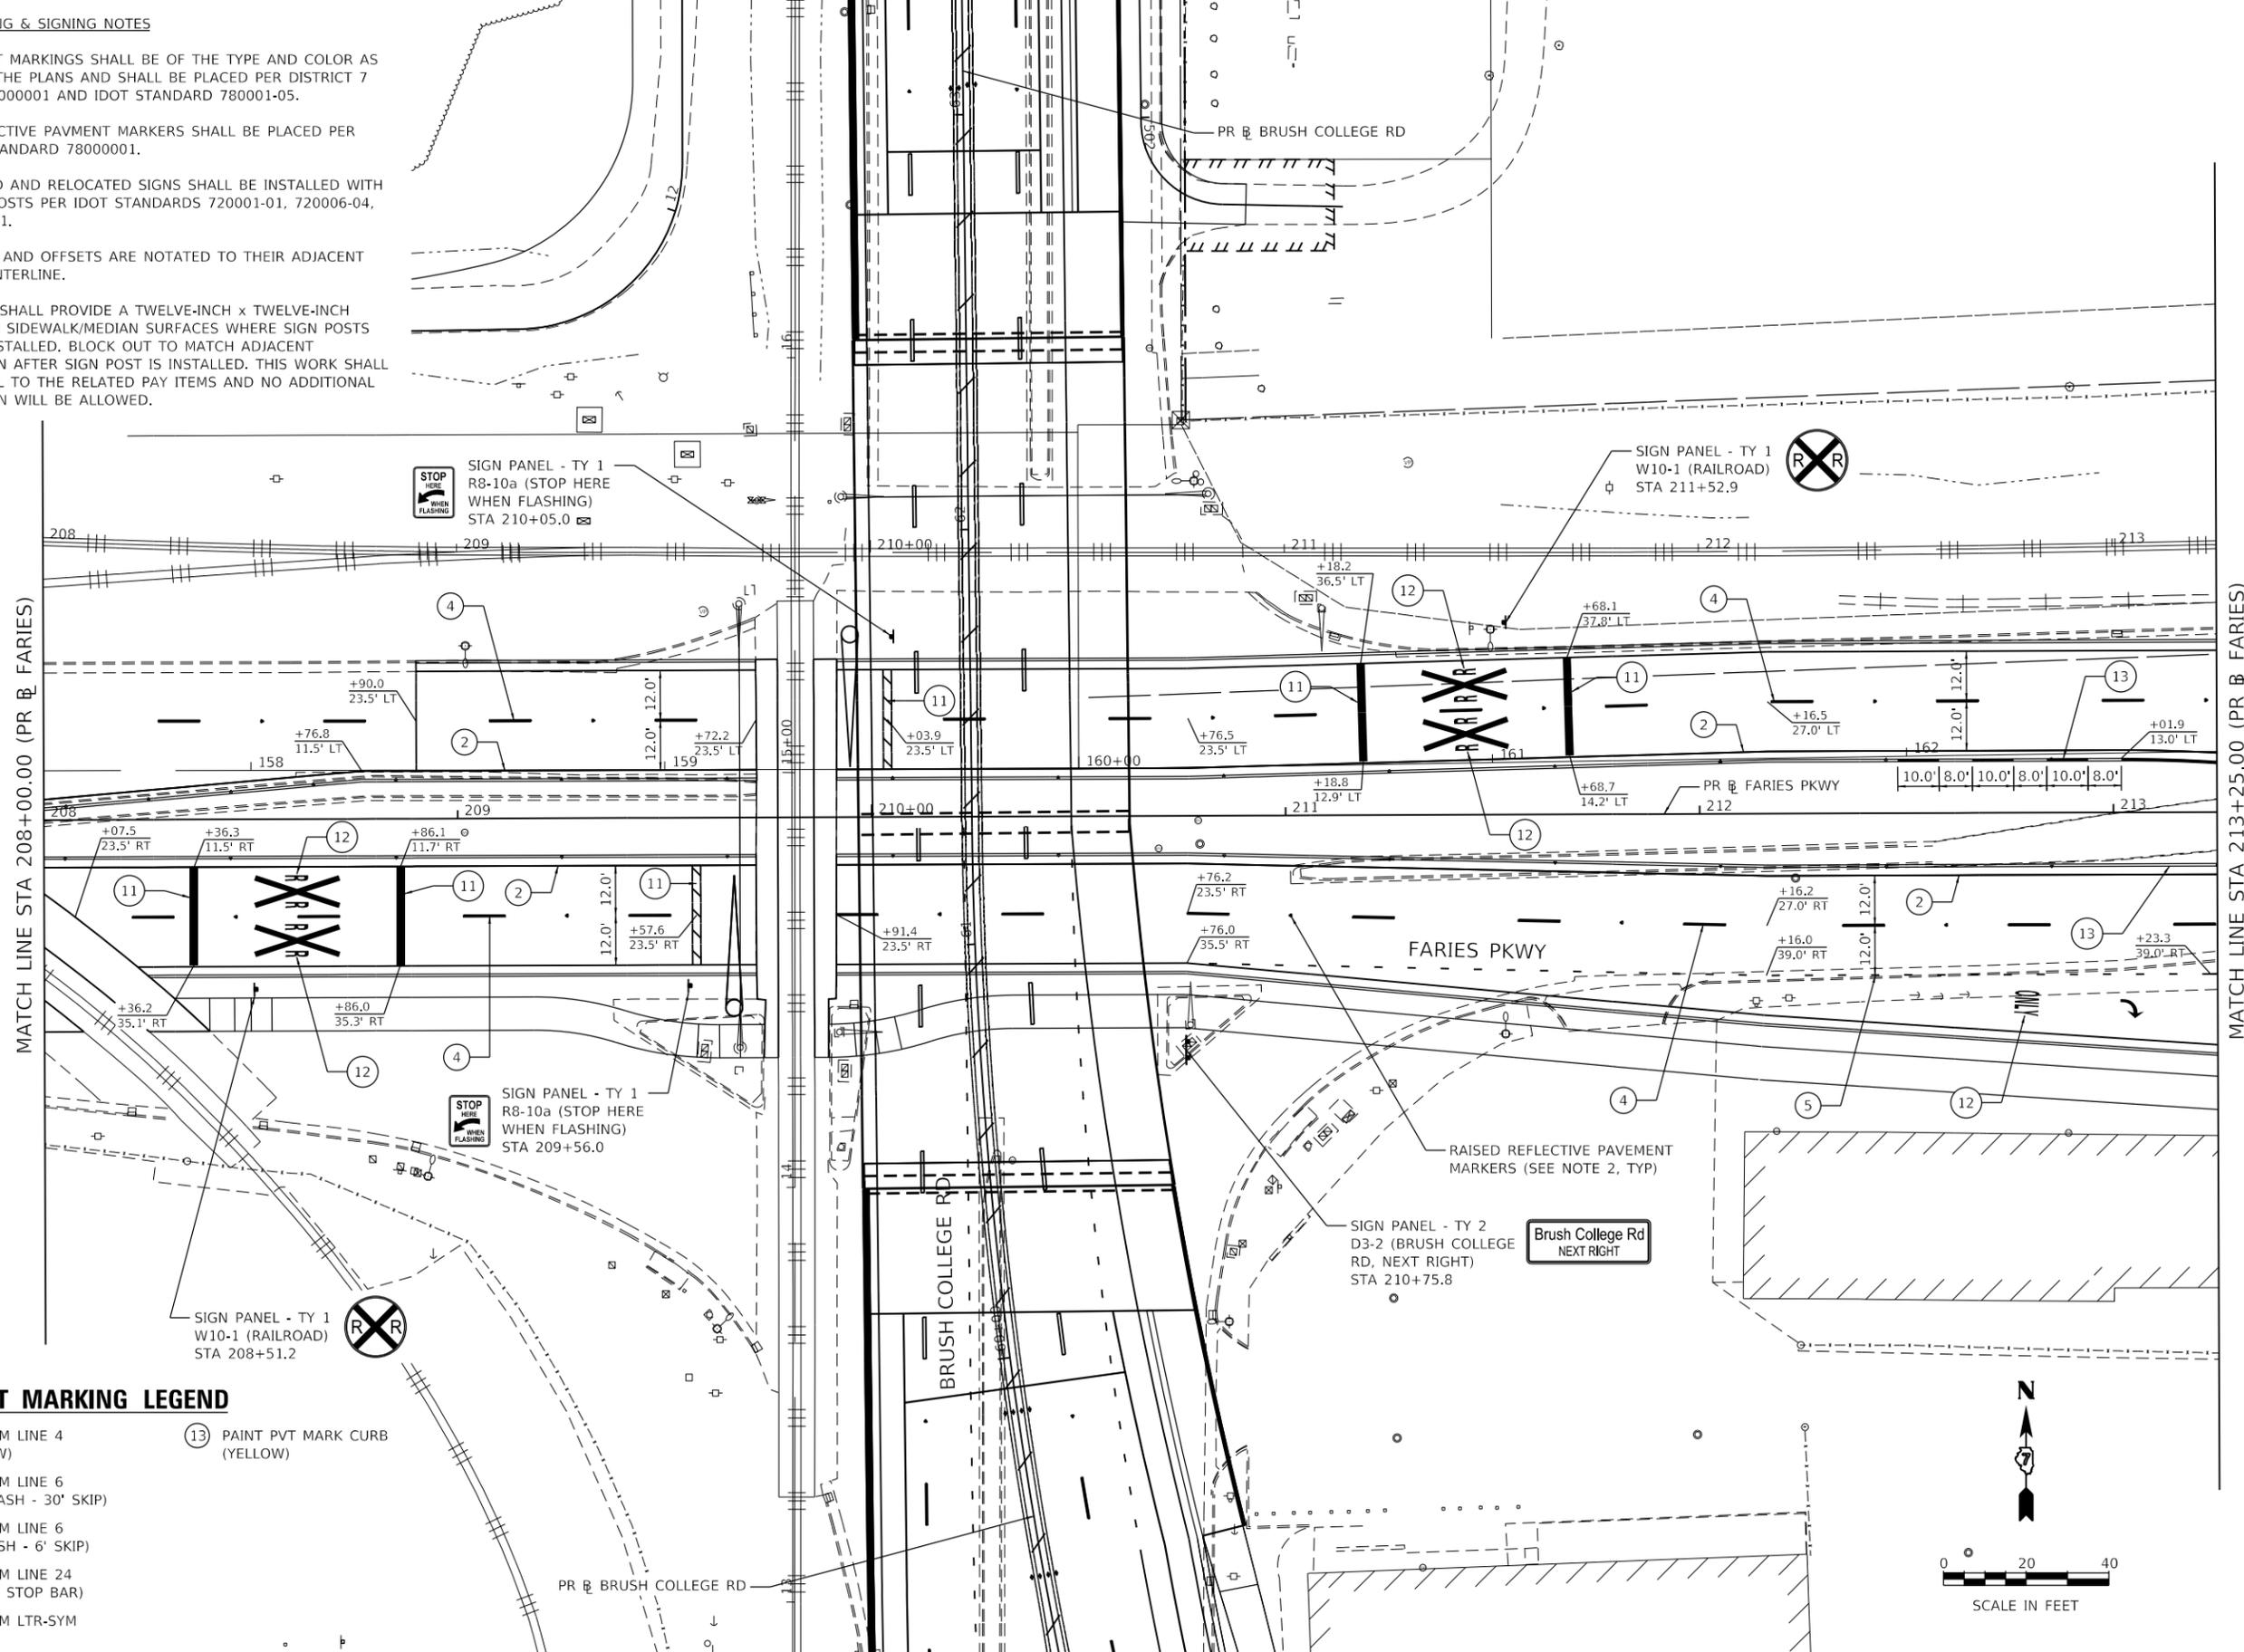


MATCH LINE STA 208+00.00 (PR & FARIES)

MATCH LINE STA 213+25.00 (PR & FARIES)

**PAVEMENT MARKING LEGEND**

- |  |                                |
|--|--------------------------------|
| ② MOD URETH PM LINE 4 (SOLID YELLOW)               | ⑬ PAINT PVT MARK CURB (YELLOW) |
| ④ MOD URETH PM LINE 6 (WHITE, 10' DASH - 30' SKIP) |                                |
| ⑤ MOD URETH PM LINE 6 (WHITE, 2' DASH - 6' SKIP)   |                                |
| ⑪ MOD URETH PM LINE 24 (SOLID WHITE, STOP BAR)     |                                |
| ⑫ MOD URETH PM LTR-SYM                             |                                |

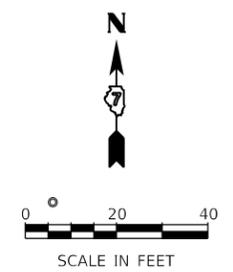

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USER NAME = rjo	DESIGNED - NDP	REVISED -
PLOT SCALE = 40.0000' / in.	DRAWN - NDP	REVISED -
PLOT DATE = 10/21/2021	CHECKED - LDC	REVISED -
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**STATE OF ILLINOIS  
DEPARTMENT OF TRANSPORTATION**


**FARIES PARKWAY  
PAVEMENT MARKING & SIGNING PLAN**

SCALE: 1"=20'    SHEET 8 OF 20 SHEETS    STA. 208+00.00 TO STA. 213+25.00

F.A.U. RTE. 7448	SECTION 09-00933-01-BR	COUNTY MACON	TOTAL SHEETS 1019	SHEET NO. 554
CONTRACT NO. 95893				
ILLINOIS FED. AID PROJECT				


**PAVEMENT MARKING & SIGNING NOTES**

1. ALL PAVEMENT MARKINGS SHALL BE OF THE TYPE AND COLOR AS SPECIFIED IN THE PLANS AND SHALL BE PLACED PER DISTRICT 7 STANDARD 78000001 AND IDOT STANDARD 780001-05.
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4. ALL STATIONS AND OFFSETS ARE NOTATED TO THEIR ADJACENT ROADWAY CENTERLINE.
5. CONTRACTOR SHALL PROVIDE A TWELVE-INCH x TWELVE-INCH BLOCK OUT IN SIDEWALK/MEDIAN SURFACES WHERE SIGN POSTS ARE TO BE INSTALLED. BLOCK OUT TO MATCH ADJACENT CONSTRUCTION AFTER SIGN POST IS INSTALLED. THIS WORK SHALL BE INCIDENTAL TO THE RELATED PAY ITEMS AND NO ADDITIONAL COMPENSATION WILL BE ALLOWED.

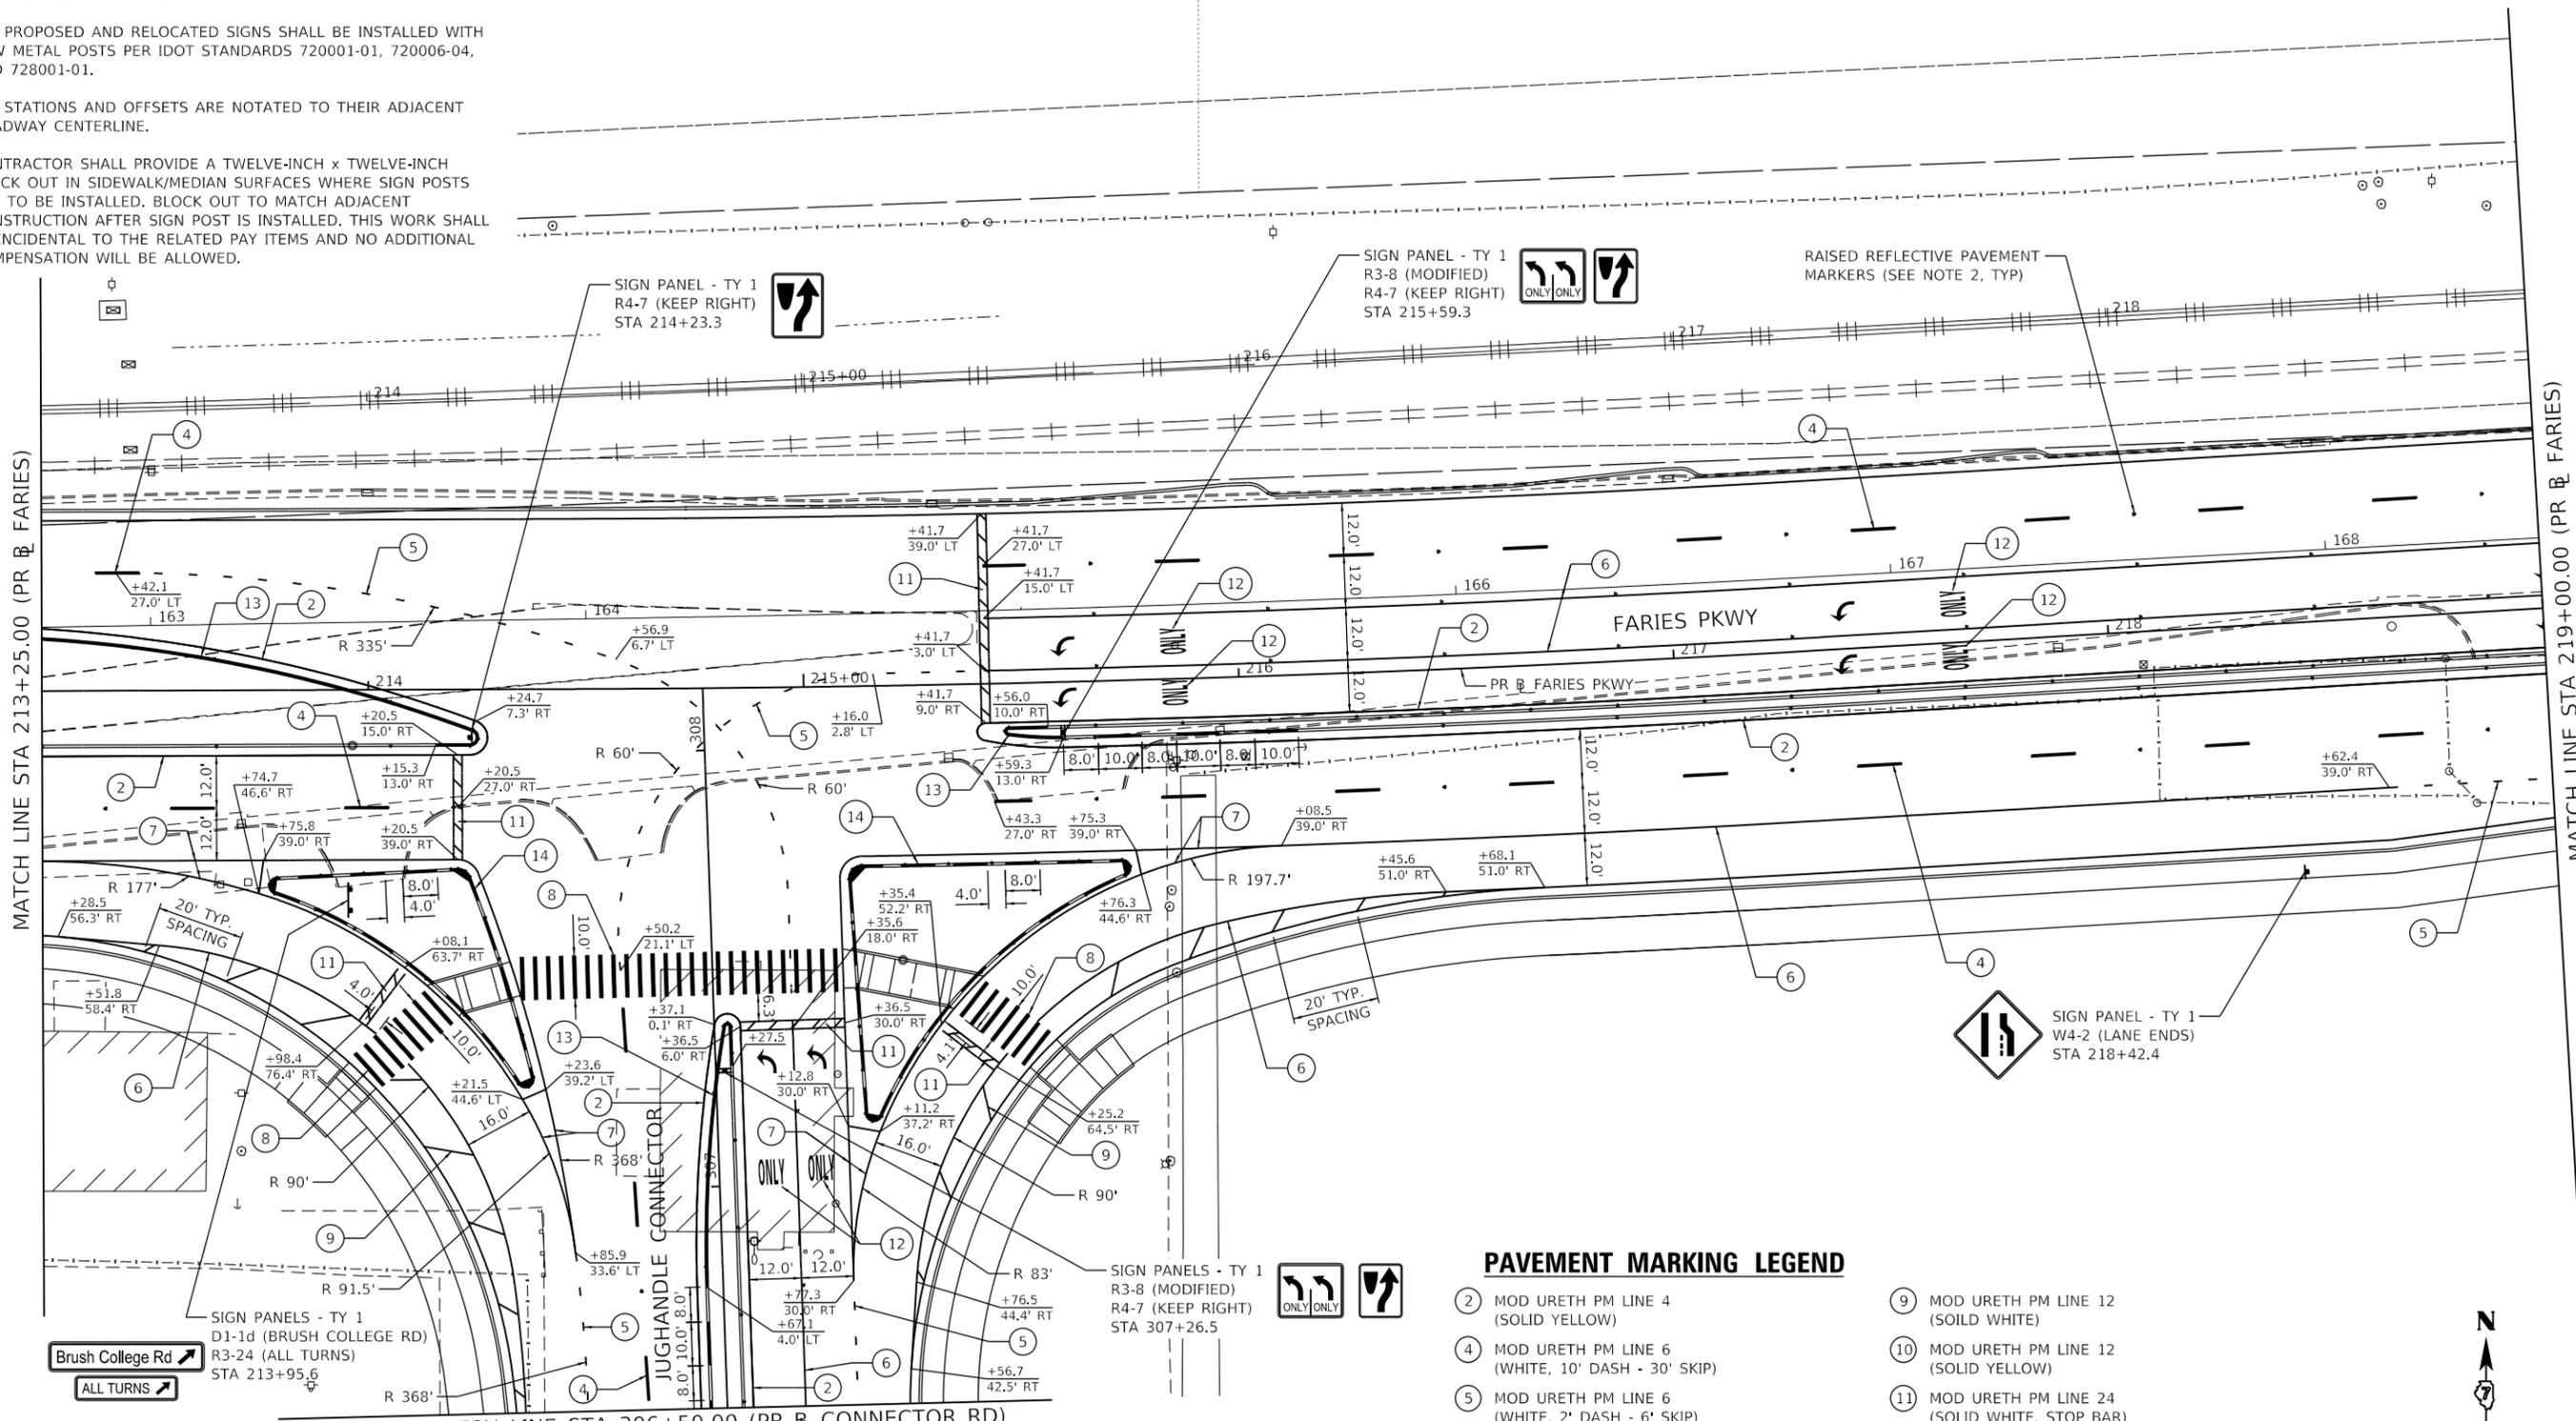

**PAVEMENT MARKING LEGEND**

- |  |  |
|--|--|
| ② MOD URETH PM LINE 4 (SOLID YELLOW)               | ⑨ MOD URETH PM LINE 12 (SOLID WHITE)           |
| ④ MOD URETH PM LINE 6 (WHITE, 10' DASH - 30' SKIP) | ⑩ MOD URETH PM LINE 12 (SOLID YELLOW)          |
| ⑤ MOD URETH PM LINE 6 (WHITE, 2' DASH - 6' SKIP)   | ⑪ MOD URETH PM LINE 24 (SOLID WHITE, STOP BAR) |
| ⑥ MOD URETH PM LINE 6 (SOLID WHITE)                | ⑫ MOD URETH PM LTR-SYM                         |
| ⑦ MOD URETH PM LINE 8 (SOLID WHITE)                | ⑬ PAINT PVT MARK CURB (YELLOW)                 |
| ⑧ MOD URETH PM LINE 12 (SOLID WHITE, CROSS WALK)   | ⑭ PAINT PVT MARK CURB (WHITE)                  |

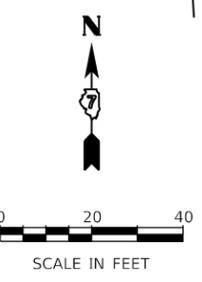

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 Kaskaskia Engineering Group, LLC  
 PROFESSIONAL REGISTERED ENGINEERS  
 Illinois Professional Design Firm  
 LICENSE NO. 184.004773  
 20-5880586



USER NAME = rjo	DESIGNED - NDP	REVISED -
PLOT SCALE = 40.0000' / in.	DRAWN - NDP	REVISED -
PLOT DATE = 4/28/2021	CHECKED - LDC	REVISED -
	DATE - 4/30/2021	REVISED -

**STATE OF ILLINOIS**  
**DEPARTMENT OF TRANSPORTATION**

<b>FARIES PARKWAY</b> <b>PAVEMENT MARKING &amp; SIGNING PLAN</b>		
SCALE: 1"=20'	SHEET 9 OF 20 SHEETS	STA. 213+25.00 TO STA. 219+00.00


F.A.U. RTE.	SECTION	COUNTY	TOTAL SHEETS	SHEET NO.
7448	09-00933-01-BR	MACON	1019	555
CONTRACT NO. 95893				
ILLINOIS FED. AID PROJECT				

PAVEMENT MARKING & SIGNING NOTES


- ALL PAVEMENT MARKINGS SHALL BE OF THE TYPE AND COLOR AS SPECIFIED IN THE PLANS AND SHALL BE PLACED PER DISTRICT 7 STANDARD 78000001 AND IDOT STANDARD 780001-05.
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PAVEMENT MARKING LEGEND

- |  |                                |
|--|--------------------------------|
| ② MOD URETH PM LINE 4 (SOLID YELLOW)               | ⑫ MOD URETH PM LTR-SYM         |
| ④ MOD URETH PM LINE 6 (WHITE, 10' DASH - 30' SKIP) | ⑬ PAINT PVT MARK CURB (YELLOW) |
| ⑤ MOD URETH PM LINE 6 (WHITE, 2' DASH - 6' SKIP)   |                                |
| ⑥ MOD URETH PM LINE 6 (SOLID WHITE)                |                                |
| ⑧ MOD URETH PM LINE 12 (SOLID WHITE, CROSS WALK)   |                                |
| ⑪ MOD URETH PM LINE 24 (SOLID WHITE, STOP BAR)     |                                |

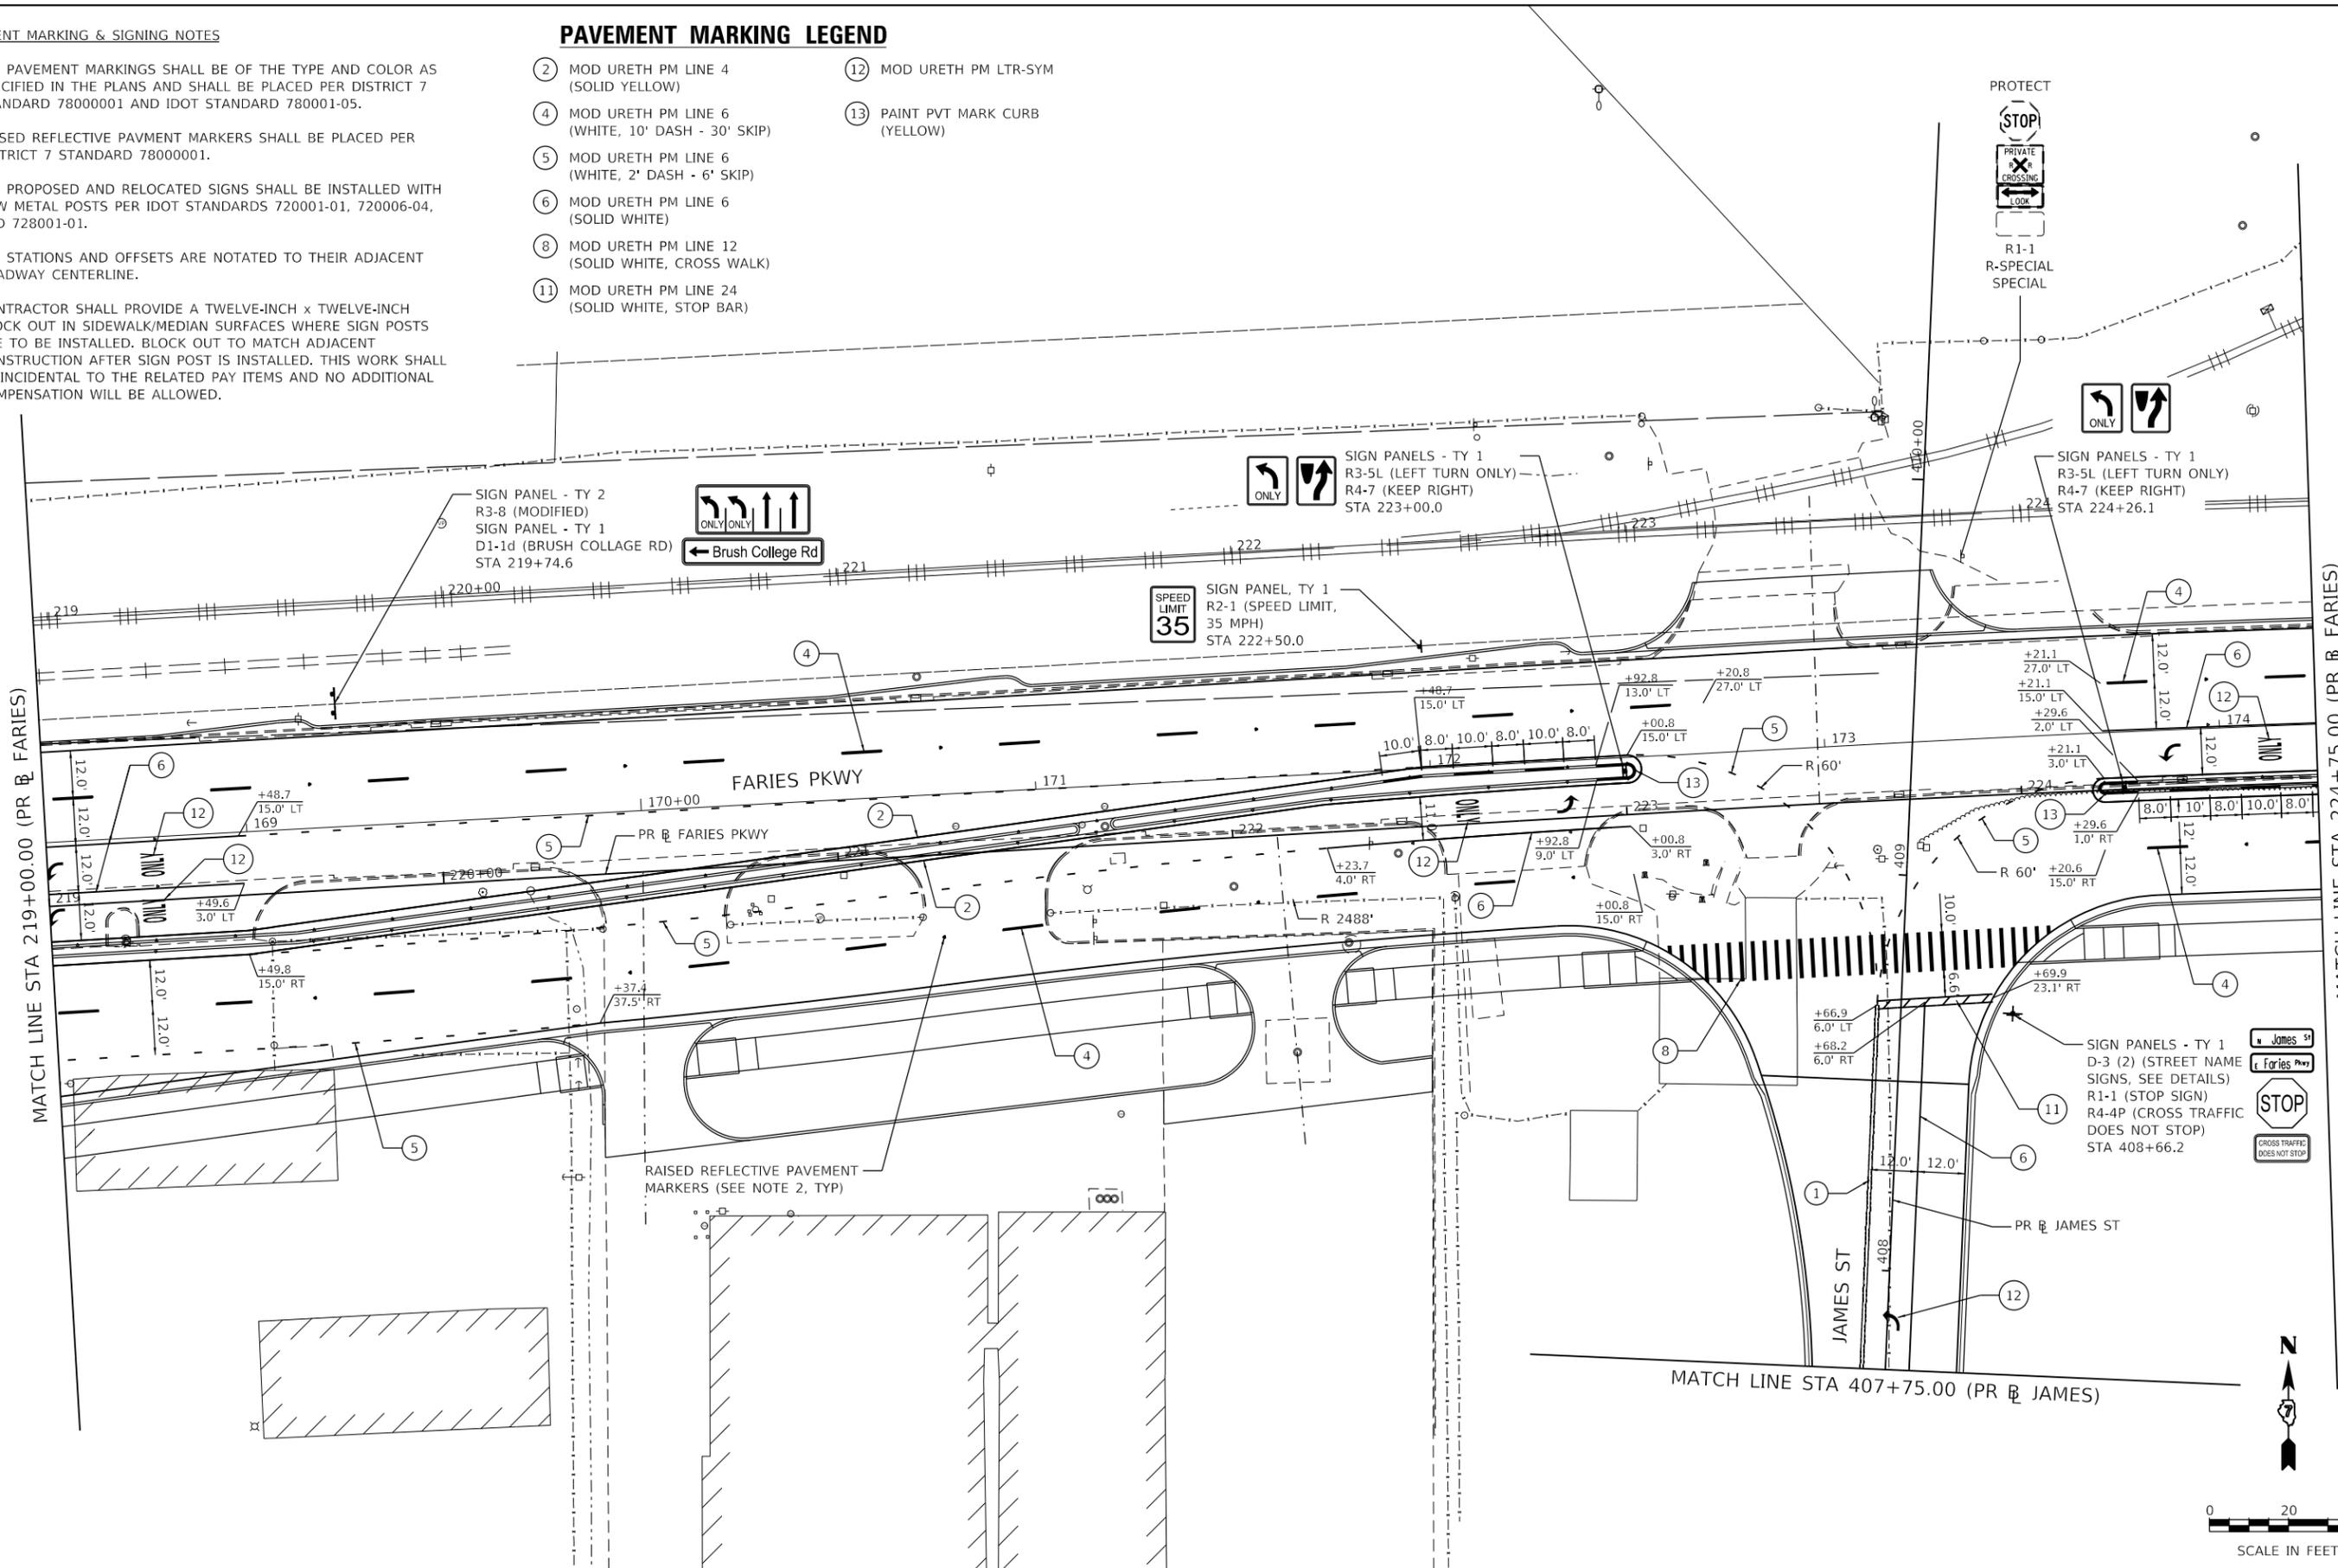

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 Kaskaskia Engineering Group, LLC  
 PROFESSIONAL REGISTERED ENGINEERS & ARCHITECTS  
 Illinois Professional Design Firm  
 184.004773  
 20-5880586

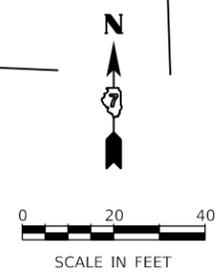

USER NAME = rjo	DESIGNED - NDP	REVISED -
PLOT SCALE = 40.0000' / in.	DRAWN - NDP	REVISED -
PLOT DATE = 4/28/2021	CHECKED - LDC	REVISED -
	DATE - 4/30/2021	REVISED -



**STATE OF ILLINOIS**  
**DEPARTMENT OF TRANSPORTATION**

<b>FARIES PARKWAY</b> <b>PAVEMENT MARKING &amp; SIGNING PLAN</b>		
SCALE: 1"=20'	SHEET 10 OF 20 SHEETS	STA. 219+00.0 TO STA. 224+75.00

F.A.U. RTE. 7448	SECTION 09-00933-01-BR	COUNTY MACON	TOTAL SHEETS 1019	SHEET NO. 556
CONTRACT NO. 95893				
ILLINOIS FED. AID PROJECT				


**PAVEMENT MARKING & SIGNING NOTES**

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**PAVEMENT MARKING LEGEND**

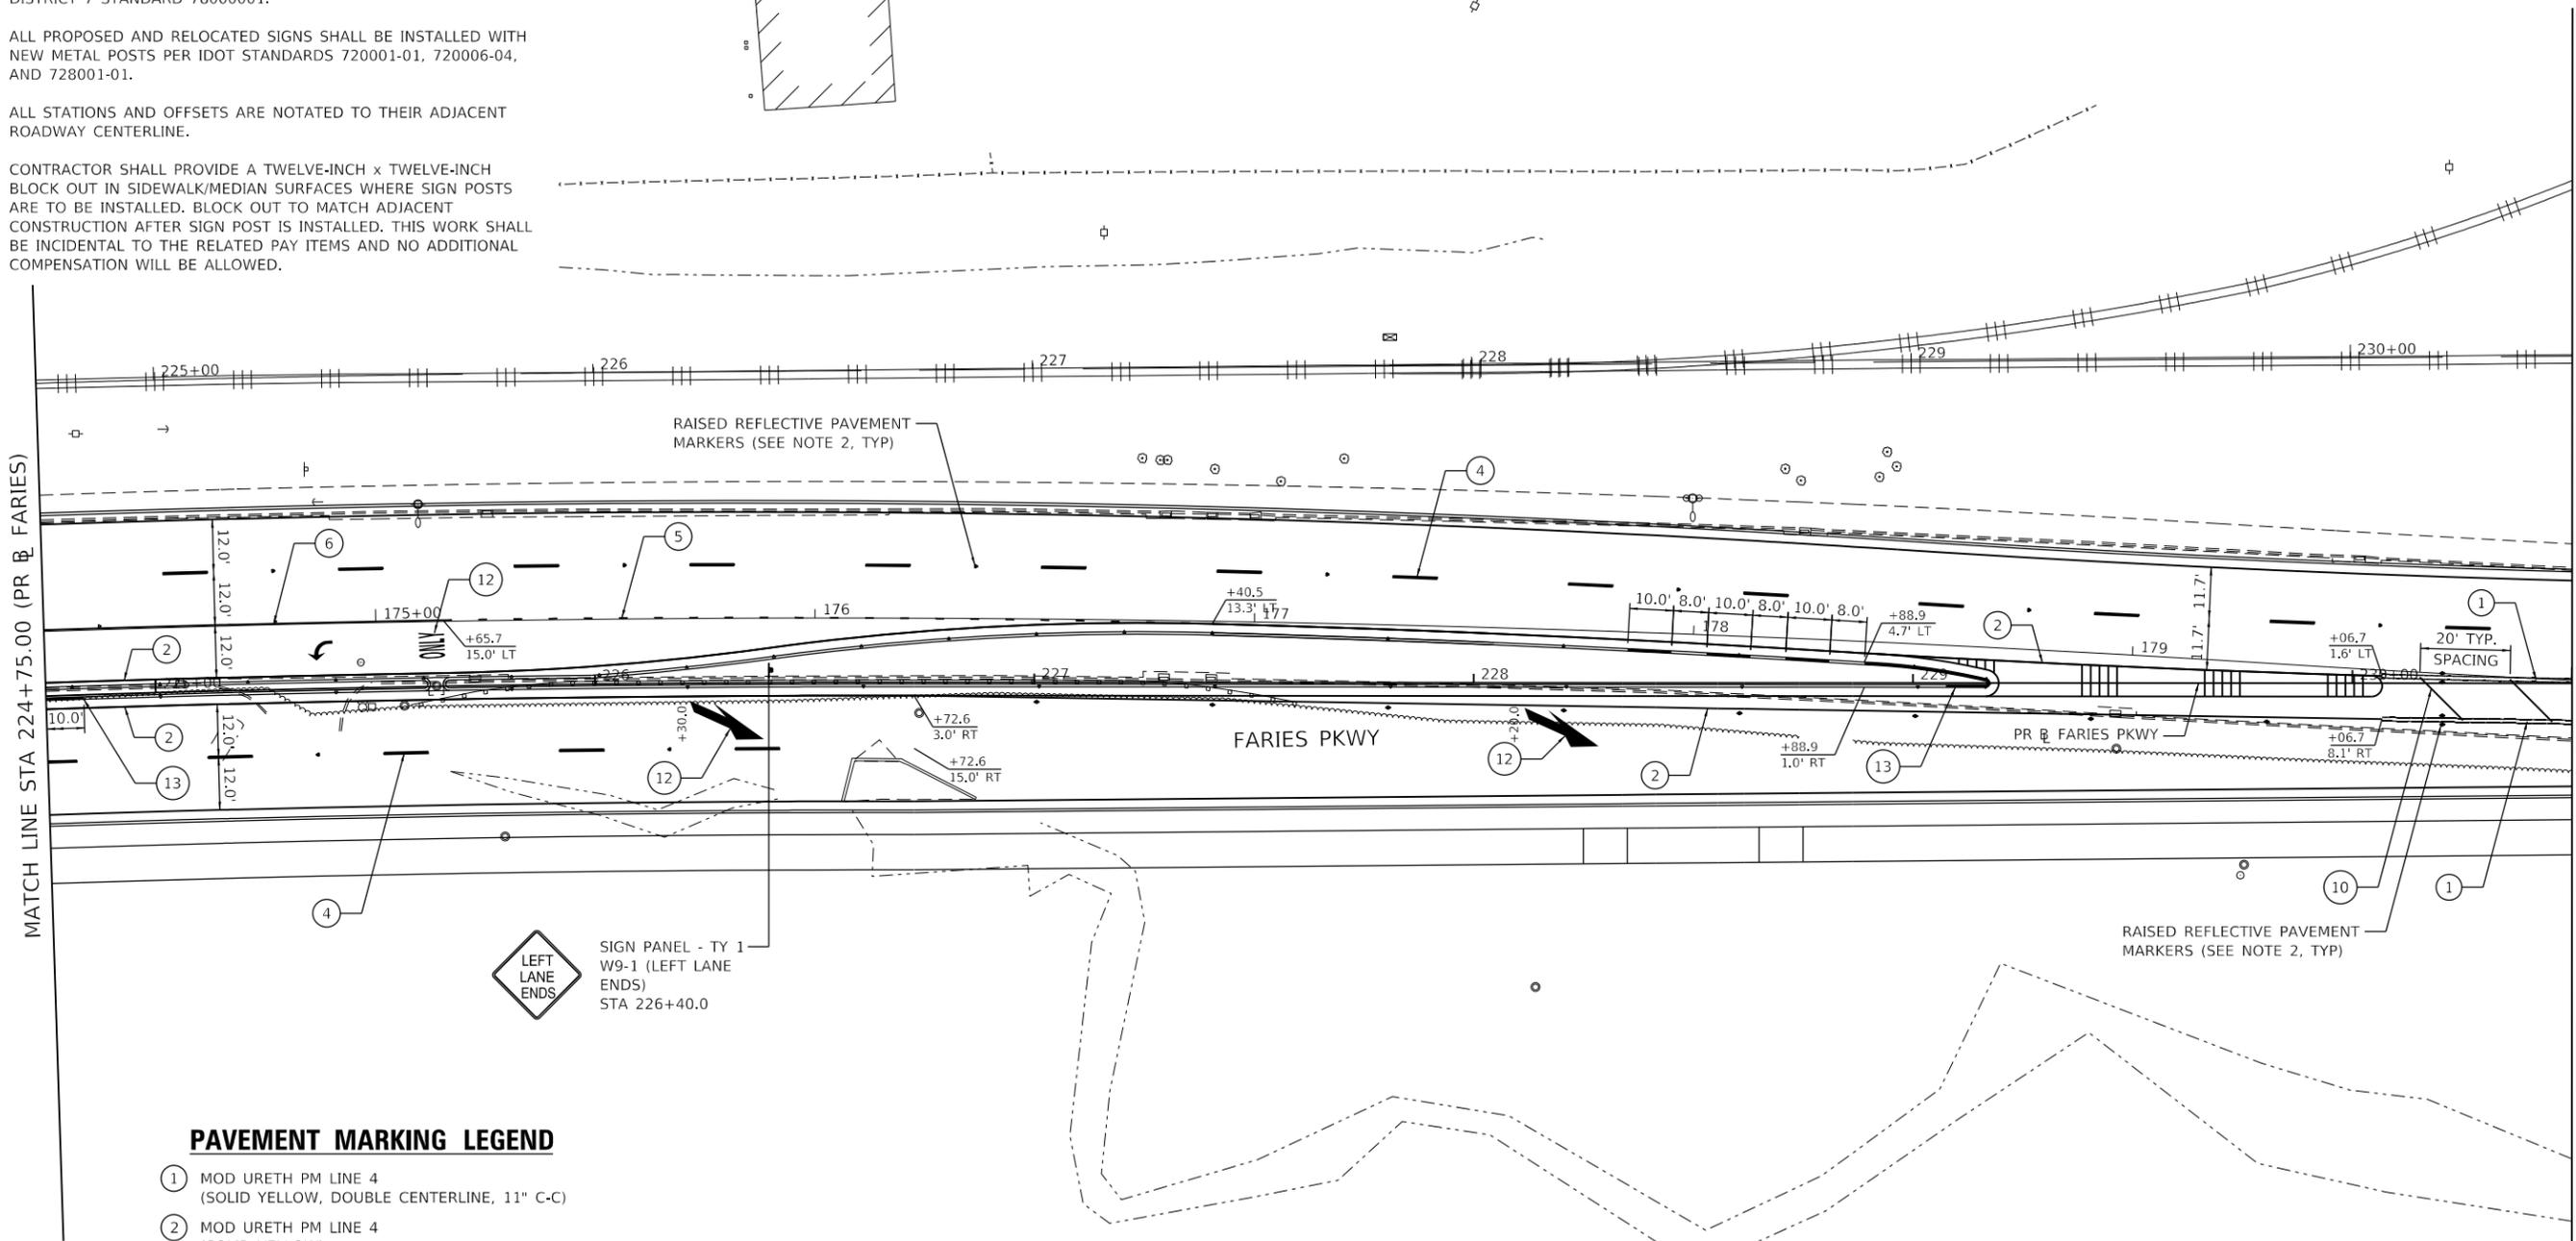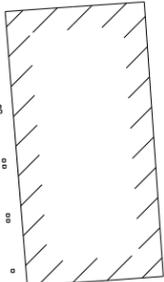- ① MOD URETH PM LINE 4 (SOLID YELLOW, DOUBLE CENTERLINE, 11" C-C)
- ② MOD URETH PM LINE 4 (SOLID YELLOW)
- ④ MOD URETH PM LINE 6 (WHITE, 10' DASH - 30' SKIP)
- ⑤ MOD URETH PM LINE 6 (WHITE, 2' DASH - 6' SKIP)
- ⑥ MOD URETH PM LINE 6 (SOLID WHITE)
- ⑩ MOD URETH PM LINE 12 (SOLID YELLOW)
- ⑫ MOD URETH PM LTR-SYM
- ⑬ PAINT PVT MARK CURB (YELLOW)



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USER NAME = rjo	DESIGNED - NDP	REVISED -
PLOT SCALE = 40.0000 ' / in.	DRAWN - NDP	REVISED -
PLOT DATE = 4/28/2021	CHECKED - LDC	REVISED -
	DATE - 4/30/2021	REVISED -

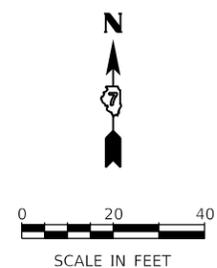**STATE OF ILLINOIS  
DEPARTMENT OF TRANSPORTATION**

<b>FARIES PARKWAY PAVEMENT MARKING &amp; SIGNING PLAN</b>	
SCALE: 1"=20'	SHEET 11 OF 20 SHEETS STA. 224+75.00 TO STA. 230+50.00




F.A.U. RTE. 7448	SECTION 09-00933-01-BR	COUNTY MACON	TOTAL SHEETS 1019	SHEET NO. 557
CONTRACT NO. 95893				
ILLINOIS FED. AID PROJECT				

PAVEMENT MARKING & SIGNING NOTES

- ALL PAVEMENT MARKINGS SHALL BE OF THE TYPE AND COLOR AS SPECIFIED IN THE PLANS AND SHALL BE PLACED PER DISTRICT 7 STANDARD 78000001 AND IDOT STANDARD 780001-05.
- RAISED REFLECTIVE PAVMENT MARKERS SHALL BE PLACED PER DISTRICT 7 STANDARD 78000001.
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PAVEMENT MARKING LEGEND

- ① MOD URETH PM LINE 4 (SOLID YELLOW, DOUBLE CENTERLINE, 11" C-C)
- ④ MOD URETH PM LINE 6 (WHITE, 10' DASH - 30' SKIP)
- ⑥ MOD URETH PM LINE 6 (SOLID WHITE)
- ⑧ MOD URETH PM LINE 12 (SOLID WHITE, CROSS WALK)
- ⑩ MOD URETH PM LINE 12 (SOLID YELLOW)
- ⑫ MOD URETH PM LTR-SYM

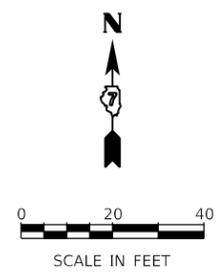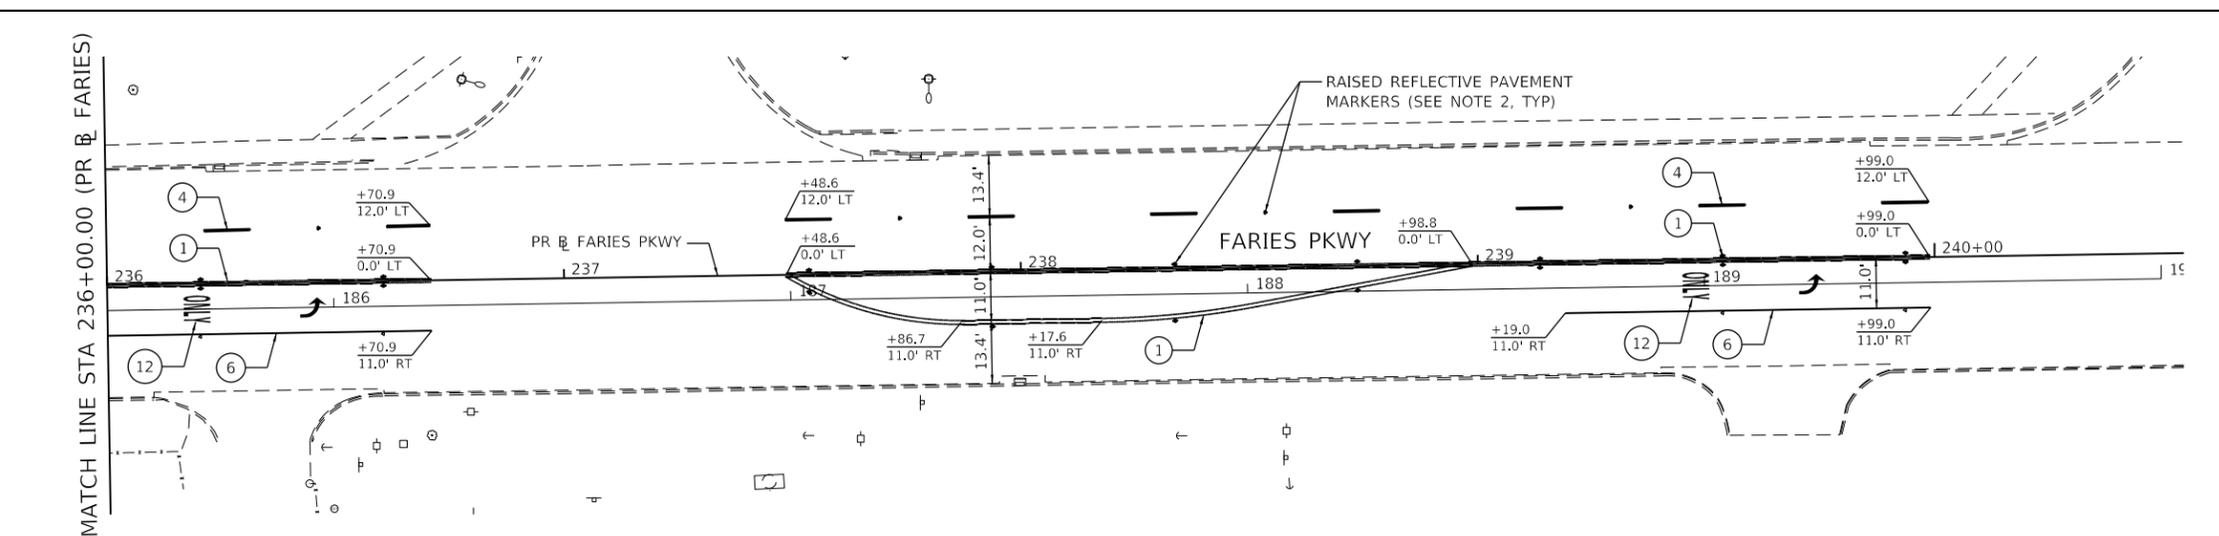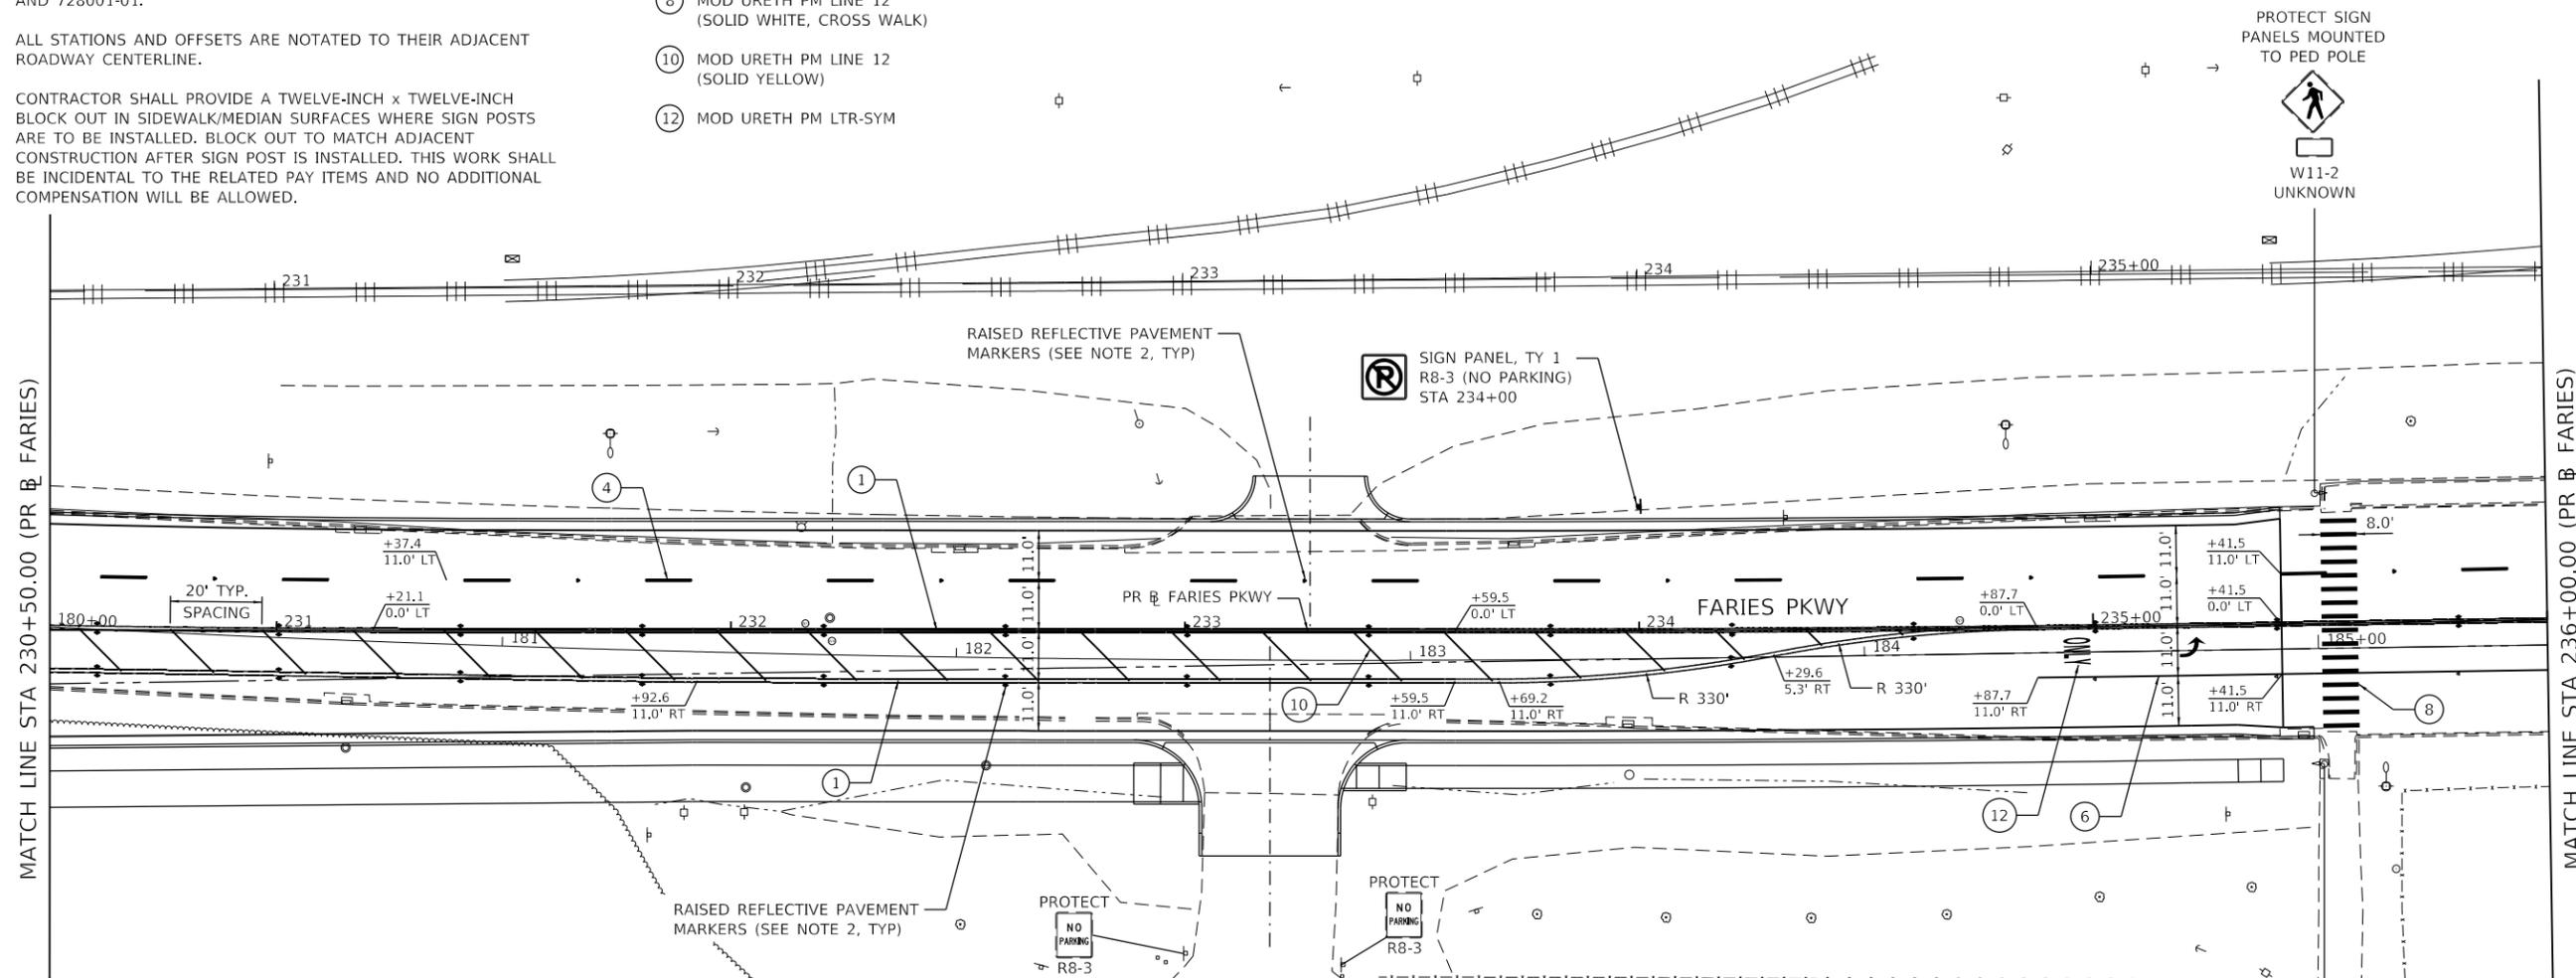

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**Kaskaskia**  
Engineering Group, LLC  
PROFESSIONAL ENGINEERS  
Illinois Professional Design Firm  
Professional Engineering Group

USER NAME = rjo	DESIGNED - NDP	REVISED -
PLOT SCALE = 40.0000' / in.	DRAWN - NDP	REVISED -
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**STATE OF ILLINOIS  
DEPARTMENT OF TRANSPORTATION**


**FARIES PARKWAY  
PAVEMENT MARKING & SIGNING PLAN**

SCALE: 1"=20'      SHEET 12 OF 20 SHEETS      STA. 230+50.00 TO STA.

F.A.U. RTE. 7448	SECTION 09-00933-01-BR	COUNTY MACON	TOTAL SHEETS 1019	SHEET NO. 558
CONTRACT NO. 95893				
ILLINOIS FED. AID PROJECT				



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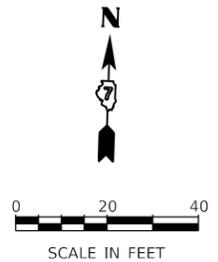


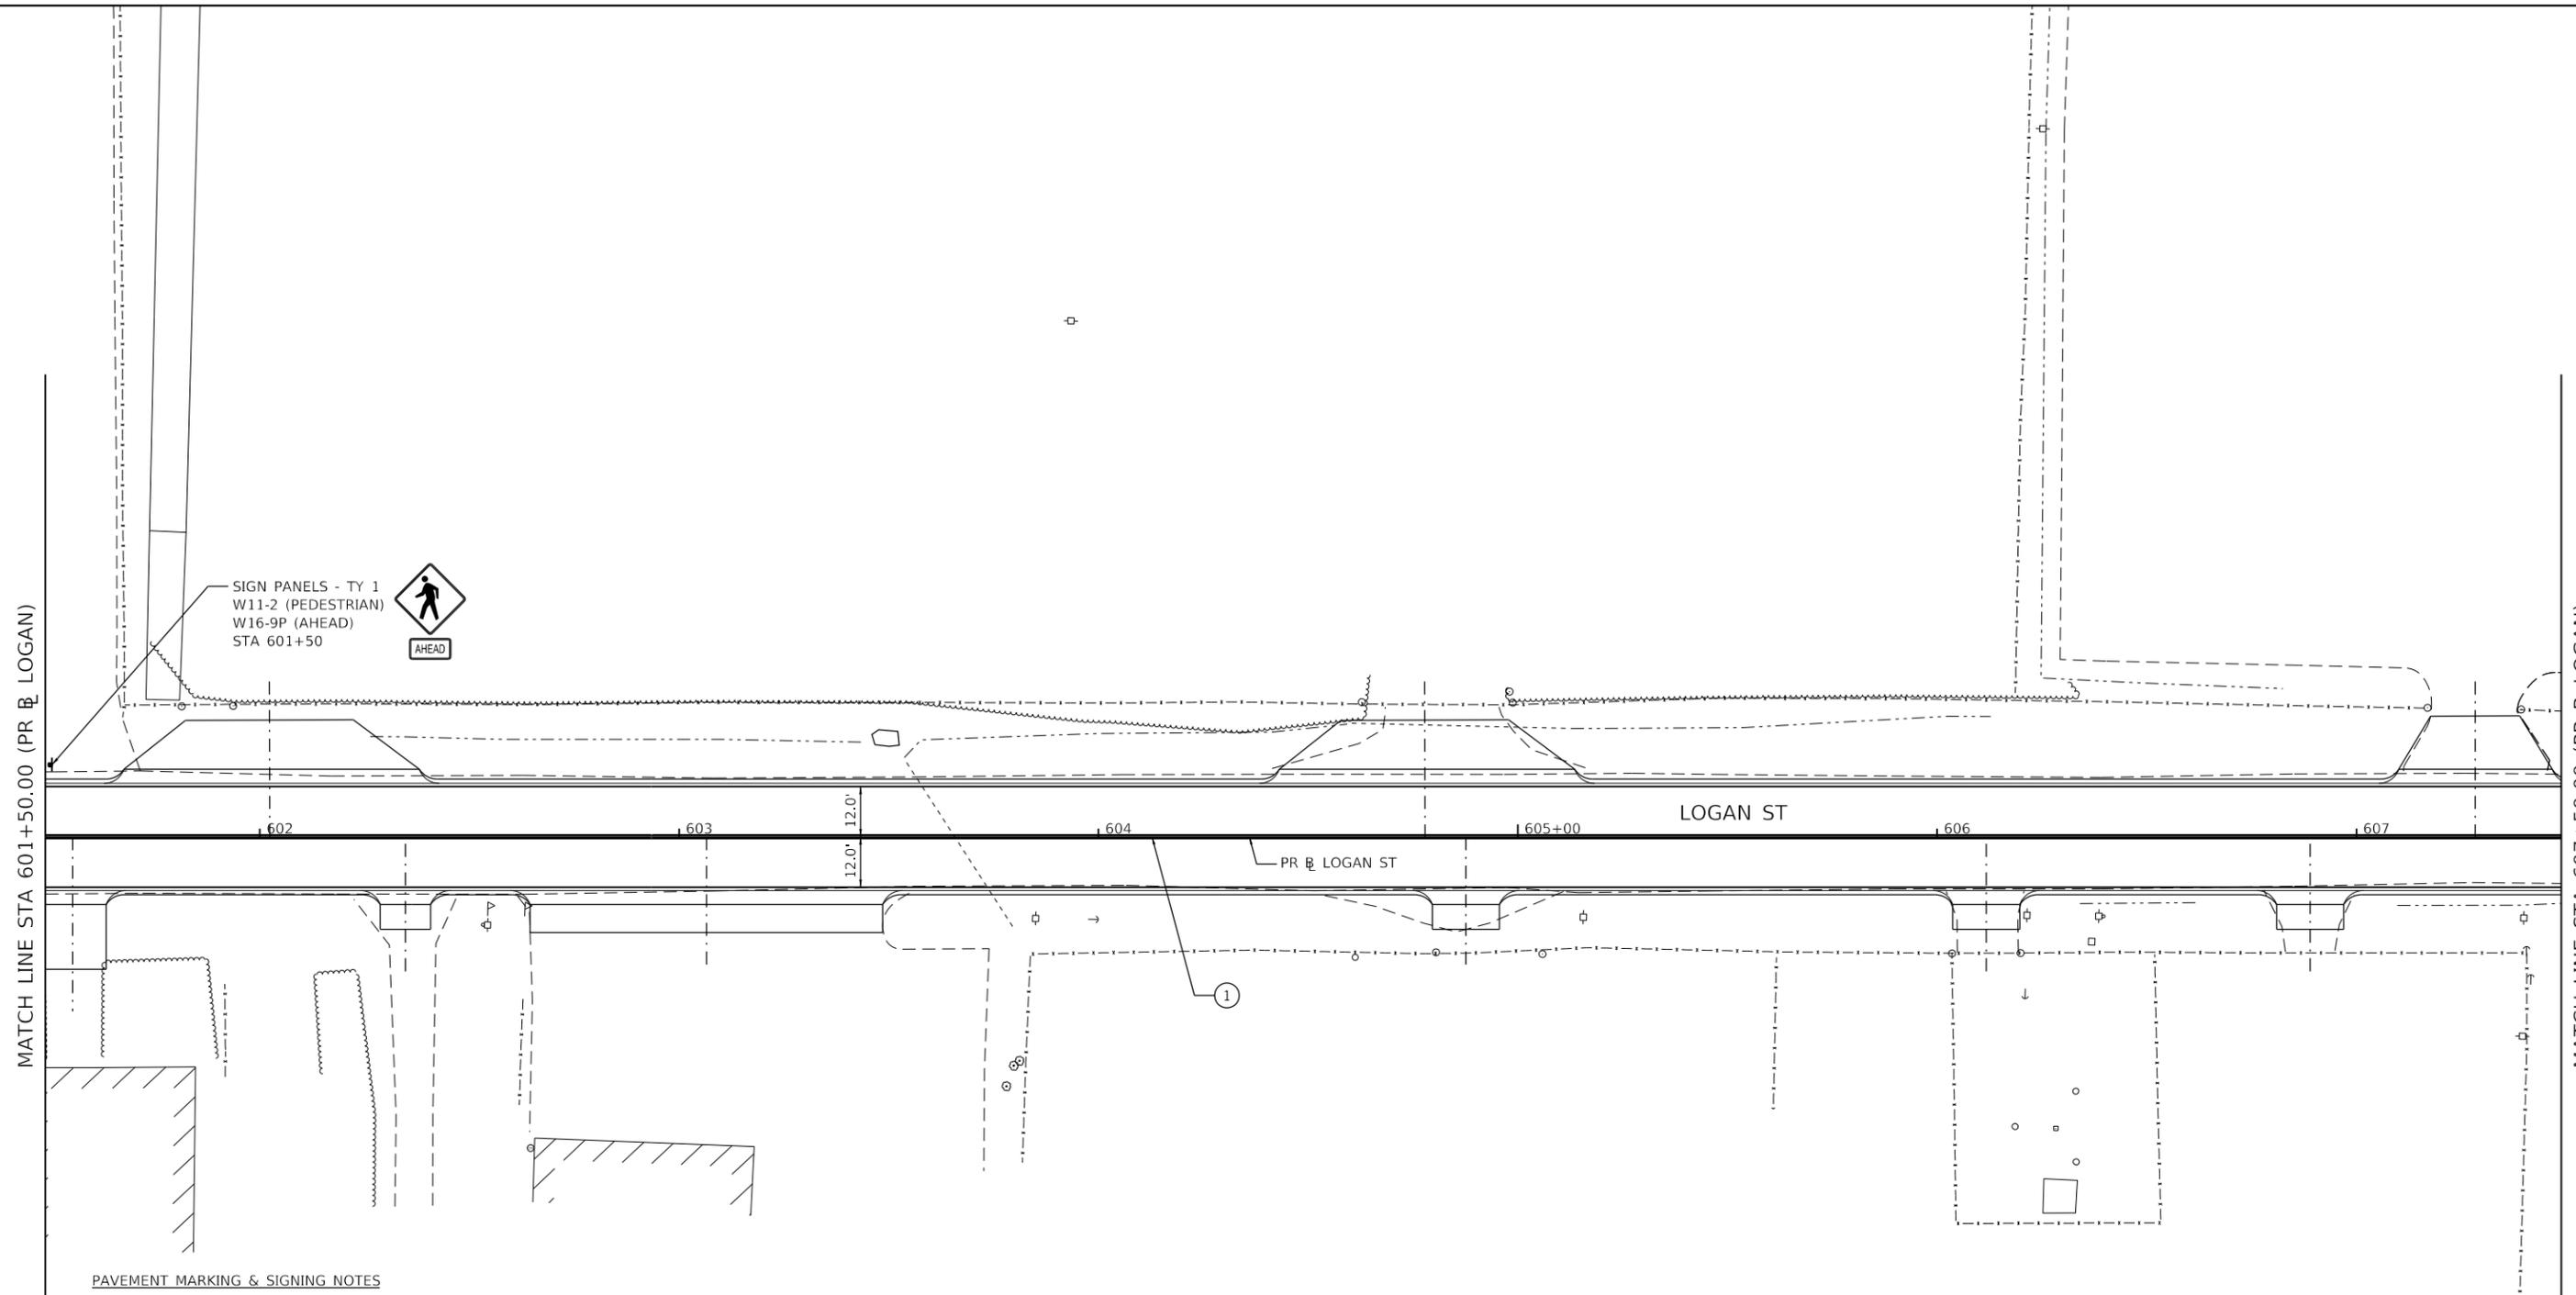**PAVEMENT MARKING & SIGNING NOTES**

1. ALL PAVEMENT MARKINGS SHALL BE OF THE TYPE AND COLOR AS SPECIFIED IN THE PLANS AND SHALL BE PLACED PER DISTRICT 7 STANDARD 78000001 AND IDOT STANDARD 780001-05.
2. RAISED REFLECTIVE PAVMENT MARKERS SHALL BE PLACED PER DISTRICT 7 STANDARD 78000001.
3. ALL PROPOSED AND RELOCATED SIGNS SHALL BE INSTALLED WITH NEW METAL POSTS PER IDOT STANDARDS 720001-01, 720006-04, AND 728001-01.
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5. CONTRACTOR SHALL PROVIDE A TWELVE-INCH x TWELVE-INCH BLOCK OUT IN SIDEWALK/MEDIAN SURFACES WHERE SIGN POSTS ARE TO BE INSTALLED. BLOCK OUT TO MATCH ADJACENT CONSTRUCTION AFTER SIGN POST IS INSTALLED. THIS WORK SHALL BE INCIDENTAL TO THE RELATED PAY ITEMS AND NO ADDITIONAL COMPENSATION WILL BE ALLOWED.

**PAVEMENT MARKING LEGEND**

- ① MOD URETH PM LINE 4 (SOLID YELLOW, DOUBLE CENTERLINE, 11" C-C)



USER NAME = rjo	DESIGNED - NDP	REVISED -
PLOT SCALE = 40.0000 ' / in.	DRAWN - NDP	REVISED -
PLOT DATE = 4/28/2021	CHECKED - LDC	REVISED -
	DATE - 4/30/2021	REVISED -

**STATE OF ILLINOIS  
 DEPARTMENT OF TRANSPORTATION**

**EAST LOGAN STREET  
 PAVEMENT MARKING & SIGNING PLAN**


SCALE: 1"=20'    SHEET 14 OF 20 SHEETS    STA. 601+50.00 TO STA. 607+50.00

F.A.U. RTE.	SECTION	COUNTY	TOTAL SHEETS	SHEET NO.
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CONTRACT NO. 95893				
ILLINOIS FED. AID PROJECT				

PAVEMENT MARKING & SIGNING NOTES


1. ALL PAVEMENT MARKINGS SHALL BE OF THE TYPE AND COLOR AS SPECIFIED IN THE PLANS AND SHALL BE PLACED PER DISTRICT 7 STANDARD 78000001 AND IDOT STANDARD 780001-05.
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MATCH LINE STA 607+50.00 (PR @ LOGAN)

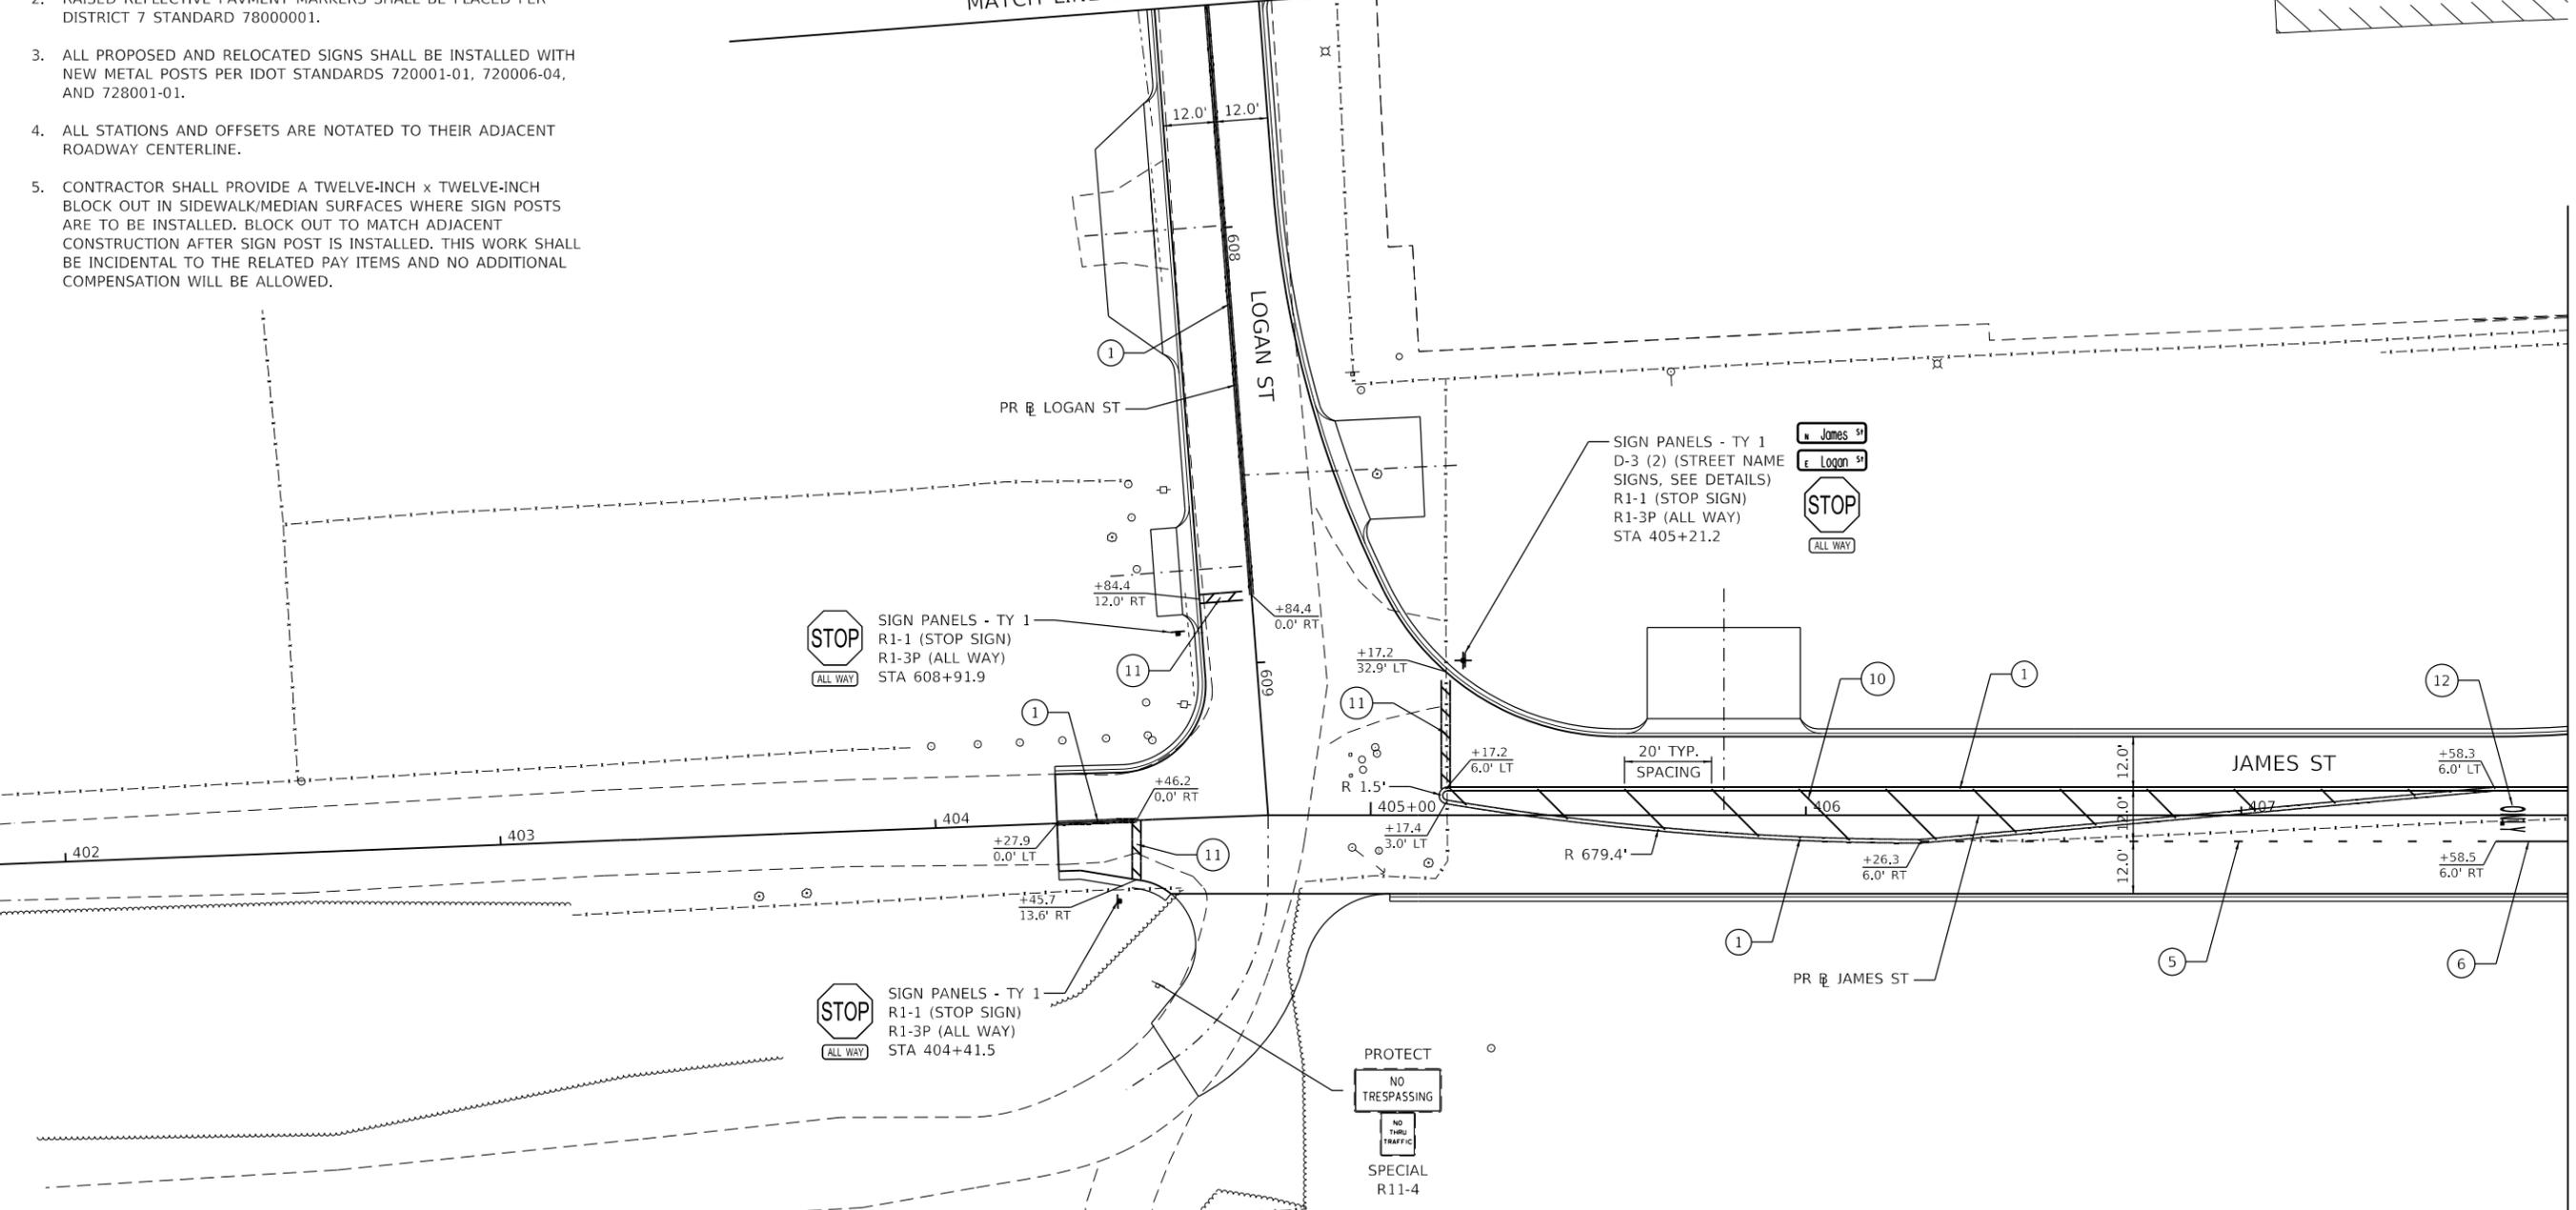

PAVEMENT MARKING LEGEND

- ① MOD URETH PM LINE 4 (SOLID YELLOW, DOUBLE CENTERLINE, 11" C-C)
- ⑤ MOD URETH PM LINE 6 (WHITE, 2' DASH - 6' SKIP)
- ⑥ MOD URETH PM LINE 6 (SOLID WHITE)
- ⑩ MOD URETH PM LINE 12 (SOLID YELLOW)
- ⑪ MOD URETH PM LINE 24 (SOLID WHITE, STOP BAR)
- ⑫ MOD URETH PM LTR-SYM

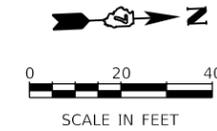

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USER NAME = rjo	DESIGNED - NDP	REVISED -
PLOT SCALE = 40.0000 ' / in.	DRAWN - NDP	REVISED -
PLOT DATE = 4/28/2021	CHECKED - LDC	REVISED -
	DATE - 4/30/2021	REVISED -

STATE OF ILLINOIS  
DEPARTMENT OF TRANSPORTATION

NORTH JAMES STREET PAVEMENT MARKING & SIGNING PLAN	
SCALE: 1"=20'	SHEET 15 OF 20 SHEETS
STA. 607+50.00 TO STA. 407+75.00	


F.A.U. RTE. 7448	SECTION 09-00933-01-BR	COUNTY MACON	TOTAL SHEETS 1019	SHEET NO. 561
CONTRACT NO. 95893				
ILLINOIS FED. AID PROJECT				

PAVEMENT MARKING & SIGNING NOTES


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PAVEMENT MARKING LEGEND

- ① MOD URETH PM LINE 4 (SOLID YELLOW, DOUBLE CENTERLINE, 11" C-C)

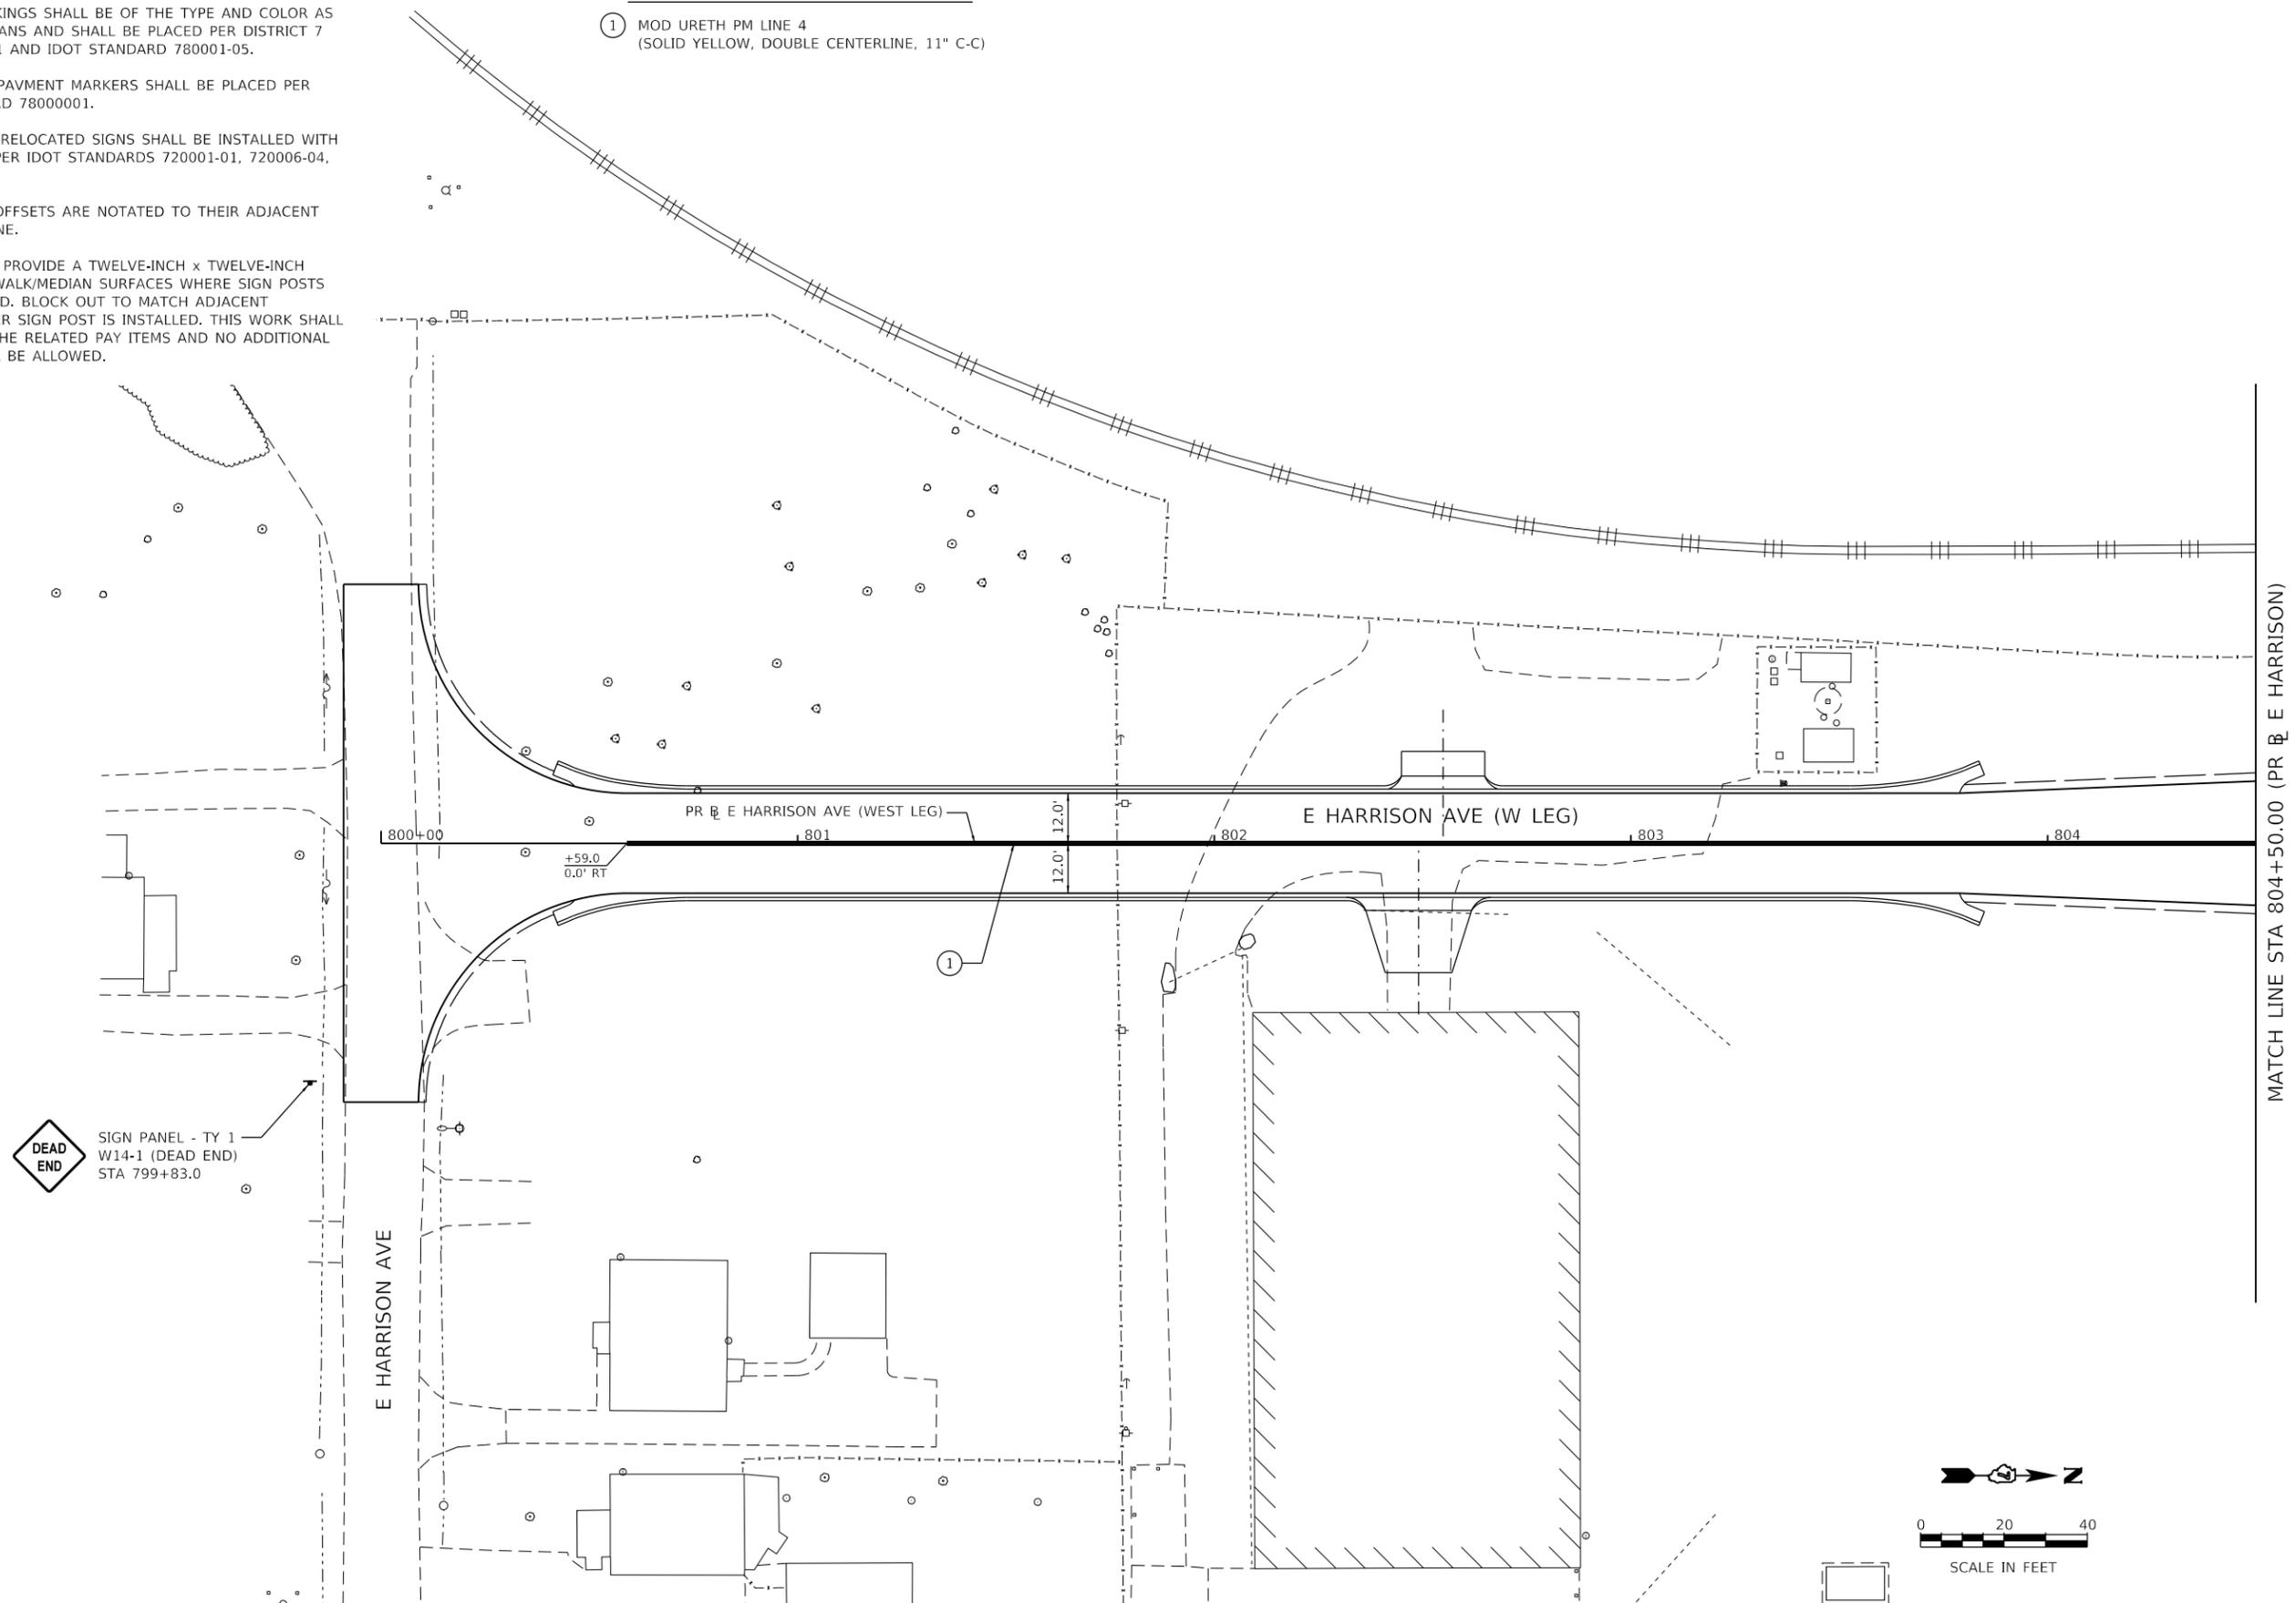

**DEAD END**  
SIGN PANEL - TY 1  
W14-1 (DEAD END)  
STA 799+83.0

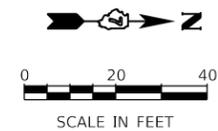

MODEL: Default  
FILE NAME: p:\lsc\com-np-pw\hendley.com\AECOM\_0516\_MIA\Documents\60603202-Brush\College\006-CAD\GIS\910\_CAD\01\_SHEETS\04-KASKASKIA\PAVEMENT MARKING Plans\60603202\_S11\_PMK5Sign\_16\_WHarrison-01.dgn

**Kaskaskia**  
Engineering Group, LLC  
PROFESSIONAL REGISTERED ENGINEERS  
Illinois Professional Design Firm  
Professional Engineering Group  
184.004773  
20-5080586

USER NAME = rjo	DESIGNED - NDP	REVISOR -
PLOT SCALE = 40.0000 ' / in.	DRAWN - NDP	REVISIONS -
PLOT DATE = 4/28/2021	CHECKED - LDC	REVISIONS -
	DATE - 4/30/2021	REVISIONS -

DESIGNED - NDP	REVISOR -
DRAWN - NDP	REVISIONS -
CHECKED - LDC	REVISIONS -
DATE - 4/30/2021	REVISIONS -

**STATE OF ILLINOIS  
DEPARTMENT OF TRANSPORTATION**


**E HARRISON AVENUE (WEST LEG)  
PAVEMENT MARKING & SIGNING PLAN**

SCALE: 1"=20'    SHEET 16 OF 20 SHEETS    STA. 800+00.00 TO STA. 804+50.00

F.A.U. RTE. 7448	SECTION 09-00933-01-BR	COUNTY MACON	TOTAL SHEETS 1019	SHEET NO. 562
CONTRACT NO. 95893				
ILLINOIS FED. AID PROJECT				

MATCH LINE STA 804+50.00 (PR E HARRISON)

MODEL: Default  
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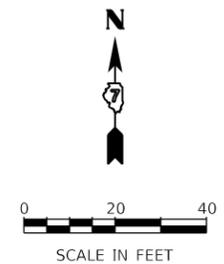


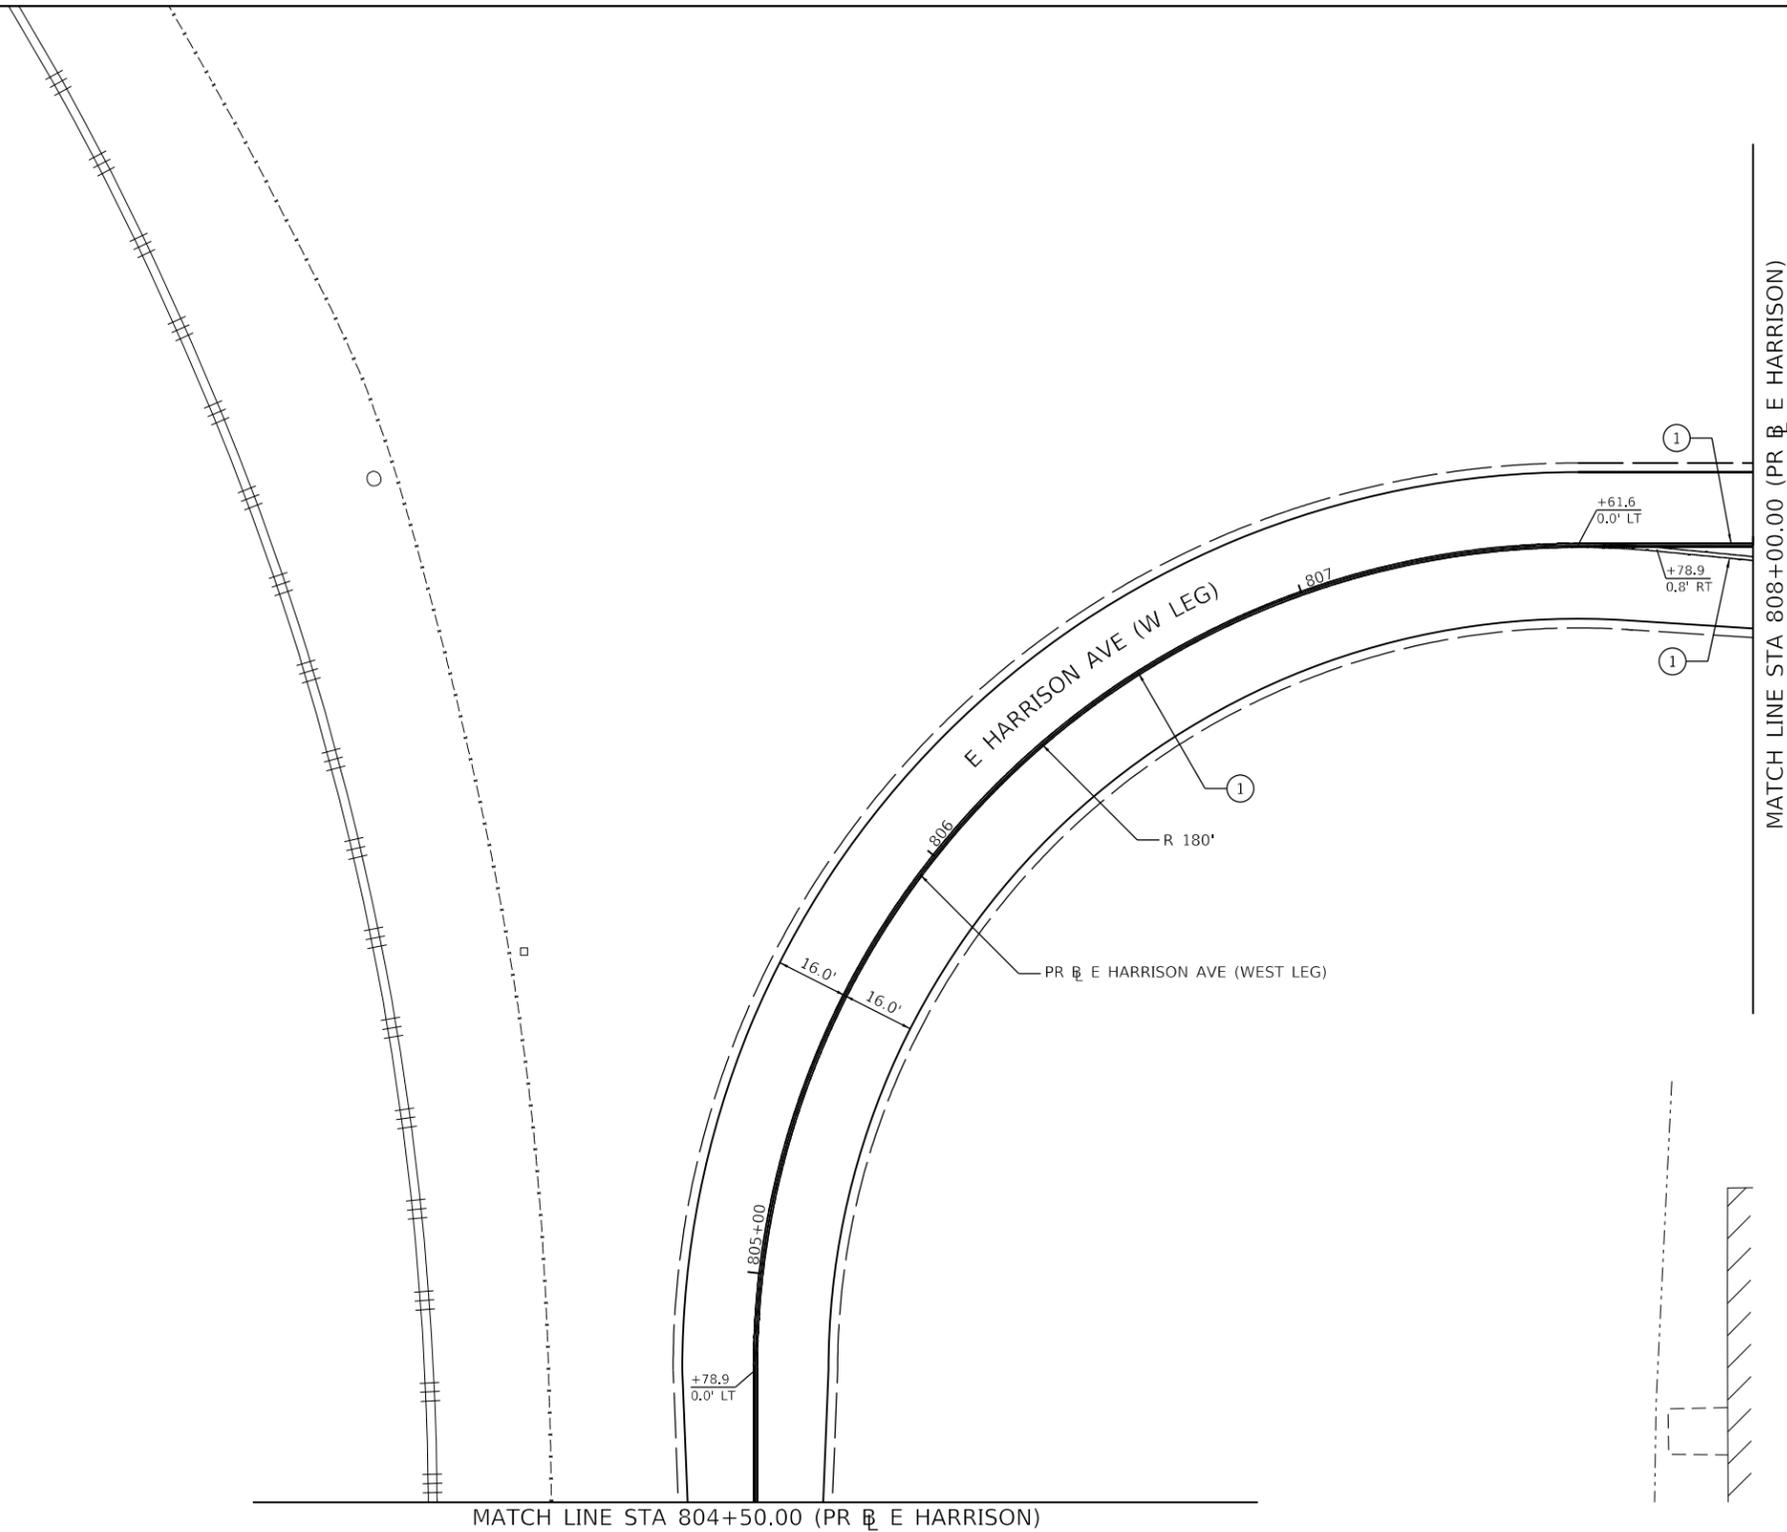**PAVEMENT MARKING & SIGNING NOTES**

1. ALL PAVEMENT MARKINGS SHALL BE OF THE TYPE AND COLOR AS SPECIFIED IN THE PLANS AND SHALL BE PLACED PER DISTRICT 7 STANDARD 78000001 AND IDOT STANDARD 780001-05.
2. RAISED REFLECTIVE PAVMENT MARKERS SHALL BE PLACED PER DISTRICT 7 STANDARD 78000001.
3. ALL PROPOSED AND RELOCATED SIGNS SHALL BE INSTALLED WITH NEW METAL POSTS PER IDOT STANDARDS 720001-01, 720006-04, AND 728001-01.
4. ALL STATIONS AND OFFSETS ARE NOTATED TO THEIR ADJACENT ROADWAY CENTERLINE.
5. CONTRACTOR SHALL PROVIDE A TWELVE-INCH x TWELVE-INCH BLOCK OUT IN SIDEWALK/MEDIAN SURFACES WHERE SIGN POSTS ARE TO BE INSTALLED. BLOCK OUT TO MATCH ADJACENT CONSTRUCTION AFTER SIGN POST IS INSTALLED. THIS WORK SHALL BE INCIDENTAL TO THE RELATED PAY ITEMS AND NO ADDITIONAL COMPENSATION WILL BE ALLOWED.

**PAVEMENT MARKING LEGEND**

- ① MOD URETH PM LINE 4 (SOLID YELLOW, DOUBLE CENTERLINE, 11" C-C)



**Kaskaskia**  
 Engineering Group, LLC  
PROFESSIONAL REGISTERED ENGINEERS  
 Illinois Professional Design Firm  
 Professional Engineering Group

USER NAME = rjo	DESIGNED - NDP	REVISED -
	DRAWN - NDP	REVISED -
PLOT SCALE = 40.0000 ' / in.	CHECKED - LDC	REVISED -
PLOT DATE = 4/28/2021	DATE - 4/30/2021	REVISED -

**STATE OF ILLINOIS  
 DEPARTMENT OF TRANSPORTATION**


**E HARRISON AVENUE (WEST LEG)  
 PAVEMENT MARKING & SIGNING PLAN**

SCALE: 1"=20'    SHEET 17 OF 20 SHEETS    STA. 804+50.00 TO STA. 808+00.00

F.A.U. RTE. 7448	SECTION 09-00933-01-BR	COUNTY MACON	TOTAL SHEETS 1019	SHEET NO. 563
CONTRACT NO. 95893				
ILLINOIS FED. AID PROJECT				

MODEL: Default  
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MATCH LINE STA 701+00.00 (PR E HARRISON)  
 SEE SHEET 550

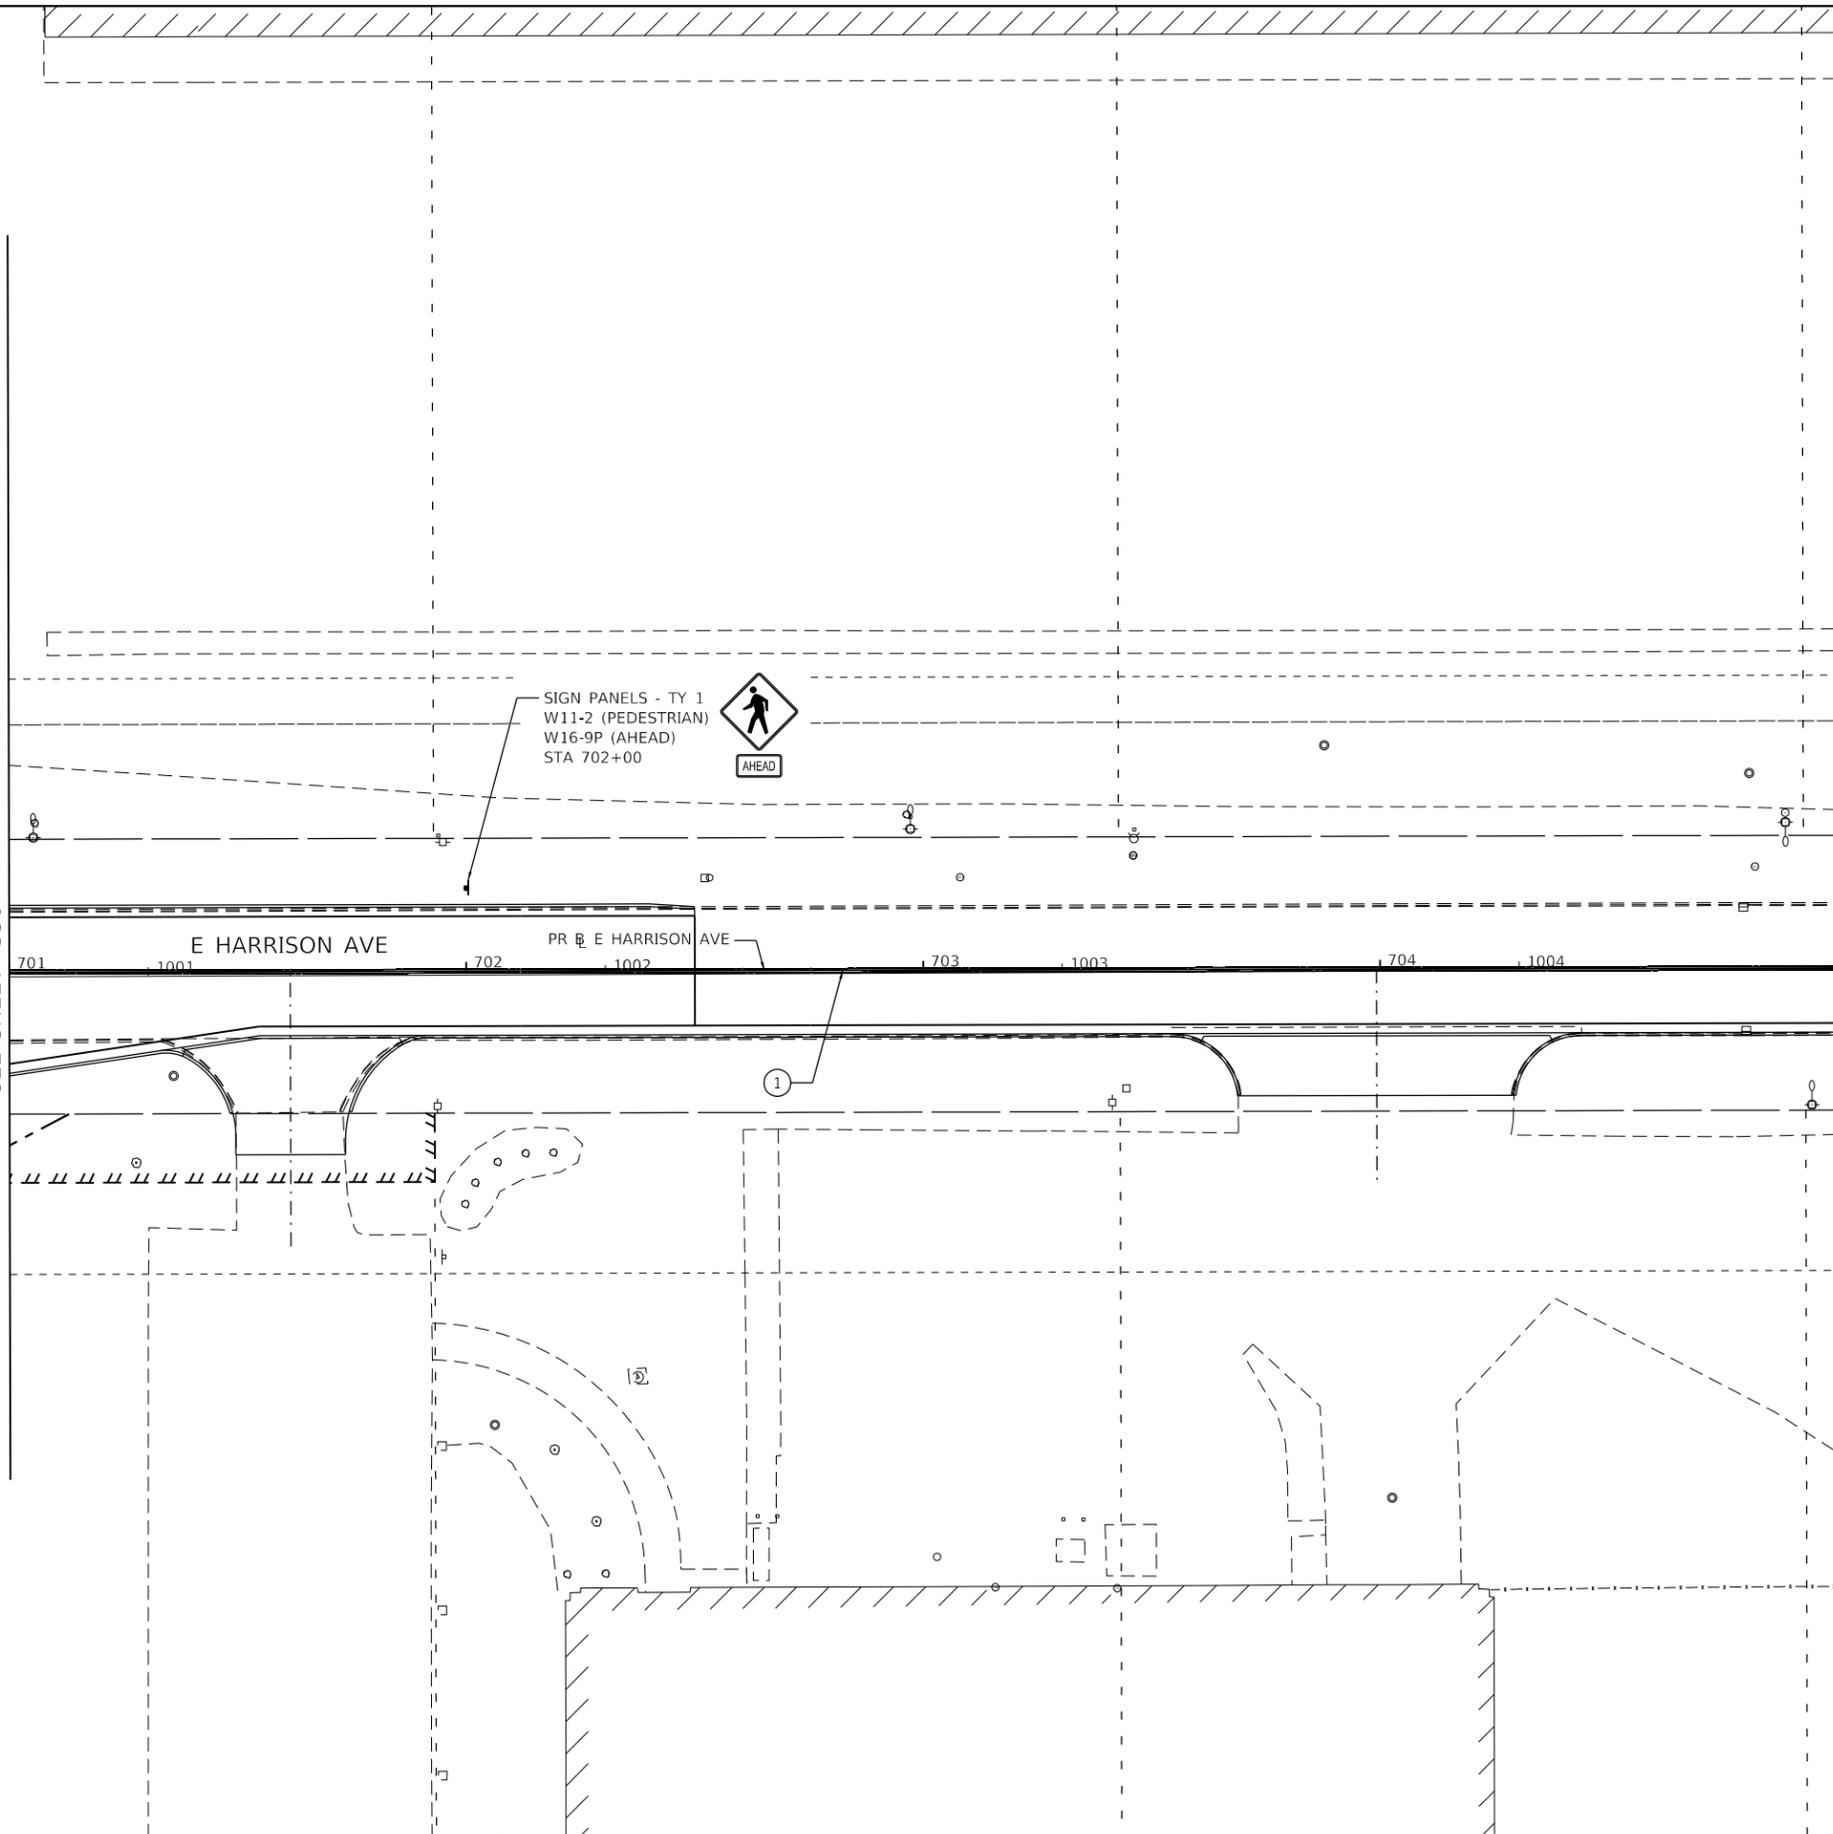


MATCH LINE STA 705+00.00 (PR E HARRISON)  
 SEE SHEET 565

**PAVEMENT MARKING & SIGNING NOTES**

1. ALL PAVEMENT MARKINGS SHALL BE OF THE TYPE AND COLOR AS SPECIFIED IN THE PLANS AND SHALL BE PLACED PER DISTRICT 7 STANDARD 78000001 AND IDOT STANDARD 780001-05.
2. RAISED REFLECTIVE PAVMENT MARKERS SHALL BE PLACED PER DISTRICT 7 STANDARD 78000001.
3. ALL PROPOSED AND RELOCATED SIGNS SHALL BE INSTALLED WITH NEW METAL POSTS PER IDOT STANDARDS 720001-01, 720006-04, AND 728001-01.
4. ALL STATIONS AND OFFSETS ARE NOTATED TO THEIR ADJACENT ROADWAY CENTERLINE.
5. CONTRACTOR SHALL PROVIDE A TWELVE-INCH x TWELVE-INCH BLOCK OUT IN SIDEWALK/MEDIAN SURFACES WHERE SIGN POSTS ARE TO BE INSTALLED. BLOCK OUT TO MATCH ADJACENT CONSTRUCTION AFTER SIGN POST IS INSTALLED. THIS WORK SHALL BE INCIDENTAL TO THE RELATED PAY ITEMS AND NO ADDITIONAL COMPENSATION WILL BE ALLOWED.

**PAVEMENT MARKING LEGEND**

- ① MOD URETH PM LINE 4 (SOLID YELLOW, DOUBLE CENTERLINE, 11" C-C)

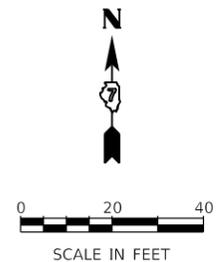

**Kaskaskia**  
 Engineering Group, LLC  
PROFESSIONAL REGISTERED ENGINEERS  
 Illinois Professional Design Firm  
 Professional Engineering Group

USER NAME = rjo	DESIGNED - NDP	REVISED -
	DRAWN - NDP	REVISED -
PLOT SCALE = 40.0000' / in.	CHECKED - LDC	REVISED -
PLOT DATE = 4/28/2021	DATE - 4/30/2021	REVISED -

**STATE OF ILLINOIS  
 DEPARTMENT OF TRANSPORTATION**

**E HARRISON AVENUE (EAST LEG)  
 PAVEMENT MARKING & SIGNING PLAN**

SCALE: 1"=20'    SHEET 18 OF 20 SHEETS    STA. 701+00.00 TO STA. 705+00.00


F.A.U. RTE. 7448	SECTION 09-00933-01-BR	COUNTY MACON	TOTAL SHEETS 1019	SHEET NO. 564
CONTRACT NO. 95893				
ILLINOIS FED. AID PROJECT				

**PAVEMENT MARKING & SIGNING NOTES**


1. ALL PAVEMENT MARKINGS SHALL BE OF THE TYPE AND COLOR AS SPECIFIED IN THE PLANS AND SHALL BE PLACED PER DISTRICT 7 STANDARD 78000001 AND IDOT STANDARD 780001-05.
2. RAISED REFLECTIVE PAVMENT MARKERS SHALL BE PLACED PER DISTRICT 7 STANDARD 78000001.
3. ALL PROPOSED AND RELOCATED SIGNS SHALL BE INSTALLED WITH NEW METAL POSTS PER IDOT STANDARDS 720001-01, 720006-04, AND 728001-01.
4. ALL STATIONS AND OFFSETS ARE NOTATED TO THEIR ADJACENT ROADWAY CENTERLINE.
5. CONTRACTOR SHALL PROVIDE A TWELVE-INCH x TWELVE-INCH BLOCK OUT IN SIDEWALK/MEDIAN SURFACES WHERE SIGN POSTS ARE TO BE INSTALLED. BLOCK OUT TO MATCH ADJACENT CONSTRUCTION AFTER SIGN POST IS INSTALLED. THIS WORK SHALL BE INCIDENTAL TO THE RELATED PAY ITEMS AND NO ADDITIONAL COMPENSATION WILL BE ALLOWED.

**PAVEMENT MARKING LEGEND**

- ① MOD URETH PM LINE 4  
(SOLID YELLOW, DOUBLE CENTERLINE, 11" C-C)
- ⑪ MOD URETH PM LINE 24  
(SOLID WHITE, STOP BAR)

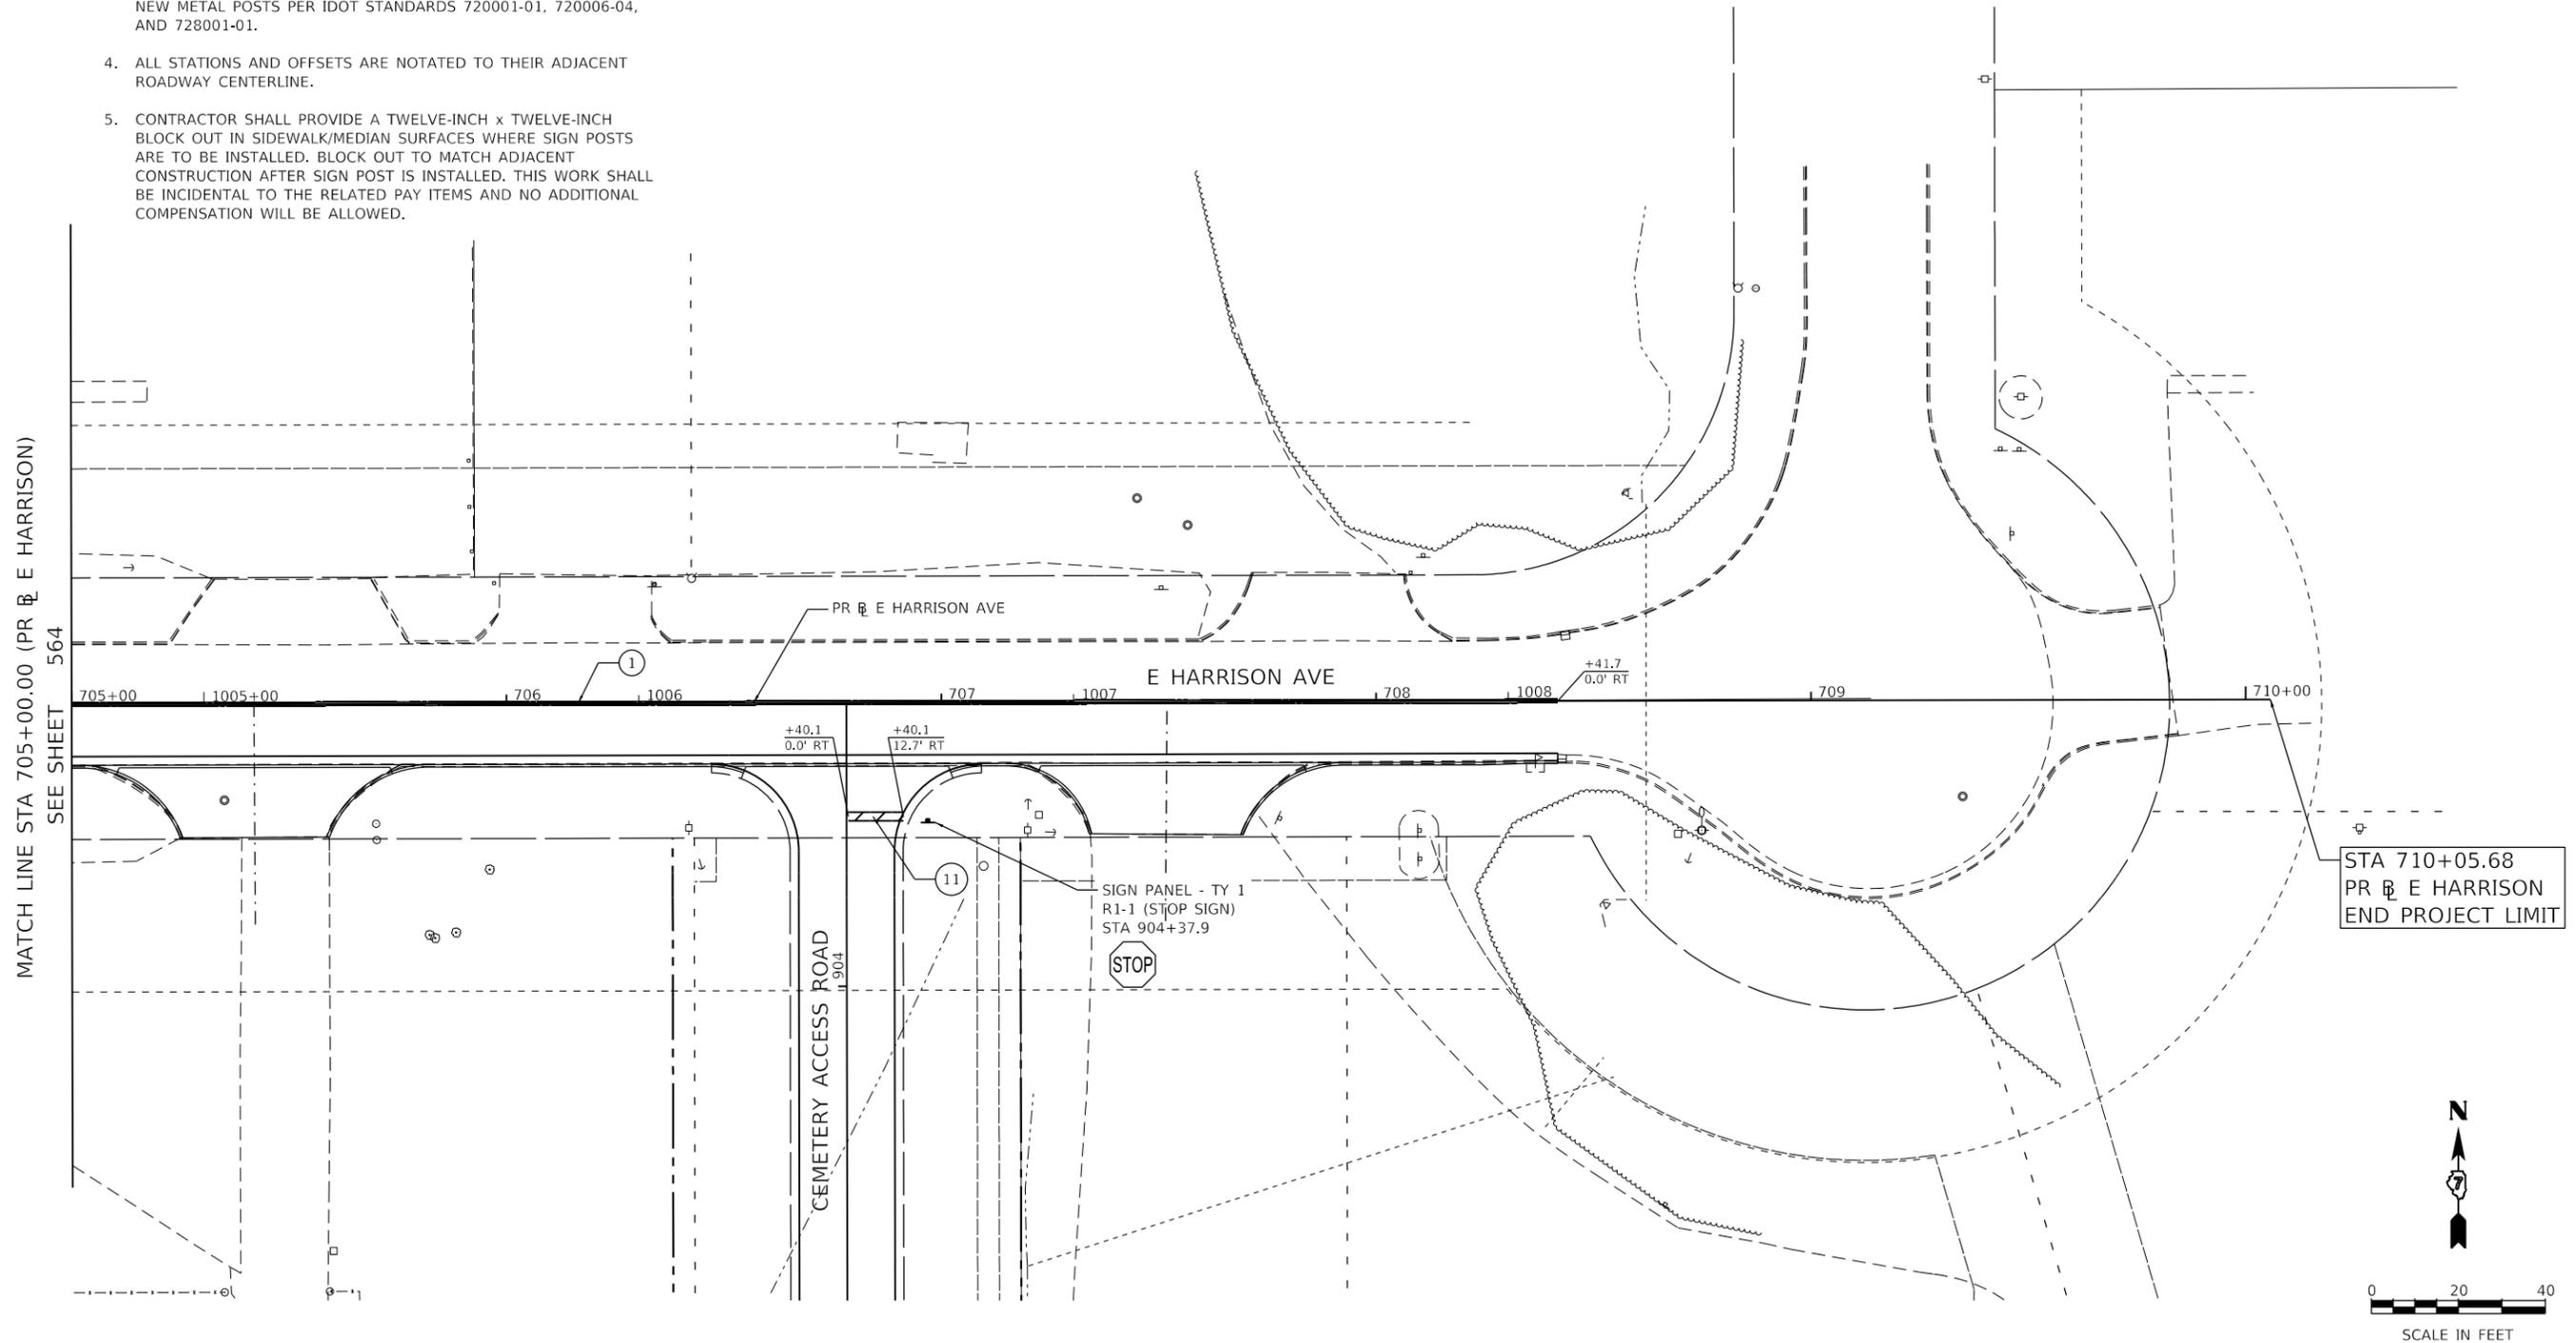

STA 710+05.68  
PR E HARRISON  
END PROJECT LIMIT

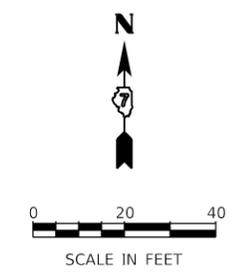

MODEL: Default; FILE NAME: p:\lsc\com-nw-bentley.com\AECOM\_051\IA\Documents\60603202-Brush\_College\006-CAD\_GIS\910\_CAD\03\_SHEETS\04-KASKASKIA\PAVEMENT MARKING Plans\60603202\_SFT\_PMK5Sign\_19\_Eharrison02.dgn

MATCH LINE STA 705+00.00 (PR E HARRISON)  
SEE SHEET 564

**Kaskaskia**  
Engineering Group, LLC  
PROFESSIONAL REGISTERED ENGINEERS  
Illinois Professional Design Firm  
Professional Engineering Group


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PLOT SCALE = 40.0000' / in.	DRAWN - NDP	REVISED -
PLOT DATE = 4/28/2021	CHECKED - LDC	REVISED -
	DATE - 4/30/2021	REVISED -

**STATE OF ILLINOIS  
DEPARTMENT OF TRANSPORTATION**

<b>E HARRISON AVENUE (EAST LEG) PAVEMENT MARKING &amp; SIGNING PLAN</b>	
SCALE: 1"=20'	SHEET 19 OF 20 SHEETS
STA. 705+00.00 TO STA. 710+05.68	


F.A.U. RTE. 7448	SECTION 09-00933-01-BR	COUNTY MACON	TOTAL SHEETS 1019	SHEET NO. 565
CONTRACT NO. 95893				
ILLINOIS FED. AID PROJECT				

MODEL: Default  
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- PAVEMENT MARKING & SIGNING NOTES**
1. ALL PAVEMENT MARKINGS SHALL BE OF THE TYPE AND COLOR AS SPECIFIED IN THE PLANS AND SHALL BE PLACED PER DISTRICT 7 STANDARD 78000001 AND IDOT STANDARD 780001-05.
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  3. ALL PROPOSED AND RELOCATED SIGNS SHALL BE INSTALLED WITH NEW METAL POSTS PER IDOT STANDARDS 720001-01, 720006-04, AND 728001-01.
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  5. CONTRACTOR SHALL PROVIDE A TWELVE-INCH x TWELVE-INCH BLOCK OUT IN SIDEWALK/MEDIAN SURFACES WHERE SIGN POSTS ARE TO BE INSTALLED. BLOCK OUT TO MATCH ADJACENT CONSTRUCTION AFTER SIGN POST IS INSTALLED. THIS WORK SHALL BE INCIDENTAL TO THE RELATED PAY ITEMS AND NO ADDITIONAL COMPENSATION WILL BE ALLOWED.

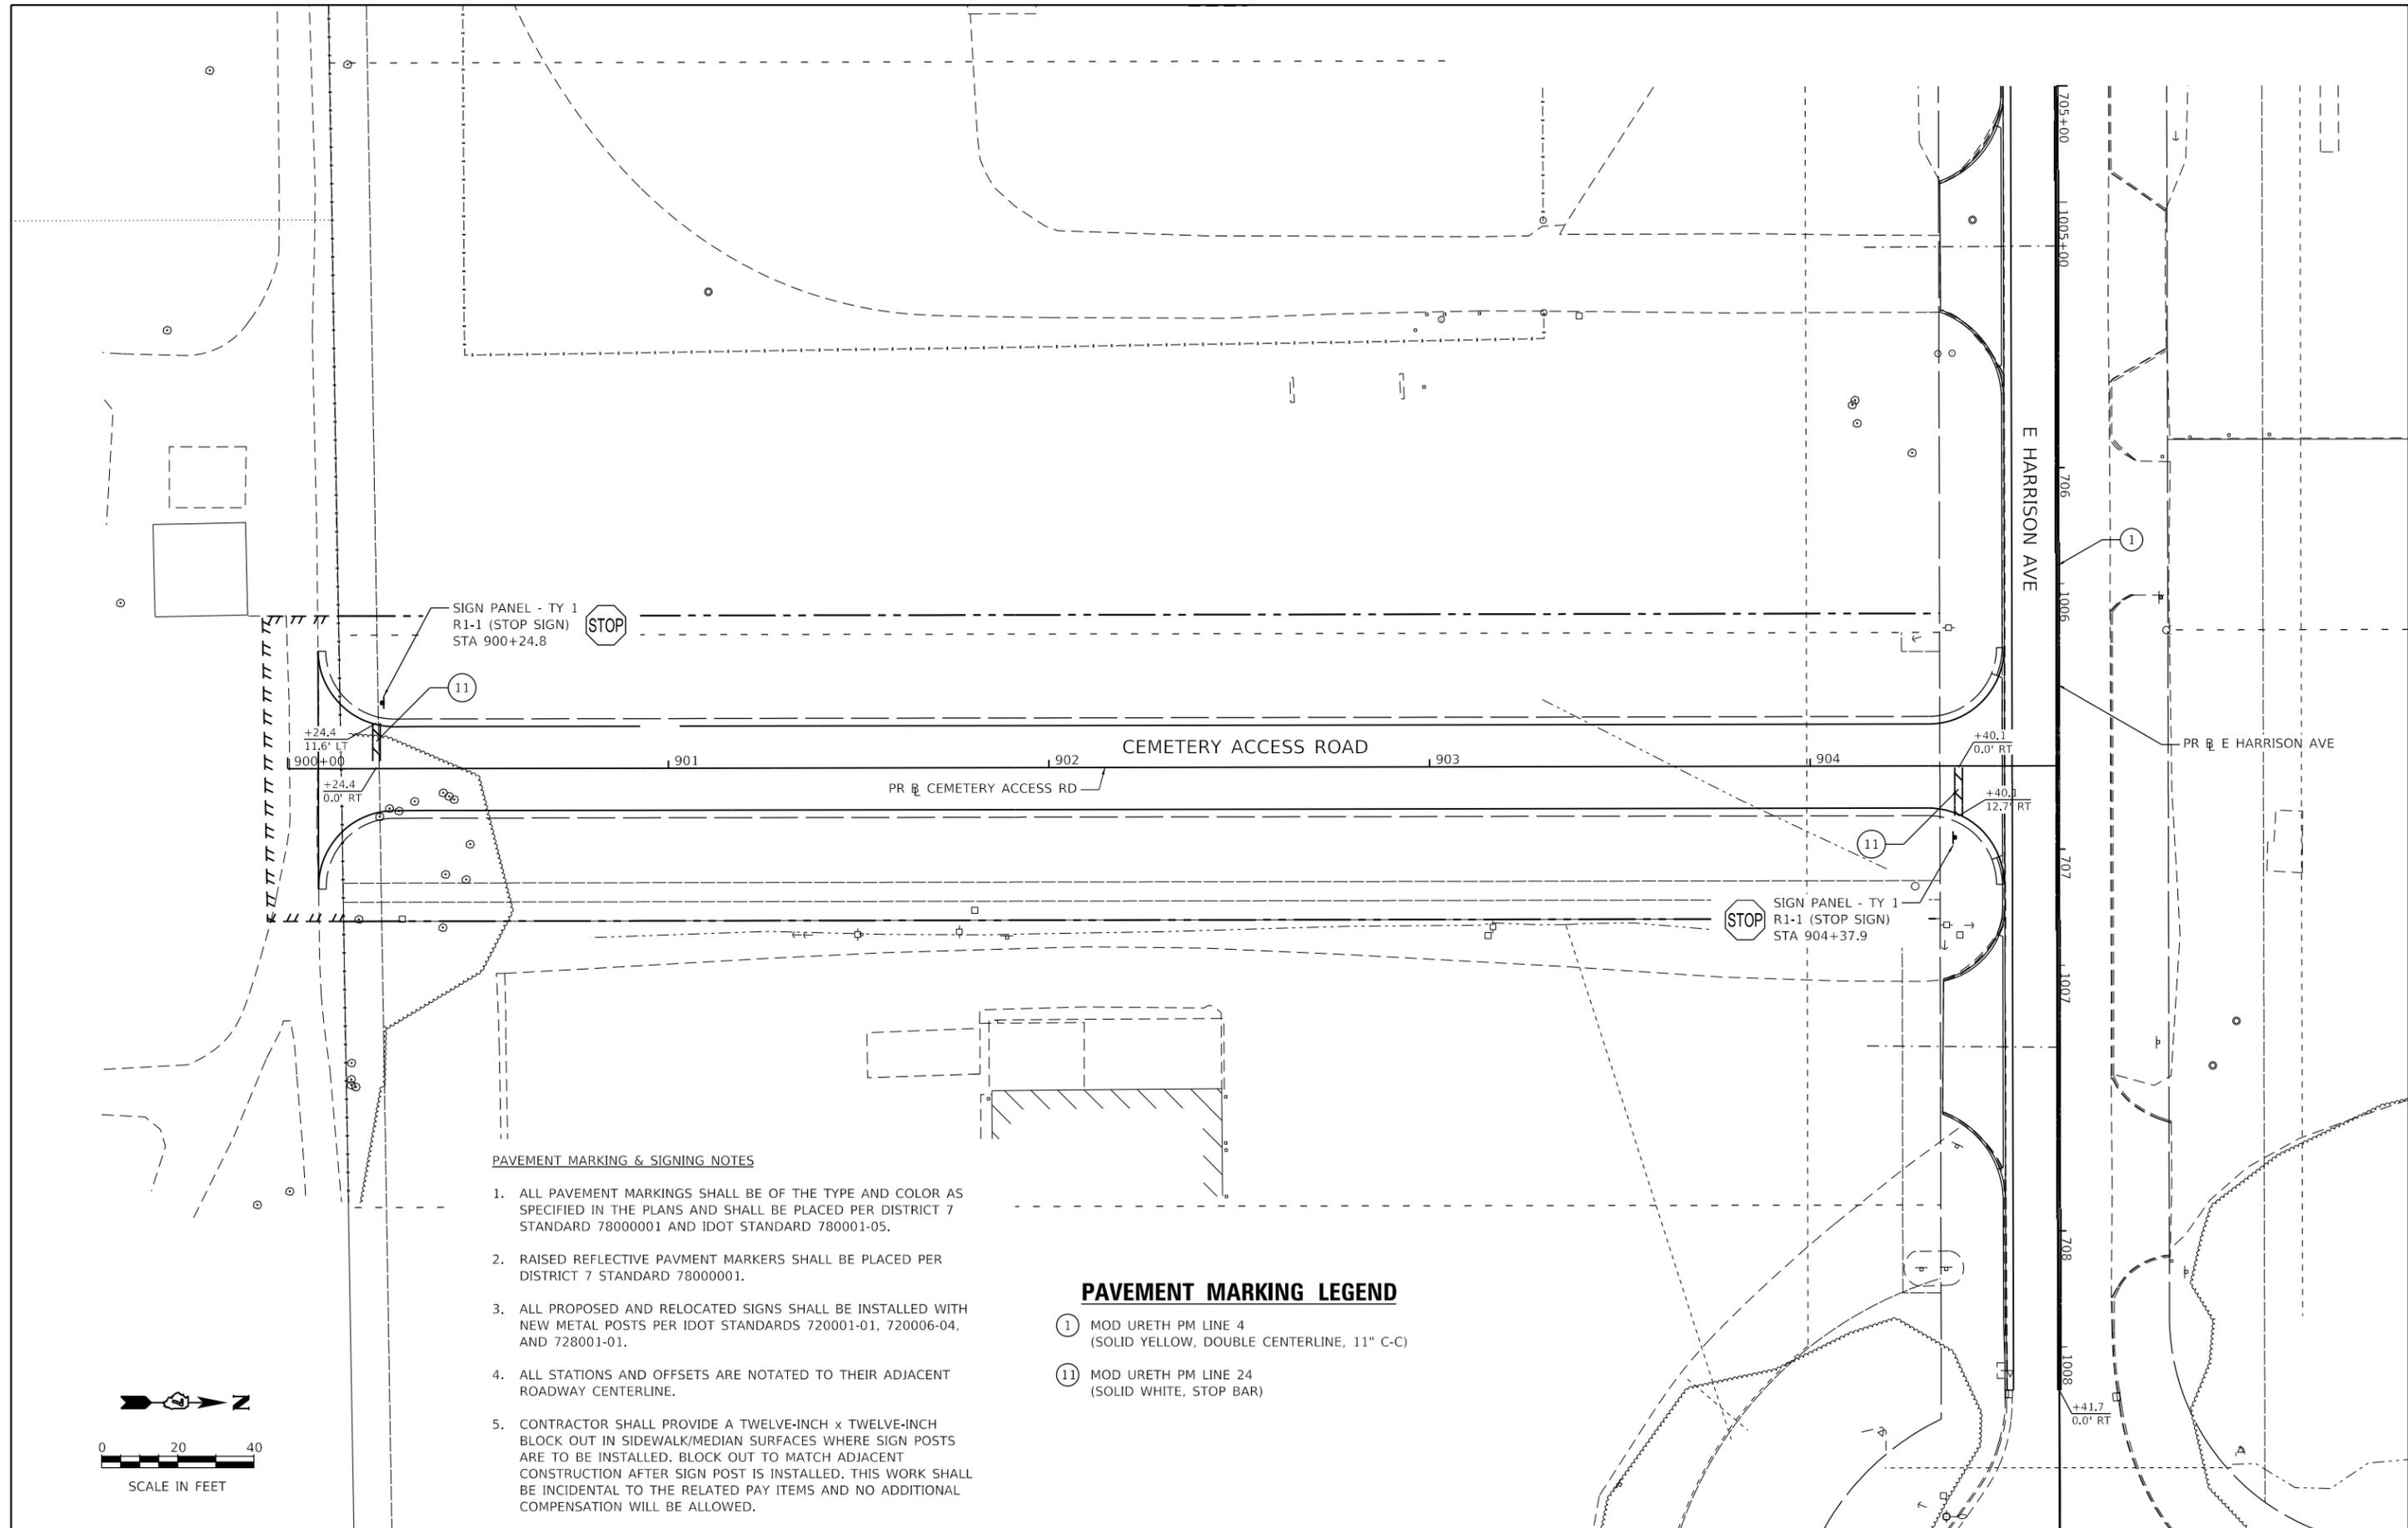- PAVEMENT MARKING LEGEND**
- ① MOD URETH PM LINE 4  
(SOLID YELLOW, DOUBLE CENTERLINE, 11" C-C)
  - ⑪ MOD URETH PM LINE 24  
(SOLID WHITE, STOP BAR)



**Kaskaskia**  
 Engineering Group, LLC  
 PROFESSIONAL REGISTERED ENGINEERS  
 Illinois Professional Design Firm  
 LICENSE NO. 184,004,733  
 20-5880586

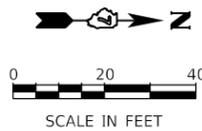
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PLOT SCALE = 40.0000' / in.	DRAWN - NDP	REVISED -
PLOT DATE = 4/28/2021	CHECKED - LDC	REVISED -
	DATE - 4/30/2021	REVISED -

**STATE OF ILLINOIS  
 DEPARTMENT OF TRANSPORTATION**


**E HARRISON AVENUE (EAST LEG) & CEMETERY ROAD  
 PAVEMENT MARKING & SIGNING PLAN**

SCALE: 1"=20'    SHEET 20 OF 20 SHEETS    STA. 900+00.00 TO STA. 904+52.12


F.A.U. RTE.	SECTION	COUNTY	TOTAL SHEETS	SHEET NO.
7448	09-00933-01-BR	MACON	1019	566
CONTRACT NO. 95893				
ILLINOIS FED. AID PROJECT				

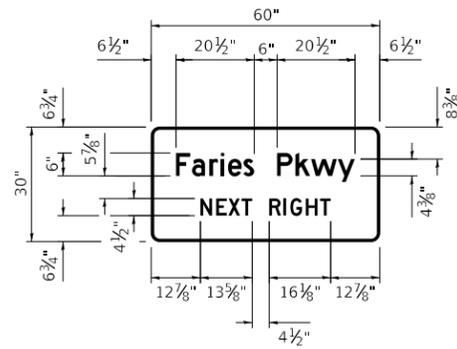


D3-2 - STA 51+95.0 RT  
 DETAIL OF  
 SIGN PANEL - TYPE 2  
 (NOT TO SCALE)

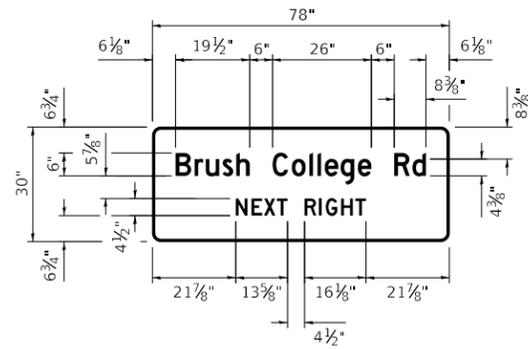


D3-2 - STA 210+75.8 RT  
 DETAIL OF  
 SIGN PANEL - TYPE 2  
 (NOT TO SCALE)

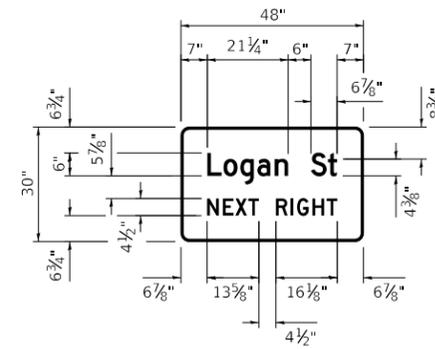


D3-2 - STA 302+00.0 RT  
 DETAIL OF  
 SIGN PANEL - TYPE 2  
 (NOT TO SCALE)

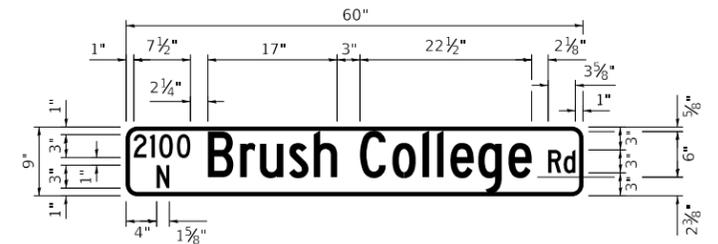


D3-1 - STA 73+16.0 LT  
 DETAIL OF  
 SIGN PANEL - TYPE 1  
 (NOT TO SCALE)

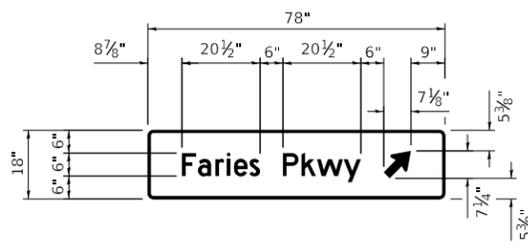


D1-1d - STA 54+33.6 RT  
 DETAIL OF  
 SIGN PANEL - TYPE 2  
 (NOT TO SCALE)

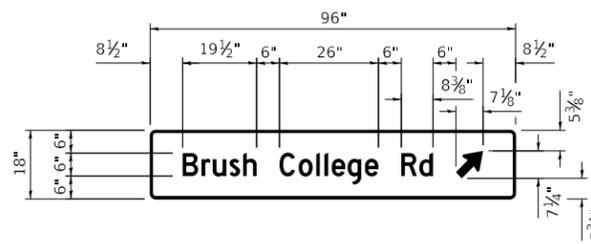


D1-1d - STA 213+95.6 RT  
 DETAIL OF  
 SIGN PANEL - TYPE 2  
 (NOT TO SCALE)

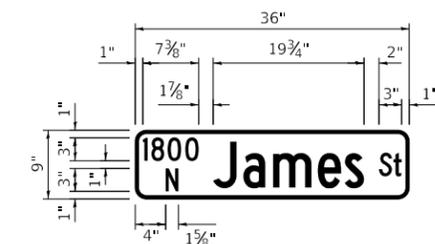


D3-1 - STA 405+21.2 LT  
 STA 408+66.2 RT  
 DETAIL OF  
 SIGN PANEL - TYPE 1  
 (NOT TO SCALE)

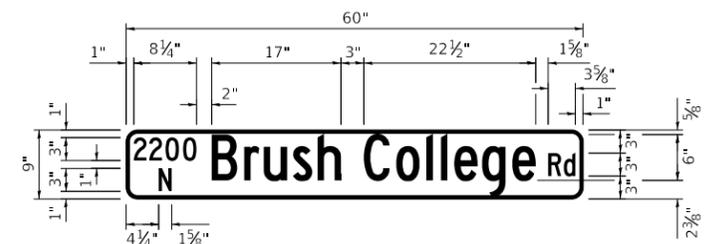


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 DETAIL OF  
 SIGN PANEL - TYPE 1  
 (NOT TO SCALE)

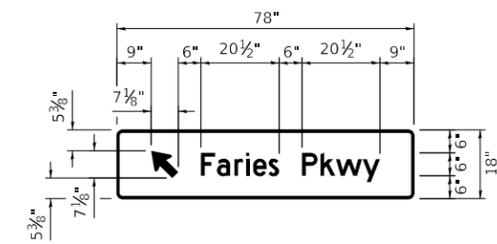


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 DETAIL OF  
 SIGN PANEL - TYPE 2  
 (NOT TO SCALE)

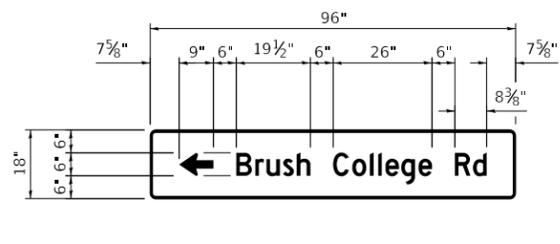


D1-1d - STA 219+74.6 LT  
 DETAIL OF  
 SIGN PANEL - TYPE 2  
 (NOT TO SCALE)

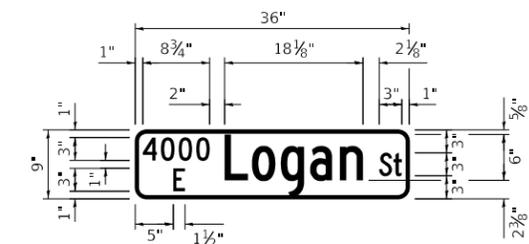


D3-1 - STA 405+21.2 LT  
 DETAIL OF  
 SIGN PANEL - TYPE 1  
 (NOT TO SCALE)

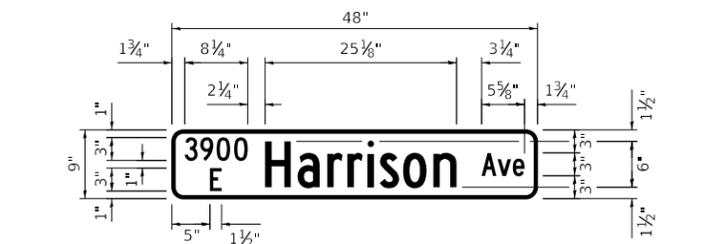


D3-1 - STA 701+66.9 RT  
 DETAIL OF  
 SIGN PANEL - TYPE 1  
 (NOT TO SCALE)

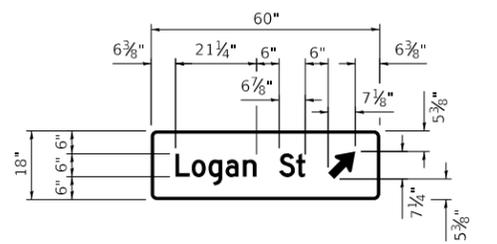

D1-1d - STA 304+25.0 RT  
 DETAIL OF  
 SIGN PANEL - TYPE 1  
 (NOT TO SCALE)

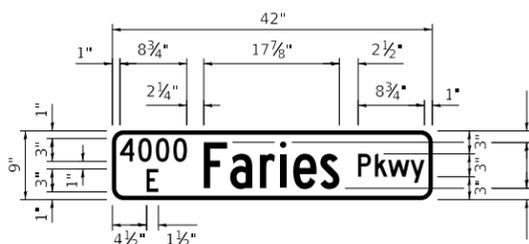

D3-1 - STA 408+66.2 RT  
 DETAIL OF  
 SIGN PANEL - TYPE 1  
 (NOT TO SCALE)

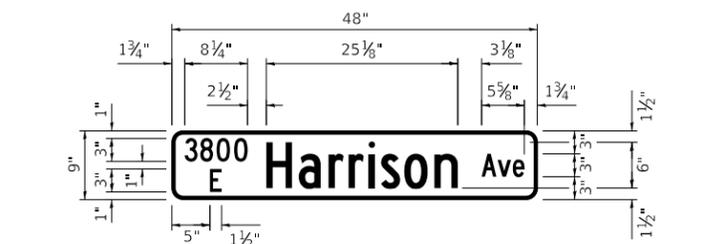

D3-1 - STA 73+16.0 LT  
 DETAIL OF  
 SIGN PANEL - TYPE 1  
 (NOT TO SCALE)

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 Kaskaskia Engineering Group, LLC  
 PROFESSIONAL DESIGNER  
 Illinois Professional Design Firm  
 184.004773  
 20-588586



USER NAME = rjo	DESIGNED - LDC	REVISED -
PLOT SCALE = 2,000' / in.	DRAWN - RJO	REVISED -
PLOT DATE = 4/28/2021	CHECKED - LDC	REVISED -
	DATE - 4/30/2021	REVISED -

**STATE OF ILLINOIS  
 DEPARTMENT OF TRANSPORTATION**

**BRUSH COLLEGE ROAD & FARIES PARKWAY  
 PAVEMENT MARKING & SIGNING - SIGN PANELS**

SCALE: SHEET 1 OF 1 SHEETS STA. TO STA.

F.A.U. RTE.	SECTION	COUNTY	TOTAL SHEETS	SHEET NO.
7448	09-00933-01-BR	MACON	1019	567
CONTRACT NO. 95893				
ILLINOIS FED. AID PROJECT				

FOR INDEX OF SHEETS AND STANDARDS SEE SHEET NO. 2

STATE OF ILLINOIS  
DEPARTMENT OF TRANSPORTATION

VOLUME I

F.A.U. RTE.	SECTION	COUNTY	TOTAL SHEETS	SHEET NO.
7448	09-00933-01-BR	MACON	56	1
ILLINOIS CONTRACT NO. 95893				

DESIGN DESIGNATIONS:

BRUSH COLLEGE ROAD (FAU 7448)	21,000 (2035) MINOR ARTERIAL	35 /40 MPH
FARIES PARKWAY (FAU 7369) (WEST LEG)	12,000 (2035) MINOR ARTERIAL	35 /40 MPH
FARIES PARKWAY (FAU 7369) (EAST LEG)	15,000 (2035) COLLECTOR	35 /40 MPH
JUG HANDLE CONNECTOR ROAD	18,000 (2035) COLLECTOR	30 /30 MPH

POSTED /DESIGN SPEEDS:

35 /40 MPH
35 /40 MPH
35 /40 MPH
30 /30 MPH

# PLANS FOR PROPOSED LOCAL AGENCY IMPROVEMENT

FAU ROUTE 7448 (BRUSH COLLEGE ROAD)  
OVER FARIES PARKWAY GRADE SEPARATION

SECTION 09-00933-01-BR

PROJECT 3ELT(222)

BRIDGE STRUCTURE, RETAINING WALLS,  
ROADWAY RECONSTRUCTION,  
LIGHTING, AND TRAFFIC SIGNALS

MACON COUNTY

C-97-106-21


NORFOLK SOUTHERN RAILROAD  
MIDWEST DIVISION, DECATUR  
TERMINAL - MP IT-44.6

BRUSH COLLEGE RD PROJECT LIMIT  
END STA 75 + 44.21

RETAINING WALL SN 058-W004  
STA 62 + 39.94 TO STA 69 + 25.33

FARIES PKWY PROJECT LIMIT  
END STA 235 + 41.47

LOCATION OF SECTION INDICATED THIS: -

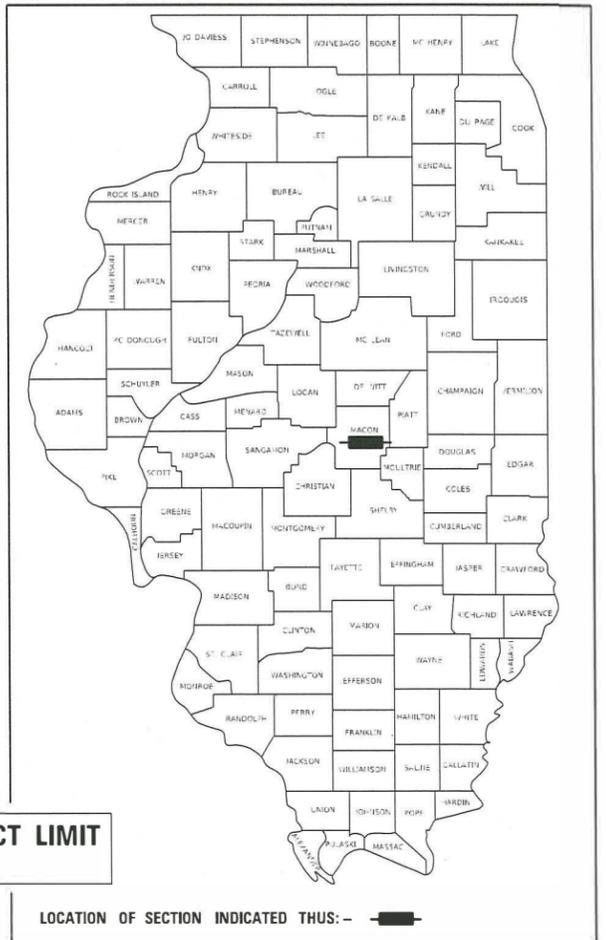

*Kirsten Mawhinney*  
KIRSTEN MAWHINNEY, P.E. DATE 10 / 22 / 2021  
LICENSE EXPIRES 2 / 28 / 2022  
SHEET RANGE: 1-49, 53, 55-92, 97-98, 100-112, 117-118, 120-132, 141, 143-157, 159-175, 177, 179-302, 379-398, 568, 742-930, 987-1009



*Cory W. Chamberlain*  
CORY W. CHAMBERLAIN, P.E. DATE 10 / 22 / 2021  
LICENSE EXPIRES 2 / 28 / 2022  
SHEET RANGE: 50-52, 54, 93-96, 99, 113-116, 119, 133-140, 142, 158, 176, 178, 399-512, 931-986, 1010-1019



*Demir Dabecic*  
DEMIR DEBEZIC, S.E. DATE 10 / 22 / 2021  
LICENSE EXPIRES 11 / 30 / 2022  
SHEET RANGE: 665-705



*Richard K. Allender III*  
RICHARD K. ALLENDER III, P.E. DATE 10 / 22 / 2021  
LICENSE EXPIRES 2 / 28 / 2022  
SHEET RANGE: 308-378



SEE SHEET 569 FOR SIGNATURE  
SCOTT D. SANFORD, S.E. DATE  
LICENSE EXPIRES 11 / 30 / 2022  
SHEET RANGE: 569-594



*Matthew J. Letourneau*  
MATTHEW J. LETOURNEAU, P.E. DATE 10 / 22 / 2021  
LICENSE EXPIRES 2 / 28 / 2022  
SHEET RANGE: 303-307, 706-720



*Keith W. Benting*  
KEITH W. BENTING, S.E. DATE 10 / 22 / 2021  
LICENSE EXPIRES 11 / 30 / 2022  
SHEET RANGE: 595-664




*William D. Stermer*  
WILLIAM D. STERMER, P.E. DATE 10 / 22 / 2021  
LICENSE EXPIRES 2 / 28 / 2022  
SHEET RANGE: 731-741



*Lance D. Chrisman*  
LANCE D. CHRISMAN, P.E. DATE 10 / 22 / 2021  
LICENSE EXPIRES 2 / 28 / 2022  
SHEET RANGE: 544-567, 721-730



*Paul St. Aubyn*  
PAUL ST. AUBYN, P.E. DATE 10 / 22 / 2021  
LICENSE EXPIRES 2 / 28 / 2022  
SHEET RANGE: 513-543

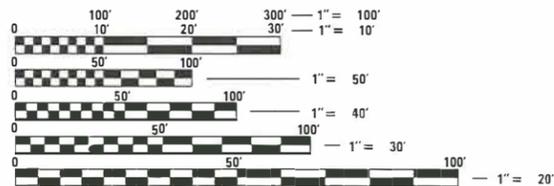

FULL SIZE PLANS HAVE BEEN PREPARED USING STANDARD ENGINEERING SCALES. REDUCED SIZED PLANS WILL NOT CONFORM TO STANDARD SCALES. IN MAKING MEASUREMENTS ON REDUCED PLANS, THE ABOVE SCALES MAY BE USED.

J.U.L.I.E.  
JOINT UTILITY LOCATION INFORMATION FOR EXCAVATION  
1-800-892-0123  
OR 811


CONTRACT NO. 95893

FARIES PKWY PROJECT LIMIT  
BEGIN STA 205 + 18.73

BRUSH COLLEGE STRUCTURE LIMIT  
STA 60 + 10.96 TO STA 62 + 76.19  
SN 058-9202

RETAINING WALL SN 058-W003  
STA 52 + 00.00 TO STA 59 + 50.20

BRUSH COLLEGE RD PROJECT LIMIT  
BEGIN STA 46 + 59.43

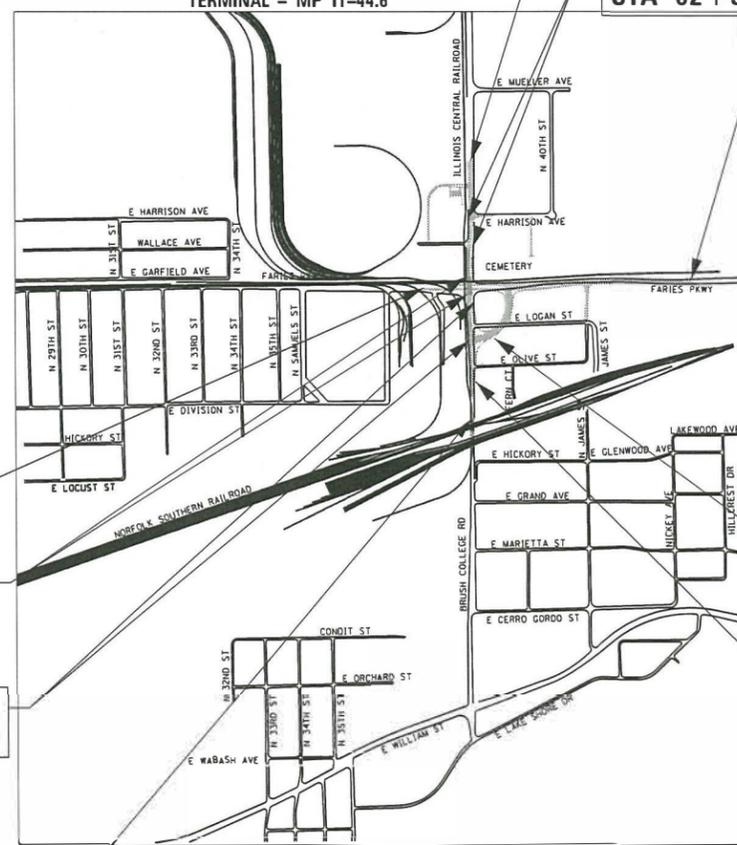

LOCATION MAP  
NOT TO SCALE

GROSS LENGTH = 5,855.36 FT (1.11 MILES)  
NET LENGTH = 5,855.36 FT (1.11 MILES)



345 EAST ASH AVE  
DECATUR, IL 62526  
PHONE: (217) 775-6065



QUIGG ENGINEERING INC

2351 S. DIRKSEN PARKWAY  
SPRINGFIELD, IL 62703  
PHONE: (217) 670-0563



design firm  
no. 184001036

3695 6TH STREET FRONTAGE  
ROAD WEST, SUITE A  
SPRINGFIELD, IL 62703  
PHONE: (217) 483-9457



208 E. MAIN STREET, SUITE 100  
BELLEVILLE, IL 62220  
PHONE: (618) 233-5877  
FAX: (618) 233-5977

APPROVED \_\_\_\_\_  
PAUL CASWELL, P.E. 10 / 29 / 2021  
CITY ENGINEER

PASSED *12/01/21*  
*Paul Caswell*  
DISTRICT SEVEN ENGINEER OF  
LOCAL ROADS & STREETS


RELEASING FOR  
BID BASED ON  
LIMITED REVIEW  
*12/01/21*  
*Jeffrey Meyer*  
REGION FOUR ENGINEER

STATE OF ILLINOIS  
DEPARTMENT OF TRANSPORTATION

Benchmark: "M" in Mueller on fire hydrant at Southeast corner of Cerro Gordo St. and Brush College Rd. - Elev. 652.58.

Existing Structure: None


Traffic Control: The existing Brush College Road shall be closed and traffic will be detoured during construction.

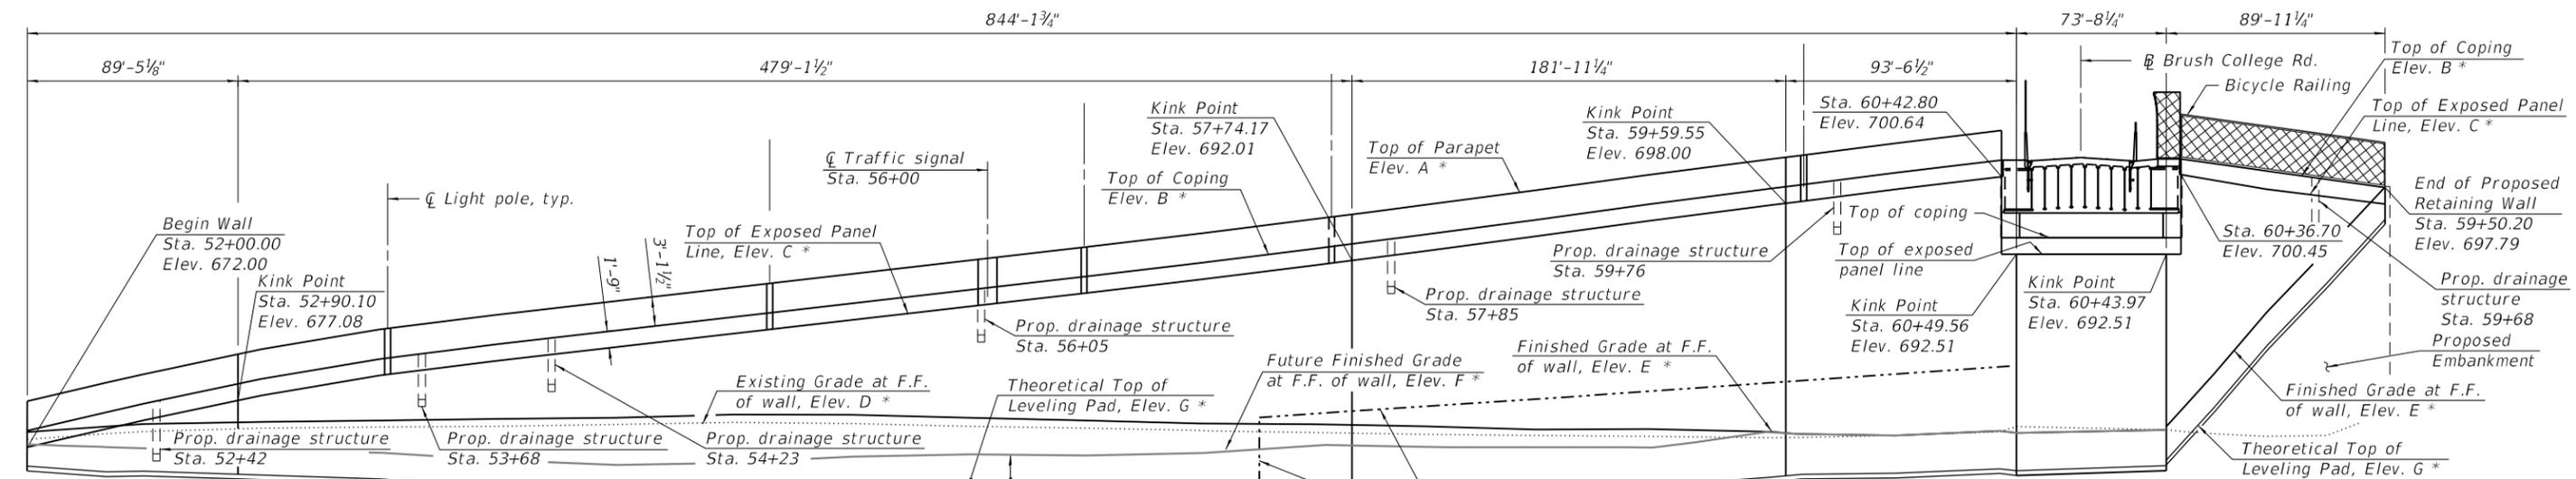

**Notes:**

- Wall offsets are measured from Brush College Road to front face of precast modular units. Horizontal dimensions are measured along F.F. of wall units.
  - For Temporary Soil Retention System (Special) details, see sheet SA-5 of SA-26.
  - F.F. denotes Front Face.
  - B.F. denotes Back Face.
- \* For Elevations, see Wall Elevations Table on sheet SA-03 of SA-26.  
 \*\* Ending station and offset of existing sheet pile retaining wall.

**UNFOLDED ELEVATION**  
(Projected View - F.F. of Wall)

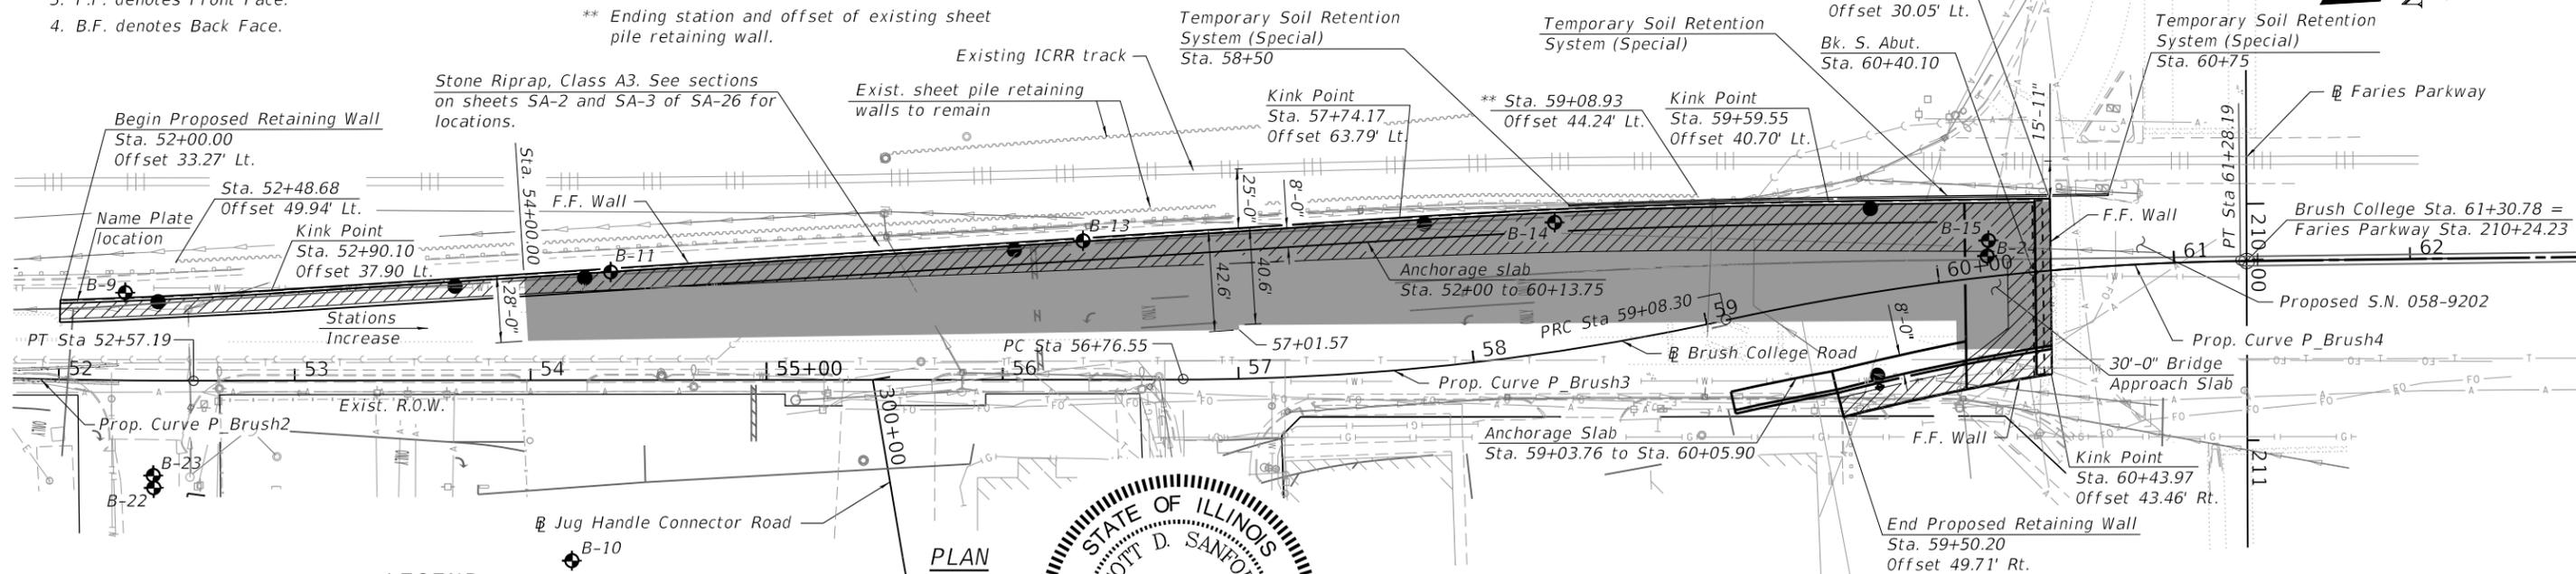

**LEGEND**

- Soil Boring Location
- Existing Aerial
- Existing Electric
- Existing Fiber Optic
- Existing Gas
- Existing Sanitary Sewer
- Existing Storm Sewer
- Existing underground Telephone
- Existing Water
- Proposed above ground Lighting
- Proposed above ground Inlet
- Proposed traffic signal
- Approximate Limits of Precast Modular Retaining Wall Mass
- Approximate Limits of Lightweight Concrete Cellular Fill



*[Signature]*  
10-22-21  
Expires: 11/30/2022

I certify that to the best of my knowledge, information and belief, this structure design is structurally adequate for the design loading shown on the plans. The design is an economical one for the style of structure and complies with requirements of the current AASHTO Standard Specifications for Highway Bridges.


**DESIGN SPECIFICATIONS**

2017 AASHTO LRFD Bridge Design Specifications, 8th Edition

**DESIGN STRESSES**

**FIELD UNITS**  
 f'c = 3,500 psi  
 fy = 60,000 psi (Reinforcement)  
 f'c = 4,000 psi (Superstructure)

**PRECAST UNITS**  
 f'c = 4,500 psi  
 Allowable Bearing Pressure = 2,670 psf

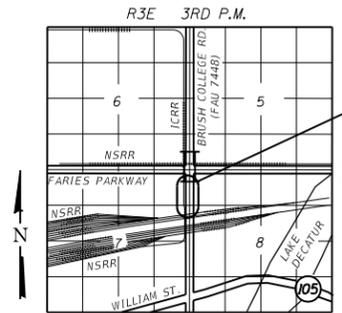

**GENERAL PLAN & ELEVATION**  
**BRUSH COLLEGE ROAD**  
 F.A.U. 7448 - SECTION 09-00933-01-BR  
 MACON COUNTY  
 STA. 52+00.00 LT TO STA. 59+50.20 RT  
 STRUCTURE NO. 058-W003



DESIGNER	DESIGNED	REVISED
FILE NAME = dtheberling	SDS	
PLOT SCALE = 0.167" / in.	CHECKED	REVISED
PLOT DATE = 10/26/2021	CEH	
	DRAWN	REVISED
	DLH	
	CHECKED	REVISED
	SDS	

STATE OF ILLINOIS  
DEPARTMENT OF TRANSPORTATION

SHEET NO. SA-01 OF SA-26 SHEETS

F.A.U. RTE.	SECTION	COUNTY	TOTAL SHEETS	SHEET NO.
7448	09-00933-01-BR	MACON	1019	569
CONTRACT NO. 95893				

ILLINOIS FED. AID PROJECT

**GENERAL NOTES**


1. Reinforcement bars designated (E) shall be epoxy coated.
2. Protective Coat shall be applied to the top and interior surfaces of the parapets and the top exposed surface of the Anchorage Slabs.
3. The Contractor shall field verify the location of all underground utilities. The contractor shall take precautions to protect existing underground utilities that are to remain in service during construction of the wall. Any damage to underground utilities will be the responsibility of the Contractor. For locations and elevations of utilities, see Utility Plans.
4. The Contractor may encounter abandoned utilities or drainage structures that obstruct construction of the proposed wall. Removal and disposal of portions of these obstructions shall not be cause for additional payment but shall be included in the cost of "Precast Modular Retaining Wall". For locations and elevations of utilities, see Utility Plans.
5. All Lightweight Cellular Concrete Fill shall be Class II. See Special Provisions.
6. The Contractor shall coordinate the construction of the proposed wall with the construction of the proposed bridge over Faries Parkway (S.N. 058-9202). See suggested Stages of Construction and Traffic Control plan sheets and Special Provisions.
7. For details and quantity of conduits embedded in structure, see Electrical Plans.
8. Fill type retaining walls (MSE and precast modular) shall be detailed and constructed to allow for proposed roadway drainage to be placed properly and as shown in the plans. Any requests for modification to drainage structure locations to accommodate wall reinforcement or details shall be submitted to the Engineer in writing for review. Any changes approved by the Engineer in writing will be coordinated by the Contractor at no additional cost.
9. Slipforming of east parapet is not allowed.

**TOTAL BILL OF MATERIAL**

ITEM	UNIT	Super	Sub	TOTAL
Structure Excavation	Cu. Yd.		3,890	3,890
Concrete Structures	Cu. Yd.		250.0	250.0
Concrete Superstructure	Cu. Yd.	536.0		536.0
Protective Coat	Sq. Yd.	1,221		1,221
Reinforcement Bars, Epoxy Coated	Pound	76,840		76,840
Bicycle Railing	Foot	55		55
Parapet Railing	Foot	100		100
Name Plates	Each	1		1
Precast Modular Retaining Wall	Sq. Ft.		19,343	19,343
Lightweight Cellular Concrete Fill	Cu. Yd.		18,134	18,134
Temporary Soil Retention System (Special)	Sq. Ft.		1,200	1,200
Portland Cement Concrete Sidewalk 5 inch, Special	Sq. Ft.	532		532
Pipe Underdrains for Structures 4"	Foot		652	652

**INDEX OF SHEETS**

- SA-01. General Plan and Elevation
- SA-02. General Data
- SA-03. Wall Cross Sections and Details 1
- SA-04. Wall Cross Sections and Details 2
- SA-05. Temporary Soil Retention System (Special) Details
- SA-06. West Parapet and Anchorage Slab Plan and Elevation 1
- SA-07. West Parapet and Anchorage Slab Plan and Elevation 2
- SA-08. West Parapet and Anchorage Slab Plan and Elevation 3
- SA-09. West Parapet and Anchorage Slab Plan and Elevation 4
- SA-10. West Parapet and Anchorage Slab Plan and Elevation 5
- SA-11. West Parapet and Anchorage Slab Plan and Elevation 6
- SA-12. West Parapet and Anchorage Slab Plan and Elevation 7
- SA-13. West Parapet and Anchorage Slab Plan and Elevation 8
- SA-14. West Parapet and Anchorage Slab Plan and Elevation 9
- SA-15. East Parapet and Anchorage Slab Plan and Elevation
- SA-16.-SA-17. Parapet and Anchorage Slab Details
- SA-18. Bicycle Railing
- SA-19. Concrete Parapet Slipforming Option
- SA-20. Existing Sheet Pile Retaining Wall Plans
- SA-21.-SA-26. Borings

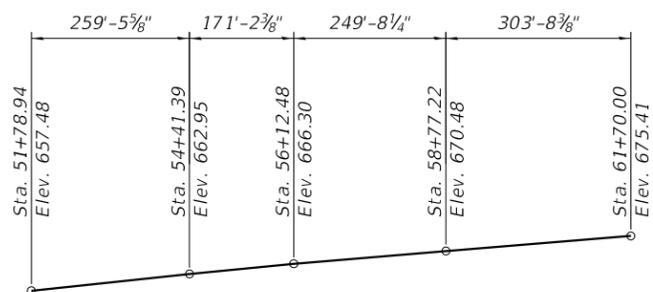


**PROFILE GRADE**

(Along top of existing rail ICRR)  
(Stations are from Brush College Road)


STA. 52+00.00 LT. TO 59+50.20 RT.  
BUILT BY  
CITY OF DECATUR  
F.A.U. RT. 7448  
SECTION 09-00933-01-BR  
LOADING HL-93  
STRUCTURE NO. 058-W003

**NAME PLATE**  
See Std. 515001

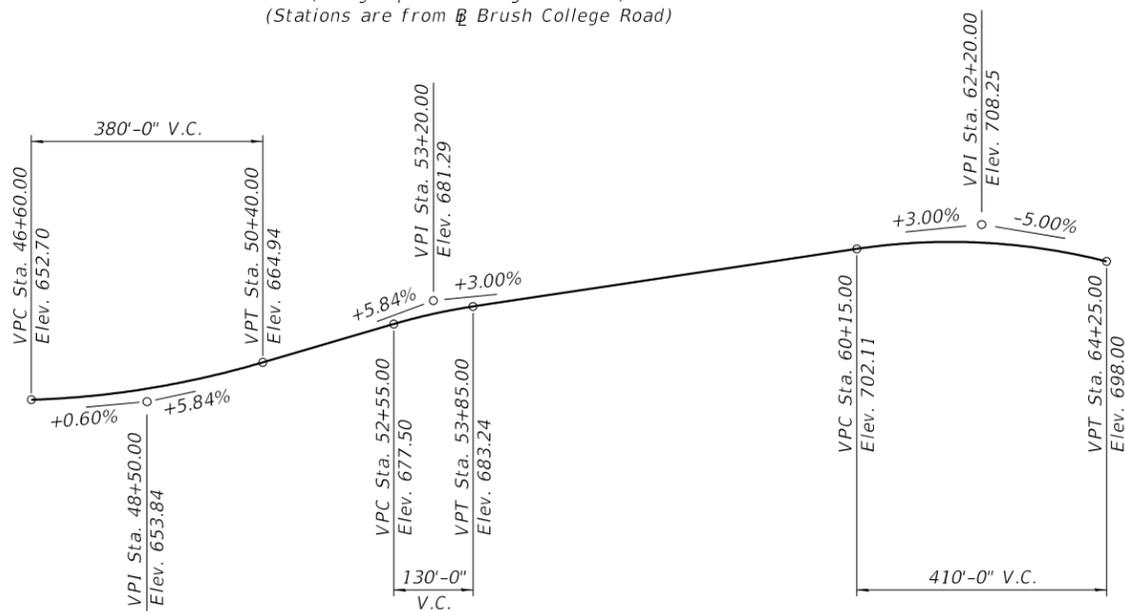

**PROFILE GRADE**

(Along Brush College Road)

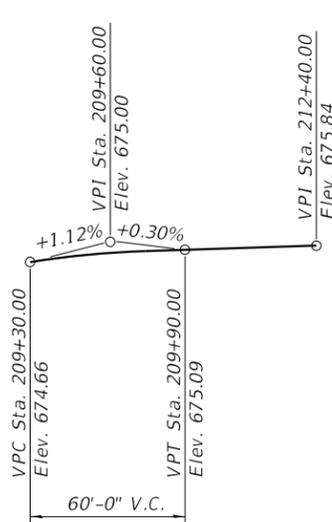

**PROFILE GRADE**

(Along Faries Parkway)

**PROP. CURVE P\_BRUSH2**

BRUSH COLLEGE RD.

PI STA. = 51+91.51  
Δ = 3° 00' 41" (LT)  
D = 2° 17' 31"  
R = 2,500.00'  
T = 65.72'  
L = 131.40'  
E = 0.86'  
e = NC  
T.R. = N/A  
S.E. RUN = N/A  
P.C. STA. = 51+25.79  
P.T. STA. = 52+57.19

**PROP. CURVE P\_BRUSH3**

BRUSH COLLEGE RD.

PI STA. = 57+92.87  
Δ = 12° 17' 41" (LT)  
D = 5° 18' 19"  
R = 1,080.00'  
T = 116.32'  
L = 231.75'  
E = 6.25'  
e = NC  
T.R. = N/A  
S.E. RUN = N/A  
P.C. STA. = 56+76.55  
P.T. STA. = 59+08.30

**PROP. CURVE P\_BRUSH4**

BRUSH COLLEGE RD.

PI STA. = 60+18.63  
Δ = 11° 39' 57" (RT)  
D = 5° 18' 19"  
R = 1,080.00'  
T = 110.33'  
L = 219.89'  
E = 5.62'  
e = NC  
T.R. = N/A  
S.E. RUN = N/A  
P.C. STA. = 59+08.30  
P.T. STA. = 61+28.19

LAST SAVED DATE: SJASTS/SAVED/DATE

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design firm  
no. 184001036



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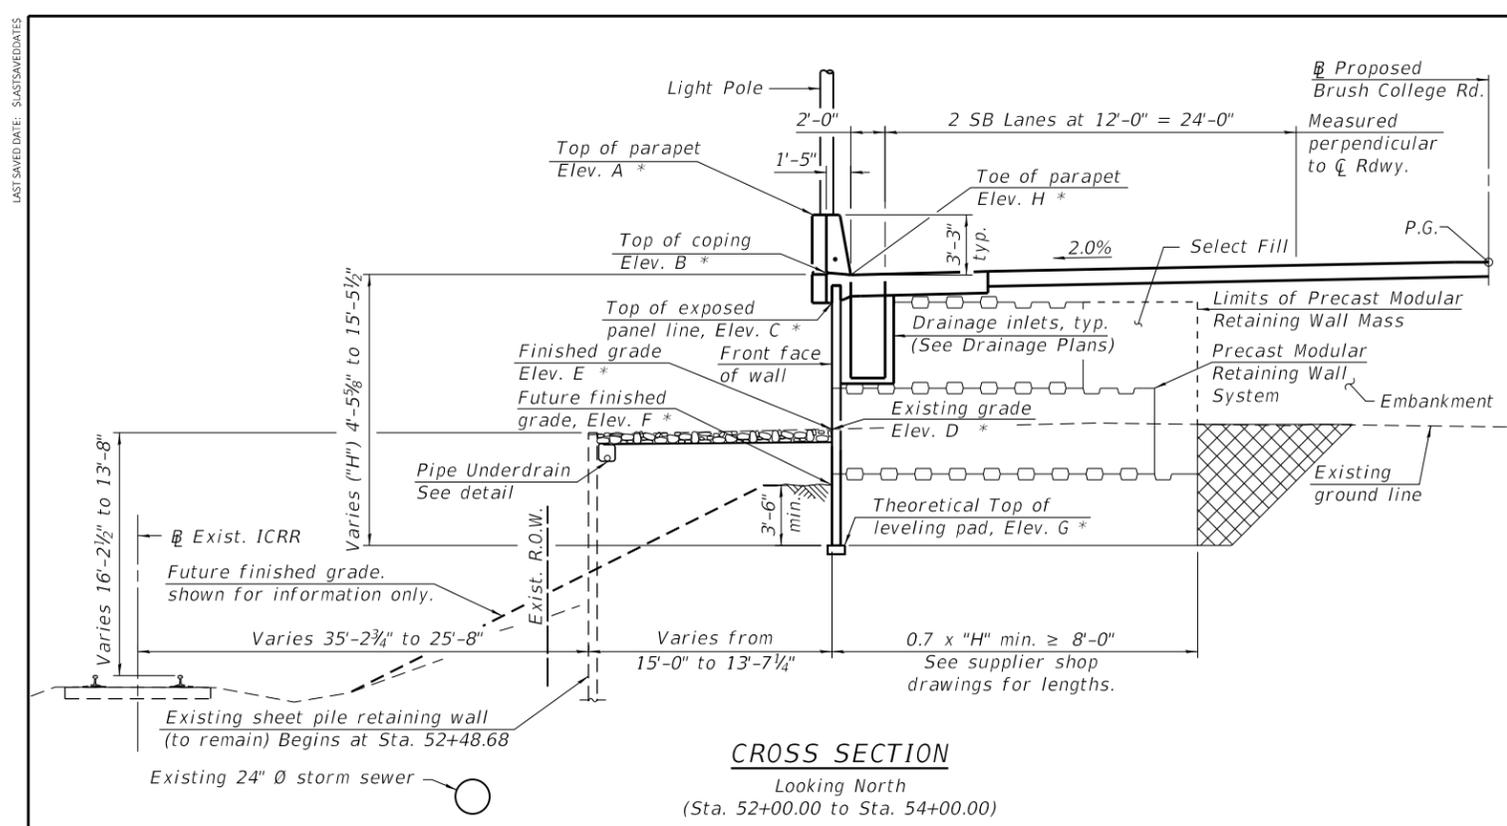
STATE OF ILLINOIS  
DEPARTMENT OF TRANSPORTATION

GENERAL DATA  
STRUCTURE NO. 058-W003


SHEET NO. SA-02 OF SA-26 SHEETS

F.A.U. RTE.	SECTION	COUNTY	TOTAL SHEETS	SHEET NO.
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CONTRACT NO. 95893			ILLINOIS FED. AID PROJECT	


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**CROSS SECTION**  
Looking North  
(Sta. 52+00.00 to Sta. 54+00.00)



**PIPE UNDERDRAIN FOR STRUCTURES DETAIL**  
(Install Pipe Underdrain for Structures at location shown for entire length of Existing Sheet Pile Retaining Wall.)

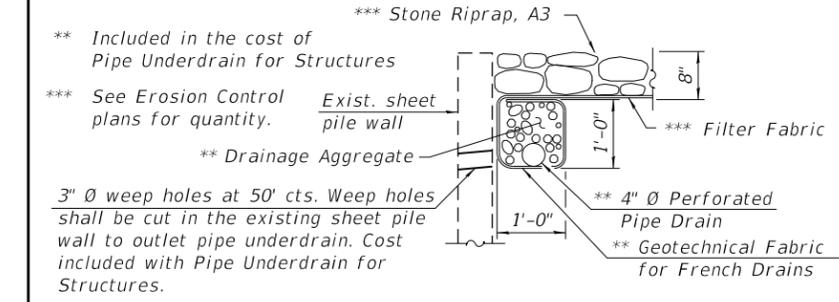

**CROSS SECTION**  
Looking North  
(Sta. 54+00.00 to Sta. 57+01.57)

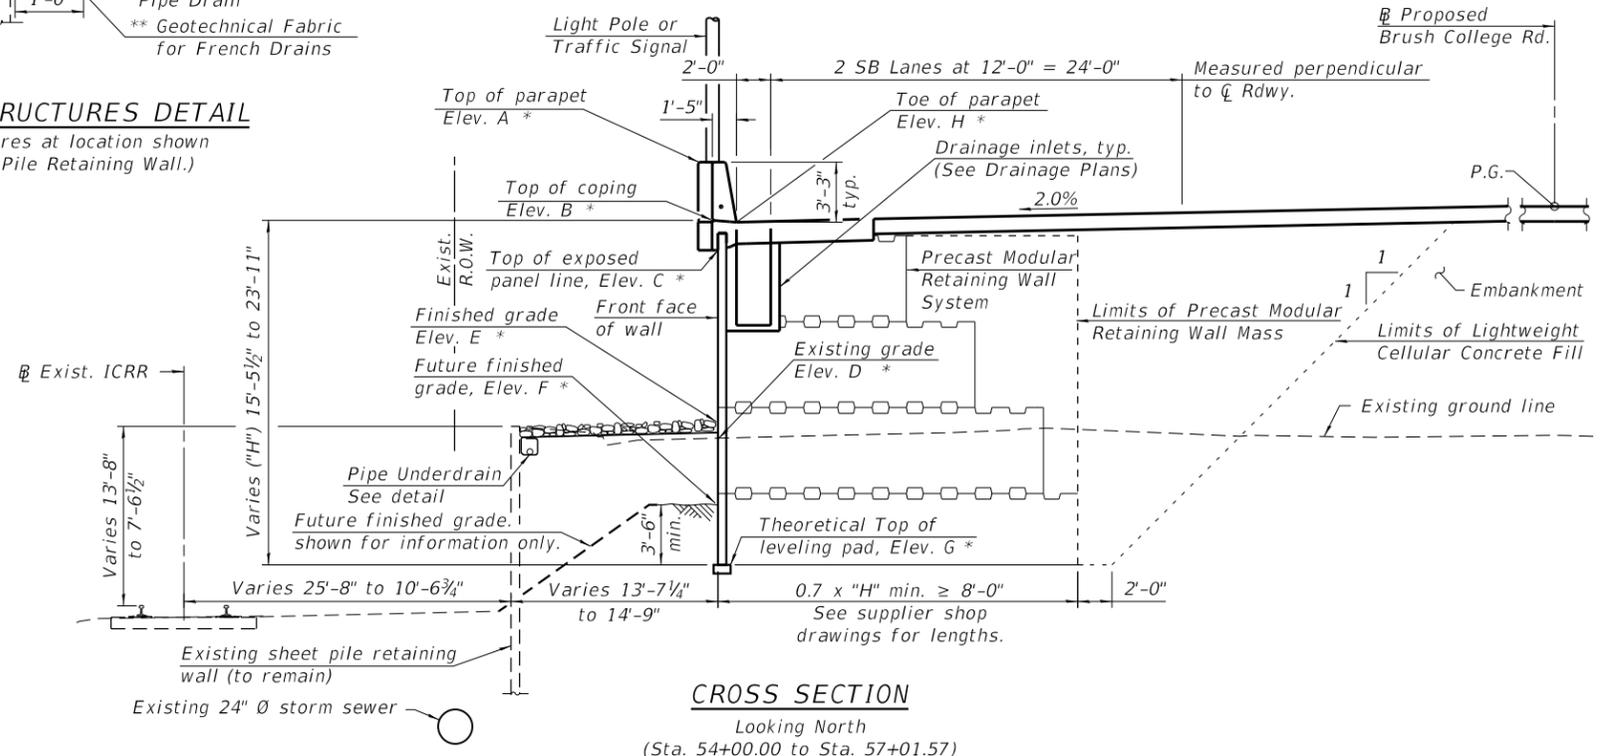**WALL ELEVATIONS**

Station	Offset		Elevation A	Elevation B	Elevation C	Elevation D	Elevation E	Elevation F	Elevation G	Elevation H
52+00.00	33.27	LT	676.87	673.75	672.00	672.90	673.68	673.57	670.07	673.62
52+50.00	35.70	LT	679.79	676.67	674.92	673.72	674.52	673.04	669.54	676.54
52+90.10	37.90	LT	681.95	678.83	677.08	674.24	674.69	672.59	669.09	678.70
53+00.00	38.52	LT	682.43	679.31	677.56	674.10	674.74	672.64	669.14	679.18
53+50.00	41.66	LT	684.51	681.39	679.64	674.21	674.89	672.23	668.73	681.26
54+00.00	44.80	LT	686.08	682.96	681.21	674.30	675.07	671.40	667.90	682.83
54+50.00	47.94	LT	687.51	684.39	682.64	674.48	675.18	670.55	667.05	684.26
55+00.00	51.08	LT	688.95	685.83	684.08	674.69	675.53	670.35	666.85	685.70
55+50.00	54.22	LT	690.38	687.26	685.51	674.58	675.51	671.19	667.69	687.13
56+00.00	57.36	LT	691.82	688.70	686.95	674.28	675.19	671.26	667.76	688.57
56+50.00	60.50	LT	693.25	690.13	688.38	674.10	674.89	671.23	667.73	690.00
57+00.00	63.32	LT	694.69	691.57	689.82	673.84	674.58	671.57	668.07	691.44
57+01.57-	63.38	LT	694.74	691.62	689.87	673.80	674.58	671.59	668.09	691.49
57.01.57+	63.38	LT	694.74	691.62	689.87	673.80	674.58	671.59	667.59	691.49
57+50.00	64.16	LT	696.16	693.04	691.29	673.63	674.51	672.32	668.32	692.91
57+74.17	63.79	LT	696.88	693.76	692.01	673.53	674.41	672.55	668.55	693.63
58+00.00	62.74	LT	697.67	694.55	692.80	673.44	674.28	672.77	668.77	694.42
58+50.00	58.55	LT	699.24	696.12	694.37	673.31	673.95	672.35	668.35	695.99
59+00.00	51.45	LT	700.86	697.74	695.99	673.23	674.00	671.92	667.92	697.61
59+50.00	42.29	LT	702.55	699.43	697.68	673.07	673.71	-	669.71	699.30
59+59.55	40.70	LT	702.87	699.75	698.00	673.10	673.49	-	669.49	699.62
60+00.00	34.92	LT	704.20	701.08	699.33	673.32	673.32	-	669.32	700.95
60+42.80	30.55	LT	705.51	702.39	700.64	673.70	673.80	-	669.80	702.26
60+49.56	30.05	LT	-	694.26	692.51	674.26	673.59	-	669.59	-
60+43.97 -	43.46	RT	-	694.26	692.51	673.92	680.24	-	676.24	-
60+43.97 +	43.46	RT	-	694.26	692.51	673.92	680.24	-	676.74	-
60+36.70	43.94	RT	-	702.20	700.45	673.70	681.74	-	678.24	-
60+25.00	44.53	RT	-	701.87	700.12	673.52	684.15	-	680.65	-
60+00.00	46.40	RT	-	701.10	699.35	673.52	689.31	-	685.81	-
59+75.00	48.07	RT	-	700.31	698.56	673.31	694.45	-	690.95	-
59+50.20	49.71	RT	-	699.54	697.79	675.64	699.54	-	696.04	-

- Elevation A - Top of Parapet  
 Elevation B - Top of Coping  
 Elevation C - Top of Exposed Panel Line  
 Elevation D - Existing Grade at F.F. of wall  
 Elevation E - Finished Grade at F.F. of wall  
 Elevation F - Future Finished Grade at F.F. of wall (For information only)  
 Elevation G - Theoretical Top of Leveling Pad  
 Elevation H - Toe of Parapet

**LEGEND**

Over excavation beyond the limits of Structure Excavation. This area not measured for payment. Area to be back-filled with the same material as used for Select Fill or Lightweight Cellular Concrete Fill.

- Note:
- The Precast Modular Retaining Wall supplier's internal stability design shall account for anchorage slab's bearing pressure surcharge of 1.0 ksf and horizontal sliding force of 0.67 kips/ft. of wall.
  - Horizontal dimensions are measured perpendicular to the F.F. of wall unless noted otherwise.

\* For Elevations, see Wall Elevations Table above.



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PLOT DATE = 4/29/2021	CHECKED = SDS	REVISED

**STATE OF ILLINOIS**  
**DEPARTMENT OF TRANSPORTATION**

**WALL CROSS SECTIONS AND DETAILS 1**  
**STRUCTURE NO. 058-W003**


SHEET NO. SA-03 OF SA-26 SHEETS

F.A.U. RTE.	SECTION	COUNTY	TOTAL SHEETS	SHEET NO.
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CONTRACT NO. 95893				


ILLINOIS FED. AID PROJECT

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**CROSS SECTION**  
Looking North  
(Sta. 57+01.57 to Sta. 59+50.20)

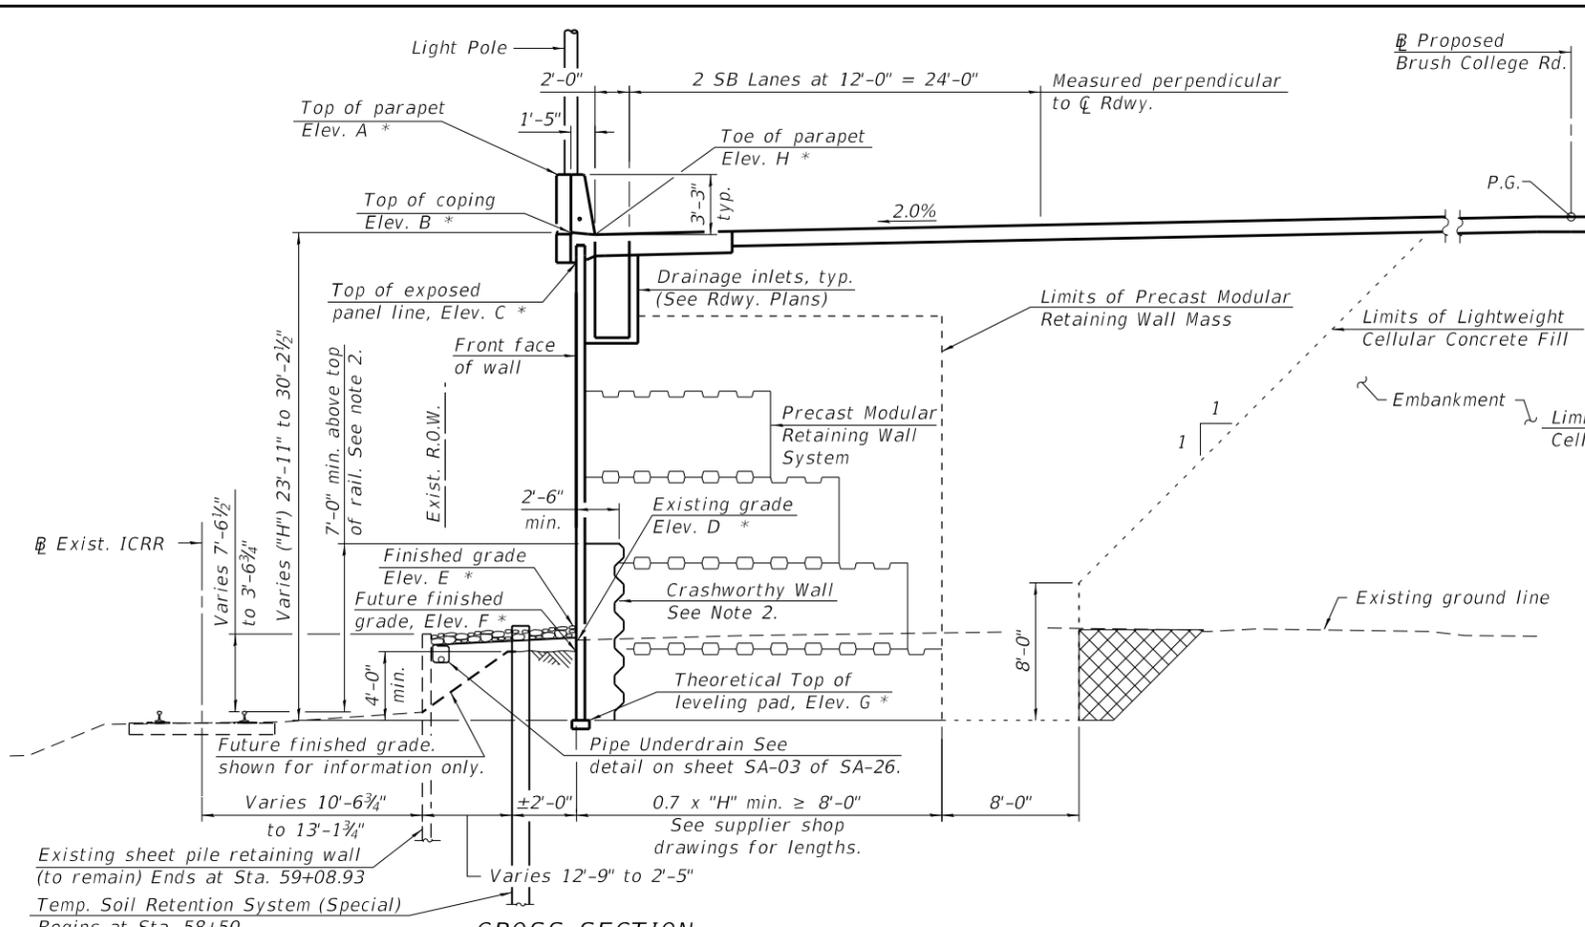


**CROSS SECTION AT ABUTMENT**  
Looking West

\* For Elevations, see Wall Elevations Table on sheet SA-03 of SA-26.

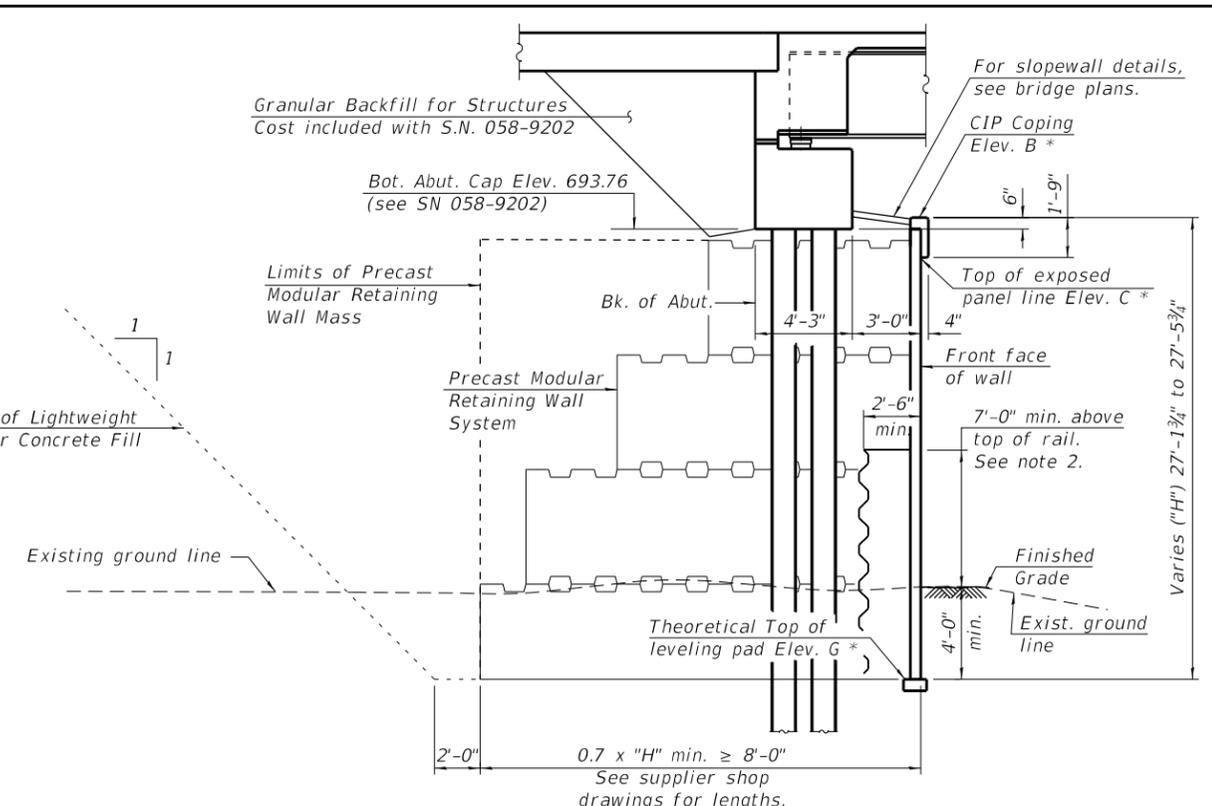**LEGEND**  
 Over excavation beyond the limits of Structure Excavation. This area not measured for payment. Area to be back-filled with the same material as used for Select Fill or Lightweight Cellular Concrete Fill.

- Note:
- The Precast Modular Retaining Wall supplier's internal stability design shall account for anchorage slab's bearing pressure surcharge of 1.0 ksf and horizontal sliding force of 0.67 kips/ft. of wall.
  - Retaining wall shall be Crashworthy per 2020 Manual for Railway Engineering from a min. of 7'-0" above top of rail down to top of leveling pad for wall within 25' of the  $\bar{C}$  existing rail from Sta. 57+01.57 Rt. to Sta. 60+49.56 Rt., see cross sections. Cost of crashworthy concrete mass paid for as Concrete Structures.
  - Horizontal dimensions are measured perpendicular to the F.F. of wall unless noted otherwise.

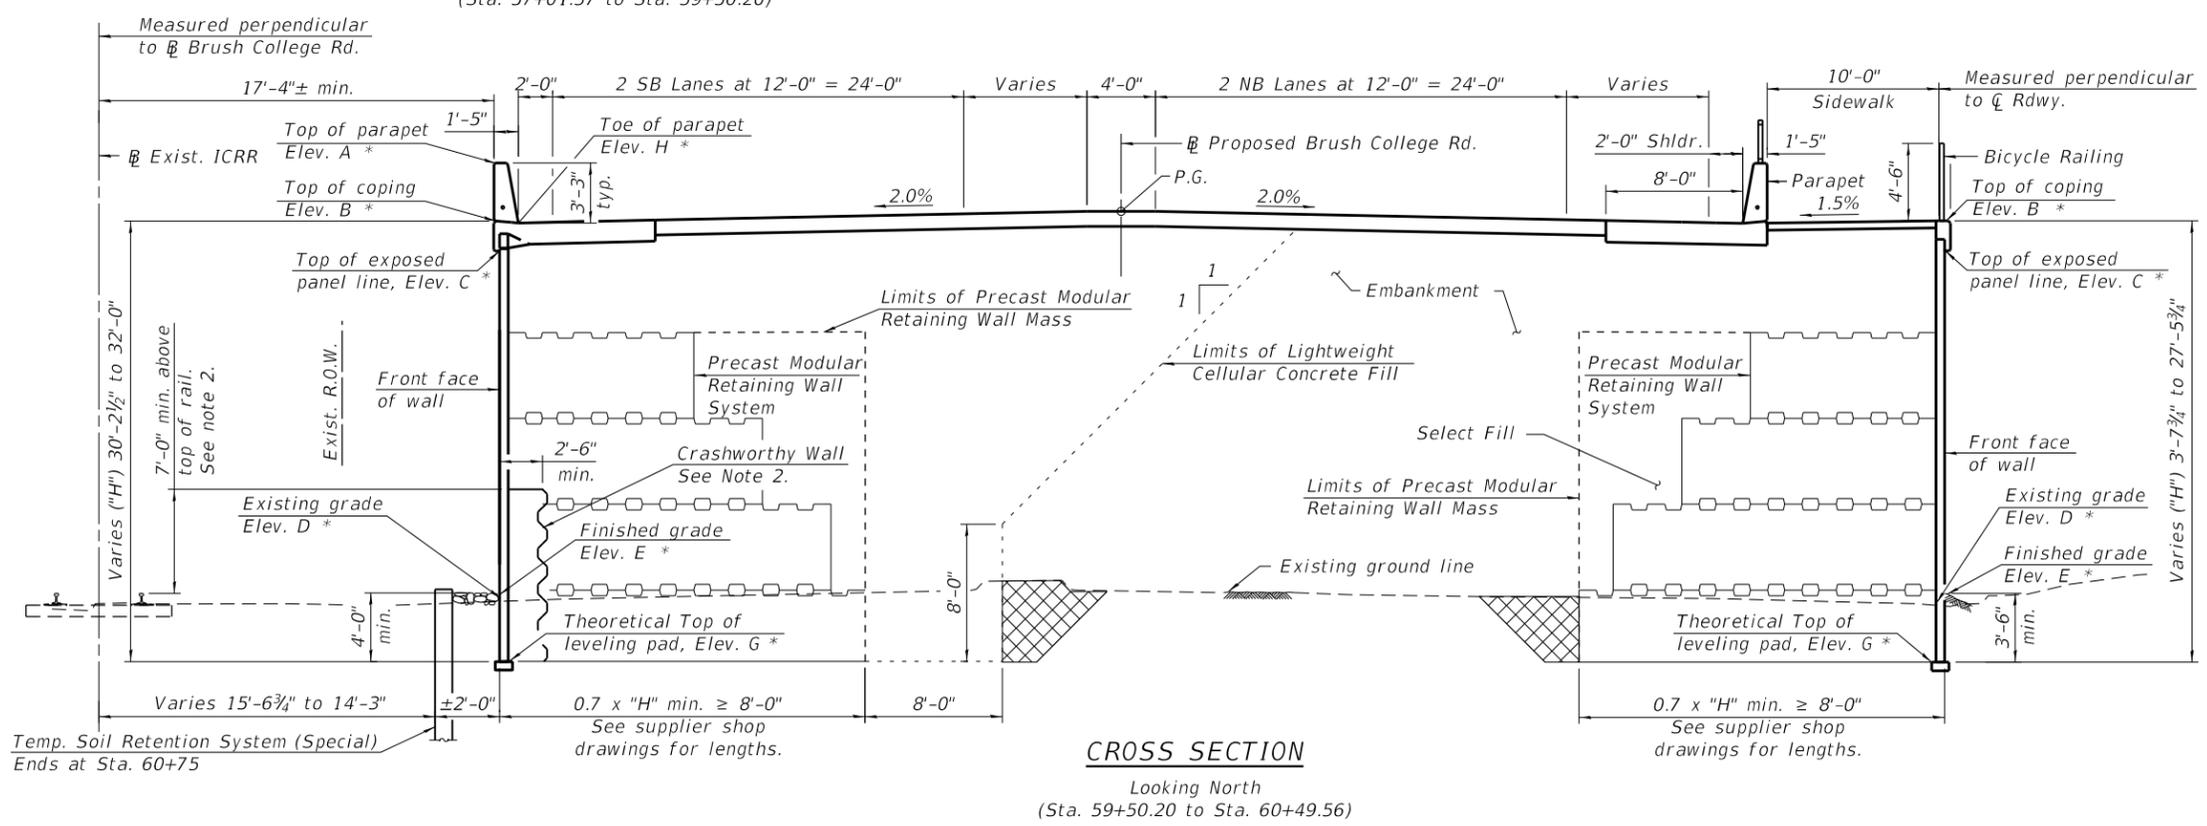

**CROSS SECTION**  
Looking North  
(Sta. 59+50.20 to Sta. 60+49.56)



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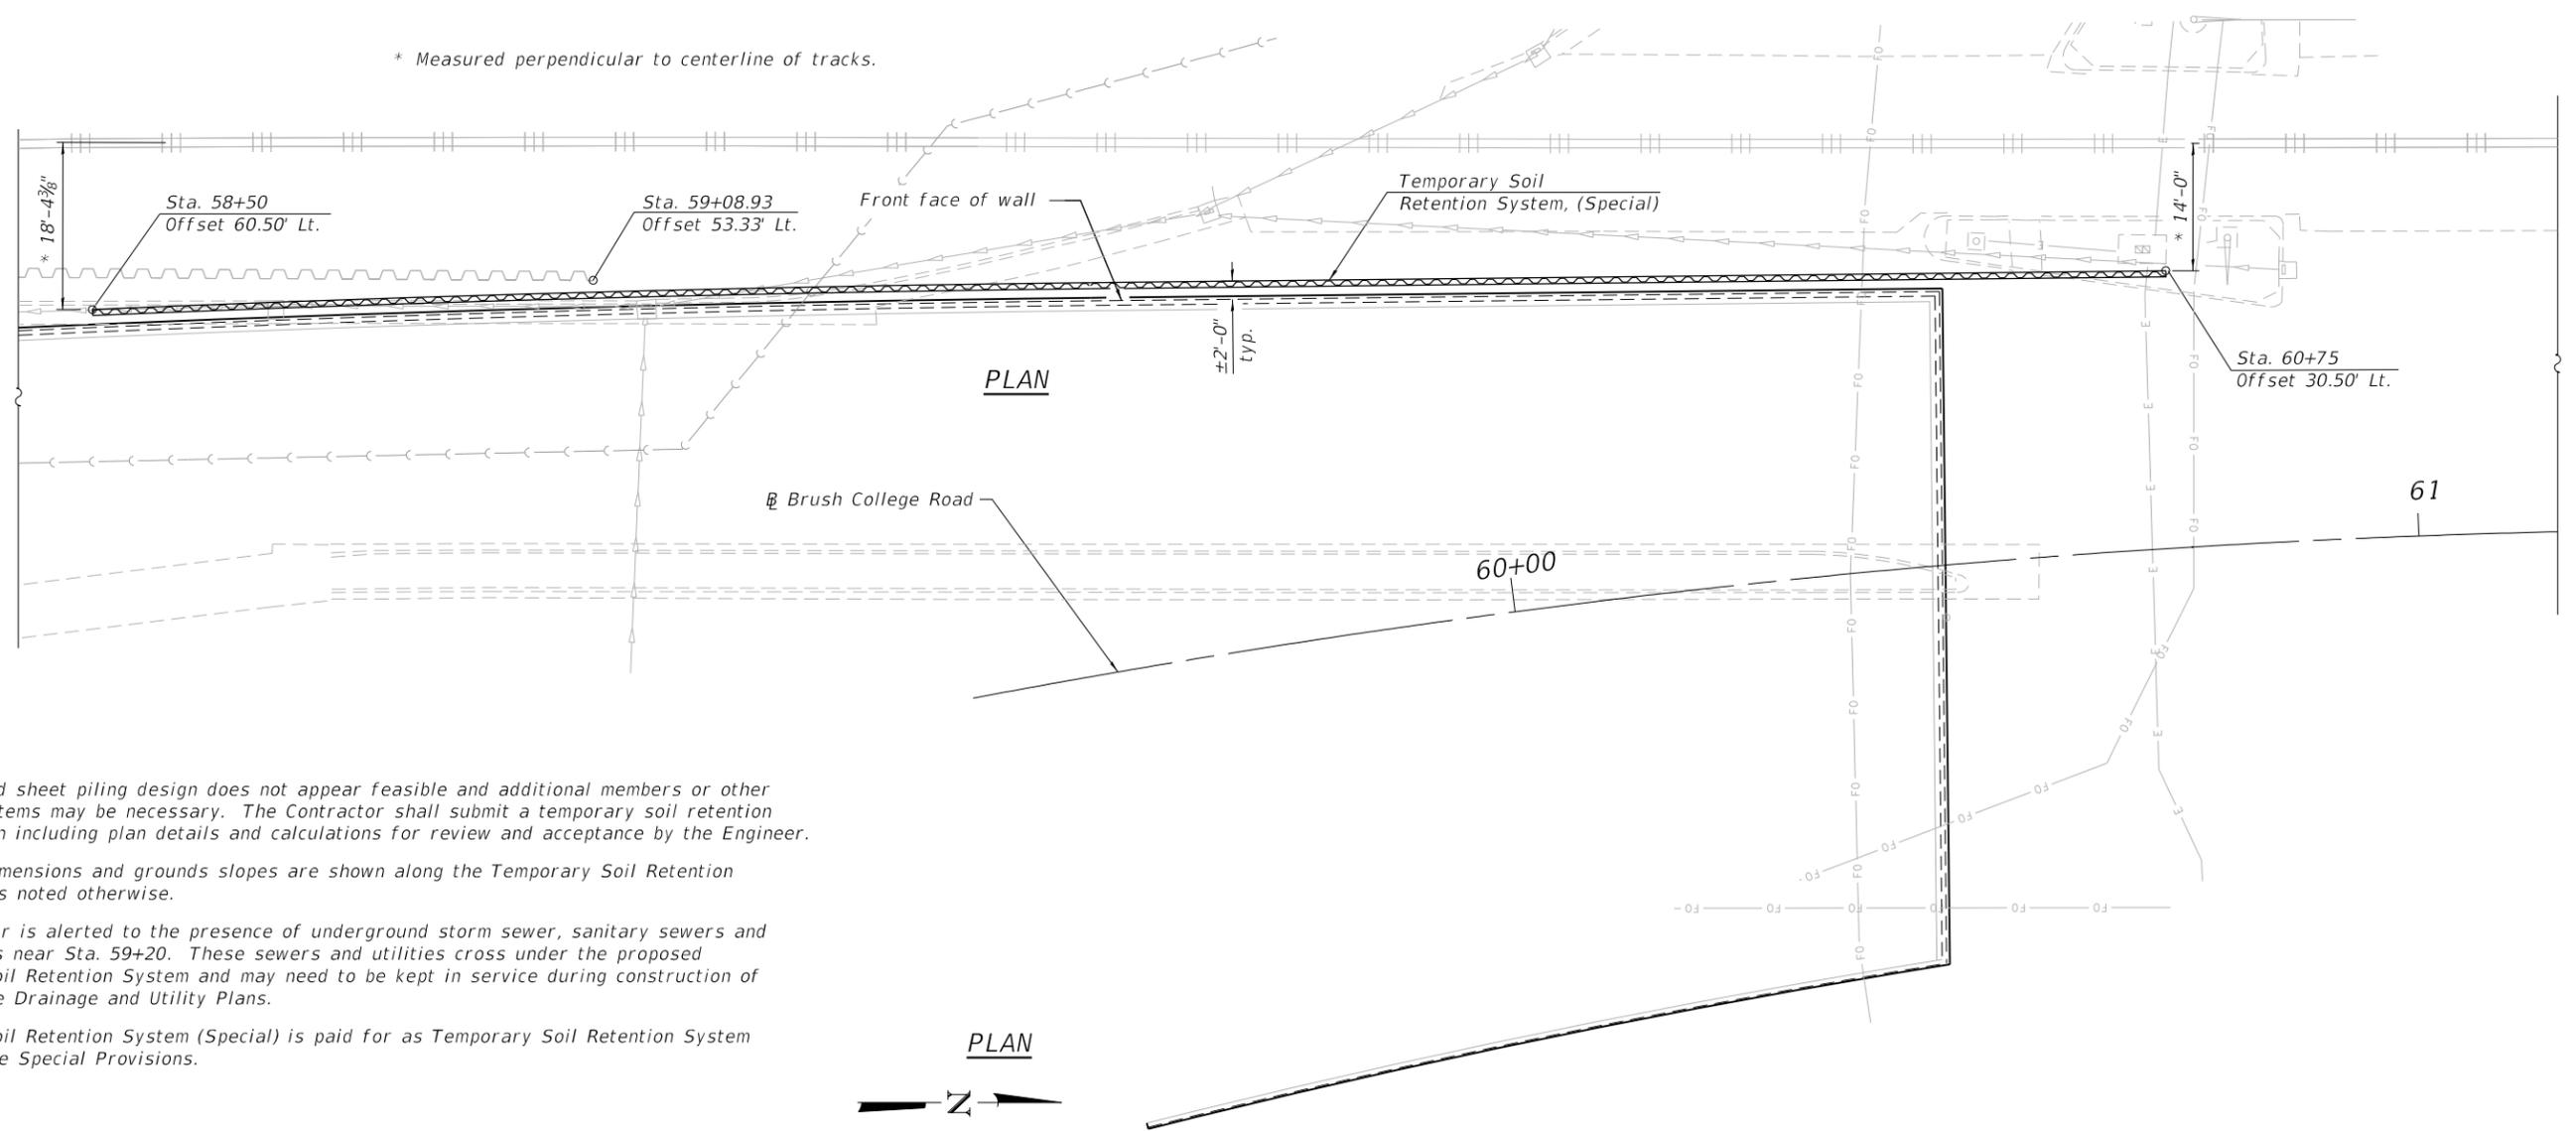
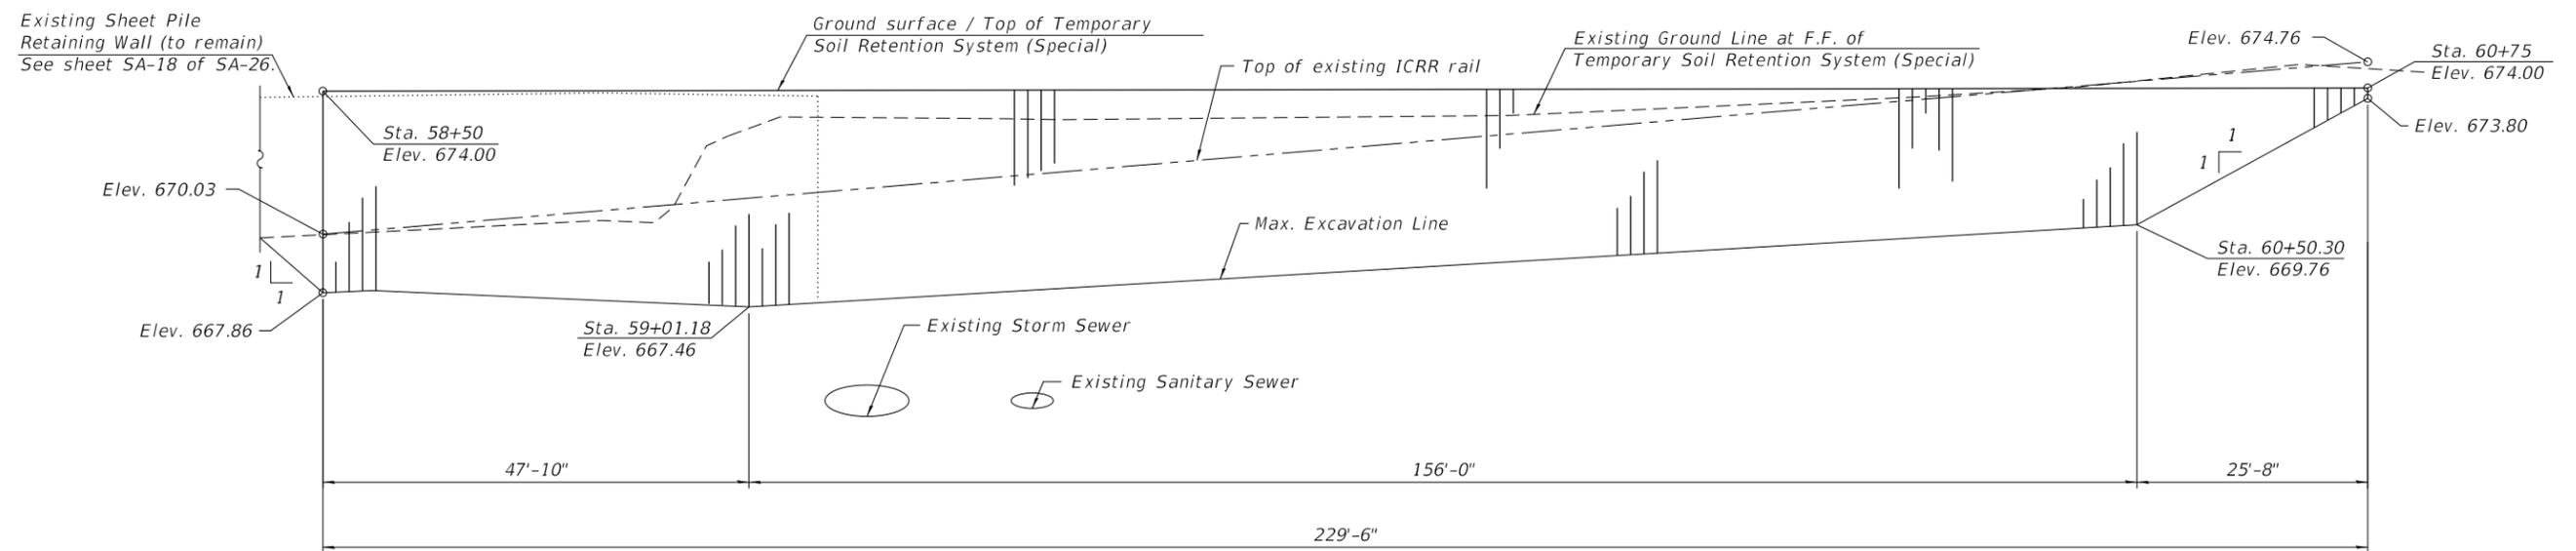
**STATE OF ILLINOIS**  
**DEPARTMENT OF TRANSPORTATION**

**WALL CROSS SECTIONS AND DETAILS 2**  
**STRUCTURE NO. 058-W003**

SHEET NO. SA-04 OF SA-26 SHEETS

F.A.U. RTE.	SECTION	COUNTY	TOTAL SHEETS	SHEET NO.
7448	09-00933-01-BR	MACON	1019	572
CONTRACT NO. 95893				
ILLINOIS FED. AID PROJECT				

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- Notes:
1. A cantilevered sheet piling design does not appear feasible and additional members or other retention systems may be necessary. The Contractor shall submit a temporary soil retention system design including plan details and calculations for review and acceptance by the Engineer.
  2. Horizontal dimensions and grounds slopes are shown along the Temporary Soil Retention System unless noted otherwise.
  3. The contractor is alerted to the presence of underground storm sewer, sanitary sewers and other utilities near Sta. 59+20. These sewers and utilities cross under the proposed Temporary Soil Retention System and may need to be kept in service during construction of the wall. See Drainage and Utility Plans.
  4. Temporary Soil Retention System (Special) is paid for as Temporary Soil Retention System (Special). See Special Provisions.



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**STATE OF ILLINOIS  
DEPARTMENT OF TRANSPORTATION**


**TEMPORARY SOIL RETENTION SYSTEM, (SPECIAL)  
STRUCTURE NO. 058-W003**

SHEET NO. SA-05 OF SA-26 SHEETS



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7448	09-00933-01-BR	MACON	1019	573
CONTRACT NO. 95893				
ILLINOIS FED. AID PROJECT				

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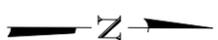
INSIDE ELEVATION OF WEST PARAPET AND ANCHORAGE SLAB

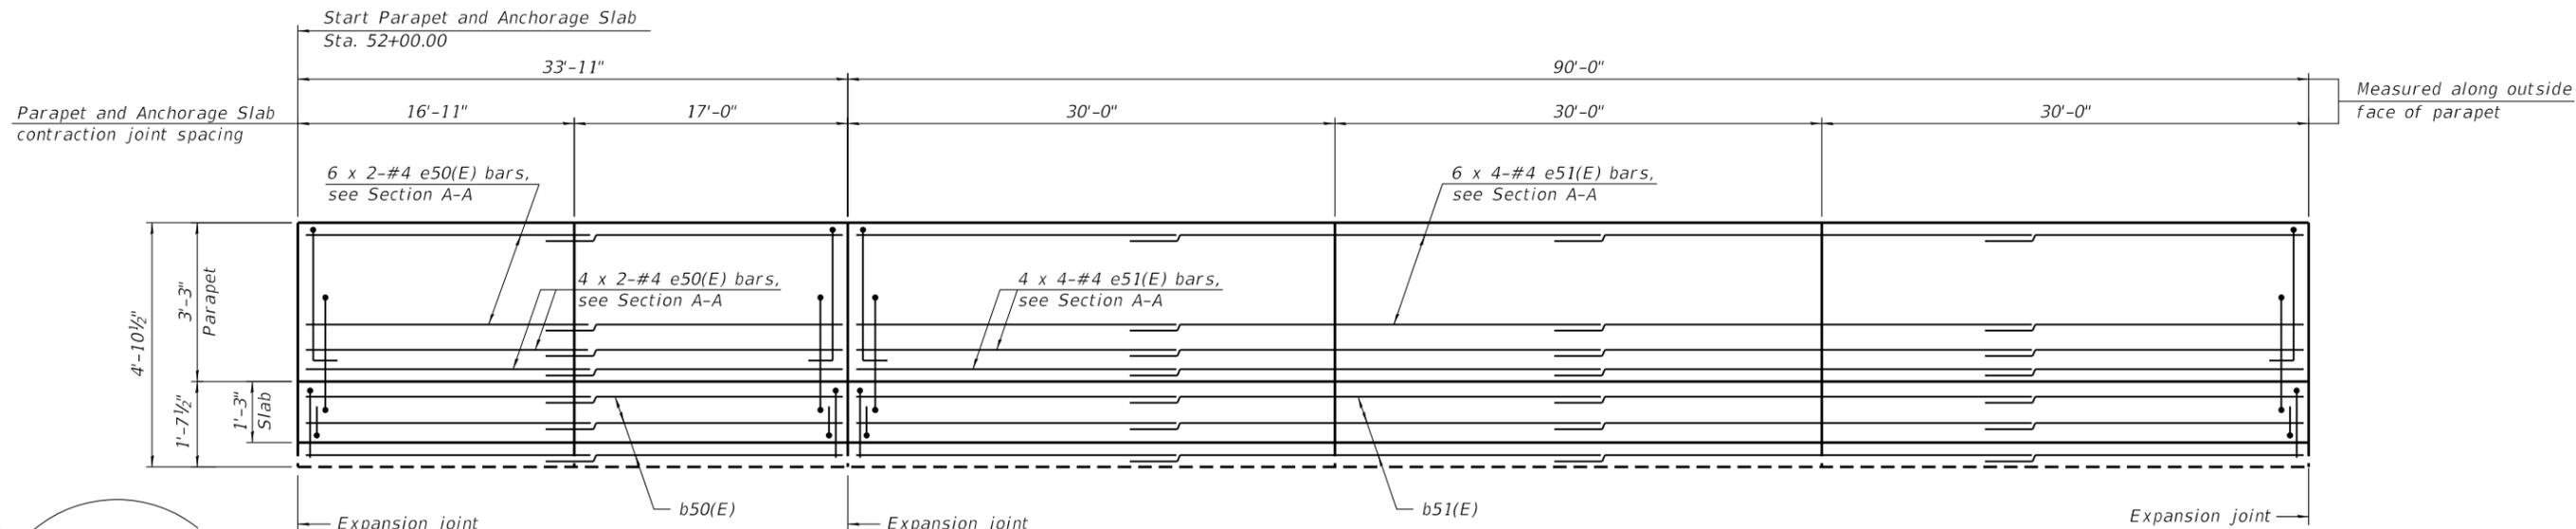

**MINIMUM BAR LAP**

- #4 bar = 2'-8"
- #5 bar = 3'-7"

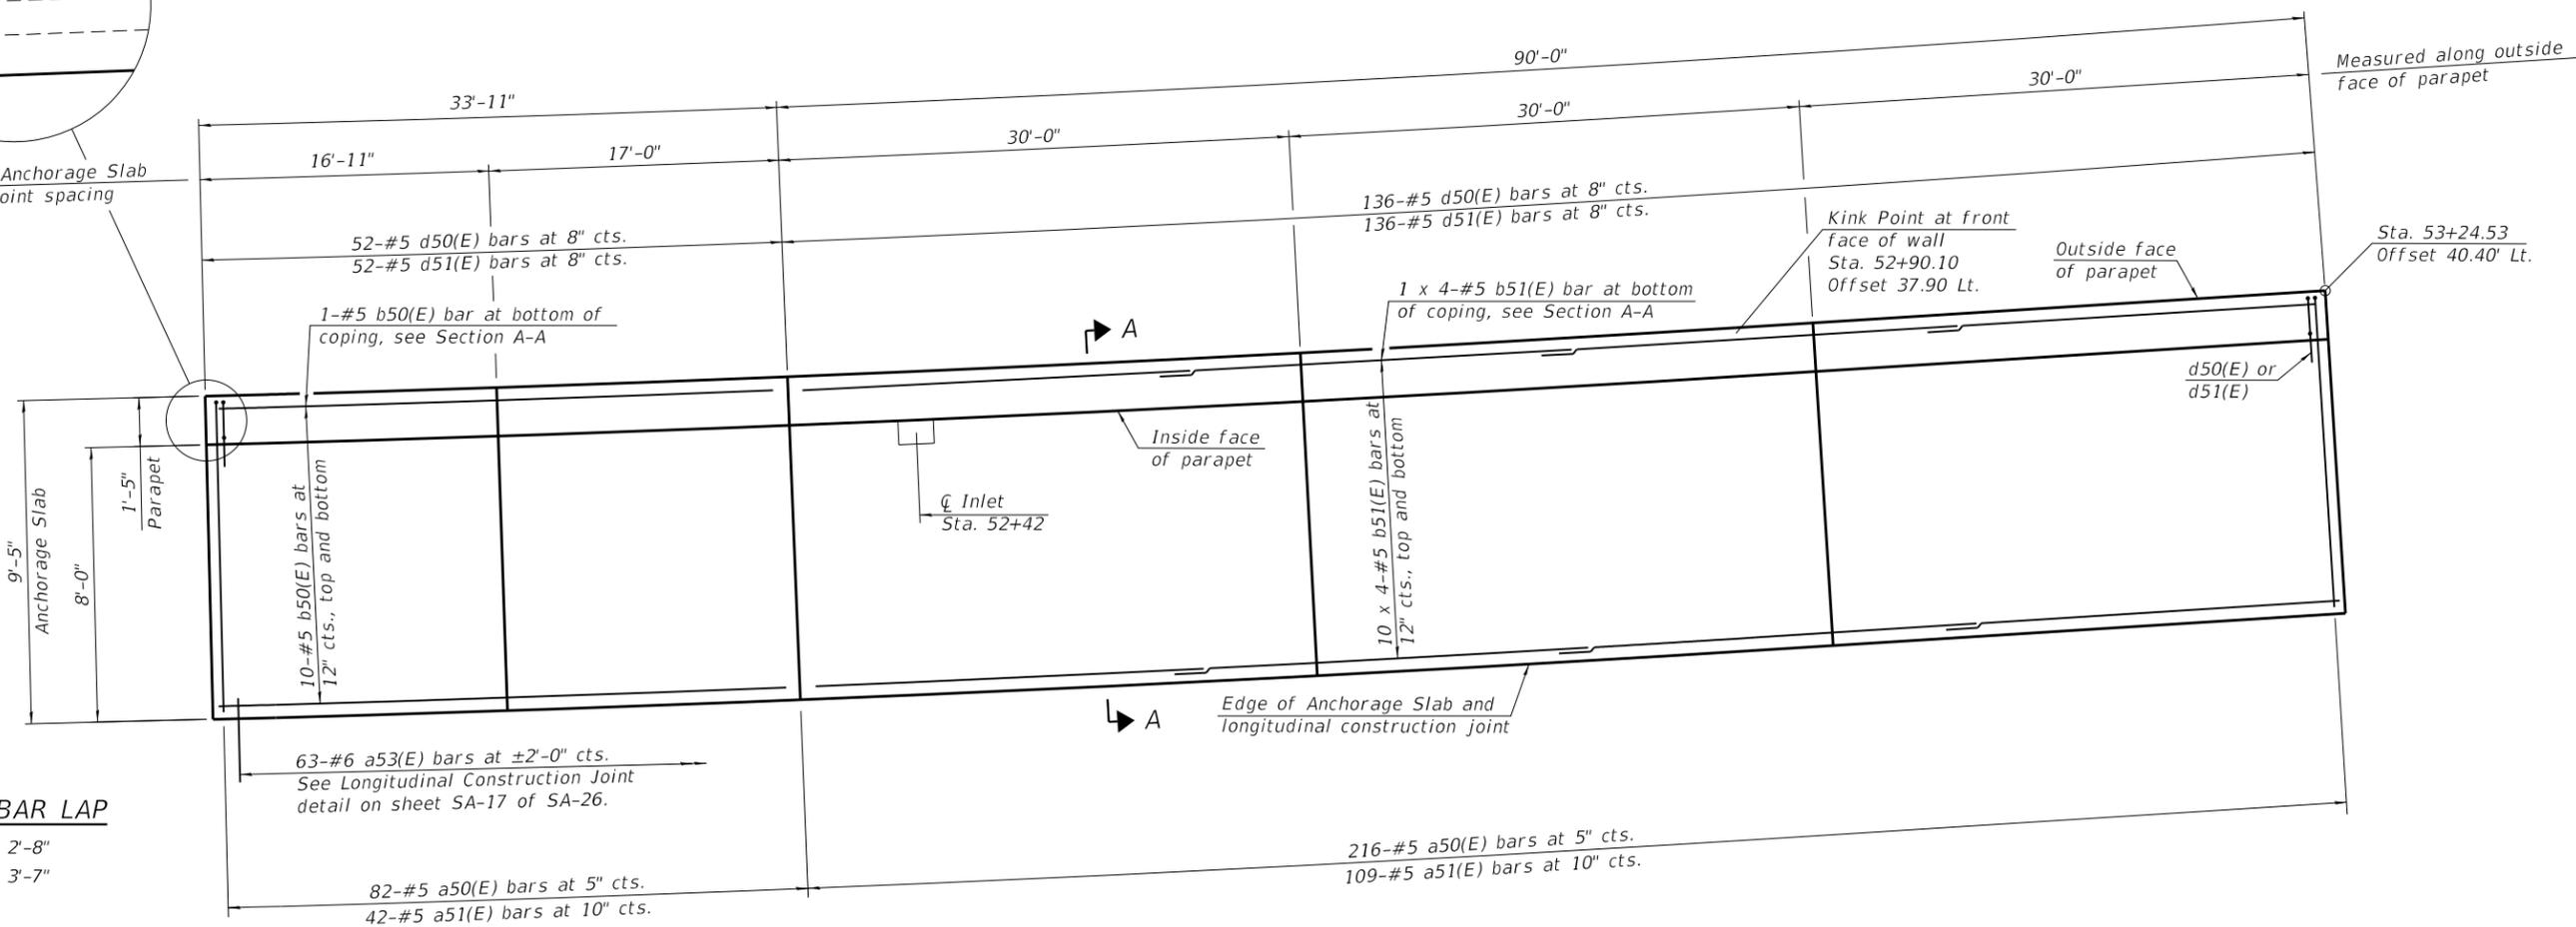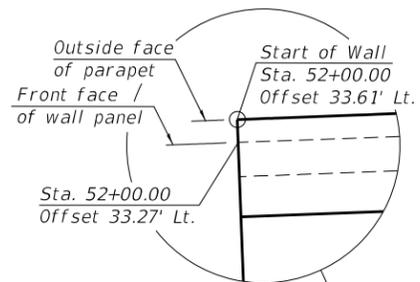- Notes:
1. For Section A-A see sheet SA-16 of SA-26.
  2. See sheet SA-16 of SA-26 for Anchorage Slab details, light pole details, parapet joint details, bar bend details and Bill of Material.
  3. Portion of Anchorage Slab within the traveled way shall be finished to match PPC pavement finish according to Section 420.09 of the Standard Specifications.
  4. For light pole, traffic signal and junction box details, see Electrical Plans.
  5. Stations and offsets are measured from Brush College Road.



WEST PARAPET AND ANCHORAGE SLAB PLAN



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PLOT SCALE = 0.167" / in.	DRAWN - DLH	REVISED
PLOT DATE = 4/29/2021	CHECKED - SDS	REVISED

STATE OF ILLINOIS  
DEPARTMENT OF TRANSPORTATION


WEST PARAPET AND ANCHORAGE SLAB PLAN AND ELEVATION 1  
STRUCTURE NO. 058-W003

SHEET NO. SA-06 OF SA-26 SHEETS


F.A.U. RTE. 7448	SECTION 09-00933-01-BR	COUNTY MACON	TOTAL SHEETS 1019	SHEET NO. 574
CONTRACT NO. 95893				

ILLINOIS FED. AID PROJECT

LAST SAVED DATE: SLASTSAVED.DATES

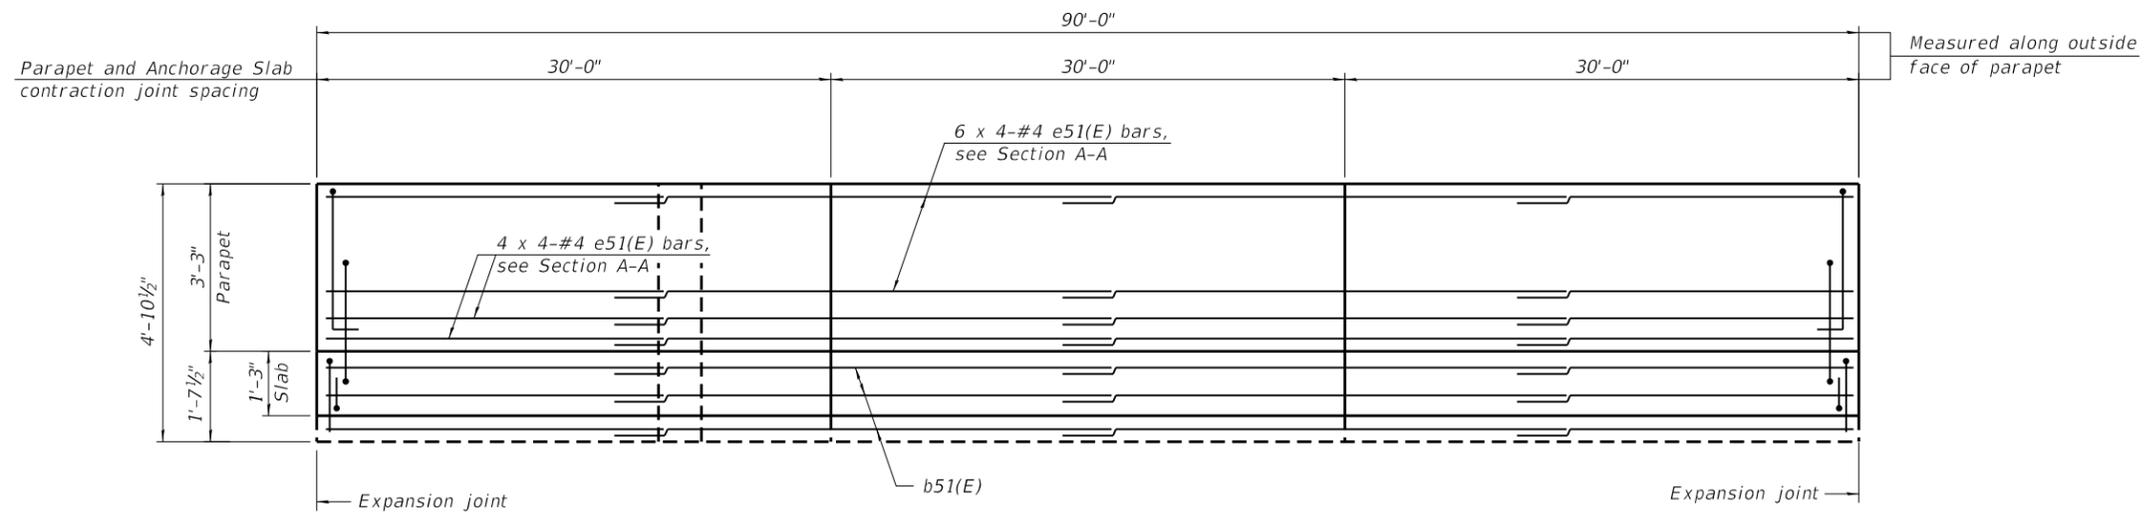

**INSIDE ELEVATION OF WEST PARAPET AND ANCHORAGE SLAB**

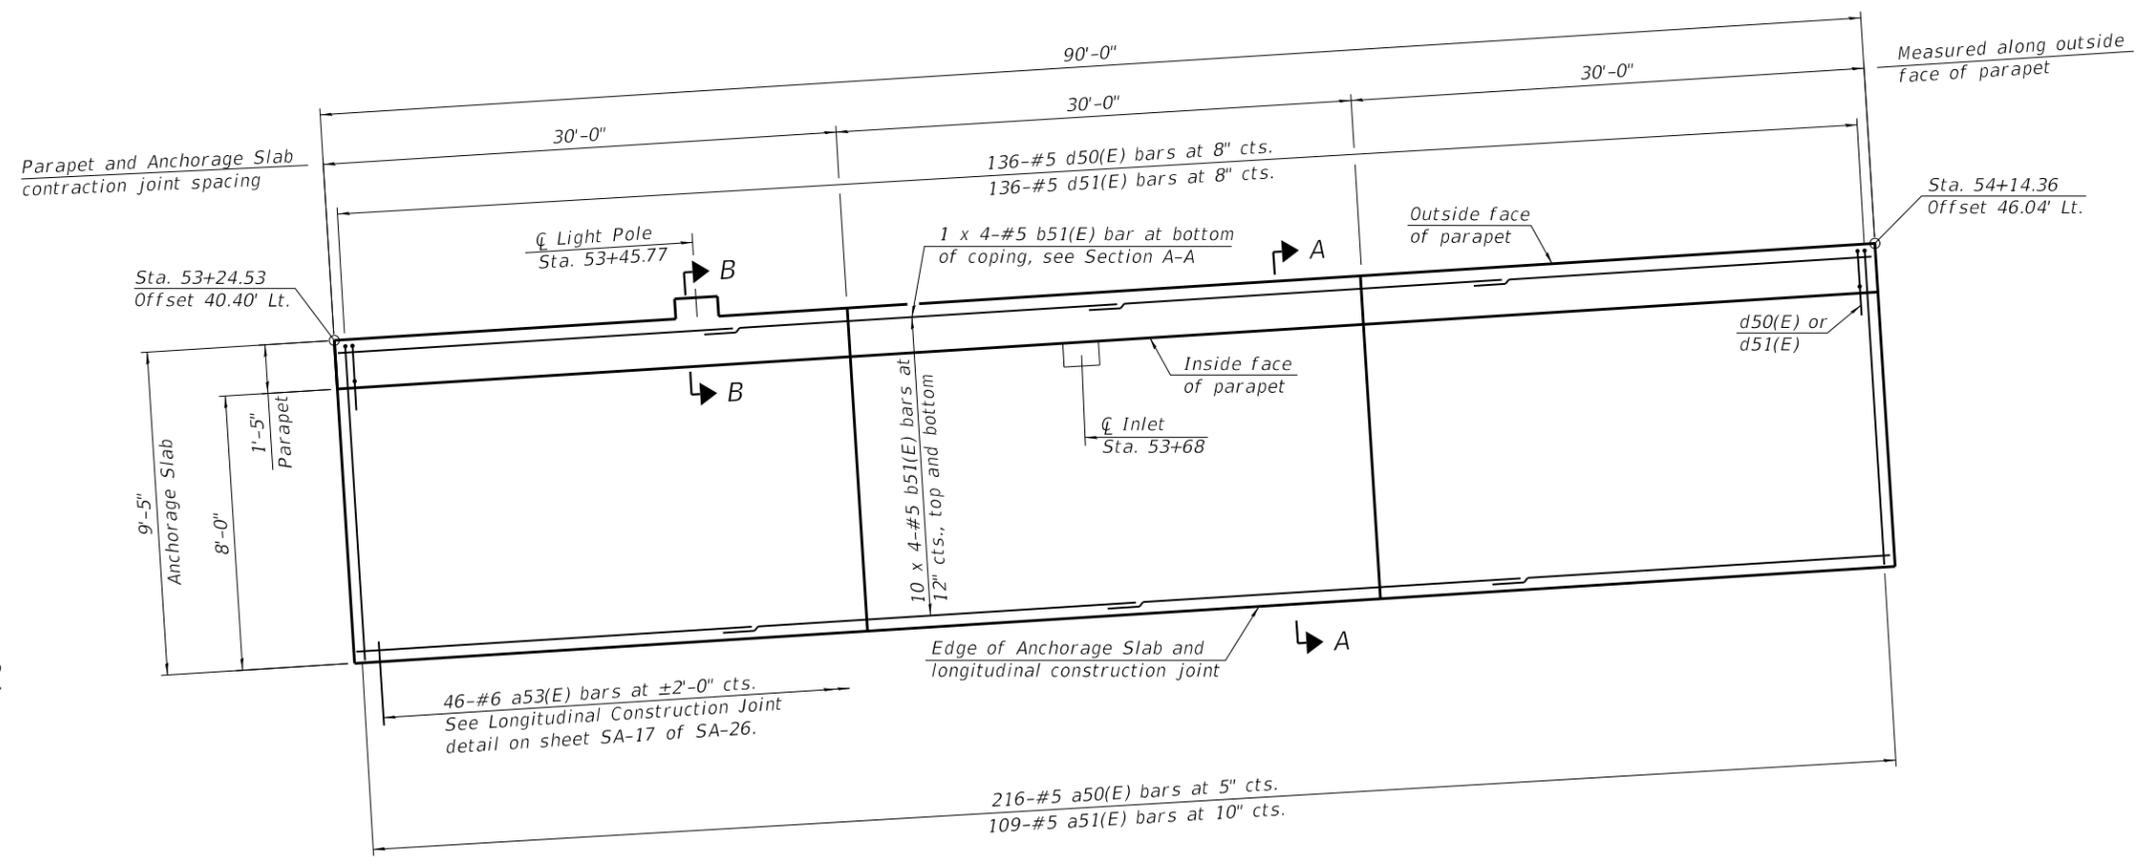


**WEST PARAPET AND ANCHORAGE SLAB PLAN**

**MINIMUM BAR LAP**

- #4 bar = 2'-8"
- #5 bar = 3'-7"

**Notes:**

1. For Section A-A and B-B see sheet SA-16 of SA-26.
2. See sheet SA-16 of SA-26 for Anchorage Slab details, light pole details, parapet joint details, bar bend details and Bill of Material.
3. Portion of Anchorage Slab within the traveled way shall be finished to match PPC pavement finish according to Section 420.09 of the Standard Specifications.
4. For light pole, traffic signal and junction box details, see Electrical Plans.
5. Stations and offsets are measured from Brush College Road.

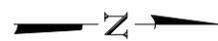

design firm  
no. 184001036



USER NAME = dheberling	DESIGNED - SDS	REVISED
FILE NAME = 60603202_SN058W003.dgn	CHECKED - CEH	REVISED
PLOT SCALE = 0.1677 / in.	DRAWN - DLH	REVISED
PLOT DATE = 4/29/2021	CHECKED - SDS	REVISED


**STATE OF ILLINOIS  
DEPARTMENT OF TRANSPORTATION**

**WEST PARAPET AND ANCHORAGE SLAB PLAN AND ELEVATION 2  
STRUCTURE NO. 058-W003**


F.A.U. RTE.	SECTION	COUNTY	TOTAL SHEETS	SHEET NO.
7448	09-00933-01-BR	MACON	1019	575
CONTRACT NO. 95893				

SHEET NO. SA-07 OF SA-26 SHEETS

ILLINOIS FED. AID PROJECT

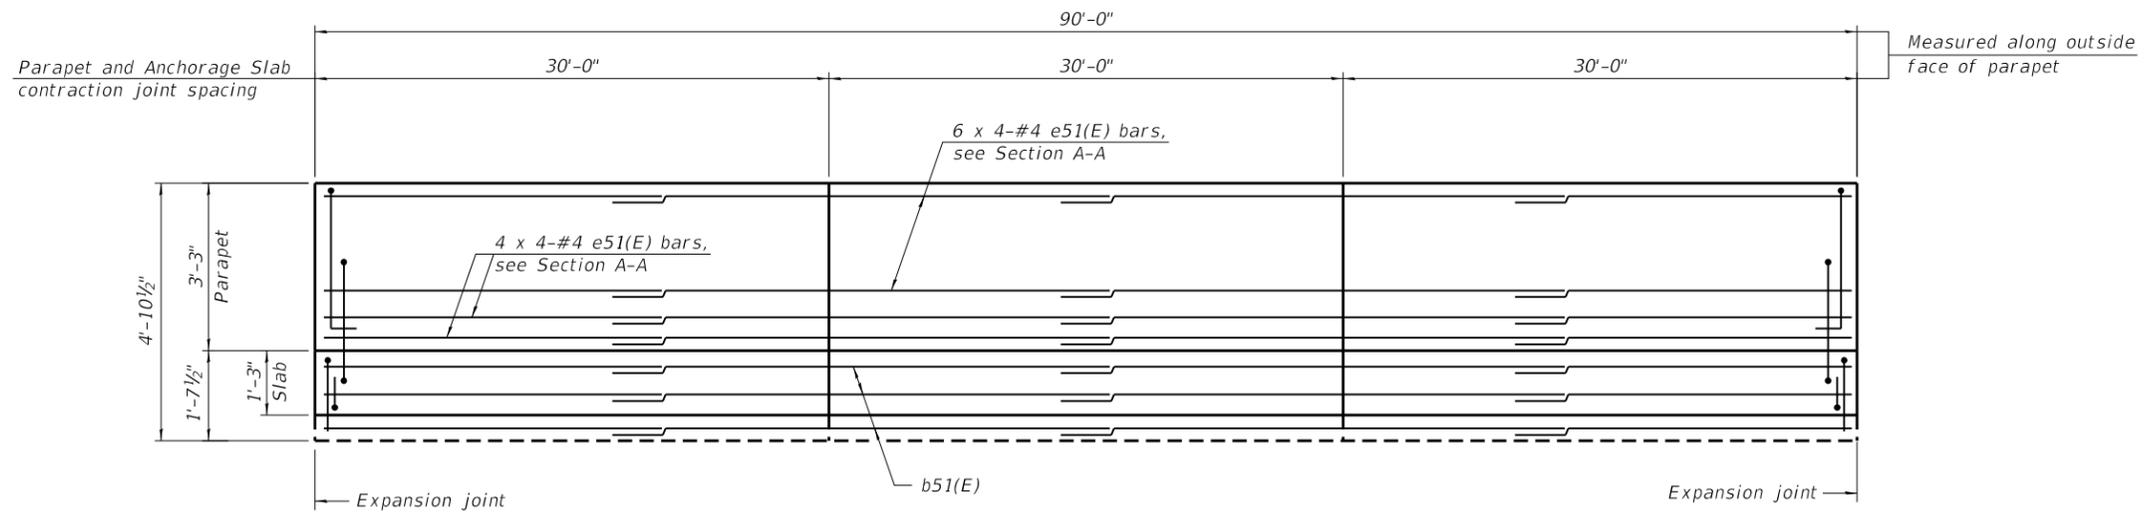

**INSIDE ELEVATION OF WEST PARAPET AND ANCHORAGE SLAB**

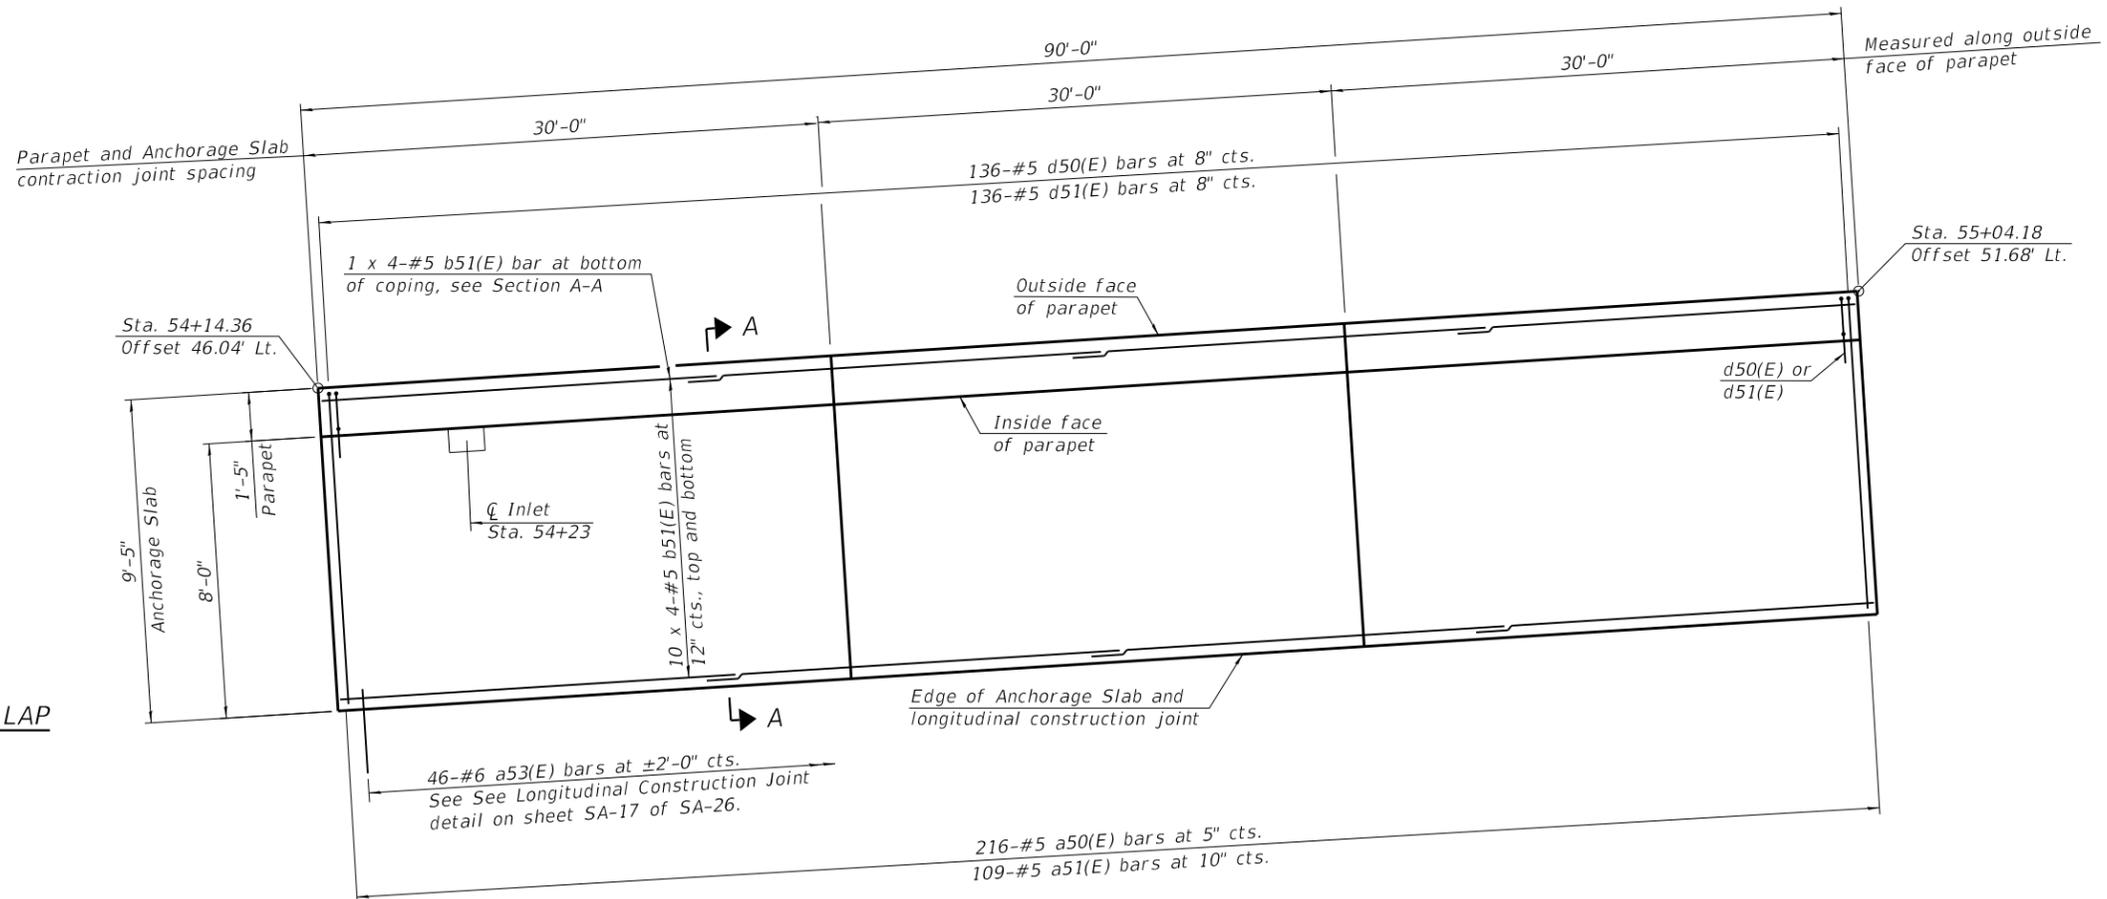

**WEST PARAPET AND ANCHORAGE SLAB PLAN**

**MINIMUM BAR LAP**


- #4 bar = 2'-8"
- #5 bar = 3'-7"

**Notes:**


1. For Section A-A see sheet SA-16 of SA-26.
2. See sheet SA-16 of SA-26 for Anchorage Slab details, light pole details, parapet joint details, bar bend details and Bill of Material.
3. Portion of Anchorage Slab within the traveled way shall be finished to match PPC pavement finish according to Section 420.09 of the Standard Specifications.
4. For light pole, traffic signal and junction box details, see Electrical Plans.
5. Stations and offsets are measured from  $\square$  Brush College Road.

USER NAME = dheberling	DESIGNED - SDS	REVISED
FILE NAME = 60603202_S058W003.dgn	CHECKED - CEH	REVISED
PLOT SCALE = 0.1677 / in.	DRAWN - DLH	REVISED
PLOT DATE = 4/29/2021	CHECKED - SDS	REVISED

F.A.U. RTE.	SECTION	COUNTY	TOTAL SHEETS	SHEET NO.
7448	09-00933-01-BR	MACON	1019	576
				CONTRACT NO. 95893

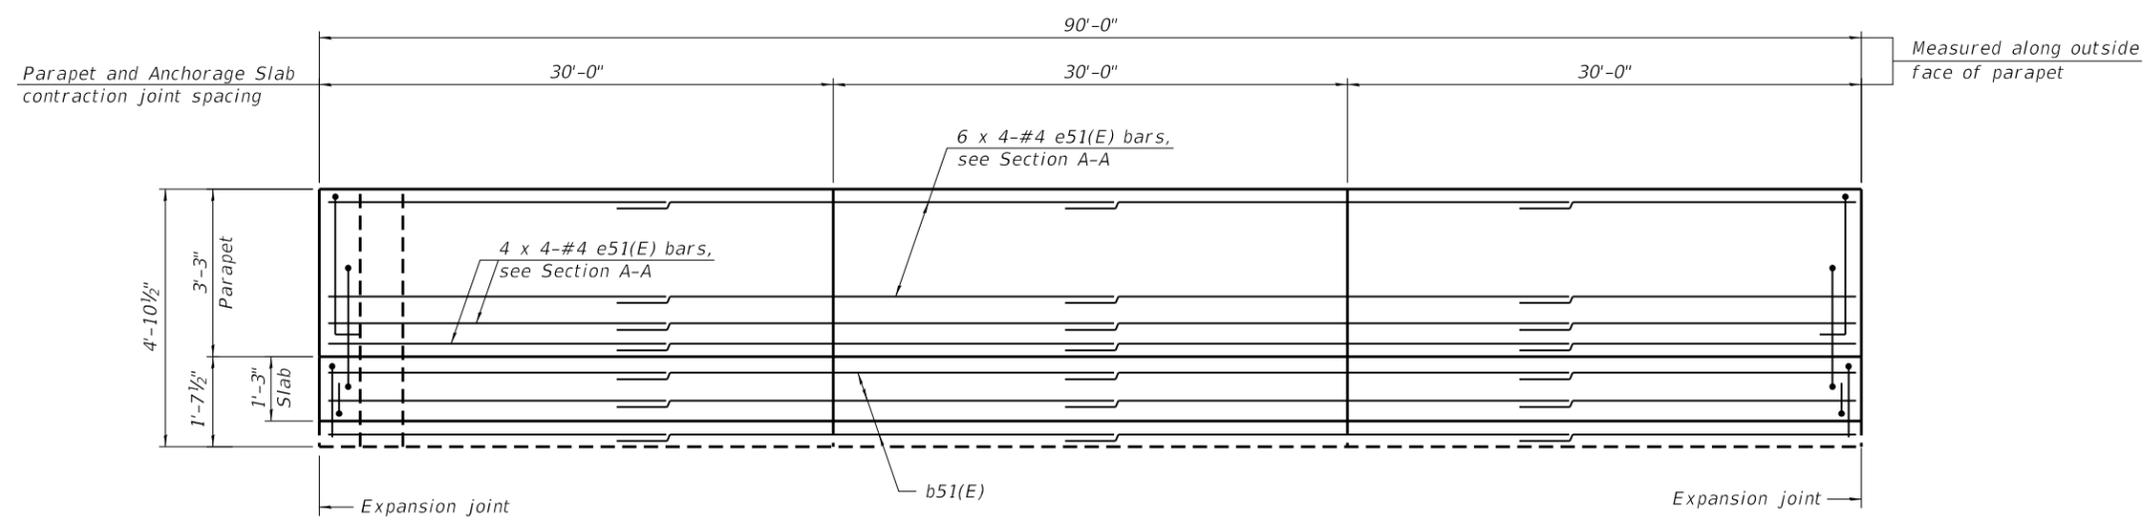

**INSIDE ELEVATION OF WEST PARAPET AND ANCHORAGE SLAB**

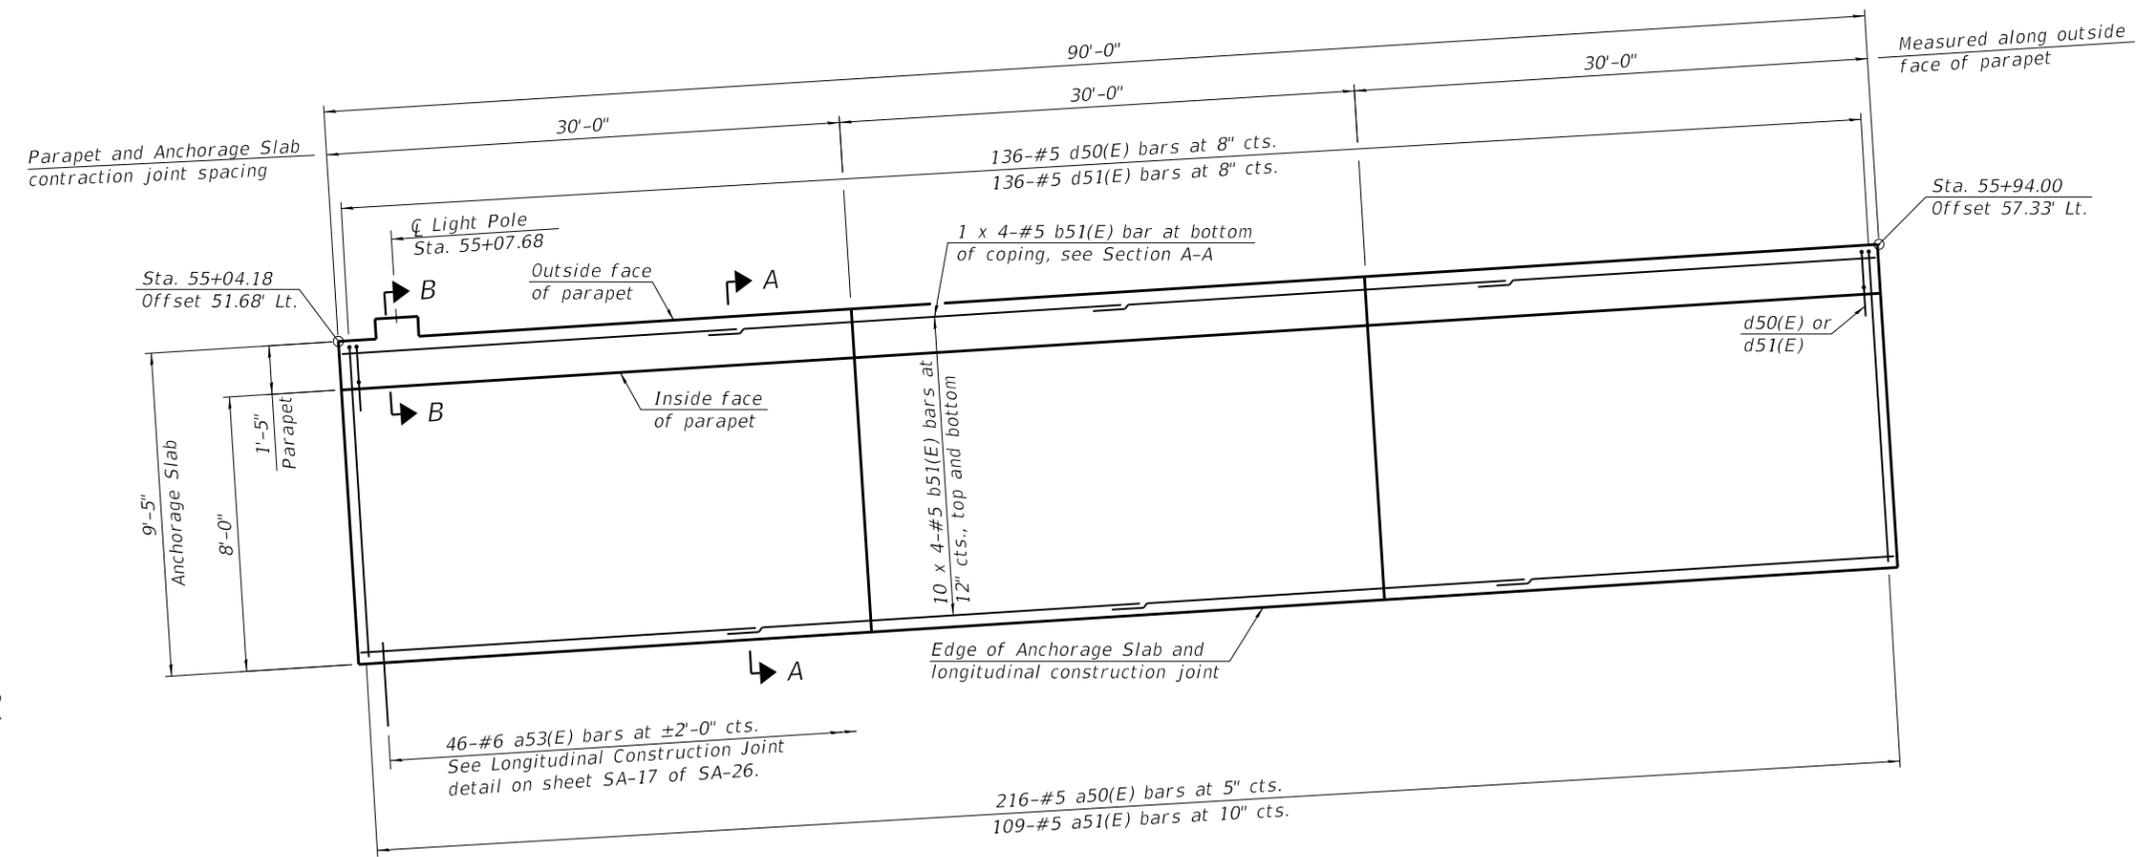


**WEST PARAPET AND ANCHORAGE SLAB PLAN**

**MINIMUM BAR LAP**

- #4 bar = 2'-8"
- #5 bar = 3'-7"

**Notes:**


1. For Section A-A and B-B see sheet SA-16 of SA-26.
2. See sheet SA-16 of SA-26 for Anchorage Slab details, light pole details, parapet joint details, bar bend details and Bill of Material.
3. Portion of Anchorage Slab within the traveled way shall be finished to match PPC pavement finish according to Section 420.09 of the Standard Specifications.
4. For light pole, traffic signal and junction box details, see Electrical Plans.
5. Stations and offsets are measured from Brush College Road.

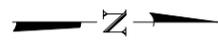


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PLOT DATE = 4/29/2021	CHECKED - SDS	REVISED

F.A.U. RTE.	SECTION	COUNTY	TOTAL SHEETS	SHEET NO.
7448	09-00933-01-BR	MACON	1019	577
CONTRACT NO. 95893				

LAST SAVED DATE: SLASTSAVED.DATES

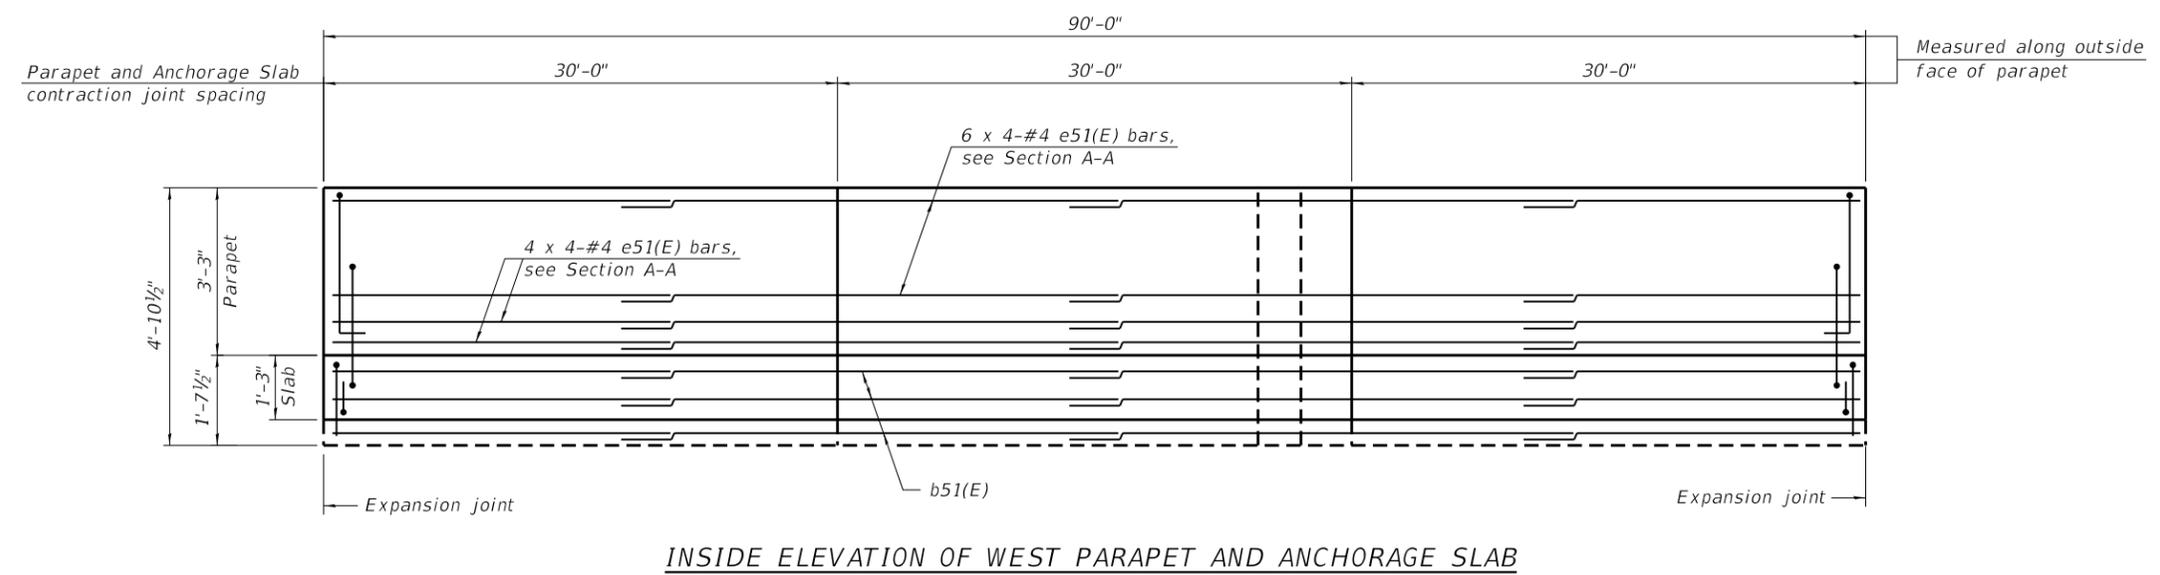

**INSIDE ELEVATION OF WEST PARAPET AND ANCHORAGE SLAB**

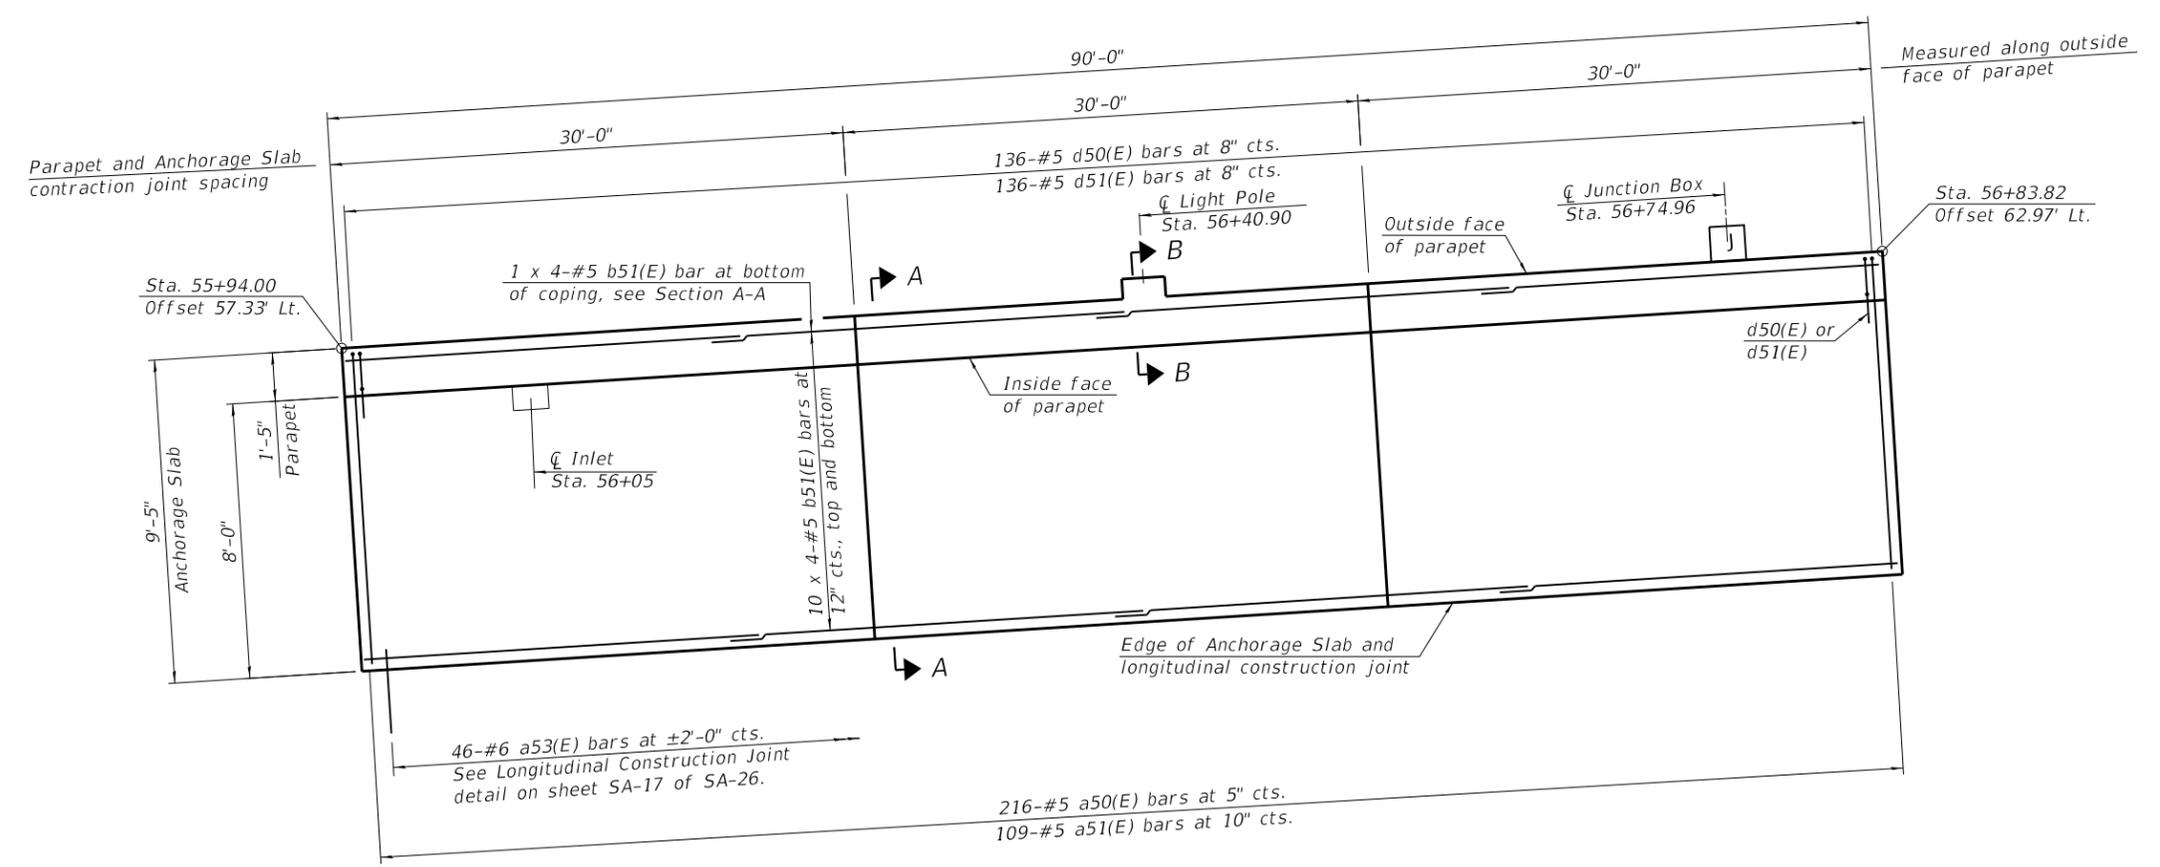


**WEST PARAPET AND ANCHORAGE SLAB PLAN**

**MINIMUM BAR LAP**

- #4 bar = 2'-8"
- #5 bar = 3'-7"

- Notes:
1. For Section A-A and B-B see sheet SA-16 of SA-26.
  2. See sheet SA-16 of SA-26 for Anchorage Slab details, light pole details, parapet joint details, bar bend details and Bill of Material.
  3. Portion of Anchorage Slab within the traveled way shall be finished to match PPC pavement finish according to Section 420.09 of the Standard Specifications.
  4. For light pole, traffic signal and junction box details, see Electrical Plans.
  5. Stations and offsets are measured from Brush College Road.

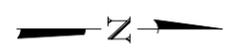

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PLOT DATE = 4/29/2021	CHECKED - SDS	REVISED

**STATE OF ILLINOIS  
DEPARTMENT OF TRANSPORTATION**


**WEST PARAPET AND ANCHORAGE SLAB PLAN AND ELEVATION 5  
STRUCTURE NO. 058-W003**

SHEET NO. SA-10 OF SA-26 SHEETS


F.A.U. RTE.	SECTION	COUNTY	TOTAL SHEETS	SHEET NO.
7448	09-00933-01-BR	MACON	1019	578
				CONTRACT NO. 95893

ILLINOIS FED. AID PROJECT

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**INSIDE ELEVATION OF WEST PARAPET AND ANCHORAGE SLAB**

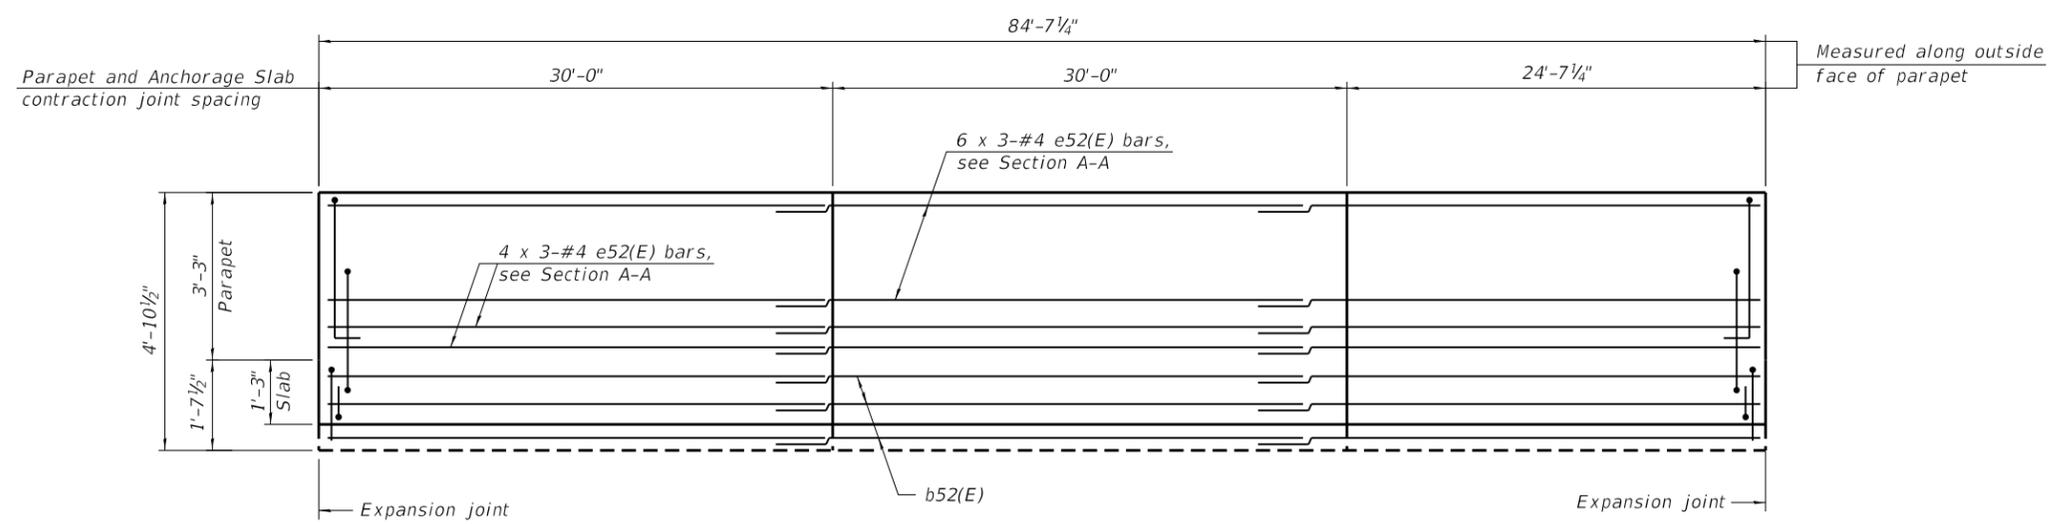


**WEST PARAPET AND ANCHORAGE SLAB PLAN**

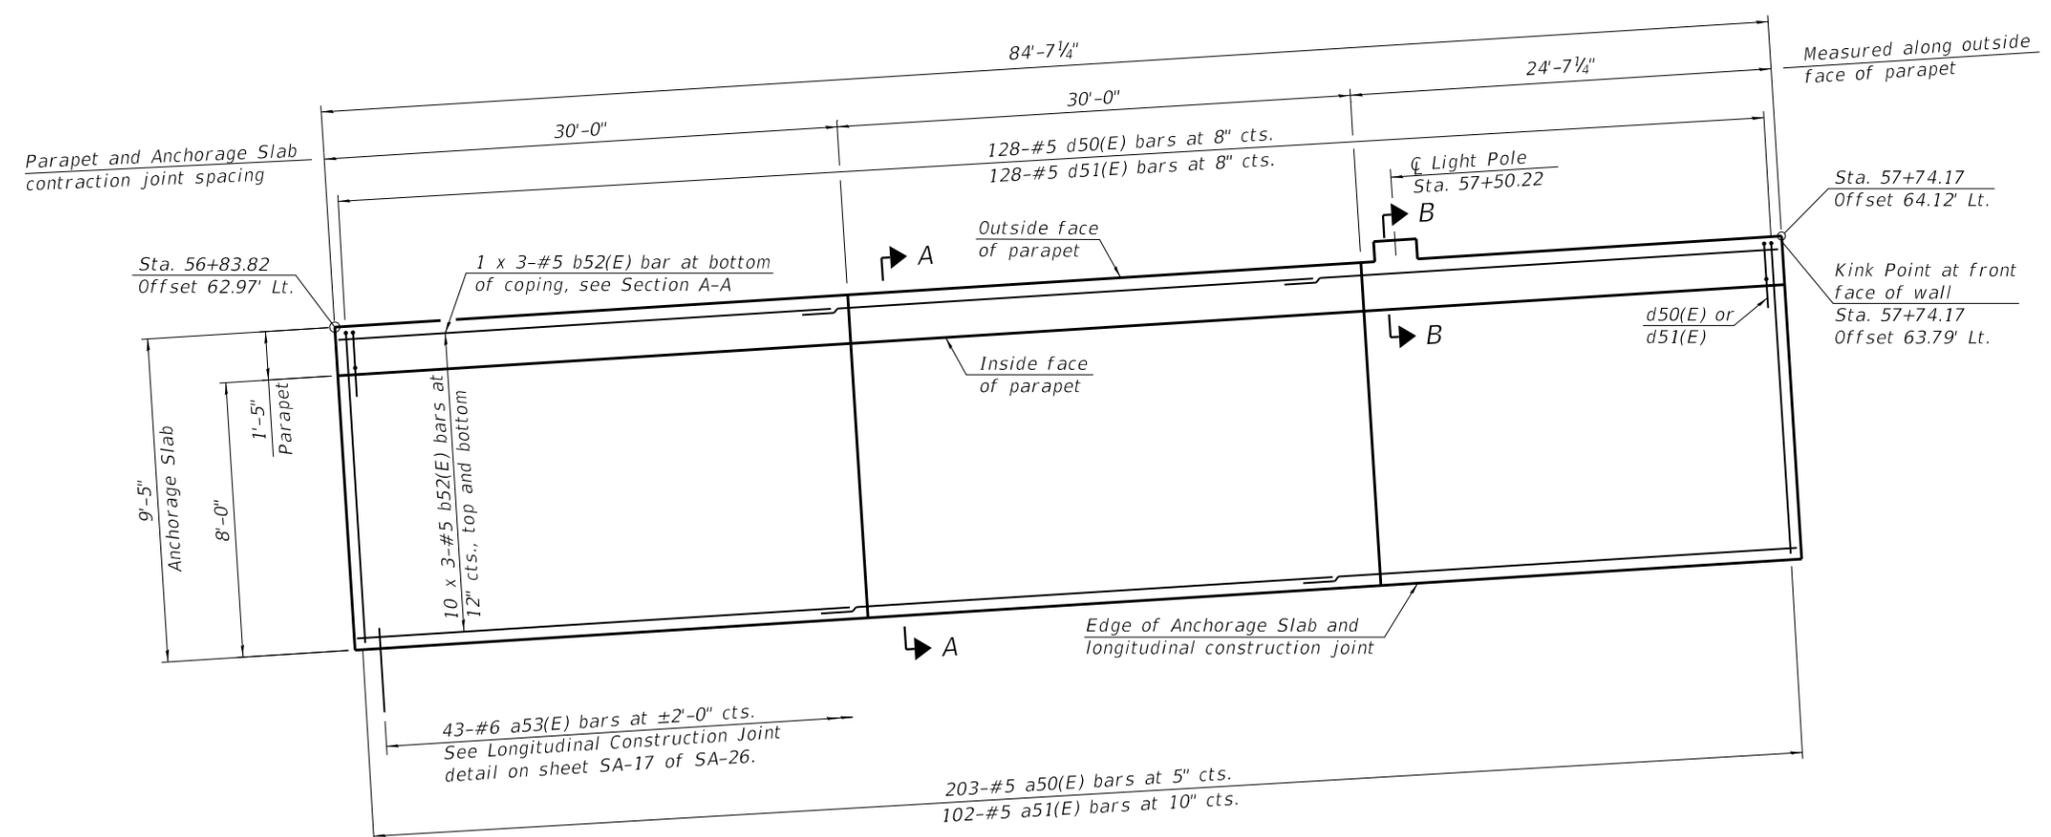**MINIMUM BAR LAP**

- #4 bar = 2'-8"
- #5 bar = 3'-7"

**Notes:**



1. For Section A-A and B-B see sheet SA-16 of SA-26.
2. See sheet SA-16 of SA-26 for Anchorage Slab details, light pole details, parapet joint details, bar bend details and Bill of Material.
3. Portion of Anchorage Slab within the traveled way shall be finished to match PPC pavement finish according to Section 420.09 of the Standard Specifications.
4. For light pole, traffic signal and junction box details, see Electrical Plans.
5. Stations and offsets are measured from  $\text{B}$  Brush College Road.

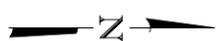

USER NAME = dheberling	DESIGNED - SDS	REVISED
FILE NAME = 60603202_SNO58W003.dgn	CHECKED - CEH	REVISED
PLOT SCALE = 0.167" / in.	DRAWN - DLH	REVISED
PLOT DATE = 4/29/2021	CHECKED - SDS	REVISED

F.A.U. RTE.	SECTION	COUNTY	TOTAL SHEETS	SHEET NO.
7448	09-00933-01-BR	MACON	1019	579
<b>CONTRACT NO. 95893</b>				



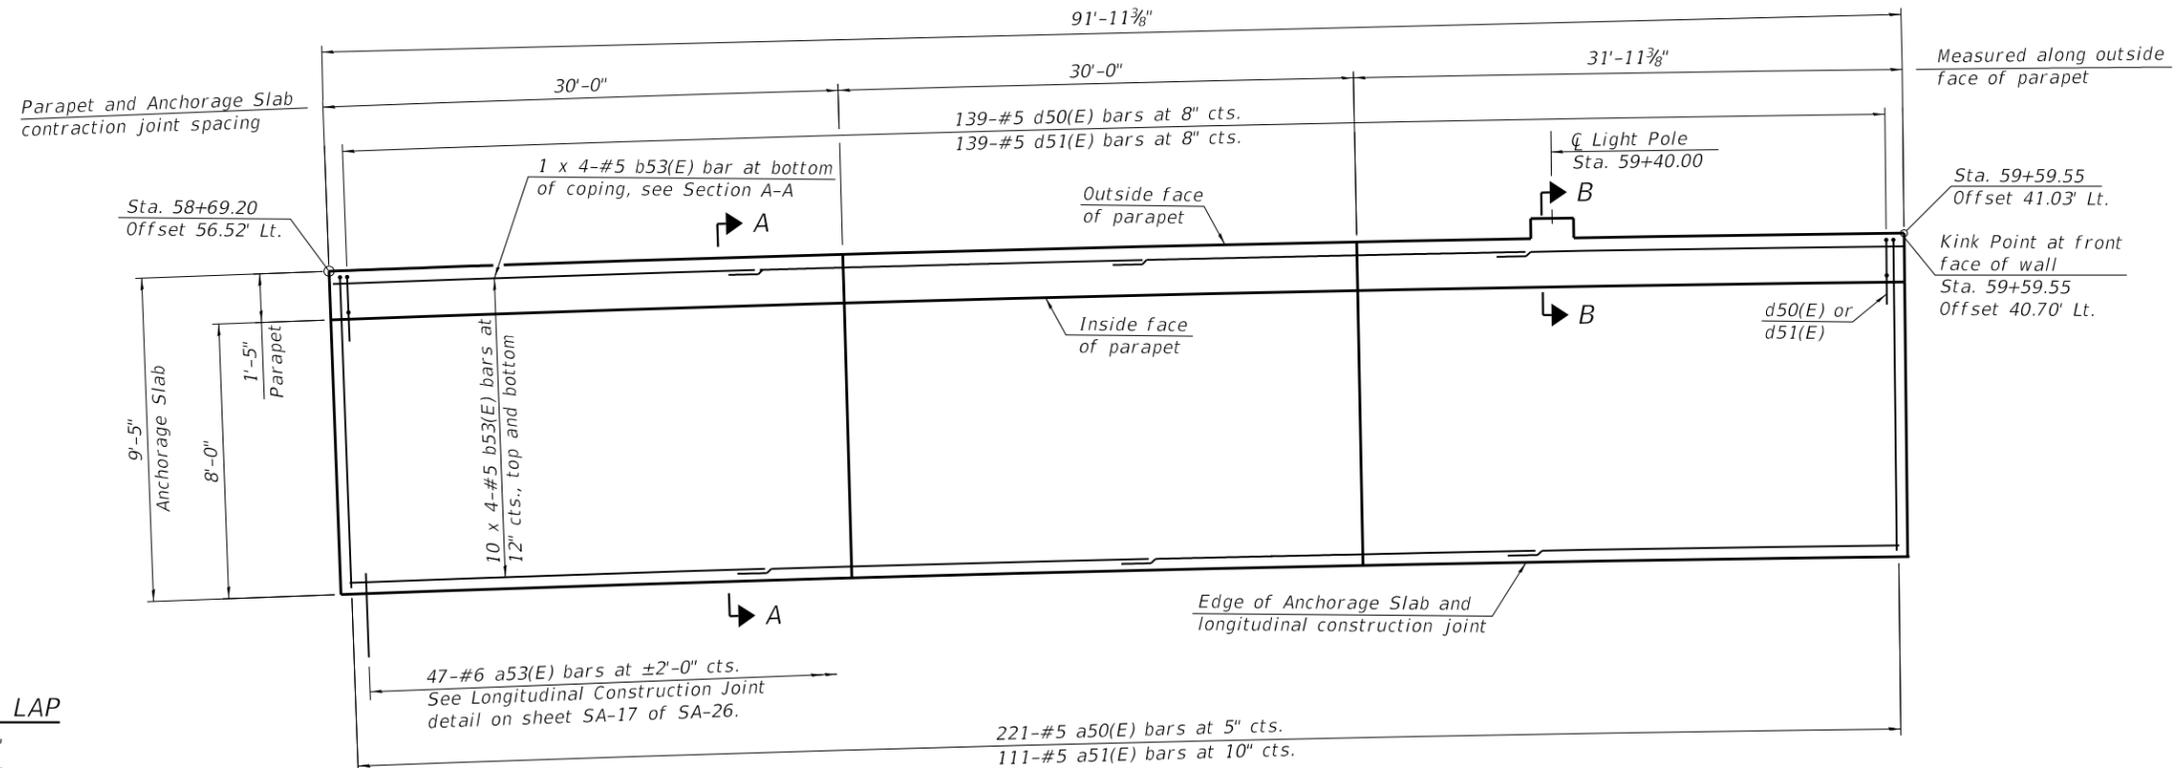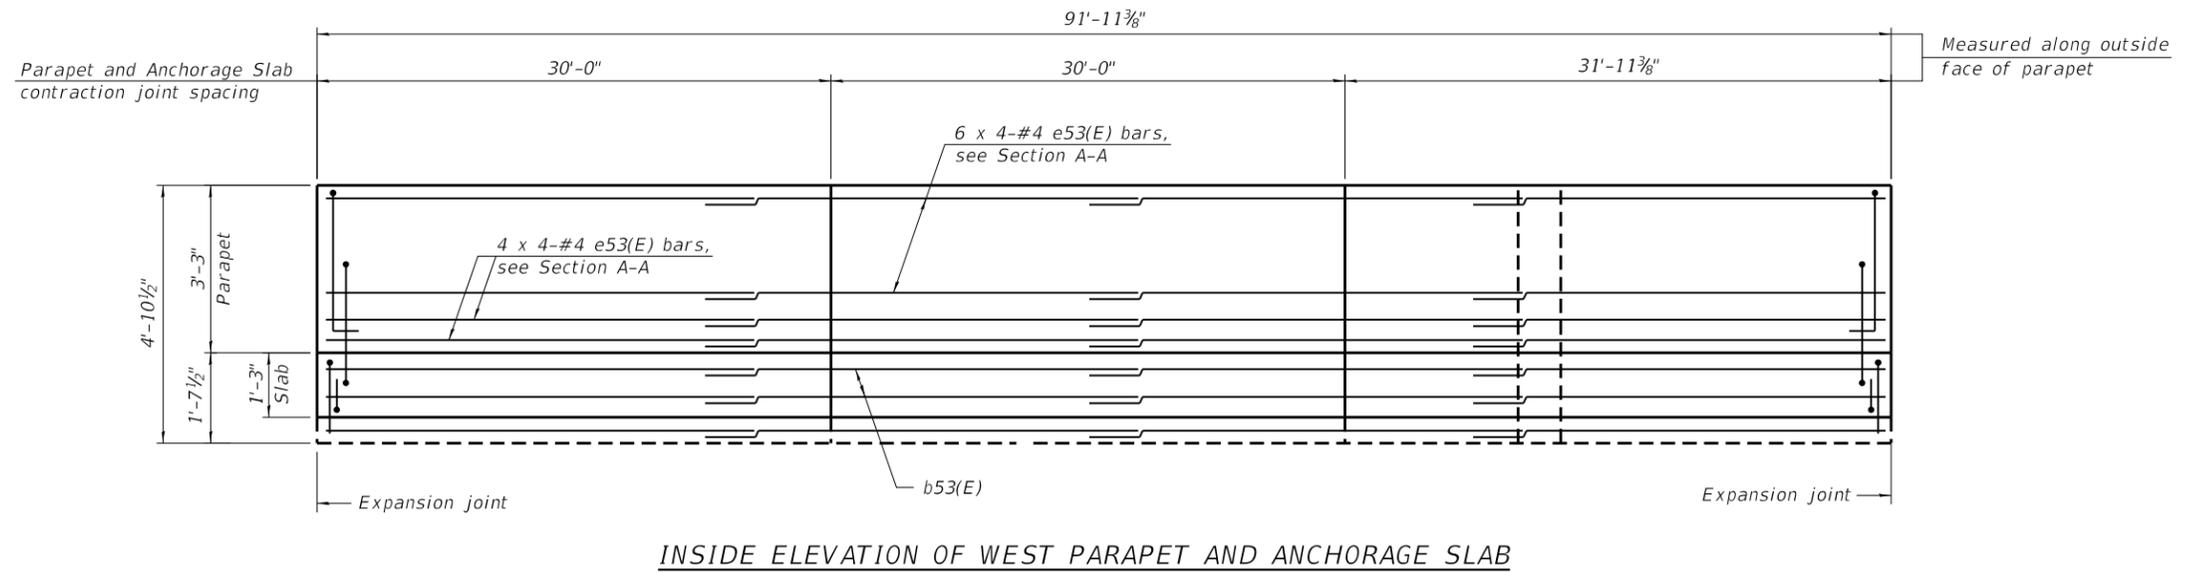

**MINIMUM BAR LAP**


- #4 bar = 2'-8"
- #5 bar = 3'-7"



**WEST PARAPET AND ANCHORAGE SLAB PLAN**


**Notes:**

1. For Section A-A and B-B see sheet SA-16 of SA-26.
2. See sheet SA-16 of SA-26 for Anchorage Slab details, light pole details, parapet joint details, bar bend details and Bill of Material.
3. Portion of Anchorage Slab within the traveled way shall be finished to match PPC pavement finish according to Section 420.09 of the Standard Specifications.
4. For light pole, traffic signal and junction box details, see Electrical Plans.
5. Stations and offsets are measured from **B** Brush College Road.

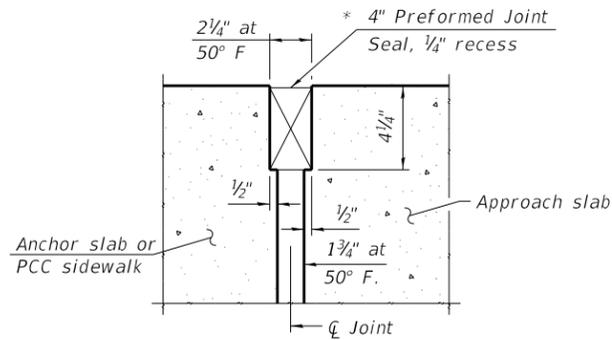

**DETAIL A**

\* Cost included with Concrete Superstructure, see Bridge Plans.

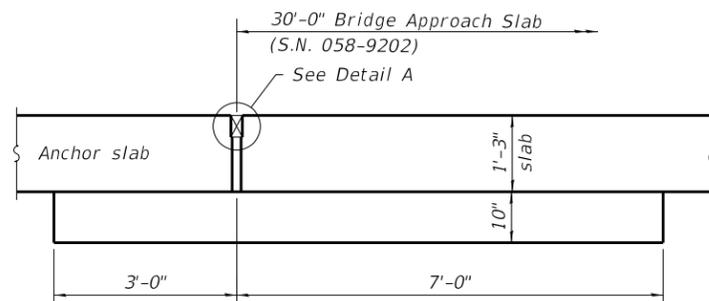


**SECTION D-D**

**MINIMUM BAR LAP**


- #4 bar = 2'-8"
- #5 bar = 3'-7"

**Notes:**


1. For Section A-A see sheet SA-16 of SA-26.
2. See sheet SA-16 of SA-26 for Anchorage Slab details, light pole details, parapet joint details, bar bend details and Bill of Material.
3. Portion of Anchorage Slab within the traveled way shall be finished to match PPC pavement finish according to Section 420.09 of the Standard Specifications.
4. For light pole, traffic signal and junction box details, see Electrical Plans.
5. Stations and offsets are measured from Brush College Road.

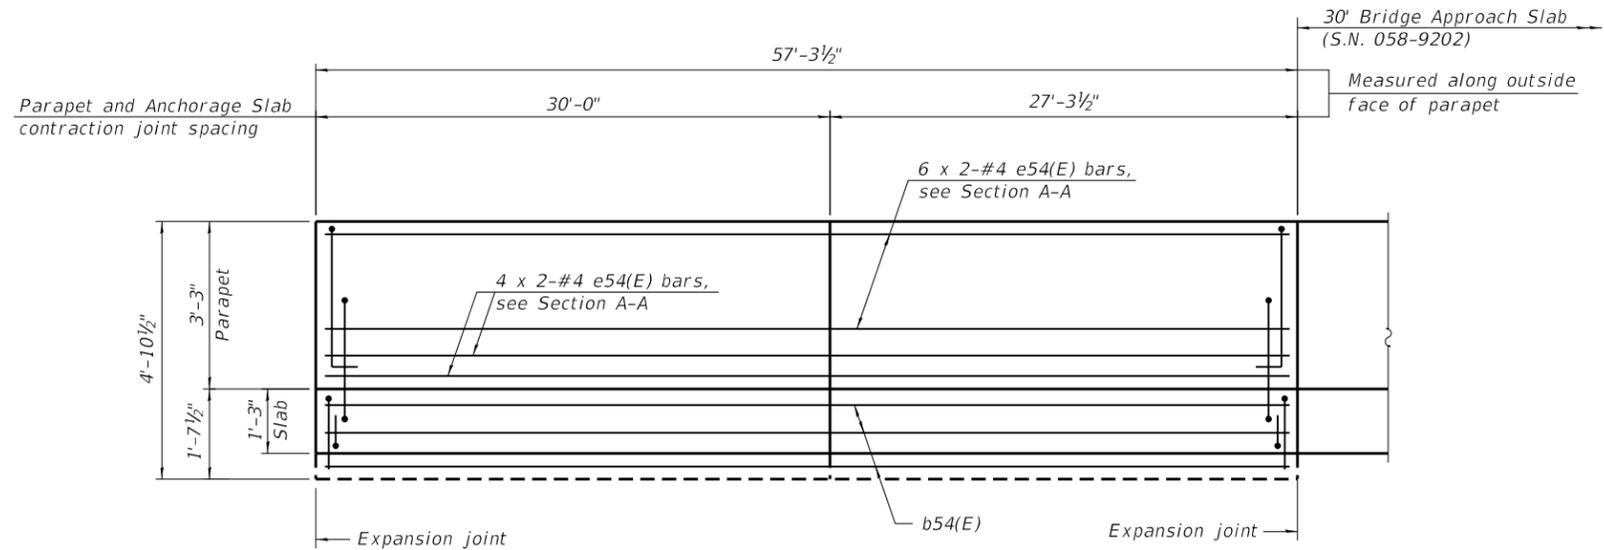


**INSIDE ELEVATION OF WEST PARAPET AND ANCHORAGE SLAB**

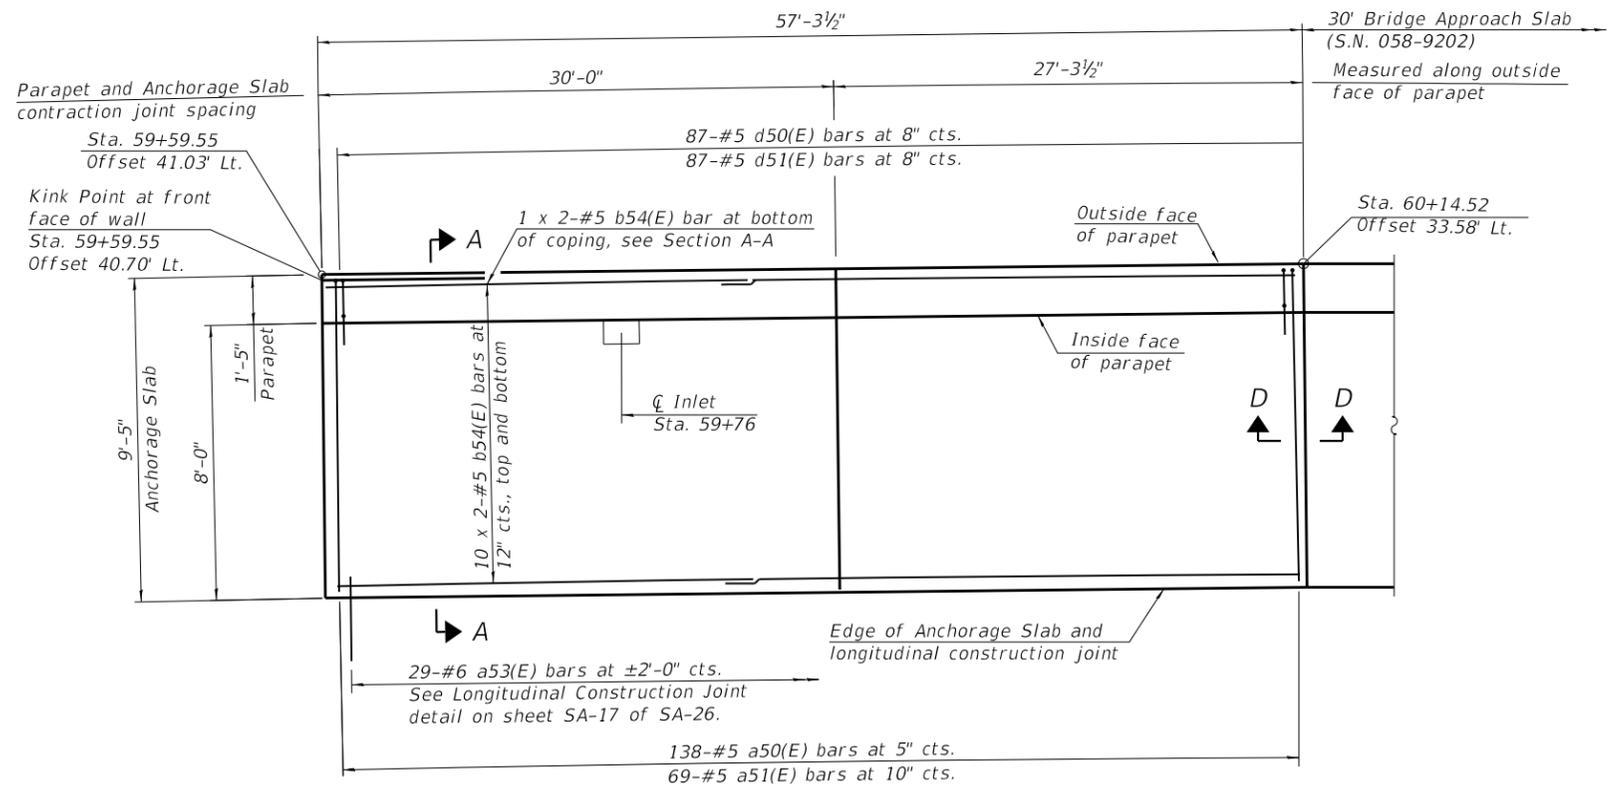


**WEST PARAPET AND ANCHORAGE SLAB PLAN**

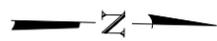

LAST SAVED DATE: 5/15/2022 10:03:00 AM

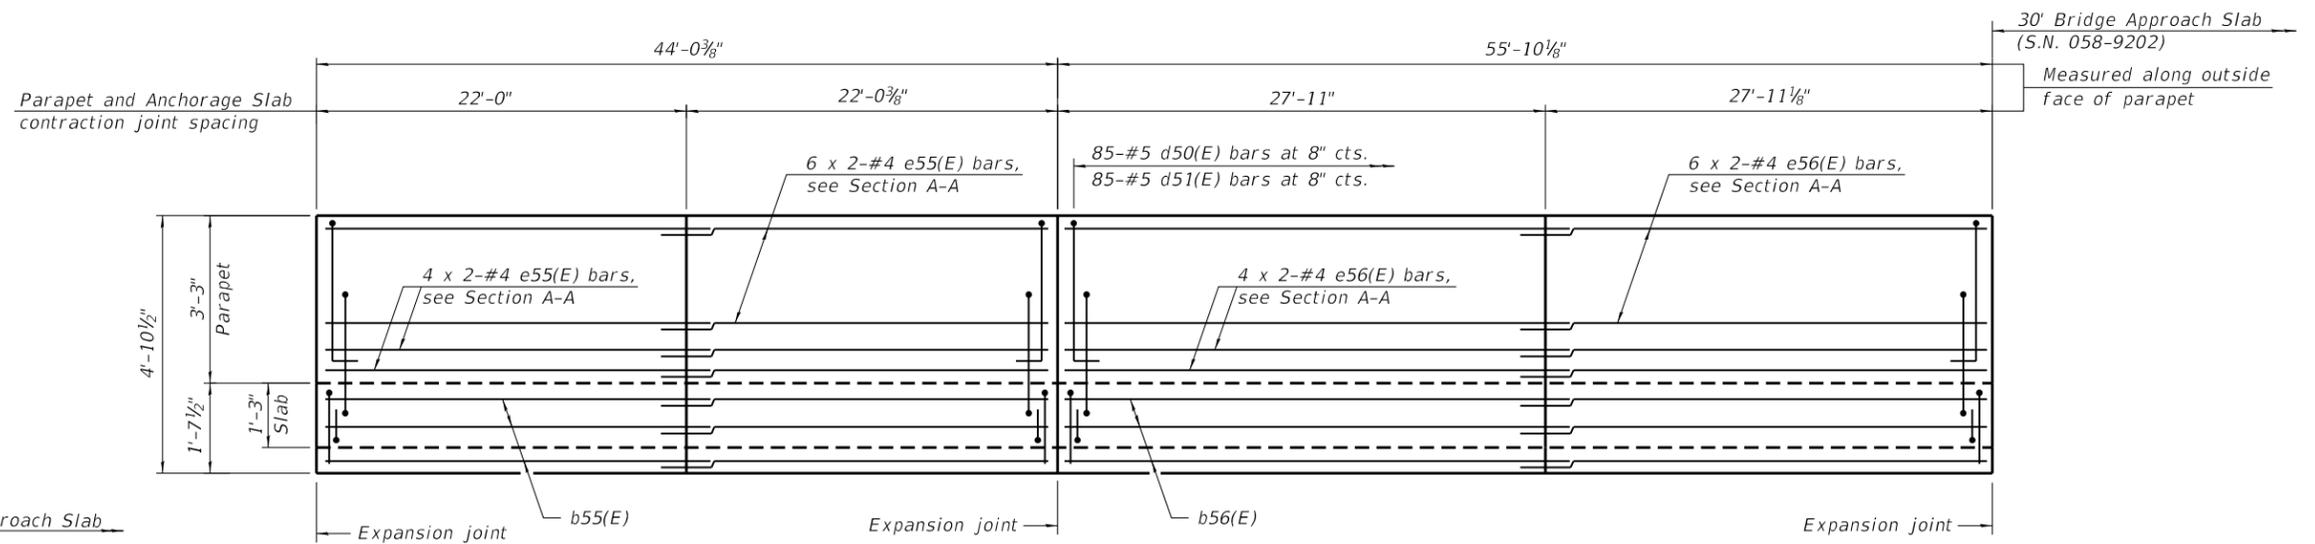


**OUTSIDE ELEVATION OF EAST PARAPET AND ANCHORAGE SLAB**

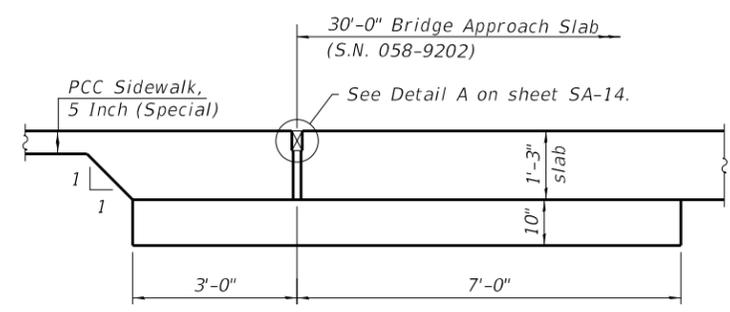

**SECTION E-E**

**MINIMUM BAR LAP**  
 #4 bar = 2'-8"  
 #5 bar = 3'-7"

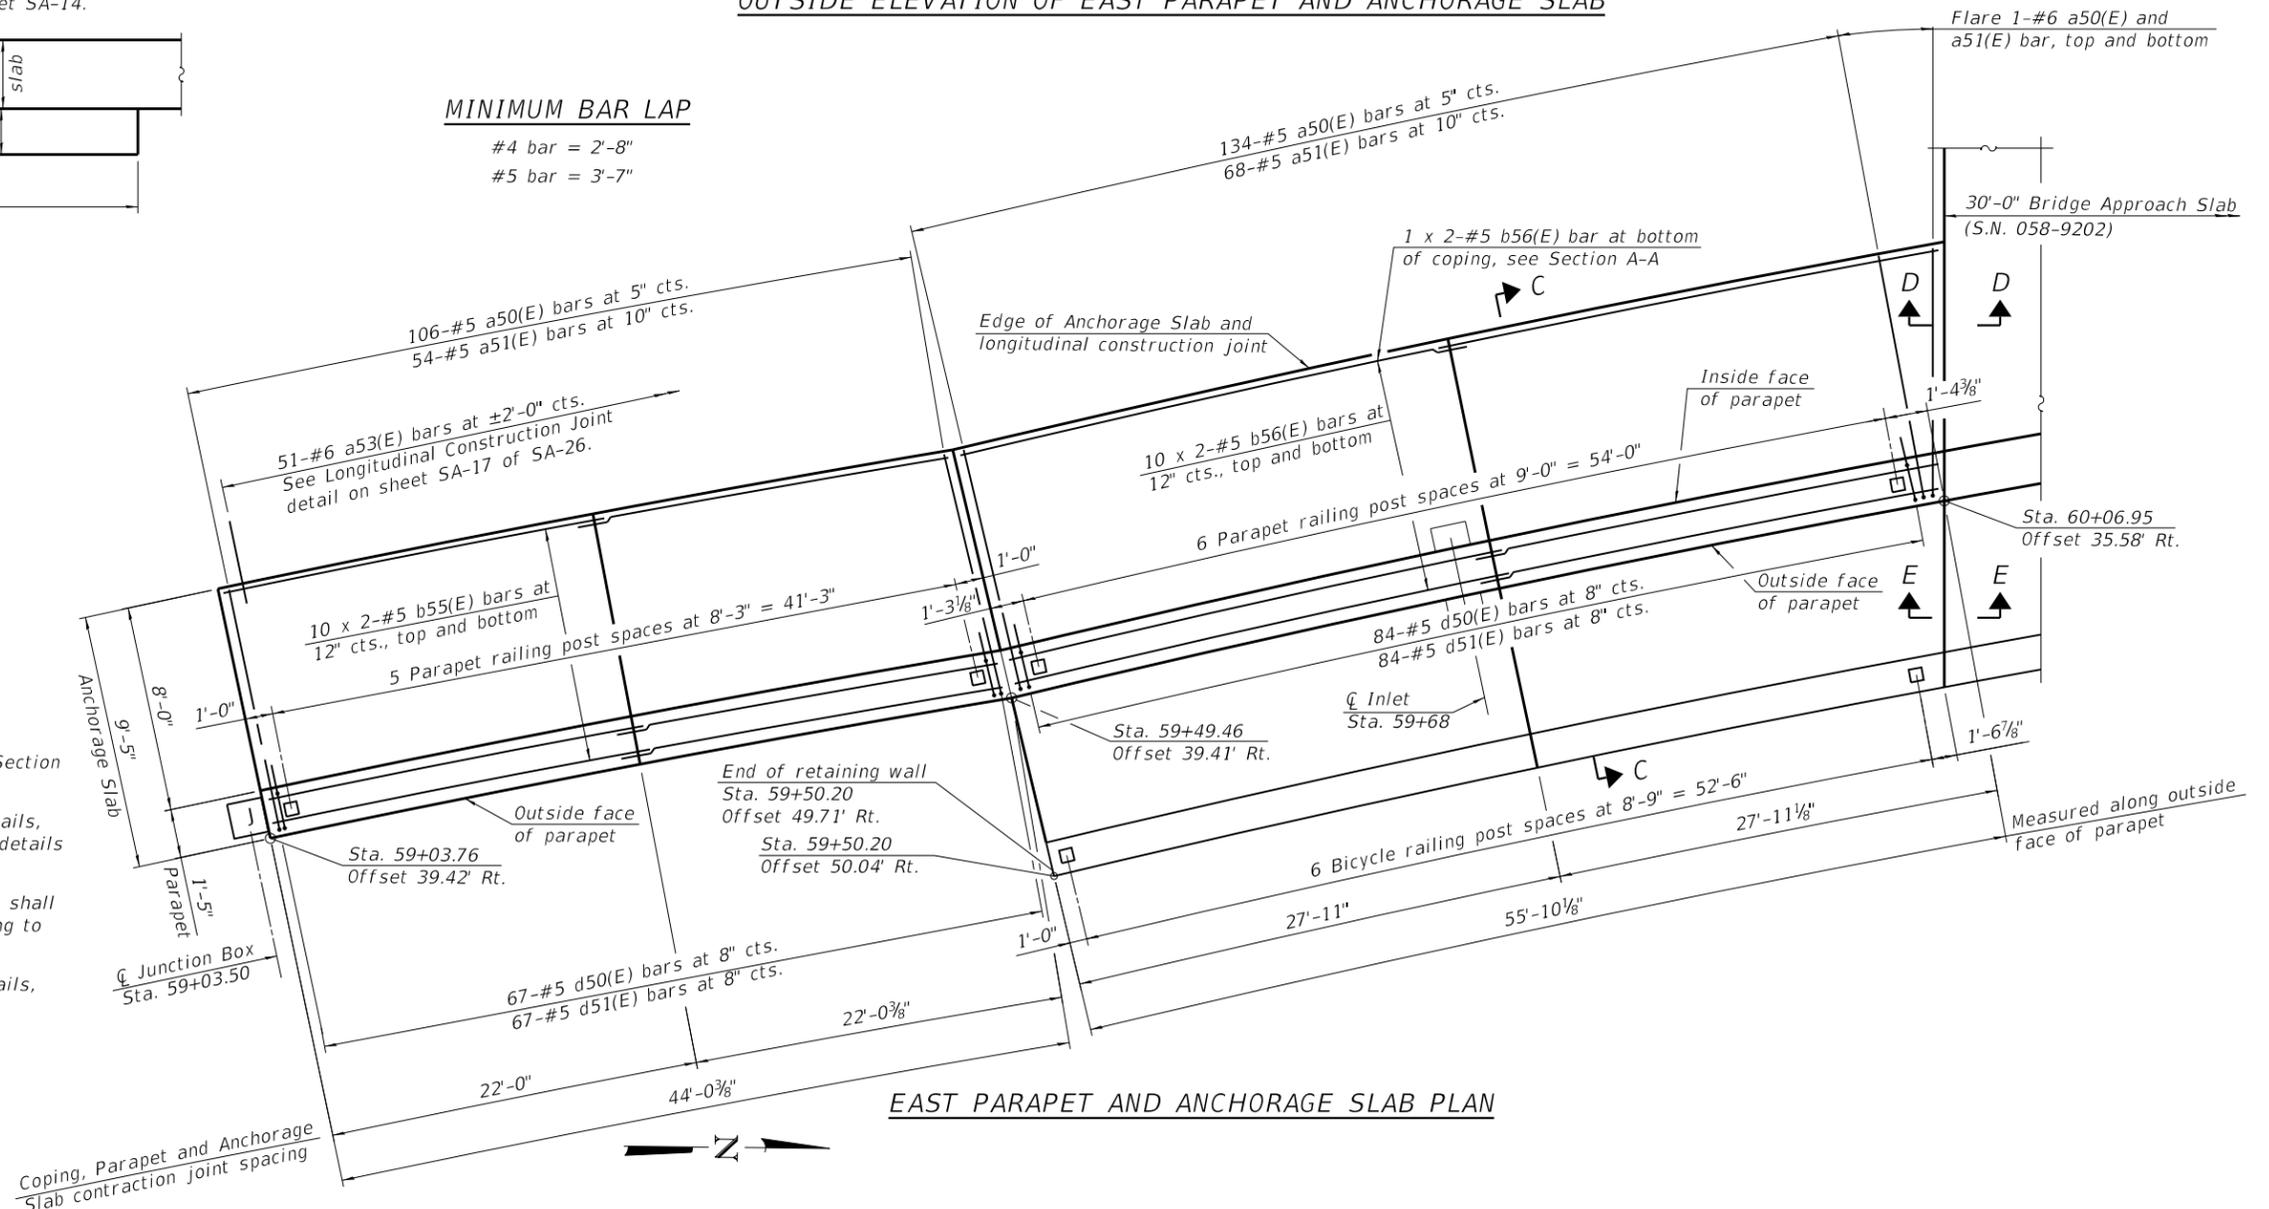

**EAST PARAPET AND ANCHORAGE SLAB PLAN**

- Notes:
1. For Section C-C see sheet SA-16 of SA-26. For Section D-D, see sheet SA-14 of SA-26.
  2. See sheet SA-16 of SA-26 for Anchorage Slab details, light pole details, parapet joint details, bar bend details and Bill of Material.
  3. Portion of Anchorage Slab within the traveled way shall be finished to match PPC pavement finish according to Section 420.09 of the Standard Specifications.
  4. For light pole, traffic signal and junction box details, see Electrical Plans.
  5. Stations and offsets are measured from  $\square$  Brush College Road.



USER NAME = dtheberling	DESIGNED - SDS	REVISED
FILE NAME = 60603202_SNO58W003.dgn	CHECKED - CEH	REVISED
PLOT SCALE = 0.167" / in.	DRAWN - DLH	REVISED
PLOT DATE = 4/29/2021	CHECKED - SDS	REVISED


**STATE OF ILLINOIS  
 DEPARTMENT OF TRANSPORTATION**

**EAST PARAPET AND ANCHORAGE SLAB PLAN AND ELEVATION  
 STRUCTURE NO. 058-W003**


SHEET NO. SA-15 OF SA-26 SHEETS

F.A.U. RTE. 7448	SECTION 09-00933-01-BR	COUNTY MACON	TOTAL SHEETS 1019	SHEET NO. 583
CONTRACT NO. 95893				
ILLINOIS FED. AID PROJECT				


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**SECTION A-A**

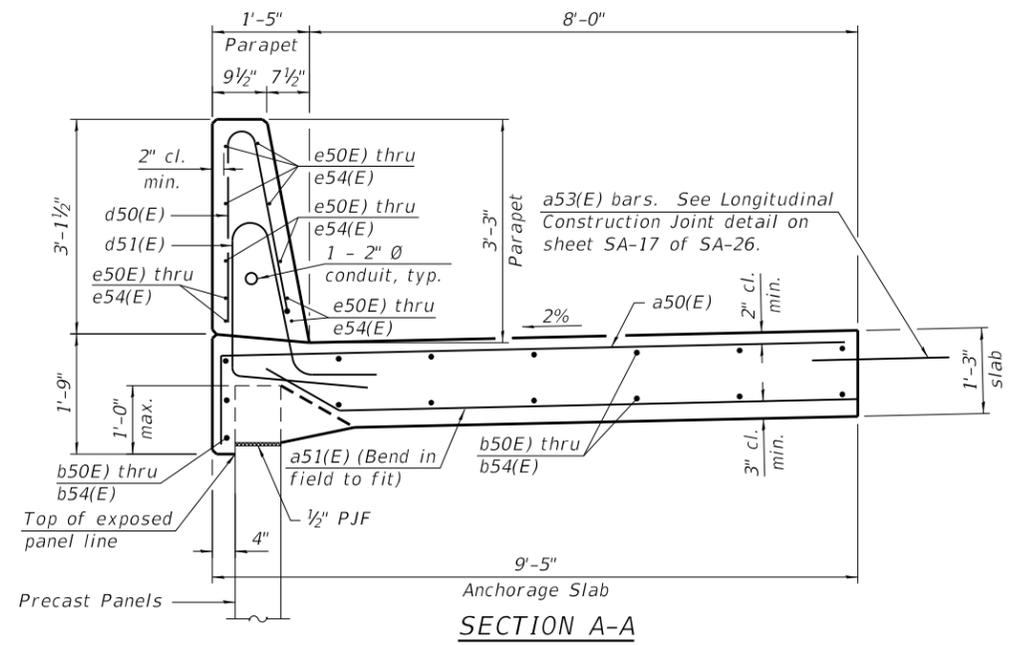


**SECTION C-C**

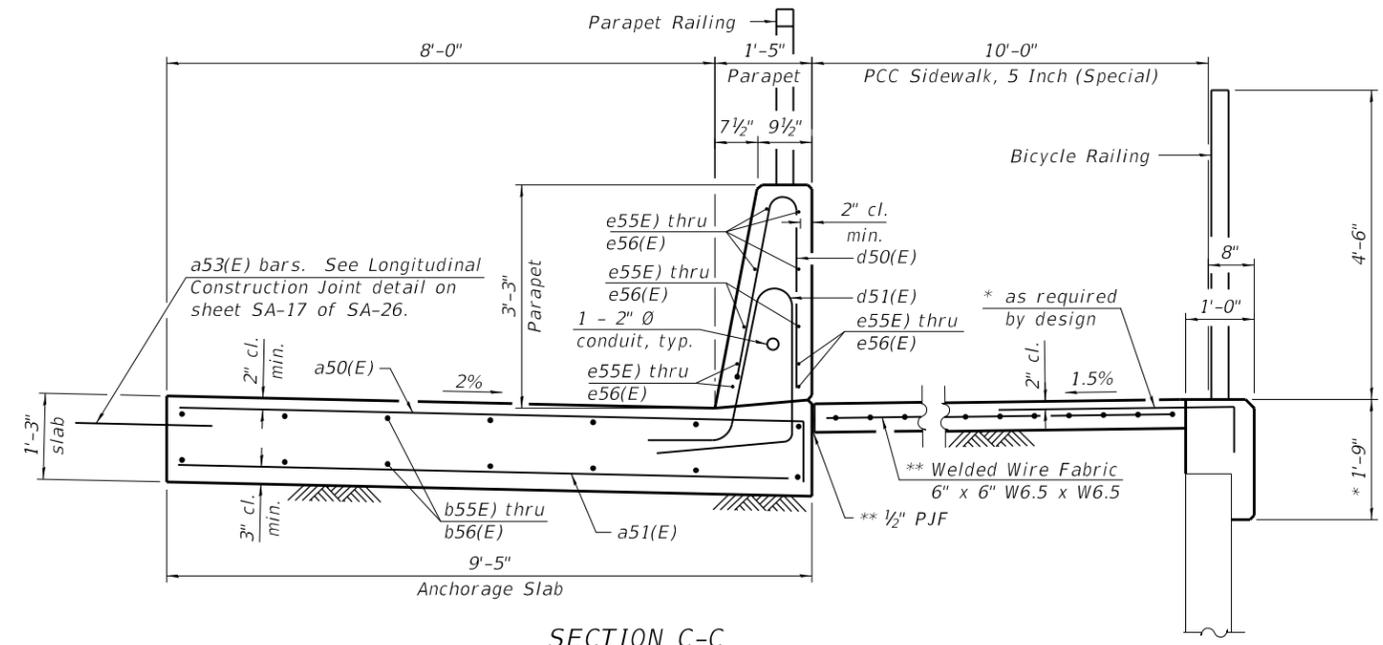


Note: Cost of anchor rods and conduit is included with Concrete Superstructure. Bolt circle to match light pole or traffic signal base. See Electrical Plans.

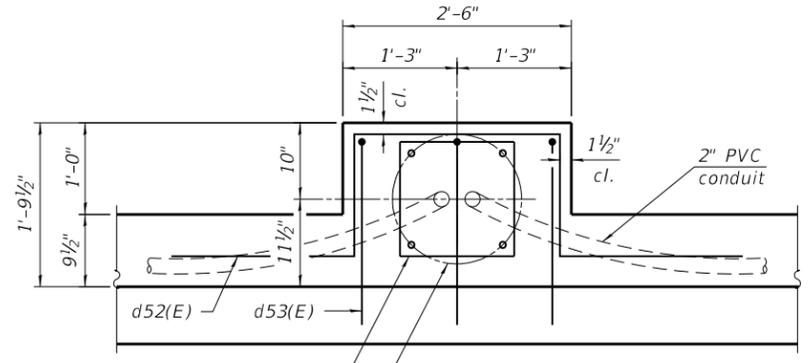
**PLAN**

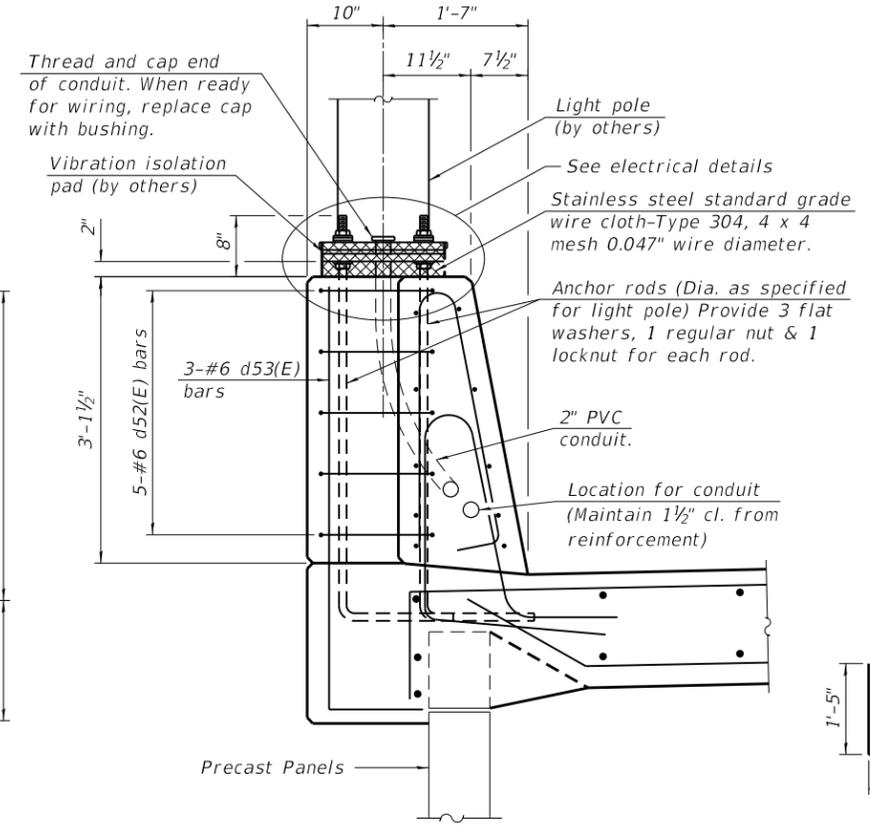


**SECTION B-B**

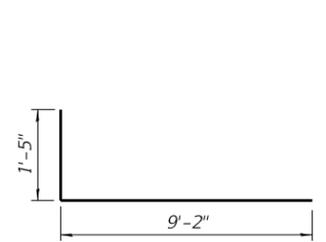

**BAR a50(E)**

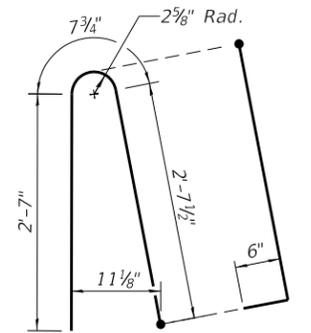


**BAR d50(E)**

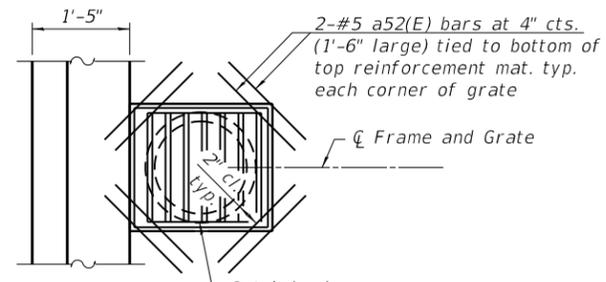


Note: Cut moment slab reinforcement in field to clear catch basin.

**DRAINAGE INLET**


(8 locations, see Drainage Plans.)

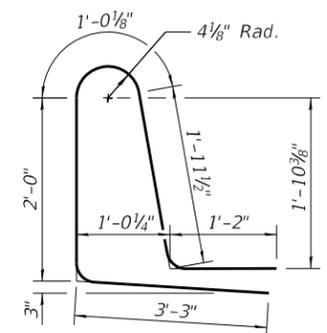

**BAR d51(E)**

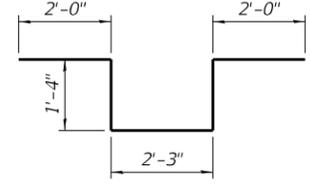

**BAR d52(E)**

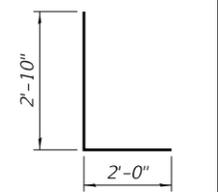

**BAR d53(E)**

**BILL OF MATERIAL**


Bar	No.	Size	Length	Shape
a50(E)	2,180	#5	10'-7"	U
a51(E)	1,100	#5	9'-3"	U
a52(E)	64	#5	1'-6"	U
a53(E)	463	#6	2'-0"	U
b50(E)	11	#5	33'-9"	U
b51(E)	264	#5	25'-2"	U
b52(E)	33	#5	30'-6"	U
b53(E)	44	#5	25'-8"	U
b54(E)	22	#5	30'-4"	U
b55(E)	20	#5	23'-8"	U
b56(E)	20	#5	30'-2"	U
d50(E)	1,373	#5	6'-5"	U
d51(E)	1,373	#5	9'-5"	U
d52(E)	24	#6	8'-11"	U
d53(E)	15	#6	4'-10"	L
e50(E)	20	#4	18'-3"	U
e51(E)	240	#4	24'-6"	U
e52(E)	30	#4	29'-11"	U
e53(E)	40	#4	25'-0"	U
e54(E)	20	#4	29'-11"	U
e55(E)	20	#4	23'-3"	U
e56(E)	20	#4	29'-3"	U
Concrete Superstructure		Cu. Yd.	536.0	
Protective Coat		Sq. Yd.	1,221	
Reinforcement Bars, Epoxy Coated		Pound	76,840	
Portland Cement Concrete Sidewalk, 5 inch (Special)		Sq. Ft.	532	

Bars indicated thus 6 x 3-#8 etc. indicates 6 line of bars with 3 lengths per line.

\* The Precast Modular Wall supplier's design of the coping and attachment to the wall facing shall account for the following service loads applied at the base of the Bicycle Rail posts. Horizontal sliding force of 0.7 kips and overturning moment of 3.1 kip-ft. Cost of concrete and reinforcement for coping under the Bicycle Railing is included with Precast Modular Retaining Wall.

\*\* Cost of Welded Wire Fabric and PJP is included with Portland Cement Concrete Sidewalk, 5 Inch (Special).

Note: The Precast Modular Retaining Wall supplier's internal stability design shall account for the sidewalk's bearing pressure surcharge of 0.16 ksf in addition to any loads imposed by the Bicycle Railing.

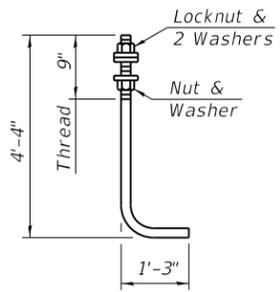

**ANCHOR ROD**

Diameter as specified for light poles. (ASTM F 1554 Grade 105) Full length hot dipped galvanized.

Design firm  
no. 184001036



USER NAME = dtheberling	DESIGNED - SDS	REVISED
FILE NAME = 60603202_SNO58W003.dgn	CHECKED - CEH	REVISED
PLOT SCALE = 0.1677 / in.	DRAWN - DLH	REVISED
PLOT DATE = 4/29/2021	CHECKED - SDS	REVISED


**STATE OF ILLINOIS  
DEPARTMENT OF TRANSPORTATION**

**PARAPET AND ANCHORAGE SLAB DETAILS  
STRUCTURE NO. 058-W003**

SHEET NO. SA-16 OF SA-26 SHEETS

F.A.U. RT. = 7448	SECTION = 09-00933-01-BR	COUNTY = MACON	TOTAL SHEETS = 1019	SHEET NO. = 584
CONTRACT NO. 95893			ILLINOIS FED. AID PROJECT	


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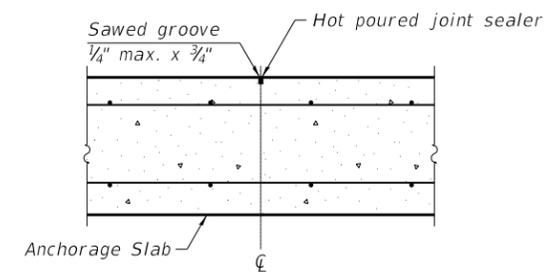
**ANCHORAGE SLAB EXPANSION JOINT**

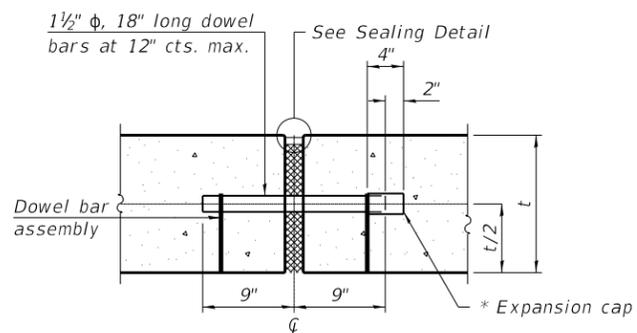Expansion joint and dowel bars included in the cost of Concrete Superstructure


\* Expansion caps shall be installed on the exposed end of each dowel bar once the header has been removed and the joint filler material has been installed.




**SEALING DETAIL**

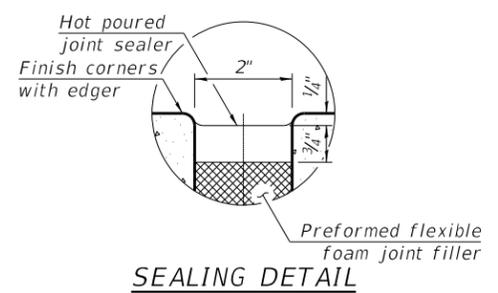

**TRANSVERSE CONTRACTION JOINT**

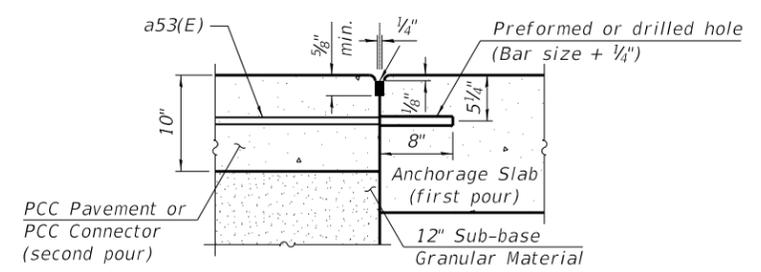


**LONGITUDINAL CONSTRUCTION JOINT GROUTED-IN-PLACE TIE BAR**

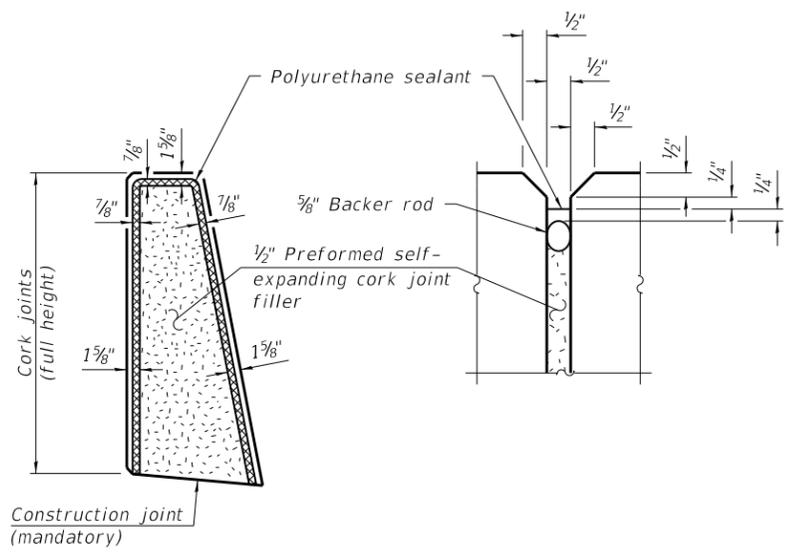


**PARAPET EXPANSION JOINT DETAILS**

Note:  
The polyurethane sealant shall be according to Article 1050.04 of the Standard Specifications and the color shall be gray.

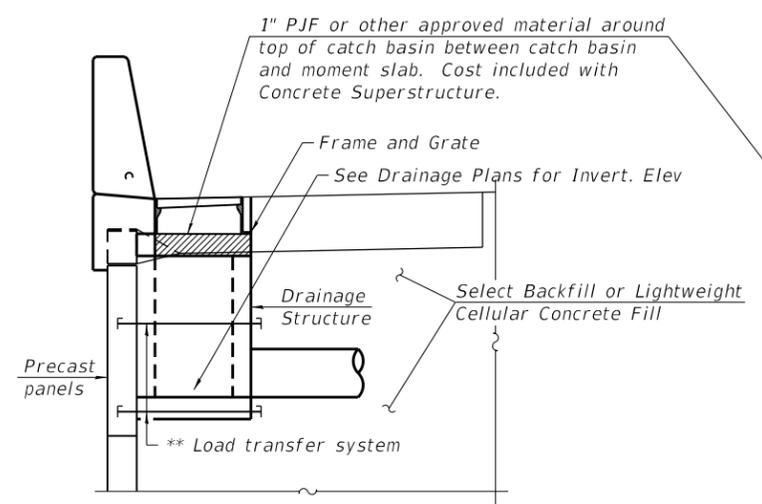


**ANCHORAGE SLAB INLET SECTION**


\*\* Precast Modular Retaining Wall supplier to design load transfer system to accommodate concrete pipe and drainage structure.

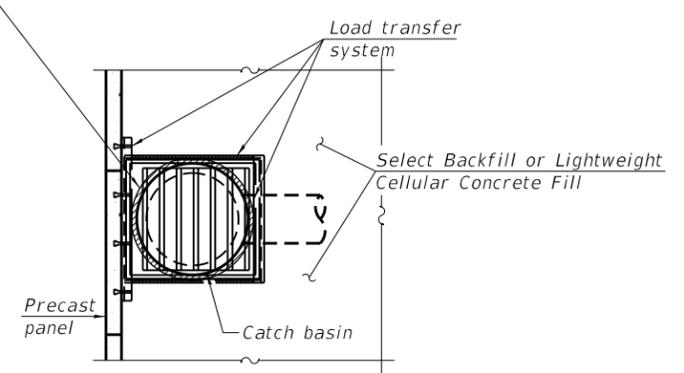

**ANCHORAGE SLAB INLET SECTION**

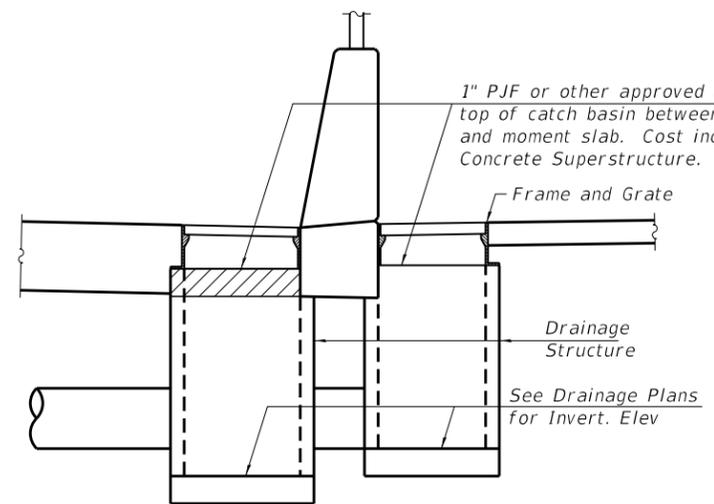

**ANCHORAGE SLAB/SIDEWALK INLET SECTION**

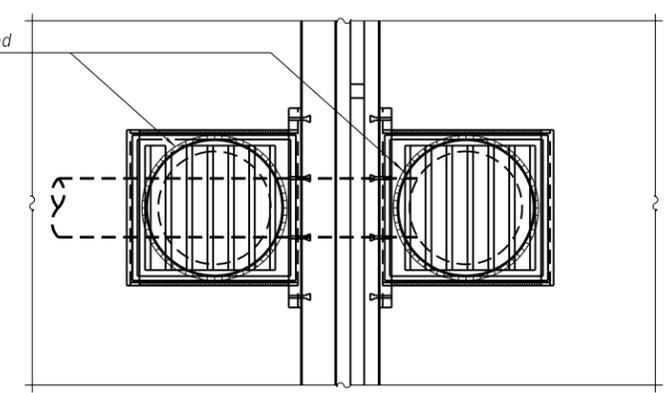

**ANCHORAGE SLAB/SIDEWALK INLET**

FILE NAME: C:\working\acrom\_0516\_nal\ep015528\0440069\60603202\_S038W003.dgn



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FILE NAME = 60603202_S038W003.dgn	CHECKED - CEH	REVISED
PLOT SCALE = 0.167" / in.	DRAWN - DLH	REVISED
PLOT DATE = 4/29/2021	CHECKED - SDS	REVISED

STATE OF ILLINOIS  
DEPARTMENT OF TRANSPORTATION

PARAPET JOINT AND DETAILS  
STRUCTURE NO. 058-W003


SHEET NO. SA-17 OF SA-26 SHEETS

F.A.U. RTE.	SECTION	COUNTY	TOTAL SHEETS	SHEET NO.
7448	09-00933-01-BR	MACON	1019	585
CONTRACT NO. 95893				


ILLINOIS FED. AID PROJECT

LAST SAVED DATE: 10/22/2021


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**BICYCLE RAILING**

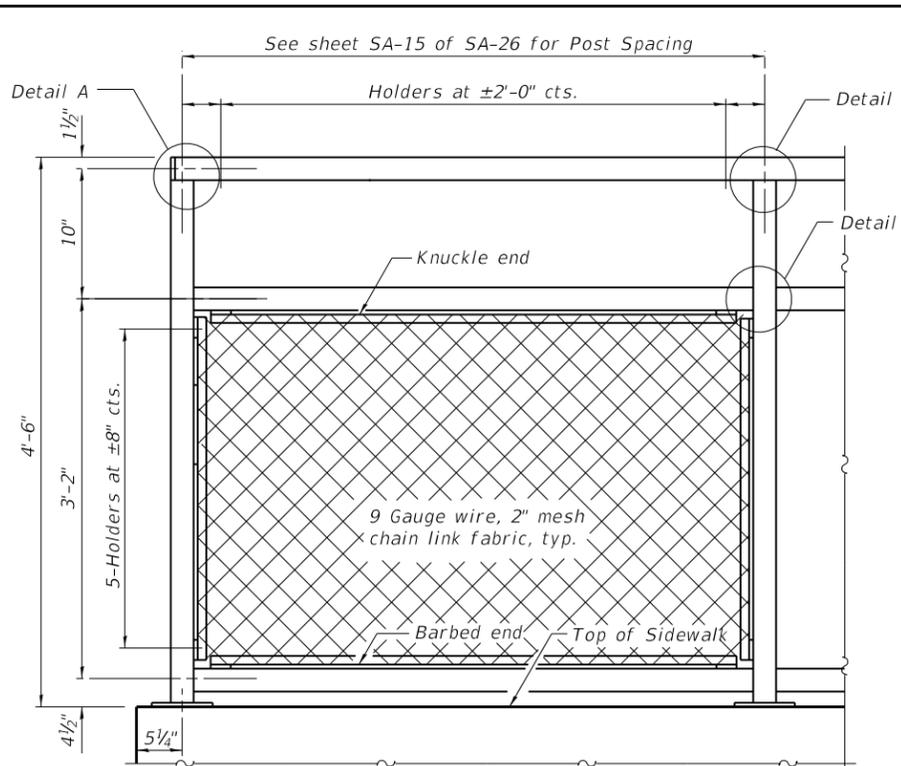


**BICYCLE RAILING**

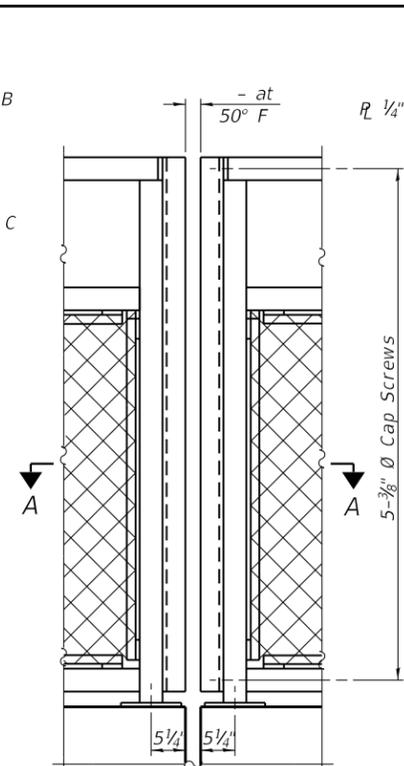

All steel rail elements shall be galvanized according to Article 509.05 of the Standard Specifications.

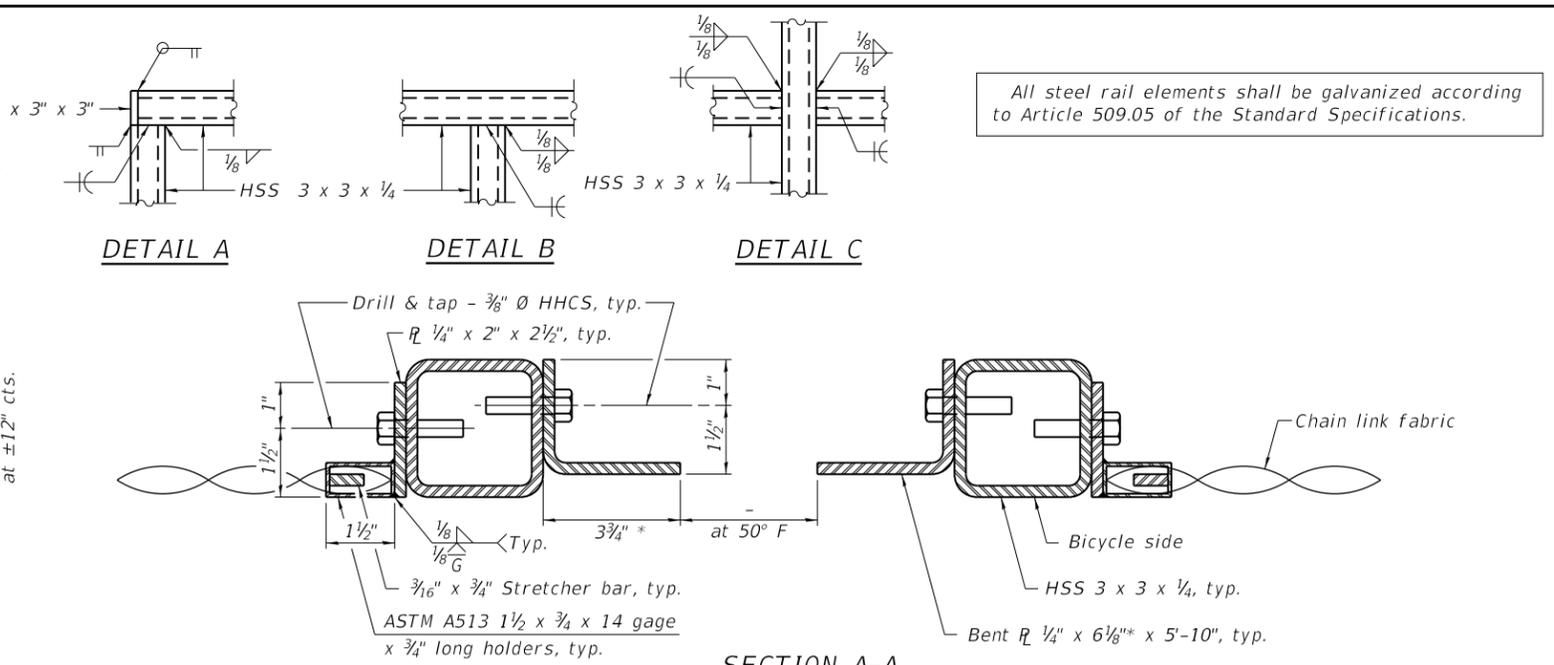
**SECTION A-A**

\* Assume 3/8" radius. Dimensions may need to be modified for larger joints to avoid gaps greater than 6".

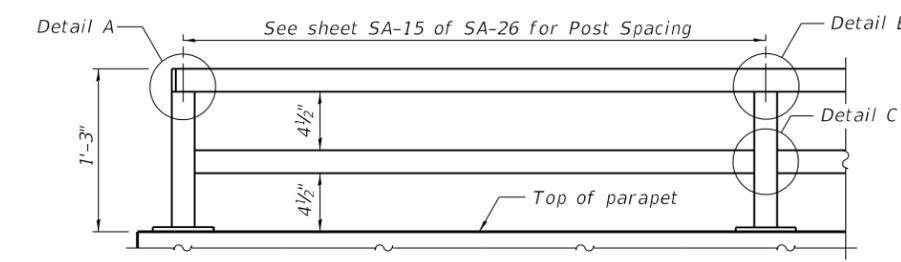


**PARAPET RAILING**

**ELEVATION**  
(Inside Face of Two Element Rail)

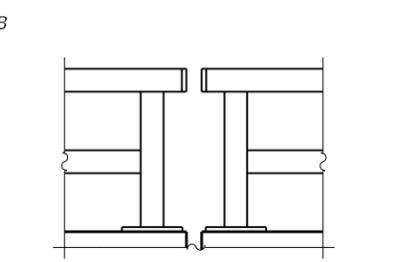


**PARAPET RAILING**


**ELEVATION AT EXPANSION JOINT**

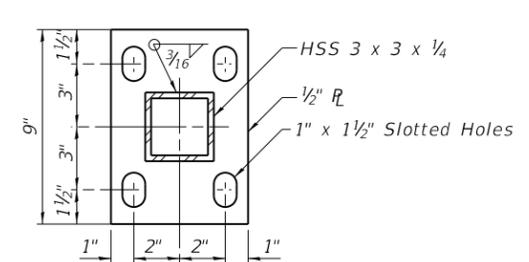


**SECTION B-B**

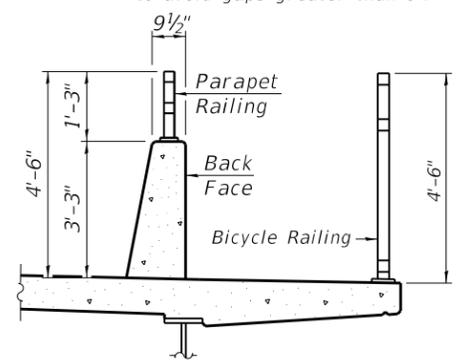

**SECTION THRU DECK**

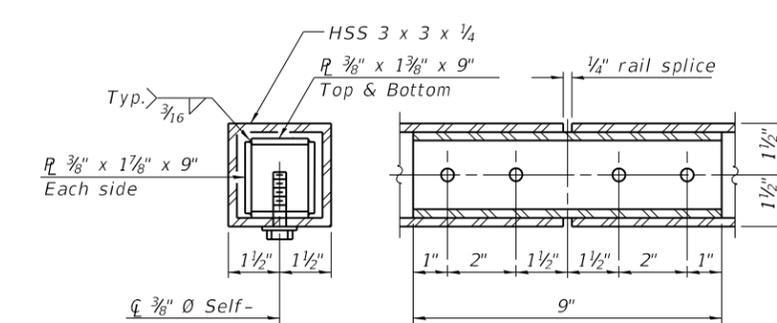

**RAIL SPLICE**

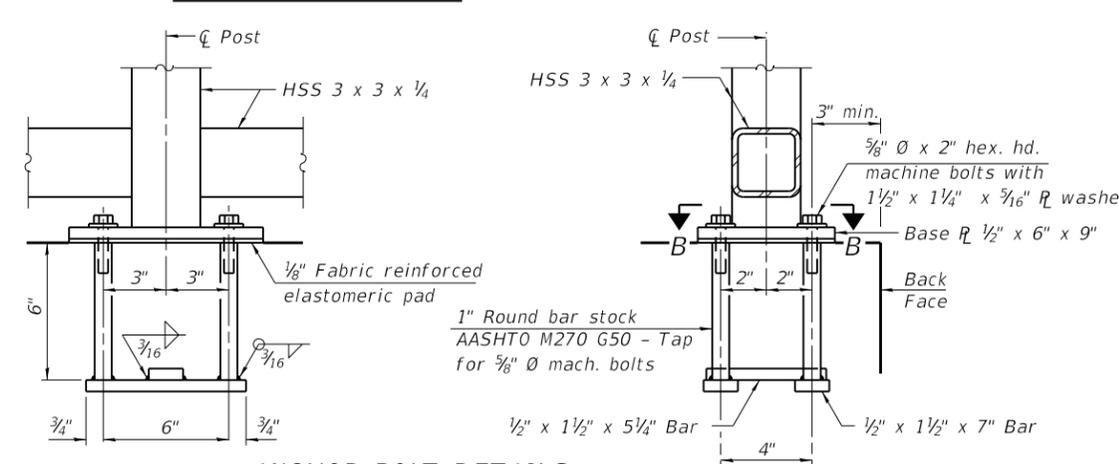

**ANCHOR BOLT DETAILS**

In lieu of the cast-in-place anchor device shown, the Contractor has the option of drilling and setting 5/8" Ø anchor rods according to Article 509.06 of the Standard Specifications. Embedment shall be according to the manufacturer's specifications.

**BILL OF MATERIAL**

Item	Unit	Quantity
Bicycle Railing	Foot	55
Parapet Railing	Foot	100

**RAILING CRITERIA**

NCHRP 350 Test Level	4
Railing Weight (plf)	25
Bicycle Railing Weight (plf)	50
Max Post Spacing	10'-0"

Notes:  
Place reinforcement bars to miss anchor rod locations.  
CVN testing is not required for the HSS tubing used in the Bicycle Railing.  
All HSS tubing used for the Parapet Railing shall be CVN tested according to Article 1006.34(b) of the Standard Specifications.

R-29 10-12-2021



USER NAME	DESIGNED	REVISIONS
dheberling	SDS	REVISED
60603202_S058W003.dgn	CEH	REVISED
0.1677 / in.	DLH	REVISED
10/22/2021	SDS	REVISED

**STATE OF ILLINOIS**  
**DEPARTMENT OF TRANSPORTATION**

**BICYCLE RAILING**  
**STRUCTURE NO. 058-W003**


SHEET NO. SA-18 OF SA-26 SHEETS

F.A.U. RTE.	SECTION	COUNTY	TOTAL SHEETS	SHEET NO.
7448	09-00933-01-BR	MACON	1019	586
CONTRACT NO. 95893				

ILLINOIS FED. AID PROJECT

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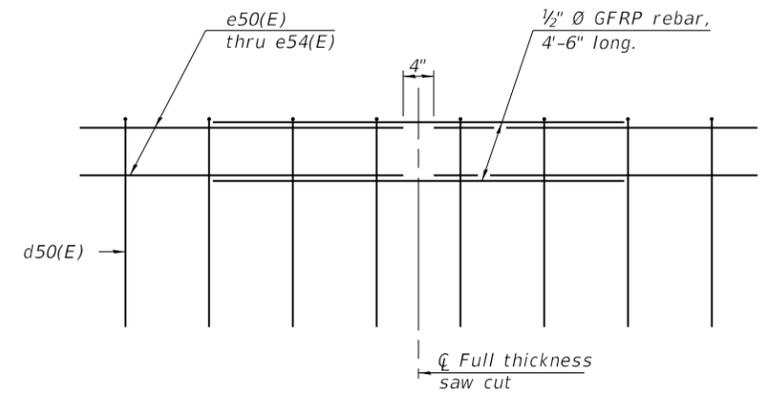
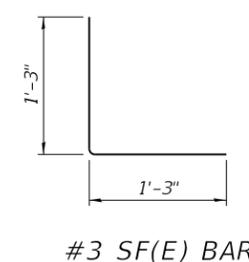
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**39" CONSTANT-SLOPE PARAPET SECTION**  
 (Showing dimensions, d50(E), d51(E) and 1/2" Ø GFRP rebar)  
 (Showing reinforcement clearances for slip forming and additional reinforcement)

**GENERAL NOTES**

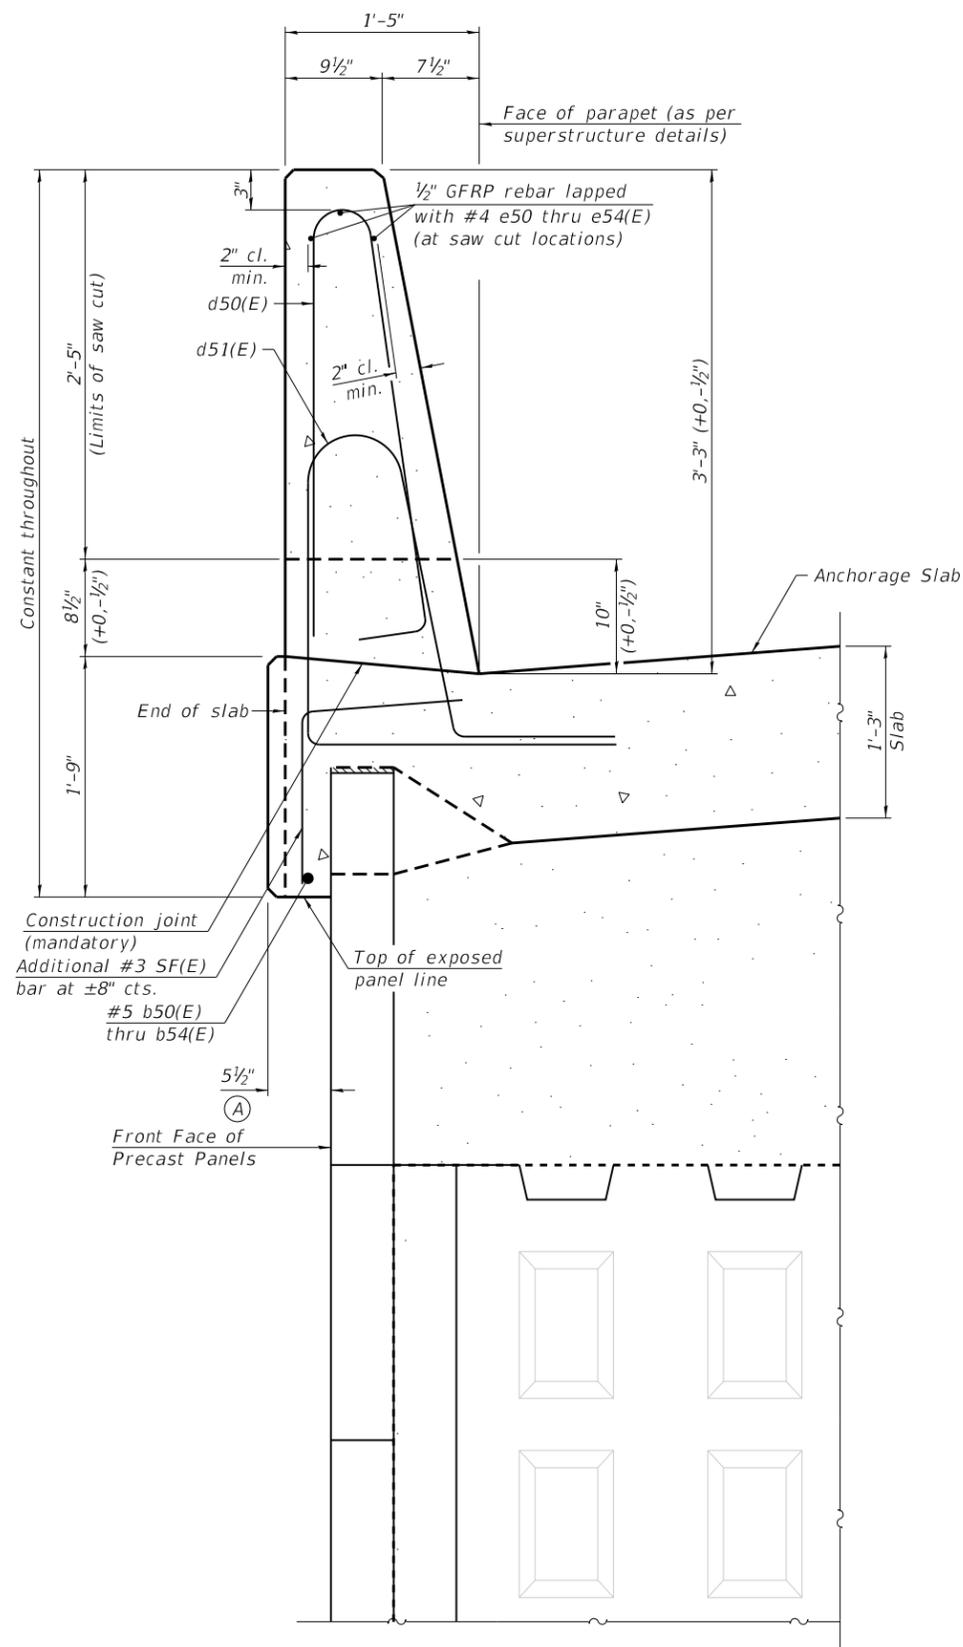All dimensions shall remain the same as shown on superstructure details, except dimension A which is to be revised as shown. Additional concrete needed to revise dimension A = 0.01 cu. yds./ft.  
 Place full depth aluminum sheets as shown on superstructure details.  
 Replace all cork joint filler locations with a full thickness saw cut.  
 Slipforming of parapets along the east anchorage slab is not allowed.



**GFRP REBAR STIFFENING DETAIL**  
 (Place as shown in parapet section at each parapet joint location.)



USER NAME = dheberling	DESIGNED - SDS	REVISED
FILE NAME = 60603202_51038W003.dgn	CHECKED - CEH	REVISED
PLOT SCALE = 0.1677 / in.	DRAWN - DLH	REVISED
PLOT DATE = 4/29/2021	CHECKED - SDS	REVISED

**STATE OF ILLINOIS  
 DEPARTMENT OF TRANSPORTATION**

**CONCRETE PARAPET SLIPFORMING OPTION  
 STRUCTURE NO. 058-W003**

SHEET NO. SA-19 OF SA-26 SHEETS






F.A.U. RTE.	SECTION	COUNTY	TOTAL SHEETS	SHEET NO.
7448	09-00933-01-BR	MACON	1019	587
CONTRACT NO. 95893				

ILLINOIS FED. AID PROJECT

ROUTE NO.	SECTION	COUNTY	TOTAL SHEETS	SHEET NO.
FAU 7448	*	MACON	94	57
FED. ROAD DIST. NO.	ILLINOIS PROJECT			
		* 90-00119-00-PV		


B.M. "X" CHISELED "O" AT BASE OF FENCE POST AT SW CORNER OF ILLINOIS POWER SUBSTATION 32' RT. STA. 52+00 ELEV. 674.75

B.M. "A" NW CORNER OF CONCRETE BASE FOR A.C. UNIT NEAR SW CORNER OF WELDING SHOP 51' RT. STA. 50+77 ELEV. 676.61

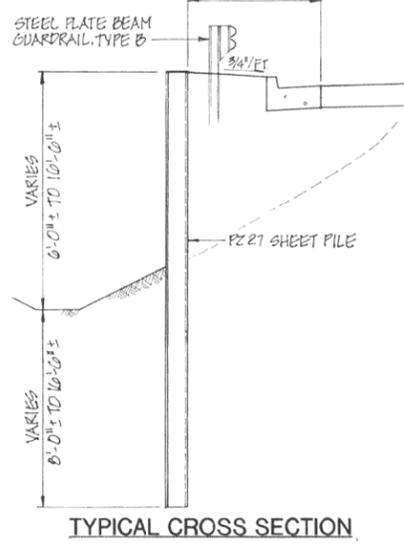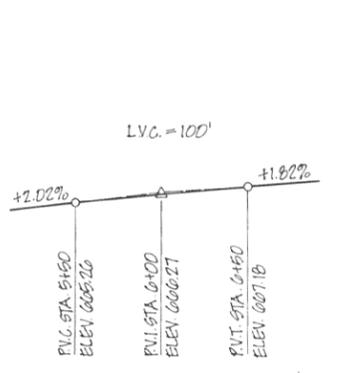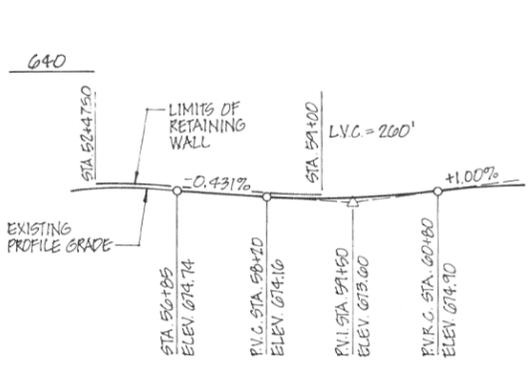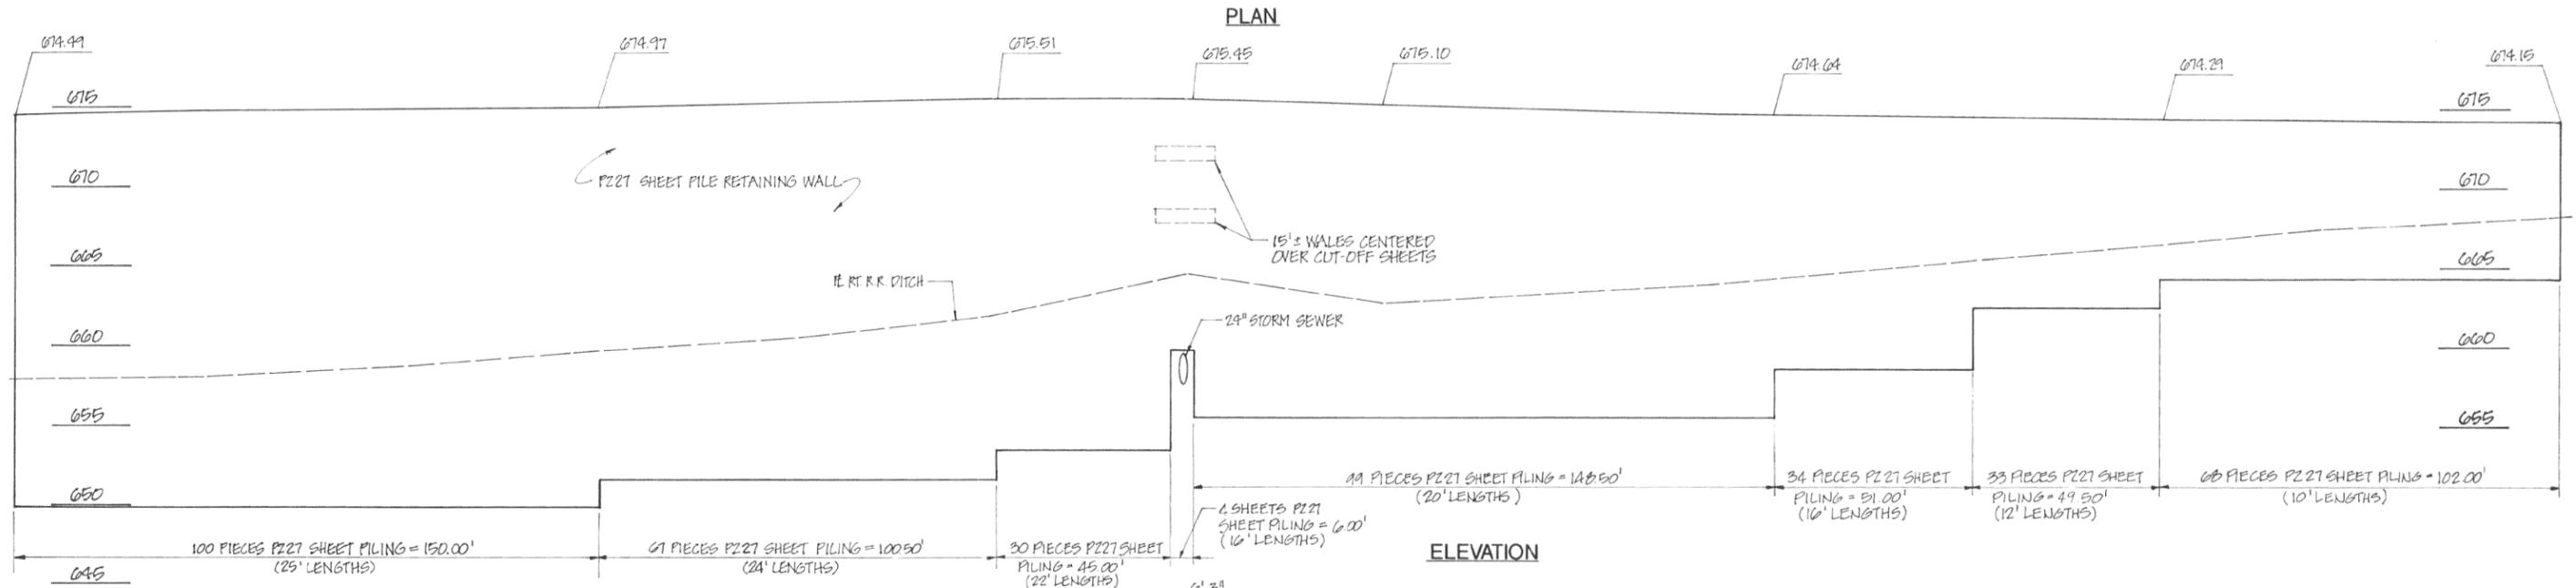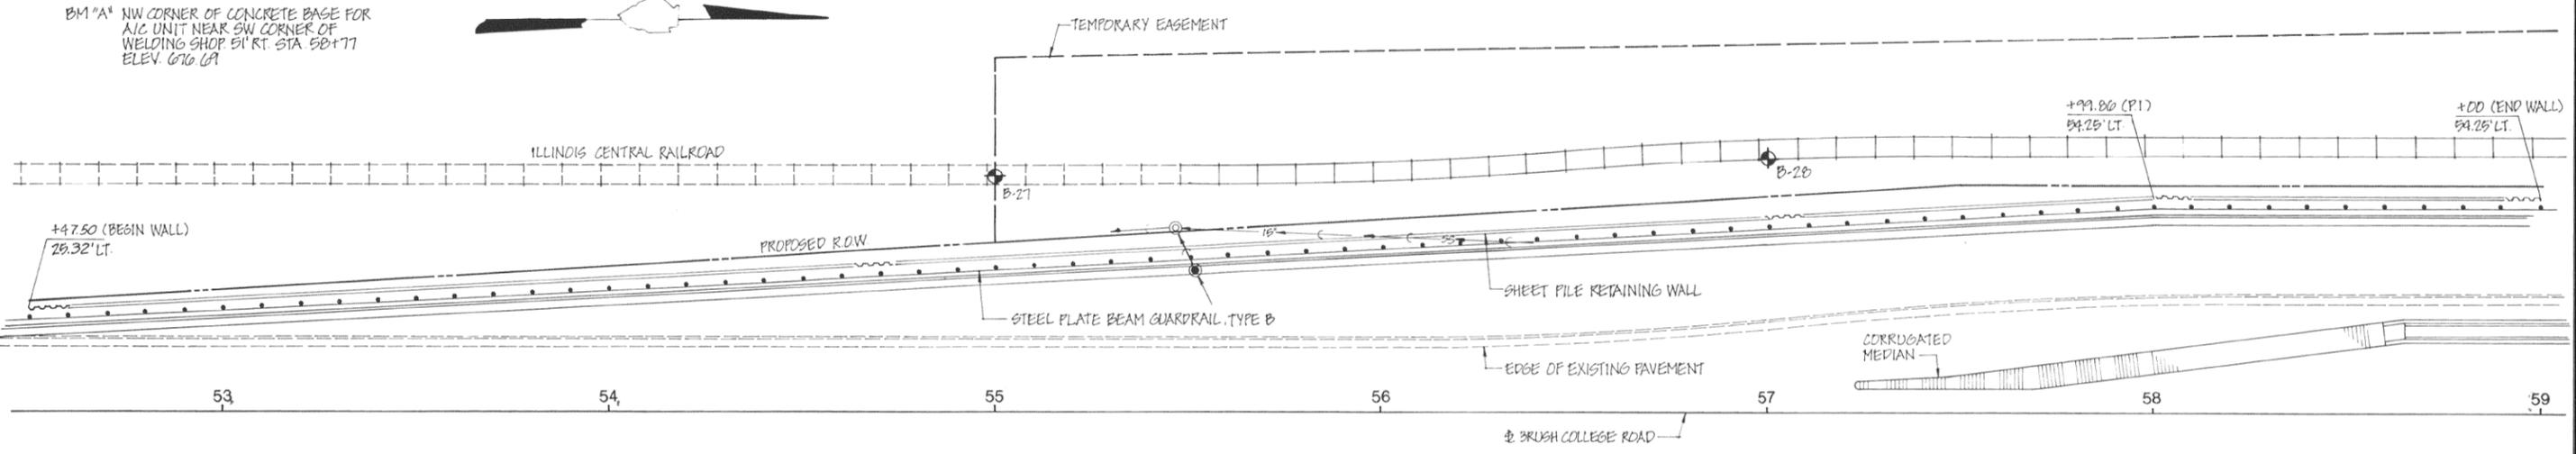

**DESIGN SPECIFICATIONS**  
1989 AASHTO, 1990 AND 1991 INTERIM

**DESIGN STRESSES**  
Fs = 32,000 PSI (GR 50)

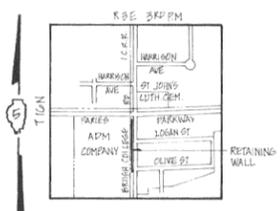

**FOR INFORMATION ONLY**

REVISIONS		BRUSH COLLEGE ROAD		DRAWN BY DATE
No.	DATE	INITIALS		R. King 1-92
1				CHECKED BY DATE
2				
3				
4				
5				
6				
7				
8				
9				
10				

F.A.U. RTE. 7448		SECTION 09-00933-01-BR		COUNTY MACON	TOTAL SHEETS 1019	SHEET NO. 588
PROJECT NO. 3570-9		CONTRACT NO. 95893		SHEET NO.		



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PLOT DATE = 4/29/2021	CHECKED - SDS	REVISED

STATE OF ILLINOIS  
DEPARTMENT OF TRANSPORTATION

EXISTING SHEET PILE RETAINING WALL  
STRUCTURE NO. 058-W003

SHEET NO. SA-20 OF SA-26 SHEETS

F.A.U. RTE. 7448	SECTION 09-00933-01-BR	COUNTY MACON	TOTAL SHEETS 1019	SHEET NO. 588
PROJECT NO. 3570-9		CONTRACT NO. 95893		SHEET NO.

ILLINOIS FED. AID PROJECT

LAST SAVED DATE: 5/15/2021 10:58:00 AM FILE NAME: C:\working\macom\_6516\_nal\eb15528\0440069\60603202\_SNO58W003.dgn







# SOIL BORING LOG

Page 1 of 2  
Project #: 313516  
Date 04/01/13

ROUTE \_\_\_\_\_ DESCRIPTION BRUSH COLLEGE ROAD LOGGED BY CM  
SECTION \_\_\_\_\_ LOCATION DECATUR, IL  
COUNTY MACON STRUCTURE NO. \_\_\_\_\_ (Exist) \_\_\_\_\_ (Prop.) \_\_\_\_\_  
BORING NO. B-15 DRILLING METHOD HOLLOW STEM HAMMER TYPE 140# SAFETY HAMMER

Station	By URS	ELEV	DEPTH	BLOW	UCS	MOIST	Surface Water Elev.	ELEV	DEPTH	BLOW	UCS	MOIST
Offset	By URS	(ft.)	(ft.)	/6"	(tsf)	(%)	(ft.)	(ft.)	(ft.)	/6"	(tsf)	(%)
Ground Surface Elev.	673.881						-					
SOIL DESCRIPTION												
12" CONCRETE												
SILTY CLAY - A-6 Gray-Mottled-Brown, moist, stiff, low plasticity												
SANDY LOAM - A-2-6 Dark Brown, moist, very loose, fine-coarse, little sand, trace gravel												
SILTY CLAY LOAM - A-4 Brown, moist, stiff, low plasticity, little sand -very stiff												
SILTY CLAY LOAM - A-6 Gray, moist, very stiff, low plasticity, little sand, trace gravel												
SAND - A-1-b Brown, saturated, dense, fine-medium (*free water @ 19.5'												
SANDY LOAM - A-2-6 Brown, wet, very dense, fine-coarse, trace gravel												
SAND - A-1-a Gray, wet, very dense, fine-coarse												
CLAY - A-6 Gray, moist, hard, low plasticity, little sand, trace gravel												
SANDY LOAM - A-2-6 Gray, moist, very dense, fine-coarse, with gravel												

The Unconfined Compressive Strength (UCS) Failure Mode is indicated by (B-Bulge, S-Shear, P-Penetrometer).  
The Standard Penetration Test (SPT) N Value is per (AASHTO T206)

BBS 137 (9/05)



# SOIL BORING LOG

Page 2 of 2  
Project #: 313516  
Date 04/01/13

ROUTE \_\_\_\_\_ DESCRIPTION BRUSH COLLEGE ROAD LOGGED BY CM  
SECTION \_\_\_\_\_ LOCATION DECATUR, IL  
COUNTY MACON STRUCTURE NO. \_\_\_\_\_ (Exist) \_\_\_\_\_ (Prop.) \_\_\_\_\_  
BORING NO. B-15 DRILLING METHOD HOLLOW STEM HAMMER TYPE 140# SAFETY HAMMER

Station	By URS	ELEV	DEPTH	BLOW	UCS	MOIST	Surface Water Elev.	ELEV	DEPTH	BLOW	UCS	MOIST
Offset	By URS	(ft.)	(ft.)	/6"	(tsf)	(%)	(ft.)	(ft.)	(ft.)	/6"	(tsf)	(%)
Ground Surface Elev.	673.881						-					
SOIL DESCRIPTION												
CLAY - A-6 Gray, moist, hard, low plasticity, little sand trace gravel END OF BORING @ 71.0 FT.												

The Unconfined Compressive Strength (UCS) Failure Mode is indicated by (B-Bulge, S-Shear, P-Penetrometer).  
The Standard Penetration Test (SPT) N Value is per (AASHTO T206)

BBS 137 (9/05)



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PLOT DATE = 4/29/2013	CHECKED - SDS	REVISED

STATE OF ILLINOIS  
DEPARTMENT OF TRANSPORTATION

BORINGS  
STRUCTURE NO. 058-W003

SHEET NO. SA-23 OF SA-26 SHEETS

F.A.U. RTE.	SECTION	COUNTY	TOTAL SHEETS	SHEET NO.
7448	09-00933-01-BR	MACON	1019	591
CONTRACT NO. 95893				
ILLINOIS FED. AID PROJECT				









**GENERAL NOTES**

1. Reinforcement bars designated (E) shall be epoxy coated.
2. Wall stations and offsets are given to the front face (FF) of the wall and are measured from the Brush College Road baseline, except as noted.
3. Protective Coat shall be applied to the top and interior surfaces of the parapets and the top exposed surface of the Anchorage Slabs and Sidewalk.
4. Slipforming of parapets along east anchorage slab is not allowed.
5. The Contractor shall field verify the location of all underground utilities. The contractor shall take precautions to protect existing underground utilities that are to remain in service during construction of the wall. Any damage to underground utilities will be the responsibility of the Contractor. For locations and elevations of utilities, see Utility Plans.
6. The Contractor may encounter abandoned utilities or drainage structures that obstruct construction of the proposed wall. Removal and disposal of portions of these obstructions shall not be cause for additional payment but shall be included in the cost of "Precast Modular Retaining Wall". For locations and elevations of utilities, see Utility Plans.
7. All Lightweight Cellular Concrete Fill shall be Class II. See Special Provisions.
8. The Contractor shall coordinate the construction of the proposed wall with the construction of the proposed bridge over Faries Parkway (S.N. 058-9202). See Suggested Stages of Construction and Traffic Control Plans and special provisions.
9. For details and quantity of conduits embedded in structure, see Electrical Plans.
10. Fill type retaining walls (MSE and Precast Modular) shall be detailed and constructed to allow for proposed roadway drainage to be placed properly and as shown in the plans. Any requests for modification to drainage structure locations to accommodate wall reinforcing or details shall be submitted to the engineer in writing for review. Any changes approved by the engineer in writing will be coordinated by the contractor at no additional cost.

**TOTAL BILL OF MATERIAL**


ITEM	UNIT	TOTAL
Structure Excavation	Cu. Yd.	3,971
Concrete Structures	Cu. Yd.	424.8
Concrete Superstructure	Cu. Yd.	679.1
Protective Coat	Sq. Yd.	2,301
Reinforcement Bars, Epoxy Coated	Pound	111,340
Bicycle Railing	Foot	603
Parapet Railing	Foot	584
Name Plates	Each	1
Temporary Soil Retention System	Sq. Ft.	1,243
Mechanically Stabilized Earth Retaining Wall	Sq. Ft.	10,612
Precast Modular Retaining Wall	Sq. Ft.	16,346
Lightweight Cellular Concrete Fill	Cu. Yd.	21,687
Temporary Soil Retention System (Special)	Sq. Ft.	4,046
Portland Cement Concrete Sidewalk 5 inch, Special	Sq. Ft.	5,900
Pipe Underdrains for Structures, 4"	Foot	690

**INDEX OF SHEETS**

- SB-1. General Plan & Elevation
- SB-2. General Notes & Bill of Material
- SB-3. Developed Elevation
- SB-4. Typical Section
- SB-5. Typical Sections
- SB-6. Temporary Soil Retention System (Special)
- SB-7. Temporary Soil Retention System
- SB-8. West Anchorage Slab (1 of 7)
- SB-9. West Anchorage Slab (2 of 7)
- SB-10. West Anchorage Slab (3 of 7)
- SB-11. West Anchorage Slab (4 of 7)
- SB-12. West Anchorage Slab (5 of 7)
- SB-13. West Anchorage Slab (6 of 7)
- SB-14. West Anchorage Slab (7 of 7)
- SB-15. East Anchorage Slab (1 of 7)
- SB-16. East Anchorage Slab (2 of 7)
- SB-17. East Anchorage Slab (3 of 7)
- SB-18. East Anchorage Slab (4 of 7)
- SB-19. East Anchorage Slab (5 of 7)
- SB-20. East Anchorage Slab (6 of 7)
- SB-21. East Anchorage Slab (7 of 7)
- SB-22. Sidewalk (1 of 2)
- SB-23. Sidewalk (2 of 2)
- SB-24. Anchorage Slab & Wall Details (1 of 3)
- SB-25. Anchorage Slab & Wall Details (2 of 3)
- SB-26. Anchorage Slab & Wall Details (3 of 3)
- SB-27. Bicycle Railing
- SB-28. Concrete Parapet Slipforming Option
- SB-29. Soil Boring Logs (B-16)
- SB-30. Soil Boring Logs (B-17)
- SB-31. Soil Boring Logs (B-18)
- SB-32. Soil Boring Logs (B-19)
- SB-33. Soil Boring Logs (B-25)
- SB-34. Soil Boring Logs (B-26 & B-27)
- SB-35. Soil Boring Logs (B-28 & B-29)

STATION 62+39.94 TO 69+25.33  
 BUILT BY  
 CITY OF DECATUR  
 F.A.U. 7448  
 SEC. 09-00933-01-BR  
 STR. NO. 058-W004

**NAME PLATE**  
 See Std. 515001

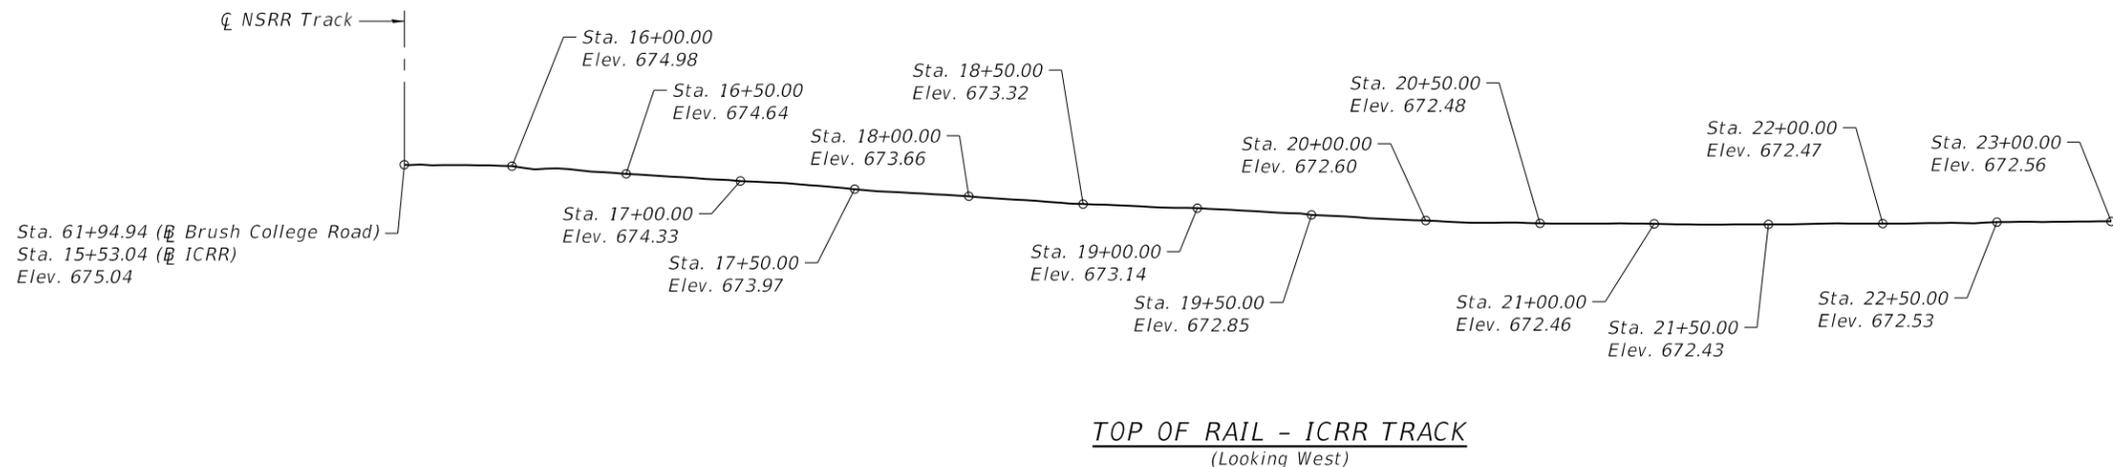

**TOP OF RAIL - ICRR TRACK**  
 (Looking West)

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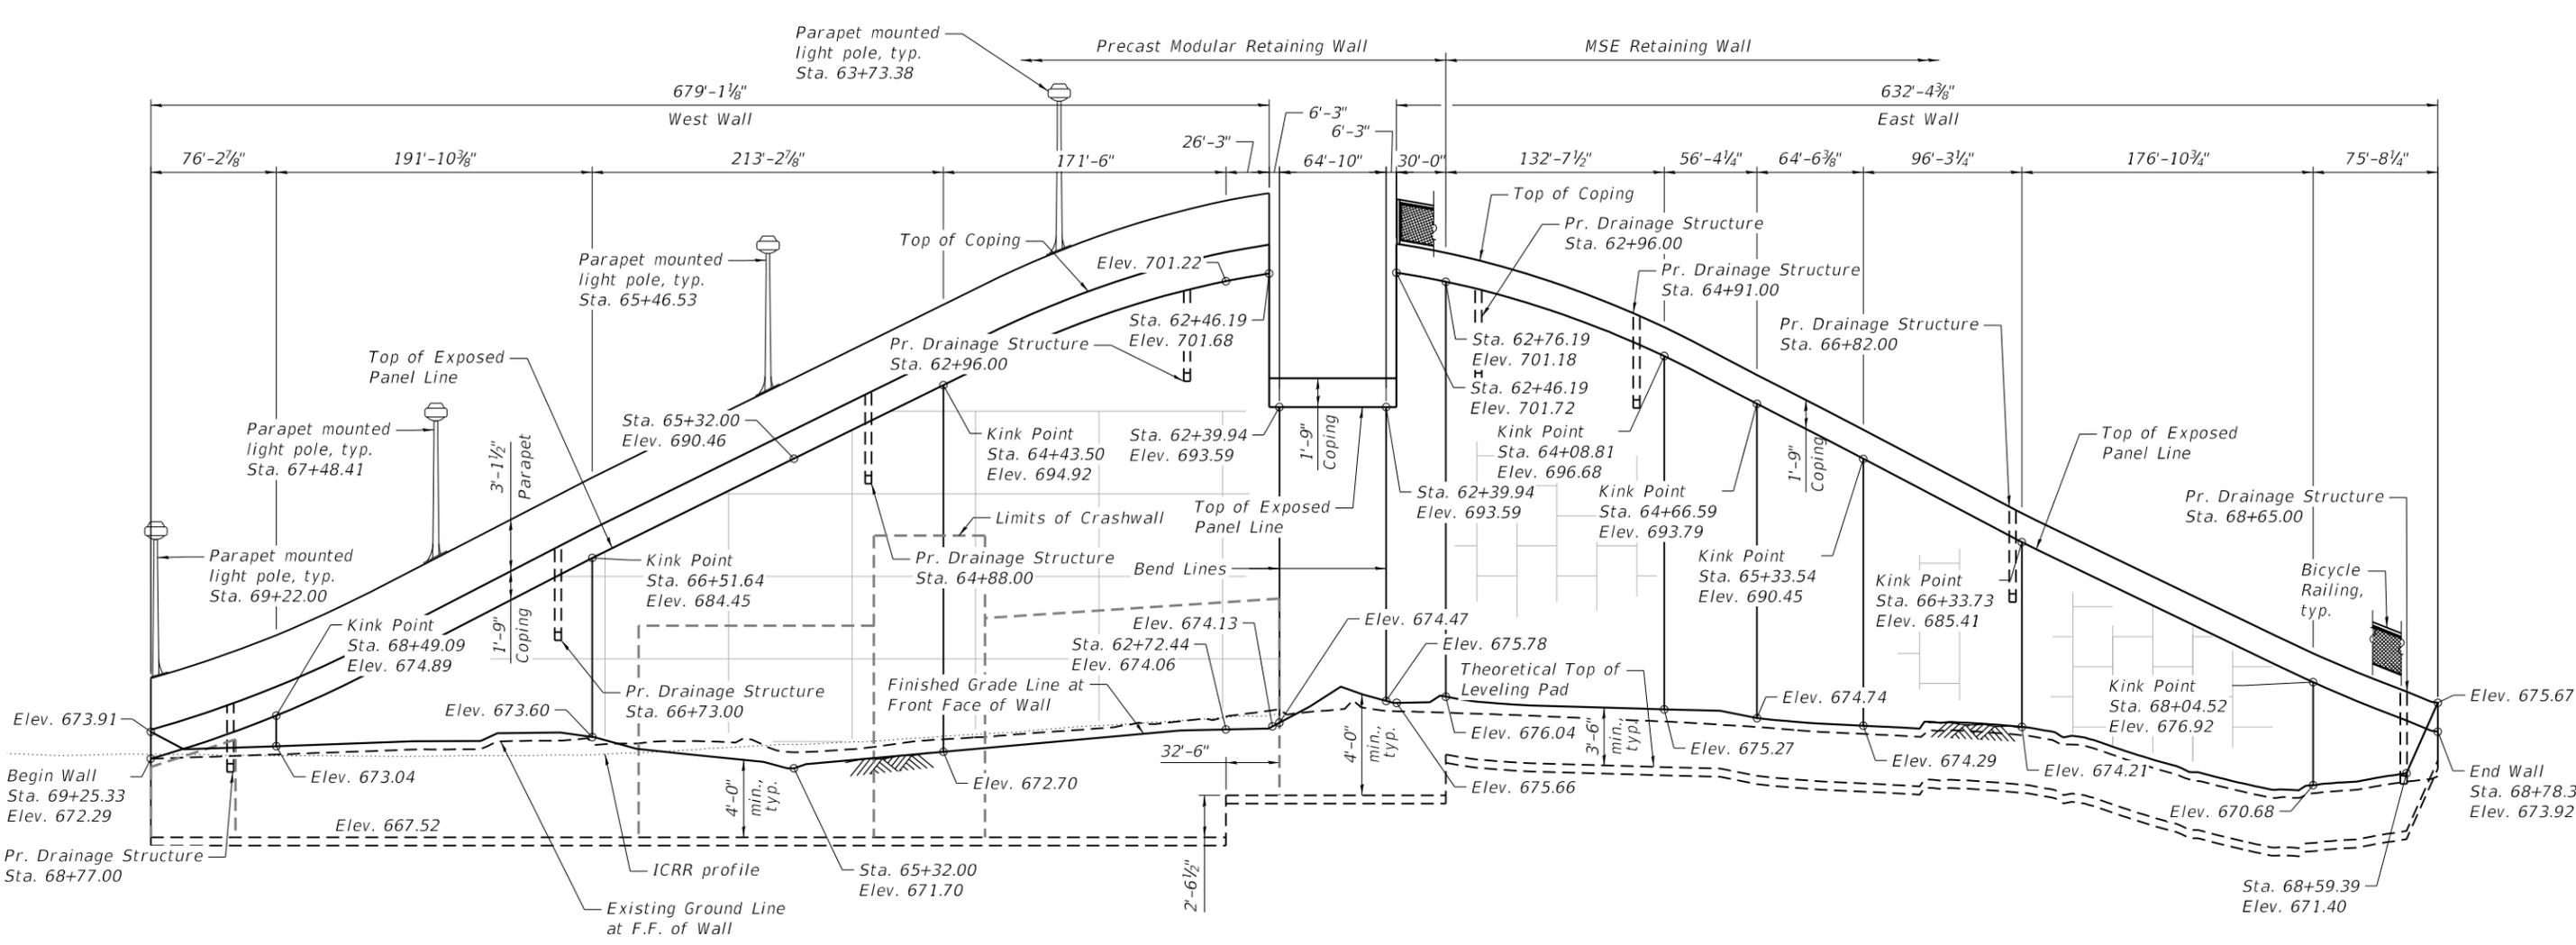
**STATE OF ILLINOIS  
 DEPARTMENT OF TRANSPORTATION**

**GENERAL NOTES & BILL OF MATERIAL  
 STRUCTURE NO. 058-W004**

SHEET SB-2 OF SB-35 SHEETS

F.A.U. RTE.	SECTION	COUNTY	TOTAL SHEETS	SHEET NO.
7448	09-00933-01-BR	MACON	1019	596
CONTRACT NO. 95893				
		ILLINOIS	FED. AID PROJECT	

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**ALLOWABLE BEARING PRESSURE**

Location	Station	Static Limit State
		Allowable Bearing $q_a$ (psf)
Abut	62+39.94	3,187
West	64+62.89	2,673
West	66+52.64	2,673
West	66+52.64	2,673
West	68+30.22	2,673
East	63+91.53	3,187
East	65+47.29	2,673
East	66+14.23	2,673
East	66+50.00	2,673
East	66+50.00	2,673
East	67+94.90	2,673

**UNFOLDED ELEVATION**

(Looking at Front Face of Wall)

Note:  
All measurements are along the F.F. of wall.




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**STATE OF ILLINOIS  
DEPARTMENT OF TRANSPORTATION**

**DEVELOPED ELEVATION  
STRUCTURE NO. 058-W004**

SHEET SB-3 OF SB-35 SHEETS

F.A.U. RTE.	SECTION	COUNTY	TOTAL SHEETS	SHEET NO.
7448	09-00933-01-BR	MACON	1019	597
CONTRACT NO. 95893				
		ILLINOIS	FED. AID PROJECT	

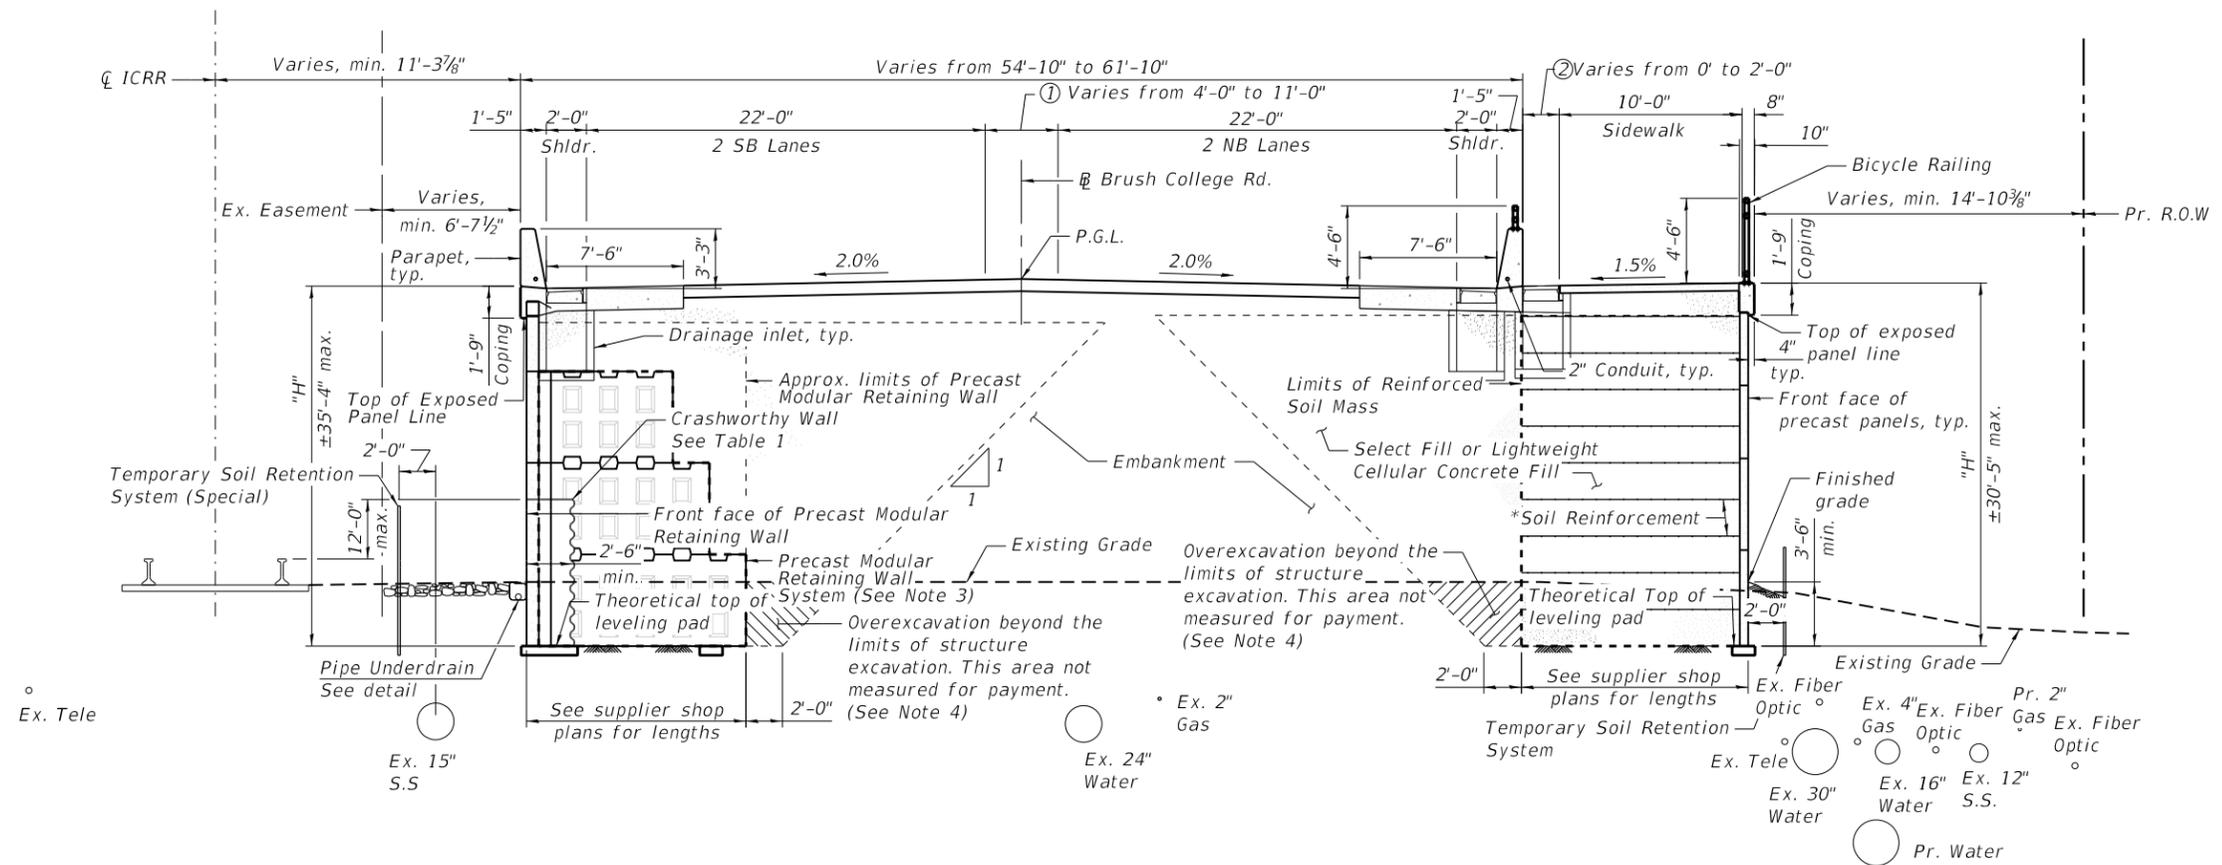

**TYPICAL ROADWAY SECTION THROUGH RETAINING WALLS**

(Looking North)

**Notes:**

1. See Sheet SB-5 of SB-35 for section through east wall beyond station 68+59.98.
2. Retaining wall shall be Crashworthy per 2020 Manual for Railway Engineering from a min. of 7'-0" above top of rail down to top of leveling pad for wall within 25' of the  $\phi$  existing rail from Sta. 62+39.94 Lt. to Sta. 69+25.33 Lt., see cross sections. Cost of crashworthy concrete mass paid for as Concrete Structures.
3. The wall supplier's interval stability design shall account for the anchorage slab's bearing pressure surcharge of 1.0 ksf and horizontal sliding force of 0.67 kips/ft. of wall.
4. Backfill overexcavation with same material as used for select fill or lightweight cellular fill.

**ROADWAY DIMENSION TABLE**

Station	①	②
62+39.94	4'-0"	0
64+08.81	4'-0"	0
64+67.08	5'-3 $\frac{1}{8}$ "	0
65+33.42	7'-5 $\frac{3}{4}$ "	2'-0"
65+47.63	7'-11 $\frac{1}{4}$ "	2'-0"
66+51.64	11'-0"	2'-0"
68+04.52	11'-0"	2'-0"
68+59.98	11'-0"	3'-4 $\frac{3}{4}$ "


(Raised Median)

(Note 1)

**TABLE 1 - CRASHWORTHY WALL LIMITS**

Start Station	Top of CW Elev.	Height (ft.)	End Station	Top of CW Elev.	Height (ft.)	Length (ft.)
62+39.94	681.98	11.92	62+72.44	681.77	11.71	32.50
62+72.44	681.77	14.25	64+18.60	680.85	13.33	146.16
64+18.60	685.85	18.33	64+84.68	685.85	18.33	67.59
64+84.68	680.34	12.82	66+23.86	680.34	12.82	142.93
66+23.86	N/R	N/R	68+73.83	N/R	N/R	244.66
68+73.83	673.45	5.93	69+25.33	671.79	4.27	51.50

N/R - Crashworthy Wall not required

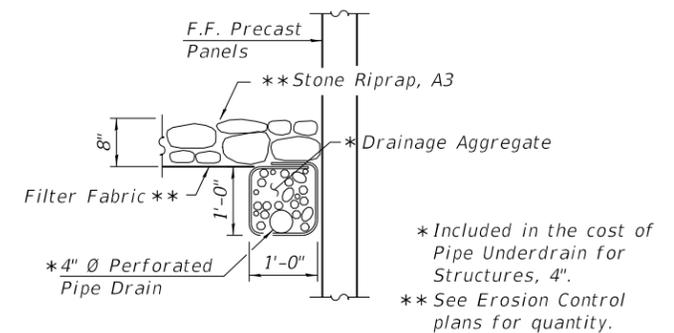

**PIPE UNDERDRAIN DETAIL**

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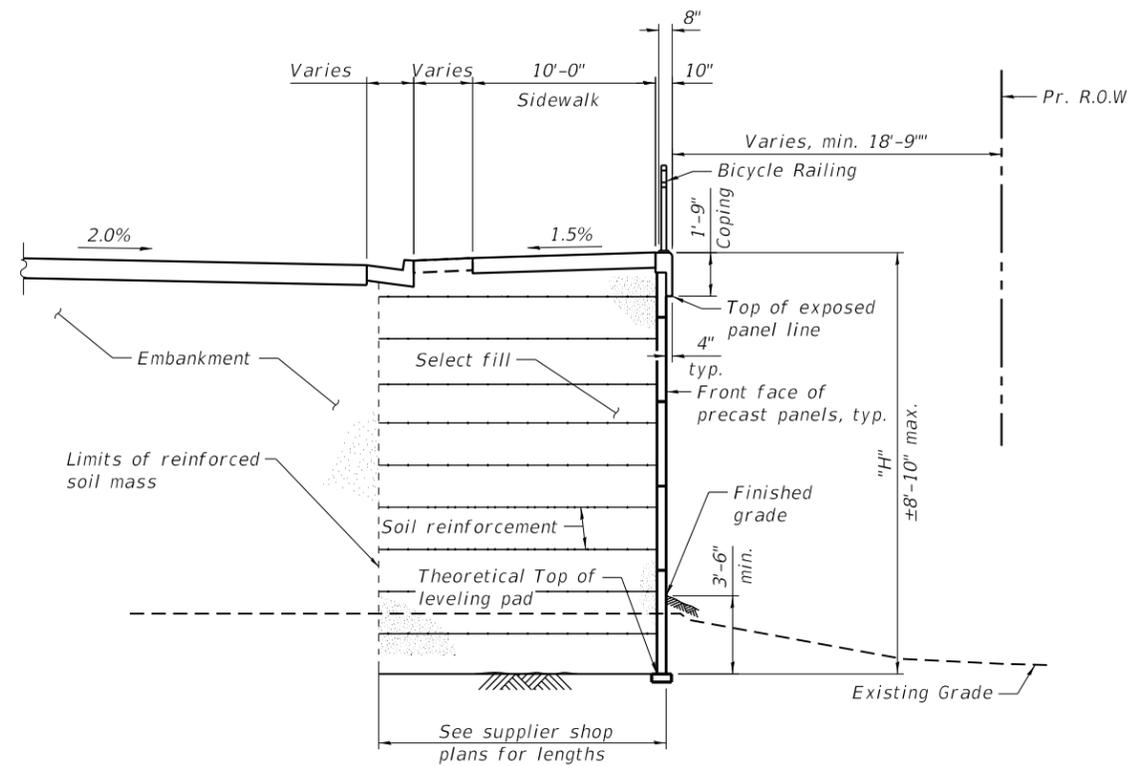
**STATE OF ILLINOIS  
DEPARTMENT OF TRANSPORTATION**

**TYPICAL SECTION  
STRUCTURE NO. 058-W004**

SHEET SB-4 OF SB-35 SHEETS


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7448	09-00933-01-BR	MACON	1019	598
CONTRACT NO. 95893				
		ILLINOIS	FED. AID PROJECT	

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**SECTION THROUGH EAST MSE WALL**  
 (From Sta. 68+59.98 to Sta. 68+78.37)

- Notes:
1. Section thru abutment showing IC railroad running parallel to the bridge beyond the west side of the structure. Crashworthy retaining walls shall extend 7'-0" above top of rail for wall within 25' of the  $\phi$  existing rail.
  2. Fabric Reinforced Elastomeric Mat according to Section 1028 of the Standard Specifications. Fabric mat shall be 24" wide and attached full width and vertically at edges to the abutment cap with a  $\frac{3}{8}$ " x 5" steel plate and  $\frac{1}{2}$ "  $\phi$  studs with nuts and washers at 12" cts. Cost included with Concrete Superstructure.



**SECTION THROUGH SEMI-INTEGRAL ABUTMENT**  
 (Horiz. dim. @ Rt. L's)

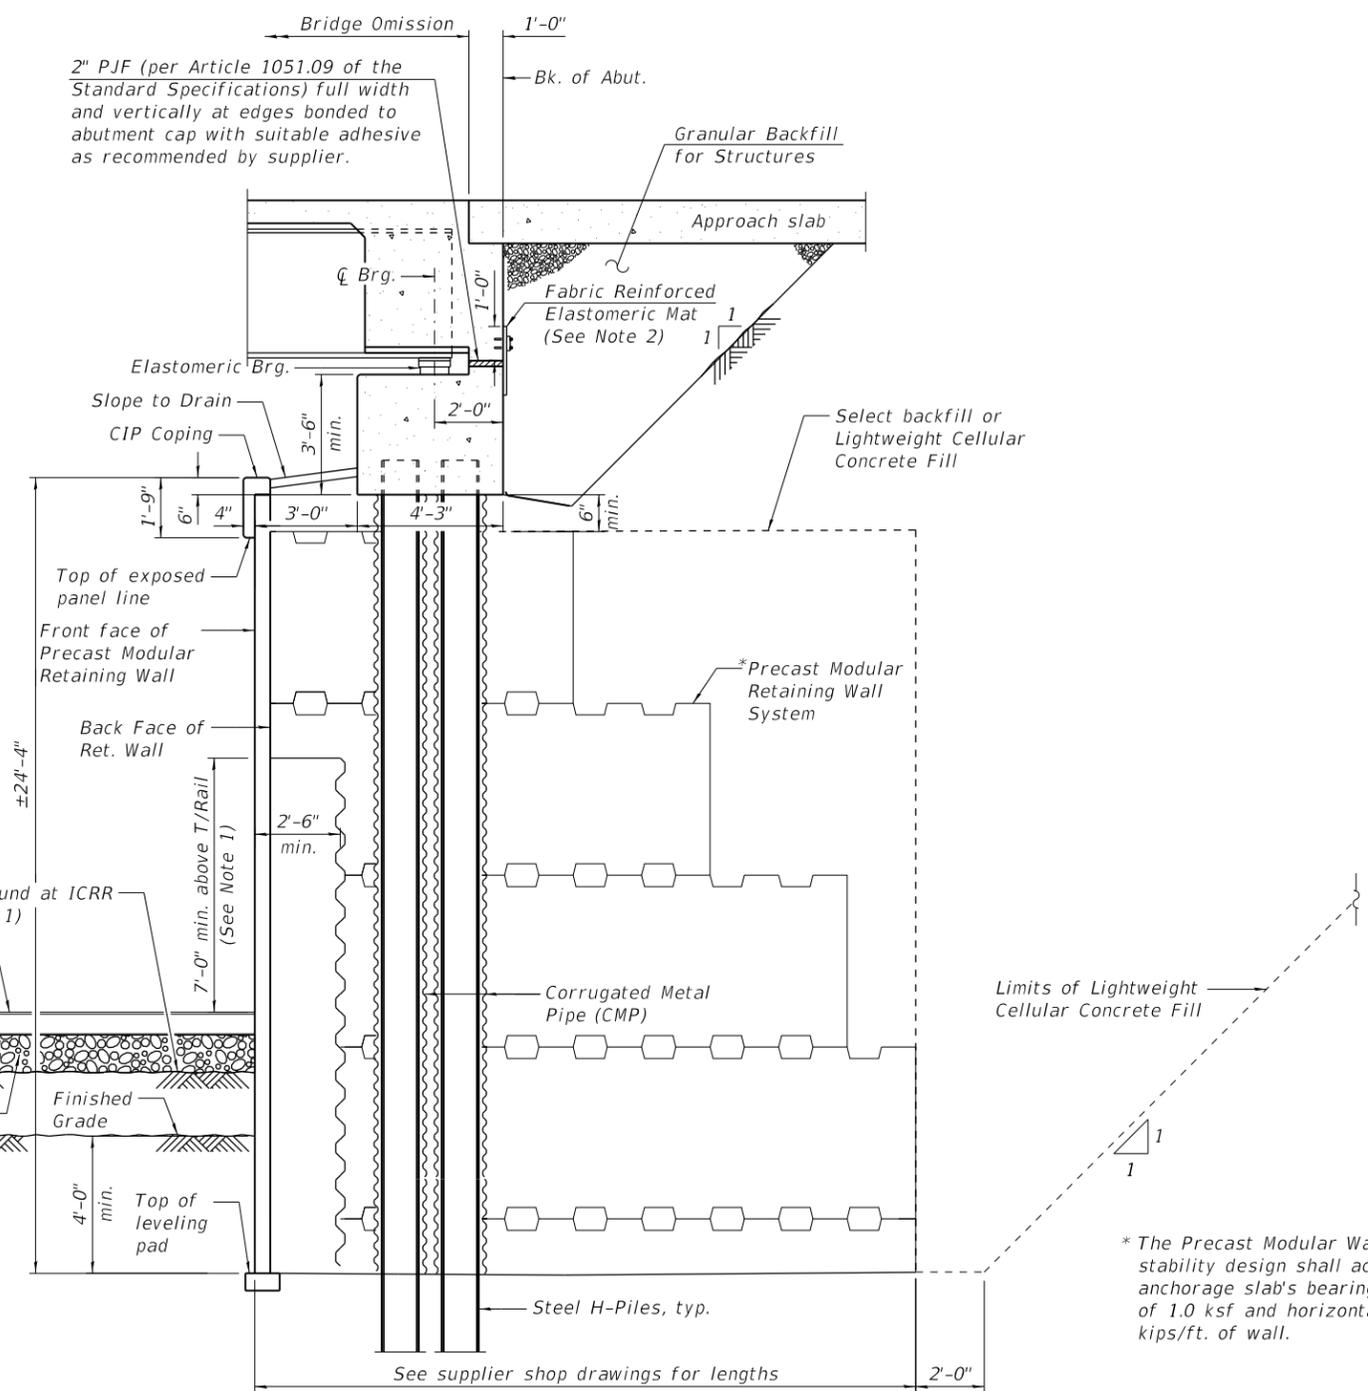\* The Precast Modular Wall supplier's internal stability design shall account for the anchorage slab's bearing pressure surcharge of 1.0 ksf and horizontal sliding force of 0.67 kips/ft. of wall.




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PLOT DATE =		CHECKED -	MDC	REVISED -	

**STATE OF ILLINOIS**  
**DEPARTMENT OF TRANSPORTATION**


**TYPICAL SECTIONS**  
**STRUCTURE NO. 058-W004**

SHEET SB-5 OF SB-35 SHEETS


F.A.U. RTE.	SECTION	COUNTY	TOTAL SHEETS	SHEET NO.
7448	09-00933-01-BR	MACON	1019	599
CONTRACT NO. 95893				
ILLINOIS FED. AID PROJECT				

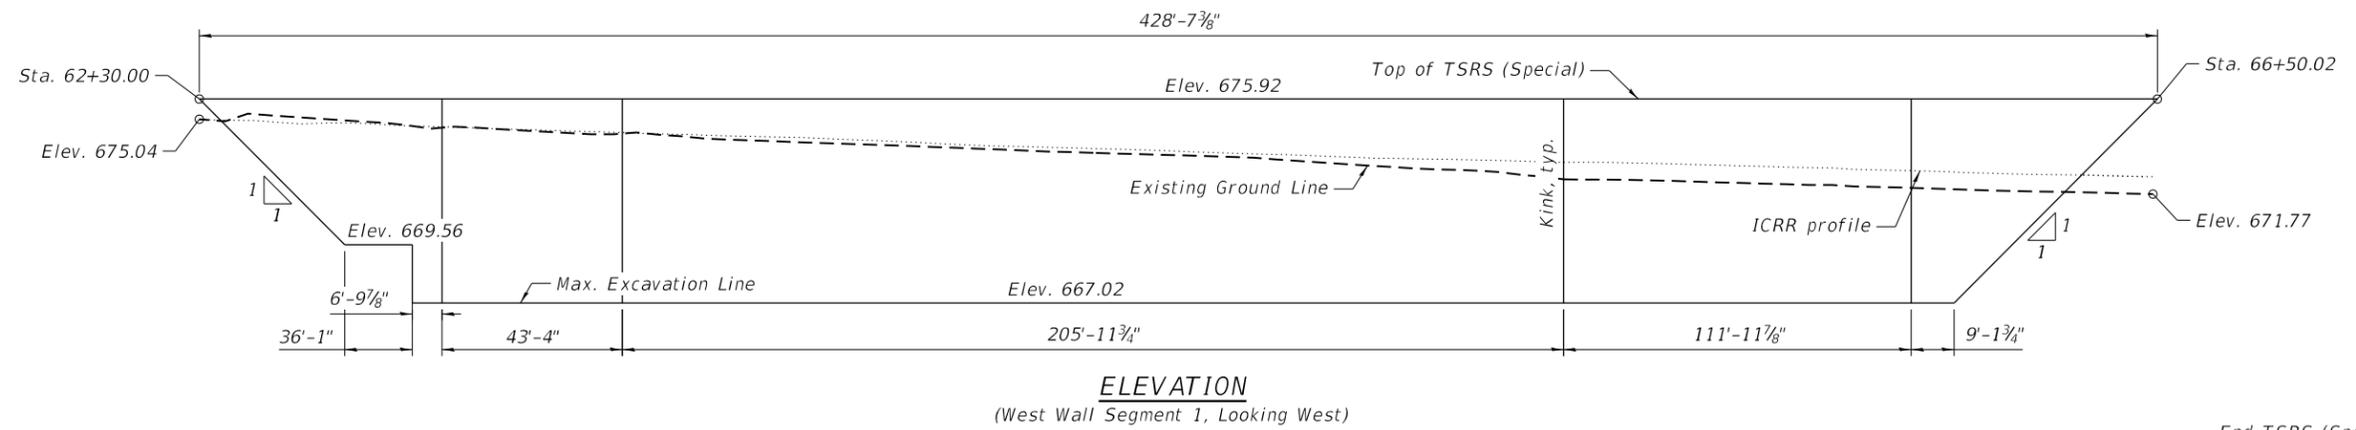


**ELEVATION**  
(West Wall Segment 1, Looking West)

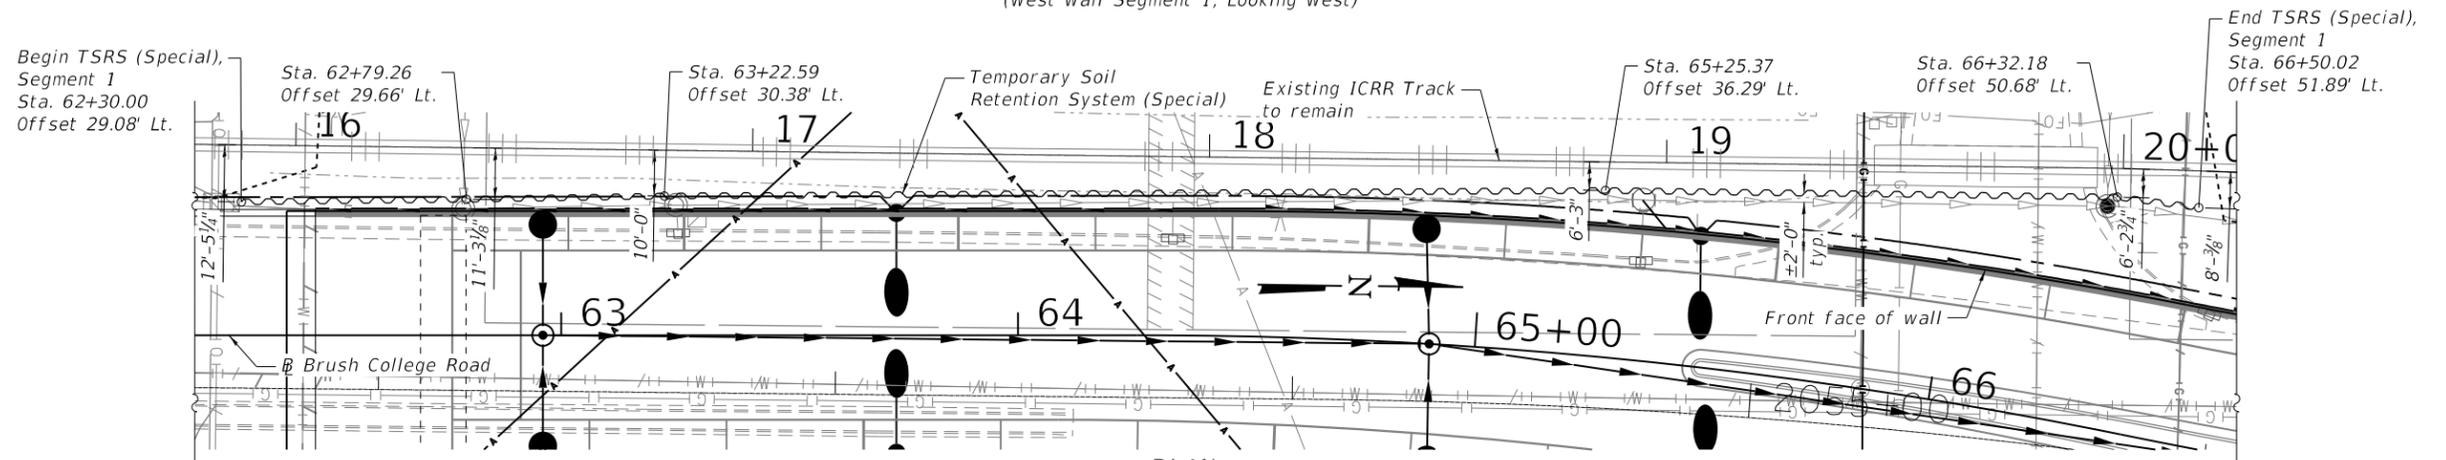

**PLAN**  
(West Wall Segment 1)

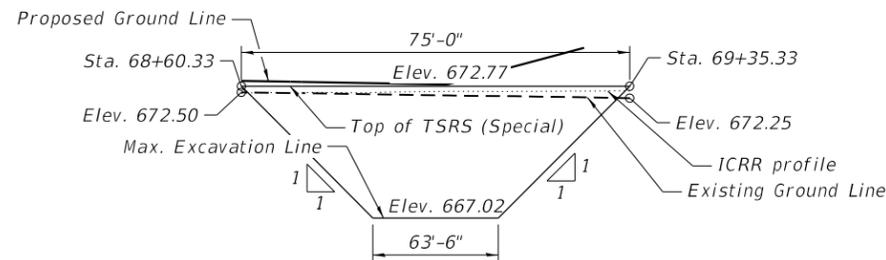

**ELEVATION**  
(West Wall Segment 2, Looking West)

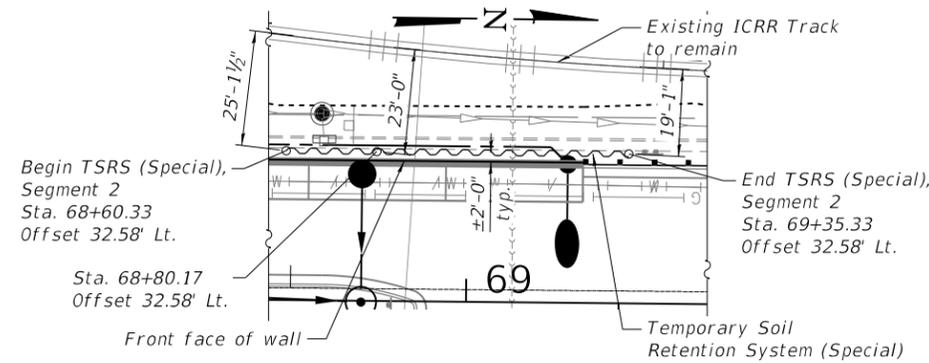

**PLAN**  
(West Wall Segment 2)

- Notes:
1. A cantilevered sheet piling design does not appear feasible and additional members or other retention systems may be necessary. The Contractor shall submit a temporary soil retention system design including plan details and calculations for review and acceptance by the Engineer.
  2. Horizontal dimensions and grounds slopes are shown along the Temporary Soil Retention System unless noted otherwise.
  3. Temporary Soil Retention System is paid for as Temporary Soil Retention System (Special). See Special Provisions.
  4. The contractor is alerted to the presence of underground utilities under the proposed Temporary Soil Retention System and may need to be kept in service during construction of the wall. See Drainage and Utility Plans.

**BILL OF MATERIAL**

Item	Unit	Quantity
* Temporary Soil Retention System (Special)	Sq. Ft.	4,046

\* See Special Provisions

MODEL: Sheet  
FILE NAME: p:\vaecom-na-pw\beniteley.com\AECOM\_DS16\_NA\Documents\60603202-Brush College\900-CAD\_GIS\910\_CAD\03\_SHEETS\03\_QUIGGWSE Walls Sheets\60603202\_058-W004\_06\_TSRS - 1.dgn



USER NAME =	Icriscione	DESIGNED -	KWB	REVISED -	
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PLOT SCALE =	40,000' / in.	DRAWN -	LMC	REVISED -	
PLOT DATE =		CHECKED -	MDC	REVISED -	

STATE OF ILLINOIS  
DEPARTMENT OF TRANSPORTATION

TEMPORARY SOIL RETENTION SYSTEM (SPECIAL)  
STRUCTURE NO. 058-W004

SHEET SB-6 OF SB-35 SHEETS

F.A.U. RTE.	SECTION	COUNTY	TOTAL SHEETS	SHEET NO.
7448	09-00933-01-BR	MACON	1019	600
CONTRACT NO. 95893				
ILLINOIS		FED. AID PROJECT		