STATE OF ILLINOIS

DEPARTMENT OF TRANSPORTATION

D-96-027-22


FOR INDEX OF SHEETS, SEE SHEET NO. 2

PROPOSED CONTRACT MAINTENANCE

FAI ROUTE 55 (I-55)
SECTION (59-1HB-2)BRR
PROJECT (STATE ONLY)
BRIDGE BEARING REPLACEMENT
MACOUPIN COUNTY

C-96-031-22



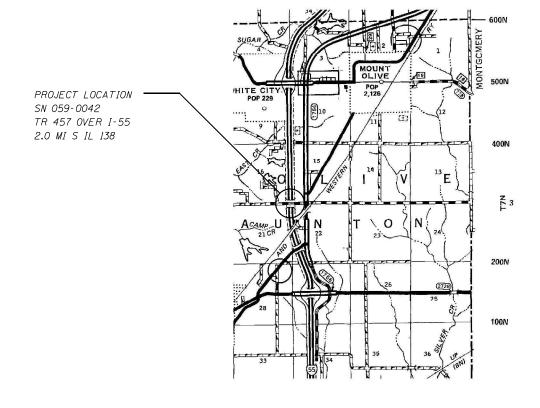

0 100' 200' 300' — 1" = 100'
0 10' 20' 30' — 1" = 10'
0 50' 100' — 1" = 50'
0 50' 100' — 1" = 40'
0 50' 100' — 1" = 30'
0 50' 100' — 1" = 20'

FULL SIZE PLANS HAVE BEEN PREPARED USING STANDARD ENGINEERING SCALES. REDUCED SIZED PLANS WILL NOT CONFORM TO STANDARD SCALES. IN MAKING MEASUREMENTS ON REDUCED PLANS, THE ABOVE SCALES MAY BE USED.

J.U.L.I.E.
JOINT UTILITY LOCATION INFORMATION FOR EXCAVATION
1–800–892–0123
OR 811

BRIDGE MAINTENANCE ENGINEER: BRANDON DUDLEY - (217) 785-9290


GROSS LENGTH = XX FT. = XX MILE

NET LENGTH = XX FT. = XX MILE

CONTRACT NO. 72N50

 \bigcirc



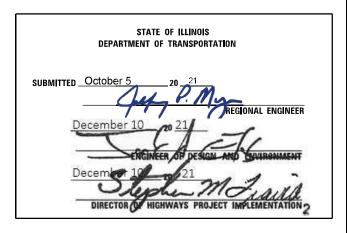

PRINTED BY THE AUTHORITY OF THE STATE OF ILLINOIS

 INDEX OF SHEETS
 STANDARDS

 1
 COVER SHEET
 000001-08

 2
 INDEX, STANDARDS, SIGNATURES, & GENERAL NOTES
 001001-02


 3
 SUMMARY OF QUANTITIES
 001006

 4-5
 SN 059-0042 BRIDGE PLANS
 701001-02

 701101-05
 701101-05

 701106-02
 701201-05

GENERAL NOTES:

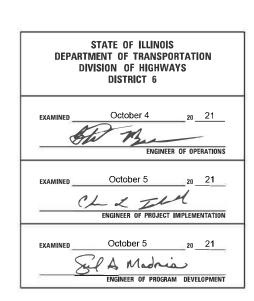

REV. - MS

USER NAME = dudleybm	DESIGNED =	REVISED =	I I I I I I I I I I I I I I I I I I I					INDEX OF SHEETS, STANDARDS.				COUNTY	TOTAL SHEET
	DRAWN	REVISED -	STATE OF ILLINOIS						55.	SECTION (59-1HB-2)BRR	MACOUPIN	SHEETS NO.	
PLOT SCALE = 100.0000 / in.	CHECKED	REVISED -	DEPARTMENT OF TRANSPORTATION	DEPARTMENT OF TRANSPORTATION GENERAL NOTES, & SIGNATURES			30	(00 1110 2)01111	CONTRACT	NO. 72N50			
PLOT DATE = 10/5/2021	DATE	REVISED 4		SCALE:	SHEET	OF	SHEETS	STA.	TO STA.		ILLINOIS FED. A	D PROJECT	


701901**-**08


0-02176-6029 SN 059-0042 100% STATE

			ı	
				BRIDGE/RURAL
CODE			TOTAL	0013
NO.	ITEM	UNIT	QUANTITY	MACOUPIN
50500405	FURNISHING AND ERECTING STRUCTURAL STEEL	POUND	1890	1890
52100010	ELASTOMERIC BEARING ASSEMBLY, TYPE I	EACH	10	10
		2.1611	10	
52100520	ANCHOR BOLTS, 1"	EACH	20	20
67100100	MOBILIZATION	L SUM	1	1
70100450	TRAFFIC CONTROL AND PROTECTION, STANDARD 701201	L SUM	1	1
Z0001899	JACK AND REMOVE EXISTING BEARINGS	EACH	10	10


REV. - MS

USER NAME = dudleybm	DESIGNED -	REVISED -								F.A.I.	SECTION	COUNTY	TOTAL SHEET
	DRAWN -	REVISED -	STATE OF ILLINOIS	SUMMARY OF QUANTITIES						55	(59-1HB-2)BRR	MACOUPIN	5 3
PLOT SCALE = 100.0000 ' / in.	CHECKED -	REVISED -	DEPARTMENT OF TRANSPORTATION								,	CONTRACT	NO. 72N50
PLOT DATE = 10/14/2021	DATE -	REVISED -		SCALE:	SHEET	OF	SHEETS	STA.	TO STA.		ILLINOIS FED. A	ID PROJECT	

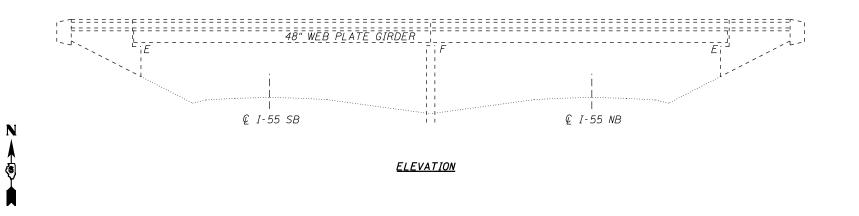

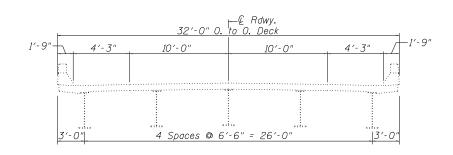

DECK CROSS SECTION

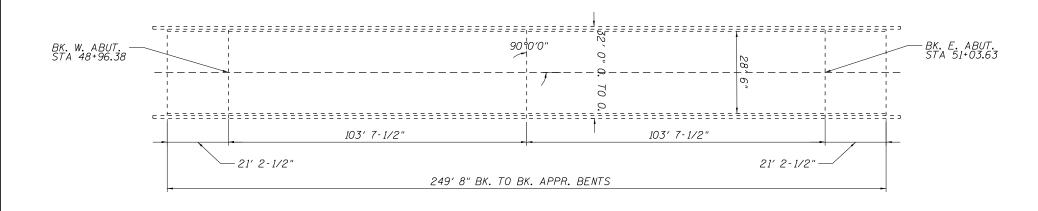

<u>PLAN</u>

DAVID CARL 6 PUZEY 9 SPRINGFIELD *
SPRINGFIELD *
LLINOIS COF ILLINOIS COFFICIAL CO

STRUCTURE GENERAL NOTES:

PLAN DIMENSIONS AND DETAILS RELATIVE TO EXISTING PLANS ARE SUBJECT TO NOMINAL CONSTRUCTION VARIATIONS. THE CONTRACTOR SHALL FIELD VERIFY EXISTING DIMENSIONS AND DETAILS AFFECTING NEW CONSTRUCTION AND MAKE NECESSARY APPROVED ADJUSTMENTS PRIOR TO CONSTRUCTION OR ORDERING OF MATERIALS. SUCH VARIATIONS SHALL NOT BE CAUSE FOR ADDITIONAL COMPENSATION FOR A CHANGE IN THE SCOPE OF WORK, HOWEVER, THE CONTRACTOR WILL BE PAID FOR THE QUANTITY ACTUALLY FURNISHED AT THE UNIT PRICE BID FOR THE WORK.

ALL STRUCTURAL STEEL SHALL BE AASHTO M270 GRADE 36 UNLESS OTHERWISE NOTED.

EXISTING STRUCTURAL STEEL THAT WILL BE IN CONTACT WITH NEW STRUCTURAL STEEL SHALL BE CLEANED AND PAINTED PRIOR TO ERECTION AS REQUIRED BY THE SPECIAL PROVISION "CLEANING AND PAINTING CONTACT SURFACE AREAS OF EXISTING STEEL STRUCTURES".

ALL NEW STRUCTURAL STEEL AND BEARING ASSEMBLIES SHALL BE HOT-DIP GALVANIZED. SEE SPECIAL PROVISIONS FOR "HOT DIP GALVANIZING FOR STRUCTURAL STEEL".


THE CONTRACTOR SHALL CORRECT ELEVATION DIFFERENCES IN THE PROFILE GRADE ACROSS THE EXISTING EXPANSION JOINTS AT THE ENDS OF THE DECK. THIS SHALL BE ACCOMPLISHED BY ADJUSTING THE VERTICAL DIMENSION OF THE PROPOSED STEEL BEARING EXTENSIONS. THE CONTRACTOR SHALL FIELD VERIFY THE EXISTING DIMENSIONS AND PROPOSE ALL VERTICAL ADJUSTMENTS TO THE ENGINEER PRIOR TO ORDERING MATERIALS. THE ALLOWABLE ELEVATION TOLERANCES BETWEEN THE TWO SIDES OF THE EXPANSION JOINTS SHALL BE ±1/4". RECORDING ACCURATE MEASUREMENTS AND ORDERING PROPERLY SIZED BEARING EXTENSIONS SHALL BE THE SOLE RESPONSIBILITY OF THE CONTRACTOR.

TOTAL BILL OF MATERIAL (SN 059-0042)


ITEM	UNIT	QUANTITY
Elastomeric Bearing Assembly, Type I	Each	10
Jack and Remove Existing Bearings	Each	10
Furnishing and Erecting Structural Steel	Pound	1890
Anchor Bolts, 1" Ø	Each	20

USER NAME = dudleybm	DESIGNED - BMD	REVISED -
	DRAWN -	REVISED -
PLOT SCALE = 100.0000 / in.	CHECKED - ATH	REVISED -
PLOT DATE = 10/14/2021	DATE -	REVISED -

STATE OF ILLINOIS
DEPARTMENT OF TRANSPORTATION

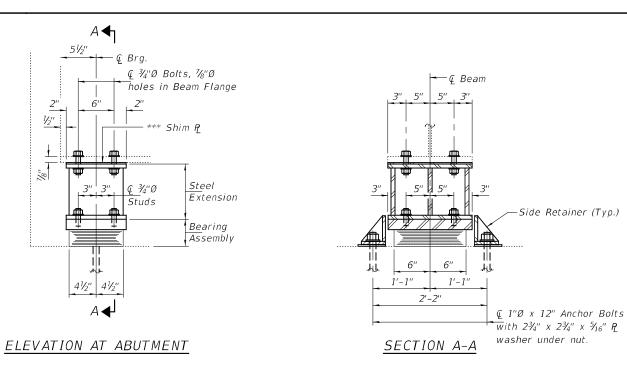


TYPE I ELASTOMERIC EXP. BRG.

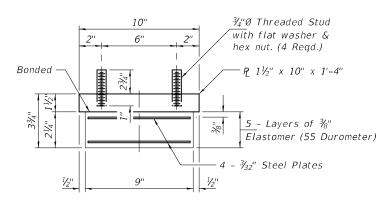

BEARING ASSEMBLY


Note:

Shim plates shall not be placed under Bearing Assembly.

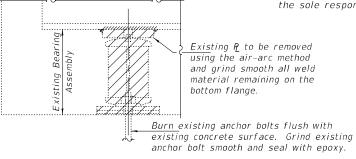

EXISTING BEARING REMOVAL DETAIL

Cost included with Jack and Remove Existing Bearings.

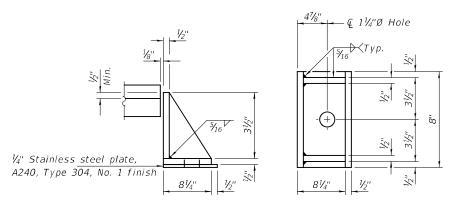

SIDE RETAINER

Equivalent rolled angle with stiffeners will be allowed in lieu of welded plates.

BEAM REACTIONS

R₽	(K)	39.7
R Ł	(K)	28.4
Imp.	(K)	6.2
R (Total)	(K)	74.3

Notes:

Diaphragm removal and reinstallation may be required to facilitate drilling holes. Cost included with Furnishing and Erecting Structural Steel.

New steel extensions, shim plates and connection bolts are included with Furnishing and Erecting Structural Steel. Prior to ordering any material, the Contractor shall verify in the field all bearing height and shim thickness dimensions. Adjustment must account for deck heave due to pack rust (if present).

Min. jack capacity = 43 Tons.

Anchor bolts shall be ASTM F1554 all-thread (or an Engineer-approved alternate material) of the grade(s) and diameter(s) specified. ASTM A307 Grade C anchor bolts may be used in lieu of ASTM F1554 Grade 36 (Fy=36ksi). The corresponding specified grade of AASHTO M314 anchor bolts may be used in lieu of ASTM F1554.


Drilled and set anchor bolts shall be installed according to Article 521.06 of the Standard Specifications.

Cost of Side retainers and Stainless Steel plates shall be included in the cost of Elastomeric Bearing Assembly, Type I.

The contractor shall correct elevation differences in the profile grade across the existing expansion joints at the ends of the deck. This shall be accomplished by adjusting the vertical dimension of the proposed steel bearing extensions. The contractor shall field verify the existing dimensions and propose all vertical adjustments to the Engineer prior to ordering materials. The allowable elevation tolerances between the two sides of the expansion joints shall be $\pm \frac{1}{4}$ ". Recording accurate measurements and ordering properly sized bearing extensions shall be the sole responsibility of the contractor.

PLAN TOP AND BOTTOM PLATE

1'-4"

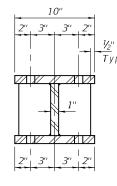

SECETION B-B

* * 1" 7" 7" 1" 1" 5/16 Typ.

STEEL EXTENSION DETAIL

* 10" – W. Abut. 10%" – E. Abut

** 8" – W. Abut. 85%" – E. Abut.

PARTIAL FRAMING PLAN

 $\langle A \rangle$ - Bearing Replacement

*** The Contractor shall correct elevation differences in the profile grade across the existing expansion joints at the ends of the deck. This shall be accomplished by adding shim plates at locations shown on the plans. No more than two shim plates shall be added to each bearing location. The Contractor shall field verify the existing dimensions and propose all vertical adjustments to the Engineer prior to ordering the extra shims. The allowable elevation tolerances between the two sides of the expansion joints shall be ±½".

Recording accurate measurements and ordering properly sized shims shall be the sole responsibility of the Contractor. Cost included with Furnishing and Erecting Structural Steel.

BILL OF MATERIAL

	11. 11	
Item	Unit	Total
Elastomeric Bearing Assembly, Type I	Each	10
Jack and Remove Existing Bearings	Each	10
Furnishing and Erecting Structural Steel	Pound	1890
Anchor Bolts, 1"Ø	Each	20

TYI/REPS 5-17-2018

DESIGNED - Victor H. Veliz	EXAMINED	Timoth A A 1 at	DATE -	DECEMBER 3, 2021
CHECKED - Stephen M. Ryan		ENGINEER OF STRUCTURAL SERVICES		
DRAWN - daburdell	PASSED	d. Carl Prayer	REVISED	-
CHECKED - VHV SMR]	ENGINEER OF BRIDGES AND STRUCTURES	REVISED	-

STATE OF ILLINOIS
DEPARTMENT OF TRANSPORTATION

BEARING DETAILS
T.R. 457 OVER I55
SN 059-0042
SHEET NO. 1 OF 1 SHEETS

 F.A.I. RTE.
 SECTION
 COUNTY SHEETS NO.
 TOTAL SHEETS NO.

 55
 (59-1HB-2)BRR
 MACOUPIN
 5
 5

 CONTRACT NO. 72N50