

FOR INDEX OF SHEETS, SEE SHEET NO. 2

FOR INDEX OF HIGHWAY STANDARDS, SEE SHEET NO. 2

01-21-2022 LETTING ITEM 070

TRAFFIC DATA

SPRING STREET
POSTED AND DESIGN SPEED LIMIT - 30 MPH
ADT = 7,650 (2018)
ROADWAY CLASSIFICATION: MINOR ARTERIAL

STATE OF ILLINOIS
DEPARTMENT OF TRANSPORTATION

**PLANS FOR PROPOSED
FEDERAL AID HIGHWAY**

FAU 1342 (SPRING STREET)
MCLEAN BLVD TO LA FOX ST (IL RTE 31)
RESURFACING
SECTION: 21-00052-00-RS
PROJECT: LR5C(581)
VILLAGE OF SOUTH ELGIN
KANE COUNTY


F.A.U. R.T.E. NO.	SECTION	COUNTY	TOTAL SHEETS	SHEET NO.
1342	21-00052-00-RS	KANE	28	1
		ILLINOIS CONTRACT NO. 61H43		



SPRING ST
IMPROVEMENT BEGINS
STA. 20 + 98

SPRING ST
IMPROVEMENT ENDS
STA. 71 + 56

C-91-162-21
LOCATION MAP
RBE

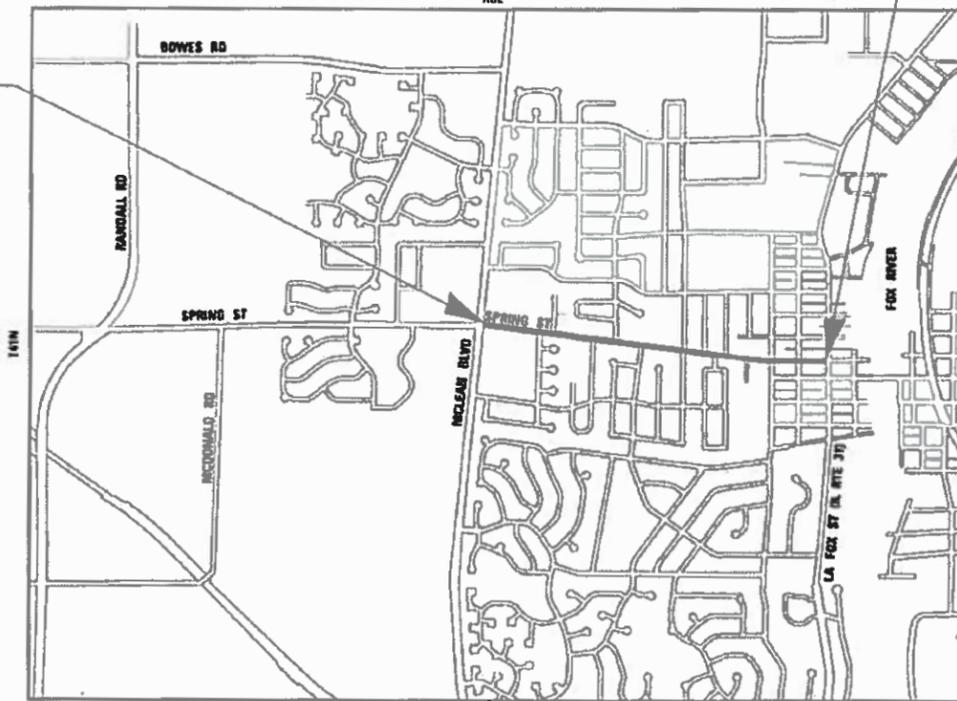

GROSS LENGTH = 5,058.01 FT. = 0.958 MILE
NET LENGTH = 5,058.01 FT. = 0.958 MILE



FULL SIZE PLANS HAVE BEEN PREPARED USING STANDARD ENGINEERING SCALES. REDUCED SIZED PLANS WILL NOT CONFORM TO STANDARD SCALES. IN MAKING MEASUREMENTS ON REDUCED PLANS, THE ABOVE SCALES MAY BE USED.

JULIE, DESIGN STAGE REQUEST
DIG. No. X1120598



CONTACT JULIE AT 811 OR 800-897-0123 WITH THE FOLLOWING:
COUNTY - KANE
CITY/TOWNSHIP - SOUTH ELGIN - ELGIN
SFC. & 1/4 SFC. NO. = 534.535 T41N RBE
48 HOURS (working days) BEFORE YOU DIG

CONTRACT NO.: 61H43

BAXTER & WOODMAN
Consulting Engineers



Jonathan B. Iken
PROJECT ENGINEER

STATE OF ILLINOIS
DEPARTMENT OF TRANSPORTATION
DIVISION OF HIGHWAYS

APPROVED: 10/28/21
[Signature]
VILLAGE OF SOUTH ELGIN DIRECTOR OF PUBLIC WORKS

PASSED: NOV 8, 2021
[Signature]
DISTRICT 1 ENGINEER OF LOCAL ROADS AND STREETS

RELEASING FOR BID BASED ON LIMITED REVIEW: NOVEMBER 8, 2021
[Signature]
REGIONAL ENGINEER

PRINTED BY THE AUTHORITY
OF THE STATE OF ILLINOIS

FEDERAL AID PROGRAM ENGINEER: CARMEN E. RABOIS, P.E., SCHAMBERG, IL.

INDEX OF SHEETS

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DISTRICT DETAILS

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- BD400-04 PAVEMENT PATCHING FOR HMA SURFACE PAVEMENT
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HIGHWAY STANDARDS

- 000001-08 STANDARD SYMBOLS, ABBREVIATIONS AND PATTERNS
- 424001-11 PERPENDICULAR CURB RAMPS FOR SIDEWALKS
- 424021-06 DEPRESSED CORNER FOR SIDEWALKS
- 442201-03 CLASS C & D PATCHES
- 604001-05 FRAMES AND LIDS TYPE 1
- 604051-04 FRAME AND GRATE TYPE 11
- 606001-08 CONCRETE CURB TYPE B AND COMBINATION CONCRETE CURB AND GUTTER
- 701006-05 OFF-RD OPERATIONS, 2L, 2W, 15' (4.5 M) TO 24" (600 MM) FROM PAVEMENT EDGE
- 701011-04 OFF-RD MOVING OPERATIONS, 2L, 2W, DAY ONLY
- 701301-04 LANE CLOSURE, 2L, 2W, SHORT TIME OPERATIONS
- 701311-03 LANE CLOSURE, 2L, 2W MOVING OPERATIONS-DAY ONLY
- 701501-06 URBAN LANE CLOSURE, 2L, 2W, UNDIVIDED
- 701701-10 URBAN LANE CLOSURE, MULTILANE INTERSECTION
- 701801-06 SIDEWALK, CORNER OR CROSSWALK CURB
- 701901-08 TRAFFIC CONTROL DEVICES
- 720006-04 SIGN PANEL ERECTION DETAILS
- 780001-05 TYPICAL PAVEMENT MARKINGS

GENERAL NOTES

- 1. L CONSTRUCTION SHALL BE DONE IN ACCORDANCE WITH THE DETAILS IN THE PLANS, THE SPECIAL PROVISIONS INCLUDED IN THE CONTRACT DOCUMENTS, AND THE FOLLOWING STATE OF ILLINOIS SPECIFICATIONS: THE JANUARY 1, 2022 VERSION OF "THE STANDARD SPECIFICATIONS FOR ROAD AND BRIDGE CONSTRUCTION" (REFERRED TO AS THE "STANDARD SPECIFICATIONS"), THE JANUARY 1, 2022 VERSION OF THE "SUPPLEMENTAL SPECIFICATIONS AND RECURRING SPECIAL PROVISIONS", THE 2009 VERSION OF THE "MANUAL ON UNIFORM TRAFFIC CONTROL DEVICES FOR STREETS AND HIGHWAYS", THE 2019 VERSION OF THE "MANUAL OF TEST PROCEDURES FOR MATERIALS" AND THE 8TH EDITION OF THE "STANDARD SPECIFICATIONS FOR WATER AND SEWER MAIN CONSTRUCTION IN ILLINOIS".

- 2. UTILITY LOCATIONS HAVE NOT BEEN SHOWN ON THESE PLANS. THE CONTRACTOR SHALL BE RESPONSIBLE FOR THE PROTECTION OF ALL UNDERGROUND OR SURFACE UTILITIES, INCLUDING SPRINKLER SYSTEMS, EVEN THOUGH THEY MAY NOT BE SHOWN ON THE PLANS. THE CONTRACTOR SHALL ALSO VERIFY THE DEPTHS OF THE EXISTING UTILITIES IF NECESSARY TO VERIFY THAT GRADE CONFLICTS WILL NOT OCCUR WITH ANY PROPOSED UTILITIES PRIOR TO CONSTRUCTION AND ORDERING ANY MATERIALS. ANY RELOCATION OR LOWERING OF UTILITIES SHALL BE COORDINATED BY THE CONTRACTOR.
- 3. THE CONTRACTOR SHALL NOTIFY THE VILLAGE PUBLIC WORKS ADMINISTRATOR AT LEAST 48 HOURS IN ADVANCE OF BEGINNING WORK TO OBTAIN VILLAGE UTILITY LOCATIONS.
- 4. THE CONTRACTOR MAY OBTAIN MUNICIPAL WATER IN BULK, AT NO CHARGE, AS LONG AS THERE IS NOT A "WATERING BAN" IN EFFECT. THE INDISCRIMINATE USE OF FIRE HYDRANTS IS STRICTLY PROHIBITED. WATER FOR CONSTRUCTION SHALL BE METERED OR OTHERWISE ACCOUNTED FOR AND A DAILY LOG MAINTAINED. THE CONTRACTOR SHALL PROVIDE THE WATER TRUCK AND DRIVER REQUIRED TO OBTAIN AND TRANSPORT THIS WATER. THE VILLAGE RESERVES THE RIGHT TO RESTRICT OR REFUSE THE USE OF VILLAGE WATER IF DEEMED NECESSARY.
- 5. ACCESS TO PRIVATE DRIVEWAYS SHALL BE PROVIDED AT ALL TIMES EXCEPT DURING ACTUAL CONSTRUCTION ADJACENT THERE TO. TEMPORARY RAMPS SHALL BE CONSTRUCTED AS NEEDED TO PROVIDE SUCH ACCESS, UTILIZING CRUSHED STONE OR CRUSHED GRAVEL AS TEMPORARY ACCESS.
- 6. IT WILL BE THE CONTRACTOR'S RESPONSIBILITY TO NOTIFY THE ENGINEER, RESIDENTS AND THE VILLAGE WHEN ACCESS TO DRIVEWAYS WILL BE TEMPORARILY CLOSED DUE TO CURB AND GUTTER AND/OR DRIVEWAY REPLACEMENT. THE CONTRACTOR SHALL DISTRIBUTE NOTICES PROVIDED BY THE VILLAGE TO RESIDENTS AT LEAST 24 HOURS PRIOR TO PLANNED CLOSURE. EVERY EFFORT SHALL BE MADE TO ACCOMMODATE ACCESS TO THESE PROPERTIES INCLUDING KNOCKING ON DOORS WHEN DRIVEWAYS ARE ABOUT TO BE CLOSED.
- 7. PORTLAND CEMENT CONCRETE SIDEWALK SHALL BE THICKENED TO 6-INCHES AT LOCATIONS WHERE THE SIDEWALK CROSSES DRIVEWAYS. TRANSVERSE EXPANSION JOINTS 3/4" SHALL BE PLACED EVERY 50 FEET OR AS DETERMINED BY THE ENGINEER. TRANSVERSE CONTRACTION JOINTS SHALL BE PLACED EVERY 5-FEET.
- 8. A 1/2-INCH THICK EXPANSION JOINT SHALL BE PROVIDED AT THE JUNCTION OF THE DRIVEWAY APRON AND CURB, AND AT THE JUNCTION OF THE DRIVEWAY APRON AND THE SIDEWALK.
- 9. THE CONTRACTOR SHALL CONTACT THE LOCAL AGENCY MATERIAL INSPECTOR AT LEAST 48 HOURS PRIOR TO ANY CONCRETE OR HOT-MIX ASPHALT MATERIAL DELIVERIES.
- 10. ALL FRAME AND LID CASTINGS LOCATED WITHIN THE PAVEMENT WHICH REQUIRE RESETTING TO FINISH GRADE SHALL BE BACKFILLED WITH CLASS SI CONCRETE AND ALLOWED TO CURE FOR 72 HOURS PRIOR TO PLACEMENT OF SURFACE COURSE. CLASS PP CONCRETE SHALL BE USED IF PLACEMENT OF SURFACE COURSE IS PLANNED IN LESS THAN 72 HOURS. HMA MATERIALS WILL NOT BE ALLOWED AS BACKFILL AROUND AN ADJUSTED CASTING. THIS WORK SHALL APPLY TO ALL CASTINGS ADJUSTED OR RECONSTRUCTED AS PART OF THIS CONTRACT.
- 11. THE TOP OF ALL NEW CURB BOXES ON DRAINAGE STRUCTURES SHALL BE STAMPED "DUMP NO WASTE - DRAINS TO RIVER".
- 12. THE CURB SHALL BE TAPERED TO THE GUTTER IN A FIVE (5) FOOT LENGTH WHEREVER THE CURB AND GUTTER TERMINATES, WITH AN EXPANSION JOINT PLACED AT THE START OF THE TAPER.
- 13. ON STREETS TO BE FULL WIDTH MILLED (2" OR MORE), THE EXISTING STRUCTURES IN THE PAVEMENT SHALL BE ADJUSTED IN ACCORDANCE WITH THE IDOT DETAIL "DETAILS FOR FRAMES AND LIDS ADJUSTMENT WITH MILLING".
- 14. DURING CONSTRUCTION, THE CONTRACTOR WILL BE PERMITTED TO LIMIT ON-STREET PARKING IN ORDER TO COMPLETE CONSTRUCTION OPERATIONS. THE CONTRACTOR WILL BE REQUIRED TO COORDINATE WITH THE VILLAGE A MINIMUM OF 48 HOURS IN ADVANCE. IT WILL BE THE RESPONSIBILITY OF THE CONTRACTOR TO PLACE ADVANCE SIGNS TO ALERT RESIDENTS AND COMMUTERS OF THE CONSTRUCTION WORK. THE PLACEMENT OF THESE SIGNS SHALL TAKE PLACE 48 HOURS IN ADVANCE IN ORDER TO ALLOW SUFFICIENT TIME FOR RESIDENTS AND GENERAL PUBLIC TO REVISE THEIR PARKING PATTERNS.
- 15. ALL POSTS, RAILROAD TIES, AND DECORATIVE TIMBER IN CONFLICT WITH THE PROPOSED IMPROVEMENTS SHALL BE REMOVED AND RELOCATED AS DETERMINED BY THE ENGINEER AT THE TIME OF CONSTRUCTION. EVERY EFFORT SHALL BE MADE BY THE CONTRACTOR WHEN REMOVING THESE ITEMS TO PRESERVE THEM FROM HARM. ITEMS NOT RELOCATED SHALL BE PROPERLY DISPOSED OF BY THE CONTRACTOR.
- 16. THE PORTABLE BATHROOM(S) SHALL BE PLACED ON THE JOB SITE(S) AND RELOCATED WHEN NECESSARY SO IT IS ACCESSIBLE TO WORKERS. IF WORK IS OCCURRING AT SEVERAL LOCATIONS, ONE PORTABLE BATHROOM SHALL BE PLACED AT EACH LOCATION WITHIN A REASONABLE DISTANCE FROM THE WORK AS DETERMINED BY THE ENGINEER.
- 17. WHEN MILLED PAVEMENT IS OPEN TO TRAFFIC, THE MAXIMUM GRADE DIFFERENTIAL BETWEEN PASSES OF THE MILLING MACHINE SHALL NOT EXCEED 1 1/2 INCHES WHERE THE SPEED LIMIT IS 45 MPH OR LESS, AND SHALL NOT EXCEED 1 INCH WHERE THE SPEED LIMIT IS OVER 45 MPH. A MAXIMUM GRADE DIFFERENCE OF 3 INCHES MAY BE ALLOWED IF THE EDGE OF THE MILLING IS SLOPED A MINIMUM OF 1:3 (V:H), AS DETERMINED BY THE ENGINEER.

COMMITMENTS

THERE ARE NO COMMITMENTS ON THIS PROJECT

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STATE OF ILLINOIS
DEPARTMENT OF TRANSPORTATION

INDEX OF SHEETS, HIGHWAY STANDARDS, GENERAL NOTES, AND COMMITMENTS

SCALE: NONE SHEET 1 OF 1 SHEETS STA. TO STA.

F.A.U. RTE.	SECTION	COUNTY	TOTAL SHEETS	SHEET NO.
1342	21-00052-00-RS	KANE	28	2
CONTRACT NO. 61H43				
ILLINOIS FED. AID PROJECT				

SUMMARY OF QUANTITIES

CODE NO.	ITEM	UNIT	TOTAL QUANTITY	CONSTRUCTION CODE	
				70% STP 30% Village	70% STP 30% Village
				Roadway 0005 Urban	Roadway 0042 Trainees
				20101100	TREE TRUNK PROTECTION
20101200	TREE ROOT PRUNING	EACH	6	6	
20101400	NITROGEN FERTILIZER NUTRIENT	POUND	36	36	
20101500	PHOSPHORUS FERTILIZER NUTRIENT	POUND	36	36	
20101600	POTASSIUM FERTILIZER NUTRIENT	POUND	36	36	
20101700	SUPPLEMENTAL WATERING	UNIT	1	1	
20200100	EARTH EXCAVATION	CU YD	10	10	
20201200	REMOVAL AND DISPOSAL OF UNSUITABLE MATERIAL	CU YD	26	26	
21001000	GEO TECHNICAL FABRIC FOR GROUND STABILIZATION	SQ YD	775	775	
21101615	TOPSOIL FURNISH AND PLACE, 4"	SQ YD	1,580	1,580	
25000210	SEEDING, CLASS 2A	ACRE	0.4	0.4	
25100630	EROSION CONTROL BLANKET	SQ YD	1,580	1,580	
28000250	TEMPORARY EROSION CONTROL SEEDING	POUND	40	40	
28000510	INLET FILTERS	EACH	52	52	
30300001	AGGREGATE SUBGRADE IMPROVEMENT	CU YD	26	26	
35101600	AGGREGATE BASE COURSE, TYPE B 4"	SQ YD	1,587	1,587	

* INDICATES SPECIAL PROVISION
s INDICATES SPECIALTY ITEM

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STATE OF ILLINOIS
DEPARTMENT OF TRANSPORTATION

SUMMARY OF QUANTITIES

SCALE: NONE SHEET 1 OF 6 SHEETS STA. TO STA.

F.A.U. RTE.	SECTION	COUNTY	TOTAL SHEETS	SHEET NO.
1342	21-0052-00-RS	KANE	28	3
CONTRACT NO. 61H43			ILLINOIS FED. AID PROJECT	

SUMMARY OF QUANTITIES

CODE NO.	ITEM	UNIT	TOTAL QUANTITY	CONSTRUCTION CODE	
				70% STP 30% Village	70% STP 30% Village
				Roadway 0005	Roadway 0042
				Urban	Trainees
35101800	AGGREGATE BASE COURSE, TYPE B 6"	SQ YD	267	267	
40600290	BITUMINOUS MATERIALS (TACK COAT)	POUND	19,327	19,327	
40600400	MIXTURE FOR CRACKS, JOINTS, AND FLANGEWAYS	TON	8	8	
40600982	HOT-MIX ASPHALT SURFACE REMOVAL - BUTT JOINT	SQ YD	734	734	
40603080	HOT-MIX ASPHALT BINDER COURSE, IL-19.0, N50	TON	4,089	4,089	
40604060	HOT-MIX ASPHALT SURFACE COURSE, IL-9.5, MIX "D", N50	TON	3,287	3,287	
42400200	PORTLAND CEMENT CONCRETE SIDEWALK 5 INCH	SQ FT	9,380	9,380	
42400800	DETECTABLE WARNINGS	SQ FT	438	438	
44000166	HOT-MIX ASPHALT SURFACE REMOVAL, 4 1/4"	SQ YD	28,632	28,632	
44000200	DRIVEWAY PAVEMENT REMOVAL	SQ YD	267	267	
44000500	COMBINATION CURB AND GUTTER REMOVAL	FOOT	1,818	1,818	
44000600	SIDEWALK REMOVAL	SQ FT	10,580	10,580	
44201737	CLASS D PATCHES, TYPE I, 8 INCH	SQ YD	101	101	
44201741	CLASS D PATCHES, TYPE II, 8 INCH	SQ YD	101	101	
44201745	CLASS D PATCHES, TYPE III, 8 INCH	SQ YD	215	215	
44201747	CLASS D PATCHES, TYPE IV, 8 INCH	SQ YD	358	358	

* INDICATES SPECIAL PROVISION
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STATE OF ILLINOIS
 DEPARTMENT OF TRANSPORTATION

SUMMARY OF QUANTITIES

SCALE: NONE SHEET 2 OF 6 SHEETS STA. TO STA.

F.A.U. RTE.	SECTION	COUNTY	TOTAL SHEETS	SHEET NO.
1342	21-00052-00-RS	KANE	28	4
CONTRACT NO. 61H43				
ILLINOIS FED. AID PROJECT				

SUMMARY OF QUANTITIES

CODE NO.	ITEM	UNIT	TOTAL QUANTITY	CONSTRUCTION CODE	
				70% STP 30% Village	70% STP 30% Village
				Roadway 0005	Roadway 0042
				Urban	Trainees
48301000	PROTECTIVE COAT	SQ YD	1,412	1,412	
60108104	PIPE UNDERDRAINS, TYPE 1, 4"	FOOT	200	200	
60202405	CATCH BASINS, TYPE A, 4'-DIAMETER	EACH	1	1	
60220200	MANHOLES, TYPE A, 4'-DIAMETER	EACH	1	1	
60238800	INLETS, TYPE A	EACH	1	1	
60404800	FRAMES AND GRATES, TYPE 11	EACH	5	5	
60406000	FRAMES AND LIDS, TYPE 1, OPEN LID	EACH	5	5	
60406100	FRAMES AND LIDS, TYPE 1, CLOSED LID	EACH	5	5	
60500040	REMOVING MANHOLES	EACH	1	1	
60500050	REMOVING CATCH BASINS	EACH	1	1	
60500060	REMOVING INLETS	EACH	1	1	
S 66900200	NON-SPECIAL WASTE DISPOSAL	CU YD	36	36	
S 66900530	SOIL DISPOSAL ANALYSIS	EACH	1	1	
S 66901001	REGULATED SUBSTANCES PRE-CONSTRUCTION PLAN	L SUM	1	1	
S 66901003	REGULATED SUBSTANCES FINAL CONSTRUCTION REPORT	L SUM	1	1	
S 66901006	REGULATED SUBSTANCES MONITORING	CAL DA	5	5	

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STATE OF ILLINOIS
DEPARTMENT OF TRANSPORTATION

SUMMARY OF QUANTITIES

SCALE: NONE SHEET 3 OF 6 SHEETS STA. TO STA.

F.A.U. RTE.	SECTION	COUNTY	TOTAL SHEETS	SHEET NO.
1342	21-00052-00-RS	KANE	28	5
CONTRACT NO. 61H43				
ILLINOIS FED. AID PROJECT				

SUMMARY OF QUANTITIES

CODE NO.	ITEM	UNIT	TOTAL QUANTITY	CONSTRUCTION CODE	
				70% STP 30% Village	70% STP 30% Village
				Roadway 0005	Roadway 0042
				Urban	Trainees
67100100	MOBILIZATION	L SUM	1	1	
70102620	TRAFFIC CONTROL AND PROTECTION, STANDARD 701501	L SUM	1	1	
70102635	TRAFFIC CONTROL AND PROTECTION, STANDARD 701701	L SUM	1	1	
70102640	TRAFFIC CONTROL AND PROTECTION, STANDARD 701801	L SUM	1	1	
70300100	SHORT TERM PAVEMENT MARKING	FOOT	1,815	1,815	
70300150	SHORT TERM PAVEMENT MARKING REMOVAL	SQ FT	202	202	
5 72400100	REMOVE SIGN PANEL ASSEMBLY - TYPE A	EACH	67	67	
5 72400200	REMOVE SIGN PANEL ASSEMBLY - TYPE B	EACH	13	13	
5 78000100	THERMOPLASTIC PAVEMENT MARKING - LETTERS AND SYMBOLS	SQ FT	351	351	
5 78000200	THERMOPLASTIC PAVEMENT MARKING - LINE 4"	FOOT	17,506	17,506	
5 78000400	THERMOPLASTIC PAVEMENT MARKING - LINE 6"	FOOT	896	896	
5 78000600	THERMOPLASTIC PAVEMENT MARKING - LINE 12"	FOOT	1,470	1,470	
5 78000650	THERMOPLASTIC PAVEMENT MARKING - LINE 24"	FOOT	289	289	
5 78100100	RAISED REFLECTIVE PAVEMENT MARKER	EACH	50	50	
78300200	RAISED REFLECTIVE PAVEMENT MARKER REMOVAL	EACH	50	50	
5 88600600	DETECTOR LOOP REPLACEMENT	FOOT	144	144	

1 INDICATES SPECIAL PROVISION
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STATE OF ILLINOIS
 DEPARTMENT OF TRANSPORTATION

SUMMARY OF QUANTITIES

SCALE: NONE SHEET 4 OF 6 SHEETS STA. TO STA.

F.A.U. RTE.	SECTION	COUNTY	TOTAL SHEETS	SHEET NO.
1342	21-00052-00-RS	KANE	28	6
CONTRACT NO. 61H43			ILLINOIS FED. AID PROJECT	

SUMMARY OF QUANTITIES

CODE NO.	ITEM	UNIT	TOTAL QUANTITY	CONSTRUCTION CODE	
				70% STP 30% Village	70% STP 30% Village
				Roadway 0005 Urban	Roadway 0042 Trainees
				* Z0017400	DRAINAGE & UTILITY STRUCTURES TO BE ADJUSTED
* Z0017700	DRAINAGE & UTILITY STRUCTURES TO BE RECONSTRUCTED	EACH	2	2	
* Z0019600	DUST CONTROL WATERING	UNIT	2	2	
* Z0030850	TEMPORARY INFORMATION SIGNING	SQ FT	103	103	
40600370	LONGITUDINAL JOINT SEALANT	FOOT	5,058	5,058	
Z0076600	TRAINEES	HOUR	500		500
Z0076604	TRAINEES TRAINING PROGRAM GRADUATE	HOUR	500		500
* X2800510	INLET FILTER CLEANING	EACH	52	52	
* X4021000	TEMPORARY ACCESS (PRIVATE ENTRANCE)	EACH	100	100	
* X4022000	TEMPORARY ACCESS (COMMERCIAL ENTRANCE)	EACH	13	13	
* X4230710	PORTLAND CEMENT CONCRETE DRIVEWAY PAVEMENT, 6 INCH, SPECIAL	SQ YD	267	267	
* X4230800	PORTLAND CEMENT CONCRETE DRIVEWAY PAVEMENT, 8 INCH, SPECIAL	SQ YD	17	17	
* X4240440	PORTLAND CEMENT CONCRETE SIDEWALK 6 INCH, SPECIAL	SQ FT	1,200	1,200	
* X6026050	SANITARY MANHOLES TO BE ADJUSTED	EACH	22	22	
* X6030310	FRAMES AND LIDS TO BE ADJUSTED (SPECIAL)	EACH	40	40	
* X6060052	COMBINATION CONCRETE CURB AND GUTTER, TYPE B-6.24 (SPECIAL)	FOOT	20	20	

* INDICATES SPECIAL PROVISION
s INDICATES SPECIALTY ITEM

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STATE OF ILLINOIS
DEPARTMENT OF TRANSPORTATION

SUMMARY OF QUANTITIES

SCALE: NONE SHEET 5 OF 6 SHEETS STA. TO STA.

F.A.U. RTE. 1342	SECTION 21-00052-00-RS	COUNTY KANE	TOTAL SHEETS 28	SHEET NO. 7
CONTRACT NO. 61H43			ILLINOIS FED. AID PROJECT	

SUMMARY OF QUANTITIES

CODE NO.	ITEM	UNIT	TOTAL QUANTITY	CONSTRUCTION CODE	
				70% STP 30% Village	70% STP 30% Village
				Roadway 0005	Roadway 0042
				Urban	Trainees
* X6064200	COMBINATION CONCRETE CURB AND GUTTER, TYPE B-6.12 (SPECIAL)	FOOT	1,818	1,818	
S X7200105	SIGN PANEL - TYPE 1 (SPECIAL)	SQ FT	659	659	
S X7280105	TELESCOPING STEEL SIGN SUPPORT (SPECIAL)	FOOT	1,179	1,179	
S X7310110	BASE FOR TELESCOPING SIGN SUPPORT, SPECIAL	EACH	77	77	
S X8950810	REMOVE AND RE-ERECT FLASHING BEACON	EACH	2	2	
* XX006947	HOT-MIX ASPHALT DRIVEWAY REMOVAL AND REPLACEMENT	SQ YD	34	34	

* INDICATES SPECIAL PROVISION
S INDICATES SPECIALTY ITEM

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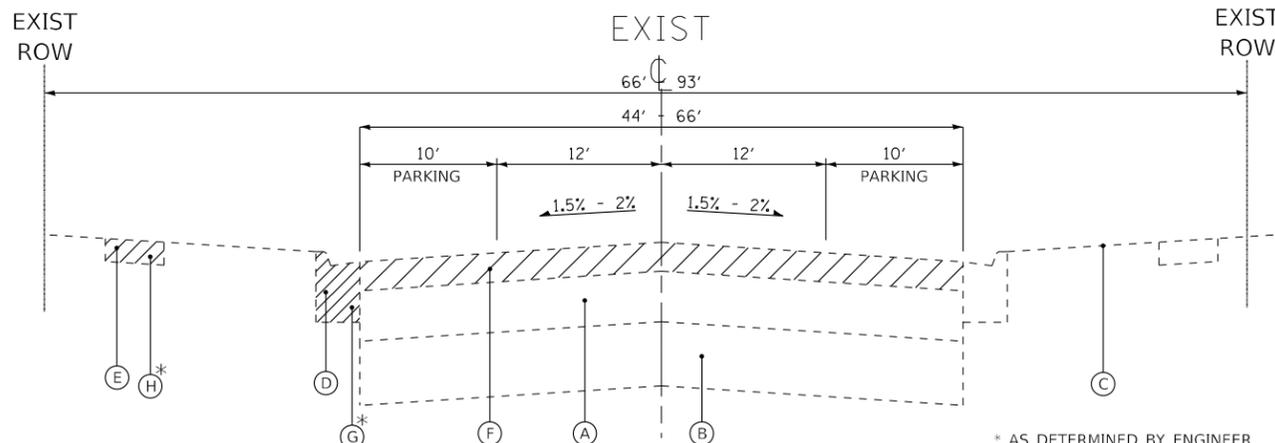
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STATE OF ILLINOIS
DEPARTMENT OF TRANSPORTATION


SUMMARY OF QUANTITIES	
SCALE: NONE	SHEET 6 OF 6 SHEETS STA. TO STA.

F.A.U. RTE.	SECTION	COUNTY	TOTAL SHEETS	SHEET NO.
1342	21-00052-00-R5	KANE	28	8
CONTRACT NO. 61H43			ILLINOIS FED. AID PROJECT	

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**EXISTING TYPICAL SECTION
SPRING STREET**
STA 20+98 TO STA 71+56



**PROPOSED TYPICAL SECTION
SPRING STREET**
STA 20+98 TO STA 71+56

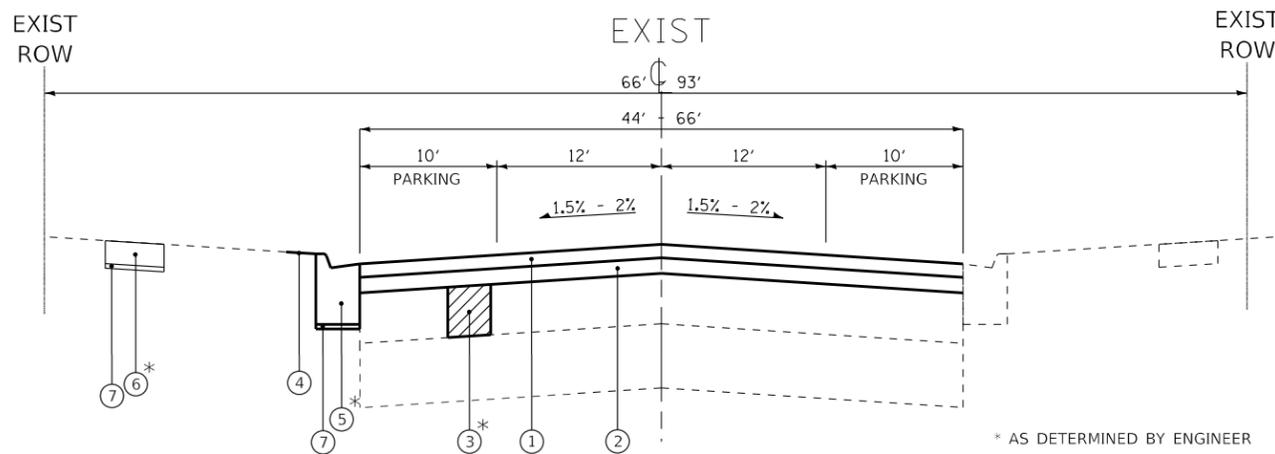EXISTING PAVEMENT THICKNESS TABLE

CORE STATION	HMA PAVEMENT (INCHES)	AGGREGATE BASE (INCHES)
22+75	12.00	5.75
28+00	12.00	11.00
33+00	10.75	12.25
38+25	11.25	7.25
43+35	11.50	11.50
47+55	12.75	5.00
53+30	11.75	11.25
58+90	10.25	12.75
64+35	11.50	7.50
71+00	13.00	4.25

HOT-MIX ASPHALT MIXTURE REQUIREMENTS

MIXTURE TYPE	AIR VOIDS @ Ndes	QMP
PAVEMENT RESURFACING		
HOT-MIX ASPHALT SURFACE COURSE, IL-9.5, MIX "D", N50 2"	4% @ 50 Gyr.	QC/QA
HOT-MIX ASPHALT BINDER COURSE, IL-19.0, N50; 2 1/2"	4% @ 50 Gyr.	QC/QA
HOT-MIX ASPHALT DRIVEWAY REMOVAL & REPLACEMENT (RESIDENTIAL DRIVEWAYS)		
HOT-MIX ASPHALT SURFACE COURSE, IL-9.5, MIX "D", N50 3" (IN 2 LIFTS)	4% @ 50 Gyr.	QC/QA
HOT-MIX ASPHALT DRIVEWAY REMOVAL & REPLACEMENT (COMMERCIAL DRIVEWAYS)		
HOT-MIX ASPHALT SURFACE COURSE, IL-9.5, MIX "D", N50 2"	4% @ 50 Gyr.	QC/QA
HOT-MIX ASPHALT BINDER COURSE, IL-19.0, N50; 4"	4% @ 50 Gyr.	QC/QA
PATCHING		
CLASS D PATCHES (HMA BINDER IL-19.0mm)	4% @ 70 Gyr.	QC/QA
QMP designation: Quality Control/Quality Assurance (QC/QA)		

- NOTES:
1. THE UNIT WEIGHT USED TO CALCULATE ALL HMA SURFACE MIXTURE QUANTITIES IS 112 LBS/SQ YD/IN.
 2. THE "AC TYPE" FOR POLYMERIZED HMA MIXES SHALL BE "SBS/SBR PG 76 -22" AND FOR NON-POLYMERIZED HMA THE "AC TYPE" SHALL BE "PG 64 -22" UNLESS MODIFIED BY RECLAIMED MATERIALS SPECIFICATIONS.
 3. THE LONGITUDINAL JOINT SEALANT SHALL BE PLACED OVER THE HMA BINDER.

EXISTING LEGEND

- (A) EXISTING HMA BINDER & SURFACE COURSE, 11" - 13"
- (B) EXISTING AGGREGATE BASE COURSE, 5" - 15"
- (C) GROUND SURFACE
- (D) EXISTING COMBINATION CURB AND GUTTER
- (E) EXISTING SIDEWALK
- (F) HOT-MIX ASPHALT SURFACE REMOVAL, 4.25"
- (G) REMOVE EXISTING COMBINATION CURB & GUTTER
- (H) REMOVE EXISTING SIDEWALK
- ☒ REMOVAL ITEM

PROPOSED LEGEND

- ① HOT-MIX ASPHALT SURFACE COURSE, IL-9.5, MIX "D", N50 - 2"
- ② HOT-MIX ASPHALT BINDER COURSE, IL-19.0, N50 - 2.5"
- ③ CLASS D PATCHES 8"
- ④ SEEDING, CLASS 2A
- ⑤ COMBINATION CONCRETE CURB AND GUTTER, TYPE B-6.12
- ⑥ PORTLAND CEMENT CONCRETE SIDEWALK 5 INCH
- ⑦ AGGREGATE BASE COURSE



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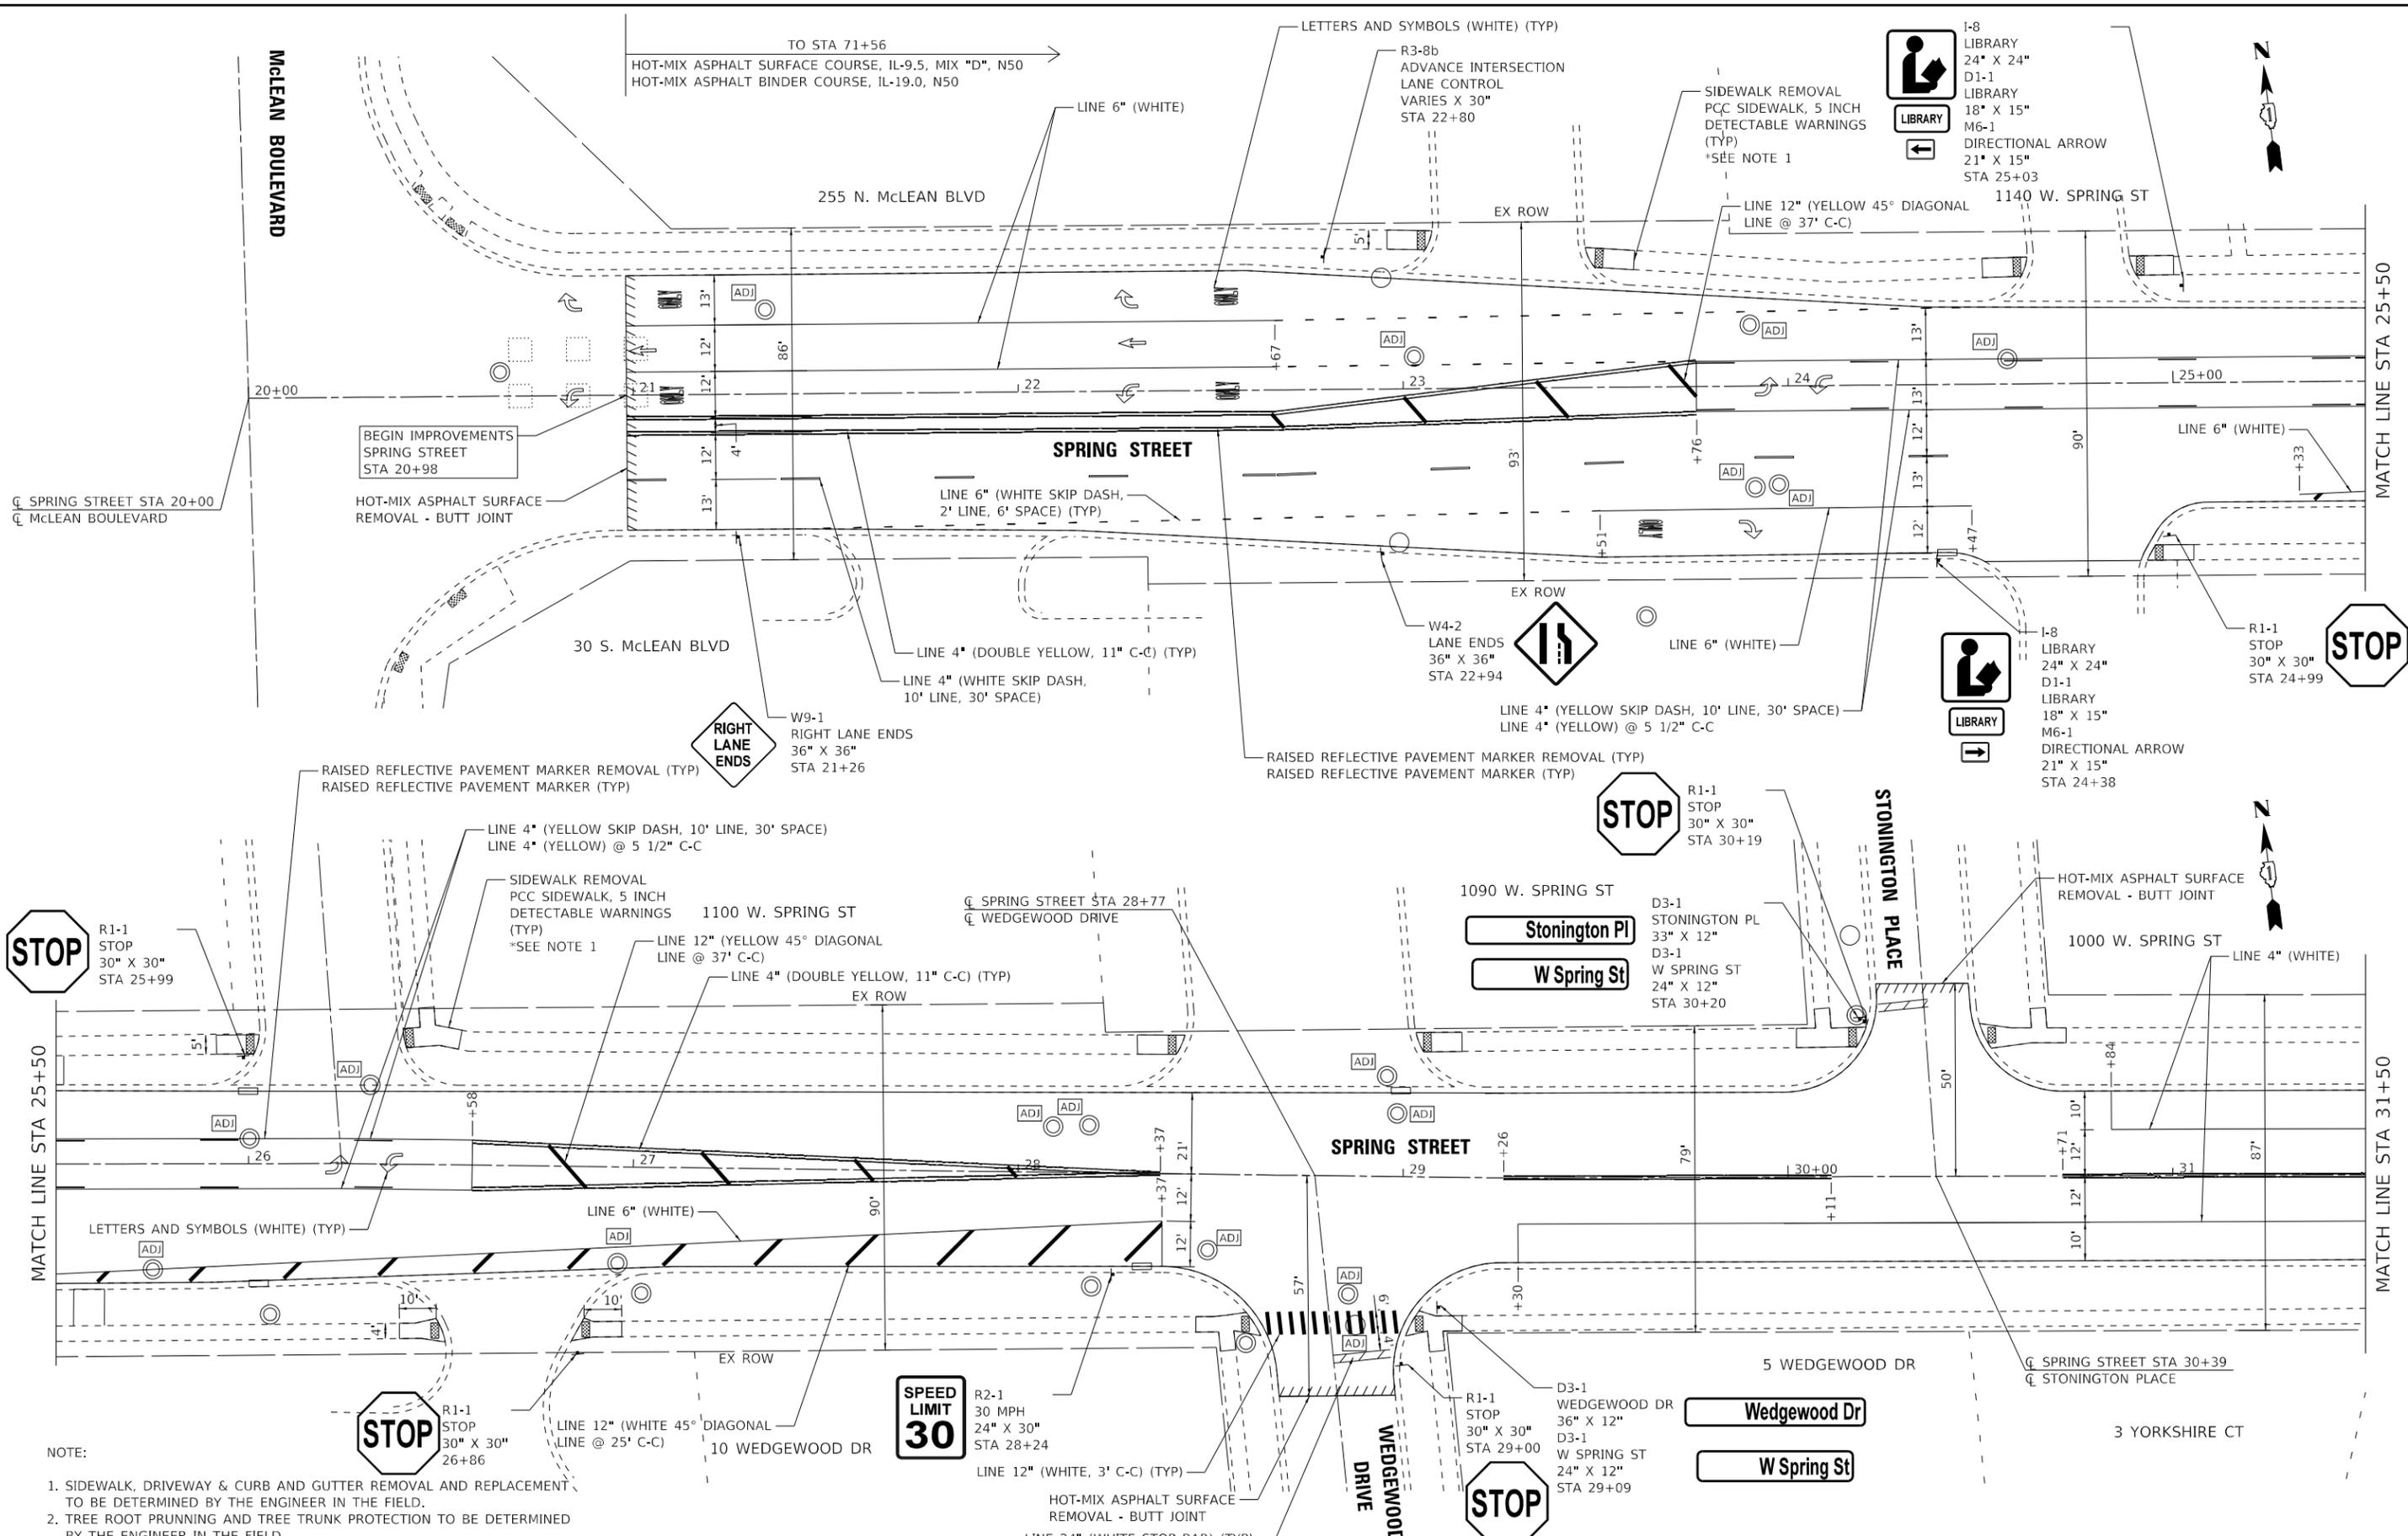
STATE OF ILLINOIS
DEPARTMENT OF TRANSPORTATION

TYPICAL SECTIONS

SCALE: NONE SHEET 1 OF 1 SHEETS STA. TO STA.

F.A.U. RTE.	SECTION	COUNTY	TOTAL SHEETS	SHEET NO.
1342	21-00052-00-R5	KANE	28	9
CONTRACT NO. 61H43				
ILLINOIS FED. AID PROJECT				

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- NOTE:
- SIDEWALK, DRIVEWAY & CURB AND GUTTER REMOVAL AND REPLACEMENT TO BE DETERMINED BY THE ENGINEER IN THE FIELD.
 - TREE ROOT PRUNNING AND TREE TRUNK PROTECTION TO BE DETERMINED BY THE ENGINEER IN THE FIELD




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STATE OF ILLINOIS
 DEPARTMENT OF TRANSPORTATION

PLAN - SPRING STREET
 SCALE: 1" = 20' SHEET 1 OF 5 SHEETS STA. 20+00 TO STA. 31+50

F.A.U. RTE.	SECTION	COUNTY	TOTAL SHEETS	SHEET NO.
1342	21-00052-00-R5	KANE	28	10
CONTRACT NO. 61H43				
ILLINOIS FED. AID PROJECT				

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- NOTE:
1. SIDEWALK, DRIVEWAY & CURB AND GUTTER REMOVAL AND REPLACEMENT TO BE DETERMINED BY THE ENGINEER IN THE FIELD.
 2. TREE ROOT PRUNING AND TREE TRUNK PROTECTION TO BE DETERMINED BY THE ENGINEER IN THE FIELD

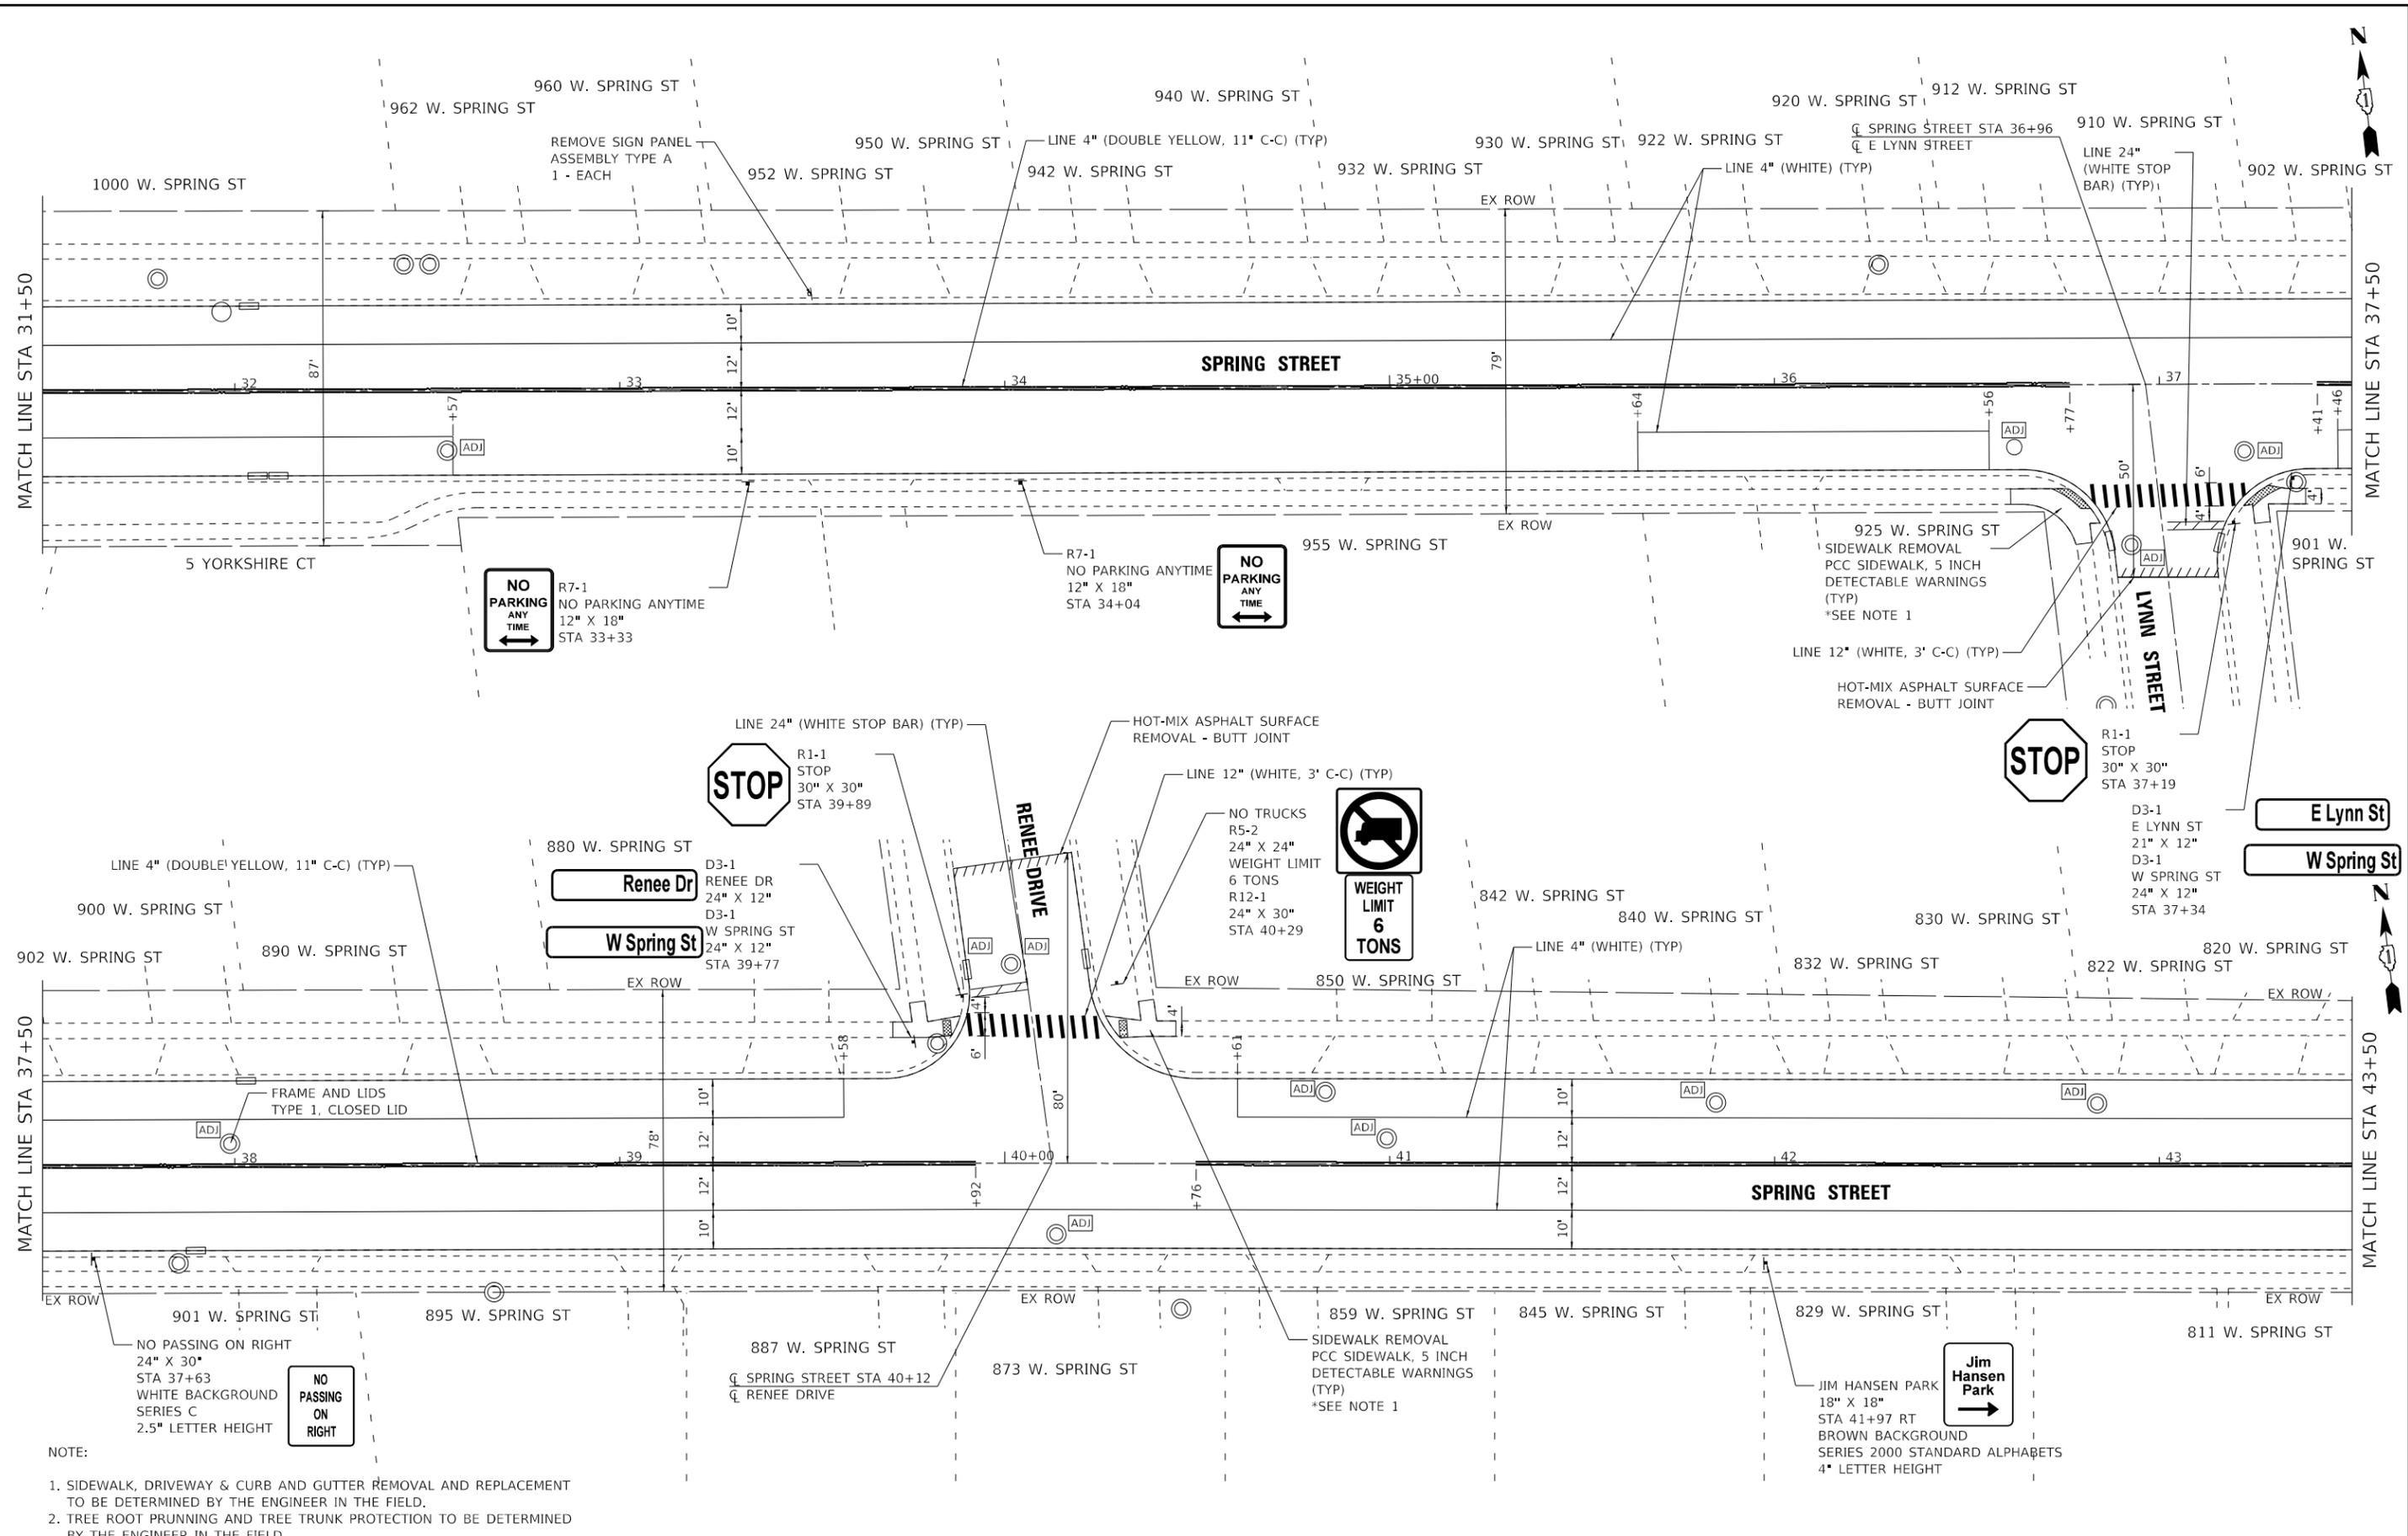


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STATE OF ILLINOIS
 DEPARTMENT OF TRANSPORTATION

PLAN - SPRING STREET
 SCALE: 1" = 20'
 SHEET 2 OF 5 SHEETS
 STA. 31+50 TO STA. 43+50

F.A.U. RTE. 1342	SECTION 21-00052-00-R5	COUNTY KANE	TOTAL SHEETS 28	SHEET NO. 11
CONTRACT NO. 61H43			ILLINOIS FED. AID PROJECT	

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- NOTE:
1. SIDEWALK, DRIVEWAY & CURB AND GUTTER REMOVAL AND REPLACEMENT TO BE DETERMINED BY THE ENGINEER IN THE FIELD.
 2. TREE ROOT PRUNNING AND TREE TRUNK PROTECTION TO BE DETERMINED BY THE ENGINEER IN THE FIELD

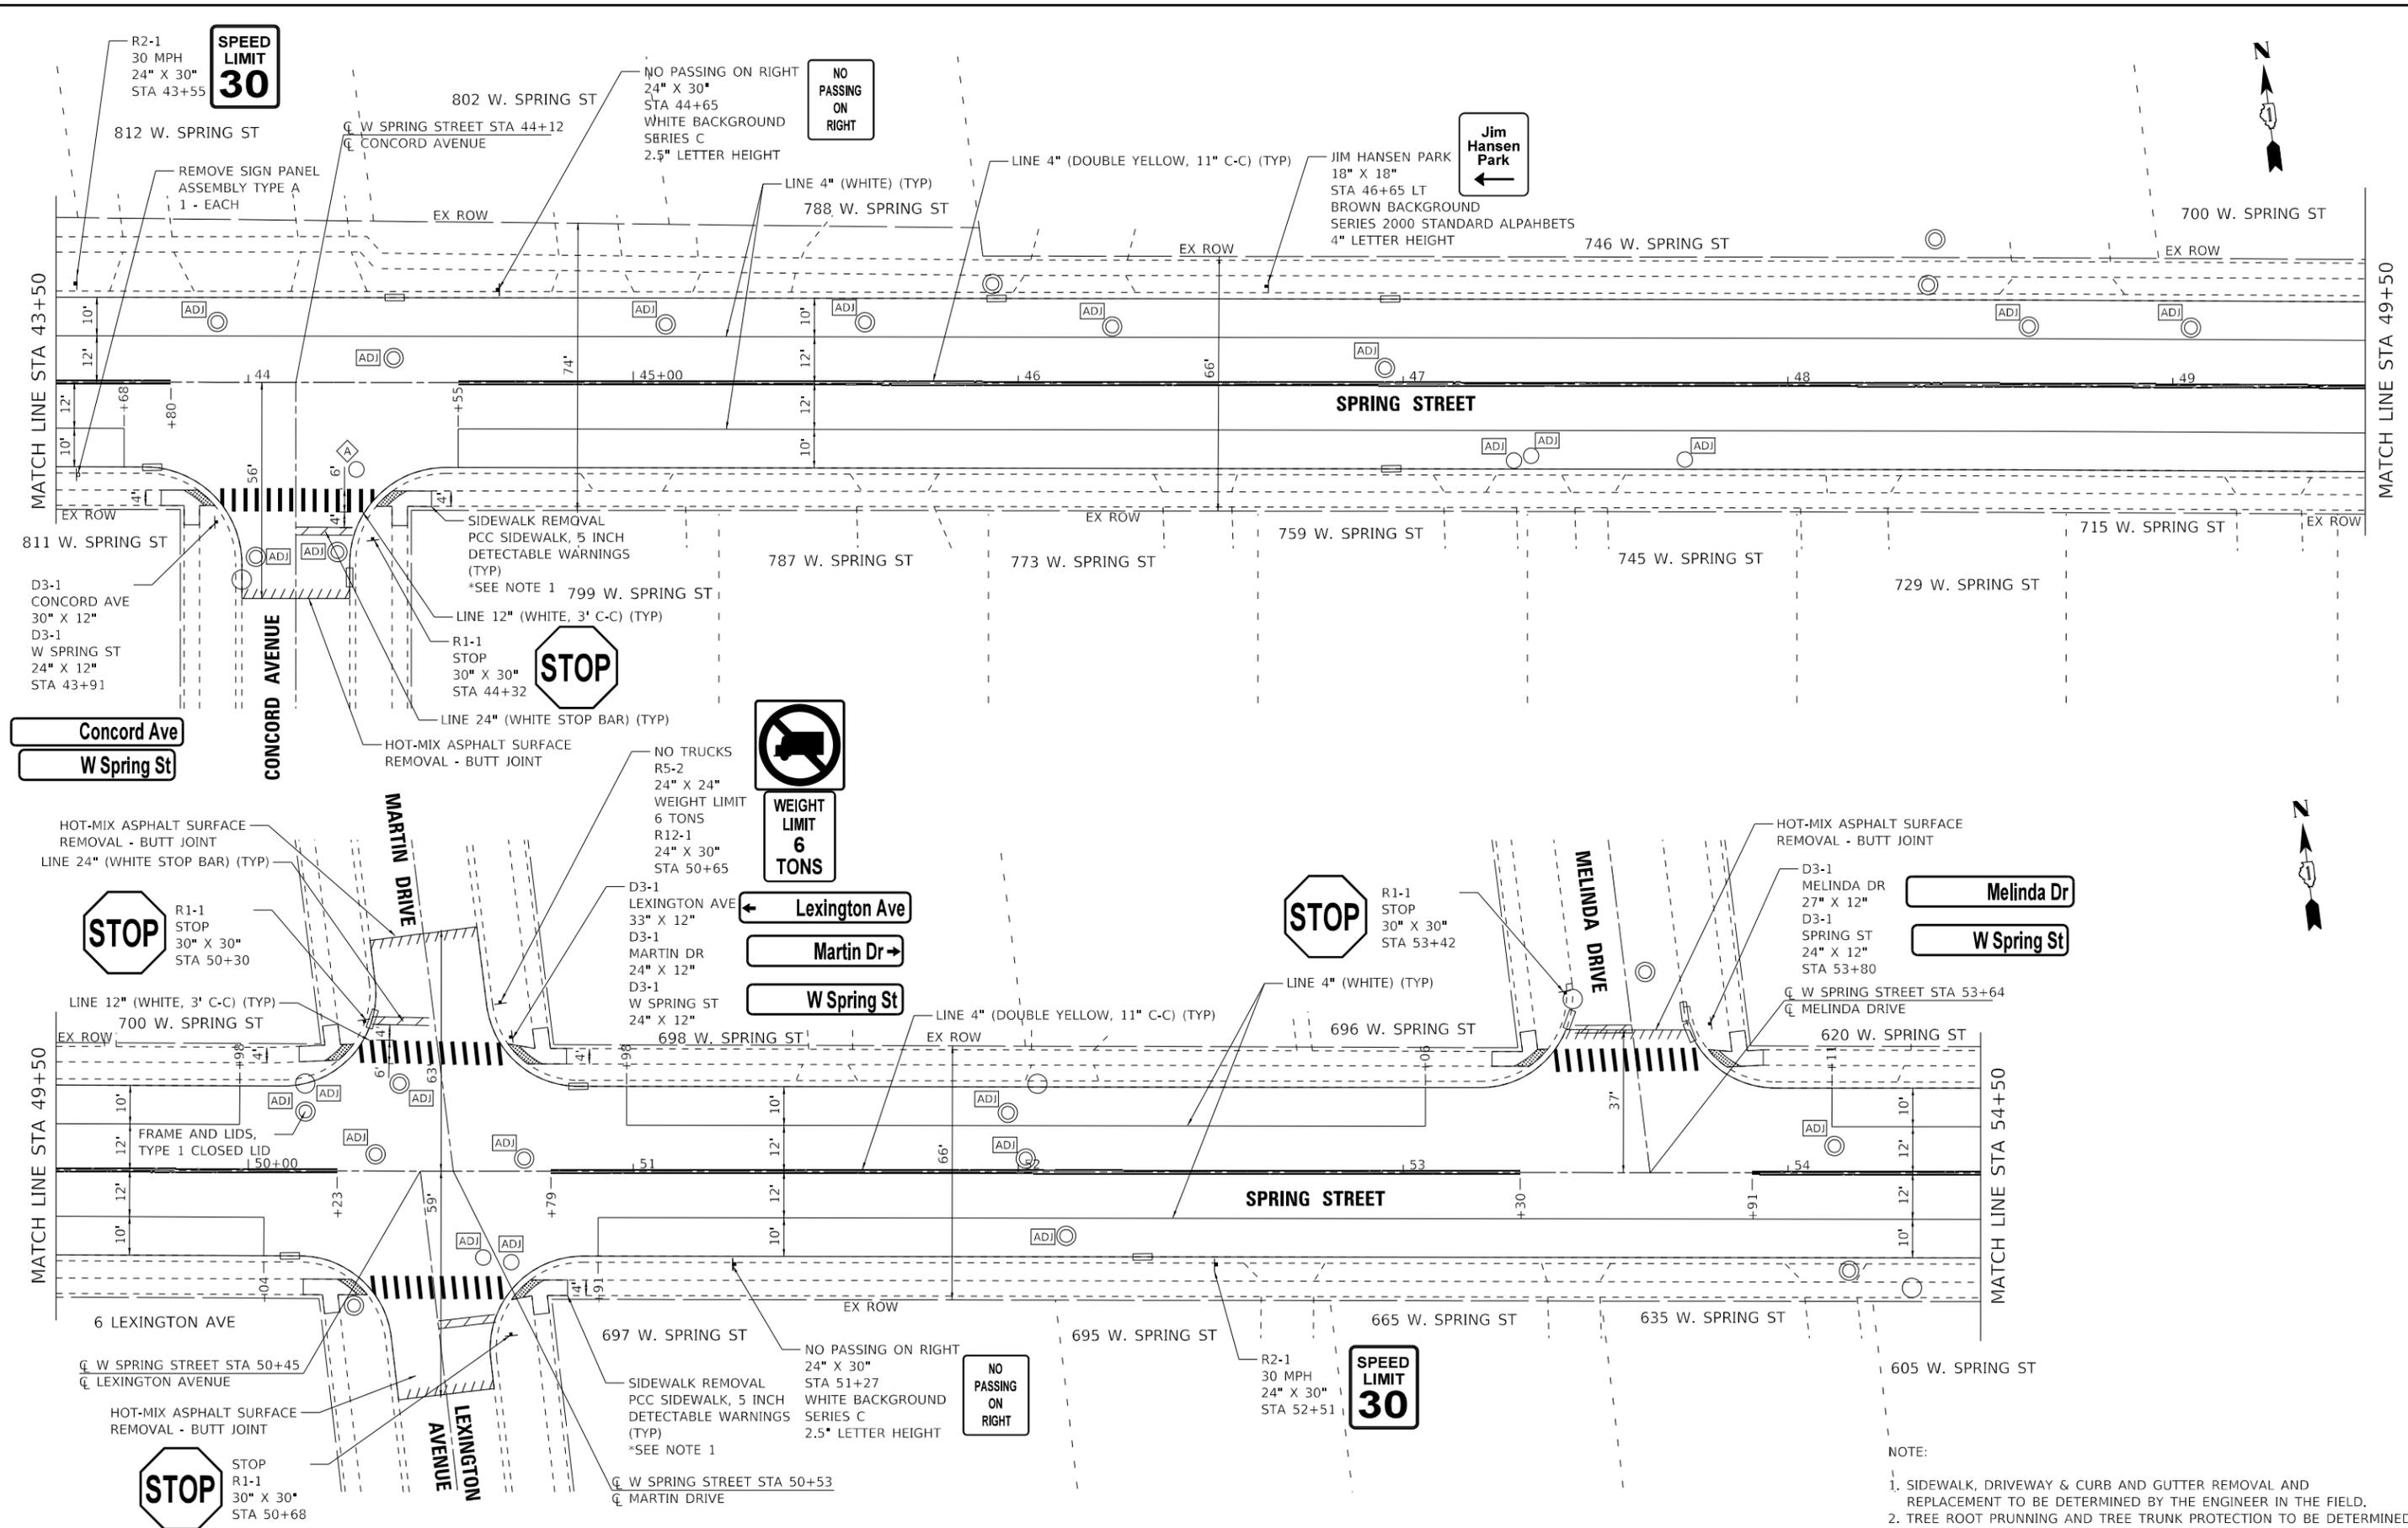

USER NAME - morning	DESIGNED - SAM	REVISED -
DRAWN - KAR	REVISED -	
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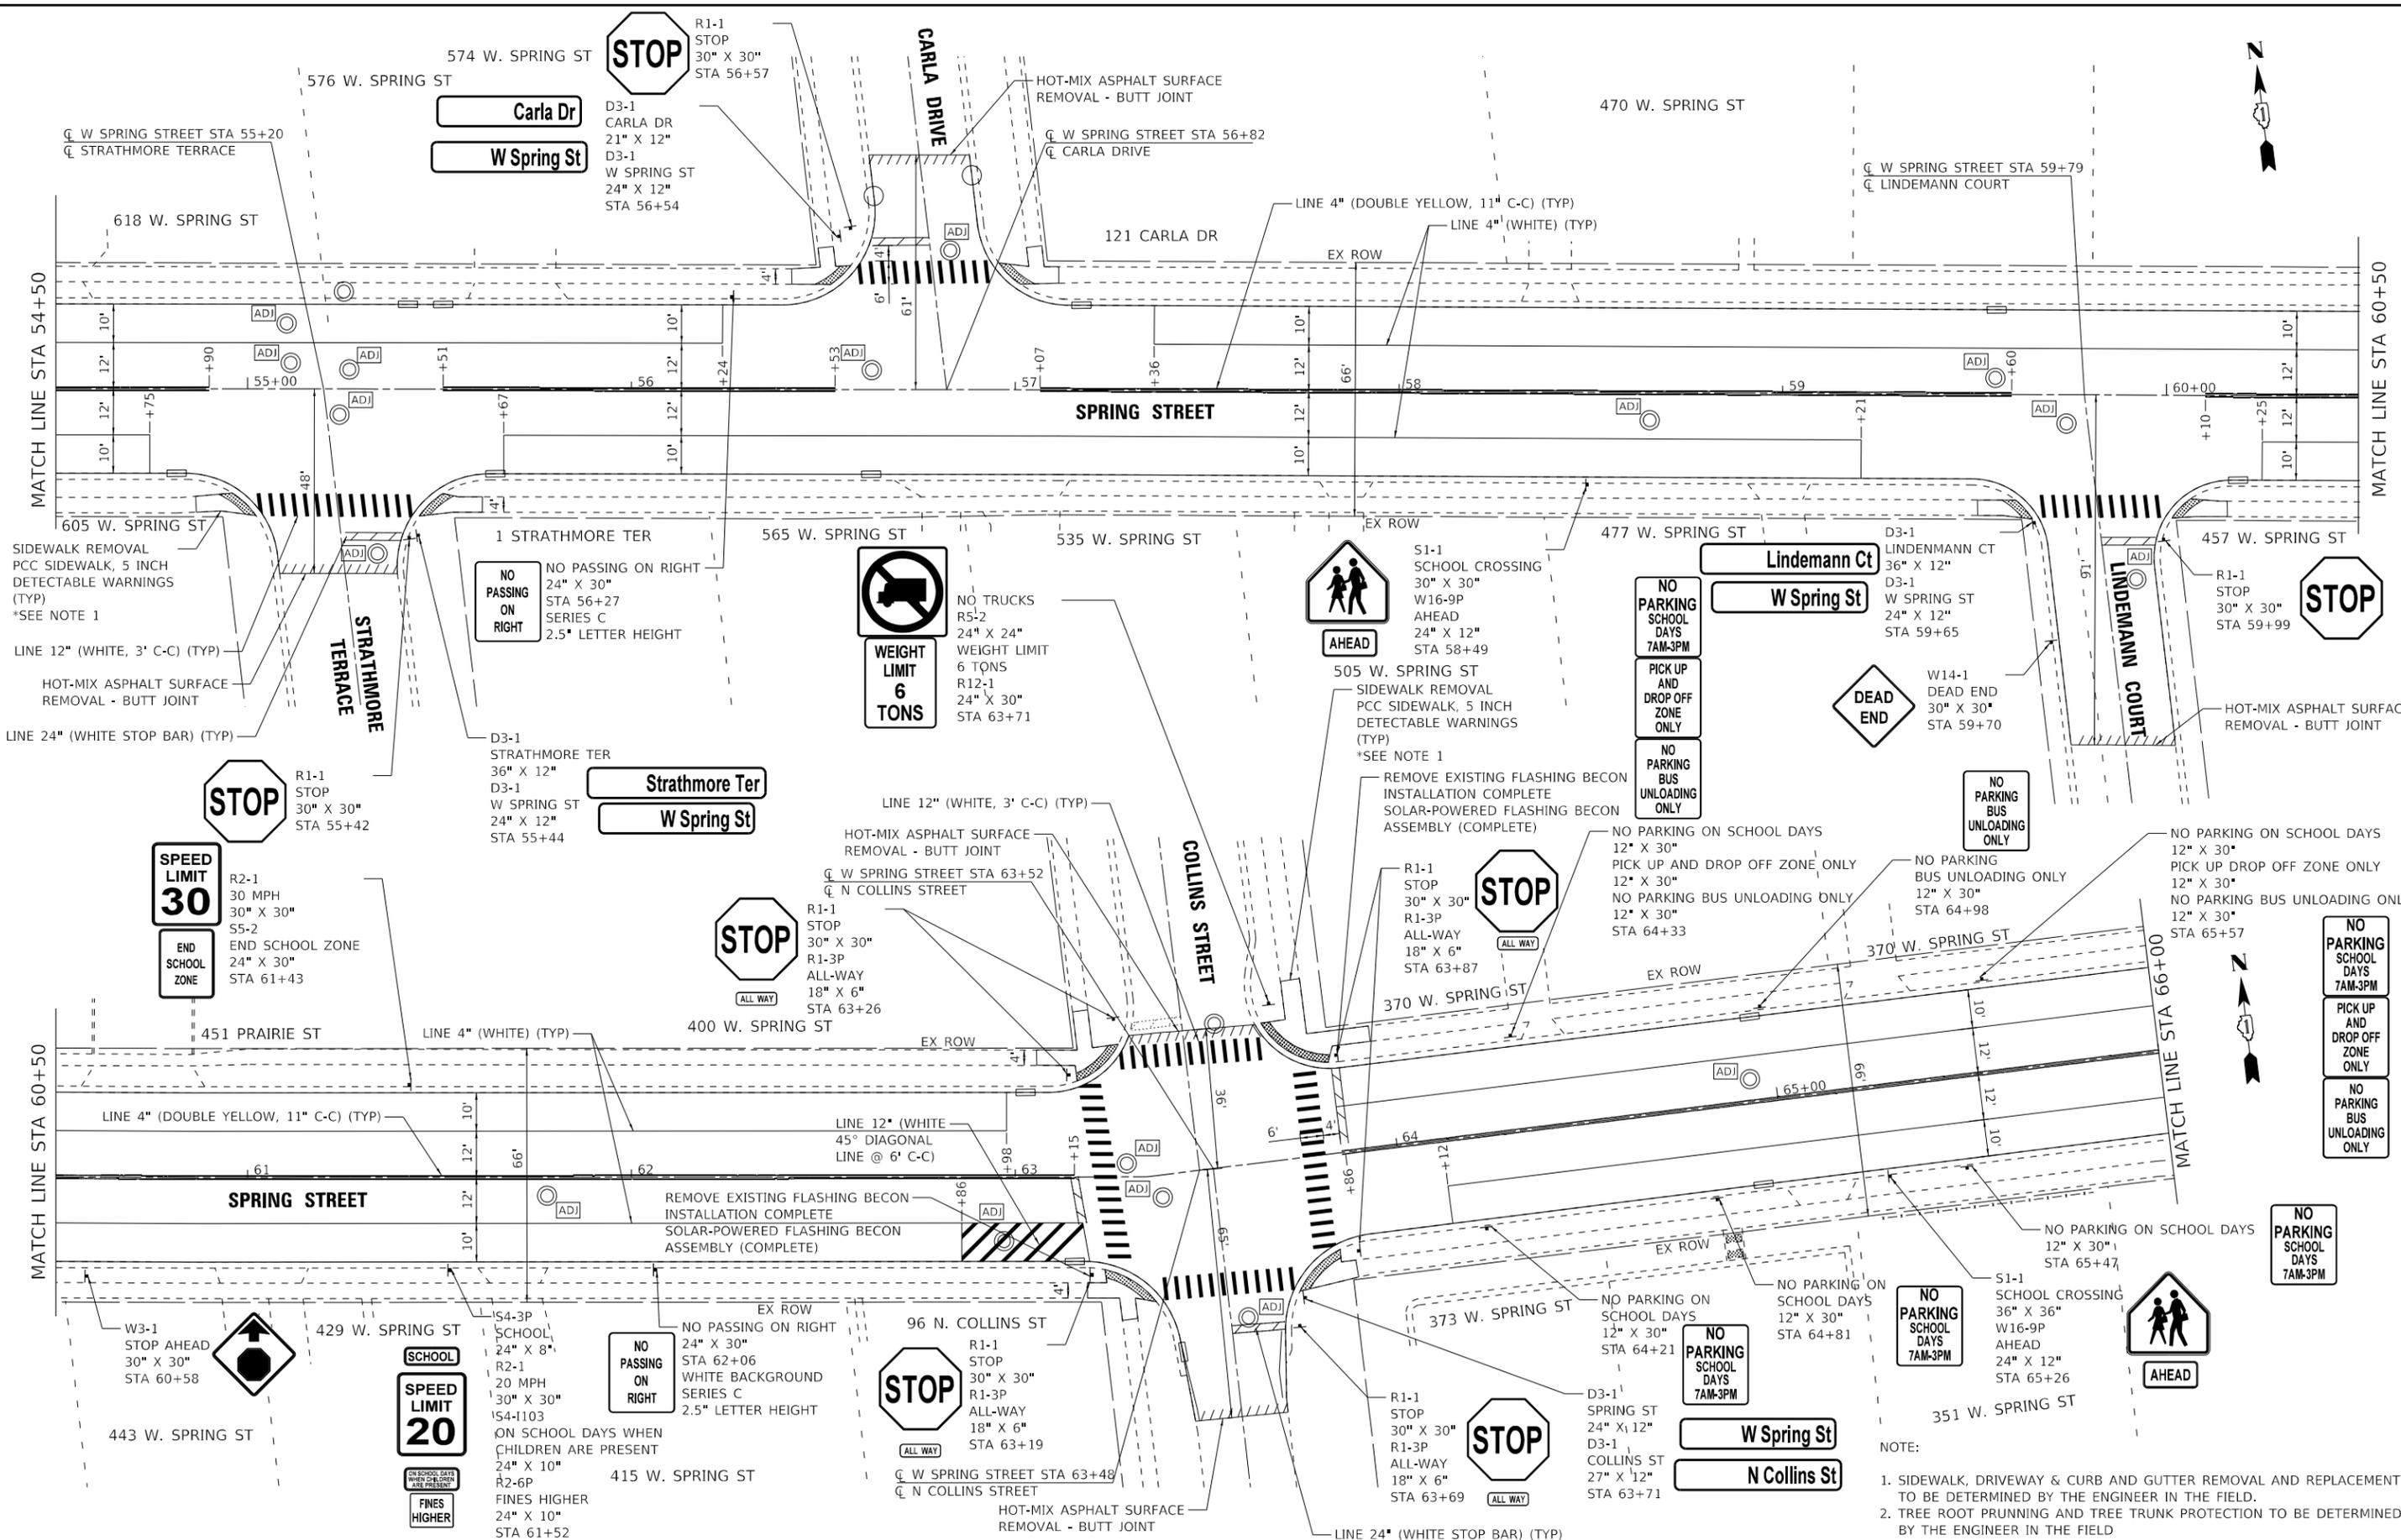
STATE OF ILLINOIS
 DEPARTMENT OF TRANSPORTATION

PLAN - SPRING STREET

SCALE: 1" = 20' SHEET 3 OF 5 SHEETS STA. 43+50 TO STA. 54+50

F.A.U. RTE.	SECTION	COUNTY	TOTAL SHEETS	SHEET NO.
1342	21-00052-00-R5	KANE	28	12
CONTRACT NO. 61H43				
ILLINOIS FED. AID PROJECT				


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NOTE:
 1. SIDEWALK, DRIVEWAY & CURB AND GUTTER REMOVAL AND REPLACEMENT TO BE DETERMINED BY THE ENGINEER IN THE FIELD.
 2. TREE ROOT PRUNNING AND TREE TRUNK PROTECTION TO BE DETERMINED BY THE ENGINEER IN THE FIELD

BAXTER & WOODMAN Consulting Engineers	USER NAME - morning	DESIGNED - SAM	REVISED -	STATE OF ILLINOIS DEPARTMENT OF TRANSPORTATION PLAN - SPRING STREET	F.A.U. RTE. - 1342	SECTION - 21-00052-00-R5	COUNTY - KANE	TOTAL SHEETS - 28	SHEET NO. - 13	
	PLOT SCALE - 20.0000' / in.	CHECKED - JBT	REVISED -		SCALE: 1" = 20'	CONTRACT NO. 61H43		ILLINOIS FED. AID PROJECT		
	PLOT DATE - 11/17/2021	DATE - 11-17-21	FILE - 210165_SHT-Plan4.dgn		SHEET 4 OF 5 SHEETS	STA. 54+50 TO STA. 66+00				

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← TO STA 20+98
 HOT-MIX ASPHALT SURFACE COURSE, IL-9.5, MIX "D", N50
 HOT-MIX ASPHALT BINDER COURSE, IL-19.0, N50

NOTE:
 1. SIDEWALK, DRIVEWAY & CURB AND GUTTER REMOVAL AND REPLACEMENT TO BE DETERMINED BY THE ENGINEER IN THE FIELD.
 2. TREE ROOT PRUNING AND TREE TRUNK PROTECTION TO BE DETERMINED BY THE ENGINEER IN THE FIELD

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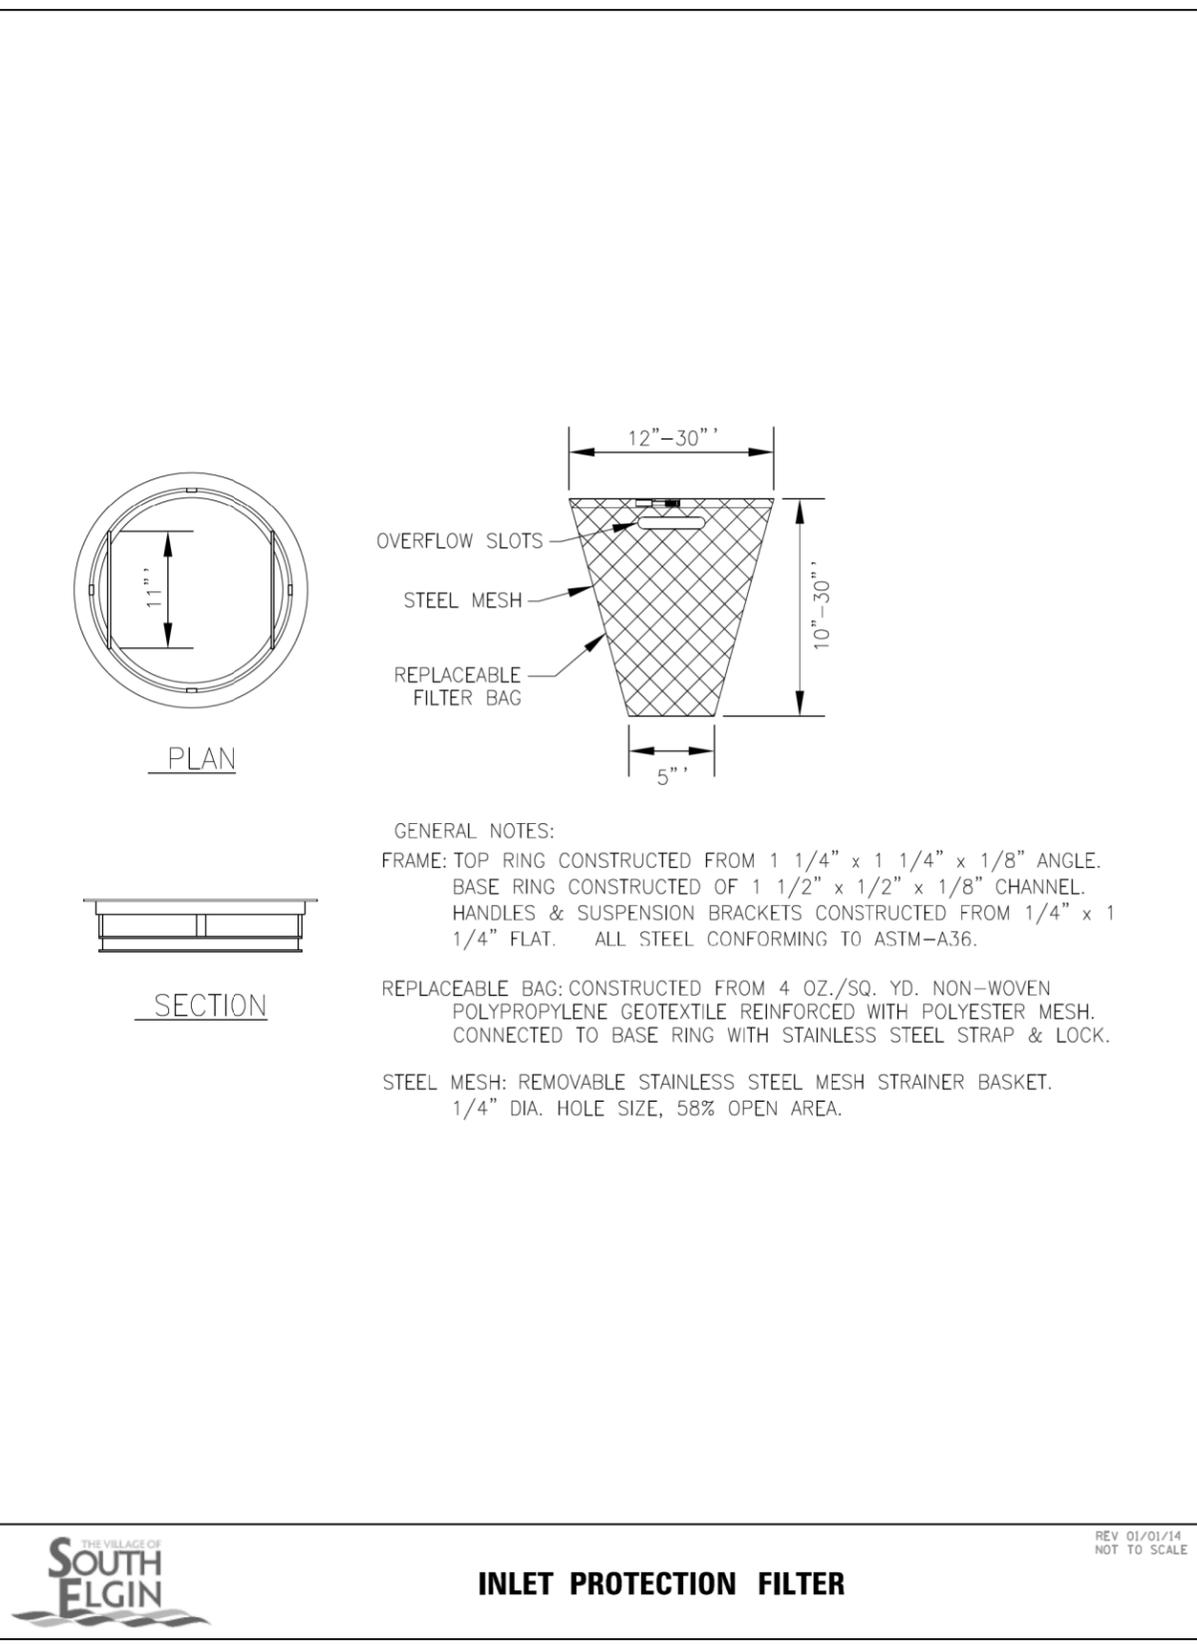
STATE OF ILLINOIS
 DEPARTMENT OF TRANSPORTATION

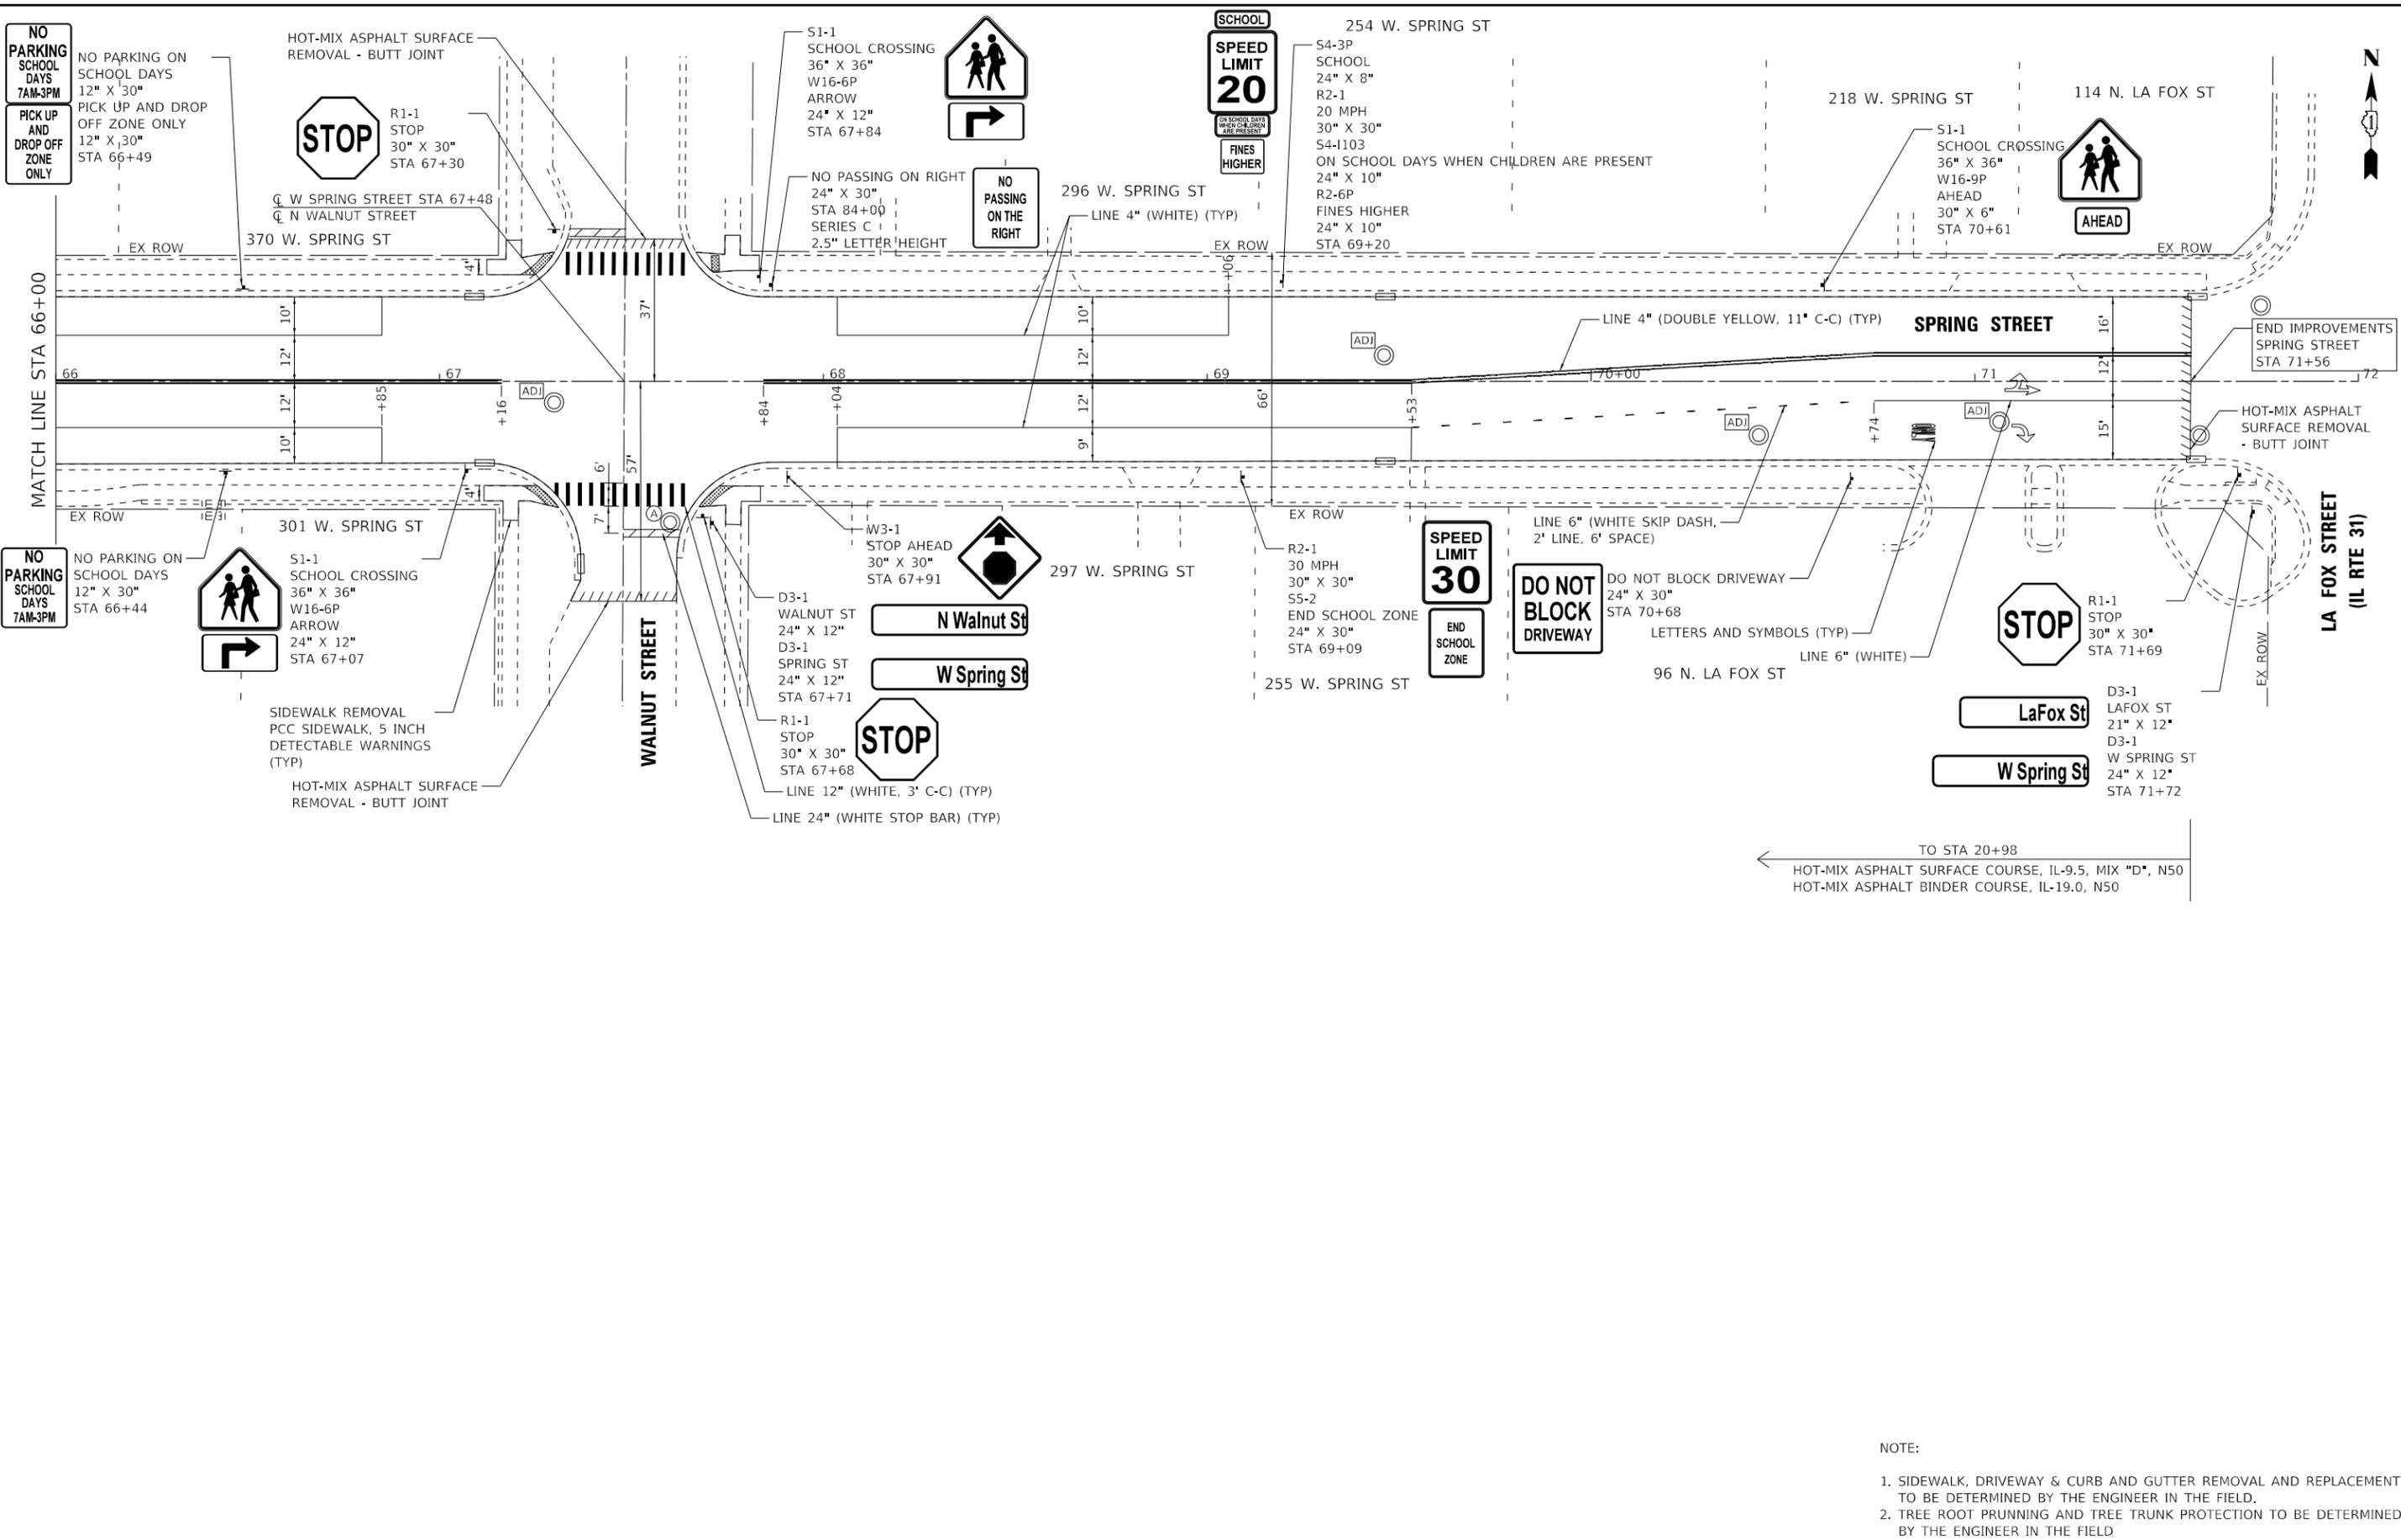PLAN - SPRING STREET	
SCALE: 1" = 20'	SHEET 5 OF 5 SHEETS
STA. 66+00	TO STA. 72+00

F.A.U. RTE.	SECTION	COUNTY	TOTAL SHEETS	SHEET NO.
1342	21-00052-00-R5	KANE	28	14
CONTRACT NO. 61H43				
ILLINOIS FED. AID PROJECT				

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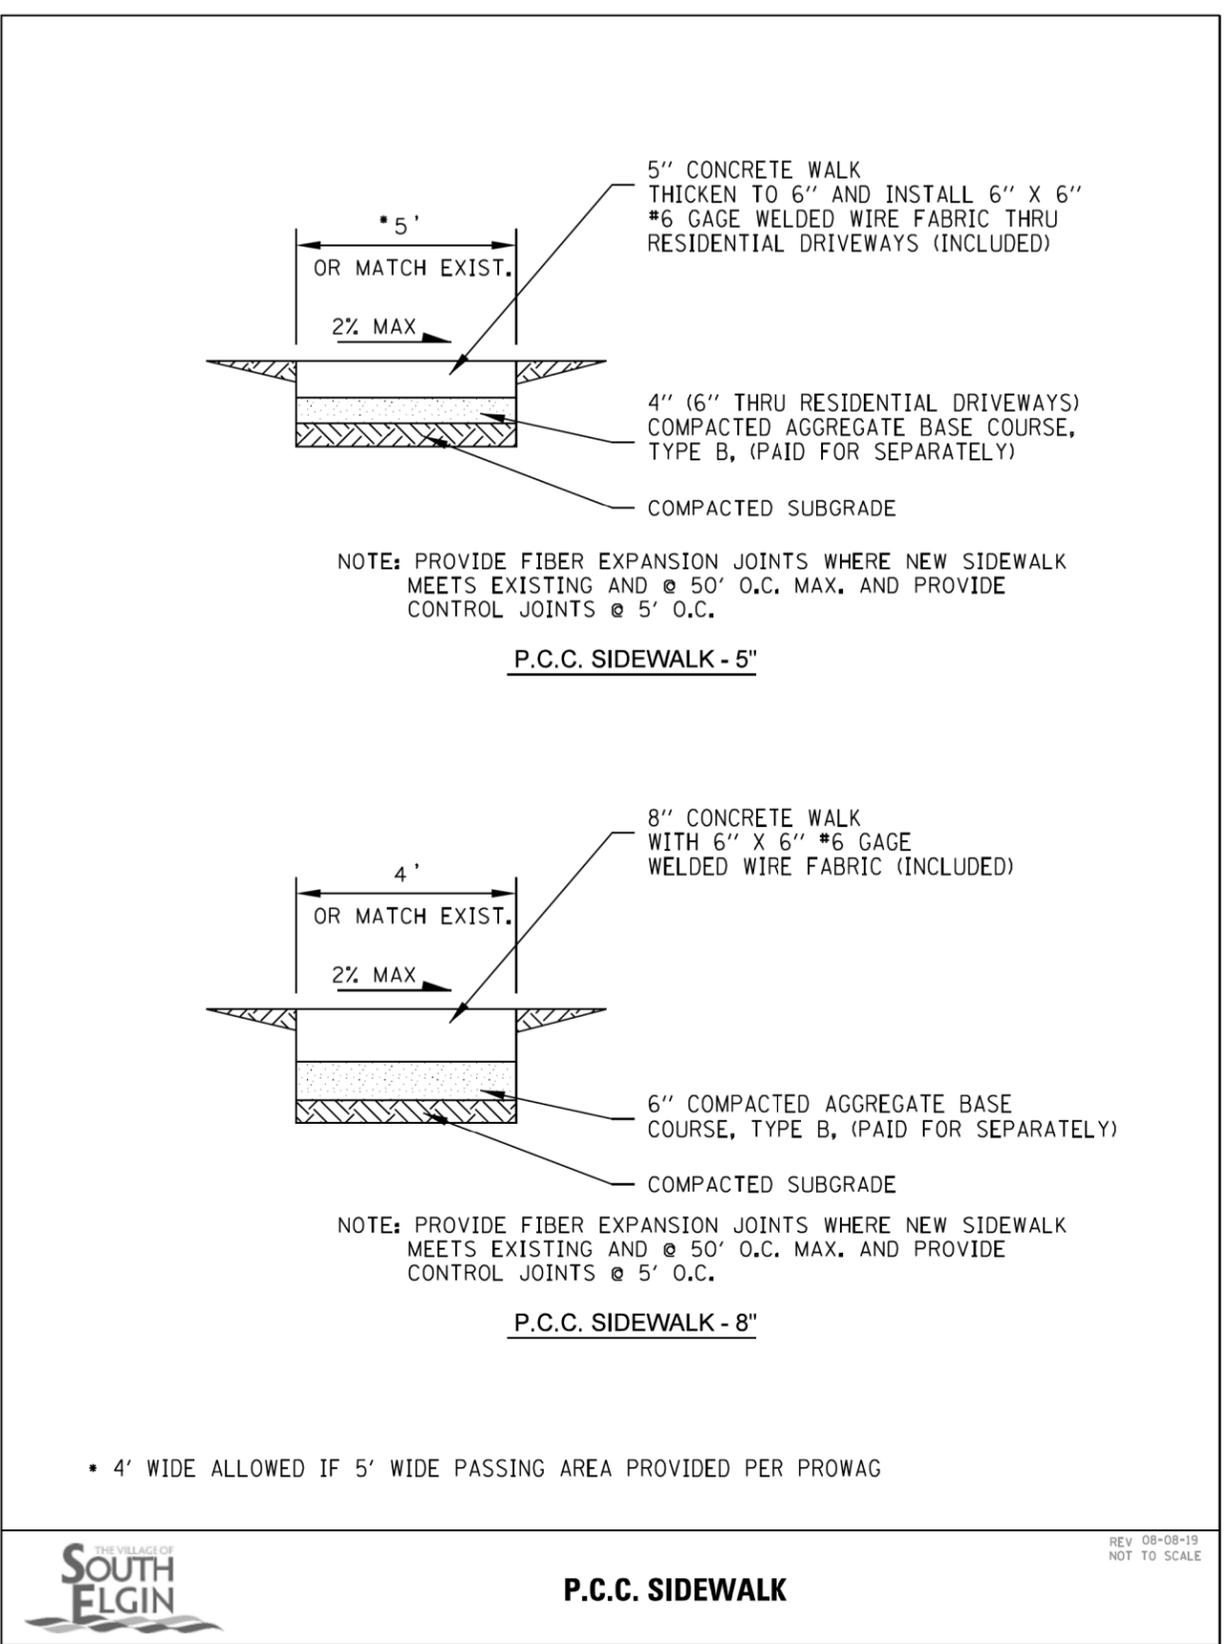
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INLET PROTECTION FILTER

REV 01/01/14
 NOT TO SCALE

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P.C.C. SIDEWALK

REV 08-08-19
 NOT TO SCALE

BAXTER & WOODMAN Consulting Engineers	USER NAME = morning	DESIGNED - SAM	REVISED -
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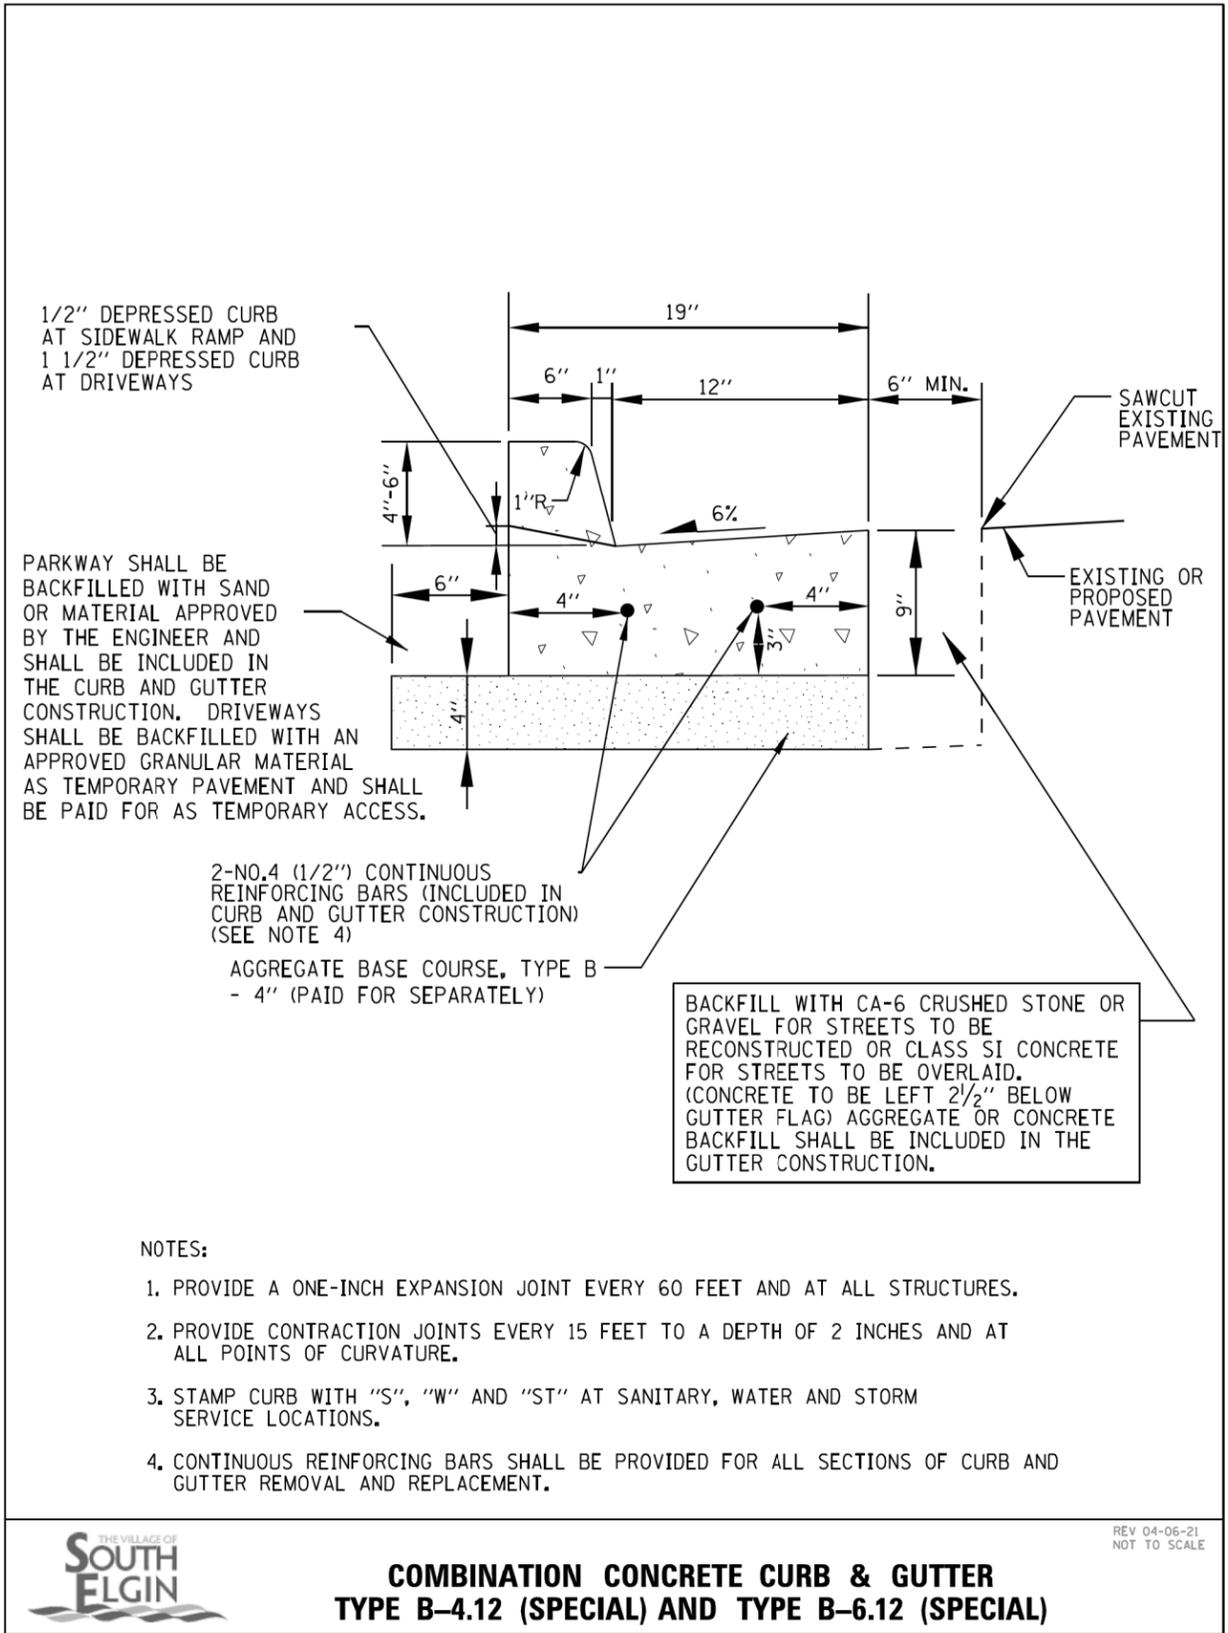
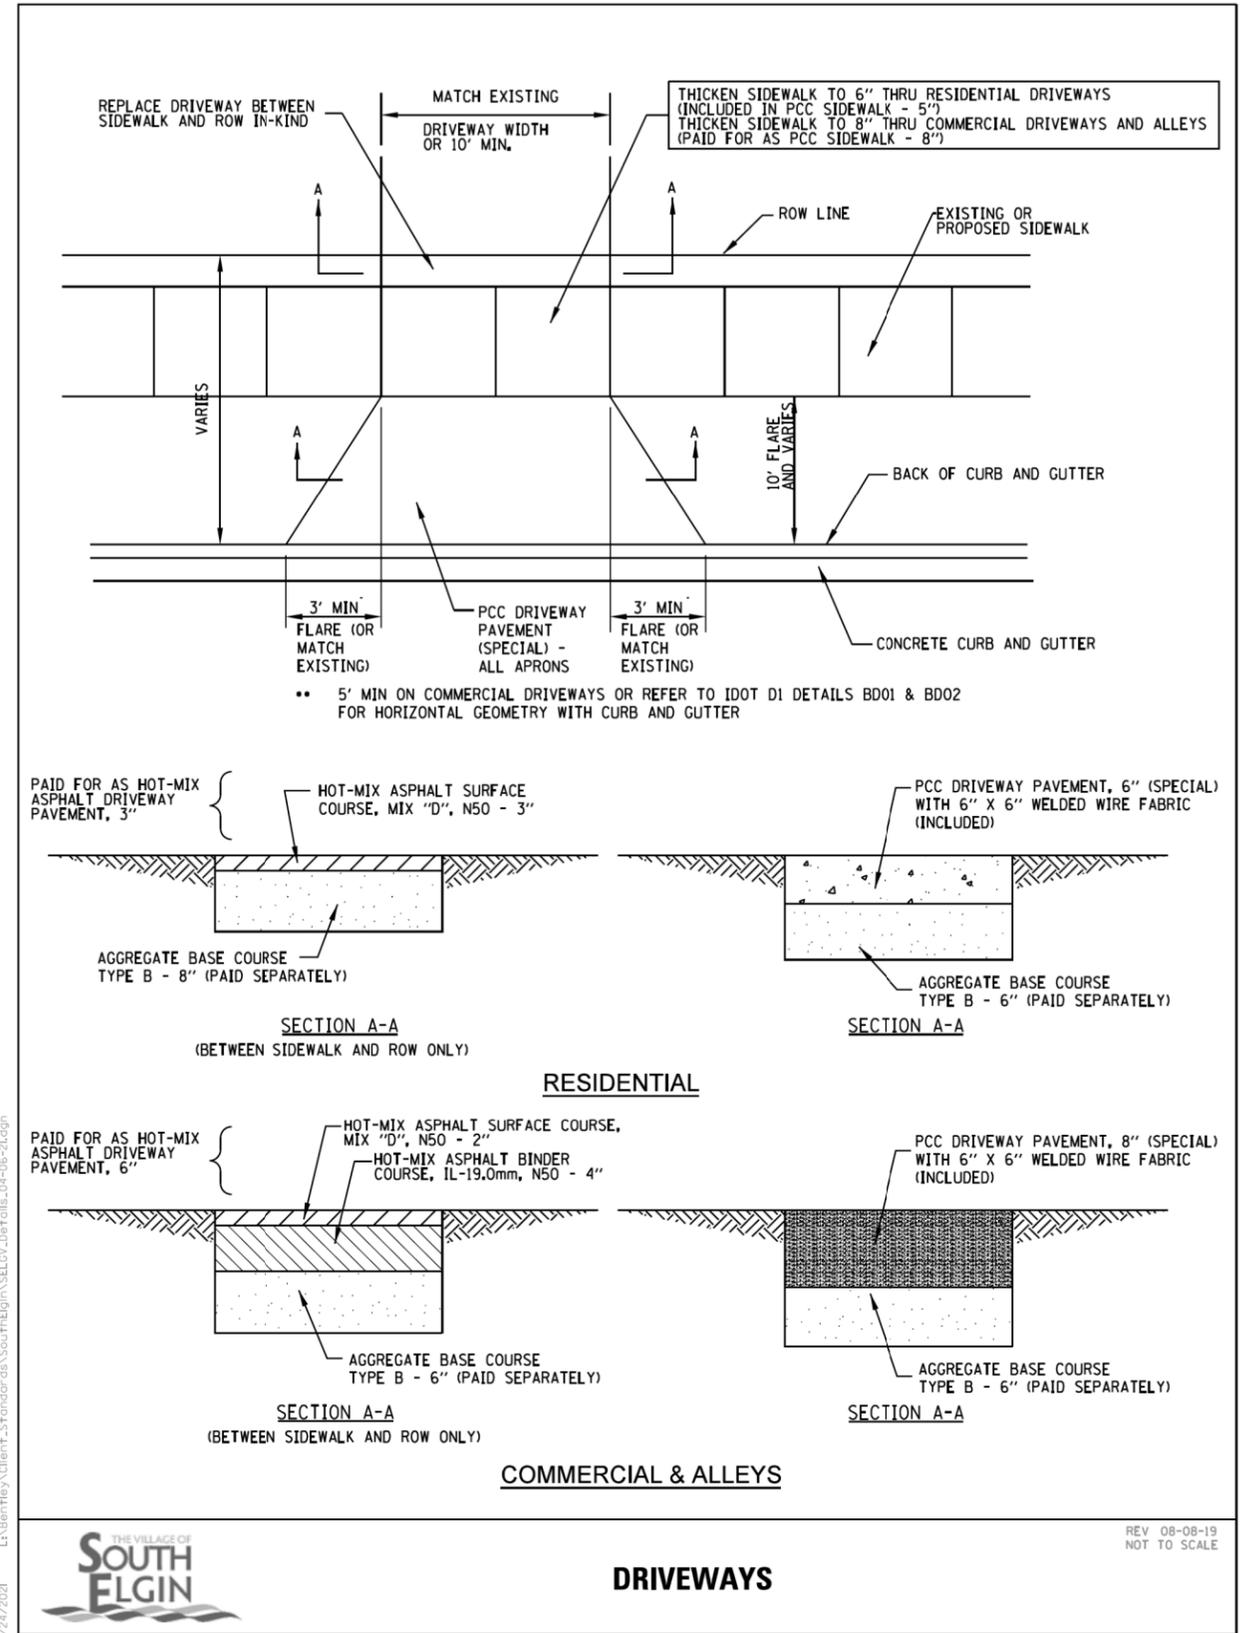
STATE OF ILLINOIS
 DEPARTMENT OF TRANSPORTATION

MISCELLANEOUS DETAILS

SCALE: NONE SHEET 1 OF 5 SHEETS STA. TO STA.

F.A.U. RTE.	SECTION	COUNTY	TOTAL SHEETS	SHEET NO.
1342	21-00052-00-R5	KANE	28	15
CONTRACT NO. 61H43				
ILLINOIS FED. AID PROJECT				

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STATE OF ILLINOIS
 DEPARTMENT OF TRANSPORTATION

MISCELLANEOUS DETAILS			
SCALE: NONE	SHEET 2 OF 5 SHEETS	STA.	TO STA.

F.A.U. RTE.	SECTION	COUNTY	TOTAL SHEETS	SHEET NO.
1342	21-00052-00-R5	KANE	28	16
CONTRACT NO. 61H43				
ILLINOIS / FED. AID PROJECT				

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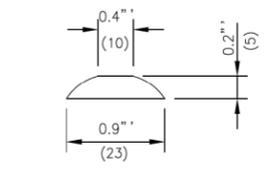
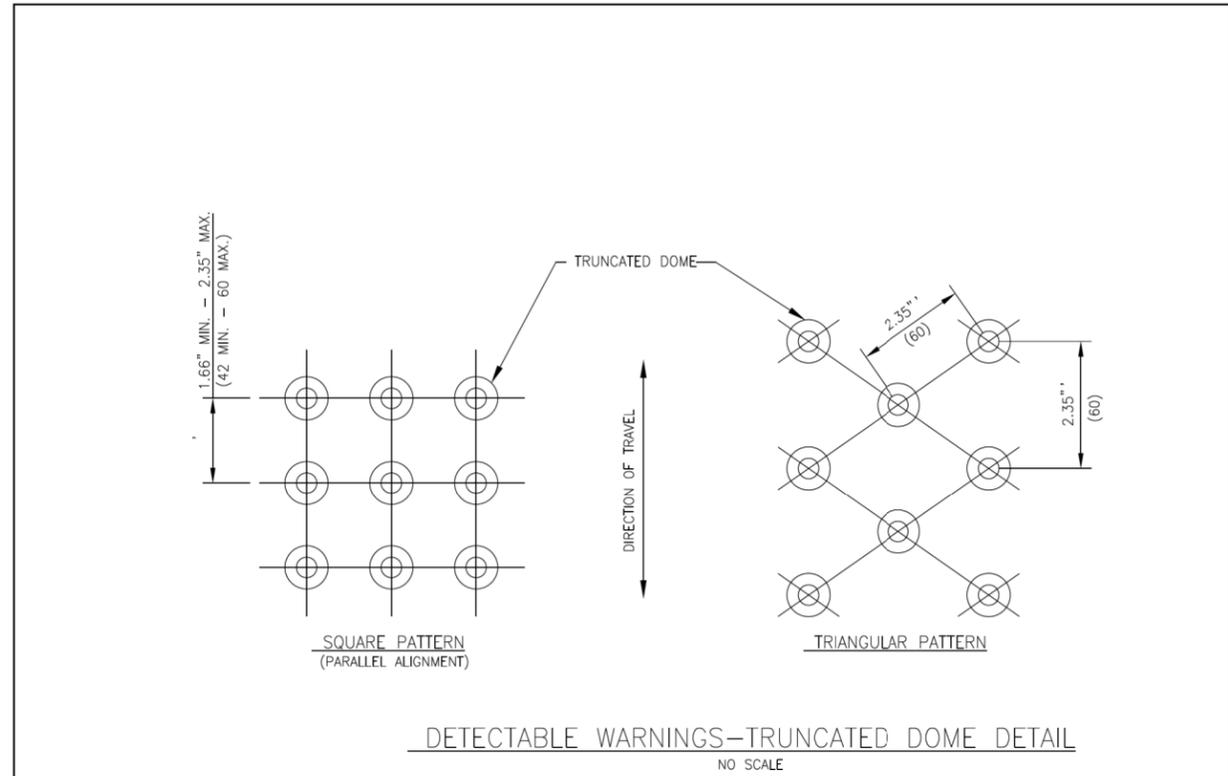
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DETECTABLE WARNINGS-TRUNCATED DOME DETAIL

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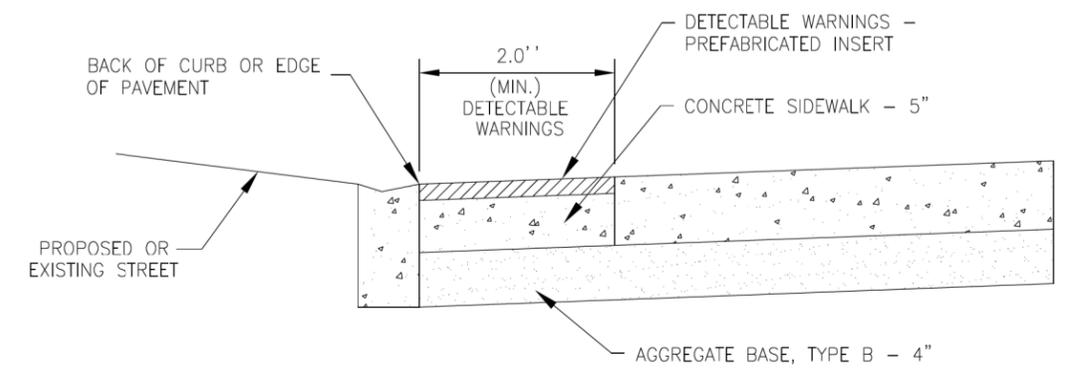
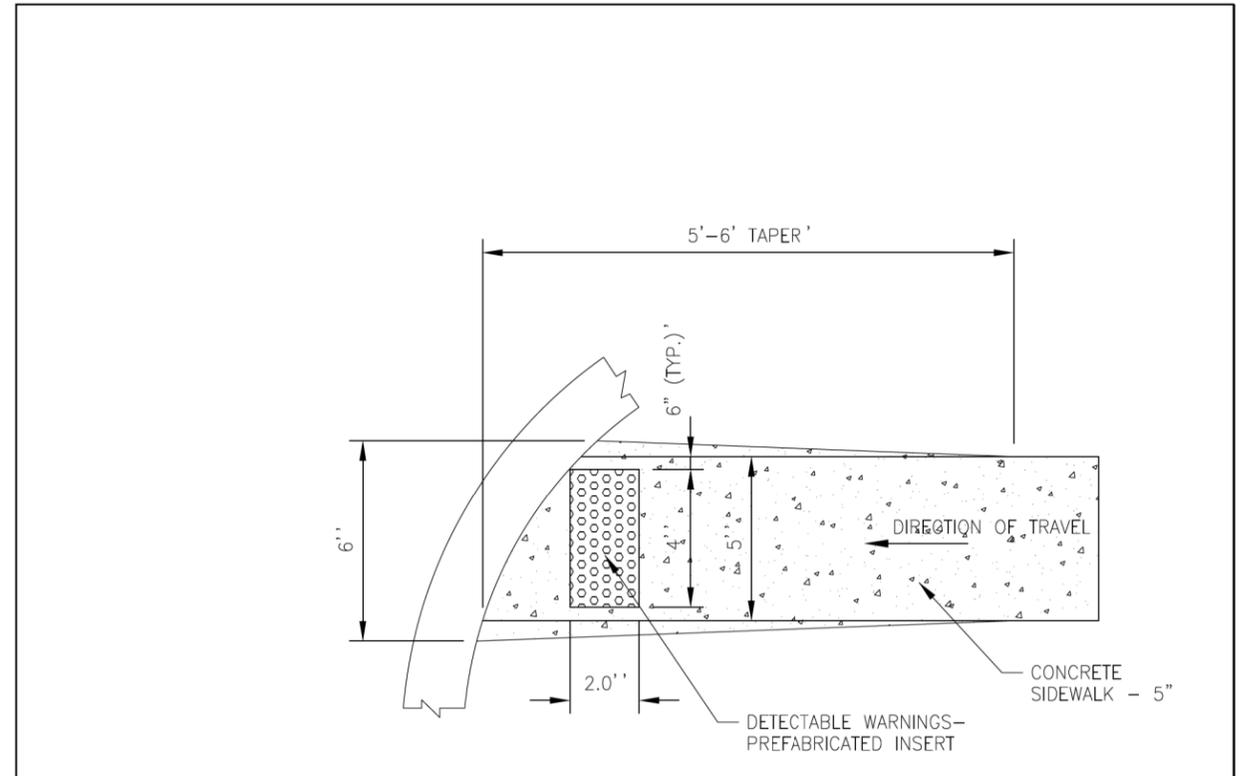


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DETECTABLE WARNING DETAIL

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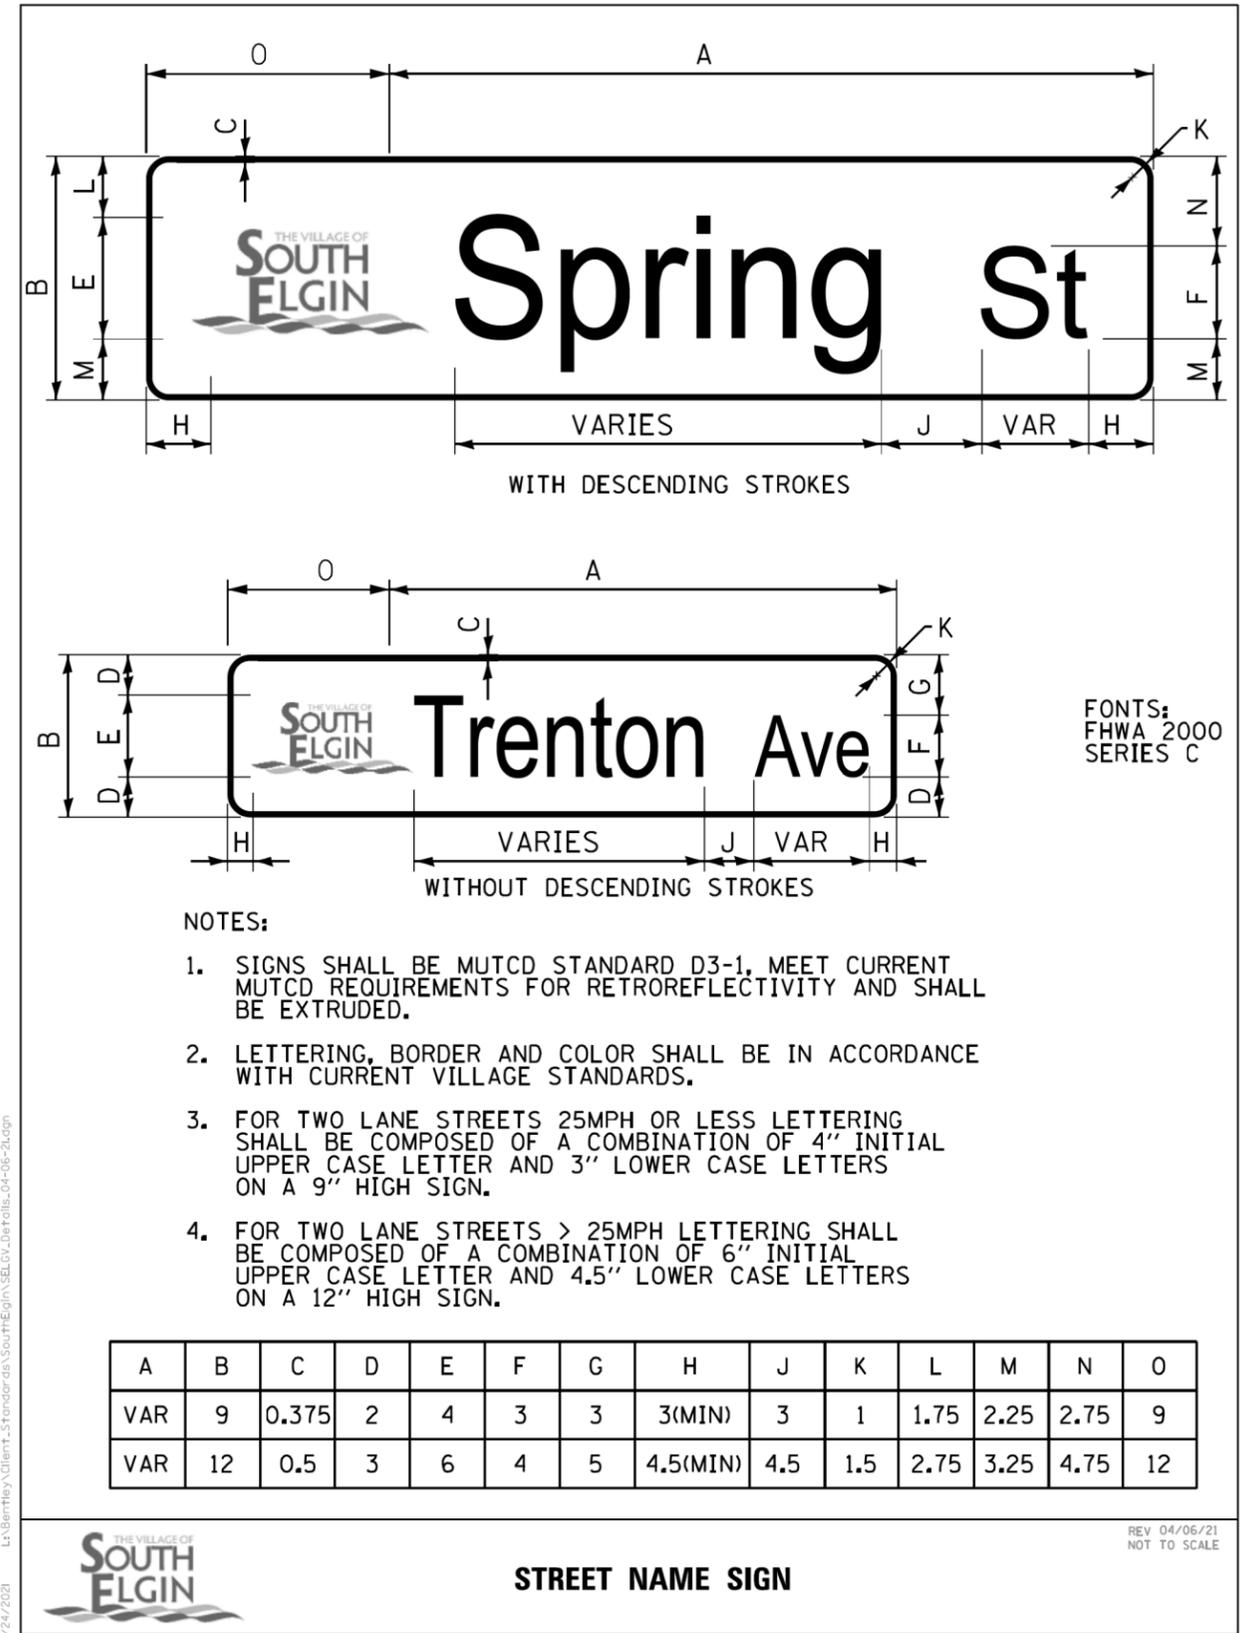


NOTE:
SEE IDOT STANDARD DETAILS OR PROWAG FOR ALTERNATE CONFIGURATIONS.


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F.A.U. RTE.	SECTION	COUNTY	TOTAL SHEETS	SHEET NO.
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CONTRACT NO. 61H43				
ILLINOIS FED. AID PROJECT				

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FONTS:
FHWA 2000
SERIES C



USER NAME	morning	DESIGNED	SAM	REVISED	
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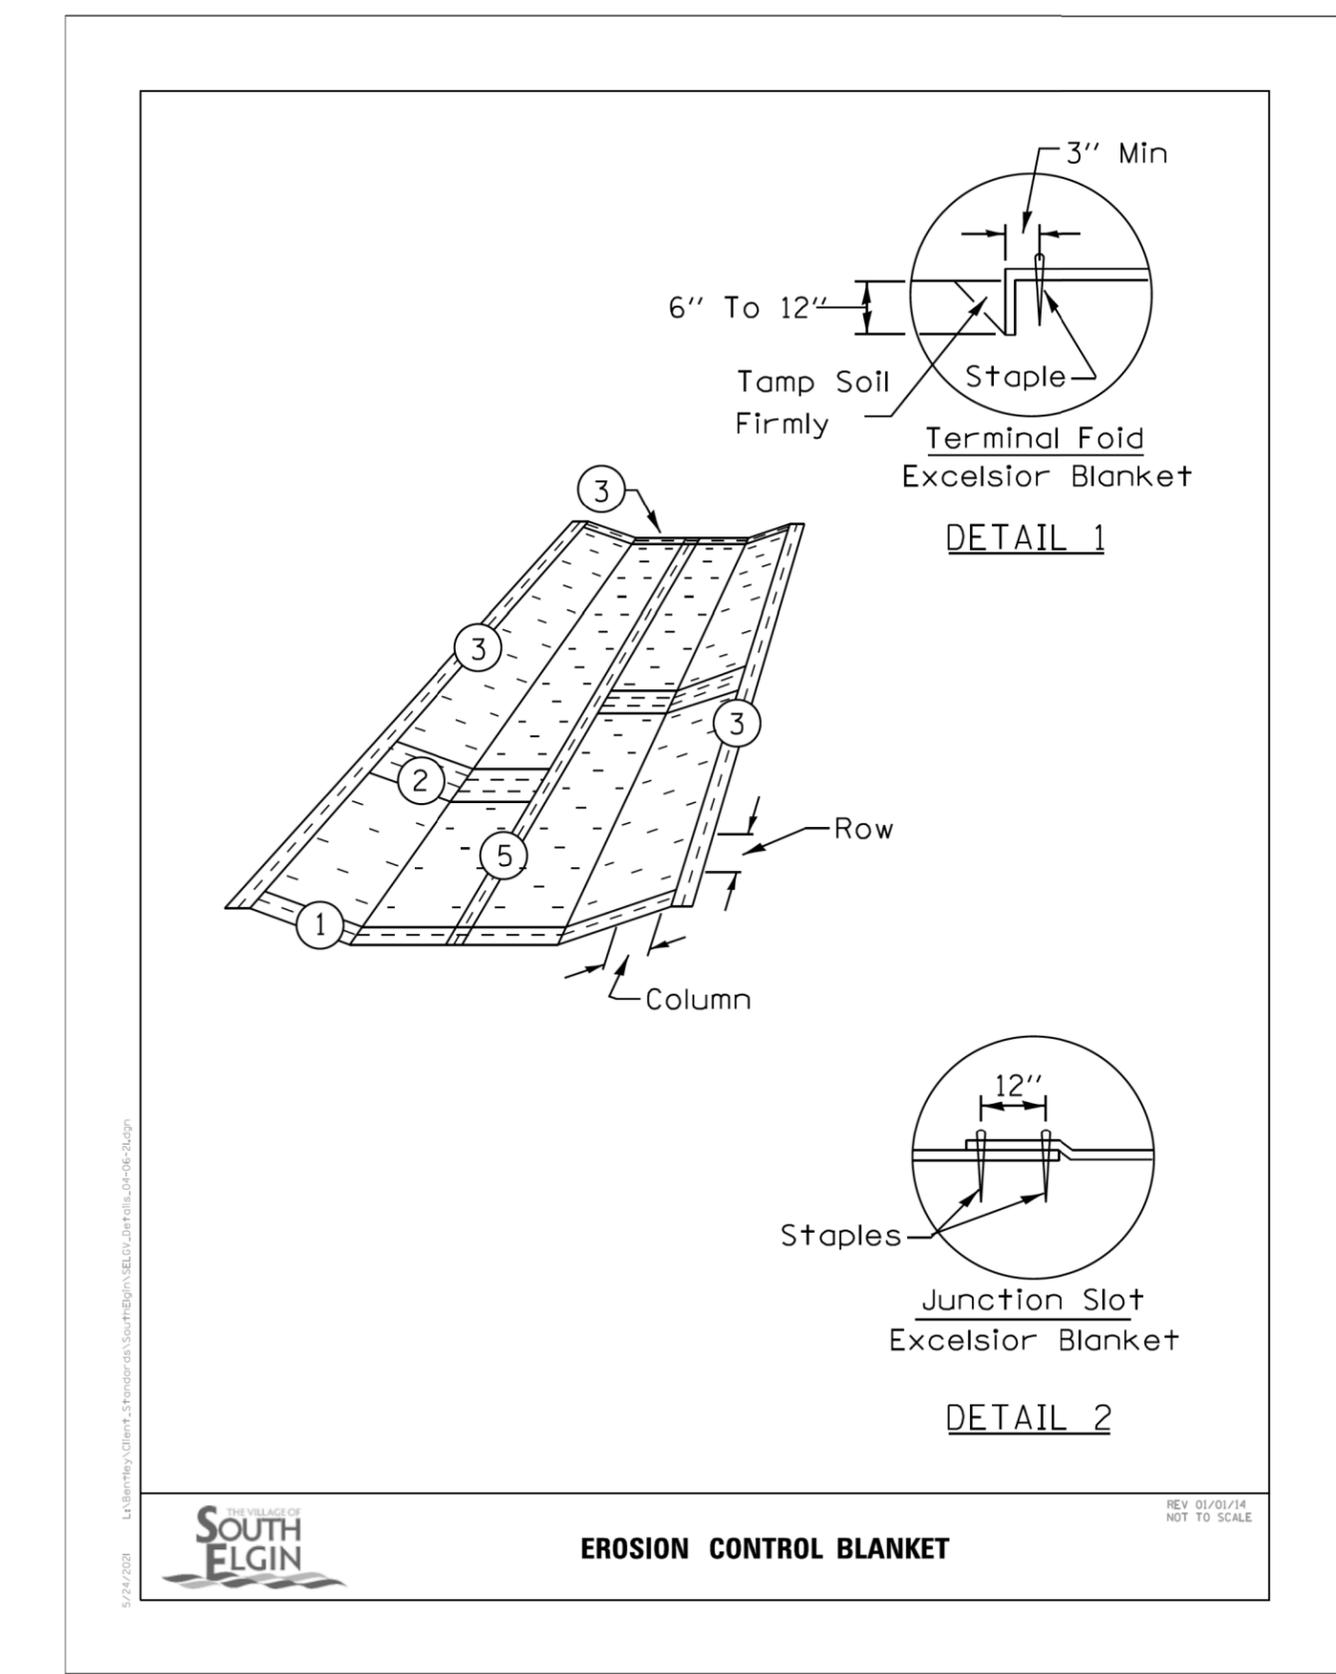
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DEPARTMENT OF TRANSPORTATION

MISCELLANEOUS DETAILS
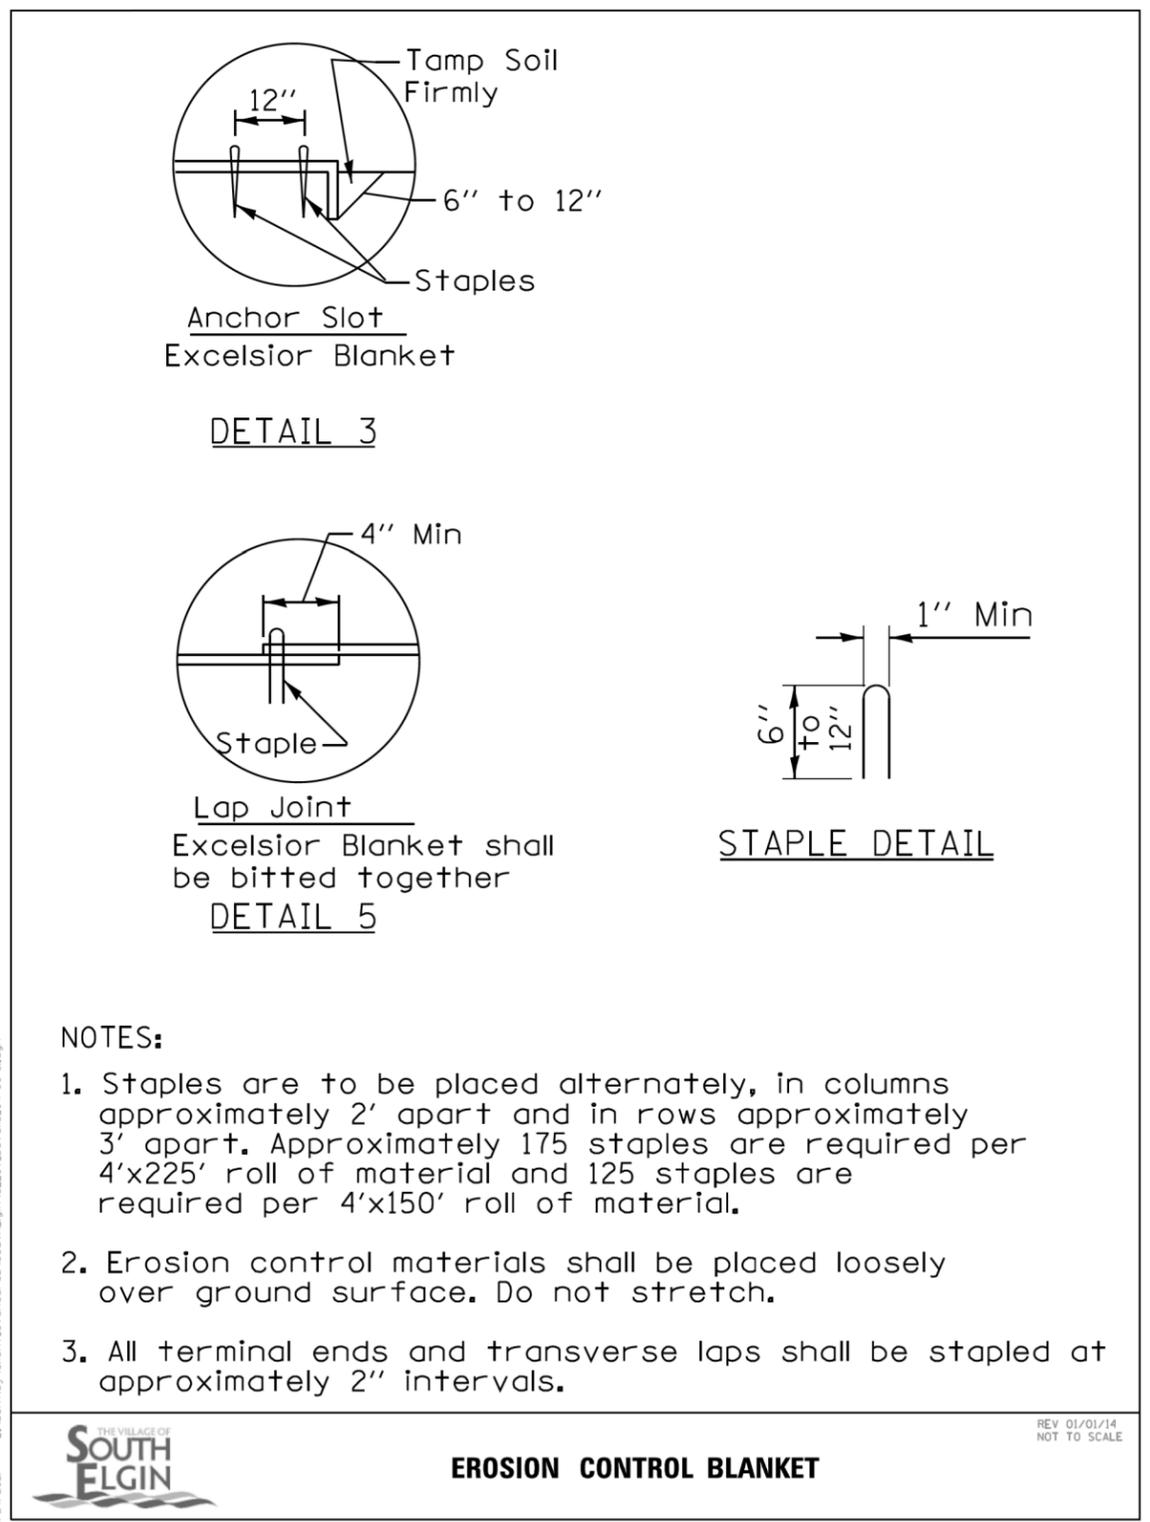
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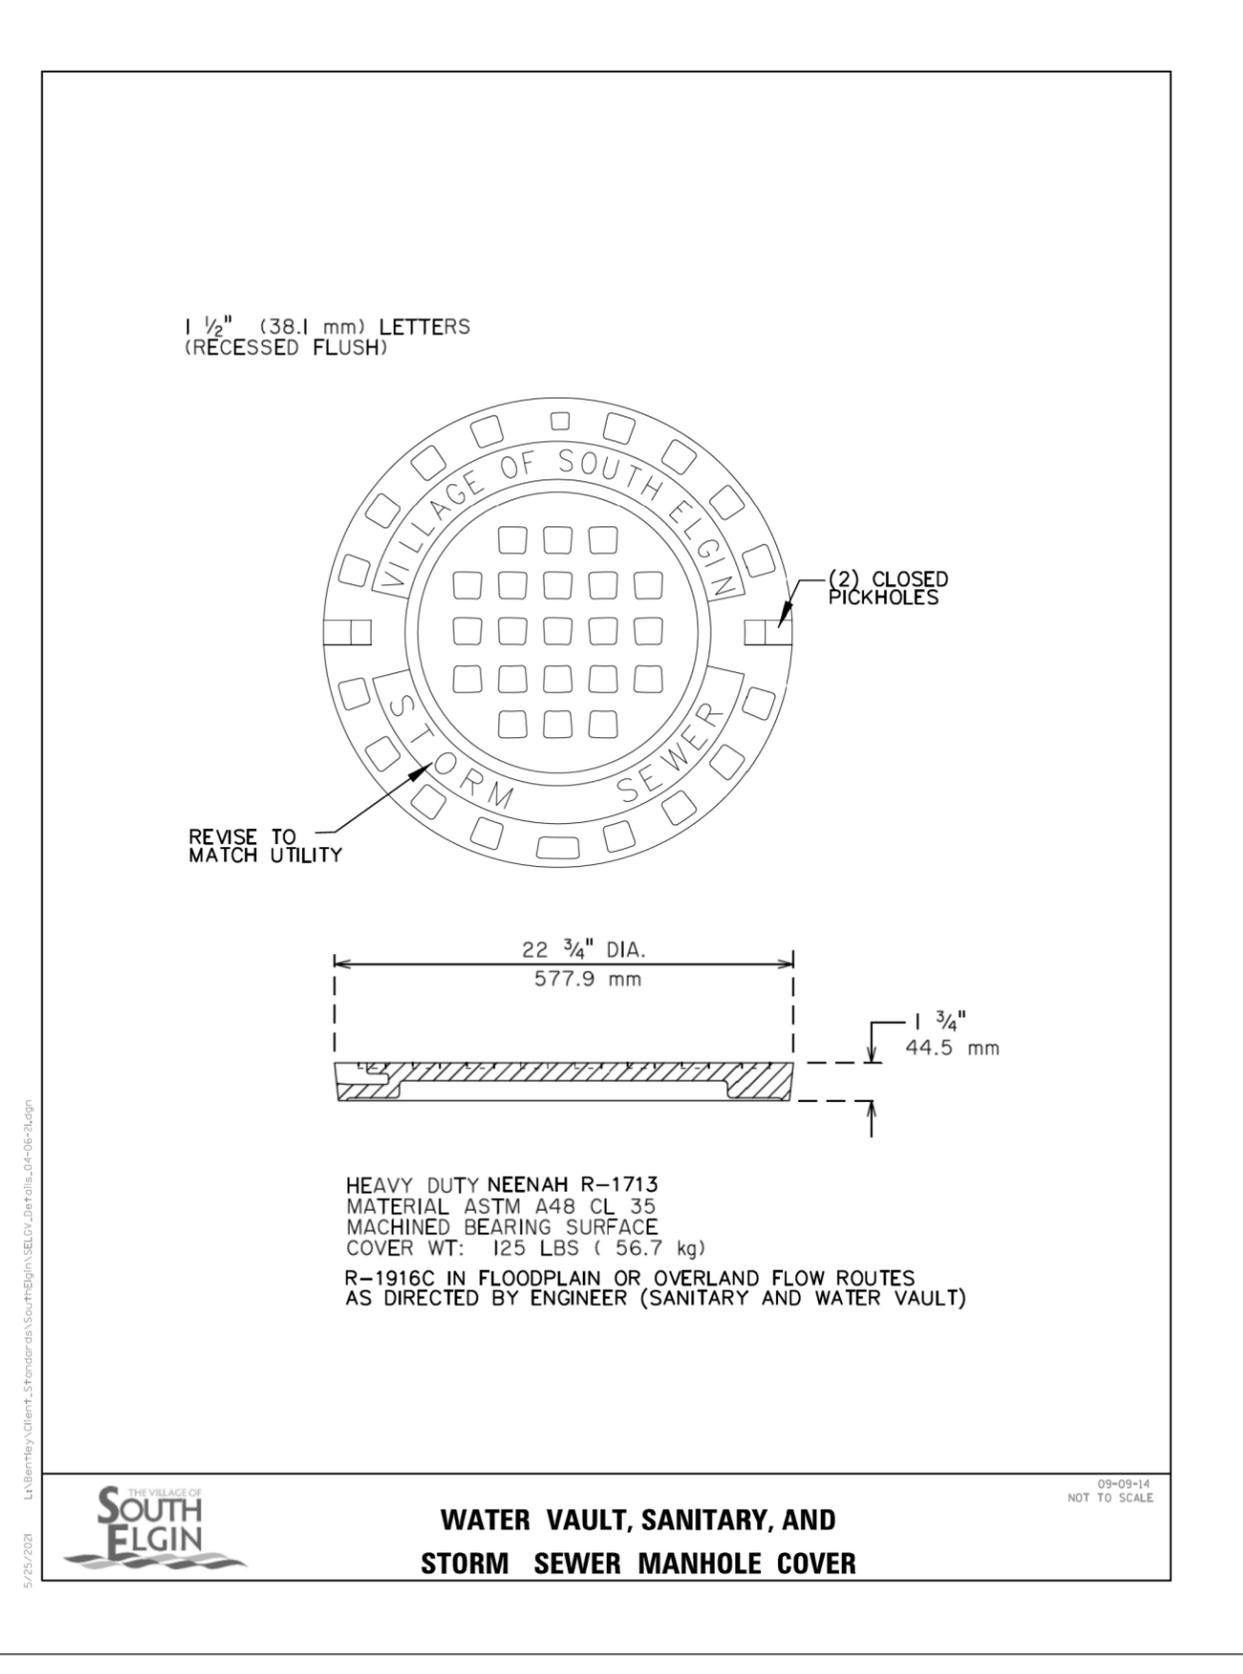
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CONTRACT NO. 61H43				
ILLINOIS FED. AID PROJECT				

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**WATER VAULT, SANITARY, AND
 STORM SEWER MANHOLE COVER**


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STATE OF ILLINOIS
 DEPARTMENT OF TRANSPORTATION

MISCELLANEOUS DETAILS			
SCALE: NONE	SHEET 5	OF 5 SHEETS	STA. TO STA.

F.A.U. RTE.	SECTION	COUNTY	TOTAL SHEETS	SHEET NO.
1342	21-00052-00-R5	KANE	28	19
CONTRACT NO. 61H43				
ILLINOIS FED. AID PROJECT				



CONSTRUCTION PROCEDURES

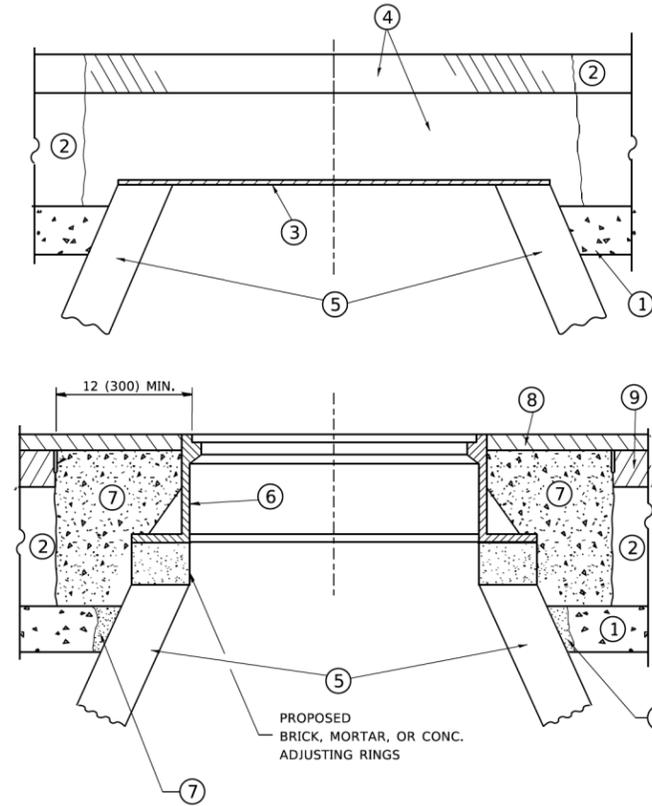STAGE 1 (BEFORE PAVEMENT MILLING)

- A) REMOVE A MINIMUM OF 12 (300) OF THE PAVEMENT FROM AROUND THE STRUCTURE.
- B) REMOVE THE EXISTING FRAME AND LID FROM THE STRUCTURE.
- C) COVER THE STRUCTURE OPENING WITH A 36 (900) DIAMETER METAL PLATE.
- D) BACKFILL WITH CRUSHED STONE AND A MINIMUM 1½ (40) THICK HMA SURFACE MIX APPROVED BY THE ENGINEER.

STAGE 2 (AFTER PAVEMENT MILLING)

- A) REMOVE THE HMA SURFACE MIX AND CRUSHED STONE.
- B) INSTALL THE FRAME AND LID; ADJUST THE FRAME TO ITS FINAL SURFACE ELEVATION.
- C) THE SURROUNDING SPACE SHALL BE FILLED WITH CLASS PP-1 * CONCRETE TO THE ELEVATION OF THE SURFACE OF THE EXISTING BASE COURSE OR THE BINDER COURSE.

* UNLESS OTHERWISE SPECIFIED IN THE PLANS.

THE PROCEDURE EXPLAINED ABOVE SHALL CONFORM TO THE APPLICABLE PORTIONS OF SECTIONS 353, 406, 602, AND 603 OF THE STANDARD SPECIFICATIONS EXCEPT THAT "THE CONTRACTOR SHALL ADJUST THE STRUCTURES TO THE FINISHED PAVEMENT ELEVATION NO MORE THAN 5 CALENDAR DAYS PRIOR TO PLACEMENT OF THE FINAL LIFT OF SURFACE UNLESS APPROVED BY THE ENGINEER."

LEGEND

- ① SUB-BASE GRANULAR MATERIAL
- ② EXISTING PAVEMENT
- ③ 36 (900) DIAMETER METAL PLATE
- ④ PROPOSED CRUSHED STONE AND HMA SURFACE MIX
- ⑤ EXISTING STRUCTURE
- ⑥ FRAME AND LID (SEE NOTES)
- ⑦ CLASS PP-1 *CONCRETE
- ⑧ PROPOSED HMA SURFACE COURSE
- ⑨ PROPOSED HMA BINDER COURSE

LOCATION OF STRUCTURES

THE CONTRACTOR WILL BE REQUIRED TO KEEP A RECORD OF THE LOCATIONS OF THE BURIED STRUCTURES ACCORDING TO THE STATION AND DISTANCE LEFT OR RIGHT OF THE CENTERLINE OF PAVEMENT. UPON COMPLETION OF THE WORK, THE CONTRACTOR WILL DELIVER THE RECORD TO THE ENGINEER.

BASIS OF PAYMENT

REMOVING FRAMES AND LIDS ON DRAINAGE AND UTILITY STRUCTURES IN THE PAVEMENT PRIOR TO MILLING, AND ADJUSTING TO FINAL GRADE PRIOR TO PLACING THE SURFACE COURSE, WILL BE PAID FOR AT THE CONTRACT UNIT PRICE EACH FOR "FRAMES AND LIDS TO BE ADJUSTED (SPECIAL)."

THIS WORK WILL NOT BE PAID FOR WHEN DRAINAGE AND UTILITY STRUCTURES ARE SPECIFIED FOR PAYMENT AS STRUCTURE RECONSTRUCTION.

NEW FRAMES AND LIDS, WHEN SPECIFIED, WILL BE PAID FOR SEPARATELY.

NOTES

EXISTING BROKEN FRAMES AND LIDS SHALL BE REMOVED AND DISPOSED OF BY THE CONTRACTOR AND SHALL BE REPLACED AS DIRECTED BY THE ENGINEER. REPLACEMENT FRAMES AND LIDS WILL BE PAID FOR IN ACCORDANCE WITH ARTICLE 109.04 OF THE STANDARD SPECIFICATIONS UNLESS A SEPARATE PAY ITEM HAS BEEN PROVIDED.

IF THE EXISTING LIDS ARE OPEN, THE FRAME WILL BE ADJUSTED TO THE ELEVATION OF THE MILLED PAVEMENT SURFACE PRIOR TO THE MILLING OPERATION. THE FRAME WILL NOT BE REMOVED AND COVERED BY THE METAL PLATE.

CITY OF CHICAGO CASTINGS ARE THE PROPERTY OF THE CITY AND THE CONTRACTOR SHALL NOTIFY THE CITY FOR REMOVAL AND DISPOSITION OF THE CASTINGS.

THE METAL PLATE USED TO COVER THE STRUCTURE SHALL REMAIN THE PROPERTY OF THE CONTRACTOR.

WHEN STRUCTURES ARE TO BE ADJUSTED OR RECONSTRUCTED, THE LOWERING AND RAISING OF THE FRAMES AND LIDS WILL NOT BE PAID FOR SEPARATELY BUT WILL BE INCLUDED IN THE COST OF THE CORRESPONDING PAY ITEM.

DETAILS FOR FRAMES AND LIDS ADJUSTMENT WITH MILLING

ALL DIMENSIONS ARE IN INCHES (MILLIMETERS) UNLESS OTHERWISE SHOWN


COPYRIGHT © 2017 BY BAXTER & WOODMAN, INC.
 STATE OF ILLINOIS - PROFESSIONAL DESIGN FIRM
 PROJECT NO. 1342
 FILE NAME: PROJECT/2019/03/27/2019-03-27-11 AM User: footem

USER NAME = footemj	DESIGNED - R. SHAH	REVISED - R. WEDEMAN 05-14-04
	DRAWN -	REVISED - R. BORO 01-01-07
PLOT SCALE = 50,0000 ' / 1"	CHECKED -	REVISED - R. BORO 03-09-11
PLOT DATE = 3/27/2019	DATE - 10-25-94	REVISED - R. BORO 12-06-11

**STATE OF ILLINOIS
DEPARTMENT OF TRANSPORTATION**

DETAILS FOR FRAMES AND LIDS ADJUSTMENT WITH MILLING			
SCALE: NONE	SHEET 1	OF 1 SHEETS	STA. TO STA.


F.A. RTE. 1342	SECTION 21-00052-00-RS	COUNTY KANE	TOTAL SHEETS 28	SHEET NO. 20
BD600-03 (BD-8)			CONTRACT NO. 61H43	
ILLINOIS FED. AID PROJECT LR5C(581)				

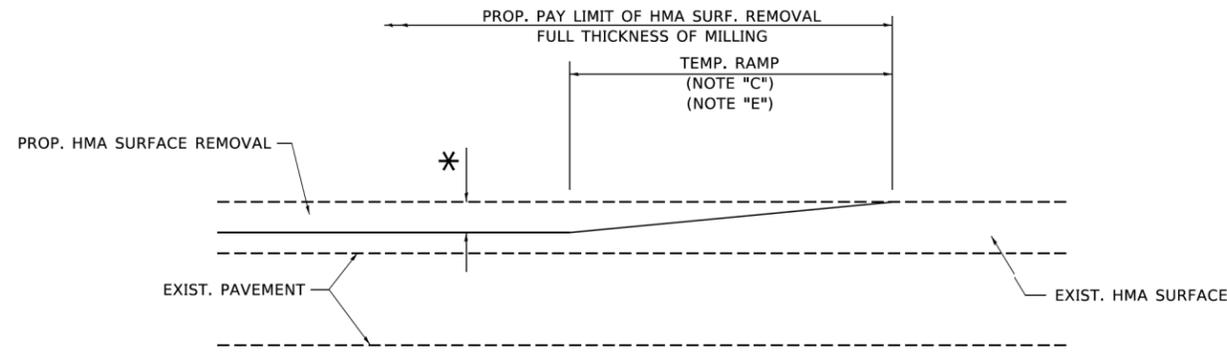

MILLED TEMPORARY RAMP

(FOR BUTT JOINT AND HMA TAPER SEE DETAIL BELOW)

OPTION 1

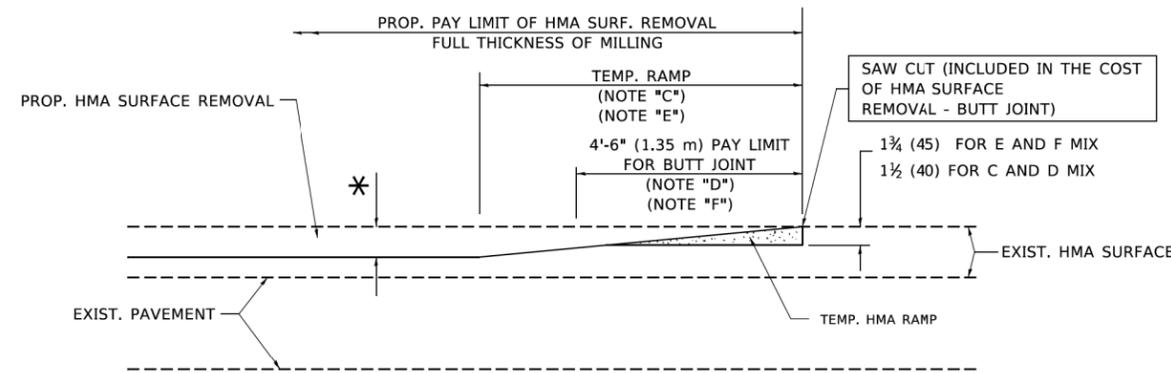


HMA CONSTRUCTED TEMPORARY RAMP


(FOR BUTT JOINT AND HMA TAPER SEE DETAIL BELOW)

OPTION 2

TYPICAL TEMPORARY RAMP

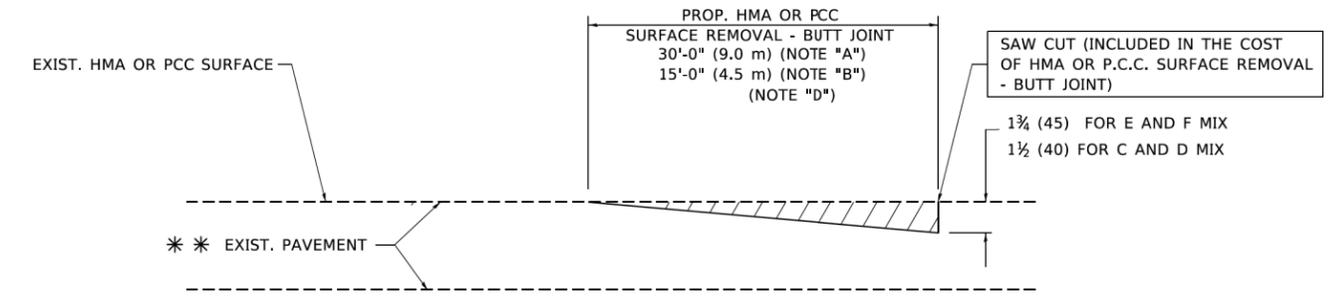

BUTT JOINT DETAIL

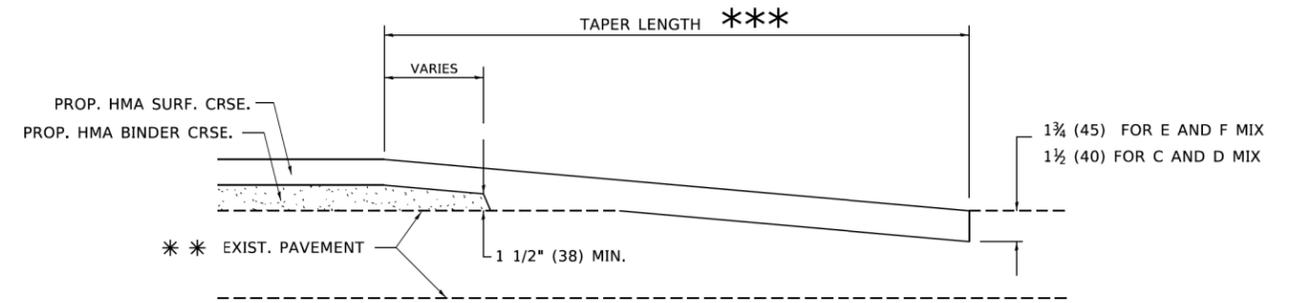

HMA TAPER DETAIL

TYPICAL BUTT JOINT AND HMA TAPER FOR RESURFACING ONLY

*** PC CONCRETE, HMA OR HMA RESURFACED PAVEMENT.


NOTES

- A. MAINLINE ROADWAYS AND MAJOR SIDE ROADS.
- B. MINOR SIDE ROADS.
- C. THE TEMP. RAMP SHALL BE CONSTRUCTED IMMEDIATELY UPON REMOVAL OF THE EXISTING HMA SURFACE.
- D. THE BUTT JOINT SHALL BE CONSTRUCTED IMMEDIATELY PRIOR TO PLACING THE PROPOSED HMA COURSES.
- E. TAPER THE TEMP. RAMP AT A RATE OF 3'-0" (900 mm) PER 1 INCH (25 mm) OF MILLING THICKNESS.
- F. INSTALLATION AND REMOVAL OF THE 4'-6" (1.35 m) TEMP. RAMP IS INCLUDED IN COST OF HMA SURFACE REMOVAL - BUTT JOINT.
* SEE TYPICAL SECTIONS FOR MILLING THICKNESS.
- G. SEE ARTICLE 406.08 AND 406.14 OF THE STANDARD SPECIFICATIONS FOR "HMA AND/OR PCC SURFACE REMOVAL, BUTT JOINT".
*** 20'-0" (6.1 m) PER 1 (25) RESURFACING (NOTE "A")
10'-0" (3.0 m) PER 1 (25) RESURFACING (NOTE "B")

BASIS OF PAYMENT

THE BUTT JOINT WILL BE PAID FOR AT THE CONTRACT UNIT PRICE PER SQUARE YARD (SQUARE METER) FOR "HOT-MIX ASPHALT SURFACE REMOVAL - BUTT JOINT" OR FOR "PORTLAND CEMENT CONCRETE SURFACE REMOVAL - BUTT JOINT".

ALL DIMENSIONS ARE IN INCHES (MILLIMETERS) UNLESS OTHERWISE SHOWN.

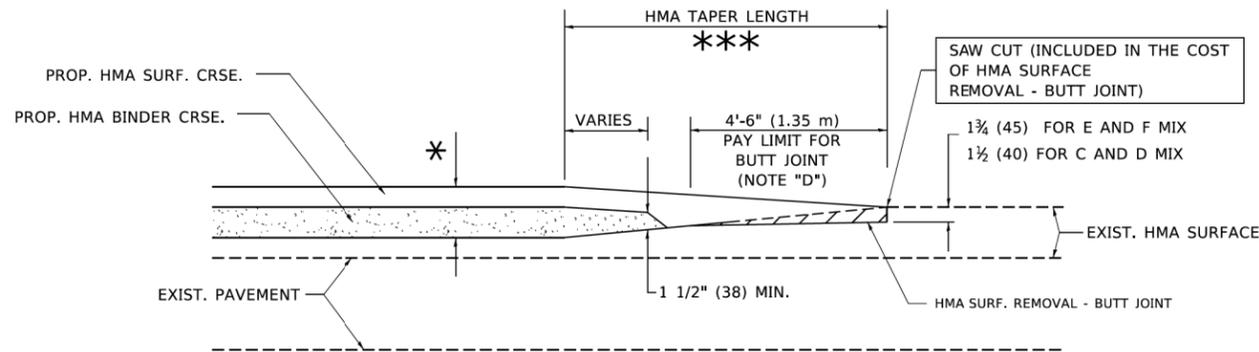

BUTT JOINT AND HMA TAPER

TYPICAL BUTT JOINT AND HMA TAPER FOR MILLING AND RESURFACING

USER NAME = footemj	DESIGNED - M. DE YONG	REVISED - R. SHAH 10-25-94
	DRAWN -	REVISED - A. ABBAS 03-21-97
PLOT SCALE = 50,0000' / 1"	CHECKED -	REVISED - M. GOMEZ 04-26-01
PLOT DATE = 3/27/2019	DATE - 06-13-90	REVISED - R.BORO 01-01-07


STATE OF ILLINOIS
DEPARTMENT OF TRANSPORTATION

BUTT JOINT AND HMA TAPER DETAILS

SCALE: NONE SHEET 1 OF 1 SHEETS STA. TO STA.


F.A. RTE.	SECTION	COUNTY	TOTAL SHEETS	SHEET NO.
1342	21-00052-00-RS	KANE	28	22
BD400-05 BD32		CONTRACT NO. 61H43		
ILLINOIS FED. AID PROJECT LR5C(581)				

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 STATE OF ILLINOIS - PROFESSIONAL DESIGN FIRM
 PROJECT NO. 21-00052-00-RS
 SHEET NO. 22 OF 28
 DATE: 06/13/2019
 DRAWN BY: M. DE YONG
 CHECKED BY: M. GOMEZ
 DESIGNED BY: M. DE YONG
 PROJECT: STATE ROUTE 1342, KANE COUNTY, ILLINOIS

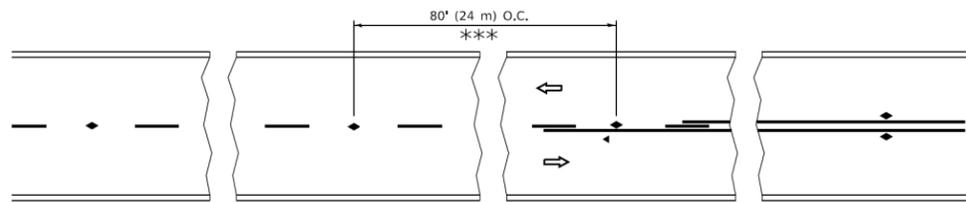


*** REDUCE TO 40' (12 m) O.C. ON CURVES WITH POSTED OR ADVISORY SPEED 45 M.P.H. (70 km/h) OR LESS.


TWO-LANE/TWO-WAY

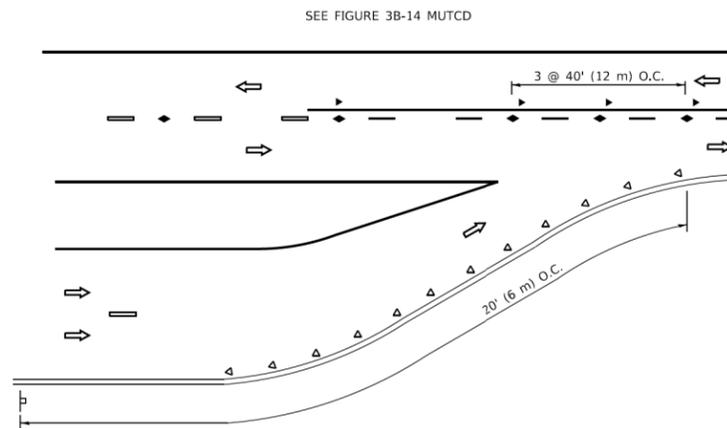


LANE REDUCTION TRANSITION

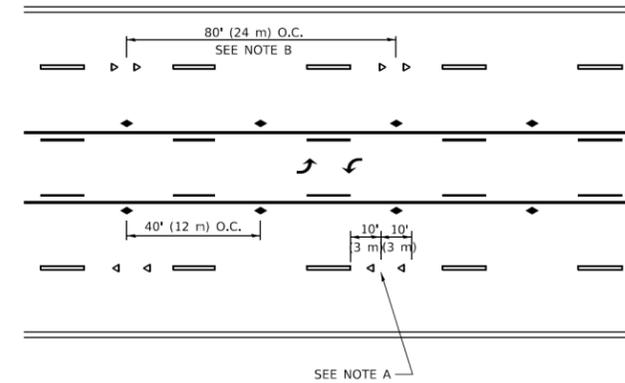

TWO-WAY LEFT TURN

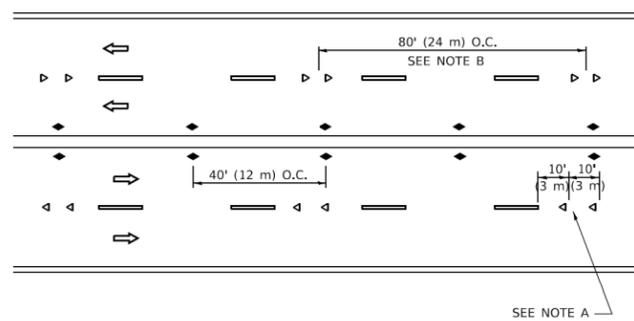

MULTI-LANE/UNDIVIDED

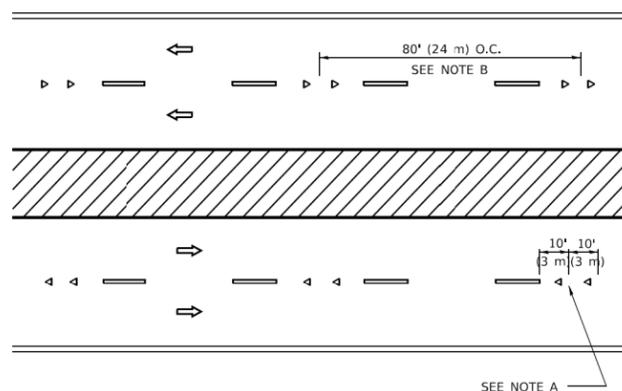

MULTI-LANE/DIVIDED

GENERAL NOTES

1. MARKERS USED WITH DASHED LINES SHALL BE CENTERED IN THE GAP BETWEEN SEGMENTS.
2. MARKERS USED ADJACENT TO SOLID LINES SHALL BE OFFSET 2 TO 3 (50 TO 75) TOWARD TRAFFIC AS SHOWN.
3. MARKERS THROUGH TANGENTS LESS THAN 500' (150 m) IN LENGTH BETWEEN CURVES SHALL BE INSTALLED AT THE LESSER OF THE TWO CURVE SPACINGS.
4. MARKERS ARE TO BE USED ADJACENT TO BOTH SOLID WHITE LINES IN DUAL LEFT TURN LANES

SYMBOLS



- YELLOW STRIPE
- WHITE STRIPE
- ◀ ONE-WAY AMBER MARKER
- ◀ ONE-WAY CRYSTAL MARKER (W/O)
- ◆ TWO-WAY AMBER MARKER

LANE MARKER NOTES

- A. USE DOUBLE LANE LINE MARKERS SPACED AS SHOWN.
- B. REDUCE TO 40' (12 m) O.C. ON CURVES WHERE ADVISORY SPEEDS ARE 10 M.P.H (20 km/h) LOWER THAN POSTED SPEEDS.

DESIGN NOTES

1. DOUBLE LANE LINE MARKERS SHALL BE USED UNLESS SPECIFIED OTHERWISE.
2. EXCEPT AS SHOWN ON THE LANE REDUCTION TRANSITION AND FREEWAY EXIT RAMP DETAIL, MARKERS ARE NOT TO BE SPECIFIED ON RIGHT EDGE LINES.
3. THE EXACT MARKER LIMITS, SPACING, AND COLOR SHALL BE INCLUDED IN THE PLANS WHEN STANDARD SPECIFICATIONS ARE NOT BEING USED.
4. MARKERS SHOULD NOT BE USED ALONGSIDE CURBS EXCEPT FOR EXTREMELY SHORT SECTIONS OF C/JRBS WHERE NOT MORE THAN TWO MARKERS WOULD BE INVOLVED.

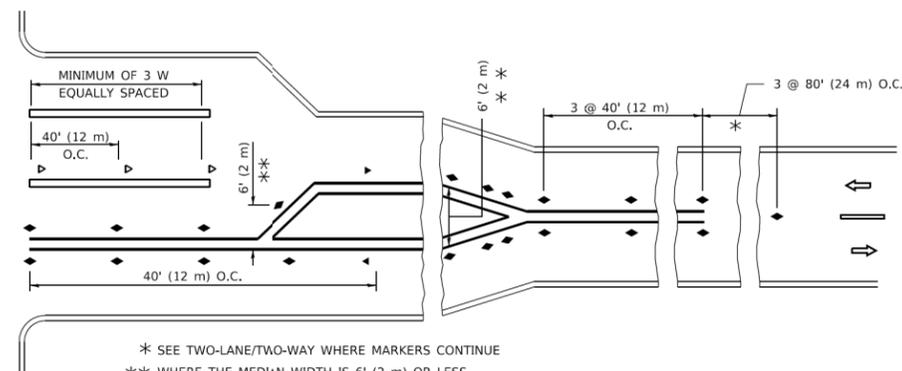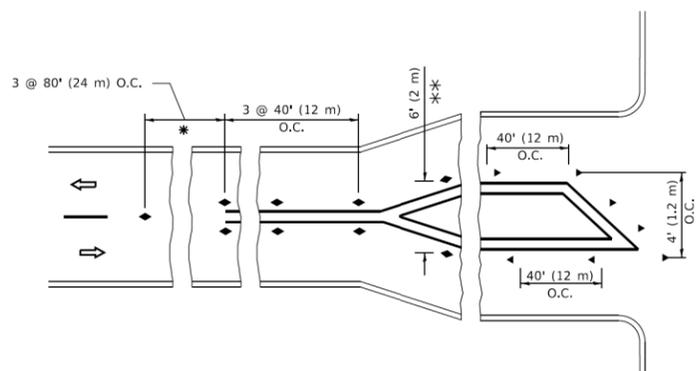

TURN LANES

* SEE TWO-LANE/TWO-WAY WHERE MARKERS CONTINUE
 ** WHERE THE MEDIAN WIDTH IS 6' (2 m) OR LESS USE TWO-WAY MARKERS.

All dimensions are in inches (millimeters) unless otherwise shown.

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 STATE OF ILLINOIS - PROFESSIONAL DESIGN FIRM
 PROJECT NO. 21-00052-00-RS
 FILE NO. 1342
 PROJECT LOCATION: ILLINOIS
 PROJECT DESCRIPTION: RAISED REFLECTIVE PAVEMENT MARKERS (SNOW-PLOW RESISTANT)
 PROJECT DATE: 3/4/2019
 PROJECT DRAWN BY: T. RAMMACHER
 PROJECT CHECKED BY: C. JUCIUS
 PROJECT DATE: 3/4/2019


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	DRAWN -	REVISED - T. RAMMACHER 01-06-00
PLOT SCALE = 50,0000 1 / 1	CHECKED -	REVISED - C. JUCIUS 09-C9-09
PLOT DATE = 3/4/2019	DATE -	REVISED - C. JUCIUS 07-C1-13

**STATE OF ILLINOIS
 DEPARTMENT OF TRANSPORTATION**

**TYPICAL APPLICATIONS
 RAISED REFLECTIVE PAVEMENT MARKERS (SNOW-PLOW RESISTANT)**


SCALE: NONE SHEET 1 OF 1 SHEETS STA. TO STA.

F.A. RTE.	SECTION	COUNTY	TOTAL SHEETS	SHEET NO.
1342	21-00052-00-RS	KANE	28	24
TC-11			CONTRACT NO. 61H43	
ILLINOIS FED. AID PROJECT			LR5C(581)	

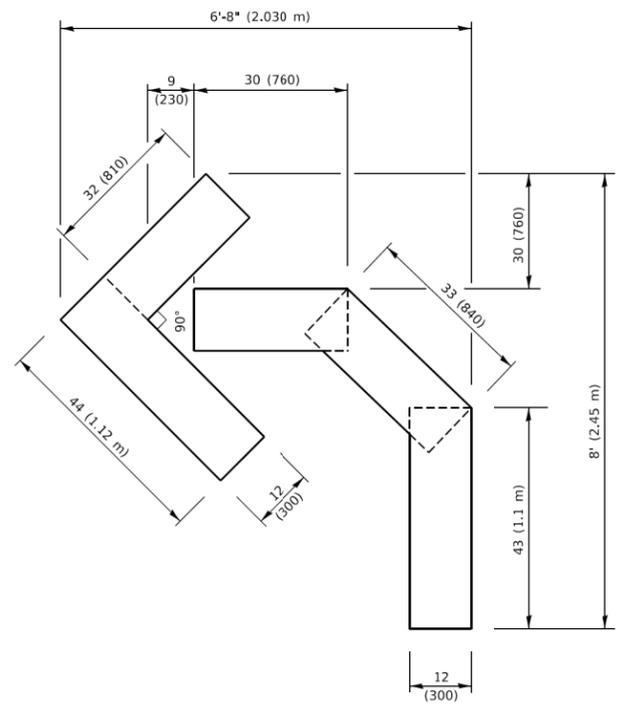


QUANTITY

4 (100) LINE = 45.5 ft. (13.9 m)
15.2 sq. ft. (1.41 sq. m)

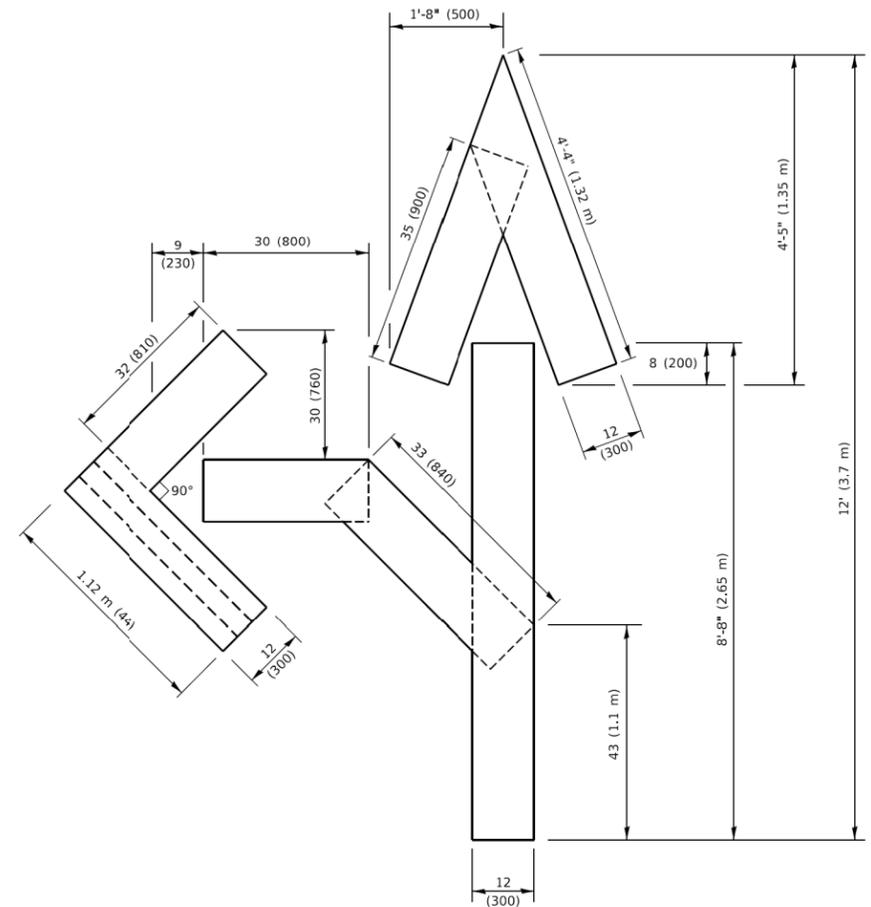


QUANTITY

4 (100) LINE = 82.5 ft. (25.1 m)
27.5 sq. ft. (2.53 sq. m)

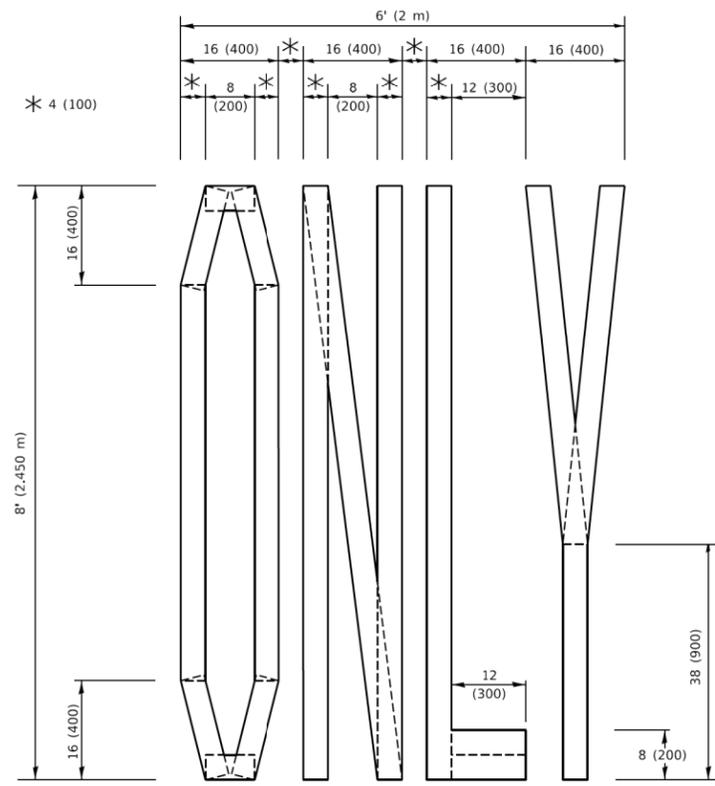

QUANTITY

4 (100) LINE = 64.1 ft. (19.5 m)
21.4 sq. ft. (1.99 sq. m)

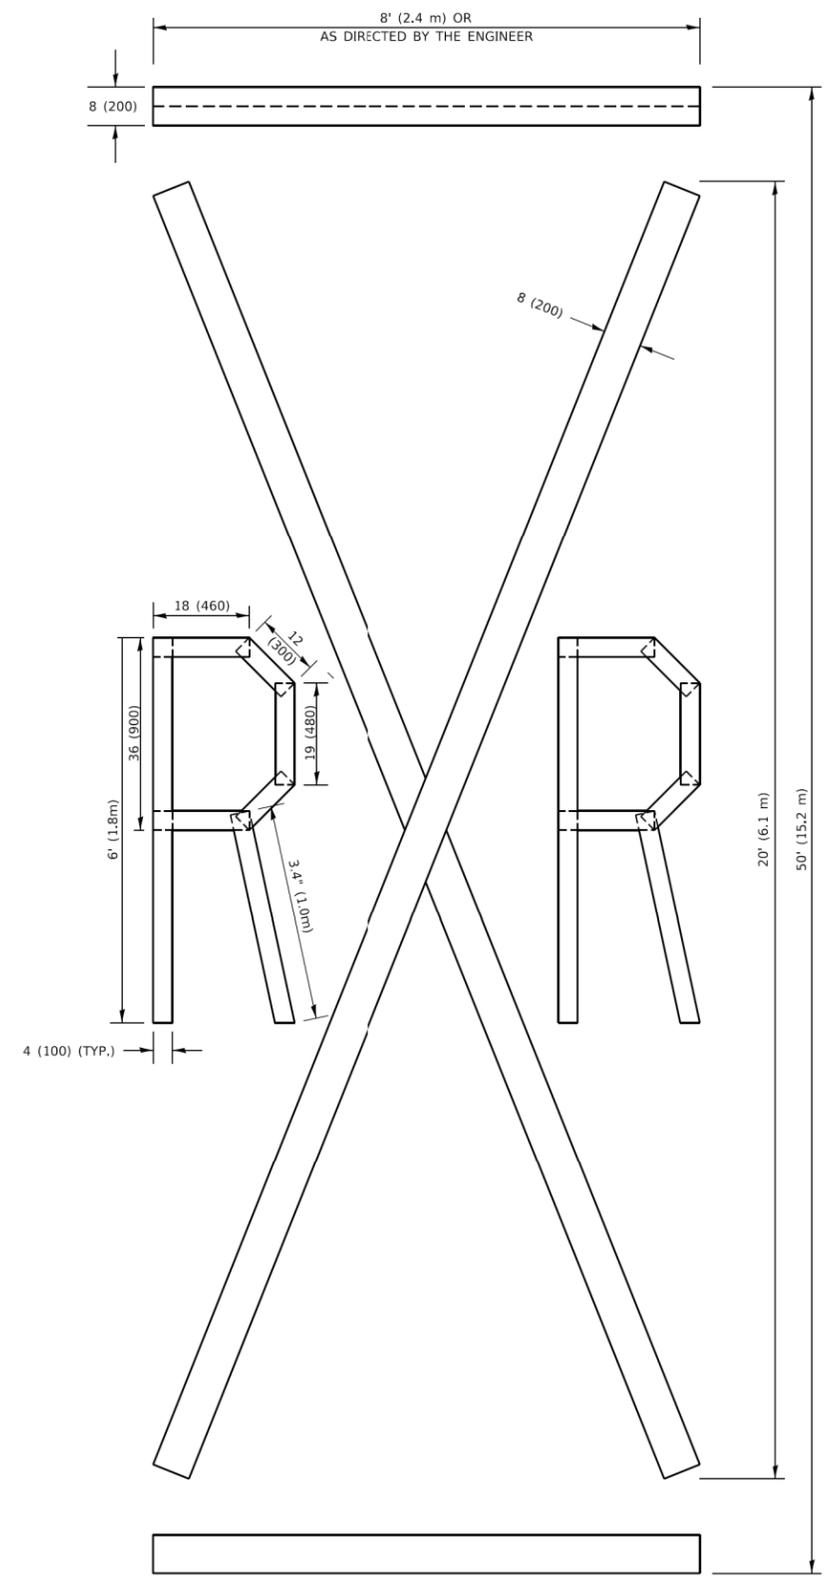

QUANTITY

4 (100) LINE = 225.9 ft. (68.9 m)
75.3 sq. ft. (6.99 sq. m)

NOTE:

ALL QUANTITIES OF PLACEMENT ARE REPRESENTED IN LINEAR FEET OF 4" LINES TO MATCH THE 4" TEMPORARY TAPE PAY ITEM AND REPRESENTS THE TOTAL QUANTITY OF 4" TAPE REQUIRED.

All dimensions are in inches (millimeters) unless otherwise shown.

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 STATE OF ILLINOIS - PROFESSIONAL DESIGN FIRM
 PROJECT NO. 1342-00052-00-RS
 DRAWING NO. TC-16
 DATE: 09/18/2019


USER NAME = footemj	DESIGNED -	REVISED - T. RAMMACHER 03-02-98
DRAWN -	REVISED - E. GOMEZ 08-28-00	
PLOT SCALE = 50.0068" / in.	CHECKED -	REVISED - E. GOMEZ 08-28-00
PLOT DATE = 3/4/2019	DATE - 09-18-94	REVISED - A. SCHUETZE 09-15-16

**STATE OF ILLINOIS
DEPARTMENT OF TRANSPORTATION**

SHORT TERM PAVEMENT MARKING LETTERS AND SYMBOLS

SCALE: NONE SHEET 1 OF 1 SHEETS STA. TO STA.

F.A. RTE.	SECTION	COUNTY	TOTAL SHEETS	SHEET NO.
1342	21-00052-00-RS	KANE	28	26
TC-16		CONTRACT NO. 61H43		
		ILLINOIS	FED. AID PROJECT	LR5C(581)

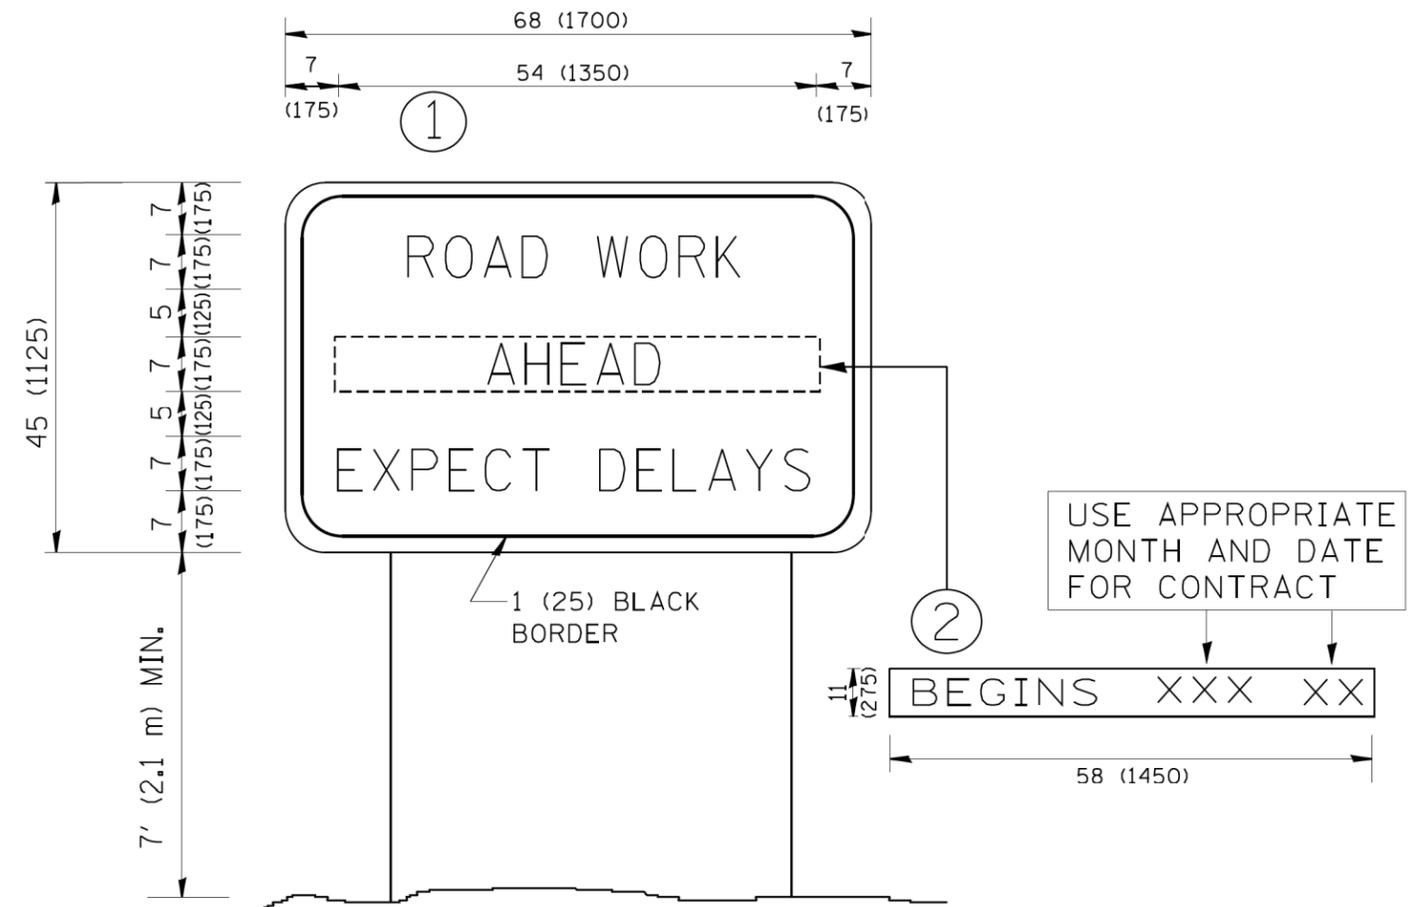

NOTES:

1. USE BLACK LETTERING ON ORANGE BACKGROUND.
2. ERECT SIGNS IN ADVANCE OF THE LOCATION FOR THE "ROAD CONSTRUCTION AHEAD" SIGN AT LOCATIONS AS DIRECTED BY THE ENGINEER.
3. ERECT SIGN ① WITH INSTALLED PANEL ② ONE WEEK PRIOR TO THE START OF CONSTRUCTION.
4. REMOVE PANEL ② SOON AFTER THE START OF CONSTRUCTION.
5. SEE SPECIAL PROVISION FOR "TEMPORARY INFORMATION SIGNING" FOR ADDITIONAL INFORMATION.
6. ONE SIGN ASSEMBLY EQUALS 25.70 SQ. FT. (2.3 SQ. M.)
7. SHALL BE PAID FOR AS TEMPORARY INFORMATION SIGNING.

ALL DIMENSIONS ARE IN INCHES (MILLIMETERS) UNLESS OTHERWISE SHOWN.

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 STATE OF ILLINOIS - PROFESSIONAL DESIGN FIRM
 No. 188-0000000 - Expires 12/31/2021
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 11/22/2017 11:24:47 AM
 i:\Azura\SELECT\20165\Spring_St_STP_Resur\CAD\Phase_II\Sheets\DISTRICT ONE DETAILS - TC.dgn

FILE NAME =	USER NAME = gegl1enobt	DESIGNED -	REVISED - R. MIRS 09-15-97
W:\diststd\22x34\tc22.dgn		DRAWN -	REVISED - R. MIRS 12-11-97
	PLOT SCALE = 50.000 ' / IN.	CHECKED -	REVISED - T. RAMMACHER 02-02-99
	PLOT DATE = 1/4/2008	DATE -	REVISED - C. JUCIUS 01-31-07


**STATE OF ILLINOIS
DEPARTMENT OF TRANSPORTATION**

ARTERIAL ROAD INFORMATION SIGN	
SCALE: NONE	SHEET NO. 1 OF 1 SHEETS
STA.	TO STA.

F.A. RTE.	SECTION	COUNTY	TOTAL SHEETS	SHEET NO.
1342	21-00052-00-RS	KANE	28	27
TC-22		CONTRACT NO. 61H43		
FED. ROAD DIST. NO. 1 ILLINOIS FED. AID PROJECT LR5C(581)				

LOOPS NEXT TO SHOULDERS

PROVIDE A PAVEMENT REPLACEMENT NOTE WHICH SHOULD EQUAL 3' (900 mm) X WIDTH OF PAVED SHOULDER.

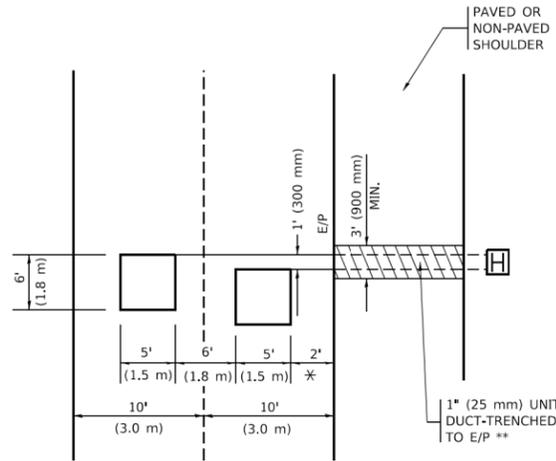


* = (600 mm)

** UNIT DUCT IS TO BE SHOWN ON PLAN SHEETS BUT SHALL NOT BE INCLUDED IN THE PAY ITEMS.

LEFT TURN LANES WITH MEDIANS
VOLUME DENSITY ("FAR OUT" DETECTION)
ON SAME APPROACH
(PROTECTED / PERMITTED LEFT TURN PHASING)

HANDHOLE LOCATION MAY VARY DEPENDING ON GEOMETRICS AND DESIGN OF TRAFFIC SIGNALS. HEAVY-DUTY HANDHOLES TO BE USED WHEN THE MEDIAN IS MOUNTABLE. REFER TO STANDARD 814001 TO ENSURE THAT HANDHOLE FITS IN MEDIAN.

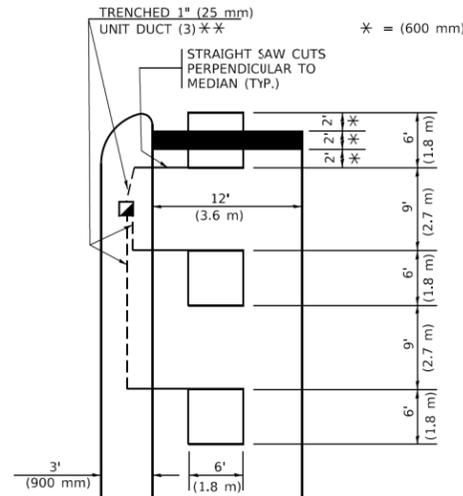


* = (600 mm)

** UNIT DUCT IS TO BE SHOWN ON PLAN SHEETS BUT SHALL NOT BE INCLUDED IN THE PAY ITEMS.

NOTE: DUAL LEFT TURNS NOT SHOWN REFER TO PLAN SHEET FOR DETECTOR LOOP REPLACEMENT

LEFT TURN LANES WITHOUT MEDIANS
VOLUME DENSITY ("FAR OUT" DETECTION)
ON SAME APPROACH
(PROTECTED / PERMITTED LEFT TURN PHASING)

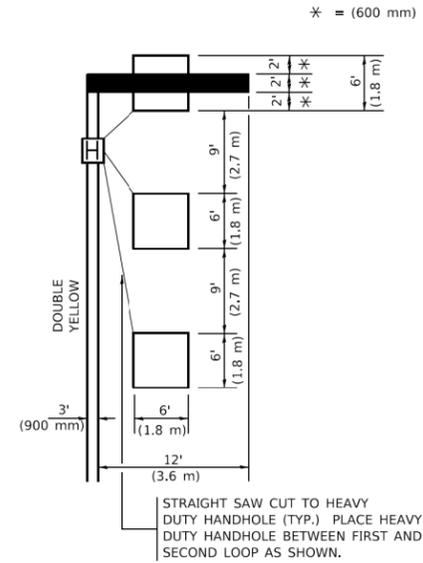

* = (600 mm)

NOTE: DUAL LEFT TURNS NOT SHOWN REFER TO PLAN SHEET FOR DETECTOR LOOP REPLACEMENT

NOTES:

VEHICLES LOOP DETECTORS

- * ALL LEAD IN CABLE SHALL BE TWO CONDUCTOR NO. 14 TWISTED, SHIELDED.
- * EACH DETECTOR LOOP SHALL HAVE ITS OWN SAW CUT FROM THE LOOP TO THE EDGE OF PAVEMENT OR TO A HANDHOLE IN THE PAVEMENT.
- * EACH DETECTOR LOOP SHALL HAVE ITS OWN ONE INCH (25 mm) UNIT DUCT BETWEEN THE EDGE OF PAVEMENT AND THE FIRST HANDHOLE OR JUNCTION BOX. EACH UNIT DUCT RUN SHALL BE SHOWN ON THE PLANS BY THE DESIGNER, BUT SHALL NOT BE PAID FOR SEPARATELY. THIS ITEM IS INCIDENTAL TO THE PAY ITEM FOR DETECTOR LOOPS.
- * ONE DIMENSION OF ALL DETECTOR LOOPS SHALL BE SIX FEET (1.8 m)
- * EACH LANE OF NON-LOCKING, PRESENCE DETECTION AND EACH LANE OF A DOUBLE LEFT TURN LANE REQUIRES A SEPARATE INDUCTIVE LOOP DETECTOR AND LEAD IN CABLE.
- * WHEN NON-LOCKING, PRESENCE DETECTION IS USED, MORE THAN ONE LOOP PER LANE IS REQUIRED BEHIND THE STOP BAR (i.e. 1-1/2, 1-3/4, 2).
- * WHEN SYSTEM LOOPS ARE REQUIRED ON AN APPROACH OF AN INTERSECTION, THE LOOPS USED FOR VOLUME DENSITY AND INTERSECTION TIMING SHALL ALSO BE USED AS SYSTEM DETECTORS. EACH ONE OF THESE TYPE OF LOOPS REQUIRES A SEPARATE TWO CONDUCTOR NO. 14 TWISTED SHIELDED CABLE AND A SEPARATE INDUCTIVE LOOP DETECTOR WHEN NEW CONTROLLERS ARE UTILIZED. THE DESIGNER SHALL LABEL THESE TYPES OF LOOPS AS "INTERSECTION AND SAMPLING (SYSTEM) DETECTORS" ON THE SIGNAL LAYOUT, THE INTERCONNECT PLAN AND THE SYSTEM CABLE PLAN. WHEN AN EXISTING CONTROLLER IS UTILIZED FOR THIS TYPE OF DETECTION, THE PAY ITEM "INDUCTIVE LOOP DETECTOR WITH SYSTEM OUTPUT" SHOULD BE USED.

PLACEMENT OF DETECTORS

THE FOLLOWING FIGURES REPRESENT THE MOST COMMON DETECTOR LOOP LOCATIONS AND SIZES. ADJUSTMENTS WILL BE NECESSARY FOR SPECIFIC GEOMETRIC CONSIDERATIONS.

LOCATIONS AND DEMENSIONS OF DETECTOR LOOPS ARE REQUIRED ON ALL SIGNAL LAYOUT PLAN SHEETS.


"FAR OUT" DETECTION REFERS TO LOCKING, PRESENCE TYPE DETECTION LOCATED IN THRU LANES, RIGHT TURN LANES, AND RIGHT TURN LANE TAPER AREAS (IF APPLICABLE), USUALLY 250' (75 m) IN ADVANCE OF STOP BARS. "UPTIGHT" DETECTION REFERS TO NON-LOCKING PRESENCE TYPE DETECTION LOCATED IN ALL LANES AND 10'-15' (3.0 m-4.5 m) BEHIND THE CROSSING STREET'S EDGE OF PAVEMENT EXTENDED.

NOTE:

ALL DETAILS AND NOTES SHOWN ARE FROM THE I.D.O.T. DISTRICT 1 TRAFFIC SIGNAL DESIGN GUIDELINES DATED JANUARY 1995

THIS DRAWING HAS BEEN PREPARED TO ASSIST THE RESIDENT ENGINEER FOR ALL ROADWAY RESURFACING OR S.M.A.R.T. PROJECTS WHERE THE DIMENSIONS ARE NOT SHOWN ON THE PLANS AND THE FINAL LOCATIONS FOR CROSSWALKS OR STOP BARS ARE NOT DETERMINED.

ARTERIAL-VOLUME DENSITY ("FAR OUT" DETECTION)
CROSS STREET-NON VOLUME DENSITY ("FAR OUT" DETECTION)

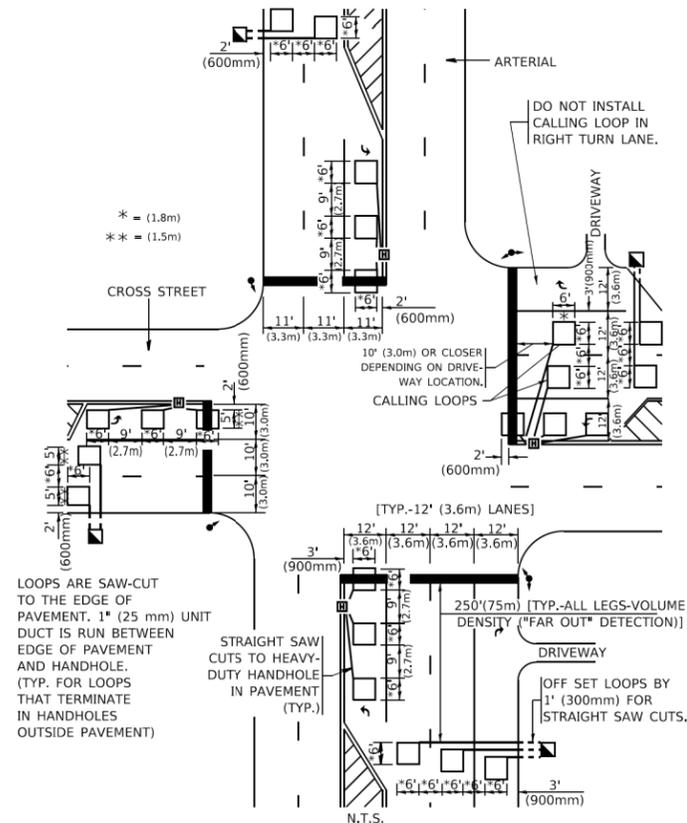


* = (1.8m)
 ** = (1.5m)

LOOPS ARE SAW-CUT TO THE EDGE OF PAVEMENT. 1" (25 mm) UNIT DUCT IS RUN BETWEEN EDGE OF PAVEMENT AND HANDHOLE. (TYP. FOR LOOPS THAT TERMINATE IN HANDHOLES OUTSIDE PAVEMENT)

STRAIGHT SAW CUTS TO HEAVY-DUTY HANDHOLE IN PAVEMENT (TYP.)

DETAIL 1
 N.T.S.

ARTERIAL-VOLUME DENSITY ("FAR OUT" DETECTION)
CROSS STREET-NON VOLUME DENSITY ("UPTIGHT" PRESENCE DETECTION)

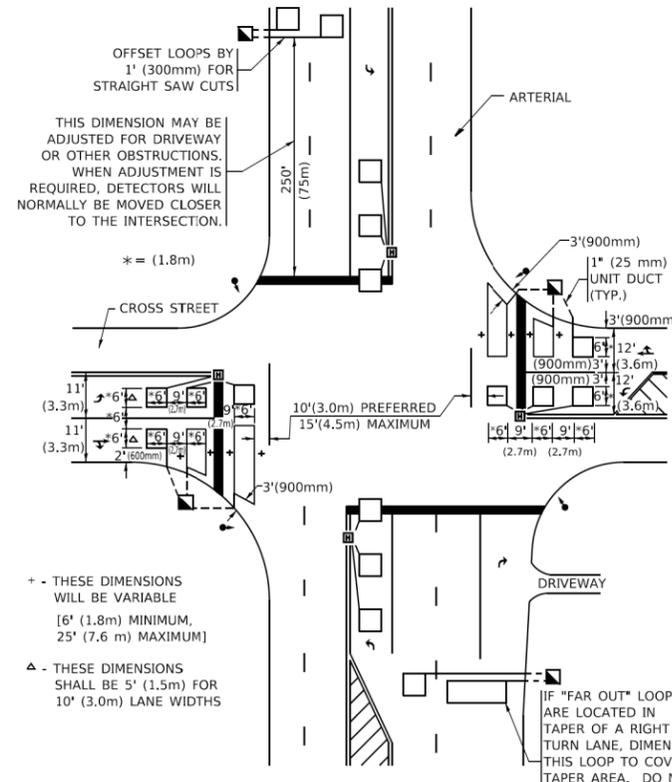

THIS DIMENSION MAY BE ADJUSTED FOR DRIVEWAY OR OTHER OBSTRUCTIONS. WHEN ADJUSTMENT IS REQUIRED, DETECTORS WILL NORMALLY BE MOVED CLOSER TO THE INTERSECTION.

+ - THESE DIMENSIONS WILL BE VARIABLE [6' (1.8m) MINIMUM, 25' (7.6 m) MAXIMUM]

△ - THESE DIMENSIONS SHALL BE 5' (1.5m) FOR 10' (3.0m) LANE WIDTHS

IF "FAR OUT" LOOPS ARE LOCATED IN TAPER OF A RIGHT TURN LANE, DIMENSION THIS LOOP TO COVER TAPER AREA. DO NOT COVER THE LEFT TURN LANE OR LEFT TURN LANE TAPER.

DETAIL 2
 N.T.S.

STATE OF ILLINOIS
DEPARTMENT OF TRANSPORTATION

DISTRICT 1 - DETECTOR LOOP INSTALLATION
DETAILS FOR ROADWAY RESURFACING

SCALE: NONE SHEET 1 OF 1 SHEETS STA. TO STA.

F.A. RTE.	SECTION	COUNTY	TOTAL SHEETS	SHEET NO.
			28	28
TS-07			CONTRACT NO.	
ILLINOIS FED. AID PROJECT				