$\circ$ 

0

 $\circ$ 

0

# STATE OF ILLINOIS

# **DEPARTMENT OF TRANSPORTATION**

#### ST. CLAIR 29 1 82-(6,7,8)PP-1 ILLINOIS CONTRACT NO. 76P88

# D-98-032-22

# **PROPOSED** FOR INDEX OF SHEETS, SEE SHEET NO. 2 HIGHWAY PLANS

C-98-061-22

SN 082-0186 WB (478.4 FT) LAT. 38.56123 LONG. -89.83269 SN 082-0187 EB (497 FT) LAT. 38.56103 LONG. -89.83217

**OMIT BRIDGES** 

**OMIT BRIDGES** 

SN 082-0188 WB (220.2 FT) LAT. 38.55879 LONG. -89.82696 SN 082-0189 EB (213.3 FT) LAT. 38.55865 LONG. -89.82662

STATE OF ILLINOIS DEPARTMENT OF TRANSPORTATION

LOCATION OF SECTION INDICATED THUS: - -

SUBMITTED 027 2820 2/

PRINTED BY THE AUTHORITY OF THE STATE OF ILLINOIS

I-64 (FROM IL 159 TO W HWY 50) 2022 ADT = 79600 (ESTIMATED)SU = 2.4% MU = 11.3%

TRAFFIC DATA

I-64 (FROM W HWY 50 TO GREENMOUNT RD) 2022 ADT = 64700 (ESTIMATED)SU = 2.4% MU = 13.6%

I-64 (FROM GREENMOUNT RD TO IL 158) 2022 ADT = 58100 (ESTIMATED)SU = 2.5% MU = 15.1%

I-64 (FROM IL 158 TO RIEDER RD) 2022 ADT = 44300 (ESTIMATED)SU = 2.3% MU = 17.9%

I-64 (FROM RIEDER RD TO IL 4) 2022 ADT = 43000 (ESTIMATED)SU = 4.1% MU = 21.7%

**OMIT BRIDGES** 

(152.5 FT)

(152.5 FT)

LAT. 38.59873


LONG. -89.96610

LAT. 38.59874

LONG. -89.96629

SN 082-0309 WB

SN 082-0308 EB

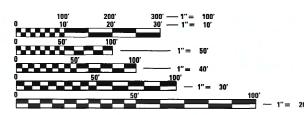


ENGINEERING SCALES. REDUCED SIZED PLANS WILL NOT CONFORM TO STANDARD SCALES. IN MAKING MEASUREMENTS ON REDUCED PLANS, THE ABOVE SCALES MAY BE USED.

JOINT UTILITY LOCATION INFORMATION FOR EXCAVATORS 1-800-892-0123

PROJECT ENGINEER: BILLIE OWEN (618) 346-3209 PROJECT MANAGER: PHILLIP FREIMUTH (618) 346-3194

**CONTRACT NO. 76P88** 

# **FAI ROUTE 64 (I-64) SECTION 82-(6,7,8)PP-1 PROJECT PAVEMENT PATCHING - CM** ST. CLAIR COUNTY

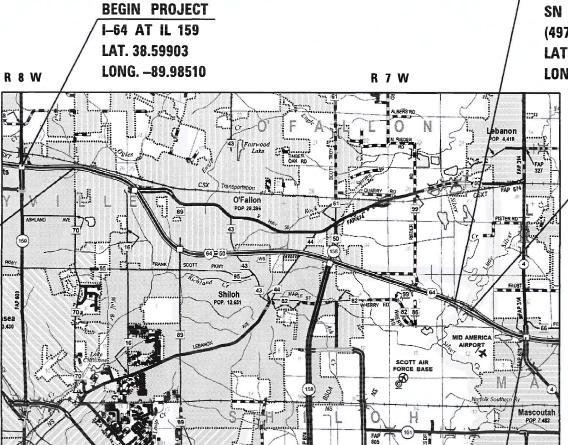

LOCATION MAP

NOT TO SCALE

GROSS LENGTH = 56,390.40 FT. = 10.680 MILE NET LENGTH EB = 55.527.60 FT. = 10.517 MILE NET LENGTH WB = 55,539.30 FT. = 10.519 MILE I-64 AT LEBANON RD LAT. 38.55154 LONG. -89.80701

END PROJECT

# **INDEX OF SHEETS**

- 1 COVER SHEET
- 2 INDEX OF SHEETS, HIGHWAY STANDARDS, GENERAL NOTES AND COMMITMENTS
- 3 4 SUMMARY OF QUANTITIES
- 5 22 TYPICAL SECTIONS
- 23 26 SCHEDULE OF QUANTITIES
- 27 LOCATION MAP
- 28 29 CLASS A PATCHING (SPECIAL) DETAIL

# **HIGHWAY STANDARDS**

000001-08	STANDARD SYMBOLS, ABBREVIATIONS AND PATTERNS
001001-02	AREAS OF REINFORCEMENT BARS
001006	DECIMAL OF AN INCH AND OF A FOOT
701101-05	OFF-ROAD OPERATIONS, MULTILANE, 15' (4.5 M) TO 24" (600 MM) FROM PAVEMENT EDGE
701106-02	OFF-ROAD OPERATIONS, MULTILANE, MORE THAN 15' (4.5 M) AWAY
701400-11	APPROACH TO LANE CLOSURE, FREEWAY/EXPRESSWAY
701401-13	LANE CLOSURE, FREEWAY/EXPRESSWAY
701406-13	LANE CLOSURE, FREEWAY/EXPRESSWAY, DAY OPERATIONS ONLY
701411-09	LANE CLOSURE, MULTILANE, AT ENTRANCE OR EXIT RAMP FOR SPEEDS ≥ 45 MPH
701426-09	LANE CLOSURE, MULTILANE, INTERMITTENT OR MOVING OPERATION, FOR SPEEDS $\geq$ 45 MPH
701428-01	TRAFFIC CONTROL SETUP AND REMOVAL FREEWAY/EXPRESSWAY
701446-11	TWO LANE CLOSURE, FREEWAY/EXPRESSWAY
701901-08	TRAFFIC CONTROL DEVICES
780001-05	TYPICAL PAVEMENT MARKINGS
781001-04	TYPICAL APPLICATIONS RAISED REFLECTIVE PAVEMENT MARKERS
420001-10	PAVEMENT JOINTS

GENERAL NOTES COMMITMENTS

1. UTILITIES KNOWN TO HAVE FACILITIES WITHIN THE PROJECT AREA ARE AS FOLLOWS:

NONE

AMEREN ILLINOIS AT&T ILLINOIS BUCKEYE PARTNERS L.P.--WOOD RIVER PIPELINE VILLAGE OF CASEYVILLE CHARTER COMMUNICATIONS, INC. CLEARWAVE COMMUNICATIONS CITY OF FAIRVIEW HEIGHTS FIDELITY COMMUNICATIONS III, INC. FRONTIER COMMUNICATIONS ILLINOIS AMERICAN WATER COMPANY LEVEL 3 COMMUNICATIONS, LLC CITY OF MASCOUTAH MID AMERICA ST. LOUIS AIRPORT CITY OF O'FALLON VILLAGE OF SHILOH WINDSTREAM COMMUNICATIONS

- 2. NO SURVEY WAS PERFORMED FOR THIS PROJECT AND THE PLANS WERE CREATED USING MICROFILM.
- 3. THE PROPOSED PAVEMENT MARKING SHALL MATCH THE LOCATIONS OF THE EXISTING PAVEMENT MARKING, AS DIRECTED BY THE ENGINEER.
- 4. FOURTEEN CHANGEABLE MESSAGE SIGNS SHALL BE REQUIRED FOR THIS PROJECT. THEY SHALL BE PLACED 2 WEEKS PRIOR TO ANY LANE CLOSURES. THE CHANGEABLE MESSAGE SIGNS SHALL BE PLACED ON 1-64 AND AT ALL INTERCHANGES FOR THE DURATION OF THE CONTRACT AT THE DIRECTION OF THE ENGINEER.
- 5. ALL BRIDGES WITHIN THE PROJECT LIMITS SHALL BE OMITTED FROM PATCHING.

SCALE:

6. THE DEPARTMENT STRONGLY ENCOURAGES THE PRIME CONTRACTOR AND THEIR APPROVED SUB-CONTRACTORS TO HIRE MINORITY, WOMEN AND DISADVANTAGED INDIVIDUALS FROM ITS FEDERALLY FUNDED HIGHWAY CONSTRUCTION CAREERS TRAINING PROGRAM (HCCTP) TO HELP MEET WORKFORCE AND TRAINEE GOALS. THIS PROGRAM IS TRAINING MINORITIES, WOMEN AND DISADVANTAGED INDIVIDUALS IN HIGHWAY CONSTRUCTION-RELATED SKILLS, E.G., MATH FOR THE TRADES, JOB READINESS, TECHNICAL SKILLS COURSEWORK (CARPENTRY, CONCRETE FLATWORK, BLUEPRINT READING, SITE PLANS, SITE WORK, TOOLS USE, ETC.) AND OSHA 10 HOUR CERTIFICATION, TO PREPARE THEM FOR A CAREER IN THE HIGHWAY CONSTRUCTION TRADES. GRADUATES ARE WELL-TRAINED AND READY TO BECOME PRODUCTIVE ENTRY-LEVEL CONSTRUCTION WORKERS. CONTACT THE DISTRICT 8 EEO OFFICE AT 618-346-3360 AND/OR THE HCCTP COORDINATOR AT 618-874-6528 TO LEARN MORE ABOUT THE PROGRAM AND FOR ASSISTANCE IN MEETING WORKFORCE AND TRAINEE GOALS.

	MIXTURE REQUIREMENTS							
THE	THE FOLLOWING MIXTURE REQUIREMENTS ARE APPLICABLE FOR THIS PROJECT							
LOCATION:			I-64 PARTIAL DEPTH F	PATCHING				
MIXTURE USE(S):	POLY SURFACE							
AC/PG	SBS PG 76-22							
RAP % (MAX)	SEE SPECIAL PROVISION							
DESIGN AIR VOIDS:	4.0% @ NDES = 90							
MIX COMPOSITION (GRADATION)	IL 9.5							
FRICTION AGGREGATE	MIXTURE "E"							
QUALITY MGMT PROGRAM	QC/QA							

PLAN QUANTITIES FOR BITUMINOUS CONCRETE SURFACE COURSE ITEMS ARE CALCULATED USING A UNIT WEIGHT OF 112 LB/SQ YD/IN

REV. - MS

USER NAME = smithma	DESIGNED -	REVISED -
	DRAWN -	REVISED -
PLOT SCALE = 100.0000 ' / in.	CHECKED -	REVISED -
PLOT DATE = 10/26/2021	DATE -	REVISED -

8	I
Š	ı
S	ı
œ	I
300	ł
37	l
õ	ı
şţ	ı
ě	ı
OS	ı
S	ı
ė	ı
Dat	ı
ō	ı
Ò	ı
88	ı
6	ı
87	ı
25	ı
ţ	ı
ő	ı
٩	ı
80	ı
Ę	ı
ts	ı
믢	ı
e	ı
美	Ì
ĭ	i
Ö	ı
븵	ı
돧	ı
ě	ı
ā	ı
ã	ı
E	i
8	ı
₹	1
9	۱
.0	۱
>	I
뫔	۱
e	۱
	۱

			7	CONSTR. CODE
				100% STATE
				ROADWAY
CODE			TOTAL	0006
NO.	ITEM	UNIT	QUANTITY	URBAN
44213000	PATCHING REINFORCEMENT	SQ YD	428	428
44213200	SAW CUTS	FOOT	1206	1206
44213204	TIE BARS 3/4"	EACH	75	75
67100100	MOBILIZATION	L SUM	1	1
70100420	TRAFFIC CONTROL AND PROTECTION, STANDARD 701411	EACH	7	7
70100700	TRAFFIC CONTROL AND PROTECTION, STANDARD 701406	L SUM	1	1
70100700	The control was the restrict, straight for the	2 30		•
70100800	TRAFFIC CONTROL AND PROTECTION, STANDARD 701401	L SUM	1	1
70100815	TRAFFIC CONTROL AND PROTECTION, STANDARD 701446	L SUM	1	1
70107025	CHANGEABLE MESSAGE SIGN	CAL DA	826	826
70200100	NIGHTTIME WORK ZONE LIGHTING	L SUM	1	1
			-	-
70300100	SHORT TERM PAVEMENT MARKING	FOOT	967	967
70300150	SHORT TERM PAVEMENT MARKING REMOVAL	SQ FT	317	317
78000400	THERMOPLASTIC PAVEMENT MARKING - LINE 6"	FOOT	1398	1398
78001130	PAINT PAVEMENT MARKING = LINE 6"	FOOT	1279	1279

*	ς	ΡF	CIA	רו ב	ΓΥ Ι	ITE	М

					CONSTR. CODE
					100% STATE
					ROADWAY
	DDE O .	ITEM	UNIT	TOTAL QUANTITY	0006 URBAN
				, , , , , , ,	
7810	0100	RAISED REFLECTIVE PAVEMENT MARKER	EACH	255	255
7830	0200	RAISED REFLECTIVE PAVEMENT MARKER REMOVAL	EACH	255	255
X170	0055	CLASS A PATCHES, TYPE II, 13 INCH (SPECIAL)	SQ YD	16	16
				183:	
X170	0056	CLASS A PATCHES, TYPE III, 13 INCH (SPECIAL)	SQ YD	32	32
X170	0079	CLASS A PATCHES, TYPE III, 12 INCH (SPECIAL)	SQ YD	40	40
X440	6020	PARTIAL DEPTH REMOVAL, TYPE I, 2"	SQ YD	7	7
X440	6220	PARTIAL DEPTH REMOVAL, TYPE II, 2"	SQ YD	264	264
X440	6420	PARTIAL DEPTH REMOVAL, TYPE III, 2"	SQ YD	375	375
X440	6620	PARTIAL DEPTH REMOVAL, TYPE IV, 2"	SQ YD	2497	2497
X442	0579	CLASS A PATCHES, TYPE IV, 12 INCH (SPECIAL)	SQ YD	233	233
X442	0621	CLASS A PATCHES, TYPE II, 14 INCH (SPEC IAL)	SQ YD	16	16
X442	0628	CLASS A PATCHES, TYPE IV, 14 INCH (SPEC IAL)	SQ YD	67	67
X442	0630	CLASS A PATCHES, TYPE II, 15 INCH (SPECIAL)	SQ YD	8	8
X442	0632	CLASS A PATCHES, TYPE III, 15 INCH (SPECIAL)	SQ YD	16	16

REV. - MS

USER NAME = smithma	DESIGNED	REVISED =		SUMMARY OF QUANTITIES		F.A.I	SECTION	cou	JNTY T	OTAL S	HEET				
	DRAWN	REVISED -	STATE OF ILLINOIS		•	JOHNNANI		DANTITIES		64	82-(6,7,8)PP-1	ST.	CLAIR	29	3
PLOT SCALE = 100.0000 / in.	CHECKED	REVISED -	DEPARTMENT OF TRANSPORTATION								(-)(-)(-)(-)	CON	TRACT N	10. 76F	88
PLOT DATE = 11/1/2021	DATE	REVISED +		SCALE:	SHEET 1	OF 2 SI	HEETS	STA.	TO STA.		ILLINOIS	FED. AID PROJE	СТ	$\overline{}$	

CONSTR.	CODE

					100% STATE
					ROADWAY
	CODE			TOTAL	0006
	NO.	ITEM	UNIT	QUANTITY	URBAN
)	Z0076604	TRAINEES TRAINING PROGRAM GRADUATE	HOUR	500	500
	X4421000	PARTIAL DEPTH PATCHING	TON	363	363

Ø 0042


Ø

REV. - MS

USER NAME = smithma	DESIGNED -	REVISED -		SUMMARY OF QUANTITIES				F.A.I RTE	SECTION	COUNTY	TOTAL	SHEET		
	DRAWN -	REVISED -	STATE OF ILLINOIS	SOMMAN OF COARTIFIES					64	82-(6.7.8)PP-1	ST. CLAIR	29	4	
PLOT SCALE = 100.0000 / in	CHECKED -	REVISED -	DEPARTMENT OF TRANSPORTATION					- (-)./-/	CONTRACT	NO. 76	P88			
PLOT DATE = 11/1/2021	DATE -	REVISED -		SCALE:	SHEET 2	OF 2	SHEETS	STA.	TO STA.		ILLINOIS FED.	AID PROJECT		

- CONTINUOUSLY REINFORCED PORTLAND CEMENT CONCRETE PAVEMENT 8" CONTINUOUSLY REINFORCED PORTLAND CEMENT CONCRETE PAVEMENT 9" LONGITUDINAL CONSTRUCTION JOINT - USE NO. 6 EPOXY COATED DEFORMED TIE BARS AT 24" C-C AND 24" LONG, DRILLED AND GROUTED
- 4 POLYMERIZED BITUMINOUS CONCRETE SURFACE COURSE, STONE MATRIX ASPHALT, CLASS I (2")
- POLYMERIZED BITUMINOUS CONCRETE BINDER COURSE, SUPERPAVE, IL-19.0, N105 (2-1/4" & VARIES)
- 13" BITUMINOUS SHOULDER
- 8" BITUMINOUS SHOULDER
- STABILIZED SUB-BASE 4"
- SUB-BASE GRANULAR MATERIAL, TYPE B 12"
- SUB-BASE GRANULAR MATERIAL, TYPE A 4"
- AGGREGATE SUBGRADE 12"
- POROUS GRANULAR EMBANKMENT, SUBGRADE
- AGGREGATE SHOULDER, TYPE B
- PORTLAND CEMENT CONCRETE SHOULDERS 8"
- (15) PORTLAND CEMENT CONCRETE SHOULDERS 9"
- (16) LONGITUDINAL CONSTRUCTION JOINT USE 3/4 INCH EPOXY COATED SMOOTH DOWEL BARS AT 24" C-C AND 24" LONG
- CONCRETE BARRIER, CONCRETE BARRIER (MODIFIED), CONCRETE BARRIER (SPECIAL), OR CONCRETE BARRIER TRANSITION
- (18) GUARDRAIL
- (19) BITUMINOUS SHOULDER CURB
- 20 PIPE UNDERDRAINS 6"
  20 SLOTTED DRAIN STRUCTURE

- 2) STORM SEWER
  2) FILTER FABRIC
  2) STRIP REFLECTIVE CRACK CONTROL TREATMENT
  2) NOISE ABATEMENT WALL
- BITUMINOUS CONCRETE SURFACE COURSE, SUPERPAVE, MIX "C", N50 (2")
- BITUMINOUS MATERIALS (PRIME COAT)
- EMBANKMENT
- MICRO-SURFACING SINGLE PASS, TYPE II, 1/2" (WITH RUT FILLING)

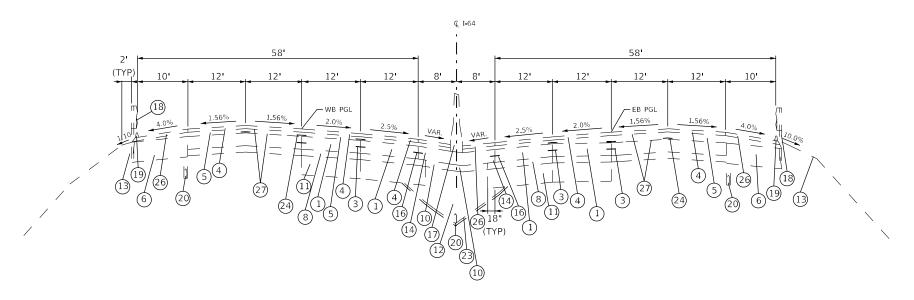


#### EXISTING TYPICAL SECTION

STA. 537+26.79 EB TO STA. 548+60.20 EB STA. 537+26.79 WB TO STA. 547+70.40 WB

STA. 607+83.78 EB TO STA. 613+80.02

STA. 693+92.51 EB TO STA. 725+00 EB STA. 692+18.71 WB TO STA. 705+00 WB

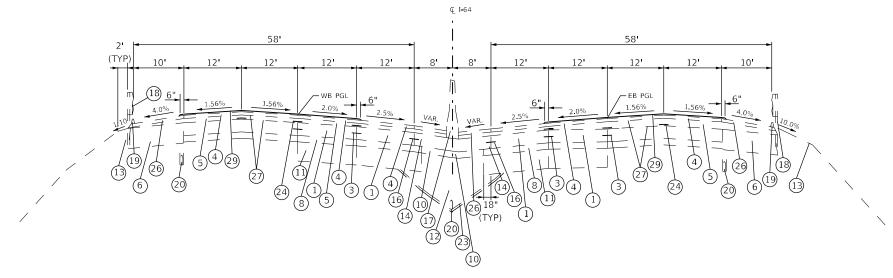

EXISTING TYPICAL SECTION


STA. 725+00 EB TO STA. 732+09.69 EB STA, 705+00 WB TO STA, 730+77.89 WB

USER NAME = smithma	DESIGNED -	REVISED -	
	DRAWN -	REVISED -	
PLOT SCALE = 100.0000 / in.	CHECKED -	REVISED -	
PLOT DATE = 11/1/2021	DATE -	REVISED -	

		TYPICA	L SEC	TIONS		F.A.I RTE.	SEC	TION		COUNTY	TOTAL SHEETS	SHEET NO.
						64	82-(6,7	,8)PP-1		ST. CLAIR	29	5
										CONTRACT	NO. 76	6P88
SCALE: NTS	SHEET 1	OF 18 S	HEETS	STA.	TO STA.			ILLINOIS	FED. A	ID PROJECT		


- 1 CONTINUOUSLY REINFORCED PORTLAND CEMENT CONCRETE PAVEMENT 8"
  2 CONTINUOUSLY REINFORCED PORTLAND CEMENT CONCRETE PAVEMENT 9"
  3 LONGITUDINAL CONSTRUCTION JOINT USE NO. 6 EPOXY COATED DEFORMED TIE BARS AT 24" C-C AND 24" LONG, DRILLED AND GROUTED
- 4 POLYMERIZED BITUMINOUS CONCRETE SURFACE COURSE, STONE MATRIX ASPHALT, CLASS I (2")
- POLYMERIZED BITUMINOUS CONCRETE BINDER COURSE, SUPERPAVE, IL-19.0, N105 (2-1/4" & VARIES)
- 13" BITUMINOUS SHOULDER
- 8" BITUMINOUS SHOULDER
- STABILIZED SUB-BASE 4"
- SUB-BASE GRANULAR MATERIAL, TYPE B 12"
- SUB-BASE GRANULAR MATERIAL, TYPE A 4"
- AGGREGATE SUBGRADE 12"
- POROUS GRANULAR EMBANKMENT, SUBGRADE
- (13) AGGREGATE SHOULDER, TYPE B
- 1 PORTLAND CEMENT CONCRETE SHOULDERS 8"
- (15) PORTLAND CEMENT CONCRETE SHOULDERS 9"
- (Î) LONGITUDINAL CONSTRUCTION JOINT USE 3/4 INCH EPOXY COATED SMOOTH DOWEL BARS AT 24" C-C AND 24" LONG
- (1) CONCRETE BARRIER, CONCRETE BARRIER (MODIFIED), CONCRETE BARRIER (SPECIAL), OR CONCRETE BARRIER TRANSITION
- (18) GUARDRAIL
- (19) BITUMINOUS SHOULDER CURB
- 20 PIPE UNDERDRAINS 6"
- SLOTTED DRAIN STRUCTURE

- 2) STORM SEWER
  2) FILTER FABRIC
  2) STRIP REFLECTIVE CRACK CONTROL TREATMENT
  2) NOISE ABATEMENT WALL
- 6 BITUMINOUS CONCRETE SURFACE COURSE, SUPERPAVE, MIX "C", N50 (2")
- BITUMINOUS MATERIALS (PRIME COAT)
- EMBANKMENT
- MICRO-SURFACING SINGLE PASS, TYPE II, 1/2" (WITH RUT FILLING)

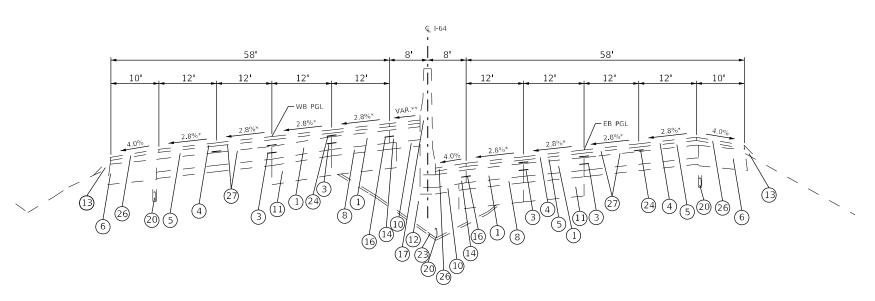

# EXISTING TYPICAL SECTION

STA. 548+60.20 EB TO STA. 559+48.32 EB STA. 547+70.40 WB TO STA. 560+38.12 WB

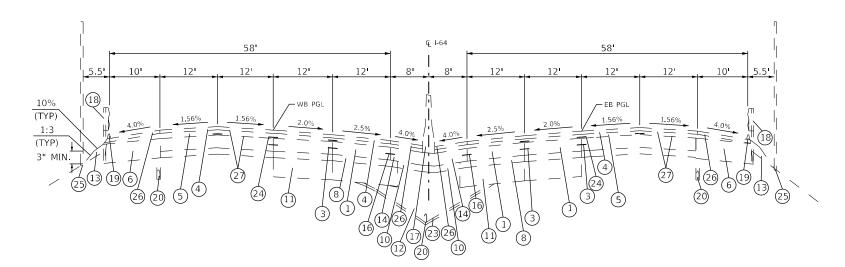

#### EXISTING TYPICAL SECTION

STA. 559+48.32 EB TO STA. 585+31.38 EB STA. 560+38.12 WB TO STA. 586+21.18 WB


USER NAME = smithma	DESIGNED -	REVISED -	
	DRAWN -	REVISED -	
PLOT SCALE = 100.0000 / in.	CHECKED -	REVISED -	
PLOT DATE = 11/1/2021	DATE -	REVISED -	

STATE OF ILLINOIS
DEPARTMENT OF TRANSPORTATION

		TYPIC	AL SEC	TIONS		F.A.I RTE	SECT	ПОИ	COUNTY	TOTAL SHEETS	SHEET NO.
						64	82-(6,7	,8)PP-1	ST. CLAIR	29	6
									CONTRACT	NO. 76	5P88
SCALE: NTS	SHEET 2	OF 18	SHEETS	STA.	TO STA.			ILLINOIS FED	. AID PROJECT		

- CONTINUOUSLY REINFORCED PORTLAND CEMENT CONCRETE PAVEMENT 8" CONTINUOUSLY REINFORCED PORTLAND CEMENT CONCRETE PAVEMENT 9" LONGITUDINAL CONSTRUCTION JOINT - USE NO. 6 EPOXY COATED DEFORMED TIE BARS AT 24" C-C AND 24" LONG, DRILLED AND GROUTED
- 4 POLYMERIZED BITUMINOUS CONCRETE SURFACE COURSE, STONE MATRIX ASPHALT, CLASS I (2")
- POLYMERIZED BITUMINOUS CONCRETE BINDER COURSE, SUPERPAVE, IL-19.0, N105 (2-1/4" & VARIES)
- 13" BITUMINOUS SHOULDER
- 8" BITUMINOUS SHOULDER
- STABILIZED SUB-BASE 4"
- SUB-BASE GRANULAR MATERIAL, TYPE B 12"
- SUB-BASE GRANULAR MATERIAL, TYPE A 4"
- AGGREGATE SUBGRADE 12"
- POROUS GRANULAR EMBANKMENT, SUBGRADE
- AGGREGATE SHOULDER, TYPE B
- (14) PORTLAND CEMENT CONCRETE SHOULDERS 8"
- (15) PORTLAND CEMENT CONCRETE SHOULDERS 9"
- (16) LONGITUDINAL CONSTRUCTION JOINT USE 3/4 INCH EPOXY COATED SMOOTH DOWEL BARS AT 24" C-C AND 24" LONG
- CONCRETE BARRIER, CONCRETE BARRIER (MODIFIED), CONCRETE BARRIER (SPECIAL), OR CONCRETE BARRIER TRANSITION
- (18) GUARDRAIL
- (19) BITUMINOUS SHOULDER CURB
- PIPE UNDERDRAINS 6"
- SLOTTED DRAIN STRUCTURE


- STORM SEWER
   FILTER FABRIC
   STRIP REFLECTIVE CRACK CONTROL TREATMENT
   NOISE ABATEMENT WALL
- BITUMINOUS CONCRETE SURFACE COURSE, SUPERPAVE, MIX "C", N50 (2")
- BITUMINOUS MATERIALS (PRIME COAT)
- EMBANKMENT
- MICRO-SURFACING SINGLE PASS, TYPE II, 1/2" (WITH RUT FILLING)

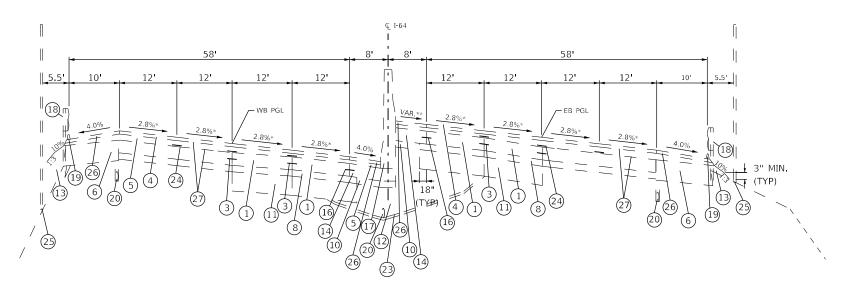

# EXISTING TYPICAL SECTION

STA. 585+31.38 EB TO STA. 607+83.78 EB STA. 586+21.18 WB TO STA. 606+93.98 WB

EXCEPT FOR OLD COLLINSVILLE ROAD BRIDGES

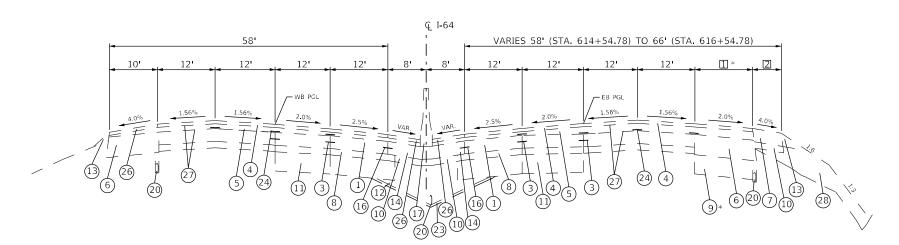

# EXISTING TYPICAL SECTION

STA. 613+80.02 TO STA. 657+24.79 EB STA. 652+43.94 WB

- \* [] SHOULDER PAVEMENT & SUB-BASE WIDTH VARY 10' (STA, 616+04.78) TO 12' (STA, 616+54.78)
- 2 VARIES O' (STA. 614+54.78) TO 6' (STA. 616+04.78)

STATION EQUATION: STA. 618+20.65 BK = STA. 643+85.18 AH


DESIGNED REVISED DRAWN REVISED HECKED REVISED LOT DATE = 11/1/2021 DATE REVISED

STATE OF ILLINOIS **DEPARTMENT OF TRANSPORTATION** 

SECTION TYPICAL SECTIONS 82-(6,7,8)PP-1 ST. CLAIR 29 CONTRACT NO. 76P88 SCALE: NTS SHEET 3 OF 18 SHEETS STA. TO STA.

- CONTINUOUSLY REINFORCED PORTLAND CEMENT CONCRETE PAVEMENT 8" CONTINUOUSLY REINFORCED PORTLAND CEMENT CONCRETE PAVEMENT 9" LONGITUDINAL CONSTRUCTION JOINT - USE NO. 6 EPOXY COATED DEFORMED TIE BARS AT 24" C-C AND 24" LONG, DRILLED AND GROUTED
- 4 POLYMERIZED BITUMINOUS CONCRETE SURFACE COURSE, STONE MATRIX ASPHALT, CLASS I (2")
- POLYMERIZED BITUMINOUS CONCRETE BINDER COURSE, SUPERPAVE, IL-19.0, N105 (2-1/4" & VARIES)
- 13" BITUMINOUS SHOULDER
- 8" BITUMINOUS SHOULDER
- STABILIZED SUB-BASE 4"
- SUB-BASE GRANULAR MATERIAL, TYPE B 12"
- SUB-BASE GRANULAR MATERIAL, TYPE A 4"
- AGGREGATE SUBGRADE 12"
- POROUS GRANULAR EMBANKMENT, SUBGRADE
- AGGREGATE SHOULDER, TYPE B
- PORTLAND CEMENT CONCRETE SHOULDERS 8"
- (15) PORTLAND CEMENT CONCRETE SHOULDERS 9"
- (16) LONGITUDINAL CONSTRUCTION JOINT USE 3/4 INCH EPOXY COATED SMOOTH DOWEL BARS AT 24" C-C AND 24" LONG
- CONCRETE BARRIER, CONCRETE BARRIER (MODIFIED), CONCRETE BARRIER (SPECIAL), OR CONCRETE BARRIER TRANSITION
- (18) GUARDRAIL
- (19) BITUMINOUS SHOULDER CURB
- PIPE UNDERDRAINS 6"
- SLOTTED DRAIN STRUCTURE


- STORM SEWER
   FILTER FABRIC
   STRIP REFLECTIVE CRACK CONTROL TREATMENT
   NOISE ABATEMENT WALL
- BITUMINOUS CONCRETE SURFACE COURSE, SUPERPAVE, MIX "C", N50 (2")
- BITUMINOUS MATERIALS (PRIME COAT)
- EMBANKMENT
- MICRO-SURFACING SINGLE PASS, TYPE II, 1/2" (WITH RUT FILLING)

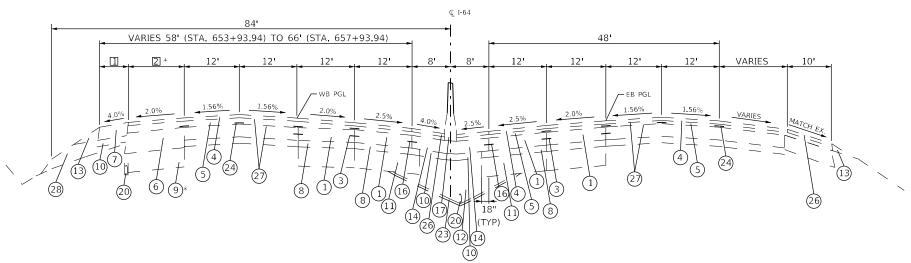

- ☐ VARIES O' (STA. 653+93.94) TO 6' (STA. 656+93.94)
- \* 2 SHOULDER PAVEMENT & SUB-BASE WIDTH VARY 10' (STA. 656+93.94) TO 12' (STA. 657+93.94)

#### EXISTING TYPICAL SECTION

STA, 657+24.79 EB TO STA, 658+69.57 EB STA. 652+43.94 WB TO STA. 658+54.90 WB

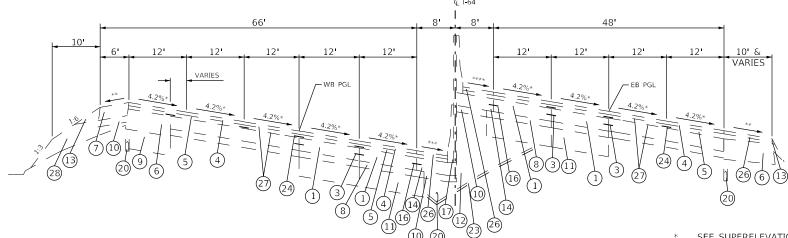

EXISTING TYPICAL SECTION

STA. 658+69.57 EB STA. 658+54.90 WB TO STA. 661+10.04 STA. 662+84.20 TO STA. 672+93.94

- SEE SUPERELEVATION TRANSITION DETAILS FOR PAVEMENT SUPERELEVATION.
- WHEN THE SUPERELEVATION RATE IS 4% OR LESS, THE SHOULDER SLOPE IS 4%. WHEN PAVEMENT SUPERELEVATION RATE EXCEEDS 4%, THE MAXIMUM ALGEBRAIC DIFFERENCE IN CROSS SLOPE IS 8%.
- \*\*\* WHEN THE SUPERELEVATION RATE IS 4% OR LESS, THE SHOULDER SLOPE IS 4%. WHEN PAVEMENT SUPERELEVATION RATE EXCEEDS 4%, THE SHOULDER SLOPE SHOULD EQUAL ADJACENT PAVEMENT SUPERELEVATION RATE.

SCALE: NTS


\*\*\*\* SHOULDER SLOPE SHOULD EQUAL ADJACENT PAVEMENT SUPERELEVATION RATE.

USER NAME = smithma	DESIGNED -	REVISED -	
	DRAWN -	REVISED -	
PLOT SCALE = 100.0000 / in.	CHECKED -	REVISED -	
PLOT DATE = 11/1/2021	DATE -	REVISED -	

	T	YPI	CAL SEC	TIONS		F.A.I RTE	SECT	ПОИ		COUNTY	TOTAL SHEETS	SHEET NO.
						64	82-(6,7	,8)PP-1		ST. CLAIR	29	8
1										CONTRACT	NO. 76	5P88
SHEET 4	OF	18	SHEETS	STA.	TO STA.			ILLINOIS	FED. AI	D PROJECT		


- CONTINUOUSLY REINFORCED PORTLAND CEMENT CONCRETE PAVEMENT 8" CONTINUOUSLY REINFORCED PORTLAND CEMENT CONCRETE PAVEMENT 9" LONGITUDINAL CONSTRUCTION JOINT - USE NO. 6 EPOXY COATED DEFORMED TIE BARS AT 24" C-C AND 24" LONG, DRILLED AND GROUTED
- 4 POLYMERIZED BITUMINOUS CONCRETE SURFACE COURSE, STONE MATRIX ASPHALT, CLASS I (2")
- POLYMERIZED BITUMINOUS CONCRETE BINDER COURSE, SUPERPAVE, IL-19.0, N105 (2-1/4" & VARIES)
- 13" BITUMINOUS SHOULDER
- 8" BITUMINOUS SHOULDER
- STABILIZED SUB-BASE 4"
- SUB-BASE GRANULAR MATERIAL, TYPE B 12"
- SUB-BASE GRANULAR MATERIAL, TYPE A 4"
- AGGREGATE SUBGRADE 12"
- POROUS GRANULAR EMBANKMENT, SUBGRADE
- AGGREGATE SHOULDER, TYPE B
- PORTLAND CEMENT CONCRETE SHOULDERS 8"
- (15) PORTLAND CEMENT CONCRETE SHOULDERS 9"
- (16) LONGITUDINAL CONSTRUCTION JOINT USE 3/4 INCH EPOXY COATED SMOOTH DOWEL BARS AT 24" C-C AND 24" LONG
- CONCRETE BARRIER, CONCRETE BARRIER (MODIFIED), CONCRETE BARRIER (SPECIAL), OR CONCRETE BARRIER TRANSITION
- (18) GUARDRAIL
- (19) BITUMINOUS SHOULDER CURB
- 20 PIPE UNDERDRAINS 6"
- SLOTTED DRAIN STRUCTURE

- 2) STORM SEWER
  2) FILTER FABRIC
  2) STRIP REFLECTIVE CRACK CONTROL TREATMENT
  2) NOISE ABATEMENT WALL
- BITUMINOUS CONCRETE SURFACE COURSE, SUPERPAVE, MIX "C", N50 (2")
- BITUMINOUS MATERIALS (PRIME COAT)
- EMBANKMENT
- MICRO-SURFACING SINGLE PASS, TYPE II, 1/2" (WITH RUT FILLING)

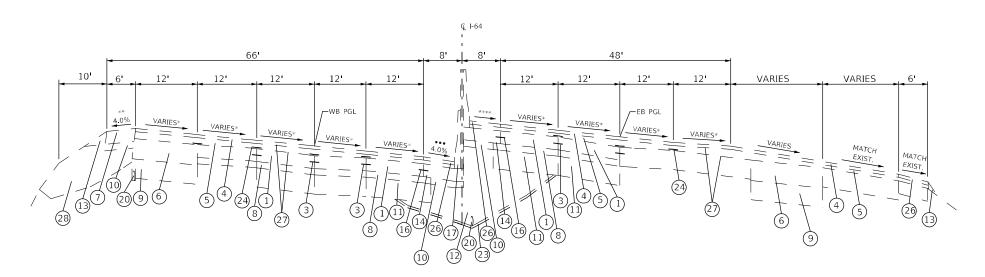

# EXISTING TYPICAL SECTION

STA 661+10.04 TO STA 662+23.36

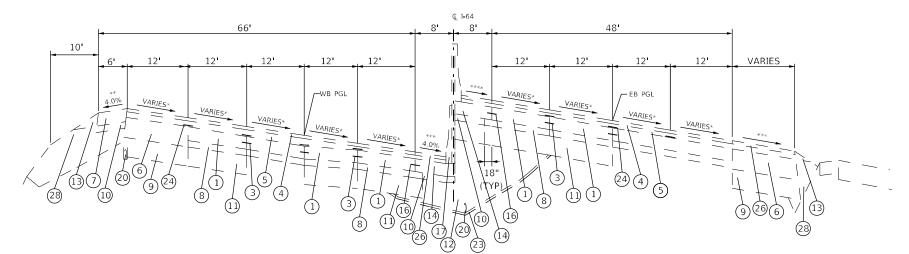

#### EXISTING TYPICAL SECTION

STA. 662+23.36 TO STA. 662+84.20


- \* SEE SUPERELEVATION TRANSITION DETAILS FOR PAVEMENT SUPERELEVATION.
- \*\* WHEN THE SUPERELEVATION RATE IS 4% OR LESS, THE SHOULDER SLOPE IS 4%. WHEN PAVEMENT SUPERELEVATION RATE EXCEEDS 4%, THE MAXIMUM ALGEBRAIC DIFFERENCE IN CROSS SLOPE IS 8%.
- \*\*\* WHEN THE SUPERELEVATION RATE IS 4% OR LESS, THE SHOULDER SLOPE IS 4%. WHEN PAVEMENT SUPERELEVATION RATE EXCEEDS 4%, THE SHOULDER SLOPE SHOULD EQUAL ADJACENT PAVEMENT SUPERELEVATION RATE.
- \*\*\*\* SHOULDER SLOPE SHOULD EQUAL ADJACENT PAVEMENT SUPERELEVATION RATE.

USER NAME = smithma	DESIGNED -	REVISED -	
	DRAWN -	REVISED -	
PLOT SCALE = 100.0000 / in.	CHECKED -	REVISED -	
PLOT DATE = 11/1/2021	DATE -	REVISED -	

		TYPICAL	SECTIONS		F.A.I RTE	SEC.	TION		COUNTY	TOTAL SHEETS	SHEET NO.
					64	82-(6,7	,8)PP-1		ST. CLAIR	29	9
					_				CONTRACT	NO. 76	5P88
SCALE: NTS	SHEET 5	OF 18 SHE	TS STA.	TO STA.			ILLINOIS	FED. A	ID PROJECT		

- CONTINUOUSLY REINFORCED PORTLAND CEMENT CONCRETE PAVEMENT 8" CONTINUOUSLY REINFORCED PORTLAND CEMENT CONCRETE PAVEMENT 9" LONGITUDINAL CONSTRUCTION JOINT - USE NO. 6 EPOXY COATED DEFORMED TIE BARS AT 24" C-C AND 24" LONG, DRILLED AND GROUTED
- 4 POLYMERIZED BITUMINOUS CONCRETE SURFACE COURSE, STONE MATRIX ASPHALT, CLASS I (2")
- POLYMERIZED BITUMINOUS CONCRETE BINDER COURSE, SUPERPAVE, IL-19.0, N105 (2-1/4" & VARIES)
- 13" BITUMINOUS SHOULDER
- 8" BITUMINOUS SHOULDER
- STABILIZED SUB-BASE 4"
- SUB-BASE GRANULAR MATERIAL, TYPE B 12"
- SUB-BASE GRANULAR MATERIAL, TYPE A 4"
- AGGREGATE SUBGRADE 12"
- POROUS GRANULAR EMBANKMENT, SUBGRADE
- AGGREGATE SHOULDER, TYPE B
- PORTLAND CEMENT CONCRETE SHOULDERS 8"
- (15) PORTLAND CEMENT CONCRETE SHOULDERS 9"
- (16) LONGITUDINAL CONSTRUCTION JOINT USE 3/4 INCH EPOXY COATED SMOOTH DOWEL BARS AT 24" C-C AND 24" LONG
- CONCRETE BARRIER, CONCRETE BARRIER (MODIFIED), CONCRETE BARRIER (SPECIAL), OR CONCRETE BARRIER TRANSITION
- (18) GUARDRAIL
- (19) BITUMINOUS SHOULDER CURB
- PIPE UNDERDRAINS 6"
- SLOTTED DRAIN STRUCTURE

- 2) STORM SEWER
  2) FILTER FABRIC
  24 STRIP REFLECTIVE CRACK CONTROL TREATMENT
- 2) NOISE ABATEMENT WALL
- BITUMINOUS CONCRETE SURFACE COURSE, SUPERPAVE, MIX "C", N50 (2")
- BITUMINOUS MATERIALS (PRIME COAT)
- EMBANKMENT
- MICRO-SURFACING SINGLE PASS, TYPE II, 1/2" (WITH RUT FILLING)

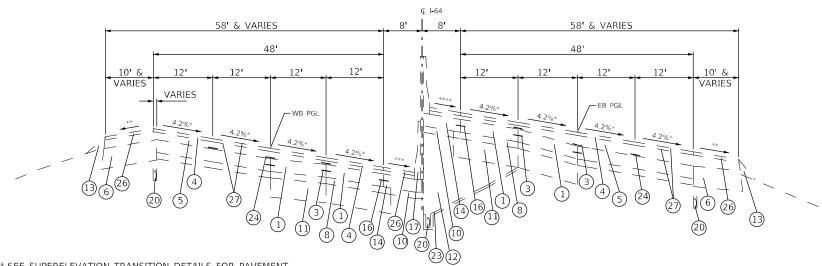


\* SEE SUPERELEVATION TRANSITION DETAILS FOR PAVEMENT SUPERELEVATION.

- \*\* WHEN THE SUPERELEVATION RATE IS 4% OR LESS, THE SHOULDER SLOPE IS 4%. WHEN PAVEMENT SUPERELEVATION RATE EXCEEDS 4%, THE MAXIMUM ALGEBRAIC DIFFERENCE IN CROSS SLOPE IS 8%.
- \*\*\* WHEN THE SUPERELEVATION RATE IS 4% OR LESS, THE SHOULDER SLOPE IS 4%. WHEN PAVEMENT SUPERELEVATION RATE EXCEEDS 4%, THE SHOULDER SLOPE SHOULD EQUAL ADJACENT PAVEMENT SUPERELEVATION RATE.
- \*\*\*\* SHOULDER SLOPE SHOULD EQUAL ADJACENT PAVEMENT SUPERELEVATION RATE.

# EXISTING TYPICAL SECTION

STA. 672+93.94 TO STA. 681+00.00

STA. 689+15.00 TO STA. 693+92.51 EB STA. 692+18.71 WB

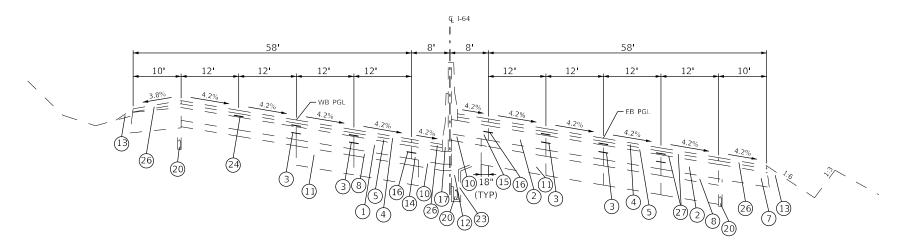

EXISTING TYPICAL SECTION


STA. 681+00.00 TO STA. 689+15.00

USER NAME = smithma	DESIGNED -	REVISED -	
	DRAWN -	REVISED -	
PLOT SCALE = 100.0000 / in.	CHECKED -	REVISED -	
PLOT DATE = 11/1/2021	DATE -	REVISED -	

		TYPICAL SE	CTIONS		F.A.I RTE	SEC	TION		COUNTY	TOTAL SHEETS	
					64	82-(6,7	,8)PP-1		ST. CLAIR	29	10
	_								CONTRACT	NO. 76	5P88
SCALE: NTS	SHEET 6	OF 18 SHEETS	STA.	TO STA.			ILLINOIS	FED. A	ID PROJECT		

- CONTINUOUSLY REINFORCED PORTLAND CEMENT CONCRETE PAVEMENT 8"
  CONTINUOUSLY REINFORCED PORTLAND CEMENT CONCRETE PAVEMENT 9"
  LONGITUDINAL CONSTRUCTION JOINT USE NO. 6 EPOXY COATED DEFORMED TIE BARS AT 24" C-C AND 24" LONG, DRILLED AND GROUTED
- 4 POLYMERIZED BITUMINOUS CONCRETE SURFACE COURSE, STONE MATRIX ASPHALT, CLASS I (2")
- POLYMERIZED BITUMINOUS CONCRETE BINDER COURSE, SUPERPAVE, IL-19.0, N105 (2-1/4" & VARIES)
- 13" BITUMINOUS SHOULDER
- 8" BITUMINOUS SHOULDER
- STABILIZED SUB-BASE 4"
- SUB-BASE GRANULAR MATERIAL, TYPE B 12"
- SUB-BASE GRANULAR MATERIAL, TYPE A 4"
- AGGREGATE SUBGRADE 12"
- POROUS GRANULAR EMBANKMENT, SUBGRADE
- AGGREGATE SHOULDER, TYPE B
- PORTLAND CEMENT CONCRETE SHOULDERS 8"
- (15) PORTLAND CEMENT CONCRETE SHOULDERS 9"
- (16) LONGITUDINAL CONSTRUCTION JOINT USE 3/4 INCH EPOXY COATED SMOOTH DOWEL BARS AT 24" C-C AND 24" LONG
- CONCRETE BARRIER, CONCRETE BARRIER (MODIFIED), CONCRETE
- BARRIER (SPECIAL), OR CONCRETE BARRIER TRANSITION
- (18) GUARDRAIL
- (19) BITUMINOUS SHOULDER CURB
- PIPE UNDERDRAINS 6"
- SLOTTED DRAIN STRUCTURE


- STORM SEWER
   FILTER FABRIC
   STRIP REFLECTIVE CRACK CONTROL TREATMENT
   NOISE ABATEMENT WALL
- BITUMINOUS CONCRETE SURFACE COURSE, SUPERPAVE, MIX "C", N50
- BITUMINOUS MATERIALS (PRIME COAT)
- EMBANKMENT
- MICRO-SURFACING SINGLE PASS, TYPE II, 1/2" (WITH RUT FILLING)

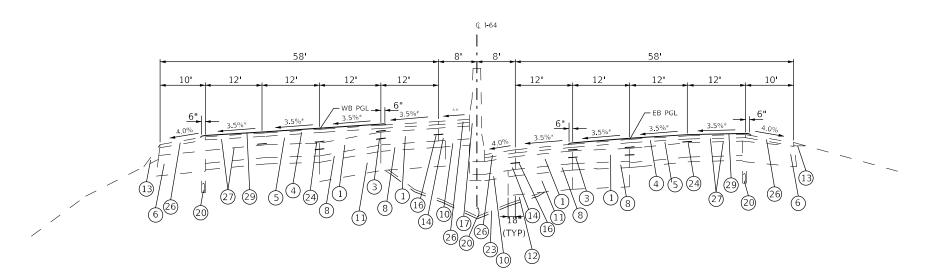

- \* SEE SUPERELEVATION TRANSITION DETAILS FOR PAVEMENT SUPERELEVATION.
- \*\* SHOULDER SLOPE SHOULD EQUAL ADJACENT PAVEMENT SUPERELEVATION RATE.

# EXISTING TYPICAL SECTION

STA. 732+09.69 EB TO STA. 735+74.76 STA. 730+77.89 WB

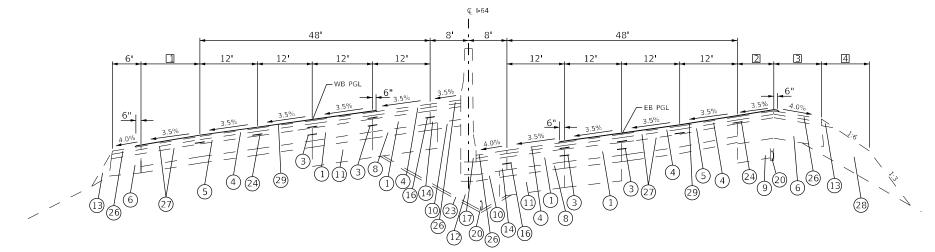

EXISTING TYPICAL SECTION

STA, 735+74,76 TO STA, 744+15,00


- ☐ VARIES 1' (STA. 734+44.72 EX. 1' STUB) TO 18' (STA. 744+15.00) SHOULDER PAVEMENT AND SUB-BASE GRANULAR MATERIAL, TYPE B
- ☑ VARIES 0' TO 8.34' (STA. 741+15.05) & 7.03' (STA. 741+15.05)
- TO 0' (STA. 742+89.11)

  VARIES 10' (STA. 742+89.11) TO 6' (STA. 743+84.48)
- VARIES

USER NAME = smithma	DESIGNED -	REVISED -	
	DRAWN -	REVISED -	
PLOT SCALE = 100.0000 / in.	CHECKED -	REVISED -	
PLOT DATE = 11/1/2021	DATE -	REVISED -	

STATE OF ILLINOIS **DEPARTMENT OF TRANSPORTATION** 

SECTION TYPICAL SECTIONS 82-(6,7,8)PP-1 29 11 CONTRACT NO. 76P88 SCALE: NTS SHEET 7 OF 18 SHEETS STA.

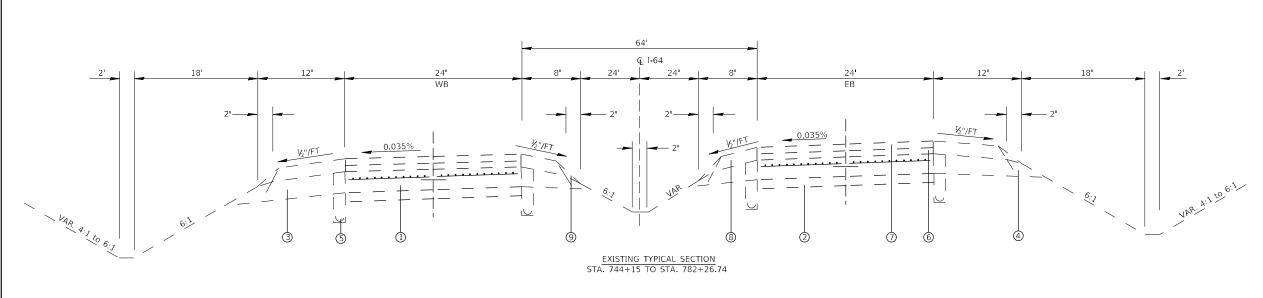


- LEGEND B (EXISTING)

  (CONTINUOUSLY REINFORCED PCC PAVEMENT 8"
- ② STABILIZED SUB-BASE 4"
  ③ STABILIZED SHOULDERS 8"
  ④ AGGREGATE SHOULDER
- ⑤ PIPE UNDERDRAINS 4"
- © BITUMINOUS BINDER COURSE, N=105, 2¼"

  → BITUMINOUS CONCRETE SURFACE COURSE,
- STONE MATRIX ASPHALT, 1½"


  BITUMINOUS SHOULDERS SUPERPAVE
  AGGREGATE SHOULDER WEDGE, TYPE B

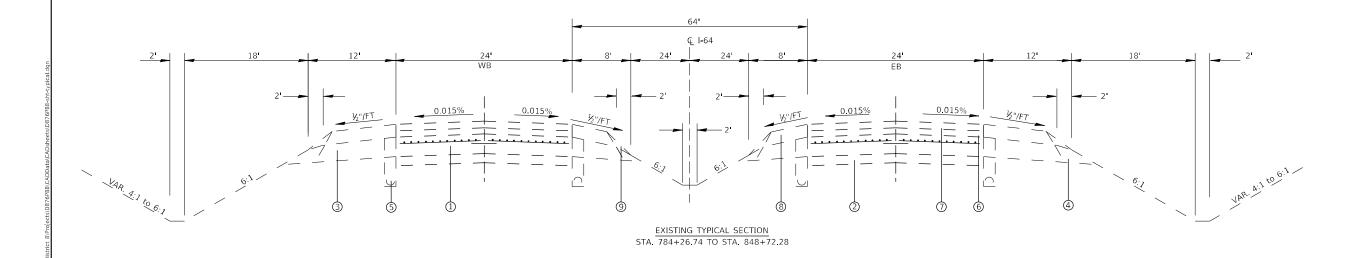

USER NAME = smithma	DESIGNED -	REVISED -
	DRAWN -	REVISED -
PLOT SCALE = 100.0000 / in.	CHECKED -	REVISED -
PLOT DATE = 11/1/2021	DATE -	REVISED -

STATI	E 01	F ILLINOIS
DEPARTMENT	OF	TRANSPORTATION

TYPICAL SECTIONS						F.A.I RTE				COUNTY	TOTAL SHEETS	SHEET NO.	
							64	82-(6,7	,8)PP-1		ST. CLAIR	29	12
									CONTRACT	NO. 76	5P88		
SCALE: NTS	SHEET 8	OF	18	SHEETS	STA.	TO STA.		ILLINOIS FED. A			ID PROJECT		

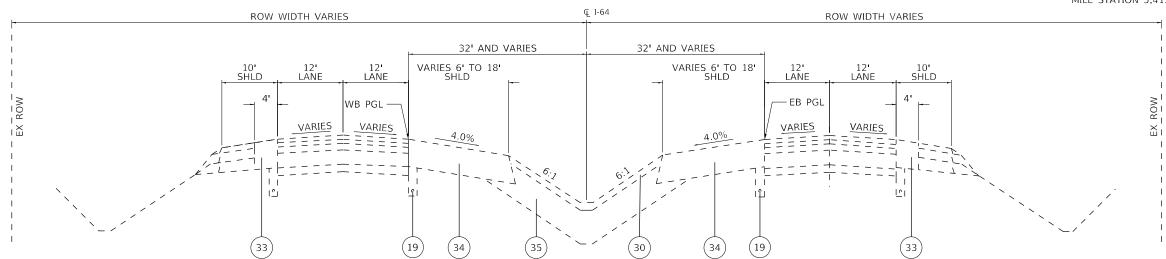

STA 848+72.28 TO STA 854+72.28 STA 999+91.46 TO STA 1005+91.46

# **LEGEND C (EXISTING)**

- (1) CONTINUOUSLY REINFORCED PCC PAVEMENT, 8"
- (2) PCC PAVEMENT, 10"
- 3 LONGITUDINAL CONSTRUCTION JOINT USE NO. 6
  TIE BARS AT 24" CTS AND 24" LONG, DRILLED
  AND GROUTED (COST INCLUDED IN PCC ITEMS)
- 4) PCC SHOULDERS, 8"
- 5) POLYMERIZED HMA SURFACE COURSE, STONE MATRIX ASPHALT, N80, 2"
- (6) PCC SHOULDERS, 10"
- (7) HMA SHOULDERS, 8"
- (8) PCC PAVEMENT, 9" (JOINTED)
- (9) POLYMERIZED HMA BINDER COURSE, IL-19.0, FG, N90, 4"

- (10) LONGITUDINAL CONSTRUCTION JOING USE NO. 6 TIE BARS AT 24" CTS AND 30" LONG, FORMED IN PLACE (COST INCLUDED IN PCC ITEMS)
- LONGITUDINAL SAWED JOINT USE NO. 6 TIE BARS AT 30" CTS AND 30" LONG (COST INCLUDED IN PCC ITEMS)
- 12) POUROUS GRANULAR EMBANKMENT, SUBGRADE
- (13) AGGREGATE SHOULDER, TYPE B
- (14) PCC SHOULDERS, 9"
- 15 HMA PAVEMENT (FULL DEPTH), 12 1/2" (2" SURFACE COURSE, 10 1/2" BINDER COURSE)
- 16) HMA PACEMENT (FULL DEPTH), 13 1/2" (2" SURFACE COURSE, 11 1/2" BINDER COURSE)
- (17) CONCRETE BARRIER, DOUBLE FACE, 42" HEIGHT


- (18) PIPE UNDERDRAINS, 6"
- (19) PIPE UNDERDRAINS. 4"
- (20) STORM SEWER
- 1) FILTER FABRIC
- (22) HMA SURFACE COURSE, MIX "C", N50, 2"
- 23) BITUMINOUS MATERIALS (PRIME COAT)
- (24) COMBINATION CONCRETE CURB AND GUTTER TYPE B-6.24
- (25) COMBINATION CONCRETE CURB AND GUTTER TYPE B-6.12
- 26) COMBINATION CONCRETE CURB AND GUTTER TYPE B-6.06

SCALE: NTS

- (27) CONCRETE MEDIAN SURFACE. 4"
- (28) PAVEMENT FABRIC

- e9) AGGREAGE BASE COURSE, TYPE A, 12"
- (30) TOPSOIL EXCAVATION AND PLACEMENT, 4"
- (31) COURSE AGGREGATE
- 32) INCIDENTAL HMA SURFACING, 3"
- 33) HMA PAVEMENT (FULL DEPTH), 12" (2' SURFACE COURSE, 11" BINDER COURSE)
- 34) HMA SHOULDERS, 13"
- 35) EMBANKMENT
- (36) SEE PAVEMENT LOG DETAIL RAMPS ADJACENT TO I-64
- (37) STABILIZED SUBBASE HMA, 4"

USER NAME = smithma	DESIGNED -	REVISED -	
	DRAWN -	REVISED -	STATE OF ILLINOIS
PLOT SCALE = 100.0000 / in.	CHECKED -	REVISED -	DEPARTMENT OF TRANSPORTATION
PLOT DATE = 11/1/2021	DATE -	REVISED -	

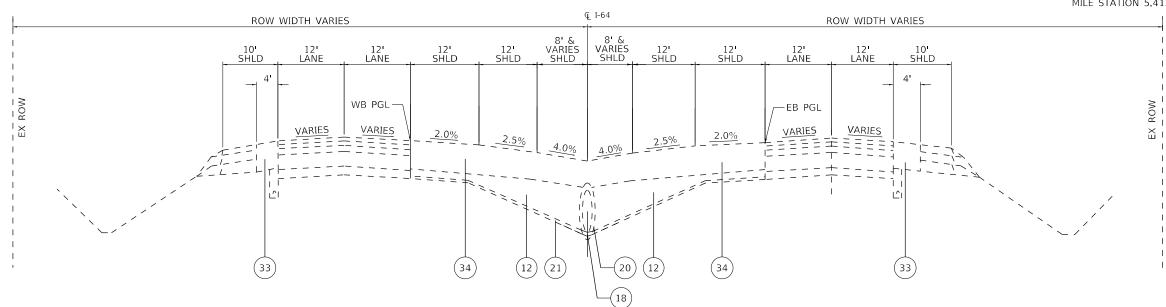

STA 854+72.28 TO STA 855+12.28 STA 999+51.46 TO STA 999+91.46

# LEGEND C (EXISTING)

- (1) CONTINUOUSLY REINFORCED PCC PAVEMENT, 8"
- (2) PCC PAVEMENT, 10"
- 3 LONGITUDINAL CONSTRUCTION JOINT USE NO. 6
  TIE BARS AT 24" CTS AND 24" LONG, DRILLED
  AND GROUTED (COST INCLUDED IN PCC ITEMS)
- 4 PCC SHOULDERS, 8"
- 5 POLYMERIZED HMA SURFACE COURSE, STONE MATRIX ASPHALT, N80, 2"
- (6) PCC SHOULDERS, 10"
- (7) HMA SHOULDERS, 8"
- (8) PCC PAVEMENT, 9" (JOINTED)
- 9 POLYMERIZED HMA BINDER COURSE, IL-19.0, FG, N90, 4"

- (10) LONGITUDINAL CONSTRUCTION JOING USE NO. 6 TIE BARS AT 24" CTS AND 30" LONG, FORMED IN PLACE (COST INCLUDED IN PCC ITEMS)
- 11) LONGITUDINAL SAWED JOINT USE NO. 6 TIE BARS AT 30" CTS AND 30" LONG (COST INCLUDED IN PCC ITEMS)
- (12) POUROUS GRANULAR EMBANKMENT, SUBGRADE
- (13) AGGREGATE SHOULDER, TYPE B
- (14) PCC SHOULDERS, 9"
- (15) HMA PAVEMENT (FULL DEPTH), 12 1/2" (2" SURFACE COURSE, 10 1/2" BINDER COURSE)
- 16) HMA PACEMENT (FULL DEPTH), 13 1/2" (2" SURFACE COURSE, 11 1/2" BINDER COURSE)
- (17) CONCRETE BARRIER, DOUBLE FACE, 42" HEIGHT

- 18) PIPE UNDERDRAINS, 6"
- (19) PIPE UNDERDRAINS. 4"
- (20) STORM SEWER
- (21) FILTER FABRIC
- (22) HMA SURFACE COURSE, MIX "C", N50, 2"
- (23) BITUMINOUS MATERIALS (PRIME COAT)
- 24) COMBINATION CONCRETE CURB AND GUTTER TYPE B-6.24
- COMBINATION CONCRETE CURB AND GUTTER TYPE B-6.12
- 26) COMBINATION CONCRETE CURB AND GUTTER TYPE B-6.06


SCALE: NTS

- 27) CONCRETE MEDIAN SURFACE. 4"
- (28) PAVEMENT FABRIC

- 29) AGGREAGE BASE COURSE, TYPE A, 12"
- (30) TOPSOIL EXCAVATION AND PLACEMENT, 4"
- (31) COURSE AGGREGATE
- (32) INCIDENTAL HMA SURFACING, 3"
- 33) HMA PAVEMENT (FULL DEPTH), 12" (2' SURFACE COURSE, 11" BINDER COURSE)
- 34) HMA SHOULDERS, 13"
- 5) EMBANKMENT
- 36 SEE PAVEMENT LOG DETAIL RAMPS ADJACENT TO I-64
- 37) STABILIZED SUBBASE HMA, 4"

USER NAME = smithma	DESIGNED -	REVISED -
	DRAWN -	REVISED -
PLOT SCALE = 100.0000 / in.	CHECKED -	REVISED -
PLOT DATE = 11/1/2021	DATE -	REVISED -

STATE OF ILLINOIS
DEPARTMENT OF TRANSPORTATION

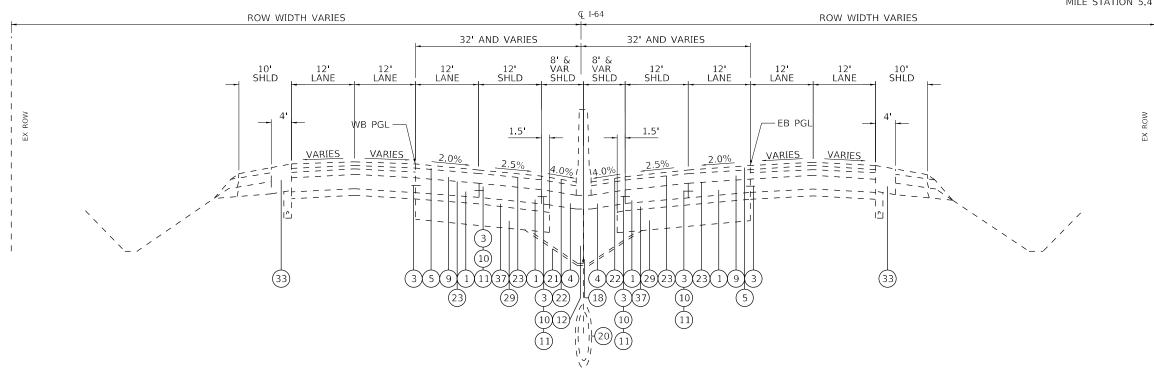

STA 855+12.28 TO STA 857+80.69 STA 905+27.07 TO STA 973+32.12 WB STA 987+02.34 TO STA 993+50.00 WB STA 905+27.07 TO STA 978+54.94 EB STA 986+56.22 TO STA 993+50.00 EB

# LEGEND C (EXISTING)

- (1) CONTINUOUSLY REINFORCED PCC PAVEMENT, 8"
- (2) PCC PAVEMENT, 10"
- 3 LONGITUDINAL CONSTRUCTION JOINT USE NO. 6
  TIE BARS AT 24" CTS AND 24" LONG, DRILLED
  AND GROUTED (COST INCLUDED IN PCC ITEMS)
- 4 PCC SHOULDERS, 8"
- 5 POLYMERIZED HMA SURFACE COURSE, STONE MATRIX ASPHALT, N80, 2"
- (6) PCC SHOULDERS, 10"
- (7) HMA SHOULDERS, 8"
- (8) PCC PAVEMENT, 9" (JOINTED)
- 9 POLYMERIZED HMA BINDER COURSE, IL-19.0, FG, N90, 4"

- (10) LONGITUDINAL CONSTRUCTION JOING USE NO. 6 TIE BARS AT 24" CTS AND 30" LONG, FORMED IN PLACE (COST INCLUDED IN PCC ITEMS)
- (11) LONGITUDINAL SAWED JOINT USE NO. 6 TIE BARS AT 30" CTS AND 30" LONG (COST INCLUDED IN PCC ITEMS)
- (12) POUROUS GRANULAR EMBANKMENT, SUBGRADE
- (13) AGGREGATE SHOULDER, TYPE B
- (14) PCC SHOULDERS, 9"
- 15) HMA PAVEMENT (FULL DEPTH), 12 1/2" (2" SURFACE COURSE, 10 1/2" BINDER COURSE)
- HMA PACEMENT (FULL DEPTH), 13 1/2" (2" SURFACE COURSE, 11 1/2" BINDER COURSE)
- (17) CONCRETE BARRIER, DOUBLE FACE, 42" HEIGHT

- 18) PIPE UNDERDRAINS, 6"
- (19) PIPE UNDERDRAINS. 4"
- (20) STORM SEWER
- (21) FILTER FABRIC
- (22) HMA SURFACE COURSE, MIX "C", N50, 2"
- (23) BITUMINOUS MATERIALS (PRIME COAT)
- 24) COMBINATION CONCRETE CURB AND GUTTER TYPE B-6.24
- (25) COMBINATION CONCRETE CURB AND GUTTER TYPE B-6.12
- 26) COMBINATION CONCRETE CURB AND GUTTER TYPE B-6.06

SCALE: NTS

SHEET 11


- 27) CONCRETE MEDIAN SURFACE. 4"
- (28) PAVEMENT FABRIC

- (29) AGGREAGE BASE COURSE, TYPE A, 12"
- (30) TOPSOIL EXCAVATION AND PLACEMENT, 4"
- (31) COURSE AGGREGATE
- 32) INCIDENTAL HMA SURFACING, 3"
- 33) HMA PAVEMENT (FULL DEPTH), 12" (2' SURFACE COURSE, 11" BINDER COURSE)
- (34) HMA SHOULDERS, 13"
- 5) EMBANKMENT
- (36) SEE PAVEMENT LOG DETAIL RAMPS ADJACENT TO 1-64
- (37) STABILIZED SUBBASE HMA, 4"

USER NAME = smithma	DESIGNED -	REVISED -
	DRAWN -	REVISED -
PLOT SCALE = 100.0000 / in.	CHECKED -	REVISED -
PLOT DATE = 11/1/2021	DATE -	REVISED -

STATE OF ILLINOIS
STAIL OF ILLINOIS
DEPARTMENT OF TRANSPORTATION

TYPICAL SECTIONS		F.A.I RTE	SECTION		COUNTY	TOTAL SHEETS	SHEET NO.			
		64	82-(6,7,8)PP-1		ST. CLAIR	29	15			
								CONTRACT	NO. 76	5P88
OF	18 SHI	EETS	STA.	TO STA.		TILINOIS	EED Δ	ID PROJECT		

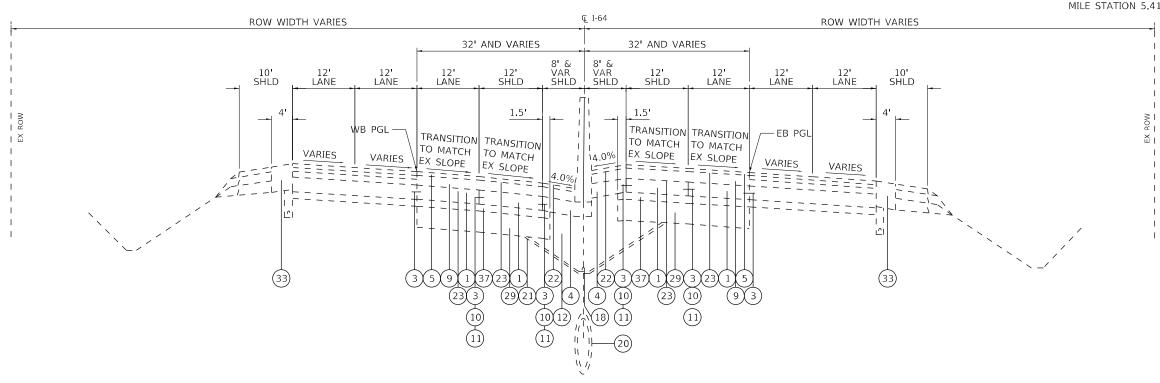

STA 857+80.69 TO STA 860+41.54 STA EQU 859+68.19 BK = STA 859+81.54 AHD STA 902+79.57 TO STA 905+27.07

#### LEGEND C (EXISTING)

- (1) CONTINUOUSLY REINFORCED PCC PAVEMENT, 8"
- (2) PCC PAVEMENT, 10"
- (3) LONGITUDINAL CONSTRUCTION JOINT USE NO. 6
  TIE BARS AT 24" CTS AND 24" LONG, DRILLED
  AND GROUTED (COST INCLUDED IN PCC ITEMS)
- 4) PCC SHOULDERS, 8"
- 5 POLYMERIZED HMA SURFACE COURSE, STONE MATRIX ASPHALT, N80, 2"
- (6) PCC SHOULDERS, 10"
- (7) HMA SHOULDERS, 8"
- 8 PCC PAVEMENT, 9" (JOINTED)
- 9 POLYMERIZED HMA BINDER COURSE, IL-19.0, FG, N90, 4"

- (10) LONGITUDINAL CONSTRUCTION JOING USE NO. 6 TIE BARS AT 24" CTS AND 30" LONG, FORMED IN PLACE (COST INCLUDED IN PCC ITEMS)
- 11) LONGITUDINAL SAWED JOINT USE NO. 6 TIE BARS AT 30" CTS AND 30" LONG (COST INCLUDED IN PCC ITEMS)
- (12) POUROUS GRANULAR EMBANKMENT, SUBGRADE
- (13) AGGREGATE SHOULDER, TYPE B
- (14) PCC SHOULDERS, 9"
- (15) HMA PAVEMENT (FULL DEPTH), 12 1/2" (2" SURFACE COURSE, 10 1/2" BINDER COURSE)
- (16) HMA PACEMENT (FULL DEPTH), 13 1/2" (2" SURFACE COURSE, 11 1/2" BINDER COURSE)
- (17) CONCRETE BARRIER, DOUBLE FACE, 42" HEIGHT

- 18) PIPE UNDERDRAINS, 6"
- (19) PIPE UNDERDRAINS. 4"
- (20) STORM SEWER
- (21) FILTER FABRIC
- (22) HMA SURFACE COURSE, MIX "C", N50, 2"
- 23) BITUMINOUS MATERIALS (PRIME COAT)
- (24) COMBINATION CONCRETE CURB AND GUTTER TYPE B-6.24
- (25) COMBINATION CONCRETE CURB AND GUTTER TYPE B-6.12
- 26) COMBINATION CONCRETE CURB AND GUTTER TYPE B-6.06

SCALE: NTS


SHEET 12

- 27) CONCRETE MEDIAN SURFACE. 4"
- (28) PAVEMENT FABRIC

- (29) AGGREAGE BASE COURSE, TYPE A, 12"
- (30) TOPSOIL EXCAVATION AND PLACEMENT, 4"
- (31) COURSE AGGREGATE
- (32) INCIDENTAL HMA SURFACING, 3"
- HMA PAVEMENT (FULL DEPTH), 12" (2' SURFACE COURSE, 11" BINDER COURSE)
- (34) HMA SHOULDERS, 13"
- 35) EMBANKMENT
- 36) SEE PAVEMENT LOG DETAIL RAMPS ADJACENT TO I-64
- (37) STABILIZED SUBBASE HMA, 4"

USER NAME = smithma	DESIGNED -	REVISED -
	DRAWN -	REVISED -
PLOT SCALE = 100.0000 / in.	CHECKED -	REVISED -
PLOT DATE = 11/1/2021	DATE -	REVISED -

TYPICAL SECTIONS		F.A.I RTE	SECTION	COUNTY	TOTAL SHEETS	SHEE NO.	
		64	82-(6,7,8)PP-1	ST. CLAIR	29	16	
					CONTRACT	NO. 76	5P88
OF 18 SE	IFFTS STA	TO STA.		ILLINOIS FED.	AID PROJECT		

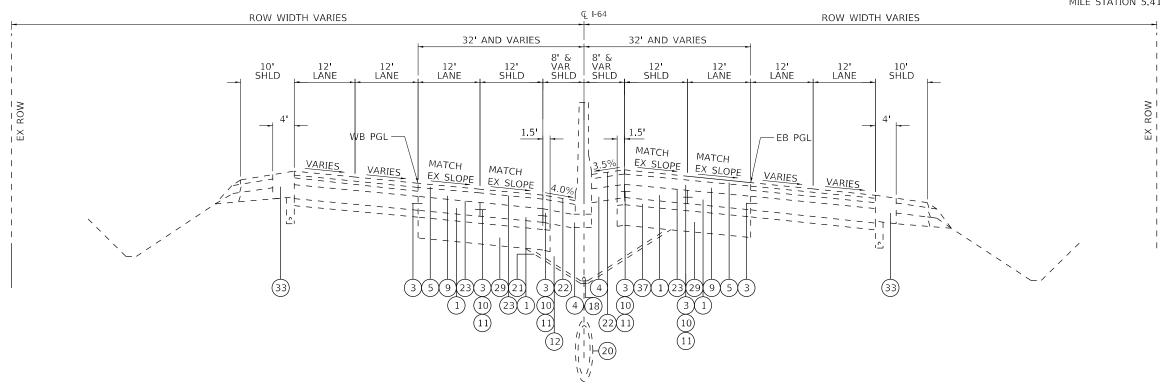

STA 860+41,54 TO STA 902+79,57

# LEGEND C (EXISTING)

- (1) CONTINUOUSLY REINFORCED PCC PAVEMENT, 8"
- (2) PCC PAVEMENT, 10"
- 3 LONGITUDINAL CONSTRUCTION JOINT USE NO. 6
  TIE BARS AT 24" CTS AND 24" LONG, DRILLED
  AND GROUTED (COST INCLUDED IN PCC ITEMS)
- (4) PCC SHOULDERS, 8"
- 5 POLYMERIZED HMA SURFACE COURSE, STONE MATRIX ASPHALT, N80, 2"
- (6) PCC SHOULDERS, 10"
- (7) HMA SHOULDERS, 8"
- (8) PCC PAVEMENT, 9" (JOINTED)
- 9 POLYMERIZED HMA BINDER COURSE, IL-19.0, FG, N90, 4"

- (10) LONGITUDINAL CONSTRUCTION JOING USE NO. 6 TIE BARS AT 24" CTS AND 30" LONG, FORMED IN PLACE (COST INCLUDED IN PCC ITEMS)
- 11) LONGITUDINAL SAWED JOINT USE NO. 6 TIE BARS AT 30" CTS AND 30" LONG (COST INCLUDED IN PCC ITEMS)
- (12) POUROUS GRANULAR EMBANKMENT, SUBGRADE
- (13) AGGREGATE SHOULDER, TYPE B
- (14) PCC SHOULDERS, 9"
- 15) HMA PAVEMENT (FULL DEPTH), 12 1/2" (2" SURFACE COURSE, 10 1/2" BINDER COURSE)
- HMA PACEMENT (FULL DEPTH), 13 1/2" (2" SURFACE COURSE, 11 1/2" BINDER COURSE)
- (17) CONCRETE BARRIER, DOUBLE FACE, 42" HEIGHT


- (18) PIPE UNDERDRAINS, 6"
- (19) PIPE UNDERDRAINS. 4"
- (20) STORM SEWER
- (21) FILTER FABRIC
- (22) HMA SURFACE COURSE, MIX "C", N50, 2"
- (23) BITUMINOUS MATERIALS (PRIME COAT)
- 24) COMBINATION CONCRETE CURB AND GUTTER TYPE B-6.24
- (25) COMBINATION CONCRETE CURB AND GUTTER TYPE B-6.12
- COMBINATION CONCRETE CURB AND GUTTER TYPE B-6.06

SCALE: NTS

- 27) CONCRETE MEDIAN SURFACE. 4"
- (28) PAVEMENT FABRIC

- (29) AGGREAGE BASE COURSE, TYPE A, 12"
- (30) TOPSOIL EXCAVATION AND PLACEMENT, 4"
- (31) COURSE AGGREGATE
- (32) INCIDENTAL HMA SURFACING, 3"
- 33) HMA PAVEMENT (FULL DEPTH), 12" (2' SURFACE COURSE, 11" BINDER COURSE)
- (34) HMA SHOULDERS, 13"
- 5) EMBANKMENT
- 36 SEE PAVEMENT LOG DETAIL RAMPS ADJACENT TO I-64
- (37) STABILIZED SUBBASE HMA, 4"

USER NAME = smithma	DESIGNED -	REVISED -
	DRAWN -	REVISED -
PLOT SCALE = 100.0000 / in.	CHECKED -	REVISED -
PLOT DATE = 11/1/2021	DATE -	REVISED -

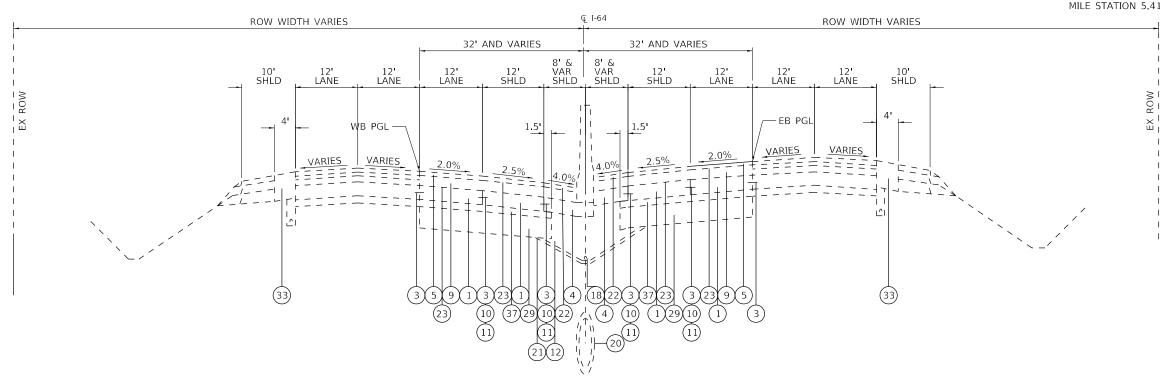

STA 993+50.00 TO STA 999+51.46

# LEGEND C (EXISTING)

- CONTINUOUSLY REINFORCED PCC PAVEMENT, 8"
- PCC PAVEMENT, 10"
- LONGITUDINAL CONSTRUCTION JOINT USE NO. 6 TIE BARS AT 24" CTS AND 24" LONG, DRILLED AND GROUTED (COST INCLUDED IN PCC ITEMS)
- PCC SHOULDERS, 8"
- POLYMERIZED HMA SURFACE COURSE, STONE MATRIX ASPHALT, N80, 2"
- PCC SHOULDERS, 10"
- HMA SHOULDERS, 8"
- PCC PAVEMENT, 9" (JOINTED)
- POLYMERIZED HMA BINDER COURSE, IL-19.0, FG, N90, 4"

- LONGITUDINAL CONSTRUCTION JOING USE NO. 6 TIE BARS AT 24" CTS AND 30" LONG, FORMED IN PLACE (COST INCLUDED IN PCC ITEMS)
- LONGITUDINAL SAWED JOINT USE NO. 6 TIE BARS AT 30" CTS AND 30" LONG (COST INCLUDED IN PCC ITEMS)
- POUROUS GRANULAR EMBANKMENT, SUBGRADE
- (13) AGGREGATE SHOULDER, TYPE B
- (14) PCC SHOULDERS, 9"
- HMA PAVEMENT (FULL DEPTH), 12 1/2" (2" SURFACE COURSE, 10 1/2" BINDER COURSE)
- HMA PACEMENT (FULL DEPTH), 13 1/2" (2" SURFACE COURSE, 11 1/2" BINDER COURSE)
- CONCRETE BARRIER, DOUBLE FACE, 42" HEIGHT

- PIPE UNDERDRAINS, 6"
- PIPE UNDERDRAINS. 4"
- (20) STORM SEWER
- FILTER FABRIC
- HMA SURFACE COURSE, MIX "C", N50, 2"
- BITUMINOUS MATERIALS (PRIME COAT)
- COMBINATION CONCRETE CURB AND GUTTER TYPE B-6.24
- COMBINATION CONCRETE CURB AND GUTTER TYPE B-6.12
- (26) COMBINATION CONCRETE CURB AND GUTTER TYPE B-6.06

SCALE: NTS

- CONCRETE MEDIAN SURFACE. 4"
- PAVEMENT FABRIC


- AGGREAGE BASE COURSE, TYPE A, 12"
- TOPSOIL EXCAVATION AND PLACEMENT, 4"
- (31) COURSE AGGREGATE
- INCIDENTAL HMA SURFACING, 3"
- HMA PAVEMENT (FULL DEPTH), 12" (2' SURFACE COURSE, 11" BINDER COURSE)
- HMA SHOULDERS, 13"
- EMBANKMENT
- 36 SEE PAVEMENT LOG DETAIL RAMPS ADJACENT TO I-64
- (37) STABILIZED SUBBASE HMA, 4"

USER NAME = smithma	DESIGNED -	REVISED -
	DRAWN -	REVISED -
PLOT SCALE = 100.0000 / in.	CHECKED -	REVISED -
PLOT DATE = 11/1/2021	DATE -	REVISED -

STATE OF ILLINOIS **DEPARTMENT OF TRANSPORTATION** 

SECTION TYPICAL SECTIONS 82-(6,7,8)PP-1 ST. CLAIR CONTRACT NO. 76P88 SHEET 14 OF 18 SHEETS STA. TO STA.

29 18

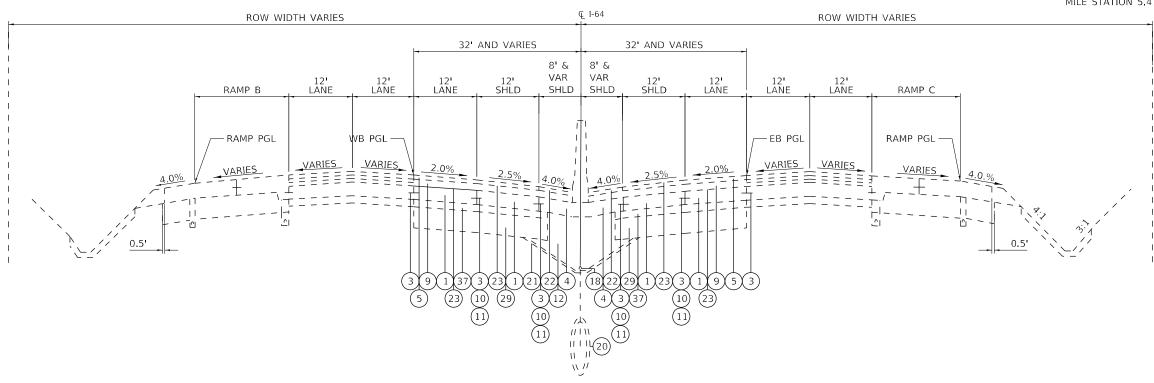

STA 973+32.12 TO STA 987+02.34 WB STA 978+54.94 TO STA 986+56.22 EB

# LEGEND C (EXISTING)


- (1) CONTINUOUSLY REINFORCED PCC PAVEMENT, 8"
- (2) PCC PAVEMENT, 10"
- 3 LONGITUDINAL CONSTRUCTION JOINT USE NO. 6
  TIE BARS AT 24" CTS AND 24" LONG, DRILLED
  AND GROUTED (COST INCLUDED IN PCC ITEMS)
- 4) PCC SHOULDERS, 8"
- 5 POLYMERIZED HMA SURFACE COURSE, STONE MATRIX ASPHALT, N80, 2"
- (6) PCC SHOULDERS, 10"
- (7) HMA SHOULDERS, 8"
- (8) PCC PAVEMENT, 9" (JOINTED)
- 9 POLYMERIZED HMA BINDER COURSE, IL-19.0, FG, N90, 4"

- (10) LONGITUDINAL CONSTRUCTION JOING USE NO. 6 TIE BARS AT 24" CTS AND 30" LONG, FORMED IN PLACE (COST INCLUDED IN PCC ITEMS)
- LONGITUDINAL SAWED JOINT USE NO. 6 TIE BARS AT 30" CTS AND 30" LONG (COST INCLUDED IN PCC ITEMS)
- (12) POUROUS GRANULAR EMBANKMENT, SUBGRADE
- (13) AGGREGATE SHOULDER, TYPE B
- (14) PCC SHOULDERS, 9"
- HMA PAVEMENT (FULL DEPTH), 12 1/2" (2" SURFACE COURSE, 10 1/2" BINDER COURSE)
- 16) HMA PACEMENT (FULL DEPTH), 13 1/2" (2" SURFACE COURSE, 11 1/2" BINDER COURSE)
- (17) CONCRETE BARRIER, DOUBLE FACE, 42" HEIGHT

- (18) PIPE UNDERDRAINS, 6"
- (19) PIPE UNDERDRAINS. 4"
- (20) STORM SEWER
- (21) FILTER FABRIC
- (22) HMA SURFACE COURSE, MIX "C", N50, 2"
- (23) BITUMINOUS MATERIALS (PRIME COAT)
- (24) COMBINATION CONCRETE CURB AND GUTTER TYPE B-6.24
- 25) COMBINATION CONCRETE CURB AND GUTTER TYPE B-6.12
- 26) COMBINATION CONCRETE CURB AND GUTTER TYPE B-6.06
- 27) CONCRETE MEDIAN SURFACE. 4"
- (28) PAVEMENT FABRIC

- (29) AGGREAGE BASE COURSE, TYPE A, 12"
- (30) TOPSOIL EXCAVATION AND PLACEMENT, 4"
- (31) COURSE AGGREGATE
- (32) INCIDENTAL HMA SURFACING, 3"
- HMA PAVEMENT (FULL DEPTH), 12" (2' SURFACE COURSE, 11" BINDER COURSE)
- (34) HMA SHOULDERS, 13"
- (35) EMBANKMENT
- 36 SEE PAVEMENT LOG DETAIL RAMPS ADJACENT TO I-64
- (37) STABILIZED SUBBASE HMA, 4"

USER NAME = smithma	DESIGNED -	REVISED -			TYPICAL SECTIONS		F.A.I RTF	SECTION	COUNTY	TOTAL	SHEE NO.
	DRAWN -	REVISED -	STATE OF ILLINOIS		TITIONE DESTIONS		64	82-(6,7,8)PP-1	ST. CLAIR	29	19
PLOT SCALE = 100,0000 / in.	CHECKED -	REVISED -	DEPARTMENT OF TRANSPORTATION						CONTRACT	NO. 76	
PLOT DATE = 11/1/2021	DATE -	REVISED -		SCALE: NTS	SHEET 15 OF 18 SHEETS STA.	TO STA.		ILLINOIS FED. A	AID PROJECT		

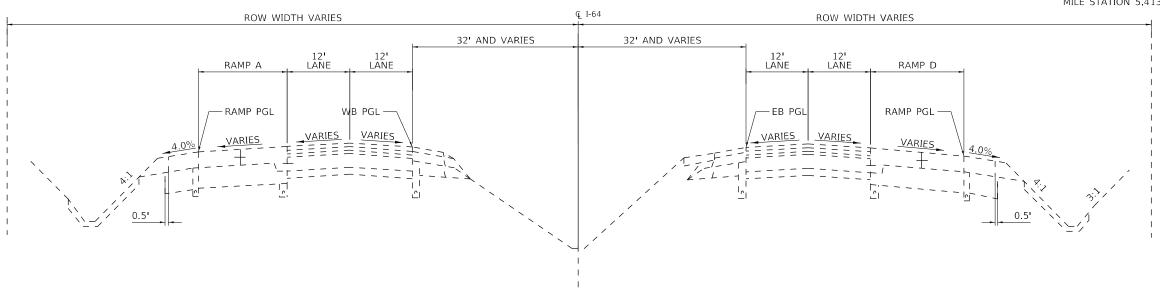

STA 1005+91.46 TO STA 1008+10.20 EB STA 1009+91.46 TO STA 1009+89.51 WB STA 1008+10.20 TO STA 1021+85.10 EB STA 1009+89.51 TO STA 1017+90.79 WB

# LEGEND C (EXISTING)

- (1) CONTINUOUSLY REINFORCED PCC PAVEMENT, 8"
- (2) PCC PAVEMENT, 10"
- 3 LONGITUDINAL CONSTRUCTION JOINT USE NO. 6
  TIE BARS AT 24" CTS AND 24" LONG, DRILLED
  AND GROUTED (COST INCLUDED IN PCC ITEMS)
- 4) PCC SHOULDERS, 8"
- 5 POLYMERIZED HMA SURFACE COURSE, STONE MATRIX ASPHALT, N80, 2"
- (6) PCC SHOULDERS, 10"
- (7) HMA SHOULDERS, 8"
- (8) PCC PAVEMENT, 9" (JOINTED)
- 9 POLYMERIZED HMA BINDER COURSE, IL-19.0, FG, N90, 4"

- (10) LONGITUDINAL CONSTRUCTION JOING USE NO. 6 TIE BARS AT 24" CTS AND 30" LONG, FORMED IN PLACE (COST INCLUDED IN PCC ITEMS)
- 11) LONGITUDINAL SAWED JOINT USE NO. 6 TIE BARS AT 30" CTS AND 30" LONG (COST INCLUDED IN PCC ITEMS)
- (12) POUROUS GRANULAR EMBANKMENT, SUBGRADE
- (13) AGGREGATE SHOULDER, TYPE B
- (14) PCC SHOULDERS, 9"
- 15) HMA PAVEMENT (FULL DEPTH), 12 1/2" (2" SURFACE COURSE, 10 1/2" BINDER COURSE)
- 16) HMA PACEMENT (FULL DEPTH), 13 1/2" (2" SURFACE COURSE, 11 1/2" BINDER COURSE)
- (17) CONCRETE BARRIER, DOUBLE FACE, 42" HEIGHT

- (18) PIPE UNDERDRAINS, 6"
- (19) PIPE UNDERDRAINS. 4"
- (20) STORM SEWER
- (21) FILTER FABRIC
- (22) HMA SURFACE COURSE, MIX "C", N50, 2"
- (23) BITUMINOUS MATERIALS (PRIME COAT)
- (24) COMBINATION CONCRETE CURB AND GUTTER TYPE B-6.24
- (25) COMBINATION CONCRETE CURB AND GUTTER TYPE B-6.12
- 26) COMBINATION CONCRETE CURB AND GUTTER TYPE B-6.06

SCALE: NTS


SHEET 16


- 27) CONCRETE MEDIAN SURFACE. 4"
- (28) PAVEMENT FABRIC

- 29) AGGREAGE BASE COURSE, TYPE A, 12"
- (30) TOPSOIL EXCAVATION AND PLACEMENT, 4"
- (31) COURSE AGGREGATE
- (32) INCIDENTAL HMA SURFACING, 3"
- 33) HMA PAVEMENT (FULL DEPTH), 12" (2' SURFACE COURSE, 11" BINDER COURSE)
- (34) HMA SHOULDERS, 13"
- (35) EMBANKMENT
- 36 SEE PAVEMENT LOG DETAIL RAMPS ADJACENT TO I-64
- (37) STABILIZED SUBBASE HMA, 4"

USER NAME = smithma	DESIGNED -	REVISED -	
	DRAWN -	REVISED -	ST
PLOT SCALE = 100.0000 / in.	CHECKED -	REVISED -	DEPARTME
PLOT DATE = 11/1/2021	DATE -	REVISED -	

TYPICAL SECTIONS				F.A.I RTE	SEC.	ΓΙΟΝ		COUNTY	TOTAL SHEETS	SHEET NO.	
					64	82-(6,7	,8)PP-1		ST. CLAIR	29	20
									CONTRACT	NO. 76	5P88
OF	18	SHEETS	STA	TO STA.			THUMOTE	EED A	ID DOOLECT		

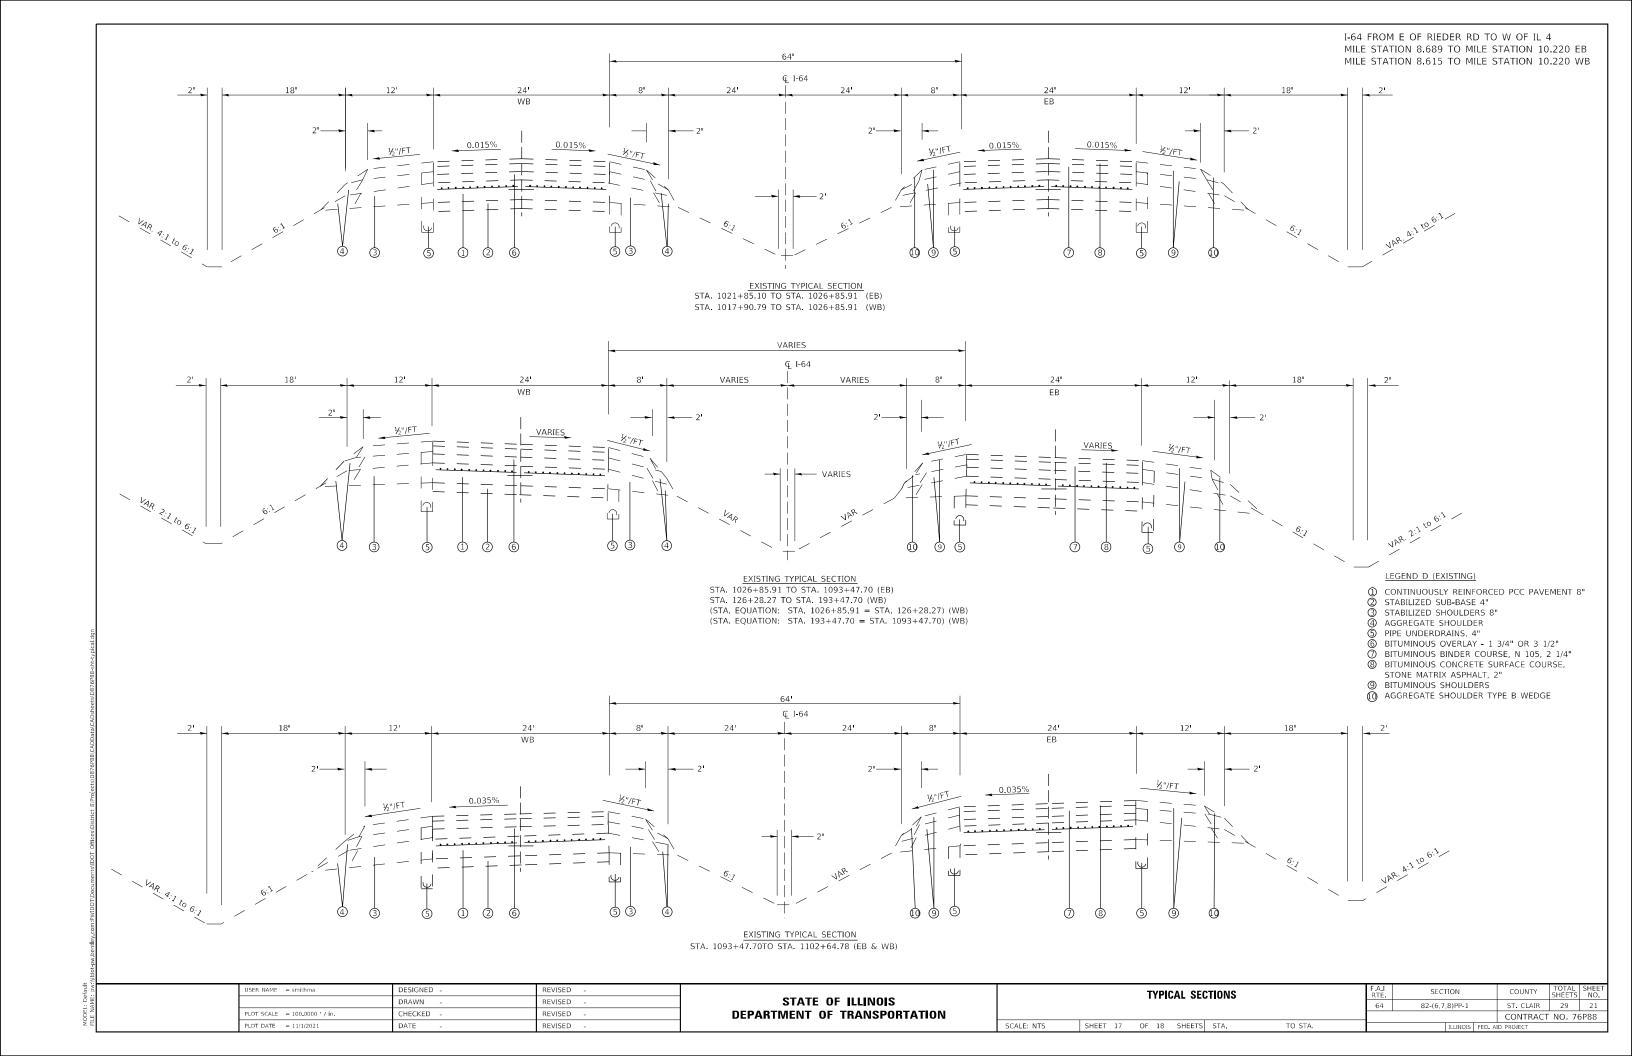


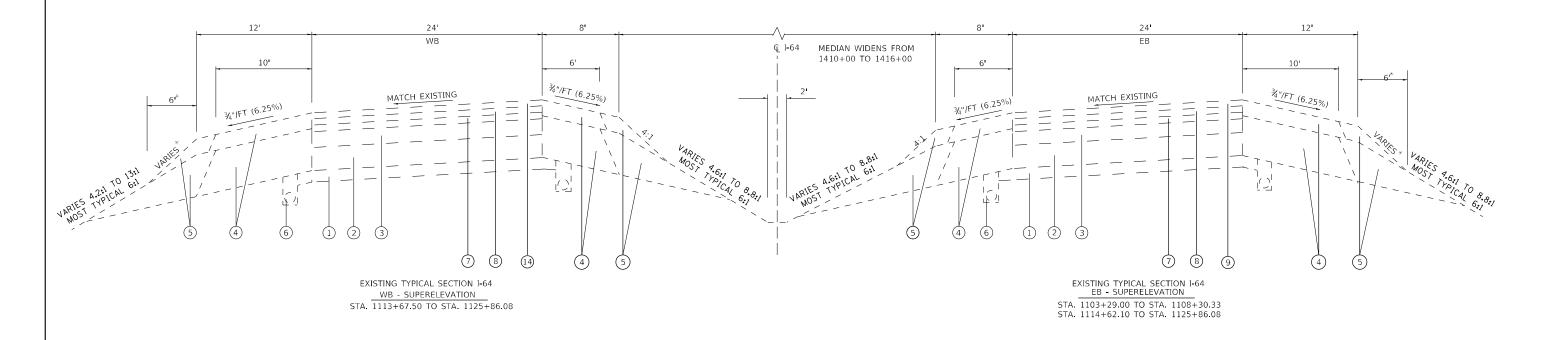

\*TOUCH-DOWN POINT FOR AGGREGATE SHOULDER WEDGE, TYPE B, TO EXISTING SLOPE SHALL BE 6' FROM EDGE OF SHOULDER. THE FLATEST SLOPE POSSIBLE SHALL BE USED WITHIN THE 6' MAXIMUM HORIZONTAL DISTANCE. THE STEEPEST ALLOWABLE AGGREGATE SLOPE SHALL BE 3:1.

# LEGEND E (EXISTING)

- 1 EXISTING SUB-BASE 4"
- 2) EXISTING C.R.P.C.C. PAVEMENT 8"
- ③ EXISTING RESURFACING 5-1/2" OR 7-1/4"
- (4) EXISTING BITUMINOUS SHOULDER
- 5 EXISTING AGGREGATE SHOULDER, TYPE B
- 6 EXISTING PIPE UNDERDRAINS
- $\bigcirc$  PROPOSED HOT MIX ASPHALT BINDER COURSE, IL-19.0, N105  $2\frac{1}{4}$ "
- 8 PROPOSED POLYMERIZED HOT-MIX ASPHALT BINDER COURSE N-105 4½"
- PROPOSED POLYMERIZED HOT-MIX ASPHALT SURFACE COURSE STONE MATRIX ASPHALT N80 2"

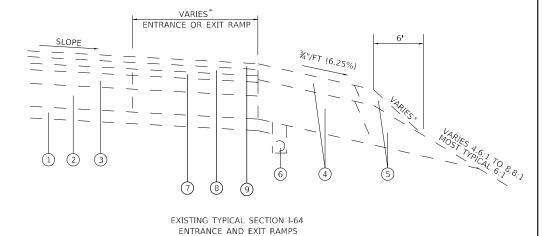

EASTBOUND

STA. 1108+30.33 TO STA. 1114+62.10

<u>WESTBOUND</u> STA. 1103+03.00 TO STA. 1113+67.50

USER NAME = smithma	DESIGNED -	REVISED -
	DRAWN -	REVISED -
PLOT SCALE = 100.0000 / in.	CHECKED -	REVISED -
PLOT DATE = 11/1/2021	DATE -	REVISED -

		TYPIC	CAL SEC	F.A.I RTE	SECTION	COUNTY	TOTAL SHEETS	SHEET NO.		
				64	82-(6,7,8)PP-1	ST. CLAIR	29	22		
								CONTRAC	T NO. 7	6P88
SCALE: NTS	SHEET 18	OF 18	SHEETS	STA.	TO STA.		ILLINOIS FED.	AID PROJECT		

t 8/Projects\D876P88\CADData\CADs	
Offices/District	
pw:\\ildot-pw.bentley.com:PWIDOT\Documents\IDOT Offices\District	
ij	ı

USER NAME = smithma	DESIGNED -	REVISED -
	DRAWN -	REVISED -
PLOT SCALE = 100.0000 / in.	CHECKED -	REVISED -
PLOT DATE = 11/1/2021	DATE -	REVISED -

SCALE:

	;	SCHEDUL	E OF QI	JANTITIES	F.A.I RTE. SECTION			COUNTY	TOTAL SHEETS	SHEET NO.	
						64	82-(6,7,8)PP-1	ST. CLAIR	29	23	
						CONTRACT			NO. 76	5P88	
SHEET	1	OF 4	SHEETS	STA.	TO STA.		ILLINOIS FED. AID PROJECT				

DL - DRIVING LANE
ML - MIDDLE LANE
PL - PASSING LANE

USER NAME = smithma	DESIGNED -	REVISED -
	DRAWN -	REVISED -
PLOT SCALE = 100.0000 / in.	CHECKED -	REVISED -
PLOT DATE = 11/1/2021	DATE -	REVISED -

SCHEDULE OF QUANTITIES	F.A.I RTE	SECTION	COUNTY	TOTAL SHEETS	SHEET NO.
	64	82-(6,7,8)PP-1	ST. CLAIR	29	24
			CONTRAC	Γ NO. 76	5P88
SHEET 2 OF 4 SHEETS STA. TO STA.		ILLINOIS FED.	AID PROJECT		

			DIMENS	1	THERMOPLASTIC	<u> </u>	<u> </u>				
N/III	E STATION	LANE	LENGTH	WIDTH	PAVEMENT MARKING - LINE 6"	PAINT PAVEMENT MARKING - LINE 6"	SHORT TERM PAVEMENT MARKING	SHORT TERM PAVEMENT MARKING	RAISED REFLECTIVE PAVEMENT MARKER	RAISED REFLECTIVE PAVEMENT MARKER	
IVII	STATION	LAINE	LENGIH	WIDIN	WHITE	WHITE	(ONE LIFT)	REMOVAL	REMOVAL		
					SKIP DASH	SKIP DASH		SQ FT		ONE-WAY CRYSTAL	
			FOOT	FOOT	FOOT	FOOT	FOOT		EACH	EACH	
WB	10.64	I-64 AT	IL Route 4								
WB	10.636	CL	50	3		13	8	3	1	1	
WB	10.33	RAMP	130	3		33	12	4	3	3	
WB	9.94	CL	3675	3	919		334	111	92	92	
WB	9.39	CL	990	3	248		90	30	25	25	
WB	9.18	CL	175	3		44	16	5	4	4	
WB	6.64	DCL	925	3	231		84	28	23	23	
WB	6.49	DCL	120	3		30	11	4	3	3	
WB	6.44	DCL	200	3		50	18	6	5	5	
WB	6.33	DCL	250	3		63	23	8	6	6	
WB	6.17	DCL	300	3		75	27	9	8	8	
WB	4.32	DCL	20	3		5	4	1	1	1	
WB	2.71	WB ON RAMP	120	3		30	11	4	3	3	
WB	2.57	WB ON RAMP	120	3		30	11	4	3	3	
WB	0.19	JOINT I-64 EAS	F OF IL ROUT	E 159							
EB	0.19	JOINT I-64 EAS	F OF IL ROUT	E 159							
EB	0.22	EB ON RAMP IL 159	40	4		10	4	1	1	1	
EB	0.30	EB ON RAMP IL 159	400	3		100	36	12	10	10	
EB	1.73	MIDDLE CL	250	3		63	23	8	6	6	
EB	1.73	DRIVING CL	250	3		63	23	8	6	6	
EB	2.11	DL	300	3		75	27	9	8	8	
EB	5.59	DRIVING CL	120	3		30	11	4	3	3	
EB	5.71	IL 158 SB OFF RAMP	300	3			27	9	8	8	
EB	7.57	CL	300	3		75	27	9	8	8	
EB	8.47	CL	300	3		75	27	9	8	8	
EB	9.33	CL	80	3		20	8	3	2	2	
		SUB - TOTAL			1398	884	863	288	237	237	
	QI	UANTITIES FROM PMS (	FFDP)			395	104	29	18	18	
		TOTAL			1398	1279	967	317	255	255	

DCL - DRIVING CENTER LINE

USER NAME = smithma	DESIGNED -	REVISED -
	DRAWN -	REVISED -
PLOT SCALE = 100.0000 / in.	CHECKED -	REVISED -
PLOT DATE = 11/1/2021	DATE -	REVISED -

SCALE:

								F.A.I RTE. SECTION			COUNTY	TOTAL SHEETS	
							64	82-(6,7,8)PP-1			ST. CLAIR	29	25
							_	CONTRACT			NO. 76	5P88	
SHEET	3	OF	4	SHEETS	STA.	TO STA.			ILLINOIS	FED. A	ID PROJECT		


DL - DRIVING LANE ML - MIDDLE LANE PL - PASSING LANE


STATE OF ILLINOIS
DEPARTMENT OF TRANSPORTATION


 SCHEDULE OF QUANTITIES
 F.A.I RTE. RTE. RTE. RTE. SECTION
 COUNTY SHEETS NO.
 TOTAL SHEETS NO.

 64
 82-(6,7,8)PP-1
 ST. CLAIR
 29
 26


 SHEET 4
 OF 4 SHEETS STA.
 TO STA.
 ILLIMOIS FED. ALD PROJECT

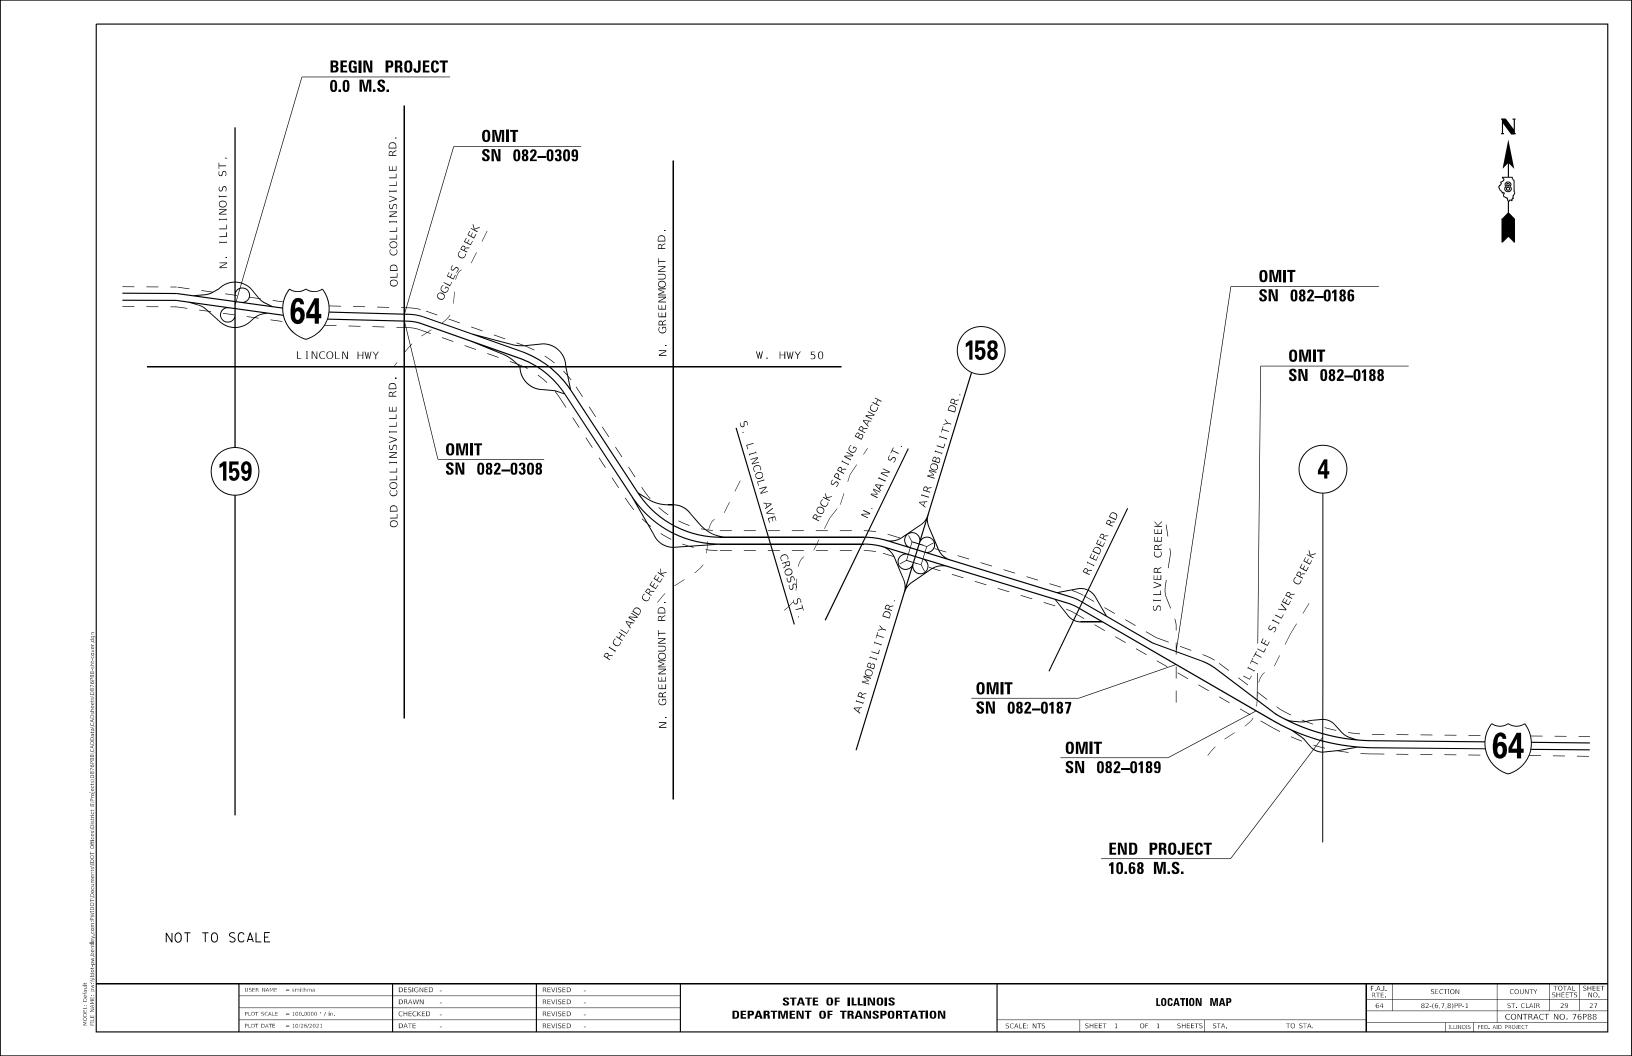


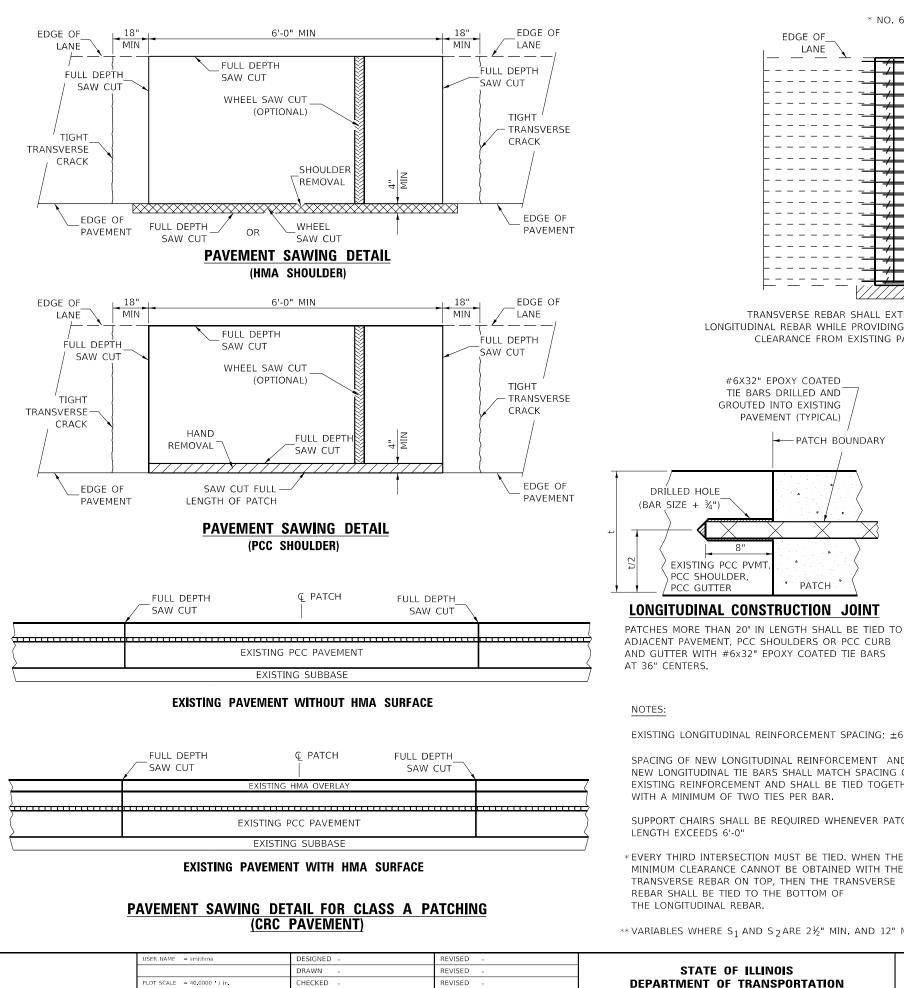

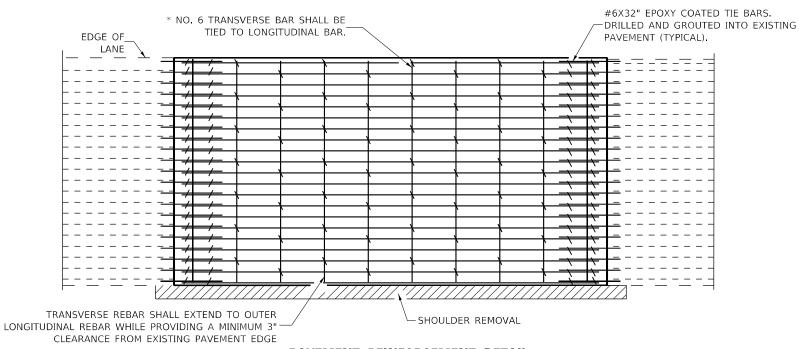

# **PAVEMENT REINFORCEMENT DETAIL**

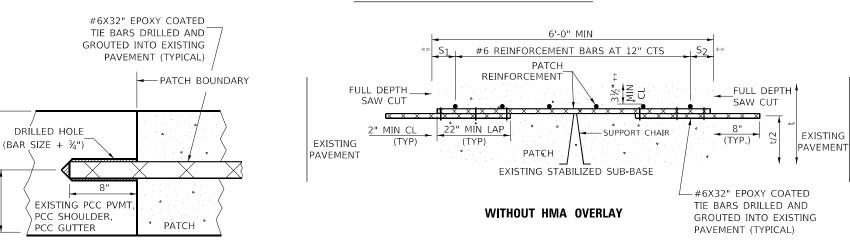

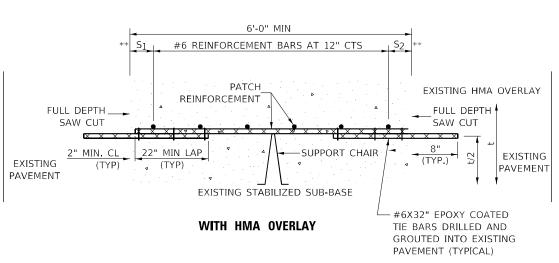

# PATCHING DETAIL FOR CLASS A PATCHING (CRC PAVEMENT)

EXISTING LONGITUDINAL REINFORCEMENT SPACING; ±6½".

SPACING OF NEW LONGITUDINAL REINFORCEMENT AND NEW LONGITUDINAL TIE BARS SHALL MATCH SPACING OF EXISTING REINFORCEMENT AND SHALL BE TIED TOGETHER WITH A MINIMUM OF TWO TIES PER BAR.

SUPPORT CHAIRS SHALL BE REQUIRED WHENEVER PATCH LENGTH EXCEEDS 6'-0"


\* EVERY THIRD INTERSECTION MUST BE TIED. WHEN THE MINIMUM CLEARANCE CANNOT BE OBTAINED WITH THE TRANSVERSE REBAR ON TOP, THEN THE TRANSVERSE REBAR SHALL BE TIED TO THE BOTTOM OF THE LONGITUDINAL REBAR.

\*\* VARIABLES WHERE S $_1$  AND S $_2$ ARE  $2\frac{1}{2}$ " MIN. AND 12" MAX.


SCALE: NONE

CLASS A PATCHING (SPECIAL) DETAIL					F.A.I RTE	SECTION		COUNTY	TOTAL SHEETS	SHEET NO.				
						64	82-(6,7	,8)PP-1		ST. CLAIR	29	28		
												CONTRACT	NO. 70	5P88
SHEET 1	1	OF :	2	SHEETS	STA.		TO STA.			TELINOIS	EED ΔI	ID PROJECT		

# TRANSVERSE EXPANSION JOINTS

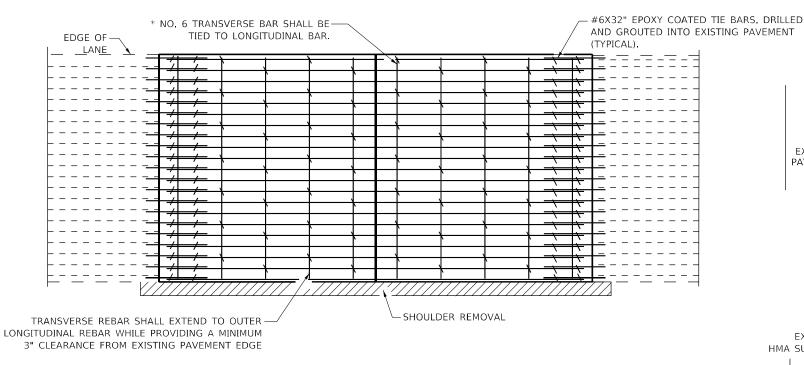



# PAVEMENT REINFORCEMENT DETAIL

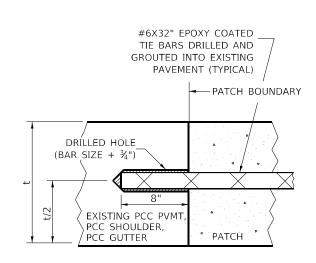

# LONGITUDINAL CONSTRUCTION JOINT

PATCHES MORE THAN 20' IN LENGTH SHALL BE TIED TO ADJACENT PAVEMENT, PCC SHOULDERS OR PCC CURB AND GUTTER WITH #6x32" EPOXY COATED TIE BARS AT 36" CENTERS.

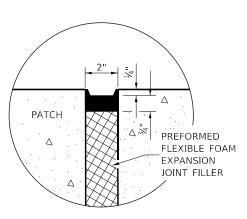

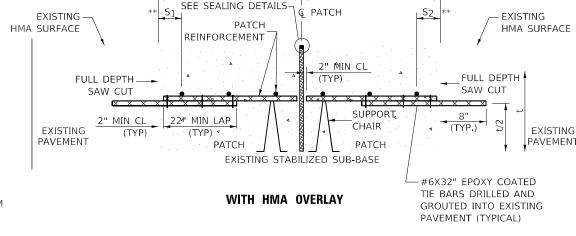

CLASS A PATCH WITH EXPANSION JOINT

12'-0" MIN

EXISTING STABILIZED SUB-BASE

12'-0" MIN

WITHOUT HMA OVERLAY

© PATCH

6'-0" MIN

SUPPORT

CHAIR

PATCH

6'-0" MIN

\_FULL DEPTH SAW CUT

EXISTING

PAVEMENT

-#6X32" EPOXY COATED
TIE BARS DRILLED AND

GROUTED INTO EXISTING PAVEMENT (TYPICAL)

6'-0" MIN

SEE SEALING DETAILS

6'-0" MIN

REINFORCEMENT

22" MIN LAP

4 (TYP)


FULL DEPTH —►

(TYP)

SAW CUT

PAVEMENT

# SEALING DETAIL

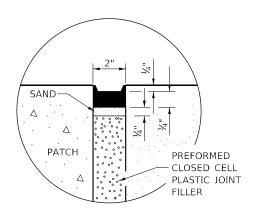

# **SEALING DETAIL**

# NOTES:

EXISTING LONGITUDINAL REINFORCEMENT SPACING; ±6½".

SPACING OF NEW LONGITUDINAL REINFORCEMENT AND NEW LONGITUDINAL TIE BARS SHALL MATCH SPACING OF EXISTING REINFORCEMENT AND SHALL BE TIED TOGETHER WITH A MINIMUM OF TWO TIES PER BAR.

SUPPORT CHAIRS SHALL BE REQUIRED WHENEVER PATCH LENGTH EXCEEDS 6'-0"

\* EVERY THIRD INTERSECTION MUST BE TIED. WHEN THE MINIMUM CLEARANCE CANNOT BE OBTAINED WITH THE TRANSVERSE REBAR ON TOP, THEN THE TRANSVERSE REBAR SHALL BE TIED TO THE BOTTOM OF THE LONGITUDINAL REBAR.

\*\* VARIABLES WHERE S  $_1$  AND S  $_2$  ARE 2½" MIN. AND 12" MAX.

29

USER NAME = smithma	DESIGNED -	REVISED -
	DRAWN -	REVISED -
PLOT SCALE = 40.0000 / in.	CHECKED -	REVISED -
PLOT DATE = 12/1/2021	DATE -	REVISED -

		F.A.I RTE	SECTION	COUNTY	TOTAL SHEETS
CLASS A PATCHING (SPECIAL) DETAIL	Ī	64	82-(6,7,8)PP-1	ST. CLAIR	29
				CONTRACT	NO. 76