01-21-2022 LETTING ITEM 005

STATE OF ILLINOIS

DEPARTMENT OF TRANSPORTATION

PROPOSED HIGHWAY PLANS

FAI ROUTE 57 (I-57) AT FAI ROUTE 80
SECTION 2020-171-BR
FEDERAL PROJECT NUMBER NHPP-EU3I(520)
BRIDGE REHABILITATION AND DECK OVERLAY
COOK COUNTY
C-91-369-20

FOR INDEX OF SHEETS, SEE SHEET NO. 2

DESIGN DESIGNATION:
INTERSTATE
FAI ROUTE 57
2019 ADT = 124,300
POSTED SPEED LIMIT 55 MPH


0

0

0

0

DESIGN DESIGNATION:
INTERSTATE
FAI ROUTE 80
2019 ADT=118,200
POSTED SPEED LIMIT 55 MPH

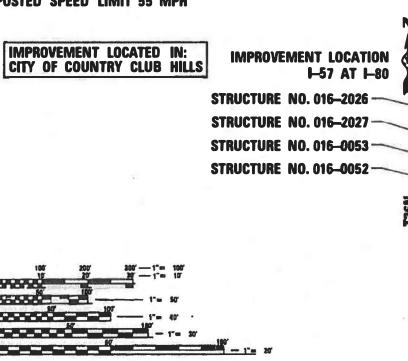


FULL SEZE PLANS HAVE BEEN PREPARED USING STANDARD ENGINEERING SCALES. REDUCED SIZED PLANS WILL NOT CONFORM TO STANDARD SCALES. IN MAKING MEASUREMENTS ON REDUCED PLANS, THE ABOVE SCALES MAY BE USED.

J.U.L.E.
JOHN UTILITY LOCATION INFORMATION FOR EXCAVATORS
1-800-892-0123
OR 811

PROJECT ENGINEER: MR. DANIEL P. WILGREEN, PE (847) 705-4240
PROJECT MANAGER: MR. FAWAD AQUEEL, PE, PTOE (847) 705-4211

CONTRACT NO. 62M54

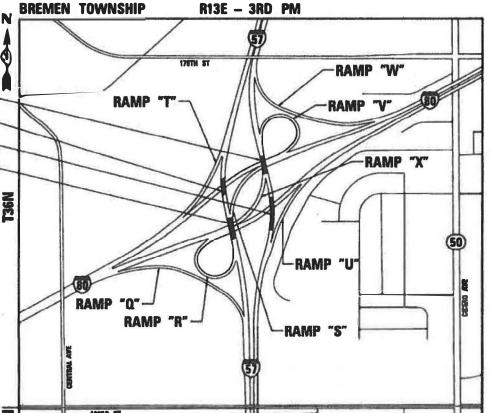


LOCATION MAP (NOT TO SCALE)
GROSS LENGTH = 2077 FT = 0.393 MILE
NET LENGTH = 1334 FT = 0.253 MILE



WWW.ACCGI.COM
101 SCHELTER RD.. SUITE B-200
LINCOLNSHIRE, ILLINOIS 80089
T (847) 613-1100 F (847) 613-1105
ILLINOIS PORESSIONA DESIGN FRM NO BALOZOS

D-91-570-20

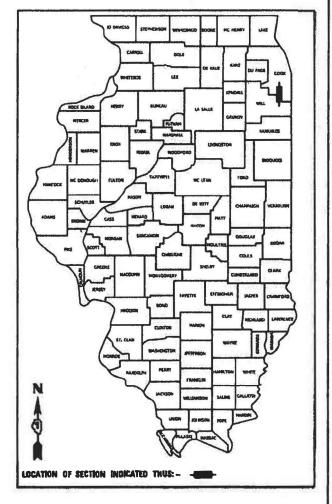



PRINTED BY THE AUTHORITY OF THE STATE OF ILLINOIS

INDEX OF SHEETS

SHEET N	IO. DESCRIPTION
1	COVER SHEET
2	INDEX OF SHEETS, STATE HIGHWAY STANDARDS, AND GENERAL NOTES
3-13	SUMMARY OF QUANTITIES
14-16	TYPICAL SECTIONS AND DETAILS
17-22	SCHEDULES OF QUANTITIES
23-29	REMOVAL AND PROPOSED PLANS
30-33	LANDSCAPE REMOVAL PLANS
34- 7 6	SUGGESTED TRAFFIC CONTROL AND PROTECTION
77-82	PAVEMENT MARKING PLANS
83-86	LANDSCAPING PLANS
87	LANDSCAPING OPERATIONS CALENDAR
88-111	STRUCTURE PLANS SN 016-2026
112-134	STRUCTURE PLANS SN 016-2027
135-157	STRUCTURE PLANS SN 016-0052
158-177	STRUCTURE PLANS SN 016-0053
178	BD-32 BUTT JOINT AND HMA TAPER
179	TC-08 ENTRANCE AND EXIT RAMP CLOSURE DETAILS
180	TC-09 FREEWAY SINGLE AND MULTI-LANE WEAVE
181	TC-11 RAISED REFLECTIVE PAVEMENT MARKERS (SNOW PLOW RESISTANT)
182-183	1 1 - 1 - 1 - 1 - 1 - 1 - 1 - 1 - 1
184	TC-13 DISTRICT ONE TYPICAL PAVEMENT MARKINGS
185	TC-16 SHORT TERM PAVEMENT MARKING LETTERS AND SYMBOLS
186	TC-17 TRAFFIC CONTROL DETAILS FOR FREEWAY SHOULDER CLOSURES AND PARTIAL RAMP CLOSURES
187	TC-18 SIGNING FOR FLAGGING OPERATIONS AT WORK ZONE OPENINGS
188	TC-22 ARTERIAL ROAD INFORMATION SIGN
189	TC-25 CENTER LANE CLOSURE, AND SHOULDER LANE
190	TC-33 SMART TRAFFIC MONITORING SYSTEM TYPICAL LAYOUT

STATE OF ILLINOIS HIGHWAY STANDARDS

STANDARD NO.	DESCRIPTION
000001-08	STANDARD SYMBOLS, ABBREVIATIONS, AND PATTERNS
001001-02	AREAS OF REINFORCEMENT BARS
001006	DECIMAL OF AN INCH AND OF A FOOT
420001-10	PAVEMENT JOINTS
420401-13	PAVEMENT CONNECTOR (PCC) FOR BRIDGE APPROACH SLAB
442001-04	CLASS A PATCHES
442201-03	CLASS C AND D PATCHES
630001-12	STEEL PLATE BEAM GUARDRAIL
631031-17	TRAFFIC BARRIER TERMINAL, TYPE 6
631046-04	TRAFFIC BARRIER TERMINAL, TYPE 10
642001-03	SHOULDER RUMBLE STRIPS, 16 IN.
701106-02	OFF-ROAD OPERATIONS, MULTILANE, MORE THAN 15' (4.5 M) AWAY
701400-11	APPROACH TO LANE CLOSURE, FREEWAY/ EXPRESSWAY
701401-13	LANE CLOSURE, FREEWAY/EXPRESSWAY, DAY OPERATIONS ONLY
701411-09	LANE CLOSURE, MULTILANE, AT ENTRANCE OR EXIT RAMP, FOR SPEEDS ≥ 45 MPH
701428-01	TRAFFIC CONTROL SETUP AND REMOVAL FREEWAY/EXPRESSWAY
701446-11	TWO LANE CLOSURE, FREEWAY/EXPRESSWAY
701901-08	TRAFFIC CONTROL DEVICES
704001-08	TEMPORARY CONCRETE BARRIER
781001-04	TYPICAL APPLICATIONS RAISED REFLECTIVE PAVEMENT MARKERS
782006-01	GUARDRAIL AND BARRIER WALL REFLECTOR MOUNTING DETAILS

COMMITMENTS

NONE

GENERAL NOTES

- ALL CONSTRUCTION SHALL BE DONE IN ACCORDANCE WITH THE STANDARD SPECIFICATIONS FOR ROAD AND BRIDGE CONSTRUCTION ADOPTED
 JANUARY 1, 2022 HEREIN AFTER REFERRED TO AS THE STANDARD SPECIFICATIONS, THE SUPPLEMENTAL SPECIFICATIONS AND RECURRING SPECIAL
 PROVISIONS ADOPTED JANUARY 1, 2022, THE LATEST EDITION OF THE ILLINOIS MANUAL ON UNIFORM TRAFFIC CONTROL DEVICES FOR STREETS AND
 HIGHWAYS, THE DETAILS IN THE PLANS, AND THE SPECIAL PROVISIONS INCLUDED IN THE CONTRACT DOCUMENTS.
- BEFORE STARTING ANY EXCAVATION, THE CONTRACTOR MUST CALL "J.U.L.I.E." AT (800) 892-0123 OR 811 FOR FIELD LOCATIONS OF BURIED ELECTRIC, TELEPHONE, AND GAS FACILITIES. NOTICE 48 HOURS IN ADVANCE IS REQUIRED.
- 3. THE CONTRACTOR SHALL COORDINATE CONSTRUCTION ACTIVITIES WITH UTILITY COMPANIES AND THE CITY OF COUNTRY CLUB HILLS.
- THE CONTRACTOR MUST CONTACT THE EXPRESSWAY TRAFFIC CONTROL SUPERVISOR AT (847) 705-4155 A MINIMUM OF 72
 HOURS PRIOR TO THE INSTALLATION OF ANY TEMPORARY TRAFFIC CONTROL DEVICES.
- 5. DO NOT SCALE PLANS FOR CONSTRUCTION DIMENSIONS.

GENERAL NOTES CONTINUED

- 6. PLAN DIMENSIONS AND DETAILS ARE SUBJECT TO ROUTINE VARIATIONS. THE CONTRACTOR SHALL VERIFY EXISTING DIMENSIONS AND DETAILS AFFECTING NEW CONSTRUCTION AND GAIN APPROVAL FOR NECESSARY ADJUSTMENTS PRIOR TO ORDERING MATERIALS. SUCH VARIATIONS SHALL NOT BE CAUSE FOR ADDITIONAL COMPENSATION IF THEY RESULT IN A CHANGE IN THE SCOPE OF THE WORK. HOWEVER, THE CONTRACTOR WILL BE PAID FOR QUANTITIES ACTUALLY FURNISHED, BASED ON THE BID UNIT PRICE.
- 7. THE CONTRACTOR WILL NOT BE ALLOWED TO SET UP A YARD OR FIELD OFFICE ON STATE PROPERTY WITHOUT WRITTEN PERMISSION FROM THE DEPARTMENT
- 8. THE RESIDENT ENGINEER SHALL CONTACT REGINA COOPER, AREA TRAFFIC FIELD ENGINEER AT (847) 705-4153 A MINIMUM OF TWO (2) WEEKS PRIOR TO THE PLACEMENT OF PERMANENT PAVEMENT MARKINGS.
- 9. BEFORE BEGINNING WORK, THE CONTRACTOR SHALL RETAIN AND RECORD FOR FUTURE REFERENCE ALL EXISTING PAVEMENT MARKING LINES, LETTERS AND SYMBOLS, AND RAISED REFLECTIVE PAVEMENT MARKERS, SO THAT THEIR LOCATIONS MAY BE REESTABLISHED. EXACT LOCATIONS OF ALL PAVEMENT MARKERS SHALL BE AS DIRECTED BY THE RESIDENT ENGINEER.
- 10. ANY PAVEMENT MARKINGS AND RAISED REFLECTIVE PAVEMENT MARKERS OUTSIDE THE REMOVAL LINE SHOWN ON THE PLANS THAT ARE DAMAGED DURING CONSTRUCTION SHALL BE REPLACED AT NO ADDITIONAL COST TO THE DEPARTMENT.
- 11. IMMEDIATELY AFTER THE COMPLETION OF CONSTRUCTION, THE CONTRACTOR SHALL RESTORE ALL PERMANENT PAVEMENT MARKINGS, SIGNS, AND OTHER TRAFFIC CONTROL DEVICES THAT WERE COVERED IF THEY WERE REMOVED, DAMAGED, OR OTHERWISE AFFECTED BY CONSTRUCTION. THE COST TO REPAIR ANY DAMAGES WILL BE BORNE BY THE CONTRACTOR AND WILL NOT BE THE RESPONSIBILITY OF THE DEPARTMENT.
- 12. THE CONTRACTOR MUST EXERCISE CAUTION WHEN REMOVING OR EXCAVATING NEAR ALL EXISTING ITEMS WHICH ARE TO REMAIN. ANY DAMAGE DONE TO EXISTING ITEMS BY THE CONTRACTOR WILL BE REPAIRED AT THE CONTRACTOR'S EXPENSE.
- 13. THE CONTRACTOR IS RESPONSIBLE FOR THE PROTECTION OF ALL UNDERGROUND AND SURFACE UTILITIES, EVEN THOSE NOT SHOWN IN PLANS. ANY UTILITY PROPERTY DAMAGED DURING CONSTRUCTION SHALL BE REPAIRED OR REPLACED TO THE SATISFACTION OF THE RESIDENT ENGINEER.
- 14. NO MATERIAL OR EQUIPMENT SHALL BE LEFT ON OR NEAR THE ROADWAY DURING NON-WORKING HOURS.
- 15. BUTT JOINTS WILL BE INSTALLED AS SHOWN IN THE PLANS (WHERE RESURFACING MEETS THE EXISTING PAVEMENT) WILL BE INSTALLED IN ACCORDANCE WITH THE DISTRICT ONE "BUTT JOINT AND HMA TAPER DETAILS" (BD-32).
- 16. IDOT FACILITIES ARE NOT LOCATED BY JULIE OR DIGGER. IDOT ELECTRICAL FACILITIES INCLUDING ROADWAY LIGHTING, FIBER OPTIC, ITS EQUIPMENT, TRAFFIC SIGNAL AND PUMP STATION FACILITIES ARE LOCATED BY THE DEPARTMENT'S ELECTRICAL MAINTENANCE CONTRACTOR. AS OF THE LETTING DATE, CONTACT THE MEADE ELECTRIC COMPANY AT (773) 287-7672.
- 17. A MAINTENANCE OF TRAFFIC PLAN SHALL BE SUBMITTED TO THE DISTRICT ONE EXPRESSWAY TRAFFIC CONTROL SUPERVISOR 14 DAYS IN ADVANCE OF ANY STAGE CHANGES OR FULL EXPRESSWAY CLOSURES. THE MAINTENANCE OF TRAFFIC PLAN SHALL INCLUDE, BUT NOT BE LIMITED TO: LANE AND RAMP CLOSURES, EXISTING GEOMETRICS, AND EQUIPMENT AND MATERIAL LOCATION.
- 18. THE CONTRACTOR SHALL REQUEST AND GAIN APPROVAL FROM THE ILLINOIS DEPARTMENT OF TRANSPORTATION'S EXPRESSWAY TRAFFIC OPERATIONS ENGINEER AT WWW.IDOTLCS.COM TWENTY-FOUR (24) HOURS IN ADVANCE OF ALL DAILY LANE, RAMP, AND SHOULDER CLOSURES AND 7 DAYS IN ADVANCE OF ALL PERMANENT AND WEEKEND CLOSURES ON ALL FREEWAYS AND/OR EXPRESSWAYS IN DISTRICT ONE, THIS ADVANCE NOTIFICATION IS CALCULATED BASED ON A WORK-WEEK OF MONDAY THROUGH FRIDAY AND SHALL NOT INCLUDE WEEKENDS OR HOLIDAYS.
- 19. STATIONS AND OFFSETS SHOWN IN PLANS ARE APPROXIMATE.

INDEX

- 20. THE CONTRACTOR WILL CONTACT THE ROADSIDE DEVELOPMENT UNIT AT (847) 705-4171, TO SCHEDULE A WALK THROUGH TO DETERMINE TREES FOR PRUNING, ROOT PRUNING, REMOVAL. AND SELECTIVE CLEARING AT LEAST 14 DAYS PRIOR TO THE COMMENCEMENT OF TREE REMOVAL.
- 21. THE CONTRACTOR SHALL TAKE EXTRA CARE IN GRADING AND EXCAVATING NEAR TREES WHICH ARE NOT MARKED FOR REMOVAL SO AS NOT TO CAUSE INJURY TO THE ROOT SYSTEM OR TRUNKS. ANY DAMAGE DONE TO EXISTING ITEMS BY THE CONTRACTOR SHALL BE REPAIRED BY THE CONTRACTOR AT THE CONTRACTOR'S OWN EXPENSE.
- 22. PHOSPHORUS FERTILIZER HAS BEEN INTENTIONALLY OMITTED FROM THE CONTRACT DUE TO THE PROXIMITY TO EXISTING WET AREAS. A PHOSPHORUS-FREE FERTILIZER SHALL BE USED (MIDDLE NUMBER SHOULD EQUAL 0).
- 23. THE CONTRACTOR WILL CONTACT THE ROADSIDE DEVELOPMENT UNIT AT (847) 705-4171, TO SCHEDULE LAYOUT OF AREAS TO BE TREATED WITH HERBICIDES AT LEAST 7 DAYS PRIOR TO APPLICATION.
- 24. THE CONTRACTOR SHALL OBSERVE AND COMPLY WITH ALL SECTIONS OF THE ILLINOIS CUSTOM SPRAY LAW, INCLUDING LICENSING. CONTRACTOR PERSONNEL APPLYING HERBICIDES SHALL HAVE A VALID PESTICIDE APPLICATOR LICENSE ISSUED BY THE ILLINOIS DEPARTMENT OF AGRICULTURE. THE LICENSED PESTICIDE APPLICATOR SHALL SUBMIT THEIR CURRENT LICENSE TO THE ENGINEER. THE LICENSED PESTICIDE APPLICATOR SHALL BE QUALIFIED AT A MINIMUM IN RIGHT-OF-WAY AND AQUATICS. ONLY LICENSED PESTICIDE APPLICATORS SHALL WORK ON-SITE.
- 25. THE REMOVAL OF GUARDRAIL TERMINAL SECTIONS SHALL BE INCLUDED IN THE UNIT PRICE PER FOOT FOR GUARDRAIL REMOVAL.
- 26. THE SEEDING DATES FOR BARE EARTH SEEDING OF MIXTURE CLASS 2A SHALL BE FROM APRIL 1 TO JUNE 1 AND FROM AUGUST 15 TO SEPTEMBER 30. ALL SEEDING NOT SOWN ACCORDING TO THE SPECIFIED SEASONAL DATE SHALL REQUIRED PRIOR WRITTED APPROVAL FROM THE ENGINEER. FAILURE TO SECURE SUCH APPROVAL SHALL RESULT IN THE REJECTION OF THE SEEDING AND REPLACEMENT BY THE CONTRACTOR AT THEIR EXPENSE.
- 27. THE SEEDING DATES FOR BARE EARTH SEEDING OF MIXUTRE CLASS 4A (MODIFIED) AND CLASS 4B (MODIFIED) SHALL BE FROM OCTOBER 15 TO MARCH 15. ALL SEEDING NOT SOWN ACCORDING TO THE SPECIFIED SEASONAL DATE SHALL REQUIRED PRIOR WRITTEN APPROVAL FROM THE ENGINEER. FAILURE TO SECURE SUCH APPROVAL SHALL RESULT IN THE REJECTION OF THE SEEDING AND REPLACEMENT BY THE CONTRACTOR AT THEIR EXPENSE.
- 28. THE SUBGRADE STABILITY SHALL BE VERIFIED BY PROOF ROLLING WITH A FULLY LOADED TANDEM-AXLE TRUCK.
- 29. GEOTECHNICAL FABRIC FOR GROUND STABILIZATION AND/OR AGGREGATE SUBGRADE IMPROVEMENT (CU YD) HAVE BEEN PROVIDED FOR USE AT THE LOCATIONS INDICATED FOR SOILS THAT TEND TO BE UNSTABLE AND/OR UNSUITABLE. THE ACTUAL NEED FOR REMOVAL AND REPLACEMENT WITH ABOVE ITEM WILL BE DETERMINED IN THE FIELD AT THE TIME OF CONSTRUCTION BY THE GEOTECHNICAL ENGINEER. ALL POTENTIALLY UNSTABLE SOILS SHOULD BE TESTED WITH A STATIC OR DYNAMIC CONE PENETROMETER AND TREATED
 - IN ACCORDANCE WITH ARTICLE 301.04 OF THE SSRBC AND IDOT SUBGRADE STABILITY MANUAL. IF UNSTABLE AND/OR UNSUITABLE SOILS ARE NOT ENCOUNTERED, THEN THE QUANTITY SHALL BE DEDUCTED AND NO ADDITIONAL COMPENSATION WILL BE DUE TO THE CONTRACTOR.
- 30. ANY AGGREGATE SUBGRADE IMPROVEMENT CONTAMINATED AND/OR DAMAGED BY THE CONTRACTOR'S VEHICLES AND/OR EQUIPMENTS IS TO BE REMOVED AND REPLACED AS DIRECT BY THE ENGINEER AT CONTRACTOR EXPENSE.
- 31. THE CONTRACTOR SHALL ENSURE THAT ALL WORKERS FOLLOW CURRENT OSHA RULES AND OTHER APPLICABLE GUIDELINES REGARDING WORKING SAFELY AROUND EXISTING OVERHEAD DISTRIBUTION ELECTRICAL FACILITIES. THE CONTRACTOR SHALL CONTACT AT 1-800-334-7661 TO REQUEST "FACILITY PROTECTION".



USER NAME = jent	DESIGNED - DW	REVISED -
	DRAWN - DW	REVISED -
PLOT SCALE = 2.0000 ' / in.	CHECKED - AB	REVISED -
PLOT DATE = 12/10/2021	DATE - 10-08-2021	REVISED -

STATE	0F	ILLINOIS
DEPARTMENT ()F T	RANSPORTATION

OF SHE	ETS, ST	TATE HIG	HWAY STA	NDARDS, AND	GENERAL NOTES	F.A.I. RTE.	SECTION	COUNTY	TOTAL SHEETS	SHEET NO.
		L 67 AT	I-80 INTE	RCHANGE	57	2020-171-BR	COOK	190	2	
		I-J/ AI	I-00 INTL	ICHANGE				CONTRACT	NO. 62	2M54
i	SHEET	OF	SHEETS	STA.	TO STA.		LILLINOIS LEED A	D PROJECT NHPP-	EU3I(520)	

			STATE 10% FED 90%								
				ROADWAY	BR I DGE	BRIDGE	BR I DGE	BR I DGE			
CODE			TOTAL	0005	0047	0047	0047	0047			
NO.	ITEM	UNIT	QUANTITY	URBAN	S.N. 016-0052	S.N. 016-0053	S.N. 016-2026	S.N. 016-2027			
			URBAN								
20100110	TREE REMOVAL (6 TO 15 UNITS DIAMETER)	UNIT	750	750							
20100210	TREE REMOVAL (OVER 15 UNITS DIAMETER)	UNIT	100	100							
20101300	TREE PRUNING (1 TO 10 INCH DIAMETER)	EACH	10	10							
20101350	TREE PRUNING (OVER 10 INCH DIAMETER)	EACH	5	5							
20101400	NITROGEN FERTILIZER NUTRIENT	POUND	225	225							
20101400	WITNOSEN FERTILIZER NOTRIENT	POUND	223	223	1						
20101600	POTASSIUM FERTILIZER NUTRIENT	POUND	225	225							
20200100	EARTH EXCAVATION	CU YD	512	512	_						
20700220	POROUS GRANULAR EMBANKMENT	CU YD	11.5		1	1.5	5	4			
		55 15	1110		<u> </u>			·			
21001000	GEOTECHNICAL FABRIC FOR GOUND STABILIZATION	CU YD	270	270							
21101605	TOPSOIL FURNISH AND PLACE, 2"	SQ YD	1285	1285							
21101645	TOPSOIL FURNISH AND PLACE, 12"	SQ YD	172	172							
21101043	TOT SOTE FUNKTISH AND FEACE, 12	30 15	172	1,2							
25000210	SEEDING, CLASS 2A	ACRE	2.50	2.50							
25000750	MOWING	ACRE	30	30							
25003200	INTERSEEDING, CLASS 2	ACRE	10	10							
							<u></u>				

* SPECIALTY ITEMS

A c	С	U GR	r our	a , inc	t :.	е	

USER NAME = jent	DESIGNED	-	JMT	REVISED -
	DRAWN	-	JMT	REVISED -
PLOT SCALE = 2.0000 ' / in.	CHECKED	-	AB	REVISED -
PLOT DATE = 10/20/2021	DATE	-	10-08-2021	REVISED -

SUMMARY OF QUANTITIES 1–57 AT 1–80 INTERCHANGE							F.A.I. SECTION				SHEET NO.
							57 2020-171-BR		COOK	190	3
		-3/ AI I-	OU HAIL	nonAlvat	<u>-</u>				CONTRACT	NO. 62	2M54
SHEET OF SHEETS STA. TO STA.						ILLINOIS FED. AID PROJECT NHPP-EU3I(520)					

						CONSTRUCTION C	JUDE		
				STATE 10%					
						FED 90%			
				ROADWAY	BR I DGE	BR I DGE	BR I DGE	BRIDGE	
CODE			TOTAL	0005	0047	0047	0047	0047	
NO.	ITEM	UNIT	QUANTITY	URBAN	S.N. 016-005	2S N 016-005	3S.N. 016-2026	S N 016-2027	
			URBAN						
25100127	MULCH, METHOD 3A	ACRE	2.1	2.1					
25100630	EROSION CONTROL BLANKET	SQ YD	6093	6093					
30300001	AGGREGATE SUBGRADE IMPROVEMENT	CU YD	105	105					
35101600	AGGREGATE BASE COURSE, TYPE B 4"	SQ YD	323	323					
40600290	BITUMINOUS MATERIALS (TACK COAT)	POUND	5353	5353					
40600982	HOT-MIX ASPHALT SURFACE REMOVAL - BUTT JOINT	SQ YD	875	875					
10603005	WAT MAY ASSUME TO MADE COMPANY AND A META	TON	665						
	HOT-MIX ASPHALT BINDER COURSE, IL-19.0, N70	TON	665	665					
40604062	HOT-MIX ASPHALT SURFACE COURSE, IL-9.5, MIX "D", N70	TON	121	121					
40004002	N70	1011	121	121					
40605026	POLYMERIZED HOT-MIX_ASPHALT_SURFACE COURSE,	TON	1387	1387					
	POLYMERIZED HOT-MIX ASPHALT SURFACE COURSE, STONE MATRIX ASPHALT, 9.5, MIX "F", N80								
42000060	WELDED WIRE REINFORCEMENT	SQ YD	719	719					
42000080	PAVEMENT CONNECTOR (PCC) FOR BRIDGE APPROACH SLAB	SQ YD	675	675					
42001300	PROTECTIVE COAT	SQ YD	3457	3457					
44000100	PAVEMENT REMOVAL	SQ YD	2388	2388					
44000157	HOT-MIX ASPHALT SURFACE REMOVAL, 2"	SQ YD	6241	6241					

* SPECIALTY ITEMS

A	С	С	U GR	а , _{INC}	е

USER NAME = jent	DESIGNED	-	JMT	REVISED	-
	DRAWN	-	JMT	REVISED	-
PLOT SCALE = 2.0000 / in	CHECKED	-	AB	REVISED	-
PLOT DATE = 10/20/2021	DATE	-	10-08-2021	REVISED	-

SCALE:

	SUMMAR	Y OF QU	ANTITIE	S	F.A.I. RTE.	SECT	ION		COUNTY	TOTAL SHEETS	SHEET NO.
I-57 AT I-80 INTERCHANGE						2020-1	2020-171-BR		COOK	190	4
	1-37 AT I	UL .	CONTRA				CONTRACT	CT NO. 62M54			
SHEET	OF	SHEETS	STA.	TO STA.	ILLINOIS FED. AI			D PROJECT NHPP-I			

rojects/20005_IDOT_DUR/WO_7 - 62M54\CADD\CADD_Sheets\Civil\

* SPECIALTY ITEMS

A	С	С	U GR	а , _{INC}	е	

USER NAME = jent	DESIGNED	-	JMT	REVISED	-
	DRAWN	-	JMT	REVISED	-
PLOT SCALE = 2.0000 / in.	CHECKED	-	AB	REVISED	-
PLOT DATE = 10/20/2021	DATE	-	10-08-2021	REVISED	-

	SUMMAR	Y OF QU	ANTITIES		F.A.I. RTE	SECT	ION		COUNTY	TOTAL SHEETS	SHEET NO.
I-57 AT I-80 INTERCHANGE						2020-171-BR		соок	190	5	
I-3/ AT I-00 INTENCHANGE									CONTRACT	NO. 62	2M54
SHEET	OF	SHEETS	STA.	TO STA.			ILLINOIS	FED. A	ID PROJECT NHPP-	EU3I(520)	

I\CADD\CADD Sheets\Civil\D162M54-sht-SOQ

						STATE 10% FED 90%		
				ROADWAY	BR I DGE	BR I DGE	BR I DGE	BR I DGE
CODE			TOTAL	0005	0047	0047	0047	0047
NO.	ITEM	UNIT	QUANTITY	URBAN	S.N. 016-0052	S.N. 016-0053	S.N. 016-2026	S.N. 016-2027
			URBAN					
50157300	PROTECTIVE SHIELD	SQ YD	3081		1140	587	991	363
50300225	CONCRETE STRUCTURES	CU YD	46.7		22.5	8.6	7	8.6
50300255	CONCRETE SUPERSTRUCTURE	CU YD	77.2		18.7	14.4	27.3	16.8
30300233	GONGLETE SOLENSTRUCTURE	00 15	,,,,,		1017	2111	2,13	1010
50300260	BRIDGE DECK GROOVING	SQ YD	6136	851	1754	995	1703	833
50300300	PROTECTIVE COAT	SQ YD	5860		1826	1042	1961	1031
50500405	FURNISHING AND ERECTING STRUCTURAL STEEL	POUND	7240		1960	1290	2150	1840
50800205	REINFORCEMENT BARS, EPOXY COATED	POUND	17160		5110	2760	5190	4100
50800515	BAR SPLICERS	EACH	168		44	22	68	34
51100100	SLOPE WALL 4 INCH	SQ YD	23				11	12
52000037	PREFORMED JOINT SEAL 3"	FOOT	119		66	53		
52000110	PREFORMED JOINT STRIP SEAL	FOOT	506		136	105	157	108
58700300	CONCRETE SEALER	SQ FT	22582		16248	4948	734	652
59000200	EPOXY CRACK INJECTION	FOOT	252		35	109	101	7
39000200	ELOXI CHACK INTECTION	1001	232		, , ,	103	101	,
59200101	BRIDGE WASHING NO. 1	EACH	1			1		
				_				
	0							

* SPECIALTY ITEMS

A c	С	U GR	r our	a , inc	t :.	е	

USER NAME = jschumann	DESIGNED	-	JMT	REVISED -
	DRAWN	-	JMT	REVISED -
PLOT SCALE = 2.0000 ' / in.	CHECKED	-	AB	REVISED -
PLOT DATE = 10/20/2021	DATE	-	10-08-2021	REVISED -

	SUMMARY	OF QU	ANTITIES		F.A.I. RTE.	SECTION		COUNTY SH		SHEET NO.
L	-57 AT I-	.an INTE	RCHANGI	=	57 2020-171-BR COOK			190	6	
	-37 AT 1-	OU HAIL	nonAllu	<u> </u>				CONTRACT	NO. 62	2M54
SHEET	OF	SHEETS(STA.	TO STA.		ILLINOIS	FED. AID	PROJECT NHPP-E	U3I(520)	

						STATE 10%	ODL	
						FED 90%		
				ROADWAY	BR I DGE	BR I DGE	BR I DGE	BRIDGE
CODE			TOTAL	0005	0047	0047	0047	0047
NO.	ITEM	UNIT	QUANTITY	URBAN	S.N. 016-0052	S.N. 016-0053	S.N. 016-202	6S.N. 016-2027
			URBAN					
5920010	2 BRIDGE WASHING NO. 2	EACH	1		1			
* 6300000	STEEL PLATE BEAM GUARDRAIL, TYPE A, 6 FOOT POSTS	5 FOOT	1287.5	1287.5				
* 6310008	5 TRAFFIC BARRIER TERMINAL, TYPE 6	EACH	7	7				
* 6310010	5 TRAFFIC BARRIER TERMINAL, TYPE 10	EACH	5	5				
* 6310016	TRAFFIC BARRIER TERMINAL, TYPE 1 (SPECIAL) TANGENT	EACH	2	2				
6320031	GUARDRAIL REMOVAL	FOOT	1614	1614				
6420011	6 SHOULDER RUMBLE STRIPS, 16 INCH	FOOT	3773	3773				
* 6690020	NON-SPECIAL WASTE DISPOSAL	CU YD	298	298				
* 6690053	SOIL DISPOSAL ANALYSIS	EACH	2	2				
* 6690100	REGULATED SUBSTANCES PRE-CONSTRUCTION PLAN	L SUM	1	1				
* 6690100	REGULATED SUBSTANCES FINAL CONSTRUCTION REPORT	L SUM	1	1				
* 66901000	REGULATED SUBSTANCES MONITORING	CAL DA	6	6				
6700040	ENGINEER'S FIELD OFFICE, TYPE A	CAL MO	12	12				
6710010) MOBILIZATION	L SUM	1	0.2	0.2	0.2	0.2	0.2

* SPECIALTY ITEMS

A c c u r a t e

USER NAME = jent	DESIGNED - JMT	REVISED -
	DRAWN - JMT	REVISED -
PLOT SCALE = 2.0000 / in.	CHECKED - AB	REVISED -
PLOT DATE = 10/21/2021	DATE - 10-08-2021	REVISED -

STATI	E 01	F ILLINOIS
DEPARTMENT	0F	TRANSPORTATION

	SUMMAR	Y OF QU	ANTITIE	S	F.A.I. RTE.	SECT	TION		COUNTY	TOTAL SHEETS	SHEET NO.
	I–57 AT I-	57	2020-171-BR		COOK	190	7				
	I-37 AT I	IICIIAIN					CONTRACT	NO. 67	2M54		
SHEET	OF	SHEETS	STA.	TO STA.			ILLINOIS	FED. A	ID PROJECT NHPP-	EU3I(520)	

						STATE 10% FED 90%		
				ROADWAY	BRIDGE	BRIDGE	BRIDGE	BRIDGE
CODE			TOTAL	0005	0047	0047	0047	0047
NO.	ITEM	UNIT	QUANTITY	URBAN		S.N. 016-0053	S.N. 016-2026	S.N. 016-2027
			URBAN					
70107025	CHANGEABLE MESSAGE SIGN	CAL DA	112	112				
70300100	SHORT TERM PAVEMENT MARKING	FOOT	4978	4978				
70300150	SHORT TERM PAVEMENT MARKING REMOVAL	SQ FT	24465	24465				
70300130	STORT TERM PAVEMENT MARKETNO REMOVAL	30 11	24403	24403				
70300211	TEMPORARY PAVEMENT MARKING LETTERS AND SYMBOLS	SQ FT	83	83				
70300211	PAINT	34 11	03	03				
70300221	TEMPORARY PAVEMENT MARKING - LINE 4" - PAINT	FOOT	18794	18794				
70300231	TEMPORARY PAVEMENT MARKING - LINE 5" - PAINT	FOOT	3540	3540				
70300241	TEMPORARY PAVEMENT MARKING - LINE 6" - PAINT	FOOT	7463	7463				
70300251	TEMPORARY PAVEMENT MARKING - LINE 8" - PAINT	FOOT	4611	4611				
70300261	TEMPORARY PAVEMENT MARKING - LINE 12" - PAINT	FOOT	1407	1407				
		5007						
70300904	PAVEMENT MARKING TAPE, TYPE IV 4"	FOOT	45188	45188				
70300905	PAVEMENT MARKING TAPE, TYPE IV 5"	FOOT	1730	1730				
70300303	TAVERENT FAMILY TAVE TO S	1 001	1,30	1730				
70300906	PAVEMENT MARKING TAPE, TYPE IV 6"	FOOT	7329	7329				
70300908	PAVEMENT MARKING TAPE, TYPE IV 8"	FOOT	4091	4091				
70300912	PAVEMENT MARKING TAPE, TYPE IV 12"	FOOT	568	568				
70400100	TEMPORARY CONCRETE BARRIER	FOOT	4050	4050				

* SPECIALTY ITEMS

A c	С	u	r	а	t	е	
				, INC			

USER NAME = jent	DESIGNED	-	JMT	REVISED -
	DRAWN	-	JMT	REVISED -
PLOT SCALE = 2.0000 ' / in.	CHECKED	-	AB	REVISED -
PLOT DATE = 10/20/2021	DATE	-	10-08-2021	REVISED -

	SUMMAR	Y OF QUA	ANTITIES		F.A.I. RTE.	SECTION	COUNTY	TOTAL SHEETS	SHEET NO.		
	I-57 AT I-80 INTERCHANGE					2020-171-BR	COOK	190	8		
I-37 AT I-00 INTERCHANGE						CONTRACT NO. 62M54					
SHEET	OF	SHEETS[STA.	TO STA.		ILLINOIS FED. A	D PROJECT NHPP-	U3I(520)			

				CONSTRUCTION CODE						
						STATE 10%				
			1	ROADWAY	BRIDGE	FED 90% BRIDGE	BRIDGE	BRIDGE		
CODE			TOTAL	0005	0047	0047	0047	0047		
NO.	ITEM	UNIT	QUANTITY	URBAN				65 N 016-2027		
	112.1	0.01	URBAN	01127111	3 515 555	201111 020 0001	910 202	91111 919 292		
70400125	PINNING TEMPORARY CONCRETE BARRIER	EACH	1014	1014						
70100123	TWING TEM GIVIN CONCRETE BANKTEN	Erterr	1011	1011						
70400300	DELOCATE TEMPORARY CONCRETE RARRIER	FOOT	4112	4112						
70400200	RELOCATE TEMPORARY CONCRETE BARRIER	FOOT	4113	4113						
70600260	IMPACT ATTENUATORS, TEMPORARY (FULLY REDIRECTIVE, NARROW), TEST LEVEL 3	EACH	4	4						
70000200	REDIRECTIVE, NARROW), TEST LEVEL 3	LACIT	4	4						
70600332	IMPACT ATTENUATORS, RELOCATE (FULLY REDIRECTIVE,	EACH	4	4						
70000332	NARROW), TEST LEVEL 3	EACH	4	4						
72501000	TERMINAL MARKER - DIRECT APPLIED	EACH	2	2						
72301000	TEMPINAL MARKER - DIRECT ATTELLED	LACIT	2							
× 78000100	THERMOPLASTIC PAVEMENT MARKING - LETTERS AND	SQ FT	83	83						
78000100	SYMBOLS	30 11	0.5	0.5						
78000200	THERMOPLASTIC PAVEMENT MARKING - LINE 4"	FOOT	15812	15812						
× 78000500	THERMOPLASTIC PAVEMENT MARKING - LINE 8"	FOOT	3140	3140						
78000600	THERMOPLASTIC PAVEMENT MARKING - LINE 12"	FOOT	891	891						
	PREFORMED PLASTIC PAVEMENT MARKING, TYPE D -									
78004620	LINE 4"	FOOT	522	522						
70004635	PREFORMED PLASTIC PAVEMENT MARKING, TYPE D -	FOOT	2100	2100						
78004625	LINE 5"	FOOT	3100	3100						
78000004	MODIFIED URETHANE PAVEMENT MARKING - LINE 4"	FOOT	2460	2460						
7 3 0 0 9 0 0 4	PRODUITED ONLINANT PAYENTING - LINE 4	1 001	2400	2400						
78009008	MODIFIED URETHANE PAVEMENT MARKING - LINE 8"	FOOT	1471	1471						
78009012	MODIFIED URETHANE PAVEMENT MARKING - LINE 12"	FOOT	515	515						
	I		1				1	1		

* SPECIALTY ITEMS

A c c u r a t e

USER NAME = jent	DESIGNED	-	JMT	REVISED	-
	DRAWN	-	JMT	REVISED	-
PLOT SCALE = 2.0000 / in.	CHECKED	-	AB	REVISED	-
PLOT DATE = 10/20/2021	DATE	-	10-08-2021	REVISED	-

	SUMMAR	Y OF QU	ANTITIE	S	F.A.I. RTE.	SECT	ION		COUNTY	TOTAL SHEETS	SHEET NO.
I-57 AT I-80 INTERCHANGE					57	2020-171-BR			COOK	190	9
I-37 AT I-00 INTERCHANGE				CONTRACT NO. 62					2M54		
SHEET	OF	SHEETS	STA.	TO STA.			ILLINOIS	FED. Al	ID PROJECT NHPP-I	U3I(520)	

						CONSTRUCTION		
						STATE 10%		
				DOADWAY	DDIDCE	FED 90%	DDIDCE	DDIDCE
CODE			TOTAL	ROADWAY 0005	BR I DGE 0047	BR I DGE 0047	BR I DGE	BRIDGE 0047
NO.	ITEM	UNIT	QUANTITY	URBAN				S.N. 016-2027
110.	1164	ONTT	URBAN	ONBAN	3.11. 010-0032	23.11. 010-003	33.11. 010-2020	J.N. 010-2027
/8011025	GROOVING FOR RECESSED PAVEMENT MARKING 5"	FOOT	522	522				
8011030	GROOVING FOR RECESSED PAVEMENT MARKING 6"	FOOT	3100	3100				
78011045	GROOVING FOR RECESSED PAVEMENT MARKING 9"	FOOT	440	440				
	RAISED REFLECTIVE PAVEMENT MARKER	EACH	66	66				
78100300	REPLACEMENT REFLECTOR	EACH	266	266				
78200011	BARRIER WALL REFLECTORS, TYPE C	EACH	580	580				
78300202	PAVEMENT MARKING REMOVAL - WATER BLASTING	SQ FT	19827	19827				
88600600	DETECTOR LOOP REPLACEMENT	FOOT	600	600				
K0029614	WEED CONTROL, AQUATIC	GALLON	2.5	2.5				
K0029626	WEED CONTROL, TEASEL	POUND	1.5	1.5				
X0322215	CLEANING BRIDGE SCUPPERS AND DOWNSPOUTS	EACH	1		1			
X0323491	SLOPE WALL CRACK SEALING	FOOT	305		46	58	148	53
X0326650	FILLING EXISTING RUMBLE STRIP	FOOT	3773	3773				
X0326766	CLEAN & RESEAL RELIEF JOINT	FOOT	622	504	72	46		

* SPECIALTY ITEMS

Accurate

USER NAME = jent	DESIGNED - JMT	REVISED -
	DRAWN - JMT	REVISED -
PLOT SCALE = 2.0000 ' / in.	CHECKED - AB	REVISED -
PLOT DATE = 10/21/2021	DATE - 10-08-2021	REVISED -

STATE OF ILLINOIS DEPARTMENT OF TRANSPORTATION

	SUMMAR	Y OF QU	ANTITIE	s	F.A.I. RTE	SEC	ΓIC
	I–57 AT I-	_80 INTE	RCHANG	if [57	2020-1	71
	I-37 AT I-	-00 HAIL	IIOIIAIV	1 L			
SHEET	OF	SHEETS	STA.	TO STA.			ΙL

				STATE 10% FED 90%						
				ROADWAY	BR I DGE	BR I DGE	BR I DGE	BRIDGE		
CODE			TOTAL	0005	0047	0047	0047	0047		
NO.	ITEM	UNIT	QUANTITY	URBAN	S.N. 016-0052	S.N. 016-0053	S.N. 016-2026	S.N. 016-2027		
			URBAN							
* X0327577	PROTECT AND MAINTAIN EXISTING UNDERPASS LUMINAIRE	L SUM	1		0.25	0.25	0.25	0.25		
X0 9 31400	INLET BOXES TO BE ADJUSTED (SPECIAL)	EACH	12		4	2	4	2		
* X2502014	SEEDING, CLASS 4A (MODIFIED)	ACRE	1.10	1.10						
* X2503110	MOWING (SPECIAL)	ACRE	1.00	1.00						
X2700001	TEMPORARY RUMBLE STRIPS (SPECIAL)	EACH	16.00	16.00						
* X2700027	PREFORMED PLASTIC PAVEMENT MARKING, TYPE D - LINE 8", CONTRAST	FOOT	440	440						
X5030530	FLOOR DRAIN EXTENSION	EACH	1			1				
X7010216	TRAFFIC CONTROL AND PROTECTION, (SPECIAL)	L SUM	1	1						
X7011015	TRAFFIC CONTROL AND PROTECTION (EXPRESSWAYS)	L SUM	1	1						
X7013820	TRAFFIC CONTROL SURVEILLANCE, EXPRESSWAYS	CAL DA	189	189						
X7830050	RAISED REFLECTIVE PAVEMENT MARKER, REFLECTOR REMOVAL	EACH	266	266						
X8570000	SMART TRAFFIC MONITORING SYSTEM	L SUM	1	1						
Z0001700	APPROACH SLAB REPAIR (FULL DEPTH)	SQ YD	0.5		0.5					
Z0001800	APPROACH SLAB REPAIR (PARTIAL DEPTH)	SQ YD	1					1		
Z0001903	STRUCTURAL STEEL REMOVAL	POUND	6910		1960	1300	2020	1630		

A c c u r a t	е
---------------	---

	USER NAME = jent	DESIGNED	-	JMT	REVISED	-	
		DRAWN	-	JMT	RE'		
Ì	PLOT SCALE = 2.0000 ' / in.	CHECKED	-	AB	REVISED	-	
1	PLOT DATE = 10/21/2021	DATE	-	10-08-2021	REVISED	-	

STATE OF ILLINOIS DEPARTMENT OF TRANSPORTATION

	SUMMA	RY OF QUA	ANTITIE	s	F.A.I. RTE.	SECTION	COUNTY	TOTAL	SHEET NO.
	I-57 AT	I-80 INTE	RCHANG	57	2020-171-BR	соок	190	11	
	1-31 AI	I-00 HAIL	IIOIIAIT	' L			CONTRACT	NO. 62	2M54
SHEET OF SHEETS STA. TO STA.						LILINOIS LEED. A	D PROJECT NHPP-	EU3I(520)	i

^{*} SPECIALTY ITEMS

					C	CIND LUCLION C	,ODE	
			STATE 10%					
						FED 90%		
				ROADWAY	BR I DGE	BR I DGE		!
CODE			TOTAL	0005	0047			
NO.	ITEM	UNIT	QUANTITY	URBAN	S.N. 016-0052	S.N. 016-0053	ATE 10% ED 90% RIDGE BRIDGE BRIDGE 0047 0047 0047 016-0053 S.N. 016-2026 S.N. 016-2 1910 770 1020 1702 844	S.N. 016-2027
			URBAN					
Z0001905	STRUCTURAL STEEL REPAIR	POUND	2880		200		1910	770
Z0006016	BRIDGE DECK LATEX CONCRETE OVERLAY, 2 3/4 INCHES	SQ YD	6237	873	1798	1020	1702	844
Z0012130	BRIDGE DECK SCARIFICATION 3/4"	SQ YD	5364		1798	1020	1702	844
	CTRUCTURAL REPAIR OF CONCRETE (DEPTH FOUND TO OR							
Z0012754	STRUCTURAL REPAIR OF CONCRETE (DEPTH EQUAL TO OR LESS THAN 5 INCHES)	SQ FT	226		34	53	63	76
70012755	STRUCTURAL REPAIR OF CONCRETE (DEPTH GREATER THAN 5 INCHES)	SQ FT	101		49	42	1	9
20012733	THAN 5 INCHES)	54 11				12	<u> </u>	
Z0012800	CONCRETE PAVEMENT SCARIFICATION	SQ YD	873	873				
Z0016001	DECK SLAB REPAIR (FULL DEPTH, TYPE I)	SQ YD	2.6		0.3	0.3	1	1
70016002	DECK SLAB REPAIR (FULL DEPTH, TYPE II)	SQ YD	3		1		2	1 1
20010002	PECK SEAB REPAIR (TOLL BEFIII, TIFE II)	30 10	3					1
Z0018051	DRAINAGE SCUPPERS TO BE ADJUSTED	EACH	3		1		2	
Z0018500	DRAINAGE STRUCTURES TO BE CLEANED	EACH	13		4	9		
Z0030850	TEMPORARY INFORMATION SIGNING	SQ FT	187	187				
Z0033028	MAINTENANCE OF LIGHTING SYSTEM	CAL MO	24		6	6	6	6
Z0062456	TEMPORARY PAVEMENT	SQ YD	323	323				
Z0062458	TEMPORARY PAVEMENT (VARIABLE DEPTH)	TON	11	11				

* SPECIALTY ITEMS

A c	;	С	U GRO	r	a	t	е
			0				

USER NAME = jent	DESIGNED	-	JMT	REVISED -
	DRAWN	-	JMT	REVISED -
PLOT SCALE = 2.0000 ' / in.	CHECKED	-	AB	REVISED -
PLOT DATE = 10/21/2021	DATE	-	10-08-2021	REVISED -

	SUMMARY	OF QUA	ANTITIES	5	F.A.I. RTE.	SECTION	COUNTY	TOTAL	SHEET NO.
	I–57 AT I–	an INTE	RCHANG	_E	57 [2020-171-BR	соок	190	12
	-37 AI -	OU HAIL	IIUIIAIVU				CONTRACT	NO. 62	2M54
SHEET	OF	SHEETS	STA.	TO STA.		ILLINOIS FED. A	ID PROJECT NHPP-	EU3I(520)	
J.I.E.E.		0.122.0	0.7.1	70 01711		TICEINOIS TED. A	ID TROJECT NITT	LOSI(SZO)	


					C	CONSTRUCTION C	ODE	
						STATE 10%		
				_	T .	FED 90%	_	_
				ROADWAY	BRIDGE	BR I DGE	BR I DGE	BR I DGE
CODE			TOTAL	0005	0047	0047	0047	0047
NO.	ITEM	UNIT	QUANTITY	URBAN	S.N. 016-0052	S.N. 016-0053	S.N. 016-2026	S.N. 016-2027
			URBAN					
Z0064800	SELECTIVE CLEARING	UNIT	95	95				
Z0065700	SLOPE WALL REPAIR	SQ YD	10.5		4	6.5		
Z0076600	TRAINEES	HOURS	1000	1000				
Z0076604	TRAINEES - TRAINING PROGRAM GRADUATE	HOURS	1000	1000				
X4428189	CLASS D PATCHES, TYPE IV, 13 INCH (SPECIAL)	SQ YD	399	399				

* SPECIALTY ITEMS

USER NAME = jent	DESIGNED - JMT	REVISED -
	DRAWN - JMT	REVISED -
PLOT SCALE = 2.0000 ' / in.	CHECKED - AB	REVISED -
PLOT DATE = 10/20/2021	DATE - 10-08-2021	REVISED -

STATE OF ILLINOIS DEPARTMENT OF TRANSPORTATION


												\wp	142
			SUMMAR	Y OF QUA	ANTITIE	s	F.A.I. RTE.	SEC	ΓΙΟΝ		COUNTY	TOTAL SHEETS	
I-57 AT I-80 INTERCHANGE							57	2020-1	171-BR		соок	190	13
	I-37 AT I-00 INTENDIANGE										CONTRACT	NO. 62	2M54
	SCALE: SHEET OF SHEETS STA.		TO STA.			ILLINOIS	FED. AI	ID PROJECT NHPP-	EU3I(520)				

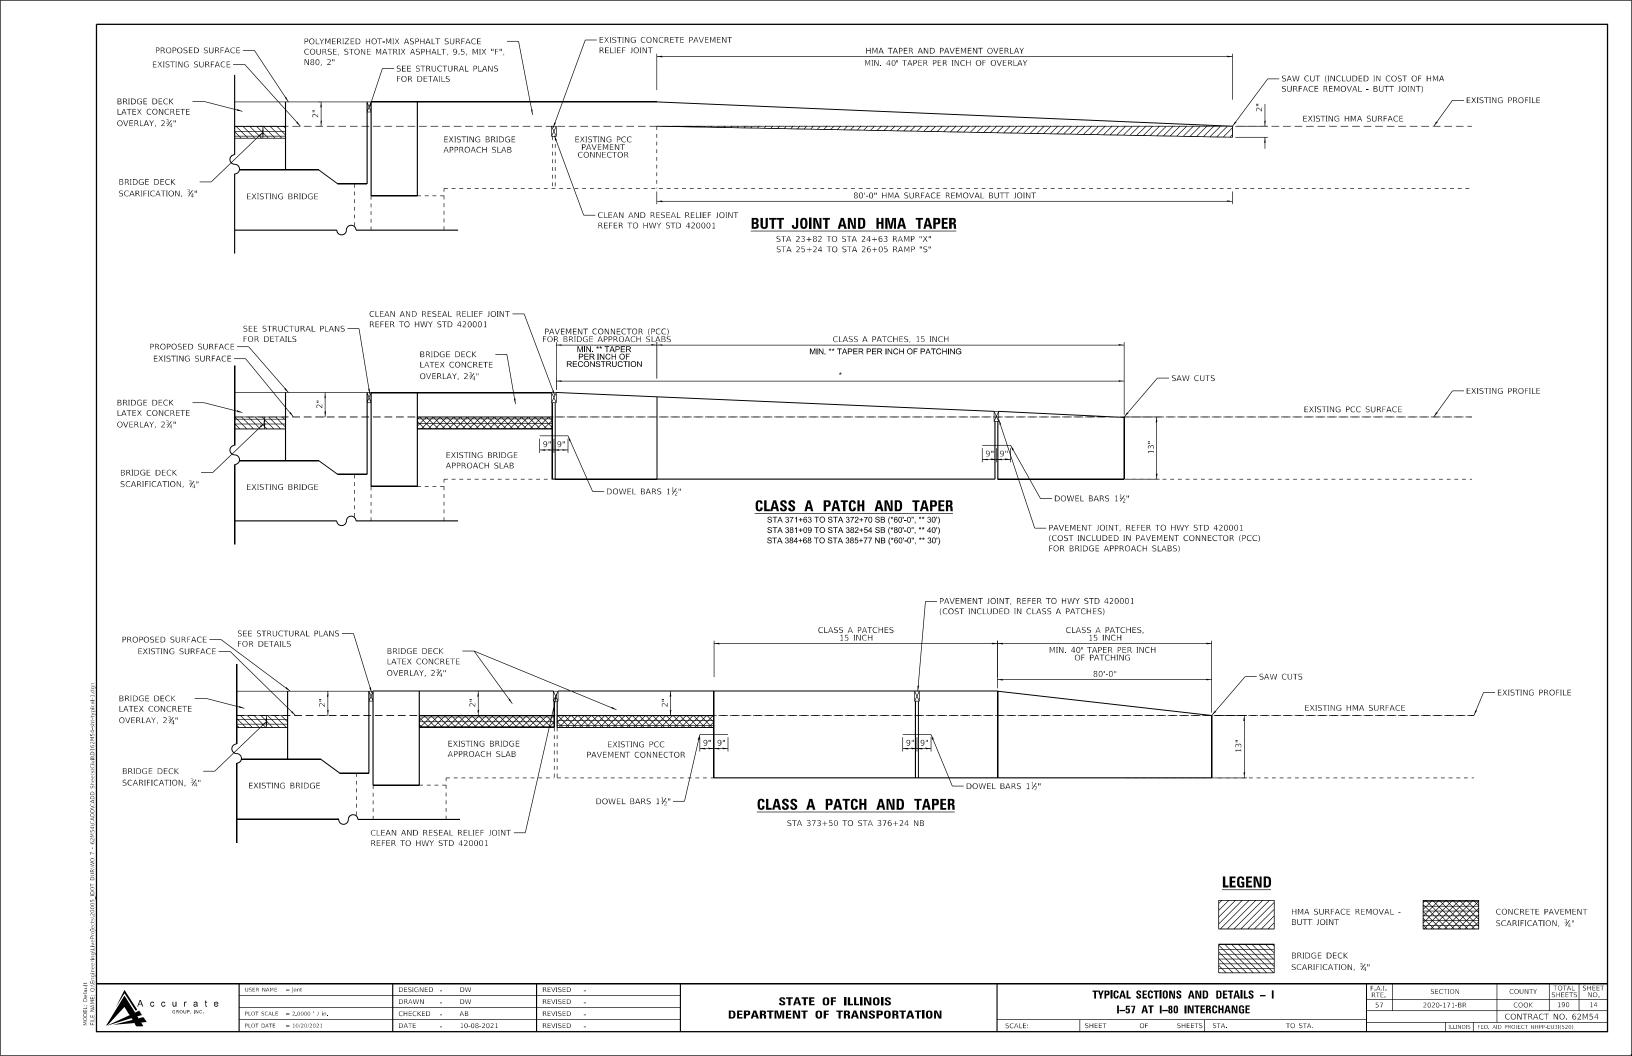

I–57 EXISTING TYPICAL SECTION

NORTHBOUND FROM STA 373+50 TO STA 375+48 FROM STA 385+10 TO STA 385+77


SOUTHBOUND FROM STA 381+58 TO STA 382+54

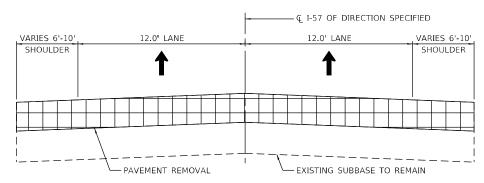

I-57 EXISTING TYPICAL SECTION

NORTHBOUND FROM STA 384+79 TO STA 385+10


SOUTHBOUND FROM STA 371+63 TO STA 372+31 FROM STA 381+28 TO STA 381+58

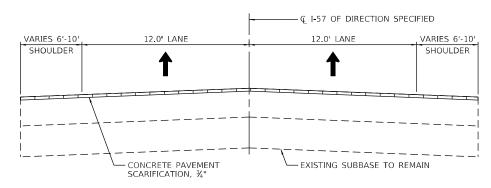

I-57 EXISTING TYPICAL SECTION

NORTHBOUND FROM STA 375+48 TO STA 376+06 FROM STA 384+79 TO STA 384+79


SOUTHBOUND FROM STA 372+31 TO STA 372+62

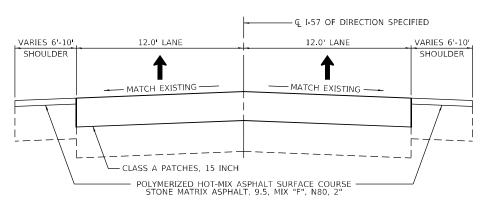

I-57 PROPOSED TYPICAL SECTION

NORTHBOUND FROM STA 373+50 TO STA 375+48 FROM STA 385+10 TO STA 385+77

SOUTHBOUND FROM STA 381+58 TO STA 382+54

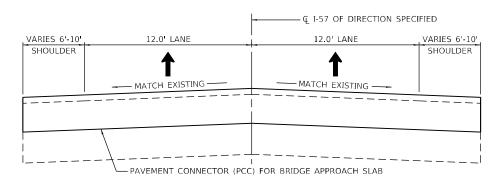

I-57 PROPOSED TYPICAL SECTION

NORTHBOUND FROM STA 384+79 TO STA 385+10

SOUTHBOUND FROM STA 371+63 TO STA 372+31 FROM STA 381+28 TO STA 381+58

VARIES 6'-10'
SHOULDER

T

BRIDGE DECK LATEX CONCRETE OVERLAY, 2¾"

I-57 PROPOSED TYPICAL SECTION

NORTHBOUND FROM STA 375+48 TO STA 376+06 FROM STA 384+79 TO STA 384+79

SOUTHBOUND FROM STA 372+31 TO STA 372+62

A	С	С	U GR		а , іме		е	
---	---	---	----------------	--	------------	--	---	--

USER NAME = jent	DESIGNED	-	DW	REVISED -
	DRAWN	-	DW	REVISED -
PLOT SCALE = 2,0000 / in.	CHECKED	-	AB	REVISED -
PLOT DATE = 10/20/2021	DATE	-	10-08-2021	REVISED -

STATE OF ILLINOIS
DEPARTMENT OF TRANSPORTATION

TYPICA	L SECTIO	ONS AND	DETAI	LS – II		F.A.I. RTE.	SEC.	TION		COUNTY	TOTAL SHEETS	SHEET NO.
I-57 AT I-80 INTERCHANGE							2020-171-BR			COOK	190	15
	I-37 AT I-80 INTERCHANGE									CONTRACT	NO. 62	2M54
SHEET	OF	SHEETS	STA.	TO S	STA.	ILLINOIS FED. AID F				D PROJECT NHPP-E	U3I(520)	

I-57 EXISTING TYPICAL SECTION

NORTHBOUND FROM STA 378+07 TO STA 382+55 SOUTHBOUND FROM STA 375+04 TO STA 379+28

₽ RAMP "T" LANE LANE SHLDR EX AGG SHLDR MATCH EXIST. MATCH EXIST. SLOPE EX AGG SHLDR POLYMERIZED HOT-MIX ASPHALT SURFACE COURSE, STONE MATRIX ASPHALT, 9.5, MIX "F", N80, 2"

RAMP "T" PROPOSED TYPICAL SECTION

FROM STA 23+15 TO STA 32+52

PAY FOR PERFORMANCE (PFP)

€ I-57 OF DIRECTION SPECIFIED VARIES 6'-10' 12.0' LANE SHOULDER SHOULDER – POLYMERIZED HOT-MIX ASPHALT SURFACE COURSE STONE MATRIX ASPHALT, 9.5, MIX "F", N80, 2"


NORTHBOUND FROM STA 378+07 TO STA 382+55 SOUTHBOUND FROM STA 375+04 TO STA 379+28

FOR THE FOLLOWING STATION RANGES, SEE THE CORRESPONDING STRUCTURAL PLANS. THE STATIONING SHOWN IN THE STRUCUTRAL PLANS WAS TAKEN FROM EXISTING STRUCTURAL PLANS AND DOES NOT MATCH THE ROADWAY STATIONING.

FROM STA 376+06 TO STA 378+07 - S.N. 016-0053 - SEE SHEET 158 FROM STA 382+55 TO STA 384+79 - S.N. 016-2026 - SEE SHEET 88

SOUTHBOUND - FROM STA 372+62 TO STA 375+04 - S.N. 016-0052 - SEE SHEET 135 - FROM STA 379+28 TO STA 381+21 - S.N. 016-2027 - SEE SHEET 112

I-57 PROPOSED TYPICAL SECTION

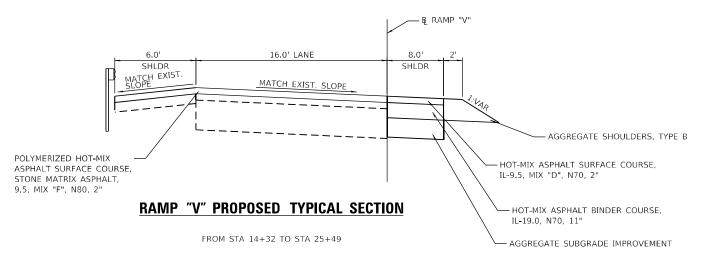

HOT-MIX ASPHALT MIXTURE REQUIREMENTS

OPERATION	MIXTURE TYPE	AIR VOIDS @ Ndes	QUALITY MANAGEMENT PROGRAM (QMP)
ROADWAY RESURFACING	POLYMERIZED HOT-MIX ASPHALT SURFACE COURSE, STONE MATRIX ASPHALT, 9.5, MIX "F", N80, 2"	3.5% @ 80 GYR.	QCP
TEMPORARY PAVEMENT	HOT-MIX ASPHALT SURFACE COURSE, IL-9.5, MIX "D", N70, 2" HOT-MIX ASPHALT BINDER COURSE, IL.19.0, N70, 10"	4% @ 70 GYR. 4% @ 70 GYR.	QC/QA QC/QA
TEMPORARY PAVEMENT (VARIABLE DEPTH)	HOT-MIX ASPHALT SURFACE COURSE, IL-9.5, MIX "D", N70, VARIES TO 2"	4% @ 70 GYR.	QC/QA
FILLING EXISTING RUMBLE STRIP	HOT-MIX ASPHALT SURFACE COURSE, IL-9.5, MIX "D", N70, 2"	4% @ 70 GYR.	QC/QA
CLASS D PATCHES 13" (SPECIAL)	HOT-MIX ASPHALT SURFACE COURSE, IL-9.5, MIX "D", N70, 2" (HMA BINDER IL-19 mm), 11"	4% @ 70 GYR. 4% @ 70 GYR	QC/QA QC/QA
SHOULDER RECONSTRUCTION	HOT-MIX ASPHALT SURFACE COURSE, IL-9.5, MIX "D", N70, 2" HOT-MIX ASPHALT BINDER COURSE, IL-19.0, N70, 11"	4% @ 70 GYR. 4% @ 70 GYR	QC/QA QC/QA
QMP DESIGNATIONS: QUALITY CONTROL/QUALI QUALITY CONTROL FOR F		'	

NOTES:

- THE UNIT WEIGHT USED TO CALCULATE ALL HMA SURFACE MIXTURE QUANTITIES IS 112 LBS/SQ YD/IN
- THE "AC TYPE" FOR POLYMERIZED HMA MIXES SHALL BE "SBS/SBR PG 76-22" AND FOR NON-POLYMERIZED HMA MIXES THE "AC TYPE" SHALL BE "PG 64-22" UNLESS MODIFIED BY RECLAIMED MATERIALS SPECIFICATIONS.
- THE PC CONCRETE TEMPORARY PAVEMENT OPTION SHALL CONSIST OF CLASS PV CONCRETE MEETING THE REQUIREMENTS OF ART. 1020 OF THE STANDARD SPECIFICATIONS, PCC PAVEMENT 12" THICK. TEMPORARY PCC PAVEMENT DOES NOT REQUIRE DOWEL BARS. ALL TEMPORARY PAVEMENT SHALL BE PROVIDED OVER SUBBASE GRANULAR MATERIAL, TYPE B, 4"

A	С	С		a , inc	е

USER NAME = jent	DESIGNED	-	DW	REVISED	-
	DRAWN	-	DW	REVISED	-
PLOT SCALE = 2,0000 / in.	CHECKED	-	AB	REVISED	-
PLOT DATE = 10/20/2021	DATE	-	10-08-2021	REVISED	-

STATE OF ILLINOIS DEPARTMENT OF TRANSPORTATION

TYPIC	AL SECTIO	NS AND	DETAI	LS – III	F.A.I. RTE.	SECTION	
	I–57 AT I-	_80 INTER	CHANC	ar [57	2020-171-BF	
	1-37 AT 1-	-00 HAILI	IUIIAIII	JL			
SHEET	OF	SHEETS	STA	TO STA		TUTNO	ac L ccn

COOK

CONTRACT NO. 62M54

нот-г	HOT-MIX ASPHALT SURFACE REMOVAL - BUTT JOINT									
STATION	STATION	OFFSET	ROADWAY	TOTAL AREA (SQ YD)						
371+63	372+13	LT	I-57 SB / RAMP R	46.7						
371+63	372+19	RT	I-57 SB / RAMP R	46.7						
381+83	382+55	LT	I-57 SB	66.1						
381+83	382+54	RT	I-57 SB	30.3						
373+50	375+48	LT	I-57 NB	162.0						
373+50	375+49	RT	I-57 NB	212.4						
23+81	24+61	CL	RAMP X	365.6						
385+17	385+77	LT	I-57 NB	63.5						
385+25	385+77	RT	I-57 NB	47.7						
14+32	14+36	CL	RAMP V	8.8						
25+45	25+49	CL	RAMP V	2.2						
23+15	23+19	CL	RAMP T	16.8						
32+58	32+62	CL	RAMP T	17.6						
			TOTAL	1087						

PAVEMENT CONNECTOR (PCC) FOR BRIDGE APPROACH SLAB									
STATION	STATION	ROADWAY	OFFSET	TOTAL AREA (SQ FT)	TOTAL AREA (SQ YD)				
371+63	372+39	I-57 SB	CL	3851	428				
381+38	381+83	I-57 SB	CL	1159	129				
385+01	385+26	I-57 NB	CL	1059	118				
				TOTAL	675				

AGGREGATE SHOULDERS, TYPE B								
STATION	STATION	OFFSET	DIRECTION OF TRAVEL	CROSS SECTION AREA (SQ FT)	VOLUME (CU YD)			
14+32	25+49	RT	RAMP V	4	157			
				TOTAL	157			

POLYMER	POLYMERIZED HOT-MIX ASPHALT SURFACE COURSE, STONE MATRIX ASPHALT, 9.5, MIX "F", N80								
STATION	STATION	OFFSET	ROADWAY	AREA (SQ FT)	THICKNESS (INCH)	TOTAL WEIGHT			
371+63	372+13	LT	I-57 SB / RAMP R	420.58	2	5.2			
371+63	372+19	RT	I-57 SB / RAMP R	420.64	2	5.2			
374+98	379+39	CL	I-57 SB/RAMP S	21566.57	2	268.4			
381+83	382+55	LT	I-57 SB	595.21	2	7.4			
381+83	382+54	RT	I-57 SB	272.90	2	3.4			
373+50	375+48	LT	I-57 NB	1457.74	2	18.1			
373+50	375+49	RT	I-57 NB	1911.62	2	23.8			
377+97	382+61	CL	I-57 NB RAMP X	24959.04	2	310.6			
385+17	385+77	LT	I-57 NB	571.46	2	7.1			
385+25	385+77	RT	I-57 NB	429.27	2	5.3			
23+15	32+52	CL	RAMP T	36023.44	2	448.3			
14+32	25+49	CL	RAMP V	22647.80	2	281.8			
21+55	21+65	RT	RAMP X	135.79	2	1.7			
					TOTAL	1387			

	TOTAL AREA
	(SQ YD)
NOMINAL	29
TOTAL	29

CLASS A PATCHES, TYPE II, 15 INCH								
STATION	STATION	DIRECTION OF TRAVEL	OFFSET	TOTAL AREA (SQ FT)	TOTAL AREA (SQ YD)			
NOMI	NAL				28,4			
·	•			TOTAL	28			

	PAVEMENT REMOVAL									
STATION	STATION	DIRECTION OF TRAVEL	OFFSET	TOTAL AREA (SQ YD)						
371+63	372+39	I-57 SB	CL	428.1						
381+38	381+83	I-57 SB	CL	128.9						
385+01	385+26	I-57 NB	CL	117.7						
23+74	25+77	WB I-80 TO SB I-57	RT	264.0						
14+32	14+71	RAMP V	LT	8.3						
14+36	25+49	RAMP V	RT	1075.6						
13+35	14+67	RAMP R	LT	50.5						
25+77	23+74	RAMP S	RT	264.0						
13+35	14+67	RAMP R	RT	50.4						
			TOTAL	2388						

CLASS A PATCHES, TYPE II, 13 INCH								
STATION	STATION STATION DIRECTION OFFSET AREA (SQ YD)							
20+57	20+63	RAMP X	RT	10.0				
			NOMINAL	6.3				
			TOTAL	17				

CLASS A PATCHES, TYPE III, 13 INCH								
STATION	DIRECTION OF TRAVEL	OFFSET	AREA (SQ YD)					
17+53	RAMP V	LT	15.8					
18+24	RAMP V	LT	15.7					
18+80	RAMP V	LT	15.5					
21+72	RAMP V	LT	15.2					
22+06	RAMP V	LT	15.3					
		NOMINAL	6.3					
		TOTAL	84					

BITUMINOUS MATERIALS (TACK COAT)										
STATION	STATION	DIRECTION OF TRAVEL	OFFSET	TOTAL AREA (SQ FT)	TOTAL WE I GHT (LB)					
371+63	372+13	SB	LT	420.58	22.0					
371+63	372+19	SB	RT	420.64	22.0					
374+99	379+39	SB	LT/RT	21566.57	1079.0					
381+83	382+54	SB	LT	595.21	30.0					
381+83	382+54	SB	RT	272.90	14.0					
373+50	374+30	NB	LT	639.12	32.0					
373+50	374+30	NB	RT	824.46	42.0					
374+30	375+48	NB	LT	818.62	41.0					
374+30	375+48	NB	RT	1087.16	55.0					
377+97	382+09	NB	LT/RT	20696.69	1035.0					
382+09	382+30	NB	LT/RT	1795.17	90.0					
382+30	382+61	NB	LT/RT	2467.18	124.0					
385+17	385+77	NB	LT	571.46	29.0					
385+25	385+77	NB	RT	429.27	22.0					
14+32	25+39	RAMP V	CL	22647.80	1133.0					
14+32	25+39	RAMP V	RT	9714.24	243.0					
14+32	25+39	RAMP V	RT	5357.66	1340.0					
				TOTAL	5353					

CLASS A PATCHES, TYPE III, 15 INCH									
STATION	STATION	DIRECTION OF TRAVEL	OFFSET	TOTAL AREA (SQ FT)	TOTAL AREA (SQ YD)				
385+21	385+77	I-57 NB	11,5' LT	160	17.8				
NOMIN	NOMINAL								
	TOTAL 47								

	TEMPORARY PAVEMENT										
STATION	STATION	OFFSET	DIRECTION OF TRAVEL	TOTAL AREA (SQ FT)	TOTAL AREA (SQ YD)						
25+77	23+74	RT	RAMP S	2376	264						
13+35	14+67	LT	RAMP R	454	50						
14+32	14+71	LT	RAMP V	74	8						
TOTAL 323											

	TEMPORARY PAVEMENT (VARIABLE DEPTH)													
STAGE	STATION	DIRECTION	LENGTH 1 (FT)	LENGTH 2 (FT)	W I DTH (FT)	VOLUME (CU FT)	WEIGHT (TON)							
	377+96	NB	6.00	19.20	20.71	21.74	1.6							
	382+41	NB	6.00	6.00	36.23	18.12	1.4							
II	381+84	SB	71.25	71.56	8.59	51.14	3.8							
	379+07	SB	6.00	6.00	17,95	8.98	0.7							
	375+45	SB	6.00	6.00	18.31	9.16	0.7							
III	379+18	SB	6.00	6.00	22.61	11.31	0.8							
111	375+49	SB	6.00	6.00	34.71	17.36	1.3							
						TOTAL	11							

	HOT-MIX ASPHALT BINDER COURSE, IL-19.0, N70									
STATION	STATION	OFFSET	ROADWAY	AREA (SQ FT)	THICKNESS (INCH)	TOTAL WEIGHT				
14+32	25+49	CL	RAMP V	9714.24	11	664.9				
			TOTAL	665						
	НОТ-	MIX ASPHALT	SURFACE COURSE, II	L-9.5, MIX "D", I						
STATION	STATION	OFFSET	ROADWAY	AREA (SQ FT)	THICKNESS (INCH)	TOTAL				
						WEIGHT				
14+32	25+49	CL	RAMP V	9716.00	2	WEIGHT 120.9				
14+32	25+49	CL	RAMP V	9716.00	(INCH) 2 TOTAL					

HOT-MIX ASPHALT BINDER COURSE, IL-19.0, N70

CLASS A PATCHES, TYPE III, 13 INCH							
STATION	DIRECTION OF TRAVEL	OFFSET	AREA (SQ YD)				
17+53	RAMP V	LT	15.8				
18+24	RAMP V	LT	15.7				
18+80	RAMP V	LT	15.5				
21+72	RAMP V	LT	15.2				
22+06	RAMP V	LT	15.3				
		NOMINAL	6.3				
		TOTAL	84				

JSER NAME = jent	DESIGNED	-	DW	REVISED -	
	DRAWN	-	DW	REVISED -	
PLOT SCALE = 2,0000 / in	CHECKED	-	AB	REVISED -	
PLOT DATE = 10/20/2021	DATE	-	10-08-2021	REVISED -	

STATE	OF	ILLINOIS
DEPARTMENT (OF '	TRANSPORTATION

		CHEDINE.	2 05 011	MITITIFE		F.A.I.	SEC.	TION		COUNTY		
		SCHEDULES I-57 AT I				RTE. 3ECTION 57 2020-171-BR			COOK	SHEETS 190	NO. 17	
	ī	1-3/ A1 I								CONTRACT	NO. 62	2M54
SCALE:	SHEET	OF	SHEETS	STA.	TO STA.			ILLINOIS	FED. Al	ID PROJECT NHPP-	EU3I(520)	

	CLASS A PATCHES, TYPE IV, 15 INCH										
STATION	STATION	DIRECTION OF TRAVEL	OFFSET	TOTAL AREA (SQ FT)	TOTAL AREA (SQ YD)						
373+50	374+30	I-57 NB	LT	969	108						
373+50	374+30	I-57 NB	RT	979	109						
374+30	375+48	I-57 NB	LT	1408	156						
374+30	375+48	I-57 NB	RT	1422	158						
381+83	382+54	I-57 SB	2' LT	975	108						
381+83	382+54	I-57 SB	CL	996	111						
385+18	385+77	I-57 NB	26.6' LT	757	84						
385+20	385+77	I-57 NB	14.3' LT	691	77						
385+22	385+77	I-57 NB	CL	757	84						
385+23	385+77	I-57 NB	2.3' RT	626	70						
11+03	11+55	RAMP V	LT	473	53						
NOMINAL				•	28						
				TOTAL	1146						

	DOWEL BARS 1 1/2"										
	DIRECTION	TOTAL LENGTH	SPACING	TOTAL NUMBER							
STATION	OF TRAVEL	OF JOINT (FT)	(INCH)	OF BARS							
373+50	I-57 NB	24	12	23							
382+54	I-57 SB	24	12	23							
385+77	I-57 NB	64	12	63							
			TOTAL	109							

		AW CUTS		
		DIRECTON		
STATION	STATION	OF TRAVEL	OFFSET	LENGTH (FT)
11+03	11+55	RAMP V	LT	78
14+92	15+12	RAMP V	LT	75
17+48	17+57	RAMP V	LT	51
18+20	18+28	RAMP V	LT	51
18+76	18+84	RAMP V	LT	50
19+76	20+03	RAMP V	LT	82
20+57	20+63	RAMP X	RT	39
21+68	21+76	RAMP V	LT	50
22+02	22+10	RAMP V	LT	138
25+09	25+49	RAMP V	LT	115
373+50	374+30	I-57 NB	LT	186
373+50	374+30	I-57 NB	RT	107
374+30	375+48	I-57 NB	LT	259
374+30	375+48	I-57 NB	RT	142
381+83	382+54	I-57 SB	2' LT	169
381+83	382+54	I-57 SB	CENTER	98
385+18	385+77	I-57 NB	26,6' LT	159
385+20	385+77	I-57 NB	14.3' LT	81
385+21	385+77	I-57 NB	11.5' LT	62
385+22	385+77	I-57 NB	CENTER	82
385+23	385+77	I-57 NB	2.3' RT	68
385+24	385+76	I-57 NB	13.7' RT	70
TEMPORARY P	AVEMENT	RAMP R		105
TEMPORARY P	AVEMENT	RAMP S		211
TEMPORARY P	AVEMENT	RAMP V		46
NOMINAL				
QUANTITY				LENGTH (FT)
TYPE PATCHES	ASSUME 7	6X6 & 2 - 4.5X	(6 PATCHES	198
TYPE II PATCHES	ASSUME 3 -	6X12 & 1 - 7.5X	(12 PATCHES	147
TYPE III PATCHES	ASSUME	2 - 12.75X12 F	PATCHES	99
TYPE IV PATCHES	ASSU	ME 1 25.5X12 I	PATCH	75
			TOTAL	3093

STATION STATION 11+03 11+55 14+92 15+12 17+49 17+57 18+20 18+28 18+76 18+84	PATCHING RE DIRECTON OF TRAVEL RAMP V RAMP V RAMP V RAMP V	OFFSET LT LT LT LT		AREA (SQ YD 53
11+03 11+55 14+92 15+12 17+49 17+57 18+20 18+28	OF TRAVEL RAMP V RAMP V RAMP V	LT LT	473	53
11+03 11+55 14+92 15+12 17+49 17+57 18+20 18+28	RAMP V RAMP V RAMP V	LT LT	473	53
14+92 15+12 17+49 17+57 18+20 18+28	RAMP V RAMP V	LT		
17+49 17+57 18+20 18+28	RAMP V		353	
18+20 18+28		LT		39
	RAMP V		143	16
18+76 18+84		LT	141	16
10.70 10.04	RAMP V	LT	139	15
19+79 20+03	RAMP V	LT	407	45
21+68 21+76	RAMP V	LT	137	15
22+02 22+10	RAMP V	LT	138	15
20+57 20+63	RAMP X	RT	81	9
25+09 25+49	RAMP V	LT	697	77
373+50 374+30	I-57 NB	LT	969	108
373+50 374+30	I-57 NB	RT	979	109
374+30 375+48	I-57 NB	LT	1408	156
374+30 375+48	I-57 NB	RT	1422	158
381+83 382+54	I-57 SB	2' LT	975	108
381+83 382+54	I-57 SB	CENTER	996	111
385+18 385+77	I-57 NB	26.6' LT	757	84
385+20 385+77	I-57 NB	14,3' LT	691	77
385+21 385+77	I-57 NB	11.5' LT	160	18
385+22 385+77	I-57 NB	CENTER	1035	115
385+23 385+77	I-57 NB	2,3' RT	626	70
·			NOMINAL	
			QUANTITY	AREA (SQ YD
			NOMINAL	141
THE NOMINAL QUANTITY I	S EQUAL TO 1	0% OF THE A		S A PATCHES
			TOTAL	1556

PROTECTIVE COAT							
STATION	STATION STATION DIRECTON OFFSET TOTAL (SQ.F.						
11+03	11+55	RAMP V	LT	473	53		
14+92	15+12	RAMP V	LT	353	39		
17+49	17+59	RAMP V	LT	143	16		
18+20	18+28	RAMP V	LT	141	16		
18+76	18+84	RAMP V	LT	139	15		
19+79	20+03	RAMP V	LT	407	45		
20+57	20+63	RAMP X	RT	81	9		
21+68	21+76	RAMP V	LT	137	15		
22+02	22+10	RAMP V	LT	138	15		
25+09	25+49	RAMP V	LT	697	77		
371+63	372+39	I-57 SB	CENTER	3851	428		
372+39	372+70	I-57 SB	CENTER	1993	221		
373+50	374+30	I-57 NB	LT	969	108		
373+50	374+30	I-57 NB	RT	979	109		
374+30	375+48	I-57 NB	LT	1408	156		
374+30	375+48	I-57 NB	RT	1422	158		
381+09	381+67	I-57 SB	CENTER	1222	136		
381+38	381+83	I-57 SB	CENTER	1161	129		
381+83	382+54	I-57 SB	2' LT	1059	118		
381+83	382+54	I-57 SB	CENTER	996	111		
384+68	384+97	I-57 NB	CENTER	2307	256		
385+01	385+26	I-57 NB	CENTER	1059	118		
385+18	385+77	I-57 NB	26.6' LT	992	110		
385+20	385+77	I-57 NB	14.3' LT	966	107		
385+21	385+77	I-57 NB	11.5' LT	219	24		
385+22	385+77	I-57 NB	CENTER	1035	115		
385+23	385+77	I-57 NB	2.3' RT	868	96		
375+48	376+24	I-57 NB	CENTER	2331	259		
384+68	385+17	I-57 NB	CENTER	2331	259		
NOMINAL					137		
	<u> </u>		<u> </u>	TOTAL	3457		

HOT-MIX ASPHALT SURFACE REMOVAL, 2"									
STATION	STATION	OFFSET	ROADWAY	TOTAL AREA (SQ YD)					
14+36	25+49	CL	RAMP V	2266.0					
21+55	21+57	RT	RAMP X	3.0					
21+63	21+65	RT	RAMP X	3.0					
23+19	32+48	CL	RAMP T	3968.2					
			TOTAL	6241					

	RAISED REFLECTIVE PAVEMENT MARKER, REFLECTOR REMOVAL							
STATION	STATION	OFFSET	LENGTH (FT)	FACTOR	NO. OF SETS OF TWO	EACH		
347+00	349+00	RT NB	200	0.0125	3.0	6.0		
349+00	362+00	RT NB	1300	0.0125	17.0	34.0		
356+99	362+00	RT SB	501	0.0125	7.0	14.0		
362+00	363+44	RT SB	144	0.0125	2.0	4.0		
368+78	371+63	LT SB	285	0.0125	4.0	8.0		
362+00	373+00	CL NB	1100	0.0125	14.0	28.0		
381+73	384+00	CL SB	227	0.0125	3.0	6.0		
16+94	25+08 F	RT RAMP "X	" 814	0.0125	11.0	22.0		
373+00	373+50	CL NB	50	0.0125	1.0	2.0		
384+00	395+00	CL SB	1100	0.0125	14.0	28.0		
385+77	388+19	LT NB	242	0.0125	4.0	8.0		
388+19	395+00	LT NB	681	0.0125	9.0	18.0		
385+77	395+00	RT NB	923	0.0125	12.0	24.0		
395+00	409+00	CL SB	1400	0.0125	18.0	36.0		
409+00	410+75	CL SB	175	0.0125	3.0	6.0		
395+00	399+00	LT NB	400	0.0125	6.0	12.0		
395+00	398+81	RT NB	381	0.0125	5.0	10.0		
					TOTAL	266.0		

RAISED REFLECTIVE PAVEMENT MARKER								
STATION	STATION	DIRECTION OF TRAVEL	OFFSET	LENGTH (FOOT)	NOMINAL COUNT (EA/FT)	COUNT (EACH)		
373+50	375+49	CL NB	CL	199	0.025	6		
378+21	382+58	CL NB	CL	437	0.025	12		
23+15	23+50	CL RAMP "T"	CL	35	0.025	2		
384+73	385+77	LT NB	CL	104	0.025	4		
384+80	385+77	RT NB	CL	97	0.025	4		
23+50	32+52	CL RAMP "T"	RT	902	0.025	24		
371+63	372+09	LT SB	CL	46	0.025	2		
375+80	378+60	CL SB	CL	280	0.025	8		
381+73	382+54	CL SB	CL	81	0.025	4		
					TOTAL	66		

	EARTH EXC	CAVATION	
LOCATION	AREA (SQ FT)	MAX EX DEPTH (FT)	VOLUME (CU YD)
RAMP V	2	0.7	72
RAMP V	75	1	2
RAMP V	4	1	157
RAMP R	177	1.5	10
RAMP R	277	0.8	9
RAMP X	3589	1.4	183
RAMP S	1387	0.8	43
RAMP S	989	1.5	37
	•	TOTAL	512

A	С	С		а , _{INC}	е

USER NAME = jent	DESIGNED .	-	DW	REVISED -
	DRAWN .	-	DW	REVISED -
PLOT SCALE = 2.0000 / in	CHECKED .	-	AB	REVISED -
PLOT DATE = 10/20/2021	DATE .	-	10-08-2021	REVISED -

STATE OF ILLINOIS **DEPARTMENT OF TRANSPORTATION**

	Sf	CHEDULES	OF QUA	NTITIES I	I	F.A.I. RTE	SEC ⁻	TION		COUNTY	TOTAL SHEETS	SHEET NO.
1	,	_57 AT I	_80 INTE	RCHANGE		57	2020-1	171-BR		соок	190	18
	_	-31 AT I					-			CONTRAC	Γ NO. 62	2M54
SCALE:	SHEET	OF	SHEETS	STA.	TO STA.			ILLINOIS	FED. A	ID PROJECT NHPP	EU3I(520)	

Т	EMPORARY PAV	/EMENT MAR	KING - LINE 4" -	TYPE IV TA	NPE .
	NEND STATION		DIRECTION	COLOR	LENGTH (FT)
	<u>'</u>	STA	GE 1		· /
353+10	372+70	RT	NB	YELLOW	1960
386+12	399+00	RT	NB	WHITE	1288
371+70	388+50	RT	NB	WHITE	1680
500+00	527+76	RT	RAMP X TO NB	YELLOW	2776
10+00	17+00	RT	RAMP X TO NB	YELLOW	700
17+00	25+00	RT	RAMP X TO NB	YELLOW	800
17+00	23+80	RT	RAMP X TO NB	WHITE	680
382+32	392+51	LT	NB	YELLOW	1019
386+12	399+00	LT	NB	WHITE	1288
388+53	401+00	RT	NB	WHITE	1247
366+00	368+48	LT	SB	WHITE	248
367+39	374+60	RT	SB	WHITE	721
367+39	375+49	RT	SB	YELLOW	810
22+72	26+02	LT	RAMP S TO SB	YELLOW	330
22+72	26+02	RT	RAMP S TO SB	WHITE	330
375+80	410+80	RT	SB	YELLOW	3500
382+85	390+80	LT	SB	WHITE	795
		STA			
349+50	381+25	<u>LT</u>	NB	YELLOW	3175
371+70	372+45	RT . . .	NB	WHITE	75
381+25	398+58	<u>LT</u>	NB	WHITE	1733
500+00	527+76	<u>LT</u>	RAMP X TO NB	YELLOW	100
10+00	23+55	RT	RAMP X TO NB	YELLOW	1355
20+09	23+98	RT	RAMP X TO NB	WHITE	389
381+26	388+58	LT LT	NB NB	WHITE	732
386+12 388+58	398+80 390+63	RT	NB NB	YELLOW WHITE	1268 205
333+03	374+62	RT	SB	YELLOW	4159
20+04	26+96	LT	RAMP S TO SB	YELLOW	692
20+04	25+07	RT	RAMP S TO SB	WHITE	503
357+00	370+00	RT	SB	WHITE	1300
357+00	370+00	LT	SB	WHITE	1300
364+00	369+00	LT	SB	WHITE	500
371+25	384+32	LT	SB	WHITE	1307
382+85	407+20	RT	SB	WHITE	2435
		STA	GE 3		
363+70	368+78	LT	SB	WHITE	508
363+70	371+25	LT	SB	YELLOW	755
12+29	13+35	LT	RAMP R	WHITE	106
369+89	384+32	LT	SB	WHITE	1443
22+30	25+53	LT	RAMP S TO SB	WHITE	323
20+04	25+07	LT	RAMP S TO SB	YELLOW	503
376+10	379+40	LT	SB	YELLOW	330
				TOTAL	45188

	SHOULDER RUMBLE STRIPS, 16 INCH									
STATION	STATION	DIRECTION OF TRAVEL	OFFSET	TOTAL LENGTH (FOOT)						
385+07	391+51	NB	LT	644						
371+51	375+49	NB	RT	398						
378+58	382+06	NB	RT	348						
388+57	393+00	NB	RT	443						
366+00	368+90	SB	LT	290						
365+00	372+10	SB	RT	710						
375+80	378+73	SB	RT	293						
381+70	385+00	SB	RT	330						
381+83	385+00	SB	LT	317						
			TOTAL	3773						

TEMF	TEMPORARY PAVEMENT MARKING - LINE 5" - TYPE IV TAPE							
BEGIN STATION	END STATION	OFFSET (LT/RT)	DIRECTION OF TRAVEL	COLOR	LENGTH (FT)			
		STAGE	2					
383+00	388+10	LT	NB	WHITE	490			
388+10	399+80	LT	NB	WHITE	290			
390+63	399+80	RT	NB	WHITE	230			
		STAGE	3					
362+70	370+00	RT	SB	WHITE	180			
362+70	384+32	LT	SB	WHITE	540			
				TOTAL	1730			

TEME	TEMPORARY PAVEMENT MARKING - LINE 6" - TYPE IV TAPE								
I CIVIP									
BEGIN STATION	END STATION	OFFSET (LT/RT)	DIRECTION OF TRAVEL	COLOR	LENGTH (FT)				
		STAGE	1						
372+70	386+12	RT	NB	YELLOW	1342				
381+00	386+12	RT	NB	WHITE	512				
371+40	382+85	LT	SB	WHITE	1145				
		STAGE	2						
372+45	386+12	RT	NB	WHITE	1367				
380+85	386+12	RT	NB	YELLOW	527				
370+00	374+62	RT	NB	WHITE	462				
25+07	26+96	RT	RAMP S	WHITE	189				
370+00	382+85	LT	NB	YELLOW	1285				
		STAGE	3						
371+25	374+62	RT	SB	WHITE	337				
25+07	26+96	RT	RAMP S	YELLOW	189				
				TOTAL	7329				

	TEMPORARY PAVEMENT MARKING - LINE 8" - TYPE IV TAPE							
IEMI	PORARY PAVE			TYPE IV TAPE				
BEGIN STATION	END STATION	OFFSET (LT/RT)	DIRECTION OF TRAVEL	COLOR	LENGTH (FT)			
	STAGE 1							
368+10	371+70	RT	NB	WHITE	360			
387+97	388+59	RT	NB	WHITE	62			
387+97	388+59	RT	NB	WHITE	62			
368+48	369+80	LT	SB	WHITE	132			
368+48	369+80	LT	SB	WHITE	132			
10+40	13+24	LT	RAMP R	WHITE	284			
374+60	375+80	RT	SB	WHITE	120			
26+02	26+96	CL	RAMP S	WHITE	94			
		STAGE	2					
364+50	371+70	RT	NB	WHITE	720			
11+90	14+07	LT	RAMP V	WHITE	217			
387+73	388+58	RT	NB	WHITE	85			
13+49	14+56	LT	RAMP V	WHITE	107			
368+78	369+79	LT	SB	WHITE	101			
12+38	13+35	LT	RAMP R	WHITE	97			
384+32	387+20	LT	SB	SB	288			
		STAGE	3					
368+78	369+89	LT	SB	WHITE	111			
12+29	13+35	LT	RAMP R	WHITE	106			
370+00	376+10	RT	SB	WHITE	610			
25+53	26+68	RT	RAMP S	WHITE	115			
384+32	387+20	RT	SB	WHITE	288			
				TOTAL	4091			

	CHANGEABLE MESSAGE SIGN							
LOCATION	NUMBER	PERIODS	WEEKS/ PERIOD	DAYS/ WEEK	TOTAL (CAL DA)			
		STAGE 1						
I-57 NB	1	1	2	7	14			
I-57 SB	1	1	2	7	14			
		STAGE 2						
I-57 NB	1	1	2	7	14			
I-57 SB	1	1	2	7	14			
		STAGE 1						
I-80 EB	1	1	2	7	14			
I-80 WB	1	1	2	7	14			
		STAGE 2						
I-80 EB	1	1	2	7	14			
I-80 WB	1	1	2	7	14			
				TOTAL	112			

IMPACT ATTE	IMPACT ATTENUATORS, TEMPORARY (FULLY REDIRECTIVE, NARROW), TEST LEVEL 3							
STATION	DIRECTION OF TRAVEL	OFFSET	SN	TOTAL COUNT (EACH)				
		STAGE 1						
23+30	RAMP "X"	RT	016-2026	1				
372+20	NB	RT	016-0053	1				
384+23	SB	LT	016-2027	1				
		STAGE 2	•					
24+57	RAMP "S"	RT	016-0052	1				
			TOTAL	4				

IMPACT ATTEN	IMPACT ATTENUATORS, RELOCATE (FULLY REDIRECTIVE, NARROW), TEST LEVEL 3							
STATION	DIRECTION OF TRAVEL	OFFSET	SN	TOTAL COUNT (EACH)				
		STAGE 2						
371+95	NB	RT	016-0053	1				
23+05	RAMP "X"	RT	016-2026	1				
384+23	SB	CL	016-2027	1				
		STAGE 3						
24+09	RAMP "S"	LT	016-0052	1				
			TOTAL	4				

RI	RELOCATE TEMPORARY CONCRETE BARRRIER									
STATION	STATION	DIRECTION OF TRAVEL	OFFSET	ROADWAY	TOTAL LENGTH (FOOT)					
STAGE 2										
371+95	386+45	NB	LT	I-57	1425.0					
23+05	28+80	NB	RT	RAMP X	575.0					
370+00	384+23	SB	RT	I-57	1425.0					
		STAGE 3								
24+08	377+42	SB	RT	RAMP S	687.5					
				TOTAL	4112.5					

A c	С		a , inc	е

USER NAME = jschumann	DESIGNED	-	DW	REVISED	-
	DRAWN	-	DW	REVISED	-
PLOT SCALE = 2.0000 / in	CHECKED	-	AB	REVISED	-
PLOT DATE = 11/16/2021	DATE	-	10-08-2021	REVISED	-

STATE OF ILLINOIS
DEPARTMENT OF TRANSPORTATION

S	CHEDULES	OF QUA	NTITIES	III	F.A.I. RTE.	SEC ⁻	ΓΙΟΝ		COUNTY	TOTAL SHEETS	SHEET NO.
I-57 AT I-80 INTERCHANGE			57	2020-1	71-BR		COOK	190	19		
1	1-37 AT I	-00 HAIL	IIUIIANUI	_					CONTRACT	T NO. 62	2M54
SHEET	OF	SHEETS	STA.	TO STA.			ILLINOIS	FED. A	D PROJECT NHPP-	EU3I(520)	

	ILLING EXIST	ING RUMBLE S	STRIP	
STATION	STATION	DIRECTION OF TRAVEL	OFFSET	LENGTH (FOOT)
385+07	391+51	NB	LT	644
371+51	375+49	NB	RT	398
378+58	382+06	NB	RT	348
388+57	393+00	NB	RT	443
366+00	368+90	SB	LT	290
365+00	372+10	SB	RT	710
375+80	378+73	SB	RT	293
381+70	385+00	SB	RT	330
381+83	385+00	SB	LT	317
		-	TOTAL	3773

	AGGREGATE BASE COURSE, TYPE B 4"								
STATION STATION OFFSET DIRECTION TOTAL AREA TOTAL AREA (SQ FT) (SQ YD)									
23+74	25+77	RT	RAMP S	2376	264				
13+35	14+67	L	RAMP R	454	50				
14+32	14+32 14+71 LT RAMP V 74 8								
	TOTAL 323								

CLASS D PATCHES, TYPE IV, 13 INCH (SPECIAL)									
STATION STATION OFFSET ROADWAY TOTAL AREA (SQ YD)									
20+93	24+03	RT	I-80 TO I-57 NB RAMP	289					
23+30	24+40	LT	I-80 TO I-57 NB RAMP	109					
			TOTAL	399					

AGGREGATE SUBGRADE IMPROVEMENT										
STATION	STATION	OFFSET	DIRECTION OF TRAVEL	TOTAL AREA (SQ FT)	THICKNESS (IN)	VOLUME (CU YD)				
14+32	25+49	RT	RAMP V	9714	3.5	105				
	TOTAL 105									

TEMP	TEMPORARY PAVEMENT MARKING - LINE 12" - TYPE IV TAPE										
BEGIN STATION	END STATION	OFFSET (LT/RT)	DIRECTION OF TRAVEL	COLOR	LENGTH (FT)						
		STAGE	<u> 1</u>								
387+87	388+59	RT	NB	WHITE	27						
368+90	369+80	RT	SB	WHITE	80						
		STAGE	2								
368+44	371+70	RT	NB	WHITE	120						
387+73	388+58	RT	NB	WHITE	44						
368+78	369+79	LT	SB	WHITE	39						
		STAGE	3								
368+78	369+89	LT	SB	WHITE	37						
375+00	376+00	LT	SB	WHITE	51						
384+32	387+20	LT	SB	WHITE	170						
				TOTAL	568						

THERMO	THERMOPLASTIC PAVEMENT MARKING - LETTERS AND SYMBOLS										
STATION	OFFSET	SYMBOL	AREA (SQ FT)								
386+16	LT	LANE DROP ARROW	42								
393+27	LT	LANE DROP ARROW	42								
		TOTAL	83								

CLEAN AND RESEAL RELIEF JOINT									
	DIRECTON		TOTAL						
STATION	OF TRAVEL	OFFSET	LENGTH (FT)						
372+19	I-57 SB	CENTER	69						
375+30	I-57 SB	CENTER	70						
375+76	I-57 NB	CENTER	51						
378+38	I-57 NB	CENTER	48						
378+97	I-57 SB	CENTER	48						
381+58	I-57 SB	CENTER	54						
382+24	I-57 NB	CENTER	85						
385+10	I-57 NB	CENTER	78						
		TOTAL	504						

TEMPORARY PAVEMENT MARKING - LINE 6" - PAINT									
STATION	STATION	OFFSET (LT/RT)	LENGTH (FT)	DIRECTION OF TRAVEL	TOTAL LENGTH (FOOT)				
		;	STAGE 1		, ,				
371+40	382+85	CL	1162.5	SB	1163				
372+70	386+12	RT	1350.0	NB	1350				
23+80	28+80	RT	512.5	RAMP "X"	513				
		(STAGE 2						
370+00	382+85	LT	1300.0	SB	1300				
370+00	374+62	RT	475.0	SB	475				
25+07	26+95	RT	200.0	RAMP "S"	200				
372+45	386+12	RT	1375.0	NB	1375				
23+55	28+80	RT	537.5	RAMP "X"	538				
		(STAGE 3						
371+25	374+62	RT	350.0	SB	350				
25+07	26+96	RT	200.0	RAMP "S"	200				
				TOTAL	7463				

BARRIER WALL REFLECTORS, TYPE C									
STATION	STATION	DIRECTION OF TRAVEL	OFFSET	TOTAL LENGTH (FOOT)	TOTAL NUMBER (EACH)				
		STA	GE 1						
372+20	386+74	NB	RT	1450.0	116				
23+31	29+44	NB	RT	612.5	48				
371+40	384+23	SB	VAR.	1287.5	102				
372+60	375+22	SB	RT	262.5	10				
379+30	381+49	SB	RT	225.0	9				
376+15	378+58	NB	RT	237.5	9				
382+35	384+78	NB	LT	237.5	9				
382+53	384+96	NB	RT	237.5	9				
		STAC	GE 2						
370+00	375+50	SB	RT	550.0	22				
24+56	26+00	SB	LT	150.0	6				
372+40	375+04	SB	RT	262.5	10				
372+60	375+22	SB	RT	262.5	10				
379+04	381+19	SB	LT	212.5	8				
375+82	378+59	NB	LT	275.0	11				
371+95	386+45	NB	LT	1450.0	58				
23+05	28+80	NB	RT	575.0	2				
370+00	384+23	SB	RT	1425.0	114				
		STAC	GE 3						
24+08	377+42	SB	RT	687.5	27				
				TOTAL	580				

	PINNING TE	MPORARY (CONCRET	E BARRIE	R
STATION	STATION	DIRECTION OF TRAVEL	OFFSET	TOTAL LENGTH (FOOT)	TOTAL NUMBER (EACH)
		STAG	E 1		
372+70	375+76	NB	RT	300.0	66
378+38	382+00	NB	RT	362.5	87
384+19	386+75	NB	RT	250.0	54
384+73	386+74	NB	LT	200.0	42
23+30	24+62	RAMP X	RT	137.5	27
371+40	372+10	SB	CL	75.0	12
375+35	378+97	SB	CL	362.5	81
381+59	382+85	SB	CL	125.0	24
382+85	384+23	SB	LT	137.5	27
		STAG	E 2		
371+95	375+77	NB	RT	387.5	87
379+39	382+24	NB	RT	287.5	69
384+73	386+12	NB	LT	137.5	27
384+80	386+12	NB	RT	137.5	27
23+05	24+85	RAMP X	RT	175.0	36
370+00	372+28	SB	L	225.0	48
370+00	372+35	SB	RT	237.5	57
375+33	378+42	SB	LT	312.5	69
381+51	384+23	SB	LT	275.0	60
24+80	25+57	RAMP S	LT	75.0	12
		STAG	E 3		
370+75	372+34	SB	RT	162.5	33
23+09	26+20	RAMP S	RT	312.5	69
				TOTAL	1014

A	С	С		a ', IN:	е	
	Ū	Ĭ			Ŭ	

USER NAME = jschumann	DESIGNED	-	DW	REVISED -	
	DRAWN	-	DW	REVISED -	
PLOT SCALE = 2 0000 / in	CHECKED	-	AB	REVISED -	
PLOT DATE = 11/16/2021	DATE	-	10-08-2021	REVISED -	

,	CHEDULES	OF QUA	NTITIES	IV	F.A.I. RTE	SEC.	TION		COUNTY	TOTAL SHEETS	SHEET NO.
	I-57 AT I	_en inte	BCHANG	2F	57	2020-1	171-BR		COOK	190	20
	1-37 AT I	-00 HAIL	IIUIIAIN	<u>, , , , , , , , , , , , , , , , , , , </u>					CONTRACT	NO. 62	2M54
SHEET	OF	SHEETS	STA.	TO STA.			ILLINOIS	FED. A	ID PROJECT NHPP-	EU3I(520)	

WELDED WIRE REINFORCEMENT										
STATION	STATION	DIRECTION OF TRAVEL	OFFSET	AREA (SQ FT)	AREA (SQ YD)					
371+63	372+39	I-57 SB	CL	4249.30	472					
381+38	381+83	I-57 SB	CL	1161.53	129					
385+01	385+26	I-57 NB	CL	1059.00	118					
				TOTAL	719					

	CONCRETE PAVEMENT SCARIFICATION								
STATION	STATION	OFFSET	DIRECTION OF TRAVEL	TOTAL AREA (SQ FT)	TOTAL AREA (SQ YD)				
372+23	372+70	APPR. SLAB	I-57 SB	1993	221				
375+48	376+25	APPR. SLAB & CONNECTO	I-57 NB	2331	259				
381+09	381+72	APPR. SLAB	I-57 SB	1222	136				
384+68	385+17	APPR. SLAB	I-57 NB	2307	256				
		•		TOTAL	873				

PREFORMED PLASTIC PAVEMENT MARKING, TYPE D - LINE 4"									
BEGIN STATION	END STATION	OFFSET (LT/RT)	DIRECTION OF TRAVEL	LENGTH (FT)					
347+00	362+00	LT	NB	377					
362+00	367+70	LT	NB	144.5					
			TOTAL	522					

THERMOPLASTIC PAVEMENT MARKING - LINE 4"								
STATION	STATION	OFFSET	LENGTH (FT)	DIRECTION OF TRAVEL				
		ELLOW S						
347+00	349+00	RT	200	NB				
349+00	362+00	RT	1300	NB				
364+38	371+63	CL	725	SB				
13+35	13+68	CL	33	RAMP "R"				
362+00	373+00	CL	1100	NB				
374+99	379+13	LT	414	SB				
382+54	384+00	LT	146	SB				
20+04	26+44	CL	640	RAMP "S"				
16+94	25+08	CL	814	RAMP "X"				
373+00	375+49	LT	249	NB				
377+97	380+69	LT	272	NB				
23+15	23+50	LT	35	RAMP "T"				
384+00	389+07	RT	507	SB				
385+77	392+51	LT	674	NB				
14+32	17+00	LT	268	RAMP "V"				
23+50	32+52	LT	902	RAMP "T"				
17+00	25+49	LT	849	RAMP "V"				
		WHITE SO	DL I D					
365+63	368+78	LT	315	SB				
10+55	10+94	CL	39	RAMP "R"				
367+70	369+50	RT	180	NB				
371+53	373+00	RT	147	NB				
375+04	379+40	LT	436	SB				
382+54	384+00	LT	146	SB				
20+04	25+80	LT	576	RAMP "S"				
16+94	24+02	RT	708	RAMP "X"				
373+00	375+49	RT	249	NB				
378+16	382+58	RT	442	NB				
17+15	22+57	LT	542	RAMP "T"				
23+15	23+50	CL	35	RAMP "T"				
384+00	384+32	LT	32	SB				
12+07	17+00	CL	493	RAMP "V"				
388+56	394+49	RT	593	NB				
23+50	32+52	CL	902	RAMP "T"				
17+00	25+49	CL	849	RAMP "V"				
		TOTAL	15812					

				GUAI	RDRAIL SCHEDULE				
STATION	STATION	DIRECTION OF TRAVEL	OFFSET	STEEL PLATE BEAM GUARDRAIL, TYPE A, 6 FOOT POSTS (FOOT)	TRAFFIC BARRIER TERMINAL, TYPE 6 (EACH)	TRAFFIC BARRIER TERMINAL, TYPE 10 (EACH)	TRAFFIC BARRIER TERMINAL, TYPE 1 (SPECIAL) TANGENT (EACH)	TERMINAL MARKER - DIRECT APPLIED (EACH)	GUARDRAIL REMOVAL (FOOT)
372+23.3	372+60.8	SB	RT	37.5					37.5
372+60.8		SB	RT			1			
25+96.6	26+34.1	RAMP "V"	LT						37.5
26+34.1		RAMP "V"	LT		1				
375+08.6	379+04.6	SB	LT	362.5					396.0
375+08.6		SB	LT		1				
379+04.6		SB	LT			1			
381+17.7	381+55.2	SB	LT						37.5
381+17.7		SB	LT		1				
381+48.4	381+85.9	SB	RT						37.5
381+48.4		SB	RT		1				
373+23.5	376+15.	NB	RT	225.0					291.5
373+23.6		NB	RT				1	1	
376+15.4		NB	RT		1				
378+57.1	382+53.7	NB	RT	362.5					396.6
378+57.1		NB	RT			1			
382+53.7		NB	RT		1				
21+95	25+00.	RAMP "X"	LT	225.0					305.0
21+95		RAMP "X"	LT				1	1	
25+01.1		RAMP "X"	LT		1				
384+77.7	385+15.2	NB	LT	37.5					37.5
384+77.7		NB	LT			1			
384+95.8	385+33.3	NB	RT	37.5					37.5
384+95.8		NB	RT			1			
		TOTAL		1287.5	7	5	2	2	1614.1

THE	THERMOPLASTIC PAVEMENT MARKING - LINE 8"								
BEGIN STATION	END STATION	OFFSET (LT/RT)	DIRECTION OF TRAVEL	LENGTH (FOOT)					
369+50	371+53	RT	NB	203.0					
380+69	382+08	LT	NB	139.0					
387+19	388+56	RT	NB	137.0					
385+77	388+19	LT	NB	242.0					
385+77	388+19	LT	NB	242.0					
24+02	25+08	RT	RAMP "X"	106.0					
13+00	14+32	RT	RAMP "V"	132.0					
11+52	12+07	CL	RAMP "V"	55.0					
366+95	371+63	RT	SB	468.0					
366+95	371+63	RT	SB	468.0					
374+99	375+67	RT	SB	68.0					
374+99	375+80	RT	SB	81.0					
384+32	389+07	LT	SB	475.0					
11+73	13+35	LT	RAMP "R"	162.0					
11+73	13+35	LT	RAMP "R"	162.0					
			TOTAL	3140.0					

	THERMOPLASTIC PAVEMENT MARKING - LINE 12"									
BEGIN STATION	END STAT I ON	OFFSET	LARGEST	SMALLEST	NUMBER OF CHEVRONS	LENGTH (FT)	DIRECTION OF TRAVEL			
STATION	STATION	(LT/RT)	CHEVRON	CHEVRON	CHEVRONS	, ,	OF TRAVEL			
CHEVRONS										
369+50	371+53	RT	21.4	7.2	6	85.8	NB			
381+25	382+58	RT	30.7	15.0	3	68.6	NB			
385+77	38819+	LT	5.9	5.7	4	23.1	NB			
387+19	388+58	RT	30.0	8.0	4	76.0	NB			
368+78	370+45	LT	30.4	4.7	5	87.6	SB			
366+95	371+63	RT	3.8	3.8	11	41.4	SB			
375+00	375+67	RT	15.5	9.5	2	25.0	SB			
			WHIT	E DIAGONAL	_S					
371+53	375+49	RT	15.0	12,5	6	82.5	NB			
377+97	382+58	RT	14.0	14.0	1	14.0	NB			
25+08	25+08	CL	12.0	12.0	1	12.0	RAMP "X"			
375+04	379+13	LT	12.0	12.0	1	12.0	SB			
381+83	384+00	LT	12.5	12.5	2	25.0	SB			
384+32	389+07	LT	23.9	7.9	16	254.1	SB			
23+15	32+52	RT	12.6	12.6	2	25.2	RAMP "T"			
20+04	25+80	RT	11.2	11.2	1	11.2	RAMP "S"			
			YELLO	OW DIAGONA	LS					
380+00	380+00	LT	12.0	12.0	1	12.0	NB			
385+23	388+00	LT	12.5	12.5	1	12.5	NB			
369+39	371+63	RT	11.5	11.5	1	11.5	SB			
375+04	379+13	RT	12.0	12.0	1	12.0	SB			
						TOTAL	891			

	TEMPO	RARY PAVE	MENT MARKIN	IG - LINE 8" - I	PAINT	
STATION	STATION	OFFSET (LT/RT)	LENGTH (FT)	DIRECTION OF TRAVEL		FOOT
369+50	371+53	RT	203.0	NB		203.0
380+69	382+08	LT	139.0	NB		139.0
387+19	388+56	RT	137.0	NB		137.0
385+77	388+19	LT	242.0	NB		242.0
385+77	388+19	LT	242.0	NB		242.0
24+02	25+08	RT	106.0	RAMP "X"		106.0
13+00	14+32	RT	132.0	RAMP "V"		132.0
11+52	12+07	CL	55.0	RAMP "V"		55.0
366+95	371+63	RT	468.0	SB		468.0
366+95	371+63	RT	468.0	SB		468.0
374+99	375+67	RT	68.0	SB		68.0
374+99	375+80	RT	81.0	SB		81.0
384+32	389+07	LT	475.0	SB		475.0
11+73	13+35	LT	162.0	RAMP "R"		162.0
11+73	13+35	LT	162.0	RAMP "R"		162.0
BEGIN STATION	IEND STATION	OFFSET (LT/RT)	LENGTH (FT)	DIRECTION OF TRAVEL	NUMBER OF LINES	
371+63	375+00	RT	337.0	SB	2	674.0
382+08	385+77	LT	369.0	NB	2	738.0
385+18	385+77	RT	59.0	NB	1	59.0
					TOTAL	4611

е

USER NAME = jschumann	DESIGNED	-	DW	REVISED	-
	DRAWN	-	DW	REVISED	-
PLOT SCALE = 2 0000 / in	CHECKED	-	AB	REVISED	-
PLOT DATE = 11/16/2021	DATE	-	10-08-2021	REVISED	-

STATE OF ILLINOIS DEPARTMENT OF TRANSPORTATION

_		s	CHEDULES	OF QUA	NTITIES	V	F.A.I. RTE	SEC	TION		COUNTY	TOTAL SHEETS	SHEET NO.
			I–57 AT I	QO INTE	BUHVNGE	•	57	2020-	171-BR		COOK	190	21
		,	I-J/ A1 I	-OU HAIL	NUITAINGL	•					CONTRAC	Γ NO. 62	2M54
	SCALE:	SHEET	OF	SHEETS	STA.	TO STA.			ILLINOIS	FED. A	ID PROJECT NHPP	EU3I(520)	

MODIF	MODIFIED URETHANE PAVEMENT MARKING - LINE 4"									
STATION	STATION	OFFSET	DIRECTION OF TRAVEL	TOTAL LENGTH (FOOT)						
	YI	ELLOW SOLID								
375+49	377+97	LT	NB	248.0						
382+43	385+77	LT	NB	334.0						
371+63	373+00	RT	SB	137.0						
373+00	375+14	RT	RAMP "S"	214.0						
379+13	382+54	RT	SB	341.0						
	\	VHITE SOLID								
371+63	373+00	LT	SB	137.0						
373+00	374+99	LT	SB	199.0						
375+49	377+16	RT	NB	167.0						
382+08	384+00	RT	NB	192.0						
384+00	385+77	RT	NB	177.0						
379+40	382+54	LT	SB	314.0						
			TOTAL	2460.0						

TEMPORARY PAVEMENT MARKING - LINE 5" - PAINT							
STATION	STATION	OFFSET (LT/RT)	LENGTH (FT)	DIRECTION OF TRAVEL	TOTAL LENGTH (FOOT)		
347+00	362+00	CL	390.0	NB	390.0		
362+00	375+49	CL	350.0	NB	350.0		
377+97	382+58	CL	130.0	NB	130.0		
385+77	398+81	CL	340.0	NB	340.0		
385+77	388+19	LT	70.0	NB	70.0		
388+19	399+00	LT	280.0	NB	280.0		
23+15	32+52	CL	240.0	RAMP "T"	240.0		
16+94	25+08	LT	210.0	RAMP "X"	210.0		
368+78	371+63	LT	80.0	SB	80.0		
375+04	379+26	CL	120.0	SB	120.0		
382+54	410+75	CL	720.0	SB	720.0		
356+99	363+44	LT	170.0	SB	170.0		
STATION	STATION	OFFSET (LT/RT)	LENGTH (FT)	DIRECTION OF TRAVEL			
375+49	377+97	CL	70.0	NB	70.0		
371+63	374+99	LT	90.0	SB	90.0		
379+13	382+54	CL	100.0	SB	100.0		
382+58	385+77	CL	90.0	NB	90.0		
382+58	385+77	LT	90.0	NB	90.0		
				TOTAL	3540		

MODIFIED URETHANE PAVEMENT MARKING - LINE 8"									
STATION	STATION OFFSET NUMBER OF LINES		DIRECTION OF TRAVEL	TOTAL LENGTH (FOOT)					
WHITE SOLID									
371+63	375+00	RT	2	SB	674.0				
382+08	385+77	LT	2	NB	738.0				
385+18	385+77	RT	1	NB	59.0				
			TOTAL	1471.0					

PREFORMED PLA	ASTIC PAVEMEN	T MARKING, TYPE	D - LINE	8", CONTRAST
BEGIN STATION	END STATION	OFFSET (LT/RT)	LENGTH	DIRECTION OF TRAVEL
375+49	377+97	CL	70.0	NB
371+63	374+99	LT	90.0	SB
379+13	382+54	CL	100.0	SB
382+58	385+77	CL	90.0	NB
382+58	385+77	LT	90.0	NB
		TOTAL	440	

		REPLACE	MENT REF	LECTOR					
STATION	STATION	DIRECTION OF TRAVEL	OFFSET	LENGTH (FOOT)	NOMINAL COUNT (EA/FT)	COUNT (EACH)			
347+00	349+00	NB	RT	200	0.025	6			
349+00	362+00	NB	RT	1300	0.025	34			
356+99	362+00	SB	RT	501	0.025	14			
362+00	363+44	SB	RT	144	0.025	4			
368+78	371+63	SB	LT	285	0.025	8			
362+00	373+00	NB	CL	1100	0.025	28			
381+73	384+00	SB	CL	227	0.025	6			
16+94	25+08	RAMP X	RT	814	0.025	22			
373+00	373+50	NB	CL	50	0.025	2			
384+00	395+00	SB	CL	1100	0.025	28			
385+77	388+19	NB	LT	242	0.025	8			
388+19	395+00	NB	LT	681	0.025	18			
385+77	395+00	NB	RT	923	0.025	24			
395+00	409+00	SB	CL	1400	0.025	36			
409+00	410+75	SB	CL	175	0.025	6			
395+00	399+00	NB	LT	400	0.025	12			
395+00	398+81	NB	RT	381	0.025	10			
			·		TOTAL	266			

	TI	EMPORAR'	Y PAVEMEN	IT MARKING -	LINE 12" - PA	NT	
STATION	STATION	OFFSET	LARGEST CHEVRON	SMALLEST CHEVRON	NUMBER OF CHEVRONS	DIRECTIO N OF TRAVEL	LENGTH (FT)
369+50	371+53	RT	21.4	7 . 2	6	NB	85.8
381+25	382+58	RT	30.7	15.0	3	NB	68.6
385+77	38819+	LT	5.9	5.7	4	NB	23.1
387+19	388+58	RT	30.0	8.0	4	NB	76.0
368+78	370+45	LT	30.4	4.7	5	SB	87.6
366+95	371+63	RT	3,8	3,8	11	SB	41.4
375+00	375+67	RT	15.5	9.5	2	SB	25.0
371+53	375+49	RT	150	10.5	6	ND	92.5
371+53	382+58	RT	15.0 14.0	12.5 14.0	1	NB NB	82.5 14.0
25+08	25+08	CL	12.0	12.0	1	RAMP "X"	12.0
375+04	379+13	LT	12.0	12.0	1	SB SB	12.0
			12.5	12.0	2	SB	25.0
381+83	384+00	LT		· - · ·			
384+32	389+07	LT	23.9	7.9	16	SB SAME "T"	254.1
23+15	32+52	RT	12.6	12.6	2	RAMP "T"	25.2
20+04	25+80	RT	11.2	11.2	1	RAMP "S"	11.2
380+00	380+00	LT	12.0	12.0	1	NB	12.0
385+23	388+00	LT	12.5	12.5	1	NB	12.5
369+39	371+63	RT	11.5	11.5	1	SB	11.5
375+04	379+13	RT	12.0	12.0	1	SB	12.0
STATION	STATION	OFFSET	LARGEST CHEVRON	SMALLEST CHEVRON	NUMBER OF CHEVRONS	DIRECTIO N OF TRAVEL	LENGTH (FT)
382+58	385+77	LT	11.7	5.9	9	NB	79.2
371+63	375+04	RT	3.8	3.8	13	SB	48.9
372+09	374+99	LT	11.5	9.0	3	SB	30.8
379+13	382+54	LT	12.0	12.0	7	SB	84.0
375+49	378+21	RT	13.0	8.5	7	NB	75.3
382+58	384+80	LT	13.9	10.2	6	NB	72.3
372+09	374+99	RT	10.5	10.5	7	SB	73.5
392+63	393+94	LT	11.5	9.0	5	NB	51.3
						TOTAL	1407


MODIFIED URETHANE PAVEMENT MARKING - LINE 12"										
STATION	STATION	OFFSET	LARGEST CHEVRON	SMALLEST CHEVRONS	NUMBERS OF CHEVRONS	DIRECTION OF TRAVEL	TOTAL LENGTH (FOOT)			
WHITE CHEVRONS										
382+58	385+77	LT	11.7	5.9	9	NB	79.2			
371+63	375+04	RT	3.8	3.8	13	SB	48.9			
WHITE DIAGONALS										
372+09	374+99	LT	11.5	9.0	3	SB	30.8			
379+13	382+54	LT	12.0	12.0	7	SB	84.0			
375+49	378+21	RT	13.0	8.5	7	NB	75.3			
382+58	384+80	LT	13.9	10.2	6	NB	72.3			
	•		YELLOW	DIAGONALS						
372+09	374+99	RT	10.5	10.5	7	SB	73.5			
392+63	393+94	LT	11.5	9.0	5	NB	51.3			
		·	·			TOTAL	515			


	TEMPORAR	Y PAVEMENT		NE 4" - PAINT	
STATION	STATION	OFFSET	DIRECTION	LENGTH (FT)	TOTAL LENG
		(LT/RT)	OF TRAVEL	` ′	(FOOT)
347+00	349+00	RT	NB	200	200
349+00	362+00	RT	NB	1300	1300
364+38	371+63	CL	SB	725	725
13+35	13+68	CL	RAMP "R"	33	33
362+00	373+00	CL	NB	1100	1100
374+99	379+13	LT	SB	414	414
382+54	384+00	LT	SB	146	146
20+04	26+44	CL	RAMP "S"	640	640
16+94	25+08	CL	RAMP "X"	814	814
373+00	375+49	LT	NB	249	249
377+97	380+69	LT	NB	272	272
23+15	23+50	LT	RAMP "T"	35	35
384+00	389+07	RT	SB	507	507
385+77	392+51	LT	NB	674	674
14+32	17+00	LT	RAMP "V"	268	268
23+50	32+52	LT	RAMP "T"	902	902
17+00	25+49	LT	RAMP "V"	849	849
365+63	368+78	LT	SB	315	315
10+55	10+94	CL	RAMP "R"	39	39
367+70	369+50	RT	NB	180	180
371+53	373+00	RT	NB	147	147
375+04	379+40	LT	SB	436	436
382+54	384+00	LT	SB	146	146
20+04	25+80	LT	RAMP "S"	576	576
16+94	24+02	RT	RAMP "X"	708	708
373+00	375+49	RT	NB	249	249
378+16	382+58	RT	NB	442	442
17+15	22+57	LT	RAMP "T"	542	542
23+15	23+50	CL	RAMP "T"	35	35
384+00	384+32	LT	SB	32	32
12+07	17+00	CL	RAMP "V"	493	493
388+56	394+49	RT	NB	593	593
23+50	32+52	CL	RAMP "T"	902	902
17+00	25+49	CL	RAMP "V"	849	849
STATION	STATION	OFFSET (LT/RT)	DIRECTION OF TRAVEL	LENGTH (FT)	
347+00	362+00	LT	NB	377.0	377
362+00	367+70	LT	NB	144.5	145
STATION	STATION	OFFSET (LT/RT)	DIRECTION OF TRAVEL	LENGTH (FT)	
375+49	377+97	LT	NB	248.0	248
382+43	385+77	LT	NB	334.0	334
371+63	373+00	RT	SB	137.0	137
373+00	375+14	RT	RAMP "S"	214.0	214
379+13	382+54	RT	SB	341.0	341
371+63	373+00	LT	SB	137.0	137
373+00	374+99	LT	SB	199.0	199
375+49	377+16	RT	NB	167.0	167
382+08	384+00	RT	NB	192.0	192
384+00	385+77	RT	NB	177.0	177
379+40	382+54	LT	SB	314,0	314
· · · · ·				TOTAL	18794.0

A	С	С		а , _{INC}	е
A	С	С			е

USER NAME = jschumann	DESIGNED	-	DW	REVISED -
	DRAWN	-	DW	REVISED -
PLOT SCALE = 2,0000 / in.	CHECKED	-	AB	REVISED -
PLOT DATE = 11/16/2021	DATE	-	10-08-2021	REVISED -

					F.A.I. RTE			COUNTY	TOTAL SHEETS	SHEET NO.		
					57	2020-171-BR		COOK	190	22		
		1-37 A1	I-00 HAIL	IIUIIAIVU	-					CONTRACT	NO. 62	2M54
	SHEET	OF	SHEETS	STA.	TO STA.			ILLINOIS	FED. A	ID PROJECT NHPP-	EU3I(520)	

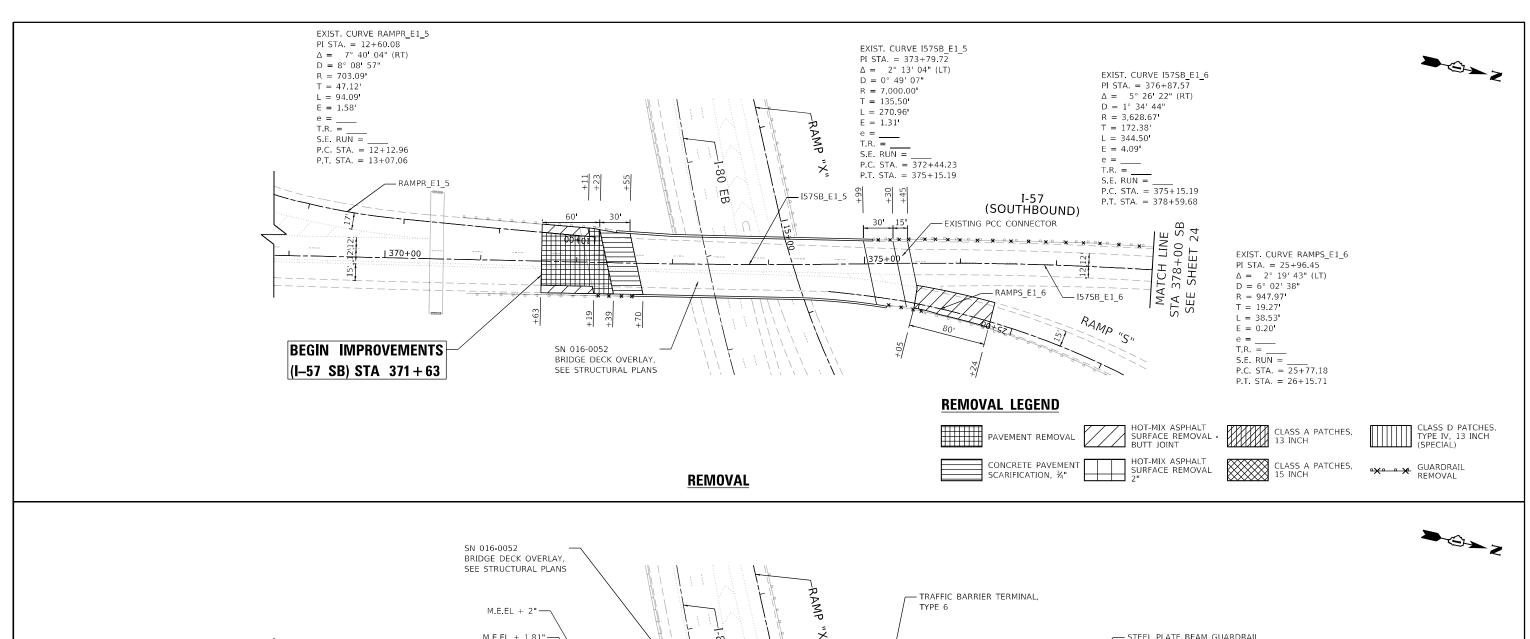

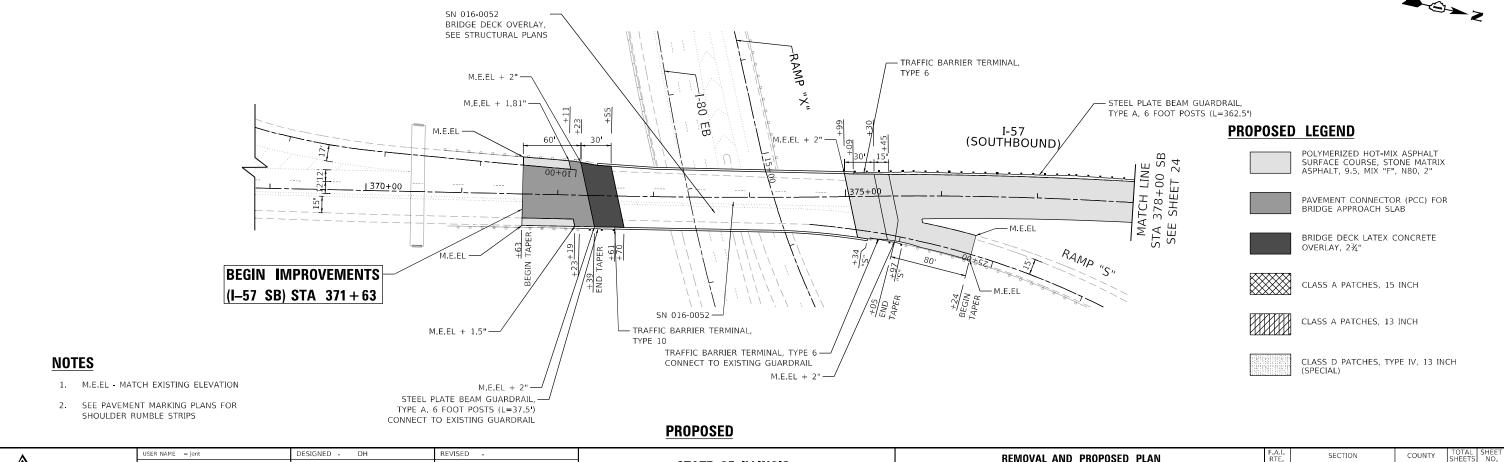




STATE OF ILLINOIS DEPARTMENT OF TRANSPORTATION

REN	IOVAL AN	ID PROP	OSED PLA	ΑN			
I-57 AT I-80 INTERCHANGE							
CHEET	O.E.	CHEETS	CTA	TO STA			

SCALE: 1" = 50'



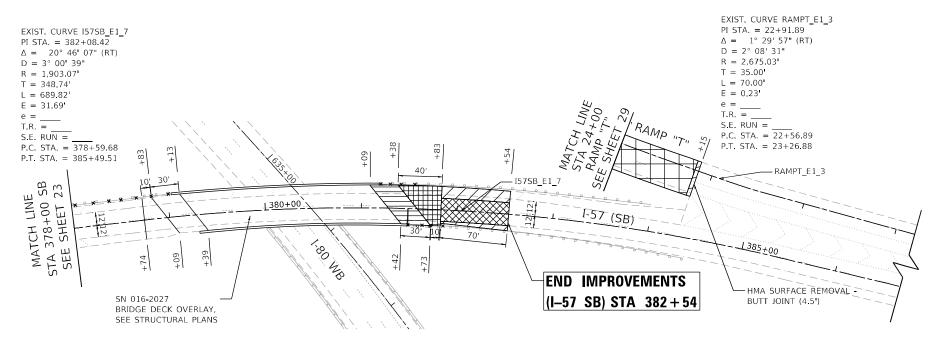

REMOVAL LEGEND

HOT-MIX ASPHALT SURFACE REMOVAL PAVEMENT REMOVAL

SURFACE REMOVAL

CONCRETE PAVEMENT

SCARIFICATION, ¾"

CLASS A PATCHES, 13 INCH


CLASS D PATCHES, TYPE IV, 13 INCH (SPECIAL)

CLASS A PATCHES, 15 INCH

GUARDRAIL REMOVAL

REMOVAL

→⊕→z

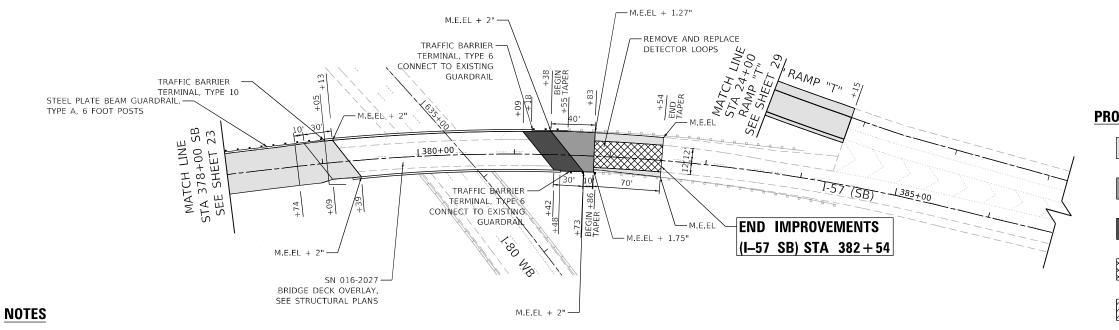

PROPOSED LEGEND

POLYMERIZED HOT-MIX ASPHALT SURFACE COURSE, STONE MATRIX ASPHALT, 9.5, MIX "F", N80, 2"

PAVEMENT CONNECTOR (PCC) FOR BRIDGE APPROACH SLAB

BRIDGE DECK LATEX CONCRETE OVERLAY, $2\frac{3}{4}$ "

CLASS A PATCHES, 15 INCH

CLASS A PATCHES, 13 INCH

CLASS D PATCHES, TYPE IV, 13 INCH (SPECIAL)

PROPOSED

뿌									
\approx									
$^{\circ}$									
66	_ A								
5	Δ Λ	_	_			_	+	_	
NAME:	A	С	С	u	r	а	ι	е	
z				G P	OLID	, INC			
щ	· / 32			a II	001	, ,,,,,,			
\equiv									

1. M.E.EL - MATCH EXISTING ELEVATION


SEE PAVEMENT MARKING PLANS FOR SHOULDER RUMBLES STRIPS


USER NAME = jent	DESIGNED	-	DH	REVISED -
	DRAWN	-	JS	REVISED -
PLOT SCALE = 100.0000 / in.	CHECKED	-	AB	REVISED -
PLOT DATE = 10/20/2021	DATE	-	10-08-2021	REVISED -

STATE OF ILLINOIS DEPARTMENT OF TRANSPORTATION


		F.A.I. RTE.	SECTIO					
ı		57	2020-171					
ı			-37 AT I	-00 HAIL	RCHANGE	-		
ı	SCALE: 1" = 50'	SHEET	OF	SHEETS	STA.	TO STA.		ILL

COOK 190 24 CONTRACT NO. 62M54

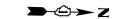

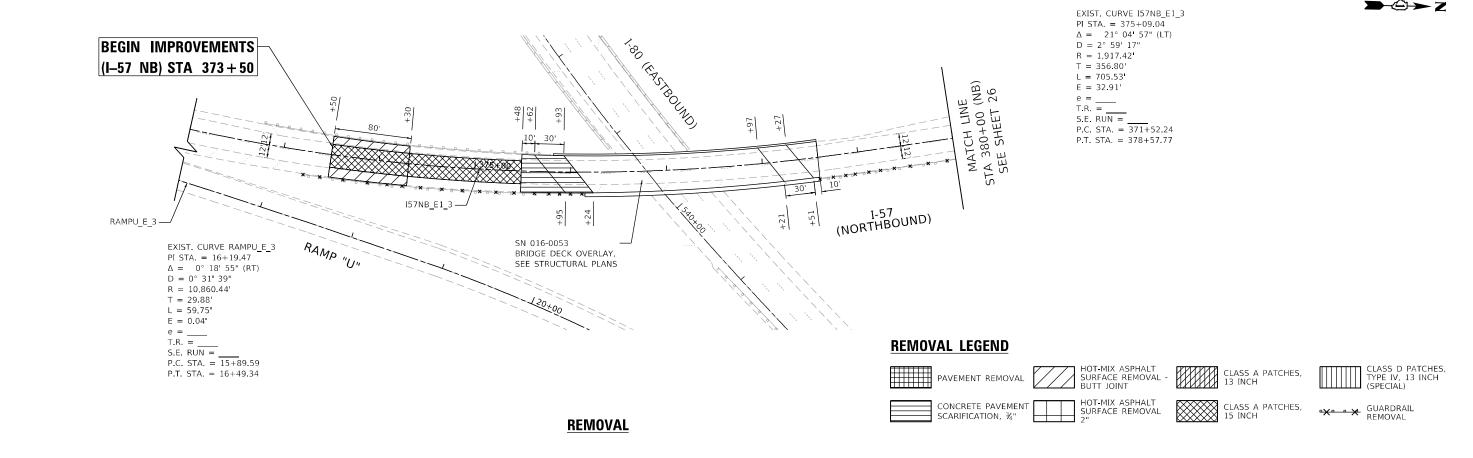



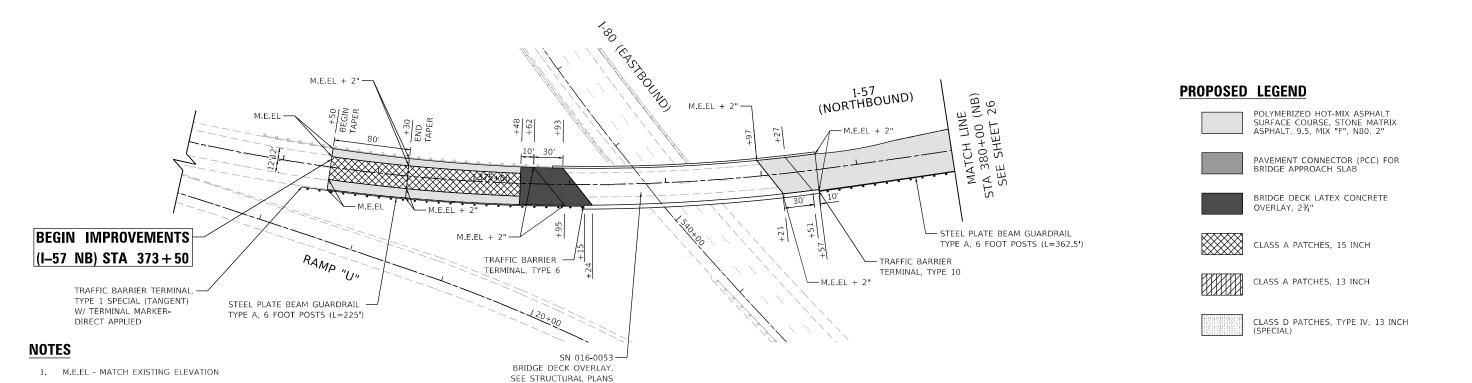

SEE PAVEMENT MARKING PLANS FOR SHOULDER RUMBLE STRIPS


USER NAME = jent	DESIGNED -	DH	REVISED -	
	DRAWN -	JS	REVISED -	
PLOT SCALE = 100.0000 ' / in.	CHECKED -	AB	REVISED -	DEP#
PLOT DATE = 10/20/2021	DATE -	10-08-2021	REVISED -	


STATE OF ILLINOIS PARTMENT OF TRANSPORTATION

PROPOSED

	REMOVAL AND PROPOSED PLAN							
I-57 AT I-80 INTERCHANGE							20	
		-37 AT 1-						
SCALE: 1" = 50'	SHEET	OF	SHEETS	STA.	TO STA.			

SECTION 2020-171-BR COOK 190 25 CONTRACT NO. 62M54

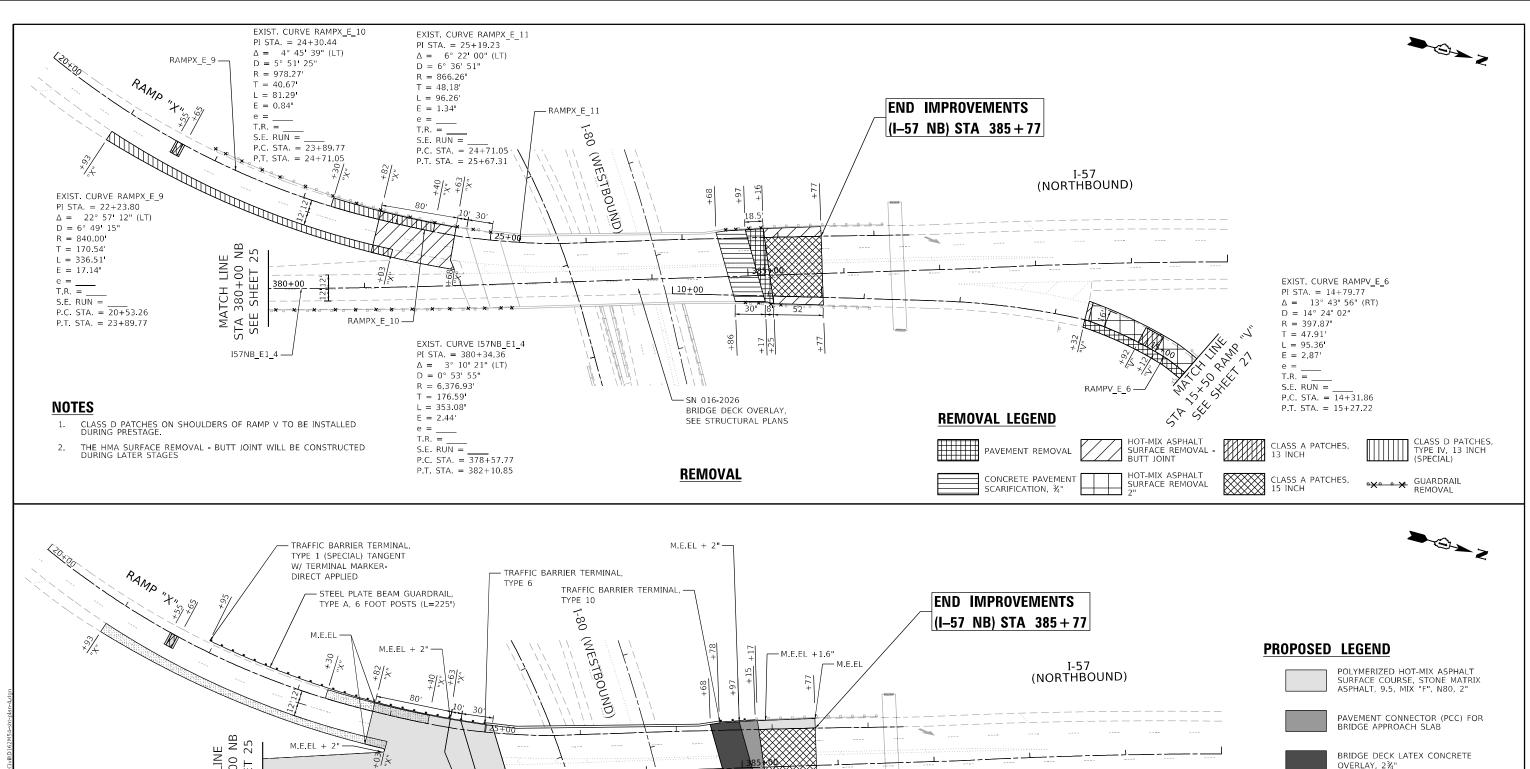

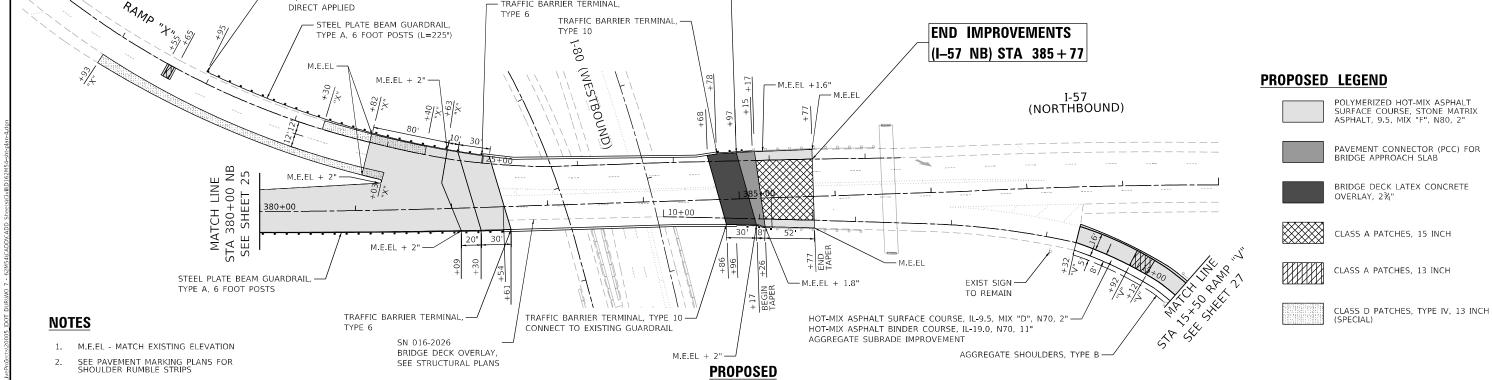


ΔA	С	С	u	r	а	t	е
			GR	OUP	, INC	٠.	

OSEN NAME = Jent	DESIGNED	-	υп	VEA12ED	-
	DRAWN	-	JS	REVISED	-
PLOT SCALE = 100.0000 ' / in.	CHECKED	-	AB	REVISED	-
PLOT DATE = 10/20/2021	DATE	-	10-08-2021	REVISED	-

STATE OF ILLINOIS **DEPARTMENT OF TRANSPORTATION**

REMOVAL AND PROPOSED PLAN							
I-57 AT I-80 INTERCHANGE							
I-3/ AT I-80 INTERCHANGE							
SCA	LE: 1" = 50'	SHEET	OF	SHEETS STA.	TO STA.		

F.A.I. RTE.	SECTION			COUNTY	TOTAL SHEETS	SHEET NO.
57	2020-171-BR			COOK	190	26
				CONTRACT	NO. 62	2M54
		ILLINOIS	FED. Al	ID PROJECT NHPP-	U3I(520)	

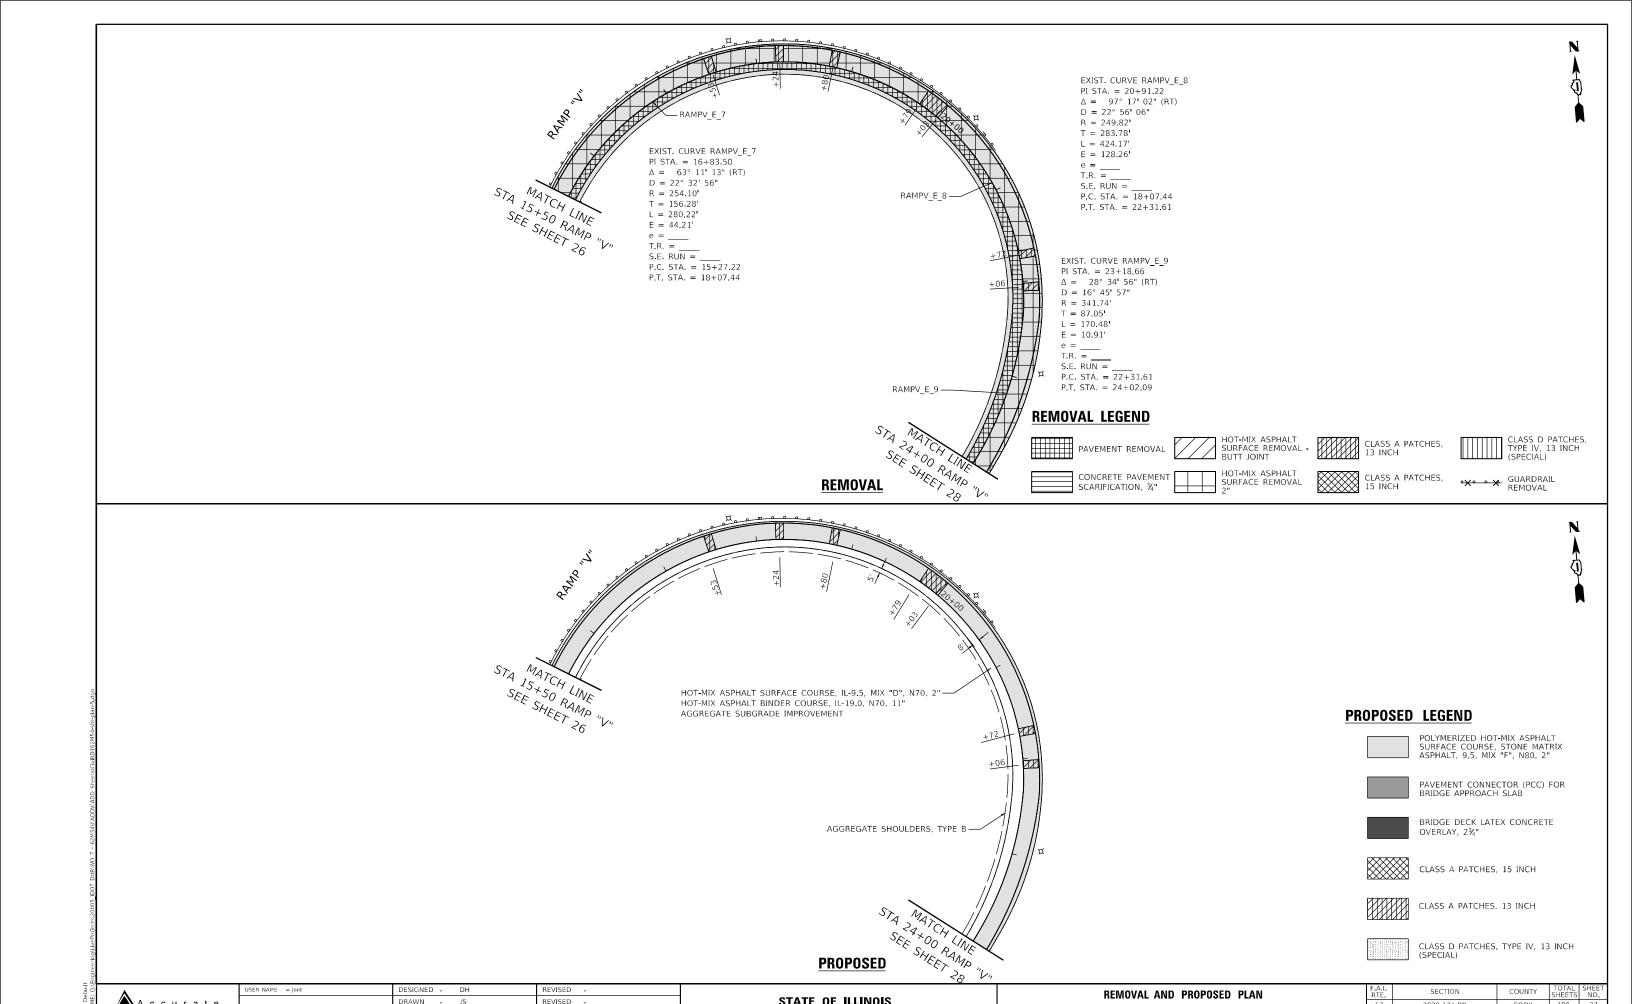

ccurate

DESIGNED -REVISED DRAWN -JS REVISED -REVISED -


STATE OF ILLINOIS **DEPARTMENT OF TRANSPORTATION**


PROPOSED

		MOVAL AN I–57 AT I–		OSED PLAI RCHANGE	N
50'	SHEET	OF	SHEETS	STA.	TO STA.

F.A.I. RTE.	SECTION	COUNTY	TOTAL SHEETS	SHEE NO.
57	2020-171-BR	COOK	190	27
		CONTRACT	NO. 62	2M54

SCALE: 1" = 50' SHEET

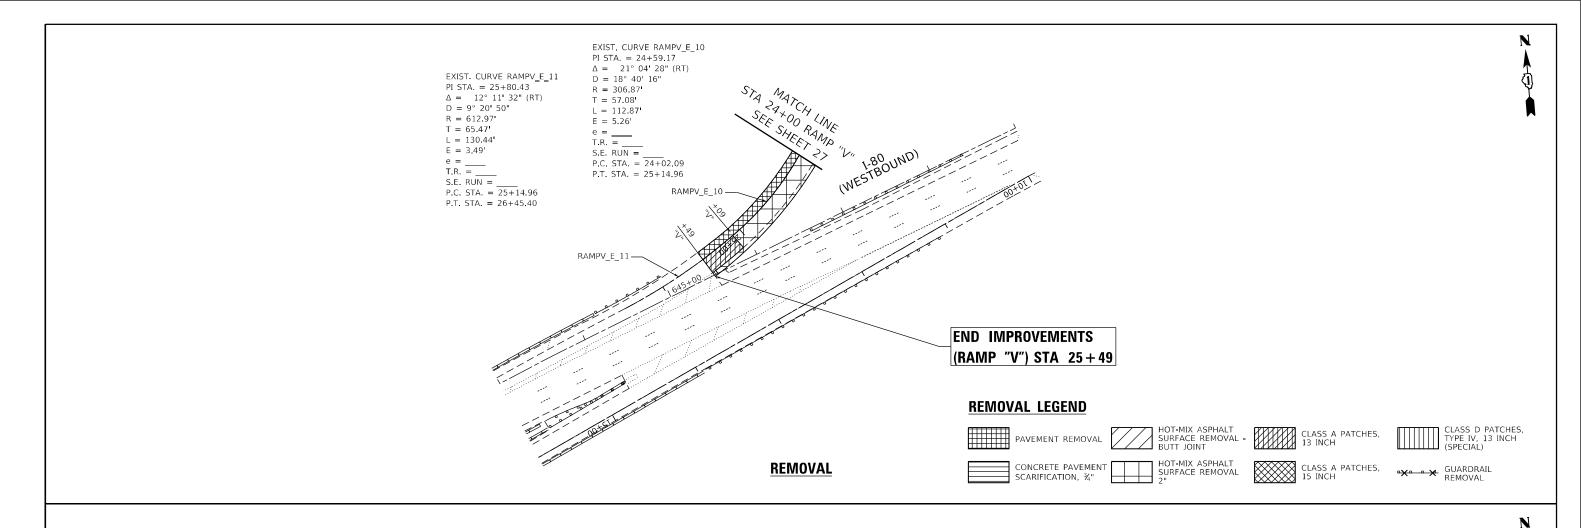

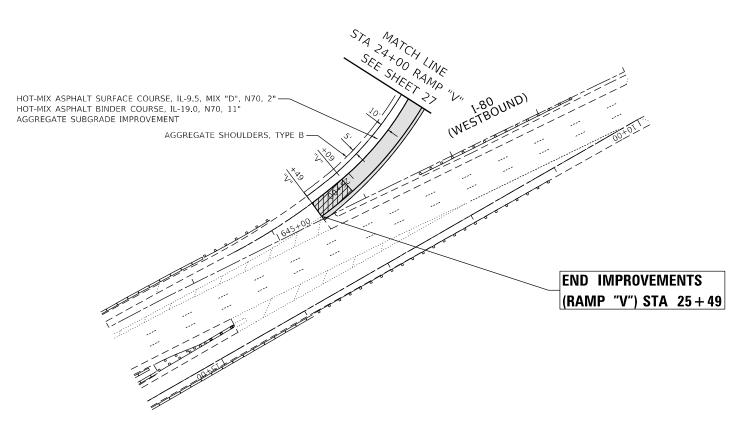

PROPOSED LEGEND

POLYMERIZED HOT-MIX ASPHALT SURFACE COURSE, STONE MATRIX ASPHALT, 9.5, MIX "F", N80, 2"



PAVEMENT CONNECTOR (PCC) FOR BRIDGE APPROACH SLAB



BRIDGE DECK LATEX CONCRETE OVERLAY, 2¾"



CLASS A PATCHES, 15 INCH



CLASS A PATCHES, 13 INCH



CLASS D PATCHES, TYPE IV, 13 INCH (SPECIAL)

PROPOSED



1. M.E.EL - MATCH EXISTING ELEVATION SEE PAVEMENT MARKING PLANS FOR SHOULDER RUMBLE STRIPS

NOTES

USER NAME = jent	DESIGNED	-	DH	REVISED -
	DRAWN	-	JS	REVISED -
PLOT SCALE = 100,0000 / in.	CHECKED	-	AB	REVISED -
PLOT DATE = 10/20/2021	DATE	-	10-08-2021	REVISED -

STATE OF ILLINOIS **DEPARTMENT OF TRANSPORTATION**


REMOVAL AND PROPOSED PLA	N
I–57 AT I–80 INTERCHANGE	


F.A.I. RTE.	SECTION	COUNTY	TC
57	2020-171-BR	COOK	1
		CONTRACT	NO

TO STA.

SCALE: 1" = 50' SHEET

SHEETS STA.

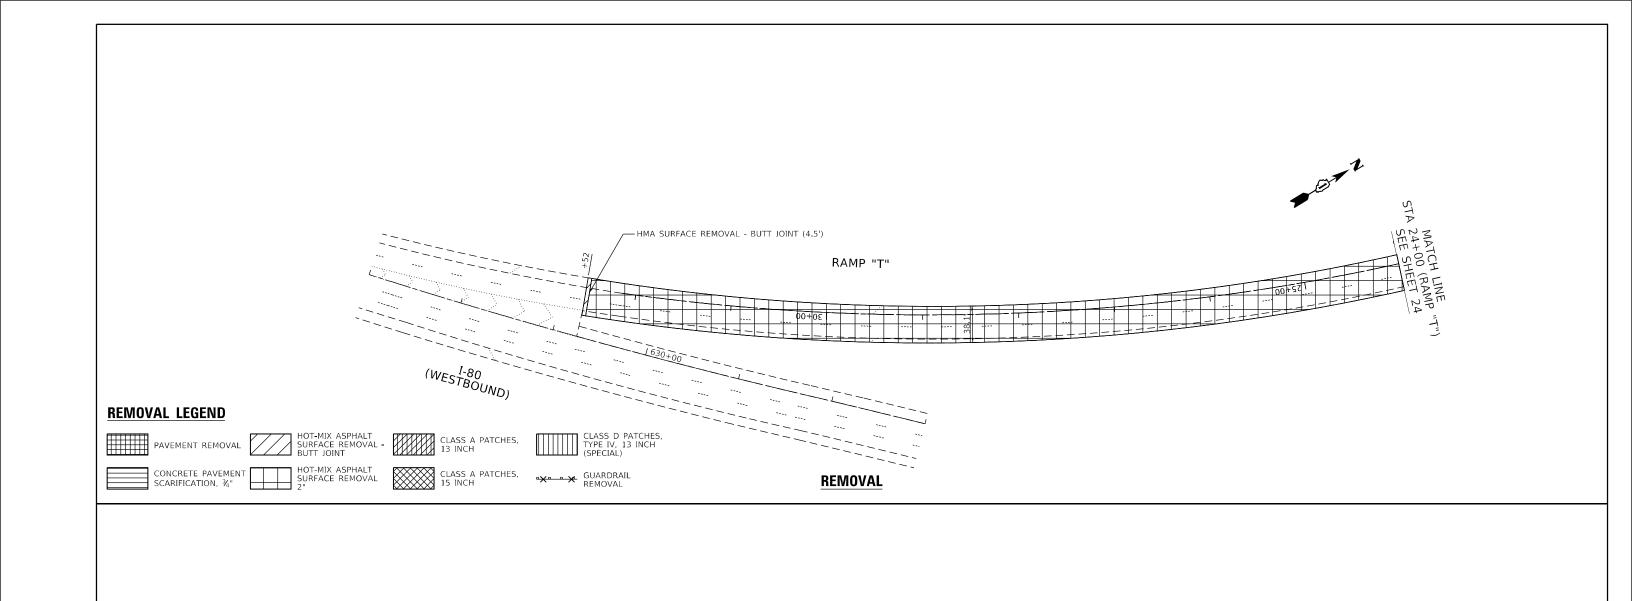

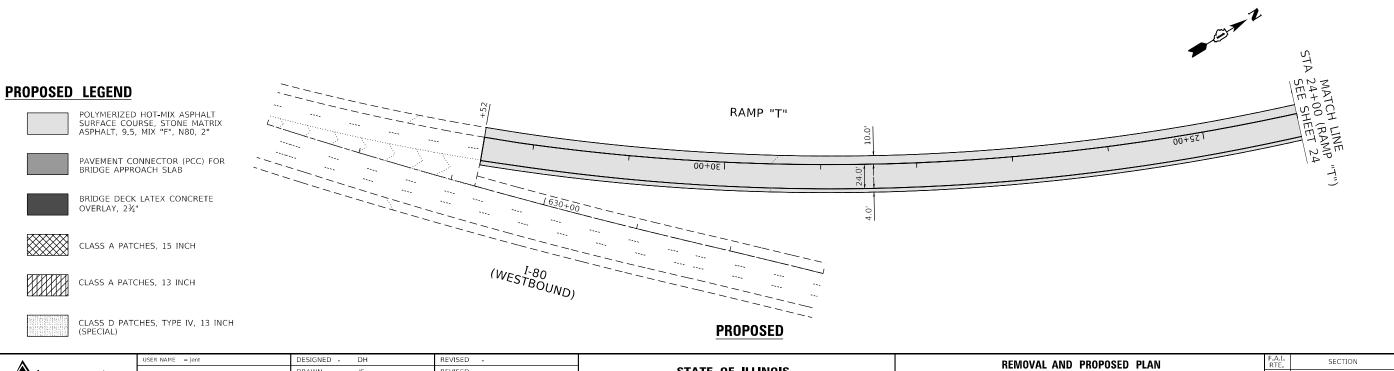

STATE OF ILLINOIS

DEPARTMENT OF TRANSPORTATION

I-57 AT I-80 INTERCHANGE

OF SHEETS STA.


CONTRACT NO. 62M54

ccurate

DRAWN - JS

REVISED -

REVISED -

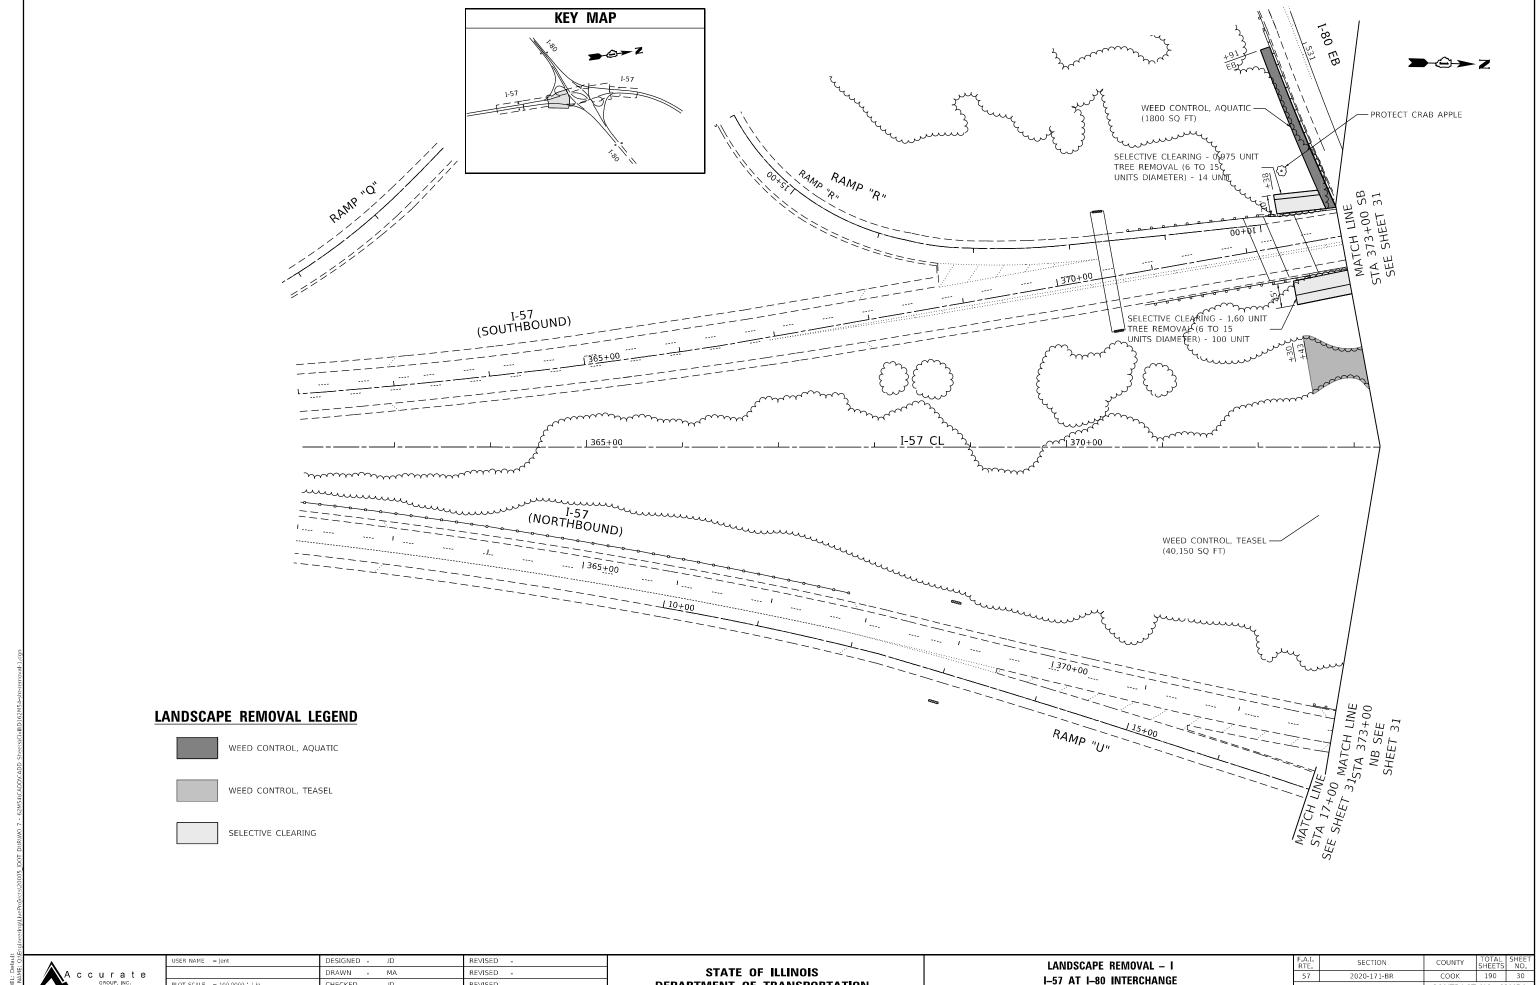



CHECKED -REVISED -


STATE OF ILLINOIS
DEPARTMENT OF TRANSPORTATION


I-57 AT I-80 INTERCHANGE TO STA.

CONTRACT NO. 62M54

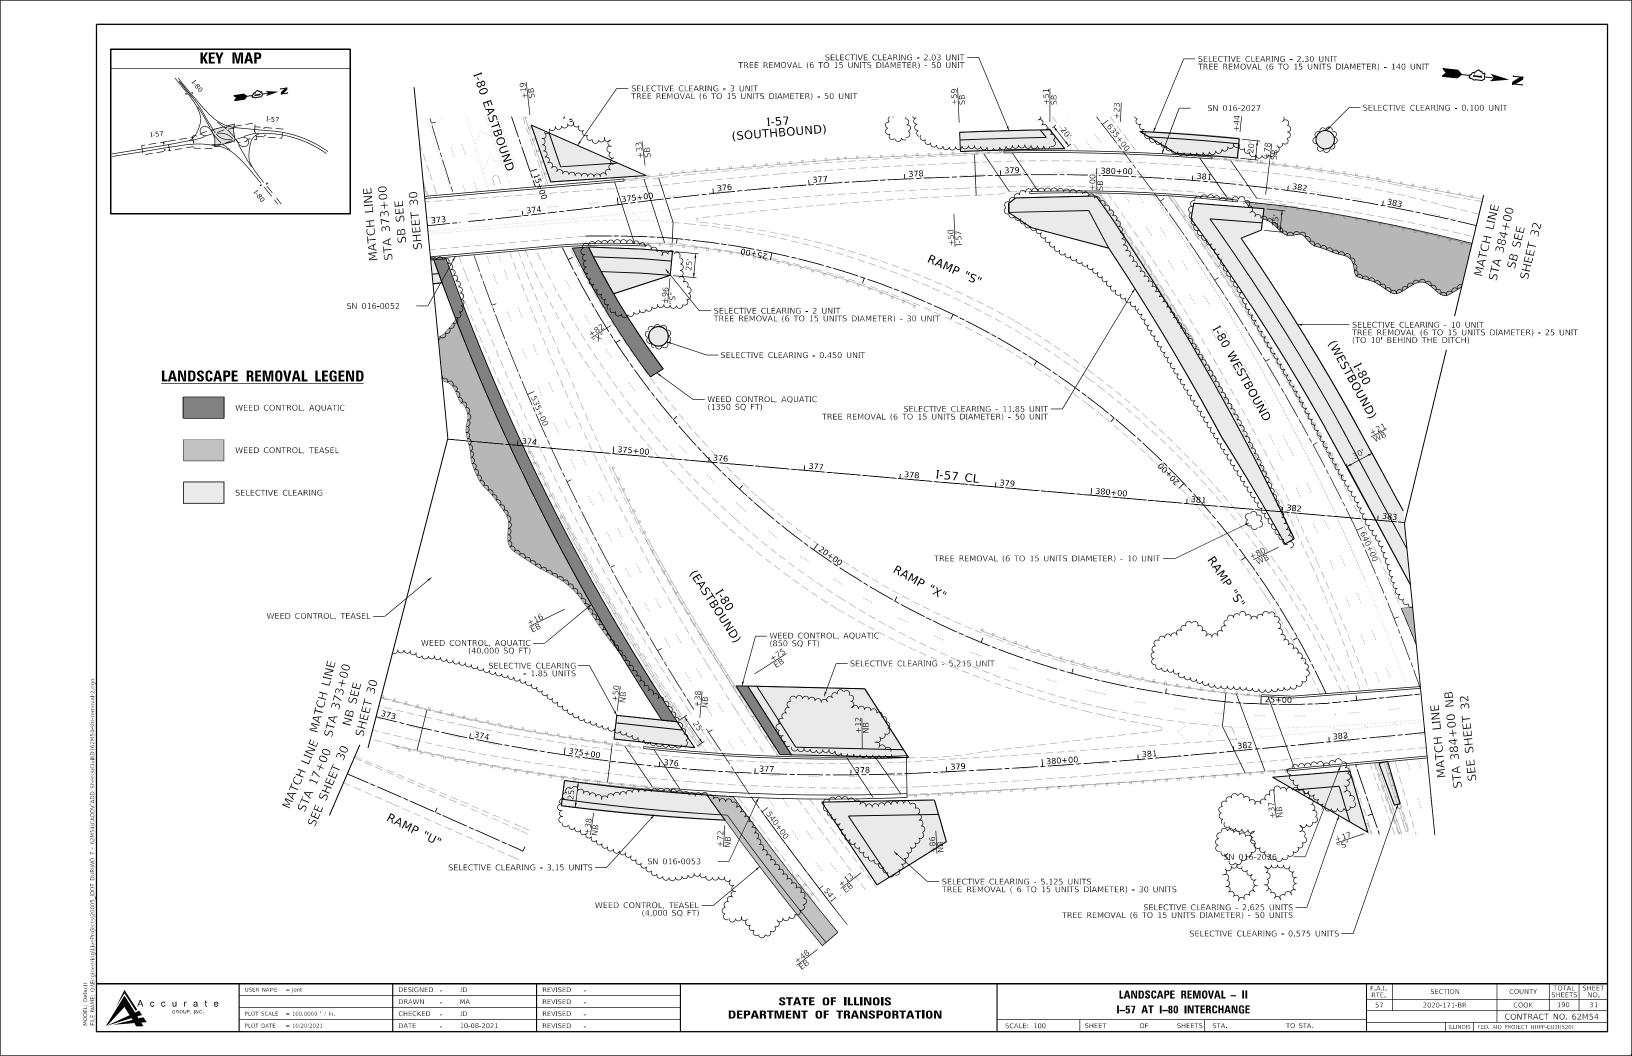

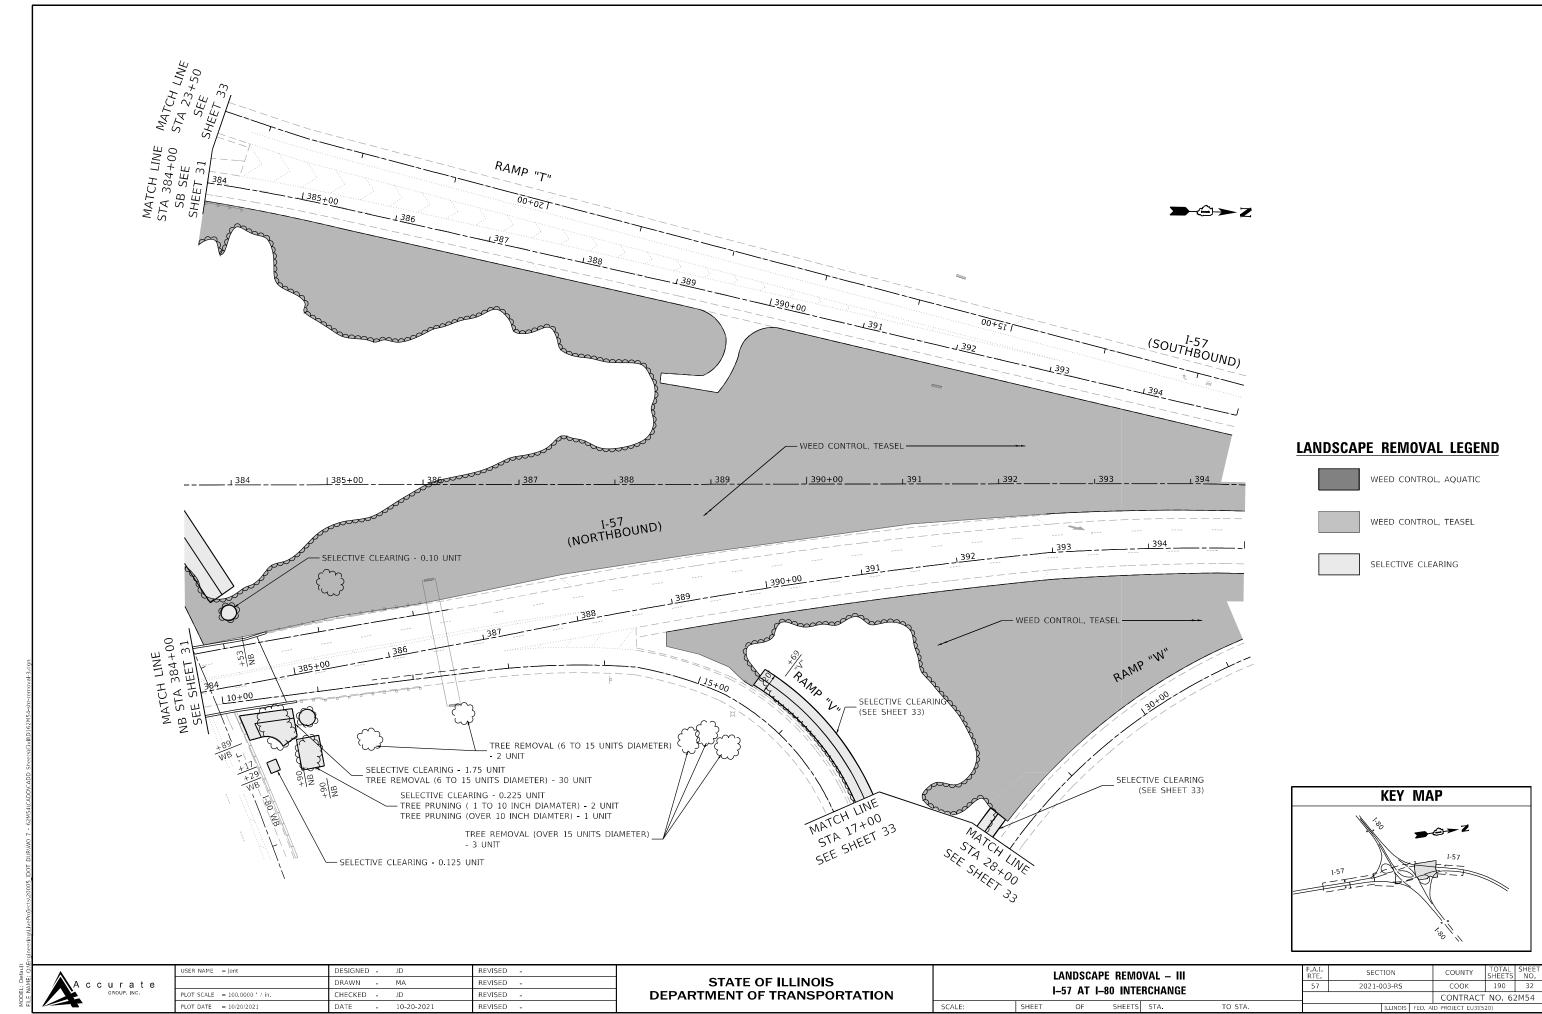

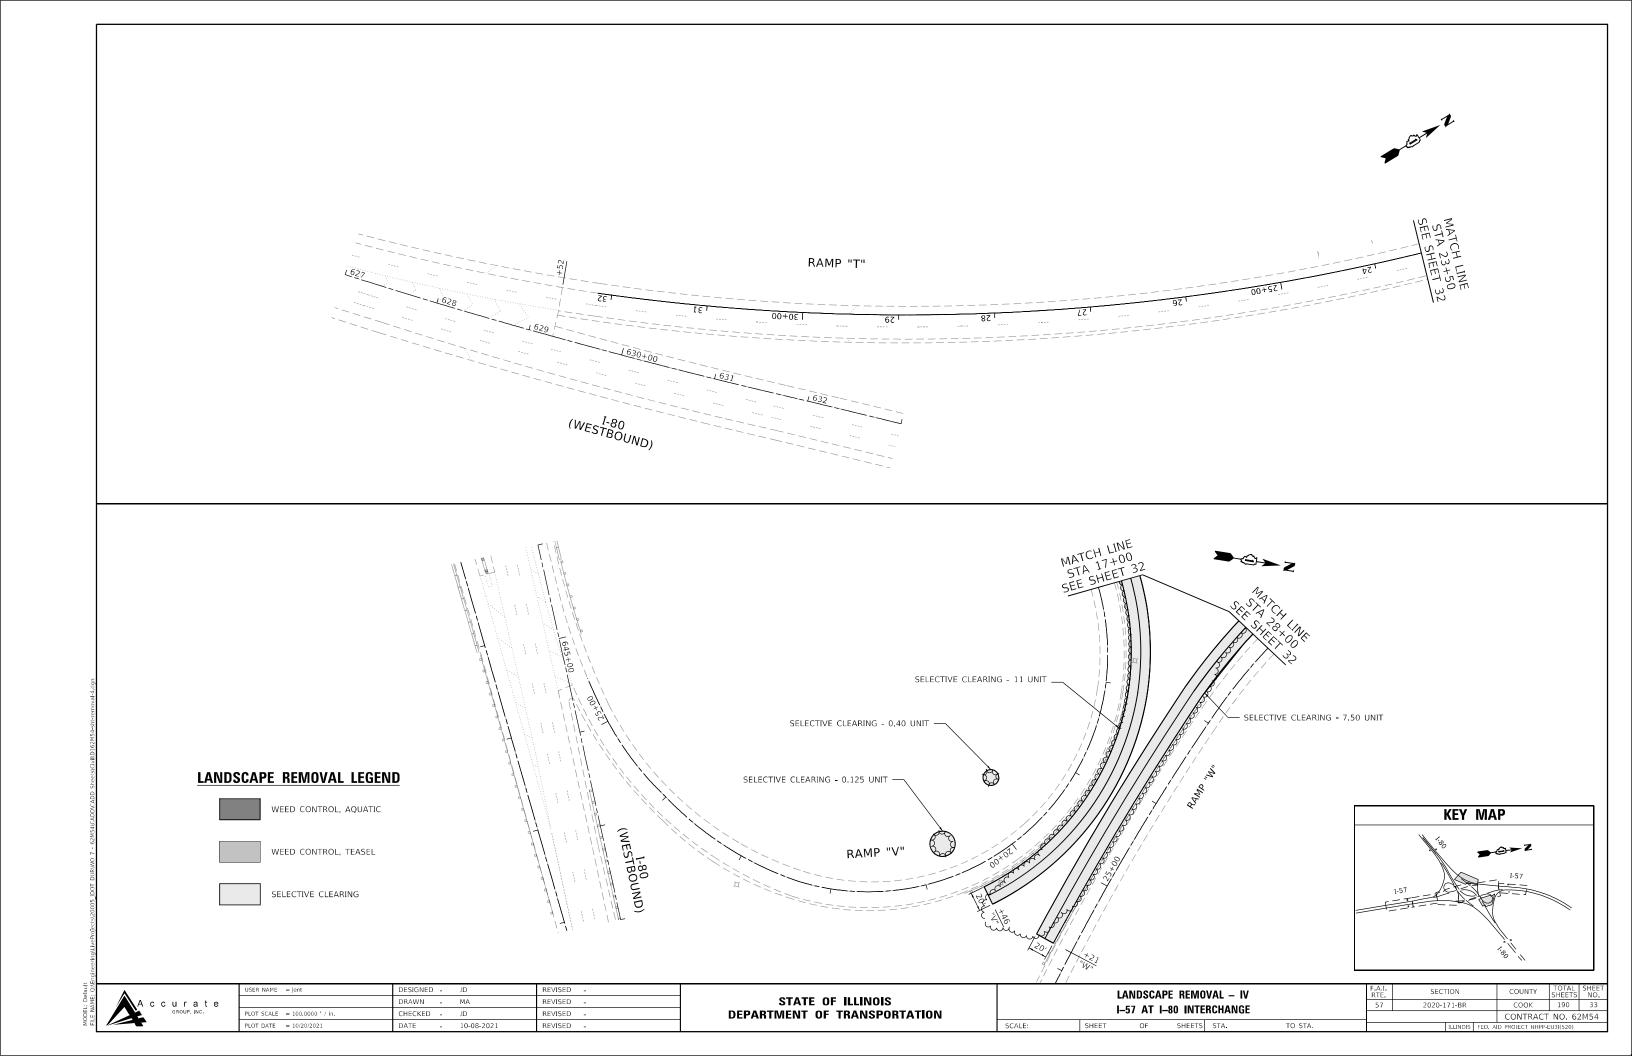

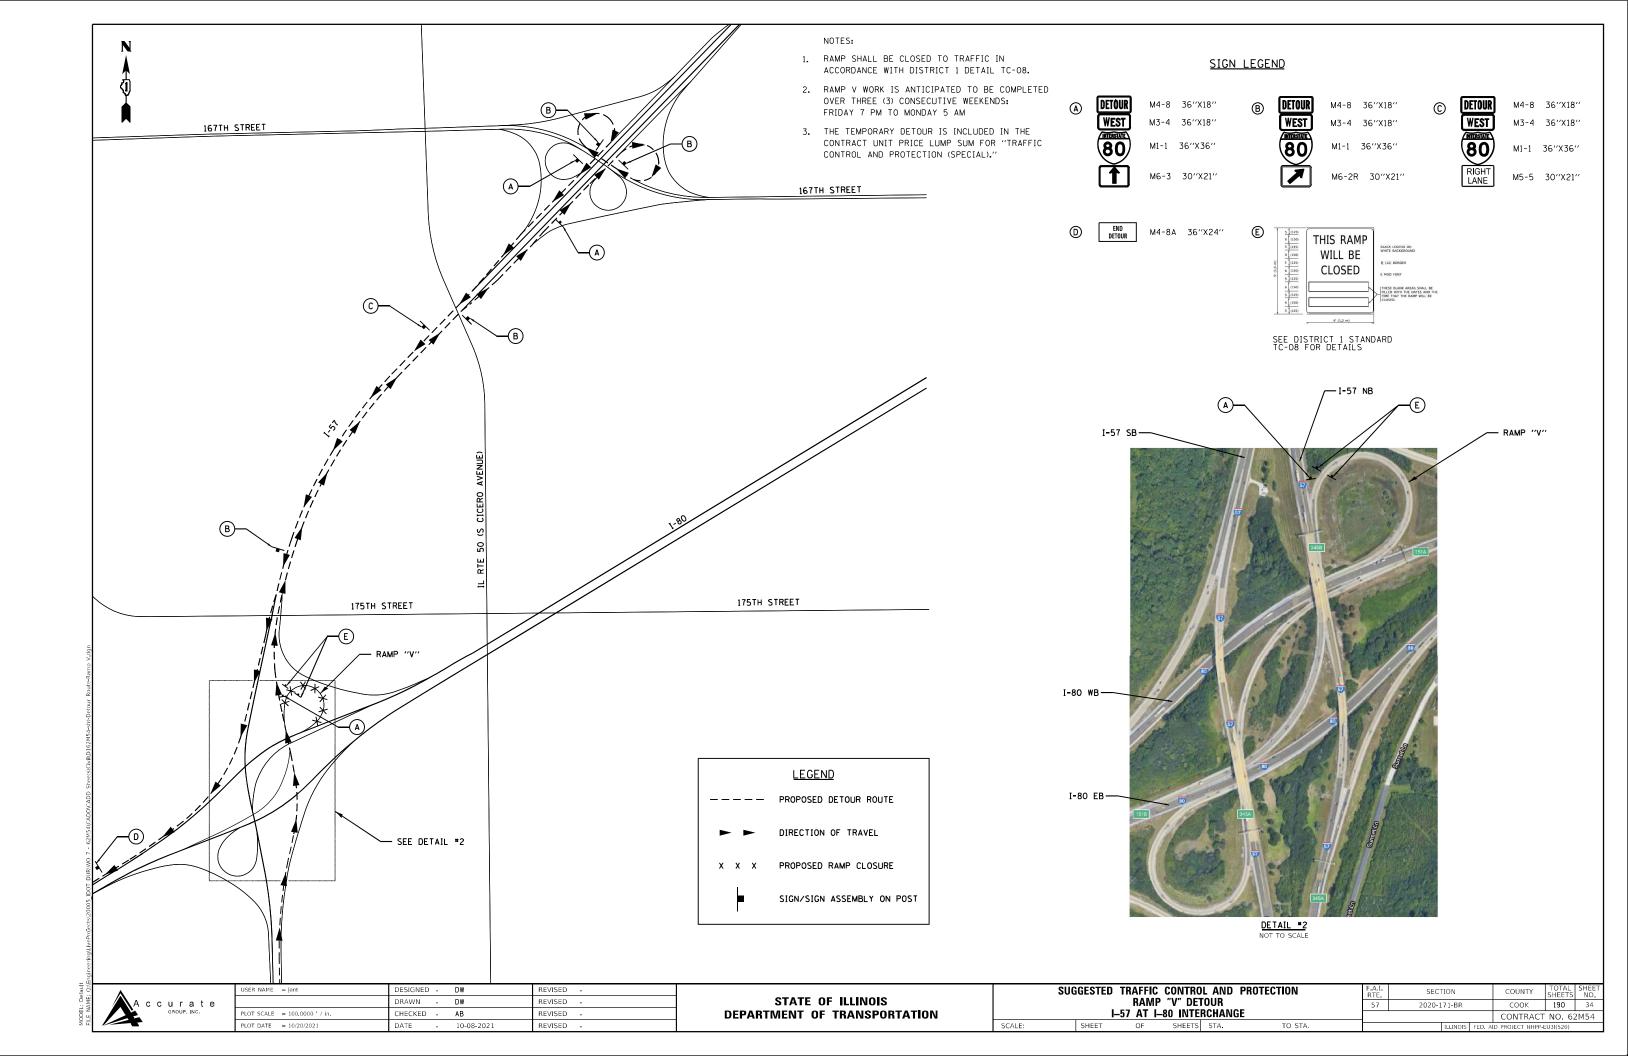

SUGGESTED TRAFFIC CONTROL AND PROTECTION GENERAL NOTES

- 1. THE TRAFFIC CONTROL DEPICTED HEREIN IS THE MINIMUM REQUIREMENT. ADDITIONAL TRAFFIC CONTROL DEVICES AS SPECIFIED IN THE HIGHWAY STANDARDS AS SHOWN ON THE INDEX OF SHEETS AND THE SPECIAL PROVISIONS SHALL BE PLACED BY THE CONTRACTOR TO THE SATISFACTION OF THE ENGINEER. ALL TRAFFIC CONTROL DEVICES SHALL BE CONSIDERED INCLUDED IN THE COST OF TRAFFIC CONTROL AND PROTECTION (EXPRESSWAYS) UNLESS OTHERWISE INDICATED WITHIN THESE GENERAL NOTES, PLANS OR SPECIAL PROVISIONS.
- 2. TRAFFIC CONDITIONS, ACCIDENTS, AND OTHER UNFORESEEN EMERGENCY CONDITIONS MAY REQUIRE THE ENGINEER TO RESTRICT, MODIFY, OR REMOVE LANE CLOSURES OR CHANNELIZATION SHOWN IN THE PLANS. THE CONTRACTOR SHALL PROMPTLY RESPOND AT THE TIME OF NOTIFICATION BY THE ENGINEER FOR THE MAINTENANCE OF TRAFFIC CONTROL DEVICES.
- 3. ALL TEMPORARY PAVEMENT MARKINGS SHOWING DETERIORATION AFTER 7 DAYS OF SERVICE SHALL BE REPLACED BY THE CONTRACTOR AS DIRECTED BY THE ENGINEER, SUFFICIENT QUANTITIES FOR THE INITIAL PLACEMENT AND A ONE-TIME REPLACEMENT HAVE BEEN PROVIDED FOR EACH STAGE. ALL MARKINGS THAT REQUIRE REPLACEMENT PRIOR TO 7 DAYS OF SERVICE OR REPLACEMENT AFTER THE INITIAL REPLACEMENT SHALL BE REPLACED BY THE CONTRACTOR AT HIS EXPENSE.
- 4. A MINIMUM OF FOURTEEN (14) DAYS IN ADVANCE OF THE BRIDGE CONSTRUCTION AND ALL SUBSEQUENT STAGES ON 1-57, THE CONTRACTOR SHALL PLACE ONE (1) PORTABLE CHANGEABLE MESSAGE SIGN AT EACH END OF THE PROJECT ALONG I-57 AND I-80 AS DIRECTED AND AT A LOCATION DESIGNATED BY THE ENGINEER TO INFORM MOTORISTS OF THE UPCOMING BRIDGE CONSTRUCTION / STAGE CHANGE. TWO (2) CHANGEABLE MESSAGE SIGNS WILL BE PLACED AT LOCATIONS WITH CLOSURES ON BOTH SIDES OF THE EXPRESSWAY. ANY ADDITIONAL RAMP CLOSURES WILL ALSO REQUIRE CHANGEABLE MESSAGE SIGNS IN ADVANCE OF CLOSURE. THE MESSAGE SHALL BE APPROVED BY THE ENGINEER. THIS WORK IS TO BE PAID FOR AT THE CONTRACT UNIT PRICE PER CALENDAR DAY FOR CHANGEABLE MESSAGE SIGN.
- 5. WORK ZONE SPEED LIMIT SHALL BE 45 MPH ON THE MAINLINE AND ON THE ARM RAMPS, AND 25 MPH ON LOOP RAMPS.
- 6. THE CONTRACTOR SHALL BE REQUIRED TO MAINTAIN TRAFFIC IN ACCORDANCE WITH THE TRAFFIC CONTROL PLANS, SPECIAL PROVISIONS. APPLICABLE STATE STANDARDS, AND AS DIRECTED BY THE ENGINEER. ANY CHANGES TO THE TRAFFIC CONTROL SHALL BE SUBMITTED TO THE ENGINEER FOR APPROVAL PRIOR TO IMPLEMENTING ANY CHANGES.
- 7. THE CONTRACTOR SHALL FURNISH, INSTALL, MAINTAIN, AND REMOVE ALL SIGNS AND SIGN SUPPORTS REQUIRED FOR TRAFFIC CONTROL AND PROTECTION.
- 8. THE CONTRACTOR SHALL BE RESPONSIBLE FOR PROVIDING LABOR, SIGNS, AND TRAFFIC CONTROL DEVICES NECESSARY FOR THE MAINTENANCE OF TRAFFIC
- 9. ALL EXISTING SIGNS THAT CONFLICT WITH THE TRAFFIC CONTROL PLAN SHALL BE COVERED OR REMOVED IN ACCORDANCE WITH ARTICLE 107.25 OF THE STANDARD SPECIFICATIONS.
- 10. THE ENGINEER SHALL BE INFORMED 48 HOURS IN ADVANCE OF ANY PROPOSED CHANGE TO THE SUGGESTED STAGE OF CONSTRUCTION AND TRAFFIC CONTROL
- 11. THE CONTRACTOR SHALL PROVIDE ADEQUATE TEMPORARY DRAINAGE AND EROSION CONTROL PROTECTION DURING ALL STAGES OF CONSTRUCTION.
- 12. THE CONTRACTOR SHALL MAINTAIN A MINIMUM OF ONE 12' THRU-LANE FOR BOTH NB AND SB TRAFFIC UNLESS NOTED OTHERWISE.
- 13. THE CONTRACTOR SHALL CONTACT THE DISTRICT ONE EXPRESSWAY TRAFFIC CONTROL SUPERVISOR AT (847) 705-4155 A MINIMUM OF 72 HOURS IN ADVANCE
- 14. THE CONTRACTOR SHALL BE REQUIRED TO REMOVE ALL EXISTING PAVEMENT MARKINGS WHICH CONFLICT WITH THE DESIGNATED TRAFFIC CONTROL AS SHOWN IN THE PLANS, THIS WORK SHALL BE PAID FOR AS PAVEMENT MARKING REMOVAL-WATER BLASTING.
- 15. IMMEDIATELY AFTER THE COMPLETION OF CONSTRUCTION, THE CONTRACTOR SHALL RESTORE ALL PERMANENT PAVEMENT MARKINGS, SIGNS, AND OTHER TRAFFIC CONTROL DEVICES THAT WERE COVERED, IF THEY WERE REMOVED, DAMAGED, OR OTHERWISE AFFECTED BY CONSTRUCTION. THE COST TO REPAIR ANY DAMAGES WILL BE BORNE BY THE CONTRACTOR AND NOT THE RESPONSIBILITY OF THE DEPARTMENT.
- 16. TEMPORARY CONCRETE BARRIER WALL AND TEMPORARY IMPACT ATTENUATORS SHALL BE PLACED AS INDICATED BY THE PLANS. TEMPORARY CONCRETE BARRIER WALL SHALL BE CONTINUOUSLY PINNED TO THE PAVEMENT IN ACCORDANCE WITH IDOT STANDARD SPECIFICATIONS FOR ROAD AND BRIDGE CONSTRUCTION WHERE A 2 FOOT CLEAR ZONE FREE FROM DROP-OFFS, FIXED OBJECTS, OR OTHER OBSTACLES CANNOT BE PROVIDED BEHIND THE WALL.
- 17. ALL TEMPORARY PAVEMENT MARKINGS WILL BE PAVEMENT MARKING TAPE, TYPE IV, UNLESS OTHERWISE NOTED.
- 18. CLASS D PATCHING, TYPE IV, 13 INCH (SPECIAL) WILL BE REQUIRED TO STRENGTHEN SHOULDERS PRIOR TO TRAFFIC SHIFTS SHOWN IN THE MAINTENANCE OF TRAFFIC PLANS. THE PATCHING LOCATION(S) IS INDICATED ON THE PLANS AND MUST BE COMPLETED IN PRE-STAGE.
- 19. ALL "ROAD CONSTRUCTION AHEAD" AND "SHOULDER CLOSED AHEAD" SIGNS WILL BE EQUIPPPED WITH MONO-DIRECTIONAL TYPE A AMBER FLASHING LIGHTS.
- 20. ALL TRAFFIC CONTROL DEVICES SHALL BE REMOVED, COVERED, OR TURNED AWAY FROM THE TRAFFIC IMMEDIATELY WHEN THEY ARE NO LONGER NECESSARY. WHEN A SIGN IS COVERED; ITS POST SHALL HAVE A REFLECTIVE 3" X 6" DELINEATOR INSTALLED. COST OF DELINEATOR IS INCLUDED IN TRAFFIC CONTROL AND PROTECTION (EXPRESSWAYS).
- 21. LANES MAY ONLY BE CLOSED DURING THE ALLOWABLE HOURS LISTED IN THE KEEPING EXPRESSWAY OPEN TO TRAFFIC SPECIAL PROVISION.
- 22. A MAINTENANCE OF TRAFFIC PLAN SHALL BE SUBMITTED TO THE DISTRICT ONE EXPRESSWAY TRAFFIC CONTROL SUPERVISOR 14 DAYS IN ADVANCE OF STAGE CHANGES, LANE CLOSURES OR FULL EXPRESSWAY CLOSURES. THE MAINTENANCE OF TRAFFIC PLAN SHALL INCLUDE, BUT NOT LIMITED TO LANE CLOSURES, EXISTING GEOMETRICS, AND EQUIPMENT AND MATERIAL LOCATIONS.
- 23. FURNISHING, INSTALLING, AND RELOCATING TEMPORARY CONCRETE BARRIER AND TEMPORARY IMPACT ATTENUATORS SHALL BE IN ACCORDANCE WITH IDOT SPECIAL PROVISIONS, IDOT HIGHWAY STANDARDS, STANDARD SPECIFICATIONS, AND AS DIRECTED BY THE ENGINEER.
- 24. IN ORDER TO STAGE TRAFFIC FOR IMPROVEMENTS EXISTING CONFLICTING SHOULDER RUMBLE STRIPS SHALL BE REMOVED AND REPLACED WITH HMA. REMOVAL SHALL BE AS PER THE SPECIAL PROVISION "FILLING EXISTING RUMBLE STRIPS". THIS WORK SHALL BE PAID FOR AS "FILLING EXISTING RUMBLE STRIPS" AFTER THE COPMLETION OF CONSTRUCTION, SHOULDER RUMBLE STRIPS SHALL BE RESTORED. THIS WORK SHALL BE PAID FOR AS "SHOULDER RUMBLE STRIPS, 16 INCH"
- 25. BLANKS AND/OR VERBIAGE INSTALLED TO COVER EXISTING SIGNAGE SHALL BE INCLUDED IN THE COST OF TRAFFIC CONTROL AND PROTECTION (EXPRESSWAYS).
- 26. ALL CALLOUTS INDICATING PAVEMENT MARKING TAPE TYPE IV, OF THE LINE WIDTH SPECIFIED, SHALL BE PAID FOR AS TEMPORARY PAVEMENT MARKING LINE (WIDTH IN INCHES) - TYPE IV TAPE.



USER NAME = jschumann	DESIGNED	-	DW	REVISED -
	DRAWN	-	DW	REVISED -
PLOT SCALE = 2.0000 / in	CHECKED	-	AB	REVISED -
PLOT DATE = 11/16/2021	DATE	-	10-08-2021	REVISED -

STATE OF ILLINOIS **DEPARTMENT OF TRANSPORTATION**

SUGGESTED TRAFFIC CONTROL AND PROTECTION		SECTION		COUNTY	TOTAL SHEETS	SHEET NO.	
GENERAL NOTES	57	2020-171-BR		соок	190	35	
I-57 AT I-80 INTERCHANGE	CONTRACT				T NO. 6:	NO. 62M54	
SHEET OF SHEETS STA. TO STA.		ILLINOIS FED. AID PROJECT N		AID PROJECT NHPP	-EU3I(520)		

SUGGESTED SEQUENCE OF CONSTRUCTION AND MAINTENANCE OF TRAFFIC FOR I-57

THE FOLLOWING SEQUENCE OF CONSTRUCTION AND MAINTENANCE OF TRAFFIC IS SUGGESTED. VARIATIONS MAY BE MADE WITH THE APPROVAL OF THE ENGINEER. FOR EACH STAGE OF CONSTRUCTION PROVIDE TRAFFIC CONTROL AS SHOWN ON THE MAINTENANCE OF TRAFFIC PLANS COORDINATE INSTALLATION OF TRAFFIC CONTROL DEVICES WITH THE EXISTING TRAFFIC PATTERNS AT THE ENDS OF THE PROJECT ALONG INTERSTATE 57 AND IMPACTED CROSS STREETS. THE IMPROVEMENTS WILL BE CONSTRUCTED USING LANE SHIFTS ONTO EXISTING SHOULDERS, SHORT TERM AND LONG TERM SHOULDER AND LANE CLOSURES, PER DISTRICT ONE STANDARDS TC-08, TC-09, TC-11, TC-12, TC-13, TC-16, TC-17, TC-18, TC-22, TC-33 HIGHWAY STANDARDS 701106, 701400, 701401, 701411, 701428, 701446, 701901, 704001, 781001, AND 782006.

PRE-STAGE

- 1. INSTALL PORTABLE CHANGEABLE MESSAGE SIGNS AS DIRECTED BY ENGINEER ACCORDING TO HIGHWAY STANDARD 701400.
- 2. PATCH SHOULDERS OF RAMP "X" (EB I-80 TO NB I-57) AND TEMPORARY PAVEMENTS ON RAMP "R" AND RAMP "S" USING NIGHT-ONLY CLOSURES ACCORDING TO HIGHWAY STANDARD 701401 AND DISTRICT ONE STANDARD TC-17 TO ALLOW TRAFFIC TO BE SHIFTED TO SHOULDERS IN FUTURE STAGES.

NORTHBOUND I-57

- 1. UTILIZE HIGHWAY STANDARD LANE CLOSURES 701401 AND 701400 TO REMOVE PERMANENT PAVEMENT MARKINGS AND RAISED REFLECTIVE PAVEMENT MARKERS THAT WILL CONFLICT WITH TEMPORARY TRAFFIC CONTROL
- 2. UTILIZE HIGHWAY STANDARD 701428 TO INSTALL TRAFFIC CONTROL DEVICES FOR THE FOLLOWING STEPS AS SHOWN IN THE PLANS.
- 3. CLOSE THE LEFT LANE OF NR I-57 PER HIGHWAY STANDARD 701401 AND SHIFT TRAFFIC ONTO THE RIGHT SHOULDER USING DISTRICT ONE DETAIL TC-09. INSTALL SMART WORK ZONE, UTILIZING DISTRICT ONE STANDARD TC-33, FOR A DISTANCE OF 5-MILES IN ADVANCE OF CLOSURE, SMART WORK ZONE MAY BE EXTENDED
- 4. CLOSE THE LEFT LANE OF RAMP "X" (EB I-80 TO NB I-57) INCLUDING THE AUXILIARY LANE ALONG EB I-80. SHIFT TRAFFIC FROM THE RIGHT LANE OF THE RAMP TO THE LEFT SHOULDER USING DISTRICT ONE DETAIL TC-17. INSTALL SMART WORK ZONE, UTILIZING DISTRICT ONE STANDARD TC-33, FOR A DISTANCE OF 3-MILES IN ADVANCE OF AUXILIARY LANE CLOSURE. SMART WORK ZONE MY BE EXTENDED IF REQUIRED BY THE ENGINEER.
- 5. STRUCTURE NOS. 016-0053 AND 016-2026; PERFORM BRIDGE DECK REPAIR, RECONSTRUCT BRIDGE DECK EXPANSION JOINTS AND PCC PAVEMENT CONNECTORS, AND INSTALL BRIDGE DECK CONCRETE OVERLAY, SMA OVERLAY, CLASS A PATCHES, AND BUTT JOINTS AS SHOWN IN PLANS, PRIOR TO REMOVING TEMPORARY CONCRETE BARRIER WALL, ANY OPEN HOLES IN THE ROADWAY SHALL BE FILLED OR PLATED FOR SAFETY. THE COST FOR PLATING OR FILLING OF OPEN HOLES SHALL BE INCLUDED IN THE LUMP SUM COST FOR TRAFFIC CONTROL AND PROTECTION (EXPRESSWAYS).

STAGE II

- 1. UTILIZE HIGHWAY STANDARD LANE CLOSURES 701401 AND 701400 TO CLOSE LEFT LANE SIMILAR TO STAGE 1. SMART WORK ZONE SHALL REMAIN IN EFFECT.
- 2. UTILIZE HIGHWAY STANDARD 701428 TO INSTALL TRAFFIC CONTROL DEVICES FOR THE FOLLOWING STEPS AS SHOWN IN THE PLANS.
- 3. SHIFT TRAFFIC TO LEFT LANE/LEFT SHOULDER AFTER I-80 EB GORE AND THE RIGHT LANE OF NB I-57 DROPS PER DISTRICT ONE DETAIL TC-09
- 4. CLOSE THE RIGHT LANE OF RAMP "X" (EB I-80 TO NB I-57) INCLUDING THE AUXILIARY LANE ALONG EB I-80. SHIFT TRAFFIC FROM THE RIGHT LANE OF THE RAMP TO THE RIGHT SHOULDER USING DISTRICT ONE DETAIL TC-17. SMART WORK ZONE ON I-80 FB TO REMAIN IN FEFECT.
- 5. STRUCTURE NOS. 016-0053 AND 016-2026: PERFORM BRIDGE DECK REPAIR, RECONSTRUCT BRIDGE DECK EXPANSION JOINTS AND PCC PAVEMENT CONNECTORS, AND INSTALL BRIDGE DECK CONCRETE OVERLAY, SMA OVERLAY, CLASS A PATCHES AND BUTT JOINTS AS SHOWN IN PLANS. PRIOR TO REMOVING TEMPORARY CONCRETE BARRIER WALL ANY OPEN HOLES IN THE ROADWAY SHALL BE FILLED OR PLATED FOR SAFETY. THE COST FOR PLATING OR FILLING OF OPEN HOLES SHALL BE INCLUDED IN THE LUMP SUM COST FOR TRAFFIC CONTROL AND PROTECTION (EXPRESSWAYS).

SOUTHBOUND I-57

- 1. UTILIZE HIGHWAY STANDARD LANE CLOSURES 701401 AND 701400 TO REMOVE PERMANENT PAVEMENT MARKINGS AND RAISED REFLECTIVE PAVEMENT MARKERS THAT WILL CONFLICT WITH TEMPORARY TRAFFIC CONTROL.
- 2. UTILIZE HIGHWAY STANDARD 701428 TO INSTALL TRAFFIC CONTROL DEVICES FOR THE FOLLOWING STEPS AS SHOWN IN THE PLANS.
- 3. CLOSE THE LEFT LANE OF SB 1-57 ACCORDING TO HIGHWAY STANDARD 701401. THEN SHIFT TRAFFIC FROM THE RIGHT LANE TO THE LEFT SHOULDER USING DISTRICT ONE DETAIL TC-09. INSTALL SMART WORK ZONE, UTILIZING DISTRICT ONE STANDARD TC-33, FOR A DISTANCE OF 5-MILES IN ADVANCE OF CLOSURE. SMART WORK ZONE MAY BE EXTENDED IF REQUIRED BY THE ENGINEER
- 4. SHIFT TRAFFIC ON RAMP "S" (WB I-80 TO SB I-57) ONTO THE LEFT SHOULDER USING DISTRICT ONE DETAIL TC-09.
- 5. STRUCTURE NOS. 016-0052 AND 016-2027: PERFORM BRIDGE DECK REPAIR, RECONSTRUCT BRIDGE DECK EXPANSION JOINTS, AND INSTALL BRIDGE DECK CONCRETE OVERLAY, SMA OVERLAY, CLASS A PATCHES AND BUTT JOINTS AS SHOWN IN PLANS. PRIOR TO REMOVING TEMPORARY CONCRETE BARRIER WALL, ANY OPEN HOLES IN THE ROADWAY SHALL BE FILLED OR PLATED FOR SAFETY. THE COST FOR PLATING OR FILLING OF OPEN HOLES SHALL BE INCLUDED IN THE LUMP SUM COST FOR TRAFFIC CONTROL AND PROTECTION (EXPRESSWAYS)

STAGE II

- 1. UTILIZE HIGHWAY STANDARD LANE CLOSURES 701401 AND 701400 TO CLOSE LEFT LANE SIMILAR TO STAGE 1. SMART WORK ZONE SHALL REMAIN IN EFFECT.
- 2. UTILIZE HIGHWAY STANDARD 701428 TO INSTALL TRAFFIC CONTROL DEVICES FOR THE FOLLOWING STEPS AS SHOWN IN THE PLANS
- 3 CLOSE THE LEFT LANE OF SR L-57 ACCORDING TO HIGHWAY STANDARD 701401. THEN SHIFT TRAFFIC FROM THE RIGHT LANE ONTO THE RIGHT SHOULDER USING DISTRICT ONE DETAIL TC-09. SMART WORK ZONE ON I-57 SB TO REMAIN IN EFFECT.
- 4. MODIFY THE TRAFFIC SHIFT TO THE LEFT ON RAMP "S" (WB 1-80 TO SB 1-57) FROM STAGE I AS SHOWN IN THE PLANS, STILL USING DISTRICT ONE DETAIL TC-09.
- 5. STRUCTURE NOS. 016-0052 AND 016-2027: CONSTRUCT TEMPORARY PAVEMENT, PERFORM BRIDGE DECK REPAIR, RECONSTRUCT BRIDGE DECK EXPANSION JOINTS AND INSTALL BRIDGE DECK CONCRETE OVERLAY, SMA OVERLAY, CLASS A PATCHES, AND BUTT JOINTS AS SHOWN IN PLANS. PRIOR TO REMOVING TEMPORARY CONCRETE BARRIER WALL, ANY OPEN HOLES IN THE ROADWAY SHALL BE FILLED OR PLATED FOR SAFETY. THE COST FOR PLATING OR FILLING OF OPEN HOLES SHALL BE INCLUDED IN THE LUMP SUM COST FOR TRAFFIC CONTROL AND PROTECTION (EXPRESSWAYS).

STAGE III

- 1. UTILIZE HIGHWAY STANDARD LANE CLOSURES 701401 AND 701400 TO REMOVE CONFLICTING PERMANENT PAVEMENT MARKINGS AND RAISED REFLECTIVE PAVEMENT MARKERS
- 2 LITHIZING HIGHWAY STANDARD 701428 TO INSTALL TRAFFIC CONTROL DEVICES AS SHOWN IN THE MOT PLANS. SHIFT BOTH LANES OF SB 1-57 ONTO THE RIGHT SHOULDER USING DISTRICT ONE DETAIL TC-09.
- 3. SHIFT TRAFFIC ON RAMP "S" (WB I-80 TO SB I-57) ONTO THE RIGHT SHOULDER USING DISTRICT ONE DETAIL TC-09, UTILIZING THE TEMPORARY PAVEMENT CONSTRUCTED IN THE PREVIOUS STAGE TO PROVIDE SUFFICIENT CLEARANCE FOR THE WORK ZONE.
- 4. STRUCTURE NOS. 016-0052 AND 016-2027: PERFORM BRIDGE DECK REPAIR, RECONSTRUCT BRIDGE DECK EXPANSION JOINTS, AND INSTALL BRIDGE DECK CONCRETE OVERLAY, SMA OVERLAY, CLASS B PATCHES, AND BUTT JOINTS AS SHOWN IN PLANS. PRIOR TO REMOVING TEMPORARY CONCRETE BARRIER WALL, ANY OPEN HOLES IN THE ROADWAY SHALL BE FILLED OR PLATED FOR SAFETY. THE COST FOR PLATING OR FILLING OF OPEN HOLES SHALL BE INCLUDED IN THE LUMP SUM FOR TRAFFIC CONTROL AND PROTECTION (EXPRESSWAYS)
- 5. AFTER COMPLETION OF WORK, REMOVE TEMPORARY PAVEMENT AND PERFORM RESTORATION AS SHOWN IN PLANS (SEE DETAILS BELOW)
- 6. INSTALL PERMANENT PAVEMENT MARKINGS AND LANDSCAPING USING STANDARD LANE CLOSURES 701401 AND 701466. REMOVE TEMPORARY TRAFFIC CONTROL DEVICES

RAMP "T" (I-57 SOUTHBOUND TO I-80 WESTBOUND)

THIS WORK IS ANTICIPATED TO BE COMPLETED WITHIN 14 DAYS THEREFORE TEMPORARY STRIPING AND CHANGES TO OVERHEAD SIGNAGE WILL NOT BE REQUIRED. IF THE WORK IS NOT COMPLETED WITHIN 14 DAYS, THE CONTRACTOR SHALL USE TEMPORARY PAVEMENT MARKINGS AND PROVIDE DETAILS FOR OVERHEAD SIGN MODIFICATIONS AT NO EXTRA COST TO THE DEPARTMENT.

STAGE I

- 1. UTILIZE IDOT HIGHWAY STANDARD 701428 TO INSTALL TRAFFIC CONTROL DEVICES FOR THE FOLLOWING STEPS SHOWN IN THE PLANS
- 2. CLOSE THE RIGHT LANE OF SOUTHBOUND I-57, INCLUDING ONE OF THE AUXILIARY LANES FOR RAMP "T", ACOCORDING TO IDOT HIGHWAY STANDARDS 701400 AND 701401 AND AS SHOWN IN THE PLANS.
- 3. SHIFT TRAFFIC FROM THE LEFT LANE OF RAMP "T" TO THE RIGHT LANE OF RAMP "T" USING DISTRICT ONE DETAIL TC-09.
- 4. PERFORM RESURFACING AS SHOWN IN THE PLANS

STAGE II

- 1. UTILIZE IDOT HIGHWAY STANDARD 701428 TO INSTALL TRAFFIC CONTROL DEVICES FOR THE FOLLOWING STEPS SHOWN IN THE PLANS
- 2. CLOSE THE RIGHT LANE OF SOUTHBOUND I-57, INCLUDING ONE OF THE AUXILIARY LANES FOR RAMP "T", ACOCORDING TO IDOT HIGHWAY STANDARDS 701400 AND 701401 AND AS SHOWN IN THE PLANS.
- 3. PERFORM RESURFACING AS SHOWN IN THE PLANS.

RAMP "V" (I-57 NORTHBOUND TO I-80 WESTBOUND)


THIS WORK IS ANTICIPATED TO BE COMPLETED OVER THREE (3) CONSECUTIVE WEEKENDS


DETOUR AND CONSTRUCTION:

- 1. CLOSE RAMP "V" AS PER DETOUR ROUTE SHOWN IN PLANS.
- 2. REMOVE EXISTING CLASS D PATCHES CONSTRUCTED UNDER CONTRACT 62N83 TO REPLACE WITH CLASS A PATCHES.
- 3 PERFORM HMA SURFACE REMOVAL OVER THE ENTIRE RAMP AS SHOWN IN PLANS
- 3. REMOVE AND RECONSTRUCT INSIDE SHOULDER UP TO THE HMA BINDER LEVEL
- 3. PERFORM RESURFACING AND ADD PAVEMENT MARKINGS AS SHOWN IN PLANS.
- 4. THIS WORK IS SUGGESTED TO BE DONE DURING STAGE II I-57 NB

LEGEND

PAVEMENT REMOVAL TOPSOIL FURNISH AND PLACE, 12' SEEDING CLASS 2A

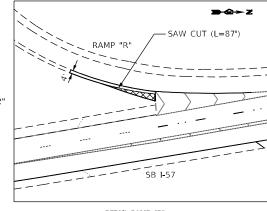

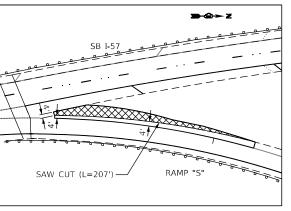

DETAIL RAMP "R"

DETAIL RAMP "S"

TEMPORARY PAVEMENT REMOVAL DETAILS



REVISED DESIGNED -DW DRAWN DW REVISED HECKED AB REVISED REVISED 10-08-2021

STATE OF ILLINOIS **DEPARTMENT OF TRANSPORTATION**

SUGGESTED SEQUENCE OF CONSTRUCTION AND MAINTENANCE OF TRAFFIC FOR I-80

FOR EACH STAGE OF CONSTRUCTION, PROVIDE TRAFFIC CONTROL AS SHOWN ON THE MAINTENANCE OF TRAFFIC PLANS. COORDINATE INSTALLATION
OF TRAFFIC CONTROL DEVICES WITH THE EXISTING TRAFFIC PATTERNS AT THE ENDS OF THE PROJECT ALONG 1-80 AND VARIOUS RAMPS TO AND FROM
1-57. THE 1-57 BRIDGES SUBSTRUCTURE IMPROVEMENTS WILL BE CONSTRUCTED USING NIGHTLY LANE/SHOULDER CLOSURES AND RAMP SHIFTS ONTO EXISTING
SHOULDERS, PER DISTRICT ONE STANDARDS TC-17, HIGHWAY STANDARDS 701400, 701401, 701411, 701428, 701456, AND 701901.

EASTBOUND I-80

STAGE 1:

- 1. USE NIGHTLY LANE CLOSURE TO CLOSE RIGHT LANE OF EB I-80 BEGINNING EAST OF THE EXIT RAMP TO I-57 SB. SHIFT RAMP TRAFFIC ENTERING EB I-80 INTO CLOSED RIGHT LANE AND MERGE INTO MAINLINE AS SHOWN TO PROVIDE LANE OF SAFETY BETWEEN I-80 AND SUBSTRUCTURE REPAIR LOCATIONS.
- 2. COMPLETE SUBSTRUCTURE REPAIRS ON SOUTH PIERS, SOUTH PIER CRASHWALLS, AND ABUTMENTS OF STRUCTURES 016-0052 AND 016-0053.

STAGE 2A:

- 1. USE NIGHTLY LANE CLOSURE TO CLOSE LEFT LANE OF WB I-80 BEGINNING AT THE TAPER THAT FORMS THE LEFT AUXILIARY LANE FOR THE EXIT RAMP TO I-57 NB. THE LEFT LANE OF THE EB I-80 TO NB I-57 WILL BE CLOSED UNTIL EAST OF STRUCTURE TO PROVIDE LANE OF SAFETY BETWEEN RAMP TRAFFIC AND SUBSTRUCTURE REPAIR AREA. THE LEFT LANE OF WB I-80 WILL REMAIN CLOSED UNTIL EAST OF STRUCTURE 016-0053 TO PROVIDE LANE OF SAFETY BETWEEN MAINLINE I-57 TRAFFIC AND SUBSTRUCTURE REPAIR LOCATIONS.
- 2. COMPLETE SUBSTRUCTURE REPAIRS ON NORTH PIERS. NORTH PIER CRASH WALLS, AND ABUTMENTS OF STRUCTURES 016-0052 AND 016-0053.

STAGE 2B

- 1. USE NIGHTLY LANE CLOSURE TO CLOSE LEFT LANE OF WB I-80 BEGINNING AT THE TAPER THAT FORMS THE LEFT AUXILIARY LANE FOR THE EXIT RAMP TO I-57 NB. THE RIGHT LANE OF THE EB I-80 TO NB I-57 WILL BE CLOSED UNTIL EAST OF STRUCTURE TO PROVIDE LANE OF SAFETY BETWEEN RAMP TRAFFIC AND SUBSTRUCTURE REPAIR AREA. THE LEFT LANE OF WB I-80 WILL REMAIN CLOSED UNTIL EAST OF STRUCTURE 016-0053 TO PROVIDE LANE OF SAFETY BETWEEN MAINLINE I-57 TRAFFIC AND SUBSTRUCTURE REPAIR LOCATIONS.
- 2. COMPLETE SUBSTRUCTURE REPAIRS ON CENTER PIER OF STRUCTURE 016-0052 AND NORTH PIER AND ABUTMENTS OF STRUCTURES 016-0053.

WESTBOUND I-80

STAGE 1

- 1. USE NIGHTLY LANE CLOSURE TO CLOSE RIGHT LANE OF WB I-80 BEGINNING WEST OF THE EXIT RAMP TO I-57 NB. SHIFT RAMP TRAFFIC ENTERING WB I-80 INTO CLOSED RIGHT LANE AND MERGE INTO MAINLINE AS SHOWN TO PROVIDE LANE OF SAFETY BETWEEN I-80 AND SUBSTRUCTURE REPAIR LOCATIONS.
- 2. COMPLETE SUBSTRUCTURE REPAIRS ON NORTH PIERS & ABUTMENTS OF STRUCTURES 016-0026 AND 016-0027.

STAGE 2A:

- 1. USE NIGHTLY LANE CLOSURE TO CLOSE LEFT LANE OF WB I-80 BEGINNING WEST OF THE EXIT TO I-57 NB. SHIFT RAMP TRAFFIC EXITING TO I-57 SB TOWARDS THE SOUTH ONTO THE LEFT SHOULDER TO PROVIDE ADEQUATE AREA TO WORK ON STRUCTURE 016-2026 CENTER PIER. MAINLINE LEFT PIER WILL REMAIN CLOSED UNTIL WEST OF STRUCTURE 016-2027 TO ALLOW LANE OF SAFETY BETWEEN MAINLINE TRAFFIC AND SUBSTRUCTURE REPAIR LOCATIONS.
- 2. COMPLETE SUBSTRUCTURE REPAIRS ON CENTER PIER OF STRUCTURE 016-2026 AND SOUTH PIERS AND ABUTMENT OF STRUCTURE 016-2027.

STAGE 2B:

- 1. USE NIGHTLY LANE CLOSURE TO CLOSE LEFT LANE OF WB I-80 BEGINNING WEST OF THE EXIT TO I-57 NB. SHIFT THE RAMP TRAFFIC EXITING TO I-57 SB TOWARDS THE NORTH ONTO THE RIGHT SHOULDER TO PROVIDE ADEQUATE WORK AREA TO WORK ON STRUCTURE 016-2026 SOUTH PIER AND ABUTMENT. MAINLINE LEFT WILL REMAIN CLOSED UNTIL WEST OF STRUCTURE 016-2027 TO ALLOW LANE OF SAFETY BETWEEN MAINLINE TRAFFIC AND SUBSTRUCTURE REPAIR LOCATIONS.
- 2. COMPLETE SUBSTRUCTURE REPAIRS ON SOUTH PIER AND ABUTMENT OF STRUCTURE 016-2026 AND SOUTH PIERS AND ABUTMENT OF STRUCTURE 016-2027.


Accurate


USER NAME = jent	DESIGNED -	DW	REVISED -
	DRAWN -	DW	REVISED -
PLOT SCALE = 2,0000 / in.	CHECKED -	AB	REVISED -
PLOT DATE = 10/20/2021	DATE -	10-08-2021	REVISED -


STATE OF ILLINOIS
DEPARTMENT OF TRANSPORTATION

SCALE:

	GESTED T					F.A.I. RTE.	SECTION	COUNTY	TOTAL SHEETS	SHEET NO.
SEQUENCE					ANCE OF TRAFFIC	57	2020-171-BR	COOK	190	37
	I-5	7 AT I-	80 INTER	CHANGE				CONTRACT	Γ NO. 62	2M54
ALE:	SHEET	OF	SHEETS	STA	TO STA.		THINOIS SED A	ID DROJECT NUDD	E1121(520)	

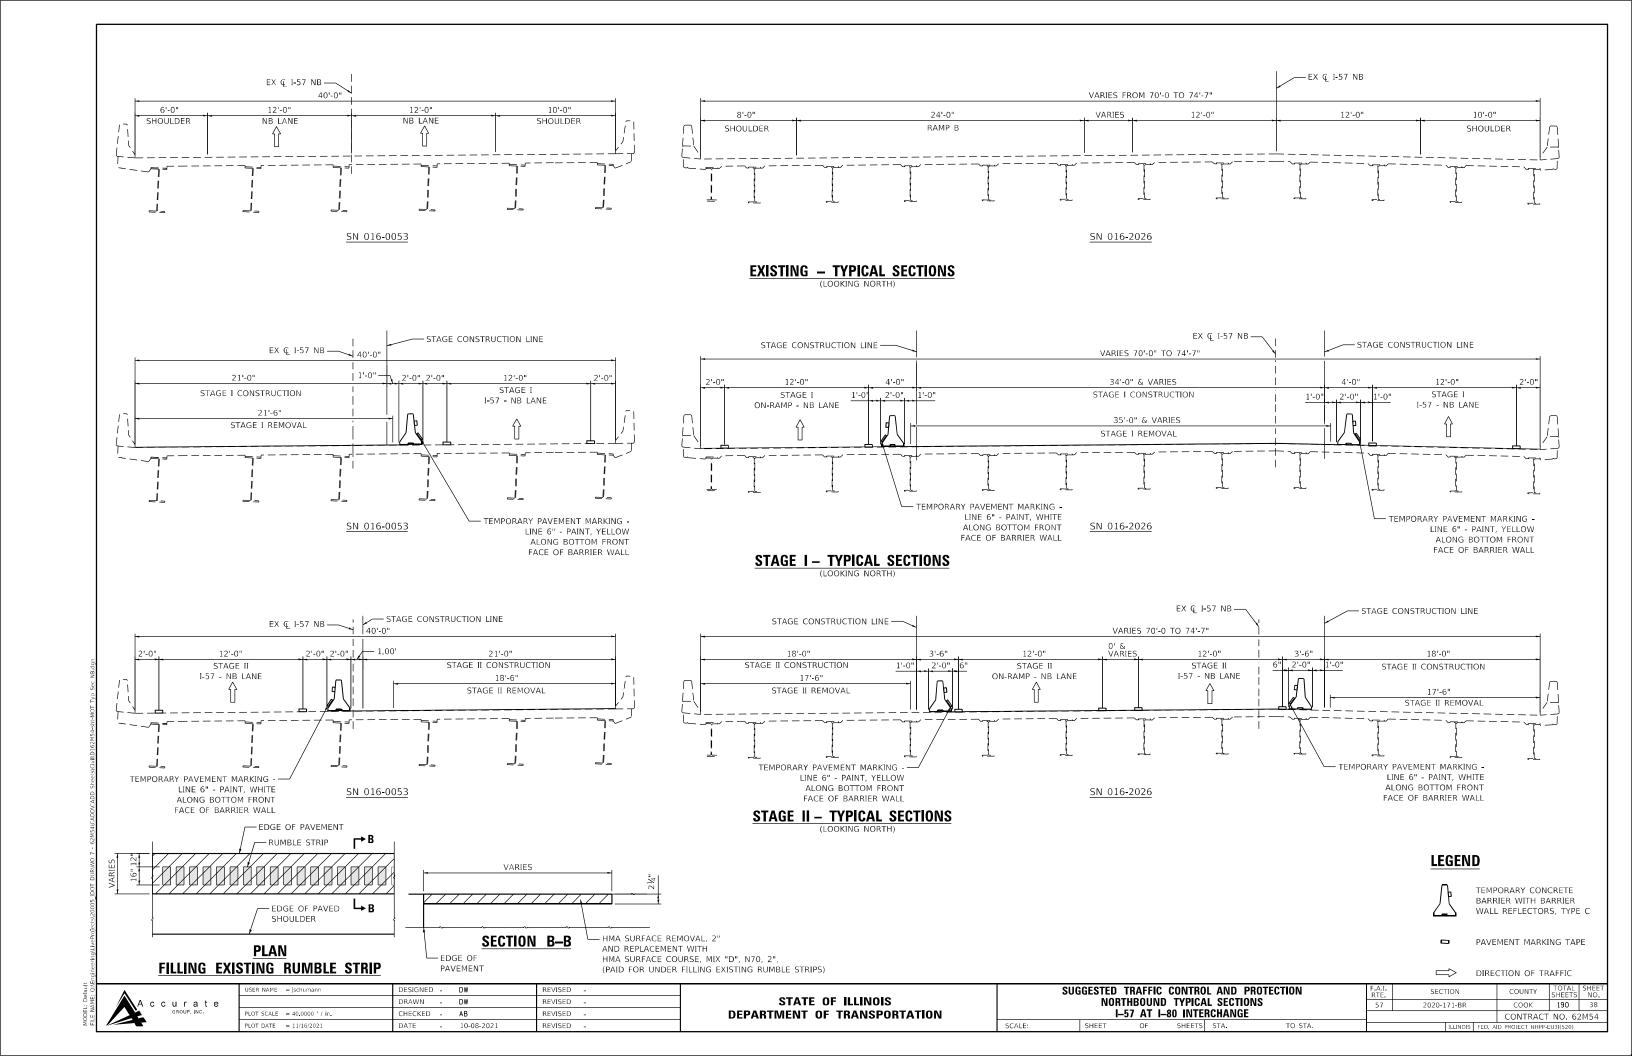


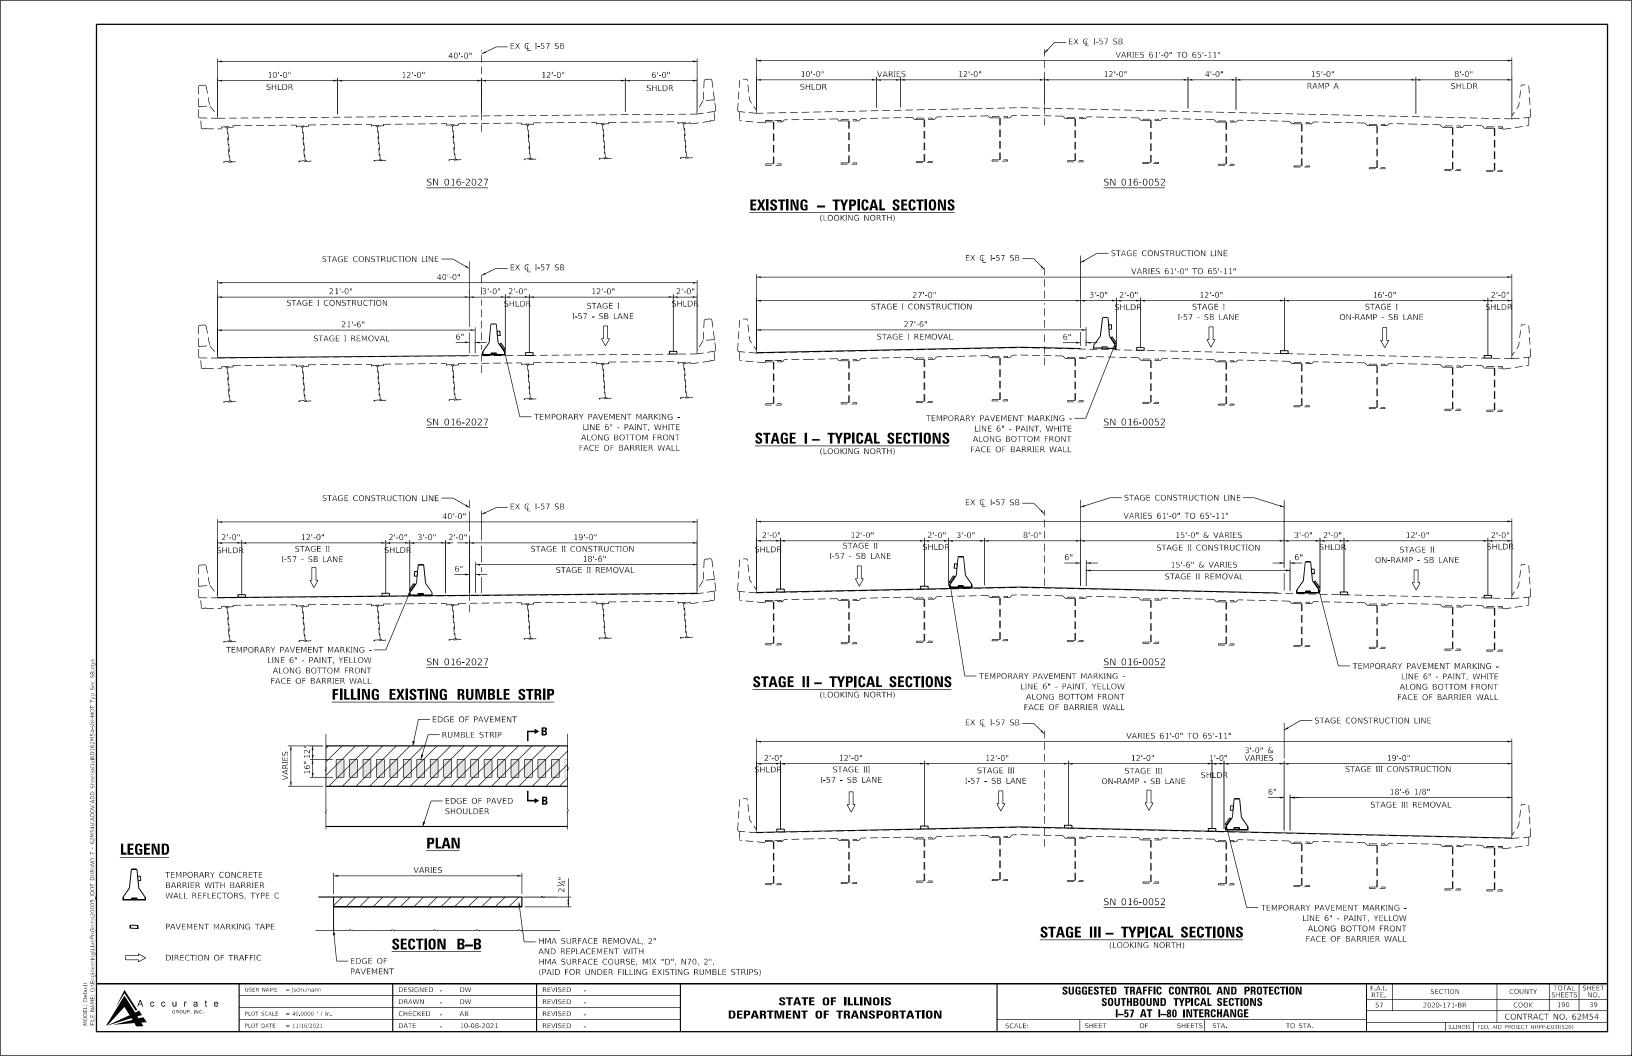

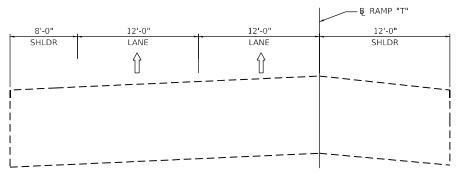


RAMP "T" EXISTING - TYPICAL SECTION

(LOOKING WEST) STA 26+44 TO STA 34+67

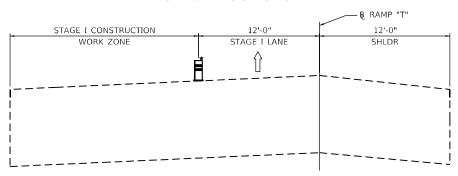

RAMP "T" STAGE I – TYPICAL SECTION

(LOOKING WEST) STA 26+44 TO STA 34+67

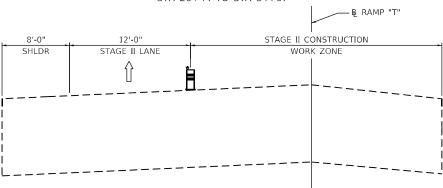

RAMP "T' STAGE II - TYPICAL SECTION

(LOOKING WEST) STA 26+44 TO STA 34+67

LEGEND



TYPE II BARRICADE OR DRUM



DIRECTION OF TRAFFIC


A	С	С		a , inc	е


USER NAME = jent	DESIGNED	-	DW	REVISED -
	DRAWN	-	DW	REVISED -
PLOT SCALE = 40.0000 / in	CHECKED	-	AB	REVISED -
PLOT DATE = 10/20/2021	DATE	-	10-08-2021	REVISED -


STATE OF ILLI	NOIS
DEPARTMENT OF TRAI	NSPORTATION


SCALE:


SUG	GESTED				F.A.I. RTE.	SECT	ION		COUNTY	TOTAL SHEETS	SHEET NO.	
	RAMP "T" TYPICAL SECTIONS						2020-17	71-BR		COOK	190	40
	<u> </u>	-57 AT I-	-80 INTE	RCHANGE						CONTRAC	Γ NO. 62	2M54
	SHEET	OF	SHEETS	STA.	TO STA.			ILLINOIS	FED. A	D PROJECT NHPP-	EU3I(520)	

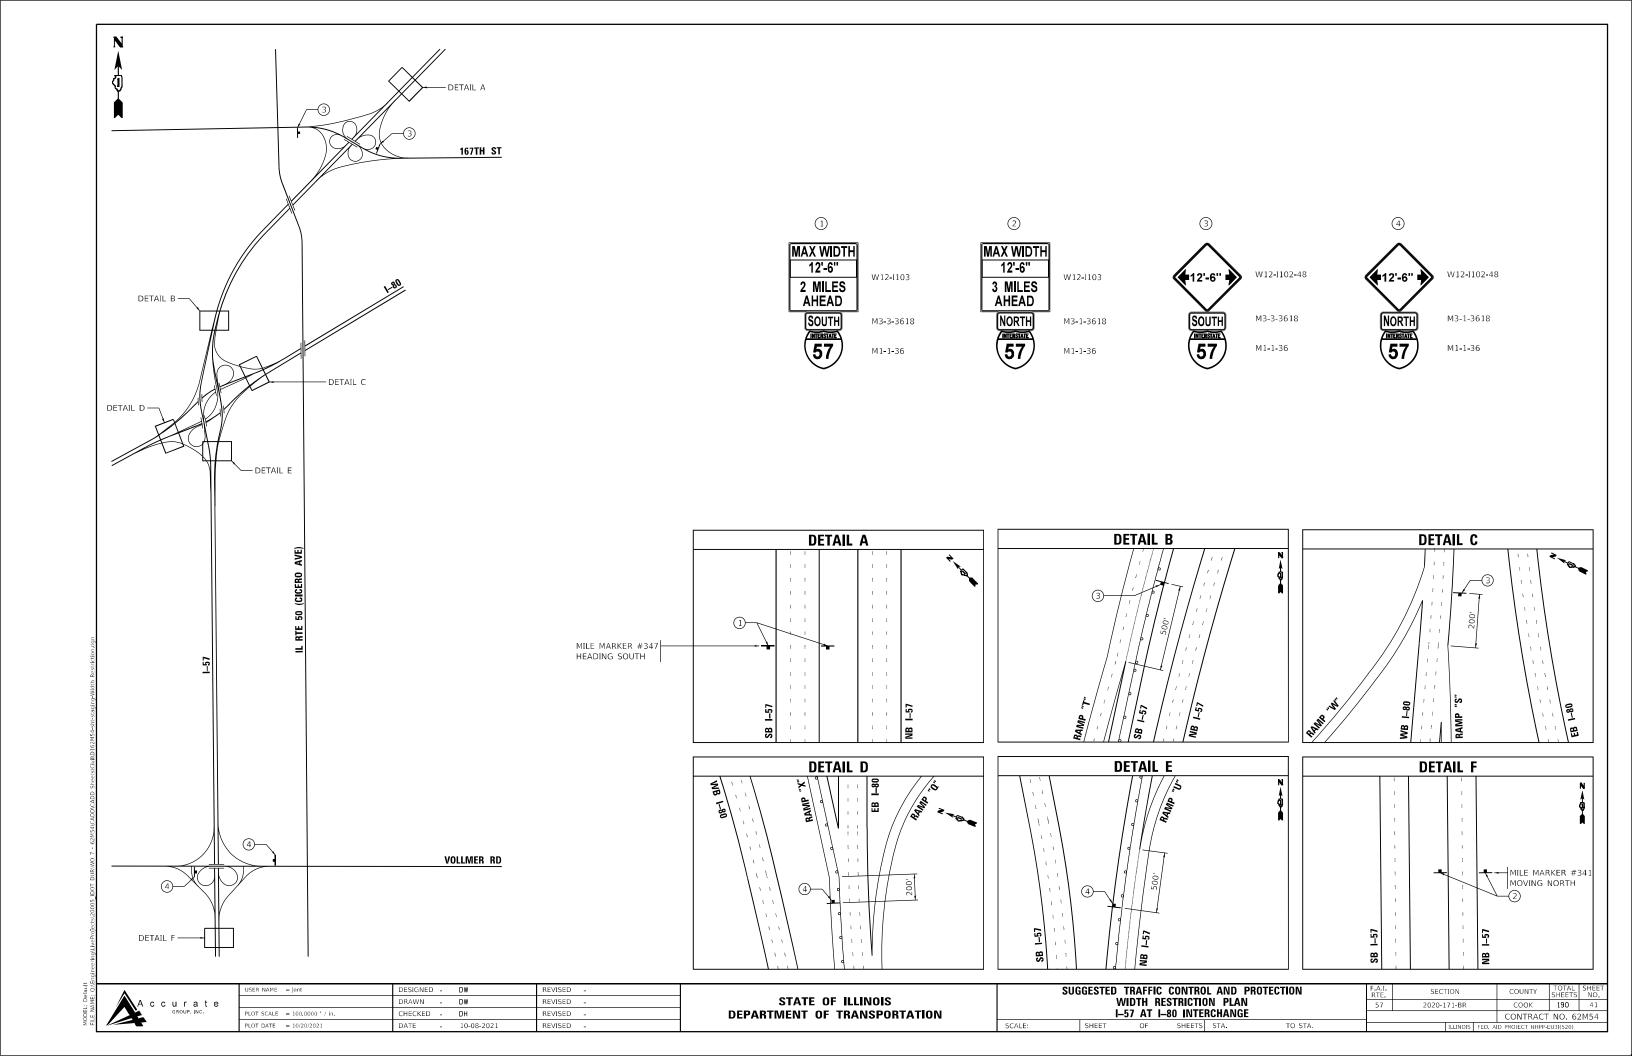

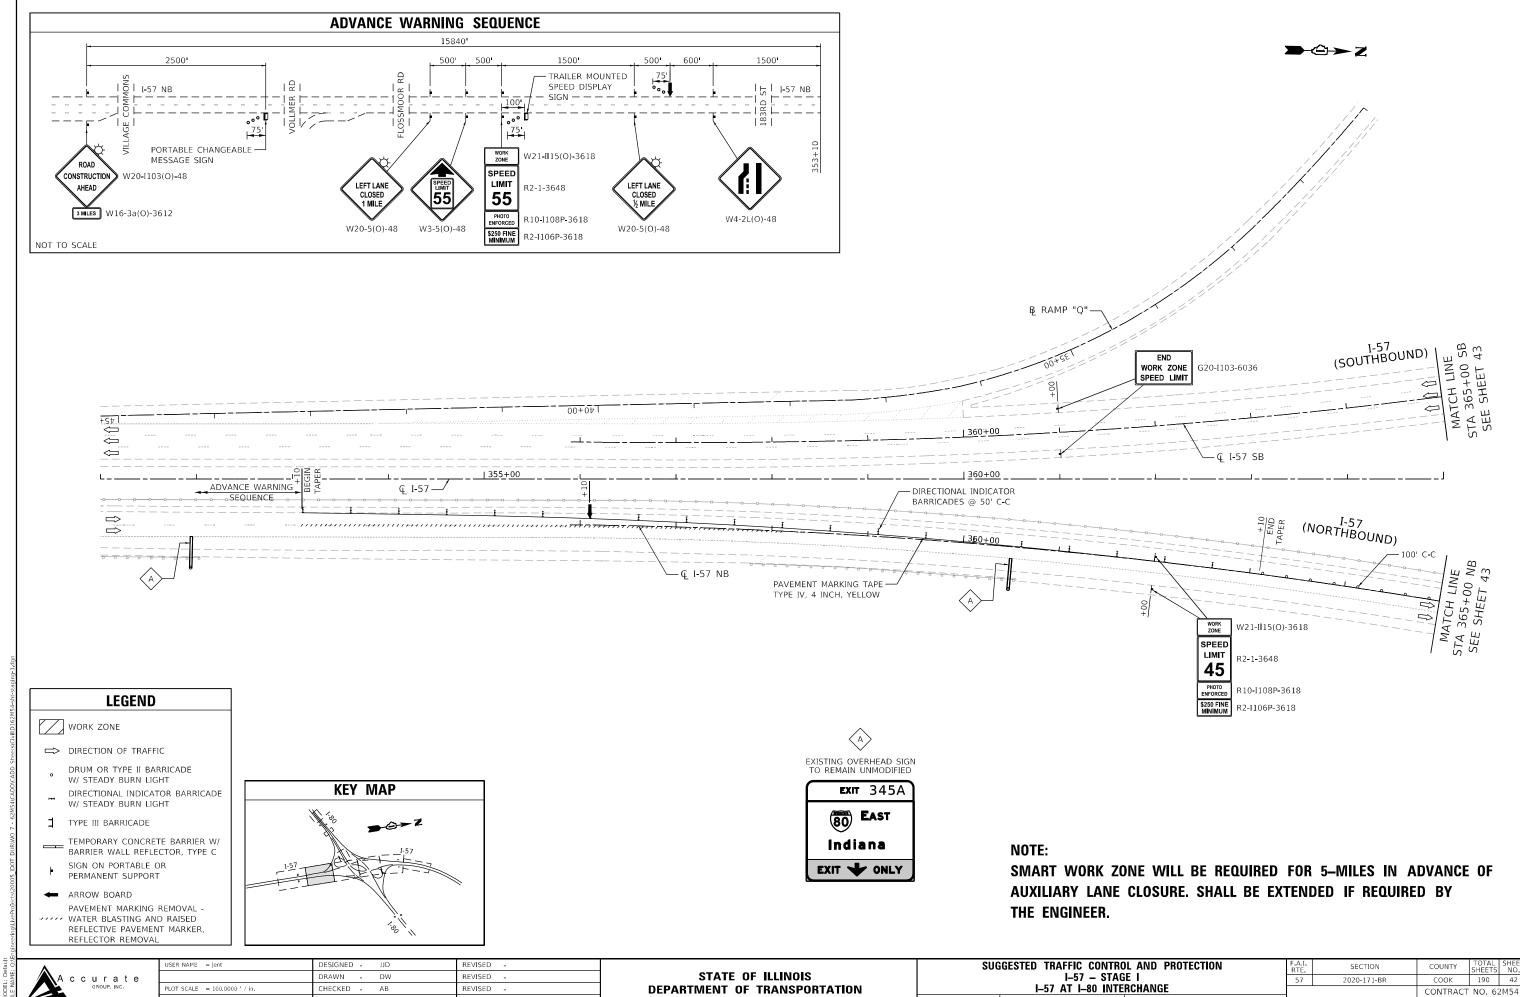

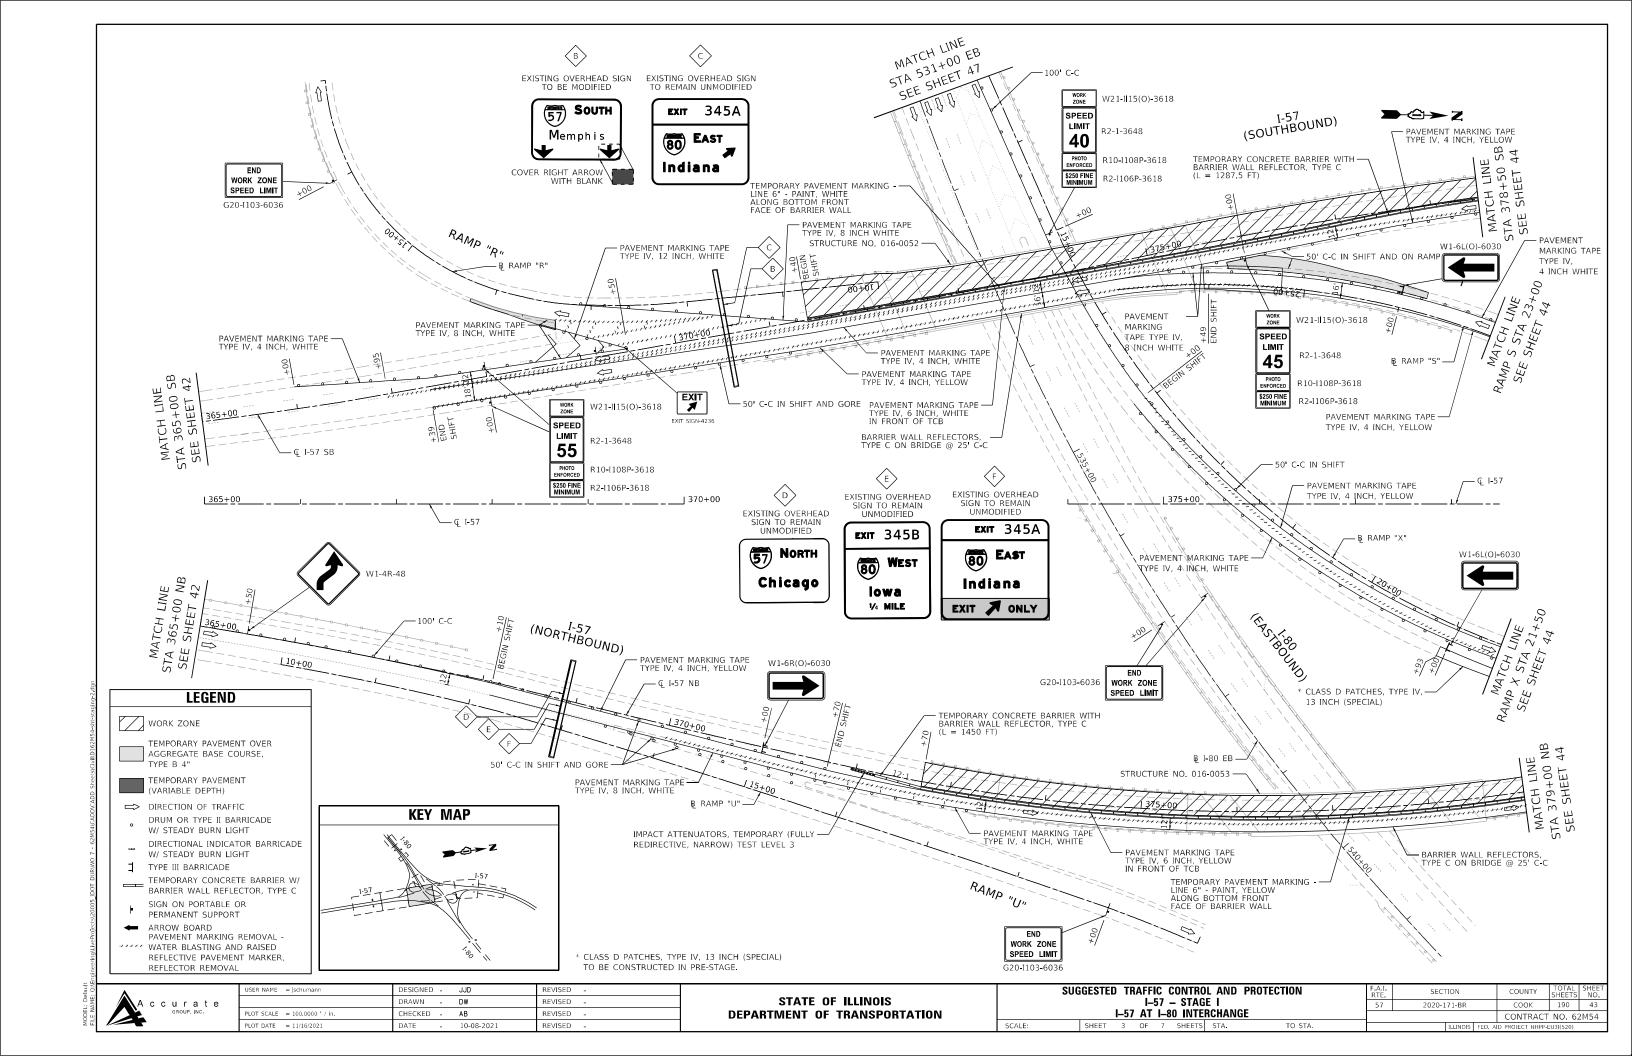

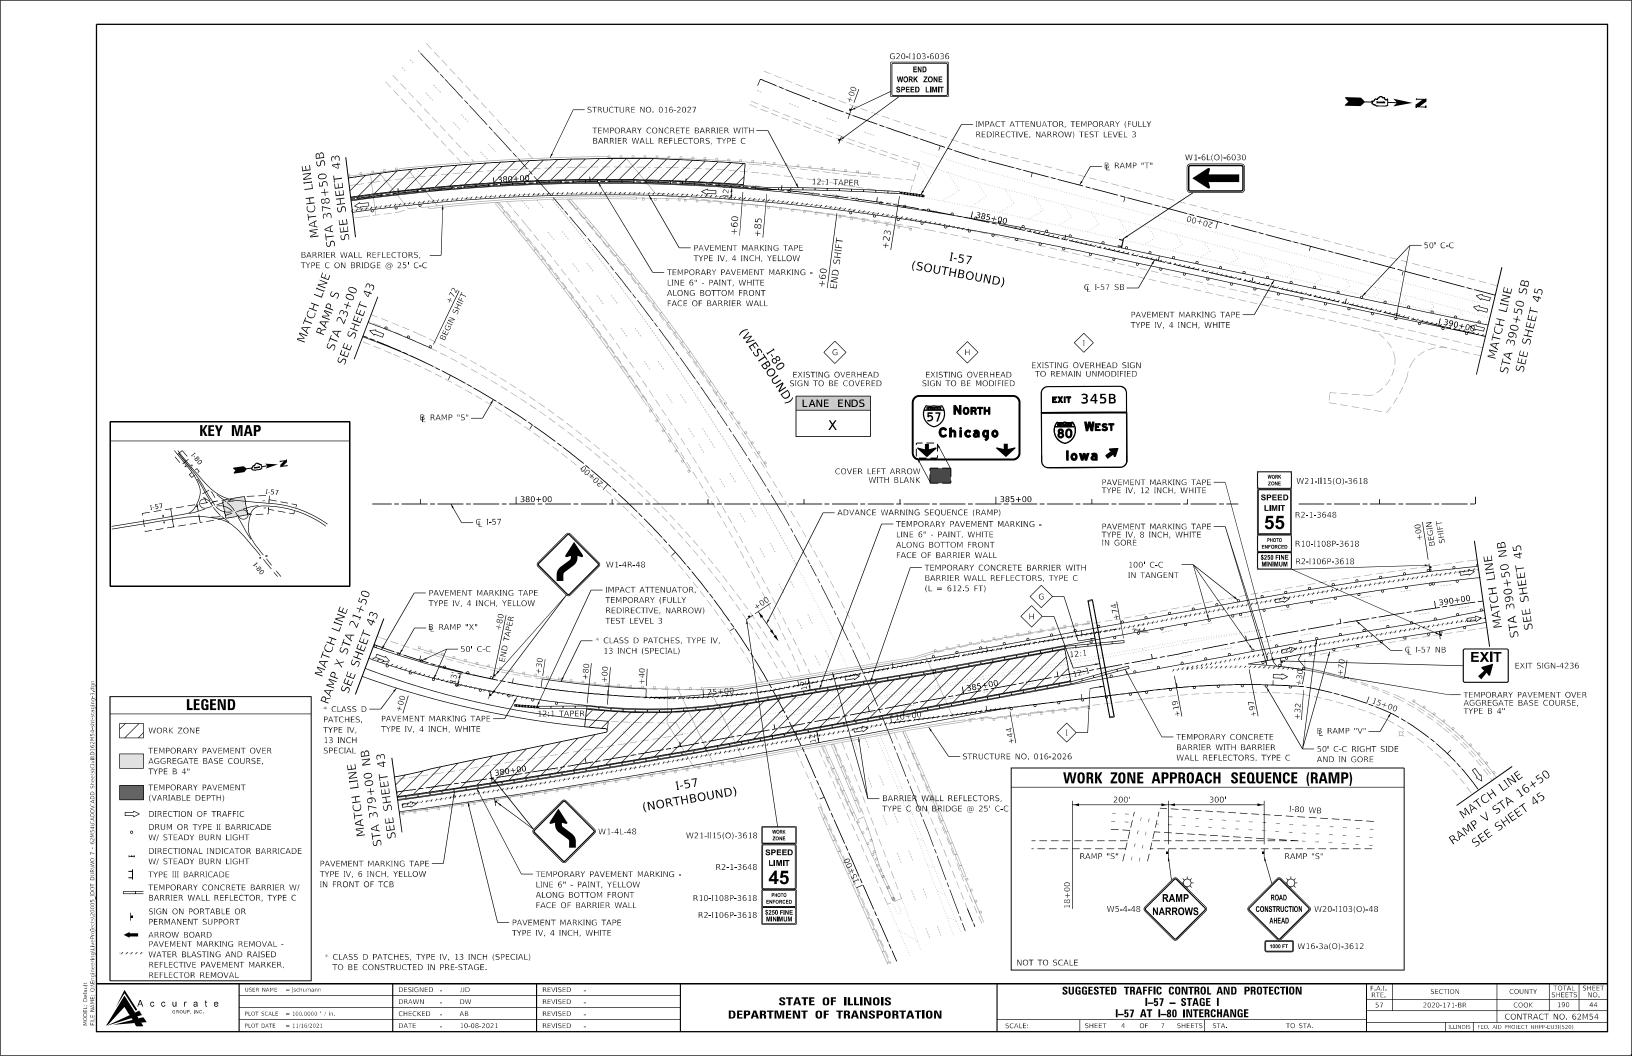

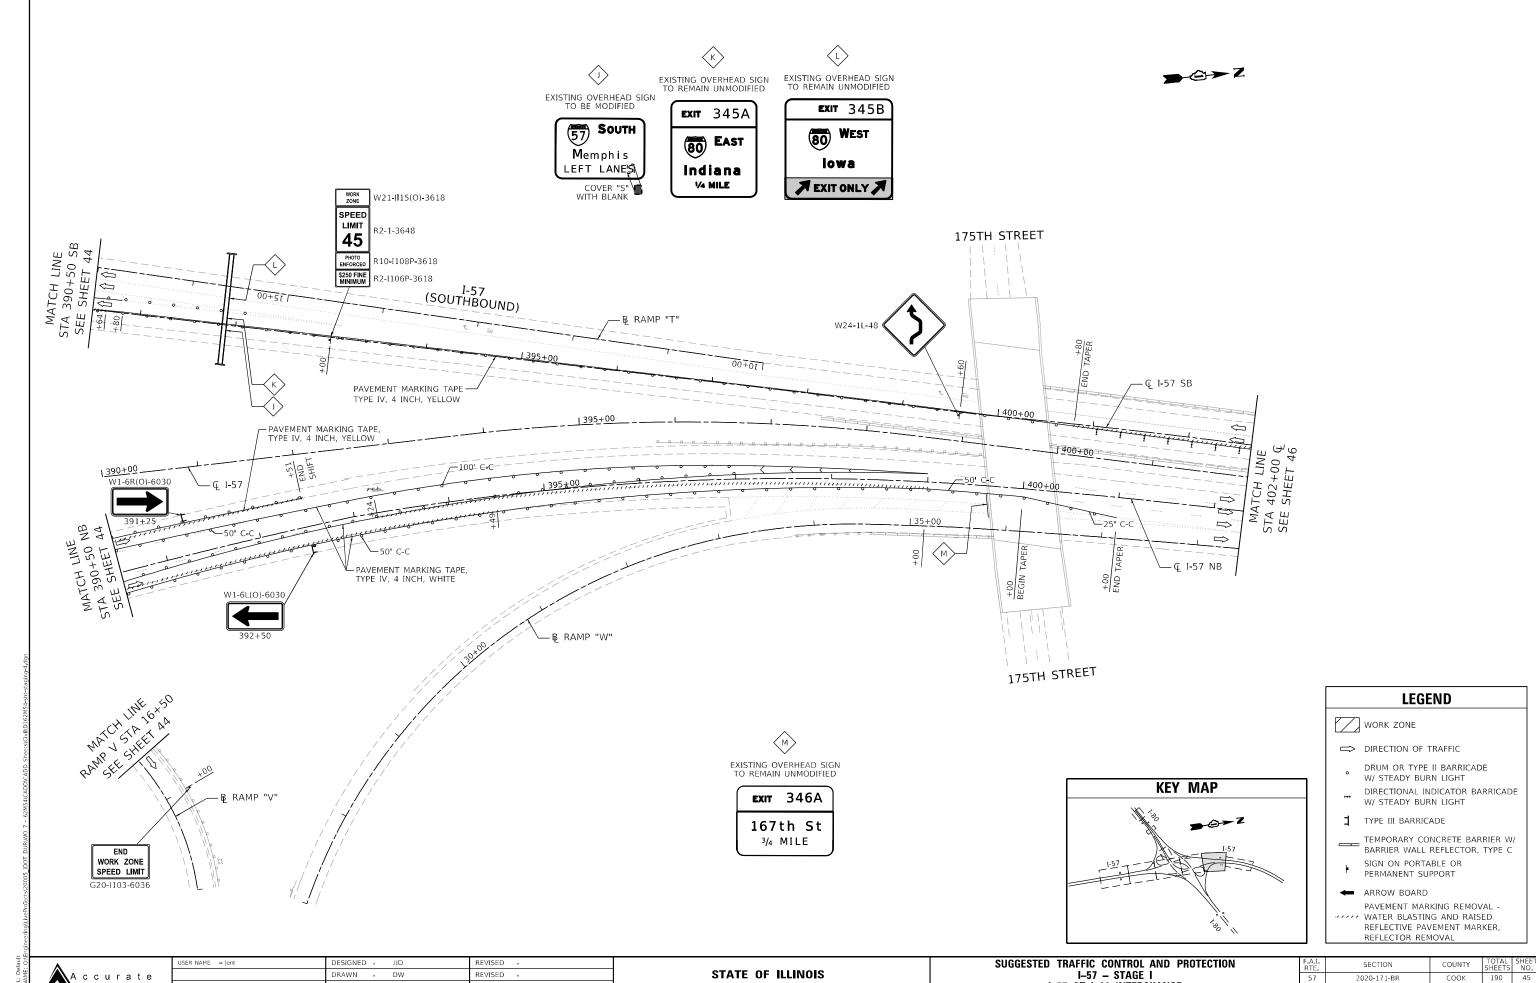

DEPARTMENT OF TRANSPORTATION


REVISED

I-57 AT I-80 INTERCHANGE

SHEET 4 OF 6 SHEETS STA.

CONTRACT NO. 62M54

FILE NAME:

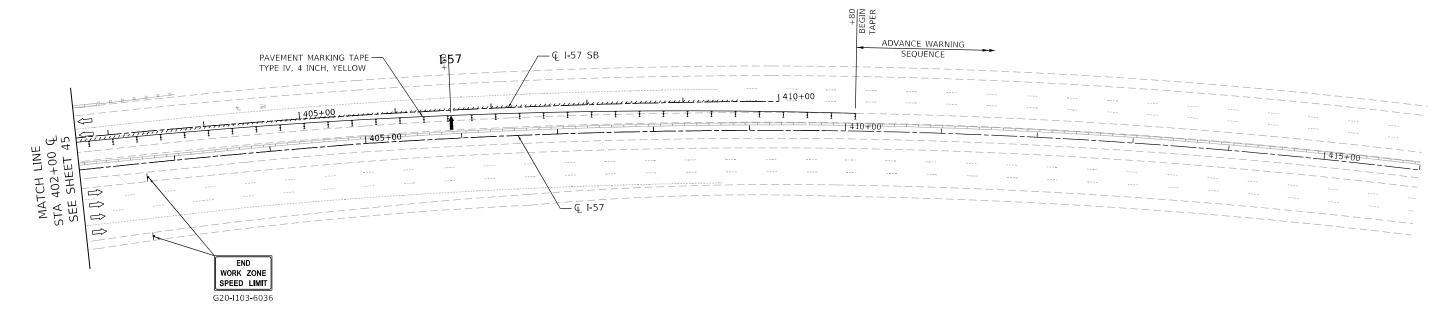






□ DIRECTION OF TRAFFIC

- DRUM OR TYPE II BARRICADE W/ STEADY BURN LIGHT
- DIRECTIONAL INDICATOR BARRICADE W/ STEADY BURN LIGHT
- TYPE III BARRICADE
- TEMPORARY CONCRETE BARRIER W/
 BARRIER WALL REFLECTOR, TYPE C
- SIGN ON PORTABLE OR PERMANENT SUPPORT
- ← ARROW BOARD
- PAVEMENT MARKING REMOVAL -WATER BLASTING AND RAISED REFLECTIVE PAVEMENT MARKER, REFLECTOR REMOVAL

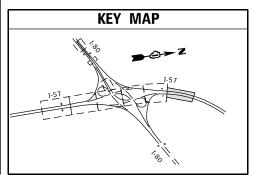

1500'		1100'	1600 '	500'	500'	8100'	2500'
2 I-57 SB	W4-2L(O)-48		D DISPLAY SIGN — 1	WORK ZONE SPEED LIMIT 55	SPEED SPEED	I-57 SB PORTABLE CHANGEABL MESSAGE SIGN LEFT LANE CLOSED 1 MILE	W20-I103(O)-48 CONSTRUCTION AHEAD W16-3a(O)-3612 3 MILES

THE ENGINEER.





	USER NAME = jent	DESIGNED -	JJD	REVISED -	
		DRAWN -	DW	REVISED -	
	PLOT SCALE = 100.0000 / in	CHECKED -	AB	REVISED -	
	PLOT DATE = 10/20/2021	DATE -	10-08-2021	REVISED -	
_	•		•	-	-

STATE OF ILLINOIS DEPARTMENT OF TRANSPORTATION

SUG	GESTE) TF					PROTECTION	F.A.I. RTE.	SEC ⁻	TION		COUNTY	TOTAL SHEETS	SHEET NO.
I-57 - STAGE I				57	57 2020-171-BR		COOK	190	46					
		I-57	AT	I–8	O INTER	CHAN	jE					CONTRAC	T NO. 62	2M54
	SHEET	6	OF	7	SHEETS	STA.	TO STA.			ILLINOIS	FED. A	D PROJECT NHPP	EU3I(520)	

SMART WORK ZONE WILL BE REQUIRED FOR 5-MILES IN ADVANCE OF AUXILIARY LANE CLOSURE. SHALL BE EXTENDED IF REQUIRED BY

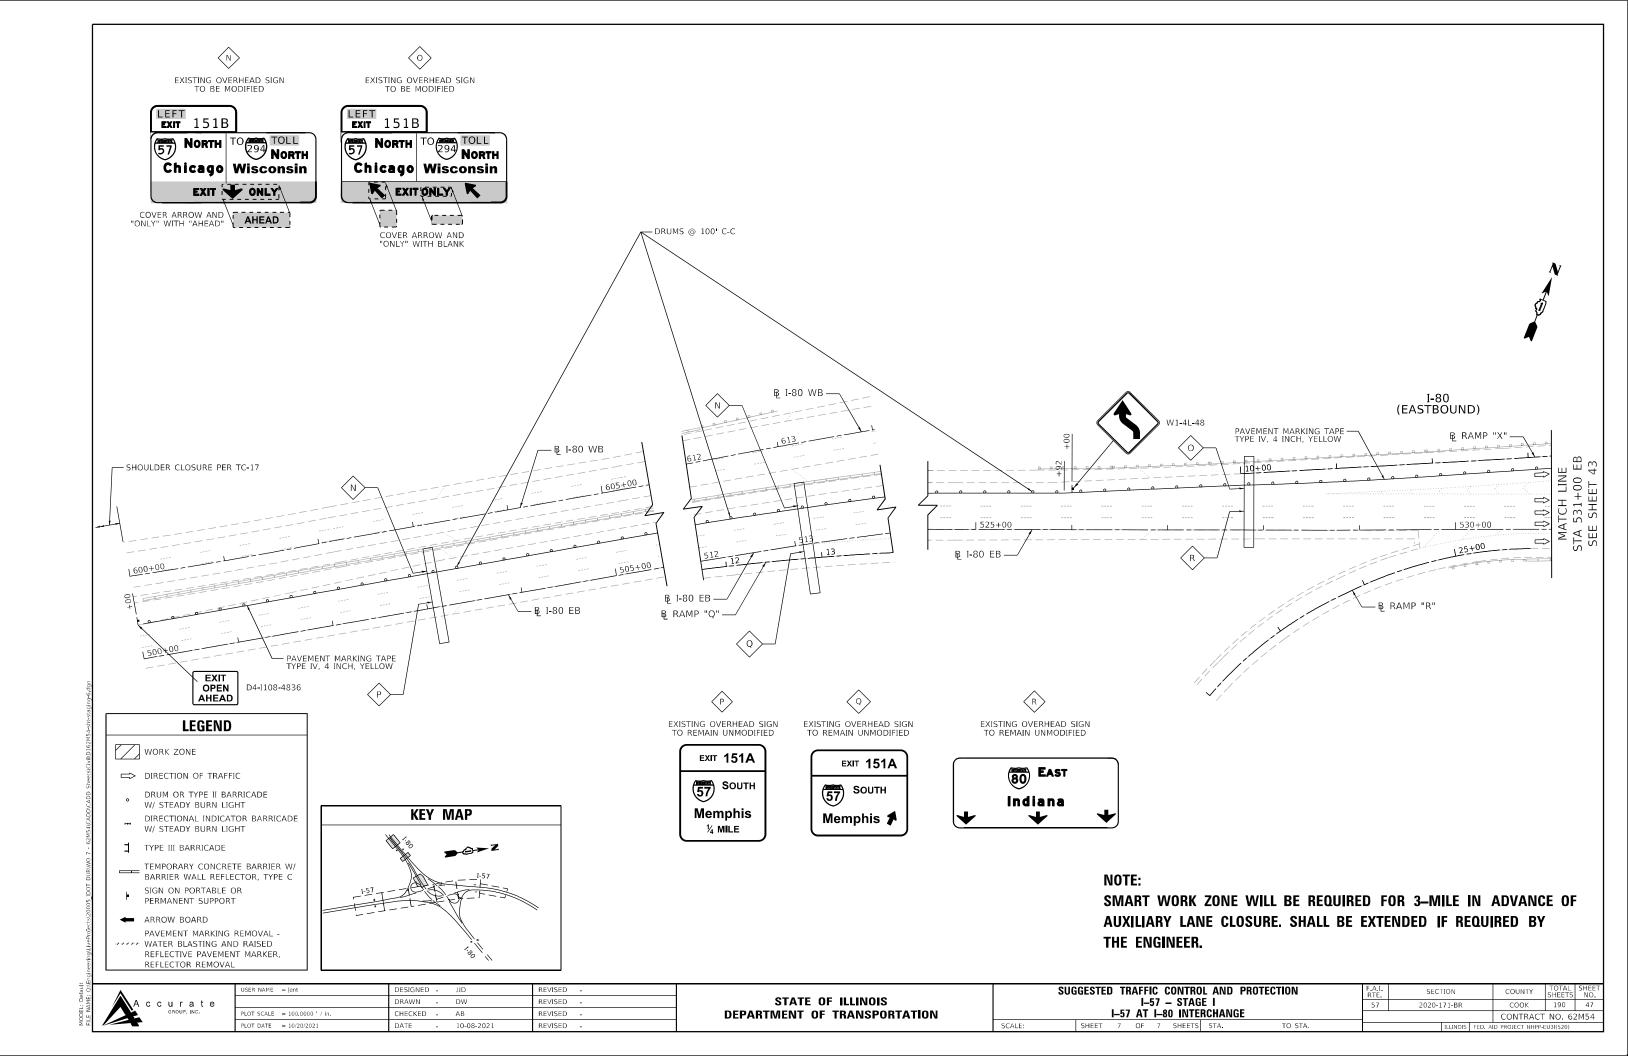

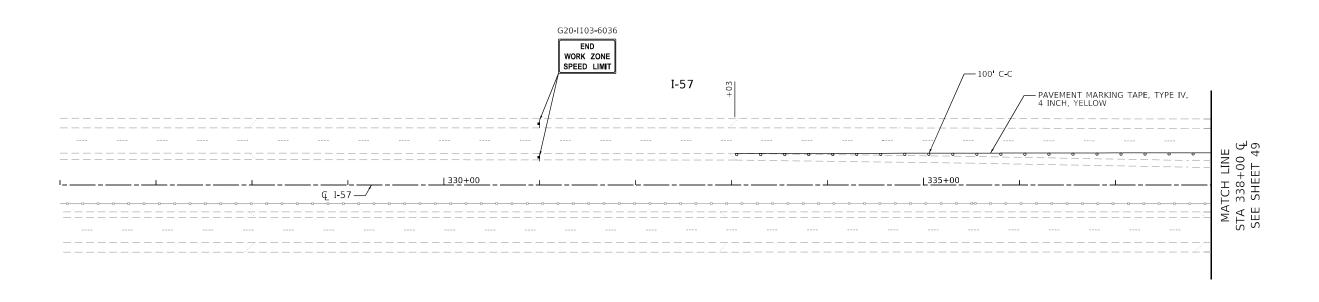

LEGEND

WORK ZONE



TEMPORARY PAVEMENT OVER AGGREGATE BASE COURSE, TYPE B 4"



 □ DIRECTION OF TRAFFIC DRUM OR TYPE II BARRICADE W/ STEADY BURN LIGHT


DIRECTIONAL INDICATOR BARRICADE W/ STEADY BURN LIGHT

TYPE III BARRICADE

TEMPORARY CONCRETE BARRIER W/
BARRIER WALL REFLECTOR, TYPE C

SIGN ON PORTABLE OR PERMANENT SUPPORT


ARROW BOARD
PAVEMENT MARKING REMOVAL WATER BLASTING AND RAISED
REFLECTIVE PAVEMENT MARKER,
REFLECTOR REMOVAL

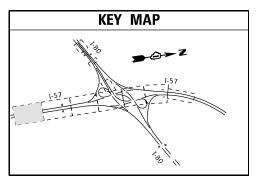

SMART WORK ZONE WILL BE REQUIRED FOR 5-MILES IN ADVANCE OF AUXILIARY LANE CLOSURE. SHALL BE EXTENDED IF REQUIRED BY THE ENGINEER.

USER NAME = jent	DESIGNED	-	DII	REVISED -
	DRAWN	-	DW	REVISED -
PLOT SCALE = 100.0000 / in.	CHECKED	-	AB	REVISED -
PLOT DATE = 10/20/2021	DATE	-	10-08-2021	REVISED -

SUGGESTED TRAFFIC CONTROL AND PROTECTION	F.A.I. RTE	SECTION	COUNTY	TOTAL SHEETS	SHEET NO.
I-57 - STAGE II	57	2020-171-BR	COOK	190	48
I-57 AT I-80 INTERCHANGE			CONTRAC	T NO. 6	2M54
SHEET 1 OF 8 SHEETS STA. TO STA.		ILLINOIS	FED. AID PROJECT NHPP	-EU3I(520)	

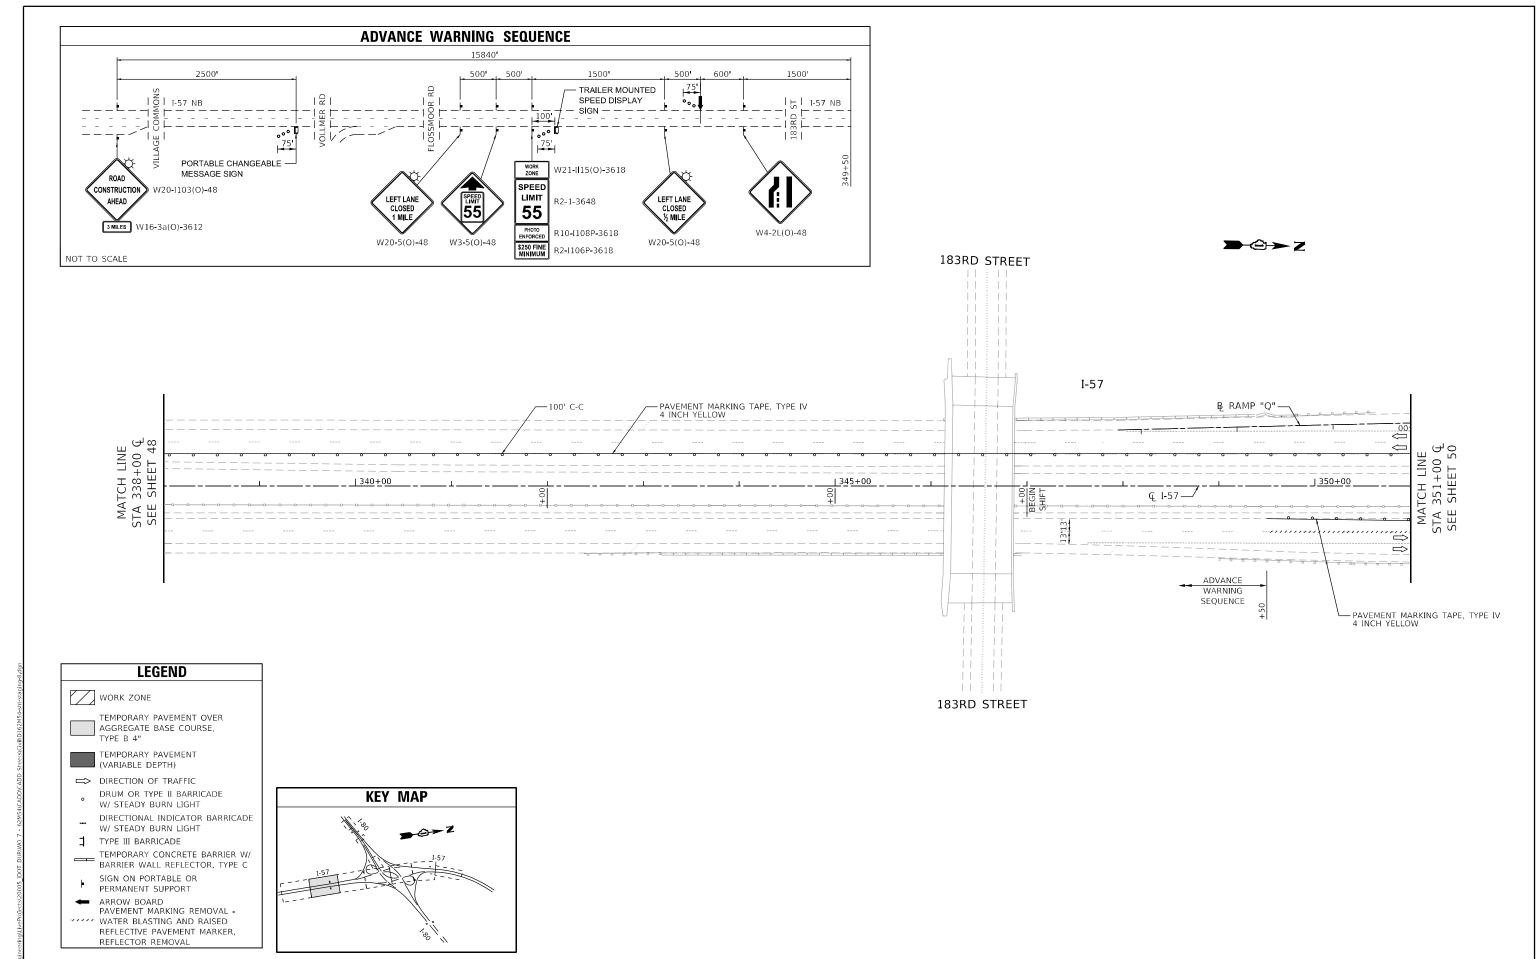


A c c u r a t e

 USER NAME
 = Jent
 DESIGNED
 JJD
 REVISED

 PLOT SCALE
 = 100,0000 / in.
 CHECKED
 AB
 REVISED

 PLOT DATE
 = 10/20/2021
 DATE
 10-08-2021
 REVISED


STATE OF ILLINOIS
DEPARTMENT OF TRANSPORTATION

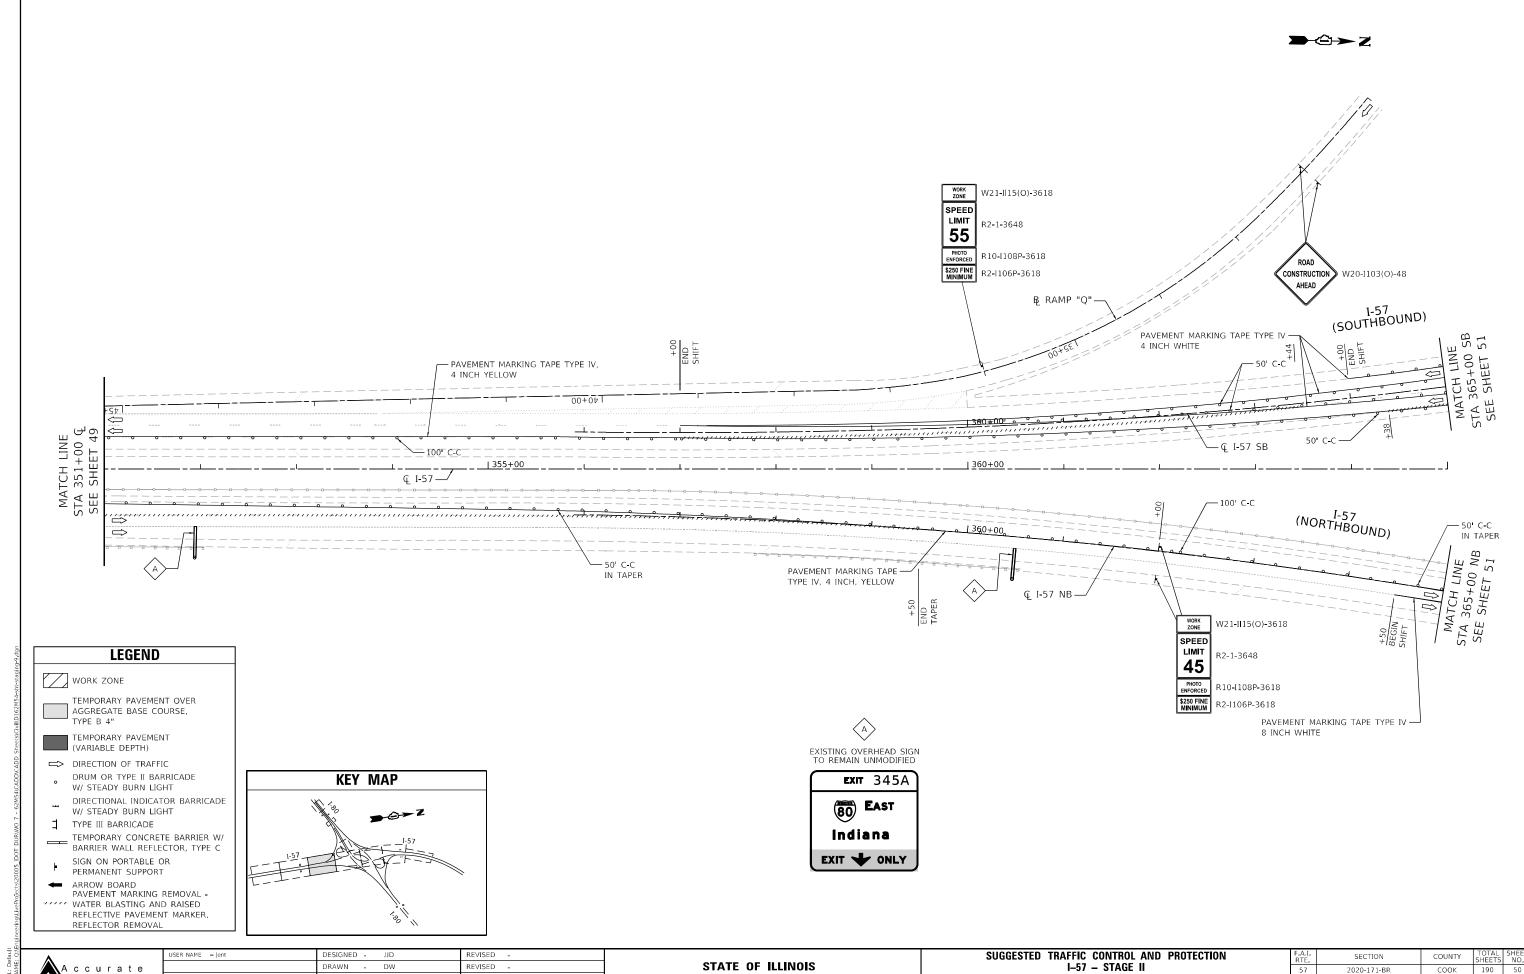



DRAWN -LOT SCALE = 100.0000 / in. REVISED -

STATE OF ILLINOIS **DEPARTMENT OF TRANSPORTATION** SUGGESTED TRAFFIC CONTROL AND PROTECTION
1-57 - STAGE II 2020-171-BR I-57 AT I-80 INTERCHANGE SHEET 2 OF 7 SHEETS STA.


CONTRACT NO. 62M54

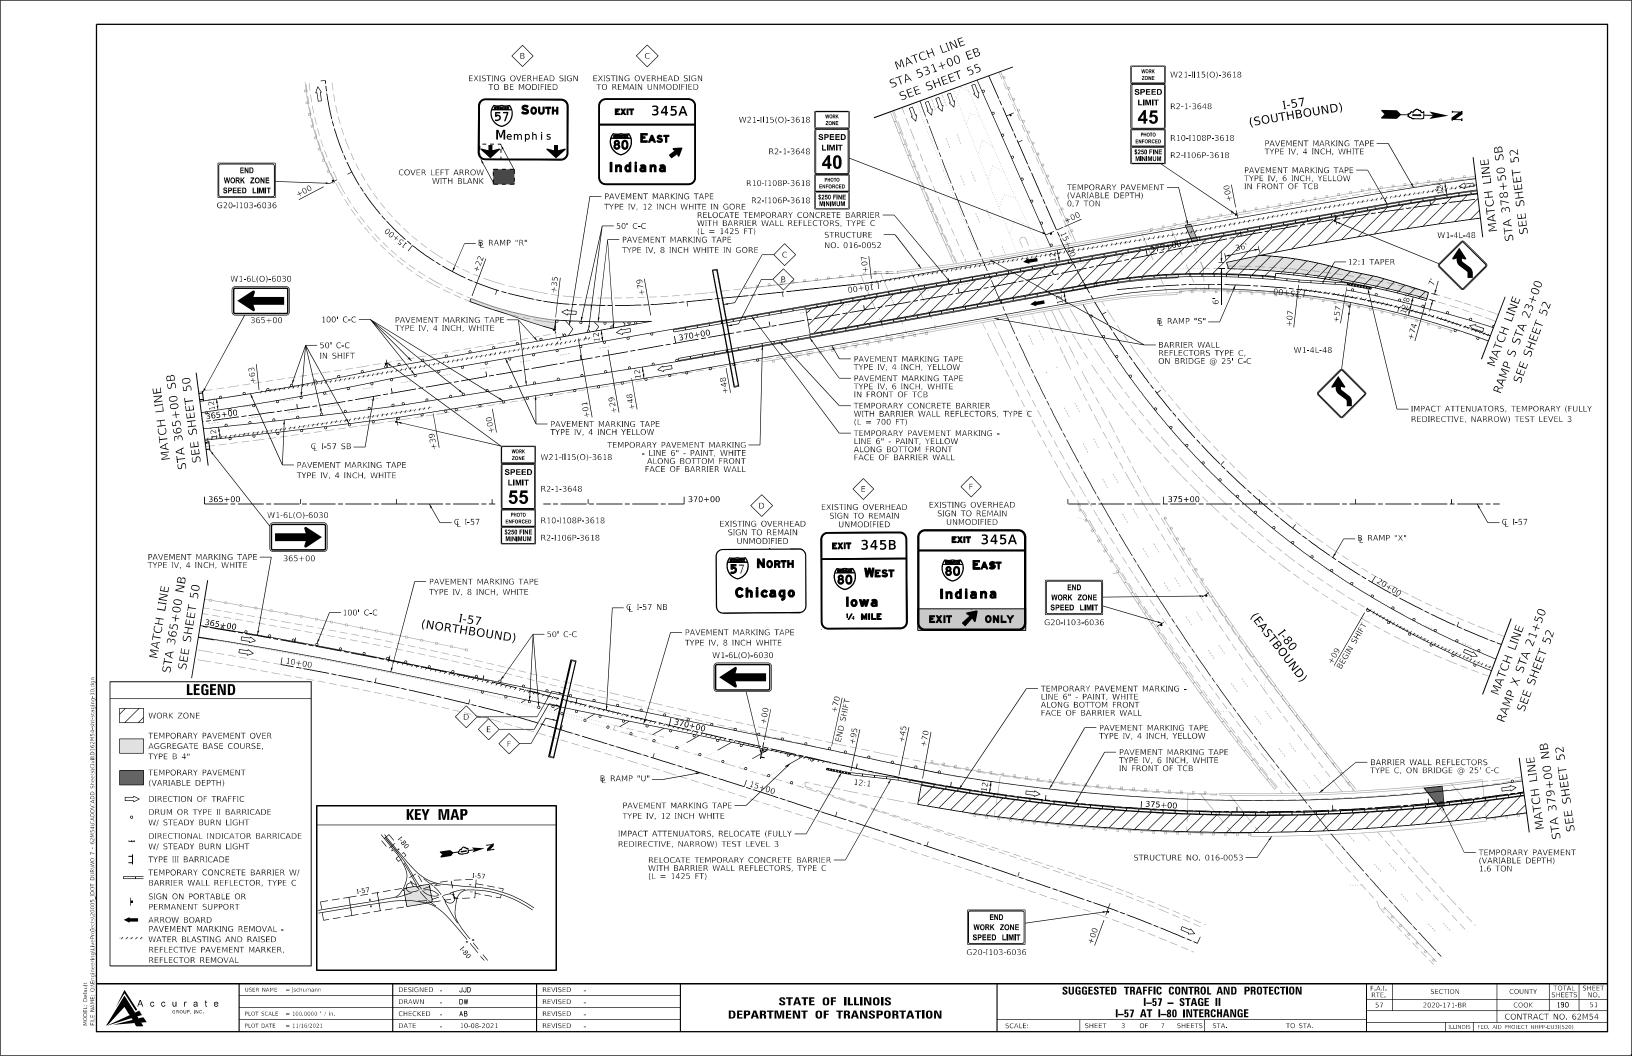

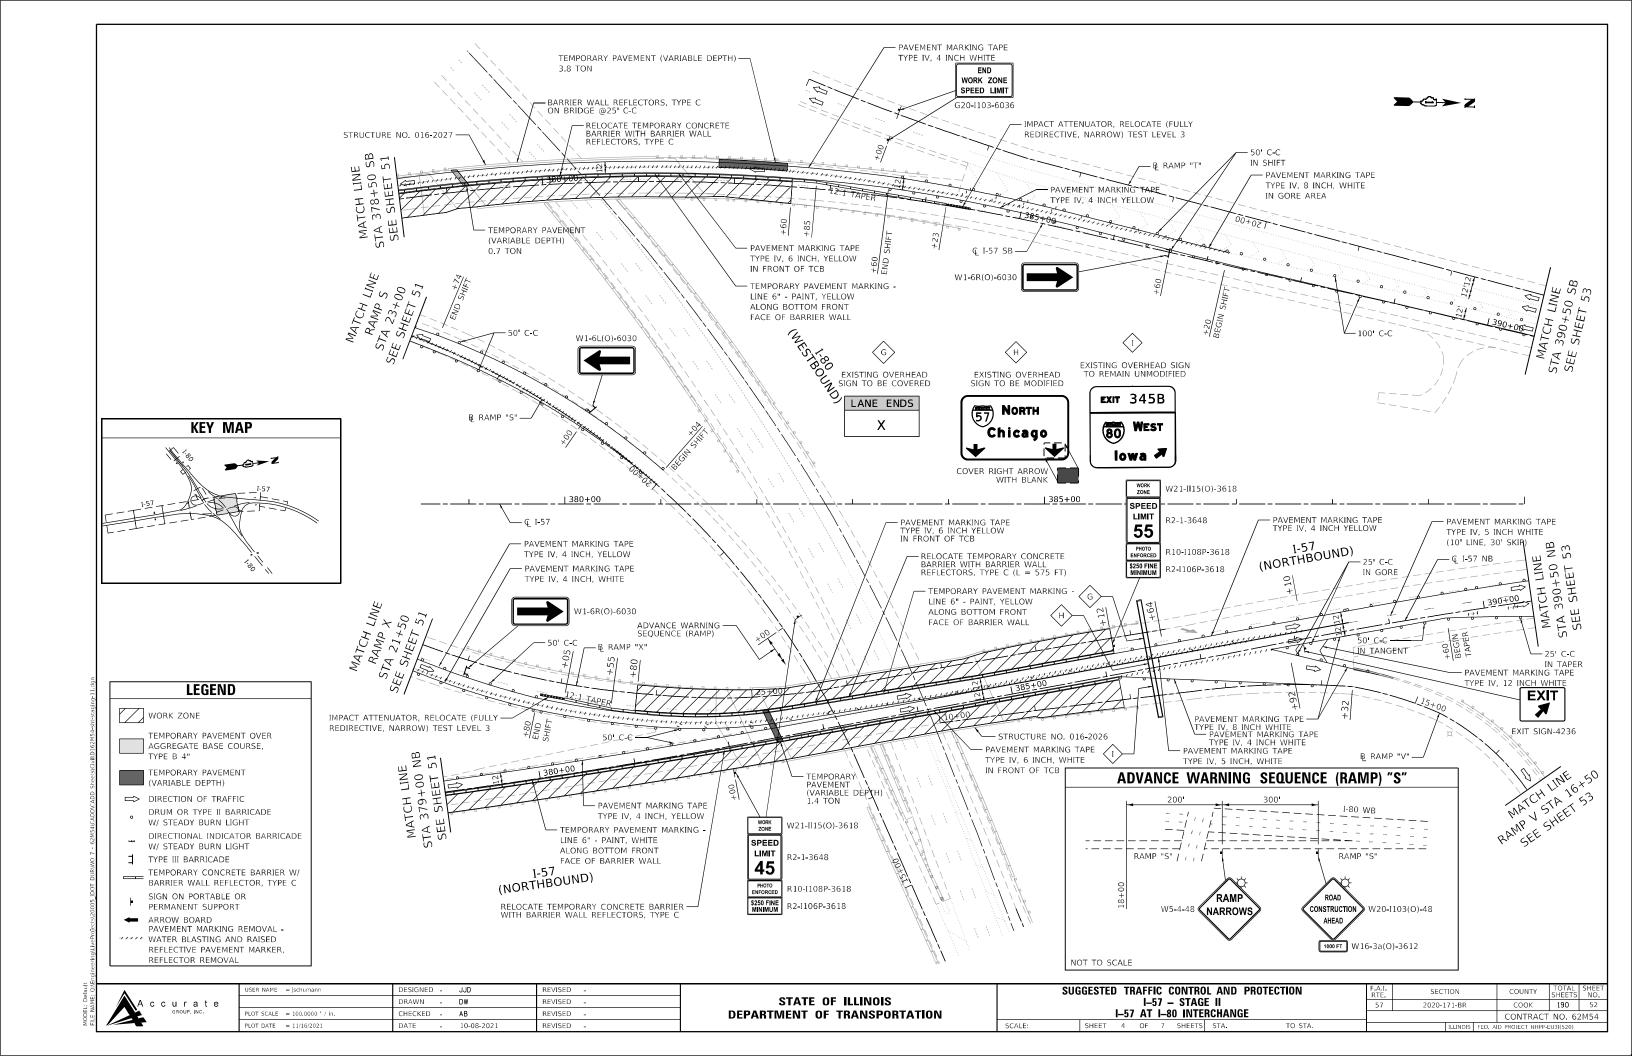

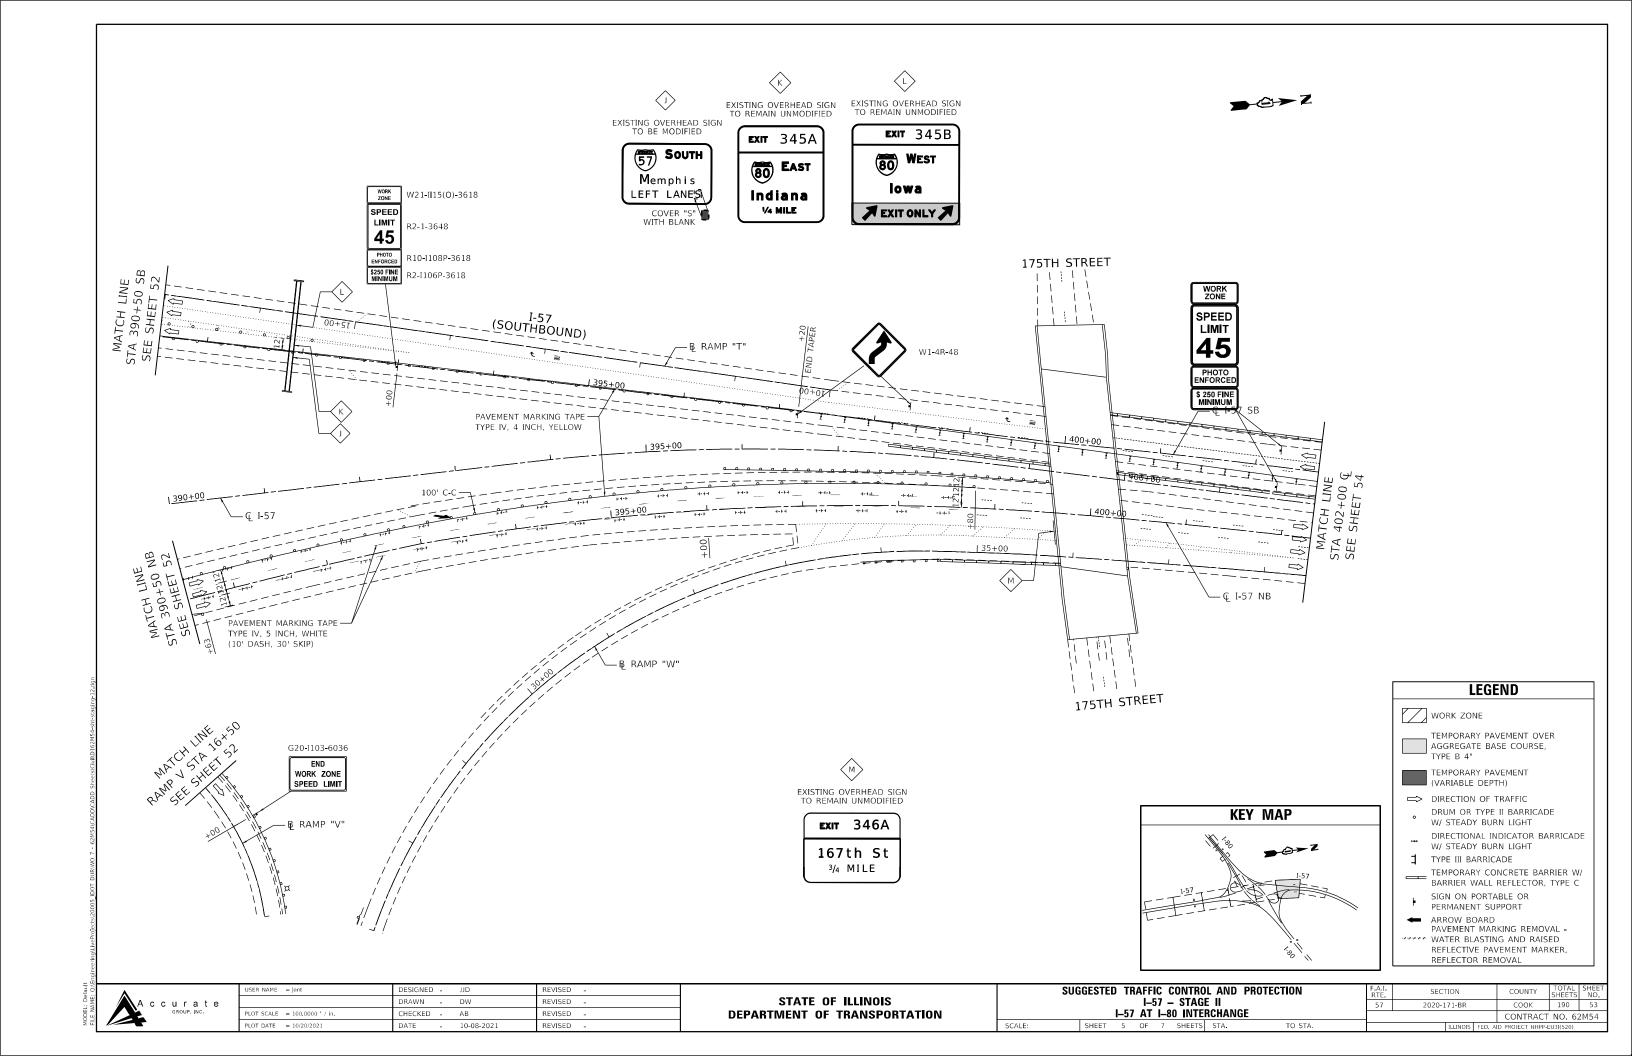

W16-3a(O)-3612 3 MILES

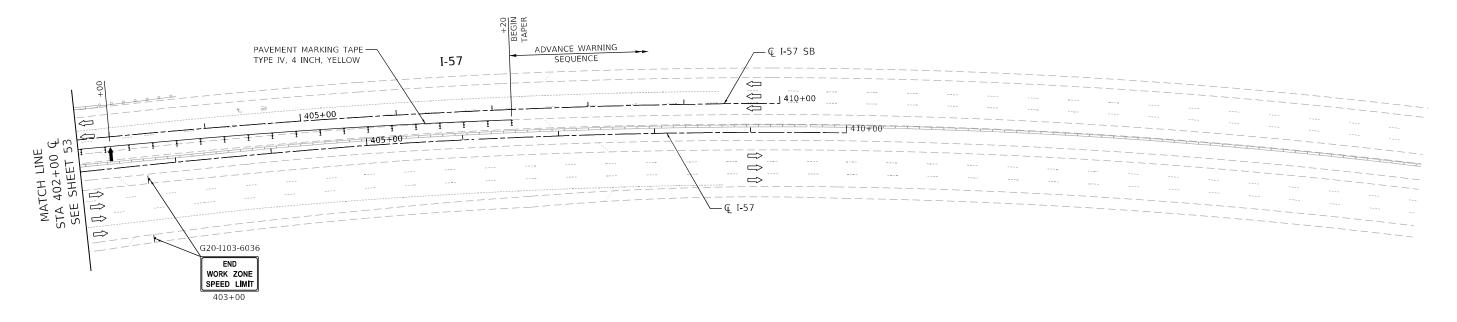

LEGEND


WORK ZONE

TEMPORARY PAVEMENT OVER AGGREGATE BASE COURSE, TYPE B 4"

TEMPORARY PAVEMENT (VARIABLE DEPTH)

□ DIRECTION OF TRAFFIC

- DRUM OR TYPE II BARRICADE W/ STEADY BURN LIGHT
- DIRECTIONAL INDICATOR BARRICADE W/ STEADY BURN LIGHT
- TYPE III BARRICADE
- TEMPORARY CONCRETE BARRIER W/ BARRIER WALL REFLECTOR, TYPE C
- SIGN ON PORTABLE OR PERMANENT SUPPORT
- ARROW BOARD
 PAVEMENT MARKING REMOVAL WATER BLASTING AND RAISED
- REFLECTIVE PAVEMENT MARKER, REFLECTOR REMOVAL

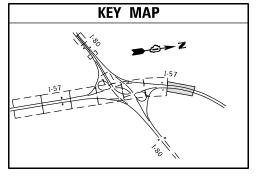

ADVANCE WARNING SEQUENCE TRAILER MOUNTED

SPEED DISPLAY SIGN PORTABLE CHANGEABLE — MESSAGE SIGN W21-II15(O)-3618 ROAD LEFT LANE CLOSED ½ MILE W20-I103(O)-48 CONSTRUCTION SPEED LEFT LANE CLOSED 1 MILE AHEAD LIMIT R2-1-3648 55

W3-5(O)-48

R10-I108P-3618 PHOTO ENFORCED R2-I106P-3618 \$250 FINE MINIMUM R10-I108P-3618

THE ENGINEER.

USER NAME = jent	DESIGNED	-	JJD	REVISED	-
	DRAWN	-	DW	REVISED	-
PLOT SCALE = 100.0000 / in.	CHECKED	-	AB	REVISED	-
PLOT DATE = 10/20/2021	DATE	-	10-08-2021	REVISED	-

STATE OF ILLINOIS **DEPARTMENT OF TRANSPORTATION**

W20-5(O)-48


SUG	GESTE) TF					PROTECTION	F.A.I. RTE.	SEC ⁻	TION		COUNTY	TOTAL SHEETS	SHEE NO.
					STAG			57	2020-1	171-BR		COOK	190	54
	,	I-57	AT	I8	O INTE	RCHAN	GE					CONTRACT	NO. 62	2M54
	SHEET	6	OF	7	SHEETS	STA.	TO STA.			ILLINOIS	FED. A	ID PROJECT NHPP-	EU3I(520)	


W20-5(O)-48


SMART WORK ZONE WILL BE REQUIRED FOR 5-MILES IN ADVANCE OF

LEFT LANE CLOSURE. SHALL BE EXTENDED IF REQUIRED BY

ccurate

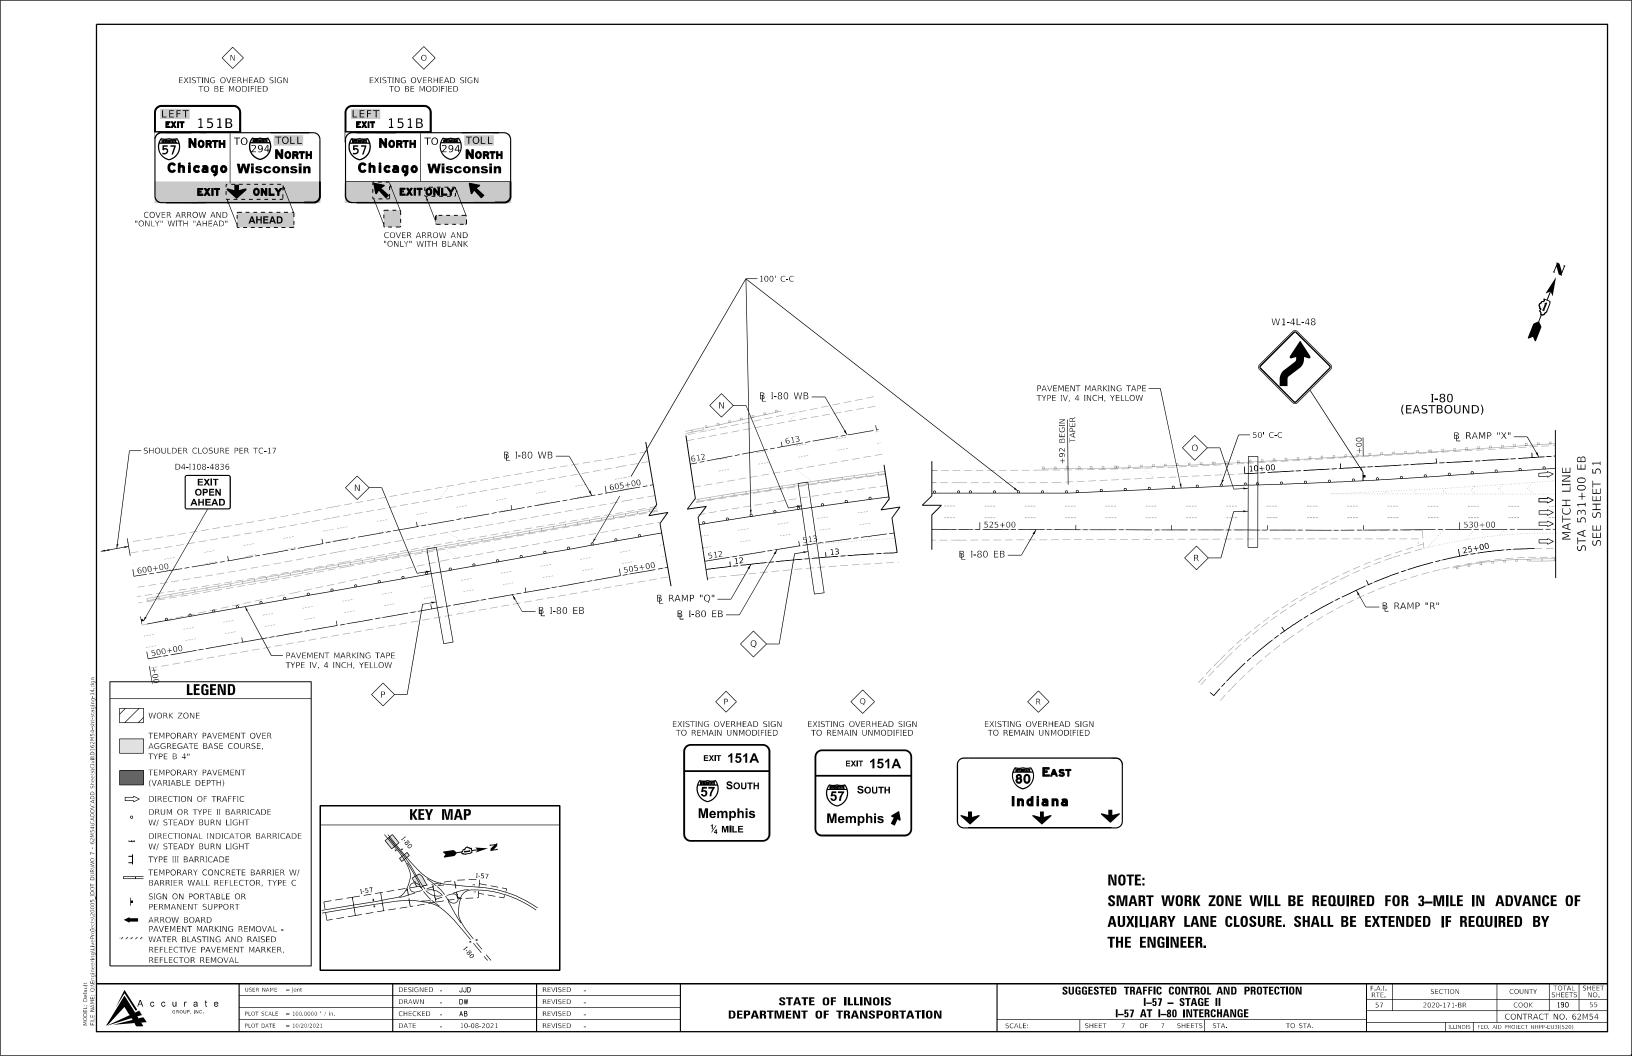

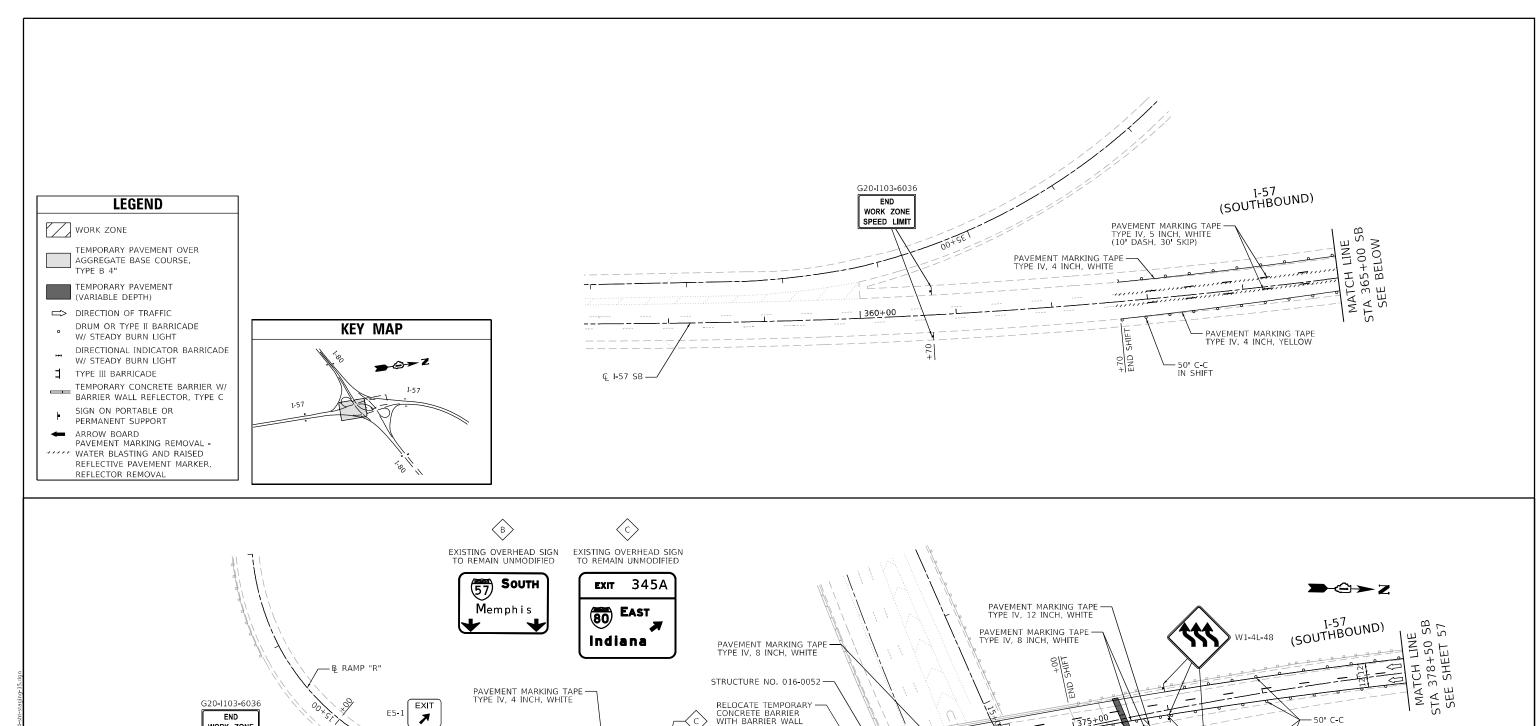

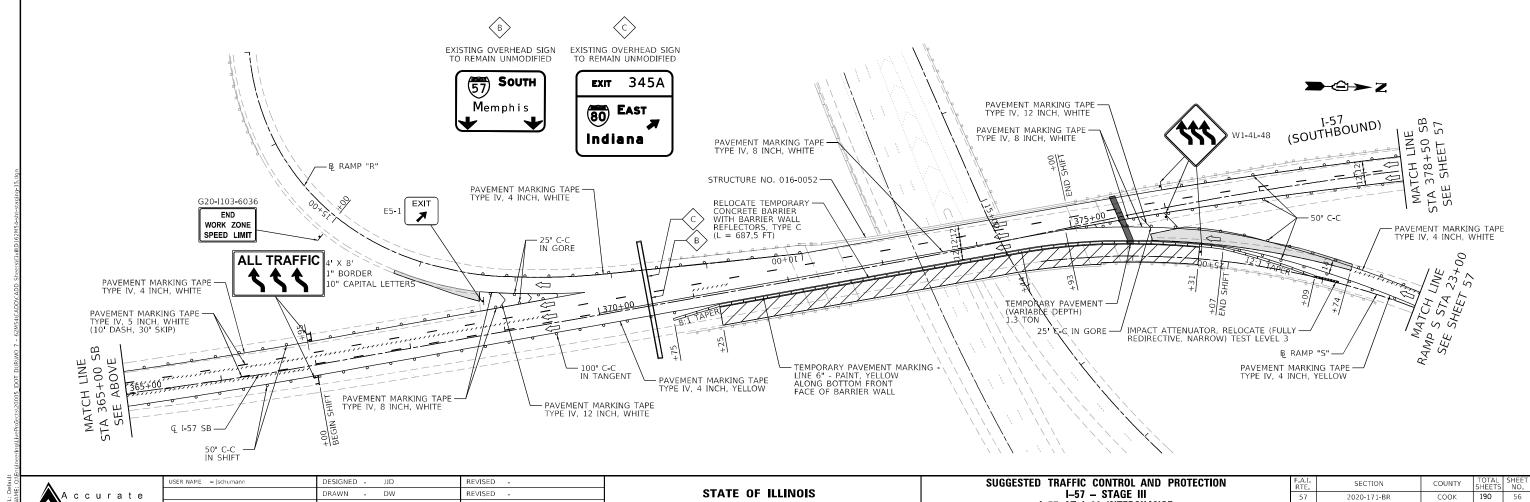


REVISED

DEPARTMENT OF TRANSPORTATION

COUNTY SHEETS NO.


COOK 190 56 I-57 AT I-80 INTERCHANGE CONTRACT NO. 62M54 SHEET 1 OF 2 SHEETS STA

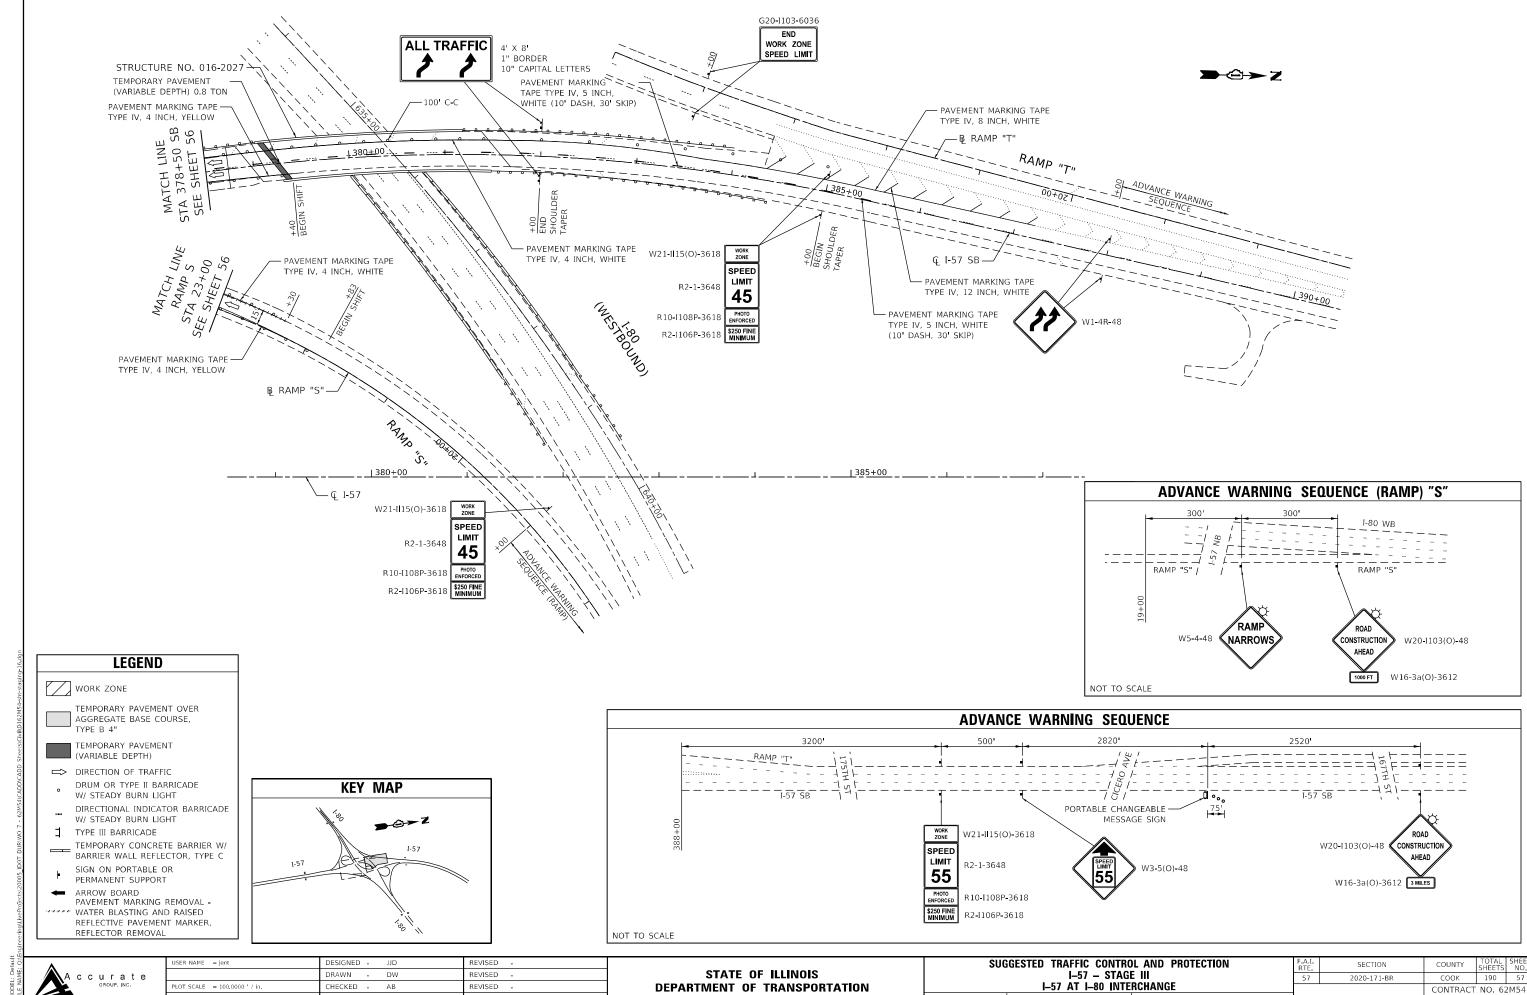


REVISED

10-08-2021

SHEET 2 OF 2 SHEETS STA.

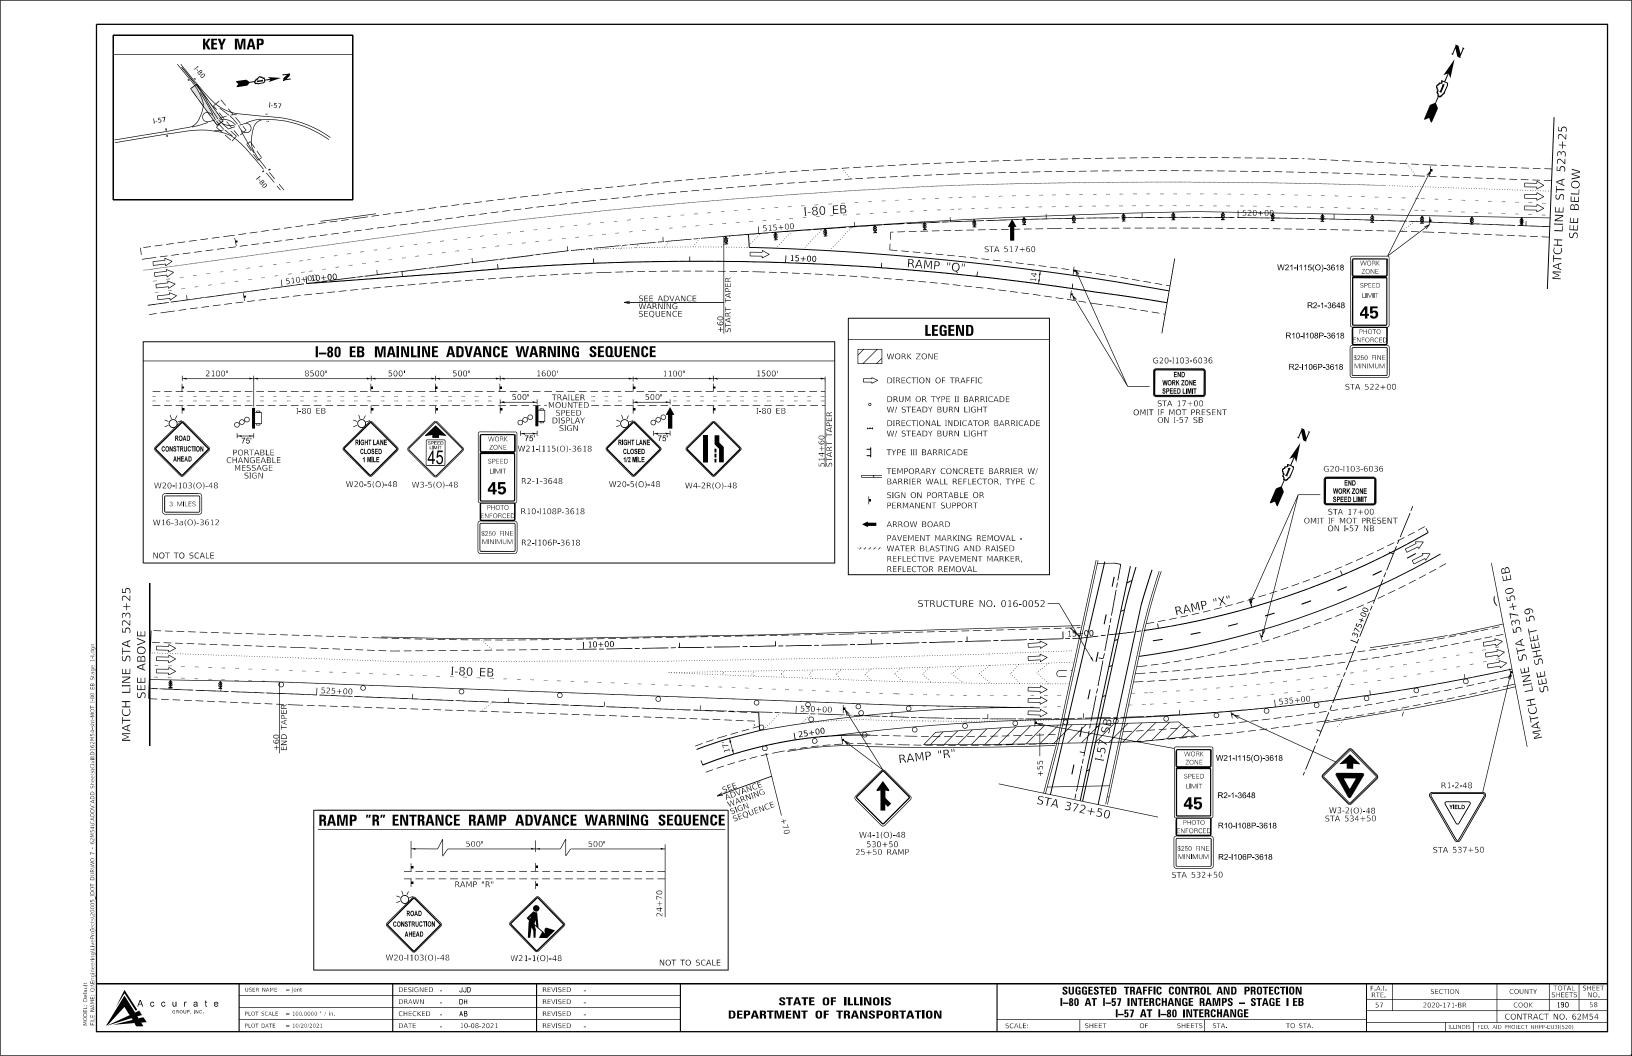

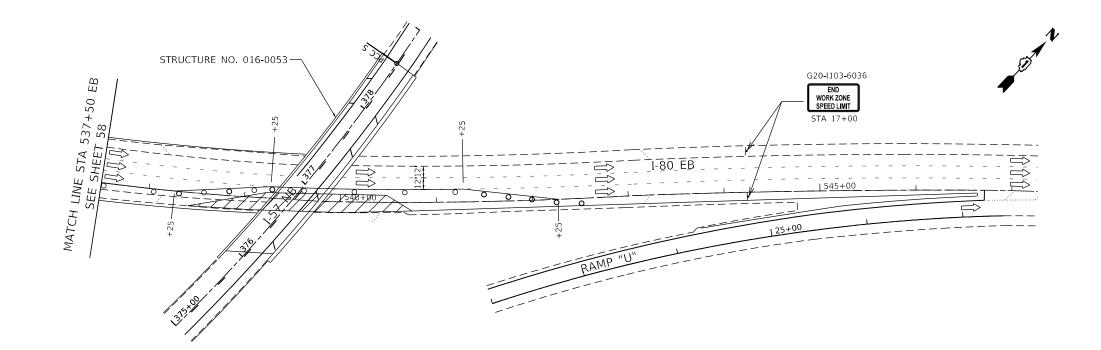


LEGEND



□ DIRECTION OF TRAFFIC

- DRUM OR TYPE II BARRICADE W/ STEADY BURN LIGHT
- DIRECTIONAL INDICATOR BARRICADE W/ STEADY BURN LIGHT
- TYPE III BARRICADE
- TEMPORARY CONCRETE BARRIER W/ BARRIER WALL REFLECTOR, TYPE C
- SIGN ON PORTABLE OR PERMANENT SUPPORT
- ← ARROW BOARD
 - PAVEMENT MARKING REMOVAL -WATER BLASTING AND RAISED REFLECTIVE PAVEMENT MARKER, REFLECTOR REMOVAL

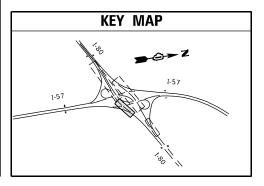


A	С	С		а , _{INC}	е


USER NAME = jent	DESIGNED - JJD	REVISED -
	DRAWN - DH	REVISED -
PLOT SCALE = 100.0000 / in.	CHECKED - AB	REVISED -
PLOT DATE = 10/20/2021	DATE - 10-08-2021	REVISED -

STATE	0F	ILLINOIS
DEPARTMENT ()F T	RANSPORTATION

					PROTECTION	F.A.I. RTE.	SECT	ION		COUNTY	TOTAL SHEETS	SHEET NO.
-80					- STAGE I EB	57	2020-1	71-BR		COOK	190	59
		I-57 AT I-	<u> 80 INTE</u>	RCHANG	<u> </u>					CONTRACT	T NO. 62	2M54
	SHEET	OF	SHEETS	STA.	TO STA.			ILLINOIS	FED. A	ID PROJECT NHPP-	EU3I(520)	

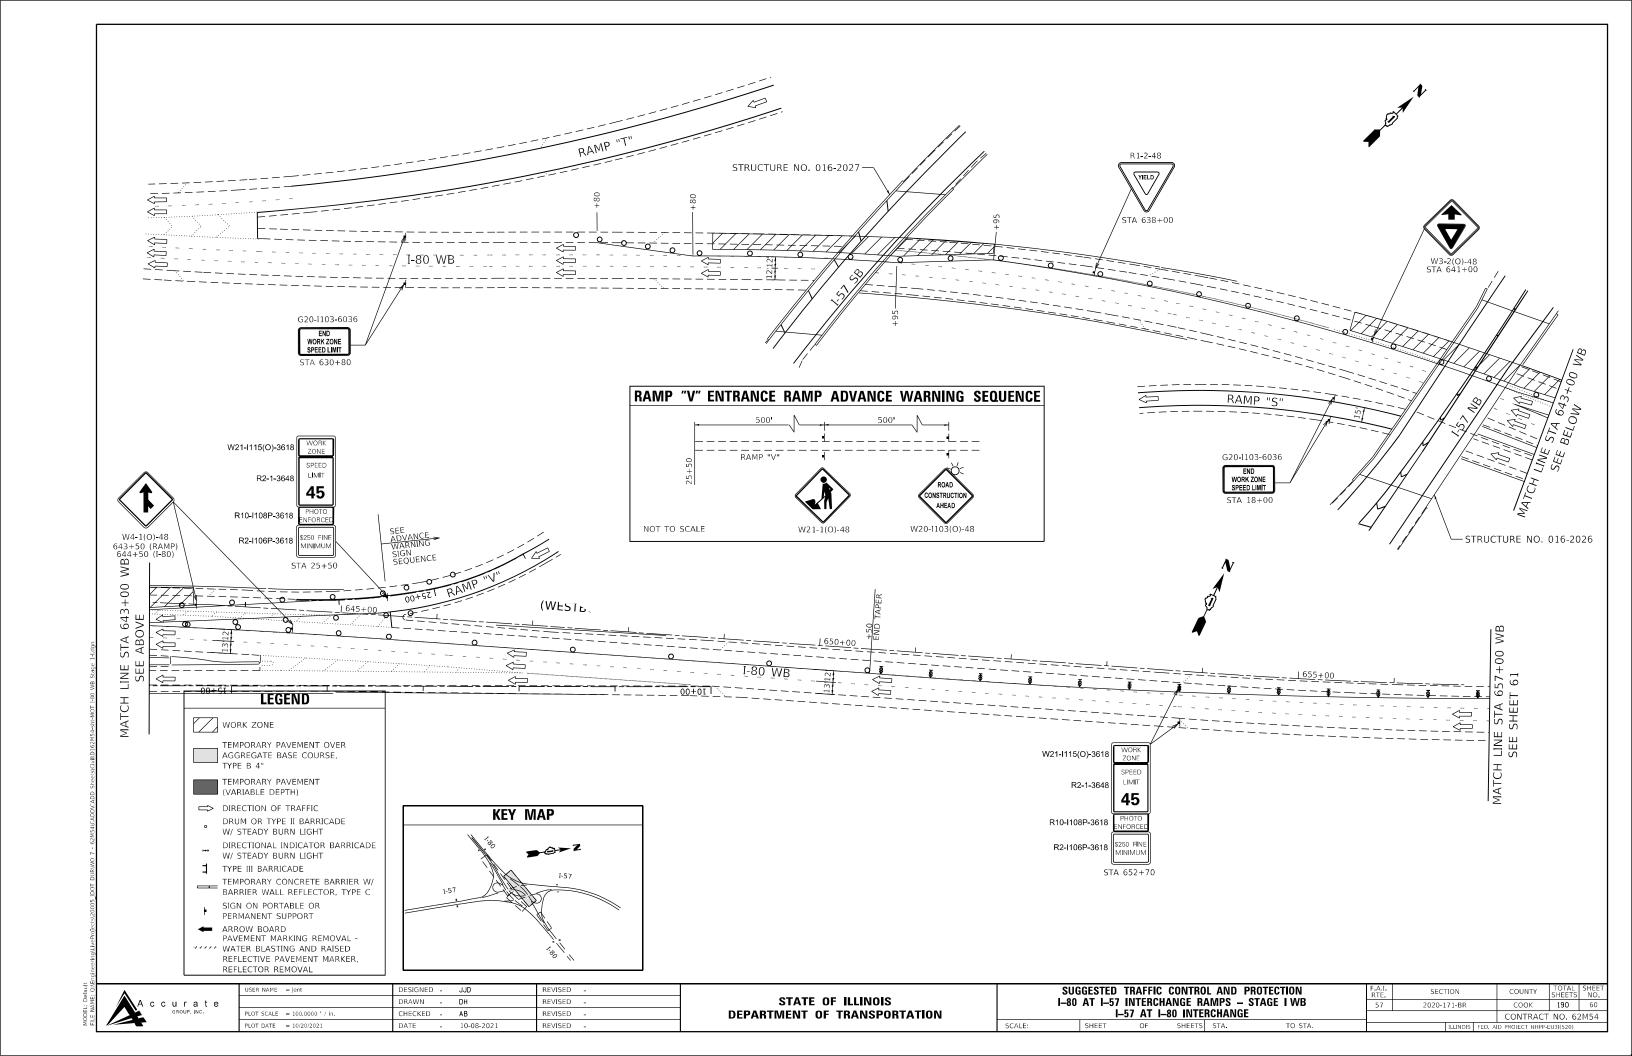



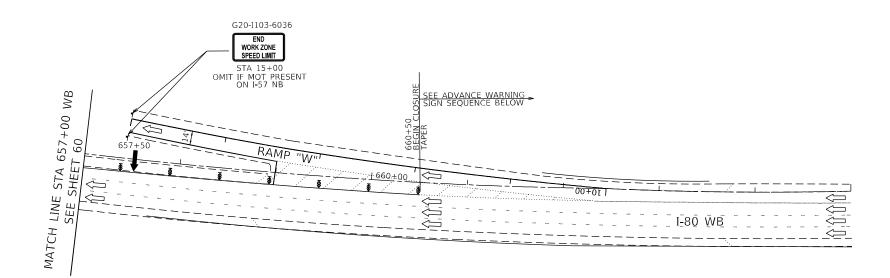






□ DIRECTION OF TRAFFIC

- DRUM OR TYPE II BARRICADE W/ STEADY BURN LIGHT
- DIRECTIONAL INDICATOR BARRICADE W/ STEADY BURN LIGHT
- TYPE III BARRICADE
- TEMPORARY CONCRETE BARRIER W/BARRIER WALL REFLECTOR, TYPE C
- SIGN ON PORTABLE OR PERMANENT SUPPORT
- ← ARROW BOARD
- PAVEMENT MARKING REMOVAL -WATER BLASTING AND RAISED REFLECTIVE PAVEMENT MARKER, REFLECTOR REMOVAL

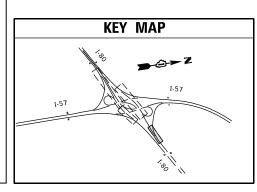


	I–80 WB	MAINLINE ADVAN	CE WARNING SEC	DUENCE	
1500'	1100'	1600'	500' 500'	8500'	2100'
660+50 BEGIN CLOSURE TAPER TAPER	RIGHT LANE (12 MLE W4-2R(O)-48 W20-5(O)-	TRAILER MOUNTED SPEED DISPLAY 500' W21-I115(0)-3618 WORK ZONE SPEED LIMIT	R CL	1-80 WB	75-1 ORTABLE
		R 10-I 108P-3618 PHOTO			3 MILES W16-3a(O)-3612
NOT TO SCALE		R2-I106P-3618			




USER NAME = jent	DESIGNED - JJD	REVISED -
	DRAWN - DH	REVISED -
PLOT SCALE = 100.0000 / in.	CHECKED - AB	REVISED -
PLOT DATE = 10/20/2021	DATE - 10-08-2021	REVISED -
		·

SUG	GESTED	TRAFFIC	CONTRO	L AND	PROTECTION				
I–80	I-80 AT I-57 INTERCHANGE RAMPS - STAGE I WB								
	I	57 AT I—8	BO INTEI	RCHANG	ìΕ				
	CHEET	O.F.	CHEETC	CTA	TO 6T4				

F.A.I. RTE.	SECT	TION		COUNTY	TOTAL SHEETS	SHEET NO.
57	2020-1	71-BR		COOK	190	61
				CONTRACT	NO. 62	2M54
		ILLINOIS	FED. A	D PROJECT NHPP-E	U3I(520)	

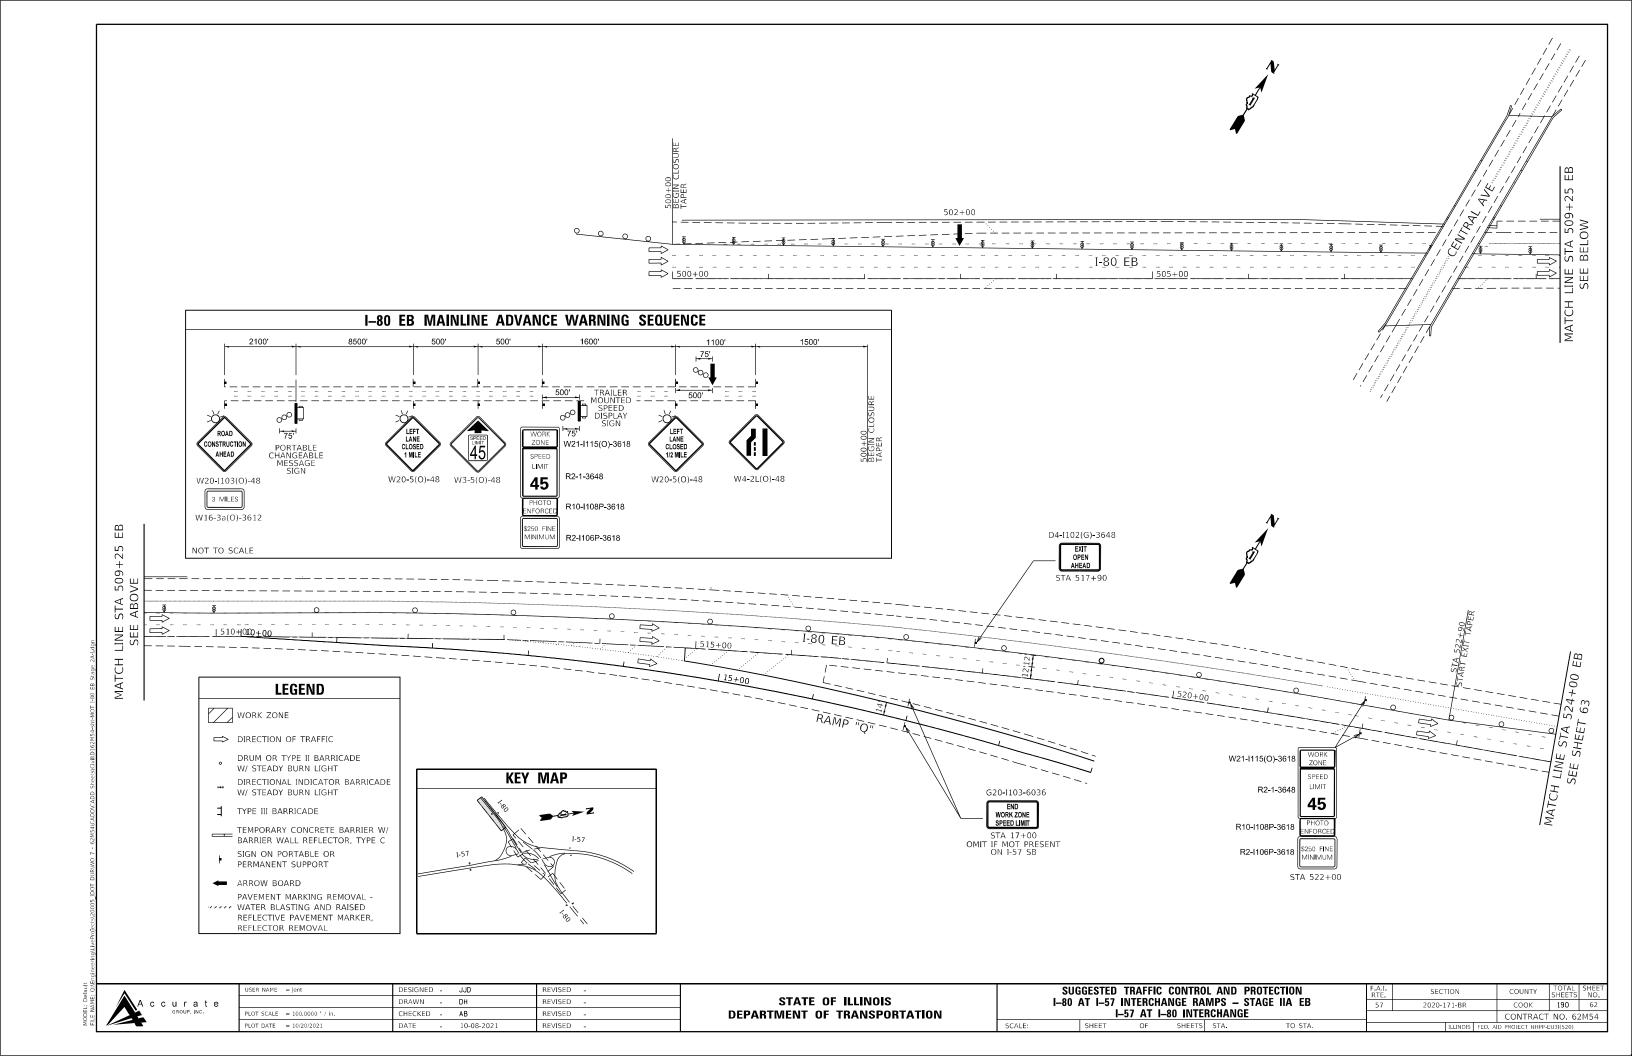

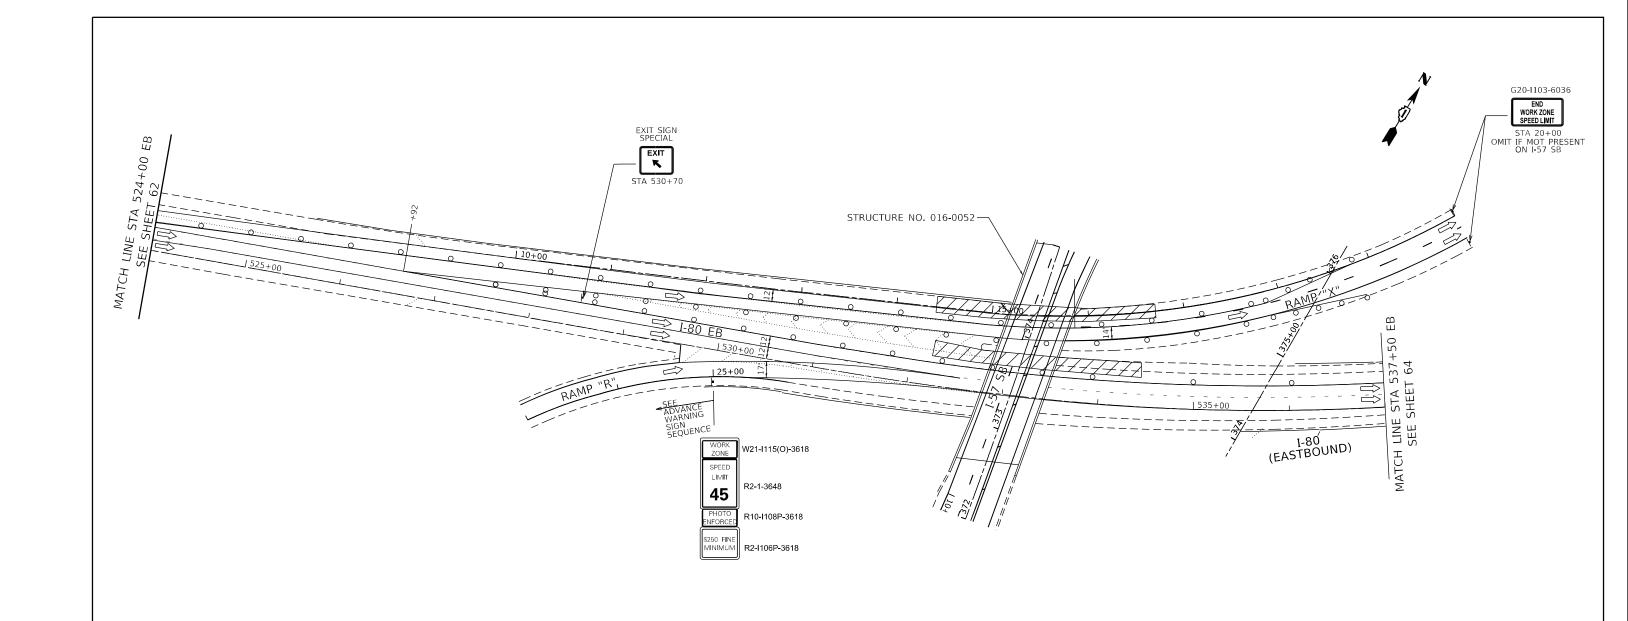




WORK ZONE

□ DIRECTION OF TRAFFIC

- DRUM OR TYPE II BARRICADE W/ STEADY BURN LIGHT
- DIRECTIONAL INDICATOR BARRICADE W/ STEADY BURN LIGHT
- TYPE III BARRICADE
- TEMPORARY CONCRETE BARRIER W/
 BARRIER WALL REFLECTOR, TYPE C
- SIGN ON PORTABLE OR PERMANENT SUPPORT
- ← ARROW BOARD
- PAVEMENT MARKING REMOVAL -WATER BLASTING AND RAISED REFLECTIVE PAVEMENT MARKER, REFLECTOR REMOVAL

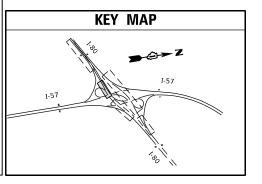


I-80	EB	ENTRANCE	RAMP	ADVANCE	WARNING	SEQUENCE
		<u> </u>	500'	<u></u>	500 '	_
	==		AMP "R"			
		ROAD				25+00
		CONSTRUCTION				
W2	20-110	3(O)-48	W21-1(0	0)-48	NOT ⁻	TO SCALE

A c c u r a t e

USER NAME = jent	DESIGNED	-	JJD	REVISED	-
	DRAWN	-	DH	REVISED	-
PLOT SCALE = 100.0000 / in.	CHECKED	-	AB	REVISED	-
PLOT DATE = 10/20/2021	DATE	-	10-08-2021	REVISED	-

						F.A.I. RTE.	SECTION	COUNTY	TOTAL SHEETS	SHEET NO.
80	GGESTED TRAFFIC CONTROL AND PROTECTION AT I–57 INTERCHANGE RAMPS – STAGE IIA EB I–57 AT I–80 INTERCHANGE SHEET OF SHEETS STA. TO STA.				57	2020-171-BR	COOK	190	63	
	AT I-57 INTERCHANGE RAMPS - STAGE IIA EB I-57 AT I-80 INTERCHANGE	iE			CONTRACT	NO. 62	2M54			
	SHEET	OF	SHEETS	STA.	TO STA.		ILLINOIS FED. A	D PROJECT NHPP-	EU3I(520)	

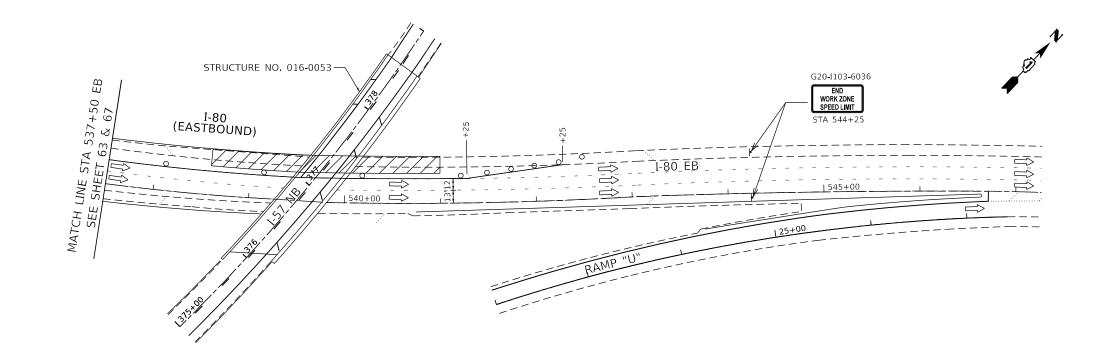

LEGEND



□ DIRECTION OF TRAFFIC

DRUM OR TYPE II BARRICADE W/ STEADY BURN LIGHT

DIRECTIONAL INDICATOR BARRICADE W/ STEADY BURN LIGHT


TYPE III BARRICADE

TEMPORARY CONCRETE BARRIER W/ BARRIER WALL REFLECTOR, TYPE C

SIGN ON PORTABLE OR PERMANENT SUPPORT

← ARROW BOARD

PAVEMENT MARKING REMOVAL WATER BLASTING AND RAISED
REFLECTIVE PAVEMENT MARKER,
REFLECTOR REMOVAL

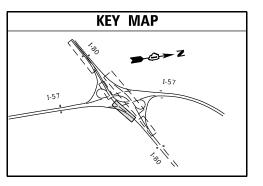


A	С	С		a , inc	е


USER NAME = jent	DESIGNED - JJD	REVISED -
	DRAWN - DH	REVISED -
PLOT SCALE = 100.0000 ' / in.	CHECKED - AB	REVISED -
PLOT DATE = 10/20/2021	DATE - 10-08-2021	REVISED -

STATE OF	ILLINOIS
DEPARTMENT OF 1	TRANSPORTATION

					PROTECTION	F.A.I. RTE.	SECTION
30 <i>I</i>					– STAGE IIA EB	57	2020-171-BR
	I-	<u>-57 AT I–</u>	80 INTE	<u>RCHAN</u>	IGE		
	SHEET	OF	SHEETS	STA	TO STA		THINOIS

F.A.I. RTE.	SECT	TION		COUNTY	TOTAL SHEETS	SHEET NO.
57	2020-1	71-BR		COOK	190	64
,				CONTRACT	NO. 62	2M54
		ILLINOIS	FED. A	ID PROJECT NHPP-E	U3I(520)	

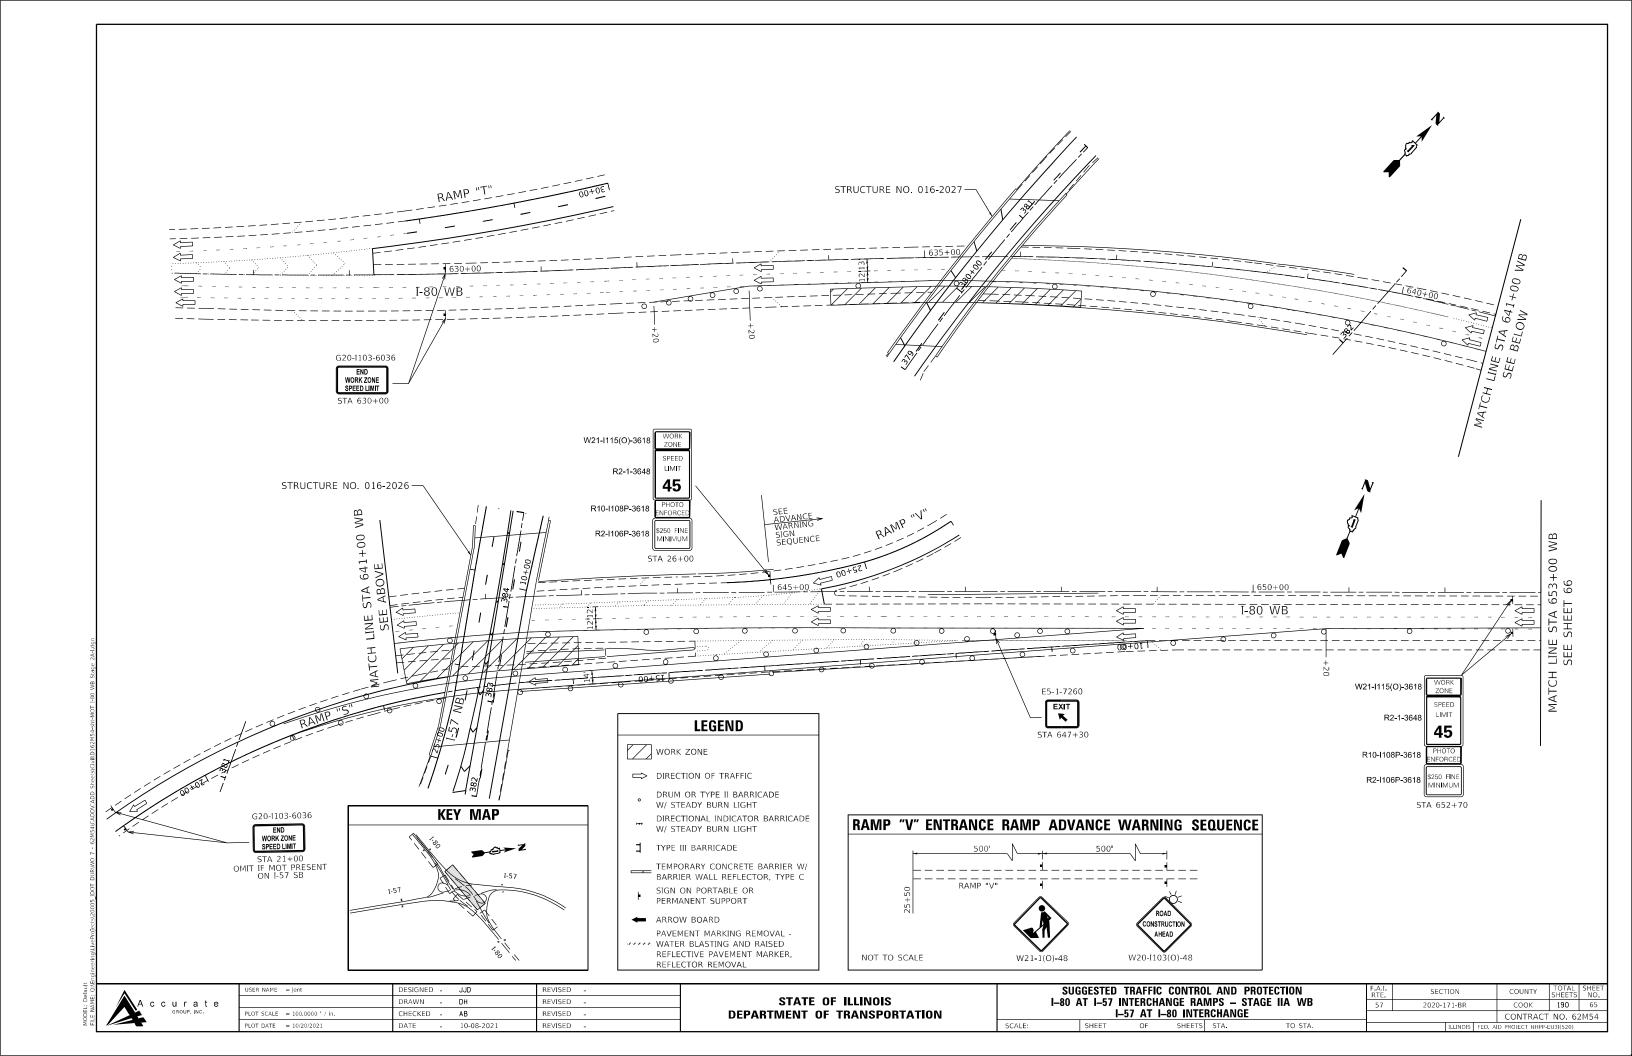

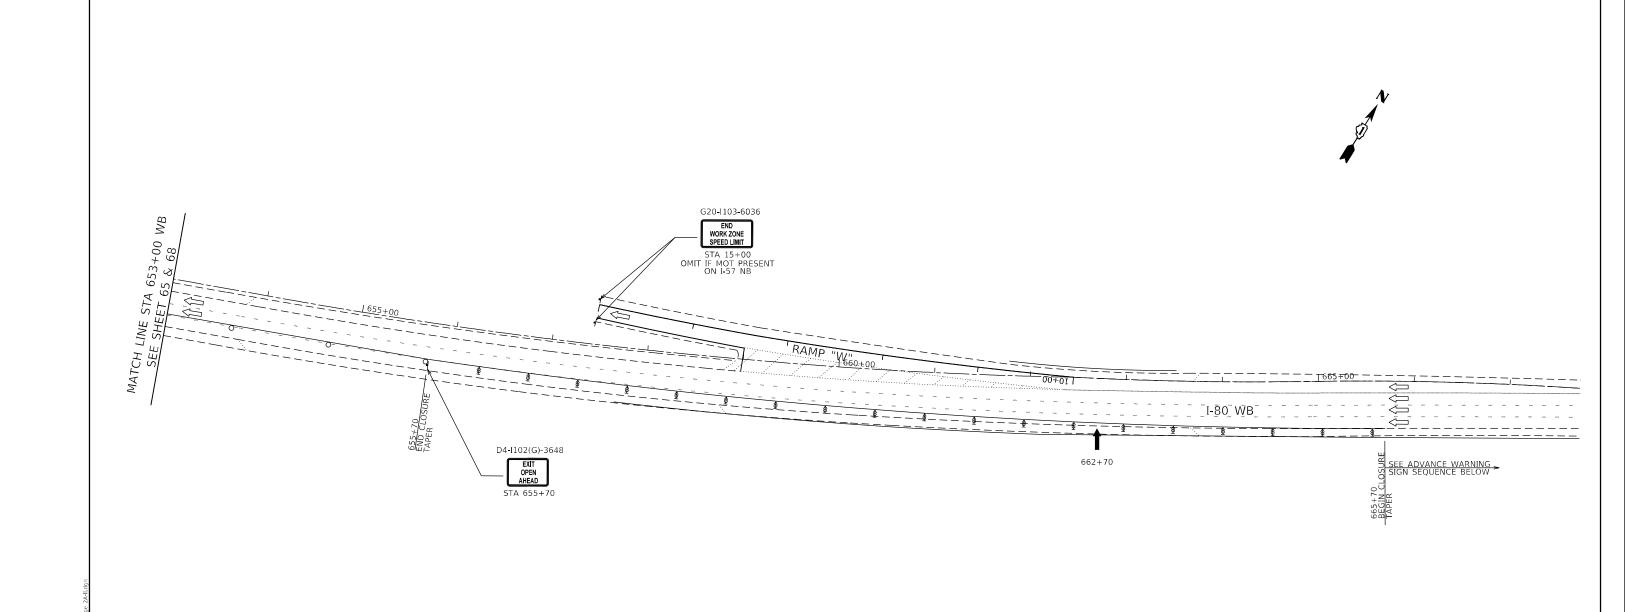






□ DIRECTION OF TRAFFIC

- DRUM OR TYPE II BARRICADEW/ STEADY BURN LIGHT
- DIRECTIONAL INDICATOR BARRICADE
 W/ STEADY BURN LIGHT
- TYPE III BARRICADE
- TEMPORARY CONCRETE BARRIER W/BARRIER WALL REFLECTOR, TYPE C
- SIGN ON PORTABLE OR PERMANENT SUPPORT
- ← ARROW BOARD
- PAVEMENT MARKING REMOVAL -WATER BLASTING AND RAISED REFLECTIVE PAVEMENT MARKER, REFLECTOR REMOVAL

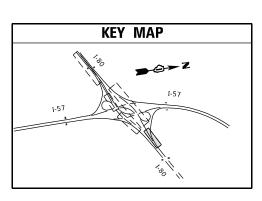



		I–80 WB	MAINLINE ADV	ANCE WA	ARNING S	SEQUENCE	
1500'	11 ماد	00'	1600'	500'	500	8500	2100'
665+70 BEGIN CLOSURE TAPER		500 = 500 EFT LANE		WORK			PORTABLE = = = = = = = = = = = = = = = = = = =
6654 BEGI TAPE	W4-2R(O)-48	CLOSED 1/2 MILE W20-5(O)-4	8 R2-1-3648	SPEED LIMIT	45	20-5(O)-48	W20-I103(O)-48
NOT TO SCALE			K10 - 1108F-3018	IFORCED 250 FINE			W16-3a(O)-3612


6


USER NAME = jent	DESIGNED	-	JJD	REVISED	-
	DRAWN	-	DH	REVISED	-
PLOT SCALE = 100.0000 / in.	CHECKED	-	AB	REVISED	-
PLOT DATE = 10/20/2021	DATE	-	10-08-2021	REVISED	-

	UGGESTED TRAFFIC CONTROL AND PROTECTION OF AT I-57 INTERCHANGE RAMPS — STAGE IIA WB I-57 AT I-80 INTERCHANGE SHEET OF SHEETS STA. TO STA.			F.A.I. RTE.	SECT	ΓΙΟΝ		COUNTY	TOTAL SHEETS	SHEET NO.		
-80 <i>F</i>						57	7 2020-171-BR			COOK	190	66
										CONTRAC	T NO. 6.	2M54
	SHEET	OF	SHEETS	STA.	TO STA.			THINOIS	EED AL	D PROJECT NHPP	-EU3I(520)	

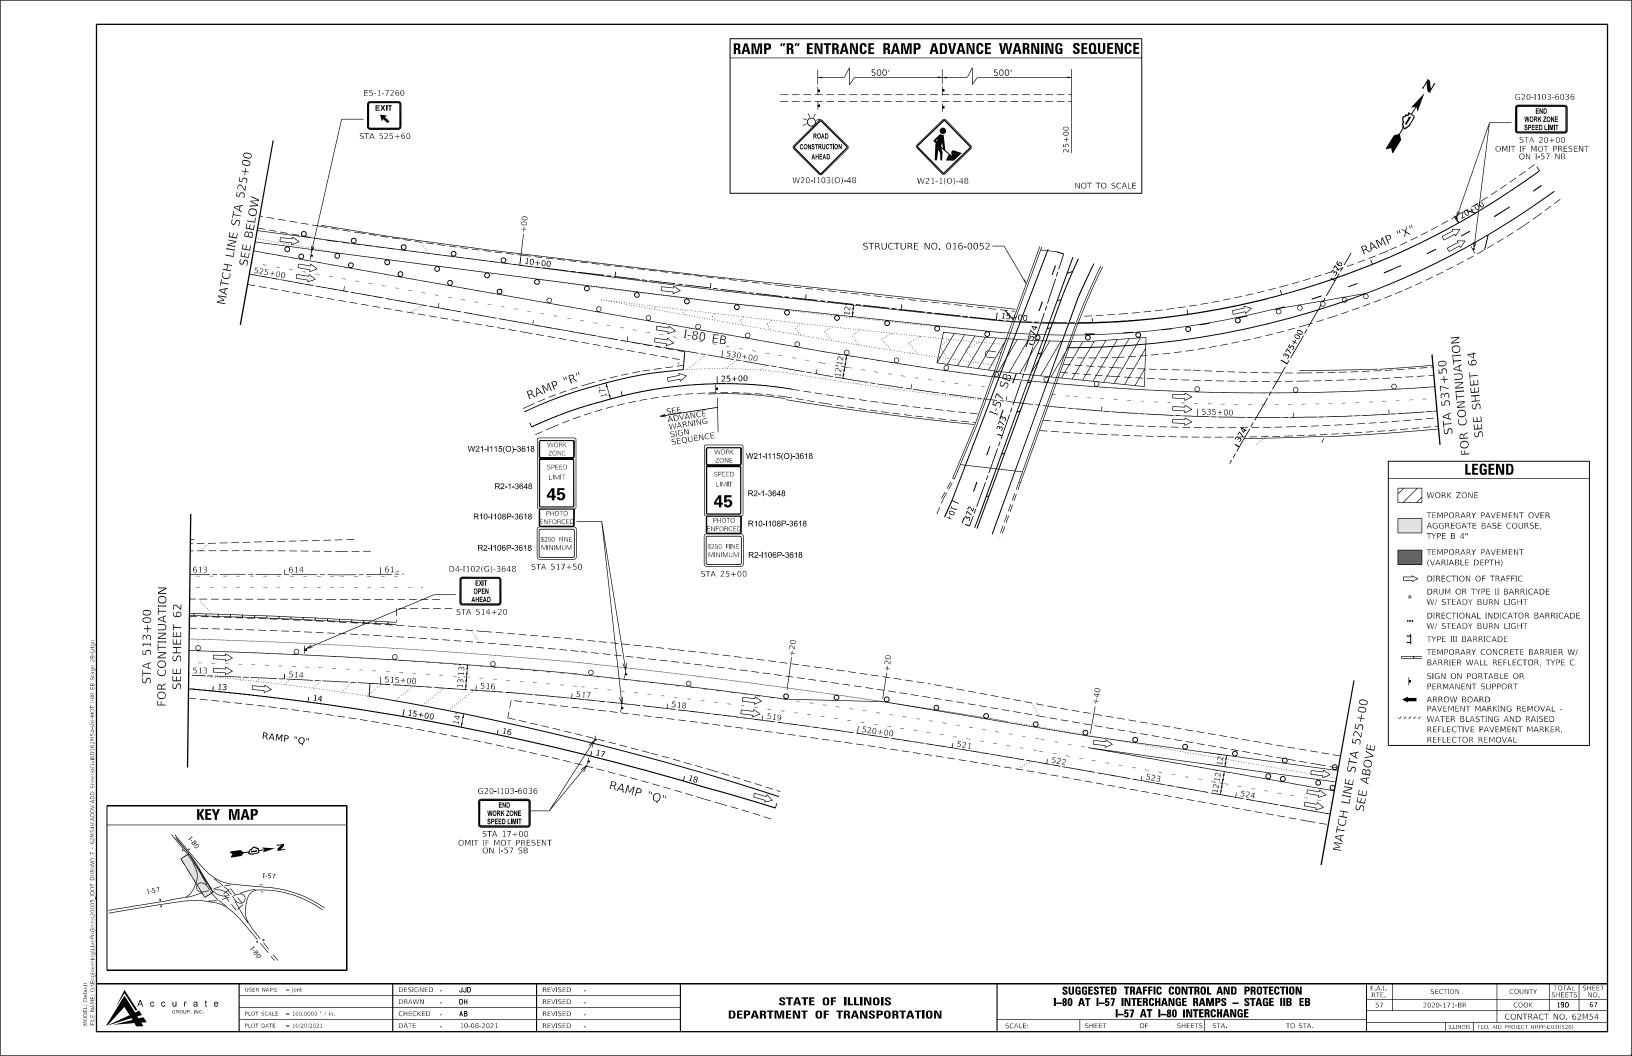

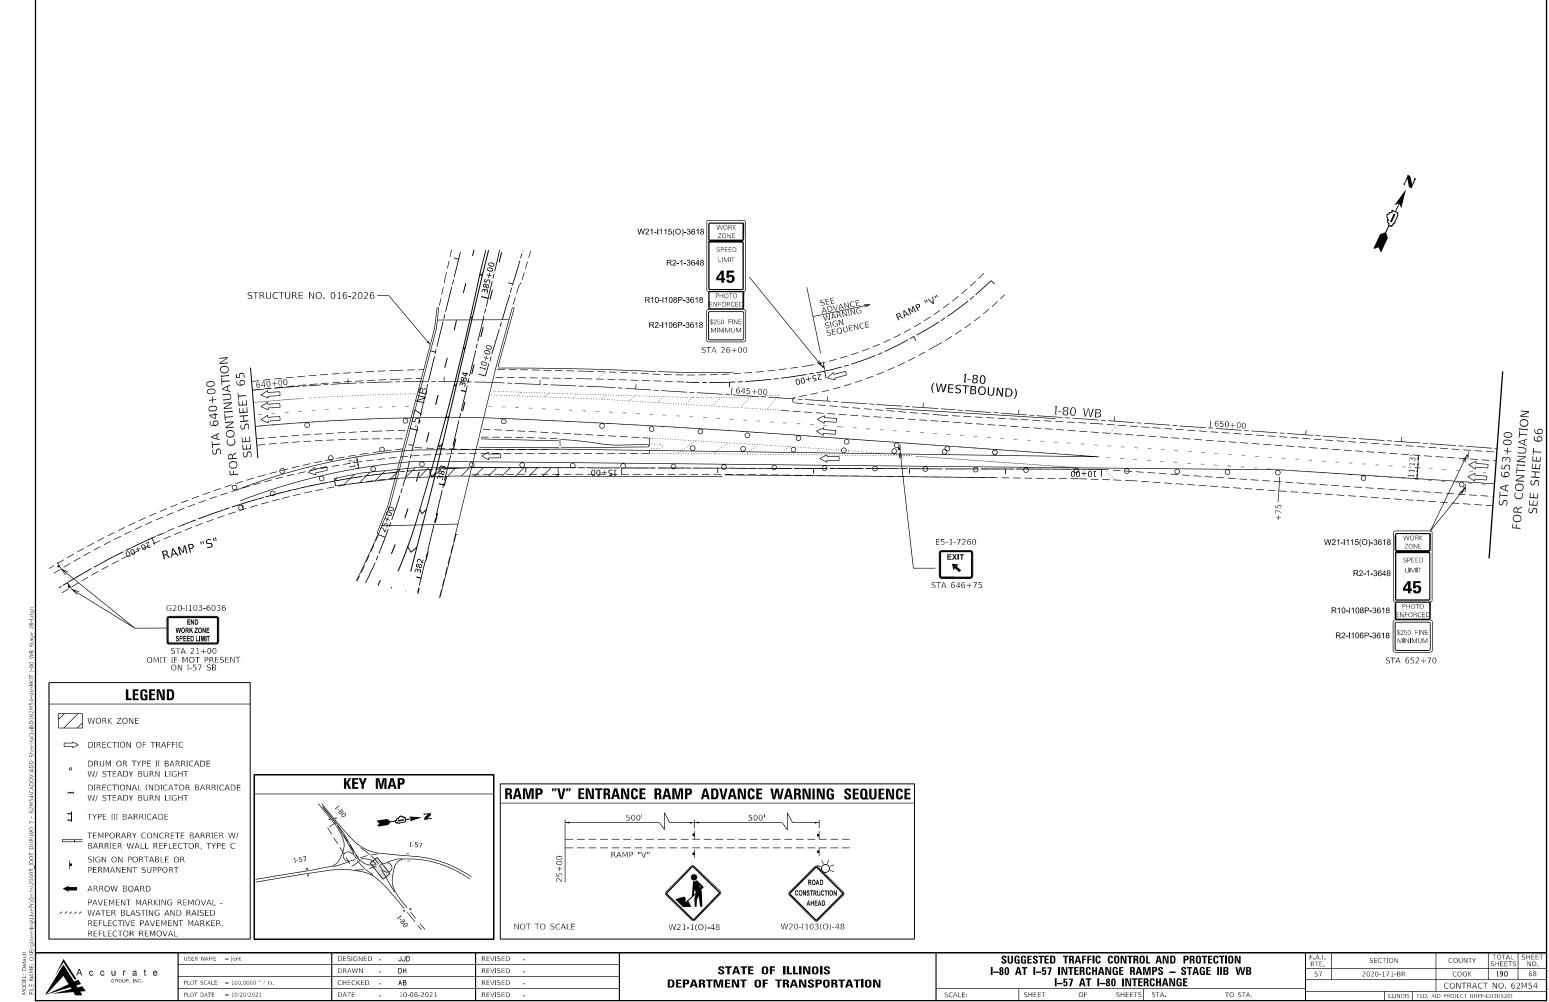

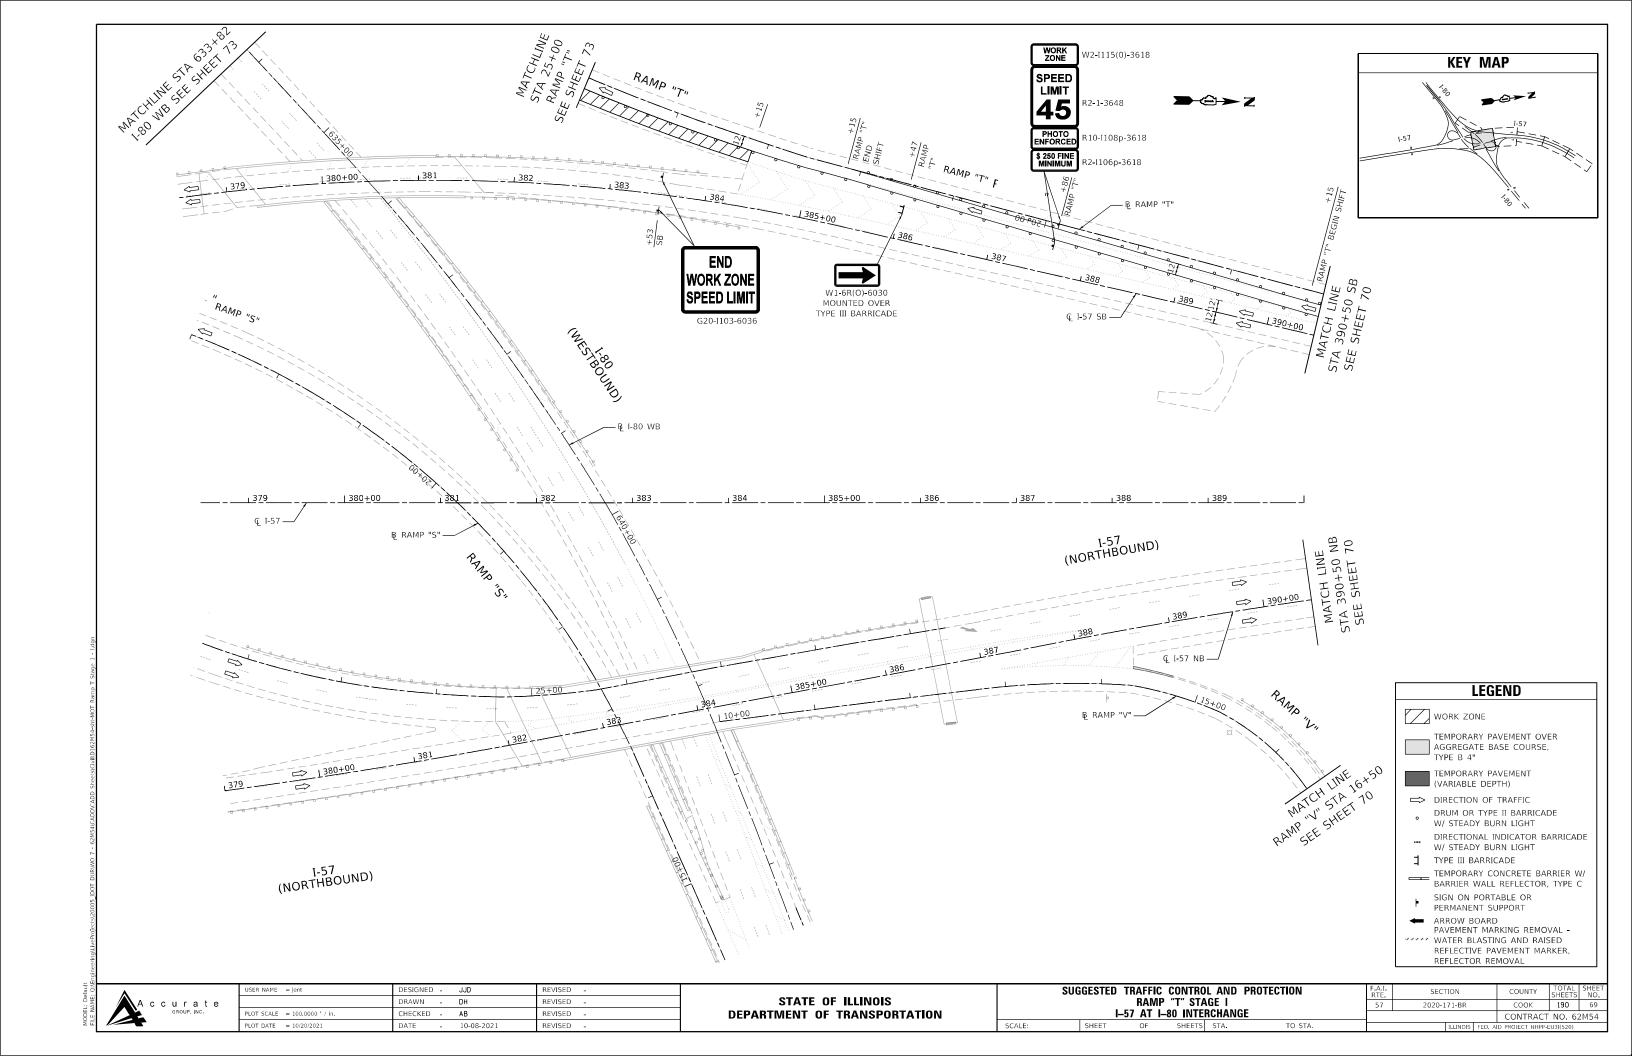

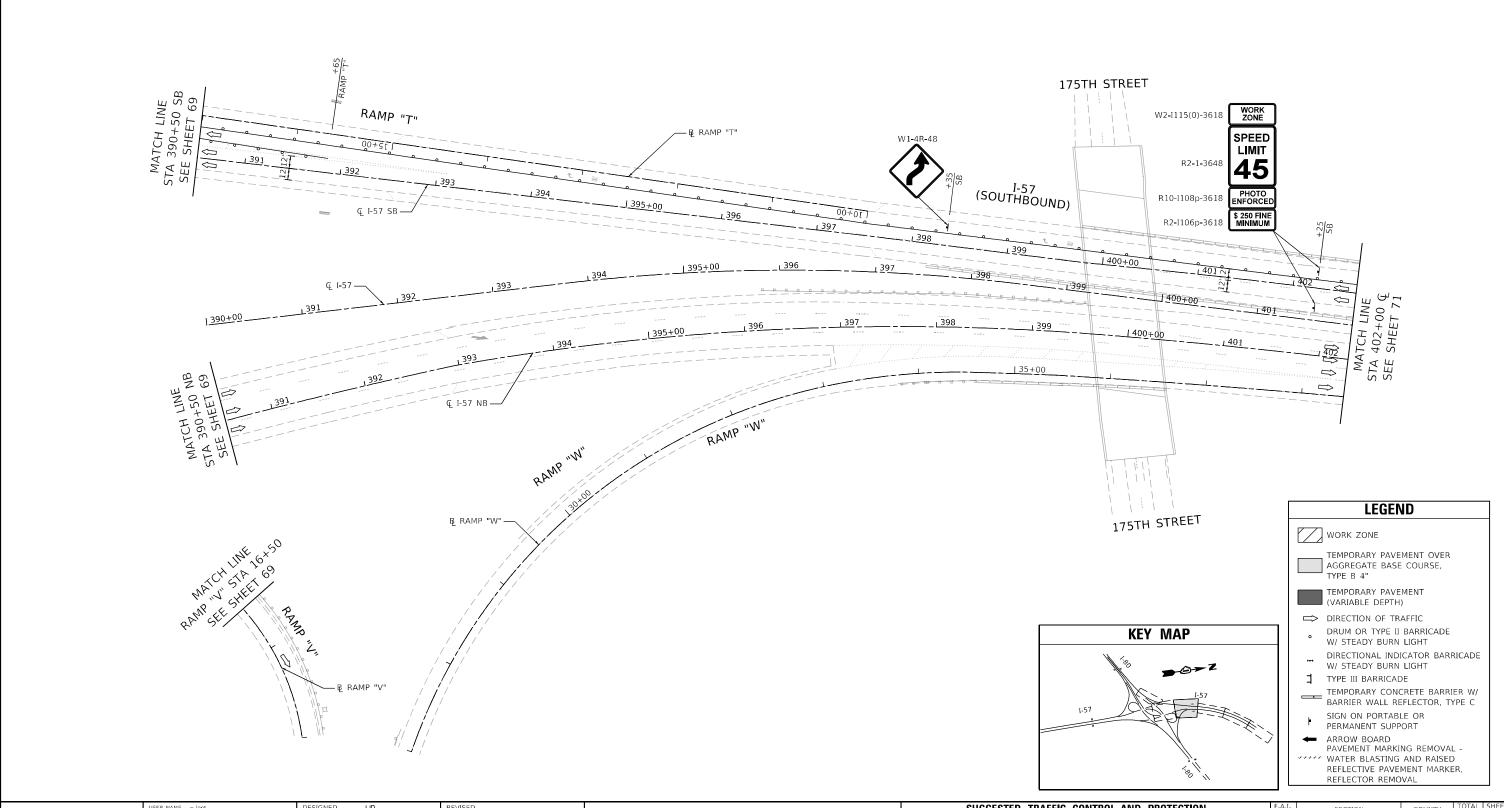


Accurate GROUP, INC.

STATE OF ILLINOIS DEPARTMENT OF TRANSPORTATION SUGGESTED TRAFFIC CONTROL AND PROTECTION RAMP "T" STAGE I


| L-57 AT | L-80 | INTERCHANGE |


| SHEET OF SHEETS STA. TO STA.


F.A.I. RTE	SECTIO	N		COUNTY	TOTAL SHEETS	SHEE NO.
57	2020-171-BR			COOK	190	70
				CONTRACT	NO. 62	2M54
	11	INOIS	EED ΔI	D PROJECT NHPP-E	H3I(520)	

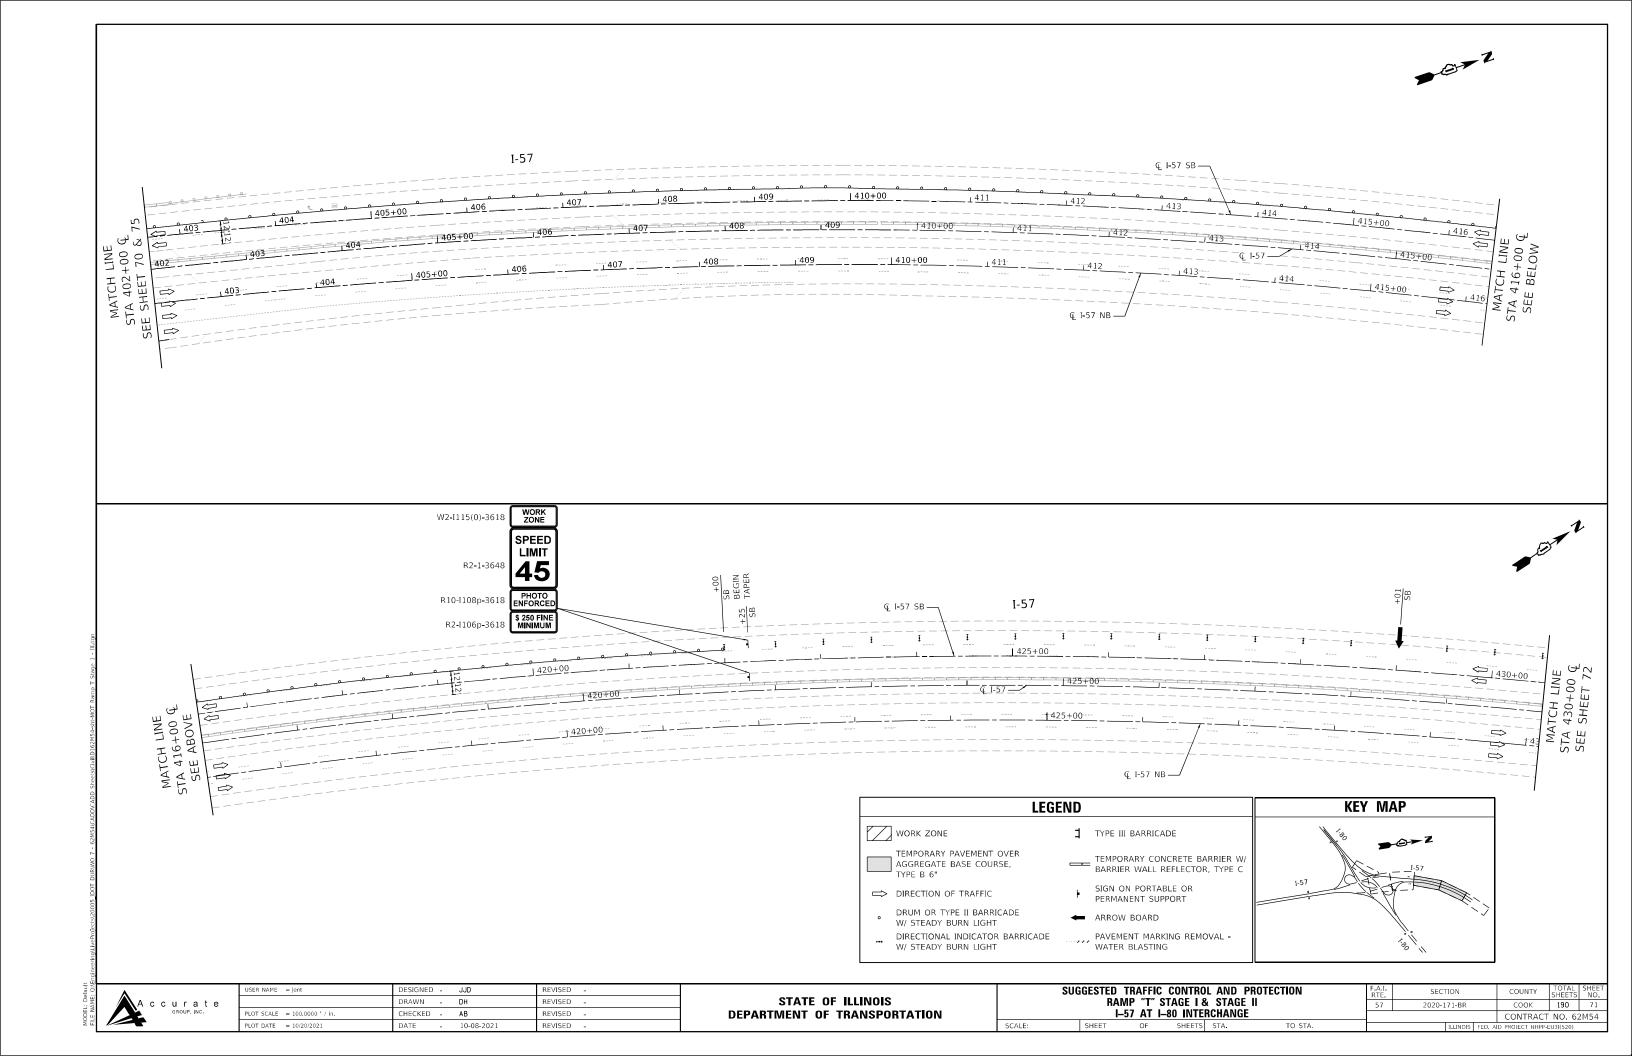


→ @ Z

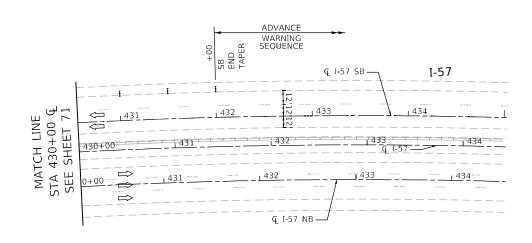

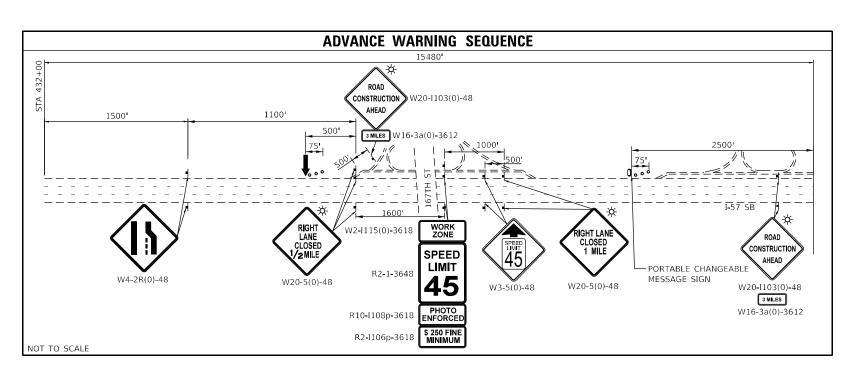

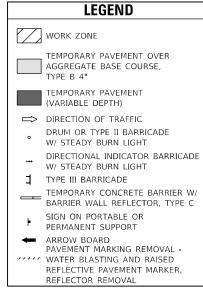

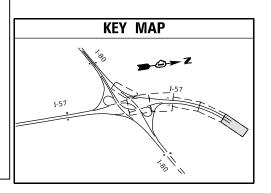



A	С	С		а , _{INC}	е


USER NAME = jent	DESIGNED	-	JJD	REVISED -
	DRAWN	-	DH	REVISED -
PLOT SCALE = 100.0000 ' / in.	CHECKED	-	AB	REVISED -
PLOT DATE = 10/20/2021	DATE	-	10-08-2021	REVISED -

:		Р "Т"	C CONTRO STAGE 1 8 1-80 INTE	STAG	E II
	CHEET	OF	CHEETC	CTA	TO STA

F.A.I. RTE.	SEC ⁻	ΓΙΟΝ	COUNTY	TOTAL SHEETS	SHEE NO.	
57	2020-1	COOK	190	72		
				CONTRACT	NO. 62	2M54
		ILLINOIS	FED. A	ID PROJECT NHPP-E	U3I(520)	

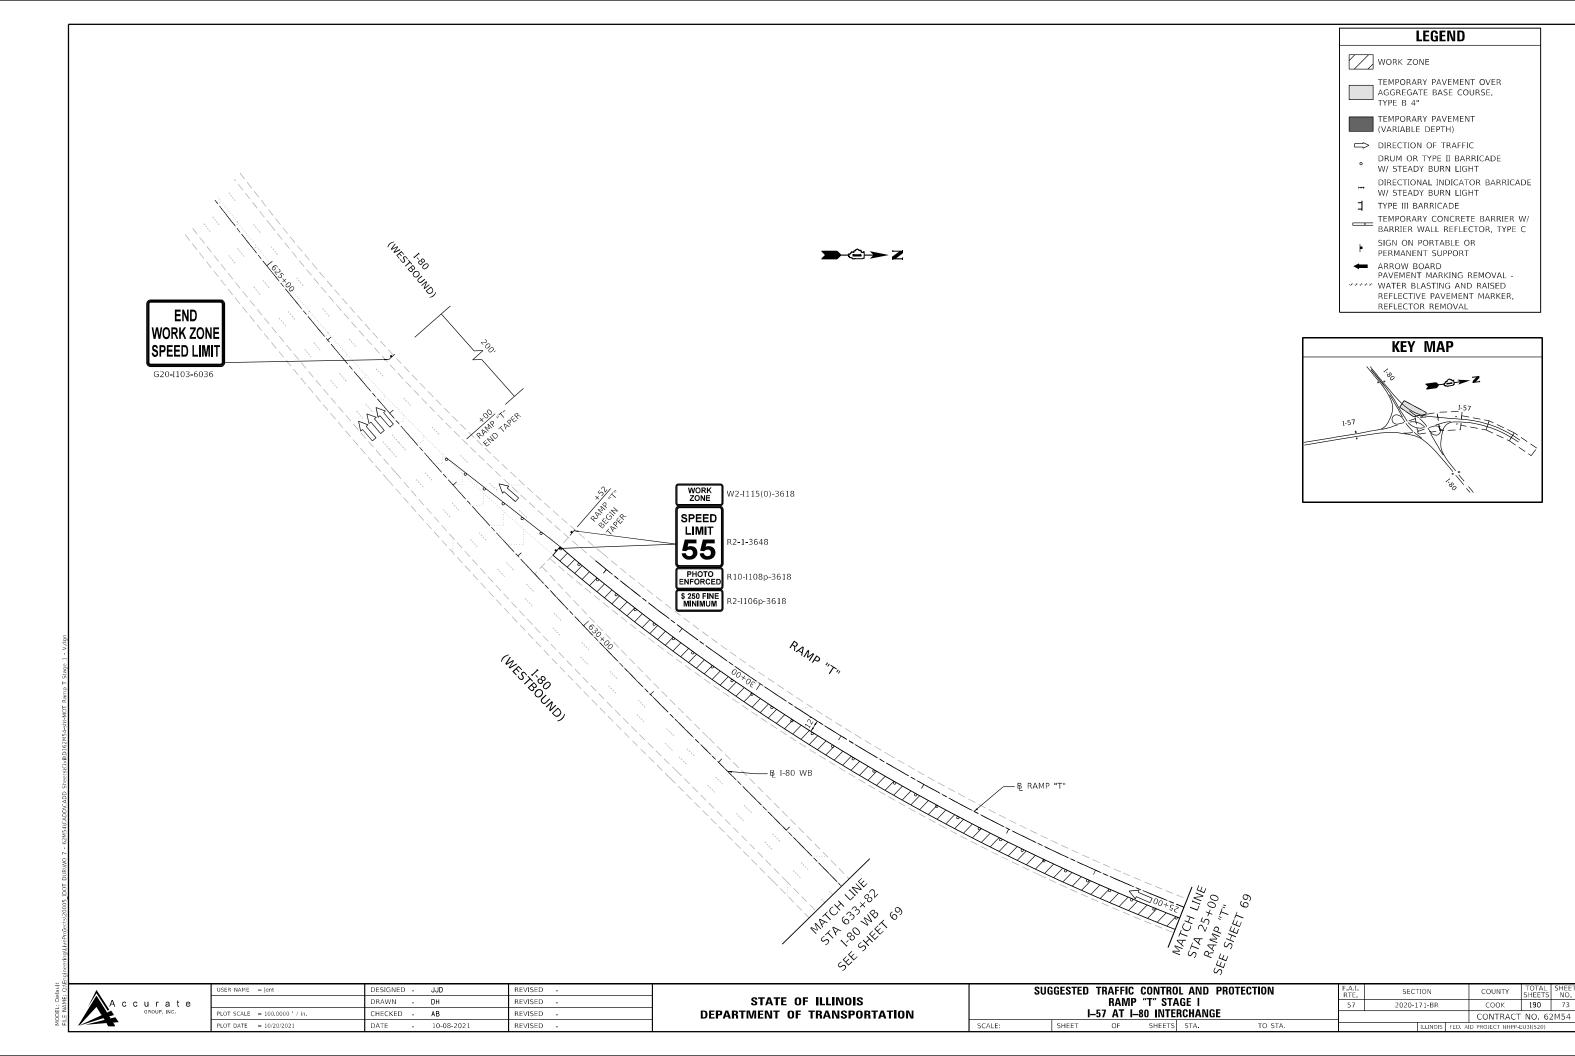

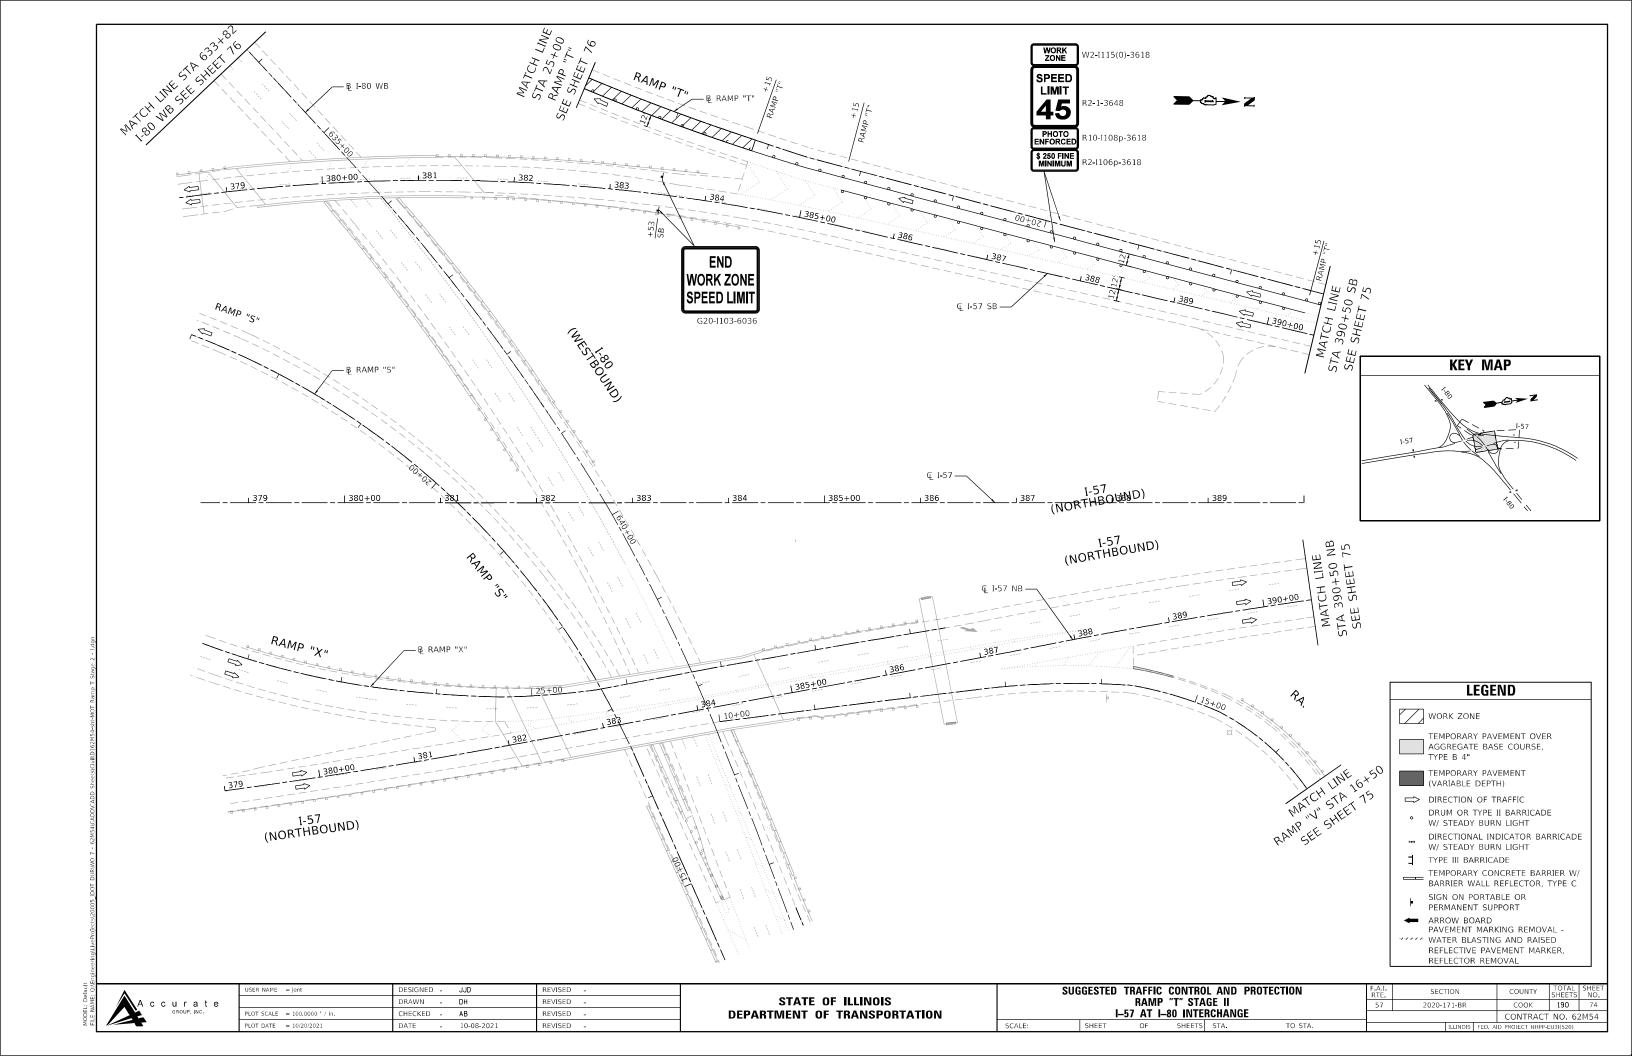

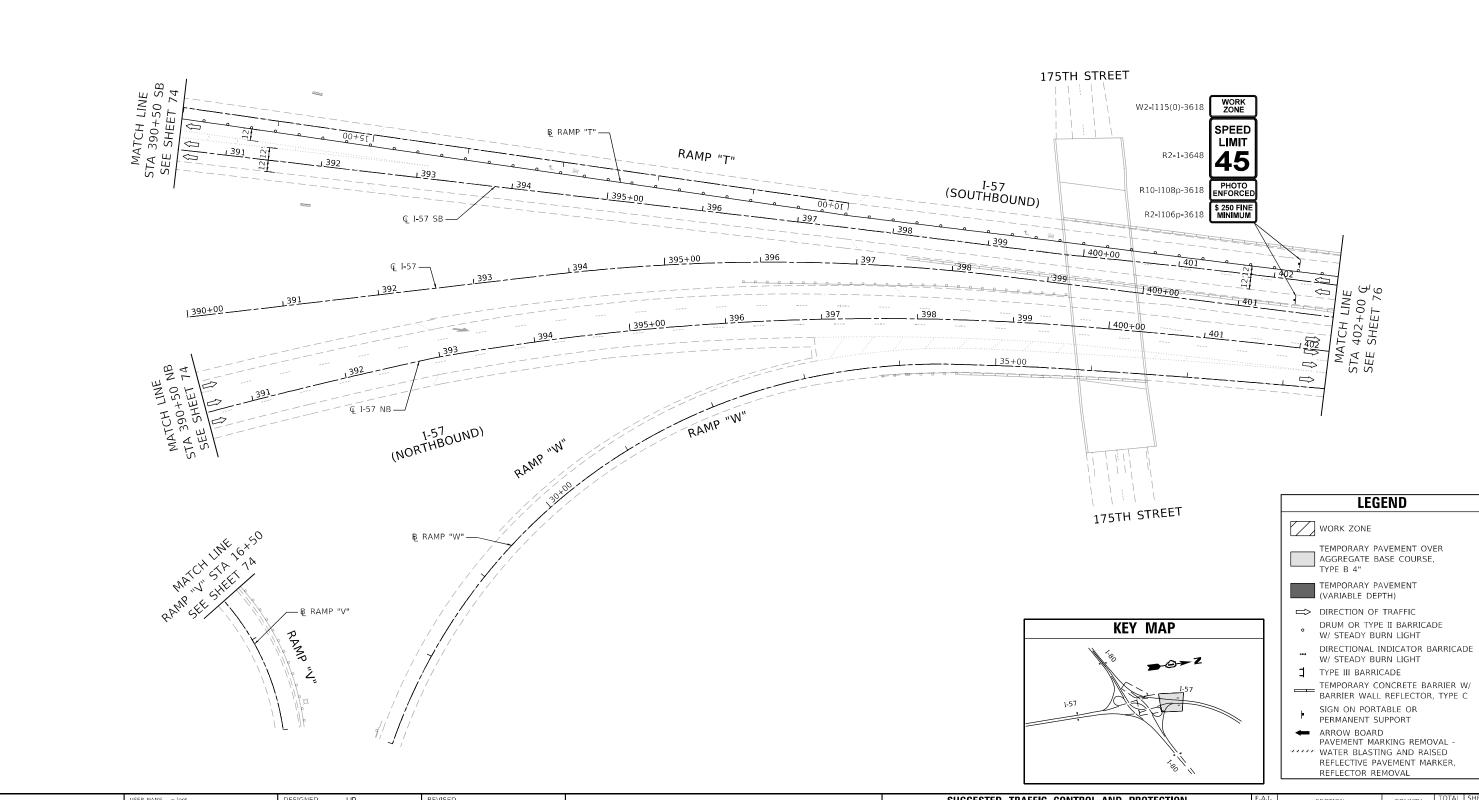


A c c u r a t e


STATE OF ILLINOIS
DEPARTMENT OF TRANSPORTATION

SUGGESTED TRAFFIC CONTROL AND PROTECTION
RAMP "T" STAGE II
1-57 AT 1-80 INTERCHANGE

SHEET OF SHEETS STA. TO STA.

A.I. RTE.	SECTION			COUNTY	TOTAL SHEETS	SHEE
57	2020-171-BR			COOK	190	75
			CONTRACT	NO. 62	2M54	
ILLINOIS FED. AI				ID PROJECT NHPP-E	U3I(520)	

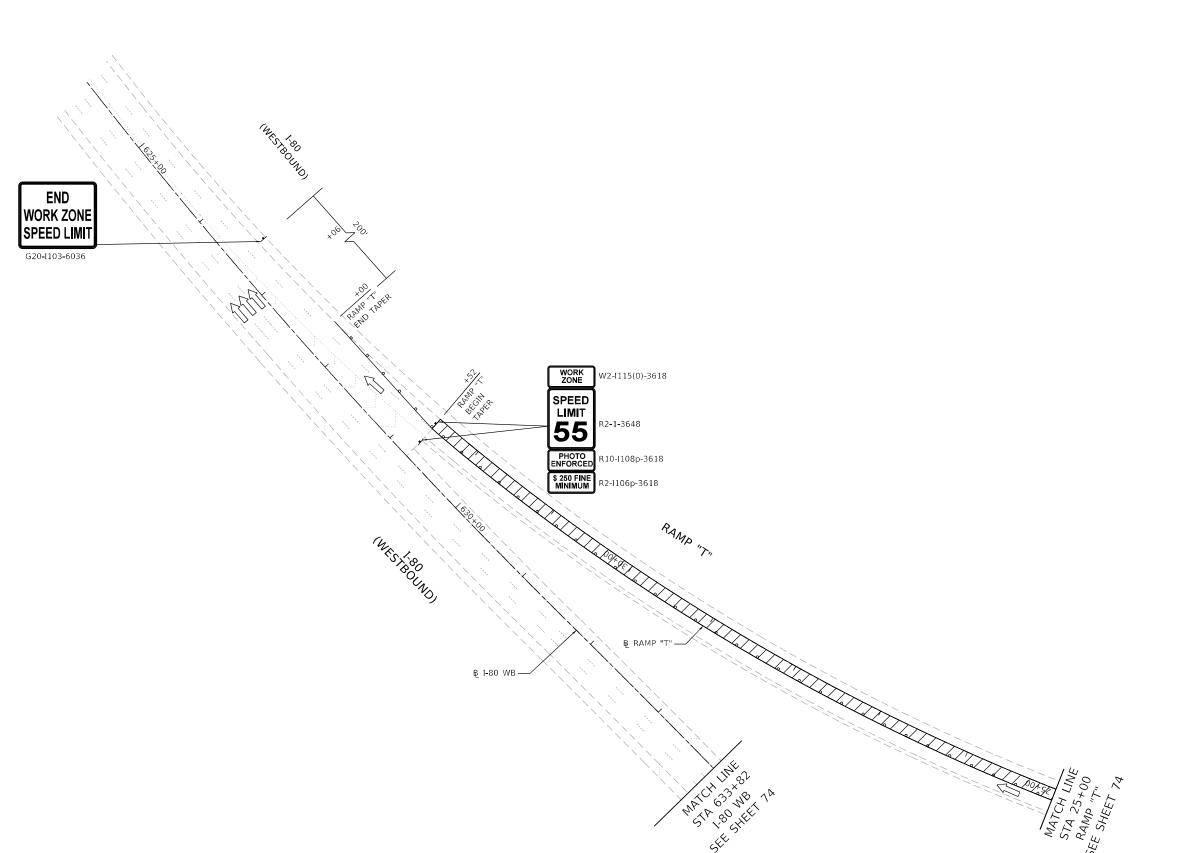

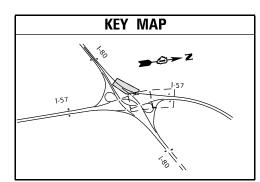

LEGEND

WORK ZONE

TEMPORARY PAVEMENT OVER AGGREGATE BASE COURSE, TYPE B 4"

TEMPORARY PAVEMENT (VARIABLE DEPTH)

□ DIRECTION OF TRAFFIC

DRUM OR TYPE II BARRICADE W/ STEADY BURN LIGHT

DIRECTIONAL INDICATOR BARRICADE W/ STEADY BURN LIGHT

TEMPORARY CONCRETE BARRIER W/
BARRIER WALL REFLECTOR, TYPE C

SIGN ON PORTABLE OR PERMANENT SUPPORT

ARROW BOARD
PAVEMENT MARKING REMOVAL WATER BLASTING AND RAISED
REFLECTIVE PAVEMENT MARKER,
REFLECTOR REMOVAL




USER NAME = jent	DESIGNED	-	JJD	REVISED -
	DRAWN	-	DH	REVISED -
PLOT SCALE = 100.0000 ' / in.	CHECKED	-	AB	REVISED -
PLOT DATE = 10/20/2021	DATE	-	10-08-2021	REVISED -

STATE OF ILLINOIS **DEPARTMENT OF TRANSPORTATION** SUGGESTED TRAFFIC CONTROL AND PROTECTION
RAMP "T" STAGE II
1-57 AT 1-80 INTERCHANGE

SHEET OF SHEETS STA. TO STA TO STA.

SECTION 2020-171-BR COOK 190 76 CONTRACT NO. 62M54

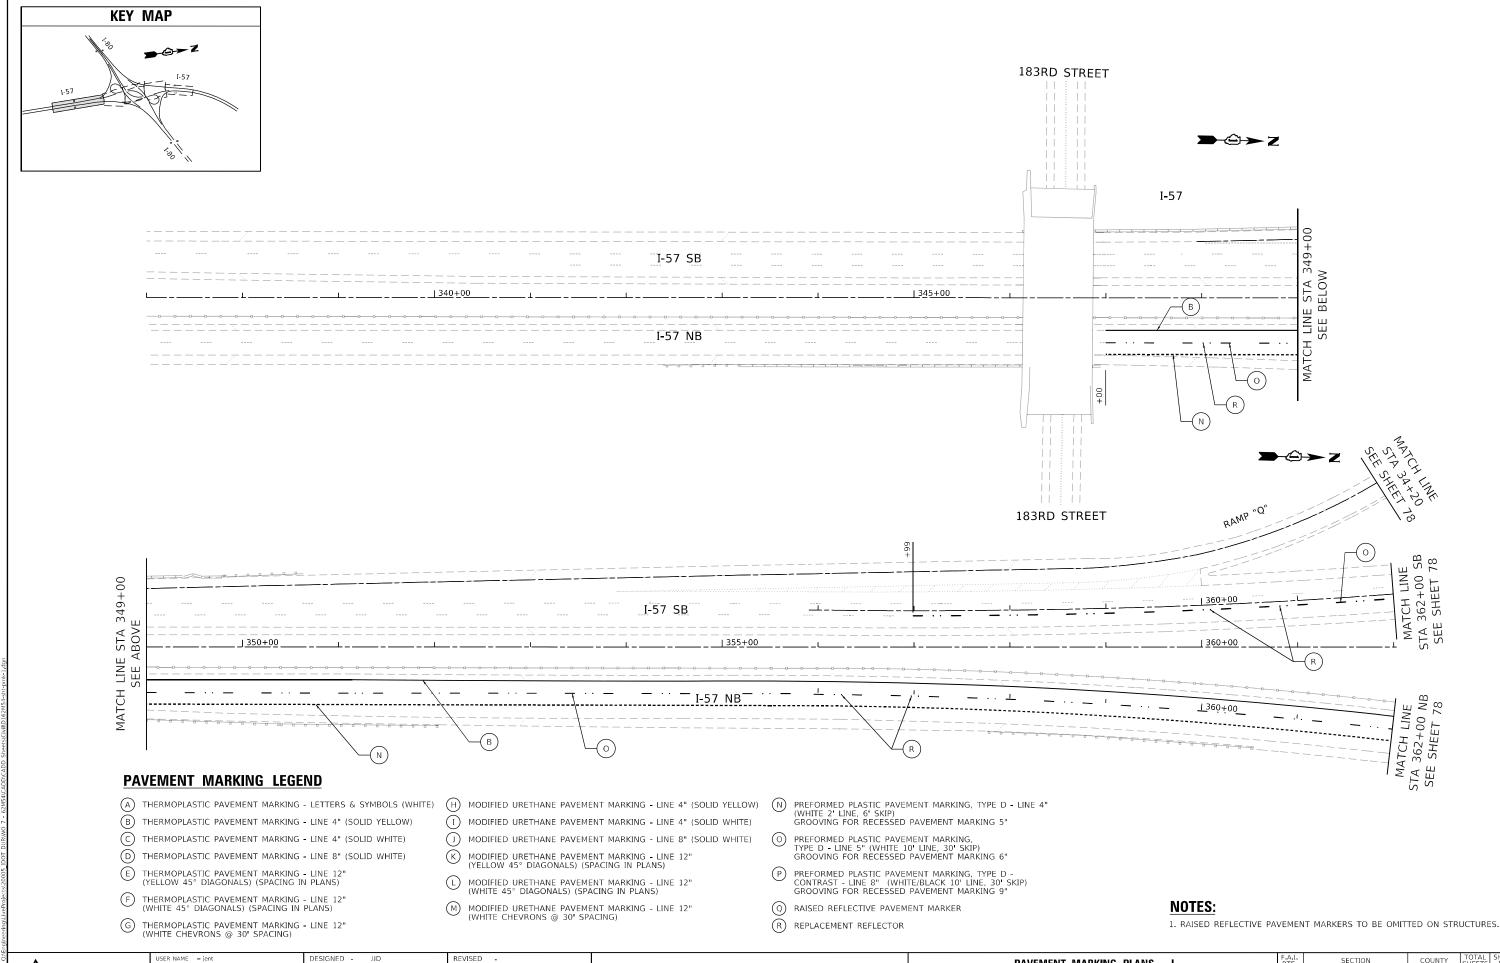

A c c u r a t e

 USER NAME
 = jent
 DESIGNED
 JID
 REVISED


 PLOT SCALE
 = 100.0144 ' / in.
 CHECKED
 AB
 REVISED

 PLOT DATE
 = 10/20/2021
 DATE
 10-08-2021
 REVISED

STATE OF ILLINOIS DEPARTMENT OF TRANSPORTATION PAVEMENT MARKING PLANS – I
1–57 AT 1–80 INTERCHANGE

SHEET OF SHEETS STA. 339+00

TO STA. 362+00

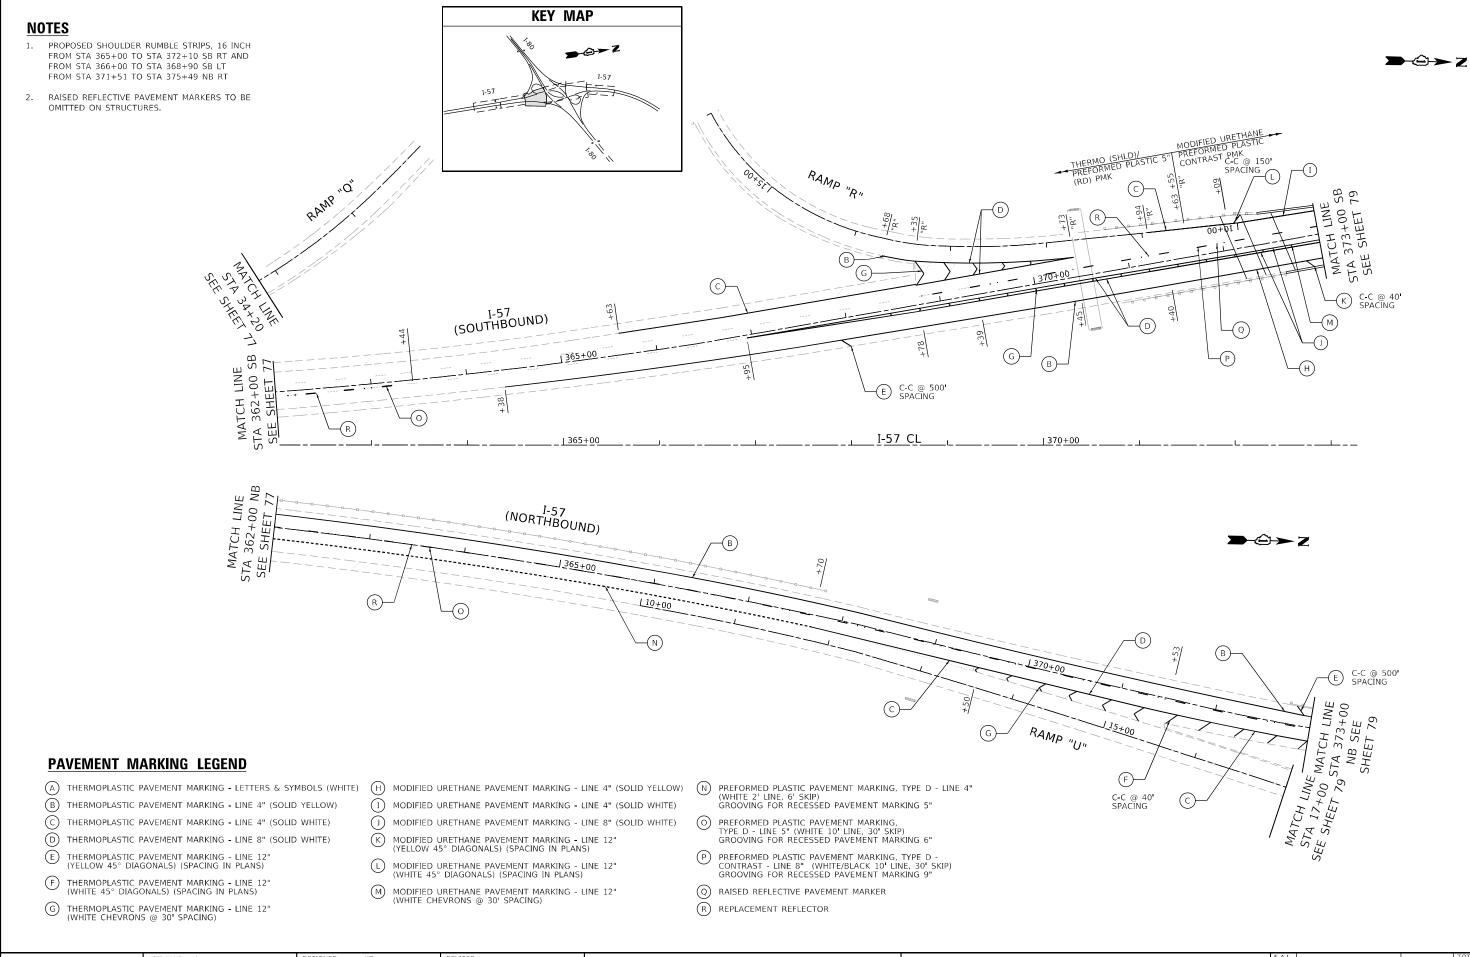

A c c u r a t e


 USER NAME
 = jent
 DESIGNED - JIJD
 REVISED - REVISED - JIJD


 DRAWN - DM
 REVISED - REVISED - JIJD

 PLOT SCALE = 100,0000 ' / in, PLOT DATE = 10/20/2021
 CHECKED - AB REVISED - JIJD

 PLOT DATE = 10/20/2021
 DATE - 10-08-2021
 REVISED - JIJD

STATE OF ILLINOIS
DEPARTMENT OF TRANSPORTATION

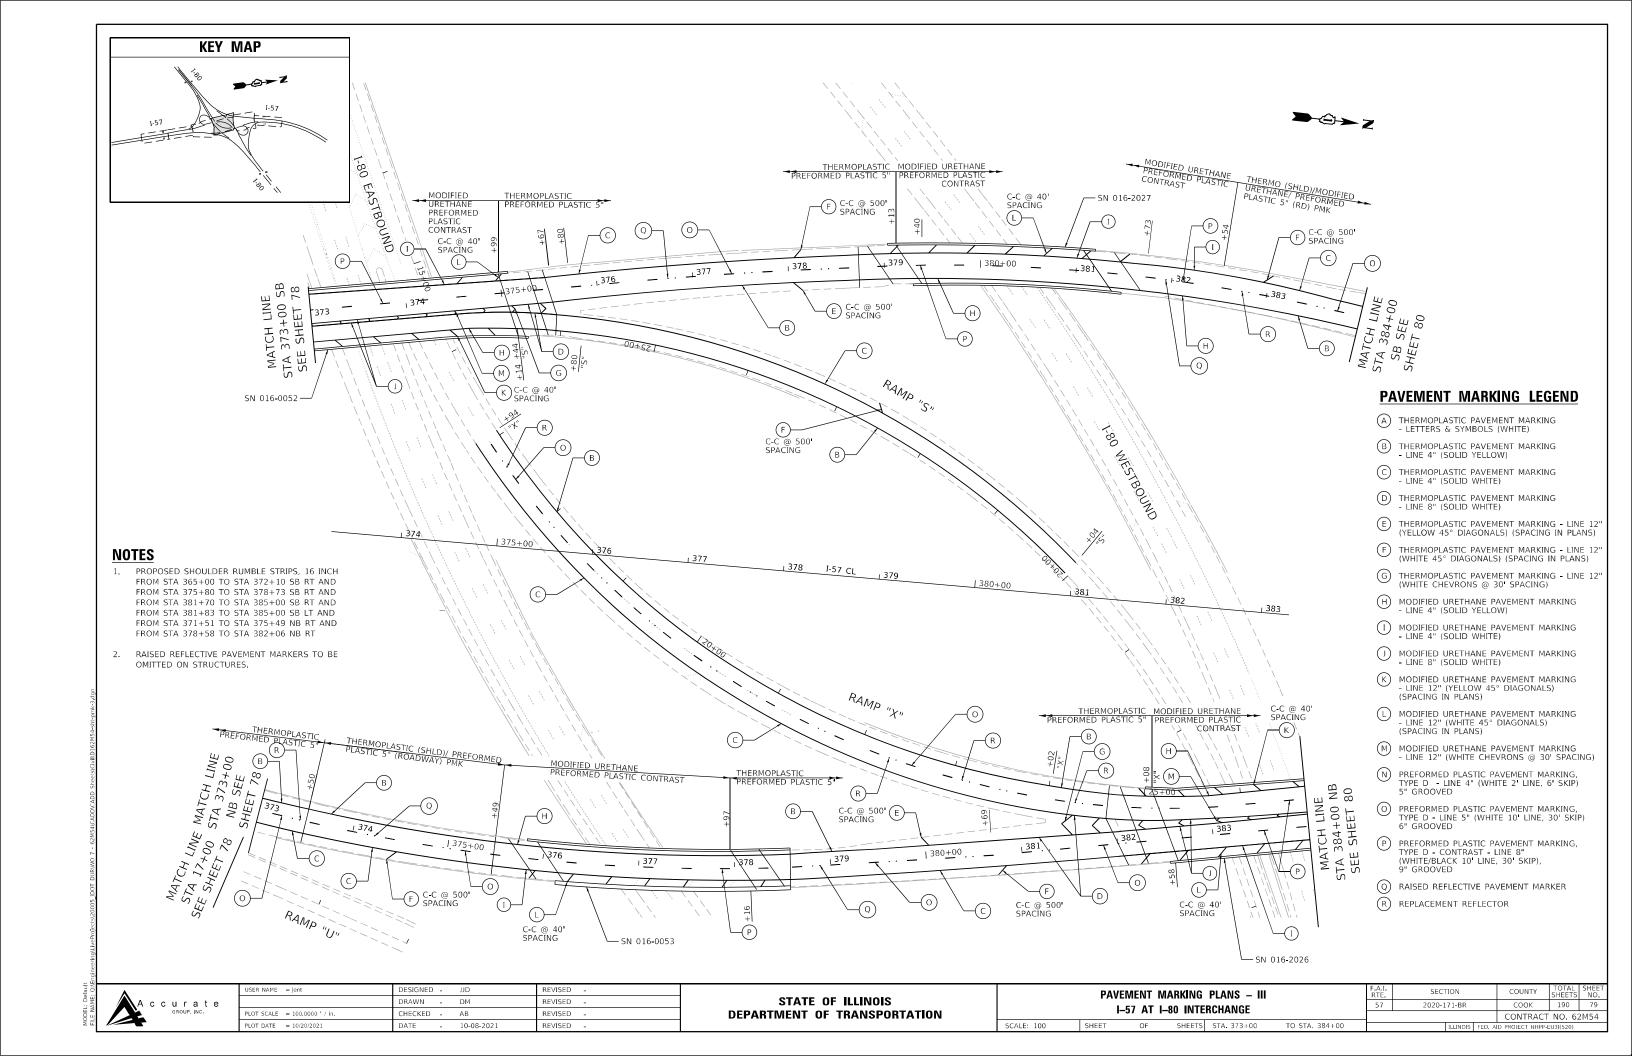

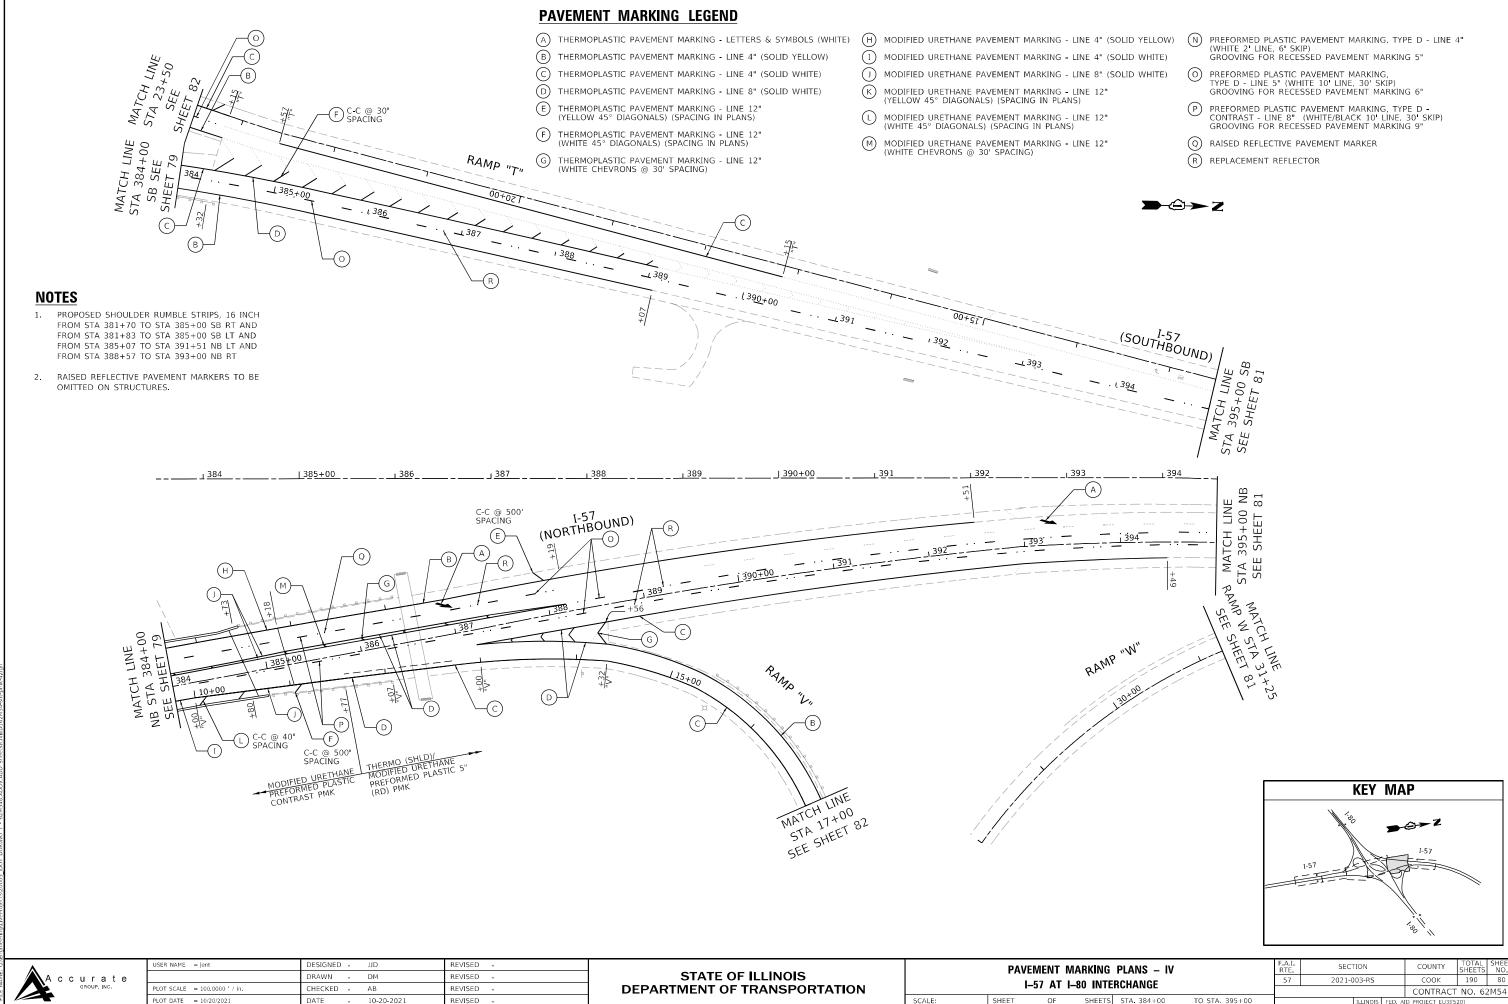


10-20-2021

DATE



1. RAISED REFLECTIVE PAVEMENT MARKERS TO BE OMITTED ON STRUCTURES.

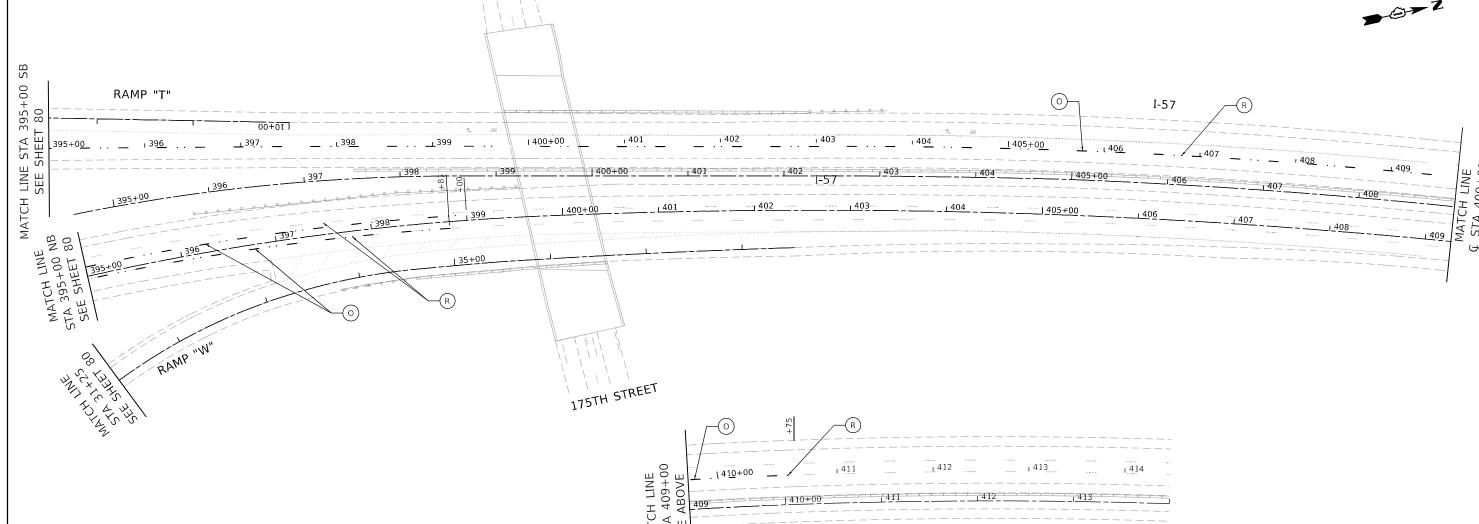

PAVEMENT MARKING LEGEND

- C) THERMOPLASTIC PAVEMENT MARKING LINE 4" (SOLID WHITE)
- (D) THERMOPLASTIC PAVEMENT MARKING LINE 8" (SOLID WHITE)
- (YELLOW 45° DIAGONALS) (SPACING IN PLANS)
- F THERMOPLASTIC PAVEMENT MARKING LINE 12" (WHITE 45° DIAGONALS) (SPACING IN PLANS)
- G THERMOPLASTIC PAVEMENT MARKING LINE 12" (WHITE CHEVRONS @ 30' SPACING)

- (J) MODIFIED URETHANE PAVEMENT MARKING LINE 8" (SOLID WHITE)
- MODIFIED URETHANE PAVEMENT MARKING LINE 12" (YELLOW 45° DIAGONALS) (SPACING IN PLANS)
- (L) MODIFIED URETHANE PAVEMENT MARKING LINE 12" (WHITE 45° DIAGONALS) (SPACING IN PLANS)
- $\begin{tabular}{ll} \hline \end{tabular} MODIFIED URETHANE PAVEMENT MARKING LINE 12" (WHITE CHEVRONS @ 30' SPACING)$
- A THERMOPLASTIC PAVEMENT MARKING LETTERS & SYMBOLS (WHITE)

 B THERMOPLASTIC PAVEMENT MARKING LINE 4" (SOLID YELLOW)


 C THERMOPLASTIC PAVEMENT MARKING LETTERS & SYMBOLS (WHITE)

 C MODIFIED URETHANE PAVEMENT MARKING LINE 4" (SOLID YELLOW)

 C MODIFIED URETHANE PAVEMENT MARKING LINE 4" (SOLID WHITE)

 C MODIFIED URETHANE PAVEMENT MARKING LINE 4" (SOLID WHITE)

 C MODIFIED URETHANE PAVEMENT MARKING LINE 4" (SOLID WHITE)
 - O PREFORMED PLASTIC PAVEMENT MARKING, TYPE D LINE 5" (WHITE 10' LINE, 30' SKIP) GROOVING FOR RECESSED PAVEMENT MARKING 6"
 - PREFORMED PLASTIC PAVEMENT MARKING, TYPE D CONTRAST LINE 8" (WHITE/BLACK 10' LINE, 30' SKIP) GROOVING FOR RECESSED PAVEMENT MARKING 9"
 - Q) RAISED REFLECTIVE PAVEMENT MARKER
 - (R) REPLACEMENT REFLECTOR

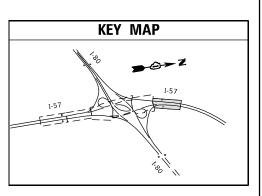


	е
	at

USER NAME = jent	DESIGNED	-	JJD	REVISED -
	DRAWN	-	DM	REVISED -
PLOT SCALE = 100.0000 ' / in.	CHECKED	-	AB	REVISED -
PLOT DATE = 10/20/2021	DATE	-	10-08-2021	REVISED -

STATE	OF	: ILLINOIS
DEPARTMENT	0F	TRANSPORTATION

PA	VEMENT I–57 AT	,		
SHEET	OF	SHEETS	STA. 395+00	TO STA. 409+00

I. E	SECTION		COUNTY	TOTAL SHEETS	SHEET NO.		
7	2020-171-BR		COOK	190	81		
·				CONTRACT NO. 62M54			
ILLINOIS FED. AI				ID PROJECT NHPP-E	U3I(520)		

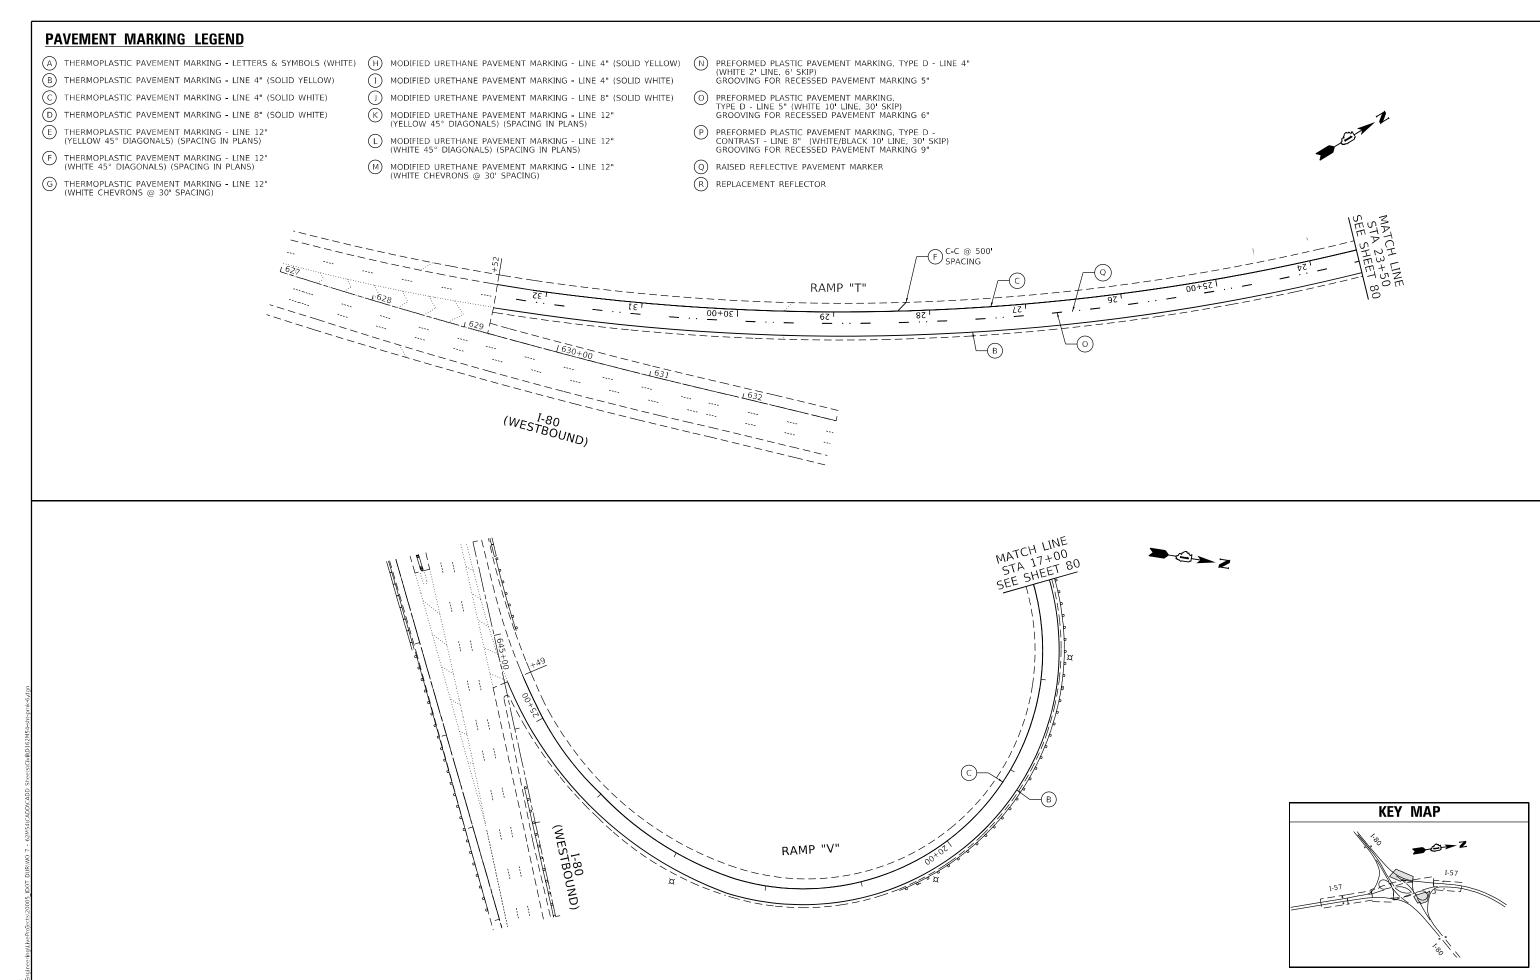

A c c u r a t e

 USER NAME
 Jent
 DESIGNED
 JJD
 REVISED


 PLOT SCALE
 = 100,0000 ' / in,
 CHECKED
 AB
 REVISED

 PLOT DATE
 = 10/20/2021
 DATE
 10-08-2021
 REVISED

STATE OF ILLINOIS
DEPARTMENT OF TRANSPORTATION

PAVEMENT MARKING PLANS – VI
1–57 AT 1–80 INTERCHANGE


SHEET OF SHEETS STA. TO STA.

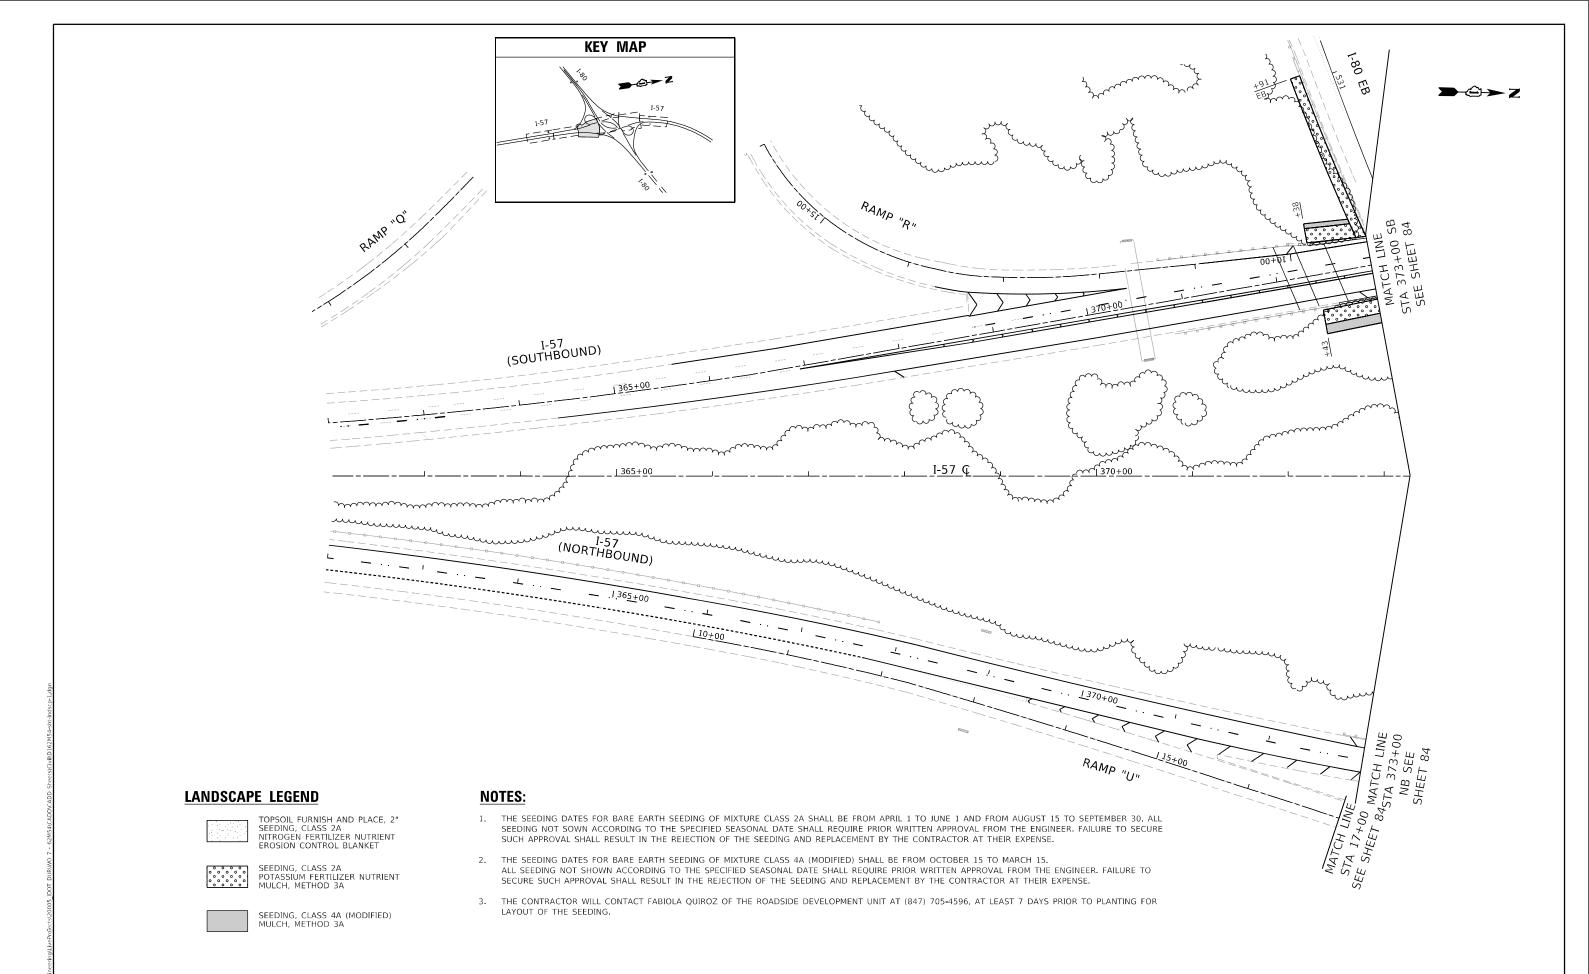

STATE OF ILLINOIS **DEPARTMENT OF TRANSPORTATION**

SHEET

LANDSCAPING PLANS – I –57 at i–80 interchange		F.A.I. RTE.	SECT	ION		COUNTY	TOTAL SHEETS	SHEET NO.	
		57	57 2020-171-BR			COOK	190	83	
-37 AT I-60 INTENUIANUE				•			CONTRAC	NO. 62	2M54
OF	SHEETS STA 362+00	TO STA 373+00			TELINOIS	EED AL	D DROIECT NUBB	E1121/5201	

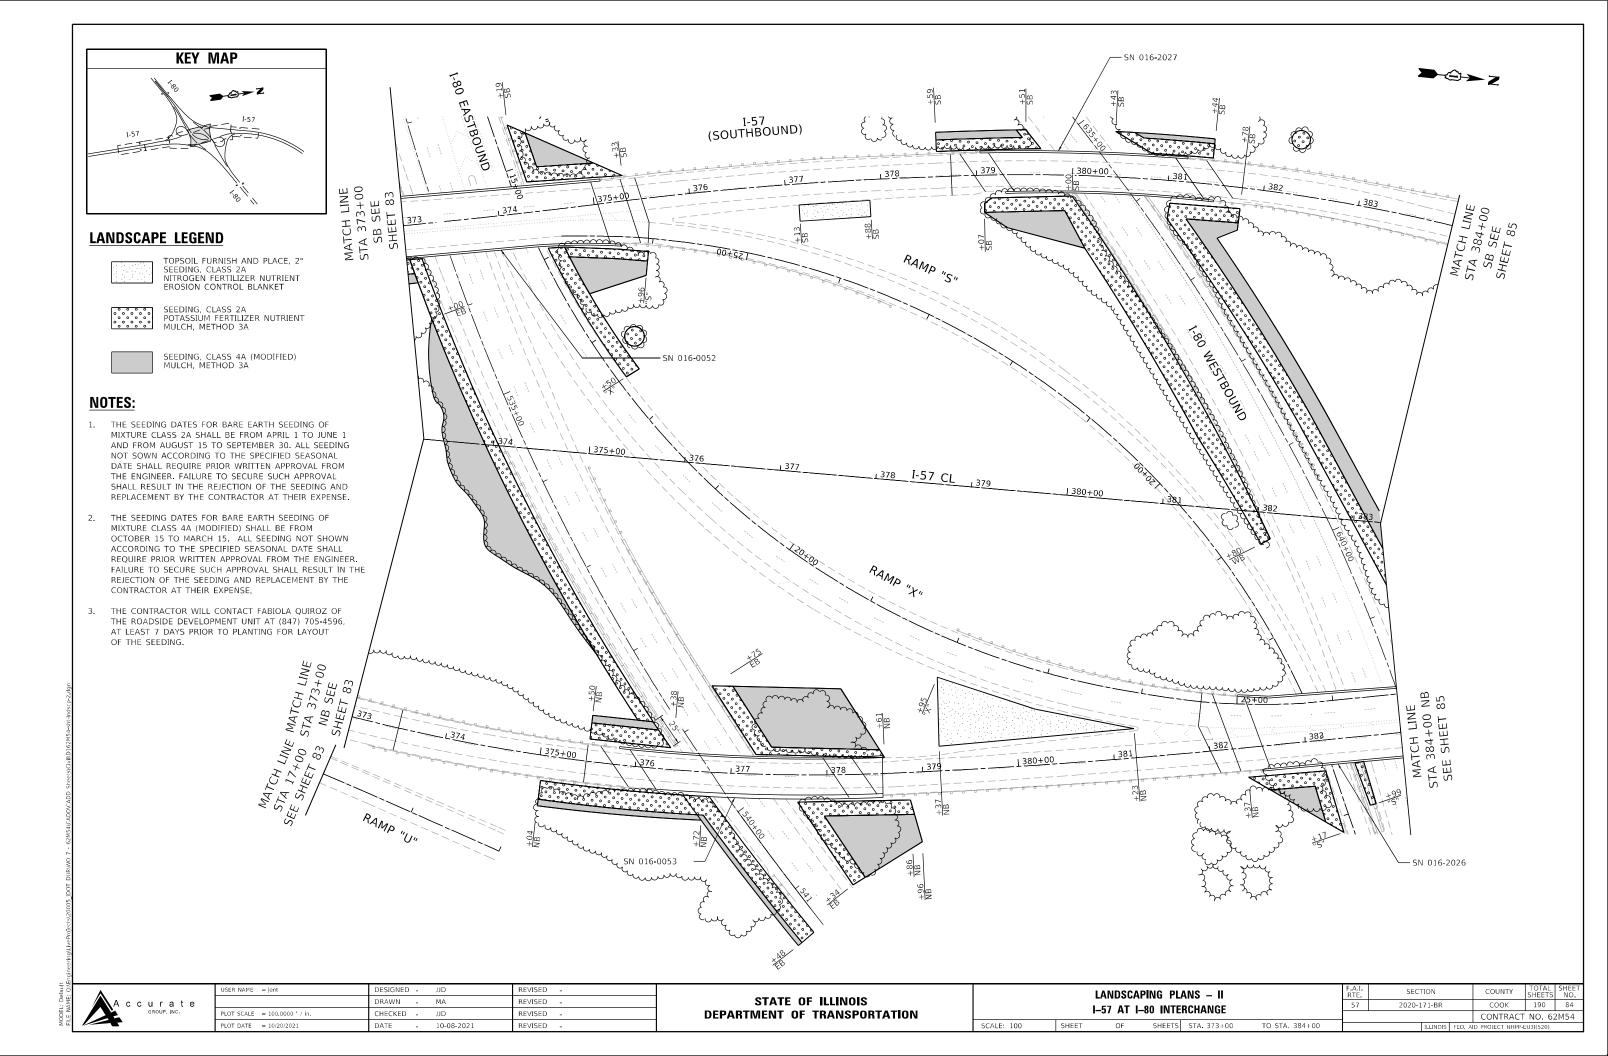

MATCH LINE STA 23+50 MATCH LINE STA 384+00 SB SEE SHEET 84 RAMP "T" (SOUTHBOUND) <u> 390+00</u> I-57 (NORTHBOUND) MATCH LINE NB STA 384+00 SEE SHEET 84 110+00 MATCH LINE MATCH LINE STA 17+00 SEE SHEET 86 MATCH SEE SHEET 86

LANDSCAPE LEGEND

TOPSOIL FURNISH AND PLACE, 2" SEEDING, CLASS 2A NITROGEN FERTILIZER NUTRIENT EROSION CONTROL BLANKET




SEEDING, CLASS 2A POTASSIUM FERTILIZER NUTRIENT MULCH, METHOD 3A



SEEDING, CLASS 4A (MODIFIED) MULCH, METHOD 3A

NOTES:

- 1. THE SEEDING DATES FOR BARE EARTH SEEDING OF MIXTURE CLASS 2A SHALL BE FROM APRIL 1 TO JUNE 1 AND FROM AUGUST 15 TO SEPTEMBER 30. ALL SEEDING NOT SOWN ACCORDING TO THE SPECIFIED SEASONAL DATE SHALL REQUIRE PRIOR WRITTEN APPROVAL FROM THE ENGINEER. FAILURE TO SECURE SUCH APPROVAL SHALL RESULT IN THE REJECTION OF THE SEEDING AND REPLACEMENT BY THE CONTRACTOR AT THEIR EXPENSE.
- 2. THE SEEDING DATES FOR BARE EARTH SEEDING OF MIXTURE CLASS 4A (MODIFIED) SHALL BE FROM OCTOBER 15 TO MARCH 15. ALL SEEDING NOT SHOWN ACCORDING TO THE SPECIFIED SEASONAL DATE SHALL REQUIRE PRIOR WRITTEN APPROVAL FROM THE ENGINEER. FAILURE TO SECURE SUCH APPROVAL SHALL RESULT IN THE REJECTION OF THE SEEDING AND REPLACEMENT BY THE CONTRACTOR AT THEIR EXPENSE.
- THE CONTRACTOR WILL CONTACT FABIOLA QUIROZ OF THE ROADSIDE DEVELOPMENT UNIT AT (847) 705-4596, AT LEAST 7 DAYS PRIOR TO PLANTING FOR LAYOUT OF THE SEEDING.

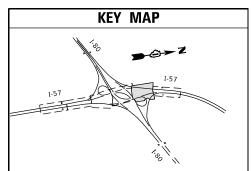

A c c u r a t e

USER NAME = jent	DESIGNED - JJD	REVISED -
	DRAWN - MA	REVISED -
PLOT SCALE = 100.0000 ' / in.	CHECKED - JJD	REVISED -
PLOT DATE = 10/20/2021	DATE - 10-20-2021	REVISED -

STATE OF ILLINOIS DEPARTMENT OF TRANSPORTATION


LANDSCAPING PLANS – III I–57 at i–80 interchange					
	SHEET	OF	SHEETS	STA. 384+00	


TO STA. 395+00

F.A.I. RTE	SECT	TION		COUNTY	TOTAL SHEETS	SHEE NO.
57	2021-0	2021-003-RS			190	85
·				CONTRACT	NO. 62	2M54
		ILLINOIS	FED. Al	ID PROJECT EU3I(5	20)	

NOTES:

- 1. THE SEEDING DATES FOR BARE EARTH SEEDING OF MIXTURE CLASS 2A SHALL BE FROM APRIL 1 TO JUNE 1 AND FROM AUGUST 15 TO SEPTEMBER 30. ALL SEEDING NOT SOWN ACCORDING TO THE SPECIFIED SEASONAL DATE SHALL REQUIRE PRIOR WRITTEN APPROVAL FROM THE ENGINEER. FAILURE TO SECURE SUCH APPROVAL SHALL RESULT IN THE REJECTION OF THE SEEDING AND REPLACEMENT BY THE CONTRACTOR AT THEIR EXPENSE.
- THE SEEDING DATES FOR BARE EARTH SEEDING OF MIXTURE CLASS 4A (MODIFIED) SHALL BE FROM OCTOBER 15 TO MARCH 15. ALL SEEDING NOT SHOWN ACCORDING TO THE SPECIFIED SEASONAL DATE SHALL REQUIRE PRIOR WRITTEN APPROVAL FROM THE ENGINEER. FAILURE TO SECURE SUCH APPROVAL SHALL RESULT IN THE REJECTION OF THE SEEDING AND REPLACEMENT BY THE CONTRACTOR AT THEIR EXPENSE.
- THE CONTRACTOR WILL CONTACT FABIOLA QUIROZ OF THE ROADSIDE DEVELOPMENT UNIT AT (847) 705-4596, AT LEAST 7 DAYS PRIOR TO PLANTING FOR LAYOUT OF THE SEEDING.

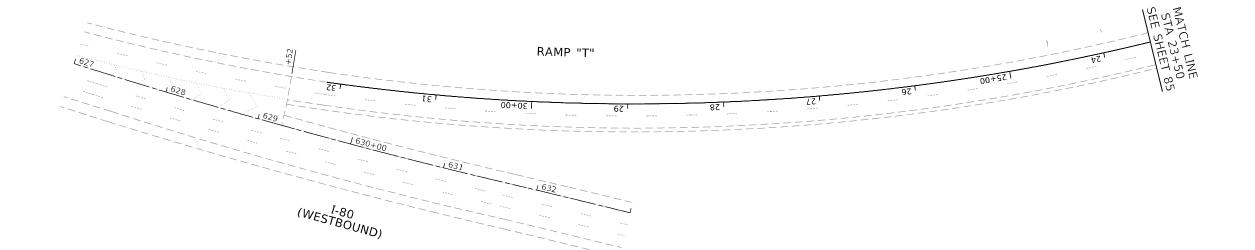

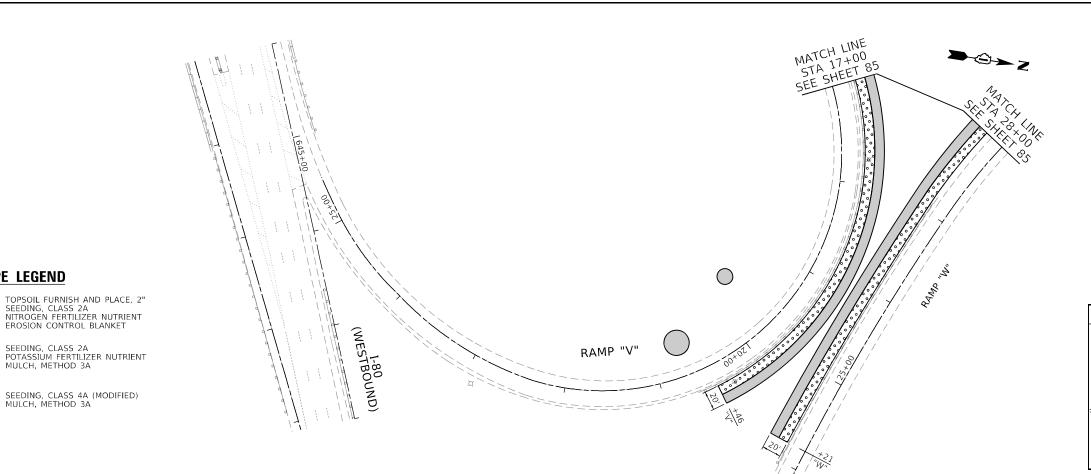



USER NAME = jent	DESIGNED	-	JJD	REVISED	-
	DRAWN	-	MA	REVISED	-
PLOT SCALE = 100.0000 / in.	CHECKED	-	JJD	REVISED	-
PLOT DATE = 10/20/2021	DATE	-	10-08-2021	REVISED	-

STATE OF ILLINOIS **DEPARTMENT OF TRANSPORTATION**

	LANDSCAI I–57 AT I-			
SHEET	OF	SHEETS	STA.	TO STA.

F.A.I. RTE.	SECT	TION		COUNTY	TOTAL SHEETS	SHEET NO.
57	7 2020-171-BR		COOK	190	86	
				CONTRACT	NO. 62	2M54
		THINOIS	FED A	D PROJECT NHPP-	H3I(520)	

KEY MAP

LANDSCAPE LEGEND

LANDSCAPE OPERATIONS CALENDAR I - 57 at I - 80 (62M54)

ITEM	MARCH	APRIL	MAY	JUNE	JULY	AUGUST	SEPTEMBER
ORESTRY VEGETATION MANAGEMENT							
TREE REMOVAL (6-15 UNITS / >15 UNITS)		*******					
TREE PRUNING (1-10 INCH DIAM / >10 INCH DIAM)	********						
SELECTIVE CLEARING	***************************************	******					
SEEDING, CLASS 2A			******	8			
SEEDING, CLASS 4A (MODIFIED)			******	8			
MULCH METHOD, 3				8			
ERBACEOUS WEED VEGETATION MANAGEMENT							
WEED CONTROL, TEASEL		***		***			
MOWING			8888		8888	- 888	
INTERSEEDING, CLASS 2A							***
WEED CONTROL, AQUATIC (TARGET PHRAGMITES)						***	
MOWING (SPECIAL)							***
SEEDING, CLASS 2A							XXX
MULCH METHOD, 3							XXX

E NAME: Q:\	A	С	С	U GR	a , inc	t :.	е
ш							

USER NAME = jent	DESIGNED	-	JJD	REVISED	-
	DRAWN	-	JLS	REVISED	-
PLOT SCALE = 2.0000 / in	CHECKED	-	DIL	REVISED	-
PLOT DATE = 10/20/2021	DATE	-	10-08-2021	REVISED	-

ANDSCA	PING O	PERATIO	NS CAL	ENDAR		F.A.I. RTE	SEC ⁻
I_57	ΛΤ I_	RO INTE	RCHANG	F		57	2020-1
1-37	A1 1-	OO HAIL	IUIIAIVU	_			
IEET	OF	SHEETS	STA		TO STA		

LOADING DESIGN SPECIFICATION Existing Structure: S.N. 016-2026 was originally build in 1965 and reconstructed/widened in 1996. The structure has a back-to-back abutment length of 224'-3" and an out-to-out deck width that varies from 73'-2" to 77'-85%". The superstructure consists of a 71/5" thick reinforced 2002 AASHTO Standard Specification for HS20-44 concrete deck supported on four span continuous steel beams of span lengths 51'-0", 46'-5", 77'-3" and 44'-8". The substructure (Existing and Proposed) Highway Bridges, 17th Edition consists of reinforced concrete abutments supported on reinforced concrete piles and reinforced concrete piers on spread footings. RECONSTRUCTION 1992 AASHTO Standard Specifications with Traffic is to be maintained utilizing stage construction. 1993 Interim No salvage. 224'-3" (Bk. to Bk. Abutments) 2'-51/2" 2'-51/2" 51'-0" 46'-5" 44'-8" Span 1 Span 2 Span 3 Span 4 121'-4" - Reconstruct Exist. Reconstruct Exist. Limits of protective shield Expansion Joint Expansion Joint - G Brg. N. Abut € Brg. S. Abut @ Pier 1 © Pier 3 © Pier 2 Perform Structural Repair of Perform Structural Repair of Concrete and Epoxy Crack Concrete and Epoxy Crack Injection at N. Abut Injection at S. Abut Conc. Piles Conc. Piles -Ramp A Below WB I-80 Below Ramp F Below Perform Structural Repair of Concrete and Epoxy Crack Perform Slopewall Repair Perform Structural Injection at Pier 3 Exist. Ground Line (typ. at both abutments) Repair of Concrete Perform Structural at Pier 2 * Measured Radially Repair of Concrete ELEVATION ·Scarify Approach Pavement ¾" and Apply Bridge Deck Latex Replace exist. traffic barrier Concrete Overlay, 23/4". See terminal with Type 6, see Roadway Plans. Roadway Plans 224'-3" (Bk. to Bk. Abutments) Replace exist. Type 6 traffic barrier terminal 2'-51/2" 51'-0" 77'-3" 44'-8" with Type 10, see Span 1 Span 2 Roadway Plans Span 3 Span 4 20'-15'8" Stage II Const. -Exist. deck drain to be Perform Bridge Exist. drainage 30'-0" 13°51'57" typ. — \ cleaned, typ. Deck Grooving 30'-0" scupper to be Approach Si ad justed, typ. Approach Slab Structure Location Range 13E, 3rd P.M. Station € I-57 NB Roadway Bk. S. Abut Sta. 386+97.89 © Brg. N. Abut Increase Sta. 385+98.01 Sta. 388+19.80 386+00 387+00 388+00 @ Structure\ Bk. of N. Abut a Pier 1 î Pier 3 🖟 Brg. S. Abut Sta. 387+34.47 Sta. 388+22.26 Sta. 386+51.47 Sta. 387+75.14 Sta. 386+00.47 19'-9 Stage Const LOCATION SKETCH -Perform ¾" Bridge Deck Reconstruct Exist. Joint Scarification and apply 23/4" Replace exist. Type 6 Ramp A Below WB I-80 Below between Bridge Deck Bridge Deck Latex Concrete traffic barrier 15'-0" and Approach Slab (Typ. Overlay and Protective Coat GENERAL PLAN AND ELEVATION terminal with Type at both Abut. Joints) 10, see Roadway I-57 NB OVER I-80 WB Pavement Connector -PLANPlans Apply 2" Stone-Matrix Asphalt (PCC), typ. F.A.I. ROUTE 57 (SMA) Overlay. See Roadway Plans. MOUSSA A. SECTION 2020-171-BR Replace exist. Type 6A ISSA 081-005738 :★ traffic barrier terminal COOK COUNTY Dr. Moussa A. Issa, S.E. II. Lic. No. 081-005738 CHICAGO. with Type 6, see Expires 11-30-2022 STATION 387+34.47 Roadway Plans 10/14/2021 STRUCTURE S.N. 016-2026 DESIGNED - LAB REVISED SECTION COUNTY STATE OF ILLINOIS CHECKED - MI, RTB REVISED -2020-171-BR COOK 190 88 **STRUCTURE NO. 016-2026** REVISED **DEPARTMENT OF TRANSPORTATION** CONTRACT NO. 62M54 SHEET S1-01 OF S1-24 SHEETS - 11/5/2021 REVISED .

GENERAL NOTES

- 1. Reinforcement bars designated (E) shall be epoxy coated.
- 2. Plan dimensions and details relative to existing plans are subject to nominal construction variations. The Contractor shall field verify existing dimensions and details affecting new construction and make necessary approved adjustments prior to construction or ordering of materials. Such variations shall not be cause for additional compensation for a change in scope of the work, however, the Contractor will be paid for the quantity actually furnished at the unit price bid for the work.
- 3. Bars noted thus, 3x2-#5, indicates 3 lines of #5 bars with 2 lengths of bars per line.
- 4. All exposed concrete edges shall have a 3/1x45° chamfer, except where shown otherwise.
- 5. For SMA overlay on South Approach Slab, Bridge Latex Concrete Overlay on North Approach Slab, see Civil Sheets.
- 6. Protective Coat shall be applied to the top of reconstructed transverse joint areas and top and inside faces of existing parapets and top of Latex Overlay.
- 7. Concrete Sealer shall be applied to the designated areas of the abutments and piers.
- 8. Joint openings shall be adjusted according to Article 520.04 of the Standard Specifications when the deck is poured at an ambient temperature other than 50°F.
- 9. Prior to pouring the new concrete deck for expansion joint reconstruction and deck slab repairs, all heavy or loose rust, loose mill scale, and other loose or potentially detrimental foreign material shall be removed from the surfaces in contact with concrete. Tightly adhered paint may remain unless otherwise noted. Removal shall be accomplished by methods that will not damage the steel and the cost will be included in the pay item covering removal of the existing concrete. As directed by the Engineer, existing construction accessories welded to the top flange of beams and girders shall be removed. The weld areas shall be ground flush and inspected for cracks using magnetic particle testing (MT) or dye penetrant testing (PT) by qualified personnel approved by the Engineer. Any cracks that cannot be removed by grinding ¼" deep shall be identified and reported to the Bureau of Bridges and Structures for further dispositions. The cost of removing welded accessories, grinding and inspecting weld areas and grinding cracks will be paid for according to Article 109.04 of the Standard Specifications.
- 10. The existing structural steel coating contains lead. The Contractor shall take appropriate precautions to deal with the presence of lead on this project.
- 11. Existing structural steel that will be in contact with new structural steel shall be cleaned and painted prior to erection as required by the Special Provision "Cleaning And Painting Contact Surface Areas Of Existing Steel Structures".
- 12. All new structural steel shall be hot-dip galvanized. See Special Provisions for "Hot Dip Galvanizing for Structural Steel".
- 13. All proposed beam end repair plates and bottom flange repair angles shall conform to the requirements of AASHTO M270 Grade 50. All proposed diaphragms and their connection angles shall conform to the requirements of AASHTO M270 Grade 36.
- 14. Fasteners shall be ASTM A325 Type I, mechanically galvanzied bolts. Bolts $\frac{3}{4}$ ", open holes $\frac{13}{16}$ ", unless otherwise noted.
- 15. The Contractor shall take the necessary precautions for the protection of passing vehicles, bicycles and pedestrians from falling objects and/or materials until completion of work.
- 16. The Contractor is responsible to remove, support and reinstall all existing electrical conduits interfering with the work. See special provision "Protection and Maintenance of Existing Underpass Luminaires".
- 17. The Contractor is responsible to protect the existing conduit and junction box embedded in the parapet during removal and construction. Any damage to the existing conduit and junction box shall be repaired by the Contractor at his or her expense at no charge to IDOT.
- 18. The Contractor shall exercise extreme caution during Concrete Removal to avoid damaging the steel beams and diaphragms to remain. Any damage to the existing steel beams and/or diaphragms to remain caused by the Contractor in the performance of his/her work shall be repaired by the Contractor, to the satisfaction of the Engineer, at no cost to the Department.
- 19. Where underpass lighting is present on the structure, the Contractor shall adjust the Protective Shielding to ride above the existing lighting fixtures in order to maintain the existing level of lighting on the roadway underneath. Details shall be approved by the Engineer before installation.
- 20. Any adjustment done to the Protective Shield System must not change the load carrying capacity (or containment specifications) as indicated in the Standard Specifications. Cost of adjusting shielding is including in the cost of Protective Shield.
- 21. Cost of cleaning existing drains shall not be paid separately, but shall be included with Bridge Deck Scarification.

INDEX OF SHEETS


- S1-01 General Plan And Elevation
- S1-02 General Notes, Index of Sheets & Total Bill of Material S1-03 Stage Construction (Sheet 1 of 2)
- S1-03 Stage Construction (Sheet 1 of 2) S1-04 Stage Construction (Sheet 2 of 2)
- S1-05 Temporary Concrete Barrier For Stage Construction
- S1-05 Temporary Concrete Bar S1-06 Deck Repair Plan
- S1-07 Approach Slab Repair Plan
- S1-08 Span 1 Scupper Adjustment
- S1-09 Inlet Adjustment
- S1-10 S. Abut. Joint Removal And Replacement (Sheet 1 of 2)
- S1-11 S. Abut. Joint Removal And Replacement (Sheet 2 of 2) S1-12 N. Abut. Joint Removal And Replacement (Sheet 1 of 2)
- S1-13 N. Abut. Joint Removal And Replacement (Sheet 2 of 2)
- S1-14 Preformed Joint Strip Seal
- S1-15 Framing Plan Steel Repairs S1-16 Structural Steel Repair Details (Sheet 1 of 2)
- S1-17 Structural Steel Repair Details (Sheet 2 of 2)
- S1-18 South Abutment Repairs
- S1-19 North Abutment Repairs
- S1-20 Pier 1 Repairs
- S1-21 Pier 2 Repairs S1-22 Pier 3 Repairs
- S1-23 Slope Wall Repairs
- S1-24 Bar Splicer Assembly And Mechanical Splicer Details


SCOPE OF WORK

- 1. Provide Protective shield within limits indicated on the plans.
- 2. Scarify 3/4" from the bridge deck slab.
- 3. Perform Deck Slab Repairs and Approach Slab Repairs and adjust existing scuppers and inlets as required.
- 4. Reconstruct Expansion Joints at the South and North abutments and install new preformed joint strip seals.
- 5. Apply a $2\frac{3}{4}$ " Bridge Deck Latex Concrete Overlay on Bridge Deck and North Approach Slab and 2" Stone-Matrix Asphalt (SMA) Overlay on the South Approach Slab. See Roadway plans for approach overlays.
- 6. Perform Bridge Deck Grooving.
- 7. Apply protective coat to the top of reconstructed transverse joint areas and top and inside faces of parapets and top of Latex Overlay.
- 8. Perform Structural steel beam end repairs, and replace diaphragms as shown in the plans.
- 9. Perform structural concrete repairs for the abutments and piers as noted on the plans.
- 10. Extend crashwalls of Pier 2 to meet standards.
- 11. Apply Concrete Sealer at North and South Abutments as shown on the plans and to the new concrete of the crashwall Pier 2 extensions.
- 12. Perform Slope wall repairs.
- 13.Clean all deck drains.

TOTAL BILL OF MATERIAL


ITEM	UNIT	SUPER	SUB	TOTAL
Porous Granular Embankment	CU YD	-	5	5
Concrete Removal	CU YD	24.2	-	24.2
Slope Wall Removal	SQ YD	-	11	11
Protective Shield	SQ YD	991	-	991
Concrete Structures	CU YD	-	7.0	7.0
Concrete Superstructure	CU YD	27.3	-	27.3
Bridge Deck Grooving	SQ YD	1,703	-	1,703
Protective Coat	SQ YD	1,961	-	1,961
Furnishing And Erecting Structural Steel	POUND	2,150	-	2,150
Reinforcement Bars, Epoxy Coated	POUND	4,190	1,000	5,190
Bar Splicers	EACH	68	-	68
Slope Wall 4 Inch	SQ YD	-	11	11
Preformed Joint Strip Seal	FOOT	157	-	157
Concrete Sealer	SQ FT	-	734	734
Epoxy Crack Injection	FOOT	80	21	101
Structural Steel Removal	POUND	2,020	-	2,020
Structural Steel Repair	POUND	1,910	-	1,910
Bridge Deck Latex Concrete Overlay, 2 3/4 Inches	SQ YD	1,702	-	1,702
Bridge Deck Scarification 3/4"	SQ YD	1,702	-	1,702
Structural Repair Of Concrete (Depth Equal To Or Less Than 5 Inches)	SQ FT	-	63	63
Structural Repair Of Concrete (Depth Greater Than 5 Inches)	SQ FT	-	1	1
Deck Slab Repair (Full Depth, Type I)	SQ YD	1	-	1
Deck Slab Repair (Full Depth, Type II)	SQ YD	2	-	2
Drainage Scuppers To Be Adjusted	EACH	2	-	2
Maintenance Of Lighting System	CAL MO	6	-	6
Slope Wall Crack Sealing	FOOT	-	148	148
Protect And Maintain Existing Underpass Luminaire	L SUM	0.25	-	0.25
Inlet Boxes To Be Adjusted (Special)	EACH	4	-	4

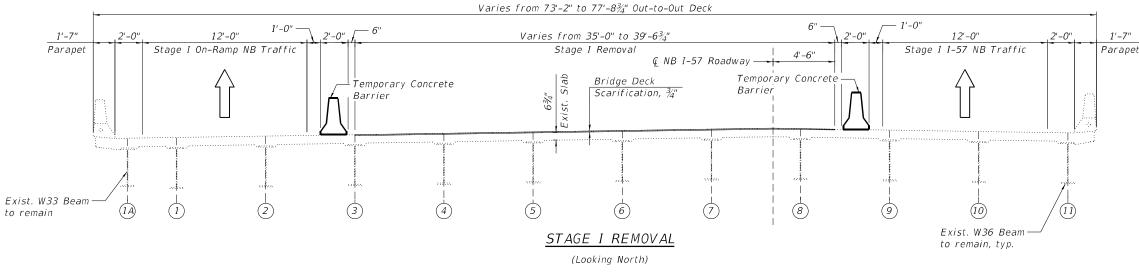

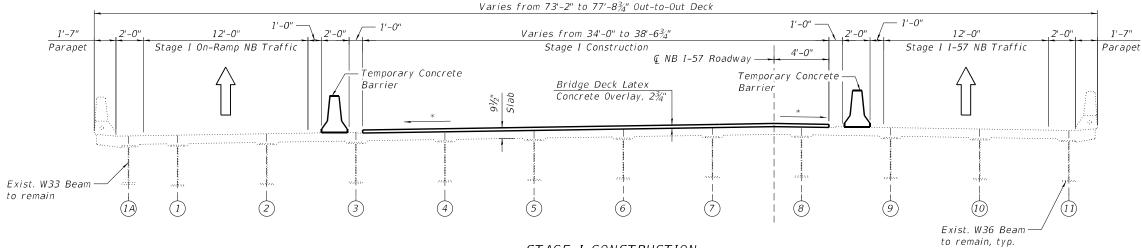

STAGE I CONSTRUCTION

(Looking North)

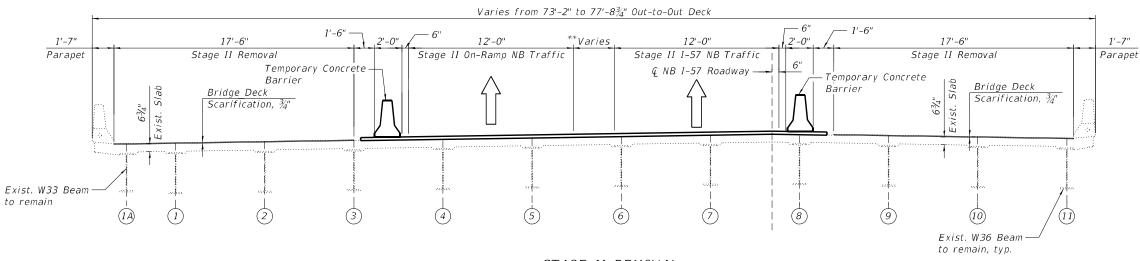

STAGE II REMOVAL

(Looking North)

STAGE I REMOVAL

- Install temporary concrete barrier as shown to locate traffic on the outside of the existing structure.
- Parapet 2. Perform $\frac{3}{4}$ " bridge deck scarification.
 - 3. Remove areas of existing deck for full-depth deck slab repairs at locations shown in the plans.
 - 4. Remove portions of bridge concrete deck/approach slab adjacent to expansion joints at the North and South Abutments

STAGE I CONSTRUCTION

- 1. Perform bridge deck slab repair.
- Reconstruct expansion joints and install new preformed joint strip seals within the limits of Stage I Construction.
- 3. Apply 2¾" bridge deck latex concrete overlay.
- 4. Perform bridge deck grooving for the 2¾ bridge deck latex concrete overlay and reconstructed abutment expansion joint areas.
- 5. Apply 2" Stone-Matrix Asphalt (SMA) Overlay to the south approach pavement, apply Bridge Latex Concrete Overlay to the north approach pavement and taper into existing roadway. See Roadway Plans.
- 6. Apply protective coat to top and inside faces of west parapet, and reconstructed abutment expansion joint areas, and to the surfaces of the new overlay.
- 7. Perform slopewall repairs as shown on the plans.


STAGE II REMOVAL


- 1. Install temporary concrete barrier as shown to locate traffic on the portion of the existing structure overlayed with latex concrete in Stage I Construction.
- 2. Perform ¾" bridge deck scarification.
- 3. Remove areas of existing deck for full-depth deck slab repairs at locations shown in the plans.
- 4. Remove portions of bridge concrete deck/approach slab adjacent to expansion joints at the North and South Abutments
 - * Match Existing Cross-slopes
 - ** Varies from 3'-0" to 7'-63/4"

HBM ENGINEERING GROUP LLC

USER NAME =	DESIGNED	-	JMI	REVISED -
	CHECKED	-	MI, RTB	REVISED -
PLOT SCALE =	DRAWN	-	JMI	REVISED -
PLOT DATE =	DATE	-	10/15/2021	REVISED -

ENGINEERING GRO

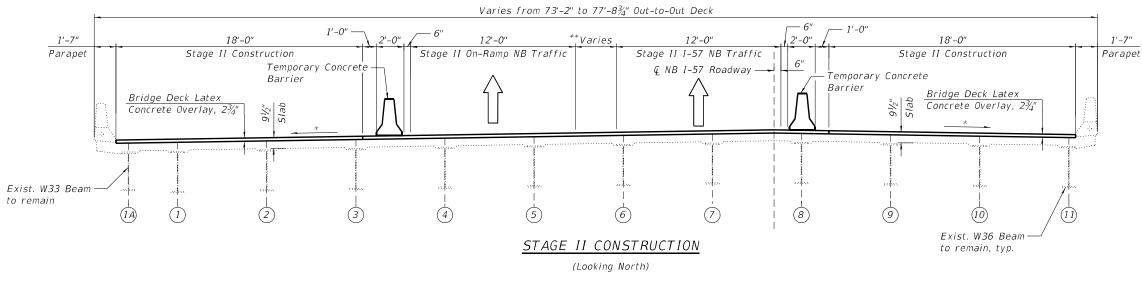

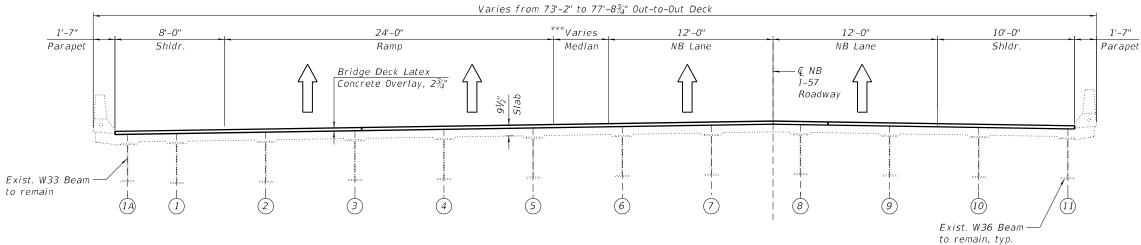

FINAL DECK CROSS SECTION

(Looking North)

STAGE II CONSTRUCTION


- 1. Perform bridge deck slab repairs.
- Reconstruct expansion joints and install new preformed joint strip seals within the limits of Stage II Construction.
- 3. Apply 2¾" bridge deck latex concrete overlay.
- 4. Perform bridge deck grooving for the 2¾" bridge deck latex concrete overlay and reconstructed abutment expansion joint areas.
- 5. Apply 2" Stone-Matrix Asphalt (SMA) Overlay to the south approach pavement, apply Bridge Latex Concrete Overlay to the north approach pavement and taper into existing roadway. See Roadway Plans.
- 6. Apply protective coat to top and inside faces of east parapet, and reconstructed abutment expansion joint areas, and to the surfaces of the new overlay.
- 7. Perform slope wall repairs as shown on the plans.

* Match Existing Cross-slopes ** Varies from 3'-0" to 7'-6¾" *** Varies from 4'-0" to 8'-6¾"

WO#7 I57 over I80\Sheet Files\2026 NB\01


FIB N

USER NAME =	DESIGNED	-	JMI	REVISED -
	CHECKED	-	MI, RTB	REVISED -
PLOT SCALE =	DRAWN	-	JMI	REVISED -
PLOT DATE =	DATE	-	10/15/2021	REVISED -

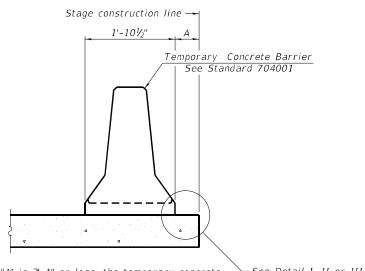

∽ See Detail I, II or III When "A" is 3'-1" or less, the temporary concrete barrier shall be restrained to the new slab according to Detail I, II or III. No restraint is required when "A" is greater than 3'-1".

NEW SLAB OR NEW DECK BEAM

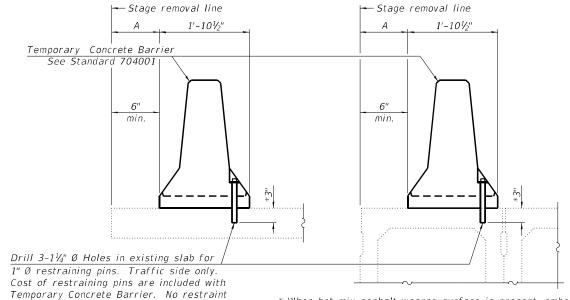


st When hot-mix asphalt wearng surface is present, embedment shall be 3" plus the wearing surface depth.


EXISTING DECK BEAM

SECTIONS THRU SLAB OR DECK BEAM

is required when "A" is greater than 3'-1".


EXISTING SLAB

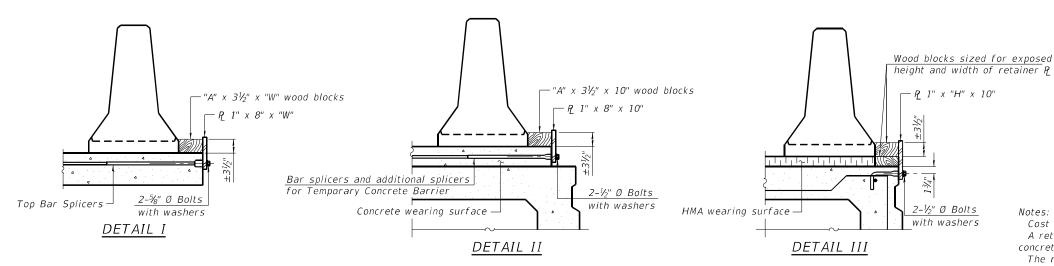

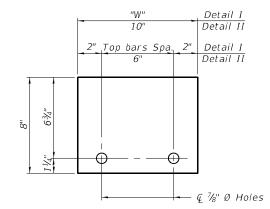


STEEL RETAINER P 1" x 8" x "W"

(Detail I and II)

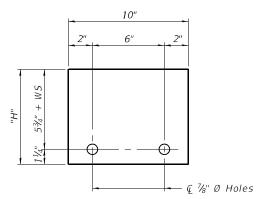

(Detail III)

STEEL RETAINER P 1" x "H" x 10"

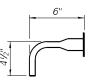

RESTRAINING PIN

BAR SPLICER FOR #4 BAR - DETAIL III

Cost of retainer assembly is included with Temporary Concrete Barrier. A retainer assembly shall be located at the approximate Q of each temporary concrete barrier.

1x8 UNC

US Std. 11/16" I.D. x 21/2" O.D. x approx. 8 guage thick washer

The retainer plate shall not be removed until the concrete on the adjacent stage is ready to be poured. For Detail III applications the retainer plate shall not be removed until just prior to placing the adjacent beam.

When the 'A' dimension is less than $1\frac{1}{2}$ ", the wood block shall be omitted and the barrier shall be placed in direct contact with the steel retainer plate. For deck beam applications the minimum required 'A' distance is 6" to accommodate the shear key clamping device.

- Detail I Installation for a new bridge deck or bridge slab.
- Detail II Installation for a new deck beam with an initial concrete wearing surface. Additional bar splicers shall be provided at 6'-0" centers and paired with the bar splicers of the concrete wearing surface reinforcement to accommodate the installation of the retainer assemblies. The cost of the additional bar splicers is included with the concrete wearing surface.
- Detail III Installation for a new deck beam with no initial wearing surface or with an initial hot-mix asphalt (HMA) wearing surface present. The deck beam directly beneath the temporary concrete barrier shall be fabricated with bar splicer inserts in the side of the beam, as detailed, to accommodate the installation of the retainer assemblies. A pair of bar splicers, 6" apart, shall be placed at 6'-0" centers along the length of the beam. The cost of the bar splicers is included with the deck beam.


190 92


2-17-2017


USER NAME =	DESIGNED	-	JMI	REVISED -
	CHECKED	-	LAB	REVISED -
PLOT SCALE =	DRAWN	-	JMI	REVISED -
PLOT DATE =	DATE	-	10/15/2021	REVISED -

STATE OF ILLINOIS DEPARTMENT OF TRANSPORTATION


TEMPORARY CONCRETE BARRIER FOR STAGE CONSTRUCTION	F.A.I. RTE	SEC	TION		COUNT
STRUCTURE NO. 016-2026	57	2020-1	71-BR		соок
3111001011E 110: 010-2020					CON
CHEET C1 05 OF C1 24 CHEETC			II I BLOSE	EED M	D DDO IECT

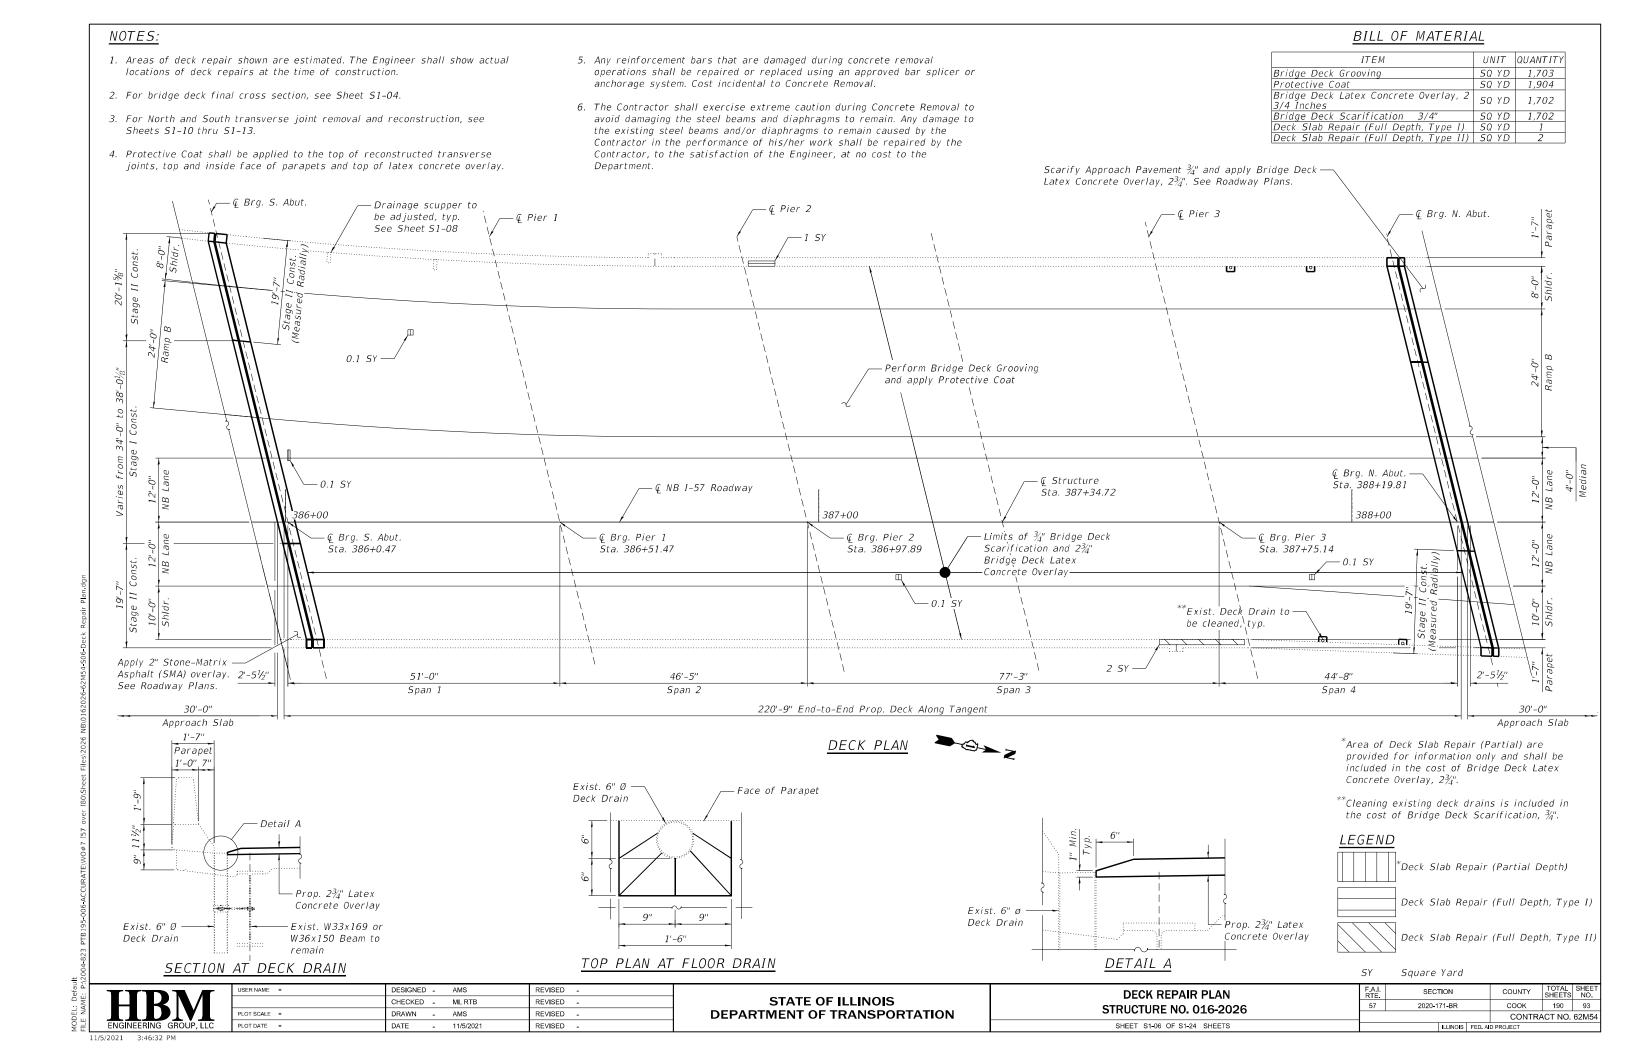

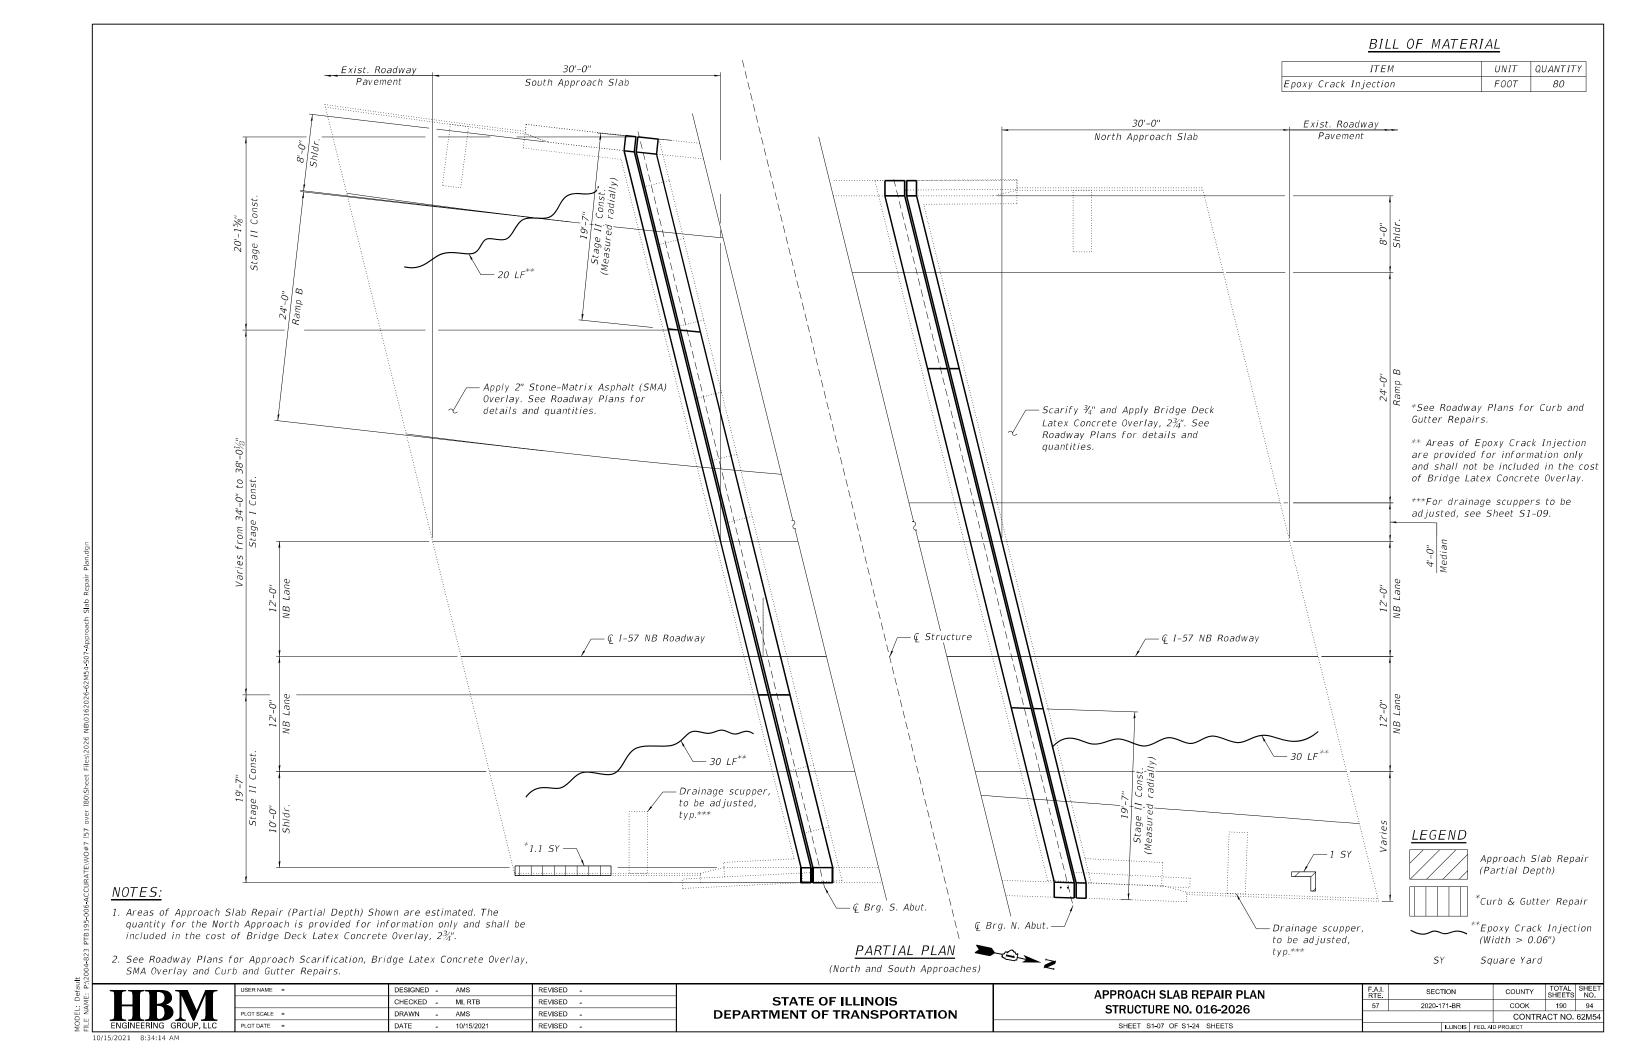

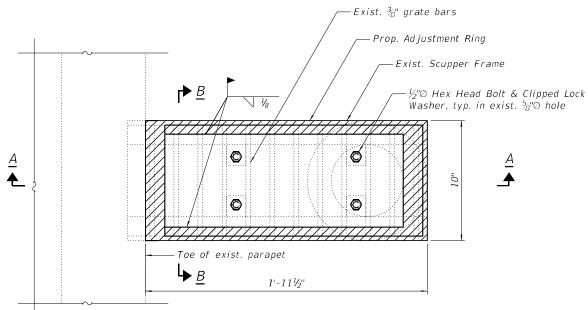


TYPICAL SCUPPER PLAN

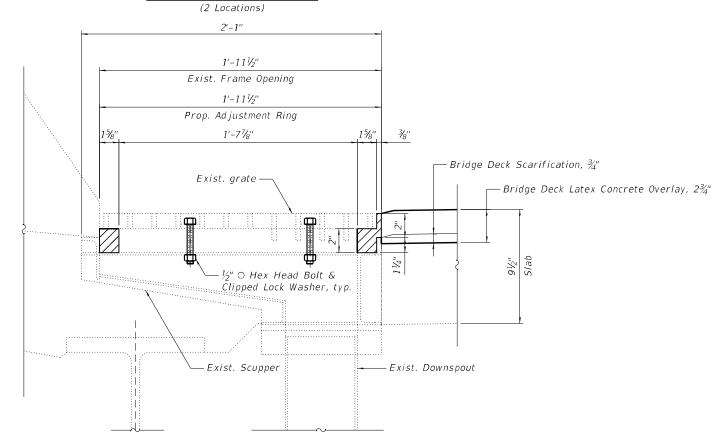

SECTION A-A

NOTES

- 1. The Contractor shall field verify Existing Dimensions and Details of the Existing Scuppers and make necessary adjustments prior to construction of New Adjusting Ring or ordering of material for Adjusting Drainage
- 2. All Cast Iron Parts shall be Grey Iron conforming to the requirements of AASHTO M 105, Class 35B.
- 3. Cast Iron Parts shall be unfinished.
- 4. The Contractor shall take appropriate measures to ensure that Protective Coat is not applied to the scuppers.
- 5. Adjusting Ring shall be from Neenah or approved equal. Structural steel weldments or equal section and of the same configuration may be submitted in place of Cast Iron. Fillet or full penetration welds may be used for weldments. Details shall be submitted to the Engineer for approval.
- 6. Bolts, Anchor Studs, Washers and Nuts shall conform to the requirements of ASTM A 307 and shall be Galvanized according to the requirements of AASHTO M 232.
- 7. Provide a $\frac{1}{8}$ " Fillet Weld around perimeter of new Adjusting Ring to secure to existing Scupper.
- 8. Cost of all labor and materials necessary to clean all existing floor drains and scuppers, install adjusting scupper rings, remove and reinstall grates is included in the cost for Drainage Scupper to be Adjusted.

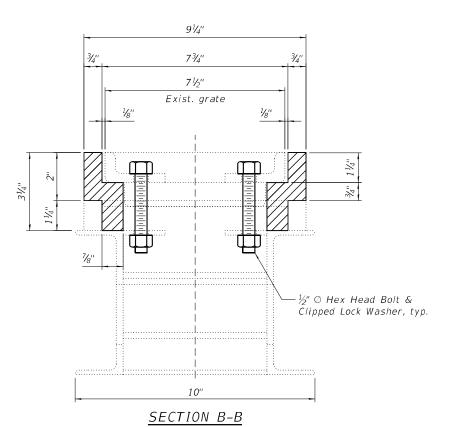


BILL OF MATERIAL

ITEM	UNIT	QUANTITY
Drainage Scuppers To Be Adjusted	EACH	2




USER NAME =	DESIGNED	-	AMS	REVISED	-
	CHECKED	-	MI, RTB	REVISED	-
PLOT SCALE =	DRAWN	-	AMS	REVISED	-
PLOT DATE =	DATE	-	10/15/2021	REVISED	-


A.I. TE.	I. SECTION			COUNTY	TOTAL SHEETS	SHEET NO.
57	2020-171-BR			соок	190	95
			CONTRACT NO. 62M54			
ILLINOIS FED. AID PROJECT						

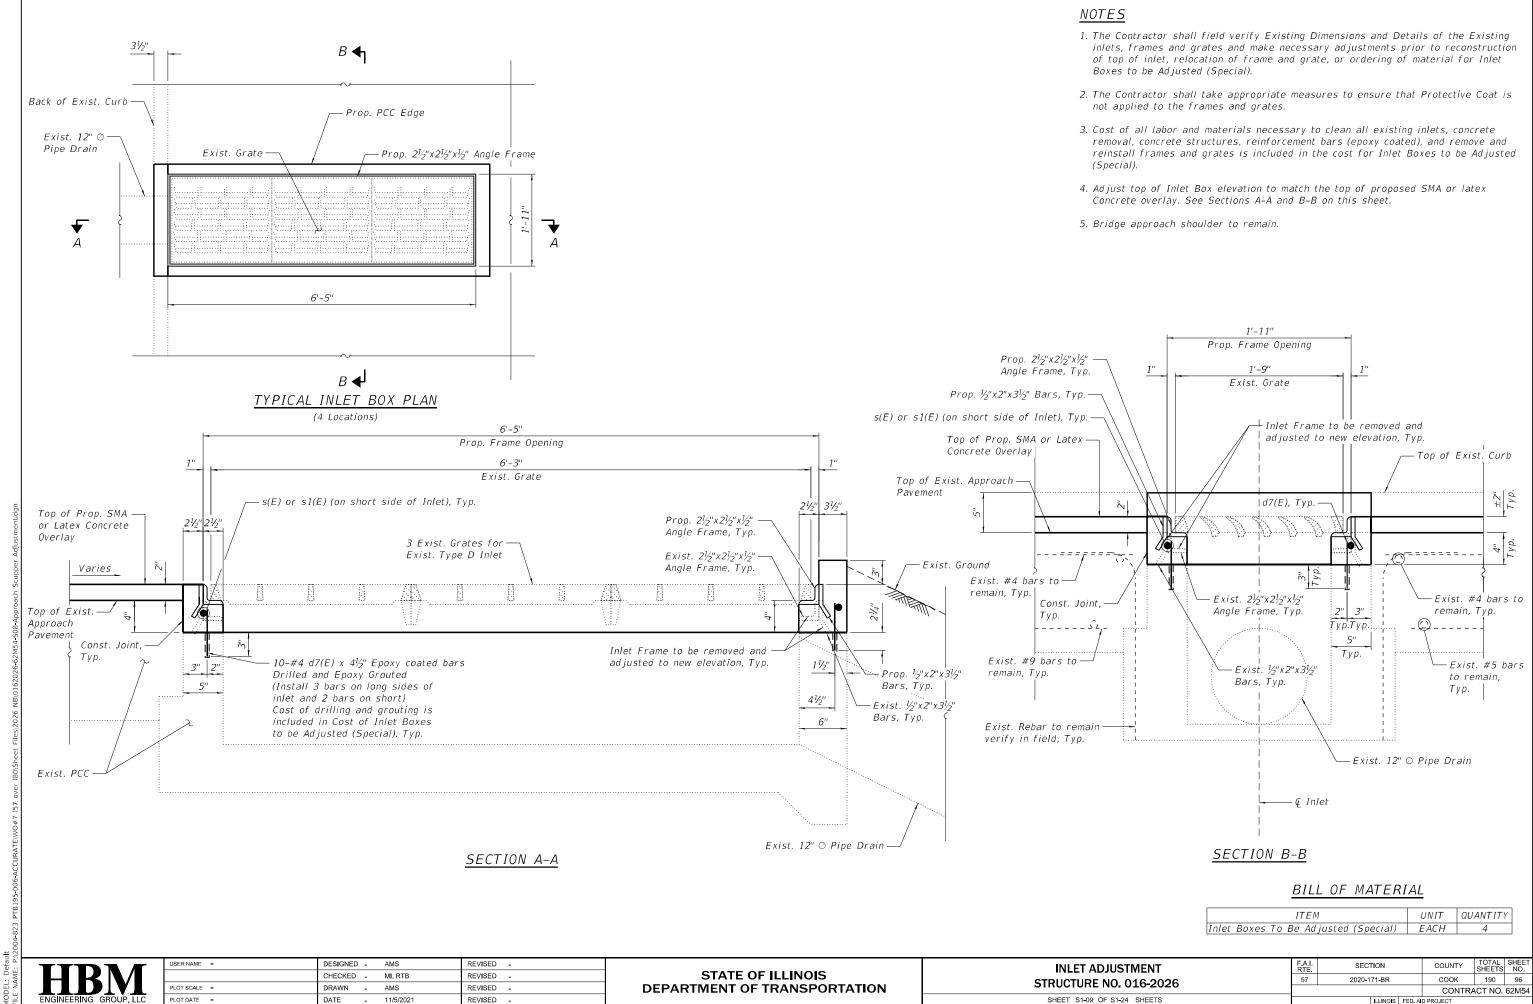



11/5/2021 3:46:41 PM

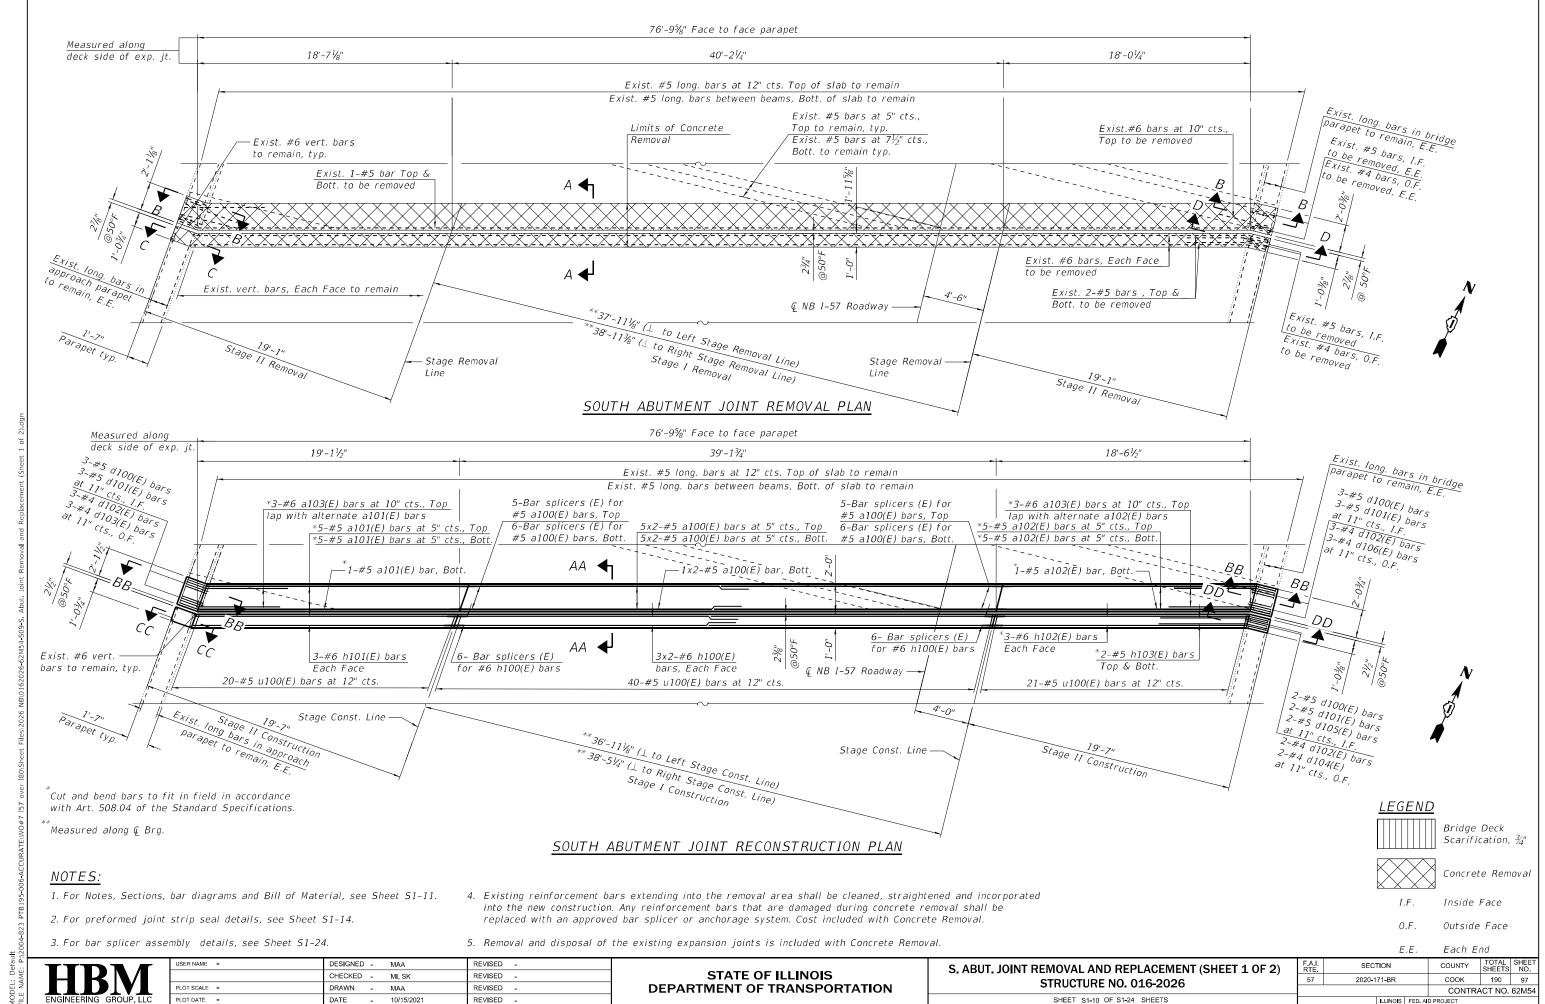

10/15/2021 8:34:20 AM

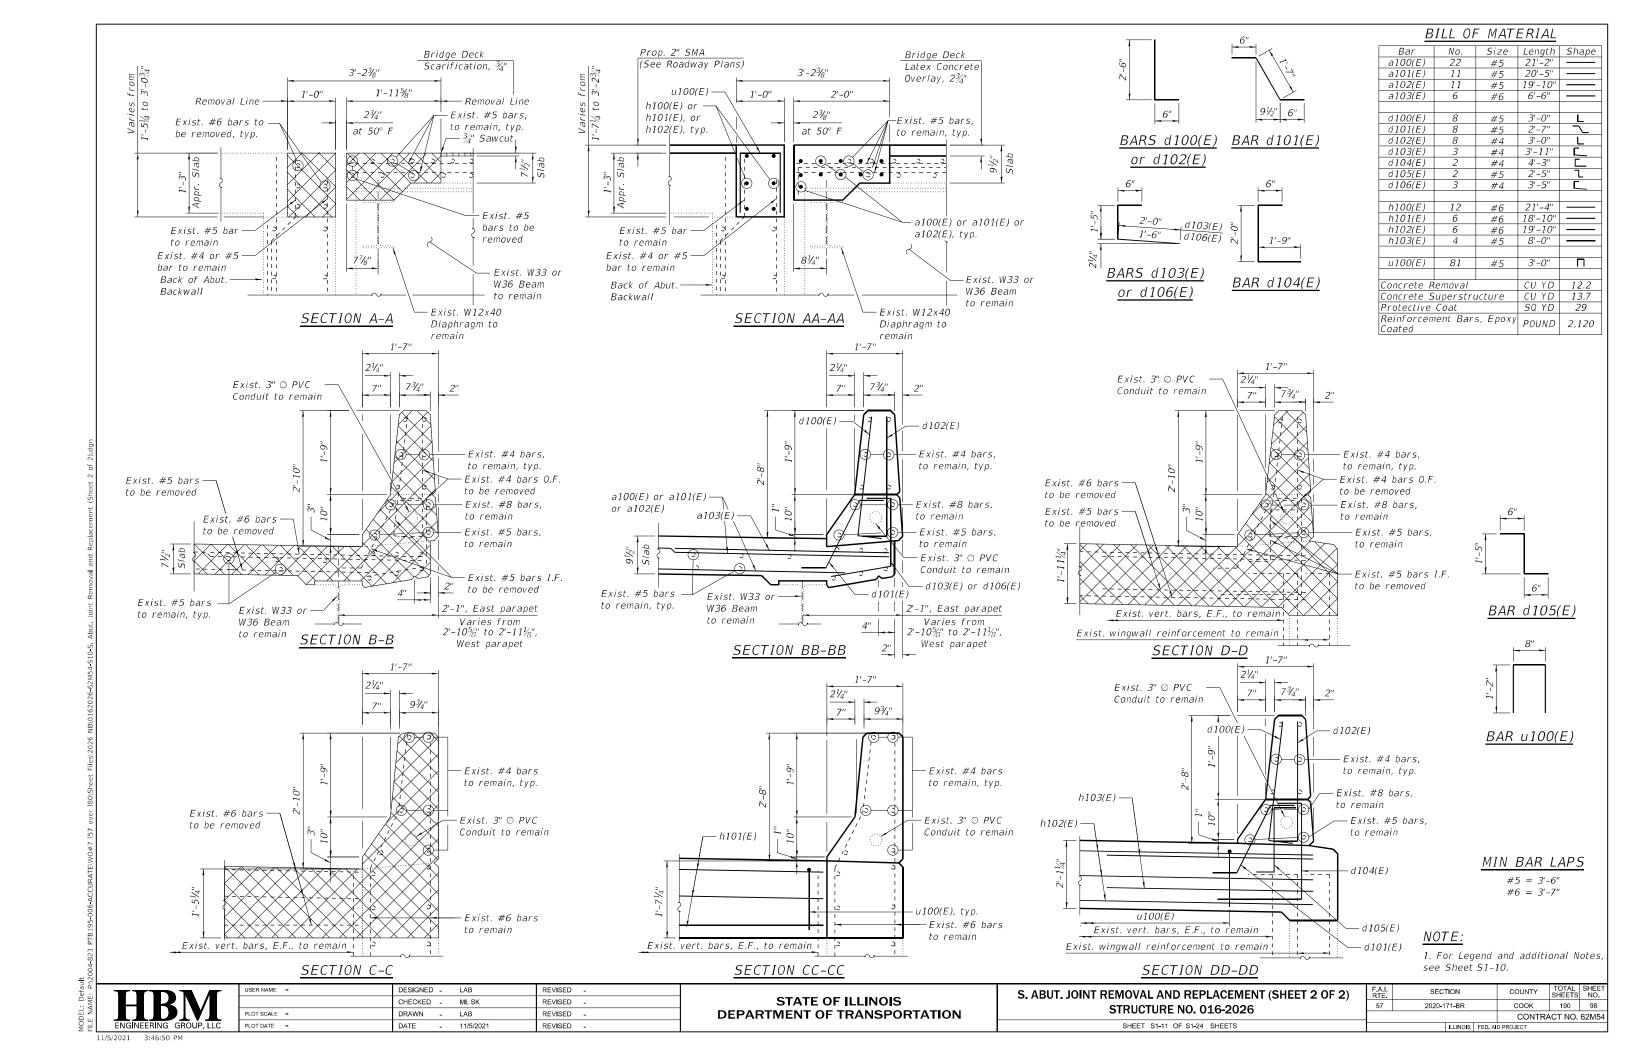

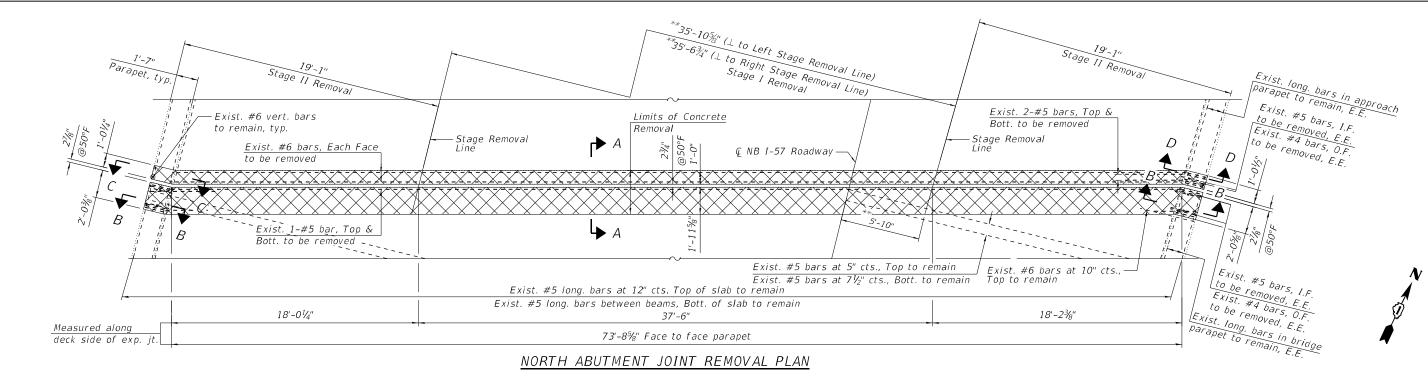

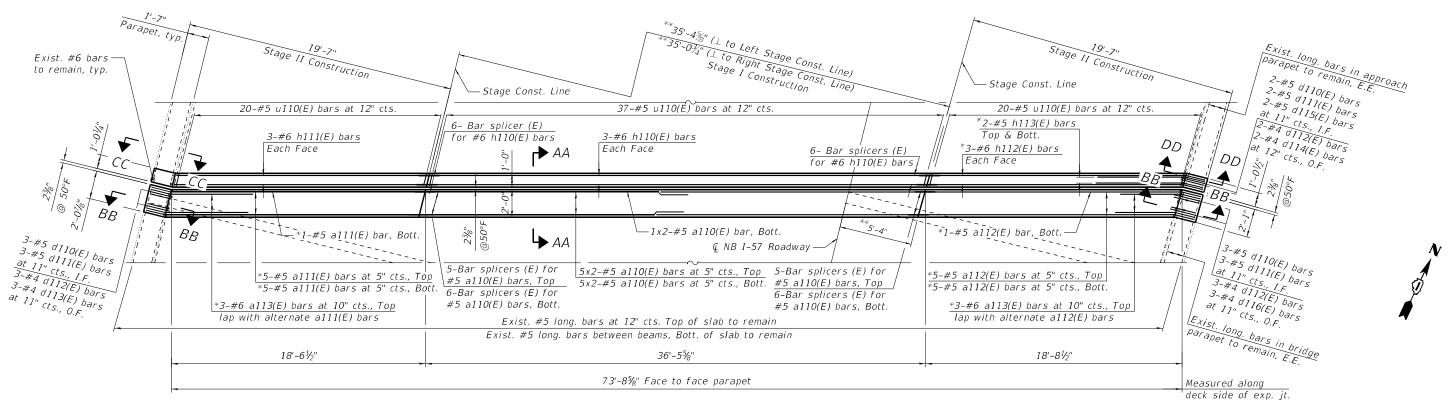

NOTES:

NORTH ABUTMENT JOINT RECONSTRUCTION PLAN

- 1. For Notes, Sections, bar diagrams and Bill of Material, see Sheet S1-13.
- 2. For preformed joint strip seal details, see Sheet S1-14.
- 3. For bar splicer assembly details, see Sheet S1-24.
- 4. Existing reinforcement bars extending into the removal area shall be cleaned, straightened and incorporated into the new construction. Any reinforcement bars that are damaged during concrete removal shall be replaced with an approved bar splicer or anchorage system. Cost included with Concrete Removal.
- 5. Removal and disposal of the existing expansion joints is included with Concrete Removal.

* Cut a	and ben	d bars	to fit in	field	in accordance
with	Art. 50	8.04 of	the Sta	ndard .	Specifications

^{**} Measured along & Brg.

0.F.

LEGEND

Inside Face

Bridge Deck Scarification, 3/4"

Concrete Removal


Outside Face

E.E. Each End

USER NAME =	DESIGNED	-	MAA	REVISED -
	CHECKED	-	MI, SK	REVISED -
PLOT SCALE =	DRAWN	-	MAA	REVISED -
PLOT DATE =	DATE	-	10/15/2021	REVISED -

STATE OF ILLINOIS DEPARTMENT OF TRANSPORTATION N. ABUT. JOINT REMOVAL AND REPLACEMENT (SHEET 1 OF 2) **STRUCTURE NO. 016-2026** SHEET S1-12 OF S1-24 SHEETS

SECTION COUNTY 2020-171-BR COOK 190 99 CONTRACT NO. 62M54

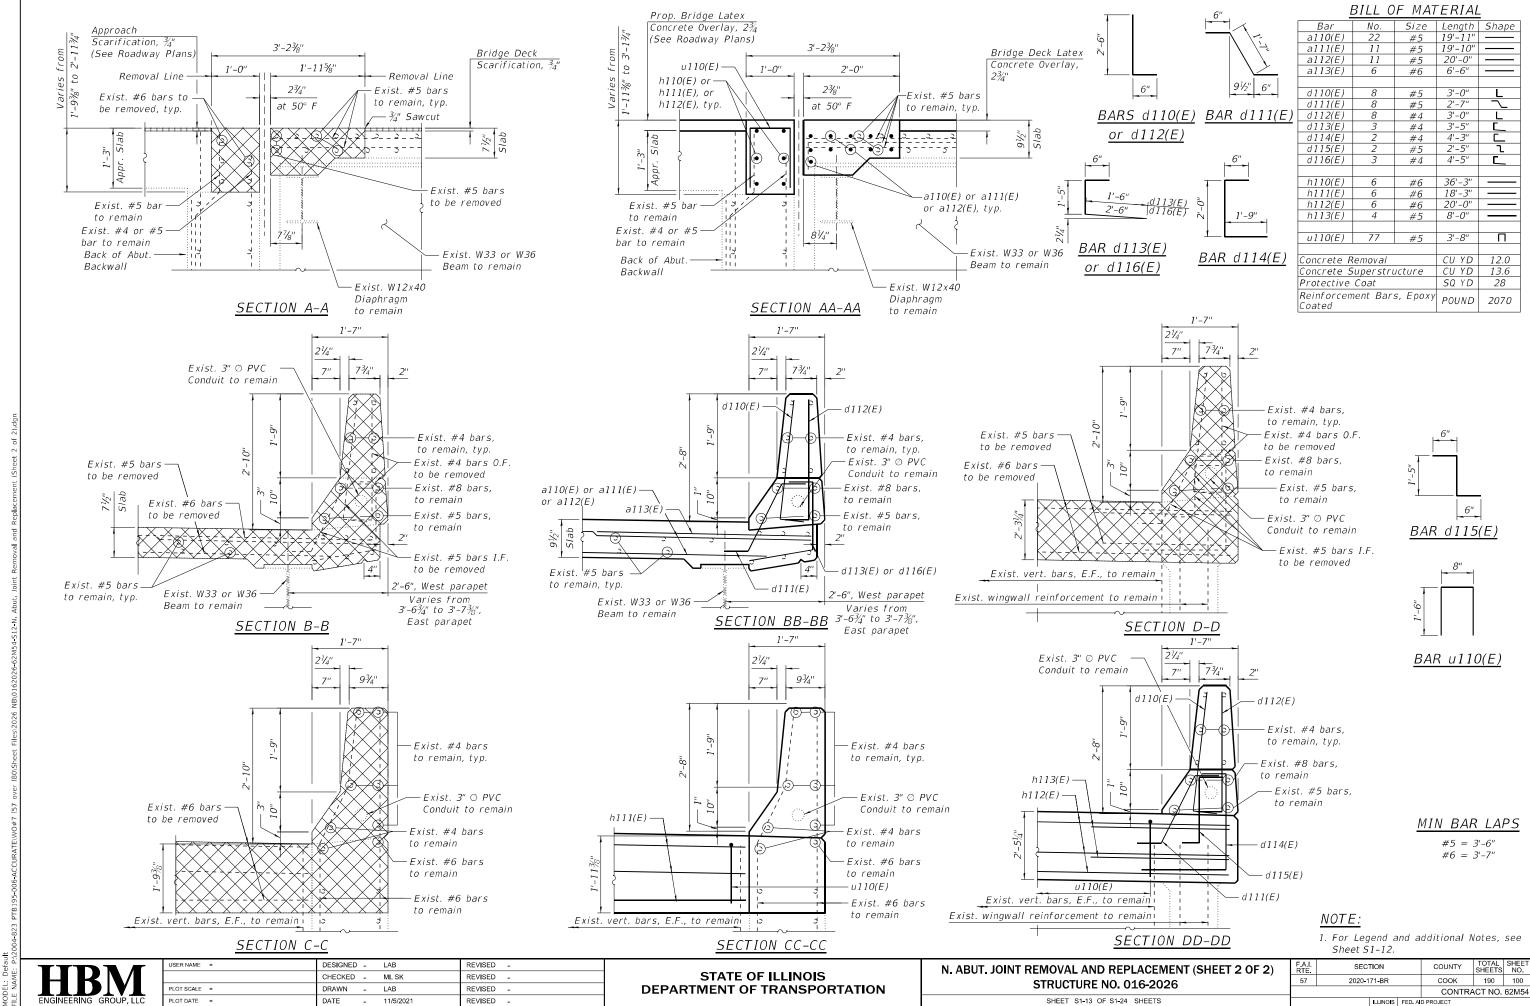

11/5/2021 3:46:59 PM