
F.A.U. ROUTE 2626 (ARLINGTON HEIGHTS ROAD)
N/B BRIDGE OVER BUFFALO CREEK
SECTION 05-00193-04-BR
PROJECT BRM-8003(792)
BRIDGE DECK REPLACEMENT
LAKE COUNTY

C-91-180-07

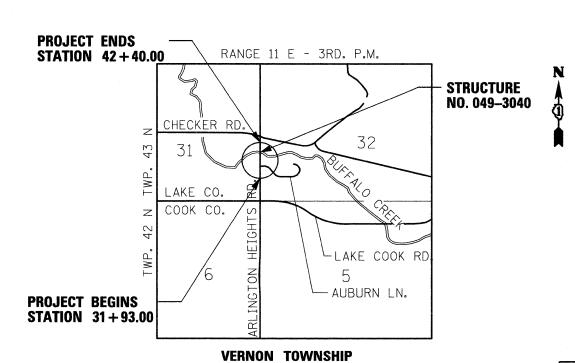

Michael R. Hurtubles

Michael R. Hurtubles

Michael R. Jury 20/2011

MRAWING MOJ. ALL EXCEPT 12 - 26

MARCOCK MC DONCUGH FLATON MASON LOGAN DE WITT CHAMPAION VERMILLON MACOUNT MACO

SECTION

2626

05-00193-04-BR

FED. ROAD DIST. NO. 1 ILLINOIS CONTRACT NO.

LAKE

STATE OF ILLINOIS DEPARTMENT OF TRANSPORTATION DIVISION OF HIGHWAYS

APPROVED October 21 20 10

Man Sullan

LAKE COUNTY DIVISION OF TRANSPORTATION, COUNTY ENGINEER

PASSED November 4 2010

RELEASING FOR BID BASED ON LIMITED REVIEW DISTRICT 1 ENGINEER OF LOCAL ROADS & STREETS


DEPUTY DIRECTOR OF HIGHWAYS, REGION 1 ENGINE

PRINTED BY THE AUTHORITY OF THE STATE OF ILLINOIS

FOR INDEX OF SHEETS, SEE SHEET NO. 2
FOR LIST OF STANDARDS, SEE SHEET NO. 2

**DESIGN DESIGNATION: MINOR ARTERIAL** 

TRAFFIC DATA 2006 ADT: 32,050 POSTED SPEED LIMIT: 45 MPH

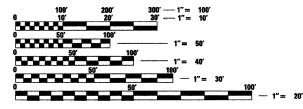

FULL SIZE PLANS HAVE BEEN PREPARED USING STANDARD ENGINEERING SCALES. REDUCED SIZED PLANS WILL NOT CONFORM TO STANDARD SCALES. IN MAKING MEASUREMENTS ON REDUCED PLANS, THE ABOVE SCALES MAY BE USED.

J.U.L.I.E.
JOINT UTILITY LOCATION INFORMATION FOR EXCAVATION
1-800-892-0123
OR 811

**CONTRACT NO. 63531** 

TOWNSHIP: VERNON
MUNICIPALITY: BUFFALO GROVE



NET AND GROSS LENGTH = 1,047 FT. = 0.20 MILE

AND OFFICE ENGINEER: CHARLES F. RIDDLE, P.E. 847–705–4406 SCHAUMBUF

 $\circ$ 

OF HEALT STATE TOTAL STATE STATES

#### INDEX OF SHEETS LIST OF STANDARDS 1 TITLE SHEET NUMBER STATE STANDARD INDEX OF SHEETS, IDOT STANDARDS AND GENERAL NOTES 000001-06 STANDARD SYMBOLS, ABBREVIATIONS AND PATTERNS 3 - 4 SUMMARY OF QUANTITIES 001001-02 AREAS OF REINFORCEMENT BARS 5 TYPICAL SECTIONS 001006 DECIMAL OF AN INCH AND OF A FOOT ALIGNMENT, CONTROL POINTS AND BENCHMARKS 280001-05 TEMPORARY EROSION CONTROL SYSTEMS EXISTING AND REMOVAL PLAN 420401-08 BRIDGE APPROACH PAVEMENT CONNECTOR ROADWAY PLAN & PROFILE 515001-03 NAME PLATES FOR BRIDGES MAINTENANCE OF TRAFFIC TYPICALS 606001-04 CONCRETE CURB TYPE B AND COMBINATION CURB AND GUTTER 10 - 11 MAINTENANCE OF TRAFFIC 630001-09 STEEL PLATE BEAM GUARDRAIL GENERAL PLAN & FLEVATION 12 631011-07 TRAFFIC BARRIER TERMINAL, TYPE 2 GENERAL NOTES, INDEX & QUANTITIES 631026-05 TRAFFIC BARRIER TERMINAL, TYPE 5 TYPICAL CROSS SECTION & STAGING 631031-09 TRAFFIC BARRIER TERMINAL, TYPE 6 17" x 36" PCC DECK BEAM 635001-01 DELINEATORS 17" x 36" PCC BEAM DETAILS 635006-03 REFLECTOR AND TERMINAL MARKER PLACEMENT PARAPET DETAILS 635011-02 REFLECTOR MARKER AND MOUNTING DETAILS - 19 BIKEWAY RAILING DETAILS 701101-02 OFF-ROAD OPERATIONS, MULTILANE, 15' (4.5M) TO 24" (600MM) FROM PAVEMENT EDGE TEMPORARY BARRIER DETAILS 701801-04 LANE CLOSURE, MULTILANE 1W OR 2W, CROSSWALK OR SIDEWALK CLOSURE SOUTH ABUTMENT DETAILS 701901-01 TRAFFIC CONTROL DEVICES 22 NORTH ABUTMENT DETAILS 704001-06 TEMPORARY CONCRETE BARRIER 23 ABUTMENT DETAILS 780001-02 TYPICAL PAVEMENT MARKINGS

781001-03

#### DISTRICT 1 STANDARDS

BD-32	BUTT JOINTS AND HMA TAPER
TC-11	RAISED REFLECTOR PAVEMENT MARKERS (SNOW PLOW RESISTANT)
TC-22	ARTERIAL ROAD INFORMATION SIGN

TYPICAL APPLICATIONS RAISED REFLECTIVE PAVEMENT MARKERS

NOTE: "THE ILLINOIS DEPOARTMENT OF TRANSPORTATION IS NOT THE OWNER OF RECORD FOR THIS BRIDGE, THOSE SEEKING HISTORIC, AS-BUILT OR OTHER EXISTING DOCUMENTS AND OWNER OF RECORD PLANS MUST CONTACT THE TO MAKE ARRANGEMENTS FOR ACCESS TO THIS INFORMATION."

24 - 26 APPROACH SLAB DETAILS

27 - 36 DETAILS

TLE NAME =	USER NAME = 3202080907	DESIGNED	-	TC	REVISED		
.C0907-sht-gennote.dgn		DRAWN	-	PWL	REVISED	-	
	PLOT SCALE = 2.0000 '/ IN.	CHECKED	-	MRH	REVISED	-	
	PLOT DATE = 11/2/2010	DATE	-	11/2/2010	REVISED	_	

#### STATE OF ILLINOIS **DEPARTMENT OF TRANSPORTATION**

#### GENERAL NOTES

- 1. ALL CONSTRUCTION SHALL BE IN CONFORMANCE WITH THE APPLICABLE REQUIREMENT SET FORTH IN "THE CONSTRUCTION SPECIFICATIONS FOR ROAD AND BRIDGE CONSTRUCTION" ADOPTED JANUARY 1, 2007 THEREINAFTER REFERRED TO AS STANDARD SPECIFICATIONS. THE LATEST EDITION OF THE "ILLINOIS MANUAL ON UNIFORM MANUAL TRAFFIC CONTROL DEVICES FOR STREETS & HIGHWAYS" IN EFFECT ON THE DATE OF INVITATION FOR BIDS: THE "SUPPLEMENTAL SPECIFICATIONS & RECURRING SPECIAL PROVISIONS" ADOPTED JANUARY 1, 2011; SPECIAL PROVISIONS AS INCLUDED IN THE CONTRACT DOCUMENTS; AND THE DETAILS AND STANDARDS CONTAIN IN THESE PLANS.
- 2. BEFORE STARTING ANY EXCAVATIONS, THE CONTRACTOR SHALL CALL "JULIE" AT 1-800-892-0123 FOR FIELD LOCATIONS OF BURIED ELECTRIC, TELEPHONE & GAS FACILITIES. (48 HOUR NOTIFICATION IS REQUIRED)
- 3. THE LOCATIONS OF THE EXISTING UTILITIES, AS SHOWN ON THE DRAWINGS, REPRESENT DATA RECEIVED FROM VARIOUS SOURCES; IT IS NOT GUARANTEED TO BE CORRECT OR ALL INCLUSIVE. THE CONTRACTOR SHALL CONDUCT HIS OWN INVESTIGATIONS INTO THE LOCATION, SIZE, DEPTH, AND NATURE OF ANY AND ALL EXISTING UTILITIES WHICH MAY INTERFERE WITH THE WORK UNDER THIS CONTRACT. ANY EXISTING UTILITIES WHICH ARE TO REMAIN IN SERVICE SHALL BE FULLY PROTECTED BY THE CONTRACTOR AND ANY DAMAGE CAUSED BY THE CONSTRUCTION SHALL BE IMMEDIATELY REPAIRED AT NO ADDITIONAL COST TO THE COUNTY.
- 4. THE CONTRACTOR SHALL COORDINATE CONSTRUCTION ACTIVITIES WITH UTILITY COMPANIES, LAKE COUNTY DIVISION OF TRANSPORTATION, AND THE VILLAGE OF BUFFALO GROVE.
- 5. ALL WORK SHALL BE COMPLETED WITHIN THE LIMITS OF THE PROJECT SHOWN. NO EQUIPMENT, MATERIALS OR A YARD OR FIELD OFFICE SHALL BE SET UP OR STORED ON COUNTY OR PRIVATE PROPERTY WITHOUT WRITTEN PERMISSION OF THE COUNTY OR THE PROPERTY OWNER.
- 6. BARRICADES: THE CONTRACTOR SHALL PROVIDE AND INSTALL TWO (2) WEIGHTED SANDBAGS ON EACH TYPE II BARRICADE USED - ONE (1) WEIGHTED SANDBAG ACROSS EACH BOTTOM RAIL.
- 7. ALL EXCAVATION AND EMBANKMENT LOCATIONS REQUIRING SEEDING OR SODDING SHALL BE CONSTRUCTED TO 6 IN BELOW FINISHED GRADE LINE TO ALLOW TOPSOIL PLACEMENT.
- 8. PAVEMENT ELEVATIONS: THE ELEVATIONS SHOWN ON THE PLANS ARE FINISHED GRADES FOR THE PAVEMENT OR SURFACE COURSE, UNLESS OTHERWISE INDICATED,
- 9. MAINTENANCE OF TRAFFIC-GENERAL: TRAFFIC CONDITIONS, ACCIDENTS AND OTHER UNFORESEEN EMERGENCY CONDITIONS MAY REQUIRE THE ENGINEER TO RESTRICT. MODIFY OR REMOVE LANE CLOSURES OR CHANNELIZATION SHOWN ON THE PLANS. THE CONTRACTOR SHALL RESPOND WITHIN 30 MINUTES OF THE TIME OF THE NOTIFICATION BY THE ENGINEER FOR THE MAINTENANCE OF TRAFFIC CONTROL DEVICES.
- 10. PROTECTION OF AND RESTORATION OF TRAFFIC SIGNS: PRIOR TO THE BEGINNING OF CONSTRUCTION OPERATIONS, THE CONTRACTOR WILL PROVIDE A SIGN LOG OF ALL EXISTING SIGNS WITHIN THE LIMITS OF THE CONSTRUCTION ZONE. THE CONTRACTOR IS RESPONSIBLE FOR VERIFYING THE ACCURACY OF THE SIGN LOG THROUGHOUT THE DURATION OF THIS PROJECT. THIS WORK IS CONSIDERED INCLUDED IN THE COST OF THE CONTRACT, ALL EXISTING TRAFFIC SIGNS SHALL MAINTAIN, FURNISH, AND REPLACE AT HIS EXPENSE, ANY TRAFFIC SIGN OR POST WHICH HAS BEEN DAMAGED OR LOST BY THE CONTRACTOR.
- 11. TRAFFIC CONTROL DEVICES: ALL TRAFFIC CONTROL DEVICES USED FOR THE MAINTENANCE OF TRAFFIC AS DETAILED ON THE PLANS SHALL BE REFLECTORIZED PRIOR TO INSTALLATION AND CLEANED AS NECESSARY THROUGHOUT THE DURATION
- 12. DURING CONSTRUCTION OPERATIONS ANY CONSTRUCTION DEBRIS DEPOSITED IN THE FLOW LINE DRAINAGE STRUCTURE SHALL BE REMOVED AT THE CLOSE OF EACH WORKING DAY AT THE CONCLUSION OF THE CONSTRUCTION OPERATIONS. ALL DRAINAGE STRUCTURES SHALL BE CLEANED AS NECESSARY TO INSURE THAT THEY ARE FREE FROM ALL DIRT AND CONSTRUCTION DEBRIS PRIOR TO THE FINAL INSPECTION OF THE PROJECT. THIS WORK WILL NOT BE PAID FOR SEPARATELY BUT SHALL BE CONSIDERED INCLUDED IN THE COST OF EARTH EXCAVATION.
- 13. OFFSETS TO DRAINAGE STRUCTURES ARE MEASURED TO THE FLOWLINE OF THE GUTTER.
- 14. IF THE CONTRACTOR CHOOSES TO DISPOSE OF UNCONTAMINATED SOIL OR UNCONTAMINATED SOIL MIXED WITH CLEAN CONSTRUCTION AND DEMOLITION DEBRIS (CCDD) AT A CCDD FILL OPERATION, IT SHALL BE THE CONTRACTOR'S RESPONSIBILITY TO PERFORM ALL NECESSARY FIELD AND LABORATORY ANALYSIS AND TO OBTAIN THE LICENSED PROFESSIONAL ENGINEER'S CERTIFICATION REQUIRED AS PER PUBLIC ACT 96-1416 TO USE THE SITE, NO ADDITIONAL COMPENSATION WILL BE PROVIDED.

JOINT UTILITY LOCATION FOR EXCAVATORS (800) 892-0123 OR 811 ILLINOIS DEPARTMENT OF TRANSPORTATION GEORGE GUDERLEY AREA PERMIT COORDINATOR 201 WEST CENTER COURT SCHAUMBURG, IL 60196 (847) 705-4131

JON NELSON (847) 377-7400

NICOR GAS 90 N. FINLEY ROAD GLEN ELLYN, IL 60137 TIM HENEGHAN

15. UTILITIES CONTACTS:

J.U.L.I.E.

SCALE: NTS

LAKE COUNTY DEPT OF PUBLIC WORKS 650 W. WINCHESTER ROAD LIBERTYVILLE, IL 60048 GORDON WHITE (847) 377-7135

LAKE COUNTY DIVISION OF TRANSPORTATION VILLAGE OF BUFFALO GROVE ENGINEER OF TRAFFIC

COMMONWEALTH EDISON ELECTRIC COMPANY 1500 FRANKLIN BLVD. LIBERTYVILLE, IL 60048 TIMOTHY TAMASON (847)816-5521

51 RAUPP BOULEVARD BUFFALO GROVE, IL 60089 (847)459-2545

688 INDUSTRIAL DRIVE

ELMHURST, IL 60126 MR. ROBERT SCHULTER, JR.

(630) 600-6347

COMCAST

255 E CHICAGO STREET ELGIN, IL 60120 DON VIRMOND (847)888-6621

SECTION COUNTY. SHEETS NO. INDEX OF SHEETS, IDOT STANDARDS, 05-00193-04-BR LAKE AND GENERAL NOTES CONTRACT NO. 63531 SHEET NO. 1 OF 1 SHEETS STA. N/A TO STA. N/A


					QUANTITIES	T	1		SUMMARY OF QUANTITIES  CONSTRUCTION								
SPECIALITY ITEMS	PROVISIONS	CODE NO.	TREE REMOVAL (C. TO 15	PAY ITEM		UNIT	TOTAL	CONSTRUCTION TYPE CODE 0014		11/041310143	CODE NO.	PAY ITEM	UNIT	TOTAL QUANTITY			
		20100110	TREE REMOVAL (6 TO 15	UNITS DIAMETER)		UNIT	55	55	S		50901750	PARAPET RAILING	FOOT	102	102		
	*	20200100	EARTH EXCAVATION			CU YD	117	117	And the second s	5	59000200	EPOXY CRACK INJECTION	FOOT	50	50		
	•	20201200	REMOVAL AND DISPOSAL	OF UNSUITABLE MATERIA	L	CU YD	138	138		(	60300105	FRAMES AND GRATES TO BE ADJUSTED	EACH	1	1		
		20400800	FURNISHED EXCAVATION			CU YD	36	36		6	60603800	COMBINATION CONCRETE CURB AND GUTTER, TYPE B-6.12	FOOT	334	334		
		21101615	TOPSOIL FURNISH AND PL	_ACE, 4"		SQ YD	802	802		6	60605000	COMBINATION CONCRETE CURB AND GUTTER, TYPE B-6.24	FOOT	170	170		
		25000210	SEEDING, CLASS 2A			ACRE	0.17	0.17	5	(	63100045	TRAFFIC BARRIER TERMINAL, TYPE 2	EACH	1	1		
		25000400	NITROGEN FERTILIZER NU	ITRIENT		POUND	15	15	5	6	63100070	TRAFFIC BARRIER TERMINAL, TYPE 5	EACH	1	1		
		25000600	POTASSIUM FERTILIZER N	UTRIENT		POUND	15	15	5	6	63100085	TRAFFIC BARRIER TERMINAL, TYPE 6	EACH	1	1		
		28000500	INLET AND PIPE PROTECT	TION		EACH	2	2	S	* 6	63100167	TRAFFIC BARRIER TERMINAL, TYPE 1 (SPECIAL) TANGENT	EACH	1	1		
		31101200	SUBBASE GRANULAR MATE	RIAL, TYPE B 4"		SQ YD	239	239		6	63200310	GUARDRAIL REMOVAL	FOOT	238	238		
		35101600	AGGREGATE BASE COURSE	, TYPE B 4"		SQ YD	242	242		6	67100100	MOBILIZATION	L SUM	1	1		
		40300100	BITUMINOUS MATERIALS (	PRIME COAT)		GALLON	39	39		• X7	7010216	TRAFFIC CONTROL AND PROTECTION, (SPECIAL)	L SUM	1	1		
		40600985	PORTLAND CEMENT CONCE	RETE SURFACE REMOVAL -	BUTT JOINT	- SQ YD	24	24		1	70300320	PAVEMENT MARKING TAPE, TYPE I 4"	FOOT	1,336	1,336		
		40603595	POLYMERIZED HOT-MIX AS	SPHALT SURFACE COURSE,	MIX "F", N90	TON	92	92		1	70300330	PAVEMENT MARKING TAPE, TYPE I 5"	FOOT	989	989		
		42400200	PORTLAND CEMENT CONCE	RETE SIDEWALK 5 INCH		SQ FT	1,998	1,998		1	70400100	TEMPORARY CONCRETE BARRIER	FOOT	504	504		
		44000100	PAVEMENT REMOVAL			SQ YD	296	296		-	72400710	RELOCATE SIGN PANEL - TYPE 1	SQ FT	6	6		
		44000500	COMBINATION CURB AND	GUTTER REMOVAL		FOOT	564	564	S	1	78000200	THERMOPLASTIC PAVEMENT MARKING - LINE 4"	FOOT	225	225		
		44000600	SIDEWALK REMOVAL	· · · · · · · · · · · · · · · · · · ·		SQ FT	2,091	2,091	S	1	78000300	THERMOPLASTIC PAVEMENT MARKING - LINE 5"	FOOT	180	180		
		50101500	REMOVAL OF EXISTING SI	UPERSTRUCTURES		EACH	1	1	5		78008210	POLYUREA PAVEMENT MARKING TYPE I - LINE 4"	FOOT	930	. 930		
		50102400	CONCRETE REMOVAL			CU YD	9.7	9.7	5		78008220	POLYUREA PAVEMENT MARKING TYPE I - LINE 5"	FOOT	777	777		
		50300225	CONCRETE STRUCTURES			CU YD	19.5	19.5	S	1	78100100	RAISED REFLECTIVE PAVEMENT MARKER	EACH	20	20		
		50300255	CONCRETE SUPERSTRUCTL	JRE		CU YD	102.1	102.1	S	. • 7	78200450	MONODIRECTIONAL GUARD RAIL REFLECTORS	EACH	4	4		
	•	50300300	PROTECTIVE COAT			SQ YD	206	206	5		78201000	TERMINAL MARKER - DIRECT APPLIED	EACH	1	1		
		50400305	PRECAST PRESTRESSED C	ONCRETE DECK BEAMS (17	" DEPTH)	SQ FT	1,853	1,853		1	78300100	PAVEMENT MARKING REMOVAL	SQ FT	63	63		
		50800205	REINFORCEMENT BARS, EF	POXY COATED		POUND	27,140	27,140	S	7	78300200	RAISED REFLECTIVE PAVEMENT MARKER REMOVAL	EACH	20	20		
S		50901720	BICYCLE RAILING			FOOT	59	59		* 7	Z0004552	APPROACH SLAB REMOVAL	SQ YD	130	130		
FILE NAME = LC0907-sht-S00_1.c		USER NAME		ESIGNED - TC RAWN - PWL	REVISED -			STATE OF	HILIMOIS			SUMMARY OF QUANTITIES	F.A.U. SECTION 2626 05-00193-04-		NTY TOTAL SI SHEETS		

					<u> </u>	CONSTRUCT
PECIALITY ITEMS	SPECIAL PROVISIONS	CODE NO.	PAY ITEM	UNIT	TOTAL QUANTITY	CONSTRUCT TYPE COI 0014
		Z0012754	STRUCTURAL REPAIR OF CONCRETE (DEPTH EQUAL TO OR LESS THAN 5 INCHES)	SQ FT	42	4
	*	Z0013798	CONSTRUCTION LAYOUT	L. SUM	1	
	*	Z0023204	SEDIMENT CONTROL, SILT FENCE	FOOT	262	2
	*	Z0030255	IMPACT ATTENUATORS, TEMPORARY (FULLY REDIRECTIVE, NARROW), TEST LEVEL 2	EACH	1	
	*	Z0030850	TEMPORARY INFORMATION SIGNING	SQ FT	26	
		Z0038119	PORTLAND CEMENT CONCRETE SURFACE REMOVAL 1 1/2"	SQ YD	154	
	*	Z0062456	TEMPORARY PAVEMENT	SQ YD	242	2
	*	Z0073500	TEMPORARY SUPPORT SYSTEM	L SUM	1	
	* Δ	Z0076600	TRAINEES	HOUR	500	Ę
	*	X0325806	WATERPROOFING MEMBRANE SYSTEM	SQ FT	1,853	1,4
	*	X4240430	PORTLAND CEMENT CONCRETE SIDEWALK 5 INCH, SPECIAL	SQ FT	169	
	•	X6700405	ENGINEER'S FIELD OFFICE, TYPE A (MODIFIED)	CAL MO	6	
		· .				
		*	· · · · · · · · · · · · · · · · · · ·			
			A = 0043			
			Δ = 0042			
				1		
			:			

 $\Delta$  = CONSTRUCTION TYPE CODE 0042

FILE NAME =	USER NAME = 3202080907	DESIGNED -	-	TC	REVISED	-
LC <b>090</b> 7-sht-S0Q_2.dgn	N. Committee of the com	DRAWN -	-	PWL	REVISED	-
	PLOT SCALE = 100.0000 '/ IN.	CHECKED -	-	MRH	REVISED	**
	PLOT DATE = 11/10/2010	DATE -	-	11/10/2010	REVISED	-

_		7	F.A.U. RTE.	SECTION	COUNTY	TOTAL SHEETS	SHEET NO.	
	SUMMARY OF QUANTITIES				05-00193-04-BR	LAKE	36	4
						CONTRACT	T NO.	63531
	SCALE: NTS	SHEET NO. 2 OF 2 SHEETS   STA. N/A	TO STA. N/A	FED. R	DAD DIST. NO. 1 ILLINOIS FED. A	D PROJECT		

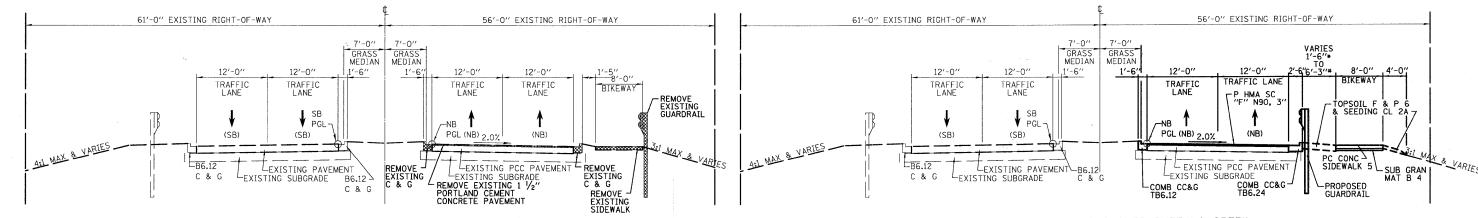


# ARLINGTON HEIGHTS ROAD EXISTING TYPICAL ROADWAY SECTION

STA. 38+93.00 TO STA 39+81.33 STA. 40+82.49 TO STA. 42+40.00

# ARLINGTON HEIGHTS ROAD OVER BUFFALO CREEK PROPOSED TYPICAL ROADWAY SECTION

STA. 31+93.00 TO STA 39+81.33 STA. 40+82.49 TO STA. 42+40.00

\* STA, 31+93.00 TO STA, 38+87.88 \* STA 38+87.88 TO STA, 39+81.33 AND STA, 40+82.49 TO STA, 42+40.00

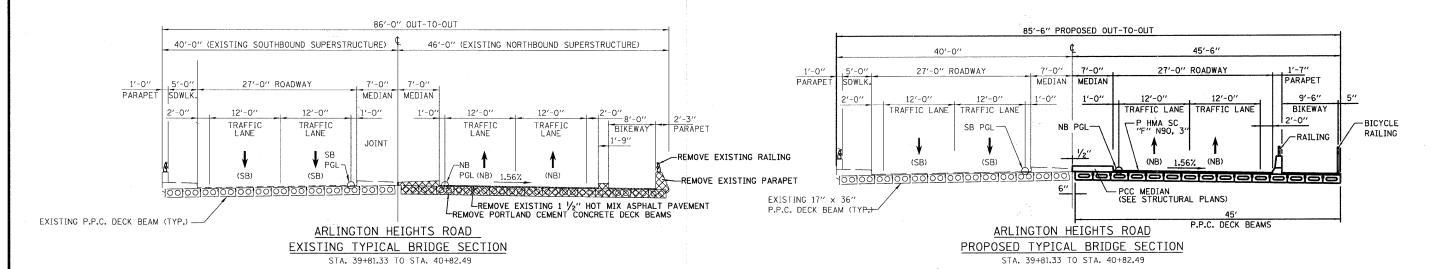

#### STRUCTURAL PAVEMENT DESIGN

SSR = POOR

STRUCTURAL DESIGN TRAFFIC: YEAR 2030
PV = 30,127 SU = 962 MU = 961
ROAD/STREET CLASSIFICATION: CLASS 1
PERCENT OF STRUCTURAL DESIGN TRAFFIC IN DESIGN LANE:
P = 94 S = 3 M = 3
TRAFFIC FACTOR: ACTUAL TF = 5.47 AC TYPE = N/A
MINIMUM TF = N/A
PG GRADE: BINDER = N/A SUBGRADE SUPPORT RATING:


#### HOT-MIX ASPHALT MIXTURE REQUIREMENTS


ITEM	VOIDS
ARLINGTON HEIGHTS ROAD	
POLYMERIZED HOT-MIX ASPHALT SURFACE COURSE, MIX "F", N90 (IL 9.5MM), 3"	4% @ 90 GYR.
TEMPORARY ROAD	
TEMPORARY PAVEMENT (HOT-MIX ASPHALT BINDER COURSE, IL-19 mm), 6"	4% <b>©</b> 50 GYR.
TEMPORARY OVERLAY	
POLYMERIZED HOT-MIX ASPHALT SURFACE COURSE, MIX "F", N90 (IL 9.5MM), 1/2"	4% @ 90 GYR.


NOTE: THE UNIT WEIGHT USED TO CALCULATE ALL HOT-MIX ASPHALT SURFACE MIXTURES IS 112 LBS/SQ YD/IN.


THE "AC TYPE" FOR POLYMERIZED HMA MIXES SHALL BE "SBS/SBR PG 70-22" AND FOR NON-POLYMERIZED HMA, THE "AC TYPE" SHALL BE "PG 64-22" UNLESS MODIFIED BY DISTRICT ONE SPECIAL PROVISIONS. FOR "PERCENT OF RAP", SEE DISTRICT ONE SPECIAL PROVISIONS.


FILE NAME =	USER NAME = 3202080907	DESIGNED - TC	REVISED -		TANDIAN OFFICIAL			F.A.U. RTE.	SECTION	COUNTY	TOTAL SHEET SHEETS NO.
LC0907-sht-typical.dgn		DRAWN PWL	REVISED -	\$TATE OF ILLINOIS		TYPICAL SECT	IONS	2626	05-00193-04-BR	LAKE	36 5
	PLOT SCALE = 20.00000 ' / IN.	CHECKED MRH	REVISED -	DEPARTMENT OF TRANSPORTATION			-			CONTRA	CT NO. 63531
	PLOT DATE = 10/25/2010	DATE - 10/25/2010	REVISED -		SCALE: NTS	SHEET NO. 1 OF 1 SHEETS	STA. N/A TO STA. N/A	FED. RO	DAD DIST. NO. 1   ILLINOIS FED.		

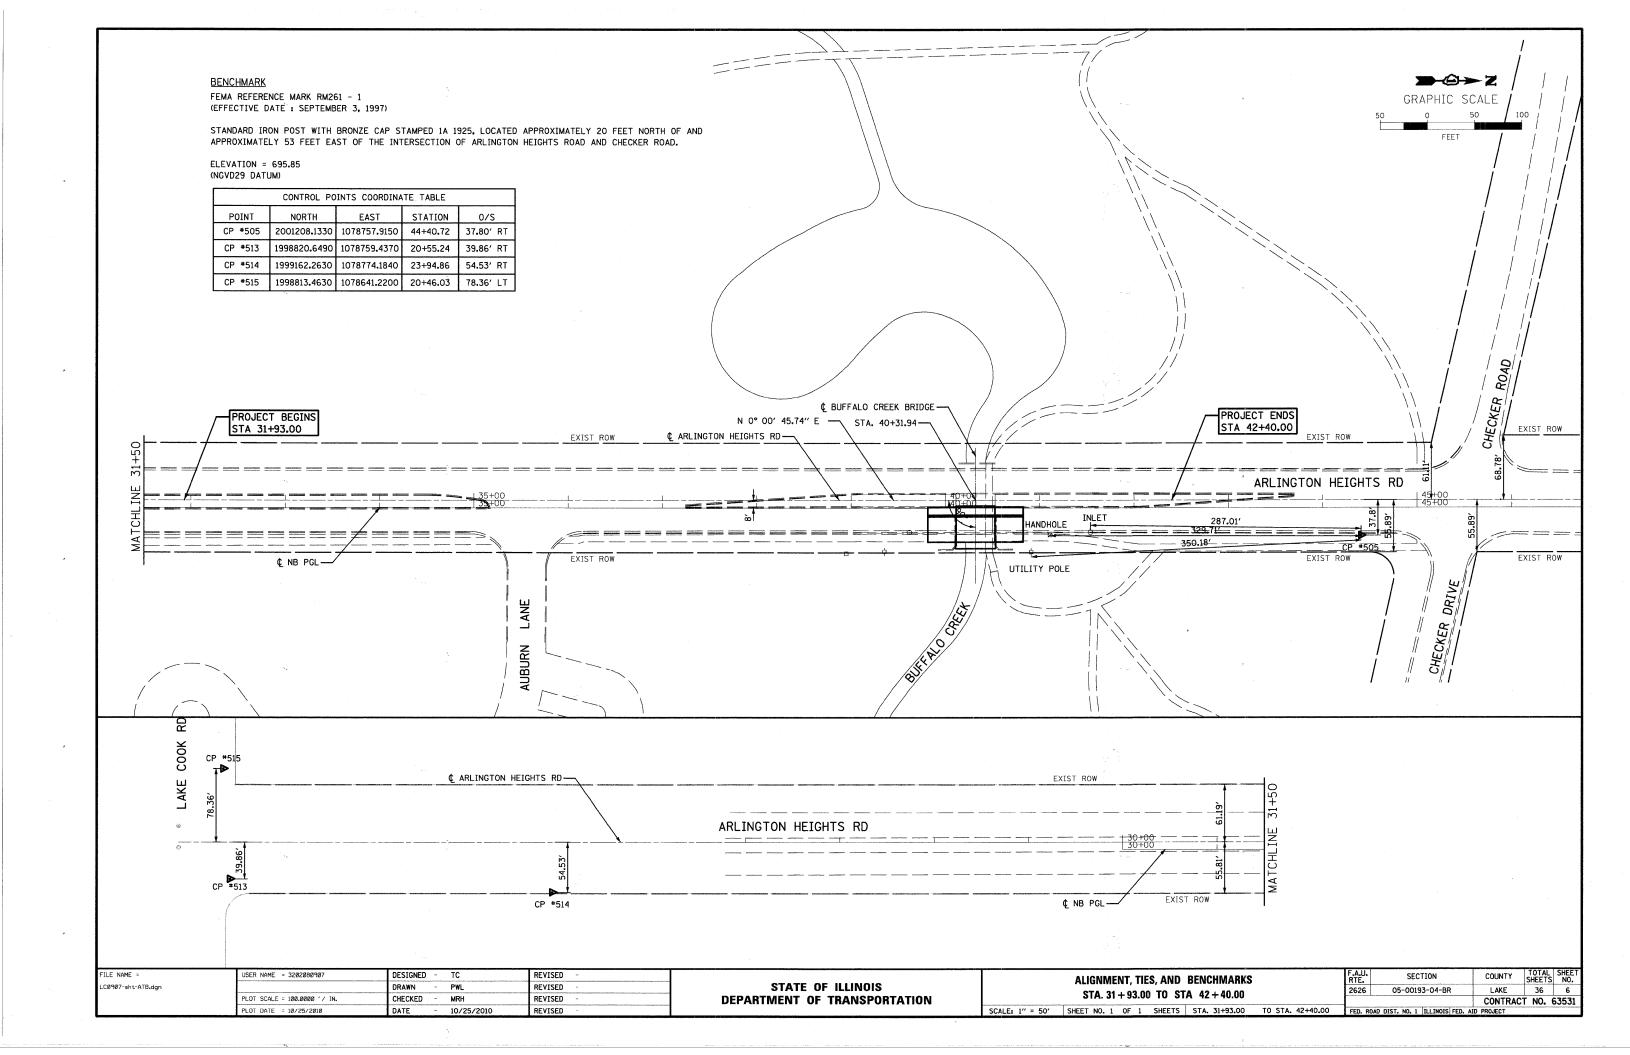

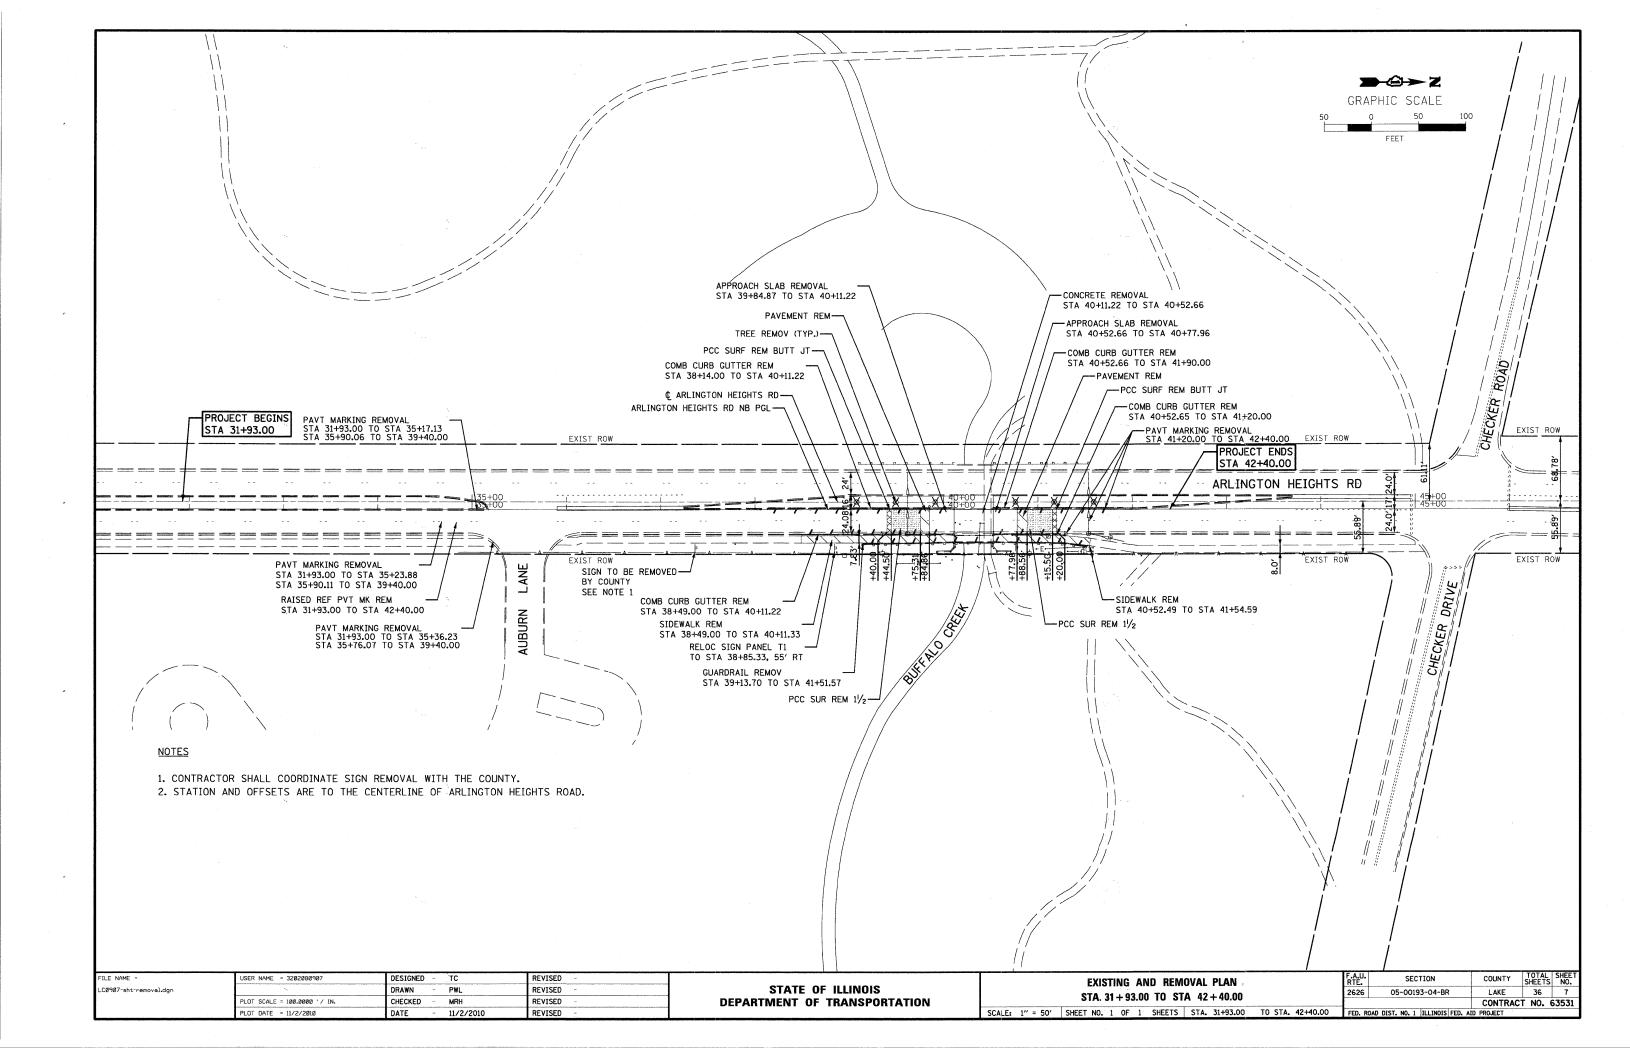


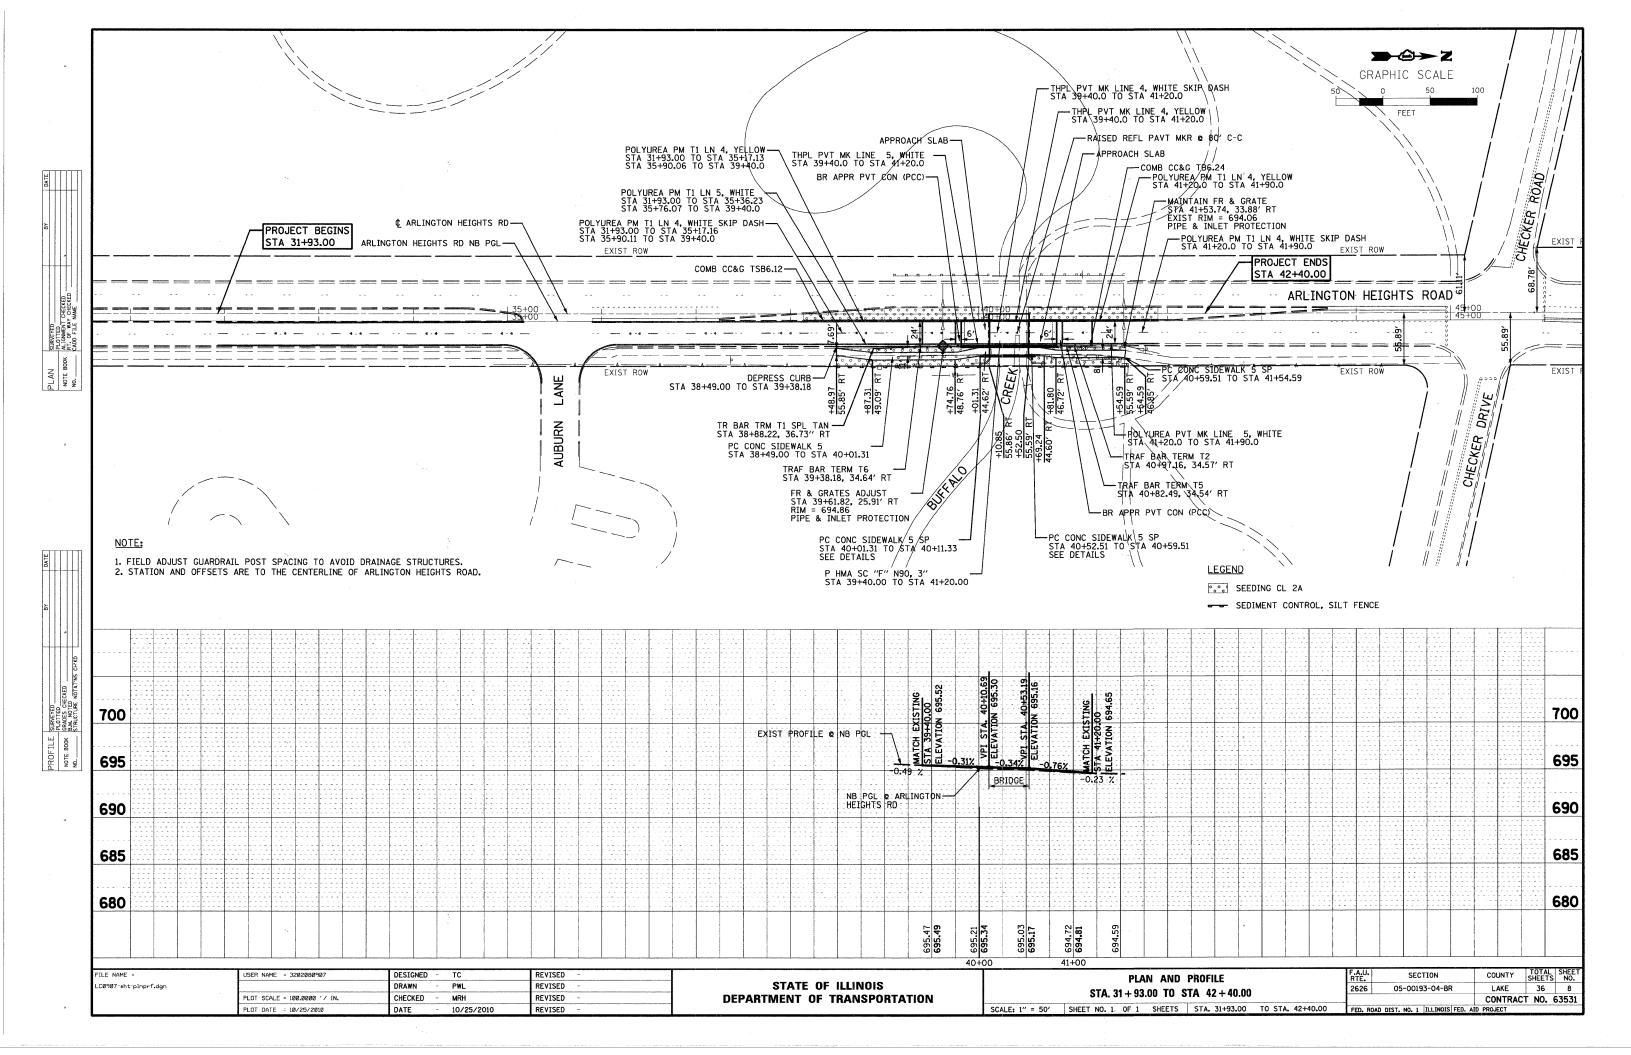


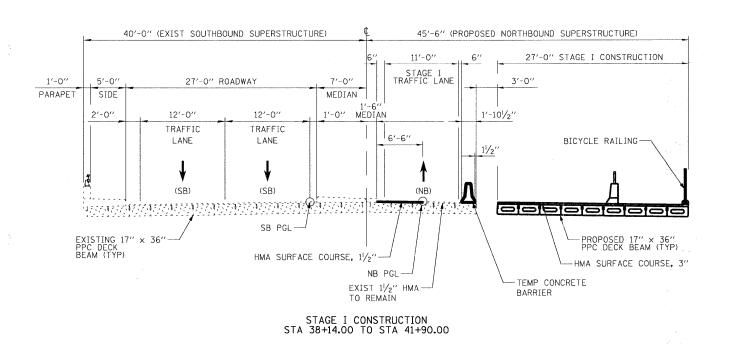


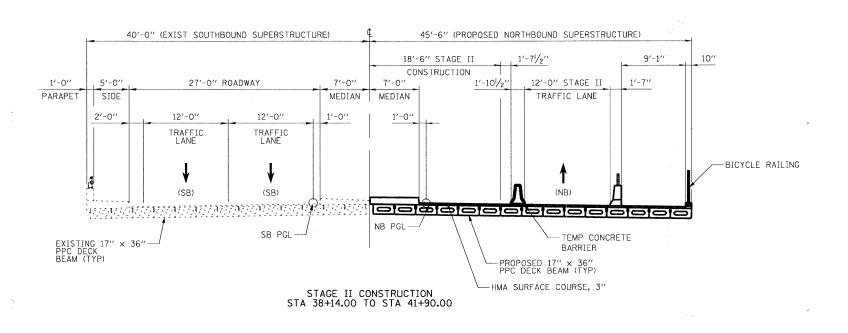

FILE NAME =	USER NAME = 3202080907	DESIGNED - TC	REVISED -		MAINTENANCE OF TRAFFIC TYPICALS  STA. 31 + 93.00 TO STA 42 + 40.00  SCALE: NTS SHEET NO. 1 OF 1 SHEETS STA. 31+93.00 TO STA. 42+40.00			F.A.U. RTE.	SECTION	COUNTY	TOTAL SHEE SHEETS NO
LC0907-staging-typical.dgn		DRAWN - PWL	REVISED -	STATE OF ILLINOIS				2626	05-00193-04-BR	LAKE	36 9
	PLOT SCALE = 20.0000 ' / IN.	CHECKED - MRH	REVISED -	DEPARTMENT OF TRANSPORTATION						CONTRAC	T NO. 6353
	PLOT DATE = 10/25/2010	DATE - 10/25/2010	REVISED -				O STA. 42+40.00	FED. ROAD DIST. NO. 1   ILLINOIS FED. AID PROJECT		D PROJECT	

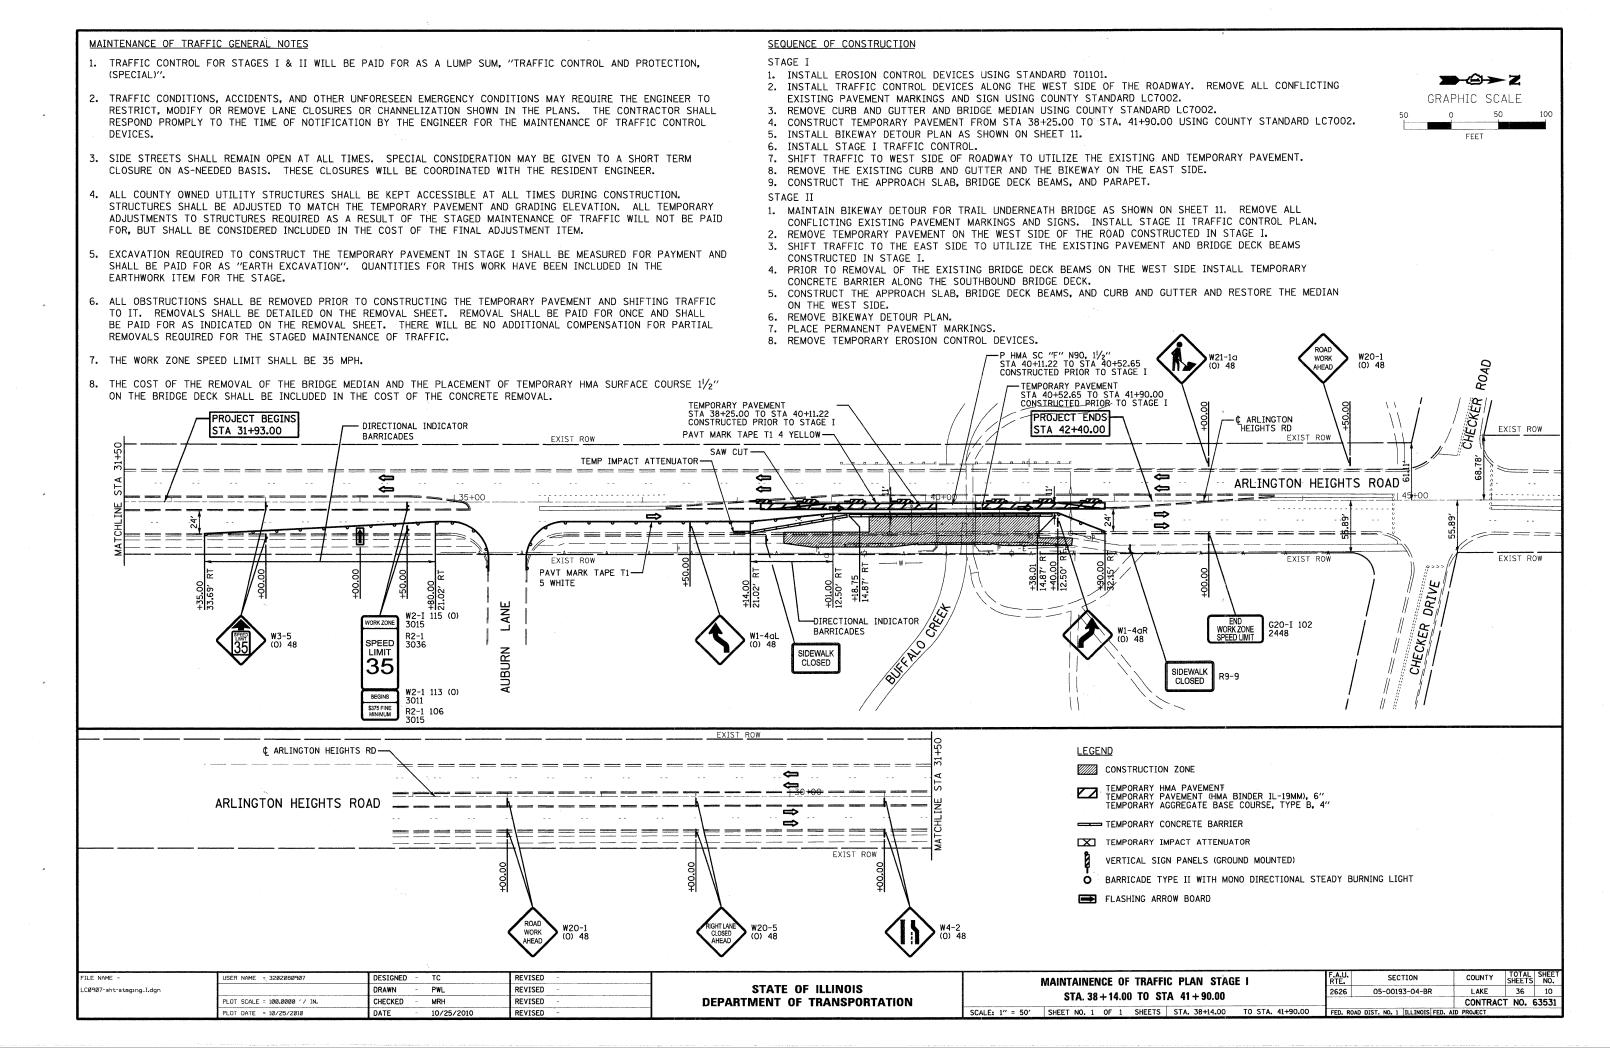

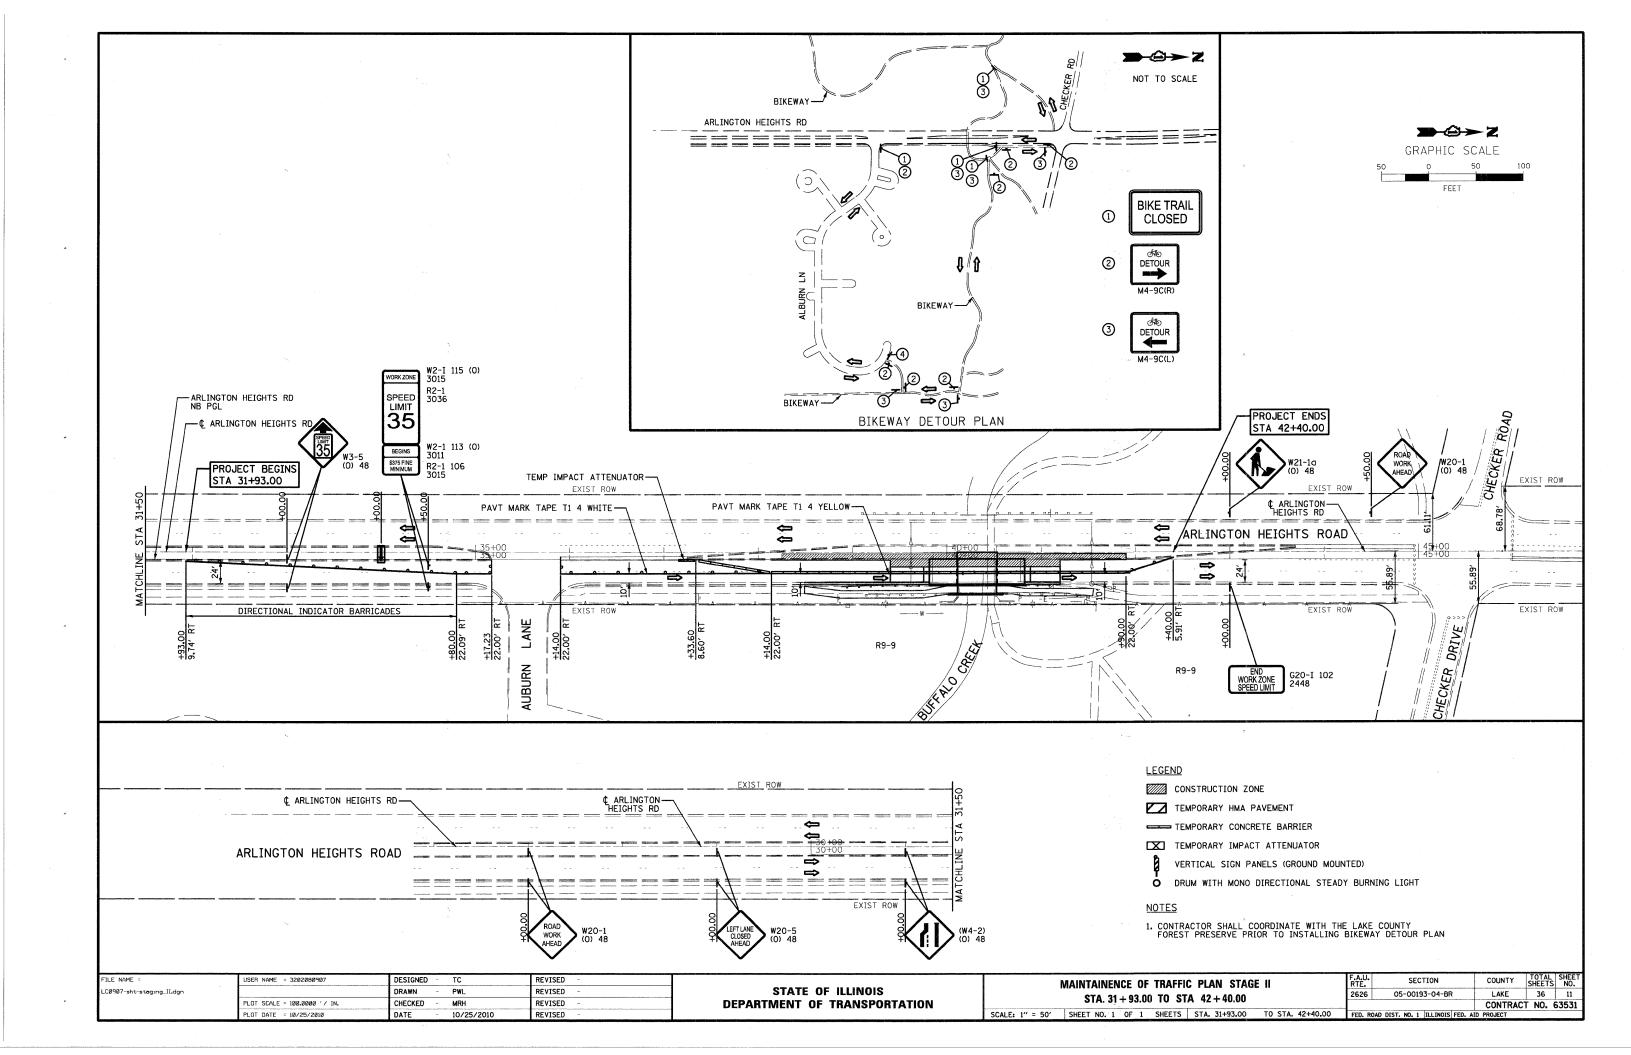

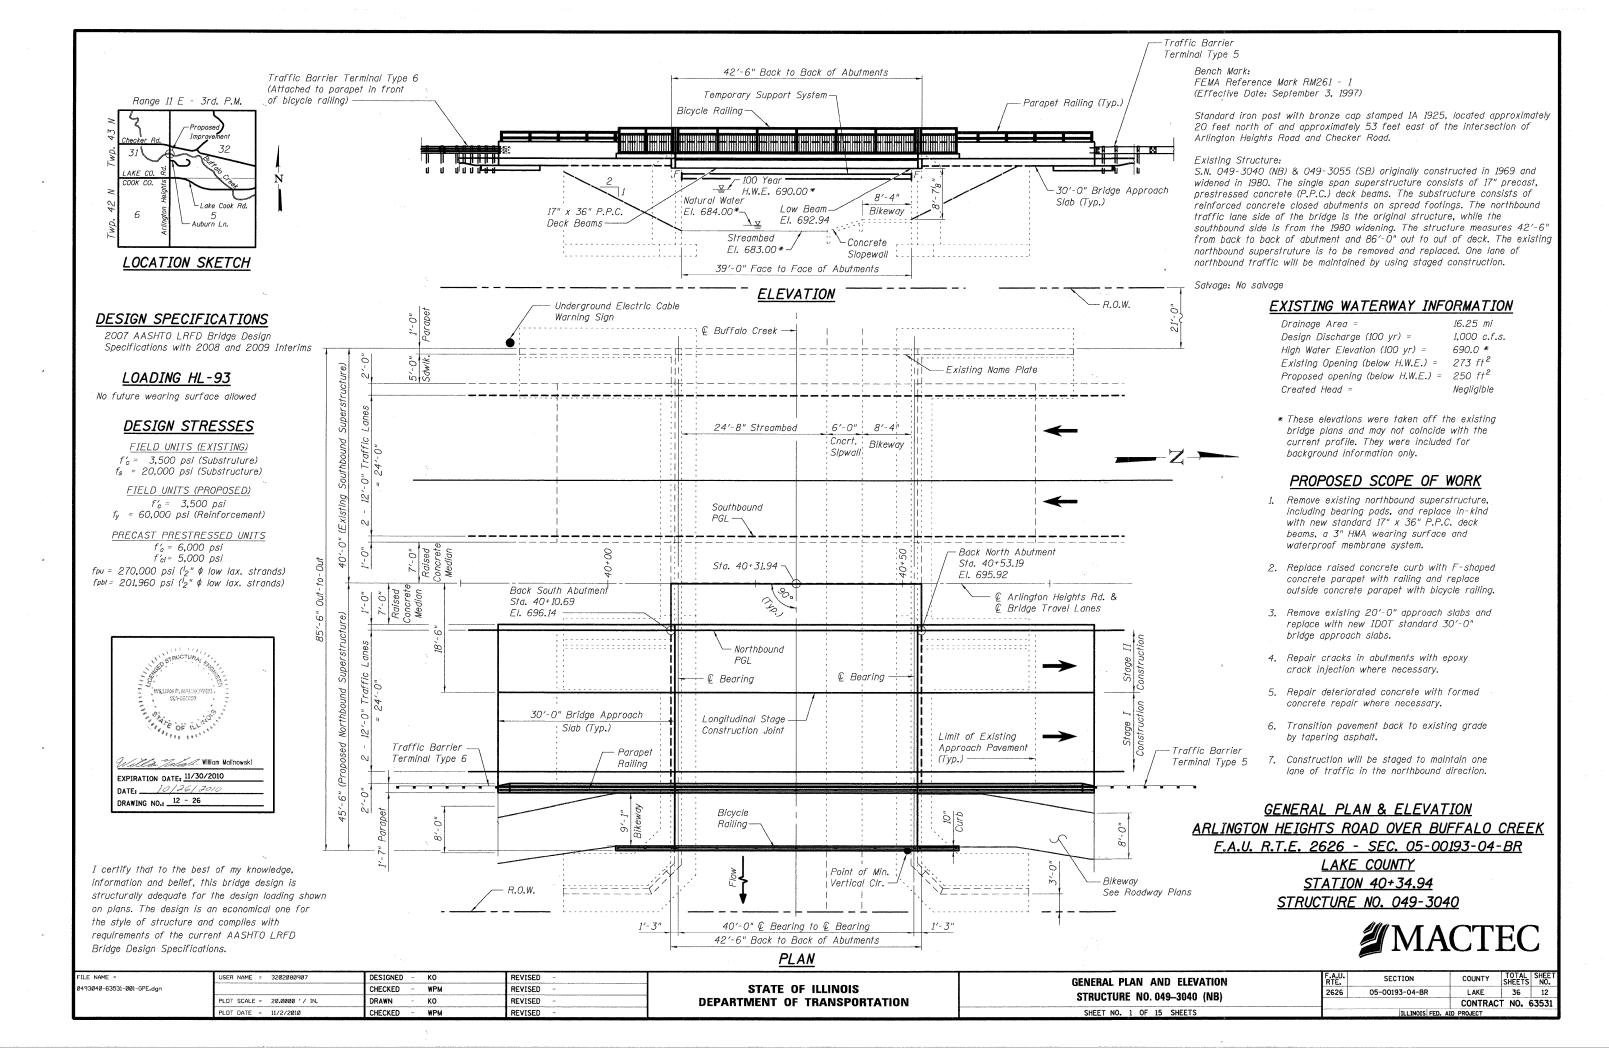

#### GENERAL NOTES


- 1. Reinforcement bars shall conform to the requirements of ASTM A 706 Gr 60. See Special Provisions.
- 2. Reinforcement bars designated (E) shall be epoxy coated.
- 3. Plan dimensions and details relative to existing plans are subject to nominal construction variations. The Contractor shall field verify existing dimensions and details affecting new construction and make necessary approved adjustments prior to construction or ordering of materials. Such variations shall not be cause for additional compensation for a change in scope of the work, however, the Contractor will be paid for the quantity actually furnished at the unit price bid for the work.
- 4. Protective coat shall not be applied to surfaces to which Waterproofing Membrane System is applied.
- 5. The Contractor shall submit Structural Assessment Report(s) as required for Contractor's means and methods of construction. See Special Provisions.
- 6. No in-stream work will be allowed on this project.
- 7. The Contractor is advised that the existing PPC Deck Beams are in a deteriorated condition with reduced load carrying capacity, particularly Beams 11 and 12. It is the Contractor's responsibility to account for the condition of the beams when developing construction procedures for removal and replacement of the superstructure.
- 8. Repair of the abutments shall be completed prior to placement of the new deck beams.
- 9. If the Contractor's procedure for existing beam removal or placement of the new beams involves placement of cranes or other heavy equipment on the new beams, a detailed procedure shall be submitted to the Engineer for approval. The procedure shall include calculations, prepared and sealed by an Illinois Licensed Structural Engineer, verifying that the equipment and procedure used will not overstress the newbeams. To distribute load to multiple beams and protect the concrete, in all cases a double layer mat of heavy timber shall be used at all times under crane tracks or wheels and any outriggers in the down position. If necessary, shims shall be used under the crane mat to ensure uniform contact with the underlying beams. Prior to placement of the timber mats, the following shall be done: placement and tightenin of transverse tie assemblies, grouting and curing the dowel rods 24 hours minimum and grouting and curing the shear keys.
- 10. The Contractor is advised that the existing abutments were not designed to support the horizontal earth load acting upon it without the support of the existing beams acting as a strut. It is the Contractors responsibility to account for this condition when developing construction procedures for removal and replacement of the superstructure.
- 11. The Temporary Support System shall be in place prior to superstructure removal.

#### INDEX OF SHEETS

Sheet No.	Sheet Title
1	General Plan And Elevation
2	General Notes, Index & Quantities
3	Typical Cross Section & Staging
4	17" x 36" PPC Deck Beam Details 1
5	17" x 36" PPC Deck Beam Details 2
6	Parapet Details
7	Bikeway Railing Details 1
8	Bikeway Railing Details 2
9	Temporary Concrete Barrier For Stage Construction
10	South Abutment Details
11	North Abutment Details
12	Abutment Details
13	Approach Slab Details 1
14	Approach Slab Details 2
15	Approach Slab Elevations

#### TOTAL BILL OF MATERIAL

TOTAL BILL OF MATERIAL											
ITEM	UNIT	SUPER	SUB	TOTAL							
Approach Slab Removal	Sq. Yd.	130		130							
Bicycle Railing	Foot	59		59							
Concrete Removal	Cu. Yd.	7.6	2.1	9.7							
Concrete Structures	Cu. Yd.		19.5	19.5							
Concrete Superstructure	Cu. Yd.	102.1		102.1							
Epoxy Crack Injection	Foot		50	50							
Structural Repair of Concrete (Depth equal to or less than 5 inches)	Sq. Ft.		42	42							
Precast Prestressed Concrete Deck Beams (17" Depth)	Sq. Ft.	1853		1853							
Parapet Railing	Foot	102		102							
Protective Coat	Sq. Yd.	99		99							
Reinforcement Bars, Epoxy Coated	Pound	23310	3830	27140							
Removal of Existing Superstructures	Each.	1		1							
Temporary Support System	L Sum		1	1							
Waterproofing Membrane System	Sq. Ft.	1853		1853							
y 4											
<i>y</i>											
		,									

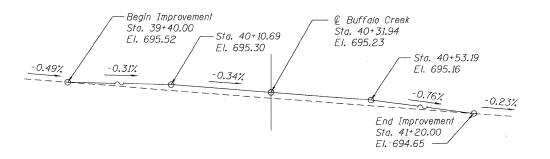


PROFILE GRADE




LE NAME =	USER NAME = 3202080907	DESIGNED - KO	REVISED -	
93040-63531-002-General.dgn		CHECKED - WPM	REVISED -	
	PLOT SCALE = 2.0000 '/ IN.	DRAWN - KO	REVISED -	
	PLOT DATE = 10/25/2010	CHECKED - WPM	REVISED -	


GENERAL NOTES, INDEX & QUANTITIES	F.A.U. RTE.	SI
STRUCTURE NO. 049-3040 (NB)	2626	05-00
SHEET NO. 2 OF 15 SHEETS		


		CONTRAC	T NO. 6	3531
2626	05-00193-04-BR	LAKE	36	13
F.A.U. RTE.	SECTION	COUNTY	TOTAL SHEETS	SHEET NO.

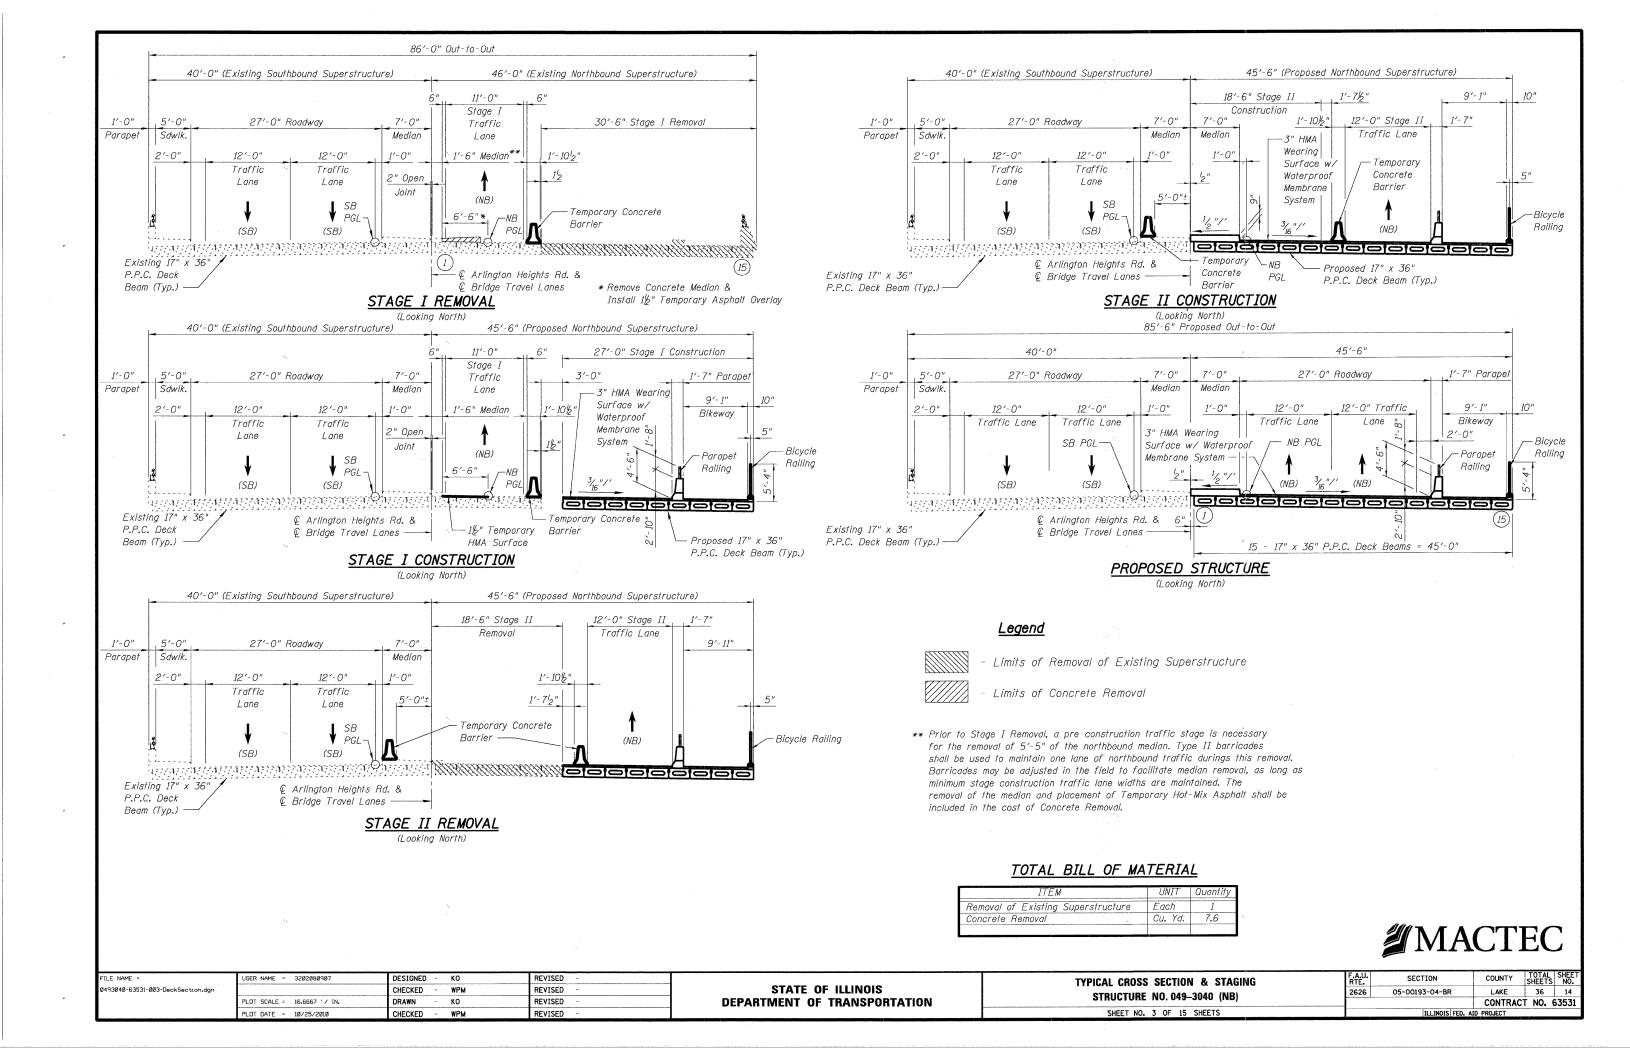

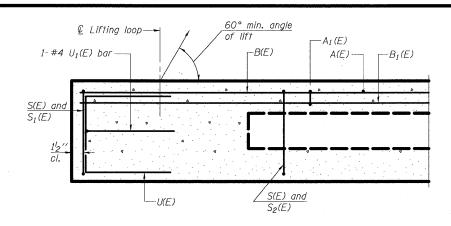



SECTION A-A

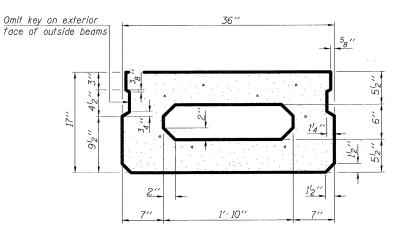

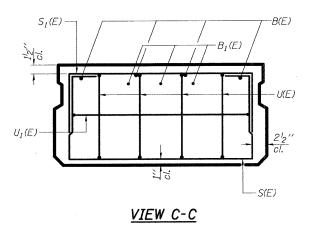



SECTION B-B

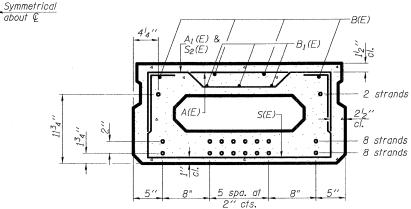


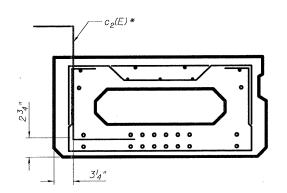


BEAM 1

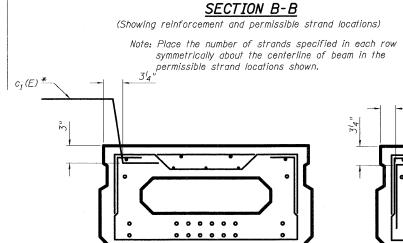

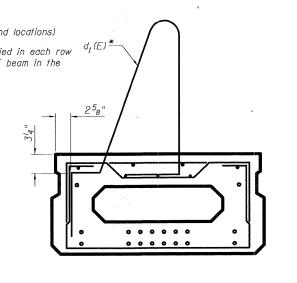

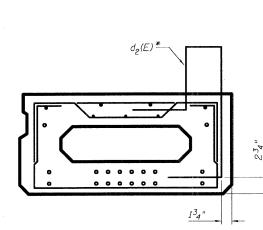

## (Showing dimensions)

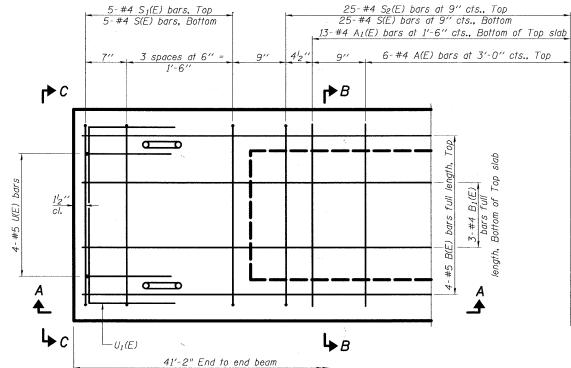

#### BAR LIST

#### ONE BEAM ONLY

Note: See sheet 5 of 15 for additional details and Bill of Material.

#### PLAN VIEW

#### Note: Spacing of S(E) and So(E

Note: Spacing of S(E) and  $S_2(E)$  bars may be adjusted up to 4" in the immediate area of the transverse tie diaphragms to miss the block outs for the transverse ties.

#### #4 bar = 2'-0" #5 bar = 2'-6"

#### ADDITIONAL BARS \*

(For information only)

Beam	Bar	No.	Size	Length	Shape
Beam 1	c (E)	42	#5	2'-9"	l
Beam 3	c1(E)	42	#5	2'-4"	て
Beam 12	d1(E)	46	#5	5'-10"	Δ
Beam 15	d&E)	42	#5	4'-7"	3

#### BEAM 3

\* These bars are additional bars required for Beams 1, 3, 12, and 15 as shown above, which is why they are not included in the "Bar List One Beam Only" table Above.

The bars are to be included in the cost of "Precast Prestressed Concrete Deck Beams (17" depth)).

#### BEAM 12

BEAM 15


**MACTEC** 


STATE OF ILLINOIS
DEPARTMENT OF TRANSPORTATION

17" x 36" PPC DECK BEAM DETAILS 1
STRUCTURE NO. 049-3040 (NB)

SHEET NO. 4 OF 15 SHEETS


F.A.U. RTE.	SECTION	COUNTY	TOTAL SHEETS	SHEET NO.
2626	05-00193-04-BR	LAKE	36	15
		CONTRAC	T NO. (	3531
	ILLINOIS FED. AI	ID PROJECT		

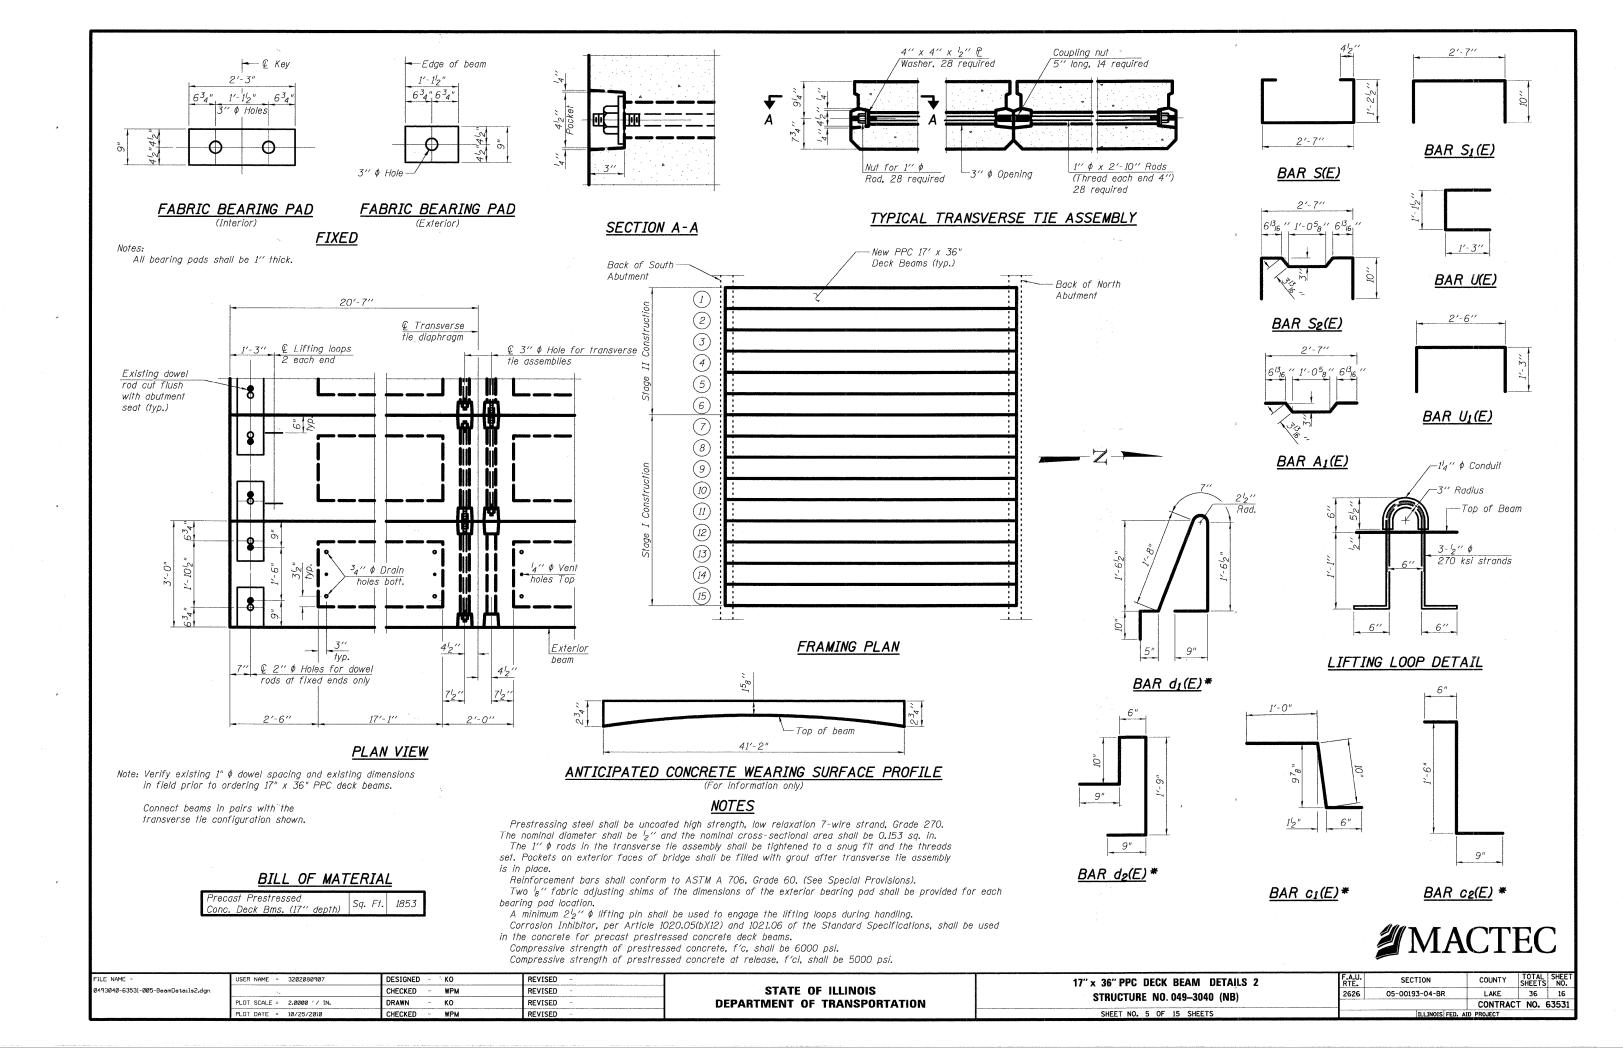

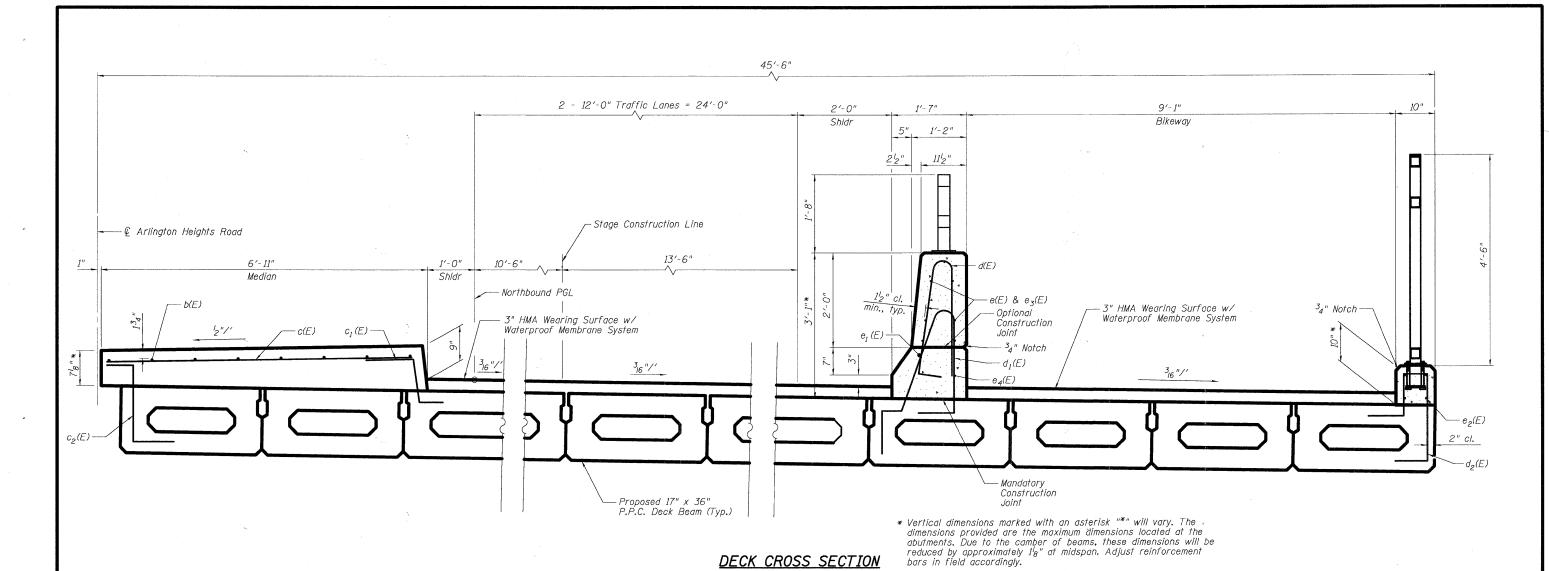

# PARAPET & BICYCLE RAILING BILL OF MATERIAL

Bar	No.	Size	Length	Shape
b(E)	16	#4	21'-6"	
c(E)	42	#5	6'-6"	
d(E)	46	#5	6'-1"	Λ
e(E)	8	#4	14'-8"	
e <sub>1</sub> (E)	1	#8	40'-11"	
e <sub>2</sub> (E)	8	#4	21'-6"	
e3(E)	16	#4	12'-10"	
e4(E)	1	#4	40'-11"	
Concrete	Superstru	ucture	Cu. Yd.	15.2
Protective	e Coat	Sq. Yd.	99	
Reinforce Epoxy Co		S,	Pound	1280

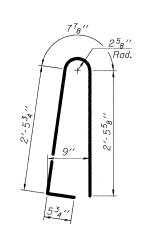


BAR d(E)


#### Notes:


- For quantities and payment of 3" HMA wearing surface see civil plan.
   Apply protective coat to the vertical projection of the traffic face and the top of the median and the parapet.

#M.	AC	TE	C
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FILE NAME =	USER NAME = 3202080907	DESIGNED - KO	REVISED -		PARAPET DETAILS	F.A.U RTE.	SECTION	COUNTY	TOTAL SHEET SHEETS NO.
0493040-63531-006-Parapet.dgn		CHECKED - WPM	REVISED -	STATE OF ILLINOIS	STRUCTURE NO. 049-3040 (NB)	2626	05-00193-04-BR	LAKE	36 17
	PLOT SCALE = 2.0000 '/ IN.	DRAWN - KO	REVISED -	DEPARTMENT OF TRANSPORTATION	51KUCTURE NO. 049-3040 (NB)			CONTRAC	CT NO. 63531
	PLOT DATE = 10/25/2010	CHECKED - WPM	REVISED -		SHEET NO. 6 OF 15 SHEETS		ILLINOIS FED.	AID PROJECT	



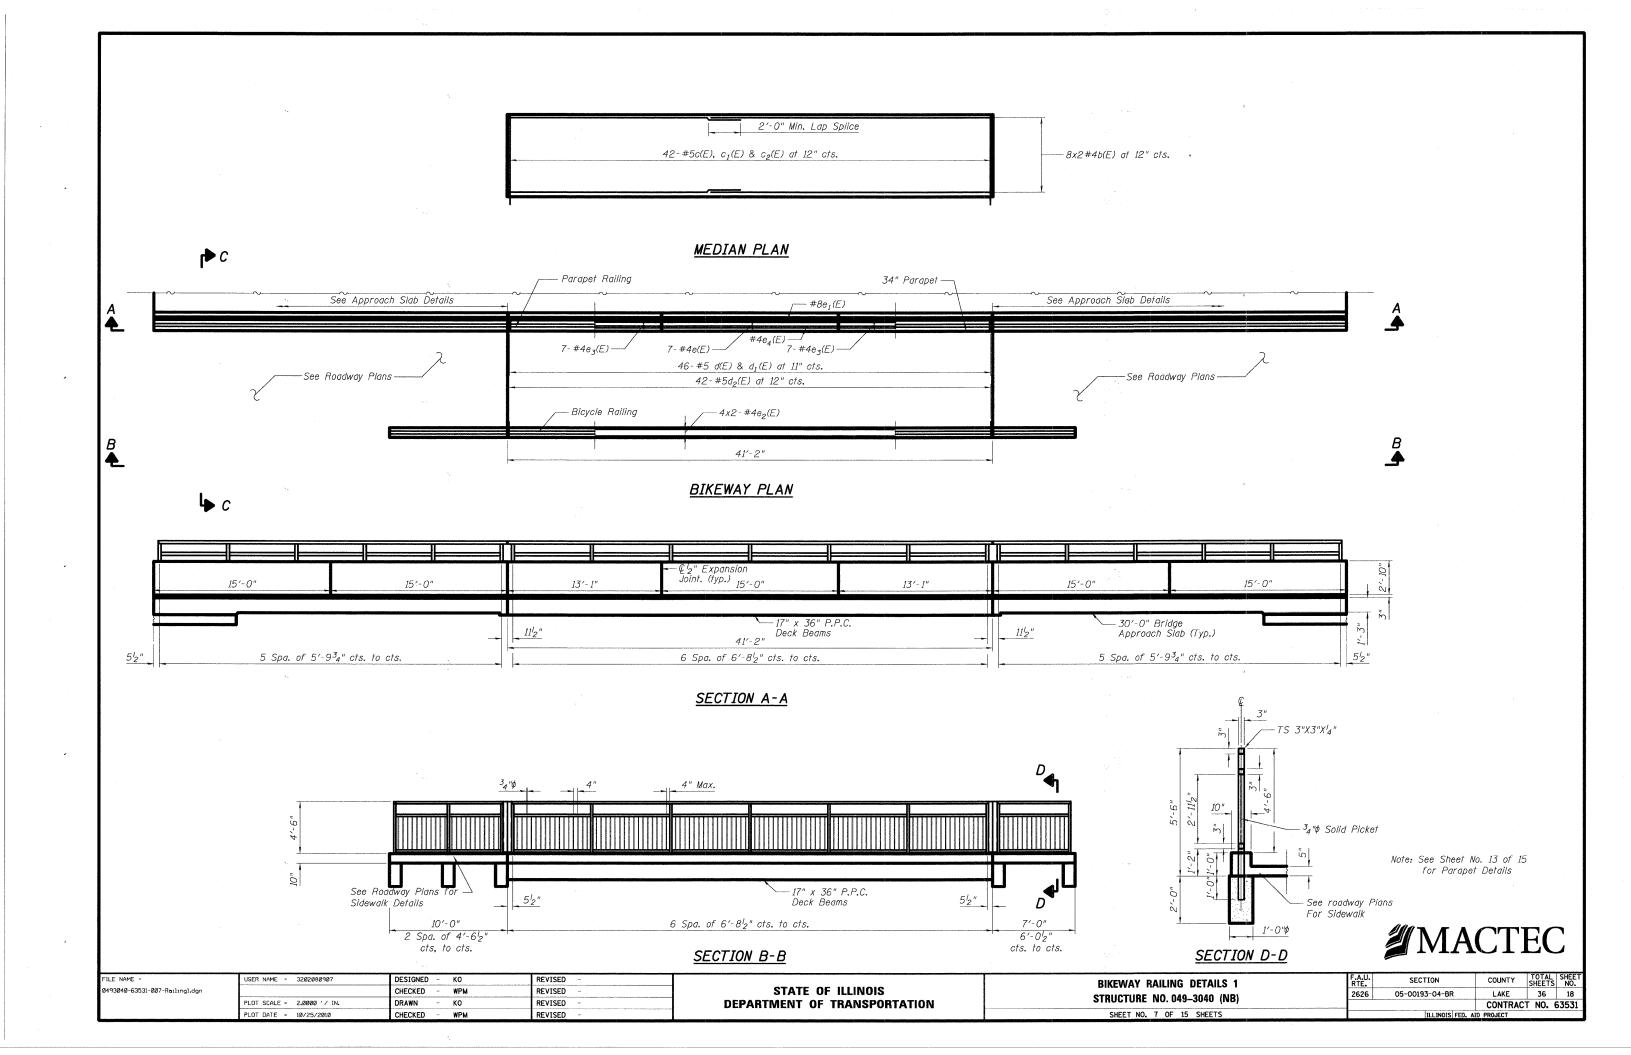

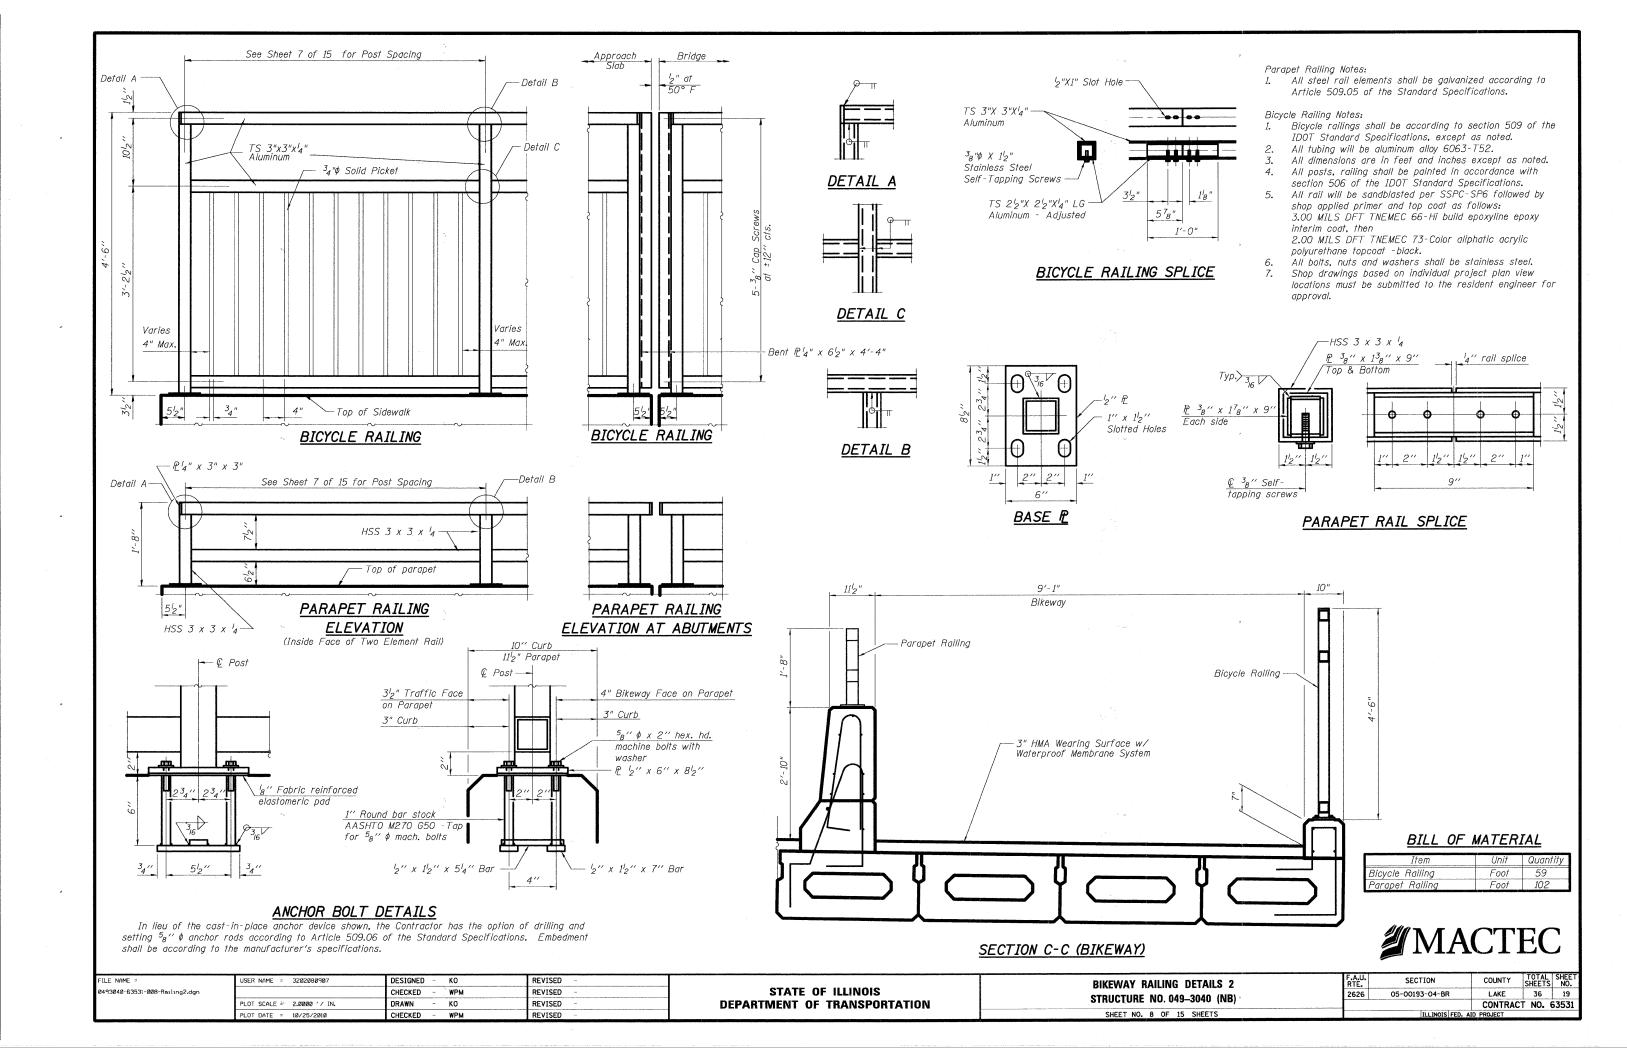
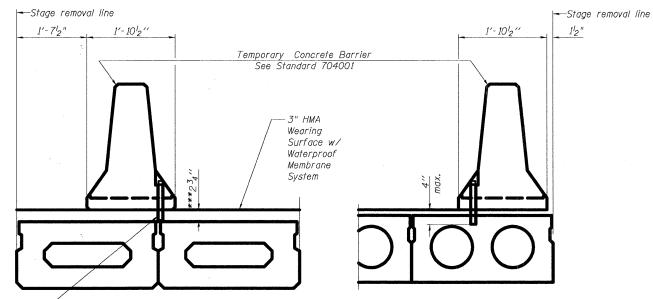
#### <u>NOTES</u>

Any hole drilled into the wearing surface shall be repaired upon removal of the Temporary Concrete Barrier. Cost shall be included in the pay item Temporary Concrete Barrier.

For quantities and payment of Temporary Concrete Barrier see Roadway Plans.

Drill 3-1'4" \( \text{ Holes in new wearing } \)
surface only for 1" \( \text{ x 11" dowel} \)
bars. Traffic side only. Cost included with Temporary Concrete Barrier.

NEW DECK BEAM

#### EXISTING DECK BEAM


\*\*\* Drilling into PPC deck beam is prohibited. Embedment of  $2^3 4^{\circ}$  Dowel Bar into HMA wearing surface only.

SECTIONS THRU OR DECK BEAM



JSER NAME = 3202080907 DESIGNED - KO REVISED TEMPORARY CONCRETE BARRIER FOR STAGE CONSTRUCTION REVISED STATE OF ILLINOIS 0493040-63531-009-TempBarrier.dgn CHECKED - WPM STRUCTURE NO. 049-3040 (NB) **DEPARTMENT OF TRANSPORTATION** PLOT SCALE = 2.0000 '/ IN. DRAWN - ко REVISED SHEET NO. 9 OF 15 SHEETS CHECKED REVISED

	ILL INOIS FED. A	CONTRAC	T NO. 6	3531
2626	05-00193-04-BR	LAKE	36	20
F.A.U. RTE.	SECTION	COUNTY	TOTAL SHEETS	SHEET NO.

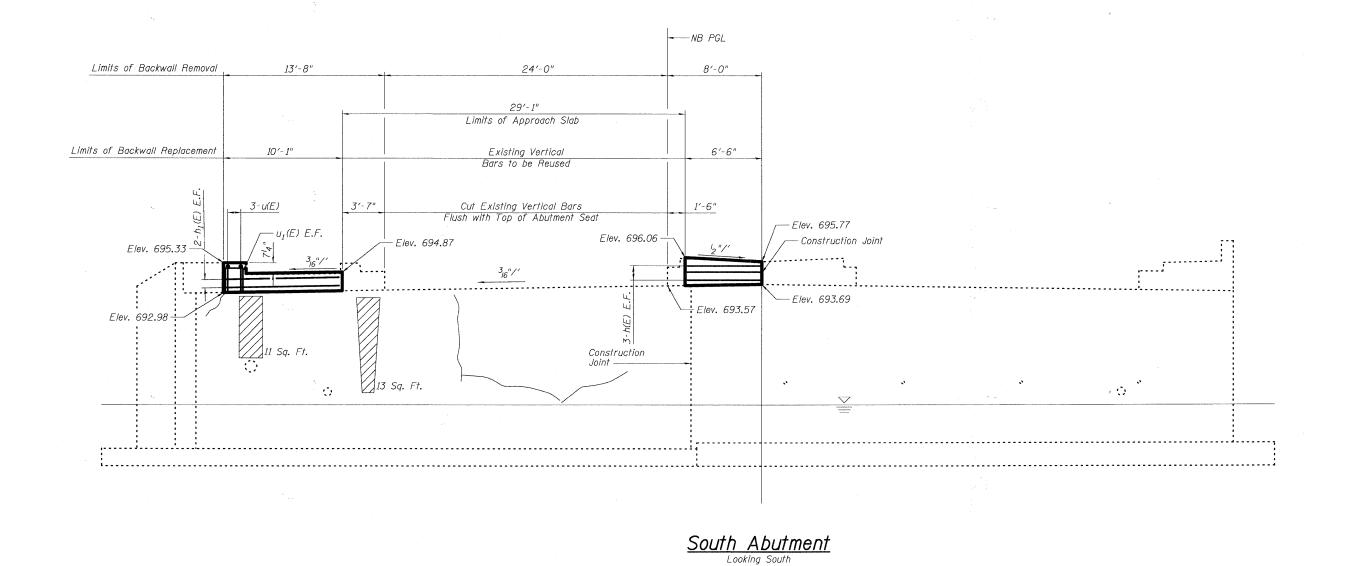

# <u>Legend</u>

- Epoxy Crack Injection




- Structural Repair of Concrete (Depth Equal to or Less Than 5 inches)

#### Notes:

See sheet No. 12 of 15 for Reinforcement Bars details.



FILE NAME =	USER NAME = 3202080907	DESIGNED - KO	REVISED -		SOUTH ABUTMENT DETAILS	F.A.U.	SECTION	COUNTY	TOTAL SHEET
Ø493Ø40-63531-Ø1Ø-S Abut.dgn		CHECKED - WPM	REVISED -	STATE OF ILLINOIS		2626	05-00193-04-BR	LAKE	36 21
	PLOT SCALE = 2.0000 '/ IN.	DRAWN - KO	REVISED -	DEPARTMENT OF TRANSPORTATION	STRUCTURE NO. 049–3040 (NB)			CONTRAC	CT NO. 63531
	PLOT DATE = 10/25/2010	CHECKED - WPM	REVISED -		SHEET NO. 10 OF 15 SHEETS		ILLINOIS FED.	AID PROJECT	

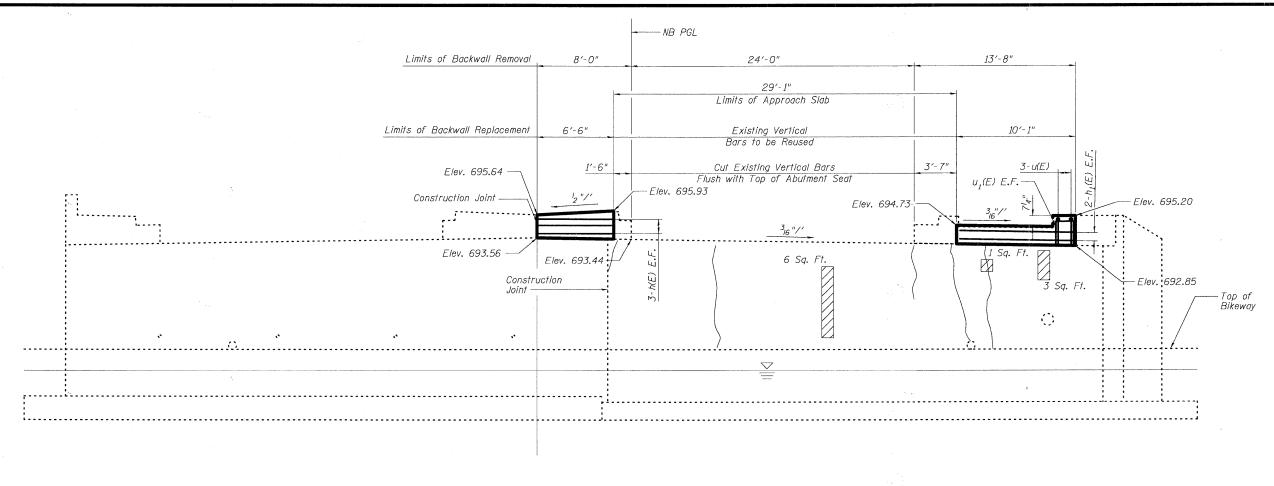

## North Abutment

Looking North


# <u>Legend</u>

Epoxy Crack Injection

Structural Repair of Concrete (Depth Equal to or Less Than 5 inhes)

#### *Notes*:


See sheet No. 12 of 15 for Reinforcement Bars details.

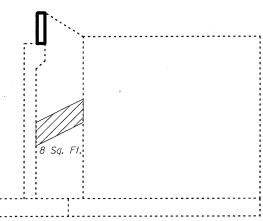

Northeast Wingwall Elevation




FILE NAME = 0493040-63531-011-N Abut-dop	USER NAME = 3202080907	DESIGNED - KO	REVISED -	STATE OF ILLINOIS	NORTH ABUTMENT DETAILS	F.A.U. SECTION	COUNTY TOTAL SHEET NO.
พอมนะagn	PLOT SCALE = 2.0000 '/ IN.	CHECKED WPM DRAWN KO	REVISED -	DEPARTMENT OF TRANSPORTATION	STRUCTURE NO. 049–3040 (NB)	2626 05-00193-04-BR	CONTRACT NO. 63531
	PLOT DATE = 10/25/2010	CHECKED - WPM	REVISED -		SHEET NO. 11 OF 15 SHEETS	ILLINOIS FED. AI	ID PROJECT

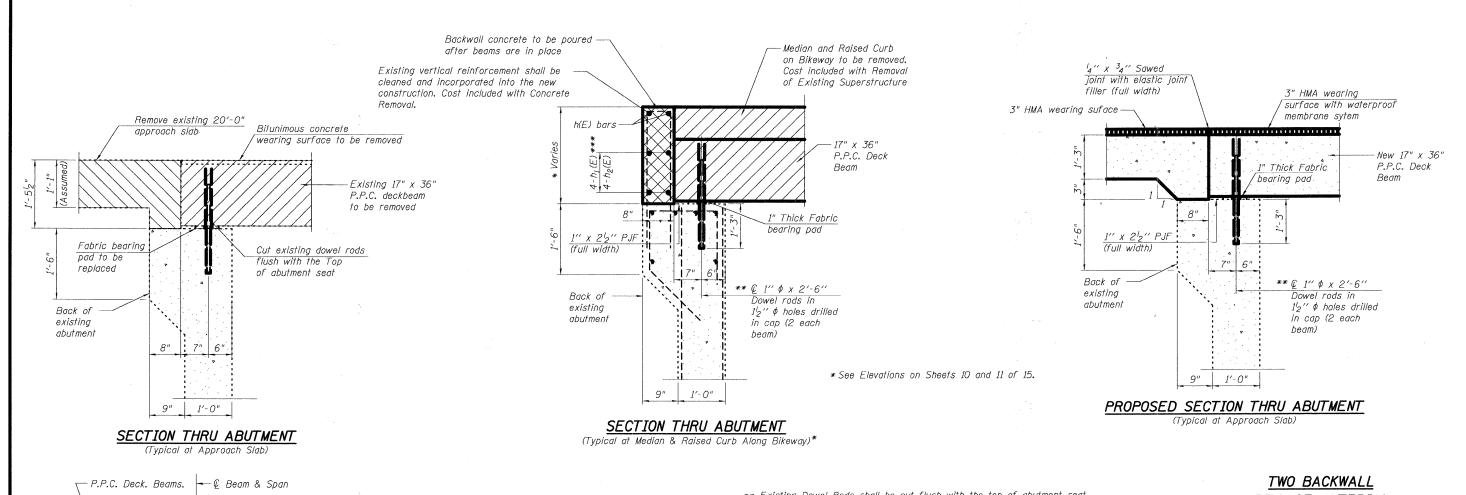

- \*\* Existing Dowel Rods shall be cut flush with the top of abutment seat.

  After beams have been erected, holes shall be drilled into substructure and anchor dowels placed.
- \*\*\* h(E) bars in backwall at Concrete Median  $h_1(E)$  bars in backwall at Sidewalk

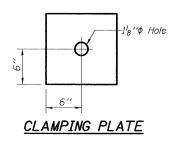



Cost included with Precast Prestressed Concrete Deck Beams. See Stage Construction Details for traffic lanes.

\*\* Cast semicircular recesses in the sides of each beam adjacent to the stage construction line. These recesses should align to form a hole at the appropriate locations for the clamping device bolts.

# 9" U1(E) 5" U(E)

BAR u(E) and  $u_1(E)$ 

# TWO BACKWALL BILL OF MATERIAL

Bar	No.	Size	Length	Shape
h(E)	12	#5	6'-2"	
h1(E)	8	#5	9′-9"	
u(E)	6	#5	4'-9"	П
$u_I(E)$	4	#5	5′-1′′	
Approach	Slab Rer	noval	Sq. Yd.	130
Concrete	Removal		Cu. Yd.	2.1
Concrete	Structure	S	Cu. Yd.	1.8
Reinforce Epoxy Co	=	s <b>,</b>	Pound	420

LEGEND:

Limits of Approach Slab Removal

Limits of Concrete removal

Limits of Removal of Existing Superstructure

**MACTEC** 

x 12'' x 1'' Steel Plate

(M-270 Grade 36) Top & Bottom

End with washers and nuts.

Coat with a water soluble

(Min. Fy=50 ksi)

lubricant.

Steel Shims, Top and

Bottom (If required)

1'-6"

Stage Construction Line -

Grouted Key-

3" x 3" x 4" P Washer

Top and Bottom

Formed hole

6 -12" x 12" x 1" Steel Plates at 3'-0" cts. Top and Bottom., Each Span

PLAN


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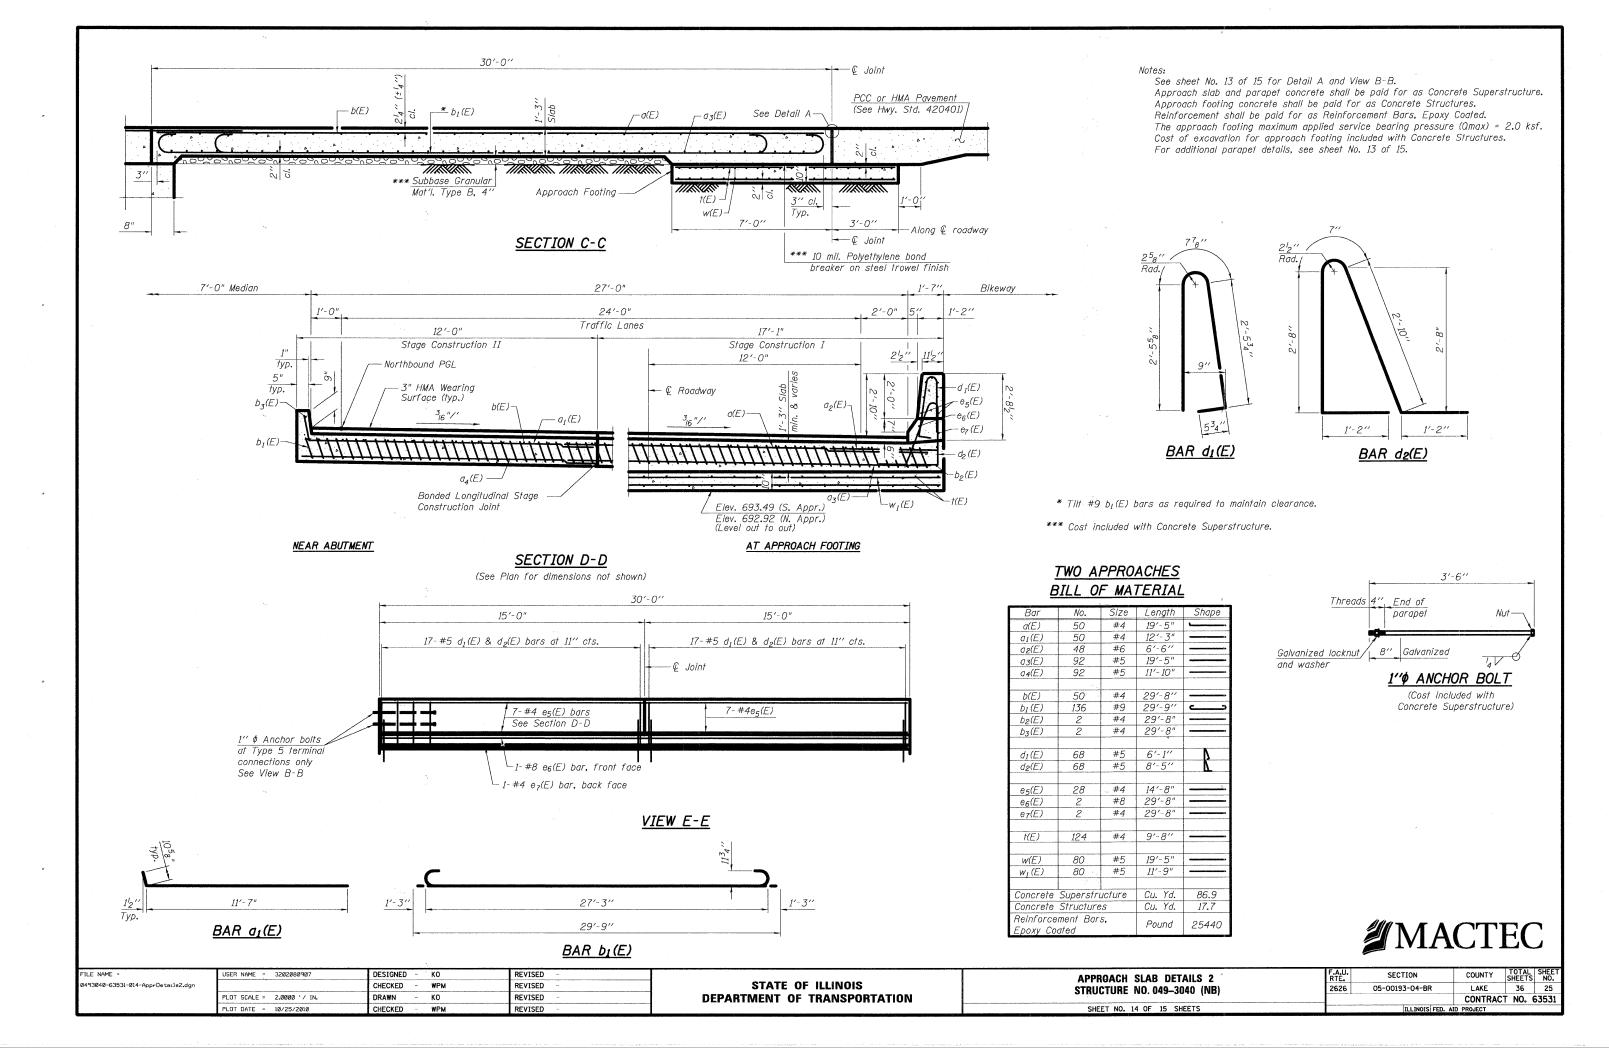
SECTION

STATE OF ILLINOIS
DEPARTMENT OF TRANSPORTATION

ABUTMENT DETAILS
STRUCTURE NO. 049-3040 (NB)
SHEET NO. 12 OF 15 SHEETS

N		TOTAL	CHET
Ν.	COUNTY	SHEETS	NO.
4-BR	LAKE	36	23
	CONTRACT	T NO. 6	53531
INOIS FED.	AID PROJECT		
	14-BR	4-BR LAKE	14-BR LAKE 36 CONTRACT NO. 6



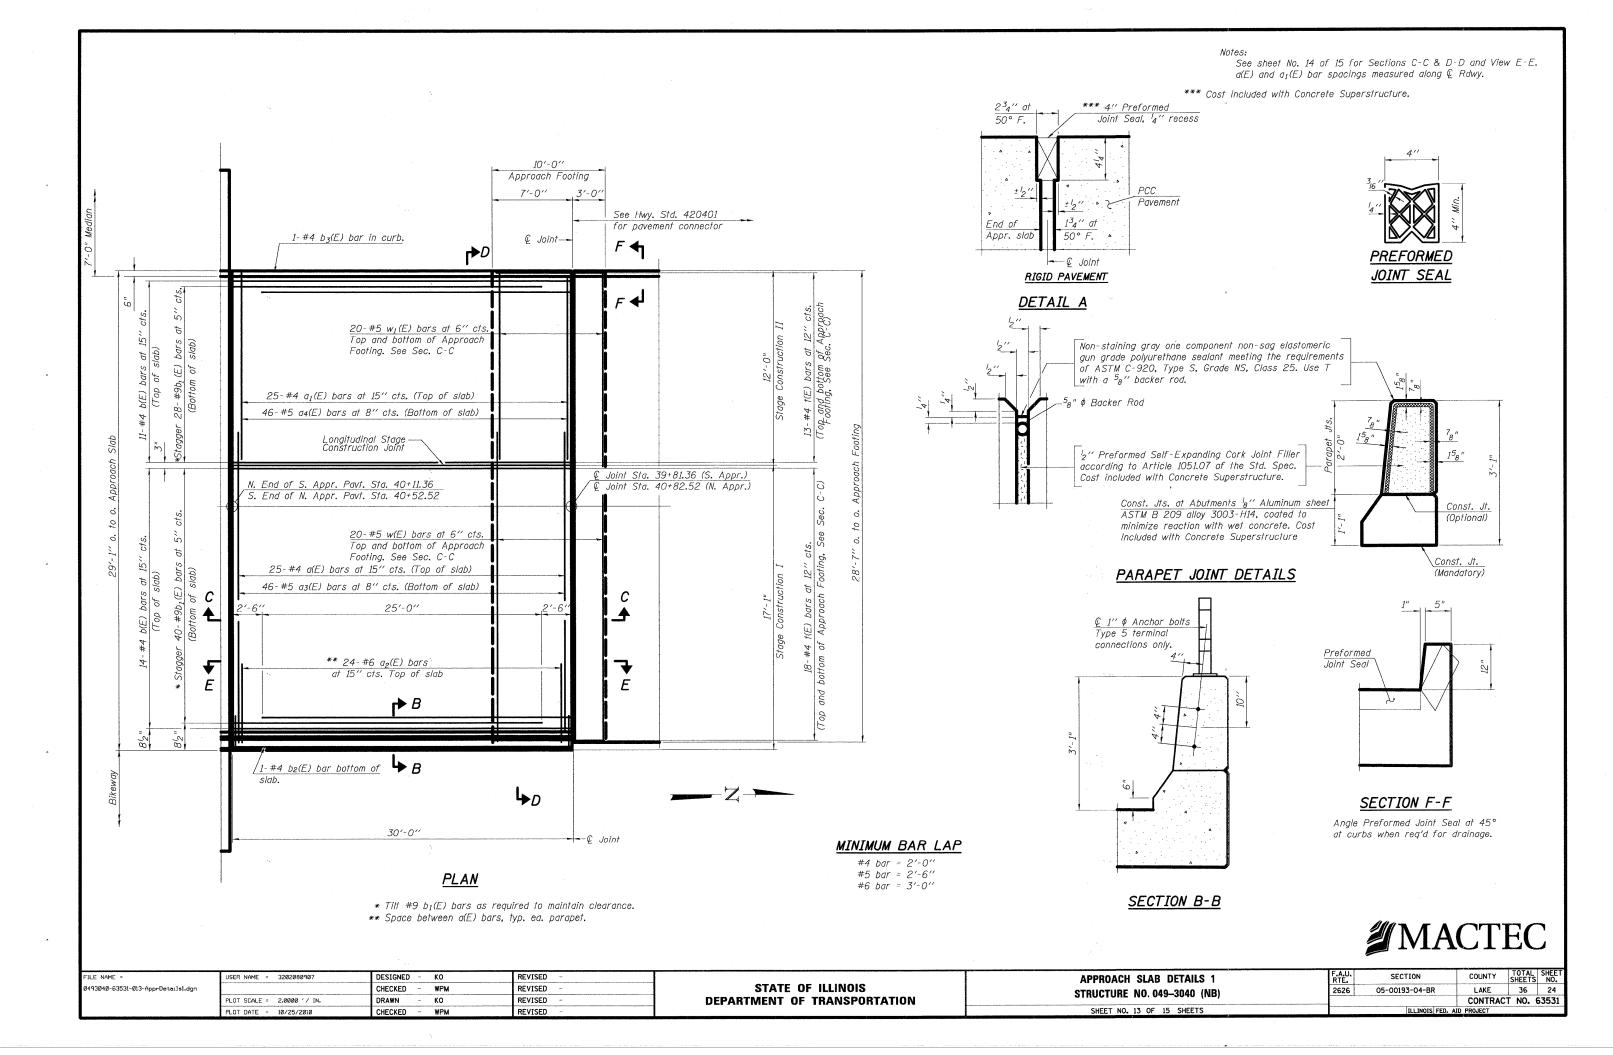

#### WEST CURB LINE

Location	Station	Offset	Theoretical Grade Elevations
S. End of S. Appr. Pav't	39+81.36	-1	695.41
A1	39+91.36	-1	695.38
A2	40+01.36	-1	695.34
N. End of S. Appr. Pav't	40+11.36	-1	695.31
S. End of N. Appr. Pav't	40+52.52	-1	695.18
A3	40+62.52	-1	695.10
A4	40+72.52	-1	695.03
N. End of N. Appr. Pav't	40+82.52	-1	694.95

#### EDGE OF PAVEMENT & NORTHBOUND PGL

Location	Station	Offset	Theoretical Grade Elevations
S. End of S. Appr. Pav't A1 A2 N. End of S. Appr. Pav't	39+81.36 39+91.36 40+01.36 40+11.36	0 0 0	695.39 695.36 695.33 695.30
S. End of N. Appr. Pav't A3 A4 N. End of N. Appr. Pav't	40+52.52 40+62.52 40+72.52 40+82.52	0 0 0 0	695.16 695.09 695.01 694.94


#### LONGIT. STG. CONST. JT.


Location	Station	Offset	Theoretical Grade Elevations
S. End of S. Appr. Pav't A1 A2 N. End of S. Appr. Pav't	39+81.36	10.5	695.23
	39+91.36	10.5	695.20
	40+01.36	10.5	695.16
	40+11.36	10.5	695.13
S. End of N. Appr. Pav't A3 A4 N. End of N. Appr. Pav't	40+52.52	10.5	695.00
	40+62.52	10.5	694.92
	40+72.52	10.5	694.85
	40+82.52	10.5	694.77

Theoretical Grade Elevations profided are measured from the top of the 3" HMA Wearing Surface.

#### EDGE OF PAVEMENT

Location	Station	Offset	Theoretical Grade Elevations
S. End of S. Appr. Pav't A1 A2 N. End of S. Appr. Pav't S. End of N. Appr. Pav't A3 A4 N. End of N. Appr. Pav't	39+81.36	24	695.02
	39+91.36	24	694.99
	40+01.36	24	694.95
	40+11.36	24	694.92
	40+52.52	24	694.79
	40+62.52	24	694.71
	40+72.52	24	694.64
	40+82.52	24	694.56

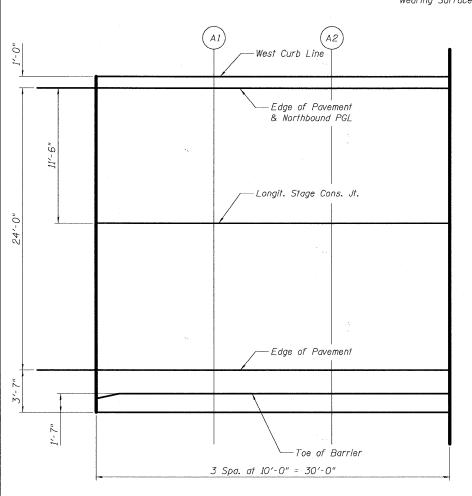

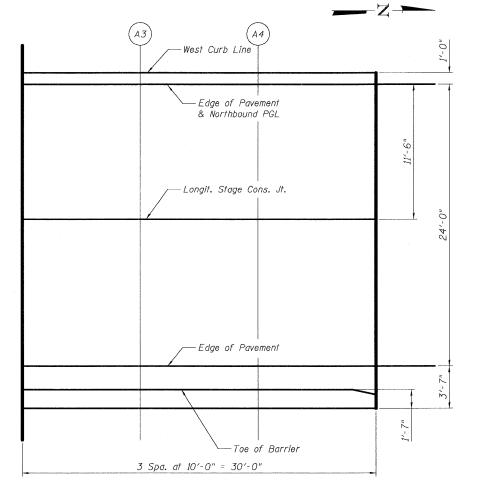

#### TOE OF BARRIER

Location	Station	Offset	Theoretical Grade Elevations
S. End of S. Appr. Pav't A1 A2 N. End of S. Appr. Pav't S. End of N. Appr. Pav't A3 A4 N. End of N. Appr. Pav't	39+81.36	26	694.99
	39+91.36	26	694.95
	40+01.36	26	694.92
	40+11.36	26	694.89
	40+52.52	26	694.76
	40+62.52	26	694.68
	40+72.52	26	694.61
	40+82.52	26	694.53

#### PLAN South Approach Slab

PLAN

North Approach Slab

FILE NAME = 0493040-63531-015-ApprsElev.dgn

DESIGNED - KO REVISED USER NAME = 3202080907 CHECKED - WPM REVISED PLOT SCALE = 2.0000 '/ IN. DRAWN - ко REVISED PLOT DATE = 10/25/2010 CHECKED - WPM REVISED


STATE OF ILLINOIS **DEPARTMENT OF TRANSPORTATION**  TOP OF APPROACH SLAB ELEVATIONS STRUCTURE NO. 049-3040 (NB) SHEET NO. 15 OF 15 SHEETS

COUNTY SHEETS NO.

LAKE 36 26


CONTRACT NO. 63531 2626 05-00193-04-BR

**MACTEC** 

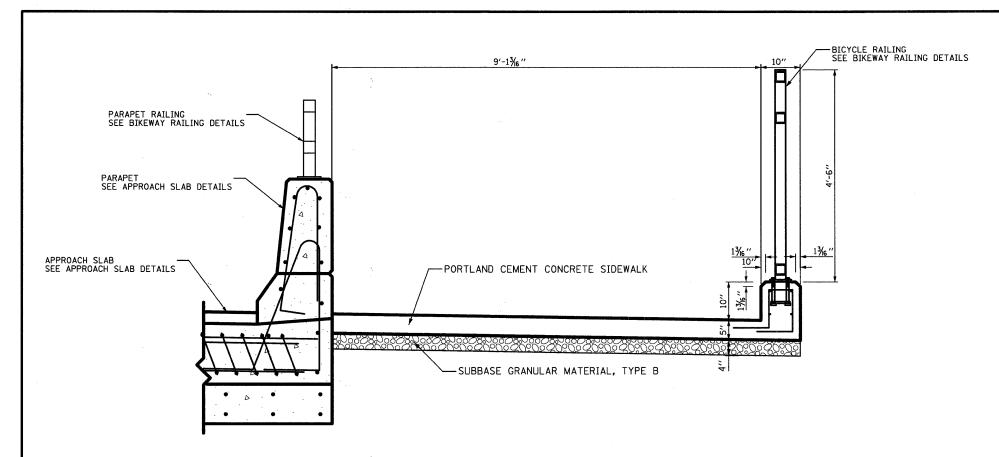

PORTLAND CEMENT CONCRETE SIDEWALK 5 INCH, SPECIAL

FILE NAME =	USER NAME = 3202080907	DESIGNED -	TC	REVISED -		DETAILS	F.A.U. SECTION	COUNTY TOTAL SHEET	AL SHEET TS NO.					
LC0907-sht-details.dgn		DRAWN -	PWL	REVISED -	STATE OF ILLINOIS	STATE OF ILLINOIS								
	PLOT SCALE = 2.00000 '/ IN.	CHECKED -	MRH	REVISED -	DEPARTMENT OF TRANSPORTATION			CONTRACT NO.	63531					
	PLOT DATE = 10/25/2010	DATE -	10/25/2010	REVISED -		SCALE: N/A SHEET NO. 1 OF 1 SHEETS STA. N/A TO STA. N/A	FED. ROAD DIST. NO. 1 ILLINOIS FED. AI	D PROJECT						

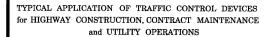


This Standard is used where at anytime, day or night, any vehicle quipment, workers or their activities encroach on the pavement requiring the closure of one or more traffic lanes in an urban area.

#### **DESIGN NOTES:**


- 1. All warning signs shall have minimum dimensions of 48" x 48".
- time exceeds four calendar days. All signs shall be posted with the bottom of the sign not less than 7' above the edge of pavement. "NO" PARKING" signs shall be installed throughout the work area at the discretion of the Engineer
- The distance "L" shall be defined as:

SPEED	FORMULA
≤ 40 MPH	$L = (WS^2)/60$
≥ 45 MPH	L = LW x S
W = Width of Clos S = Normal Poste LW = Lane Width	d Speed Limit in MPH

- Type II barricades with Type C steady burning lights shall be used in lieu of cones for night operations. All cones and barricades shall be in accordance with IDOT Standard 701901.
- Type A flashing lights shall be used on each approach in advance of the work area during hours of darkness and installed above the first two signs in each series and the high level warning devices
- If the work operation is performed between 9:00 am and 3:00 pm and the work does not exceed 15 minutes, the traffic protection shall be as shown for IDOT Standard 701301. Signs, when required, shall be at
- If the work area is in the parking lane and the parking exists during work hours, a "ROAD WORK AHEAD" sign shall be installed in Warning Sign Spacing Table and the area protected with cones or
- 9. Form BT 725 is required

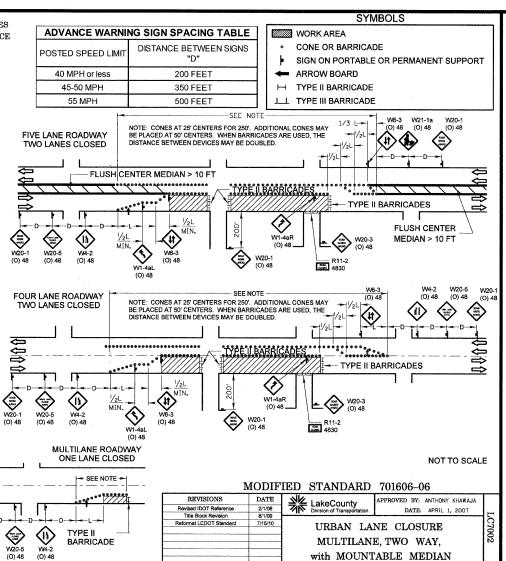

TYPICAL APPLICATION OF TRAFFIC CONTROL DEVICES for HIGHWAY CONSTRUCTION, CONTRACT MAINTENANCE and UTILITY OPERATIONS

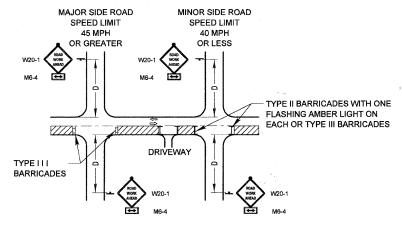

#### **SYMBOLS**

WORK AREA

55 MPH

SIGN ON PORTABLE OR PERMANENT SUPPORT 

LL TYPE III BARRICADE

#### ADVANCE WARNING SIGN SPACING TABLE DISTANCE BETWEEN SIGNS POSTED SPEED LIMI 40 MPH or less 200 FEET 45-50 MPH 350 FEET

500 FEET

#### **GENERAL NOTE:**

This Standard is used where at anytime, day or night, any vehicle, equipment, workers or their

#### **DESIGN NOTES:**

- 1. For a side road with a speed limit of 40 mph or less, the closed portion of the main route shall be protected by blocking with Type II or Type III barricades, % of the cross section of
- 2. For a side road with a speed limit of 45 mph or greater, the closed portion of the main route shall be protected by blocking with Type III barricades, ½ of the cross section of the closed
- 3. All W20-1 "ROADWORK AHEAD" signs shall be 48" x 48" with fluorescent orange reflective sheeting with an amber Type A flashing light mounted on the sign.
- 4. When the side road lies between the beginning of the mainline signing and the work zone, a M6-1 Single Headed Arrow shall be used in lieu of the M6-4 Double Headed Arrow.
- 5. For a lane closure on a side road or driveway, use the applicable portions of the appropriate Highway Standard or Traffic Control Detail. The spacing of the signs and barricades shall be adjusted for field conditions as directed by the engineer. The directional arrow shall be covered or removed when no longer consistent with the side road lane closure.
- 6. Advance warning signs shall be omitted on driveways unless otherwise noted
- 7. The traffic control and protection for side roads and intersections shall be included in the contract unit lump sum price for "TRAFFIC CONTROL AND PROTECTION."

MODIFIED IDOT DISTRICT ONE SIDE ROAD DETAIL


REVISIONS	DATE	LakeCounty	APPROVED BY: ANTHONY KHAWAJA	ı
Title Block Revision	8/1/09	LakeCounty  Division of Transportation	DATE: APRIL 1, 2007	
Reformat LCDOT Standard	7/15/10	for SIDEROADS	L and PROTECTION I, INTERSECTIONS	.C7004

	Reformat LCDOT Standard	7/15/10		S.
			TRAFFIC CONTROL and PROTECTION	700
			for SIDEROADS, INTERSECTIONS	4
NOT TO SCALE			and DRIVEWAYS	
				_

FILE NAME =	USER NAME = 3202080907	DESIGNED -	TC	REVISED -
LC0907-sht-details2.dgn		DRAWN ~	PWL	REVISED -
	PLOT SCALE = 2.0000 '/ IN.	CHECKED -	MRH	REVISED -
· ·	PLOT DATE = 11/3/2010	DATE -	11/3/2010	REVISED -


W20-1 (O) 48

			DETAILS			ř			 F.A.U. RTE.	SECTION	COUNTY	TOTAL SHEETS	SHEET NO.
									2626	05-00193-04-BR	LAKE	36	28
				,							CONTRAC	CT NO.	63531
SCALE: N/A	SHEET NO. 1	OF 1	SHEETS	STA.	N/A	TO	STA.	N/A	FED. RO	AD DIST. NO. 1 ILLINOIS FED.	AID PROJECT		

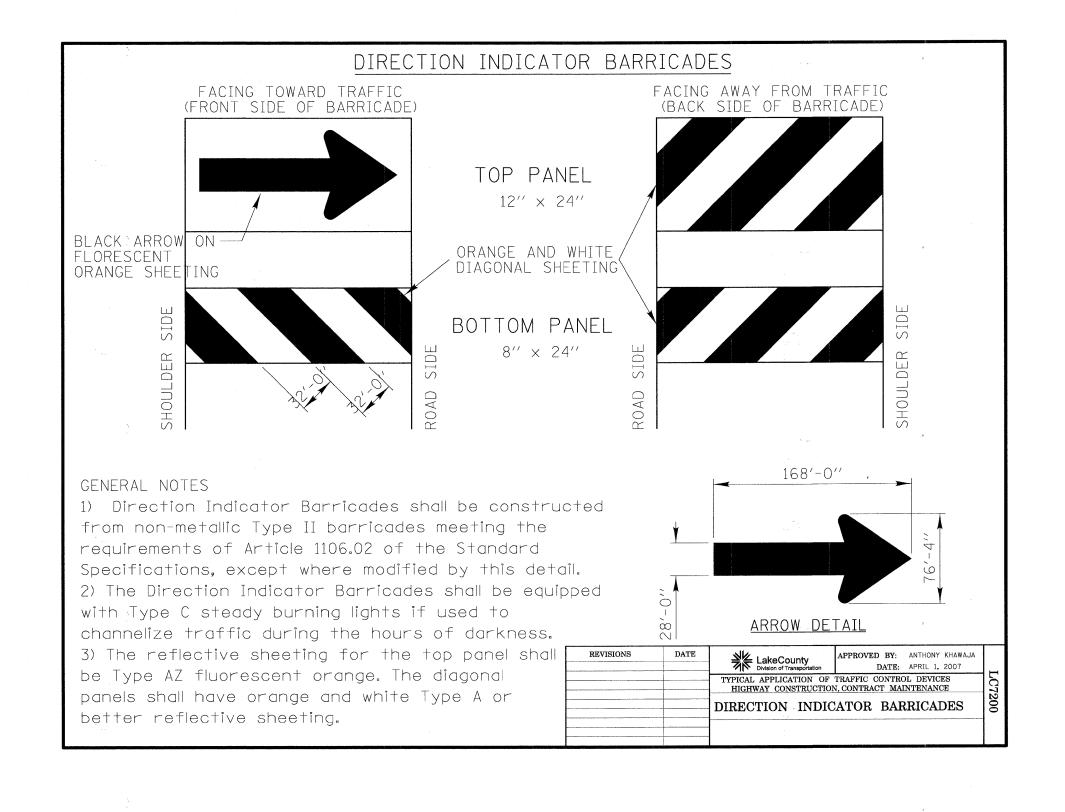

FILE NA	ME =	USER NAME = 3202080907	DESIGNED - TC	REVISED -		DETAILS	F.A.U. RTE.	SECTION	COUNTY	TOTAL SHEETS	HEET NO.
LCØ9Ø7-	sht-details3.dgn		DRAWN - PWL	REVISED -	STATE OF ILLINOIS		2626	05-00193-04-BR	LAKE	36	29
		PLOT SCALE = 2.0000 '/ IN.	CHECKED - MRH	REVISED ~	DEPARTMENT OF TRANSPORTATION				CONTRACT	NO. 63	531
I		PLOT DATE = 10/25/2010	DATE - 10/25/2010	REVISED -		SCALE: N/A SHEET NO. 1 OF 1 SHEETS STA. N/A TO STA. N/A	FED. ROAD DIS	ST. NO. 1 ILLINOIS FED. AI	PROJECT		

# WORK ZONE SPEED LIMIT SIGNS

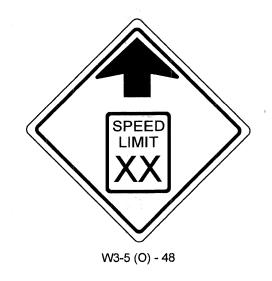

SPEED LIMIT

W2-I 115 (O) 3015

R2-1 3036

**BEGINS** 

MINIMUM

\$375 FINE R

W2-I 113 (O) 3011

R2-I 106 3015

END WORK ZONE SPEED LIMIT

G20-I 102, 24"X48"

WORK ZONE

W2-I 115 (O) 3015

SPEED LIMIT


R2-1 3036

\$375 FINE MINIMUM

R2-I 106 3015

R2-1 SPECIAL

# REVISIONS DATE Reformat LCDOT Standard 7/15/10 LakeCounty Division of Transportation PAPPROVED BY: A.KHAWAJA DATE: 4/14/09 WORK ZONE SPEED LIMIT SIGNING DIAGRAM (SHEET 2 OF 2)

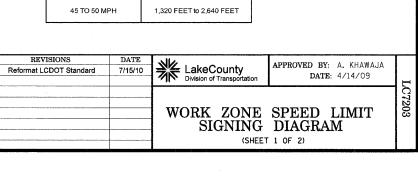

SIGNING FOR OPPOSITE TRAFFIC DIRECT	TION NOT SHOWN	OF OI TAPER	R OF THE LIMIT OF CONSTRUCTION	CONSTRUCTION			
ROAD WORK AHEAD AHEAD	D=150' 150'  THESE SIGNS WILL VARY DEPENDING ON CONSTRUCTION ACTIVI	WORK ZONE SPEED LIMIT 35 BEGINS S375 FINE MINIMUM	S  WORK ZONE SPEED LIMIT 35 S375 FINE MINIMUM  NOTE: SPEED L	S  WORK ZONE SPEED LIMIT 35 \$35 \$376 FINE MINIMUM  IMIT VALUES SHOWN FOR EXAMPLE ON	S SPEED LIMIT 45  * WORK ZONE SPEED LIMIT		

BEGINNING

200 FEET IN ADVANCE

ADVANCE WARNING SIGN SPACING TABLE

WORK ZONE SPEED LIMIT SIGN SPACING

(EXISTING SPEED LIMIT)

URBAN-LOW SPEED (40 MPH or less)

URBAN-HIGH SPEED

(55 MPH or greater)

SPEED LIMIT

35 TO 40 MPH

DISTANCE BETWEEN SIGNS

200 FEET

350 FEET

500 FEET

DISTANCE BETWEEN SIGNS

990 FEET to 1,980 FEET

#### NOTES:


- 1. \*= EXISTING SPEED LIMIT BEFORE CONSTRUCTION.
- 2. THE SIGN SPACING BETWEEN WORK ZONE SPEED LIMIT SIGNS SHALL BE THE SAME AS COMPARABLE REGULAR SPEED LIMIT SIGNING AS STATED IN THE L.C.D.O.T. POLICY FOR THE ESTABLISHMENT AND POSTING OF SPEED LIMITS ON COUNTY AND TOWNSHIP HIGHWAYS WITHIN LAKE COUNTY, ILLINOIS. A MINIMUM OF 2 WORK ZONE SPEED LIMIT SIGNS SHALL BE REQUIRED PER DIRECTION OF TRAFFIC.
- 3. EXISTING SPEED LIMIT SIGNS AND POST SHALL BE REMOVED AND RETURNED TO THE L.C.D.O.T.'S SIGN SHOP WITHIN 24 HOURS OF REMOVAL.
- 4. ON MULTILANE HIGHWAYS, WORK ZONE SPEED LIMIT AND ADVANCE CONSTRUCTION SIGNING SHALL BE ON THE RIGHT SIDE RIGHT-OF-WAY AND THE LEFT MEDIAN, WHEN THE MEDIAN IS NOT PAVED AND THE WIDTH IS 10 FEET OR GREATER.
- ALL SIGNS SHALL BE PERMANENTLY POST MOUNTED IF THE SIGNS WILL BE DISPLAYED FOR MORE THAN 48 HOURS.


STATE OF ILLINOIS
DEPARTMENT OF TRANSPORTATION


SCALE: N/A


LIMIT

		DETAILS				F.A.U. RTE.	SECTION	COUNTY	TOTAL SHEETS	SHEE NO.
						2626	05-00193-04-BR	LAKE	36	30
·								CONTRAC	T NO.	6353
SHEET NO 1	OF 1	SHEETS	STA	N/A	TO STA. N/A	EED BO	ID DIST NO 1 THE THOIS EED A	ID DOO IECT		

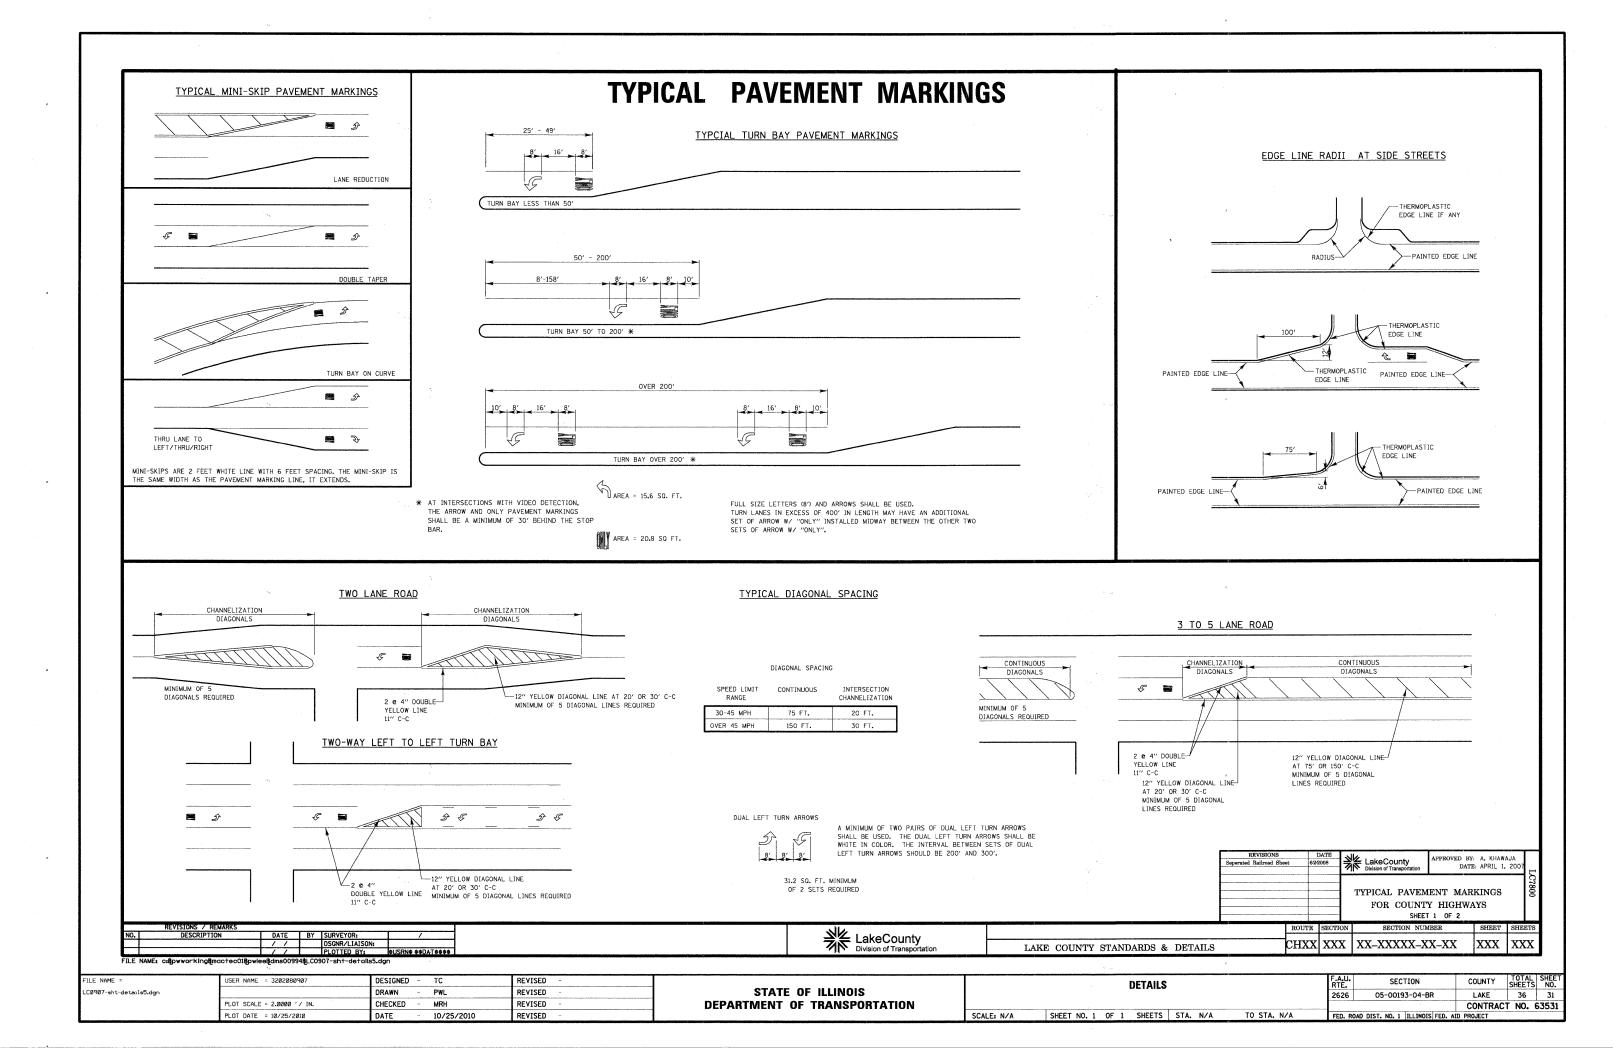

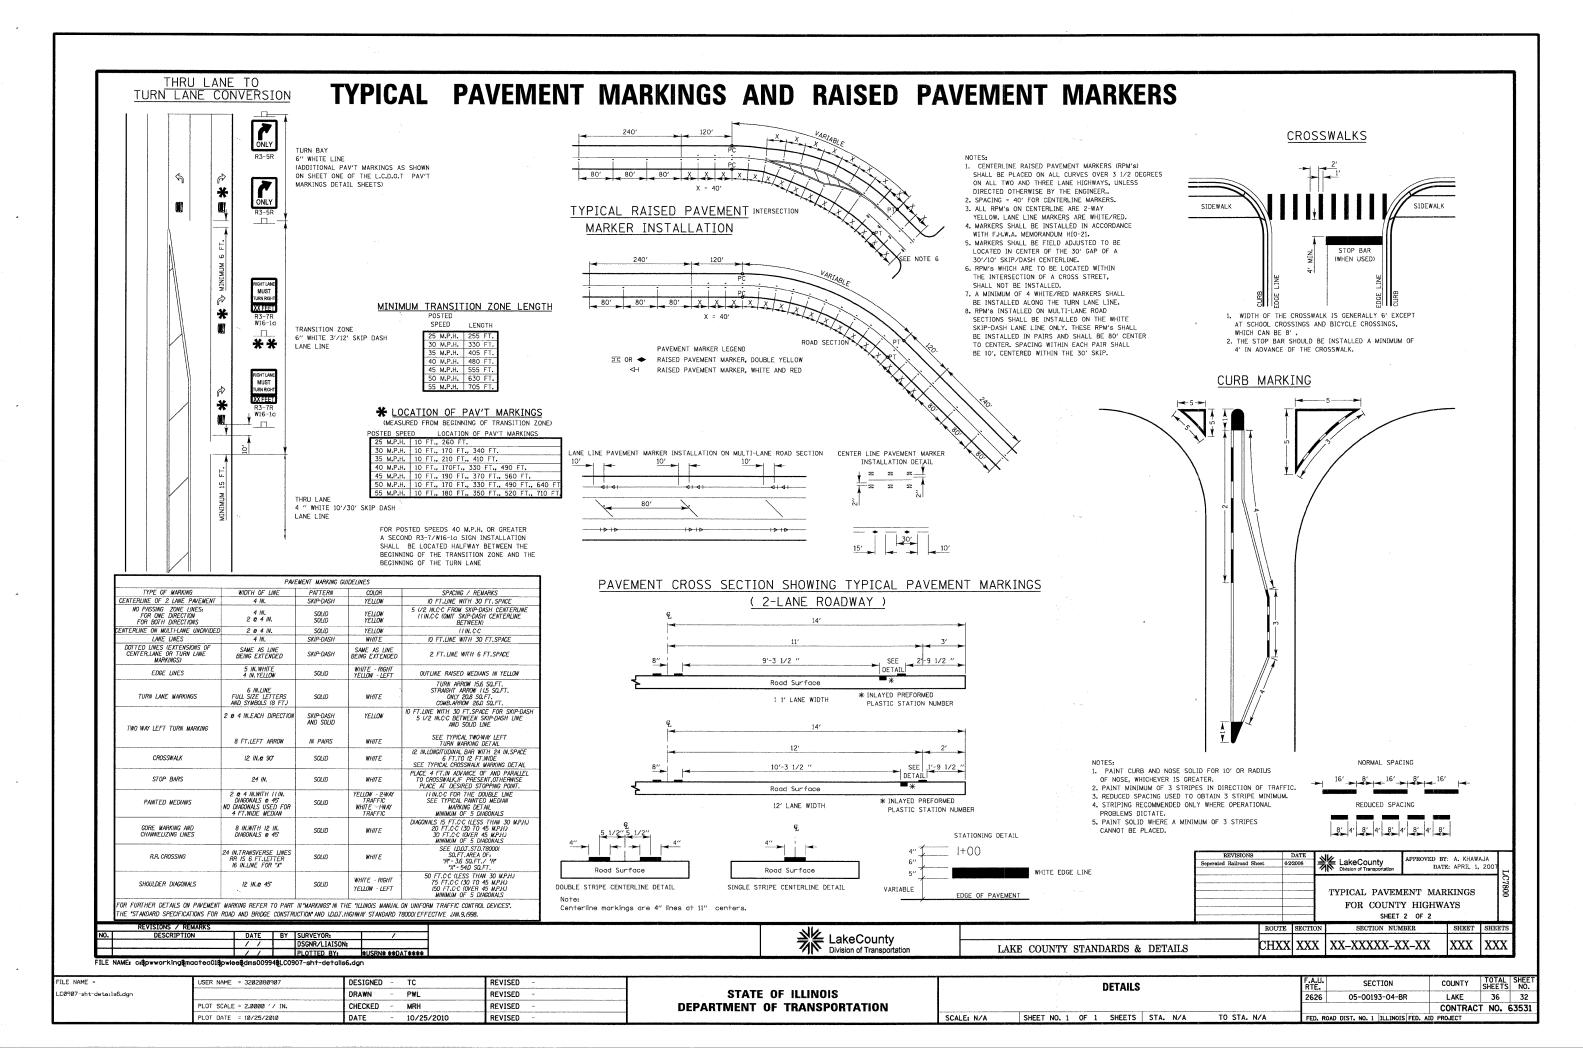


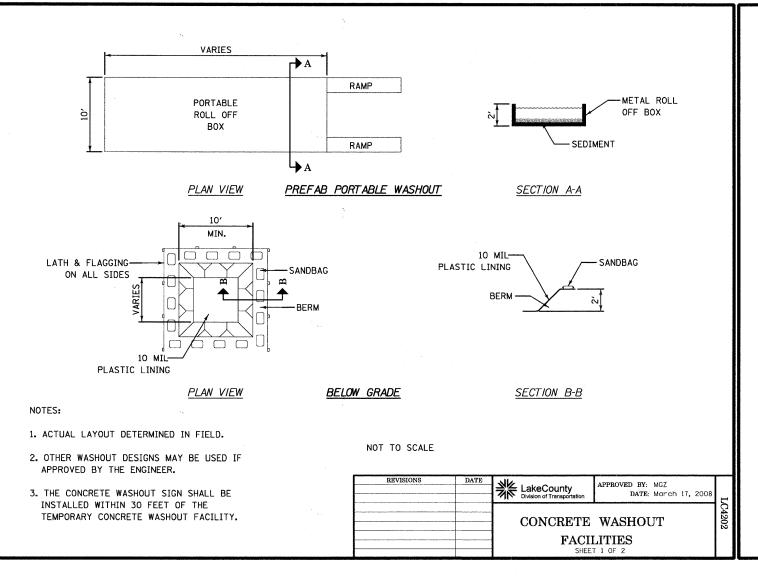

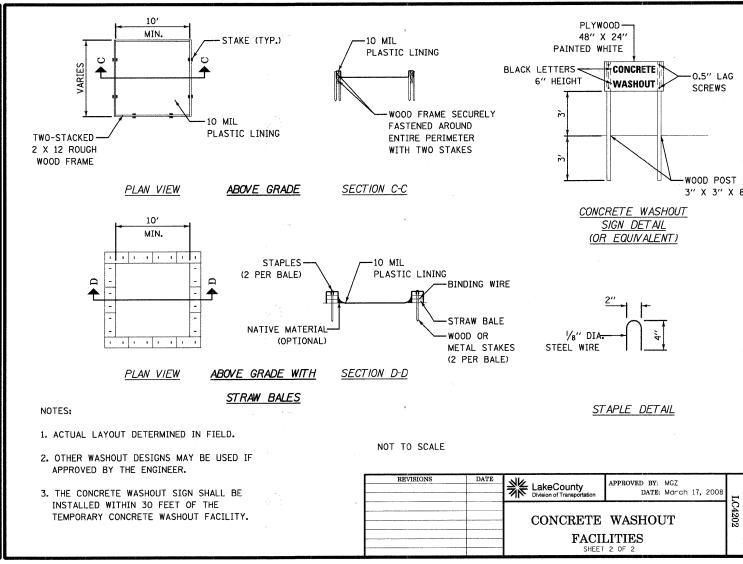


FILE NAME =	USER NAME = 3202080907	DESIGNED	-	TC	REVISED -
LC0907-sht-details7.dgn		DRAWN		PWL	REVISED -
	PLOT SCALE = 2.0000 '/ IN.	CHECKED	- ,	MRH	REVISED -
	PLOT DATE = 10/25/2010	DATE	-	10/25/2010	REVISED -

DETAILS						F.A.U. RTE.	SECTION	COUNTY	TOTAL SHEETS						
											2626	05-00193-04-BR	LAKE	36	33
													CONTRAC	T NO.	63531
SCALE: N/A	SHEET NO	) <b>.</b> 1	OF	1	SHEETS	STA.	N/A	TO STA	N/A		FED. ROA	AD DIST. NO. 1 ILLINOIS FED.	AID PROJECT		

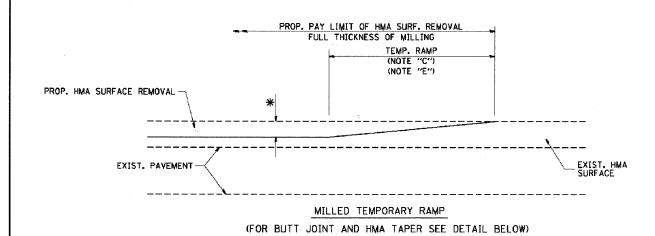


#### OPTION 1

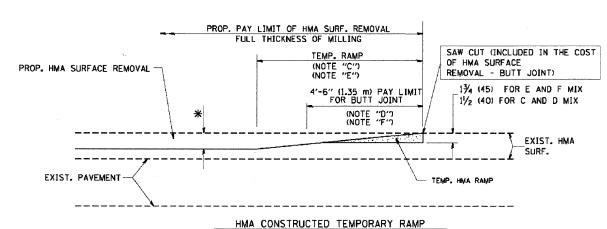


#### (FOR BUTT JOINT AND HMA TAPER SEE DETAIL BELOW)


#### OPTION 2

#### TYPICAL TEMPORARY RAMP

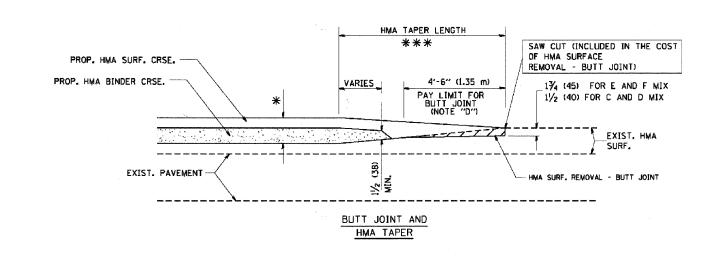

# TYPICAL BUTT JOINT AND HMA TAPER FOR MILLING AND RESURFACING

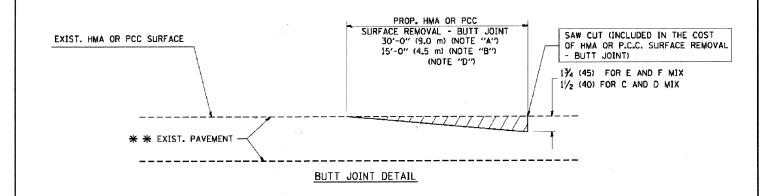

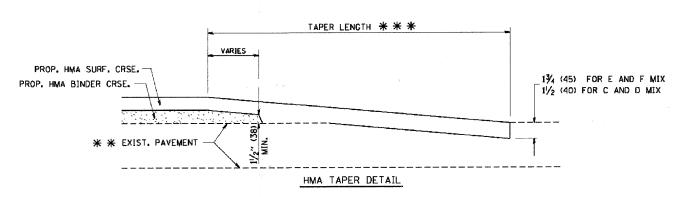

# TYPICAL BUTT JOINT AND HMA TAPER FOR RESURFACING ONLY

\* \* PC CONCRETE, HMA OR HMA RESURFACED PAVEMENT.

#### NOTES

- A: MAINLINE ROADWAYS AND MAJOR SIDE ROADS.
- B: MINOR SIDE ROADS.
- C: THE TEMP. RAMP SHALL BE CONSTRUCTED IMMEDIATELY UPON REMOVAL OF THE EXISTING HMA SURFACE.
- D: THE BUTT JOINT SHALL BE CONSTRUCTED IMMEDIATELY PRIOR TO PLACING THE PROPOSED HMA COURSES.
- E: TAPER THE TEMP. RAMP AT A RATE OF 3'-0" (900 mm) PER 1 INCH (25 mm) OF MILLING THICKNESS.
- F: INSTALLATION AND REMOVAL OF THE 4'-6" (1.35 m) TEMP. RAMP IS INCLUDED IN COST OF HMA SURFACE REMOVAL BUTT JOINT
- G: SEE ARTICLE 406.08 AND 406.14 OF THE STANDARD SPECIFICATIONS FOR "HMA AND/OR PCC SURFACE REMOVAL, BUTT JOINT".
- \* SEE TYPICAL SECTIONS FOR MILLING THICKNESS.


#### BASIS OF PAYMENT:

THE BUTT JOINT WILL BE PAID FOR AT THE CONTRACT UNIT PRICE PER SOUARE YARD (SQUARE METER) FOR "HOT-MIX ASPHALT SURFACE REMOVAL - BUTT JOINT" OR FOR "PORTLAND CEMENT CONCRETE SURFACE REMOVAL- BUTT JOINT".

ALL DIMENSIONS ARE IN INCHES (MILLIMETERS) UNLESS OTHERWISE SHOWN,


П					
	FILE NAME =	USER NAME = geglienobt	DESIGNED - M. DE YONG	REVISED - F	R. SHAH 10-25-94
	W:\diststd\22x34\bd32.dgn		DRAWN -	REVISED - A	A. ABBAS 03-21-97
		PLOT SCALE = 50.00000 '/ IN.	CHECKED -	REVISED - I	M. GOMEZ 04-06-01
		PLOT DATE = 1/4/2008	DATE - 06-13-90	REVISED - F	R. BORO 01-01-07


	BUTT JOINT AND					SECTION	COUNTY	SHEETS	SHEE NO.
I		HMA TAPER	2626	05-00193-04-BR	LAKE	36	34		
I		NIWA IAFEN		BD400-05 BD32	CONTRACT	NO.	63531		
	SCALE: NONE	SHEET NO. 1 OF 1 SHEETS	STA. N/A	TO STA. N/A	FEB. RI	OAD DIST. NO. 1 ILLINOIS FED.	AID PROJECT		

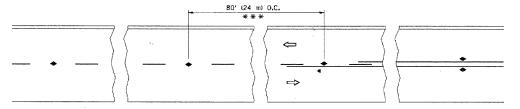


\*\*\* REDUCE TO 40' (12 m) O.C. ON CURVES WITH POSTED OR ADVISORY SPEED 45 M.P.H. (TO km/h) OR LESS.

TWO-LANE/TWO-WAY

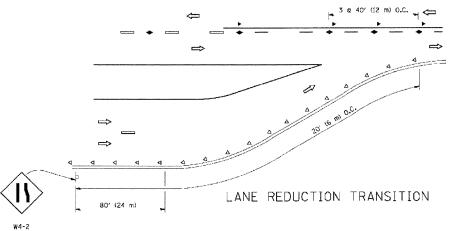


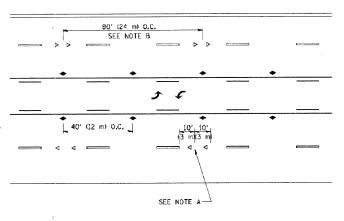

TWO-WAY LEFT TURN

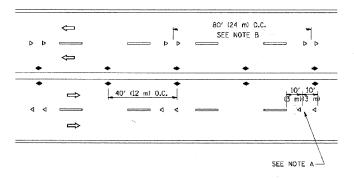

MULTI-LANE/UNDIVIDED

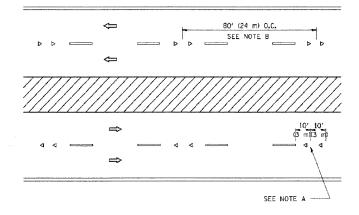

MULTI-LANE/DIVIDED

#### GENERAL NOTES

- MARKERS USED WITH DASHED LINES SHALL BE CENTERED IN THE GAP BETWEEN SEGMENTS.
- 2. MARKERS USED ADJACENT TO SOLID LINES SHALL BE OFFSET 2 TO 3 (50 TO 75) TOWARD TRAFFIC AS SHOWN.
- 3. MARKERS THROUGH TANGENTS LESS THAN 500' (150 m) IN LENGTH BETWEEN CURVES SHALL BE INSTALLED AT THE LESSER OF THE TWO CURVE SPACINGS.

#### LANE MARKER NOTES

A USE DOUBLE LANE LINE MARKERS SPACED AS SHOWN.

B. REDUCE TO 40' (12 m) O.C. ON CURYES WHERE ADVISORY SPEEDS ARE 10 M.P.H (20 km/h) LOWER THAN POSTED SPEEDS.

#### SYMBOLS

---- YELLOW STRIPE

WHITE STRIPE


- ONE-WAY AMBER MARKER
- ONE-WAY CRYSTAL MARKER (W/O)
- TWO-WAY AMBER MARKER

#### DESIGN NOTES

1. DOUBLE LANE LINE MARKERS SHALL BE USED UNLESS SPECIFIED OTHERWISE.

\_\_\_\_\_

- 2. EXCEPT AS SHOWN ON THE LANE REDUCTION TRANSITION AND FREEWAY EXIT RAMP DETAIL, MARKERS ARE NOT TO BE SPECIFIED ON RIGHT EDGE LINES.
- 3. THE EXACT WARKER LIMITS, SPACING, AND COLOR SHOULD BE INCLUDED IN THE PLANS.
- 4. MARKERS SHOULD NOT BE USED ALONGSIDE CURBS EXCEPT FOR EXTREMELY SHORT SECTIONS OF CURBS WHERE NOT MORE THAN TWO MARKERS WOULD BE INVOLVED.

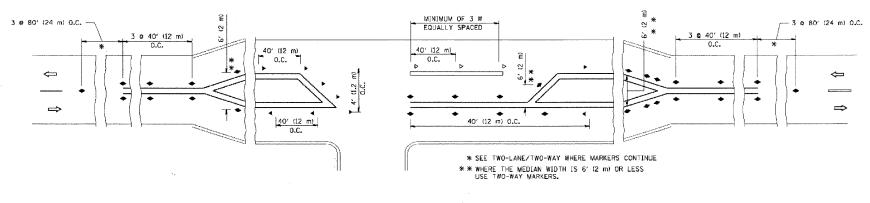


LEFT TURN

All dimensions are in inches (millimeters) unless otherwise shown.

FILE NAME -	USER NAME - drivakosgn	DESIGNED -	REVISED	-T. RAMMACHER 09-19-94
c:\pw_work\pwidot\drivakosgi\d0180315\to	l1.dgn	DRAWN -	REVISED	T. RAMMACHER 03-12-99
	PLOT SCALE - 50.000 '/ IN.	CHECKED -	REVISED	-T. RAMMACHER 01-06-00
	PLD1 DATE = 97972009	DATE -	REVISED	- C. JUCIUS 09-09-09

STATE	OF	ILLINOIS
DEPARTMENT	OF	TRANSPORTATION

TYPICAL APPLICATIONS						SECTIÓN	COUNTY	TOTAL SHEETS	SHEE'
DAICED DEEL		-		RESISTANT)	2626	05-00193-04-BR	LAKE	36	35
HAISED KEFLI	Clive Pavewicia	I WANKEN	2 (214044-LF044	nealatAivi)		TC-11	CONTRACT	NO. (	63531
SCALE: NONE SHI	EET NO. 1 OF 1	SHEETS	STA. N/A	TO STA. N/A	FED. RO	DAD DIST. NO. 1 ILLINOIS FED. A	ID PROJECT		

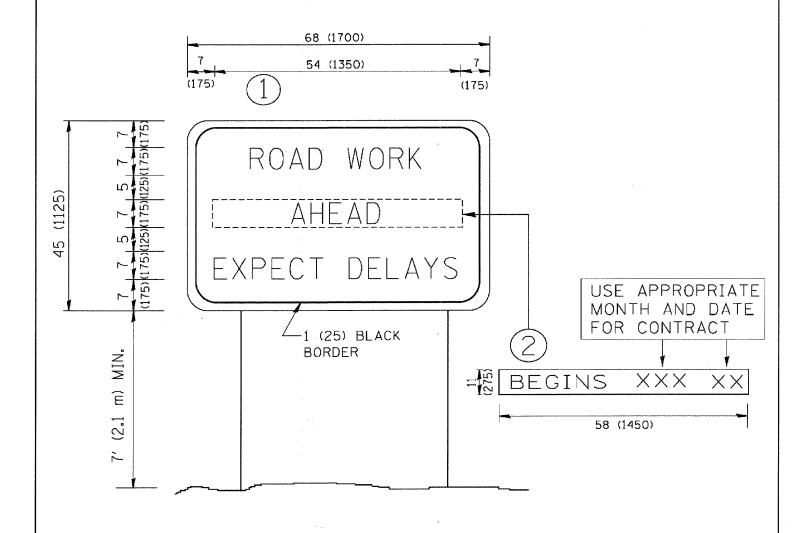

# NOTES:

- 1. USE BLACK LETTERING ON ORANGE BACKGROUND.
- 2. ERECT SIGNS IN ADVANCE OF THE LOCATION FOR THE "ROAD CONSTRUCTION AHEAD" SIGN AT LOCATIONS AS DIRECTED BY THE ENGINEER.
- 3. ERECT SIGN () WITH INSTALLED PANEL (2) ONE WEEK PRIOR TO THE START OF CONSTRUCTION.
- 4. REMOVE PANEL 2 SOON AFTER THE START OF CONSTRUCTION.
- 5. SEE SPECIAL PROVISION FOR "TEMPORARY INFORMATION SIGNING" FOR ADDITIONAL INFORMATION.
- 6. ONE SIGN ASSEMBLY EQUALS 25.70 SQ. FT. (2.3 SQ. M.)
- 7. SHALL BE PAID FOR AS TEMPORARY INFORMATION SIGNING.

ALL DIMENSIONS ARE IN INCHES (MILLIMETERS) UNLESS OTHERWISE SHOWN.

L						· ·					
	FILE NAME =	USER NAME = gaglianobt	DESIGNED -	REVISED - R. MIRS 09-15-97		ARTERIAL ROAD	F.A	SECTION	COUNTY	TOTAL	SHEET
- 1	Wr\diatatd\22x34\to22.dgn		DRAWN -	REVISED - R. MIRS 12-11-97	STATE OF ILLINOIS DEPARTMENT OF TRANSPORTATION	*	2626	05-00193-04-BR	LAKE	36	36
		PLOT SCALE = 50.000 1/ IN.	CHECKED -	REVISED -T. RAMMACHER 02-02-99		INFORMATION SIGN	TC-22		CONTRACT NO.		3531
L		PLOT DATE = 1/4/2008	DATE -	REVISED - C. JUCIUS 01-31-07		SCALE: NONE SHEET NO. 1 OF 1 SHEETS STA. N/A TO STA. N/A	FED. ROAD	DIST, NO. 1 ILLINOIS FED. AIL	) PROJECT		