01-20-2023 LETTING ITEM 053

STATE OF ILLINOIS DEPARTMENT OF TRANSPORTATION

F.AU SECTION COUNTY TOTAL SHEET NO. 2906 22-00115-00-RS COOK 35 1 ILLINOIS CONTRACT NO. 61J24

PLANS FOR PROPOSED FEDERAL AID PROJECT

FOR INDEX OF SHEETS, SEE SHEET NO. 2
FOR HIGHWAY STANDARDS, SEE SHEET NO. 2

STATE STREET

US ROUTE 6 TO SIBLEY BOULEVARD

2021 ADT-

12,200

POSTED SPEED LIMIT-

35 MPH

FUNCTIONAL CLASSIFICATION-

MINOR ARTERIAL

FAU ROUTE 2906 (STATE STREET)
US ROUTE 6 TO SIBLEY BOULEVARD (IL ROUTE 83)
ROADWAY RESURFACING

SECTION NO.: 22-00115-00-RS

PROJECT NO.: 95KT(361)

VILLAGE of SOUTH HOLLAND

COOK COUNTY

JOB NO.: C-91-377-22

RANGE 14 E

END PROJECT STA 88+88.39

END RESURFACING STA 88+35.06

BRIDGE RESURFACING OMISSION STA 65+80.90 TO STA 67+70.55



0 50' 100'

FULL SIZE PLANS HAVE BEEN PREPARED USING STANDARD ENGINEERING SCALES, REDUCED SIZED PLANS WILL NOT CONFORM TO STANDARD SCALES, IN MAKING MEASUREMENTS ON REDUCED PLANS, THE ABOVE SCALES MAY BE USED.

J. U. L. I. E.

JOINT UTILITY LOCATION INFORMATION FOR EXCAVATION 1 - 800 - 892 - 0123 OR 811

BEGIN RESURFACING STA 10+85.50

> BEGIN PROJECT STA 10+58.85

SOUTH HOLLAND

SN 016-0796


SN 016-8046


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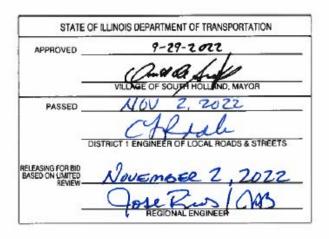
LOCATION MAP
NOT TO SCALE

GROSS LENGTH= 7,830 FEET= 1.48 MILES

NET LENGTH= 7,560 FEET= 1.43 MILES



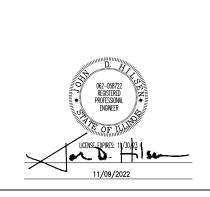

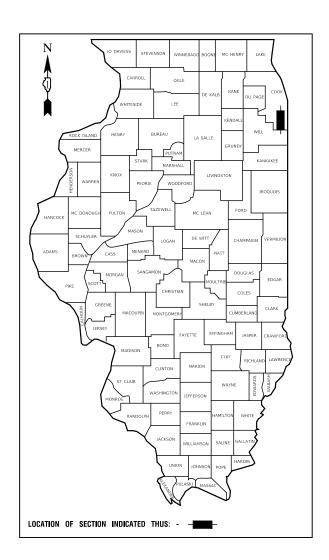

PRINTED BY THE AUTHORITY OF THE STATE OF ILLINOIS

CONTRACT NO. 61J24

22R0706-COVR-01 - C0

.D.O.T. FEDERAL AID PROGRAM ENGINEER: CARMEN RAMOS, PE, SCHAL

INDEX OF SHEETS

- 1 COVER SHEET
- 2 INDEX OF SHEETS, HIGHWAY STANDARDS AND GENERAL NOTES
- 3-6 SUMMARY OF QUANTITIES
- 7-8 TYPICAL CROSS SECTIONS
- 9-11 ALIGNMENT, TIES AND BENCHMARKS
- 12-15 PROPOSED IMPROVEMENT PLAN
- 16-19 PAVEMENT MARKING AND SIGNAGE PLAN
- 20 DETECTOR LOOP REPLACEMENT US ROUTE 6
- 21 DETECTOR LOOP REPLACEMENT SIBLEY BLVD
- 22-35 IDOT DISTRICT 1 STANDARDS

HIGHWAY STANDARDS

| 000001-08 | STANDARD SYMBOLS, ABBREVIATIONS AND PATTERNS |
|-----------|--|
| 424001-11 | PERPENDICULAR CURB RAMPS FOR SIDEWALKS |
| 424006-05 | DIAGONAL CURB RAMPS FOR SIDEWALKS |
| 424011-04 | CORNER PARALLEL CURB RAMPS FOR SIDEWALKS |
| 424026-03 | ENTRANCE / ALLEY PEDESTRIAN CROSSINGS |
| 442201-03 | CLASS C AND D PATCHES |
| 606001-08 | CONCRETE CURB TYPE B AND COMBINATION CONCRETE CURB AND GUTTER |
| 701001-02 | OFF ROAD OPERATIONS, 2L, 2W, MORE THAN 15'(4.5m) AWAY |
| 701006-05 | OFF ROAD OPERATIONS, 2L, 2W, 15'(4.5m) TO 24"(600mm) FROM PAVEMENT EDGE |
| 701011-04 | OFF FOAD MOVING OPERATIONS, 2L,2W, DAY ONLY |
| 701301-04 | LANE CLOSURE, 2L, 2W, SHORT TIME OPERATIONS |
| 701311-03 | LANE CLOSURE, 2L, 2W, MOVING OPERATIONS - DAY ONLY |
| 701427-05 | LANE CLOSURE, MULTILANE, INTERMITTENT OR MOVING OPERATION FOR SPEEDS \leq 40 MPH |
| 701501-06 | URBAN LANE CLOSURE, 2L, 2W, UNDIVIDED |
| 701602-10 | URBAN LANE CLOSURE, MULTILANE, 2W WITH BIDIRECTIONAL LEFT TURN LANE |
| 701606-10 | URBAN SINGLE LANE CLOSURE, MULTILANE, 2W WITH MOUNTABLE MEDIAN |
| 701611-01 | URBAN HALF ROAD CLOSURE, MULTILANE, 2W WITH MOUNTABLE MEDIAN |
| 701701-10 | URBAN LANE CLOSURE, MULTILANE INTERSECTION |
| 701801-06 | SIDEWALK, CORNER OR CROSSWALK CLOSURE |
| 701901-08 | TRAFFIC CONTROL DEVICES |
| 720001-01 | SIGN PANEL MOUNTING DETAILS |
| 720006-04 | SIGN PANEL ERECTION DETAILS |
| 728001-01 | TELESCOPING STEEL SIGN SUPPORT |
| 731001-01 | BASE FOR TELESCOPING STEEL SIGN SUPPORT |
| | |

DISTRICT ONE DETAILS

DETECTOR LOOP INSTALLATIONS

886001-01

FILE NAME = 22R0706-INDX-01 - P01

| BD-01 | DRIVEWAY DETAIL - DISTANCE BETWEEN R.O.W. AND FACE OF CURB & EDGE OF SHOULDER $\geq 15'(4.5\text{m})$ |
|-------|---|
| BD-02 | DRIVEWAY DETAIL - DISTANCE BETWEEN R.O.W. AND FACE OF CURB < 15'(4.5m) |
| BD-08 | FRAMES AND LIDS ADJUSTMENT WITH MILLING |
| BD-22 | PAVEMENT PATCHING FOR HMA SURFACED PAVEMENT |
| BD-24 | CURB OR CURB AND GUTTER REMOVAL AND REPLACEMENT |
| BD-32 | BUTT JOINTS AND HMA TAPER |
| TC-10 | TRAFFIC CONTROL AND PROTECTION FOR SIDE ROADS, INTERSECTIONS AND DRIVEWAYS |
| TC-11 | TYPICAL APPLICATIONS RAISED REFLECTIVE PAVEMENT MARKERS (SNOW-PLOW RESISTANT) |
| TC-13 | DISTRICT ONE TYPICAL PAVEMENT MARKINGS |
| TC-14 | TRAFFIC CONTROL AND PROTECTION AT TURN BAYS (TO REMAIN OPEN TO TRAFFIC) |
| TC-16 | SHORT TERM PAVEMENT MARKING LETTERS AND SYMBOLS |
| TC-26 | DRIVEWAY ENTRANCE SIGNING |
| TS-05 | DISTRICT ONE STANDARD TRAFFIC SIGNAL DESIGN DETAILS |
| TS-07 | DETECTOR LOOP INSTALLATION DETAIL FOR ROADWAY RESURFACING |

GENERAL NOTES

- ITEMS OF WORK LISTED IN THE SUMMARY OF QUANTITIES NOT SPECIFICALLY CALLED OUT ON THE PLANS SHALL BE PERFORMED AS DIRECTED BY THE ENGINEER.
- 2. THE ROBINSON ENGINEERING, LTD. FIELD OFFICE (708-331-6700), AND THE PUBLIC WORKS DIRECTOR, AT THE VILLAGE OF SOUTH HOLLAND, SHALL BE NOTIFIED TWO (2) WORKING DAYS BEFORE CONSTRUCTION BEGINS.
- 3. BEFORE STARTING ANY EXCAVATION THE CONTRACTOR SHALL CALL "J.U.L.I.E." AT (800) 892-0123 OR 811 AND (312) 744-7000 FOR FIELD LOCATIONS OF BURIED ELECTRIC, TELEPHONE AND GAS UTILITIES. (48 HOUR NOTIFICATION REQUIRED)
- 4. UTILITIES INDICATED ON THE PLANS ARE PROVIDED FOR THE CONTRACTOR'S USE AND ARE BASED UPON INFORMATION AVAILABLE AT THE TIME OF THE ADVERTISEMENT FOR BIDS. THE OWNER AND ENGINEER DO NOT GUARANTEE THE ACCURACY OF UTILITY INFORMATION.
- 5. IT SHALL BE THE CONTRACTOR'S RESPONSIBILITY TO VERIFY ALL DIMENSIONS AND CONDITIONS EXISTING IN THE FIELD PRIOR TO CONSTRUCTION AND ORDERING OF MATERIALS.
- 6. THE THICKNESS OF HMA MIXTURE STATED IN THE SPECIFICATIONS IS THE NOMINAL THICKNESS. DEVIATIONS FROM THE NOMINAL THICKNESS WILL BE PERMITTED WHEN SUCH DEVIATIONS OCCUR DUE TO IRREGULARITIES IN THE EXISTING SURFACE OR BASE ON WHICH THE HMA SURFACE IS PLACED.
- 7. ANY LOOSE MATERIAL DEPOSITED IN THE FLOW LINE OF DITCHES, GUTTERS OR OTHER DRAINAGE STRUCTURES SHALL BE REMOVED BY THE END OF EACH DAY BY THE CONTRACTOR.
- 8. CLASS D PATCHING QUANTITIES FOR THIS CONTRACT SHALL BE PERFORMED AT THE DIRECTION OF THE ENGINEER AFTER PAVEMENT MILLING. PATCHES WITHIN THE ROADWAY SHALL BE PERFORMED AFTER MILLING.
- CONTRACTOR SHALL TAKE PRECAUTION BY PRESERVING EXISTING TREES WITHIN THE RIGHT OF WAY. IF ANY DAMAGE OCCURS, TREES SHALL BE REPLACED IN KIND PER ARTICLE 201.07 REPAIR OR REPLACEMENT OF EXISTING PLANT MATERIAL REQUIREMENTS STATED HEREIN.
- 10. NO PAVEMENT PATCHING SHALL BE PERMITTED AFTER FRIDAY AT 3:00 PM OF EACH AND EVERY WEEK AND NO HOLES WILL BE ALLOWED TO REMAIN OPEN OVERNIGHT OR OVER THE WEEKEND.
- 11. ALL EQUIPMENT SHALL BE REMOVED OFF THE VILLAGE STREETS DURING ALL HOLIDAY WEEKENDS AS COORDINATED WITH THE VILLAGE.
- 12. HMA PAVING SHALL BE PERFORMED WITH HOT JOINTS.
- 13. THE CONTRACTOR SHALL CONTACT KALPANA KANNAN-HOSADURGA, THE DISTRICT ONE TRAFFIC CONTROL SUPERVISOR, AT KALPANA.KANNAN-HOSADURGA@ILLINOIS.GOV A MINIMUM OF 72 HOURS IN ADVANCE OF BEGINNING WORK.

| USER NAME = | DESIGNED — BM | REVISED — | | | STATE STRE | ET | | F.A.U RTF | SECTION | COUNTY | TOTAL | SHEET |
|------------------------|---------------|-----------|------------------------------|--|--------------------------|----------|--------------------|--------------------|----------------------|----------|----------|-------|
| | CHECKED — WPD | REVISED — | STATE OF ILLINOIS | STATE STREET ROADWAY RESURFACING INDEX OF SHEETS & STATE STANDARDS. STANDARDS & GENERAL NO | | | | 2906 | 22-00115-00-RS | соок | 35 | 2 |
| PLOT SCALE = | DRAWN — RG | REVISED — | DEPARTMENT OF TRANSPORTATION | INDEX OF SHE | EETS & STATE STANDARDS, | STANDARI | DS & GENERAL NOTES | - | | CONTRACT | NO. 61J2 | 4 |
| PLOT DATE = 11-07-2022 | CHECKED — AG | REVISED — | | SCALE: NONE | SHEET NO. 2 OF 35 SHEETS | STA. | TO STA. | FED. BOAD DIST. NO | D. 1 ILLINOIS FED. A | | | |

| | | | | | FED 80% | FED 80% | FED 80% |
|---------------------------------------|-------------|---|--------|----------------|-------------|----------------------------|-------------|
| | | SUMMARY OF QUANTITIES | | | VILLAGE 20% | VILLAGE 20% | VILLAGE 20% |
| | | | | 1 | ROADWAY | SAFETY ONSTRUCTION TYPE CO | TRAINEES |
| S.P. | S.I. CODE N | PAY ITEM | UNIT | TOTAL QUANTITY | 0005 | 0021 | 0042 |
| | 2110161 | TOPSOIL FURNISH AND PLACE, 4" | SQ YD | 350 | 350 | | |
| | | | | | | | |
| ** | 2520011 | SODDING, SALT TOLERANT | SQ YD | 350 | 350 | | |
| | | | | | | | |
| ** | 2520020 | SUPPLEMENTAL WATERING | UNIT | 9 | 9 | | |
| | | | | | | | |
| | 2800025 | TEMPORARY EROSION CONTROL SEEDING | POUND | 7 | 7 | | |
| | | | | | | | |
| | 2800051 | INLET FILTERS | EACH | 94 | 94 | | |
| | | | | | | | |
| | 3510160 | AGGREGATE BASE COURSE, TYPE B 4" | SQ YD | 1,200 | 633 | 567 | |
| | | | | | | | |
| | 4060029 | BITUMINOUS MATERIALS (TACK COAT) | POUND | 33,072 | 33,072 | | |
| | | | | | | | |
| BDE | 4060037 | LONGITUDINAL JOINT SEALANT | FOOT | 24,520 | 24,520 | | |
| | | | | | | | |
| | 4060098 | HOT-MIX ASPHALT SURFACE REMOVAL - BUTT JOINT | SQ YD | 338 | 338 | | |
| | | | | | | | |
| D1 | 4060308 | HOT-MIX ASPHALT BINDER COURSE, IL-19.0, N70 | TON | 6,359 | 6,359 | | |
| | | | | | | | |
| D1 | 4060406 | HOTMIX ASPHALT SURFACE COURSE, IL-9.5, MIX "D", N70 | TON | 5,776 | 5,776 | | |
| | | | | | | | |
| ** | 4230040 | PORTLAND CEMENT CONCRETE DRIVEWAY PAVEMENT, 8 INCH | SQ YD | 179 | 179 | | |
| | | · | | | | | |
| ** | 4240020 | PORTLAND CEMENT CONCRETE SIDEWALK 5 INCH | SQ FT | 4,802 | | 4,802 | |
| | | | | -, | | | |
| ** | 4240041 | PORTLAND CEMENT CONCRETE SIDEWALK 8 INCH | SQ FT | 283 | | 283 | |
| | .2.3311 | | | | | | |
| ** | 4240080 | DETECTABLE WARNINGS | SQ FT | 525 | | 525 | |
| · · · · · · · · · · · · · · · · · · · | 1270000 | | 28(11 | 020 | | 525 | |
| | 4400016 | HOT-MIX ASPHALT SURFACE REMOVAL, 4" | SQ YD | 49,000 | 49,000 | | |
| | 7700010. | THE THE CONTROL NEMOTILE, T | 34 10 | 10,000 | | | *** |
| ** | 4400020 | DRIVEWAY PAVEMENT REMOVAL | SQ YD | 633 | 633 | | |
| | 4400020 | DAIVERAL FAVENCINI REMOVAL | 3 V 10 | 033 | | | |
| | 4400070 | CURD DEMOVAL | 5007 | 70 | 70 | | |
| | 4400030 | CURB REMOVAL | FOOT | 39 | 39 | | |

| FILE NAME = 22R0706-QUAN-01 - Q01 | USER NAME = | DESIGNED - BM | REVISED — | | STATE STREET | F.A.U. SECTION COUNTY TOTAL SHEETS NO. |
|-----------------------------------|------------------------|---------------|-----------|------------------------------|---|---|
| | | CHECKED JDH | REVISED | STATE OF ILLINOIS | ROADWAY RESURFACING | 2906 22-00115-00-RS COOK 35 3 |
| | PLOTSCALE = | DRAWN BG | REVISED | DEPARTMENT OF TRANSPORTATION | SUMMARY OF QUANTITIES | CONTRACT NO. 61J24 |
| | PLOT DATE = 11-07-2022 | CHECKED AG | REVISED | | SCALE: NONE SHEET NO. 3 OF 35 SHEETS STA. TO STA. | FED. ROAD DIST, NO. 1 ILLINOIS FED, AID PROJECT 95KT(361) |

| | | | | | | FED 80% | FED 80% | FED 80% |
|------|------|----------|--|--------|----------------|---------------------|-------------|-------------|
| | | | SUMMARY OF QUANTITIES | | | VILLAGE 20% | VILLAGE 20% | VILLAGE 20% |
| | | | | | | ROADWAY | SAFETY | TRAINEES |
| S.P. | S.I. | CODE NO. | PAY ITEM | UNIT | TOTAL QUANTITY | CONSTRUCTION TYPE (| | DE |
| | 2.1. | | PAT IIEM | UNII | TOTAL QUANTITY | 0005 | 0021 | 0042 |
| ** | | 44000500 | COMBINATION CURB AND GUTTER REMOVAL | FOOT | 4,016 | 4,016 | | |
| | | | | | | | | |
| ** | | 44000600 | SIDEWALK REMOVAL | SQ FT | 5,109 | | 5,109 | |
| | | | | | | | | |
| | | 44201741 | CLASS D PATCHES, TYPE II, 8 INCH | SQ YD | 120 | 120 | | |
| | | | | | | | | |
| | | 44201745 | CLASS D PATCHES, TYPE III, 8 INCH | SQ YD | 70 | 70 | | |
| | | | | | | | | |
| | | 44201747 | CLASS D PATCHES, TYPE IV, 8 INCH | SQ YD | 140 | 140 | | |
| | | 44201747 | CLASS D FAIGHES, TIPE IV, B INCH | 30 10 | 140 | 140 | | |
| ** | | | | | | | | |
| * * | | 60266600 | VALVE BOXES TO BE ADJUSTED | EACH | 9 | 9 | | |
| | | | | | | | | |
| | | 60406000 | FRAMES AND LIDS, TYPE 1, OPEN LID | EACH | 3 | 3 | | |
| | | | | | | | | |
| | | 60600605 | CONCRETE CURB, TYPE B | FOOT | 39 | 39 | | |
| | | | | | | | | |
| | | 60604400 | COMBINATION CONCRETE CURB AND GUTTER, TYPE B-6.18 | FOOT | 4,016 | 4,016 | | |
| | | | | | | • | | |
| ** | * | 66900200 | NON-SPECIAL WASTE DISPOSAL | CU YD | 10 | 10 | | |
| | | | | | | | | |
| | * | 66900530 | SOIL DISPOSAL ANALYSIS | EACH 1 | | | | |
| | ~~ | | | | | 1 | | |
| | | 66901001 | REGULATED SUBSTANCES PRE-CONSTRUCTION PLAN | LSUM | 1 | 1 | | |
| | * | 00301001 | REGULATED SUBSTANCES FRE-CONSTRUCTION FLAN | ESOW | <u>'</u> | ı | | |
| | | | | | | | | |
| | * | 66901003 | REGULATED SUBSTANCES FINAL CONSTRUCTION REPORT | L SUM | 1 | 1 | | |
| | | | | | | | | |
| | * | 66901006 | REGULATED SUBSTANCES MONITORING | CAL DA | 7 | 7 | | |
| | | | | | | | | |
| | | 67100100 | MOBILIZATION | L SUM | 1 | 1 | | |
| | | | | | | | | |
| | | 70102620 | TRAFFIC CONTROL AND PROTECTION, STANDARD 701501 | L SUM | 1 | 1 | | |
| | | | | | | | | |
| | | 70102625 | TRAFFIC CONTROL AND PROTECTION, STANDARD 701606 | L SUM | 1 | 1 | | |
| | | | | | | | | |
| | İ | 70102632 | TRAFFIC CONTROL AND PROTECTION, STANDARD 701602 | L SUM | 1 | 1 | | |
| | | 70102002 | TOTAL OF THE PROPERTY OF THE P | E 30M | 1 | 1 | | |

| , | | | | | | | | |
|-----------------------------------|-------------------------|-------------|-------------------|------------------------------|---------------------|---------------------------------------|-----------------------------|--------------------------------|
| FILE NAME = 22R0706-QUAN-01 - Q02 | CHECKED — JDH REVISED — | | | STATE STREET | | F.A.U. SECTION | COUNTY TOTAL SHEET NO. | |
| | | | STATE OF ILLINOIS | | ROADWAY RESURFACING | 2906 22-00115-00-9 | S COOK 35 4 | |
| | PLOTSCALE = | DRAWN BG | REVISED | DEPARTMENT OF TRANSPORTATION | | SUMMARY OF QUANTITIES | | CONTRACT NO. 61J24 |
| | PLOT DATE = 11-07-2022 | CHECKED APG | REVISED | | SCALE: | SHEET NO. 4 OF 35 SHEETS STA. TO STA. | FEO. ROAD DIST, NO. 1 ILLIN | OIS FED. AID PROJECT 95KT(361) |

| | SUMMARY OF QUANTITIES | | | | | FED 80% VILLAGE 20% | FED 80% VILLAGE 20% | FED 80% VILLAGE 20% |
|------|-----------------------|-----------|--|--------|----------------|------------------------|------------------------|------------------------|
| | | | SOMINALLY OF QUARTITIES | | | ROADWAY | SAFETY | TRAINEES |
| | | | | | | | DNSTRUCTION TYPE CO | Į |
| S.P. | S.I. | CODE NO. | PAY ITEM | UNIT | TOTAL QUANTITY | 0005 | 0021 | 0042 |
| | | 70102634 | TRAFFIC CONTROL AND PROTECTION, STANDARD 701611 | L SUM | 1 | 1 | | |
| | | | | | | | | |
| | | 70102635 | TRAFFIC CONTROL AND PROTECTION, STANDARD 701701 | L SUM | 1 | 1 | | |
| | | 70102640 | TRAFFIC CONTROL AND PROTECTION, STANDARD 701801 | L SUM | 1 | 1 | | |
| | | | | | | | | |
| | | 70107025 | CHANGEABLE MESSAGE SIGN | CAL DA | 70 | 70 | | |
| | | 70300100 | SHORT TERM PAVEMENT MARKING | FOOT | 4,370 | | 4,370 | |
| | | | | | | | | |
| | | 70300150 | SHORT TERM PAVEMENT MARKING REMOVAL | SQ FT | 1,460 | | 1,460 | |
| | * | 72000100 | SIGN PANEL - TYPE 1 | SQ FT | 91 | | 91 | |
| | * | 72400100 | REMOVE SIGN PANEL ASSEMBLY — TYPE A | EACH | 12 | | 12 | |
| | | | | | | | | |
| | * | 72400310 | REMOVE SIGN PANEL - TYPE 1 | SQ FT | 34 | | 34 | |
| | * | 72800100 | TELESCOPING STEEL SIGN SUPPORT | FOOT | 186 | | 186 | |
| | * | 78000100 | THERMOPLASTIC PAVEMENT MARKING - LETTERS AND SYMBOLS | SQ FT | 437 | | 437 | |
| | * | 78000200 | THERMOPLASTIC PAVEMENT MARKING — LINE 4" | FOOT | 25,220 | | 25,220 | |
| | * | 78000400 | THERMOPLASTIC PAVEMENT MARKING — LINE 6" | FOOT | 2,000 | | 2,000 | |
| | | | | | | | · | |
| | * | 78000600 | THERMOPLASTIC PAVEMENT MARKING — LINE 12" | FOOT | 2,240 | | 2,240 | |
| | * | 78000650 | THERMOPLASTIC PAVEMENT MARKING — LINE 24" | FOOT | 460 | | 460 | |
| | * | 78100100 | RAISED REFLECTIVE PAVEMENT MARKER | EACH | 723 | | 723 | |
| | | 78300200 | RAISED REFLECTIVE PAVEMENT MARKER REMOVAL | EACH | 723 | | 723 | |
| | | , 3530200 | TO SEE THE PARTIES OF STREET OF STRE | LACH | ,25 | | 7 20 | |
| 1 | * | 88600600 | DETECTOR LOOP REPLACEMENT | FOOT | 1,079 | 1,079 | | |

| FILE NAME = 22R0708-QUAN-01 - Q03 | USER NAME = | DESIGNED 8M | REVISED — |
|-----------------------------------|------------------------|---------------|-----------|
| | | CHECKED — JDH | REVISED |
| | PLOTSCALE = | DRAWN BG | REVISED — |
| | PLOT DATE = 11-07-2022 | CHECKED - APG | REVISED |

STATE OF ILLINOIS DEPARTMENT OF TRANSPORTATION

SCALE:

| | ST | ATE STRE | ET | |
|------------|-------|----------|----------|------|
| R | OADW. | AY RESU | RFACING | |
| SI | JMMAF | RY OF QU | ANTITIES | |
| IEET NO. 5 | OF 35 | SHEETS | STA. | TOST |

| | | | | CONTRACT NO, 61J24 | | | | | | |
|------|---------|---------|--------|--------------------|----|---|--|--|--|--|
| 906 | 22-0011 | 5-00-AS | | COOK | 35 | 5 | | | | |
| I.U. | SECT | TON | COUNTY | SHEETS NO | | | | | | |

| | | | | | · | FED 80% | FED 80% | FED 80% |
|---------|------|----------|---|-------------|----------------|-------------|---------------------|----------|
| | | | SUMMARY OF QUANTITIES | VILLAGE 20% | VILLAGE 20% | VILLAGE 20% | | |
| | | | | | | ROADWAY | SAFETY | TRAINEES |
| S.P. | S.I. | CODE NO. | PAY ITEM | UNIT | TOTAL QUANTITY | C | ONSTRUCTION TYPE CO | DE |
| | 0,,, | 0052 No. | LOT TIEM | OWI | TOTAL QUARTITY | 0005 | 0021 | 0042 |
| D1 | * | 89502376 | REBUILD EXISTING HANDHOLE | EACH | 4 | 4 | | |
| D1 | | X4021000 | TEMPORARY ACCESS (PRIVATE ENTRANCE) | EACH | 32 | 32 | | |
| D1 | | X4022000 | TEMPORARY ACCESS (COMMERCIAL ENTRANCE) | EACH | 7 | 7 | | |
| ** | : | Z0004530 | HOT-MIX ASPHALT DRIVEWAY PAVEMENT, 8" | SQ YD | 454 | 454 | | |
| ** | | Z0017400 | DRAINAGE & UTILITY STRUCTURES TO BE ADJUSTED | EACH | 187 | 187 | | |
| ** | | Z0017700 | DRAINAGE & UTILITY STRUCTURES TO BE RECONSTRUCTED | EACH | 2 | 2 | | |
| D1 | | Z0030850 | TEMPORARY INFORMATION SIGNING | SQ FT | 56 | 56 | | |
| BDE | | Z0076600 | TRAINEES | HOUR | 500 | | | 500 |
| BDE | | Z0076604 | TRAINESS TRAINING PROGRAM GRADUATE | HOUR | 500 | | | 500 |
| | | | | | | | | |


| E NAME = 22R0705-QUAN-01 - Q04 | USER NAME = | DESIGNED - BM | REVISED |
|--------------------------------|------------------------|---------------|-----------|
| | | CHECKED — JDH | REVISED |
| | PLOT SCALE | DRAWN BG | REVISED — |
| | PLOT DATE = 11-07-2022 | CHECKED APG | REVISED — |

| STATE OF ILLINOIS |
|------------------------------|
| DEPARTMENT OF TRANSPORTATION |

SCALE:


| | ST | ATE STRE | ET | | | | | | | | | |
|-----------------------|-------|----------|--------|--------|--|--|--|--|--|--|--|--|
| R | OADW | AY RESUR | FACING | | | | | | | | | |
| SUMMARY OF QUANTITIES | | | | | | | | | | | | |
| SHEET NO. 6 | OF 35 | SHEETS | STA. | TO STA | | | | | | | | |

| F.A.U. RTE. | | ; | SEC | ΠΟN | | COUNTY | TOTAL SHEETS | SHEE NO. | | | | | | | | |
|----------------|---------|------|------|-------------|-------|---------------------------|-----------------|-------------|--|--|--|--|--|--|--|--|
| 2906 | | 22-1 | 0011 | 5-00-RS | | соок | 35 | 6 | | | | | | | | |
| | | | | | | CONTRACT | VO, 61J2 | 4 | | | | | | | | |
| FED 90 | AD OICT | 110 | • | it i turnic | CEO N | TO AID DOOLECT DELCT/OCA) | | | | | | | | | | |

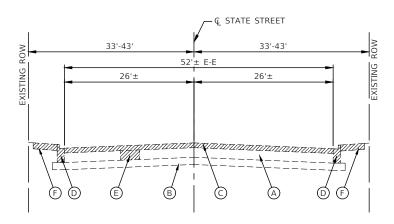

EXISTING TYPICAL SECTION


STATE STREET
STA 10+85.50 TO STA 19+33

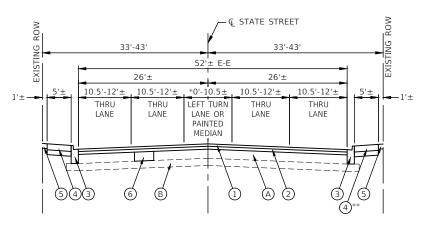

PROPOSED TYPICAL SECTION


*PAINTED MEDIAN TRANSITIONS: STA 12+88 TO STA 14+43 FROM 0' TO 10.5' STA 14+43 TO STA 15+33 FROM 10.5' TO 4'

STATE STREET STA 10+85.50 TO STA 19+33 **SIDEWALK RIGHT: BEGINS STA 16+68

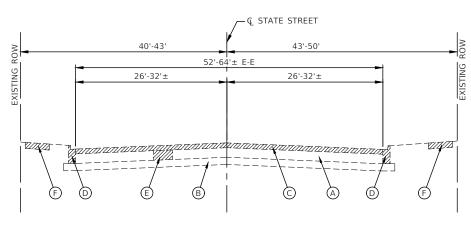

EXISTING TYPICAL SECTION

STATE STREET STA 19+33 TO STA 36+33 STA 58+94 TO STA 62+87

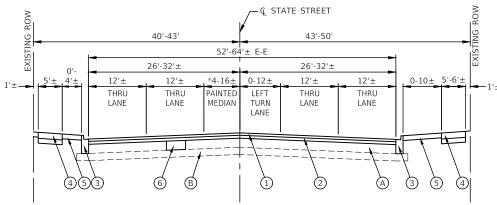

PROPOSED TYPICAL SECTION

*MEDIAN TRANSITIONS: STA 19+33 TO STA 21+49 FROM 4' TO 16'

STATE STREET STA 19+33 TO STA 36+33 STA 58+94 TO STA 62+87

HOT-MIX ASPHALT MIXTURE REQUIREMENTS

| MIXTURE TYPE | AIR VOIDS @ Ndes | QMP |
|--|------------------|-----------|
| ROADWAY RESURFACING | | |
| HOT-MIX ASPHALT SURFACE COURSE, IL-9.5, MIX "D", N70, 2" | 4% @ 70 Gyr. | LR 1030-2 |
| HOT-MIX ASPHALT BINDER COURSE, IL-19.0, N70, 2 1/4" | 4% @ 70 Gyr. | LR 1030-2 |
| HMA DRIVEWAY PAVEMENT 8" | | |
| HOT-MIX ASPHALT SURFACE COURSE, IL-9.5, MIX "D", N50, 2" | 4% @ 50 Gyr. | LR 1030-2 |
| HOT-MIX ASPHALT BINDER COURSE. IL-19.0, N50, 6" | 4% @ 50 Gyr. | LR 1030-2 |
| PATCHING | | |
| CLASS D PATCHES (HMA BINDER IL-19.0 mm), 8 INCH | 4% @ 70 Gyr. | LR 1030-2 |
| QMP DESIGNATION: QUALITY CONTROL/QUALITY ASSURANCE (QC/QA) PER | LR1030-2 | |

NOTES:

- 1. THE UNIT WEIGHT USED TO CALCULATE ALL HMA SURFACE MIXTURE IS 112 LBS/SQ/IN.
- 2. ALL PATCHING OPERATIONS SHALL TAKE PLACE AFTER SURFACE MILLING HAS BEEN COMPLETED.
- 3. THE "AC TYPE" FOR POLYMERIZED HMA MIXES SHALL BE "SBS/SBR PG 76-22" AND FOR NON-POLYMERIZED HMA THE "AC TYPE" SHALL BE "PG-64-22" UNLESS MODIFIED BY RECLAIMED MATERIALS SPECIFICATIONS.

EXISTING LEGEND

- A EXISTING PAVEMENT, 5" TO 15"±
- B EXISTING SUBBASE, 5" TO 8"±
- C HOT-MIX ASPHALT SURFACE REMOVAL, 4"
- D EXISTING CURB AND GUTTER, TYPE B-6.18
- E PAVEMENT REMOVAL FOR CLASS "D" PATCHED, 8 INCH
- F EXISTING SIDEWALK
- G EXISTING CORRUGATED PC CONCRETE MEDIAN
- ITEM TO BE REMOVED (AS DIRECTED BY ENGINEER)

NOTE

THE LONGITUDINAL JOINT SEALANT SHALL BE PLACED OVER THE HOT-MIX ASPHALT BINDER COURSE, IL-19.0, N70

PLOT DATE = 11-07-2022

PROPOSED LEGEND

REVISED

- 1) HOT-MIX ASPHALT SURFACE COURSE, IL-9.5, MIX "D", N70, 2"
- HOT-MIX ASPHALT BINDER COURSE, IL-19.0, N70, 2-1/4"
- OMBINATION CONCRETE CURB AND GUTTER, TYPE B-6.18
 (AT LOCATIONS SHOWN ON PLANS OR DIRECTED BY ENGINEER)
- PORTLAND CEMENT CONCRETE SIDEWALK, 5" OR 8" AT DRIVEWAYS
 ON AGGREGATE BASE COURSE, TYPE B, 4"
 (AT LOCATIONS SHOWN ON PLANS OR DIRECTED BY ENGINEER)
- RESTORATION PER PARKWAY COMPOSITION (AS DIRECTED BY THE ENGINEER)
 -HOT-MIX ASPHALT DRIVEWAY PAVEMENT, 8" OR
- -PORTLAND CEMENT CONCRETE DRIVEWAY PAVEMENT, 8 INCH OR
 -TOPSOIL FURNISH AND PLACE, 4" WITH SODDING, SALT TOLERANT
- 6 CLASS D PATCHES, 8 INCH (AT LOCATIONS SHOWN ON PLANS OR DIRECTED BY ENGINEER)

 FILE NAME = 22R0706-TYPX-01 - P01
 USER NAME = DESIGNED - BM
 REVISED - CHECKED - JDH
 REVISED - CHECKED - DRAWN - BG

 PLOT SCALE = DRAWN - BG
 REVISED - CHECKED - DRAWN - BG
 REVISED - CHECKED - DRAWN - BG


CHECKED - AG

STATE OF ILLINOIS
DEPARTMENT OF TRANSPORTATION

SCALE: NONE


SCALE: NONE

| ROADWAY RESURFACING | | | | | | | F.A.U. RTE. | SEC. | TION | | COUNTY | TOTAL SHEETS | |
|------------------------|-------------|-------|--------|------|---------|------|----------------|----------------|----------|----------|------------------|-----------------|--|
| | | | | | | 2906 | 22-0011 | 5-00-RS | | COOK | 35 | | |
| TYPICAL CROSS SECTIONS | | | | | | | | | CONTRACT | NO. 61J2 | 24 | | |
| | SHEET NO. 7 | OF 35 | SHEETS | STA. | TO STA. | | FED. RO. | AD DIST. NO. 1 | ILLINOIS | FED. Al | ID PROJECT 95KT(| 361) | |

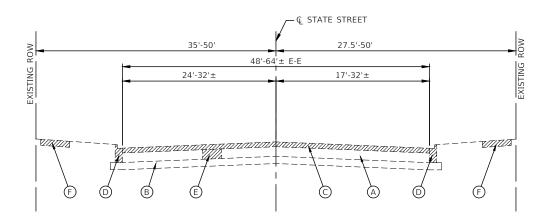

EXISTING TYPICAL SECTION

STATE STREET STA 36+33 TO STA 58+94 STA 62+87 TO STA 81+67

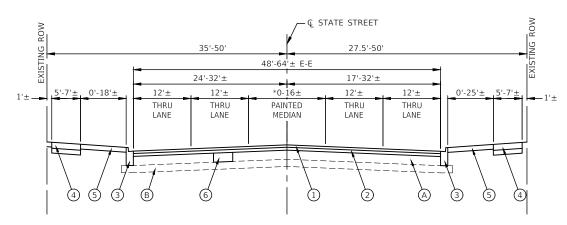

PROPOSED TYPICAL SECTION

*MEDIAN TRANSITIONS: STA 36+33 TO STA 43+36 FROM 16' TO 0' STA 55+03 TO STA 58+94 FROM 0' TO 16' STA 62+87 TO STA 66+12 FROM 16' TO 0'

FILE NAME = 22R0706-TYPX-01 - P02

STATE STREET STA 36+33 TO STA 58+94 STA 62+87 TO STA 81+67

EXISTING LEGEND

- A EXISTING PAVEMENT, 5" TO 15"±
- lacksquare EXISTING SUBBASE, 5" TO 8"±
- C HOT-MIX ASPHALT SURFACE REMOVAL, 4"
- D EXISTING CURB AND GUTTER, TYPE B-6.18
- E PAVEMENT REMOVAL FOR CLASS "D" PATCHED, 8 INCH
- F EXISTING SIDEWALK
- G EXISTING CORRUGATED PC CONCRETE MEDIAN
- ITEM TO BE REMOVED (AS DIRECTED BY ENGINEER)


NOTE

THE LONGITUDINAL JOINT SEALANT SHALL BE PLACED OVER THE HOT-MIX ASPHALT BINDER COURSE, IL-19.0, N70

\$ 50' 50' \$ 60' \$

EXISTING TYPICAL SECTION

STATE STREET
STA 81+67 TO STA 88+35.06

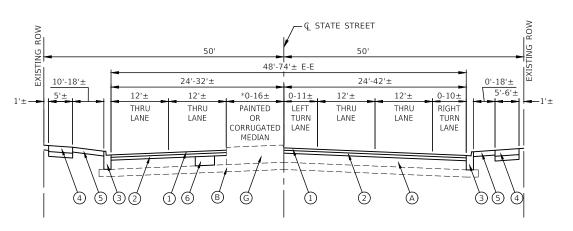

PROPOSED TYPICAL SECTION


*MEDIAN TRANSITIONS: STA 81+67 TO STA 84+35 FROM 0' TO 16' STA 84+35 TO STA 86+25 FROM 16' TO 5' BEGINS STA 83+11


STATE STREET STA 81+67 TO STA 88+35.06 RIGHT TURN LANE TRANSITIONS: STA 84+34 TO STA 86+19 FROM 0' TO 10'


PROPOSED LEGEND


- (1) HOT-MIX ASPHALT SURFACE COURSE, IL-9.5, MIX "D", N70, 2"
- 2 HOT-MIX ASPHALT BINDER COURSE, IL-19.0, N70, 2-1/4"
- ③ COMBINATION CONCRETE CURB AND GUTTER, TYPE B-6.18 (AT LOCATIONS SHOWN ON PLANS OR DIRECTED BY ENGINEER)
- PORTLAND CEMENT CONCRETE SIDEWALK, 5" OR 8" AT DRIVEWAYS ON AGGREGATE BASE COURSE, TYPE B, 4"
 (AT LOCATIONS SHOWN ON PLANS OR DIRECTED BY ENGINEER)
 - RESTORATION PER PARKWAY COMPOSITION (AS DIRECTED BY THE ENGINEER) -HOT-MIX ASPHALT DRIVEWAY PAVEMENT, 8" OR
- -PORTLAND CEMENT CONCRETE DRIVEWAY PAVEMENT, 8 INCH OR
 -TOPSOIL FURNISH AND PLACE, 4" WITH SODDING, SALT TOLERANT
- 6 CLASS D PATCHES, 8 INCH
 (AT LOCATIONS SHOWN ON PLANS OR DIRECTED BY ENGINEER)

REVISED USER NAME = DESIGNED - BM STATE STREET SECTION COUNTY STATE OF ILLINOIS CHECKED - JDH REVISED ROADWAY RESURFACING 2906 22-00115-00-RS соок 35 PLOT SCALE = DRAWN REVISED **DEPARTMENT OF TRANSPORTATION** TYPICAL CROSS SECTIONS CONTRACT NO. 61J24 SCALE: NONE SHEET NO. 8 OF 35 SHEETS STA. TO STA. PLOT DATE = 11-07-2022 CHECKED - AG REVISED

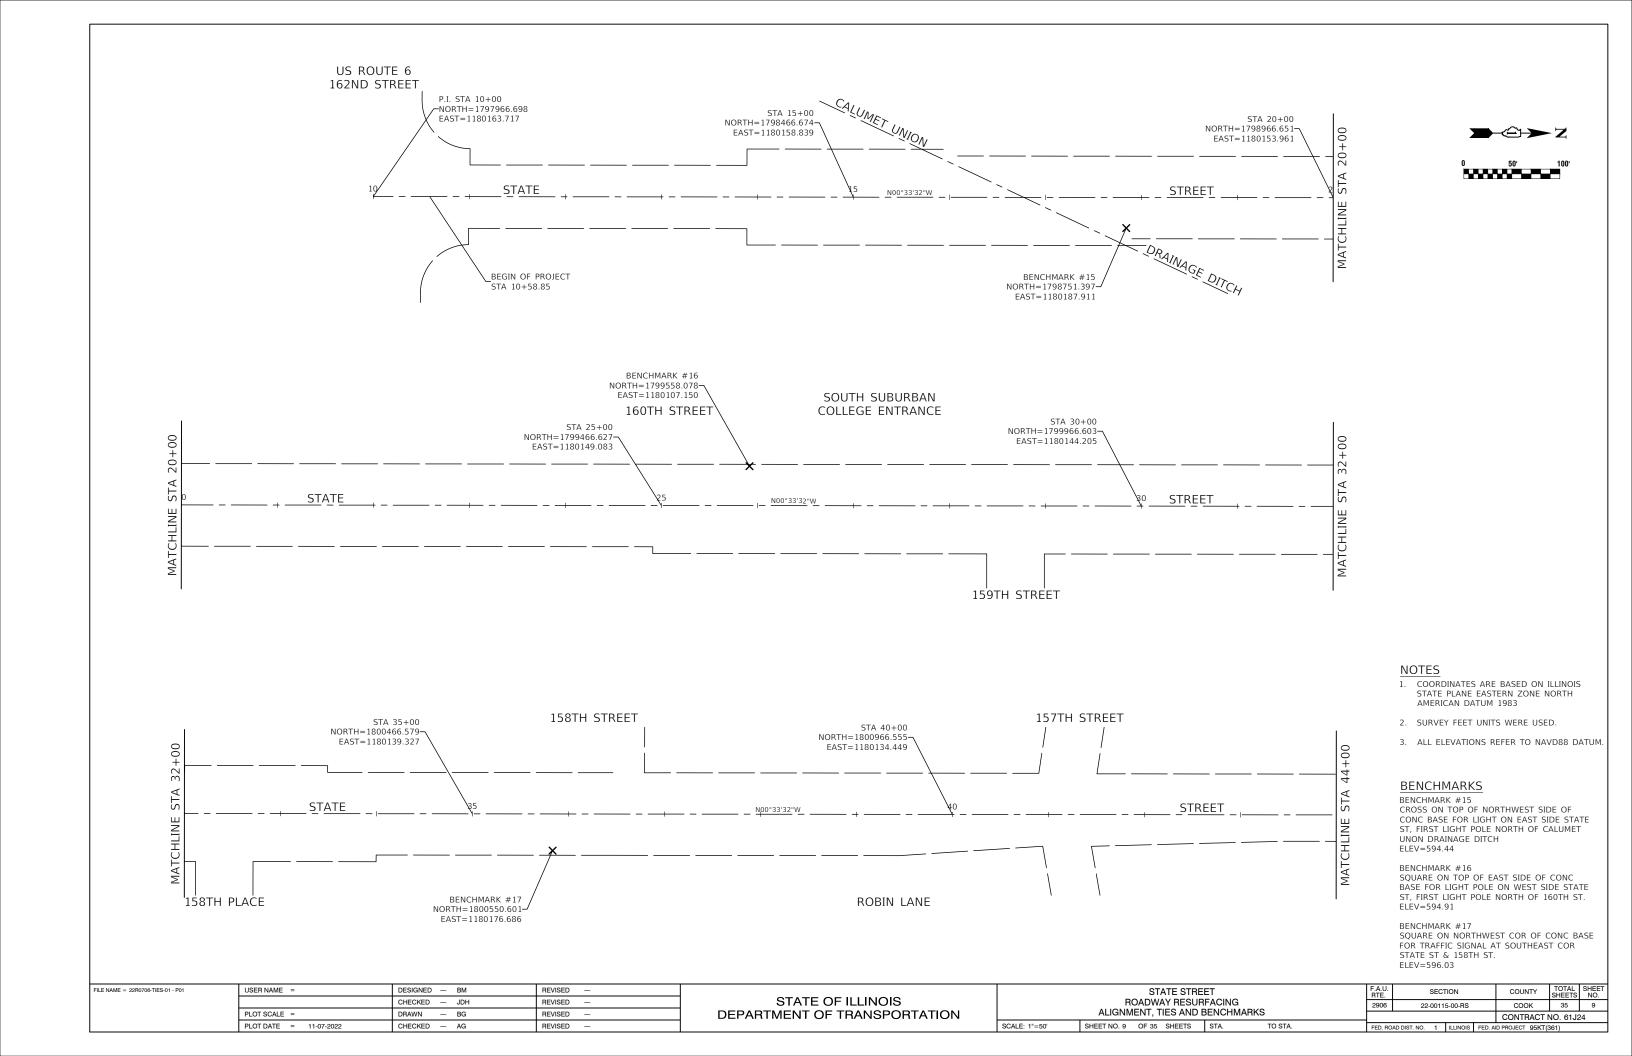

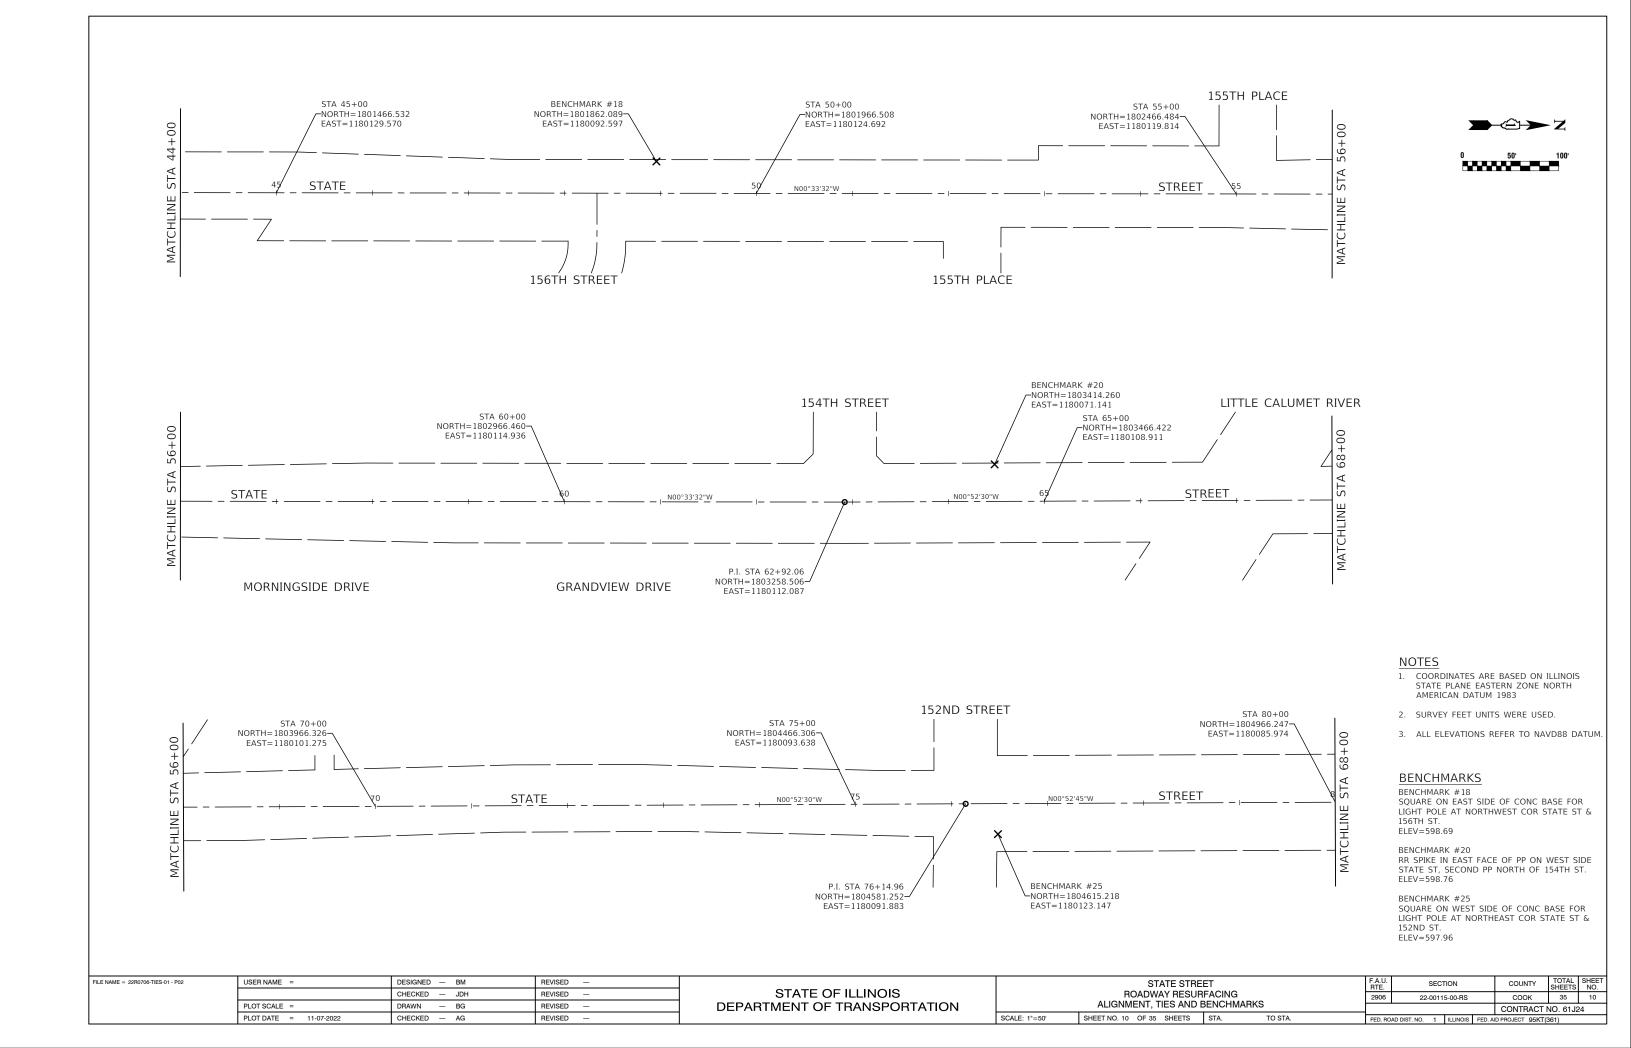

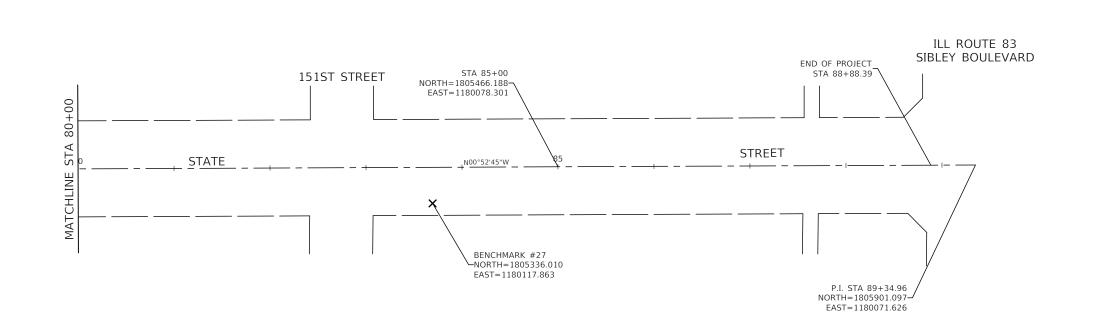

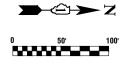


NOTES


- 1. COORDINATES ARE BASED ON ILLINOIS STATE PLANE EASTERN ZONE NORTH AMERICAN DATUM 1983
- 2. SURVEY FEET UNITS WERE USED.
- 3. ALL ELEVATIONS REFER TO NAVD88 DATUM.


BENCHMARKS


BENCHMARK #27 SQUARE ON WEST SIDE OF CONC BASE FOR LIGHT POLE ON EAST SIDE STATE ST, FIRST LIGHT POLE NORTH OF 151ST ST. ELEV=597.87


| FILE NAME = 22R0706-TIES-01 - P03 | USER NAME = | DESIGNED — BM | REVISED — | | | STATE STREET | F.A.U. RTF | SECTION | | COUNTY | TOTAL S | HEET |
|-----------------------------------|------------------------|---------------|-----------|------------------------------|---------------|--|---------------|-----------------------|-----------------|----------|-----------|--------|
| | | CHECKED — JDH | REVISED — | STATE OF ILLINOIS | | ROADWAY RESURFACING | 2906 | 22-00115-00-R | RS | соок | 35 | 11 |
| | PLOT SCALE = | DRAWN — BG | REVISED — | DEPARTMENT OF TRANSPORTATION | | ALIGNMENT, TIES AND BENCHMARKS | | | | CONTRACT | √O. 61J24 | - |
| | PLOT DATE = 11-07-2022 | CHECKED — AG | REVISED — | | SCALE: 1"=50' | SHEET NO. 11 OF 35 SHEETS STA. TO STA. | FED. ROA | AD DIST. NO. 1 ILLINO | OIS FED. AID PF | | | \neg |

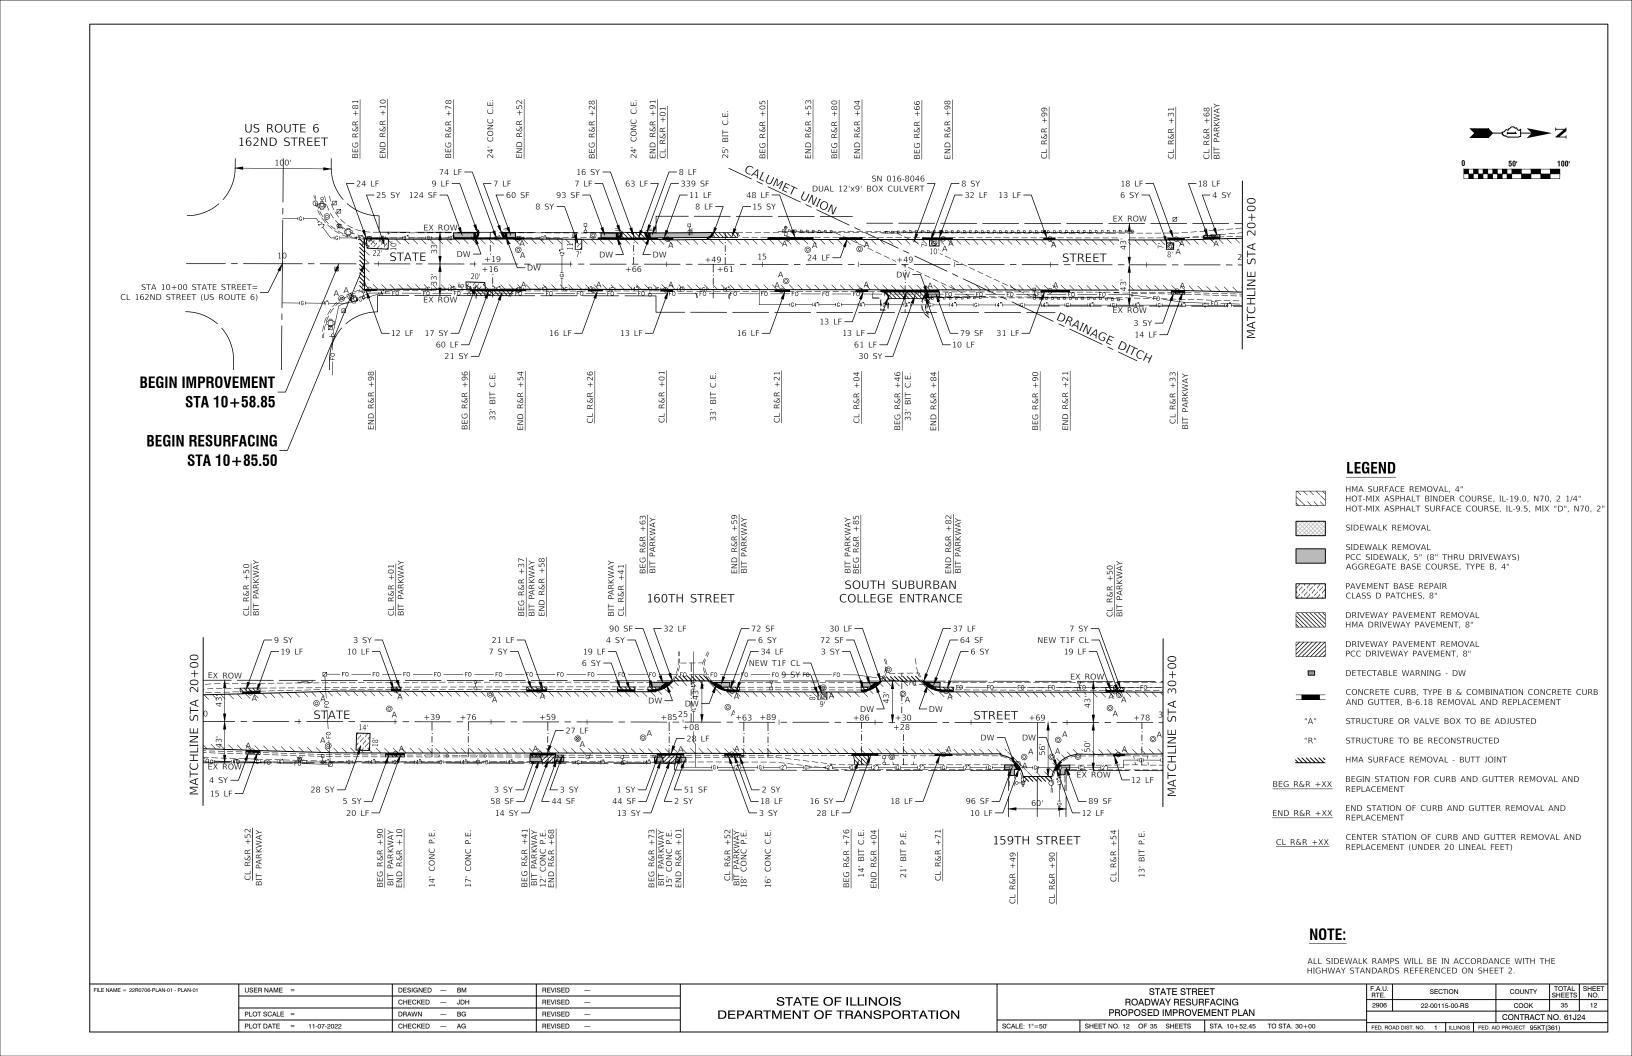


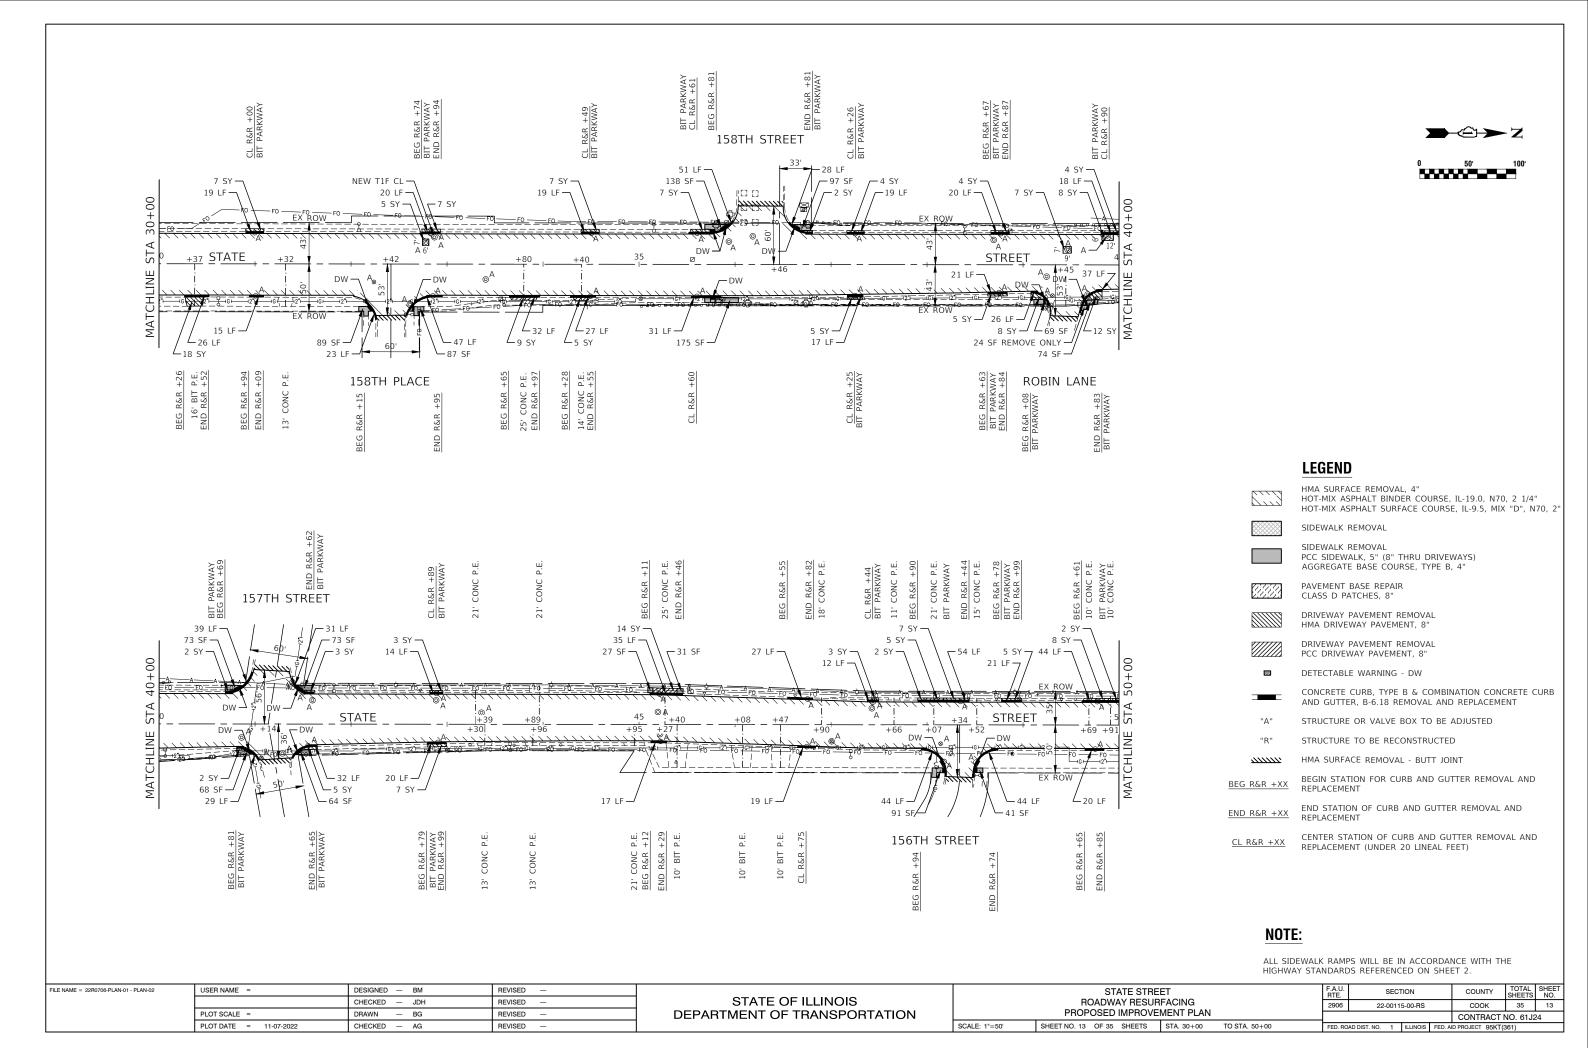


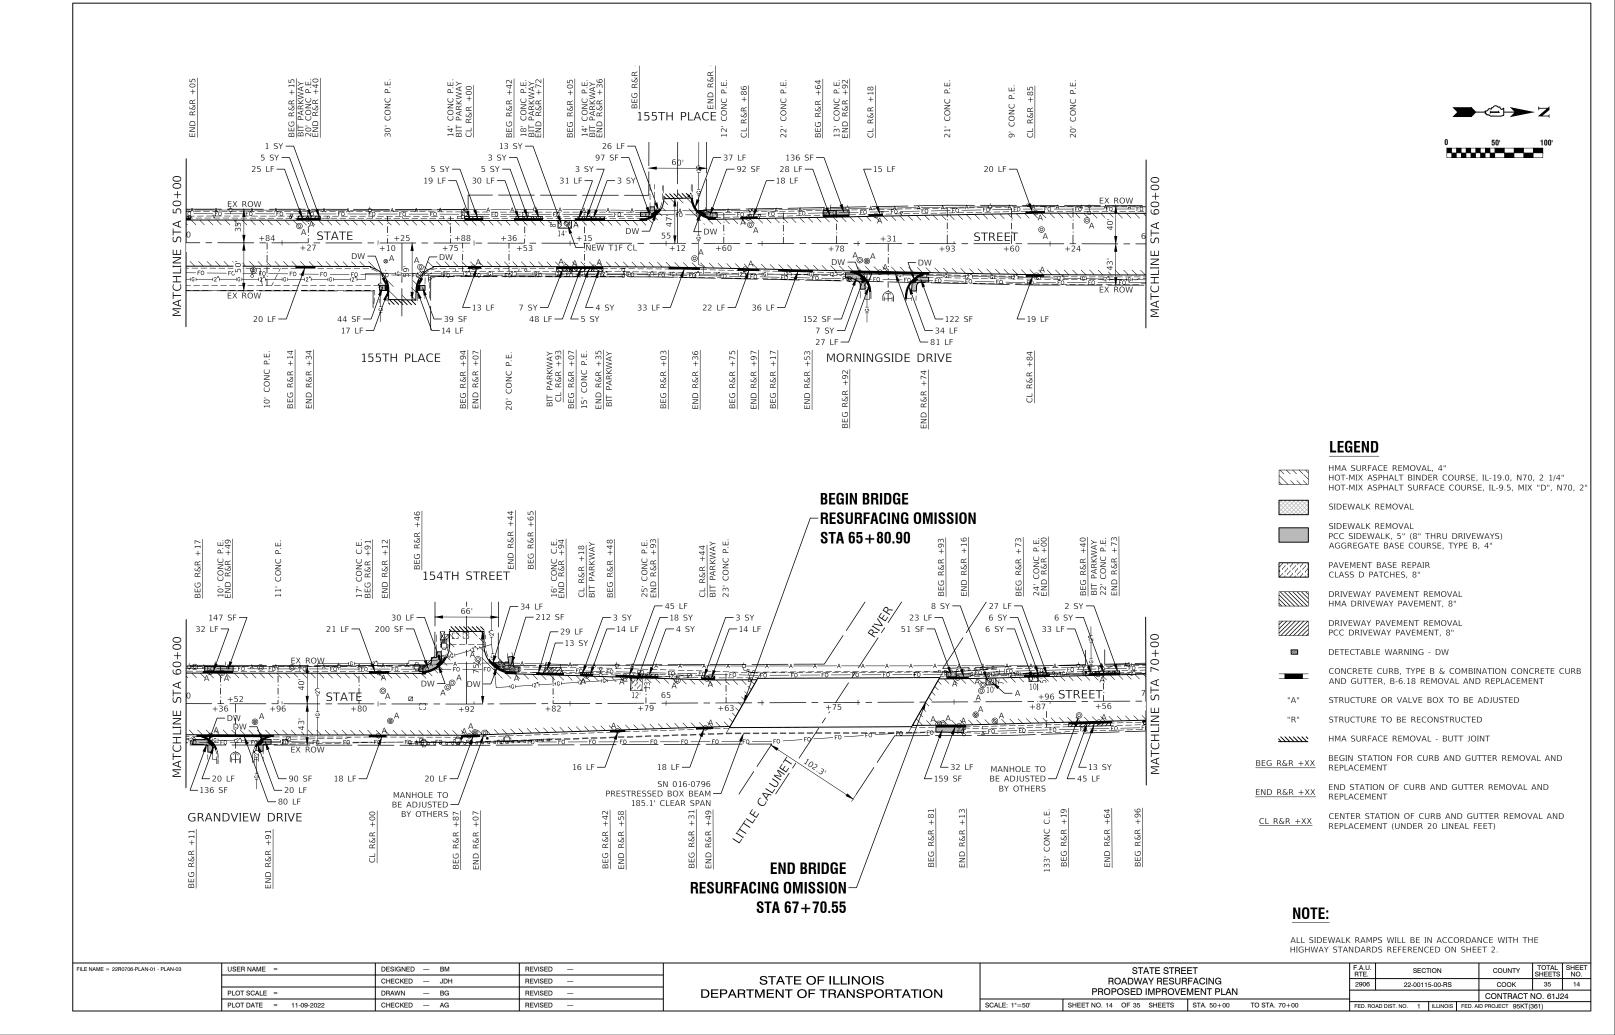


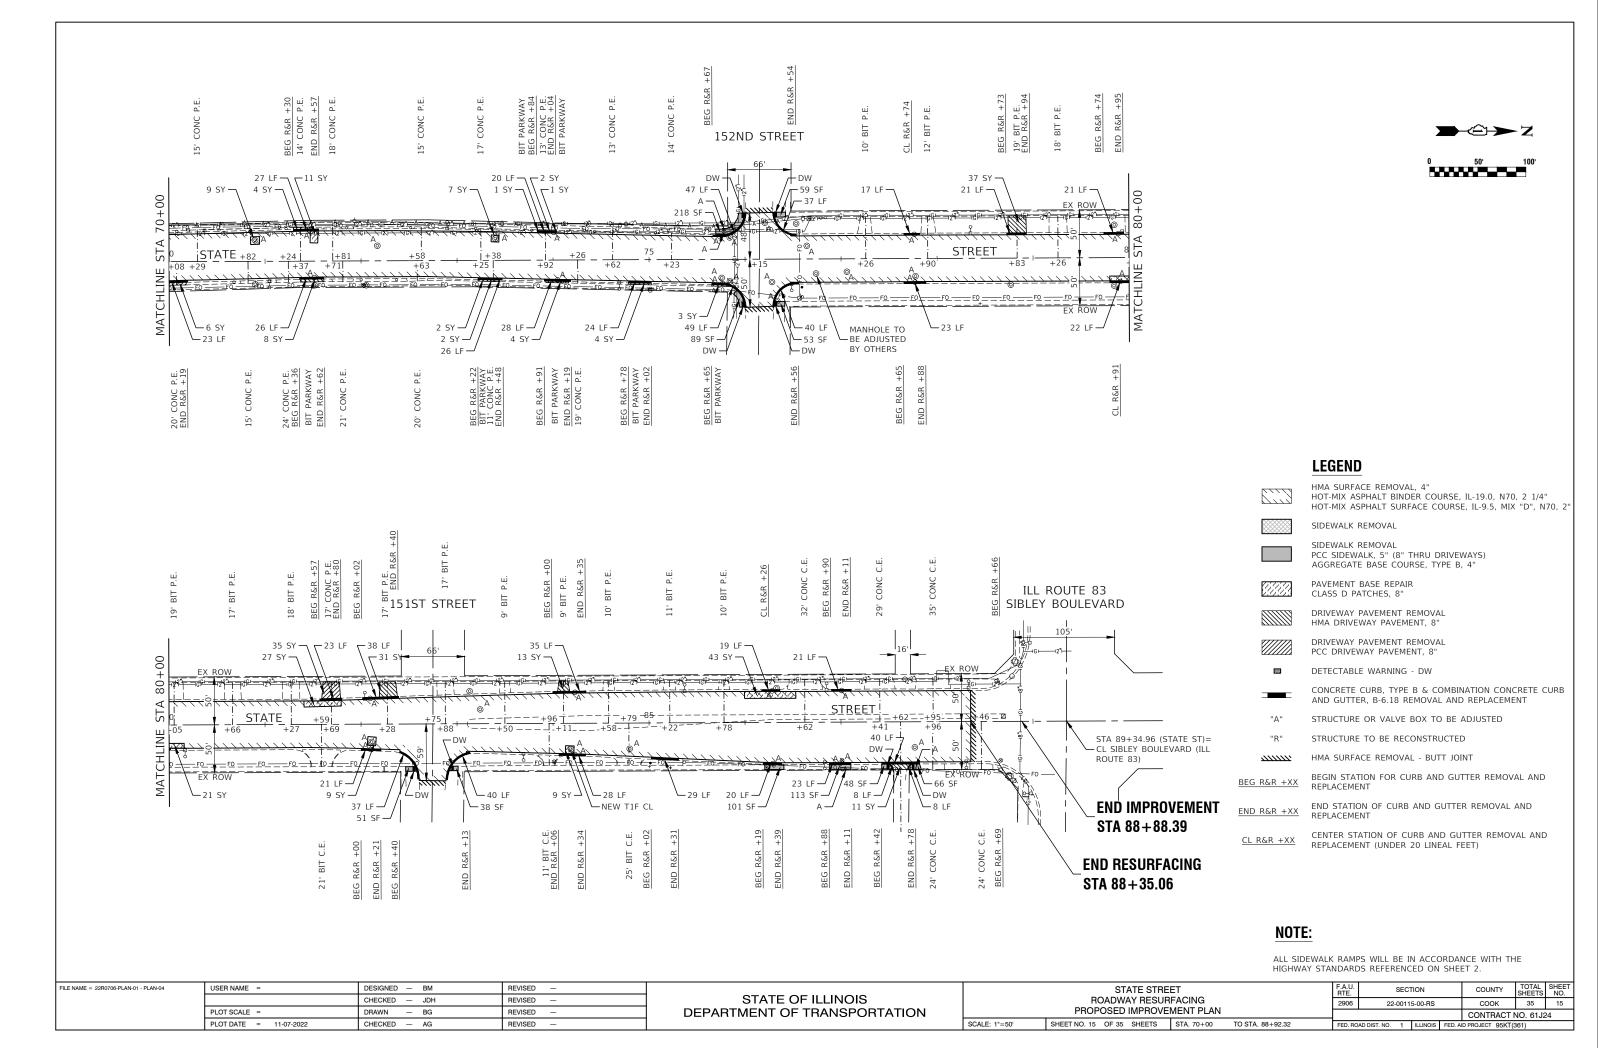


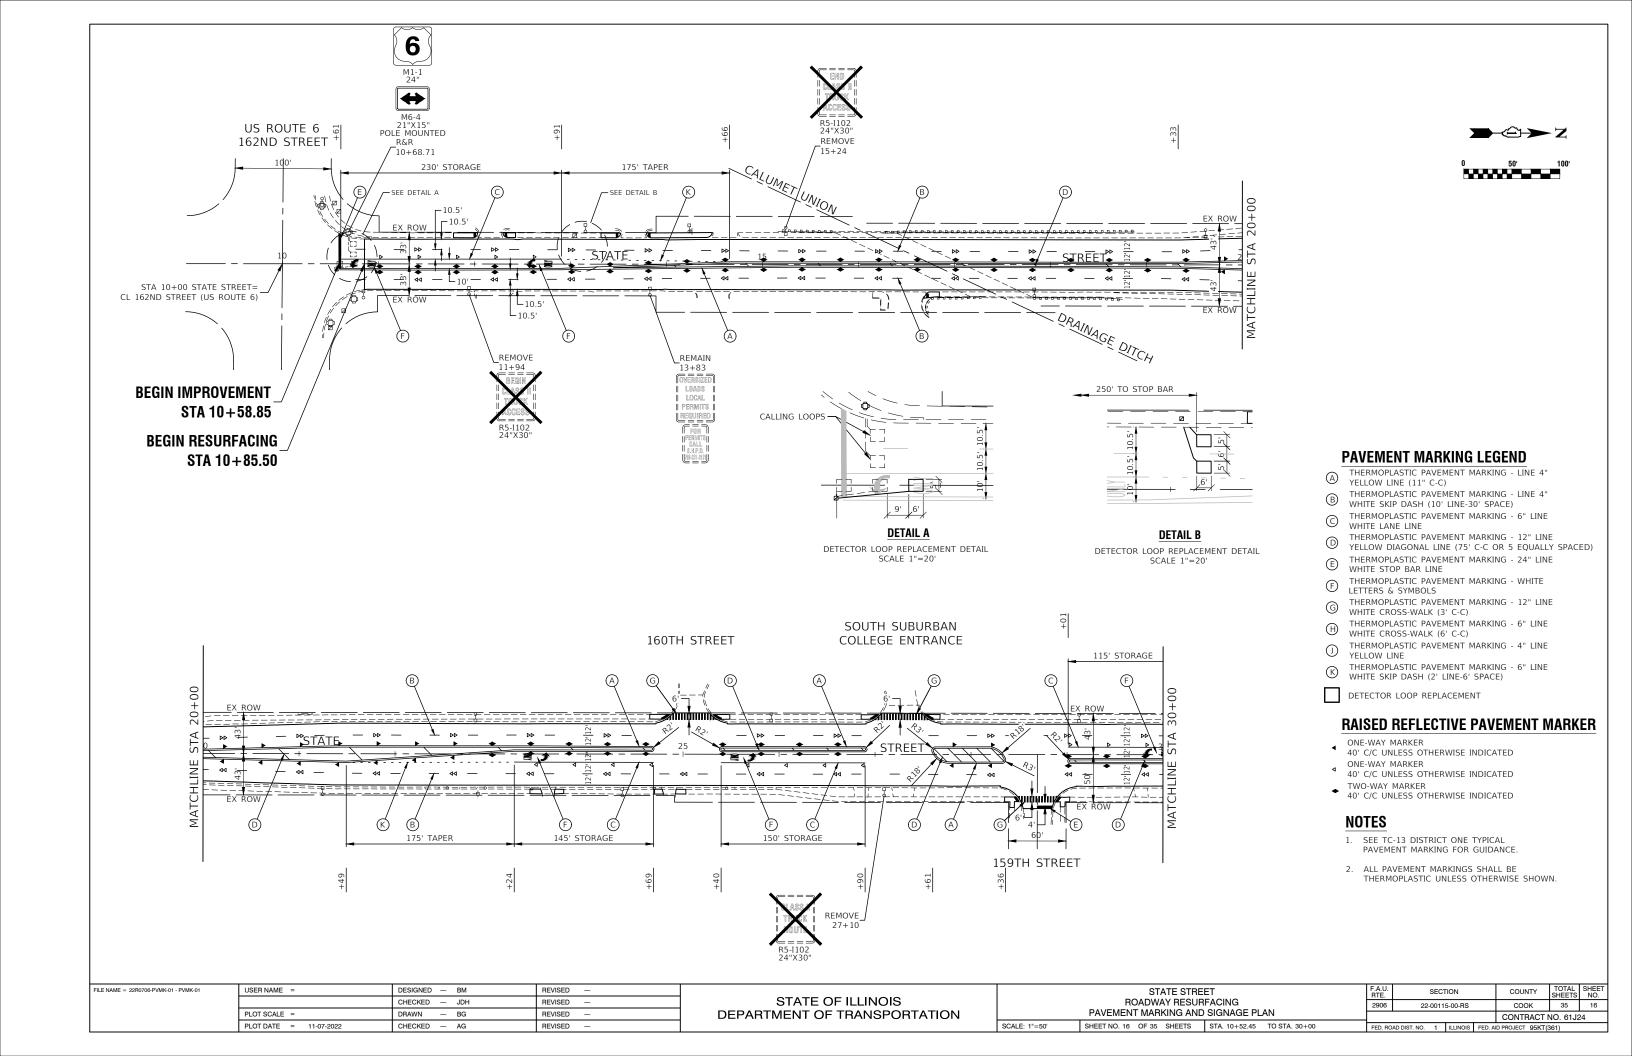


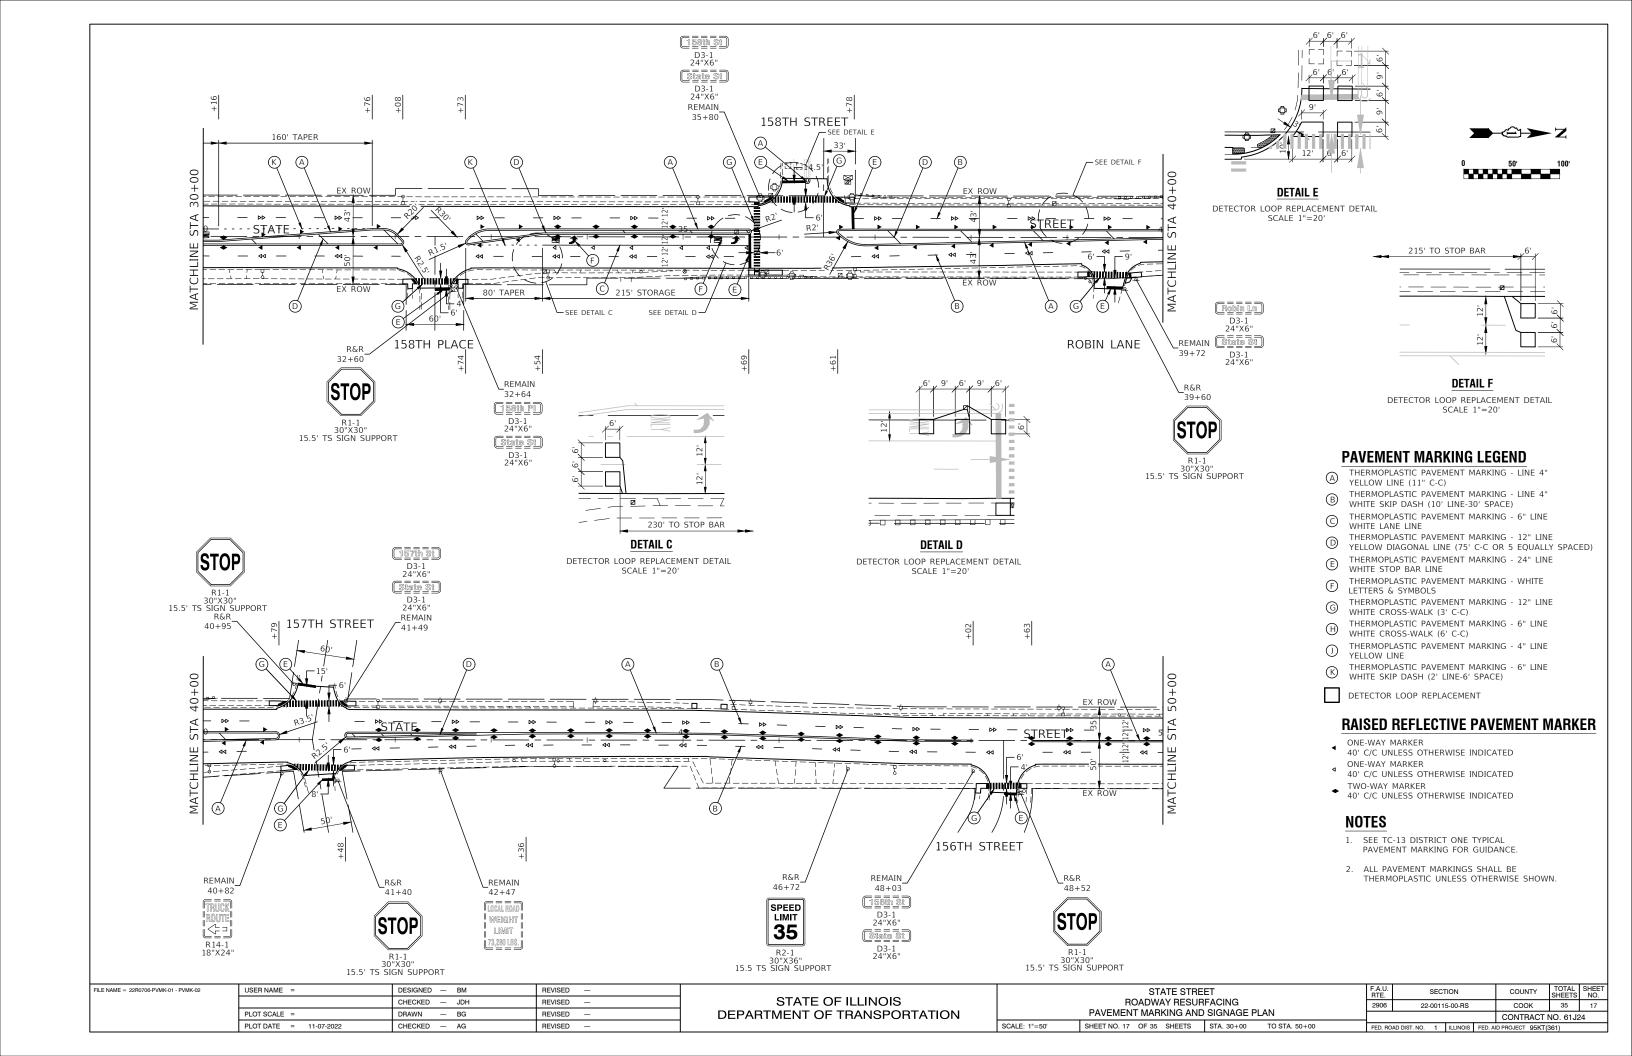


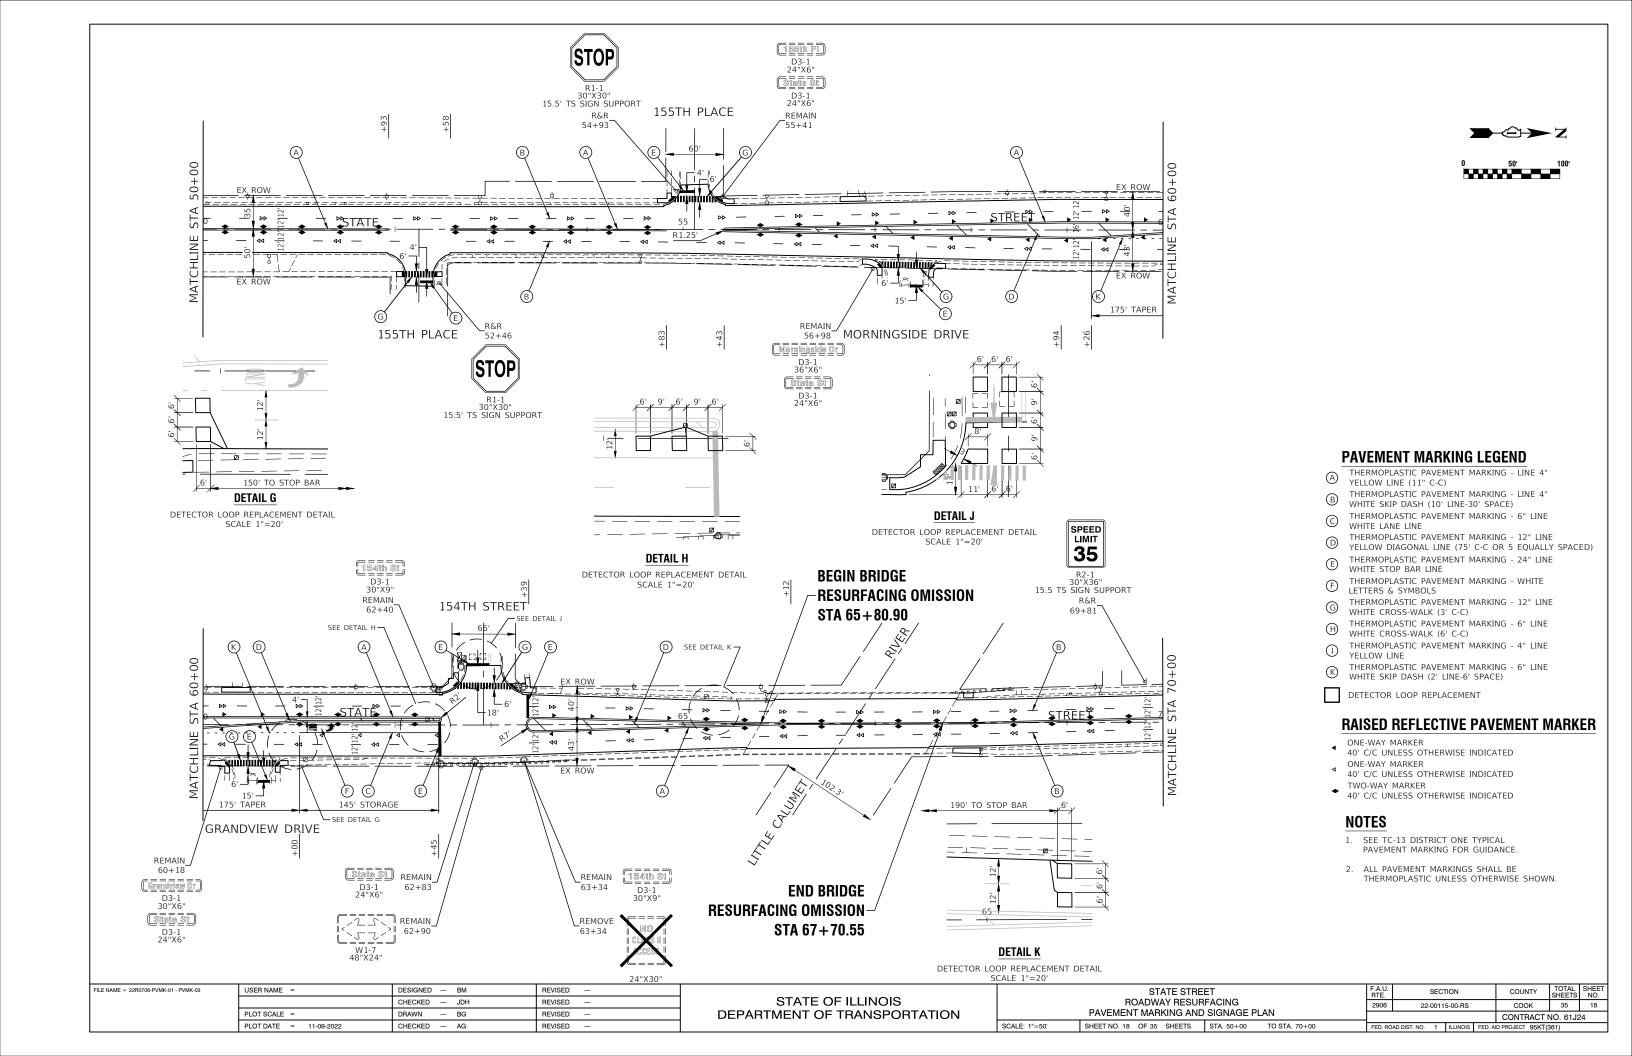


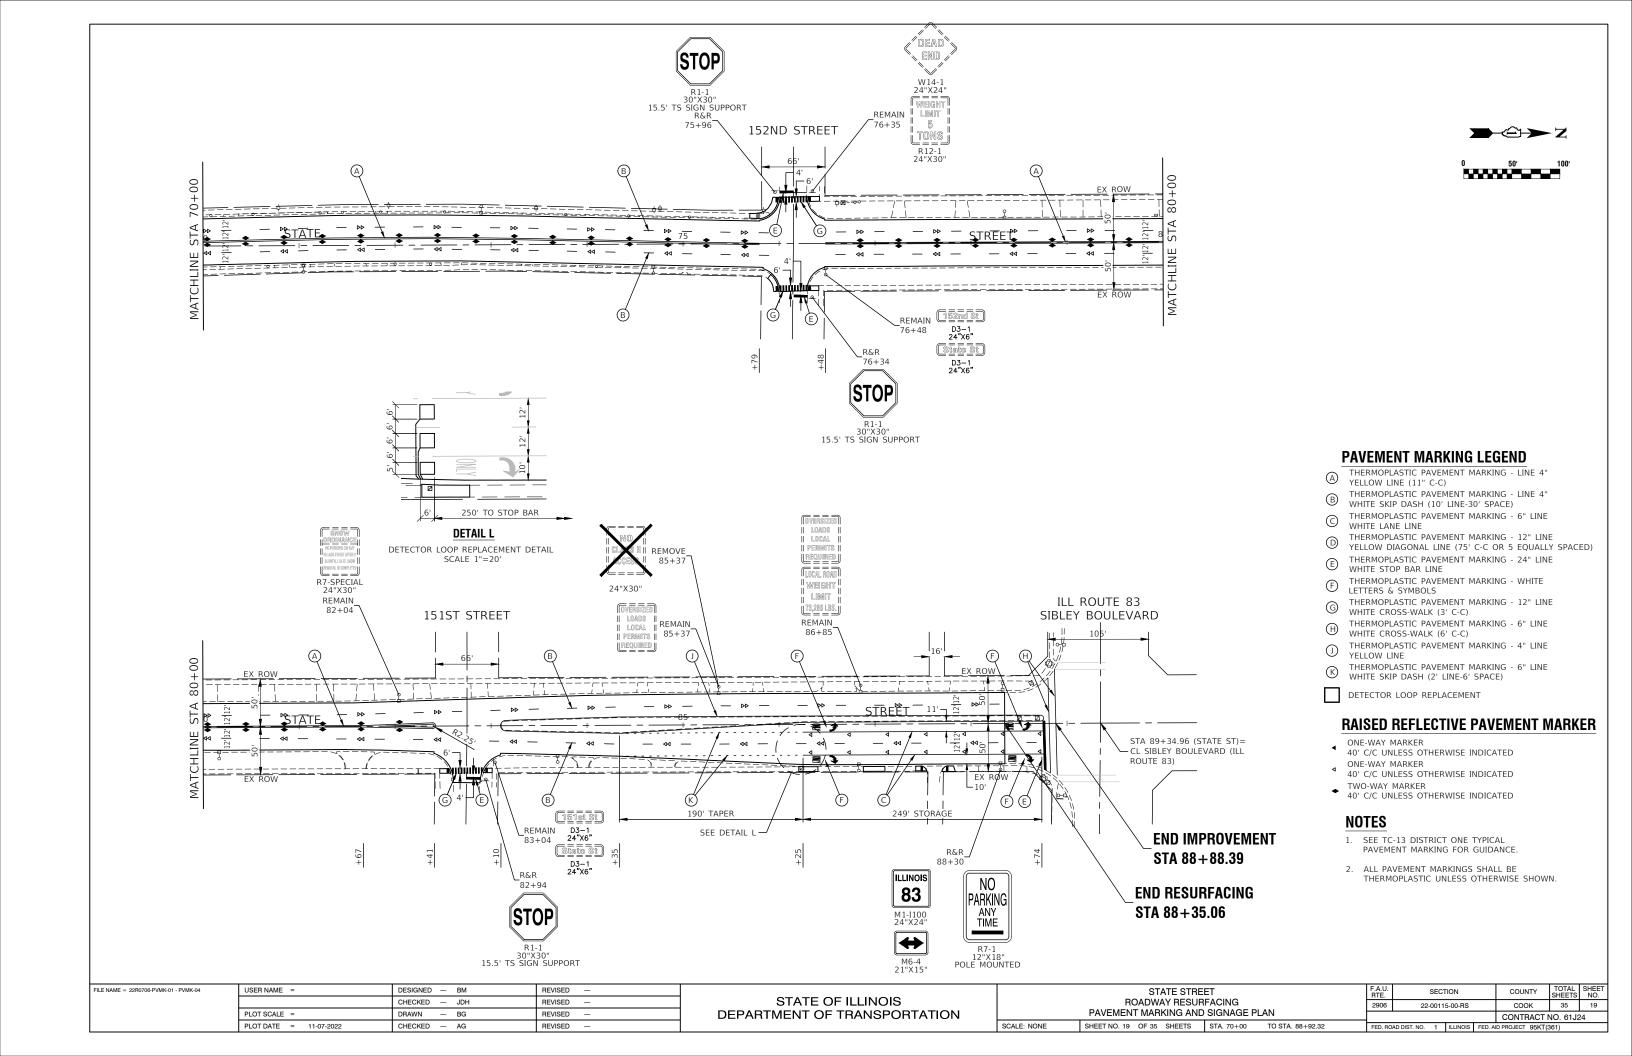


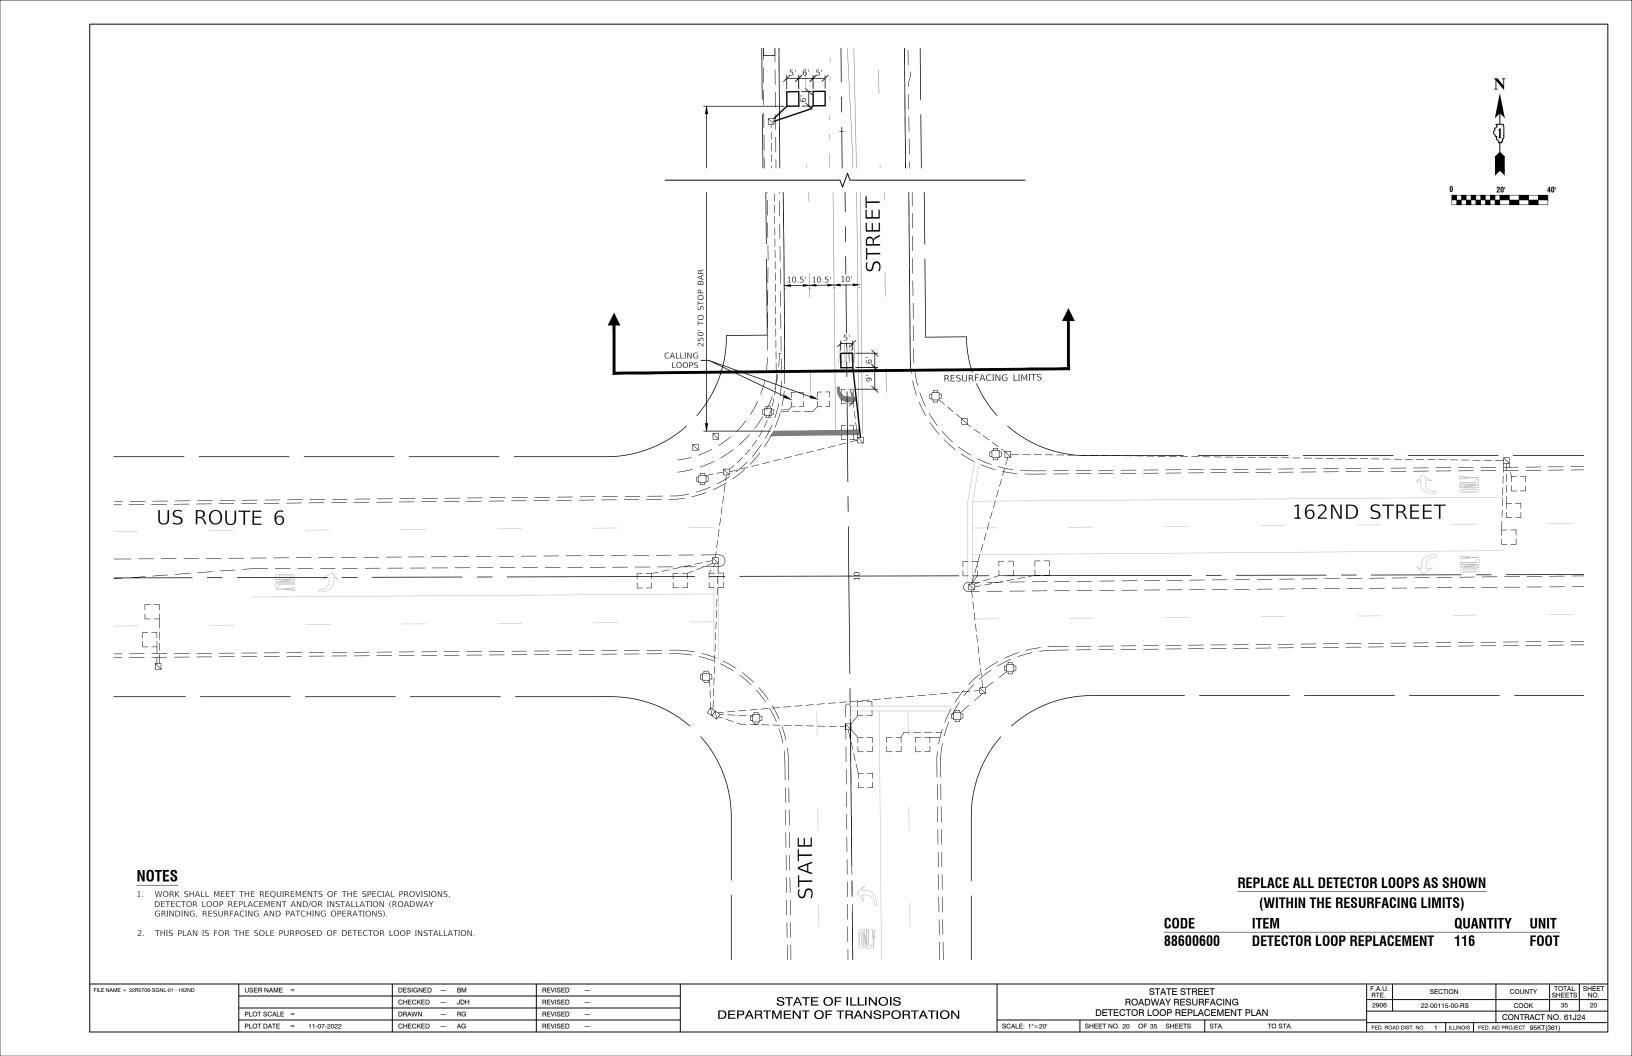

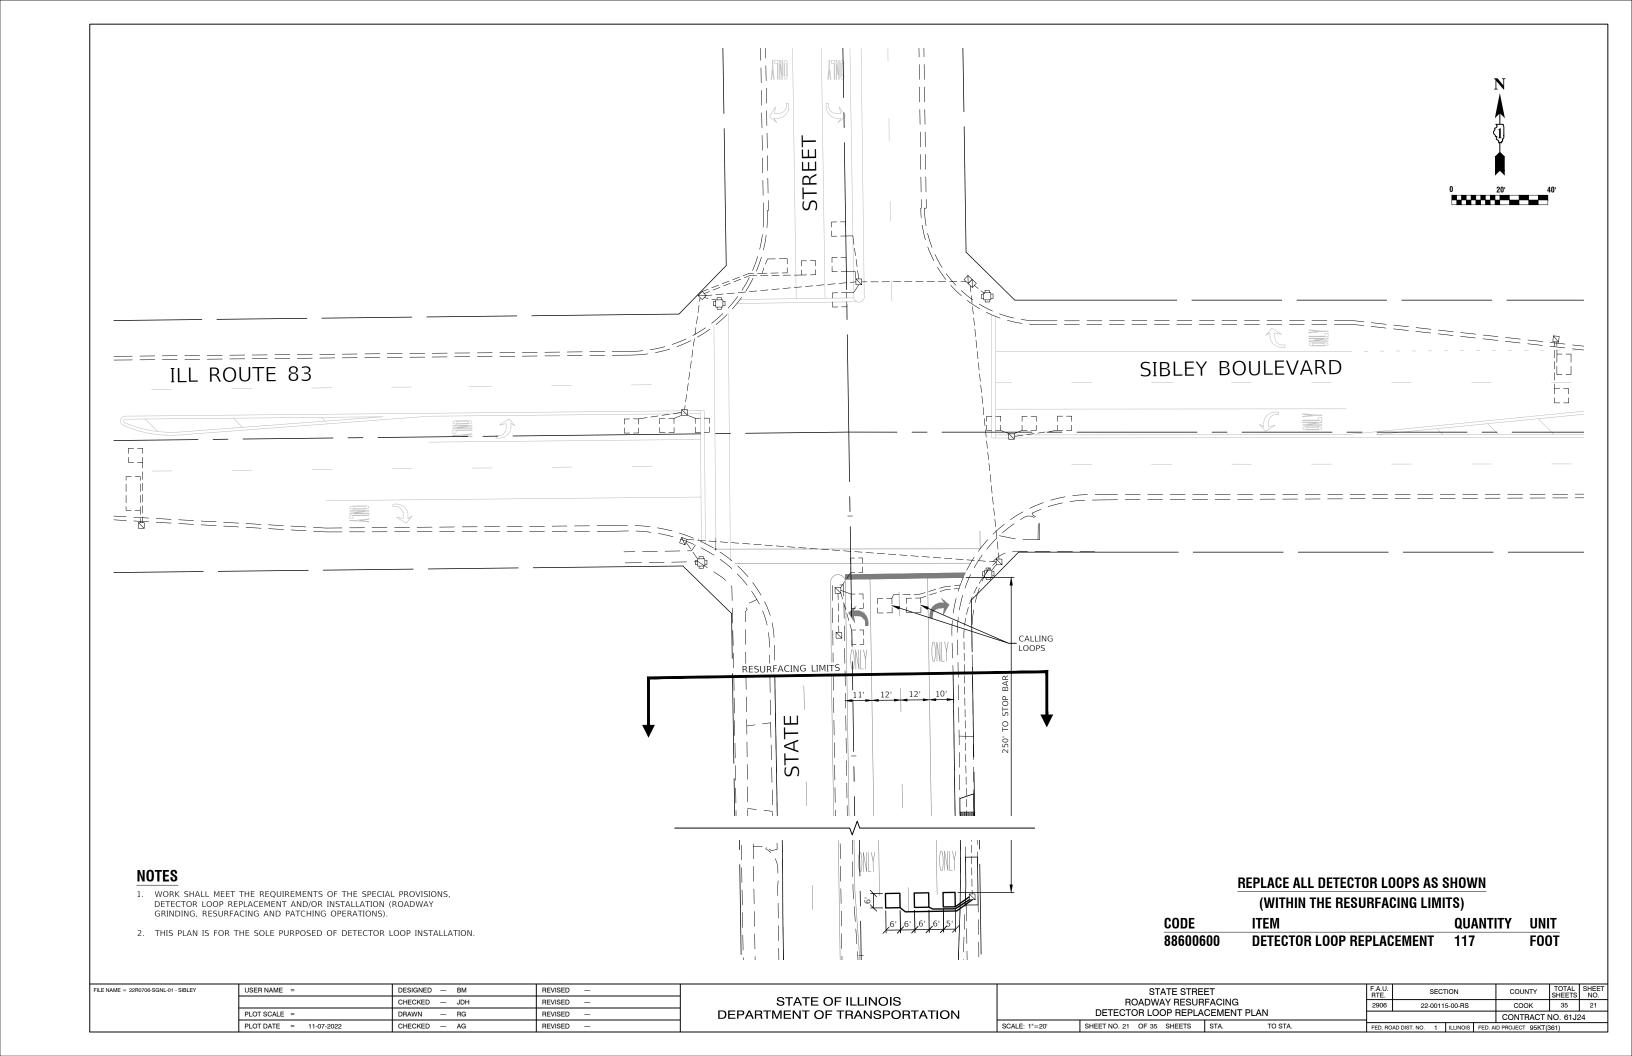

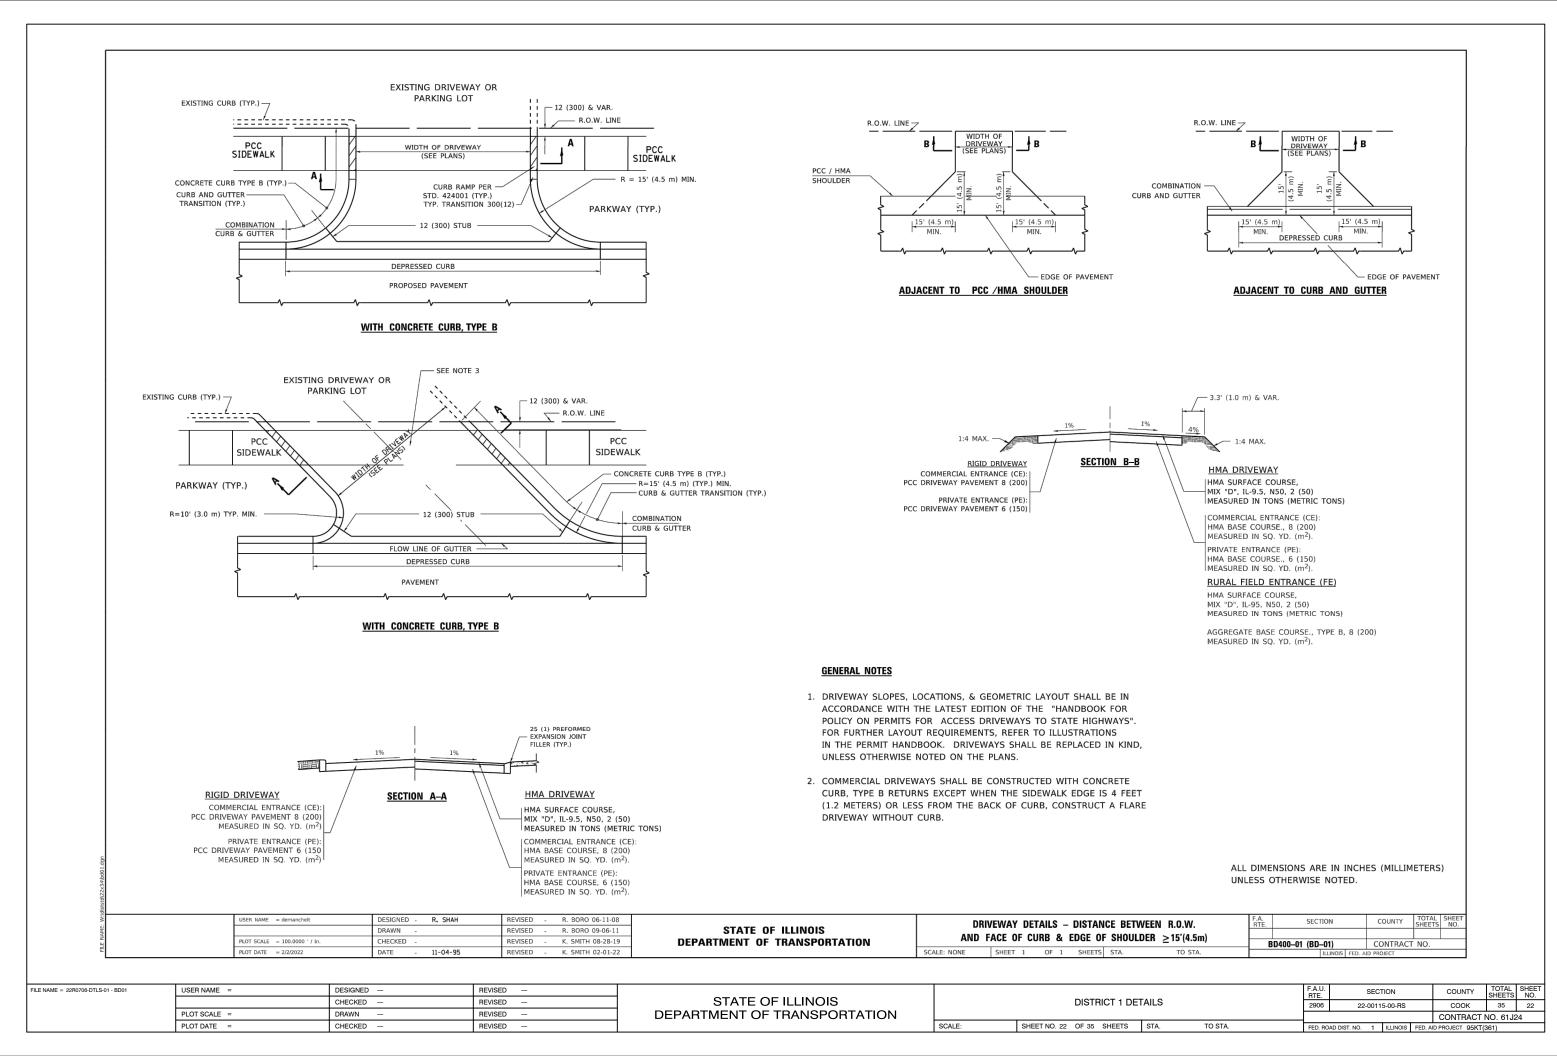

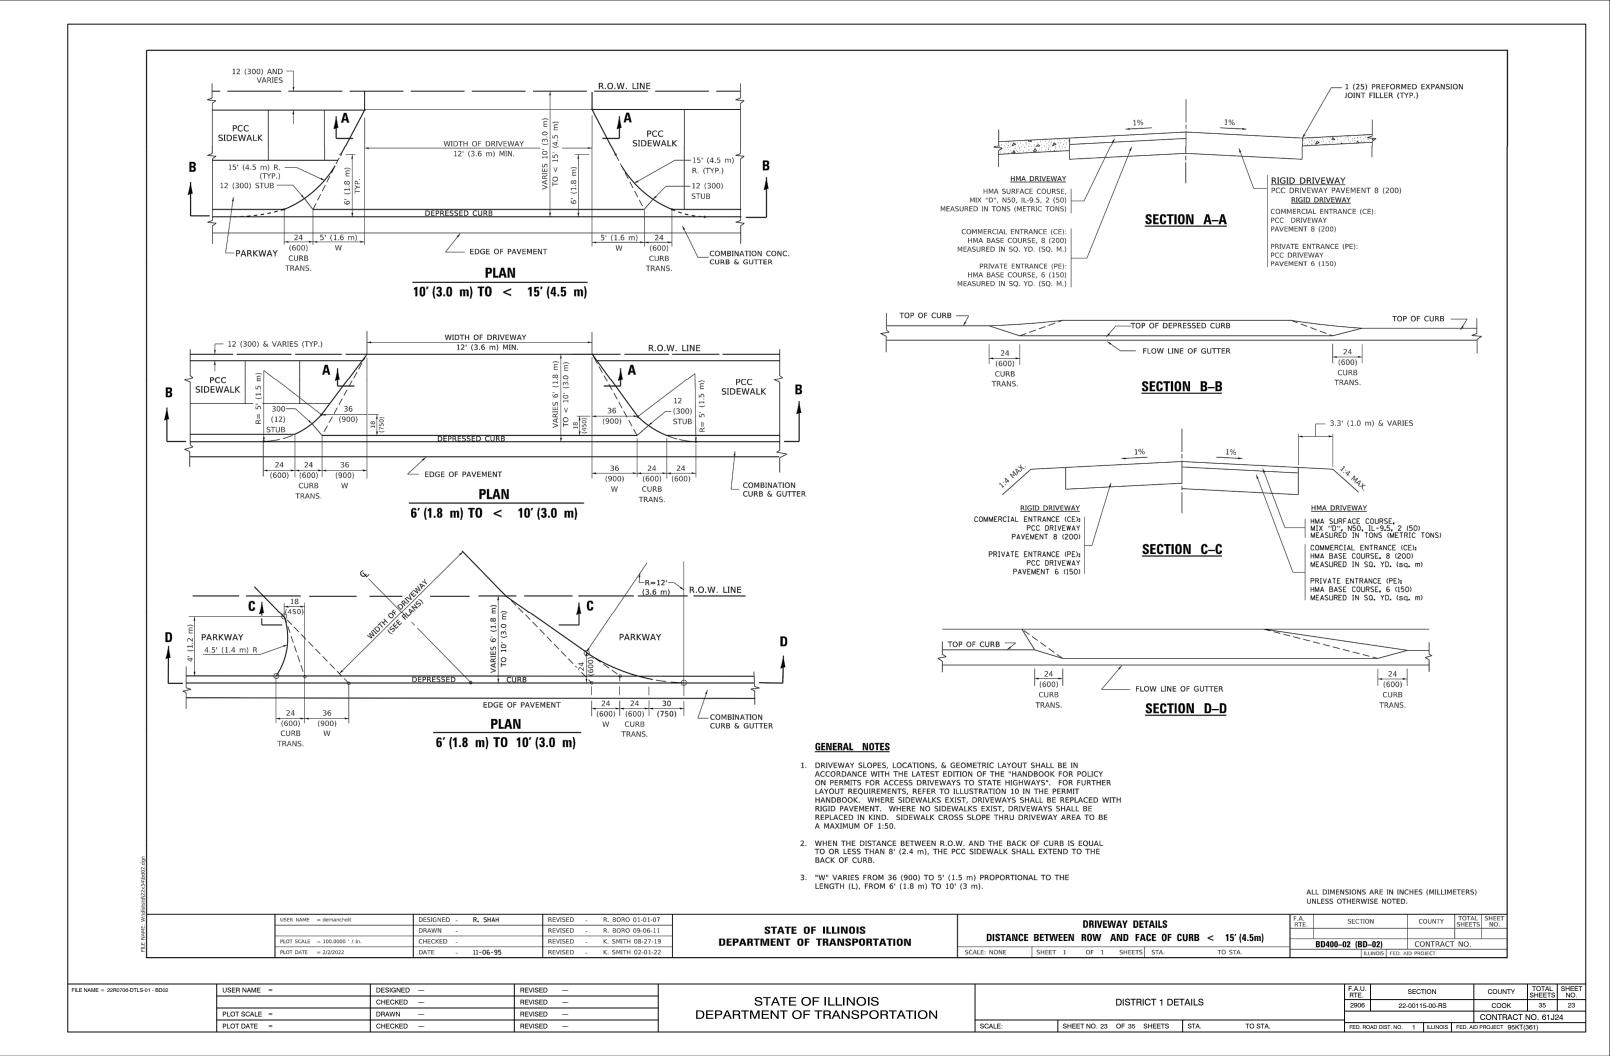

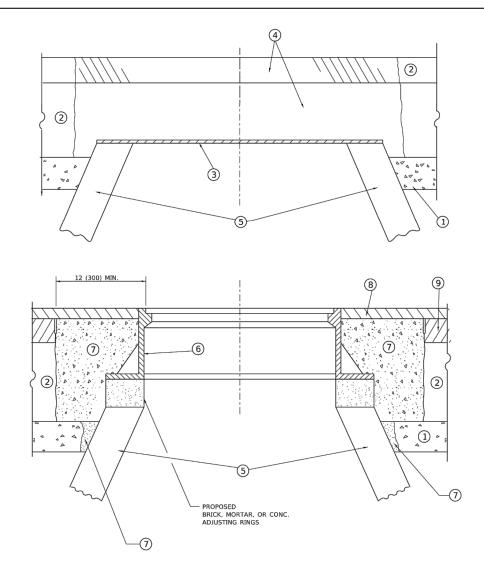

DETAILS FOR FRAMES AND LIDS ADJUSTMENT WITH MILLING

NOTES

- EXISTING BROKEN FRAMES AND LIDS SHALL BE REMOVED AND DISPOSED OF BY THE CONTRACTOR AND SHALL BE REPLACED AS DIRECTED BY THE ENGINEER. REPLACEMENT FRAMES AND LIDS WILL BE PAID FOR IN ACCORDANCE WITH ARTICLE 109.04 OF THE STANDARD SPECIFICATIONS UNLESS A SEPARATE PAY ITEM HAS BEEN PROVIDED.
- IF THE EXISTING LIDS ARE OPEN, THE FRAME WILL BE ADJUSTED TO THE ELEVATION OF THE MILLED PAVEMENT SURFACE PRIOR TO THE MILLING OPERATION. THE FRAME WILL NOT BE REMOVED AND COVERED BY THE METAL PLATE.
- CITY OF CHICAGO CASTINGS ARE THE PROPERTY OF THE CITY AND THE CONTRACTOR SHALL NOTIFY THE CITY FOR REMOVAL AND DISPOSITION OF THE CASTINGS.
- THE METAL PLATE USED TO COVER THE STRUCTURE SHALL REMAIN THE PROPERTY OF THE CONTRACTOR.

CONSTRUCTION PROCEDURES

STAGE 1 (BEFORE PAVEMENT MILLING)

- A) REMOVE A MINIMUM OF 12 (300) OF THE PAVEMENT FROM AROUND THE STRUCTURE.
- B) REMOVE THE EXISTING FRAME AND LID FROM THE STRUCTURE.

 C) COVER THE STRUCTURE OPENING WITH A 36 (900) DIAMETER METAL PLATE.
- D) BACKFILL WITH CRUSHED STONE AND HMA SURFACE MIX APPROVED BY THE ENGINEER. (MIN. 1 1/2 (40) HMA TO REMAIN AFTER MILLING).

STAGE 2 (AFTER PAVEMENT MILLING)

- A) REMOVE THE HMA SURFACE MIX AND CRUSHED STONE.
- B) INSTALL THE FRAME AND LID; ADJUST THE FRAME TO ITS FINAL SURFACE ELEVATION.
- C) THE SURROUNDING SPACE SHALL BE FILLED WITH CLASS*PP-1 CONCRETE TO THE ELEVATION OF THE SURFACE OF THE EXISTING BASE COURSE OR THE BINDER COURSE.
- *UNLESS OTHERWISE SPECIFIED IN THE PLANS.

THE PROCEDURE EXPLAINED ABOVE SHALL CONFORM TO THE APPLICABLE PORTIONS OF SECTIONS 353, 406, 602, AND 603 OF THE STANDARD SPECIFICATIONS EXCEPT THAT "THE CONTRACTOR SHALL ADJUST THE STRUCTURES TO THE FINISHED PAVEMENT ELEVATION NO MORE THAN 5 CALENDAR DAYS PRIOR TO PLACEMENT OF THE FINAL LIFT OF SURFACE UNLESS APPROVED BY THE ENGINEER."

LEGEN

- ① SUB-BASE GRANULAR MATERIAL
- (6) FRAME AND LID (SEE NOTES)
- 2 EXISTING PAVEMENT
- (7) CLASS*PP-1 CONCRETE
- 3 36 (900) DIAMETER METAL PLATE
- (8) PROPOSED HMA SURFACE COURSE
- 4 PROPOSED CRUSHED STONE AND HMA SURFACE MIX
 - AND
- (5) EXISTING STRUCTURE
- PROPOSED HMA BINDER COURSE

LOCATION OF STRUCTURES

THE CONTRACTOR WILL BE REQUIRED TO KEEP A RECORD OF THE LOCATIONS OF THE BURIED STRUCTURES ACCORDING TO THE STATION AND DISTANCE LEFT OR RIGHT OF THE CENTERLINE OF PAVEMENT. UPON COMPLETION OF THE WORK, THE CONTRACTOR WILL DELIVER THE RECORD TO THE ENGINEER.

BASIS OF PAYMENT

- REMOVING FRAMES AND LIDS ON DRAINAGE AND UTILITY STRUCTURES IN THE PAVEMENT PRIOR TO MILLING, AND ADJUSTING TO FINAL GRADE PRIOR TO PLACING THE SURFACE COURSE, WILL BE PAID FOR AT THE CONTRACT UNIT PRICE EACH FOR "FRAMES AND LIDS TO BE ADJUSTED (SPECIAL)."
- 2. THIS WORK WILL NOT BE PAID FOR WHEN DRAINAGE AND UTILITY STRUCTURES ARE SPECIFIED FOR PAYMENT AS STRUCTURE RECONSTRUCTION.
- 3. NEW FRAMES AND LIDS, WHEN SPECIFIED, WILL BE PAID FOR SEPARATELY.
- 4. WHEN STRUCTURES ARE TO BE ADJUSTED OR RECONSTRUCTED, THE LOWERING AND RAISING OF THE FRAMES AND LIDS WILL NOT BE PAID FOR SEPARATELY BUT WILL BE INCLUDED IN THE COST OF THE CORRESPONDING PAY ITEM.

ALL DIMENSIONS ARE IN INCHES (MILLIMETERS) UNLESS OTHERWISE SHOWN

| USER NAME = demanchelt | DESIGNED - R. SHAH | REVISED - R. BORO 01-01-07 | | | DETAILS FOR | F.A. RTE. | SECTION | COUNTY | TOTAL SHEETS | SHEET NO. |
|-------------------------------|--------------------|-----------------------------|------------------------------|-------------|---|--------------|------------------|------------|-----------------|--------------|
| | DRAWN - | REVISED - R. BORO 03-09-11 | STATE OF ILLINOIS | ED | AMES AND LIDS ADJUSTMENT WITH MILLING | | | | | |
| PLOT SCALE = 100.0000 ' / in. | CHECKED - | REVISED - R. BORO 12-06-11 | DEPARTMENT OF TRANSPORTATION | rn | AIVIES AIVD LIDS ADJUSTIVIENT VVITA IVIILLING | | BD600-03 (BD-08) | CONTRACT | NO. | |
| PLOT DATE = 2/2/2022 | DATE - 10-25-94 | REVISED - K. SMITH 02-01-22 | | SCALE: NONE | SHEET 1 OF 1 SHEETS STA. TO STA. | | ILLINOIS FED. A | ID PROJECT | | |


| Ī | FILE NAME = 22R0706-DTLS-01 - BD08 | USER NAME = | DESIGNED — | REVISED — | | | | | F.A.U. RTF | SECTION | COUNTY | TOTAL | SHEET | |
|---|------------------------------------|--------------|------------|-----------|------------------------------|--------|---------------------------|------|---------------|-----------|-----------------------------|-----------------|----------|----|
| | | | CHECKED — | REVISED — | STATE OF ILLINOIS | | DISTRICT 1 DET | | | 2906 | 22-00115-00-RS | соок | 35 | 24 |
| | | PLOT SCALE = | DRAWN — | REVISED — | DEPARTMENT OF TRANSPORTATION | | | | | | | CONTRACT | NO. 61J2 | 4 |
| | | PLOT DATE = | CHECKED — | REVISED — | | SCALE: | SHEET NO. 24 OF 35 SHEETS | STA. | TO STA. | FED. ROAD | DIST. NO. 1 ILLINOIS FED. A | ID PROJECT 95KT | | |

METHOD OF MEASUREMENT

REFER TO SECTION 442 OF THE STANDARD SPECIFICATIONS FOR ROAD AND BRIDGE CONSTRUCTION AND THE RECURRING SPECIAL PROVISION "PATCHING WITH HOT-MIX ASPHALT OVERLAY REMOVAL."

BASIS OF PAYMENT

- 1. REFER TO SECTION 442 OF THE STANDARD SPECIFICATIONS FOR ROAD AND BRIDGE CONSTRUCTION AND THE RECURRING SPECIAL PROVISION "PATCHING WITH HOT-MIX ASPHALT OVERLAY REMOVAL."
- 2. SAW CUT/SCORING OF EXISTING HMA OVERLAY IS INCLUDED IN THE COST OF PAVEMENT PATCHING.
- 3. SAW CUT/SCORING OF EXISTING PAVEMENT IS INCLUDED IN THE COST OF PAVEMENT PATCHING.

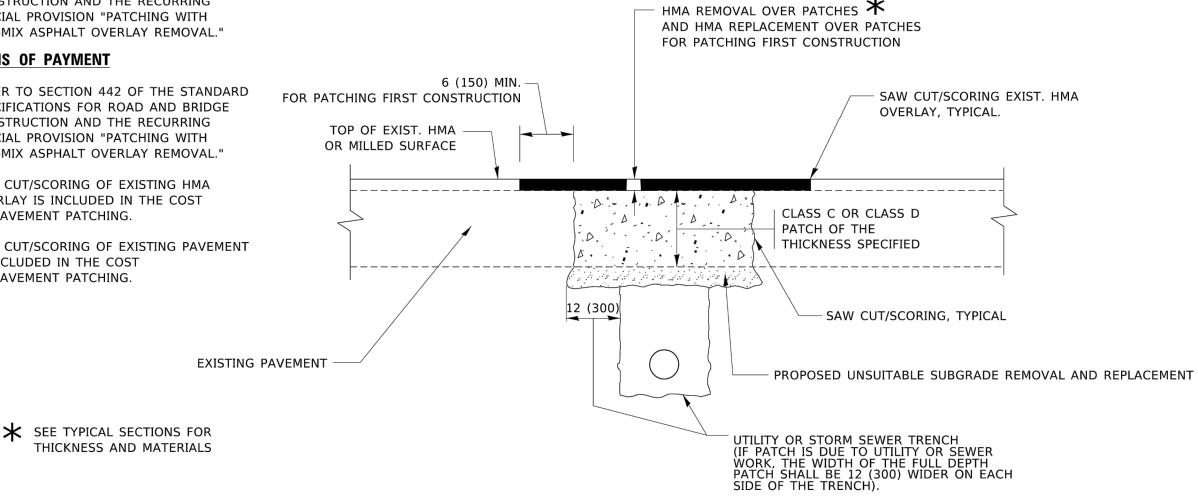

SEQUENCE OF CONSTRUCTION (PATCHING FIRST)

- 1. REMOVE THE EXISTING HMA MATERIAL OVER THE AREA TO BE PATCHED.
- 2. REMOVE AND REPLACE WITH CLASS C OR D PATCH.
- 3. REPLACE HMA MATERIAL OVER THE AREA TO BE PATCHED.


SEQUENCE OF CONSTRUCTION (MILLING FIRST)

- 1. MILL HMA FIRST IF THERE IS AT LEAST 4½ INCHES OR MORE OF HMA MATERIAL ON TOP OF THE EXISTING PAVEMENT OR IF THE PAVEMENT IS FULL DEPTH HMA. A MINIMUM OF 2 INCHES OF HMA MATERIAL SHALL BE IN PLACE AFTER MILLING.
- 2. REMOVE AND REPLACE WITH FULL DEPTH CLASS D PATCHES TO TOP OF MILLED SURFACE.

ALL DIMENSIONS ARE IN INCHES (MILLIMETERS) UNLESS OTHERWISE SHOWN.

| USER NAME = demanchelt | DESIGNED - R. SHAH | REVISED - R. BORO 01-01-07 | | | PAVEMENT | РАТСН | ING FOR | | F.A. RTF | SECTION | COUNTY | TOTAL S | IEET |
|-------------------------------|--------------------|-----------------------------|------------------------------|-------------|--------------|--------|-----------|---------|-------------|------------------|-----------|---------|--------|
| | DRAWN - | REVISED - R. BORO 09-04-07 | STATE OF ILLINOIS | | | | | | 1112. | | | SHEETS | ,0. |
| PLOT SCALE = 100.0000 ' / in. | CHECKED - | REVISED - K. ENG 10-27-08 | DEPARTMENT OF TRANSPORTATION | | HMA SURFA | CED P | AVEIVIENI | | | BD400-04 (BD-22) | CONTRACT | NO. | \neg |
| PLOT DATE = 2/2/2022 | DATE - 10-25-94 | REVISED - K. SMITH 02-01-22 | | SCALE: NONE | SHEET 1 OF 1 | SHEETS | STA. | TO STA. | | ILLINOIS FED. AI | D PROJECT | | |

| FILE NAME = 22R0706-DTLS-01 - BD22 | USER NAME = | DESIGNED — | REVISED — | | | | | | F.A.U. | SECTION | COUNTY | TOTAL | SHEET |
|------------------------------------|--------------|------------|-----------|------------------------------|--------|---------------------------|------|---------|-----------|---------------------------|------------------|------------|-------|
| | | CHECKED — | REVISED — | STATE OF ILLINOIS | | DISTRICT 1 DET | | | 2906 | 22-00115-00-RS | соок | 35 | 25 |
| | PLOT SCALE = | DRAWN — | REVISED — | DEPARTMENT OF TRANSPORTATION | | | | | | | CONTRACT | F NO. 61J2 | 4 |
| | PLOT DATE = | CHECKED — | REVISED — | | SCALE: | SHEET NO. 25 OF 35 SHEETS | STA. | TO STA. | FED. ROAD | DIST. NO. 1 ILLINOIS FED. | AID PROJECT 95KT | | |

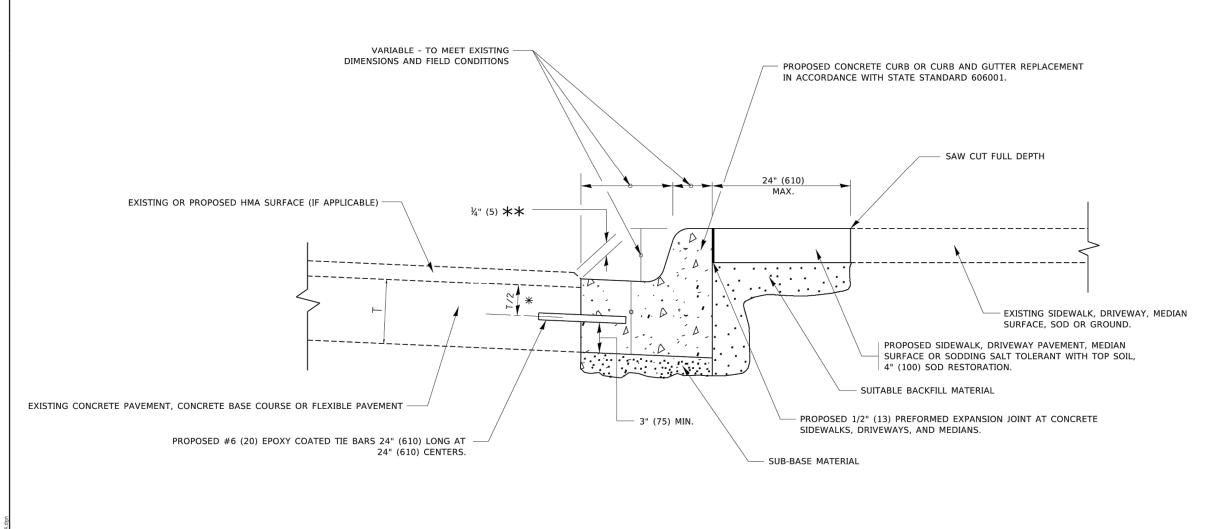

 \divideontimes 3" (75) MINIMUM FROM TOP AND BOTTOM OF THE CONCRETE PAVEMENT OR BASE COURSE.


 $\star\star$ if the final surface of the pavement is concrete, the gutter is to be flush with the pavement.


CURB OR CURB AND GUTTER REMOVAL AND REPLACEMENT


ALL DIMENSIONS ARE IN INCHES (MILLIMETERS) UNLESS OTHERWISE SHOWN.


| USER NAME = footemj | DESIGNED - A. HOUSEH | REVISED - A. ABBAS 03-21-97 | | | CURB OR CURB | R AND | GUTTER | | F.A. RTF | SECTION | COUNTY | TOTAL S | HEET |
|------------------------------|----------------------|-----------------------------|------------------------------|-------------|-----------------|-------|---------|---------|-------------|------------------|-----------|---------|--------|
| | DRAWN - | REVISED - M. GOMEZ 01-22-01 | STATE OF ILLINOIS | | | | | | IXIL. | | | SHEETS | 140. |
| PLOT SCALE = 50.0000 ' / in. | CHECKED - | REVISED - R. BORO 12-15-09 | DEPARTMENT OF TRANSPORTATION | | REMOVAL AND | KEPL | ACEMENT | | ı | BD600-06 (BD-24) | CONTRACT | NO. | \neg |
| PLOT DATE = 7/11/2019 | DATE - 03-11-94 | REVISED - K. SMITH 07-11-19 | | SCALE: NONE | SHEET 1 OF 1 SH | HEETS | STA. | TO STA. | | ILLINOIS FED. A | D PROJECT | | |

| FILE NAME = 22R0706-DTLS-01 - BD24 | USER NAME = | DESIGNED — | REVISED — | FAU. | | | | | | col | JNTY TO | OTAL SHEET |
|------------------------------------|--------------|------------|-----------|------------------------------|--------|--------------------------------|---------|-------------|----------------------|-----------------|-------------|------------|
| | | CHECKED — | REVISED — | STATE OF ILLINOIS | | DISTRICT 1 DETAILS | | | 22-00115-00-RS | CC | OK : | 35 26 |
| | PLOT SCALE = | DRAWN — | REVISED — | DEPARTMENT OF TRANSPORTATION | | | | | | | RACT NO. | 61J24 |
| | PLOT DATE = | CHECKED — | REVISED — | | SCALE: | SHEET NO. 26 OF 35 SHEETS STA. | TO STA. | FED. ROAD D | DIST. NO. 1 ILLINOIS | FED. AID PROJEC | T 95KT(361) | , |

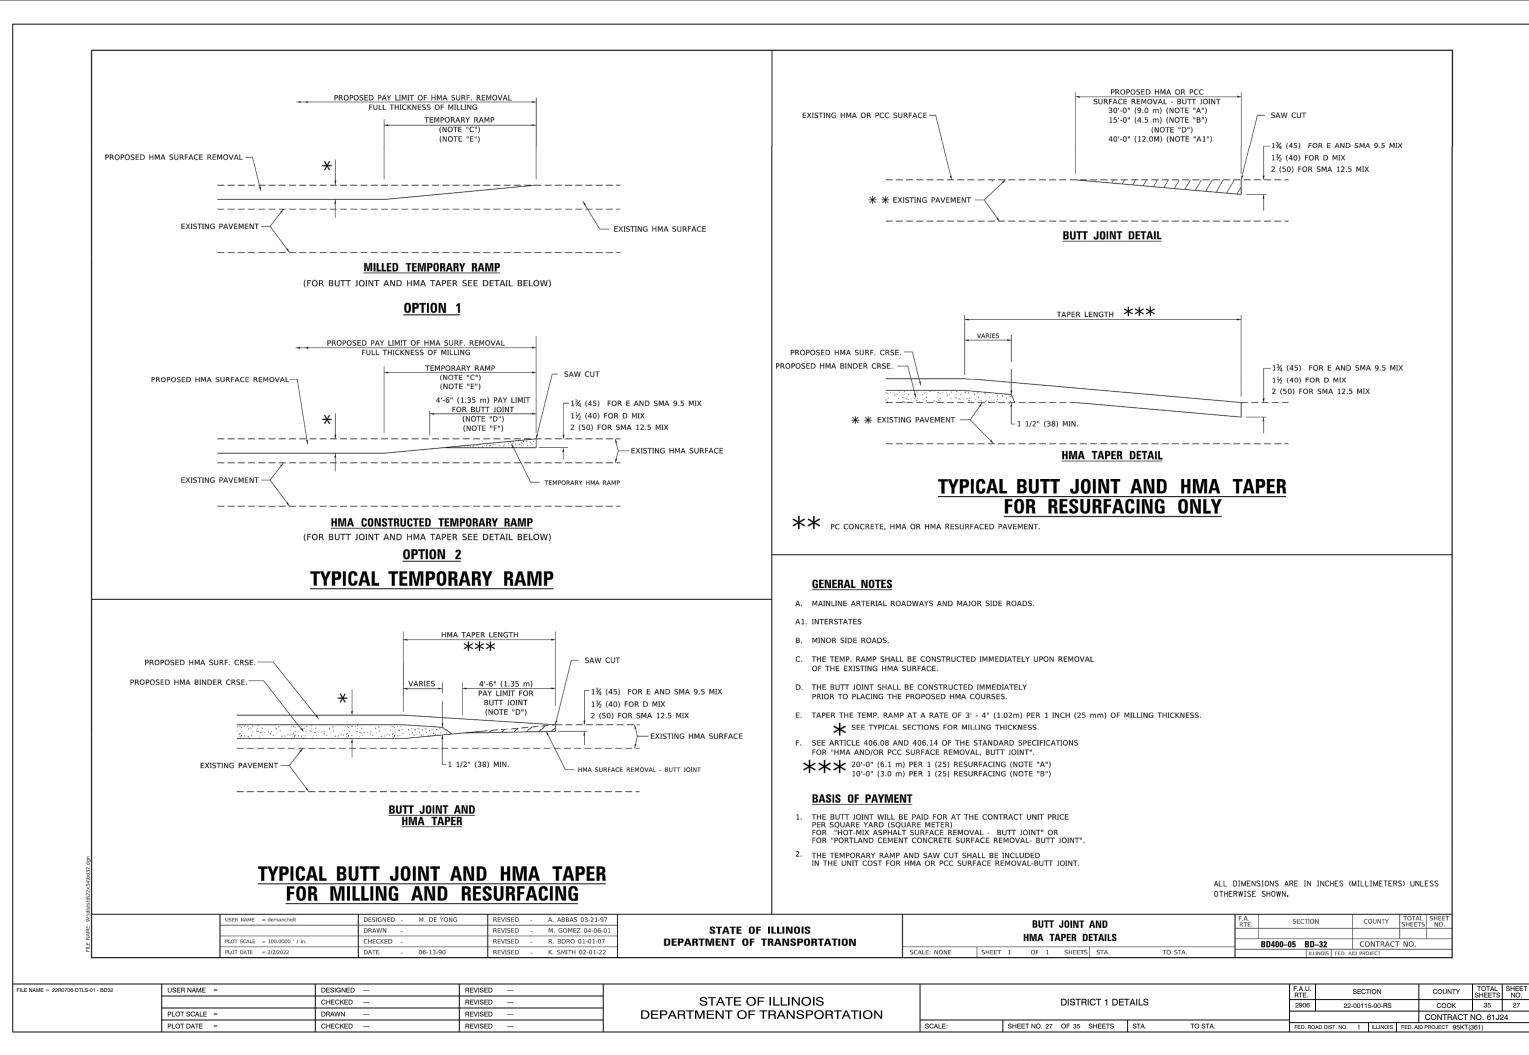


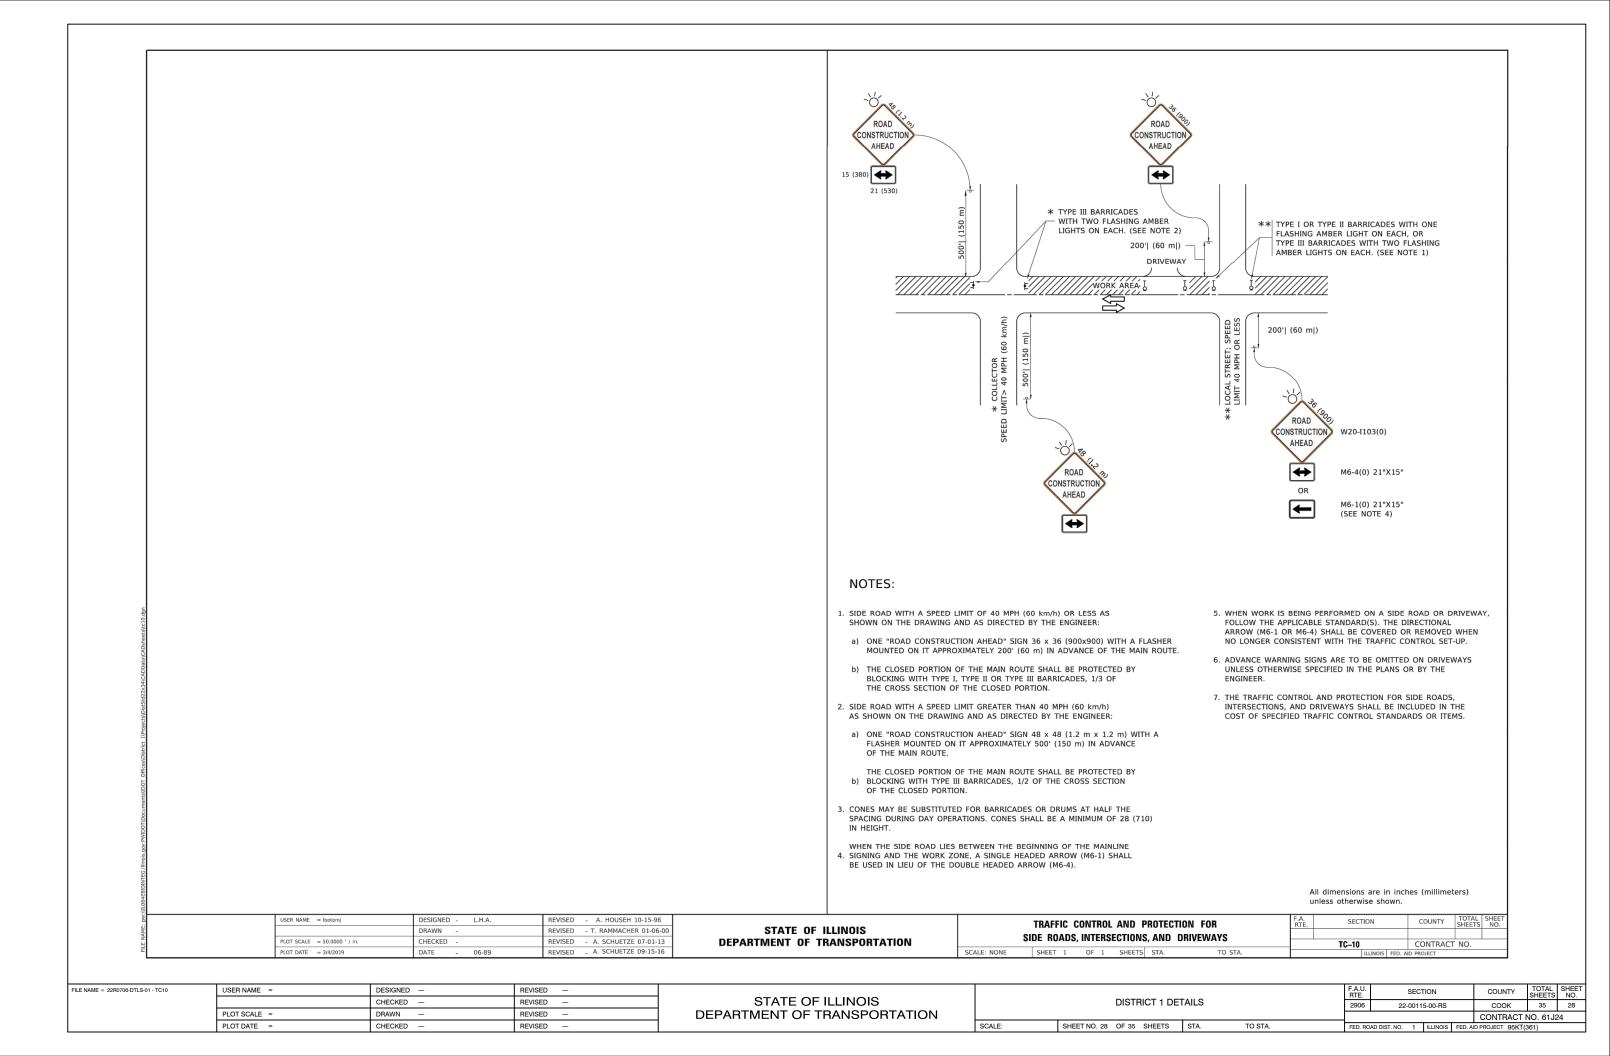

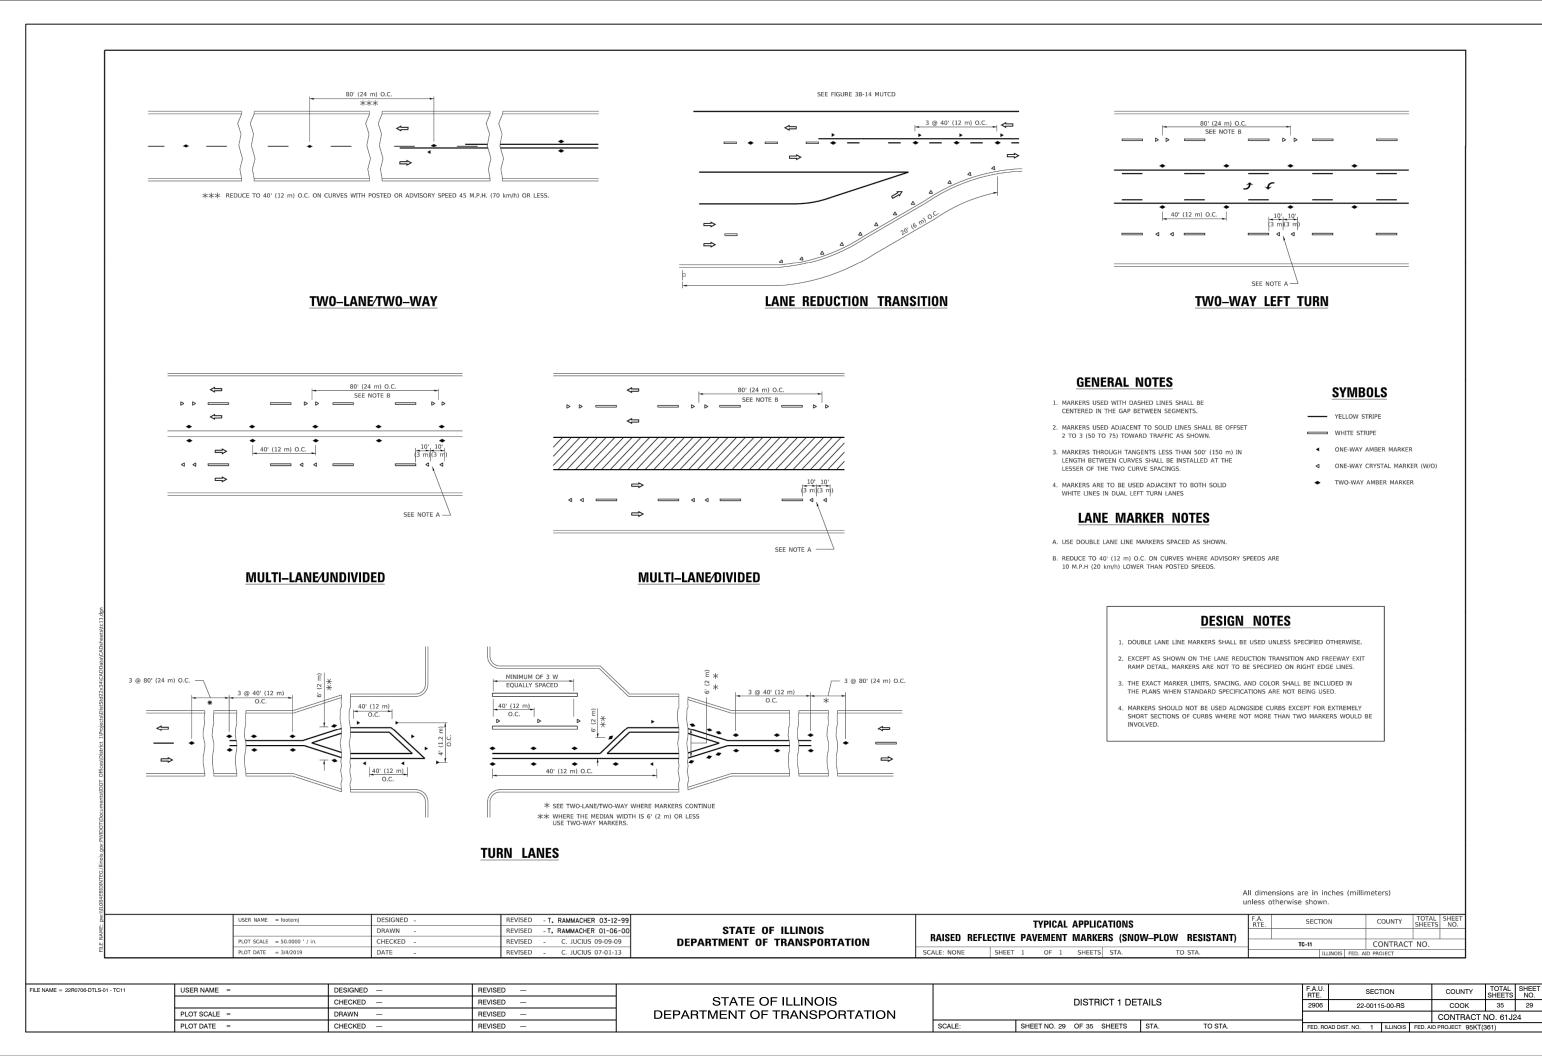

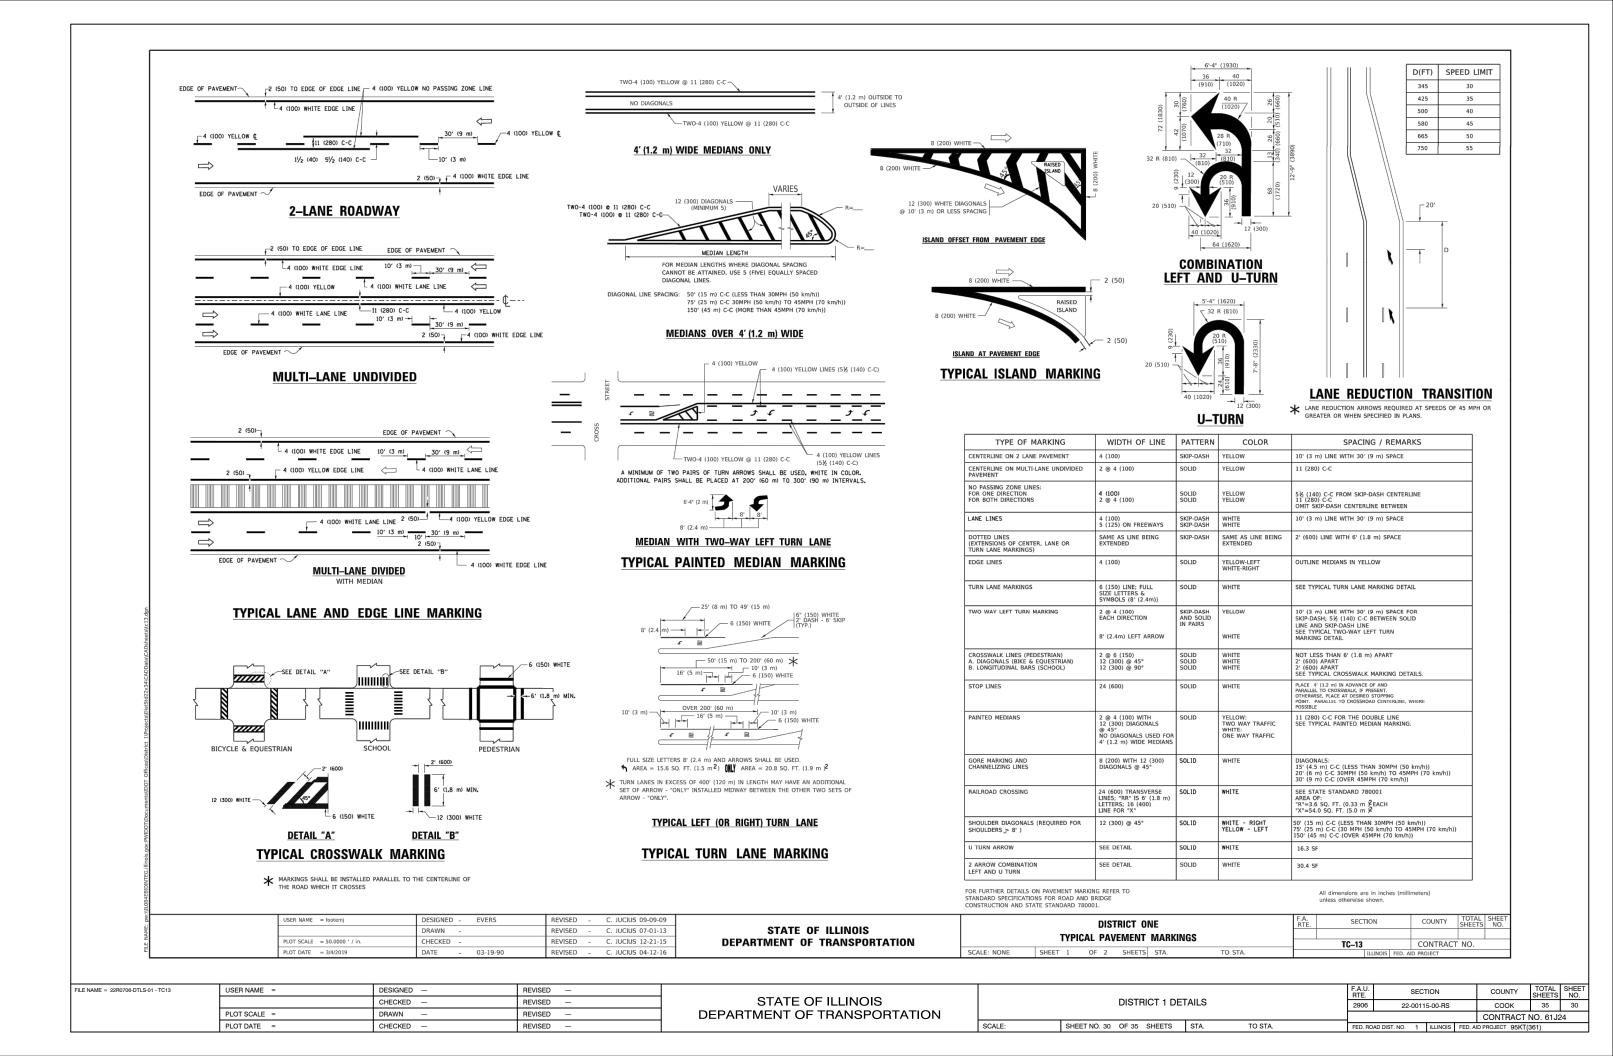

TURN BAY ENTRANCE AT START OF LANE CLOSURE TAPER

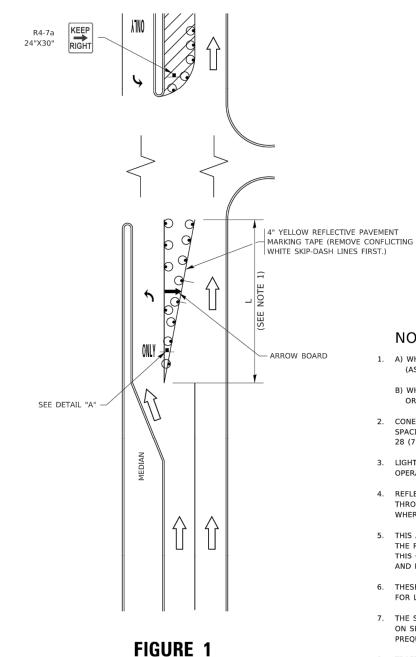


LEGEND WORK AREA LANE OPEN TO TRAFFIC ARROW BOARD TYPE I OR II BARRICADE OR DRUM WITH STEADY BURN LIGHT DRUM WITH STEADY BURN LIGHT SIGN ASSEMBLY TYPE I OR II CHECK BARRICADE WITH FLASHING LIGHT

NOTES:

- 1. A) WHEN "L" IS \leq THE STORAGE LENGTH OF THE TURN LANE (AS SHOWN IN FIG. 1), USE FIGURE 1.
- B) WHEN "L" IS > THE STORAGE LENGTH OF THE TURN LANE
 OR THE TURN LANE IS WITHIN THE LANE CLOSURE, USE FIGURE 2.
- CONES MAY BE SUBSTITUTED FOR BARRICADES OR DRUMS AT HALF THE SPACING DURING DAY OPERATIONS. CONES SHALL BE A MINIMUM OF 28 (710) IN HEIGHT.
- LIGHTS WILL NOT BE REQUIRED ON BARRICADES OR DRUMS FOR DAY OPERATIONS. ALL LIGHTS SHALL BE MONODIRECTIONAL.
- REFLECTIVE TEMPORARY PAVEMENT MARKINGS SHALL BE PLACED
 THROUGHOUT THE BARRICADED AREAS OF EACH TURN BAY AS SHOWN
 WHERE THE CLOSURE TIME IS GREATER THAN FOURTEEN (14) DAYS.
- THIS APPLICATION ALSO APPLIES WHEN WORK IS BEING PERFORMED IN THE RIGHT LANE(S) AND THE RIGHT TURN BAY IS TO REMAIN OPEN. UNDER THIS CONDITION, "RIGHT TURN LANE" R3-I100R 24 x 24 (600 x 600) AND M6-2R 21 x 15 (530 x 380) SHALL BE USED.
- THESE CONTROLS SHALL SUPPLEMENT MAINLINE TRAFFIC CONTROL
 FOR LANE CLOSURES.
- THE SIGNS SHALL BE MOUNTED ABOVE THE BARRICADES/DRUMS ON SEPARATE SIGN SUPPORTS THAT MEET NCHRP 350 OR MASH PREQUIREMENTS.
- 8. TRAFFIC CONTROL AND PROTECTION AT TURN BAYS (TO REMAIN OPEN TO TRAFFIC) SHALL BE INCLUDED IN THE COST OF SPECIFIED TRAFFIC CONTROL STANDARDS OR ITEMS.

TURN BAY ENTRANCE WITHIN A LANE CLOSURE

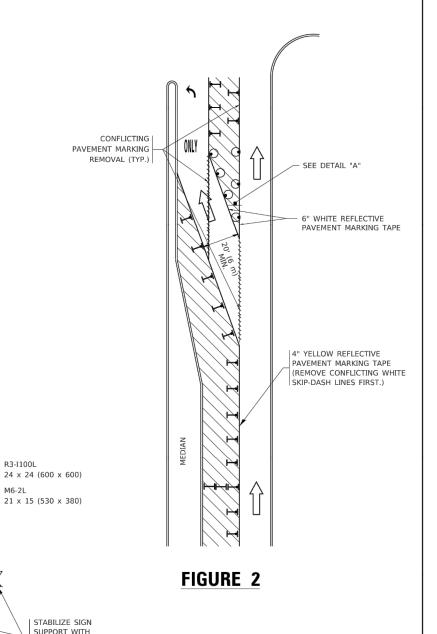

DETAIL A

SCALE:

SANDBAGS AS

TURN

LANE

K

All dimensions are in inches (millimeters) unless otherwise shown.

| USER NAME = footemj | DESIGNED | - T. | RAMMACHER O | 9-08-94 | REVISED | - | R. BORO 09-14-09 |
|------------------------------|----------|------|-------------|---------|---------|------|------------------|
| | DRAWN | - | A. HOUSEH 1 | 1-07-95 | REVISED | - A. | SCHUETZE 07-01-1 |
| PLOT SCALE = 50.0000 ' / in. | CHECKED | - | A. HOUSEH 1 | 0-12-96 | REVISED | - A. | SCHUETZE 09-15-1 |
| PLOT DATE = 3/4/2019 | DATE | - T. | RAMMACHER O | 1-06-00 | REVISED | - | |
| | | | | | | | |

STATE OF ILLINOIS
DEPARTMENT OF TRANSPORTATION


| TRAFFIC CONTROL AND PROTECTION AT TURN BAYS | | | | | | | | SECTION | COUNTY | TOTAL SHEETS | SHEET NO. | | |
|---|---|------|-----|--------|--|--|--|--------------------|-------------|-----------------|--------------|--|--|
| | /TO | REM/ | INI | OPEN 1 | | | | | | | | | |
| (TO REMAIN OPEN TO TRAFFIC) | | | | | | | | TC-14 CONTRACT NO. | | | | | |
| SCALE: NONE | CALE: NONE SHEET 1 OF 1 SHEETS STA. TO STA. | | | | | | | | AID PROJECT | | | | |


FILE NAME = 22R0706-DTLS-01 - TC14

USER NAME = DESIGNED - REVISED
CHECKED - REVISED
PLOT SCALE = DRAWN - REVISED
PLOT DATE = CHECKED - REVISED -

STATE OF ILLINOIS
DEPARTMENT OF TRANSPORTATION

| | | F.A.U. RTE. | | SEC1 | ION | | COUNTY | TOTAL SHEETS | SHEET NO. |
|----------------------------------|--------|----------------|----------------|------|----------|---------|---------------|-----------------|--------------|
| DISTRICT 1 DETAILS | 2906 | 22- | 22-00115-00-RS | | | COOK | 35 | 31 | |
| | | | | | | | CONTRACT | NO. 61J2 | .4 |
| SHEET NO. 31 OF 35 SHEETS STA. T | O STA. | FFD. BO | AD DIST. NO. | 1 | ILLINOIS | FFD AII | PROJECT Q5KT/ | 361) | |

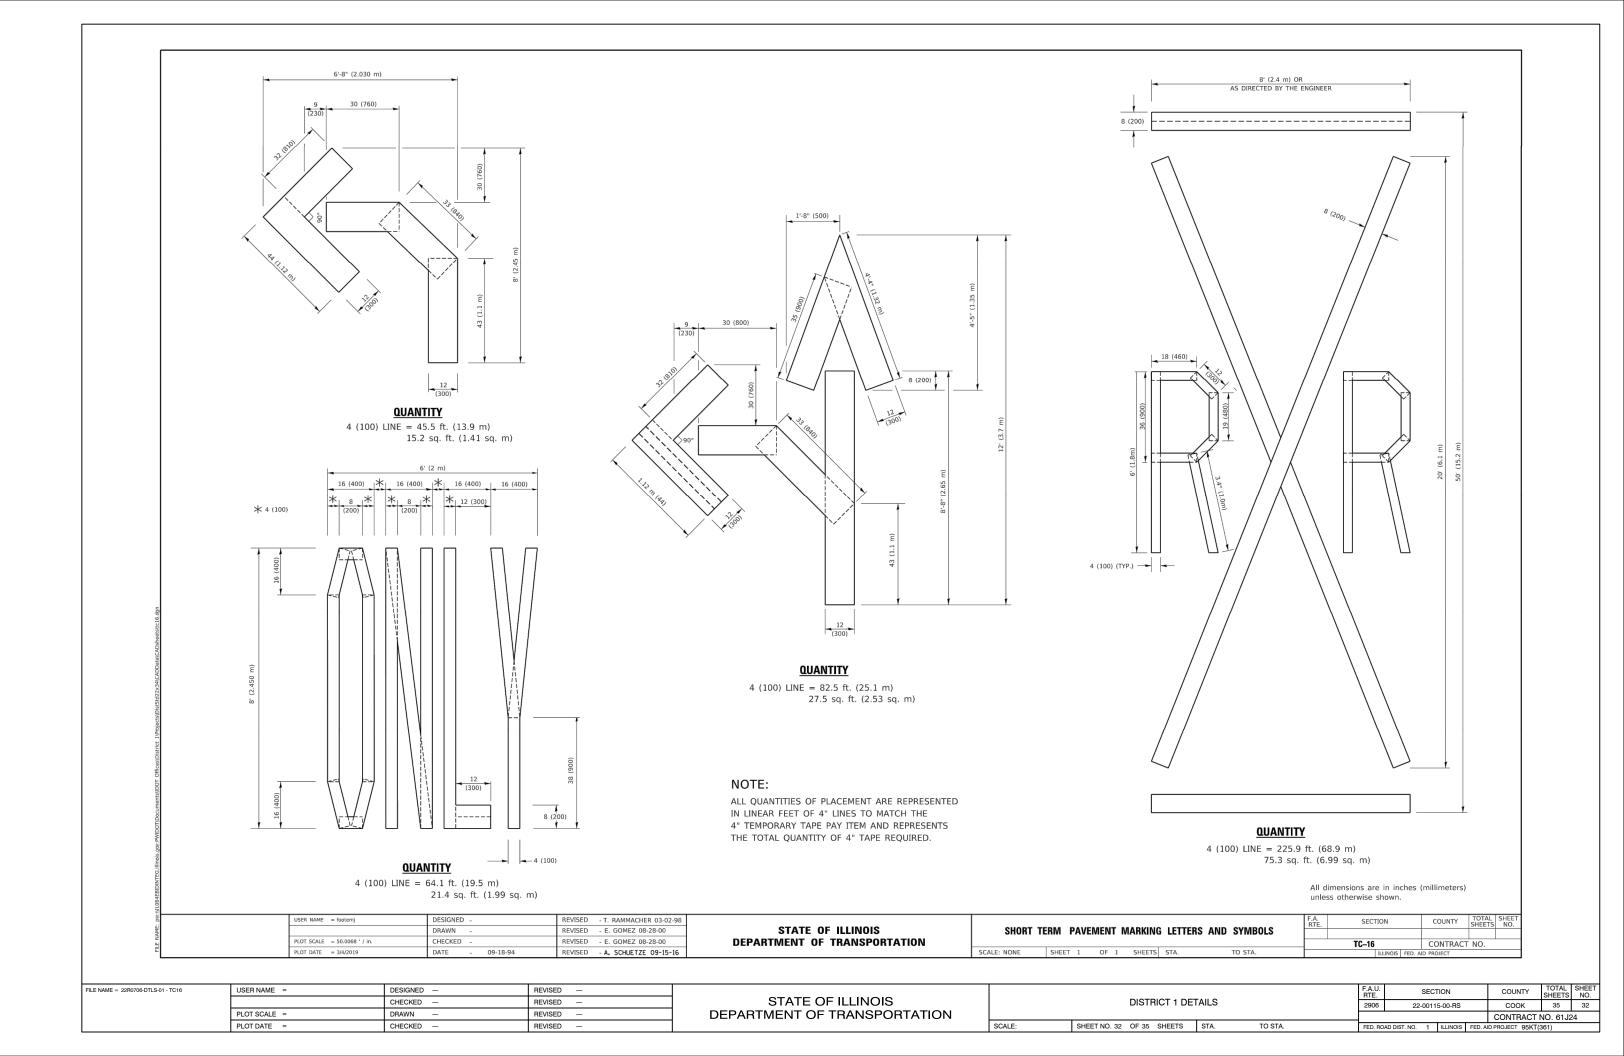

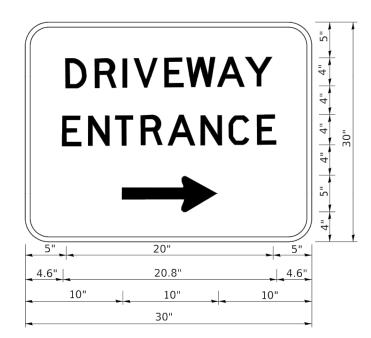

3.0" RADIUS, 0.5" BORDER, WHITE ON GREEN; REFLECTORIZED "DRIVEWAY" D; "ENTRANCE" D; STANDARD ARROW CUSTOM 12.0" x 5.0"

NOTES:

- 1. HALF OF THE SIGNS WILL REQUIRE A LEFT HAND FACING ARROW.
- 2. TWO SIGNS SHALL BE USED AT EACH COMMERCIAL ENTRANCE PLACED BACK-TO-BACK: ONE WITH A RIGHT HAND ARROW (SHOWN) SHALL BE PLACED ON THE NEAR RIGHT SIDE THE DRIVEWAY AND ONE WITH A LEFT HAND ARROW SHALL BE PLACED ON THE FAR LEFT SIDE OF THE DRIVEWAY.
- 3. SIGNS TO BE PAID FOR AS ITEM "TEMPORARY INFORMATION SIGNING".

| USER NAME = leysa | DESIGNED - | REVISED | - | C. JUCIUS 02-15-07 | Γ |
|------------------------------|------------|---------|---|--------------------|---|
| | DRAWN - | REVISED | - | | |
| PLOT SCALE = 50.0000 ' / in. | CHECKED - | REVISED | - | | ı |
| PLOT DATE = 8/6/2021 | DATE - | REVISED | - | | L |

STATE OF ILLINOIS DEPARTMENT OF TRANSPORTATION

| | DRIVEWAY ENTRANCE SIGNING | | | | | | | SEC | COUNTY | TOTAL SHEETS | SHEET NO. | | |
|--|--|--|-------|--|--|--|--|-----|----------|-----------------|--------------|--|--|
| | | | | | | | | | | | | | |
| | | | TC-26 | | | | | | | | | | |
| | SCALE: NONE SHEET 1 OF 1 SHEETS STA. TO STA. | | | | | | | | ILLINOIS | FED. A | ID PROJECT | | |

FILE NAME = 22R0706-DTLS-01 - TC26

| USER NAME = | DESIGNED — | REVISED — |
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| STATE OF ILLINOIS |
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| DEPARTMENT OF TRANSPORTATION |


SCALE:

| | F.A.U. RTE. | SECT | ION | | COUNTY | TOTAL SHEETS | SHEET NO. |
|--|----------------|----------------|----------------|----------|-----------------|-----------------|--------------|
| DISTRICT 1 DETAILS | 2906 | 22-0011 | 22-00115-00-RS | | | 35 | 33 |
| | | | CONTRACT NO. 6 | | | | 24 |
| SHEET NO. 33 OF 35 SHEETS STA. TO STA. | FFD. RO | AD DIST. NO. 1 | ILLINOIS | FFD. All | D PROJECT 95KT/ | 361) | - |

LOOP DETECTOR NOTES

- EACH PAIR OF LOOP WIRES SHALL BE PLACED IN A SEPARATE EMPTY COILABLE NONMETALLIC CONDUIT FROM THE EDGE OF PAVEMENT TO THE HANDHOLE. SPACING BETWEEN THE HOLES DRILLED IN THE PAVEMENT SHALL NOT BE LESS THAN 6" (150 mm). EMPTY COILABLE NONMETALLIC CONDUIT SHALL BE INCLUDED IN THE COST OF THE LOOP WIRE.
- THE NUMBER OF LOOP TURNS SHALL BE AS RECOMMENDED BY THE AMPLIFIER MANUFACTURER. ALL ADJACENT SIDES OF THE LOOPS SHALL BE INSTALLED IN SUCH A WAY THAT THE CURRENT FLOW IS IN THE SAME DIRECTION TO REINFORCE ITS MAGNETIC FIELDS FOR SMALL VEHICLE DETECTION.
- 3. EACH LOOP LEAD-IN SHALL BE IDENTIFIED AND PERMANENTLY TAGGED IN THE HANDHOLE. EACH LEAD-IN CABLE TAG SHALL INDICATE THE LOCATION OF THE LOOP, LOOP ROTATION (CLOCKWISE/COUNTERCLOCKWISE), LOOP LEAD-IN DIRECTION (IN OR OUT), LOOP CABLE NUMBER AND LOCATION IN CABINET, AND NUMBER OF TURNS IN THE DETECTOR LOOPS IN WATER PROOF INK AS INDICATED ON THE DISTRICT 1 STANDARD TRAFFIC SIGNAL DESIGN DETAIL. THE CONTRACTOR SHALL MARK LOOP LOCATIONS ON RECORD DRAWINGS AND PRESENT TO THE ENGINEER AFTER FINAL INSPECTION. LOOPS SHALL BE MARKED BY LANE AND LOOP NUMBER. SEE DETAIL BELOW.
- 4. ALL LOOP CABLE SHALL BE FASTENED WITH PLASTIC TIE WRAP TO THE HANDHOLE HOOKS.
- 5. IN ASPHALT PAVEMENT, LOOPS SHOULD BE PLACED IN THE BINDER AND DIVEHOLES MARKED AT THE CURB WITH A SAW-CUT. THE SAW-CUT SHALL BE CUT IN ACCORDANCE WITH LOCAL AND E.P.A. DUST CONTROL REQUIREMENTS. DETECTOR LOOP(S) SHALL NOT BE INSTALLED IN WET CONDITIONS AND THE SAW-CUTS MUST BE FREE OF DEBRIS AND RESIDUE SUCH AS DUST AND WATER WHICH IS TO BE ACHIEVED BY THE USE OF COMPRESSED AIR, WIRE BRUSHING AND HEAT DRYING ACCORDING TO SEALANT MANUFACTURER REQUIREMENTS. THE DETECTOR WIRE SHALL BE HELD IN PLACE BY THE USE OF FORM WEDGES. WEDGES SHALL BE SPACED NO MORE THAN
- LOOP SPLICES SHALL BE SOLDERED USING A SOLDERING IRON. BLOW TORCHES OR OTHER DEVICES WHICH OXIDIZE COPPER CABLE SHALL NOT BE ALLOWED FOR SOLDERING OPERATIONS. SEE DETAIL BELOW RIGHT.
- 7. PREFORMED DETECTOR LOOPS SHALL BE USED, AS SHOWN ON THE PLANS, WHERE NEW CONCRETE PAVEMENT IS PROPOSED. THE INSTALLATION OF PREFORMED LOOPS SHALL BE IN ACCORDANCE WITH THE DISTRICT 1 SPECIFICATIONS OR AS DIRECTED BY THE ENGINEER.

LOOP LEAD-IN CABLE TAG

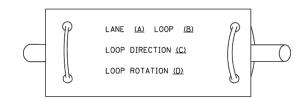


- A. LANE 1 IS THE LANE CLOSEST TO THE CENTERLINE OF THE ROADWAY
- B. LOOP #1 IS THE LOOP IN THE LANE CLOSEST TO THE INTERSECTION.
- C. LABEL LOOP CABLE "IN" OR LOOP CABLE "OUT".

CHECKED -

PLOT DATE =


D. LABEL LOOP CABLE CLOCKWISE OR LOOP CABLE COUNTERCLOCKWISE.


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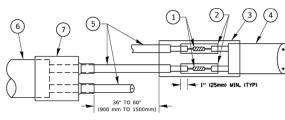
DETECTOR LOOP WIRING SCHEMATIC

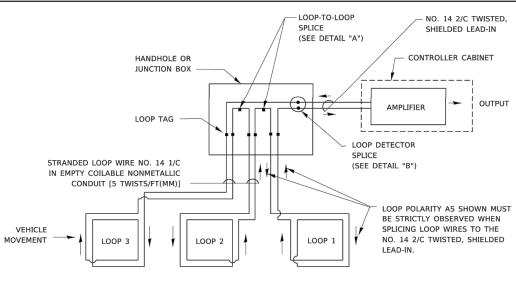- LOOPS SHALL BE SPLICED IN SERIES.
 SAW-CUTS SHALL BE A MINIMUM WIDTH OF 5/16" (8 mm).
- SAW-CUT DEPTHS SHALL BE 3" (75 mm). IF IN CONCRETE,
- THE SAW-CUT DEPTH SHALL BE TO THE TOP OF THE REINFORCEMENT.
- LOOP CORNERS SHALL BE DRILLED WITH A 2" (50 mm) DIAMETER CORE.



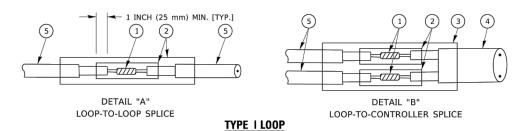

LOOP-TO-LOOP SPLICE

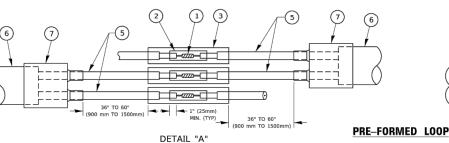

DETAIL "B"

LOOP-TO-CONTROLLER SPLICE

SECTION

TS-05

COUNTY

CONTRACT NO

FED. ROAD DIST. NO. 1 ILLINOIS FED. AID PROJECT 95KT(361)

LOOP DETECTOR SPLICE

SHEET NO. 34 OF 35 SHEETS STA.

- (1) WESTERN UNION SPLICE SOLDERED WITH ROSIN CORE FLUX. ALL EXPOSED SURFACES OF THE SOLDER SHALL BE SMOOTH. THE WESTERN UNION SPLICES SHALL BE STAGGERED.
- (2) WCSMW 30/100 HEAT SHRINK TUBE, MINIMUM LENGTH 3" (75 mm), UNDERWATER GRADE.

SCALE:

- (3) WCS 200/750 HEAT SHRINK TUBE, MINIMUM LENGHT 6" (150 mm), UNDERWATER GRADE.
- (4) NO. 14 2/C TWISTED, SHIELDED CABLE.

- 5 LOOP CONDUCTOR WITH FLEXIBLE PLASTIC TUBE. PRE-FORMED LOOP
- 6 XL POLYOLEFIN 2 CONDUCTOR

TO STA.

7 BREAKOUT SEALS. TYCO CBR-2 OR APPROVED EQUAL

| USER NAME = footemj | E = footenj DESIGNED - REVISED - | | | | | DISTRICT ONE | | | | | | |
|------------------------------|----------------------------------|-----------|------------------------------|-------------|----------|--------------|--------|------------|---------|-------|---|--|
| | DRAWN - | REVISED - | STATE OF ILLINOIS | | | | | | | 1012. | | |
| PLOT SCALE = 50.0000 ' / in. | CHECKED - | REVISED - | DEPARTMENT OF TRANSPORTATION | | STANDARD | TRAFFIC | SIGNA | L DESIGN D | JETAILS | | _ | |
| PLOT DATE = 3/4/2019 | DATE - | REVISED - | | SCALE: NONE | SHEET 2 | OF 7 | SHEETS | STA. | TO STA. | - | _ | |

FILE NAME = 22R0706-DTLS-01 - TS05 USER NAME = DESIGNED -REVISED SECTION COLINTY STATE OF ILLINOIS CHECKED REVISED DISTRICT 1 DETAILS 2906 22-00115-00-RS COOK 35 34 PLOT SCALE = DRAWN REVISED DEPARTMENT OF TRANSPORTATION CONTRACT NO. 61J24

** = (1.5m)

LOOPS ARE SAW-CUT TO THE EDGE OF PAVEMENT. 1" (25 mm) UNIT

DUCT IS RUN BETWEEN

EDGE OF PAVEMENT

OUTSIDE PAVEMENT)

AND HANDHOLE.
(TYP. FOR LOOPS
THAT TERMINATE

IN HANDHOLES


CROSS STREET

LEFT TURN LANES WITH MEDIANS

VOLUME DENSITY ("FAR OUT" DETECTION) ON SAME APPROACH

(PROTECTED / PERMITTED LEFT TURN PHASING)
HANDHOLE LOCATION MAY

HANDHOLE LOCATION MAY
VARY DEPENDING ON GEOMETRICS
AND DESIGN OF TRAFFIC SIGNALS.
HEAVY-DUTY HANDHOLES TO BE
USED WHEN THE MEDIAN IS
NOUNTABLE. REFER TO STANDARD
814001 TO ENSURE THAT HANDHOLE
FITS IN MEDIAN.

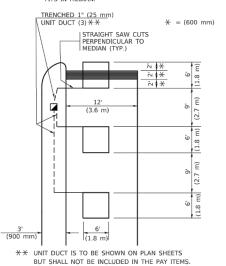

PLAN SHEET FOR DETECTOR LOOP REPLACEMENT

LEFT TURN LANES WITHOUT MEDIANS


VOLUME DENSITY ("FAR OUT" DETECTION)
ON SAME APPROACH
(PROTECTED / PERMITTED LEFT TURN PHASING)

NOTE: DUAL LEFT TURNS NOT SHOWN REFER TO
PLAN SHEET FOR DETECTOR LOOP REPLACEMENT

SCALE: 1

SCALE:

ARTERIAL-VOLUME DENSITY ("FAR OUT" DETECTION) CROSS STREET-NON VOLUME DENSITY ("UPTIGHT" PRESENCE DETECTION)

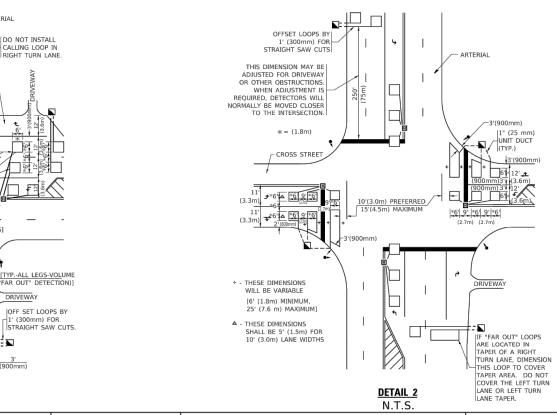

NOTES:

VEHICLES LOOP DETECTORS

- * ALL LEAD IN CABLE SHALL BE TWO CONDUCTOR NO. 14 TWISTED, SHIELDED.
- * EACH DETECTOR LOOP SHALL HAVE ITS OWN SAW CUT FROM THE LOOP TO THE EDGE OF PAVEMENT OR TO A HANDHOLE IN THE PAVEMENT.
- * EACH DETECTOR LOOP SHALL HAVE ITS OWN ONE INCH (25 mm) UNIT DUCT BETWEEN THE EDGE OF PAVEMENT AND THE FIRST HANDHOLE OR JUNCTION BOX, EACH UNIT DUCT RUN SHALL BE SHOWN ON THE PLANS BY THE DESIGNER, BUT SHALL NOT BE PAID FOR SEPARATLY. THIS ITEM IS INCIDENTAL TO THE PAY ITEM FOR DETECTOR LOOPS.
- * ONE DIMENSION OF <u>ALL</u> DETECTOR LOOPS SHALL BE SIX FEET (1.8 m)
- * EACH LANE OF NON-LOCKING, PRESENCE DETECTION AND EACH LANE OF A DOUBLE LEFT TURN LANE REQUIRES A SEPARATE INDUCTIVE LOOP DETECTOR AND LEAD IN CABLE.
- * WHEN NON-LOCKING, PRESENCE DETECTION IS USED, MORE THAN ONE LOOP PER LANE IS REQUIRED BEHIND THE STOP BAR (i.e. 1-1/2, 1-3/4, 2).
- * WHEN SYSTEM LOOPS ARE REQUIRED ON AN APPROACH OF AN INTERSECTION, THE LOOPS USED FOR VOLUME DENSITY AND INTERSECTION TIMING SHALL ALSO BE USED AS SYSTEM DETECTORS. EACH ONE OF THESE TYPE OF LOOPS REQUIRES A SEPARATE TWO CONDUCTOR NO. 14 TWISTED SHIELDED CABLE AND A SEPARATE INDUCTIVE LOOP DETECTOR WHEN NEW CONTROLLERS ARE UTILIZED. THE DESIGNER SHALL LABEL THESE TYPES OF LOOPS AS "INTERSECTION AND SAMPLING (SYSTEM) DETECTORS" ON THE SIGNAL LAYOUT, THE INTERCONNECT PLAN AND THE SYSTEM CABLE PLAN. WHEN AN EXISTING CONTROLLER IS UTILIZED FOR THIS TYPE OF DETECTION, THE PAY ITEM "INDUCTIVE LOOP DETECTOR WITH SYSTEM OUTPUT" SHOULD BE USED.

PLACEMENT OF DETECTORS

THE FOLLOWING FIGURES REPRESENT THE MOST COMMON DETECTOR LOOP LOCATIONS AND SIZES. ADJUSTMENTS WILL BE NECESSARY FOR SPECIFIC GEOMETRIC CONSIDERATIONS.

LOCATIONS AND DEMENSIONS OF DETECTOR LOOPS ARE REQUIRED ON $\underline{\mathsf{ALL}}$ SIGNAL LAYOUT PLAN SHEETS.

"FAR OUT" DETECTION REFERS TO LOCKING, PRESENCE TYPE DETECTION LOCATED IN THRU LANES, RIGHT TURN LANES, AND RIGHT TURN LANE TAPER AREAS (IF APPLICABLE), USUALLY 250' (75 m) IN ADVANCE OF STOP BARS. "UPTIGHT" DETECTION REFERS TO NON-LOCKING PRESENCE TYPE DETECTION LOCATED IN ALL LANES AND 10'-15' (3.0 m-4.5 m) BEHIND THE CROSSING STREET'S EDGE OF PAVEMENT EXTENDED.

NOTE

ALL DETAILS AND NOTES SHOWN ARE FROM THE I.D.O.T. DISTRICT 1 TRAFFIC SIGNAL DESIGN GUIDELINES DATED JANUARY 1995

THIS DRAWING HAS BEEN PREPARED TO ASSIST THE RESIDENT ENGINEER FOR ALL ROADWAY RESURFACING OR S.M.A.R.T. PROJECTS WHERE THE DIMENSIONS ARE NOT SHOWN ON THE PLANS AND THE FINAL LOCATIONS FOR CROSSWALKS OR STOP BARS ARE NOT DETERMINED.

| USER NAME = footemj | DESIGNED - | REVISED - |
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| | DRAWN - | REVISED - |
| PLOT SCALE = 50.0000 ' / in. | CHECKED - R.K.F. | REVISED - |
| PLOT DATE = 3/4/2019 | DATE - | REVISED - |
| | | |

DETAIL 1

N.T.S.

CROSS STREET-NON VOLUME DENSITY ("FAR OUT" DETECTION)

CALLING LOOPS

[TYP.-12' (3.6m) LANES] 12' 12' 12' 12' 3.6m) (3.6m) (3.6m) (3.6m)

STATE OF ILLINOIS
DEPARTMENT OF TRANSPORTATION

| DISTRICT 1 - DETECTOR LO | | | | | | ISTALLATION | RTE. | SECTION | | COUNTY | SHEETS | NO. |
|----------------------------------|--|--|--|----------|------|--|------|----------|---------|-----------|--------|-----|
| DETAILS FOR ROADWAY | | | | | RESI | IRFACING | | | | | | |
| DETAILS FUN NUMBERAT RESURFACING | | | | | | A STATE OF THE STA | | TS-07 | | CONTRACT | NO. | |
| NONE SHEET 1 OF 1 SHEETS | | | | 1 SHEETS | STA. | TO STA. | | ILLINOIS | FED. Al | D PROJECT | | |
| | | | | | | | | | | | | |

| FILE NAME = 22R0706-DTLS-01 - TS07 | USER NAME = | DESIGNED — | REVISED — |
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| | PLOT SCALE = | DRAWN — | REVISED — |
| | PLOT DATE = | CHECKED — | REVISED — |

STRAIGHT SAW

CUTS TO HEAVY-DUTY HANDHOLE-IN PAVEMENT

STATE OF ILLINOIS
DEPARTMENT OF TRANSPORTATION

| DISTRICT 1 DETAILS | | | F.A.U. RTE. | SECTION | | | COUNTY | TOTAL SHEETS | SHEET NO. | |
|--------------------|---------------------------|-----|----------------|----------------|---|------|--------|-----------------|--------------|----|
| | | | 2906 | 22-00115-00-RS | | соок | 35 | 35 | | |
| | | | | | CONTRACT NO | | | | NO. 61J2 | 24 |
| | SHEET NO. 35 OF 35 SHEETS | STA | TO STA | EED B | FED DOAD DICT NO. 4 HUNDIN FED AID DDO JECT OF KT (004) | | | | | |