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STATE OF ILLINOIS

DEPARTMENT OF TRANSPORTATION

1195 1128[SR:BR(1,2,3)B)R,BDR KNOX 47 1

INDEX OF SHEETS

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PROPOSED HIGHWAY PLANS

FAS ROUTE 1195 (IL 180) SECTION112B[BR;BR(1,2,3)]BJR,BDR PROJECT HBFP-V9G9(005) **BRIDGE PRESERVATION** KNOX COUNTY

C-94-025-22

HIGHWAY STANDARDS

000001-08	STANDARD SYMBOLS, ABBREVIATIONS AND PATTERNS
001001-02	AREAS OF REINFORCEMENT BARS
001006	DECIMAL OF AN INCH AND OF A FOOT
701001-02	OFF-ROAD OPERATIONS, 2L, 2W, MORE THAN 15' AWAY
701201-05	LANE CLOSURE, 2L,2W, DAY ONLY, FOR SPEEDS 45 MPH
701311-03	LANE CLOSURE, 2L, 2W, MOVING OPERATIONS - DAY ONLY LANE
701321-18	CLOSURE, 2L. 2W, BRIDGE REPAIR WITH BARRIER TRAFFIC
701901-08	CONTROL DEVICES
704001-08	TEMPORARY CONCRETE BARRIER
781001-04	TYPICAL APPLICATIONS RAISED REFLECTIVE PAVEMENT MARKERS
782006-01	GUARDRAIL AND BARRIER WALL REFLECTOR MOUNTING DETAILS
BLR 21-9	TYPICAL APPLICATION OF TRAFFIC CONTROL DEVICES FOR
	CONSTRUCTION ON RURAL LOCAL HIGHWAYS
701006-05	OFF-RD OPERATIONS, 2L, W 15' (4.5m) TO 24" (600mm) FROM
	PAVEMENT EDGE

OFF-RD MOVING OPERATIONS, 2L, 2W, DAY ONLY

SN 048-0085

FULL SIZE PLANS HAVE BEEN PREPARED USING STANDARD ENGINEERING SCALES. REDUCED SIZED PLANS WILL NOT CONFORM TO STANDARD SCALES. IN MAKING MEASUREMENTS ON REDUCED PLANS, THE ABOVE SCALES MAY BE USED.

JOINT UTILITY LOCATION INFORMATION FOR EXCAVATORS 1-800-892-0123

IL 180 OVER CADWELL CREEK STA 609+94.55 TO 610+75.72 SN 048-0086 **IL 180 OVER CADWELL CREEK** STA 636+68.39 TO 637+93.39 LOCATION MAP NOT TO SCALE SN 048-0080 **IL 180 OVER SPOON RIVER** STA 667+24.00 TO 671+57.00 SN 048-0089 **IL 180 OVER BRANDYWINE CREEK** STA 586+28.06 TO 587+21.94

LOCATION OF SECTION INDICATED THUS: -

D-94-010-22

FUNCTIONAL CLASSIFICATION MAJOR COLLECTOR 2021 ADT: 1150

PV: 93.9% SU: 2.6% MU: 3.5%

STATE OF ILLINOIS December 9, 2023

PRINTED BY THE AUTHORITY OF THE STATE OF ILLINOIS

GROSS LENGTH = 2159 FT. = 0.409 MILE NET LENGTH = 2159 FT. = 0.409 MILE

CIVIL DESIGN INC. WBE / DBE LICENSE #184.003222

STATE OF ILLINOIS NO. 062-064104 EXPIRES 11-30-2023

PROJECT ENGINEER NICOLE FAYANT (309) 671–3454 PROJECT MANAGER TRAVIS WALLENFANG (309) 671-3474 CATALOG NO. 036299-00D

REV. 12/7/22 REV. 10/31/22 REV. 10/25/22

CONTRACT NO. 68G91

NO COMMITMENTS HAVE BEEN MADE FOR THIS PROJECT.
COMMITMENTS ARE NOT TO BE ALTERED WITHOUT THE WRITTEN APPROVAL OF
ALL PARTIES TO WHICH THE COMMITMENT WAS MADE.

ENVIRONMENTAL REVIEW

PRIOR TO THE USE OF ANY PROPOSED BORROW AREAS, USE AREAS (TEMPORARY ACCESS ROADS, DETOURS, RUN-AROUNDS, ETC.) AND/OR WASTE AREAS, THE CONTRACTOR SHALL FILE THE REQUIRED ENVIRONMENTAL RESOURCE REQUEST SURVEYS ACCORDING TO SECTION 107.22 OF THE STANDARD SPECIFICATIONS. THESE SURVEYS ARE REQUIRED IN ORDER FOR THE DEPARTMENT TO CONDUCT CULTURAL AND BIOLOGICAL RESOURCE SURVEYS FOR THE PROPOSED SITE.

THE REQUIRED ENVIRONMENTAL RESOURCE DOCUMENTATION SHALL INCLUDE THE FOLLOWING:

- BDE FORM 2289 (BORROW SITE REVIEW)
- BDE FORM 2290 (WASTE/USE AREA REVIEW)
- · A LOCATION MAP SHOWING THE SIZE LIMITS AND LOCATION OF THE USE AREA
- COLOR PHOTOGRAPHS DEPICTING THE USE AREA
- BORROW AREA ENTRY AGREEMENT FORM D4 PI0101

PRIOR TO ANY WASTE MATERIALS BEING REMOVED FROM THE CONSTRUCTION SITE THE REQUIRED ENVIRONMENTAL RESOURCE SURVEYS SHALL BE OBTAINED AND FILED BY THE CONTRACTOR. EXCESS WASTE PRODUCTS REMOVED FROM THE CONSTRUCTION SITE SHALL BE DISPOSED OF AS REQUIRED IN SECTION 202.03 OF THE STANDARD SPECIFICATIONS.

ANY PROTRUDING METAL BARS SHALL BE REMOVED PRIOR TO THE DISPOSAL OF BROKEN CONCRETE AT APPROVED DISPOSAL SITES.

PLEASE NOTE THAT A MINIMUM OF FOUR WEEKS SHALL BE ALLOWED FOR THE DISTRICT TO OBTAIN THE REQUIRED WASTE SITE ENVIRONMENTAL CLEARANCES AND SIX WEEKS FOR THE REQUIRED BORROW SITE ENVIRONMENTAL CLEARANCES.

BRIDGE OVERLAY NOTIFICATION

AFTER PLACEMENT OF THE BRIDGE DECK OVERLAY, THE RESIDENT ENGINEER SHALL NOTIFY THE DISTRICT BRIDGE MAINTENANCE ENGINEER OF THE "AS CONSTRUCTED" MILLING DEPTH AND OVERLAY THICKNESS FOR UPDATING THE ILLINOIS HIGHWAY INFORMATION SYSTEM.

PROJECT SPECIFIC NOTES

CHANGEABLE MESSAGE SIGNS

TWO (2) CHANGEABLE MESSAGE SIGNS SHALL BE PLACED SEVEN (7) DAYS IN ADVANCE OF WORK. FOR CH 1750N, AN ADDITIONAL CHANGEABLE MESSAGE SIGN SHALL BE PLACED 7 DAYS IN ADVANCE OF WORK. LOCATION AND MESSAGE TO BE COORDINATED AT PRECONSTRUCTION MEETING.

APPROACH ROADWAY CORRECTIONS

TO CORRECT THE DIP AT THE END OF THE APPROACHES, THE CONTRACTOR SHALL PLACE AND COMPACT A SCRATCH PASS OF BINDER MIX PRIOR TO PAVING AS DIRECTED BY THE RESIDENT ENGINEER. THIS WORK SHALL CONSIST OF A COMBINATION OF VARIABLE DEPTH MILLING AND HMA BINDER PLACEMENT. THIS WORK SHALL BE PAID FOR AT THE CONTRACT UNIT PRICE PER TON FOR POLYMERIZED HOT MIX ASPHALT BINDER COURSE, IL 9.5 N50.

BLR-21 ADDITIONAL SIGNAGE

A TYPE III BARRICADE SHALL BE PLACED AT THE INTERSECTION OF CH 1800N AND 2150E TO READ "ROAD CLOSED AT IL 180 - LOCAL TRAFFIC ONLY." THE PLACEMENT SHALL BE INCLUDED IN THE CONTRACT UNIT PRICE PER L SUM FOR TRAFFIC CONTROL AND PROTECTION, STANDARD BLR 21.

WIDTH RESTRICTION SIGNAGE

SIX (6) WIDTH RESTRICTION SIGNS SHALL BE USED THROUGHOUT THE PROJECT LOCATION. PRECISE LOCATIONS WILL BE COORDINATED AT THE PRE-CONSTRUTION MEETING.

HOT-MIX ASPHALT MIXTURE REQUIREMENTS

LOCATION(S)	MAINLINE	MAINLINE	SHOULDER	10' APPROACH PVMT PATCHING
MIXTURE USE(S)	SURFACE	POLYMER BINDER (VAR. IF NEEDED - 1.25" MAX	SHOULDER REPAIR 2" LIFTS	PRE-STAGE PATCHING, 2"
AC/PG	PG 58-28	SBS OR SBR 70-28	PG 58-28	PG 58-28
DESIGN AIR VOIDS	4.0% @ N=50	4.0% @ N=50	4.0% @ N=50	4.0% @ N=50
MIXTURE COMPOSITION (MIXTURE GRADATION)	IL 9.5	IL 4.75	IL 9.5	IL 9.5
FRICTION AGGREGATE	MIX C	N.A.	MIX C	MIX C
QUALITY MANAGEMENT PROGRAM	QCQA	QCQA	QCQA	QCQA
MTD	NO	NO	NO	NO

BITUMINOUS MATERIALS APPLICATION RATES

SURFACE TYPE	RESIDUAL RATE ON PAVEMENT
MILLED SURFACE	0.08 LBS/SQFT
DETWEEN ALL LIETS	O OO I DO/COET

CIVIL DESIGN,INC.

WHE | DHE

EFFINGHAM, IL

LICENSE # 184.003222

 DESIGNED
 RLH
 REVISED

 DRAWN
 EJB
 REVISED

 LOT SCALE
 = 2.0000 '/ in.
 CHECKED
 RLH
 REVISED

 LOT DATE
 = 10/17/2022
 DATE
 10/17/2022
 REVISED

STATE OF ILLINOIS
DEPARTMENT OF TRANSPORTATION

				80% FED 20% STATE	80% FED 20% STATE	80% FED 20% STATE	80% FED 20% STATE
				BR I DGE	BRIDGE	BRIDGE	BR I DGE
CODE			TOTAL	0047	0047	0047	0047
NO.	ITEM	UNIT	QUANTITY	048-0080	048 - 0085	048-0086	048-0089
28100707	STONE DUMPED RIPRAP, CLASS A4	SQ YD	127		127		
35100300	AGGREGATE BASE COURSE, TYPE A 4"	SQ YD	15	15			
40600290	BITUMINOUS MATERIALS (TACK COAT)	POUND	2802	671	639	661	831
40600982	HOT-MIX ASPHALT SURFACE REMOVAL - BUTT JOINT	SQ YD	2046	413	446	487	700
40603205	POLYMERIZED HOT-MIX ASPHALT BINDER COURSE, IL-9.5, N50	TON	19	4	5	5	5
40604050	HOT-MIX ASPHALT SURFACE COURSE, IL-9.5, MIX "C", N50	TON	172	35	37	41	59
44000165	HOT-MIX ASPHALT SURFACE REMOVAL, 4"	SQ YD	923	259	221	215	228
			15				
44004250	PAVED SHOULDER REMOVAL	SQ YD	15	15			
48102100	AGGREGATE WEDGE SHOULDER, TYPE B	TON	11	7			4
48203100	HOT-MIX ASPHALT SHOULDERS	TON	210	59	50	49	 52
48300500	PORTLAND CEMENT CONCRETE SHOULDERS 10"	SQ YD	15	15			_
50102400	CONCRETE REMOVAL	CU YD	9.1	9.1			
50300255	CONCRETE SUPERSTRUCTURE	CU YD	9.5	9.5			
50300260	BRIDGE DECK GROOVING	SQ YD	3207	1474	467	611	655
	DROTECTIVE COAT	50 VD	2401	1562	498	650	689
50300300	PROTECTIVE COAT	SQ YD	3401	1562	490	652	689
50800205	REINFORCEMENT BARS, EPOXY COATED	POUND	1490	1490			

CONSTRUCTION CODE

* SEE SPECIAL PROVISIONS



USER NAME = rhanfland	DESIGNED	-	RLH	REVISED	-
	DRAWN	-	EJB	REVISED	-
PLOT SCALE = 2.0000 / in	CHECKED	-	RLH	REVISED	-
PLOT DATE = 10/17/2022	DATE	-	10/17/2022	REVISED	-

SCALE:

CURREADY OF CUARTITIFO					F.A.S. SECTION			COUNTY	TOTAL SHEETS	SHEET NO.
SUMMARY OF QUANTITIES				1195	112B[BR;BR(1,2,3)BJR	,BDR	KNOX	47	3	
								CONTRACT	NO. 68	3G91
SHEET 1	OF 3	SHEETS	STA.	TO STA.		ILLINOIS	FED. A	D PROJECT		

					CONSTRUC	TION CODE	
				80% FED	80% FED	80% FED	80% FED
				20% STATE	20% STATE	20% STATE	20% STATE
	· · · · · · · · · · · · · · · · · · ·		·				
				BR I DGE	BR I DGE	BR I DGE	BR I DGE
CODE			TOTAL	0047	0047	0047	0047
NO.	ITEM	UNIT	QUANTITY	048 - 0080	048-0085	048-0086	048-0089
50800515	BAR SPLICERS	EACH	28	28			
52000110	PREFORMED JOINT STRIP SEAL	FOOT	65	65			
60300105	FRAMES AND GRATES TO BE ADJUSTED	EACH	10	4	2	4	
60600605	CONCRETE CURB, TYPE B	FOOT	32	32			
67000400	ENGINEER'S FIELD OFFICE, TYPE A	CAL MO	7	1.75	1.75	1.75	1.75
			4500	2.0			220
63300575	REMOVE AND REERECT RAIL ELEMENT OF EXISTING GUARDRAIL	FOOT	1520	360	400	440	320
67100100	MOBILIZATION	L SUM	1	0.25	0.25	0.25	0.25
70100405	TRAFFIC CONTROL AND PROTECTION, STANDARD 701321	EACH	4	1	1	1	1
70100450	TRAFFIC CONTROL AND PROTECTION, STANDARD 701201	L SUM	1	0.25	0.25	0.25	0.25
70106500	TEMPORARY BRIDGE TRAFFIC SIGNALS	EACH	4	1	1	1	1
70106700	TEMPORARY RUMBLE STRIPS	EACH	24	6	6	6	6
, 0100,00	TENIGRAM NONDEE STATES	EXCIT		<u> </u>		<u> </u>	
70107005	PAVEMENT MARKING BLACKOUT TAPE, 5"	FOOT	5850	1800	1160	1690	1200
70107025	CHANGEABLE MESSAGE SIGN	CAL DA	21	3.5	3.5	3.5	10.5
70300100	SHORT TERM PAVEMENT MARKING	FOOT	135	54	24	30	27
70300150	SHORT TERM PAVEMENT MARKING REMOVAL	SQ FT	1995	618	395	573	409
70300221	TEMPORARY PAVEMENT MARKING - LINE 4" - PAINT	FOOT	8596	2268	1699	2609	2020
PECIAL PROVI		F 00 1	0390	2200	1099	2009	2020

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P:\6	CIVIL DESIGN.INC.	U
NME:	WBE DBE	
EN	EFFINGHAM, IL	PI
Ē	LICENSE #184.003222	Pl

STATE OF ILLINOIS
DEPARTMENT OF TRANSPORTATION

SCALE:

						F.A.S. RTE	SECTION
						1195	112B[BR;BR(1,2,3)BJR,BDR
	SHEET 2	OF 3	SHEETS	STA.	TO STA.		ILLINOIS FED. A

CONSTRUCTION CODE

				I		CONSTRUC	TION CODE	
					80% FED	80% FED	80% FED	80% FED
					20% STATE	20% STATE	20% STATE	20% STATE
29					BRIDGE	BRIDGE	BRIDGE	BRIDGE
	CODE			TOTAL	0047	0047	0047	0047
	NO.	ITEM	UNIT	QUANTITY	048-0080	048-0085	048-0086	048-0089
18	INO.	1 1 E IVI	UNII	QUANTITI	048-0080	048-0083	048-0086	048-0089
	70400100	TEMPORARY CONCRETE BARRIER	FOOT	1813	675	350	413	375
	70400200	RELOCATE TEMPORARY CONCRETE BARRIER	FOOT	1813	675	350	413	375
	31.				:			
	70600250	IMPACT ATTENUATORS, TEMPORARY (NON- REDIRECTIVE), TEST LEVEL 3	EACH	8	2	2	2	2
-								
	70600350	IMPACT ATTENUATORS, RELOCATE (NON- REDIRECTIVE), TEST LEVEL 3	EACH	8	2	2	2	2
ij.					1			
*	78009004	MODIFIED URETHANE PAVEMENT MARKING - LINE 4"	FOOT	8596	2268	1699	2609	2020
8	78300202	PAVEMENT MARKING REMOVAL - WATER BLASTING	SQ FT	2865	756	566	870	673
	X0556100	PARTIAL DEPTH PATCHING (SPECIAL)	SQ YD	220	49	57	56	58
3					'			_
	X4421000	PARTIAL DEPTH PATCHING	TON	25	6	6	6	7
	X7011800	TRAFFIC CONTROL AND RECTECTION CTANDARD BLD 31	L CLIM	1			1	
10	X/011800	TRAFFIC CONTROL AND PROTECTION, STANDARD BLR 21	L SUM	1	\$		1	
	Z0001905	STRUCTURAL STEEL REPAIR	POUND	170	170			
18	Z0012130	BRIDGE DECK SCARIFICATION 3/4"	SQ YD	3398	1559	498	652	689
	Z0012162	BRIDGE DECK MICROSILICA CONCRETE OVERLAY 2 1/4"	SQ YD	3398	1559	498	652	689
9								
	Z0016001	DECK SLAB REPAIR (FULL DEPTH, TYPE I)	SQ YD	2.9	2.9			
-	17					,		
	Z0016002	DECK SLAB REPAIR (FULL DEPTH, TYPE II)	SQ YD	9.9	9.9			
Ø	Z0076600	TRAINEES	HOUR	500	500			
18	Z0018002	DRAINAGE SCUPPERS, DS-11	EACH	4	4			
Ø		TRAINEES - TRAINING PROGRAM GRADUATE	HOUR	500	500			

* SEE SPECIAL PROVISIONS Ø 0042



	USER NAME = rhanfland	DESIGNED	RLH	REVISED =
3		DRAWN	EJB	REVISED -
	PLOT SCALE = 2.0000 / in.	CHECKED	RLH	REVISED .
3	PLOT DATE = 10/17/2022	DATE	10/17/2022	REVISED =

SCALE:

	SUI	MM	ARY	OF QU	ANTITIES	3		
SHEET 3	3	OF	3	SHEETS	STA.	TO STA.	Ì	

								PAVING S	CHEDULE							
				PAVED	HMA SURF	HMA SURF	BIT MATL	POLY HMA BINDER	HMA	AGG WEDGE	HMA SC IL-9.5	AGG BASE CRSE	PCC SHLDR	CONC CURB	PARTIAL DEPTH	H PARTIAL DEPTH
SN	STATION	ТО	STATION	SHLDR REM	REM, 4"	REM BUTT JT	(TACK COAT)	COURSE, IL-9.5, N50	SHLDRS	SHLDR, TYPE E	MIX C N50	TYPE A, 4"	10"	TYPE B	PATCHING	PATCHING (SP
				SQ YD	SQ YD	SQ YD	LB	TON	TON	TON	TON	SQ YD	SQ YD	FEET	TON	SQ YD
048-0089	585+46 LT		586+08 LT		27.6		39.7		6.3	0.9						
048-0089	585+26 RT		585+91 RT		86.7		124.8		19.8	0.9						
048-0089	585+21		585+98			297.8	214.4	2.4			25				3.2	28.9
048-0089	587+52		588+22			401.9	289.4	2.4			33.8				3.2	28.9
048-0089	587+38 RT		588+04 RT		88.0		126.7		20.1	0.9						
048-0089	587+59 LT		588+16 LT		25.3		36.4		5.8	0.9						
048-0080	665+65 LT		667+04 LT		69.5		100.1		15.8	2						
048-0080	665+69 RT		667+04 RT		67.5		97.2		15.4	1.9						
048-0080	666+34		667+04			206.7	148.8	2.1			17.4				2.7	24.4
048-0080	667+04 LT		667+12 LT	3.5								3.5	3.5	8.0		
048-0080	667+04 RT		667+12 RT	4.1								4.1	4.1	8.0		
048-0080	671+67 LT		671+75 LT	3.8								3.8	3.8	8.0		
048-0080	671+67 RT		671+75 RT	3.6								3.6	3.6	8.0		
048-0080	671+75		672+45			206.7	148.8	2.1			17.4				2.7	24.4
048-0080	671+75 LT		672+85 LT		55.0		79.2		12.5	1.6						
048-0080	671+75 RT		673+10 RT		67.5		97.2		15.4	1.9						
048-0085	608+00 LT		609+69 LT		56.3		81.1		12.8							
048-0085	608+02 RT		609+62 RT		53.3		76.8		12.2							
048-0085	608+90		609+64			222.8	160.4	2.4			18.7				3.2	28.3
048-0085	611+05		611+79			222.8	160.4	2.4	4.2.7		18.7				3.2	28.3
048-0085	611+08 LT		612+75 LT		55.7		80.2		12.7							
048-0085	611+03 RT		612+69 RT		55.3		79.6		12.6							
048-0086	634+43 LT		636+34 LT		63.7		91.7		14.5							
048-0086	634+51 RT		636+47 RT		65.3		94		14.9							
048-0086	635+58		636+38		05.5	243.7	175.5	2.4	14.5		20.5				3.2	28.3
048-0086	638+23		639+03			243.7	175.5	2.4			20.5				3.2	28.3
048-0086	638+14 LT		639+30 LT		38.7		55.7		8.8						1	3010
048-0086	638+29 RT		639+71 RT		47.3		68.1		10.8							
	ı	·	TOTAL	15.0	922.7	2046.1	2801.7	18.6	210.4	11.0	172.0	15.0	15.0	32.0	24.6	219.8
		Ī	USE	15	923	2046	2802	19**	210	11	172	15	15	32	25*	220*

* NOTE 1: PARTIAL DEPTH PATCHING QUANTITY BASED ON 10 LONG PATCH IN FRONT OF APPROACH PAVEMENT AT 2" DEPTH

** NOTE 2: TONS BASED ON ASSUMPTION OF 1/2" DEPTH AND 30' LONG AT EACH APPROACH. SEE PROJECT SPECIFIC NOTES

TEMPORARY PAVEMENT MARKING

REMOVE AND REERECT RAIL ELEMENT OF EXISTING GUARDRA	ΑI
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SN	STATION	то	STATION	SIDE	FEET
048-0089	585+46		586+40	LT	94.0
048-0089	585+59		586+14	RT	55.0
048-0089	587+33		588+12	LT	79.0
048-0089	587+08		588+00	RT	92.0
048-0080	666+34		667+24	LT	90.0
048-0080	666+34		667+24	RT	90.0
048-0080	671+55		672+45	LT	90.0
048-0080	671+55		672+45	RT	90.0
048-0085	608+92		609+99	LT	107.0
048-0085	608+92		609+90	RT	98.0
048-0085	610+80		611+73	LT	93.0
048-0085	610+71		611+73	RT	102.0
048-0086	635+59		636+59	LT	100.0
048-0086	635+59		636+78	RT	119.0
048-0086	637+82		639+03	LT	121.0
048-0086	638+03		639+03	RT	100.0
				TOTAL	1520.0
				LICE	1530

PLOT SCALE = 2.0000 / in.

				TEITH GROWN TARVE	I I I I I I I I I I I I I I I I I I I		
					PAVEMENT MARKING	SHORT TERM	SHORT TERM
SN	STATION	TO	STATION	TYPE	BLACKOUT TAPE 5"	PAVEMENT MARKING	PAVT MARKING REM
					FOOT		SQ FT
048-0089	584+00		590+00	EDGE LINE STAGE I	600.0		250.0
048-0089	585+26		588+22			26.9	9.0
048-0089	584+00		590+00	EDGE LINE STAGE II	600.0		250.0
048-0080	665+00		674+00	EDGE LINE STAGE I	900.0		375.0
048-0080	666+44		672+35			53.7	17.9
048-0080	665+00		674+00	EDGE LINE STAGE II	900.0		375.0
048-0085	607+00		608+60	CENTER NPZ LINE	160.0		66.7
048-0085	609+00		611+69			24.5	8.2
048-0085	608+00		613+00	EDGE LINE STAGE I	500.0		208.3
048-0085	608+00		613+00	EDGE LINE STAGE II	500.0		208.3
048-0086	633+50		635+00	CENTER NPZ LINE	150.0		62.5
048-0086	635+69		638+93			29.5	9.8
048-0086	639+00		640+70	DOUBLE YELLOW CL	340.0		141.7
048-0086	634+00		640+00	EDGE LINE STAGE I	600.0		250.0
048-0086	634+00		640+00	EDGE LINE STAGE 11	600.0		250.0
			•	TOTAL	5850.0	134.6	2482.4
				USE	5850	135	2482

FRAMES AND LIDS TO BE ADJUSTED SN STATION SIDE FRAMES AND LIDS TO BE ADJUSTED EACH 048-0085 609+77 RT 1 048-0085 609+85 LT 1 048-0086 636+45 LT 1 048-0086 636+64 PT						
			FRAMES AND LIDS			
SN	STATION	SIDE	TO BE ADJUSTED			
			RT 1 LT 1 LT 1			
048-0085	609+77	RT	1			
048-0085	609+85	LT	1			
048-0086	636+45	LT	1			
048-0086	636+64	RT	1			
048-0086	637+97	LT	1			
048-0086	638+16	RT	1			
048-0080	671+66	LT/RT	2			
048-0080	667+14	LT/RT	2			
			10			

MODIFIED URETHANE TEMP PAV MARK

4" LINE

SOLID

FOOT

1530.0

2016.0

448.0

6298.0

WHITE | YELLOW |

FOOT

383.0

252.0

156.0

293.0

659.0

448.0

2298.0

PAV MARK

- WATER

SQ FT

637.7

35.7

756.0

468.7

97.7

571.0

298.7

2865.3

YELLOW BLASTING

LINE 4" - PAINT REMOVAL

FOOT

383.0

252.0

156.0

293.0

659.0

2298.0

SOLID

WHITE

FOOT

1530.0

2016.0

448.0

6298.0

8596 ×

AS NEEDED FOR PAVING OPERATIONS

	TC&P	TC&P	TC&P	TEMP BRIDGE	CHANGEABLE	TEMP CONC.	RELOCATE	TEMP RUMBLE	IMPACT ATTN,	RELOCATE
SN	701201	701321	BLR 21	SIGNALS	MESSAGE SIGNS	BARRIER	ТСВ	STRIPS	TEMP (NON-REDIR) TL3	IMP. ATTN
	L SUM	EACH	L SUM	EACH	CAL DA	FEET	FEET	EACH	EACH	EACH
048-0089	0.25	1		1	10.5	375	375	6	2	2
048-0080	0.25	1		1	3.5	675	675	6	2	2
048-0085	0.25	1		1	3.5	350	350	6	2	2
048-0086	0.25	1	1	1	3.5	412.5	412.5	6	2	2
TOTAL	1.0	4	1	4	21.0	1812.5	1812.5	24	8	8
USE	1	4	1	4	21	1813	1813	24	8	8

LOCATIONS AND MESS

DRAWN - EJB

RLH

CHECKED -

DATE

TRAFFIC CONTROL AND PROTECTION

201	701321	BLK 21	SIGNALS	MESSAGE SIGNS	BARRIER	ICB	STRIPS	TEMP (NON-REDIR) IL3	IMP. ATIN
UM	EACH	L SUM	EACH	CAL DA	FEET	FEET	EACH	EACH	EACH
25	1		1	10.5	375	375	6	2	2
25	1		1	3.5	675	675	6	2	2
25	1		1	3.5	350	350	6	2	2
25	1	1	1	3.5	412.5	412.5	6	2	2
0	4	1	4	21.0	1812.5	1812.5	24	8	8
	4	1	4	21	1813	1813	24	8	8
SSAGE	S FOR CHANGE	EABLE MESSAGE	E SIGNS TO B	E COORDINATED AT	PRECONSTRUCT	ION MEETING			
DESIGN	USER NAI	ME = rhanfland	DESIGN	IED - RLH	REVISED -				

REVISED -

REVISED

REVISED

048-0089 582+93

048-0080 664+21

048-0085 606+67

048-0085 606+67

048-0086 633+23

048-0086 638+50

582+93

048-0089

STATION TO STATION

590+58

584+00

674+29

612+92

609+60

638+50

*NOTE: TEMPORARY PAVEMENT MARKINGS AND REMOVAL ONLY REQUIRED IF PROJECT REQUIRES WINTER SHUTDOWN PERIOD.
 F.A.S. RTE.
 SECTION
 COUNTY
 IO IAL SHEETS
 SHEETS
 NO.

 1195
 1128[BR;BR(1,2,3)BJR,BDR
 KNOX
 47
 6
 SCHEDULE OF QUANTITIES CONTRACT NO. 68G91 SHEET 1 OF 1 SHEETS STA. TO STA.

PAVEMENT MARKING SCHEDULE

TYPE

EDGE LINE / SKIP DASH

EDGE LINE / SKIP DASH

EDGE LINE / SKIP DASH

NB NPZ

EDGE LINES / SB NPZ

SUB TOTAL


USE

640+74 EDGE LINES / DOUBLE YELLOW

DEPARTMENT OF TRANSPORTATION

CIVIL DESIGN,INC. WBE | DBE EFFINGHAM, IL LICENSE #184.003222

STATE OF ILLINOIS

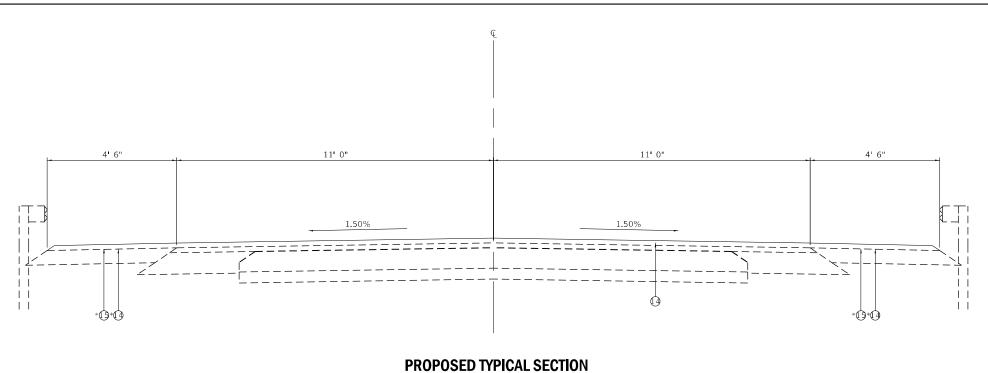

STA. 666+34 TO STA. 667+04 (MAINLINE OVERLAY) STA. 671+75 TO STA. 672+45 (MAINLINE OVERLAY)

* PRE STAGE SHOULDER CONSTRUCTION LIMITS STA. 665+90 TO STA. 667+04 LT STA. 665+93 TO STA. 667+04 RT STA. 671+75 TO STA. 672+80 LT STA. 671+75 TO STA. 673+00 RT

© EXISTING HMA 2½"

(*) EXISTING HMA 10"

(*) EXISTING BASE COURSE WIDENING 9"

(*) EXISTING BITUMINOUS SHOULDER 6"

(*) EXISTING AGG SHOULDER

(*) EXISTING EROSION CONTROL CURB

(*) EXISTING GUARDRAIL

(*) PROPOSED HOT-MIX ASPHALT SURFACE COURSE, 1½"

(*) PROPOSED HOT-MIX ASPHALT SURFACE REMOVAL, 4"

(*) PROPOSED HOT-MIX ASPHALT SHOULDERS 11' 0" 4' 6" 11'0"

EXISTING TYPICAL SECTION

STA. 666+34 TO STA. 667+04 STA. 671+75 TO STA. 672+45


	CIVIL DESIGN,ING.	U
	WBE DBE	
	EFFINGHAM, IL	Р
1	LICENSE #184.003222	Р

USER NAME = rhanfland	DESIGNED	-	RLH	REVISED -
	DRAWN	-	EJB	REVISED -
PLOT SCALE = 10.0000 / in.	CHECKED	-	RLH	REVISED -
PLOT DATE = 10/17/2022	DATE	-	10/17/2022	REVISED -

STATE O	F ILLINOIS
DEPARTMENT OF	TRANSPORTATION

	TYPICA	AL SEC	TIONS		F.A.S. RTE	SECTION	COUNTY	TOTAL SHEETS	SHE
SN 048-0080						112B[BR;BR(1,2,3)BJR,BDR	KNOX	47	7
	OIV	070-0	000				CONTRACT	NO. 68	3G9
EET 1	OF 4	SHEETS	STA.	TO STA.		ILLINOIS FED. A	ID PROJECT		

① EXISTING SUBBASE GRANULAR MATERIAL, 12"
② EXISTING AREA REFLECTIVE CRACK CONTROL
③ EXISTING P.C.C. PAVEMENT
④ EXISTING HMA 4"±
⑤ EXISTING HMA 2"
⑥ EXISTING HMA 2"

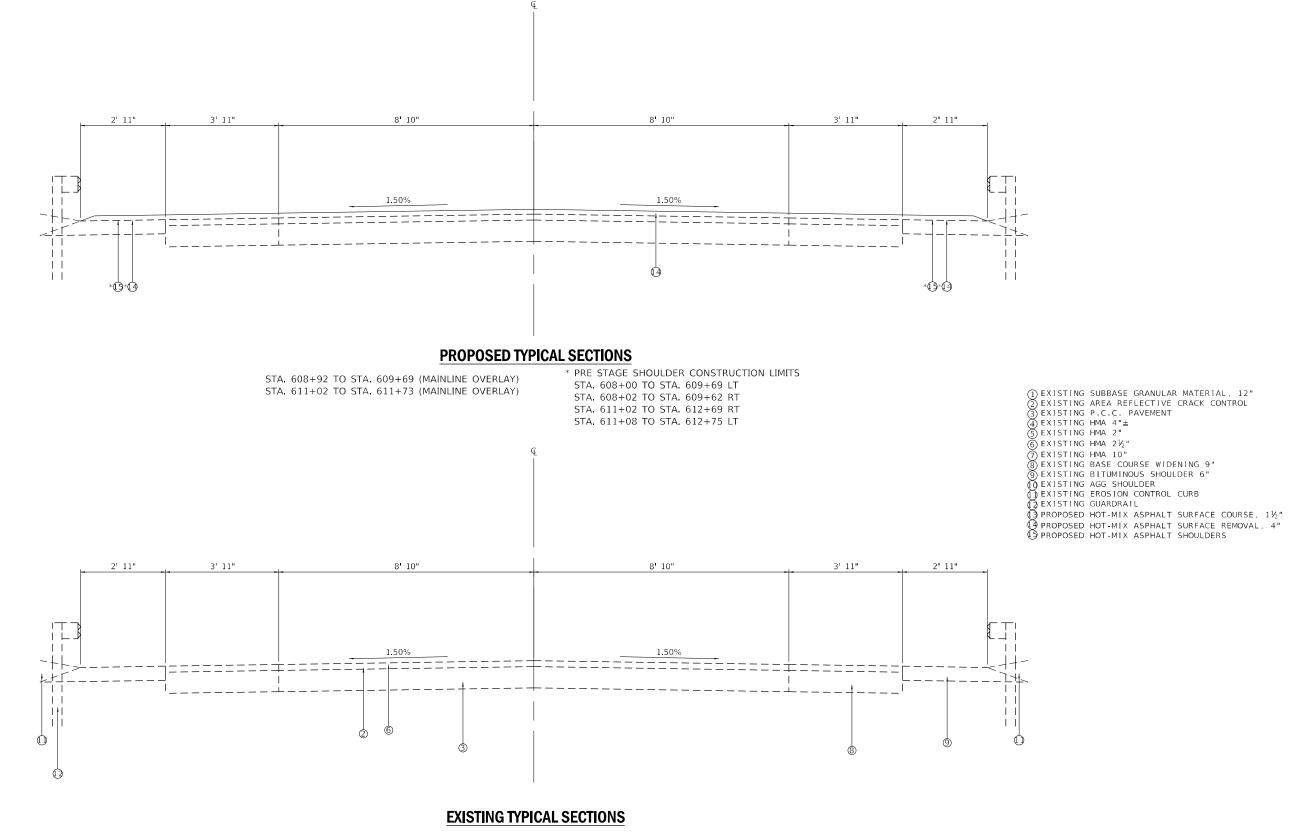


STA. 608+92 TO STA. 609+64 STA. 611+05 TO STA. 611+73

9.	CIVIL DESIGN,INC.	U
AME:	WBE DBE	
Ž H	EFFINGHAM, IL	PI
Ē	LICENSE #184.003222	Pl

USER NAME = rhanfland	DESIGNED	-	RLH	REVISED -
	DRAWN	-	EJB	REVISED -
PLOT SCALE = 10.0000 / in.	CHECKED	-	RLH	REVISED -
PLOT DATE = 10/17/2022	DATE	-	10/17/2022	REVISED -

STATE	OF ILLINOIS	
DEPARTMENT	OF TRANSPORTATION	NO

				F.A.S. RTE	SECTION	COUNTY	TOTAL SHEETS	SHEET NO.		
		SN	048-00			1195	112B[BR;BR(1,2,3)BJR,BDR	KNOX	47	8
314 040-0003							CONTRACT	NO. 68	3G91	
	SHEET 2	OF 4	SHEETS	STA.	TO STA.		ILLINOIS FED. A	ID PROJECT		

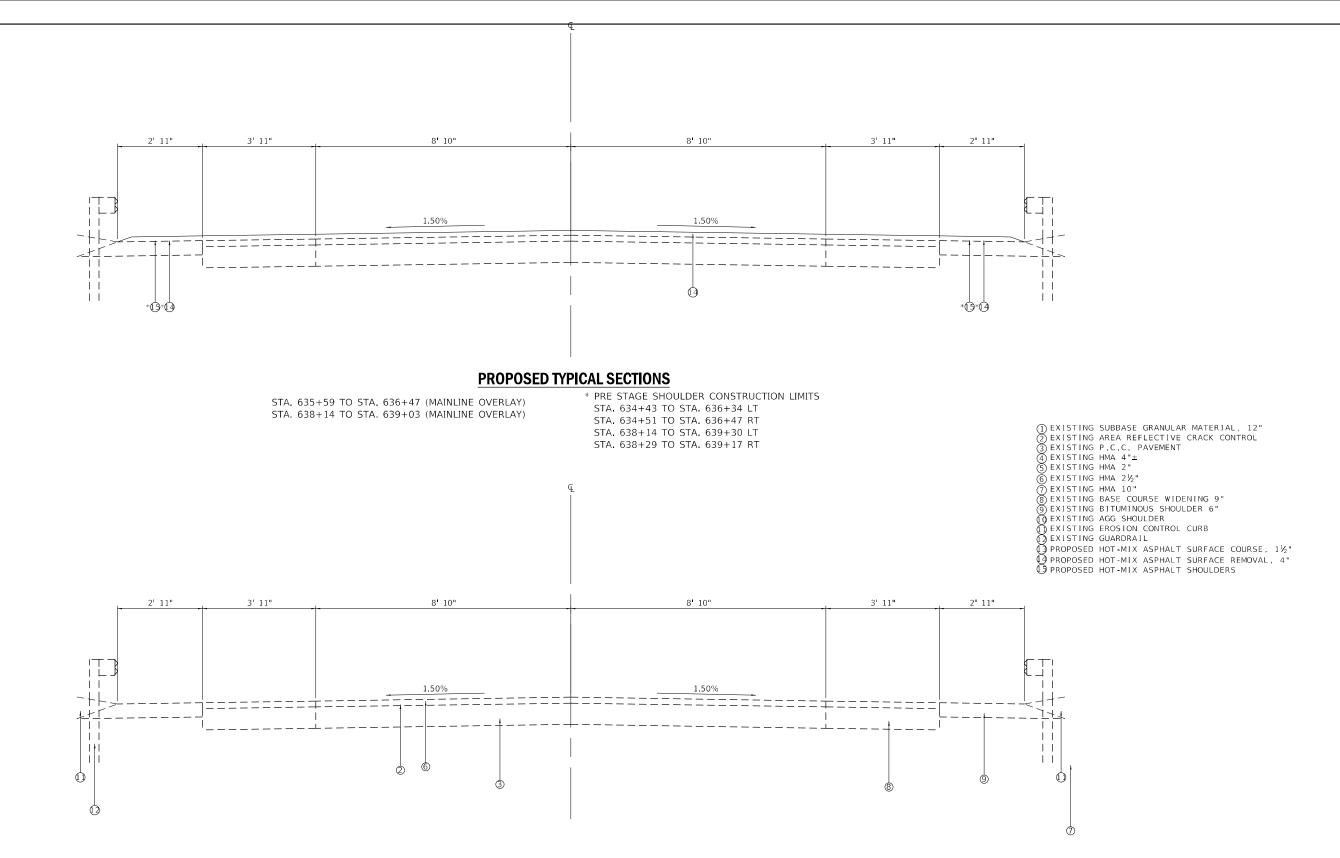

EXISTING TYPICAL SECTIONS

STA. 635+59 TO STA. 636+38 STA. 638+23 TO STA. 639+03


21		
-	CIVIL DESIGN.INC.	U
Į.	WBE DBE	
2	EFFINGHAM, IL	PI
Ē	LICENSE #184.003222	PI

USER NAME = rhanfland	DESIGNED - RLH	REVISED -
	DRAWN - EJB	REVISED -
PLOT SCALE = 10.0000 / in.	CHECKED - RLH	REVISED -
PLOT DATE = 10/17/2022	DATE - 10/17/2022	REVISED -

STATE OF I	LLINOIS
DEPARTMENT OF TR	ANSPORTATION

SCALE:

TYPICAL SECTIONS					F.A.S. RTE.	SECTION	COUNTY	TOTAL SHEETS		
	SN 048-0086					1195	112B[BR;BR(1,2,3)BJR,BDR	KNOX	47	9
314 040-0000							CONTRACT	NO. 68	3G91	
	SHEET 3	OF 4	SHEETS	STA.	TO STA.		ILLINOIS FED. A	ID PROJECT		

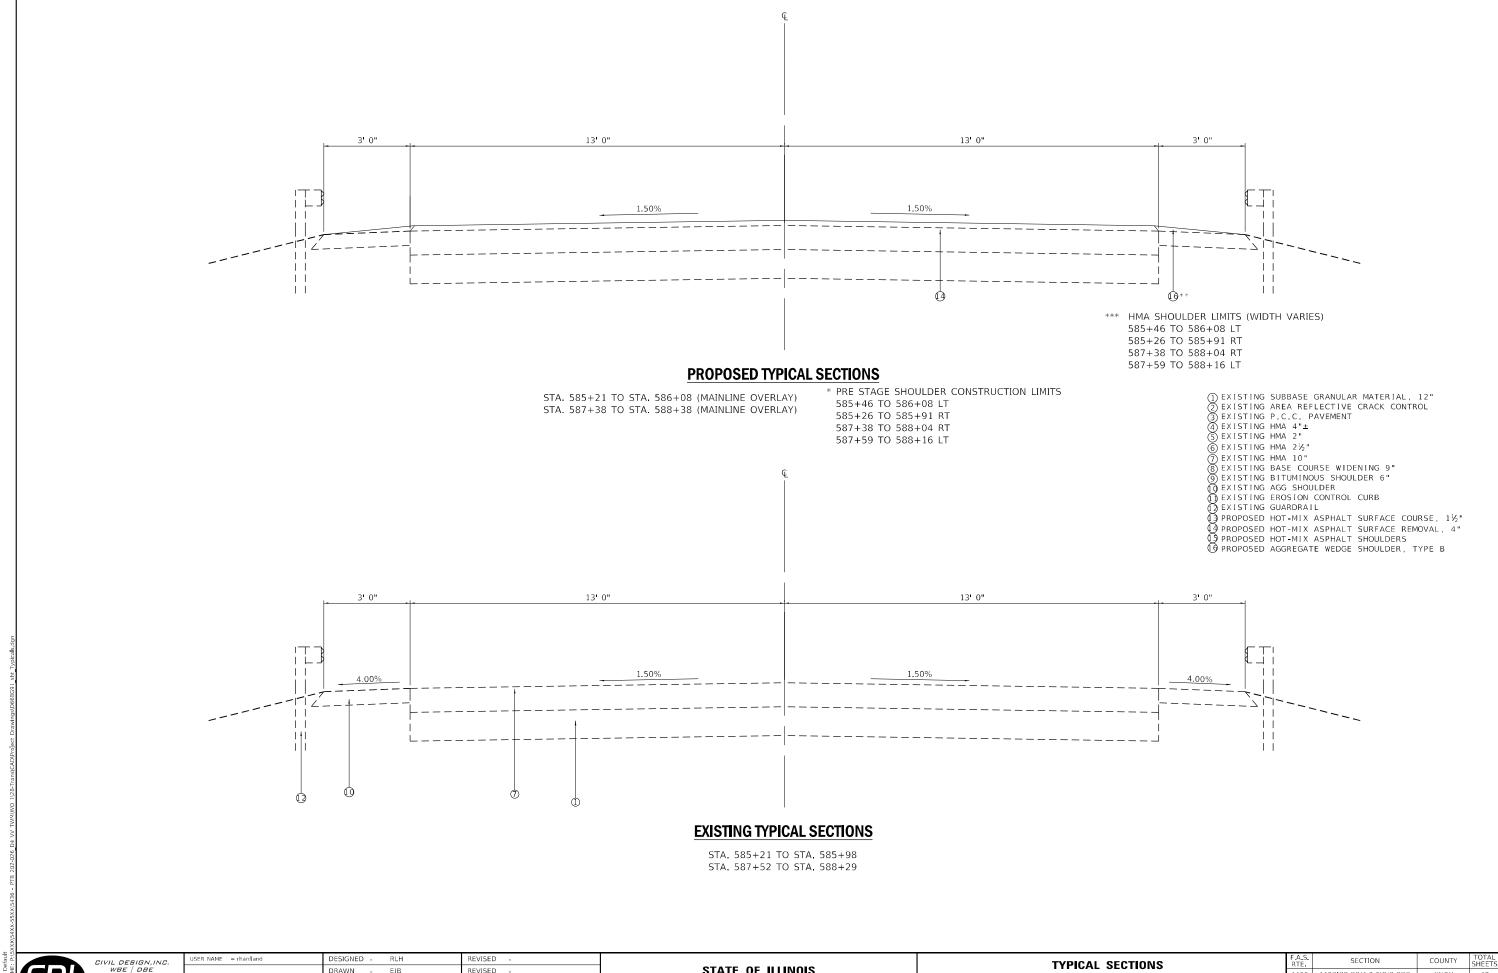


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STATE OF ILLINOIS
DEPARTMENT OF TRANSPORTATION

 TYPICAL SECTIONS
 F.A.S. RTE.
 SECTIONS

 SN 048—0089
 1195
 112B[BR;BR(1,2]

RTE. SECTION COUNTY SHEETS NO. 1195 1128[BR;BR(1,2,3)BJR,BDR KNOX 47 10 CONTRACT NO. 68G91

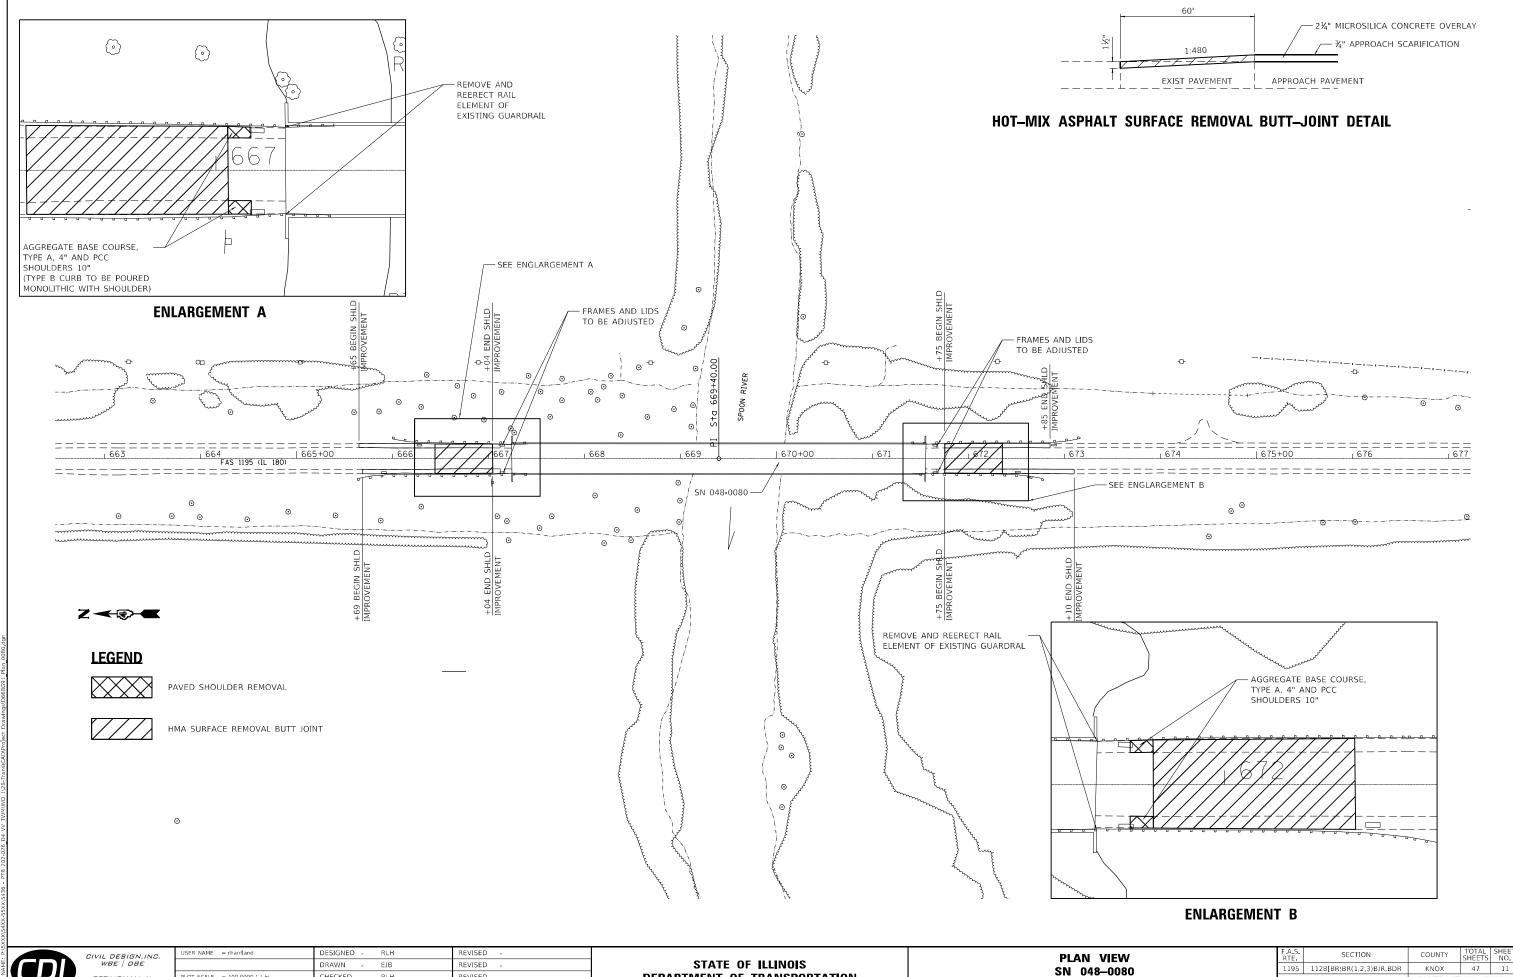

DEPARTMENT OF TRANSPORTATION


SCALE: 1"=50' SHEET 1 OF 1 SHEETS STA.


TO STA.


CONTRACT NO. 68G91


REVISED


ICENSE #184.003222

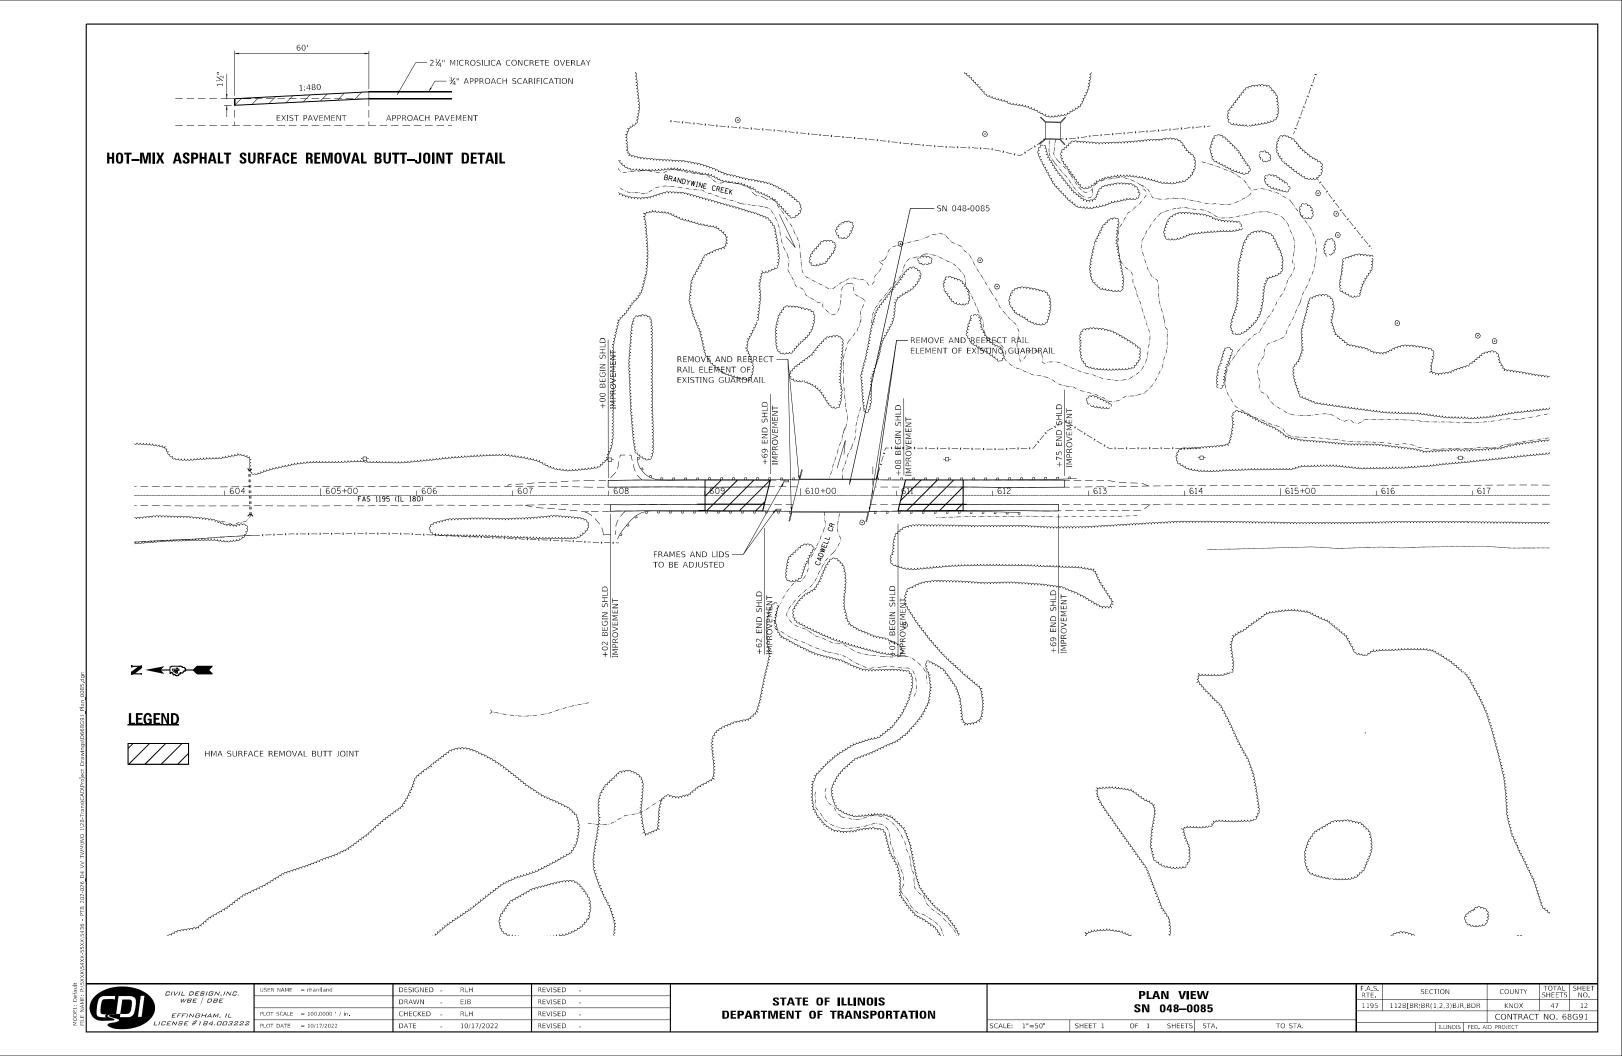


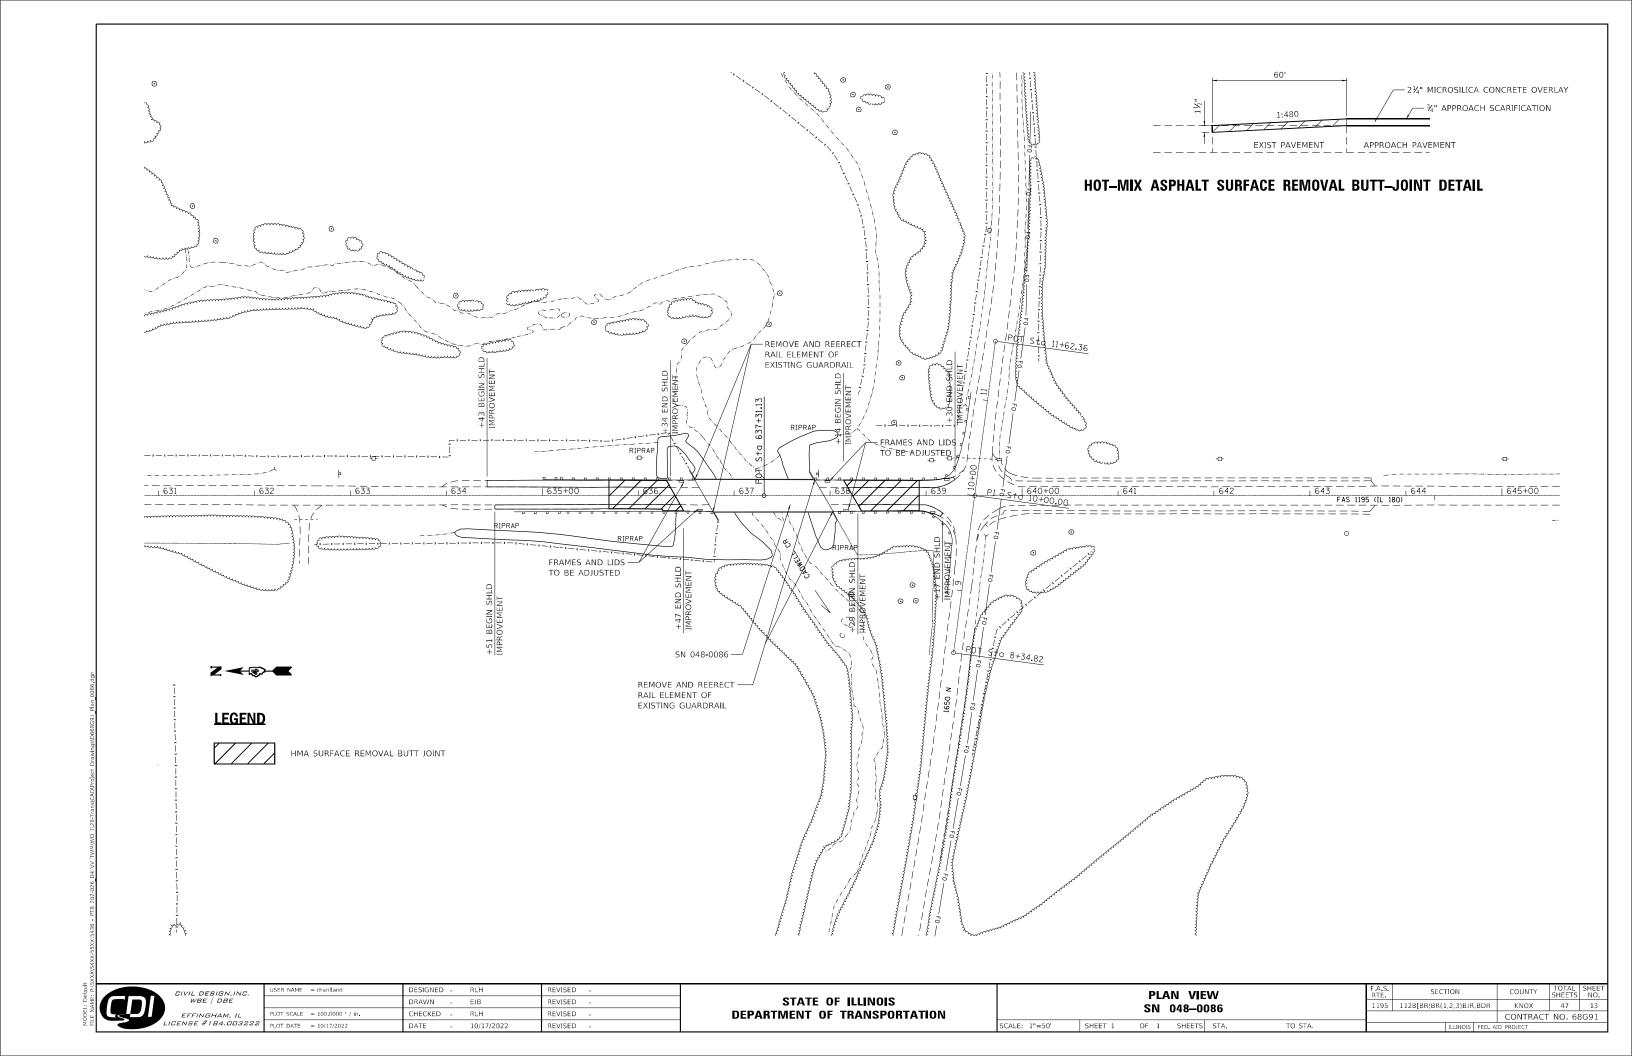


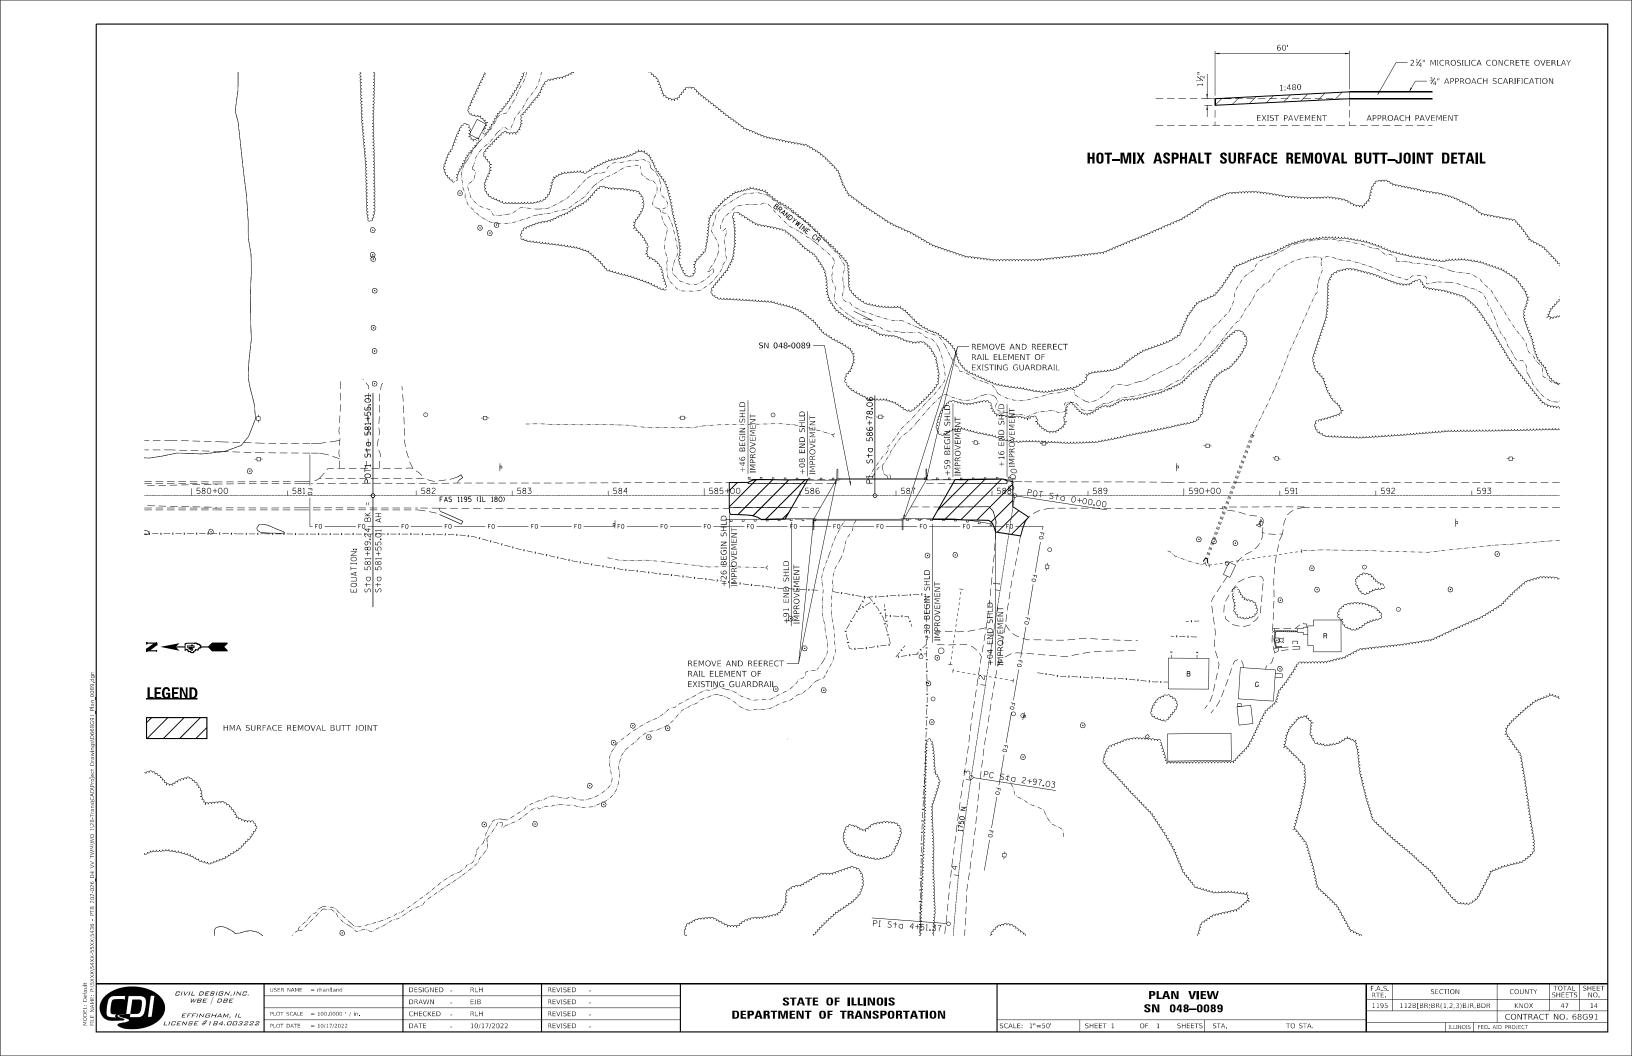

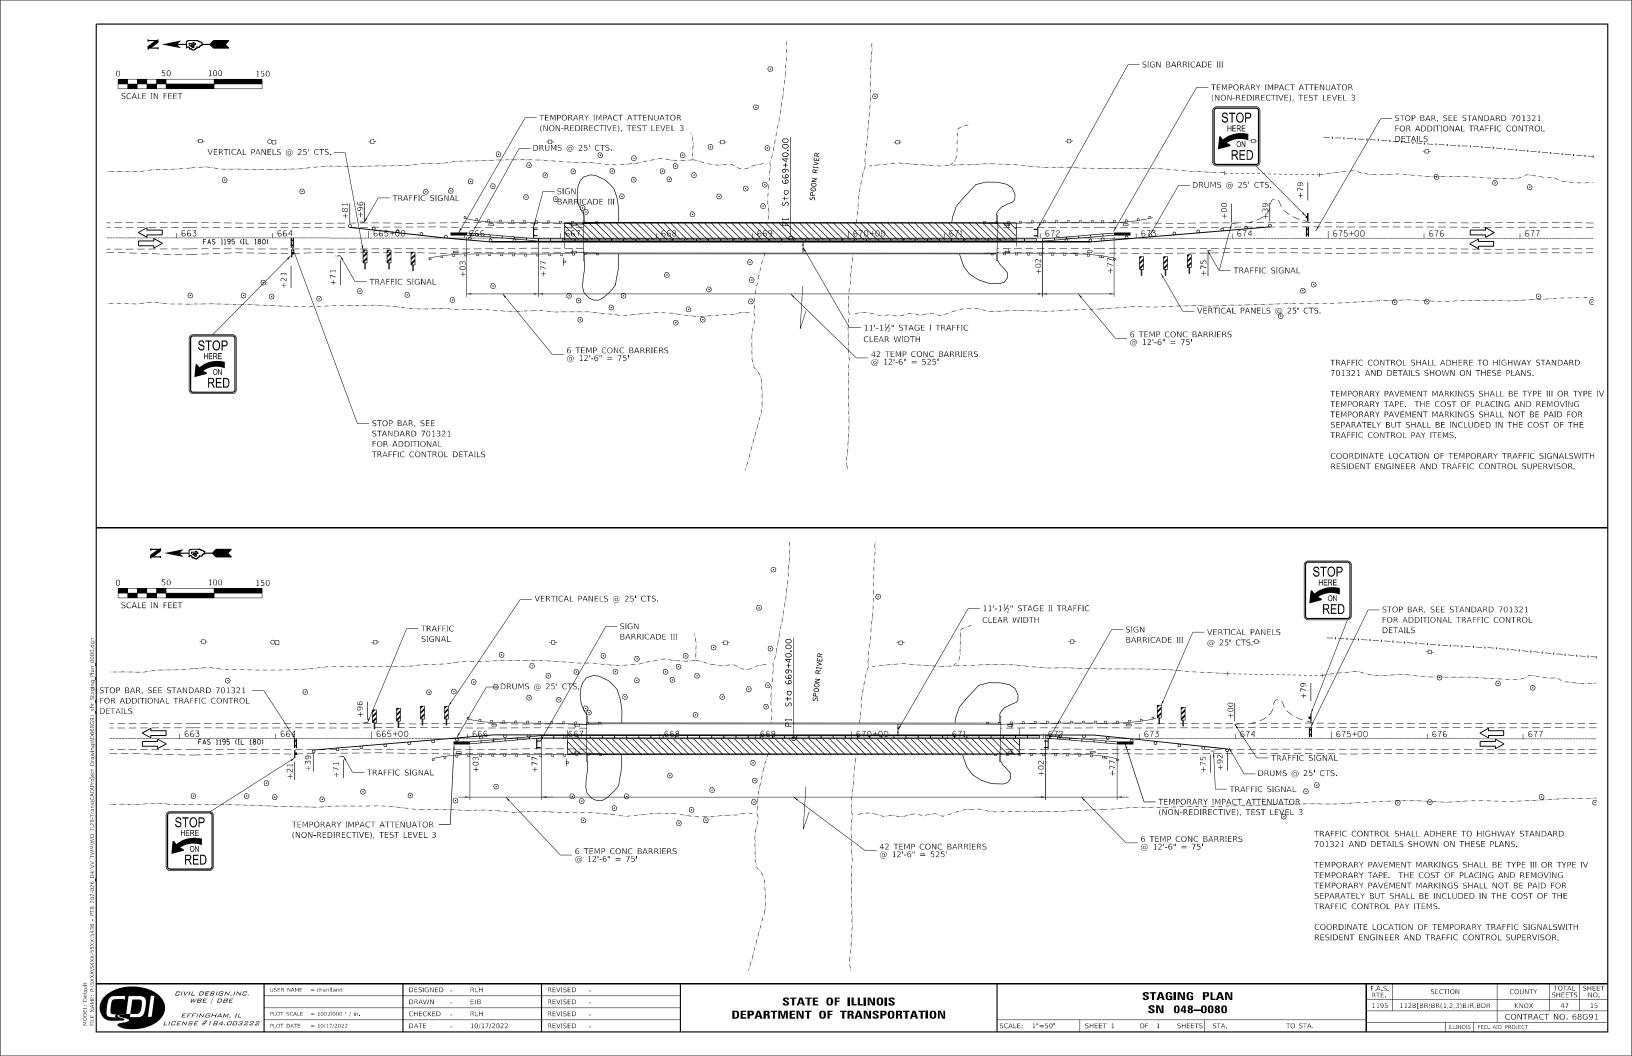

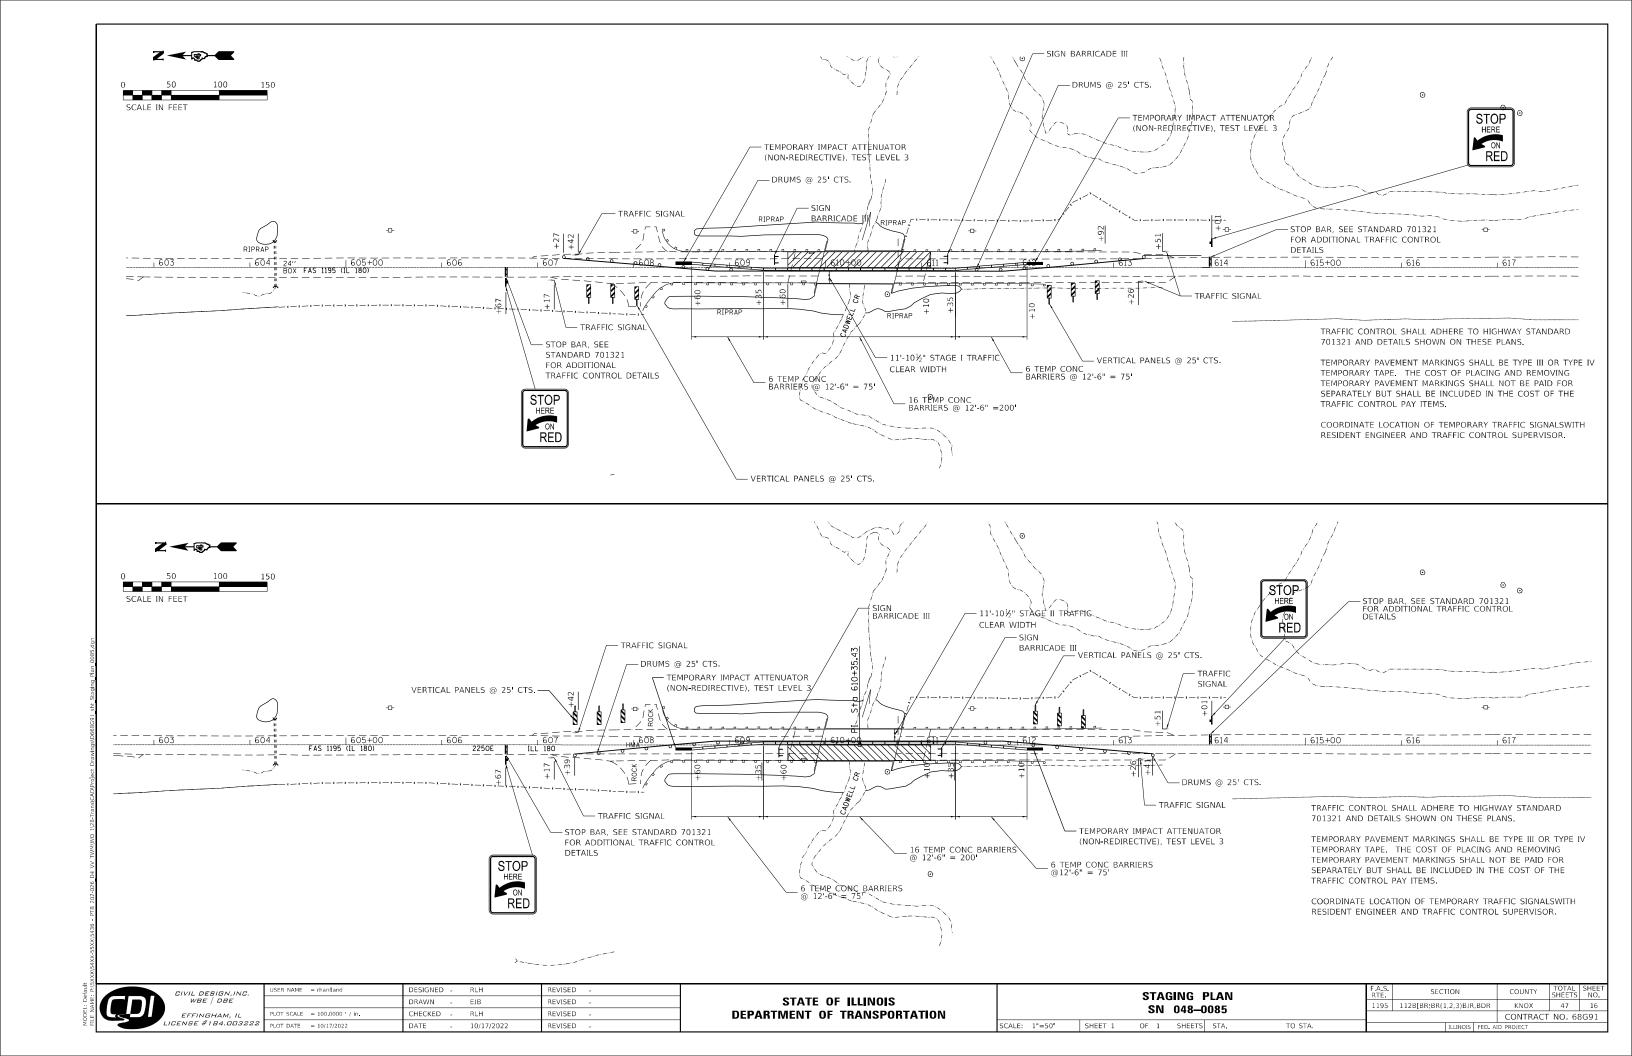

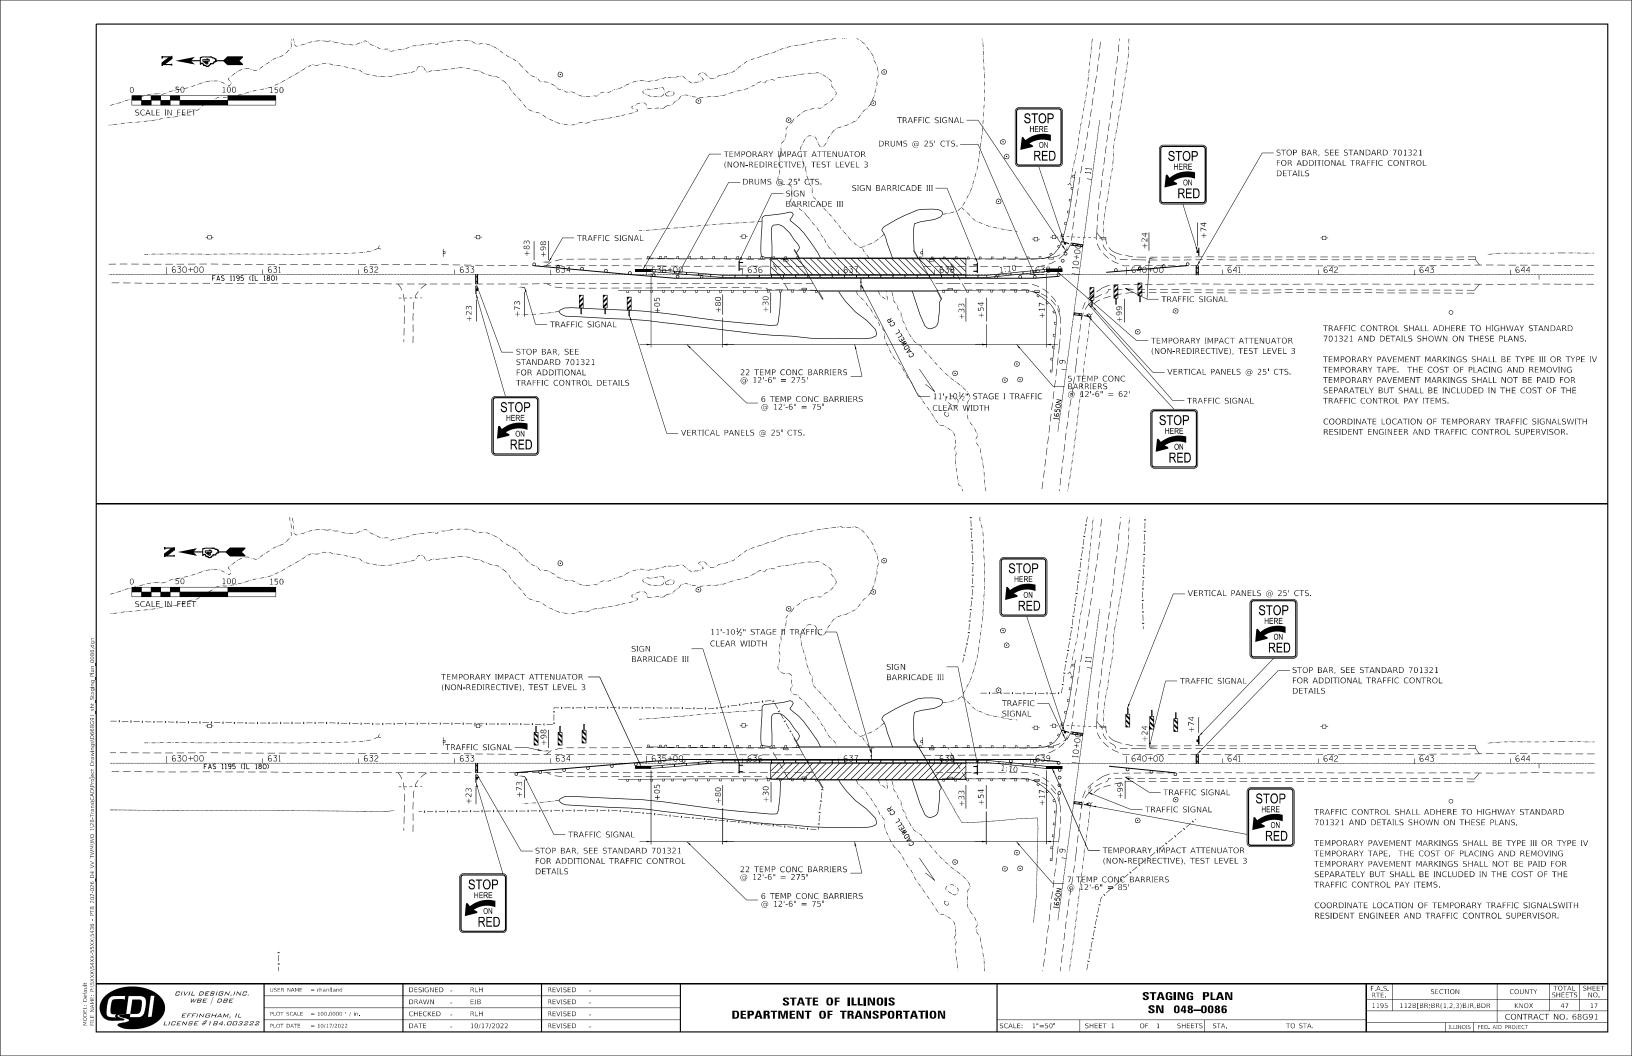

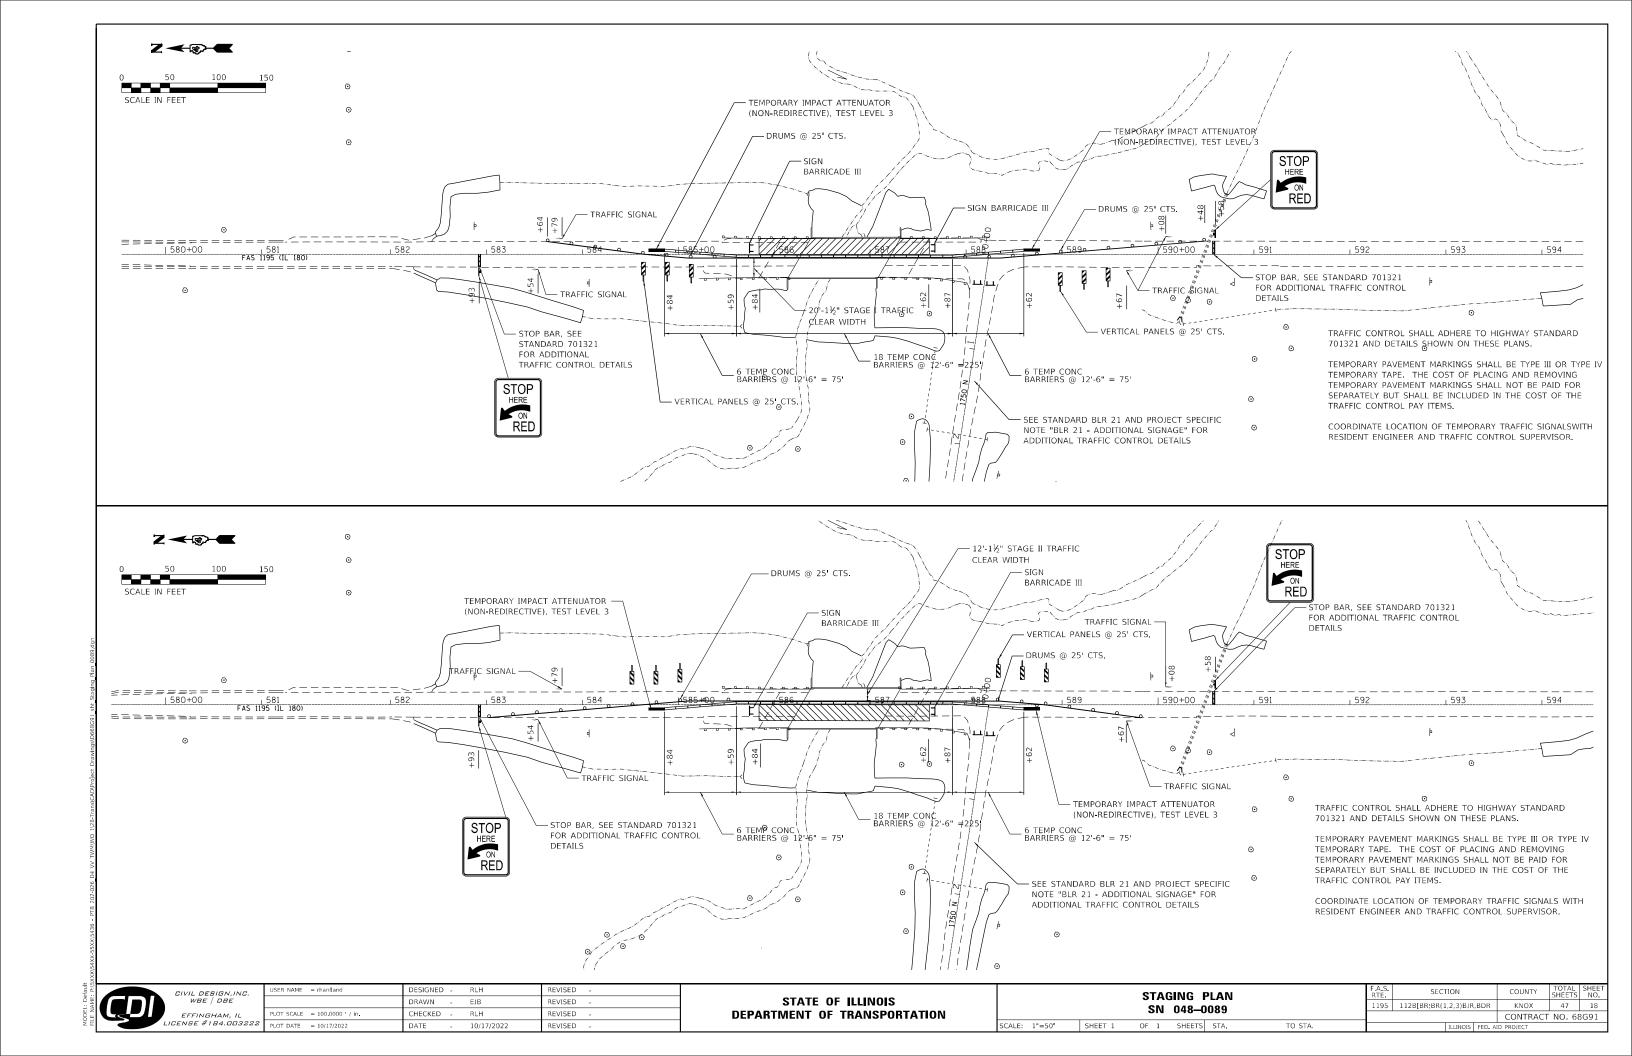


Structure 048-0080 was originally constructed in 1990 as SBI 180, Contract 88061, Section (112 B,C)BR at Station 669+40.50 in Knox County. It has not been reconstructed or rehabilitated. It is not known whether is has received minor repairs.


The existing structure is a three span steel continuous multi beam bridge. The superstructure consists of four 54" welded steel plate girders supporting a nominal $7\frac{V_2}{2}$ " thick RC deck. There is no existing overlay on the bridge deck. The existing abutments are pile supported stub abutments. The existing piers are hammerhead piers supported on spread footings founded on rock.

The structure has an overall length of 433'-0" from back to back of abutments. The deck has an out to out width of 33'-2", and a deck (clear area) width of 30'-0" base to base of curb.

te:

See Sheet 2 of 13 for Proposed Work, Bill of Material, and General Notes.

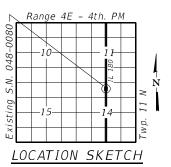

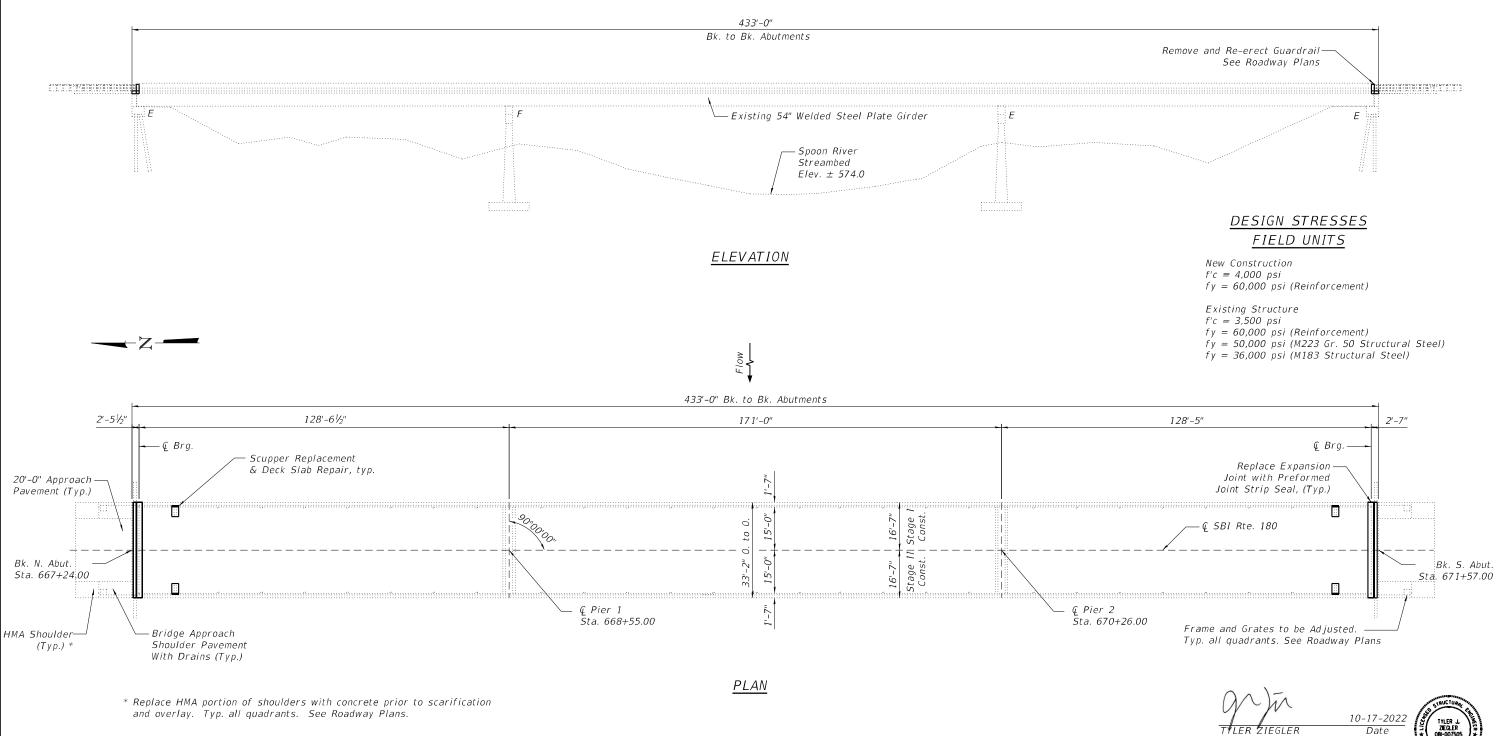

STATE OF ILLINOIS
DEPARTMENT OF TRANSPORTATION

GENERAL PLAN AND ELEVATION
S.N. 048-0080

SHEET 1 OF 13 SHEETS

A I. RTE	SECTION		COUNTY	TOTAL SHEETS	SHEE NO			
195	112B[BR;BR(1,2,3)]BJR,B	KNOX	47	19				
			CONTRAC	T NO. 6	8G9			
	NUMBER OF AN ADDITION							

Licensed Structural Engineer State of Illinois No. 081-007505

Expires 11-30-2024

TOTAL BILL OF MATERIAL

Item	Unit	Total
Bridge Deck Grooving	Sq. Yd.	1,474
Protective Coat	Sq. Yd.	1,562
Concrete Removal	Cu. Yd.	9.1
Concrete Superstructure	Cu. Yd.	9.5
Reinforcement Bars, Epoxy Coated	Pound	1,490
Bar Splicers	Each	28
Preformed Joint Strip Seal	Foot	65
Structural Steel Repair	Pound	170
Bridge Deck Scarification ¾"	Sq. Yd.	1,559
Bridge Deck Microsilica Concrete Overlay, 21⁄4"	Sq. Yd.	1,559
Deck Slab Repair (Full Depth, Type I)	Sq. Yd.	2.9
Deck Slab Repair (Full Depth, Type II)	Sq. Yd.	9.9
Drainage Scuppers, DS-11	Each	4

INDEX OF SHEETS

- 1. General Plan and Elevation
- 2. General Data
- 3. Existing and Proposed Typical Cross Sections
- 4. Stage Construction Details
- 5. Wearing Surface Plan
- 6. Patching Details
- 7. Drainage Scupper Details
- 8. Drainage Scupper DS-11 Details
- 9. Concrete Removal Details
- 10. Deck Reinforcement Details
- 11. Preformed Joint Strip Seal Details
- 12. Beam End Repair Details
- 13. Bar Splicer Assembly and Mechanical Bar Splicer Details

PROPOSED WORK

- 1. Perform Bridge Deck Scarification on Bridge Deck and Concrete Approaches.
- 2. Removal of Deck Ends and Parapet at Deck Ends.
- Removal of Existing Joints.
- 4. Perform Beam End Repair.
- 5. Replace Scuppers at 4 locations.
- . Perform Full-Depth Patching.
- 7. Pour Deck Ends.
- 8. Insert Rubber Strip Seal into Locking Edge Rails.
- 9. Pour Parapets.
- 10. Place Microsilica Concrete Overlay on Bridge Deck and Concrete Approaches.
- 11. Perform Deck Grooving.
- 12. Apply Protective Coat.

GENERAL NOTES

Plan dimensions and details relative to the existing structure have been taken from existing plans and are subject to nominal construction variations. It shall be the Contractor's responsibility to verify such dimensions and details in the field and make the necessary approved adjustments prior to construction or ordering of materials. Such variations shall not be cause for additional compensation for a change in the scope of work. However, the Contractor will be paid for the quantity actually furnished at the unit price for the work.

Reinforcement bars designated (E) shall be epoxy coated.

Prior to pouring the new concrete deck, all heavy or loose rust, loose mill scale, and other loose or potentially detrimental foreign material shall be removed from the surfaces in contact with concrete. Tightly adhered paint may remain unless otherwise noted. Removal shall be accomplished by methods that will not damage the steel and the cost will be included in the pay item covering removal of the existing concrete.

Existing reinforcement bars extending into the removal area shall be cleaned, straightened and incorporated into the new construction. Any reinforcement bars that are damaged during concrete removal shall be replaced with approved bar splicer or anchorage system. Cost included with Concrete Removal.

Joint openings shall be adjusted according to Article 520.04 of the Std. Specs. when the deck is poured at an ambient temperature other than 50°F.

Expansion joints shall be fabricated and installed according to the manufacturer's recommendations and as approved by the Engineer.

Expansion joints shall be fabricated to conform to the existing cross slopes of the bridge.

Protective Coat shall be applied to new concrete overlay areas from end to end of bridge deck to entire deck surface and top and inside face of new parapet concrete.

Synthetic fibers shall be included in the bridge deck concrete overlay specified. See Special Provisions.


All structural steel shall conform to AASHTO Classification M-270 Gr. 36, unless otherwise noted.

All structural steel shall be hot-dip galvanized. See Special Provisions for "Hot Dip Galvanizing for Structural Steel."

GENERAL DATA S.N. 048-0080		SECTION	COUNTY	TOTAL SHEETS	
		112B[BR;BR(1,2,3)]BJR,BDR	KNOX	47	20
			CONTRAC	T NO. 6	8G91
SHEET 2 OF 13 SHEETS		ILLINOIS FED. A	D PROJECT		

EXISTING CROSS SECTION

(Looking South)

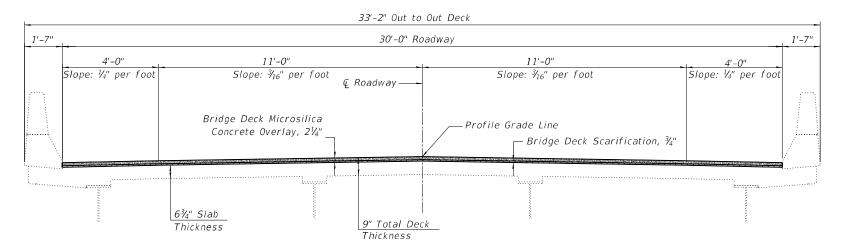

PROPOSED CROSS SECTION

(Looking South)


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	WBE DBE	
	EFFINGHAM, IL	P
	LICENSE #184.003222	P

USER NAME =	DESIGNED _ KAS	REVISED -
	CHECKED - TJZ	REVISED _
PLOT SCALE =	DRAWN - DWS	REVISED _
PLOT DATE =	CHECKED - KAS	REVISED _

EXISTING AND PROPOSED TYPICAL CROSS SECTIONS	F.A.I. RTE	SECTION	COUNTY	TOTAL SHEETS	
S.N. 048-0080	1195	112B[BR;BR(1,2,3)]BJR,BDR	KNOX	47	21
3.14. 070-0000			CONTRAC	T NO. 6	8G91
SHEET 3 OF 13 SHEETS		ILLINOIS FED. AID	PROJECT		

STAGE I CONSTRUCTION DETAILS

(Looking South)

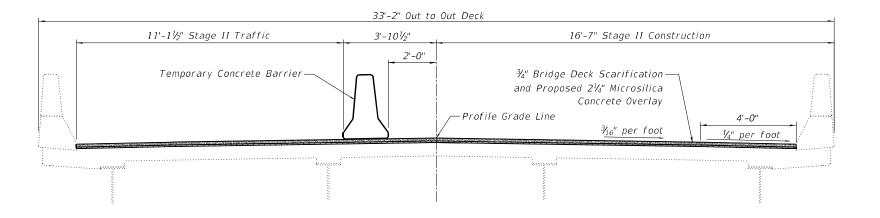

STAGE II CONSTRUCTION DETAILS

(Looking South)

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PLOT DATE =	CHECKED _ KAS	REVISED -

STAGE CONSTRUCTION DETAILS	F.A.I. RTE	SECTION	COUNTY	TOTAL SHEETS	SHEET NO.
S.N. 048-0080	1195	112B[BR;BR(1,2,3)]BJR,BDR	KNOX	47	22
3.14. 0-70-0000			CONTRAC	T NO. 6	8G91
SHEET 4 OF 13 SHEETS		ILLINOIS FED. AID	PROJECT		

STATE OF ILLINOIS

DEPARTMENT OF TRANSPORTATION

S.N. 048-0080

SHEET 5 OF 13 SHEETS

KNOX 47 23

CONTRACT NO. 68G91

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ICENSE #184.003222 PLOT DATE

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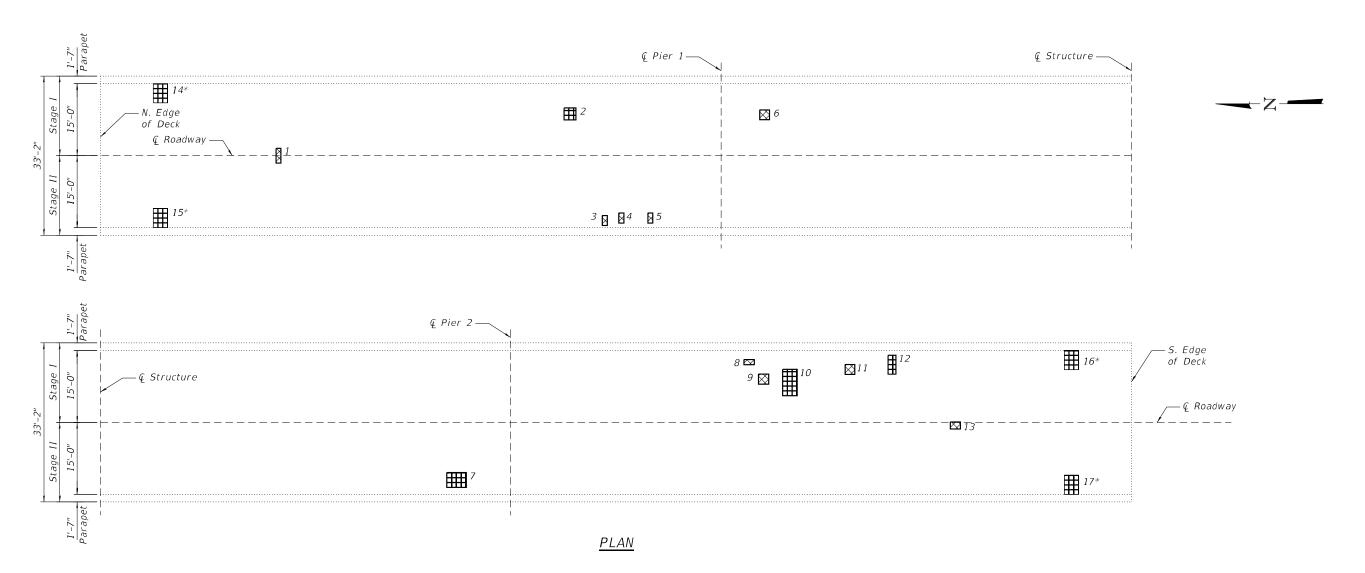
TJZ

DWS

REVISED

REVISED

REVISED



PATCH NO.	SIZE	S Deck Slab Repair (Full Depth Type I)	b Deck Slab Repair (Full Depth Type II)
1	1'-0" x 3'-0"	3.0	
2	2'-6" x 2'-6"		6.25
3	1'-0" x 2'-0"	2.0	
4	1'-0" x 2'-0"	2.0	
5	1'-0" x 2'-0"	2.0	
6	2'-0" x 2'-0"	4.0	
7	4'-0" x 3'-0"		12.0
8	2'-0" x 1'-0"	2.0	
9	2'-0" x 2'-0"	4.0	
10	3'-0" x 5'-6"		16.5
11	2'-0" x 2'-0"	4.0	
12	1'-6" x 4'-0"		6.0
13	2'-0" x 1'-6"	3.0	
14	3'-0" x 4'-0"		12.0
15	3'-0" x 4'-0"		12.0
16	3'-0" x 4'-0"		12.0
17	3'-0" x 4'-0"		12.0

NOTES:

Patch sizes shown represent conditions at the time the plans were completed.

The actual sizes and locations of patching shall be determined by the Engineer. The Engineer shall show the actual locations of the deck repairs on this sheet.

* The existing scuppers at these locations will be removed and replaced. See Sheet No. 7 of 13. The existing 50 floor drains shall remain in place.

<u>LEGEND</u>

Deck Slab Repair (Full Depth, Type I)


Deck Slab Repair (Full Depth, Type II)

BILL OF MATERIAL

Item	Unit	Total
Deck Slab Repair (Full Depth, Type I)	Sq. Yd.	2.9
Deck Slab Repair (Full Depth, Type II)	Sq. Yd.	9.9

	CIVIL DESIGN,INC. WBE DBE
رال	EFFINGHAM, IL ICENSE #184.003222

PATCHING DETAILS		SECTION	COUNTY	TOTAI SHEET
S.N. 048-0080		112B[BR;BR(1,2,3)]BJR,BDR	KNOX	47
3.11. 040-0000			CONTRAC	T NO.
HEET 6 OF 13 SHEETS		ILLINOIS FED AID	PROJECT	

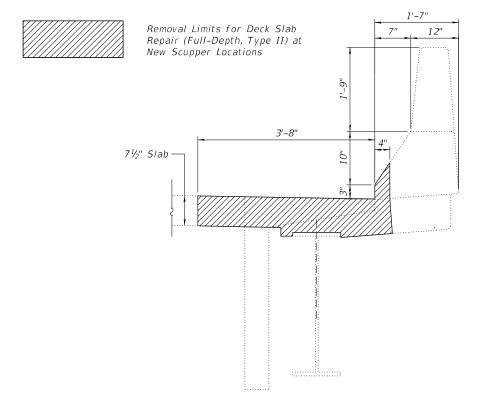

TYPICAL REMOVAL LIMITS


Notes:

All dimensions shall be field verified by the Contractor prior to ordering of materials. Fiberglass shall conform to ASTM D2996, with short-time rupture strength hoop tensile stress of 30,000 psi minimum.


The exterior surfaces of the scupper shall be painted according to Article 506 with the finish coat to match the outside of the fascia beams.

The exterior surfaces of the scuppers shall be cleaned according to the Society of Protective Coating Spec. SSPC-SPI prior to painting.

Cost of removal of existing scuppers is included in Deck Slab Repair (Full Depth, Type II).

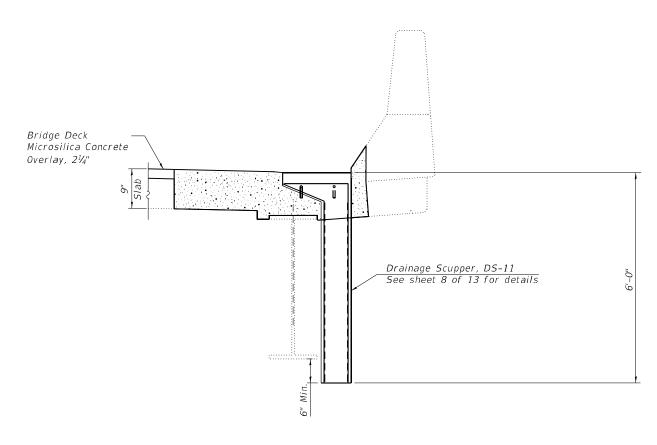

SECTION AT PROPOSED DRAINAGE SCUPPER

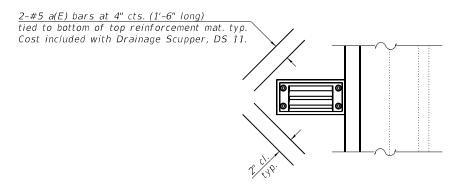

PARTIAL PLAN




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	CHECKED - TJZ	REVISED _
PLOT SCALE =	DRAWN - DWS	REVISED _
PLOT DATE =	CHECKED _ KAS	REVISED -

STATE OF ILLINOIS
DEPARTMENT OF TRANSPORTATION

 DRAINAGE SCUPPER DETAILS
 F.A.I. SECTION COUNTY TOTAL SHEETS NO.
 SHEET NO.
 1195 1128[BR;BR(1,2,3)]BJR,BDR KNOX 47 25
 CONTRACT NO. 68G91

 SHEET 7 OF 13 SHEETS

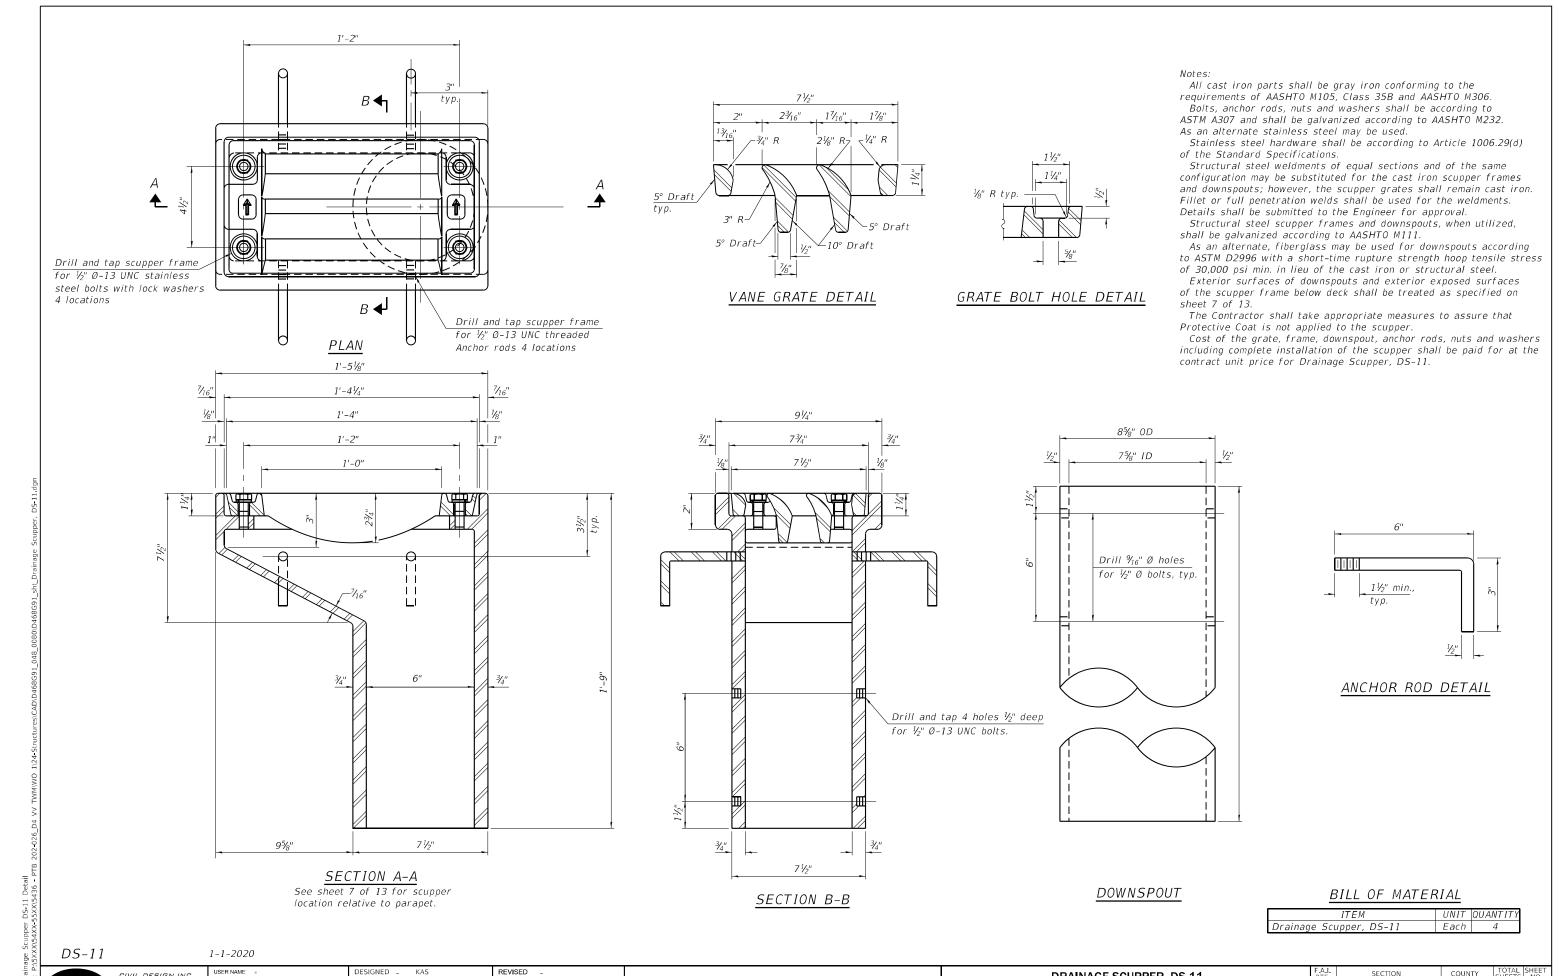

LICENSE #184.003222 PLOT DATE =

CIVIL DESIGN,INC. WBE | DBE

EFFINGHAM, IL

CHECKED _ TJZ

CHECKED - KAS

DWS

DRAWN _

REVISED

REVISED

REVISED

STATE OF ILLINOIS DEPARTMENT OF TRANSPORTATION DRAINAGE SCUPPER, DS-11 S.N. 048-0080 SHEET 8 OF 13 SHEETS

SECTION 1195 | 112B[BR;BR(1,2,3)]BJR,BDR KNOX 47 26 CONTRACT NO. 68G91

ABUTMENT PLAN

Note: North Abutment shown, South Abutment similar

N. Abut. - 2" at 50°F S. Abut. - 3" at 50°F 1'-0" 2'-0" 3" Sawcut (Typ.)

BILL OF MATERIAL

Item	Unit	Lotal
Concrete Removal	Cu. Yd.	9.1

SHEETS NO.

<u>NOTES:</u>

Existing reinforcement bars extending into the removal area shall be cleaned, straightened and incorporated into the New Construction. Any reinforcement bars that are damaged during Concrete Removal shall be replaced with an approved bar splicer or anchorage system. Cost included with Concrete Removal.

The existing expansion joint system shall be removed completely, as well as any foreign material that has accumulated or been placed in the joint openings. The cost for this work is included in Concrete Removal and no additional compensation will be allowed.

CIVIL DESIGN,INC.
WBE | DBE


EFFINGHAM, IL
LICENSE #184.003222

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PLOT DATE =	CHECKED - KAS	REVISED _

STATE OF ILLINOIS DEPARTMENT OF TRANSPORTATION

SECTION A-A

SUPERSTRUCTURE PLAN - CONCRETE REMOVAL DETAILS	F.A.I. RTE	SECTION	COUNTY
S.N. 048-0080		112B[BR;BR(1,2,3)]BJR,BDR	KNOX
3.11. 070-0000			CONTRA
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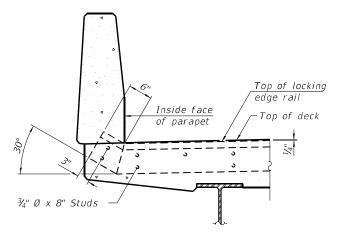


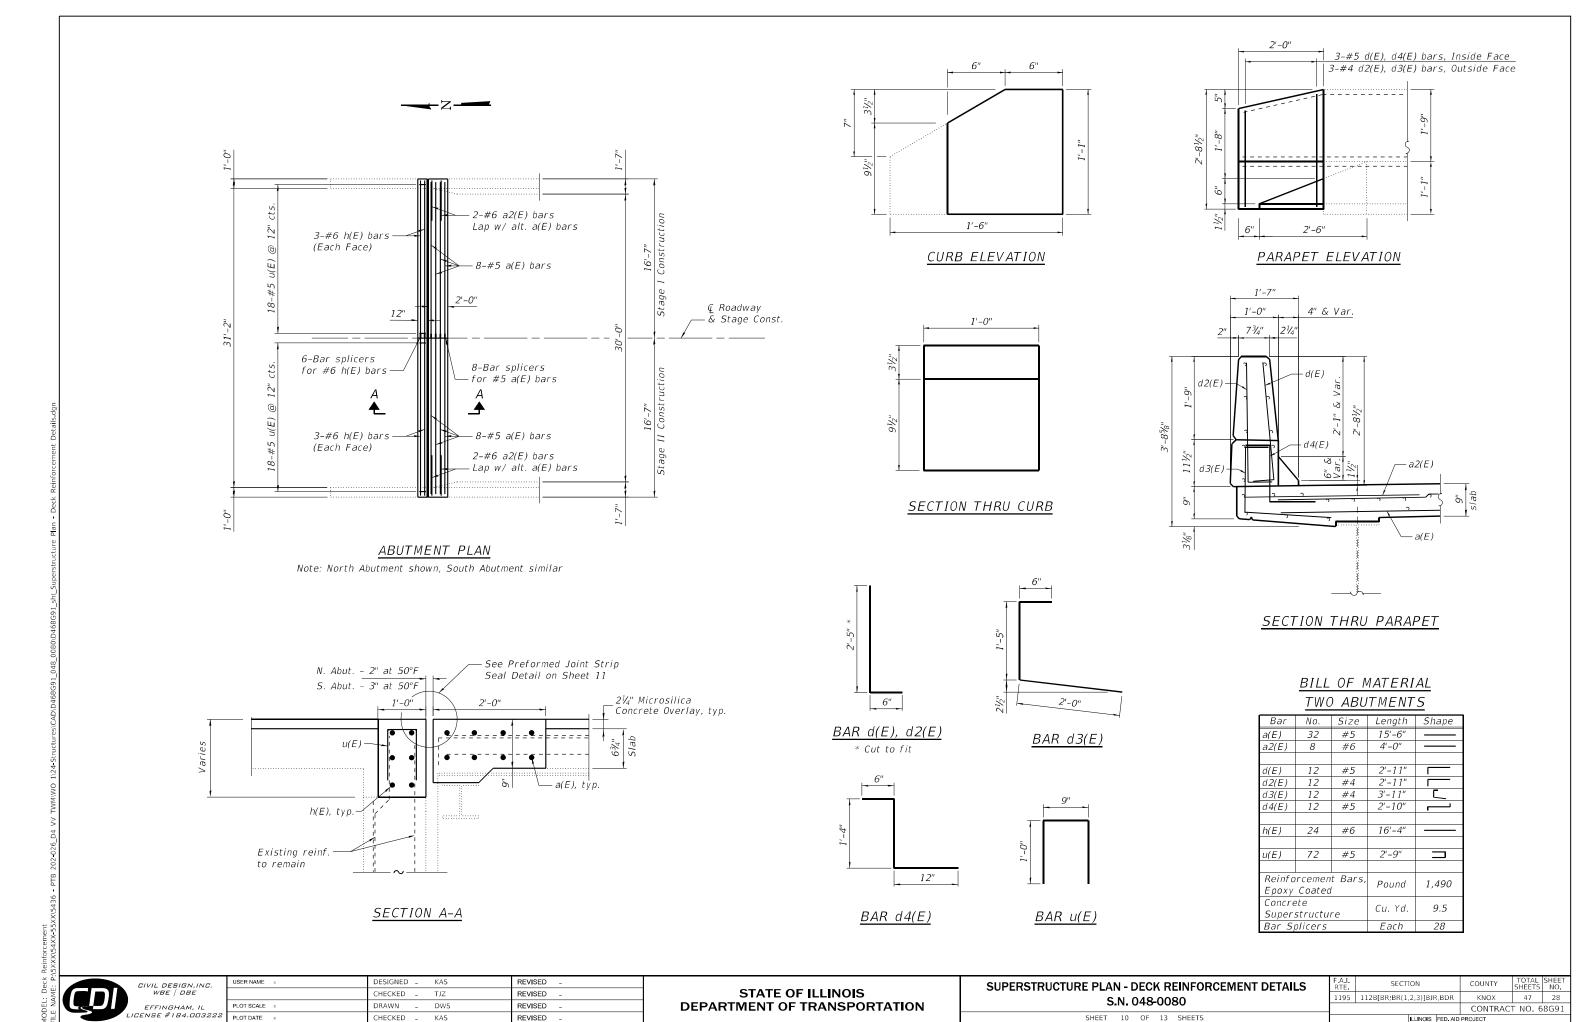SHEET 10 OF 13 SHEETS


CHECKED - KAS

REVISED

(For skews ≤ 30°)



SECTION AT PARAPET

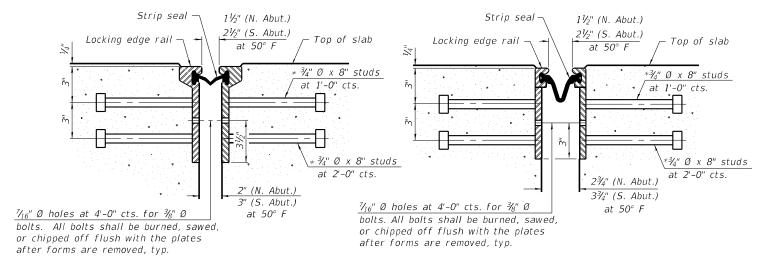

<u>SECTION THRU</u> ROLLED RAIL JOINT

<u>SECTION THRU</u> WELDED RAIL JOINT

* Granular or solid flux filled headed studs conforming to Article 1006.32 of the Std. Specs., automatically end welded.



The strip seal shall be made continuous and shall have a minimum thickness of V_4 ". The configuration of the strip seal shall match the configuration of the locking edge rails. Open or "webbed" strip seal gland configurations are not permitted. The gland shall be sized for a maximum rated movement of 4 inches.


The locking edge rails depicted are configured for typical applications and are conceptual only. The actual configuration of the locking edge rails and matching strip seal may vary from manufacturer to manufacturer provided they fit the application and meet the minimum anchorage shown. Flanged edge rails, however, will not be allowed.


The manufacturer's recommended installation methods shall be followed.


All steel components shall be galvanized after fabrication according to Article 520.03 of the Standard Specifications.

The maximum space between locking edge rail segments shall be $\frac{3}{16}$ " and sealed with a suitable sealant; however, any rail joint within 10' measured perpendicular to the face of the curb or parapet shall be welded as shown in the locking edge rail splice detail.

The joint opening and deck dimensions detailed on the superstructure are based on a rolled rail expansion joint. If the Contractor elects to use the welded rail expansion joint, the opening and deck dimensions shall be modified according to the dimensions detailed on this sheet. Required modifications shall be made at no additional cost to the State

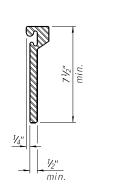

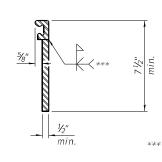

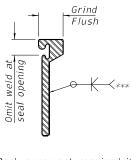

*** Back gouge not required if complete joint penetration is verified by mock-up.

ROLLED

EXTRUDED RAIL WELDED RAIL

LOCKING EDGE RAIL SPLICE

The inside of the locking edge rail groove shall be free of weld residue.

Rolled rail shown, welded rail similar.

LOCKING EDGE RAILS


BILL OF MATERIAL

1	Item	Unit	Total
	Preformed Joint Strip Seal	Foot	65




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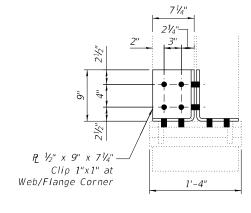
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PARTIAL FRAMING PLAN

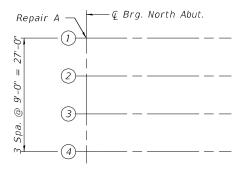

REPAIR A

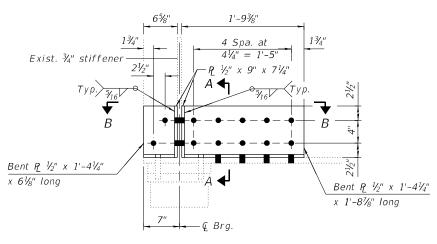


Notes:

Repairs.

Structures".

unless otherwise noted.

SECTION A-A

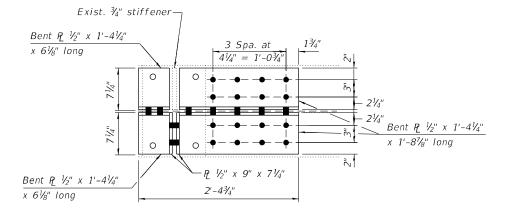

SECTION B-B

BOLT HOLE LEGEND

Fasteners shall be high strength bolts. Bolts % %, open holes $^{15}\!\!/_{16}$ %

Cost of all repairs on this sheet are included with Structural Steel

Existing structural steel that will be in contact with new structural steel shall be cleaned and painted prior to erection as required by the Special Provision "Cleaning and Painting Contact Surface Areas of Existing Steel

Field drill using existing steel as template.

Field drill using new steel as template.

BILL OF MATERIAL

Item	Unit	Total
Structural Steel Repair	Pound	170

CIVIL DESIGN,INC. WBE | DBE EFFINGHAM, IL LICENSE #184.003222 PLOT DATE =

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STATE OF ILLINOIS **DEPARTMENT OF TRANSPORTATION** **NORTHEAST BEAM END REPAIR** S.N. 048-0080 SHEET 12 OF 13 SHEETS

SECTION KNOX 47 30 1195 | 112B[BR;BR(1,2,3)]BJR,BDR CONTRACT NO. 68G91


STANDARD BAR SPLICER ASSEMBLY PLAN

(All components shall be provided from one supplier)

Threaded splicer bar length = min. lap length + $1\frac{1}{2}$ " + thread length

* Epoxy not required on Bar Splicer Assembly components used in conjunction with black bars.


Location	Bar size	No. assemblies required	Minimum Iap length
Deck End	#5	16	3'-6"
Deck End	#6	12	4'-0"

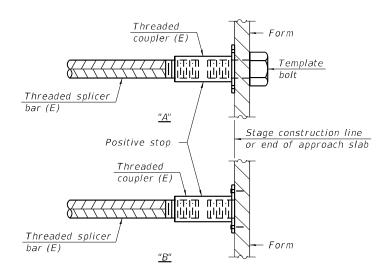

INSTALLATION AND SETTING METHODS

"A": Set bar splicer assembly by means of a template bolt "B": Set bar splicer assembly by nailing to wood forms or cementing to steel forms.

(E): Indicates epoxy coating.

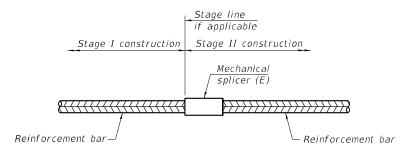

STANDARD MECHANICAL SPLICER

Location	Bar size	No. assemblies required

Notes:

Splicer bars shall be deformed with threaded ends and have a minimum $60\ ksi$ yield strength.

All reinforcement shall be lapped and tied to the splicer bars.

Bar splicer assemblies shall be epoxy coated according to the requirements for reinforcement bars. See Section 508 of the Standard Specifications. See approved list of bar splicer assemblies and mechanical splicers for alternatives.

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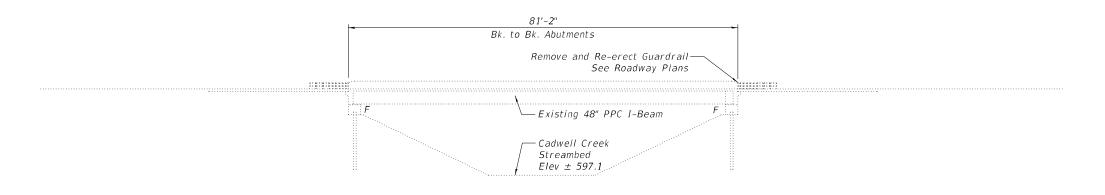
Structure 048-0085 was originally constructed in 2000 as FAS 1195, Contract 88615, Section (112B)BR-2 at Station 610+35 in Knox County. It has not been reconstructed or rehabilitated. It is not known whether is has received minor repairs.

The existing structure is a single span PPC I-beam bridge. The superstructure consists of five 48" I-beams supporting a nominal 7½" thick RC deck. There is no existing overlay on the bridge deck. The existing abutments are integral


The structure has an overall length of 81'-2" from back to back of abutments. The deck has an out to out width of $34'-9\frac{3}{8}''$, and a deck (clear area) width of 31'-6'' base to base of curb.

See Sheet 2 of 6 for Proposed Work, Bill of Material, and General Notes.





ELEVATION

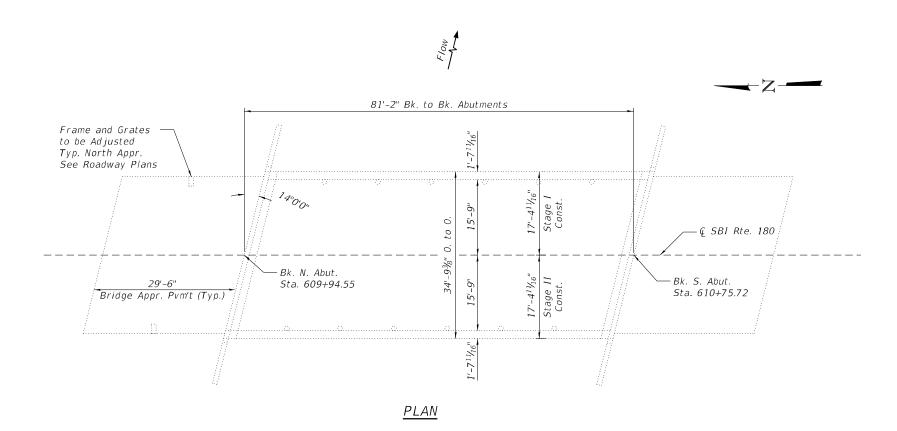

DESIGN STRESSES FIELD UNITS

New Construction f'c = 4,000 psify = 60,000 psi (Reinforcement)

Existing Structure $f'c = 3,500 \ psi$ fy = 60,000 psi (Reinforcement)f'c = 6,000 psi (Prestressed Units)

f's = 270,000 psi (Strands)

10-17-2022

Licensed Structural Engineer State of Illinois No. 081-007505 Expires 11-30-2024





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STATE OF ILLINOIS DEPARTMENT OF TRANSPORTATION **GENERAL PLAN AND ELEVATION** S.N. 048-0085 SHEET 1 OF 6 SHEETS

SECTION 1195 | 112B[BR;BR(1,2,3)]BJR,BDR KNOX 47 32 CONTRACT NO. 68G91

TOTAL BILL OF MATERIAL

Item	Unit	Total
Stone Dumped Riprap, Class A4	Sq. Yd.	127
Bridge Deck Grooving	Sq. Yd.	467
Protective Coat	Sq. Yd.	498
Bridge Deck Scarification ¾"	Sq. Yd.	498
Bridge Deck Microsilica Concrete Overlay, 21/4"	Sq. Yd.	498

INDEX OF SHEETS

- General Plan and Elevation
- General Data
- Existing and Proposed Typical Cross Sections
 Stage Construction Details
- Wearing Surface Plan
- Riprap Placement at Abutments

PROPOSED WORK

- Perform Bridge Deck Scarification on Bridge Deck and Concrete Approaches.
- Place Microsilica Concrete Overlay on Bridge Deck and Concrete Approaches.
- Perform Deck Grooving.
 Perform Bridge Relief Joint Sealer work.
- Apply Protective Coat.
- 6. Place Stone Riprap at Abutments.

GENERAL NOTES

Plan dimensions and details relative to the existing structure have been taken from existing plans and are subject to nominal construction variations. It shall be the Contractor's responsibility to verify such dimensions and details in the field and make the necessary approved adjustments prior to construction or ordering of materials. Such variations shall not be cause for additional compensation for a change in the scope of work. However, the Contractor will be paid for the quantity actually furnished at the unit price for the work.

Protective Coat shall be applied to new concrete overlay areas only.

Synthetic fibers shall be included in the bridge deck concrete overlay specified. See Special Provisions.

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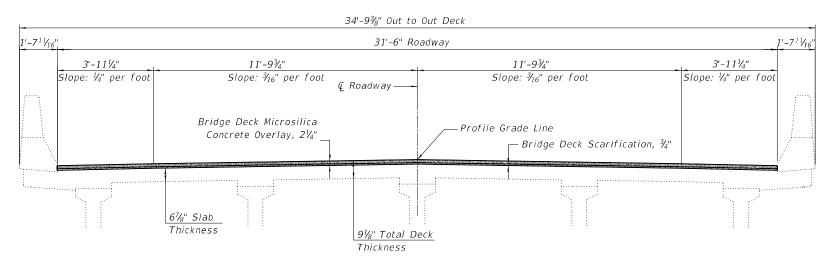
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STATE OF ILLINOIS **DEPARTMENT OF TRANSPORTATION**

GENERAL DATA	F.A.I. RTE	SECTION	COUNTY	TOTAL SHEETS	SHEET NO.
S.N. 048-0085	1195	112B[BR;BR(1,2,3)]BJR,BDR	KNOX	47	33
S.N. 048-0085			CONTRAC	T NO. 6	8G91
FT 2 OF 6 SHEFTS	ILLINOIS FED AID PROJECT				

EXISTING CROSS SECTION

(Looking South)



PROPOSED CROSS SECTION


(Looking South)

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EXISTING AND PROPOSED TYPICAL CROSS SECTIONS		SECTION	COUNTY	TOTAL SHEETS	SHEET NO.
S.N. 048-0085	1195	112B[BR;BR(1,2,3)]BJR,BDR	KNOX	47	34
3.N. U40-U000			CONTRAC	T NO. 6	8G91
SHEET 3 OF 6 SHEETS	ILLINOIS FED AID PROJECT			$\overline{}$	

$\frac{\textit{STAGE I CONSTRUCTION DETAILS}}{\textit{(Looking South)}}$



STAGE II CONSTRUCTION DETAILS (Looking South)
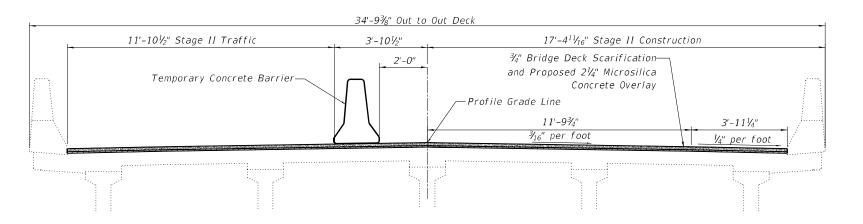
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	CIVIL DESIGN,INC.	ι
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STAGE CONSTRUCTION DETAILS S.N. 048-0085		SECTION	COUNTY	TOTAL SHEETS	SHEET NO.
		112B[BR;BR(1,2,3)]BJR,BDR	KNOX	47	35
			CONTRAC	T NO. 6	8G91
SHEET 4 OF 6 SHEETS		ILLINOIS FED. AID	PROJECT		

FLOOR DRAIN TOP PLAN

* Slope Overlay 1" to Drain

Bridge Deck Scarification, 3/4", Bridge Deck Microsilica Concrete Overlay, 21/4", and Bridge Deck Grooving

BILL OF MATERIAL

Item	Unit	Total
Bridge Deck Microsilica Concrete Overlay, 21/4"	Sq. Yd.	498
Bridge Deck Scarification, ¾"	Sq. Yd.	498
Bridge Deck Grooving	Sq. Yd.	467

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WEARING SURFACE PLAN	F.A.I. RTE	SECTION		
S.N. 048-0085	1195	112B[BR;BR(1,2,3)]BJF		
SHEET 5 OF 6 SHEETS		II I NIOIO		

<u>PLAN</u>

BILL OF MATERIAL

Item	Unit	Total
Stone Dumped Riprap, Class A4	Sq. Yd.	127

Note:
Minimum thickness of Stone Dumped Riprap, Class A4 = 18 inches.
No fabric or bedding stone required.

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STATE OF ILLINOIS DEPARTMENT OF TRANSPORTATION

RIPRAP PLACEMENT AT ABUTMENTS SECTION S.N. 048-0085 SHEET 6 OF 6 SHEETS

KNOX 47 37 CONTRACT NO. 68G91

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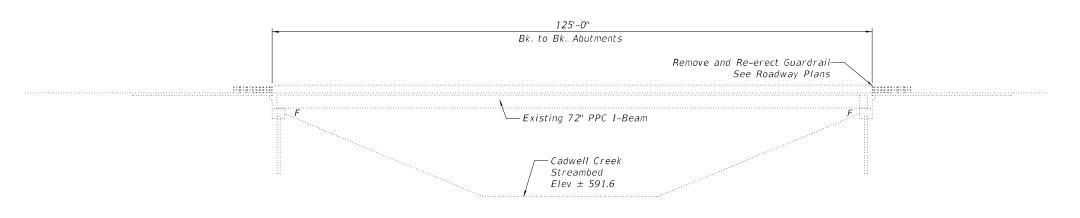
Structure 048-0086 was originally constructed in 2000 as FAS 1195, Contract 88615, Section (112B)BR-1 at Station 637+31 in Knox County. It has not been reconstructed or rehabilitated. It is not known whether is has received minor repairs.

The existing structure is a single span PPC I-beam bridge. The superstructure consists of six $72^{"}$ I-beams supporting a nominal $7\frac{5}{6}$ " thick RC deck. There is no existing overlay on the bridge deck. The existing abutments are integral abutments.

The structure has an overall length of 125'-0'' from back to back of abutments. The deck has an out to out width of 34'-9%'', and a deck (clear area) width of 31'-6'' base to base of curb.

Note: See Sheet 2 of 5 for Proposed Work, Bill of Material, and General Notes.





ELEVATION

KION

<u>DESIGN STRESSES</u> FIELD UNITS

New Construction f'c = 4,000 psi fy = 60,000 psi (Reinforcement)


Existing Structure

f'c = 3,500 psi

fy = 60,000 psi (Reinforcement)

f'c = 6,000 psi (Prestressed Units)

 $f's = 270,000 \ psi \ (Strands)$

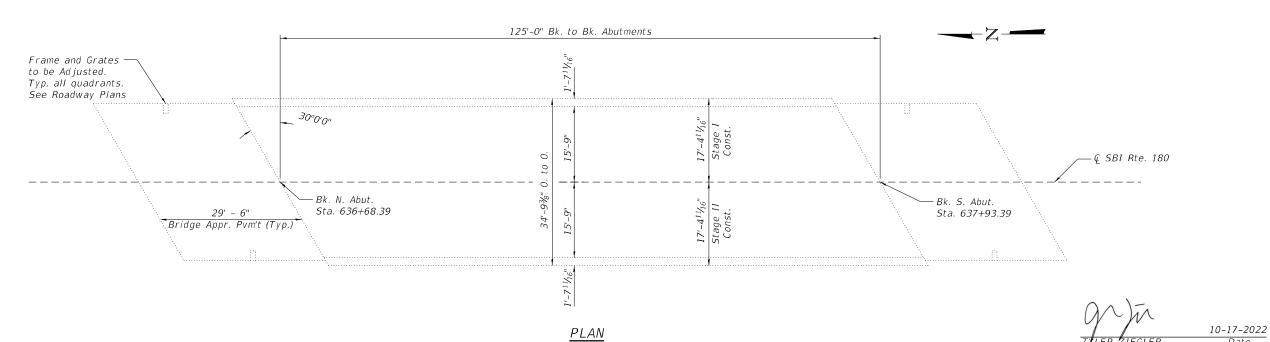

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STATE OF ILLINOIS
DEPARTMENT OF TRANSPORTATION

GENERAL PLAN AND ELEVATION
S.N. 048-0086

SHEET 1 OF 5 SHEETS

Licensed Structural Engineer State of Illinois No. 081-007505

Expires 11-30-2024

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TOTAL BILL OF MATERIAL

Item	Unit	Total
Bridge Deck Grooving	Sq. Yd.	611
Protective Coat	Sq. Yd.	652
Bridge Deck Scarification ¾"	Sq. Yd.	652
Bridge Deck Microsilica Concrete Overlay, 21⁄4"	Sq. Yd.	652

INDEX OF SHEETS

- General Plan and Elevation
- General Data
- Existing and Proposed Typical Cross Sections
- Stage Construction Details
 Wearing Surface Plan

PROPOSED WORK

- Perform Bridge Deck Scarification on Bridge Deck and Concrete Approaches.
- Place Microsilica Concrete Overlay on Bridge Deck and Concrete Approaches.
- Perform Deck Grooving.

 Perform Bridge Relief Joint Sealer work.
- Apply Protective Coat.

GENERAL NOTES

Plan dimensions and details relative to the existing structure have been taken from existing plans and are subject to nominal construction variations. It shall be the Contractor's responsibility to verify such dimensions and details in the field and make the necessary approved adjustments prior to construction or ordering of materials. Such variations shall not be cause for additional compensation for a change in the scope of work. However, the Contractor will be paid for the quantity actually furnished at the unit price for the work.

Protective Coat shall be applied to new concrete overlay areas only.

Synthetic fibers shall be included in the bridge deck concrete overlay specified. See Special Provisions.

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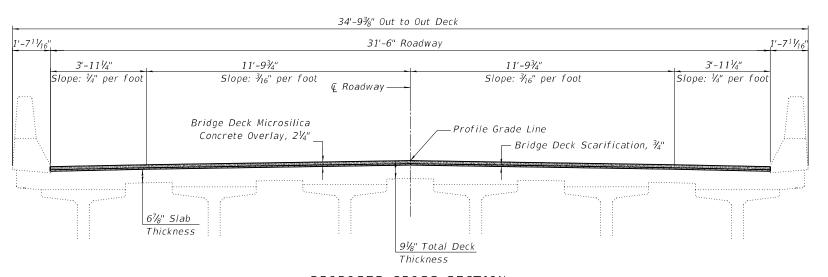
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STATE OF ILLINOIS **DEPARTMENT OF TRANSPORTATION**

GENERAL DATA S.N. 048-0086		SECTION	COUNTY	TOTAL SHEETS	SHEET NO.
		112B[BR;BR(1,2,3)]BJR,BDR	KNOX	47	39
			CONTRAC	T NO. 6	8G91
SHEET 2 OF 5 SHEETS		ILLINOIS FED. AID	PROJECT		

EXISTING CROSS SECTION

(Looking South)



PROPOSED CROSS SECTION

(Looking South)


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EXISTING AND PROPOSED TYPICAL CROSS SECTIONS	F.A.I. RTE	SECTION	COUNTY	TOTAL SHEETS	
S.N. 048-0086		112B[BR;BR(1,2,3)]BJR,BDR	KNOX	47	40
			CONTRAC	T NO. 6	8G91
SHEET 3 OF 5 SHEETS		ILLINOIS FED AID	PROJECT		

STAGE I CONSTRUCTION DETAILS

(Looking South)



STAGE II CONSTRUCTION DETAILS

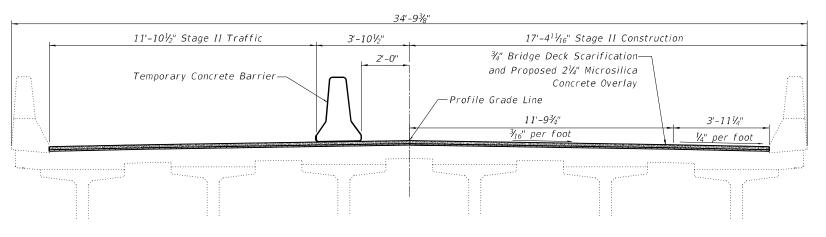(Looking South)

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STAGE CONSTRUCTION DETAILS S.N. 048-0086		SECTION	COUNTY	TOTAL SHEETS	SHEET NO.
		195 112B[BR;BR(1,2,3)]BJR,BDR KN0		47	41
			CONTRAC	T NO. 6	8G91
SHEET 4 OF 5 SHEETS		ILLINOIS FED AID	PROJECT		

PLAN

Bridge Deck Scarification, ¾", Bridge Deck Microsilica Concrete Overlay, 2¼", and Bridge Deck Grooving

BILL OF MATERIAL

Item	Unit	Total
Bridge Deck Microsilica Concrete Overlay, 21/4"	Sq. Yd.	652
Bridge Deck Scarification, ¾"	Sq. Yd.	652
Bridge Deck Grooving	Sq. Yd.	611



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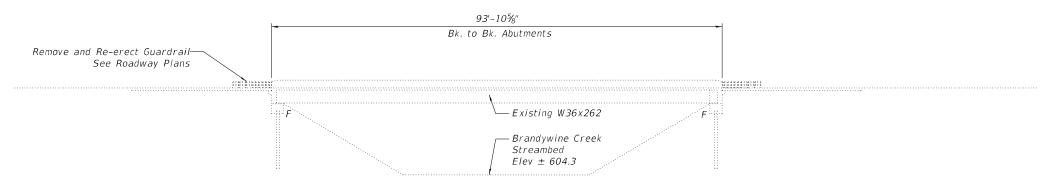
Structure 048-0089 was originally constructed in 2009 as FAS 1195, Contract 88896, Section (112B)BR-3 at Station 586+75 in Knox County. It has not been reconstructed or rehabilitated. It is not known whether is has received minor repairs.

The existing structure is a single span composite steel multi-beam bridge. The superstructure consists of six W36x262 beams supporting a nominal 8" thick RC deck. There is no existing overlay on the bridge deck. The existing abutments are integral abutments.

The structure has an overall length of 93'-10%'' from back to back of abutments. The deck has an out to out width of 43'-2", and a deck (clear area) width of 40'-0" base to base of curb.

See Sheet 2 of 5 for Proposed Work, Bill of Material, and General Notes.





ELEVATION


FIELD UNITS New Construction

DESIGN STRESSES

 $f'c = 4,000 \ psi$ fy = 60,000 psi (Reinforcement)

Existing Structure f'c = 3,500 psi

fy = 60,000 psi (Reinforcement) fy = 50,000 psi (M223 Gr. 50 Structural Steel)

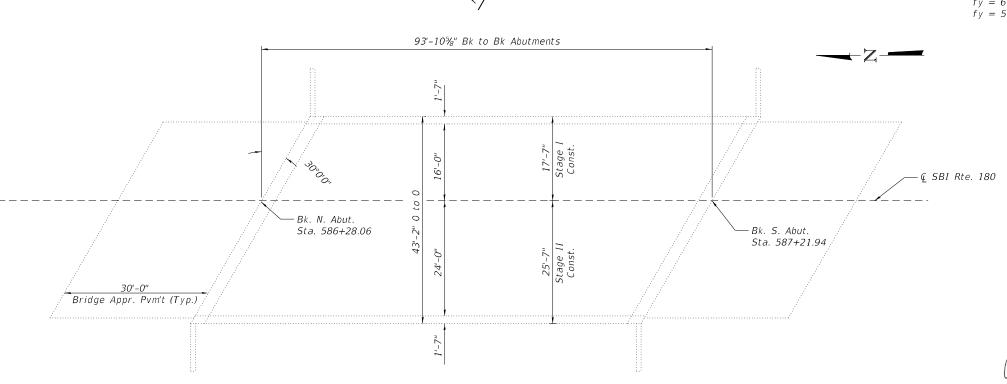

PLAN

10-17-2022

Licensed Structural Engineer State of Illinois No. 081-007505 Expires 11-30-2024



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STATE OF ILLINOIS **DEPARTMENT OF TRANSPORTATION** **GENERAL PLAN AND ELEVATION** S.N. 048-0089 SHEET 1 OF 5 SHEETS

SECTION 1195 | 112B[BR;BR(1,2,3)]BJR,BDR KNOX 47 43 CONTRACT NO. 68G91

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TOTAL BILL OF MATERIAL

Item	Unit	Total
Bridge Deck Grooving	Sq. Yd.	655
Protective Coat	Sq. Yd.	689
Bridge Deck Scarification ¾"	Sq. Yd.	689
Bridge Deck Microsilica Concrete Overlay, 21⁄4"	Sq. Yd.	689

INDEX OF SHEETS

- General Plan and Elevation
- General Data
- Existing and Proposed Typical Cross Sections
- Stage Construction Details Wearing Surface Plan

PROPOSED WORK

- Perform Bridge Deck Scarification on Bridge Deck and Concrete Approaches.
- Place Microsilica Concrete Overlay on Bridge Deck and Concrete Approaches.
- Perform Deck Grooving.

 Perform Bridge Relief Joint Sealer work.
- Apply Protective Coat.

GENERAL NOTES

Plan dimensions and details relative to the existing structure have been taken from existing plans and are subject to nominal construction variations. It shall be the Contractor's responsibility to verify such dimensions and details in the field and make the necessary approved adjustments prior to construction or ordering of materials. Such variations shall not be cause for additional compensation for a change in the scope of work. However, the Contractor will be paid for the quantity actually furnished at the unit price for the work.

Protective Coat shall be applied to new concrete overlay areas only.

Synthetic fibers shall be included in the bridge deck concrete overlay specified. See Special Provisions.

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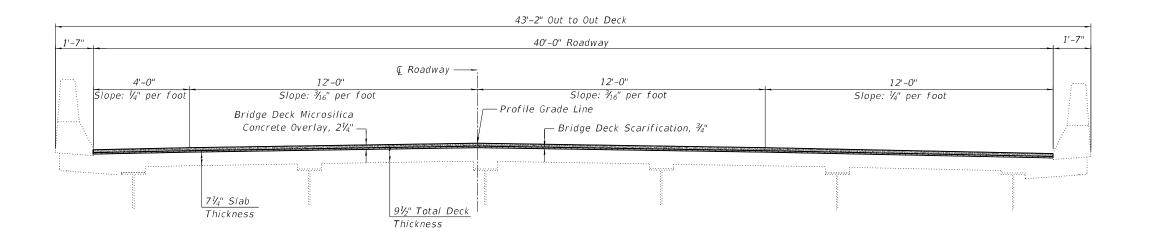
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STATE OF ILLINOIS **DEPARTMENT OF TRANSPORTATION**

GENERAL DATA	F.A.I. RTE	SECTION	COUNTY	TOTAL SHEETS	
S.N. 048-0089		112B[BR;BR(1,2,3)]BJR,BDR	KNOX	47	44
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EXISTING CROSS SECTION

(Looking South)




PROPOSED CROSS SECTION

(Looking South)

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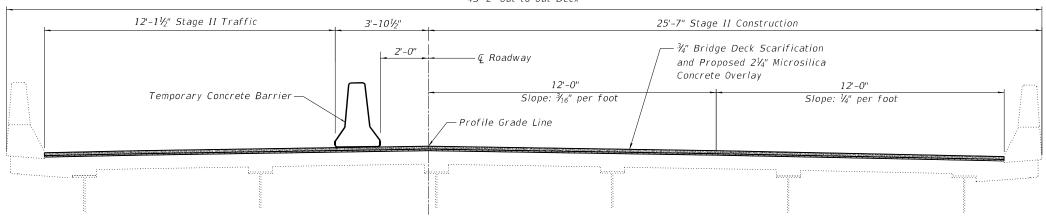
EXISTING AND PROPOSED TYPICAL CROSS SECTIONS S.N. 048-0089		F.A.I. SECTION		TOTAL SHEETS	
		1195 112B[BR;BR(1,2,3)]BJR,BDR KI		47	45
			CONTRAC	T NO. 6	8G91
SHEET 3 OF 5 SHEETS		ILLINOIS FED. AID	PROJECT		



STAGE I CONSTRUCTION DETAILS

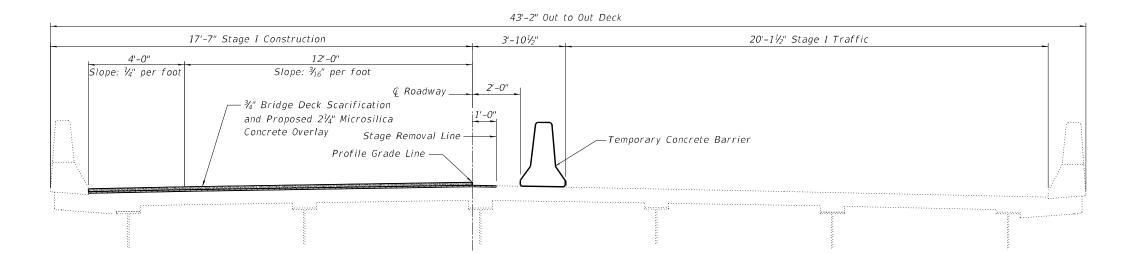(Looking South)

43'-2" Out to Out Deck




STAGE II CONSTRUCTION DETAILS

(Looking South)

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2	EFFINGHAM, IL	PL
i	LICENSE #184.003222	PL

CHECKED - TJZ REVISED - PLOT SCALE = DRAWN - DWS REVISED - PLOT DATE = CHECKED - KAS REVISED -	USER NAME =	DESIGNED _ KAS	REVISED -
1		CHECKED - TJZ	REVISED _
PLOT DATE = CHECKED - KAS REVISED -	PLOT SCALE =	DRAWN _ DWS	REVISED _
	PLOT DATE =	CHECKED _ KAS	REVISED _

STAGE CONSTRUCTION DETAILS S.N. 048-0089	F.A.I. RTE	SECTION		COUNTY	TOTAL SHEETS	SHEET NO.
	1195	112B[BR;BR(1,2,3)]BJR,B	DR	KNOX	47	46
3.N. 040-0003				CONTRAC	T NO. 6	8G91
SHEET 4 OF 5 SHEETS		ILLINOIS FEI	D. AID P	ROJECT		

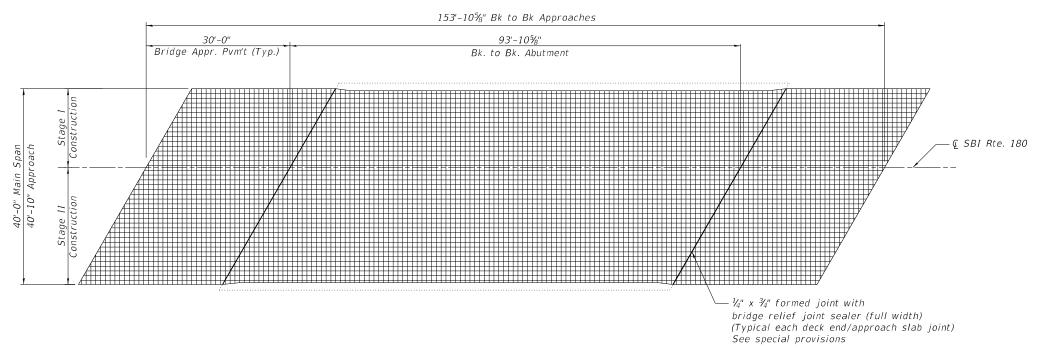

PLAN

Bridge Deck Scarification, $\frac{3}{4}$ ", Bridge Deck Microsilica Concrete Overlay, $2\frac{1}{4}$ ", and Bridge Deck Grooving

BILL OF MATERIAL

Item	Unit	Total
Bridge Deck Microsilica Concrete Overlay, 21/4"	Sq. Yd.	689
Bridge Deck Scarification, ¾"	Sq. Yd.	689
Bridge Deck Grooving	Sq. Yd.	655



JSER NAME =	DESIGNED	-	KAS	REVISED
	CHECKED	-	TJZ	REVISED
PLOT SCALE =	DRAWN	-	DWS	REVISED
PLOT DATE =	CHECKED	-	KAS	REVISED

VEARING SURFACE PLAN S.N. 048-0089		SECTION COUNT			TOTAL SHEETS	SHEET NO.
		112B[BR;BR(1,2,3)]BJR,BDR K		KNOX	47	47
0,11, 0 10 0000				CONTRAC	T NO. 6	8G91
SHEET 5 OF 5 SHEETS		ILLINOIS	FED. AID	PROJECT		