01-20-2017 LETTING ITEM 064

STATE OF ILLINOIS DEPARTMENT OF TRANSPORTATION

09-00065-00-RS COOK ILLINOIS PROJECT M-9003(512) CONTRACT NO. 61D45

PLANS FOR PROPOSED FEDERAL AID HIGHWAY

FAU 1557 (59th STREET)

CANADIAN NATIONAL RAILROAD TO FAU 3565 (ARCHER ROAD - IL ROUTE 171)

RESURFACING

SECTION 09-00065-00-RS PROJECT M-9003(512)

VILLAGE OF SUMMIT COOK COUNTY C-91-134-10

SEE SHEET 2 **DESIGN DESIGNATION** TRAFFIC DATA 59th STREET 1000 (2014) MAJOR COLLECTOR POSTED SPEED DESIGN SPEED 30 MPH (EXISTING) 30 MPH (EXISTING) 30 MPH (PROPOSED) 30 MPH (PROPOSED) 1"=100' 1"=10 1"=50" 1"=40" 1"=30' 1"=20' ENGINEERING SCALES. REDUCED SIZED PLANS WILL NOT CONFORM TO STANDARD SCALES. IN MAKING MEASUREMENTS ON REDUCED PLANS, THE ABOVE SCALES MAY BE USED. JOINT NFORMATION FOR Know what's below. Call before you diq. CALL 811 Frank Novotny & Associates, Inc. 2

INDEX OF SHEETS SEE SHEET 2

INDEX OF DISTRICT 1 DETAILS SEE SHEET 2

INDEX OF HIGHWAY STANDARDS

59th STREET PROJECT BEGINS AT STA. 1+50


PROJECT LOCATION MAP RANGE 12 EAST 1ST AVE. BULLDOG DR. 59th STREET PROJECT ENDS AT STA. 25+34 STREET (FAU 1557) 61ST ST. LYONS TOWNSHIP 3rd PRINCIPAL MERIDIAN

DENOTES LOCATION OF IMPROVEMENT

LENGTH OF PROJECT

LOCATION OF SECTION INDICATED THUS:

STATE OF ILLINOIS DEPARTMENT OF TRANSPORTATION DISTRICT 1 ENGINEER OF LOCAL ROADS & STREETS RELEASING FOR BID BASED ON LIMITED

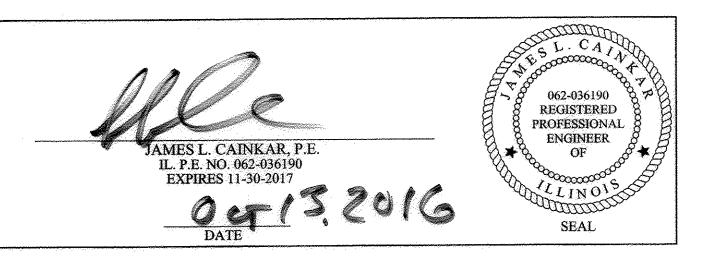

PRINTED BY THE AUTHORITY OF THE STATE OF ILLINOIS

825 Midway Drive ♦ Willowbrook, IL ♦ 60527 ♦ Telephone: (630) 887-8640 ♦ Fax: (630) 887-0132 Civil Engineers/ ILLINOIS PROFESSIONAL DESIGN FIRM NO. 184-000928

09058 DRAWN/DESIGNED JFP/THK CHECKED/APPROVED JLC/JLC NA PROJECT NO.

SIONS IO. BY DATE DESCRIPTION PER IDOT REVIEW JLC 9-09-16 2 JLC 10-13-10 PER IDOT REVIEW NO. 61D45

GROSS LENGTH OF PROJECT

2,384 FEET (0.45 MILES)

NET LENGTH OF PROJECT

2,384 FEET (0.45 MILES)

GENERAL CONSTRUCTION NOTES

PAVING AND STORM SEWERS

SPECIFICATIONS

THE APRIL 1, 2016 EDITIONS OF THE "STANDARD SPECIFICATIONS FOR ROAD AND BRIDGE CONSTRUCTION", THE "SUPPLEMENTAL SPECIFICATIONS AND RECURRING SPECIAL PROVISIONS", PREPARED BY THE ILLINOIS DEPARTMENT OF TRANSPORTATION AND THE "MANUAL OF UNIFORM TRAFFIC CONTROL DEVICES" SHALL GOVERN ALL WORK ASSOCIATED WITH THIS PROJECT THE "STANDARD SPECIFICATIONS FOR WATER AND SEWER MAIN CONSTRUCTION IN ILLINOIS" MAY GOVERN OTHER WORK ON THIS PROJECT AS INDICATED BY REFERENCE.

CARE IN EXCAVATION

CARE SHALL BE EXERCISED BY THE CONTRACTOR IN CARRYING OUT EARTH AND/OR TRENCHING OPERATIONS SO THAT LOCAL UTILITY SERVICES, WATER VALVES, MANHOLES, CATCH BASINS, INLETS, BUFFALO BOXES, AND OTHER STRUCTURES ARE NOT DAMAGED OR REMOVED. ANY DAMAGE DONE BY THE CONTRACTOR, WHETHER THE STRUCTURE OR SERVICE IS VISIBLE AT THE GROUND SURFACE OR NOT, SHALL BE REPAIRED OR REPLACED BY THE CONTRACTOR IN ACCORDANCE WITH ARTICLE 105.07 OF THE "STANDARD SPECIFICATIONS FOR ROAD AND BRIDGE CONSTRUCTION".

NOTIFICATION OF PUBLIC UTILITIES

PRIOR TO STARTING CONSTRUCTION, THE CONTRACTOR SHALL NOTIFY THE OFFICIALS OF THE PUBLIC WORKS DEPARTMENT OF THE LOCAL MUNICIPALITIES AT (708)466-2646, LYONS, (708)447-2276, McCOOK, J.U.L.I.E. AT 1-800-892-0123 OR 811, AND OTHER PUBLIC AND PRIVATE UTILITIES SO THAT ARRANGEMENTS CAN BE MADE TO LOCATE THEIR VARIOUS FACILITIES WITHIN THE LIMITS OF CONSTRUCTION UNDER THIS CONTRACT, AS WELL AS TO PROVIDE ADEQUATE PROTECTION AND INSPECTION THERETO. IT SHALL BE THIS CONTRACTOR'S RESPONSIBILITY TO DETERMINE THE ACTUAL LOCATION OF ALL SUCH FACILITIES IN THE FIELD.

TRAFFIC CONTROL DEVICES

BARRICADES AND WARNING SIGNS SHALL BE PROVIDED IN ACCORDANCE WITH ARTICLE 107.14 OF THE "STANDARD SPECIFICATIONS FOR ROAD AND BRIDGE CONSTRUCTION".

PROTECTION OF SIGNS AND PROPERTY

ALL TRAFFIC SIGNS, STREET SIGNS, ETC., THAT INTERFERE WITH THE CONSTRUCTION OPERATIONS SHALL BE REMOVED AND PLACED AT NEW LOCATIONS AS DESIGNATED BY THE ENGINEER. THIS WORK SHALL BE CONSIDERED INCLUDED IN THE COST OF "MOBILIZATION", AND NO ADDITIONAL COMPENSATION WILL BE ALLOWED. IN ADDITION, ALL MAIL BOXES THAT INTERFERE WITH CONSTRUCTION SHALL BE SIMILARLY RELOCATED AT NO ADDITIONAL COST IN ACCORDANCE WITH ARTICLES 107.20 AND 107.21 OF THE "STANDARD SPECIFICATIONS FOR ROAD AND BRIDGE CONSTRUCTION".

SUPERINTENDENCE

SPECIAL ATTENTION IS DRAWN TO ARTICLE 105.06 OF THE "STANDARD SPECIFICATIONS FOR ROAD AND BRIDGE CONSTRUCTION" WHICH REQUIRES THE CONTRACTOR TO HAVE A COMPETENT SUPERINTENDENT ON THE PROJECT SITE AT ALL TIMES, IRRESPECTIVE OF THE AMOUNT OF WORK SUBLET. THE SUPERINTENDENT SHALL BE CAPABLE OF READING AND UNDERSTANDING THE PLANS AND SPECIFICATIONS, SHALL HAVE FULL AUTHORITY TO EXECUTE ORDERS TO EXPEDITE THE PROJECT AND SHALL BE RESPONSIBLE FOR SCHEDULING AND HAVING CONTROL OF ALL THE WORK AS THE AGENT OF THE GENERAL CONTRACTOR. FAILURE TO COMPLY WITH THIS PROVISION WILL RESULT IN A SUSPENSION OF WORK AS PROVIDED IN ARTICLE 108.07.

CONSTRUCTION LAYOUT STAKES

THE CONTRACTOR SHALL PROVIDE THE ENGINEER WITH WOODEN STAKES OR OTHER LAYOUT MATERIALS FOR LAYOUT OF THE LINES AND GRADES OF THE PROJECT. FAILURE TO PROVIDE STAKES IN A TIMELY MANNER WILL RESULT IN A DELAY IN STAKEOUT WHICH WILL BE APPLICABLE AGAINST THE TIME LIMIT FOR COMPLETION SHOWN IN THE PROJECT SPECIFICATIONS. LINE AND GRADE WILL BE ESTABLISHED BY THE ENGINEER AT REGULAR INTERVALS ON PERMANENTLY PAVED SURFACES, SIDEWALKS OR STAKES AT THE ENGINEER'S OPTION, ALL WITHIN THE PUBLIC RIGHT—OF—WAY AND SHALL BE TRANSFERRED BY THE CONTRACTOR TO THE ACTUAL LINE OF CONSTRUCTION.

PROJECT SAFETY

WHEN MILLED PAVEMENT IS OPEN TO TRAFFIC THE MAXIMUM GRADE DIFFERENTIAL BETWEEN PASSES OF THE MILLING MACHINE SHALL NOT EXCEED 1-1/2 INCHES WHERE THE SPEED LIMIT IS 45 MPH OR LESS AND 1 INCH WHERE THE SPEED LIMIT IS GREATER THAN 45 MPH. WITH WRITTEN APPROVAL FROM THE ENGINEER, A MAXIMUM GRADE DIFFERENTIAL OF 3 INCHES MAY BE ALLOWED IF THE EDGE OF THE MILLING IS SLOPED A MINIMUM 1:3 (V:H).

BUTT JOINTS WILL BE INSTALLED AT THE ENDS OF ALL RESURFACING (WHERE RESURFACING MEETS EXISTING PAVEMENT), IN ACCORDANCE WITH THE "BUTT JOINT AND HOT-MIX ASPHALT TAPER DETAILS" SHEET INCLUDED IN THE PLANS, UNLESS OTHERWISE SPECIFIED.

THE CONTRACTOR SHALL COMPLY WITH AND OBSERVE THE RULES AND REGULATIONS OF O.S.H.A. AND APPROPRIATE AUTHORITIES REGARDING SAFETY PROVISIONS. THE CONTRACTOR, ENGINEER, AND OWNER SHALL EACH BE RESPONSIBLE FOR THEIR OWN RESPECTIVE AGENTS AND EMPLOYEES.

THE ENGINEER AND OWNER ARE NOT RESPONSIBLE FOR THE CONSTRUCTION MEANS, METHODS, TECHNIQUES, SEQUENCES OR PROCEDURES, TIME OF PERFORMANCE, PROGRAMS, OR FOR ANY SAFETY PRECAUTIONS USED BY THE CONTRACTOR. THE CONTRACTOR IS SOLELY RESPONSIBLE FOR EXECUTION OF HIS WORK IN ACCORDANCE WITH THE DOCUMENTS AND SPECIFICATIONS.

THE RESIDENT ENGINEER SHALL CONTACT THE TRAFFIC CONTROL SUPERVISOR AT (847) 705-4470 A MINIMUM OF 72 HOURS PRIOR TO THE PLACEMENT OF ANY TEMPORARY TRAFFIC CONTROL DEVICES.

MISCELLANEOUS

ALL PATCHING ON THE HOT-MIX ASPHALT PORTIONS OF THIS PROJECT WILL BE MARKED OUT AND CONSTRUCTED AFTER MILLING. A PROOF ROLL WILL BE REQUIRED PRIOR TO PATCHING

BEFORE BEGINNING ANY WORK, THE CONTRACTOR SHALL RETAIN AND RECORD FOR FUTURE REFERENCE, ALL EXISTING PAVEMENT MARKING LINES (AND RAISED REFLECTIVE PAVEMENT MARKERS) IN ORDER THAT THESE LOCATIONS CAN BE RE-ESTABLISHED FOR STRIPING. EXACT LOCATIONS OF ALL PAVEMENT MARKINGS SHALL BE AS DIRECTED BY THE ENGINEER.

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- 1.) COVER SHEET: LOCATION MAP, INDEX OF SHEETS, INDEX OF DISTRICT 1 DETAILS
- 2.) GENERAL CONSTRUCTION NOTES, SPECIAL PROJECT NOTES, INDEX OF HIGHWAY STANDARDS
- 3.) SUMMARY OF QUANTITIES
- 4.) TYPICAL SECTIONS, HOT-MIX ASPHALT MIXTURE REQUIREMENTS
- 5.-7.) PLAN: 59th STREET (RESURFACING)

CANADIAN NATIONAL RAILROAD TO FAU 3565 (ARCHER ROAD - IL ROUTE 171)

8.) PLAN: 59th STREET - (PAVEMENT MARKING)

CANADIAN NATIONAL RAILROAD TO FAU 3565 (ARCHER ROAD - IL ROUTE 171)

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 -) BD-22 PAVEMENT PATCHING FOR HMA SURFACED PAVEMENT
- 11.) BD-24 CURB OR CURB AND GUTTER REMOVAL AND REPLACEMENT
- 2.) BD-32 BUTT JOINT AND HMA TAPER DETAILS
- 13.) TC-10 TRAFFIC CONTROL & PROTECTION FOR SIDE ROADS, INTERSECTIONS & DRIVEWAYS
- 14.) TC-11 TYPICAL APPLICATIONS RAISED REFLECTIVE PAVEMENT MARKINGS (SNOW PLOW RESISTANT)
- 15.) TC-13 DISTRICT ONE TYPICAL PAVEMENT MARKINGS
- 16.) TC-16 PAVEMENT MARKING LETTERS AND SYMBOLS FOR TRAFFIC STAGING
- 17.) TC-22 ARTERIAL ROAD INFORMATION SIGN

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- 280001-07 TEMPORARY EROSION CONTROL SYSTEMS
- 442201-03 CLASS C AND D PATCHES
- 602011-02 CATCH BASIN-TYPE C
- 602401-03 MANHOLE-TYPE A
- 604001-04 FRAMES & LIDS-TYPE 1
- 606001-06 CONCRETE CURB TYPE B AND COMBINATION CONCRETE CURB & GUTTER
- 701301-04 LANE CLOSURE, 2L, 2W, SHORT TIME OPERATIONS
- 701311-03 LANE CLOSURE, 2L, 2W, MOVING OPERATIONS-DAY ONLY
- 701501-06 URBAN LANE CLOSURE, 2 L, 2 W UNDIVIDED
- 701701-10 URBAN LANE CLOSURE, MULTILANE INTERSECTION
- 701901-06 TRAFFIC CONTROL DEVICES
- 780001-05 TYPICAL PAVEMENT MARKINGS

Frank Novotny & Associates, Inc.

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ILLINOIS PROFESSIONAL DESIGN FIRM NO. 184-000928

FILE NAME VILLAGE OF SUMMIT

59th STREET

CANADIAN NATIONAL RAILROAD TO

FAU 3565 (ARCHER ROAD — IL ROUTE 171)

ROAD RESURFACING

 USER NAME =
 DESIGNED — THK
 REVISED — JLC 9—09—16

 DRAWN — JFP
 REVISED — JLC 10—13—16

 PLOT SCALE =
 CHECKED — JLC
 REVISED —

 PLOT DATE =
 DATE — 8/15
 REVISED —

STATE OF ILLINOIS
DEPARTMENT OF TRANSPORTATION

GENERAL CONSTRUCTION NOTES,
INDEX OF HIGHWAY STANDARDS, SPECIAL PROJECT NOTES

SCALE: NONE SHEET NO. OF SHEETS STA. TO STA. FEE

A.U. SECTION COUNTY TOTAL SHEETS NO.

557 09-00065-00-RS COOK 17 2

CONTRACT NO. 61D45

FED. ROAD DIST. NO. | ILLINOIS | FED. AID | PROJECT

Specialty	Special	Code			Total	Construction Code
ltem	Provision	No	ltem	Unit	Quantity	Roadway 0005 3789
kooluussa ku suurus saaraa aa aa gariya milyiin maaniindhan waadiibaaniih kooloni K	SP	40600290	BITUMINOUS MATERIALS (TACK COAT)	POUND	3,789	
	eranne i kant film der film fram kritiske film i kan på er en en efter fram fram fram fram er en en en en en e En en er film fram fram fram fram fram fram er en	40600400	MIXTURE FOR CRACKS, JOINTS, AND FLANGEWAYS	TON	37	37
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	egya egyeket dagaga arabiga yakka kerin ya pala kifa falia ke keriliki keke dibumbuh kekebiki teke keriniki te Keriniki dagaga keriniki keriniki daga daga daga keriniki kerin tu keriniki keriniki keriniki kelikuliki daga	40600982	HOT-MIX ASPHALT SURFACE REMOVAL - BUTT JOINT	(14.55) (15.44) (15.44) (15.44) (15.44) (15.44) (15.44) (15.44) (15.44) (15.44) (15.44) (15.44) (15.44) (15.44 SQ YD ***Commonwealth*** **Commonwealth*** **Commonwealth*** **Commonwealth*** **Commonwealth*** **Commonwealth*** **Commonwealth*** **Commonwealth** **Commonw	tine principal con la consequenti della consequenti della consequenti della consequenti della consequenti della 31	31
		40603335	HOT-MIX ASPHALT SURFACE COURSE, MIX "D", N50	TON	847 	847 managan paga saman paga saman paga paga paga paga paga paga paga pa
	gammigh, en ingge enere ener is often geliese to half et description and electrons is a sustained	42300600	PORTLAND CEMENT CONCRETE DRIVEWAY PAVEMENT, 10 INCH	SQ YD	90	
	ing ngganalake sa manganang pulatur su kanaka tugin tagu ahari ki matropol ti ti Kanaka kanaka nganaka sa manganaka taki di kining a ti ti ti untuk sa menganakang kanaka taki sa menganakan k	44000160	HOT-MIX ASPHALT SURFACE REMOVAL, 2-3/4"	SQ YD	7,468	7468
		44000200	DRIVEWAY PAVEMENT REMOVAL	SQ YD	430	430
and the state of t		44201765	CLASS D PATCHES, TYPE II, 10 INCH	SQ YD	98	98
, paragana a seria da santa a santa anta anta anta a seria da seria da seria da seria de seria de seria de ser La seria da seria de		44201769	CLASS D PATCHES, TYPE III, 10 INCH	SQ YD	68	68
angangan kanangan saman kanangan kanangan kanangan kanan di Mana, sepinah kanan di Amerikan Kanangan kanangan sebagai kanangan kanangan kanangan kanangan kanangan kanangan kanangan kanangan kanangan kan	anning samalan garasid ka maningka shi manin kadamba shi na kata bata shi kata ma kata shi kata shi ka dhi ka Maning samalan shi ka shi k	44201771	CLASS D PATCHES, TYPE IV, 10 INCH	SQ YD	555	555
and progression of the section of th	andreaman (van je rafimarminen), samen krim safera sep je mengef debekerintekkine. 1901.	60206905	CATCH BASINS, TYPE C, TYPE 1 FRAME, OPEN LID	EACH	12	12
ka se _{ga} ana ke _{gaan} ayan ayan ayan salamahan ayahan in damahan ke garan ayan ayan ayan ayan ayan ayan ayan	a digitarian kipula digitah sa sa malayan na yungan da malaya da maham sa mana u masa sa masa sa masa kababal Baran kababan sa masa sa maham sa maham sa masa	60218400	MANHOLES, TYPE A, 4'-DIAMETER, TYPE 1 FRAME, CLOSED LID	EACH	an samu an	La companya da la companya da positiva de companya da la companya da la companya da la companya da la companya La companya da la companya da
rige _{kala} n international general medial finish in regular to come per gradient medial to the technique.	agamaga angan anganaga pagata a digamaka at ta	60252800	CATCH BASINS TO BE RECONSTRUCTED	EACH	10	10
	ga engalam na mengalah nyadidiga hari selah kilampi majalah 1998 mengalah selah sebagai hari sebagai hari seba Sebagai mengalah sebagai hari sebagai mengalah sebagai sebagai sebagai hari mengalah sebagai sebagai hari seba	60257900	MANHOLES TO BE RECONSTRUCTED	EACH	5 5 4 4	en grande en
	Дан од жените становичение и при при при при при при при при при п	60300305	FRAMES AND LIDS TO BE ADJUSTED	EACH	4 2	4
		60406000	FRAMES AND LIDS, TYPE 1, OPEN LID	EACH	1 1	
		60406100	FRAMES AND LIDS, TYPE 1, CLOSED LID	EACH	2 2	<u> </u>
		60500040	REMOVING MANHOLES	EACH		
		60500050	REMOVING CATCH BASINS	EACH	12 12	12 graph and the second of the
		67100100	MOBILIZATION	LSUM LA CALL DE LA CALLADA DE	e e e e e e e e e e e e e e e e e e e	en egi sa paga ngan gangana antan mana mana manana mana na manan na manana manana manan sa manan na manan mana Manana manana na manana man
		70102620	TRAFFIC CONTROL AND PROTECTION, STANDARD 701501	en e	agonita uja esenti ura en estreno en mentreti un en e 1.	en de la companya de 11.
	a analysi ya afaran iyo aga aga araa a a aa ay a a a aa aa ah ah ah ah ah ah ah ah ah	70102635	TRAFFIC CONTROL AND PROTECTION, STANDARD 701701	LSUM LOUIS CARREST CONTRACTOR CO	taga paggiga a sana satipa a satipapanya terus anta terenti 1	a garaga garaga garagaga sagagang ang pangang pangang pangang pangang na pangang na mananan mananan La
		70300100	SHORT TERM PAVEMENT MARKING	FOOT	246	246
		70300150	SHORT TERM PAVEMENT MARKING REMOVAL	SQ FT	. 82	82.
*		78000200	THERMOPLASTIC PAVEMENT MARKING - LINE 4"	FOOT	4,770	4770
*		78008210	POLYUREA PAVEMENT MARKING TYPE I - LINE 4"	FOOT	80	
*		78008230	POLYUREA PAVEMENT MARKING TYPE I - LINE 6"	FOOT	126	126
		78008250	POLYUREA PAVEMENT MARKING TYPE I - LINE 12"	FOOT	30 30	30
		78100100	RAISED REFLECTIVE PAVEMENT MARKER		*,hannan********************************	66
	SP	X6030310	FRAMES AND LIDS TO BE ADJUSTED (SPECIAL)	EACH	a phinippunian survival new mee, appear sum priviter tension 22.	en de sans de seu en mesone accumentant de deut de contra de contra como de como de cidad de descripción de de 2
	SP	Z0004562	COMBINATION CONCRETE CURB AND GUTTER REMOVAL AND REPLACEMENT	FOOT	2,413	2413
en e	SP	Z0030850	TEMPORARY INFORMATION SIGNING	SQ FT	53	53

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ILLINOIS PROFESSIONAL DESIGN FIRM NO. 184-000928


FILE NAM	VILLAGE OF SUMMIT
	59th STREET
	CANADIAN NATIONAL RAILROAD TO
	FAU 3565 (ARCHER ROAD - IL ROUTE 171
#09058	ROAD RESURFACING

USER NAME =	DESIGNED - THK	REVISED - JLC 9-09-16
	DRAWN - JFP	REVISED - JLC 10-13-16
PLOT SCALE =	CHECKED — JLC	REVISED -
PLOT DATE =	DATE - 8/15	REVISED -

STAT	TE OF ILL	INOIS
DEPARTMENT	OF TRA	NSPORTATION

SUMMARY OF QUANTITIES									
SCALE:	NONE	SHEET NO.	OF	SHEETS	STA.	TO STA.			

F.A.U. RTE.		SE	CTION	***************************************	COUNTY	TOTAL SHEETS	SHEE NO.	
1557	09-	-000	65-00-R		COOK	17	3	
 	L.,					CONTRA	CT NO. 6	1D45
EED BO	TAIL OLG	NO	ILLINOIS	FFD	AID	PROJECT		

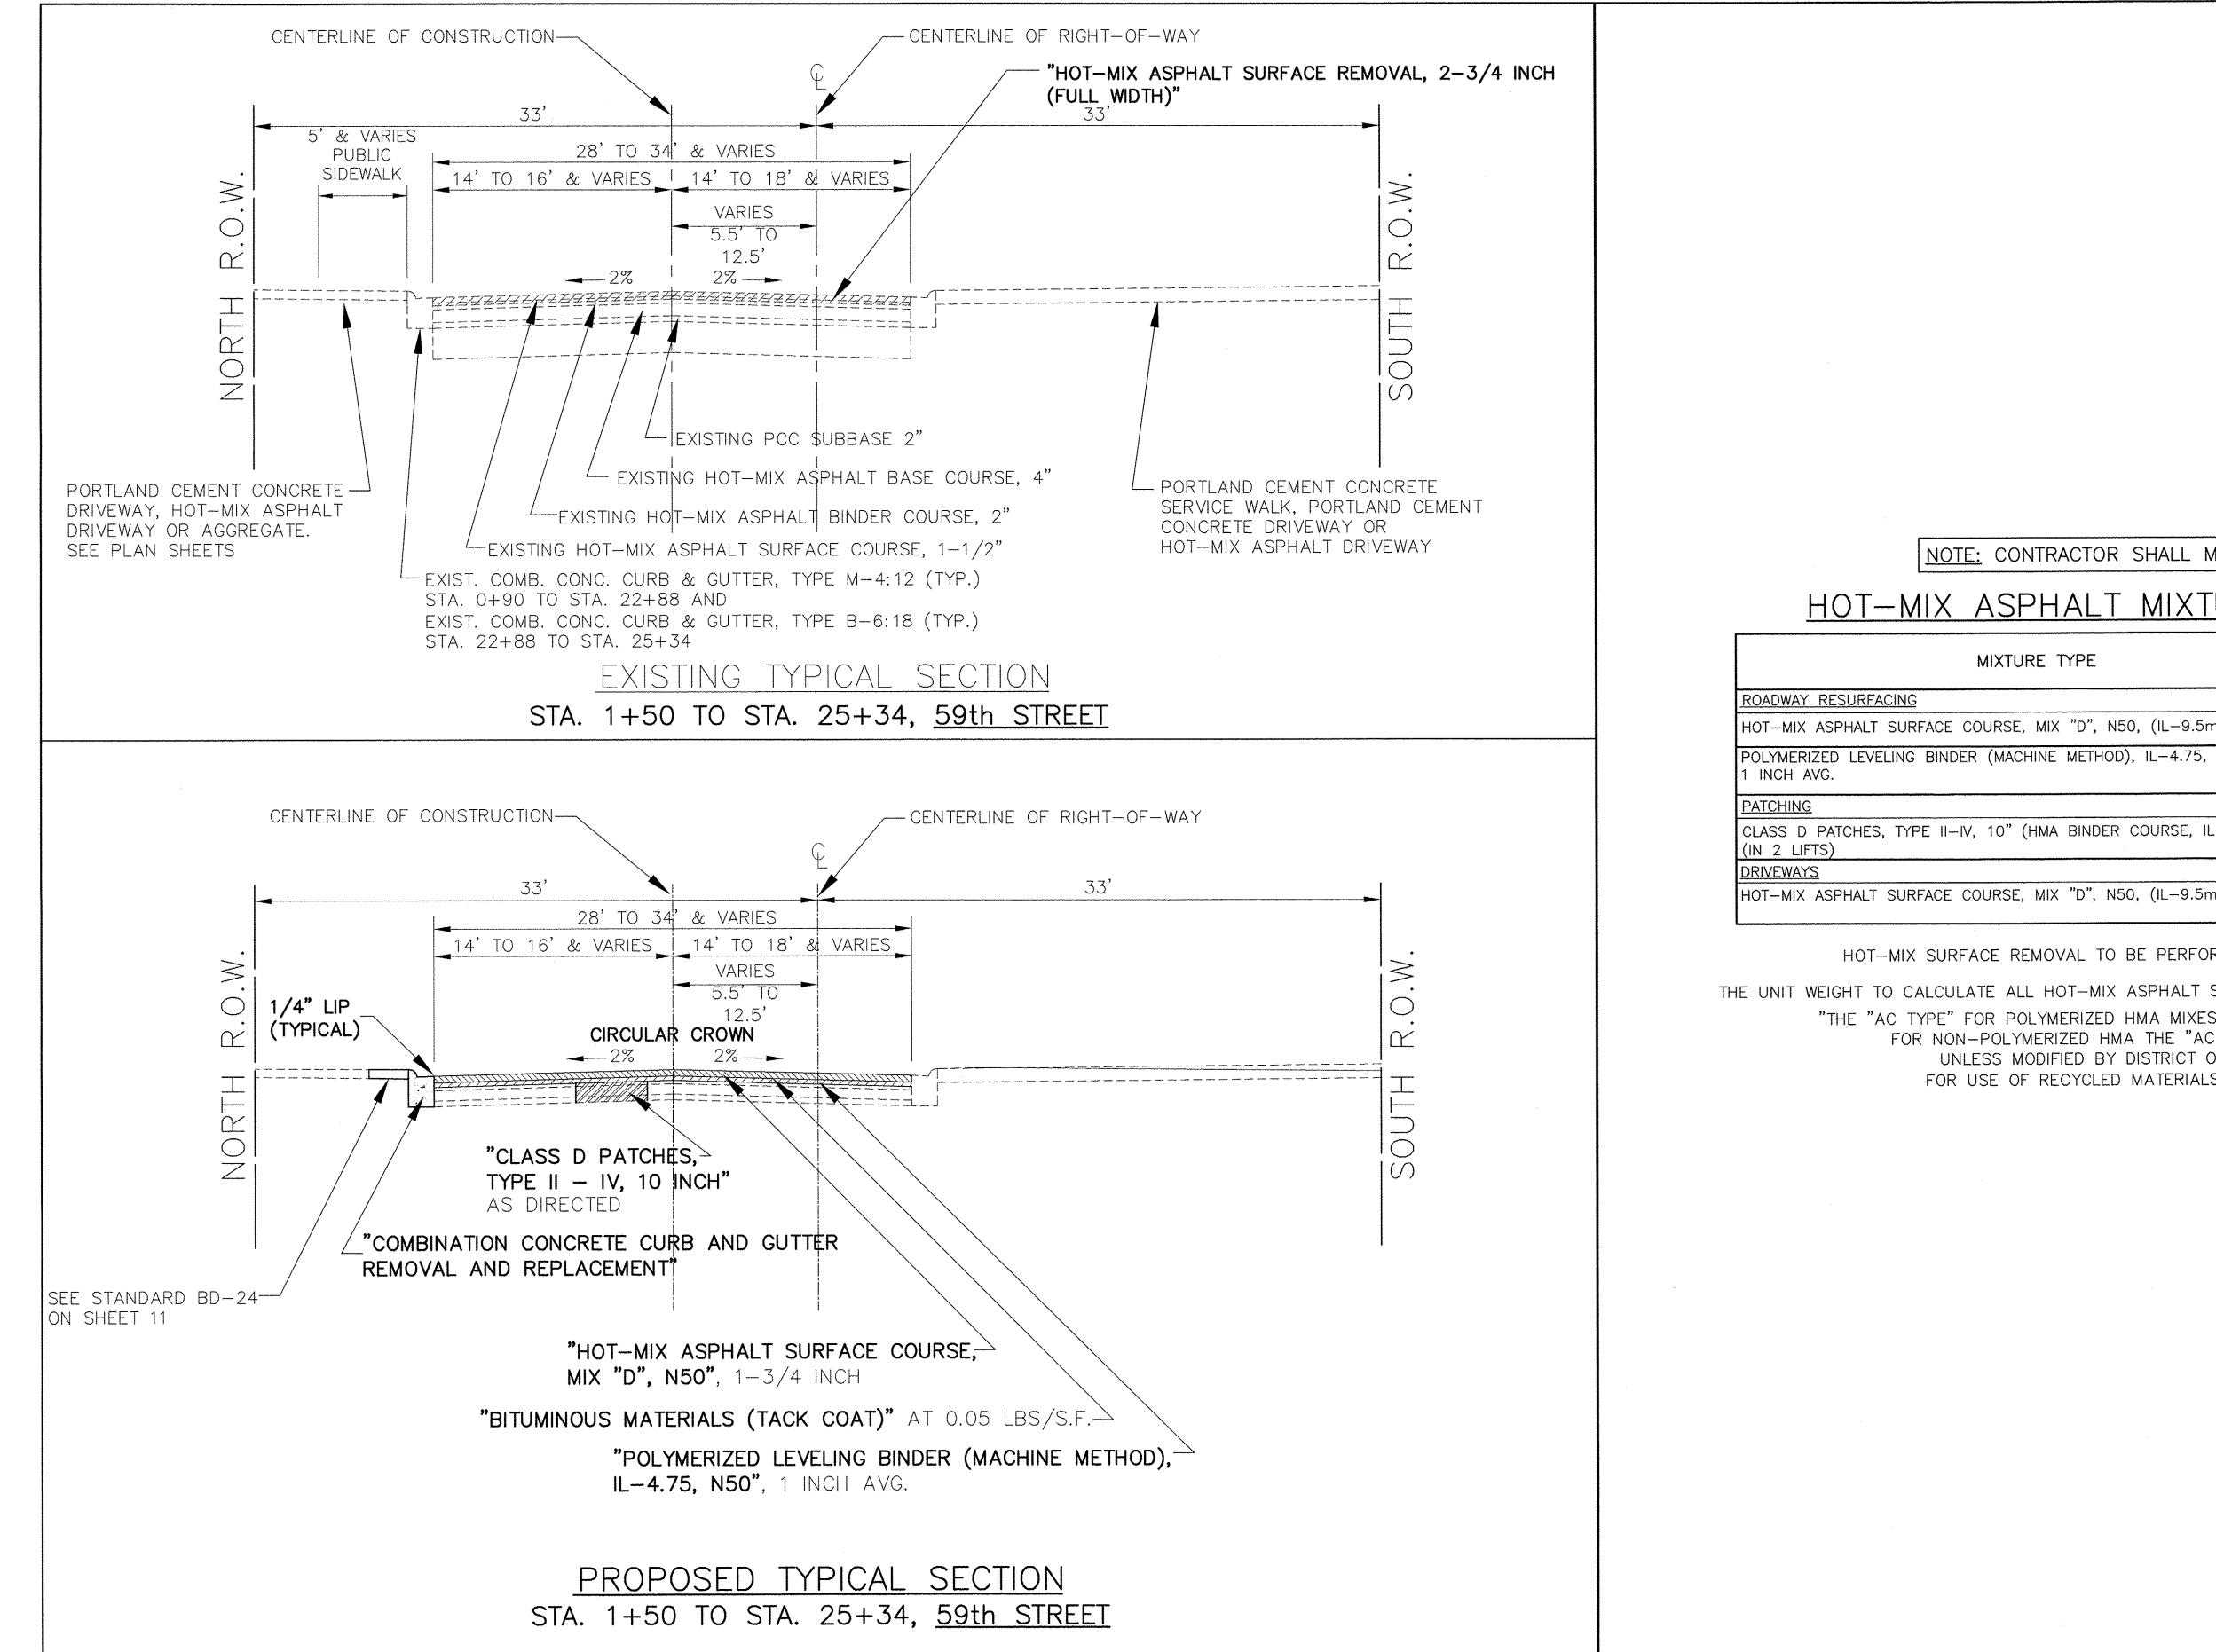

REVISED - JLC 9-09-16

REVISED - JLC 10-13-16

REVISED -

REVISED -

STATE OF ILLINOIS

DEPARTMENT OF TRANSPORTATION

DESIGNED - THK

DRAWN - JFP

CHECKED - JLC

DATE -3/10

VILLAGE OF SUMMIT

59th STREET CANADIAN NATIONAL RAILROAD TO

FAU 3565 (ARCHER ROAD - IL ROUTE 171)

ROAD RESURFACING

USER NAME =

PLOT SCALE =

PLOT DATE =

NOTE: CONTRACTOR SHALL MILL BEFORE PATCHING.

HOT-MIX ASPHALT MIXTURE REQUIREMENTS

MIXTURE TYPE	AIR VOIDS @ NDES
ROADWAY RESURFACING	
HOT-MIX ASPHALT SURFACE COURSE, MIX "D", N50, (IL-9.5mm), 1-3/4"	4% @ 50 GYR
POLYMERIZED LEVELING BINDER (MACHINE METHOD), IL—4.75, N50, 1 INCH AVG.	3.5% @ 50 GYR
PATCHING CLASS D PATCHES, TYPE II—IV, 10" (HMA BINDER COURSE, IL—19 mm), 10" (IN 2 LIFTS)	4% @ 70 GYR
<u>DRIVEWAYS</u> HOT-MIX ASPHALT SURFACE COURSE, MIX "D", N50, (IL-9.5mm), 4" (IN TWO LIFTS)	4% @ 50 GYR

HOT-MIX SURFACE REMOVAL TO BE PERFORMED BEFORE PATCHING OPERATIONS


THE UNIT WEIGHT TO CALCULATE ALL HOT-MIX ASPHALT SURFACE MIXTURE QUANTITIES IS 112 LBS/SQ YD/IN. "THE "AC TYPE" FOR POLYMERIZED HMA MIXES SHALL BE "SBS/SBR PG 76-22" AND FOR NON-POLYMERIZED HMA THE "AC TYPE" SHALL BE "PG 64-22" UNLESS MODIFIED BY DISTRICT ONE SPECIAL PROVISIONS" FOR USE OF RECYCLED MATERIALS SEE SPECIAL PROVISIONS


IMPORTANT!


FULL SIZE PLANS HAVE BEEN PREPARED USING STANDARD ENGINEERING SCALES. REDUCED SIZED PLANS WILL NOT CONFORM TO STANDARD SCALES INDICATED IN TITLE BLOCK.


Frank Novotny & Associates, Inc. 825 Midway Drive • Willowbrook, IL • 60527 • Telephone: (630) 887-8640 • Fax: (630) 887-013. ILLINOIS PROFESSIONAL DESIGN FIRM NO. 184-000928


TOTAL SHEE SHEETS NO. **TYPICAL CROSS SECTIONS &** 09-00065-00-RS COOK 17 4 **HOT-MIX ASPHALT MIXTURE REQUIREMENTS** CONTRACT NO. 61D45 SCALE: 1"=5' SHEET NO. OF SHEETS STA. FED. ROAD DIST. NO. ILLINOIS FED. AID PROJECT

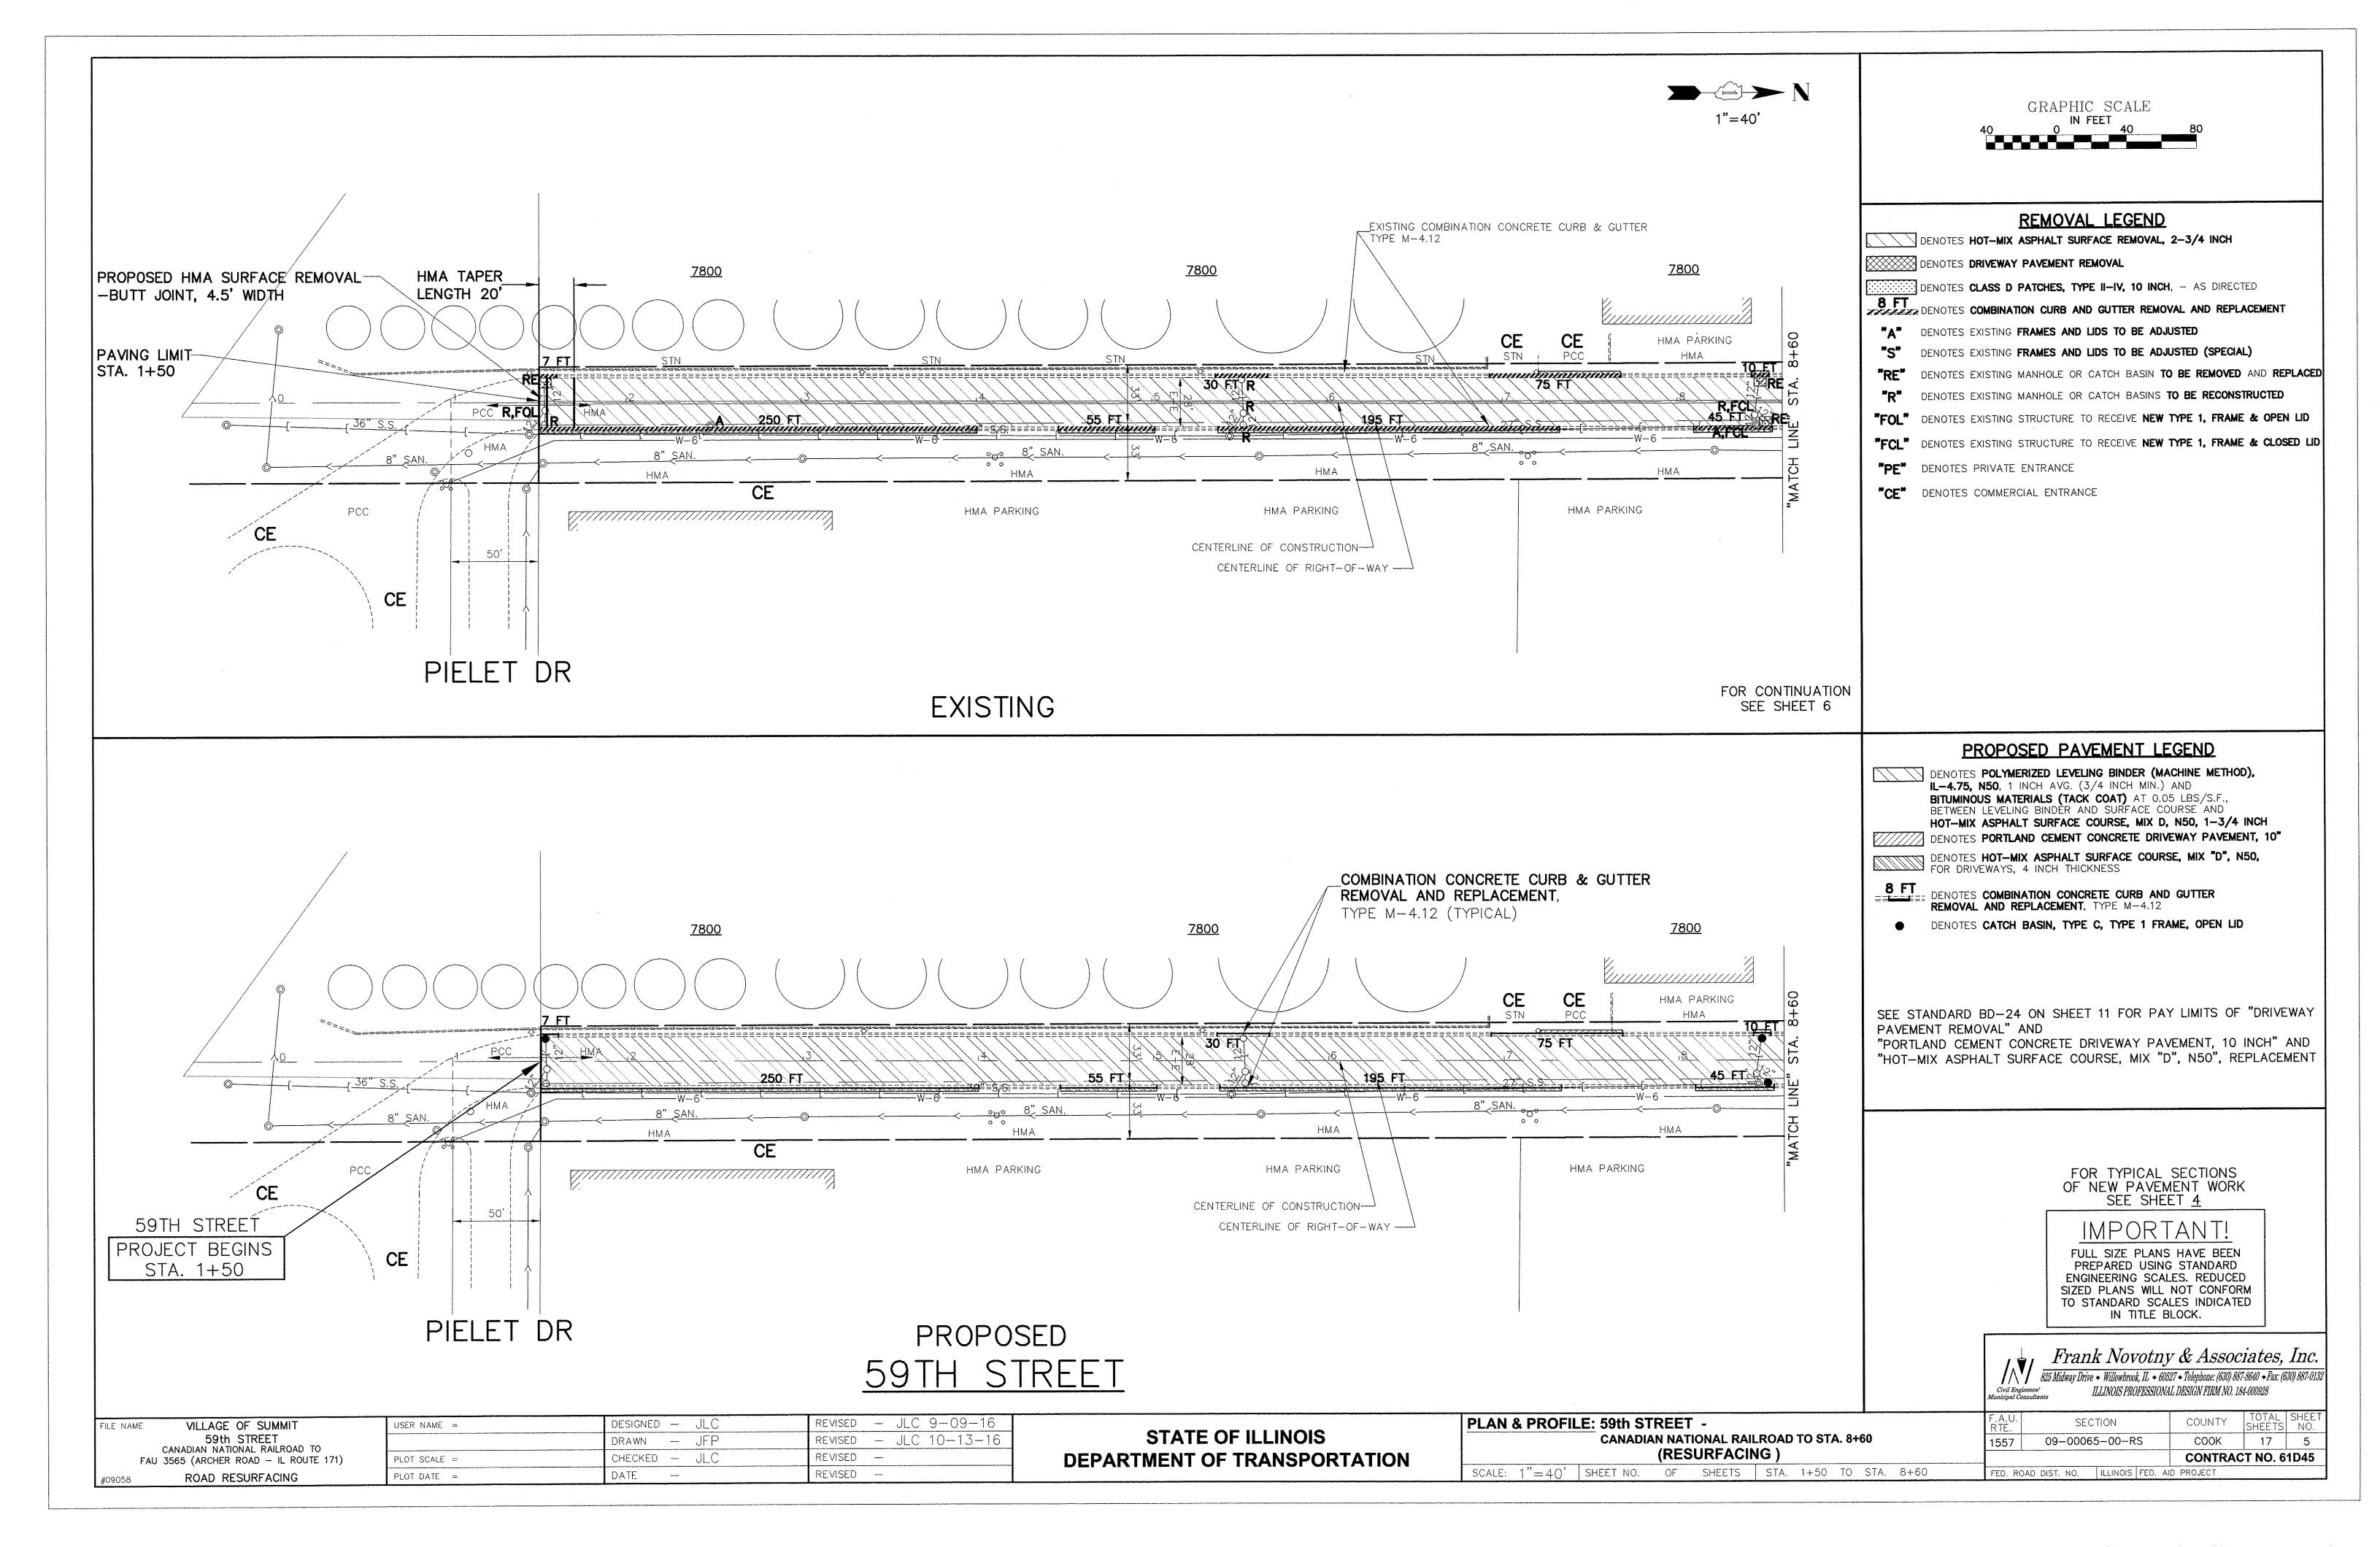

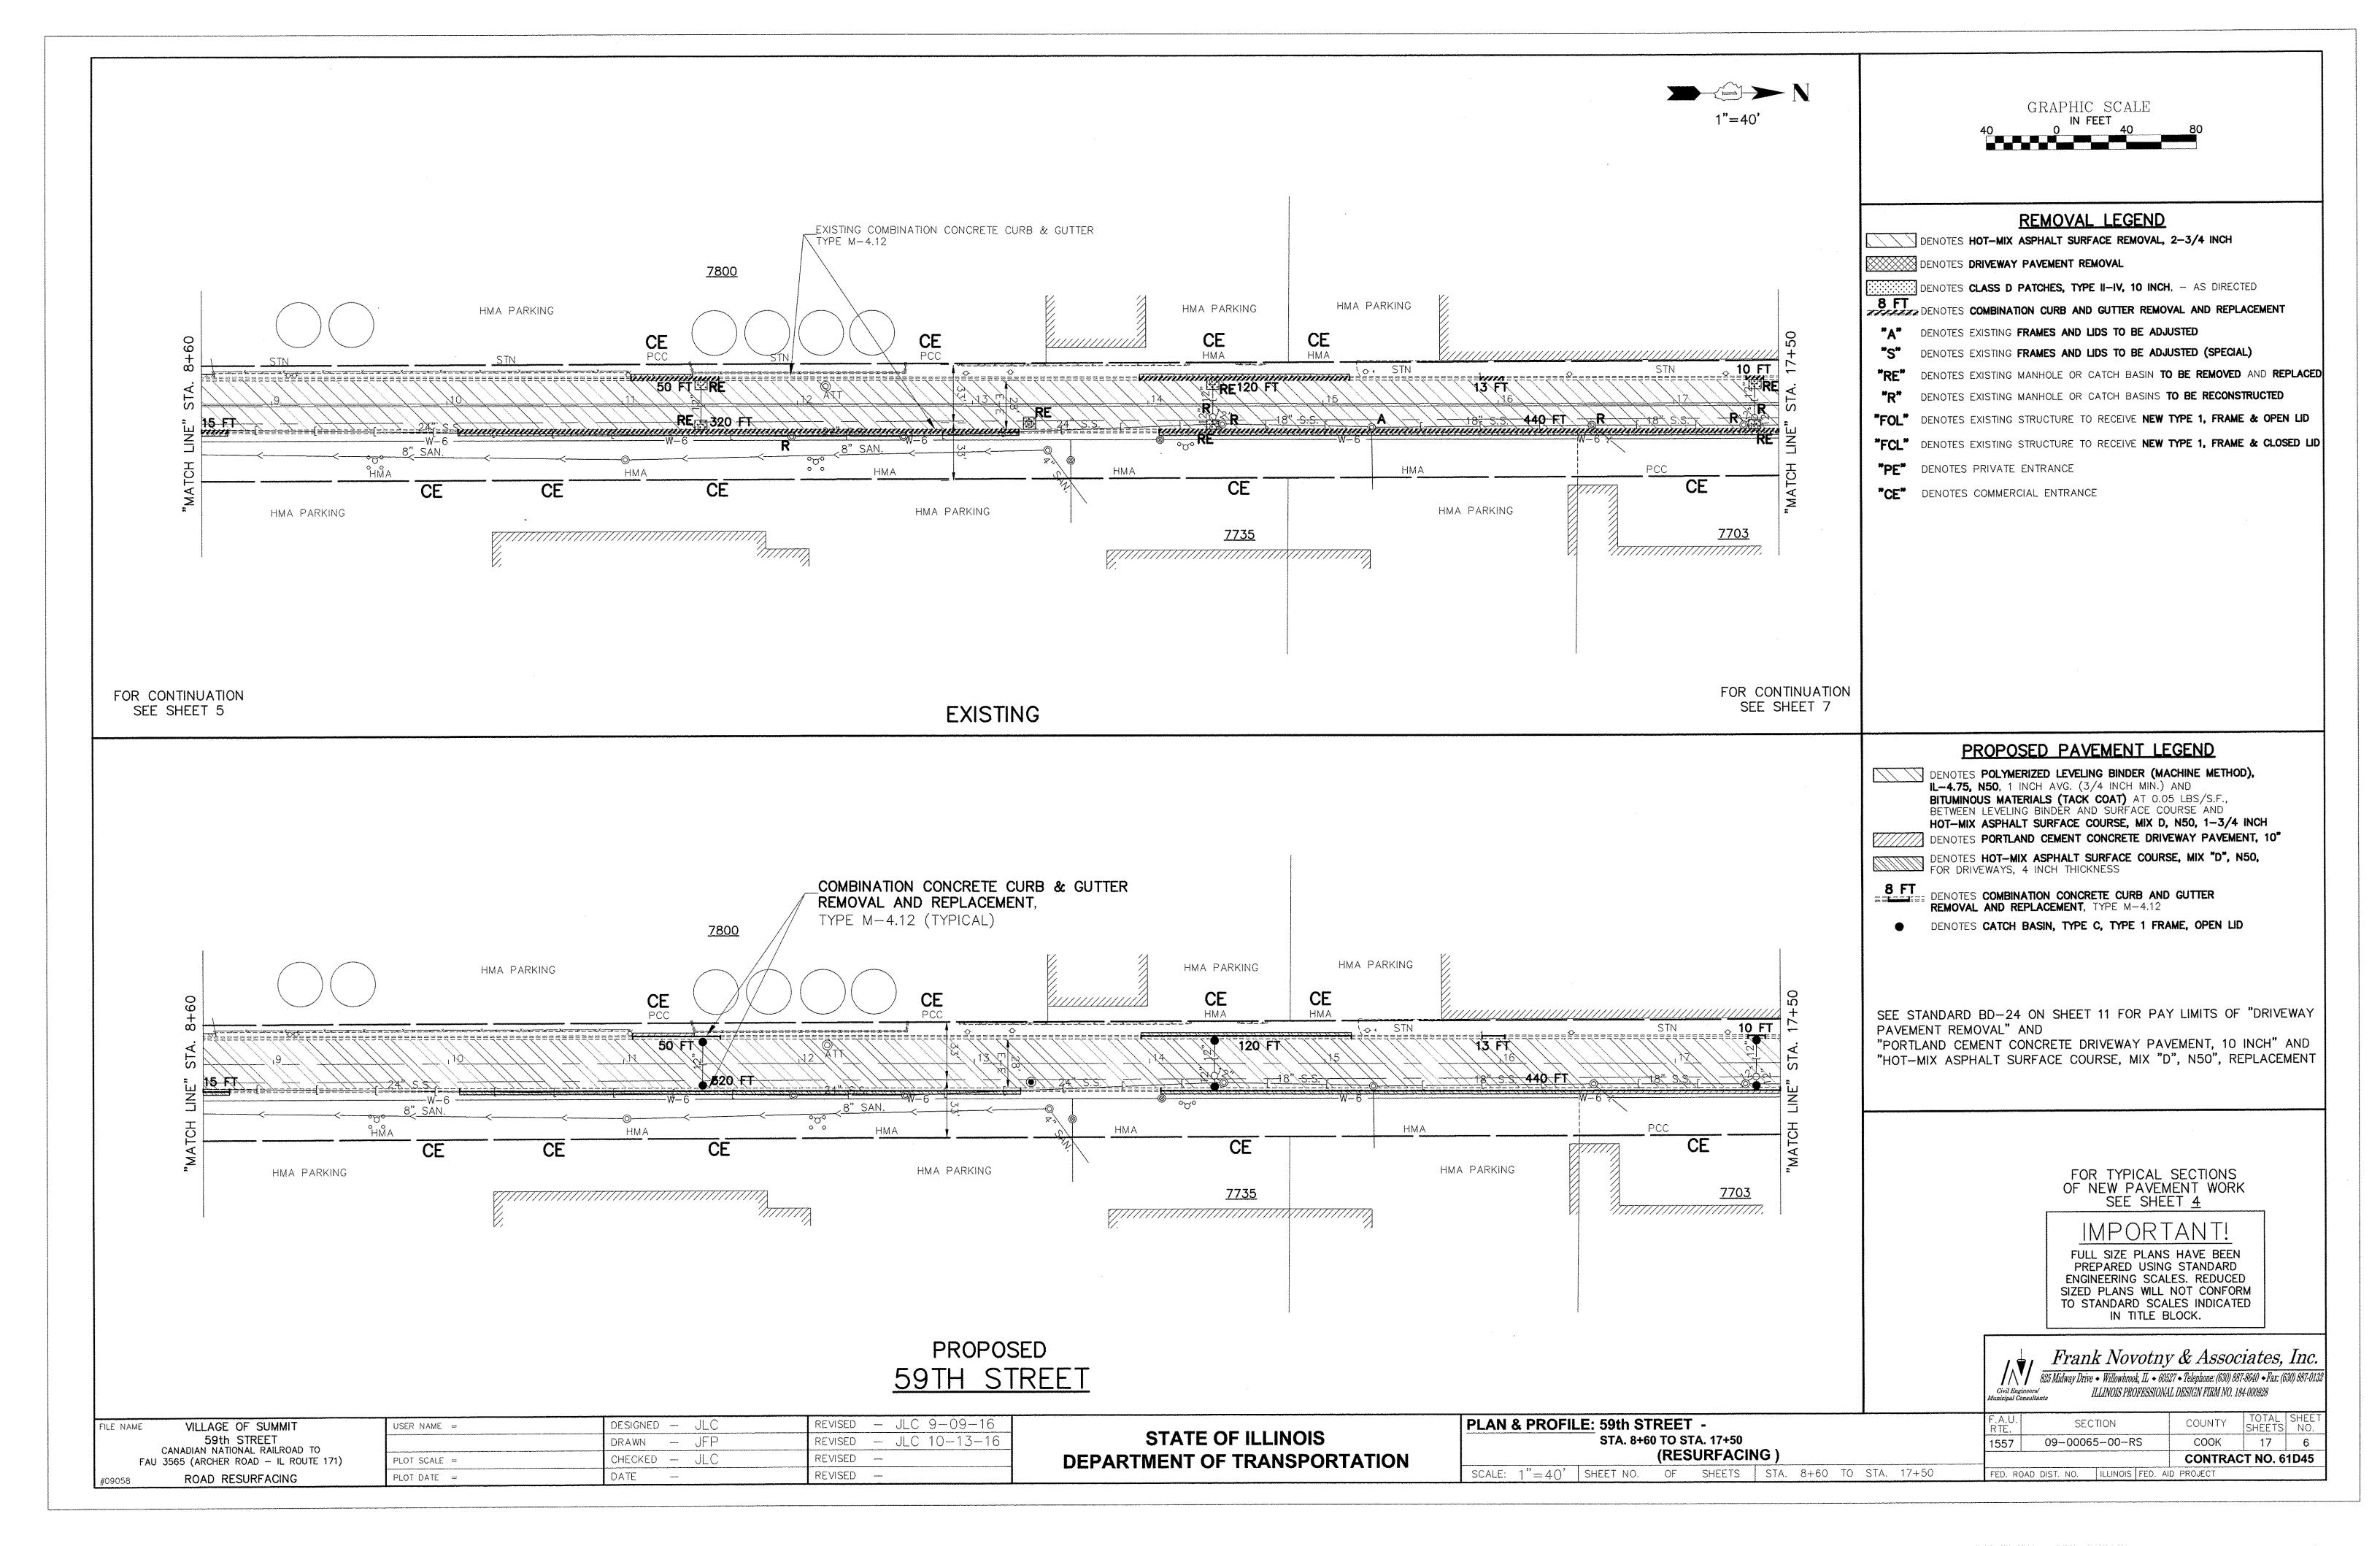

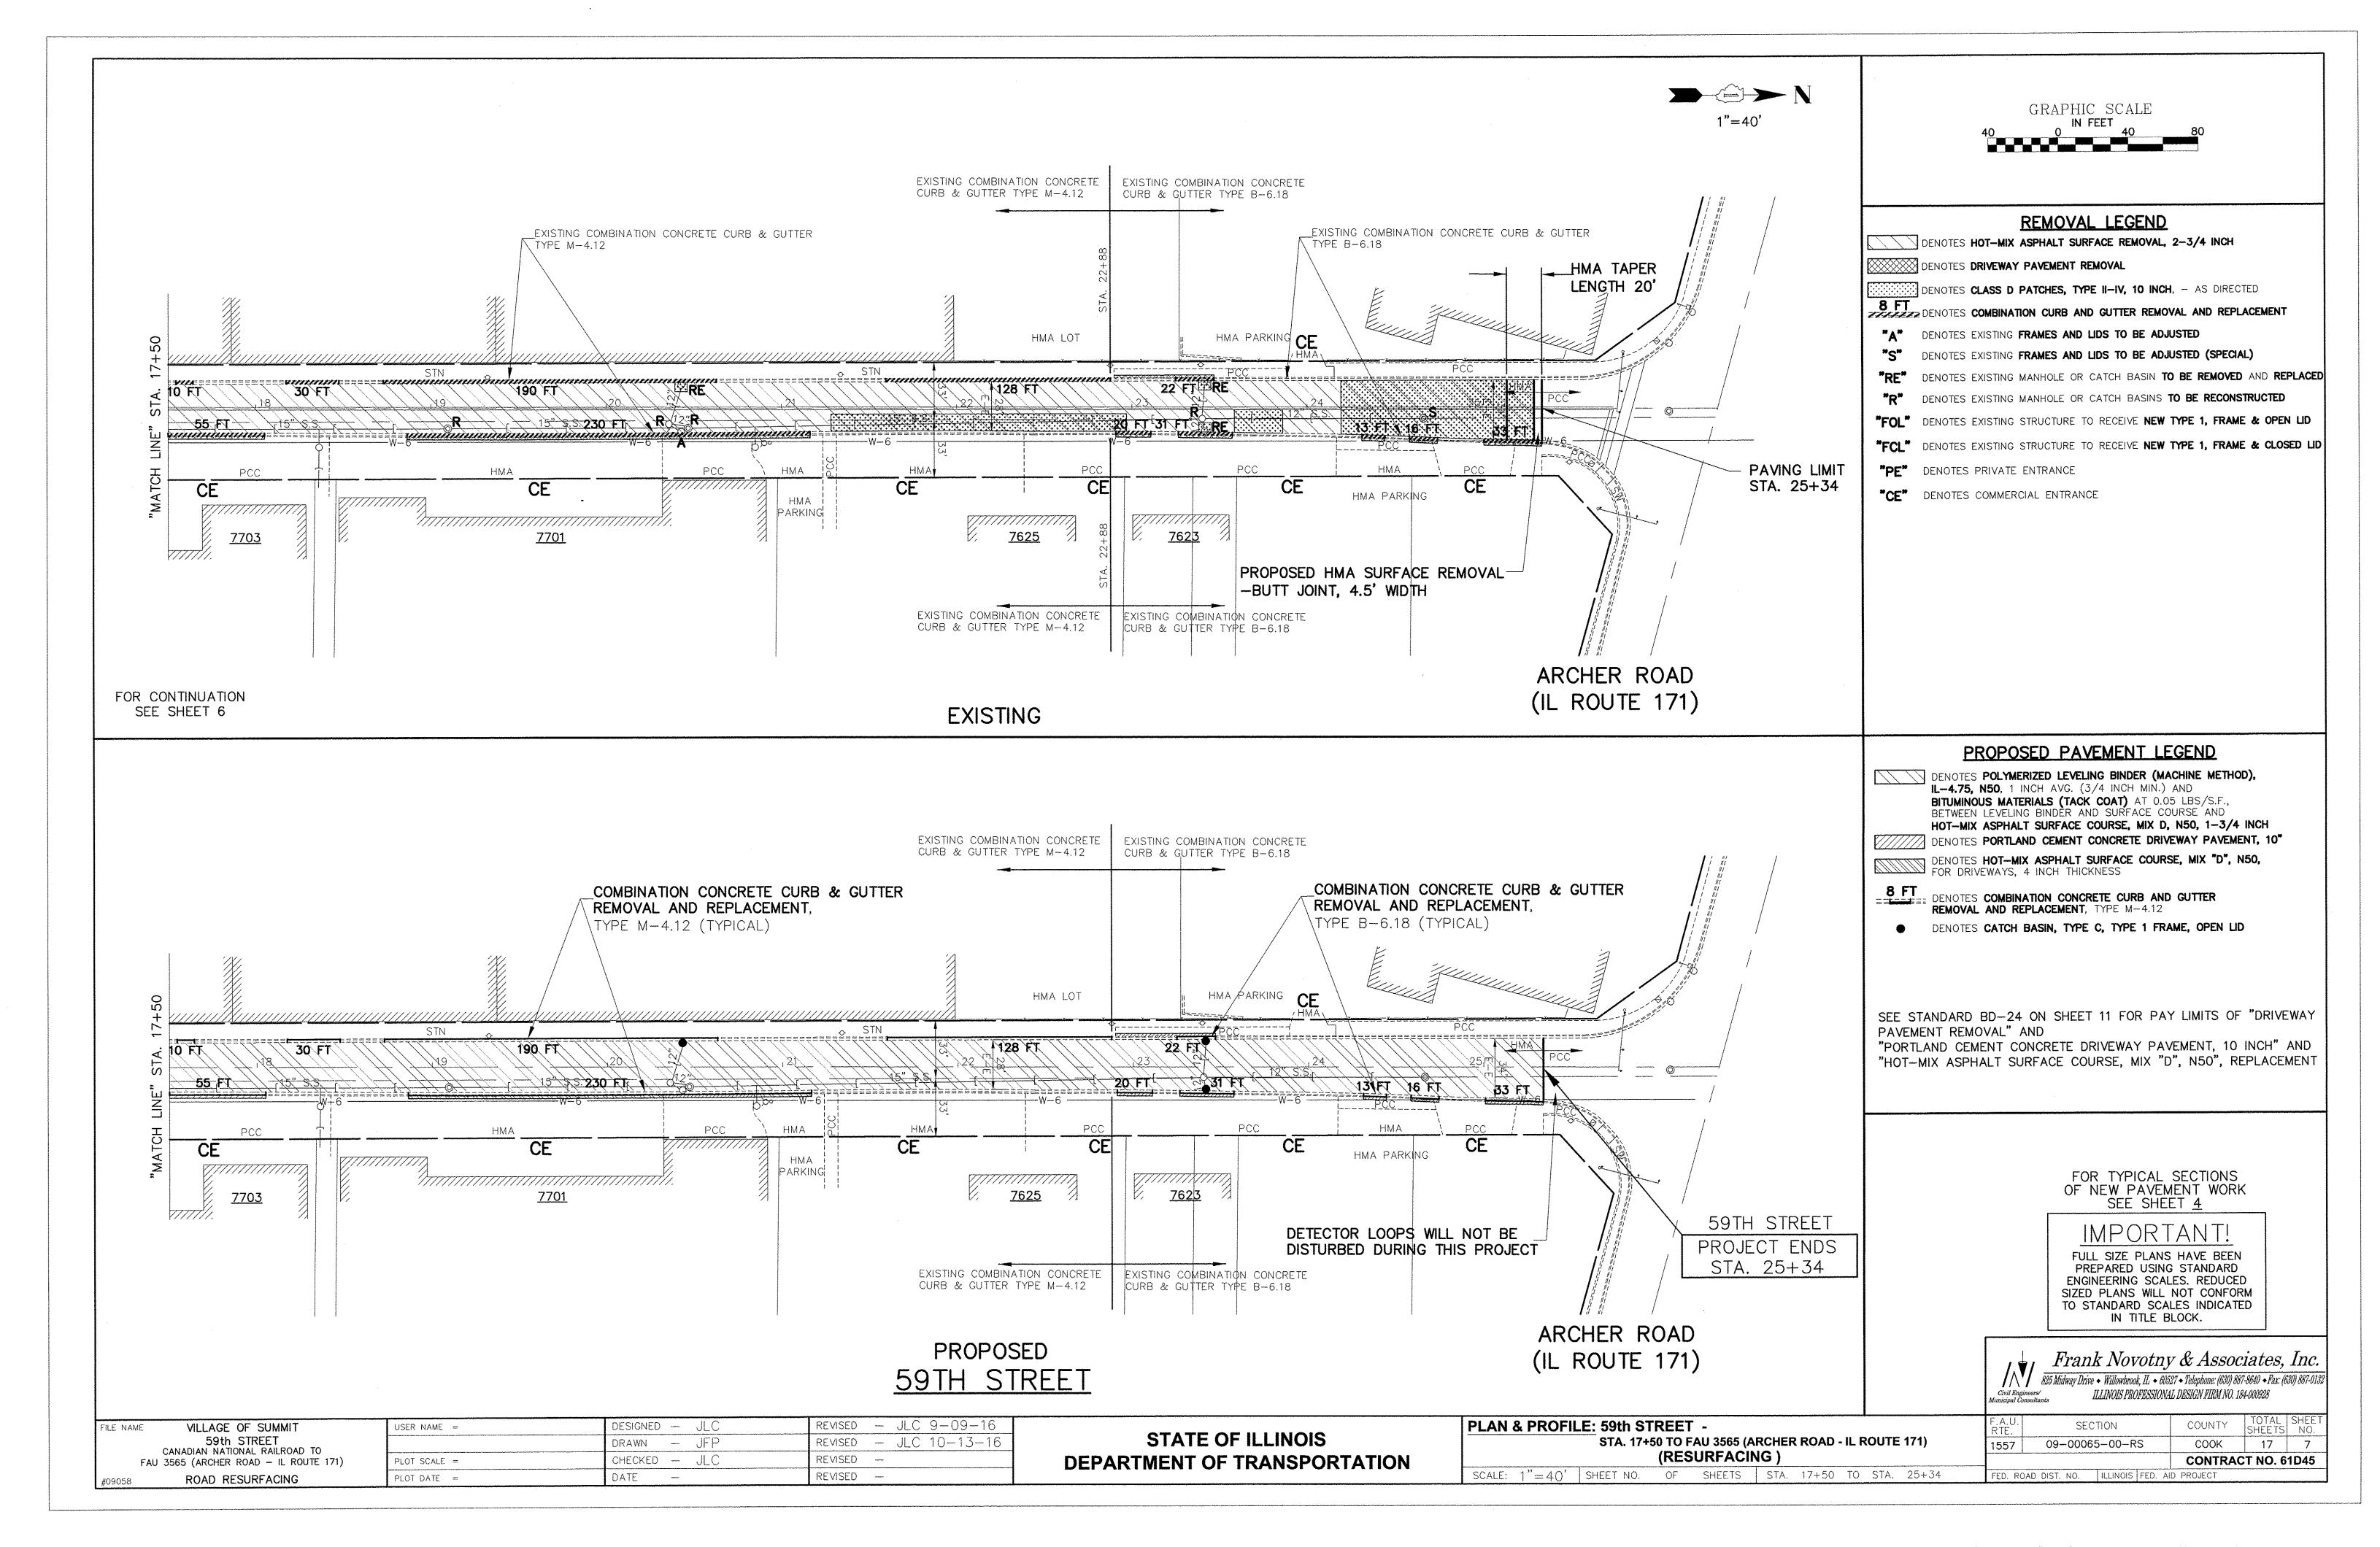

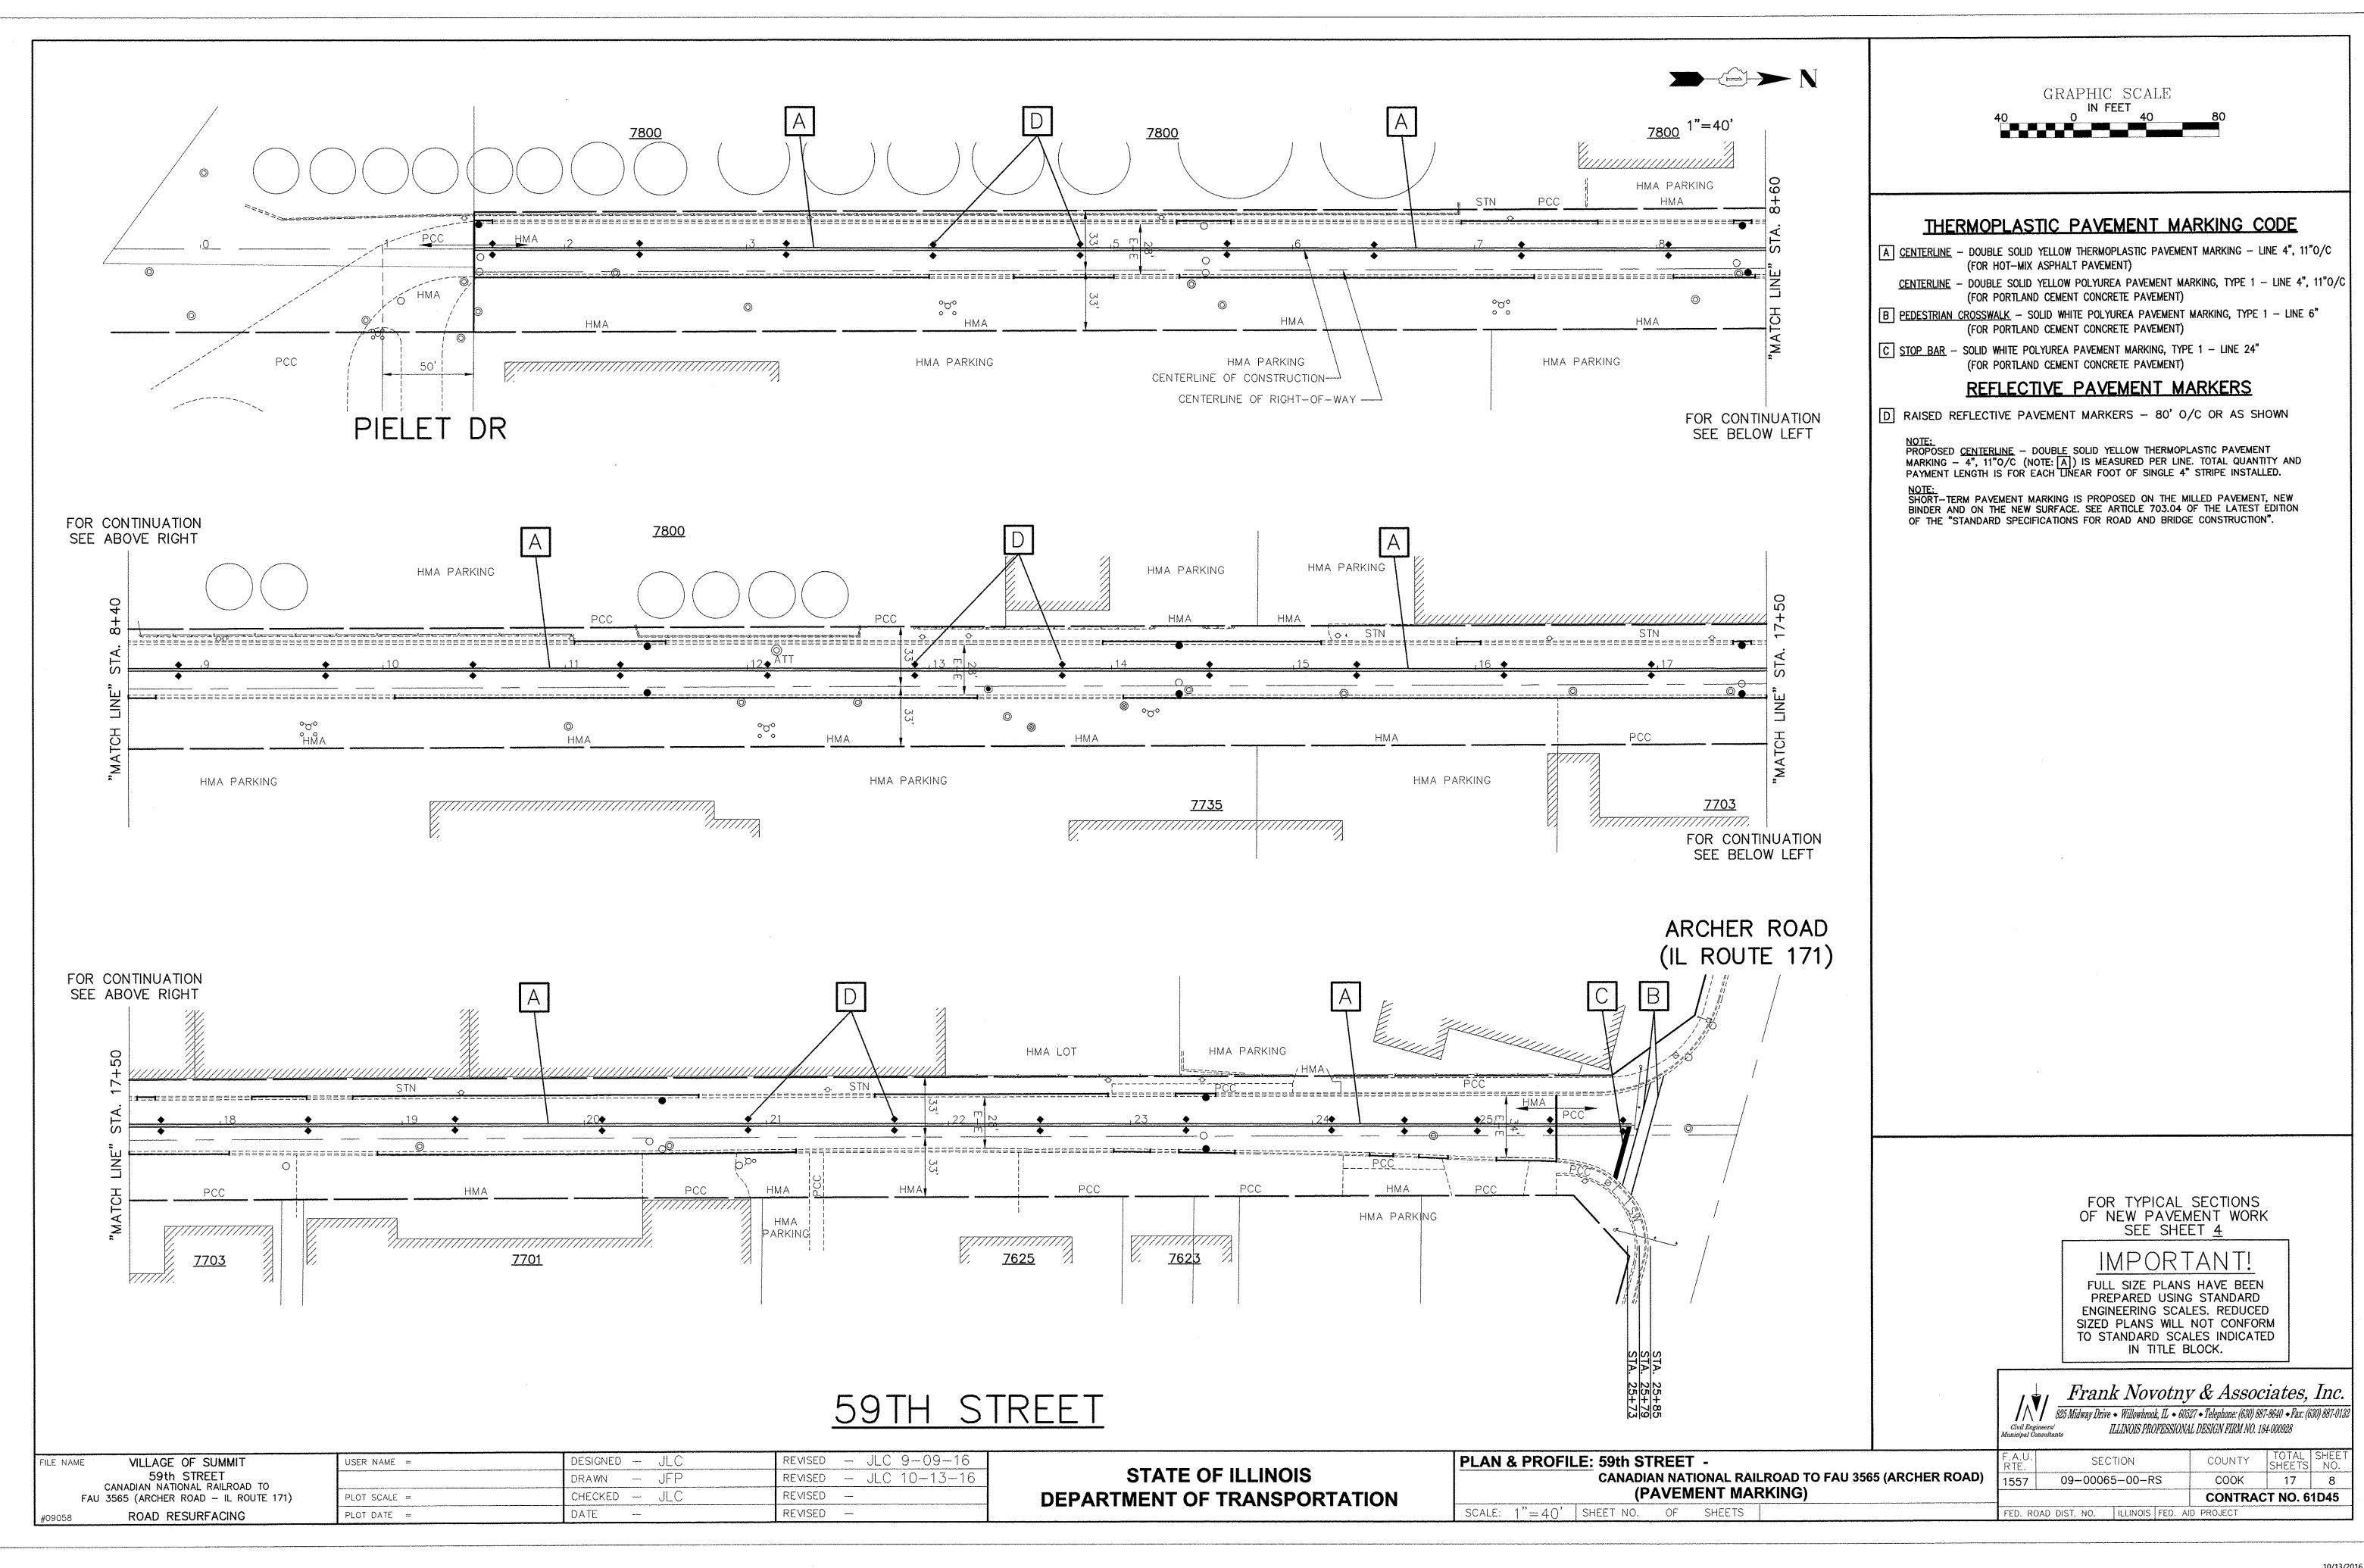

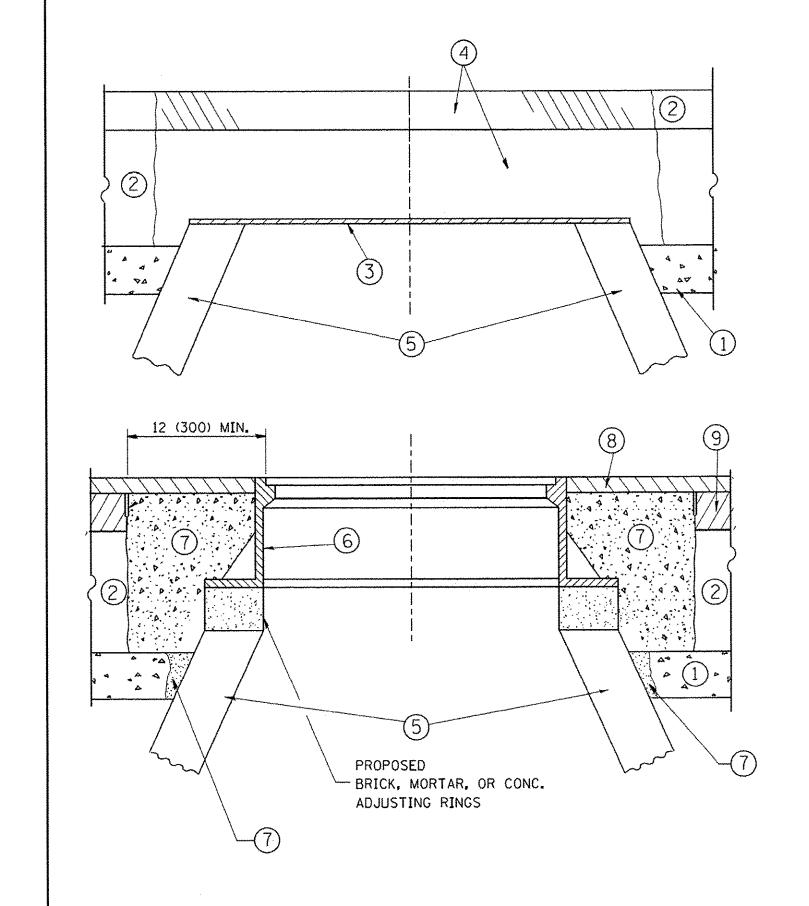

EXISTING BROKEN FRAMES AND LIDS SHALL BE REMOVED AND DISPOSED OF BY THE CONTRACTOR AND SHALL BE REPLACED AS DIRECTED BY THE ENGINEER. REPLACEMENT FRAMES AND LIDS WILL BE PAID FOR IN ACCORDANCE WITH ARTICLE 109.04 OF THE STANDARD SPECIFICATIONS UNLESS A SEPARATE PAY ITEM HAS BEEN PROVIDED.

IF THE EXISTING LIDS ARE OPEN, THE FRAME WILL BE ADJUSTED TO THE ELEVATION OF THE MILLED PAVEMENT SURFACE PRIOR TO THE MILLING OPERATION. THE FRAME WILL NOT BE REMOVED AND COVERED BY THE METAL PLATE.

CITY OF CHICAGO CASTINGS ARE THE PROPERTY OF THE CITY AND THE CONTRACTOR SHALL NOTIFY THE CITY FOR REMOVAL AND DISPOSITION OF THE CASTINGS.

THE METAL PLATE USED TO COVER THE STRUCTURE SHALL REMAIN THE PROPERTY OF THE CONTRACTOR.

WHEN STRUCTURES ARE TO BE ADJUSTED OR RECONSTRUCTED, THE LOWERING AND RAISING OF THE FRAMES AND LIDS WILL NOT BE PAID FOR SEPARATELY BUT WILL BE INCLUDED IN THE COST OF THE CORRESPONDING PAY ITEM.

CONSTRUCTION PROCEDURES

STAGE 1 (BEFORE PAVEMENT MILLING)

- A) REMOVE A MINIMUM OF 12 (300) OF THE PAVEMENT FROM AROUND THE STRUCTURE.
- B) REMOVE THE EXISTING FRAME AND LID FROM THE STRUCTURE.
- C) COVER THE STRUCTURE OPENING WITH A 36 (900) DIAMETER METAL PLATE.
- D) BACKFILL WITH CRUSHED STONE AND A MINIMUM $1\frac{1}{2}$ (40) THICK HMA SURFACE MIX APPROVED BY THE ENGINEER.

STAGE 2 (AFTER PAVEMENT MILLING)

- A) REMOVE THE HMA SURFACE MIX AND CRUSHED STONE.
- B) INSTALL THE FRAME AND LID; ADJUST THE FRAME TO ITS FINAL SURFACE ELEVATION.
- C) THE SURROUNDING SPACE SHALL BE FILLED WITH CLASS PP-1*
 CONCRETE TO THE ELEVATION OF THE SURFACE OF THE EXISTING
 BASE COURSE OR THE BINDER COURSE.
- *UNLESS OTHERWISE SPECIFIED IN THE PLANS.

THE PROCEDURE EXPLAINED ABOVE SHALL CONFORM TO THE APPLICABLE PORTIONS OF SECTIONS 353, 406, 602, AND 603 OF THE STANDARD SPECIFICATIONS EXCEPT THAT "THE CONTRACTOR SHALL ADJUST THE STRUCTURES TO THE FINISHED PAVEMENT ELEVATION NO MORE THAN 5 CALENDAR DAYS PRIOR TO PLACEMENT OF THE FINAL LIFT OF SURFACE UNLESS APPROVED BY THE ENGINEER."

LEGEND

- 1 SUB-BASE GRANULAR MATERIAL
- 6 FRAME AND LID (SEE NOTES)
- 2 EXISTING PAVEMENT
- 7 CLASS PP-1* CONCRETE
- 3) 36 (900) DIAMETER METAL PLATE

 4) PROPOSED CRUSHED STONE AND
 HMA SURFACE MIX
- 8 PROPOSED HMA SURFACE COURSE
- 5 EXISTING STRUCTURE
- (9) PROPOSED HMA BINDER COURSE

LOCATION OF STRUCTURES:

THE CONTRACTOR WILL BE REQUIRED TO KEEP A RECORD OF THE LOCATIONS OF THE BURIED STRUCTURES ACCORDING TO THE STATION AND DISTANCE LEFT OR RIGHT OF THE CENTERLINE OF PAVEMENT. UPON COMPLETION OF THE WORK, THE CONTRACTOR WILL DELIVER THE RECORD TO THE ENGINEER.

BASIS OF PAYMENT:

REMOVING FRAMES AND LIDS ON DRAINAGE AND UTILITY STRUCTURES IN THE PAVEMENT PRIOR TO MILLING, AND ADJUSTING TO FINAL GRADE PRIOR TO PLACING THE SURFACE COURSE, WILL BE PAID FOR AT THE CONTRACT UNIT PRICE EACH FOR "FRAMES AND LIDS TO BE ADJUSTED (SPECIAL)."

THIS WORK WILL NOT BE PAID FOR WHEN DRAINAGE AND UTILITY STRUCTURES ARE SPECIFIED FOR PAYMENT AS STRUCTURE RECONSTRUCTION.

NEW FRAMES AND LIDS, WHEN SPECIFIED. WILL BE PAID FOR SEPARATELY.

DETAILS FOR FRAMES AND LIDS ADJUSTMENT WITH MILLING

ALL DIMENSIONS ARE IN INCHES (MILLIMETERS) UNLESS OTHERWISE SHOWN


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	SCALE = 1968.5000 '/ m	CHECKED -	REVISED - R. BORO 03-09-11
PLOT I	DATE = 12/6/2011	DATE - 10-25-94	REVISED - R. BORO 12-06-11

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STATE OF ILLINOIS
DEPARTMENT OF TRANSPORTATION

DETAILS FOR
FRAMES AND LIDS ADJUSTMENT WITH MILLING

SCALE: NONE SHEET NO. 1 OF 1 SHEETS STA. TO STA.

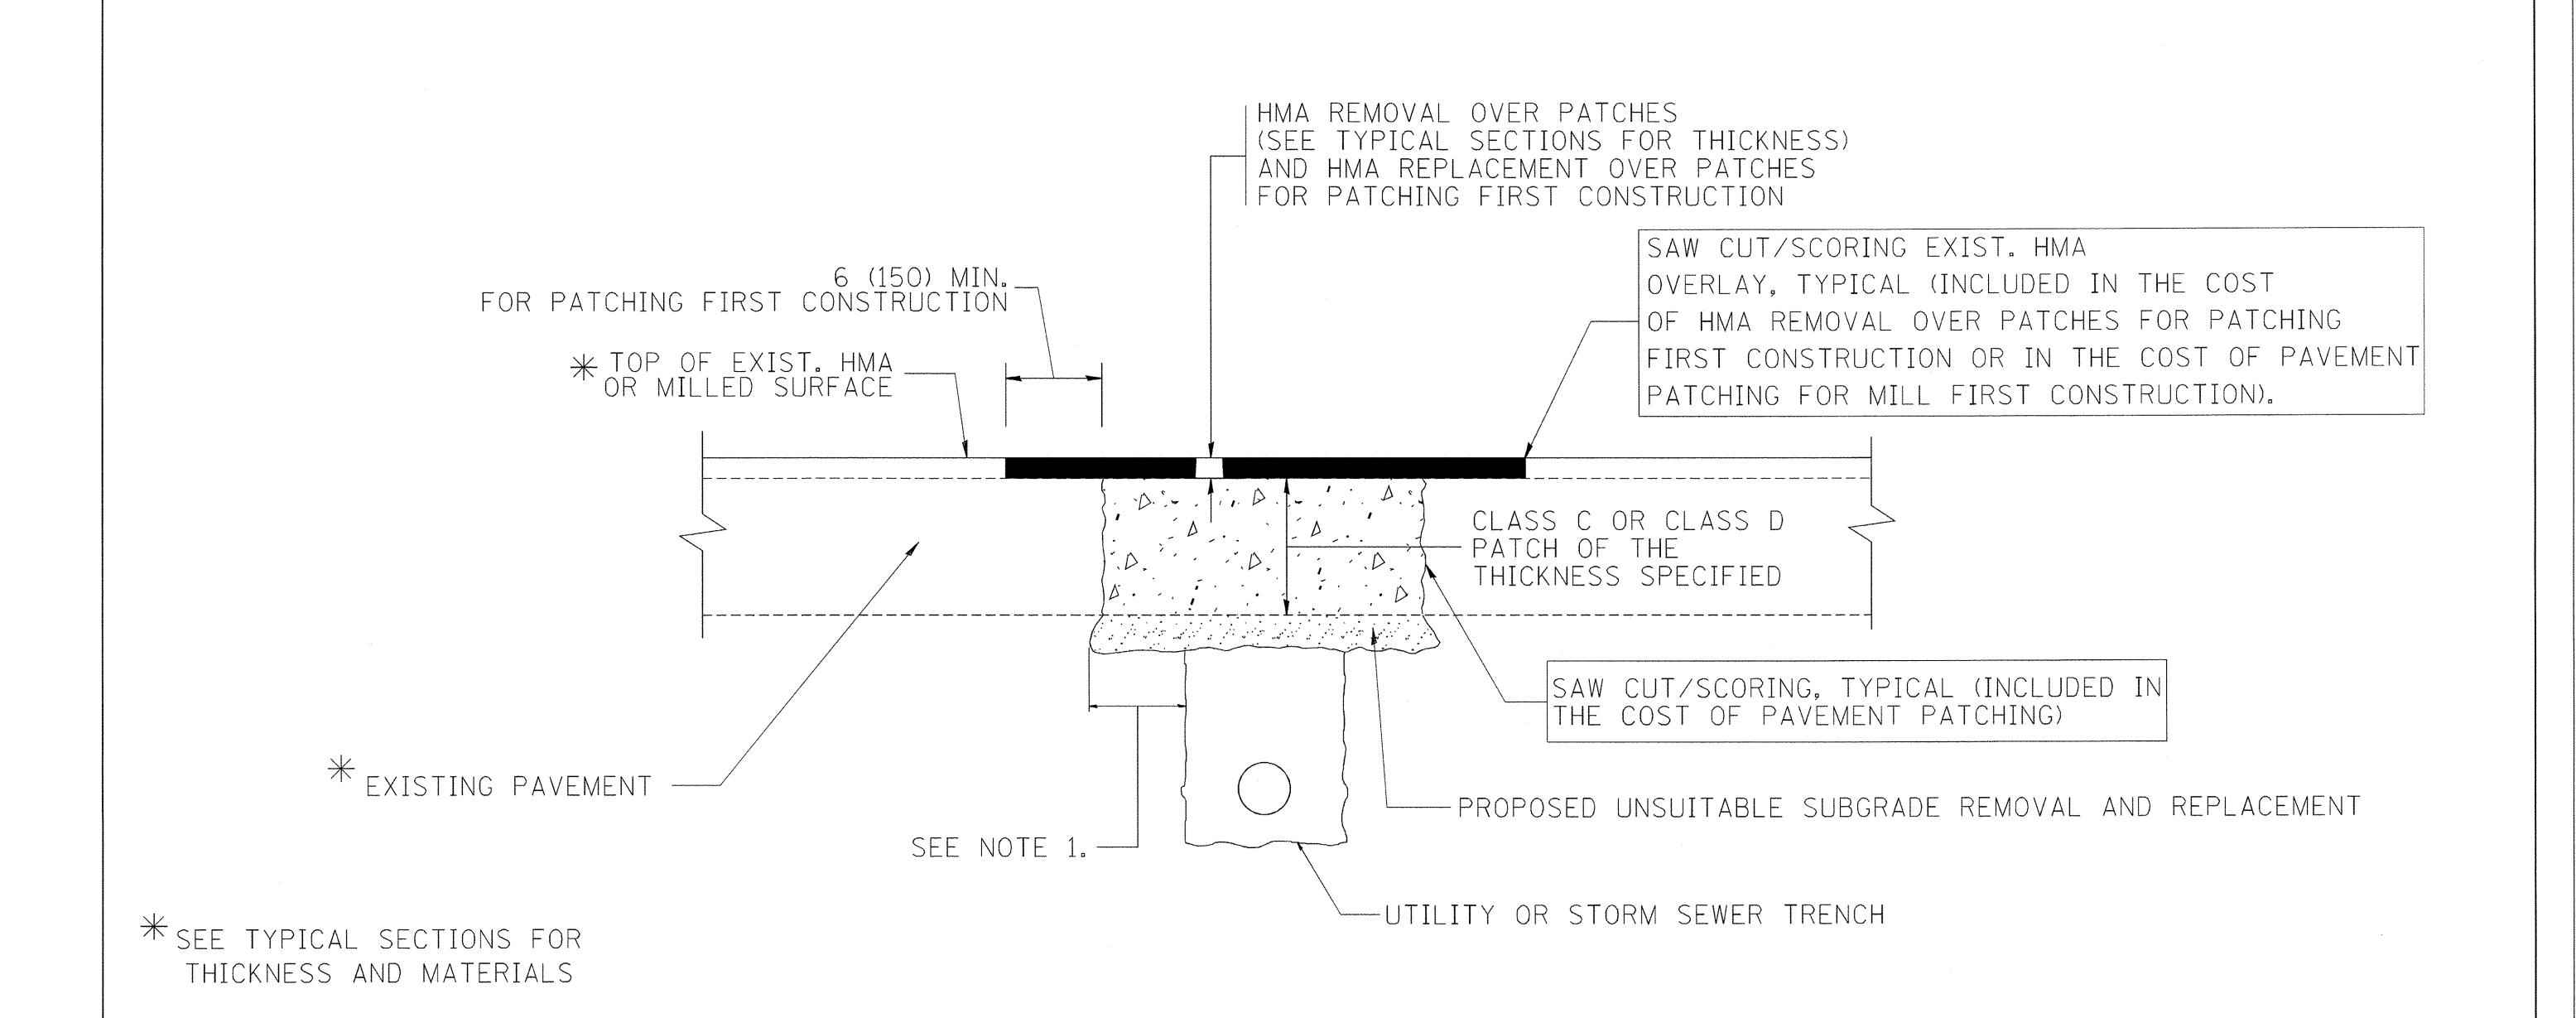

- 1. THE WIDTH OF THE FULL DEPTH PATCH OVER A TRENCH SHALL BE 12 (300) WIDER ON EACH SIDE OF THE TRENCH.
- 2. FOR METHOD OF MEASUREMENT AND BASIS OF PAYMENT, SEE RECURRING SPECIAL PROVISION "PATCHING WITH HOT-MIX ASPHALT OVERLAY REMOVAL".

SEQUENCE OF CONSTRUCTION (PATCHING FIRST)


- 1. REMOVE THE EXISTING HMA MATERIAL OVER THE AREA TO BE PATCHED.
- 2. REMOVE AND REPLACE WITH CLASS C OR D PATCH.
- 3. REPLACE HMA MATERIAL OVER THE AREA TO BE PATCHED.

SEQUENCE OF CONSTRUCTION (MILLING FIRST)

- 1. MILL HMA FIRST IF THERE IS AT LEAST 4/2 INCHES OR MORE OF HMA MATERIAL ON TOP OF THE EXISTING PAVEMENT OR IF THE PAVEMENT IS FULL DEPTH HMA. A MINIMUM OF 2 INCHES OF HMA MATERIAL SHALL BE IN PLACE AFTER MILLING.
- 2. REMOVE AND REPLACE WITH FULL DEPTH CLASS D PATCHES TO TOP OF MILLED SURFACE.

ALL DIMENSIONS ARE IN INCHES (MILLIMETERS) UNLESS OTHERWISE SHOWN.


FILE NAME =	USER NAME = bauerdl	DESIGNED - R. SHAH	REVISED - A. ABBAS 04-27-98		PAVEMENT PATCHING FOR	F.A.U. SECTION COUNTY TOTAL SHEET SHEETS NO.
c:\projects\diststd22x34\bd22.dgn		DRAWN -	REVISED - R. BORO 01-01-07	STATE OF ILLINOIS	HMA SURFACED PAVEMENT	1557 09-00065-00-RS COOK 17 10
	PLOT SCALE = 50.000 '/ IN.	CHECKED -	REVISED - R. BORO 09-04-07	DEPARTMENT OF TRANSPORTATION		BD400-04 (BD-22) CONTRACT NO. 61D45
	PLOT DATE = 10/27/2008	DATE - 10-25-94	REVISED - K. ENG 10-27-08		SCALE: NONE SHEET NO. 1 OF 1 SHEETS STA. TO STA.	FED. ROAD DIST. NO. 1 ILLINOIS FED. AID PROJECT M-9003(512)

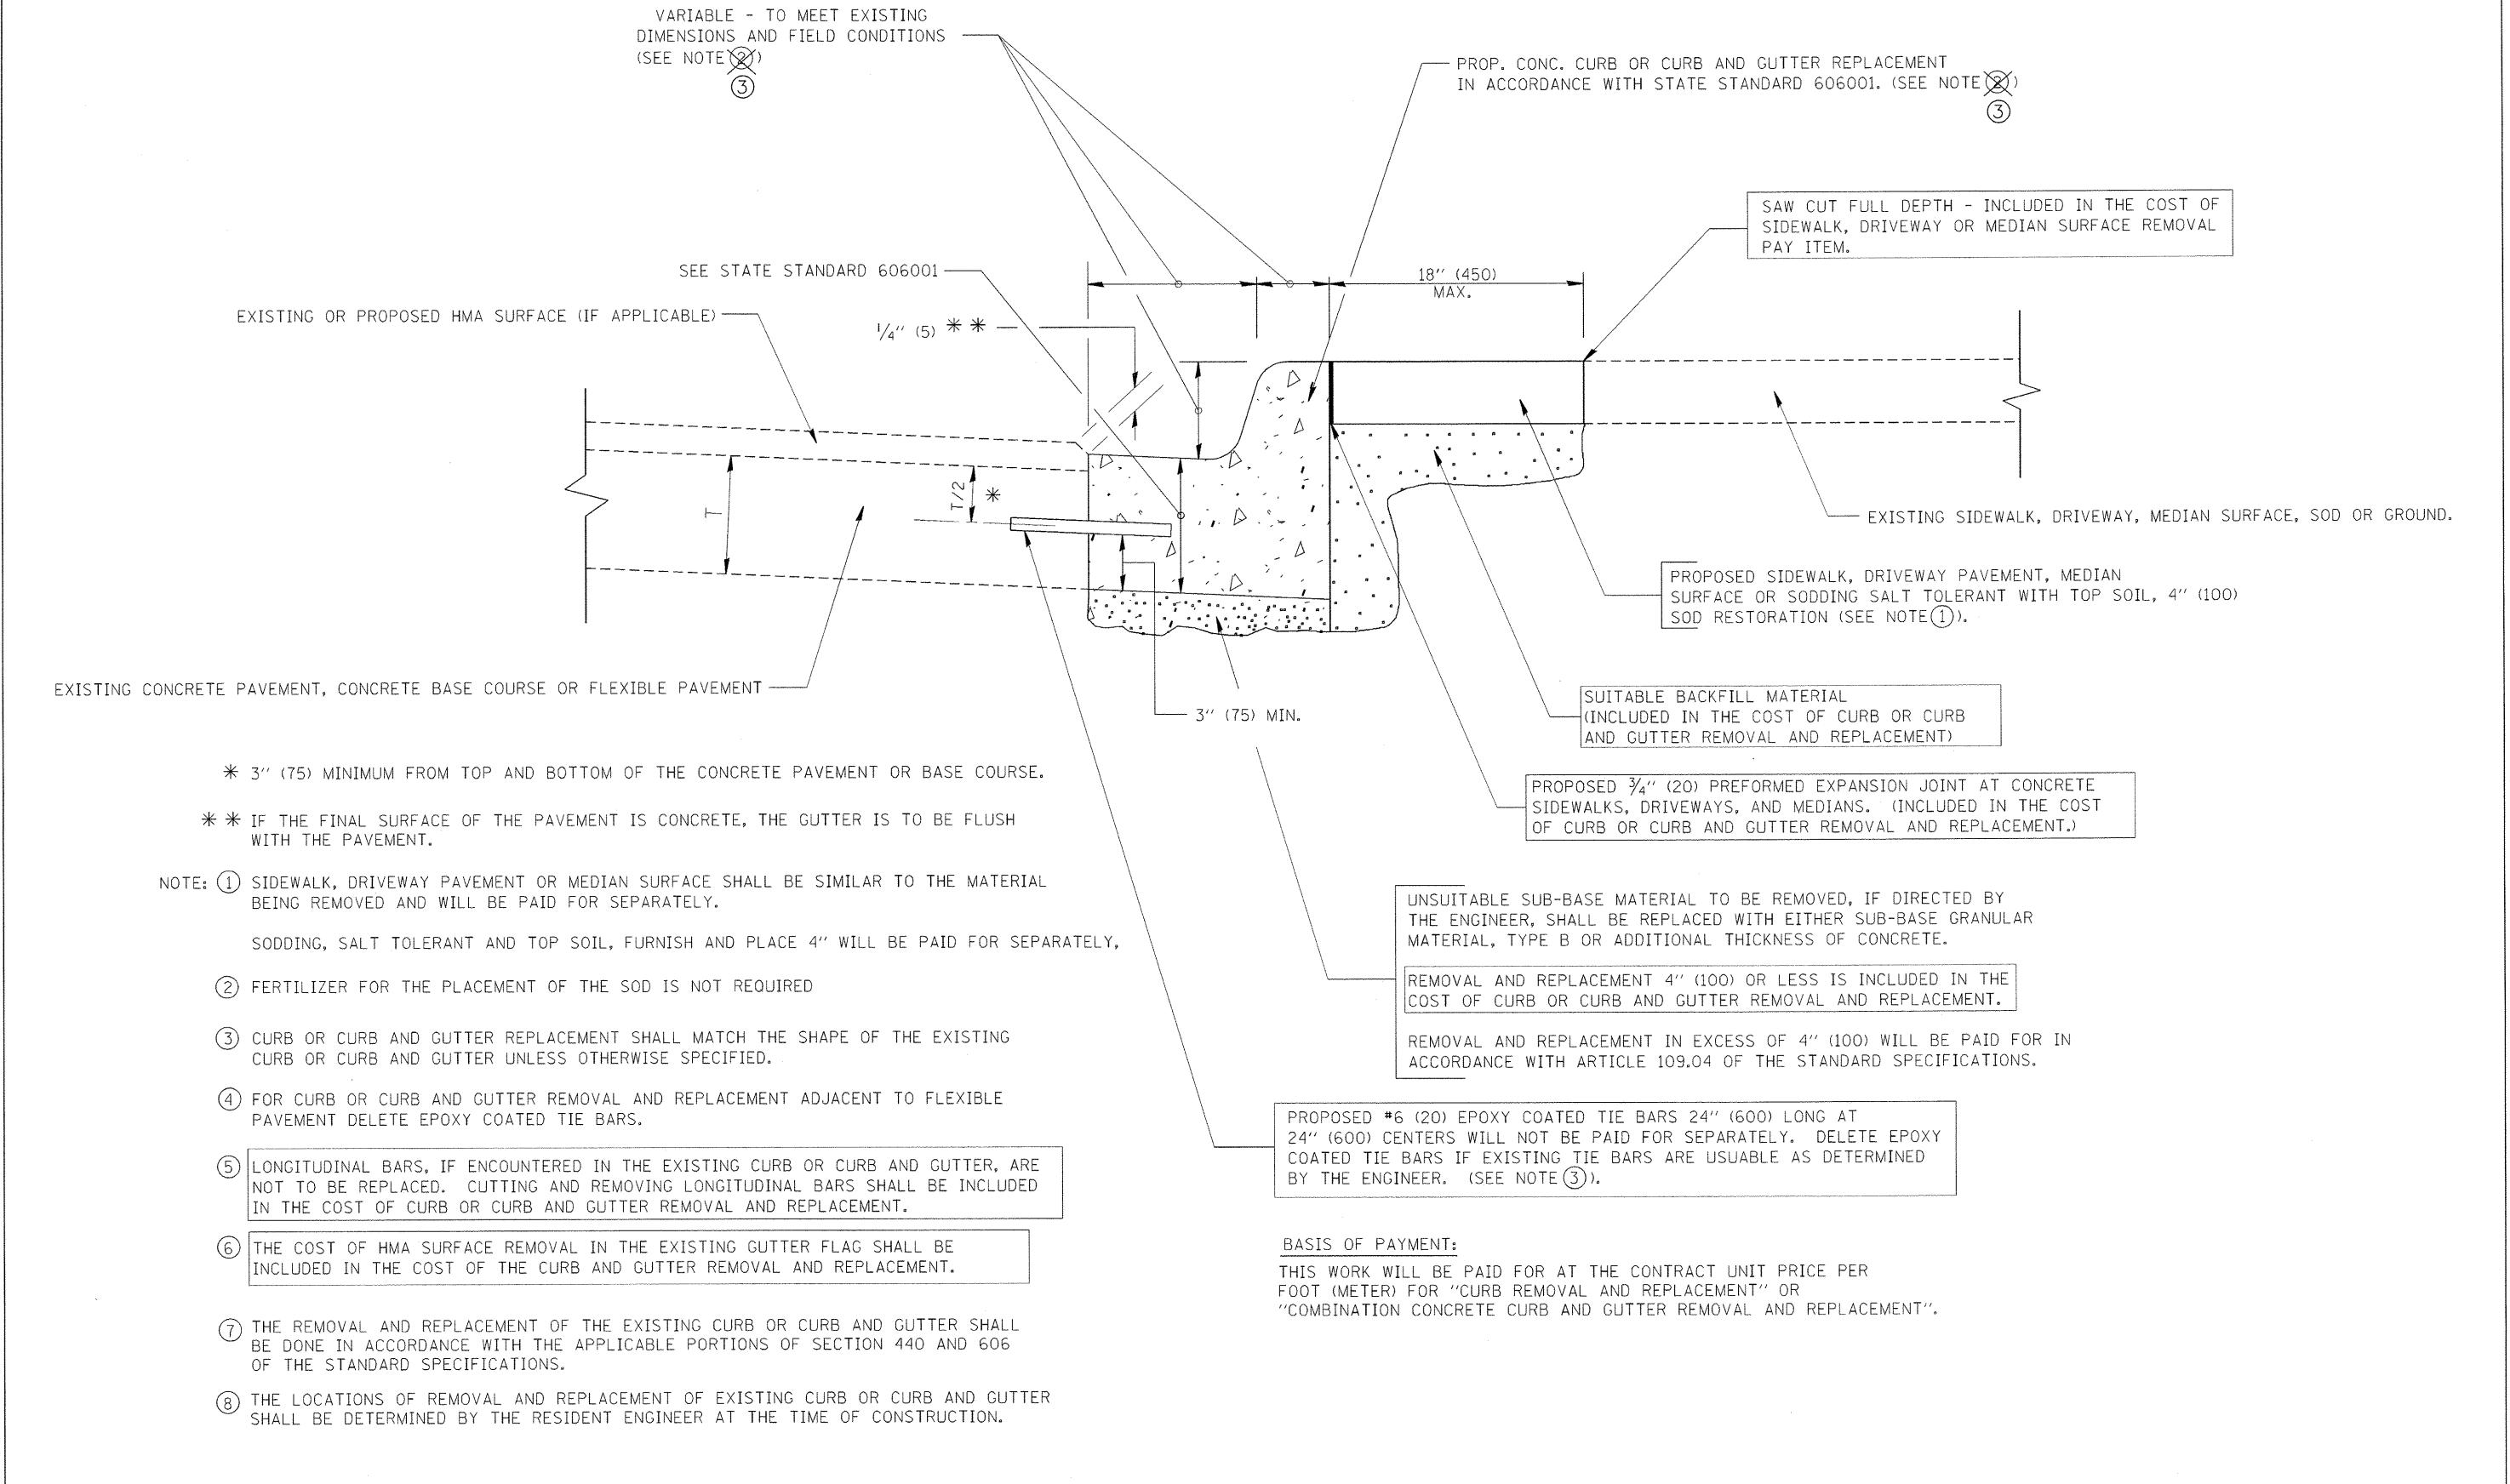

CURB OR CURB AND GUTTER REMOVAL AND REPLACEMENT


ALL DIMENSIONS ARE IN INCHES (MILLIMETERS)
UNLESS OTHERWISE SHOWN.

FILE NAME =	USER NAME = drivakosgn	DESIGNED - A. HOUSEH	REVISED - R. SHAH 10-03-96		CURB OR CURB AND GUTTER	F.A.U. SECTION COUNTY SHEETS NO.	
c:\pw_work\pwidot\drivakosgn\d01	d0108315\bd24.dgn	DRAWN -	- REVISED - A. ABBAS 03-21-97	STATE OF ILLINOIS	REMOVAL AND REPLACEMENT	1557 09-00065-00-RS COOK 17 11	
	PLOT SCALE = 50.000 '/ IN.	CHECKED -	REVISED - M. GOMEZ 01-22-01	DEPARTMENT OF TRANSPORTATION	KEWUVAL AND KEPLACEWENT	BD600-06 (BD-24) CONTRACT NO. 61D45	
	PLOT DATE = 12/15/2009	DATE - 03-11-94	REVISED - R. BORO 12-15-09		SCALE: NONE SHEET NO. 1 OF 1 SHEETS STA. TO STA.	FED. ROAD DIST. NO. 1 ILLINOIS FED. AID PROJECT	

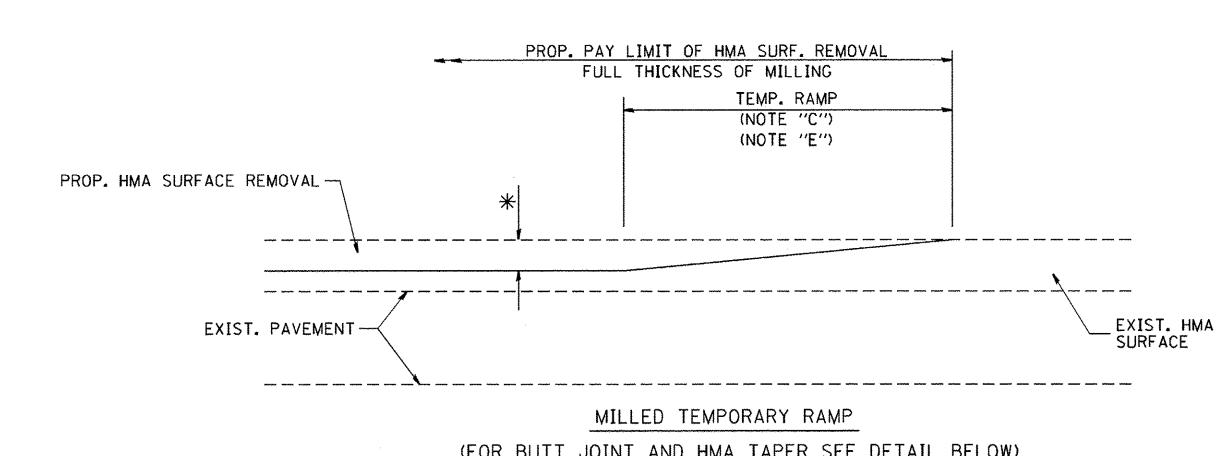

(FOR BUTT JOINT AND HMA TAPER SEE DETAIL BELOW)


OPTION 1

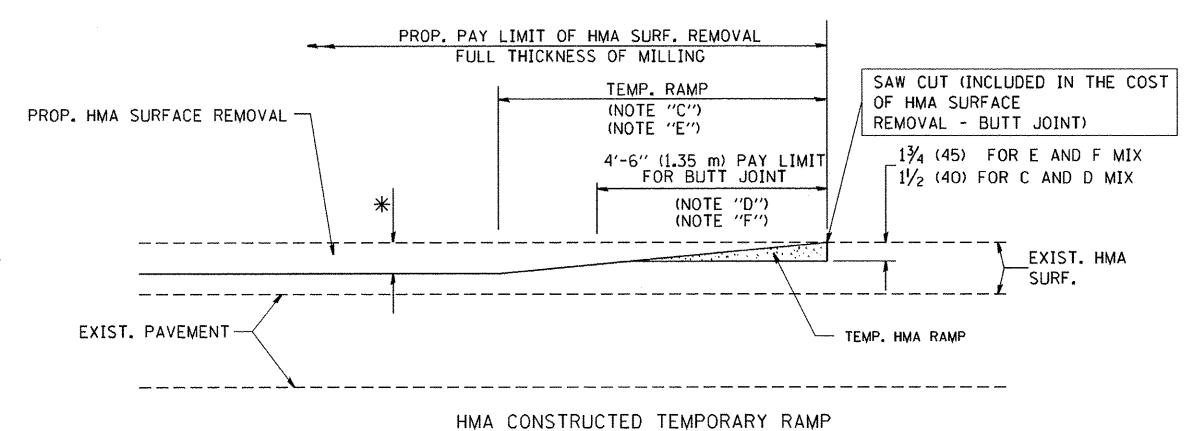


(FOR BUTT JOINT AND HMA TAPER SEE DETAIL BELOW)

OPTION 2

TYPICAL TEMPORARY RAMP

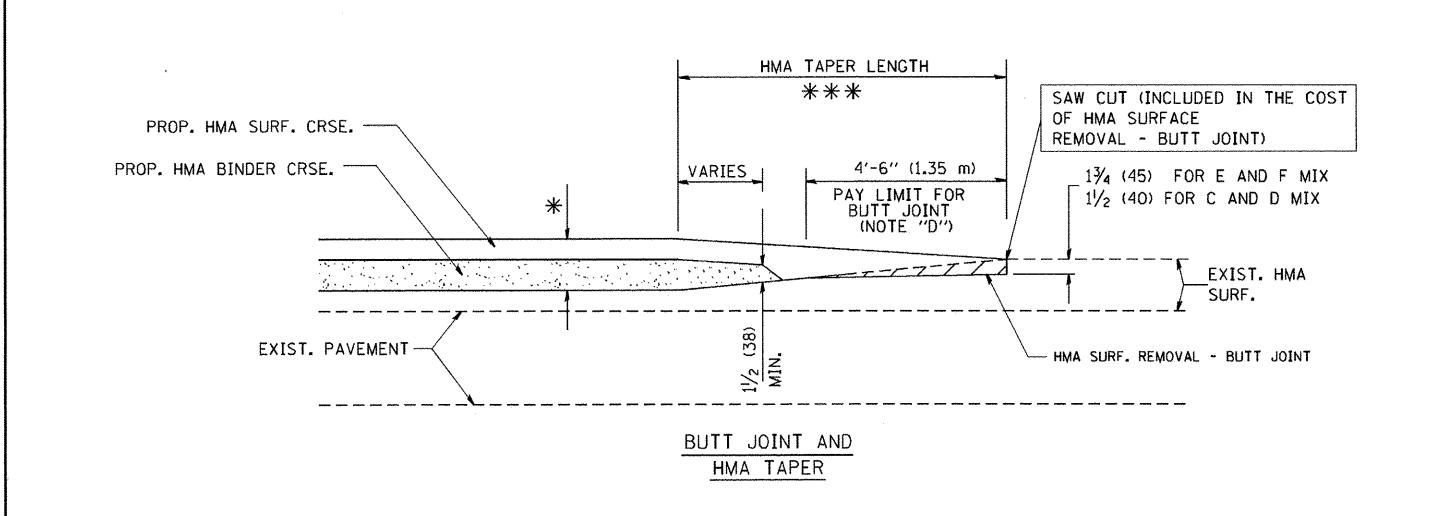



TYPICAL BUTT JOINT AND HMA TAPER FOR MILLING AND RESURFACING

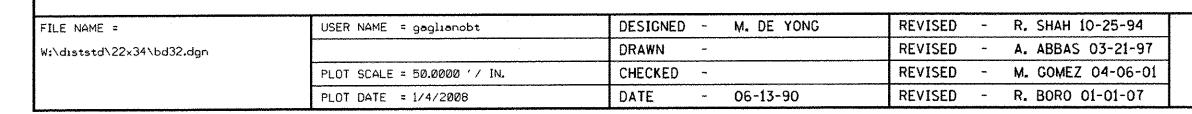

STATE OF ILLINOIS **DEPARTMENT OF TRANSPORTATION**

TOTAL SHEE SHEETS NO. COUNTY SECTION **BUTT JOINT AND** 17 | 12 1557 COOK 09-00065-00-RS HMA TAPER DETAILS BD400-05 BD32 CONTRACT NO. 61D45 FED. ROAD DIST. NO. 1 ILLINOIS FED. AID PROJECT SCALE: NONE SHEET NO. 1 OF 1 SHEETS STA. TO STA.

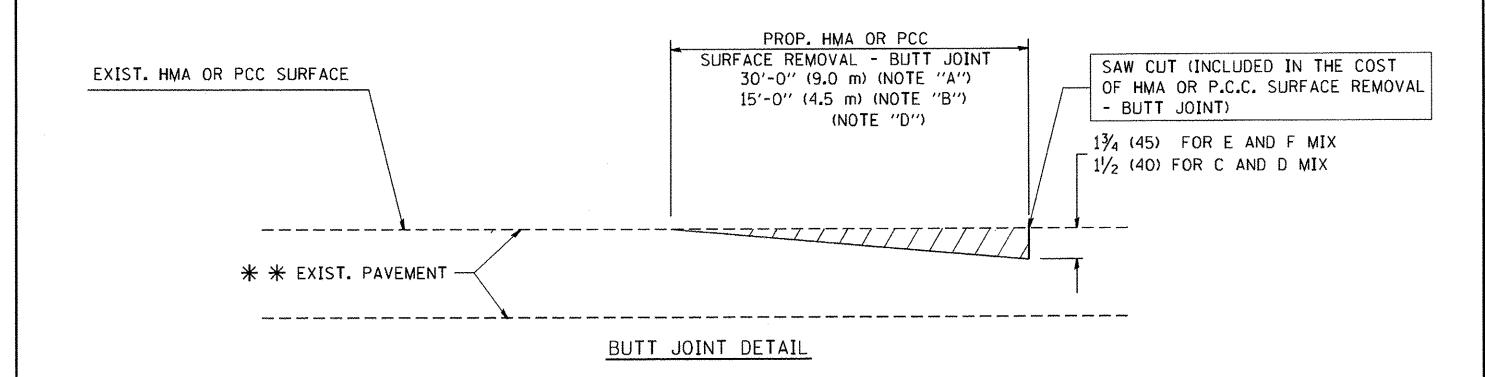

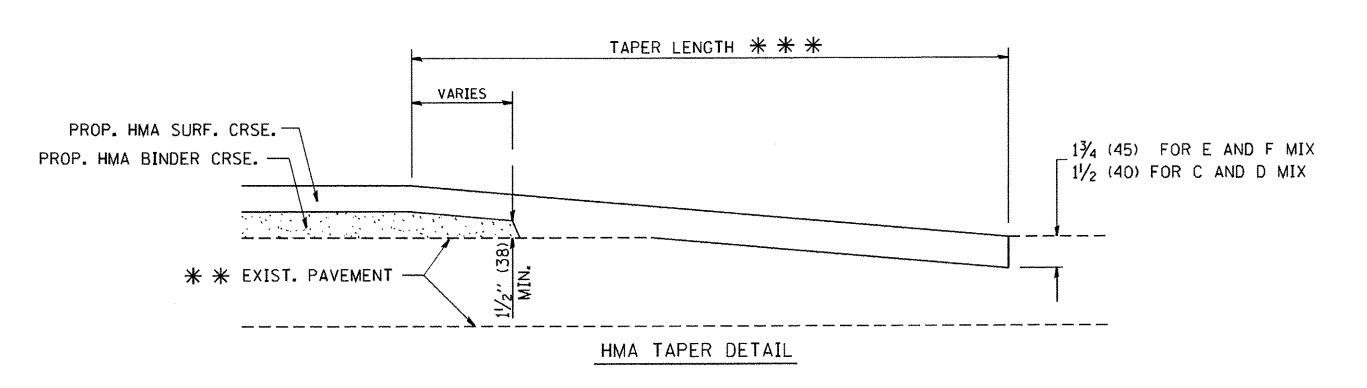

TYPICAL BUTT JOINT AND HMA TAPER FOR RESURFACING ONLY

* * PC CONCRETE, HMA OR HMA RESURFACED PAVEMENT.

NOTES


- A: MAINLINE ROADWAYS AND MAJOR SIDE ROADS.
- B: MINOR SIDE ROADS.
- C: THE TEMP. RAMP SHALL BE CONSTRUCTED IMMEDIATELY UPON REMOVAL OF THE EXISTING HMA SURFACE.
- D: THE BUTT JOINT SHALL BE CONSTRUCTED IMMEDIATELY PRIOR TO PLACING THE PROPOSED HMA COURSES.
- E: TAPER THE TEMP. RAMP AT A RATE OF 3'-0" (900 mm) PER 1 INCH (25 mm) OF MILLING THICKNESS.
- F: INSTALLATION AND REMOVAL OF THE 4'-6" (1.35 m) TEMP. RAMP IS INCLUDED IN COST OF HMA SURFACE REMOVAL - BUTT JOINT
- G: SEE ARTICLE 406.08 AND 406.14 OF THE STANDARD SPECIFICATIONS FOR "HMA AND/OR PCC SURFACE REMOVAL, BUTT JOINT".
- * SEE TYPICAL SECTIONS FOR MILLING THICKNESS.
- ** ** * 20'-0" (6.1 m) PER 1 (25) RESURFACING (NOTE "A") 10'-0" (3.0 m) PER 1 (25) RESURFACING (NOTE "B")

BASIS OF PAYMENT:

THE BUTT JOINT WILL BE PAID FOR AT THE CONTRACT UNIT PRICE PER SQUARE YARD (SQUARE METER)

FOR "HOT-MIX ASPHALT SURFACE REMOVAL - BUTT JOINT" OR FOR "PORTLAND CEMENT CONCRETE SURFACE REMOVAL- BUTT JOINT".

ALL DIMENSIONS ARE IN INCHES (MILLIMETERS) UNLESS OTHERWISE SHOWN.

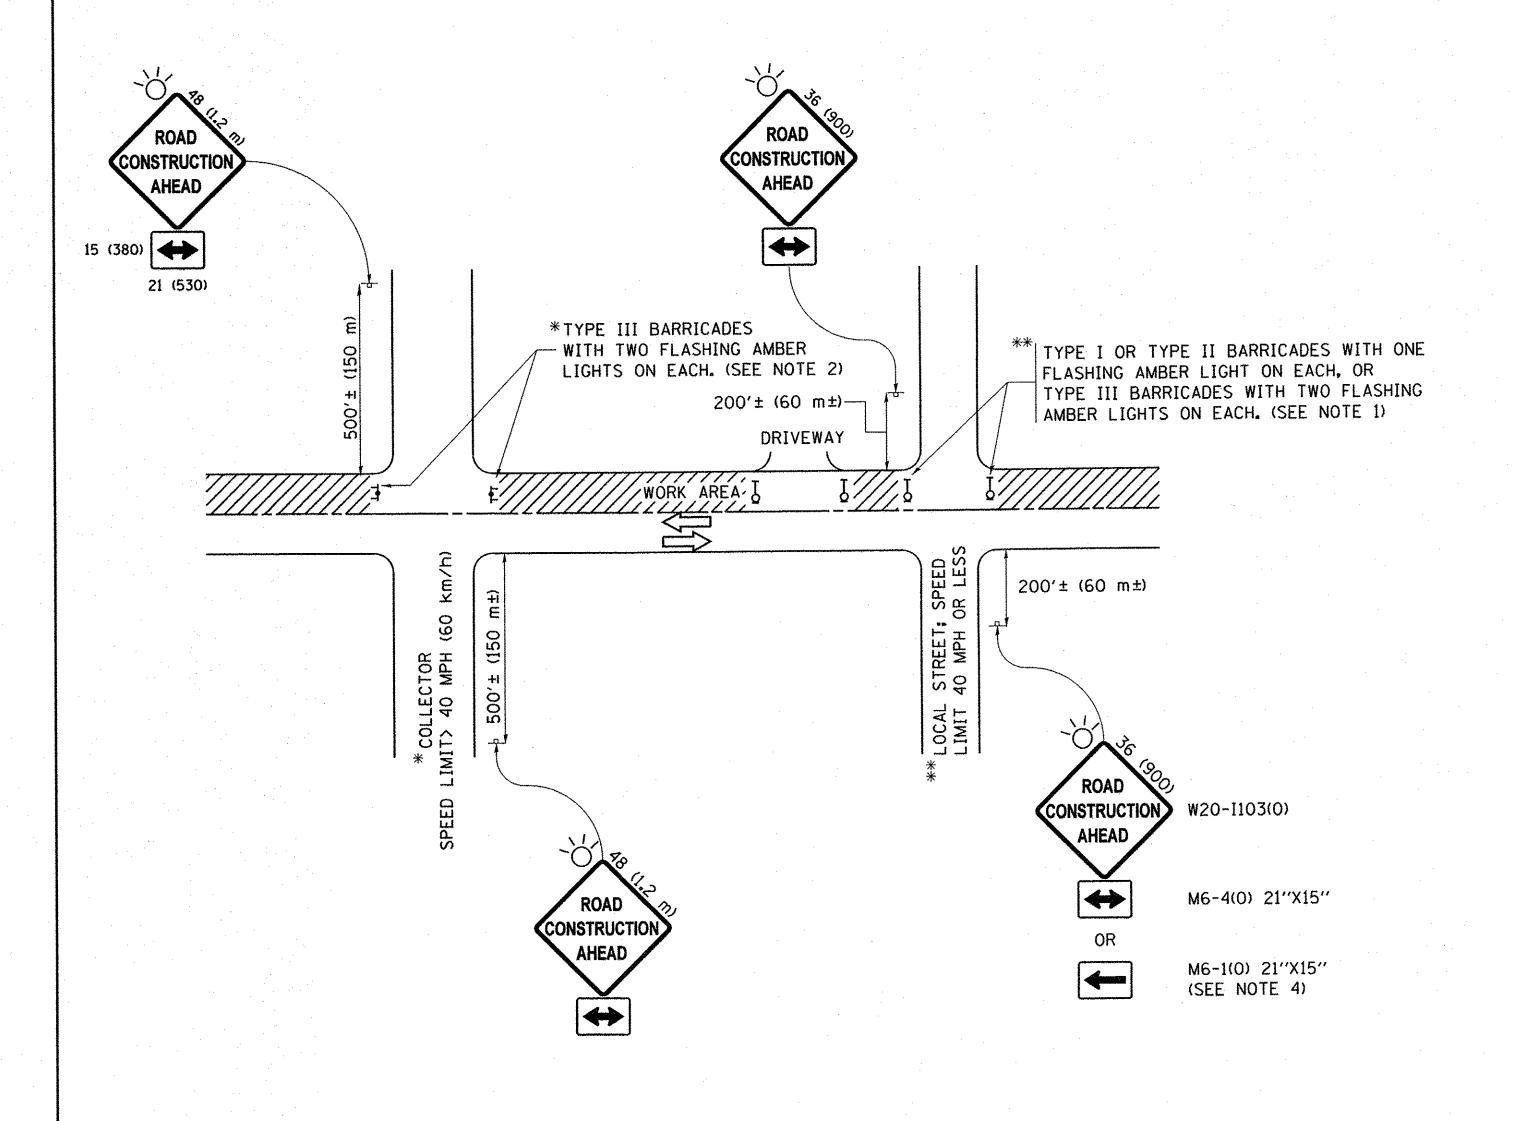

- 1. SIDE ROAD WITH A SPEED LIMIT OF 40 MPH (60 km/h) OR LESS AS SHOWN ON THE DRAWING AND AS DIRECTED BY THE ENGINEER:
 - O) ONE "ROAD CONSTRUCTION AHEAD" SIGN 36 x 36 (900x900) WITH A FLASHER MOUNTED ON IT APPROXIMATELY 200" (60 m) IN ADVANCE OF THE MAIN ROUTE.
 - b) THE CLOSED PORTION OF THE MAIN ROUTE SHALL BE PROTECTED BY BLOCKING WITH TYPE I, TYPE II OR TYPE III BARRICADES, 1/3 OF THE CROSS SECTION OF THE CLOSED PORTION.
- 2. SIDE ROAD WITH A SPEED LIMIT GREATER THAN 40 MPH (60 km/h) AS SHOWN ON THE DRAWING AND AS DIRECTED BY THE ENGINEER:
 - O) ONE "ROAD CONSTRUCTION AHEAD" SIGN 48 × 48 (1.2 m × 1.2 m) WITH A FLASHER MOUNTED ON IT APPROXIMATELY 500' (150 m) IN ADVANCE OF THE MAIN ROUTE.
 - b) THE CLOSED PORTION OF THE MAIN ROUTE SHALL BE PROTECTED BY BLOCKING WITH TYPE III BARRICADES, 1/2 OF THE CROSS SECTION OF THE CLOSED PORTION.
- 3. CONES MAY BE SUBSTITUTED FOR BARRICADES OR DRUMS AT HALF THE SPACING DURING DAY OPERATIONS. CONES SHALL BE A MINIMUM OF 28 (710) IN HEIGHT.
- 4. WHEN THE SIDE ROAD LIES BETWEEN THE BEGINNING OF THE MAINLINE SIGNING AND THE WORK ZONE, A SINGLE HEADED ARROW (M6-1) SHALL BE USED IN LIEU OF THE DOUBLE HEADED ARROW (M6-4).

- 5. WHEN WORK IS BEING PERFORMED ON A SIDE ROAD OR DRIVEWAY, FOLLOW THE APPLICABLE STANDARD(S). THE DIRECTIONAL ARROW (M6-1 OR M6-4) SHALL BE COVERED OR REMOVED WHEN NO LONGER CONSISTENT WITH THE TRAFFIC CONTROL SET-UP.
- 6. ADVANCE WARNING SIGNS ARE TO BE OMITTED ON DRIVEWAYS UNLESS OTHERWISE SPECIFIED IN THE PLANS OR BY THE ENGINEER.
- 7. THE TRAFFIC CONTROL AND PROTECTION FOR SIDE ROADS, INTERSECTIONS, AND DRIVEWAYS SHALL BE INCLUDED IN THE COST OF SPECIFIED TRAFFIC CONTROL STANDARDS OR ITEMS.

All dimensions are in inches (millimeters) unless otherwise shown.

FILE NAME =	USER NAME = footemj	DESIGNED - L.H.A.	REVISED	- A. HOUSEH 10-15-96
	cuments\IDOT Offices\District 1\Projects\Dist	Gt DRAWN \CADData\CADsheets\tc10.dgn	REVISED	-T. RAMMACHER 01-06-00
	PLOT SCALE = 50.000 '/ 10.	CHECKED -	REVISED	- A. SCHUETZE 07-01-13
Default	PLOT DATE = 9/15/2016	DATE - 06-89	REVISED	- A. SCHUETZE 09-15-16

STATE OF ILLINOIS
DEPARTMENT OF TRANSPORTATION


TRAFFIC CONTROL AND PROTECTION FOR										
SIDE ROADS, INTERSECTIONS, AND DRIVEWAYS										
SCALE: NONE	SHEET 1	OF 1	SHEETS	STA.	TO STA.					

 F.A.U RTE.
 SECTION
 COUNTY
 TOTAL SHEET SHEETS NO.

 1557
 09-00065-00-RS
 COOK
 17
 13

 TC-10
 CONTRACT NO. 61D45


 ILLINOIS FED. AID PROJECT

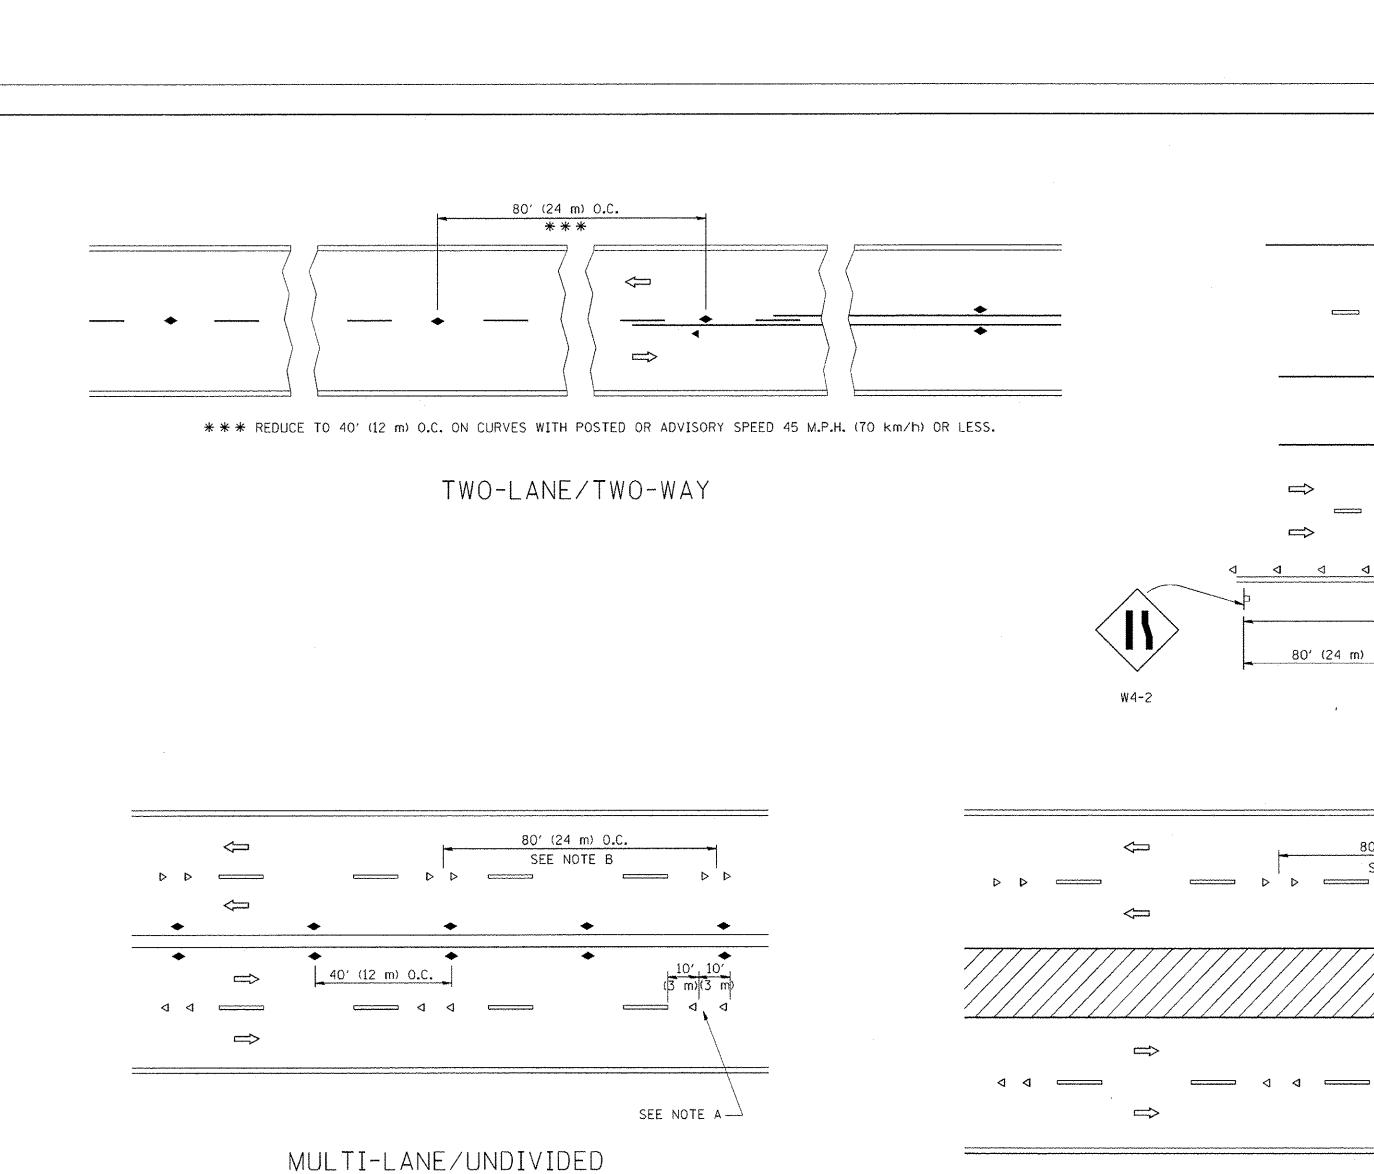



80' (24 m) O.C.

10′ 10′ (B m)(3 m

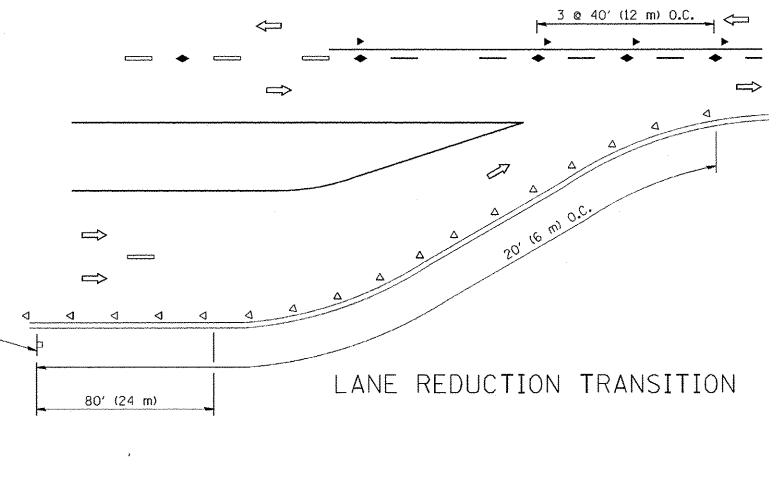

GENERAL NOTES

- MARKERS USED WITH DASHED LINES SHALL BE CENTERED IN THE GAP BETWEEN SEGMENTS.
- 2. MARKERS USED ADJACENT TO SOLID LINES SHALL BE OFFSET 2 TO 3 (50 TO 75) TOWARD TRAFFIC AS SHOWN.
- 3. MARKERS THROUGH TANGENTS LESS THAN 500' (150 m) IN LENGTH BETWEEN CURVES SHALL BE INSTALLED AT THE LESSER OF THE TWO CURVE SPACINGS.

LANE MARKER NOTES

A. USE DOUBLE LANE LINE MARKERS SPACED AS SHOWN.

B. REDUCE TO 40' (12 m) O.C. ON CURVES WHERE ADVISORY SPEEDS ARE
10 M.P.H (20 km/h) LOWER THAN POSTED SPEEDS.

SYMBOLS

---- YELLOW STRIPE

SEE NOTE A-

TWO-WAY LEFT TURN

80' (24 m) O.C.

40' (12 m) O.C.

SEE NOTE B

- WHITE STRIPE
- ONE-WAY AMBER MARKER
- ONE-WAY CRYSTAL MARKER (W/O)
- ★ TWO-WAY AMBER MARKER

DESIGN NOTES

1. DOUBLE LANE LINE MARKERS SHALL BE USED UNLESS SPECIFIED OTHERWISE.


- 2. EXCEPT AS SHOWN ON THE LANE REDUCTION TRANSITION AND FREEWAY EXIT RAMP DETAIL, MARKERS ARE NOT TO BE SPECIFIED ON RIGHT EDGE LINES.
- 3. THE EXACT MARKER LIMITS, SPACING, AND COLOR SHOULD BE INCLUDED IN THE PLANS.
- 4. MARKERS SHOULD NOT BE USED ALONGSIDE CURBS EXCEPT FOR EXTREMELY SHORT SECTIONS OF CURBS WHERE NOT MORE THAN TWO MARKERS WOULD BE INVOLVED.


LEFT TURN


All dimensions are in inches (millimeters) unless otherwise shown.

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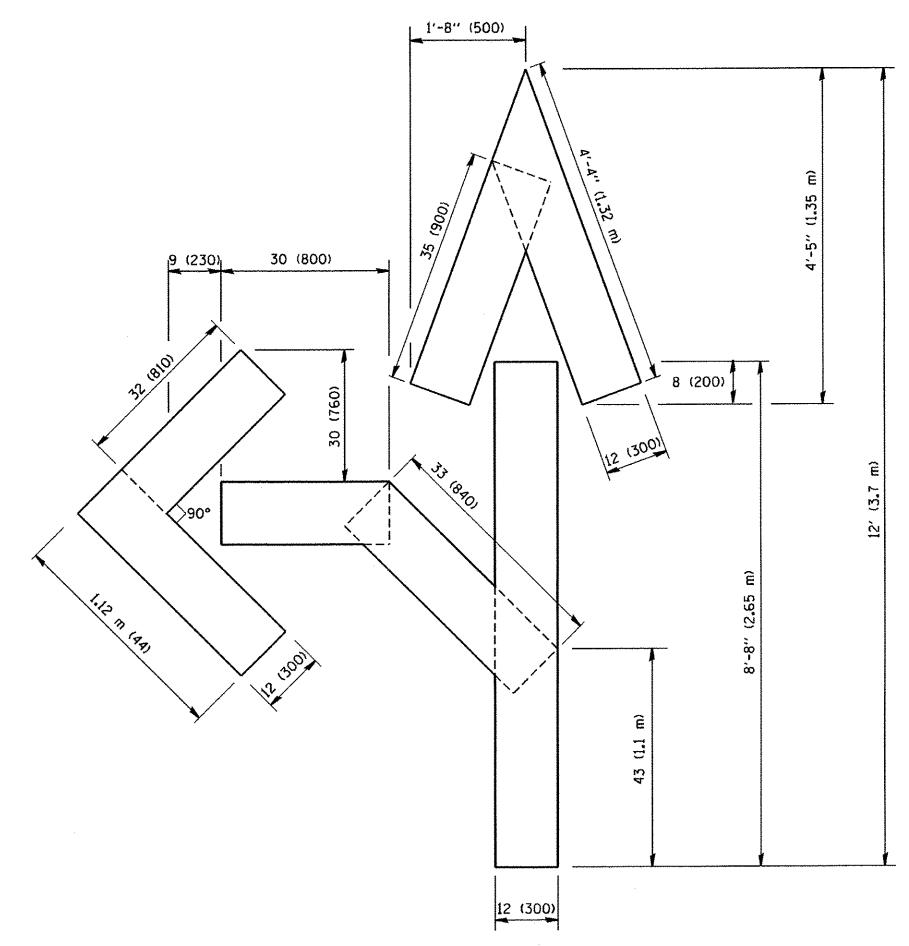
DESIGNED -REVISED -T. RAMMACHER 09-19-94 COUNTY SECTION USER NAME = drivakosgn FILE NAME = TYPICAL APPLICATIONS STATE OF ILLINOIS REVISED -T. RAMMACHER 03-12-99 c:\pw_work\pwidot\drivakosgn\d0108315\to|1.dgn DRAWN 09-00065-00-RS 17 14 RAISED REFLECTIVE PAVEMENT MARKERS (SNOW-PLOW RESISTANT) **DEPARTMENT OF TRANSPORTATION** REVISED -T. RAMMACHER 01-06-00 CHECKED -PLOT SCALE = 50.000 '/ IN. CONTRACT NO. 61D45 TC-11 REVISED - C. JUCIUS 09-09-09 SCALE: NONE SHEET NO. 1 OF 1 SHEETS STA. TO STA. DATE FED. ROAD DIST. NO. 1 | ILLINOIS FED. AID PROJECT PLOT DATE = 9/9/2009



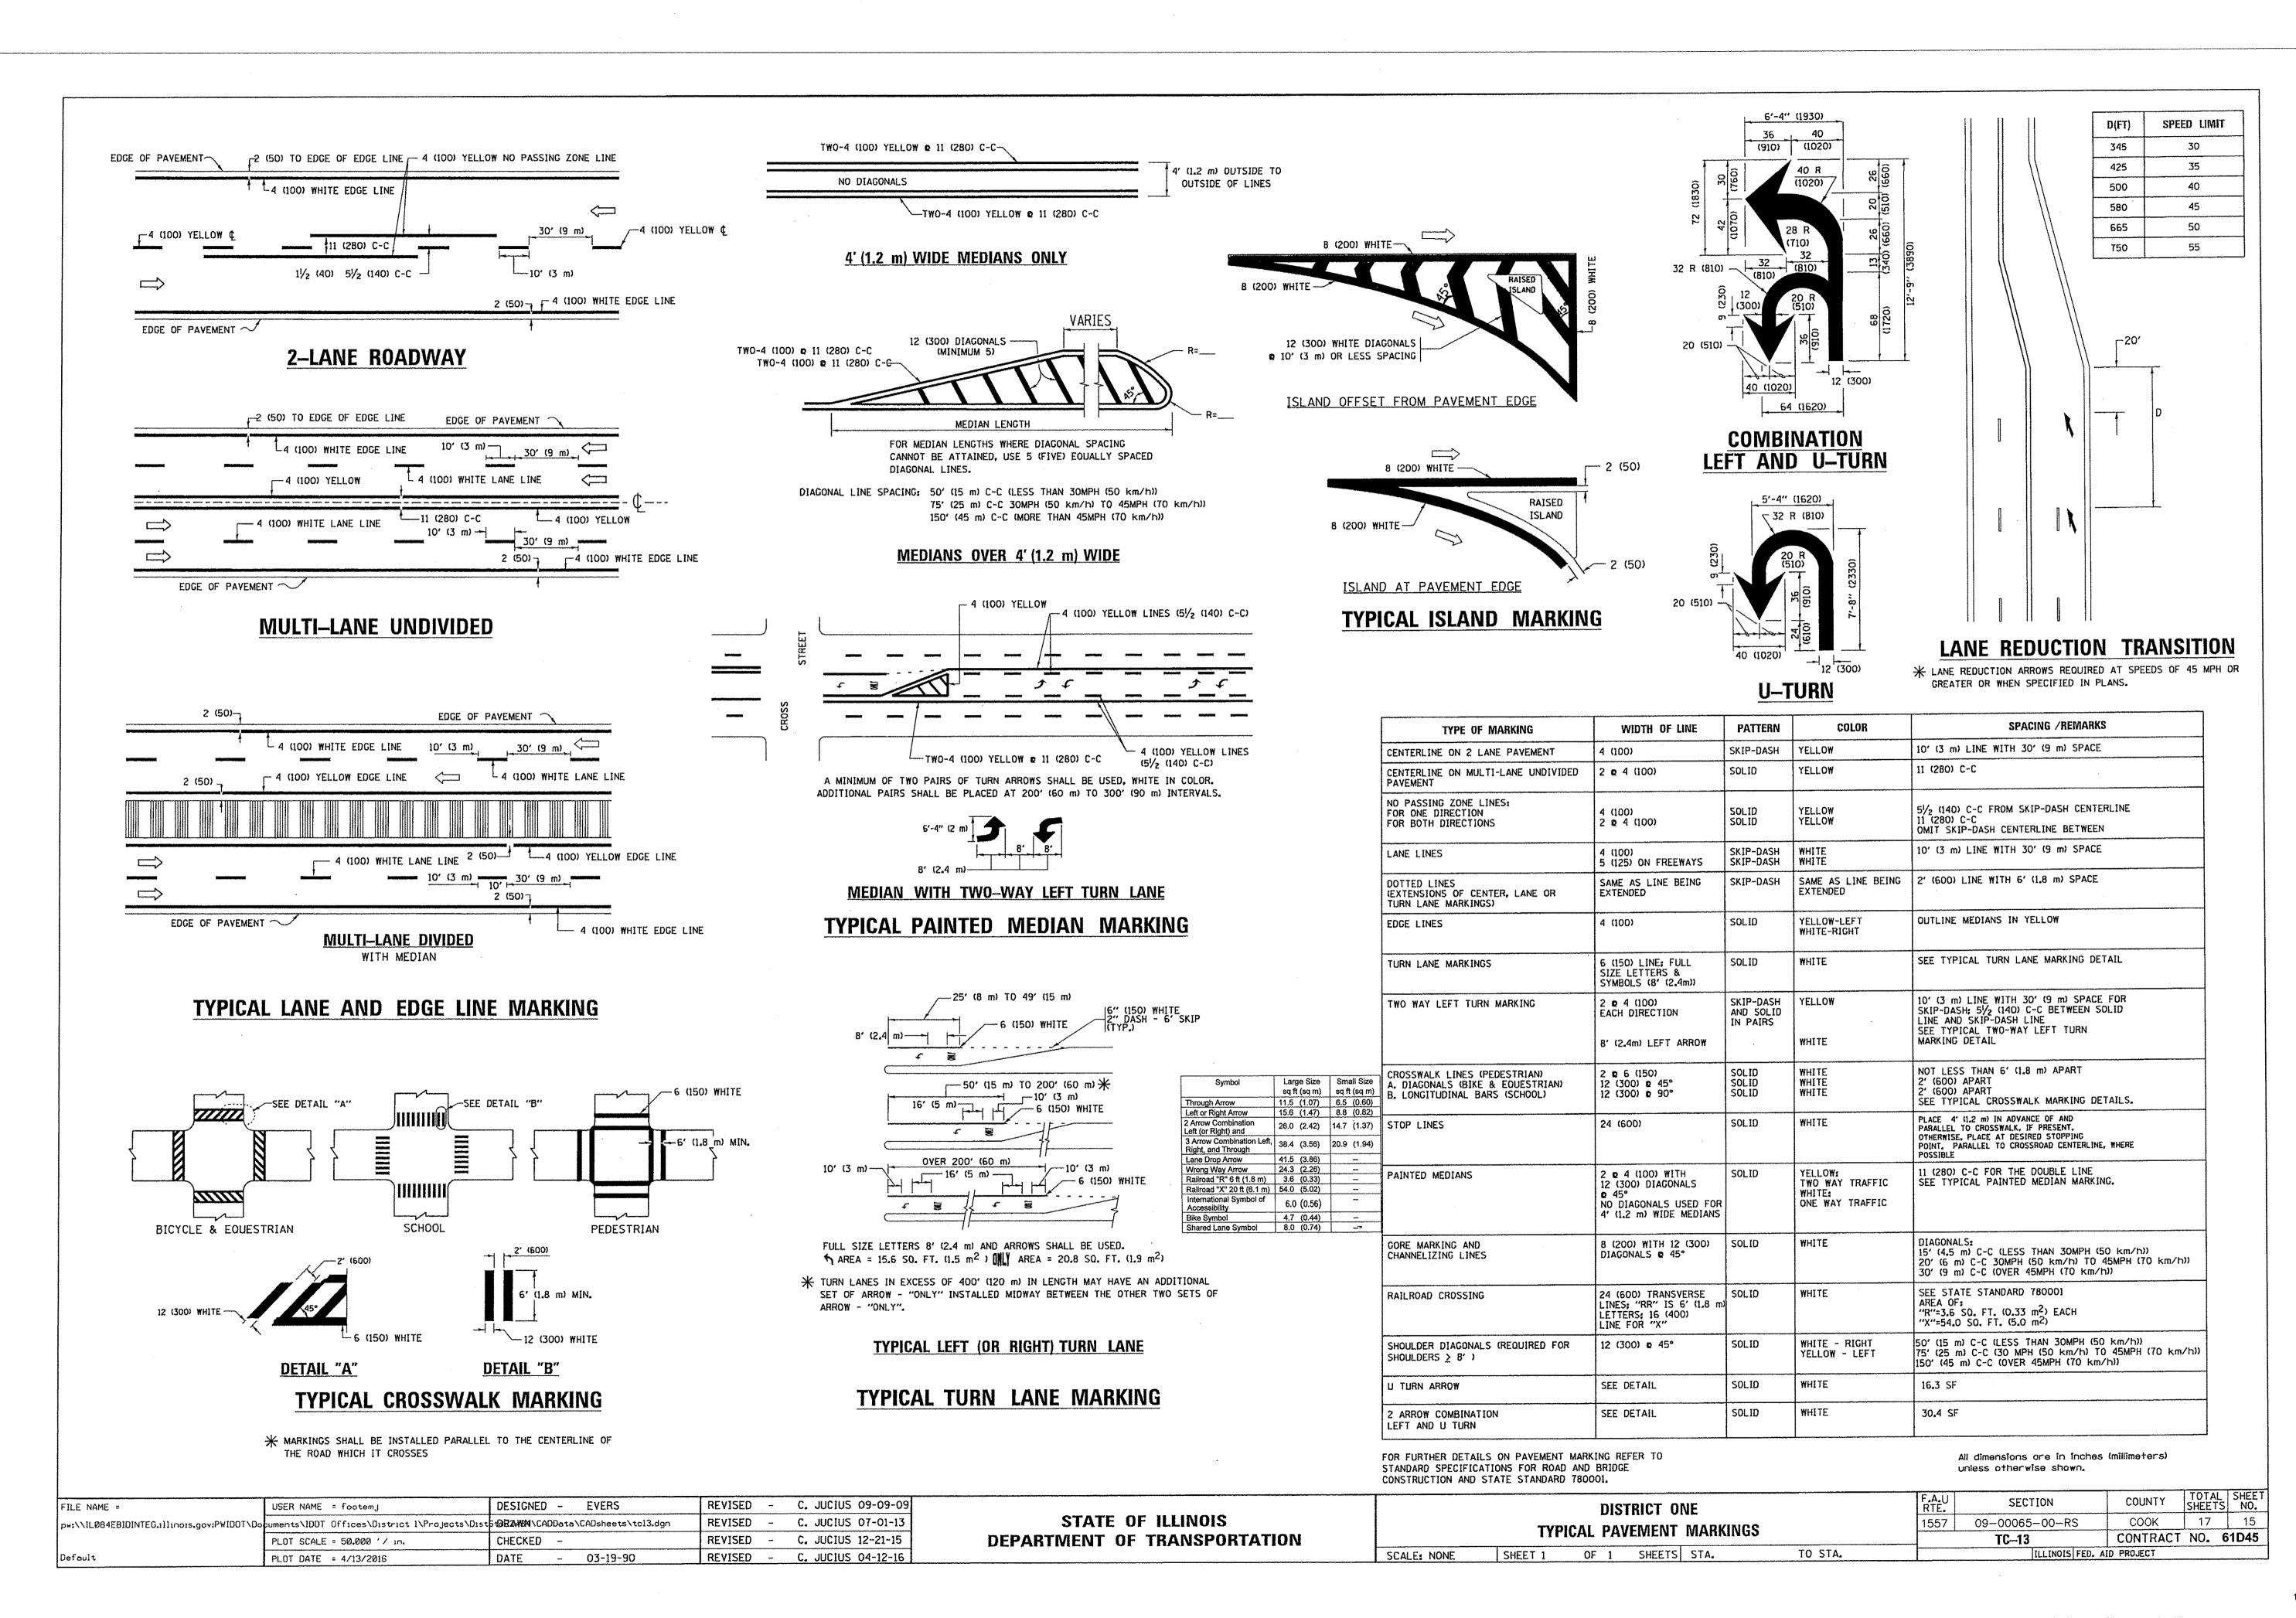

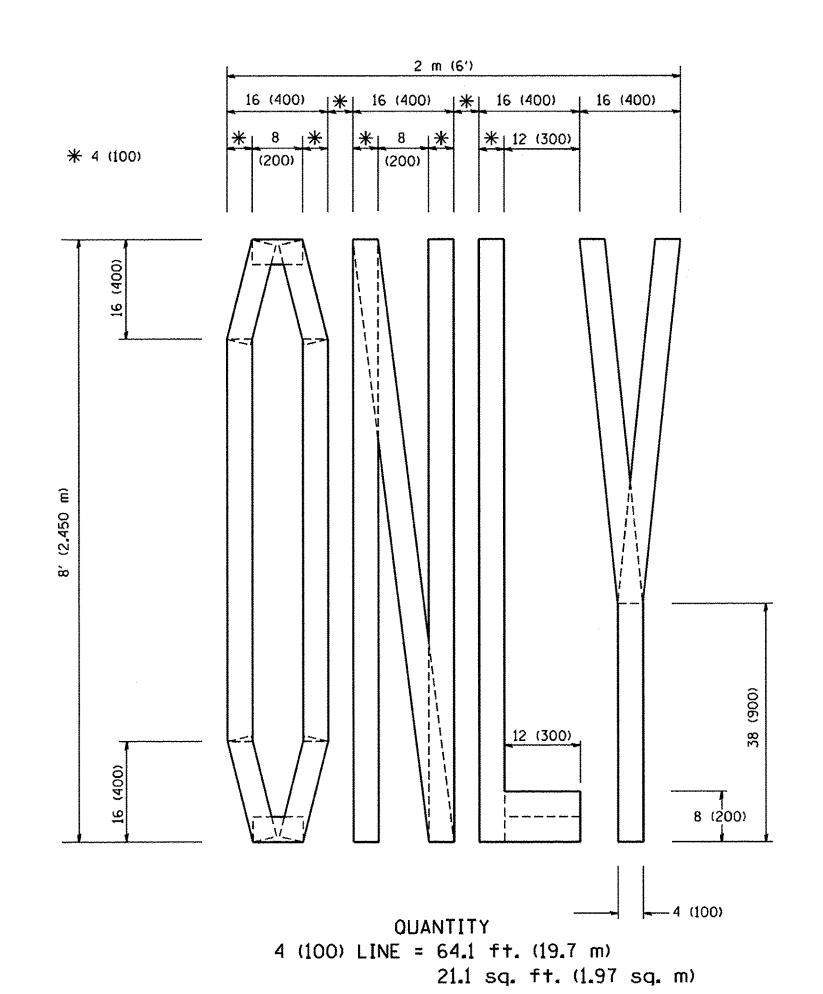

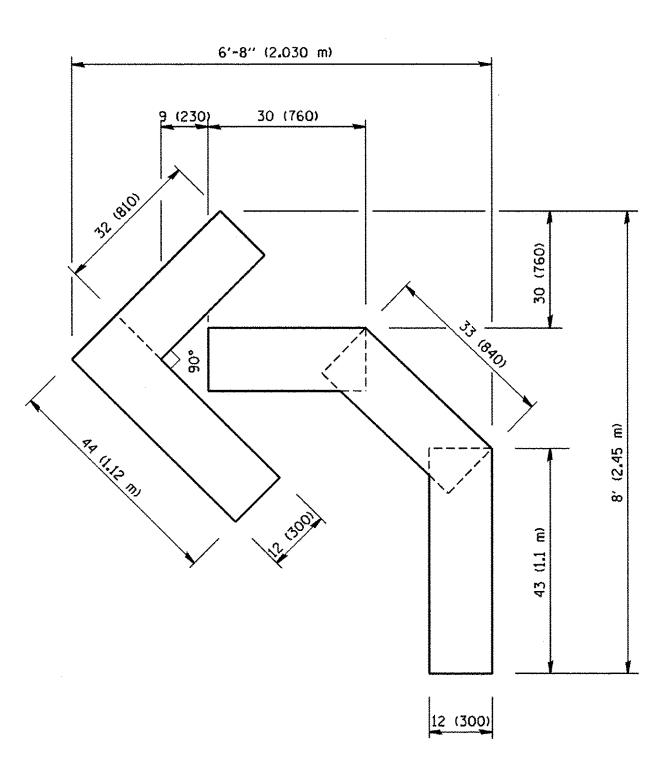
QUANTITY 4 (100) LINE = 45.5 ft. (13.9 m) 15.2 sq. ft. (1.39 sq. m)



QUANTITY
4 (100) LINE = 82.5 ft. (25.3 m)
27.5 sq. ft. (2.53 sq. m)

All dimensions are in inches (millimeters) unless otherwise shown.

FILE NAME =	USER NAME = gaglianobt	DESIGNED -	REVISED -T. RAMMACHER 06-05-96	STATE OF ILLINOIS DEPARTMENT OF TRANSPORTATION S	PAVEMENT MARKING LETTERS AND SYMBOLS	F.A.U. SECTION	COUNTY SHEET NO.
W:\diststd\22x34\tc16.dgn		DRAWN -	REVISED -T. RAMMACHER 11-04-97			1557 09-00065-00-RS	COOK 17 16
	PLOT SCALE = 50.0000 ' / IN.	CHECKED -	REVISED -T. RAMMACHER 03-02-98		FOR TRAFFIC STAGING	TC-16	CONTRACT NO. 61D45
	PLOT DATE = 1/4/2008	DATE - 09-18-94	REVISED -E. GOMEZ 08-28-00		SCALE: NONE SHEET NO. 1 OF 1 SHEETS STA. TO STA.	FED. ROAD DIST. NO. 1 ILLINOIS FED	. AID PROJECT
		, , , , , , , , , , , , , , , , , , ,					10/10

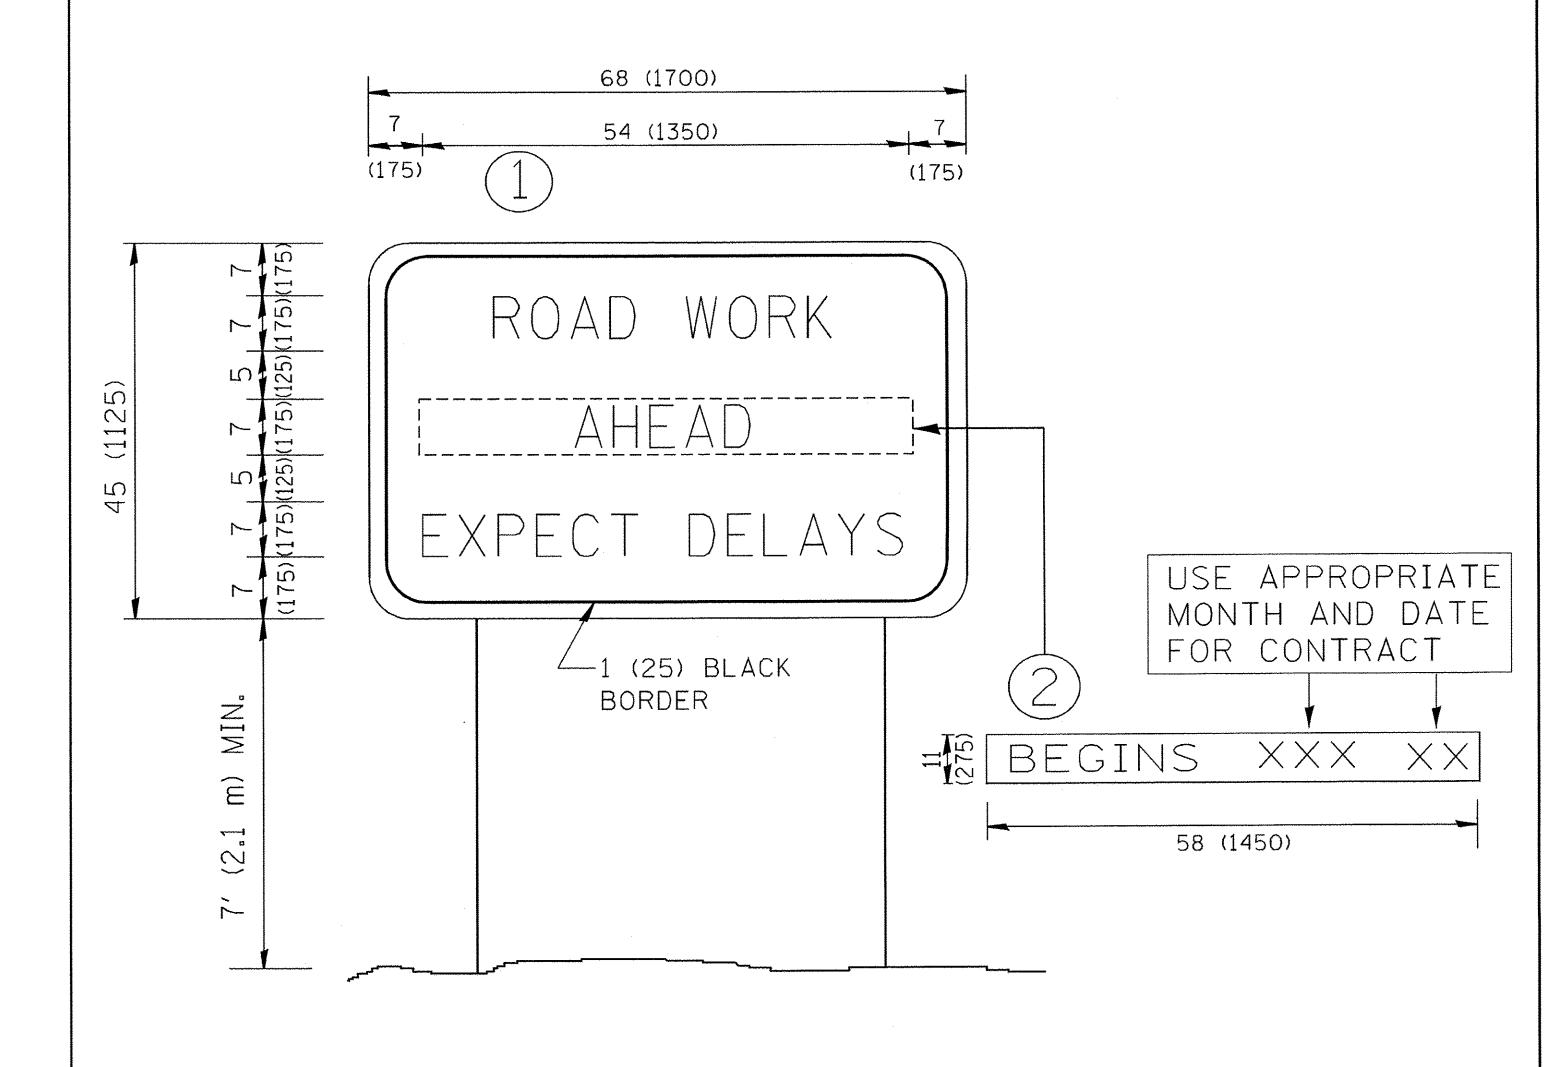

- 1. USE BLACK LETTERING ON ORANGE BACKGROUND.
- 2. ERECT SIGNS IN ADVANCE OF THE LOCATION FOR THE "ROAD CONSTRUCTION AHEAD" SIGN AT LOCATIONS AS DIRECTED BY THE ENGINEER.
- 3. ERECT SIGN 1) WITH INSTALLED PANEL 2) ONE WEEK PRIOR TO THE START OF CONSTRUCTION.
- 4. REMOVE PANEL 2 SOON AFTER THE START OF CONSTRUCTION.
- 5. SEE SPECIAL PROVISION FOR "TEMPORARY INFORMATION SIGNING" FOR ADDITIONAL INFORMATION.
- 6. ONE SIGN ASSEMBLY EQUALS 25.70 SQ. FT. (2.3 SQ. M.)
- 7. SHALL BE PAID FOR AS TEMPORARY INFORMATION SIGNING.

ALL DIMENSIONS ARE IN INCHES (MILLIMETERS)
UNLESS OTHERWISE SHOWN.

FILE NAME =	USER NAME = gaglianobt	DESIGNED -	REVISED - R. MIRS 09-15-97	STATE OF ILLINOIS	ARTERIAL ROAD		F.A.U. RTE.	SECTION	COUNTY TOTAL SHEET SHEETS NO.	
W:\diststd\22x34\tc22.dgn		DRAWN -	REVISED - R. MIRS 12-11-97						09-00065-00-RS	COOK 17 17
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	PLOT DATE = 1/4/2008	DATE - REVISED - C. JUCIUS 01-31-07		SCALE: NONE	SHEET NO. 1 OF 1 SHEETS STA.	TO STA.	FED. ROAD DIST. NO. 1 ILLINOIS FED. A		AID PROJECT	