STATE OF ILLINOIS

DEPARTMENT OF TRANSPORTATION

DIVISION OF HIGHWAYS

PLANS FOR PROPOSED FEDERAL AID HIGHWAY

SOUTHERN DU PAGE COUNTY REGIONAL TRAIL 101st STREET CONNECTOR — WATERFALL GLEN SPUR **WOODWARD AVENUE TO LEMONT ROAD** SECTION 03-00001-06-BT PROJECT NO: M-8003 (440) **DUPAGE COUNTY**

C-91-309-04 31 87th ST WATERFALL GLEN FOREST PRESERVE ARGONNE NATIONAL PROJECT BEGINS STA. 1+00 PROJECT ENDS STA, 41 + 57,13

NOT TO SCALE DOWNERS GROVE TOWNSHIP T37N R11E GROSS LENGTH OF PROJECT = 4,057.13 FT = 0.768 MILE NET LENGTH OF PROJECT = 4,057.13 FT = 0.768 MILE



COUNTY

DUPAGE

SECTION

03-00001-06-BT CONTRACT NO.: 83805

STATE OF ILLINOIS DEPARTMENT OF TRANSPORTATION DIVISION OF HIGHWAYS Charles F. Fokarshi DUPAGE COUNTY APPROVED June 10 LOCAL ROADS ENGINEER APPROVED June 13, 2005 Dine O'Keele/AP DEPUTY DIRECTOR OF HIGHWAYS - REGION ENGINEER

PLANS PREPARED BY: RJN GROUP, INC. CONSULTING ENGINEERS WHEATON, ILLINOIS

> ILLINOIS PROFESSIONAL DESIGN FIRM LICENSE No. 184-000813

PRINTED BY THE AUTHORITY OF THE STATE OF ILLINOIS

INDEX OF SHEETS

- 1. COVER SHEET
- 2. GENERAL NOTES
- 3. SUMMARY OF QUANTITIES AND TYPICAL SECTIONS
- 4. SCHEDULES
- 5-11. PLAN & PROFILE
- 12-15. LANDSCAPING AND EROSION CONTROL PLAN
- 16-26. CROSS SECTIONS
- 27. CULVERT EXTENSION
- 28. CULVERT EXTENSION DETAILS
- 29. HANDRAIL DETAILS
- 30. DETAIL PRUNING FOR SAFETY AND EQUIPMENT CLEARANCE

HIGHWAY STANDARDS

000001-04	STANDARD SYMBOLS. ABBREVIATIONS AND PATTERNS
280001-02	TEMPORARY EROSION CONTROL SYSTEMS
424001-04	SIDEWALK RAMPS ACCESSIBLE TO THE DISABLED
542301	PRECAST REINFORCED CONCRETE FLARED END SECTION
602401	MANHOLE, TYPE A
604001-02	FRAME AND LIDS, TYPE 1
606001-02	CONCRETE CURB TYPE B AND COMBINATION CONCRETE
	CURB AND GUTTER
664001-01	CHAIN LINK FENCE
701101-01	OFF ROAD OPERATIONS, MULTILANE, 4.5m (15') TO 600mm (24")
	FROM PAVEMENT EDGE
701106-01	OFF-ROAD OPERATIONS, MULTILANE, MORE THAN 4.5 m (15') AWAY
701301-02	LANE CLOSURE, 2L, 2W, SHORT TIME OPERATIONS
701606-04	URBAN LANE CLOSURE, MULTILANE, 2W WITH MOUNTABLE MEDIAN
701701-04	urban lane closure, multilane intersection
702001-05	TRAFFIC CONTROL DEVICES




FULL SIZE PLANS HAVE BEEN PREPARED USING STANDARD ENGINEERING SCALES. REDUCED SIZED PLANS WILL NOT CONFORM TO STANDARD SCALES. IN MAKING MEASUREMENTS ON REDUCED PLANS. THE ABOVE SCALES MAY BE USED.

JOINT UTILITY LOCATION INFORMATION FOR EXCAVATION 1-800-892-0123

PLANS PREPARED FOR **DUPAGE COUNTY DIVISION OF TRANSPORTATION CHARLES F. TOKARSKI, P.E. COUNTY ENGINEER**

CONTRACT NO. 83805

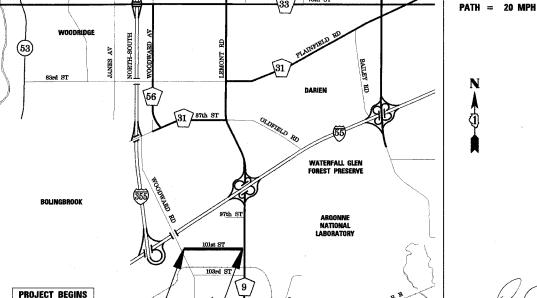

WILLIAM J. VEGRZYN

DESIGN SPEED OF MULTI-USE

REGISTERED P.E., STATE OF ILLINOIS

(SHEETS 1-26)

William V. Vega OF ILLINOIS

GENERAL NOTES

- 1. NO WORK SHALL COMMENCE UNTIL TRAFFIC CONTROL REQUIREMENTS ARE MET.
- 2. ALL UTILITIES, SCHOOL DISTRICTS, LOCAL POLICE, AND FIRE DEPARTMENTS SHALL BE NOTIFIED BY THE CONTRACTOR PRIOR TO THE START OF CONSTRUCTION.
- DURING THE CONSTRUCTION, THE CONTRACTOR WILL BE REQUIRED, AT HIS EXPENSE, TO HAVE AVAILABLE A WATER TRUCK OR SIMILAR EQUIPMENT TO CONTROL DUST. IF NECESSARY, THE CONTRACTOR SHALL BE REQUIRED TO CONTROL DUST DURING NON-WORKING HOURS
- 4. ALL EXCESS MATERIAL (BROKEN CONCRETE, CULVERT PIPE, WASTE ROADWAY EXCAVATION, SURPLUS MATERIAL FROM SEWER TRENCHES, ETC.) SHALL BE LEGALLY DISPOSED OF OUTSIDE THE LIMITS OF THE RIGHT-OF-WAY. IT SHALL BE THE CONTRACTOR'S RESPONSIBILITY TO SELECT DUMP SITE. PAYMENT FOR THIS WORK SHALL BE INCLUDED IN THE CONTRACT UNIT PRICE FOR EARTH EXCAVATION.
- 5. TEMPORARY FENCE SHOULD BE ERECTED ALONG THE DRIPLINE OF EXISTING TREES TO REMAIN WITHIN THE LIMITS OF CONSTRUCTION. AFTER TREES ARE SAFELY FENCED NOTHING IS TO BE STORED, DRIVEN, OR DISTURBED INSIDE THE FENCE. REMOVE PROTECTIVE TEMPORARY FENCE ONLY AFTER ALL CONSTRUCTION WORK HAS BEEN COMPLETED.
- 6. EROSION CONTROL WORK ITEMS ARE CONSIDERED TO BE HIGH PRIORITY ITEMS ON THIS CONTRACT. THE ENGINEER WILL IMPLEMENT ALL PROVISIONS OF THE SPECIFICATION NECESSARY TO ASSURE THAT EROSION CONTROL ITEMS ARE CONSTRUCTED AND MAINTAINED IN A TIMELY WAY. ALL EROSION CONTROL MEASURES SHALL BE INSTALLED PRIOR TO BEGINNING ANY CONSTRUCTION ACTIVITIES WHICH WILL POTENTIALLY CREATE ERODABLE CONDITIONS.
- 7. THE LANDSCAPING AND EROSION CONTROL MEASURES SHOWN ARE BUT A GRAPHICAL REPRESENTATION OF SUGGESTED MEASURES. DEVIATIONS FROM THIS PLAN ARE TO BE EXPECTED PENDING A JOBSITE INSPECTION BETWEEN THE CONTRACTOR AND THE DEPARTMENT.

TREE REMOVAL CLEARING HEDGE REMOVAL

- TREES NOT MARKED FOR REMOVAL SHALL BE CONSIDERED AS DESIGNATED TO BE SAVED AND SHALL BE PROTECTED UNDER THE PROVISIONS OF ARTICLE 201.05 OF THE STANDARD SPECIFICATIONS.
- 2. ALL LIMBS, BRANCHES, AND OTHER DEBRIS RESULTING FROM THIS WORK MUST BE REMOVED FROM THE RIGHT-OF-WAY AND DISPOSED OF AT THE END OF EACH DAY IN ACCORDANCE WITH ARTICLE 202.03. THE COST OF THIS WORK WILL NOT BE PAID FOR SEPARATELY BUT SHALL BE INCLUDED IN THE CONTRACT UNIT PRICE FOR TREE REMOVAL.
- 3. ALL CLEARING, REMOVAL OF BUSHES, HEDGES AND TREES UNDER SIX (6) INCHES IN DIAMETER WILL BE INCLUDED IN THE CONTRACT UNIT PRICE FOR EARTH EXCAVATION.

OVERHANGING LIMBS

- 1. ALL CUTS OVER ONE (1) INCH IN DIAMETER SHALL BE MADE FLUSH WITH THE NEXT LARGE BRANCH.
- 2. ALL LIMBS, BRANCHES, AND OTHER DEBRIS RESULTING FROM THIS WORK MUST BE REMOVED FROM THE RIGHT-OF-WAY AND DISPOSED OF AT THE END OF EACH DAY IN ACCORDANCE WITH ARTICLE 202,03. THE COST OF THIS WORK WILL NOT BE PAID FOR SEPARATELY BUT SHALL BE INCLUDED IN THE CONTRACT UNIT PRICE FOR AS PRUNING FOR SAFETY AND EQUIPMENT CLEARANCE.
- 3. ALL BRANCHES THAT ARE LESS THAN 8 FEET ABOVE THE FINISHED SURFACE OF THE TRAIL SHALL BE REMOVED BY A CERTIFIED ARBORIST. THIS WORK SHALL BE UNDERTAKEN IN A TIMELY FASHION SO AS NOT TO INTERFERE WITH CONSTRUCTION. THIS WORK WILL BE PAID FOR AS "PRUNING FOR SAFETY AND EQUIPMENT CLEARANCE".

TOPSOIL

- TOPSOIL SHALL BE PLACED TO A DEPTH OF SIX (6) INCHES AND BE MEASURED IN SQUARE YARDS.
- 2. THE CROSS SECTIONS INDICATE THE FINISHED GRADE OF TOPSOIL.
- TOPSOIL SHALL NOT BE STOCKPILED WITHIN THE LIMITS OF CONSTRUCTION; THE LOCATIONS OF TOPSOIL STOCKPILES WITHIN THE RIGHT-OF-WAY MUST BE APPROVED BY THE ENGINEER.

ROADWAY EXCAVATION

- 1. ALL EXISTING CULVERTS, STORM SEWERS, OR DRAINAGE STRUCTURES MARKED FOR REMOVAL ON THE PLANS OR DESIGNATED IN THE FIELD BY THE ENGINEER TO BE REMOVED SHALL BE REMOVED AND ANY EXCAVATION SHALL BE BACKFILLED WITH A GRANULAR MATERIAL MEETING THE SPECIFICATIONS FOR FA-1 OR FA-2. THE COST OF ALL LABOR AND MATERIALS REQUIRED TO COMPLETE THIS WORK SHALL BE INCLUDED IN THE CONTRACT UNIT PRICES FOR STORM SEWER OR PIPE CULVERT UNLESS PAID FOR AS A SPECIFIC ITEM.
- 2. ALL EXISTING GRANULAR AND BITUMINOUS MATERIALS TO BE REMOVED AND NOT PAID AS A SPECIFIC ITEM SHALL BE CONSIDERED EARTH EXCAVATION AND WILL BE PAID FOR AT THE UNIT PRICE FOR EARTH EXCAVATION. THE CONTRACTOR WILL HAVE THE OPTION OF REMOVING THE EXISTING BITUMINOUS MATERIAL BY GRINDING OR EXCAVATION, IT MAY NOT BE USED IN EMBANKMENT AREAS UNLESS SPECIFICALLY AUTHORIZED BY THE ENGINEER. BITUMINOUS MATERIAL REMOVED BY GRINDING MAY BE USED AS EMBANKMENT MATERIAL. NO BITUMINOUS MATERIAL SHALL BE REMOVED IN AREAS TO BE USED FOR TEMPORARY ROADWAY.
- THE CONTRACTOR SHALL NOT CROSS COMPLETED BASE COURSE OR EXISTING PAVEMENT NOT SCHEDULED TO BE REMOVED WITH LOADED SCRAPERS OR TRACK FOILIPMENT.
- 4. ALL EMBANKMENTS AND SUB-GRADE SHALL BE COMPACTED TO THE SATISFACTION OF THE ENGINEER PRIOR TO PLACING AGGREGATE SUBGRADE OR SUB-BASE GRANULAR MATERIAL.

STORM SEWERS STRUCTURES UTILITIES

- I. THE STATION / OFFSET / ELEVATIONS NOTED FOR ALL DRAINAGE STRUCTURES LOCATED IN THE CURB LINE REFER TO THE POSITION OF THE ADJACENT PROPOSED EDGE OF PAVEMENT. THE CONTRACTOR SHALL BE RESPONSIBLE FOR DETERMINING THE OFFSET NECESSARY FOR THE STRUCTURES TO SET THE FRAME AND GRATES IN THE PROPER LOCATION. ALL OTHER STRUCTURES ARE DIMENSIONED TO THE CENTER OF THE STRUCTURE; ELEVATION INDICATES DIM GRADES
- THE CONTRACTOR SHALL BE RESPONSIBLE FOR CONTACTING LOCAL AGENCIES MAINTAINING SANITARY SEWERS, WATERMAINS, AND STREET LIGHTS TO VERIFY THE MATERIALS AND METHODS ALLOWED FOR THE ADJUSTMENT, RELOCATION, OR EXTENSION OF THE UTILITY INVOLVED.
- 3. THE LOCATION AND ELEVATION OF EXISTING UTILITIES ARE APPROXIMATE AND ARE PROVIDED BY THE OWNERS. THE EXACT LOCATIONS AND ELEVATIONS ARE TO BE VERIFIED BY THE CONTRACTOR THROUGH THE OWNER OF THE UTILITY.
- . EMBANKMENTS SHALL BE COMPLETED TO THE SATISFACTION OF THE ENGINEER PRIOR TO EXCAVATION FOR STORM SEWER.
- . THE COST OF MAKING STORM SEWER CONNECTIONS TO EXISTING OR PROPOSED SEWER SHALL BE INCLUDED IN THE CONTRACT UNIT PRICE FOR THE STORM SEWER BEING CONNECTED.
- 6. MANHOLES AND CATCH BASINS TYPE A WHERE THE DIFFERENCE BETWEEN THE RIM ELEVATION AND INVERT ELEVATION IS LESS THAN SIX (6) FEET, SHALL BE CONSTRUCTED WITH FLAT TOPS.
- ALL ADJUSTMENTS OR RECONSTRUCTIONS SHALL INCLUDE THE REMOVAL AND REPLACEMENT, AT THE CONTRACTOR'S EXPENSE, OF ALL UNSUITABLE TWO (2) FOOT INSIDE DIAMETER AD HISTOR PINES.
- ADJUSTMENT OF STRUCTURES MAINTAINED BY OTHER AGENCIES SHALL BE MADE TO THE SATISFACTION OF THE ENGINEER AND THE AGENCY MAINTAINING THE SYSTEM OF THE STRUCTURE TRIVELY FOR A STRUCTURE TRIVELY FOR A STRUCTURE TRIVELY FOR A
- ALL MANHOLES AND INLETS SHALL HAVE POURED INVERTS. THE COST OF INVERTS SHALL BE INCLUDED IN THE COST OF THE STRUCTURE.
- 10. ALL FIELD TILES ENCOUNTERED SHALL BE CAREFULLY PRESERVED AND CONNECTED TO PROPOSED DRAINAGE STRUCTURES, SEWERS, OR DITCHES, AS DIRECTED BY THE ENGINEER; THIS WORK WILL BE PAID FOR AT THE APPLICABLE CONTRACT UNIT PRICE OR IN ACCORDANCE WITH ARTICLE 109.04 OF THE STANDARD SPECIFICATIONS.

COUNTY HIGHWAY	FISCAL · YEAR	TOTAL SHEETS	SHEET NO.
	2005	30	2
SEC 03-000	01-06-BT	DUPA	AGE COUNTY

CONTRACT NO.: 83805

BITUMINOUS CONCRETE SURFACE COURSE AND BITUMINOUS BASE COURSE

- BITUMINOUS CONCRETE SURFACE COURSE, SUPERPAVE SHALL NOT BE PLACED UNTIL ALL EARTH EXCAVATION, TOPSOIL PLACEMENT, AGGREGATE BASE COURSE, AND BITUMINOUS CONCRETE BINDER COURSE, SUPERPAVE HAVE BEEN COMPLETED TO THE SATISFACTION OF THE ENGINEER.
- THE MAXIMUM COMPACTED THICKNESS OF ANY LIFT OF BINDER OR SURFACE COURSE, SUPERPAVE SHALL BE 2.5 INCHES.
- 4. THE MAXIMUM COMPACTED THICKNESS OF A LIFT OF BASE COURSE WILL BE FOUR (4) INCHES UNLESS OTHERWISE AUTHORIZED BY THE ENGINEER.
- 5. BASE COURSE SHALL NOT BE PLACED ADJACENT TO CURB AND GUTTER UNTIL THE CURB AND GUTTER HAS BEEN BACKFILLED TO THE SATISFACTION OF THE ENGINEER.

TRENCH BACKFILL

WHERE TRENCH BACKFILL IS REQUIRED, THE MATERIAL USED SHALL BE COMPACTED
AS SPECIFIED IN ARTICLE 550.07 OF THE STANDARD SPECIFICATIONS USING METHOD
ONE

TRAFFIC CONTROL AND PROTECTION

- TRAFFIC CONTROL AND PROTECTION SHALL BE PERFORMED IN ACCORDANCE WITH THE TRAFFIC CONTROL PLAN AND SECTION 701 OF THE STANDARD SPECIFICATIONS AS AMENDED BY THE SPECIAL PROVISION FOR CONSTRUCTION ZONE TRAFFIC CONTROL (CHECK SHEET LRS 9).
- THE TYPE III BARRICADES ARE TO BE PLACED IN ACCORDANCE WITH STANDARD 702001 UNLESS AUTHORIZED BY THE ENGINEER TO USE AN ALTERNATE ARRANGEMENT.
- 3. ANY DROP OFF GREATER THAN THREE (3) INCHES BUT LESS THAN SIX (6) INCHES, WITHIN EIGHT (8) FEET OF THE PAVEMENT EDGE, SHALL BE PROTECTED BY TYPE I OR TYPE II BARRICADES, DRUMS OR VERTICAL PANELS WITH MONODIRECTIONAL STEADY-BURN LIGHTS AT 100 FOOT CENTER TO CENTER SPACING, IF THE DROP OFF WITHIN EIGHT (8) FEET OF THE PAVEMENT EDGE EXCEEDS SIX (6) INCHES, THE BARRICADES, DRUMS OR VERTICAL PANELS MENTIONED ABOVE SHALL BE PLACED AT FIFTY (50) FOOT CENTER TO CENTER SPACING, BARRICADES THAT MUST BE PLACED IN EXCAVATED AREAS SHALL HAVE LEG EXTENSIONS INSTALLED SUCH THAT THE TOP OF THE BARRICADE IS IN COMPLIANCE WITH THE HEIGHT REQUIREMENTS OF STANDARD TOZOOI.
- 4. TYPE I OR TYPE II BARRICADES WITH TWO-WAY FLASHING LIGHTS SHALL BE REQUIRED AT ALL OPEN TRENCHES, EXCAVATIONS, OPEN OR EXPOSED SEWER STRUCTURES, TRANSVERSE PAVEMENT JOINTS, MATERIALS OR EQUIPMENT WITHIN THE RIGHT-OF-WAY (NUMBER AND SPACING DEPENDS ON THE CONDITIONS); AND AT LOCATIONS DESIGNATED BY THE ENGINEER OR LOCAL LAW ENFORCEMENT AGENCIES.
- 5. TYPE I, II AND / OR III BARRICADES WITH TWO-WAY FLASHING LIGHTS WILL BE REQUIRED TO GUIDE TRAFFIC AWAY FROM PAVEMENT AREAS CLOSED FOR CONSTRUCTION.
- THE COST OF SUPPLYING, ERECTING, AND MAINTAINING BARRICADES, WARNING LIGHTS, AND SIGNS WILL BE INCLUDED IN THE CONTRACT LUMP SUM PRICE FOR TRAFFIC CONTROL AND PROTECTION.
- WHERE REQUIRED, TRAFFIC SIGNS SHALL BE RELOCATED FOR EACH STAGE OF CONSTRUCTION.
- 8. ARROW BOARDS WILL BE REQUIRED WHEN IMPLEMENTING ALL LANE CLOSURES.
- THE FOLLOWING TRAFFIC CONTROL STANDARDS ARE THE MINIMUM REQUIREMENTS FOR THE TRAFFIC CONTROL FOR THIS PROJECT: 701101, 701106, 701301, 701606, 701701 & 702001.

NO.		REVISION	NO.	DATE	BY	REVISION	SCALE		
							DRAWN BY	DATE	KI
							CHECKED BY	DATE	-0
							APPROVED BY DWB	DATE	GRO

RJN GROUP, INC.
CONSULTING ENGINEERS

Southern DuPage County Regional Trail 101st Street Connector — Waterfall Glen Spur GENERAL NOTES


PROJECT NO.: II-1900-01

		SUMMARY OF QUANTITIES			Y047 BIKE/	Y007	Y047 BIKE/PEDESTRIAN	
ITEM NO.	CODE NUMBER 20100110	PAY ITEM TREE REMOVAL (6 TO 15 UNITS DIAMETER)	UNIT UNIT	TOTAL QUANTITY 330	PEDESTRIAN PATH 330	MINOR STRUCTURE	PATH (LOO% CNTY)	
					1,000		1	
2	20101000	TEMPORARY FENCE	FOOT	1,000				
3	20200100	EARTH EXCAVATION	CU YD	2,809	2,809			
4	20201200	REMOVAL AND DISPOSAL OF UNSUITABLE MATERIAL	CU YD	1,742	1,742			
5	20700420	POROUS GRANULAR EMBANKMENT, SUBGRADE	CU YD	300	300			
6	20800150	TRENCH BACKFILL	CU YD	68	68			
7	21101625	TOPSOIL FURNISH AND PLACE, 6"	SQ YD	7,617	7,617			
8	25000200	SEEDING, CLASS 2	ACRE	0.05	0.05			
9	25000400	NITROGEN FERTILIZER NUTRIENT	POUND	5	5			
10	25000500	PHOSPHORUS FERTILIZER NUTRIENT	POUND	5	5			
11	25000600	POTASSIUM FERTILIZER NUTRIENT	POUND	5	5			
12	25000322	SEEDING, CLASS 5A	ACRE	1.52	1,52			
13		SELECTIVE MOWING STAKES	EACH	4	4			
14		SEEDING, CLASS 4A (MODIFIED)	ACRE	1,52	1.52			
15		EROSION CONTROL BLANKET	SQ YD	7,617	7,617			
			POUND	166	166			
16	28000250	TEMPORARY EROSION CONTROL SEEDING						
17		TEMPORARY DITCH CHECKS	EACH	20	20			
18	28000400	PERIMETER EROSION BARRIER	FOOT	6,865	6,865			
19 20	28000500 28000510	INLET AND PIPE PROTECTION INLET FILTERS	EACH EACH	13 1	13			
21	35101500	AGGREGATE BASE COURSE, TYPE B	CU YD	826	826			
22	42400300	PORTLAND CEMENT CONCRETE SIDEWALK, 6 INCH	SQ FT	60	60			
23	42400800	DETECTABLE WARNINGS	SQ FT	20	20			
24	44000500	COMBINATION CURB AND GUTTER REMOVAL	FOOT	32	32			
25	50102400	CONCRETE REMOVAL	CU YD	1.4		1.4		
26	50800105	REINFORCEMENT BARS	POUND	3,830		3,830		
27	51000105	PIPE HANDRAIL	FOOT	33		33		
28		EXPANSION BOLTS 3/4 INCH	EACH	40		40		
29		CONCRETE BOX CULVERTS	CU YD	19.2		19.2		
30		PRECAST REINFORCED CONCRETE FLARED END SECTIONS 12"	EACH	5	5			
				70	70			
31		STORM SEWERS, CLASS A, TYPE 1 12"	FOOT		10			
* D		STORM SEWERS, CLASS A, TYPE 1 15"	FOOT	7	7			

CONTRACT NO.: 83805	COUNTY HIGHWAY	FISCAL YEAR	TOTAL SHEETS	SHEET NO.
		2005	30	3
	SEC 03-000	01-06-BT	DUPA	AGE COUNTY

p			SEC 03-0000		DUPAGE COUN		
		SUMMARY OF QUANTITIES			YO47 BIKE/	Y007	Y047 BIKE/PEDESTRIAN
ITEM	CODE	JOHNNAILI OI GOARTITIED		TOTAL	PEDESTRIAN	MINOR	PATH
NO.	NUMBER	PAY ITEM	UNIT	QUANTITY	PATH	STRUCTURE	GOO% CNTY)
33		STORM SEWERS, CLASS A, TYPE 2 12"	FOOT	57	57		
			FOOT	10			
34	550A0450	STORM SEWERS, CLASS A, TYPE 2 36"	FOOT	10	10		-
35	55100500	STORM SEWER REMOVAL 12"	FOOT	15	15		
36	55100700	STORM SEWER REMOVAL 15"	FOOT	6	6		
37	60221100	MANHOLES, TYPE A, 5'-DIAMETER, TYPE 1 FRAME, CLOSED LID	EACH	1	1		
38	60223800	MANHOLES, TYPE A, 6'-DIAMETER, TYPE I FRAME, CLOSED LID	EACH	11	1		
39	60250200	CATCH BASINS TO BE ADJUSTED	EACH	3	3		
33	80230200	CALCIL DASTAS TO BE ADDRESTED	LACII	, , , , , , , , , , , , , , , , , , ,			
40	60252800	CATCH BASINS TO BE RECONSTRUCTED	EACH	2	2		
	60055410	CATOU DACING TO DE CUEMED	EVCII	-			5
41	60255410	CATCH BASINS TO BE CLEANED	EACH	5			2
42	60605000	COMBINATION CONCRETE CURB AND GUTTER, TYPE B-6.24	FOOT	17	17		
43	63200310	GUARDRAIL REMOVAL	FOOT	71	. 71		
44	66400305	CHAIN LINK FENCE, 6'	FOOT	40	40		
	00100303	On the City of the Court of the					
45	66410300	CHAIN LINK FENCE REMOVAL	FOOT	193	193		
46	67100100	MOBILIZATION	L SUM	1	1		
46	67100100	MODILIZATION	L JOW	1	*		
47	70102625	TRAFFIC CONTROL AND PROTECTION, STANDARD 701606	L SUM	1	11		
40		TRUSTED COUTON, AND PROTECTION, CTANDING TO TO	I CINA		4		
48	70102635	TRAFFIC CONTROL AND PROTECTION, STANDARD 701701	L SUM	11	11		
49	Z0013798	CONSTRUCTION LAYOUT	L SUM	1	1		
50	Z0041700	PLUG EXISTING STORM SEWERS	EACH	2	2		
51	A2001720	TREE, ACER SACCHARUM (SUGAR MAPLE), 2-1/2" CALIPER, BALLED AND BURLAPPED	EACH	12	12		
52		TREE, BETULA NIGRA (RIVER BIRCH), 6' HEIGHT, CLUMP FORM, BALLED AND BURLAPPED	EACH	20	20		
53		TREE, CELTIS OCCIDENTALIS (COMMON HACKBERRY), 2" CALIPER, BALLED AND BURLAPPED	EACH	5	5		
54	A2004820	TREE, SKYLINE THORNLESS COMMON HONEYLOCUST, 2-1/2" CALIPER, BALLED AND BURLAPPED	EACH	12	12		
55	A2006512	TREE, QUERCUS BICOLOR (SWAMP WHITE OAK), 1-1/2" CALIPER, BALLED AND BURLAPPED	EACH	6	6		
56	A2007820	TREE, AMERICAN LINDEN/BASSWOOD, 2-1/2" CALIPER, BALLED AND BURLAPPED	EACH	12	12		
57	C2005348	SHRUB, PRUNUS AMERICANA (AMERICAN PLUM) 4' HEIGHT, BALLED AND BURLAPPED	EACH	16	16		
58	C2008936	SHRUB, ROSA SETIGERA (PRAIRIE ROSE), 36" HEIGHT, BALLED AND BURLAPPED	EACH	3	3		
59	C2009636	SHRUB, SAMBUCUS CANADENSIS (AMERICAN ELDER) 3' HEIGHT, BALLED AND BURLAPPED	EACH	12	12		
60	C2012448	SHRUB, VIBURNUM LENTAGO (NANNYBERRY), 4' HEIGHT, BALLED AND BURLAPPED	EACH	6	6		
61	K0026505	WETLAND EMERGENT PLANTINGS	UNIT	300	300		
62	K1003679	MULCH	CU YD	7	7		
		FRANCIA FOR CIPETY AND FOURNIENT OF FRANCE	CINA		ļ		ļ
63	K1004595	PRUNING FOR SAFETY AND EQUIPMENT CLEARANCE	L SUM	1	1		
64	XX003437	REMOVE AND REINSTALL EXISTING PRECAST REINFORCED CONCRETE FLARED END SECTIONS	EACH	1	1		
65	XX005676	RED-OSIER DOGWOOD	EACH	12	12		
CC	V4000414	DITUNTADUS CONODETE CUDEACE COURSE CUDERDAVE MIX "C" MEO	TON	504	504		
66		BITUMINOUS CONCRETE SURFACE COURSE, SUPERPAVE, MIX "C", N50	LIUN	1 504	1 304	L	1

DENOTES SPECIALTY ITEM

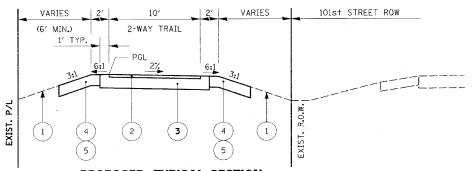

PROPOSED TYPICAL SECTION

(NOT TO SCALE)

TWO-WAY SHARED USE TRAIL FROM WOODWARD AVENUE TO LEMONT ROAD
STATION 1+00 TO 2+12.26
STATION 2+26.16 TO 41+53

ļ.		30′			I		
Ì		1'	3.46	10'		5'	101st STREET
i	HANDRAIL -			2-WAY	TRAIL		
	(SEE SHEET NO. 29)		±6:1	PGL	27/*	1' TYP	
EXIST. P/L	CULVERT HEADWALI		4 5	EXIST. R.O.W.	3	4 (5)	6

PROPOSED TYPICAL SECTION

(NOT TO SCALE)
TWO-WAY SHARED USE TRAIL AT CULVERT HEADWALL
STATION 2+12.26 TO 2+26.16

BITUMINOUS MIX	TURE REQUIR	EMENTS	
PAY ITEM	AC TYPE	VOIDS	MAX RAP %
BITUMINOUS CONCRETE SURFACE COURSE, SUPERPAVE, MIX "C", N50	PG 64-22	4% @ 50 Gyr.	15

THE UNIT WEIGHT USED TO CALCULATE ALL BITUMINOUS SURFACE MIXTURE QUANTITIES IS 112 LBS/SQ YD/INCH.

- 1 EXISTING GRADE
- 2) BITUMINOUS CONCRETE SURFACE COURSE, SUPERPAVE, MIX "C", N50 2"
- 3) AGGREGATE BASE COURSE, TYPE B 6"
- 4 TOPSOIL EXCAVATION AND PLACEMENT 6"
- 5 SEEDING
- 6 EXISTING COMBINATION CURB & GUTTER, TYPE B-6.24
- * CROSS-SLOPE PATH 2% DOWN TO THE NORTH FROM STA. 1+81 TO STA. 3+67.

N	DATE	1	REVISION	DATE		REVISION	SCALE			
Γ							DRAWN BY	JMC	DATE	KI
Г	1				Γ		CHECKED BY	MRH	DATE	-3
Г		1					APPROVED BY	DWB	DATE	GRO

RJN GROUP, INC. consulting engineers

Southern DuPage County Regional Trail 101st Street Connector — Waterfall Glen Spur SUMMARY OF QUANTITIES AND TYPICAL SECTIONS

DATE: JUNE 9, 2005
PROJECT No.; II-1900-01
SHEET;

STATION	OFFSET	6 - 15 UNITS	STATION	OFFSET	6 - 15 UNITS
1+57	20' LT	8"	14+43	2' RT	6"
1+98	17' LT	8"	14+55	15′ RT	7''
5+27	11' RT	7''	15+13	13' RT	6"
5+36	2′ LT	11''	15+89	1' RT	6"
8+12	15′ RT	11''	16+15	13' RT	8"
8+28	5′ LT	7''	17+99	13' RT	11"
8+33	- 7' LT	9"	19+08	15′ RT	8''
8+52	9' LT	9"	19+68	15' RT	8′′
9+03	14′ RT	12"	20+17	3′ LT	6"
9+16	5′ LT	6"	20+41	7′ RT	8''
9+56	15′ RT	9″	23+19	8′ LT	6"
9+79	3′ RT	9″	23+26	17′ RT	9"
10+17	5′ RT	13"	23+54	7′ LT	9"
10+49	21' RT	13"	26+54	15′ RT	6"
11+38	15′ RT	8"	27+45	14' RT	8"
12+11	7′ RT	7"	27+67	1' RT	11''
13+07	5′ RT	6"	28+35	5′ LT	11''
13+32	15' RT	13"	31+06	18' RT	9"
13+88	11' RT	6"	39+95	7′ LT	15''
				TOTAL	330 UNI

EROSION	CONTRO	L					
		TEMPORARY	INLET & PIPE			TEMPORARY	INLET & PIPE
STATION	OFFSET	DITCH CHECKS	PROTECTION	STATION	OFFSET	DITCH CHECKS	PROTECTION
		28000300	28000500			28000300	28000500
5+01	23′ RT	1		35+99	29' RT	1	
5+77	21' RT	1		37+55	30′ RT	1	
6+53	20' RT	1		39+00	30′ RT	1	
7+23	23' RT	1		2+31	16′ RT		1
7+99	25′ RT	1		4+62	22′ RT		1
8+77	27′ RT	1		4+39	19′ RT		1
9+55	29' RT	1		8+51	7′ LT		1
10+24	32' RT	1		10+04	6′ LT		1
13+00	28' RT	1		10+75	34′ RT		1
14+59	27′ RT	1		23+19	8′ LT		1
16+77	26′ RT	1		24+18	27′ RT		1
26+99	27′ RT	1		25+71	27′ RT		1
28+38	18' RT	1		36+72	10' LT		1
29+99	21' RT	1		40+17	6′ LT		1
31+56	27′ RT	1		41+08	22′ RT		1
33+00	27′ RT	1		41+45	6′ LT		1
34+54	28′ RT	1					
					TOTALS	20	13

COUNTY HIGHWAY	FISCAL YEAR	TOTAL SHEETS	SHEET NO.	
	2005	30	4	
SEC 03-000	01-06-BT	DUPAGE COUNTY		

CONTRACT NO.: 83805

FENCE										
		CHAIN LINK	CHAIN LINK							
STATION	OFFSET	FENCE, 6'	FENCE REMOVAL							
		66400305	66410300							
14+25	11' LT	20′	40′							
33+07	15' LT	20′	40′							
	TOTALS	40′	80′							

DRAIN	IAGE															
		TRENCH	PRECAST REINFORCED CONCRETE FLARED END	STORM SEWERS, CLASS A, TYPE 1	STORM SEWERS, CLASS A, TYPE 1	STORM SEWERS, CLASS A, TYPE 2	STORM SEWERS, CLASS A, TYPE 2	STORM SEWER REMOVAL	STORM SEWER REMOVAL	MANHOLES, TYPE A 5'-DIAMETER, TYPE 1	MANHOLES, TYPE A 6'-DIAMETER, TYPE 1	CATCH BASINS TO BE	CATCH BASINS TO BE	CATCH BASINS TO BE	PLUG EXISTING	REMOVE AND REINSTALL EXISTING PRECAST REINFORCED
STATION	OFFSET	BACKFILL 20800150	SECTIONS, 12" 54213657	12" (FT) 550A0050	15" (FT) 550A0070	12" (FT) 550A0340	36" (FT) 550A0450	12" (FT) 55100500	15" (FT) 55100700	FRAME, CLOSED LID 60221100	FRAME, CLOSED LID 60223800	ADJUSTED 60250200	RECONSTRUCTED 60252800	CLEANED 60255410	ZOO41700	CONCRETE FLARED END SECTIONS XX003437
2+38	5′ RT	18,20	54215651	550A0050	550A0070	25	550A0450	33100300	33100100	60221100	60223600	00230200	60232000	60233410	20041100	77003431
	L		1	26												
8+51	10' RT	5.04				 										
10+04	12.5′ RT	5.63		29												
23+20	.11' RT	10.91				32			· · · · · · · · · · · · · · · · · · ·							
40+11	2′ RT	10.92		15				15								
28+50	12′ RT	2.14			7				6							_, _ , _ , _ , _ , _ , _ , _ , _ , _ ,
2+36	8.5′ LT	15.08					10									
8+51	7′ LT		1													
8+51	26′ RT		1													
10+04	6' LT		1													
10+04	30.5′ RT		1													
23+20	8' LT		1													
2+44	8′ LT									1						
23+21	30.5′ RT										1					
28+50	6' RT											1		1		
33+41	10' RT											1	-	1		
36+91	15' RT											1		1		
29+89	10' RT									-			1	1		
40+05	9' RT												1	1		
2+29	10' RT														2	
28+50	19' RT															1
	TOTALS	68	5	70	7	57	10	15	6	1	1	3	2	5	2	1

	REM & DISP OF UNSUITABLE MATERIAL (PGES) (CU YD)	REM & DISP OF UNSUITABLE MATERIAL (TOPSOIL) (CU YD)	EARTH EXCAVATION (CU YD)	STORM SEWER EXCAVATION (CU YD)	TOTAL SUITABLE EXCAVATION (CU YD)	EXCAVATION TO BE USED IN EMBANKMENT (ADJ FOR 15% SHRINKAGE (CU YD)	EMBANKMENT (CU YD)	EARTHWORK BALANCE WASTE (+) OR SHORTAGE -) (CU YD)
1+00 TO 10+00	O	416	573	38	611	519	226	+293
10+00 TO 20+00	0	388	617	6	623	530	48	+482
20+00 T0 30+00	0	435	734	13	747	635	91	+544
30+00 TO 41+57.13	0	503	885	11	896	762	188	+574
TOTALS	0	1,742	2,809	68	2,877	2,445	553	+1,892

2:	NO.	DATE	BY	REVISION	NO.	BY	REVISION	SCALE		
.05								DRAWN BY	JMC	DATE
720								CHECKED BY	MRH	DATE
/17.								APPROVED BY	DWB	DATE





RJN GROUP, INC. CONSULTING ENGINEERS


Southern DuPage County Regional Trail 101st Street Connector — Waterfall Glen Spur


SCHEDULES


DATE: JUNE 9, 2005
PROJECT No.: II-1900-01
SHEET:

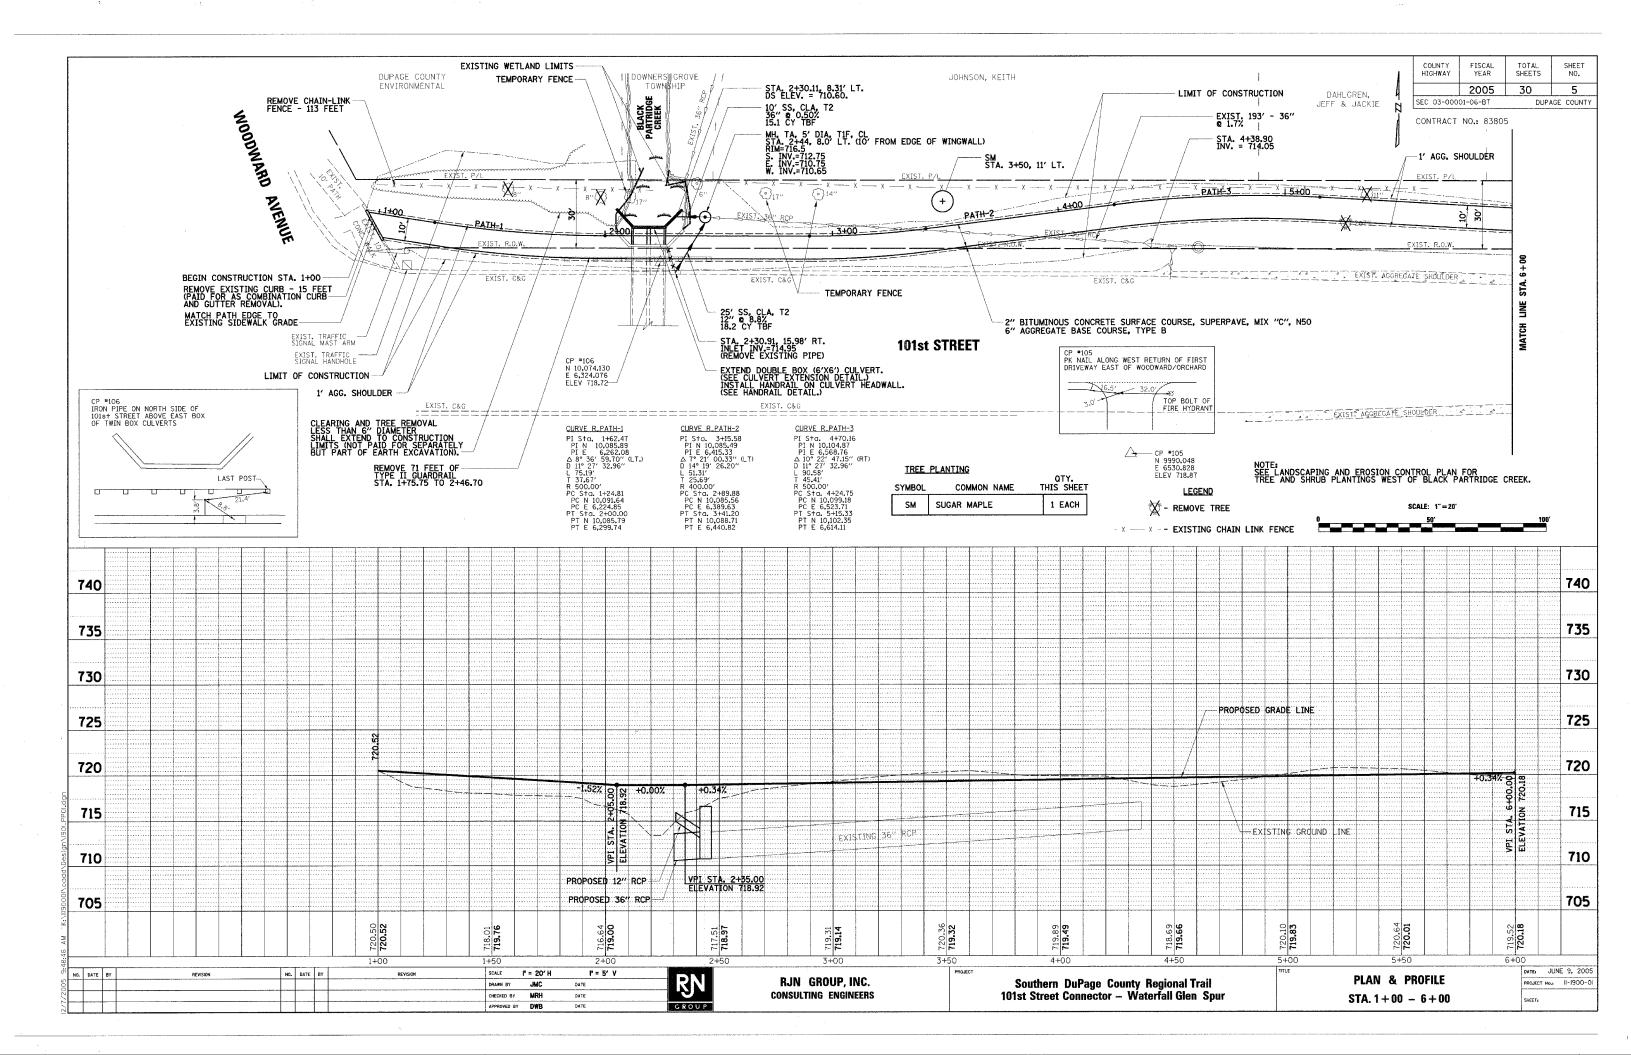


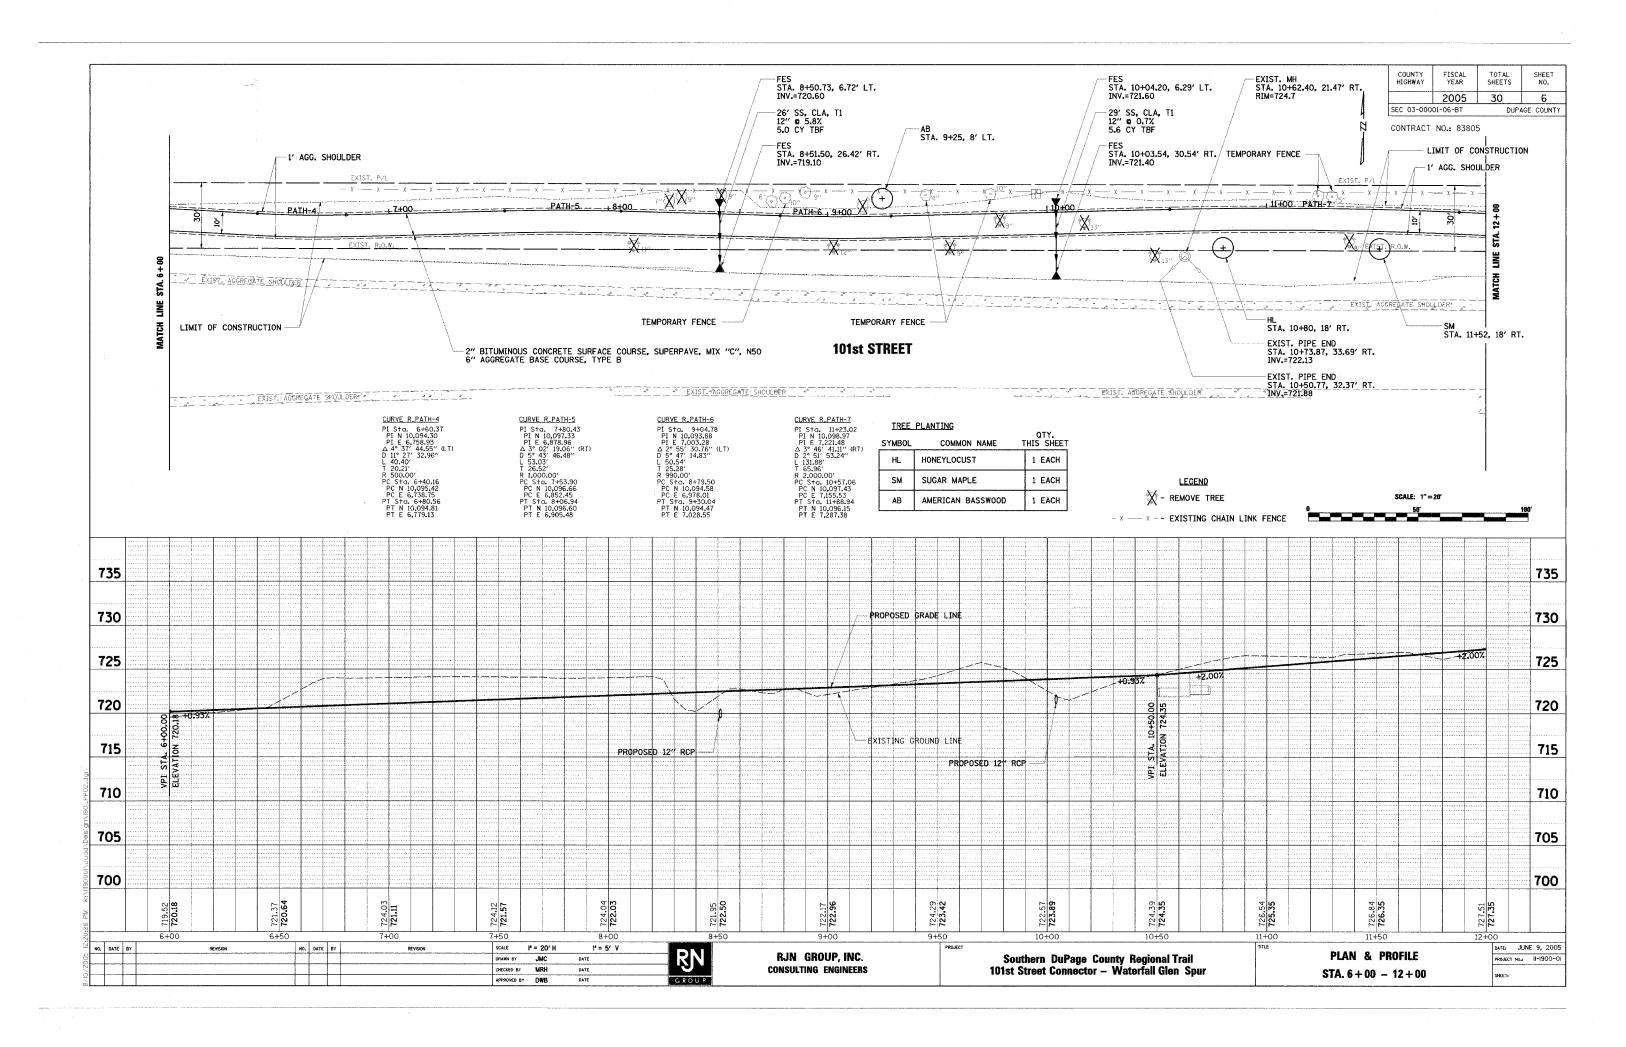


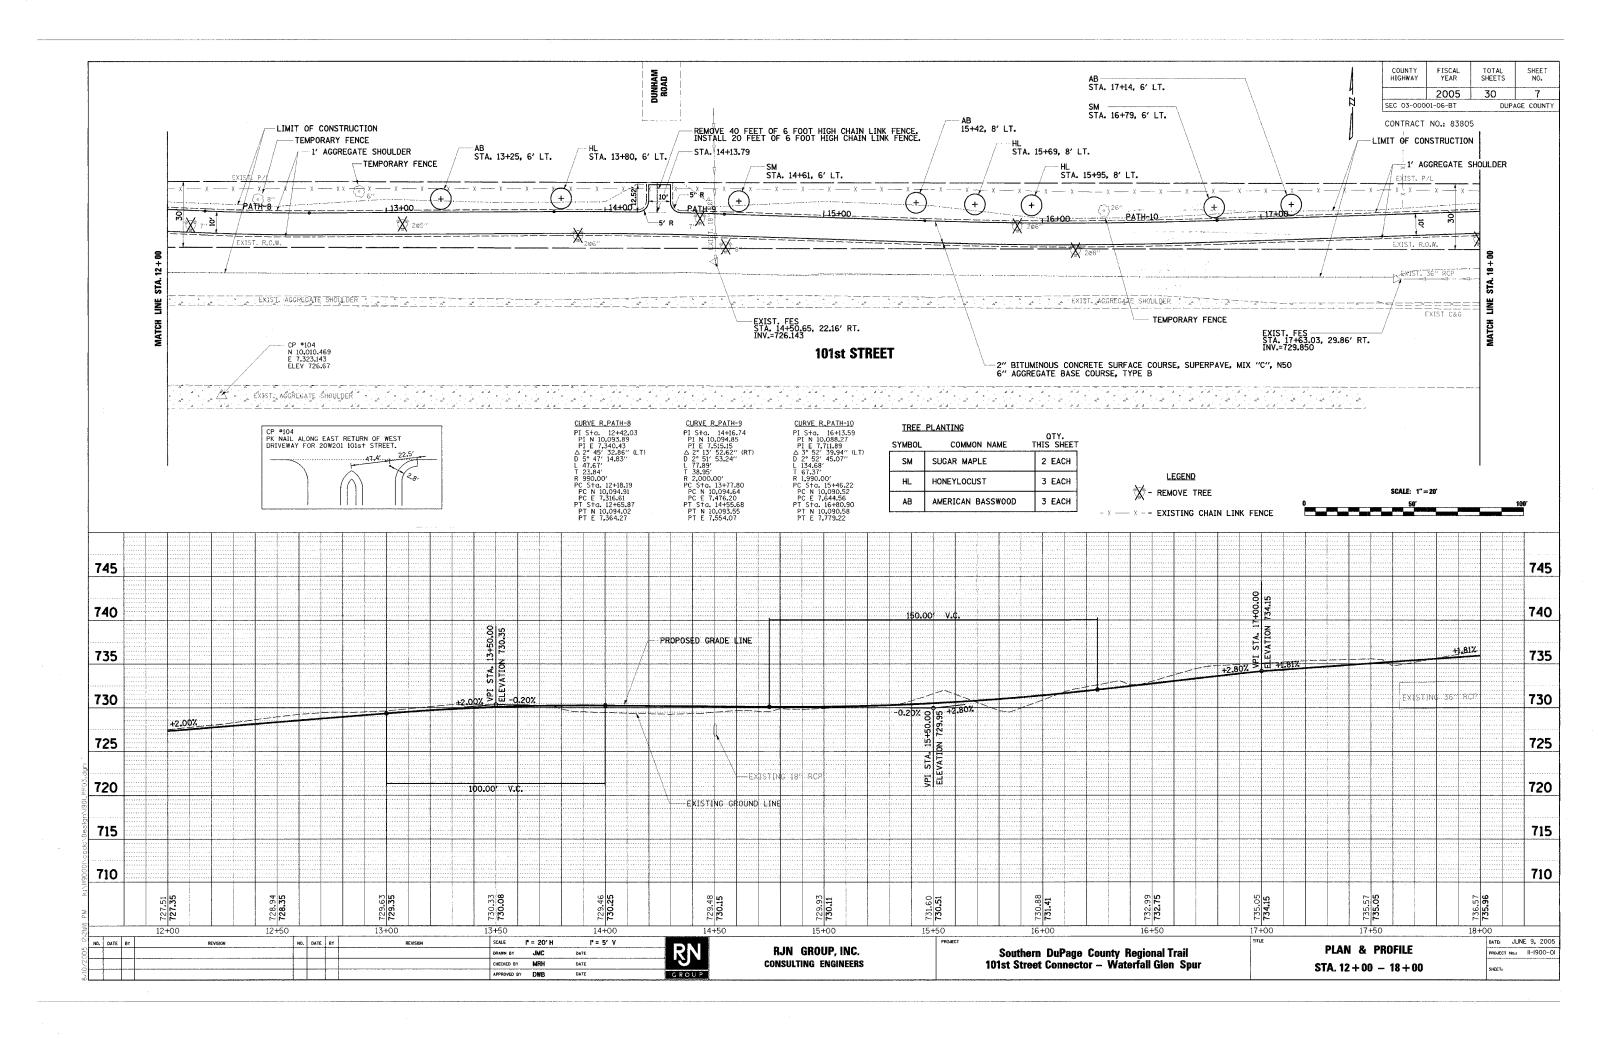


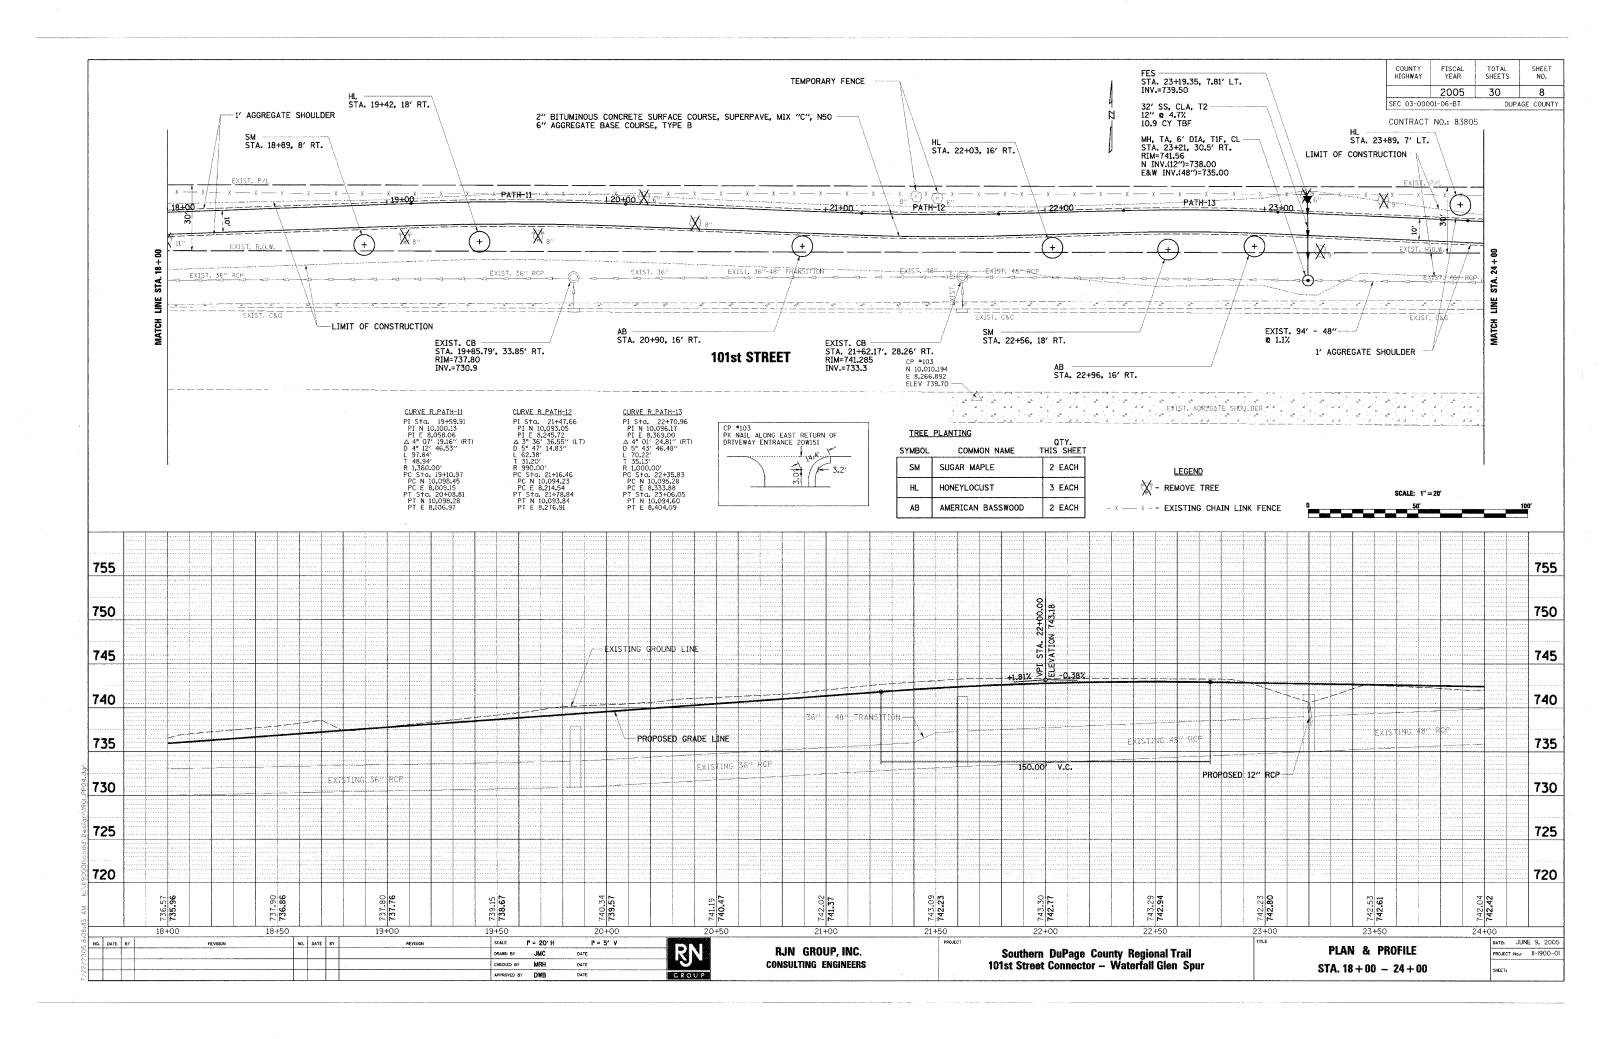


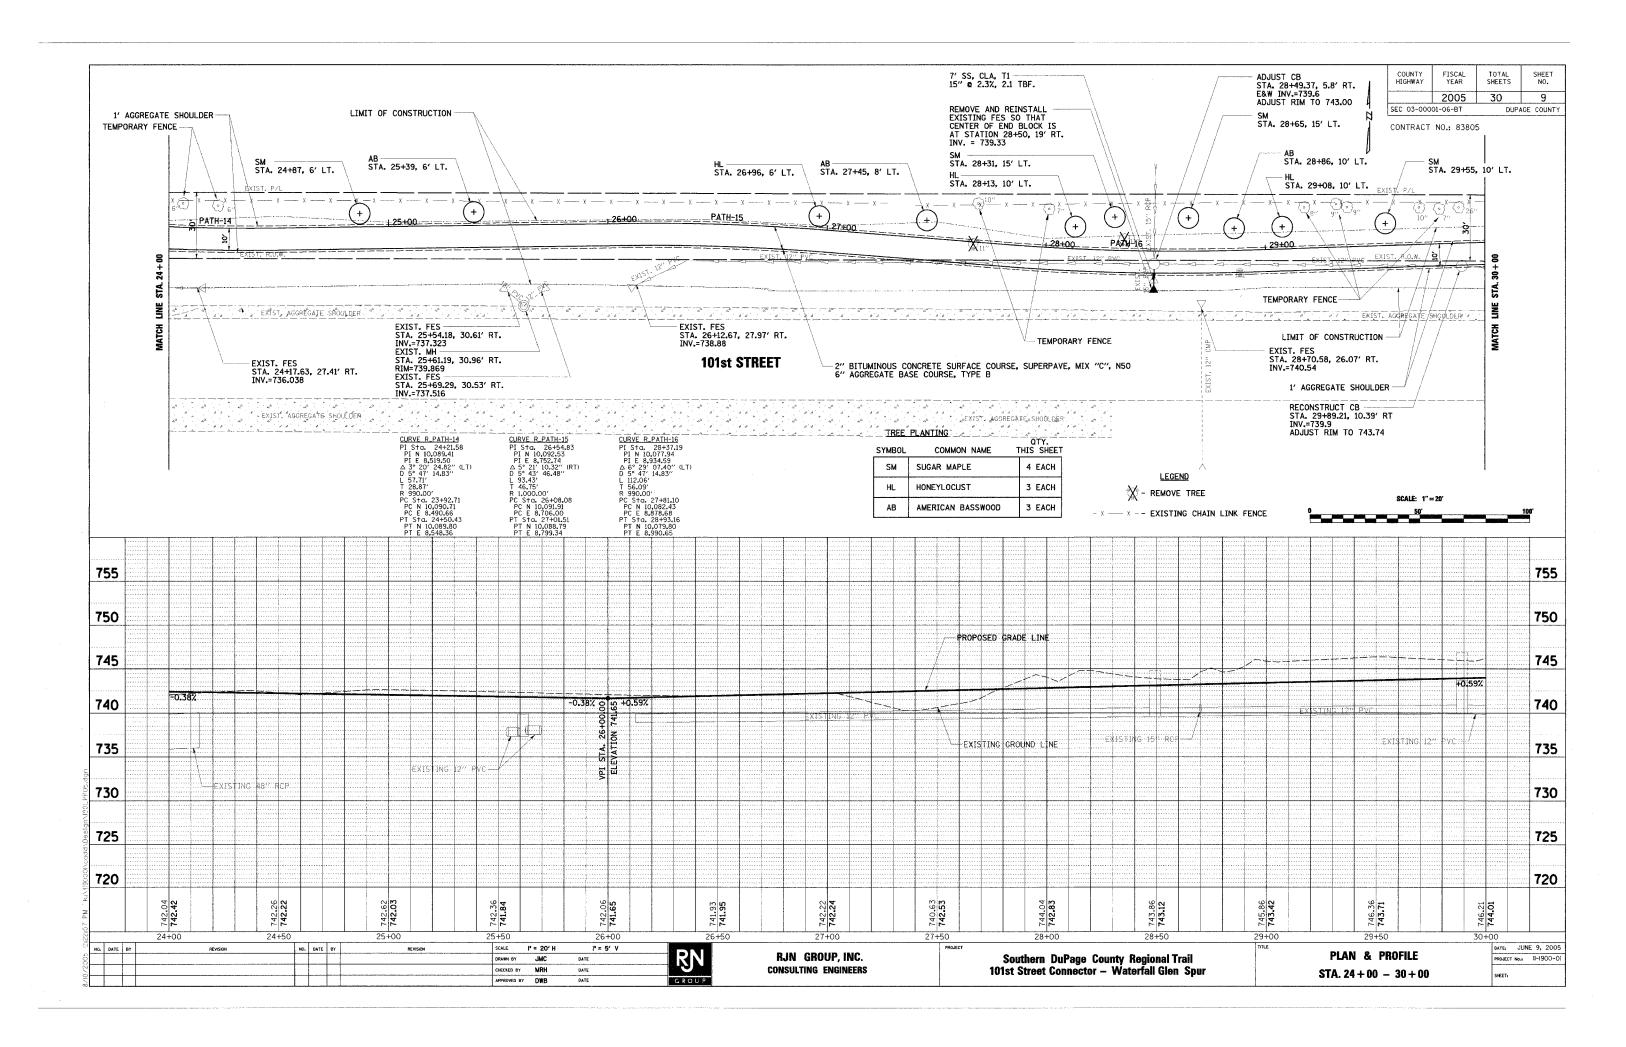


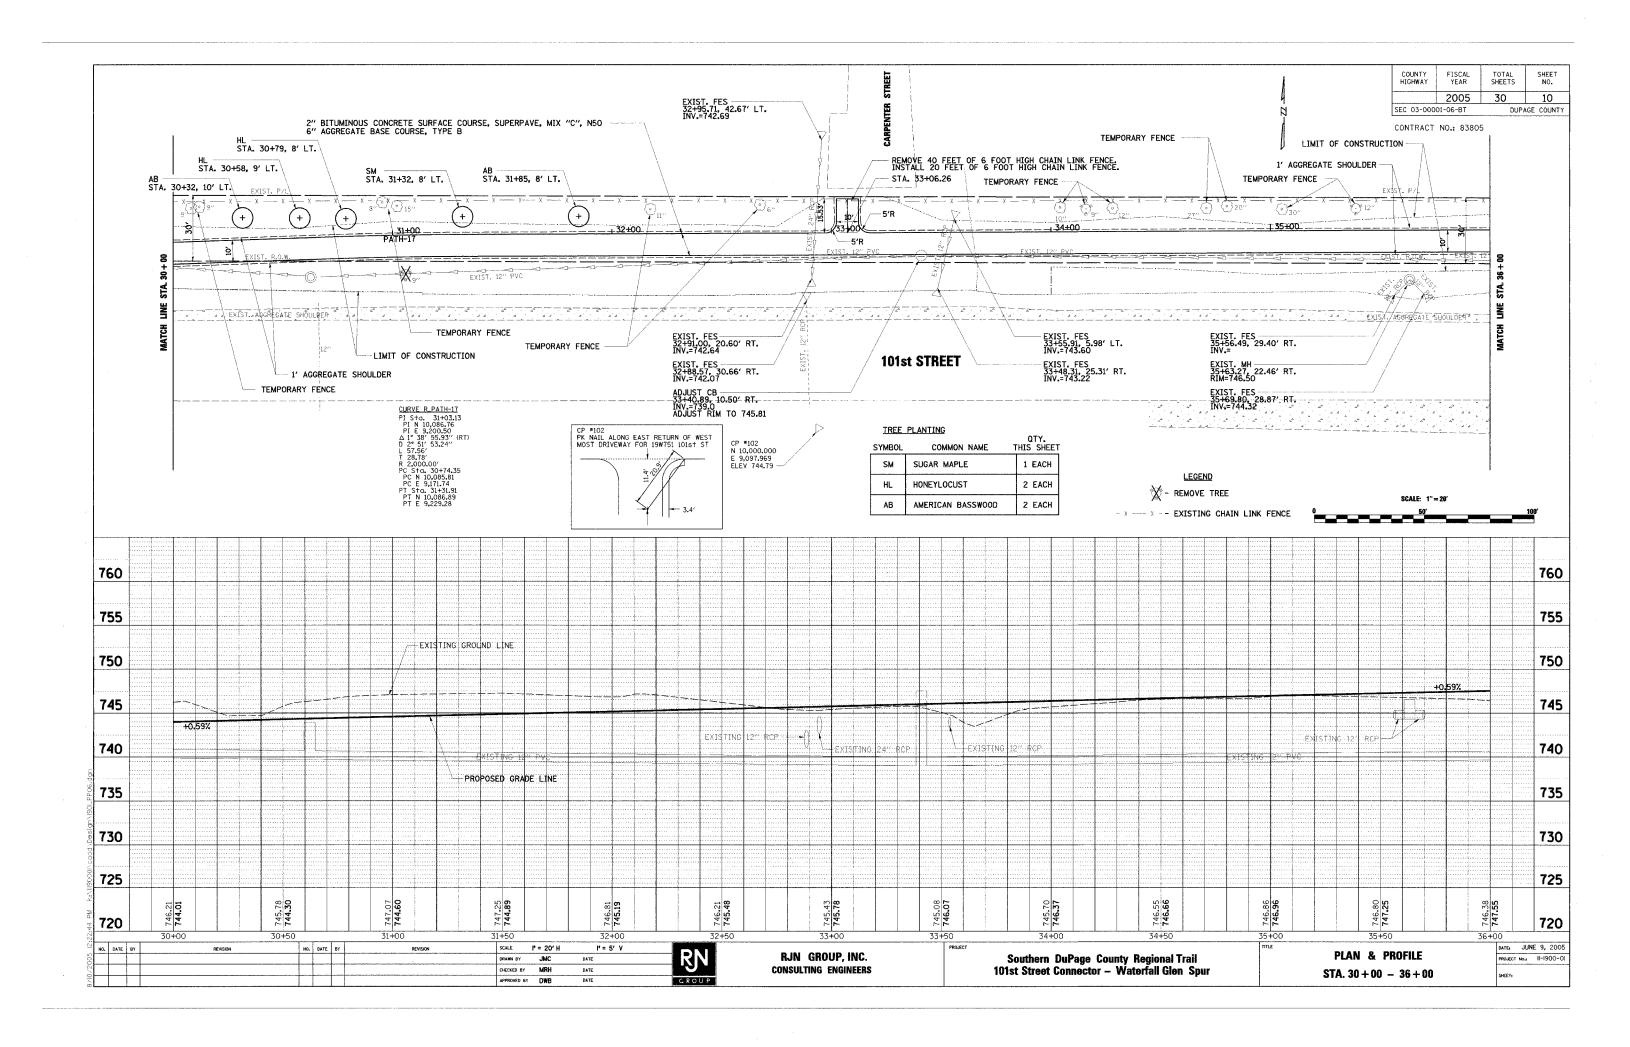

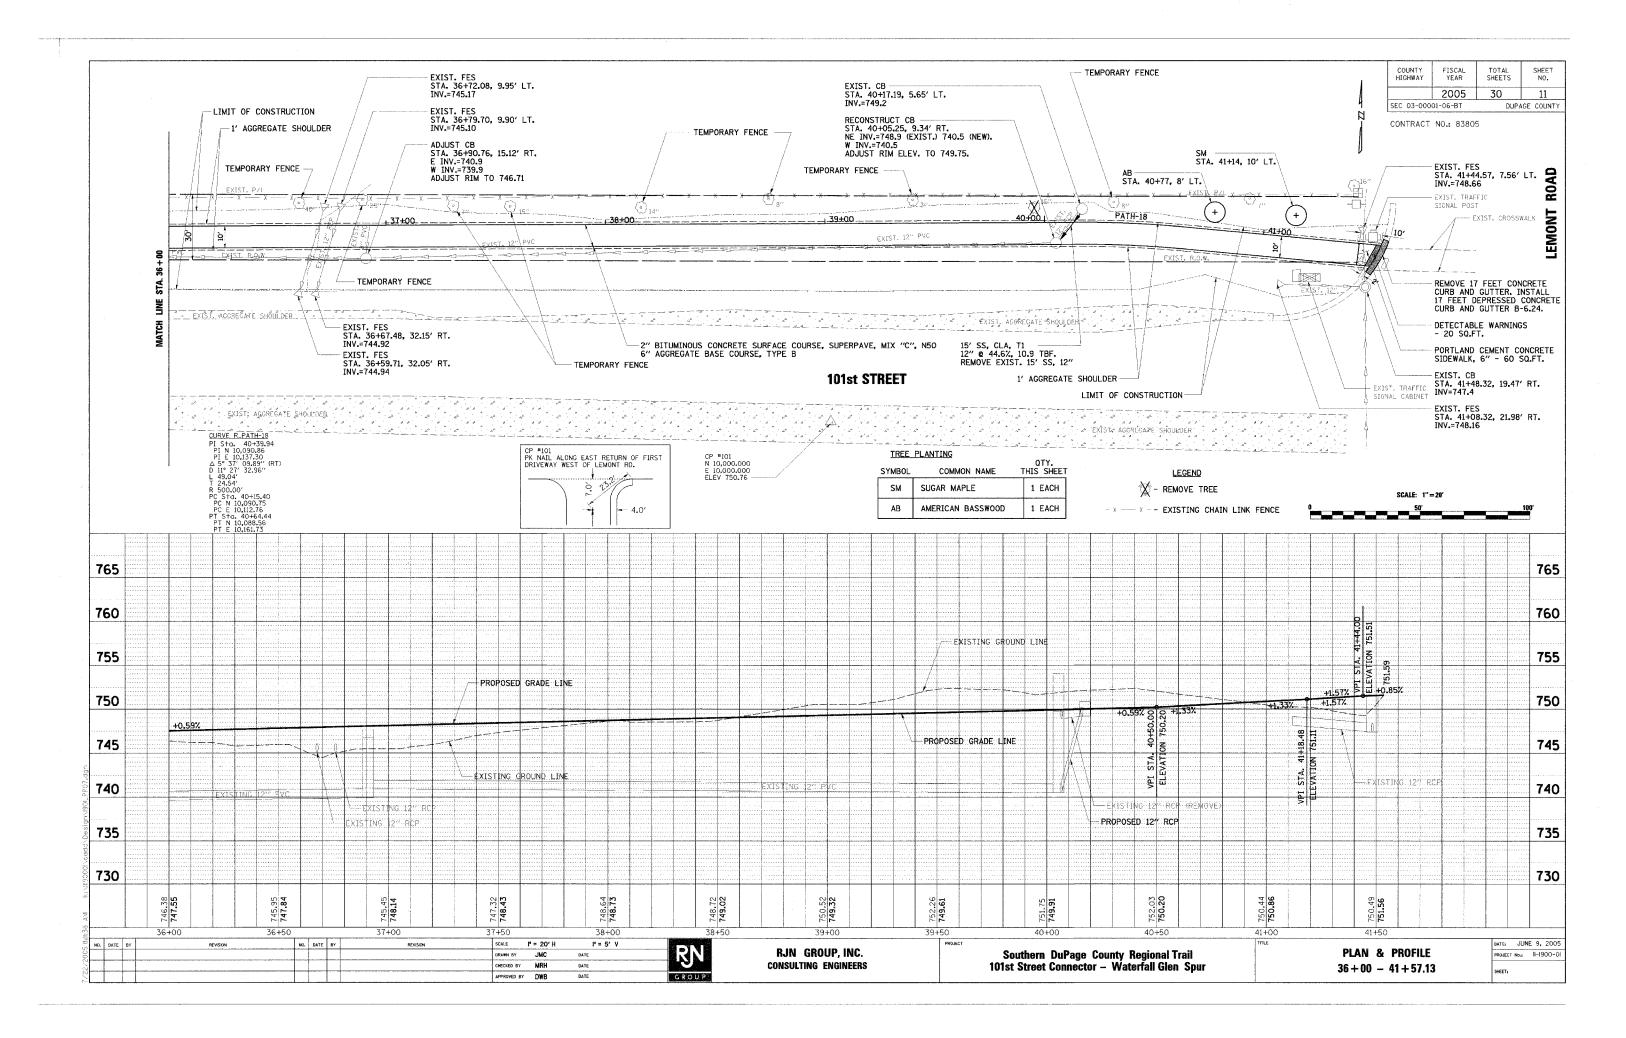


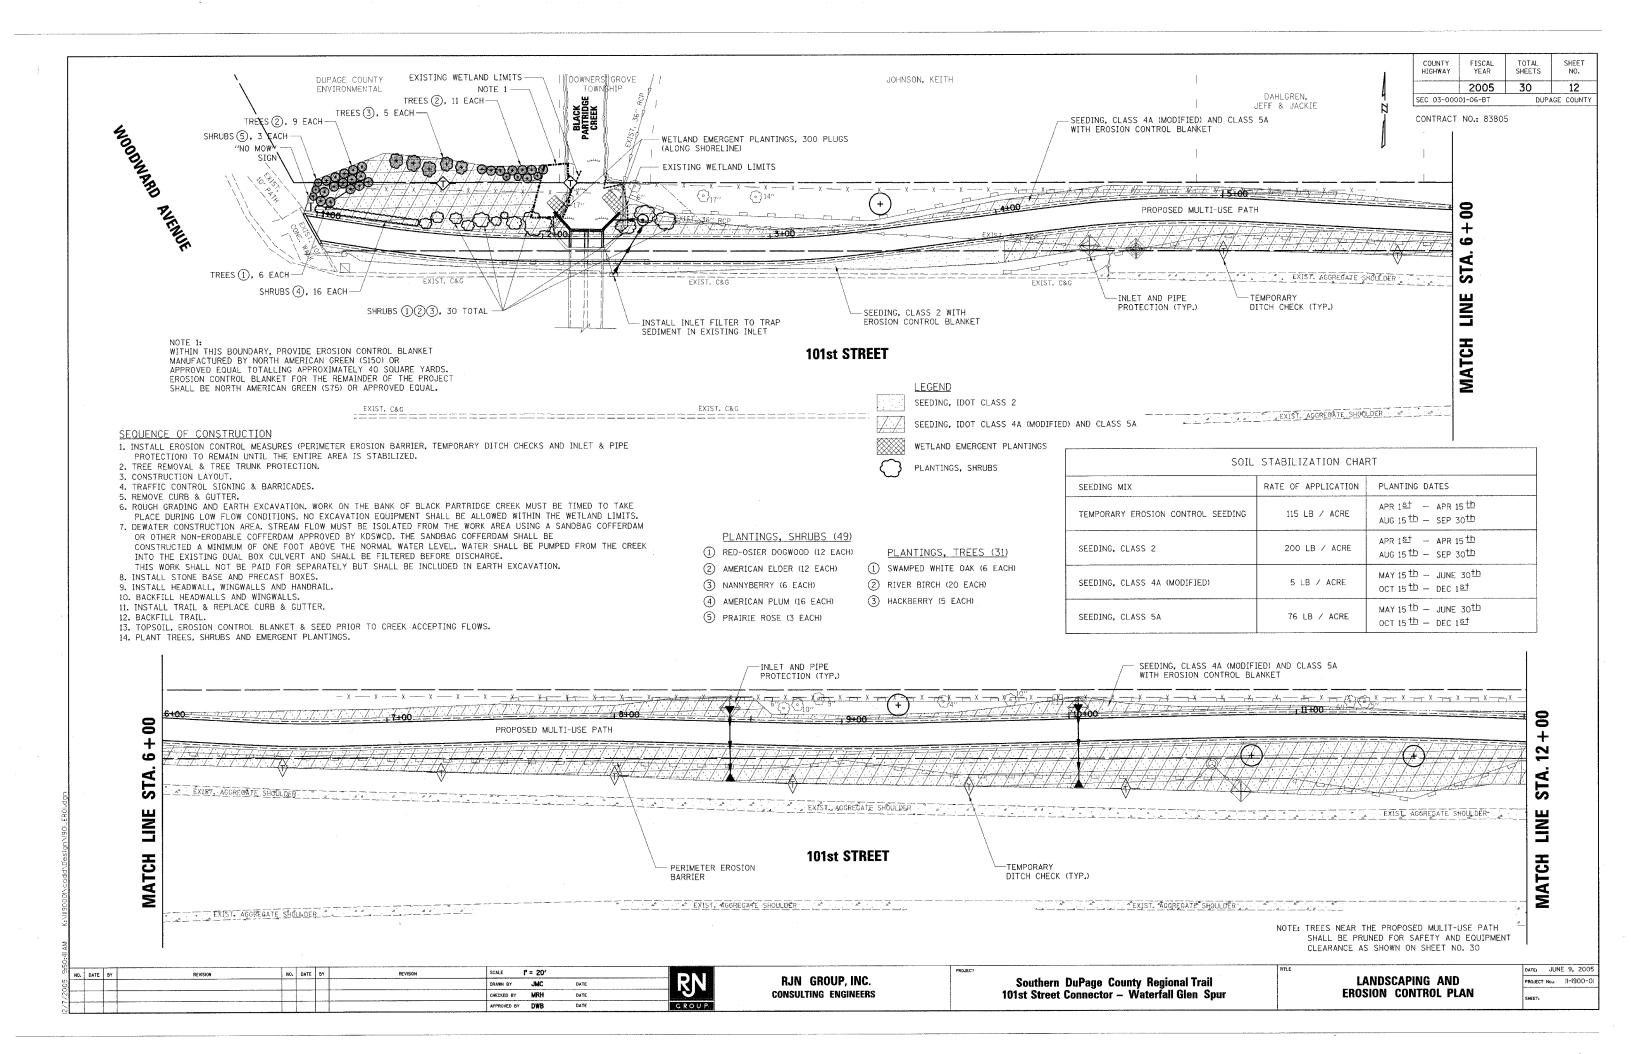

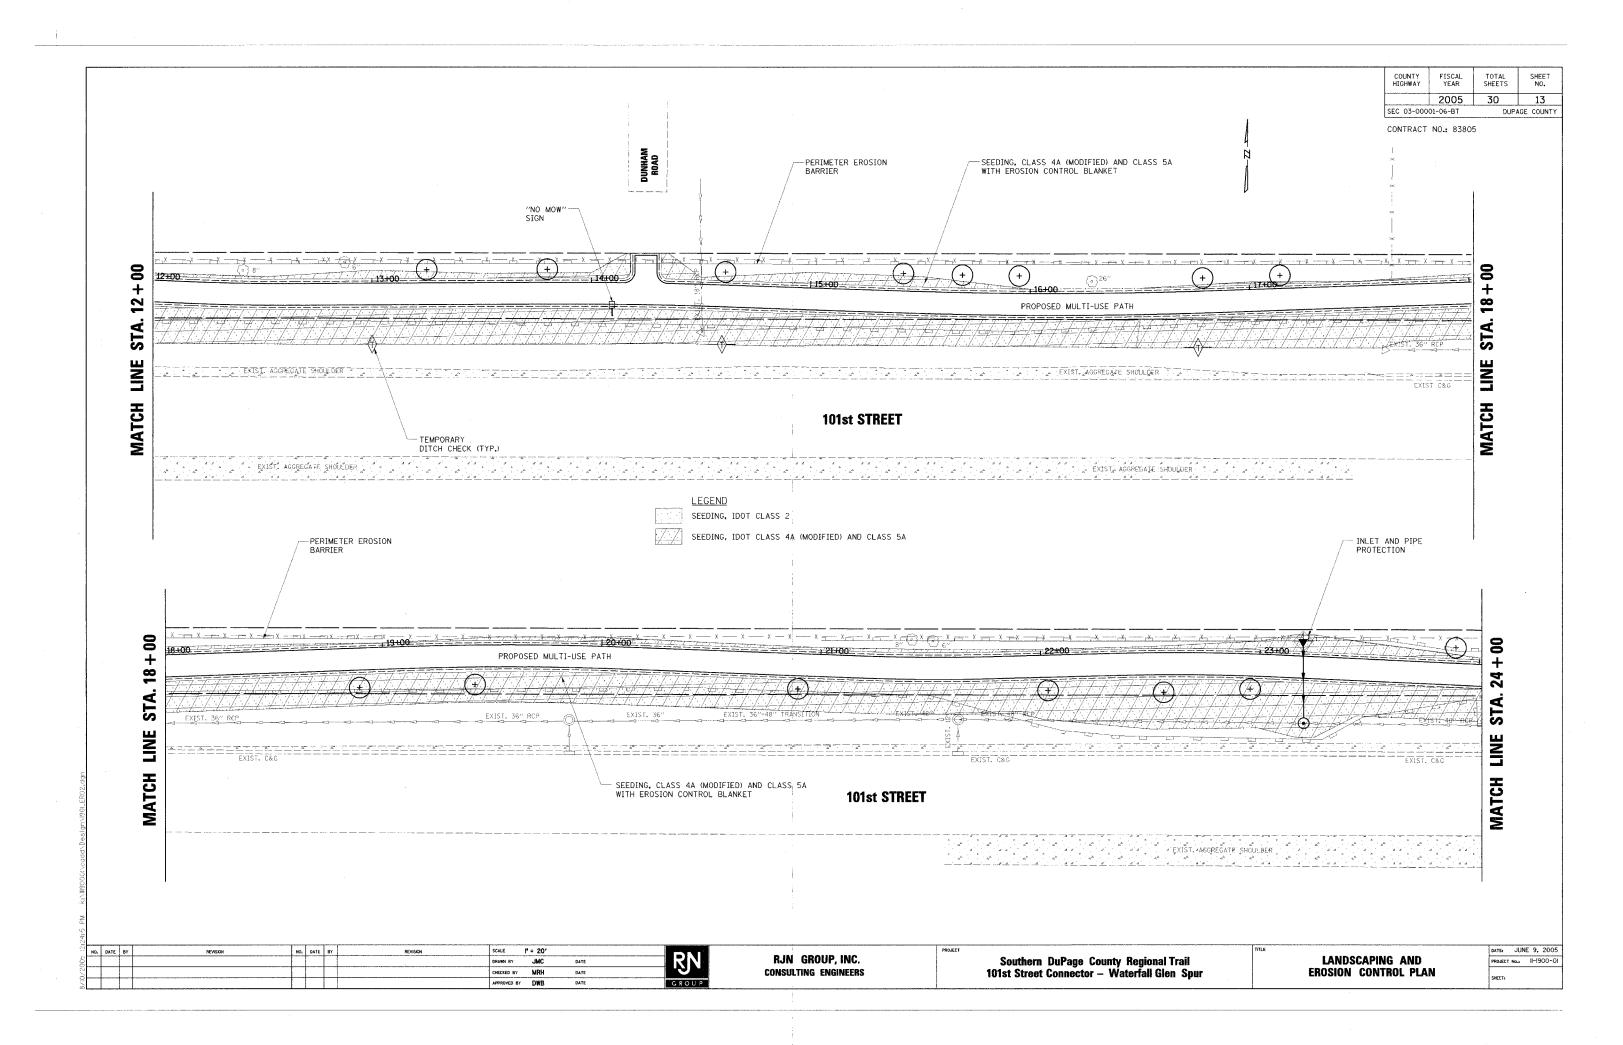

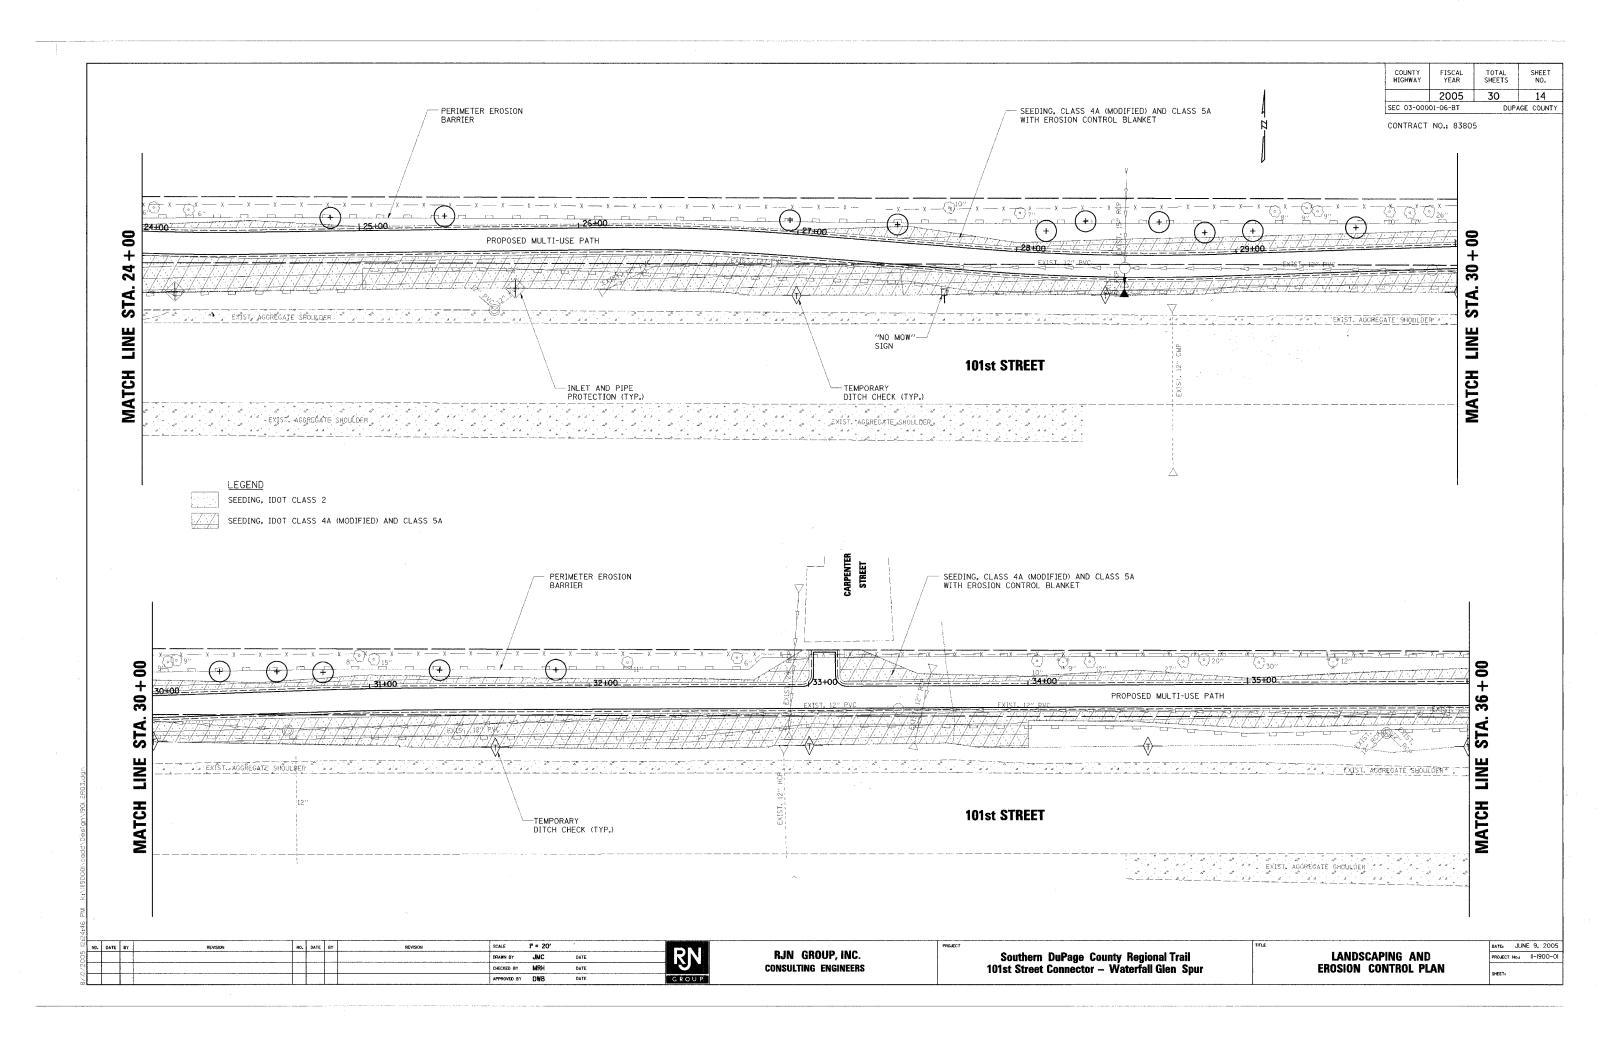

HIGHWAY SHEETS 2005 30 15 SEC 03-00001-06-B1 DUPAGE COUNT CONTRACT NO.: 83805

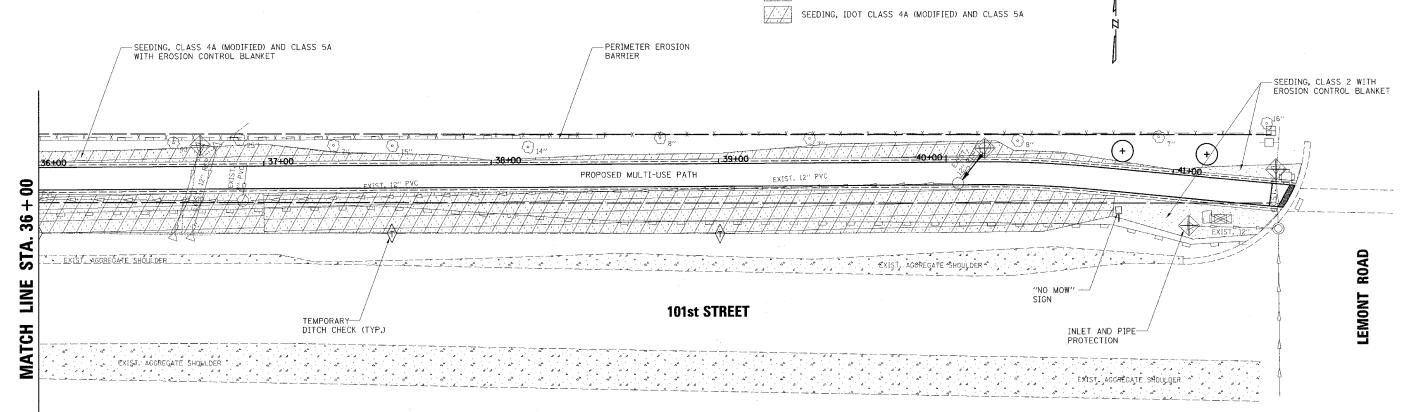

LEGEND

SEEDING, IDOT CLASS 2

EROSION CONTROL NOTES

- ALL WORK SHALL BE DONE IN ACCORDANCE WITH SECTION 15-116 OF THE DU PAGE COUNTY COUNTYWIDE STORM WATER AND FLOOD PLAIN ORDINANCE, EFFECTIVE SEPTEMBER 24, 1991 AND ALL SUBSEQUENT REVISIONS. ALL SEDIMENT AND EROSION CONTROL MEASURES WILL BE INSTALLED PER IDOT STANDARD 280001 OR AS SPECIFIED HEREIN AND PAID FOR IN ACCORDANCE WITH SECTION 280 OF THE STANDARD SPECIFICATIONS. ALL CONSTRUCTION ACTIVITIES WILL BE IN ACCORDANCE WITH THE NATIONAL POLLUTANT DISCHARGE ELIMINATION SYSTEM STORM WATER PERMIT ILR40.
- EROSION CONTROL SHALL BE PROVIDED IN ACCORDANCE WITH THE SEQUENCE OF STAGE CONSTRUCTION. THE CONTRACTOR SHALL SUBMIT A DETAILED SCHEDULE FOR APPROVAL.
- SEDIMENT AND EROSION CONTROL DEVICES SHALL BE FUNCTIONAL BEFORE THE PROJECT SITE IS OTHERWISE DISTURBED.
- ALL DISTURBED AREAS SHALL BE SEEDED OR SODDED AS SOON AS PRACTICAL AFTER CONSTRUCTION ACTIVITIES IN THAT AREA HAVE CONCLUDED. ALL ERODABLE/BARE AREAS SHALL BE SEEDED EVERY 7 DAYS WITH TEMPORARY EROSION CONTROL SEEDING. ERODABLE AREAS OUTSIDE AND DOWN SLOPE FROM THE CONSTRUCTION LIMITS SHALL BE
- THE CONTRACTOR SHALL TAKE ALL PRECAUTIONS TO PROTECT WETLANDS TO REMAIN FROM DAMAGE BY SEDIMENT, CONSTRUCTION EQUIPMENT OR BY HIS WORK CREWS. THE CONTRACTOR SHALL ASSURE THAT DEBRIS OR ANY CONSTRUCTION MATERIAL IS NOT DISPOSED OF IN
- WATER PUMPED OR OTHERWISE DISCHARGED FROM THE SITE DURING CONSTRUCTION DEWATERING
- WHEN TEMPORARY DRAINAGE IS ESTABLISHED, EROSION CONTROL MEASURES MAY BE REQUIRED
- GRAVEL ROADS, ACCESS DRIVES, PARKING AREAS OF SUFFICIENT WIDTH AND LENGTH, AND VEHICLE WASH DOWN FACILITIES IF NECESSARY, SHALL BE PROVIDED TO PREVENT SOIL FROM BEING TRACKED ONTO PUBLIC OR PRIVATE ROADWAYS. ANY SOIL REACHING A PUBLIC OR PRIVATE ROADWAY SHALL BE REMOVED BEFORE THE END OF EACH WORKDAY AND AS NEEDED.
- CLEANING OF VEHICLES AND EQUIPMENT, INCLUDING CONCRETE MIXERS, SHALL BE PERFORMED IN A MANNER TO REDUCE THE AMOUNT OF POLLUTANTS TRIBUTARY TO STORM SEWERS AND OPEN WATERS TO THE MAXIMUM EXTENT PRACTICAL.

- ALL NECESSARY MEASURES SHALL BE TAKEN TO CONTAIN ANY FUEL OR POLLUTION RUNOFF. LEAKING EQUIPMENT OR SUPPLIES SHALL BE IMMEDIATELY REPAIRED OR REMOVED FROM THE
- SEDIMENT COLLECTED DURING CONSTRUCTION BY THE VARIOUS TEMPORARY EROSION CONTROL SYSTEMS SHALL BE DISPOSED OF ON THE SITE ON A REGULAR BASIS. SEDIMENT SHALL BE REMOVED FROM EROSION CONTROL SYSTEMS WHEN THE HEIGHT OF THE SEDIMENT EXCEEDS ONE-HALF OF THE HEIGHT OF THE FILTER DEVICE.
- THE ENGINEER SHALL INSPECT EROSION CONTROL MEASURES PERIODICALLY AND WITHIN 24 HOURS OF ANY STORM EXCEEDING $\frac{1}{2}$ INCH PRECIPITATION. DAMAGED AND INEFFECTIVE EROSION CONTROL MEASURES SHALL BE REPAIRED OR REPLACED WITHIN 72 HOURS. EROSION CONTROL SYSTEMS REPLACED DUE TO SEDIMENT LOADING WILL BE PAID FOR AT THE CONTRACT UNIT PRICE FOR THE APPLICABLE EROSION CONTROL ITEM.
- THE COST OF REPAIRING OR REMOVING SEDIMENT FROM EROSION CONTROL SYSTEMS SHALL BE INCLUDED IN THE CONTRACT UNIT PRICE FOR THE APPLICABLE EROSION CONTROL ITEM.
- ALL EROSION CONTROL MEASURES SHALL BE KEPT OPERATIONAL AND MAINTAINED CONTINUOUSLY THROUGHOUT THE PERIOD OF LAND DISTURBANCE UNTIL PERMANENT SEDIMENT AND EROSION CONTROL MEASURES ARE OPERATIONAL.
- 15. $\bar{\ }$ ALL DISTURBED AREAS SHALL BE DRESSED WITH 6" OF TOPSOIL, SEEDED AND COVERED WITH AN EROSION CONTROL BLANKET STAPLED DOWN PER THE MANUFACTURER'S RECOMMENDATION.
- 16. OMIT FERTILIZER FOR CLASS 4A (MODIFIED) AND CLASS 5A SEEDING.

GROUP

- NO WORK SHALL BE PERFORMED IN FLOWING WATER. WORK IN AND NEAR THE CRITICAL AREAS SHOULD BE ISOLATED FROM CONCENTRATED FLOWS OR STREAM FLOW. THE STREAM BANKS SHOULD BE STABILIZED AT THE END OF EACH DAY. ONCE WORK IN THIS AREA BEGINS, PRIORITY SHALL BE GIVEN TO THE COMPLETION OF THE WORK AND FINAL STABILIZATION OF ALL DISTURBED AREAS.
- THE KANE AND DUPAGE SOIL & WATER CONSERVATION DISTRICT (DSWCD) MUST BE IN AGREEMENT WITH OVERALL EXACT METHOD OF DIVERSION/ISOLATION AND CONTACTED 48 HOURS PRIOR TO THE COMMENCEMENT OF CONSTRUCTION.


- THE EROSION CONTROL BLANKET SHALL BE AN EXCELSIOR BLANKET MEETING THE REQUIREMENTS AS SPECIFIED IN ARTICLE 1081.10 OF THE STANARD SPECIFICATIONS. THE BLANKET SHALL BE COVERED ON THE TOP SIDE WITH A 90 DAY BIODEGRADABLE EXTRUDED PLASTIC MESH NETTING WITH A MINIMUM OPENING OF 36" X 36" AND A MAXIMUM OPENING OF 2" X 1". THE MINIMUM REQUIRED WEIGHT IS 0.63 LB/SY AND MINIMUM ROLL DIMENSION
- IN THE EVENT THAT THE PROJECT WILL NOT BE COMPLETED BEFORE WINTER SHUTDOWN, ALL SLOPES AND BARE EARTH AREAS SHALL BE STABILIZED WITH TEMPORARY AND/OR PERMANENT VEGETATIVE COVER IN ACCORDANCE WITH THE SOIL STABILIZATION CHART FOR PROPER EROSION AND SEDIMENT CONTROL.
- THE ROADWAY INLET IN THE NORTH CURB LINE OF 101ST STREET JUST EAST OF THE EXISTING DUAL 6' X 6' CULVERT SHALL BE PROTECTED WITH AN INLET FILTER THROUGHOUT THE DURATION OF THE PROJECT.
- STRAW BALES ARE EXCLUDED AS AN OPTION FOR TEMPORARY DITCH CHECKS.
- UNLESS OTHERWISE INDICATED, ALL VEGETATIVE AND STRUCTURAL EROSION AND SEDIMENT CONTROL PRACTICES WILL BE CONSTRUCTED ACCORDING TO MINIMUM STANDARDS AND SPECIFICATIONS IN THE ILLINOIS URBAN MANUAL REVISED FEBRUARY 2002.
- THE KDSWCD MUST BE NOTIFIED ONE WEEK PRIOR TO THE PRE-CONSTRUCTION CONFERENCE, ONE WEEK PRIOR TO THE COMMENCEMENT OF LAND DISTURBING ACTIVITIES, AND ONE WEEK PRIOR TO THE FINAL INSPECTION. PHONE NUMBER: (630) 584-7961 EXTENSION #3.
- A COPY OF THE APPROVED EROSION AND SEDIMENT CONTROL PLAN SHALL BE MAINTAINED
- PRIOR TO COMMENCING LAND-DISTURBING ACTIVITIES IN AREAS OTHER THAN INDICATED ON THESE PLANS (INCLUDING BUT NOT LIMITED TO, ADDITIONAL PLASES OF DEVELOPMENT AND OFF-SITE BORROW OR WASTE AREAS) A SUPPLEMENTARY EROSION CONTROL PLAN SHALL BE SUBMITTED TO THE OWNER FOR REVIEW BY THE KDSWCD.
- THE CONTRACTOR IS RESPONSIBLE FOR INSTALLATION OF ANY ADDITIONAL EROSION CONTROL MEASURES NECESSARY TO PREVENT EROSION AND SEDIMENTATION AS DETERMINED BY THE KDSWCD.


SCALE | = 20' DRAWN BY JMC CHECKED BY MRH DWB


RJN GROUP, INC. CONSULTING ENGINEERS


Southern DuPage County Regional Trail 101st Street Connector - Waterfall Glen Spur


LANDSCAPING AND **EROSION CONTROL PLAN** DATE: JUNE 9, 2005 PROJECT No. 11-1900-01

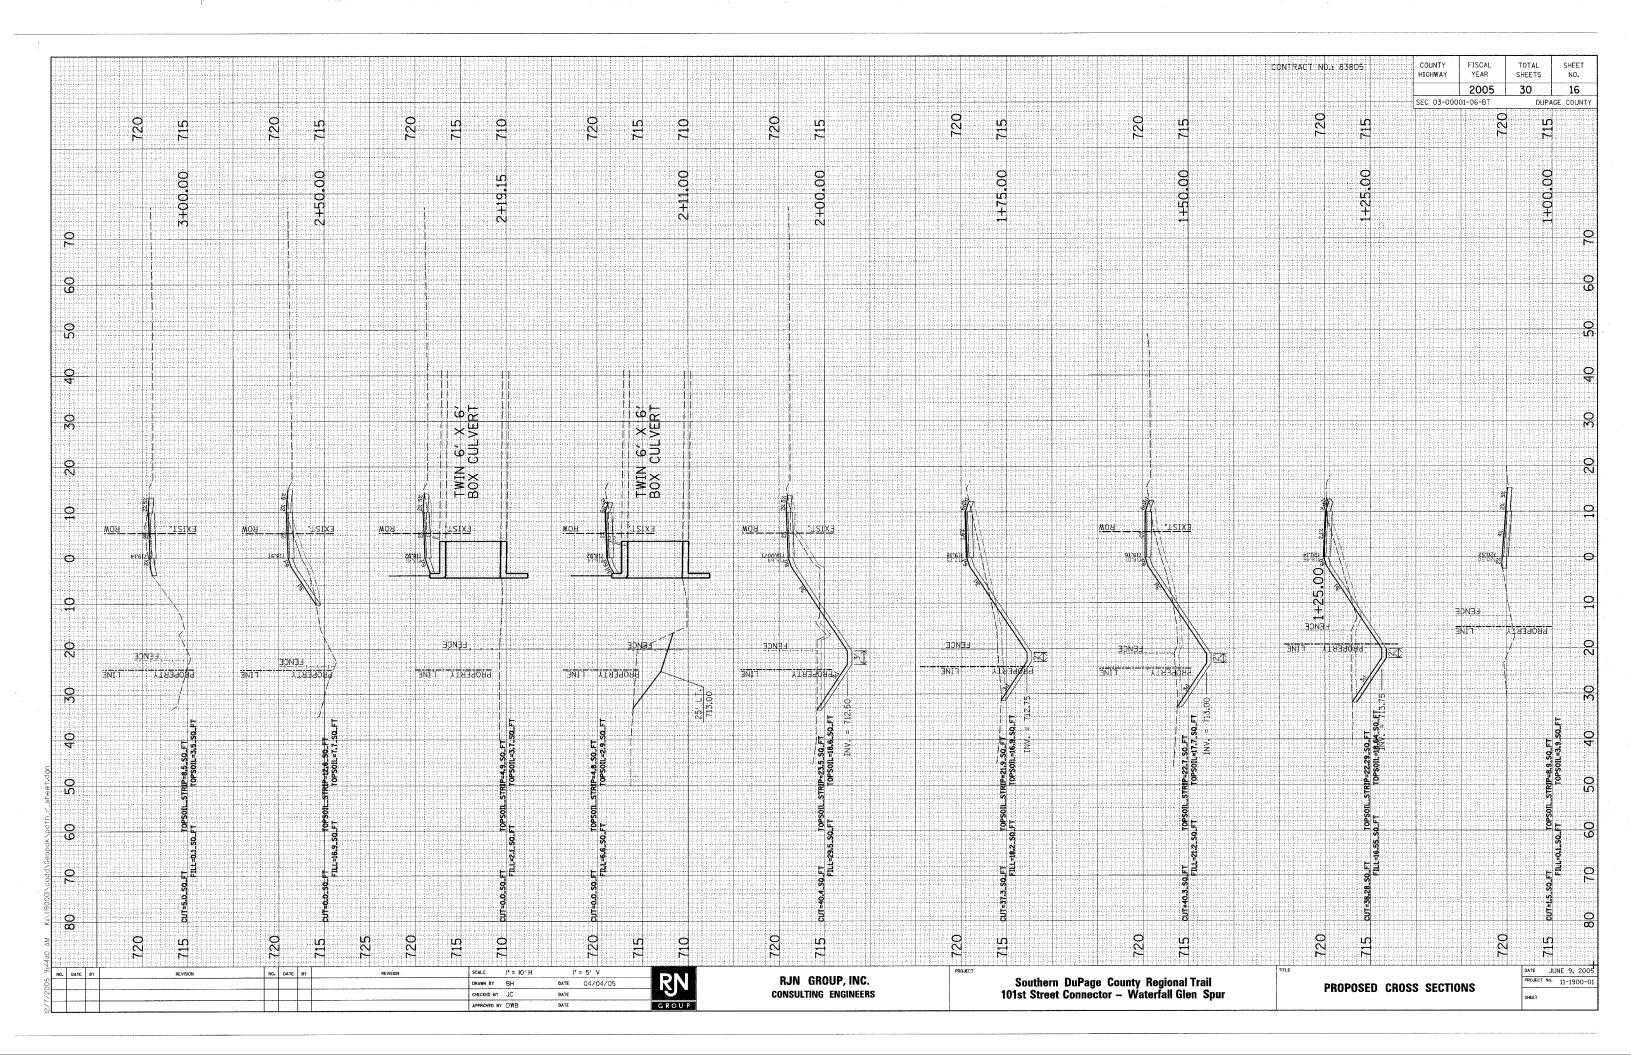


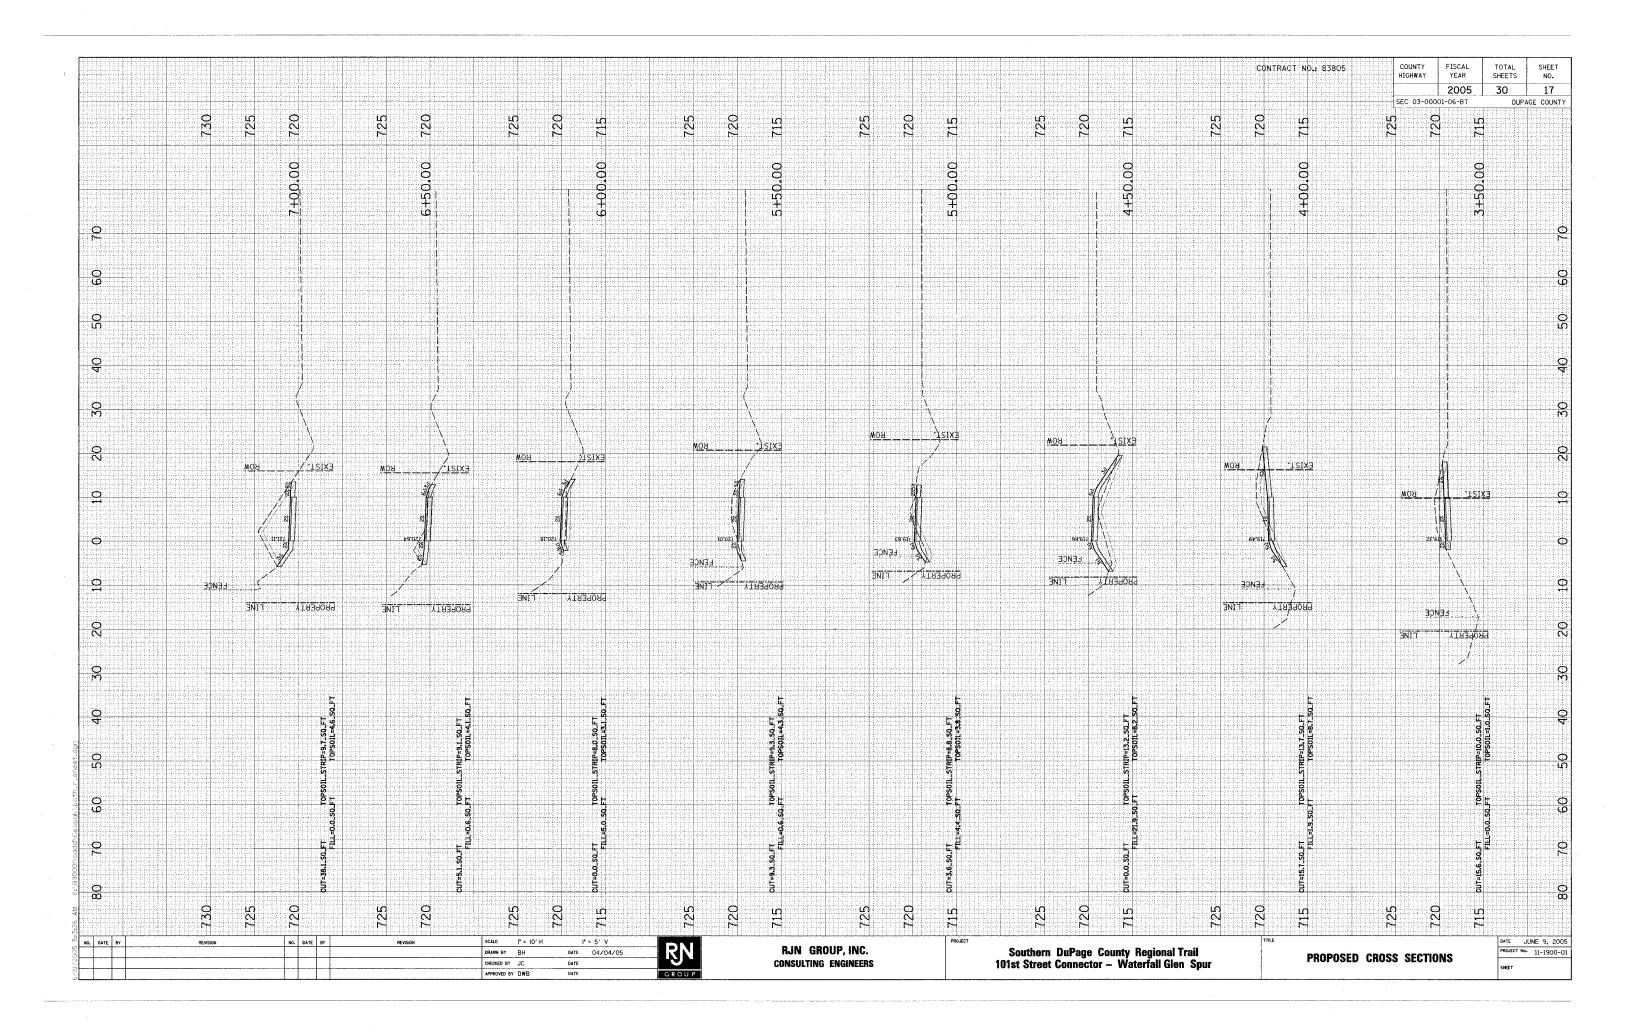


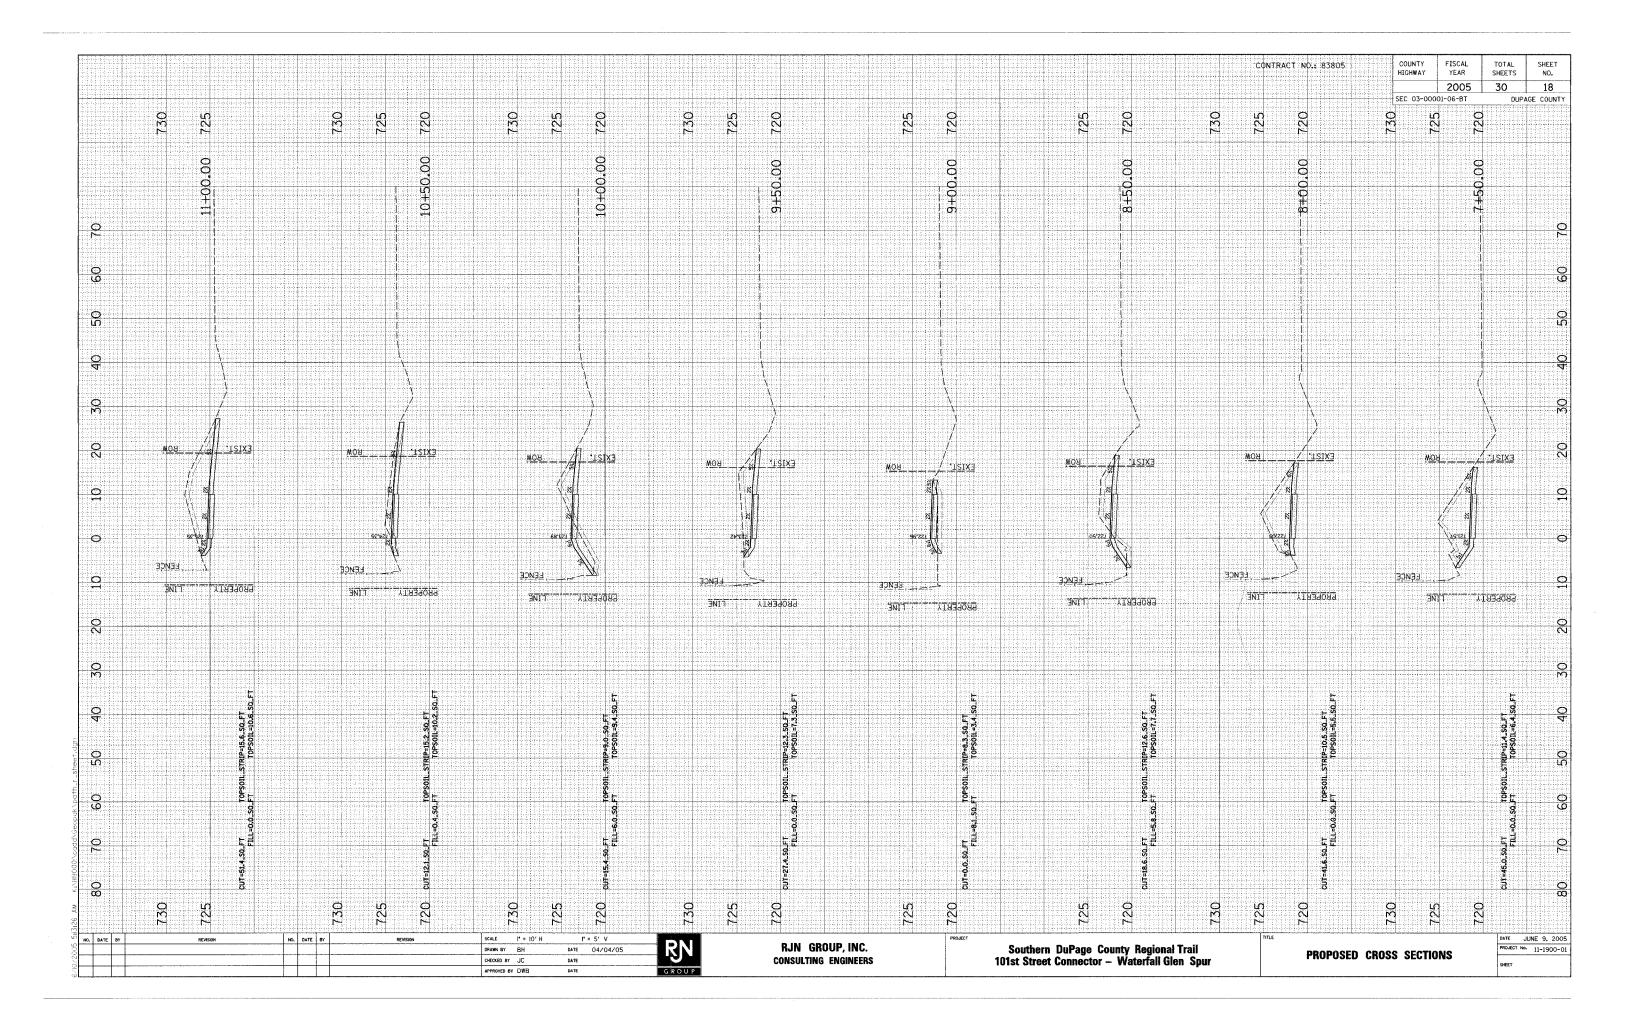


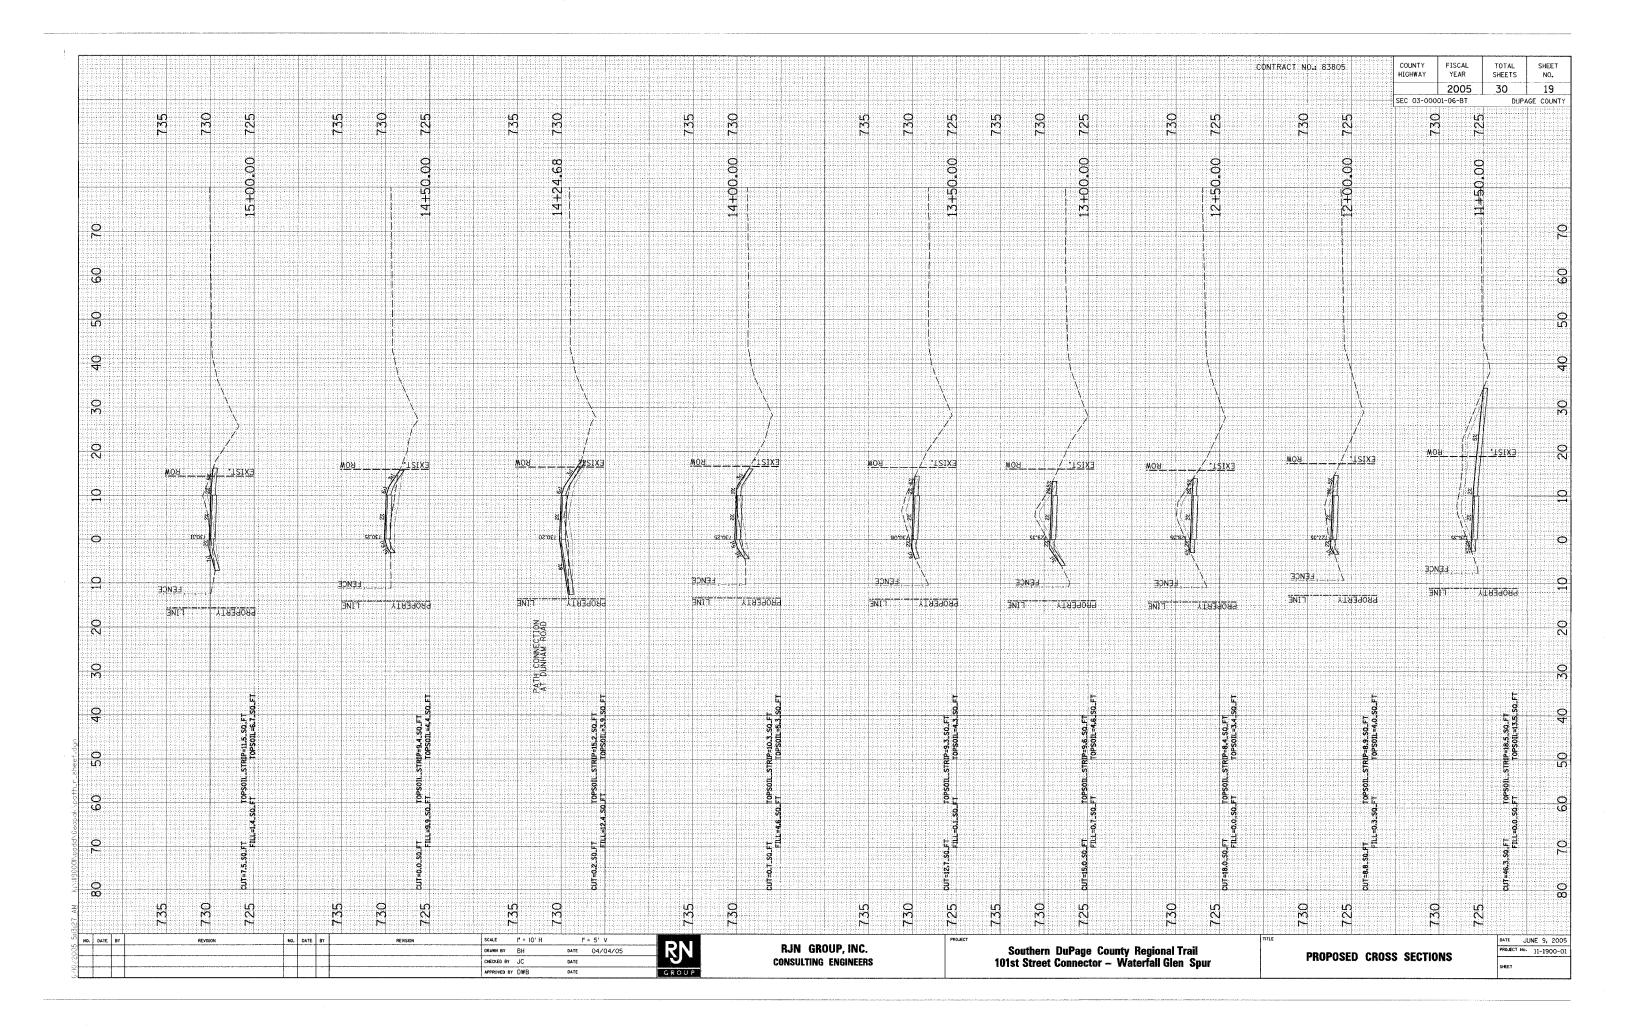


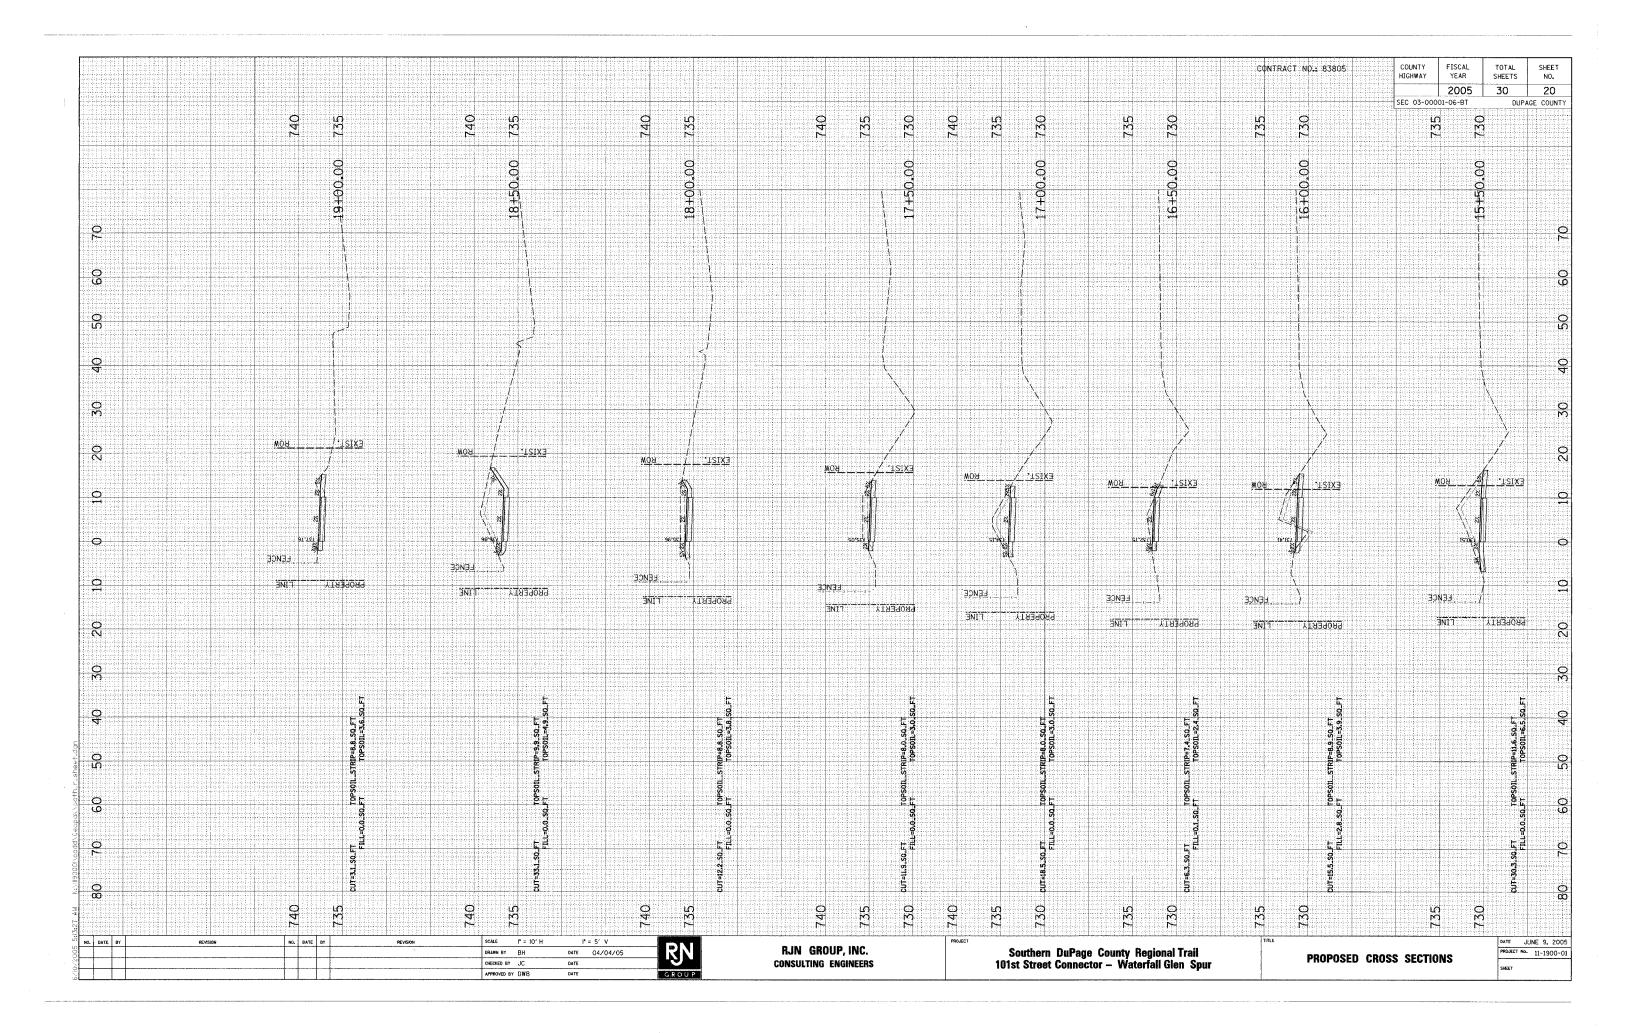


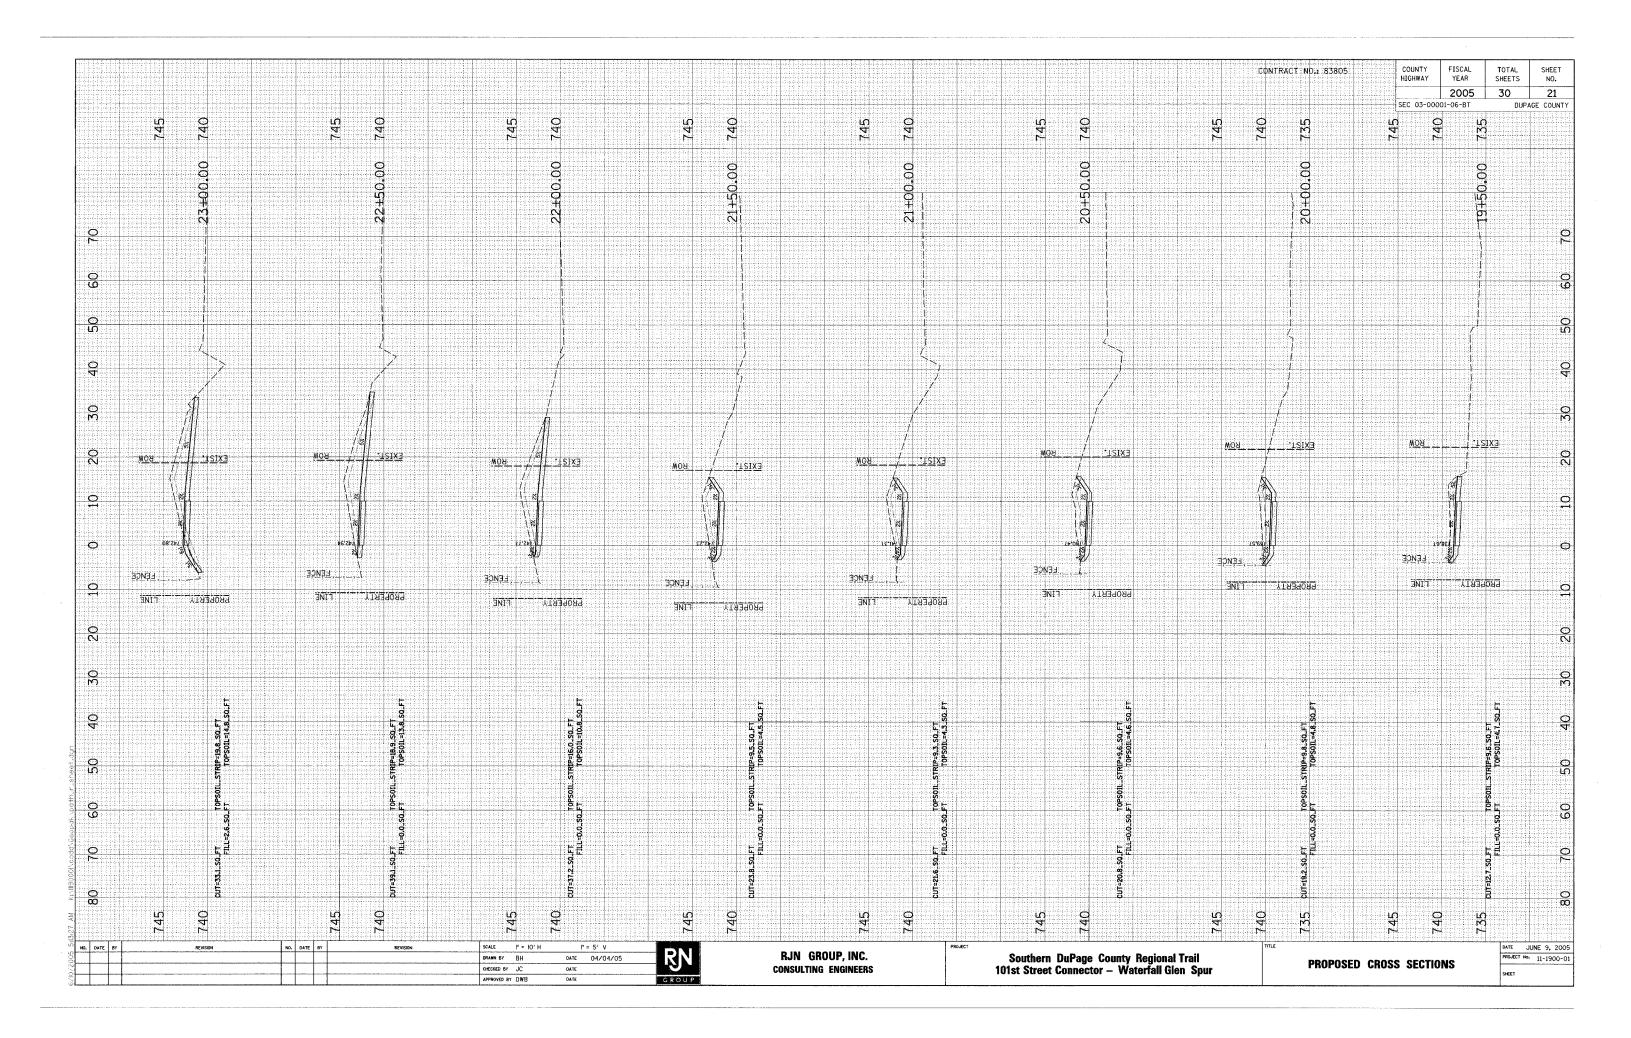


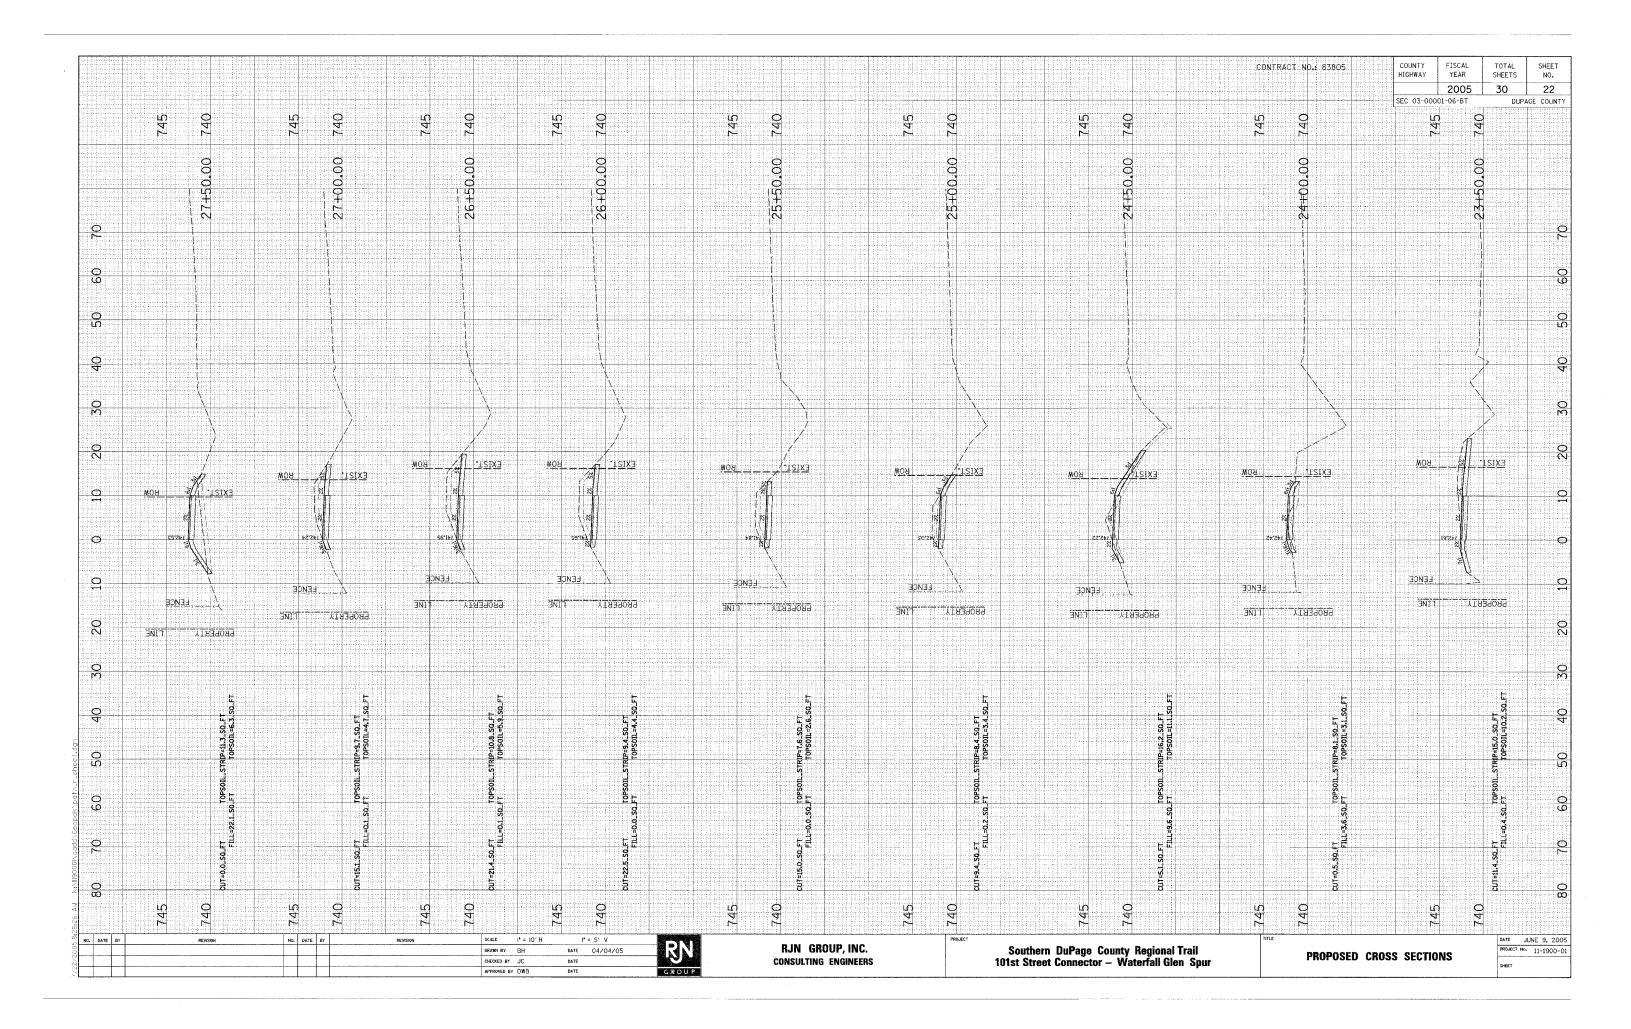

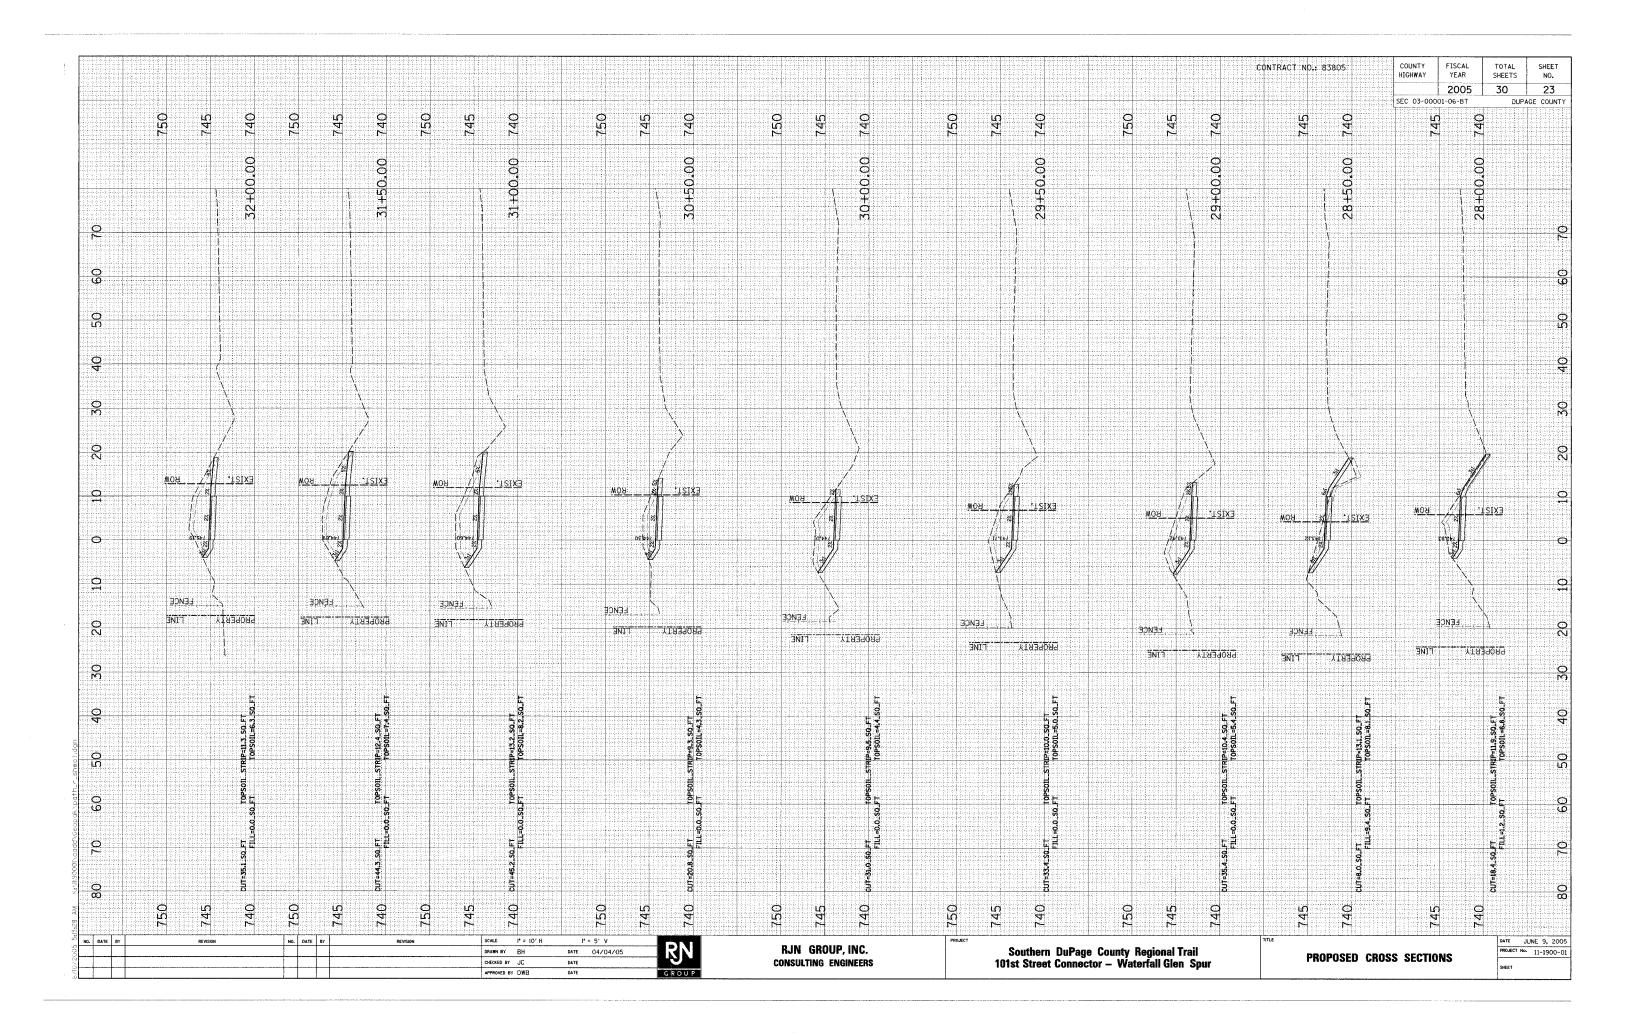

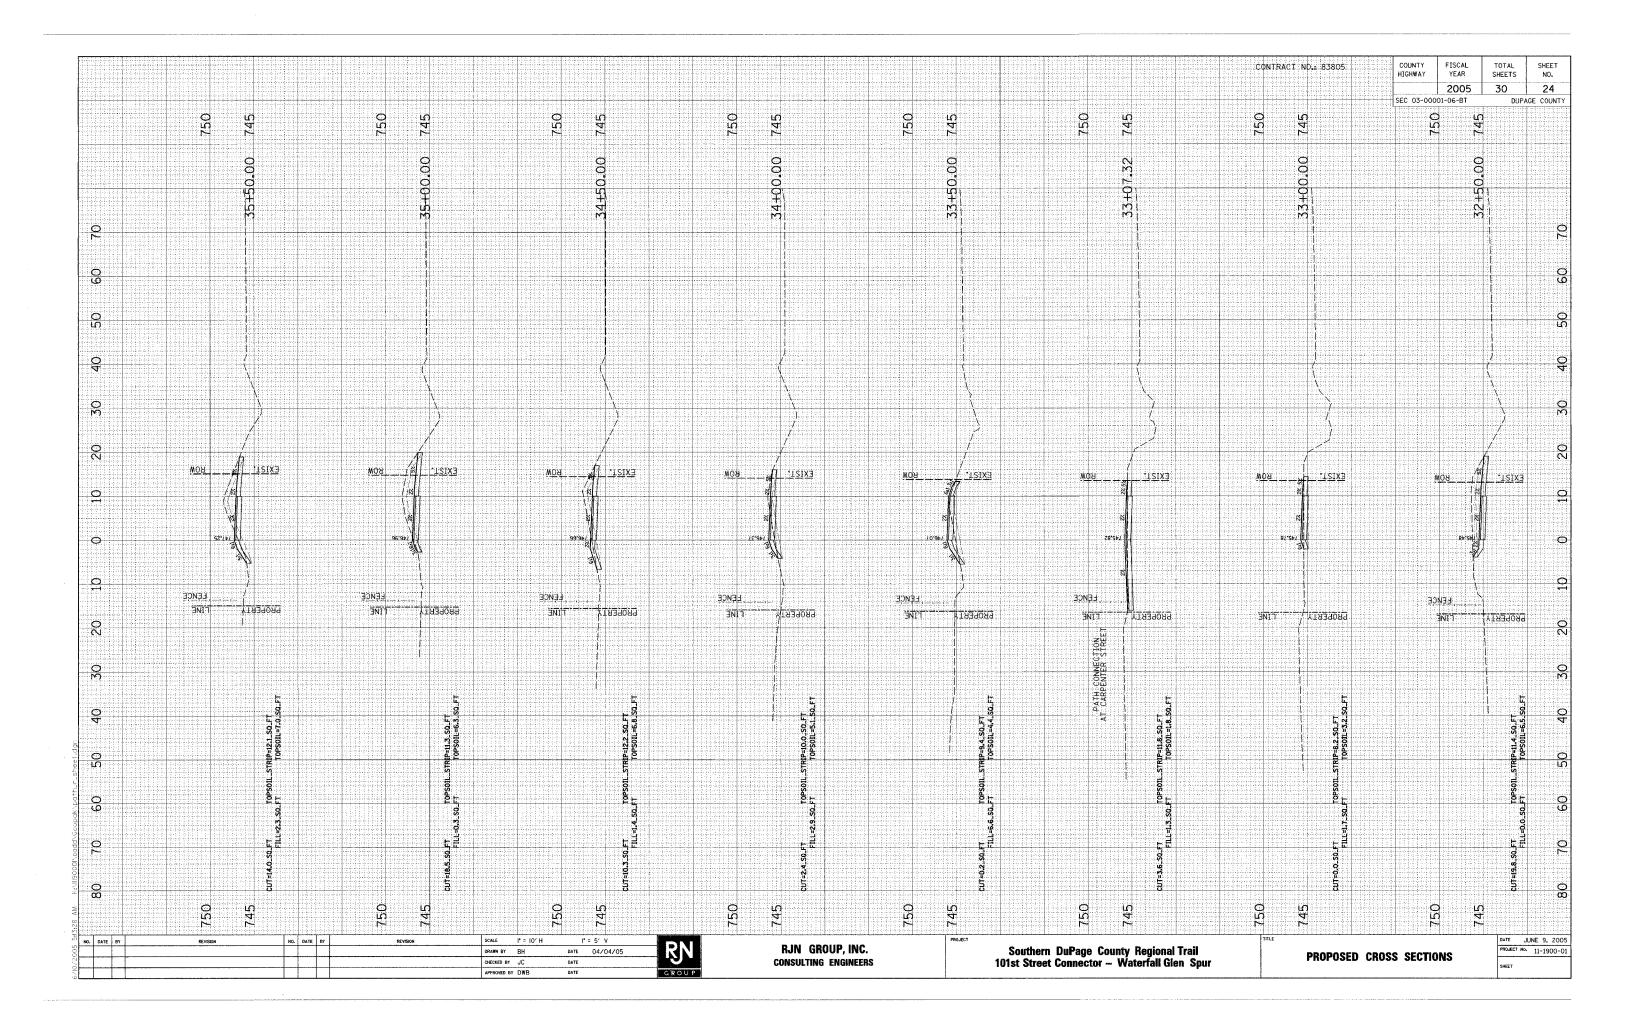

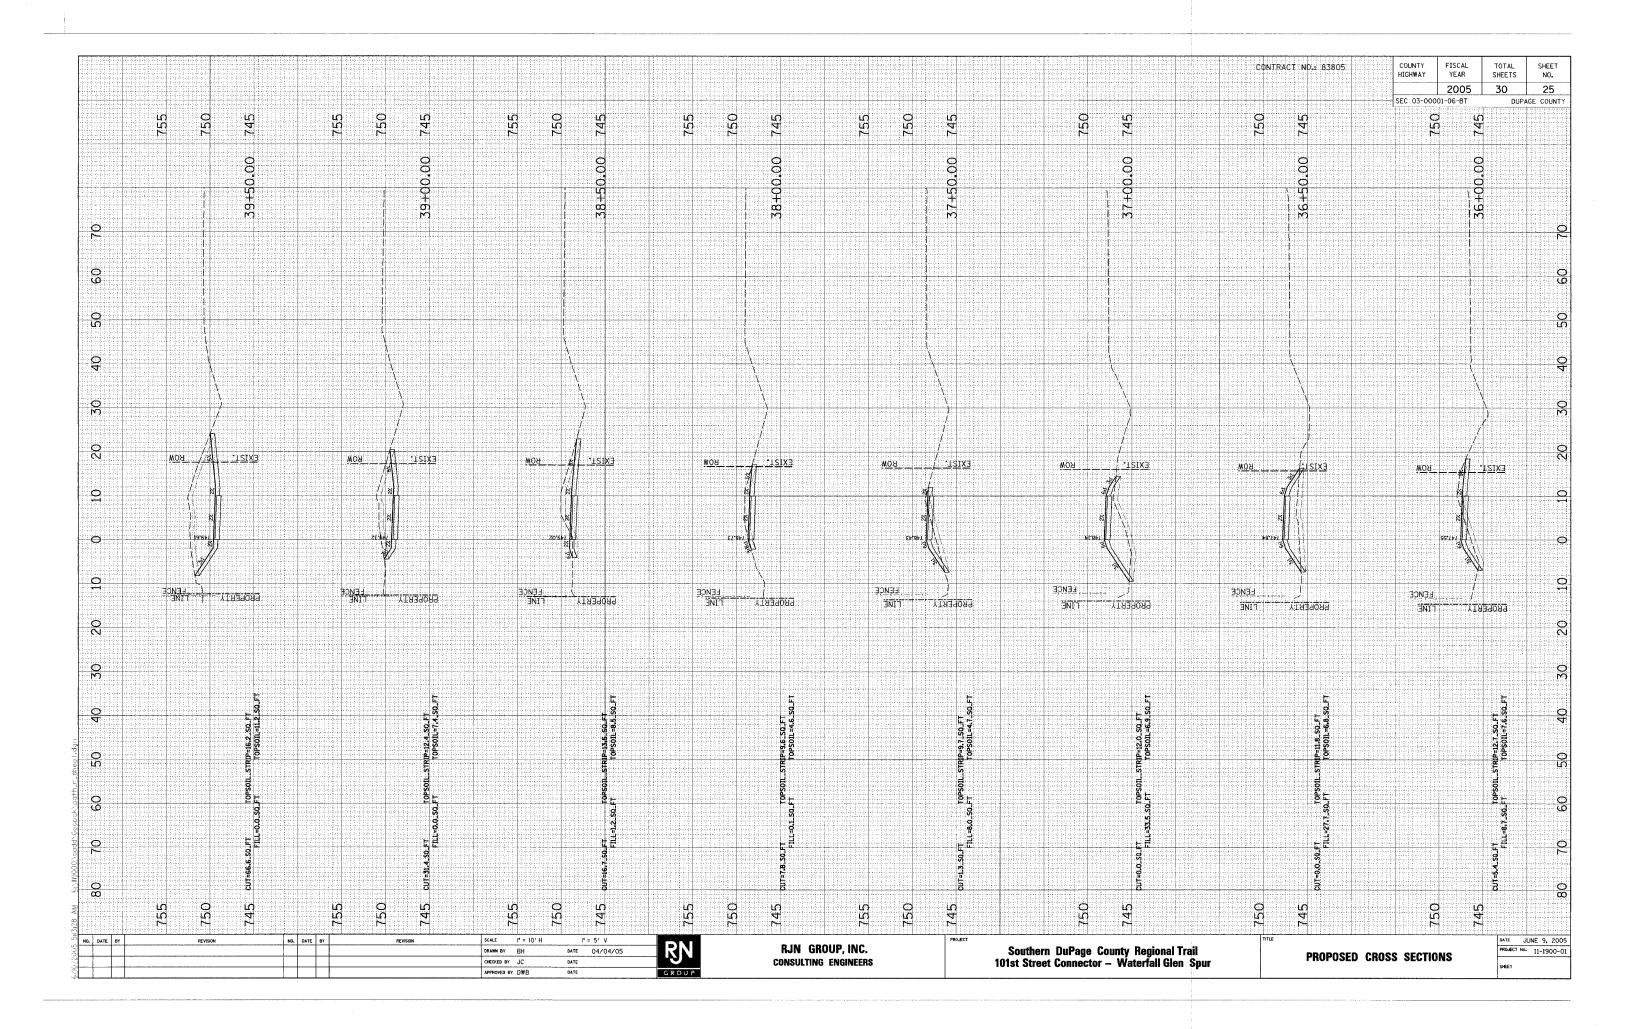

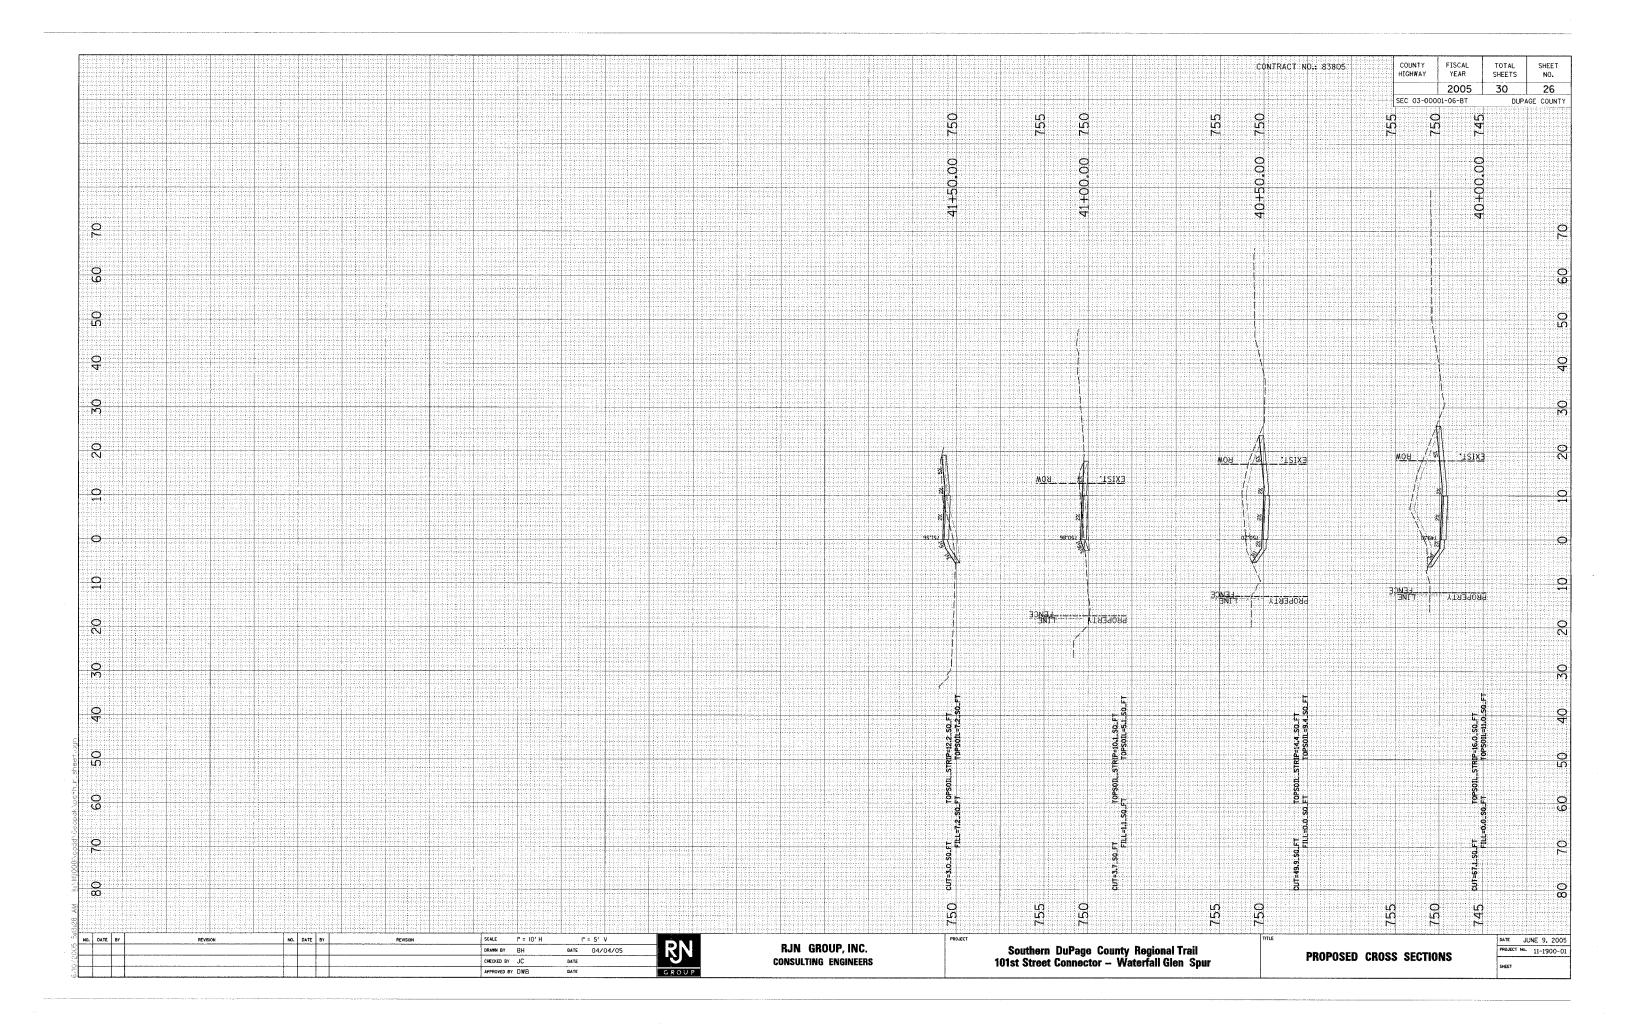

Benchmark: Chiseled "x" on east end of existing headwall. Elev. 718.76

* Match invert and slope of existing culvert

⇒z

Existing Structure: Double 6'x6' Precast Concrete Box Culvert, extended in 1998.

Steel Handrail See Sheet 3 of 3 for

location and details

Flow

© Culvert —— Path Sta. 2+19.15 10'-0" Multi-Use Path 5'-0"

-- Profile Grade Elev. = 718.92

> Invert Elev. 710.59*

LONGITUDINAL SECTION

Existing 12" RCP |

-- Back of Existing C&G

No Salvage.

CONTRACT NO.: 83805


GENERAL NOTES

Plan dimensions and details relative to existing structure have been taken from existing plans and are subject to nominal construction variations. It shall be the Contractor's responsibility to verify such dimensions and details in the field and make necessary approved adjustments prior to construction or ordering of materials. Such variations shall not be cause for additional compensation for a change in the scape of the work, however, the Contractor will be paid for the quantity actually furnished at the unit price for the work.

Reinforcement bars shall conform to the requirements of AASHTO M 31 or M 322 Grade 60.

All Construction joints shall be bonded.

Coordinate construction of the east wingwall with storm sewer reconstruction plans.

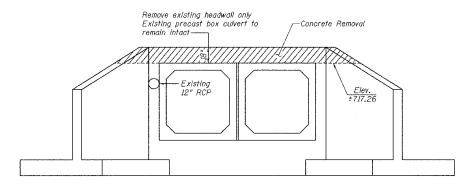

REMOVAL NOTES:

 ${\it Cut\ existing\ reinforcement\ flush\ with\ removal\ surface}.$

Existing 12" storm sewer shall be removed.

REMOVAL DETAILS

Looking South



I certify to the best of my knowledge, information and belief, this bridge, box cuivert design is structurally adequate for the design loading shown on the plans. The design is an economical one for the style of structure and complies with requirements of the current "AASHTO Standard Specification for Highway Bridges".

LOADING HS20-44

DESIGN SPECIFICATIONS

AASHTO 17th Ed. - 2002

DESIGN STRESSES

 $f'_6 = \frac{FIELD \ UNITS}{5,500 \ psi}$ $f_y = 60,000 \ psi \ (reinforcement)$

TOTAL BILL OF MATERIAL

ITEM	UNIT	TOTAL
Concrete Removal	Cu. Yd.	1.4
Concrete Box Culverts	Cu. Yd.	19.2
Reinforcement Bars	Pound	3830
Expansion Bolts 3/4 Inch	Each	40
Pipe Handrail	Foot	33

NO.	DATE	BY	REVISION	NO.	DATE	BY	REVISION	SCALE	N/A		
								DRAWN BY	BLB	DATE	KN
		1						CHECKED BY	₩JV	DATE	. G.
						_		APPROVED BY		DATE	GROUP

---- P.G.L.


PLAN


RJN GROUP, INC. CONSULTING ENGINEERS

Southern DuPage County Regional Trail 101st Street Connector — Waterfall Glen Spur

CULVERT EXTENSION


DATE	JUI	ME 9	, 20	0
PROJECT	No ₋₆	H-	1900-	-(
SHEETI	1	of	3	

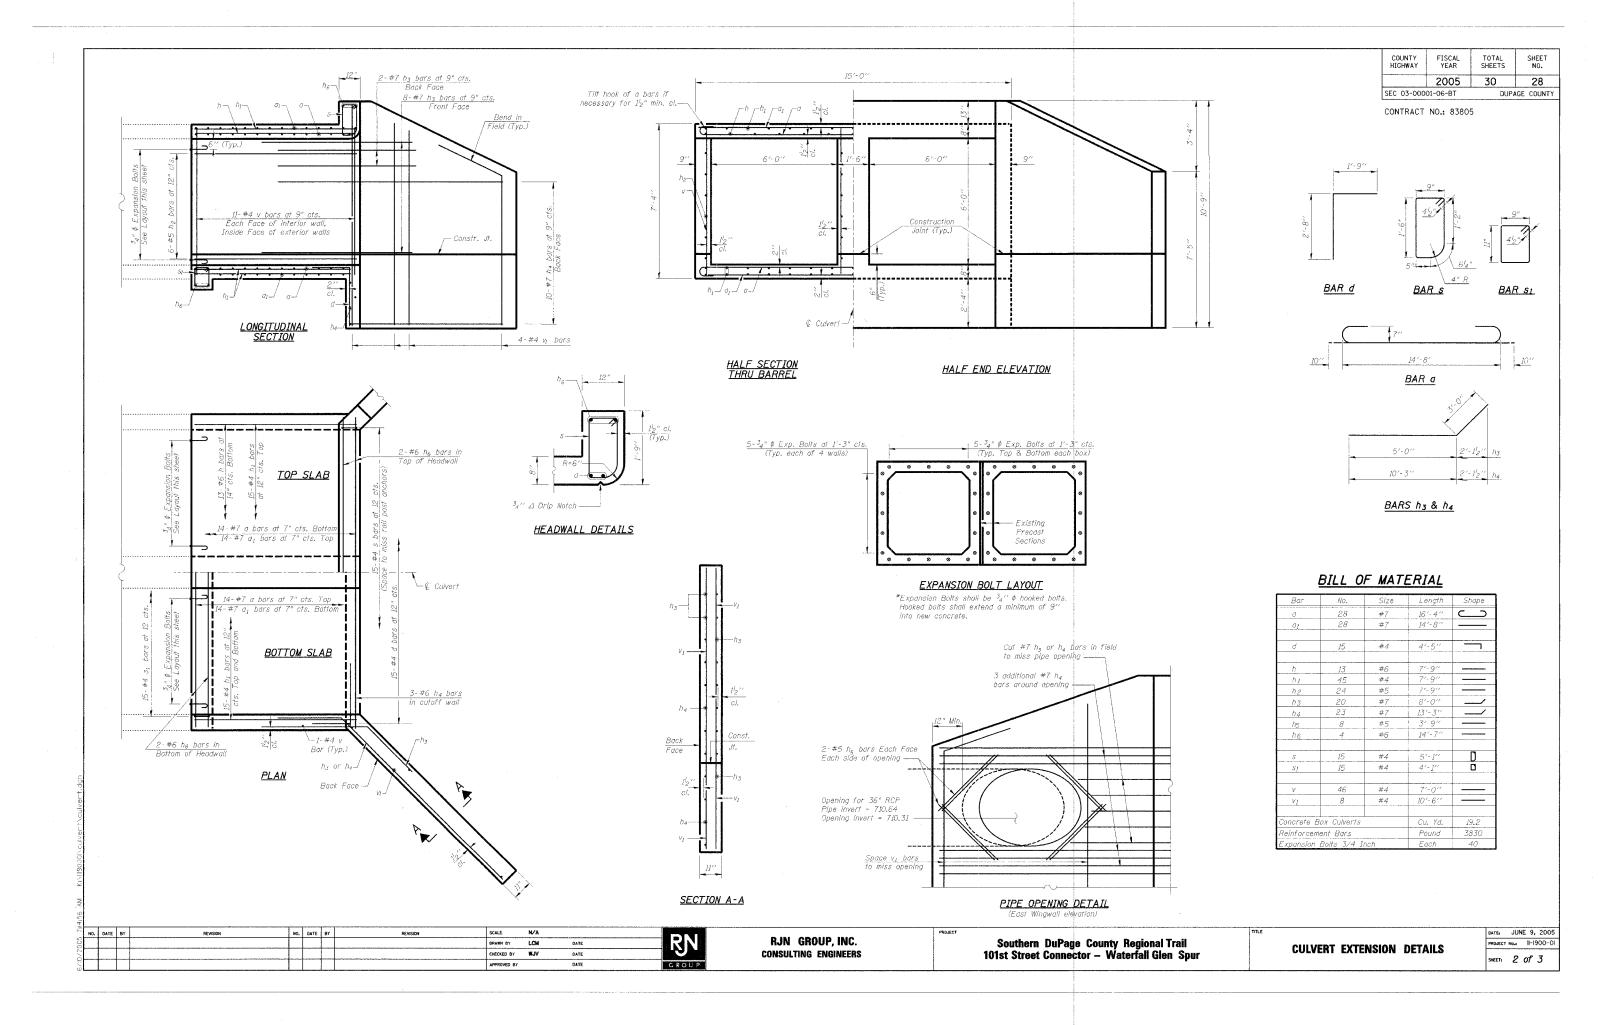

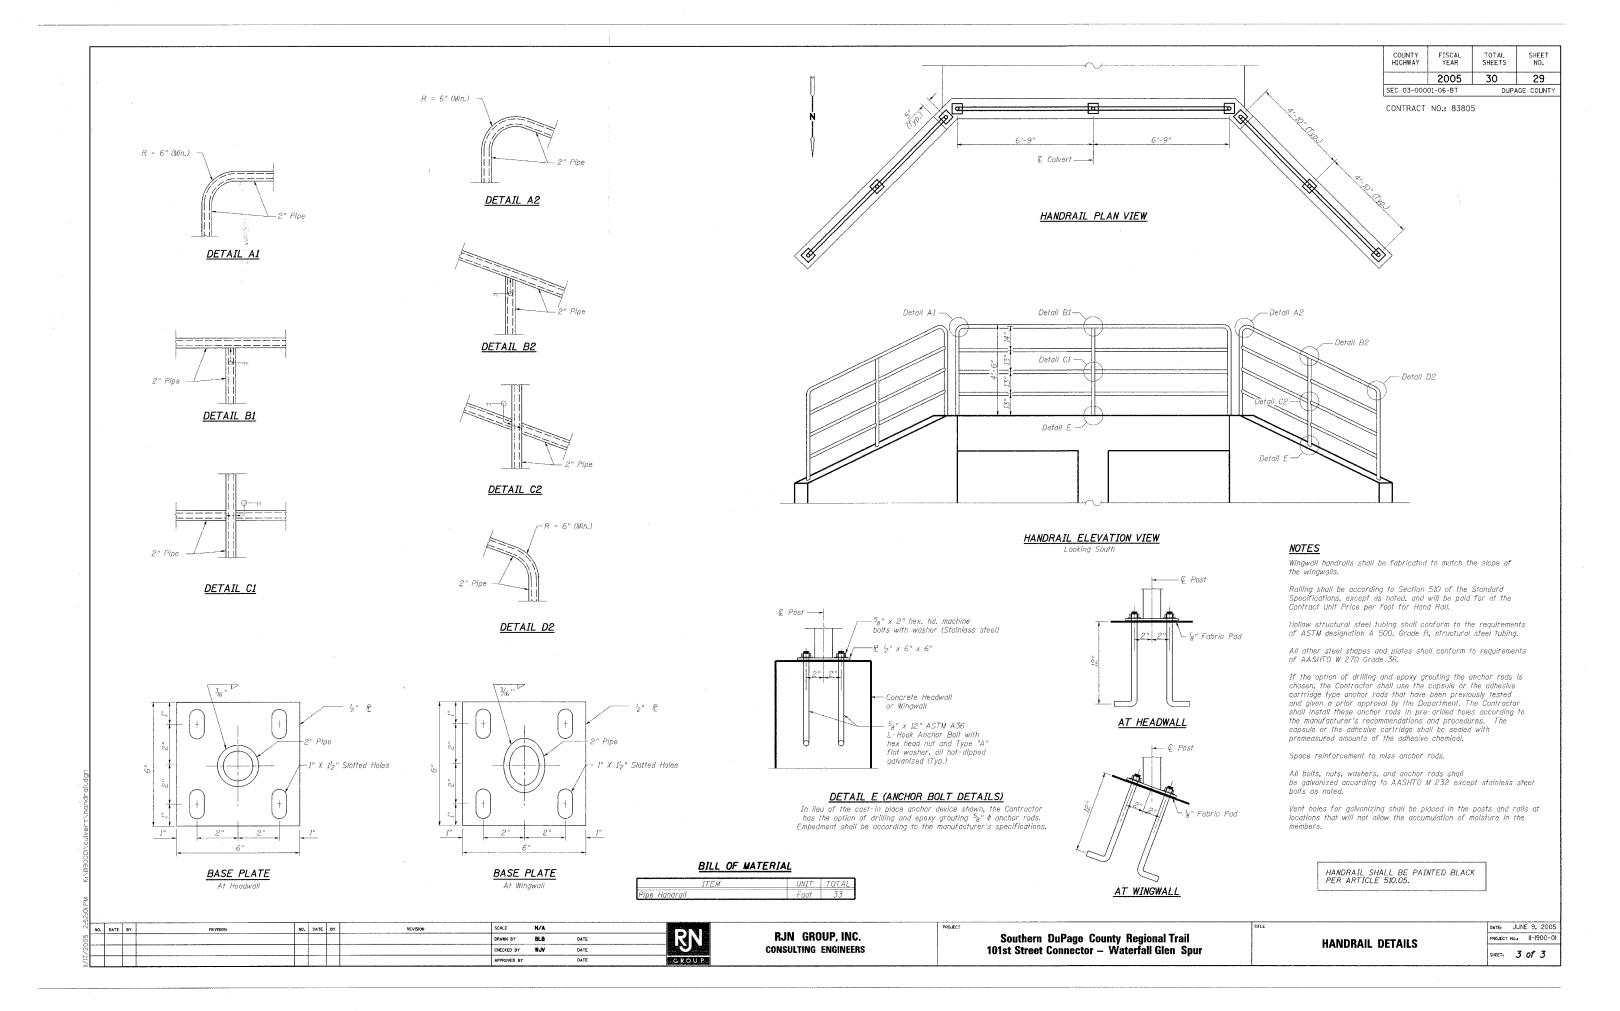

COUNTY HIGHWAY	FISCAL YEAR	TOTAL SHEETS	SHEET NO.
	2005	30	30
SEC 03-000	01-06-BT	DUPA	AGE COUNTY

CONTRACT NO.: 83805

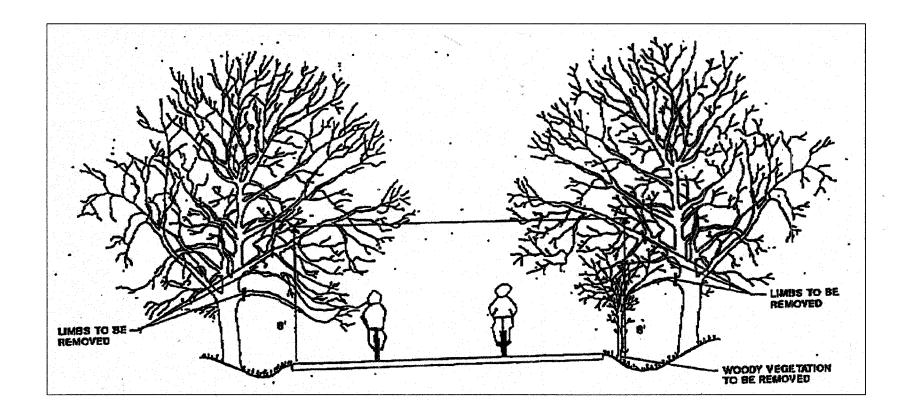

GENERAL NOTES

1. THE NATIONAL ARBORIST ASSOCIATIONS PRUNING STANDARDS FOR SHADE TREES CLASS II - STANDARD PRUNING SPECIFICATIONS SHALL BE FOLLOWED.

NO. DATE BY REVISION NO. DATE BY REVISION SCALE NOT TO SCALE

ORANN BY JMC DATE

ORACKED BY MRH DATE

APPROVED BY DWB DATE

ŖN

RJN GROUP, INC. CONSULTING ENGINEERS

Southern DuPage County Regional Trail 101st Street Connector — Waterfall Glen Spur PRUNING FOR SAFETY AND EQUIPMENT CLEARANCE

DATE: JUNE 9, 2005
PROJECT No.: #-1900-01
SHEET: #-1900-01