


- 1. REMOVE EQUIPMENT THAT ARE CALLED OUT FOR REMOVAL ONLY. REMOVE EQUIPMENT BEFORE THE START OF THE CONSTRUCTION ACTIVITIES AROUND THE LIGHT POLES. DON'T DISCONNECT OR REMOVE ANY LIGHTING EQUIPMENT UNLESS A REPLACEMENT (TEMPORARY OR PERMANENT) LIGHTING EQUIPMENT HAS BEEN INSTALLED AND MADE OPERATIONAL.
- 2. COORDINATE ALL EXISTING LIGHTING EQUIPMENT REMOVAL WITH THE CONSTRUCTION STAGING AND OTHER WORK,
- 3. DE-ENERGIZE EXISTING LIGHTING CIRCUITS AND POLES AT THE ELECTRICAL DISTRIBUTION PANELBOARD IN THE LIGHTING CABINET BEFORE DISCONNECTING AND REMOVING THE EQUIPMENT.
- 4. REMOVE EXISTING WIRE AND CONDUIT SHOWN TO BE REMOVED AND DISPOSE OF IT OUTSIDE THE PROJECT LIMITS UNLESS OTHERWISE SPECIFIED. CONDUITS THAT WILL NOT BE USED CAN ALSO BE ABANDONED IN PLACE, CONTRACTOR MAY CHOOSE TO REMOVE WIRES FROM ABANDONED CONDUIT AT THEIR OWN EXPENSE.
- 5, RETURN ALL SALVAGEABLE LIGHTING EQUIPMENT TO IDOT, PROPERLY PACKAGE AND TRANSPORT REMOVED EQUIPMENT TO THE IDOT DESIGNATED YARD OR STORAGE FACILITY.
- 6. DISPOSE OF REMOVED EXISTING LAMPS, BALLASTS AND OTHER MATERIALS THAT WILL NOT BE SALVAGED IN ACCORDANCE WITH IDOT REQUIREMENTS AND ABIDE BY ALL RECYCLING AND SAFE DISPOSAL REGULATIONS.
- 7. VERIFY ROUTING OF EXISTING CIRCUIT CONDUCTORS AND MAKE ANY NECESSARY ADJUSTMENTS TO KEEP THE EXISTING POLES OPERATIONAL AS INDICATED, THIS WORK IS COVERED UNDER MAINTAIN LIGHTING SYSTEM PAY ITEM, NO SEPARATE PAYMENT WILL BE MADE FOR MATERIALS OR LABOR.
- 8. COMPLETELY REMOVE ENTIRE LIGHTING UNIT FROM FOUNDATION, SALVAGE LIGHTING UNIT AND DELIVER TO IDOT YARD OR FACILITY, COMPLETELY REMOVE POLE FOUNDATION PER IDOT STANDARDS,
- 9. SEE PROPOSED LIGHTING PLANS FOR OTHER INFORMATION AND INCORPORATION OF EXISTING AND RELOCATED LIGHT POLES AND EQUIPMENT INTO THE FINAL PROPOSED LIGHTING SYSTEM.

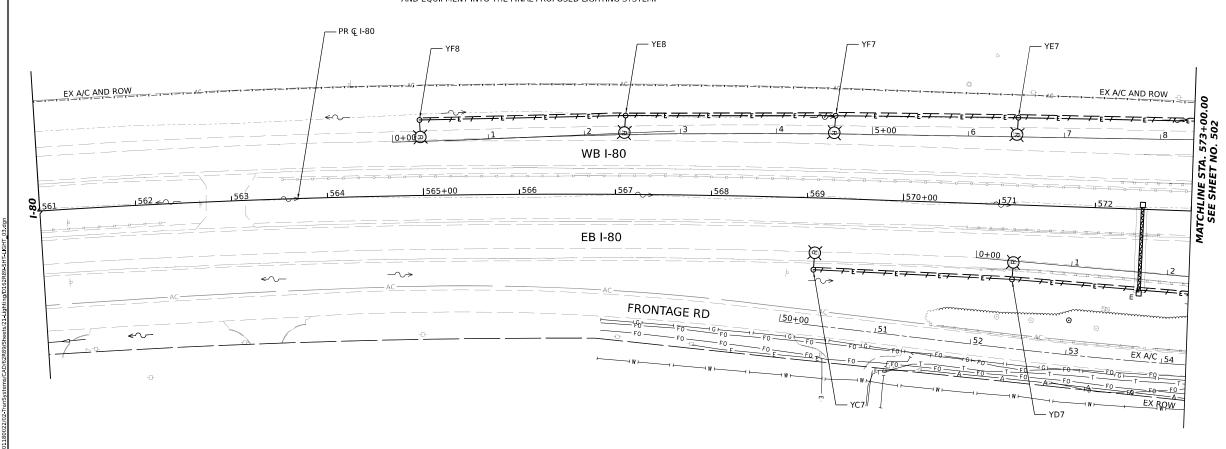

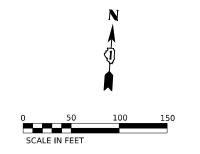

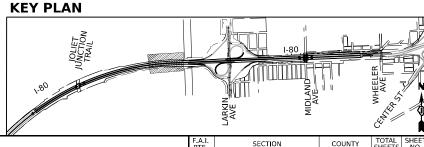






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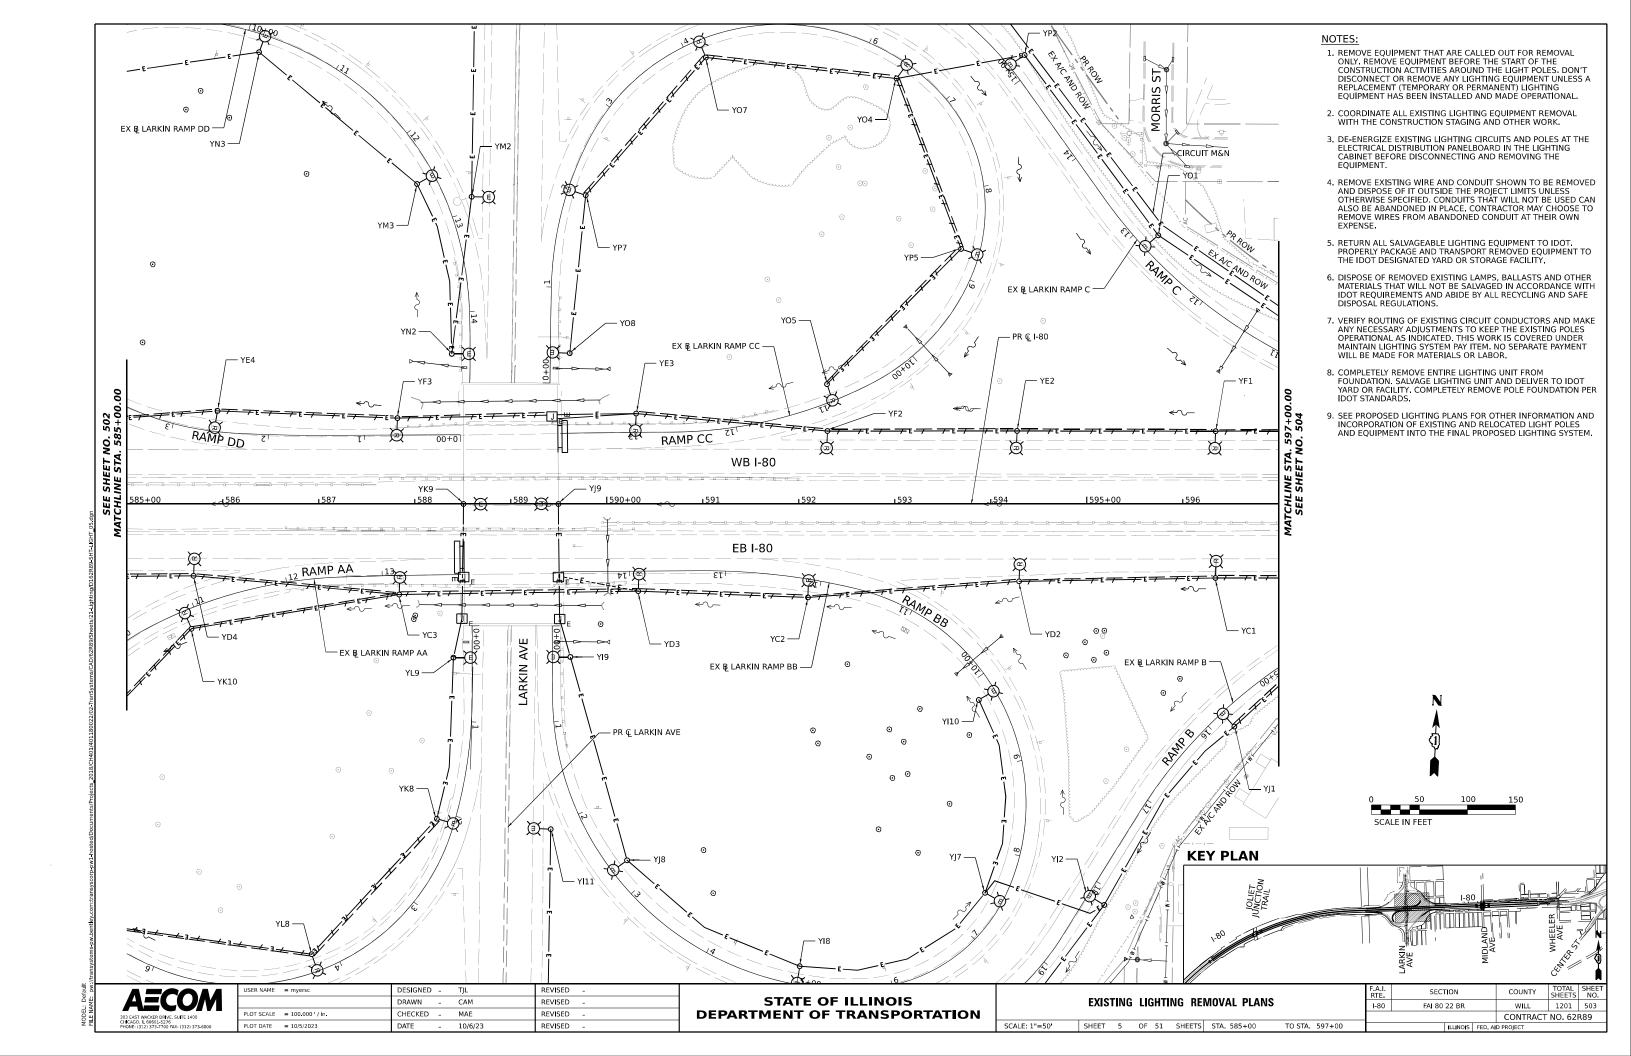
**STATE OF ILLINOIS DEPARTMENT OF TRANSPORTATION** 


**EXISTING LIGHTING REMOVAL PLANS** SHEET 3 OF 51 SHEETS STA. 561+00


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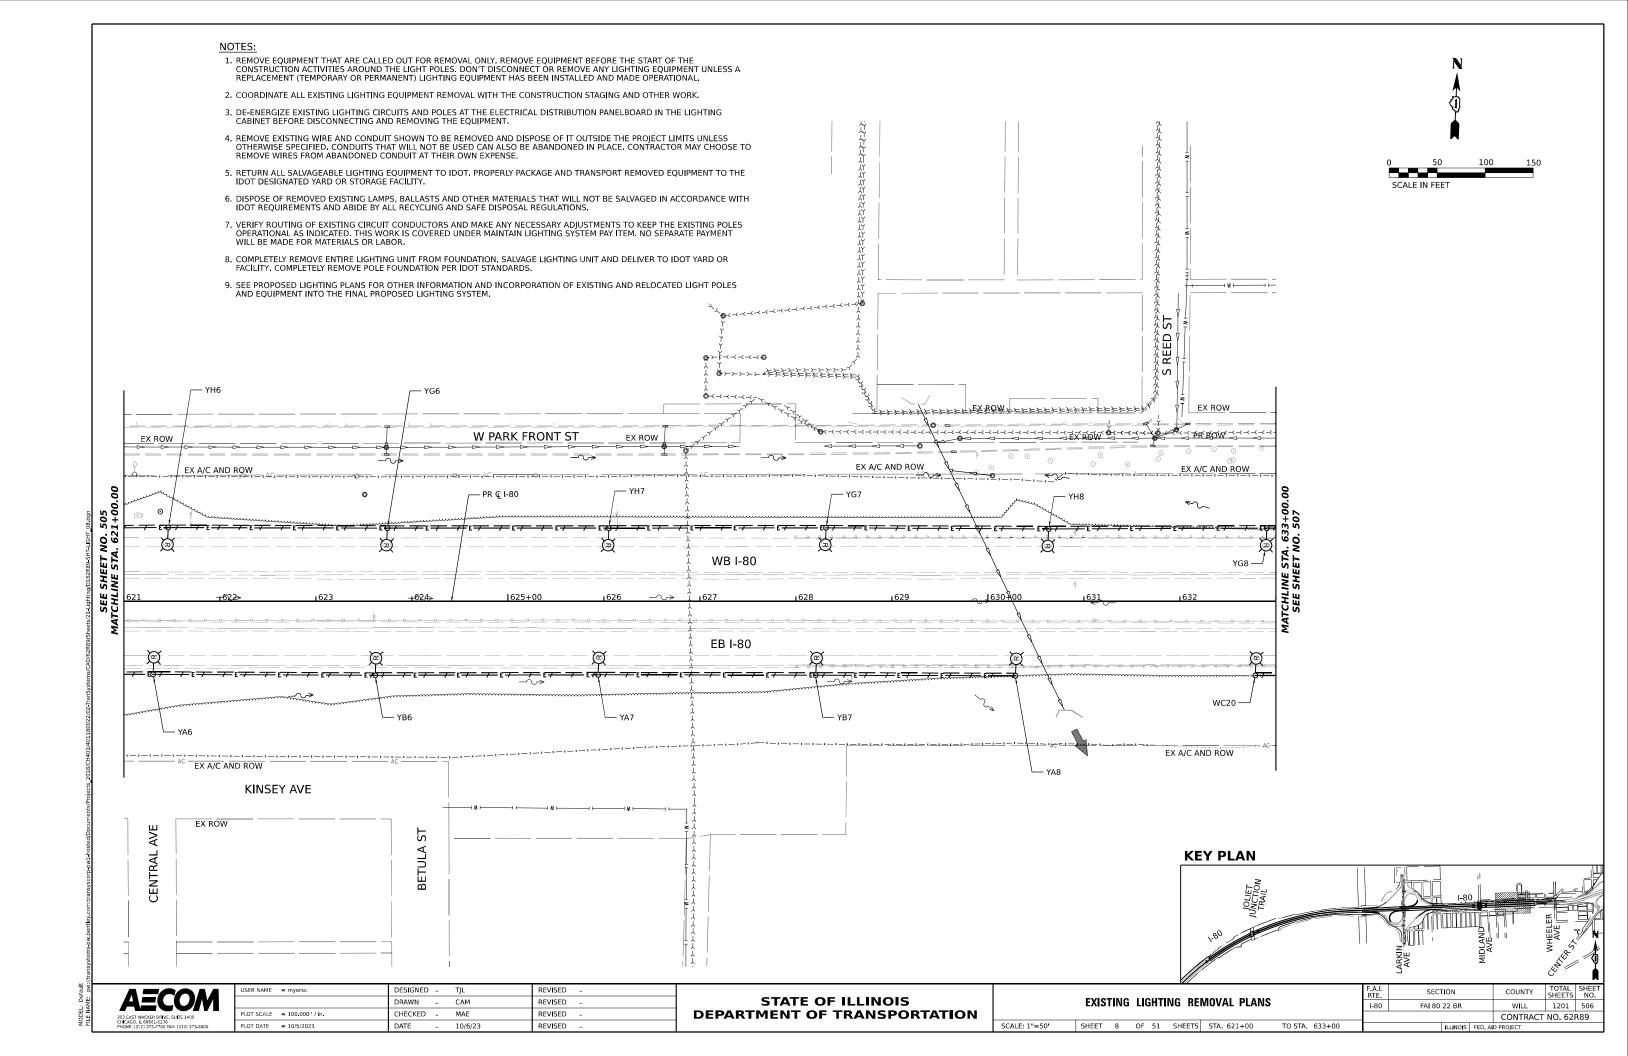
FAI 80 22 BR WILL 1201 501 CONTRACT NO. 62R89






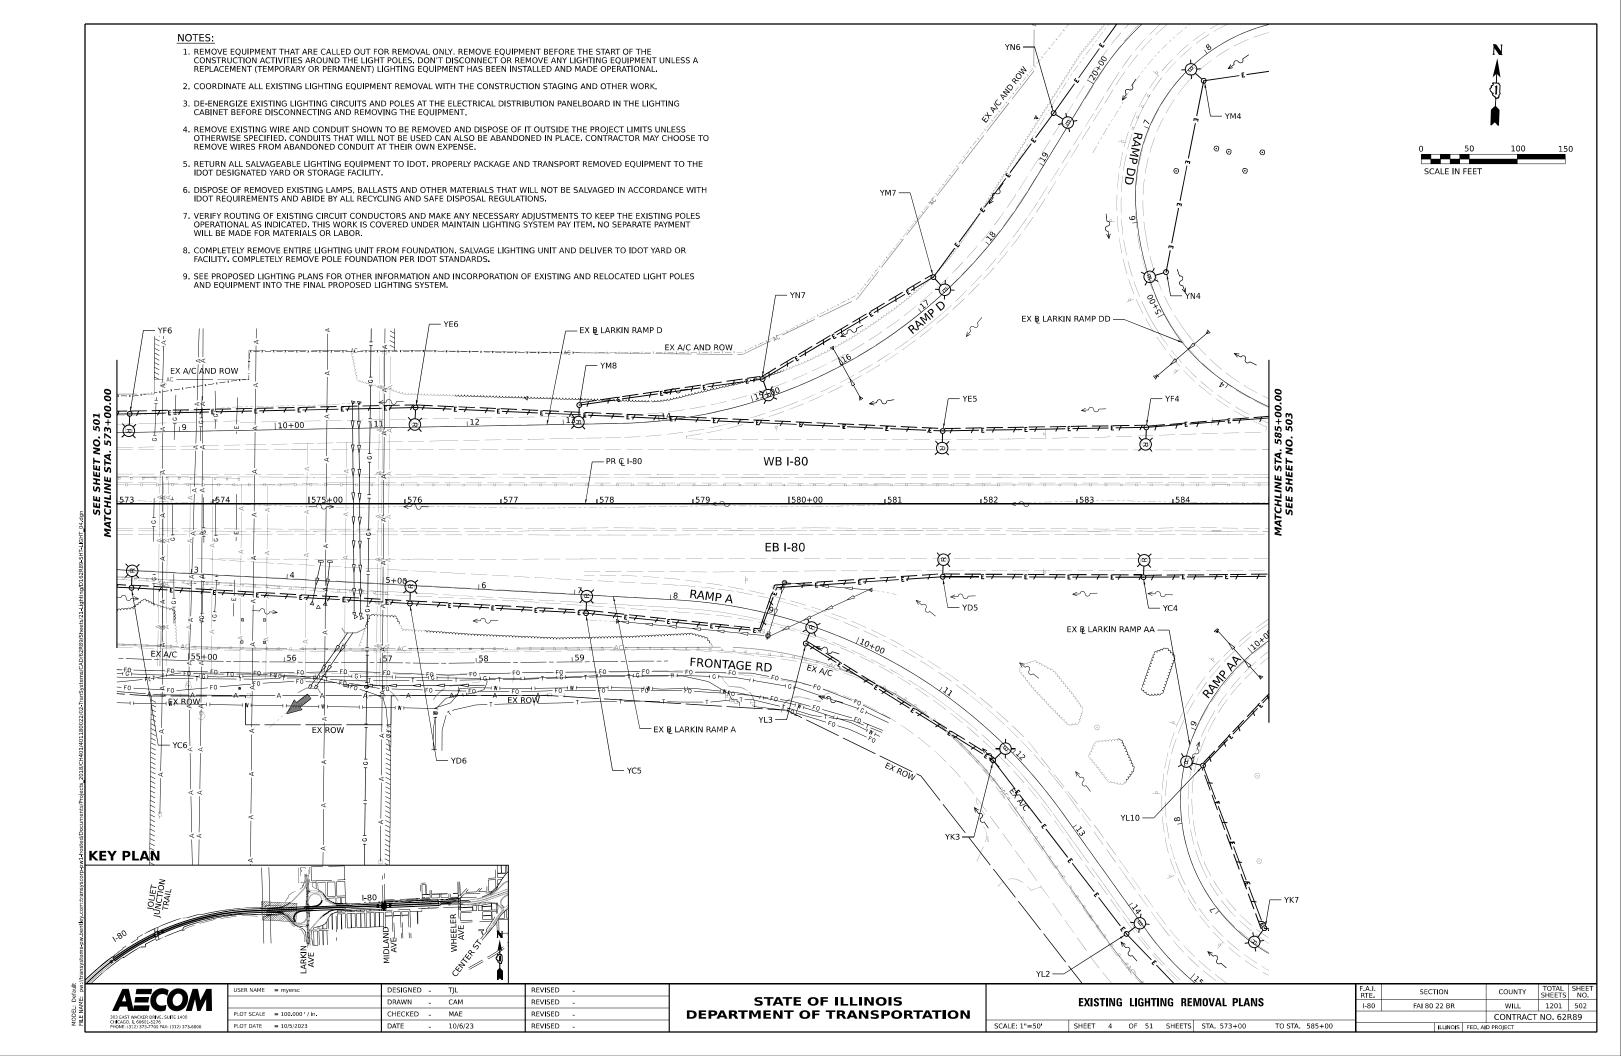


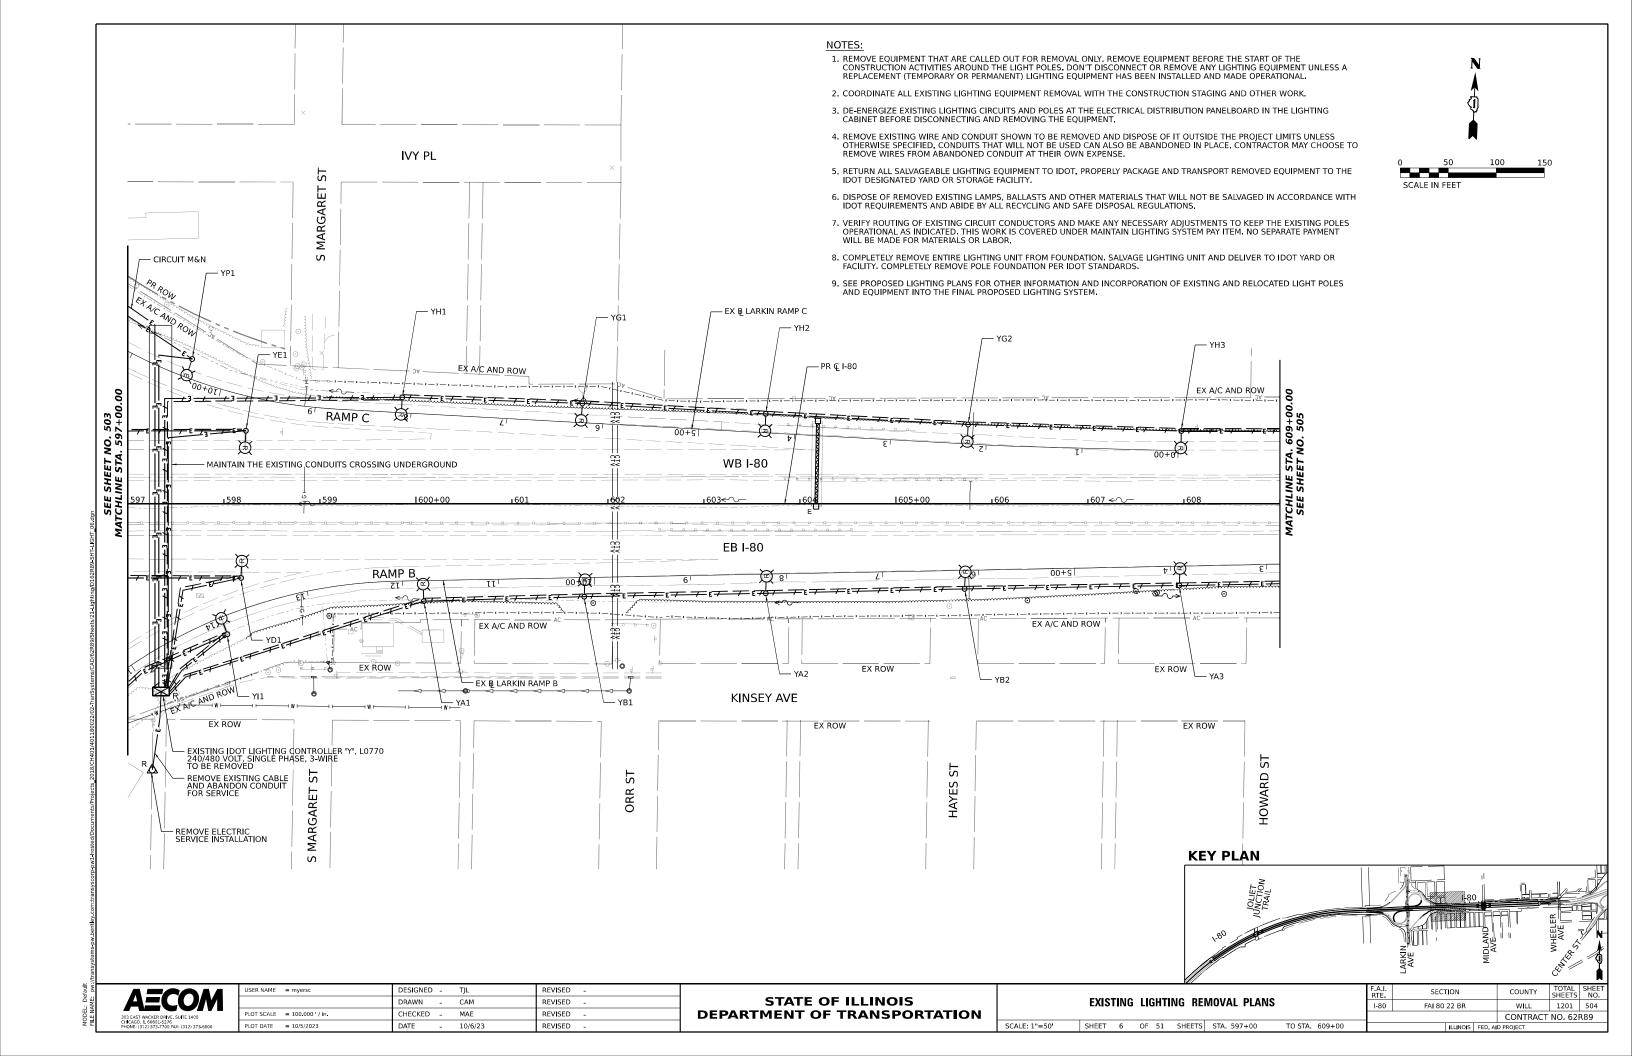


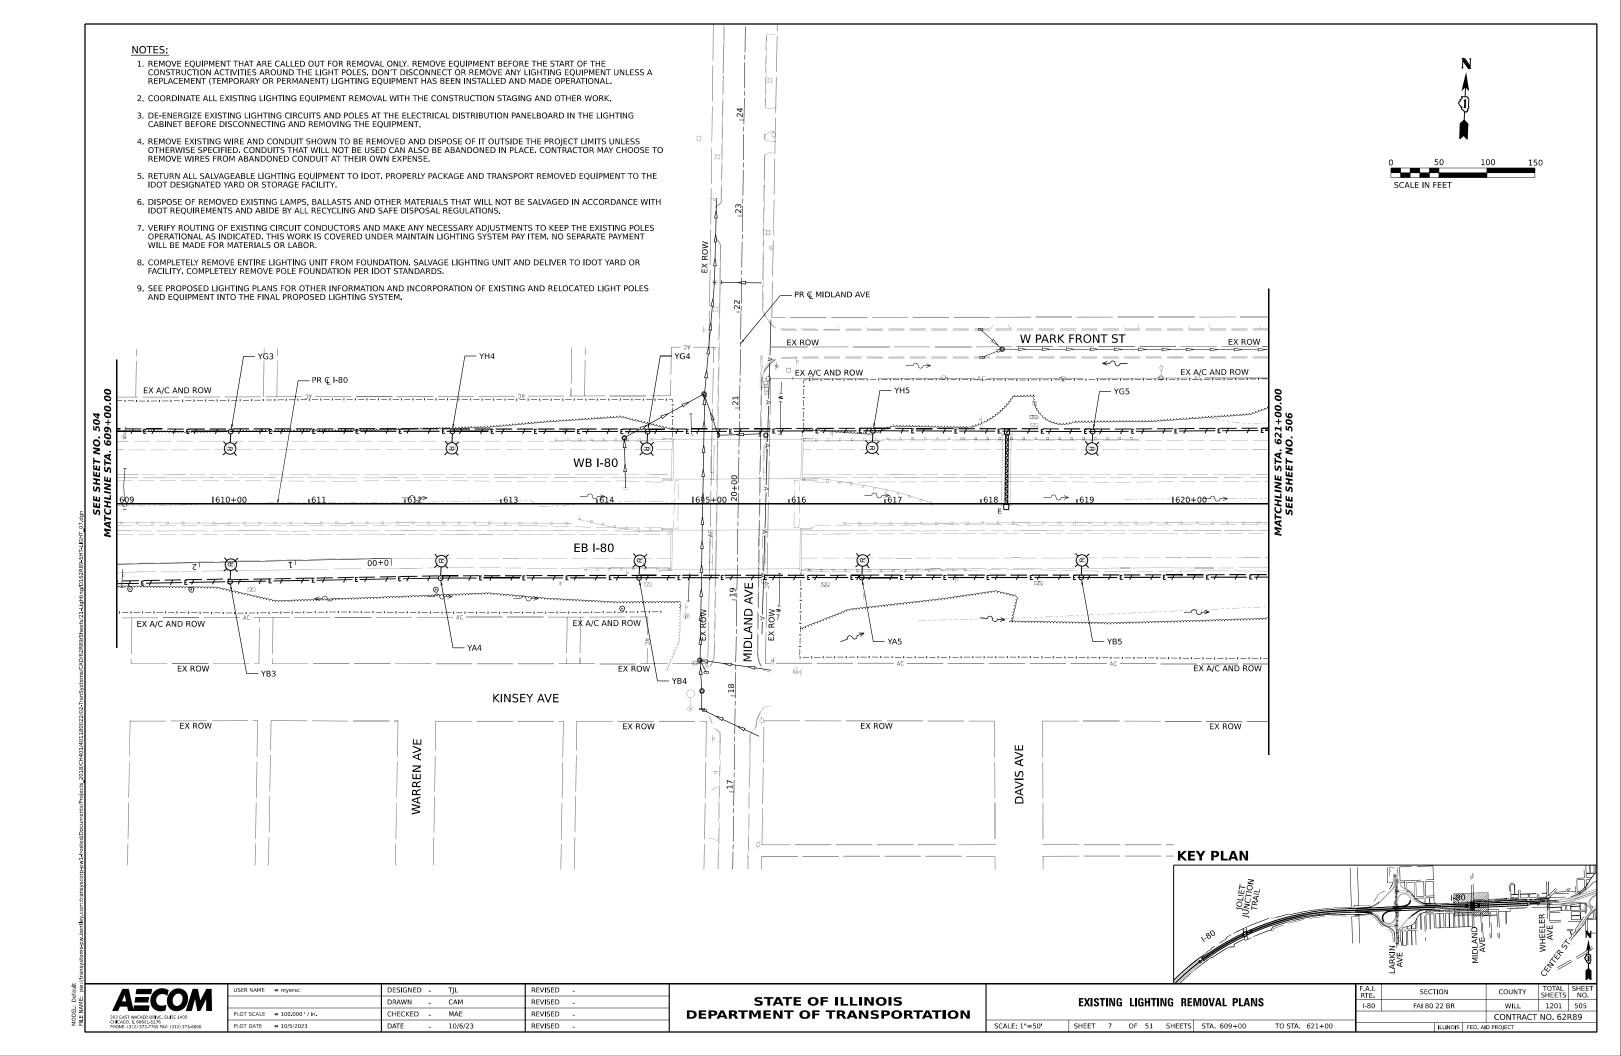


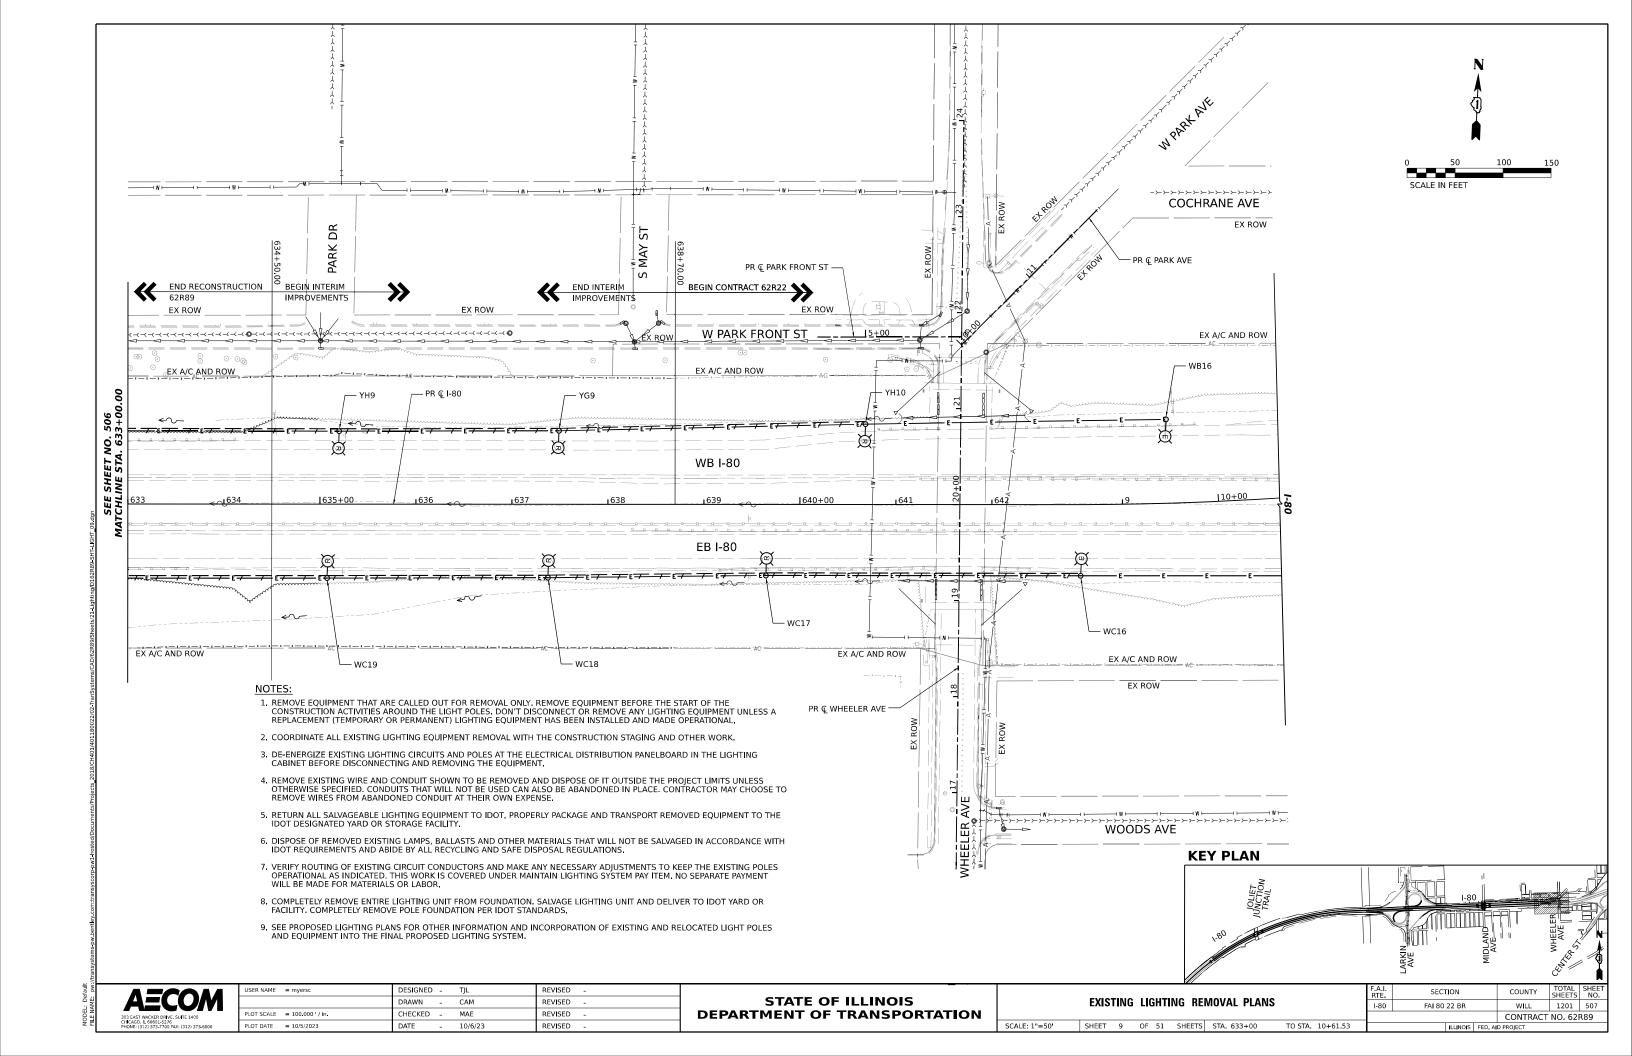



## 1. PROVIDE A TEMPORARY AERIAL CABLE FEED WITH MESSENGER WIRE BETWEEN TEMPORARY LIGHTING UNITS AS SHOWN. ROUTE AERIAL CABLE ON WOOD POLES IN ORDER TO CONNECT THE ROADWAY LIGHTING CIRCUITS AS SHOWN 2. THE CONTRACTOR SHALL MAINTAIN THE EXISTING LIGHTING EQUIPMENT FULLY OPERATIONAL ON THE TRAFFIC SIDE OF THE ROADWAY. THE CONTRACTOR SHALL REWIRE EXISTING LIGHTING CIRCUITS AS NECESSARY TO KEEP ALL OF THE LIGHT POLES OPERATIONAL DURING CONSTRUCTION. THE CONTRACTOR SHALL PROVIDE ANY EQUIPMENT, MATERIALS, AND LABOR NECESSARY TO ACCOMPLISH THIS GOAL EVEN IF NOT SPECIFIED OR DETAILED IN THE PLANS. THIS WORK SHALL BE PAID FOR UNDER EACH INDIVIDUAL LIGHTING PAY ITEMS. 3. THE CONTRACTOR SHALL SPLICE AERIAL CABLE AT LIGHT POLES USING HEAT-SHRINK CAPS WITH FACTORY APPLIED WATERPROOF SEALANT. 4. WHERE THE CONTINUITY OF CIRCUITS OR CONDUITS SERVING ANY EXISTING LIGHTING/EQUIPMENT TO REMAIN IN OPERATION IS INTERFERED WITH, RE-ROUTE, AND REWIRE SUCH CIRCUITS OR CONDUITS IN ORDER TO KEEP THE LIGHTING SYSTEM OPERATIONAL AT ALL TIMES. SCALE IN FEET 5. THE TEMPORARY WIRING OF THE EXISTING LIGHTING MUST BE INSTALLED AND THE LIGHTING SYSTEM MADE FULLY OPERATIONAL BEFORE THE EXISTING UNDERGROUND CONDUITS AND WIRING ARE DISCONNECTED OR REMOVED. 6. REMOVE WOOD POLE MOUNTED LIGHTING UNITS, OVERHEAD CABLE, WOOD POLES, AND OTHER TEMPORARY EQUIPMENT AT THE END OF CONSTRUCTION. LUMINAIRES REMOVED FROM TEMPORARY LIGHTING UNITS SHALL BE SALVAGED TO IDOT. CKTS E&F: AERIAL 3-1/C #2 W/MESSENGER WIRE (TYPICAL) PROPOSED MEDIAN LIGHT POLES AND ASSOCIATED CONDUITS SHALL BE INSTALLED AND OPERATIONAL PRIOR TO STAGE 2A SWITCHOVER, MAINLINE TEMPORARY LIGHTING SYSTEM CAN BE REMOVED ONCE MEDIAN MOUNT LIGHTING UNITS ARE ACTIVE AND TRAFFIC HAS SHIFTED TO STAGE 2A. YF7 / STA. 565+52, 109' LT YE8 STA. 562+62, 109' LT YE7 / STA. 568+42, 109' LT YF6 STA. 571+32, 109' LT - CKTS E&F: AERIAL 3-1/C #2 W/MESSENGER WIRE (TYPICAL) - PR **Ç I-**80 EX A/C AND ROW EB I-80 FRONTAGE RD 154 EX ROW STA, 571+32, 111' RT - CKTS C&D: AERIAL 3-1/C #2 W/MESSENGER WIRE (TYPICAL) **KEY PLAN** DESIGNED -REVISED SECTION COUNTY **STATE OF ILLINOIS** DRAWN CAM REVISED TEMPORARY LIGHTING PLANS 1-80 FAI 80 22 BR WILL 1201 508 CHECKED -MAE REVISED **DEPARTMENT OF TRANSPORTATION** CONTRACT NO. 62R89 SCALE: 1"=50' SHEET 10 OF 51 SHEETS STA. 561+00 TO STA. 573+00 PLOT DATE = 10/5/2023 DATE REVISED

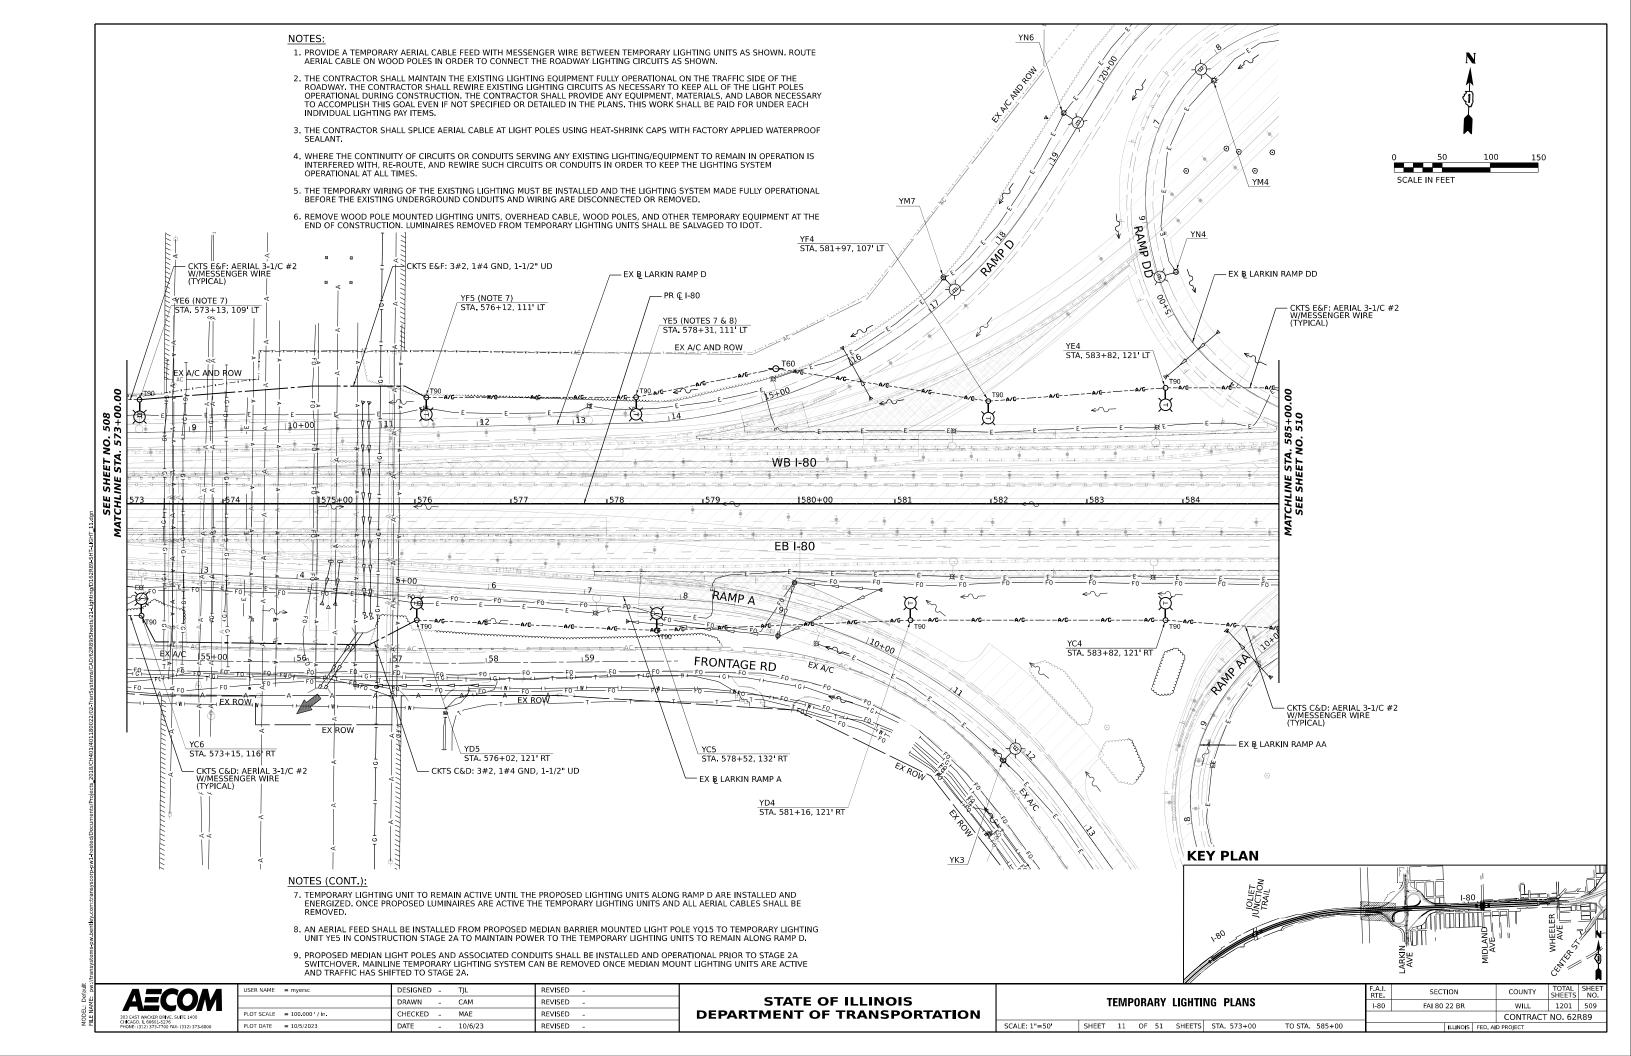


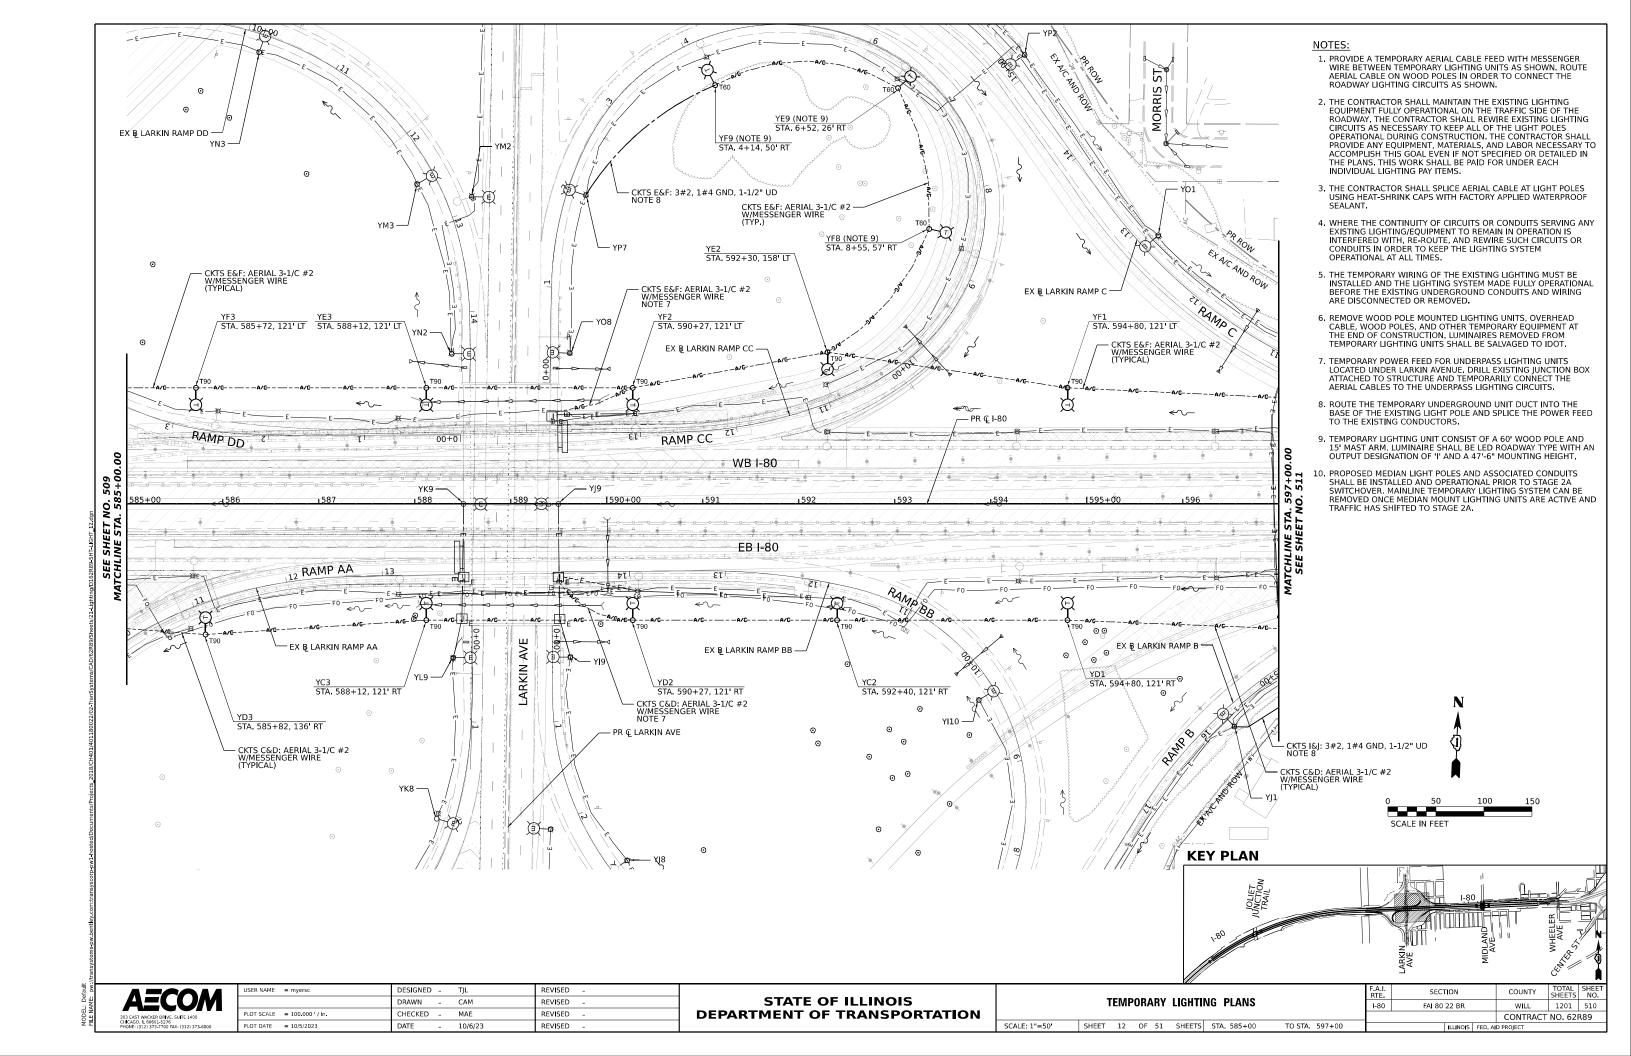


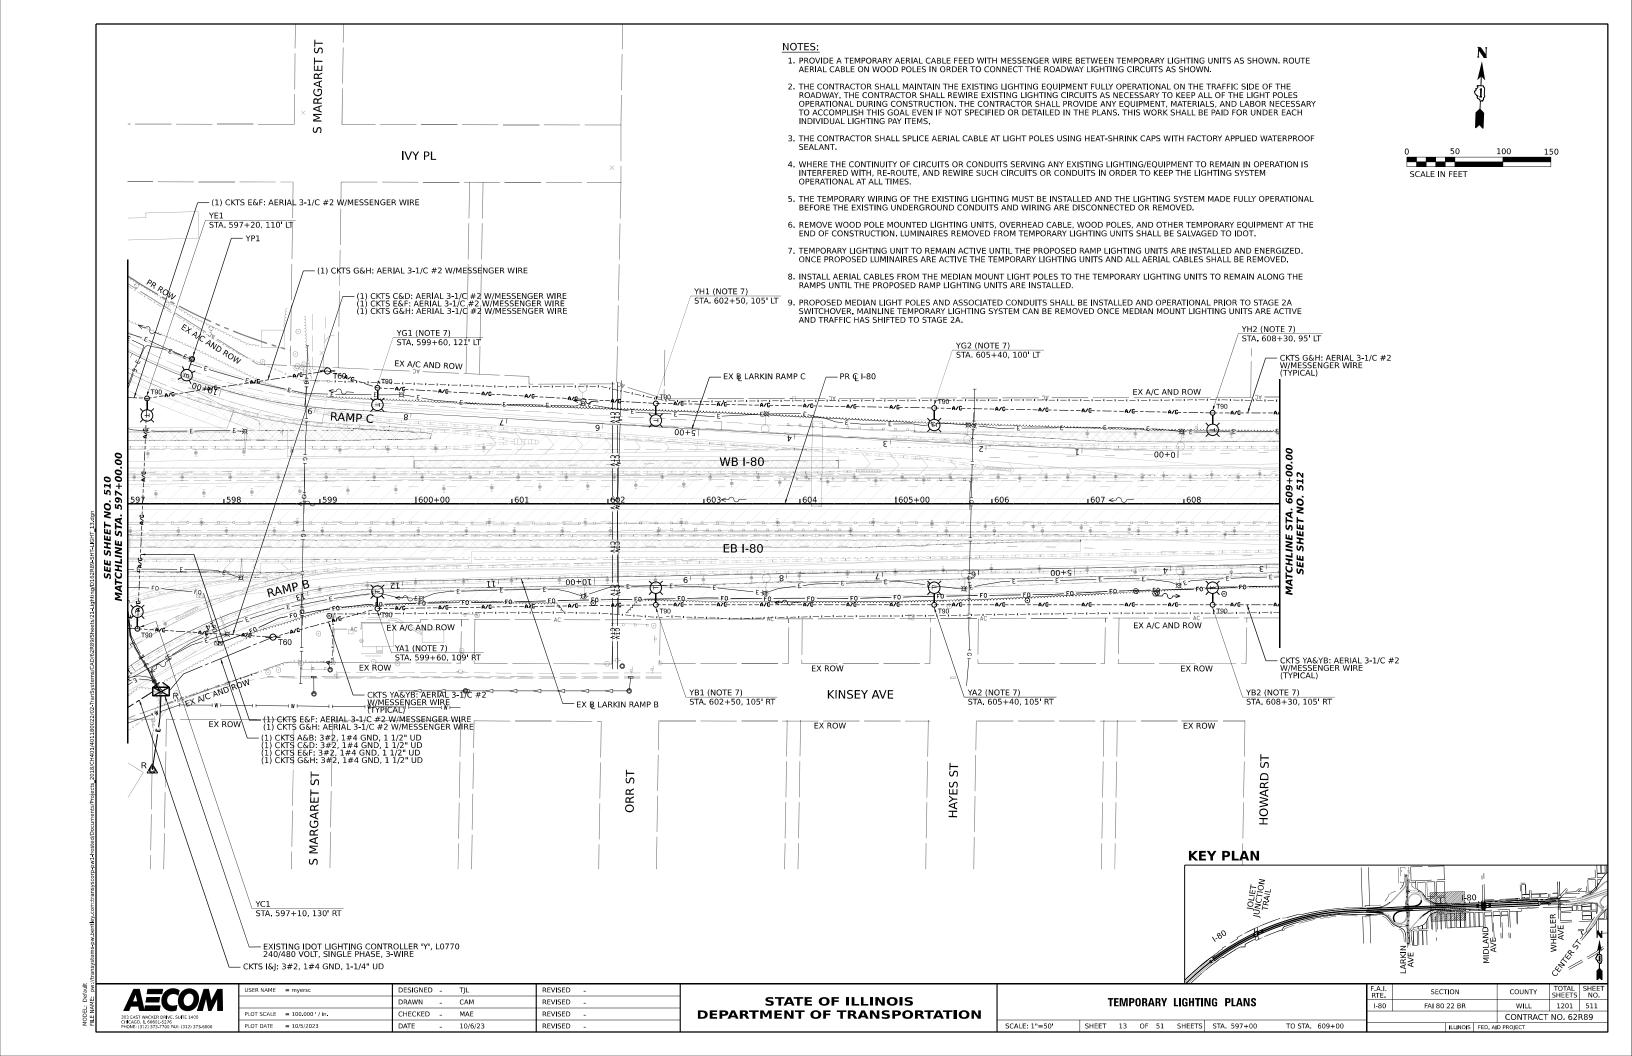


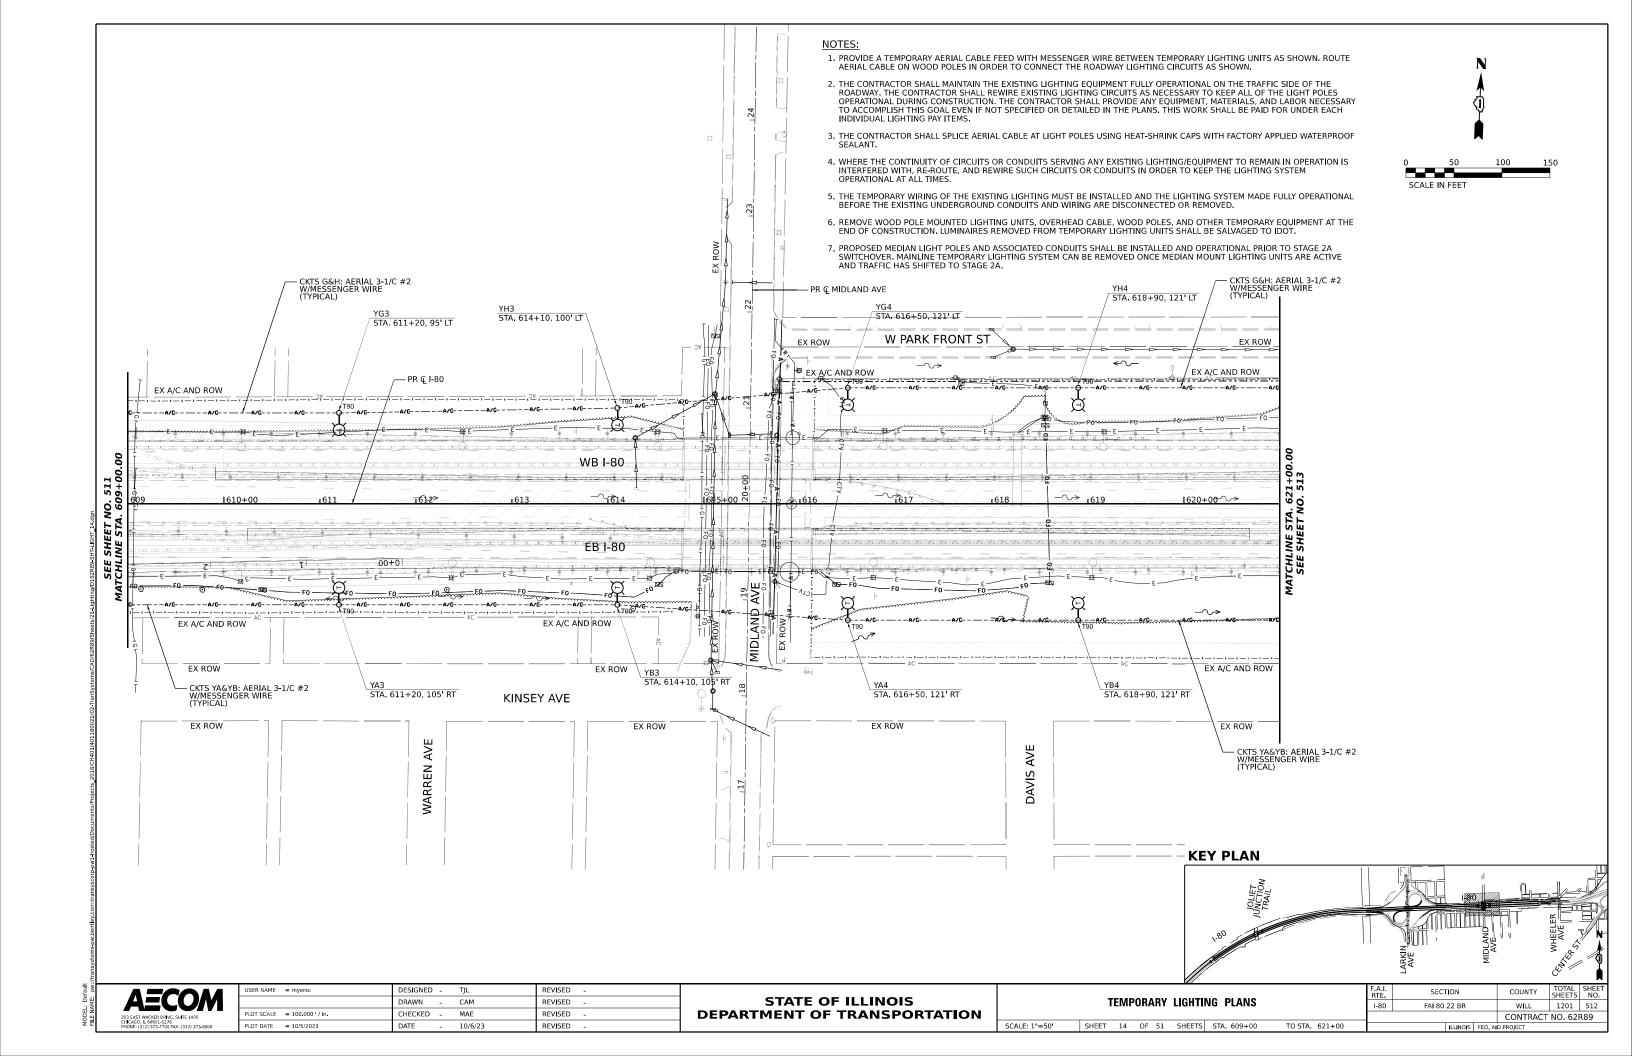

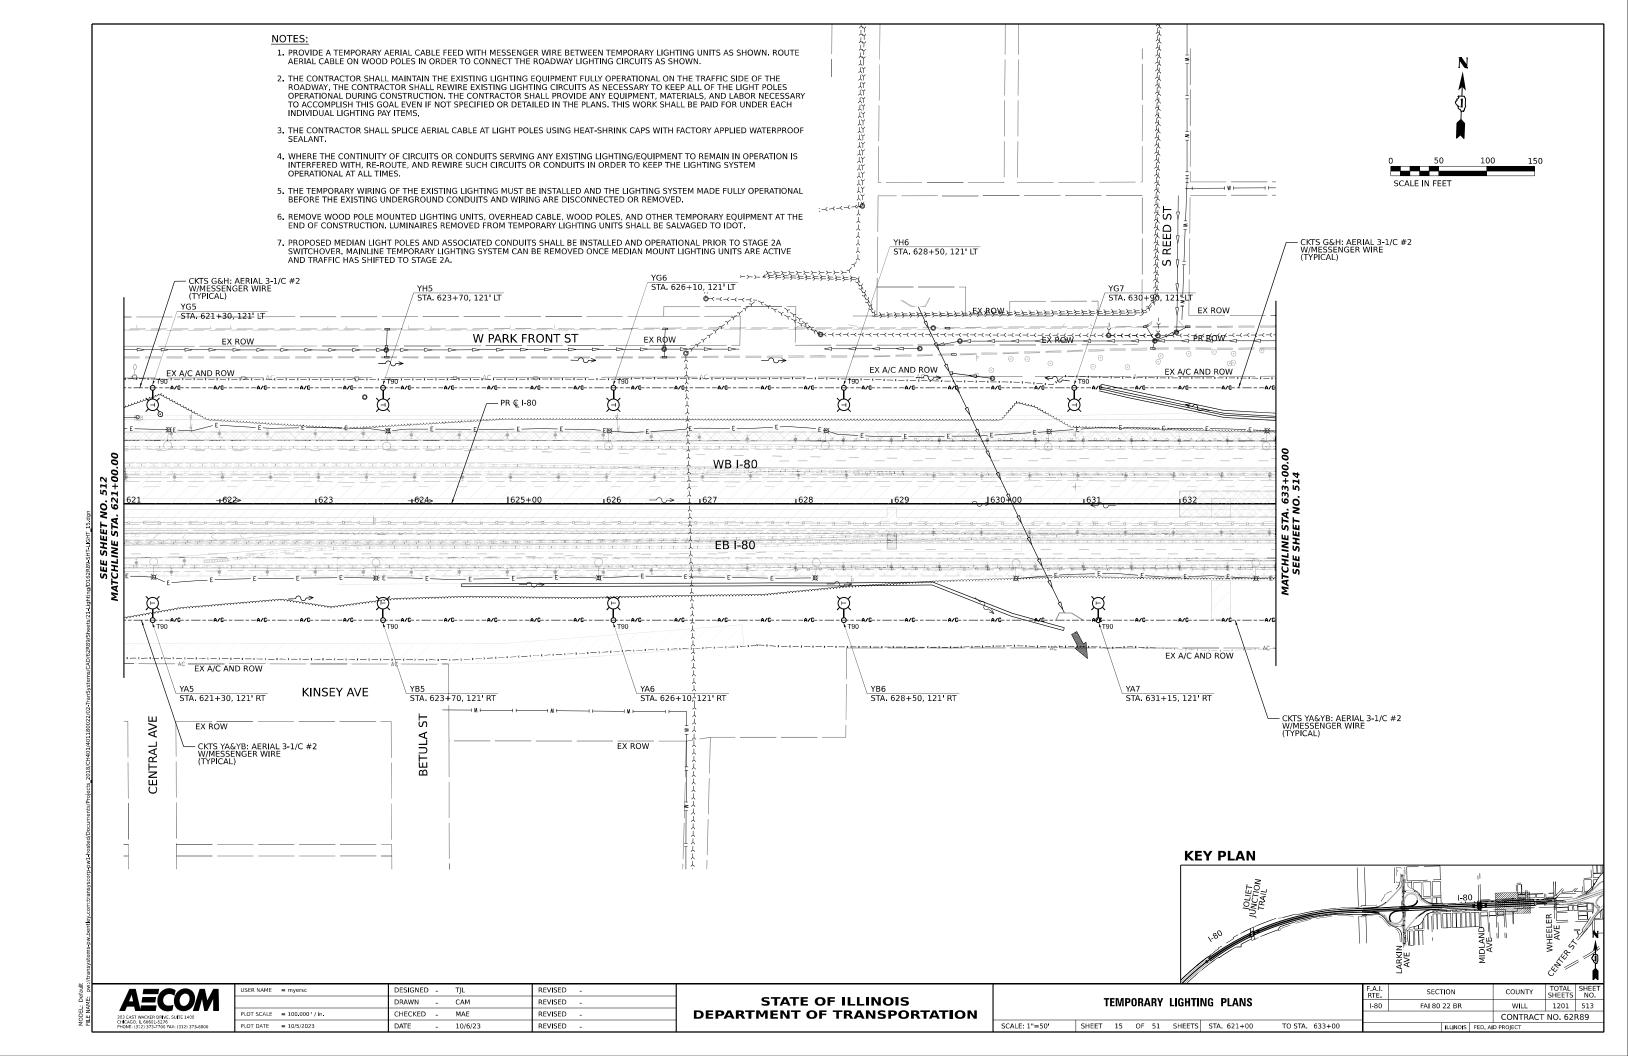

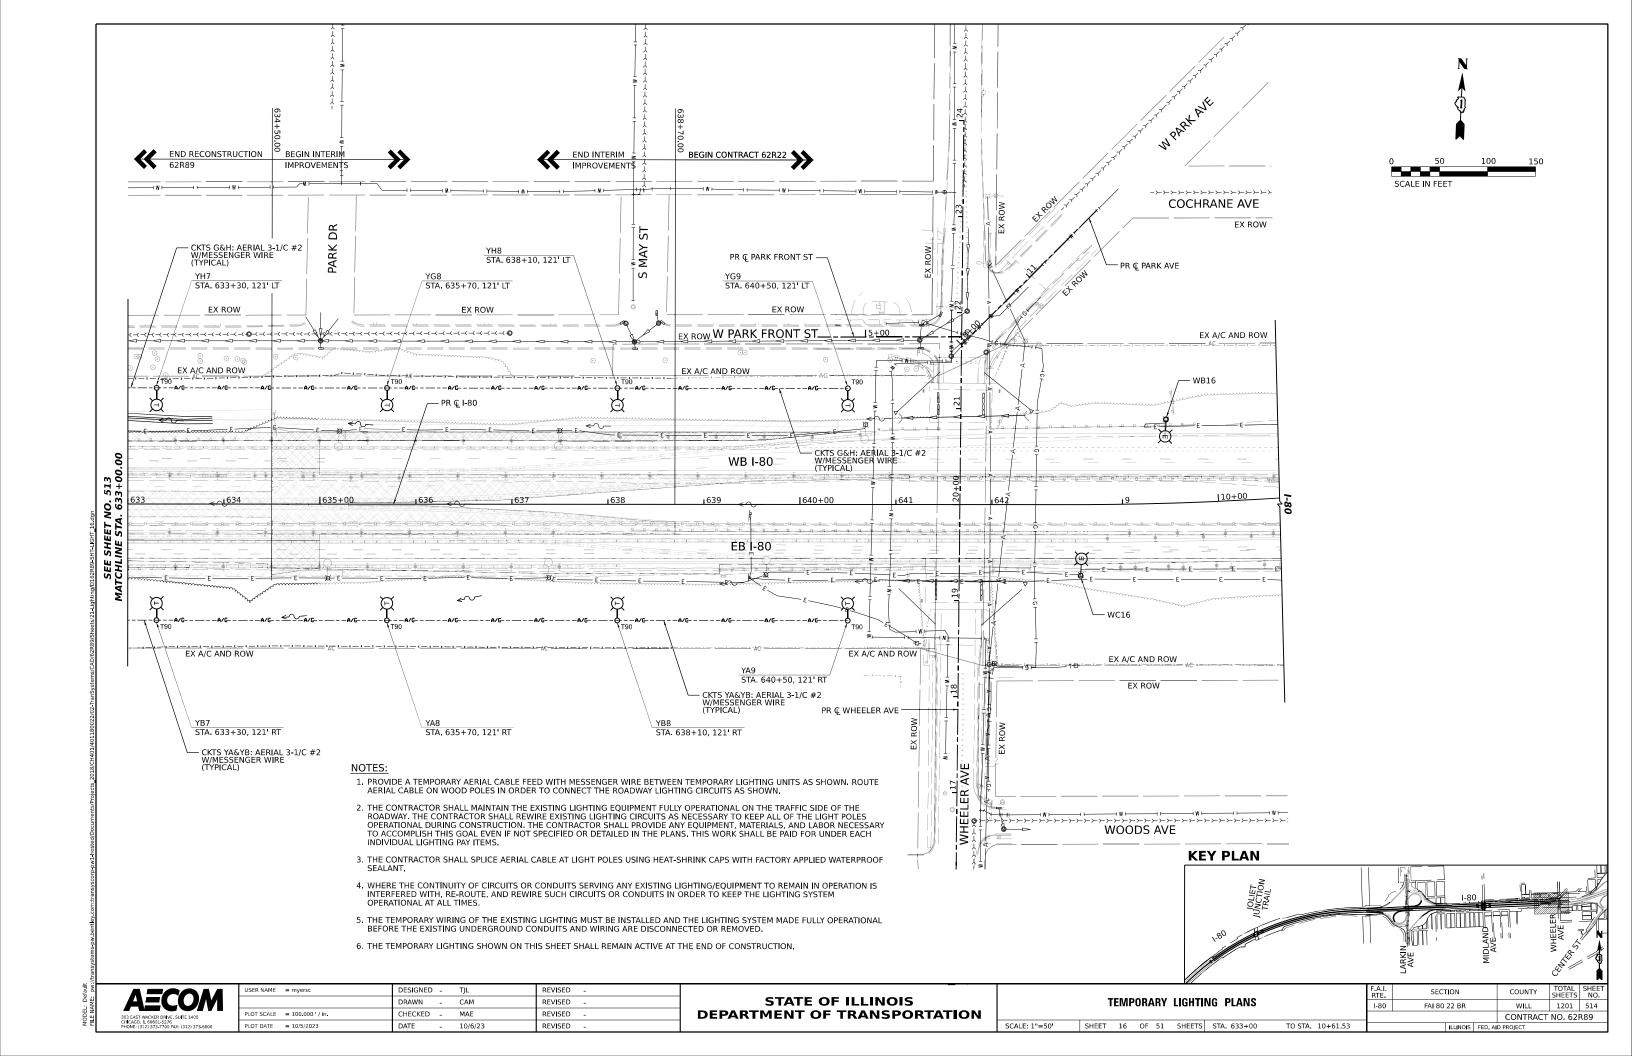

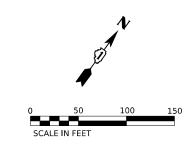

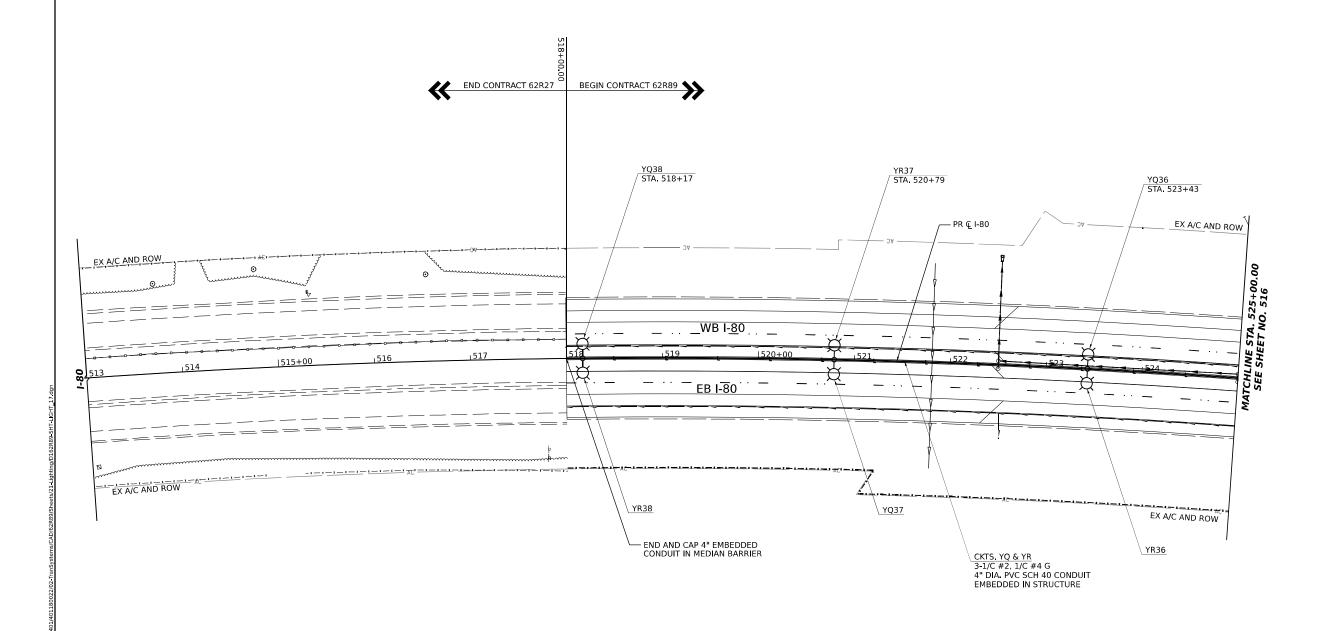

KEY PLAN


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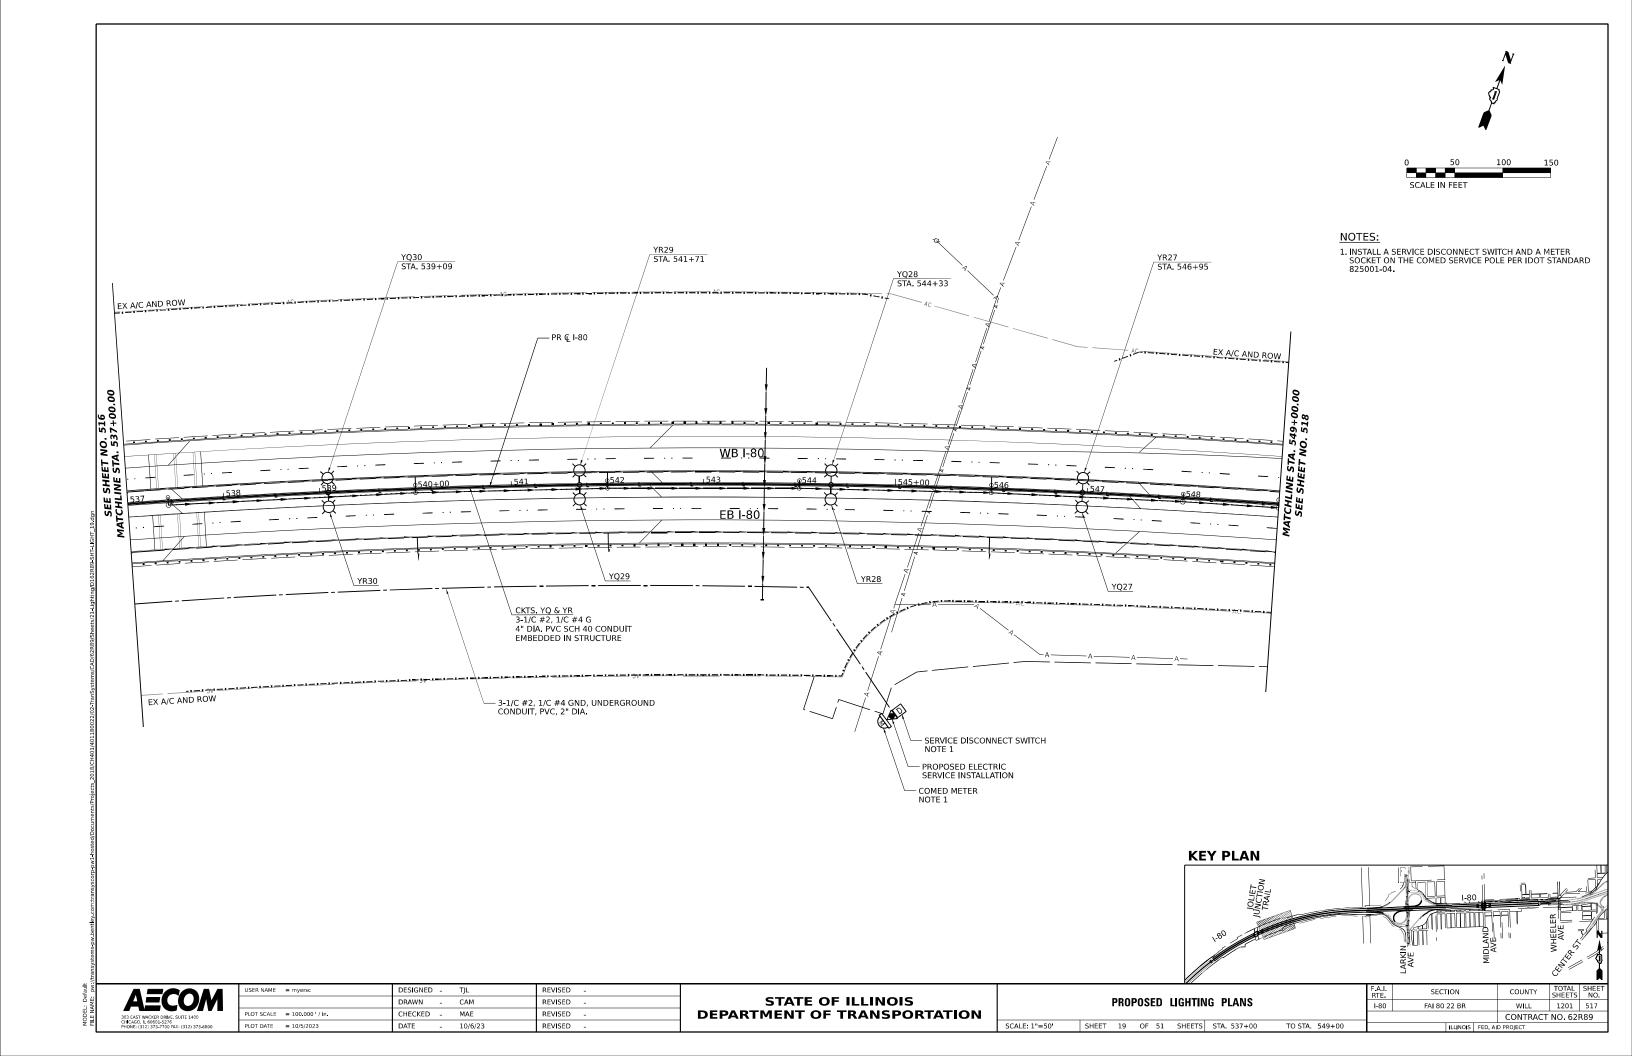
<b>AECOM</b>	
303 EAST WACKER DRIVE, SUITE 1400 CHICAGO, IL 60601-5276 PHONE: (312) 373-7700 FAX: (312) 373-6800	


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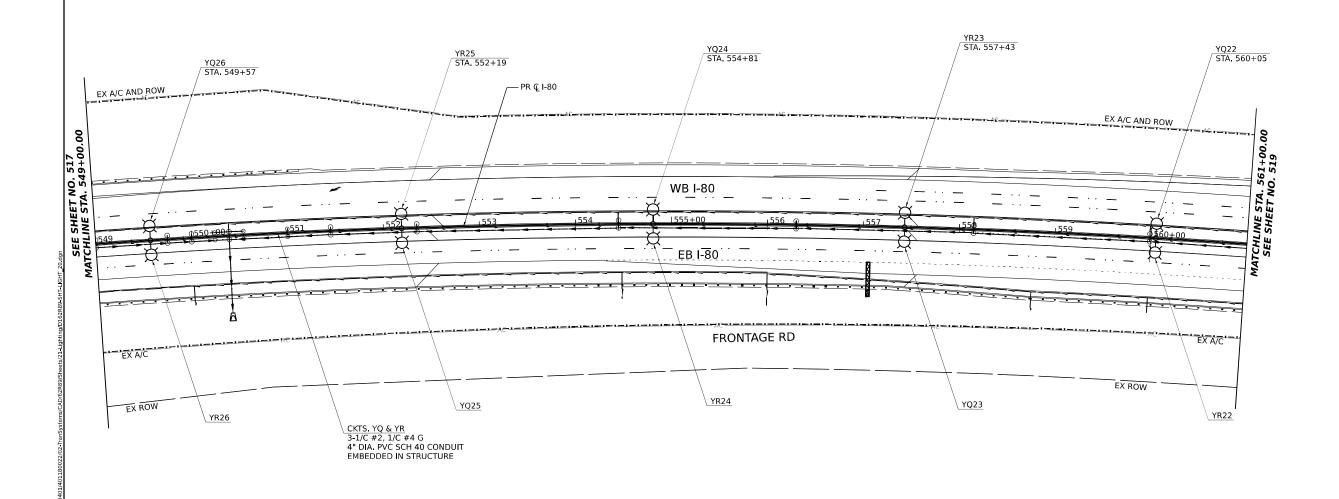
STATE OF ILLINOIS DEPARTMENT OF TRANSPORTATION


							RTE.	SECTION
		PRO	POSED	LIGHTIN	IG PLANS		I-80	FAI 80 22 BR
SCALE: 1"=50'	SHEET	17	OF 51	SHEETS	STA. 513+00	TO STA. 525+00		ILLINOIS





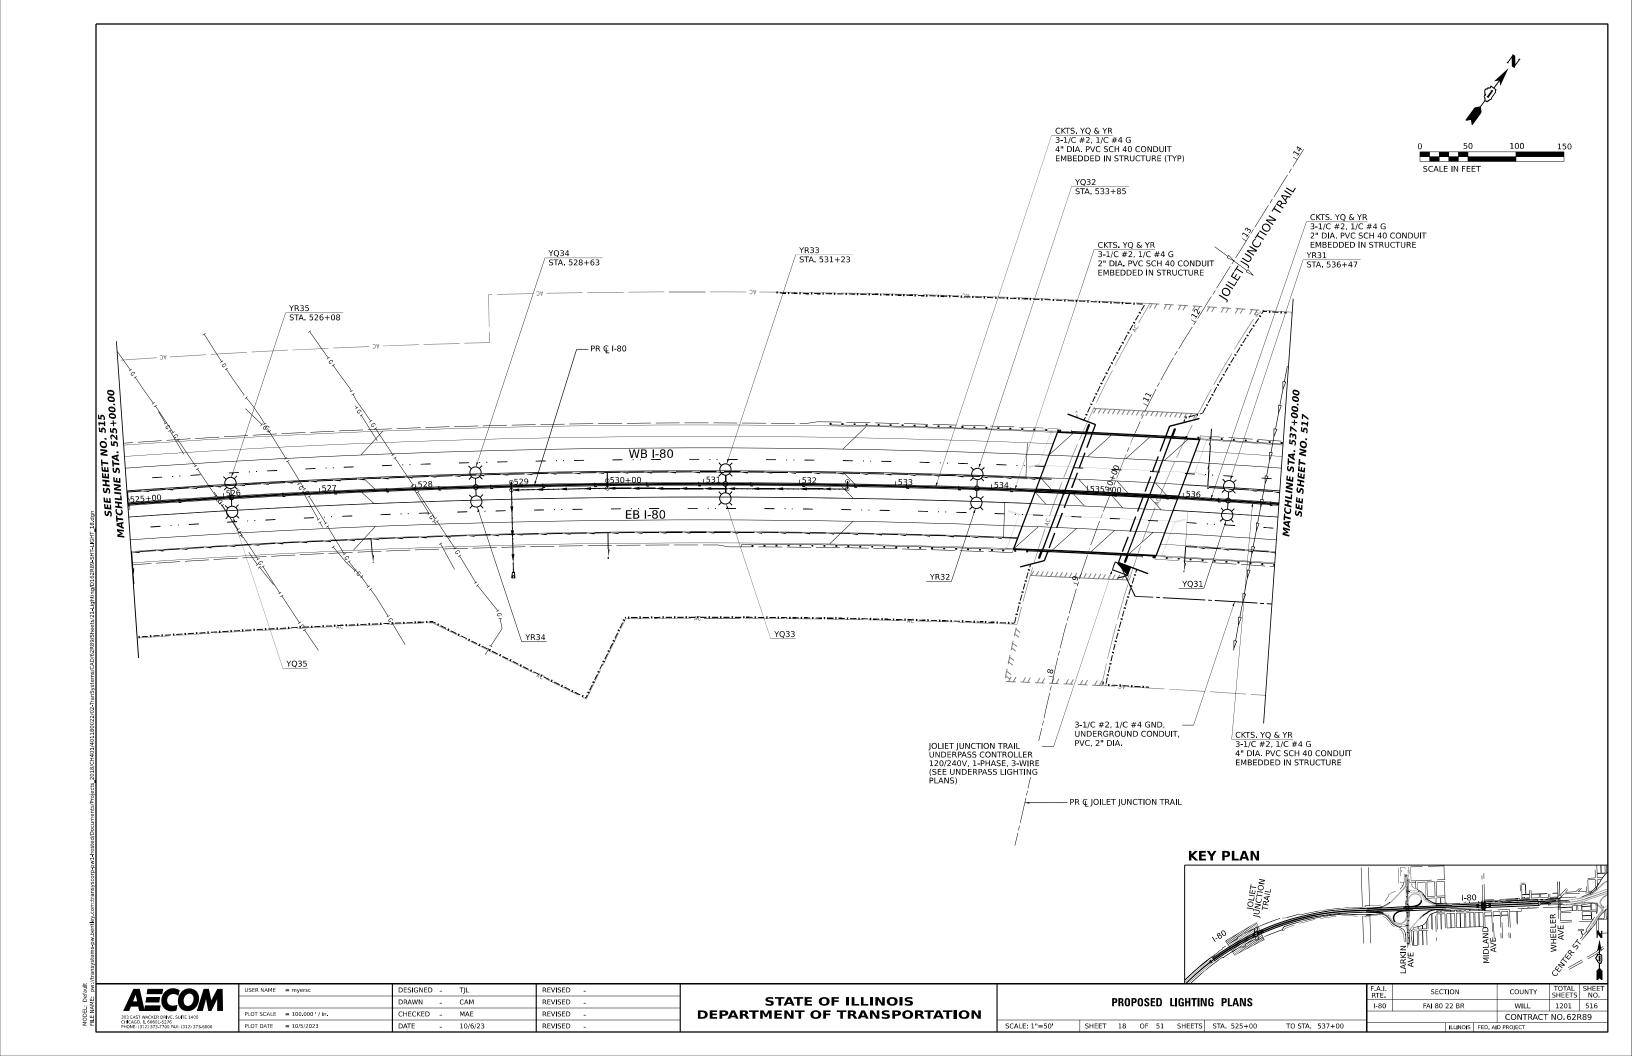

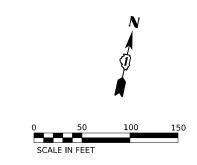

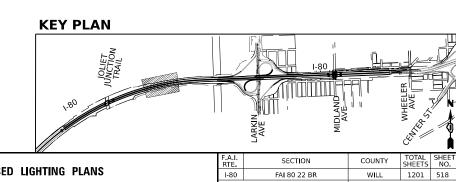

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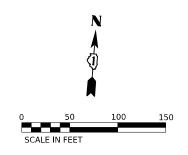
303 EAST WACKER DRIVE, SUITE 1400
CHCACO, IL 06051-5276
PHONE: 13(2) 373-700 PAX: (312) 373-6800


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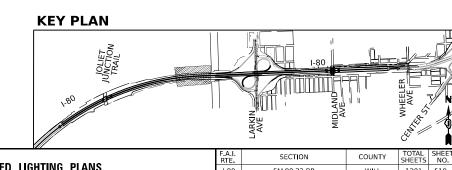
SCALE: 1"=50'

 PROPOSED LIGHTING PLANS
 RIE. | 1-80 | FAI 80 2

 SHEET 20 OF 51 SHEETS STA. 549+00 TO STA. 561+00
 10 STA. 561+00






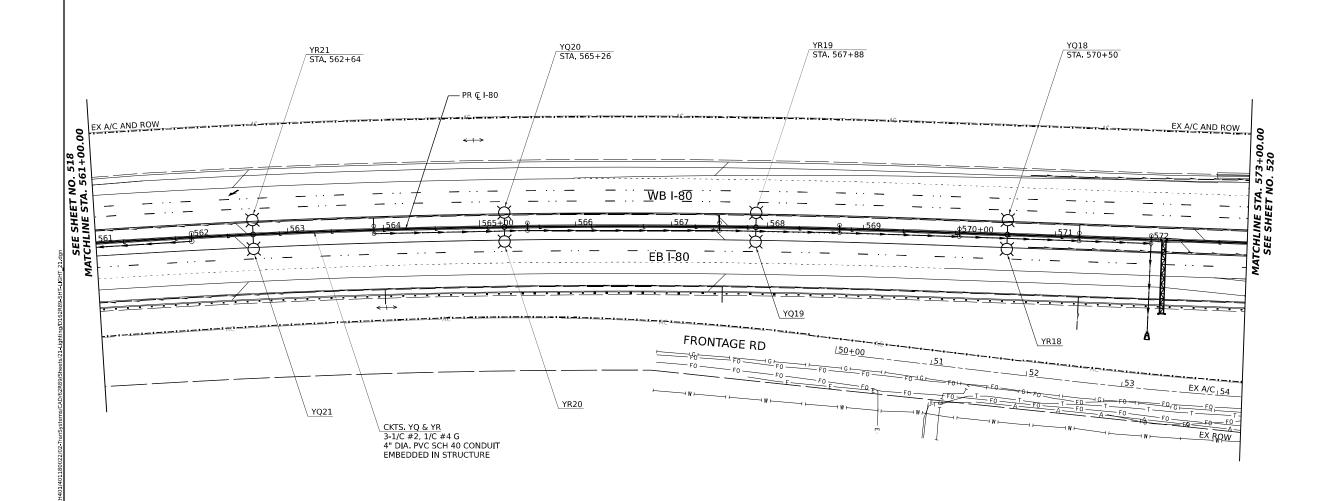



AECOM
303 EAST WACKER DRIVE. SUITE 1400
CHCAGO, 1. 60601-5276
PHONE: 3(32) 373-7700 PAX: (312) 373-8800


STATE OF ILLINOIS DEPARTMENT OF TRANSPORTATION


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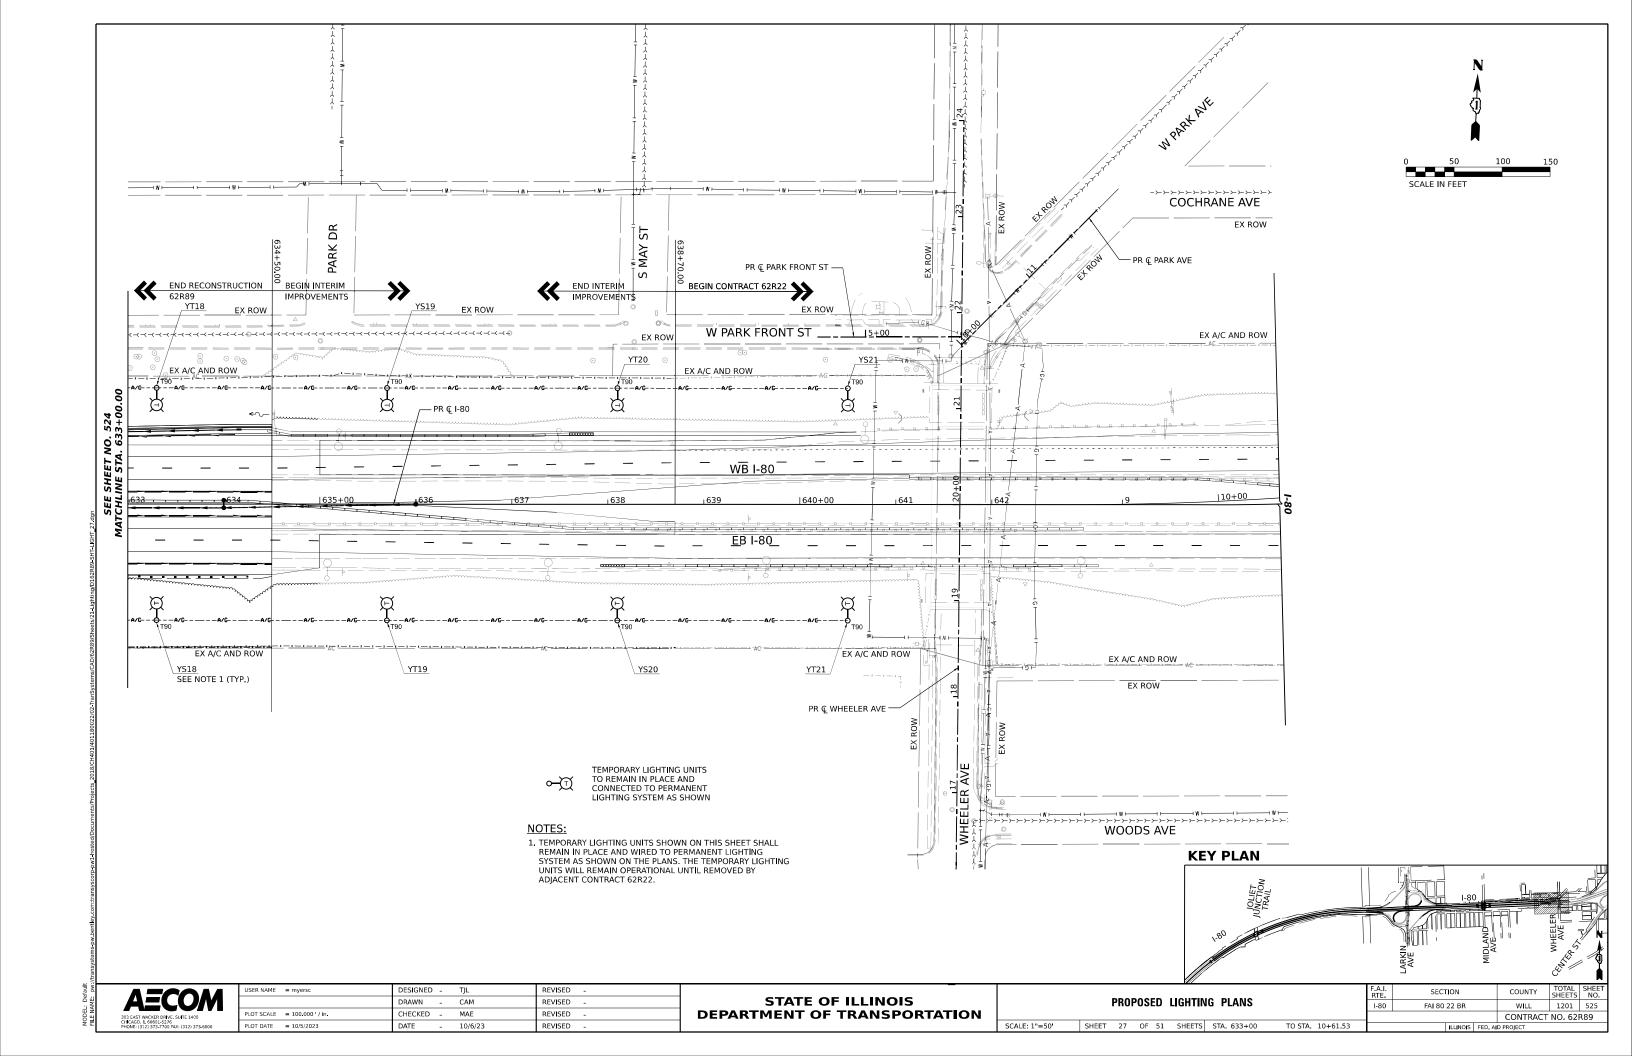


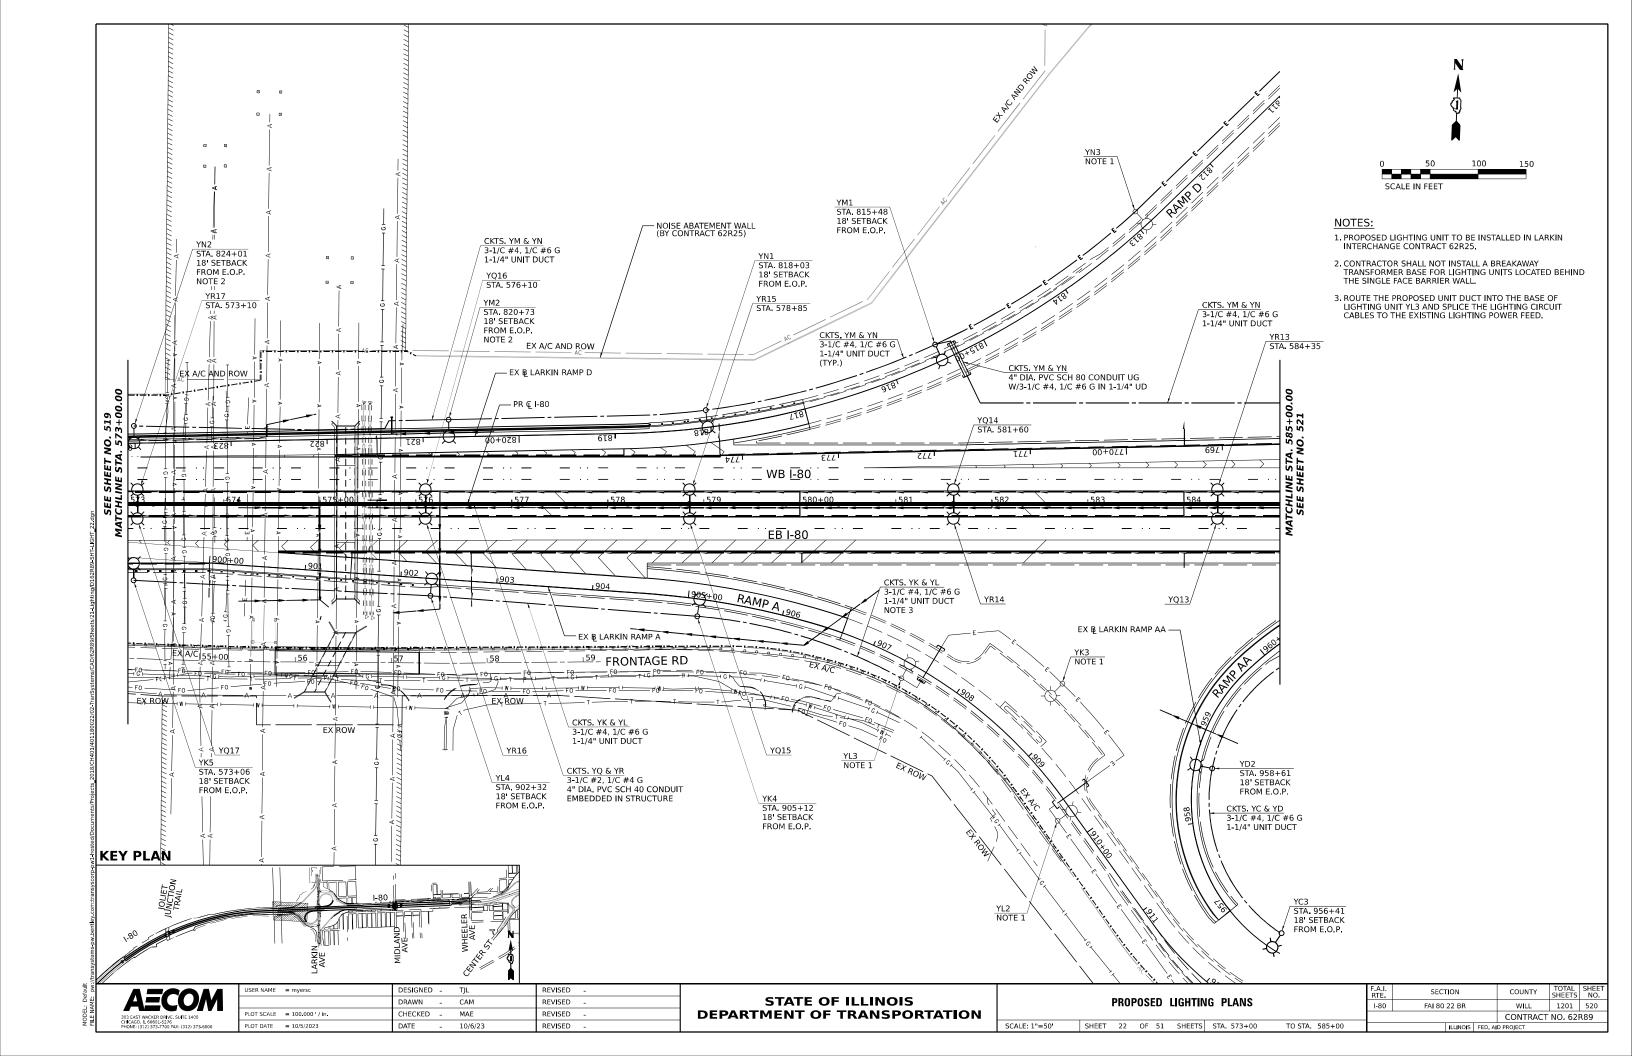


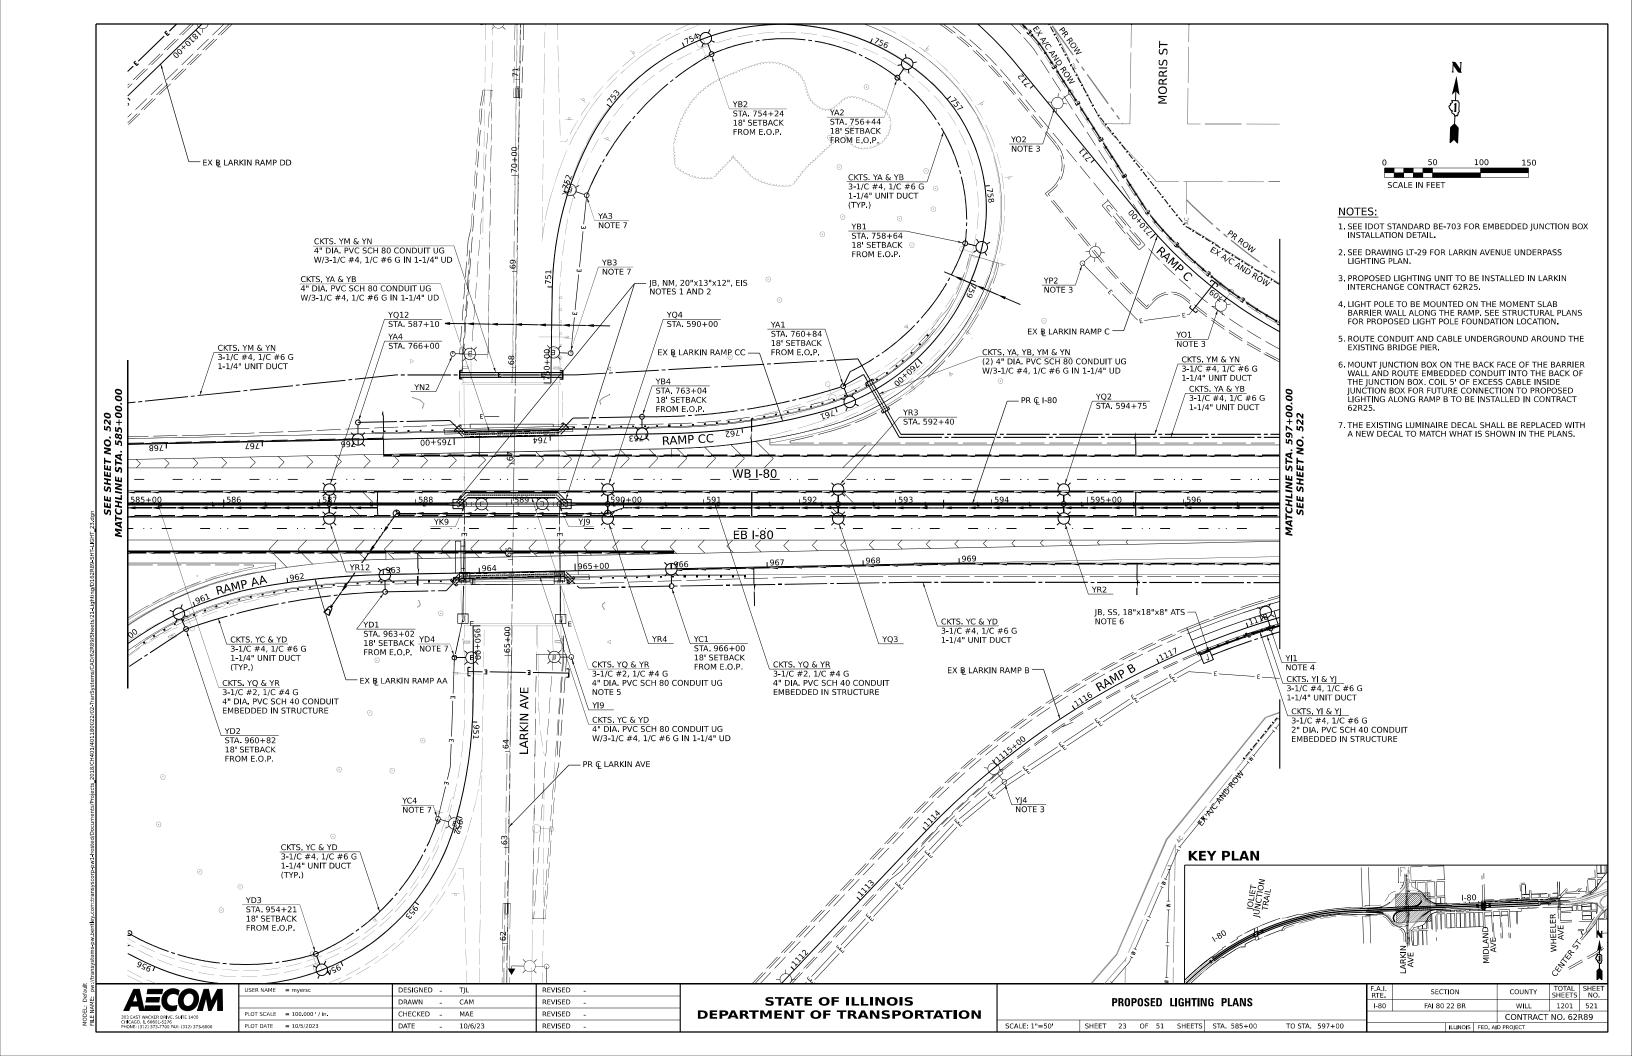

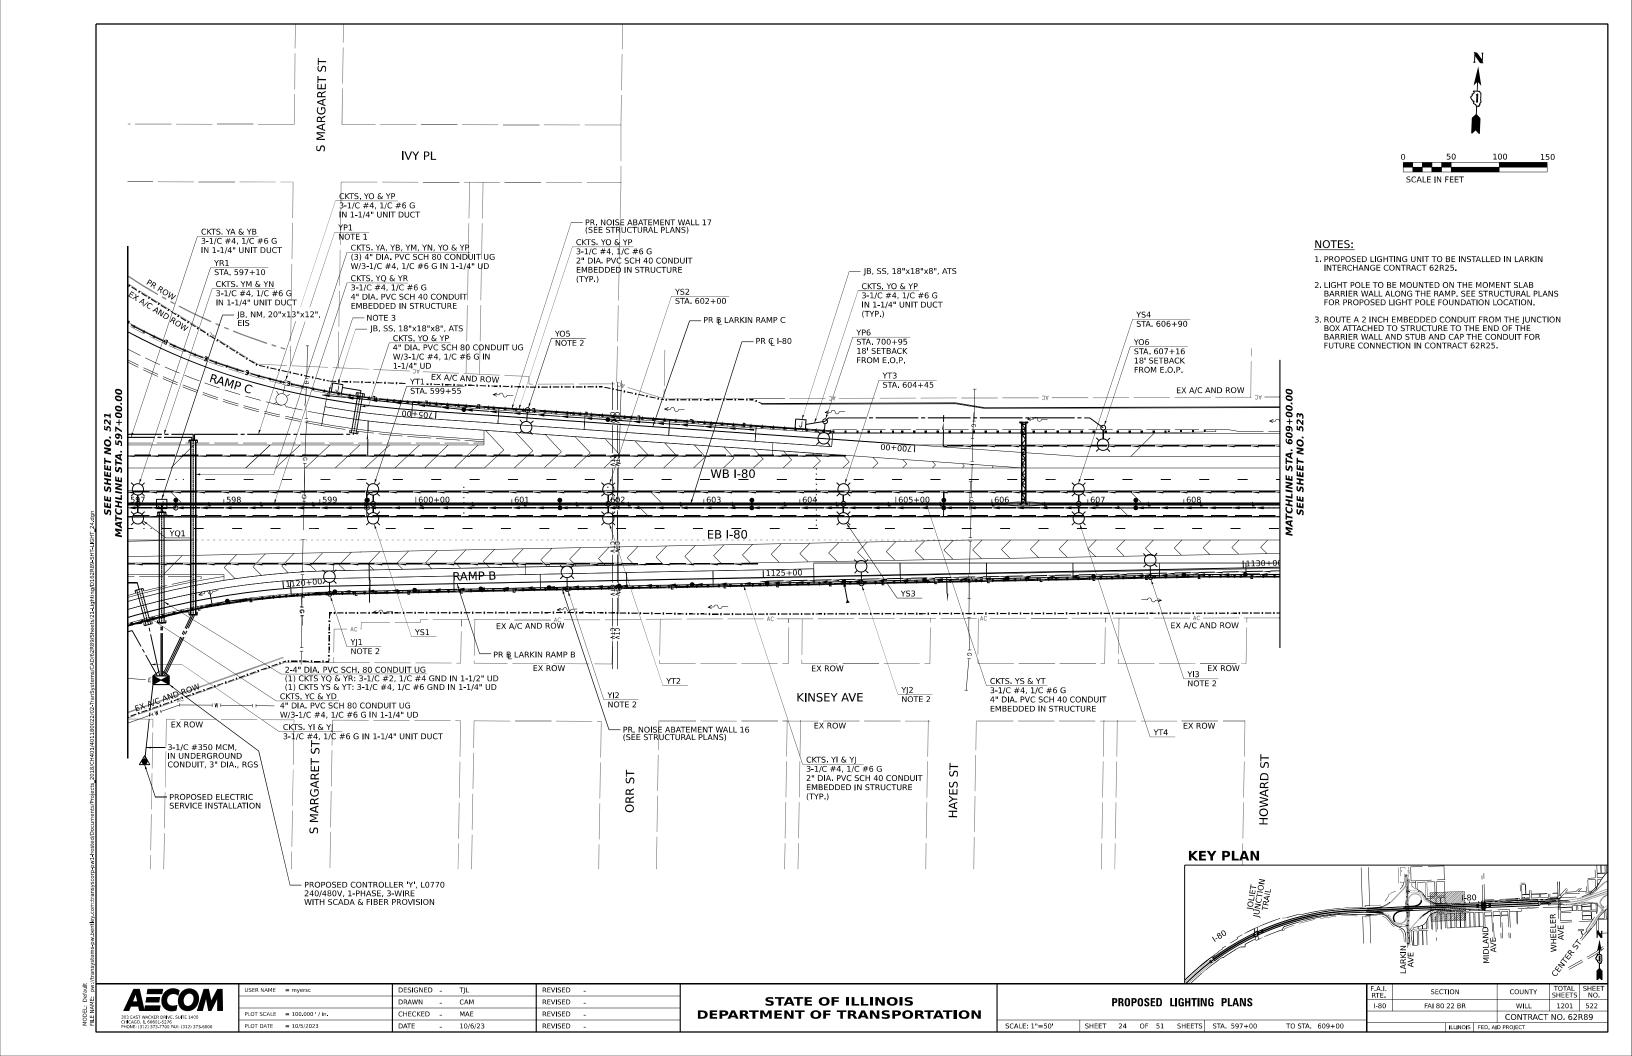

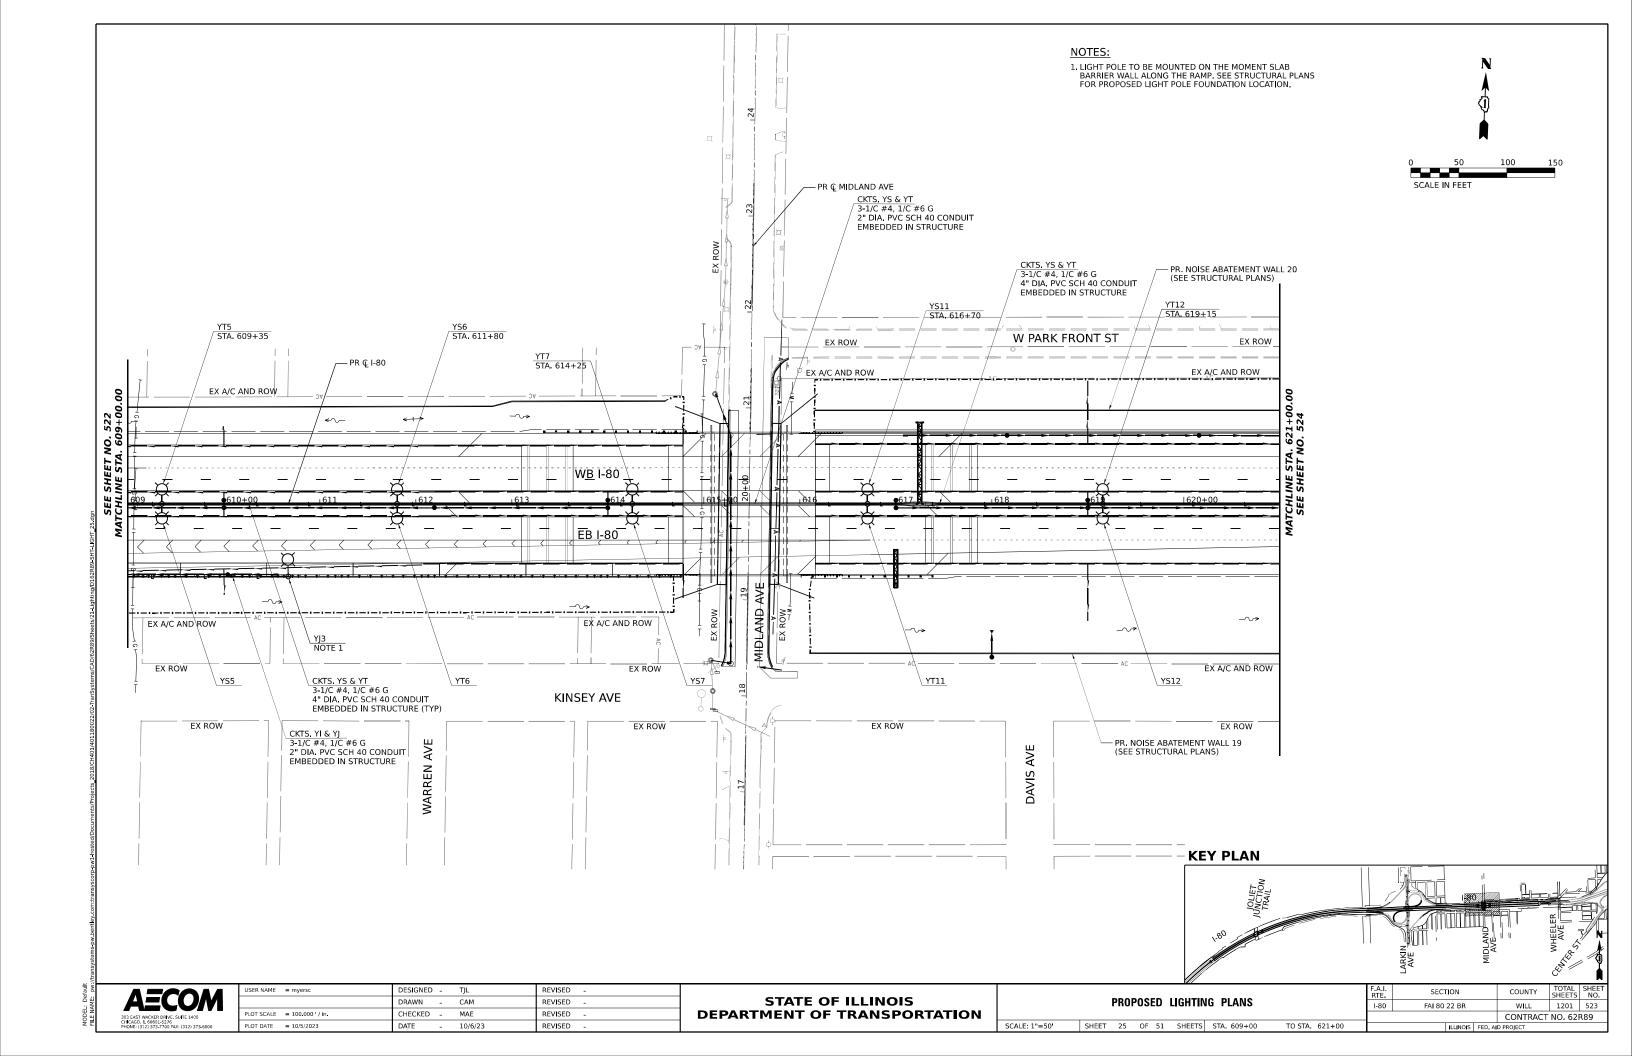

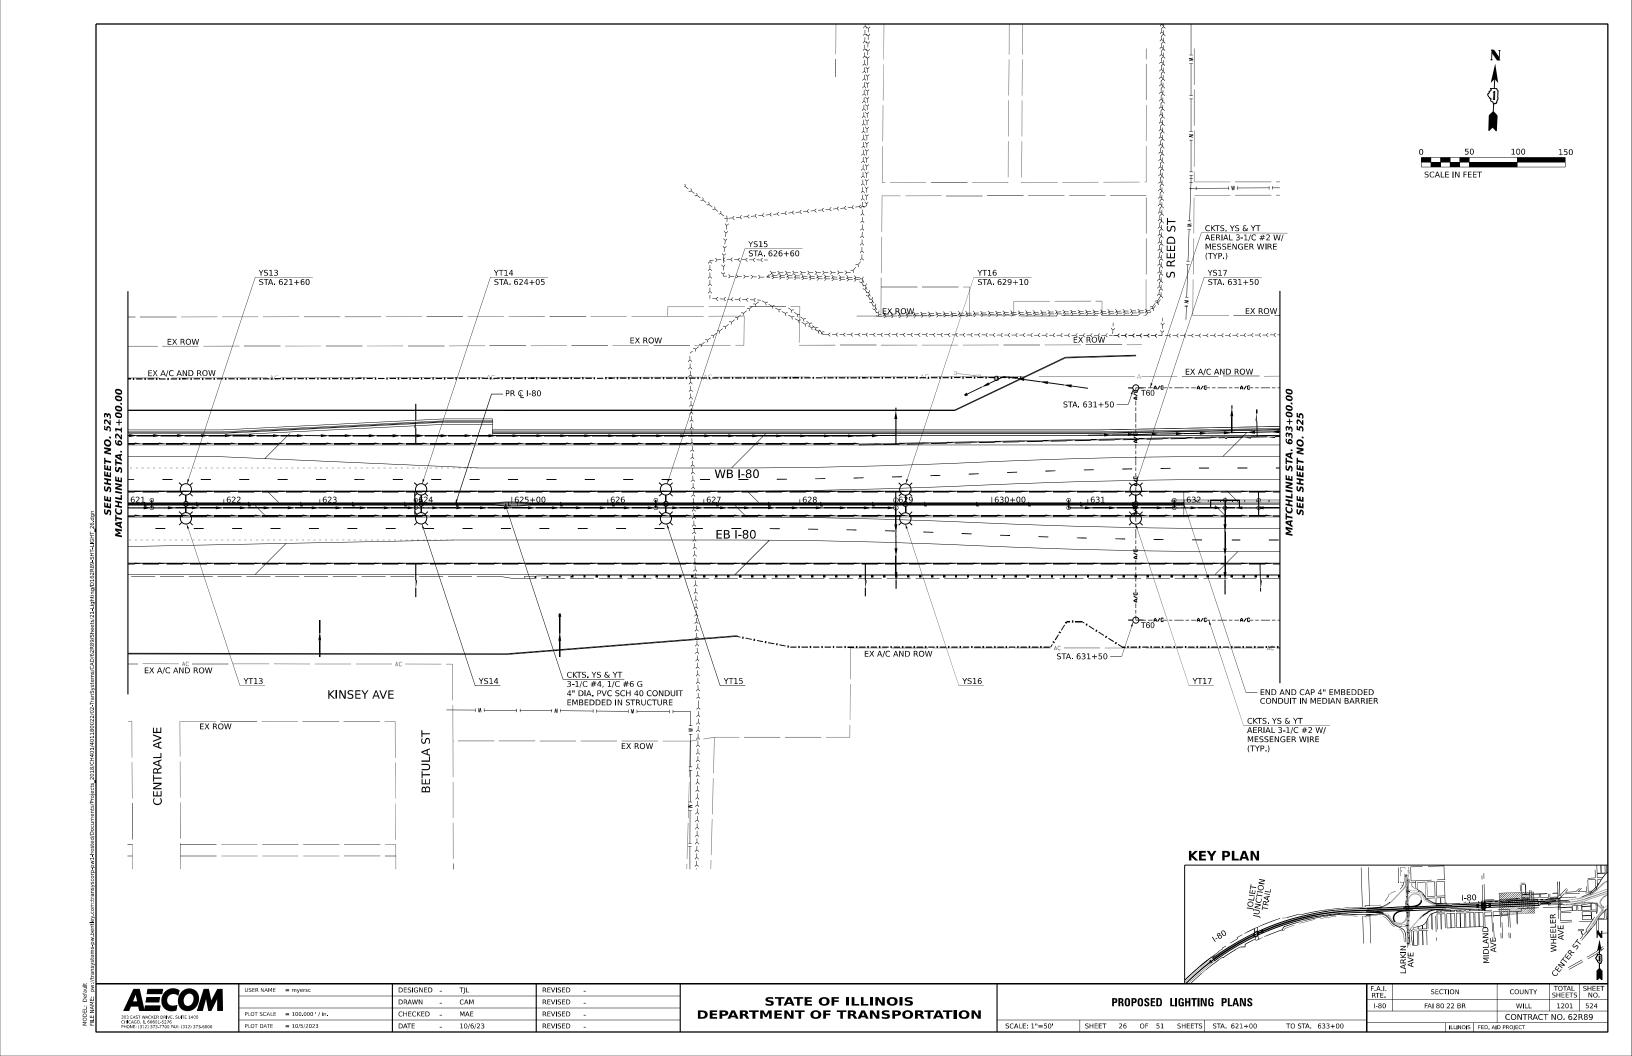

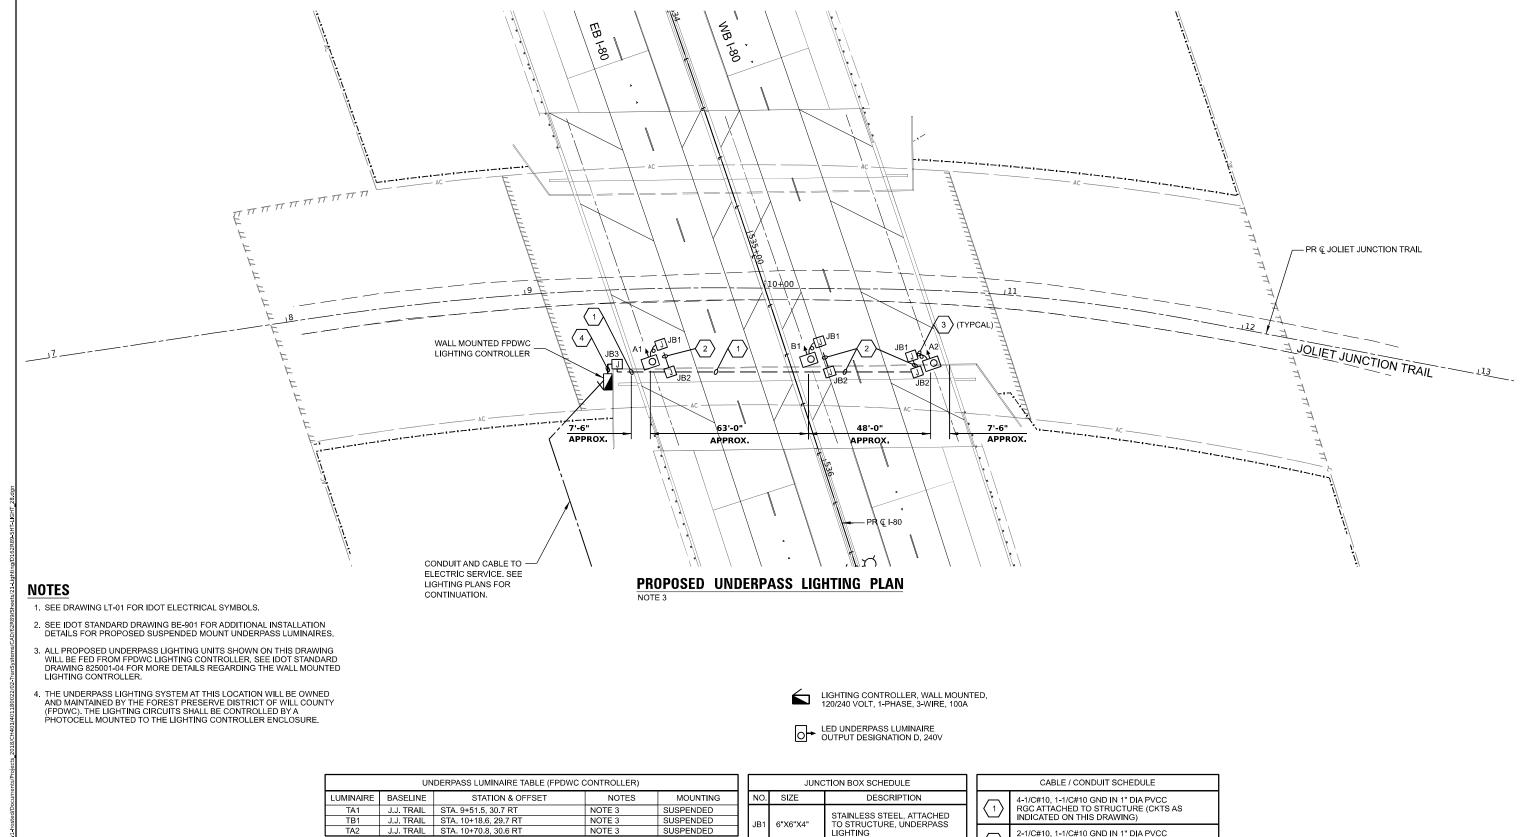


UNDERPASS LUMINAIRE TABLE (FPDWC CONTROLLER)							
LUMINAIRE	BASELINE	STATION & OFFSET	NOTES	MOUNTING			
TA1	J.J. TRAIL	STA. 9+51.5, 30.7 RT	NOTE 3	SUSPENDED			
TB1	J.J. TRAIL	STA. 10+18.6, 29.7 RT	NOTE 3	SUSPENDED			
TA2	J.J. TRAIL	STA. 10+70.8, 30.6 RT	NOTE 3	SUSPENDED			
NOTE: CENTERING THE UNDERPASS LUMINAIRES BETWEEN							

NO IE: CENTERING THE UNDERPASS LUMINAIRES BETWEEN THE STRUCTURAL BEAMS TAKES PRECEDENCE OVER THE STATION AND OFFSET PROVIDED IN THE TABLE.

JUNCTION BOX SCHEDULE								
NO.	SIZE	DESCRIPTION						
JB1	6"X6"X4"	STAINLESS STEEL, ATTACHED TO STRUCTURE, UNDERPASS LIGHTING						
JB2	12"X10"X6"	STAINLESS STEEL, ATTACHED TO STRUCTURE, UNDERPASS LIGHTING						
JB3	18"X18"X8"	STAINLESS STEEL, ATTACHED TO STRUCTURE, UNDERPASS LIGHTING						

CABLE / CONDUIT SCHEDULE							
(1)	4-1/C#10, 1-1/C#10 GND IN 1" DIA PVCC RGC ATTACHED TO STRUCTURE (CKTS AS INDICATED ON THIS DRAWING)						
2	2-1/C#10, 1-1/C#10 GND IN 1" DIA PVCC RGC ATTACHED TO STRUCTURE (CKTS AS INDICATED ON THIS DRAWING)						
3	2-1/C#10, 1-1/C#10 GND IN 3/4" DIA LIQUID TIGHT FLEXIBLE CONDUIT (CKTS AS INDICATED ON THIS DRAWING)						
4	4-1/C#10, 1-1/C#10 GND IN 3" DIA PVCC RGC ATTACHED TO STRUCTURE (CKTS AS INDICATED ON THIS DRAWING)						

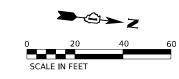




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PLOT SCALE = 40.000 / in.	CHECKED -	MAE	REVISED	-
PLOT DATE = 10/5/2023	DATE -	10/6/23	REVISED	-

**STATE OF ILLINOIS DEPARTMENT OF TRANSPORTATION** 

0 0VED	IOLIET		JUNCTION TRAIL UNDERPASS LIGHTING	DIAN	F.A.I. RTE					
U UVEK	JULIET	JUN	CHUI	IKAI	L UNDI	KPA35	LIGHTING	PLAN	I-80	
"=20 <b>'</b>	SHEET	28	OF 5	1 SHEE	TS STA		TO STA			

F.A.I. RTE	SECT	TION	COUNTY	TOTAL SHEETS	SHE	
I-80	FAI 80	22 BR	WILL	1201	526	
				CONTRACT	NO.62F	₹89
		ILLINOIS	FED. A	D PROJECT		

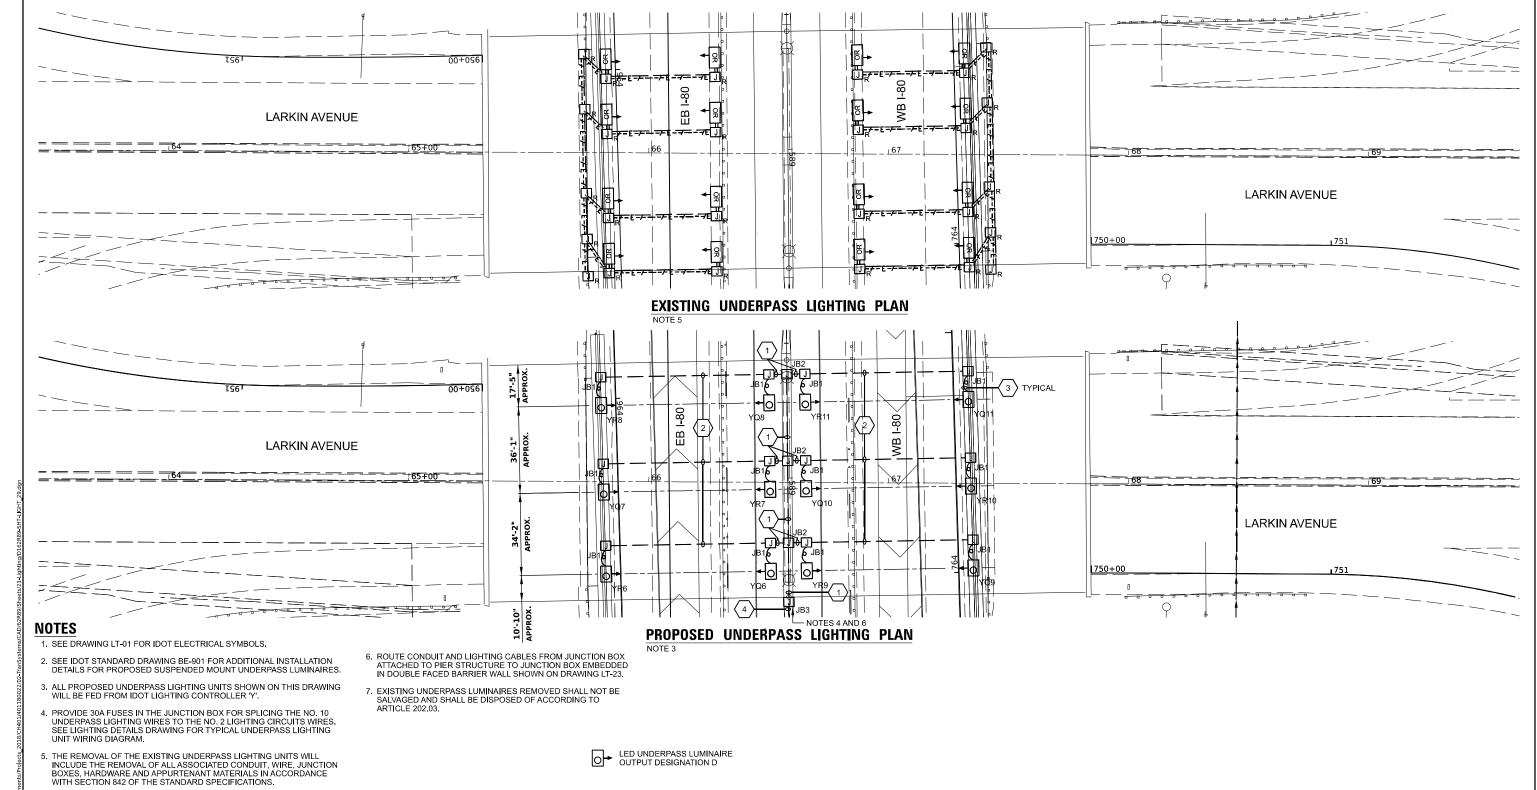

UNDERPASS LUMINAIRE TABLE EB I-80 (CONTROLLER 'Y')								
BASELINE	STATION & OFFSET	NOTES	MOUNTING					
LARKIN	STA. 65+82.4, 38.6 RT	NOTE 3	SUSPENDED					
LARKIN	STA. 66+51.1, 37.1 RT	NOTE 3	SUSPENDED					
LARKIN	STA. 66+50.6, 2.9 RT	NOTE 3	SUSPENDED					
LARKIN	STA. 65+81.3, 4.4 RT	NOTE 3	SUSPENDED					
LARKIN	STA. 65+80.0, 31.6 LT	NOTE 3	SUSPENDED					
LARKIN	STA. 66+50.1, 33.1 LT	NOTE 3	SUSPENDED					
	BASELINE LARKIN LARKIN LARKIN LARKIN LARKIN LARKIN	BASELINE STATION & OFFSET  LARKIN STA. 65+82.4, 38.6 RT  LARKIN STA. 66+51.1, 37.1 RT  LARKIN STA. 66+50.6, 2.9 RT  LARKIN STA. 65+81.3, 4.4 RT  LARKIN STA. 65+80.0, 31.6 LT	BASELINE         STATION & OFFSET         NOTES           LARKIN         STA. 65+82.4, 38.6 RT         NOTE 3           LARKIN         STA. 66+51.1, 37.1 RT         NOTE 3           LARKIN         STA. 66+50.6, 2.9 RT         NOTE 3           LARKIN         STA. 65+81.3, 4.4 RT         NOTE 3           LARKIN         STA. 65+80.0, 31.6 LT         NOTE 3					

NOTE: CENTERING THE UNDERPASS LUMINAIRES BETWEEN THE STRUCTURAL BEAMS TAKES PRECEDENCE OVER THE STATION AND OFFSET PROVIDED IN THE TABLE.


_										
	JUNCTION BOX SCHEDULE									
	NO.	SIZE	DESCRIPTION							
	JB1	6"X6"X4"	STAINLESS STEEL, ATTACHED TO STRUCTURE, UNDERPASS LIGHTING							
	JB2	12"X10"X6"	STAINLESS STEEL, ATTACHED TO STRUCTURE, UNDERPASS LIGHTING							
	JB3	18"X18"X8"	STAINLESS STEEL, ATTACHED TO STRUCTURE, UNDERPASS LIGHTING							

		CABLE / CONDUIT SCHEDULE
	(-)	3-1/C#10, 1-1/C#10 GND IN 1" DIA PVCC RGC ATTACHED TO STRUCTURE (CKTS AS INDICATED ON THIS DRAWING)
	2	2-1/C#10, 1-1/C#10 GND IN 1" DIA PVCC RGC ATTACHED TO STRUCTURE (CKTS AS INDICATED ON THIS DRAWING)
	3	2-1/C#10, 1-1/C#10 GND IN 3/4" DIA LIQUID TIGHT FLEXIBLE CONDUIT (CKTS AS INDICATED ON THIS DRAWING)
4	3-1/C#2, 1-1/C#4 GND IN 3" DIA PVCC RGC ATTACHED TO STRUCTURE (CKTS AS INDICATED ON THIS DRAWING)	

SCALE: 1"=20'

	UNDERPASS LUMINAIRE TABLE WB I-80 (CONTROLLER 'Y')								
1	LUMINAIRE	BASELINE	STATION & OFFSET	NOTES	MOUNTING				
	YR9	LARKIN	STA. 66+66.1, 36.8 RT	NOTE 3	SUSPENDED				
1	YQ9	LARKIN	STA. 67+35.4, 35.3 RT	NOTE 3	SUSPENDED				
1	YR10	LARKIN	STA. 67+34.3, 1.1 RT	NOTE 3	SUSPENDED				
l	YQ10	LARKIN	STA. 66+65.6, 2.6 RT	NOTE 3	SUSPENDED				
l	YR11	LARKIN	STA. 66+65.1, 33.5 LT	NOTE 3	SUSPENDED				
1	YQ11	LARKIN	STA. 67+33.0, 34.9 LT	NOTE 3	SUSPENDED				

NOTE: CENTERING THE UNDERPASS LUMINAIRES BETWEEN THE STRUCTURAL BEAMS TAKES PRECEDENCE OVER THE STATION AND OFFSET PROVIDED IN THE TABLE.

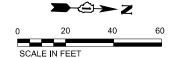


<b>AECOM</b>
303 EAST WACKER DRIVE, SUITE 1400 CHICAGO, IL 60601-5276

USER NAME = myersc	DESIGNED	-	TJL	REVISED	-
	DRAWN	-	CAM	REVISED	-
PLOT SCALE = 40.000 ' / in.	CHECKED	-	MAE	REVISED	-
PLOT DATE = 10/5/2023	DATE	-	10/6/23	REVISED	-

STATE OF ILLINOIS
DEPARTMENT OF TRANSPORTATION

	LARKIN AVENUE OVER I-80 UNDERPASS LIGHTING PLAN										TOTAL SHEETS	SHEET NO.
LARKIN	AVENU	F 0	VEK	I–8	O UNDI	:RPASS	LIGHTING PLAN	I-80	FAI 80 22 BR	WILL	1201	527
										CONTRACT	NO. 62	R89
1"=20'	SHEET	29	OF	51	SHEETS	STA.	TO STA.	ILLINOIS FED. AID PROJECT				

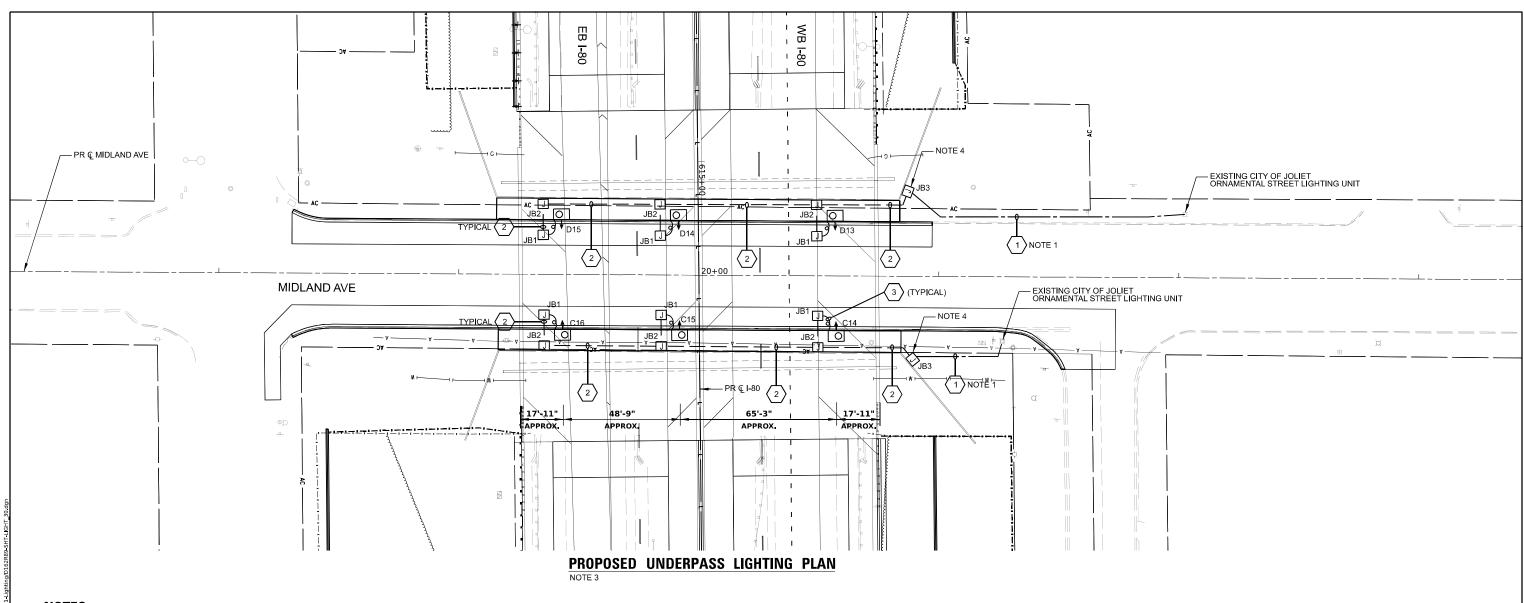

#### NOTES

- 1. SEE DRAWING LT-01 FOR IDOT ELECTRICAL SYMBOLS.
- 2. SEE IDOT STANDARD DRAWING BE-901 FOR ADDITIONAL INSTALLATION DETAILS FOR PROPOSED SUSPENDED MOUNT UNDERPASS LUMINAIRES.
- 3. ALL PROPOSED UNDERPASS LIGHTING UNITS SHOWN ON THIS DRAWING WILL BE FED FROM THE EXISTING CITY OF JOLIET LIGHTING CONTROLLER LOCATED ON THE SOUTHEAST CORNER OF MORGAN STREET AND MIDLAND AVENUE.
- 4. PROVIDE 30A FUSES IN THE JUNCTION BOX FOR SPLICING THE NO. 10 UNDERPASS LIGHTING WIRES TO THE NO. 4 LIGHTING CIRCUITS WIRES.
- 5. ROUTE THE PROPOSED UNIT DUCT INTO THE BASE OF THE EXISTING CITY OF JOLIET ORNAMENTAL LIGHTING UNIT THROUGH THE EXISTING FOUNDATION CONDUIT SLEEVE AND SPLICE THE PROPOSED LIGHTING CABLES TO THE EXISTING LIGHTING CABLES IN THE BASE OF THE LIGHTING UNIT.

UNDERPASS LUMINAIRE TABLE (CITY OF JOLIET LIGHTING CONTROLLER)								
LUMINAIRE	BASELINE	STATION & OFFSET	NOTES	MOUNTING				
D13	MIDLAND	STA. 20+56.6, 25.1 LT	NOTE 3	SUSPENDED				
D14	MIDLAND	STA. 19+91.4, 25.0 LT	NOTE 3	SUSPENDED				
D15	MIDLAND	STA. 19+42.6, 25.0 LT	NOTE 3	SUSPENDED				

NOTE: CENTERING THE UNDERPASS LUMINAIRES BETWEEN THE STRUCTURAL BEAMS TAKES PRECEDENCE OVER THE STATION AND OFFSET PROVIDED IN THE TABLE.

# LED UNDERPASS LUMINAIRE OUTPUT DESIGNATION D

		JUNC	CTION BOX SCHEDULE
	NO.	SIZE	DESCRIPTION
	JB1	6"X6"X4"	STAINLESS STEEL, ATTACHED TO STRUCTURE, UNDERPASS LIGHTING
	JB2	12"X10"X6"	STAINLESS STEEL, ATTACHED TO STRUCTURE, UNDERPASS LIGHTING
	JB3	18"X18"X8"	STAINLESS STEEL, ATTACHED TO STRUCTURE, UNDERPASS LIGHTING


Ш		CABLE / CONDUIT SCHEDULE
	1	2-1/C#4, 1/C#6 GND IN 1-1/4" UNIT DUCT
	2	2-1/C#10, 1-1/C#10 GND IN 1" DIA PVCC RGC ATTACHED TO STRUCTURE
	3	2-1/C#10, 1-1/C#10 GND IN 3/4" DIA LIQUID TIGHT FLEXIBLE CONDUIT
Ι'		

SCALE: 1"=20'

SHEET

	UNDERPASS LUMINAIRE TABLE (CITY OF JOLIET LIGHTING CONTROLLER)								
1	LUMINAIRE	BASELINE	STATION & OFFSET	NOTES	MOUNTING				
ı	C14	MIDLAND	STA. 20+57.4, 25.0 RT	NOTE 3	SUSPENDED				
1	C15	MIDLAND	STA. 19+92.1, 25.0 RT	NOTE 3	SUSPENDED				
ı	SUSPENDED								
	NOTE: OFNIT	EDIMO THE H	NDEDDA OO LUMINIAIDEO DETIMEEN						

NOTE: CENTERING THE UNDERPASS LUMINAIRES BETWEEN THE STRUCTURAL BEAMS TAKES PRECEDENCE OVER THE STATION AND OFFSET PROVIDED IN THE TABLE.

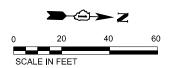


<b>AECOM</b>
303 EAST WACKER DRIVE, SUITE 1400 CHICAGO, II. 60601-5276

USER NAME = myersc	DESIGNED	-	TJL	REVISED	-
	DRAWN	-	CAM	REVISED	-
PLOT SCALE = 40.000 ' / in.	CHECKED	-	MAE	REVISED	-
PLOT DATE = 10/5/2023	DATE	-	10/6/23	REVISED	-

STATE OF ILLINOIS							
DEPARTMENT OF TRANSPORTATION							

-80 OVER MIDLAND AVENUE UNDERPASS LIGHTING PLAN					F.A.I. RTE	SECTION			COUNTY	TOTAL SHEETS	SHEE NO.	
					I-80	FAI 80 22 BR			WILL	1201	528	
										CONTRACT	NO. 62	R89
30	OF	51	SHEETS	STA.	TO STA.			ILLINOIS	FED, A	D PROJECT		

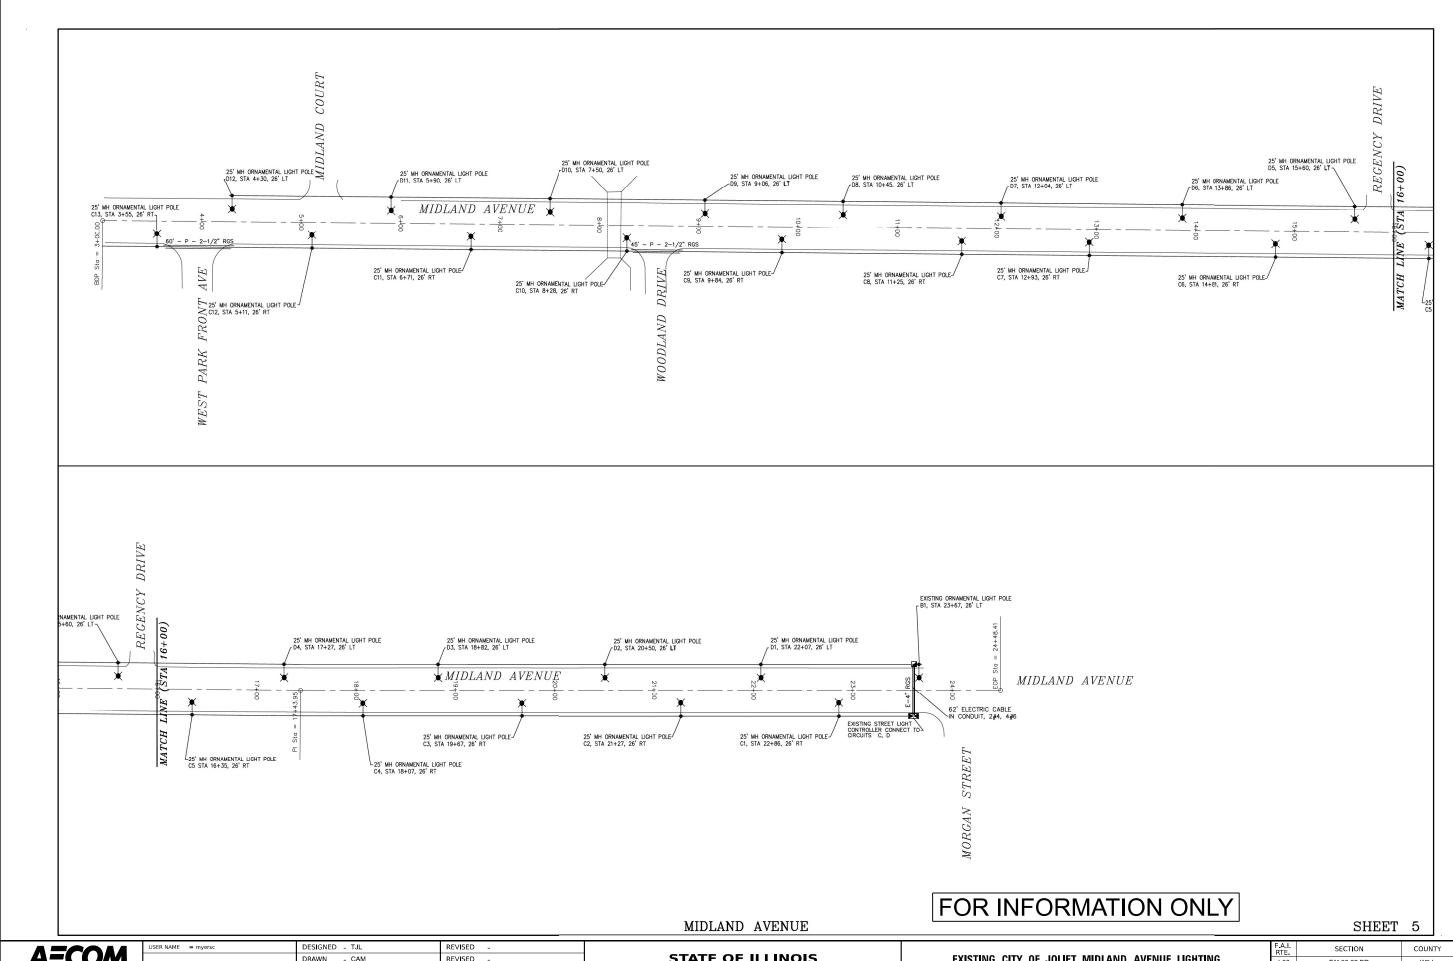


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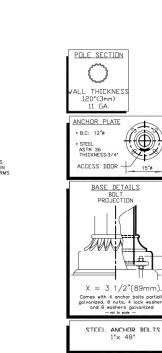
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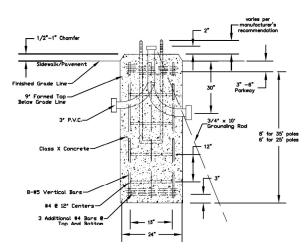
303 EAST WACKER DRIVE, SUITE 1400
CHICAGO, IL 60603-5276

STATE OF ILLINOIS DEPARTMENT OF TRANSPORTATION EXISTING CITY OF JOLIET MIDLAND AVENUE LIGHTING

N.T.S. SHEET 31 OF 51 SHEETS STA. TO STA.





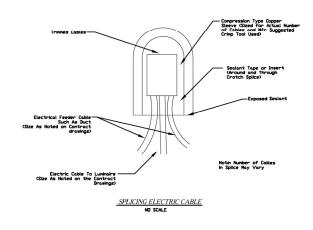


STREET LIGHT POLE FOUNDATION TYPE A (TYPICAL)


 $CITY \ OF \ JOLIET$  department of public works 921 E. WASHINGTON STREET, JOLIET, ILLINOIS 60433


Street Lighting Standards

Pole, Foundation, Wiring, and Conduit Details

EOD INICODMATION ONLY				
FOR INFORMATION ONLY	DESIGNED BY: RAL	CHECKED BY: JRT	SCALE: NONE	
	DRAWN BY: RJH	DATE: JULY 2003	SHEET 6	

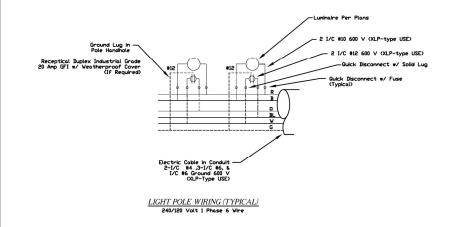

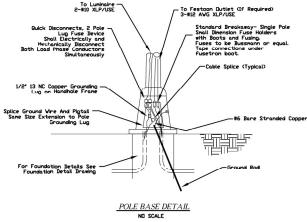

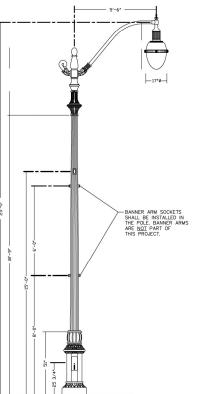


**AECOM** 

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	DRAWN - CAM	REVISED -
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PLOT DATE = 10/5/2023	DATE - 10/6/23	REVISED -

STATE OF ILLINOIS DEPARTMENT OF TRANSPORTATION

EXISTII	NG CIT	Y OF	J0	LIET	MIDLA	AND	AVENUE LIGHTING	
SCALE: N.T.S.	SHEET	32	OF	51	SHEETS	STA.	TO STA.	


	-					
F.A.I. RTE	SECT	TION		COUNTY	TOTAL SHEETS	SHEET NO.
I-80	FAI 80	22 BR		WILL	1201	530
			CONTRACT	NO. 62F	₹89	
		ILLINOIS	D PROJECT			

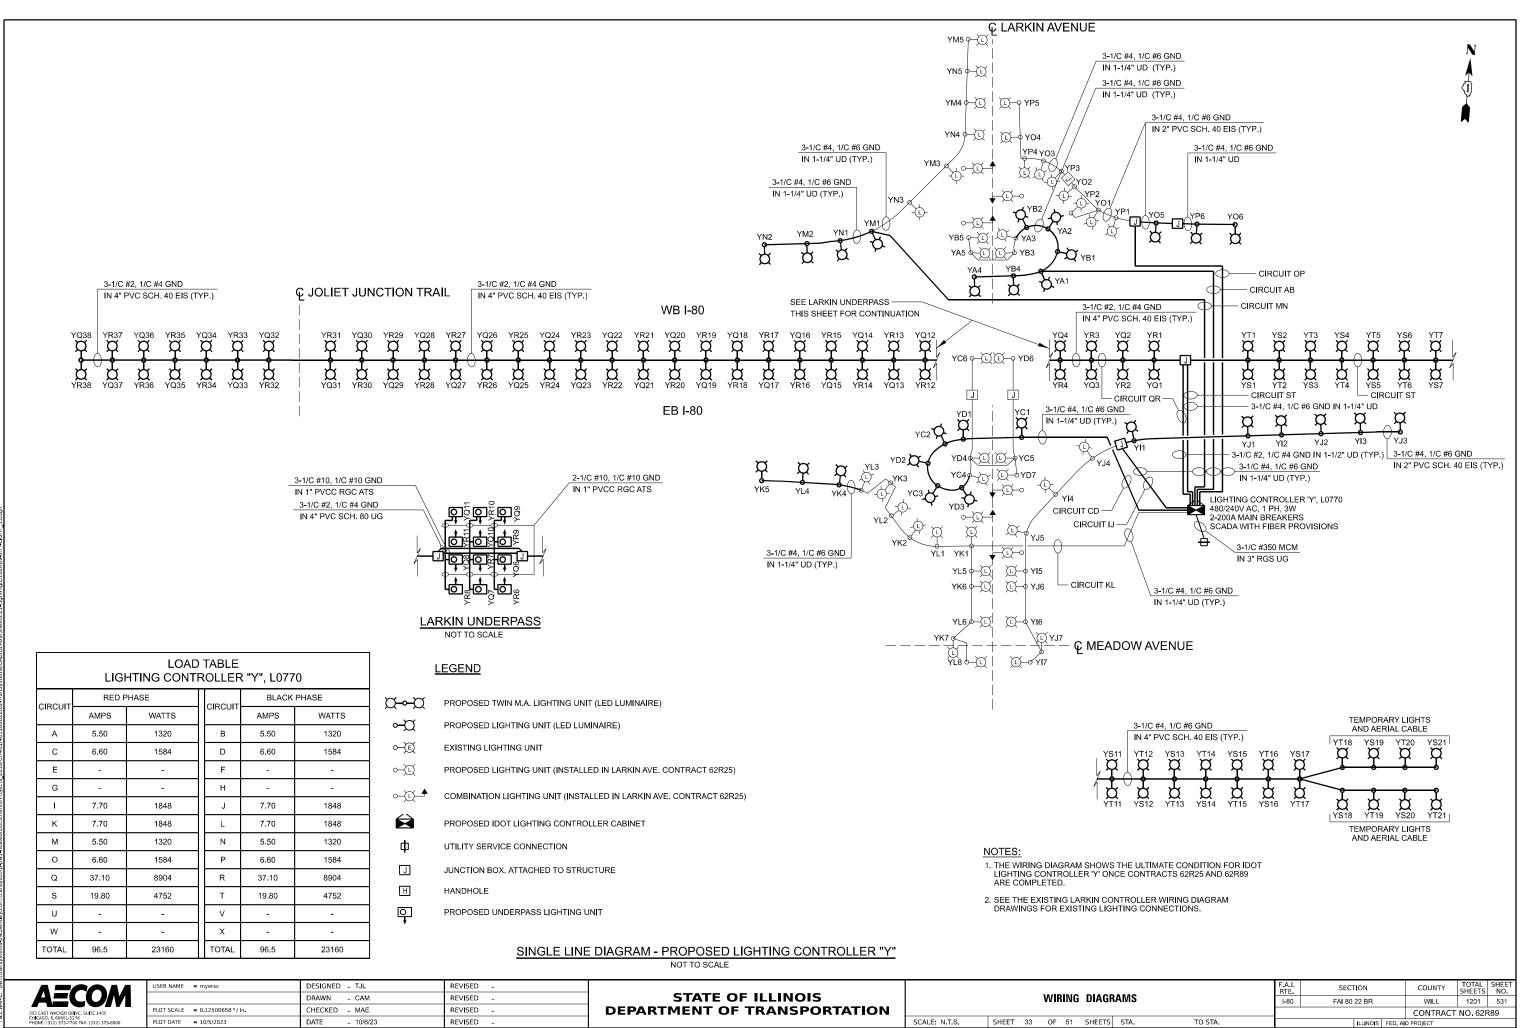

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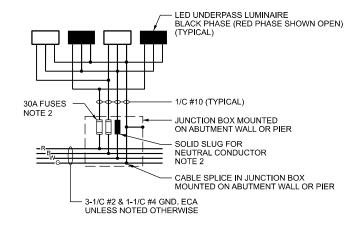
#### JOLIET JUNCTION TRAIL (JJT) WIRING DIAGRAM

MAINTAINED BY FOREST PRESERVE DISTRICT OF WILL COUNTY (FPDWC)

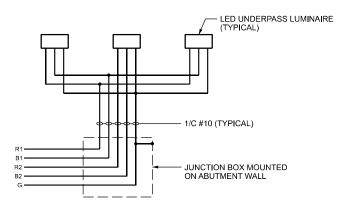

#### JOILET JUNCTION TRAIL UNDERPASS LIGHTING UNIT WIRING DIAGRAM

NOT TO SCALE



### TYPICAL IDOT UNDERPASS LIGHTING UNIT WIRING DIAGRAM

NOT TO SCALE

SCALE: N.T.S.

#### NOTES

- 1. SEE DRAWING LT-01 FOR IDOT ELECTRICAL SYMBOLS.
- 2. THE FUSES, FUSE HOLDERS, AND SOLID SLUGS SHALL BE PROVIDED ACCORDING TO ARTICLE 1065.01 OF THE IDOT STANDARDS. THE COST OF PROVIDING THE FUSES, FUSE HOLDERS, AND SOLID SLUGS IN THE JUNCTION BOX WILL NOT BE PAID FOR SEPARATELY AND WILL BE INCLUDED IN THE COST OF THE JUNCTION BOX IN WHICH THEY ARE INSTALLED.

AECOM
303 EAST WACKER DRIVE. SUITE 1400
CHCAGO, IL 60601-5276

 USER NAME
 = myersc
 DESIGNED
 - TJL
 REVISED

 DRAWN
 - CAM
 REVISED


 PLOT SCALE
 = 0.08333772 \*/ in.
 CHECKED
 - MAE
 REVISED

 PLOT DATE
 = 10/5/2023
 DATE
 - 10/6/23
 REVISED

STATE OF ILLINOIS DEPARTMENT OF TRANSPORTATION 
 UNDERPASS
 WIRING
 DIAGRAMS
 FA.I. RTE. I-80
 SECTION
 COUNTY SHEETS
 NO. SHEET NO.

 SHEET 34
 OF 51
 SHEETS STA.
 TO STA.
 ILLINOIS FED, AID PROJECT
 TO PROJECT

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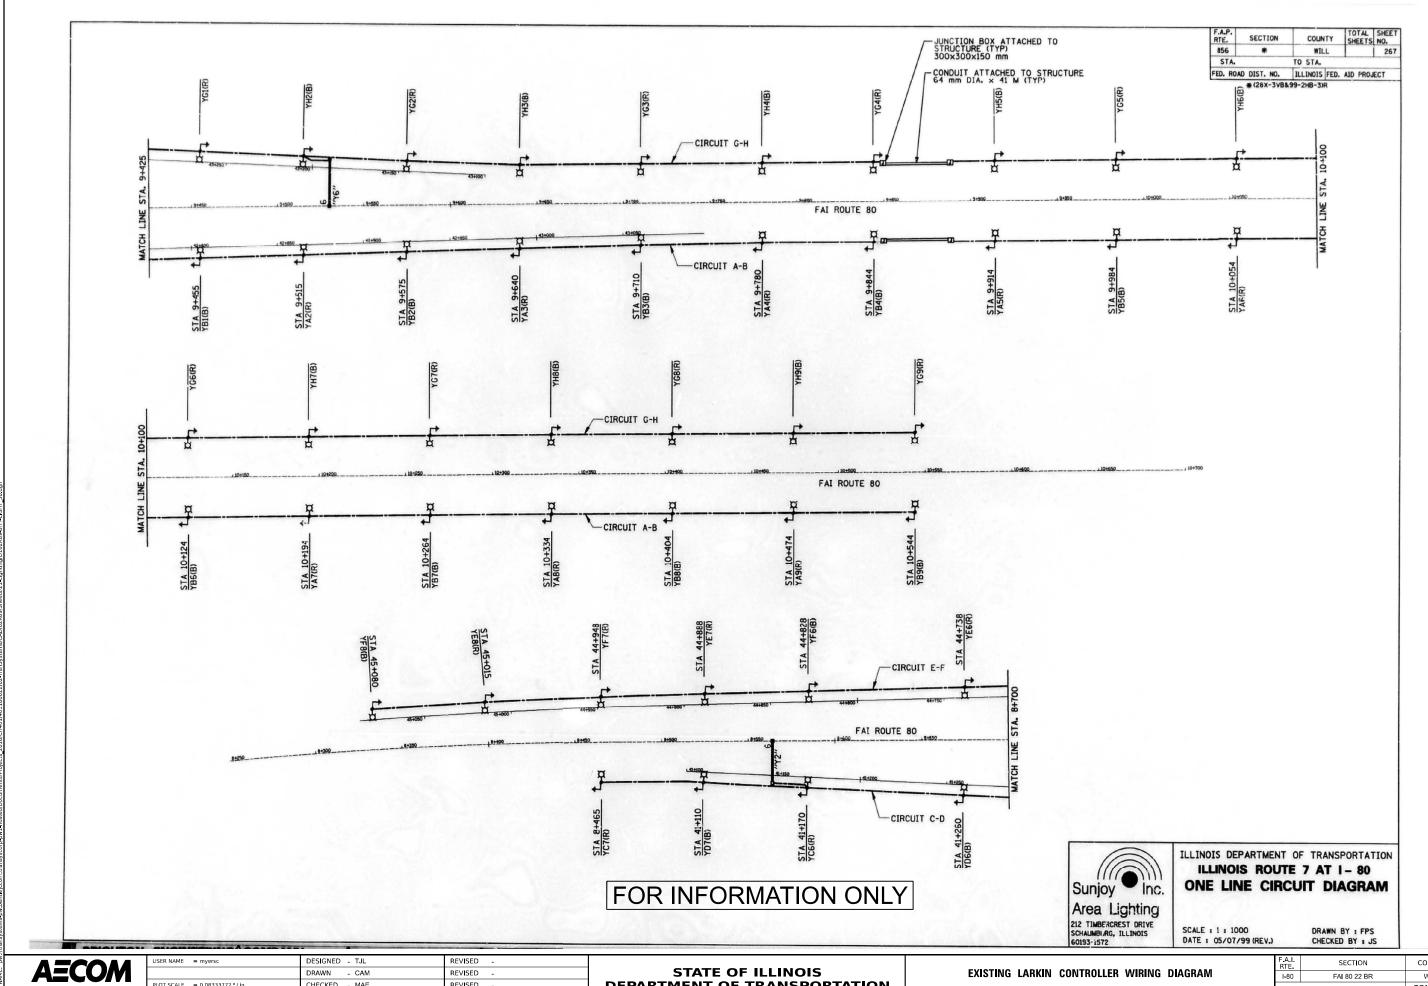
**AECOM** 

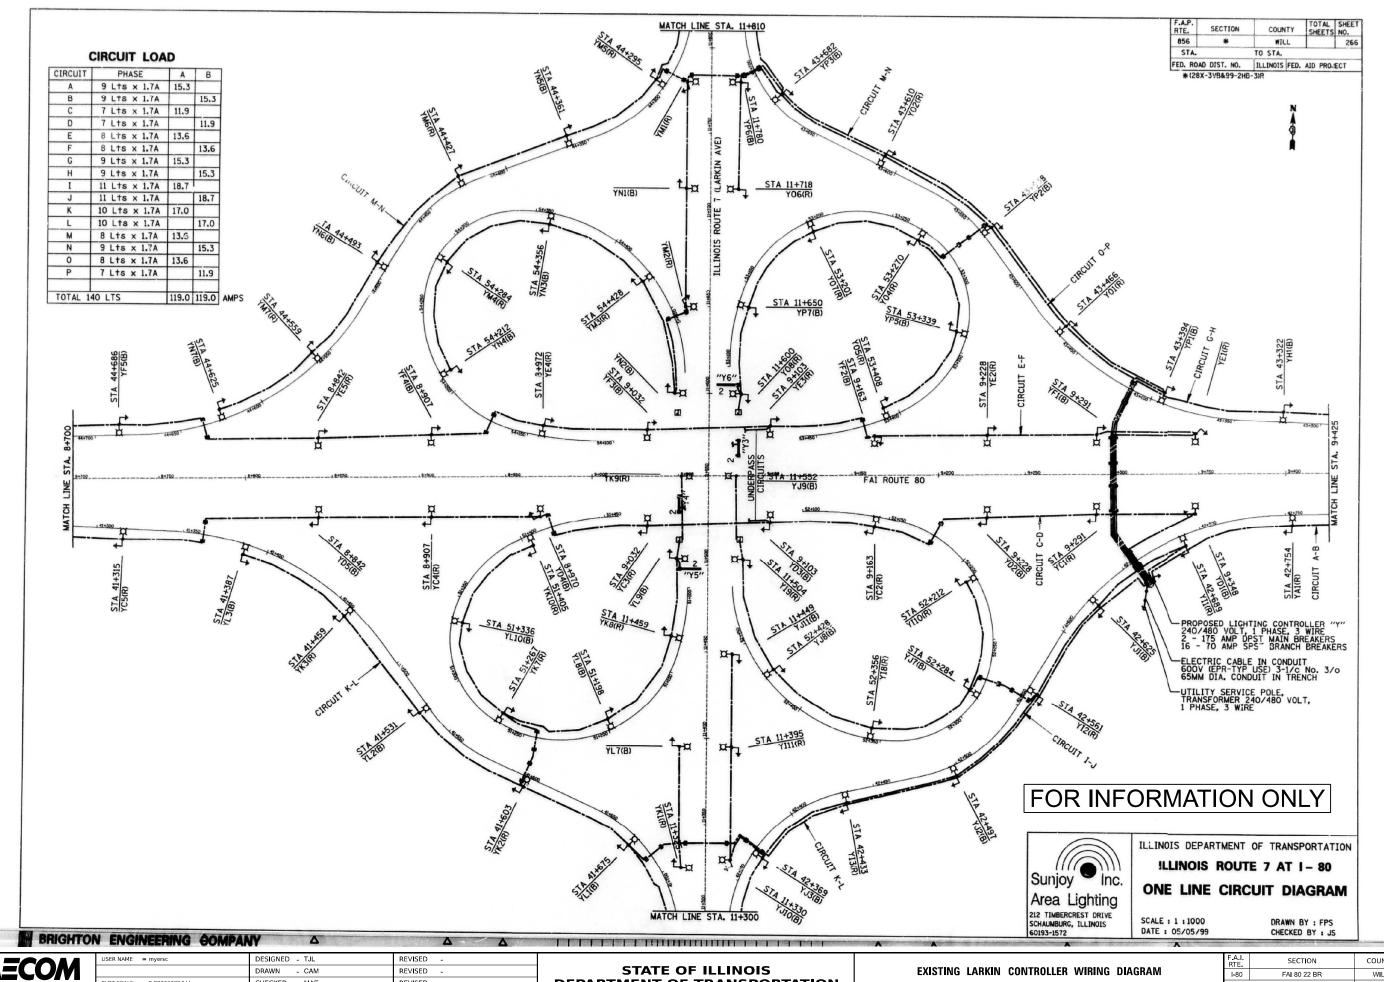LOT SCALE = 0.08333772 ' / in. CHECKED - MAE REVISED PLOT DATE = 10/5/2023 REVISED DATE

**DEPARTMENT OF TRANSPORTATION** 

SHEET 35 OF 51 SHEETS STA.

TOTAL SHEET NO. WILL 1201 533 CONTRACT NO. 62R89




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**DEPARTMENT OF TRANSPORTATION** 


SHEET 36 OF 51 SHEETS STA.

WILL 1201 534 CONTRACT NO. 62R89

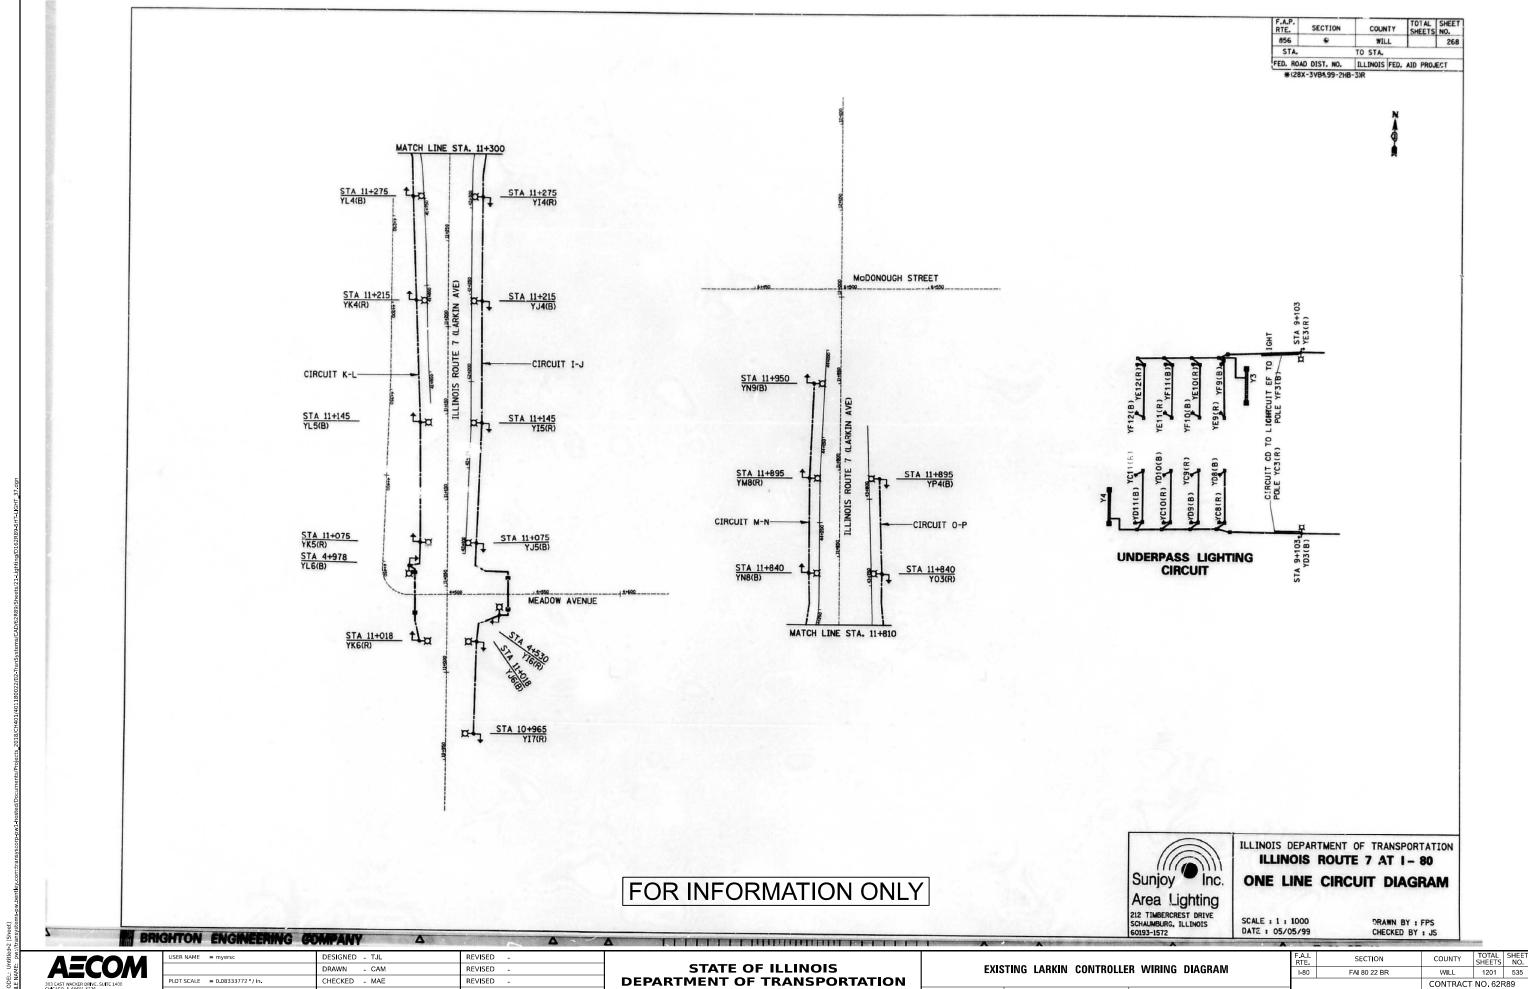

REVISED

SHEET 37 OF 51 SHEETS STA.

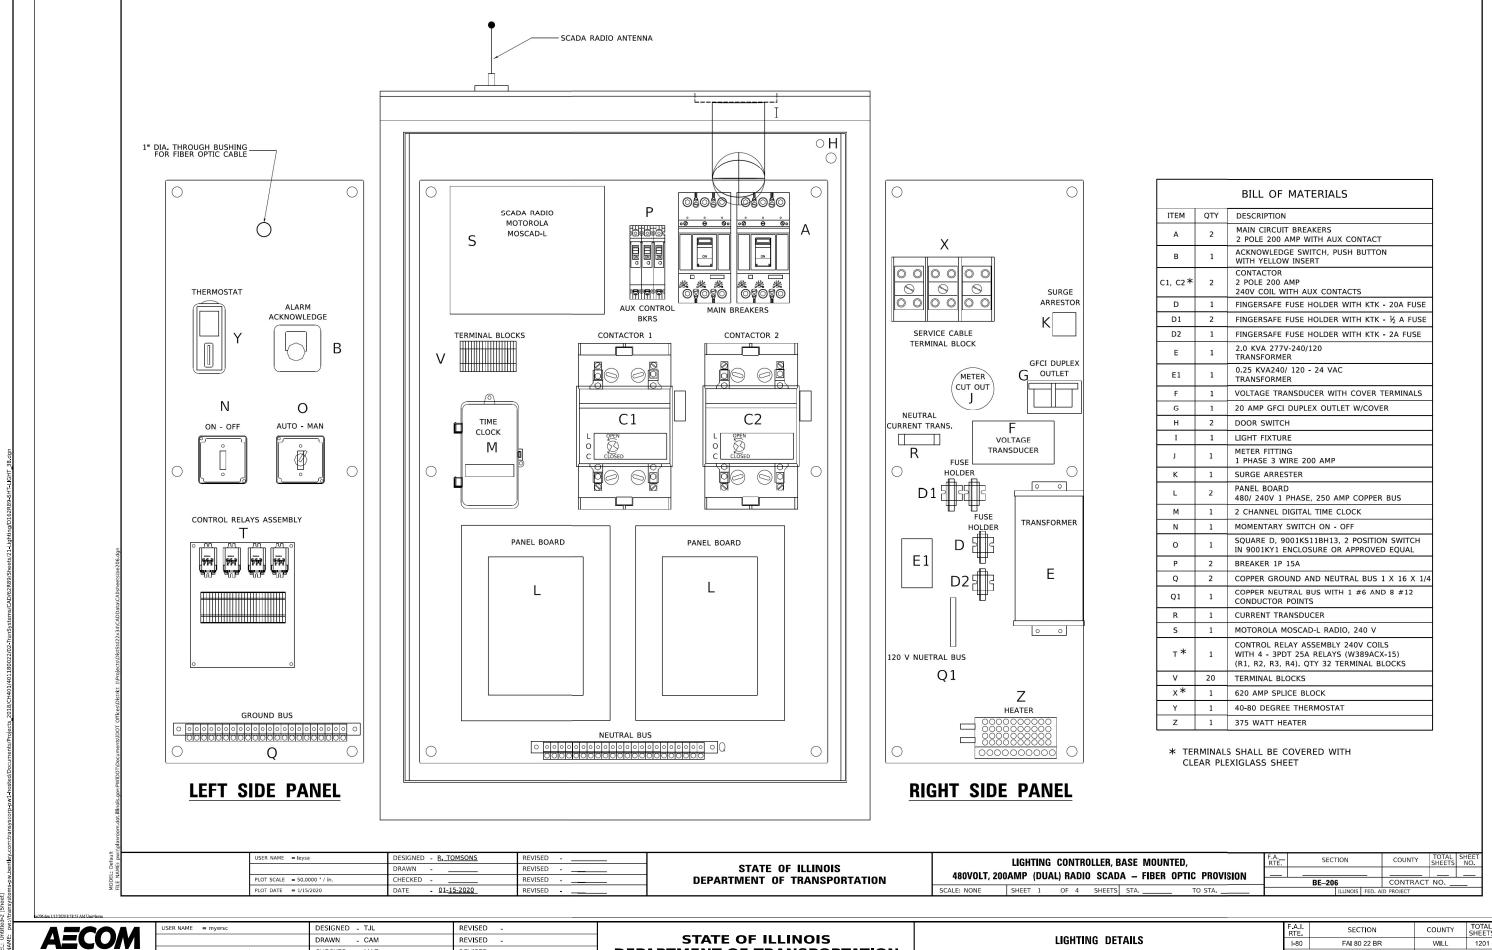

**DEPARTMENT OF TRANSPORTATION** 

LIGHTING DETAILS

SHEET 38 OF 51 SHEETS STA.

SCALE: N.T.S.

I-80

TO STA.

FAI 80 22 BR

WILL

CONTRACT NO. 62R89

1201 536

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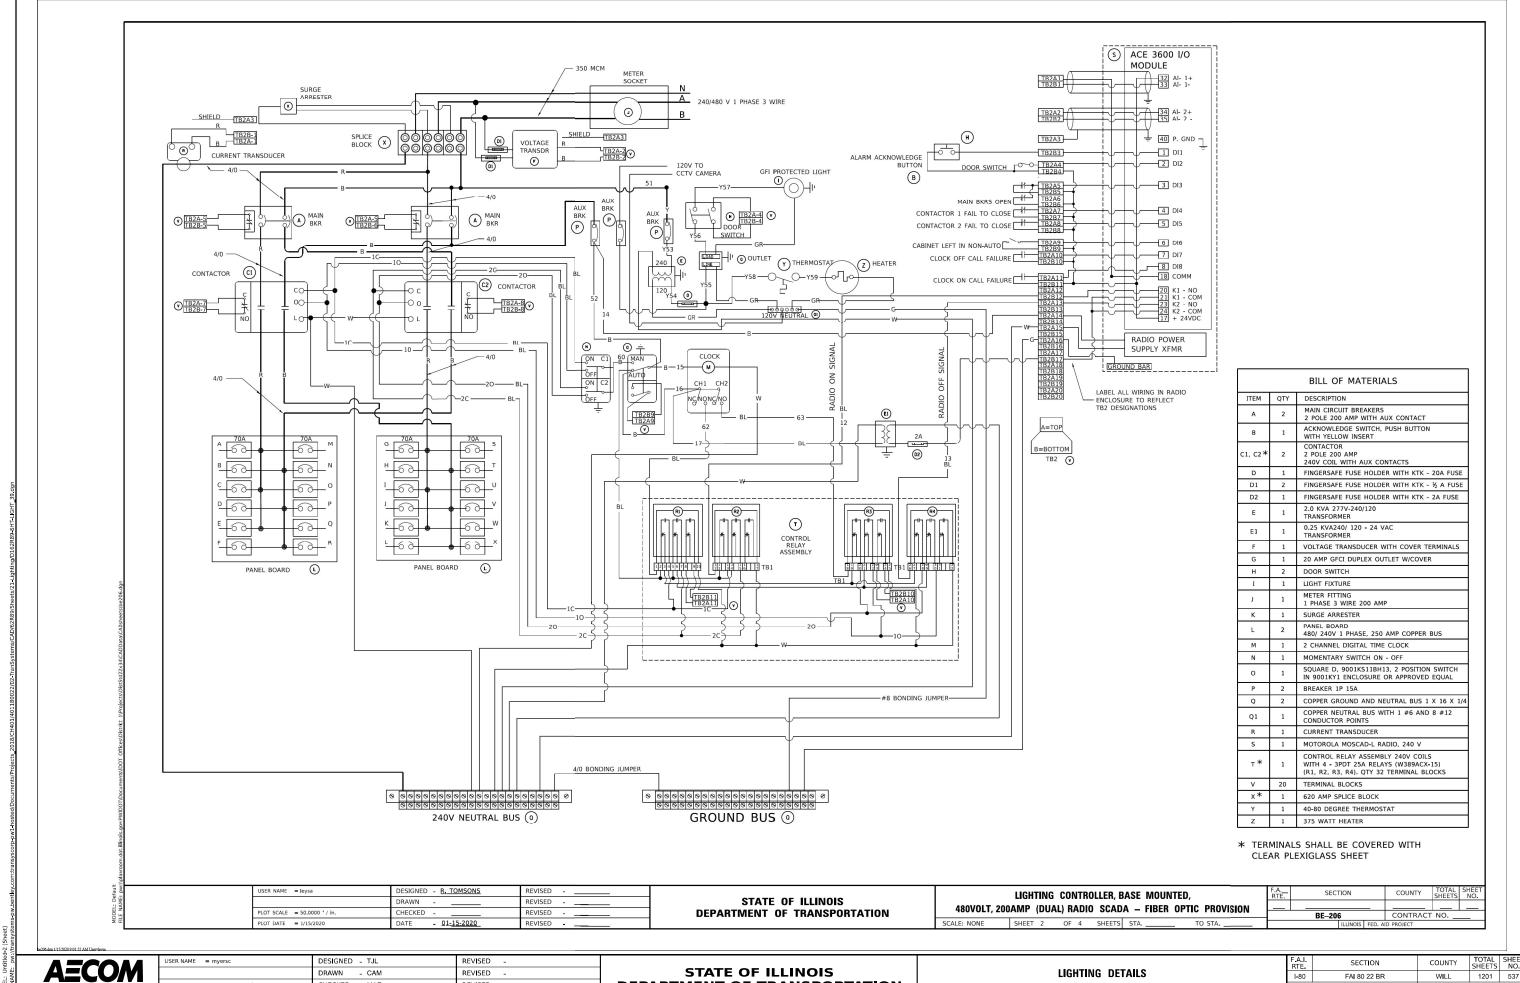
DATE

PLOT DATE = 10/5/2023

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**DEPARTMENT OF TRANSPORTATION** 

SCALE: N.T.S.

SHEET 39 OF 51 SHEETS STA.

CONTRACT NO. 62R89


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DATE

PLOT DATE = 10/5/2023

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303 EAST WACKER DRIVE, SUITE 1400
CHICACO, I. 60601-5276


STATE OF ILLINOIS DEPARTMENT OF TRANSPORTATION

SCALE: N.T.S.

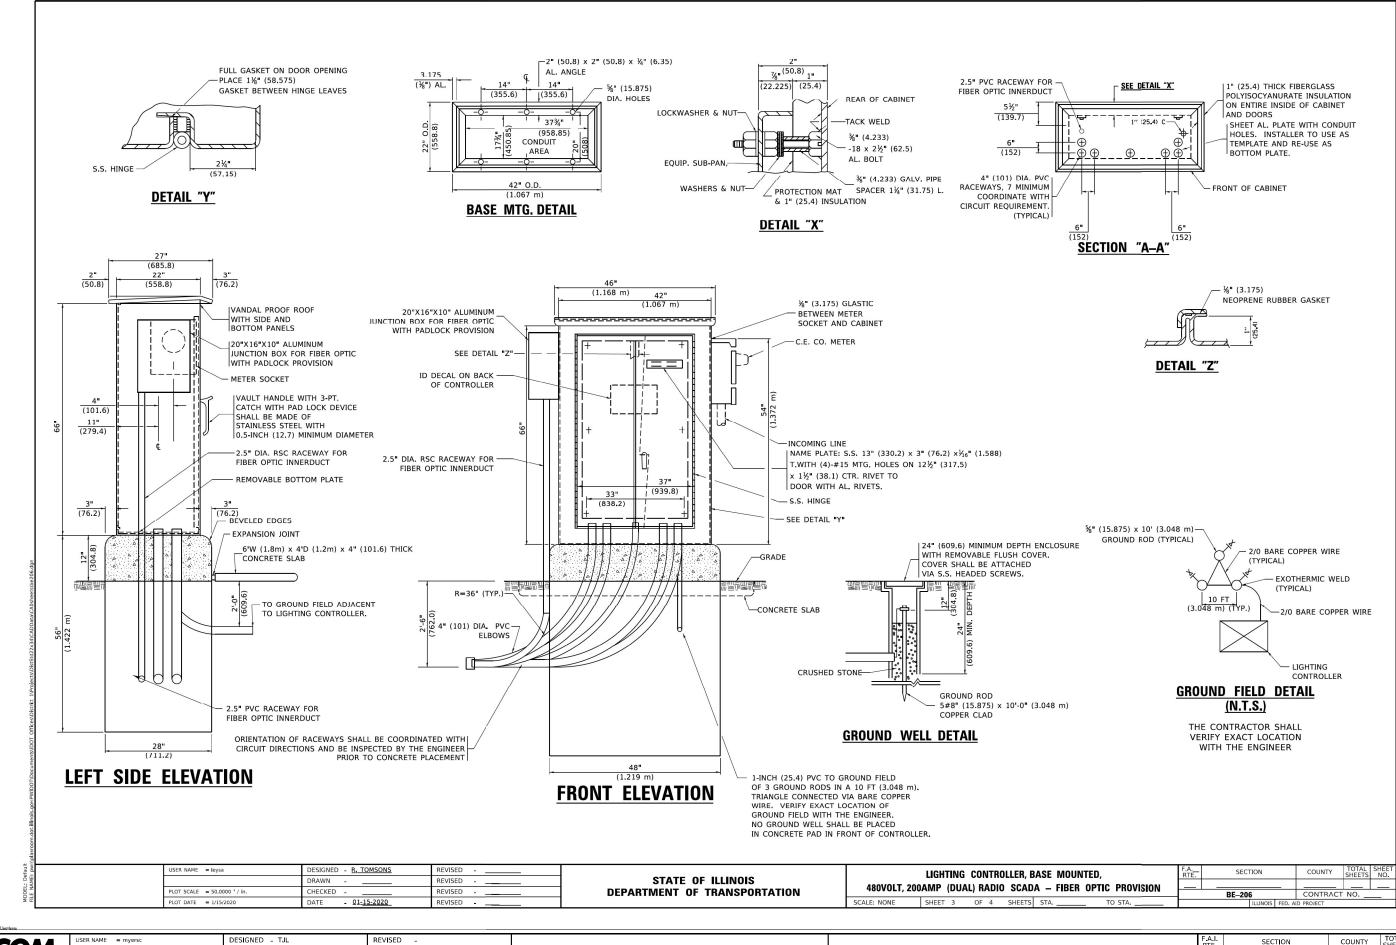- CABINET SHALL BE FABRICATED FROM 0.125-INCH (3.175) SHEET ALUMINUM #3003H14, FORMED AND ARC WELDED.
- ALL SCREWS AND HARDWARE SHALL BE PLATED, GALVANIZED, OR MADE OF BRASS, ALUMINUM OR STAINLESS STEEL, UNLESS OTHERWISE NOTED.
- 3. NAME PLATE SHALL HAVE ENGRAVED 0.75-INCH (19.05) HIGH LETTERS FILLED IN BLACK: "STATE OF ILLINOIS LIGHTING CONTROLS" UNLESS OTHERWISE SPECIFIED.
- 4. ONE INCH THICK POLYISOCYANURATE INSULATION SHALL BE INSTALL AND PERMANENTLY CEMENTED ON ALL SIDES OF THE CABINET AND DOORS.
- 5. CABINET SHALL BE PRIMED AND PAINTED AS SPECIFIED.
- 6. ELECTRIC UTILITY METER BOX SHALL BE MOUNTED ON THE SIDE OF CONTROL CABINET AS SHOWN ON THE PANEL LAYOUT DIAGRAM.
- THE COMPLETED CONTROLLER SHALL BE U.L. LISTED AS AN INDUSTRIAL CONTROL PANEL UNDER UL508,
- 8. METAL MOUNTING PANEL SHALL BE FABRICATED FROM THE SAME MATERIAL AS THE CABINET AND SHALL BE FLANGED BACK 0.75-INCHES I.D. ON 4 SIDES.
- CIRCUIT BREAKERS AND CONTACTORS AND OTHER COMPONENTS SHALL BE MOUNTED ON 0.125-INCH (3.175) THICK GLASTIC INSULATION BACK PANEL.
- 10. ALL DEVICES SHALL BE FRONT REMOVABLE.
- 11. TIME CLOCK CHANNEL 1 N.O. CONTACT IS CLOSED NIGHT AND OPEN DAY (LIGHTS ON).
- SET LATITUDE TO 42 DEGREES. SET CH.1 TO 23 MINUTES AFTER ASTRONOMICAL SUNSET, 50 MINUTES BEFORE ASTRONOMICAL SUNRISE. SET CH.2 TO 60 MINUTES AFTER ASTRONOMICAL SUNSET (WITH A SIGNAL LENGTH OF 1 SECOND), +28 MINUTES AFTER ASTRONOMICAL SUNRISE (WITH A SIGNAL LENGTH OF 7 SECONDS.)
- 13. BUS BAR SHALL HAVE 22 LUG TERMINALS SIZED TO ACCOMMODATE REQUIRED WIRE SIZES. 240V NEUTRAL BUS SHALL BE PAINTED WHITE, GROUND BUS SHALL BE PAINTED GREEN, AND THE 120V NEUTRAL BUS SHALL BE PAINTED GREY.
- 14. ALL LUGS SHALL BE OF COPPER SCREWS AND CONNECTORS, SPRING HELD.
- 15. ALL WIRING TERMINATIONS SHALL BE RATED NOT LESS THAN 75 DEGREE CENTIGRADE.
- 16. ALL CONTROL WIRING SHALL BE 600V #12 TYPE MTW, SCADA WIRING SHALL BE #18.
- 17. ALL POWER WIRING SHALL BE 600V TYPE RHH/RHW.
- 18. ALL WIRING WITHIN THE CABINET SHALL BE COLOR CODED AS INDICATED:

R = RED Y = YELLOW B = BLACK W = WHITE BL = BLUE G = GREEN G = GREY

- 19. MOSCAD I/O WIRING SHALL BE: DIGITAL INPUT (DI) WIRING SHALL BE #18 MTW PURPLE. ANALOG INPUT (AI) WIRING SHALL BE #18, 2/C SHIELDED. AI AND DI WIRING MAY BE BUNDLED TOGETHER, BUT SHALL NOT BE BUNDLED WITH OTHER WIRING.
- 20. ALL DIMENSIONS ARE IN INCHES (MILLIMETERS) UNLESS OTHERWISE INDICATED.
- 21. SCHEMATIC SHOWN WITH BREAKER OPEN, CONTACTOR OPEN, CABINET DOOR CLOSED, CLOCK NOT ACTIVE (DE-ENERGIZED STATE).
- 22. A LAMINATED COPY OF THE CIRCUIT SCHEMATIC AND SCADA I/O DIAGRAM (NO SMALLER THAN 11"x17" EACH) SHALL BE ATTACHED TO THE INSIDE OF THE CONTROLLER WITH STAINLESS STEEL SCREWS.

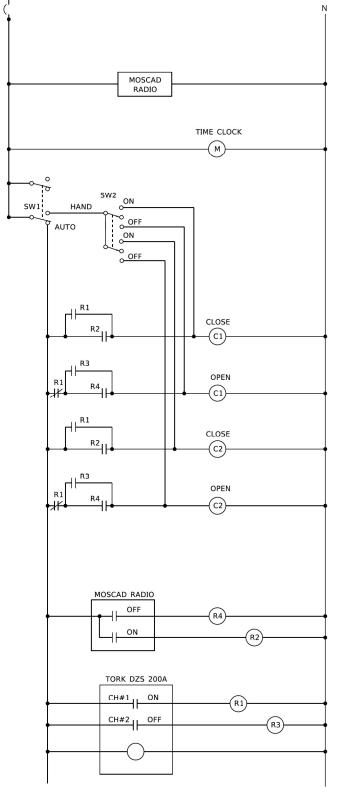

	MOSCAD I/O ASS	SIGNMENTS
TERM	MOSCAD DESTINATION	DESCRIPTION OF INPUT
1	DIGITAL INPUT 1	ALARM KNOWLEDGE
2	DIGITAL INPUT 2	DOOR OPEN
3	DIGITAL INPUT 3	MAIN(S) BREAKER OPEN
4	DIGITAL INPUT 4	CONTACTOR 1 OPEN
5	DIGITAL INPUT 5	CONTACTOR 2 OPEN
6	DIGITAL INPUT 6	CABINET IN NON-AUTO
7	DIGITAL INPUT 7	BACK-UP CLOCK OFF CALL
8	DIGITAL INPUT 8	BACK-UP CLOCK ON CALL
17	24 V+	24+VDC
18	DI COMMON	COMMON
21	K1 C	K1 COMMON
22	K1 NO	LIGHTS ON CALL
24	K2 C	K2 COMMON
25	K2 NO	LIGHTS OFF CALL
32	ANALOG INPUT 1 (+)	CABINET NEUTRAL CURRENT
33	ANALOG INPUT 1 (-)	CABINET NEUTRAL CURRENT
34	ANALOG INPUT 2 (+)	CABINET SERVICE VOLTAGE
35	ANALOG INPUT 2 (-)	CABINET SERVICE VOLTAGE
40	P. GROUND	GROUND
		<u> </u>

ALL ANALOG INPUTS WILL BE 4-20 MA ONLY. DIGITAL OUTPUT RELAYS WILL BE ELECTRICALLY ENERGIZED AND MOMENTARILY HELD

MIXED I/O MODULE MODEL NUMBER V436

### CONTROL CIRCUIT LADDER LOGIC DIAGRAM

USER NAME = leysa	DESIGNED - R. TOMSONS	REVISED			LIGHTING CONTROLLER, BASE MOUNTED,	F.A	- SECTION	COUNTY	TO
	DRAWN	REVISED	STATE OF ILLINOIS DEPARTMENT OF TRANSPORTATION	4000/017 00	·	ON INIE.		+	Jill
PLOT SCALE = 50.0000 ' / in.	CHECKED	REVISED		480VOLT, 20	DOAMP (DUAL) RADIO SCADA – FIBER OPTIC PROVISION	UN	BE-206	CONTRACT	NC
PLOT DATE = 1/15/2020	DATE - 01-15-2020	REVISED		SCALE: NONE	SHEET 4 OF 4 SHEETS STA TO STA		ILLINOIS FED.	AID PROJECT	


5 days 1/15/2020 9:02:21 A.M.Tisermiesson




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	DRAWN - CAM	REVISED -
PLOT SCALE = 0.08333772 ' / in.	CHECKED - MAE	REVISED -
PLOT DATE = 10/5/2023	DATE - 10/6/23	REVISED -

STATE OF ILLINOIS DEPARTMENT OF TRANSPORTATION


						F.A.I. RTE	SECTION	COUNTY	TOTAL SHEETS	SHEET NO.		
LIGHTING DETAILS								I-80	FAI 80 22 BR	WILL	1201	539
										CONTRACT	NO. 62F	R89
ALE: N.T.S.	SHEET	41	OF	51	SHEETS	STA.	TO STA.	ILLINOIS FED. AID PROJECT				

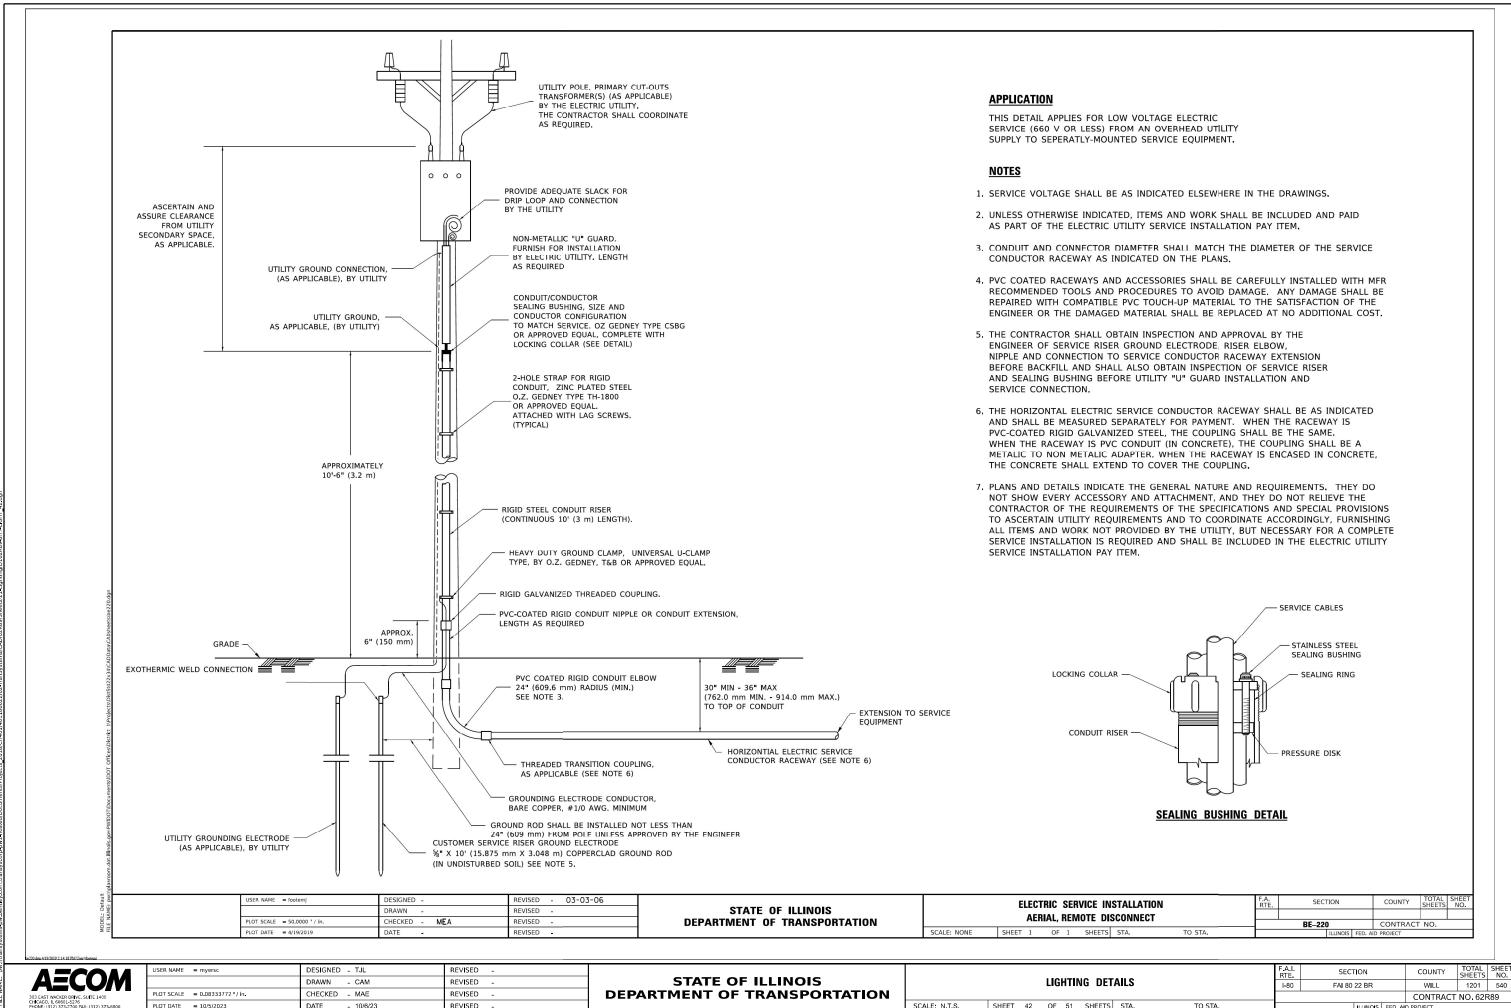

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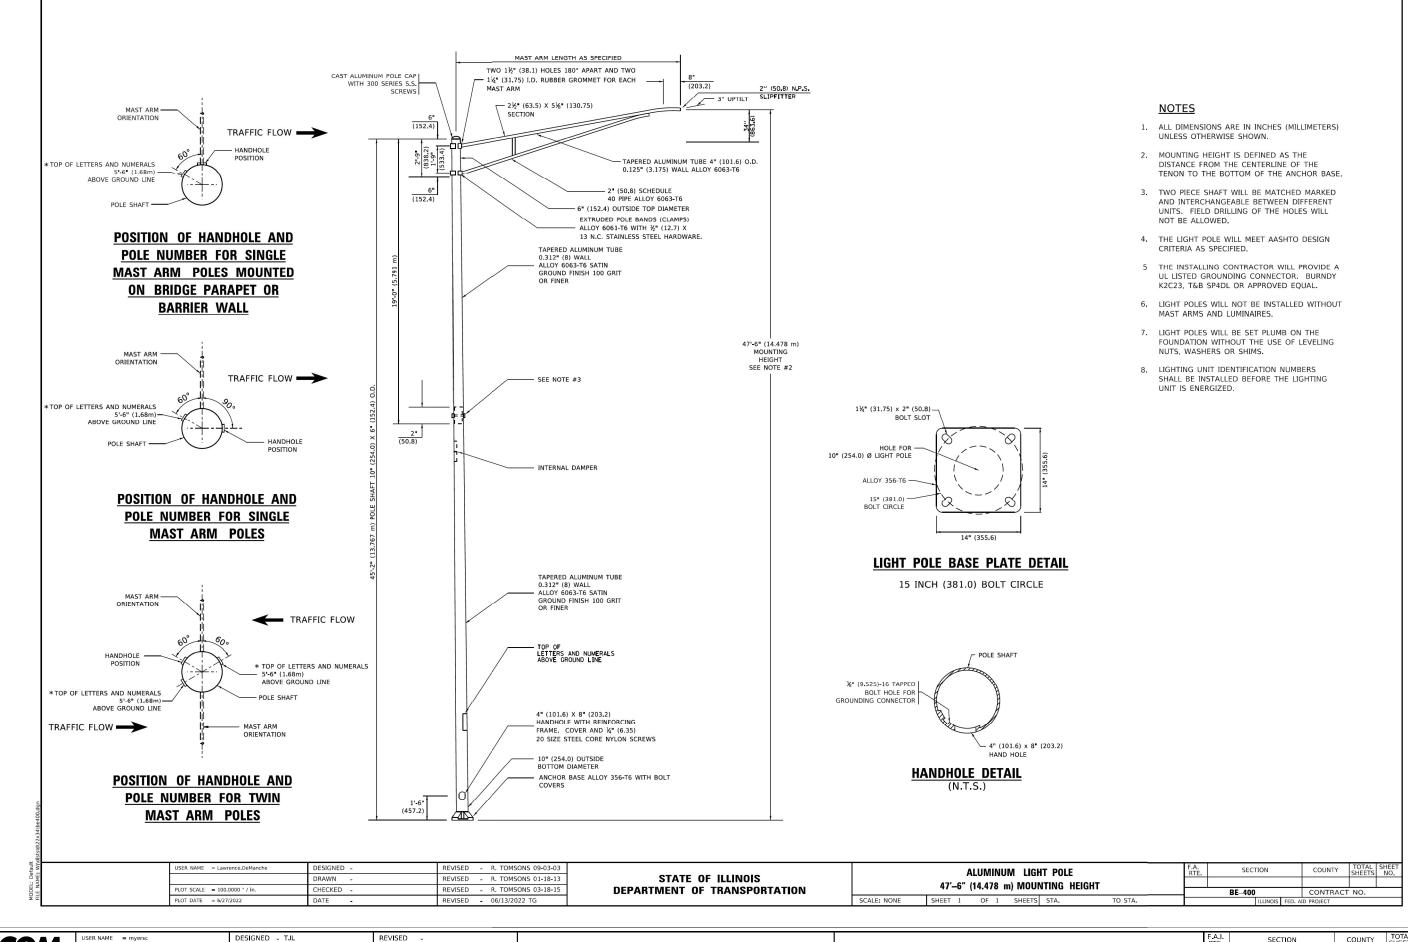
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REVISED

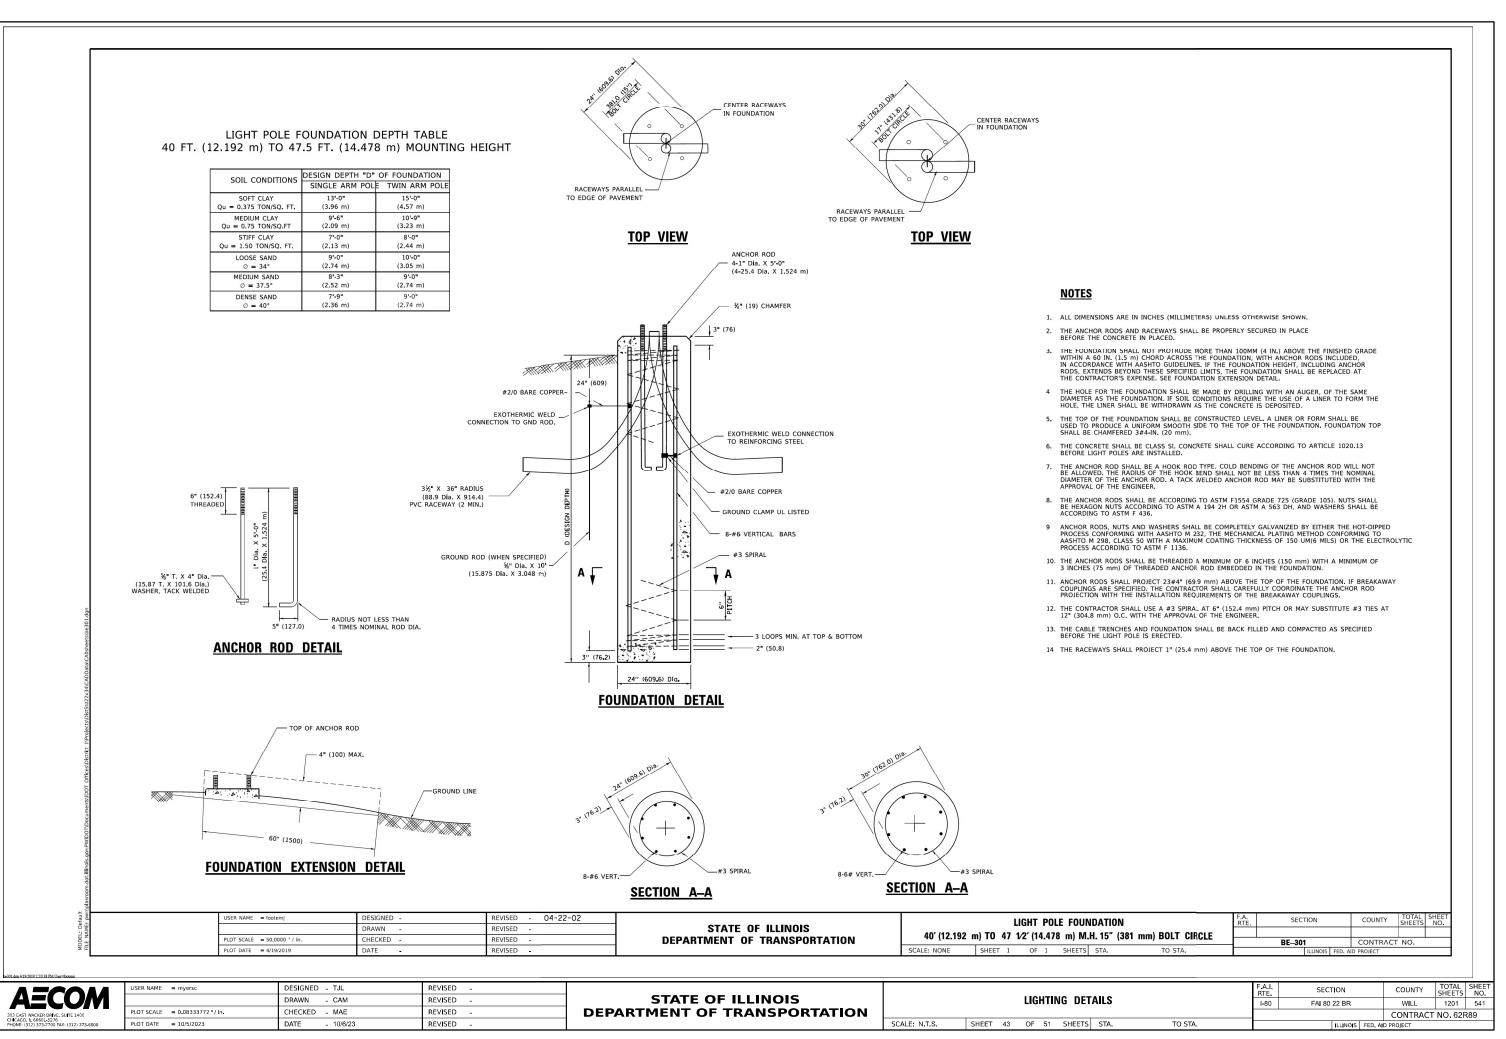PLOT DATE = 10/5/2023

DATE

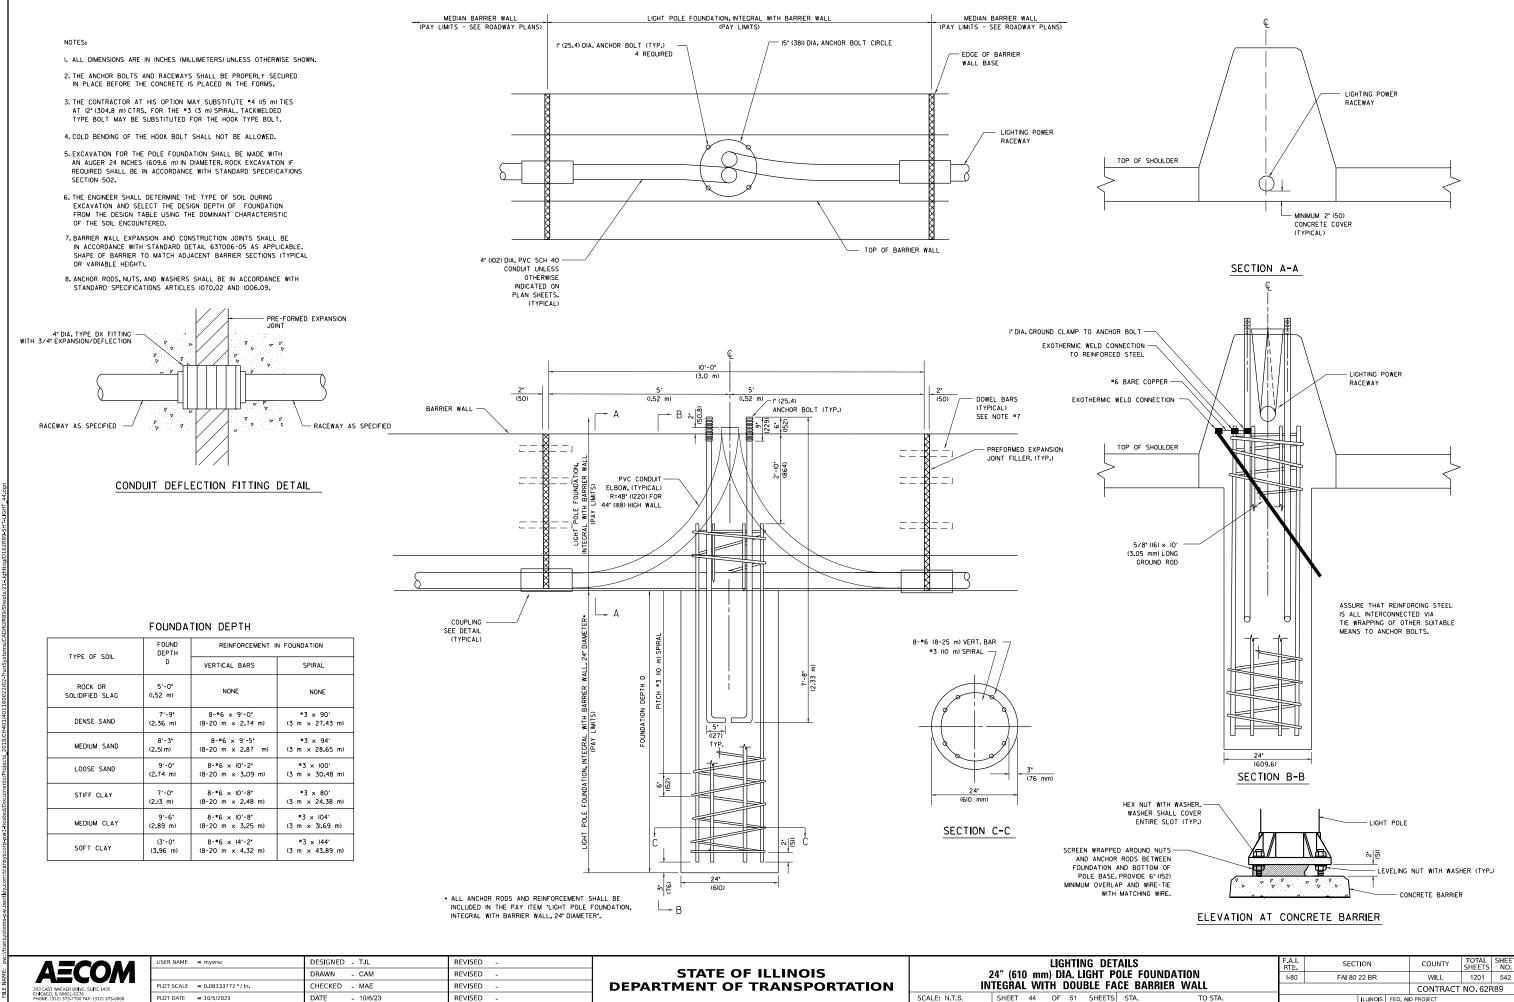


**AECOM**303 EAST WACKER DRIVE. SUITE 1400
CHEAGO. II. 60603-5276
PHONE: (312) 373-7700 FAX: (312) 373-6000


STATE OF ILLINOIS DEPARTMENT OF TRANSPORTATION

SCALE: N.T.S.

| F.A.I. | SECTION | COUNTY | TOTAL | SHEET | STA. | TO STA. | SHEET |

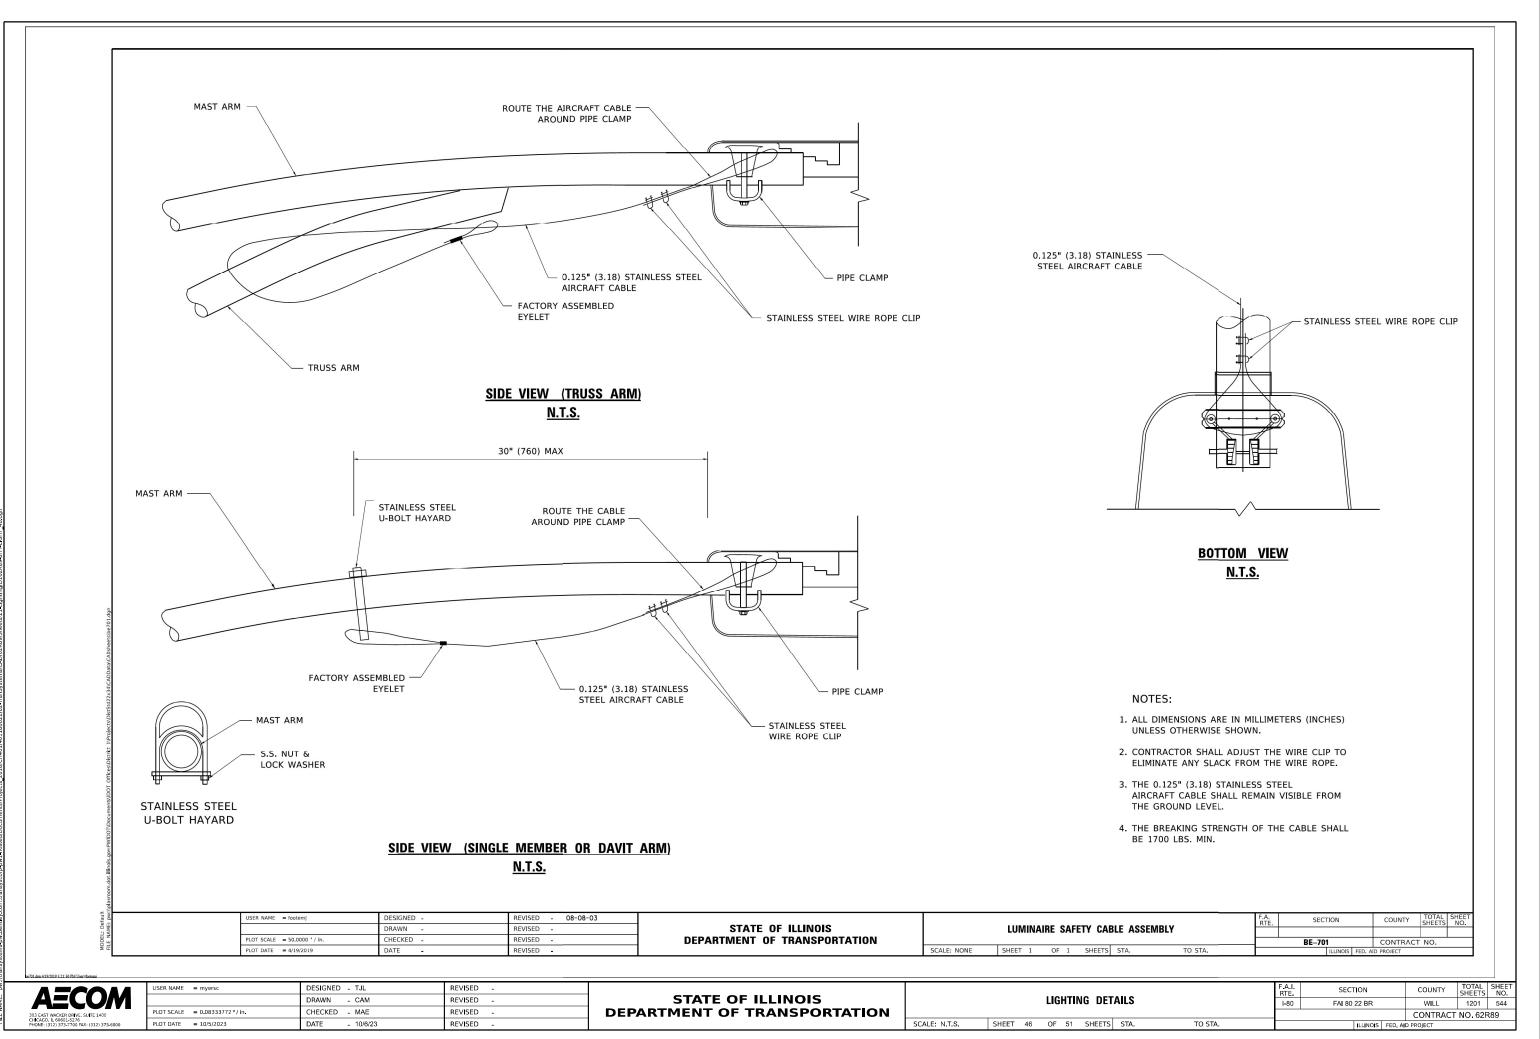


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PLOT DATE = 10/5/2023	DATE - 10/6/23	REVISED -

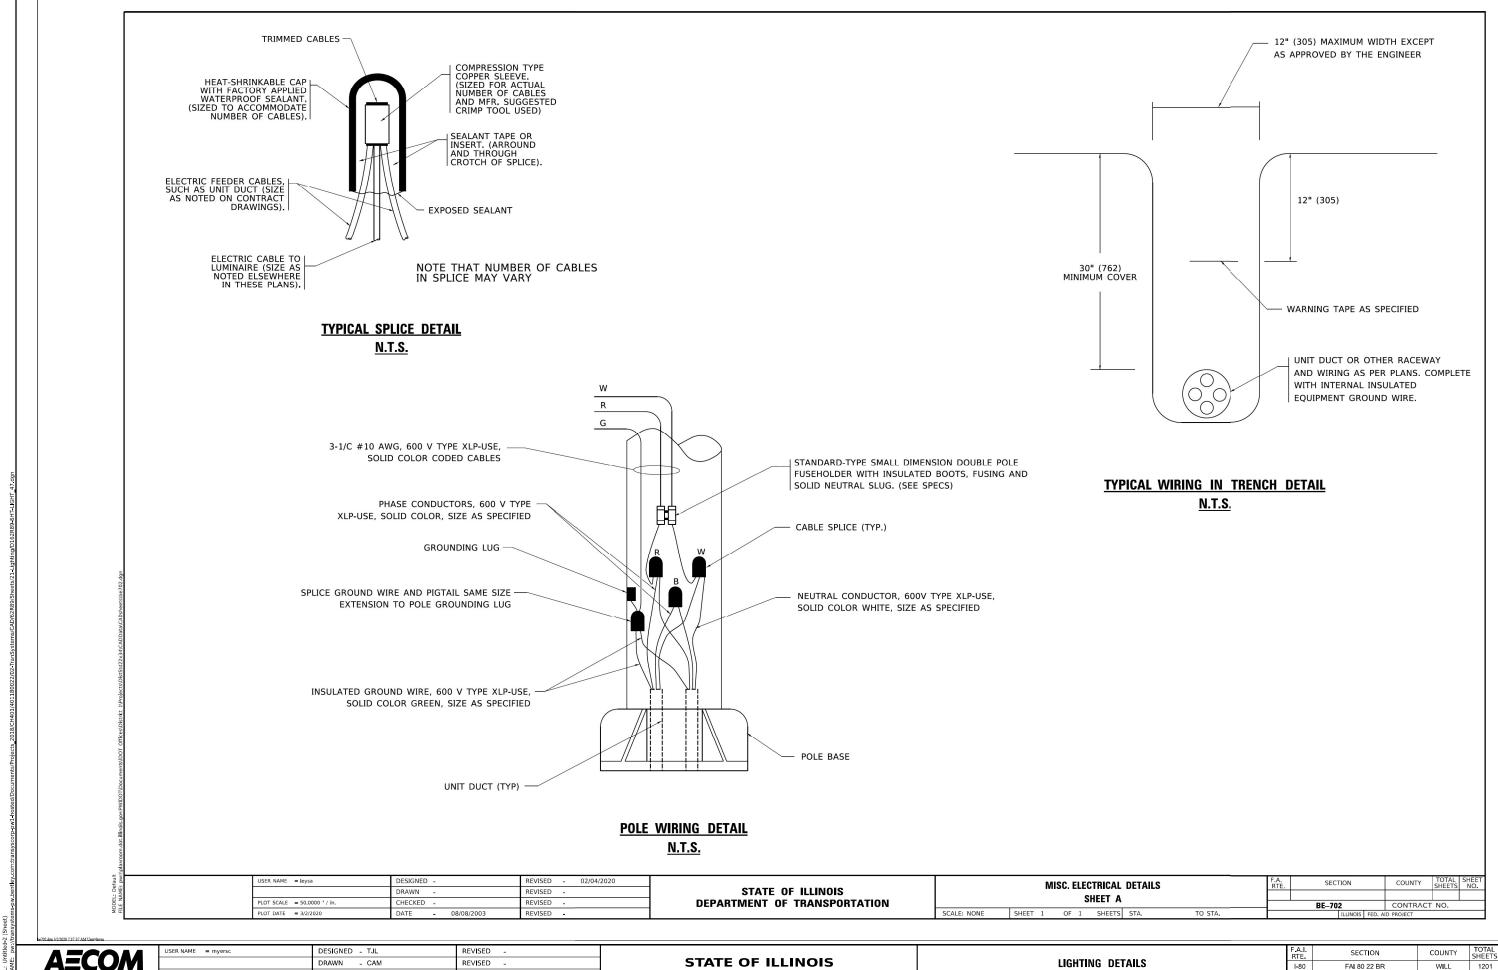**DEPARTMENT OF TRANSPORTATION** 

	RTE.	SEC	TION		COUNTY	SHEETS	NO.							
LIGHTING DETAILS						I-80	FAI 80	22 BR		WILL 1		545		
												CONTRACT	NO. 62F	R89
SCALE: N.T.S.	SHEET	47	OF	51	SHEETS	STA.	TO STA.	ILLINOIS FED. AID PROJECT						



SCALE: N.T.S.

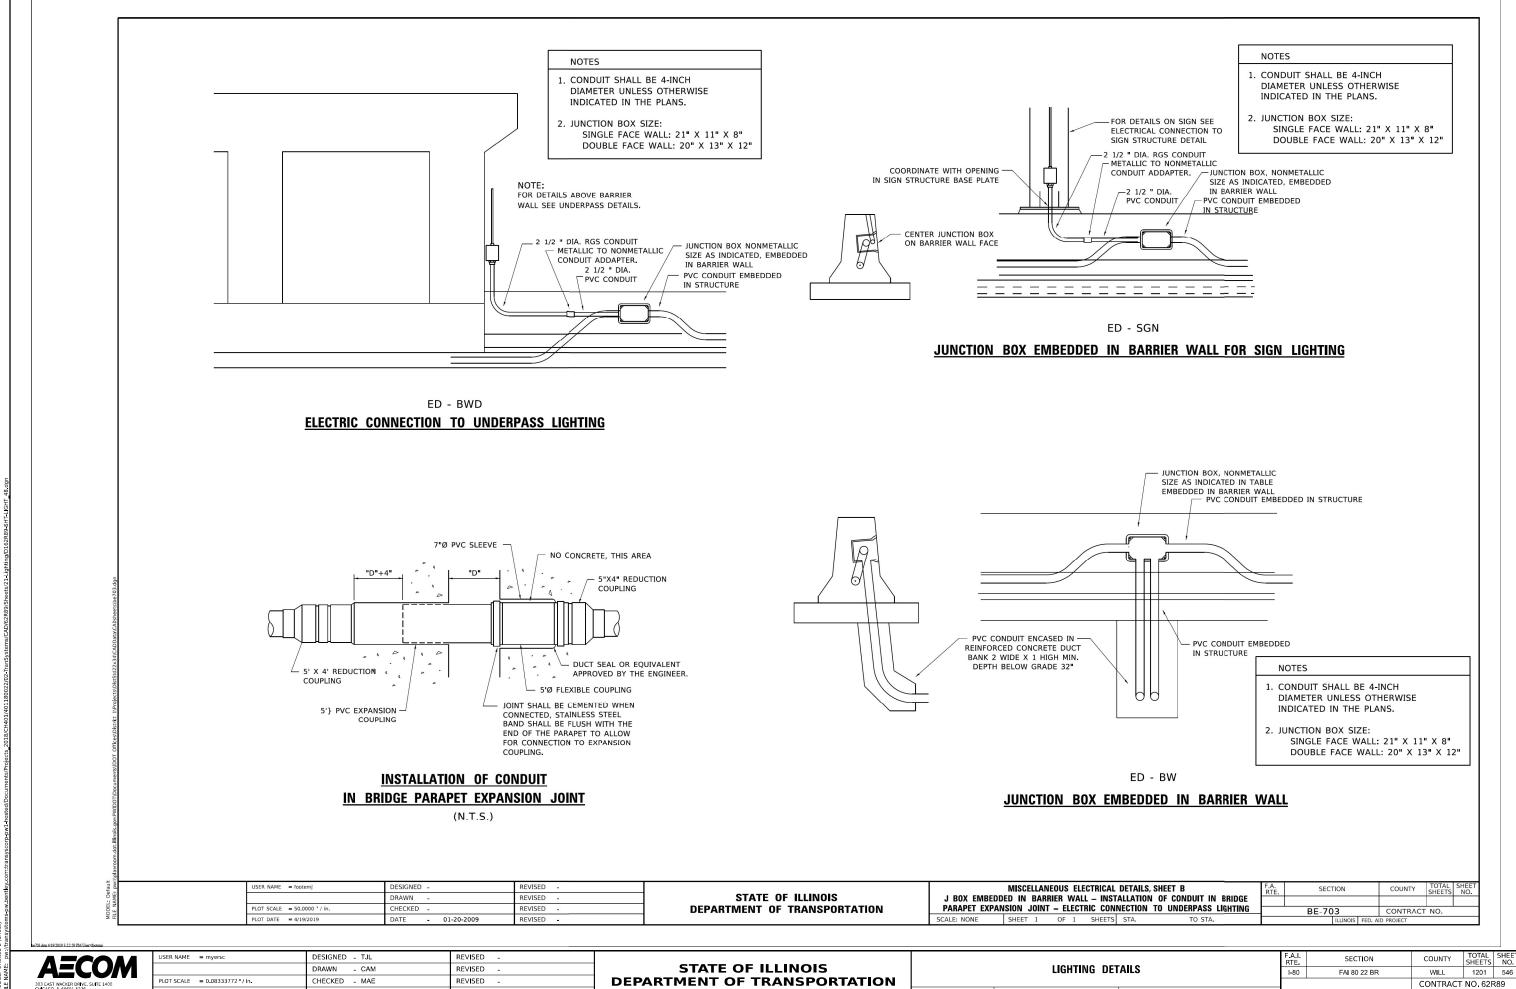SHEET 48 OF 51 SHEETS STA.


TO STA.

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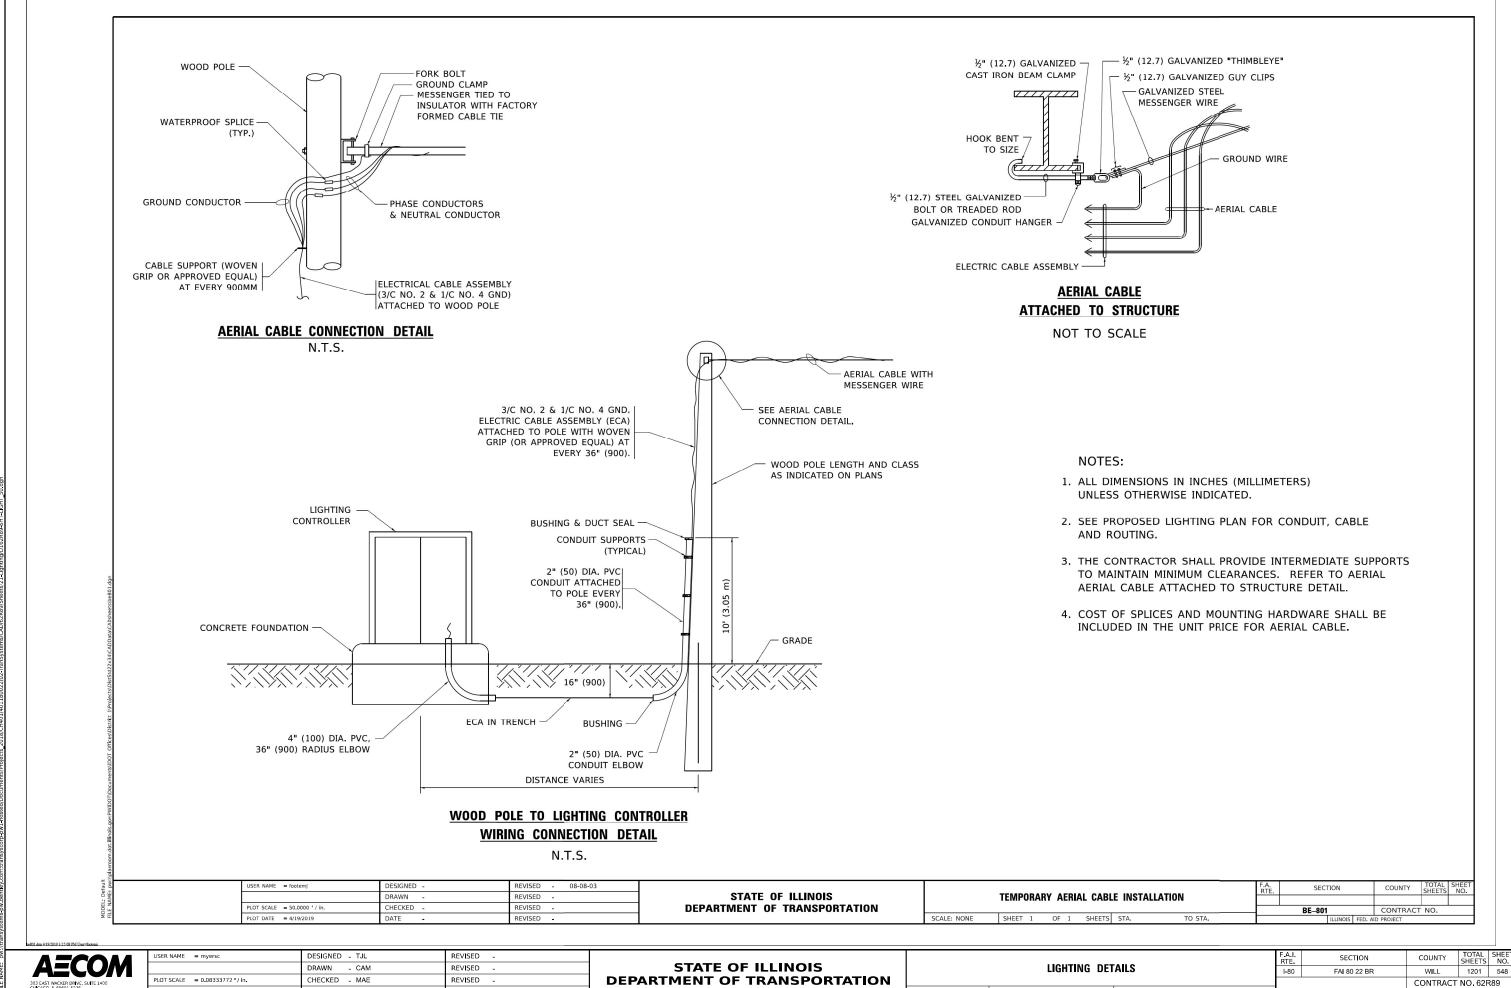
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DATE

REVISED



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SCALE: N.T.S.

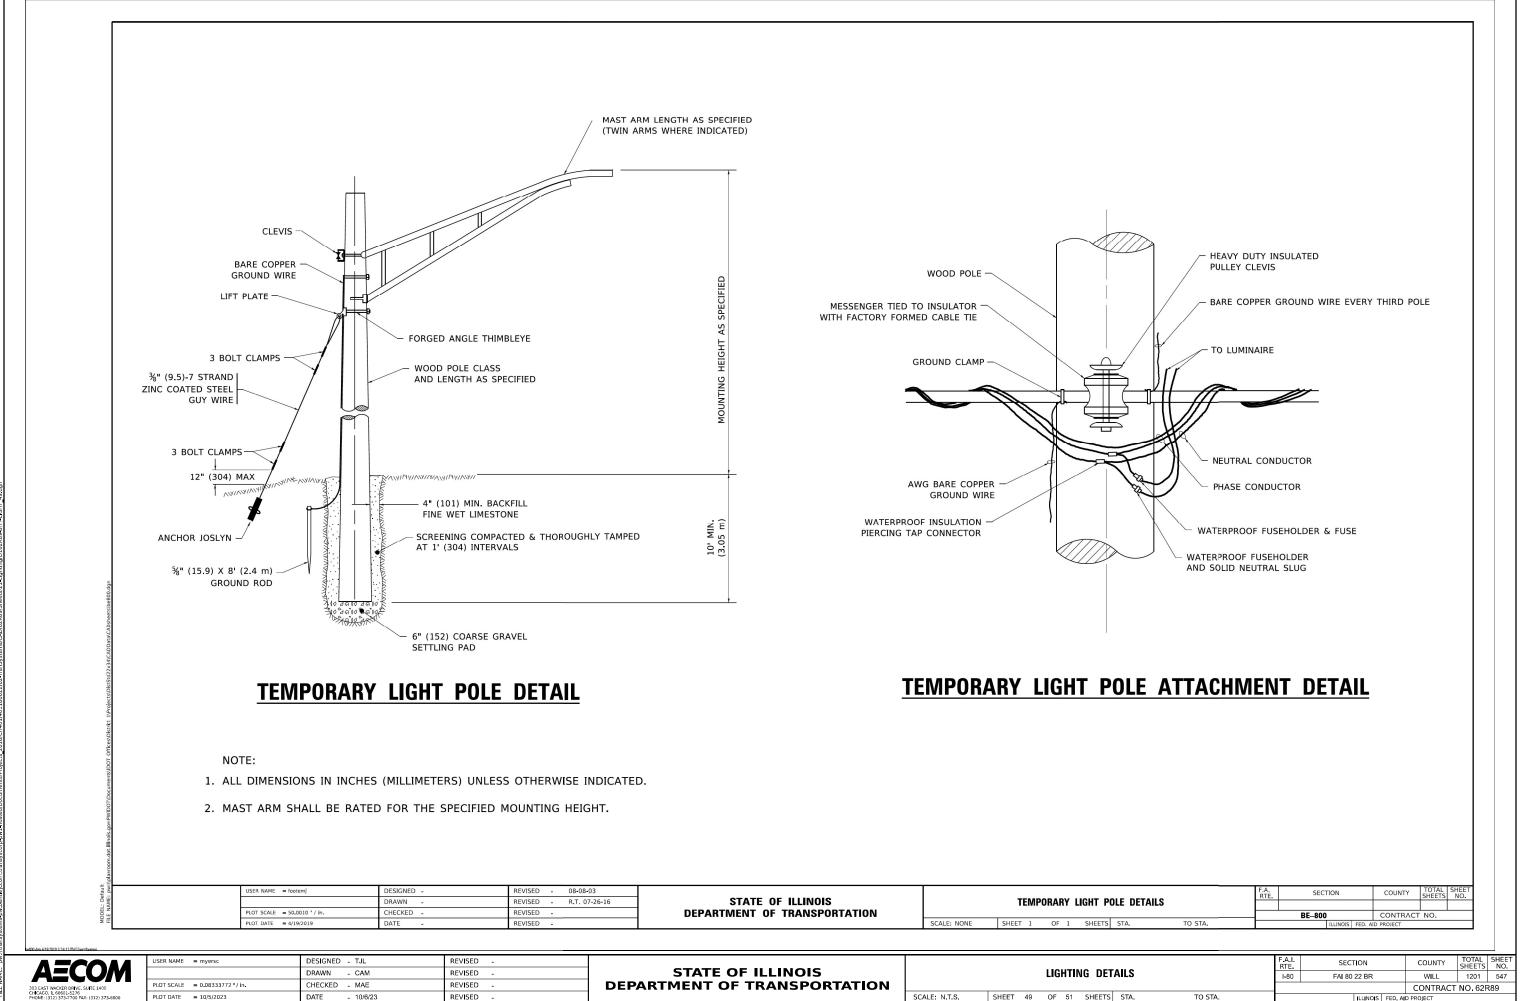SHEET 50 OF 51 SHEETS STA.


TO STA.

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PLOT DATE = 10/5/2023

DATE

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A=COA
303 EAST WACKER DRIVE, SUITE 1400
CHICAGO, 1. 60601-2576
PHONE: (332) 373-7700 FAX: (312) 373-6000

STATE OF ILLINOIS DEPARTMENT OF TRANSPORTATION

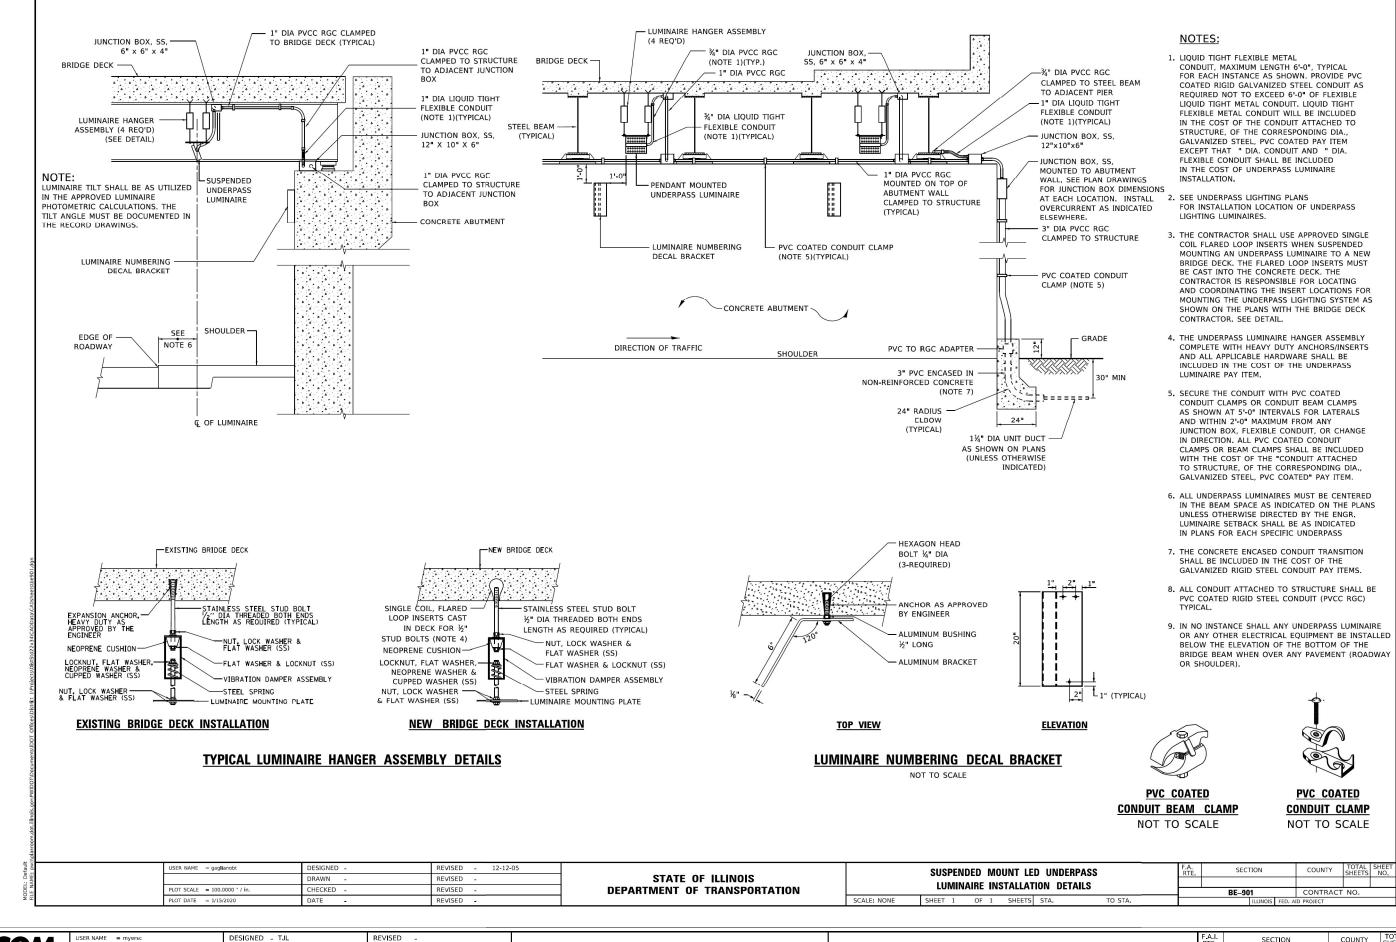SCALE: N.T.S.

#### **SYMBOLS FOR EXISTING CONDITIONS**

- AUTOMATIC TRAFFIC RECORDER (ATR) STATION
- **B** BLUETOOTH DETECTION ASSEMBLY
- CLOSED CIRCUIT TELEVISION CAMERA
- DMS DYNAMIC MESSAGE SIGN
- E HEAVY DUTY HANDHOLE (ELECTRICAL)
- COMMUNICATIONS VAULT
- JUNCTION BOX ATTACHED TO STRUCTURE
- O ITS POLE AND FOUNDATION
- ☑ GROUND MOUNTED CABINET
- ELECTRIC UTILITY POLE
- POLE MOUNTED ELECTRIC UTILITY TRANSFORMER(S)
- □ PAD MOUNTED ELECTRIC UTILITY TRANSFORMER
- SERVICE METER PEDESTAL

#### **SYMBOLS FOR PROPOSED WORK**

- HEAVY DUTY HANDHOLE (ELECTRICAL)
- COMMUNICATIONS VAULT (IDOT)
- COMMUNICATIONS VAULT (THIRD PARTY)
- JUNCTION BOX ATTACHED TO STRUCTURE\*
- CONCRETE FOUNDATION FOR FUTURE ITS POLE
- TYPE "A" FOUNDATION FOR FUTURE DISCONNECT
- FND FOUNDATION FOR FUTURE GROUND MOUNTED CABINET\*
- **■** FOUNDATION MOUNTED CABINET\*
- **■** ELECTRIC UTILITY POLE
- ▲ POLE MOUNTED ELECTRIC UTILITY TRANSFORMER(S)
- PAD MOUNTED ELECTRIC UTILITY TRANSFORMER
- SERVICE METER PEDESTAL

\*TYPE AND/OR SIZE AS INDICATED ON PLANS

#### **LINESTYLES FOR EXISTING CONDITIONS**

EE	ELECTRICAL CABLE IN CONDUIT*
F0F0	FIBER OPTIC CABLE IN CONDUIT*
EE	CONDUIT AND ELECTRICAL CABLE TO REMAIN
F0 F0	CONDUIT AND FIBER OPTIC CABLE TO REMAIN
	*CABLE TO BE REMOVED; CONDUIT TO BE ABANDONED

#### **LINESTYLES FOR PROPOSED WORK**

EE	CONDUIT FOR FUTURE ELECTRICAL CABLE*
F0 F0	MICRODUCT OR INNERDUCT FOR FUTURE FIBER OPTIC CABLE*
	CONDUIT SLEEVE*

\*TYPE AND SIZE AS INDICATED ON PLANS

### NON-ITS ELEMENTS LEGEND

T	EXISTING UNDERGROUND TELEPHONE
⊢ G ⊢ ⊢	EXISTING UNDERGROUND GAS
стvст	EXISTING UNDERGROUND CABLE TV
$\longmapsto W \longmapsto \longmapsto \vdash$	EXISTING UNDERGROUND WATER
<b></b> 0 <b></b> -	EXISTING UNDERGROUND OIL
AC	EXISTING ACCESS CONTROL AND ROW FENCE
A	EXISTING AERIAL LINE
	EXISTING GUARDRAIL
	Existing STORM SEWER
<b>⊶</b> ©	EXISTING LIGHTING
þ	EXISTING SIGNAGE
	PROPOSED ACCESS CONTROL AND ROW FENCE
<del></del>	PROPOSED GUARDRAIL
<del></del>	PROPOSED STORM SEWER
<del></del>	PROPOSED UNDERDRAIN
• • ~	PROPOSED DRAINAGE
<b>*</b> ~~	PROPOSED DRAINAGE FLOW
-−- ¤-	PROPOSED LIGHTING
ŀ	PROPOSED SIGNAGE

# **ABBREVIATIONS\***

(A)	ABANDON IN PLACE
ATR	AUTOMATIC TRAFFIC RECORDER
ATS	ATTACHED TO STRUCTURE
CCTV	CLOSED CIRCUIT TELEVISION
CNC	COILABLE NONMETALLIC CONDUIT
COMM	COMMUNICATION
DCF	DISTRIBUTION CABLE FIBER
DMS	DYNAMIC MESSAGE SIGN
F	FIBER
FRE	FIBER REINFORCED EPOXY (CONDUIT)
FT	FEET
GS	GALVANIZED STEEL
HDHH	HEAVY DUTY HANDHOLE
JB	JUNCTION BOX
NTS	NOT TO SCALE
OFF	OFFSET
SM	SINGLE MODE
TCF	TRUNK CABLE FIBER
TRNS	TRANSFORMER

\*NOT LISTED IN IDOT STANDARD 000001-08

Transmart\*\*\*

100 S. Wacker Drive Suite 400
Chicago, Illinois 60606

USER NAME = dmeier	DESIGNED - DJM	REVISED -	_
	DRAWN - DJM	REVISED -	
PLOT SCALE = 0.16666633 ' / in.	CHECKED - REL	REVISED -	
PLOT DATE = 10/5/2023	DATE - 10/6/23	REVISED -	

STATE OF ILLINOIS DEPARTMENT OF TRANSPORTATION

SCALE: NONE

							F.A.I. SECTION COUNTY			COUNTY	TOTAL SHEETS	SHEE NO.	
ITS LEGEND & ABBREVIATIONS						I-80	I-80 FAI 80 22 BR WILL					550	
										CONTRACT	NO. 62	R89	
	SHEET 1	OF	3	SHEETS	STA.	TO STA.		ILLINOIS FED. AID PROJECT					

#### **GENERAL NOTES**

- 1. A MINIMUM OF SEVENTY-TWO (72) HOURS BEFORE STARTING ANY EXCAVATION, THE CONTRACTOR SHALL CALL J.U.L.I.E. AT (800-892-0123) OR 811 TO HAVE THE LOCATION OF EXISTING UNDERGROUND UTILITIES MARKED IN THE FIELD.
- IDOT FACILITIES ARE NOT LOCATED BY JULIE OR DIGGER. IDOT ELECTRICAL FACILITIES INCLUDING ROADWAY LIGHTING, FIBER OPTIC, ITS EQUIPMENT, TRAFFIC SIGNAL AND PUMP STATION FACILITIES ARE LOCATED BY THE DEPARTMENT'S ELECTRICAL MAINTENANCE CONTRACTOR. AS OF THE LETTING DATE, CONTACT THE MEADE ELECTRIC COMPANY AT 773-287-7672.
- 3. AFTER THE INITIAL LOCATE OF IDOT FACILITIES, THE CONTRACTOR WILL BE RESPONSIBLE FOR LOCATING EXISTING IDOT ELECTRICAL FACILITIES AT HIS/HER OWN EXPENSE. THE CONTRACTOR SHALL ALSO BE LIABLE FOR ANY DAMAGE TO IDOT FACILITIES RESULTING FROM INACCURATE LOCATING.
- 4. THE CONTRACTOR SHALL BE RESPONSIBLE FOR THE PROTECTION OF ALL UNDERGROUND OR SURFACE UTILITIES EVEN THOUGH THEY MAY NOT BE SHOWN IN THE PLANS. ANY UTILITY THAT IS DAMAGED DURING CONSTRUCTION SHALL BE REPAIRED OR REPLACED TO THE SATISFACTION OF THE ENGINEER. THIS WORK WILL BE AT THE CONTRACTOR'S EXPENSE.
- 5. THE LOCATIONS OF PUBLIC OR PRIVATE UTILITIES SHOWN ON THE PLANS ARE APPROXIMATE AND THEIR ACCURACY IS NOT GUARANTEED. THE CONTRACTOR SHALL VERIFY THE EXACT LOCATION AND ELEVATION OF ALL UTILITIES. THE CONTRACTOR SHALL REPORT ANY ENCOUNTERED DISCREPANCIES TO THE ENGINEER AT ONCE. THE CONTRACTOR SHALL TAKE DUE CARE.
- 6. POTHOLING TO LOCATE EXISTING UNDERGROUND UTILITIES SHALL BE INCLUDED IN THE CONTRACT BID PRICE FOR THE UNDERGROUND CONDUIT PAY ITEMS.
- 7. THE CONTRACTOR IS RESPONSIBLE FOR THE COST OF UNCOVERING OR HAND DIGGING AROUND UTILITIES AS NECESSARY. THIS COST OF THIS WORK SHALL BE INCLUDED IN THE UNIT PRICES FOR THE CONDUITS.
- 8. THE CONTRACTOR SHALL VERIFY ADEQUATE CLEARANCE OVER/UNDER EXISTING AND PROPOSED FACILITIES BEFORE INSTALLING DUCTS, CONDUIT AND CABLES. WHERE THE CONTRACTOR'S EXCAVATION MEETS AN OBSTRUCTION, THE CONTRACTOR SHALL NOTIFY THE ENGINEER FOR DIRECTION IN WRITING PRIOR TO EXCAVATION.
- 9. CONDUIT CROSSING OVER/UNDER OTHER UTILITIES OR DRAINAGE SHALL MAINTAIN A SEPERATION OF AT LEAST 18 INCHES OR AS SPECIFIED BY OWNING UTILITY.
- 10. CONDUITS AND UNIT DUCTS SHALL BE INSTALLED AT A MINIMUM 30" DEPTH BELOW GRADE AND POSITIONED IN THE FIELD TO AVOID CONFLICT WITH ROADWAY UNDERDRAINS AND OTHER EXISTING AND PROPOSED UTILITIES.
- 11. NO ADDITIONAL COMPENSATION SHALL BE ALLOWED FOR PLACING CONDUIT AT GREATER THAN 30 INCHES MINIMUM DEPTH TO AVOID OBSTACLES SUCH AS UNDERGROUND UTILITIES, DRAIANGE PIPES, AND STRUCTURES OR TO ENTER COMMUNICATIONS VAULTS OR HANDHOLES.
- 12. THE CONTRACTOR SHALL AVOID TRENCHING THROUGH WETLAND AREA, ROADSIDE DITCHES AND RETENTION PONDS.
- 13. IDOT MICRODUCT SHALL ONLY ENTER IDOT COMMUNICATIONS VAULTS.
- 14. THIRD PARTY MICRODUCT SHALL ONLY ENTER THIRD PARTY COMMUNICATIONS VAULTS.
- 15. THE COMMUNICATION VAULT SHALL BE CONSTRUCTED SO THAT THE TOP OF THE FRAME WILL BE FLUSH WITH THE SURFACE OF THE MEDIAN. SIDEWALK, OR GROUND LINE.
- 16. IT SHALL BE THE CONTRACTOR'S RESPONSIBILITY TO VERIFY ALL DIMENSIONS AND CONDITIONS EXISTING IN THE FIELD PRIOR TO ORDERING MATERIALS AND BEGINNING CONSTRUCTION.
- 17. ITS REMOVAL PLAN SHEETS DEPICT EXISTING CONDITIONS AND WORK TO BE PERFORMED TO MAINTAIN, REMOVE, SALVAGE, OR ABANDON EXISTING ITS INFRASTRUCTURE. PROPOSED ITS PLAN SHEETS DEPICT NEW ITS INFRASTRUCTURE TO BE INSTALLED.
- 18. ALL EXCAVATED MATERIAL, WHICH INCLUDES DIGGING OR GRADING OF ANY SOIL OR FILL MATERIAL, WITH THE EXCEPTION OF AGGREGATE FILLS, MUST BE INCORPORATED WITHIN THE IDOT RIGHT OF WAY DUE TO ENVIRONMENTAL DOCUMENTATION REQUIREMENTS. EXCAVATED MATERIALS SHALL BE DISPOSED OF AT LOCATIONS DESIGNATED BY THE ENGINEER. ANY SUCH DISPOSAL SHALL BE COMPLETED IN SUCH A MANNER THAT PUBLIC OR PRIVATE PROPERTY WILL NOT BE DAMAGED OR ENDANGERED AND SHALL NOT CREATE AN UNSIGHTLY OR OBJECTIONABLE APPEARANCE OR DETRACT FORM THE NATURAL TOPOGRAPHIC FEATURES WITHOUT WRITTEN PERMISSION FROM THE ENGINEER.
- 19. ALL SURPLUS MATERIALS SHALL BE DISPOSED OF IN ACCORDANCE WITH ARTICLE 202.03 OF THE STANDARD SPECIFICATIONS.
- 20. ELECTRICAL WORK SHALL CONFORM WITH NATIONAL, STATE, AND LOCAL CODES.
- 21. ANY REFERENCE TO A STANDARD IN THESE PLANS SHALL BE INTERPRETED TO MEAN THE EDITION AS INDICATED BY THE SUBNUMBER SHOWN IN THE LIST OF STANDARDS OR THE COPY INCLUDED IN THESE PLANS.
- 22. ELECTRICAL HANDHOLE COVER LEGEND SHALL BE "IDOT ITS".
- 23. ITS SYMBOLS ARE OVERSIZED ON THE PLANS FOR CLARITY. CONTRACTOR SHALL USE STATIONS AND OFFSETS TO ACCURATELY LOCATE EQUIPMENT.

# TranSmart\*\*\* 100 S. Wacker Drive Suite 400 Chicago, Illinois 60606

USER NAME = dmeier	DESIGNED	-	DJM	REVISED -
	DRAWN	-	DJM	REVISED -
PLOT SCALE = 0.16666633 ' / in.	CHECKED	-	REL	REVISED -
PLOT DATE = 10/5/2023	DATE	-	10/6/23	REVISED -

# STATE OF ILLINOIS DEPARTMENT OF TRANSPORTATION

SCALE: NONE

					F.A.I. RTE.	SECT	ION		COUNTY	TOTAL SHEETS	SHEET NO.
	ITS GI	ENERAL I	NOTES		I-80	FAI 80	22 BR		WILL	1201	551
									CONTRACT	NO. 621	₹89
SHEET 2	OF 3	SHEETS	STA.	TO STA.			ILLINOIS	FED AL	D PROJECT		

# **BILL OF MATERIALS**

ITEM	DESCRIPTION	UNIT	QTY	IDOT QTY*	THIRD PARTY QTY*
80400100	ELECTRIC SERVICE INSTALLATION	EACH	4	-	-
80400200	ELECTRIC UTILITY SERVICE CONNECTION	L SUM	0.5**	-	-
81024600	CONDUIT ENCASED, CONCRETE, 6" DIA., PVC 1 WIDE X 1 HIGH	FOOT	20	-	-
81028200	UNDERGROUND CONDUIT, GALVANIZED STEEL, 2" DIA.	FOOT	104	-	-
81028240	UNDERGROUND CONDUIT, GALVANIZED STEEL, 4" DIA.	FOOT	1,950	1,526	424
81028750	UNDERGROUND CONDUIT, COILABLE NONMETALLIC CONDUIT, 2" DIA.	FOOT	11,597	-	-
81300915	JUNCTION BOX, STAINLESS STEEL, ATTACHED TO STRUCTURE, 20" X 20" X 8"	EACH	2	-	-
81400200	HEAVY-DUTY HANDHOLE	EACH	21	-	-
81702150	ELECTRIC CABLE IN CONDUIT, 600V (XLP-TYPE USE) 1/C NO. 2	FOOT	900	-	-
84200804	REMOVAL OF POLE FOUNDATION	EACH	6	-	-
84500120	REMOVAL OF ELECTRIC SERVICE INSTALLATION	EACH	2	-	-
87800100	CONCRETE FOUNDATION, TYPE A	FOOT	15	-	-
87800400	CONCRETE FOUNDATION, TYPE E 30-INCH DIAMETER	FOOT	80	-	-
89502300	REMOVE ELECTRIC CABLE FROM CONDUIT	FOOT	8,264	-	-
89502380	REMOVE EXISTING HANDHOLE	EACH	25	-	-
89502385	REMOVE EXISTING CONCRETE FOUNDATION	EACH	1	-	-
X8710318	FIBER OPTIC UTILITY MARKER	EACH	69	44	25
X8710402	FIBER OPTIC INNERDUCT 1 1/4" DIA.	FOOT	1,392	-	-
X8780200	CONCRETE FOUNDATION, SURVEILLANCE CABINET MODEL 334	EACH	1	-	-
X8950425	REMOVE EXISTING TRAFFIC SURVEILLANCE EQUIPMENT	L SUM	1	-	-
X8950510	REMOVE FIBER OPTIC CABLE FROM CONDUIT	FOOT	23,260	-	-
Z0033052	COMMUNICATIONS VAULT	EACH	37	24	13
	UNDERGROUND CONDUIT, MULTI-DUCT, 7-18MM MICRODUCTS	FOOT	36,398	23,677	12,721
	CONDUIT ATTACHED TO STRUCTURE, RIGID NONMETALLIC, 2" DIA.	FOOT	280	-	-
	CONDUIT ATTACHED TO STRUCTURE, RIGID NONMETALLIC, 4" DIA.	FOOT	810	540	270

\*THESE COLUMNS ARE NOT ADDITIONAL QUANTITY. THEY PROVIDE THE QUANTITY SPLIT BETWEEN IDOT AND THIRD PARTY FOR THE ITEMS LISTED.

\*\*LUMP SUM QUANTITY OF 1.0 FOR THE PROJECT IS SHARED WITH LIGHTING.

# SITE REMOVALS SCHEDULE

STATION	OFFSET	ASSOCIATED PAY ITEM	SHEET
529+69	82' RT	84200804, X8950425	554
556+04	90' LT	84200804, X8950425	556
582+56	87' RT	84200804, X8950425	558
609+25	76' LT	84200804, X8950425	561
618+56	90' LT	89502385, X8950425	561
621+18	90' LT	84200804, X8950425	562
635+40	77' RT	84200804, X8950425	563
	529+69 556+04 582+56 609+25 618+56 621+18	529+69 82' RT 556+04 90' LT 582+56 87' RT 609+25 76' LT 618+56 90' LT 621+18 90' LT	529+69         82' RT         84200804, X8950425           556+04         90' LT         84200804, X8950425           582+56         87' RT         84200804, X8950425           609+25         76' LT         84200804, X8950425           618+56         90' LT         89502385, X8950425           621+18         90' LT         84200804, X8950425

<sup>\*</sup>STATION/OFFSET OF THE CONTROLLER CABINET IS LISTED


# PROPOSED SITE SCHEDULE


ITEM	STATION	OFFSET	ASSOCIATED PAY ITEM	SHEET
30" DIA. CONCRETE FOUNDATION	520+00	85' LT	87800400	564
30" DIA. CONCRETE FOUNDATION	541+50	72.5' RT	87800400	566
30" DIA. CONCRETE FOUNDATION	555+90	100' LT	87800400	567
ELECTRIC SERVICE	579+44	202' RT	80400100, 80400200	569
30" DIA. CONCRETE FOUNDATION	582+00	90' RT	87800400	569
30" DIA. CONCRETE FOUNDATION	588+15	87' RT	87800400	570
30" DIA. CONCRETE FOUNDATION	596+00	88' LT	87800400	570
ELECTRIC SERVICE	602+53	115' LT	80400100, 80400200	571
30" DIA. CONCRETE FOUNDATION	613+60	84.5' LT	87800400	572
334 CABINET FOUNDATION	625+85	83' LT	87800400	573
30" DIA. CONCRETE FOUNDATION	628+75	83' LT	X8780200	573

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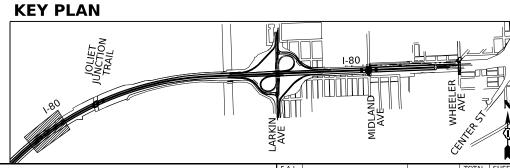
STATE OF ILLINOIS
DEPARTMENT OF TRANSPORTATION

						F.A.I. RTE.	SECTION		COUNTY	TOTAL SHEETS	SHEET NO.
	ITS SCHEDULES								WILL	1201	552
						,			CONTRACT	NO. 621	389
SCALE: NONE	SHEET 3	OF 3	SHEETS	STA.	TO STA.		ILLINOIS	FED. AID	PROJECT		



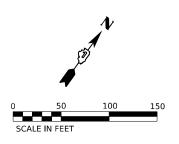

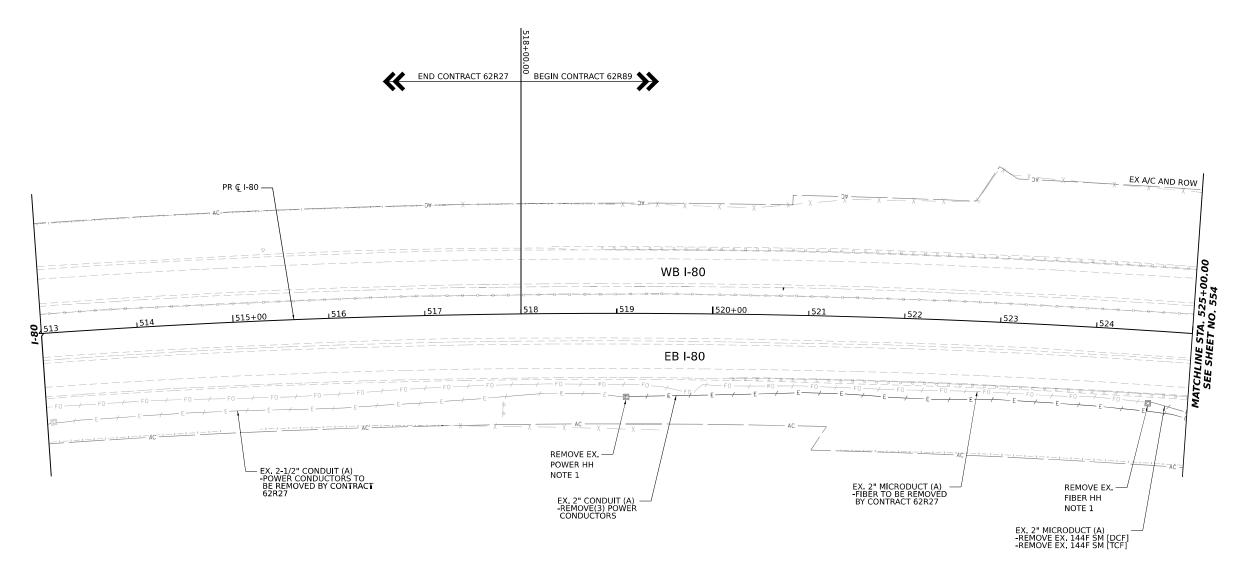1. PRIOR TO REMOVING HANDHOLE, COORDINATE WITH CONTRACT 62R27 TO ENSURE THAT CABLES TO THE WEST HAVE BEEN REMOVED.





ME DW	TranSmart*
FILE NAME	100 S. Wacker Drive Suite 400 Chicago, Illinois 60606


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	DRAWN -	-	DJM	REVISED -
USER NAME   dmeler	DESIGNED .	•	DJM	REVISED -

STATE OF ILLINOIS DEPARTMENT OF TRANSPORTATION

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		ITS REN	IUVAL P	LANS		1-80	FAI 80 22 BR		WILL	1201	
									CONTRACT	NO. 62	R
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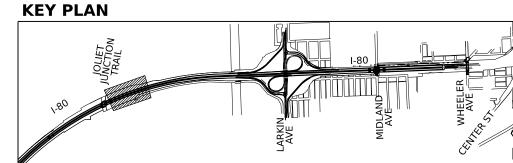


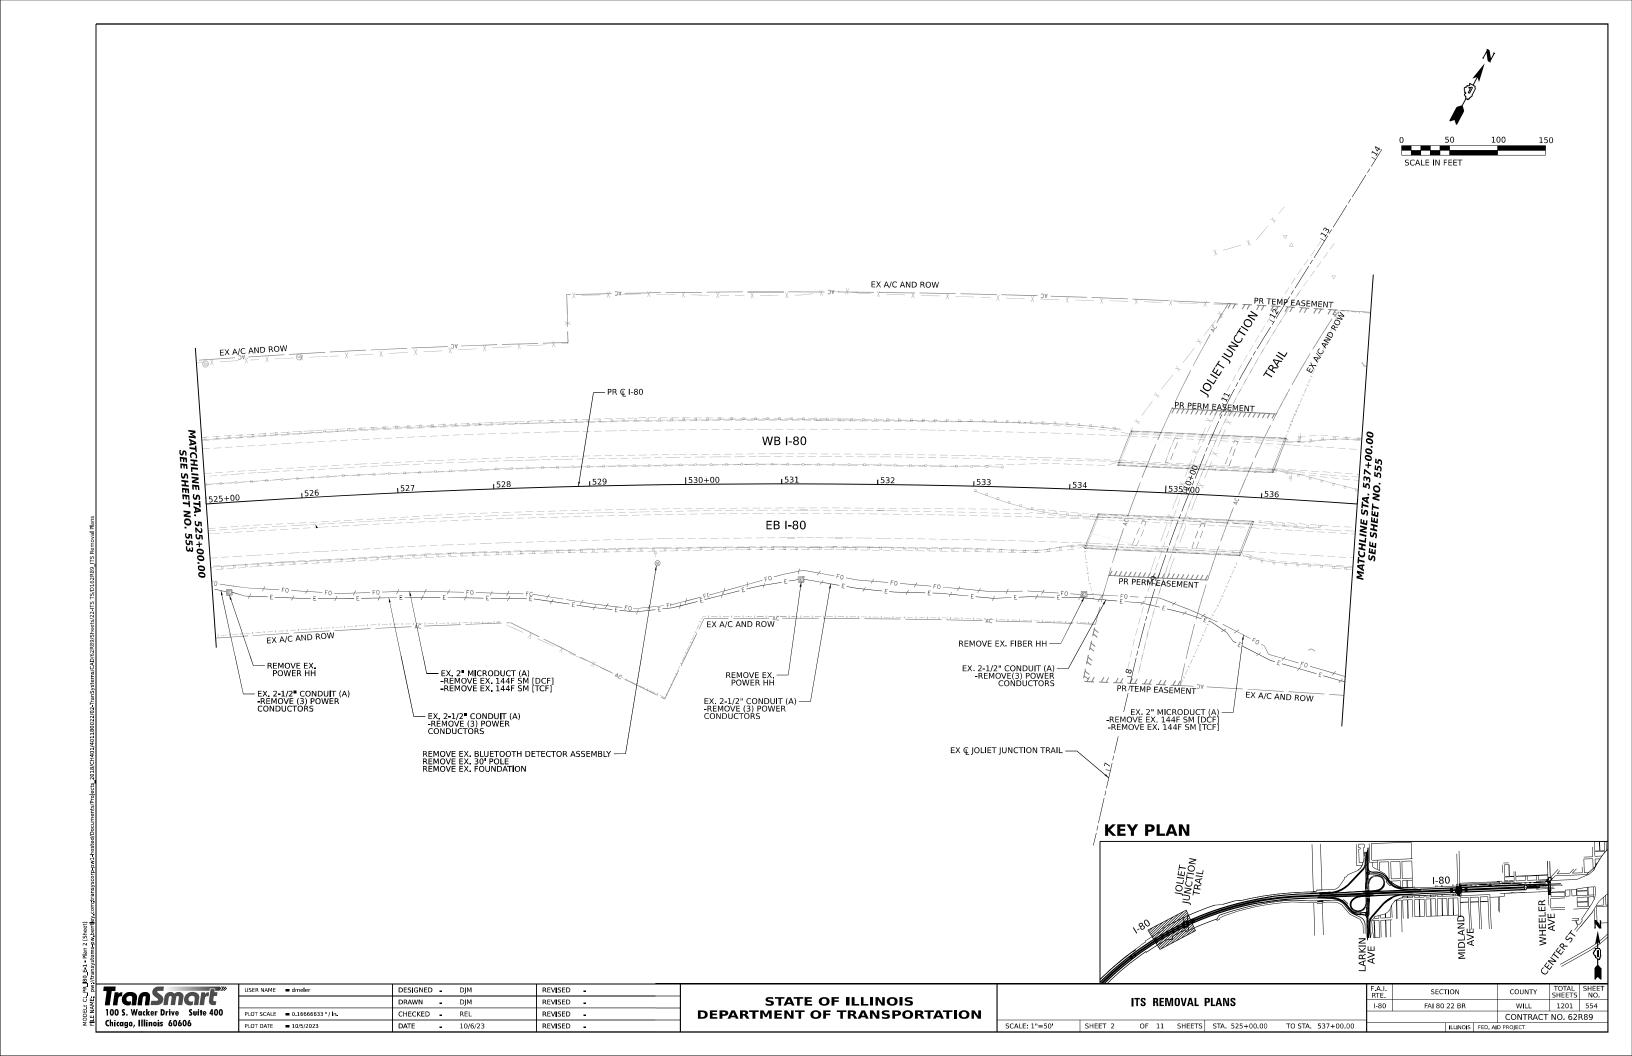

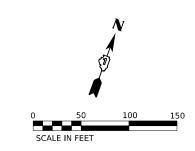

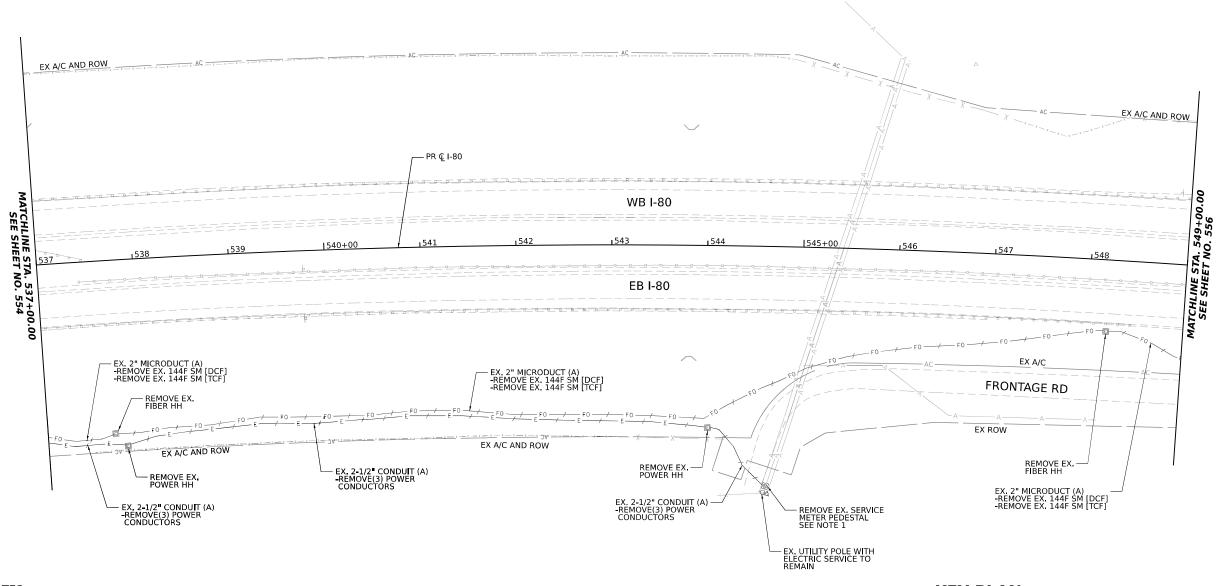REMOVAL OF THE SERVICE METER PEDESTAL WILL BE PAID FOR AS PAY ITEM 84500120 (REMOVAL OF ELECTRIC SERVICE INSTALLATION).

NEW SERVICE PEDSTAL TO BE INSTALLED UTILIZING THE EXISTING ELECTRIC SERVICE (SEE ITS INFRASTRUCTURE PLANS).





ME DW	TranSmart"
F LE NAME	100 S. Wacker Drive Suite 400 Chicago, Illinois 60606


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STATE OF ILLINOIS DEPARTMENT OF TRANSPORTATION

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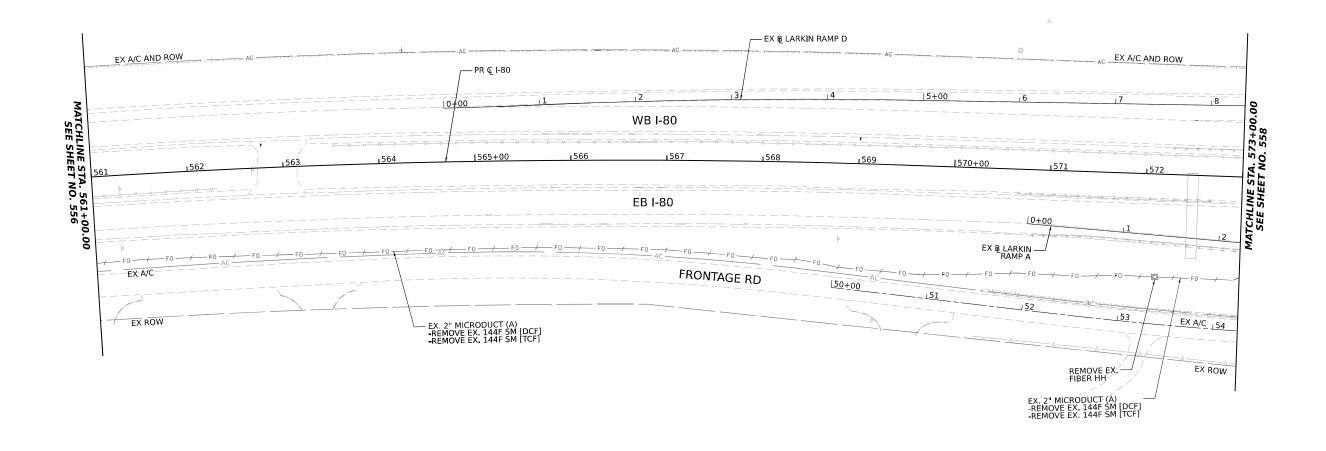
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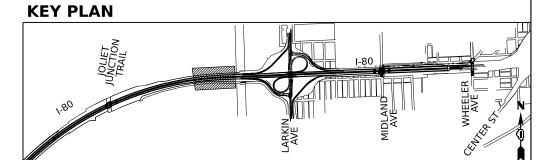
100 S. Wacker Drive Suite 400
Chicago, Illinois 60606

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STATE OF ILLINOIS DEPARTMENT OF TRANSPORTATION

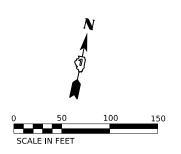SCALE: 1"=50' SHEET 4 OF 11 SHEETS STA. 549+00.00 TO STA. 561+00.00

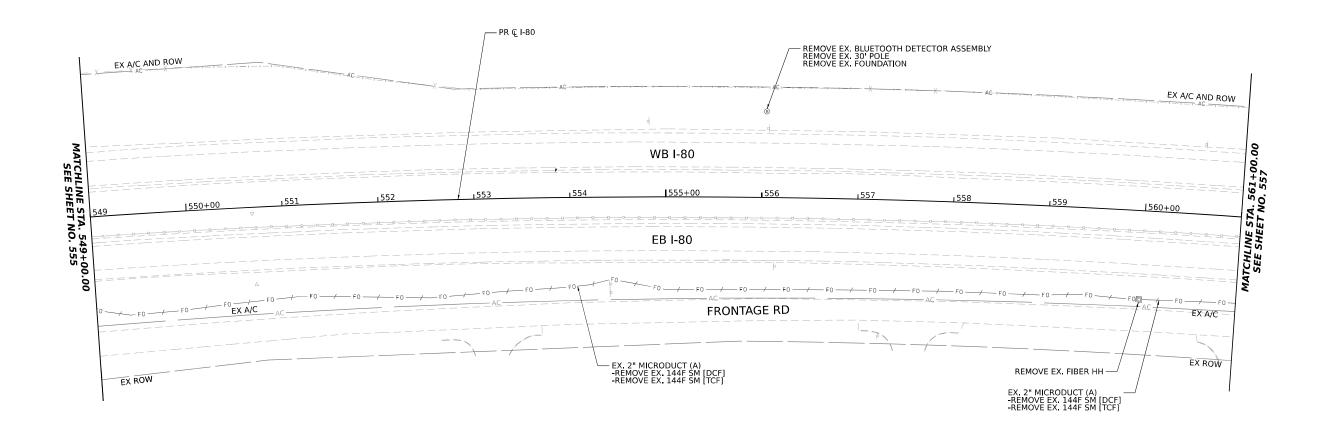

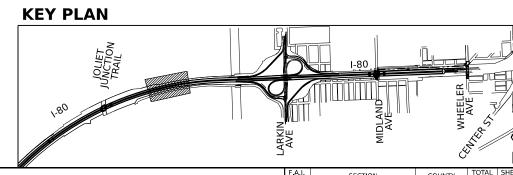


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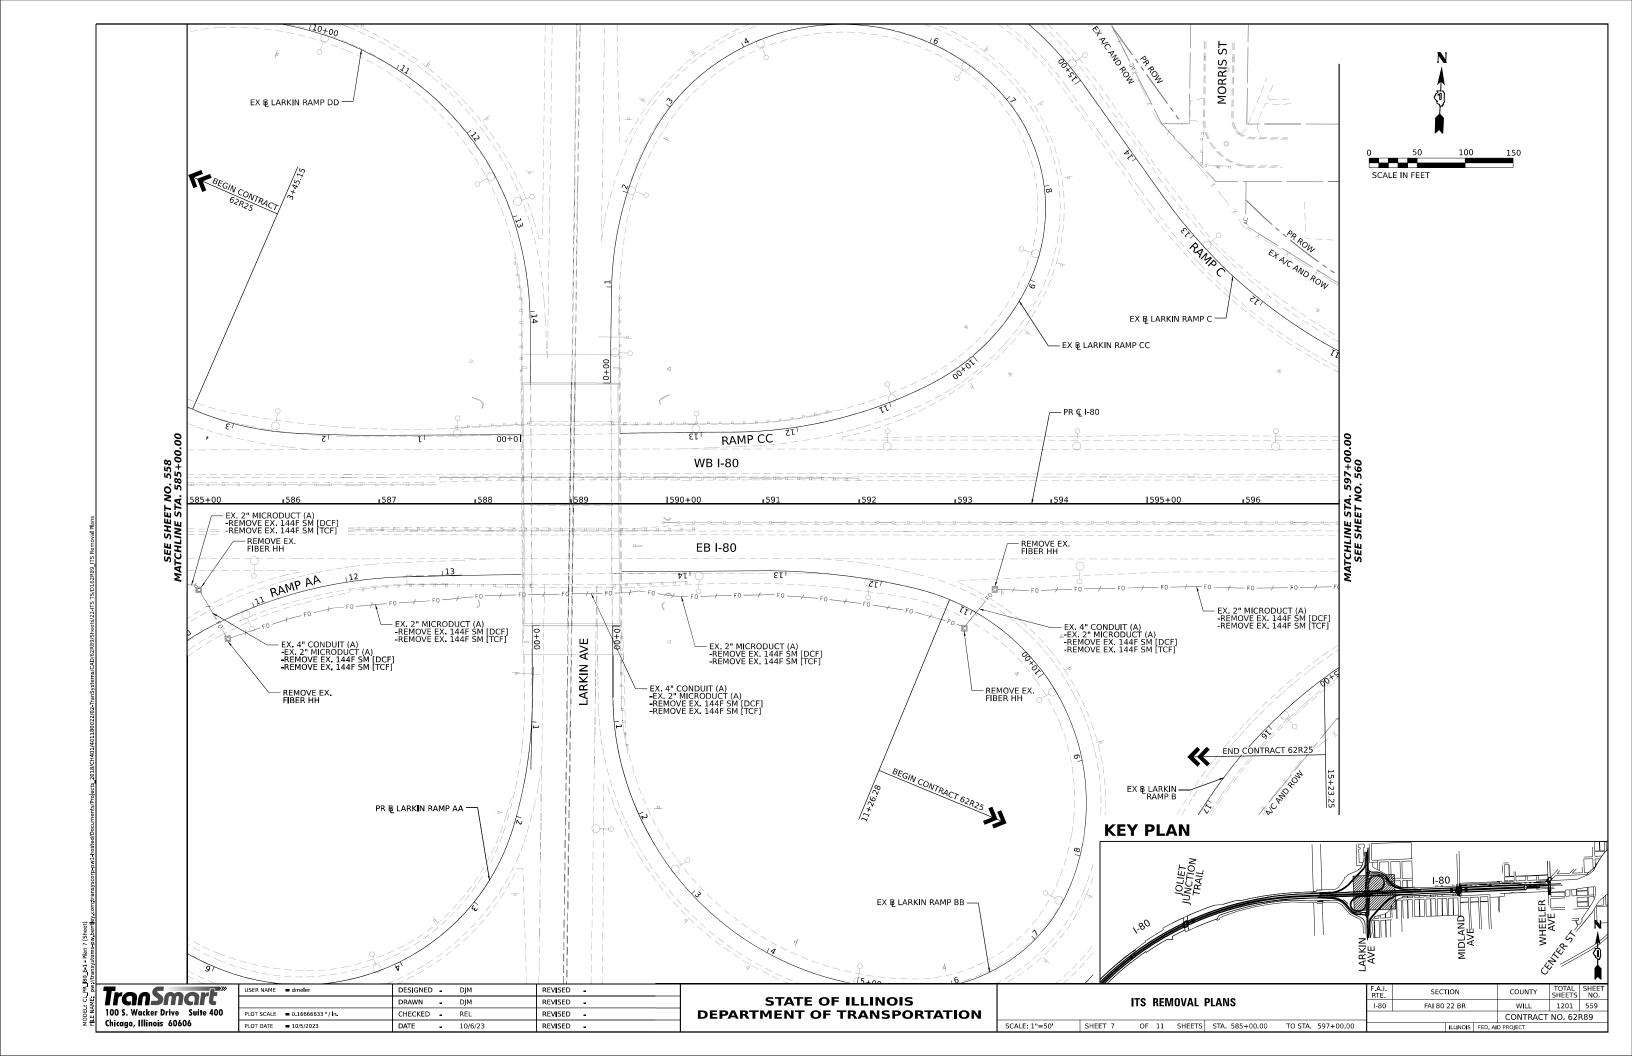
100 S. Wacker Drive Suite 400
Chicago, Illinois 60606


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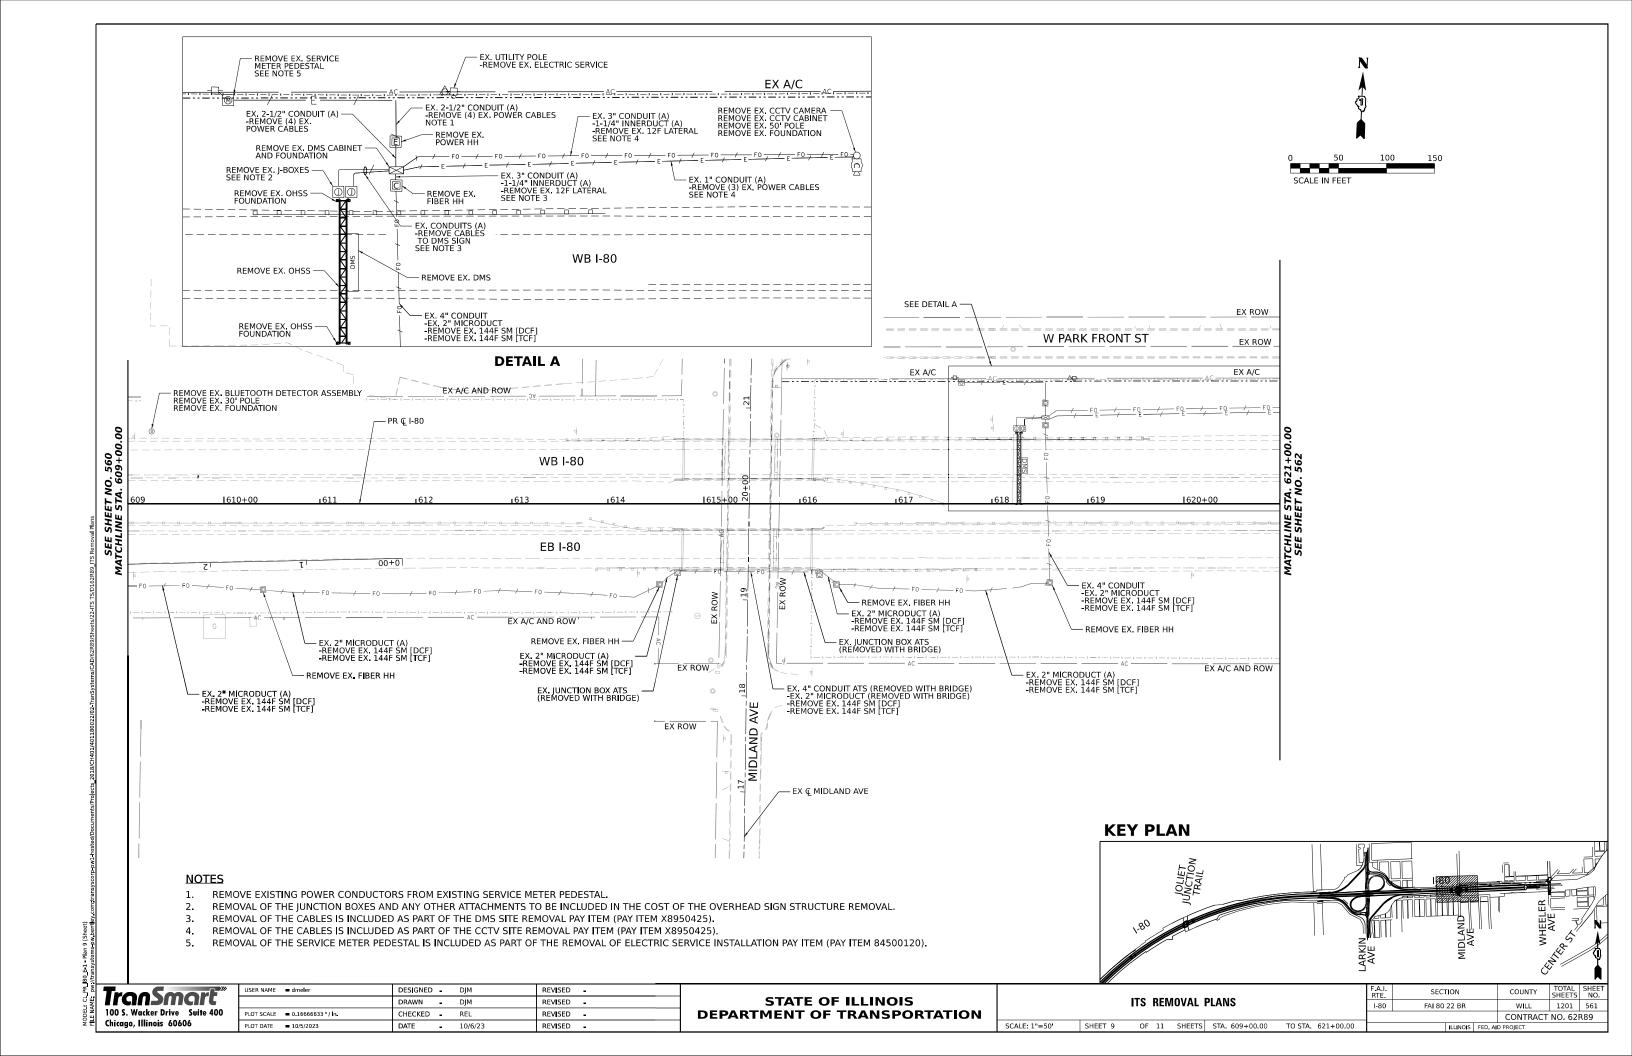
STATE OF ILLINOIS DEPARTMENT OF TRANSPORTATION


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SCALE: 1"=50'	SHEET 5	OF 11	SHEETS	STA. 561+00.00	TO STA. 573+00.00	






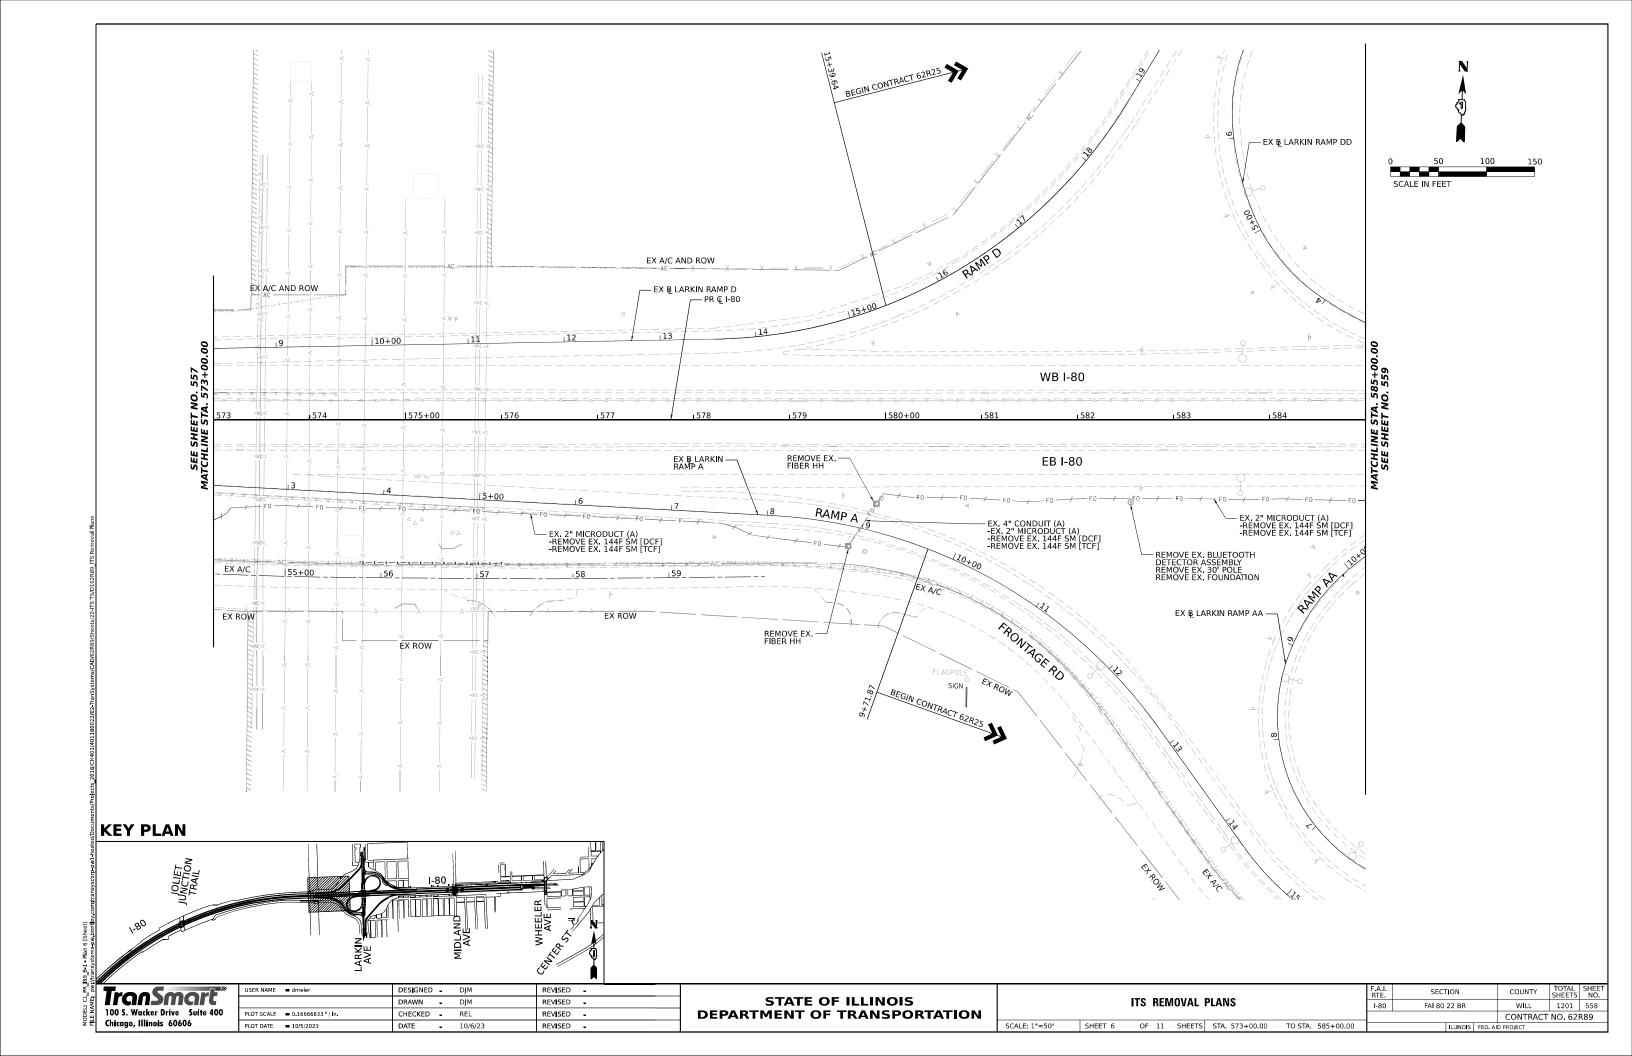


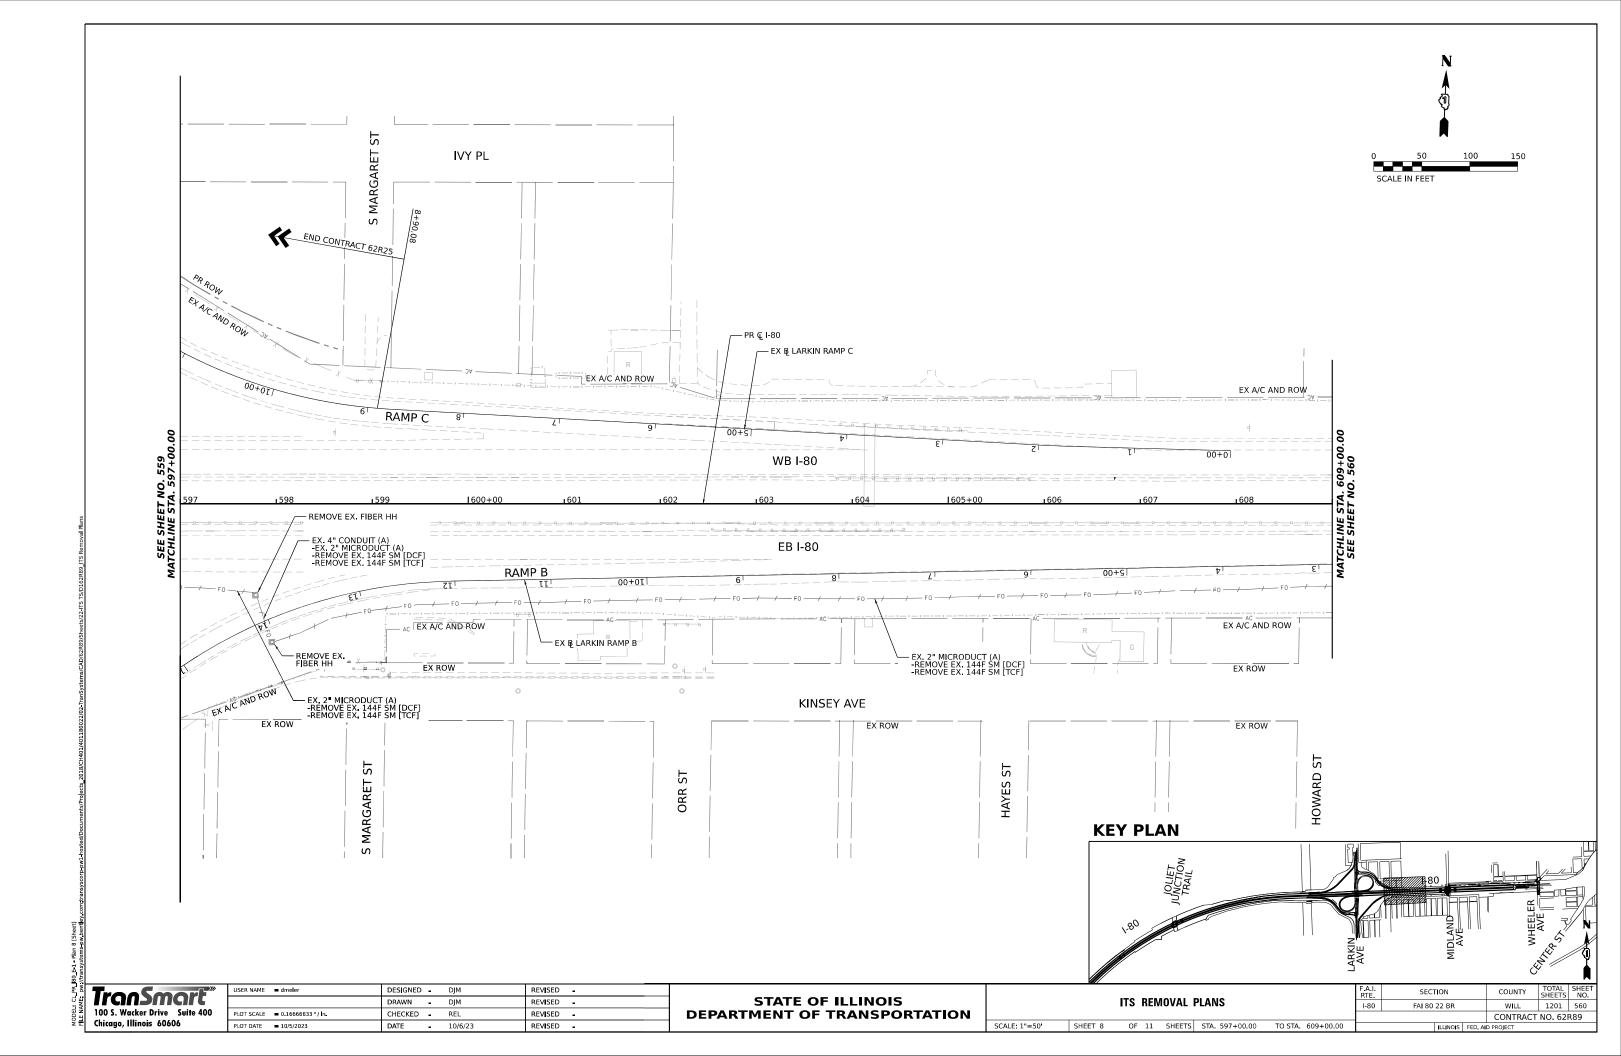


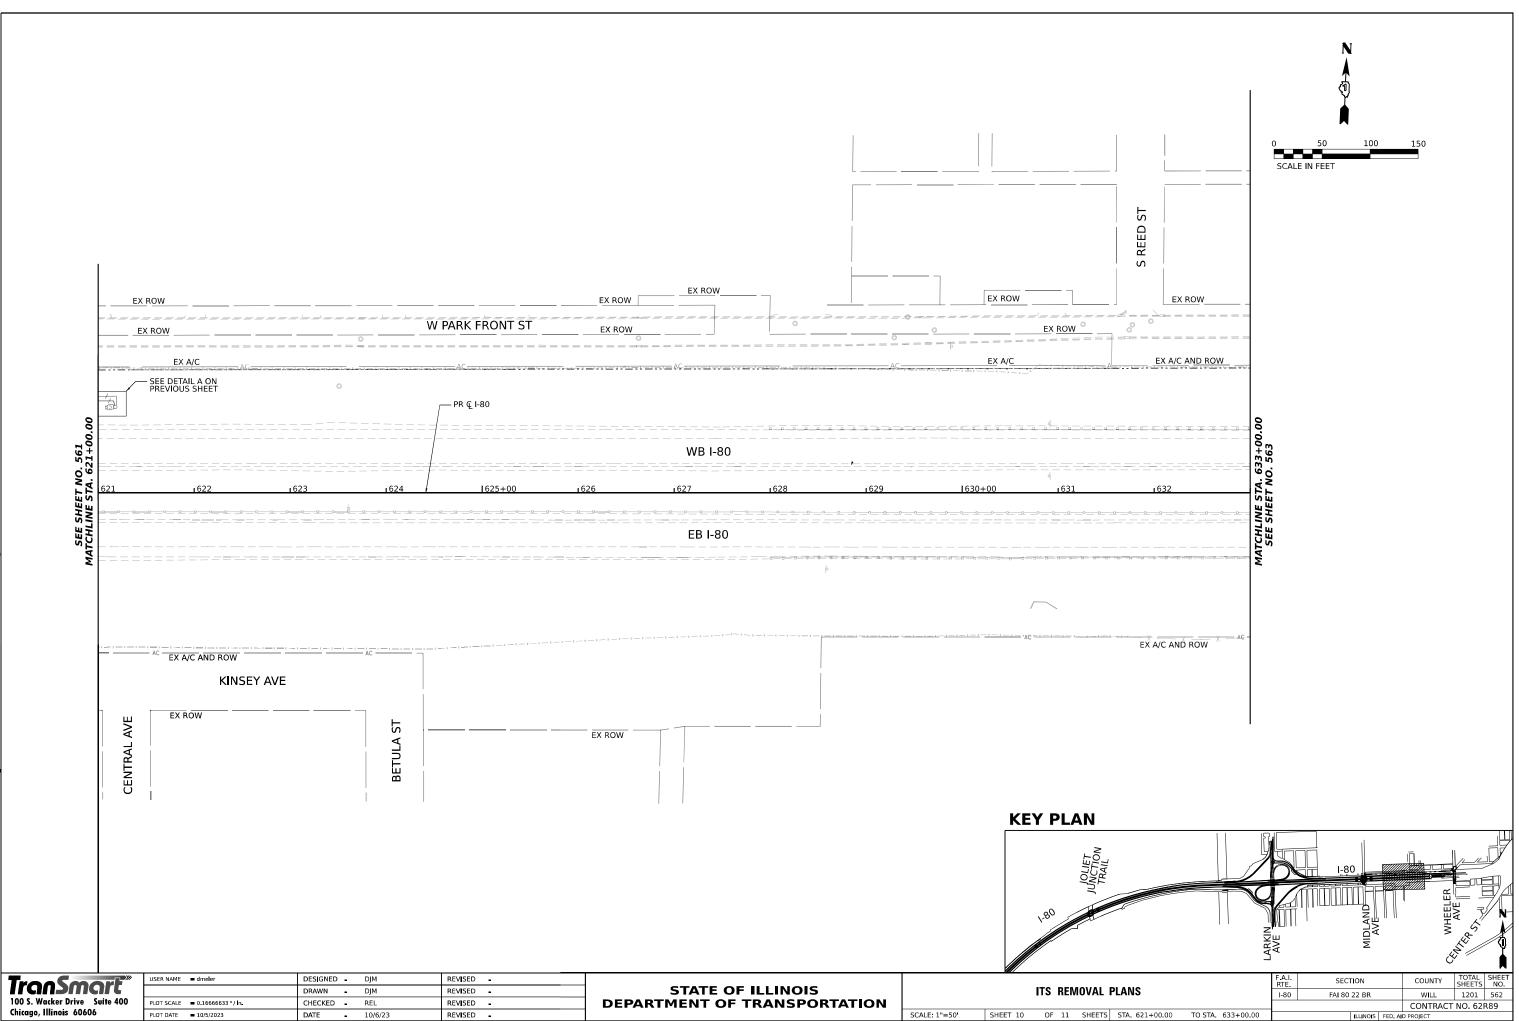

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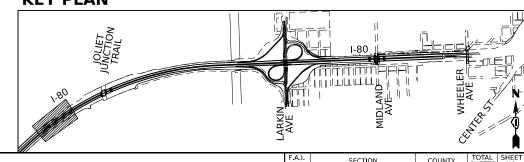


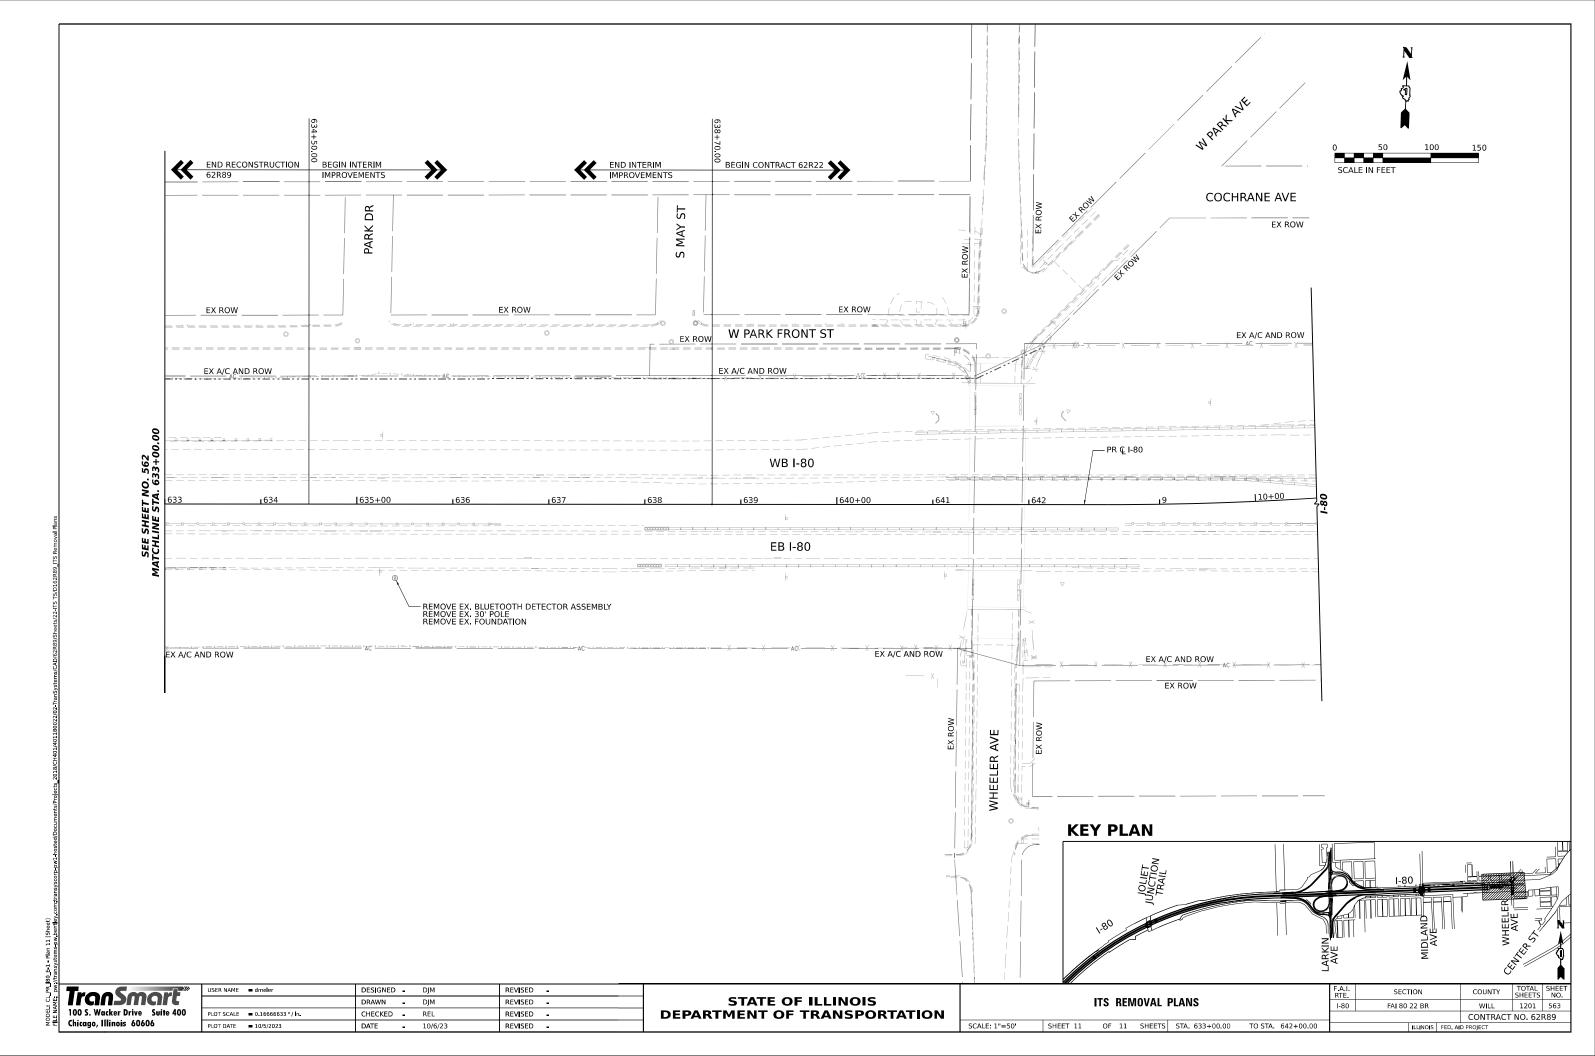

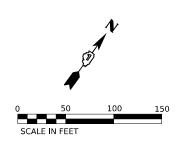

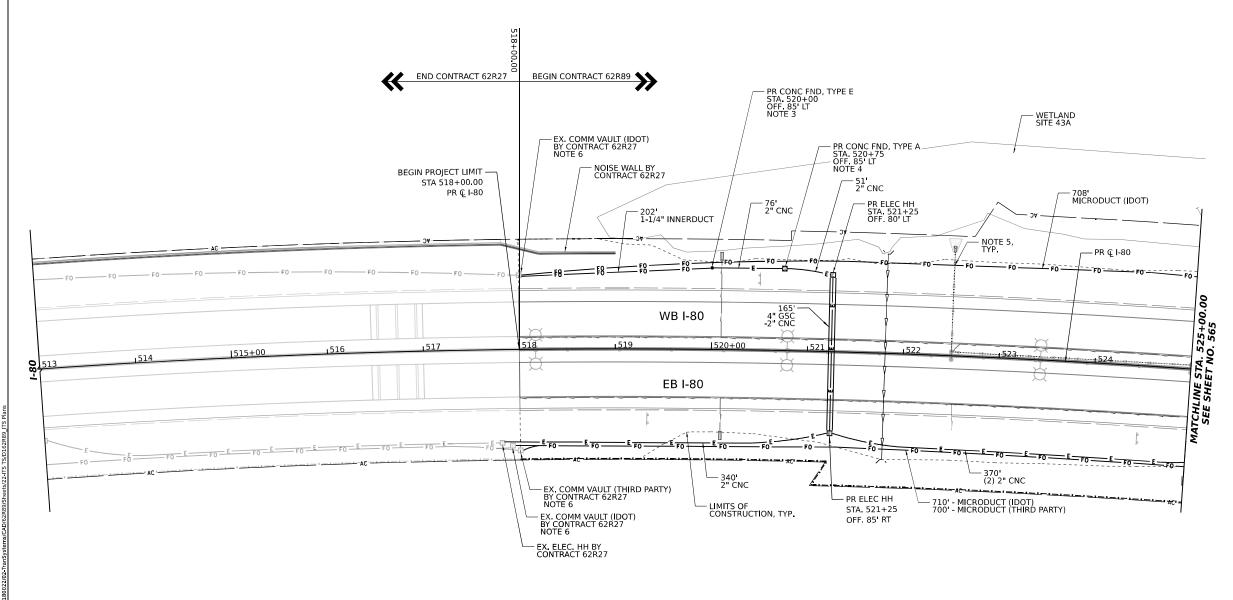- IDOT MICRODUCT SHALL ONLY ENTER IDOT COMMUNICATIONS VAULTS.
  THIRD PARTY MICRODUCT SHALL ONLY ENTER THIRD PARTY COMMUNICATION VAULTS.
  2" CNC CONDUIT SHALL BE COUPLED TO THE 2" CONCRETE FOUNDATION CONDUIT STUB OUT. 1-1/4" INNERDUCT SHALL BE INSTALLED IN THE OTHER 2" CONCRETE FOUNDATION CONDUIT STUB OUT UP THROUGH THE TOP OF THE FOUNDATION.
  THE 2" COC CONDUITS SHALL BE COUPLED TO THE 2" CONCRETE FOUNDATION CONDUIT STUB OUTS. COORDINATE INSTALLATION WITH DRAINAGE, MAINTAIN MINIMUM 18" CLEARANCE BETWEEN ITS MICRODUCT/CONDUIT AND DRAINAGE PIPES/STRUCTURES/UNDERDRAIN. TYP.
  CONTRACTOR SHALL NOT DRILL EXISTING COMMUNICATIONS VAULTS. ALL CONDUITS SHALL ENTER THE VAULT THROUGH THE BOTTOM.

# **KEY PLAN**








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**STATE OF ILLINOIS DEPARTMENT OF TRANSPORTATION** 

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	112	INFKA5	KUUTU	RE PLANS		I-80	FAI 80 22 BR	WILL	1201	564
								CONTRACT	NO. 621	₹89
CALE: 1"=50'	SHEET 1	OF 11	SHEETS	STA. 518+00.00	TO STA. 525+00.00		ILLINOIS FED. A	ND PROJECT		



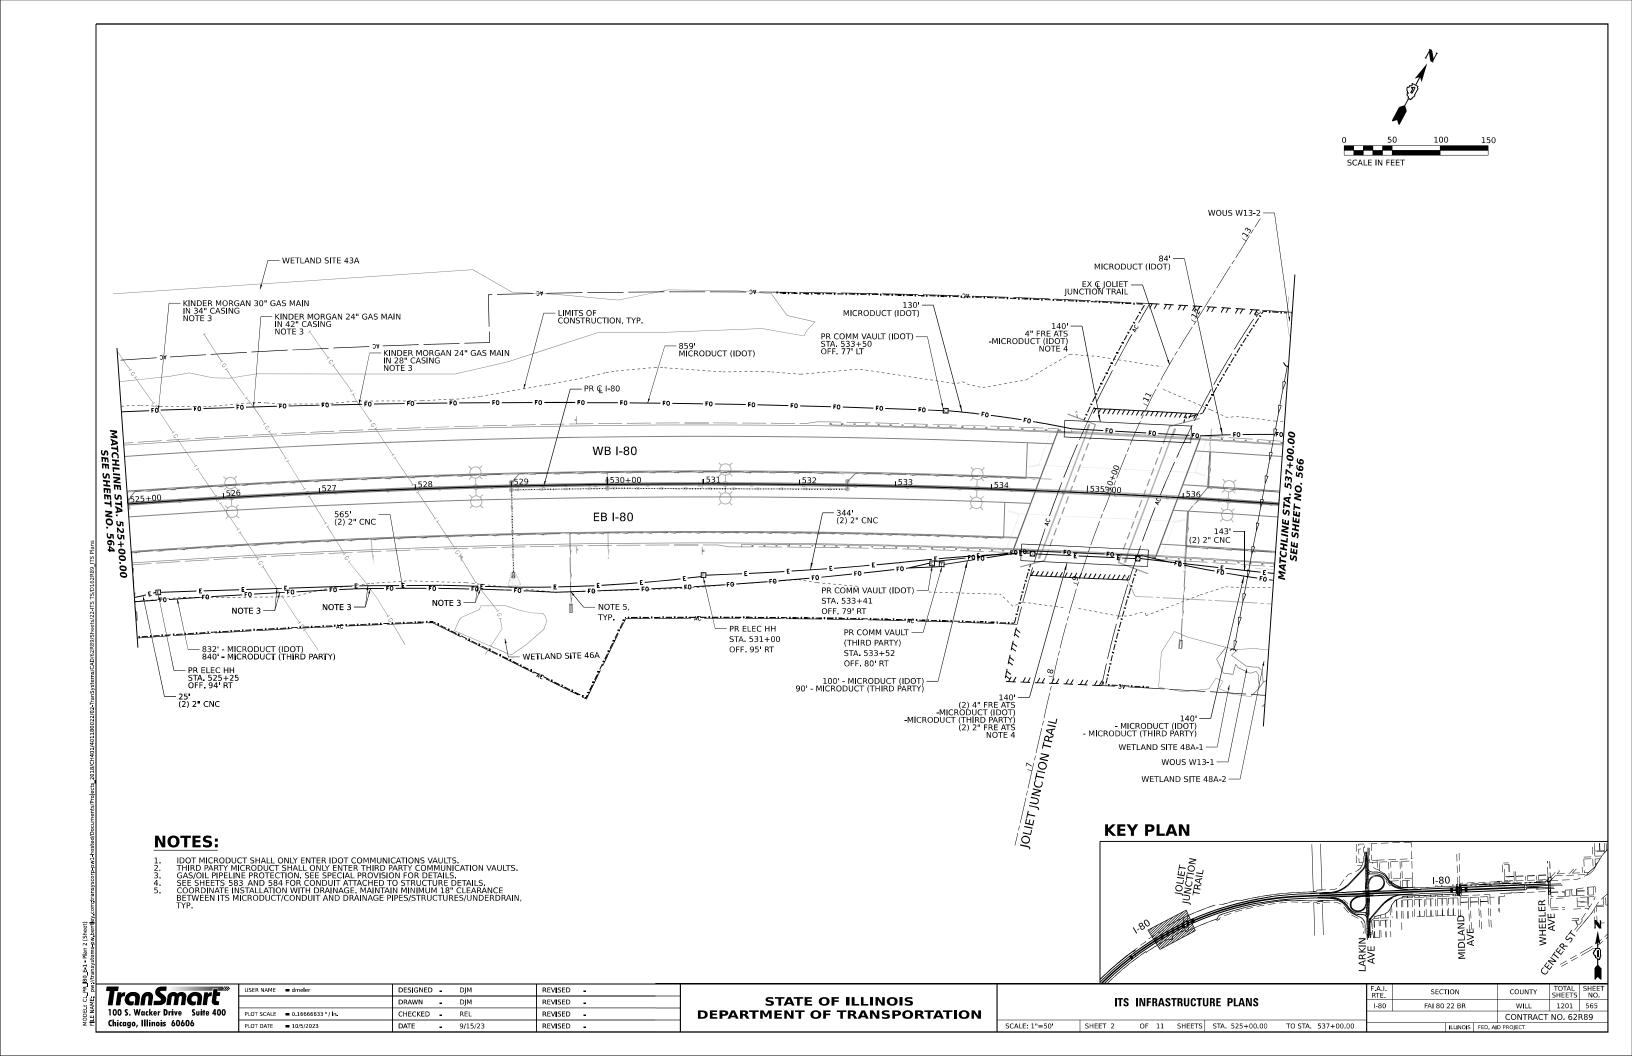

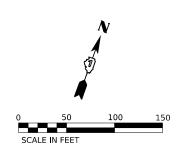

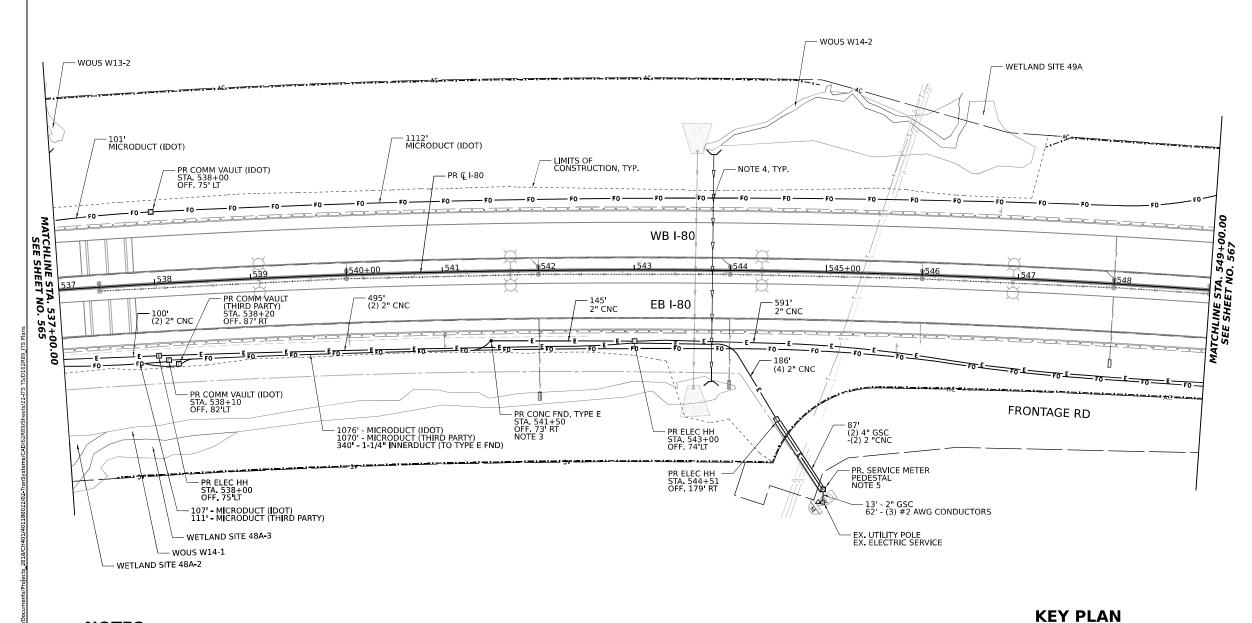
- IDOT MICRODUCT SHALL ONLY ENTER IDOT COMMUNICATIONS VAULTS,
  THIRD PARTY MICRODUCT SHALL ONLY ENTER THIRD PARTY COMMUNICATION VAULTS.
  2" CNC CONDUIT SHALL BE COUPLED TO THE 2" CONCRETE FOUNDATION CONDUIT STUB
  OUT, 1-1/4" INNERDUCT SHALL BE INSTALLED IN THE OTHER 2" CONCRETE FOUNDATION
  CONDUIT STUB OUT UP THROUGH THE TOP OF THE FOUNDATION.
  COORDINATE INSTALLATION WITH DRAINAGE, MAINTAIN MINIMUM 18" CLEARANCE BETWEEN
  ITS MICRODUCT/CONDUIT AND DRAINAGE PIPES/STRUCTURES/UNDERDRAIN, TYP.
  EXISTING ELECTRIC SERVICE TO REMAIN, PROPOSED ELECTRIC SERVICE METER PEDESTAL
  SHALL BE PAID FOR AS 80400100 (ELECTRIC SERVICE INSTALLATION).


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≥ 10	0 S. Wacker Drive Suite 400	PLOT SCALE	■ 0.16666633 '/ln.	CHECKED	-	REL	REVISED	-	DEF
WE I	ransmart			DRAWN	-	DJM	REVISED	-	
Μď	ranSmart <sup>**</sup> O S. Wacker Drive Suite 400 lago, Illinois 60606	USER NAME	■ dmeler	DESIGNED	-	DJM	REVISED	-	
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**STATE OF ILLINOIS DEPARTMENT OF TRANSPORTATION** 

AVE MIDLAND AVE

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												CONTRACT	NO. 621	₹89
CALE: 1"=50'	SHEET 3	OF	11 5	SHEETS	STA. 537+00.00	TO STA.	549+00.00			ILLINOIS	FED. All	D PROJECT		



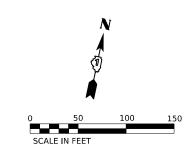

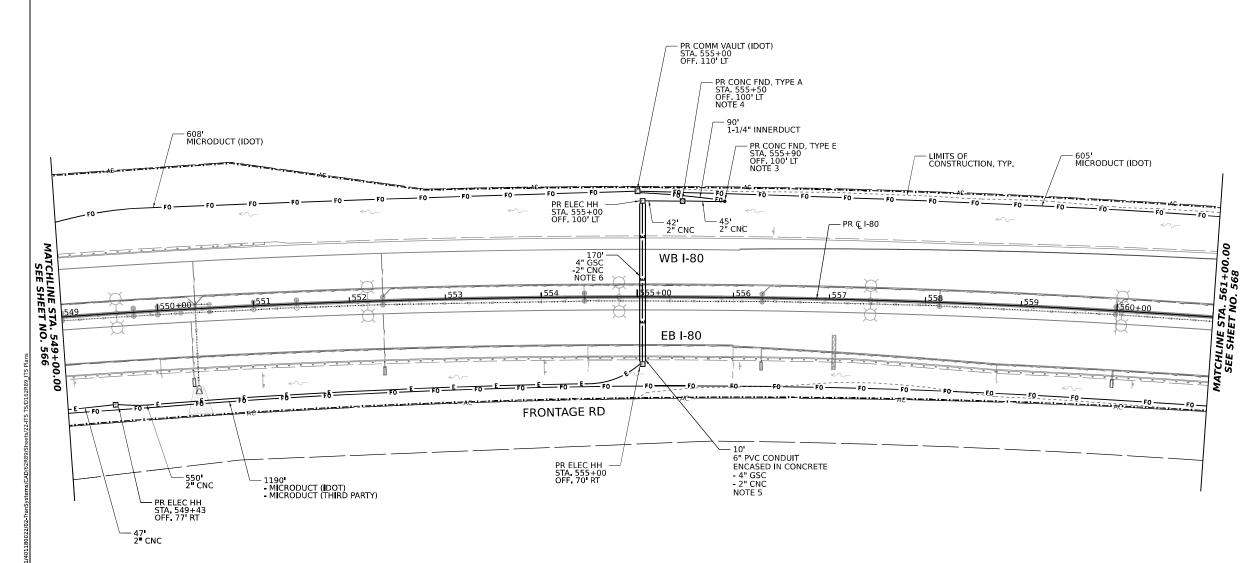- IDOT MICRODUCT SHALL ONLY ENTER IDOT COMMUNICATIONS VAULTS.
  THIRD PARTY MICRODUCT SHALL ONLY ENTER THIRD PARTY COMMUNICATION VAULTS.
  2" CNC CONDUIT SHALL BE COUPLED TO THE 2" CONCRETE FOUNDATION CONDUIT STUB OUT. 1-1/4" INNERDUCT SHALL BE INSTALLED IN THE OTHER 2" CONCRETE FOUNDATION CONDUIT STUB OUT UP THROUGH THE TOP OF THE FOUNDATION.
  THE 2" CNC CONDUITS SHALL BE COUPLED TO THE 2" CONCRETE FOUNDATION CONDUIT STUB OUTS.
  CONDUINTS TUB OUTS.
  CONDUINATE INSTALLATION WITH GUARDRAIL. CENTER THE PVC CONDUIT ENCASED IN CONCRETE ON THE PROPOSED GUARDRAIL AND IN BETWEEN POSTS.
  DEPTH IN ADDITION TO THE TYPICAL 5' BELOW TOP OF PROPOSED PAVEMENT WILL BE REQUIRED IN ORDER TO PROVIDE A MINIMUM 18" CJF PROPOSED STORM SEWER. COORDINATE INSTALLATION WITH DRAINAGE.

# Transmart\* 100 S. Wacker Drive Suite 400 Chicago, Illinois 60606


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	PLOT DATE ■ 10/5/2023	DATE	-	9/15/23	REVISED	-


**STATE OF ILLINOIS DEPARTMENT OF TRANSPORTATION** 

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**KEY PLAN** 

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	IIS	INFR	ASTRUCT	URE PLANS		I-80	FAI 80 22 BR	WILL	1201	567
								CONTRACT	NO. 621	R89
SCALE: 1"=50'	SHEET 4	OF 11	SHEETS	STA. 549+00.00	TO STA. 561+00.00		ILLINOIS FED.	AID PROJECT		



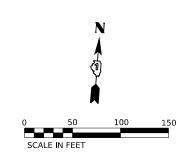

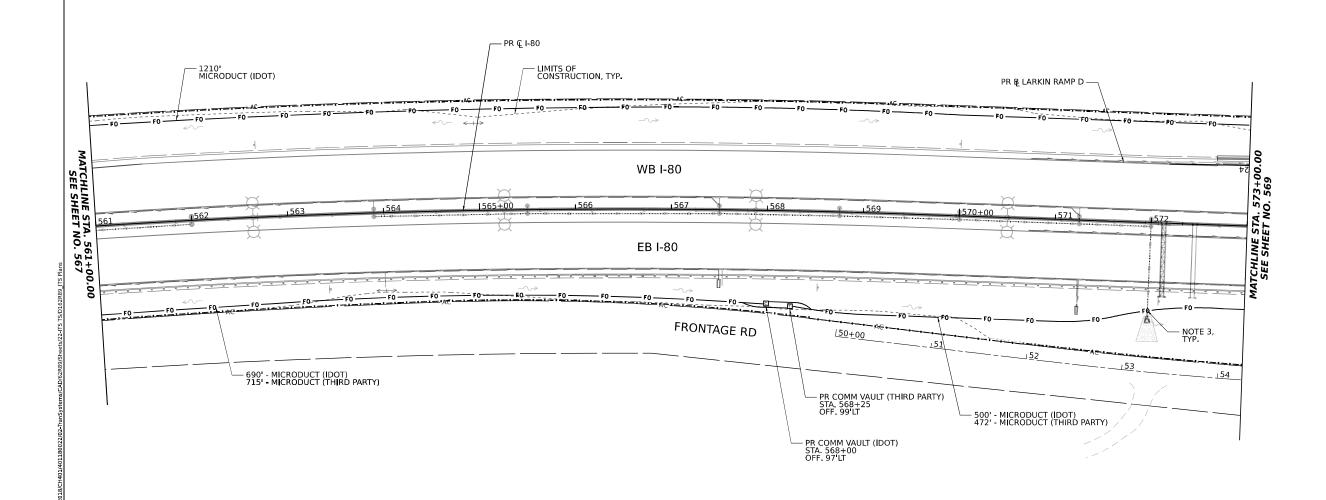- IDOT MICRODUCT SHALL ONLY ENTER IDOT COMMUNICATIONS VAULTS.
  THIRD PARTY MICRODUCT SHALL ONLY ENTER THIRD PARTY COMMUNICATION VAULTS.
  COORDINATE INSTALLATION WITH DRAINAGE. MAINTAIN MINIMUM 18" CLEARANCE
  BETWEEN ITS MICRODUCT/CONDUIT AND DRAINAGE PIPES/STRUCTURES/UNDERDRAIN,
  TYP.

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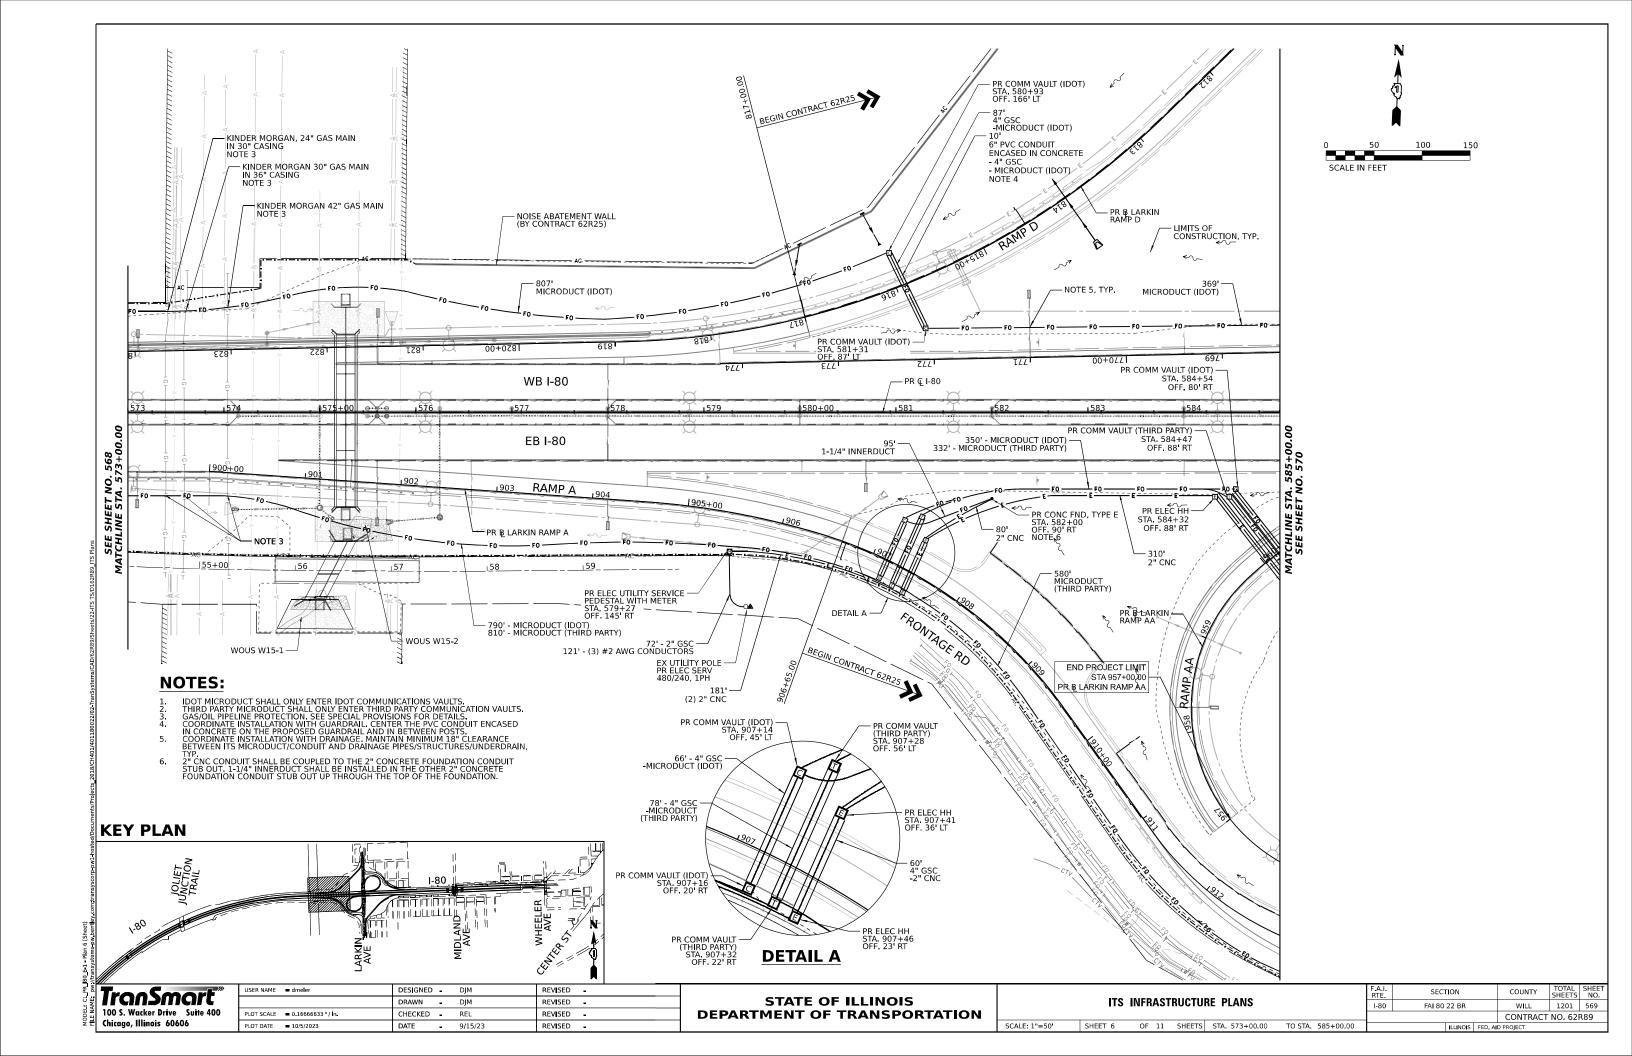
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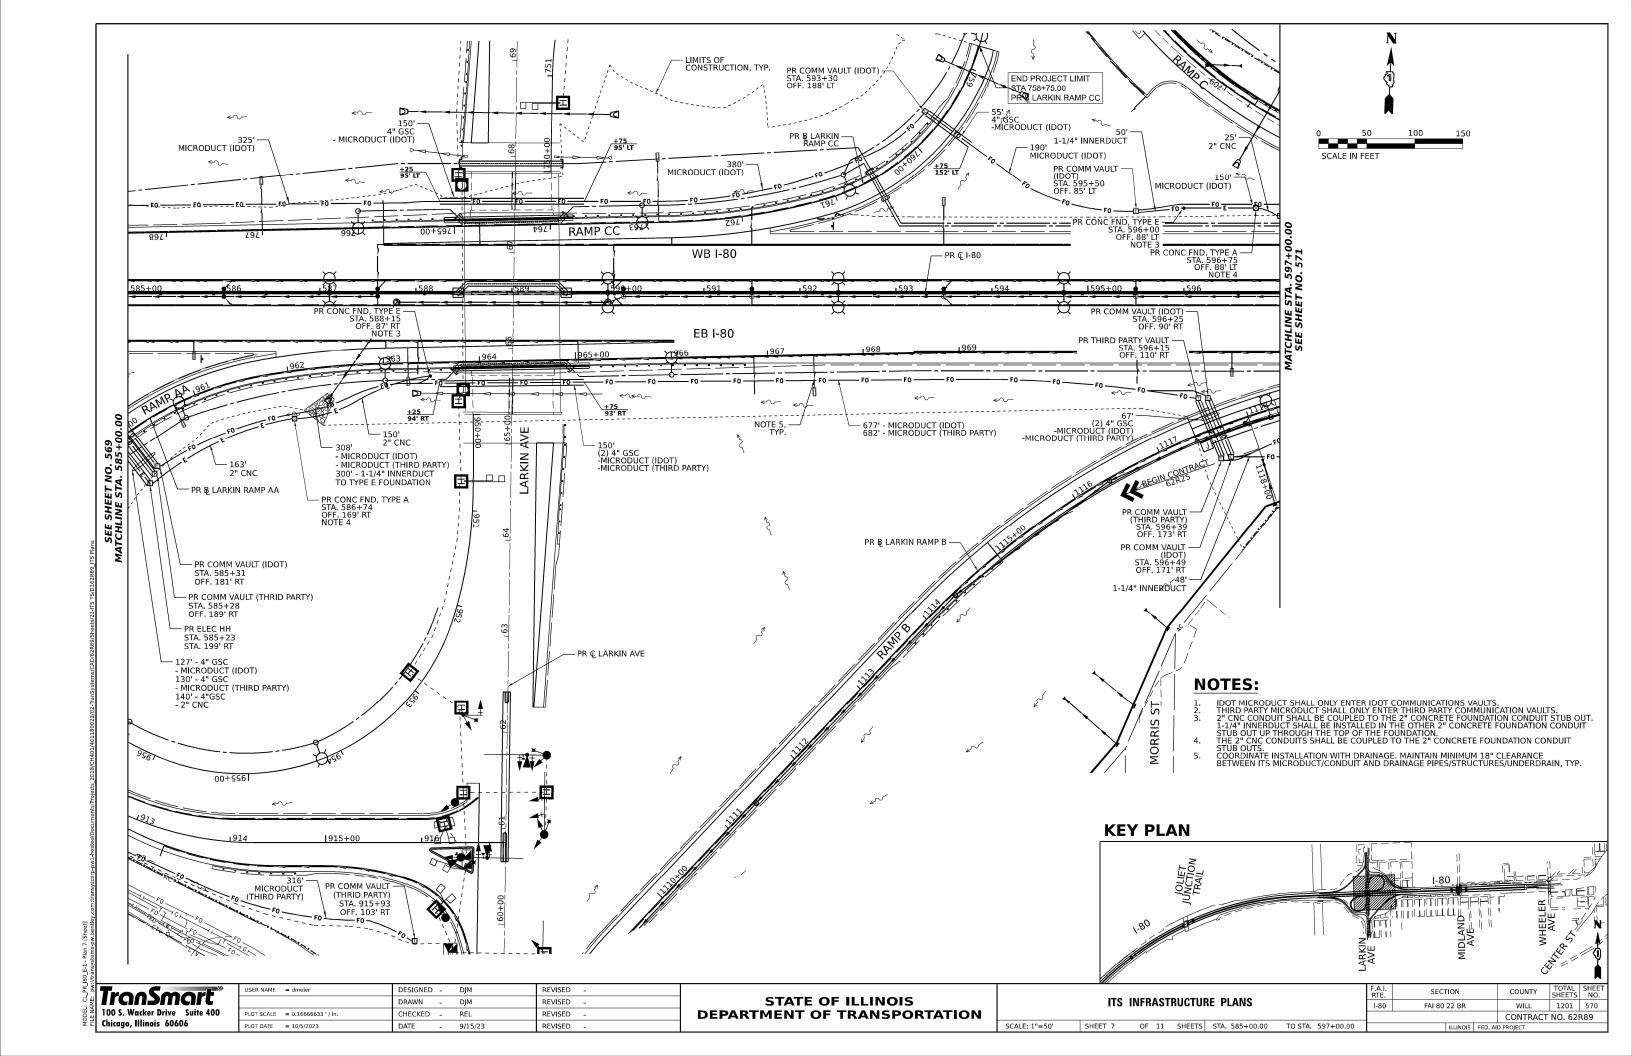
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MODEL FILE NA	Transmart  100 S. Wacker Drive Suite 400 Chicago, Illinois 60606


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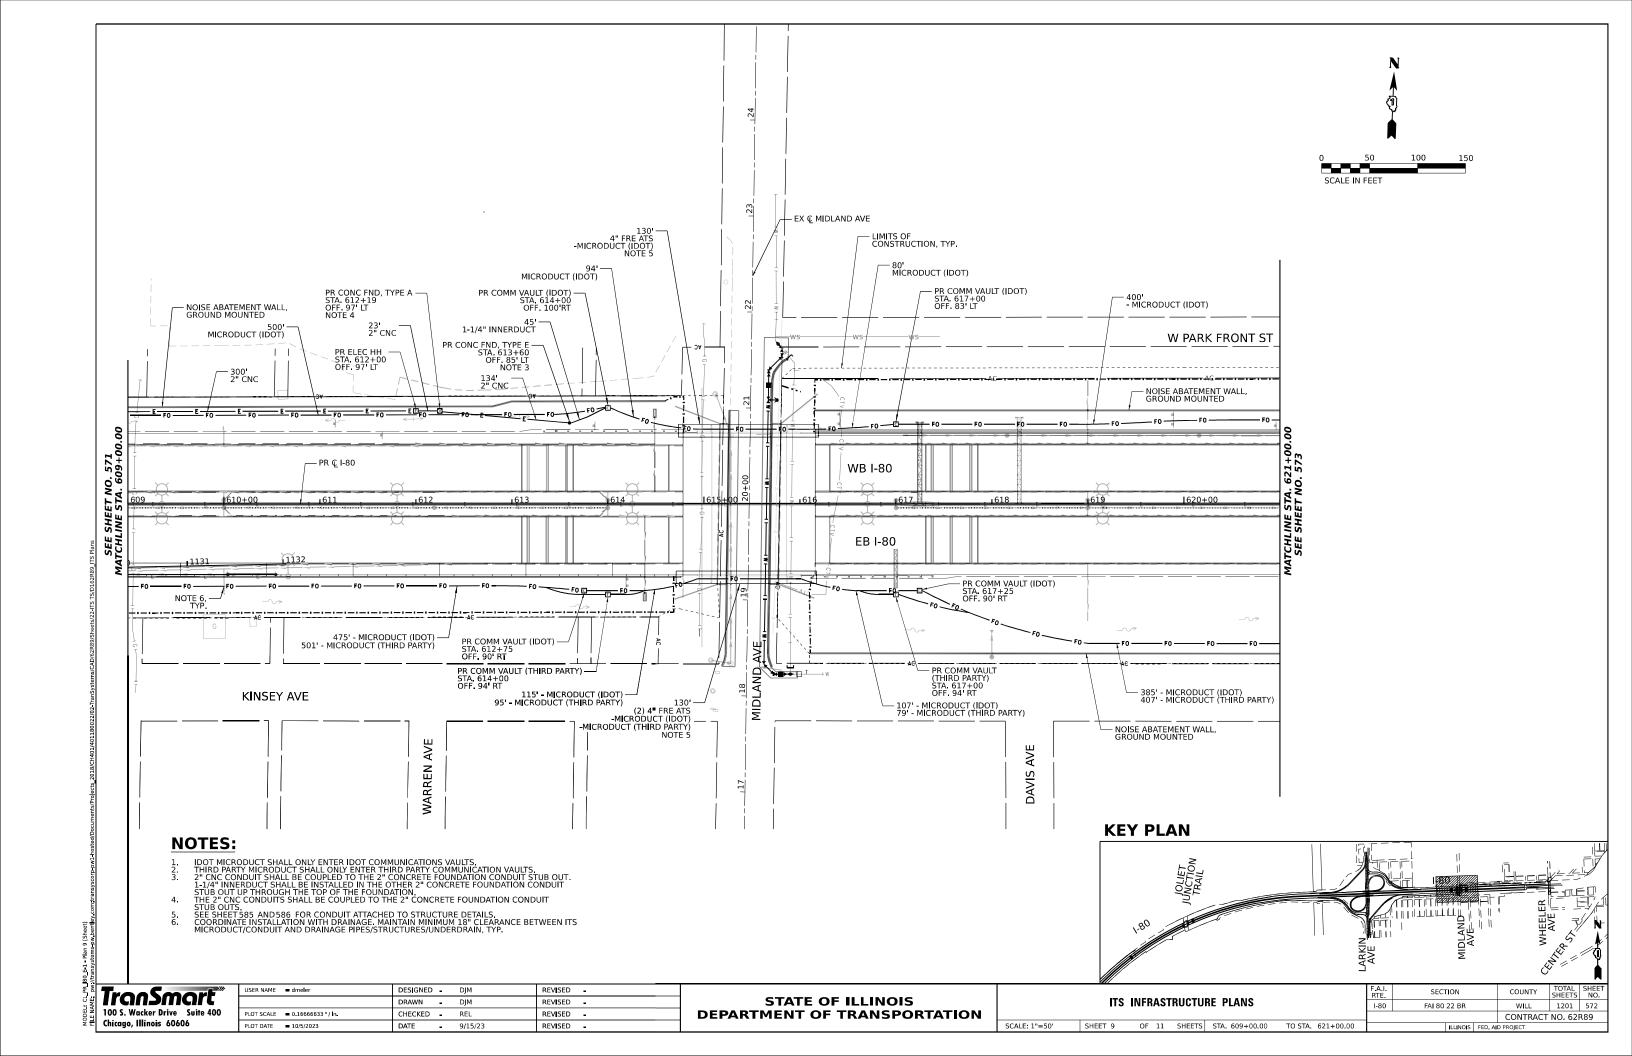
STATE OF ILLINOIS DEPARTMENT OF TRANSPORTATION


								F.A.I. RTE	SECTION		COUNTY	TOTAL SHEETS	SHEET NO.
ITS INFRASTRUCTURE PLANS							I-80	FAI 80 22 BR		WILL	1201	568	
								CONTRACT NO. 62R89					
SCALE: 1"=50'	SHEET 5	OF	11	SHEETS	STA. 561+00.00	TO STA.	573+00.00	ILLINOIS FED. AID PROJECT					









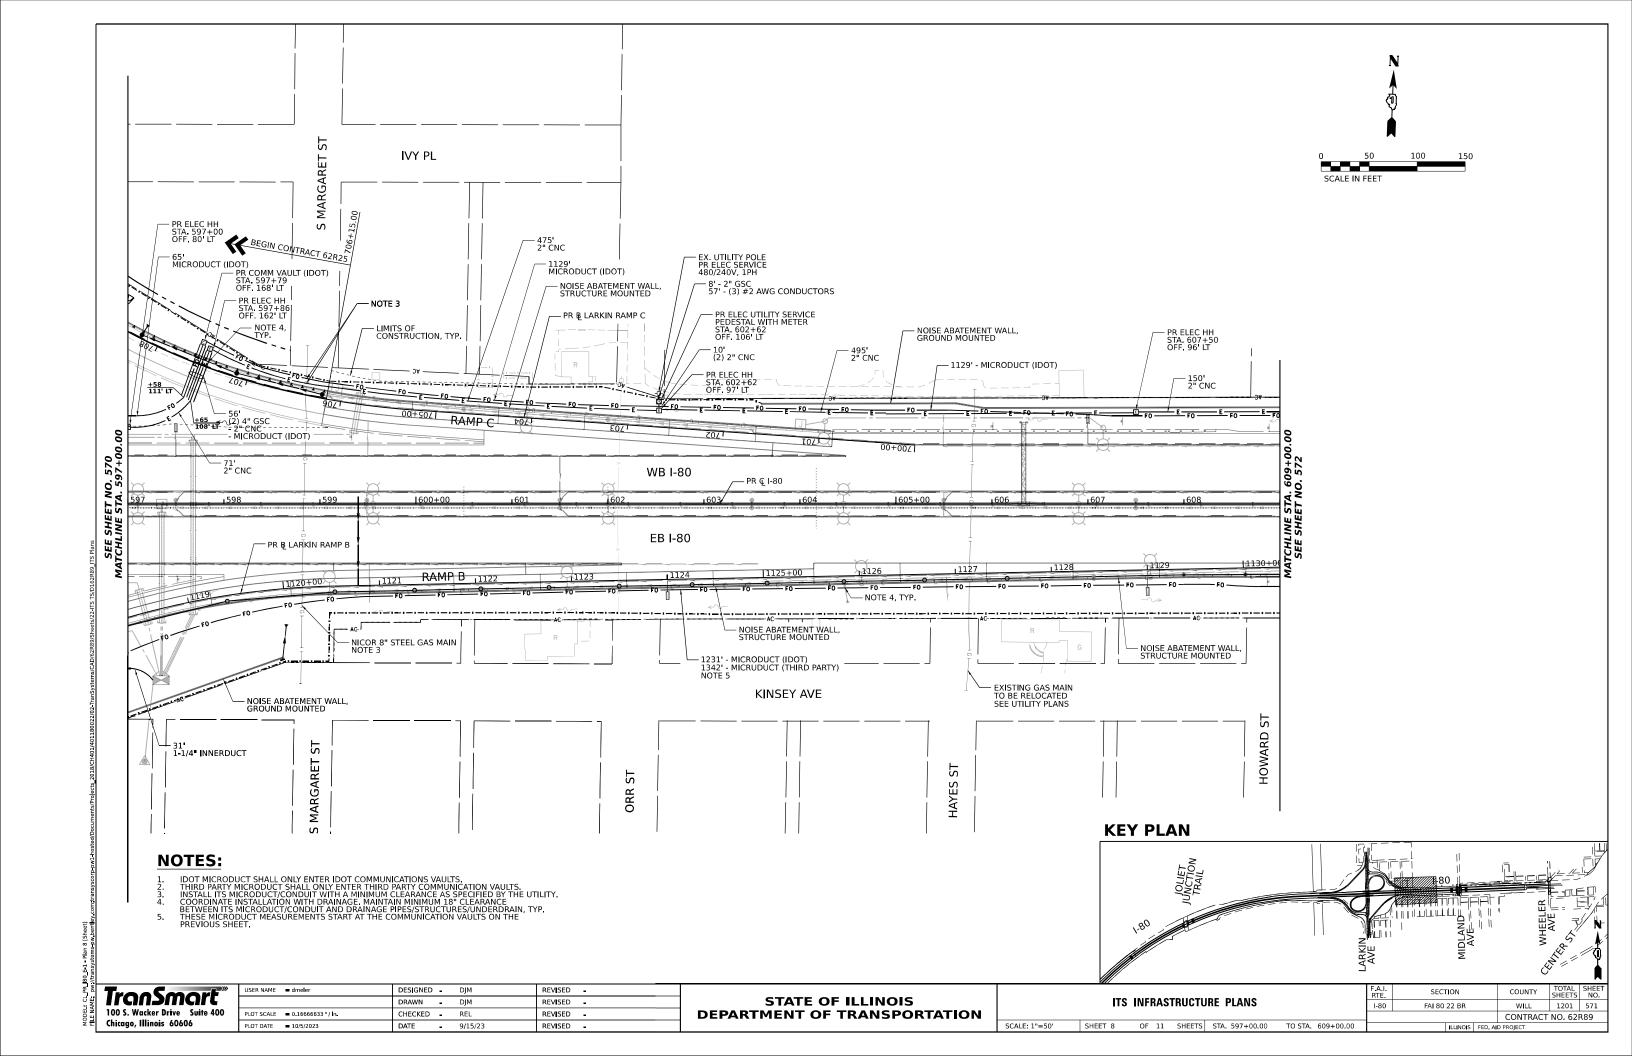

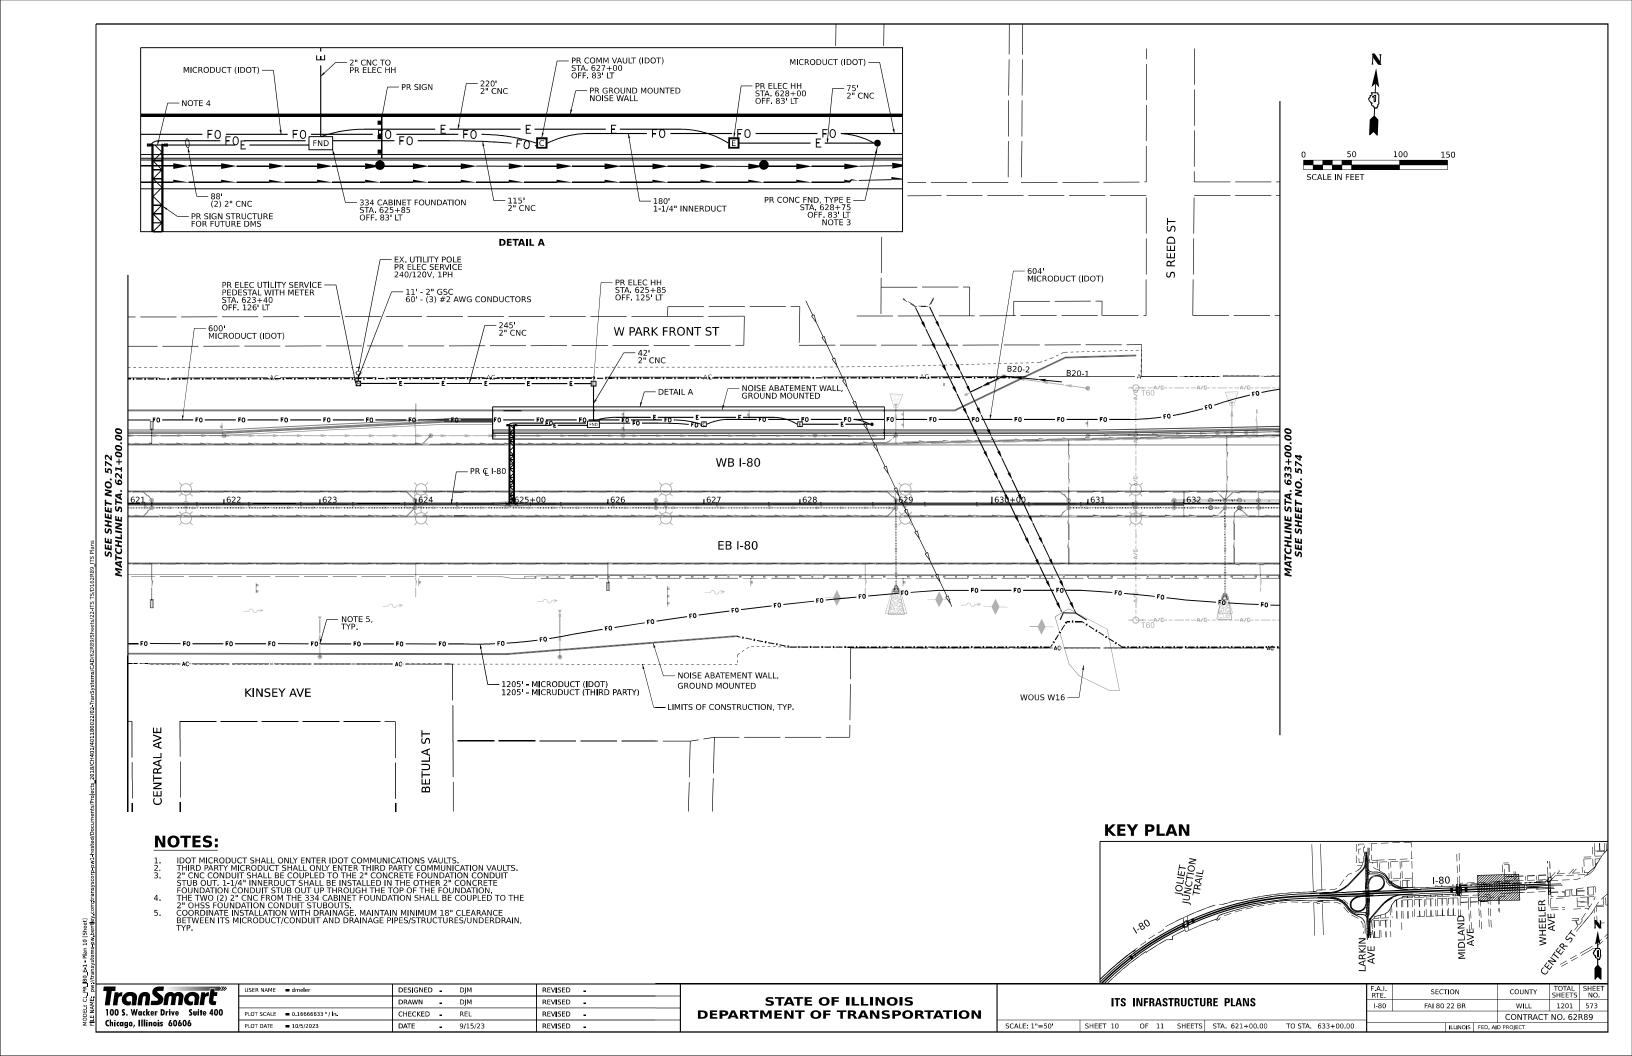

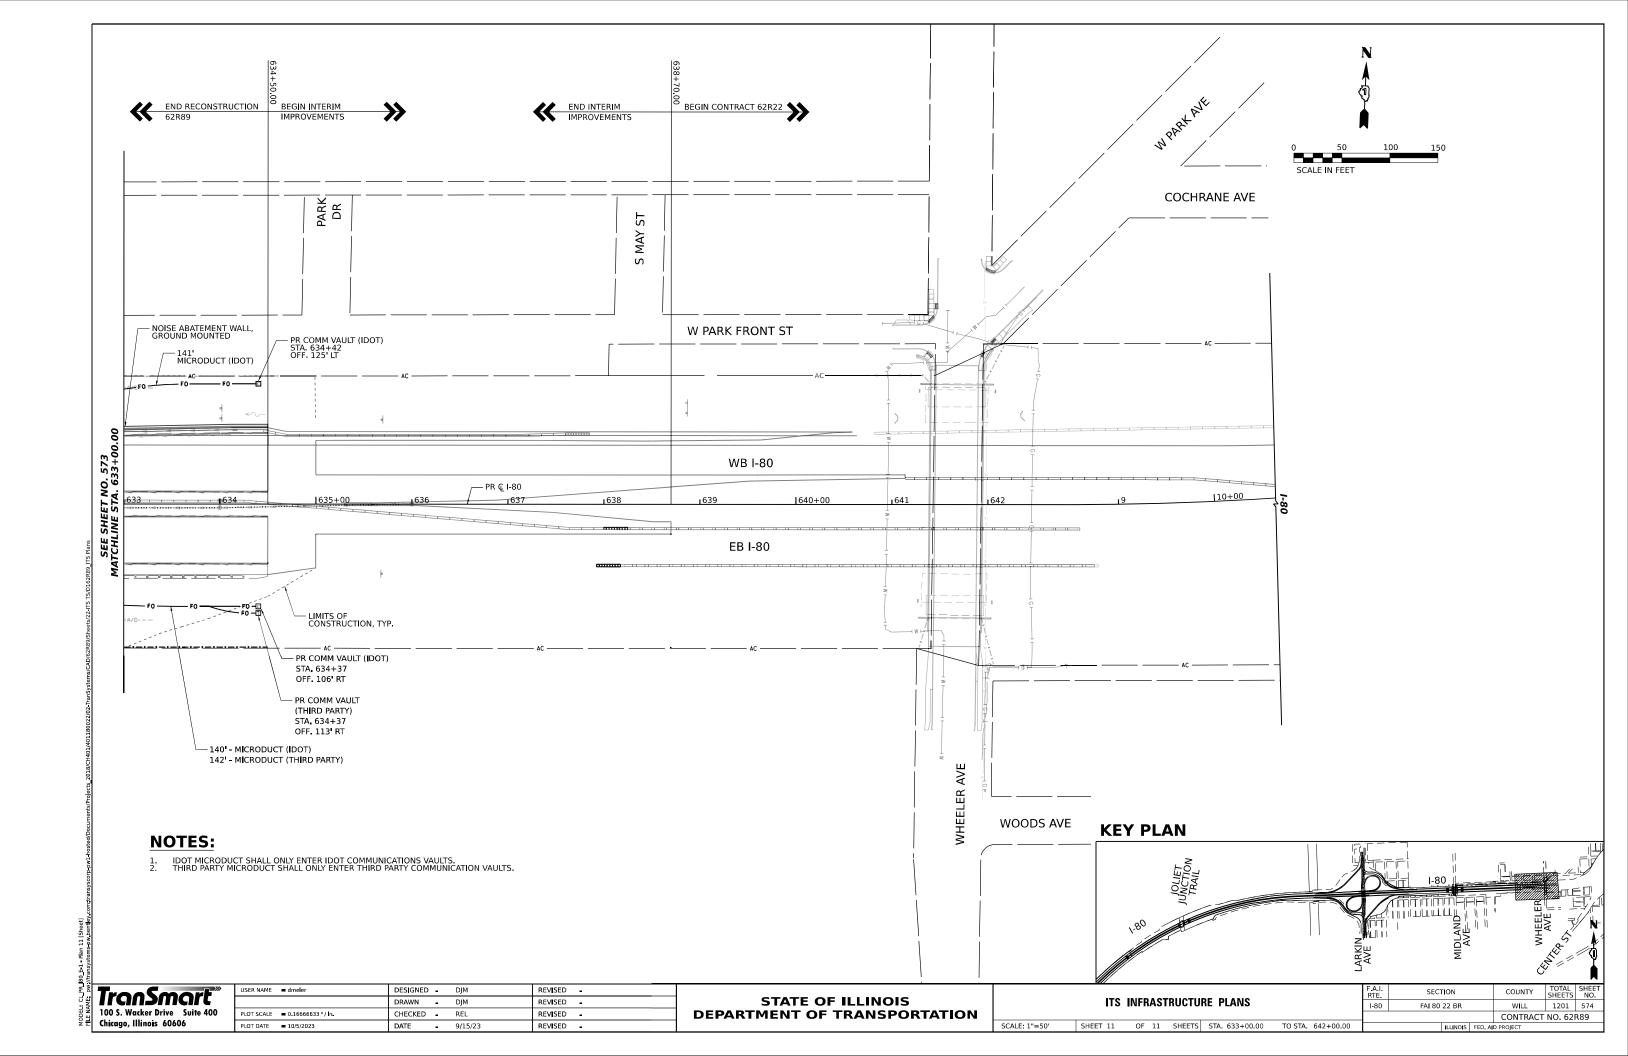


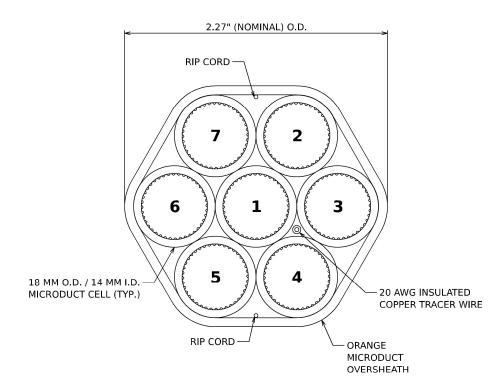

### **IDOT MICRODUCT DETAIL**

CELL NO.	CELL COLOR	CELL ALLOCATION
1	BLUE	FUTURE 144 IDOT (TCF)
2	ORANGE	FUTURE 144 IDOT (DCF)
3	GREEN	SPARE
4	BROWN	SPARE
5	GREY	SPARE
6	WHITE	SPARE
7	RED	SPARE

### **IDOT MICRODUCT CELL INFORMATION**

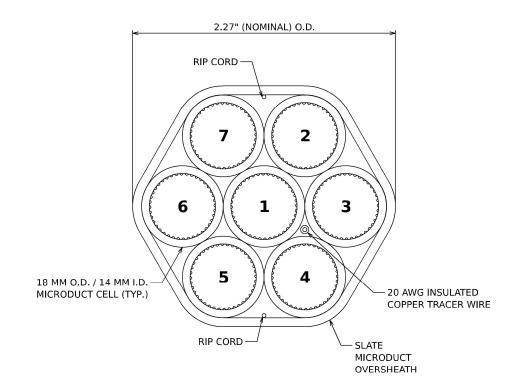

### THIRD PARTY MICRODUCT DETAIL

CELL NO.	CELL COLOR	CELL ALLOCATION
1	BLUE	FUTURE 144 THIRD PARTY
2	ORANGE	SPARE
3	GREEN	SPARE
4	BROWN	SPARE
5	GREY	SPARE
6	WHITE	SPARE
7	RED	SPARE


### THIRD PARTY MICRODUCT CELL INFORMATION



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SCALE: NONE


	_						F.A.I. RTE.				COUNTY	TOTAL SHEETS	SHEET NO.	
	ITS INFRASTRUCTURE DETAILS							I-80	FAI 80 22 BR			WILL	1201	575
												CONTRACT	NO. 62	२८९
	SHEET :	1 /	OF	13	SHEETS	STA.	TO STA.			ILLINOIS	FED. AI	D PROJECT		

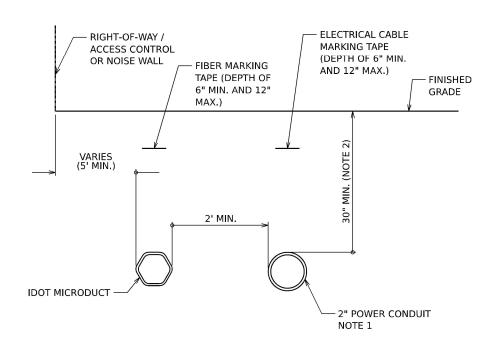


## I-80 WESTBOUND TYPICAL CONDUIT SECTION

### NOTES

- 1. INSTALLATION CONFIGURATION/QUANTITY OF POWER CONDUITS VARIES BY LOCATION.
- 2. GREATER DEPTH MAY BE REQUIRED IN CERTAIN SITUATIONS, INCLUDING, BUT NOT LIMITED TO: ENTERING HANDHOLES/VAULTS, UTILITY AVOIDANCE, CROSSING BENEATH BOX CULVERTS.

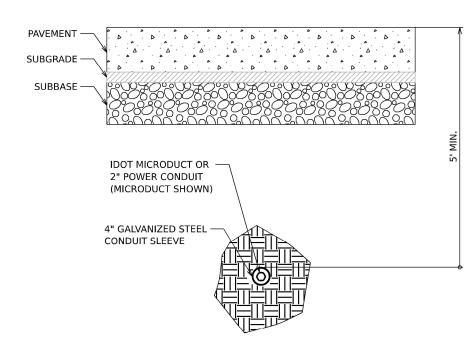


### **BORED CONDUIT UNDER ROADWAY**

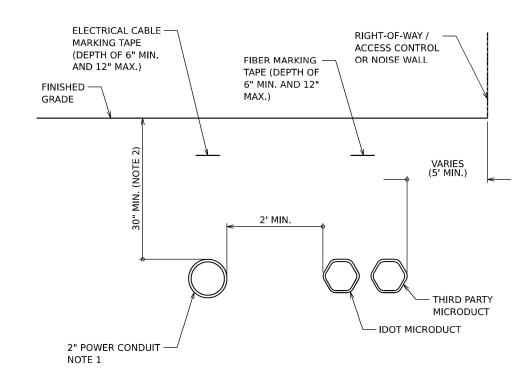

# I-80 EASTBOUND TYPICAL CONDUIT SECTION

### NOTES

- 1. INSTALLATION CONFIGURATION/QUANTITY OF POWER CONDUITS VARIES BY LOCATION.
- GREATER DEPTH MAY BE REQUIRED IN CERTAIN SITUATIONS, INCLUDING, BUT NOT LIMITED TO: ENTERING HANDHOLES/VAULTS, UTILITY AVOIDANCE, CROSSING BENEATH BOX CULVERTS.

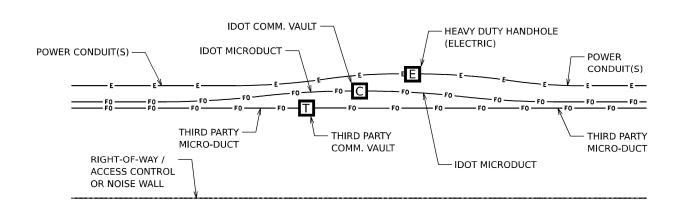

### TYPICAL CONDUIT ROUTING AT HANDHOLES

### NOTES


- INSTALLATION CONFIGURATION/QUANTITY OF POWER CONDUITS VARIES BY LOCATION AND ROADWAY DIRECTION.
   EASTBOUND DIRECTION SHOWN ABOVE WITH POWER CONDUIT, IDOT MICRODUCT, AND THIRD PARTY MICRODUCT.
- 2. IDOT MICRODUCT SHALL ENTER IDOT COMMUNICATIONS VAULTS ONLY.
- B. THIRD PARTY MICRODUCT SHALL ENTER THIRD PARTY COMMUNICATIONS VAULTS ONLY.


# Transmart\*\* 100 S. Wacker Drive Suite 400 Chicago, Illinois 60606

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DEPARTMENT OF TRANSPORTATION									

	F.A.I. RTE. SECTION				COUNTY TOTA		SHEET NO.							
	ITS INFRASTRUCTURE DETAILS								I-80 FAI 80 22 BR			WILL	1201	576
					CONTRACT	NO. 621	389							
SCALE: NONE	SHEET 2	OF	13	SHEETS	STA.	TO STA.		ILLINOIS FED. AID PROJECT						



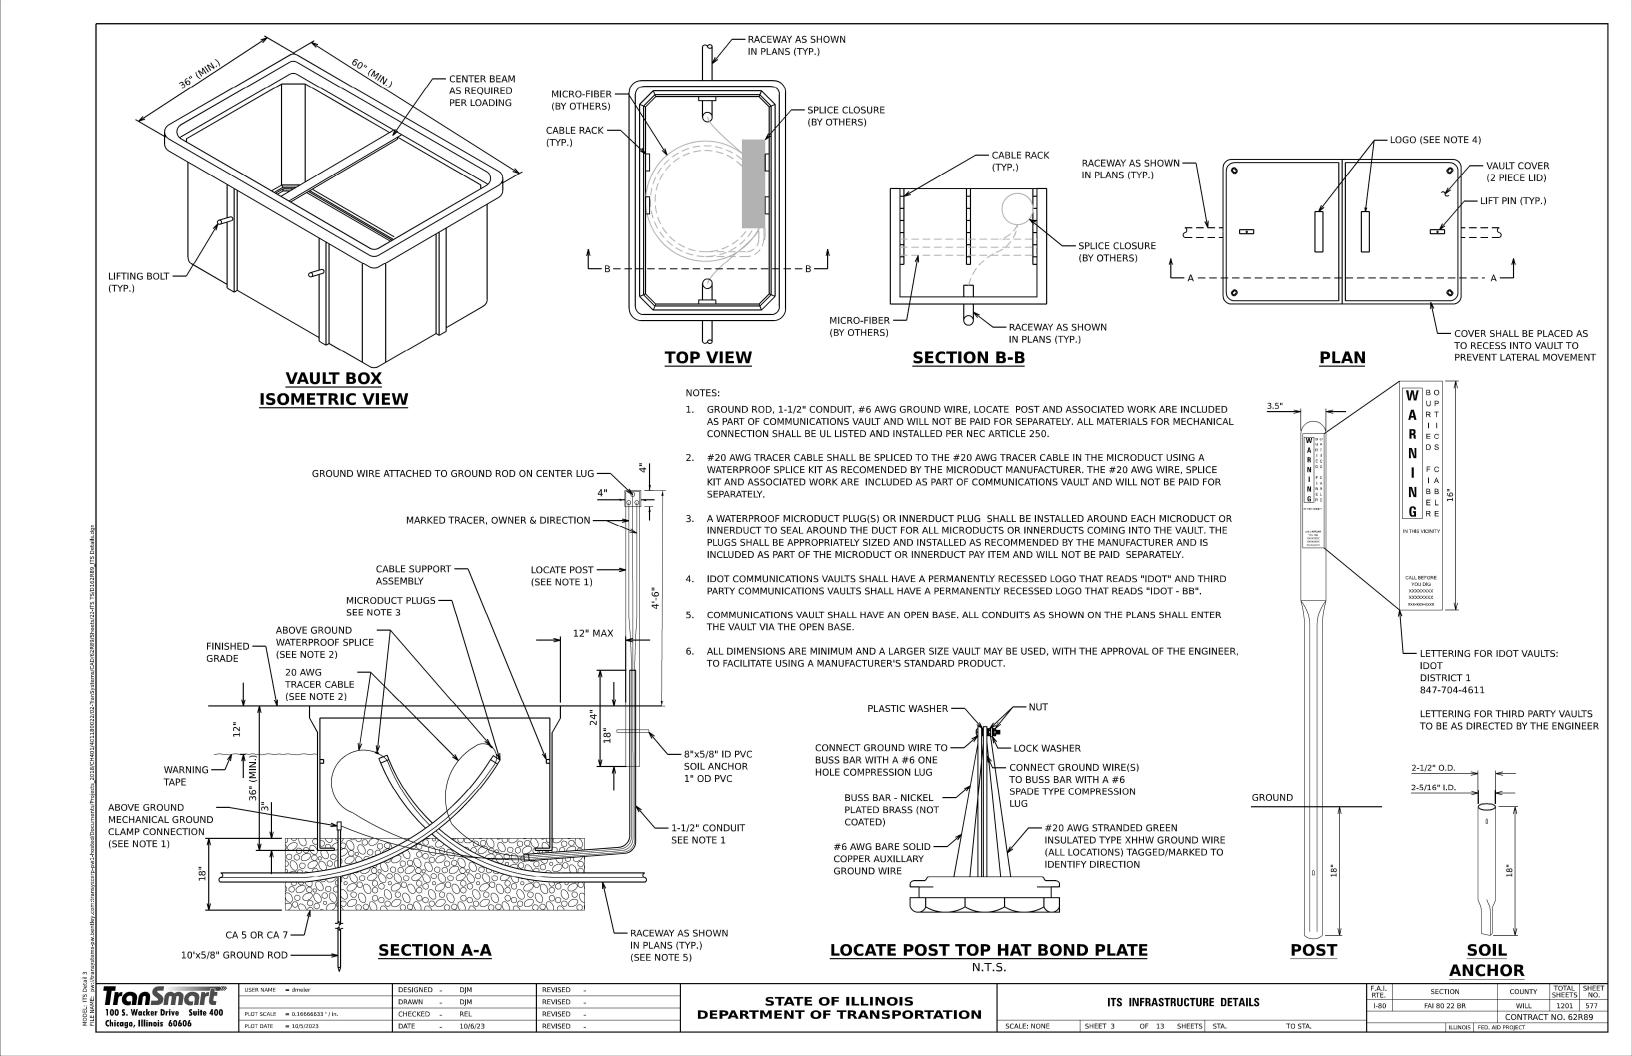
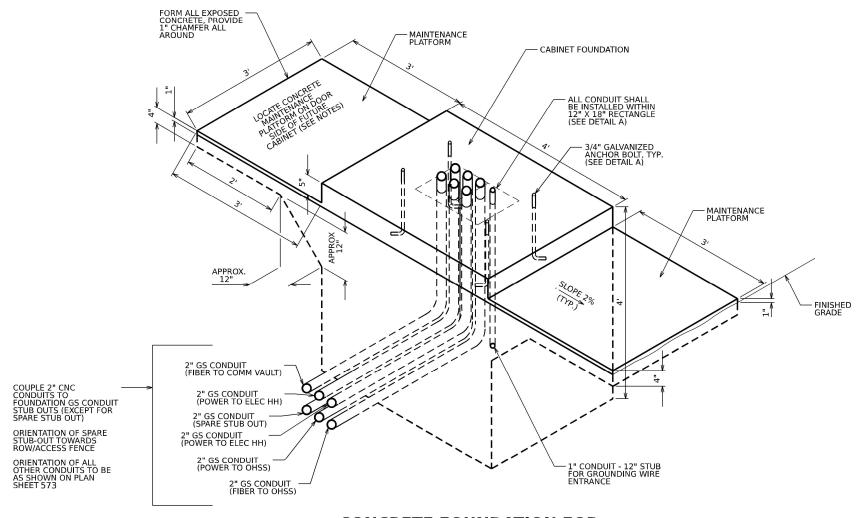
# FUTURE 334 FOUNDATION MOUNTED CABINET (BY OTHERS) ANCHOR BOLT, TYP. (SEE DETAIL A) FINISHED GRADE 1" CONDUIT - 12" STUB FOR GROUNDING WIRE ENTRANCE NUMBER AND SIZE OF CONDUITS AS SHOWN ON DETAIL TO LEFT

# CONCRETE FOUNDATION FOR SURVEILLANCE CABINET MODEL 334 ELEVATION VIEW

# 3' ALL CONDUIT SHALL BE INSTALLED WITHI 12" X 18" RECTANGL 12" X 18" RECTANGL 12" ANCHOR BOLT (TYP.)

DETAIL A
CABINET FOUNDATION
ANCHOR BOLT AND
CONDUIT LAYOUT

### CONCRETE FOUNDATION FOR SURVEILLANCE CABINET MODEL 334 ELEVATION VIEW

### NOTES

- .. INSTALL FOUR 3/4 INCH DIAMERTER X 12 INCH MINIMUM LENGTH APPROVED J-BOLTS TO ANCHOR THE FUTURE CABINET BASES. THE ANCHOR BOLTS SHALL BE HOT-DIPPED GALVANIZED STEEL AND LOCATED AS SHOWN IN DETAIL A.
- CONTROL CABINET BASE TOP SURFACES SHALL BE TROWEL FINISHED AND LEVEL, LEVELING OF TOP SURFACES
  AFTER CONCRETE BASE HAS CURED SHALL ONLY BE ACCOMPLISHED BY GRINDING.
- 3. MAINTENANCE PLATFORMS ARE NOT REQUIRED WHEN THE SURROUNDING AREA IS PAVED.
- CONCRETE FORM DEPTH BELOW FINISHED GRADE SHALL BE 6" MAXIMUM. CONCRETE FORMS SHALL BE REMOVED
  AFTER CONCRETE HAS SET.
- 5. CONCRETE MAINTENANCE PLATFORM AND CABINET FOUNDATION FOR CABINET SHALL BE MONOLITHIC POUR.
- WHEN REQUIRED TO CONNECT NONMETALLIC CONDUIT TO METALLIC CONDUIT, ONLY ADAPTER FITTINGS, U.L. LISTED FOR ELECTRICAL USE, SHALL BE USED.
- . CONDUIT HEIGHT ABOVE THE CONCRETE BASE SHALL BE 3 INCHES.
- 8. MINIMUM BENDING RADIUS OF CONDUIT = 6 X THE DIAMETER
- 9. ALL METALLIC CONDUIT ENDS SHALL BE REAMED AND THREADED.

- 10. CAP ALL BELOW GRADE METALLIC CONDUIT ENDS IN WHICH WIRE OR CABLE IS NOT BEING INSTALLED.
- 11. PLUG ALL BELOW GRADE NONMETALLIC CONDUIT ENDS IN WHICH WIRE OR CABLE IS NOT BEING INSTALLED.
- 12. ALL CONDUIT ENDS AT THE TOP OF CONCRETE BASES SHALL BE CAPPED IF METALLIC OR PLUGGED IF NONMETALLIC IMMEDIATELY AFTER PLACEMENT AND BEFORE CONCRETE IS POURED. CONDUITS IN WHICH WIRE OR CABLE IS NOT BEING INSTALLED SHALL REMAIN CAPPED OR PLUGGED.
- 13. ALL METALLIC CONDUIT ENDS AT TOP OF CONCRETE BASES SHALL BUSHINGS AND ALL NONMETALLIC CONDUIT ENDS AT TOP OF CONCRETE BASES SHALL HAVE END BELLS.
- 14. REFER TO SPECIAL PROVISIONS FOR ADDITIONAL REQUIREMENTS.
- 15. THE CONTRACTOR SHALL INSTALL INSULATED BUSHINGS AND DUCT SEALANT AT ALL CONDUIT BEND TERMINATIONS IN FOUNDATIONS.
- 16. CONCRETE BASE TO BE FORMED AT LEAST 6" ABOVE THE GROUND SURFACE.

SCALE: NONE

SHEET

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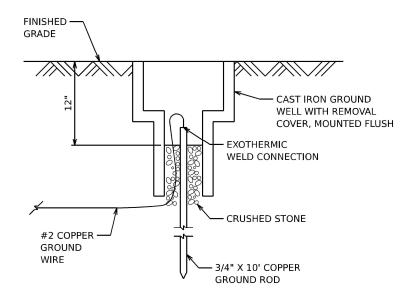
STATE OF ILLINOIS DEPARTMENT OF TRANSPORTATION

ITC INFRACTRUCTURE DETAILS							F.A.I. RTE.	SECT	ΓΙΟΝ		COUNTY	TOTAL SHEETS	SHEET NO.
ITS INFRASTRUCTURE DETAILS				1-80	FAI 80 22 BR			WILL	1201	578			
											CONTRACT	NO. 62	₹89
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# DMS SIGN STRUCTURE GROUNDING DETAIL

### **NOTES**

- 1. THE COST FOR GROUNDING OF THE DMS SIGN STRUCTURE SHALL BE INCLUDED AND PAID AS PART OF THE OVERHEAD SIGN STRUCTURE PAY ITEM.
- 2. CONTRACTOR SHALL TERMINATE THE GROUND COPPER WIRE TO OHSS GROUND LUG USING APPROVED CLAMPS FOR GROUNDING.
- 3. ONLY STUB OUT CONDUITS FOR GROUNDING SHOWN. OTHER CONDUITS FOR POWER OR COMMUNICATIONS ARE NOT SHOWN FOR CLARITY.




### **GROUND WELL DETAIL**

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STATE OF ILLINOIS DEPARTMENT OF TRANSPORTATION

SCALE: NONE

	F.A.I. SECTION			COUNTY	TOTAL SHEETS	SHEET NO.					
ITS INFRASTRUCTURE DETAILS						FAI 80 22 BR			WILL	1201	579
									CONTRAC	NO. 62	R89
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### **SERVICE PEDESTAL WITH METER**

### NOTI

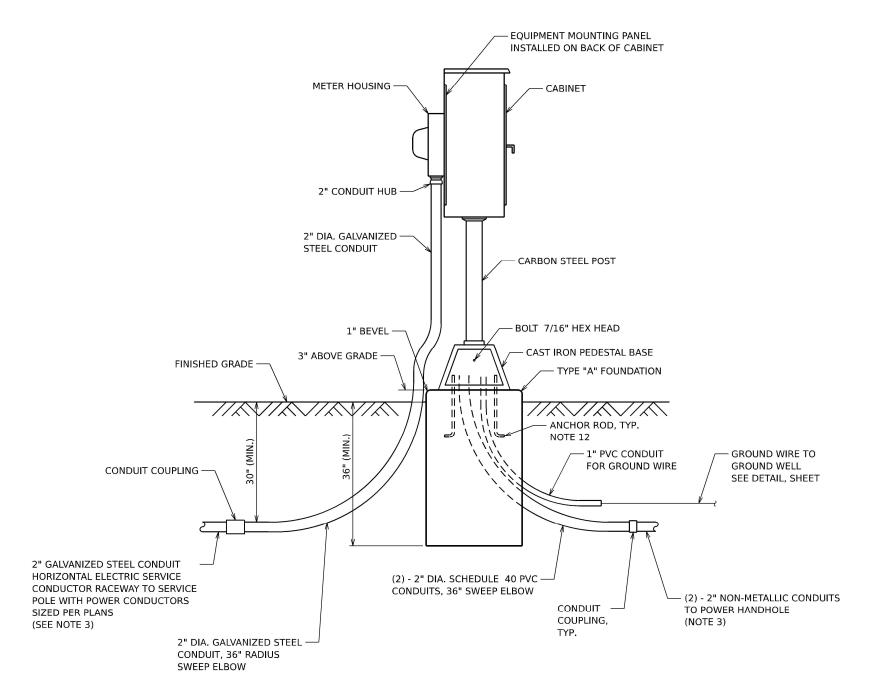SCALE: NONE


- 1. SERVICE VOLTAGE SHALL BE AS INDICATED ELSEWHERE IN THE DRAWINGS.
- 2. UNLESS OTHERWISE INDICATED, ALL ITEMS AND WORK SHOWN SHALL BE INCLUDED AND PAID AS PART OF THE ELECTRIC UTILITY SERVICE INSTALLATION PAY ITEM.
- 3. THE HORIZONTAL ELECTRIC SERVICE CONDUCTOR RACEWAY/CONDUCTORS AND NON-METALLIC CONDUITS TO POWER HANDHOLE SHALL BE MEASURED SEPARATELY FOR PAYMENT.
- 4. CABINETS, CABINET POSTS AND CABINET PEDESTALS SHALL BE PRIMED AND PAINTED. THE EXTERIOR SHALL HAVE TWO EPOXY FINISH COATS OF ANSI-61 GRAY. THE INTERIOR SHALL BE PAINTED WHITE.
- 5. METER HOUSING SHALL BE MOUNTED TO BACK WALL OF CABINET. PROVIDE A GATE IN ROW FENCE TO ALLOW UTILITY ACCESS TO READ THE METER.
- CABLES FROM METER HOUSING SHALL PASS THROUGH BACK WALL OF CABINET.
- 7. METER HOUSING SHALL BE AS REQUIRED BY THE UTILITY.
- 8. THE CABINET SHALL BE 36"H X 20"W X 15"D, FABRICATED FROM ALUMINUM WITH A MINIMUM THICKNESS OF .125", RATED NEMA TYPE 3R AND HAVE A MOUNTING BACK PLATE.
- THE CABINET DOOR SHALL HAVE A CONTINUOUS HINGE THAT IS BOLTED TO THE CABINET AND DOOR WITH 1/4-20 STAINLESS STEEL CARRIAGE BOLTS AND NY-LOCK NUTS. THE HINGE SHALL BE INSTALLED ON THE RIGHT SIDE WHEN FACING THE CABINET AND BE MADE OF STAINLESS STEEL WITH A 0.25 INCH DIAMETER STAINLESS STEEL HINGE PIN. THE HINGE PIN SHALL BE CAPPED TOP AND BOTTOM BY WELD TO RENDER IT TAMPER-PROOF. THE CABINET SHALL HAVE A GASKET THAT FORMS A WEATHER-TIGHT SEAL BETWEEN THE CABINET AND DOOR. THE DOOR LATCHING MECHANISM SHALL BE THE 3-POINT DRAW ROLLER TYPE. WHEN THE DOOR IS CLOSED AND LATCHED, IT WILL BE LOCKED. THE LATCHING HANDLE SHALL BE FABRICATED FROM A 0.75" STAINLESS STEEL ROUND BAR AND SHALL HAVE A PROVISION FOR PADLOCKING IN THE CLOSED POSITION.
- 10. THE ENCLOSURE SHALL BE EQUIPPED WITH TWO ADJUSTABLE "C" MOUNTING CHANNELS WELDED ON BOTH SIDE WALLS AND BACK WALL OF THE ENCLOSURE, ALLOWING VERSATILE POSITIONING OF SHELVES OR PANELS. MOUNTING CHANNELS SHALL BE FACTORY PAINTED SAME COLOR AS INTERIOR OF CABINET.
- 11. CABINET DOOR SHALL NOT HAVE COMPARTMENT DOORS OR LOUVERS. INTERIOR OF CABINET DOOR SHALL HAVE A PLASTIC POCKET FOR WIRING SCHEMATIC.
- 12. CONTRACTOR MUST COORDINATE WITH PEDESTAL BASE SUPPLIER AND FURNISH THE NECESSARY ANCHOR RODS.
- 13. THE ELECTRIC SERVICE EQUIPMENT ASSEMBLY SHALL BE ASSEMBLED BY A UL 508A INDUSTRIAL CONTROL PANEL FABRICATOR. THE PANEL ASSEMBLY SHALL BE UL LABELED AND SUITABLE FOR USE AS SERVICE FOLIPMENT.
- 14. ALL EQUIPMENT SHALL BE GROUNDED AND BONDED IN ACCORDANCE WITH THE NATIONAL ELECTRICAL CODE AND THE NATIONAL ELECTRICAL SAFETY CODE.
- 15. PLANS AND DETAILS INDICATE THE GENERAL NATURE AND REQUIREMENTS. THEY DO NOT SHOW EVERY ACCESSORY AND ATTACHMENT, AND THEY DO NOT RELIEVE THE CONTRCTOR OF THE REQUIREMENTS OF THE SPECIFICATIONS AND SPECIAL PROVISIONS TO ASCERTAIN UTILITY REQUIREMENTS AND TO COORDINATE ACCORDINGLY. FURNISHING ALL ITEMS AND WORK NOT PROVIDED BY THE UTILITY, BUT NECESSARY FOR A COMPLETE SERVICE INSTALLATION IS REQUIRED AND SHALL BE INCLUDED IN THE ELECTRIC UTILITY SERVICE INSTALLATION PAY ITEM.


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100 S. Wacker Drive Suite 400
Chicago, Illinois 60606


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STATE OF ILLINOIS DEPARTMENT OF TRANSPORTATION

ITC INICHACTRUCTURE RETAILS							SECTION	COUNTY	TOTAL SHEETS	SHEET NO.	
ITS INFRASTRUCTURE DETAILS						I-80	FAI 80 22 BR	WILL	1201	580	
								CONTRACT	NO. 62	R89	
	SHEET 6	OF 13	SHEETS	STA.	TO STA.		ILLINOIS FED, AID PROJECT				



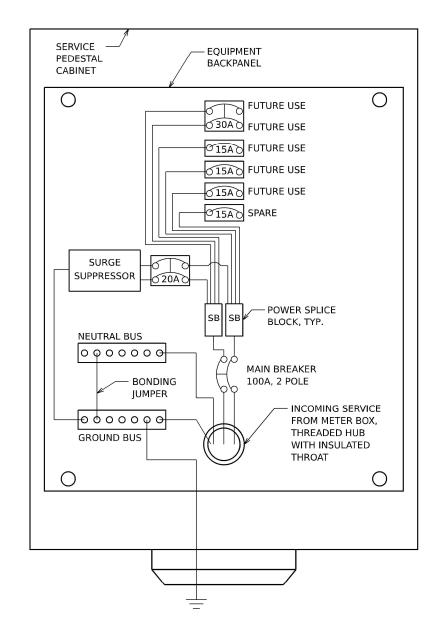

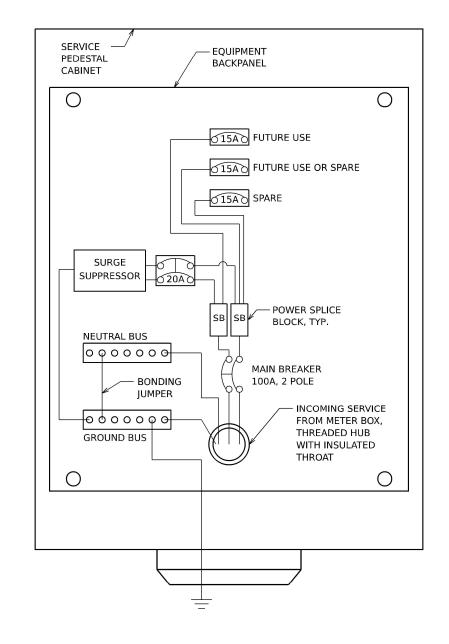
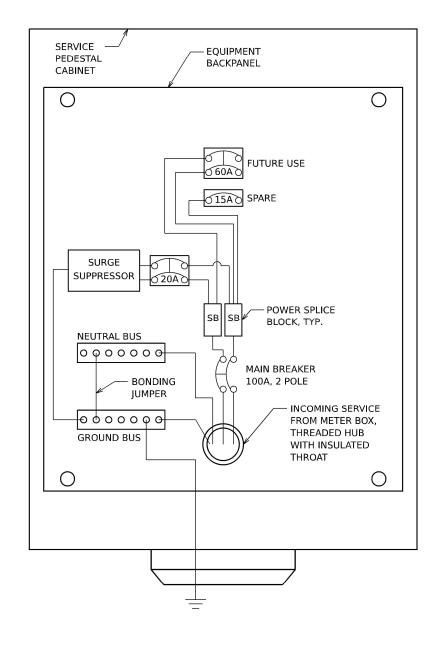
# SERVICE PEDESTAL CABINET WIRING AND EQUIPMENT LAYOUT STA 545+02

# SERVICE PEDESTAL CABINET WIRING AND EQUIPMENT LAYOUT STA 579+44 & 602+53

# AND EQUIPMENT LAYOUT STA 622+00

### **NOTES**

- THE ELECTRIC SERVICE EQUIPMENT ASSEMBLY SHALL BE UL LABELED, SUITABLE FOR USE AS SERVICE
  EQUIPMENT.
- CIRCUIT BREAKERS SHALL BE THERMAL MAGNETIC BOLT-ON TYPE WITH A MINIMUM INTERRUPTING CAPACITY
  OF 15,000 SYMETRICAL AMPERES AT 240 VOLTS MINIMUM. THEY SHALL BE LOCKABLE IN THE "OFF" POSITION
  FOR COMPLIANCE WITH OSHA LOCK-OUT/TAG-OUT REQUIREMENTS. HANDLES SHALL BE TRIP FREE.
- 3. THE SURGE PROTECTOR SHALL BE SUITABLE FOR 240 / 480 VOLT SINGLE PHASE 60HZ AC ELECTRICAL SERVICE, WITH A SURGE CURRENT RATING OF 50,00 AMPS OR BETTER, RATED -40 TO 65 DEGREES C., WITH LED OPERATING IDICATORS, AND SHALL BE UL LISTED PER UL 1449. SURGE PROTECTOR SHALL BE WIRED FOR 240/480 V SERVICE. FOLLOW MANUFACTURER RECOMMENDED WIRING SPECIFICATIONS.
- 4. BUS BARS, CONNECTORS AND LUGS SHALL BE COPPER, INSULATED AND ISOLATED AND CONFIGURED TO PREVENT SHORTED CONDITIONS FROM TIGHTENING TERMINATIONS, ETC. THE OVERALL BUS SECTION SHALL BE CONFIGURED BEHIND AN INSULATING BARRIER SHIELD WHICH IS REMOVABLE FOR ACCESS TO CONNECTIONS.
- 5. THE COMBINATION GROUND AND NEUTRAL BAR SHALL BE CONFIGURED WITH SEPARATE GROUND AND NEUTRAL SECTIONS AND SPARE TERMINALS AS INDICATED, THE HEADS OF GROUND SCREWS SHALL BE PAINTED GREEN. THE HEADS OF NEUTRAL SCREWS SHALL BE PAINTED WHITE.
- 6. A PLASTIC LAMINATED CABINET LAYOUT DIAGRAM, CIRCUIT SCHEMATIC, AND BILL OF MATERIALS WITH CATALOG NUMBERS USED SHALL BE AFFIXED TO THE INTERIOR SIDE OF THE ENCLOSURE DOOR.

SCALE: NONE

7. EQUIPMENT IN DIAGRAM ABOVE IS NOT TO SCALE AND WIRING SCHEMATIC IS DIAGRAMMATIC. CONTRACTOR TO SUBMIT WIRING DIAGRAM AND EQUIPMENT LAYOUT FOR APPROVAL BY THE ENGINEER.



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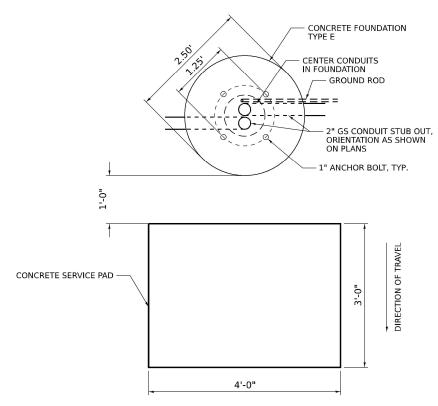
STATE OF ILLINOIS DEPARTMENT OF TRANSPORTATION

	ΙΤ	S INFR	AST	RUCTUF	RE DETAILS	F.A.I. RTE.	SECTION		COUNTY	TOTAL SHEETS	SHEET NO.		
	METER PEDESTAL WIRING							FAI 80 22 BR		WILL	1201	581	
										CONTRACT	NO. 621	₹89	
	SHEET 7	OF	13	SHEETS	STA.	TO STA.		ILLINOIS	FED. AI	D PROIECT			


# TOP VIEW TYPE A FOUNDATION FOR FUTURE SERVICE DISCONNECT

### NOTES

1. TOP VIEW FOR CONCRETE FOUNDATIONS, TYPE A AND E SHOWN ON THIS SHEET ARE FOR INFORMATION ONLY ON CONDUITS ENERTING FOUNDATION AND ANOCHOR BOLT CIRCLE DIMENSIONS REQUIRED FOR FUTURE EQUIPMENT INSTALLATION. FOR FURTHER FOUNDATION DETAILS, SEE HIGHWAY STANDARD 878001-11 (CONCRETE FOUNDATION DETAILS).



# TOP VIEW TYPE E FOUNDATION FOR FUTURE CCTV POLE

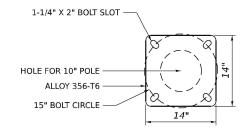

SCALE: NONE

# FUTURE CCTV POLE BASE PLATE DETAIL 15" BOLT CIRCLE (SHOWN FOR REFERENCE ONLY)


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THE PARTIE.	Iransmart
	100 S. Wacker Drive Suite 400
1	Chicago, Illinois 60606

USER NAME = dmeier	DESIGNED	-	DJM	REVISED	-
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PLOT DATE = 10/5/2023	DATE	-	10/6/23	REVISED	-

STATE OF ILLINOIS
DEPARTMENT OF TRANSPORTATION

ITS INFRASTRUCTURE DETAILS						SEC	TION		COUNTY	TOTAL SHEETS	SHEET NO.
CONCRETE FOUNDATIONS					1-80	I-80 FAI 80 22 BR			WILL	1201	582
									CONTRAC	ΓNO. 62	R89
T 8	OF 13	3 SHEETS	STA.	TO STA.			ILLINOIS	FED. AI	D PROJECT		

ITS CONDUIT ATTACHED TO STRUCTURE I-80 WB OVER JOLIET JUNCTION TRAIL **ELEVATION** 

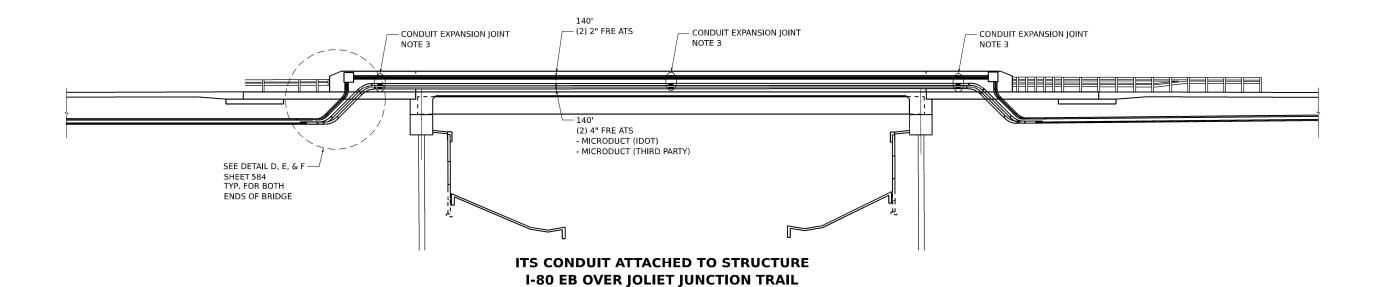

- THIS SHEET IS FOR ITS CONDUIT ATTACHED TO STRUCTURE ONLY. SEE STRUCTURE NO. 099-8320 (EB) AND 099-8321 (WB) SHEETS FOR BRIDGE PLANS.
   CONDUIT SUPPORTS NOT SHOWN FOR CLARITY.
   CONDUIT EXPANSION JOINTS SHALL BE INSTALLED AT EACH END OF THE BRIDGE AND AT ALL BRIDGE EXPANSION JOINT OR INTERIOR FULL-DEPTH PARAPET JOINT LOCATIONS AND PER MANUFACTURER'S RECOMMENDATIONS.

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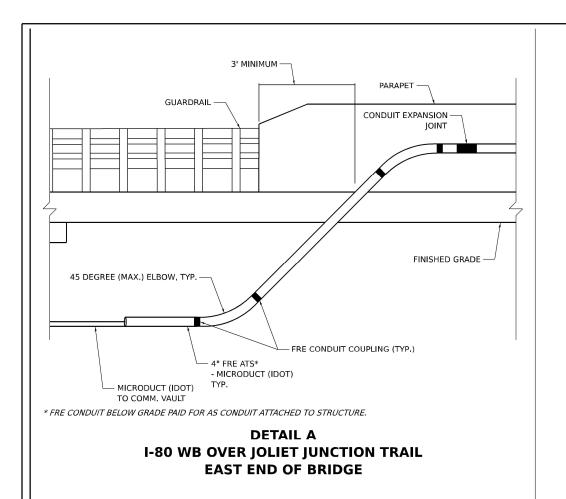
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PLOT DATE = 10/5/2023	DATE - 10/6/23	REVISED -


**STATE OF ILLINOIS DEPARTMENT OF TRANSPORTATION** 


SCALE: NONE

**ELEVATION** 

	ITS INFRASTRUCTURE DETAILS						SEC	TION		COUNTY	TOTAL SHEETS	SHEET NO.
CONDUIT ATS - JOLIET JUNCTION TRAIL						1-80	FAI 80	22 BR		WILL	1201	583
										CONTRACT	NO. 621	R89
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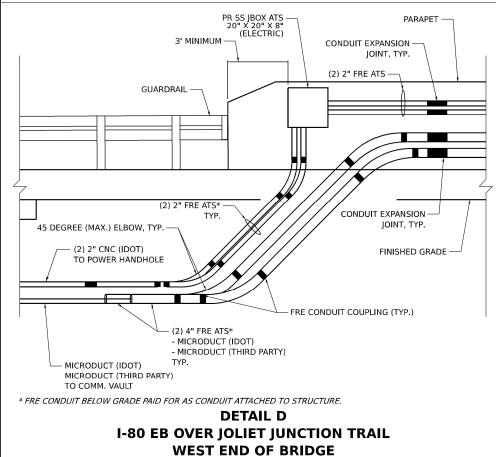





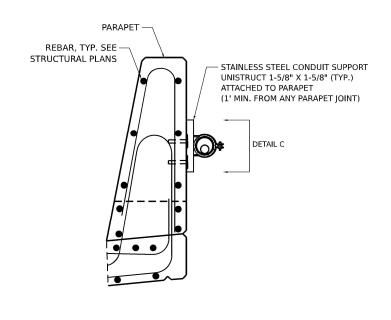

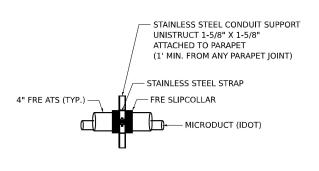
### **DETAIL B** I-80 WB OVER JOLIET JUNCTION TRAIL **BRIDGE PARAPET CROSS SECTION**

**DETAIL C** I-80 WB OVER JOLIET JUNCTION TRAIL TYPICAL CONDUIT SUPPORT DETAIL



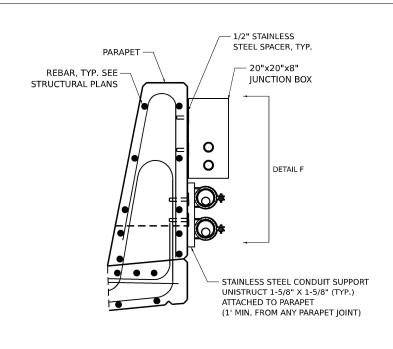



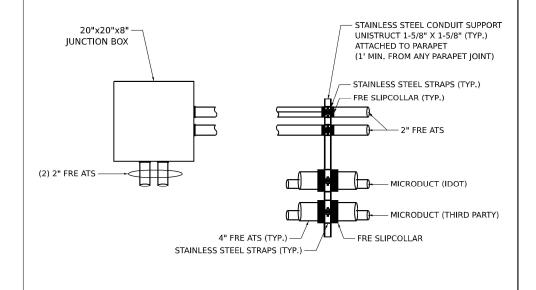

**DETAIL F I-80 EB OVER JOLIET JUNCTION TRAIL** TYPICAL JUNCTION BOX AND CONDUIT SUPPORT DETAIL



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	DRAWN -	JAM	REVISED -	
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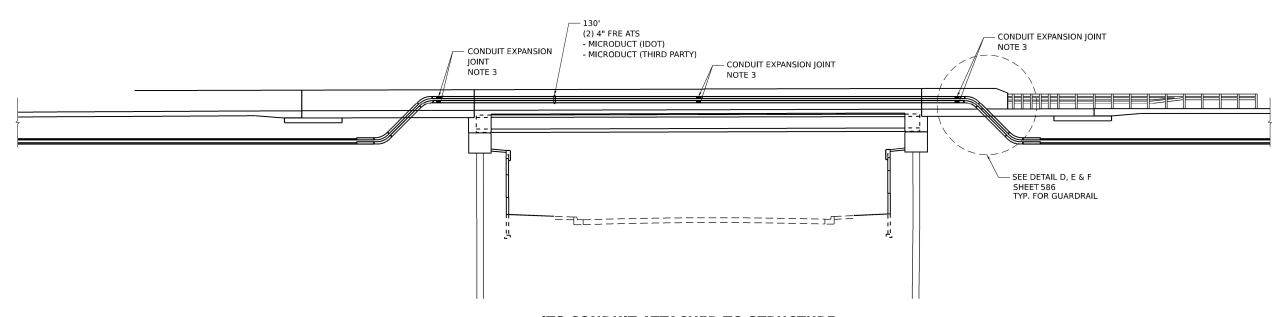
**STATE OF ILLINOIS** 

ITS	INFR	AST	RUCTUR	E DETA	AILS	F.A.I. RTE.	SECTI
ONDUIT ATS - JOLIET JUNCTION TRAIL						I-80	FAI 80 2
UNDUIT	AIS		OLILI J	UNUIL	DIV THAIL		
SHEET 10	OF	13	SHEETS	STA	TO STA.		

**DEPARTMENT OF TRANSPORTATION** 

WILL 1201 584 CONTRACT NO. 62R89

### ITS CONDUIT ATTACHED TO STRUCTURE I-80 WB OVER MIDLAND AVE **ELEVATION**



### ITS CONDUIT ATTACHED TO STRUCTURE I-80 EB OVER MIDLAND AVE **ELEVATION**

- THIS SHEET IS FOR ITS CONDUIT ATTACHED TO STRUCTURE ONLY. SEE STRUCTURE NO. 099-8322 (EB) AND 099-8323 (WB) SHEETS FOR BRIDGE PLANS.
   CONDUIT SUPPORTS NOT SHOWN FOR CLARITY.
   CONDUIT EXPANSION JOINTS SHALL BE INSTALLED AT EACH END OF THE BRIDGE AND AT ALL BRIDGE EXPANSION JOINT OR FULL-DEPTH PARAPET JOINT LOCATIONS AND PER MANUFACTURER'S RECOMMENDATIONS.




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PLOT DATE = 10/5/2023	DATE - 10/6/23	REVISED -	7

STATE OF ILLINOIS
DEPARTMENT OF TRANSPORTATION

SCALE: NONE

ITS INFRASTRUCTURE DETAILS	F.A.I. RTE.			COUNTY	TOTAL SHEETS	SHEET NO.	
CONDUIT ATS - MIDLAND	I-80	FAI 80 22 BR		WILL	1201	585	
CONDOIT ATS - WIDLAND				CONTRACT	NO. 621	₹89	
ET 11 OF 13 SHEETS STA.	TO STA.		ILLINOIS	FED. All	D PROJECT		

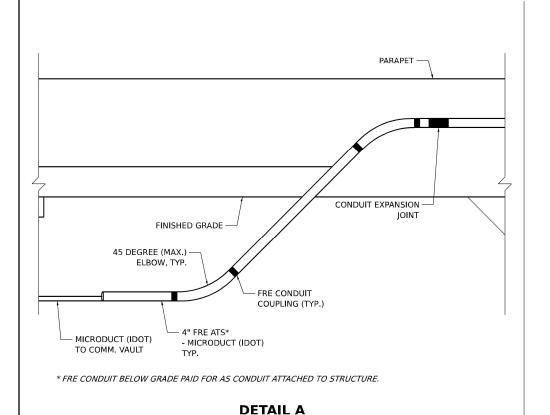


I-80 WB OVER MIDLAND AVE

**EAST END OF BRIDGE** 

# UNISTRUCT 1-5/8" X 1-5/8" (TYP.) ATTACHED TO PARAPET (1' MIN. FROM ANY PARAPET JOINT) DETAIL C

STAINLESS STEEL CONDUIT SUPPORT

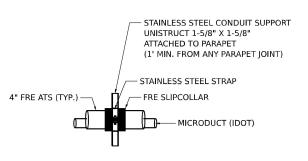


### DETAIL B I-80 WB OVER MIDLAND AVE BRIDGE PARAPET CROSS SECTION

PARAPET -

REBAR, TYP. SEE

STRUCTURAL PLANS


DETAIL C
I-80 WB OVER MIDLAND AVE
TYPICAL CONDUIT SUPPORT DETAIL

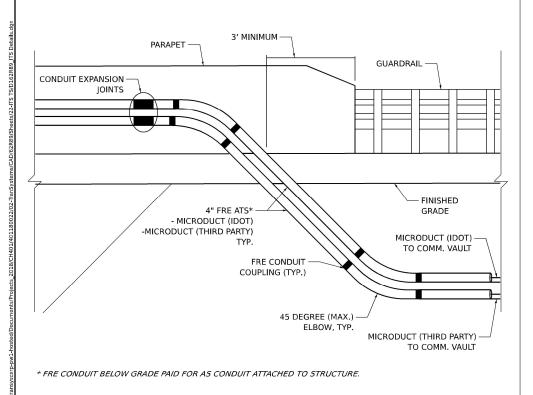


**DETAIL D** 

I-80 EB OVER MIDLAND AVE

**WEST END OF BRIDGE** 

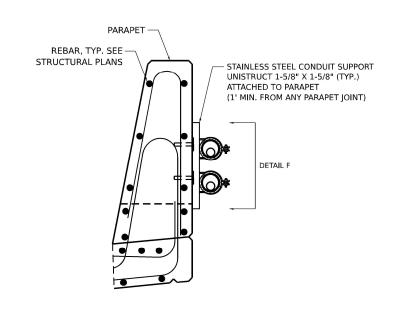

### DETAIL E I-80 EB OVER MIDLAND AVE BRIDGE PARAPET CROSS SECTION

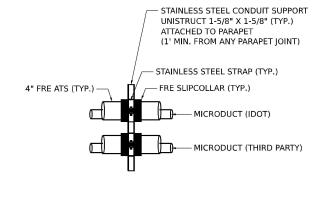

### DETAIL F I-80 EB OVER MIDLAND AVE TYPICAL CONDUIT SUPPORT DETAIL

# Transmart 100 S. Wacker Drive Suite 400 Chicago, Illinois 60606

	PLOT DATE = 10/5/2023	DATE -	10/6/23	REVISED -
	PLOT SCALE = 0.16666633 ' / in.	CHECKED -	REL	REVISED -
		DRAWN -	JAM	REVISED -
1	USER NAME = dmeler	DESIGNED -	DJM	REVISED -


STATE OF ILLINOIS DEPARTMENT OF TRANSPORTATION

SCALE: NONE


ITS	INFF	RAST	RUCTUE	RE DETA	AILS	F.A.I. RTE.	
CONDUIT ATS - MIDLAND						I-80	
GUNDUIT ATS - WIDLAND							
SHEET 12	OF	13	SHEETS	STA.	TO STA.		

RTE.	SECT	TION		COUNTY	SHEETS	NO.
I-80	FAI 80	WILL	1201	586		
				CONTRACT	NO. 621	₹89
		ILLINOIS	FED. All	D PROJECT		


TOTAL SHEET

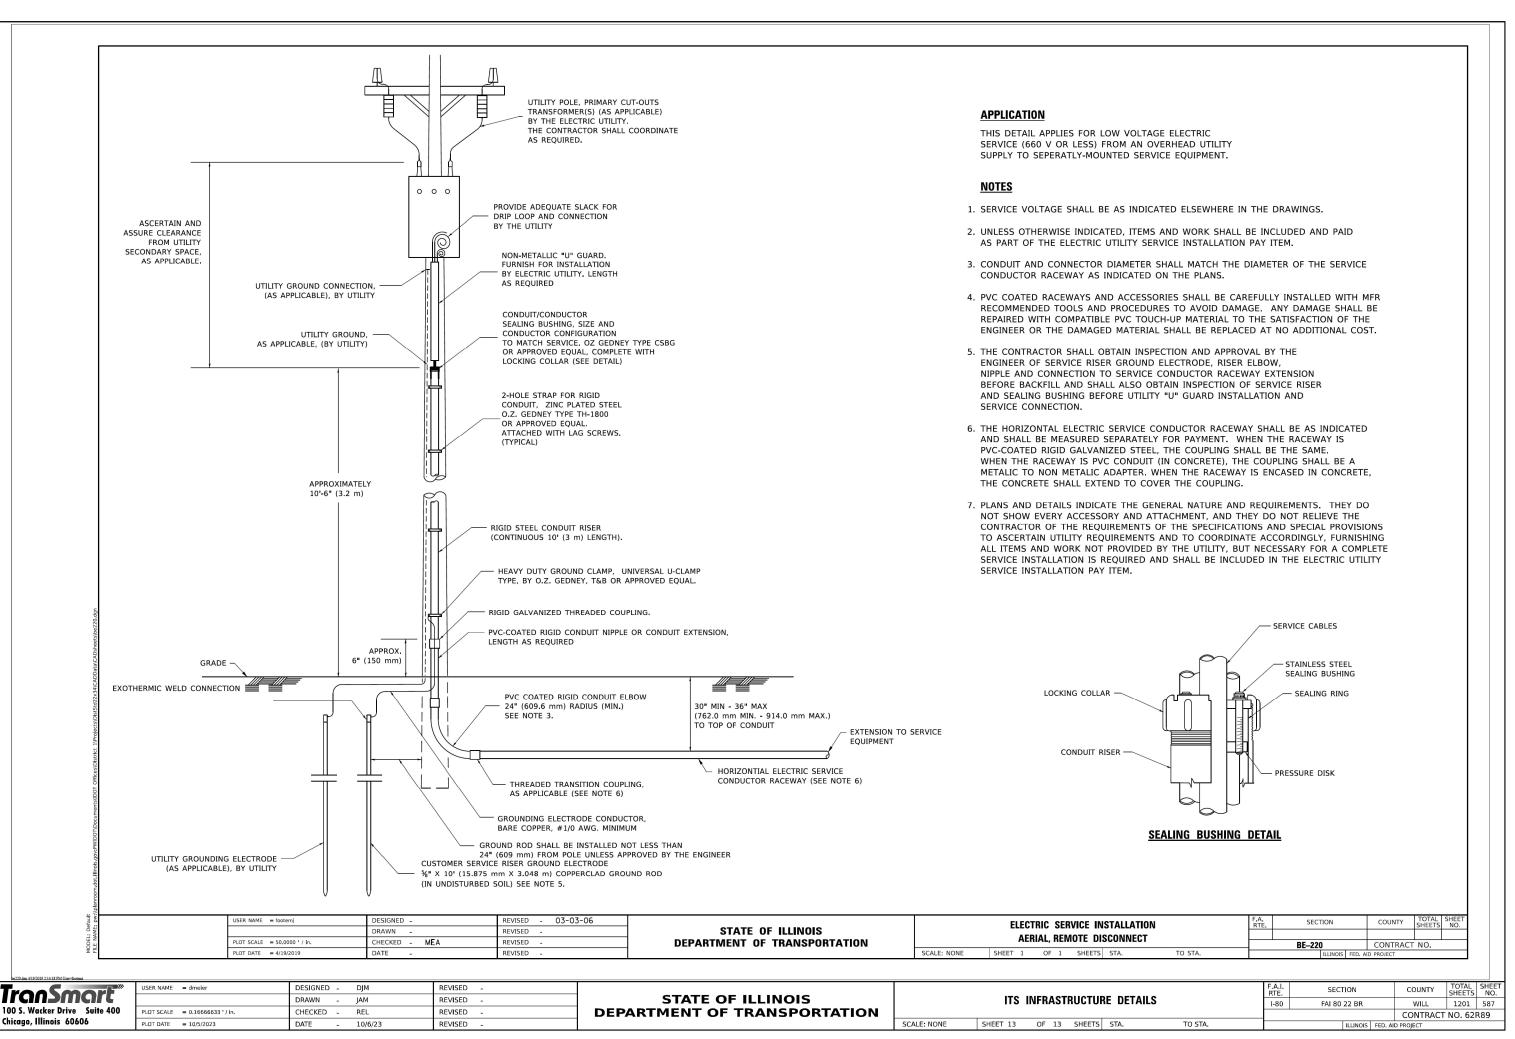

MODEL: ITS Detail 13

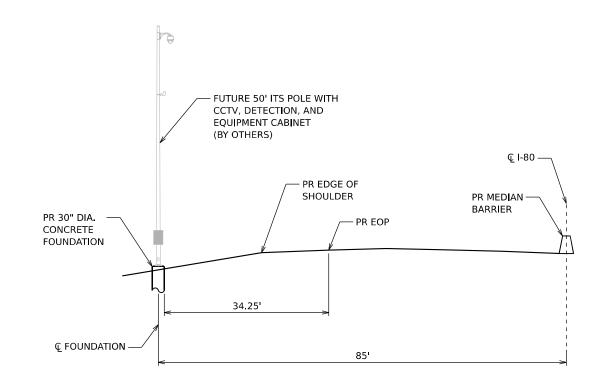

STA 520+00 (LOOKING EAST) 30" DIA. CONCRETE FOUNDATION

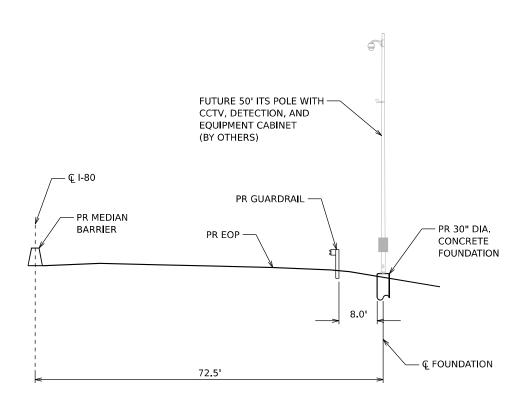

STA 541+50 (LOOKING EAST) 30" DIA. CONCRETE FOUNDATION

**\***ехр.


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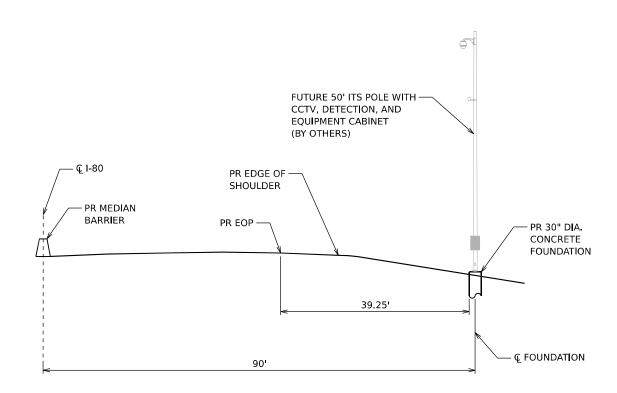
 PLOT DATE
 = 10/5/2023
 DATE
 10/6/23
 REVISED

STATE OF ILLINOIS DEPARTMENT OF TRANSPORTATION

| FAI. | SECTION | COUNTY | TOTAL SHEET | NO. | FAI. | SECTION | SHEET | NO. | SHEET | SECTION | SHEET | NO. | SHEET | SECTION | SHEET | NO. | SHEET | NO. | SHEET | SHE



STA 555+90 (LOOKING EAST) 30" DIA. CONCRETE FOUNDATION

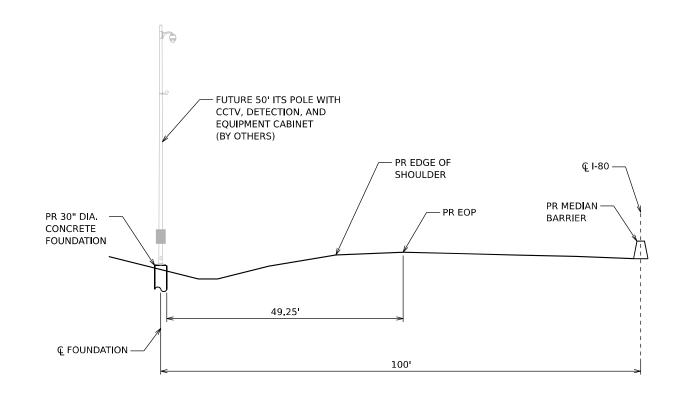

STA 582+00 (LOOKING EAST) 30" DIA. CONCRETE FOUNDATION


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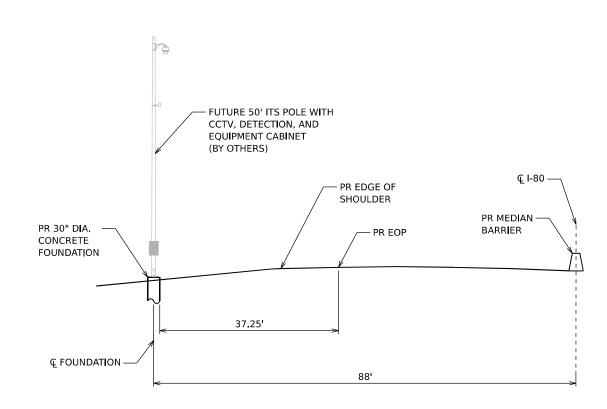
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 = 0.16666633 ' / in.
 CHECKED
 BRH
 REVISED

 PLOT DATE
 = 10/5/2023
 DATE
 10/6/23
 REVISED

STATE OF ILLINOIS DEPARTMENT OF TRANSPORTATION



STA 588+00 (LOOKING EAST) 30" DIA. CONCRETE FOUNDATION

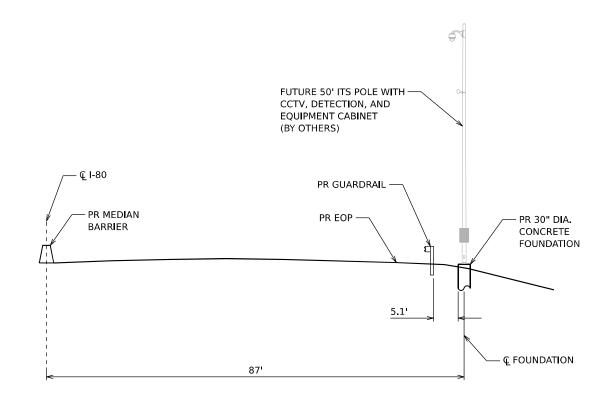


STA 596+00 (LOOKING EAST) 30" DIA. CONCRETE FOUNDATION

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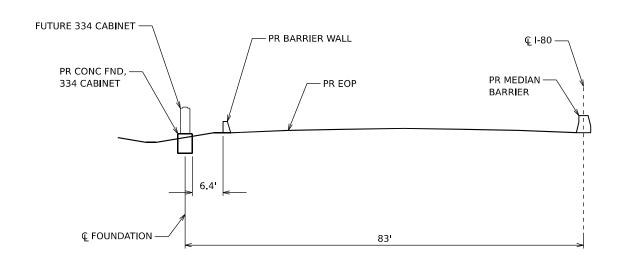
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STATE OF ILLINOIS
DEPARTMENT OF TRANSPORTATION

ITS CROSS SECTIONS  I-80 FAI 80 22 BR WII		
·	1201 !	590
CONT	ACT NO. 62R8	89
SCALE: NONE SHEET 3 OF 5 SHEETS STA. TO STA.   ILLINOIS FED. AID PROJECT		



STA 613+60 (LOOKING EAST) 30" DIA. CONCRETE FOUNDATION

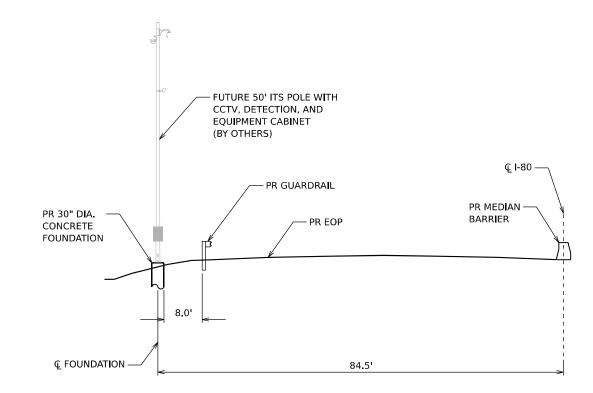


STA 625+85 (LOOKING EAST) 334 CABINET FOUNDATION

**\***exp.

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STATE OF ILLINOIS
DEPARTMENT OF TRANSPORTATION

			F.A.I. RTE	SECTION	COUNTY	TOTAL SHEETS	SHEET NO.				
		ITS CRO	ISS SEC	TIONS		1-80	FAI 80 22 BR	22 BR WILL			
								CONTRACT	NO. 621	₹89	
SCALE: NONE	SHEET 4	OF 5	SHEETS	STA.	TO STA.	ILLINOIS FED. AID PROJECT					

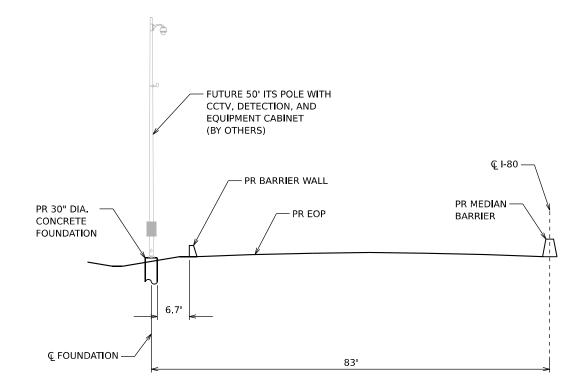


STA 628+75 (LOOKING EAST) 30" DIA. CONCRETE FOUNDATION

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PLOT DATE = 10/5/2023	DATE - 10/6/23	REVISED -

STATE OF ILLINOIS									
DEPARTMENT OF TRANSPORTATION									

				F.A.I. RTE	SECTION	COUNTY	TOTAL SHEETS	SHEET NO.			
		IIS C	ROSS SEC		I-80	FAI 80 22 BR	WILL	1201	592		
						CONTRACT	NO. 62	R89			
SCALE: NONE	SHEET 5	OF 5	SHEETS	STA.	TO STA.		ILLINOIS FED.	. AID PROJECT			

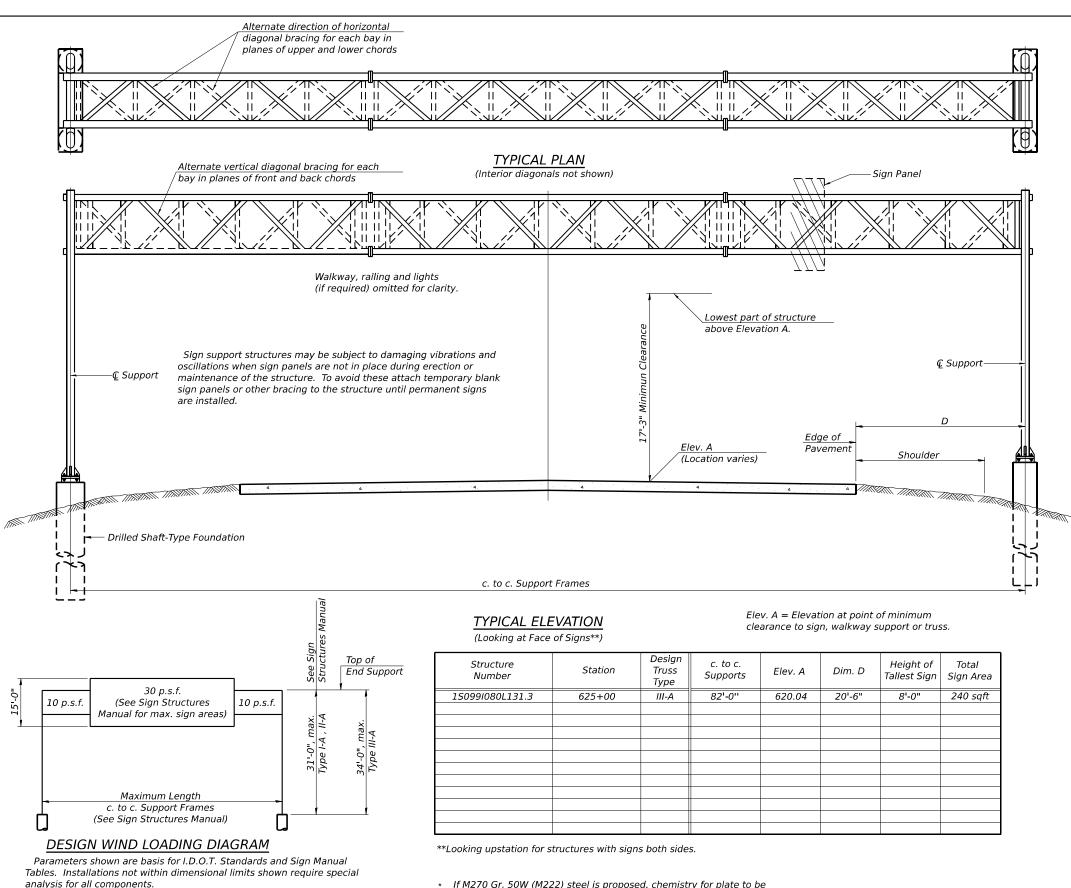

\* If M270 Gr. 50W (M222) steel is proposed, chemistry for plate to be used shall first be approved by the Engineer as suitable for galvanizing and welding.

ITEM	UNIT	TOTAL
OVERHEAD SIGN STRUCTURE - SPAN, TYPE III-A (5'-0" X 7'-0")	Foot	82
OVERHEAD SIGN STRUCTURE WALKWAY, TYPE A	Foot	49
DRILLED SHAFT CONCRETE FOUNDATIONS	Cu Yd	30.7
REMOVE OVERHEAD SIGN STRUCTURE - SPAN	Each	1
REMOVE CONCRETE FOUNDATION - OVERHEAD	Each	4

TOTAL BILL OF MATERIAL

**GENERAL NOTES** 

DESIGN: AASHTO Standard Specifications for Structural Supports for Highway

CONSTRUCTION: Current (at time of letting) Illinois Department of Transportation Standard Specifications for Road and Bridge Construction, Supplemental Specifications and Special Provisions. ("Standard Specifications")

WELDING: All welds to be continuous unless otherwise shown. All welding to be done in accordance with current AWS D1.1 and D1.2 Structural Welding Codes

MATERIALS: Aluminum Alloys as shown throughout plans. All Structural Steel

shall conform to AASHTO M270 Gr. 36, Gr. 50 or Gr. 50W\*. Stainless steel for

shims, sleeves and handhole covers shall be ASTM A240, Type 302 or 304, or another alloy suitable for exterior exposure and acceptable to the Engineer.

The steel pipe and stiffening ribs at the base plate for the column shall have

FASTENERS FOR ALUMINUM TRUSSES: All bolts noted as "high strength" must satisfy the requirements of AASHTO M164 (ASTM A325), or approved alternate, and must have matching lock nuts. Threaded studs for splices (if Members

interfere) must satisfy the requirements of ASTM A449, ASTM A193, Grade B7,

or approved alternate, and must have matching lock nuts. Bolts and lock nuts

not required to be high strength must satisfy the requirements of ASTM A307. All bolts and lock nuts must be hot dip galvanized per AASHTO M232. The lock nuts must have nylon or steel inserts. A stainless steel flat washer conforming to ASTM A240 Type 302 or 304, is required under both head and nut or under both nuts where threaded studs are used. High strength bolt installation shall conform to Artie 505.04 (f) (2)d of the IDOT Standard Specifications for Road and Bridge Construction. Rotational capacity ("ROCAP") testing of bolts

U-BOLTS AND EYEBOLTS: U-Bolts and Eyebolts must be produced from ASTM A276 Type 304, 304L, 316 or 316L, Condition A, cold finished stainless

steel, or an equivalent material acceptable to the Engineer. All nuts for U-Bolts and Eyebolts must be lock nuts equivalent to ASTM A307 with nylon or steel inserts and hot dip galvanized per AASHTO M232. A stainless steel flat washer

conforming to ASTM A240, Type 302 or 304, is required under each U-Bolt and

Galvanized after fabrication in accordance with AASHTO M111. Painting is not

CONCRETE SURFACES: All concrete surfaces above an elevation 6" below the

lowest final ground line at each foundation shall be eaned and coated with

REINFORCEMENT BARS: Reinforcement Bars designated (E) shall be epoxy

FOUNDATIONS: The contract unit price for Concrete Foundations and Drilled

Shaft Concrete Foundations shall include reinforcement bars complete in place. FOUNDATION REMOVAL: Existing foundation removal shall be at least 3 feet

Concrete Sealer in accordance with the Standard Specifications.

GALVANIZING: All Steel Grating, Plates, Shapes and Pipe shall be Hot Dip

ANCHOR RODS: Shall conform to ASTM F1554 Gr. 105.

coated in accordance with the Standard Specifications.

a minimum longitudinal Charpy V-Notch (CVN) energy of 15 lb.-ft. at 40° F.

Pipe shall be ASTM A53 Grade B or A500 Grade B or C. If A500 pipe is substituted for A53, then the outside diameter shall be as detailed and wall thickness greater than or equal to A53. All Structural Steel Plates and Shapes

Signs, Luminaires and Traffic Signals. ("AASHTO Specifications")

WALKWAY LOADING: Dead load plus 500 lbs. concentrated live load.

(Steel and Aluminum) and the Standard Specificiations.

LOADING: 90 M.P.H. WIND VELOCITY

fy = 60,000 p.s.i. (reinforcement)

(Zone 2) before galvanizing.

will not be required.

Evebolt lock nut.

below existing ground.

DESIGN STRESSES:


Field Units f'c = 3,500 p.s.i.

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PLOT DATE = 10/5/2023	DATE -	REVISED -

**STATE OF ILLINOIS DEPARTMENT OF TRANSPORTATION** 

OVERHEAD SIGN STRUCTURES - GENERAL PLAN & **ELEVATION - ALUMINUM TRUSS & STEEL SUPPORTS** SHEET 1 OF 12 SHEETS STA.

SECTION COUNTY I-80 FAI 80 22 BR WILL 1201 593 CONTRACT NO. 62R89

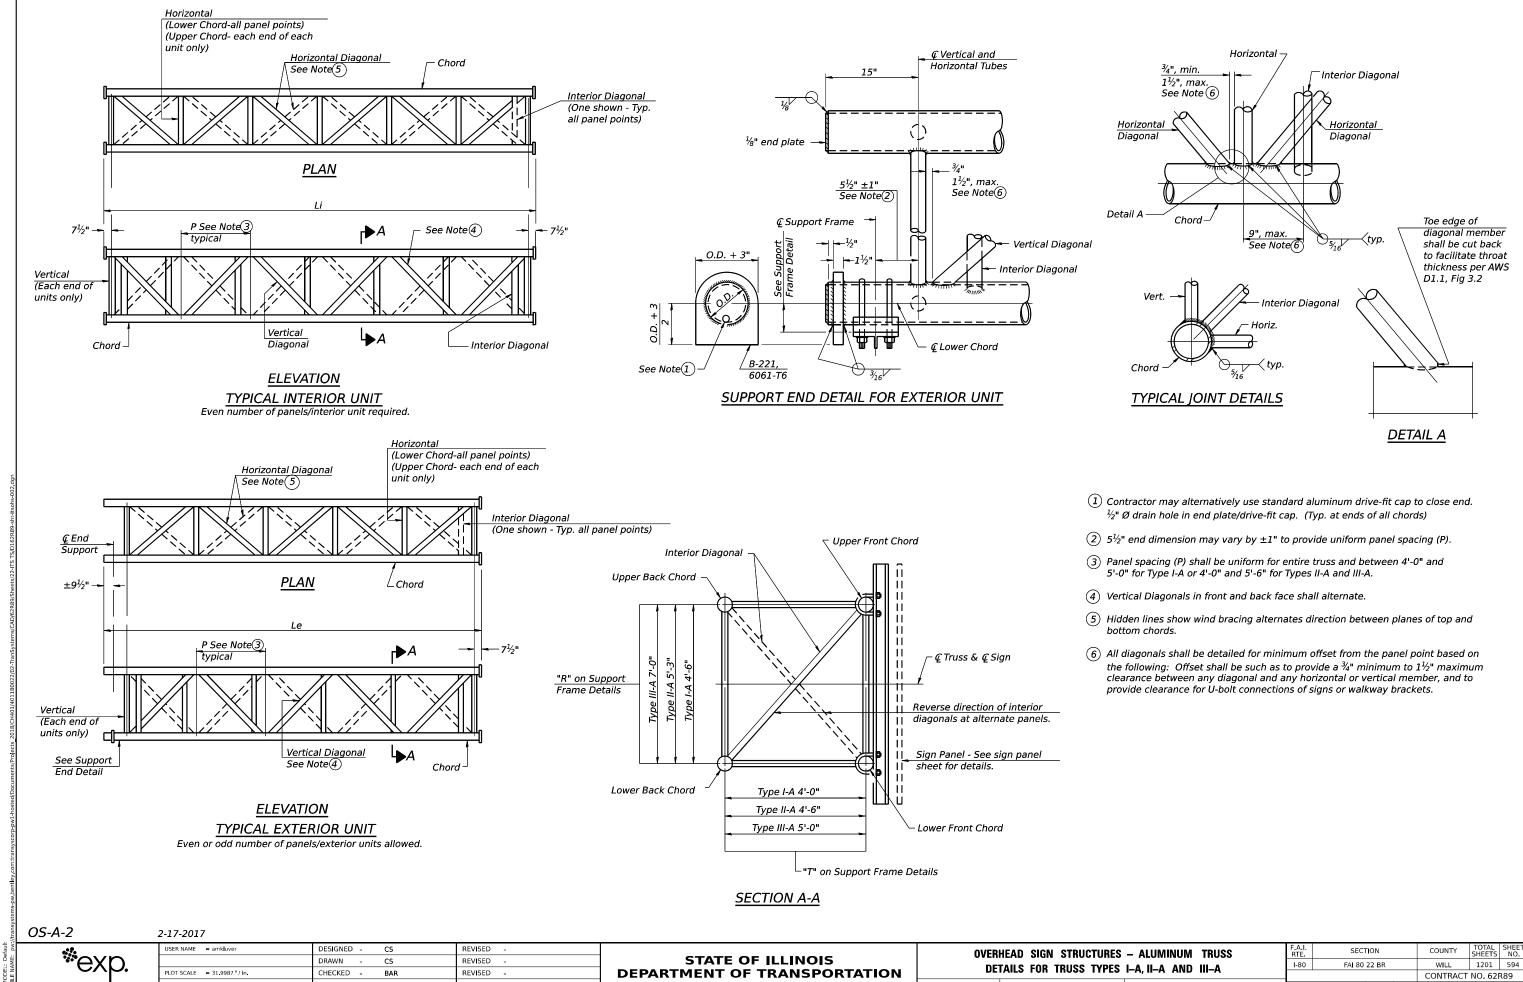

**STATE OF ILLINOIS** 

**DEPARTMENT OF TRANSPORTATION** 

I-80

DETAILS FOR TRUSS TYPES I-A, II-A AND III-A

OF 12 SHEETS STA.

FAI 80 22 BR

WILL

1201 594

CONTRACT NO. 62R89

DRAWN

DATE

PLOT DATE = 10/5/2023

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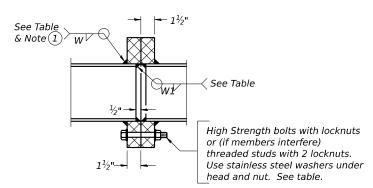
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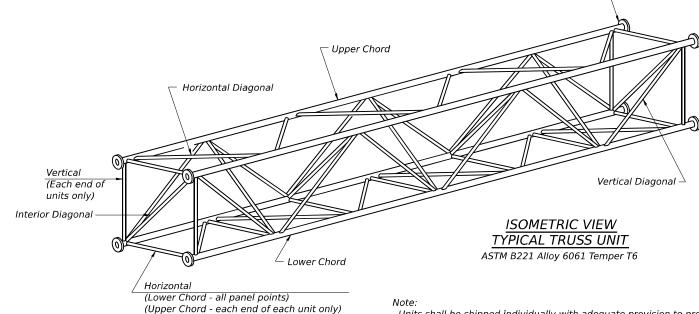
### TRUSS UNIT TABLE

Structure	Design Station Truss			ior Units (2	nits (2) Interior Unit					Upper & Lower		Vertical,H	Verticals; Horizontals; Call Vertical, Horizontal,		Splicing Flange									
Number	Station	Truss				Type	No. Panels	Unit	Panel	No.	No. Panels	Unit	Panel	1	ora	and Interior	r Diagonals	at Midspan	Bolt		Weld	Sizes	Λ	D
		Type	per Unit	Lgth.(Le)	Lgth.(P)	Req'd.	per Unit	Lgth.(Li)	Lgth.(P)	O.D.	Wall	O.D.	Wall	maspan	No./Splice	Dia.	W	W1	A	В				
15099I080L131.3	625+00	III-A	5	26'-5 <sup>1</sup> / <sub>2</sub> ''	4'-11"	1	6	30'-9"	4'-11"	7"	<sup>5</sup> / <sub>16</sub> "	31/4"	<sup>5</sup> ⁄ <sub>16</sub> "	1"	6	1"	7/16"	<sup>5</sup> ⁄ <sub>16</sub> "	11½"	15"				




### SECTION B-B

1) Splicing Flanges shall be attached to each truss unit with the truss shop assembled to camber shown. Truss units shall be in proper alignment and flange surfaces shall be shop bolted into full contact before welding. Sufficient external welds or tacks shall be made to secure flanges until remaining welds are made after disassembly. Adjacent flanges shall be "match marked" to insure proper field assembly.




Units shall be shipped individually with adequate provision to prevent detrimental motion during transport. This may require ropes between horizontals and diagonals or energy dissipating (elastic) ties to the vehicle. The Contractor is responsible for maintaining the configuration and protection of the units.

Splicing Flange

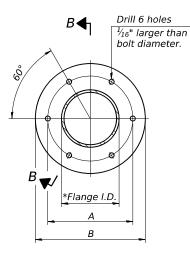

### TRUSS TYPES I-A, II-A, & III-A

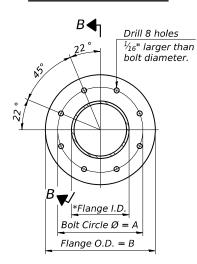

### TRUSS TYPES II-A & III-A

### SPLICING FLANGES


ASTM B221, Alloy 6061-T6 or ASTM B209, Alloy 6061-T651 \*To fit O.D. of Chord with maximum gap of  $\frac{1}{16}$ ".

### CAMBER DIAGRAM

Camber curve shown is theoretical. Actual camber attained by slope changes at splices between units.

c to c of support frame

### CAMBER ATTAINMENT EXAMPLES:

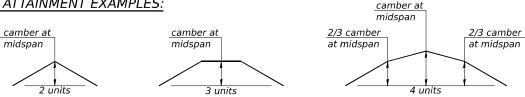

Camber required See table.

Camber shown is for fabrication only, measured with truss fully supported. (No-load condition)

*OS4-A-2* 

exp.


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**STATE OF ILLINOIS DEPARTMENT OF TRANSPORTATION** 


OVERHEAD					.UMINUM II–A AND	TRUSS DETAILS	
i:	SHEET	3 C	F 12	SHEETS	STA.	TO STA.	_

F.A.I. RTE	SECT	TION		COUNTY	TOTAL SHEETS	SHEET NO.
I-80	FAI 80	22 BR		WILL	1201	595
				CONTRACT	NO. 621	२८९
		ILLINOIS	FED. All	D PROJECT		



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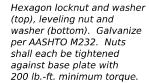
OF 12 SHEETS STA. TO STA.

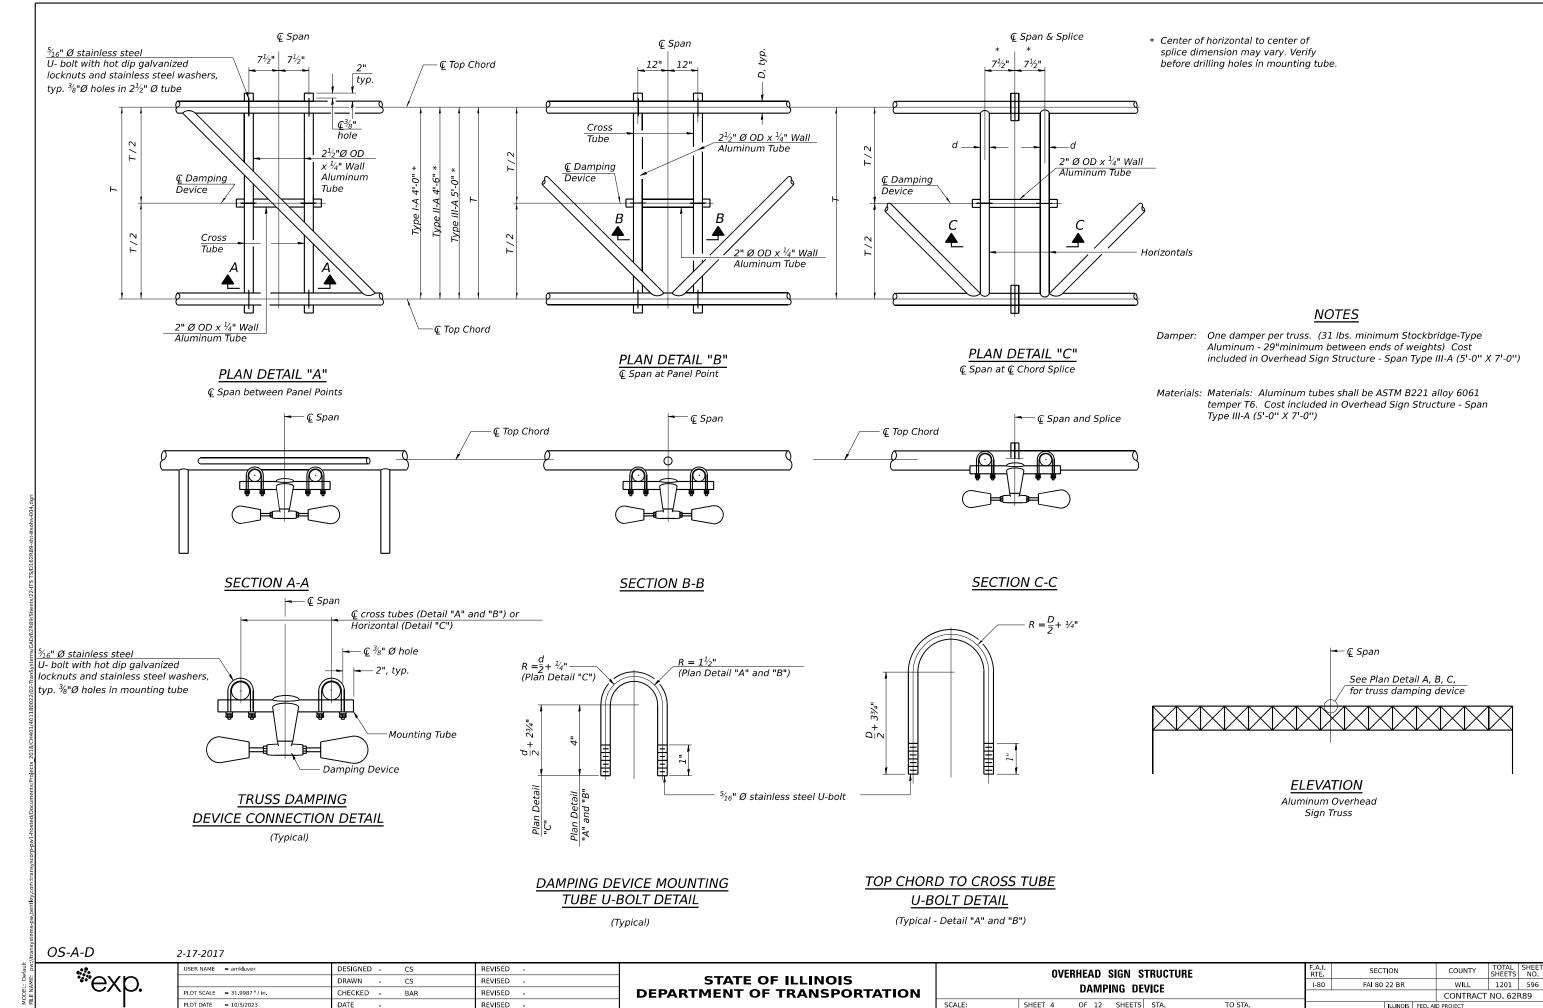


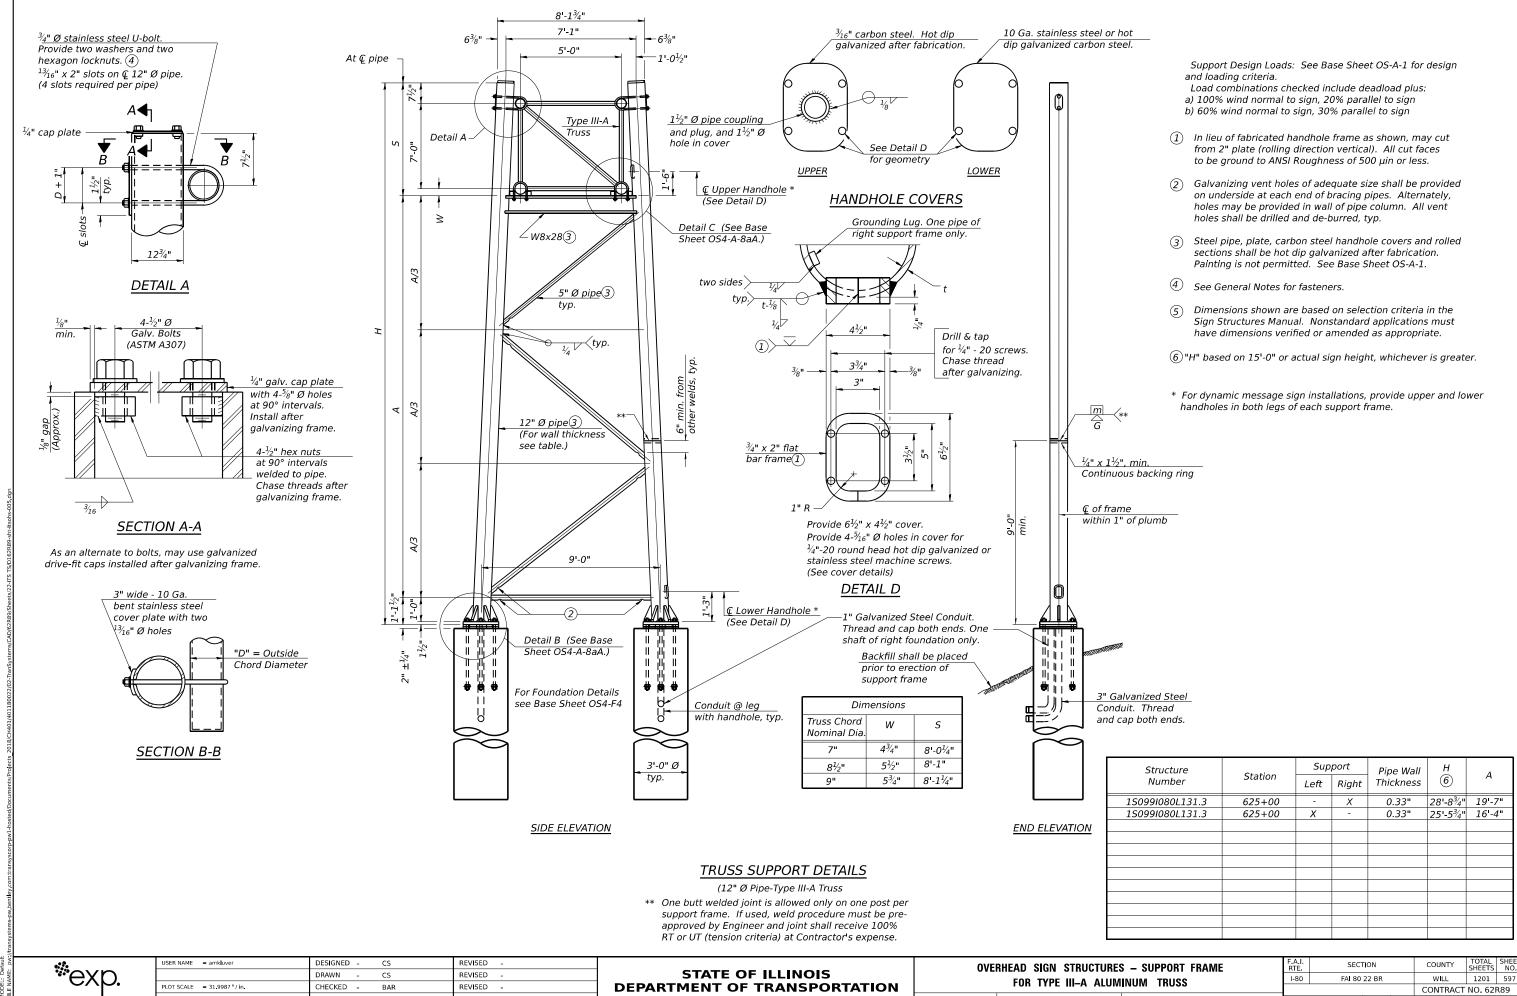CHECKED -REVISED PLOT DATE = 10/5/2023 DATE REVISED

**DEPARTMENT OF TRANSPORTATION** 


OVE	RHEAD S	IGN STRU	CTURES	5 – SU	IPPORT FRAME	F.A.I. RTE	SECTION		COUNTY	TOTAL SHEETS	SHEET NO.
	FOR TYPE III-A ALUMINUM TRUSS						FAI 80 22 BR		WILL	1201	597
	1 011	111 E III-A	ALUM	INOIN	111000				CONTRACT	NO. 621	R89
	SHEET 5	OF 12	SHEETS	STA.	TO STA.		ILLINOIS	FED. All	D PROJECT		



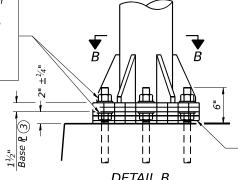



DETAIL B Ribs shall be cut to fit slope of pipe.

Stainless Steel Standard Grade Wire Cloth, 3" wide,  $\frac{1}{4}$ " maximum opening with a minimum wire diameter of AWG. No. 16 with a minimum 2" lap. Secure to base plate after erection with  $\frac{3}{4}$ " stainless steel banding.

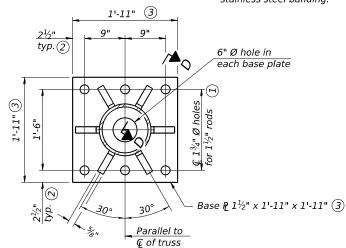

### SECTION B-B

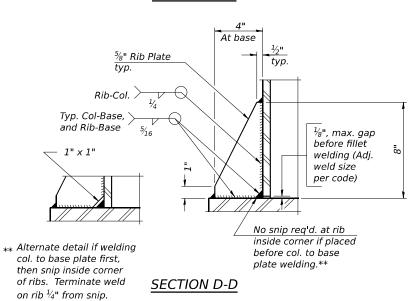

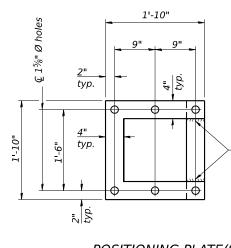


Provide 1 nut per rod. Deform thread or use chemical thread lock to secure.

### ANCHOR ROD DETAIL

Anchor rods shall conform to ASTM F1554 Grade 105 Galvanize upper 12" minimum per AASHTO M232. No welding shall be permitted on rods.

## TYPE III-A TRUSS

For Type III-A Truss spans greater than 150 ft, and up to 160 ft.:

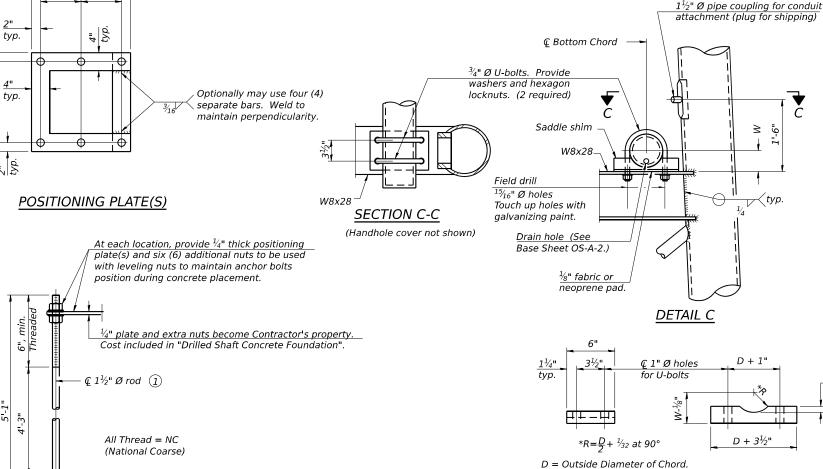

### SADDLE SHIM DETAIL ASTM B26 Alloy 356-F

For W, see Base Sheet OS-A-6.

Truss Chord

8½"

9"

Nominal Dia.

11/4"

13/8"

ASTM B209 Alloy 6061-T651 (4 required per sign truss)

# 12" Ø PIPE SUPPORT FRAME DETAILS

1 13/4" Ø rod, 2" Ø holes

- (2) 2<sup>3</sup>/<sub>4</sub>" edge distance
- (3) Base  $\frac{1}{8}$  1  $\frac{1}{8}$ " x 1 -11  $\frac{1}{2}$ " x 1 -11  $\frac{1}{2}$ "

OS4-A-8aA


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PLOT DATE = 10/5/2023	DATE -	REVISED -

### **STATE OF ILLINOIS DEPARTMENT OF TRANSPORTATION**

						F.A.I. RTE	SEC <sup>-</sup>	LION		COUNTY	TOTAL SHEETS	SHEE NO.	
						I-80	FAI 80 22 BR			WILL	1201	598	
SOFFORT TRAINE FOR TIFE III-A ALDININGIN TROSS				INDIN THOSE						CONTRACT	NO. 621	R89	
	SHEET 6	OF 12	SHEETS	STA.	TO STA.				ILLINOIS	FED. AI	D PROJECT		



Grating and handrail splices placed as needed.

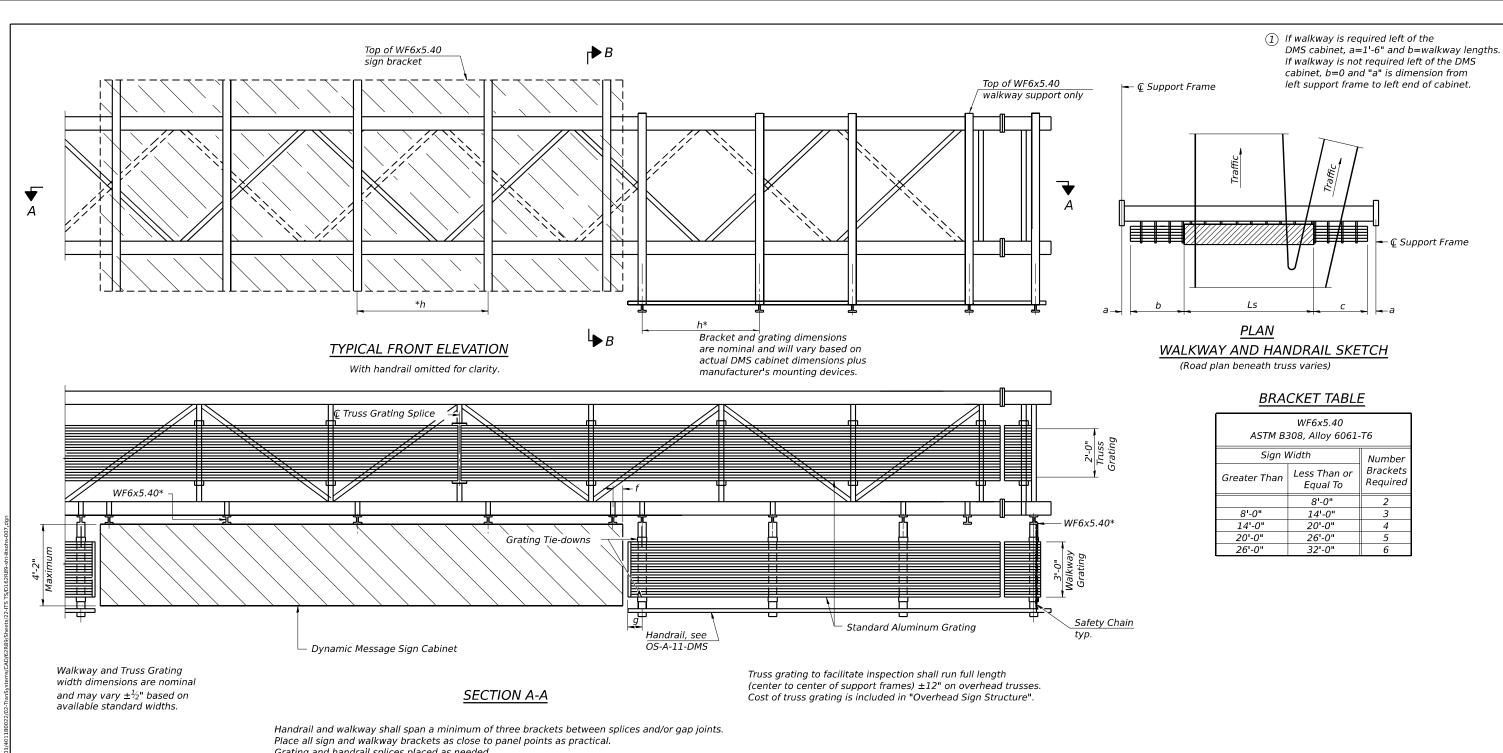Structure Number	Station	а	b	С	Ls	Walkway Grating and Handrail Lengths
15099I080L131.3	625+00	1'-6"	21'-0"	28'-0"	30'-0"	49'-0"

### Notes:

- \* Space walkway brackets WF6x5.40 for efficiency and within limits shown:
- f = 12" maximum, 4" minimum (End of sign to Q of nearest bracket) g = 12" maximum, 4" minimum (End of walkway grating to € of nearest support bracket)
- h = 6'-0" maximum ( $\mathbb{Q}$  to  $\mathbb{Q}$  sign and/or walkway support brackets, WF6x5.40)

Maximum DMS weight = 5000 lbs. 4'-2" maximum cabinet depth includes depth of cabinet plus connection to WF6x5.40.

For Section B-B and Grating Splice Details, see Base Sheet OS-A-10-DMS. For Handrail Splice Details, see Base Sheet OS-A-11-DMS.

OS-A-9-DMS

\*exp.


2-17-2017

USER NAME = amkluver	DESIGNED	-	CS	REVISED	-
	DRAWN	-	cs	REVISED	-
PLOT SCALE = 31.9987 / in.	CHECKED	-	BAR	REVISED	-
PLOT DATE = 10/5/2023	DATE	-		REVISED	-

**STATE OF ILLINOIS DEPARTMENT OF TRANSPORTATION** 

	OVERHEAD SIGN STRUCTURES								
ALTERNATE ALUMINUM WALKWAY DETAILS FOR DMS									
	SHEET 7	OF 12	SHEETS	STA.	TO STA.		_		

SECTION COUNTY I-80 FAI 80 22 BR WILL 1201 599 CONTRACT NO. 62R89

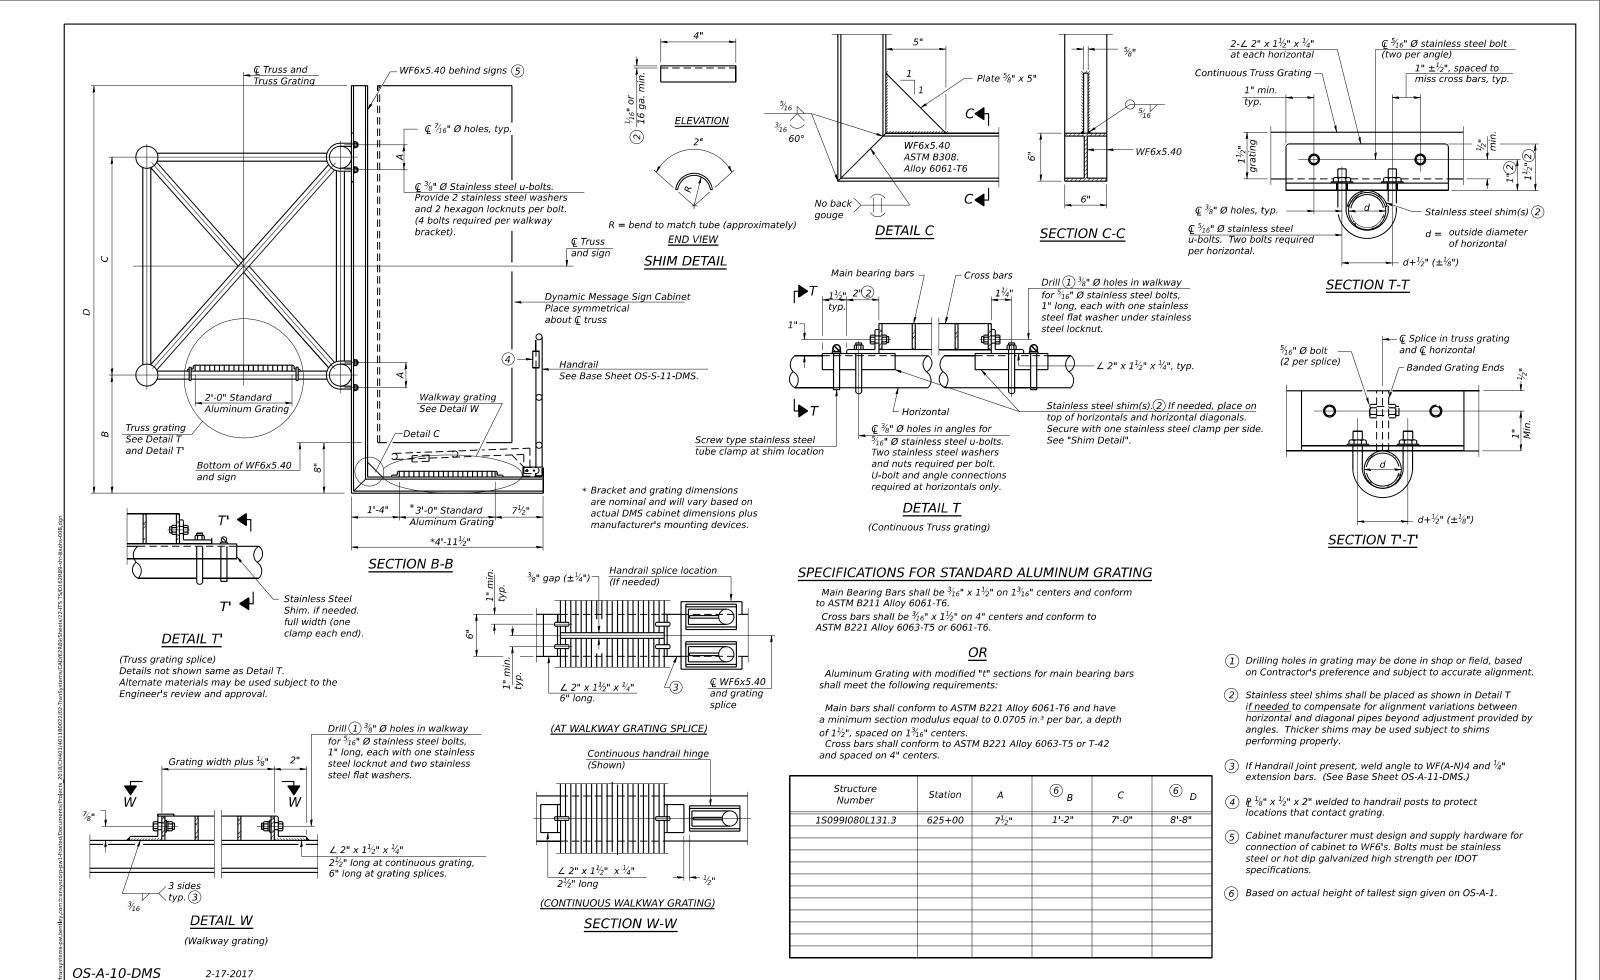

**\***ехр.

 USER NAME
 = amkluver
 DESIGNED
 CS
 REVISED

 PLOT SCALE
 = 31.9987 '/ in.
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 BAR
 REVISED

 PLOT DATE
 = 10/5/2023
 DATE
 REVISED

### STATE OF ILLINOIS DEPARTMENT OF TRANSPORTATION

SCALE:

OVERHEAD SIGN STRUCTURES									F.A.I. RTE	SECTION		COUNTY	TOTAL SHEETS	SHEET NO.
ALTERNATE ALUMINUM WALKWAY DETAILS FOR DMS							I-80	FAI 80 22 BR		WILL	1201	600		
ALTERIVATE ALDIVIJIVOIVI WALKWAT DETAILS FOR DIVIS										CONTRACT	NO. 621	R89		
SHEET 8 OF 12 SHEETS STA. TO STA.								ILLINOI	FED. A	D PROJECT				