#### 01-19-2024 LETTING ITEM 088 STATE OF ILLINOIS **DEPARTMENT OF TRANSPORTATION INDEX OF SHEET** COVER SHEET GENERAL NOTES 3-9 SUMMARY OF QUANTITIES **PROPOSED** 10 TYPICAL SECTIONS 11-16 SCHEDULES 17 PROJECT LAYOUT 18-19 STAGING PLANS **HIGHWAY PLANS** ALTERNATE ROUTE SINGING 20-21 22-31 BRIDGE REPAIR PLANS 32-39 DETAILS **FAI ROUTE 55 (I-55) SECTION (32-2)RS,BRR** PROJECT NHPP-5WZI(166) RESURFACING, STRUCTURE PRESERVATION **GRUNDY COUNTY** C-93-106-22 **PROJECT ENDS** STA. 745+15 (NB) STA. 749+82 (SB) 032-5716 032-3300 GARDNER RD 032-3295 032-5551 **STRUCTURE** LOCATION OF SECTION INDICATED THUS: -**PRESERVATION** 032-2006 SN 032-0078 STA. 626+00 **PROJECT BEGINS** STA. 460+00 (NB) 032-5605 GRUNDY CO STA. 459+93 (SB) 032-5556 032-572 032-2517 032-2507 032-5581 032-2516 032-3390 E SCULLY RD 032-5725 **FULL SIZE PLANS HAVE BEEN PREPARED USING STANDARD ENGINEERING SCALES. REDUCED SIZED PLANS WILL NOT**

032-0125

LIVINGSTON CO DWIGHT

 $\bigcirc$ 

 $\circ$ 

 $\circ$ 

CONFORM TO STANDARD SCALES. IN MAKING MEASUREMENTS

ON REDUCED PLANS, THE ABOVE SCALES MAY BE USED.

1-800-892-0123

JOINT UTILITY LOCATION INFORMATION FOR EXCAVATION

PROJECT ENGINEER: JOSEPH KANNEL, P.E.

**UNIT CHIEF: DARCY MITCHELL** 

**DISTRICT 3 NO. (815) 434-6131** 

**CONTRACT NO. 66K67** 

GROSS LENGTH = 28.649 FT. = 5.42 MILE NET LENGTH = 28,649 FT. = 5.42 MILE

032-5731

053-4057

032-5736



D-93-084-22

GRUNDY ILLINOIS CONTRACT NO. 66K67

#### **FUNCTION CLASSIFICATION** INTERSTATE

2021 ADT = 20,600P.V. = 78.5% S.U. = 17.5% M.U. = 4.0%



PRINTED BY THE AUTHORITY OF THE STATE OF ILLINOIS

#### GENERAL NOTES

EXCEPT AS NOTED ON THE PLANS, PAVEMENT GRADES SHOWN ARE AT THE TOP OF PAVEMENT SURFACES.

BEFORE ORDERING PIPE CULVERTS OR PIPE DRAINS, THE CONTRACTOR SHALL CONSULT THE ENGINEER FOR EXACT LENGTHS.

THE ENGINEER WILL BE THE SOLE JUDGE CONCERNING CURING TIME FOR THE VARIOUS HMA LIFTS.

THE FINISHED EARTHWORK SHALL HAVE A VEGETATION SUSTAINING SOIL COVERING THE TOP FOUR INCHES ( 100 MILLIMETERS) IN AREAS TO BE SEEDED OR SODDED. THE VEGETATION SUSTAINING SOIL REQUIRED WILL NOT BE PAID FOR SEPARATELY BUT WILL BE INCLUDED IN THE COST OF FURNISHED EXCAVATION.

SHORT TERM PAVEMENT MARKING SHALL BE USED TO OUTLINE EXIT AND ENTRANCE RAMPS FOR THE PRIME COAT APPLICATION AND EACH RESURFACING LIFT.

ON EXISTING PAVEMENT WHICH MAY BE SUPERELEVATED, THE NEW HMA PAVEMENT SHALL BE BUILT WITH THE SAME SUPERELEVATION UNLESS NEW SUPERELEVATION RATES ARE GIVEN ON THE PLANS.

ALL ELEVATIONS REFERRING TO U.S.G.S. MEAN SEA LEVEL DATUM.

THE FOLLOWING RATES OF APPLICATION HAVE BEEN USED IN CALCULATING PLAN QUANTITIES:

GRANULAR MATERIALS	2.05	TONS / CU YD
HMA RESURFACING	112	LBS / SQ YD / IN
SHORT TERM PAVEMENT MARKING	10	FT /100 FT OF APPLICATION
MIX FOR CRACKS, JTS & FLGWYS	0.0003	TONS / SQ YD

ALL DAMAGE TO DEPARTMENT OWNED UNDERGROUND FACILITIES, CAUSED BY THE CONTRACTOR SHALL BE REPAIRED TO THE SATISFACTION OF THE ENGINEER AND AT NO EXPENSE TO THE DEPARTMENT. THIS SHALL INCLUDE ALL TEMPORARY REPAIRS REQUIRED TO KEEP THE FACILITY OPERATIONAL WHILE MATERIAL IS BEING OBTAINED TO MAKE PERMANENT REPAIRS. SPLICING OF ELECTRIC CABLE WILL NOT BE ALLOWED. ELECTRIC CABLE SHALL BE REPLACED FROM POLE TO POLE OR CONTROLLER.

MEMBERS OF JULIE KNOWN TO BE WITHIN THE LIMITS OF THE IMPROVEMENT ARE: AT&T, COMED, ENTERPRISE PRODUCTS, KINDER MORGAN, LUMEN TECHNOLOGY (LEVEL 3/CENTURYLINK), NICOR, PEMBINA-COCHIN, VILLAGE OF GARDNER, KRAUS CABLE TV, AND SPRINT.

NON-MEMBERS OF JULIE KNOWN TO BE WITHIN THE LIMITS OF THE IMPROVEMENT ARE:

#### LIST OF ILLINOIS DOT HIGHWAY STANDARDS

## 000001-08 STANDARD SYMBOLS, ABBREVIATIONS AND PATTERNS 001001-02 AREAS OF REINFORCEMENT BARS 001006 DECIMAL OF AN INCH AND OF A FOOT 280001-07 TEMPORARY EROSION CONTROL SYSTEMS

420001-10 PAVEMENT JOINTS 442001-04 CLASS A PATCHES 635001-02 DELINEATORS

637006-05 CONCRETE BARRIER, DOUBLE FACE, 42 in. HEIGHT

642001-03 SHOULDER RUMBLE STRIPS, 16 INCH 643001-02 SAND MODULE IMPACT ATTENUATORS

666001-01 RIGHT-OF-WAY MARKERS

701001-02 OFF-ROAD OPERATIONS 2L, 2W, MORE THAN 15' AWAY

701006-05 OFF-ROAD OPERATIONS 2L, 2W, 15' TO 24" FROM PAVEMENT EDGE

701011-04 OFF-ROAD MOVING OPERATIONS 2L, 2W, DAY ONLY

701101-05 OFF-ROAD OPERATIONS, MULTILANE, 15' TO 24" FROM PAVEMENT EDGE

701106-02 OFF-ROAD OPERATIONS, MULTILANE, MORE THAN 15' AWAY 701201-05 LANE CLOSURE, 2L, 2W, DAY ONLY, FOR SPEEDS ≥ 45 MPH

701301-04 LANE CLOSURE, 2L, 2W, SHORT TIME OPERATIONS

701306-04 LANE CLOSURE, 2L, 2W, SLOW MOVING OPERATIONS DAY ONLY,

FOR SPEEDS ≥ 45 MPH

701311-03 LANE CLOSURE, 2L, 2W, MOVING OPERATIONS - DAY ONLY

701316-13 LANE CLOSURE, 2L, 2W, BRIDGE REPAIR, FOR SPEEDS ≥ 45 MPH

701321-18 LANE CLOSURE, 2L, 2W, BRIDGE REPAIR WITH BARRIER

701400-12 APPROACH TO LANE CLOSURE, FREEWAY/EXPRESSWAY

701401-13 LANE CLOSURE, FREEWAY/EXPRESSWAY

701402-12 LANE CLOSURE, FREEWAY/EXPRESSWAY, WITH BARRIER

701406-13 LANE CLOSURE, FREEWAY/EXPRESSWAY, DAY OPERATIONS ONLY

701411-09 LANE CLOSURE, MULTILANE, AT ENTRANCE OR EXIT RAMP

FOR SPEEDS ≥ 45 MPH

701426-09 LANE CLOSURE, MULTILANE INTERMITTENT OR MOVING OPERATION,

FOR SPEEDS ≥ 45 MPH

701428-01 TRAFFIC CONTROL, SETUP AND REMOVAL, FREEWAY/EXPRESSWAY

701451-05 RAMP CLOSURE FREEWAY/EXPRESSWAY

701456-05 PARTIAL EXIT RAMP CLOSURE FREEWAY/EXPRESSWAY

701901-09 TRAFFIC CONTROL DEVICES

704001-08 TEMPORARY CONCRETE BARRIER

780001-05 TYPICAL PAVEMENT MARKINGS

781001-04 TYPICAL APPLICATIONS RAISED REFLECTIVE PAVEMENT MARKERS

#### COMMITMENTS:

NONE

STATE OF ILLINOIS
DEPARTMENT OF TRANSPORTATION
DISTRICT THREE
AS BUILT INFORMATION

SUPERVISING CONSTRUCTION FIELD ENGINEER

RESIDENT ENGINEER / TECHNICIAN

START & END DATES OF CONSTRUCTION:

INSPECTORS:

STATE OF ILLINOIS
DEPARTMENT OF TRANSPORTATION

| F.A.| SECTION | COUNTY | TOTAL | SHEETS | N | SHEETS | SHEETS | N | SHEETS | SHEETS | N | SHEETS | S

				CONSTRU	JCTION CODE
				90% FED 10% STATE	90% FED 10% STATE
				ROADWAY	BR∃DGE
CODE			TOTAL	0005	0047
NO.	ITEM	UNIT	QUANTITY	RURAL	S.N. 032-0078
20400800	FURNISHED EXCAVATION	CU YD	30	30	
21400100	GRADING AND SHAPING DITCHES	FOOT	3050	3050	
25000210	SEEDING, CLASS 2A	ACRE	0.5	0.5	
25000400	NITROGEN FERTILIZER NUTRIENT	POUND	39	39	
23000400		1 00142	33		
25000500	PHOSPHORUS FERTILIZER NUTRIENT	POUND	39	39	
0500000	DOTAGOUN FEDTUATED MUTDIENT	20,000	20		
25000600	POTASSIUM FERTILIZER NUTRIENT	POUND	39	39	
25100630	EROSION CONTROL BLANKET	SQ YD	2078	2078	
28100107	STONE RIPRAP, CLASS A4	SQ YD	126		126
28100107	STONE RIFRAF, CLASS A4	30,10	120		120
28100707	STONE DUMPED RIPRAP, CLASS A4	SQ YD	39	39	
28200200	FILTER FABRIC	SQ YD	165	39	126
40600290	BITUMINOUS MATERIALS (TACK COAT)	POUND	133334	133334	
40600370	LONGITUDINAL JOINT SEALANT	FOOT	58083	58083	
40600400	MIXTURE FOR CRACKS, JOINTS, AND FLANGEWAYS	TON	76	76	
40603200	POLYMERIZED HOT-MIX ASPHALT BINDER COURSE, IL-4.75, N50	TON	8609	8609	

Ö	FLE NAME: pw://ildot-pw.bentlev.com:PW DO //Document
MODE	LILE

USER NAME = brandon.criss	DESIGNED	REVISED
	DRAWN	REVISED
PLOT SCALE = 0.16666633 ' / in.	CHECKED	REVISED
PLOT DATE = 11/2/2023	DATE -	REVISED -

STATE OF ILLINOIS
DEPARTMENT OF TRANSPORTATION

											TOTAL	OUE
SUM	IMARY	OF QU	ANTI	TIES			F.A.I RTE.	SECTION		COUNTY	TOTAL SHEETS	SHEE
							55	(32-2)RS,BRR		GRUNDY	39	3
										CONTRACT	NO. 66K	(67
SHEET 1	OF 7	SHEETS	STA.	+	TO STA.	+		ILLINOIS	FED. AID	PROJECT		

				CONSTRU	CTION CODE
				90% FED 10% STATE	90% FED 10% STATE
			T	ROADWAY	BR⊺DGE
CODE			TOTAL	0005	0047
NO.	ITEM	UNIT	QUANTITY	RURAL	S.N. 032-0078
40603235	POLYMERIZED HOT-MIX ASPHALT BINDER COURSE, IL-19.0, N70	TON	19681	19681	
40604162	POLYMERIZED HOT-MIX ASPHALT SURFACE COURSE, IL-9.5, MIX "D", N70	TON	10941	10941	
40605045	DOLYMEDIZED HOT MIX ASSULALT DINIDED COLIDER STONE MATERIX ASSULALT 12.5, NO.	TON	17266	17266	
40605015	POLYMERIZED HOT-MIX ASPHALT BINDER COURSE, STONE MATRIX ASPHALT 12.5, N80	TON	1/266	17266	
40605034	POLYMERIZED HOT-MIX ASPHALT SURFACE COURSE, STONE MATRIX ASPHALT, 12.5, MIX "E", N80	TON	17247	17247	
44000157	HOT-MIX ASPHALT SURFACE REMOVAL, 2"	SQ YD	75613	 75613	
44000169	HOT-MIX ASPHALT SURFACE REMOVAL, 5"	SQ YD	153728	153728	
44000182	HOT-MIX ASPHALT SURFACE REMOVAL, 8"	SQ YD	76038	76038	
44200553	CLASS A PATCHES, TYPE II, 10 INCH	SQ YD	1169	1169	
44200557	CLASS A PATCHES, TYPE III, 10 INCH	SQ YD	48	48	
44200559	CLASS A PATCHES, TYPE IV, 10 INCH	SQ YD	33	33	
44200624	CLASS A PATCHES, TYPE III, 14 INCH	SQ YD	16	16	
44213000	PATCHING REINFORCEMENT	SQ YD	1250	1250	
44213200	SAWCUTS	FOOT	5330	5330	
44213204	TIE BARS 3/4"	EACH	6018	6018	

	S/IDO
	5
	Ě
	PWIDOT/Document
	2
	ĕ
	E
	ă
	≥
	ë
	Š
	>
듄	픁
ě	//ildot-ow.bent
ള	3
2	3
įщ	8
Ξ	5
S	õ
SOQ SHEET 2 [Sheet]	ă.
	ž
చ	ž
MODEL:	FILE NAME
ĭ	Ē

USER NAME = brandon.criss	DESIGNED	REVISED
	DRAWN	REVISED
PLOT SCALE = 0.16666633 ' / in.	CHECKED	REVISED
PLOT DATE = 11/2/2023	DATE -	REVISED -

STATE OF ILLINOIS
DEPARTMENT OF TRANSPORTATION

SU	SUMMARY OF QUANTITIES				F.A.I RTE.			COUNTY	TOTAL SHEETS	SHEET NO.			
								55	(32-2)RS,BF	RR	GRUNDY	39	4
											CONTRACT	NO. 66K	67
SHEET 2	OF	7	SHEETS	STA.	+	TO STA.	+		I	ILLINOIS FED. A	ID PROJECT		

			l l		TION CODE
				90% FED 10% STATE	90% FED 10% STATE
				ROADWAY	BR∃DGE
CODE			TOTAL	0005	0047
NO.	ITEM	UNIT	QUANTITY	RURAL	S.N. 032-0078
48102100	AGGREGATE WEDGE SHOULDER, TYPE B	TON	4330	4330	
50102400	CONCRETE REMOVAL	CU YD	4		4
30102400	OUNTIL TENEVAL	00 15			
50157300	PROTECTIVE SHIELD	SQ YD	620		620
50300255	CONCRETE SUPERSTRUCTURE	CU YD	4.2		4.2
50300260	BRIDGE DECK GROOVING	SQ YD	1444		1444
50300300	PROTECTIVE COAT	SQ YD	1565		1565
50800205	REINFORCEMENT BARS, EPOXY COATED	POUND	801	161	640
50800515	BAR SPLICERS	EACH	8		8
50800530	MECHANICAL SPLICERS	EACH	44		44
52000110	PREFORMED JOINT STRIP SEAL	FOOT	66		66
54213669	PRECAST REINFORCED CONCRETE FLARED END SECTIONS 24"	EACH	1	1	
54248510	CONCRETE COLLAR	CU YD	3	3	
58700300	CONCRETE SEALER	SQ FT	449		449
59000200	EPOXY CRACK INJECTION	FOOT	12		12

II/ofuc
/ danage Di MID OT / Dogumento
TOOL
Ald mo
Carolina
od and
· oww//ildot on
ij
CHICKLAND
ū

USER NAME = brandon.criss	DESIGNED	REVISED
	DRAWN	REVISED
PLOT SCALE = 0.16666633 '/in.	CHECKED	REVISED
PLOT DATE = 11/2/2023	DATE	REVISED

SUMMARY OF QUANTITIES									F.A.I SECTION COUN				SHEET NO.
								55	(32-2)RS,BRR		GRUNDY	39	5
								CONTRACT NO. 66K67					
	SHEET 3	OF 7	SHEETS	STA.	+	TO STA	+	ILLINOIS FED. A			D PROJECT		

CONSTRUCTION CODE

			ļ		CITON CODE
				90% FED 10% STATE	90% FED 10% STATE
				ROADWAY	BRIDGE
CODE			TOTAL	0005	0047
NO.	ITEM	UNIT	QUANTITY	RURAL	S.N. 032-0078
59300100	CONTROLLED LOW-STRENGTH MATERIAL	CU YD	4		4
60202215	CATCH BASINS, TYPE A, 4'-DIAMETER, WITH MEDIAN INLET (604101)	EACH	1	1	
60905305	BOX CULVERTS TO BE CLEANED	FOOT	40	40	
60920024	PIPE CULVERTS TO BE CLEANED 24"	FOOT	66	66	
63500105	DELINEATORS	EACH	184	184	
64200116	SHOULDER RUMBLE STRIPS, 16 INCH	FOOT	115006	115006	
64300450	IMPACT ATTENUATORS (NON-REDIRECTIVE), TEST LEVEL 3	EACH	3	3	
66900200	NON-SPECIAL WASTE DISPOSAL	CU YD	344	344	
66900530	SOIL DISPOSAL ANALYSIS	EACH	2	2	
66901001	REGULATED SUBSTANCES PRE-CONSTRUCTION PLAN	L SUM	1	1	
	TRESCRIED COBOTANCES TRE-CONCINCIONAL EAV	E OOW	1	1	
66901003	REGULATED SUBSTANCES FINAL CONSTRUCTION REPORT	L SUM	1	1	
66901006	REGULATED SUBSTANCES MONITORING	CAL DA	5	5	
67000400	ENGINEER'S FIELD OFFICE, TYPE A	CAL MO	12	12	
67100100	MOBILIZATION	L SUM	1	1	

USER NAME = brandon.criss	DESIGNED	REVISED
	DRAWN	REVISED
PLOT SCALE = 0.16666633 ' / in.	CHECKED	REVISED
PLOT DATE = 11/2/2023	DATE -	REVISED -

SUM	IMARY (	OF QU	ANTITIE	3			F.A.I RTE.	SEC <sup>-</sup>	TION		COUNTY	TO' SHE
							55	(32-2)RS,E	BRR		GRUNDY	3
											CONTRACT	ΓNO
SHEET 4	OF 7	SHEETS	STA+_		TO STA.	+			ILLINOIS	FED. AII	D PROJECT	

CONSTRUCTION CODE

<sup>\*=</sup> SPECIALTY ITEM

			000/ EED	
			90% FED 10% STATE	90% FED 10% STATE
			ROADWAY	BRIDGE
		TOTAL		0047
ITEM	UNIT	QUANTITY	RURAL	S.N. 032-0078
TRAFFIC CONTROL AND PROTECTION, STANDARD 701321	EACH	1	1	
TRAFFIC CONTROL AND PROTECTION, STANDARD 701411	EACH	1	1	
TRAFFIC CONTROL AND PROTECTION, STANDARD 701201	L SUM	1	1	1
TRAFFIC CONTROL AND PROTECTION, STANDARD 701406	EACH	1	1	
TEMPORARY BRIDGE TRAFFIC SIGNALS	EACH	1	1	
CHANGEABLE MESSAGE SIGN	CAL DA	28	28	
SHORT TERM PAVEMENT MARKING	FOOT	11501	11501	
SHORT TERM PAVEMENT MARKING REMOVAL	SQ FT	6709	6709	
TEMPORARY PAVEMENT MARKING - LINE 6" - TYPE IV TAPE	FOOT	5750	5750	
TEMPORARY CONCRETE BARRIER	FOOT	800	800	
RELOCATE TEMPORARY CONCRETE BARRIER	FOOT	787.5	787.5	
MPACT ATTENUATORS, TEMPORARY (NON- REDIRECTIVE), TEST LEVEL 3	EACH	2	2	1
MPACT ATTENUATORS, RELOCATE (NON- REDIRECTIVE), TEST LEVEL 3	EACH	2	2	
REMOVE SIGN PANEL ASSEMBLY - TYPE A	EACH	10	10	
	TRAFFIC CONTROL AND PROTECTION, STANDARD 701321  TRAFFIC CONTROL AND PROTECTION, STANDARD 701411  TRAFFIC CONTROL AND PROTECTION, STANDARD 701201  TRAFFIC CONTROL AND PROTECTION, STANDARD 701406  TEMPORARY BRIDGE TRAFFIC SIGNALS  CHANGEABLE MESSAGE SIGN  SHORT TERM PAVEMENT MARKING  SHORT TERM PAVEMENT MARKING REMOVAL.  TEMPORARY PAVEMENT MARKING - LINE 6" - TYPE IV TAPE  TEMPORARY CONCRETE BARRIER  RELOCATE TEMPORARY CONCRETE BARRIER  MPACT ATTENUATORS, TEMPORARY (NON- REDIRECTIVE), TEST LEVEL 3  MPACT ATTENUATORS, RELOCATE (NON- REDIRECTIVE), TEST LEVEL 3	IRAFFIC CONTROL AND PROTECTION, STANDARD 701321  EACH  IRAFFIC CONTROL AND PROTECTION, STANDARD 701411  EACH  IRAFFIC CONTROL AND PROTECTION, STANDARD 701411  EACH  IRAFFIC CONTROL AND PROTECTION, STANDARD 701406  EACH  IRAFFIC CON	ITEM UNIT QUANTITY  TRAFFIC CONTROL AND PROTECTION, STANDARD 701321  EACH 1  TRAFFIC CONTROL AND PROTECTION, STANDARD 701411  EAGH 1  TRAFFIC CONTROL AND PROTECTION, STANDARD 701411  L SUM 1  TRAFFIC CONTROL AND PROTECTION, STANDARD 701406  EACH 1  TEMPORARY BRIDGE TRAFFIC SIGNALS  EACH 1  CHANGEABLE MESSAGE SIGN  CAL DA 28  SHORT TERM PAVEMENT MARKING  SHORT TERM PAVEMENT MARKING REMOVAL  SQ FT 6709  TEMPORARY PAVEMENT MARKING - LINE 6"-TYPE IV TAPE  FOOT 5750  TEMPORARY CONCRETE BARRIER  FOOT 787. 5  MPACT ATTENUATORS, TEMPORARY (NON-REDIRECTIVE), TEST LEVEL 3  MPACT ATTENUATORS, RELOCATE (NON-REDIRECTIVE), TEST LEVEL 3  EACH 2  MPACT ATTENUATORS, RELOCATE (NON-REDIRECTIVE), TEST LEVEL 3  EACH 2	TOTAL QUANTITY

USER NAME = brandon.criss	DESIGNED	REVISED
	DRAWN	REVISED
PLOT SCALE = 0.16666633 '/in.	CHECKED	REVISED
PLOT DATE = 11/2/2023	DATE	REVISED

SUM	MARY	OF QU	ANTI	TIES			F.A.I RTE	SEC	TION		COUNTY	TOTAL SHEETS	SHE
							55	(32-2)RS,I	BRR		GRUNDY	39	7
											CONTRACT	NO. 66K	(67
SHEET 5	OF 7	SHEETS	STA.	+	TO STA.	+			ILLINOIS	FED. AII	PROJECT		

CONSTRUCTION CODE

<sup>\*=</sup> SPECIALTY ITEM

CONSTRUCTION CODE

USER NAME = brandon criss	DESIGNED	REVISED	
	DRAWN	REVISED	
PLOT SCALE = 0.16666633 ' / in.	CHECKED	REVISED	
PLOT DATE = 11/2/2023	DATE	REVISED	
			-

<sup>\*=</sup> SPECIALTY ITEM

				L	CONSTRO	LITON CODE
					90% FED 10% STATE	90% FED 10% STATE
					ROADWAY	BRIDGE
	CODE			TOTAL	0005	0047
	NO.	ITEM	UNIT	QUANTITY	RURAL	S.N. 032-0078
				Quintin		
	X6430120	REMOVE IMPACT ATTENUATORS, NO SALVAGE	EACH	3	3	
	X7010239	CHANGEABLE MESSAGE SIGN (SPECIAL)	CAL WK	560	560	
	X7260100	MILE POST MARKER ASSEMBLY (SPECIAL)	EACH	10	10	
	X8570002	SMART TRAFFIC MONITORING SYSTEM	CAL WK	70	70	
	X8570004	SMART TRAFFIC MONITORING DEVICE	CAL WK	350	350	
_	Z0004556	HOT-MIX ASPHALT SURFACE REMOVAL (DECK)	SQ YD	1549		1549
	Z0006016	BRIDGE DECK LATEX CONCRETE OVERLAY, 2 3/4 INCHES	SQ YD	1549		1549
	Z0012130	BRIDGE DECK SCARIFICATION 3/4"	SQ YD	1549		1549
	Z0012754	STRUCTURAL REPAIR OF CONCRETE (DEPTH EQUAL TO OR LESS THAN 5 INCHES)	SQ FT	13		13
	Z0016001	DECK SLAB REPAIR (FULL DEPTH, TYPE I)	SQ YD	7		7
	25010001			,		,
	Z0016002	DECK SLAB REPAIR (FULL DEPTH, TYPE II)	SQ YD	2		2
	Z0018300	DRAINAGE STRUCTURE REPAIR	EACH	4	4	
	Z0021908	SILICONE JOINT SEALER, 2"	FOOT	64		64
$\mid$	Z0030850	TEMPORARY INFORMATION SIGNING	SQ FT	84	84	
Z		TRAINEES	HOUR	2,000	2,000	
	Z0034105	MATERIAL TRANSFER DEVICE	TON	43045	43045	
Z		TRAINEES - TRAINING PROGRAM GRADUATE	HOUR	2,000	2,000	
	Z0048665	RAILROAD PROTECTIVE LIABILITY INSURANCE	L SUM	1	1	


CONSTRUCTION CODE

Ø 0042 \*= SPECIALTY ITEM

USER NAME = brandon.criss	DESIGNED	REVISED						F.A.I RTE	SECTION	COUNTY	TOTAL SHEET
	DRAWN	REVISED	STATE OF ILLINOIS		COM	W/ II CI QO/ II III LO		55	(32-2)RS.BRR	GRUNDY	39 9
PLOT SCALE = 0.16666633 ' / in.	CHECKED	REVISED	DEPARTMENT OF TRANSPORTATION					111	()	CONTRACT	T NO. 66K67
PLOT DATE = 11/2/2023	DATE	REVISED		SCALE:	SHEET 7	OF 7 SHEETS STA+	TO STA+		ILLINOIS F	ED. AID PROJECT	

#### **EXISTING TYPICAL SECTION**

STA. 460+00 TO STA. 745+14 (N.B.) STA. 459+93 TO STA. 749+82 (S.B.)

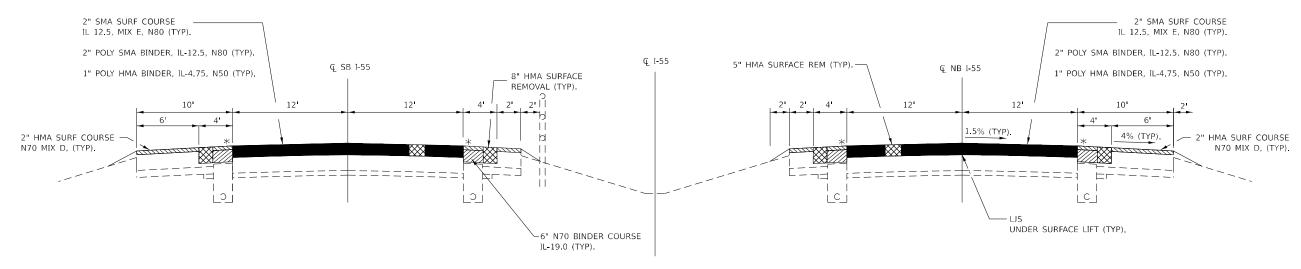

PROPOSED TYPICAL SECTION

STA. 460+00 TO STA. 745+14 (N.B.) STA. 459+93 TO STA. 749+82 (S.B.) \* 16" RUMBLE STRIP (TYP).

HMA SURFACE REMOVAL IS INTENDED TO REMOVE ALL EXISTING HMA.

ON SUPERELEVATED ROADWAYS THE RESURFACING SHALL

ROLLOVER BETWEEN EDGE OF PAVEMENT AND SHOULDER

MATCH THE EXISTING PAVEMENT WITH A MAXIMUM 8%

LOCATIONS:	ENTIRE PROJECT					
MIXTURE USE(S):	HMA	SMA	SMA	HMA SHOULDERS	6' HMA INNER	10' HMA OUTER
					SHOULDER TOP	SHOULDER TOP
	BINDER	BINDER	SURFACE	BOTTOM LIFT(S)	LIFT	LIFT
BINDER GRADE (PG):	SBS PG 76-28	SBS PG 76-28	SBS PG 76-28	SBS PG 70-28	SBS PG 70-28	SBS PG 70-28
DESIGN AIR VOIDS:	4.0% @ N50	4.0% @ N80	4.0% @ N80	4.0% @ N70	4.0% @ N70	4.0% @ N70
MIXTURE COMPOSITION:	IL 4.75	IL 12.5	IL 12.5	IL 19.0	IL 9.5	IL 9.5
(MIXTURE GRADATION)						
FRICTION AGGREGATE:			MIXTURE E		MIXTURE D	MIXTURE D
MIXTURE WEIGHT:	112.0 LB/SY/IN					
QUALITY MANAGEMENT PROGRAM:	PFP	PFP	PFP	QCQA	QCQA	QCP
SUBLOT SIZE:	1000 TONS	1000 TONS	1000 TONS	N/A	N/A	1000 TONS
DENSITY TEST METHOD:	CORES	CORES	CORES	CORES/NUCLEAR	CORES/NUCLEAR	CORES
MATERIAL TRANSFER DEVICE (REQUIRED):	YES	YES	YES	NO	YES	YES

USER NAME = brandon.criss	DESIGNED	REVISED
	DRAWN	REVISED
PLOT SCALE = 0.16666633 ' / in.	CHECKED	REVISED
PLOT DATE = 11/2/2023	DATE	REVISED -

STATE OF ILLINOIS
DEPARTMENT OF TRANSPORTATION

						F.A.I RTE.				COUNTY	TOTAL SHEETS	SHEET NO.				
										55	(32-2)RS,	BRR		GRUNDY	39	10
														CONTRACT	NO. 66K	67
SHEET	1	OF	1	SHEETS	STA.	+	TO STA	+	_			ILLINOIS	FED. AII	D PROJECT		

	TURN	AROUN	D SCHEDU	ILE						
CTATION	LENGTH	LANE	POLY SMA BINDER	POLY SMA SURF CSE	BIT MAT'L					
STATION	LENGTH	WIDTH	IL-12.5 N80	IL-12.5 MIX "E"	(TACK COAT)					
			(2 1/2")	N80 (1 1/2")						
	FT	FT	TONS	TONS	POUND					
TURN AROUND										
	88	35	48	29	231					
TOTAL			48	29	231					

					SH	HOULDER	SCHEDULE							
					INSIDE SHO	OULDER 6'			OUTSIE	E SHOULDE	ER 10'			
							HMA F SURFACE BI			HMA SURF CSE	MIX FOR JTS,	BIT MAT'L		
STA. TO STA.		SIDE	LENGTH	REM	OVAL	COURSE IL-19.0	IL-9.5 MIX "D"		REMOVAL		COURSE IL-19.0	IL-9.5 MIX "D <b>"</b>	CRACKS & FLGWYS	(TACK COAT)
				8"	2"	N70	N70	8"	2"	2"	N70	N70		
				INNER 4'	OUTER 2'	(6")	(2")	INNER 4'	OUTER 6'	INNER 4'	(8")	(2")		
			FT	SQ YD	SQ YD	TONS	TONS	SQ YD	SQ YD	SQ YD	TONS	TONS	TONS	POUND
I-55 NB														
460+00	745+14	OUTSIDE	28514.0					12,672.9	19,009.3	12,672.9	5,677.5	3,548.4	9.5	14,257.0
460+00	703+03	INSIDE	24303.0	12,672.9	5,400.7	3,629.2	946.2						4.9	8,133.1
703+00	715+03	INSIDE	OMISSION FOI	R CROSSOVER	PCC SHOULDER	₹								
714+97	745+14	INSIDE	3017.0	12,672.9	670.4	450.5	946.2						0.6	6,004.5
	SUBTOTAL			25,345.8	6,071.1	4,079.8	1,892.5	12,672.9	19,009.3	12,672.9	5,677.5	3,548.4	15.0	28,394.6
I-55 SB														
459+93	749+82	OUTSIDE	28989.0					12,672.9	19,009.3	12,672.9	5,772.0	3,607.5	9.7	14,257.0
459+93	703+03	INSIDE	24310.0	12,672.9	5,402.2	3,630.3	946.2						4.9	8,133.8
703+00	715+03	INSIDE	OMISSION FOI	R CROSSOVER	PCC SHOULDER	₹								
714+97	749+82	INSIDE	3485.0	12,672.9	774.4	520.4	946.2						0.7	6,051.3
	SUBTOTAL			25,345.8	6,176.7	4,150.7	1,892.5	12,672.9	19,009.3	12,672.9	5,772.0	3,607.5	15.2	28,442.1
·	TOTAL			50,692	12,248	8,231	3,785	25,346	38,019	25,346	11,449	7,156	30	56,837

					PAVEMEN	IT MARKING	SCHEDULE	E				
			PAVEMENT	EPOXY P	AVEMENT	PREFORM	GROOV I N	NG FOR			RAISED	RAISED
	MARKING MARKING * PLASTIC REC PVMT_MRKG C		DELINEATORS	DELINEATOR	REFLECT	REFLECT						
LOCATI	ON	LENGTH	REMOVAL	4	II	TY D, 8"	E =	5" 0"		REMOVAL	PVMT MRKS	PVMT
			WATER BLASTING	WH	ΥW	CONTRAST	5	9			REMOVAL_	MRKS
STA TO	STA		SQ FT	FOOT	FOOT	FOOT	FOOT	FOOT	EACH	EACH	EACH	EACH
I - 55 NB												
460+00 TO	745+14	28,514	18,819	114,056	114,056	7,130	114,056	7,130	71	71	713	713
1-55 SB												
459+93 TO	749+82	28,989	19,133	115,956	115,956	7,250	115,956	7,250	72	72	725	725
	TOTAL		37,952	230,012	230,012	14,380	230,012	14,380	144	144	1,438	1,438

\* QUANTITY REPRESENTS 2 APPLICATIONS.

USER NAME = brandon.criss	DESIGNED	REVISED
	DRAWN	REVISED
PLOT SCALE = 0.16666633 ' / in.	CHECKED	REVISED
PLOT DATE = 11/2/2023	DATE	REVISED

	SCH	EDULE	ES .	F.A.I RTE	SECTION		COUNTY	TOTAL SHEETS	SHEET NO.	
					55	(32-2)RS,BRR		GRUNDY	39	11
								CONTRACT	NO. 66K	67
SHEET 1	OF 6	SHEETS	STA+	TO STA+		ILLINOIS	FED. AID F	PROJECT		

	IMPACT	r attenua	TOR SCHEDULE	
LOCATION	STR CL STA	LOCATION	IMPACT ATTENUATORS (NON- REDIRECTIVE), TEST LEVEL 3 EACH	REM IMPACT ATTENUATOR, NO SALVAGE
_		MEDIAN/NORTH	1	1
SN 032-0078	626+00	MEDIAN/SOUTH	1	1
		RT(NB)/SOUTH	1	1
		TOTAL	3	3

	I-55 MAINLINE PATCHING SCHEDULE																					
				-			NORT	HBOUND I	ANES			-										
				PASSIN	G LANE					_		DRIVIN	G LANE									
MILE	MILE PATCH PATCH AREA CLASS A PATCHING PATCH SAW TIE BA									PATCH	AREA	CLASS A	PATCHING	PATCH	SAW	TIE BARS						
MARKER	ER LENGTH WIDTH TY II TY III REINF. CUTS 3/4"								LENGTH	WIDTH		TY II	TY III	REINF.	CUTS	3/4"						
	10"   14"									_		10"	10"									
(MM)	FOOT	FOOT	SQ YD	SQ YD	SQ YD	SQ YD	FOOT	EACH	FOOT	FOOT	SQ YD	SQ YD	SQ YD	SQ YD	FOOT	EACH						
0.0									6	12	8	8		8	36	42						
3.2	6	12	8	8		8	36	42	6	12	8	8		8	36	42						
3.5	6	12	8	8		8	36	42														
5.1	5.1									12	8	8		8	36	42						
5.3	5.3 12 12 16 16 40 42							42	12	12	16		16	16	48	42						
	NORTH BOU	ND TOTALS	32	16	16	16	120	126	30	48	40	24	16	40	156	168						

\*ALL 10 INCH PACHES SHALL BE DONE AFTER THE FIRST LEVEL OF BINDER HAS BEEN APPLIED

USER NAME = brandon criss	DESIGNED	REVISED
	DRAWN	REVISED
PLOT SCALE = 0.16666633 ' / in.	CHECKED	REVISED
PLOT DATE = 11/2/2023	DATE	REVISED

STATE OF ILLINOIS
DEPARTMENT OF TRANSPORTATION

	SCH	EDULE	ES			F.A.I RTE.	SECT	TION		COUNTY	TOTAL SHEETS	SHEET NO.
						55	(32-2)RS,E	BRR		GRUNDY	39	12
										CONTRACT	NO. 66K	.67
SHEET 2	OF 6	SHEETS	STA+	 TO STA.	+			ILLINOIS	FED. AII	PROJECT		

\*FOR SOUTHBOUND LM 0.0 IS STA 749+82. MILES INCREASING TO THE SOUTH.

NOTE: ALL 10 INCH PACHES SHALL BE DONE AFTER THE FIRST LEVEL OF BINDER HAS BEEN APPLIED

USER NAME = brandon.criss	DESIGNED	REVISED
	DRAWN	REVISED
PLOT SCALE = 0.16666633 ' / in.	CHECKED	REVISED
PLOT DATE = 11/2/2023	DATE	REVISED -

	9	SCH	HEDULE	ES					F.A.I RTE.		SECT	ION		COUNTY	TOTAL SHEETS	SHEET NO.
									55	(32-2	2)RS,B	RR		GRUNDY	39	13
														CONTRAC	NO. 66K	67
SHEET 3	OF	6	SHEETS	STA.	+	Т	ro sta.	+				ILLINOIS	FED. AII	PROJECT		

\*FOR SOUTHBOUND LM 0.0 IS STA 749+82. MILES INCREASING TO THE SOUTH.

NOTE: ALL 10 INCH PACHES SHALL BE DONE AFTER THE FIRST LEVEL OF BINDER HAS BEEN APPLIED

USER NAME = brandon criss	DESIGNED	REVISED
	DRAWN	REVISED
PLOT SCALE = 0.16666633 ' / in.	CHECKED	REVISED
PLOT DATE = 11/2/2023	DATE	REVISED

SCHEDULES													
CONTRACT NO. 66K67		SCH	IEDULE	ES				F.A.I RTE.	SECTION		COUNTY		
								55	(32-2)RS,BRR		GRUNDY	39	14
SHEET 4 OF 6 SHEETS STA. + . TO STA. + .											CONTRACT	NO. 66K	67
	SHEET 4	OF 6	SHEETS	STA.	+	TO STA+	_		ILLINOIS	FED. AID	PROJECT		

MODEL: 301EJOLE Janeary
FILE NAME: pw.//ildot-pw.bentley.com:PWIDOT/Documents/IDOT Offices/District 3/ORD Projects/D366k

USER NAME = brandon criss	DESIGNED	REVISED
	DRAWN	REVISED
PLOT SCALE = 0.16666633 ' / in.	CHECKED	REVISED
PLOT DATE = 11/2/2023	DATE _	REVISED -

STATE OF ILLINOIS
DEPARTMENT OF TRANSPORTATION

		SCH	EDULE	ES .		F.A.I RTE.	SECTION	COUNTY	TOTAL SHEETS	SHEET NO.
						55	(32-2)RS,BRR	GRUNDY	39	15
								CONTRACT	NO. 66K	67
5	HEET 5	OF 6	SHEETS	STA+	TO STA+		ILLINOIS FED. A	D PROJECT		

		LINEAR DE	LINEATOR	PANEL SC	CHEDULE								
LINEAR LINEAR													
STRUCTURE GUARDRAIL PARAPET DELINEATOR DELI													
STRUCTURE	PANELS, 6"												
NUMBER	SIDE	STATION	FT	FT	EACH	EACH							
BRIDGE													
032-0078	032-0078 NORTH 42+51.94 828 531.5 12 9												
032-0078	SOUTH	42+51.94	834	531.5	12	9							
	TOTAL		1662	1063	24	18							

MILE MARKER SCHEDULE												
MILE	SIDE	MILE POST MARKER ASSY SPECIAL	TELESCOPING STEEL SIGN SUPPORT	REM SIGN PANEL ASSY TY A								
		EACH	FOOT	EACH								
MM 222	NB/SB	2	30	2								
MM 223	NB/SB	2	30	2								
MM 224	NB/SB	2	30	2								
MM 225	NB/SB	2	30	2								
MM 226	NB/SB	2	30	2								
TOTAL		10	150	10								

\*NOTE: REMOVED SIGNS SHALL BE DELIVERED TO THE GARDNER IDOT MAINTENANCE FACILITY.

				GRAI	DING AN	ID SHAPINO	G DITCHES S	CHEDULE					
								GRADING	SEEDING	NITRO	PHOSP	POT	EROSION
						DIRECTION	FURNISHED	AND	CL 2A	FERT	FERT	FERT	CONTROL
CTA-	TION	LOCATION	LENGTH	WIDTH	DEPTH	OF	EXCAVATION	SHAPING	CL Z.	NUT	NUT	NUT	BLANKET
SIAI	HON	LUCATION	LENGIII	WILLIAM	DEFILI		EXCAVATION			NUI	I NO I	INO I	DLANKLI
						FLOW		DITCHES					
STA T	O STA.	LT/MED/RT	FOOT	FOOT	FOOT		CU YD	FOOT	ACRE	LB	LB	LB	SQ YD
		<u> </u>			FUUT	COLUTIA	COTD			LD	LD	LD	
465+20	466+20	LT	100	6	1	SOUTH		100	0.014	1	1	1	67
480+00	481+00	LT	100	6	1	NORTH		100	0.014	1	1	1	67
514+50	517+50	LT	300	6	1	SOUTH		300	0.041	4_	4	4	200
534+00	535+00	LT	100	б	1	SOUTH		100	0.014	1	1	1	67
545+00	546+50	LT	150	6	1	NORTH		150	0.021	2	2	2	100
576+00	578+00	LT	200	6	1	NORTH		200	0.028	2	2	2	133
599+80	602+30	LT	250	6	1	NORTH		250	0.034	(")	3	3	167
618+70	620+70	LT	200	6	1	NORTH		200	0.028	2	2	2	133
626+00	628+00	LT	200	6	1	NORTH		200	0.028	2	2	2	133
626+00	629+00	*MED	300	6	1	NORTH		300	0.041	4	4	4	200
633+00	635+50	LT	250	6	1	NORTH		250	0.034	3	3	3	167
640+00	642+00	LT	200	6	1	NORTH		200	0.028	2	2	2	133
672+00	674+00	LT	200	6	1	NORTH		200	0.028	2	2	2	133
687+00	688+00	LT	100	6	1	NORTH		100	0.014	1	1	1	67
/04+00	/06+00	LI	200	6	1	NORTH		200	0.028	2	2	2	133
742+00	744+00	LT	200	6	1	NORTH		200	0.028	2	2	2	133
SN 032-0078 (F	EMBANKMENT CO	ONE FACING SB TE	RAFFIC)										
626	5+00	LT	50	8	2		30		0.01	1	1	1	44
						TOTALS	30	3.050	0.50	39	39	39	2.078

\* LOCATION TO BE GRADED AWAY FROM CONCRETE PAD FOR IMPACT ATTENUATORS

I - 55	LOCATION: 1.2 MI N OF IL 47 TO GARDNER RD IN GARDNER					GRUNDY COUNTY
			EXISTING	PROPOSED	MONUMENT	
MONUMENT	DESCRIPTION		MONUMENT	MONUMENT	RECORD TO BE	RESPONSIBILITY
NUMBER			TYPE	TYPE	RECORDED	
N/A	NO PERMANENT SURVEY MARKERS OR		N/A	N/A	N/A	N/A
	OTHER MARKERS TO BE SET OR RESET.					
	  AL SCOPE OF THIS JOB HAS BEEN SEARCHED FOR MONUMENTS.  G IF ADDENDUMS HAVE BEEN ADDED TO THIS JOB.	R.E	. MUST INFORM P	LATS AND PLANS	TO SEARCH FOR ADDIT	IONAL MONUMENTS
UNKNOWN MONU	MENTS MAY EXIST. IF AN UNLISTED MONUMENT IS FOUND, R.E.	. IS R	EQUIRED TO PRO	TECT THE MONUM	ENT FROM DAMAGE UN	TIL A PLATS AND PLANS
LAND SURVEYOR	CAN DOCUMENT THE MONUMENT. PLATS AND PLANS WILL RES	ET SU	ICH MONUMENTS	IN KIND FOLLOWI	NG CONSTRUCTION.	
NO MONUMENT R	ECORDS ARE REQUIRED FOR THIS JOB.					


					TEMPOR	ARY TRAFFIC CONTI	ROL 701321 GOODFARM	1 ROAD SCHEDULE			
						STAGE 1		ST <i>A</i>			
LOCATION			LENGTH	TEMPORARY BRIDGE TEMPORARY		TEMPORARY	IMPACT ATTENUATOR	TEMPORARY IMPACT ATTENUATOR		TEMPORAY	
LOCATION			LENGIR	TRAFFIC	SIGNALS	CONCRETE BARRIER	NON-REDIRECTIVE TL 3	CONCRETE BARRIER	NON-REDIRECTIVE TL 3	RUMBLE S	STRIP
				LOCA	TIONS	INSTALL	INSTALL	RELOCATE RELOCATE		LOCATIONS*	
STA	TO	STA	FOOT	STA	WB/EB	FOOT	EACH	FOOT	EACH	WB/EB	EACH
GOODFARM	RD (SN	032-0078)		37+98 RT	WB			<del></del>		WB	3
38+52	ТО	46+52	800.0	47+16 LT	EB	800.0	1		1	EB	3
38+58.5	TO	46+46	787.5				1	787.5	1		
			TOTALS		2	800	2	787.5	2		6

\*LOCATIONS TO BE SET PER STANDARD

USER NAME = brandon.criss	DESIGNED	REVISED
	DRAWN	REVISED
PLOT SCALE = 0.16666633 ' / in.	CHECKED	REVISED
PLOT DATE = 11/2/2023	DATE -	REVISED -

STATE OF ILLINOIS
DEPARTMENT OF TRANSPORTATION


	SCH	EDULE	ES				F.A.I RTE.	SECTION	COUNTY	TOTAL SHEETS	SHEET NO.
							55	(32-2)RS,BRR	GRUNDY	39	16
									CONTRACT	NO. 66K	67
SHEET 6	OF 6	SHEETS	STA.	+	TO STA.	+		ILLINOIS FED. A	ID PROJECT		

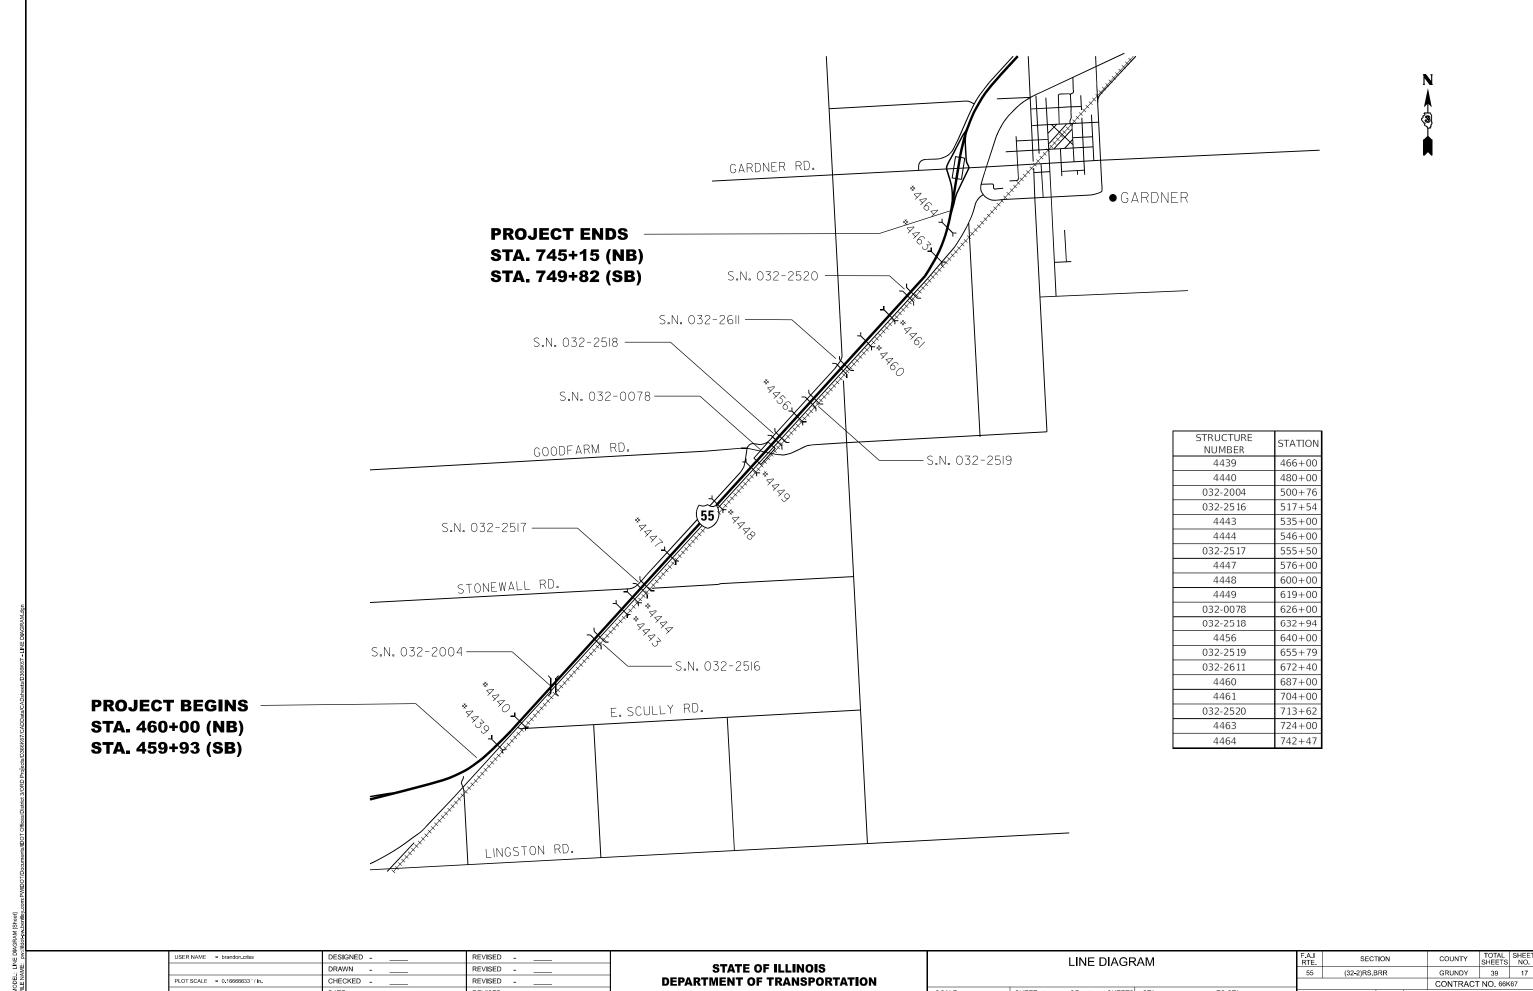

CHECKED -


**STATE OF ILLINOIS DEPARTMENT OF TRANSPORTATION** 

(32-2)RS,BRR SHEET 1 OF 1 SHEETS STA. \_\_+\_. TO STA.

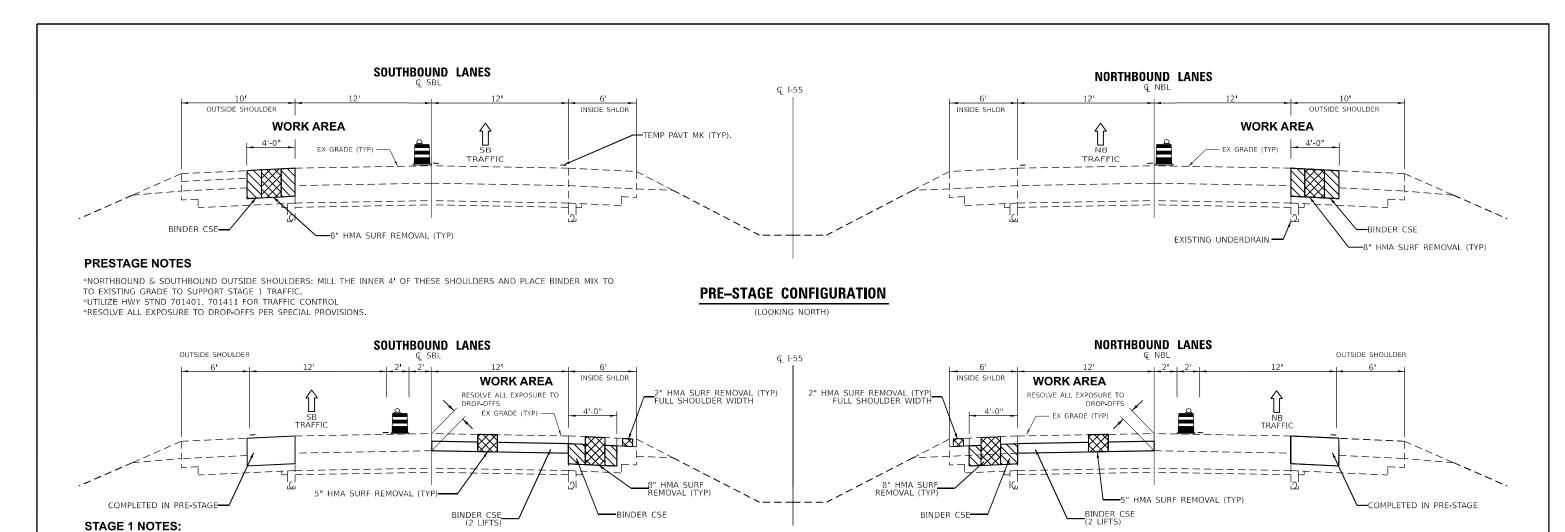


\*IMPROVE ALL MEDIAN STRUCTURAL ITEMS. \*UTILIZE HWY STND 701401, 701411 FOR TRAFFIC CONTROL \*IMPROVE INSIDE SHOULDER (BINDER) FOR STAGE 2. \*MILL AND RESURFACE MAINLINE PAVEMENT (PROPOSED BINDER MIXES ONLY), PATCHING TO BE DONE AFTER THE FIRST LIFT OF BINDER IS PLACED. \*EXPOSURE TO DROP-OFFS SHALL BE RESOLVED PER SPECIAL PROVISIONS. IN ADDITION, ALL DROP-OFFS TO BE RESOLVED BY END OF WORKDAY ON FRIDAY, PRIOR TO HOLIDAYS, AND END OF STAGE 1.

STAGE 1 (LOOKING NORTH)

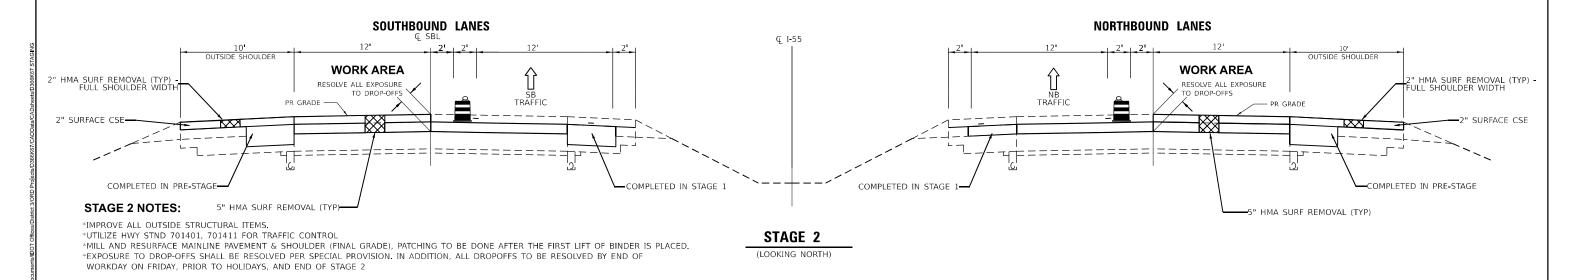

NOTE: LIGHTS ARE NOT REQUIRED ON BARRELS IN TANGENT SECTIONS.

USER NAME = brandon criss	DESIGNED	REVISED			STAGE CONST	RUCTION		F.A.I RTF	SECTION	COUNTY	TOTAL SI	HEET NO.
	DRAWN	REVISED	STATE OF ILLINOIS		017102 001101	110011011		55	(32-2)RS,BRR	GRUNDY	39	18
PLOT SCALE = 0.16666633 ' / in.	CHECKED	REVISED	DEPARTMENT OF TRANSPORTATION						, ,	CONTRACT	NO 66K67	,
PLOT DATE = 11/2/2023	DATE	REVISED		SCALE:	SHEET 1 OF 2 SHEE	TS STA+	TO STA+		ILLINOIS FED. A	ID PROJECT	-	

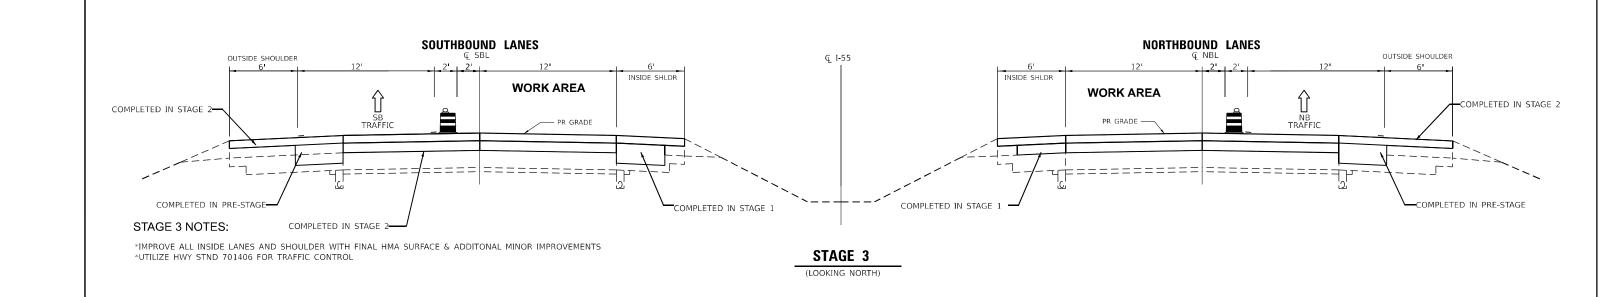


DEE: STACHAGE SHORT FINAME: pw://iidot-pw.hentlev.com:PWIDOT/Documents/IDOT Offices/

USER NAME = brandon.criss	DESIGNED	REVISED	
	DRAWN	REVISED	
PLOT SCALE = 0.16666633 ' / in.	CHECKED	REVISED	
PLOT DATE = 11/2/2023	DATE -	REVISED -	

STATE OF ILLINOIS
DEPARTMENT OF TRANSPORTATION

ST/	AGE CO	ONSTRI	UCTI	ON		F.A.I RTE.	SEC	TION		COUNTY	TOTAL SHEETS	SHEET NO.
						55	(32-2)RS,I	3RR		GRUNDY	39	19
										CONTRACT	NO. 66K	67
SHEET 2	OF 2	SHEETS	STA.	+	TO STA+_			ILLINOIS	FED. AII	PROJECT		

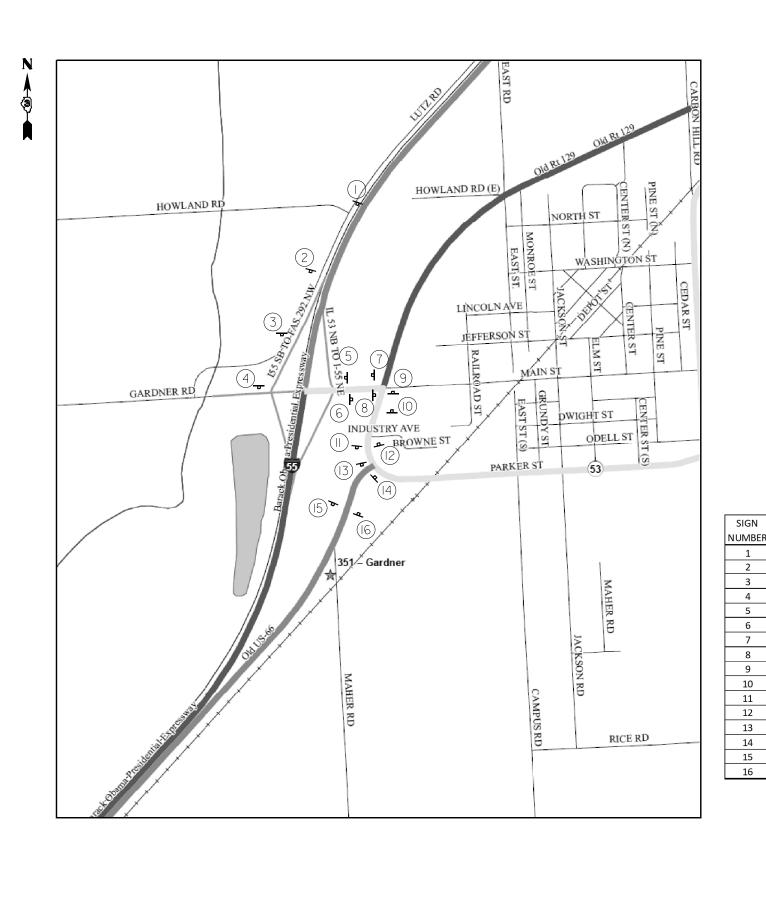

#### ALTERNATE ROUTE SIGNS:

ALTERNATE ROUTE FOR 1-55 DURING CONSTRUCTION UTILIZES IL 47, OLD RTE 66, IL 53, AND COUNTY RD 7000S.

THE CONTRACTOR SHALL FURNISH, INSTALL, MAINTAIN AND REMOVE THE SIGNING FOR THE ALTERNATE ROUTE.

TWO EXTRA MESSAGE BOARDS ON 1-55 AS OUTLINED IN THE SPECIAL PROVISIONS SHALL DISPLAY THE FOLLOWING MESSAGE:

I-55 CONSTRUCTION AHEAD EXPECT DELAYS ALT ROUTE AVAILABLE

SIGNS AI, BI, C. D. E. F. G. H. I: FLORESCENT ORANGE WITH BLACK SYMBOLS.

SIGNS A2, A3, B2, B3: BLUE WITH WHITE LETTERS.

SIGN

SIGN NUMBER

#### SIGN ASSEMBLY

NORTHBOUND SOUTHBOUND **ALT** M4-Ia-2115 **ALT** M4-Ia-2II5 **SOUTH** M3-3-2412 B)-M-I-2424 √II-I-2424 ARROW SIGN ARROW SIGN \* SEE BELOW

ARROW SIGNS

M5-I(R)-2II5























OSEK NAME = DIAHUUH.CHSS	DESIGNED -	KEVISED -
	DRAWN -	REVISED -
PLOT SCALE = 0.16666633 ' / in.	CHECKED -	REVISED -
PLOT DATE = 11/2/2023	DATE -	REVISED -

LOCATION

TOP OF RAMP FOR I-55 (SB) TRAFFIC HEADING EAST ONTO COUNTY RD 7000 S

I-55 (SB)AT 1/2 MILE EXIT BOARD

COUNTY RD 7000 S AT IL 53

IL 53 AT COUNTY RD 7000 S

OLD RTE 66 SOUTH OF IL 53

OLD RTE 66 200 FT BEFORE SIGN 14

IL 53 AT OLD RTE 66

OLD RTE 66 AT IL 53

I-55 (SB) AT START OF RAMP FOR IL 53

I-55 (SB) RAMP 750 FT PRIOR TO SIGN 4

COUNTY RD 7000 S AT TOP OF I-55 (NB) RAMP

COUNTY RD 7000 S 200FT PRIOR TO SIGN 8 COUNTY RD 7000 S 200 FT PRIOR TO SIGN 5

IL 53 PRIOR TO 200 FT PRIOR TO SIGN 9

IL 53 PRIOR TO 300 FT PRIOR TO SIGN 13

IL 53 150 FT AFTER CLD RTE 66 AND IL 53 INTERSECTION

SCALE: 1"=50'

**PANELS** 

BE

ВН

BD

BF

ΛG BC

AC

BG

AF

AD

BC


ΑI

BG

ΑF

ВΙ

ΑD

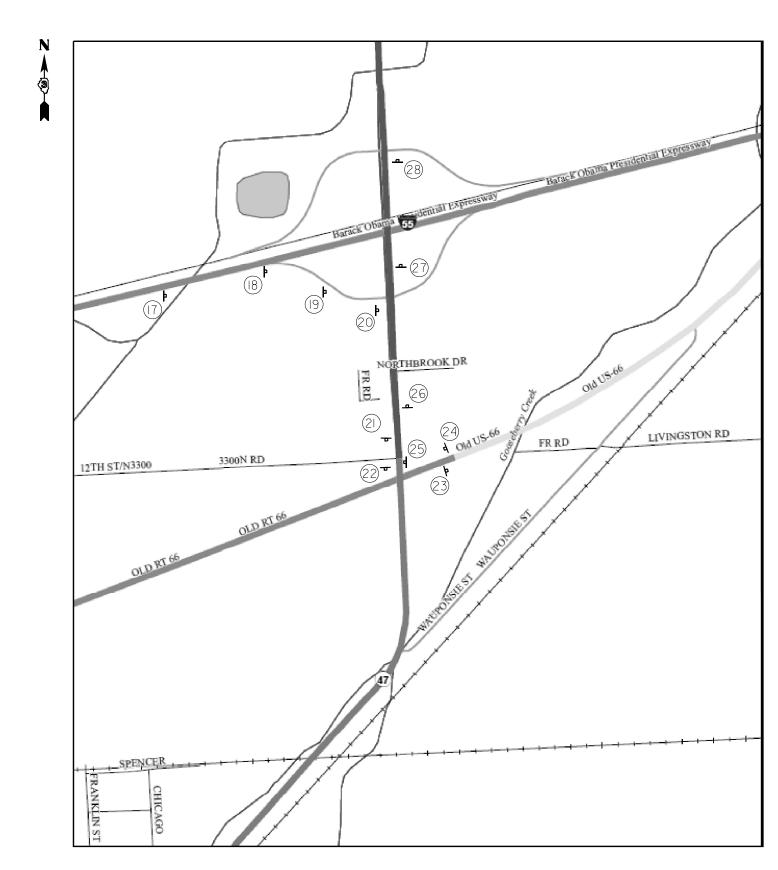

SIGN NUMBER	LOCATION	PANELS
17	I-55 (NB) AT 1/2 MILE EXIT BOARD	AE
18	I-55 (NB) AT THE STAT OF RAMP FOR IL 47	АН
19	I-55 (NB) RAMP 750 FT PRIOR TO SIGN 20	AC
20	TOP OF THE RAMP FOR I-55 (NB) TRAFFIC HEADING SOUTH ON IL 47	AG
21	IL 47 250 FT PRIOR TO SIGN 22	AD
22	IL 47 AT OLD RTE 66 INTERSECTION	AF
23	OLD RTE 66 250 FT AFTER IL 47 AND OLD RTE 66 INTERSECTION	AI
24	OLD RTE 66 250 FT PRIOR TO SIGN 25	ВС
25	OLD RTE 66 AT IL 47 INTERSECTION	BG
26	IL 47 250 FT AFTER IL 47 AND OLD RTE 66 INTERSECTION	ВІ
27	IL 47 1000 FT PRIOR TO SIGN 28	BD
28	IL 47 AT RAMP FOR I-55 (SB)	BF

USER NAME = brandon.criss	DESIGNED -	REVISED -
	DRAWN -	REVISED -
PLOT SCALE = 0.16666633 ' / in.	CHECKED -	REVISED -
PLOT DATE = 11/2/2023	DATE -	REVISED -

STATE OF ILLINOIS
DEPARTMENT OF TRANSPORTATION

	ALTERNATE ROUTE SINGING				F.A.I RTE.	SECTION	COUNTY	TOTAL SHEETS	SHEET NO.
						(32-2)RS,BRR	GRUNDY	39	21
							CONTRAC	T NO. 66K	67
SCALE: 1"=50'	SHEET 2	OF 2	SHEETS STA+	TO STA+	ILLINOIS FED. AID PROJECT				-

Existing Structure: SN 032-0078 built in 1979 as FAI Rte. 55, Section 32-2HVB at I-55 Sta. 626+00. The structure is a four-span continuous steel girder bridge composite in positive moment regions, supported on sand-filled vaulted abutments and trapezoidal piers. In 2002, the expansion joints and deck overlay was replaced and floor drains were retrofit. In 2007, the structural steel was painted. In 2008, steel beams over SB traffic were repaired. In 2012, the pier crash walls were raised. The bridge measures 531'-6" back to back approach bents and 30'-0" out to out, with a 30°00'00" left forward skew. Stage construction will be utilized to maintain one lane of traffic.


#### \*Limits of Protective Shield

#### INDEX OF SHEETS

- 1. General Plan and Elevation
- 2. General Data
- 3. Stage Construction Details
- 4. Deck Slab Repair Plan
- 5-7. Joint Replacement Details 8. Preformed Joint Strip Seal
- 9. Bar Splicer Assembly Details
- 10. Substructure Repairs

#### SCOPE OF WORK

- 1. Remove portions of existing concrete deck and parapets as required to replace expansion joints at abutments.
- 2. Remove existing overlay and perform 3/4" scarification of existing slab.
- 3. Provide new strip seal expansion joints and adjacent superstructure concrete over abutments.
- 4. Perform repairs to existing parapets.
- 5. Place new  $2\frac{3}{4}$ " latex concrete overlay on deck and approach slabs.
- 6. Perform concrete reapirs on abutment backwalls and seal the joints between the abutment and slope wall.
- 7. Place CLSM under approach shoulders as required.
- 8. Add strip of riprap along edges of existing slope walls.

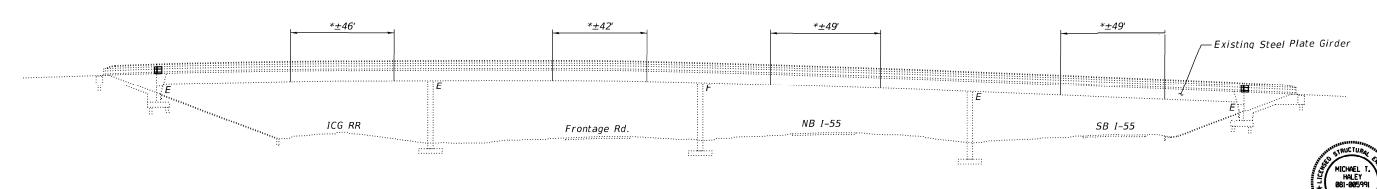


#### **ELEVATION**

Michael T. Haley Licensed Structural Engineer

State of Illinois No. 081-005991 Expires 11/30/2024

10/2/2023

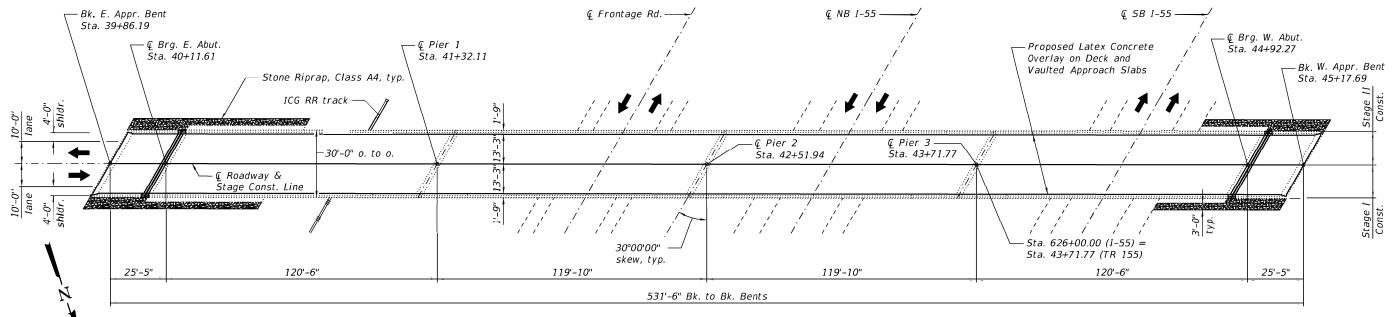

PLAN

#### DESIGN SPECIFICATIONS

(New Construction) 2002 AASHTO Standard Specifications for Highway Bridges, 17th Edition

#### DESIGN STRESSES

FIELD UNITS - NEW CONSTRUCTION f'c = 4,000 psi (Superstructure)fy = 60,000 psi (Reinforcement)

#### LOADING HS-15

(Original Construction) No allowance for future wearing surface. LOCATION SKETCH

SHEET 1 OF 10 SHEETS

Range 8E, 3rd P.M

GENERAL PLAN AND ELEVATION TR 155 OVER I-55/OR 66/ ICG RR F.A.I. RTE. 55 SECTION (32-2)RS,BRR GRUNDY COUNTY I-55 STATION 626+00.00 STRUCTURE NO. 032-0078

LIN ENGINEERING LT Consulting Engineers


	USER NAME =		DESIGNED	-	MTH	REVISED	-
TD.			CHECKED	-	CZ	REVISED	-
1	PLOT SCALE =		DRAWN	-	AJF	REVISED	-
	PLOT DATE = 1	0/18/2023	CHECKED	-	CZ	REVISED	-

**STATE OF ILLINOIS DEPARTMENT OF TRANSPORTATION** 

SECTION COUNTY (32-2)RS,BRR GRUNDY 39 22 55 CONTRACT NO. 66K67


#### GENERAL NOTES

- 1. Reinforcement bars designated (E) shall be epoxy coated.
- 2. Plan dimensions and details relative to existing plans are subject to nominal construction variations. The Contractor shall field verify existing dimensions and details affecting new construction and make necessary approved adjustments prior to construction or ordering of materials. Such variations shall not be cause for additional compensation for a change in scope of the work, however, the Contractor will be paid for the quantity actually furnished at the unit price bid for the work.
- 3. Existing reinforcement bars extending into the removal area shall be cleaned, straightened and incorporated into the new construction. Any reinforcement bars that are damaged during concrete removal shall be replaced with an approved bar splicer or anchorage system. Cost included with Concrete Removal.
- 4. Cost of removal and disposal of existing expansion joints shall be included in the cost of Concrete Removal.
- 5. Protective Coat shall be applied to the top surface of new overlay and the inside and top faces of new concrete adjacent to joints.
- 6. Concrete Sealer shall be applied to the exposed faces of the abutment backwalls and
- 7. Joint openings shall be adjusted according to Article 520.04 of the Std. Specs. when the concrete adjacent to joints is poured at an ambient temperature other than 50°F.
- 8. Expansion joints shall be fabricated to conform to the existing cross slope of the bridge.
- 9. Callouts in the plans for '1½" Overlay Removal' include removing the 1½" HMA overlay and the nominally  $\frac{1}{2}$ " thick waterproofing membrane system. All work shall be included in the cost of Hot-Mix Asphalt Surface Removal (Deck).

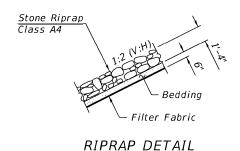


#### TOTAL BILL OF MATERIAL


ITEM	UNIT	SUPER	SUB	TOTAL
Stone Riprap, Class A4	Sq. Yd.	-	126	126
Filter Fabric	Sq. Yd.	-	126	126
Concrete Removal	Cu. Yd.	4.0	-	4.0
Protective Shield	Sq. Yd.	620	-	620
Concrete Superstructure	Cu. Yd.	4.2	-	4.2
Bridge Deck Grooving	Sq. Yd.	1,444	-	1,444
Protective Coat	Sq. Yd.	1,565	-	1,565
Reinforcement Bars, Epoxy Coated	Pound	640	-	640
Bar Splicers	Each	8	-	8
Mechanical Splicers	Each	44	-	44
Preformed Joint Strip Seal	Foot	66	-	66
Concrete Sealer	Sq. Ft.	-	449	449
Epoxy Crack Injection	Foot	-	12	12
Controlled Low-Strength Material	Cu. Yd.	-	4.0	4.0
Bridge Deck Latex Concrete Overlay, 2¾ Inches	Sq. Yd.	1,549	-	1,549
Bridge Deck Scarification, ¾ Inch	Sq. Yd.	1,549	-	1,549
Structural Repair of Concrete (Depth Equal to or Less Than 5 Inches)	Sq. Ft.	10	3	13
Deck Slab Repair (Full Depth, Type I)	Sq. Yd.	7	-	7
Deck Slab Repair (Full Depth, Type II)	Sq. Yd.	2	-	2
Hot-Mix Asphalt Surface Removal (Deck)	Sq. Yd.	1,549	-	1,549
Silicone Joint Sealer, 2"	Foot	-	64	64

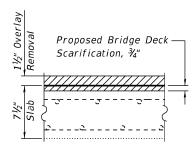


EXISTING BRIDGE DECK CROSS SECTION

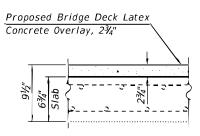

PROPOSED BRIDGE DECK CROSS SECTION

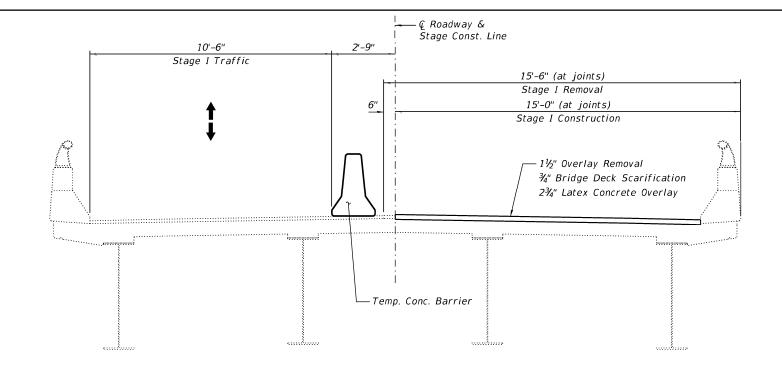

#### STAGE I REMOVAL & CONSTRUCTION

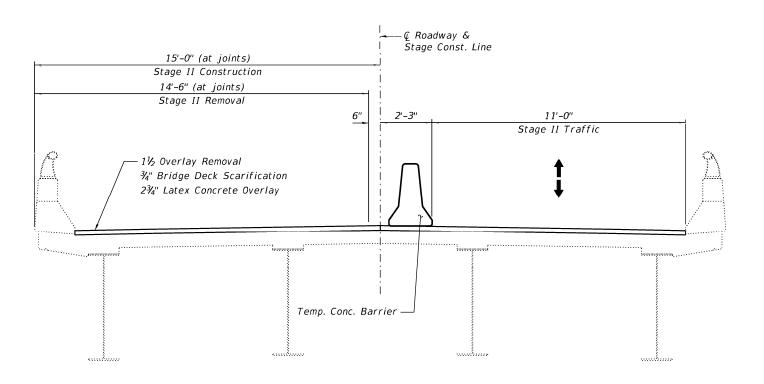

#### STAGE II REMOVAL & CONSTRUCTION

Notes:

All sections are looking west. See Roadway Plans for Temporary Concrete Barrier quantities.
All transverse dimensions are measured at right angles to © Roadway.

DESIGNED -REVISED -LIN ENGINEERING, LTD.


Consulting Engineers STATE OF ILLINOIS
DEPARTMENT OF TRANSPORTATION CZ CHECKED REVISED Consulting Engineers DRAWN REVISED PLOT DATE = 10/18/2023 CHECKED -REVISED

STAGE CONSTRUCTION DETAILS STRUCTURE NO. 032-0078 SHEET 3 OF 10 SHEETS

COUNTY TOTAL SHEET NO.

GRUNDY 39 24 F.A.I. RTE. 55 SECTION (32-2)RS,BRR CONTRACT NO. 66K67

10/18/2023 7:34:04 AM

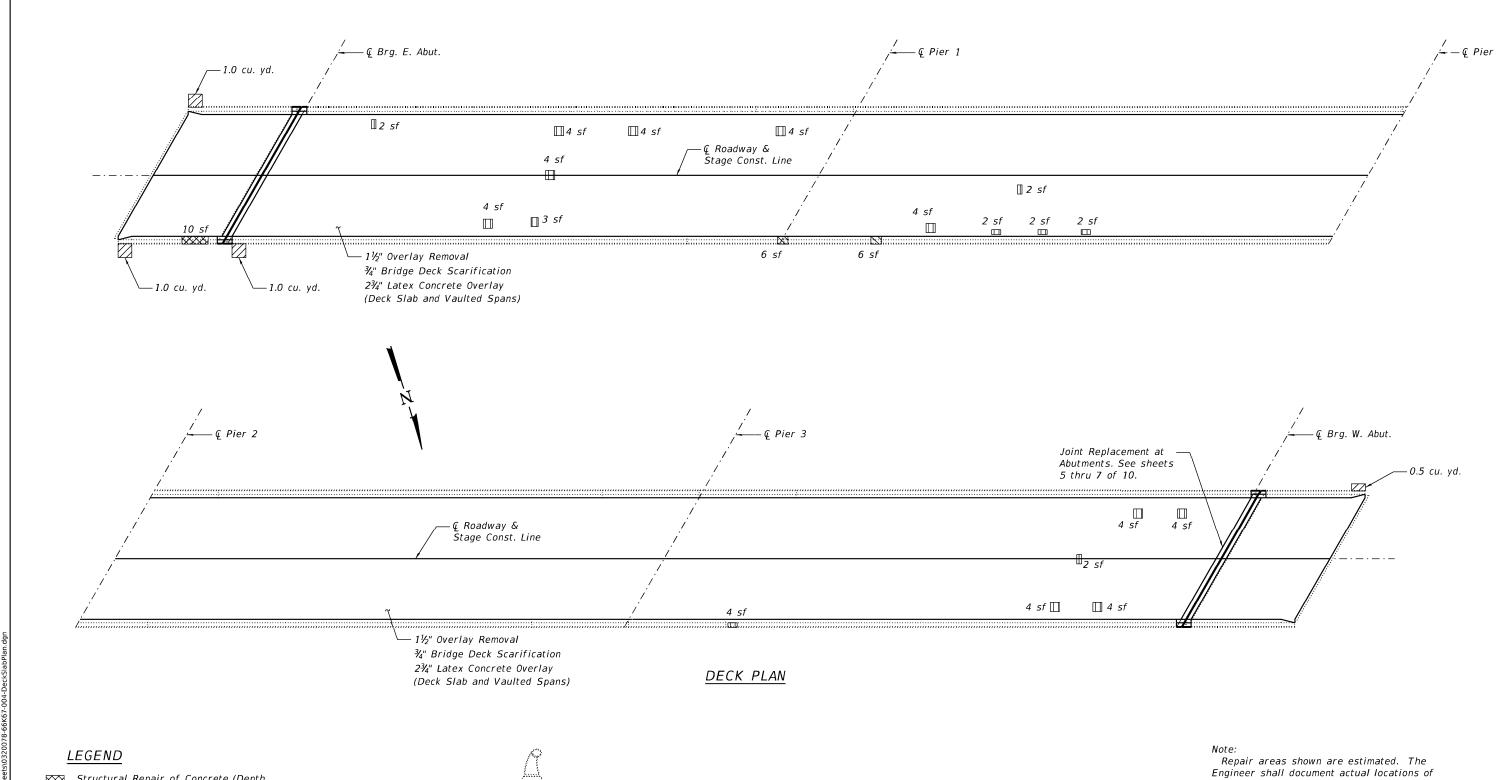

Structural Repair of Concrete (Depth Equal to or Less Than 5 Inches)

Deck Slab Repair (Full Depth, Type I)

Deck Slab Repair (Full Depth, Type II)

Controlled Low Strength Material

←Area of removal and replacement

DECK SLAB REPAIR AT OVERHANG

repairs on As-Built Plans.

#### BILL OF MATERIAL

UNII	IOIAL
Cu. Yd.	3.5
Sq. Ft	10
Sq. Yd.	7
Sq. Yd.	2
	Cu. Yd. Sq. Ft Sq. Yd.

sf - Square Feet




	USER NAME =	DESIGNED - MTH	REVISED -
LTD.		CHECKED - CZ	REVISED -
rs	PLOT SCALE =	DRAWN - AJF	REVISED -
	PLOT DATE = 10/18/2023	CHECKED - CZ	REVISED -


DECK SLAB REPAIR PLAN						
STRUCTURE NO. 032-0078						
SHEET	4	OF	10	SHEETS	_	

F.A.I. RTE.	SECTION		COUNTY	TOTAL SHEETS	SHEE NO.
55	(32-2)RS,BRR		GRUNDY	<b>3</b> 9	<b>2</b> 5
			CONTRA	CT NO. 6	6K67
	ILLINOIS E	ED A	ID BBO IECT		

10/18/2023 7:34:04 AM

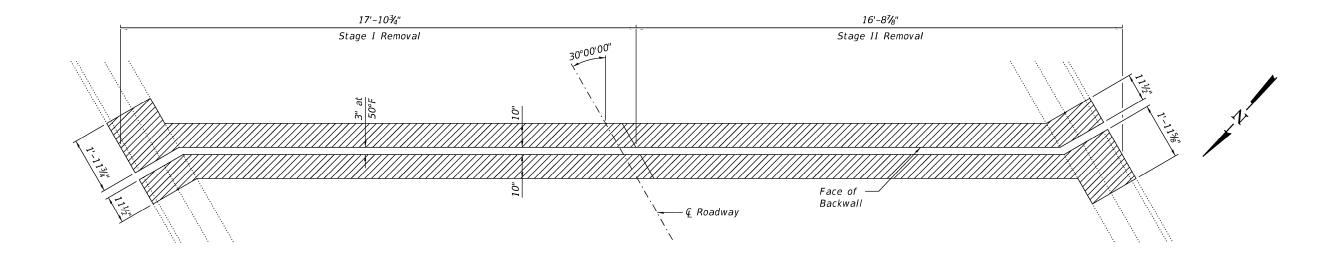


#### JOINT REMOVAL AT EAST ABUTMENT

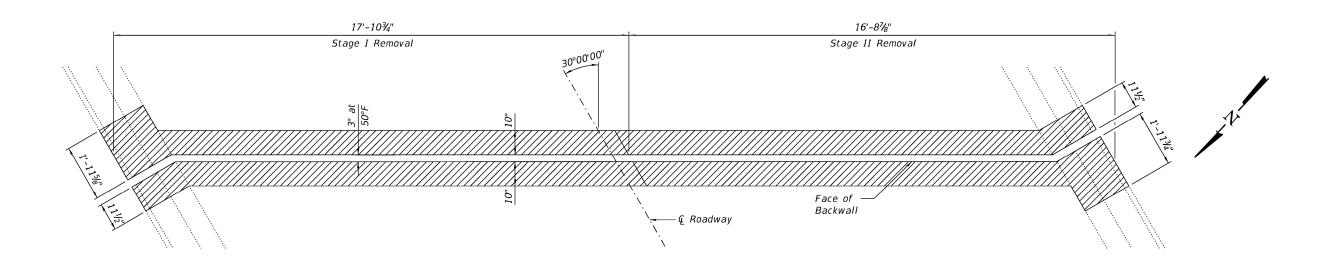

Notes: Hatched areas indicate limits of Concrete Removal. See Sheet 7 of 10 for Sections. JOINT REMOVAL AT WEST ABUTMENT

		USER NAME =	DESIGNED -	MTH	REVISED -		JOINT REPLACEMENT DETAILS	F.A.I.	SECTION	COUNTY TOTAL S
AM	LIN ENGINEERING,LID.		CHECKED -	CZ	REVISED -	STATE OF ILLINOIS		55	(32-2)RS,BRR	GRUNDY (39
≥' <b></b>	PLOT SCALE =	PLOT SCALE =	DRAWN	AJF	REVISED	DEPARTMENT OF TRANSPORTATION	STRUCTURE NO. 032-0078	1		CONTRACT NO. 66
	Springfield, Illinois	PLOT DATE = 10/18/2023	CHECKED -	CZ	REVISED -		SHEET 5 OF 10 SHEETS		ILLINOIS FI	D. AID PROJECT

#### JOINT REPLACEMENT AT EAST ABUTMENT

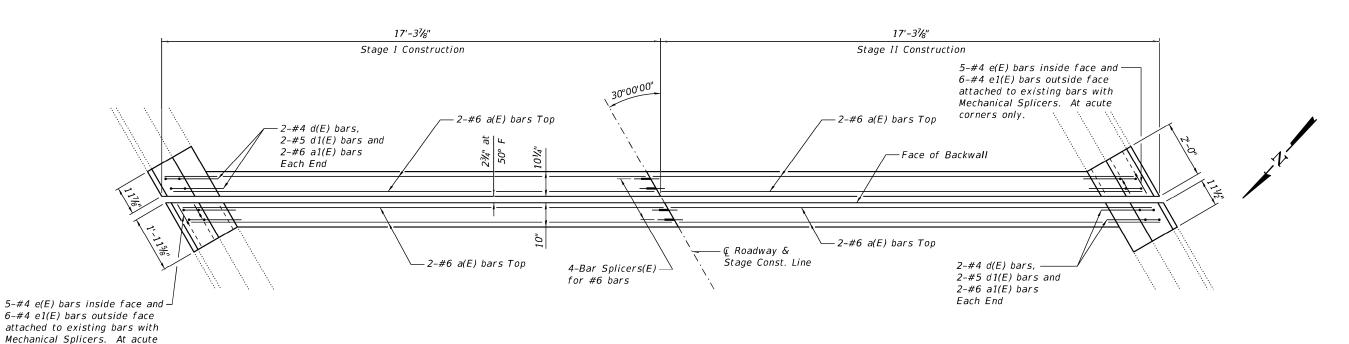

JOINT REPLACEMENT AT WEST ABUTMENT

LIN ENGINEERING,LTD.

Consulting Engineers

Springfield, Illinois

corners only.

corners only.

STATE OF ILLINOIS
DEPARTMENT OF TRANSPORTATION

(Sheet 2 of 3)


JOINT REPLACEMENT DETAILS
STRUCTURE NO. 032-0078

SHEET 6 OF 10 SHEETS

10/18/2023 7:34:06 AM

gn\CADD\CADD\_Sheets\0320078-66K67-006-JtRepDets.dg

MODEL: Default

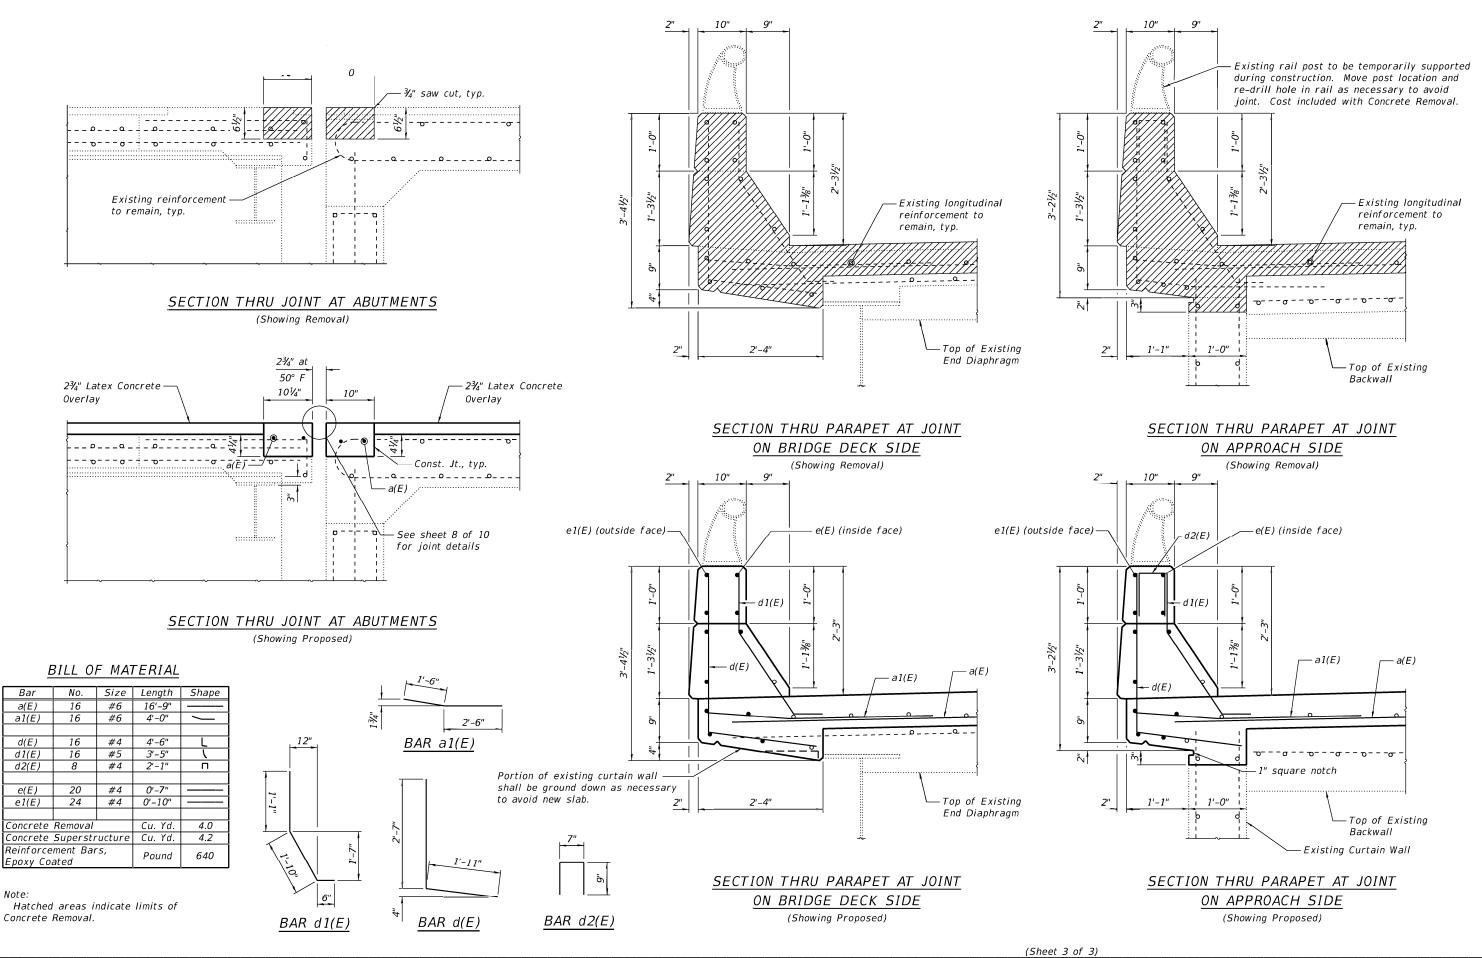

MODEL: Default FILF NAMF: F:\2124-9\SN 032-00

LIN ENGINEERING,LTD.

Consulting Engineers

Springfield, Illinois

DESIGNED - MTH REVISED 
CHECKED - CZ REVISED 
PLO TSCALE = DRAWN - AJF REVISED 
PLOT DATE = 10/18/2023 CHECKED - CZ REVISED -

STATE OF ILLINOIS
DEPARTMENT OF TRANSPORTATION


JOINT REPLACEMENT DETAILS
STRUCTURE NO. 032-0078


SHEET 7 OF 10 SHEETS

 
 F.A.I. RTE.
 SECTION
 COUNTY
 TOTAL SHEETS
 SHEETS NO.

 55
 (32-2)RS,BRR
 GRUNDY
 39
 28

 CONTRACT NO. 66K67
 PLAN AT PARAPET

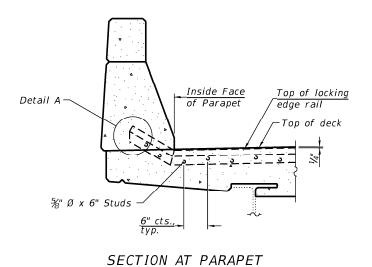

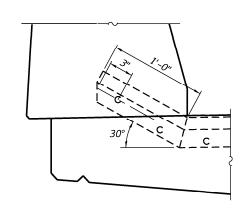

DETAIL A

Note

The strip seal shall be made continuous and shall have a minimum thickness of  $V_4$ ". The configuration of the strip seal shall match the configuration of the locking edge rails. Open or "webbed" strip seal gland configurations are not permitted. The gland shall be sized for a maximum rated movement of 4 inches.


The locking edge rails depicted are configured for typical applications and are conceptual only. The actual configuration of the locking edge rails and matching strip seal may vary from manufacturer to manufacturer provided they fit the application and meet the minimum anchorage shown. Flanged edge rails, however, will not be allowed. Locking edge rails may exceed the 4½" maximum depth provided the anchorage system is revised according to the manufacturer's recommendation.

The manufacturer's recommended installation methods shall be followed.


All steel components shall be galvanized after fabrication according to Article 520.03 of the Standard Specifications.

The Maximum space between locking edge rail segments shall be  $\frac{3}{6}$ " and sealed with a suitable sealant; however, any rail joint within 10' measured perpendicular to the face of the curb or parapet shall be welded as shown in the locking edge rail splice detail.

The concrete opening below the strip seal will vary based on the locking edge rail chosen by the Contractor. Deck and parapet lengths shown elsewhere in the plans are dimensioned to the concrete opening, not the joint opening, and are based on the rolled locking edge rail. If the Contractor elects to use a different locking edge rail, dimensional adjustments may be required.

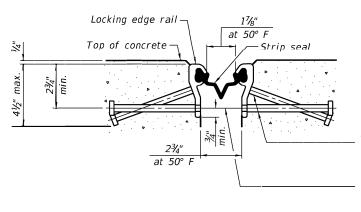

SHOWING ROLLED RAIL JOINT

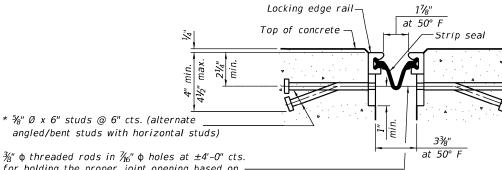

for holding the proper joint opening based on the temperature during the deck pour. Place to miss studs. All rods shall be burned, or sawed off flush with the plates after concrete is set.


\* Granular or solid flux filled headed studs conforming to Article 1006.32 of the Std. Specs., automatically end welded.

SHOWING WELDED RAIL JOINT

# 7/16" 3/4" WELDED RAIL WELDED RAIL

#### <u>LOCKING EDGE RAILS</u>

\*\* Back gouge not required if complete joint penetration is verified by mock-up.

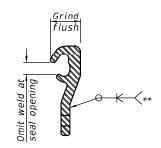

#### LOCKING EDGE RAIL SPLICE

The inside of the locking edge rail groove shall be free of weld residue. Rolled rail shown, welded rail similar.

#### BILL OF MATERIAL

Item	Unit	Total
Preformed Joint Strip Seal	Foot	66

LIN ENGINEERING,LTD.
Consulting Engineers
Springfield, Illinois

STATE OF ILLINOIS
DEPARTMENT OF TRANSPORTATION

PREFORMED JOINT STRIP SEAL STRUCTURE NO. 032-0078

SHEET 8 OF 10 SHEETS

口 10/18/2023 7:34:07 AM

\\FinalDesign\CADD\CADD\_Sheets\0320078-66K67-008-PrefJtStr


#### STANDARD BAR SPLICER ASSEMBLY PLAN

Only bar splicer assemblies as presented on the approved QPL list may be used.

Threaded splicer bar length = min. lap length +  $1\frac{1}{2}$ " + thread length

\* Epoxy not required on Bar Splicer Assembly components used in conjunction with black bars.


Location	Bar size	No. assemblies required	Minimum lap length
Approach Slab	#6	4	3'-7"
Deck	#6	4	3'-7"

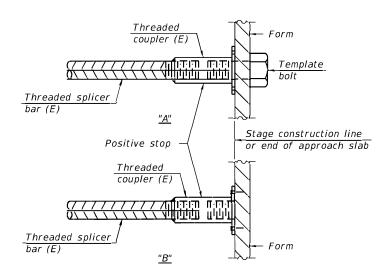

#### INSTALLATION AND SETTING METHODS

"A" : Set bar splicer assembly by means of a template bolt. "B" : Set bar splicer assembly by nailing to wood forms or cementing to steel forms.

(E): Indicates epoxy coating.

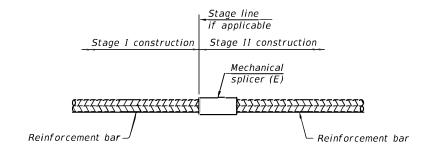

#### STANDARD MECHANICAL SPLICER

Location	Bar size	No. assemblies required
Parapets	#4	44

Notes:

Splicer bars shall be deformed with threaded ends and have a minimum 60 ksi yield strength.

All reinforcement shall be lapped and tied to the splicer bars. Bar splicer assemblies shall be epoxy coated according to the requirements for reinforcement bars. See Section 508 of the Standard Specifications.

See approved list of bar splicer assemblies and mechanical splicers for alternatives.

BSD-1

2-1-2023


LIN ENGINEERING,LTD. Consulting Engineers

USER NAME = DESIGNED -REVISED CHECKED -CZ REVISED REVISED CHECKED -PLOT DATE = 10/18/2023 REVISED

**STATE OF ILLINOIS DEPARTMENT OF TRANSPORTATION**  BAR SPLICER ASSEMBLY DETAILS STRUCTURE NO. 032-0078 SHEET 9 OF 10 SHEETS

SECTI ON COUNTY (32-2)RS,BRR GRUNDY 39 30 55 CONTRACT NO. 66K67

10/18/2023 7:34:08 AM

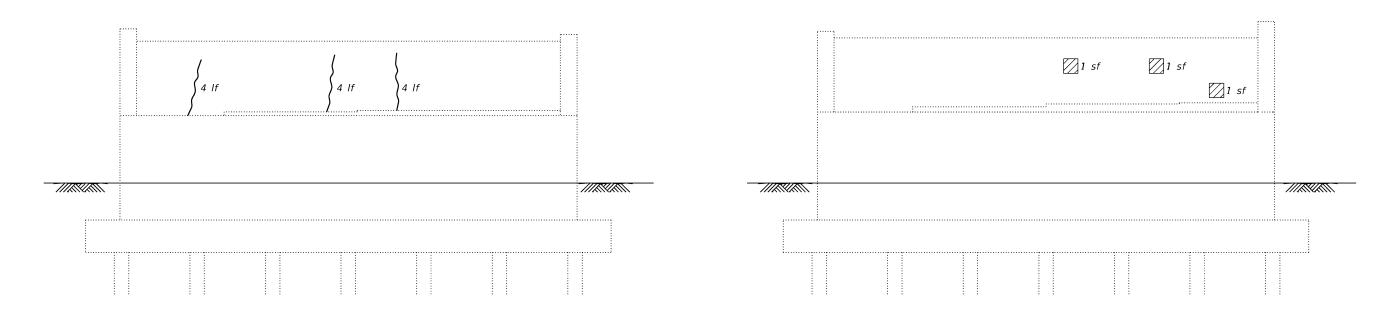


 $\frac{\textit{EAST ABUTMENT}}{\textit{(Looking East)}}$ 

WEST ABUTMENT (Looking West)

#### LEGEND

- Structural Repair of Concrete (Depth equal to or less than 5")
- --- Epoxy Crack Injection
- sf Square Feet
- If Linear Feet

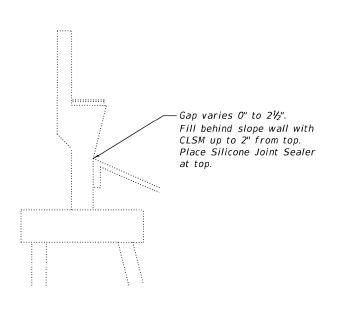

SECTION THRU ABUTMENT

Repair of the existing abutments shall include but may not be limited to the areas shown. The actual area to be repaired will be determined by the Engineer at the time of construction.

#### BILL OF MATERIAL

Item	Unit	Total
recin	0,,,,,	7 000
Structural Repair of Concrete (Depth equal to or less than 5")	Sq. Ft.	3
Epoxy Crack Injection	Foot	12
Controlled Low Strength Material	Cu. Yd.	0.5
Silicone Joint Sealer, 2"	Foot	64

LIN ENGINEERING,LTD. Consulting Engineers

USERNAME = DESI GNED - MTH REVISED -CHECKED - CZ REVI SED REVISED -PLOT DATE = 10/18/2023 CHECKED - CZ REVILSED -


STATE OF ILLINOIS DEPARTMENT OF TRANSPORTATION

SUBSTRUCTURE REPAIRS STRUCTURE NO. 032-0078 SHEET 10 OF 10 SHEET S

F.A. I. RTE. 55 COUNTY TOTAL SHEET NO.

GRUNDY 39 31 SECTION (32-2)RS,BRR CONTRACT NO. 66K67

10/18/2023 7:34:09 AM

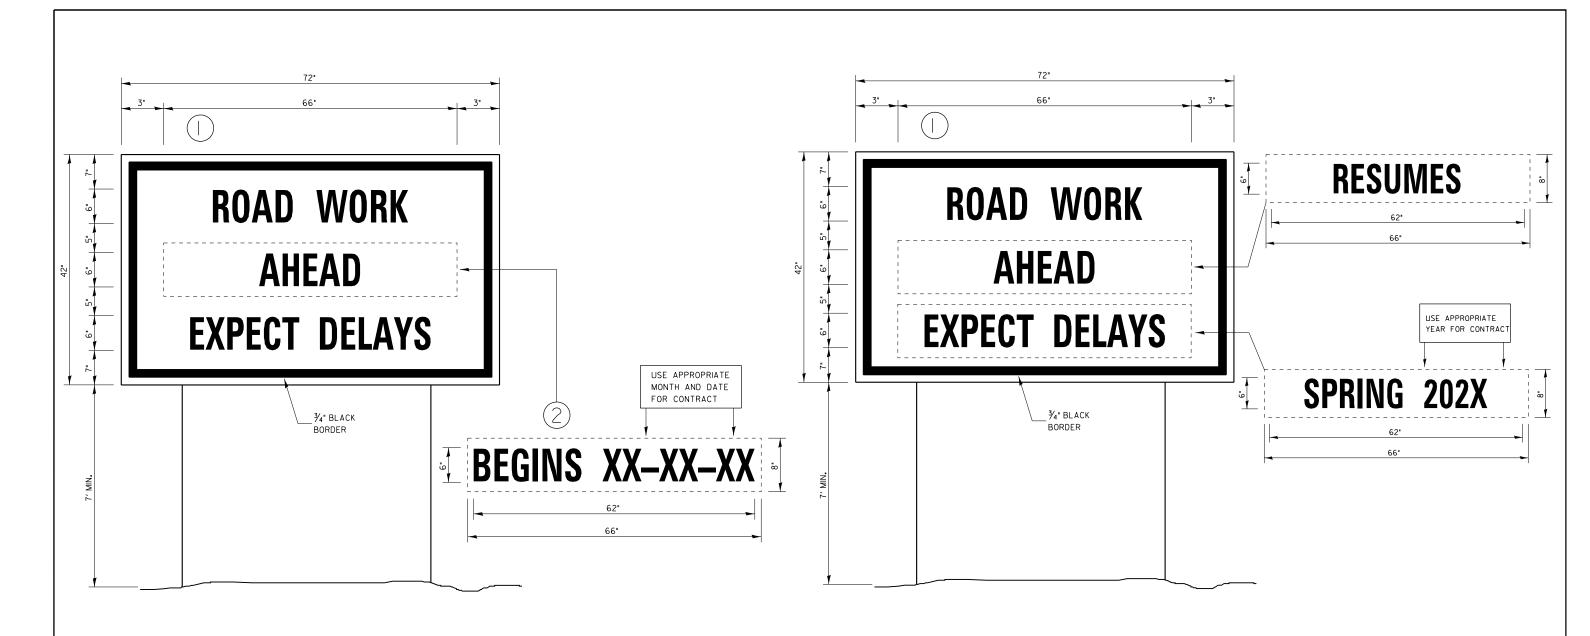

#### TEMPORARY INFORMATION SIGNING

#### WINTER SHUT DOWN SIGNING


#### NOTES:


- I. USE 6'D BLACK LETTERING ON FLOURESENT ORANGE BACKGROUND.
- ERECT SIGNS AT LOCATIONS IN ADVANCE OF THE "ROAD CONSTRUCTION AHEAD" SIGNS AS DIRECTED BY THE ENGINEER.
- 3. ERECT SIGN () WITH INSTALLED PANEL (2) A MINIMUM OF ONE WEEK PRIOR TO THE START OF THE LANE CLOSURE.
- 4. REMOVE PANEL 2 ON THAT DATE.
- 5. SEE SPECIAL PROVISION "TEMPORARY INFORMATION SIGNING" FOR ADDITIONAL INFORMATION.
- 6. WILL BE PAID FOR PER SO FT AS "TEMPORARY INFORMATION SIGNING".

  EACH SIGN = 21SO FT AND THE DATE PANEL (2) WILL NOT BE MEASURED SEPARATELY FOR PAYMENT.

NOTE: THE TEMPORARY INFORMATION SIGNS ARE TO BE INSTALLED ON GOODFARM ROAD.

| USER NAME | = brandon, criss | DESIGNED - | REVISED - | REVISED

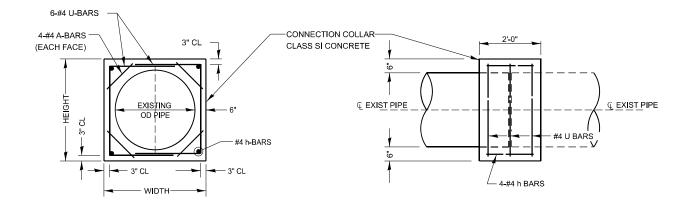

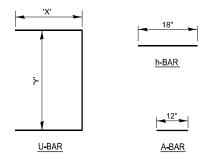


LOCATION	EXISTING CULVERT	COI	.LAR	A-BAR	U-B	AR	h-BAR	CONC	REINFORCEMENT BARS
	SIZE	WIDTH	HEIGHT	12	'X'	'Y'	18	COLLAR	
STATION	IN	IN	IN	IN	IN	IN	IN.	CU YD	POUND
466+00	24	42	42	96	33	36	72	0.55	32.1
480+00	24	42	42	96	33	36	72	0.55	32.1
600+00	24	42	42	96	33	36	72	0.55	32.1
724+00	24	42	42	96	33	36	72	0.55	32.1
742+47	24	42	42	96	33	36	72	0.55	32.1
	TOTALS	210	210	480	165	180	360	2.75	160.5

# AMBER TYPE "C" PRISMATIC BARRIER WALL REFLECTORS AT 25' CTS. 24" 32" ORANGE 6" White

### LINEAR DELINEATOR PANELS FOR TEMPORARY CONCRETE BARRIER


#### **COLLAR DETAIL (DIRECT PIPE CULVERT CONNECTION)**

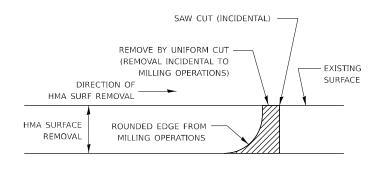

#### NOTE:

WHEN MILLING OPERATIONS PRODUCE A ROUNDED EDGE, THEN A SAW CUT SHALL BE USED TO MANUFACTURE A PERPENDICULAR EDGE AS SHOWN IN THE DETAIL. THE ENGINEER SHALL BE THE SOLE JUDGE CONCERNING THE USE OF THIS DETAIL

#### HMA BUTT JOINT SAW CUTS

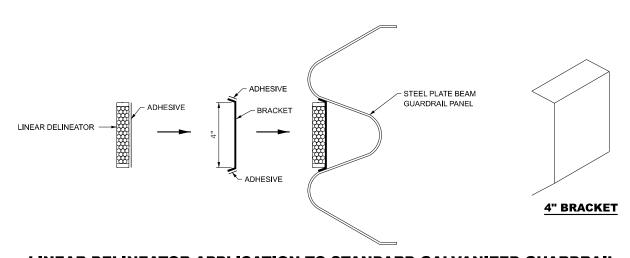


#### LINEAR DELINEATOR APPLICATION TO STANDARD GALVANIZED GUARDRAIL

LINEATOR DELINEATOR SHALL BE APLLIED ACCORDING TO THE MANUFACTURER'S RECOMMENDATIONS

USER NAME = brandon.criss	DESIGNED	REVISED	
	DRAWN	REVISED	
PLOT SCALE = 0.16666633 ' / in.	CHECKED	REVISED	
PLOT DATE = 11/2/2023	DATE	REVISED	

		[	DETAIL	s				F.A.I RTE.	SECTION		COUNTY	TOTAL SHEETS	SHEET NO.
								55	(32-2)RS,BRR		GRUNDY	39	33
							CONTRACT NO. 66K6					(67	
SHEET 2 OF 7 SHEETS STA+ TO STA+						+		ILLINOIS	FED. AII	O PROJECT			

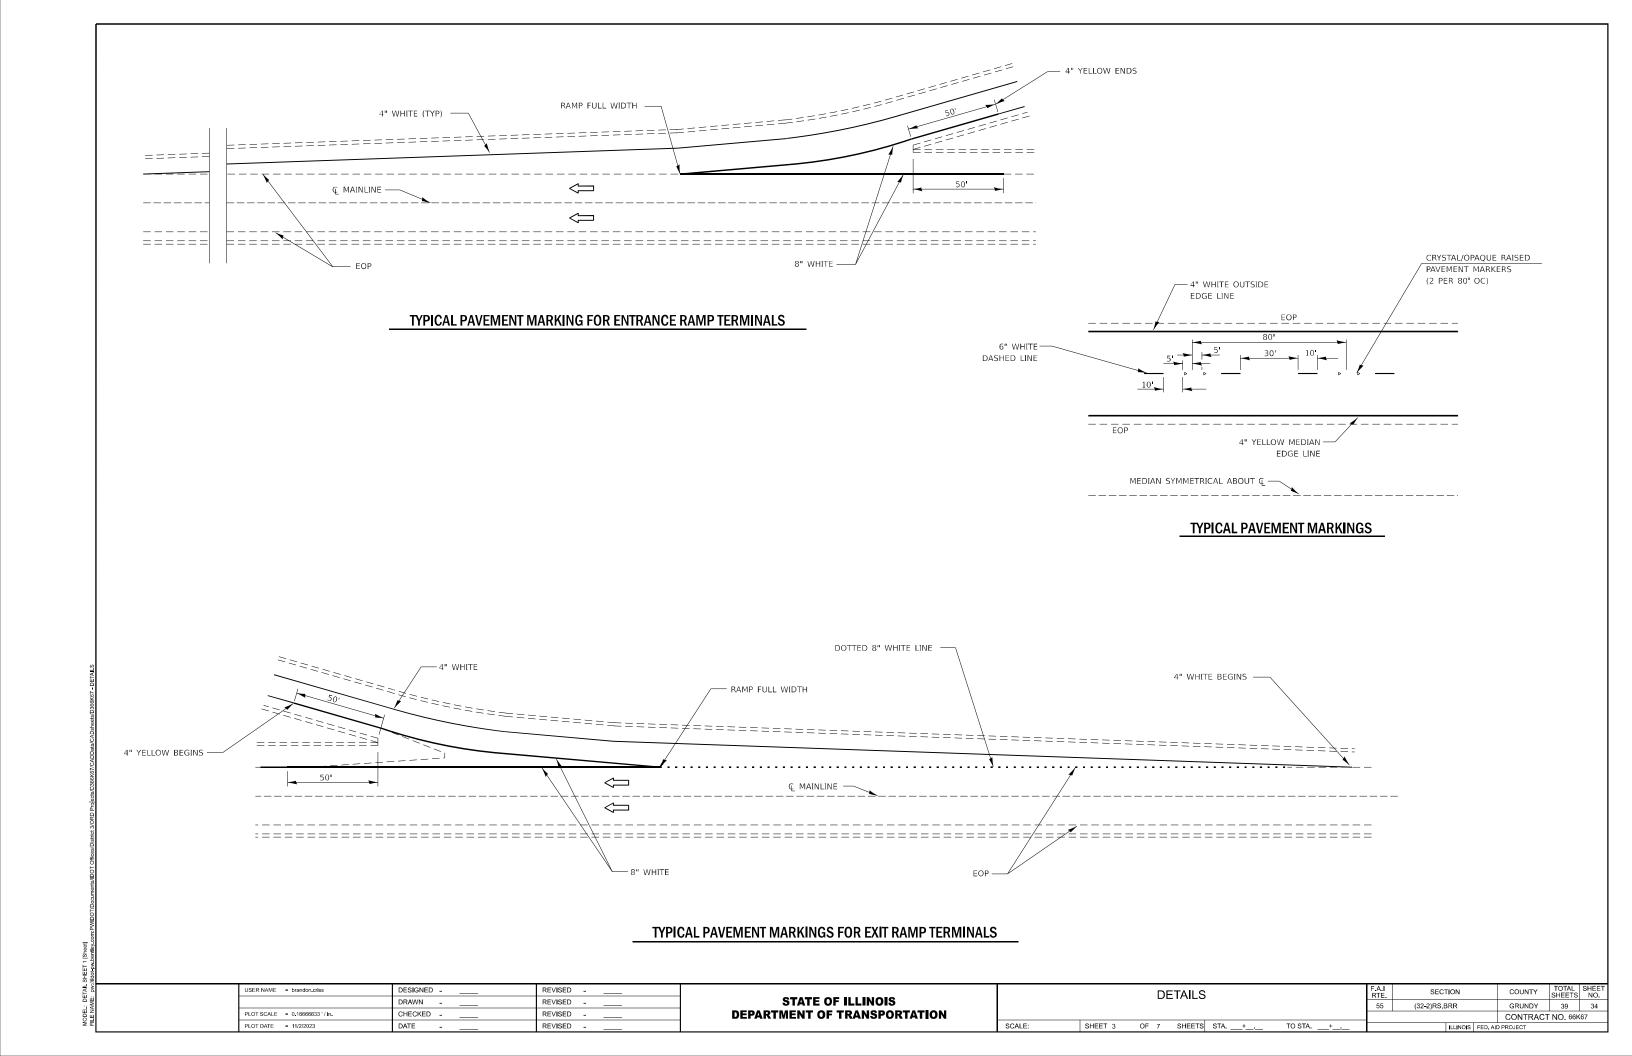

#### CURVE A

P.I. 454+71.29

 $\Delta = 33^{\circ}40'45'' \text{ LT}$ 

 $D = 01^{\circ}00'00"$ 

T = 1,734.18

R = 5,729.58

L = 3,367.92

E = 256.69' S.E. = 0.033 (EXIST. / PROP.)

S.A. - 435+77 to 438+17 = 240' (EXIST.)

S.A. - 472+65 to 470+25 = 240 (EXIST.)

S.A. - 435+41.11 to 437+81.11 = 240' (PROP.)

S.A. - 473+01.03 to 470+61.03 = 240' (PROP.)

#### CURVE B

P.I. 731+64.04

 $\Delta = 32^{\circ}56'41" \text{ LT}$ 

 $D = 01^{\circ}00'00"$ 

T = 1,694.17R = 5,729.58

L = 3,294.47

E = 245.23


S.E. = 0.033 (EXIST. / PROP.)

S.A. - 713+09.87 to 715+49.87 = 240' (EXIST.)

S.A. - 749+24.34 to 746+84.34 = 240' (EXIST.)

S.A. -712+73.87 to 715+13.87 = 240' (PROP.)


S.A. - 749+60.4 to 747+20.34 = 240' (PROP.)

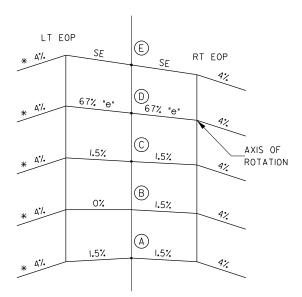

## CROSS SECTION DIAGRAM SUPERELEVATION TRANSITION


CURVE	А	В	С	D	E	SE	TR	
А	435+41.II 473+01.03	435+95.6I 472+46.53	436+50.II 47I+92.03	437+37.II 47I+05.03	437+8I.II 470+6I.03	3.3	54 <b>.</b> 5	I85 <b>.</b> 5
В	712+73.87 749+60.34	7 3+28.37 749+05.84	713+82.87 748+51.34	714+69.87 747+64.34	715+13.87 747+20.34	3.3	54.5	I85 <b>.</b> 5

\*NOTE: No shoulder transitions required.

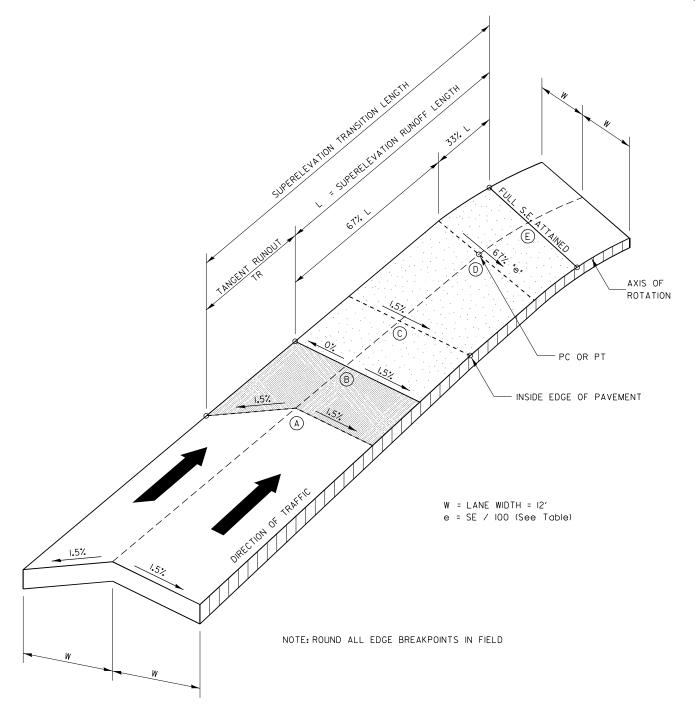

#### **SUPERELEVATION TRANSITION**

USER NAME = brandon.criss	DESIGNED	REVISED			DETAILS		F.A.I RTE	SECTION	COUNTY	TOTAL SHEET SHEETS NO.
	DRAWN	REVISED	STATE OF ILLINOIS		DE IT IIEO	55	(32-2)RS.BRR	GRUNDY	39 35	
PLOT SCALE = 0.16666633 '/ in.	CHECKED	REVISED	DEPARTMENT OF TRANSPORTATION					(),	CONTRACT	NO. 66K67
PLOT DATE = 11/2/2023	DATE	REVISED		SCALE:	SHEET 4 OF 7 SHEETS STA+ To	TO STA+		ILLINOIS FED. AI	D PROJECT	-

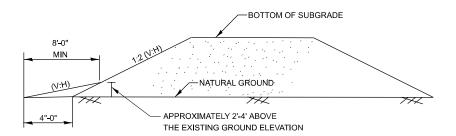


#### **SECTION A-A**

#### NOTES:

- APPLIES TO STRAIGHT OR SKEWED SINGLE STRUCTURES.
- UNDER RESTRICTIVE CONDITIONS, A 1:4 CAN BE USED FOR ANY FACILITY TYPE. SEE FIGURES 3.14.1-1 AND 3.14.1-2 OF THE BRIDGE MANUAL.
- PER BDE 38-4.C, THE RECOMMENDED TRANSVERSE SLOPES ARE AS FOLLOWES.

TYPE OF FACILITY	DES <b>I</b> RABLE (V:H)	ACCEPTABLE (V:H)
FREEWAYS	1:10	1:6
RURAL NON-FREEWAYS*	1:10	1:6
URBAN NON-FREEWAYS*	1:6	1:4
URBAN NON-FREEWAYS**	1:6	1:4

- \* DESIGN SPEED (V) GREATER THAN OR EQUAL TO 50 MPH.
- \*\* DESIGN SPEED (V) LESS THAN OR EQUAL TO 45 MPH.

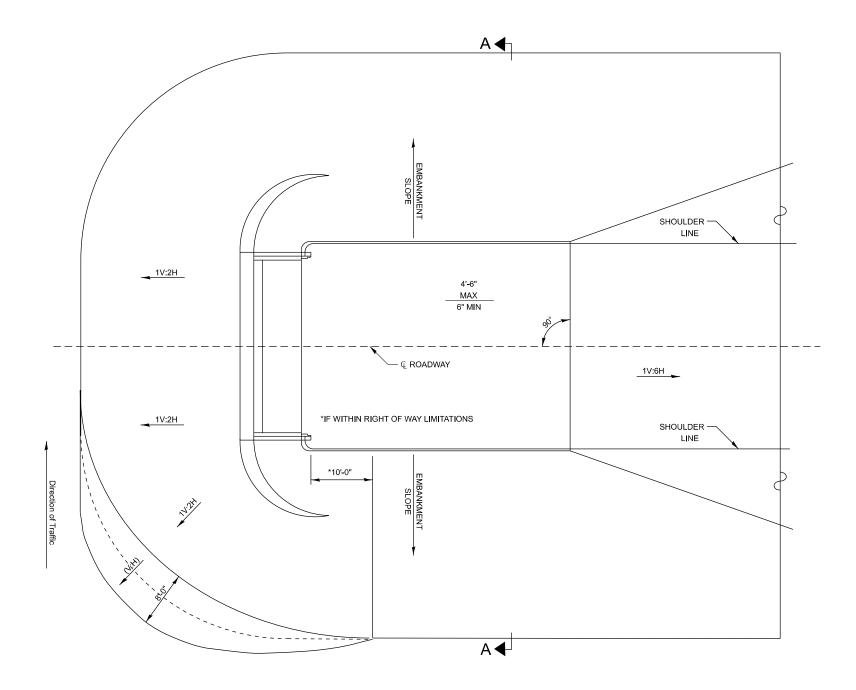


#### **EMBANKMENT CONE DETAIL**

USER NAME = brandon.criss	DESIGNED	REVISED				DE	ETAILS		F.A.I RTE	SECTION	COUNTY	TOTAL S	NO
	DRAWN	REVISED	STATE OF ILLINOIS				_ 17 (ILO		55	(32-2)RS,BRR	GRUNDY	39	36
PLOT SCALE = 0.16666633 "/ in.	CHECKED	REVISED	DEPARTMENT OF TRANSPORTATION								CONTRACT	NO 66K67	,
PLOT DATE = 11/2/2023	DATE	REVISED		SCALE:	SHEET 5	OF 7	SHEETS STA+	TO STA+		ILLINOIS FED.	AID PROJECT		

# ± 35' Q 1/2" HMA SURF IL 9.5, N70 3/6"/FT 3/6"/FT 2/4" HMA BINDER IL 19.0, N70 SUBBASE GRADING LIMITS EARTH EXCAVATION 4"

#### SECTION A-A

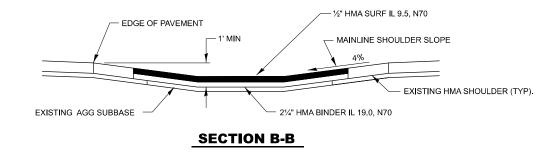

#### **HMA MAINTENANCE CROSSOVER**

USER NAME = brandon.criss	DESIGNED -	REVISED -		DETAILS					F.A.I RTE	SECTION	COUNTY	TOTAL	. SHEET
	DRAWN -	REVISED -	STATE OF ILLINOIS			ال	LIAILO		55	(32-2)RS,BRR	GRUNDY	39	37
PLOT SCALE = 0.16666633 ' / in.	CHECKED -	REVISED -	DEPARTMENT OF TRANSPORTATION							(/	CONTRAC	CT NO. 66	6K67
PLOT DATE = 11/2/2023	DATE -	REVISED -		SCALE: 1"=50'	SHEET 6	OF 7	SHEETS STA+	TO STA+		ILLINOIS FED	AID PROJECT		

NOTES:


WITH HMA BINDER AND SURFACE.

SHOULDERS AS DIRECTED BY THE ENGINEER.

1). EXISTING AGGREGATE MAINTENANCE CROSSOVER TO BE RESURFACED


2). EXCAVATE 4" OF EXISTING AGGREGATE CROSSOVER AND REPLACE WITH 2½" OF HMA BINDER IL 19.0, N70 AND 1½" OF HMA SURFACE IL 9.5, N70.
 3). EXCAVATED AGGREGATE SHALL REMAIN ON SITE AND USED FOR GRADING AROUND THE EDGE OF THE CROSSOVER AND ON EXISTING I-55 AGGREGATE

#### **IDENTIFICATION OF ROADSIDE HAZARDS FOR TWO-LANE ROADWAYS**

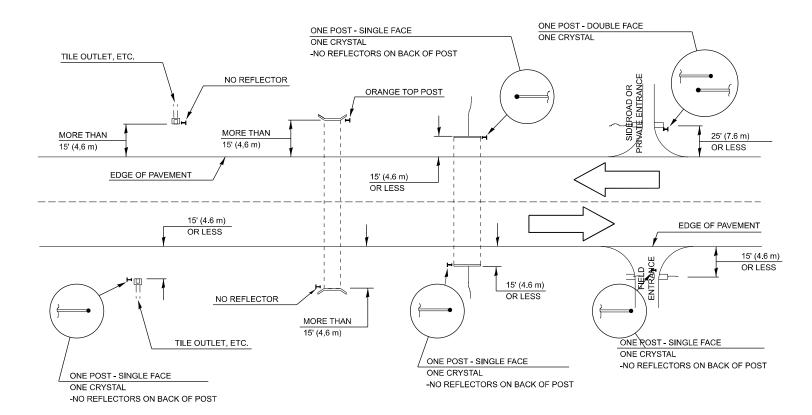

#### **MEDIAN DELINEATORS AT CROSSOVER**

(FOR INTERSTATES, EXPRESSWAYS, DUAL HIGHWAYS)

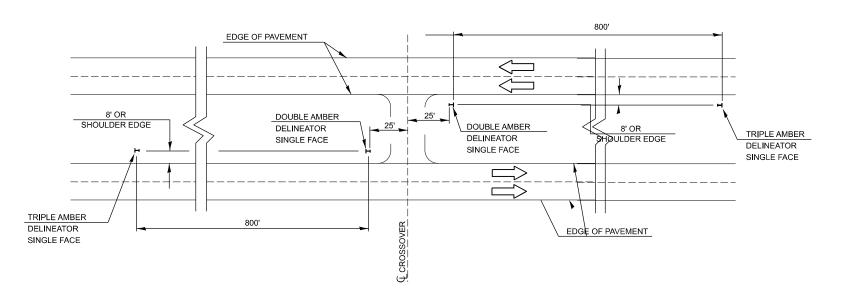

#### **BILL OF MATERIALS**

		ROADS	DE HAZAR	D DELINE	ATOR	
					NO	TOTAL
		STRUCTURE	SINGLE	DOUBLE	REFLECTOR	DELINEATORS
STRUCTURE		CENTERLINE	FACE	FACE		
NUMBER	SIDE	STATION	EACH	EACH	N/A	EACH
4439	SB	466+00	2			2
4440	SB	480+00	1			1
032-2004	SB	500+76	1			1
032-2516	NB/SB	517+54	2	1	_	3
4443	NB/SB	535+00	2	1		3
4444	NB/SB	546+00	2	1		3
032-2517	NB/SB	555+50			N/A	0
4446	ETO	575+90		2		
4447	NB/SB	576+00	2	1		3
4448	NB/SB	600+00	2	1		3
4449	NB/SB	619+00	2	1		3
032-0078	NB/SB	626+00			N/A	0
032-2518	NB/SB	632+94	2	1		3
4456	NB/SB	640+00	2	1		3
032-2519	NB/SB	655+79			N/A	0
032-2611	NB/SB	672+40			N/A	0
4460	NB/SB	687+00	2	1		3
4461	ETO	704+00		2		2
032-2520	SB	713+62	1		-	1
4462	MEDIAN	714+00		1		
4463	NB/SB	724+00	2	1		3
4464	NB/SB	742+47	2	1		3
					TOTAL	40

#### NOTE:

DELINEATORS FOR ROADSIDE HAZARDS SHALL ONLY BE PLACED AT LOCATIONS WHERE THERE IS NO GUARDRAIL, OR OTHER PERMANENT BARRIER, ON THE SAME SIDE OF THE ROAD AS THE HAZZARD.

DELINEATORS FOR ROADSIDE HAZARDS SHALL ONLY BE PLACED AT LOCATIONS WHERE DELINEATORS ARE NOT IN PLACE ALONG THE EDGE OF SHOULDER.

EACH POST SHALL BE CONSIDERED AS ONE DELINEATOR FOR PAYMENT, REGUARDLESS OF THE NUMBER OF DELINEATORS ATTACHED TO IT.

FOR ONE-WAY AND INTERSTATE ROADWAYS THE APPLICATION SHALL BE SIMILAR WITH DELINEATORS PLACED ON THE TRAFFIC APPROACH SIDE OF HAZARDS AND OBJECTS, ONLY SINGLE FACE DELINEATORS WILL BE REQUIRED ON ONE-WAY ROADWAYS, CRYSTAL ON THE RIGHT SIDE AND AMBER ON THE LEFT SIDE.


FOR OTHER DELINEATOR APPLICATIONS, REFER TO HIGHWAY STANDARD 635001.

DESIGNER NOTE:
REMOTE OPENING FOR FILL CLOSURE.

USER NAME = brandon.criss	DESIGNED -	REVISED -
	DRAWN -	REVISED -
PLOT SCALE = 0.16666633 ' / in.	CHECKED -	REVISED -
PLOT DATE = 11/2/2023	DATE -	REVISED -

STATE OF ILLINOIS
DEPARTMENT OF TRANSPORTATION

				DE	TAILS					F.A.I RTE.	SECTION	ON	COUNTY	TOTAL SHEETS	SHEET NO.
										55	(32-2)RS,BF	RR	GRUNDY	39	38
													CONTRACT	NO. 66K	67
SCALE: 1"=50"         SHEET 7         OF 7         SHEETS         STA+         TO STA+											Į.	LLINOIS FED. AID	PROJECT		

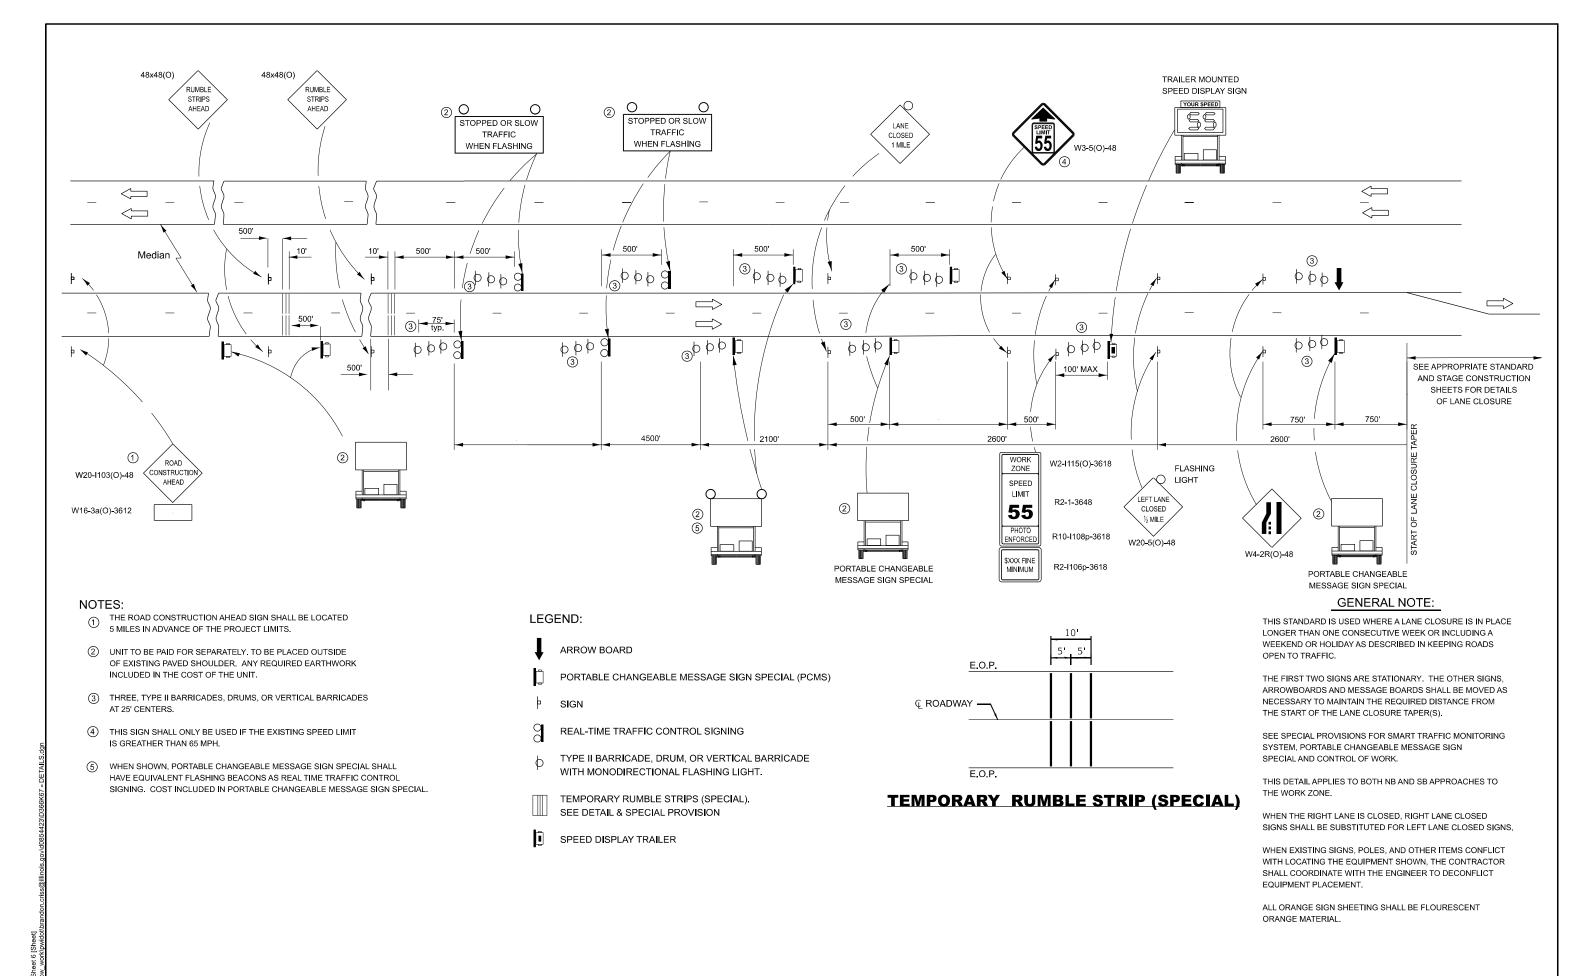

DRAWN - REVISED - STATE OF ILLINOIS  SMART WORK ZONE DETAIL  REVISED - SECTION 55 (32-2)RS,BRR	GRUNDY 39 39
DEPARTMENT AT THE ALL PROPERTY AT THE ALL PROP	
PLOT SCALE = 0.16666833 / In. CHECKED - REVISED - DEPARTMENT OF TRANSPORTATION	CONTRACT NO. 66K67
0015 (150 0157 07) 70.07	PROJECT