

F.A.U. RTE.	SECTION	COUNTY	TOTAL SHEETS	SHEET NO.
2503	16-00313-00-MS	KANE	254	1
		ILLINOIS	CONTRACT NO. 61E18	

STATE OF ILLINOIS  
DEPARTMENT OF TRANSPORTATION

# PLANS FOR PROPOSED FEDERAL-AID HIGHWAY

FAU 2503 (IL ROUTE 25) (BROADWAY)  
SPRING ST. TO AURORA TRANSPORTATION CENTER (ATC) N. ENTRANCE  
PARKING, INTERSECTION, RECONSTRUCTION, TRAFFIC SIGNAL  
SECTION 16-00313-00-MS  
PROJECT WXJJ(747)  
CITY OF AURORA  
KANE COUNTY  
JOB NO. C-91-279-16



OCTOBER 13 2017  
*Matthew N. Baldwin*  
WBK engineering  
MATTHEW N. BALDWIN  
ILLINOIS REG. PROFESSIONAL ENGINEER NO. 062-063297  
EXPIRATION DATE 11-30-2019  
SHEETS: 1-13,17-20,27-28,36-37,40-44,46-50,63-68,75-82, 89-90,99,106-107,160-161,241-250,252-254

OCTOBER 13 2017  
*John S. Peradotti*  
WBK engineering  
JOHN S. PERADOTTI  
ILLINOIS REG. STRUCTURAL ENGINEER NO. 081-005671  
EXPIRATION DATE 11-30-2018  
SHEETS: 231-239


OCTOBER 13 2017  
*Bryan M. Welch*  
CB B  
BRYAN M. WELCH  
ILLINOIS REG. PROFESSIONAL ENGINEER NO. 062-059072  
EXPIRATION DATE 11-30-2017  
SHEETS: 14-16,21-26,29-35,38-39,45,51-62,69-74,83-88,91-98 100-105,240,251

OCTOBER 13 2017  
*Elizabeth A. Jensen*  
CB B  
ELIZABETH A. JENSEN  
ILLINOIS REG. PROFESSIONAL ENGINEER NO. 062-067808  
EXPIRATION DATE 11-30-2017  
SHEETS: 108-135

OCTOBER 13 2017  
*Anthony J. Dericco*  
CB B  
ANTHONY J. DERICCO  
ILLINOIS REG. PROFESSIONAL ENGINEER NO. 062-57484  
EXPIRATION DATE 11-30-2017  
SHEETS: 136-159


OCTOBER 10 2017  
*Phillip D. Frey*  
TYLIN INTERNATIONAL  
PHILLIP D. FREY  
ILLINOIS REG. STRUCTURAL ENGINEER NO. 081-004826  
EXPIRATION DATE 11-30-2018  
SHEETS: (S-1 THRU S-59)

OCTOBER 10 2017  
*Brent L. Molenydk*  
TYLIN INTERNATIONAL  
BRENT MOLENDYK  
ILLINOIS REG. ELECTRICAL ENGINEER NO. 062-065743  
EXPIRATION DATE 11-30-2017  
SHEETS: (S-60 THRU S-69)

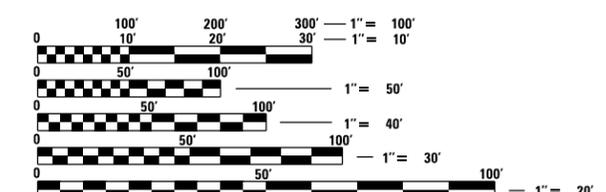

FULL SIZE PLANS HAVE BEEN PREPARED USING STANDARD ENGINEERING SCALES. REDUCED SIZED PLANS WILL NOT CONFORM TO STANDARD SCALES. IN MAKING MEASUREMENTS ON REDUCED PLANS, THE ABOVE SCALES MAY BE USED.

J.U.L.I.E.  
JOINT UTILITY LOCATION INFORMATION FOR EXCAVATION  
1-800-892-0123  
OR 811

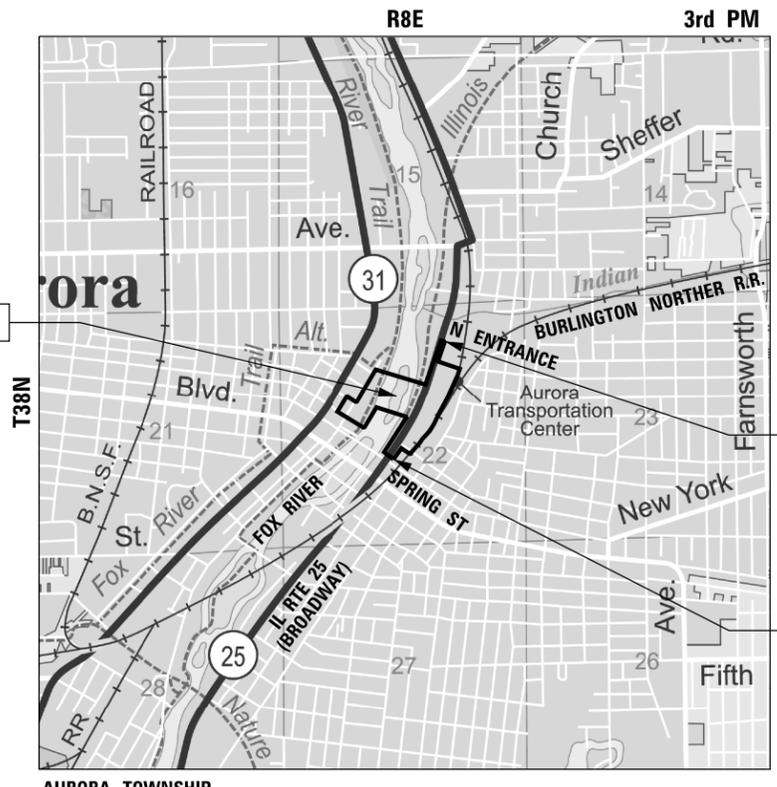

PROJECT ENDS  
STA. 31 + 50.00

PROJECT BEGINS  
STA. 12 + 00.00

LOCATION MAP  
SCALE: 1" = 2000'

PROJECT GROSS LENGTH = 1950 LIN FT (0.37 MILE)  
PROJECT NET LENGTH = 1950 LIN FT (0.37 MILE)

MINOR ARTERIAL  
TRAFFIC VOLUME = 23,700 (2016)  
TRUCKS = 1.37%  
POSTED SPEED = 35 MPH

FOR INDEX OF SHEETS, SEE SHEET NO. 2

STATE OF ILLINOIS  
DEPARTMENT OF TRANSPORTATION

APPROVED *Stephen K. Andras*  
STEVE ANDRAS, ASSISTANT CITY ENGINEER

PASSED *Christopher Holt*  
DISTRICT 1 ENGINEER OF LOCAL ROADS & STREETS

RELEASING FOR BID  
BASED ON LIMITED  
REVIEW *Anthony J. Quigley*  
REGIONAL ENGINEER

PRINTED BY THE AUTHORITY  
OF THE STATE OF ILLINOIS

CONTRACT NO. 61E18

PROGRAM & OFFICE ENGINEER: CHARLES F. RIDDLE, P.E. (847) 705-4406 SCHAUMBURG, IL



**GENERAL NOTES**

- ALL CONSTRUCTION SHALL BE IN ACCORDANCE WITH THE DETAILS IN THE PLANS. THE SPECIAL PROVISIONS INCLUDED IN THE CONTRACT DOCUMENTS, AND THE LATEST EDITION OF THE FOLLOWING STATE OF ILLINOIS SPECIFICATIONS: "THE STANDARD SPECIFICATIONS FOR ROAD AND BRIDGE CONSTRUCTION" ADOPTED APRIL 1, 2016 (REFERRED TO AS THE STANDARD SPECIFICATIONS), THE "MANUAL ON UNIFORM TRAFFIC CONTROL DEVICES FOR STREETS AND HIGHWAYS", THE "MANUAL OF TEST PROCEDURES FOR MATERIALS", THE "SUPPLEMENTAL SPECIFICATIONS AND RECURRING SPECIAL PROVISIONS" ADOPTED JANUARY 1, 2017.
- BEFORE STARTING ANY EXCAVATIONS, THE CONTRACTOR SHALL CALL "JULIE" AT 1-800-892-0123 FOR FIELD LOCATIONS OF BURIED ELECTRIC, TELEPHONE AND GAS FACILITIES. (48 HOUR NOTIFICATION IS REQUIRED)
- THE LOCATIONS OF THE EXISTING UTILITIES, AS SHOWN ON THE DRAWINGS, REPRESENT DATA RECEIVED FROM VARIOUS SOURCES, IT IS NOT GUARANTEED TO BE CORRECT OR ALL INCLUSIVE. THE CONTRACTOR SHALL CONDUCT HIS OWN INVESTIGATIONS INTO THE LOCATION, SIZE, DEPTH, AND NATURE OF ANY AND ALL EXISTING UTILITIES WHICH MAY INTERFERE WITH THE WORK UNDER THIS CONTRACT. ANY EXISTING UTILITIES WHICH ARE TO REMAIN IN SERVICE SHALL BE FULLY PROTECTED BY THE CONTRACTOR AND ANY DAMAGE CAUSED BY THE CONSTRUCTION SHALL BE IMMEDIATELY REPAIRED IN ACCORDANCE WITH ARTICLE 105.07.
- PRIOR TO NEW WORK, IT SHALL BE THE CONTRACTOR'S RESPONSIBILITY TO FIELD CHECK ALL DIMENSIONS AND ELEVATIONS AND TO VERIFY THE LOCATION AND ELEVATION OF EXISTING UTILITY LINES AND STRUCTURES THAT MAY BE IMPACTED BY THE PROPOSED WORK PRIOR TO ORDERING MATERIAL OR BEGINNING CONSTRUCTION. ANY DISCREPANCIES FROM THE PLANS SHALL BE REPORTED TO THE ENGINEER IMMEDIATELY.
- THE CONTRACTOR SHALL COORDINATE CONSTRUCTION ACTIVITIES WITH UTILITY COMPANIES.
- ALL WORK SHALL BE COMPLETED WITHIN THE LIMITS OF THE PROJECT SHOWN. NO EQUIPMENT, MATERIAL YARD OR FIELD OFFICE SHALL BE SET UP OR STORED ON TOWNSHIP OR PRIVATE PROPERTY WITHOUT WRITTEN PERMISSION OF THE ENGINEER.
- MAINTENANCE OF TRAFFIC - GENERAL: TRAFFIC CONDITIONS, ACCIDENTS AND OTHER UNFORESEEN EMERGENCY CONDITIONS MAY REQUIRE THE ENGINEER TO RESTRICT, MODIFY OR REMOVE LANE CLOSURES OR CHANNELIZATION SHOWN IN THE PLANS. THE CONTRACTOR SHALL RESPOND WITHIN 30 MINUTES OF THE TIME OF NOTIFICATION BY THE ENGINEER FOR THE MAINTENANCE OF TRAFFIC CONTROL DEVICES.
- TRAFFIC CONTROL DEVICES: ALL TRAFFIC CONTROL DEVICES USED FOR THE MAINTENANCE OF TRAFFIC AS DETAILED ON THE PLANS SHALL BE REFLECTORIZED PRIOR TO INSTALLATION AND CLEANED AS NECESSARY THROUGHOUT THE DURATION OF THE CONTRACT OR AS DIRECTED BY THE ENGINEER.
- PAVEMENT AND CURBS TO REMAIN SHALL BE PROTECTED FROM DAMAGE, AND, IF DAMAGED, SHALL BE REPLACED PROMPTLY BY THE CONTRACTOR IN CONFORMANCE WITH IDOT STANDARD SPECIFICATIONS IN MATERIALS.
- ALL DIMENSIONS, INCLUDING RADII, ARE GIVEN TO THE EDGE OF PAVEMENT UNLESS OTHERWISE NOTED.
- FULL DEPTH OR RESURFACING SAW CUTS SHALL BE USED TO REMOVE EXISTING PAVING AND APPURTENANCES FROM MATERIAL TO REMAIN IN ACCORDANCE WITH SECTION 440 OF THE STANDARD SPECIFICATIONS.
- WHERE SECTION OR SUBSECTION MONUMENTS ARE ENCOUNTER, THE ENGINEER SHALL BE NOTIFIED BEFORE SUCH MONUMENTS ARE DISTURBED. THE CONTRACTOR SHALL CAREFULLY PRESERVE ALL PROPERTY MARKERS AND MONUMENTS UNTIL THE OWNER, AN AUTHORIZED SURVEYOR OR AGENT HAS WITNESSED OR OTHERWISE REFERENCED EACH LOCATION.
- ALL AREAS OF PLANNED SUBGRADE TREATMENT SHOULD BE VERIFIED IN THE FIELD AT THE TIME OF CONSTRUCTION BY A QUALIFIED SOILS INSPECTOR, ALL POTENTIALLY UNSTABLE/ UNSUITABLE SOILS SHOULD BE TESTED WITH A STATIC CONE PENETROMETER AND TREATED IN ACCORDANCE WITH ARTICLE 301.04 OF THE STANDARD SPECIFICATIONS FOR ROAD AND BRIDGE CONSTRUCTION AND THE UNDERCUT GUIDELINES IN THE IDOT SUBGRADE STABILITY MANUAL (SSM), ANY AGGREGATE SUBGRADE IMPROVEMENTS (CY) QUANTITIES NOT USED DURING CONSTRUCTION SHOULD BE DELETED FROM THE CONTRACT.
- THE CONTRACTOR SHALL USE ALL NECESSARY PRECAUTIONARY AND PROTECTIVE MEASURES REQUIRED TO MAINTAIN AND PROTECT EXISTING UTILITIES, SEWERS, MAINS AND APPURTENANCES THAT MUST BE KEPT IN OPERATION. IN PARTICULAR, THE CONTRACTOR SHALL TAKE ADEQUATE MEASURES TO PREVENT THE UNDERMINING OF UTILITIES, SEWERS AND MAINS WHICH WILL REMAIN IN SERVICE. THE CONTRACTOR SHALL COORDINATE WITH THE ENGINEER AND UTILITY COMPANY IF IT IS DETERMINED THAT TEMPORARY BRACING OR SUPPORT OF THE UTILITIES IS REQUIRED.

**DRAINAGE NOTES**

- DURING CONSTRUCTION OPERATIONS ALL LOOSE MATERIAL DEPOSITED IN THE FLOW LINE OF DRAINAGE STRUCTURES AND TEMPORARY DITCHES THAT OBSTRUCTS THE NATURAL FLOW OF WATER SHALL BE REMOVED AT THE CLOSE OF EACH WORKING DAY. AT THE CONCLUSION OF THE CONSTRUCTION OPERATIONS, ALL DRAINAGE STRUCTURES SHALL BE CLEANED AS NECESSARY TO INSURE THAT THEY ARE FREE FROM ALL DIRT AND DEBRIS PRIOR TO THE FINAL INSPECTION OF THE PROJECT.
- EXISTING MANHOLE / CATCH BASIN RIMS SHALL BE ADJUSTED AS NOTED.
- ALL SEWER AND WATERMAIN CROSSINGS SHALL MEET WITH THE APPLICABLE LOCAL AND STATE GUIDELINES AS DESCRIBED IN THE LATEST EDITION OF THE "STANDARD SPECIFICATIONS FOR WATER AND SEWER MAIN CONSTRUCTION IN ILLINOIS".
- THE CONTRACTOR SHALL COORDINATE THE PROPOSED STORM SEWER CONSTRUCTION WITH ALL OTHER UTILITY ADJUSTMENTS AND INSTALLATIONS AS APPROVED BY THE ENGINEER.
- UNDERGROUND UTILITIES AND DRAINAGE SYSTEMS SHOWN ON THE PLANS ARE BASED ON AVAILABLE SURVEYS AND AS-BUILT INFORMATION. THE LOCATION OF UNDERGROUND FACILITIES ARE APPROXIMATE. PRIOR TO CONSTRUCTION, THE CONTRACTOR IS REQUIRED TO VERIFY ALL UTILITY LOCATION AND DEPTHS.
- DURING CONSTRUCTION, THE CONTRACTOR SHALL MAINTAIN ALL SURFACE DRAINAGE WITHIN THE PROJECT LIMITS. ALL STORM FLOW MUST BE MAINTAINED AT ALL TIMES, UNLESS OTHERWISE DIRECTED BY ENGINEER.
- EXISTING DRAINAGE FACILITIES DISTURBED OR DAMAGED DURING CONSTRUCTION SHALL BE REPAIRED OR REPLACED BY THE CONTRACTOR. THIS WORK SHALL BE PERFORMED TO THE SATISFACTION OF THE ENGINEER.
- ALL PROPOSED STORM SEWERS SHALL BE RCP UNLESS OTHERWISE NOTED.
- THE EXISTING STORM SEWER TO REMAIN SHALL BE INSPECTED BY THE CONTRACTOR BEFORE CONSTRUCTION STARTS. EXISTING ACCUMULATED MATERIAL SHALL BE DOCUMENTED BY THE CONTRACTOR. UNDOCUMENTED ACCUMULATION OF MATERIAL FOUND IN THE STRUCTURES OR PIPES AFTER CONSTRUCTION IS COMPLETED SHALL BE REMOVED BY THE CONTRACTOR.
- THE CONTRACTOR SHALL FURNISH ALL LABOR, EQUIPMENT AND MATERIAL NECESSARY FOR DEWATERING TRENCH EXCAVATIONS AS WELL AS SHORING TRENCH WALLS DURING UTILITY AND STORM SEWER OPERATIONS.
- TOP OF FRAME ("RIM") ELEVATIONS GIVEN ON THE PLANS ARE TO ASSIST IN DETERMINING THE APPROXIMATE OVERALL HEIGHT OF EACH STRUCTURE. FRAMES ON ALL NEW STRUCTURES SHALL BE ADJUSTED TO THE FINAL ELEVATIONS OF THE AREAS IN WHICH THEY ARE LOCATED.

**KANE-DUPAGE SOIL & WATER CONSERVATION DISTRICT**

- THE CONTRACTOR AND ENGINEER SHALL MEET WITH THE KANE-DUPAGE SOIL & WATER CONSERVATION DISTRICT TO COORDINATE ALL RIVER WORK ACTIVITIES.
- THE CONTRACTOR'S RIVER WORK PLAN SHALL BE SUBMITTED TO THE SOIL & WATER CONSERVATION DISTRICT AND KANE COUNTY FOR REVIEW AND APPROVAL PRIOR TO STARTING.
- SEE EROSION CONTROL PLAN SHEETS FOR ADDITIONAL DETAILS, CONDITIONS AND NOTES.

**TREE PROTECTION**

- THE CONTRACTOR SHALL REMOVE ONLY THOSE TREES AND SHRUBS AS SHOWN TO BE REMOVED ON THE PLANS, AS DIRECTED BY THE ENGINEER, OR WITH ENGINEER'S APPROVAL, THOSE TREES WHICH DIRECTLY INTERFERE WITH THE SAFETY OR QUALITY OF CONSTRUCTION PRACTICES. THE CONTRACTOR SHALL EXERCISE EXTREME CARE WHEN WORKING NEAR EXISTING TREES AND SHRUBS TO AVOID DAMAGING THOSE NOT SCHEDULED FOR REMOVAL AND SHALL REPLACE IN-KIND ANY DAMAGED PLANTS.

**EARTHWORK AND ROADWAY**

- THE CONTRACTOR WILL NOT BE ALLOWED TO STOCK PILE MATERIAL(S) BEYOND THE PROJECT LIMITS. THE CONTRACTOR WILL NOT PLACE STOCK PILES IN LOCATIONS WHERE THEY WILL INTERFERE WITH DRAINAGE WAYS OR ON PAVEMENTS THAT ARE NOT SPECIFIED FOR REMOVAL.
- GEOTECHNICAL FABRIC FOR GROUND STABILIZATION: ITEM NO. 21001000 GEOTECHNICAL FABRIC FOR GROUND STABILIZATION WILL ONLY BE UTILIZED IN AREAS THAT HAVE BEEN IDENTIFIED AS SUBGRADE UNDERCUT AREAS OR WHERE DETERMINED IN THE FIELD BY A GEOTECHNICAL ENGINEER. THE FABRIC WILL BE USED IN COMBINATION WITH AGGREGATE SUBGRADE IMPROVEMENT. THE QUANTITY INCLUDED IN THE PLANS IS BASED ON THE SUBSURFACE INVESTIGATION PREPARED BY TESTING SERVICE CORPORATION RECOMMENDATIONS FOR UNDERCUT AREAS.
- ALL EXCAVATION AND EMBANKMENT LOCATIONS REQUIRING SEEDING SHALL BE CONSTRUCTED TO 6 INCHES BELOW FINISHED GRADE LINE TO ALLOW TOPSOIL PLACEMENT.
- PAVEMENT ELEVATIONS: THE ELEVATIONS SHOWN ON THE PLANS ARE FINISHED GRADES FOR THE PROPOSED PAVEMENT OR SURFACE COURSE, UNLESS OTHERWISE INDICATED.

**REMOVAL NOTES**

- SAW CUTS: PROVIDE AT ALL LOCATIONS WHERE A SAW CUT IS REQUIRED FOR THE REMOVAL OF PAVEMENT, CURB, GUTTER, MEDIANS, DRIVEWAYS, SIDEWALK, BUTT JOINTS, PATCHES OR ANY OTHER STRUCTURE WHICH ARE ALL ONE PIECE WITH NO CONSTRUCTION JOINTS. THIS SAW CUT SHALL BE MADE AT THE LIMITS OF CONSTRUCTION OR OTHER AREAS AS REQUIRED TO PERFORM THE PROPOSED IMPROVEMENTS SHOWN ON THE PLANS. THE SAW CUT SHALL BE ACCOMPLISHED WITH A "PAVEMENT SAW". VERMEER TYPE TRENCHERS WILL NOT BE ALLOWED FOR FINAL SAW CUT AT THE LIMITS OF CONSTRUCTION.

**OWNER OF RECORD**

THE CITY OF AURORA.

**SURVEY DATUM**

THE HORIZONTAL DATUM IS NAD 83 AND THE VERTICAL DATUM IS NAVD 88.

**HYDRAULIC REPORT**

THOSE SEEKING THE FULL HYDRAULIC REPORT SHOULD CONTACT THE OWNER OF RECORD. TO MAKE ARRANGEMENTS FOR ACCESS TO THIS INFORMATION PLEASE CONTACT:

MATT BALDWIN  
WBK ENGINEERING, LLC.  
630-443-7755  
mbaldwin@wbkengineering.com

**GEOTECHNICAL REPORT**

THOSE SEEKING THE FULL GEOTECHNICAL REPORT SHOULD CONTACT THE OWNER OF RECORD. TO MAKE ARRANGEMENTS FOR ACCESS TO THIS INFORMATION PLEASE CONTACT:

MATT BALDWIN  
WBK ENGINEERING, LLC.  
630-443-7755  
mbaldwin@wbkengineering.com

**PRELIMINARY SITE INVESTIGATION**

THOSE SEEKING THE FULL PRELIMINARY SITE INVESTIGATION REPORT SHOULD CONTACT THE OWNER OF RECORD. TO MAKE ARRANGEMENTS FOR ACCESS TO THIS INFORMATION PLEASE CONTACT:

MATT BALDWIN  
WBK ENGINEERING, LLC.  
630-443-7755  
mbaldwin@wbkengineering.com

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WBK ENGINEERING, LLC  
116 WEST MAIN STREET, SUITE 201  
ST. CHARLES, ILLINOIS 60174  
(630) 443-7755

USER NAME = nparris	DESIGNED - MNB	REVISED -
PLOT SCALE = 1:2	DRAWN - NDP	REVISED -
PLOT DATE = 11/8/2017	CHECKED - MNB	REVISED -
	DATE - 10/18/17	REVISED -

STATE OF ILLINOIS  
DEPARTMENT OF TRANSPORTATION

**GENERAL NOTES**

SCALE: SHEET NO. 2 OF 2 SHEETS STA. TO STA.

F.A.U. RTE.	SECTION	COUNTY	TOTAL SHEETS	SHEET NO.
2503	16-00313-00-MS	KANE	254	3
ILLINOIS FED. AID PROJECT			CONTRACT NO. 61E18	

SPECIALTY ITEM	SPECIAL PROVISION	CODE NO.	ITEM	UNIT	TOTAL QUANTITY	CONSTRUCTION CODE						
						80% FEDERAL 20% STATE		NON-PART 100% LOCAL		SAFETY 0021 URBAN	TRAINEES 0042 URBAN	SAFETY 0021 URBAN
						ROADWAY 0004 URBAN	BRIDGE 0008 URBAN	SAFETY 0021 URBAN	TRAINEES 0042 URBAN			
•		20100110	TREE REMOVAL (6 TO 15 UNITS DIAMETER)	UNIT	462	462						
•		20100210	TREE REMOVAL (OVER 15 UNITS DIAMETER)	UNIT	100	100						
		20101000	TEMPORARY FENCE	FOOT	1,652	1,652						
		20101100	TREE TRUNK PROTECTION	EACH	13	13						
	S	20200100	EARTH EXCAVATION	CU YD	7,720	7,720						
		20201200	REMOVAL AND DISPOSAL OF UNSUITABLE MATERIAL	CU YD	757	757						
		20800150	TRENCH BACKFILL	CU YD	1,363	591		772				
		20900110	POROUS GRANULAR BACKFILL	CU YD	53		53					
		21001000	GEOTECHNICAL FABRIC FOR GROUND STABILIZATION	SO YD	1,459	1,459						
		21101505	TOPSOIL EXCAVATION AND PLACEMENT	CU YD	787	787						
		21101615	TOPSOIL FURNISH AND PLACE, 4"	SO YD	7,357	7,357						
•		25000100	SEEDING, CLASS 1	ACRE	0.9	0.9						
•		25000110	SEEDING, CLASS 1A	ACRE	1.6	1.6						
•		25000400	NITROGEN FERTILIZER NUTRIENT	POUND	349	349						
•		25000600	POTASSIUM FERTILIZER NUTRIENT	POUND	349	349						
*		25003100	INTERSEEDING, CLASS 1	ACRE	1.5	1.5						
•		25100115	MULCH, METHOD 2	ACRE	1.6	1.6						
•		25100630	EROSION CONTROL BLANKET	SO YD	4,103	4,103						
•		28000250	TEMPORARY EROSION CONTROL SEEDING	POUND	341	341						
•		28000305	TEMPORARY DITCH CHECKS	FOOT	100	100						
•		28000400	PERIMETER EROSION BARRIER	FOOT	3,944	3,944						
		28000500	INLET AND PIPE PROTECTION	EACH	2	2						
		28000510	INLET FILTERS	EACH	88	88						
		28001100	TEMPORARY EROSION CONTROL BLANKET	SO YD	4,103	4,103						
	S	30300001	AGGREGATE SUBGRADE IMPROVEMENT	CU YD	757	757						
	S	30300112	AGGREGATE SUBGRADE IMPROVEMENT 12"	SO YD	19,674	19,674						
	S	40600290	BITUMINOUS MATERIALS (TACK COAT)	POUND	11,533	11,533						
		40600625	LEVELING BINDER (MACHINE METHOD), N50	TON	217	217						
		40600982	HOT-MIX ASPHALT SURFACE REMOVAL - BUTT JOINT	SO YD	603	603						
		40603080	HOT-MIX ASPHALT BINDER COURSE, IL-19.0, N50	TON	1,569	1,569						
		40603085	HOT-MIX ASPHALT BINDER COURSE, IL-19.0, N70	TON	2,294	2,294						
		40603335	HOT-MIX ASPHALT SURFACE COURSE, MIX "D", N50	TON	1,612	1,612						
		40603340	HOT-MIX ASPHALT SURFACE COURSE, MIX "D", N70	TON	1,756	1,756						
	S	40700100	BITUMINOUS MATERIALS (TACK COAT)	POUND	13,253	13,253						
		42001300	PROTECTIVE COAT	SO YD	2,530	2,530						

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**WBK engineering**  
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 116 WEST MAIN STREET, SUITE 201  
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 (630) 443-7755

USER NAME = nparris  
 PLOT SCALE = 1:2  
 PLOT DATE = 12/4/2017

DESIGNED - MNB  
 DRAWN - NDP  
 CHECKED - MNB  
 DATE - 12/04/17

REVISED -  
 REVISED -  
 REVISED -  
 REVISED -

**STATE OF ILLINOIS  
 DEPARTMENT OF TRANSPORTATION**

**SUMMARY OF QUANTITIES**

SCALE: SHEET NO. 1 OF 10 SHEETS STA. TO STA.

F.A.U. RTE.	SECTION	COUNTY	TOTAL SHEETS	SHEET NO.
2503	16-00313-00-MS	KANE	254	4
CONTRACT NO. 61E18				
ILLINOIS FED. AID PROJECT				

SPECIALTY ITEM	SPECIAL PROVISION	CODE NO.	ITEM	UNIT	TOTAL QUANTITY	CONSTRUCTION CODE						
						80% FEDERAL 20% STATE		NON-PART 100% LOCAL		SAFETY 0021 URBAN	TRAINEES 0042 URBAN	SAFETY 0021 URBAN
						ROADWAY 0004 URBAN	BRIDGE 0008 URBAN	SAFETY 0021 URBAN	TRAINEES 0042 URBAN			
	S	42400200	PORTLAND CEMENT CONCRETE SIDEWALK 5 INCH	SO FT	71,943	71,943						
		42400800	DETECTABLE WARNINGS	SO FT	1,149	1,149						
		44000100	PAVEMENT REMOVAL	SO YD	17,308	17,308						
		44000154	HOT-MIX ASPHALT SURFACE REMOVAL, 1 1/4"	SO YD	7,785	7,785						
		44000159	HOT-MIX ASPHALT SURFACE REMOVAL, 2 1/2"	SO YD	7,736	7,736						
		44000200	DRIVEWAY PAVEMENT REMOVAL	SO YD	240	240						
		44000500	COMBINATION CURB AND GUTTER REMOVAL	FOOT	10,703	10,703						
		44000600	SIDEWALK REMOVAL	SO FT	48,003	48,003						
		44201741	CLASS D PATCHES, TYPE II, 8 INCH	SO YD	89	89						
		44201785	CLASS D PATCHES, TYPE I, 12 INCH	SO YD	8	8						
		44201789	CLASS D PATCHES, TYPE II, 12 INCH	SO YD	21	21						
		44201794	CLASS D PATCHES, TYPE III, 12 INCH	SO YD	22	22						
		44201796	CLASS D PATCHES, TYPE IV, 12 INCH	SO YD	323	323						
		50105220	PIPE CULVERT REMOVAL	FOOT	20	20						
		50200100	STRUCTURE EXCAVATION	CU YD	133		133					
		50300100	FLOOR DRAINS	EACH	30		30					
	S	50300225	CONCRETE STRUCTURES	CU YD	207.0		207.0					
	S	50300255	CONCRETE SUPERSTRUCTURE	CU YD	1,567.0		1,567.0					
	S	50300285	FORM LINER TEXTURED SURFACE	SO FT	2,039		2,039					
		50300300	PROTECTIVE COAT	SO YD	94		94					
	S	50301350	CONCRETE SUPERSTRUCTURE (APPROACH SLAB)	CU YD	33		33					
		50800205	REINFORCEMENT BARS, EPOXY COATED	POUND	592,232		592,232					
		50800515	BAR SPLICERS	EACH	72		72					
	S	50900805	PEDESTRIAN RAILING	FOOT	1,355		1,355					
		51500100	NAME PLATES	EACH	1		1					
	S	51602000	PERMANENT CASING	FOOT	99		99					
	S	51603000	DRILLED SHAFT IN SOIL	CU YD	197		197					
	S	51604000	DRILLED SHAFT IN ROCK	CU YD	153		153					
		52100520	ANCHOR BOLTS, 1"	EACH	16		16					
		52200500	MECHANICALLY STABILIZED EARTH RETAINING WALL	SO FT	977		977					
		550A0050	STORM SEWERS, CLASS A, TYPE 1 12"	FOOT	474	474						
		550A0070	STORM SEWERS, CLASS A, TYPE 1 15"	FOOT	92	92						
		550A0090	STORM SEWERS, CLASS A, TYPE 1 18"	FOOT	112	112						
		550A2520	STORM SEWERS, RUBBER GASKET, CLASS A, TYPE 2 12"	FOOT	1,317	1,317						
		550A2530	STORM SEWERS, RUBBER GASKET, CLASS A, TYPE 2 15"	FOOT	270	270						

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116 WEST MAIN STREET, SUITE 201  
ST. CHARLES, ILLINOIS 60174  
(630) 443-7755

USER NAME = nporris	DESIGNED - MNB	REVISED -
PLOT SCALE = 1:2	DRAWN - NDP	REVISED -
PLOT DATE = 12/4/2017	CHECKED - MNB	REVISED -
	DATE - 12/04/17	REVISED -

**STATE OF ILLINOIS  
DEPARTMENT OF TRANSPORTATION**

**SUMMARY OF QUANTITIES**

SCALE: SHEET NO. 2 OF 10 SHEETS STA. TO STA.

F.A.U. RTE.	SECTION	COUNTY	TOTAL SHEETS	SHEET NO.
2503	16-00313-00-MS	KANE	254	5
CONTRACT NO. 61E18			ILLINOIS FED. AID PROJECT	

SPECIALTY ITEM	SPECIAL PROVISION	CODE NO.	ITEM	UNIT	TOTAL QUANTITY	CONSTRUCTION CODE				
						80% FEDERAL 20% STATE				NON-PART 100% LOCAL
						ROADWAY 0004 URBAN	BRIDGE 0008 URBAN	SAFETY 0021 URBAN	TRAINEES 0042 URBAN	SAFETY 0021 URBAN
		55100400	STORM SEWER REMOVAL 10"	FOOT	7	7				
		55100500	STORM SEWER REMOVAL 12"	FOOT	390	390				
•	S	56400100	FIRE HYDRANTS TO BE MOVED	EACH	3	3				
•	S	56500600	DOMESTIC WATER SERVICE BOXES TO BE ADJUSTED	EACH	4	4				
		59100100	GEOCOMPOSITE WALL DRAIN	SQ YD	44		44			
		60107600	PIPE UNDERDRAINS 4"	FOOT	138		138			
		60108200	PIPE UNDERDRAINS 6" (SPECIAL)	FOOT	40	40				
		60108500	PIPE UNDERDRAINS 12" (SPECIAL)	FOOT	35	35				
		60200105	CATCH BASINS, TYPE A, 4'-DIAMETER, TYPE 1 FRAME, OPEN LID	EACH	12	12				
		60200305	CATCH BASINS, TYPE A, 4'-DIAMETER, TYPE 3 FRAME AND GRATE	EACH	4	4				
		60201340	CATCH BASINS, TYPE A, 4'-DIAMETER, TYPE 24 FRAME AND GRATE	EACH	1	1				
		60206905	CATCH BASINS, TYPE C, TYPE 1 FRAME, OPEN LID	EACH	3	3				
		60208240	CATCH BASINS, TYPE C, TYPE 24 FRAME AND GRATE	EACH	1	1				
		60218300	MANHOLES, TYPE A, 4'-DIAMETER, TYPE 1 FRAME, OPEN LID	EACH	1	1				
		60218400	MANHOLES, TYPE A, 4'-DIAMETER, TYPE 1 FRAME, CLOSED LID	EACH	5	5				
		60218500	MANHOLES, TYPE A, 4'-DIAMETER, TYPE 3 FRAME AND GRATE	EACH	1	1				
		60221100	MANHOLES, TYPE A, 5'-DIAMETER, TYPE 1 FRAME, CLOSED LID	EACH	1	1				
		60223800	MANHOLES, TYPE A, 6'-DIAMETER, TYPE 1 FRAME, CLOSED LID	EACH	1	1				
		60223810	MANHOLES, TYPE A, 6'-DIAMETER, TYPE 3 FRAME AND GRATE	EACH	1	1				
		60234200	INLETS, TYPE A, TYPE 1 FRAME, OPEN LID	EACH	11	11				
		60235300	INLETS, TYPE A, TYPE 1 FRAME, CLOSED LID	EACH	1	1				
		60235700	INLETS, TYPE A, TYPE 3 FRAME AND GRATE	EACH	6	6				
		60240210	INLETS, TYPE B, TYPE 1 FRAME, OPEN LID	EACH	2	2				
		60240215	INLETS, TYPE B, TYPE 1 FRAME, CLOSED LID	EACH	2	2				
		60240310	INLETS, TYPE B, TYPE 11 FRAME AND GRATE	EACH	3	3				
		60255500	MANHOLES TO BE ADJUSTED	EACH	3	3				
•		60266600	VALVE BOXES TO BE ADJUSTED	EACH	2	2				
		60406100	FRAMES AND LIDS, TYPE 1, CLOSED LID	EACH	2	2				
		60500060	REMOVING INLETS	EACH	3	3				
		60603500	COMBINATION CONCRETE CURB AND GUTTER, TYPE B-6.06	FOOT	886	886				
		60603800	COMBINATION CONCRETE CURB AND GUTTER, TYPE B-6.12	FOOT	7,953	7,953				
		60604400	COMBINATION CONCRETE CURB AND GUTTER, TYPE B-6.18	FOOT	1,598	1,598				
		60605000	COMBINATION CONCRETE CURB AND GUTTER, TYPE B-6.24	FOOT	440	440				
		60618300	CONCRETE MEDIAN SURFACE, 4 INCH	SO FT	226	226				
•		66900200	NON-SPECIAL WASTE DISPOSAL	CU YD	902	902				

FILE NAME = W:\Projects\2016\160194\_ATPhone\1\cadd\Civil\Drawn\500\_02.dgn

**WBK engineering**  
 WBK ENGINEERING, LLC  
 116 WEST MAIN STREET, SUITE 201  
 ST. CHARLES, ILLINOIS 60174  
 (630) 443-7755

USER NAME = mparris  
 PLOT SCALE = 1:2  
 PLOT DATE = 12/4/2017

DESIGNED - MNB  
 DRAWN - NDP  
 CHECKED - MNB  
 DATE - 12/04/17

REVISED -  
 REVISED -  
 REVISED -  
 REVISED -

**STATE OF ILLINOIS  
 DEPARTMENT OF TRANSPORTATION**

**SUMMARY OF QUANTITIES**

SCALE: SHEET NO. 3 OF 10 SHEETS STA. TO STA.

F.A.J. RTE.	SECTION	COUNTY	TOTAL SHEETS	SHEET NO.
2503	16-00313-00-MS	KANE	254	6
CONTRACT NO. 61E18			ILLINOIS FED. AID PROJECT	

SPECIALTY ITEM	SPECIAL PROVISION	CODE NO.	ITEM	UNIT	TOTAL QUANTITY	CONSTRUCTION CODE				
						80% FEDERAL 20% STATE		NON-PART 100% LOCAL		
						ROADWAY 0004 URBAN	BRIDGE 0008 URBAN	SAFETY 0021 URBAN	TRAINEES 0042 URBAN	
•		66900450	SPECIAL WASTE PLANS AND REPORTS	LSUM	1	1				
•		66900530	SOIL DISPOSAL ANALYSIS	EACH	23	23				
		67000400	ENGINEER'S FIELD OFFICE, TYPE A	CAL MO	19	19				
		67100100	MOBILIZATION	LSUM	1	1				
		70103815	TRAFFIC CONTROL SURVEILLANCE	CAL DA	14	14				
		70300100	SHORT TERM PAVEMENT MARKING	FOOT	6,764	6,764				
		70300150	SHORT TERM PAVEMENT MARKING REMOVAL	SO FT	6,764	6,764				
•		72000100	SIGN PANEL - TYPE 1	SO FT	309	309				
•		72000200	SIGN PANEL - TYPE 2	SO FT	44	44				
•		72300100	INSTALL EXISTING SIGN PANEL	SO FT	50	50				
•		72400710	RELOCATE SIGN PANEL - TYPE 1	SO FT	3	3				
•		72800100	TELESCOPING STEEL SIGN SUPPORT	FOOT	47.5	47.5				
•		72900100	METAL POST - TYPE A	FOOT	540	540				
•		72900200	METAL POST - TYPE B	FOOT	565	565				
•	S	73500010	REMOVE OVERHEAD SIGN STRUCTURE - CANTILEVER	EACH	1	1				
•		78000100	THERMOPLASTIC PAVEMENT MARKING - LETTERS AND SYMBOLS	SO FT	532	532				
•		78000200	THERMOPLASTIC PAVEMENT MARKING - LINE 4"	FOOT	19,191	19,191				
•		78000400	THERMOPLASTIC PAVEMENT MARKING - LINE 6"	FOOT	2,713	2,713				
•		78000600	THERMOPLASTIC PAVEMENT MARKING - LINE 12"	FOOT	2,451	2,451				
•		78000650	THERMOPLASTIC PAVEMENT MARKING - LINE 24"	FOOT	655	655				
•		78100100	RAISED REFLECTIVE PAVEMENT MARKER	EACH	10	10				
*		78300200	RAISED REFLECTIVE PAVEMENT MARKER REMOVAL	EACH	48	48				
•	S	80300100	LOCATING UNDERGROUND CABLE	FOOT	1,940	1,940				
•	S	80400100	ELECTRIC SERVICE INSTALLATION	EACH	1				1	
•	S	80400200	ELECTRIC UTILITY SERVICE CONNECTION	LSUM	1				1	
•		80500010	SERVICE INSTALLATION, GROUND MOUNTED	EACH	2		2			
•		81028170	UNDERGROUND CONDUIT, GALVANIZED STEEL, 1" DIA.	FOOT	65		65			
•		81028200	UNDERGROUND CONDUIT, GALVANIZED STEEL, 2" DIA	FOOT	1,738		570		1,168	
•		81028210	UNDERGROUND CONDUIT, GALVANIZED STEEL, 2 1/2" DIA.	FOOT	450				450	
•		81028220	UNDERGROUND CONDUIT, GALVANIZED STEEL, 3" DIA.	FOOT	298				298	
•		81028240	UNDERGROUND CONDUIT, GALVANIZED STEEL, 4" DIA.	FOOT	983		200		783	
•		81028320	UNDERGROUND CONDUIT, PVC, 1" DIA	FOOT	405		275		130	
•		81028350	UNDERGROUND CONDUIT, PVC, 2" DIA	FOOT	8,518		525		7,993	
•		81028360	UNDERGROUND CONDUIT, PVC, 2 1/2" DIA.	FOOT	127				127	
•		81028370	UNDERGROUND CONDUIT, PVC, 3" DIA.	FOOT	15				15	

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**WBK ENGINEERING, LLC**  
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USER NAME = nperris	DESIGNED - MNB	REVISED -
PLOT SCALE = 1:2	DRAWN - NDP	REVISED -
PLOT DATE = 12/4/2017	CHECKED - MNB	REVISED -
	DATE - 12/04/17	REVISED -

**STATE OF ILLINOIS  
DEPARTMENT OF TRANSPORTATION**

**SUMMARY OF QUANTITIES**

SCALE: SHEET NO. 4 OF 10 SHEETS STA. TO STA.

F.A.U. RTE. 2503	SECTION 16-00313-00-MS	COUNTY KANE	TOTAL SHEETS 254	SHEET NO. 7
CONTRACT NO. 61E18			ILLINOIS FED. AID PROJECT	

SPECIALTY ITEM	SPECIAL PROVISION	CODE NO.	ITEM	UNIT	TOTAL QUANTITY	CONSTRUCTION CODE				
						80% FEDERAL 20% STATE				NON-PART 100% LOCAL
						ROADWAY 0004 URBAN	BRIDGE 0008 URBAN	SAFETY 0021 URBAN	TRAINEES 0042 URBAN	SAFETY 0021 URBAN
•		81028390	UNDERGROUND CONDUIT, PVC, 4" DIA	FOOT	280		280			
•		81028730	UNDERGROUND CONDUIT, COILABLE NONMETALLIC CONDUIT, 1 1/4" DIA.	FOOT	5,280			5,280		
•		81200210	CONDUIT EMBEDDED IN STRUCTURE, 1" DIA, PVC	FOOT	645		645			
•		81200230	CONDUIT EMBEDDED IN STRUCTURE, 2" DIA, PVC	FOOT	2,700		2,700			
•		81200270	CONDUIT EMBEDDED IN STRUCTURE, 4" DIA, PVC	FOOT	3,520		3,520			
•	S	81304500	JUNCTION BOX EMBEDDED IN STRUCTURE, 18"X6"X6"	EACH	26		26			
•		81400100	HANDHOLE	EACH	14		5	9		
•		81400300	DOUBLE HANDHOLE	EACH	4			4		
•	S	81400730	HANDHOLE, COMPOSITE CONCRETE	EACH	30			30		
•	S	81500100	GULFBOX JUNCTION	EACH	2		2			
•		81702100	ELECTRIC CABLE IN CONDUIT, 600V, (XLP-TYPE USE) 1/C NO. 12	FOOT	1,190			1,190		
•		81702110	ELECTRIC CABLE IN CONDUIT, 600V, (XLP-TYPE USE) 1/C NO. 10	FOOT	975		975			
•		81702120	ELECTRIC CABLE IN CONDUIT, 600V, (XLP-TYPE USE) 1/C NO. 8	FOOT	34,340		2,625	28,490		3,225
•		81702130	ELECTRIC CABLE IN CONDUIT, 600V (XLP-TYPE USE) 1/C NO. 6	FOOT	13,695		215	13,480		
•		81702145	ELECTRIC CABLE IN CONDUIT, 600V (XLP-TYPE USE) 1/C NO. 3	FOOT	720		430	290		
•		81702150	ELECTRIC CABLE IN CONDUIT, 600V (XLP-TYPE USE) 1/C NO. 2	FOOT	7,280			7,280		
•		81702431	ELECTRIC CABLE IN CONDUIT, 600V (XLP-TYPE USE) 3-1/C NO. 8, 1/C NO. 8 GROUND	FOOT	1,170			1,170		
•		82500350	LIGHTING CONTROLLER, BASE MOUNTED, 240VOLT, 100AMP	EACH	1			1		
•		82500370	LIGHTING CONTROLLER, BASE MOUNTED, 240V, 200AMP	EACH	2		2			
•		83006200	LIGHT POLE, ALUMINUM, 30 FT. M.H., 6 FT. MAST ARM	EACH	8			8		
•		83600200	LIGHT POLE FOUNDATION, 24" DIAMETER	FOOT	147			147		
•	S	84200500	REMOVAL OF LIGHTING UNIT, SALVAGE	EACH	50			50		
•		84200804	REMOVAL OF POLE FOUNDATION	EACH	39			39		
•	S	84400105	RELOCATE EXISTING LIGHTING UNIT	EACH	2			2		
•	S	85000200	MAINTENANCE OF EXISTING TRAFFIC SIGNAL INSTALLATION	EACH	4			4		
•	S	85100500	PAINT NEW TRAFFIC SIGNAL POST	EACH	9			9		
•	S	85100600	PAINT NEW MAST ARM AND POLE, UNDER 40 FOOT	EACH	2			2		
•	S	85100701	PAINT NEW MAST ARM AND POLE, 40 FOOT AND OVER	EACH	3			3		
•	S	85100800	PAINT NEW COMBINATION MAST ARM AND POLE, UNDER 40 FOOT	EACH	2			2		
•	S	86400100	TRANSCEIVER - FIBER OPTIC	EACH	2			2		
•	S	87300010	GROUNDING EXISTING HANDHOLE FRAME AND COVER	EACH	1			1		
•	S	87300925	ELECTRIC CABLE IN CONDUIT, TRACER, NO. 14 1C	FOOT	2,658			2,658		
•	S	87301215	ELECTRIC CABLE IN CONDUIT, SIGNAL NO. 14 2C	FOOT	2,552			2,552		
•	S	87301225	ELECTRIC CABLE IN CONDUIT, SIGNAL NO. 14 3C	FOOT	2,895			2,895		
•	S	87301245	ELECTRIC CABLE IN CONDUIT, SIGNAL NO. 14 5C	FOOT	2,600			2,600		

FILE NAME = W:\Projects\2016\180194\_ATPhase1\cadd\civil\Ugr\Shst\500\_05.dgn



**WBK ENGINEERING, LLC**  
116 WEST MAIN STREET, SUITE 201  
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USER NAME = nparris	DESIGNED - MNB	REVISED -
PLOT SCALE = 1:2	DRAWN - NDP	REVISED -
PLOT DATE = 12/14/2017	CHECKED - MNB	REVISED -
	DATE - 12/04/17	REVISED -

**STATE OF ILLINOIS  
DEPARTMENT OF TRANSPORTATION**

SUMMARY OF QUANTITIES			
SCALE:	SHEET NO. 5 OF 10 SHEETS	STA.	TO STA.

F.A.U. RTE. 2503	SECTION 16-00313-00-MS	COUNTY KANE	TOTAL SHEETS 254	SHEET NO. 8
CONTRACT NO. 61E18				
ILLINOIS FED. AID PROJECT				

SPECIALTY ITEM	SPECIAL PROVISION	CODE NO.	ITEM	UNIT	TOTAL QUANTITY	CONSTRUCTION CODE						
						80% FEDERAL 20% STATE		NON-PART 100% LOCAL		SAFETY	TRAINEES	SAFETY
						ROADWAY 0004 URBAN	BRIDGE 0008 URBAN	0021 URBAN	0042 URBAN			
•	S	87301255	ELECTRIC CABLE IN CONDUIT, SIGNAL NO. 14 7C	FOOT	2,260			2,260				
•	S	87301305	ELECTRIC CABLE IN CONDUIT, LEAD-IN, NO. 14 1 PAIR	FOOT	2,617			2,617				
•	S	87301805	ELECTRIC CABLE IN CONDUIT, SERVICE, NO. 6 2 C	FOOT	112			112				
•	S	87301900	ELECTRIC CABLE IN CONDUIT, EQUIPMENT GROUNDING CONDUCTOR, NO. 6 1C	FOOT	1,064			1,064				
•	S	87502440	TRAFFIC SIGNAL POST, GALVANIZED STEEL 10 FT.	EACH	3			3				
•	S	87502500	TRAFFIC SIGNAL POST, GALVANIZED STEEL 16 FT.	EACH	6			6				
•		87700160	STEEL MAST ARM ASSEMBLY AND POLE, 24 FT.	EACH	1			1				
•	S	87700200	STEEL MAST ARM ASSEMBLY AND POLE, 32 FT.	EACH	1			1				
•	S	87700240	STEEL MAST ARM ASSEMBLY AND POLE, 40 FT.	EACH	2			2				
•	S	87700250	STEEL MAST ARM ASSEMBLY AND POLE, 42 FT.	EACH	1			1				
•	S	87702890	STEEL COMBINATION MAST ARM ASSEMBLY AND POLE 32 FT.	EACH	1			1				
•	S	87702910	STEEL COMBINATION MAST ARM ASSEMBLY AND POLE 36 FT.	EACH	1			1				
•		87800100	CONCRETE FOUNDATION, TYPE A	FOOT	44			44				
•		87800150	CONCRETE FOUNDATION, TYPE C	FOOT	8			8				
•		87800400	CONCRETE FOUNDATION, TYPE E 30-INCH DIAMETER	FOOT	10			10				
•		87800415	CONCRETE FOUNDATION, TYPE E 36-INCH DIAMETER	FOOT	72			72				
•		87900200	DRILL EXISTING HANDHOLE	EACH	11			11				
•		88030020	SIGNAL HEAD, LED, 1-FACE, 3-SECTION, MAST-ARM MOUNTED	EACH	11			11				
•		88030050	SIGNAL HEAD, LED, 1-FACE, 3-SECTION, BRACKET MOUNTED	EACH	4			4				
•		88030100	SIGNAL HEAD, LED, 1-FACE, 5-SECTION, BRACKET MOUNTED	EACH	6			6				
•		88030110	SIGNAL HEAD, LED, 1-FACE, 5-SECTION, MAST-ARM MOUNTED	EACH	6			6				
•		88102717	PEDESTRIAN SIGNAL HEAD, LED, 1-FACE, BRACKET MOUNTED WITH COUNTDOWN TIMER	EACH	12			12				
•		88200410	TRAFFIC SIGNAL BACKPLATE, LOUVERED, FORMED PLASTIC	EACH	17			17				
•		88500100	INDUCTIVE LOOP DETECTOR	EACH	6			6				
•		88600100	DETECTOR LOOP, TYPE I	FOOT	258			258				
•		88700200	LIGHT DETECTOR	EACH	4			4				
•		88700300	LIGHT DETECTOR AMPLIFIER	EACH	2			2				
•		88800100	PEDESTRIAN PUSH-BUTTON	EACH	16			16				
•		89000100	TEMPORARY TRAFFIC SIGNAL INSTALLATION	EACH	1			1				
•		89500200	RELOCATE EXISTING PEDESTRIAN SIGNAL HEAD	EACH	1			1				
•	S	89502210	MODIFY EXISTING CONTROLLER CABINET	EACH	1			1				
•		89502300	REMOVE ELECTRIC CABLE FROM CONDUIT	FOOT	718			718				
•	S	89502375	REMOVE EXISTING TRAFFIC SIGNAL EQUIPMENT	EACH	2			2				
•	S	89502376	REBUILD EXISTING HANDHOLE	EACH	1			1				
•	S	89502380	REMOVE EXISTING HANDHOLE	EACH	18			18				

FILE NAME = W:\Projects\2016\160194\_ATPhone\cadd\Cvt1\Dgn\Shk\S00\_06.dgn

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USER NAME = nparris  
 PLOT SCALE = 1:2  
 PLOT DATE = 12/4/2017

DESIGNED - MNB  
 DRAWN - NDP  
 CHECKED - MNB  
 DATE - 12/04/17

REVISED -  
 REVISED -  
 REVISED -  
 REVISED -

**STATE OF ILLINOIS  
 DEPARTMENT OF TRANSPORTATION**

**SUMMARY OF QUANTITIES**

SCALE: SHEET NO. 6 OF 10 SHEETS STA. TO STA.

F.A.U. RTE. 2503	SECTION 16-00313-00-M5	COUNTY KANE	TOTAL SHEETS 254	SHEET NO. 9
CONTRACT NO. 61E18				
ILLINOIS FED. AID PROJECT				

SPECIALTY ITEM	SPECIAL PROVISION	CODE NO.	ITEM	UNIT	TOTAL QUANTITY	CONSTRUCTION CODE				
						80% FEDERAL 20% STATE				NON-PART 100% LOCAL
						ROADWAY 0004 URBAN	BRIDGE 0008 URBAN	SAFETY 0021 URBAN	TRAINEES 0042 URBAN	SAFETY 0021 URBAN
•	S	89502382	REMOVE EXISTING DOUBLE HANDHOLE	EACH	2			2		
*		89502385	REMOVE EXISTING CONCRETE FOUNDATION	EACH	32			32		
•		A2000120	TREE, ACER X FREEMANII AUTUMN BLAZE (AUTUMN BLAZE FREEMAN MAPLE), 2-1/2" CALIPER, BALLED AND BURLAPPED	EACH	15	15				
•		A2002320	TREE, BETULA NIGRA (RIVER BIRCH), 2-1/2" CALIPER, BALLED AND BURLAPPED	EACH	4	4				
•		A2002920	TREE, CELTIS OCCIDENTALIS (COMMON HACKBERRY), 2-1/2" CALIPER, BALLED AND BURLAPPED	EACH	3	3				
•		A2006520	TREE, QUERCUS BICOLOR (SWAMP WHITE OAK), 2-1/2" CALIPER, BALLED AND BURLAPPED	EACH	7	7				
•		A2006716	TREE, QUERCUS MACROCARPA (BUR OAK), 2" CALIPER, BALLED AND BURLAPPED	EACH	10	10				
•		A2007120	TREE, QUERCUS RUBRA (RED OAK), 2-1/2" CALIPER, BALLED AND BURLAPPED	EACH	9	9				
•		A2008120	TREE, TILIA CORDATA GREENSPIRE (GREENSPIRE LITTLE LEAF LINDEN), 2-1/2" CALIPER, BALLED AND BURLAPPED	EACH	3	3				
•		B2000778	TREE, AMELANCHIER LAEVIS (ALLEGHENY SERVICEBERRY), 3" CALIPER, TREE FORM, BALLED AND BURLAPPED	EACH	3	3				
•		B2004416	TREE, MALUS RED BARON (RED BARON CRAB APPLE), 2" CALIPER, TREE FORM, BALLED AND BURLAPPED	EACH	2	2				
•		C2012424	SHRUB, VIBURNUM LENTAGO (NANNYBERRY VIBURNUM), 2' HEIGHT, BALLED AND BURLAPPED	EACH	9	9				
•		C2C015G3	SHRUB, CORNUS OBLIQUA (PALE DOGWOOD), CONTAINER GROWN, 3-GALLON	EACH	4	4				
•		C2C06218	SHRUB, RIBES AMERICANUM (WILD BLACK CURRANT), 18" HEIGHT, CONTAINER	EACH	7	7				
•	S	K1005421	SEEDING (SPECIAL)	ACRE	0.6	0.6				
•	S	X0320031	SIGN LIGHTING UNIT COMPLETE	EACH	2			2		
•	S	X0320051	CROSSHOLE SONIC LOGGING ACCESS DUCTS	FOOT	305		305			
•	S	X0320052	CROSSHOLE SONIC LOGGING TESTING	EACH	3		3			
•	S	X0320622	FIELD MEASUREMENTS	LSUM	1	1				
•	S	X0321461	PILLAR REMOVAL	EACH	3	3				
•	S	X0321865	ANTI GRAFFITI PROTECTION SYSTEM	SO FT	1,071		1,071			
•	S	X0322917	PROPOSED STORM SEWER CONNECTION TO EXISTING MANHOLE	EACH	3	3				
•	S	X0323265	REMOVE EXISTING RIPRAP	SO YD	6	6				
•	S	X0324085	EMERGENCY VEHICLE PRIORITY SYSTEM LINE SENSOR CABLE, NO. 20 3/C	FOOT	445			445		
•	S	X0324097	COARSE SAND PLACEMENT, 2"	SO YD	1,785	1,785				
•	S	X0324599	ROD AND CLEAN EXISTING CONDUIT	FOOT	286			286		
•	S	X0325815	REMOVE EXISTING CABLE	FOOT	440			440		
•	S	X0326266	ETHERNET SWITCH	EACH	3			3		
•	S	X0326275	RAILROAD RIGHT-OF-WAY ENTRY PERMIT	EACH	1	1				
•	S	X0326366	ELECTRICAL EQUIPMENT REMOVAL AND SALVAGE	EACH	2			2		
•	S	X0326654	ORNAMENTAL LIGHT UNIT, COMPLETE	EACH	40			40		
•	S	X0326672	PEDESTRIAN BRIDGE LIGHTING SYSTEM	LSUM	1		1			
•	S	X0326806	WASHOUT BASIN	LSUM	1	1				
•	S	X0326885	VIDEO DETECTION SYSTEM	EACH	2			2		
•	S	X0327036	BIKE PATH REMOVAL	SO YD	2,379	2,379				

FILE NAME = \\A:\Projects\2016\160194\_ATCPPhase1\Cadd\Civil\Ugr\Bkt\500\_07.dgn

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USER NAME = nparris	DESIGNED - MNB	REVISED -
PLOT SCALE = 1/2	DRAWN - NDP	REVISED -
PLOT DATE = 12/4/2017	CHECKED - MNB	REVISED -
	DATE - 12/04/17	REVISED -

**STATE OF ILLINOIS  
DEPARTMENT OF TRANSPORTATION**

**SUMMARY OF QUANTITIES**

SCALE:	SHEET NO. 7 OF 10 SHEETS	STA. TO STA.
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F.A.U. RTE.	SECTION	COUNTY	TOTAL SHEETS	SHEET NO.
2503	16-00313-00-MS	KANE	254	10
CONTRACT NO. 61E18			ILLINOIS FED. AID PROJECT	

SPECIALTY ITEM	SPECIAL PROVISION	CODE NO.	ITEM	UNIT	TOTAL QUANTITY	CONSTRUCTION CODE						
						80% FEDERAL 20% STATE		NON-PART 100% LOCAL		SAFETY 0021 URBAN	TRAINEES 0042 URBAN	SAFETY 0021 URBAN
						ROADWAY 0004 URBAN	BRIDGE 0008 URBAN	SAFETY 0021 URBAN	TRAINEES 0042 URBAN			
	S	X0327139	AGGREGATE COLUMN GROUND IMPROVEMENT	LSUM	1		1					
•	S	X0327303	REMOVAL OF EXISTING SIGN LIGHTING UNIT WITH NO SALVAGE	EACH	1			1				
•	S	X0327357	CONSTRUCTION VIBRATION MONITORING	LSUM	1	1						
•	S	X0327739	MISCELLANEOUS ELECTRICAL WORK	LSUM	1			1				
•	S	X0327980	PAVEMENT MARKING REMOVAL - WATER BLASTING	SO FT	2,000	2,000						
•	S	X1400028	REMOVE RADIO INTERCONNECT	EACH	1			1				
•	S	X1400031	REMOVE PEDESTRIAN PUSH-BUTTON	EACH	3			3				
•	S	X1400081	FULL-ACTUATED CONTROLLER AND TYPE SUPER P CABINET (SPECIAL)	EACH	2			2				
•	S	X1400088	POWER PEDESTALS	EACH	3			3				
•	S	X1400095	LUMINAIRE, LED, HORIZONTAL MOUNT, HIGH WATTAGE	EACH	14			14				
•	S	X1400102	OUTDOOR RATED NETWORK CABLE	FOOT	208			208				
•	S	X1400150	SERVICE INSTALLATION, GROUND MOUNTED, METERED	EACH	2			2				
•	S	X1400211	LIGHT POLE, SPECIAL, 30'	EACH	3			3				
	S	X2110100	TOPSOIL FURNISH AND PLACE, SPECIAL	CU YD	492	492						
	S	X2130010	EXPLORATION TRENCH, SPECIAL	FOOT	450	450						
•	S	X2200003	FENCE (SPECIAL)	FOOT	839	839						
*	S	X2511630	EROSION CONTROL BLANKET (SPECIAL)	SO YD	2,724	2,724						
•	S	X2600004	REMOVE AND DISPOSE SIGN PANEL	EACH	6	6						
	S	X2810108	STONE RIPRAP, CLASS A4 (SPECIAL)	SO YD	272	272						
	S	X4022000	TEMPORARY ACCESS (COMMERCIAL ENTRANCE)	EACH	10	10						
	S	X4023000	TEMPORARY ACCESS (ROAD)	EACH	3	3						
	S	X4230800	PORTLAND CEMENT CONCRETE DRIVEWAY PAVEMENT, 8 INCH, SPECIAL	SO YD	189	189						
	S	X4240470	PORTLAND CEMENT CONCRETE SIDEWALK 10 INCH, SPECIAL	SO FT	313	313						
	S	X5030400	SIDEWALK FLOOR DRAINS	EACH	2		2					
*	S	X5090810	PEDESTRIAN RAIL (SPECIAL)	FOOT	276		276					
	S	X5210130	HIGH LOAD MULTI-ROTATIONAL BEARINGS, GUIDED EXPANSION, 300K	EACH	4		4					
	S	X6022712	CATCH BASINS, TYPE A, 4'-DIAMETER, WITH SPECIAL FRAME AND GRATE	EACH	1	1						
*	S	X6026050	SANITARY MANHOLES TO BE ADJUSTED	EACH	3	3						
	S	X6030310	FRAMES AND LIDS TO BE ADJUSTED (SPECIAL)	EACH	27	27						
	S	X6060505	CONCRETE CURB (SPECIAL)	FOOT	165	165						
	S	X6061005	CONCRETE CURB, TYPE B (SPECIAL)	FOOT	1,585	1,585						
	S	X7010216	TRAFFIC CONTROL AND PROTECTION, (SPECIAL)	LSUM	1	1						
	S	X7010237	CHANGEABLE MESSAGE SIGN, SPECIAL	CAL DA	819	819						
*	S	X7240205	REMOVE SIGN COMPLETE	EACH	24	24						
•	S	X7240300	SIGN REMOVAL	EACH	1	1						

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WBK ENGINEERING, LLC  
116 WEST MAIN STREET, SUITE 201  
ST. CHARLES, ILLINOIS 60174  
(630) 443-7755

USER NAME = mperris	DESIGNED - MNB	REVISED -
PLOT SCALE = 1/2	DRAWN - NDP	REVISED -
PLOT DATE = 12/4/2017	CHECKED - MNB	REVISED -
	DATE - 12/04/17	REVISED -

**STATE OF ILLINOIS  
DEPARTMENT OF TRANSPORTATION**

**SUMMARY OF QUANTITIES**

SCALE: SHEET NO. 8 OF 10 SHEETS STA. TO STA.

F.A.U. RTE.	SECTION	COUNTY	TOTAL SHEETS	SHEET NO.
2503	16-00313-00-MS	KANE	254	11
CONTRACT NO. 61E18				
ILLINOIS FED. AID PROJECT				

SPECIALTY ITEM	SPECIAL PROVISION	CODE NO.	ITEM	UNIT	TOTAL QUANTITY	CONSTRUCTION CODE				
						80% FEDERAL 20% STATE				NON-PART 100% LOCAL
						ROADWAY 0004 URBAN	BRIDGE 0008 URBAN	SAFETY 0021 URBAN	TRAINEES 0042 URBAN	SAFETY 0021 URBAN
	S	X7800200	PAINT PAVEMENT MARKING CURB	FOOT	69	69				
•	S	X8100105	CONDUIT SPLICE	EACH	1			1		
•	S	X8130350	JUNCTION BOX EMBEDDED IN STRUCTURE, SPECIAL	EACH	7		7			
•	S	X8140230	HANDHOLE, COMPOSITE CONCRETE (SPECIAL)	EACH	2			2		
•	S	X8211125	LUMINAIRE, LED, HORIZONTAL MOUNT, SPECIAL	EACH	1					1
•	S	X8250500	LIGHTING UNIT COMPLETE, SPECIAL	EACH	1					1
*	S	X8300001	LIGHT POLE, SPECIAL	EACH	2			2		
•	S	X8360110	LIGHT POLE FOUNDATION, SPECIAL	FOOT	43			43		
•	S	X8360210	LIGHT POLE FOUNDATION, 24" DIAMETER, SPECIAL	FOOT	330			330		
•	S	X8360215	LIGHT POLE FOUNDATION, 24" DIAMETER, OFFSET	FOOT	105			105		
•	S	X8620200	UNINTERRUPTABLE POWER SUPPLY, SPECIAL	EACH	2			2		
•	S	X8710031	FIBER OPTIC CABLE 36 FIBERS, SINGLE MODE	FOOT	873			873		
•	S	X8950090	RELOCATE EXISTING LIGHTING CONTROLLER	EACH	1			1		
*	S	X8950450	REMOVE EXISTING UNDERGROUND CONDUIT	FOOT	1,492			1,492		
•	S	XX002185	RELOCATE EXISTING LIGHT POLE	EACH	5			5		
•	S	XX002260	STRUCTURES TO BE REMOVED	EACH	19	19				
•	S	XX003079	REMOVE JUNCTION BOX	EACH	8			8		
•	S	XX003711	BUS SHELTER REMOVAL	EACH	5	5				
•	S	XX004101	ORNAMENTAL METAL FENCE	FOOT	547	547				
•	S	XX004951	CONCRETE STAIRS	LSUM	1	1				
•	S	XX005913	TEMPORARY ACCESS CAUSEWAY	LSUM	1		1			
•	S	XX005963	ANTI GRAFFITI COATING	SO FT	25,155		25,155			
•	S	XX006614	MODIFY EXISTING CABINET EQUIPMENT AND APPURTENANCES	EACH	1			1		
•	S	XX006752	REMOVE, STORE AND RE-INSTALL EXISTING MONUMENT	LSUM	1	1				
•	S	XX007251	INTERSECTION VIDEO TRAFFIC MONITORING SYSTEM WITH PTZ CAMERA	EACH	2			2		
•	S	XX007562	SIGN REMOVAL, SPECIAL	LSUM	1	1				
•	S	XX007993	CENTRALIZED SYSTEM FIELD INTEGRATION/ SETUP	LSUM	1			1		
•	S	XX008626	TEMPORARY BRIDGE	LSUM	1		1			
•	S	XZ006305	BRIDGE DECK WEARING SURFACE	SO YD	1,541		1,541			
•	S	Z0004002	BOLLARDS	EACH	45	45				
•	S	Z0007430	TEMPORARY SIDEWALK	SO FT	1,000	1,000				
•	S	Z0013797	STABILIZED CONSTRUCTION ENTRANCE	SO YD	156	156				
•	S	Z0013798	CONSTRUCTION LAYOUT	LSUM	1	1				
•	S	Z0022800	FENCE REMOVAL	FOOT	108	108				
•	S	Z0030850	TEMPORARY INFORMATION SIGNING	SO FT	96	96				

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WBK ENGINEERING, LLC  
136 WEST MAIN STREET, SUITE 201  
ST. CHARLES, ILLINOIS 60174  
(630) 443-7755

USER NAME = nporris	DESIGNED - MNB	REVISED -
PLOT SCALE = 1/2	DRAWN - NDP	REVISED -
PLOT DATE = 12/14/2017	CHECKED - MNB	REVISED -
	DATE - 12/04/17	REVISED -

**STATE OF ILLINOIS  
DEPARTMENT OF TRANSPORTATION**

**SUMMARY OF QUANTITIES**

SCALE: SHEET NO. 9 OF 10 SHEETS STA. TO STA.

F.A.U. RTE.	SECTION	COUNTY	TOTAL SHEETS	SHEET NO.
2503	16-00313-00-MS	KANE	254	12
CONTRACT NO. 61E18			ILLINOIS FED. AID PROJECT	

SPECIALTY ITEM	SPECIAL PROVISION	CODE NO.	ITEM	UNIT	TOTAL QUANTITY	CONSTRUCTION CODE						
						80% FEDERAL 20% STATE		NON-PART 100% LOCAL		SAFETY 0021 URBAN	TRAINEES 0042 URBAN	SAFETY 0021 URBAN
						ROADWAY 0004 URBAN	BRIDGE 0008 URBAN	SAFETY 0021 URBAN	TRAINEES 0042 URBAN			
•	S	Z0033028	MAINTENANCE OF LIGHTING SYSTEM	CAL MO	9			9				
•	S	Z0033046	RE-OPTIMIZE TRAFFIC SIGNAL SYSTEM LEVEL 2	EACH	4			4				
	S	Z0034390	MODULAR EXPANSION JOINT 6"	FOOT	39		39					
	S	Z0040530	PIPE UNDERDRAIN REMOVAL	FOOT	278	278						
	S	Z0048665	RAILROAD PROTECTIVE LIABILITY INSURANCE	LSUM	1	1						
	S	Z0055905	TEMPORARY CONSTRUCTION FENCE	FOOT	8,690	8,690						
	S	Z0062456	TEMPORARY PAVEMENT	SO YD	716	716						
	S	Z0068800	STONE LINED DITCH	SO YD	104	104						
•	S	Z0073510	TEMPORARY TRAFFIC SIGNAL TIMING	EACH	2			2				
	S	Z0076600	TRAINEES	HOUR	1,500				1,500			
	S	Z0076604	TRAINEES TRAINING PROGRAM GRADUATE	HOUR	1,500				1,500			
	S	XX009211	RETAINING WALL REMOVAL - LOCATION #1	LSUM	1	1						
	S	XX009212	RETAINING WALL REMOVAL - LOCATION #2	LSUM	1	1						

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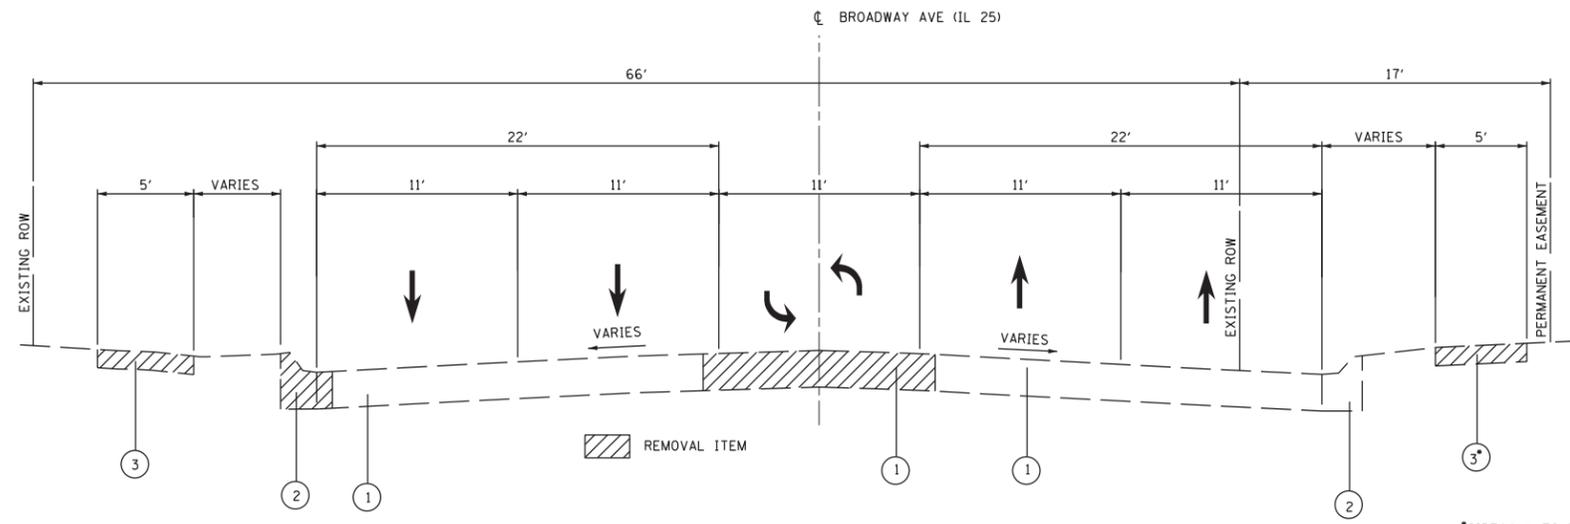
WBK ENGINEERING, LLC  
116 WEST MAIN STREET, SUITE 201  
ST. CHARLES, ILLINOIS 60174  
(630) 483-7755

USER NAME = nparris	DESIGNED - MNB	REVISED -
PLOT SCALE = 1/2	DRAWN - NDP	REVISED -
PLOT DATE = 12/4/2017	CHECKED - MNB	REVISED -
	DATE - 12/04/17	REVISED -

**STATE OF ILLINOIS  
DEPARTMENT OF TRANSPORTATION**

SUMMARY OF QUANTITIES			
SCALE:	SHEET NO. 10 OF 10 SHEETS	STA.	TO STA.

F.A.I. RTE. 2503	SECTION 16-00313-00-MS	COUNTY KANE	TOTAL SHEETS 254	SHEET NO. 13
CONTRACT NO. 61E18				
ILLINOIS FED. AID PROJECT				




**EXISTING TYPICAL SECTION**  
**STA. 10+70 TO 31+11 - IL ROUTE 25 (BROADWAY AVE)**

\*SIDEWALK TO BE RELOCATED OUTSIDE ROADWAY EASEMENT AT SOME LOCATIONS - SEE PLANS


- LEGEND**
- ① EXISTING HMA PAVEMENT AND STONE BASE
  - ② EXISTING CONCRETE CURB AND GUTTER (TYPE VARIES)
  - ③ EXISTING PCC SIDEWALK (EXCAVATION INCLUDED IN COST OF SIDEWALK)
  - ④ PROPOSED CONCRETE CURB AND GUTTER (TYPE VARIES - SEE PLANS)
  - ⑤ PCC SIDEWALK, 5"
  - ⑥ SUB-BASE GRANULAR MATERIALS, TYPE B, 4"
  - ⑦ HOT-MIX ASPHALT SURFACE COURSE, MIX "D", N70, 1.5"
  - ⑧ HOT-MIX ASPHALT BINDER COURSE, IL-19.0, N70, 4"
  - ⑨ BITUMINOUS MATERIALS (TACK COAT)
  - ⑩ NOT USED
  - ⑪ AGGREGATE SUBGRADE IMPROVEMENT, 12"
  - ⑫ CLASS D PATCHES, 12"
  - ⑬ TOPSOIL FURNISH AND PLACE 4" SEEDING, CLASS 1A MULCH, METHOD 2
  - ⑭ TOPSOIL FURNISH AND PLACE, SPECIAL (24" MIN. DEPTH) SEEDING, CLASS 1A MULCH, METHOD 2

- NOTES**
1. CONTRACTOR SHALL SAWCUT PAVEMENT PRIOR TO REMOVING ALL PAVEMENT.

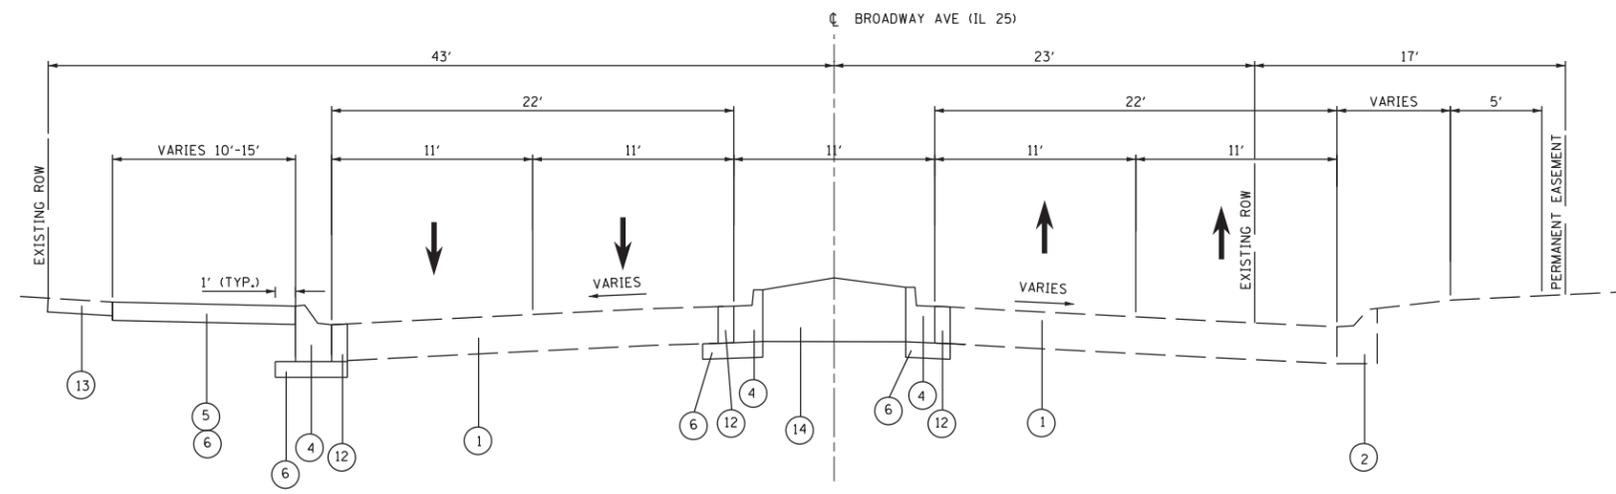

**PROPOSED TYPICAL SECTION**  
**STA. 10+70 TO 31+11 - IL ROUTE 25 (BROADWAY AVE)**


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Default	PLOT SCALE = 10'	CHECKED - BMW	REVISED -			SCALE: 10'	SHEET OF 254 SHEETS	STA. TO STA.	CONTRACT NO. 61E18		
	PLOT DATE = 10/16/2017	DATE = 10/16/2017	REVISED -			ILLINOIS FED. AID PROJECT					

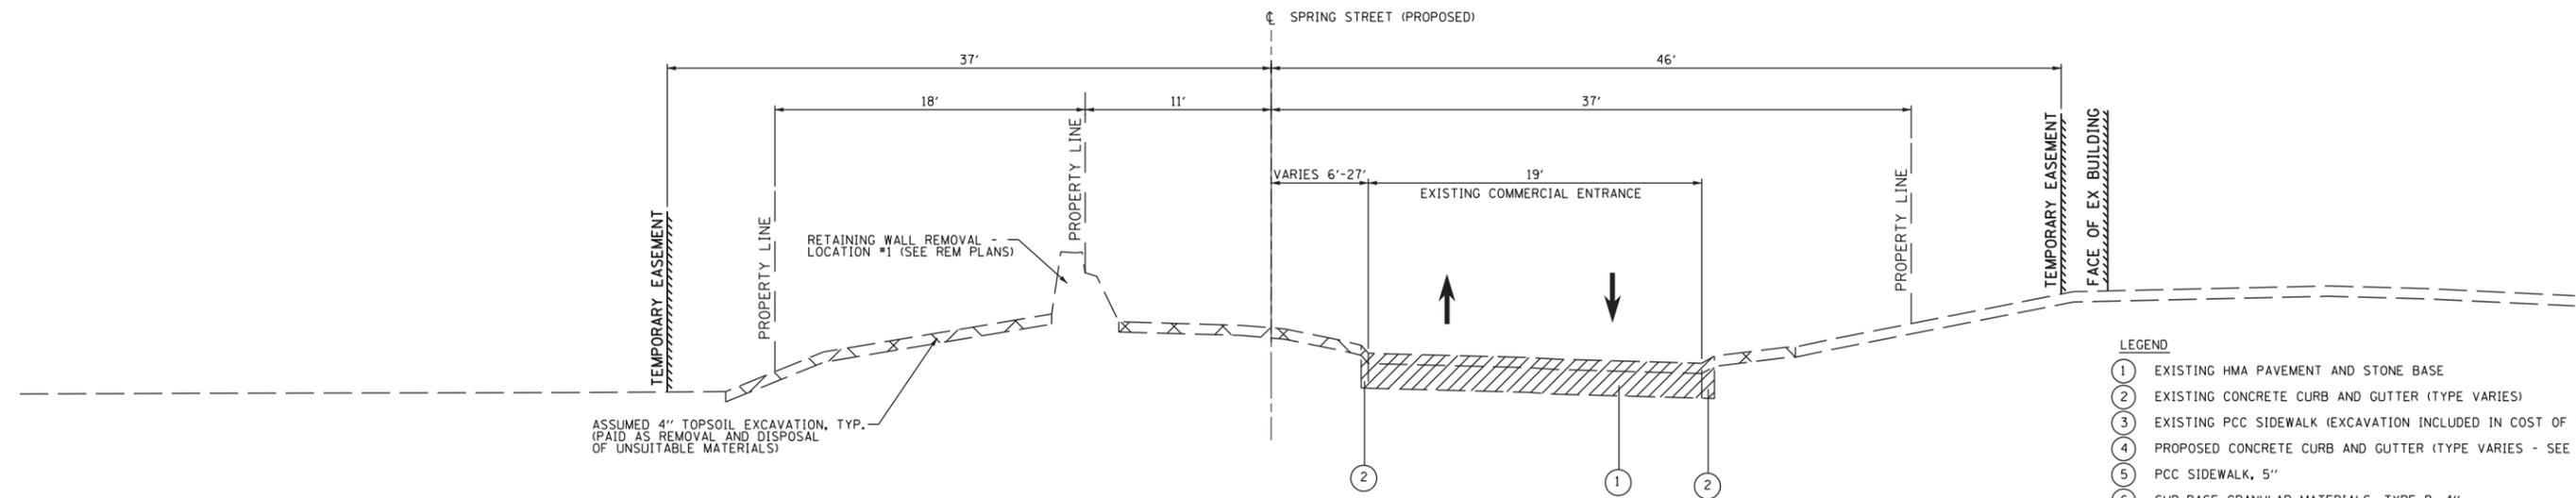

**EXISTING TYPICAL SECTION**  
**STA. 70+21 TO STA. 71+92 - SPRING STREET**


- LEGEND**
- ① EXISTING HMA PAVEMENT AND STONE BASE
  - ② EXISTING CONCRETE CURB AND GUTTER (TYPE VARIES)
  - ③ EXISTING PCC SIDEWALK (EXCAVATION INCLUDED IN COST OF SIDEWALK)
  - ④ PROPOSED CONCRETE CURB AND GUTTER (TYPE VARIES - SEE PLANS)
  - ⑤ PCC SIDEWALK, 5"
  - ⑥ SUB-BASE GRANULAR MATERIALS, TYPE B, 4"
  - ⑦ HOT-MIX ASPHALT SURFACE COURSE, MIX "D", N70, 1.5"
  - ⑧ HOT-MIX ASPHALT BINDER COURSE, IL-19.0, N70, 4"
  - ⑨ BITUMINOUS MATERIALS (TACK COAT)
  - ⑩ NOT USED
  - ⑪ AGGREGATE SUBGRADE IMPROVEMENT, 12"
  - ⑫ CLASS D PATCHES, 12"
  - ⑬ TOPSOIL FURNISH AND PLACE 4" SEEDING, CLASS 1A MULCH, METHOD 2
  - ⑭ TOPSOIL FURNISH AND PLACE, SPECIAL (24" MIN. DEPTH) SEEDING, CLASS 1A MULCH, METHOD 2

- NOTES**
1. CONTRACTOR SHALL SAWCUT PAVEMENT PRIOR TO REMOVING ALL PAVEMENT.

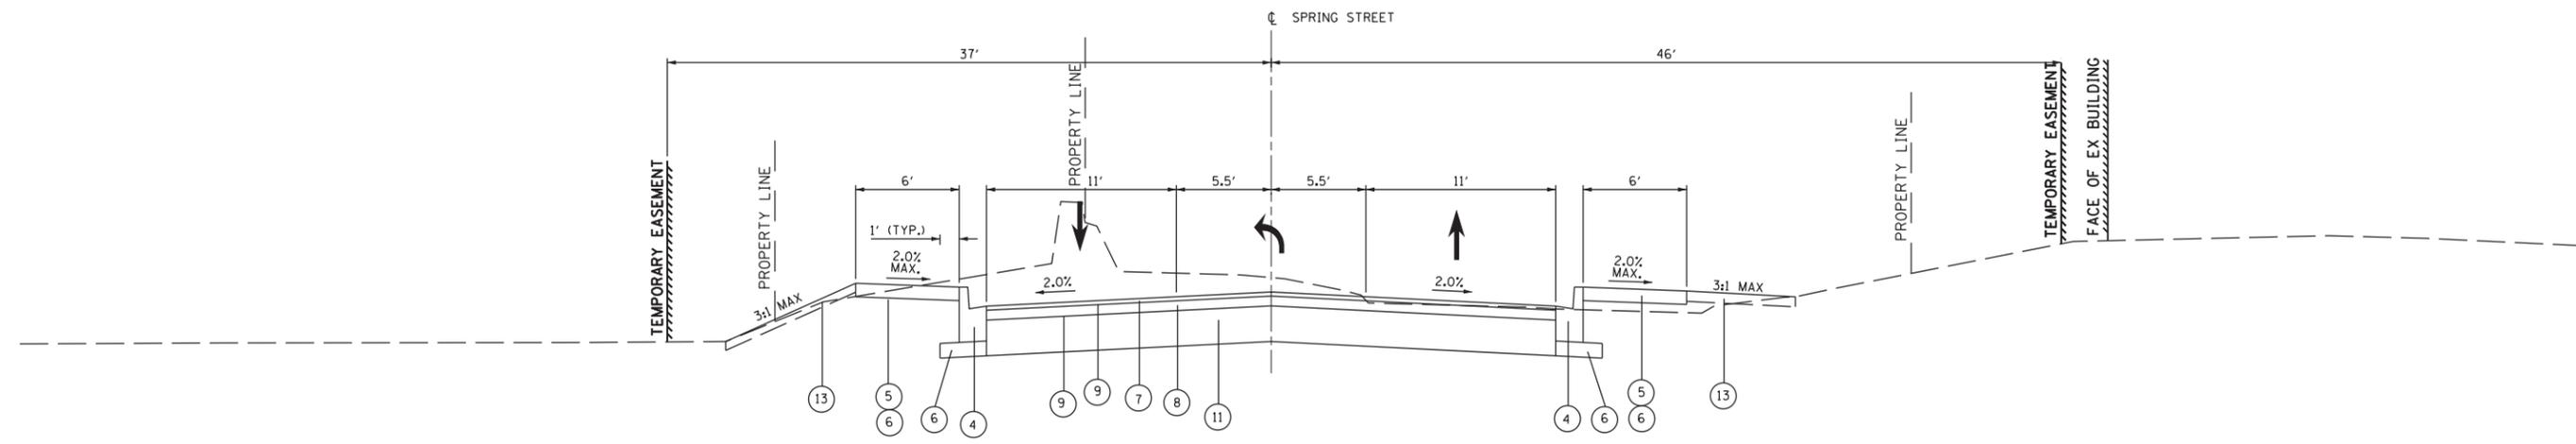


**PROPOSED TYPICAL SECTION**  
**STA. 70+21 TO STA. 71+92 - SPRING STREET**


FILE NAME = N:\WBK\150077.2\Civi1\TYP-150077.2.01.sht	USER NAME = bweich	DESIGNED - BMW	REVISED -	<b>STATE OF ILLINOIS DEPARTMENT OF TRANSPORTATION</b>	<b>AURORA TRANSIT CENTER IMPROVEMENTS TYPICAL SECTION - SPRING STREET</b>	F.A.U. RTE. 2503	SECTION 16-00313-00-MS	COUNTY KANE	TOTAL SHEETS 254	SHEET NO. 15	
Default	PLOT SCALE = 10'	CHECKED - BMW	REVISED -			SCALE: 10'	SHEET OF 254 SHEETS	STA. TO STA.	CONTRACT NO. 61E18		
	PLOT DATE = 10/16/2017	DATE - 10/16/2017	REVISED -			ILLINOIS FED. AID PROJECT					

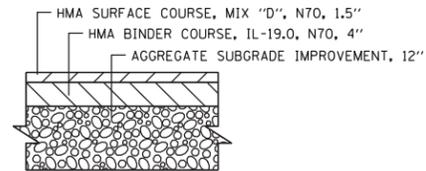


**FULL DEPTH PAVEMENT – PARKING LOT  
HEAVY DUTY SECTION**

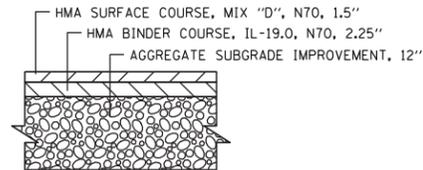

**FULL DEPTH PAVEMENT – PARKING LOT  
STANDARD SECTION**

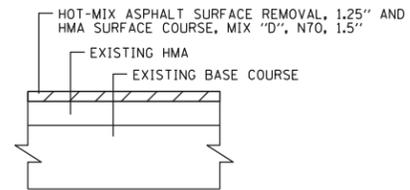

**PARKING LOT RESURFACING**

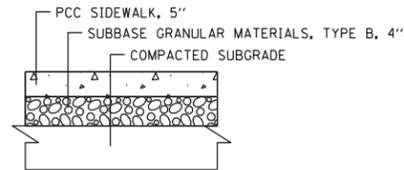

**PCC SIDEWALK, 5"**

HOT-MIX ASPHALT MIXTURE REQUIREMENTS	
MIXTURE ITEM	AIR VOIDS @ Ndes
<b>PATCHING (IL ROUTE 25)</b>	
HOT-MIX ASPHALT SURFACE COURSE, MIX "D", N70, 2"	4% @ 70 GYR
HOT-MIX ASPHALT BINDER COURSE, IL-19.0, N70, 10"	4% @ 70 GYR
<b>PAVEMENT RESURFACING</b>	
HOT-MIX ASPHALT SURFACE COURSE, MIX "D", N70, 1 1/2"	4% @ 70 GYR
<b>FULL DEPTH PAVEMENT - PARKING LOT (STANDARD SECTION)</b>	
HOT-MIX ASPHALT SURFACE COURSE, MIX "D", N70, 1 1/2"	4% @ 70 GYR
HOT-MIX ASPHALT BINDER COURSE, IL-19.0, N70, 2 1/4"	4% @ 70 GYR
<b>FULL DEPTH PAVEMENT - SPRING STREET AND PARKING LOT (HEAVY DUTY SECTION)</b>	
HOT-MIX ASPHALT SURFACE COURSE, MIX "D", N70, 1 1/2"	4% @ 70 GYR
HOT-MIX ASPHALT BINDER COURSE, IL-19.0, N70, 4"	4% @ 70 GYR
<b>TEMPORARY PAVEMENT</b>	
HOT-MIX ASPHALT BINDER COURSE, IL-19.0, N70, 3" MIN.	4% @ 70 GYR

**NOTES:**

1. THE UNIT WEIGHT USED TO CALCULATE ALL HMA SURFACE MIXTURE QUANTITIES IS 112 LBS/SQ YD/IN.
2. THE "AC TYPE" SHALL BE "PG 64-22" UNLESS MODIFIED BY DISTRICT ONE SPECIAL PROVISIONS. FOR "PERCENT OF RAP AND RAS" SEE DISTRICT ONE SPECIAL PROVISIONS.

FILE NAME = N:\WBK\150077.2\Civil\TYP-150077.2.01.sht	USER NAME = bweich	DESIGNED - BMW	REVISED -
		DRAWN - PWN	REVISED -
	PLOT SCALE = 10'	CHECKED - BMW	REVISED -
Default	PLOT DATE = 10/16/2017	DATE - 10/16/2017	REVISED -

**STATE OF ILLINOIS  
DEPARTMENT OF TRANSPORTATION**

**AURORA TRANSIT CENTER IMPROVEMENTS  
TYPICAL SECTIONS – PARKING LOT**


SCALE: 10' SHEET OF 254 SHEETS STA. TO STA.

F.A.U. RTE.	SECTION	COUNTY	TOTAL SHEETS	SHEET NO.
2503	16-00313-00-MS	KANE	254	16
CONTRACT NO. 61E18				
ILLINOIS FED. AID PROJECT				

HOT-MIX ASPHALT MIXTURE REQUIREMENTS


ITEM	AIR VOIDS @ Ndes
<b>PARKING LOTS - FULL DEPTH RECONSTRUCTION (7 1/4")</b>	
HOT-MIX ASPHALT SURFACE COURSE, MIX "D", N50 (IL 9.5 mm), 2"	4% @ 50 GYR.
HOT-MIX ASPHALT BASE COURSE (HMA BINDER IL-19 mm), 5 1/4" (2-1/4" MIN. - 4" MAX.)*	4% @ 50 GYR.
<b>FOX RIVER TRAIL - MULTI-USE PATH (3")</b>	
HOT-MIX ASPHALT SURFACE COURSE, MIX "D", N50 (IL 9.5 mm), 3"	4% @ 50 GYR.

THE UNIT WEIGHT USED TO CALCULATE ALL HMA SURFACE MIXTURE QUANTITIES IS 112 LB/SO YD/IN.  
 THE AC TYPE FOR NON-POLYMERIZED HMA THE "AC TYPE" SHALL BE "PG64-22" UNLESS MODIFIED BY DISTRICT ONE SPECIAL PROVISIONS. FOR "PERCENT OF RAP AND RAS" SEE DISTRICT ONE SPECIAL PROVISIONS.  
 \*NUMBER OF LIFTS TO BE DETERMINED BY THE ENGINEER.

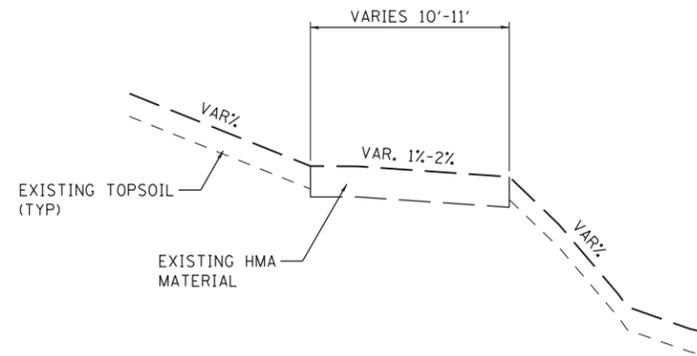


**EXISTING TYPICAL SECTION**

STA. 9+30.00 TO STA. 14+00.00, FOX RIVER TRAIL

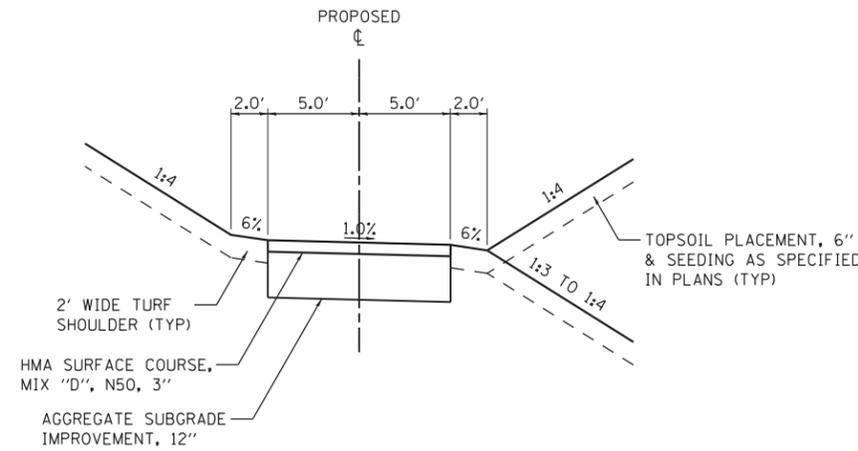


**PROPOSED TYPICAL SECTION**

STA. 9+30.00 TO STA. 14+00.00, FOX RIVER TRAIL

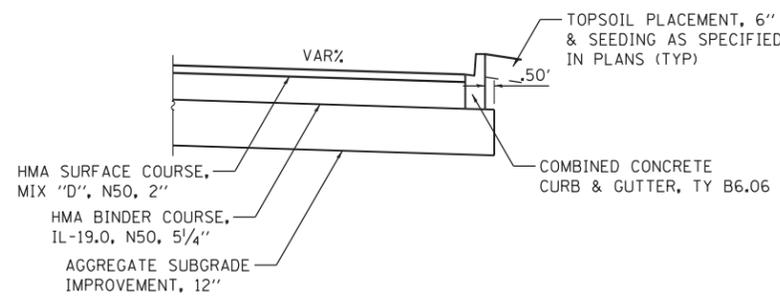

**PROPOSED TYPICAL SECTION**

PARKING LOT X

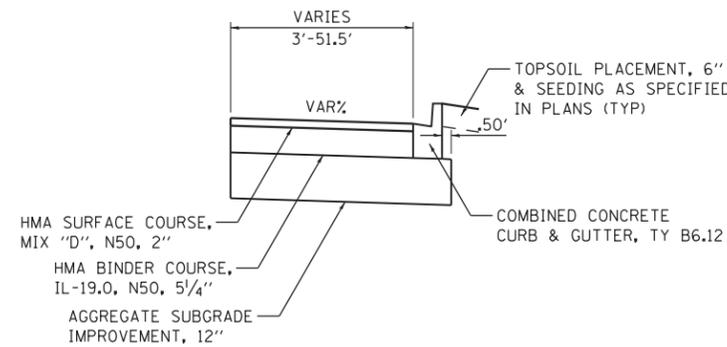

**PROPOSED TYPICAL SECTION**

PARKING LOT W

FILE NAME = W:\Projects\2016\160194\_ATCPhaseII\Cadd\Civil\Dgn\Shd\Typ\_01.dgn

USER NAME = nparris	DESIGNED - MNB	REVISED -
PLOT SCALE = 1:10	DRAWN - NDP	REVISED -
PLOT DATE = 10/17/2017	CHECKED - MNB	REVISED -
	DATE - 10/18/17	REVISED -

F.A.U. RTE.	SECTION	COUNTY	TOTAL SHEETS	SHEET NO.
2503	16-00313-00-MS	KANE	254	17
				<b>CONTRACT NO. 61E18</b>
ILLINOIS FED. AID PROJECT				

# EARTHWORK SUMMARY

LOCATION	EARTHWORK				TOPSOIL			SUBGRADE IMPROVEMENT		
	20200100			66900200	21101505			20201200	30300001	210010000
	EARTHWORK EXCAVATION	EMBANKMENT	BALANCE WASTE (+) OR SHORTAGE (-)	NON-SPECIAL WASTE DISPOSAL	TOPSOIL EXCAVATION & PLACEMENT	TOPSOIL EMBANKMENT	BALANCE WASTE (+) OR SHORTAGE (-) (NO SHRINKAGE)	REMOVAL & DISPOSAL OF UNSUITABLE MATERIAL	AGGREGATE SUBGRADE IMPROVEMENT	GEOTECHNICAL FABRIC FOR GROUND STABILIZATION
	(CU YD)	(CU YD)	(CU YD)	(CU YD)	(CU YD)	(CU YD)	(CU YD)	(CU YD)	(CU YD)	(SQ YD)
ATC	2892.0	1424.0	1034.0					381.0	381.0	762.0
SPRING STREET	386.0	50.0	278.0					266.0	266.0	532.0
PARKING LOT X	3942.0	14.0	3338.0	701.0	645.0	177.0	468.0			
MUP & LOT W	452.0	219.0	166.0	17.0	137.0	144.0	-7.0			
EAST LANDING	48.0	281.0	-241.0	184.0	5.0	431.0	-426.0			
R.E. DESCRETION								110.0	110.0	165.0
<b>TOTAL</b>	<b>7720.0</b>	<b>1988.0</b>	<b>4575.0</b>	<b>902.0</b>	<b>787.0</b>	<b>752.0</b>	<b>35.0</b>	<b>757.0</b>	<b>757.0</b>	<b>1459.0</b>

**NOTE: EARTH EXCAVATION AND TOPSOIL EXCAVATION DO NOT INCLUDE EXCAVATION OF NON-SPECIAL WASTE.**

### EARTHWORK GENERAL NOTES

1. ALL EARTHWORK QUANTITIES ARE CALCULATED BY THE METHOD OF AVERAGE END AREAS USING THE PLAN CROSS SECTIONS.
2. SHRINKAGE FACTOR, ASSUMED TO BE 15% FOR THIS PROJECT IS ESTIMATED FOR THE PURPOSE OF DETERMINING A BALANCE OF EARTHWORK. THE CONTRACTOR SHALL ESTIMATE HIS OWN SHRINKAGE FACTORS IN DETERMINING HIS EARTHWORK. NO PAYMENT WILL BE MADE ON EARTHWORK QUANTITIES DUE TO VARIATION IN THE SHRINKAGE FACTOR SINCE EARTHWORK IS MEASURED IN ITS FINAL POSITION.
3. RECOMMENDATIONS OUTLINED IN THE REPORTS OF SOIL EXPLORATION REPORTS PREPARED BY TESTING SERVICE CORPORATION, DATED, AUG 12, 2016 AND FEB 16, 2017 WERE USED IN PREPARATION OF THE ROADWAY PLANS AND RELATED QUANTITY CALCULATIONS.
4. FOR THE PURPOSE OF ESTIMATING THE TOPSOIL STRIPPING QUANTITIES, THE TOPSOIL THICKNESS WAS ESTIMATED AT SIX (6) INCHES.
5. IF UNDERCUTS ARE ENCOUNTERED, UNDERCUTS WILL BE PAID FOR AS REMOVAL AND DISPOSAL OF UNSUITABLE MATERIAL. AFTER TOPSOIL STRIPPING AND VEGETATION CLEARING AND PRIOR TO UNDERCUTTING, THE SUBGRADE WILL BE TESTED WITH A STATIC OR DYNAMIC CONE PENETROMETER IN ACCORDANCE WITH THE IDOT SUBGRADE STABILITY MANUAL TO DETERMINE REMEDIAL TREATMENT.
6. TESTING OF SUBGRADES AND EMBANKMENTS WILL BE REQUIRED. TESTING REQUIREMENTS WILL BE PER THE APPLICABLE SECTIONS OF THE STANDARD SPECIFICATIONS AND THE SUBGRADE STABILITY MANUAL. IF PROOF ROLLS ARE REQUIRED BY THE ENGINEER, THE COST SHALL BE CONSIDERED INCLUDED IN THE COST OF EXCAVATION.
7. BASED ON THE GEOTECHNICAL REPORT, 167 CY OF AGGREGATE SUBGRADE IMPROVEMENT HAS BEEN PROVIDED FOR LOCATIONS WHERE SOILS TEND TO BE UNSTABLE WHEN WET. AN ADDITIONAL 110 CY HAVE BEEN INCLUDED TO BE USED AT THE RE'S DESCRETION. THE ACTUAL NEED FOR REMOVAL AND REPLACEMENT WITH AGGREGATE SUBGRADE IMPROVEMENT WILL BE DETERMINED IN THE FIELD AT THE TIME OF CONSTRUCTION BY THE SOILS ENGINEER (BY USE OF A CONE PENETROMETER IN CONJUNCTION WITH THE IDOT SUBGRADE STABILITY MANUAL AND ROLLED USING FULL LOAD SEMI), IF UNSUITABLE AND/OR UNSTABLE MATERIALS ARE NOT ENCOUNTERED, THEN THE QUANTITY SHALL BE DEDUCTED AND NO ADDITIONAL COMPENSATION WILL BE DUE THE CONTRACTOR.
8. EARTH EXCAVATION SHALL BE PAID FOR ONLY ONCE, REGARDLESS OF STAGING OR SEQUENCING OF CONTRACTORS OPERATIONS THAT REQUIRE STOCKPILING OF MATERIALS FOR LATER USE FOR REDISTRIBUTION AND RESREADING IN SHOULDERS AND CONSTRUCTING OF EMBANKMENTS.
9. TOPSOIL EXCAVATION WILL INCLUDE EXCAVATION OF THE TOPSOIL MATERIAL IN ITS ORIGINAL POSITION, TEMPORARY STOCK PILING FOR LATER USE, RE-HANDLING AND SPREADING OF THE FINAL TOPSOIL COURSE FOR THE THICKNESS SPECIFIED.

FILE NAME = W:\Projects\2016\160194\_ATCPhase1\cadd\civil\Drawn\Shit\SCHEDULE.dgn

**WBK engineering**  
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 116 WEST MAIN STREET, SUITE 201  
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USER NAME = nparris	DESIGNED - MNB	REVISED -
PLOT SCALE = 1:20	DRAWN - NDP	REVISED -
PLOT DATE = 10/17/2017	CHECKED - MNB	REVISED -
	DATE - 10/18/17	REVISED -

**STATE OF ILLINOIS  
DEPARTMENT OF TRANSPORTATION**

SCHEDULE OF QUANTITIES			
SCALE:	SHEET NO. 1	OF 1 SHEETS	STA. TO STA.


F.A.U. RTE.	SECTION	COUNTY	TOTAL SHEETS	SHEET NO.
2503	16-00313-00-MS	KANE	254	18
CONTRACT NO. 61E18				
ILLINOIS FED. AID PROJECT				

**CURVE DATA - PROPOSED MULTI-USE PATH**

PROP. CURVE PR_PATH-1	PROP. CURVE PR_PATH-2	PROP. CURVE PR_PATH-3
PI STA. = 10+57.38 Δ = 39° 17' 49" (LT) D = 16° 22' 13" R = 350.00' T = 124.96' L = 240.05' E = 21.64' e = ----- T.R. = ----- S.E. RUN = ----- P.C. STA. = 9+32.42 P.T. STA. = 11+72.47	PI STA. = 12+95.60 Δ = 56° 24' 49" (RT) D = 54° 34' 03" R = 105.00' T = 56.32' L = 103.38' E = 14.15' e = ----- T.R. = ----- S.E. RUN = ----- P.C. STA. = 12+39.28 P.T. STA. = 13+42.66	PI STA. = 13+60.72 Δ = 20° 28' 30" (LT) D = 57° 17' 45" R = 100.00' T = 18.06' L = 35.74' E = 1.62' e = ----- T.R. = ----- S.E. RUN = ----- P.C. STA. = 13+42.66 P.T. STA. = 13+78.40

**CURVE DATA - ATC ENTRANCE**

PR. CURVE PR_ATC-1	PR. CURVE PR_ATC-2
PI STA. = 42+24.02 Δ = 28° 58' 11" (RT) D = 43° 24' 21" R = 132.00' T = 34.10' L = 66.74' E = 4.33' e = ----- T.R. = ----- S.E. RUN = ----- P.C. STA. = 41+89.92 P.T. STA. = 42+56.66	PI STA. = 42+82.94 Δ = 12° 45' 36" (LT) D = 35° 22' 04" R = 162.00' T = 18.11' L = 36.08' E = 1.01' e = ----- T.R. = ----- S.E. RUN = ----- P.C. STA. = 42+64.83 P.T. STA. = 43+00.90

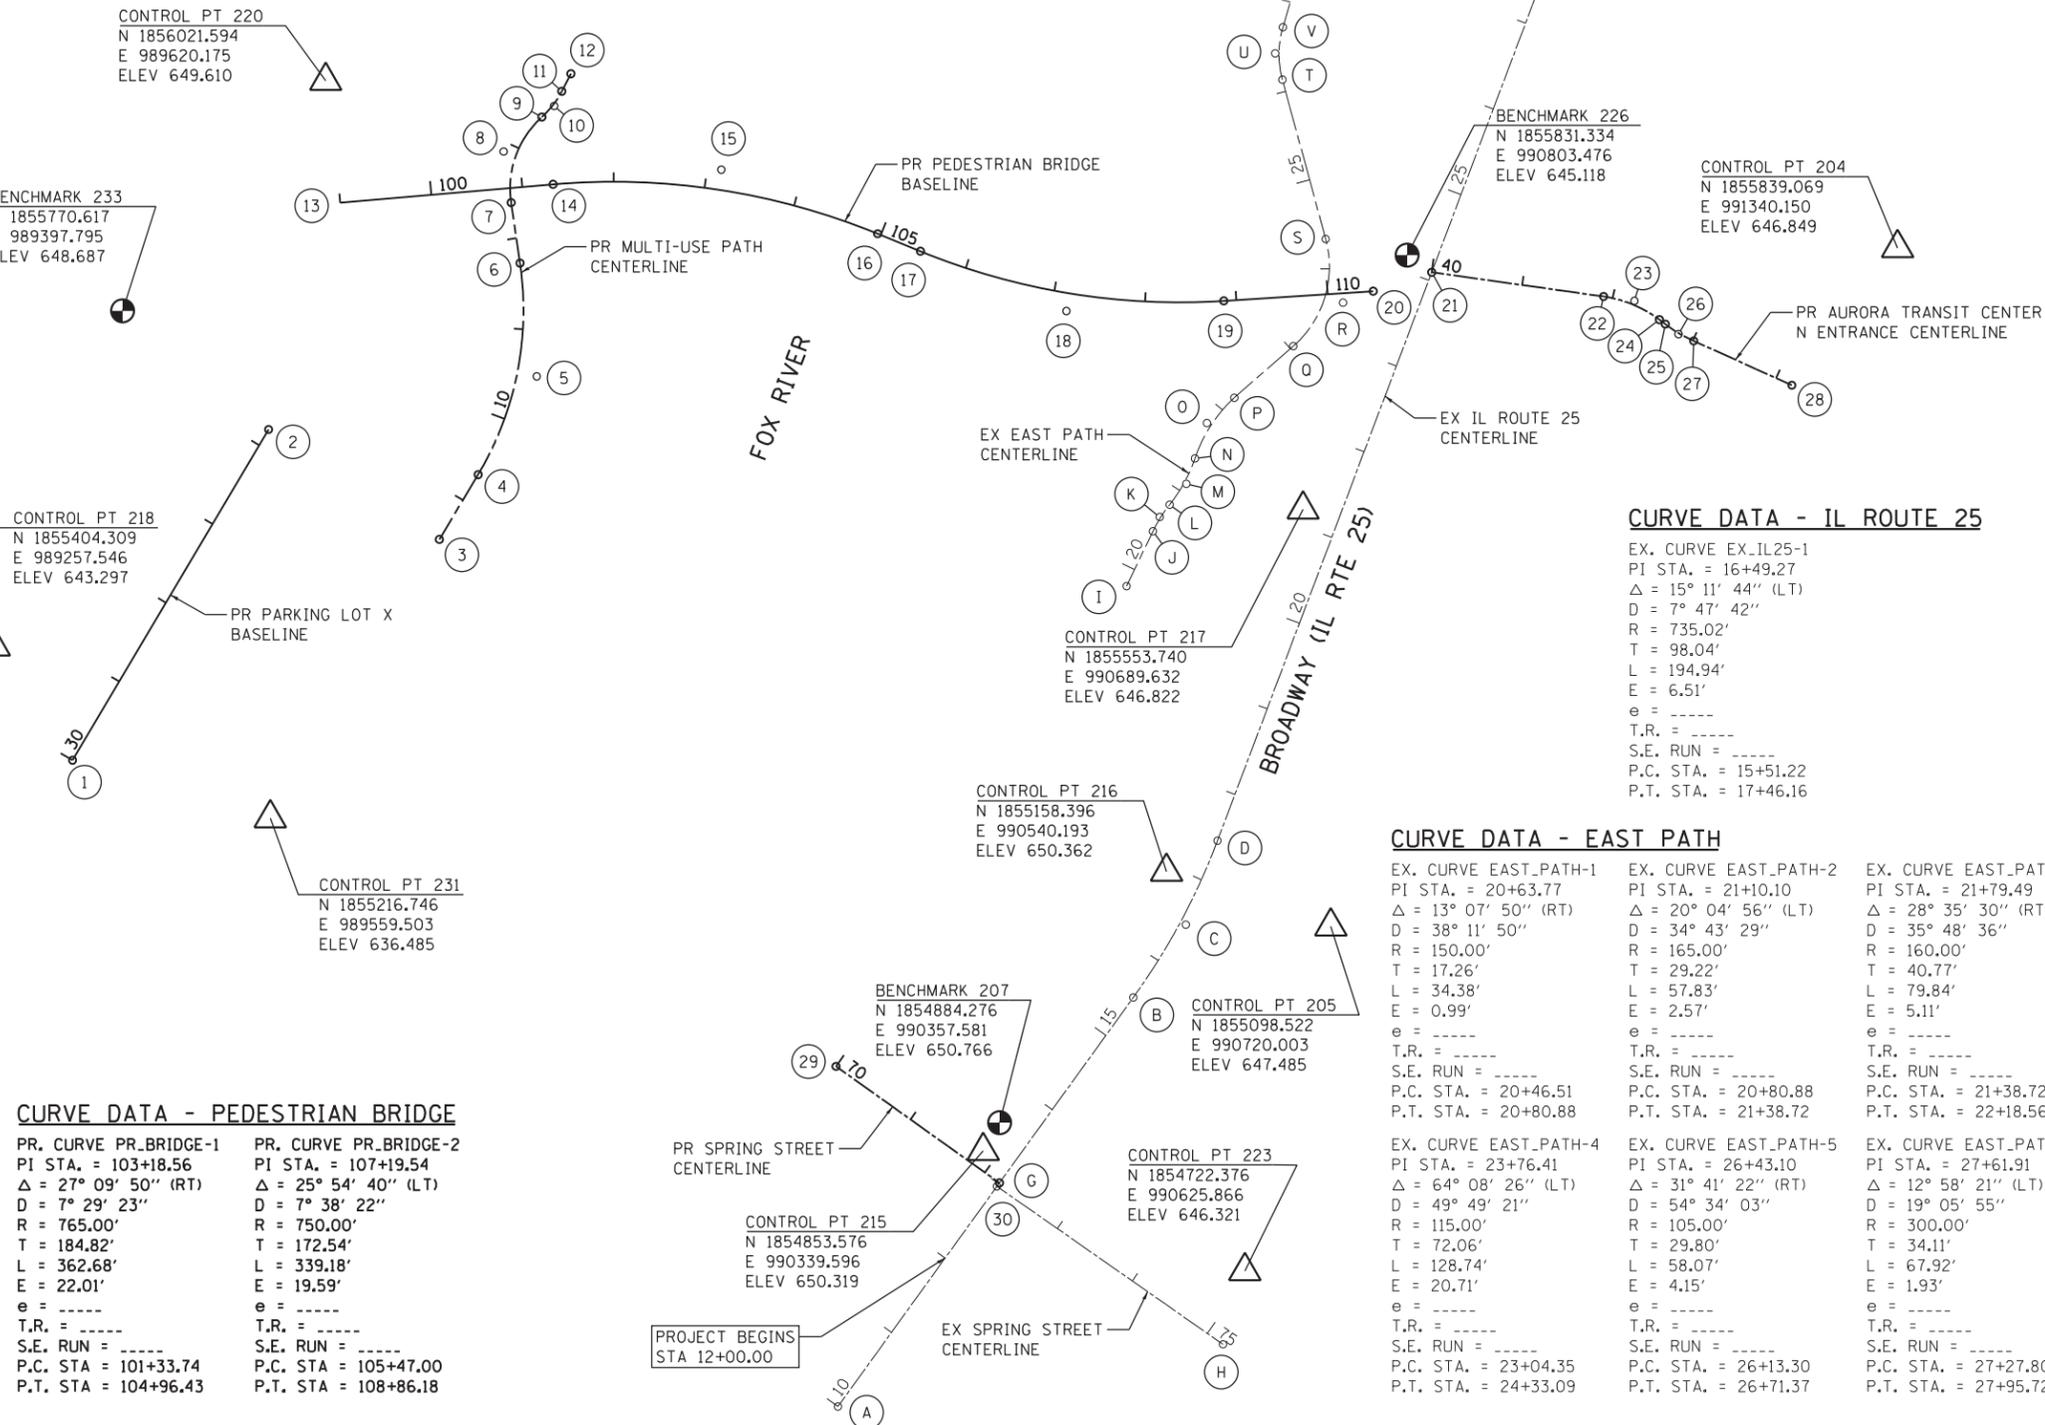

PROJECT ENDS  
STA 31+50.00

BENCHMARK 212  
N 1856456.250  
E 991105.792  
ELEV 639.185

CONTROL PT 203  
N 1856307.328  
E 991551.171  
ELEV 647.584

BENCHMARK 226  
N 1855831.334  
E 990803.476  
ELEV 645.118

CONTROL PT 204  
N 1855839.069  
E 991340.150  
ELEV 646.849

BENCHMARK 233  
N 1855770.617  
E 989397.795  
ELEV 648.687

CONTROL PT 218  
N 1855404.309  
E 989257.546  
ELEV 643.297

CONTROL PT 217  
N 1855553.740  
E 990689.632  
ELEV 646.822

CONTROL PT 216  
N 1855158.396  
E 990540.193  
ELEV 650.362

BENCHMARK 207  
N 1854884.276  
E 990357.581  
ELEV 650.766

CONTROL PT 205  
N 1855098.522  
E 990720.003  
ELEV 647.485

CONTROL PT 223  
N 1854722.376  
E 990625.866  
ELEV 646.321

CONTROL PT 215  
N 1854853.576  
E 990339.596  
ELEV 650.319

**CURVE DATA - IL ROUTE 25**

EX. CURVE EX\_IL25-1  
PI STA. = 16+49.27  
Δ = 15° 11' 44" (LT)  
D = 7° 47' 42"  
R = 735.02'  
T = 98.04'  
L = 194.94'  
E = 6.51'  
e = -----  
T.R. = -----  
S.E. RUN = -----  
P.C. STA. = 15+51.22  
P.T. STA. = 17+46.16

**CURVE DATA - EAST PATH**

EX. CURVE EAST_PATH-1	EX. CURVE EAST_PATH-2	EX. CURVE EAST_PATH-3
PI STA. = 20+63.77 Δ = 13° 07' 50" (RT) D = 38° 11' 50" R = 150.00' T = 17.26' L = 34.38' E = 0.99' e = ----- T.R. = ----- S.E. RUN = ----- P.C. STA. = 20+46.51 P.T. STA. = 20+80.88	PI STA. = 21+10.10 Δ = 20° 04' 56" (LT) D = 34° 43' 29" R = 165.00' T = 29.22' L = 57.83' E = 2.57' e = ----- T.R. = ----- S.E. RUN = ----- P.C. STA. = 20+80.88 P.T. STA. = 21+38.72	PI STA. = 21+79.49 Δ = 28° 35' 30" (RT) D = 35° 48' 36" R = 160.00' T = 40.77' L = 79.84' E = 5.11' e = ----- T.R. = ----- S.E. RUN = ----- P.C. STA. = 21+38.72 P.T. STA. = 22+18.56
EX. CURVE EAST_PATH-4	EX. CURVE EAST_PATH-5	EX. CURVE EAST_PATH-6
PI STA. = 23+76.41 Δ = 64° 08' 26" (LT) D = 49° 49' 21" R = 115.00' T = 72.06' L = 128.74' E = 20.71' e = ----- T.R. = ----- S.E. RUN = ----- P.C. STA. = 23+04.35 P.T. STA. = 24+33.09	PI STA. = 26+43.10 Δ = 31° 41' 22" (RT) D = 54° 34' 03" R = 105.00' T = 29.80' L = 58.07' E = 4.15' e = ----- T.R. = ----- S.E. RUN = ----- P.C. STA. = 26+13.30 P.T. STA. = 26+71.37	PI STA. = 27+61.91 Δ = 12° 58' 21" (LT) D = 19° 05' 55" R = 300.00' T = 34.11' L = 67.92' E = 1.93' e = ----- T.R. = ----- S.E. RUN = ----- P.C. STA. = 27+27.80 P.T. STA. = 27+95.72

**CURVE DATA - PEDESTRIAN BRIDGE**

PR. CURVE PR_BRIDGE-1	PR. CURVE PR_BRIDGE-2
PI STA. = 103+18.56 Δ = 27° 09' 50" (RT) D = 7° 29' 23" R = 765.00' T = 184.82' L = 362.68' E = 22.01' e = ----- T.R. = ----- S.E. RUN = ----- P.C. STA. = 101+33.74 P.T. STA. = 104+96.43	PI STA. = 107+19.54 Δ = 25° 54' 40" (LT) D = 7° 38' 22" R = 750.00' T = 172.54' L = 339.18' E = 19.59' e = ----- T.R. = ----- S.E. RUN = ----- P.C. STA. = 105+47.00 P.T. STA. = 108+86.18

**LEGEND**

- ⊕ = BENCH MARK LOCATION
- △ = HORIZONTAL CONTROL POINT LOCATION

**VERTICAL REFERENCE MARK**

CITY OF AURORA CONTROL MONUMENT, NO. 13 IS A STANDARD BRASS DISC SET APPROXIMATELY 37.6 FEET EAST OF THE CENTERLINE OF IL ROUTE 25 AND IN THE GRASS MEDIAN OF THE NORTH ENTRANCE TO THE U.S. POST OFFICE. ELEVATION: 638.39, DATUM: NAVD88

**POINT TABLE - PROPOSED ALIGNMENTS**

POINT NO.	STATION & CHAIN	NORTHING & EASTING
1	POT STA. 30+00.00, LOTX	N 1855279.968, E 989343.081
2	POT STA. 34+20.00, LOTX	N 1855641.046, E 989557.610
3	POT STA. 8+50.00, PR_PATH	N 1855521.069, E 989744.567
4	PC STA. 9+32.42, PR_PATH	N 1855591.791, E 989786.887
5	PI STA. 10+52.44, PR_PATH	N 1855699.021, E 989851.054
6	PT STA. 11+72.47, PR_PATH	N 1855822.644, E 989832.799
7	PC STA. 12+39.28, PR_PATH	N 1855888.738, E 989823.039
8	PI STA. 12+90.97, PR_PATH	N 1855944.450, E 989814.811
9	PRC STA. 13+42.66, PR_PATH	N 1855982.124, E 989856.672
10	PI STA. 13+60.53, PR_PATH	N 1855994.205, E 989870.096
11	PT STA. 13+78.40, PR_PATH	N 1856010.219, E 989878.446
12	POT STA. 14+00.00, PR_PATH	N 1856029.374, E 989888.434
13	POT STA. 99+00.00, PR_BRIDGE	N 1855888.569, E 989636.054
14	PC STA. 101+33.74, PR_BRIDGE	N 1855908.703, E 989868.929
15	PI STA. 103+15.09, PR_BRIDGE	N 1855924.623, E 990053.059
16	PT STA. 104+96.43, PR_BRIDGE	N 1855854.724, E 990224.149
17	PC STA. 105+47.00, PR_BRIDGE	N 1855835.598, E 990270.965
18	PI STA. 107+16.59, PR_BRIDGE	N 1855770.343, E 990430.687
19	PT STA. 108+86.18, PR_BRIDGE	N 1855781.444, E 990602.868
20	POT STA. 110+50.00, PR_BRIDGE	N 1855791.983, E 990766.352
21	POT STA. 40+00.00, PR_ATC	N 1855812.655, E 990830.417
22	PC STA. 41+89.92, PR_ATC	N 1855786.213, E 991018.485
23	PI STA. 42+23.29, PR_ATC	N 1855781.466, E 991052.253
24	PT STA. 42+56.66, PR_ATC	N 1855760.957, E 991079.496
25	PC STA. 42+64.83, PR_ATC	N 1855756.044, E 991086.022
26	PI STA. 42+82.86, PR_ATC	N 1855745.150, E 991100.493
27	PT STA. 43+00.90, PR_ATC	N 1855737.721, E 991117.013
28	POT STA. 44+18.79, PR_ATC	N 1855689.371, E 991224.533
29	POT STA. 70+00.00, PR_SPRING	N 1854945.826, E 990178.608
30	POT STA. 72+19.38, PR_SPRING	N 1854818.673, E 990357.379

**POINT TABLE - EXISTING ALIGNMENTS**

POINT NO.	STATION & CHAIN	NORTHING & EASTING
A	POT STA. 10+00.00, EX_IL25	N 1854574.534, E 990180.693
B	PC STA. 15+51.22, EX_IL25	N 1855021.084, E 990503.866
C	PI STA. 16+48.69, EX_IL25	N 1855100.510, E 990561.347
D	PT STA. 17+46.16, EX_IL25	N 1855192.225, E 990596.000
E	PI STA. 28+61.88, EX_IL25	N 1856235.934, E 990990.346
F	POT STA. 36+47.22, EX_IL25	N 1856977.157, E 991249.842
G	POT STA. 72+19.38, EX_SPRING	N 1854814.900, E 990354.648
H	POT STA. 75+20.93, EX_SPRING	N 1854642.402, E 990601.993
I	POT STA. 20+00.00, EAST_PATH	N 1855488.071, E 990505.179
J	PC STA. 20+46.51, EAST_PATH	N 1855529.987, E 990525.328
K	PI STA. 20+63.70, EAST_PATH	N 1855545.546, E 990532.807
L	PRC STA. 20+80.88, EAST_PATH	N 1855559.000, E 990543.625
M	PI STA. 21+09.80, EAST_PATH	N 1855581.768, E 990561.933
N	PRC STA. 21+38.72, EAST_PATH	N 1855609.438, E 990571.311
O	PI STA. 21+78.64, EAST_PATH	N 1855648.052, E 990584.397
P	PT STA. 22+18.56, EAST_PATH	N 1855675.694, E 990614.367
Q	PC STA. 23+04.35, EAST_PATH	N 1855732.088, E 990679.018
R	PI STA. 23+68.72, EAST_PATH	N 1855779.454, E 990733.319
S	PT STA. 24+33.09, EAST_PATH	N 1855848.977, E 990714.380
T	PC STA. 26+13.30, EAST_PATH	N 1856022.852, E 990667.014
U	PI STA. 26+43.79, EAST_PATH	N 1856053.126, E 990658.767
V	PT STA. 26+71.37, EAST_PATH	N 1856080.185, E 990667.621
W	PC STA. 27+27.80, EAST_PATH	N 1856134.303, E 990683.602
X	PI STA. 27+61.91, EAST_PATH	N 1856167.015, E 990693.261
Y	PT STA. 27+95.72, EAST_PATH	N 1856201.060, E 990695.330
Z	POT STA. 28+31.93, EAST_PATH	N 1856237.198, E 990697.527

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**WBK ENGINEERING, LLC**  
116 WEST MAIN STREET, SUITE 201  
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USER NAME = nparris	DESIGNED - MNB	REVISED -
PLOT SCALE = 1:200	DRAWN - NDP	REVISED -
PLOT DATE = 10/17/2017	CHECKED - MNB	REVISED -
	DATE - 10/18/17	REVISED -

STATE OF ILLINOIS	SECTION	COUNTY	TOTAL SHEETS	SHEET NO.
DEPARTMENT OF TRANSPORTATION	2503	16-00313-00-MS	KANE	254
				19
			CONTRACT NO. 61E18	
			ILLINOIS FED. AID PROJECT	

SCALE:	SHEET NO. 1	OF 2 SHEETS	STA.	TO STA.
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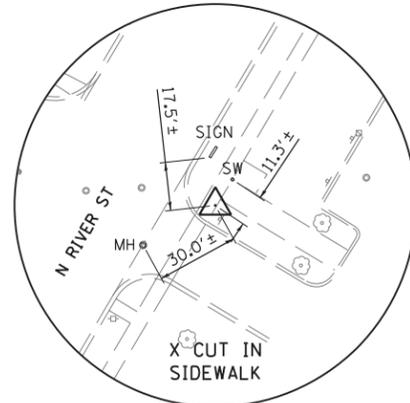
**ALIGNMENT, TIES & BENCHMARKS**

STATE OF ILLINOIS	SECTION	COUNTY	TOTAL SHEETS	SHEET NO.
DEPARTMENT OF TRANSPORTATION	2503	16-00313-00-MS	KANE	254
				19
			CONTRACT NO. 61E18	
			ILLINOIS FED. AID PROJECT	

# WEST OF FOX RIVER




BENCHMARK  
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CONTROL  
POINT NO. 218



CONTROL  
POINT NO. 220



CONTROL  
POINT NO. 231

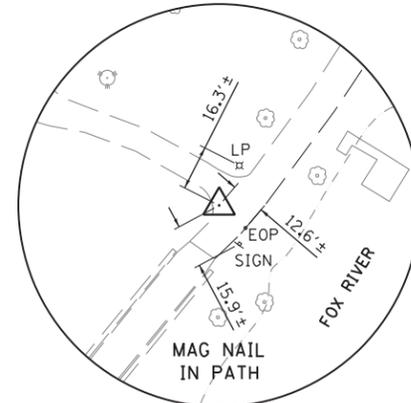


NOTES

- SEE SHEET 19 FOR COORDINATES AND ELEVATIONS OF CONTROL POINTS AND BENCHMARKS DETAILED ON THIS SHEET.
- LOCATION DETAILS ARE NOT TO SCALE.


**TIE POINT LEGEND**

- EOP EDGE OF PAVEMENT
- PP POWER/UTILITY POLE
- SW EDGE OF SIDEWALK
- MH MANHOLE
- HH HANDHOLE
- LP LIGHT POLE
- SIGN SIGN POST
- TS TRAFFIC SIGNAL
- RW EDGE OF RETAINING WALL
- CL ROADWAY CENTERLINE
- TREE TREE TRUNK

# EAST OF FOX RIVER

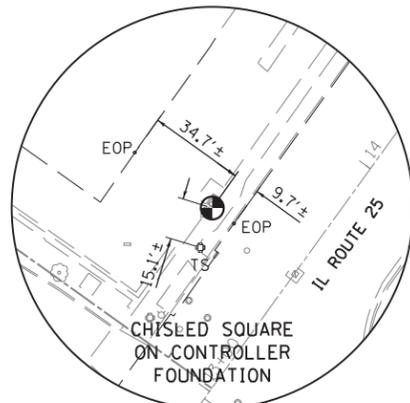


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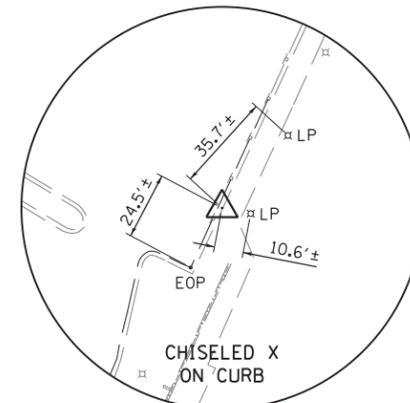
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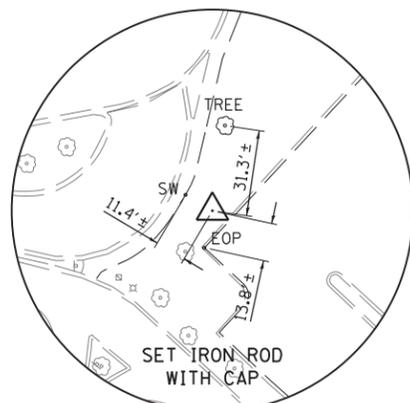
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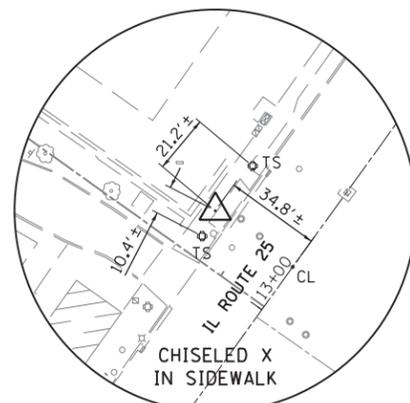
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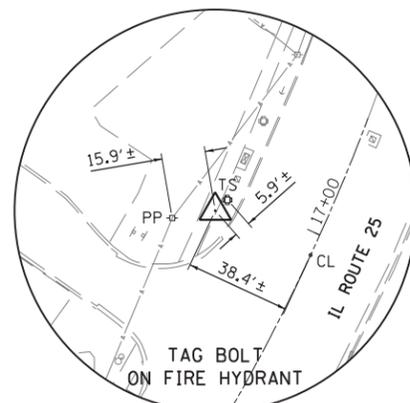
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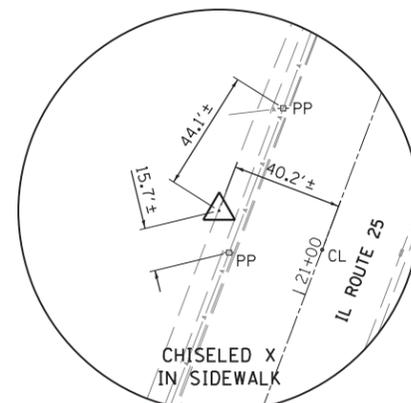
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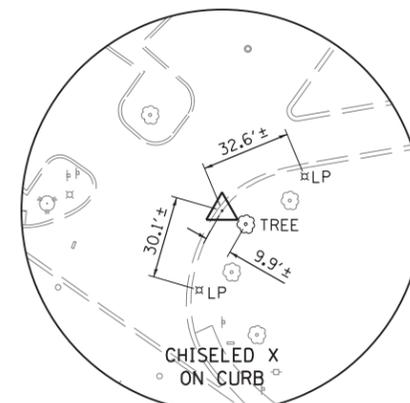
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POINT NO. 215

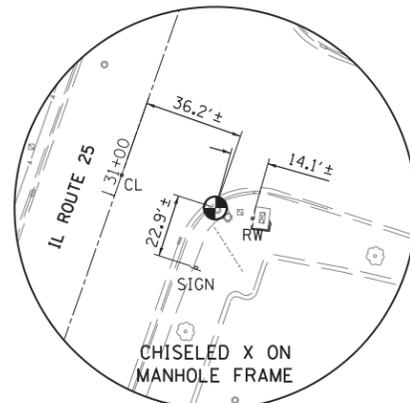

CONTROL  
POINT NO. 216



CONTROL  
POINT NO. 217

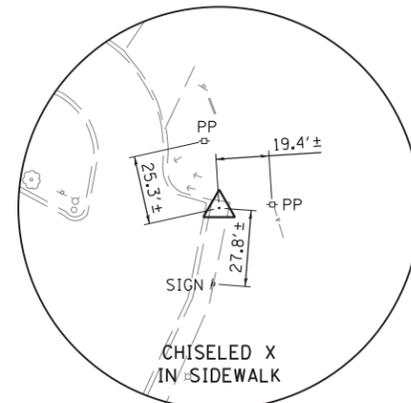

CONTROL  
POINT NO. 223

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WBK ENGINEERING, LLC  
116 WEST MAIN STREET, SUITE 201  
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USER NAME = nparris  
DESIGNED - MNB  
DRAWN - NDP  
CHECKED - MNB  
DATE - 10/17/2017  
PLOT SCALE = 1:200  
PLOT DATE = 10/17/2017

DESIGNED - MNB  
DRAWN - NDP  
CHECKED - MNB  
DATE - 10/18/17


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REVISED -  
REVISED -  
REVISED -

STATE OF ILLINOIS  
DEPARTMENT OF TRANSPORTATION

ALIGNMENT, TIES & BENCHMARKS

SCALE: SHEET NO. 2 OF 2 SHEETS STA. TO STA.

F.A.U. RTE.	SECTION	COUNTY	TOTAL SHEETS	SHEET NO.
2503	16-00313-00-MS	KANE	254	20
				CONTRACT NO. 61E18
ILLINOIS FED. AID PROJECT				


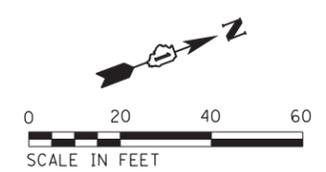


**REMOVAL PLAN LEGEND**

- CURB AND GUTTER REMOVAL
- SIDEWALK REMOVAL
- PAVEMENT REMOVAL
- DRIVEWAY PAVEMENT REMOVAL
- FRAMES AND GRATES TO BE ADJ (SPL)
- STRUCTURE REMOVAL
- SEWER REMOVAL OR ABANDON AS REQ'D FOR CONSTRUCTION
- 
- PROPOSED PERMANENT EASEMENT
- PROPOSED TEMPORARY EASEMENT



**NOTES:**

1. TRAFFIC SIGNAL & LIGHTING REMOVAL ITEMS ARE SHOWN ON THE RESPECTIVE TRAFFIC SIGNAL AND LIGHTING REMOVAL SHEETS.
2. ALL SIGNS ON POSTS, INCLUDING FOUNDATIONS SHALL BE REMOVED AS NECESSARY TO FACILITATE CONSTRUCTION. THIS WORK SHALL BE PAID AS "REMOVE SIGN COMPLETE".
3. CITY SHALL REMOVE ALL STREET FURNITURE (BENCHES, TRASH CANS, BIKE RACKS, REMOVABLE PLANTERS ETC.) AS NECESSARY TO FACILITATE CONSTRUCTION.

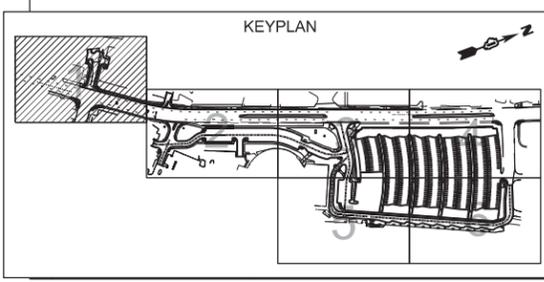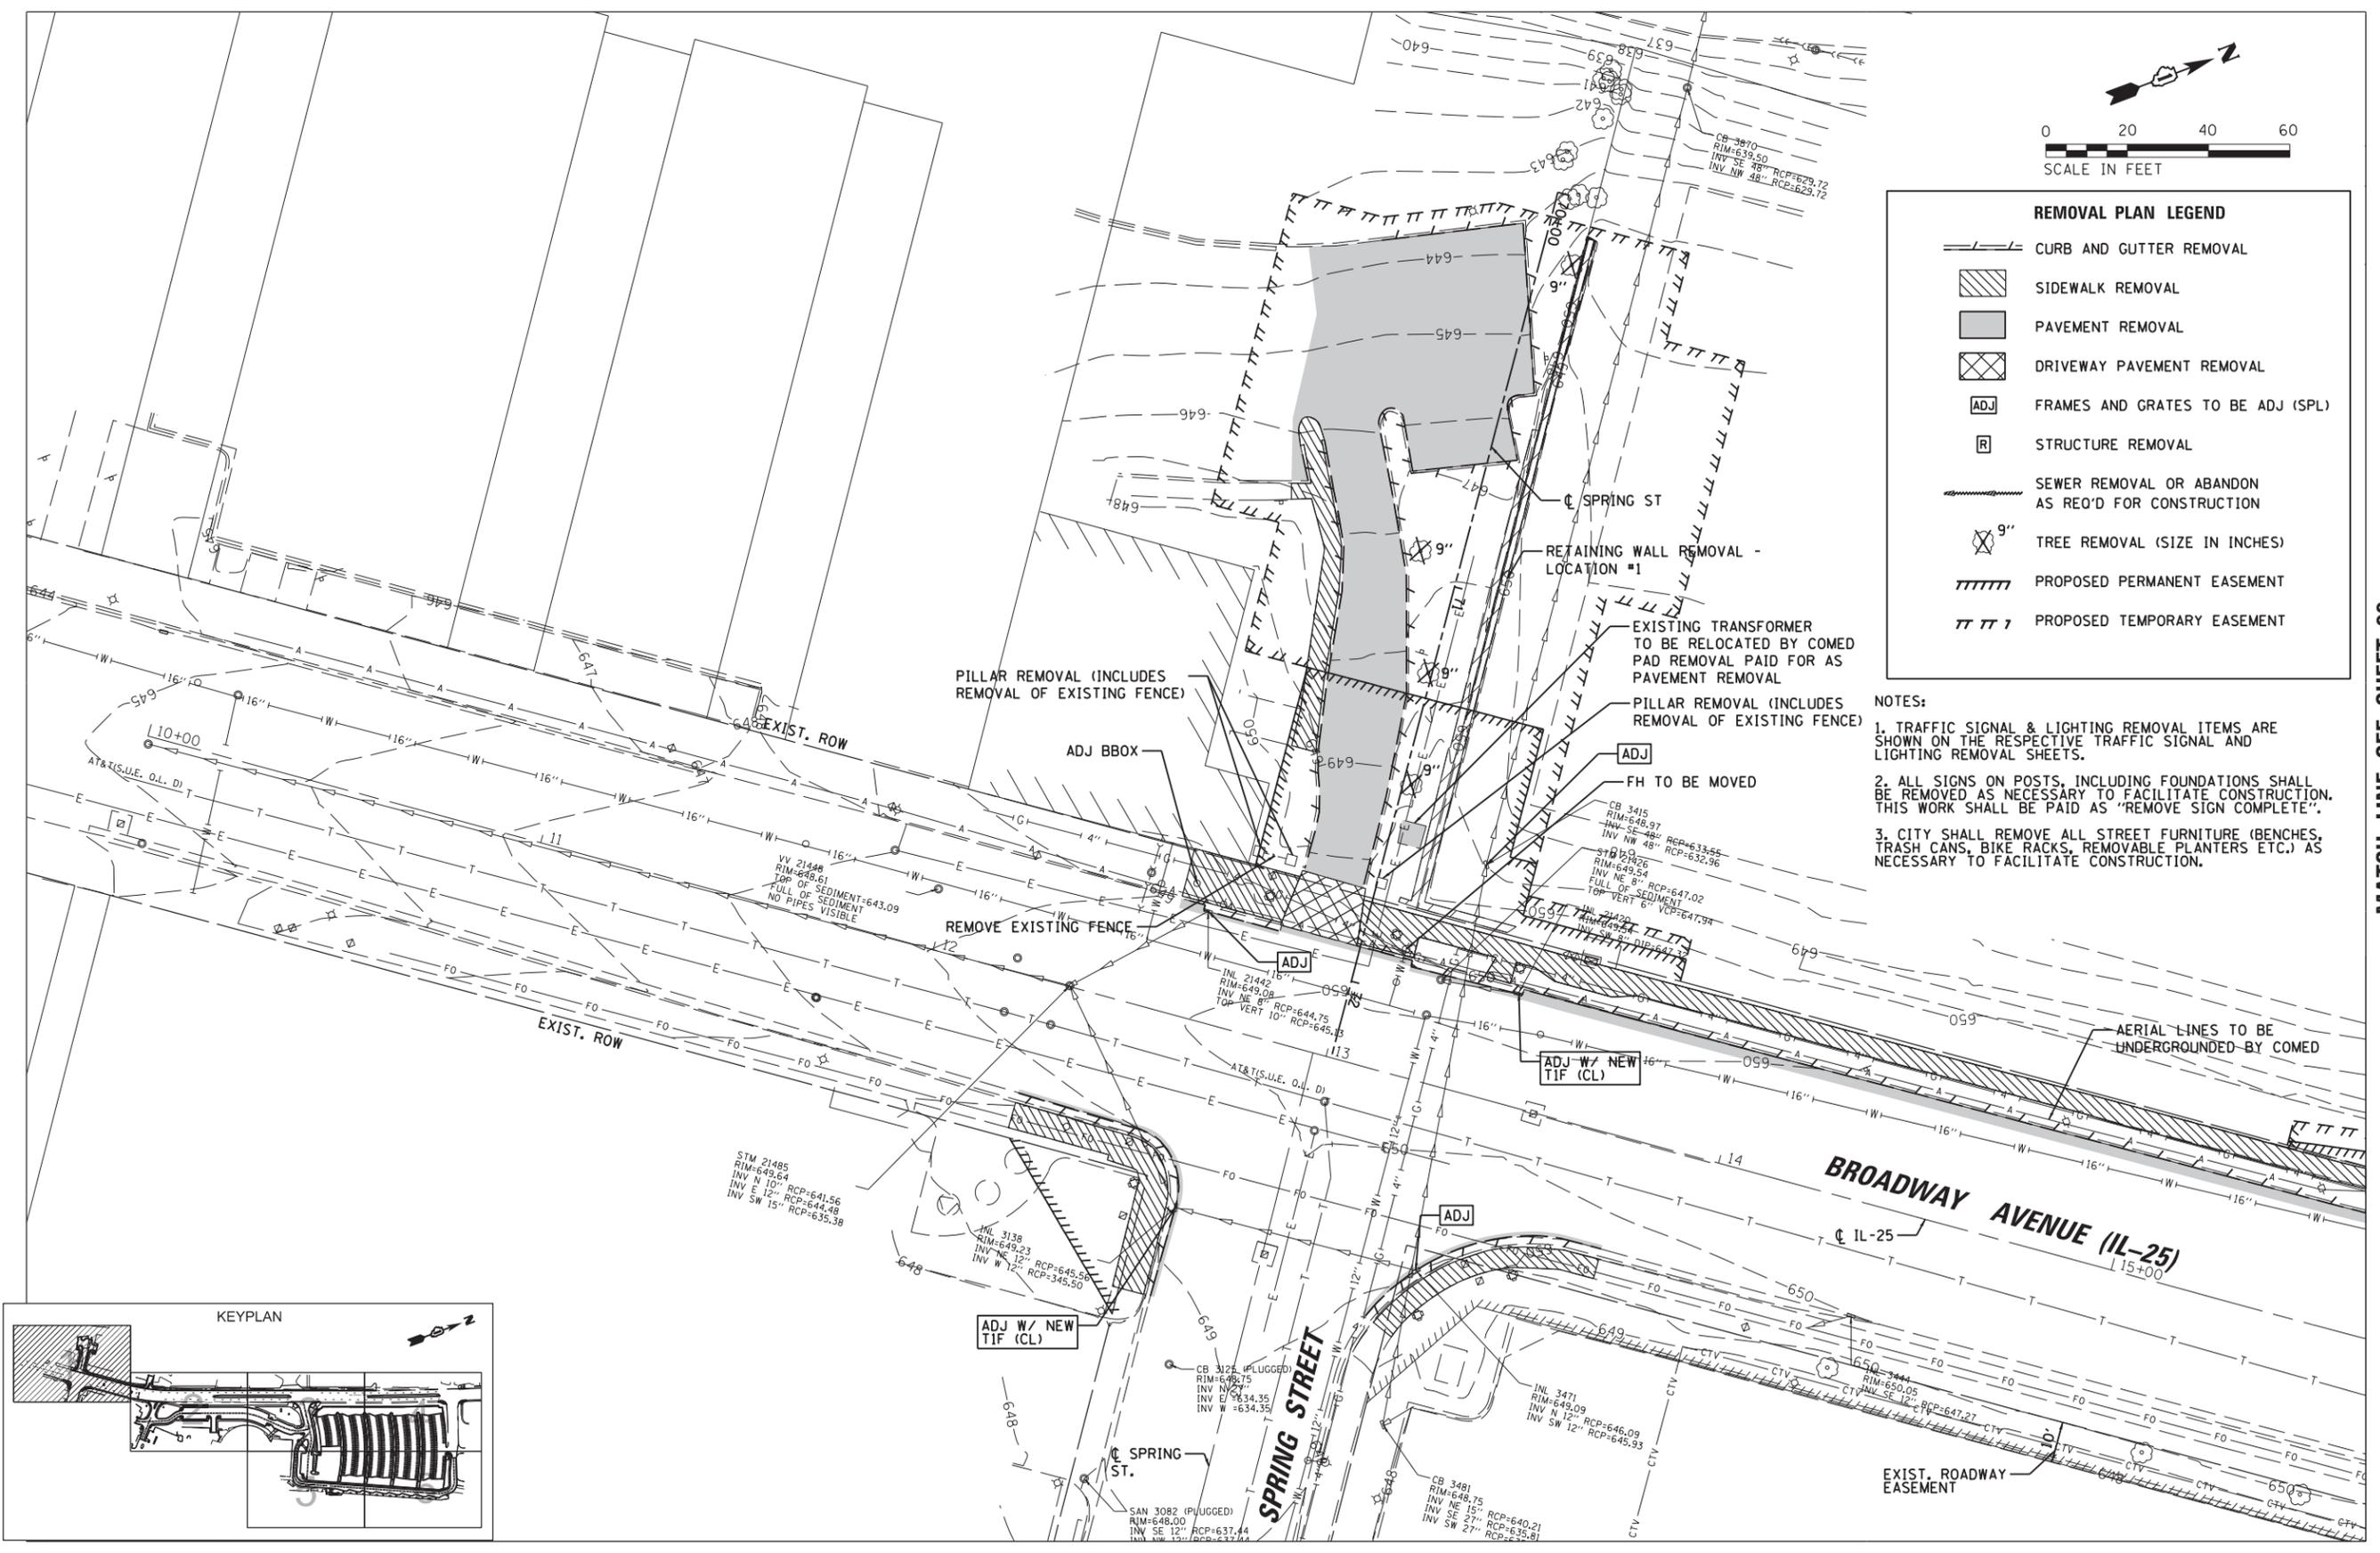

MATCH LINE SEE SHEET 22

FILE NAME = N:\WBK\150077.2\Civil\REM-150077.2.01.sht	USER NAME = bweich	DESIGNED - BMW	REVISED -	<b>STATE OF ILLINOIS DEPARTMENT OF TRANSPORTATION</b>	<b>AURORA TRANSIT CENTER IMPROVEMENTS EXISTING CONDITIONS &amp; REMOVAL PLAN</b>	F.A.U. R.E. = 2503	SECTION = 16-00313-00-MS	COUNTY = KANE	TOTAL SHEETS = 254	SHEET NO. = 21		
Default	PLOT SCALE = 48"	CHECKED - BMW	REVISED -			SCALE: 48"	SHEET OF 254 SHEETS	STA. TO STA.	CONTRACT NO. 61E18			
	PLOT DATE = 10/16/2017	DATE = 10/16/2017	REVISED -			ILLINOIS FED. AID PROJECT						

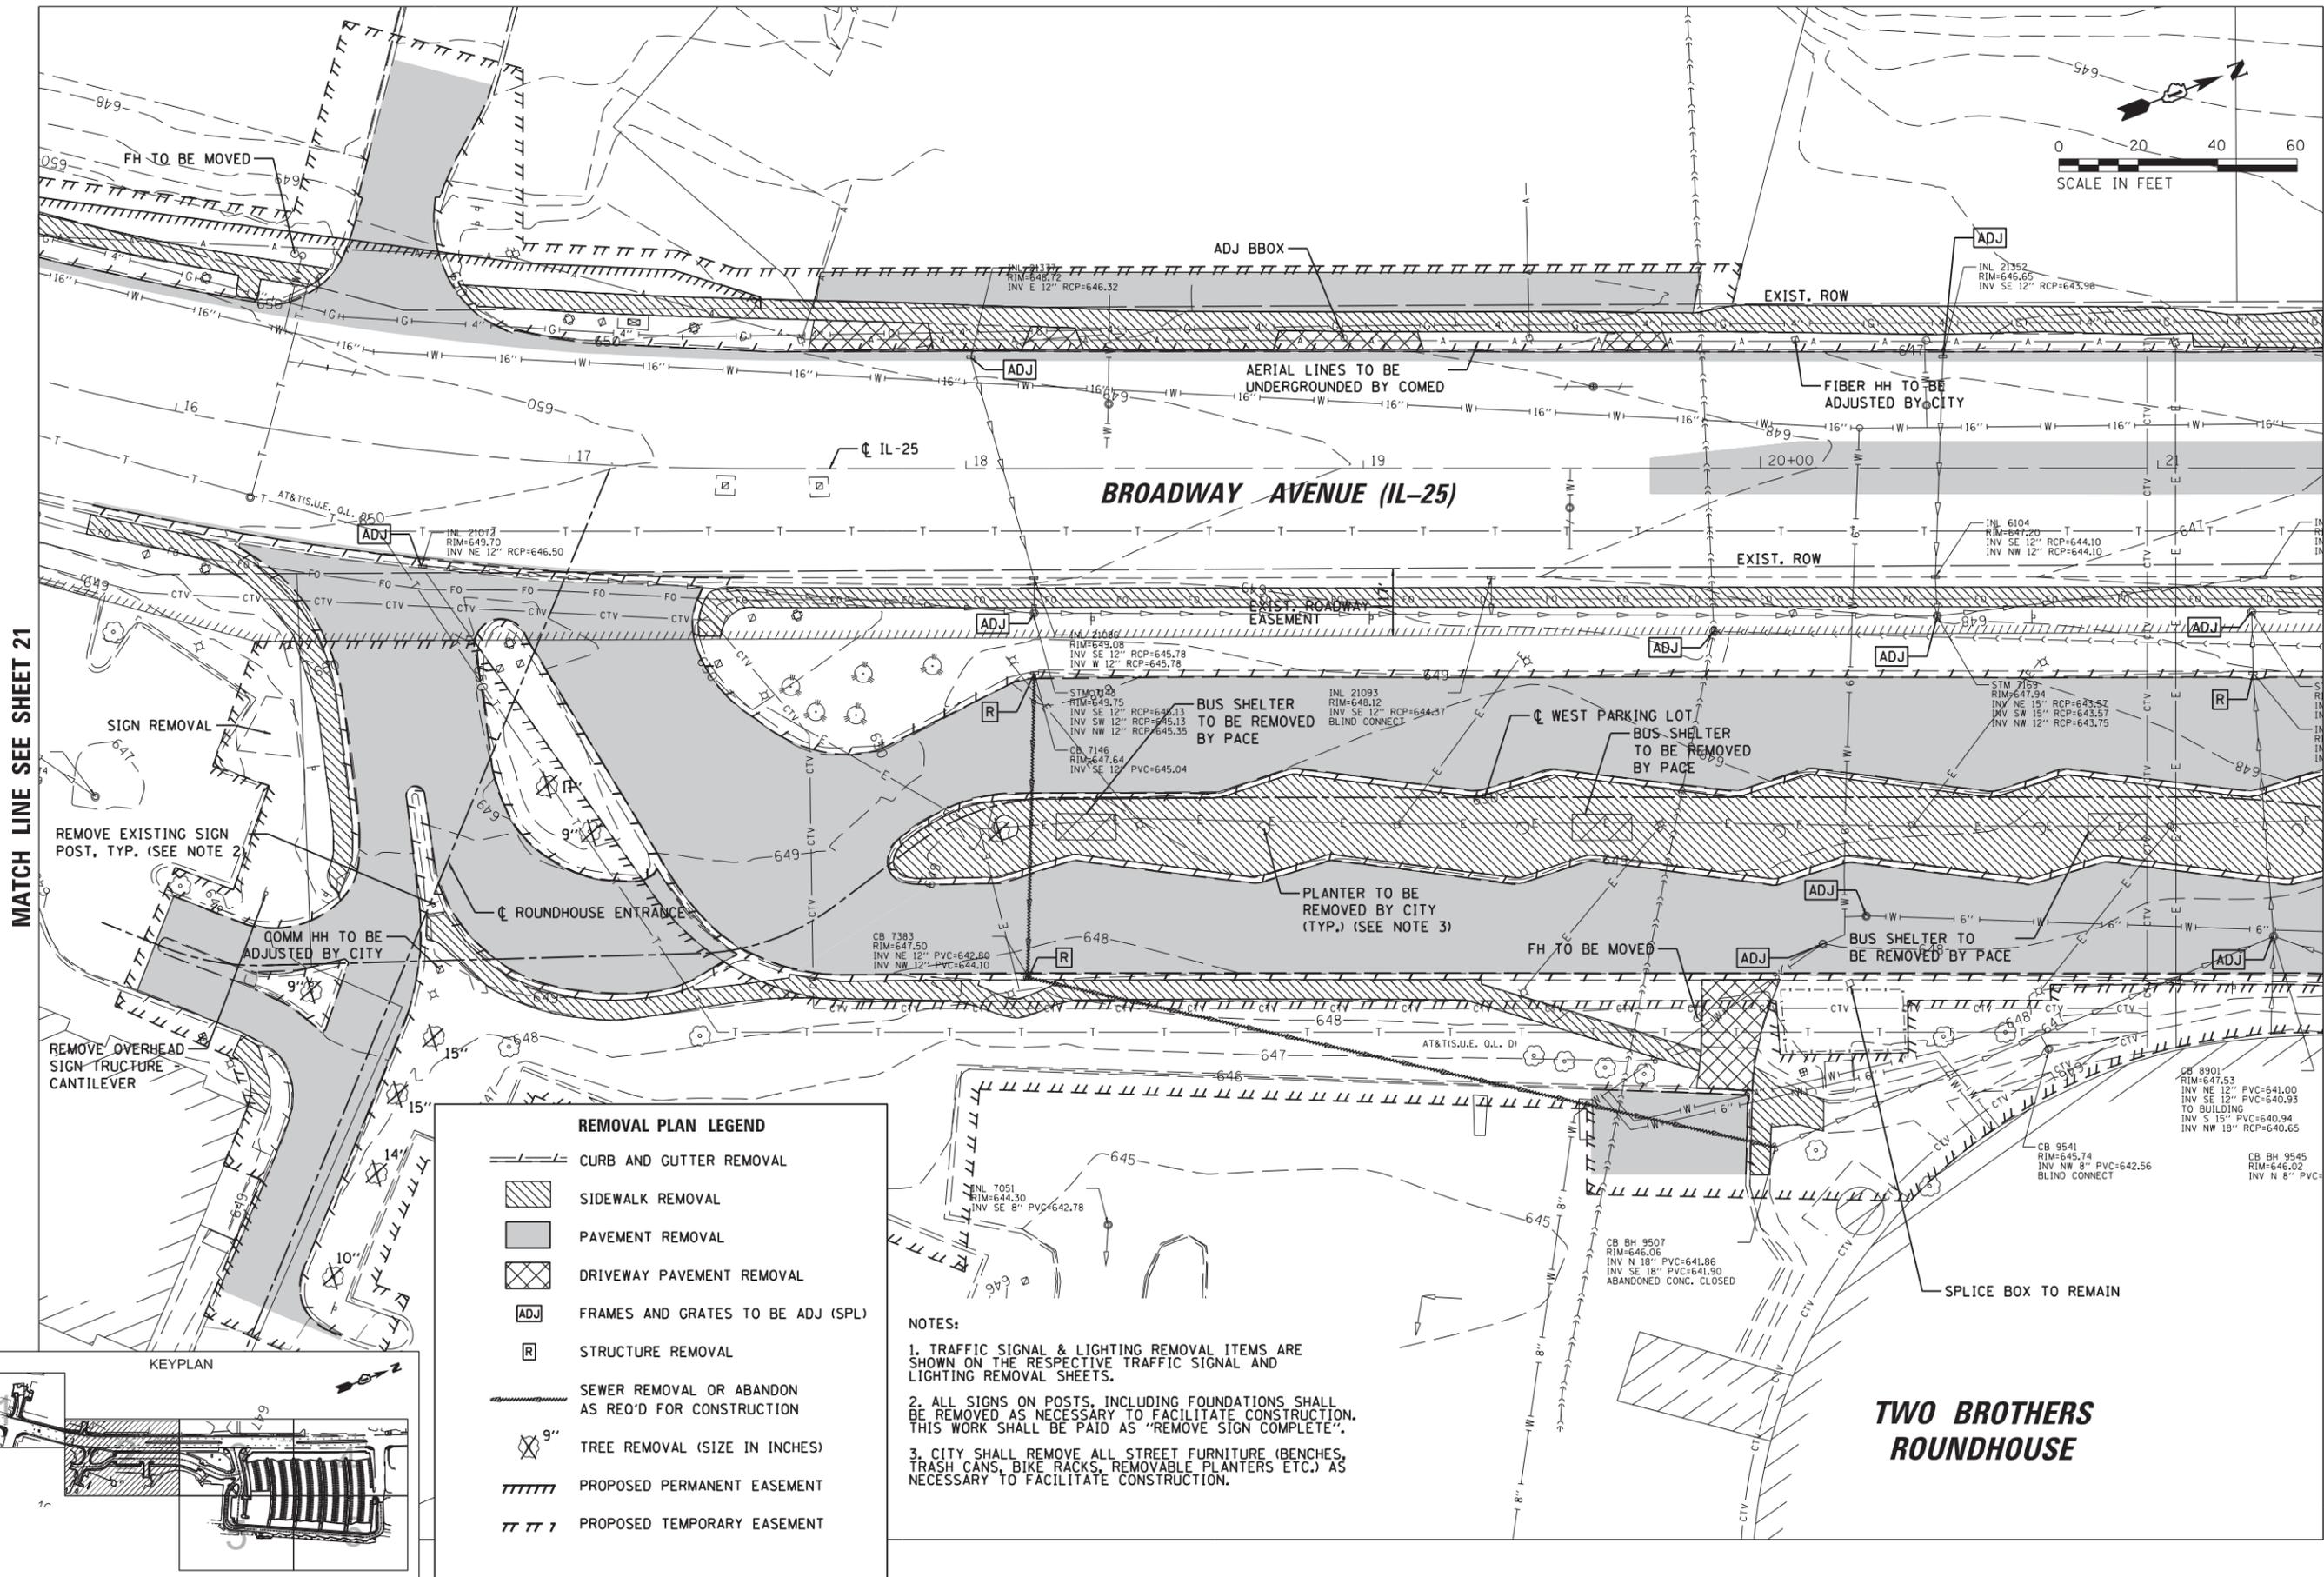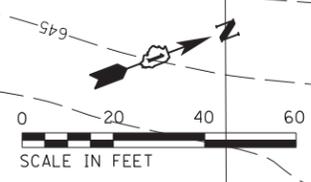


MATCH LINE SEE SHEET 21

MATCH LINE SEE SHEET 23



**REMOVAL PLAN LEGEND**

- CURB AND GUTTER REMOVAL
- SIDEWALK REMOVAL
- PAVEMENT REMOVAL
- DRIVEWAY PAVEMENT REMOVAL
- FRAMES AND GRATES TO BE ADJ (SPL)
- STRUCTURE REMOVAL
- SEWER REMOVAL OR ABANDON AS REQ'D FOR CONSTRUCTION
- TREE REMOVAL (SIZE IN INCHES)
- PROPOSED PERMANENT EASEMENT
- PROPOSED TEMPORARY EASEMENT

- NOTES:**
1. TRAFFIC SIGNAL & LIGHTING REMOVAL ITEMS ARE SHOWN ON THE RESPECTIVE TRAFFIC SIGNAL AND LIGHTING REMOVAL SHEETS.
  2. ALL SIGNS ON POSTS, INCLUDING FOUNDATIONS SHALL BE REMOVED AS NECESSARY TO FACILITATE CONSTRUCTION. THIS WORK SHALL BE PAID AS "REMOVE SIGN COMPLETE".
  3. CITY SHALL REMOVE ALL STREET FURNITURE (BENCHES, TRASH CANS, BIKE RACKS, REMOVABLE PLANTERS ETC.) AS NECESSARY TO FACILITATE CONSTRUCTION.

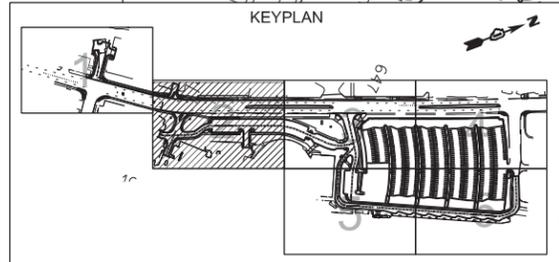

FILE NAME = N:\WBK\150077.2\Civil\REM-150077.2.02.sht	USER NAME = bweich	DESIGNED - BMW	REVISED -	<b>STATE OF ILLINOIS DEPARTMENT OF TRANSPORTATION</b>	<b>AURORA TRANSIT CENTER IMPROVEMENTS EXISTING CONDITIONS &amp; REMOVAL PLAN</b>	F.A.U. RTE. 2503	SECTION 16-00313-00-MS	COUNTY KANE	TOTAL SHEETS 254	SHEET NO. 22
Default	PLOT SCALE = 48"	CHECKED - BMW	REVISED -	SCALE: 48"	SHEET OF 254 SHEETS STA. TO STA.	CONTRACT NO. 61E18		ILLINOIS FED. AID PROJECT		
	PLOT DATE = 10/16/2017	DATE = 10/16/2017	REVISED -							

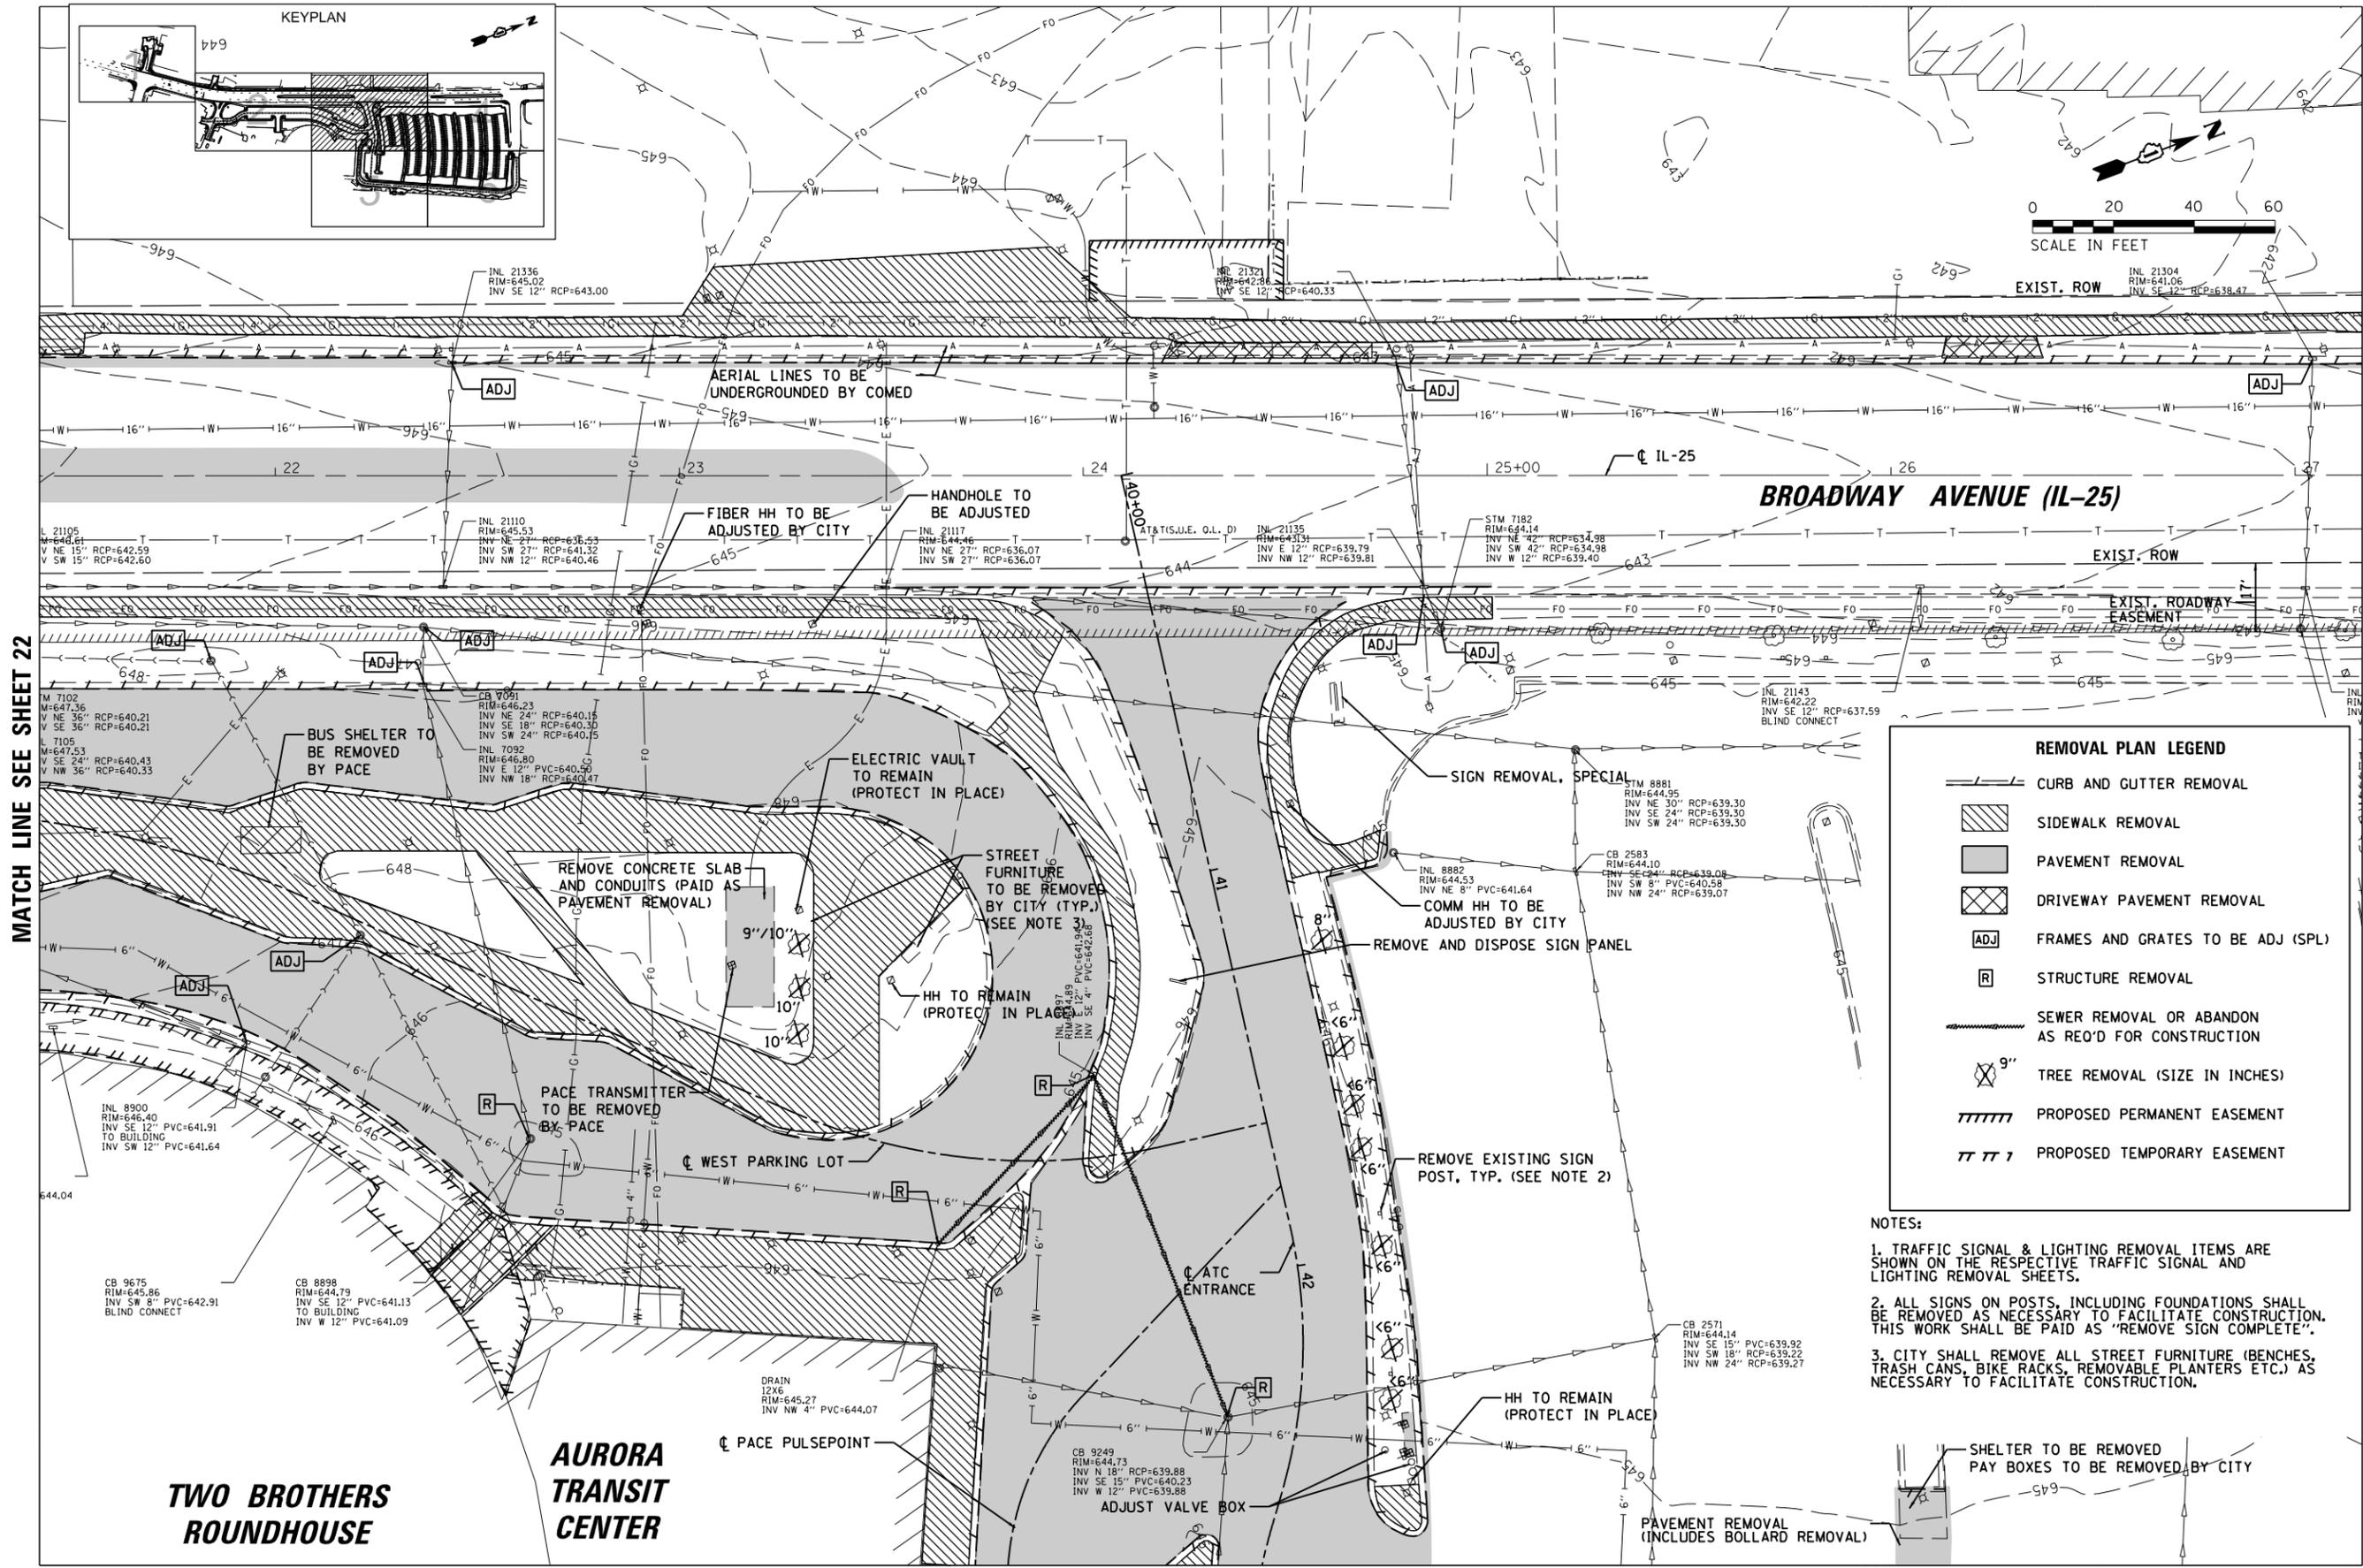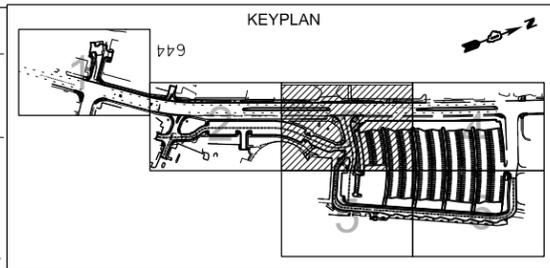

MATCH LINE SEE SHEET 22

MATCH LINE SEE SHEET 24

**REMOVAL PLAN LEGEND**

- CURB AND GUTTER REMOVAL
- SIDEWALK REMOVAL
- PAVEMENT REMOVAL
- DRIVEWAY PAVEMENT REMOVAL
- FRAMES AND GRATES TO BE ADJ (SPL)
- STRUCTURE REMOVAL
- SEWER REMOVAL OR ABANDON AS REQ'D FOR CONSTRUCTION
- TREE REMOVAL (SIZE IN INCHES)
- PROPOSED PERMANENT EASEMENT
- PROPOSED TEMPORARY EASEMENT

**NOTES:**



1. TRAFFIC SIGNAL & LIGHTING REMOVAL ITEMS ARE SHOWN ON THE RESPECTIVE TRAFFIC SIGNAL AND LIGHTING REMOVAL SHEETS.
2. ALL SIGNS ON POSTS, INCLUDING FOUNDATIONS SHALL BE REMOVED AS NECESSARY TO FACILITATE CONSTRUCTION. THIS WORK SHALL BE PAID AS "REMOVE SIGN COMPLETE".
3. CITY SHALL REMOVE ALL STREET FURNITURE (BENCHES, TRASH CANS, BIKE RACKS, REMOVABLE PLANTERS ETC.) AS NECESSARY TO FACILITATE CONSTRUCTION.

**TWO BROTHERS ROUNDHOUSE**

**AURORA TRANSIT CENTER**

MATCH LINE SEE SHEET 25

FILE NAME = N:\WBK\150077.2\Civil\REM-150077.2.03.sht	USER NAME = bweich	DESIGNED - BMW	REVISED -	<b>STATE OF ILLINOIS DEPARTMENT OF TRANSPORTATION</b>	<b>AURORA TRANSIT CENTER IMPROVEMENTS EXISTING CONDITIONS &amp; REMOVAL PLAN</b>	F.A.U. RTE. 2503	SECTION 16-00313-00-MS	COUNTY KANE	TOTAL SHEETS 254	SHEET NO. 23		
Default	PLOT SCALE = 48"	CHECKED - BMW	REVISED -			SCALE: 48"	SHEET OF 254 SHEETS	STA. TO STA.	CONTRACT NO. 61E18			
	PLOT DATE = 12/4/2017	DATE = 12/4/2017	REVISED -			ILLINOIS FED. AID PROJECT						

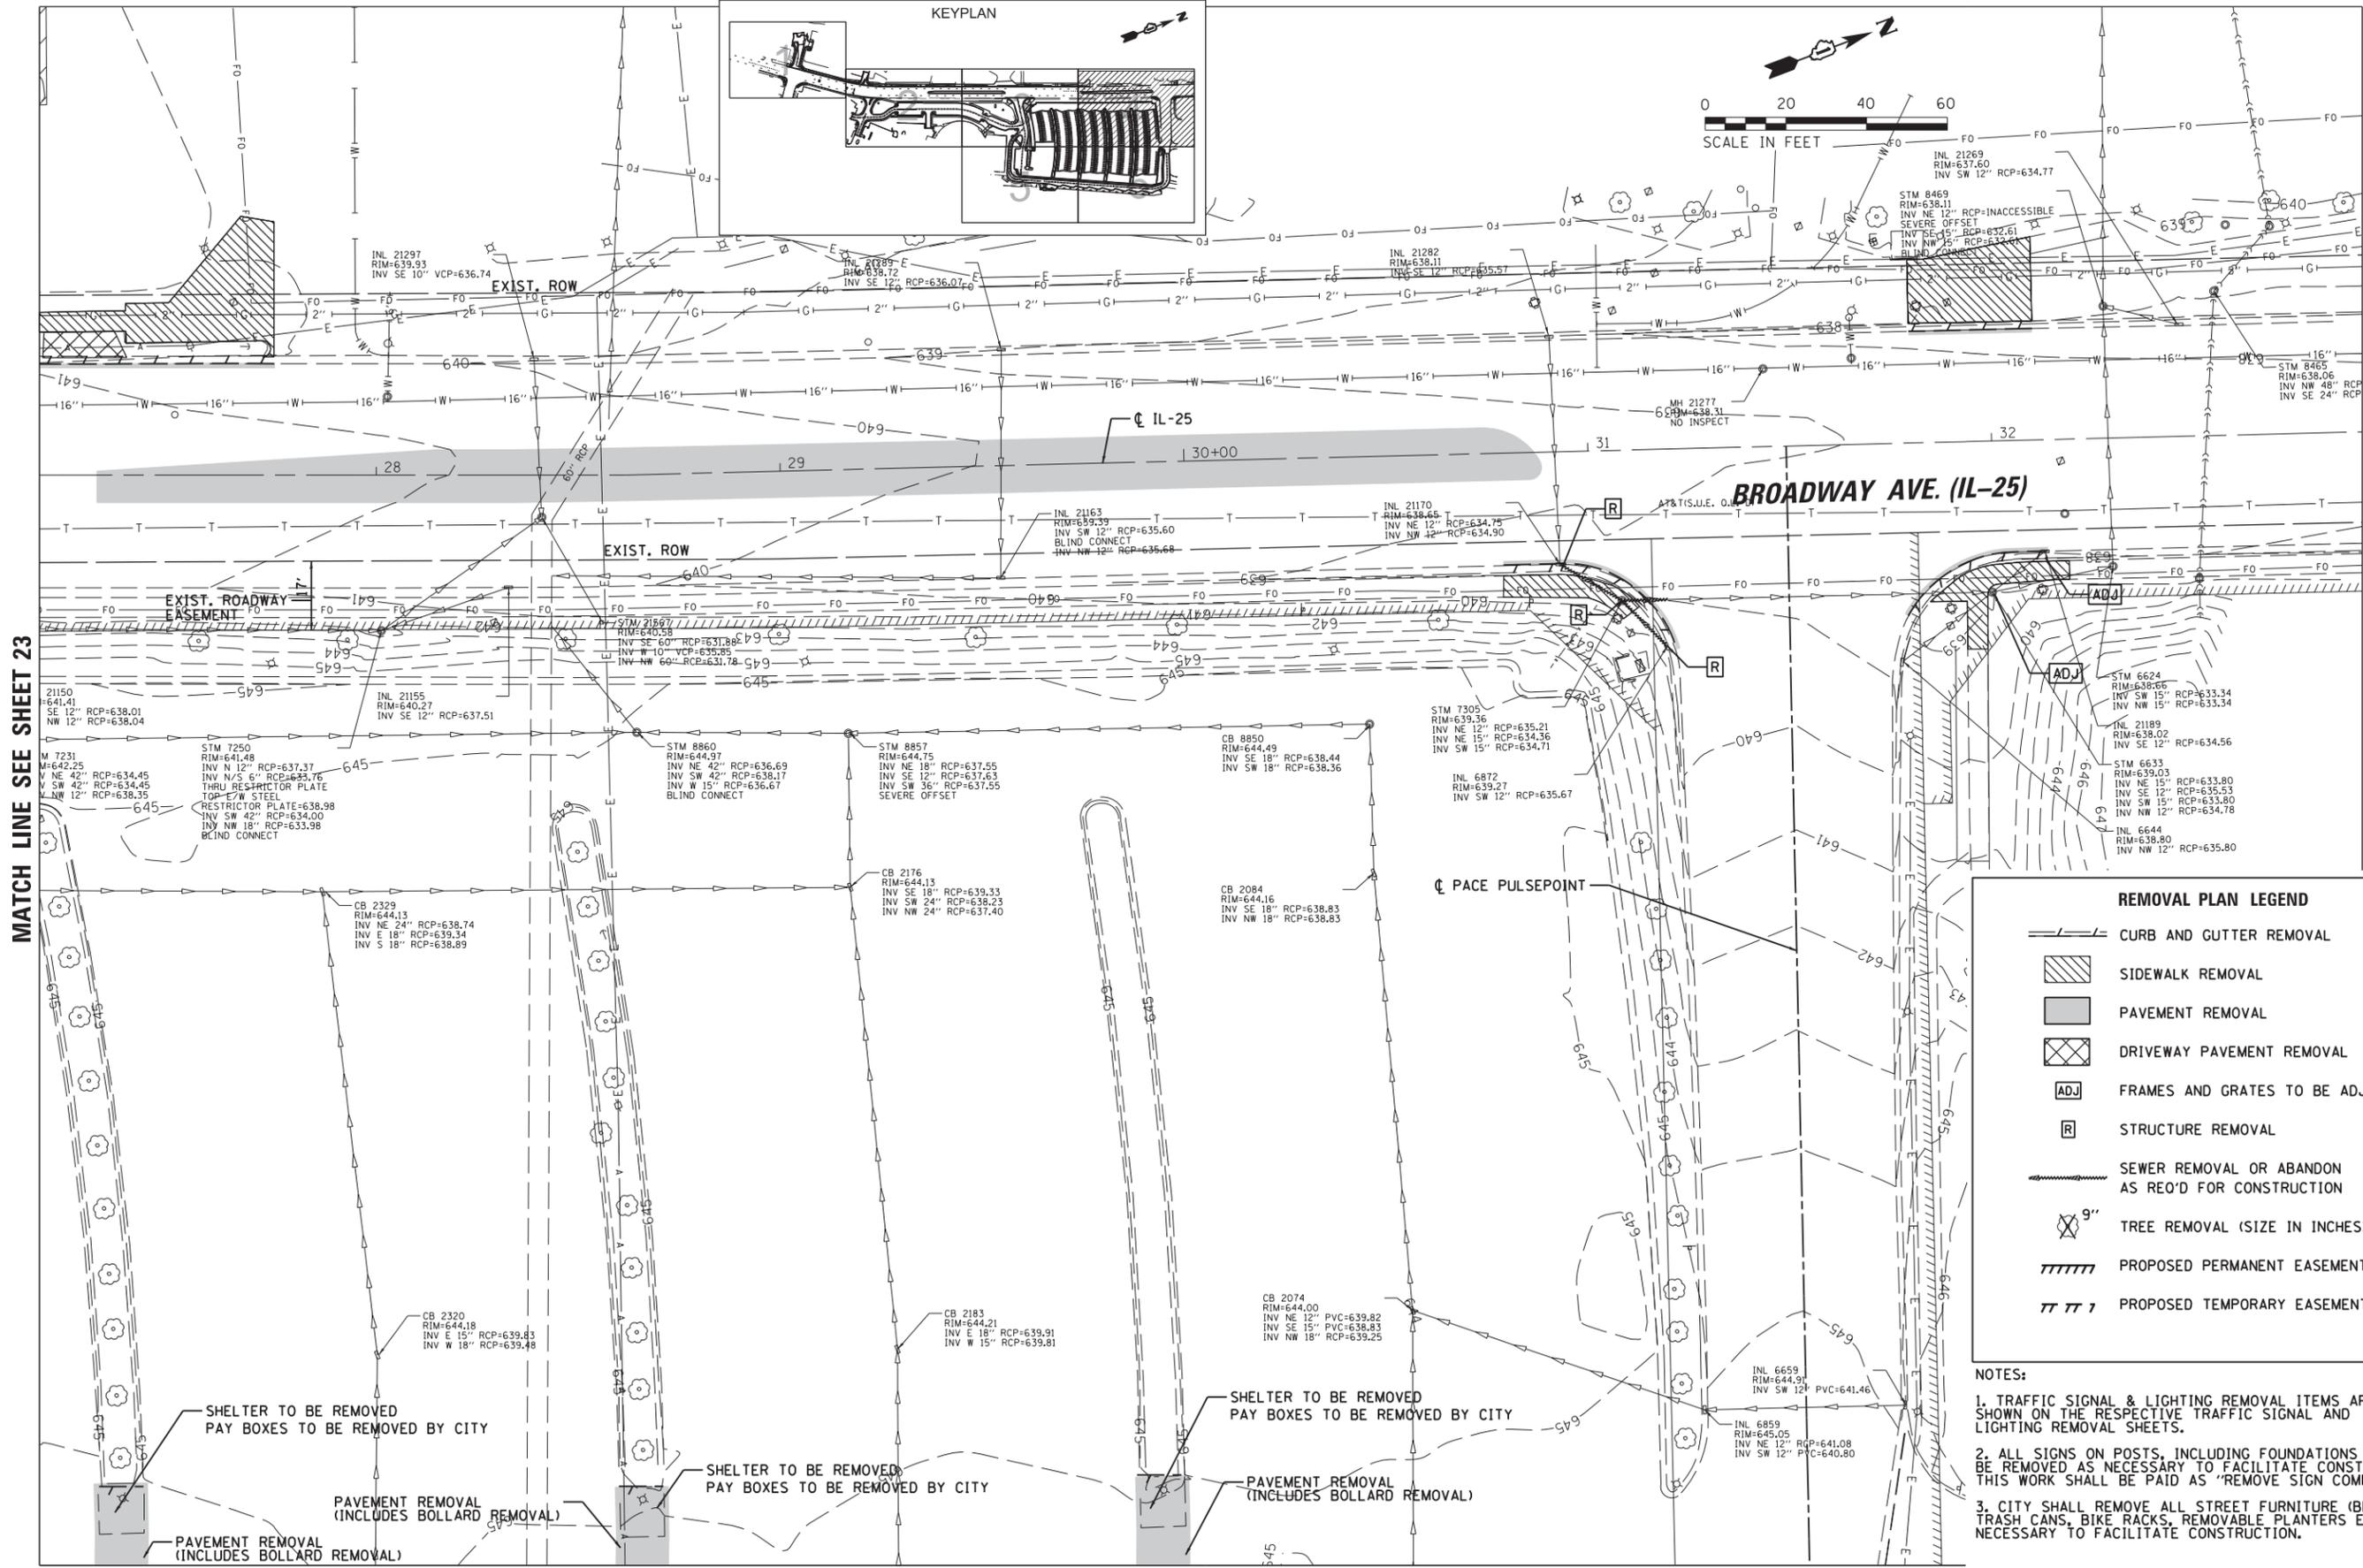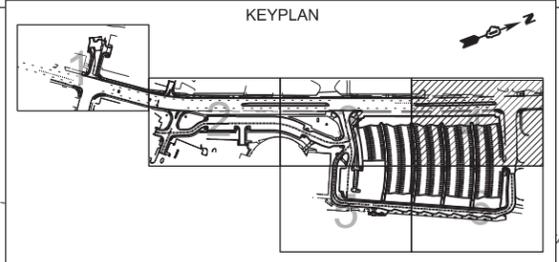

MATCH LINE SEE SHEET 23

MATCH LINE SEE SHEET 26

**REMOVAL PLAN LEGEND**

- CURB AND GUTTER REMOVAL
- SIDEWALK REMOVAL
- PAVEMENT REMOVAL
- DRIVEWAY PAVEMENT REMOVAL
- FRAMES AND GRATES TO BE ADJ (SPL)
- STRUCTURE REMOVAL
- SEWER REMOVAL OR ABANDON AS REQ'D FOR CONSTRUCTION
- TREE REMOVAL (SIZE IN INCHES)
- PROPOSED PERMANENT EASEMENT
- PROPOSED TEMPORARY EASEMENT


**NOTES:**

1. TRAFFIC SIGNAL & LIGHTING REMOVAL ITEMS ARE SHOWN ON THE RESPECTIVE TRAFFIC SIGNAL AND LIGHTING REMOVAL SHEETS.
2. ALL SIGNS ON POSTS, INCLUDING FOUNDATIONS SHALL BE REMOVED AS NECESSARY TO FACILITATE CONSTRUCTION. THIS WORK SHALL BE PAID AS "REMOVE SIGN COMPLETE".
3. CITY SHALL REMOVE ALL STREET FURNITURE (BENCHES, TRASH CANS, BIKE RACKS, REMOVABLE PLANTERS ETC.) AS NECESSARY TO FACILITATE CONSTRUCTION.

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Default	PLOT SCALE = 40'	CHECKED - BMW	REVISED -			2503	16-00313-00-MS	KANE	254	24
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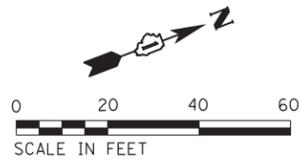
ILLINOIS FED. AID PROJECT

MATCH LINE SEE SHEET 23

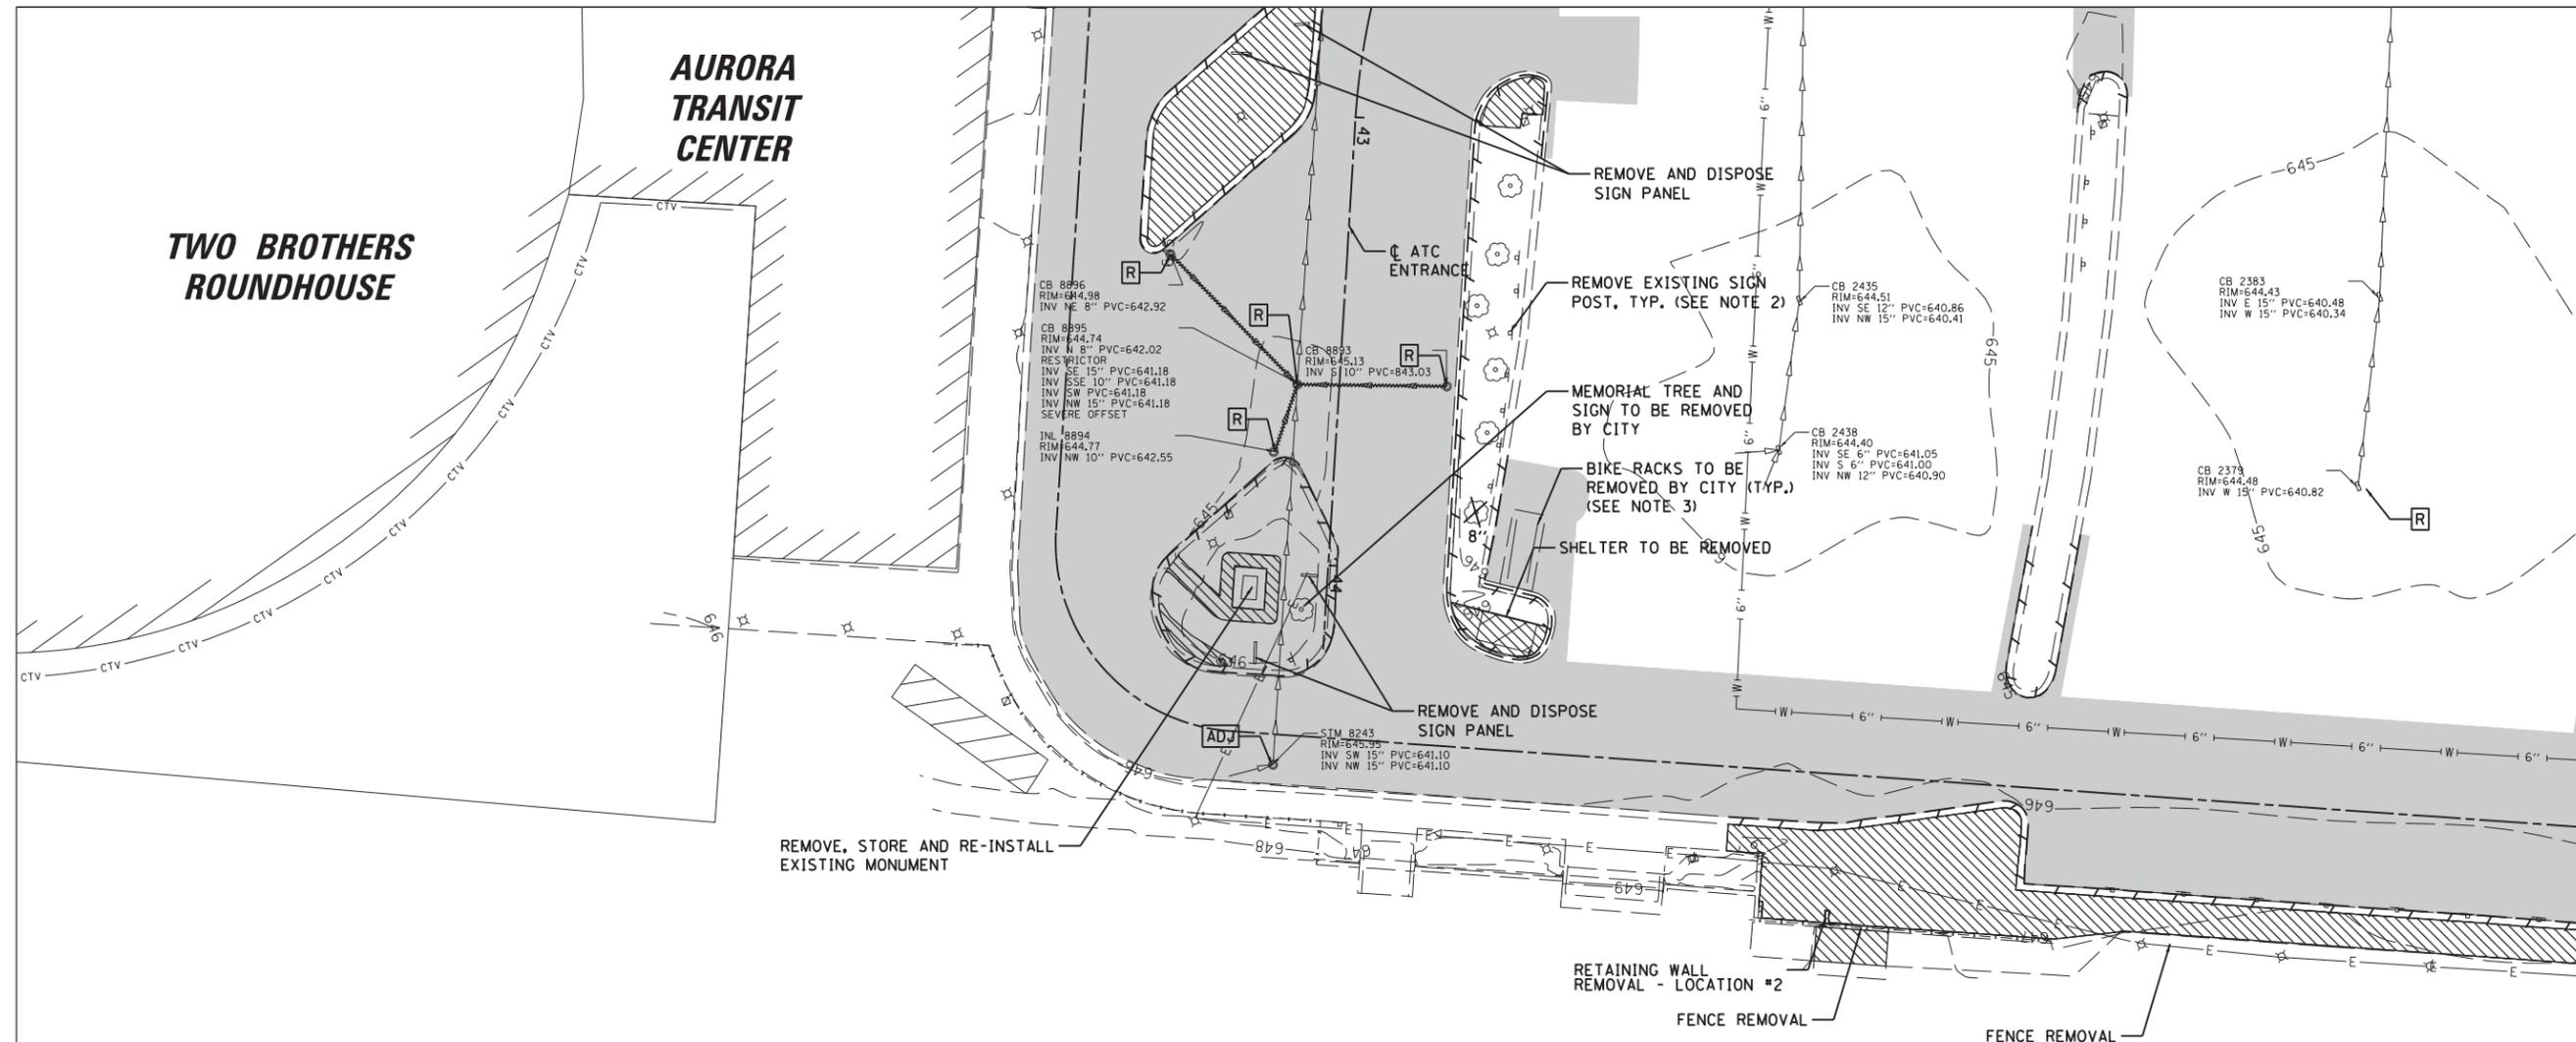


MATCH LINE SEE SHEET 26

REMOVAL PLAN LEGEND	
	CURB AND GUTTER REMOVAL
	SIDEWALK REMOVAL
	PAVEMENT REMOVAL
	DRIVEWAY PAVEMENT REMOVAL
	FRAMES AND GRATES TO BE ADJ (SPL)
	STRUCTURE REMOVAL
	SEWER REMOVAL OR ABANDON AS REQ'D FOR CONSTRUCTION
	TREE REMOVAL (SIZE IN INCHES)
	PROPOSED PERMANENT EASEMENT
	PROPOSED TEMPORARY EASEMENT





NOTES:  
 1. TRAFFIC SIGNAL & LIGHTING REMOVAL ITEMS ARE SHOWN ON THE RESPECTIVE TRAFFIC SIGNAL AND LIGHTING REMOVAL SHEETS.  
 2. ALL SIGNS ON POSTS, INCLUDING FOUNDATIONS SHALL BE REMOVED AS NECESSARY TO FACILITATE CONSTRUCTION. THIS WORK SHALL BE PAID AS "REMOVE SIGN COMPLETE".  
 3. CITY SHALL REMOVE ALL STREET FURNITURE (BENCHES, TRASH CANS, BIKE RACKS, REMOVABLE PLANTERS ETC.) AS NECESSARY TO FACILITATE CONSTRUCTION.

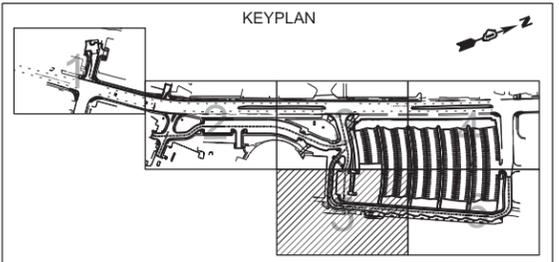

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Default	PLOT SCALE = 48"	CHECKED - BMW	REVISED -			SCALE: 48"	SHEET OF 254 SHEETS	STA. TO STA.	CONTRACT NO. 61E18		
	PLOT DATE = 10/16/2017	DATE - 10/16/2017	REVISED -			ILLINOIS FED. AID PROJECT					

MATCH LINE SEE SHEET 24


MATCH LINE SEE SHEET 25

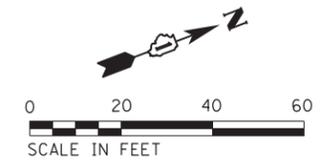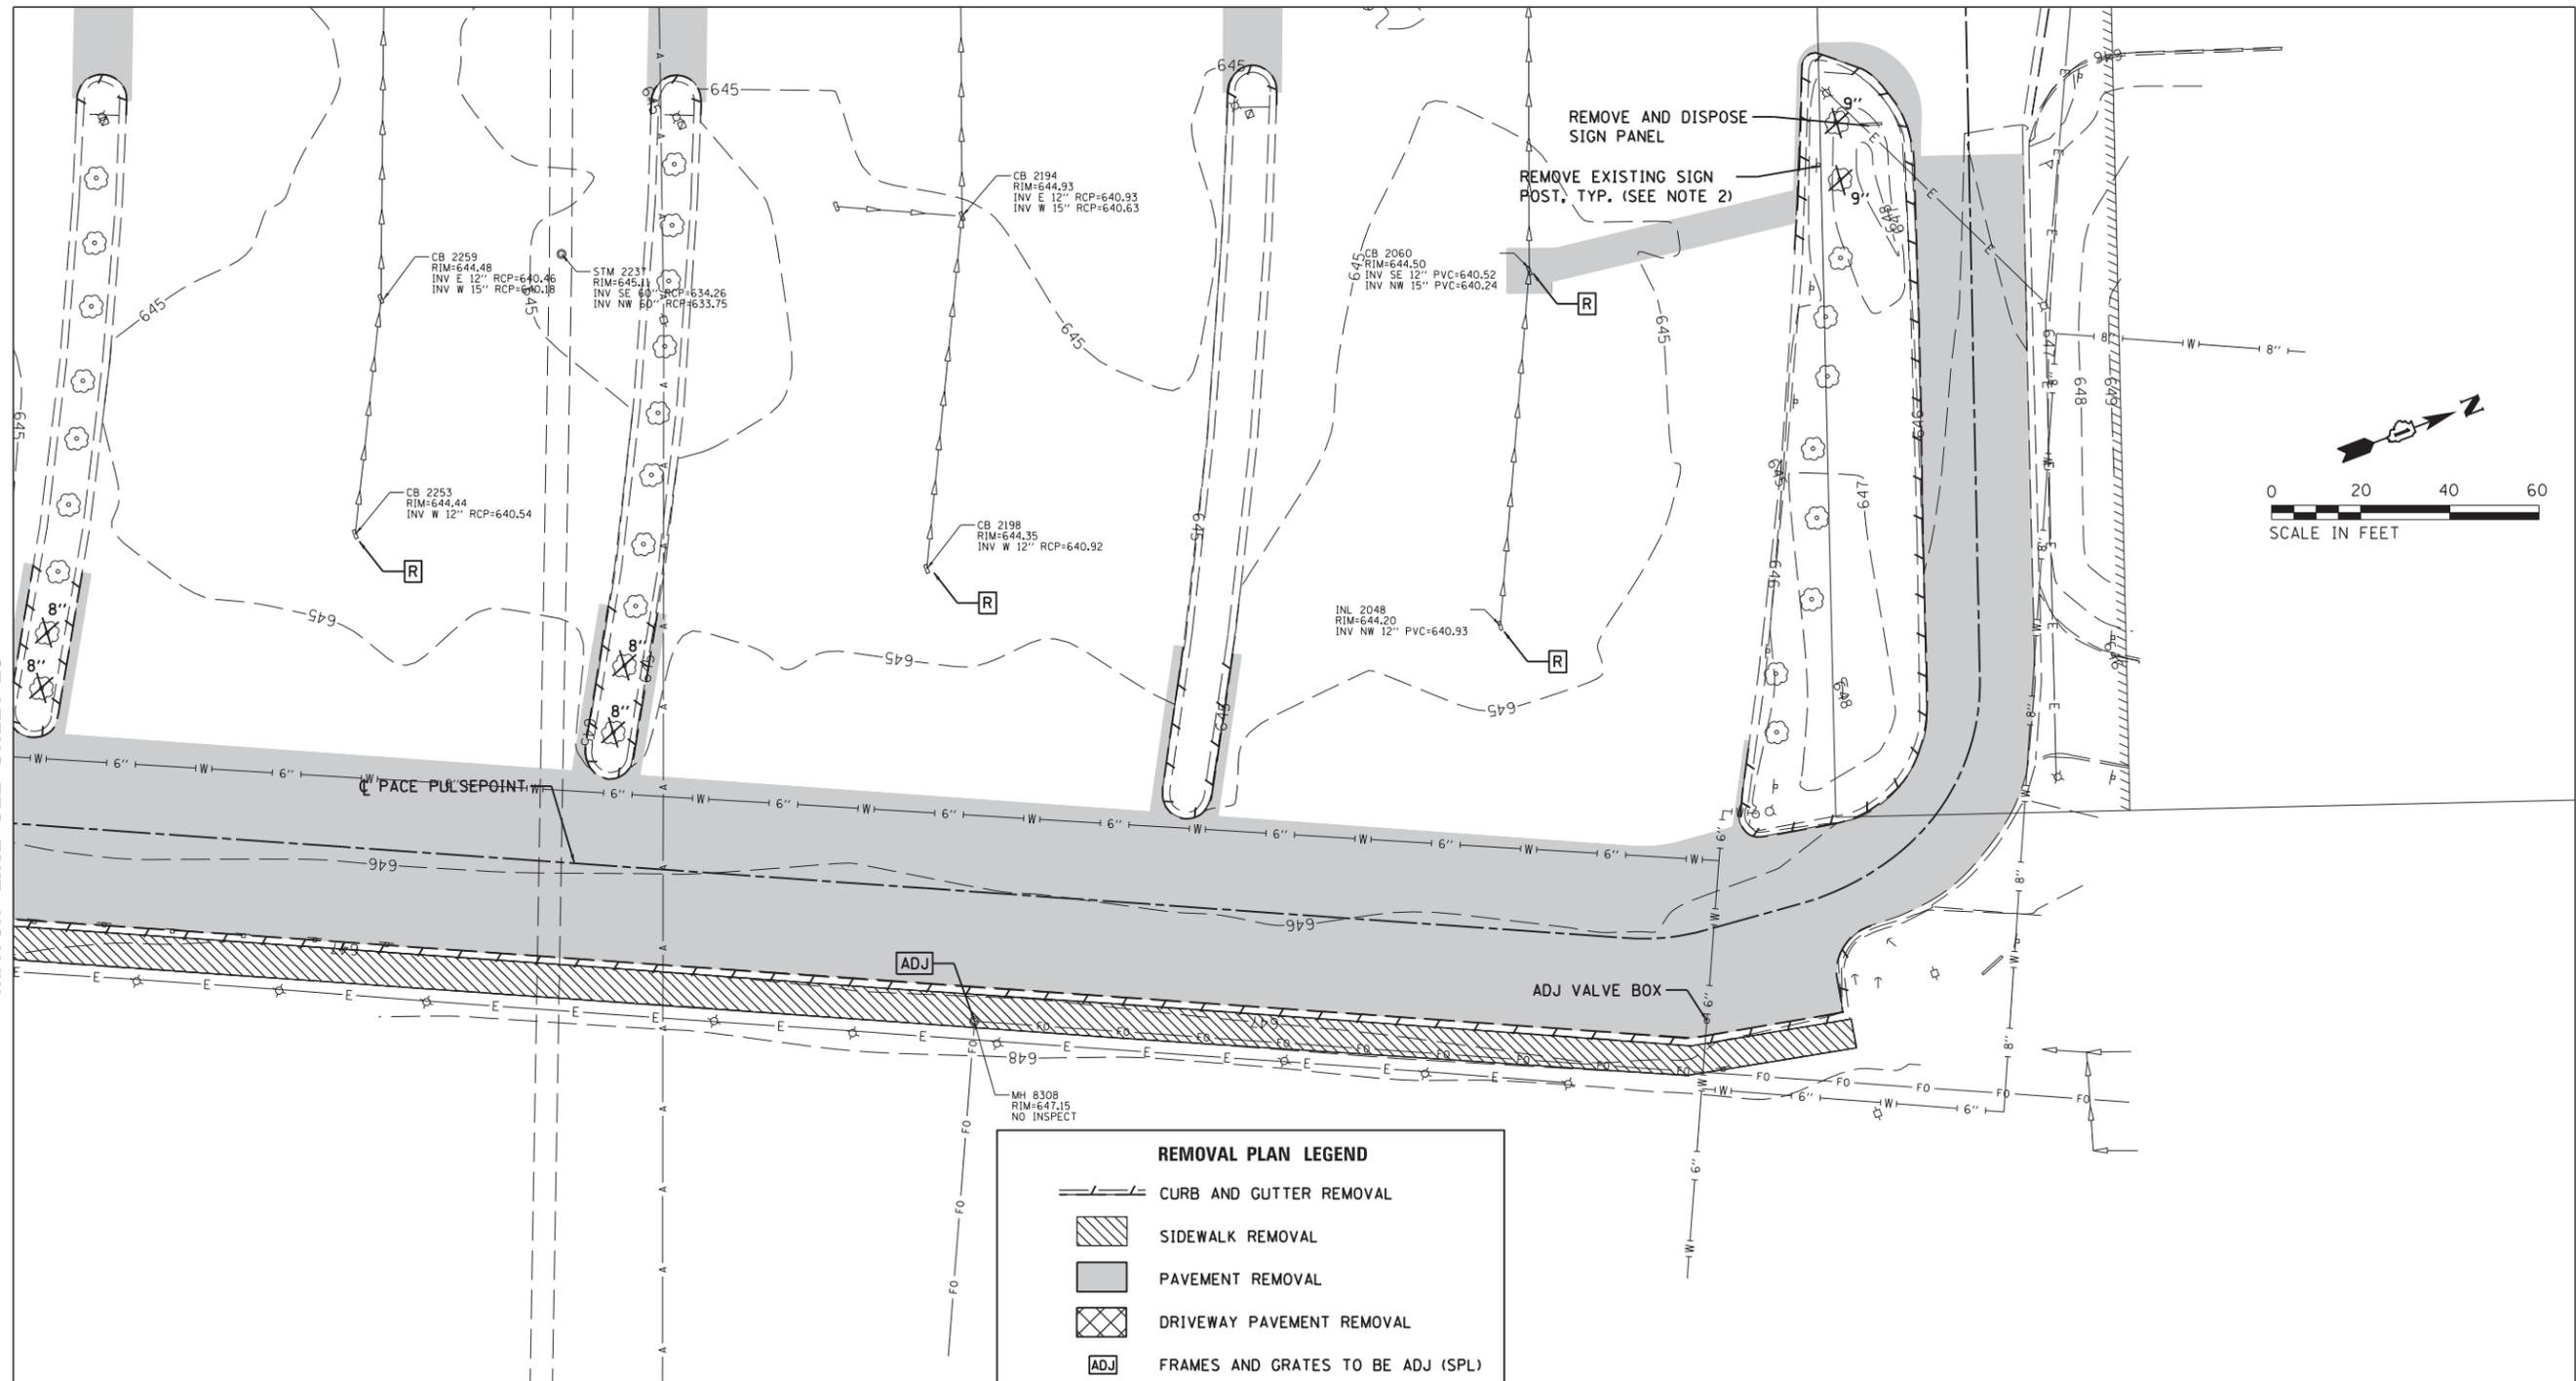

**NOTES:**  
 1. TRAFFIC SIGNAL & LIGHTING REMOVAL ITEMS ARE SHOWN ON THE RESPECTIVE TRAFFIC SIGNAL AND LIGHTING REMOVAL SHEETS.  
 2. ALL SIGNS ON POSTS, INCLUDING FOUNDATIONS SHALL BE REMOVED AS NECESSARY TO FACILITATE CONSTRUCTION. THIS WORK SHALL BE PAID AS "REMOVE SIGN COMPLETE".  
 3. CITY SHALL REMOVE ALL STREET FURNITURE (BENCHES, TRASH CANS, BIKE RACKS, REMOVABLE PLANTERS ETC.) AS NECESSARY TO FACILITATE CONSTRUCTION.

**REMOVAL PLAN LEGEND**

	CURB AND GUTTER REMOVAL
	SIDEWALK REMOVAL
	PAVEMENT REMOVAL
	DRIVEWAY PAVEMENT REMOVAL
	FRAMES AND GRATES TO BE ADJ (SPJ)
	STRUCTURE REMOVAL
	SEWER REMOVAL OR ABANDON AS REQ'D FOR CONSTRUCTION
	TREE REMOVAL (SIZE IN INCHES)
	PROPOSED PERMANENT EASEMENT
	PROPOSED TEMPORARY EASEMENT

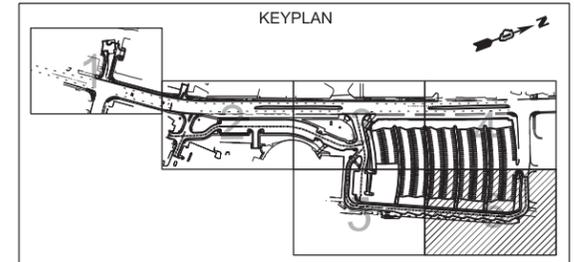

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Default	PLOT SCALE = 48'	DRAWN - PWN	REVISED -
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		DATE - 10/16/2017	REVISED -


STATE OF ILLINOIS  
DEPARTMENT OF TRANSPORTATION

AURORA TRANSIT CENTER IMPROVEMENTS  
EXISTING CONDITIONS & REMOVAL PLAN

SCALE: 48' SHEET OF 254 SHEETS STA. TO STA.

F.A.U. RTE.	SECTION	COUNTY	TOTAL SHEETS	SHEET NO.
2503	16-00313-00-MS	KANE	254	26
CONTRACT NO. 61E18				

ILLINOIS FED. AID PROJECT

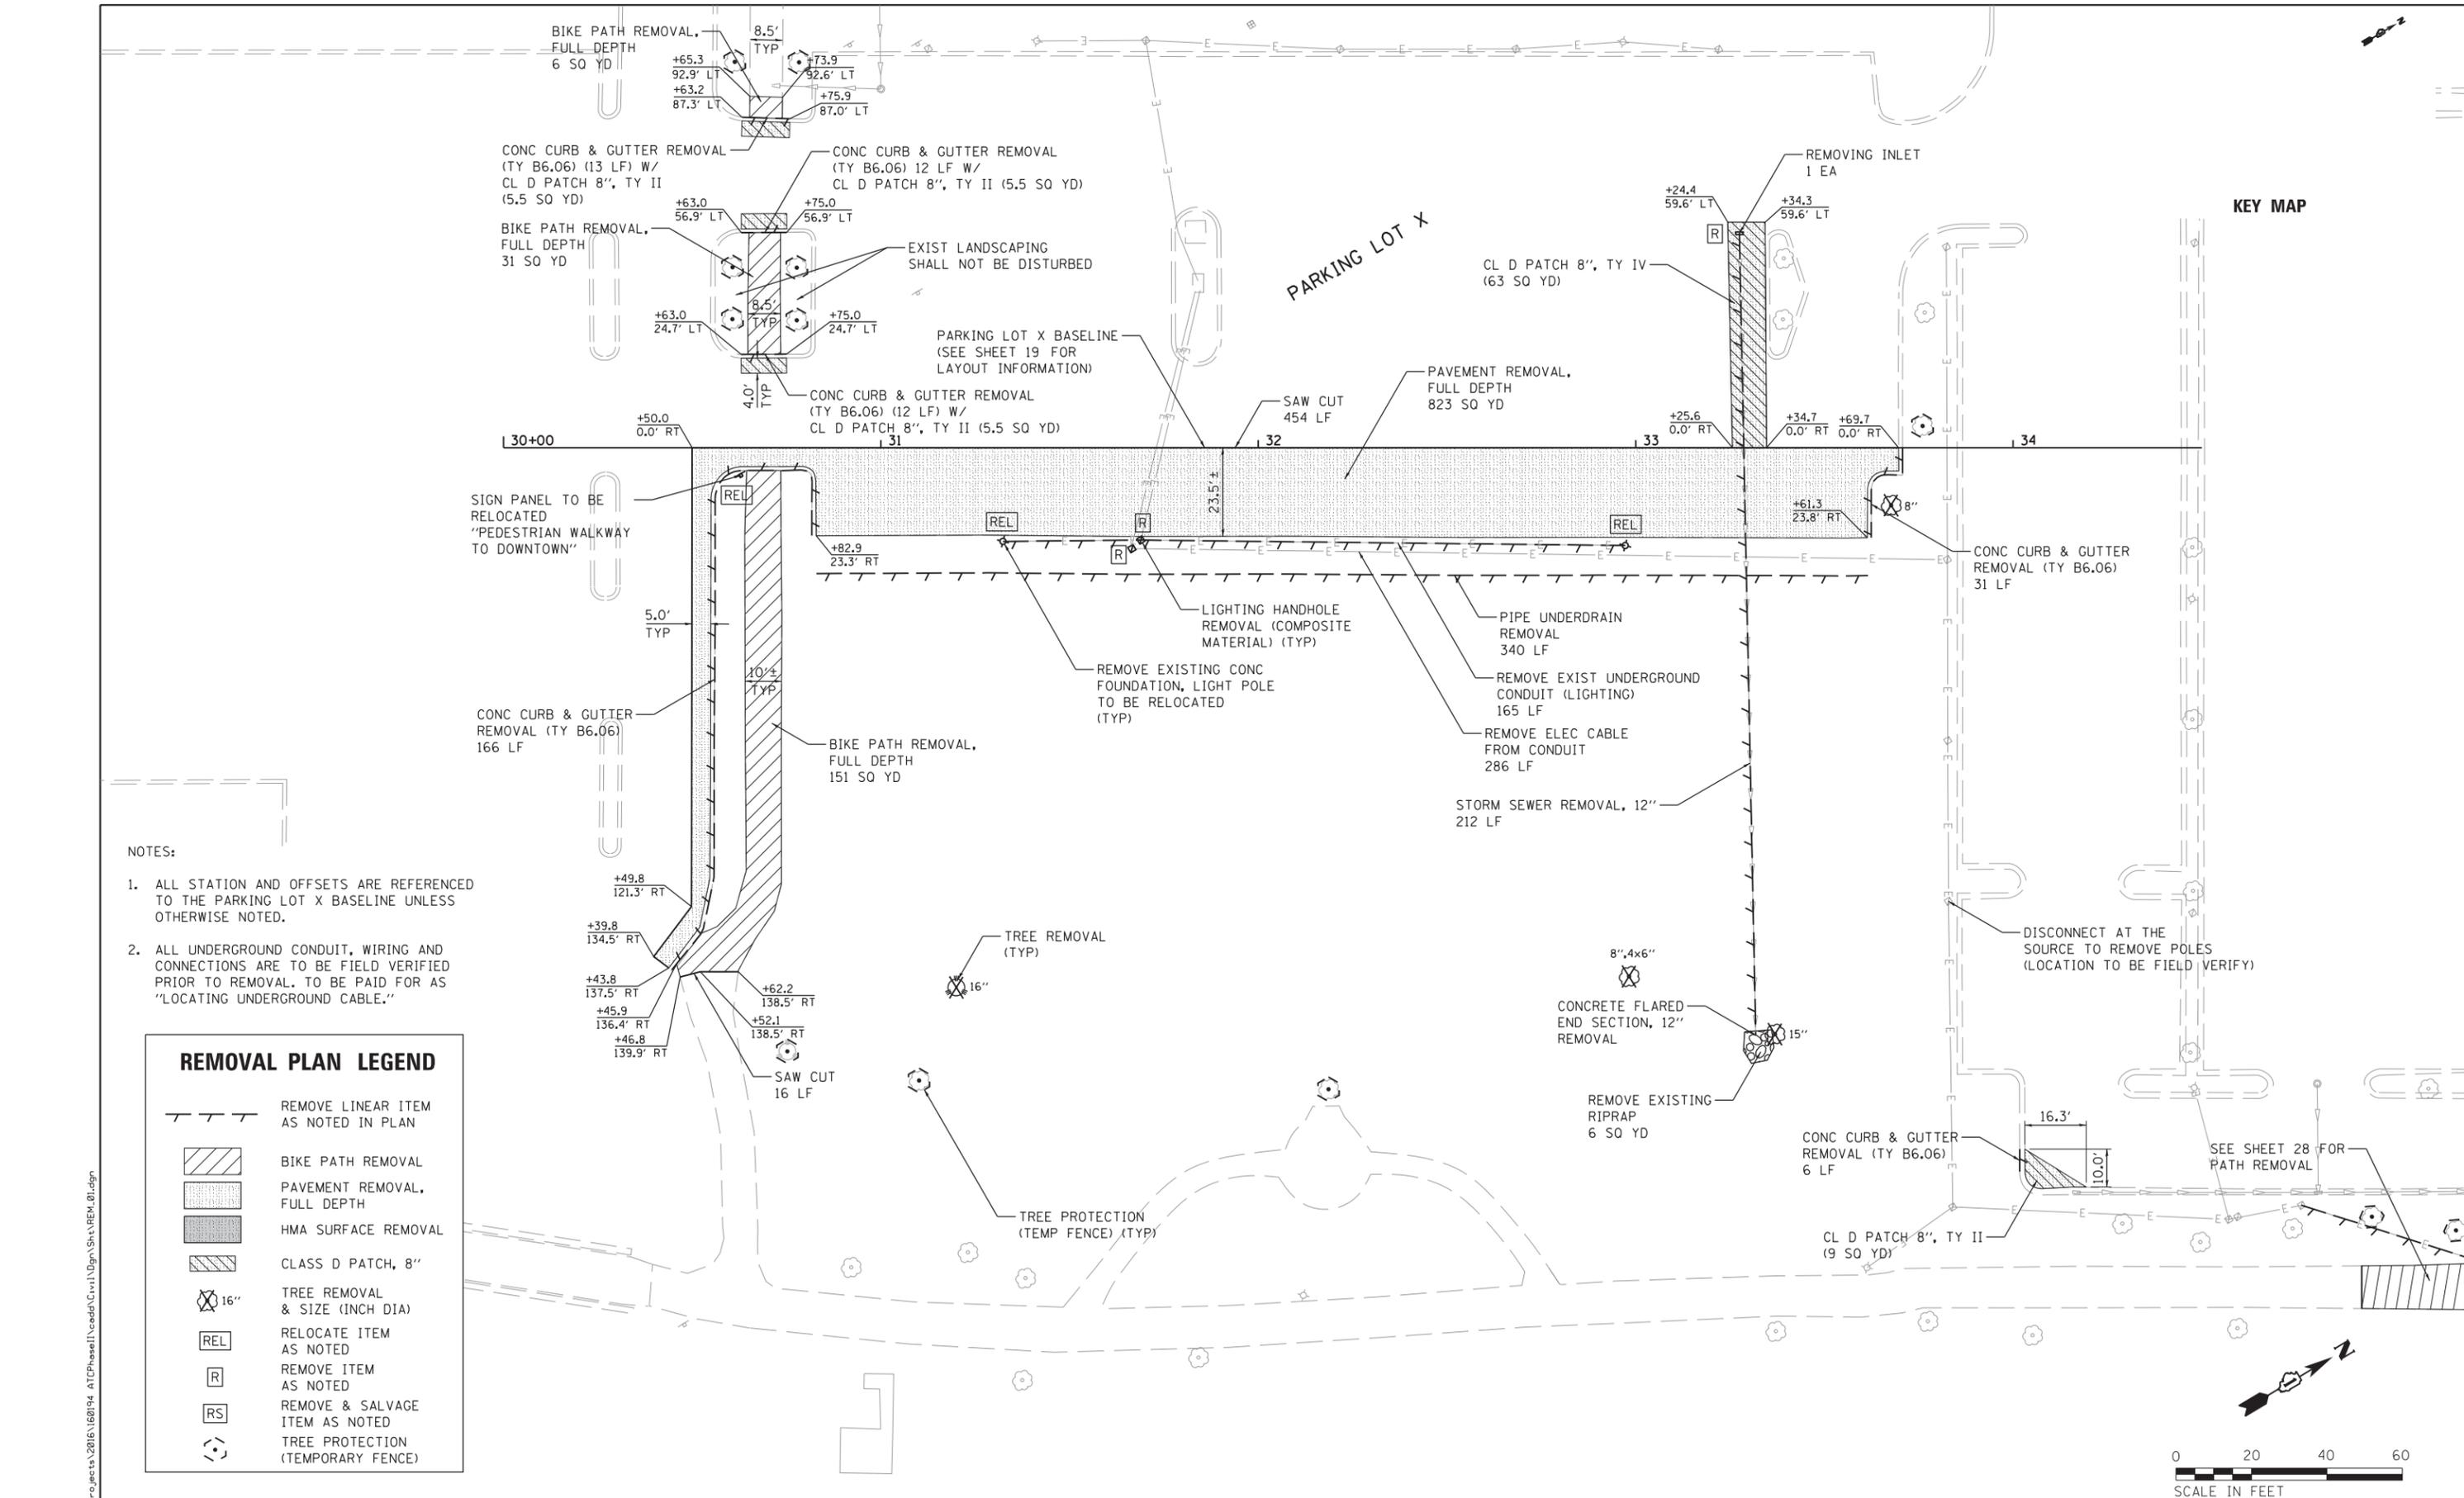

KEY MAP

- NOTES:
1. ALL STATION AND OFFSETS ARE REFERENCED TO THE PARKING LOT X BASELINE UNLESS OTHERWISE NOTED.
  2. ALL UNDERGROUND CONDUIT, WIRING AND CONNECTIONS ARE TO BE FIELD VERIFIED PRIOR TO REMOVAL. TO BE PAID FOR AS "LOCATING UNDERGROUND CABLE."

**REMOVAL PLAN LEGEND**

- REMOVE LINEAR ITEM AS NOTED IN PLAN
- BIKE PATH REMOVAL
- PAVEMENT REMOVAL, FULL DEPTH
- HMA SURFACE REMOVAL
- CLASS D PATCH, 8"
- TREE REMOVAL & SIZE (INCH DIA)
- RELOCATE ITEM AS NOTED
- REMOVE ITEM AS NOTED
- REMOVE & SALVAGE ITEM AS NOTED
- TREE PROTECTION (TEMPORARY FENCE)



FILE NAME = W:\Projects\2016\160194 - ATCPhaseII\cadd\Civil\Dgn\Sh\REM\_01.dgn



**WBK ENGINEERING, LLC**  
 116 WEST MAIN STREET, SUITE 201  
 ST. CHARLES, ILLINOIS 60174  
 (630) 443-7755

USER NAME = nparris  
 PLOT SCALE = 1:40  
 PLOT DATE = 10/17/2017

DESIGNED - MNB	REVISED -
DRAWN - NDP	REVISED -
CHECKED - MNB	REVISED -
DATE - 10/18/17	REVISED -



**STATE OF ILLINOIS  
 DEPARTMENT OF TRANSPORTATION**

**REMOVAL PLAN  
 PARKING LOT X**



SCALE: 1"=20'  
 SHEET NO. 7 OF 8 SHEETS  
 STA. TO STA.

F.A.U. RTE.	SECTION	COUNTY	TOTAL SHEETS	SHEET NO.
2503	16-00313-00-MS	KANE	254	27
CONTRACT NO. 61E18				

ILLINOIS FED. AID PROJECT

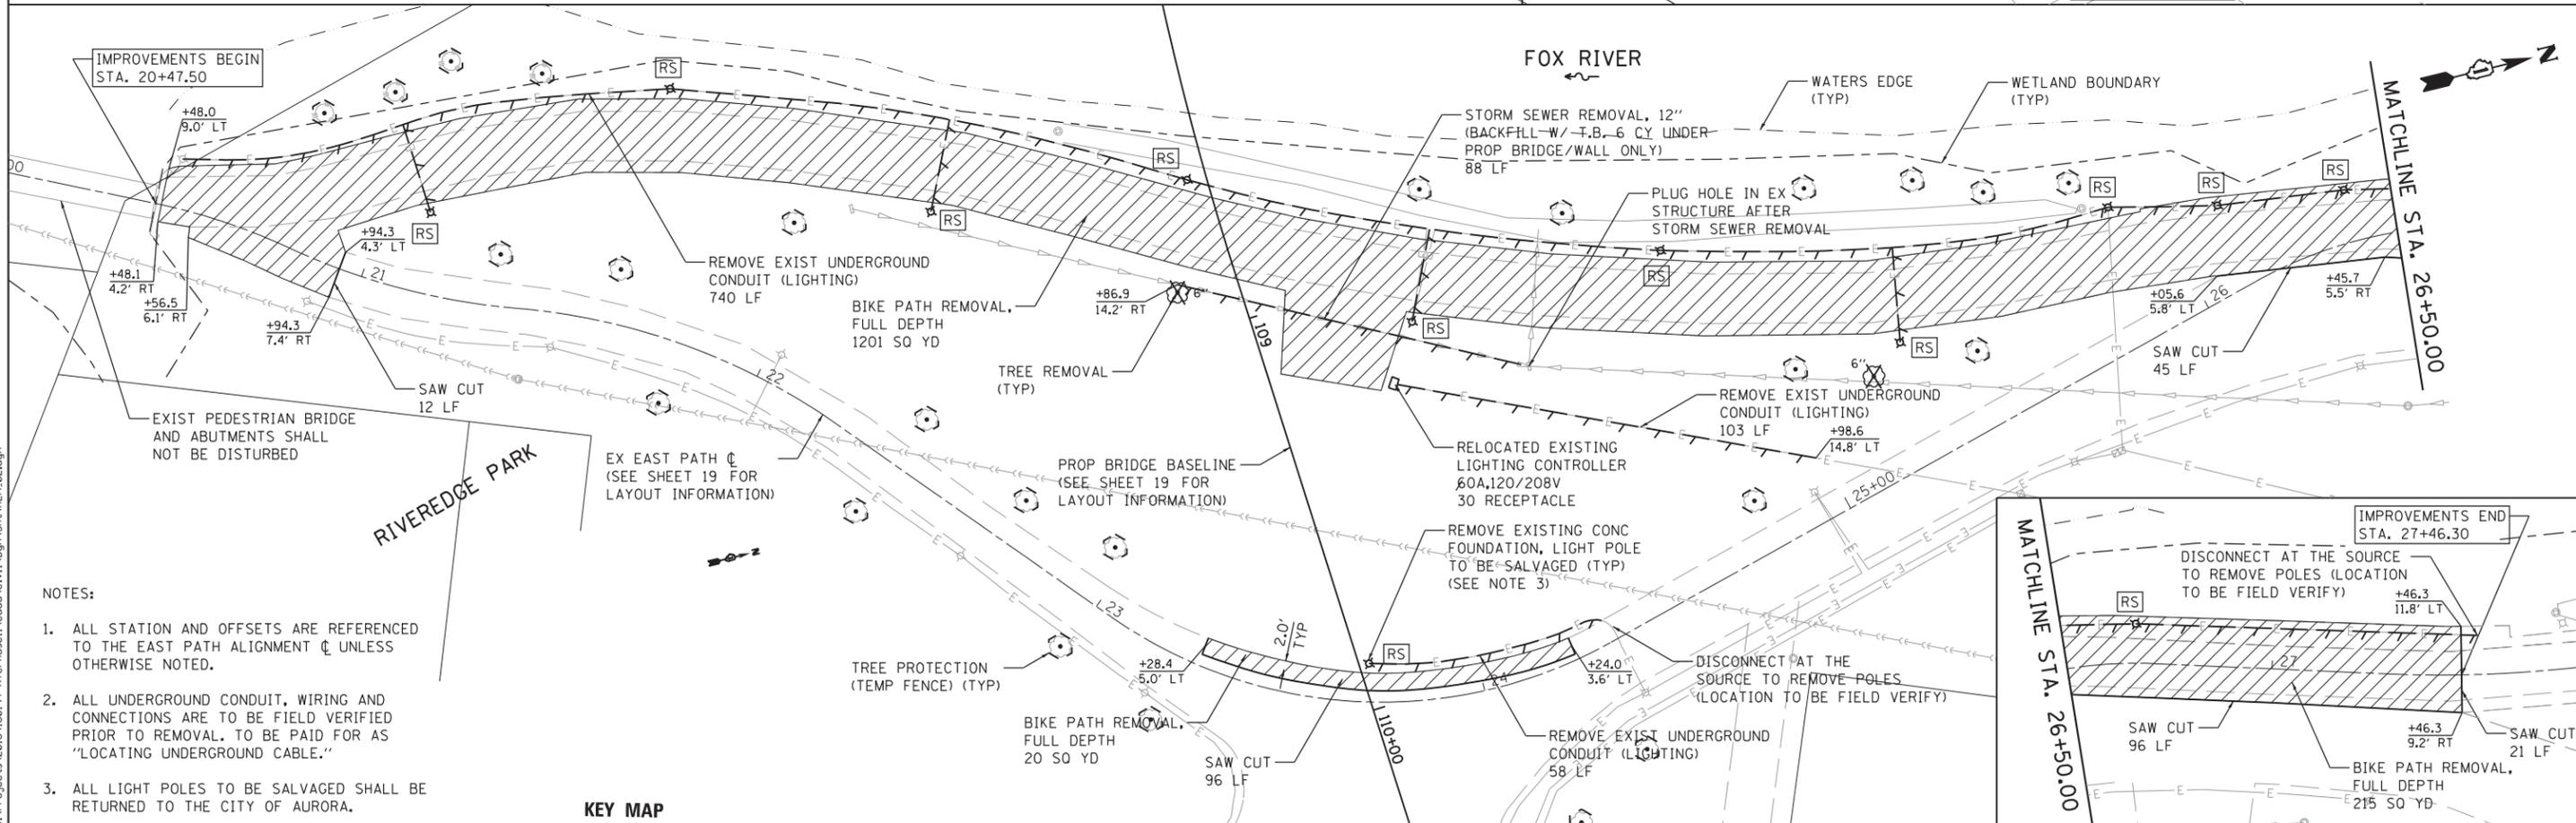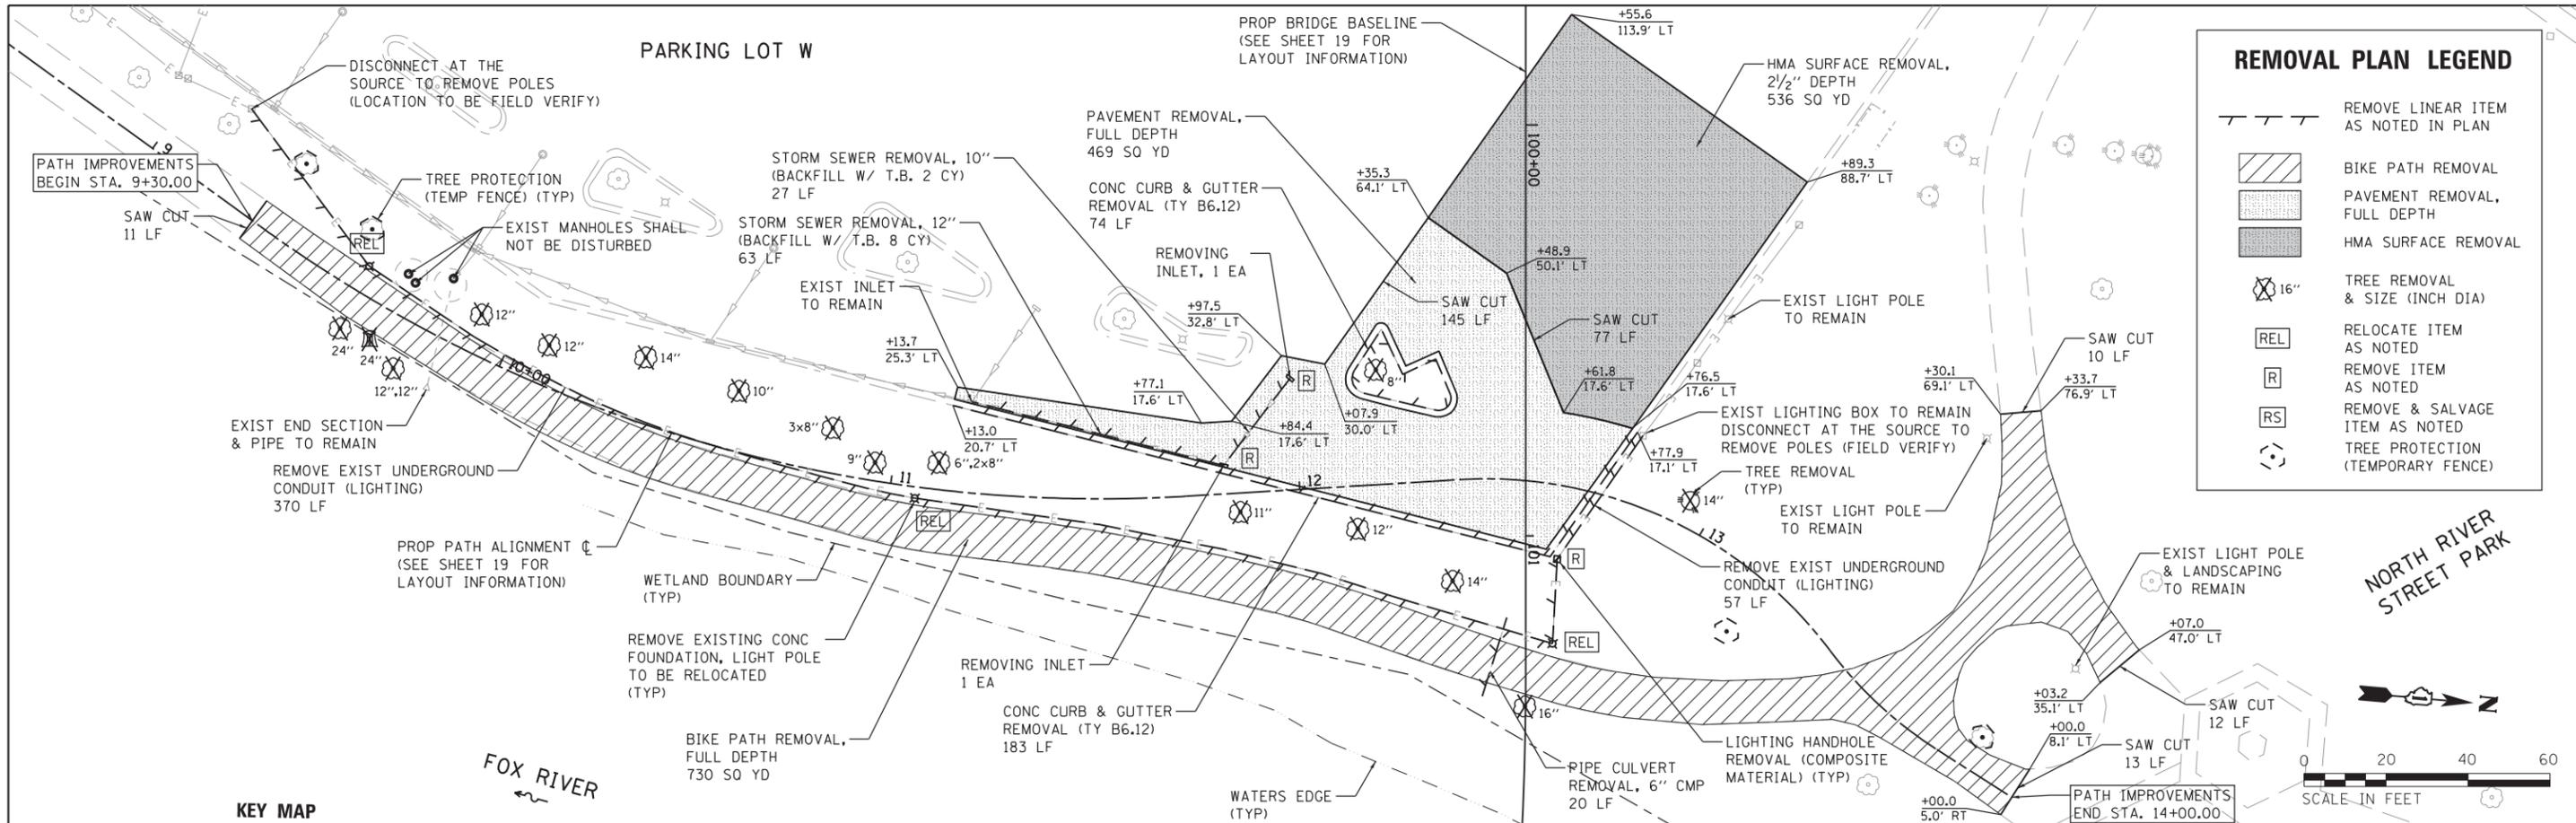

	WBK ENGINEERING, LLC 116 WEST MAIN STREET, SUITE 201 ST. CHARLES, ILLINOIS 60174 (630) 443-7755	USER NAME = nparris DESIGNED - MNB DRAWN - NDP CHECKED - MNB DATE - 10/17/2017	REVISED - REVISED - REVISED - REVISED -	<b>STATE OF ILLINOIS DEPARTMENT OF TRANSPORTATION</b>	<b>REMOVAL PLAN - PARKING LOT W, MULTI-USE PATH &amp; PEDESTRIAN BRIDGE LANDINGS</b>		F.A.U. R.E. 2503	SECTION 16-00313-00-MS	COUNTY KANE	TOTAL SHEETS 254	SHEET NO. 28
	SCALE: 1"=20'				SHEET NO. 8 OF 8 SHEETS	STA. TO STA.	CONTRACT NO. 61E18 ILLINOIS FED. AID PROJECT				

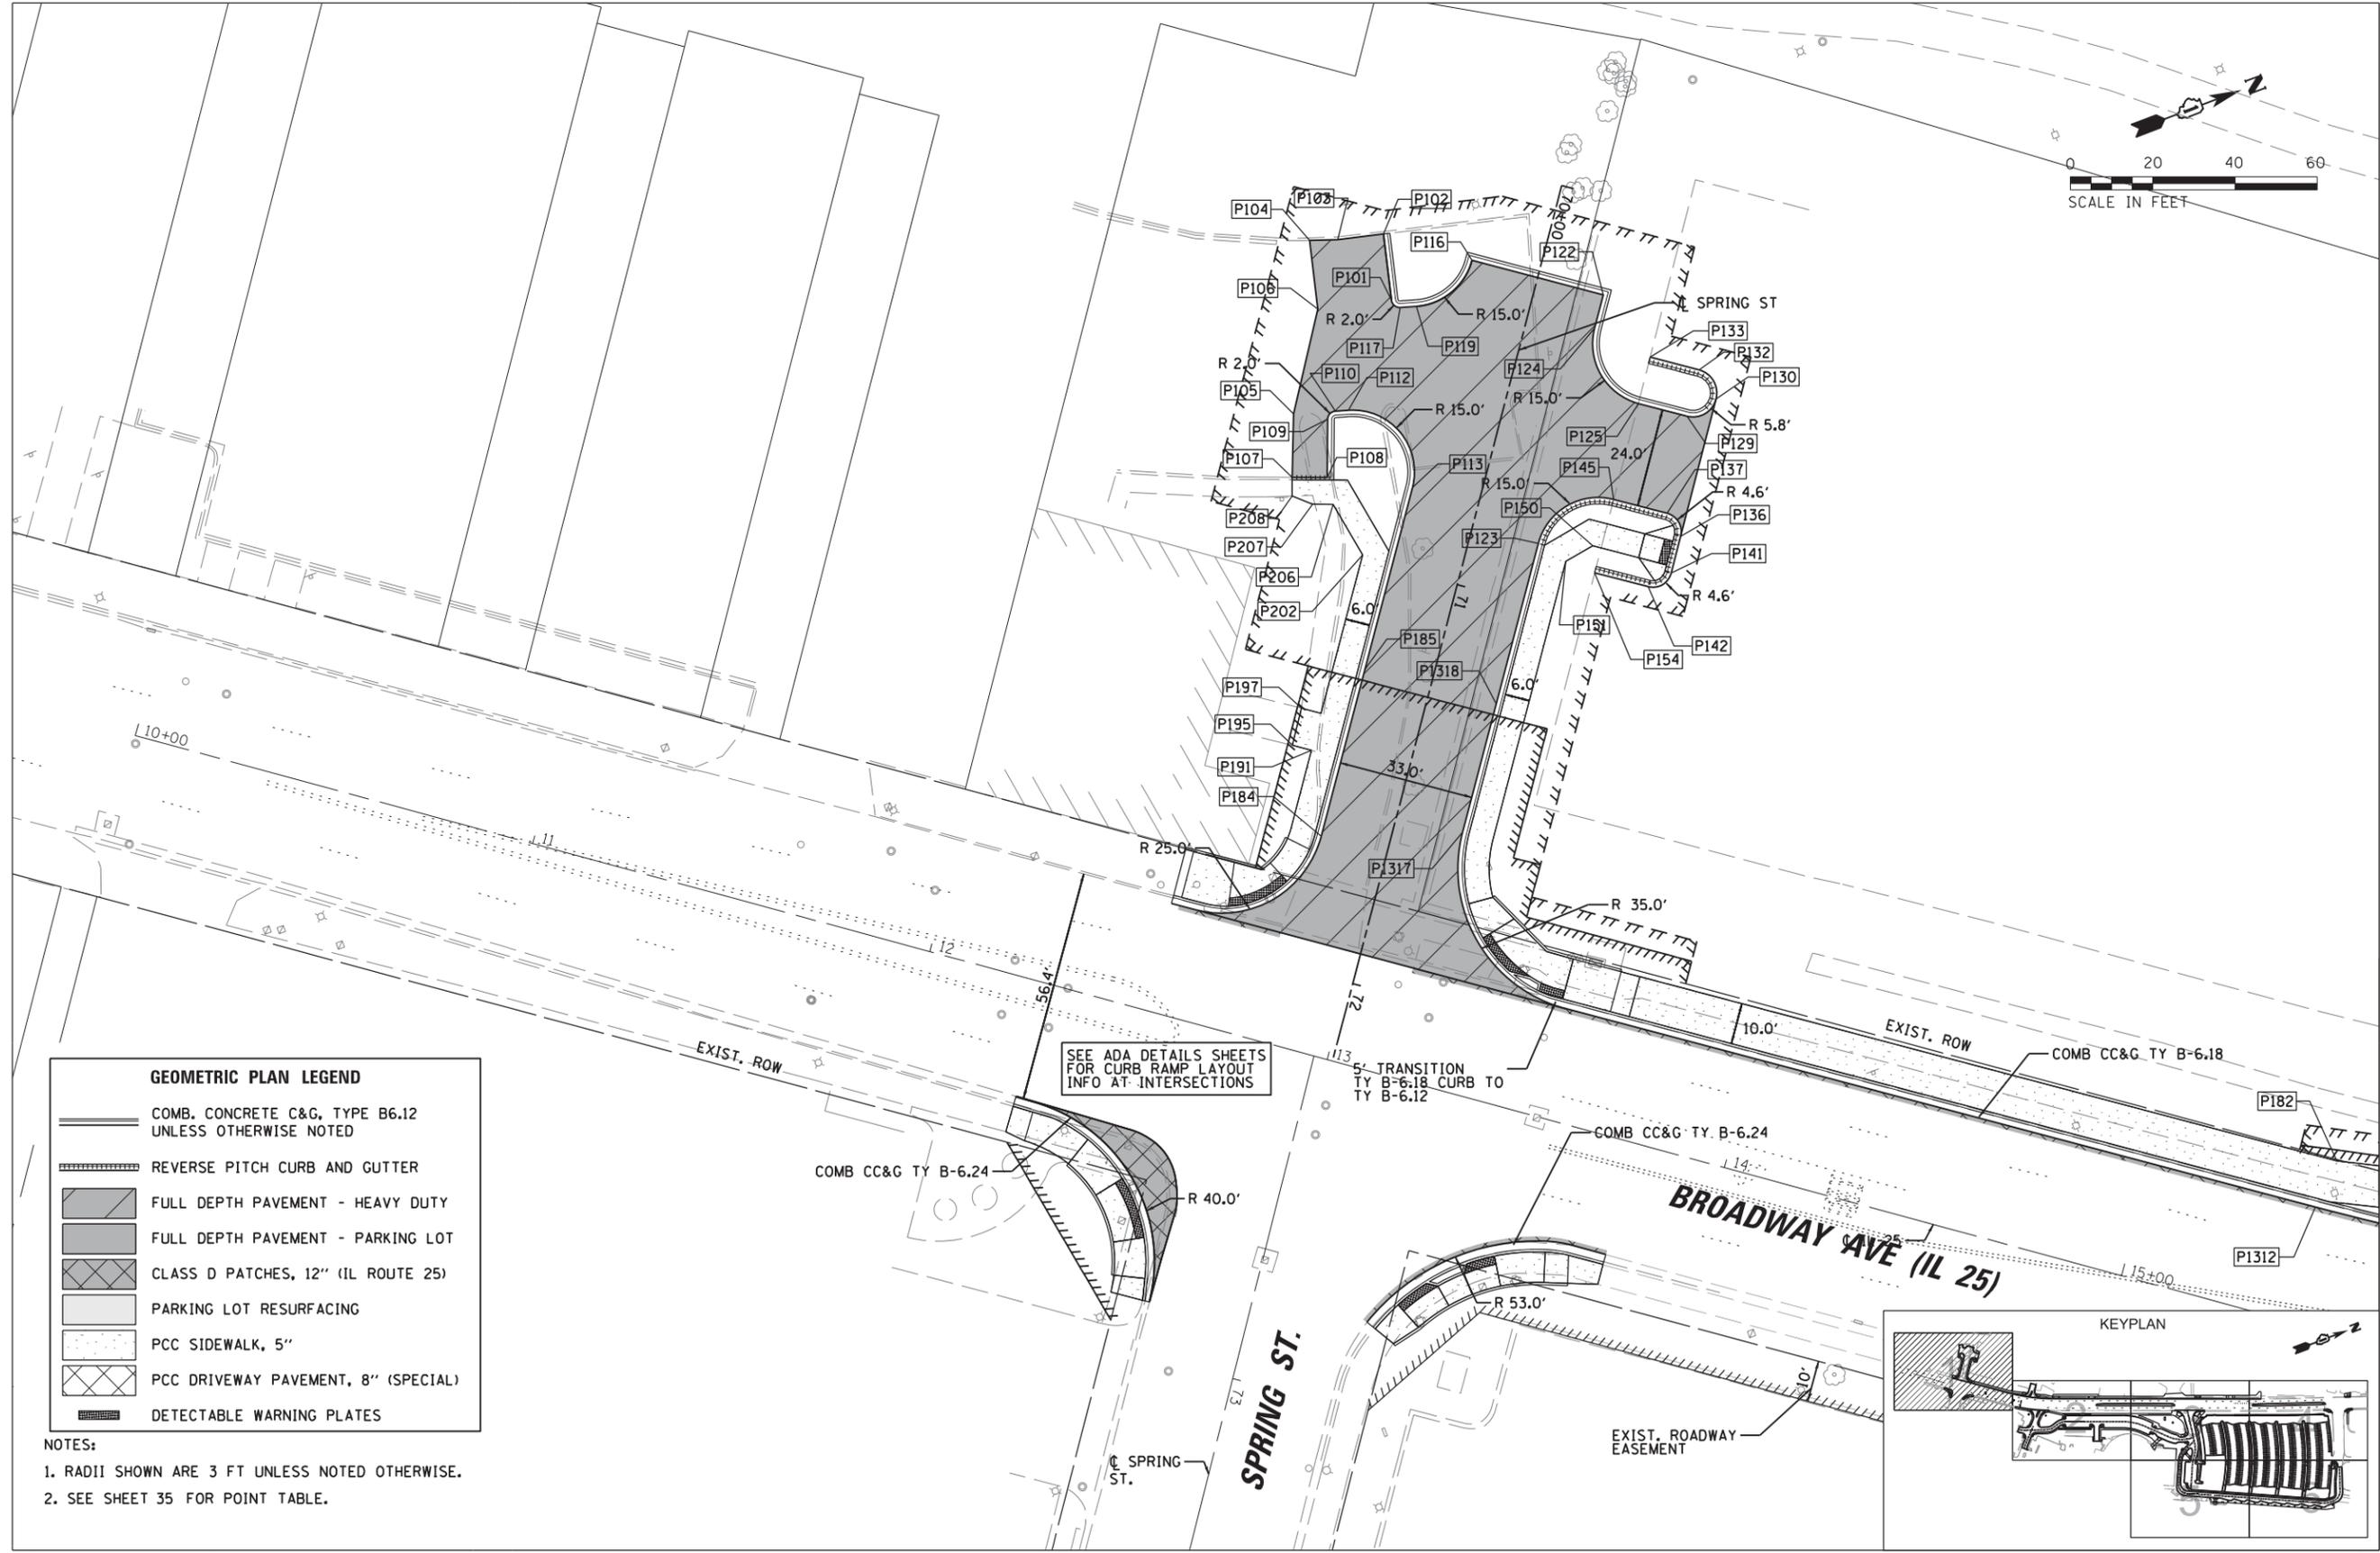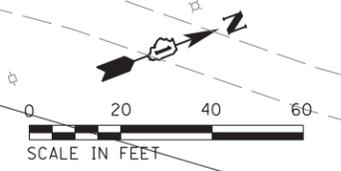


**GEOMETRIC PLAN LEGEND**

	COMB. CONCRETE C&G, TYPE B6.12 UNLESS OTHERWISE NOTED
	REVERSE PITCH CURB AND GUTTER
	FULL DEPTH PAVEMENT - HEAVY DUTY
	FULL DEPTH PAVEMENT - PARKING LOT
	CLASS D PATCHES, 12" (IL ROUTE 25)
	PARKING LOT RESURFACING
	PCC SIDEWALK, 5"
	PCC DRIVEWAY PAVEMENT, 8" (SPECIAL)
	DETECTABLE WARNING PLATES

**NOTES:**



1. RADII SHOWN ARE 3 FT UNLESS NOTED OTHERWISE.
2. SEE SHEET 35 FOR POINT TABLE.

SEE ADA DETAILS SHEETS FOR CURB RAMP LAYOUT INFO AT INTERSECTIONS

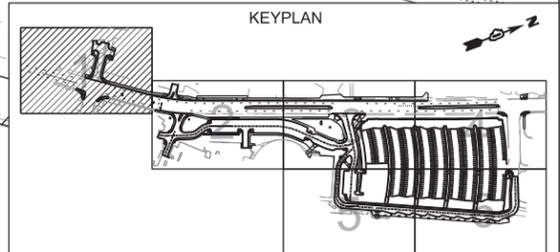

MATCH LINE SEE SHEET 30

FILE NAME = N:\WBK\150077.2\Civil\GM_150077.2_01.sht	USER NAME = bweich	DESIGNED - BMW	REVISED -	<b>STATE OF ILLINOIS DEPARTMENT OF TRANSPORTATION</b>	<b>AURORA TRANSIT CENTER IMPROVEMENTS GEOMETRIC PLAN</b>	F.A.U. R.E. = 2503	SECTION = 16-00313-00-MS	COUNTY = KANE	TOTAL SHEETS = 254	SHEET NO. = 29		
Default	PLOT SCALE = 48"	CHECKED - BMW	REVISED -			SCALE: 48"	SHEET OF 254 SHEETS	STA. TO STA.	CONTRACT NO. 61E18			
	PLOT DATE = 10/16/2017	DATE = 10/16/2017	REVISED -			ILLINOIS FED. AID PROJECT						

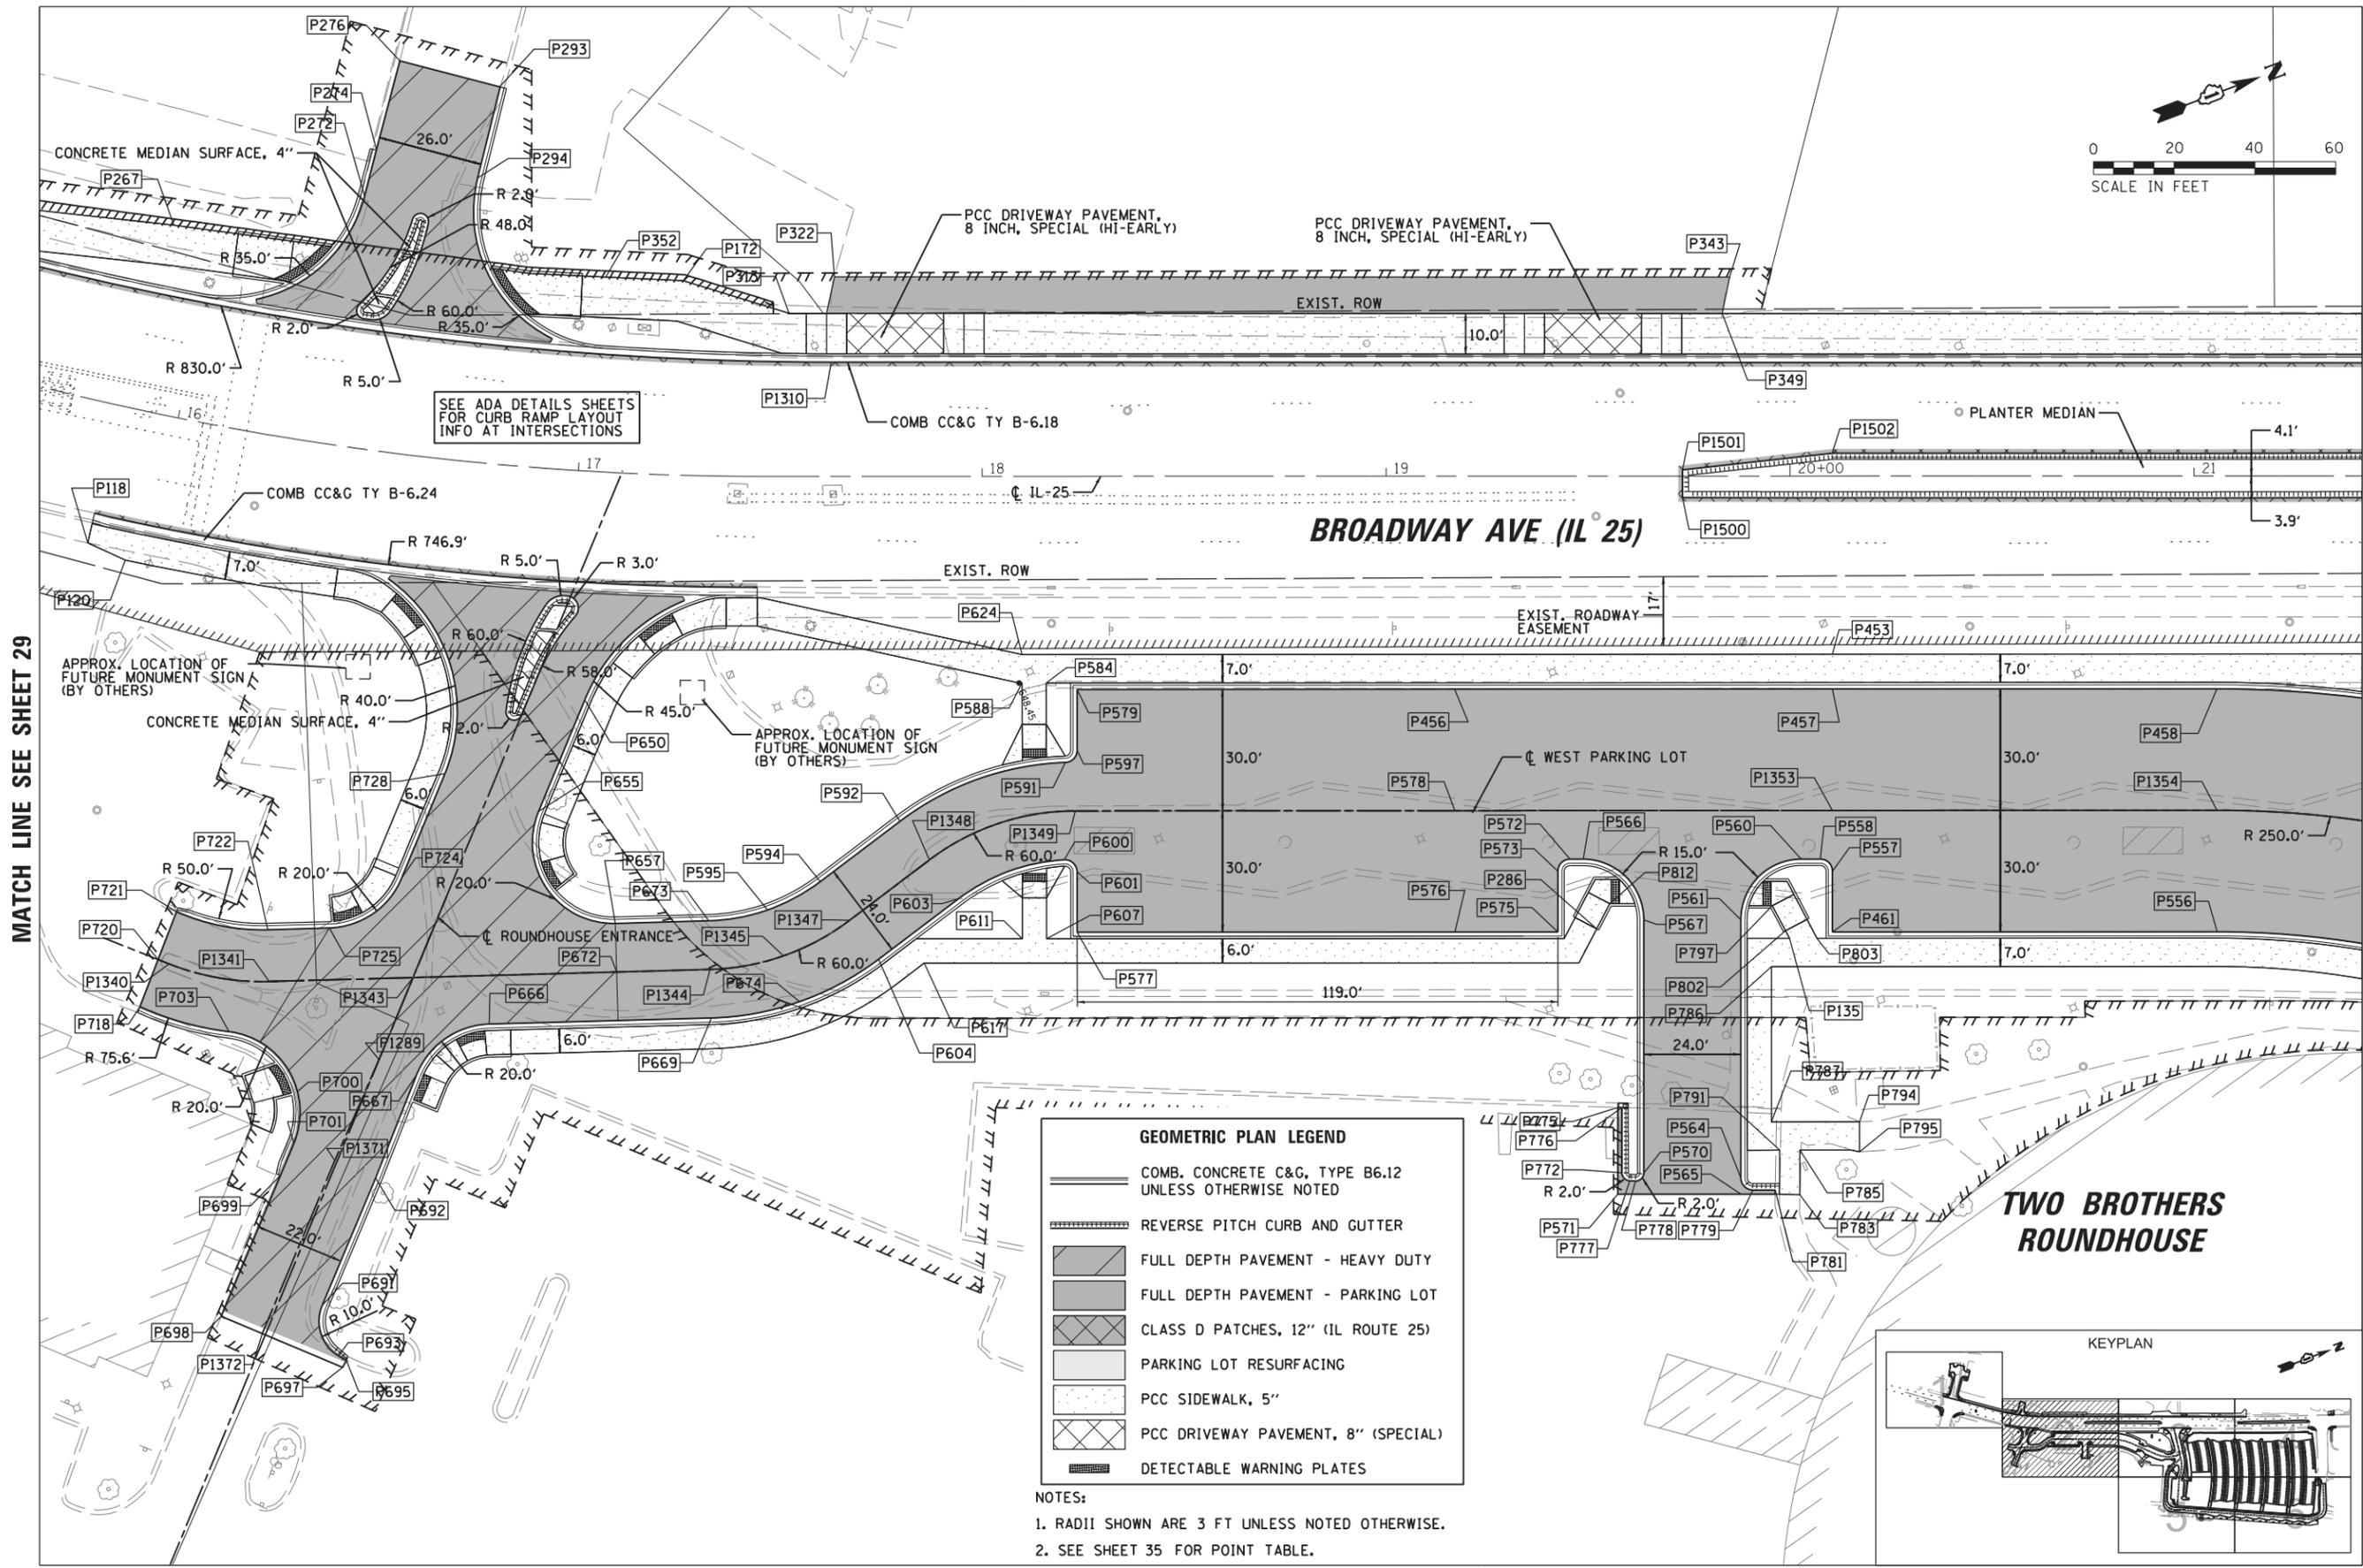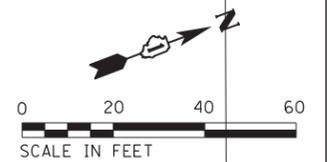

**GEOMETRIC PLAN LEGEND**

- COMB. CONCRETE C&G, TYPE B6.12 UNLESS OTHERWISE NOTED
- REVERSE PITCH CURB AND GUTTER
- FULL DEPTH PAVEMENT - HEAVY DUTY
- FULL DEPTH PAVEMENT - PARKING LOT
- CLASS D PATCHES, 12" (IL ROUTE 25)
- PARKING LOT RESURFACING
- PCC SIDEWALK, 5"
- PCC DRIVEWAY PAVEMENT, 8" (SPECIAL)
- DETECTABLE WARNING PLATES

**NOTES:**

1. RADII SHOWN ARE 3 FT UNLESS NOTED OTHERWISE.
2. SEE SHEET 35 FOR POINT TABLE.



MATCH LINE SEE SHEET 29

MATCH LINE SEE SHEET 31

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	PLOT SCALE = 48"	CHECKED - BMW	REVISED -			SCALE: 48"	SHEET OF 254 SHEETS	STA. TO STA.	CONTRACT NO. 61E18	
Default	PLOT DATE = 10/16/2017	DATE = 10/16/2017	REVISED -	ILLINOIS FED. AID PROJECT						

**RIVEREDGE PARK  
(CITY OF AURORA PROPERTY)**

**RIVEREDGE PARK  
(CITY OF AURORA PROPERTY)**

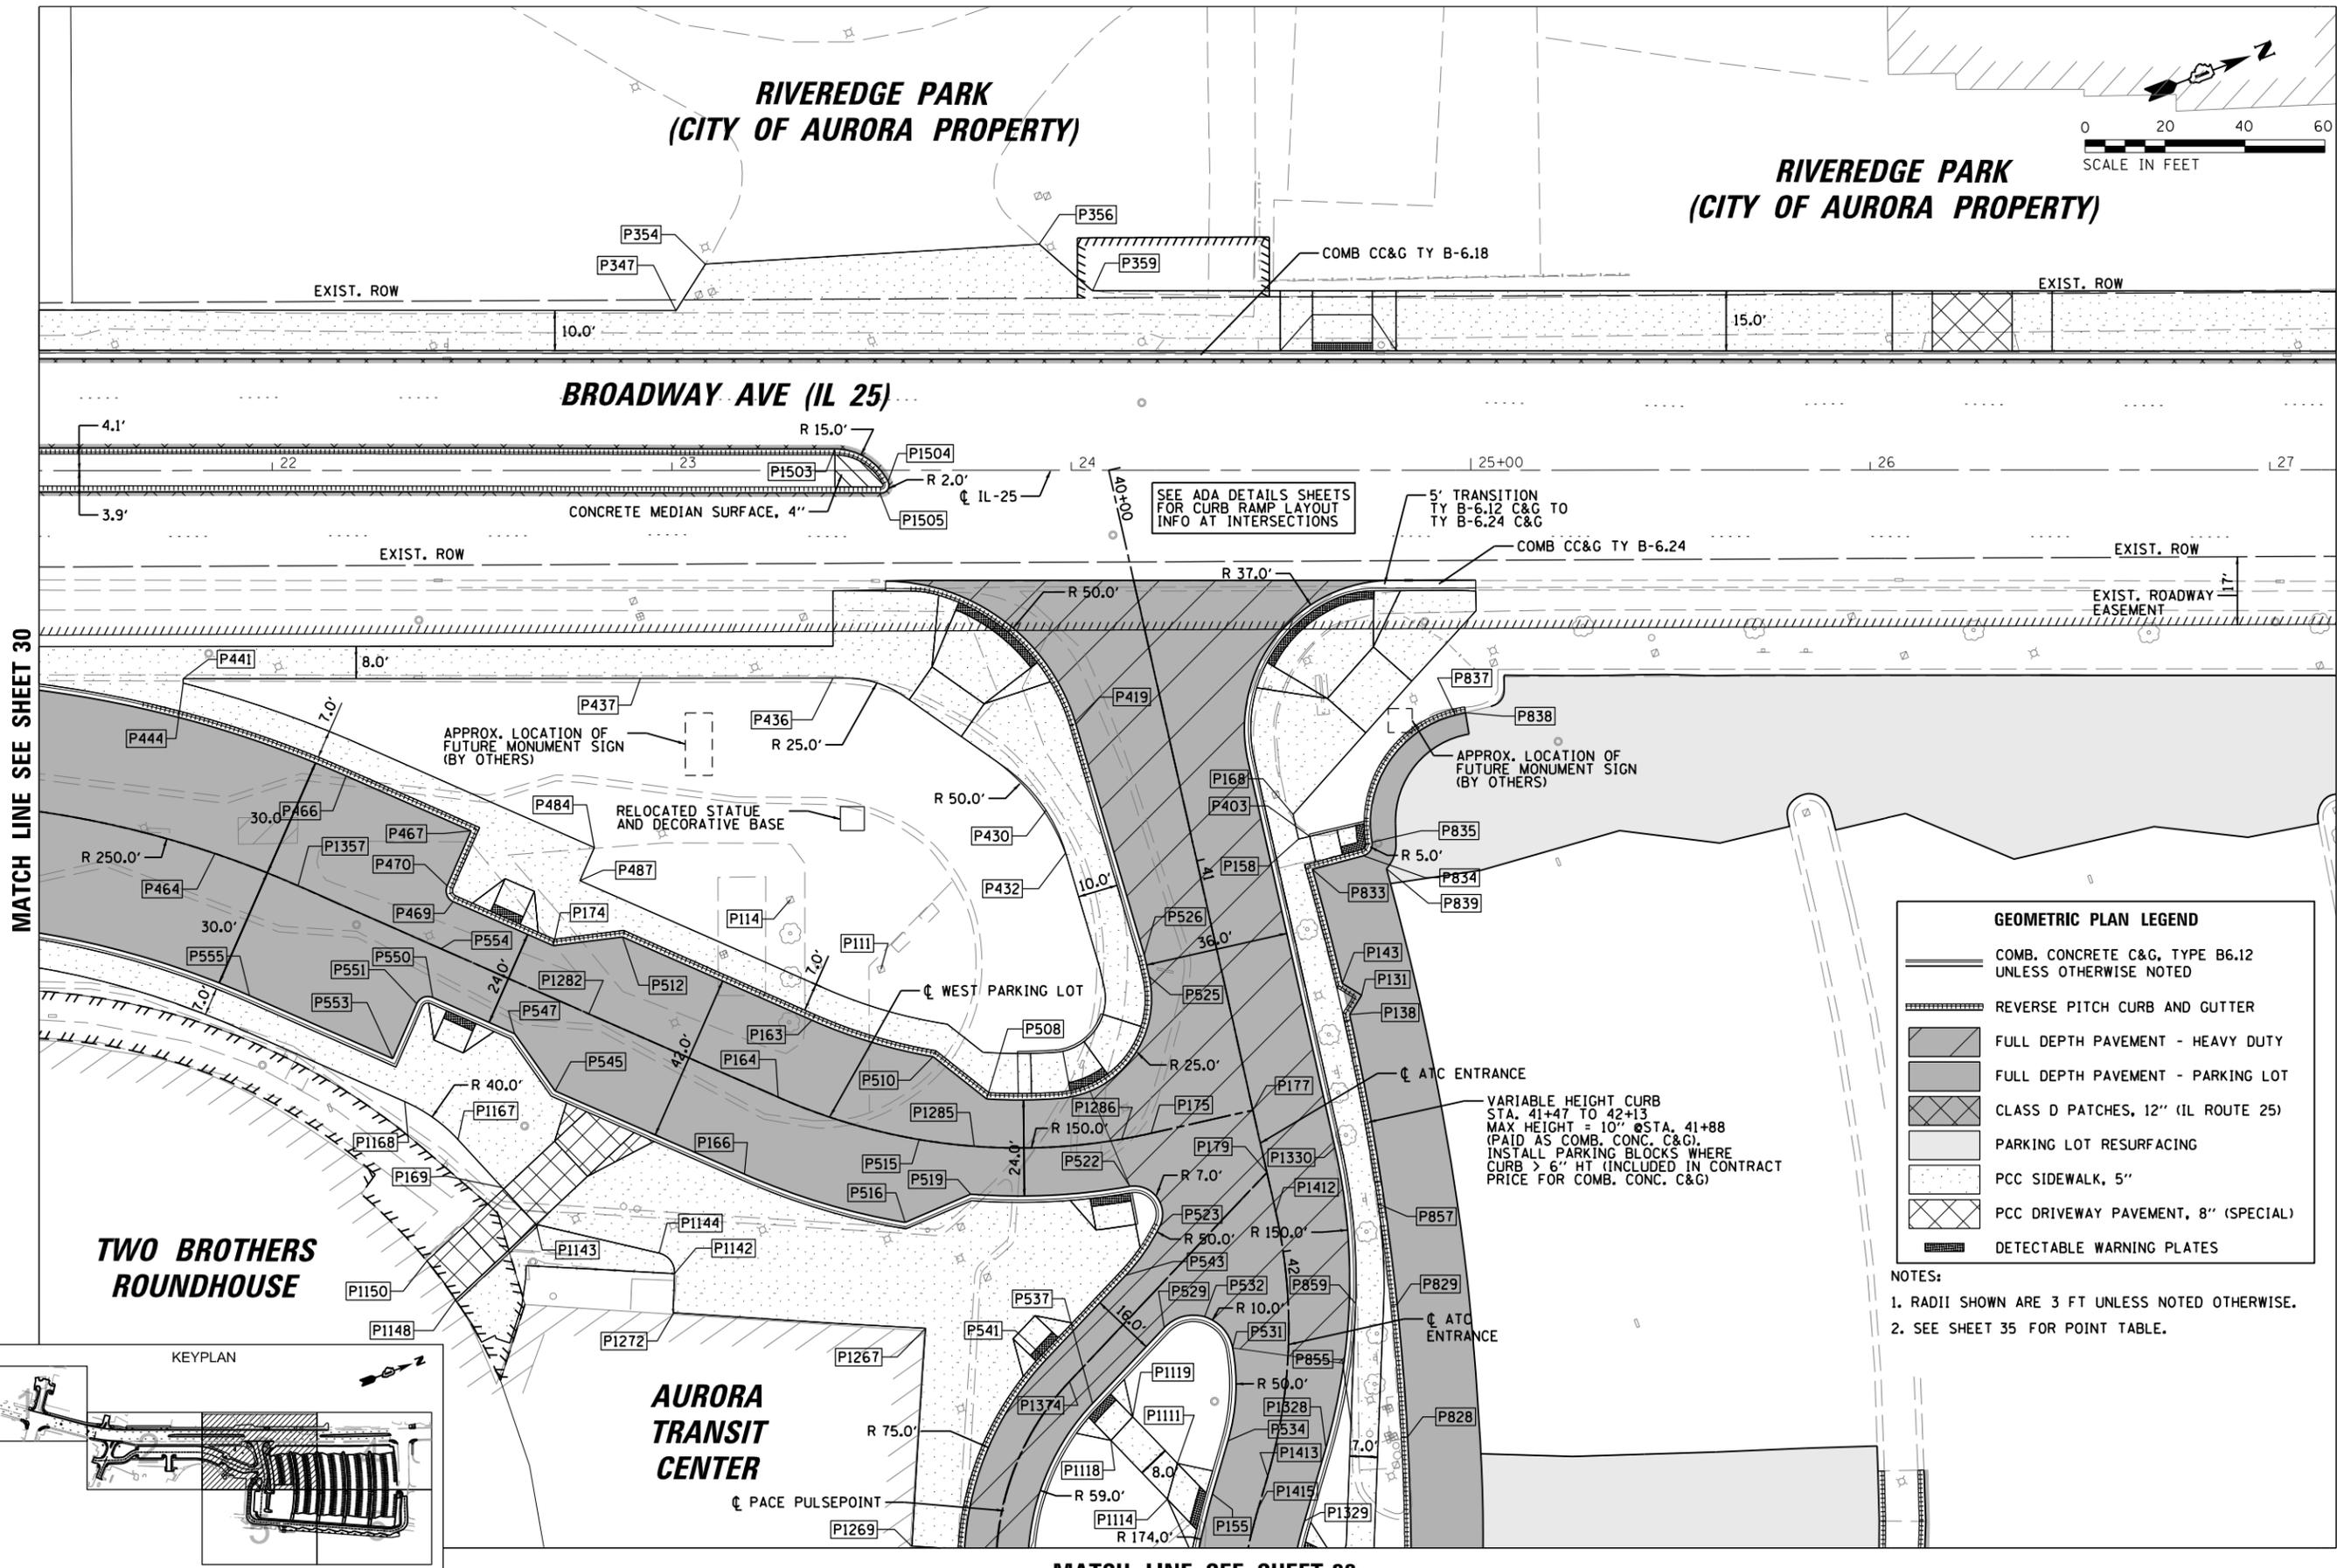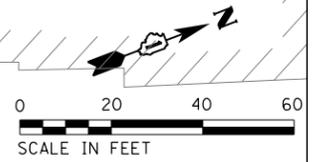

MATCH LINE SEE SHEET 30

MATCH LINE SEE SHEET 32

SEE ADA DETAILS SHEETS FOR CURB RAMP LAYOUT INFO AT INTERSECTIONS

5' TRANSITION TY B-6.12 C&G TO TY B-6.24 C&G

APPROX. LOCATION OF FUTURE MONUMENT SIGN (BY OTHERS)

APPROX. LOCATION OF FUTURE MONUMENT SIGN (BY OTHERS)

RELOCATED STATUE AND DECORATIVE BASE

WEST PARKING LOT

ATC ENTRANCE

VARIABLE HEIGHT CURB STA. 41+47 TO 42+13 MAX HEIGHT = 10" @ STA. 41+88 (PAID AS COMB. CONC. C&G). INSTALL PARKING BLOCKS WHERE CURB > 6" HT (INCLUDED IN CONTRACT PRICE FOR COMB. CONC. C&G)

**TWO BROTHERS ROUNDHOUSE**


**AURORA TRANSIT CENTER**

PACE PULSEPOINT

**GEOMETRIC PLAN LEGEND**


- COMB. CONCRETE C&G, TYPE B6.12 UNLESS OTHERWISE NOTED
- REVERSE PITCH CURB AND GUTTER
- FULL DEPTH PAVEMENT - HEAVY DUTY
- FULL DEPTH PAVEMENT - PARKING LOT
- CLASS D PATCHES, 12" (IL ROUTE 25)
- PARKING LOT RESURFACING
- PCC SIDEWALK, 5"
- PCC DRIVEWAY PAVEMENT, 8" (SPECIAL)
- DETECTABLE WARNING PLATES

- NOTES:
1. RADII SHOWN ARE 3 FT UNLESS NOTED OTHERWISE.
  2. SEE SHEET 35 FOR POINT TABLE.

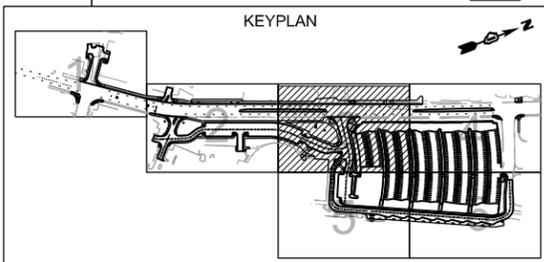


MATCH LINE SEE SHEET 33

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Default	PLOT SCALE = 48"	DRAWN - PWN, ELA	REVISED -							
	PLOT DATE = 12/4/2017	CHECKED - BMW	REVISED -							
		DATE - 12/4/2017	REVISED -							
					SCALE: 48"		SHEET OF 254 SHEETS	STA. TO STA.		CONTRACT NO. 61E18
										ILLINOIS FED. AID PROJECT

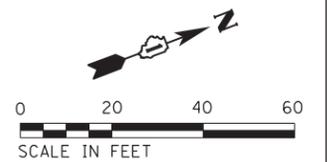

**RIVEREDGE PARK  
(CITY OF AURORA PROPERTY)**

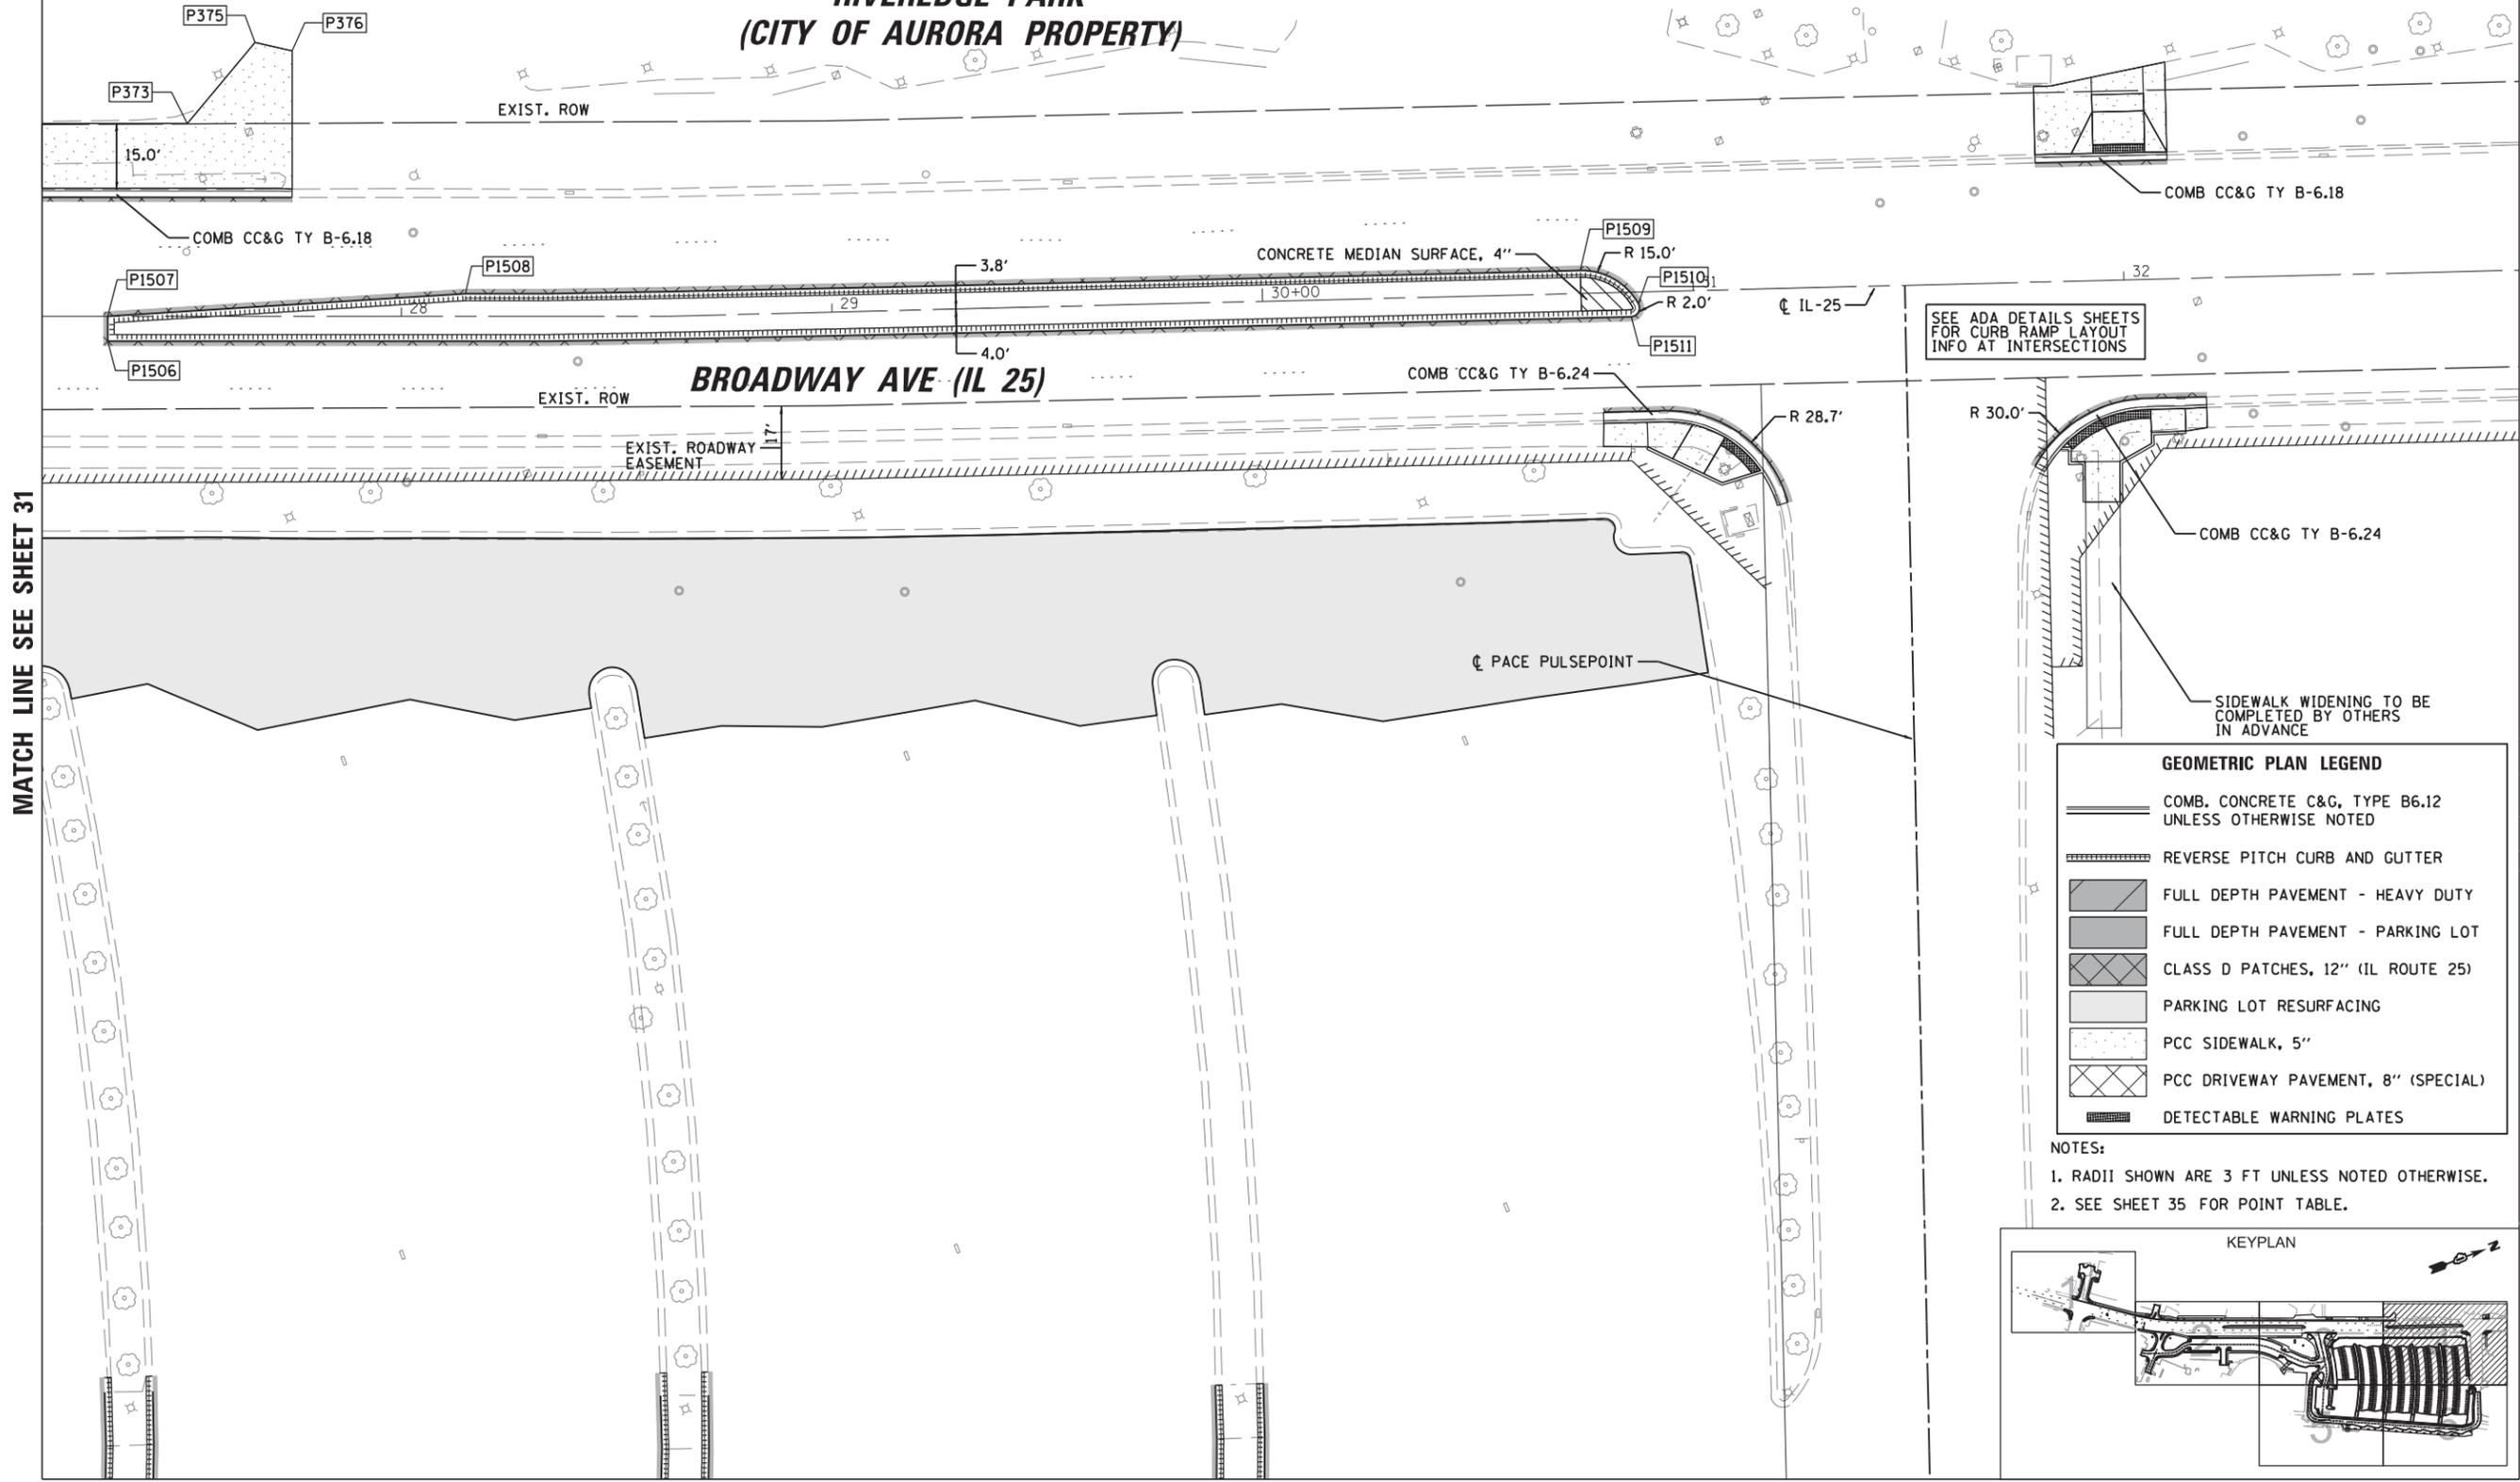


SEE ADA DETAILS SHEETS FOR CURB RAMP LAYOUT INFO AT INTERSECTIONS

**GEOMETRIC PLAN LEGEND**

- COMB. CONCRETE C&G, TYPE B6.12 UNLESS OTHERWISE NOTED
- REVERSE PITCH CURB AND GUTTER
- FULL DEPTH PAVEMENT - HEAVY DUTY
- FULL DEPTH PAVEMENT - PARKING LOT
- CLASS D PATCHES, 12" (IL ROUTE 25)
- PARKING LOT RESURFACING
- PCC SIDEWALK, 5"
- PCC DRIVEWAY PAVEMENT, 8" (SPECIAL)
- DETECTABLE WARNING PLATES

- NOTES:**
1. RADII SHOWN ARE 3 FT UNLESS NOTED OTHERWISE.
  2. SEE SHEET 35 FOR POINT TABLE.

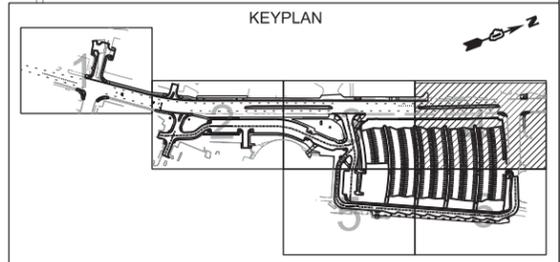

MATCH LINE SEE SHEET 31

MATCH LINE SEE SHEET 34

FILE NAME = N:\WBK\150077.2\Civil\GM_150077.2_04.sht	USER NAME = bweich	DESIGNED - BMW	REVISED -
		DRAWN - PWN, ELA	REVISED -
	PLOT SCALE = 40'	CHECKED - BMW	REVISED -
Default	PLOT DATE = 10/16/2017	DATE - 10/16/2017	REVISED -



**STATE OF ILLINOIS  
DEPARTMENT OF TRANSPORTATION**

**AURORA TRANSIT CENTER IMPROVEMENTS  
GEOMETRIC PLAN**

SCALE: 40' SHEET OF 254 SHEETS STA. TO STA.

F.A.U. R.T.E.	SECTION	COUNTY	TOTAL SHEETS	SHEET NO.
2503	16-00313-00-MS	KANE	254	32
CONTRACT NO. 61E18				
ILLINOIS FED. AID PROJECT				

MATCH LINE SEE SHEET 30

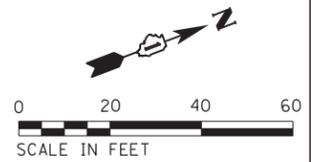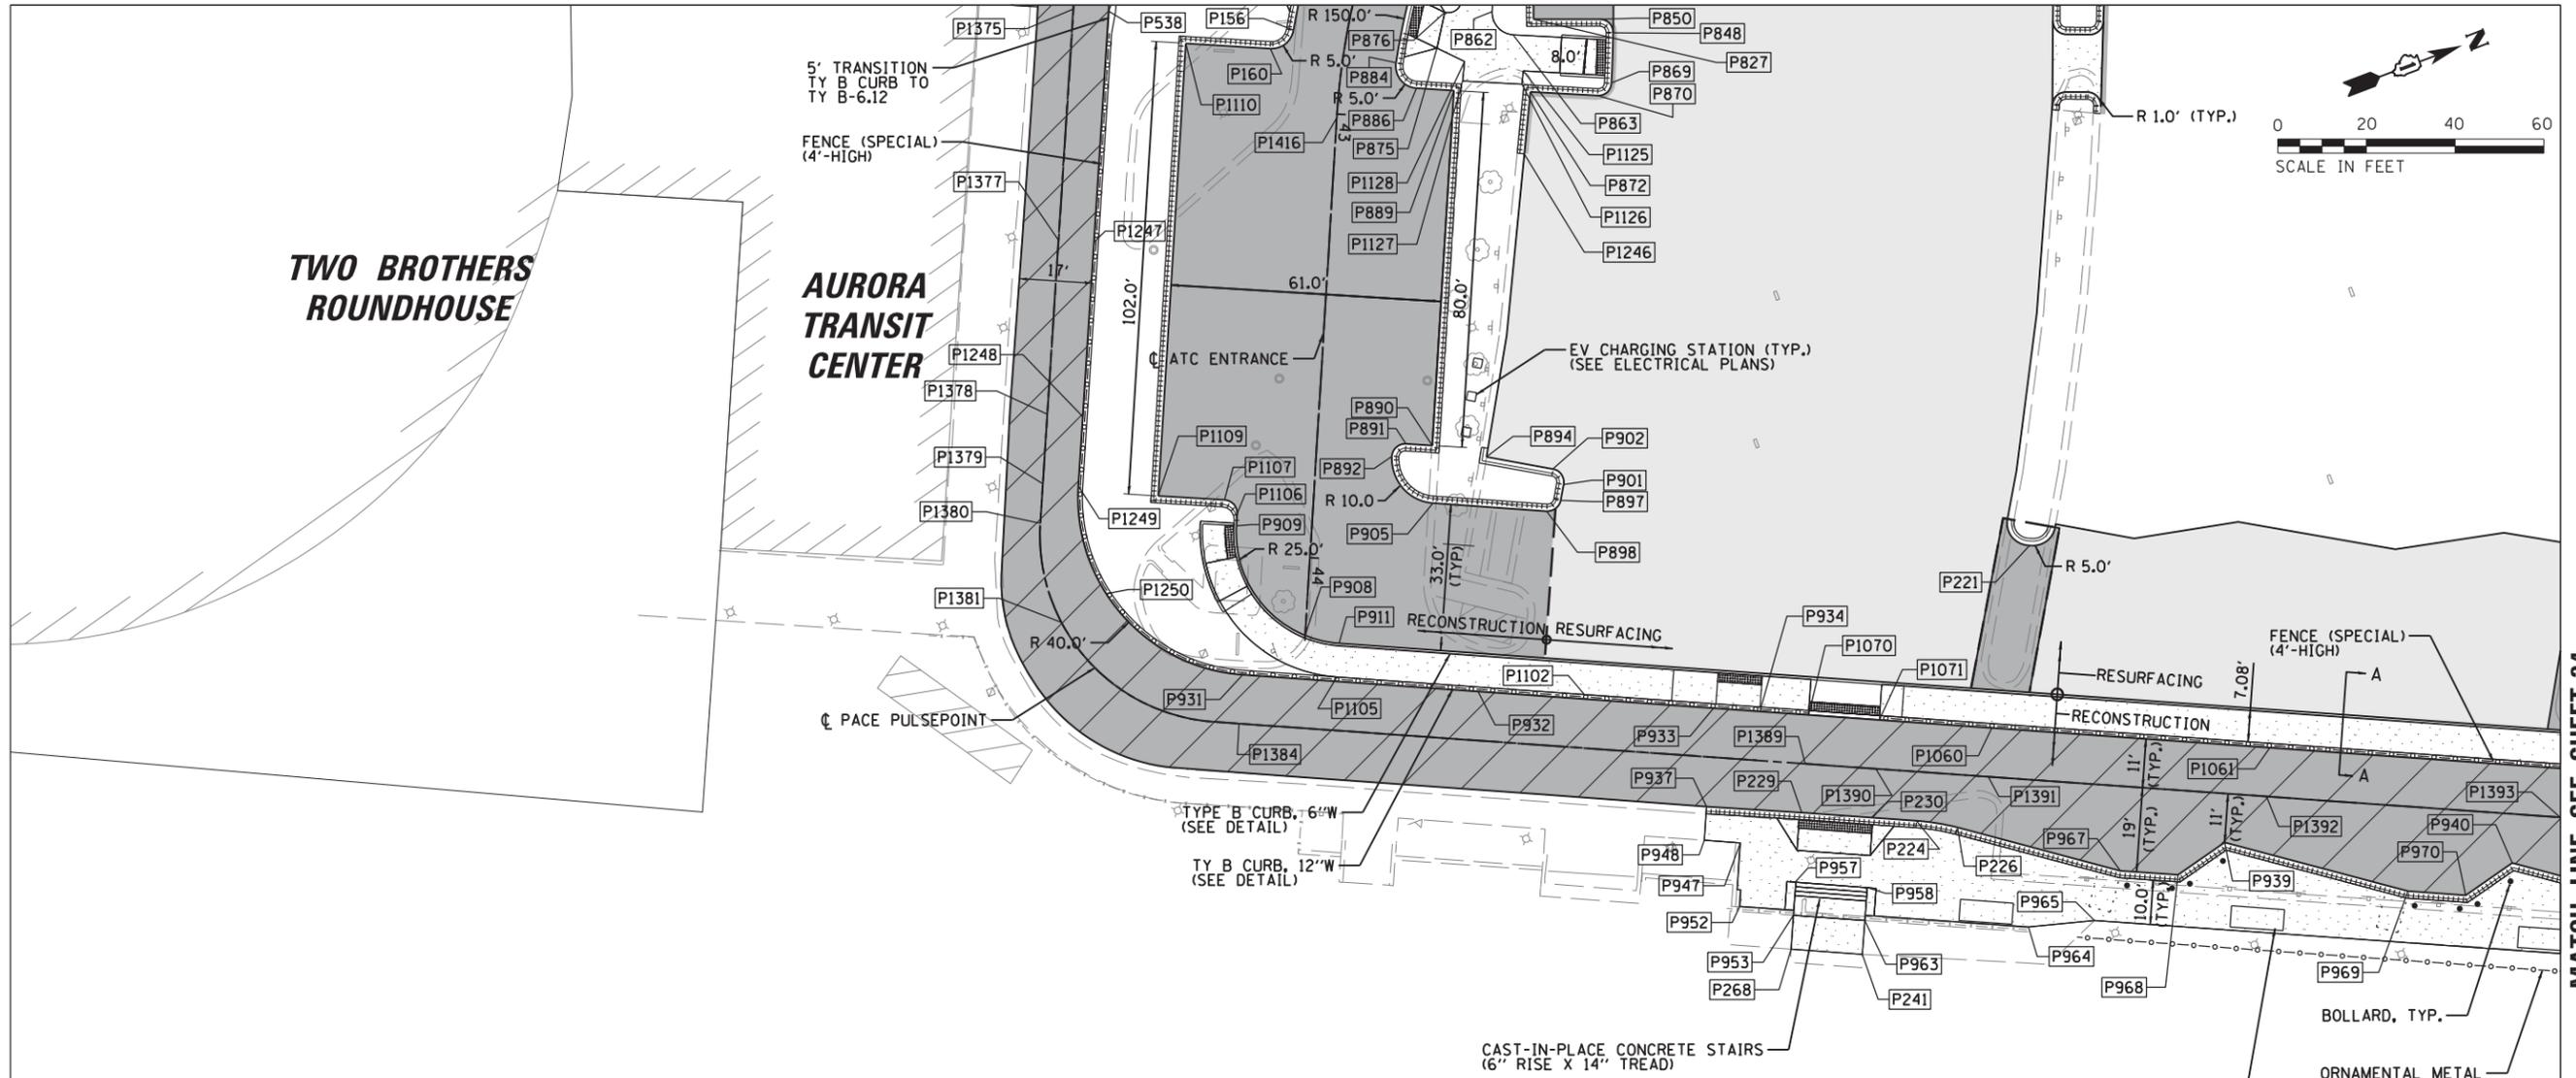

**TWO BROTHERS  
ROUNDHOUSE**


**AURORA  
TRANSIT  
CENTER**

MATCH LINE SEE SHEET 34


**GEOMETRIC PLAN LEGEND**

	COMB. CONCRETE C&G, TYPE B6.12 UNLESS OTHERWISE NOTED
	REVERSE PITCH CURB AND GUTTER
	FULL DEPTH PAVEMENT - HEAVY DUTY
	FULL DEPTH PAVEMENT - PARKING LOT
	CLASS D PATCHES, 12" (IL ROUTE 25)
	PARKING LOT RESURFACING
	PCC SIDEWALK, 5"
	PCC DRIVEWAY PAVEMENT, 8" (SPECIAL)
	DETECTABLE WARNING PLATES


**NOTES:**  
 1. RADII SHOWN ARE 3 FT UNLESS NOTED OTHERWISE.  
 2. SEE SHEET 35 FOR POINT TABLE.

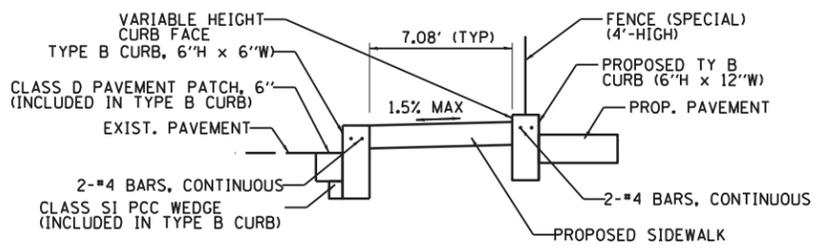

**SECTION A-A**

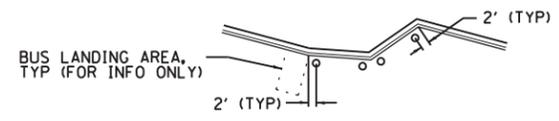

**BOLLARD LAYOUT DETAIL**

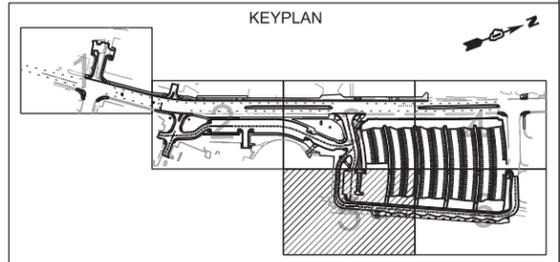

FILE NAME = N:\WBK\150077.2\Civil\GM_150077.2_05.sht	USER NAME = bweilch	DESIGNED - BMW	REVISED -	<b>STATE OF ILLINOIS DEPARTMENT OF TRANSPORTATION</b>	<b>AURORA TRANSIT CENTER IMPROVEMENTS GEOMETRIC PLAN</b>	F.A.U. RTE. 2503	SECTION 16-00313-00-MS	COUNTY KANE	TOTAL SHEETS 254	SHEET NO. 33		
Default	PLOT SCALE = 48"	CHECKED - BMW	REVISED -			SCALE: 48"	SHEET OF 254 SHEETS	STA. TO STA.	CONTRACT NO. 61E18			
	PLOT DATE = 10/16/2017	DATE - 10/16/2017	REVISED -			ILLINOIS FED. AID PROJECT						



**GEOMETRIC PLAN POINT TABLES**


POINT	NORTHING	EASTING	ELEVATION
P102	1854901.15	990174.26	643.68
P103	1854890.28	990171.60	643.63
P104	1854883.82	990169.32	643.65
P105	1854865.32	990207.31	645.87
P106	1854879.81	990185.64	644.54
P108	1854867.50	990224.65	646.60
P109	1854872.60	990211.19	645.92
P110	1854875.05	990210.26	645.82
P111	1855715.22	990926.78	647.16
P112	1854878.13	990211.19	645.81
P113	1854886.01	990234.25	646.61
P114	1855700.10	990902.58	648.63
P116	1854919.02	990187.82	644.19
P117	1854858.65	990192.33	644.62
P118	1855029.66	990552.10	650.61
P119	1854902.45	990193.48	644.63
P120	1855036.86	990559.35	650.63
P122	1854945.92	990206.95	644.19
P123	1854909.79	990257.74	646.83
P124	1854941.09	990213.73	644.55
P125	1854944.56	990234.61	645.75
P129	1854954.53	990241.65	646.21
P130	1854962.61	990240.25	646.27
P131	1855825.42	990975.47	645.16
P132	1854961.22	990232.17	646.06
P133	1854951.20	990225.09	646.05
P135	1855389.16	990792.47	648.49
P136	1854942.77	990268.36	646.84
P137	1854941.67	990261.94	646.70
P138	1855820.91	990978.91	645.29
P141	1854937.48	990275.85	646.95
P142	1854931.07	990276.95	647.00
P143	1855821.98	990970.98	645.26
P145	1854930.72	990254.22	646.47
P150	1854922.00	990262.90	647.36
P151	1854914.53	990264.16	647.45
P154	1854920.08	990269.19	646.99
P155	1855746.46	991078.80	645.28
P156	1855735.59	991095.08	645.53
P158	1855824.51	990933.38	645.53
P160	1855729.23	991097.10	645.62
P163	1855654.55	990932.64	646.32
P164	1855679.85	990947.63	645.90
P166	1855665.15	990962.63	645.48
P168	1855825.38	990927.16	645.39
P170	1855667.40	990944.70	646.35
P172	1855190.49	990543.67	650.06
P174	1855640.57	990989.32	646.66
P175	1855763.98	990989.07	645.81
P177	1855789.84	990992.70	645.96
P179	1855787.62	991008.49	645.88
P180	1856350.60	991377.54	645.56
P182	1855038.32	990466.35	650.73
P183	1856353.20	991371.11	645.71
P184	1854835.37	990305.43	649.03
P185	1854859.62	990271.34	648.17
P186	1856355.80	991364.68	645.86
P188	1856356.90	991344.92	645.55
P191	1854840.53	990285.10	649.22
P192	1856381.68	991343.07	645.49
P193	1856375.41	991345.83	645.63
P195	1854836.62	990282.34	649.51
P197	1854841.87	990274.69	649.19
P202	1854868.91	990245.20	647.68
P203	1856363.67	991373.57	645.35
P206	1854866.55	990231.26	647.19
P207	1854861.87	990229.44	647.12
P208	1854857.94	990225.80	647.00
P221	1855849.84	991262.22	645.04
P223	1855967.54	991316.52	645.07
P224	1855804.03	991311.11	646.34
P225	1856085.06	991370.74	644.89
P226	1855812.16	991315.83	646.40
P227	1856202.56	991424.94	644.95
P229	1855780.48	991300.25	646.21
P230	1855795.01	991306.95	646.29
P241	1855782.02	991334.94	648.76

POINT	NORTHING	EASTING	ELEVATION
P267	1855077.33	990486.17	650.63
P268	1855767.38	991328.14	648.96
P272	1855124.09	990496.13	649.28
P274	1855130.85	990486.52	648.86
P276	1855144.02	990468.02	648.04
P286	1855345.33	990773.37	648.70
P293	1855164.91	990482.79	648.13
P294	1855151.79	990501.94	648.85
P313	1855212.11	990560.43	649.62
P322	1855225.78	990555.97	649.70
P343	1855433.06	990634.45	647.90
P347	1855725.39	990754.76	645.02
P349	1855154.97	990642.22	647.97
P352	1855172.81	990536.00	650.27
P354	1855736.35	990746.46	644.95
P356	1855816.35	990771.45	644.15
P359	1855824.67	990787.06	644.10
P373	1856147.34	990909.17	641.24
P375	1856168.69	990897.16	640.85
P376	1856176.06	990902.02	640.80
P403	1855827.32	990933.75	645.49
P419	1855782.50	990886.86	644.68
P430	1855767.91	990904.33	645.27
P432	1855768.75	990916.00	645.52
P436	1855729.70	990854.59	645.12
P437	1855684.56	990837.55	646.63
P441	1855577.50	990797.13	648.09
P444	1855577.10	990798.18	648.10
P453	1855423.90	990730.59	648.38
P456	1855333.40	990705.59	648.62
P457	1855420.87	990738.62	648.04
P458	1855509.95	990772.25	647.58
P460	1855410.27	990766.68	648.64
P461	1855399.68	990794.75	648.04
P464	1855569.48	990840.81	647.19
P466	1855607.07	990834.26	647.46
P467	1855631.49	990858.21	646.97
P469	1855621.03	990873.16	646.56
P470	1855620.99	990868.92	646.67
P484	1855658.87	990873.03	647.71
P487	1855652.57	990879.46	647.53
P508	1855728.49	990966.49	646.17
P510	1855719.71	990951.86	646.43
P512	1855657.58	990896.39	646.92
P515	1855709.10	990969.98	646.01
P516	1855698.49	990988.11	645.59
P519	1855716.31	990987.31	645.68
P522	1855754.28	990999.61	645.67
P523	1855757.73	991011.61	645.60
P525	1855777.34	990952.30	645.63
P526	1855778.11	990946.83	645.56
P529	1855749.87	991035.66	645.25
P531	1855764.08	991046.41	645.45
P532	1855760.27	991036.68	645.42
P534	1855754.80	991067.73	645.35
P537	1855726.38	991047.04	645.38
P538	1855698.12	991076.31	645.59
P541	1855719.40	991032.64	645.62
P543	1855745.45	991020.02	645.51
P545	1855628.18	990926.38	646.08
P547	1855623.77	990909.46	646.18
P550	1855607.74	990893.74	646.07
P551	1855603.50	990893.78	645.99
P553	1855592.99	990904.49	645.69
P554	1855614.00	990883.07	646.29
P555	1855565.07	990877.11	646.26
P556	1855488.76	990828.38	647.58
P557	1855404.98	990780.71	648.34
P558	1855403.23	990776.85	648.42
P560	1855398.82	990775.18	648.45
P561	1855379.48	990783.92	648.24
P564	1855356.97	990843.55	645.70
P565	1855355.55	990847.30	645.54
P566	1855348.30	990756.11	648.79
P567	1855357.03	990775.44	648.39
P570	1855334.96	990833.90	645.66
P571	1855327.06	990836.54	645.33

POINT	NORTHING	EASTING	ELEVATION
P572	1855345.23	990754.95	648.81
P573	1855341.36	990756.70	648.76
P575	1855336.06	990770.73	648.46
P576	1855312.20	990761.72	648.62
P577	1855224.73	990728.69	647.69
P578	1855322.80	990733.66	649.22
P579	1855245.93	990722.56	647.69
P584	1855239.39	990668.40	648.35
P588	1855233.78	990666.28	648.44
P591	1855236.84	990688.42	648.12
P592	1855193.43	990687.51	648.30
P594	1855169.66	990694.49	648.43
P595	1855154.97	990696.41	648.53
P597	1855240.61	990686.64	647.99
P600	1855228.10	990710.81	648.13
P601	1855250.20	990714.73	647.99
P603	1855200.19	990710.54	648.30
P604	1855176.42	990717.51	648.43
P607	1855217.08	990727.50	648.37
P611	1855211.47	990725.38	648.46
P617	1855186.64	990722.42	648.92
P624	1855236.25	990659.73	648.55
P650	1855131.02	990631.84	649.15
P655	1855110.56	990653.60	648.79
P657	1855118.58	990686.20	648.33
P666	1855080.58	990698.41	648.17
P667	1855059.24	990703.83	648.08
P669	1855132.53	990716.44	648.44
P672	1855114.64	990697.53	648.51
P673	1855140.40	990693.77	648.44
P674	1855154.39	990720.41	648.53
P690	1855044.40	990724.00	647.81
P691	1855017.30	990748.80	647.18
P693	1855016.70	990761.88	646.65
P695	1855018.11	990763.57	646.56
P697	1855016.61	990764.89	646.75
P698	1854992.98	990742.46	647.19
P699	1855018.99	990715.07	647.79
P700	1855030.28	990697.18	647.90
P701	1855024.89	990708.86	647.81
P703	1855019.64	990677.35	647.63
P718	1855001.20	990663.78	647.91
P720	1855009.53	990654.49	647.76
P721	1855017.98	990645.08	647.36
P722	1855037.54	990657.21	647.78
P724	1855073.05	990657.01	648.46
P725	1855051.92	990662.20	648.05
P728	1855096.15	990636.64	648.80
P772	1855329.87	990831.92	645.42
P775	1855334.63	990816.49	645.78
P776	1855335.55	990816.88	645.80
P777	1855330.97	990834.47	645.45
P778	1855332.31	990835.04	645.49
P779	1855358.71	990847.42	645.58
P781	1855363.85	990849.36	645.56
P783	1855369.15	990852.60	646.24
P785	1855373.03	990842.29	646.57
P786	1855382.49	990797.43	648.31
P787	1855368.96	990833.27	646.78
P791	1855368.26	990840.53	646.53
P794	1855389.36	990840.98	646.59
P795	1855386.74	990847.91	646.46
P797	1855388.05	990783.41	648.39
P802	1855388.90	990790.35	648.52
P803	1855395.49	990794.86	648.48
P812	1855350.56	990768.72	648.56
P827	1855316.38	991111.93	645.82
P828	1855797.19	991082.77	645.56
P829	1855806.45	991050.89	645.31
P833	1855825.03	99041.69	645.19
P834	1855838.17	99043.01	644.82
P835	1855841.41	99040.60	644.73
P837	1855803.35	990918.32	644.85
P838	1855874.77	990918.65	

NOTES:

1. ALL DIMENSIONS ARE TO THE EDGE OF PAVEMENT UNLESS OTHERWISE NOTED.
2. ALL STATION AND OFFSETS ARE REFERENCED TO THE PARKING LOT X BASELINE UNLESS OTHERWISE NOTED.

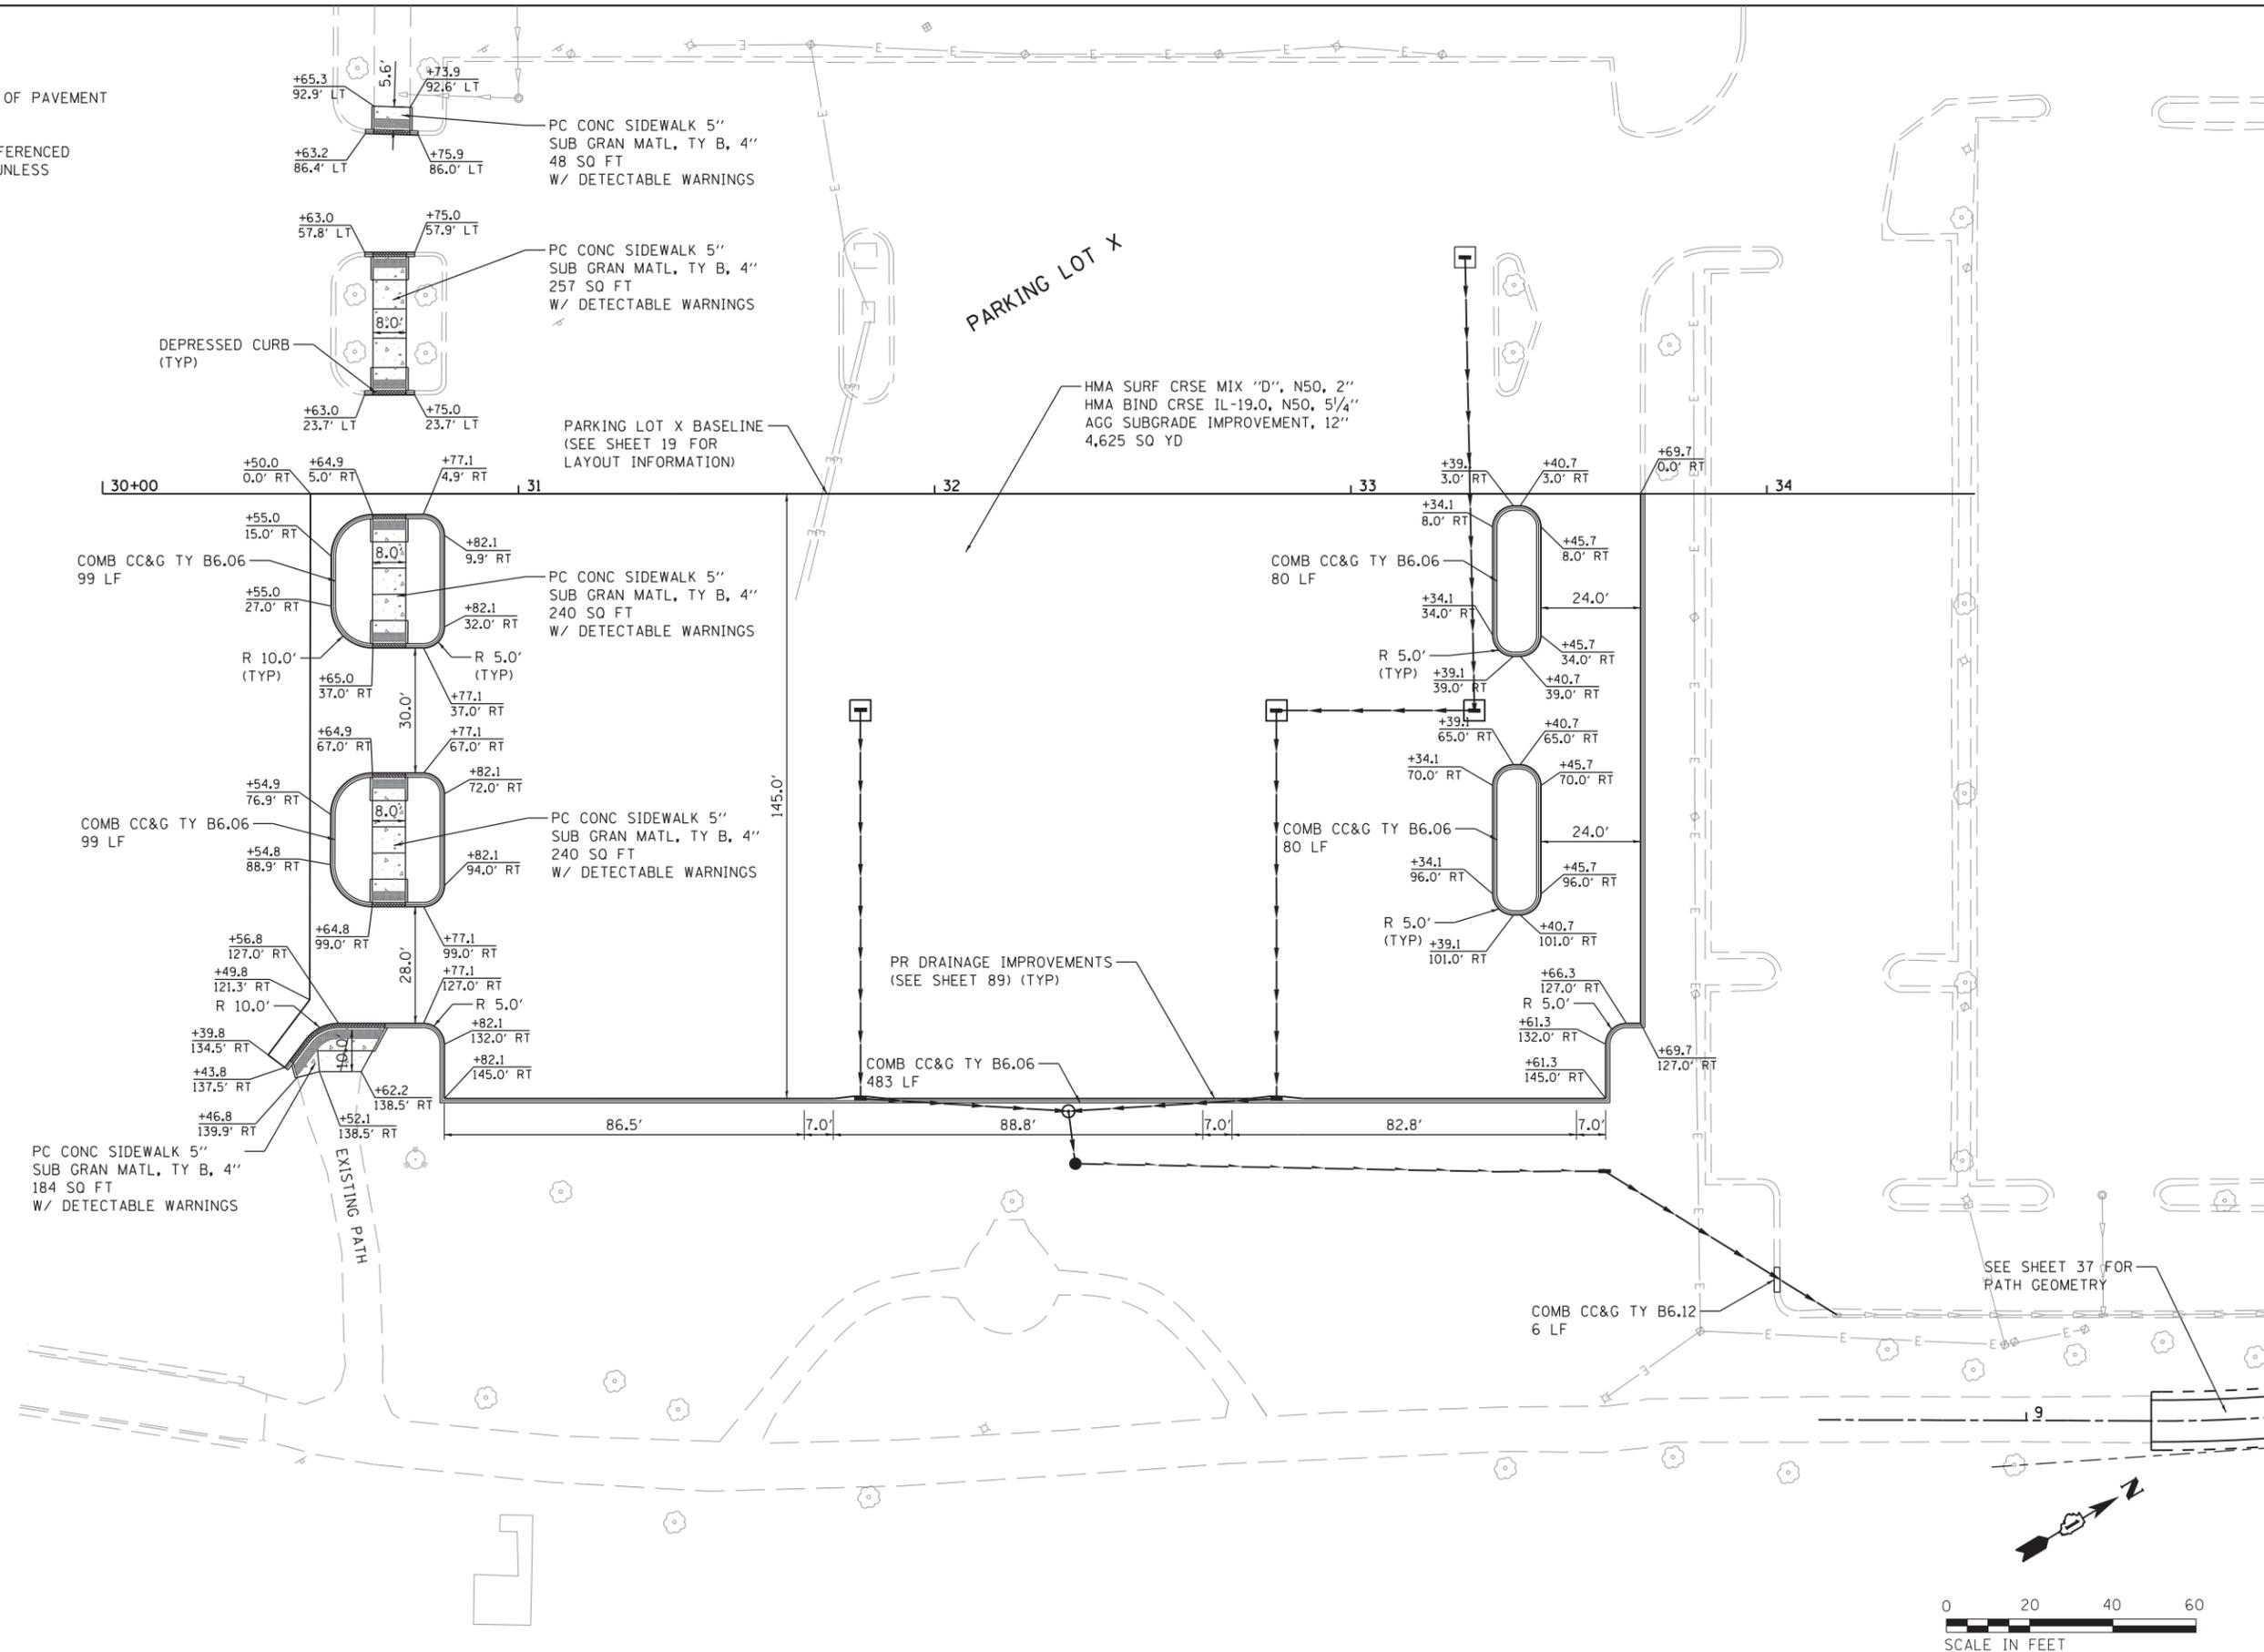

FILE NAME = W:\Projects\2016\160194\_ATCPhaseII\cadd\Civil\Drawn\Sh\GEO.dwg




**WBK ENGINEERING, LLC**  
 116 WEST MAIN STREET, SUITE 201  
 ST. CHARLES, ILLINOIS 60174  
 (630) 443-7755

USER NAME = nparris	DESIGNED - MNB	REVISED -
PLOT SCALE = 1:40	DRAWN - NDP	REVISED -
PLOT DATE = 10/17/2017	CHECKED - MNB	REVISED -
	DATE - 10/18/17	REVISED -


**STATE OF ILLINOIS  
 DEPARTMENT OF TRANSPORTATION**

<b>GEOMETRIC PLAN                  PARKING LOT X</b>	
SCALE: 1"=20'	STATIONING: STA. TO STA.
SHEET NO. 8	OF 9 SHEETS

F.A.U. RTE.	SECTION	COUNTY	TOTAL SHEETS	SHEET NO.
2503	16-00313-00-MS	KANE	254	36
CONTRACT NO. 61E18				
ILLINOIS FED. AID PROJECT				

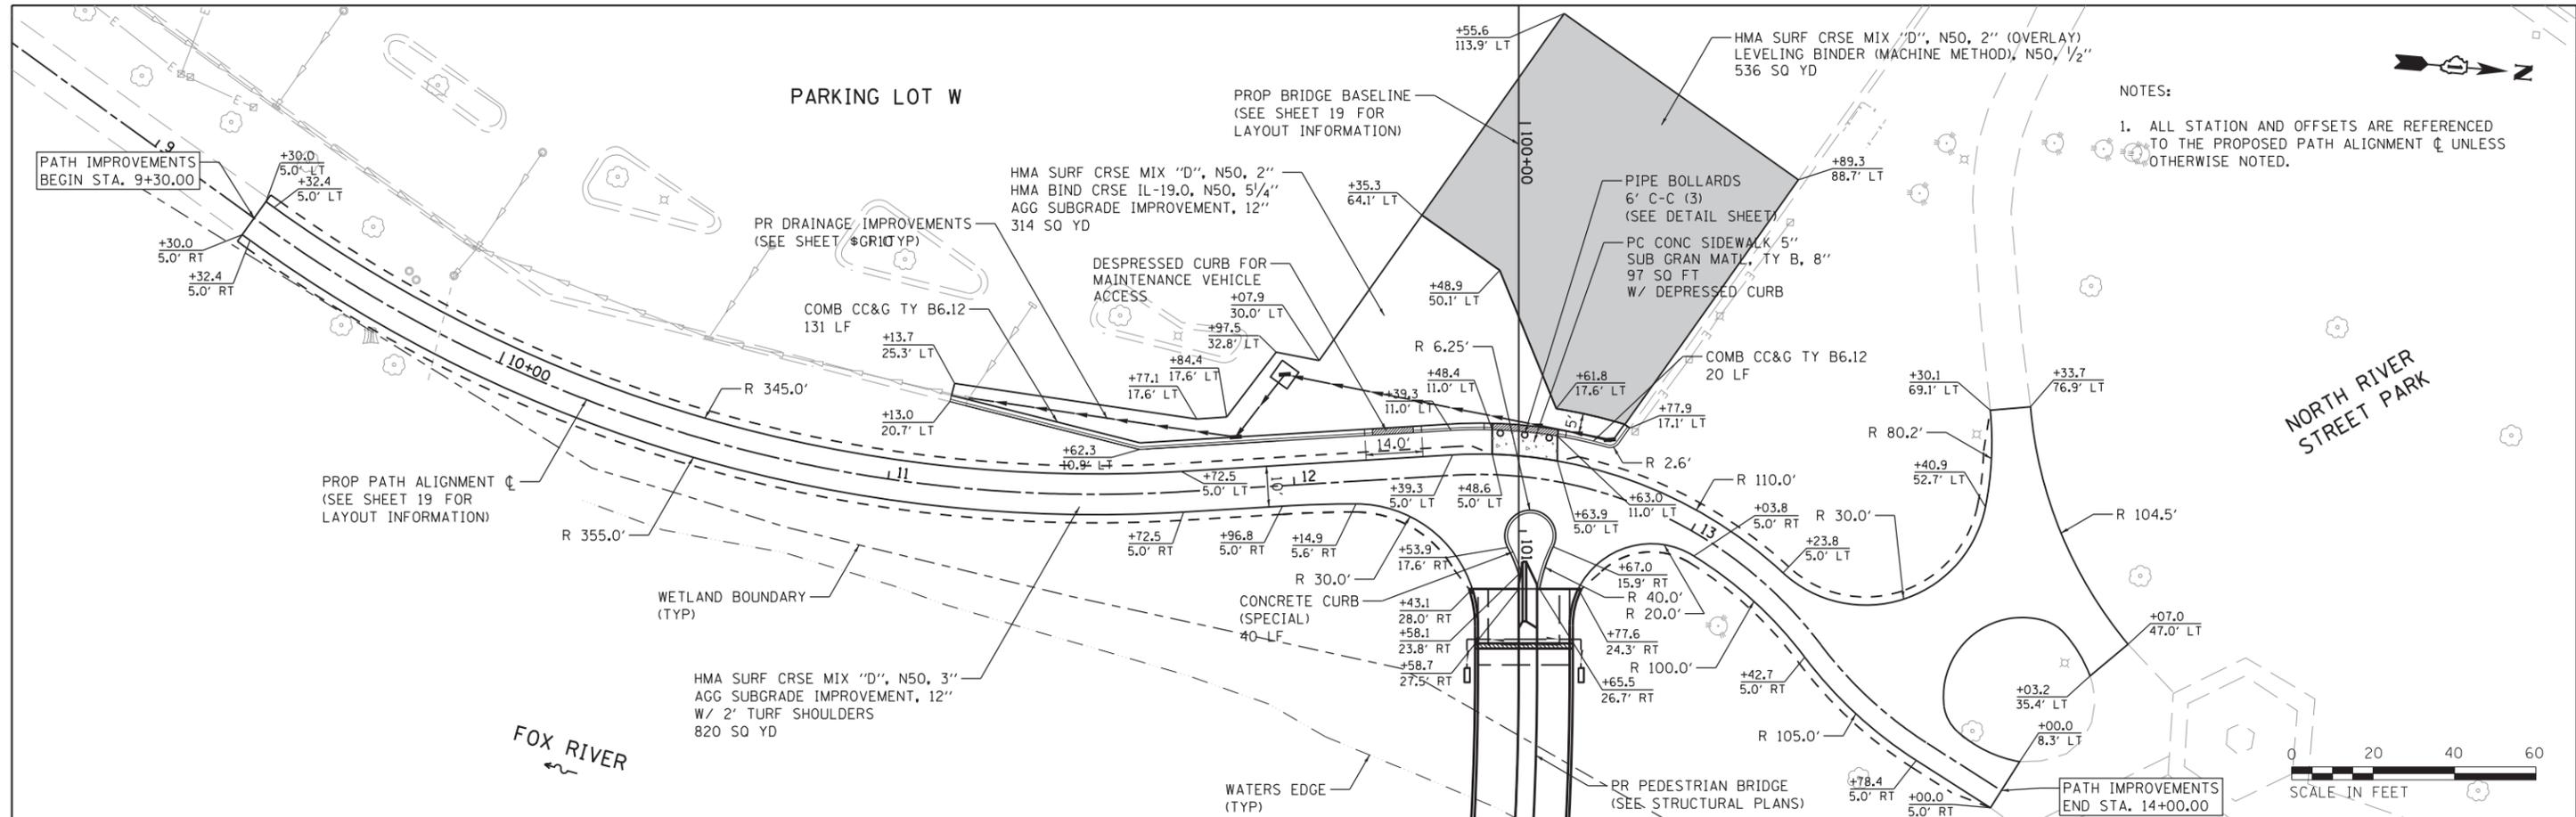

NOTES:  
 1. ALL STATION AND OFFSETS ARE REFERENCED TO THE PROPOSED PATH ALIGNMENT  $\text{C}$  UNLESS OTHERWISE NOTED.

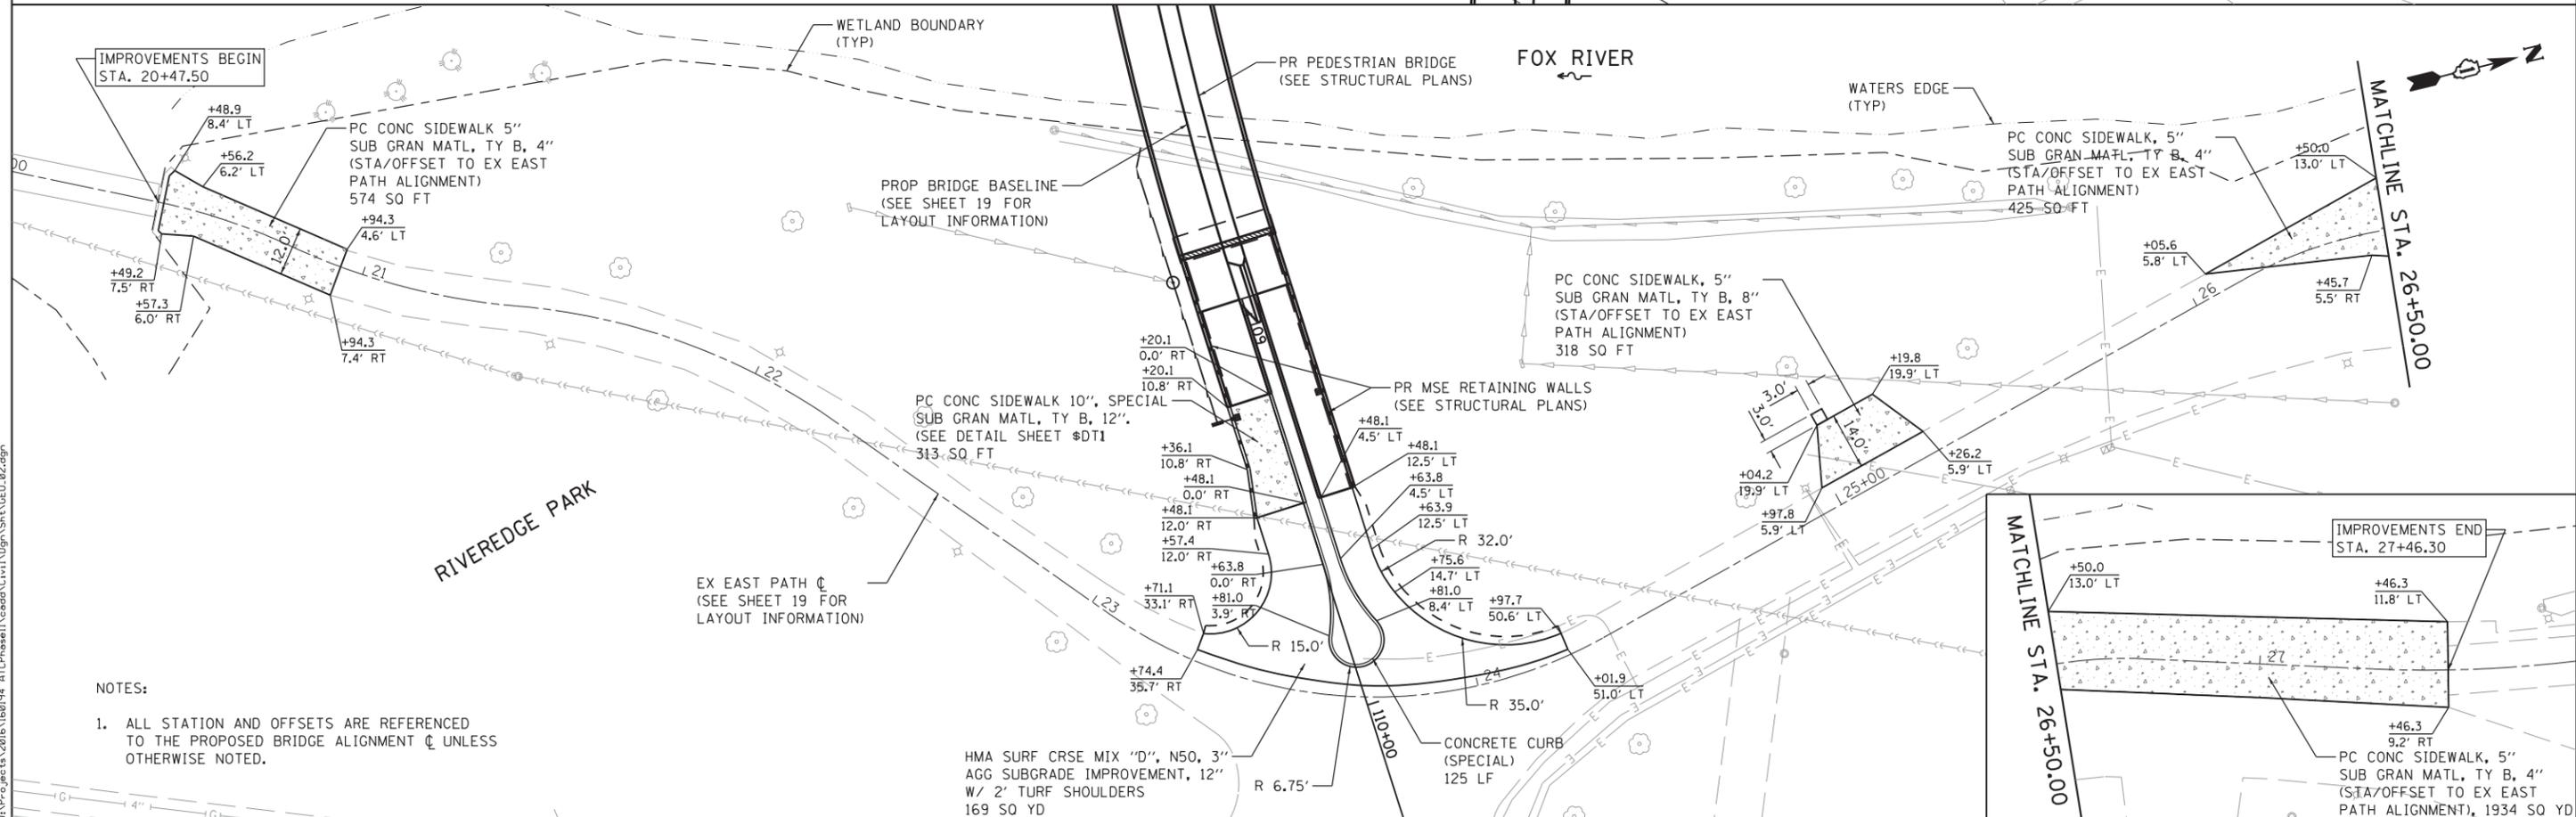

NOTES:  
 1. ALL STATION AND OFFSETS ARE REFERENCED TO THE PROPOSED BRIDGE ALIGNMENT  $\text{C}$  UNLESS OTHERWISE NOTED.

**WBK engineering**  
 WBK ENGINEERING, LLC  
 116 WEST MAIN STREET, SUITE 201  
 ST. CHARLES, ILLINOIS 60174  
 (630) 443-7755

USER NAME = nparris	DESIGNED - MNB	REVISED -
PLOT SCALE = 1:40	DRAWN - NDP	REVISED -
PLOT DATE = 10/17/2017	CHECKED - MNB	REVISED -
	DATE - 10/18/17	REVISED -



STATE OF ILLINOIS  
 DEPARTMENT OF TRANSPORTATION

GEOMETRIC PLAN - PARKING LOT W,  
 MULTI-USE PATH & PEDESTRIAN BRIDGE LANDINGS  
 SCALE: 1"=20'  
 SHEET NO. 9 OF 9 SHEETS  
 STA. TO STA.

F.A.U. R.T.E. 2503	SECTION 16-00313-00-MS	COUNTY KANE	TOTAL SHEETS 254	SHEET NO. 37
CONTRACT NO. 61E18				ILLINOIS FED. AID PROJECT

PLAN	SURVEYED	BY	DATE
	PLOTTED		
	NOTE BOOK		
	NO.		
	ALIGNED		
	CHECKED		
	FILE NAME		
	CARD		



PROFILE	SURVEYED	BY	DATE
	PLOTTED		
	GRADES		
	CHECKED		
	STRUCTURE		
	NOTATIONS		
	CPAD		

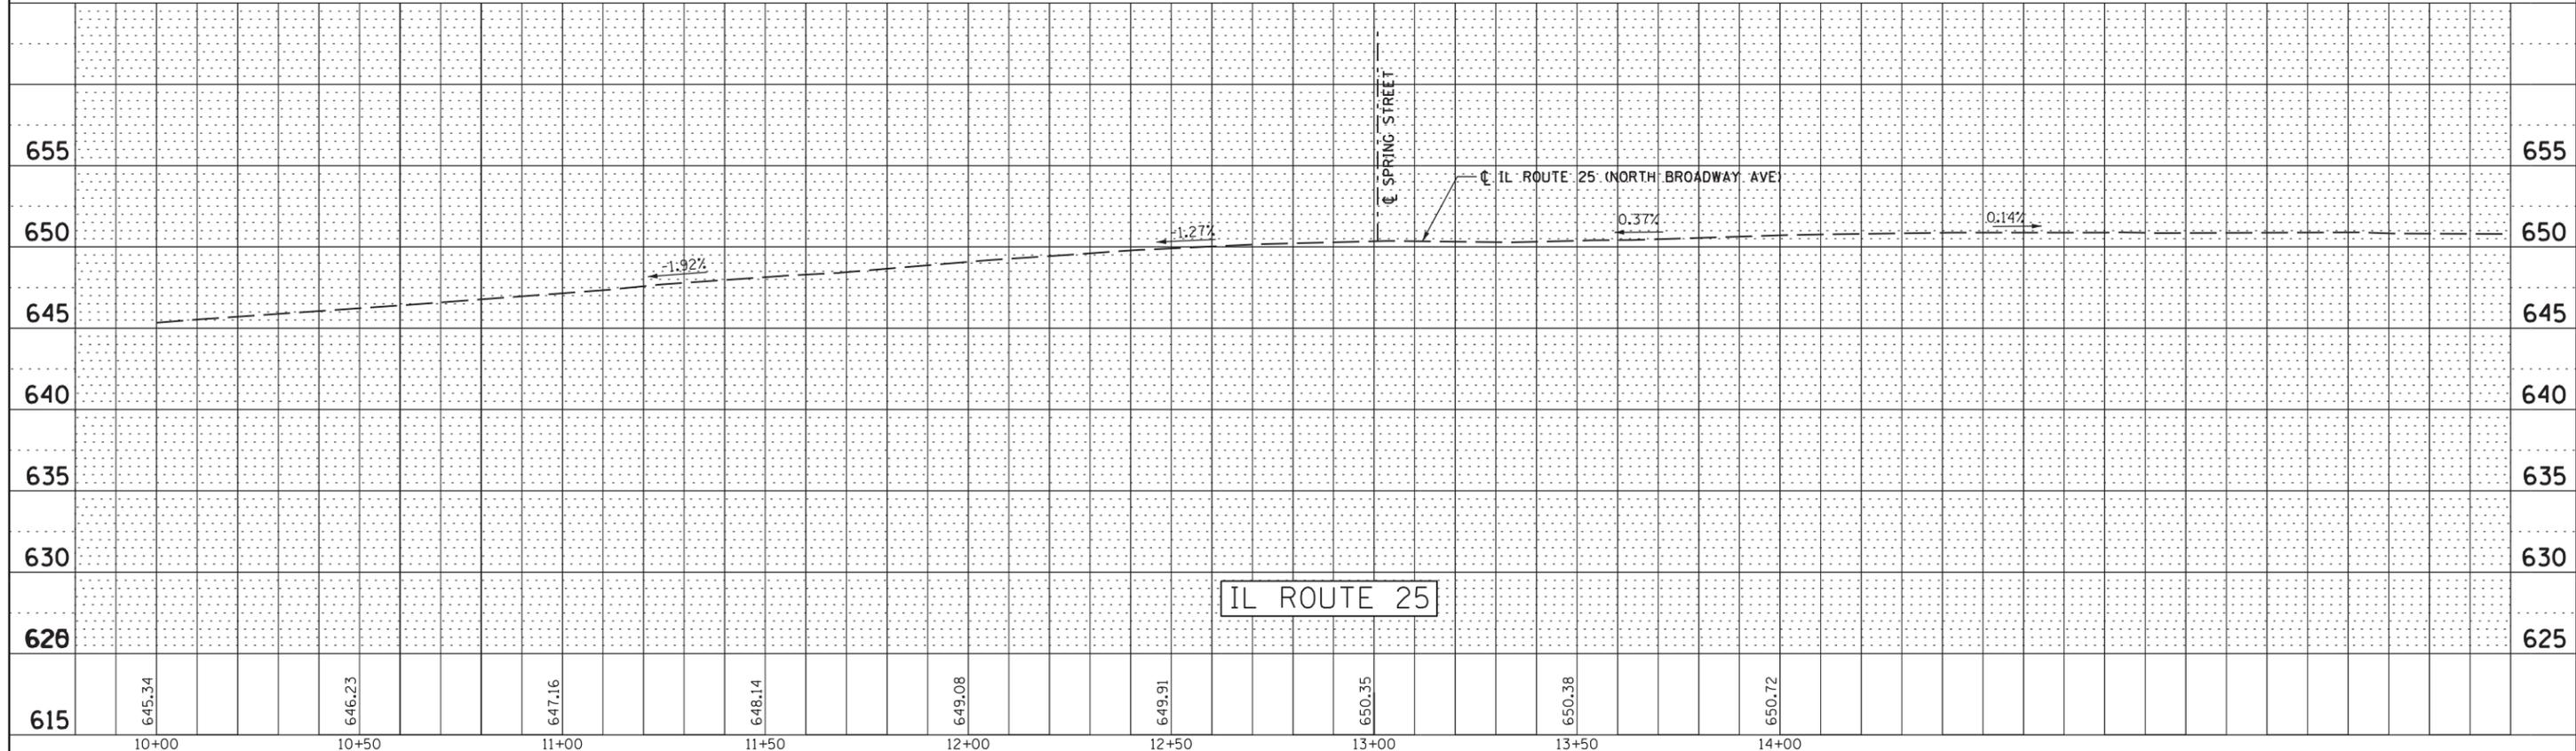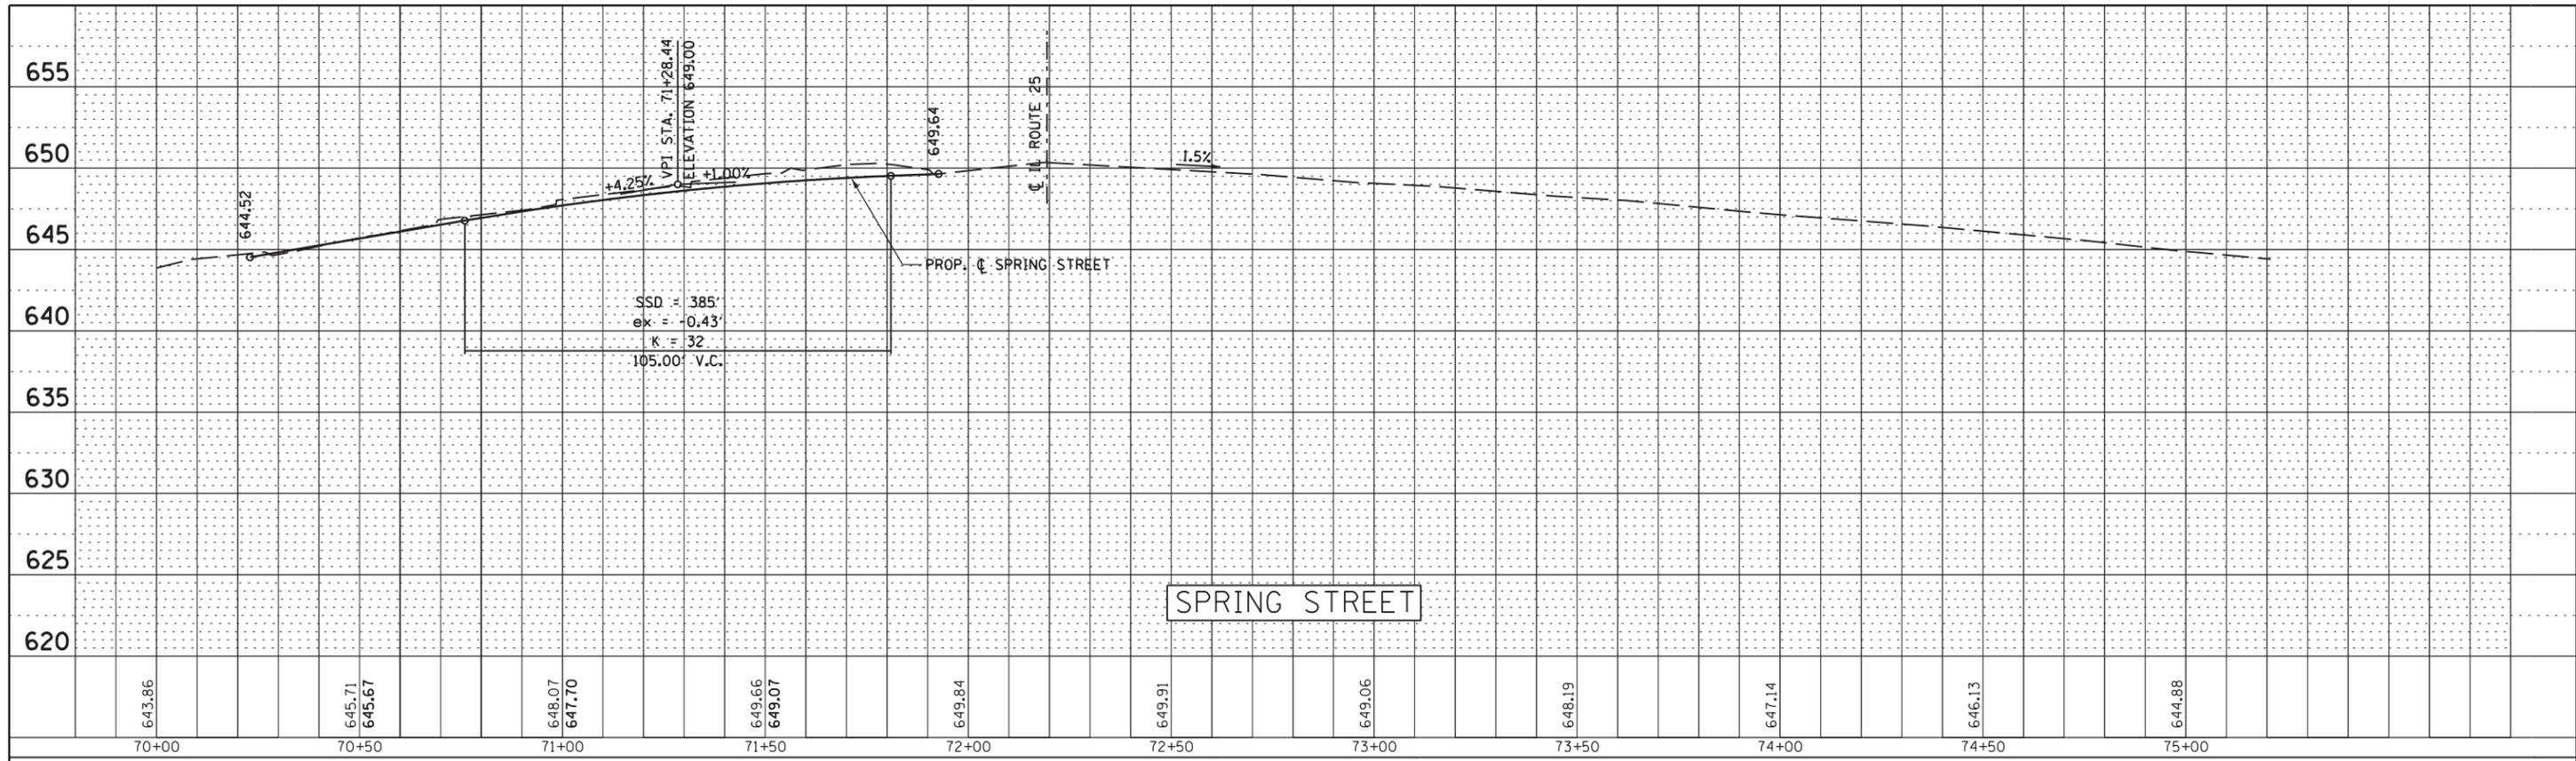

FILE NAME =	USER NAME = bweich	DESIGNED -	REVISED -	<b>STATE OF ILLINOIS</b> <b>DEPARTMENT OF TRANSPORTATION</b>	<b>AURORA TRANSIT CENTER IMPROVEMENTS</b>	F.A.U. RTE.	SECTION	COUNTY	TOTAL SHEETS	SHEET NO.
N:\WBK\150077.2\Civil\PRF-150077.2.SPRING.02.dgn		DRAWN -	REVISED -			2503	16-00313-00-MS	KANE	254	38
PLOT SCALE = 48'		CHECKED -	REVISED -			CONTRACT NO. 61E18				
Default	PLOT DATE = 10/16/2017	DATE -	REVISED -			SCALE: 40'	SHEET OF SHEETS	STA. TO STA.	ILLINOIS FED. AID PROJECT	

PLAN	SURVEYED	BY	DATE
	PLOTTED		
	NOTE BOOK		
	NO.		
	ALIGNED		
	CHECKED		
	FILE NAME		

PROFILE	SURVEYED	BY	DATE
	PLOTTED		
	NOTE BOOK		
	NO.		
	GRADES		
	CHECKED		
	STRUCTURE		
	NOTATIONS		
	CPROD		

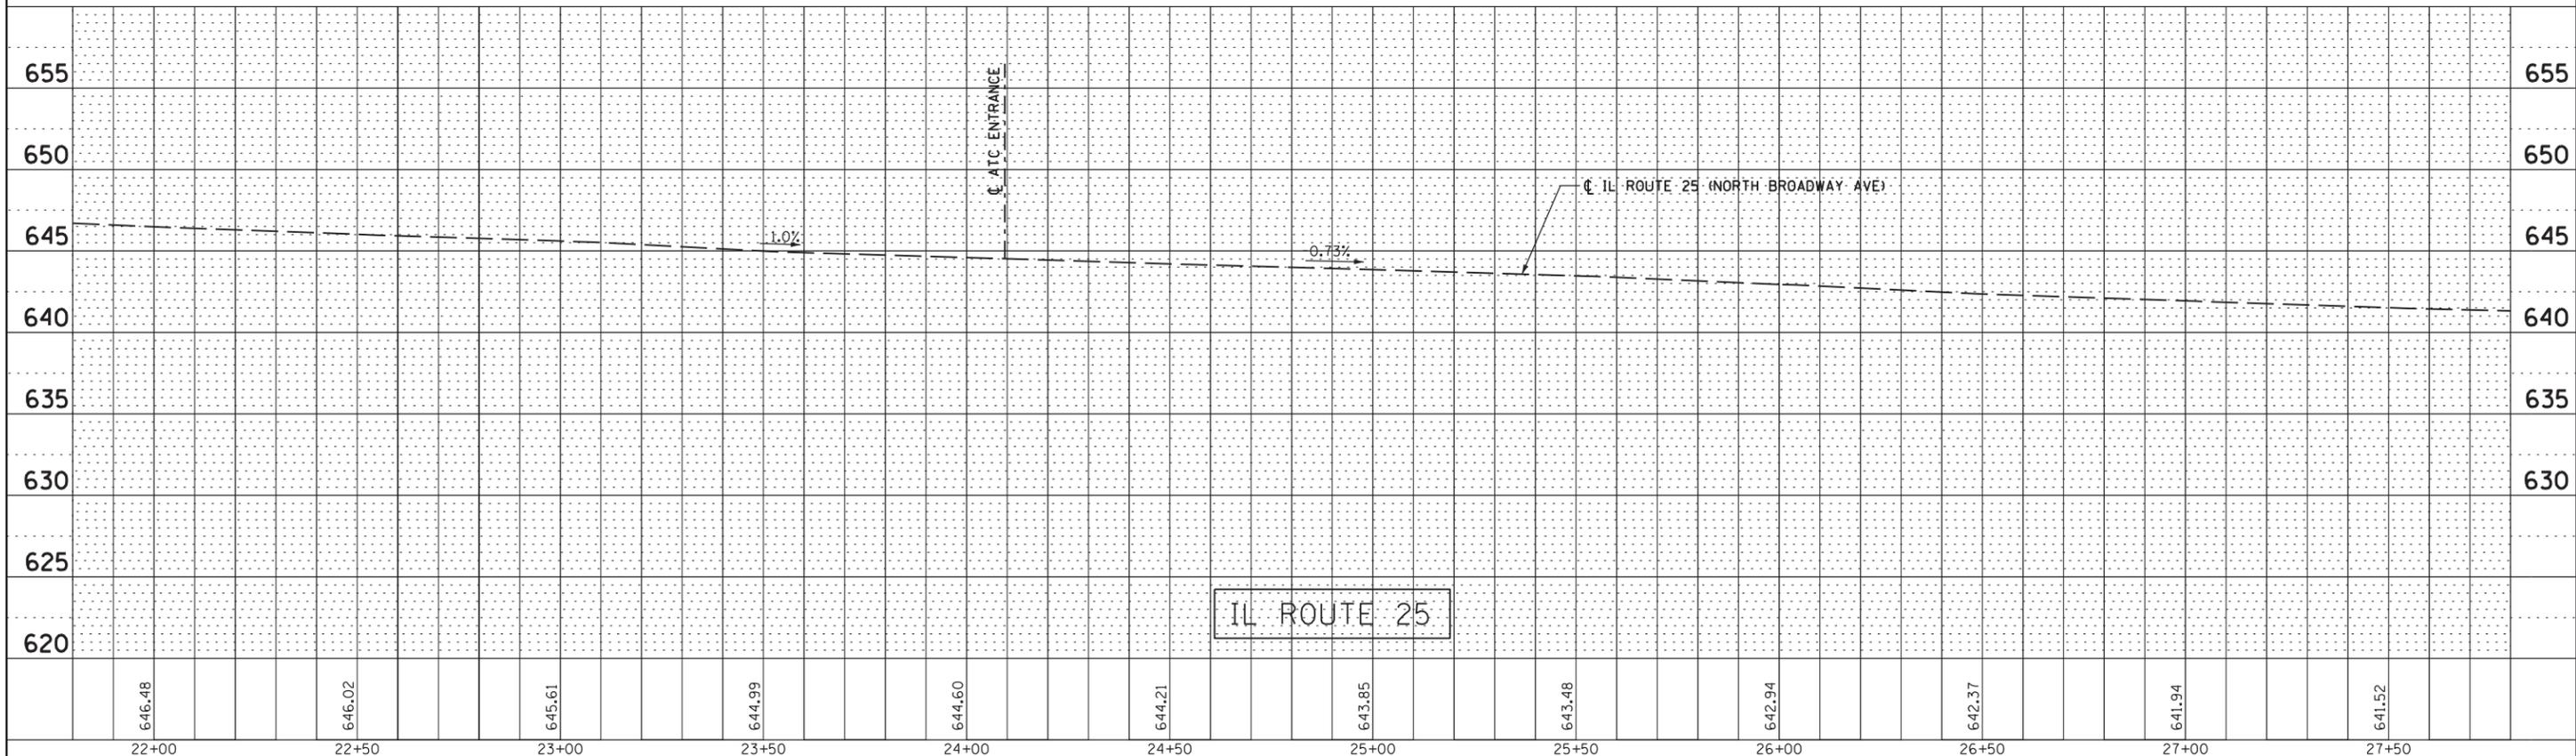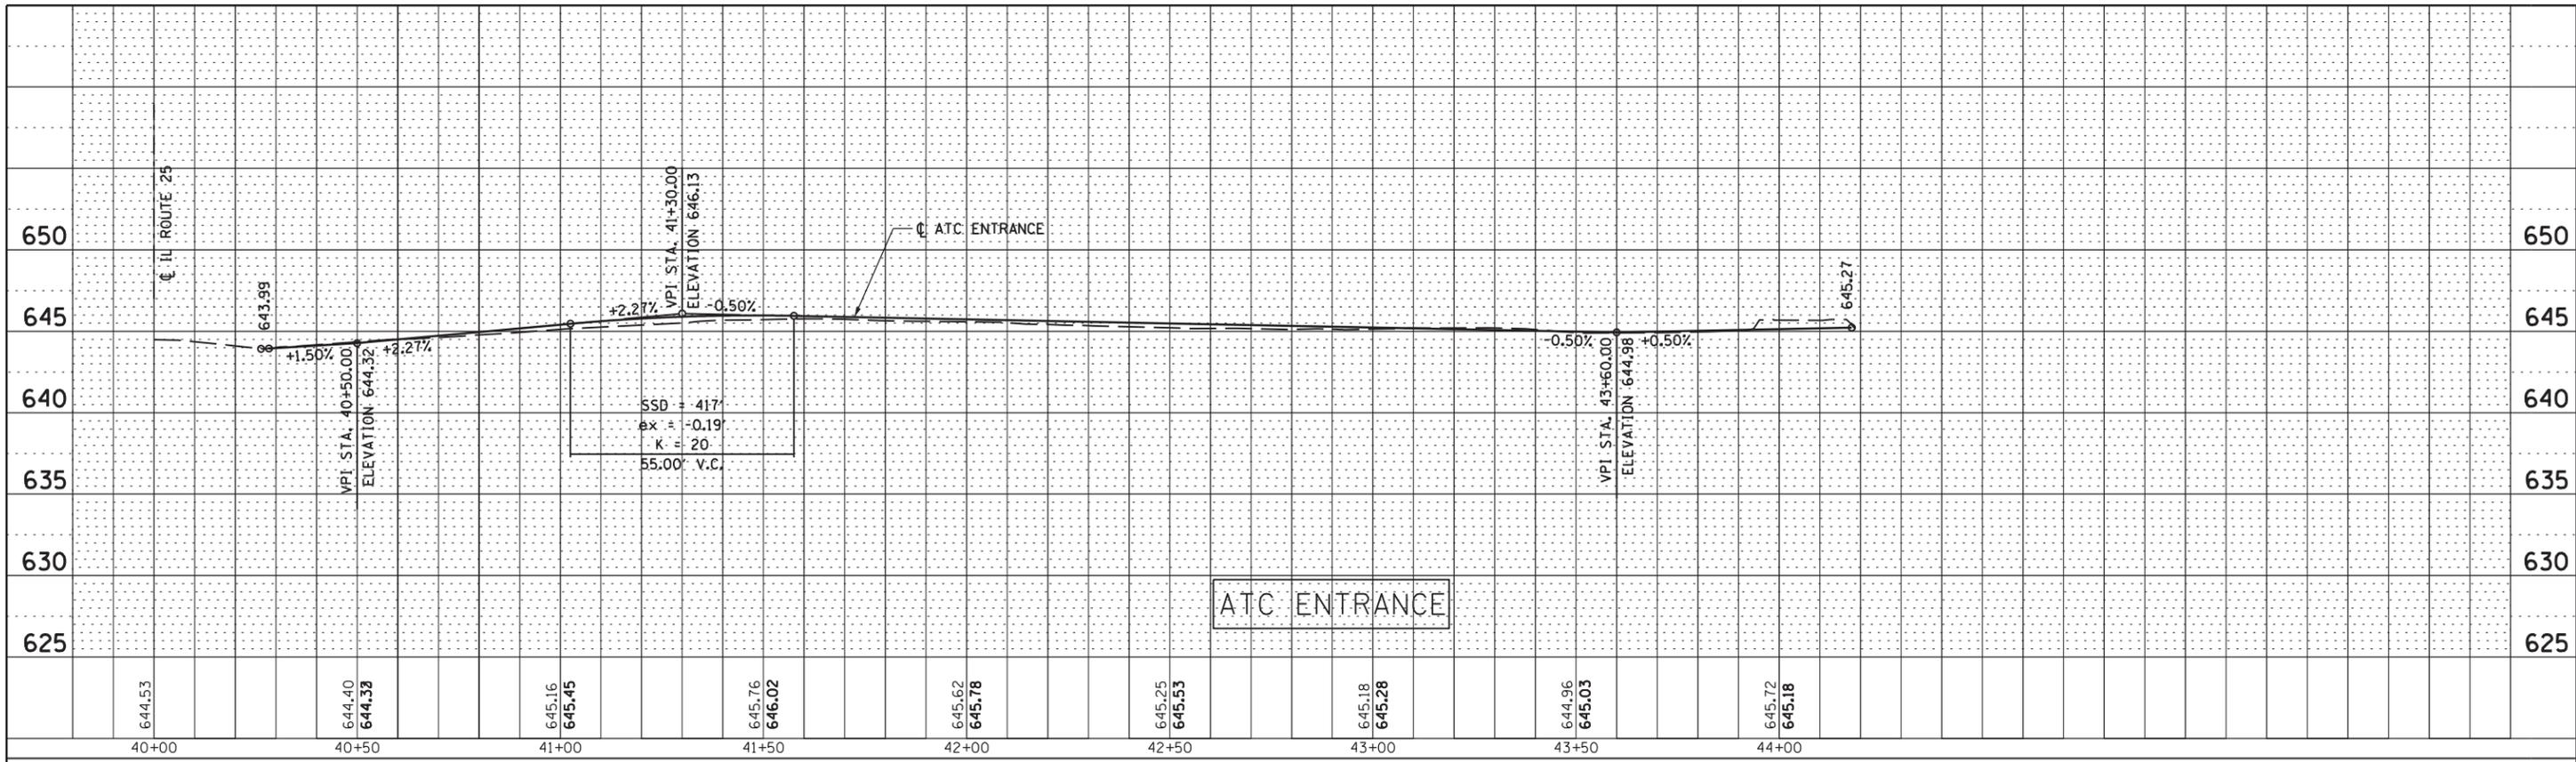


FILE NAME =	USER NAME = bweich	DESIGNED -	REVISED -	<b>STATE OF ILLINOIS</b> <b>DEPARTMENT OF TRANSPORTATION</b>	<b>AURORA TRANSIT CENTER IMPROVEMENTS</b> <b>ATC ENTRANCE AND IL ROUTE 25</b>	F.A.U. RT.E.	SECTION	COUNTY	TOTAL SHEETS	SHEET NO.
N:\WBK\150077.2\Civil\PRF-150077.2_ATC_02.dgn		DRAWN -	REVISED -			2503	16-00313-00-MS	KANE	254	39
PLOT SCALE = 48"		CHECKED -	REVISED -			CONTRACT NO. 61E18				
Default	PLOT DATE = 10/16/2017	DATE -	REVISED -			ILLINOIS FED. AID PROJECT				

SCALE: 40' SHEET OF SHEETS STA. TO STA.

PLAN	SURVEYED	BY	DATE
	PLOTTED		
	GRADES CHECKED		
	ALIGNMENT CHECKED		
	NOTE BOOK NO.		
	CADD FILE NAME		

PROFILE	SURVEYED	BY	DATE
	PLOTTED		
	GRADES CHECKED		
	STRUCTURE NOTATIONS CHECKED		
	NOTE BOOK NO.		
	CADD FILE NAME		

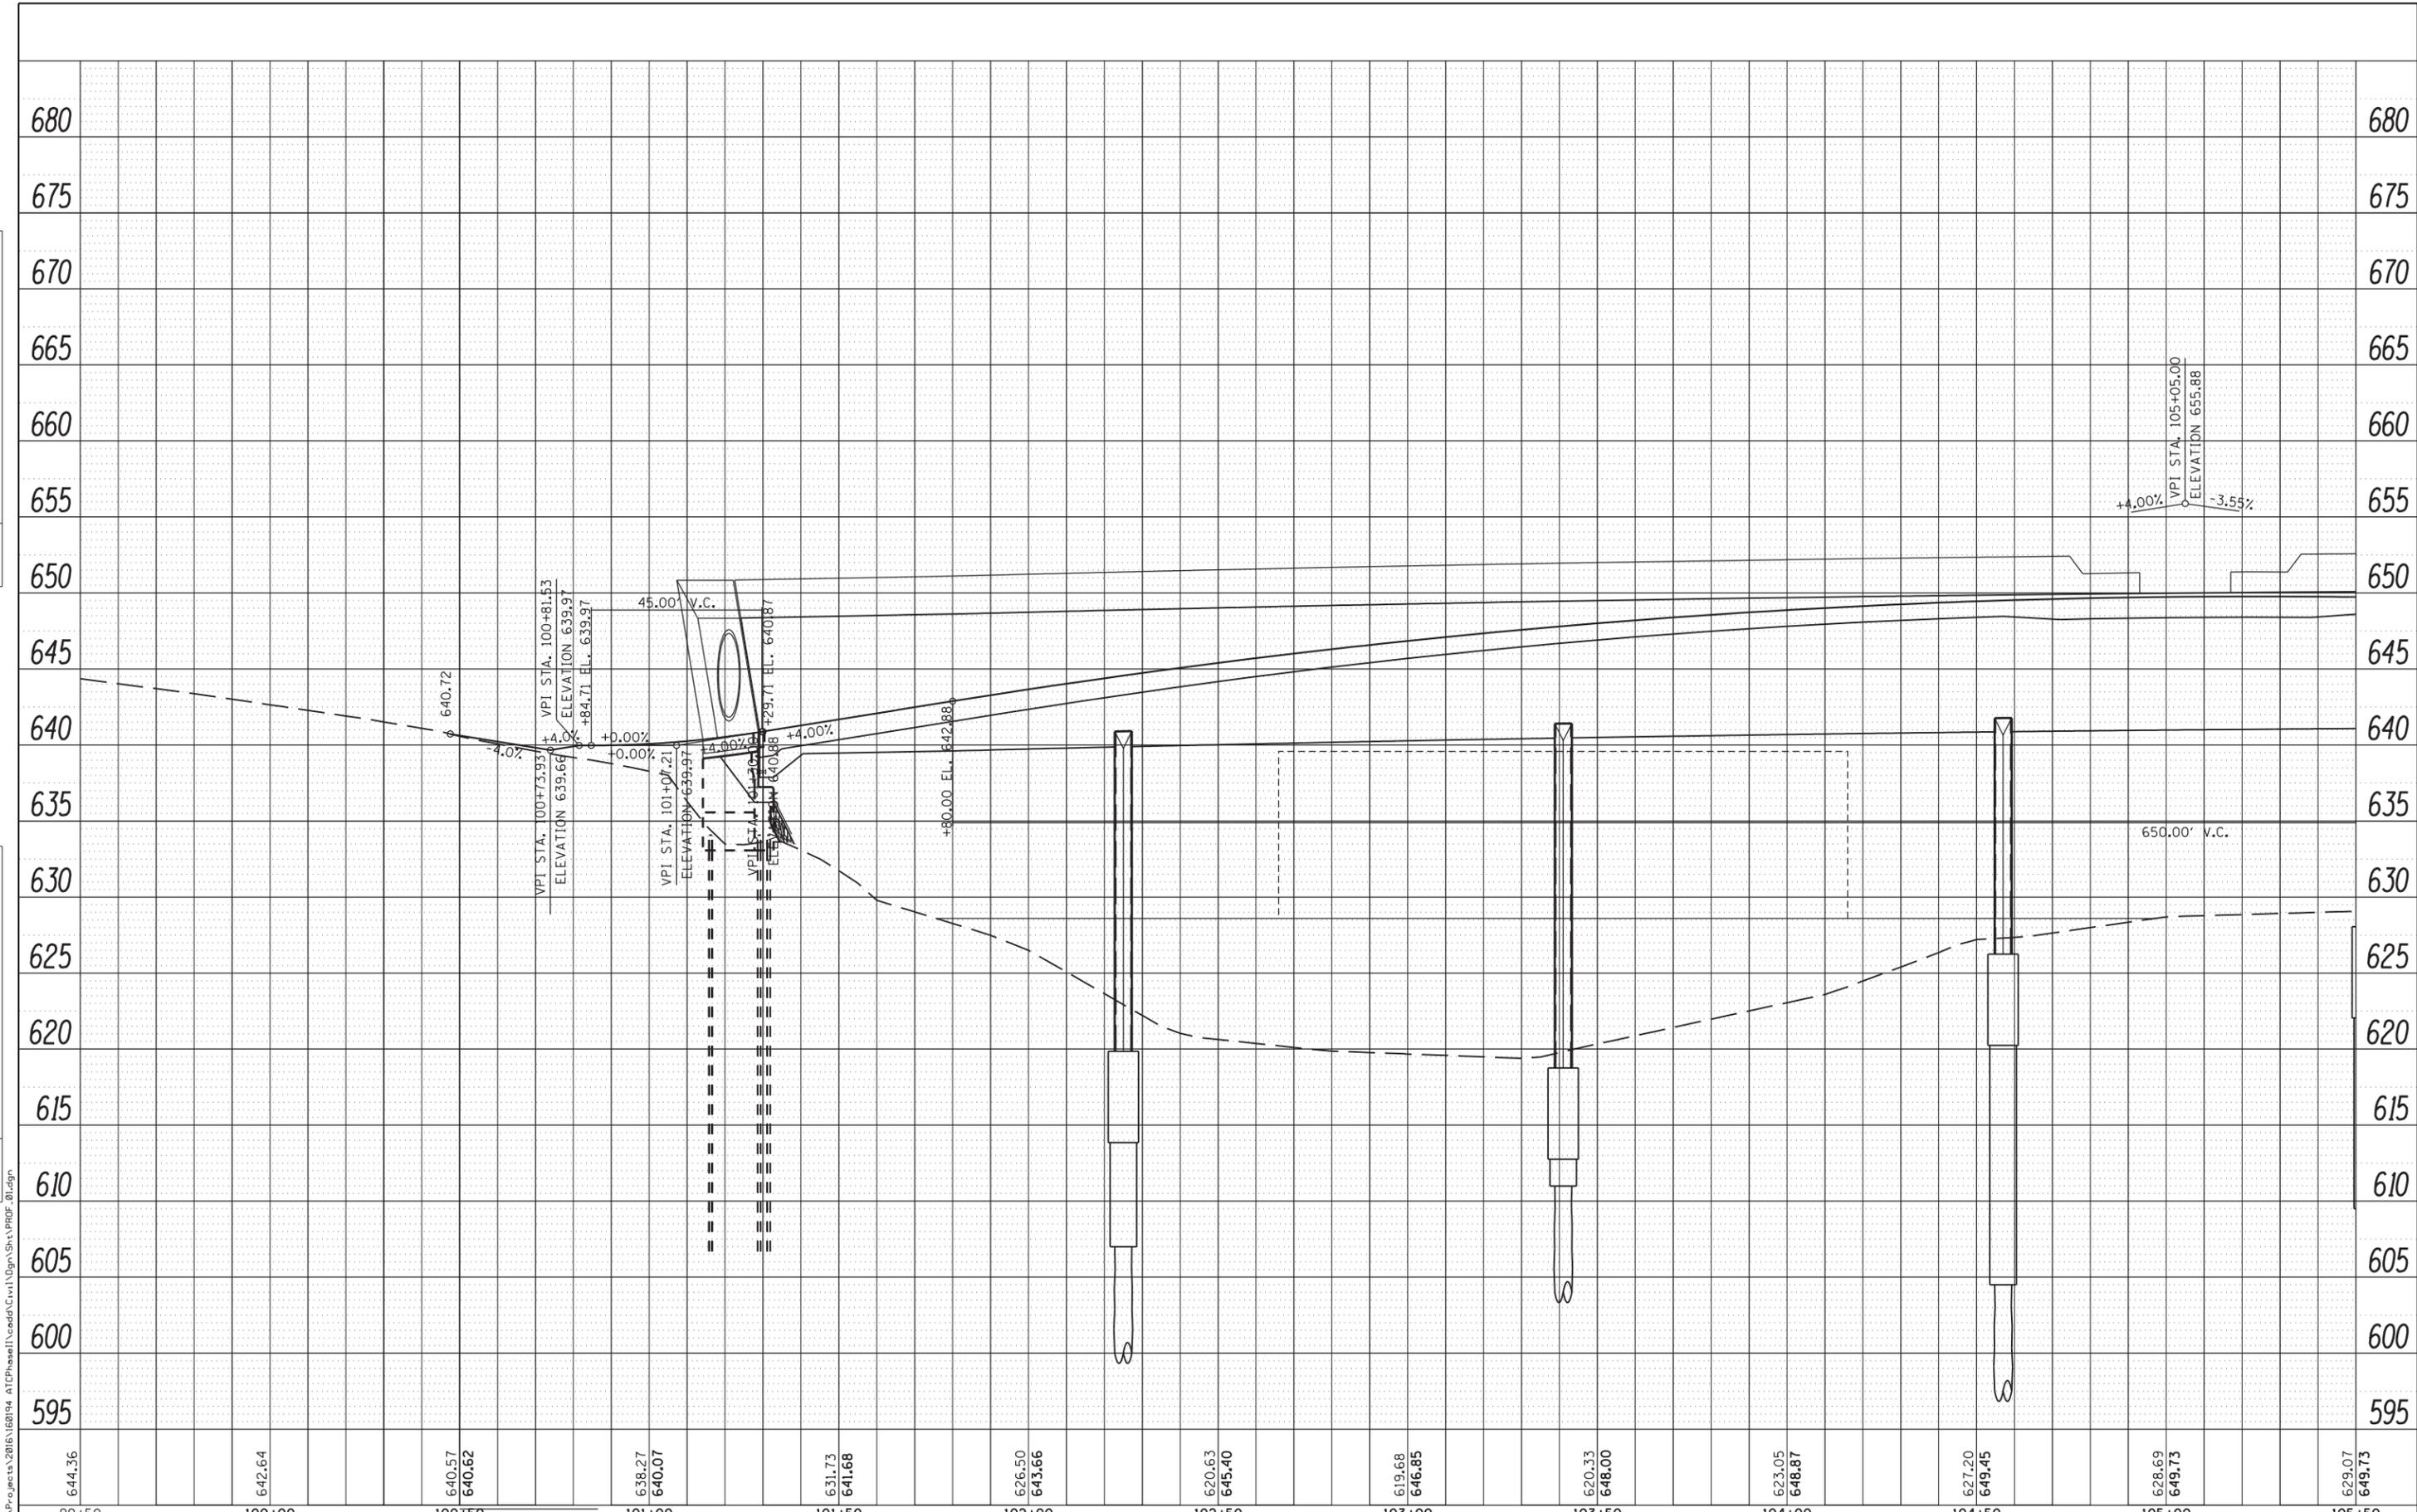

99+50	100+00	100+50	101+00	101+50	102+00	102+50	103+00	103+50	104+00	104+50	105+00	105+50
644.36	642.64	640.57 640.62	638.27 640.07	631.73 641.68	626.50 643.66	620.63 645.40	619.68 646.85	620.33 648.00	623.05 648.87	627.20 649.45	628.69 649.73	629.07 649.73

**WBK engineering**  
 WBK ENGINEERING, LLC  
 116 WEST MAIN STREET, SUITE 201  
 ST. CHARLES, ILLINOIS 60174  
 (630) 443-7755

USER NAME = nporris	DESIGNED - MNB	REVISED -
PLOT SCALE = 1:40	DRAWN - NDP	REVISED -
PLOT DATE = 10/17/2017	CHECKED - MNB	REVISED -
	DATE - 10/18/17	REVISED -


**STATE OF ILLINOIS  
 DEPARTMENT OF TRANSPORTATION**

<b>PROFILES</b>	
<b>PEDESTRIAN BRIDGE</b>	
SCALE: H=20 V=5	SHEET NO. 3 OF 5 SHEETS STA. TO STA.

F.A.U. RTE.	SECTION	COUNTY	TOTAL SHEETS	SHEET NO.
2503	16-00313-00-MS	KANE	254	40
CONTRACT NO. 61E18			ILLINOIS FED. AID PROJECT	

PLAN	SURVEYED	BY	DATE
	PLOTTED		
	NOTE BOOK		
	NO.		
	CHECKED		
	FILE NAME		

PROFILE	SURVEYED	BY	DATE
	PLOTTED		
	GRADES CHECKED		
	NO.		
	STRUCTURE		
	NOTATION		
	CPAD		

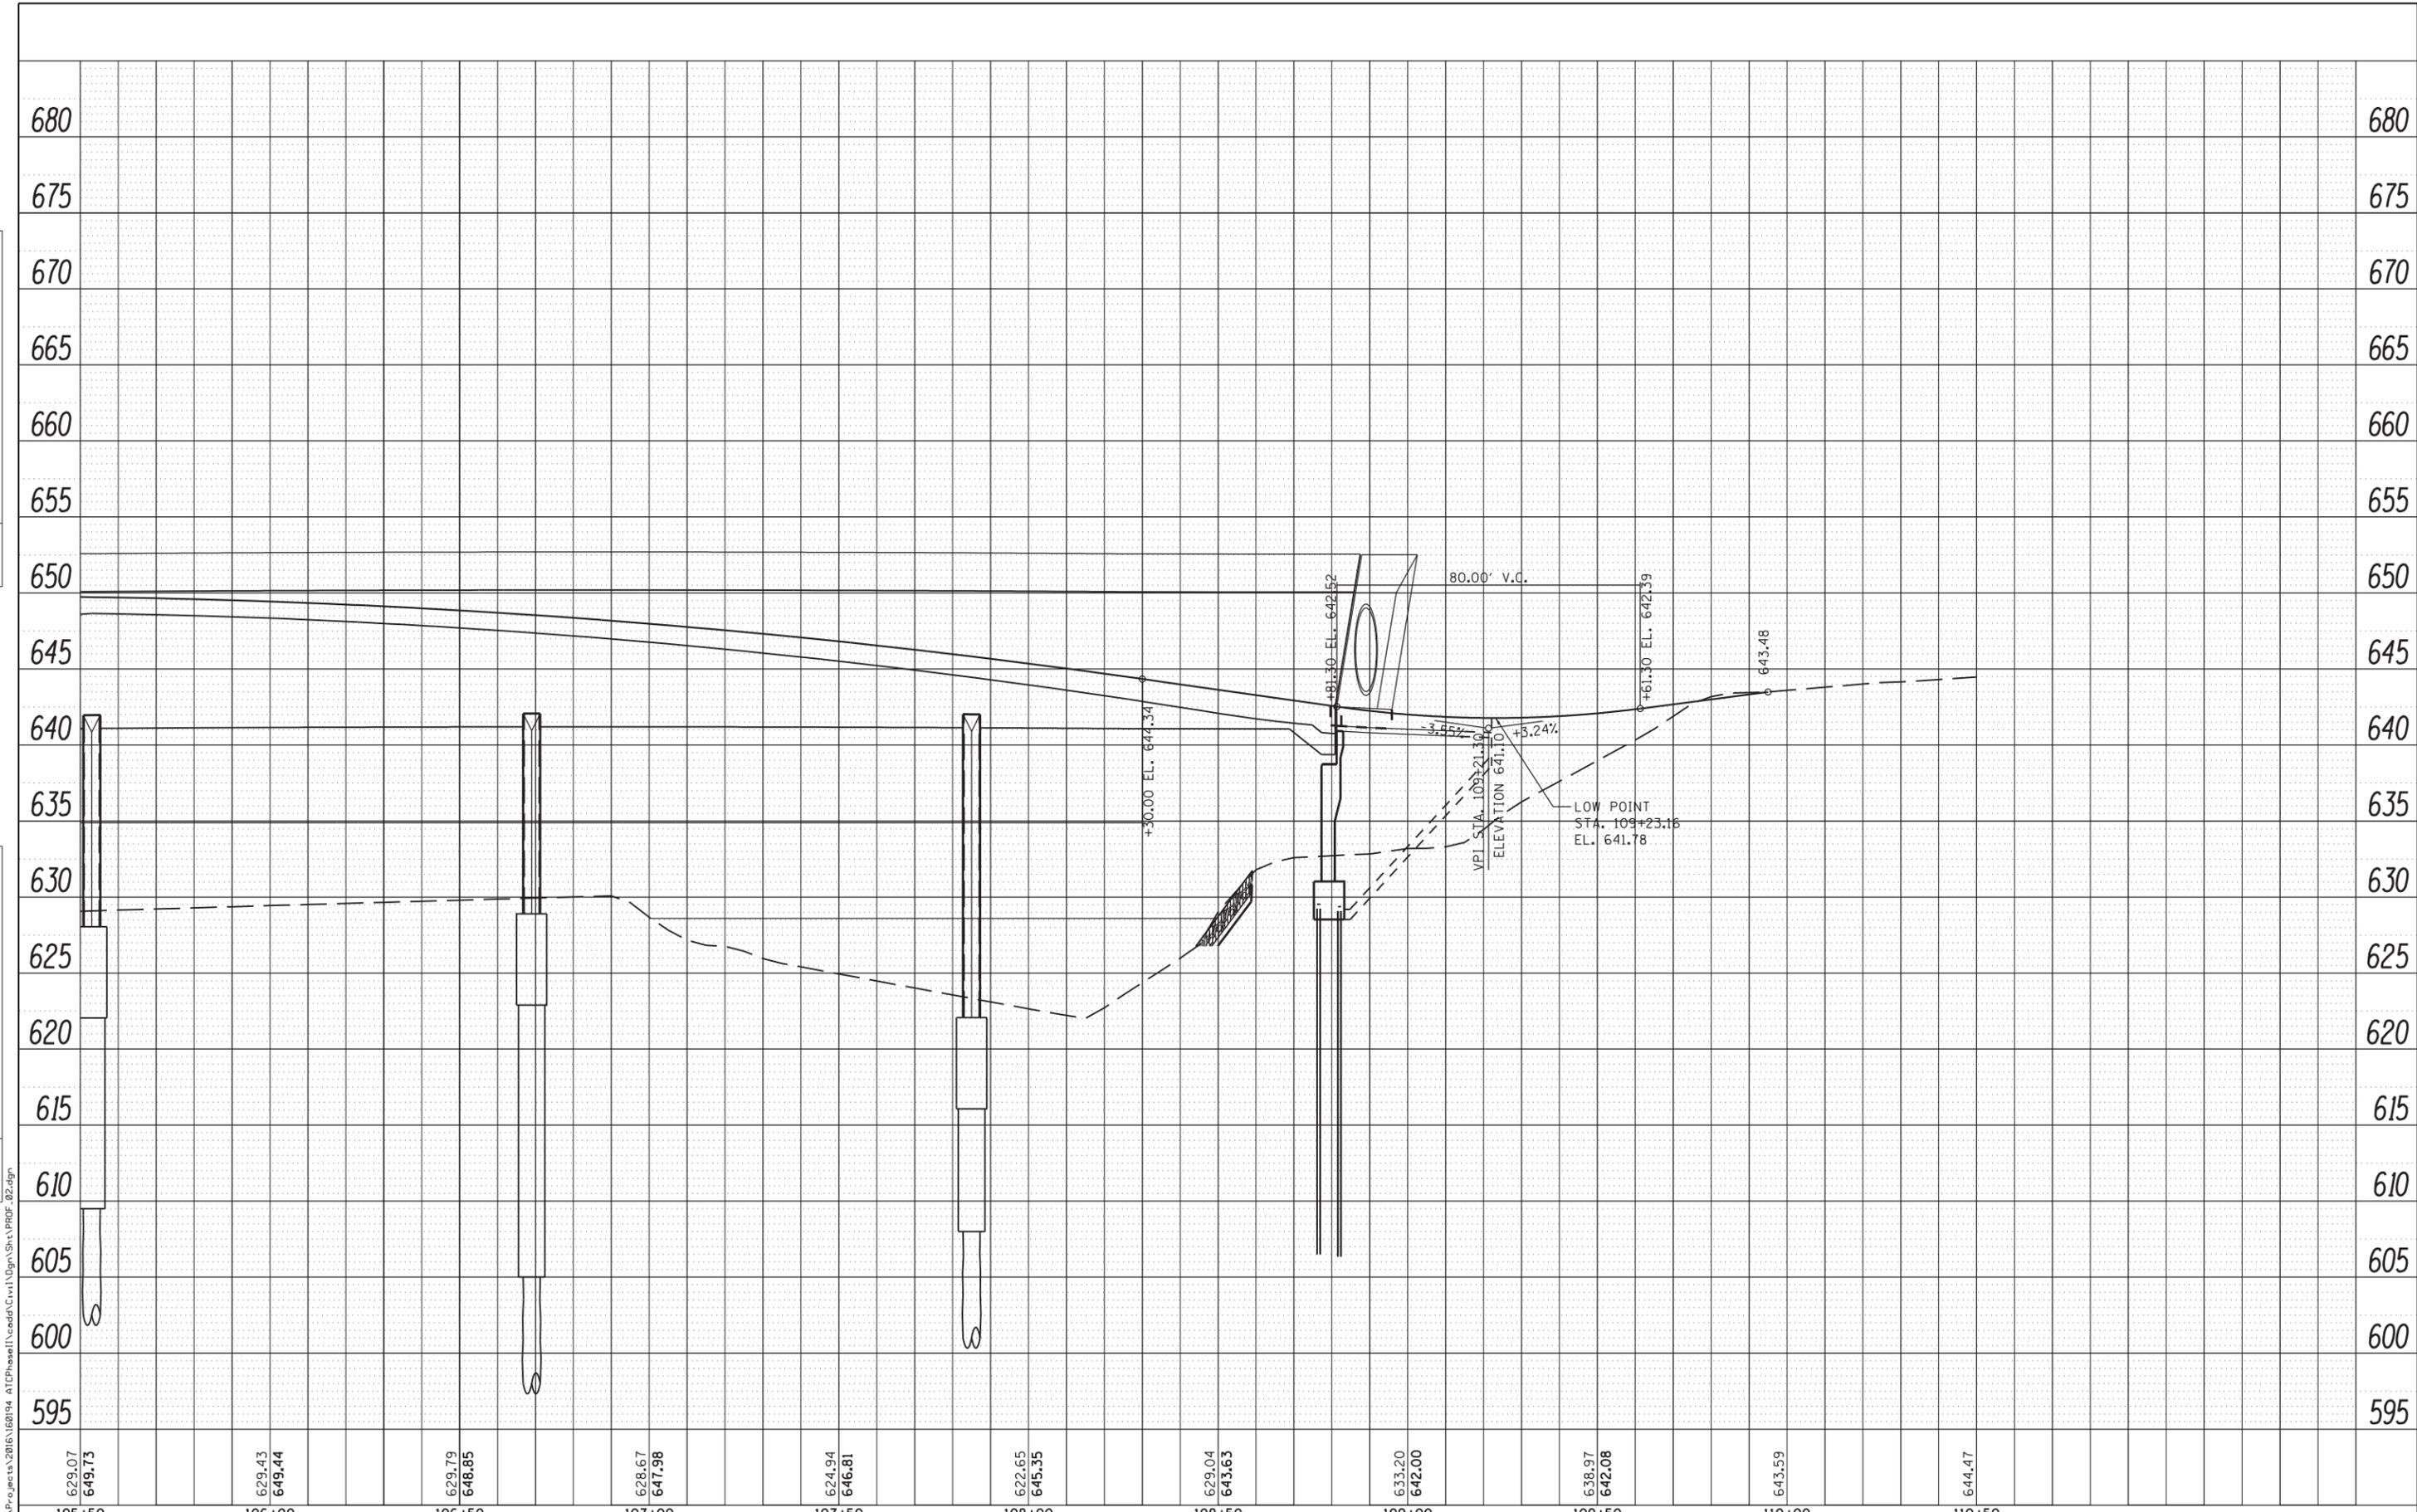

**WBK engineering**  
 WBK ENGINEERING, LLC  
 116 WEST MAIN STREET, SUITE 201  
 ST. CHARLES, ILLINOIS 60174  
 (630) 443-7755

USER NAME = nporris	DESIGNED - MNB	REVISED -
PLOT SCALE = 1:40	DRAWN - NDP	REVISED -
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	DATE - 10/18/17	REVISED -

**STATE OF ILLINOIS  
 DEPARTMENT OF TRANSPORTATION**



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<b>PEDESTRIAN BRIDGE</b>	
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STA.	TO STA.

F.A.U. RTE.	SECTION	COUNTY	TOTAL SHEETS	SHEET NO.
2503	16-00313-00-MS	KANE	254	41
CONTRACT NO. 61E18				
ILLINOIS FED. AID PROJECT				

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NOTE BOOK NO.	PLOTTED		
	ALIGNMENT		
	CARD FILE NAME		

PROFILE	SURVEYED	BY	DATE
NOTE BOOK NO.	GRADES CHECKED		
	STRUCTURE		
	NOTATIONS		

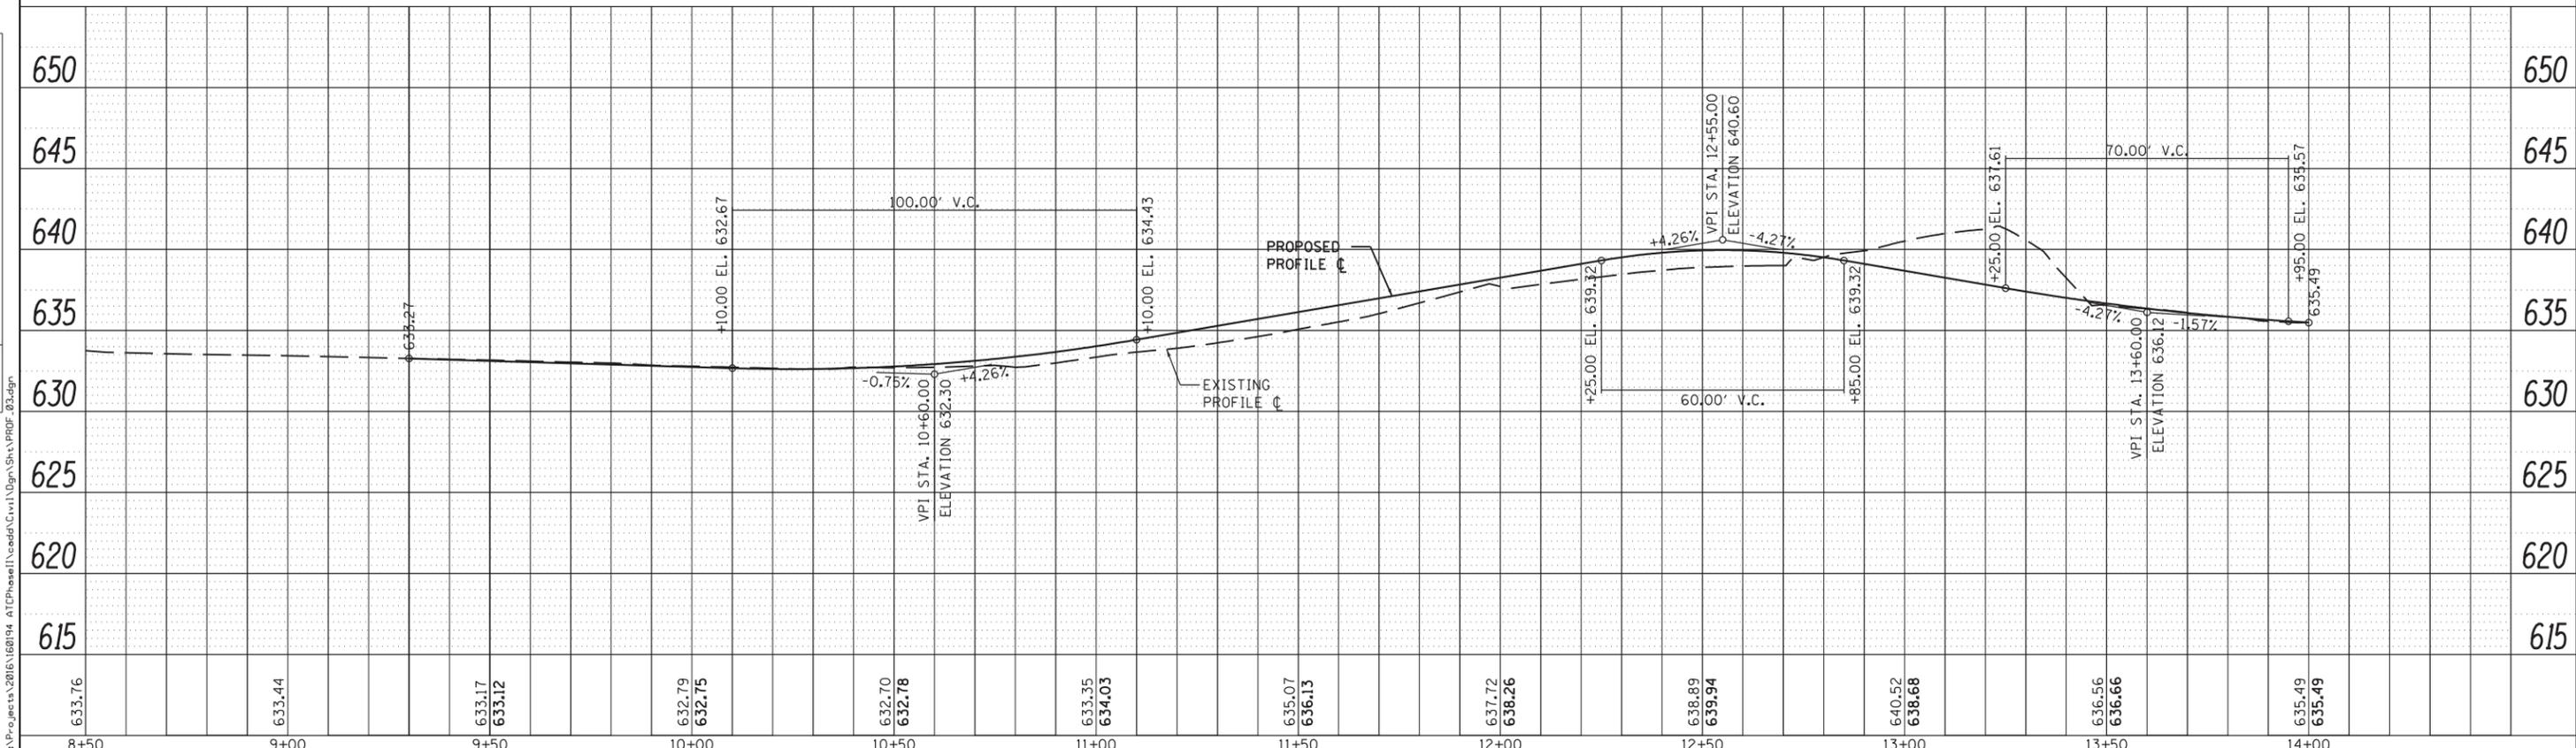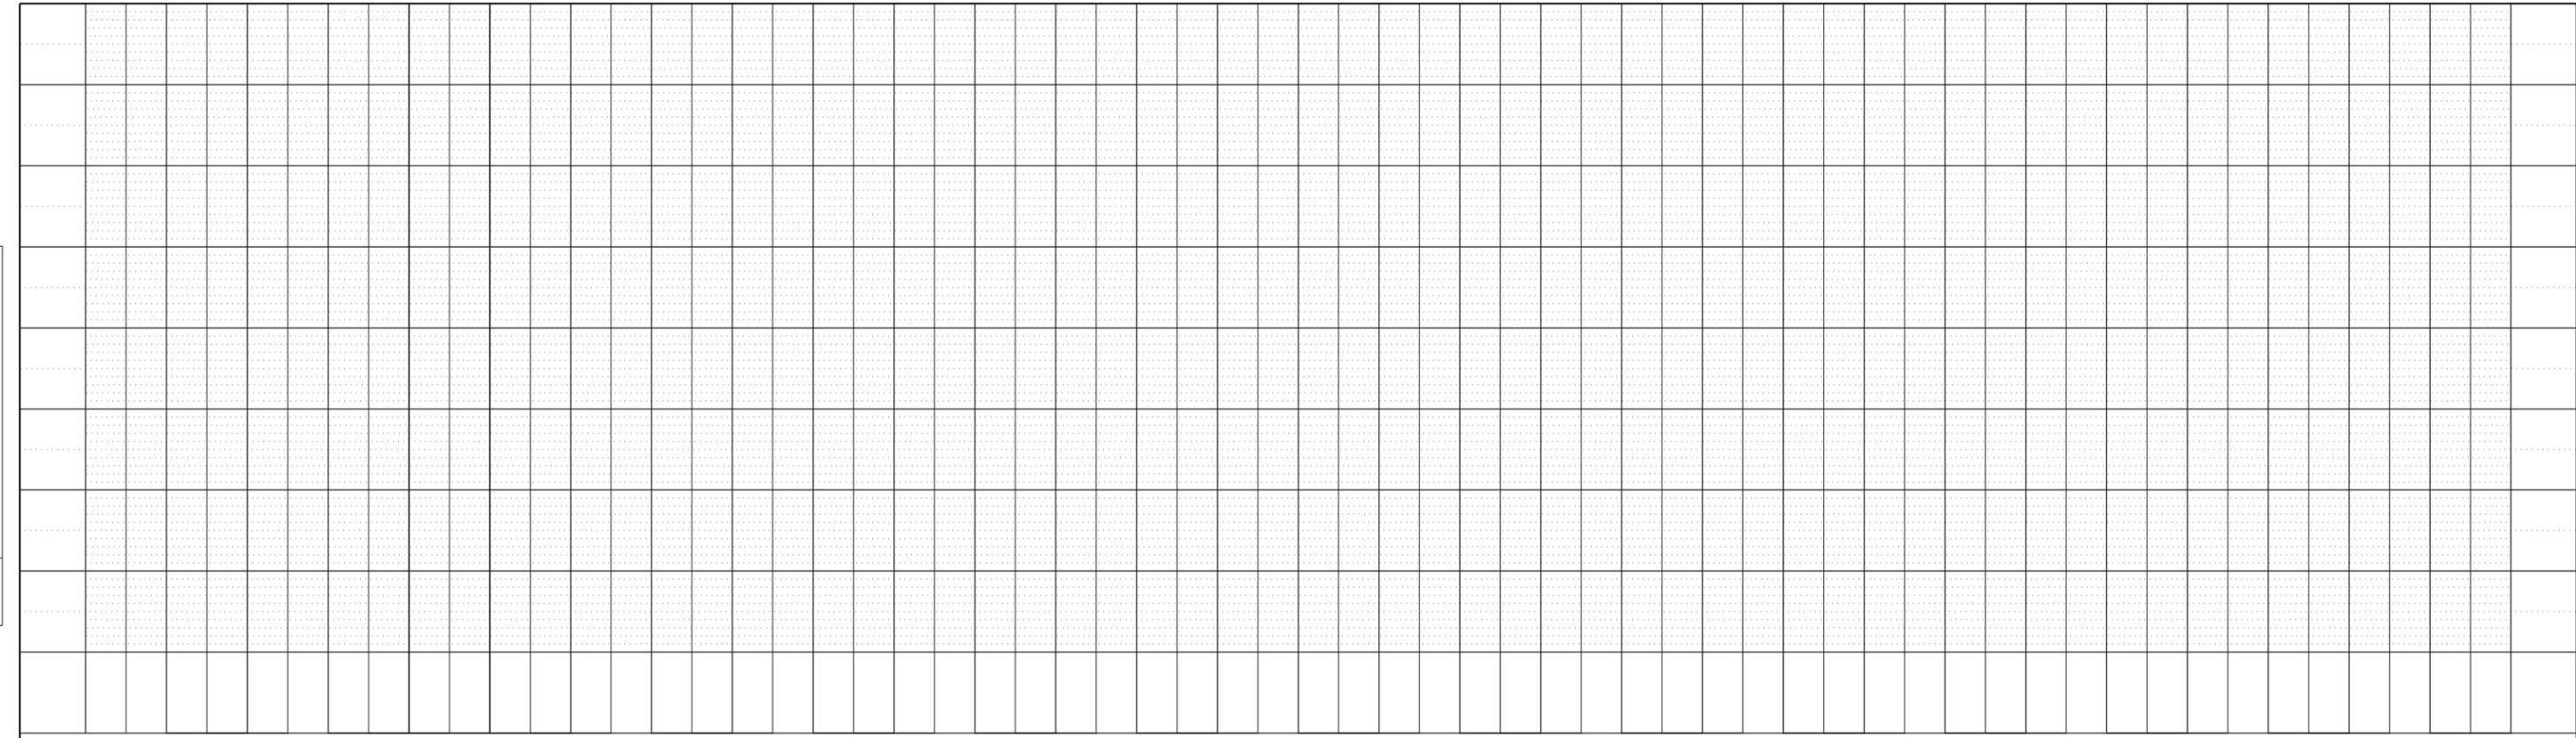

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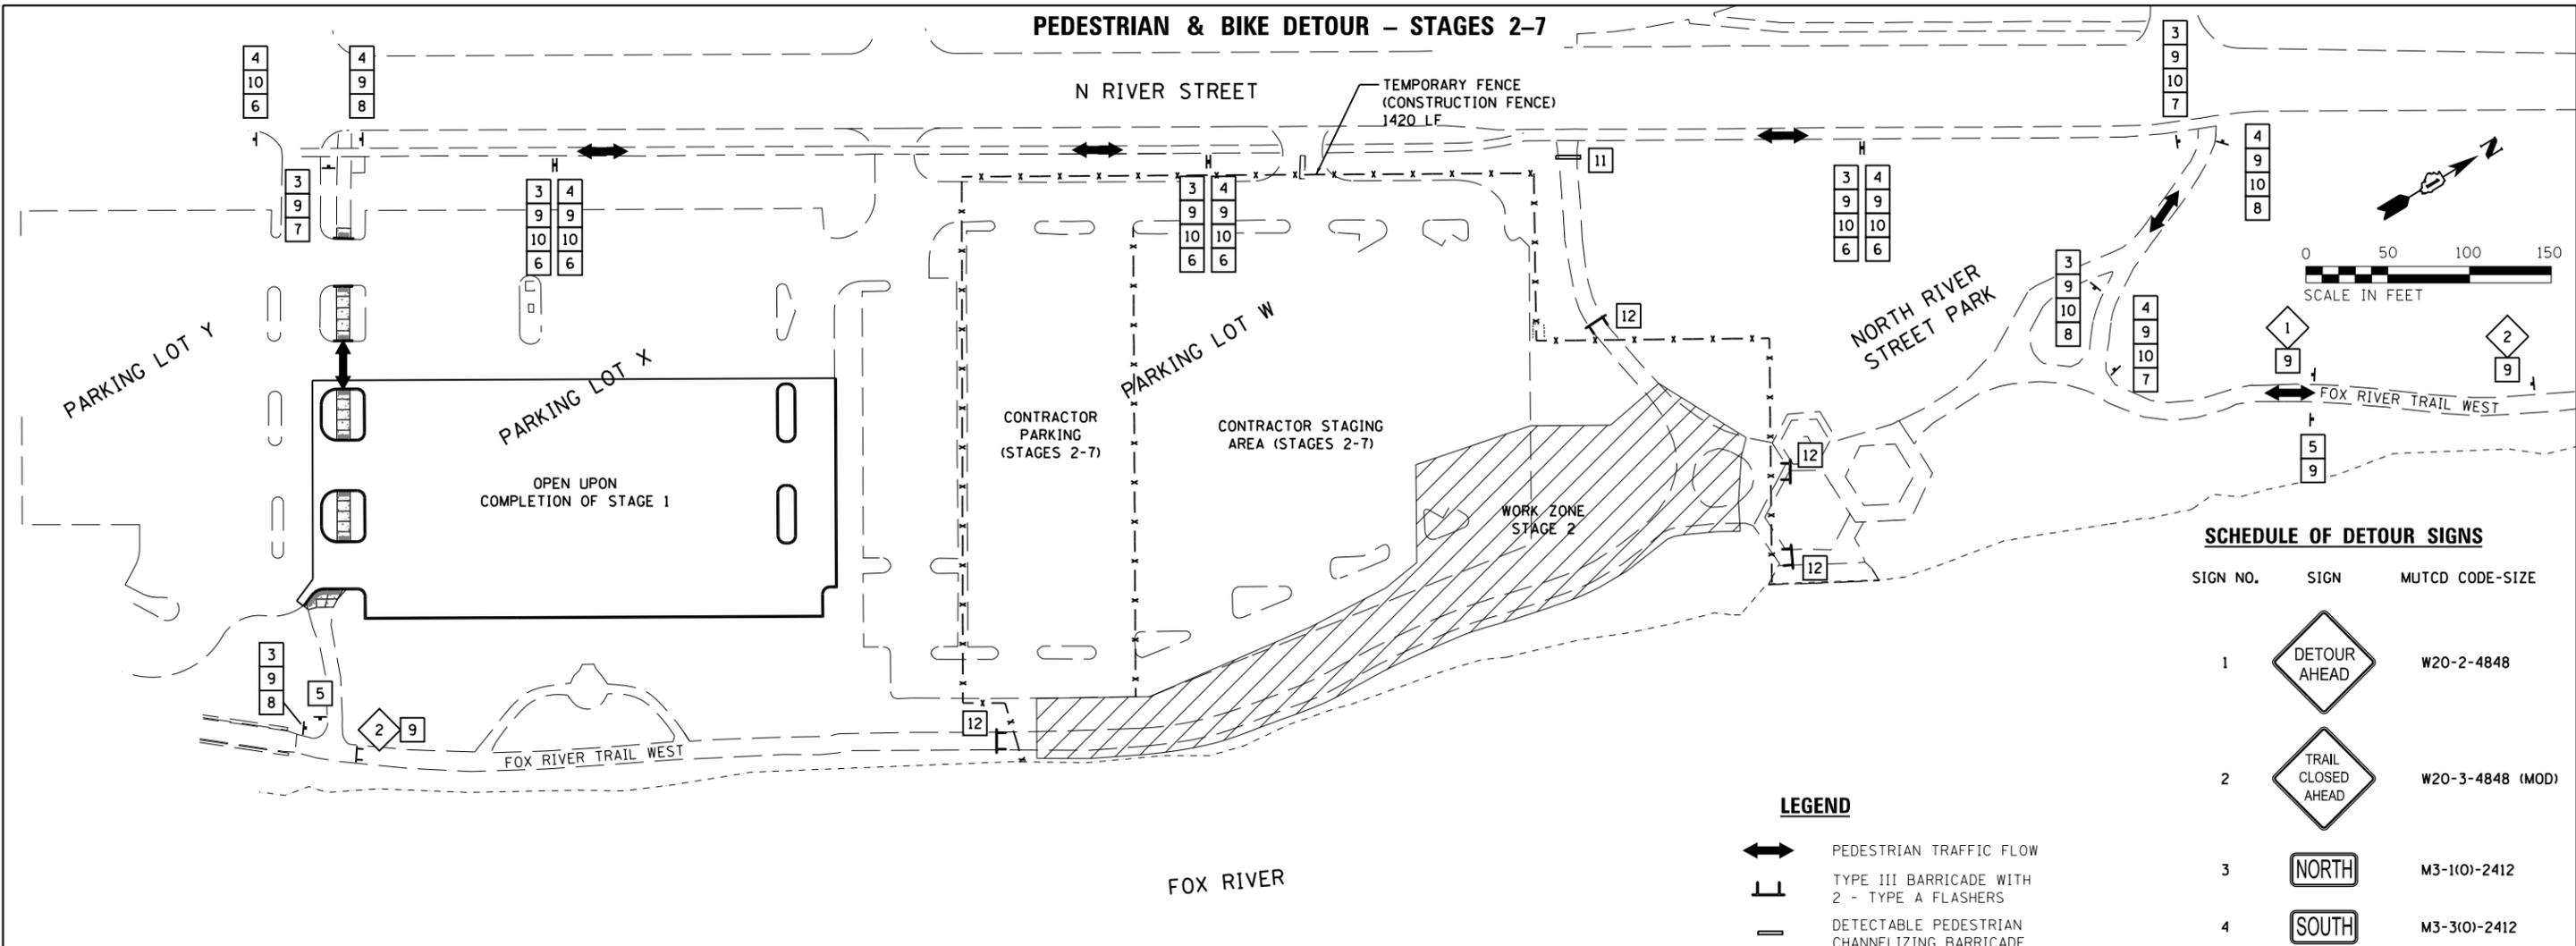
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	DATE - 10/18/17	REVISED -

**STATE OF ILLINOIS  
 DEPARTMENT OF TRANSPORTATION**

<b>PROFILES MULTI-USE PATH</b>	
SCALE: H=20 V=5	SHEET NO. 5 OF 5 SHEETS STA. TO STA.

F.A.U. RTE. 2503	SECTION 16-00313-00-MS	COUNTY KANE	TOTAL SHEETS 254	SHEET NO. 42
CONTRACT NO. 61E18			ILLINOIS FED. AID PROJECT	

**PEDESTRIAN & BIKE DETOUR – STAGES 2-7**




**SCHEDULE OF DETOUR SIGNS**

SIGN NO.	SIGN	MUTCD CODE-SIZE
1		W20-2-4848
2		W20-3-4848 (MOD)
3		M3-1(O)-2412
4		M3-3(O)-2412
5		M4-8A-2418
6		M4-9a (MOD)
7		M4-9aR
8		M4-9aL
9		D3-(O)3612-VAR
10		D3-(O)3612-VAR
11		M4-10L-4818
12		R11-2-6030 (MOD)
13		R11-1101
14		CUSTOM-6030



**LEGEND**

- PEDESTRIAN TRAFFIC FLOW
- TYPE III BARRICADE WITH 2 - TYPE A FLASHERS
- DETECTABLE PEDESTRIAN CHANNELIZING BARRICADE
- TYPE II BARRICADE
- SIGN PANEL ASSEMBLY
- DETOUR SIGN ASSEMBLY WITH STREET NAME AND DIRECTION PLATES (NUMBER DENOTES TYPE)
- W20 SERIES SIGN (NUMBER DENOTES TYPE)
- OTHER SIGN (NUMBER DENOTES TYPE)
- WORK ZONE

**TYPICAL DETOUR SIGN ASSEMBLIES**

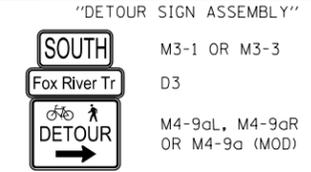

NOTES:  
THE DETOUR SIGN CONFIGURATION FOLLOWS  
IDOT DISTRICT ONE STANDARD TC-21.

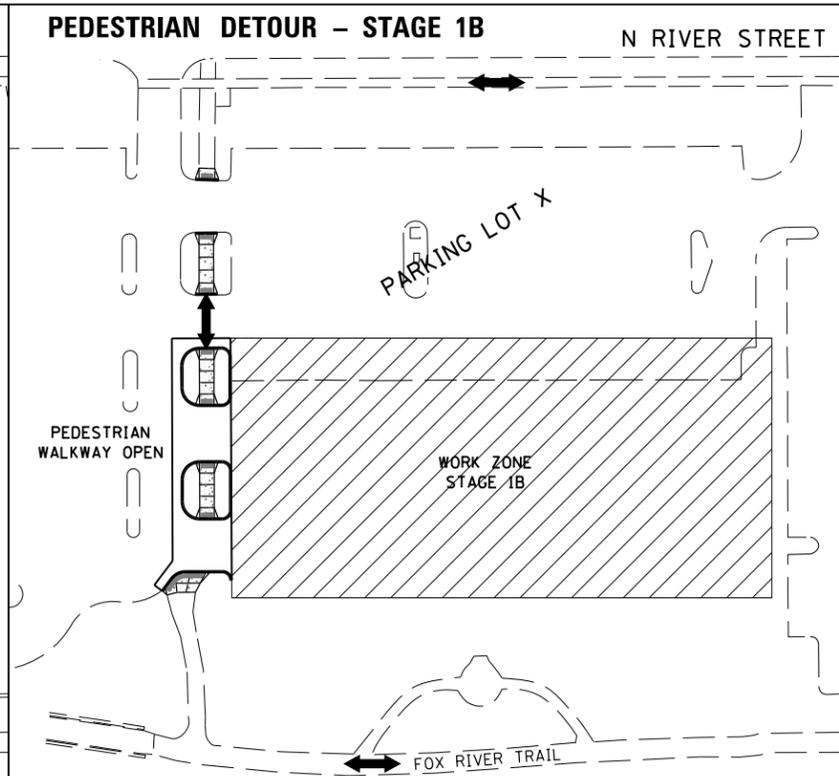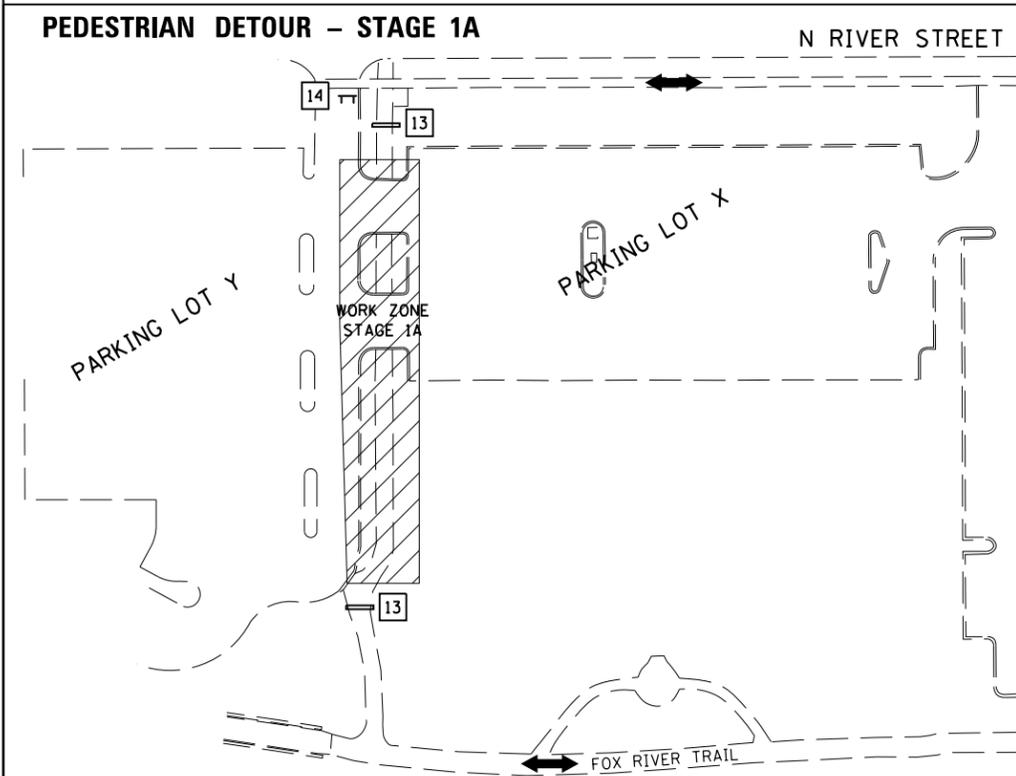

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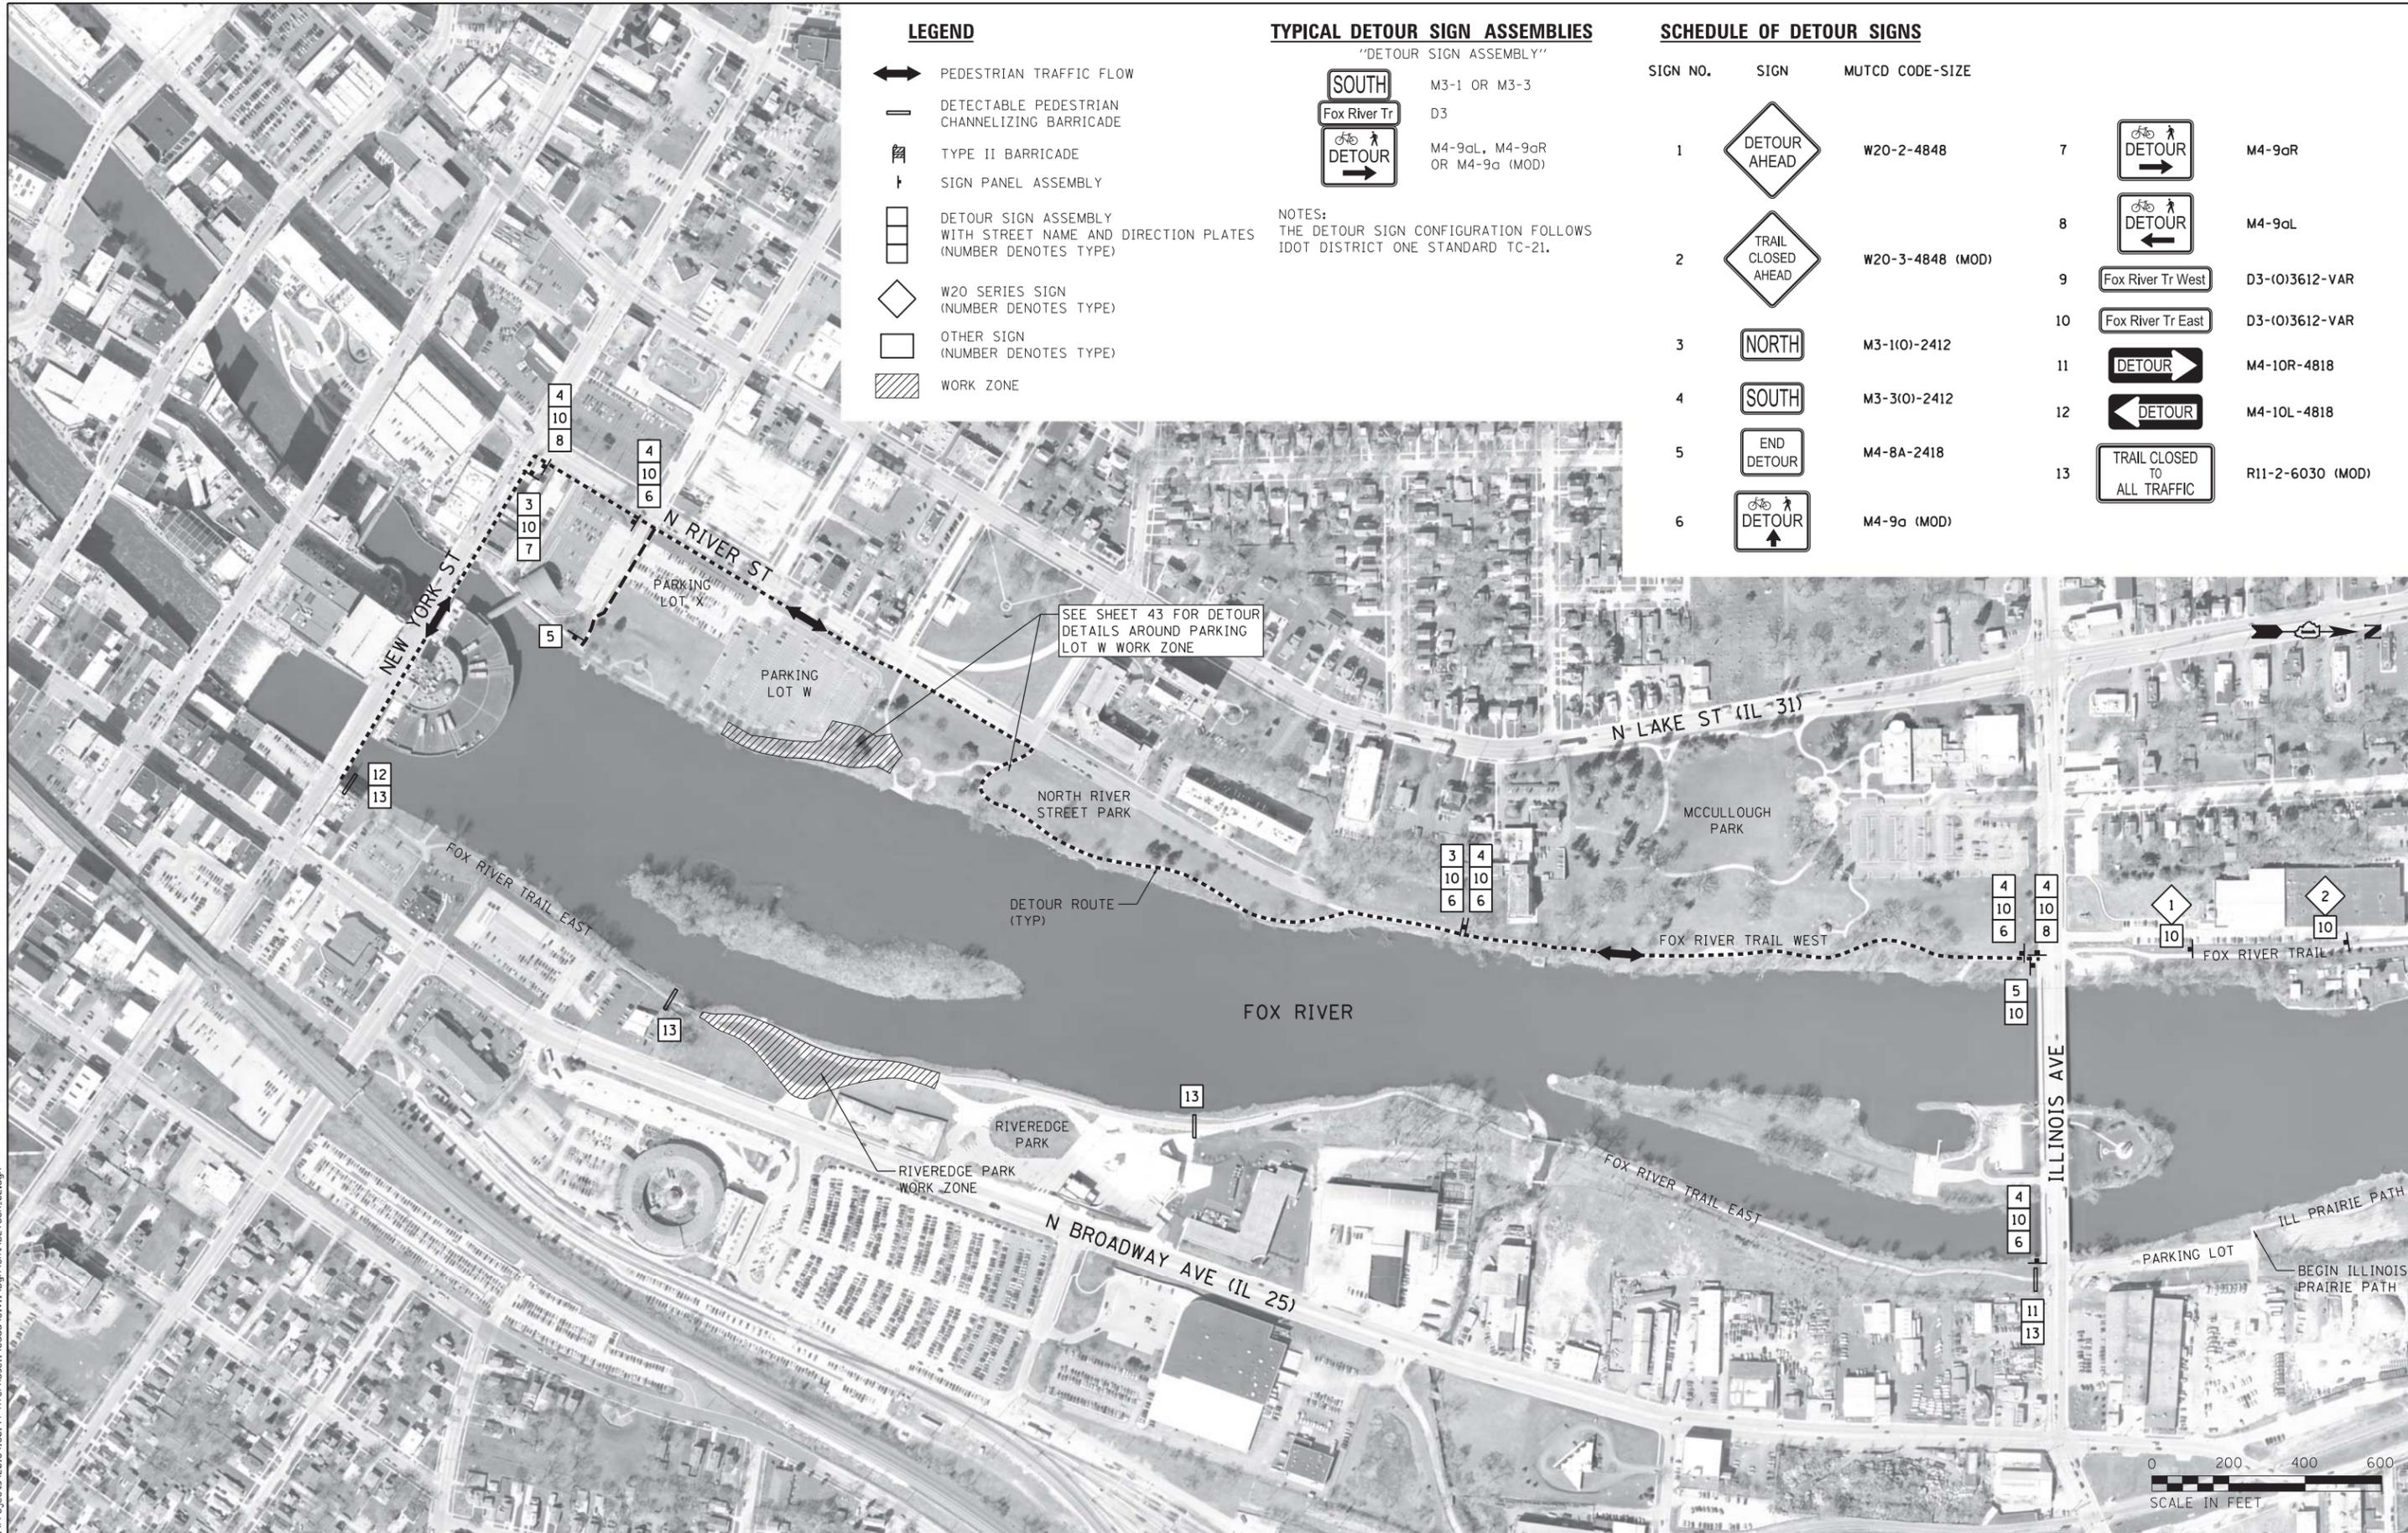
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PLOT DATE = 11/8/2017	CHECKED - MNB	REVISED -
	DATE - 10/18/17	REVISED -

**STATE OF ILLINOIS  
DEPARTMENT OF TRANSPORTATION**

**PEDESTRIAN & BIKE DETOUR PLAN  
FOX RIVER TRAIL WEST**

SCALE: 1"=50' SHEET NO. 1 OF 2 SHEETS STA. TO STA.


F.A.U. R.T.E.	SECTION	COUNTY	TOTAL SHEETS	SHEET NO.
2503	16-00313-00-MS	KANE	254	43
CONTRACT NO. 61E18			ILLINOIS FED. AID PROJECT	



**LEGEND**

- PEDESTRIAN TRAFFIC FLOW
- DETECTABLE PEDESTRIAN CHANNELIZING BARRICADE
- TYPE II BARRICADE
- SIGN PANEL ASSEMBLY
- DETOUR SIGN ASSEMBLY WITH STREET NAME AND DIRECTION PLATES (NUMBER DENOTES TYPE)
- W20 SERIES SIGN (NUMBER DENOTES TYPE)
- OTHER SIGN (NUMBER DENOTES TYPE)
- WORK ZONE

**TYPICAL DETOUR SIGN ASSEMBLIES**  
"DETOUR SIGN ASSEMBLY"

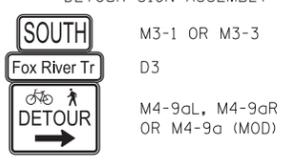

NOTES:  
THE DETOUR SIGN CONFIGURATION FOLLOWS  
IDOT DISTRICT ONE STANDARD TC-21.

**SCHEDULE OF DETOUR SIGNS**

SIGN NO.	SIGN	MUTCD CODE-SIZE	SIGN NO.	SIGN	MUTCD CODE-SIZE
1		W20-2-4848	7		M4-9aR
2		W20-3-4848 (MOD)	8		M4-9aL
3		M3-1(0)-2412	9		D3-(0)3612-VAR
4		M3-3(0)-2412	10		D3-(0)3612-VAR
5		M4-8A-2418	11		M4-10R-4818
6		M4-9a (MOD)	12		M4-10L-4818
			13		R11-2-6030 (MOD)

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USER NAME = nparris  
DESIGNED - MNB  
DRAWN - NDP  
CHECKED - MNB  
DATE - 10/18/17  
PLOT SCALE = 1:200  
PLOT DATE = 11/8/2017

DESIGNED - MNB  
DRAWN - NDP  
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DATE - 10/18/17  
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REVISED -

**STATE OF ILLINOIS  
DEPARTMENT OF TRANSPORTATION**

**PEDESTRIAN & BIKE DETOUR PLAN  
FOX RIVER TRAIL EAST**

SCALE: 1"=200' SHEET NO. 2 OF 2 SHEETS STA. TO STA.

F.A.U. R.T.E.	SECTION	COUNTY	TOTAL SHEETS	SHEET NO.
2503	16-00313-00-MS	KANE	254	44
CONTRACT NO. 61E18			ILLINOIS FED. AID PROJECT	

**MAINTENANCE OF TRAFFIC – AURORA TRANSIT CENTER & IL ROUTE 25**

**GENERAL NOTES**

1. TYPE I OR II BARRICADES AND VERTICAL PANELS SHALL BE EQUIPPED WITH MONO-DIRECTIONAL STEADY BURN LIGHTS AND SHALL BE PLACED AT A MAXIMUM OF 50 FOOT INTERVALS ALONG THE PROPOSED WORK ZONE, 20 FOOT INTERVALS IN TAPER SECTIONS, AND 10 FOOT INTERVALS AROUND RADII AS SHOWN ON THE PLANS OR AS DIRECTED BY THE ENGINEER. BARRICADES WITH LEG EXTENSIONS SHALL BE USED WHERE NEEDED TO PROVIDE A MINIMUM DISTANCE OF 36" BETWEEN THE PAVEMENT AND TOP OF BARRICADE. BARRICADE IN TAPER SECTIONS SHALL HAVE DIRECTION INDICATOR PANELS.
2. THE CONTRACTOR SHALL MAINTAIN ACCESS TO ALL PROPERTIES AND SIDE ROADS DURING CONSTRUCTION OPERATIONS. A QUANTITY OF "TEMPORARY PAVEMENT" HAS BEEN INCLUDED IN THE CONTRACT FOR THIS PURPOSE.
3. THE CONTRACTOR SHALL BE RESPONSIBLE FOR REPLACING ANY NEW PAVEMENT OR PAVEMENT NOT PROPOSED TO BE REPLACED AS PART OF THE PROJECT, INCLUDING SIDEWALK AND CURB AND GUTTER, THAT IS DAMAGED BY CONSTRUCTION ACTIVITIES.
4. THE CONTRACTOR SHALL KEEP PEDESTRIAN ROUTES FREE AND CLEAR FROM DIRT, DEBRIS AND BLOCKAGE AT ALL TIMES. IF AT THE ENGINEER'S SOLE DETERMINATION, PEDESTRIAN ROUTES ARE NOT BEING MAINTAINED PROPERLY, THE ENGINEER RESERVES THE RIGHT TO CONTRACT A THIRD PARTY TO PERFORM THE CLEANUP AND BACKCHARGE THE CONTRACTOR.
5. ADVANCE SIGNS PER APPLICABLE IDOT HIGHWAY STANDARDS AND SHALL BE MAINTAINED THROUGH ALL STAGES OF CONSTRUCTION.
6. THE CONTRACTOR SHALL CONTACT THE IDOT DISTRICT 1 TRAFFIC CONTROL SUPERVISOR AT 847-705-4470 A MINIMUM OF 72 HOURS IN ADVANCE OF BEGINNING WORK.
7. ALL LANE CLOSURES ON IL ROUTE 25 SHALL BE IN ACCORDANCE WITH APPLICABLE IDOT HIGHWAY STANDARDS DURING ALLOWABLE HOURS AS SPECIFIED IN THE SPECIAL PROVISION "KEEPING ARTERIAL ROADWAYS OPEN TO TRAFFIC".
8. THE CONTRACTOR SHALL INFORM THE ENGINEER OF ANY CHANGE IN STAGING AT LEAST TWO (2) WORKING DAYS IN ADVANCE.
9. IT IS ANTICIPATED THAT UNDERGROUND IMPROVEMENTS WILL BE INSTALLED NEAR ACTIVE PEDESTRIAN ROUTES PRIOR TO COMPLETION OF THE CORRESPONDING ABOVE GROUND IMPROVEMENT. AN EXAMPLE OF THIS IS THE INSTALLATION OF LIGHT POLE FOUNDATIONS ALONG THE WEST SIDEWALK OF IL ROUTE 25, WHICH WILL BE INSTALLED IN THE FIRST STAGE OF THE PROJECT, BUT LIGHT POLES WILL NOT BE ERECTED UNTIL A LATER STAGE. ALL UNDERGROUND WORK PARTIALLY COMPLETED ADJACENT TO ACTIVE PEDESTRIAN ROUTES, INCLUDING BUT NOT LIMITED TO LIGHT POLE FOUNDATIONS, SIGNAL MAST ARM AND PED POLE FOUNDATIONS, SIGNAL CABINET FOUNDATIONS AND LIGHTING CABINET FOUNDATIONS SHALL BE PROTECTED THROUGHOUT THE PROJECT FROM DAMAGE AND VANDALISM, AND FROM CAUSING DANGER OR INJURY TO PEDESTRIANS, BICYCLISTS AND THE MOTORING PUBLIC.
10. THE CONTRACTOR SHALL BE REQUIRED TO REMOVE EXISTING PAVEMENT MARKINGS WHICH CONFLICT WITH THE DESIGNATED TRAFFIC CONTROL PLAN.
11. ARROW BOARDS WILL BE REQUIRED WHEN IMPLEMENTING ALL LANE CLOSURES AND SHALL BE CONSIDERED AS PART OF THE PAY ITEM "TRAFFIC CONTROL AND PROTECTION, (SPECIAL)".
12. THE CONTRACTOR SHALL MAINTAIN DRAINAGE OF THE ROADWAY DURING ALL STAGES OF CONSTRUCTION.
13. TYPE III BARRICADES ARE TO BE PLACED IN ACCORDANCE WITH STANDARD 701901 UNLESS AUTHORIZED BY THE ENGINEER TO USE AN ALTERNATE ARRANGEMENT. BARRICADES ARE TO BE INCIDENTAL TO "TRAFFIC CONTROL PROTECTION, (SPECIAL)". ALL TYPE III BARRICADES SHALL HAVE TWO (2) FLASHING AMBER LIGHTS.
14. TEMPORARY PAVEMENT MARKING TAPE SHALL BE USED ON ALL SURFACES OUTSIDE OF THE RESURFACING LIMITS AND ON FINISHED PAVEMENT.
15. A QUANTITY FOR THREE "CHANGEABLE MESSAGE SIGNS" HAS BEEN INCLUDED FOR USE WHEN DIRECTED BY THE ENGINEER.
16. FLAGGERS MUST BE CERTIFIED AND CARRY THEIR CERTIFICATION CARD ON THEM WHEN WORKING, PROPER STOP/SLOW PADDLES MUST BE UTILIZED AND ALL REQUIRED SAFETY GARMENTS MUST BE WORN ON THE JOB SITE. "FLAGGER" WARNING SIGNS MUST BE IN PLACE WHENEVER FLAGGERS ARE PRESENT. THESE SIGNS MUST BE COVERED OR REMOVED WHEN NOT APPLICABLE.
17. "CAUTION" TAPE OR RIBBON IS NOT TO BE USED BETWEEN BARRICADES.
18. HOT-MIX ASPHALT PAVEMENT NECESSARY DURING MAINTENANCE OF TRAFFIC CONSTRUCTION OPERATIONS IS TO BE MIX "D", N50 AND IS TO BE PAID FOR AS "TEMPORARY PAVEMENT".
19. TYPE I OR TYPE II BARRICADES WITH TWO-WAY FLASHING LIGHTS SHALL BE REQUIRED AT ALL OPEN TRENCHES, EXCAVATIONS, OPEN OR EXPOSED SEWER STRUCTURES, TRANSVERSE PAVEMENT JOINTS, MATERIALS OR EQUIPMENT WITHIN THE RIGHT-OF-WAY (NUMBER AND SPACING DEPENDS ON THE CONDITIONS), AND AT LOCATIONS DESIGNATED BY THE ENGINEER OR LOCAL LAW ENFORCEMENT AGENCIES.
20. TYPE I, II, AND / OR III BARRICADES WITH TWO-WAY FLASHING LIGHTS WILL BE REQUIRED TO GUIDE TRAFFIC AWAY FROM PAVEMENT AREAS CLOSED FOR CONSTRUCTION.
21. THE COST OF SUPPLYING, ERECTING, AND MAINTAINING BARRICADES, WARNING LIGHTS, AND SIGNS WILL BE INCLUDED IN THE CONTRACT LUMP SUM PRICE FOR TRAFFIC CONTROL AND PROTECTION, (SPECIAL).
22. WHEN REQUIRED, TRAFFIC SIGNS SHALL BE RELOCATED FROM EACH STAGE OF CONSTRUCTION AS PART OF TRAFFIC CONTROL AND PROTECTION, (SPECIAL).
23. CONTRACTOR TO INSTALL CHANNELIZED BARRIERS OR TEMPORARY FENCE TO DIRECT PEDESTRIANS THROUGH THE CONSTRUCTION AREAS. THIS WORK SHALL BE INCLUDED IN THE UNIT PRICE FOR "TEMPORARY SIDEWALK". THE USE OF THE FENCE OR BARRIERS ARE UP TO THE ENGINEER'S DISCRETION.
24. THE CONTRACTOR SHALL MAINTAIN HANDICAPPED PARKING STALLS AND ADA-ACCESSIBLE ROUTES THROUGHOUT CONSTRUCTION AS SHOWN ON THE PLANS AND AS DIRECTED BY THE ENGINEER. STRIPING AND SIGNAGE OF TEMPORARY HANDICAPPED STALLS AND ACCESSIBLE ROUTES SHALL BE INCLUDED IN "TEMPORARY PAVEMENT MARKING PLACEMENT AND REMOVAL".

**Motorist Notification for Turning on New Traffic Signals in District 1**

This procedure shall be followed whenever a new traffic signal is turned on where signals did not previously exist. The plans must specify the CMS locations, durations, and messages as specified below:

**2 weeks prior to scheduled signal turn-on:**

Place a Changeable Message Sign (CMS) on each mainline approach to the intersection which reads:



**On the day of the turn-on, change messages to read:**




Yellow W3-3 Signal Ahead warning signs shall be placed on each approach to the intersection, each with an 18" x 18" orange flag mounted on the traffic side of the signs. These sign assemblies shall also be installed on raised barrier medians of multilane highways (2<sup>nd</sup> left side installation across from the sign on the right side) where applicable.

The temporary warning devices and sign accessories shall be removed in the following order:

- Changeable message signs - 2 weeks after signal turn-on
- Orange flags - At least 4 weeks after signal turn-on
- If the W3-3 Signal Ahead warning signs are not warranted by the MUTCD (this determination shall be made solely by the Area Traffic Field Engineer/Technician), then they shall be removed as well after a period of 2 months following the signal turn-on. This determination shall be made separately for each approach to the intersection, as conditions may vary by direction requiring the signs to remain permanently in one direction and not in the other direction. Where signs are still warranted to remain, then after 2 months they may be replaced with standard size signs (remove the oversize signs and replace with the normal standard size).

Changeable message signs, W3-3 Signal Ahead signs, and flags should all be provided in the contract. Sequential removal of these items will be performed by the sign shop. Installation of the signs (possibly replacing intersection warning signs with the W3-3 signs) shall be coordinated to be completed on the day of the traffic signal turn-on scheduled with the Area Traffic Signal Engineer.

FILE NAME = N:\WBK\150077.2\Civil\MOT-150077.2.01.sht	USER NAME = bwelech	DESIGNED - BMW	REVISED -	<b>STATE OF ILLINOIS DEPARTMENT OF TRANSPORTATION</b>	<b>AURORA TRANSIT CENTER IMPROVEMENTS SUGGESTED CONSTRUCTION STAGING - GENERAL NOTES</b>	F.A.U. RTE.	SECTION	COUNTY	TOTAL SHEETS	SHEET NO.
Default	PLOT SCALE = 10'	DRAWN - PWN	REVISED -			2503	16-00313-00-MS	KANE	254	45
	PLOT DATE = 10/16/2017	CHECKED - BMW	REVISED -			CONTRACT NO. 61E18				
		DATE - 10/16/2017	REVISED -			ILLINOIS FED. AID PROJECT				
				SCALE: 10'	SHEET OF 254 SHEETS	STA.	TO STA.			

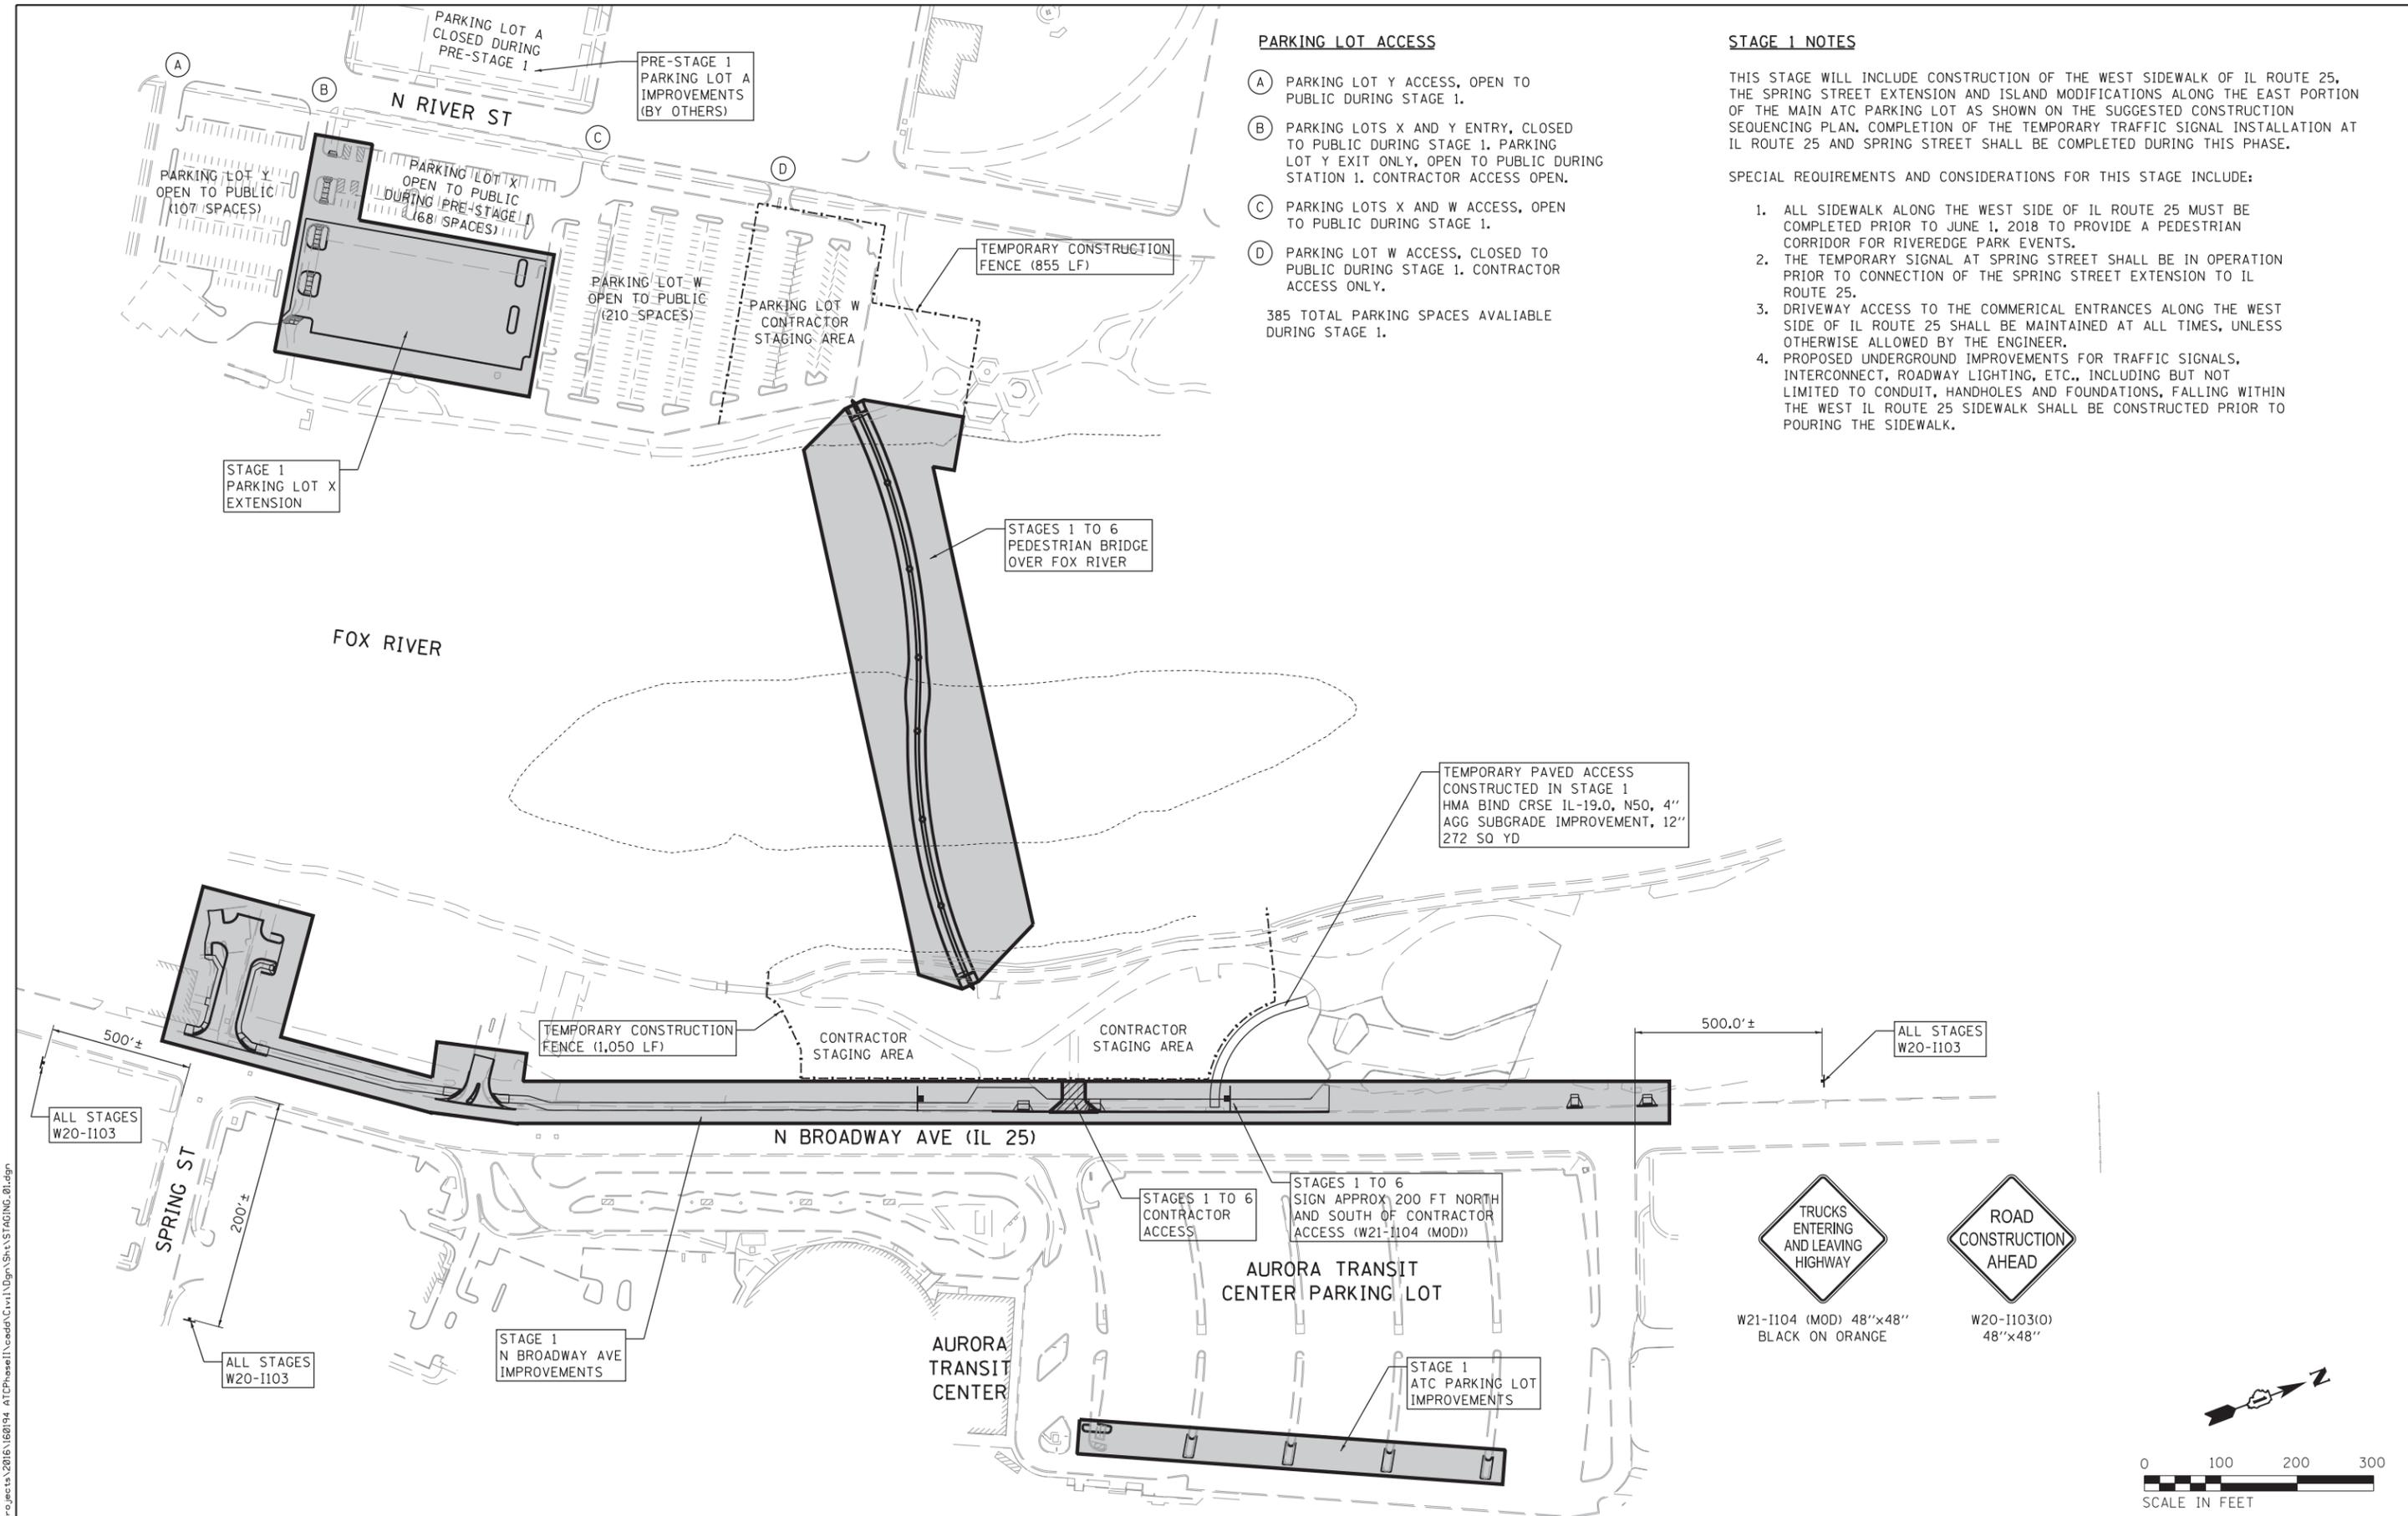

**PARKING LOT ACCESS**

- (A) PARKING LOT Y ACCESS, OPEN TO PUBLIC DURING STAGE 1.
  - (B) PARKING LOTS X AND Y ENTRY, CLOSED TO PUBLIC DURING STAGE 1. PARKING LOT Y EXIT ONLY, OPEN TO PUBLIC DURING STATION 1. CONTRACTOR ACCESS OPEN.
  - (C) PARKING LOTS X AND W ACCESS, OPEN TO PUBLIC DURING STAGE 1.
  - (D) PARKING LOT W ACCESS, CLOSED TO PUBLIC DURING STAGE 1. CONTRACTOR ACCESS ONLY.
- 385 TOTAL PARKING SPACES AVAILABLE DURING STAGE 1.

**STAGE 1 NOTES**

THIS STAGE WILL INCLUDE CONSTRUCTION OF THE WEST SIDEWALK OF IL ROUTE 25, THE SPRING STREET EXTENSION AND ISLAND MODIFICATIONS ALONG THE EAST PORTION OF THE MAIN ATC PARKING LOT AS SHOWN ON THE SUGGESTED CONSTRUCTION SEQUENCING PLAN. COMPLETION OF THE TEMPORARY TRAFFIC SIGNAL INSTALLATION AT IL ROUTE 25 AND SPRING STREET SHALL BE COMPLETED DURING THIS PHASE.

SPECIAL REQUIREMENTS AND CONSIDERATIONS FOR THIS STAGE INCLUDE:

1. ALL SIDEWALK ALONG THE WEST SIDE OF IL ROUTE 25 MUST BE COMPLETED PRIOR TO JUNE 1, 2018 TO PROVIDE A PEDESTRIAN CORRIDOR FOR RIVEREDGE PARK EVENTS.
2. THE TEMPORARY SIGNAL AT SPRING STREET SHALL BE IN OPERATION PRIOR TO CONNECTION OF THE SPRING STREET EXTENSION TO IL ROUTE 25.
3. DRIVEWAY ACCESS TO THE COMMERCIAL ENTRANCES ALONG THE WEST SIDE OF IL ROUTE 25 SHALL BE MAINTAINED AT ALL TIMES, UNLESS OTHERWISE ALLOWED BY THE ENGINEER.
4. PROPOSED UNDERGROUND IMPROVEMENTS FOR TRAFFIC SIGNALS, INTERCONNECT, ROADWAY LIGHTING, ETC., INCLUDING BUT NOT LIMITED TO CONDUIT, HANDHOLES AND FOUNDATIONS, FALLING WITHIN THE WEST IL ROUTE 25 SIDEWALK SHALL BE CONSTRUCTED PRIOR TO POURING THE SIDEWALK.

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**WBK ENGINEERING, LLC**  
 116 WEST MAIN STREET, SUITE 201  
 ST. CHARLES, ILLINOIS 60174  
 (630) 443-7755

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 PLOT SCALE = 1:200  
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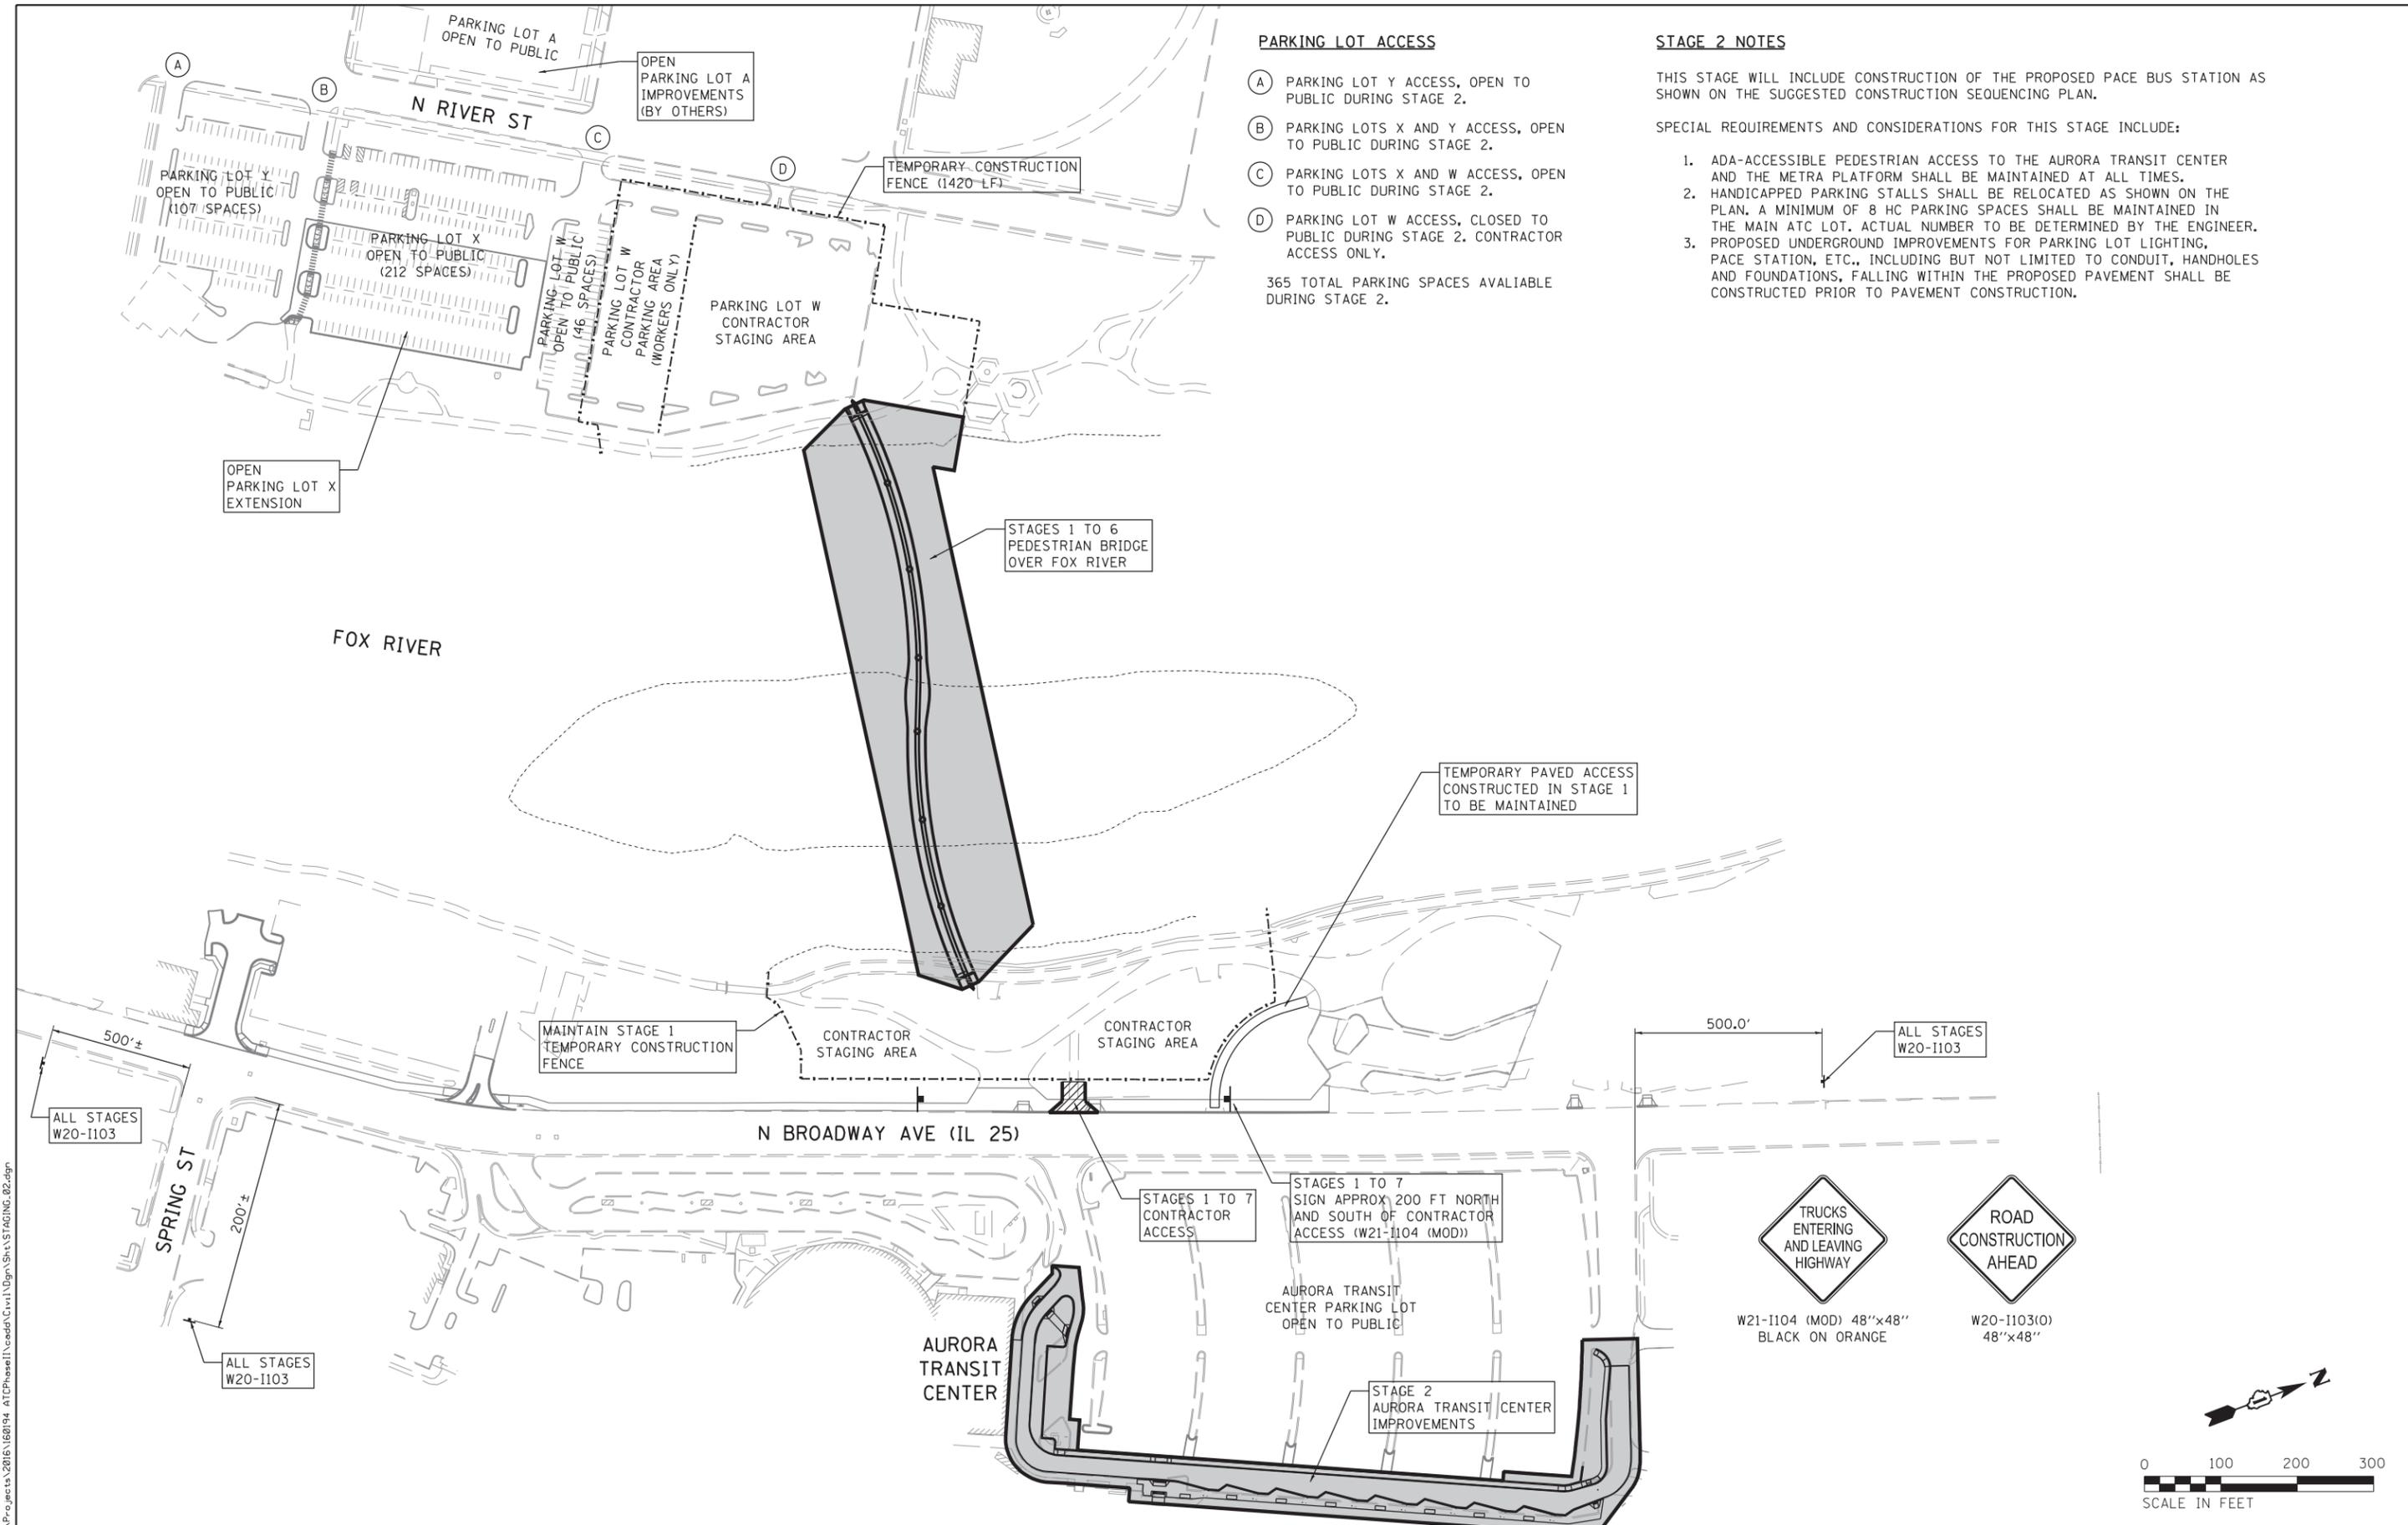
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DRAWN - NDP	REVISED -
CHECKED - MNB	REVISED -
DATE - 10/18/17	REVISED -

**STATE OF ILLINOIS  
 DEPARTMENT OF TRANSPORTATION**

**AURORA TRANSIT CENTER IMPROVEMENTS  
 STAGING PLAN - STAGE 1**

SCALE: 1"=100' SHEET NO. 1 OF 5 SHEETS STA. TO STA.

F.A.U. RTE.	SECTION	COUNTY	TOTAL SHEETS	SHEET NO.
2503	16-00313-00-MS	KANE	254	46
				CONTRACT NO. 61E18
ILLINOIS FED. AID PROJECT				



**PARKING LOT ACCESS**

- (A) PARKING LOT Y ACCESS, OPEN TO PUBLIC DURING STAGE 2.
  - (B) PARKING LOTS X AND Y ACCESS, OPEN TO PUBLIC DURING STAGE 2.
  - (C) PARKING LOTS X AND W ACCESS, OPEN TO PUBLIC DURING STAGE 2.
  - (D) PARKING LOT W ACCESS, CLOSED TO PUBLIC DURING STAGE 2. CONTRACTOR ACCESS ONLY.
- 365 TOTAL PARKING SPACES AVAILIABLE DURING STAGE 2.

**STAGE 2 NOTES**

THIS STAGE WILL INCLUDE CONSTRUCTION OF THE PROPOSED PACE BUS STATION AS SHOWN ON THE SUGGESTED CONSTRUCTION SEQUENCING PLAN.

SPECIAL REQUIREMENTS AND CONSIDERATIONS FOR THIS STAGE INCLUDE:

1. ADA-ACCESSIBLE PEDESTRIAN ACCESS TO THE AURORA TRANSIT CENTER AND THE METRA PLATFORM SHALL BE MAINTAINED AT ALL TIMES.
2. HANDICAPPED PARKING STALLS SHALL BE RELOCATED AS SHOWN ON THE PLAN. A MINIMUM OF 8 HC PARKING SPACES SHALL BE MAINTAINED IN THE MAIN ATC LOT. ACTUAL NUMBER TO BE DETERMINED BY THE ENGINEER.
3. PROPOSED UNDERGROUND IMPROVEMENTS FOR PARKING LOT LIGHTING, PACE STATION, ETC., INCLUDING BUT NOT LIMITED TO CONDUIT, HANDHOLES AND FOUNDATIONS, FALLING WITHIN THE PROPOSED PAVEMENT SHALL BE CONSTRUCTED PRIOR TO PAVEMENT CONSTRUCTION.

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**WBK ENGINEERING, LLC**  
 116 WEST MAIN STREET, SUITE 201  
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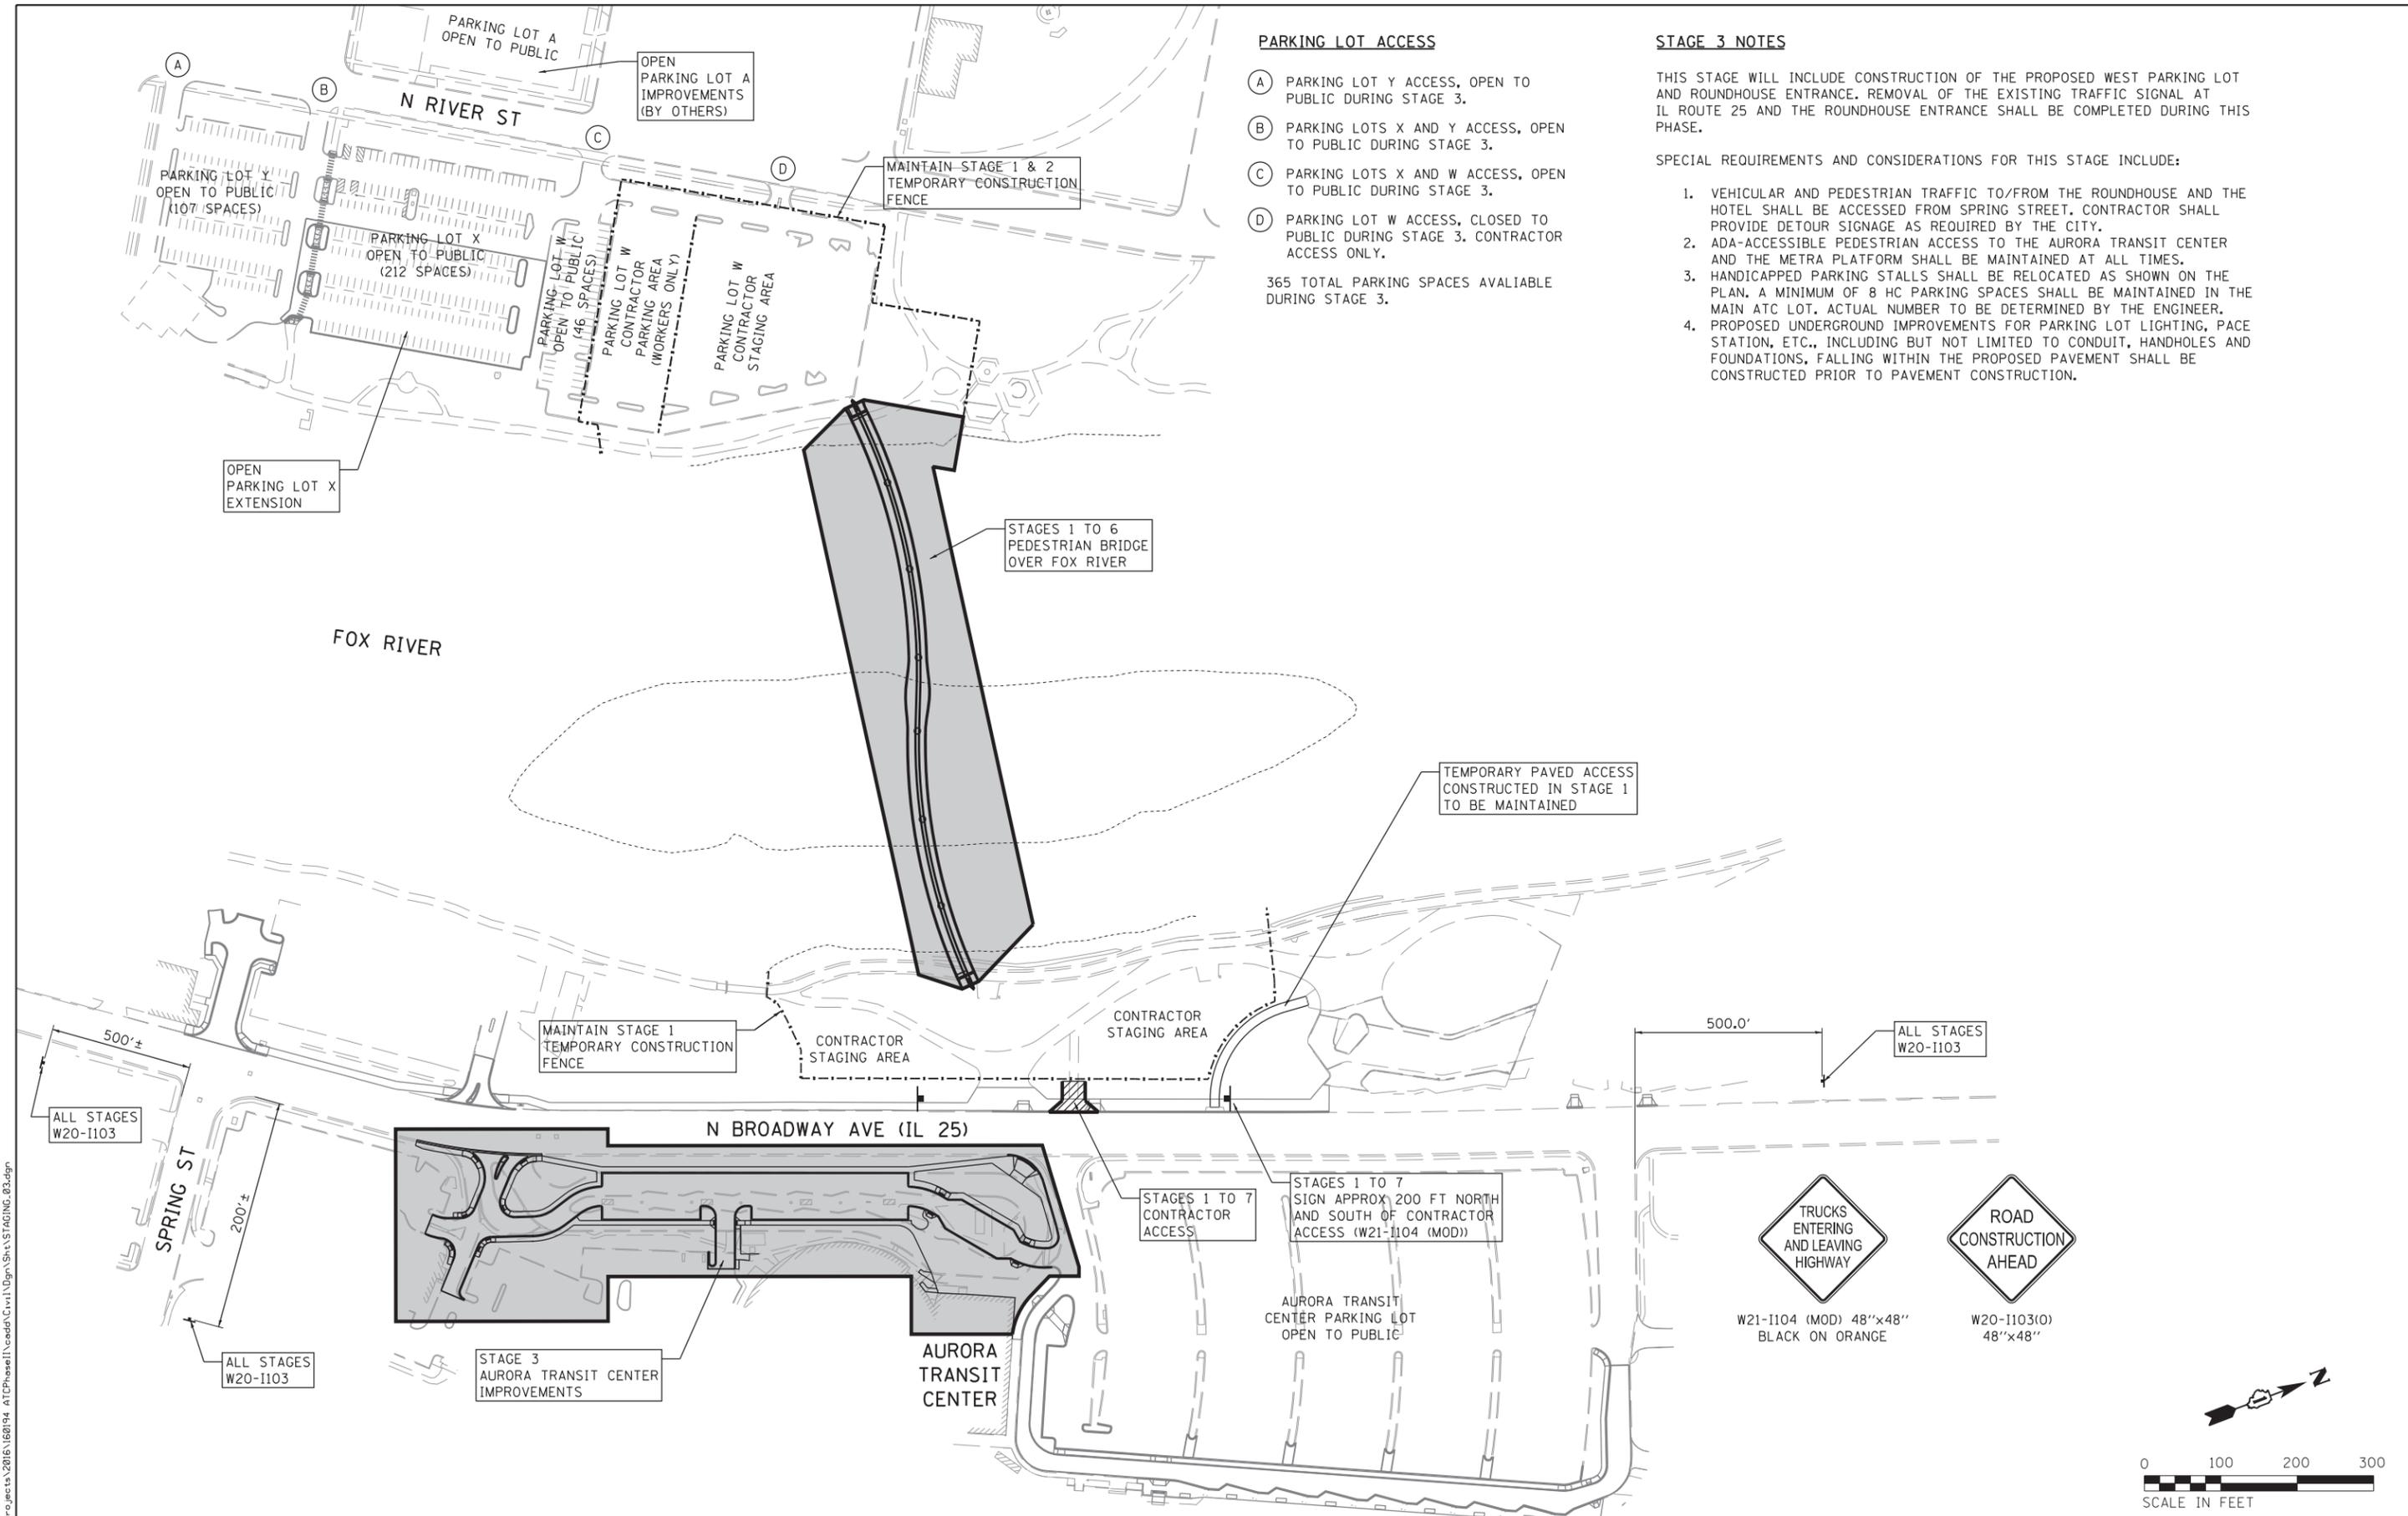
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PLOT DATE = 10/17/2017	CHECKED - MNB	REVISED -
	DATE - 10/18/17	REVISED -

**STATE OF ILLINOIS  
 DEPARTMENT OF TRANSPORTATION**

**AURORA TRANSIT CENTER IMPROVEMENTS  
 STAGING PLAN - STAGE 2**

SCALE: 1"=100' SHEET NO. 2 OF 5 SHEETS STA. TO STA.

F.A.U. RTE.	SECTION	COUNTY	TOTAL SHEETS	SHEET NO.
2503	16-00313-00-MS	KANE	254	47
CONTRACT NO. 61E18				
ILLINOIS FED. AID PROJECT				



**PARKING LOT ACCESS**

- (A) PARKING LOT Y ACCESS, OPEN TO PUBLIC DURING STAGE 3.
- (B) PARKING LOTS X AND Y ACCESS, OPEN TO PUBLIC DURING STAGE 3.
- (C) PARKING LOTS X AND W ACCESS, OPEN TO PUBLIC DURING STAGE 3.
- (D) PARKING LOT W ACCESS, CLOSED TO PUBLIC DURING STAGE 3, CONTRACTOR ACCESS ONLY.

365 TOTAL PARKING SPACES AVAILIABLE DURING STAGE 3.

**STAGE 3 NOTES**

THIS STAGE WILL INCLUDE CONSTRUCTION OF THE PROPOSED WEST PARKING LOT AND ROUNDHOUSE ENTRANCE. REMOVAL OF THE EXISTING TRAFFIC SIGNAL AT IL ROUTE 25 AND THE ROUNDHOUSE ENTRANCE SHALL BE COMPLETED DURING THIS PHASE.

SPECIAL REQUIREMENTS AND CONSIDERATIONS FOR THIS STAGE INCLUDE:

1. VEHICULAR AND PEDESTRIAN TRAFFIC TO/FROM THE ROUNDHOUSE AND THE HOTEL SHALL BE ACCESSED FROM SPRING STREET. CONTRACTOR SHALL PROVIDE DETOUR SIGNAGE AS REQUIRED BY THE CITY.
2. ADA-ACCESSIBLE PEDESTRIAN ACCESS TO THE AURORA TRANSIT CENTER AND THE METRA PLATFORM SHALL BE MAINTAINED AT ALL TIMES.
3. HANDICAPPED PARKING STALLS SHALL BE RELOCATED AS SHOWN ON THE PLAN. A MINIMUM OF 8 HC PARKING SPACES SHALL BE MAINTAINED IN THE MAIN ATC LOT. ACTUAL NUMBER TO BE DETERMINED BY THE ENGINEER.
4. PROPOSED UNDERGROUND IMPROVEMENTS FOR PARKING LOT LIGHTING, PACE STATION, ETC., INCLUDING BUT NOT LIMITED TO CONDUIT, HANDHOLES AND FOUNDATIONS, FALLING WITHIN THE PROPOSED PAVEMENT SHALL BE CONSTRUCTED PRIOR TO PAVEMENT CONSTRUCTION.

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 116 WEST MAIN STREET, SUITE 201  
 ST. CHARLES, ILLINOIS 60174  
 (630) 443-7755

USER NAME = nparris  
 PLOT SCALE = 1:200  
 PLOT DATE = 10/17/2017


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DRAWN - NDP	REVISED -
CHECKED - MNB	REVISED -
DATE - 10/18/17	REVISED -

**STATE OF ILLINOIS**  
**DEPARTMENT OF TRANSPORTATION**

**AURORA TRANSIT CENTER IMPROVEMENTS**  
**STAGING PLAN - STAGE 3**

SCALE: 1"=100'    SHEET NO. 3 OF 5 SHEETS    STA.    TO STA.

F.A.U. RTE.	SECTION	COUNTY	TOTAL SHEETS	SHEET NO.
2503	16-00313-00-MS	KANE	254	48
CONTRACT NO. 61E18				
ILLINOIS FED. AID PROJECT				

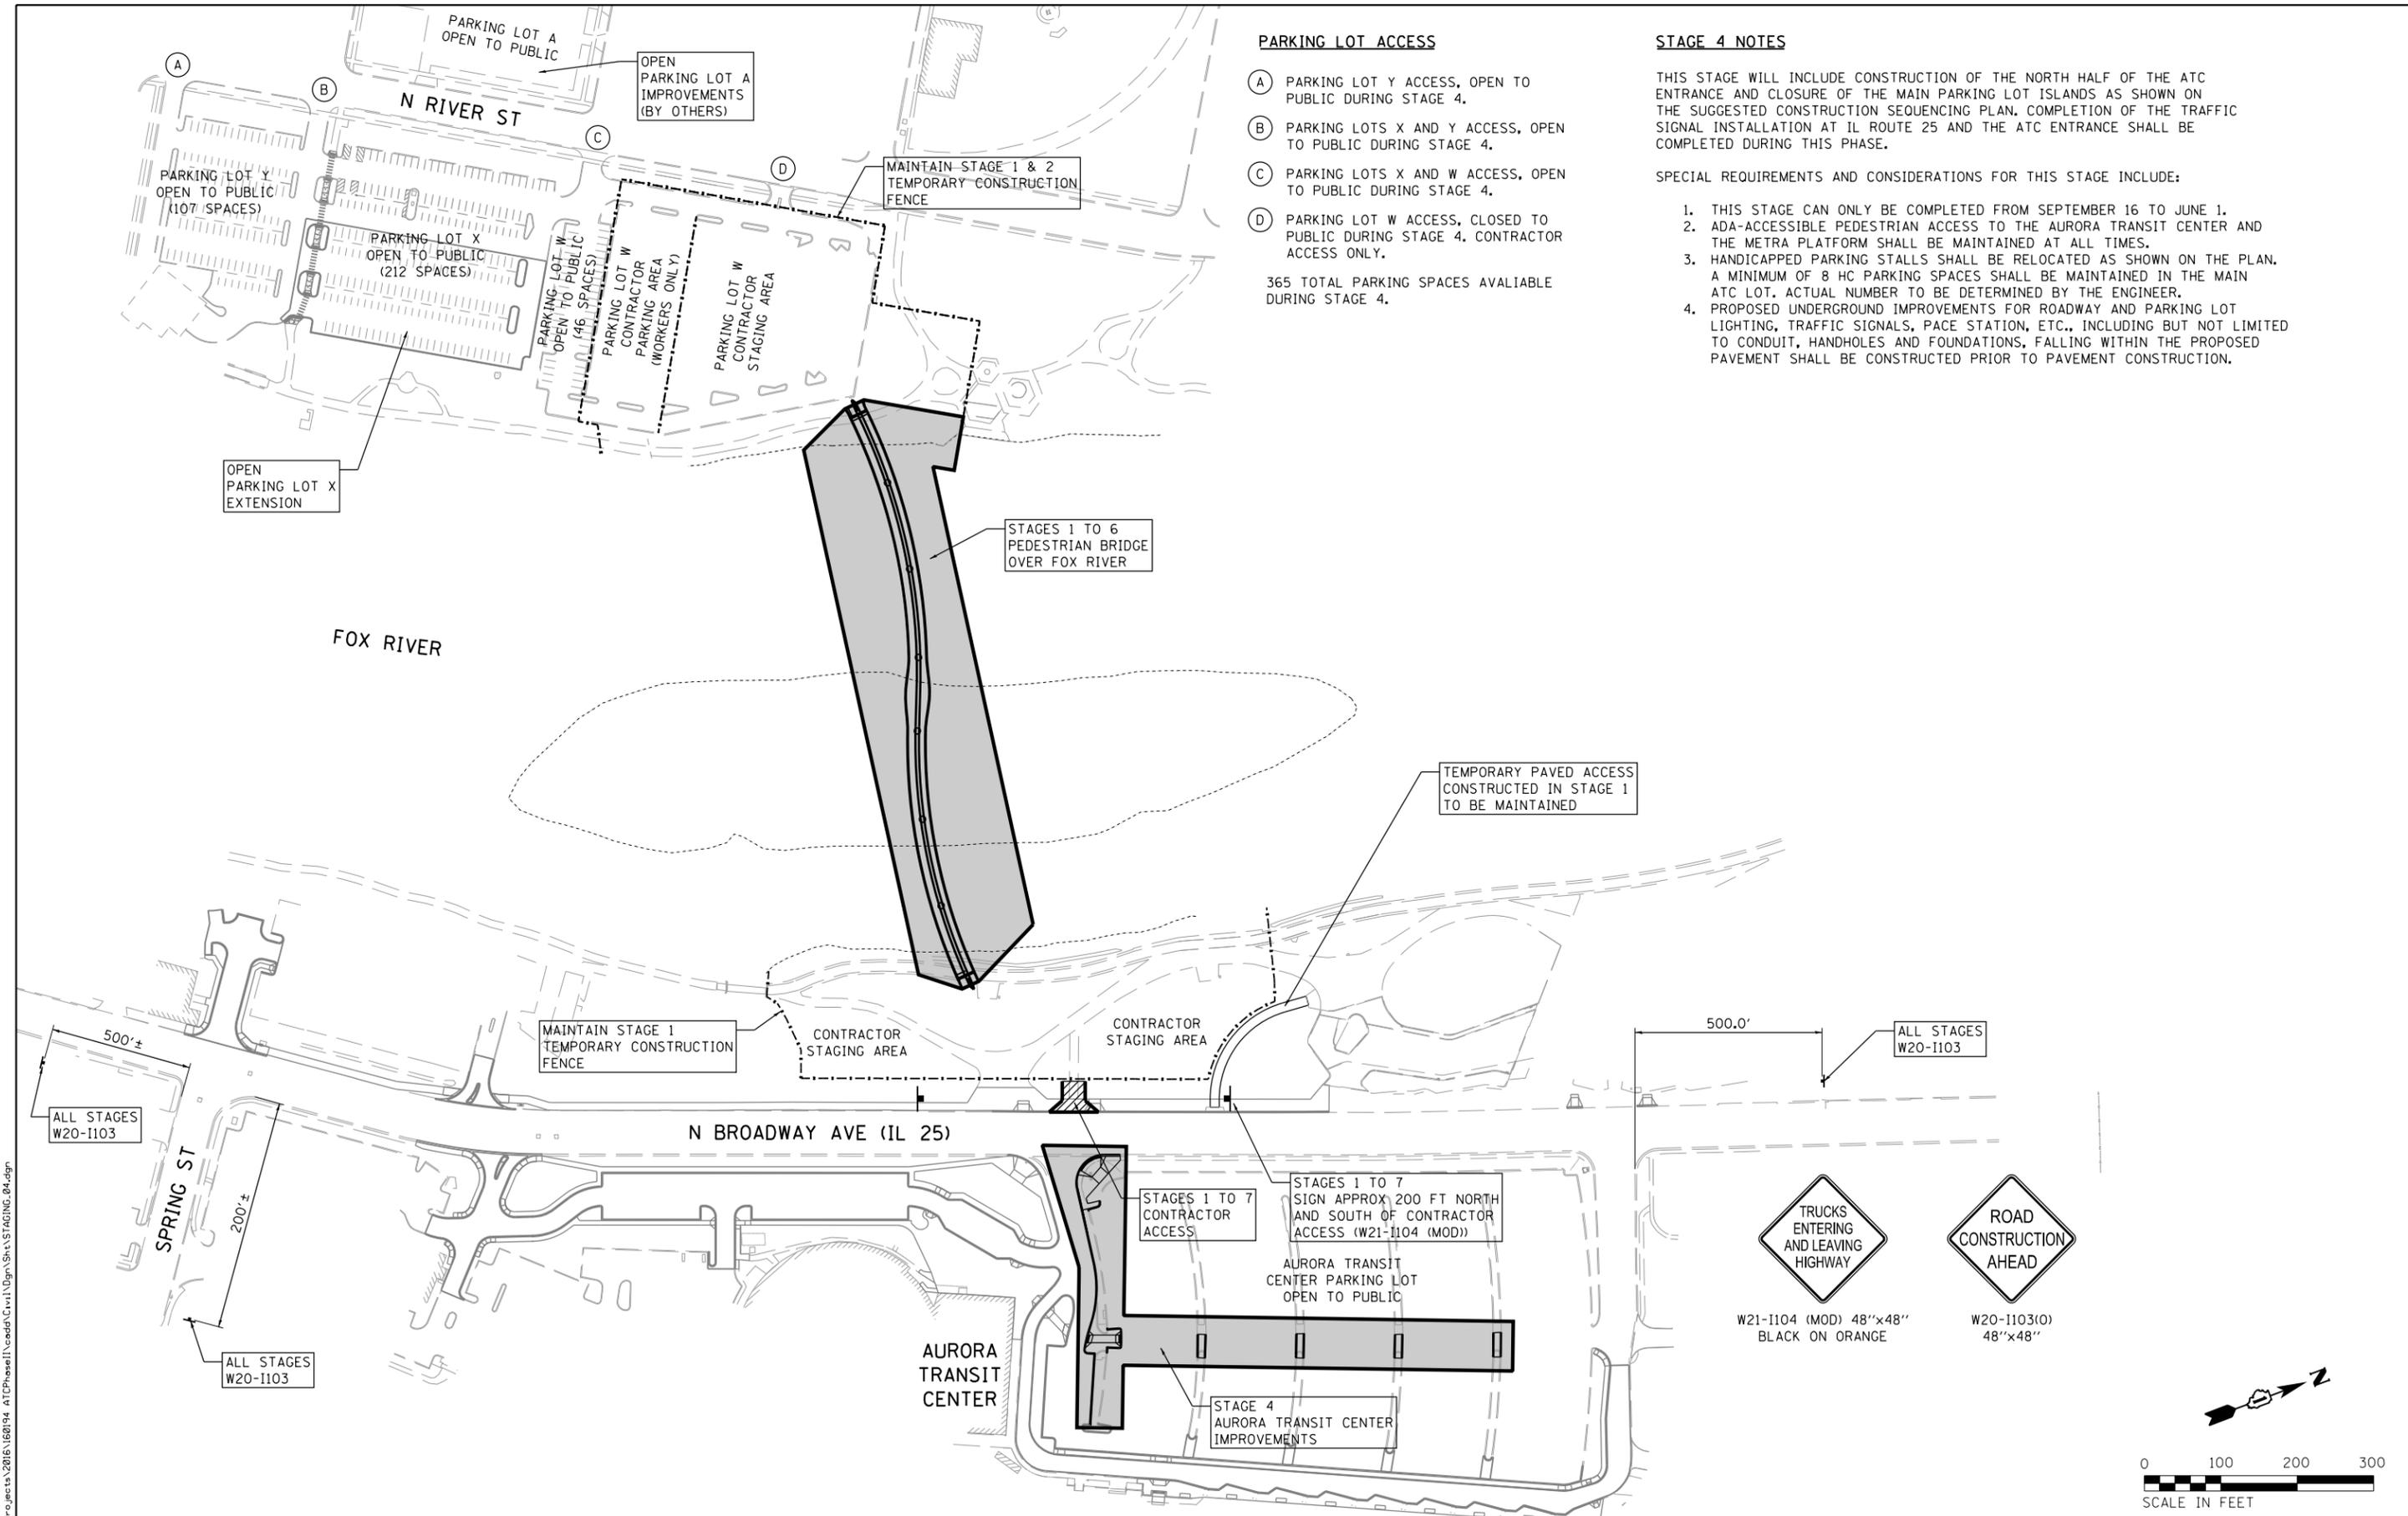

**PARKING LOT ACCESS**

- (A) PARKING LOT Y ACCESS, OPEN TO PUBLIC DURING STAGE 4.
- (B) PARKING LOTS X AND Y ACCESS, OPEN TO PUBLIC DURING STAGE 4.
- (C) PARKING LOTS X AND W ACCESS, OPEN TO PUBLIC DURING STAGE 4.
- (D) PARKING LOT W ACCESS, CLOSED TO PUBLIC DURING STAGE 4, CONTRACTOR ACCESS ONLY.

365 TOTAL PARKING SPACES AVAILIABLE DURING STAGE 4.

**STAGE 4 NOTES**

THIS STAGE WILL INCLUDE CONSTRUCTION OF THE NORTH HALF OF THE ATC ENTRANCE AND CLOSURE OF THE MAIN PARKING LOT ISLANDS AS SHOWN ON THE SUGGESTED CONSTRUCTION SEQUENCING PLAN. COMPLETION OF THE TRAFFIC SIGNAL INSTALLATION AT IL ROUTE 25 AND THE ATC ENTRANCE SHALL BE COMPLETED DURING THIS PHASE.

**SPECIAL REQUIREMENTS AND CONSIDERATIONS FOR THIS STAGE INCLUDE:**

1. THIS STAGE CAN ONLY BE COMPLETED FROM SEPTEMBER 16 TO JUNE 1.
2. ADA-ACCESSIBLE PEDESTRIAN ACCESS TO THE AURORA TRANSIT CENTER AND THE METRA PLATFORM SHALL BE MAINTAINED AT ALL TIMES.
3. HANDICAPPED PARKING STALLS SHALL BE RELOCATED AS SHOWN ON THE PLAN. A MINIMUM OF 8 HC PARKING SPACES SHALL BE MAINTAINED IN THE MAIN ATC LOT. ACTUAL NUMBER TO BE DETERMINED BY THE ENGINEER.
4. PROPOSED UNDERGROUND IMPROVEMENTS FOR ROADWAY AND PARKING LOT LIGHTING, TRAFFIC SIGNALS, PACE STATION, ETC., INCLUDING BUT NOT LIMITED TO CONDUIT, HANDHOLES AND FOUNDATIONS, FALLING WITHIN THE PROPOSED PAVEMENT SHALL BE CONSTRUCTED PRIOR TO PAVEMENT CONSTRUCTION.

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**WBK ENGINEERING, LLC**  
 116 WEST MAIN STREET, SUITE 201  
 ST. CHARLES, ILLINOIS 60174  
 (630) 443-7755


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	DATE - 10/18/17	REVISED -

**STATE OF ILLINOIS  
 DEPARTMENT OF TRANSPORTATION**

**AURORA TRANSIT CENTER IMPROVEMENTS  
 STAGING PLAN - STAGE 4**

SCALE: 1"=100' SHEET NO. 4 OF 5 SHEETS STA. TO STA.

F.A.U. RTE.	SECTION	COUNTY	TOTAL SHEETS	SHEET NO.
2503	16-00313-00-MS	KANE	254	49
CONTRACT NO. 61E18				
ILLINOIS FED. AID PROJECT				

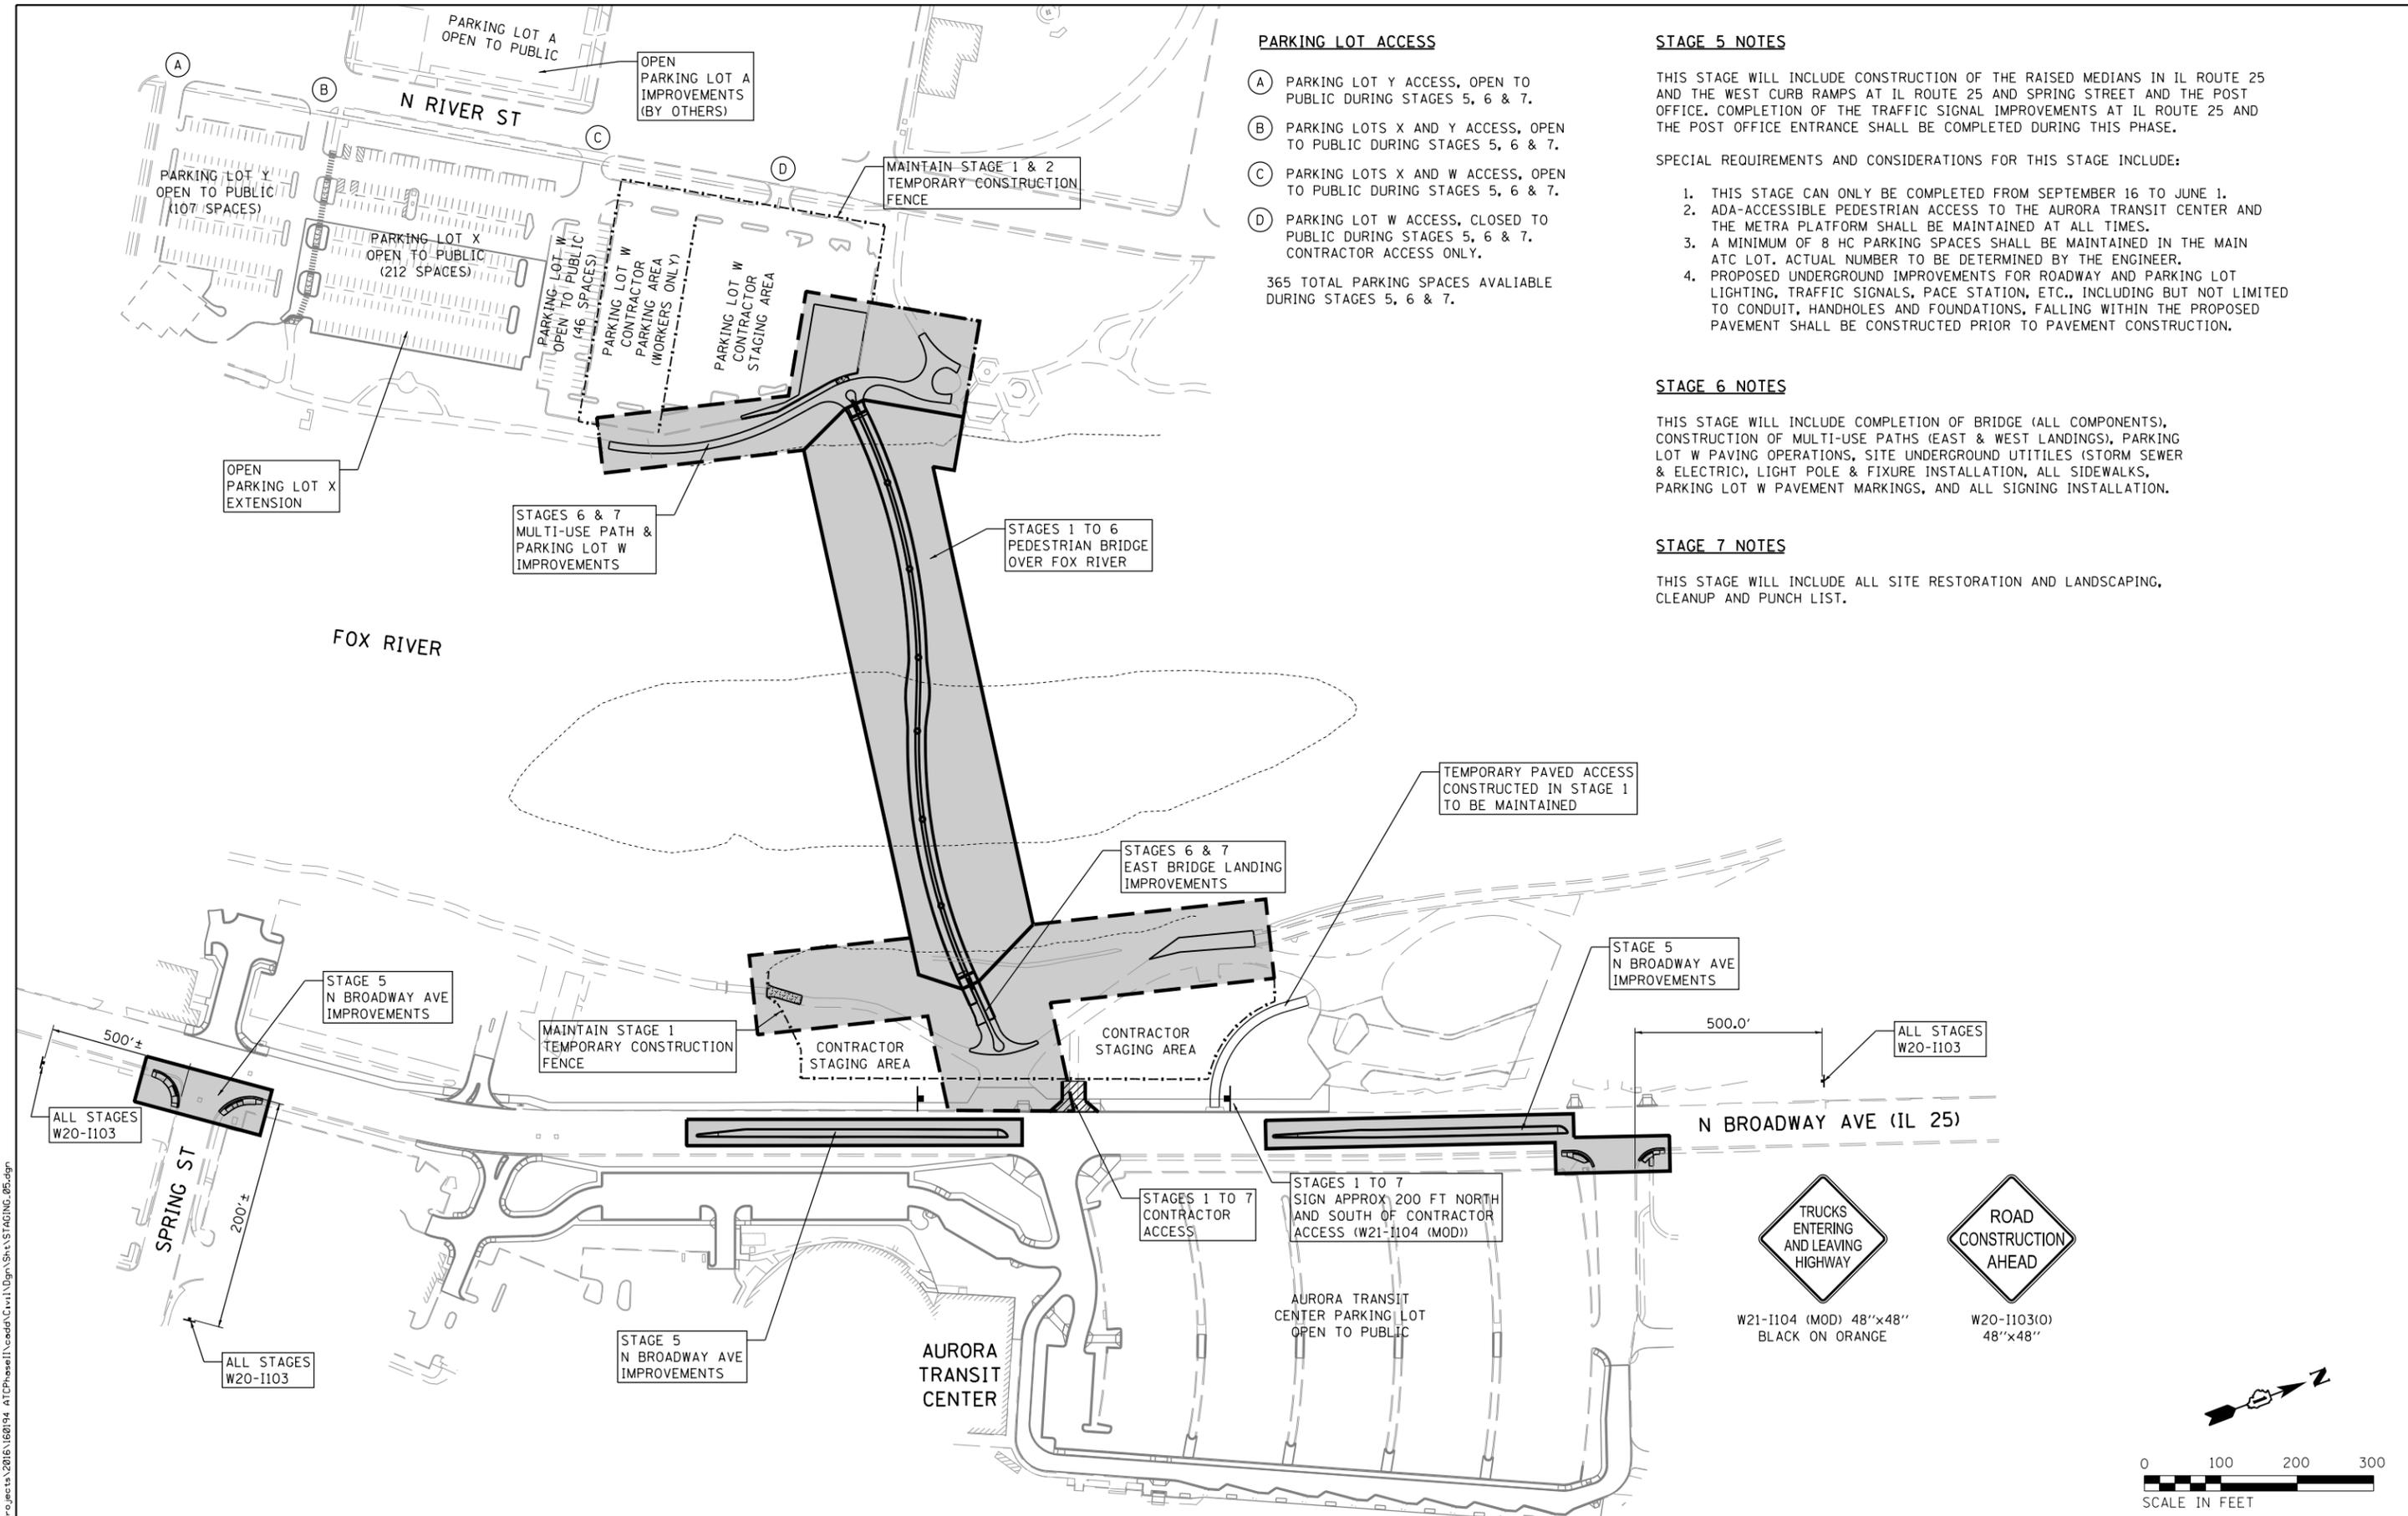

**PARKING LOT ACCESS**

- (A) PARKING LOT Y ACCESS, OPEN TO PUBLIC DURING STAGES 5, 6 & 7.
- (B) PARKING LOTS X AND Y ACCESS, OPEN TO PUBLIC DURING STAGES 5, 6 & 7.
- (C) PARKING LOTS X AND W ACCESS, OPEN TO PUBLIC DURING STAGES 5, 6 & 7.
- (D) PARKING LOT W ACCESS, CLOSED TO PUBLIC DURING STAGES 5, 6 & 7. CONTRACTOR ACCESS ONLY.

365 TOTAL PARKING SPACES AVAILIABLE DURING STAGES 5, 6 & 7.

**STAGE 5 NOTES**

THIS STAGE WILL INCLUDE CONSTRUCTION OF THE RAISED MEDIANS IN IL ROUTE 25 AND THE WEST CURB RAMPS AT IL ROUTE 25 AND SPRING STREET AND THE POST OFFICE. COMPLETION OF THE TRAFFIC SIGNAL IMPROVEMENTS AT IL ROUTE 25 AND THE POST OFFICE ENTRANCE SHALL BE COMPLETED DURING THIS PHASE.

SPECIAL REQUIREMENTS AND CONSIDERATIONS FOR THIS STAGE INCLUDE:

1. THIS STAGE CAN ONLY BE COMPLETED FROM SEPTEMBER 16 TO JUNE 1.
2. ADA-ACCESSIBLE PEDESTRIAN ACCESS TO THE AURORA TRANSIT CENTER AND THE METRA PLATFORM SHALL BE MAINTAINED AT ALL TIMES.
3. A MINIMUM OF 8 HC PARKING SPACES SHALL BE MAINTAINED IN THE MAIN ATC LOT, ACTUAL NUMBER TO BE DETERMINED BY THE ENGINEER.
4. PROPOSED UNDERGROUND IMPROVEMENTS FOR ROADWAY AND PARKING LOT LIGHTING, TRAFFIC SIGNALS, PACE STATION, ETC., INCLUDING BUT NOT LIMITED TO CONDUIT, HANDHOLES AND FOUNDATIONS, FALLING WITHIN THE PROPOSED PAVEMENT SHALL BE CONSTRUCTED PRIOR TO PAVEMENT CONSTRUCTION.

**STAGE 6 NOTES**

THIS STAGE WILL INCLUDE COMPLETION OF BRIDGE (ALL COMPONENTS), CONSTRUCTION OF MULTI-USE PATHS (EAST & WEST LANDINGS), PARKING LOT W PAVING OPERATIONS, SITE UNDERGROUND UTILITIES (STORM SEWER & ELECTRIC), LIGHT POLE & FIXTURE INSTALLATION, ALL SIDEWALKS, PARKING LOT W PAVEMENT MARKINGS, AND ALL SIGNING INSTALLATION.

**STAGE 7 NOTES**

THIS STAGE WILL INCLUDE ALL SITE RESTORATION AND LANDSCAPING, CLEANUP AND PUNCH LIST.

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**WBK ENGINEERING, LLC**  
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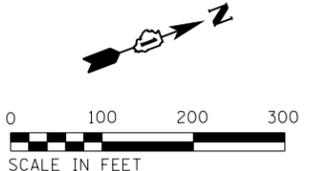
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	DATE - 10/18/17	REVISED -

**STATE OF ILLINOIS  
 DEPARTMENT OF TRANSPORTATION**

**AURORA TRANSIT CENTER IMPROVEMENTS  
 STAGING PLAN - STAGES 5, 6 & 7**

SCALE: 1"=100' SHEET NO. 5 OF 5 SHEETS STA. TO STA.


F.A.U. RTE.	SECTION	COUNTY	TOTAL SHEETS	SHEET NO.
2503	16-00313-00-MS	KANE	254	50
CONTRACT NO. 61E18				
ILLINOIS FED. AID PROJECT				



NOTE: PLACE "SIDEWALK CLOSED AHEAD - USE OTHER SIDE" SIGN AT NEW YORK STREET



NOT TO SCALE

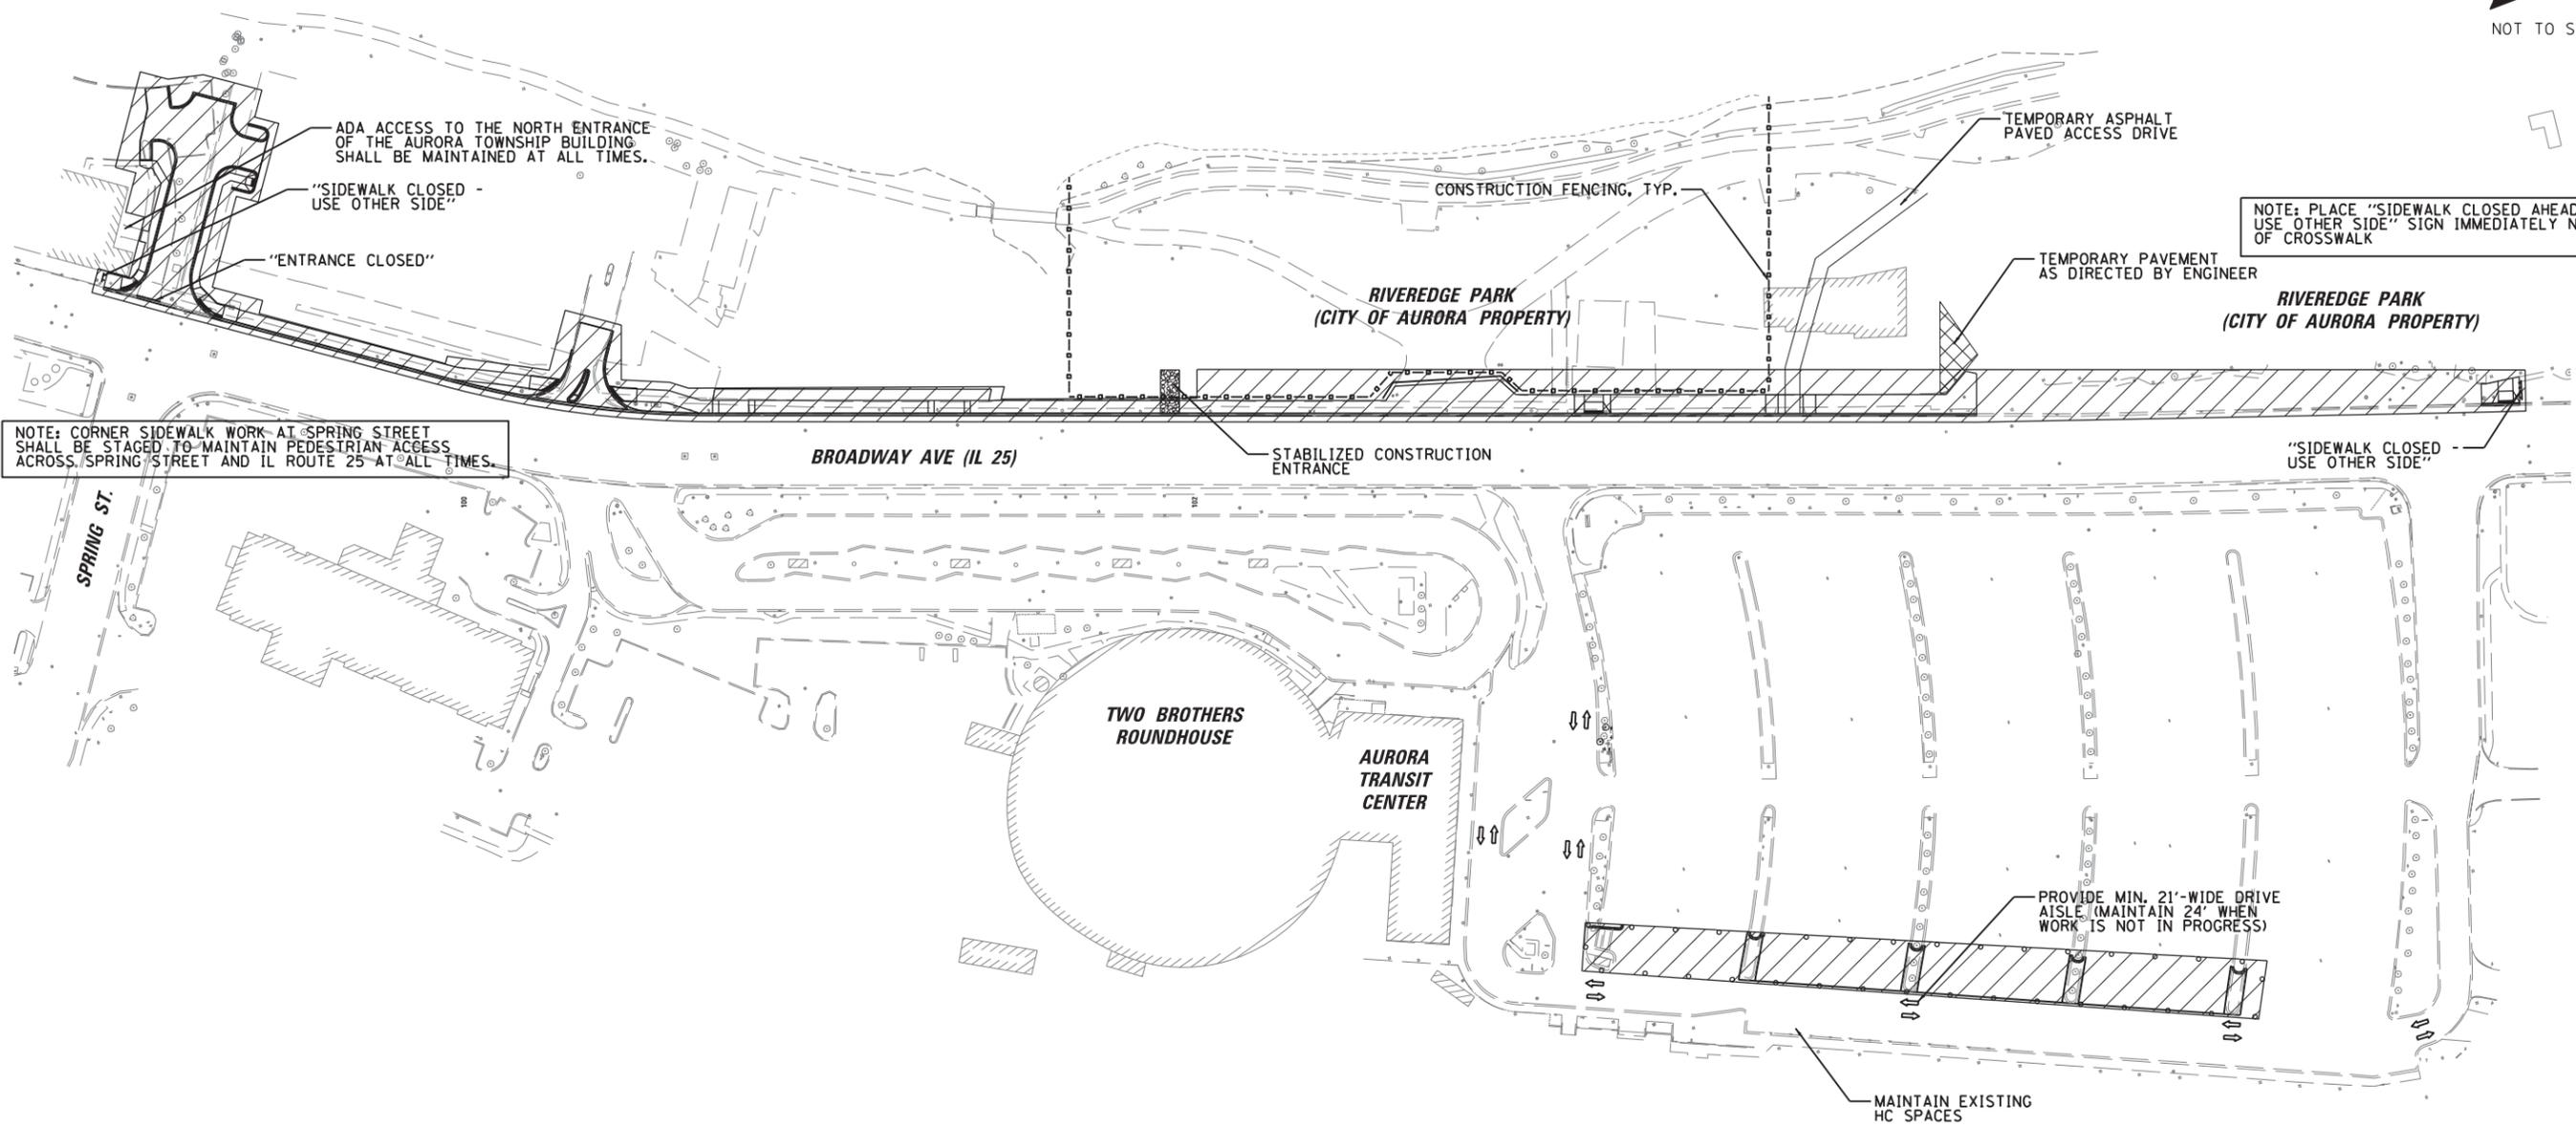

NOTE: CORNER SIDEWALK WORK AT SPRING STREET SHALL BE STAGED TO MAINTAIN PEDESTRIAN ACCESS ACROSS SPRING STREET AND IL ROUTE 25 AT ALL TIMES.

NOTE: PLACE "SIDEWALK CLOSED AHEAD - USE OTHER SIDE" SIGN IMMEDIATELY NORTH OF CROSSWALK

**SUGGESTED SEQUENCING LEGEND**

- WORK ZONE
- TEMPORARY PAVEMENT
- STABILIZED CONSTRUCTION ENTRANCE
- TEMPORARY SIDEWALK
- TYPE III BARRICADE
- DIRECTION OF TRAFFIC FLOW

**SUGGESTED SEQUENCE OF CONSTRUCTION**

**STAGE 1**

THIS STAGE WILL INCLUDE CONSTRUCTION OF THE WEST SIDEWALK OF IL ROUTE 25, THE SPRING STREET EXTENSION AND ISLAND MODIFICATIONS ALONG THE EAST PORTION OF THE MAIN ATC PARKING LOT AS SHOWN ON THE SUGGESTED CONSTRUCTION SEQUENCING PLAN. COMPLETION OF THE TEMPORARY TRAFFIC SIGNAL INSTALLATION AT IL ROUTE 25 AND SPRING STREET SHALL BE COMPLETED DURING THIS STAGE.

SPECIAL REQUIREMENTS AND CONSIDERATIONS FOR THIS STAGE INCLUDE:

1. ALL SIDEWALK ALONG THE WEST SIDE OF IL ROUTE 25 MUST BE **COMPLETED** PRIOR TO JUNE 1, 2018 TO PROVIDE A PEDESTRIAN CORRIDOR FOR RIVEREDGE PARK EVENTS.
2. THE TEMPORARY SIGNAL AT SPRING STREET SHALL BE IN OPERATION PRIOR TO CONNECTION OF THE SPRING STREET EXTENSION TO IL ROUTE 25.
3. DRIVEWAY ACCESS TO THE COMMERCIAL ENTRANCES ALONG THE WEST SIDE OF IL ROUTE 25 SHALL BE MAINTAINED AT ALL TIMES, UNLESS OTHERWISE ALLOWED BY THE ENGINEER.
4. PROPOSED UNDERGROUND IMPROVEMENTS FOR TRAFFIC SIGNALS, INTERCONNECT, ROADWAY LIGHTING, ETC., INCLUDING BUT NOT LIMITED TO CONDUIT, HANDHOLES AND FOUNDATIONS, FALLING WITHIN THE WEST IL ROUTE 25 SIDEWALK SHALL BE CONSTRUCTED PRIOR TO POURING THE SIDEWALK.


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**STATE OF ILLINOIS  
DEPARTMENT OF TRANSPORTATION**


**AURORA TRANSIT CENTER IMPROVEMENTS  
SUGGESTED CONSTRUCTION STAGING - STAGE 1**

SCALE: 1/4" = 1'-0" SHEET OF 254 SHEETS STA. TO STA.

F.A.U. RTE.	SECTION	COUNTY	TOTAL SHEETS	SHEET NO.
2503	16-00313-00-MS	KANE	254	51
CONTRACT NO. 61E18				
ILLINOIS FED. AID PROJECT				

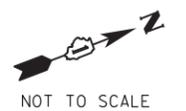

NOT TO SCALE

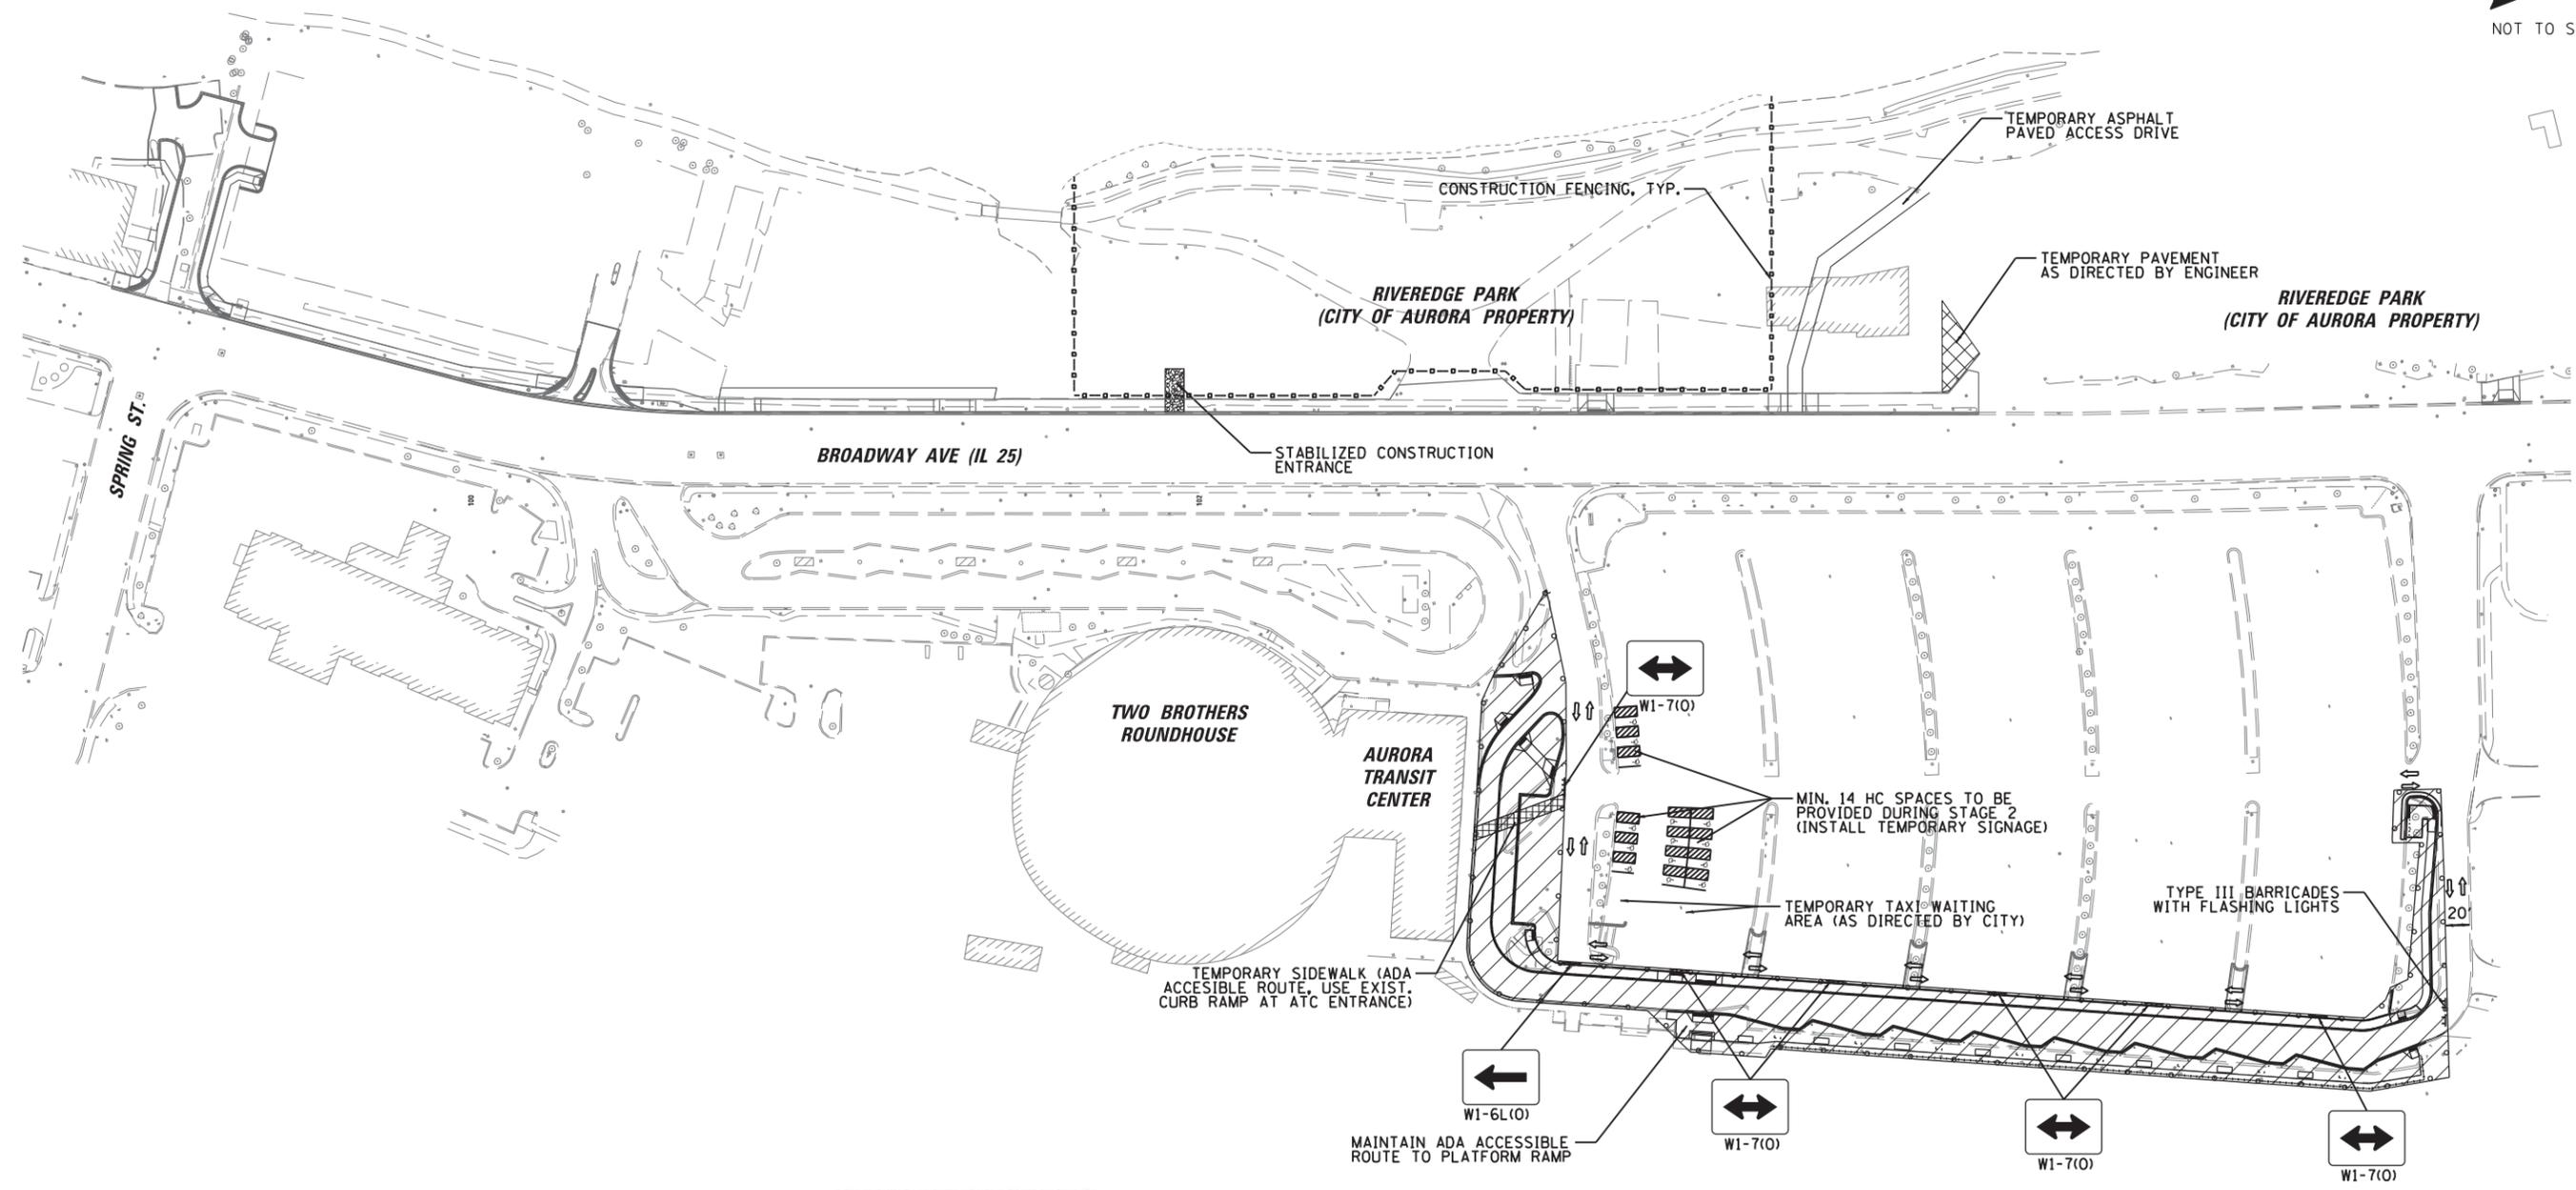

SUGGESTED SEQUENCING LEGEND	
	WORK ZONE
	TEMPORARY PAVEMENT
	STABILIZED CONSTRUCTION ENTRANCE
	TEMPORARY SIDEWALK
	TYPE III BARRICADE
	DIRECTION OF TRAFFIC FLOW

**SUGGESTED SEQUENCE OF CONSTRUCTION**

**STAGE 2**  
 THIS STAGE WILL INCLUDE CONSTRUCTION OF THE PROPOSED PACE BUS STATION AS SHOWN ON THE SUGGESTED CONSTRUCTION SEQUENCING PLAN.

SPECIAL REQUIREMENTS AND CONSIDERATIONS FOR THIS STAGE INCLUDE:

1. ADA-ACCESSIBLE PEDESTRIAN ACCESS TO THE AURORA TRANSIT CENTER AND THE METRA PLATFORM SHALL BE MAINTAINED AT ALL TIMES.
2. HANDICAPPED PARKING SPACES SHALL BE RELOCATED AS SHOWN ON THE PLAN. A MINIMUM OF 8 HC PARKING SPACES SHALL BE MAINTAINED IN THE MAIN ATC LOT. ACTUAL NUMBER TO BE DETERMINED BY THE ENGINEER.
3. PROPOSED UNDERGROUND IMPROVEMENTS FOR PARKING LOT LIGHTING, PACE STATION, ETC., INCLUDING BUT NOT LIMITED TO CONDUIT, HANDHOLES AND FOUNDATIONS, FALLING WITHIN THE PROPOSED PAVEMENT SHALL BE CONSTRUCTED PRIOR TO PAVEMENT CONSTRUCTION.


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**STATE OF ILLINOIS  
 DEPARTMENT OF TRANSPORTATION**

**AURORA TRANSIT CENTER IMPROVEMENTS  
 SUGGESTED CONSTRUCTION STAGING - STAGE 2**

SCALE: 1/40" SHEET OF 254 SHEETS STA. TO STA.

F.A.U. RTE.	SECTION	COUNTY	TOTAL SHEETS	SHEET NO.
2503	16-00313-00-MS	KANE	254	52
CONTRACT NO. 61E18				
ILLINOIS FED. AID PROJECT				

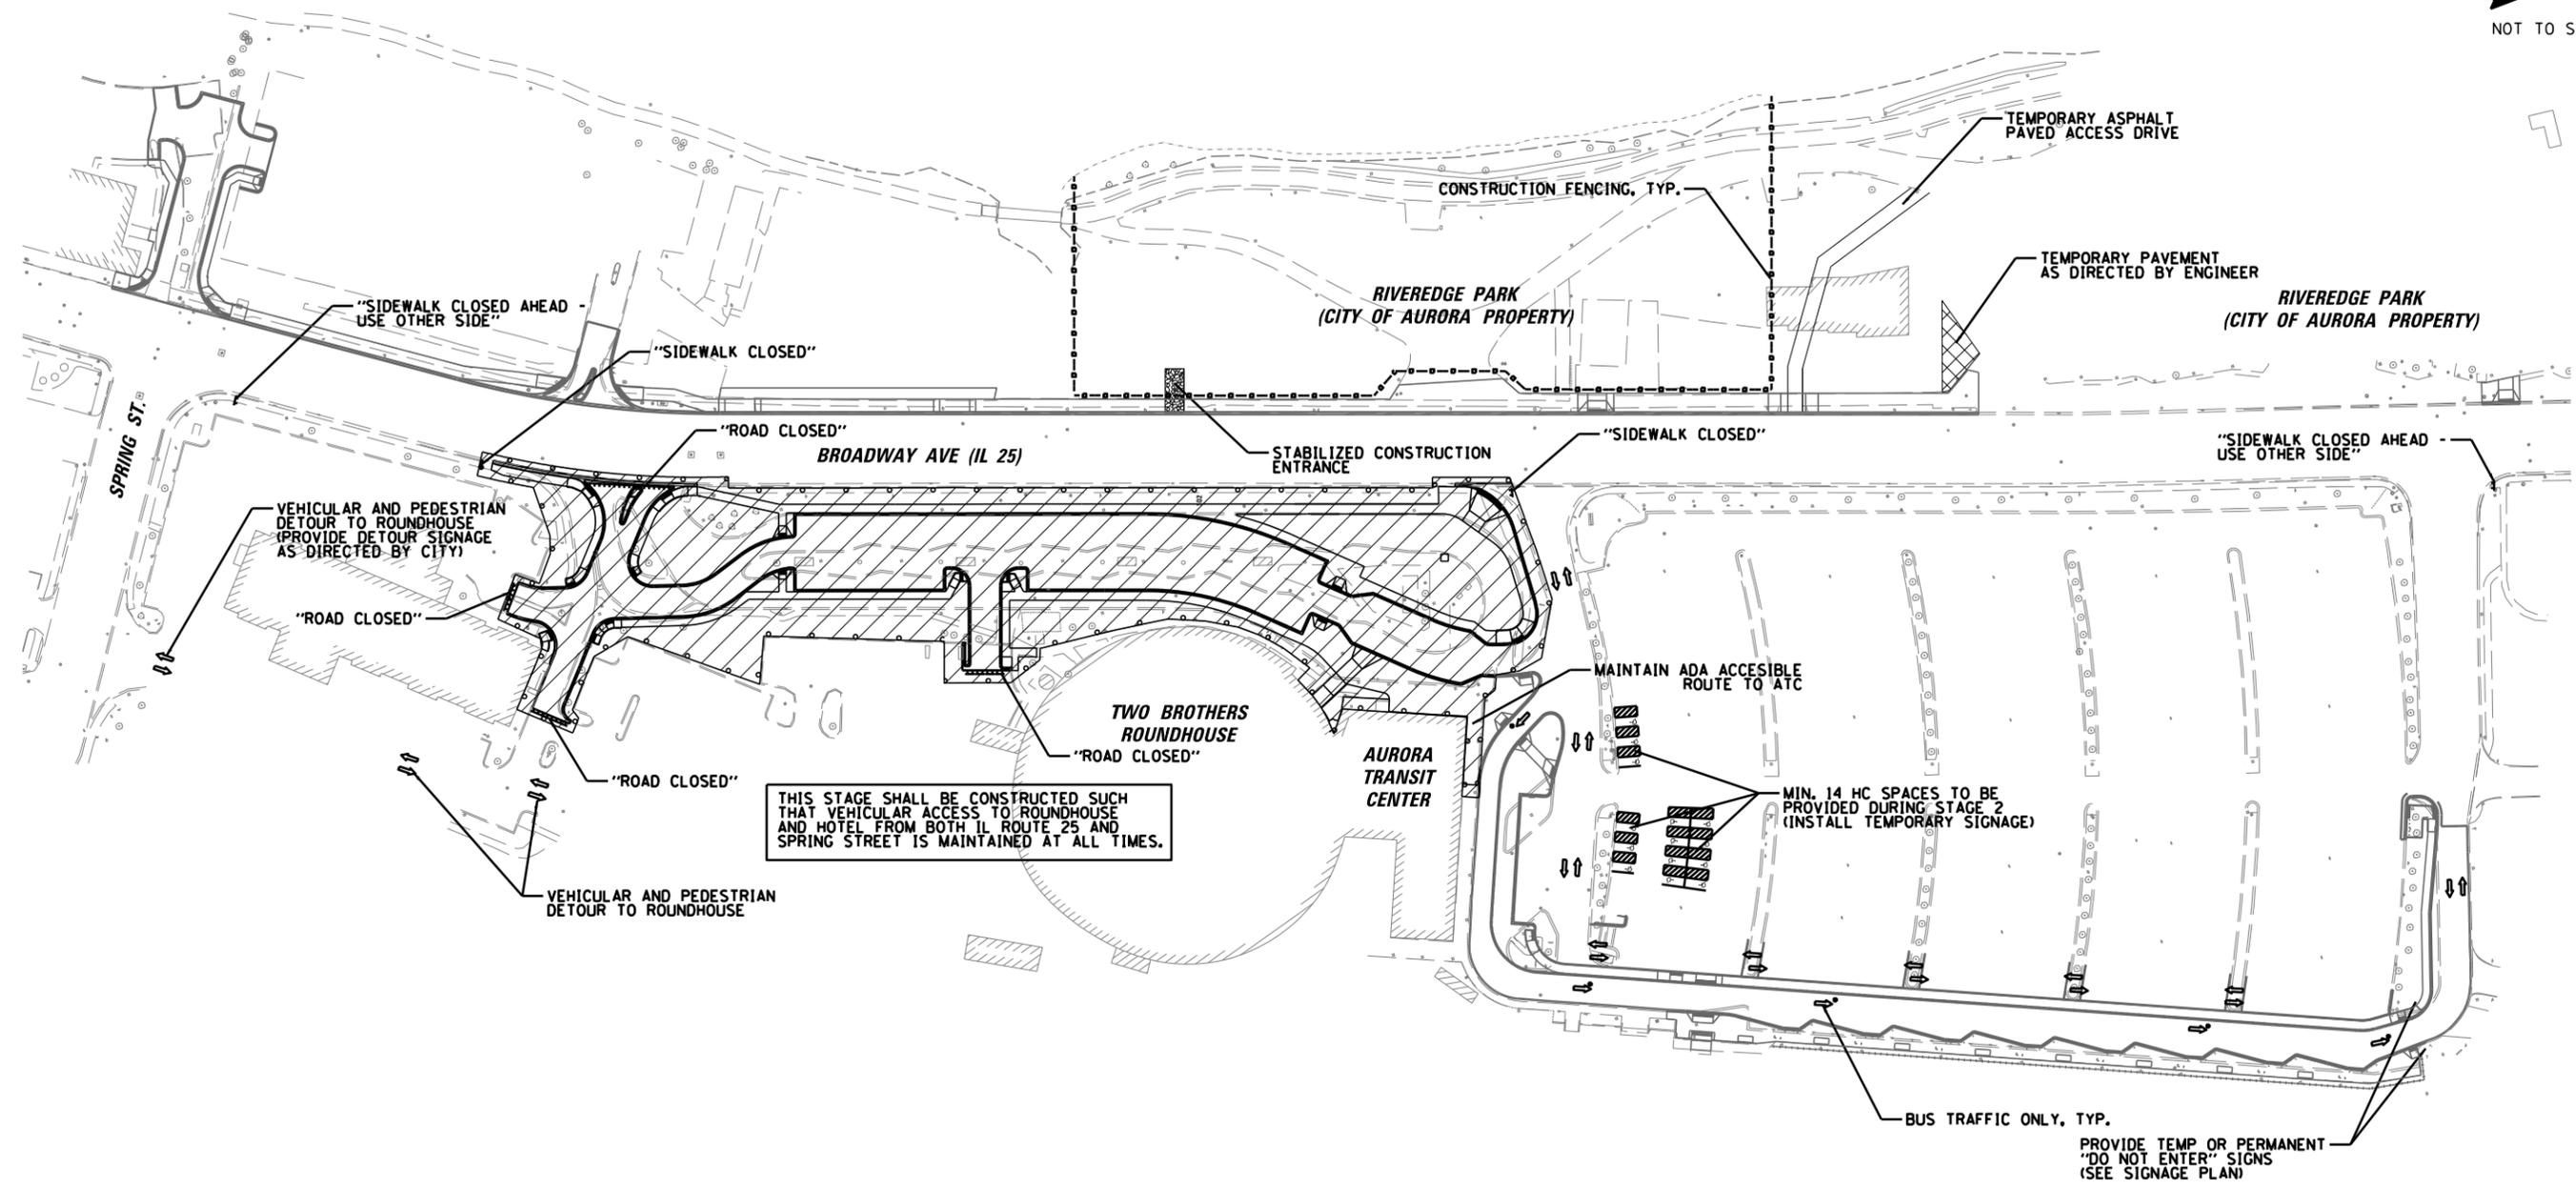

THIS STAGE SHALL BE CONSTRUCTED SUCH THAT VEHICULAR ACCESS TO ROUNDHOUSE AND HOTEL FROM BOTH IL ROUTE 25 AND SPRING STREET IS MAINTAINED AT ALL TIMES.

**SUGGESTED SEQUENCING LEGEND**

	WORK ZONE
	TEMPORARY PAVEMENT
	STABILIZED CONSTRUCTION ENTRANCE
	TEMPORARY SIDEWALK
	TYPE III BARRICADE
	DIRECTION OF TRAFFIC FLOW

**SUGGESTED SEQUENCE OF CONSTRUCTION**

**STAGE 3**  
 THIS STAGE WILL INCLUDE CONSTRUCTION OF THE PROPOSED WEST PARKING LOT AND ROUNDHOUSE ENTRANCE. REMOVAL OF THE EXISTING TRAFFIC SIGNAL AT IL ROUTE 25 AND THE ROUNDHOUSE ENTRANCE SHALL BE COMPLETED DURING THIS STAGE.

- SPECIAL REQUIREMENTS AND CONSIDERATIONS FOR THIS STAGE INCLUDE:
1. VEHICULAR AND PEDESTRIAN ACCESS TO/FROM THE ROUNDHOUSE AND THE HOTEL SHALL BE MAINTAINED FROM BOTH IL ROUTE 25 AND SPRING STREET AT ALL TIMES. CONTRACTOR SHALL PROVIDE DETOUR SIGNAGE AS REQUIRED BY THE ENGINEER AS COORDINATED WITH THE CITY.
  2. ADA-ACCESSIBLE PEDESTRIAN ACCESS TO THE AURORA TRANSIT CENTER AND THE METRA PLATFORM SHALL BE MAINTAINED AT ALL TIMES.
  3. HANDICAPPED PARKING STALLS SHALL BE RELOCATED AS SHOWN ON THE PLAN. A MINIMUM OF 14 HANDICAPPED PARKING SPACES SHALL BE MAINTAINED IN THE MAIN ATC LOT. ACTUAL NUMBER TO BE DETERMINED BY THE ENGINEER.
  4. PROPOSED UNDERGROUND IMPROVEMENTS FOR PARKING LOT LIGHTING, PACE STATION, ETC., INCLUDING BUT NOT LIMITED TO CONDUIT, HANDHOLES AND FOUNDATIONS, FALLING WITHIN THE PROPOSED PAVEMENT SHALL BE CONSTRUCTED PRIOR TO PAVEMENT CONSTRUCTION.


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**STATE OF ILLINOIS  
 DEPARTMENT OF TRANSPORTATION**


**AURORA TRANSIT CENTER IMPROVEMENTS  
 SUGGESTED CONSTRUCTION STAGING - STAGE 3**

SCALE: 1/4" = 1'-0" SHEET OF 254 SHEETS STA. TO STA.

F.A.U. RTE.	SECTION	COUNTY	TOTAL SHEETS	SHEET NO.
2503	16-00313-00-MS	KANE	254	53
<b>CONTRACT NO. 61E18</b>				
ILLINOIS FED. AID PROJECT				

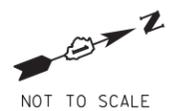

NOT TO SCALE

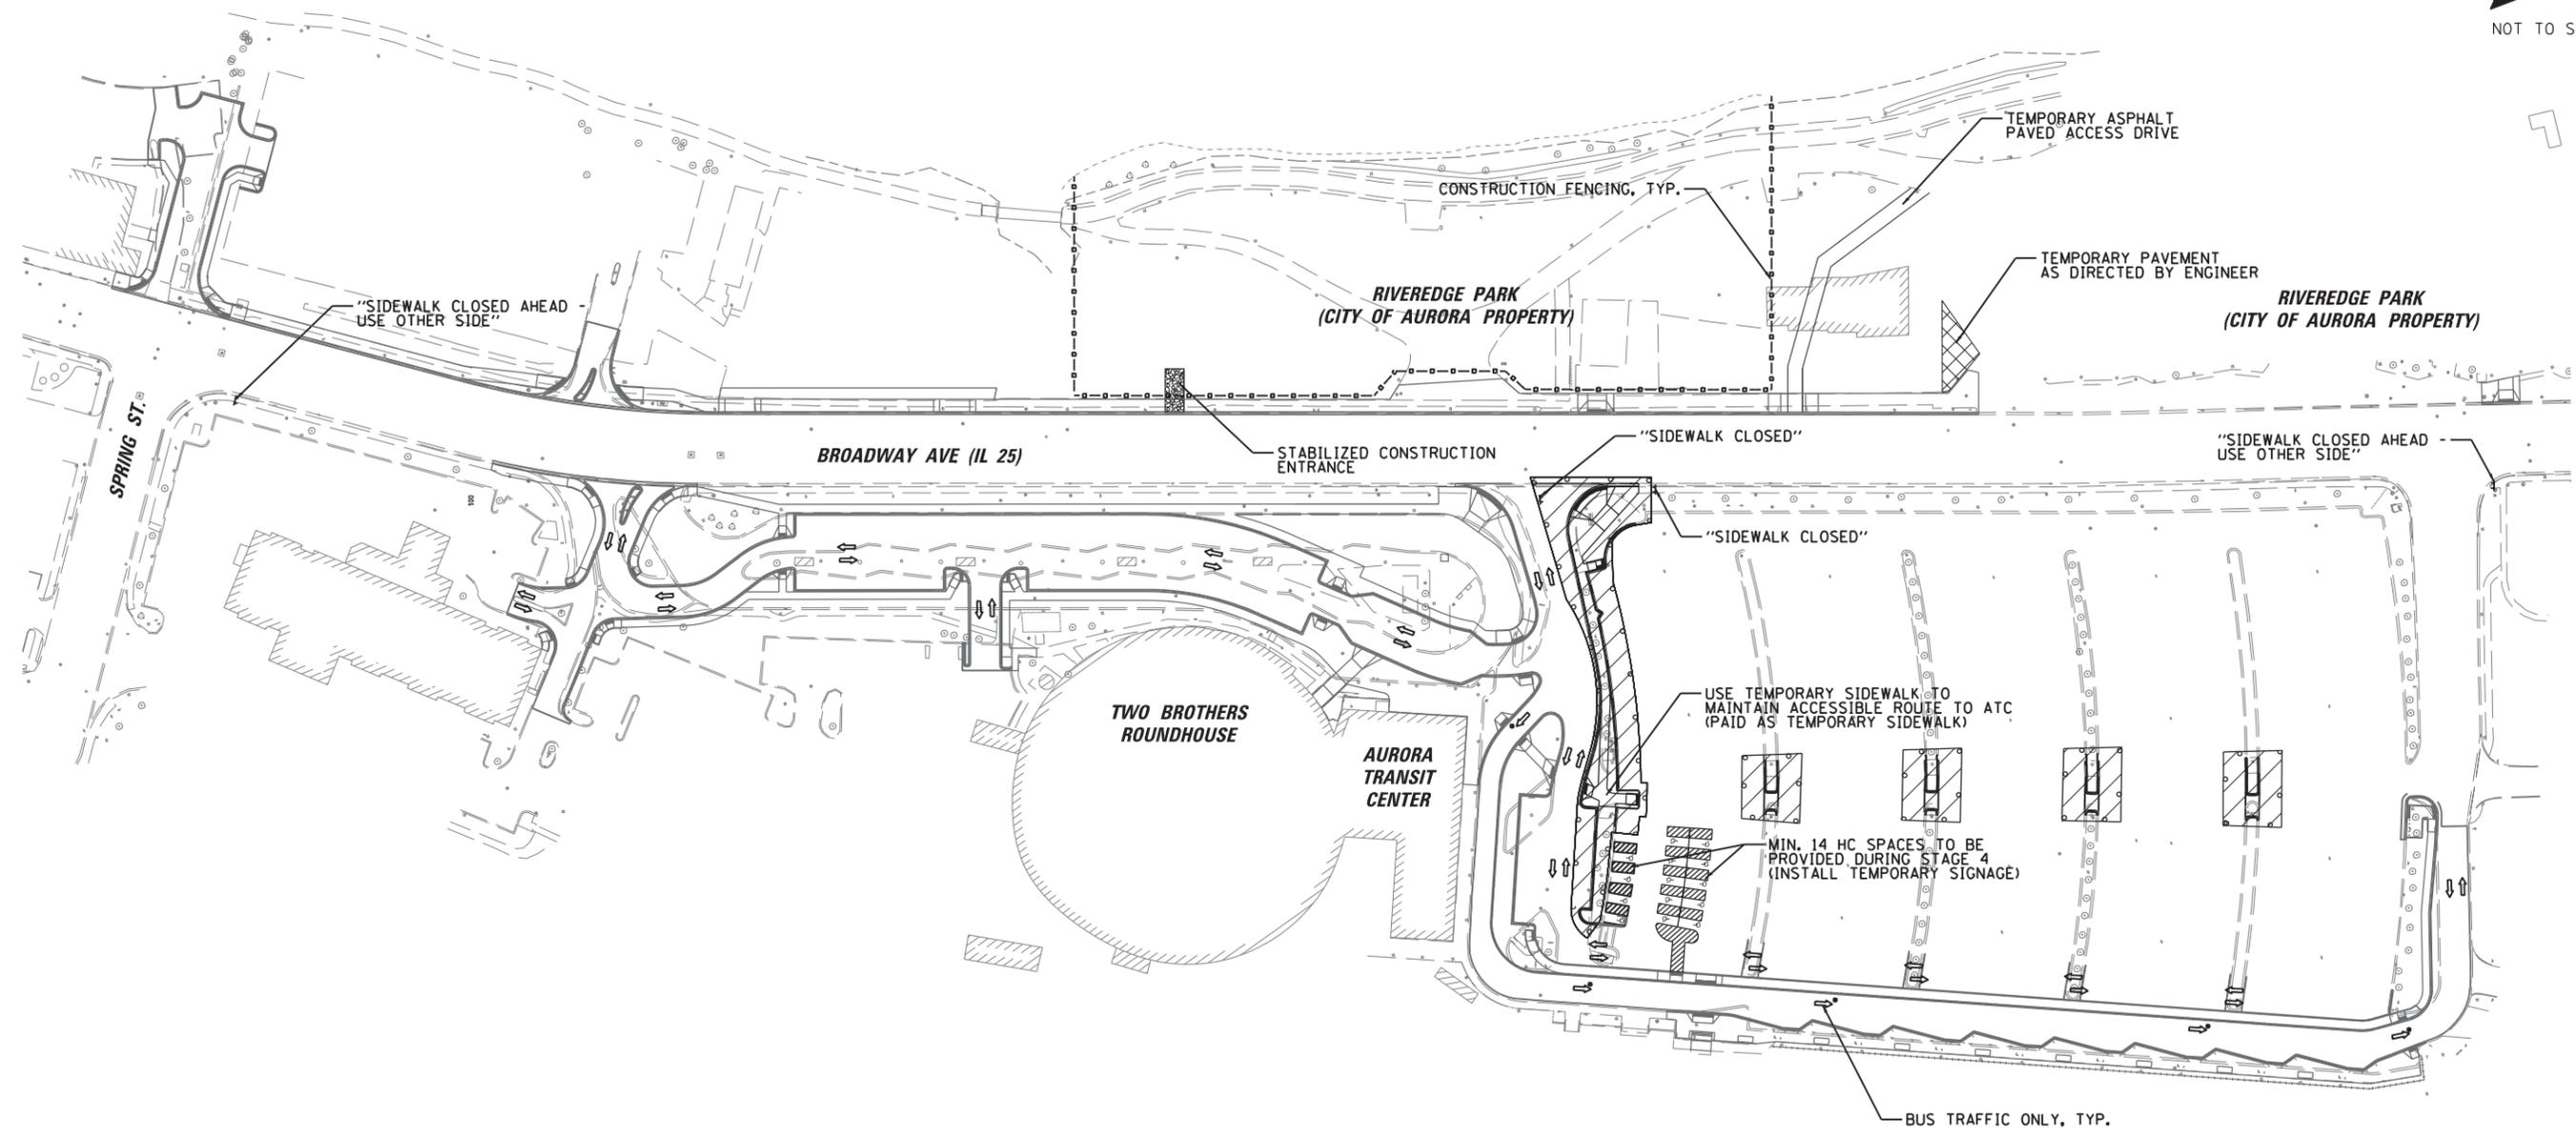

SUGGESTED SEQUENCING LEGEND	
	WORK ZONE
	TEMPORARY PAVEMENT
	STABILIZED CONSTRUCTION ENTRANCE
	TEMPORARY SIDEWALK
	TYPE III BARRICADE
	DIRECTION OF TRAFFIC FLOW

**SUGGESTED SEQUENCE OF CONSTRUCTION**

**STAGE 4**  
 THIS STAGE WILL INCLUDE CONSTRUCTION OF THE NORTH HALF OF THE ATC ENTRANCE AND CLOSURE OF THE MAIN PARKING LOT ISLANDS AS SHOWN ON THE SUGGESTED CONSTRUCTION SEQUENCING PLAN. COMPLETION OF THE TRAFFIC SIGNAL INSTALLATION AT IL ROUTE 25 AND THE ATC ENTRANCE SHALL BE COMPLETED DURING THIS STAGE.

SPECIAL REQUIREMENTS AND CONSIDERATIONS FOR THIS STAGE INCLUDE:

1. THIS STAGE CAN ONLY BE COMPLETED FROM SEPTEMBER 16<sup>TH</sup> TO JUNE 1<sup>ST</sup> OF THE FOLLOWING YEAR.
2. ADA-ACCESSIBLE PEDESTRIAN ACCESS TO THE AURORA TRANSIT CENTER AND THE METRA PLATFORM SHALL BE MAINTAINED AT ALL TIMES.
3. HANDICAPPED PARKING STALLS SHALL BE RELOCATED AS SHOWN ON THE PLAN. A MINIMUM OF 14 HANDICAPPED PARKING SPACES SHALL BE MAINTAINED IN THE MAIN ATC LOT. ACTUAL NUMBER TO BE DETERMINED BY THE ENGINEER.
4. PROPOSED UNDERGROUND IMPROVEMENTS FOR ROADWAY AND PARKING LOT LIGHTING, TRAFFIC SIGNALS, PACE STATION, ETC., INCLUDING BUT NOT LIMITED TO CONDUIT, HANDHOLES AND FOUNDATIONS, FALLING WITHIN THE PROPOSED PAVEMENT SHALL BE CONSTRUCTED PRIOR TO PAVEMENT CONSTRUCTION.


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		DATE - 10/16/2017	REVISED -

**STATE OF ILLINOIS  
 DEPARTMENT OF TRANSPORTATION**

<b>AURORA TRANSIT CENTER IMPROVEMENTS    SUGGESTED CONSTRUCTION STAGING - STAGE 4</b>			
SCALE: 1/40"	SHEET	OF 254 SHEETS	STA. TO STA.

F.A.U. RTE.	SECTION	COUNTY	TOTAL SHEETS	SHEET NO.
2503	16-00313-00-MS	KANE	254	54
CONTRACT NO. 61E18				
ILLINOIS FED. AID PROJECT				

NOTE: PLACE "SIDEWALK CLOSED AHEAD - USE OTHER SIDE" SIGN AT NEW YORK STREET

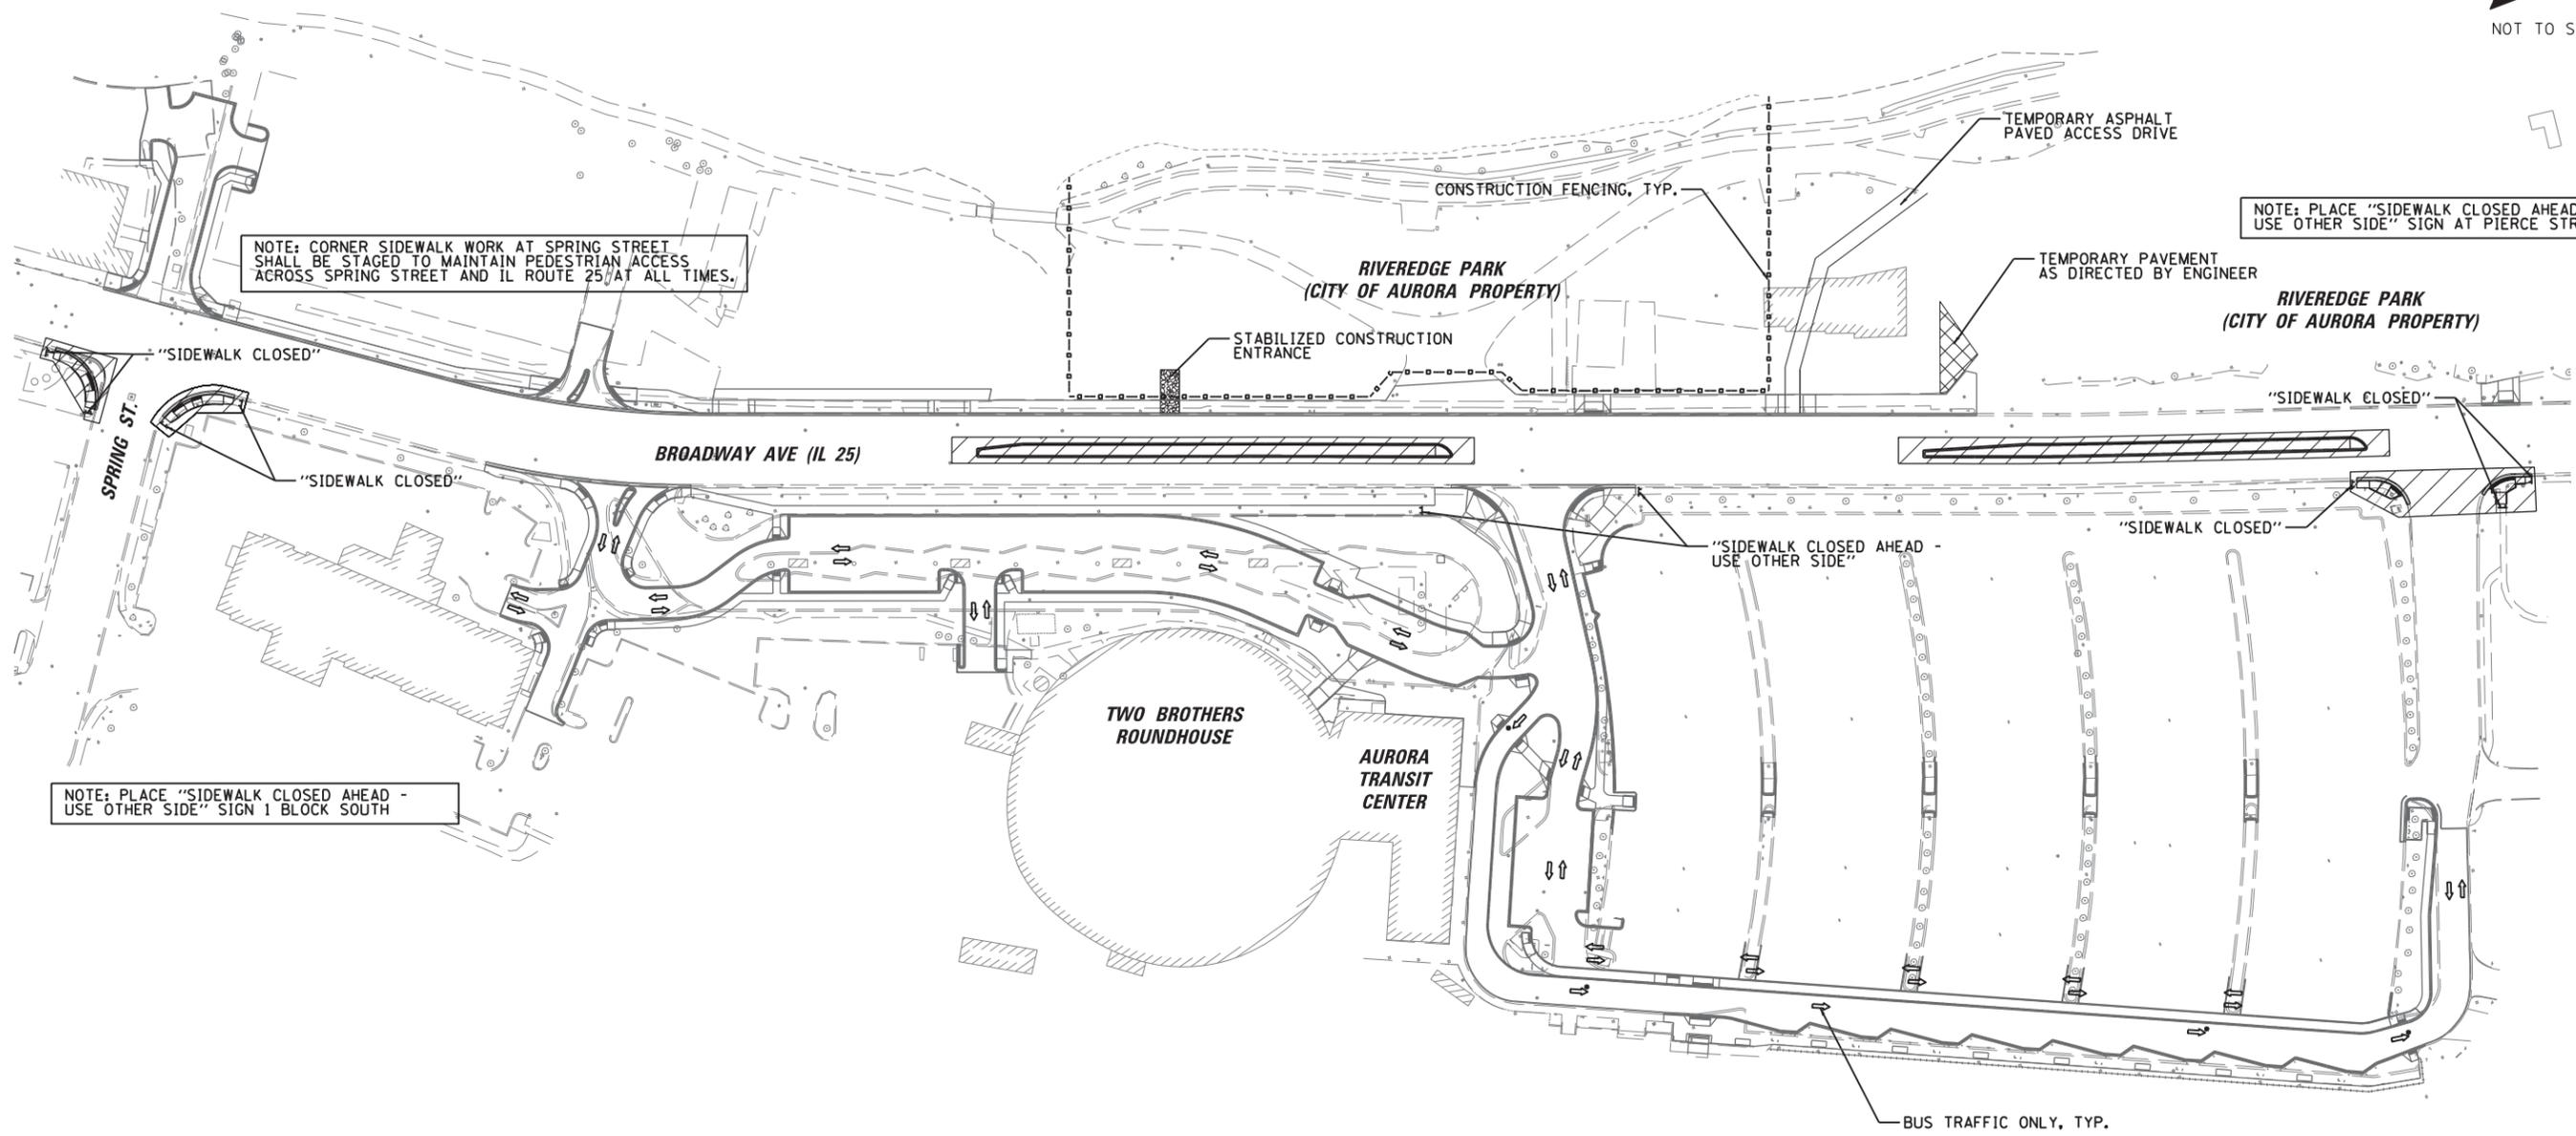

NOTE: CORNER SIDEWALK WORK AT SPRING STREET SHALL BE STAGED TO MAINTAIN PEDESTRIAN ACCESS ACROSS SPRING STREET AND IL ROUTE 25 AT ALL TIMES.

NOTE: PLACE "SIDEWALK CLOSED AHEAD - USE OTHER SIDE" SIGN AT PIERCE STREET

NOTE: PLACE "SIDEWALK CLOSED AHEAD - USE OTHER SIDE" SIGN 1 BLOCK SOUTH

**SUGGESTED SEQUENCING LEGEND**

	WORK ZONE
	TEMPORARY PAVEMENT
	STABILIZED CONSTRUCTION ENTRANCE
	TEMPORARY SIDEWALK
	TYPE III BARRICADE
	DIRECTION OF TRAFFIC FLOW

**SUGGESTED SEQUENCE OF CONSTRUCTION**

**STAGE 5**  
 THIS STAGE WILL INCLUDE CONSTRUCTION OF THE RAISED MEDIANS IN IL ROUTE 25 AND THE WEST CURB RAMPS AT IL ROUTE 25 AND SPRING STREET AND THE POST OFFICE. COMPLETION OF THE TRAFFIC SIGNAL IMPROVEMENTS AT IL ROUTE 25 AND THE POST OFFICE ENTRANCE SHALL BE COMPLETED DURING THIS STAGE.

- SPECIAL REQUIREMENTS AND CONSIDERATIONS FOR THIS STAGE INCLUDE:
1. THIS STAGE CAN ONLY BE COMPLETED FROM SEPTEMBER 16<sup>TH</sup> TO JUNE 1<sup>ST</sup> OF THE FOLLOWING YEAR.
  2. ADA-ACCESSIBLE PEDESTRIAN ACCESS TO THE AURORA TRANSIT CENTER AND THE METRA PLATFORM SHALL BE MAINTAINED AT ALL TIMES.
  3. A MINIMUM OF 14 HANDICAPPED PARKING SPACES SHALL BE MAINTAINED IN THE MAIN ATC LOT. ACTUAL NUMBER TO BE DETERMINED BY THE ENGINEER.
  4. PROPOSED UNDERGROUND IMPROVEMENTS FOR ROADWAY AND PARKING LOT LIGHTING, TRAFFIC SIGNALS, PACE STATION, ETC., INCLUDING BUT NOT LIMITED TO CONDUIT, HANDHOLES AND FOUNDATIONS, FALLING WITHIN THE PROPOSED PAVEMENT SHALL BE CONSTRUCTED PRIOR TO PAVEMENT CONSTRUCTION.

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	PLOT DATE = 10/16/2017	DATE - 10/16/2017	REVISED -

**STATE OF ILLINOIS  
 DEPARTMENT OF TRANSPORTATION**

<b>AURORA TRANSIT CENTER IMPROVEMENTS        SUGGESTED CONSTRUCTION STAGING - STAGE 5</b>			
SCALE: 1/40"	SHEET	OF 254 SHEETS	STA. TO STA.



F.A.U. RTE.	SECTION	COUNTY	TOTAL SHEETS	SHEET NO.
2503	16-00313-00-MS	KANE	254	55
CONTRACT NO. 61E18				
ILLINOIS FED. AID PROJECT				

**SOIL EROSION CONTROL AND SEDIMENT CONTROL NOTES**

- SOIL EROSION AND SEDIMENT CONTROL (SESC) FEATURES MUST BE CONSTRUCTED PRIOR TO THE COMMENCEMENT OF UPLAND DISTURBANCE. SOIL DISTURBANCE MUST BE PHASED OR ENACTED IN SUCH A MANNER AS TO MINIMIZE EROSION SOIL STABILIZATION MEASURES MUST CONSIDER THE TIME OF YEAR, SITE CONDITIONS AND THE USE OF TEMPORARY AND/OR PERMANENT MEASURES.
- UNLESS OTHERWISE INDICATED, ALL VEGETATIVE AND STRUCTURAL EROSION AND SEDIMENT CONTROL PRACTICES WILL BE INSTALLED AT MINIMUM ACCORDING TO THE STANDARDS AND SPECIFICATIONS IN THE ILLINOIS URBAN MANUAL, REVISED TO LATEST VERSION AS AMENDED. A COPY OF THE APPROVED SOIL EROSION AND SEDIMENT CONTROL (SESC) PLAN MUST BE MAINTAINED ON THE SITE AT ALL TIMES.
- THE EROSION AND SEDIMENT CONTROLS SHOWN ON THE PLANS ARE THE MINIMUM REQUIREMENTS. ADDITIONAL MEASURES MAY BE REQUIRED AS DIRECTED BY THE R.E. ALL ADDITIONAL MEASURES MUST BE IN PLACE WITHIN 3 DAYS OF DISTURBANCE AND ANY EMERGENCY SESC MEASURES MUST BE INSTALLED IMMEDIATELY.
- THE CONTRACTOR MUST CLEAN UP, GRADE THE WORK AREAS AS THE PROJECT PROGRESSES, AND INSTALL EROSION PROTECTION TO ELIMINATE THE CONCENTRATION OF RUNOFF, OR MUST INSTALL APPROPRIATE SEDIMENT CONTROL DEVICES TO TRAP SEDIMENT. PAVEMENT MUST BE CLEANED DAILY OR AS NECESSARY TO REMOVE TRACK-OUT MATERIAL.
- AFTER ALL PERIMETER EROSION BARRIER IS REMOVED, THE AREAS DAMAGED BY THE PERIMETER EROSION BARRIER MUST BE RESTORED.
- IT SHALL BE THE RESPONSIBILITY OF THE CONTRACTOR TO DIVERT ALL WATER (GROUND, STORM, AND CONSTRUCTION) DURING CONSTRUCTION IN ORDER TO KEEP THE CONSTRUCTION AREAS FREED OF WATER, BYPASS PUMPING, INCLUDING SILT BAGS AND AN ENERGY DISSIPATION SURFACE FOR THE PUMPS, SHALL NOT BE MEASURED AND PAID FOR SEPARATELY BUT SHALL BE CONSIDERED INCIDENTAL TO THE COST OF THE CONTRACT. IT SHALL BE THE CONTRACTOR'S RESPONSIBILITY TO SIZE THE PUMPS APPROPRIATELY.
- DURING DE-WATERING/PUMPING OPERATIONS, ONLY UNCONTAMINATED WATER SHOULD BE ALLOWED TO DISCHARGE TO PROTECTED NATURAL AREAS, WATERS OF THE STATE, WATERS OF THE U.S. OR TO A STORM SEWER SYSTEM (IN ACCORDANCE WITH LOCAL PERMITS). INLET HOSES SHOULD BE PLACED IN A STABILIZED SUMP PIT OR FLOATED AT THE SURFACE OF THE WATER IN ORDER TO LIMIT THE AMOUNT OF SEDIMENT INTAKE. PUMPING OPERATIONS MAY BE DISCHARGED TO A STABILIZED


AREA THAT CONSISTS OF AN ENERGY DISSIPATING DEVICE (E.G. STONE), SEDIMENT FILTER BAG, OR BOTH. ADEQUATE EROSION AND SEDIMENT CONTROLS SHOULD BE USED DURING DE-WATERING OPERATIONS AS NECESSARY. DEWATERING SEDIMENT LADEN WATER DIRECTLY INTO FIELD TILES, STORM WATER STRUCTURES, WATERS OF THE STATE OR WATERS OF THE U.S. IS PROHIBITED.

- ANY WORK WITHIN A STREAM OR DITCH CAPABLE OF CONVEYING WATER MUST BE CONDUCTED IN THE DRY. PROVISIONS MUST BE MADE TO BY-PASS PUMP OR DEWATER ANY AREAS WITHIN THE STREAM OR DITCH IN WHICH WORK WILL BE CONDUCTED.
- CONSTRUCTION ACTIVITIES MUST BE SCHEDULED TO MINIMIZE THE TIME SOIL IS EXPOSED AND UNPROTECTED. IN NO CASE WILL THE EXISTING VEGETATION BE DESTROYED, REMOVED, OR DISTURBED MORE THAN FOURTEEN (14) DAYS PRIOR TO THE INITIATION OF IMPROVEMENTS.
- TEMPORARY CONSTRUCTION ENTRANCES WILL BE CONSTRUCTED AT ALL LOCATIONS WHERE CONSTRUCTION TRAFFIC ENTERS OR LEAVES THE SITE. GRAVELED ROADS, ACCESS DRIVES, PARKING AREAS OF SUFFICIENT WIDTH AND LENGTH, AND VEHICLE WASH DOWN FACILITIES IF NECESSARY, MUST BE PROVIDED TO PREVENT THE DEPOSIT OF SOIL FROM BEING TRACKED ONTO PUBLIC OR PRIVATE ROADWAYS. ANY SOIL REACHING PUBLIC OR PRIVATE ROADWAY MUST BE REMOVED IMMEDIATELY.
- ALL DISTURBED SOILS ARE TO BE STABILIZED, TEMPORARILY OR PERMANENTLY, WITHIN SEVEN (7) DAYS OF CONSTRUCTION ACTIVITY HAVING CEASED.
- STOCK PILES OR SOIL MUST NOT BE LOCATED IN FLOOD PLAINS, RIPARIAN AREAS (VEGETATED FLOOD PLAINS), WETLANDS AND WATERS OF THE U.S., UNLESS OTHERWISE AUTHORIZED BY THE RELEVANT PERMITTING AUTHORITY. IF A STOCKPILE IS TO REMAIN IN PLACE FOR MORE THAN THREE DAYS, PERIMETER EROSION BARRIER MUST BE PROVIDED. IF THE STOCKPILE IS INACTIVE FOR MORE THAN 14 DAYS, SOIL STABILIZATION MUST BE PROVIDED BY THE 7<sup>TH</sup> DAY AFTER ACTIVITY HAS STOPPED.
- CONTRACTOR MUST INSTALL PERIMETER EROSION BARRIER AT ANY LOCATION IN WHICH SHEET FLOWS MAY RESULT IN SEDIMENT RUNOFF OUTSIDE THE CONSTRUCTION LIMITS. THE CONTRACTOR MAY USE OTHER METHODS TO CONTROL RUNOFF, INCLUDING, BUT NOT LIMITED TO, TEMPORARY DIVERSION SWALES, TEMPORARY SEDIMENT TRAPS, SHAPED DITCHES TO CONVEY WATER, ETC.
- ALL STORM SEWER INLET STRUCTURES (INCLUDING INLETS LOCATED WITHIN THE HAUL ROUTES) MUST BE PROTECTED WITH STORM SEWER INLET PROTECTION (I.E. INLET FILTERS) PER INLET PROTECTION DETAILS IN THE PLANS.

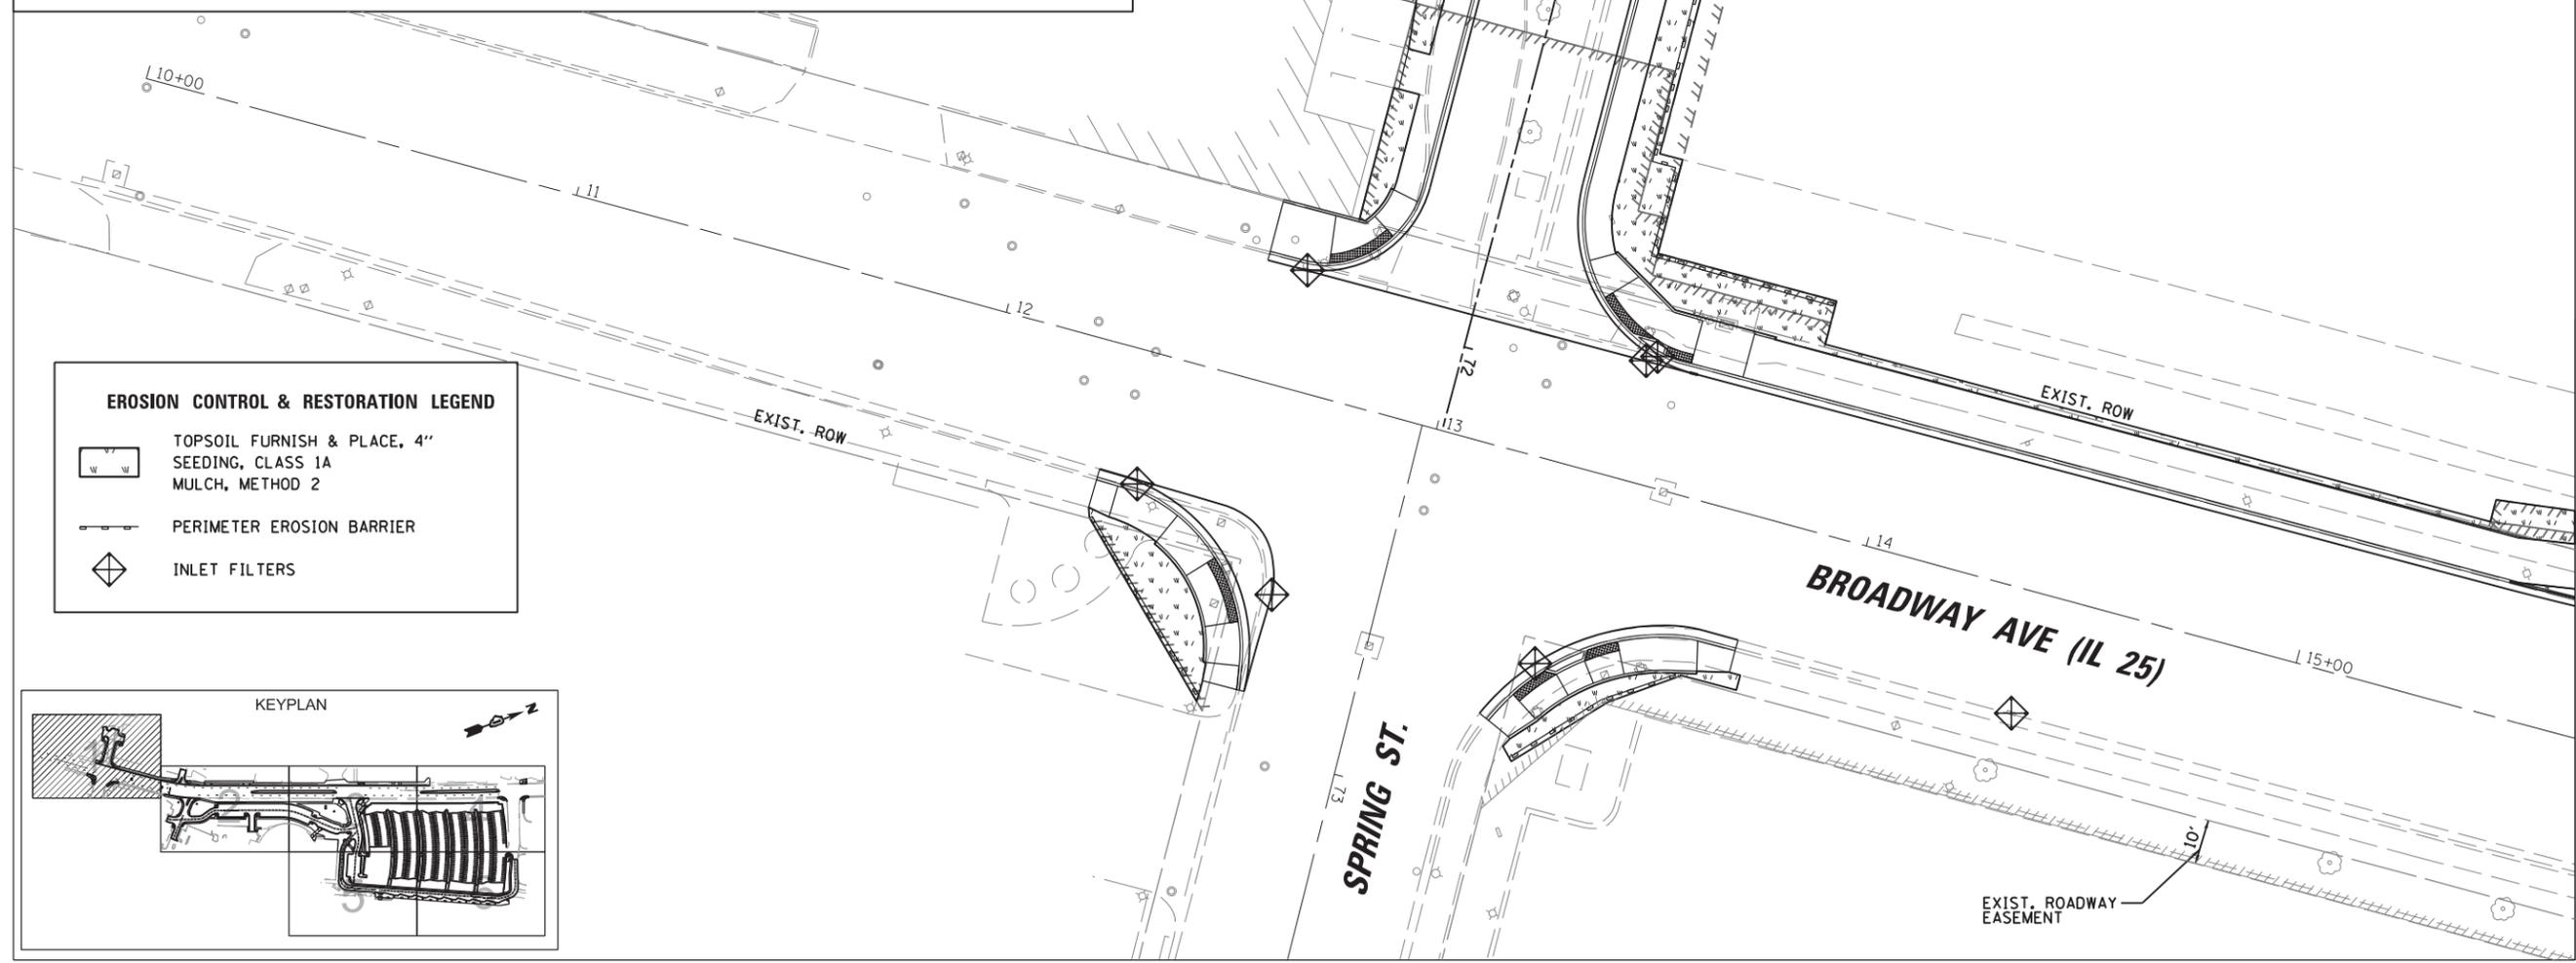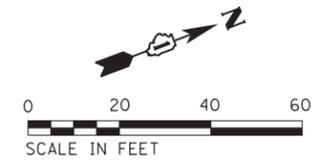



**EROSION CONTROL & RESTORATION LEGEND**

- TOPSOIL FURNISH & PLACE, 4" SEEDING, CLASS 1A MULCH, METHOD 2
- PERIMETER EROSION BARRIER
- INLET FILTERS

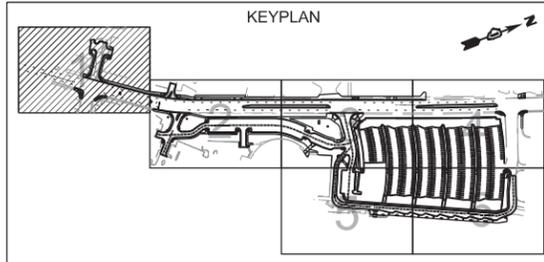

MATCH LINE SEE SHEET 57

FILE NAME = N:\WBK\150077.2\Civil\150077.2.01.sht	USER NAME = bweich	DESIGNED - BMW	REVISED -	<b>STATE OF ILLINOIS DEPARTMENT OF TRANSPORTATION</b>	<b>AURORA TRANSIT CENTER IMPROVEMENTS EROSION CONTROL &amp; RESTORATION PLAN</b>	F.A.U. RTE. 2503	SECTION 16-00313-00-MS	COUNTY KANE	TOTAL SHEETS 254	SHEET NO. 56		
Default	PLOT SCALE = 48"	CHECKED - BMW	REVISED -			SCALE: 48"	SHEET OF 254 SHEETS	STA. TO STA.	CONTRACT NO. 61E18			
	PLOT DATE = 10/16/2017	DATE - 10/16/2017	REVISED -			ILLINOIS FED. AID PROJECT						

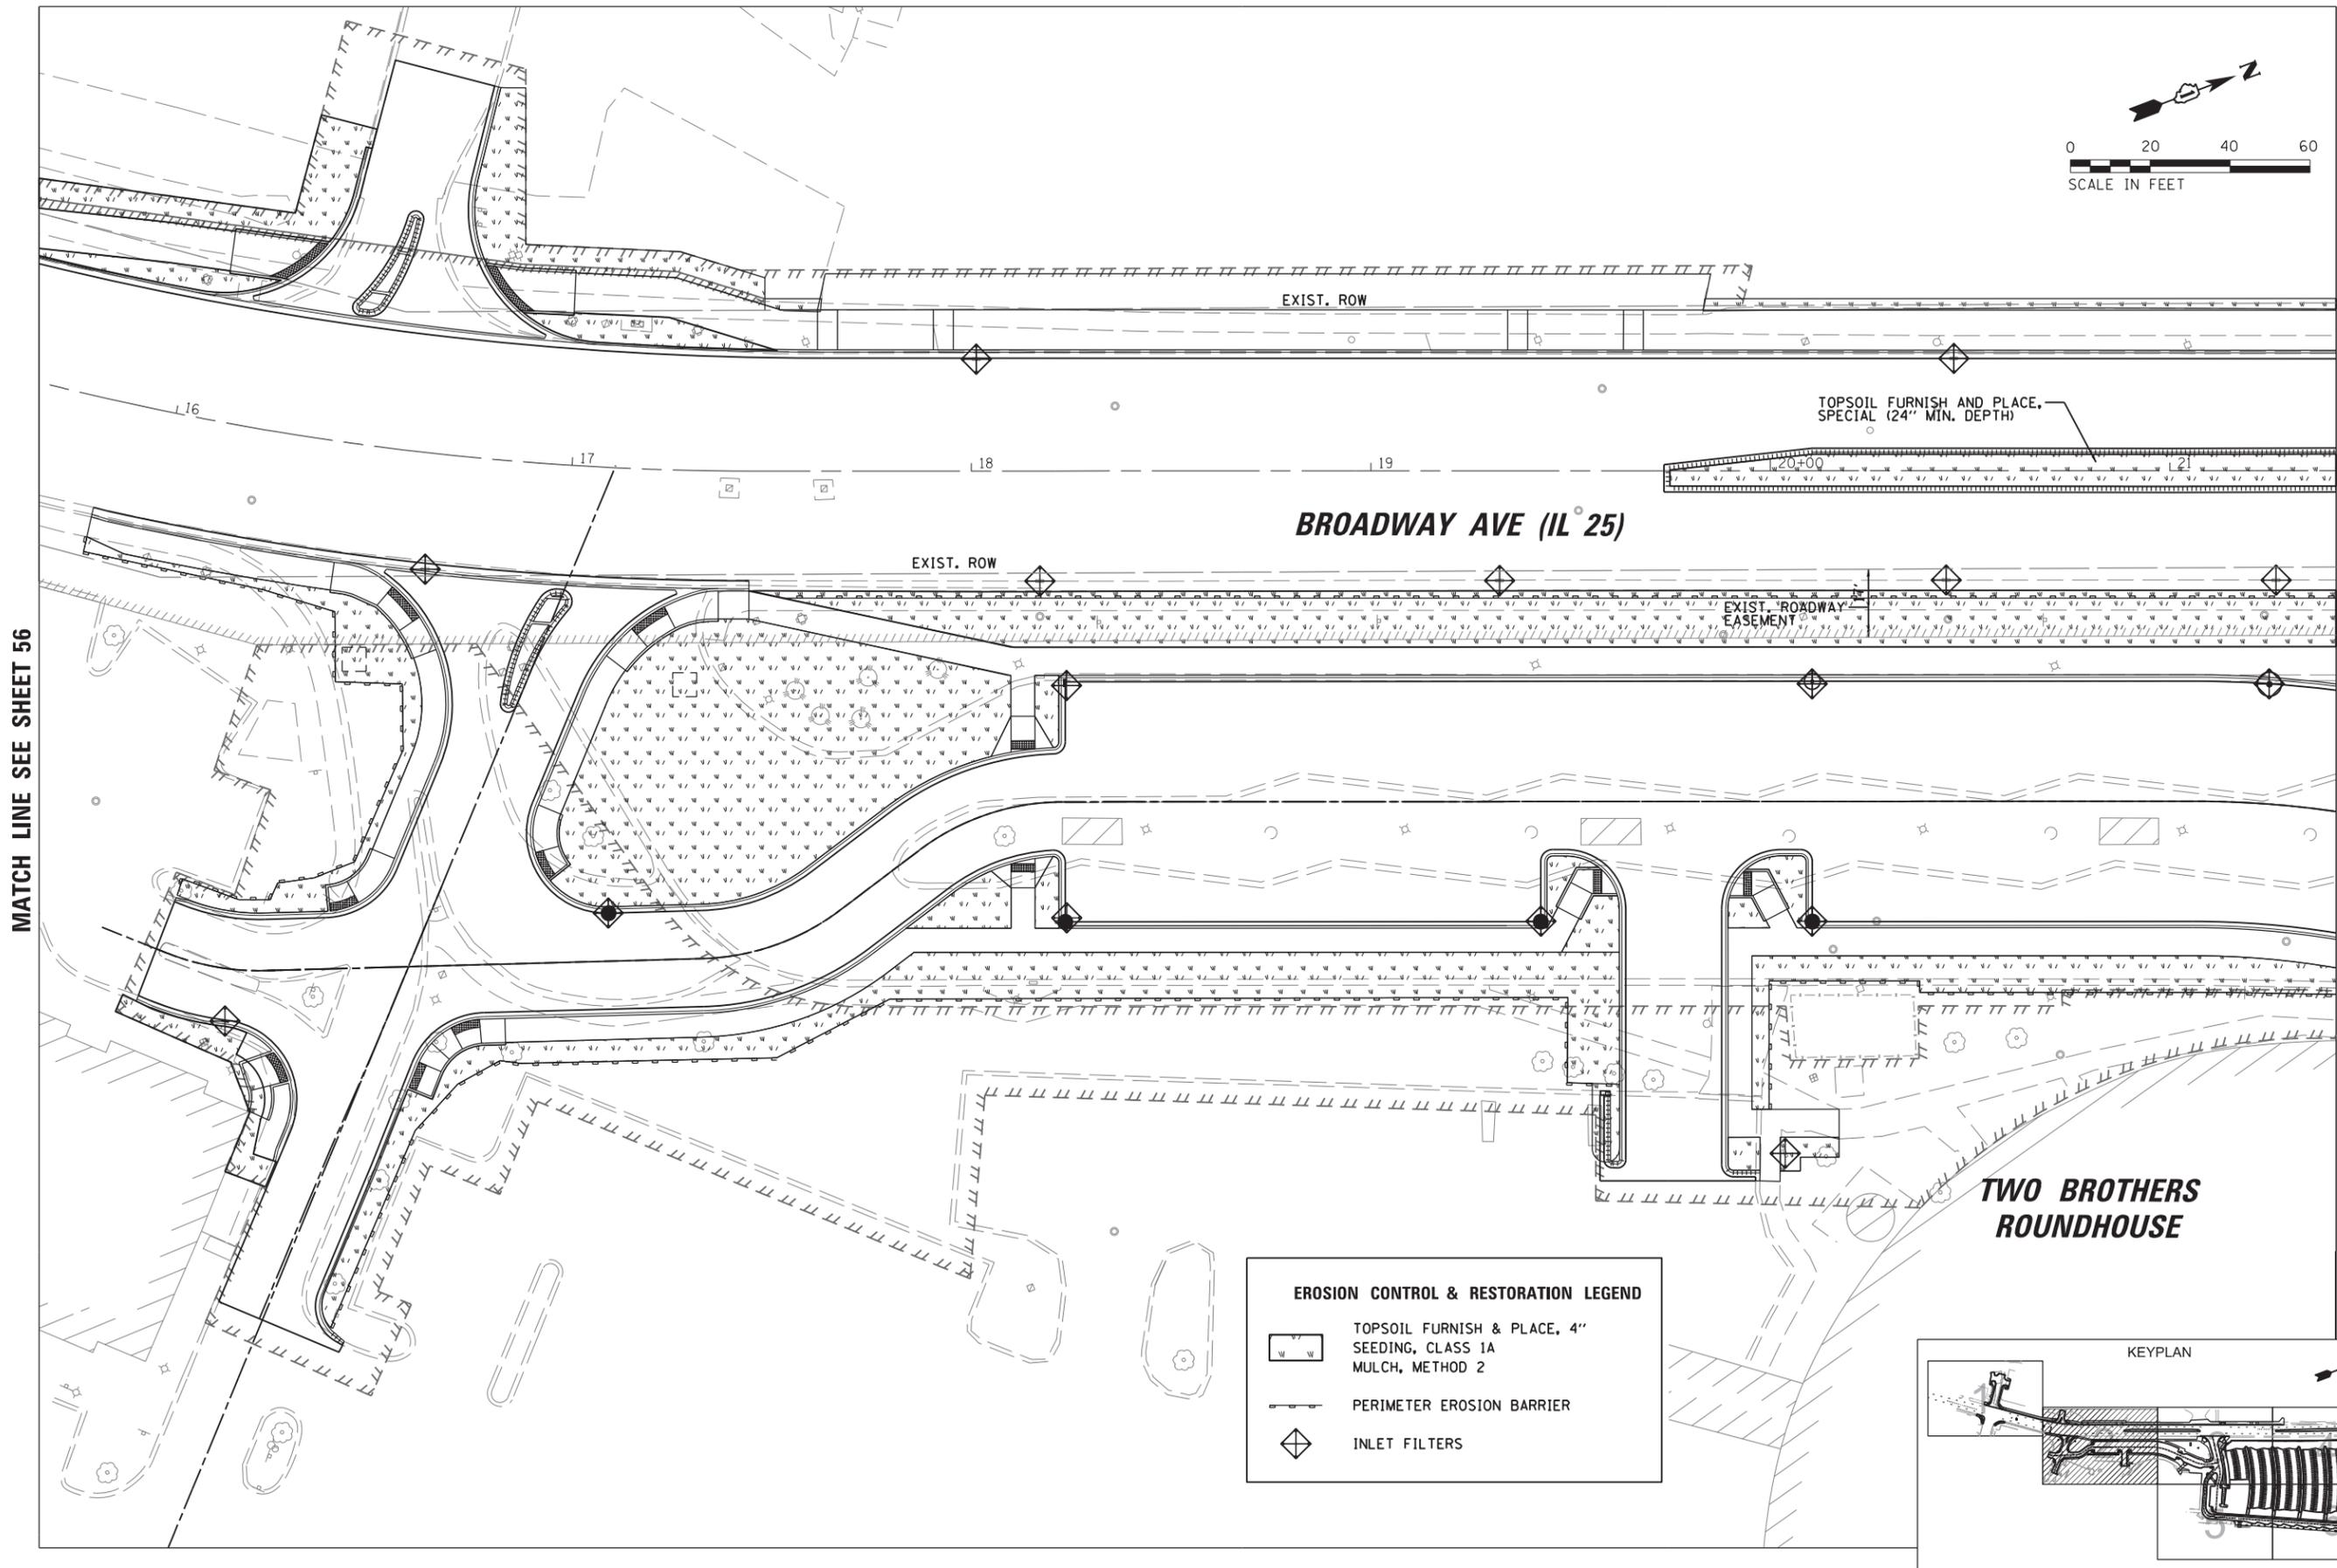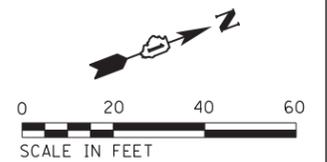


MATCH LINE SEE SHEET 56

MATCH LINE SEE SHEET 58

**EROSION CONTROL & RESTORATION LEGEND**

	TOPSOIL FURNISH & PLACE, 4" SEEDING, CLASS 1A MULCH, METHOD 2
	PERIMETER EROSION BARRIER
	INLET FILTERS

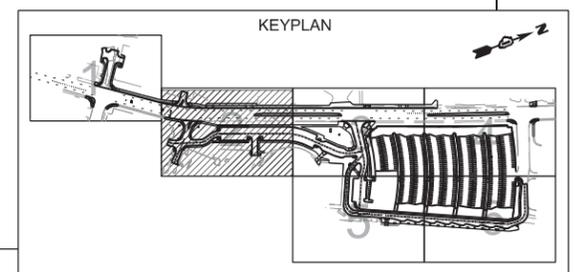

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**STATE OF ILLINOIS  
DEPARTMENT OF TRANSPORTATION**


**AURORA TRANSIT CENTER IMPROVEMENTS  
EROSION CONTROL & RESTORATION PLAN**

SCALE: 48" SHEET OF 254 SHEETS STA. TO STA.

F.A.U. RTE.	SECTION	COUNTY	TOTAL SHEETS	SHEET NO.
2503	16-00313-00-MS	KANE	254	57
CONTRACT NO. 61E18				
ILLINOIS FED. AID PROJECT				

**RIVEREDGE PARK  
(CITY OF AURORA PROPERTY)**

**RIVEREDGE PARK  
(CITY OF AURORA PROPERTY)**

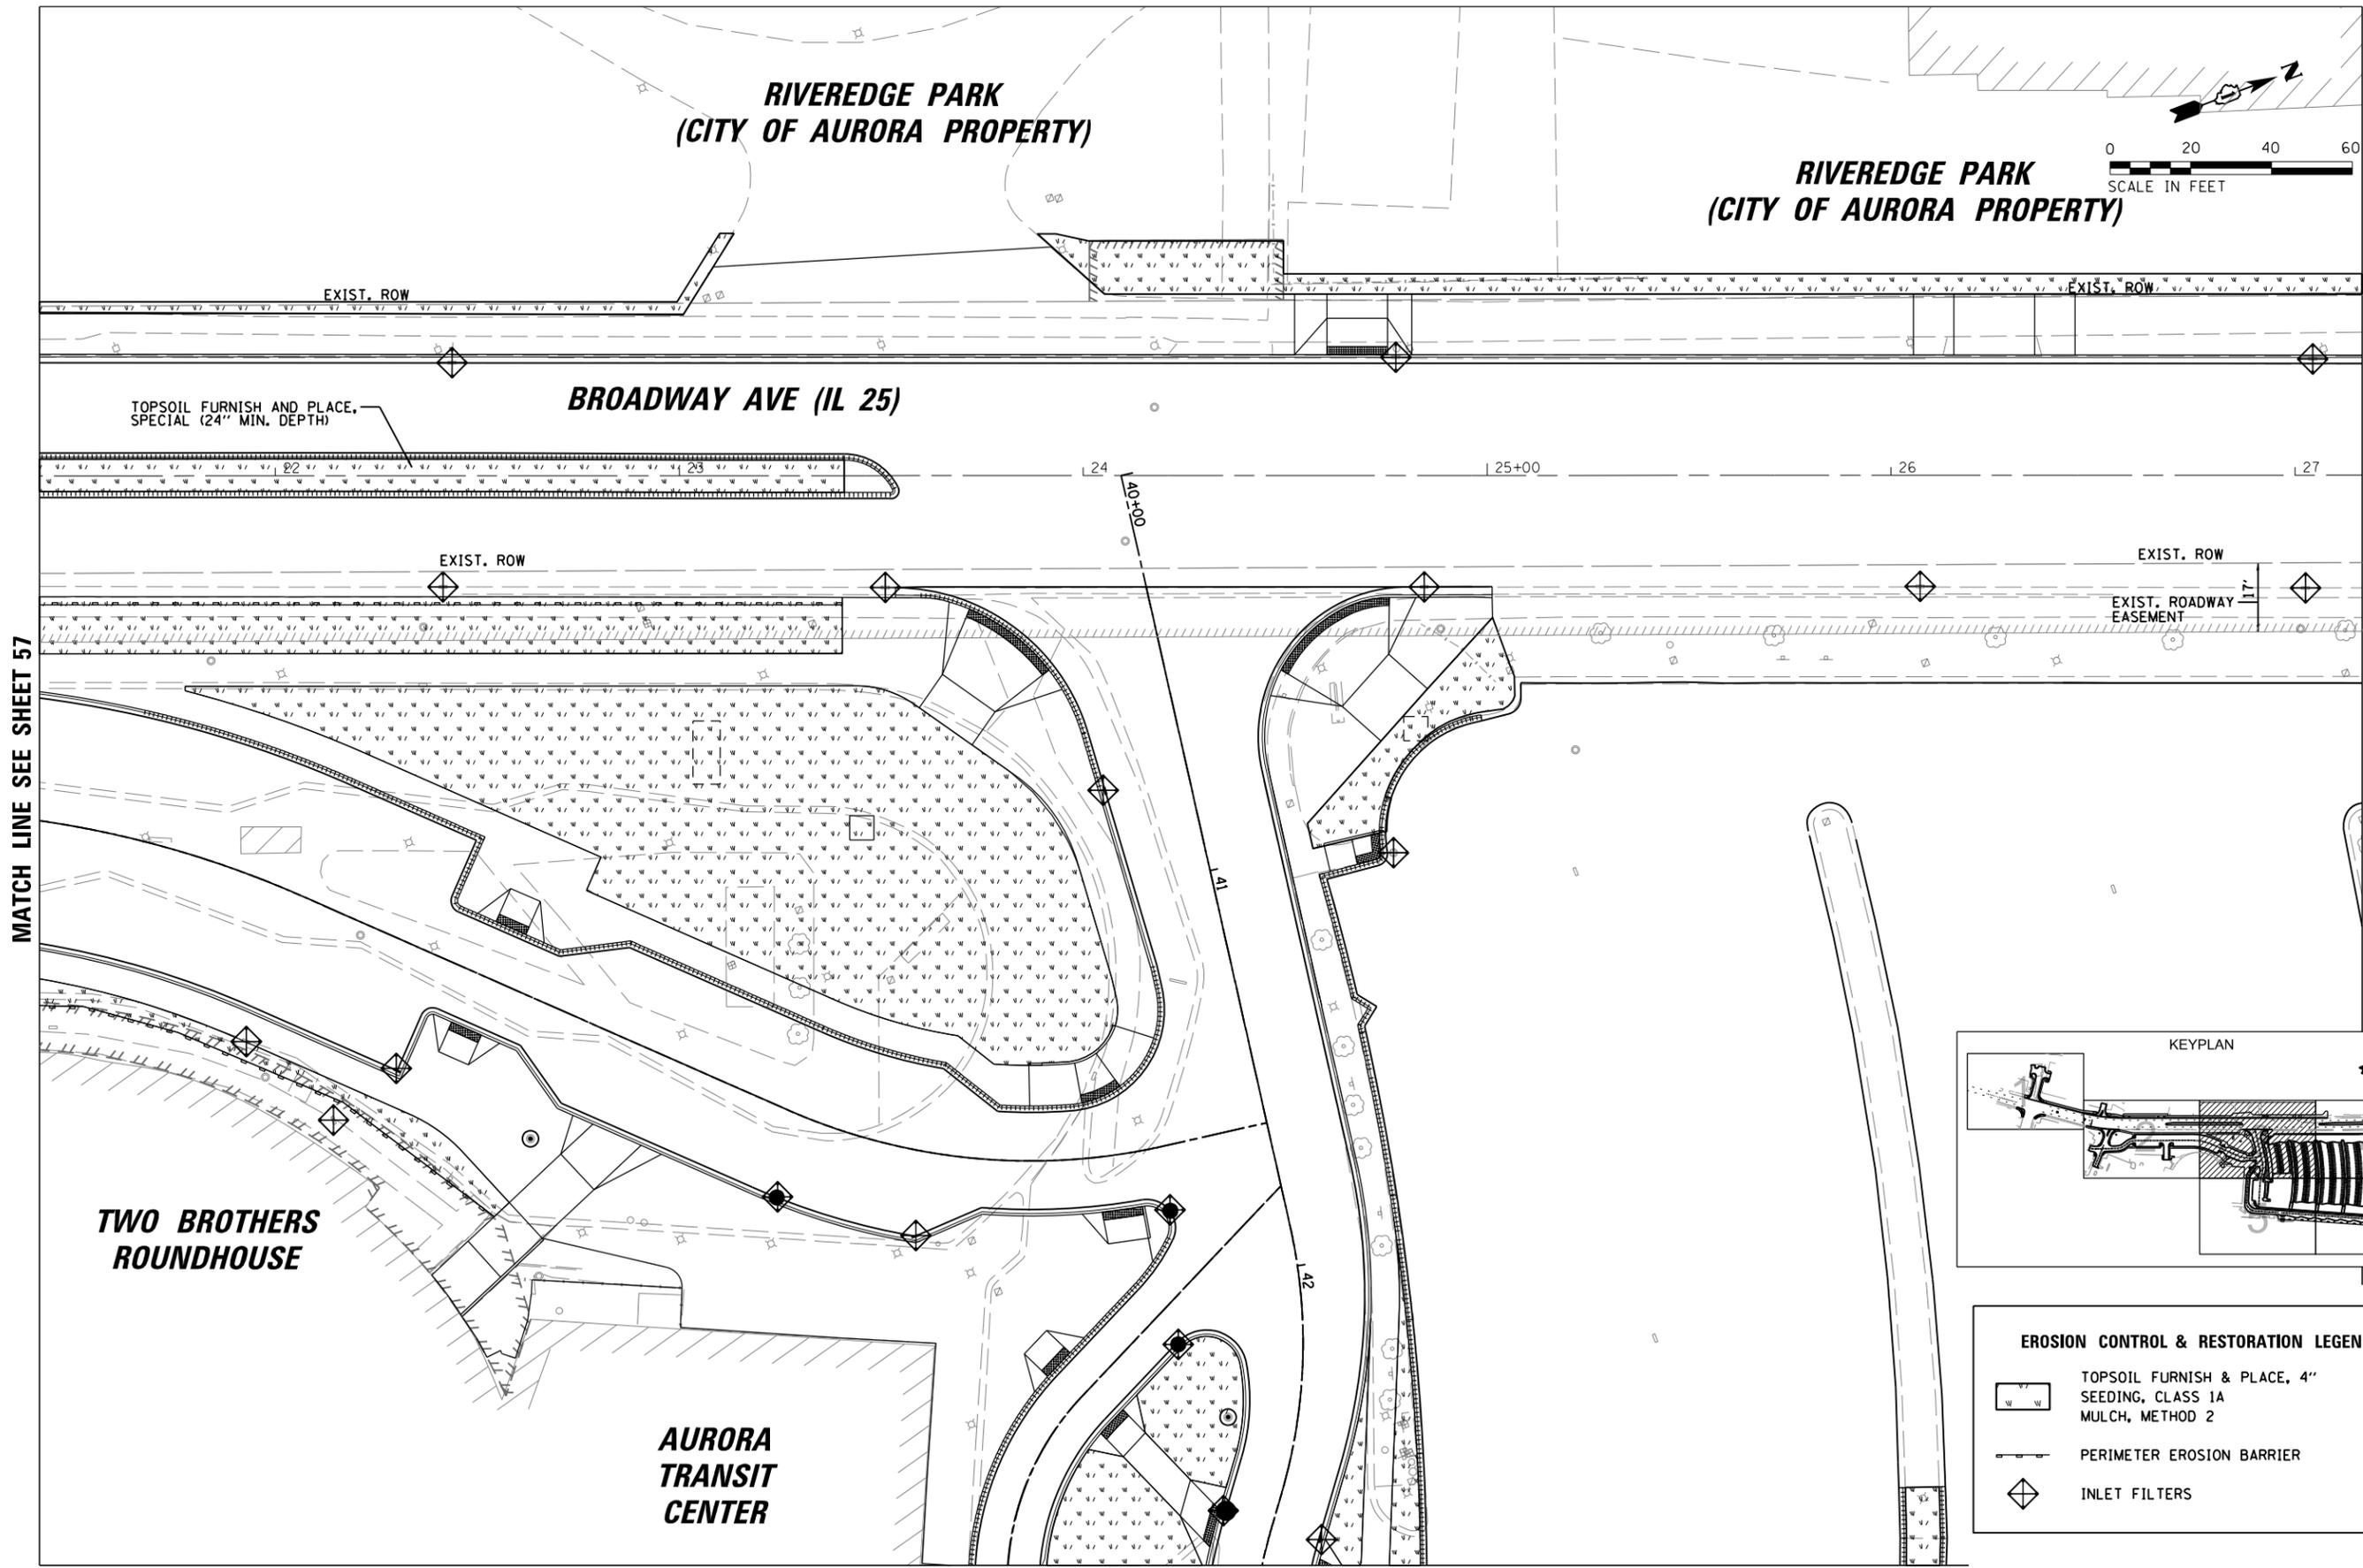

TOPSOIL FURNISH AND PLACE,  
SPECIAL (24" MIN. DEPTH)

**BROADWAY AVE (IL 25)**


**TWO BROTHERS  
ROUNDHOUSE**

**AURORA  
TRANSIT  
CENTER**

MATCH LINE SEE SHEET 57

MATCH LINE SEE SHEET 59

MATCH LINE SEE SHEET 60

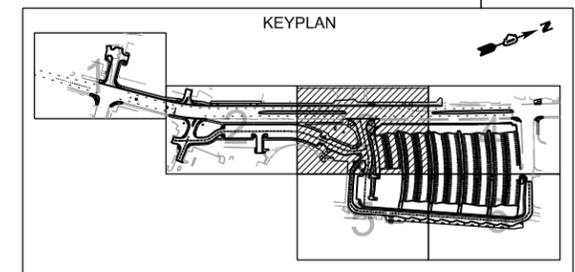

**EROSION CONTROL & RESTORATION LEGEND**

	TOPSOIL FURNISH & PLACE, 4"
	SEEDING, CLASS 1A MULCH, METHOD 2
	PERIMETER EROSION BARRIER
	INLET FILTERS

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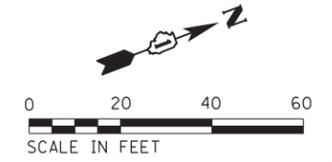
**STATE OF ILLINOIS  
DEPARTMENT OF TRANSPORTATION**

**AURORA TRANSIT CENTER IMPROVEMENTS  
EROSION CONTROL & RESTORATION PLAN**

SCALE: 48" SHEET OF 254 SHEETS STA. TO STA.

F.A.U. RTE.	SECTION	COUNTY	TOTAL SHEETS	SHEET NO.
2503	16-00313-00-MS	KANE	254	58
CONTRACT NO. 61E18				
ILLINOIS FED. AID PROJECT				

**RIVEREDGE PARK  
(CITY OF AURORA PROPERTY)**



EXIST. ROW

TOPSOIL FURNISH AND PLACE,  
SPECIAL (24" MIN. DEPTH)


**BROADWAY AVE (IL 25)**

EXIST. ROW

EXIST. ROADWAY  
EASEMENT

MATCH LINE SEE SHEET 58

KEYPLAN

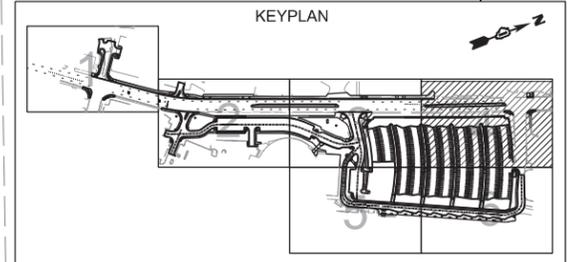

**EROSION CONTROL & RESTORATION LEGEND**

-  TOPSOIL FURNISH & PLACE, 4"  
SEEDING, CLASS 1A  
MULCH, METHOD 2
-  PERIMETER EROSION BARRIER
-  INLET FILTERS

MATCH LINE SEE SHEET 61

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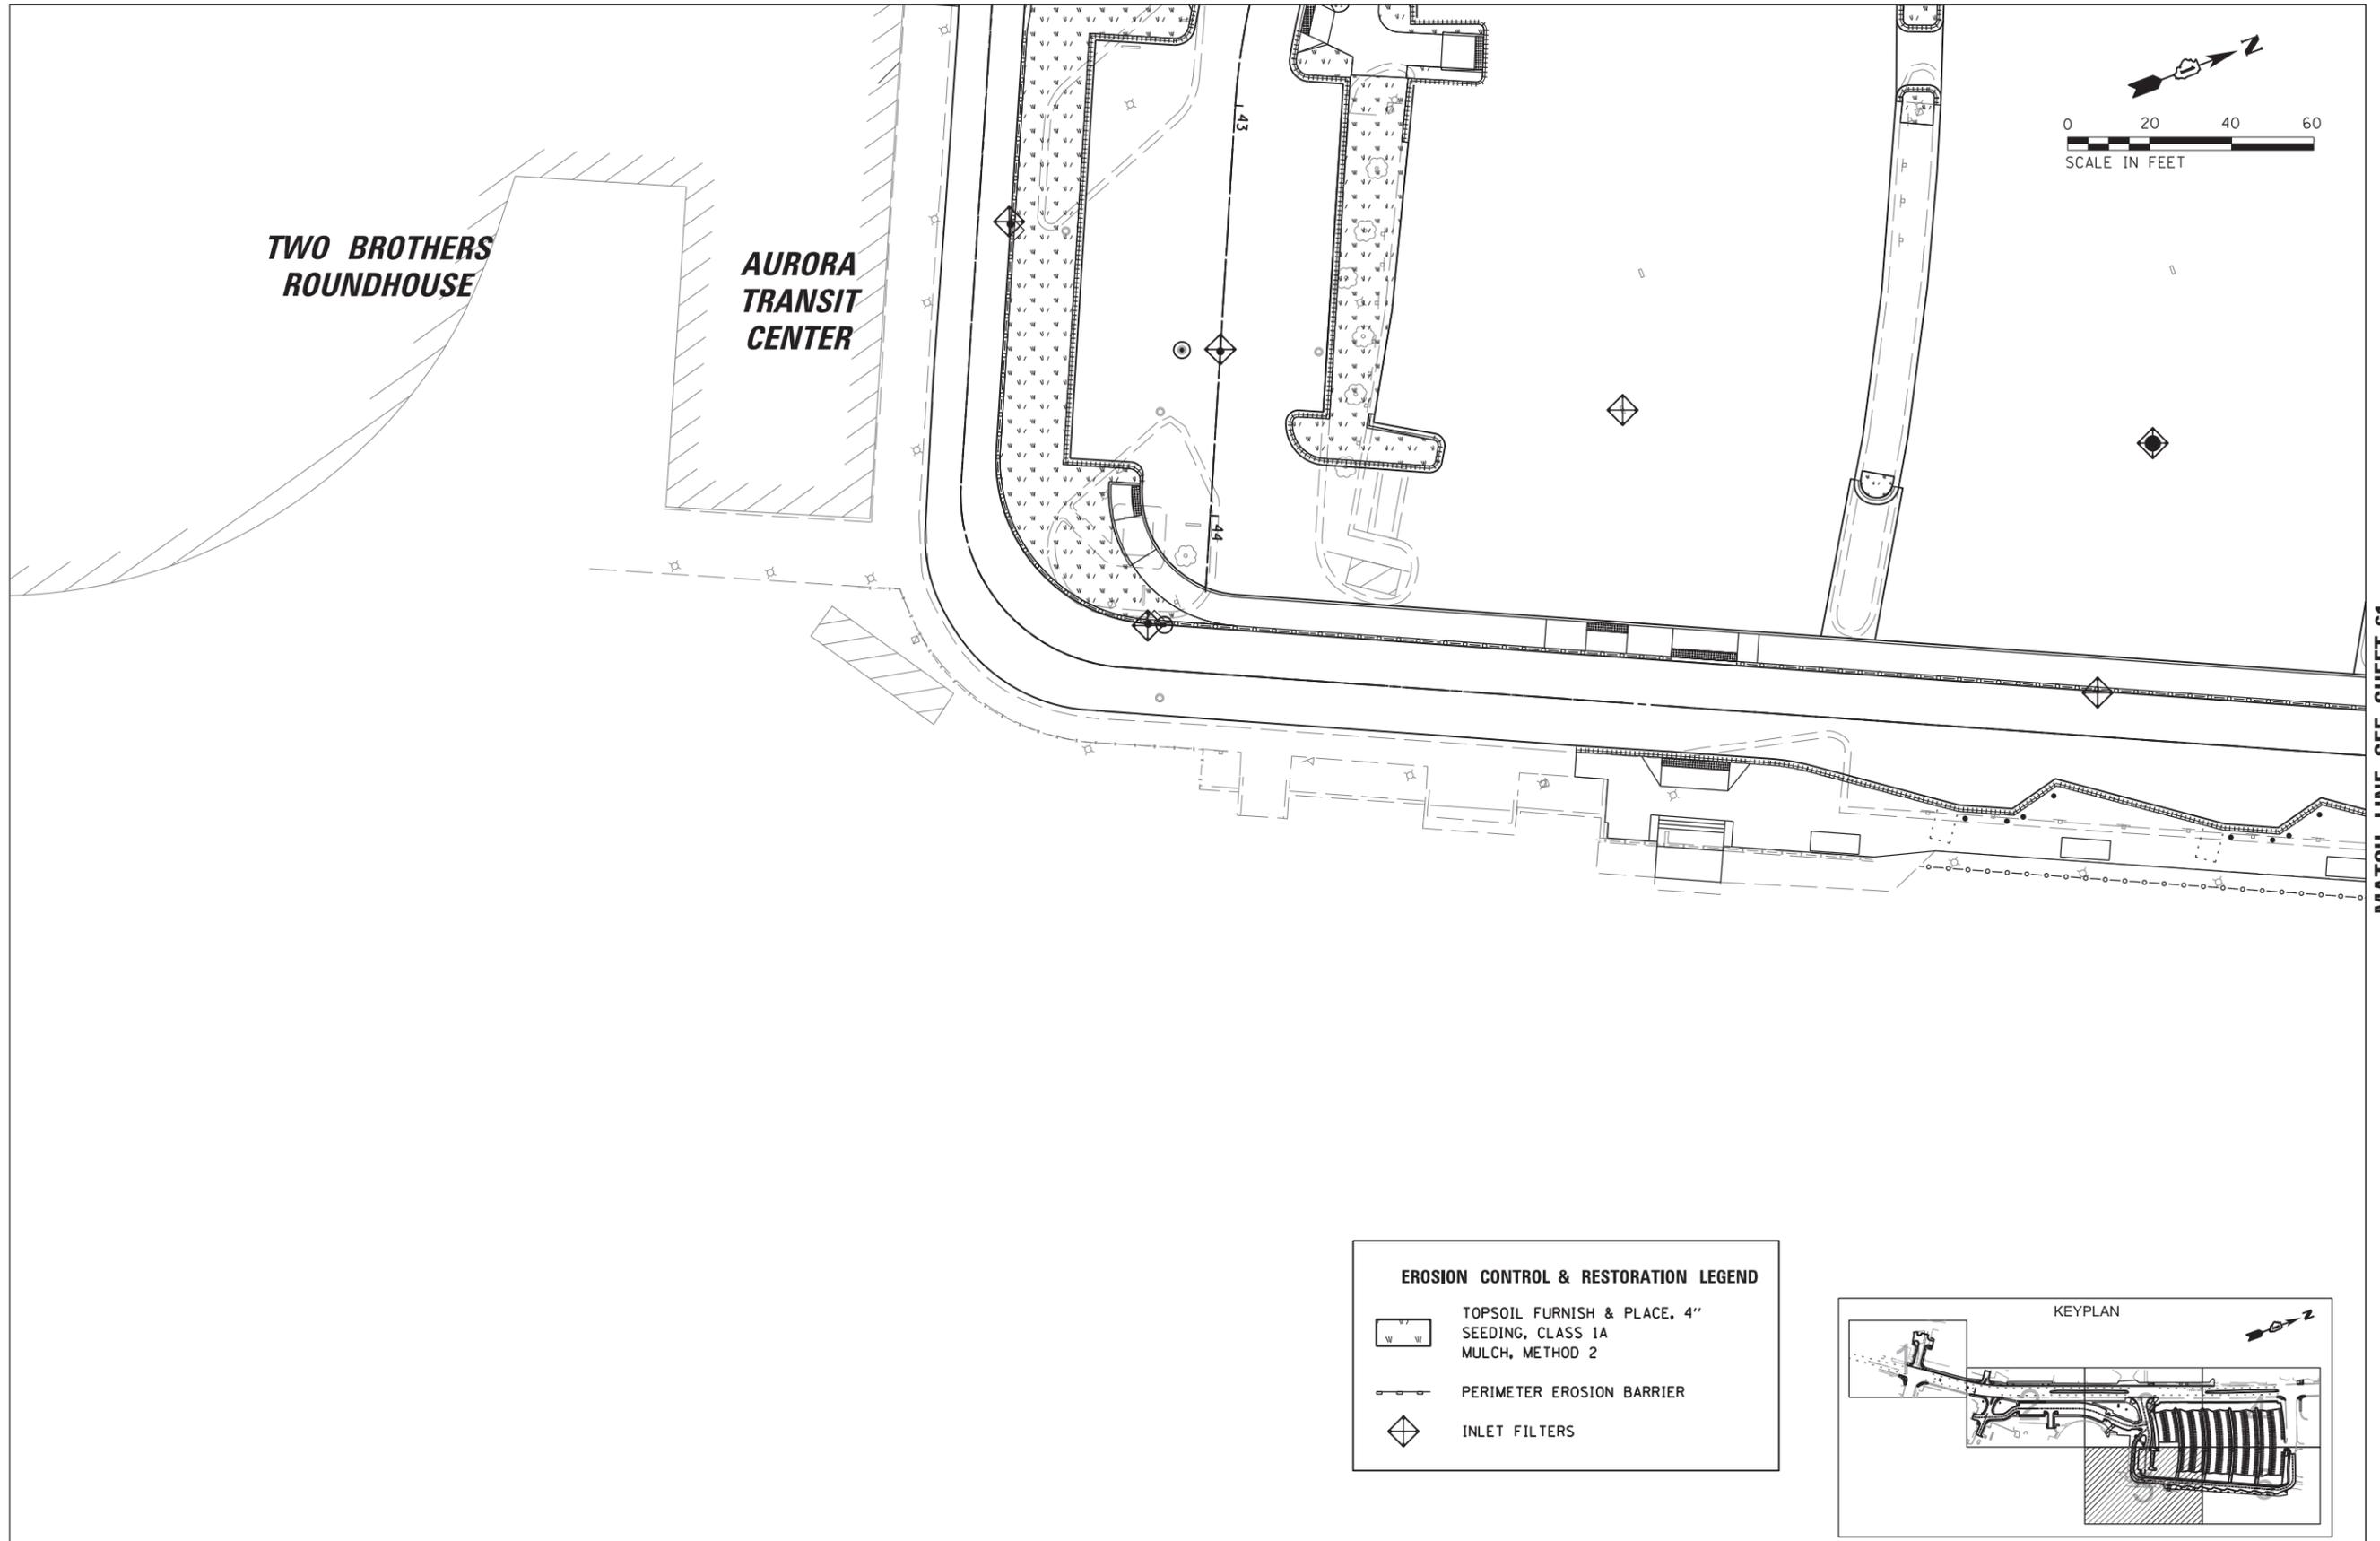
**STATE OF ILLINOIS  
DEPARTMENT OF TRANSPORTATION**

**AURORA TRANSIT CENTER IMPROVEMENTS  
EROSION CONTROL & RESTORATION PLAN**

SCALE: 40' SHEET OF 254 SHEETS STA. TO STA.


F.A.U. RTE.	SECTION	COUNTY	TOTAL SHEETS	SHEET NO.
2503	16-00313-00-MS	KANE	254	59
CONTRACT NO. 61E18				
ILLINOIS FED. AID PROJECT				

MATCH LINE SEE SHEET 57



**TWO BROTHERS  
ROUNDHOUSE**


**AURORA  
TRANSIT  
CENTER**

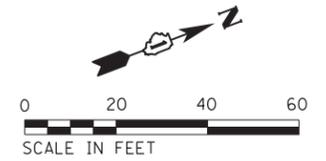

MATCH LINE SEE SHEET 61

**EROSION CONTROL & RESTORATION LEGEND**

- TOPSOIL FURNISH & PLACE, 4"  
SEEDING, CLASS 1A  
MULCH, METHOD 2
- PERIMETER EROSION BARRIER
- INLET FILTERS

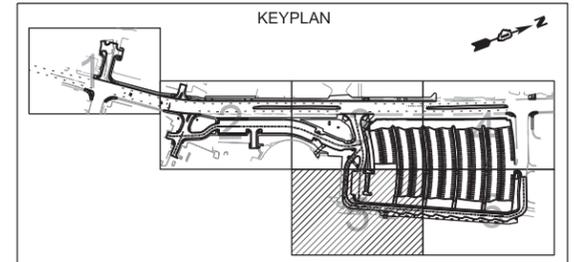

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**STATE OF ILLINOIS  
DEPARTMENT OF TRANSPORTATION**




**AURORA TRANSIT CENTER IMPROVEMENTS  
EROSION CONTROL & RESTORATION PLAN**

SCALE: 40' SHEET OF 254 SHEETS STA. TO STA.

F.A.U. RTE.	SECTION	COUNTY	TOTAL SHEETS	SHEET NO.
2503	16-00313-00-MS	KANE	254	60
CONTRACT NO. 61E18				
ILLINOIS FED. AID PROJECT				

MATCH LINE SEE SHEET 59

MATCH LINE SEE SHEET 60

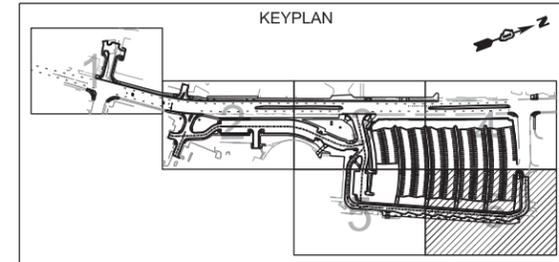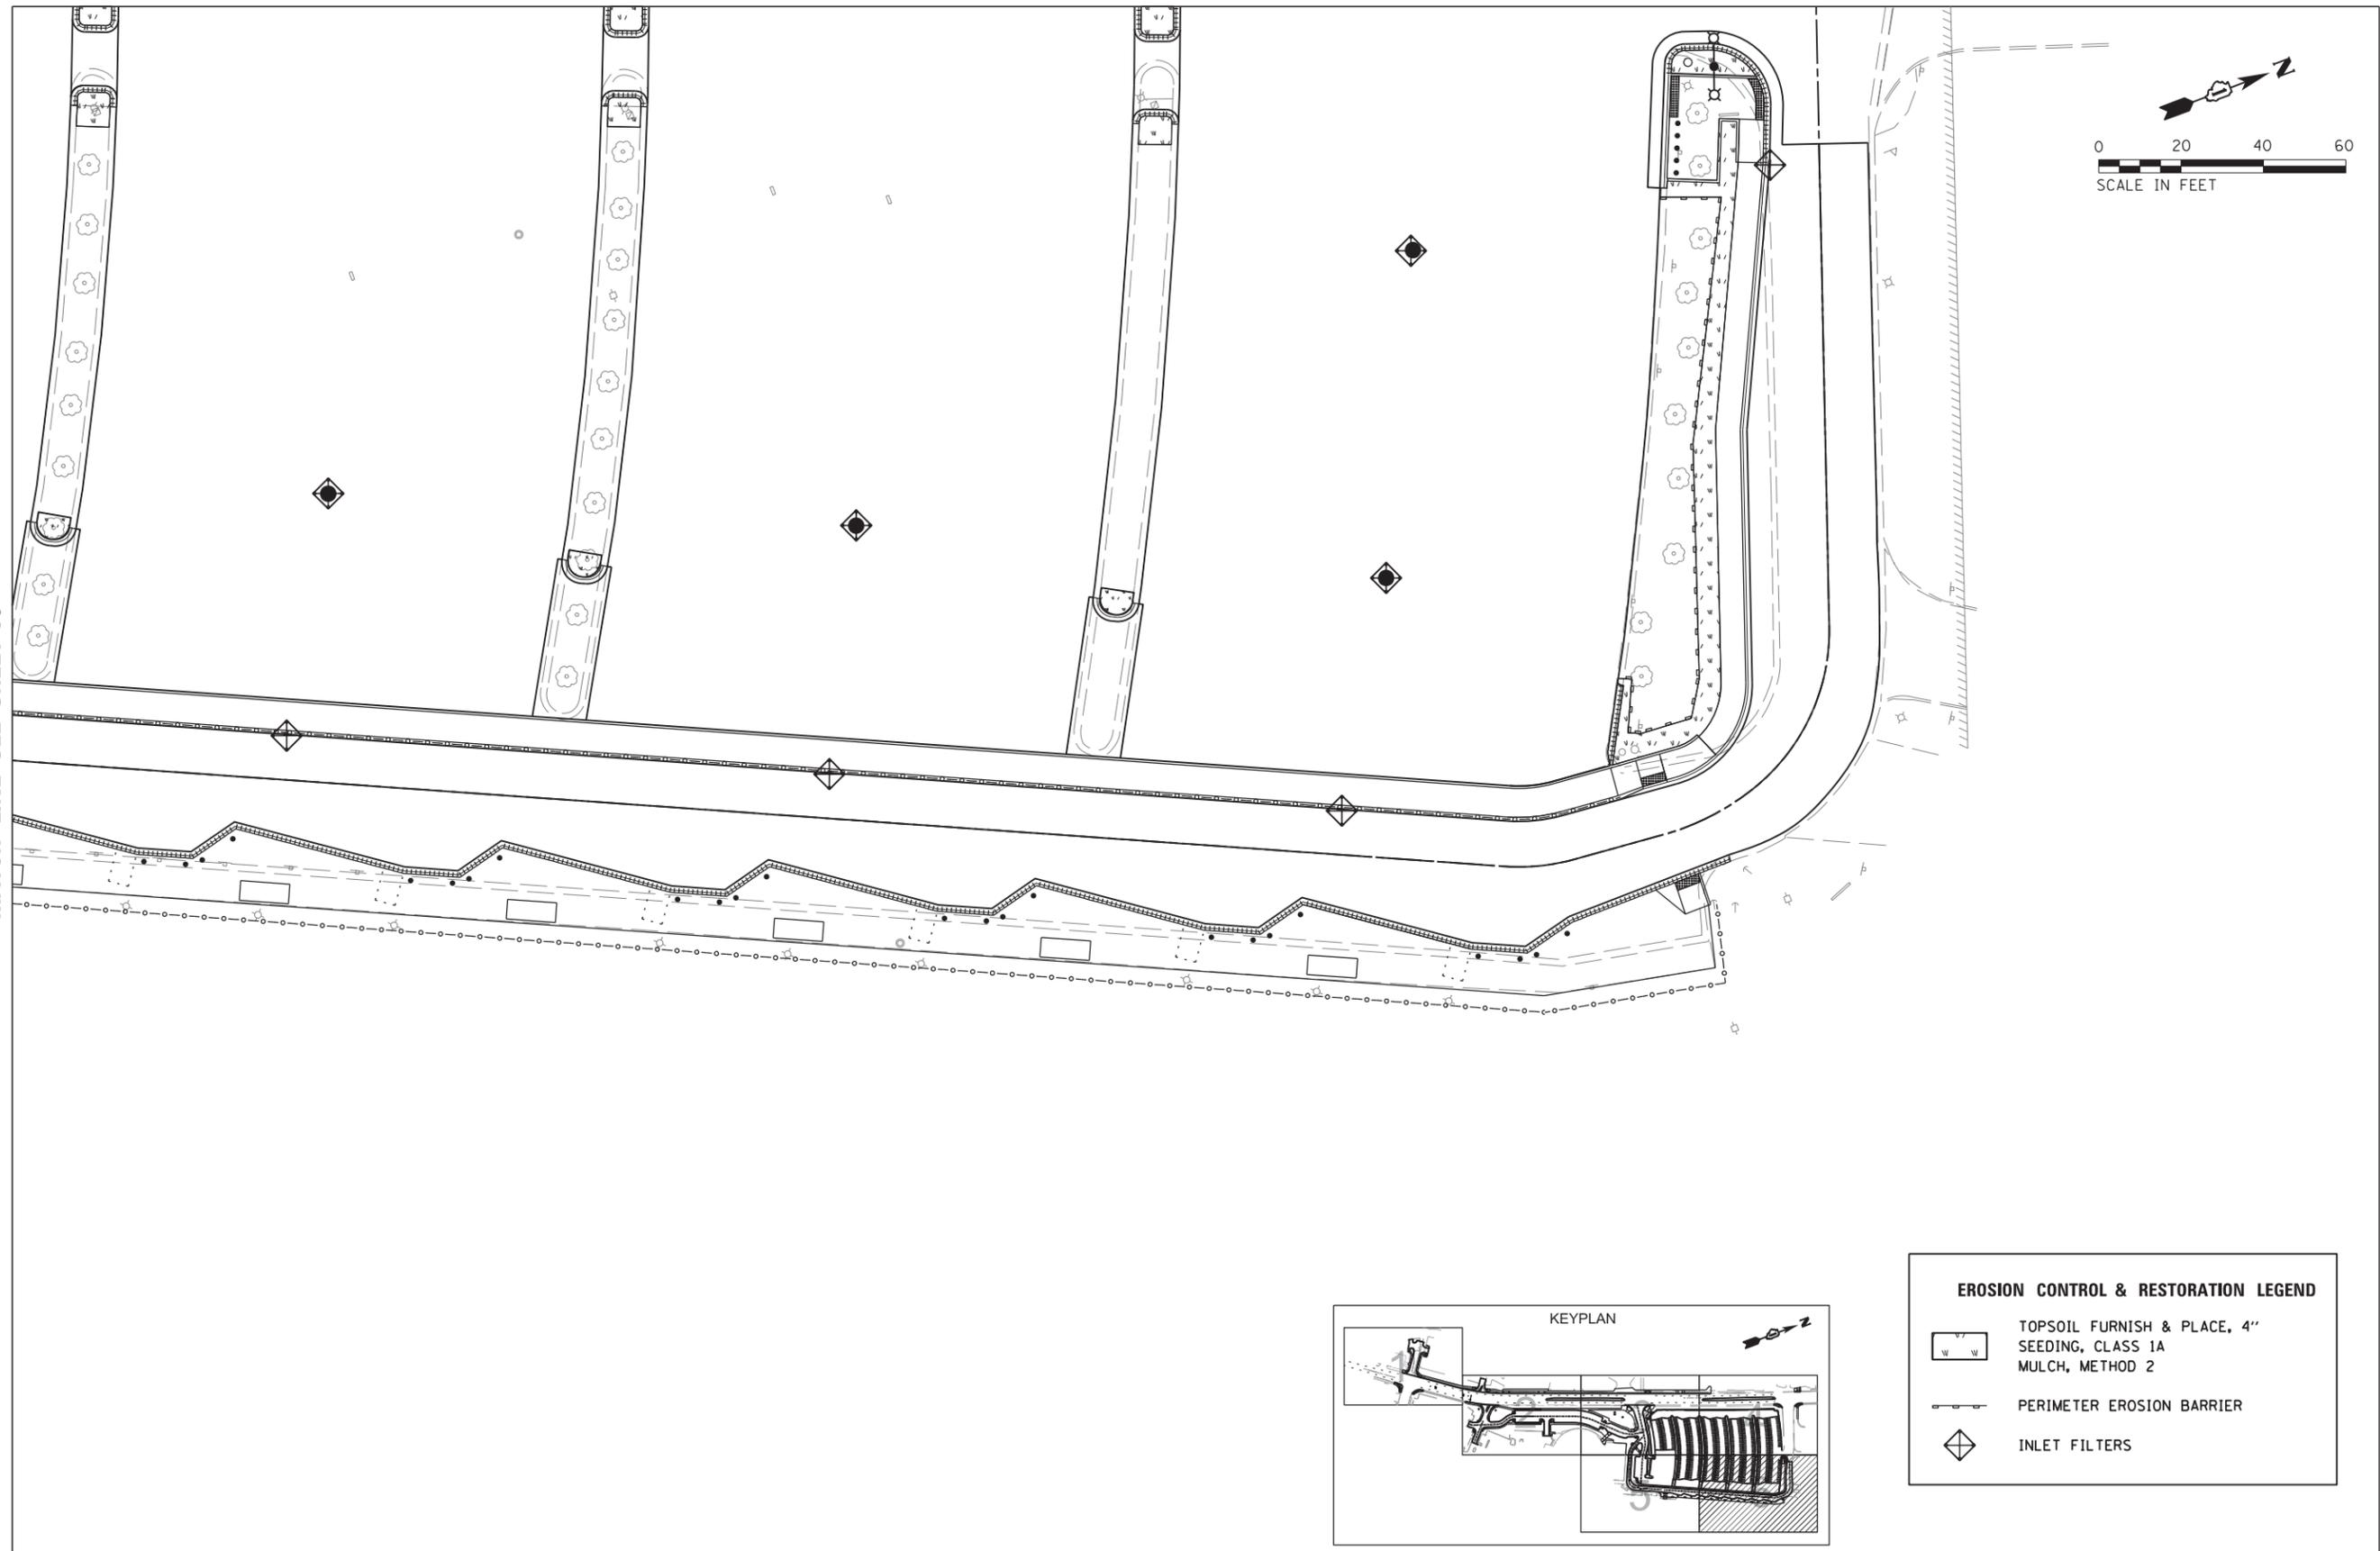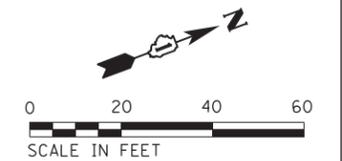

**EROSION CONTROL & RESTORATION LEGEND**

	TOPSOIL FURNISH & PLACE, 4" SEEDING, CLASS 1A MULCH, METHOD 2
	PERIMETER EROSION BARRIER
	INLET FILTERS






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**STATE OF ILLINOIS  
DEPARTMENT OF TRANSPORTATION**

**AURORA TRANSIT CENTER IMPROVEMENTS  
EROSION CONTROL & RESTORATION PLAN**

SCALE: 40' SHEET OF 254 SHEETS STA. TO STA.

F.A.U. RTE.	SECTION	COUNTY	TOTAL SHEETS	SHEET NO.
2503	16-00313-00-MS	KANE	254	61
				CONTRACT NO. 61E18
ILLINOIS FED. AID PROJECT				

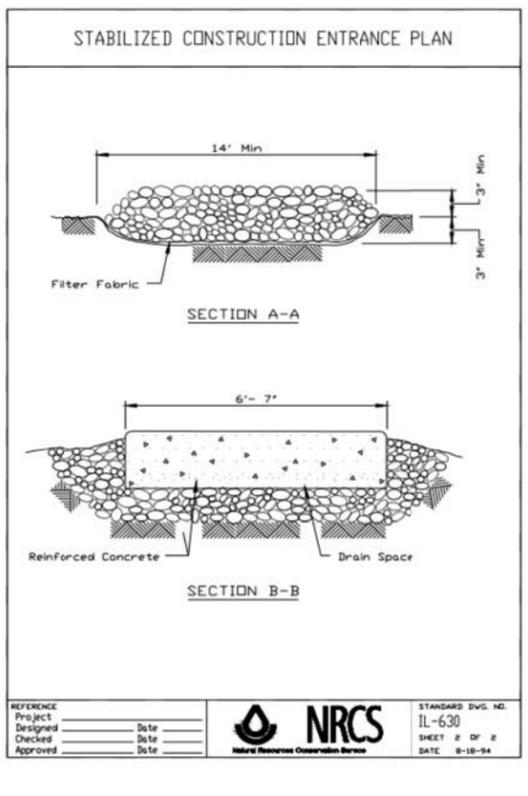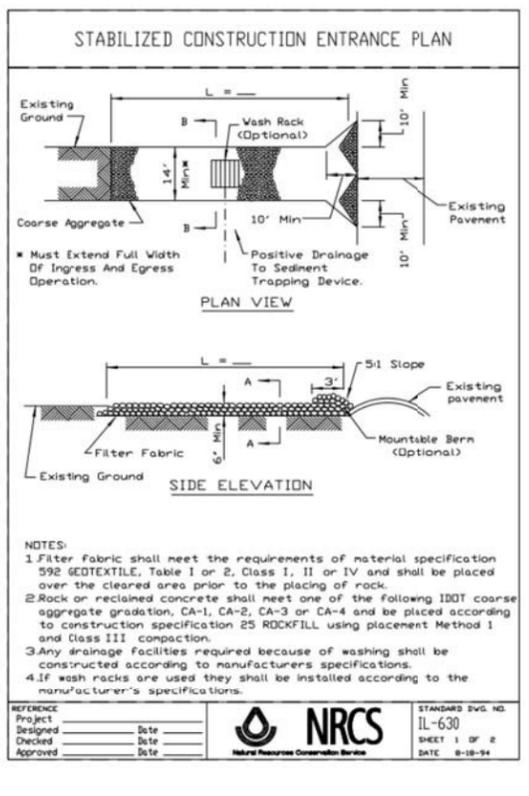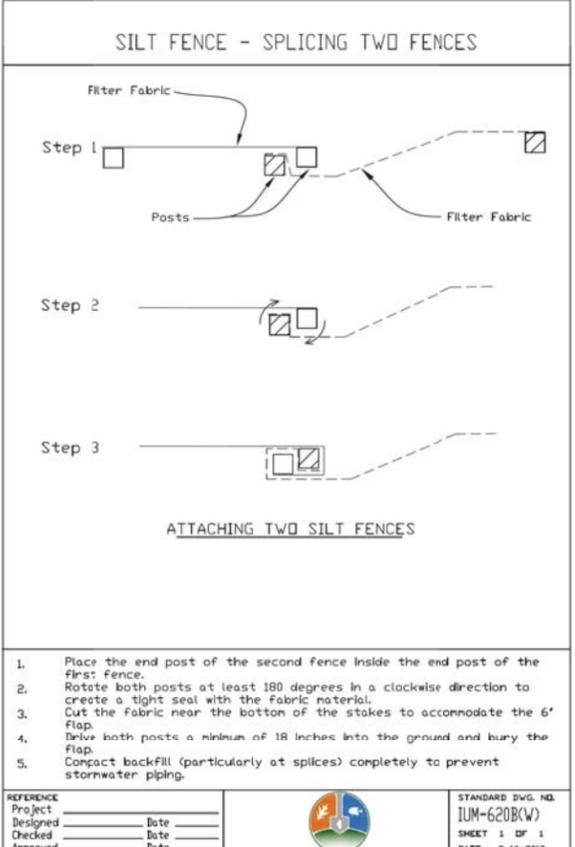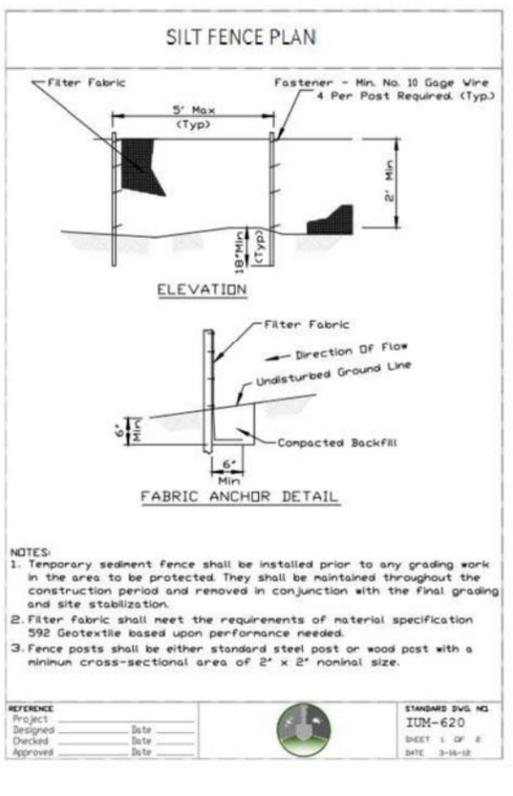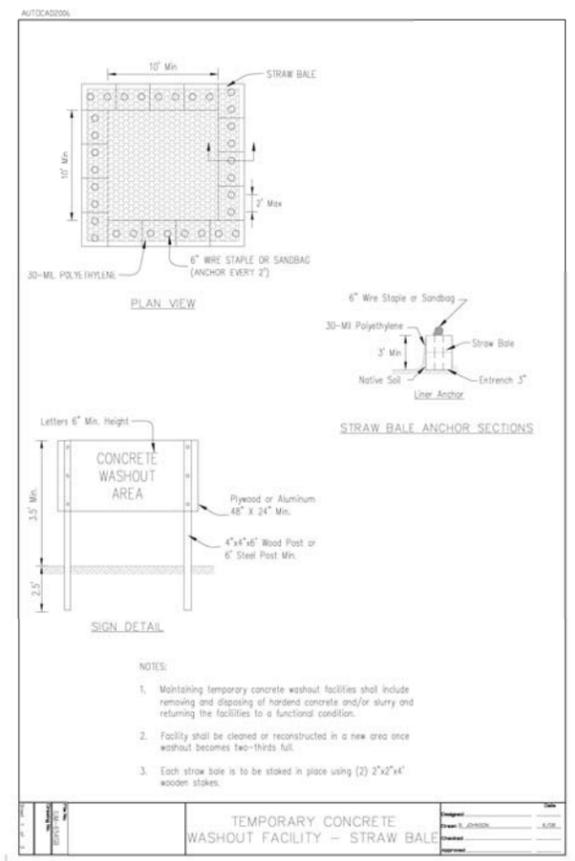

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**STATE OF ILLINOIS  
DEPARTMENT OF TRANSPORTATION**

**AURORA TRANSIT CENTER IMPROVEMENTS  
EROSION CONTROL DETAILS**

F.A.U. RTE.	SECTION	COUNTY	TOTAL SHEETS	SHEET NO.
2503	16-00313-00-MS	KANE	254	62
CONTRACT NO. 61E18				
ILLINOIS FED. AID PROJECT				

SCALE: 10' SHEET OF 254 SHEETS STA. TO STA.





**EROSION CONTROL INSPECTION**

ALL EROSION CONTROL MEASURES MUST BE INSPECTED WEEKLY AND AFTER EACH 1/2" RAIN EVENT.

**WINTER SHUT DOWN**

A WINTER SHUT DOWN IS NOT ANTICIPATED FOR THIS PROJECT. BUT IN THE EVENT THAT UNAVOIDABLE CIRCUMSTANCE REQUIRE A WINTER SHUT DOWN, THE CONDITION OF THE CONSTRUCTION SITE FOR WINTER SHUTDOWN SHALL BE ADDRESSED EARLY IN THE FALL GROWING SEASON SO THAT SLOPES AND OTHER BARE EARTH AREAS MAY BE STABILIZED WITH TEMPORARY AND/OR PERMANENT VEGETATIVE COVER FOR PROPER EROSION AND SEDIMENT CONTROL. ALL OPEN AREAS THAT ARE TO REMAIN IDLE THROUGHOUT THE WINTER SHALL RECEIVE TEMPORARY EROSION CONTROL MEASURES INCLUDING TEMPORARY SEEDING, MULCHING AND/OR EROSION CONTROL BLANKET PRIOR TO THE END OF THE FALL GROWING SEASON. THE AREAS TO BE WORKED BEYOND THE END OF THE GROWING SEASON MUST INCORPORATE SOIL STABILIZATION MEASURES THAT DO NOT RELY ON VEGETATIVE COVER SUCH AS EROSION CONTROL BLANKET AND HEAVY MULCHING.

**TEMPORARY DITCH CHECKS**

TEMPORARY DITCH CHECKS WILL BE REQUIRED AT THOSE LOCATIONS WHERE THE CONTRACTORS OPERATIONS REQUIRE TEMPORARY OR PERMANENT DITCHES. THE LOCATION OF TEMPORARY DITCH CHECKS ARE SHOWN ON THE PLANS. THE EXACT LOCATION MAY REQUIRE FIELD ADJUSTMENT AND WILL BE COORDINATED IN THE FIELD WITH THE ENGINEER. THE QUANTITIES INCLUDE A PLAN ALLOWANCE OF 10% OF THE TOTAL TEMPORARY DITCH CHECKS, FOR MAINTENANCE PURPOSES. TEMPORARY DITCH CHECKS SHALL BE CONSTRUCTED AS SPECIFIED IN SECTION 280 OF THE STANDARD SPECIFICATIONS FOR ROAD AND BRIDGE CONSTRUCTION, LATEST EDITION.

**PERIMETER EROSION BARRIER (SILT FENCE)**

PERIMETER EROSION CONTROL BARRIER (SILT FENCE) SHALL BE PLACED AT THE LOCATIONS SHOWN ON THE PLANS. THE PERIMETER EROSION CONTROL BARRIER SHALL BE CONSTRUCTED AS DETAILED ON THE PLANS AND AS SPECIFIED IN SECTION 280 OF THE STANDARD SPECIFICATIONS FOR ROAD AND BRIDGE CONSTRUCTION, LATEST EDITION.

**STOCK PILE LOCATIONS AND PROTECTING STOCK PILE AREAS**

STOCK PILES SHOULD NOT BE PLACED IN OR NEAR CRITICAL AREAS, OR AREAS THAT HAVE HIGH POTENTIAL FOR CONTRIBUTING SEDIMENTS TO STORMWATER FACILITIES.

CONTRACTOR MAY OPT TO STOCK PILE MATERIAL. STAGING OF THE PROJECT IS AT THE DISCRETION OF THE CONTRACTOR AND COORDINATION OF STOCK PILES WILL BE WITH THE ENGINEER AND KANE-DUPAGE SOIL AND WATER CONSERVATION DISTRICT (KDSWCD). STOCKPILES OF SOIL AND OTHER CONSTRUCTION MATERIALS TO REMAIN IN PLACE MORE THAN THREE (3) DAYS SHALL BE FURNISHED WITH EROSION AND SEDIMENT CONTROL MEASURES (I.E. PERIMETER SILT FENCE). STOCKPILES, NOT BEING ACTIVELY WORKED AND TO REMAIN IN PLACE FOR 14 DAYS OR MORE SHALL RECEIVE TEMPORARY SEEDING.

**STABILIZED CONSTRUCTION AREA**

TEMPORARY STABILIZATION OF THE CONSTRUCTION AREA SHOULD TAKE PLACE AT THE END OF EACH WORK DAY.

PERMANENT STABILIZATION OF THE CONSTRUCTION AREA SHALL BE COMPLETED WITHIN 7 DAYS OF FINAL GRADING.

**DEWATERING**

WHEN DEWATERING THE CONSTRUCTION AREA IS NECESSARY, ALL WATERS SHALL BE FILTERED BY USING FILTER BAGS OR AN ALTERNATIVE MEASURE APPROVED BY THE KANE-DUPAGE SOIL & WATER CONSERVATION DISTRICT. ALL FILTER BAGS MUST HAVE SECONDARY CONTAINMENT DEVICES, AND SHOULD BE PLACED ON LEVEL GROUND. WATER MUST HAVE SEDIMENT REMOVED BEFORE BEING ALLOWED TO RETURN TO THE ORIGINAL CREEK. THE DISCHARGE SHALL BE DESIGNED SO THAT RETURNING WATERS DO NOT CAUSE EROSION. THE CONTRACTOR WILL COORDINATE THE METHOD, DESIGN AND LOCATION OF THE DEWATERING PLAN AND FILTER BAG(S) WITH KANE-DUPAGE SOIL & WATER CONSERVATION DISTRICT AT THE PRE-CONSTRUCTION MEETING.

DEWATERING AND FILTERING BAG SYSTEMS REQUIRED FOR ALL CONSTRUCTION OPERATIONS WILL NOT BE MEASURED SEPARATELY FOR PAYMENT BUT SHALL BE INCLUDED IN THE COST OF THE RELATED WORK ITEM REQUIRING DEWATERING. DEWATERING WILL INCLUDE MEANS, METHODS AND ALL MATERIALS TO DEWATER AND TO PROVIDE FILTRATION OF WATERS BEFORE RE-ENTERING THE RIVER AND/OR WATERWAY.

**IN-WATERWAY NOTES**

SEE SHEET 65 FOR ADDITIONAL NOTES.

**KEEPING PAVEMENTS CLEAN**

THE CONTRACTOR WILL KEEP ALL PERMANENT PAVEMENT SURFACES CLEAN OF DIRT OR CONSTRUCTION DEBRIS. THE PAVEMENT SHALL BE CLEANED AT THE END OF EACH DAYS OPERATION OR MORE FREQUENTLY AS REQUIRED BY THE ENGINEER IF THE DEBRIS IS DEEMED TO BE A HAZARD TO THE MOTORING PUBLIC.

**STABILIZED CONSTRUCTION ENTRANCE**

A STABILIZED CONSTRUCTION ENTRANCE IS NOT ANTICIPATED FOR THIS PROJECT. HOWEVER, NOMINAL QUANTITY HAS BEEN INCLUDED IN THE CONTRACT IF A STABILIZED CONSTRUCTION ENTRANCE IS REQUIRED BY THE ENGINEER. THE ENTRANCE WILL BE AS DETAILED IN THE EROSION CONTROL DETAILS.

**CONCRETE WASHOUT**

CONCRETE WASHOUT(S) ARE ANTICIPATED FOR THIS PROJECT. IT SHOULD BE DRAWN ON THESE PLANS BY THE CONTRACTOR AT THE TIME OF INSTALLATION. WASHOUTS ARE TO BE CONSTRUCTED AND MAINTAINED IN A MANNER CONSISTENT WITH THE DETAILS ON THE PLANS AND THE LATEST EDITION OF THE ILLINOIS URBAN MANUAL.

CONCRETE WASHOUT SHALL BE CONTAINED AT ALL TIMES. WASHOUT MATERIAL SHALL NOT BE ALLOWED TO ENTER WATER BODIES, STORM SEWERS OR LEACH INTO THE SOIL UNDER ANY CIRCUMSTANCES. ANY WASTE SHALL BE DISPOSED OF PROPERLY AND THE LOCATION OF THE WASHOUT SHALL BE DESIGNATED WITH PROPER SIGNAGE. FAILURE TO COMPLY COULD RESULT IN A VIOLATION.

STABILIZATION TYPE	JAN.	FEB.	MAR.	APR.	MAY	JUNE	JULY	AUG.	SEPT.	OCT.	NOV.	DEC.
PERMANENT SEEDING	B			A		*	*	A		B		
DORMANT SEEDING	C										C	
TEMPORARY SEEDING			D									
EROSION CONTROL	E											

- A. CLASS 1 & 1A
  - B. SEEDING (SPECIAL)
  - C. INCREASE SEEDING RATES BY 25% WHEN DORMANT SEEDING (NOT ANTICIPATED)
  - D. TEMPORARY SEEDING (PERENNIAL RYE GRASS, SPRING OATS)
  - E. TEMPORARY & EROSION CONTROL BLANKET (PERMANENT SEED AREAS, TEMPORARY SEED AREAS AS DIRECTED BY THE ENGINEER)
- \* IRRIGATION MAY BE NEEDED DURING JUNE AND JULY (INCLUDED IN SEEDING)

NOTE: SEEDING TO BE COMPLETED PER REQUIREMENTS OF SECTION 250 OF THE IDOT STANDARD SPECIFICATIONS FOR ROAD AND BRIDGES AND THE SPECIAL PROVISIONS.

**WATERWAY INFORMATION**

Flood	Freq. Yr.	0 C.F.S.	Opening Sq. Ft.		Nat. H.W.E.	Head - Ft.		Headwater El.	
			Exist.	Prop.		Exist.	Prop.	Exist.	Prop.
	10	12,100	-	5,353	633.60	-	0.04	-	633.64
	30	15,000	-	5,903	634.34	-	0.04	-	633.38
Design	50	17,000	-	6,289	634.86	-	0.04	-	634.90
Base	100	18,600	-	6,594	635.27	-	0.04	-	635.31
Max. Calc.	500	24,100	-	7,580	636.34	-	0.04	-	636.38

10-Year Velocity through existing bridge = N/A  
10-Year Velocity through prop. bridge = 1.32 fps

**GENERAL NOTES**

- A) UNLESS OTHERWISE INDICATED, ALL VEGETATIVE AND STRUCTURAL EROSION AND SEDIMENT CONTROL PRACTICES WILL BE CONSTRUCTED ACCORDING TO MINIMUM STANDARDS AND SPECIFICATIONS IN THE ILLINOIS URBAN MANUAL, LATEST EDITION.
- B) THE KANE-DUPAGE SOIL AND WATER CONSERVATION DISTRICT (KDSWCD) MUST BE NOTIFIED ONE WEEK PRIOR TO THE PRE-CONSTRUCTION CONFERENCE, ONE WEEK PRIOR TO THE COMMENCEMENT OF LAND DISTURBING ACTIVITIES, AND ONE WEEK PRIOR TO THE FINAL INSPECTION.
- C) A COPY OF THE APPROVED EROSION AND SEDIMENT CONTROL PLAN SHALL BE MAINTAINED ON THE SITE AT ALL TIMES.
- D) PRIOR TO COMMENCING LAND-DISTURBING ACTIVITIES IN AREAS OTHER THAN INDICATED ON THESE PLANS (INCLUDING BUT NOT LIMITED TO, ADDITIONAL PHASES OF DEVELOPMENT AND OFF-SITE BORROW OR WASTE AREAS) A SUPPLEMENTARY EROSION CONTROL PLAN SHALL BE SUBMITTED TO THE OWNER FOR REVIEW BY THE KDSWCD.
- E) THE CONTRACTOR IS RESPONSIBLE FOR INSTALLATION OF ANY ADDITIONAL EROSION CONTROL MEASURES NECESSARY TO PREVENT EROSION AND SEDIMENTATION AS DETERMINED BY THE KDSWCD.
- F) IT IS THE RESPONSIBILITY OF THE OWNER AND/OR GENERAL CONTRACTOR TO INFORM ANY SUB-CONTRACTOR(S) WHO MAY PERFORM WORK ON THIS PROJECT, OF THE REQUIREMENTS IN IMPLEMENTING AND MAINTAINING THESE EROSION CONTROL PLANS AND THE NATIONAL POLLUTANT DISCHARGE ELIMINATION SYSTEM (NPDES) PERMIT REQUIREMENTS SET FORTH BY THE ILLINOIS EPA.
- G) THE CONTRACTOR IS RESPONSIBLE FOR INDICATING THE CURRENT LOCATION OF THE CONCRETE WASHOUT AND ANY MODIFICATIONS TO THE LOCATIONS OR DETAILS OF EROSION AND SEDIMENT CONTROLS ON THESE PLANS.
- H) ALL DROP INLETS ON AND ADJACENT TO THE SITE MUST HAVE SEDIMENT TRAPPING OR CONTAINMENT DEVICE INSTALLED DURING CONSTRUCTION ACTIVITIES. FILTER FABRIC ON ITS OWN IS NOT AN APPROVED METHOD. PREFABRICATED DROP INLET PROTECTION SHOULD BE AS RESTRICTIVE AS THE ILLINOIS URBAN MANUAL STANDARD 861 FOR INLET PROTECTION.

**CONTRACTOR SUBMITTAL**

MEANS AND METHODS TO CONSTRUCT THE BRIDGE AND OTHER APPURTENANT WORK IS THE CONTRACTORS RESPONSIBILITY. THE CONTRACTOR IS REQUIRED TO SUBMIT TO KDSWCD FOR APPROVAL ALL DRAWINGS AND/OR DETAILS SHOWING THE EXACT SEQUENCING, METHODS, AND LOCATIONS OF THE COFFERDAMS WHICH WILL INCLUDE DEWATERING AND FILTRATION METHODS.

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**WBK ENGINEERING, LLC**  
116 WEST MAIN STREET, SUITE 201  
ST. CHARLES, ILLINOIS 60174  
(630) 443-7755

USER NAME = nparris	DESIGNED - MNB	REVISED -
PLOT SCALE = 1:200	DRAWN - NDP	REVISED -
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**STATE OF ILLINOIS  
DEPARTMENT OF TRANSPORTATION**


**EROSION CONTROL & RESTORATION NOTES**

SCALE: SHEET NO. 10 OF 13 SHEETS STA. TO STA.

F.A.U. RTE.	SECTION	COUNTY	TOTAL SHEETS	SHEET NO.
2503	16-00313-00-MS	KANE	254	65
				<b>CONTRACT NO. 61E18</b>
ILLINOIS FED. AID PROJECT				

**IN-WATERWAY WORK**

- A. WORK IN THE WATERWAY SHOULD BE TIMED TO TAKE PLACE DURING LOW OR NO-FLOW CONDITIONS. LOW FLOW CONDITIONS ARE FLOW AT OR BELOW THE NORMAL WATER ELEVATION.
- B. THE PLAN WILL BE DESIGNED TO ALLOW FOR THE CONVEYANCE OF THE 2-YEAR PEAK FLOW PAST THE WORK AREA WITHOUT OVERTOPPING THE COFFERDAM. THE CORPS HAS THE DISCRETION TO REDUCE THIS REQUIREMENT IF DOCUMENTED BY THE APPLICANT TO BE INFEASIBLE OR UNNECESSARY.
- C. WATER SHALL BE ISOLATED FROM THE IN-WATERWAY WORK AREA USING A COFFERDAM CONSTRUCTED OF NON-ERODIBLE MATERIALS (STEEL SHEETS, AQUA BARRIERS, RIP RAP AND GEOTEXTILE LINER, ETC.). EARTHEN COFFERDAMS ARE NOT PERMISSIBLE.
- D. THE COFFERDAM MUST BE CONSTRUCTED FROM THE UPLAND AREA AND NO EQUIPMENT MAY ENTER FLOWING WATER AT ANY TIME. IF THE INSTALLATION OF THE COFFERDAM CANNOT BE COMPLETED FROM SHORE AND ACCESS IS NEEDED TO REACH THE AREA TO BE COFFERED, OTHER MEASURES, SUCH AS THE CONSTRUCTION OF A CAUSEWAY WILL BE NECESSARY TO ENSURE THAT EQUIPMENT DOES NOT ENTER THE WATER. ONCE THE COFFERDAM IS IN PLACE AND THE ISOLATED AREA IS DEWATERED, EQUIPMENT MAY ENTER THE COFFERED AREA TO PERFORM THE REQUIRED WORK.
- E. IF BYPASS PUMPING IS NECESSARY, THE INTAKE HOSE SHALL BE PLACED ON A STABLE SURFACE OR FLOATED TO PREVENT SEDIMENT FROM ENTERING THE HOSE. THE BYPASS DISCHARGE SHALL BE PLACED ON A NON-ERODIBLE, ENERGY DISSIPATING SURFACE PRIOR TO REJOINING THE STREAM FLOW AND SHALL NOT CAUSE EROSION. FILTERING OF BYPASS WATER IS NOT NECESSARY UNLESS THE BYPASS WATER HAS BECOME SEDIMENT-LADEN AS A RESULT OF THE CURRENT CONSTRUCTION ACTIVITIES.
- F. DURING DEWATERING OF THE COFFERED WORK AREA, ALL SEDIMENT-LADEN WATER MUST BE FILTERED TO REMOVE SEDIMENT. POSSIBLE OPTIONS FOR SEDIMENT REMOVAL INCLUDE BAFFLE SYSTEMS, ANIONIC POLYMERS SYSTEMS, DEWATERING BAGS, OR OTHER APPROPRIATE METHODS. WATER SHALL HAVE SEDIMENT REMOVED PRIOR TO BEING RE-INTRODUCED TO THE DOWNSTREAM WATERWAY. A STABILIZED CONVEYANCE FROM THE DEWATERING DEVICE TO THE WATERWAY MUST BE IDENTIFIED IN THE PLAN. DISCHARGE WATER IS CONSIDERED CLEAN IF IT DOES NOT RESULT IN A VISUALLY IDENTIFIABLE DEGRADATION OF WATER CLARITY.
- G. THE AREA FROM THE TOE TO THE TOP OF THE SIDE SLOPE SHALL BE TEMPORARILY STABILIZED DURING CONSTRUCTION TO REDUCE THE POTENTIAL FOR EROSION. ALL AREAS DISTURBED DUE TO CONSTRUCTION ACTIVITIES SHALL BE RESTORED TO PROPOSED CONDITIONS AND FULLY STABILIZED PRIOR TO ACCEPTING FLOWS.

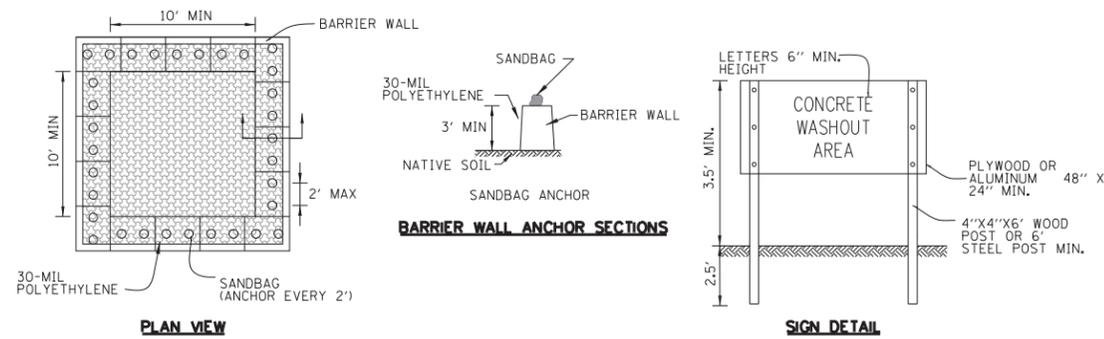


**WASHOUT NOTES:**

- 1. MAINTAINING TEMPORARY CONCRETE WASHOUT FACILITIES SHALL INCLUDE REMOVING AND DISPOSING OF HARDENED CONCRETE AND/OR SLURRY AND RETURNING THE FACILITIES TO A FUNCTIONAL CONDITION.
- 2. FACILITY SHALL BE CLEANED OR RECONSTRUCTED IN A NEW AREA ONCE WASHOUT BECOMES TWO-THIRDS FULL.


**TEMPORARY CONCRETE WASHOUT FACILITY - BARRIER WALL**

STD. IUM-654BW  
(TEMPORARY CONCRETE WASHOUT)

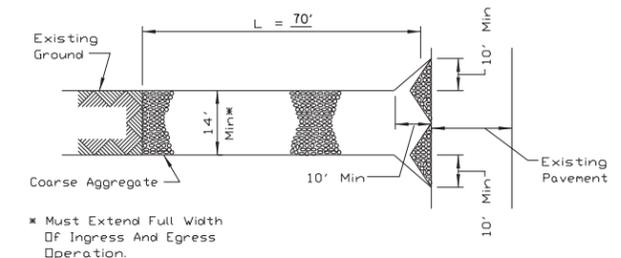


\* Must Extend Full Width Of Ingress And Egress Operation.

**PLAN VIEW**

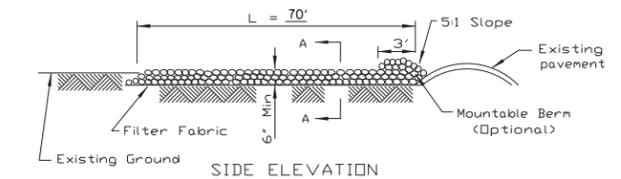

**SIDE ELEVATION**

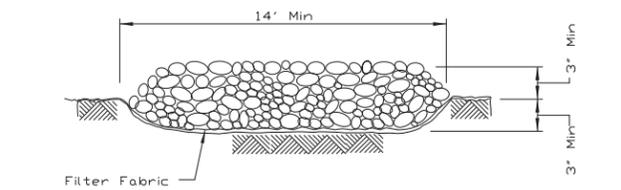

**SECTION A-A**

**NOTES:**

- 1. FILTER FABRIC SHALL MEET THE REQUIREMENTS OF ARTICLE 1080.03 OF THE STANDARD SPECIFICATIONS AND SHALL BE PLACED OVER THE CLEARED SUBGRADE AREA PRIOR TO PLACING THE ROCK.
- 2. AGGREGATE FILL SHALL MEET ONE OF THE FOLLOWING IDOT COARSE AGGREGATE GRADATIONS, CA-1, CA-2, CA-3 OR CA-4 AND BE PLACED ACCORDING TO SPECIAL PROVISION "STABILIZED CONSTRUCTION ENTRANCE".
- 3. ANY DRAINAGE FACILITIES REQUIRED BECAUSE OF WASHING SHALL BE CONSTRUCTED ACCORDING TO MANUFACTURERS SPECIFICATIONS.
- 4. IF WASH RACKS ARE USED THEY SHALL BE INSTALLED ACCORDING TO MANUFACTURERS SPECIFICATIONS.

**STABILIZED CONSTRUCTION**

**ENTRANCE PLAN**

STD. IL-630(A), IL-630(B)  
(STABILIZED CONSTRUCTION ENTRANCE PLAN)


**DIVERSION AND DEWATERING**

DIVERSION AND DEWATERING WORK SHALL CONSIST OF FURNISHING ALL LABOR, TOOLS, EQUIPMENT, AND MATERIALS TO INSTALL, MAINTAIN, AND OPERATE ALL NECESSARY DEWATERING SYSTEMS TO DIVERT, REMOVE WATER FROM THE CHANNEL REACH OR DESIGNED TO CONTROL SEDIMENT DISCHARGE IN DEWATERING APPLICATIONS WHERE WATER IS BEING PUMPED FOR THE CONSTRUCTION OF THE PROPOSED CULVERT, HEADWALLS, STONE RIP RAP CHANNEL LINING AND OTHER WORK ASSOCIATED WITH CONSTRUCTION OF THE CULVERT TO ASSURE THE WORK CAN BE COMPLETED IN THE DRY OR IN MANAGEABLE CONDITIONS AS APPROVED BY THE ENGINEER.

THIS ITEM WILL ALSO CONSIST OF CONSTRUCTING A DEWATERING FILTERING SYSTEM CONSISTING OF FILTRATION OR SEDIMENT BAGS FOR COLLECTING SEDIMENT FROM PUMPING OPERATIONS WITHIN COFFER DAMS AND SUMP PITS. CONSTRUCTION WATERS WILL INCLUDE, BUT NOT BE LIMITED TO, ALL WATERS GENERATED FROM THE INSTALLATION OF CULVERTS, HEADWALLS, DRAINAGE SYSTEMS, FOOTING AND AGGREGATE BASE CONSTRUCTION.

**DIVERSION & DEWATERING - BASIS OF PAYMENT**

THIS WORK REQUIRED FOR CONSTRUCTION OF DIVERSION AND DEWATERING SYSTEMS NECESSARY TO CONSTRUCT THE PROPOSED BRIDGE AND RELATED SITE WORK AS SHOWN IN THE PLANS WILL NOT BE MEASURED SEPARATELY FOR PAYMENT BUT SHALL BE CONSIDERED INCLUDED IN THE COST OF THE BRIDGE CONSTRUCTION ITEMS. DIVERSION WORK SHALL INCLUDE DIVERSION SYSTEM(S) (IE: COFFERDAMS, BARRIER WALL, ETC), FILTER FABRIC, PIPING, PUMPING, FLOCCULENT TREATMENT SYSTEM, FOUNDATION PREPARATION, FRAMING AND SUPPORTS, DEWATERING FILTERING SYSTEM CONSISTING OF FILTRATION OR SEDIMENT BAGS, INSTALLATION, MAINTENANCE, REMOVAL OF SYSTEMS AND ALL LABOR, MATERIAL, AND EQUIPMENT REQUIRED TO PERFORM THE WORK DESCRIBED HEREIN AND AS SPECIFIED ON THE PLANS.

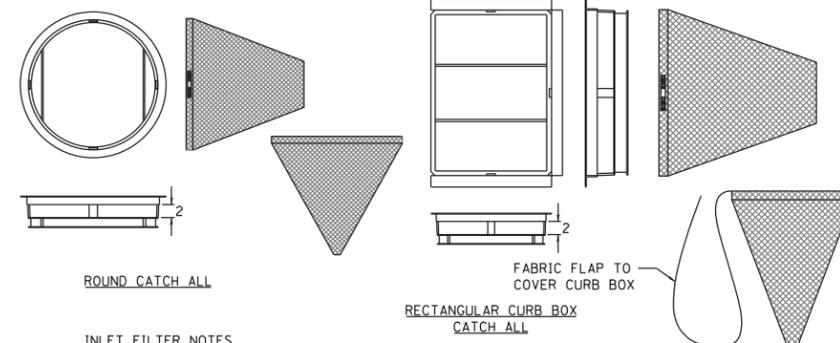

ROUND CATCH ALL

FABRIC FLAP TO COVER CURB BOX  
RECTANGULAR CURB BOX CATCH ALL


**INLET FILTER NOTES**

FRAME: TOP FLANGE FABRICATED FROM 1/4"x1/4"x1/8" ANGLE. BASE RIM FABRICATED FROM 1/2"x1/2"x1/8" CHANNEL. HANDLES AND SUSPENSION BRACKETS FABRICATED FROM 1/4"x1/4" FLAT STOCK. ALL STEEL CONFORMING TO ASTM-A36.

SEDIMENT BAG: BAG FABRICATED FROM 4 OZ./SQ.YD. NON-WOVEN POLYPROPYLENE GEOTEXTILE REINFORCED WITH POLYESTER MESH. BAG SECURED TO BASE RIM WITH A STAINLESS STEEL BAND AND LOCK.

**INLET FILTER DETAIL**

N.T.S.

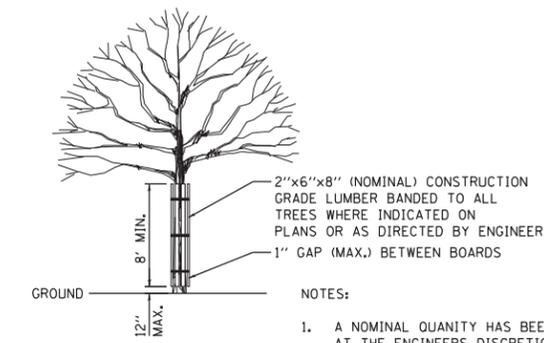

**NOTES:**

- 1. A NOMINAL QUANTITY HAS BEEN ADDED FOR USE AT THE ENGINEERS DISCRETION.

**TREE TRUNK PROTECTION**

N.T.S.

FILE NAME = W:\Projects\2016\160194\_ATCPhaseII\cadd\civil\Drawings\ERO\_04.dgn

**WBK engineering**  
WBK ENGINEERING, LLC  
116 WEST MAIN STREET, SUITE 201  
ST. CHARLES, ILLINOIS 60174  
(630) 443-7755


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PLOT DATE = 10/17/2017	CHECKED - MNB	REVISED -
	DATE - 10/18/17	REVISED -

**STATE OF ILLINOIS  
DEPARTMENT OF TRANSPORTATION**

**EROSION CONTROL & RESTORATION NOTES & DETAILS**

SCALE: SHEET NO. 11 OF 13 SHEETS STA. TO STA.

F.A.U. RT.E.	SECTION	COUNTY	TOTAL SHEETS	SHEET NO.
2503	16-00313-00-MS	KANE	254	66
CONTRACT NO. 61E18			ILLINOIS FED. AID PROJECT	

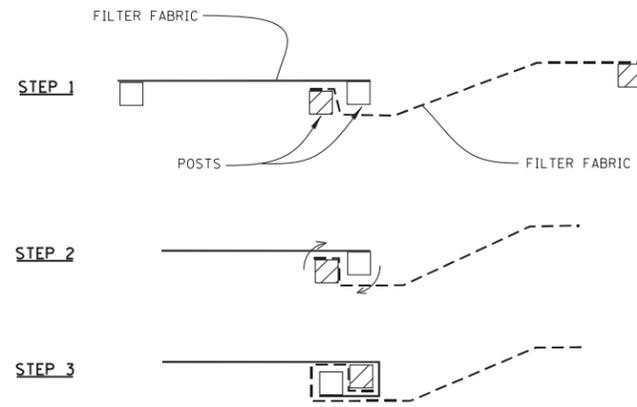


ATTACHING TWO SILT FENCES

NOTES:

1. PLACE THE END POST OF THE SECOND FENCE INSIDE THE END POST OF THE FIRST FENCE.
2. ROTATE BOTH POSTS AT LEAST 180 DEGREES IN A CLOCKWISE DIRECTION TO CREATE A TIGHT SEAL WITH THE FABRIC MATERIAL.
3. CUT THE FABRIC NEAR THE BOTTOM OF THE STAKES TO ACCOMMODATE THE 6" FLAP.
4. DRIVE BOTH POSTS A MINIMUM OF 18 INCHES INTO THE GROUND AND BURY THE FLAP.
5. COMPACT BACKFILL (PARTICULARLY AT SPLICES) COMPLETELY TO PREVENT STORMWATER PIPING.

**PERIMETER EROSION BARRIER  
(SILT FENCE) – SPLICING TWO FENCES**

STD. IUM-620B  
(SILT FENCE - SPLICING TWO FENCES)

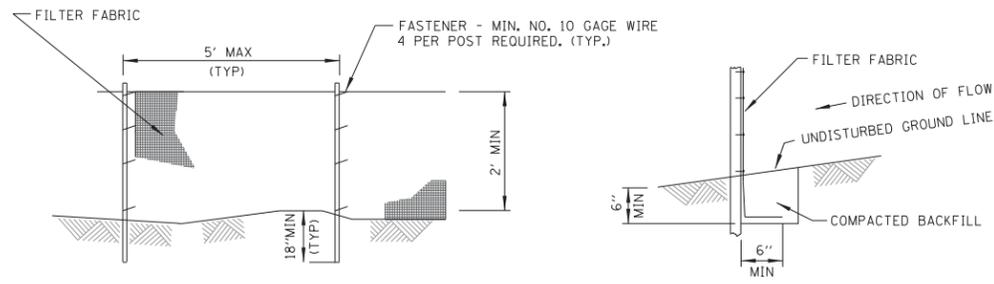

ELEVATION


FABRIC ANCHOR DETAIL

NOTES:


1. TEMPORARY SEDIMENT FENCE SHALL BE INSTALLED PRIOR TO ANY GRADING WORK IN THE AREA TO BE PROTECTED. THEY SHALL BE MAINTAINED THROUGHOUT THE CONSTRUCTION PERIOD AND REMOVED IN CONJUNCTION WITH THE FINAL GRADING AND SITE STABILIZATION.
2. FILTER FABRIC SHALL MEET THE REQUIREMENTS OF MATERIAL SPECIFICATION 592 GEOTEXTILE TABLE 1 OR 2, CLASS WITH EQUIVALENT OPENING SIZE OF AT LEAST 30 FOR NONWOVEN AND 40 FOR WOVEN.
3. FENCE POSTS SHALL BE EITHER STANDARD STEEL POST OR WOOD POST WITH A MINIMUM CROSS-SECTIONAL AREA OF 3.0 SQ. IN.

**PERIMETER EROSION BARRIER  
(SILT FENCE)**

STD. IUM-620A  
(SILT FENCE PLAN)

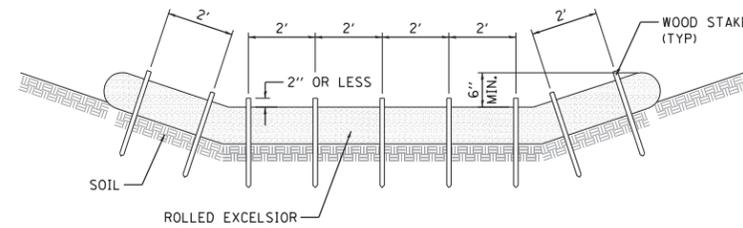

STAKING PATTERN GUIDE

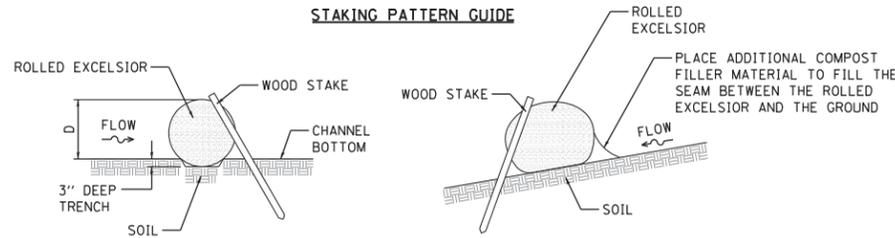

STAKE DETAIL


COMPOST FILTER SOCK DETAIL

NOTES:

1. ENDS OF ROLLED EXCELSIOR SHALL BE TURNED AT LEAST 6" UPSLOPE.
2. RECOMMENDED STAKES ARE 1/8" WIDE x 1/8" THICK x 30" LONG.
3. STAKES SHALL NOT EXTEND ABOVE THE ROLLED EXCELSIOR MORE THAN 2".
4. SPACING: THE TOE OF THE UPSLOPE DITCH CHECK SHALL CREATE A HORIZONTAL LINE WITH THE TOP OF THE DOWNSTREAM DITCH CHECK.
5. WHEN COMPOST FILTER SOCK DITCH CHECK IS USED, PLACE A COMPOST BERM UPSLOPE OF THE FILTER SOCK (SEE IUM 805). A TRENCH IS NOT REQUIRED.
6. OVERLAP MINIMUM IS THE DIAMETER OF THE ROLL.
7. STAKES SHALL BE PLACED EVERY 2' FOR ROLLED EXCELSIOR, OR AS SPECIFIED BY THE MANUFACTURER.

**TEMPORARY DITCH CHECK  
ROLLED EXCELSIOR**

STD. IUM-514  
(ROLLED EROSION CONTROL PRODUCTS)

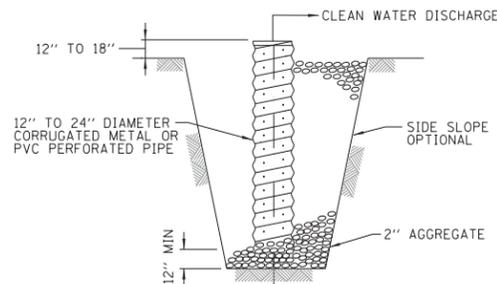


SECTION

SUMP PIT NOTES:

1. PIT DIMENSIONS ARE OPTIONAL.
2. THE STANDPIPE WILL BE CONSTRUCTED BY PERFORMING A 12"-24" DIAMETER CORRUGATED METAL OR PVC PIPE.
3. A BASE OF 2" AGGREGATED WILL BE PLACED IN THE PIT TO A MINIMUM DEPTH OF 12". AFTER INSTALLING THE STANDPIPE, THE PIT SURROUNDING THE STANDPIPE WILL THEN BE BACKFILLED WITH 2" AGGREGATE.
4. THE STANDPIPE WILL EXTEND 12" TO 18" ABOVE THE LIP OF THE PIT.
5. IF DISCHARGE WILL BE PUMPED DIRECTLY TO A STORM DRAINAGE SYSTEM, THE STANDPIPE WILL BE WRAPPED WITH FILTER FABRIC BEFORE INSTALLATION.
6. IF DESIRED, 1/4"-1/2" HARDWARE CLOTH MAY BE PLACED AROUND THE STANDPIPE PRIOR TO ATTACHING THE FILTER FABRIC. THIS WILL INCREASE THE RATE OF WATER SEEPAGE INTO THE PIPE.


**SUMP PIT PLAN**

STD. IL-650  
(SUMP PIT PLAN)

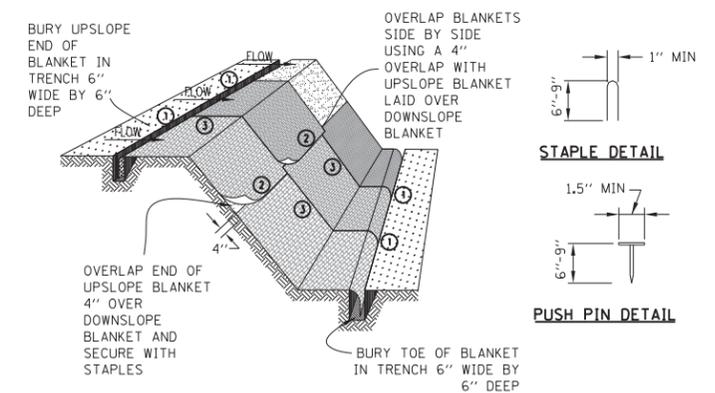

STAPLE DETAIL

PUSH PIN DETAIL

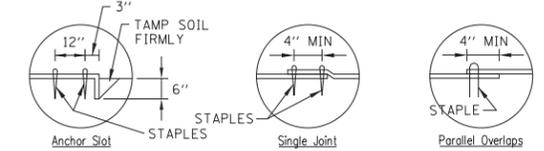

DETAIL 1

DETAIL 2


DETAIL 3

NOTES:

1. STAPLES SHALL BE PLACED IN A DIAMOND PATTERN AT 2 PER S.Y. FOR STITCHED BLANKETS. NON-STICHED SHALL USE 4 STAPLES PER S.Y. OF MATERIAL. THIS EQUATES TO 200 STAPLES WITH STITCHED BLANKET AND 400 STAPLES WITH NON-STICHED BLANKET PER 100 S.Y. OF MATERIAL.
2. STAPLE OR PUSH PIN LENGTHS SHALL BE SELECTED BASED ON SOIL TYPE AND CONDITIONS. (MINIMUM STAPLE LENGTH IS 6")
3. EROSION CONTROL MATERIAL SHALL BE PLACED IN CONTACT WITH THE SOIL OVER A PREPARED SEEDBED.
4. ALL ANCHOR SLOTS SHALL BE STAPLED AT APPROXIMATELY 12" INTERVALS.

**EROSION CONTROL BLANKET  
INSTALLATION DETAILS**

STD. IL-530A, IL-530B, IUM-531  
(EROSION CONTROL BLANKET)

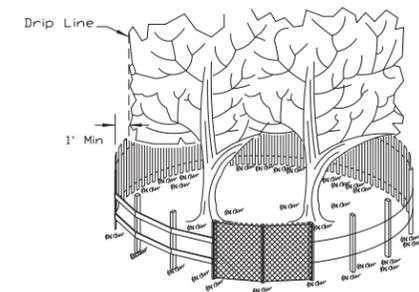


SIDE VIEW

NOTES:

1. THE FENCE SHALL BE LOCATED A MINIMUM OF 1 FOOT OUTSIDE THE DRIP LINE OF THE TREE TO BE SAVED AND IN NO CASE CLOSER THAN 5 FEET TO THE TRUNK OF ANY TREE.
2. FENCE POSTS SHALL BE EITHER STANDARD STEEL POSTS OR WOOD POSTS WITH A MINIMUM CROSS SECTIONAL AREA OF 3.0 SQ. IN.
3. THE FENCE MAY BE EITHER 40" HIGH SNOW FENCE, 40" PLASTIC WEB FENCING OR ANY OTHER MATERIAL AS APPROVED BY THE ENGINEER/INSPECTOR.
4. TO BE PAID FOR AS "TEMPORARY FENCE."

**TREE PROTECTION**

(PAID FOR AS "TEMPORARY FENCE")  
N.T.S.

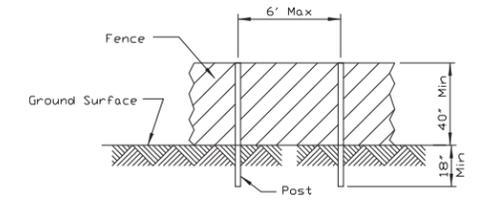

POST AND FENCE DETAIL

FILE NAME = W:\Projects\2016\160194\_ATCPhaseII\cadd\civil\Drawn\Shr\ERD\_06.dgn



WBK ENGINEERING, LLC  
116 WEST MAIN STREET, SUITE 201  
ST. CHARLES, ILLINOIS 60174  
(630) 443-7755

USER NAME = nparris	DESIGNED - MNB	REVISED -
PLOT SCALE = 1:20	DRAWN - NDP	REVISED -
PLOT DATE = 10/17/2017	CHECKED - MNB	REVISED -
	DATE - 10/18/17	REVISED -

STATE OF ILLINOIS  
DEPARTMENT OF TRANSPORTATION


EROSION CONTROL & RESTORATION DETAILS

SCALE: SHEET NO. 12 OF 13 SHEETS STA. TO STA.

F.A.U. RTE.	SECTION	COUNTY	TOTAL SHEETS	SHEET NO.
2503	16-00313-00-MS	KANE	254	67
CONTRACT NO. 61E18			ILLINOIS FED. AID PROJECT	

# INLET PROTECTION LOG TYPE

NOT-TO SCALE

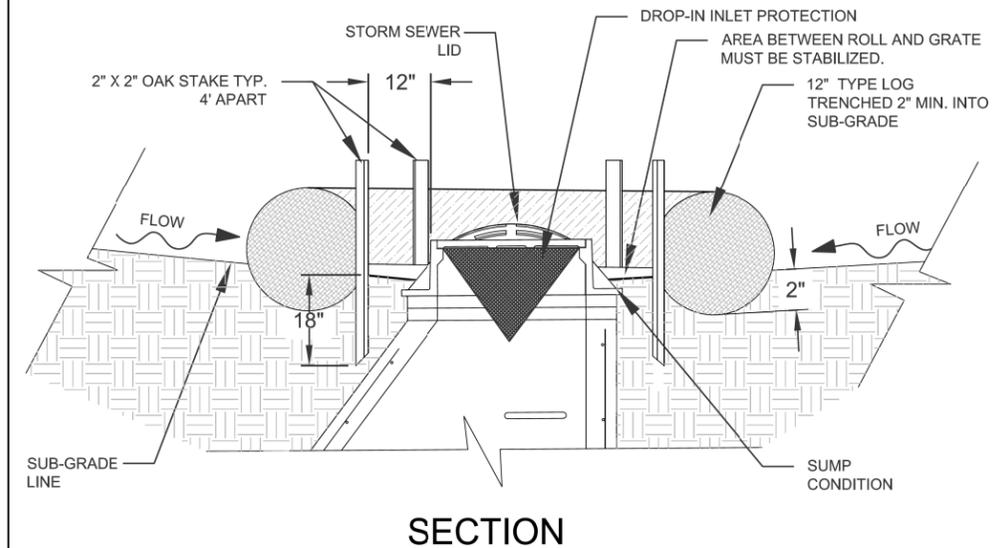

**NOTES:**

1. 2" x 2" nominal hardwood stakes, 4 foot minimum length, driven into ground approximately 18 inches, stakes driven a minimum width of 12 inches away from the drop inlet.
2. Area inside the log, from edge of fabric to structure, must be stabilized with Erosion Control Blanket, Turf Reinforcement Mat, Geotextile 592 Table 2 Class 2 or CA-7 stone
3. The maximum distance between the stakes should be 4 feet.
4. A maintenance schedule must maintain a sediment accumulation of less than 50% of the height of the log.

REFERENCE  
Project \_\_\_\_\_  
Designed \_\_\_\_\_ Date \_\_\_\_\_  
Checked \_\_\_\_\_ Date \_\_\_\_\_  
Approved \_\_\_\_\_ Date \_\_\_\_\_

STANDARD DWG. NO.  
**IUM-562**  
SHEET 1 OF 1  
DATE 11-30-15

FILE NAME = W:\Projects\2016\160194\_ATCPhaseII\cadd\Civil\Drawings\ERD\_06.dgn



**WBK ENGINEERING, LLC**  
116 WEST MAIN STREET, SUITE 201  
ST. CHARLES, ILLINOIS 60174  
(630) 443-7755

USER NAME = nparris  
PLOT SCALE = 1:20  
PLOT DATE = 10/18/2017

DESIGNED -	MNB	REVISED -	
DRAWN -	NDP	REVISED -	
CHECKED -	MNB	REVISED -	
DATE -	10/18/17	REVISED -	



**STATE OF ILLINOIS  
DEPARTMENT OF TRANSPORTATION**

**EROSION CONTROL & RESTORATION DETAILS**

SCALE: SHEET NO. 13 OF 13 SHEETS STA. TO STA.


F.A.U. RTE.	SECTION	COUNTY	TOTAL SHEETS	SHEET NO.
2503	16-00313-00-MS	KANE	254	68
CONTRACT NO. 61E18				
ILLINOIS FED. AID PROJECT				



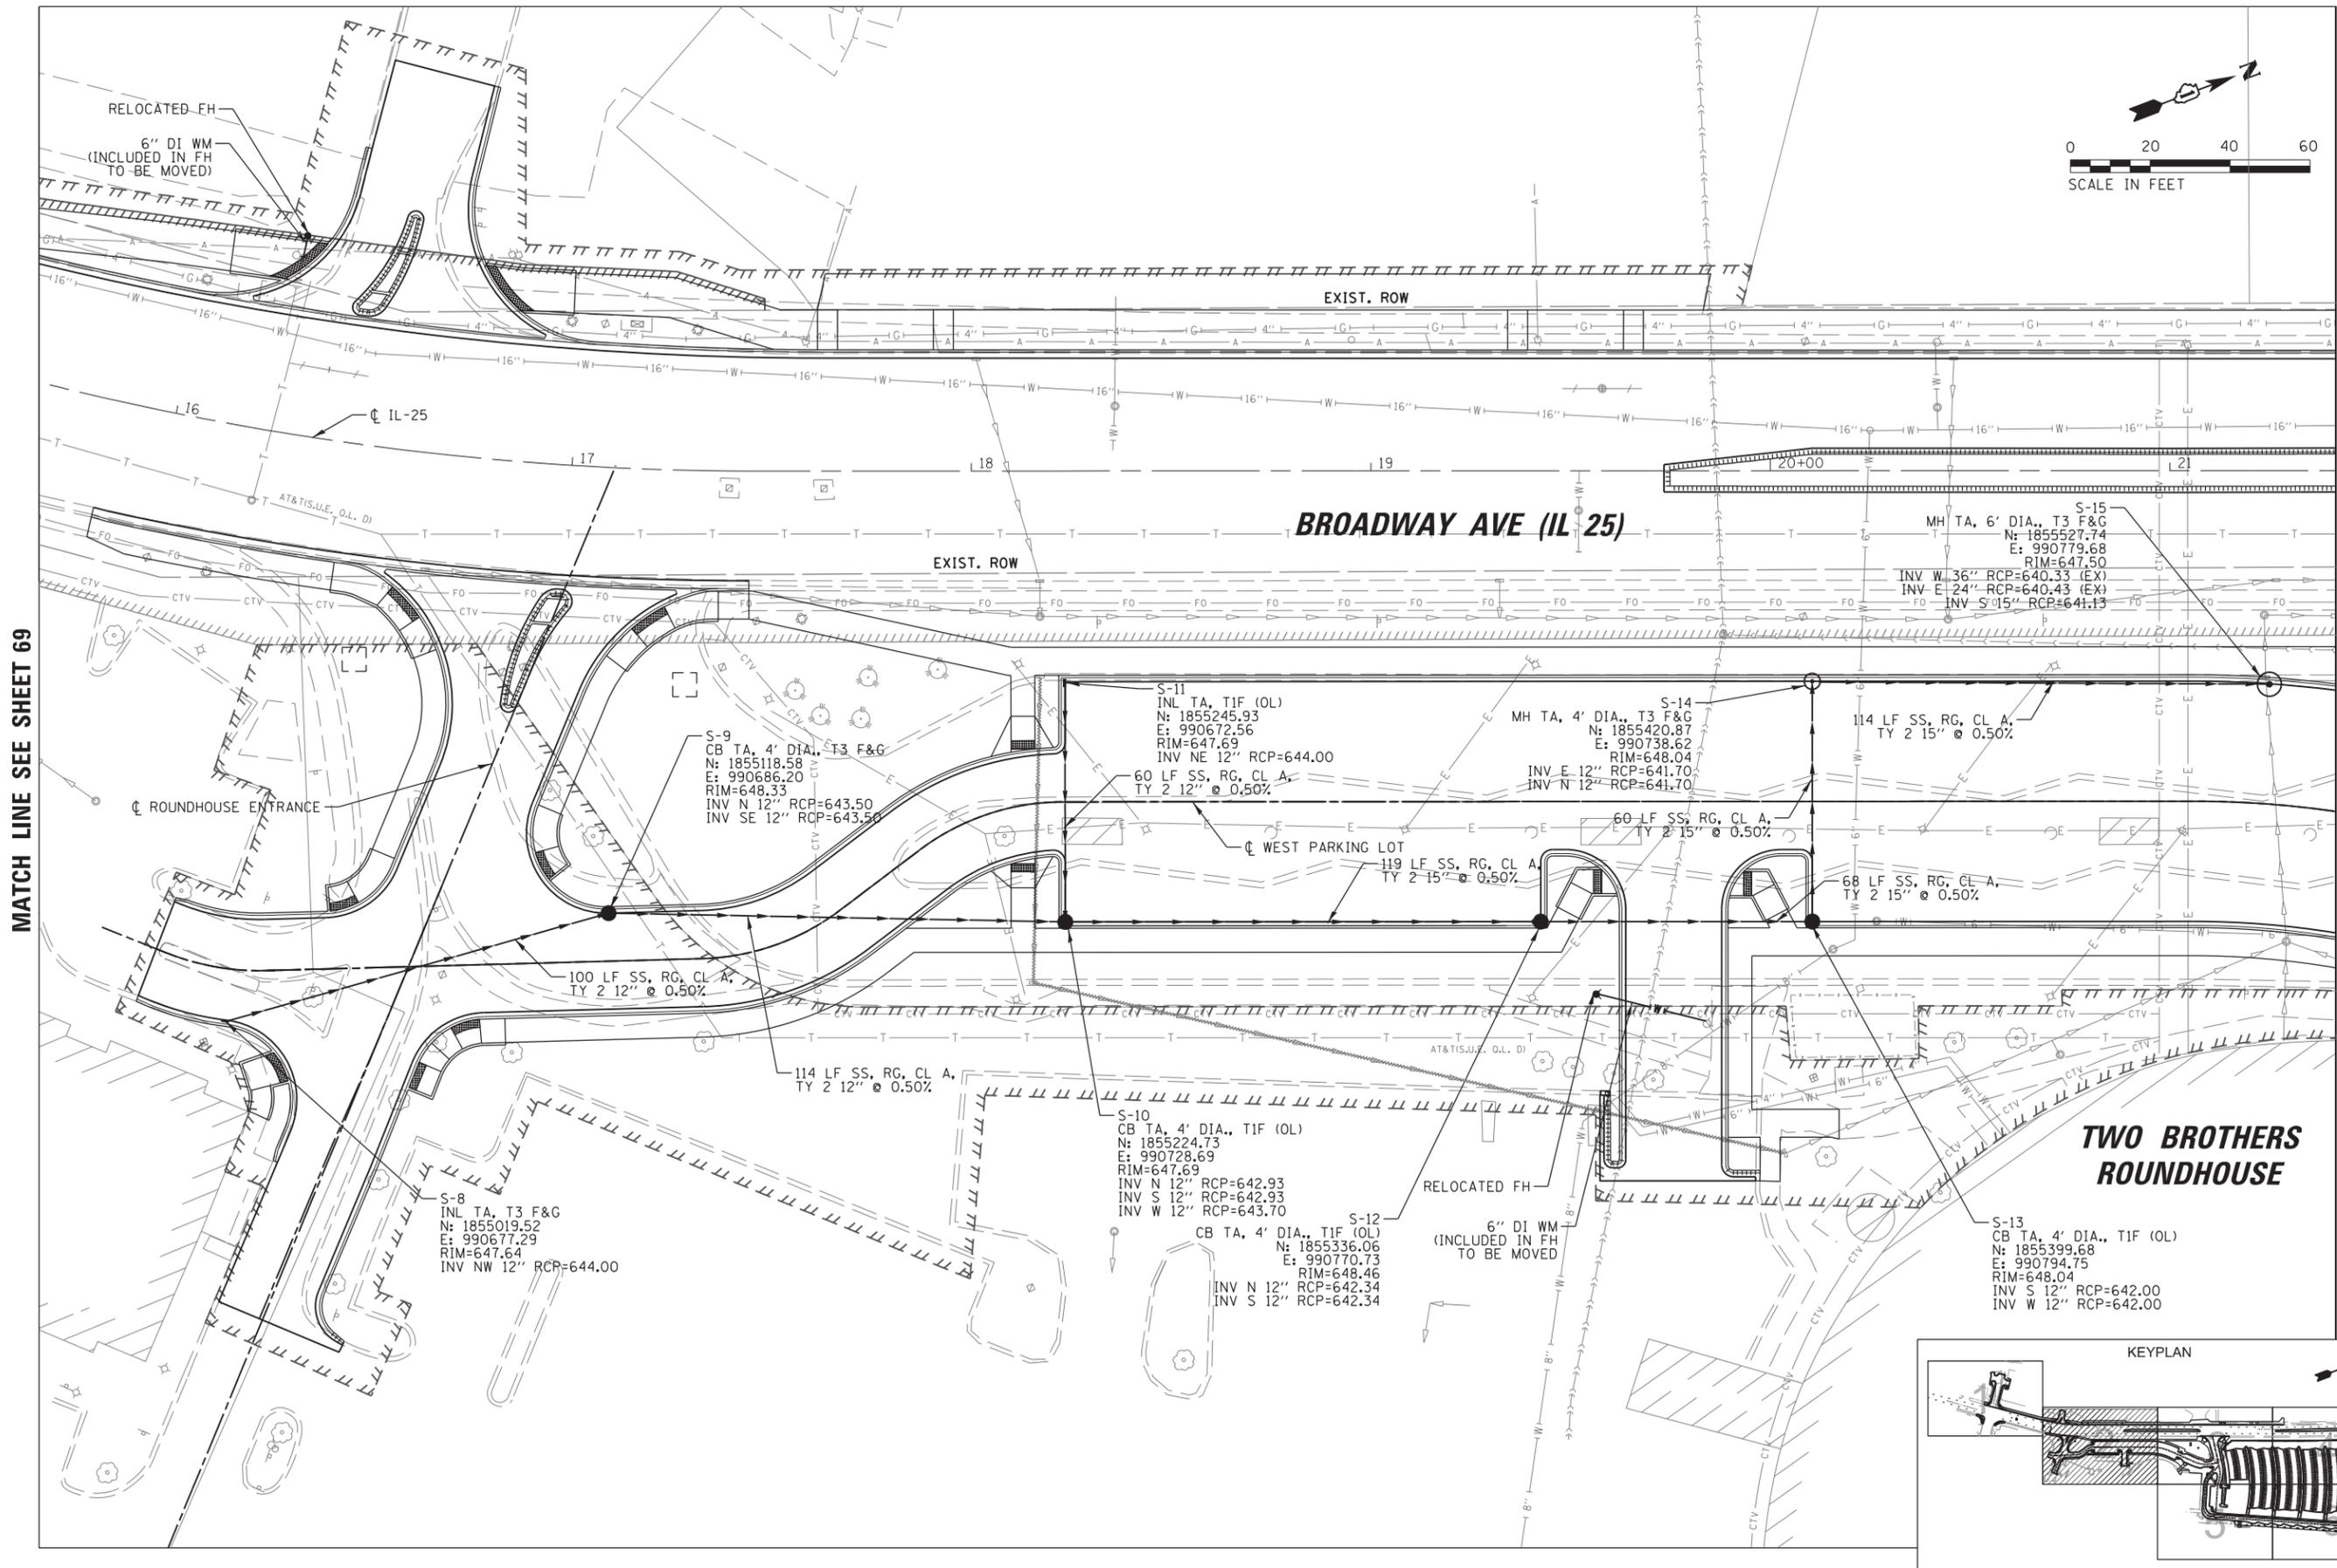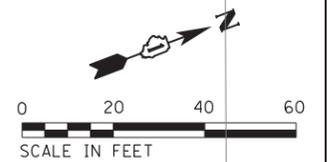

MATCH LINE SEE SHEET 69

MATCH LINE SEE SHEET 71

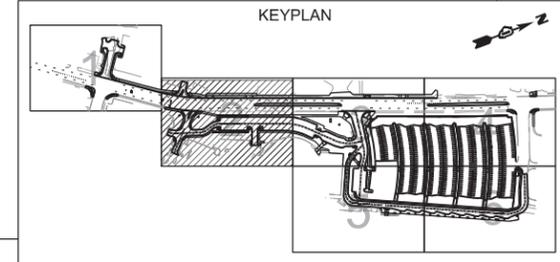

FILE NAME = N:\WBK\150077.2\Civil\UPP-150077.2.02.sht	USER NAME = bweich	DESIGNED - BMW	REVISED -
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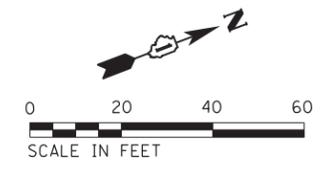
**STATE OF ILLINOIS  
DEPARTMENT OF TRANSPORTATION**

**AURORA TRANSIT CENTER IMPROVEMENTS  
DRAINAGE & UTILITY PLAN**

SCALE: 48" SHEET OF 254 SHEETS STA. TO STA.

F.A.U. R.T.E.	SECTION	COUNTY	TOTAL SHEETS	SHEET NO.
2503	16-00313-00-MS	KANE	254	70
CONTRACT NO. 61E18				
ILLINOIS FED. AID PROJECT				





**RIVEREDGE PARK  
(CITY OF AURORA PROPERTY)**

EXIST. ROW

**BROADWAY AVE (IL 25)**

EXIST. ROW

S-41  
CB TA, 4' DIA., T24 F&G  
N: 1856444.38  
E: 991092.60  
RIM=638.45  
INV NW 12"= 634.90 (EX)  
INV NE 15"=634.80

S-42  
MH TA, 4' DIA., T1F (CL)  
N: 1856466.52  
E: 991110.44  
RIM=638.99  
INV E 12" RCP=635.91  
INV NE 15" RCP=634.05 (EX)  
INV SW 15" RCP=634.24


28 LF SS, RG, CL A,  
TY 2 15" @ 2.00%

11 LF SS, RG, CL A,  
TY 2 12" @ 2.00%

S-43  
CB TC, T24 F&G  
N: 1856463.98  
E: 991121.00  
RIM=639.13  
INV NW 12"=636.13

☉ PACE PULSEPOINT

MATCH LINE SEE SHEET 71

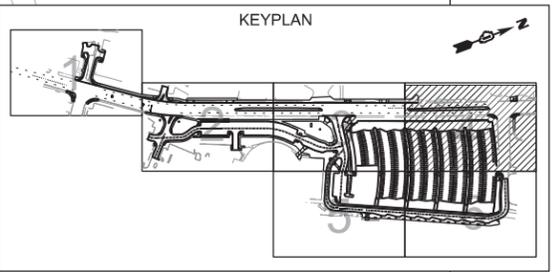

MATCH LINE SEE SHEET 74

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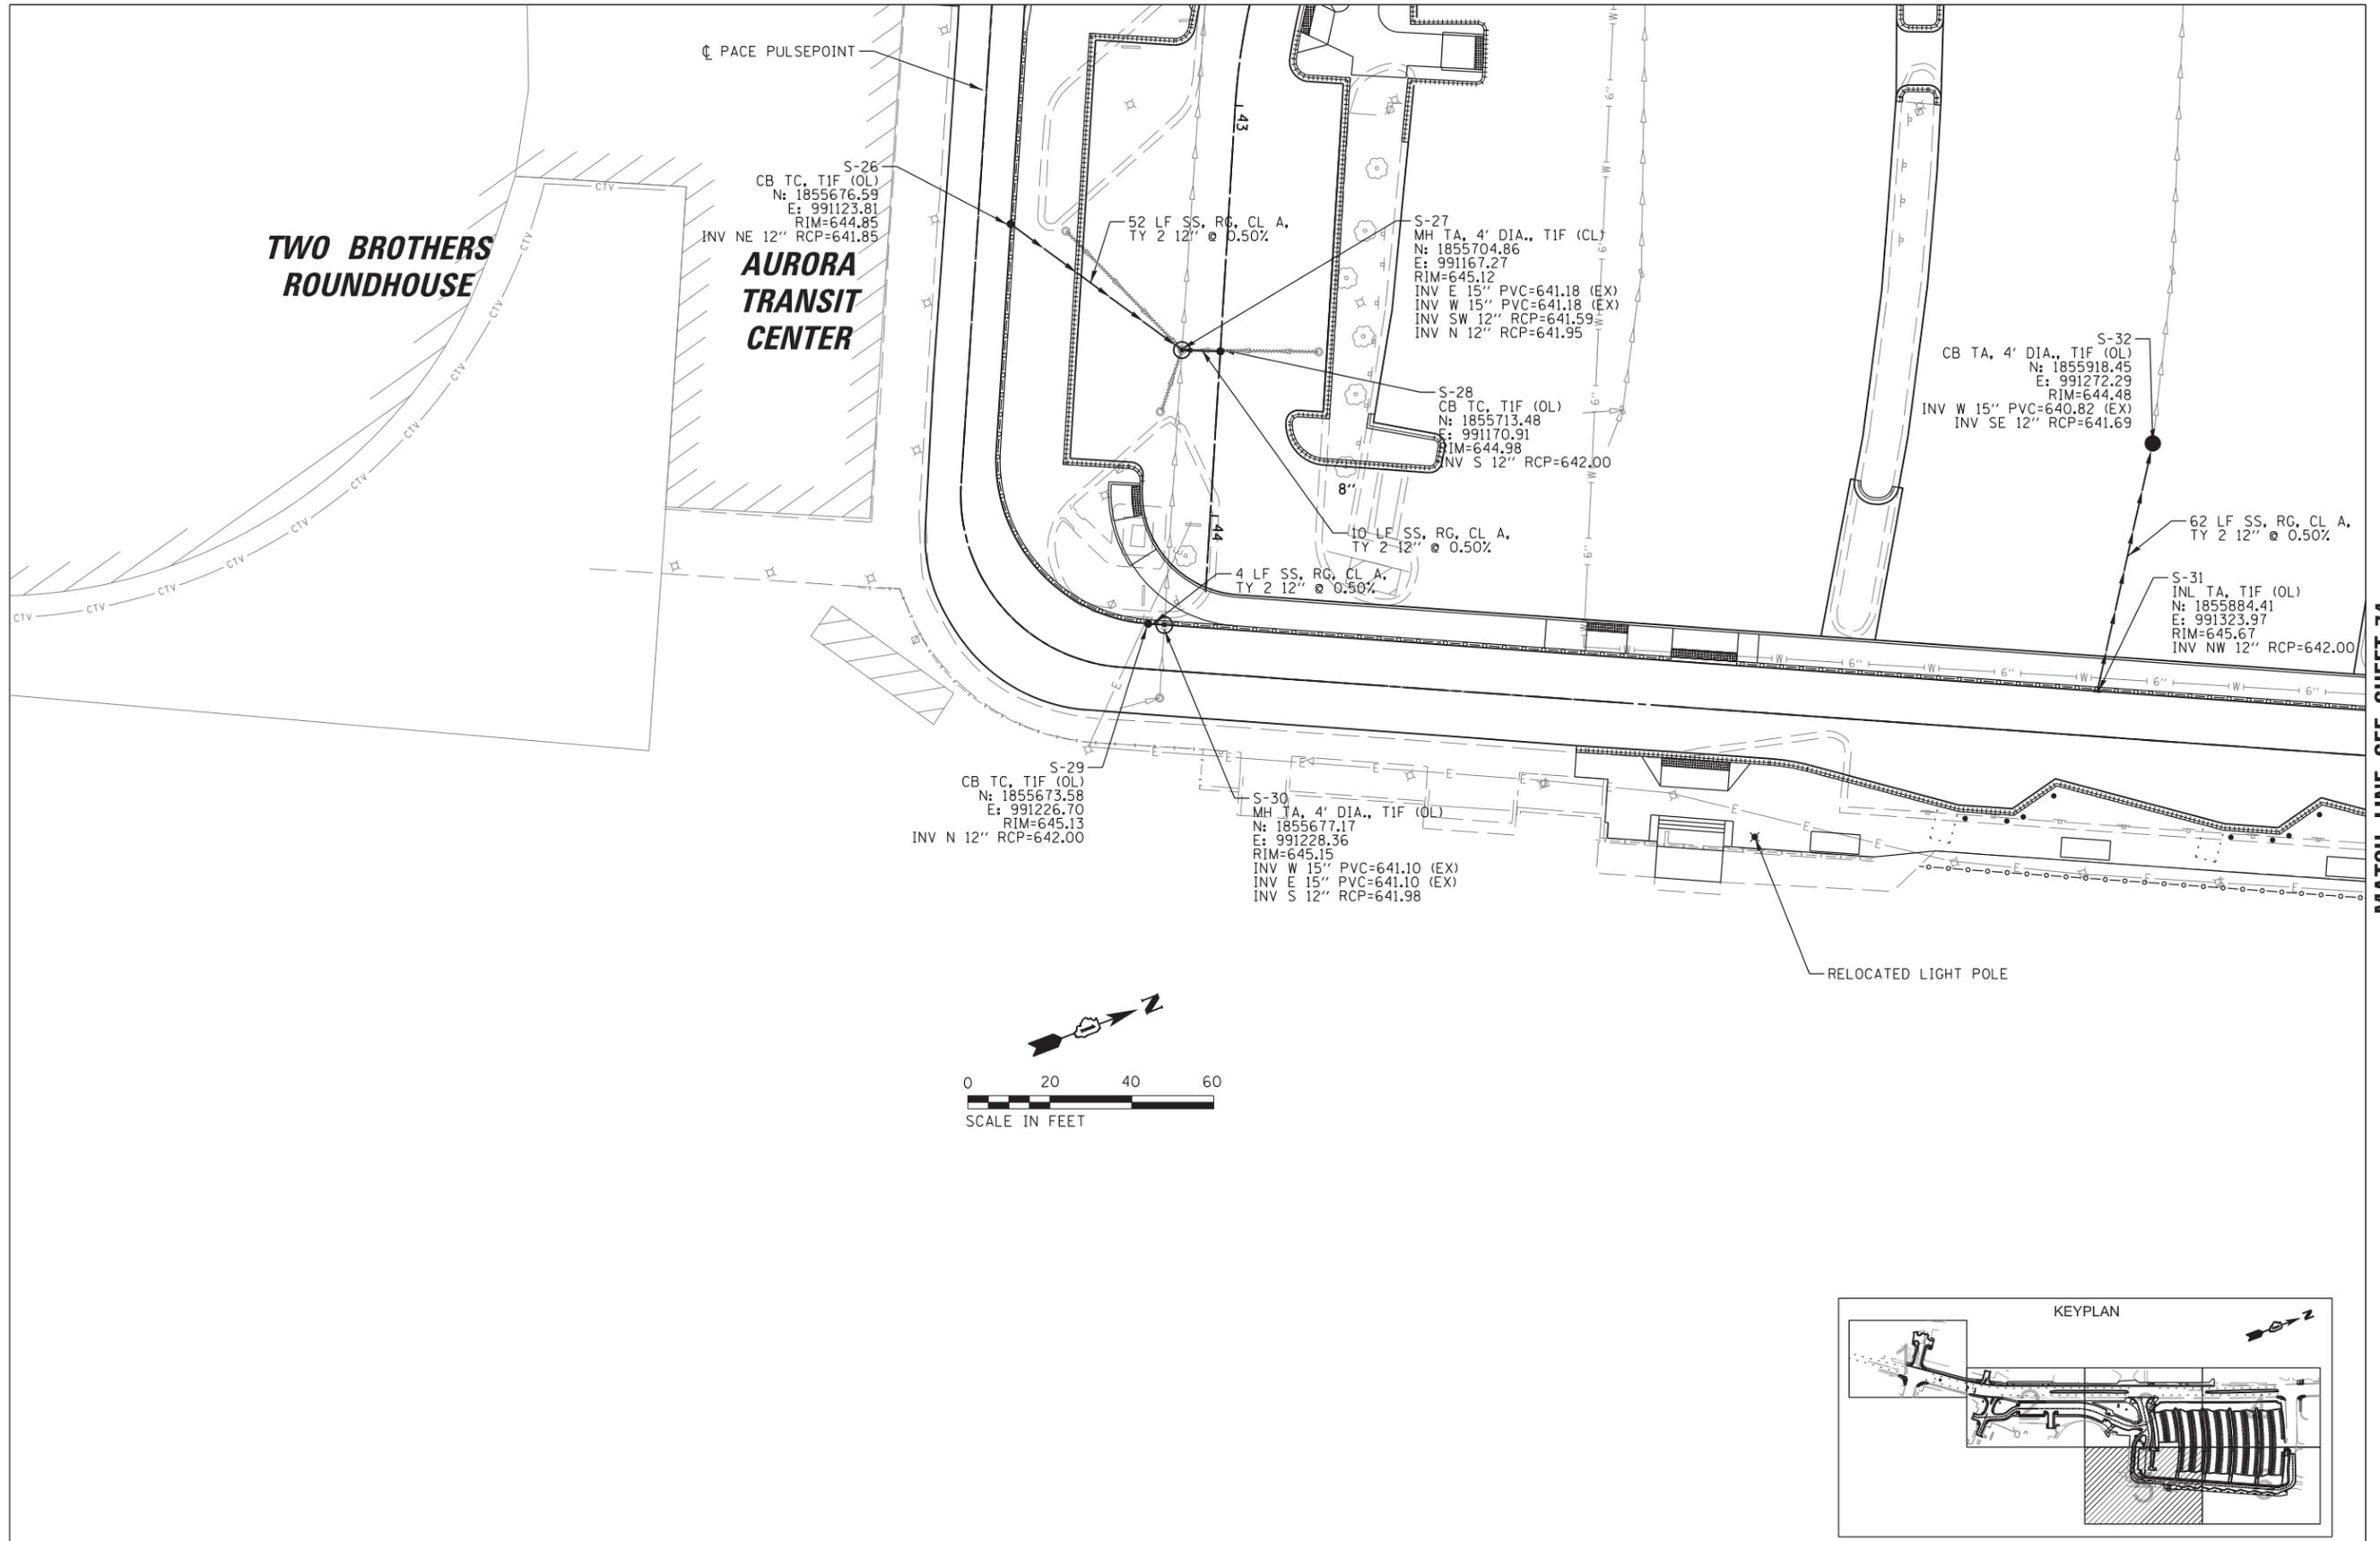
**STATE OF ILLINOIS  
DEPARTMENT OF TRANSPORTATION**

**AURORA TRANSIT CENTER IMPROVEMENTS  
DRAINAGE & UTILITY PLAN**

SCALE: 48" SHEET OF 254 SHEETS STA. TO STA.

F.A.U. RTE.	SECTION	COUNTY	TOTAL SHEETS	SHEET NO.
2503	16-00313-00-MS	KANE	254	72
CONTRACT NO. 61E18				
ILLINOIS FED. AID PROJECT				

MATCH LINE SEE SHEET 71



MATCH LINE SEE SHEET 74

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	PLOT DATE = 10/16/2017	DATE - 10/16/2017	REVISED -

**STATE OF ILLINOIS  
DEPARTMENT OF TRANSPORTATION**

**AURORA TRANSIT CENTER IMPROVEMENTS  
DRAINAGE & UTILITY PLAN**

SCALE: 40' SHEET OF 254 SHEETS STA. TO STA.

F.A.U. RTE.	SECTION	COUNTY	TOTAL SHEETS	SHEET NO.
2503	16-00313-00-MS	KANE	254	73
CONTRACT NO. 61E18				
ILLINOIS FED. AID PROJECT				





PART OF THE NORTHEAST & SOUTHEAST QUARTER OF SECTION 22, TWP. 38 N., R. 08 E. OF THE 3RD. P.M., IN KANE COUNTY, ILLINOIS.

COORDINATE TABLE ILLINOIS STATE PLANE, EAST ZONE, NAD83 (2011)			
STATION	OFFSET	NORTHING	EASTING
15+33.74	46.98' LT	1,855,034.463	990,455.552
15+33.76	41.94' LT	1,855,031.528	990,459.649
15+33.77	40.88' LT	1,855,030.909	990,460.512
15+51.22	CL	1,855,021.084	990,503.866
16+12.08	149.61' RT	1,854,994.110	990,665.500
16+19.62	112.71' RT	1,855,020.972	990,638.385
16+20.92	54.63' LT	1,855,107.090	990,494.904
16+24.04	85.98' RT	1,855,038.819	990,617.870
16+26.12	104.06' LT	1,855,136.006	990,454.548
16+29.10	53.35' RT	1,855,059.934	990,592.381
16+32.87	115.85' RT	1,855,032.645	990,648.762
16+36.29	34.91' RT	1,855,075.664	990,580.103

COORDINATE TABLE ILLINOIS STATE PLANE, EAST ZONE, NAD83 (2011)			
STATION	OFFSET	NORTHING	EASTING
16+37.25	88.60' RT	1,855,050.354	990,627.459
16+37.30	157.35' RT	1,855,016.886	990,687.516
16+39.24	51.63' RT	1,855,070.242	990,596.225
16+39.36	184.59' RT	1,855,005.849	990,712.552
16+39.86	222.69' RT	1,854,987.931	990,746.175
16+42.60	169.05' RT	1,855,016.880	990,700.887
16+47.27	186.79' RT	1,855,013.479	990,719.233
16+50.61	226.67' RT	1,854,998.360	990,759.391

COORDINATE TABLE ILLINOIS STATE PLANE, EAST ZONE, NAD83 (2011)			
STATION	OFFSET	NORTHING	EASTING
16+51.82	132.26' RT	1,855,044.151	990,673.810
16+53.87	34.27' LT	1,855,124.198	990,527.760
16+67.17	30.60' RT	1,855,106.148	990,591.469
16+71.98	139.61' RT	1,855,062.025	990,691.289
16+72.29	209.63' RT	1,855,031.152	990,754.140
16+72.98	235.74' RT	1,855,020.340	990,777.923
16+78.97	212.04' RT	1,855,037.802	990,760.097
16+79.51	97.87' LT	1,855,173.770	990,481.607
16+80.10	46.29' RT	1,855,111.383	990,611.564
16+80.17	177.22' RT	1,855,054.372	990,729.434
16+83.50	49.19' LT	1,855,155.864	990,527.018
16+83.79	54.20' LT	1,855,158.269	990,522.611
16+94.65	182.93' RT	1,855,068.242	990,742.296
17+01.08	159.13' RT	1,855,085.307	990,723.920
17+24.33	107.22' RT	1,855,131.066	990,687.115
17+24.86	49.54' LT	1,855,191.263	990,542.366
17+25.65	54.53' LT	1,855,193.829	990,538.028
17+41.98	50.15' LT	1,855,206.310	990,547.703
17+46.16	CL	1,855,192.226	990,596.000
17+48.33	40.18' LT	1,855,208.458	990,559.176
17+48.33	43.06' LT	1,855,209.476	990,556.483
17+52.48	50.20' LT	1,855,215.878	990,551.270
17+54.73	48.26' LT	1,855,217.295	990,553.884
17+60.70	40.24' LT	1,855,220.409	990,563.498
17+73.42	133.87' RT	1,855,170.415	990,730.864
17+99.59	201.75' RT	1,855,170.919	990,803.617
18+03.31	155.91' RT	1,855,190.584	990,762.050

PARCEL NUMBER	TOTAL HOLDINGS ACRES	PART TAKEN ACRES	AREA IN EXISTING R.O.W.	REMAINDER AREA ACRES	EASEMENT AREA		PARCEL INDEX NUMBER
					ACRES	SQUARE FEET	
1MN0002PE A	1.947			1.947	0.031		15-22-327-002
1MN0002PE B					0.044		
1MN0002TE A					0.106		
1MN0002TE B					0.005	208	
1MN0002TE C					0.081		15-22-201-035
1MN0003TE	0.914			0.914	0.054		15-22-201-053
1MN0006TE	4.135			4.135	0.617		15-22-253-001
1MN0007TE	1.992			1.992	0.105		15-22-409-001

**LEGEND**

SECTION / QUARTER SECTION LINE  
 PLATTED LOT LINES  
 PROPERTY (DEED) LINE  
 EXISTING CENTERLINE  
 PROPOSED CENTERLINE  
 EXISTING RIGHT OF WAY LINE  
 PROPOSED RIGHT OF WAY LINE  
 EXISTING EASEMENT  
 PROPOSED EASEMENT  
 WATER LINE

MEASURED DIMENSION  
 RECORDED DIMENSION

EXISTING BUILDING

IRON PIPE OR ROD FOUND  
 CUT CROSS FOUND OR SET  
 "MAG" NAIL SET  
 5 / 8" REBAR SET

STAKING OF PROPOSED RIGHT-OF-WAY. SET DIVISION OF HIGHWAYS SURVEY MARKER TO MONUMENT THE POSITION SHOWN. IDENTIFIED BY INSCRIPTION DATA AND SURVEYORS REGISTRATION NUMBER.

STAKING OF PROPOSED RIGHT-OF-WAY IN CULTIVATED AREAS. BURIED 5/8 INCH METAL ROD 20 INCHES BELOW GROUND TO MARK FUTURE SURVEY MARKER POSITION IDENTIFIED BY COLORED PLASTIC BEARING SURVEYORS REGISTRATION NUMBER.

PERMANENT SURVEY MARKER, I.D.O.T. STANDARD 2135 (TO BE SET BY OTHERS)

RIGHT-OF-WAY STAKING PROPOSED TO BE SET

STATE OF ILLINOIS )  
 )SS  
 COUNTY OF KANE )

THIS IS TO CERTIFY THAT I, DONALD RERICKA, AN ILLINOIS PROFESSIONAL LAND SURVEYOR, (WBK ENGINEERING, LLC, AN ILLINOIS PROFESSIONAL DESIGN FIRM LAND SURVEYING CORPORATION, NUMBER 184.007317), HAVE SURVEYED THE PLAT OF HIGHWAYS SHOWN HEREON IN SECTION 22, TOWNSHIP 38 NORTH, RANGE 08 EAST OF THE THIRD PRINCIPAL MERIDIAN, KANE COUNTY, ILLINOIS, THAT THE SURVEY IS TRUE AND COMPLETE-AS SHOWN TO THE BEST OF MY KNOWLEDGE AND BELIEF, THAT THE PLAT CORRECTLY REPRESENTS SAID SURVEY, THAT ALL MONUMENTS FOUND AND ESTABLISHED ARE OF PERMANENT QUALITY AND OCCUPY THE POSITIONS SHOWN THEREON AND THAT THE MONUMENTS ARE SUFFICIENT TO ENABLE THE SURVEY TO BE RETRACED. MADE FOR THE DEPARTMENT OF TRANSPORTATION, STATE OF ILLINOIS.

DATED AT ST. CHARLES, ILLINOIS THIS \_\_\_\_\_ DAY OF \_\_\_\_\_ 20\_\_ A.D.


ILLINOIS PROFESSIONAL LAND SURVEYOR NO. 035-003465  
 LICENSE EXPIRATION DATE: \_\_\_\_\_

THIS PROFESSIONAL SERVICE CONFORMS TO THE CURRENT ILLINOIS MINIMUM STANDARDS FOR A BOUNDARY SURVEY.

**WBK engineering** WBK ENGINEERING, LLC  
 116 WEST MAIN STREET, SUITE 201  
 ST. CHARLES, ILLINOIS 60174  
 (630) 443-7755

**PLAT OF HIGHWAYS**  
 STATE OF ILLINOIS  
 DEPARTMENT OF TRANSPORTATION  
 IL ROUTE 25  
 COUNTY: KANE  
 LIMITS: AURORA TRANSPORTATION CENTER  
 SECTION: 16-00313-00-MS JOB NO: R-91-003-18  
 STA. 15+33.74 TO STA. 18+03.31  
 SCALE: 1"=20' SHEET 3 OF 9 SHEETS

BUREAU OF LAND ACQUISITION  
 201 WEST CENTER COURT  
 SCHAUMBURG, ILLINOIS 60196

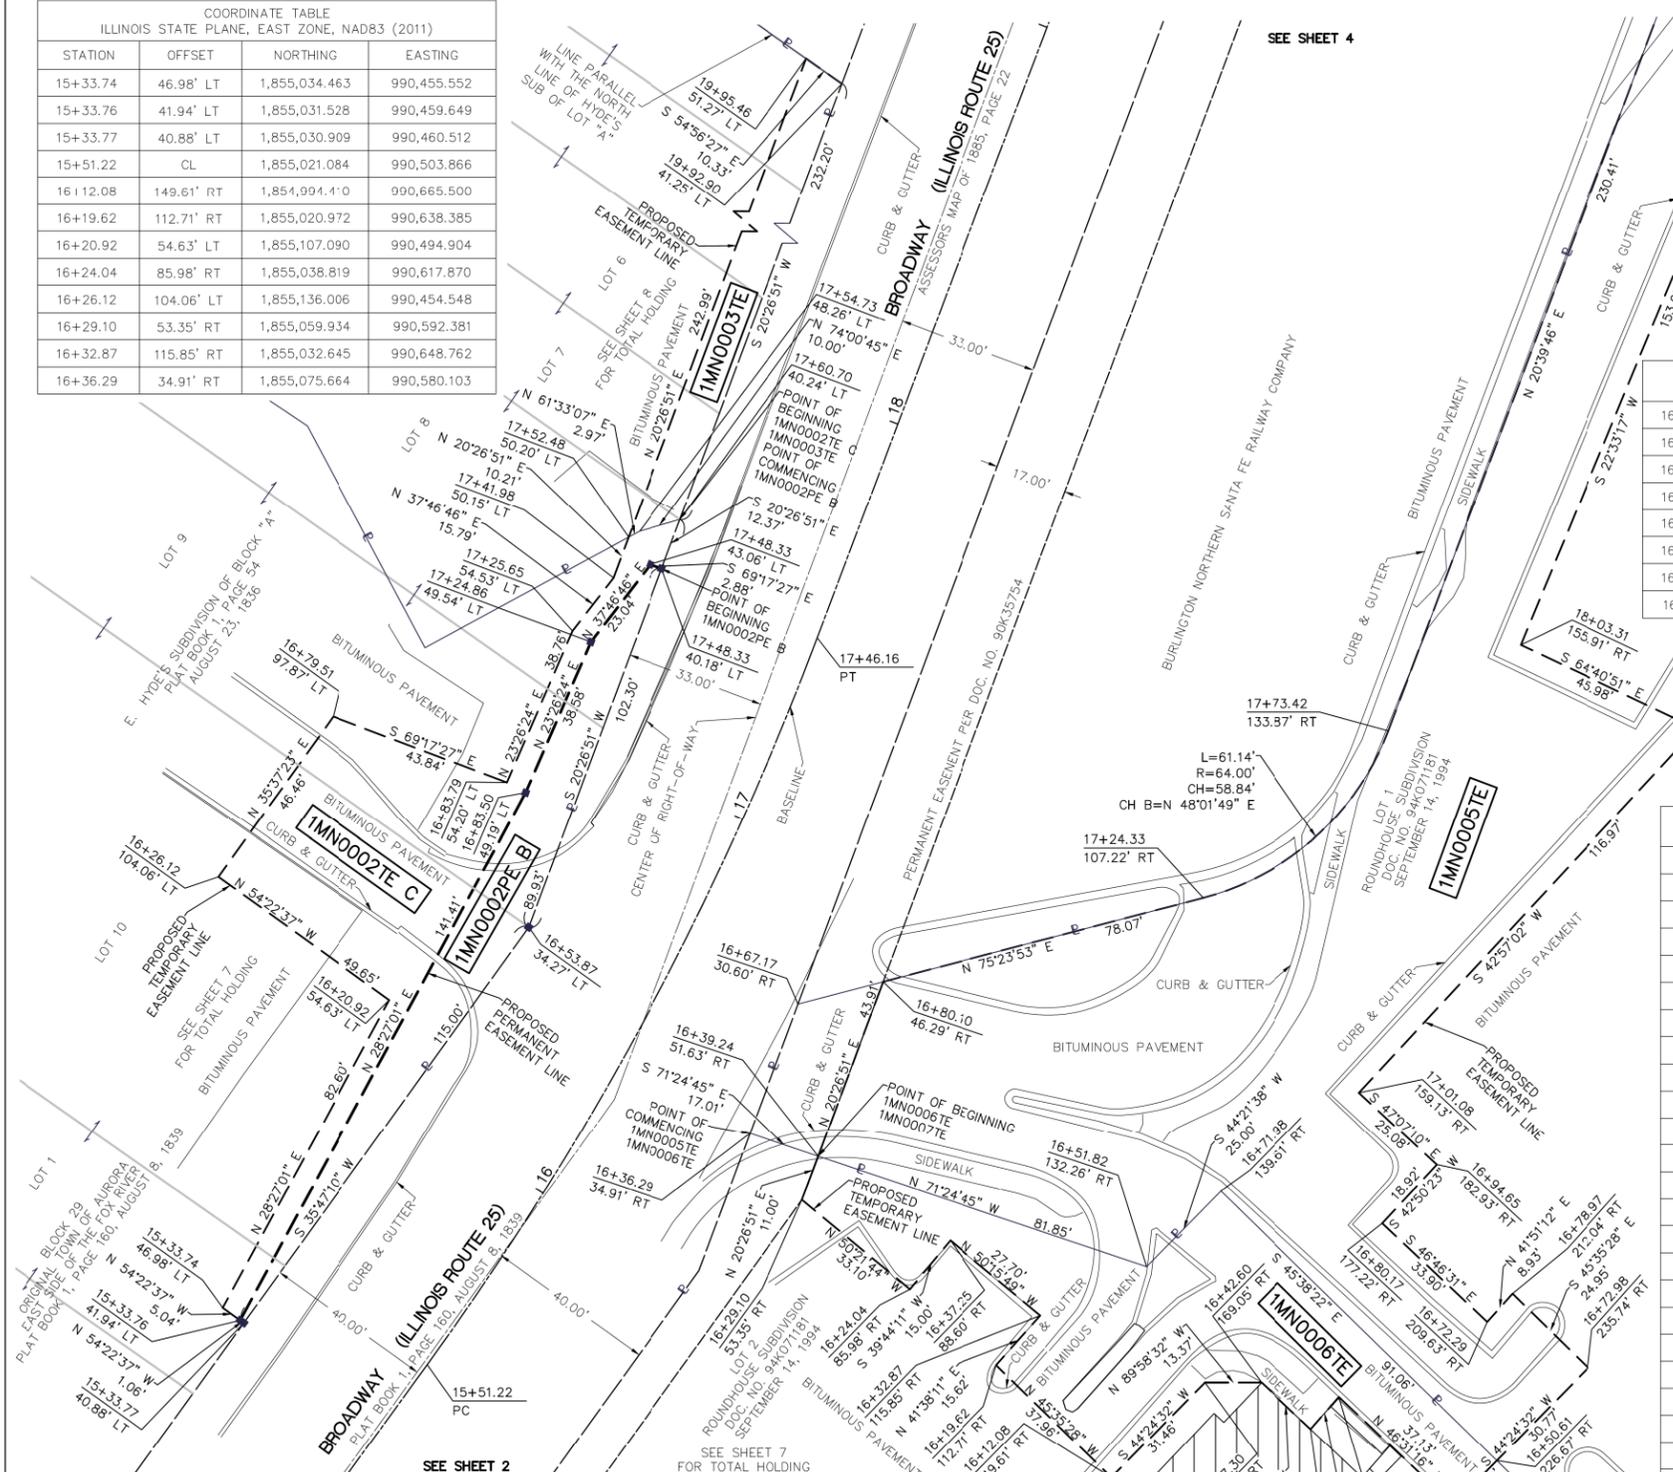

FILE NAME = W:\Projects\2016\160194\_ATCPhaseII\cadd\Civil\Drawn\Sh\PLAT\_02.dgn

REVISION DATE: \_\_\_/\_\_\_/\_\_\_ REVISION MADE BY: \_\_\_\_\_

**WBK engineering**  
 WBK ENGINEERING, LLC  
 116 WEST MAIN STREET, SUITE 201  
 ST. CHARLES, ILLINOIS 60174  
 (630) 443-7755

USER NAME = nparris	DESIGNED -	REVISED -
PLOT SCALE = 1:200	DRAWN -	REVISED -
PLOT DATE = 12/4/2017	CHECKED -	REVISED -
	DATE = 12/04/17	REVISED -

**STATE OF ILLINOIS  
 DEPARTMENT OF TRANSPORTATION**


<b>PLAT OF HIGHWAYS FOR REFERENCE ONLY</b>	
SCALE:	SHEET NO. 2 OF 8 SHEETS STA. TO STA.

F.A.U. RT.	SECTION	COUNTY	TOTAL SHEETS	SHEET NO.
2503	16-00313-00-MS	KANE	254	76
CONTRACT NO. 61E18				
ILLINOIS FED. AID PROJECT				





PART OF THE NORTHEAST, SOUTHEAST & SOUTHWEST QUARTERS OF SECTION 22, TWP. 38 N., R. 08 E. OF THE 3RD. P.M., IN KANE COUNTY, ILLINOIS.

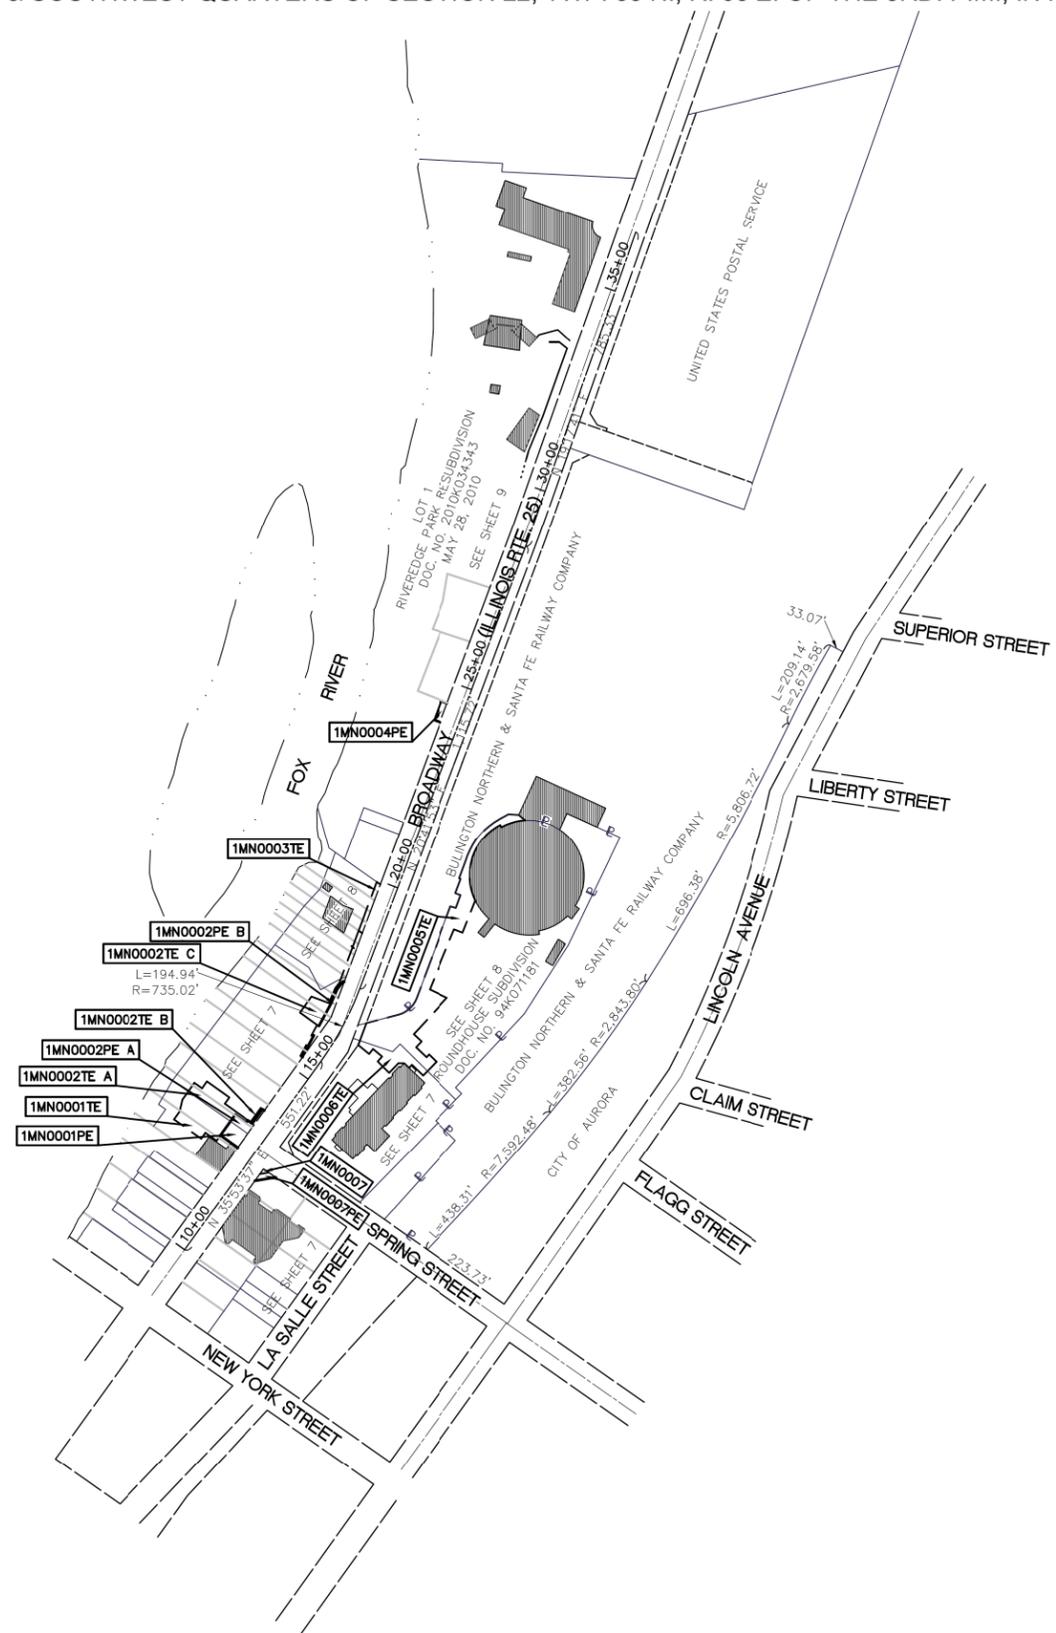

**LEGEND**

SECTION CORNER: 9 10 16 15  
 QUARTER SECTION CORNER: 16 15

SECTION / QUARTER SECTION LINE  
 PLATTED LOT LINES  
 PROPERTY (DEED) LINE  
 EXISTING CENTERLINE  
 PROPOSED CENTERLINE  
 EXISTING RIGHT OF WAY LINE  
 PROPOSED RIGHT OF WAY LINE  
 EXISTING EASEMENT  
 PROPOSED EASEMENT  
 WATER LINE

MEASURED DIMENSION: 129.32'  
 RECORDED DIMENSION: (129.32')

EXISTING BUILDING

GRAPHIC SCALE: 0 100 200 FEET  
 SCALE: 1" = 200'

ALL DIMENSIONS ARE MEASURED UNLESS OTHERWISE SPECIFIED.

BEARINGS AND DISTANCES SHOWN HEREON REFERENCE THE ILLINOIS STATE PLANE COORDINATE SYSTEM, EAST ZONE, NORTH AMERICAN DATUM OF 1983 (2011 ADJUSTMENT) "GRID". ALL MEASURED AND CALCULATED DISTANCES ARE "GRID" NOT "GROUND". TO OBTAIN GROUND DISTANCES, DIVIDE GRID DISTANCES SHOWN BY THE COMBINATION FACTOR OF 0.9998952584.

AREAS SHOWN ON PLAT ARE GROUND.

- IRON PIPE OR ROD FOUND
- ⊕ "MAG" NAIL SET
- ⊕ CUT CROSS FOUND OR SET
- 5 / 8" REBAR SET
- STAKING OF PROPOSED RIGHT-OF-WAY. SET DIVISION OF HIGHWAYS SURVEY MARKER TO MONUMENT THE POSITION SHOWN, IDENTIFIED BY INSCRIPTION DATA AND SURVEYORS REGISTRATION NUMBER.
- M STAKING OF PROPOSED RIGHT-OF-WAY IN CULTIVATED AREAS. BURIED 5/8 INCH METAL ROD 20 INCHES BELOW GROUND TO MARK FUTURE SURVEY MARKER POSITION IDENTIFIED BY COLORED PLASTIC BEARING SURVEYORS REGISTRATION NUMBER.
- ⊕ PERMANENT SURVEY MARKER, I.D.O.T. STANDARD 2135 (TO BE SET BY OTHERS)
- RIGHT-OF-WAY STAKING PROPOSED TO BE SET

STATE OF ILLINOIS )  
 )SS  
 COUNTY OF KANE )

THIS IS TO CERTIFY THAT I, DONALD RERICKA, AN ILLINOIS PROFESSIONAL LAND SURVEYOR, (WBK ENGINEERING, LLC, AN ILLINOIS PROFESSIONAL DESIGN FIRM LAND SURVEYING CORPORATION, NUMBER 184.007317), HAVE SURVEYED THE PLAT OF HIGHWAYS SHOWN HEREON IN SECTION 22, TOWNSHIP 38 NORTH, RANGE 08 EAST OF THE THIRD PRINCIPAL MERIDIAN, KANE COUNTY, ILLINOIS, THAT THE SURVEY IS TRUE AND COMPLETE-AS SHOWN TO THE BEST OF MY KNOWLEDGE AND BELIEF, THAT THE PLAT CORRECTLY REPRESENTS SAID SURVEY, THAT ALL MONUMENTS FOUND AND ESTABLISHED ARE OF PERMANENT QUALITY AND OCCUPY THE POSITIONS SHOWN T-HEREON AND THAT THE MONUMENTS ARE SUFFICIENT TO ENABLE THE SURVEY TO BE RETRACED. MADE FOR THE DEPARTMENT OF TRANSPORTATION, STATE OF ILLINOIS.

DATED AT ST. CHARLES, ILLINOIS THIS \_\_\_\_ DAY OF \_\_\_\_\_ 20\_\_ A.D.

ILLINOIS PROFESSIONAL LAND SURVEYOR NO. 035-003465  
 LICENSE EXPIRATION DATE: \_\_\_\_\_

THIS PROFESSIONAL SERVICE CONFORMS TO THE CURRENT ILLINOIS MINIMUM STANDARDS FOR A BOUNDARY SURVEY.



**PLAT OF HIGHWAYS**

STATE OF ILLINOIS  
 DEPARTMENT OF TRANSPORTATION

IL ROUTE 25  
 COUNTY: KANE  
 LIMITS: AURORA TRANSPORTATION CENTER

SECTION: 16-00313-00-MS JOB NO.: R-91-003-18  
 STA. TO STA.  
 SCALE: 1"=200' SHEET 6 OF 9 SHEETS

BUREAU OF LAND ACQUISITION  
 201 WEST CENTER COURT  
 SCHAUMBURG, ILLINOIS 60196

REVISION DATE: \_\_\_/\_\_\_/\_\_\_ REVISION MADE BY: \_\_\_\_\_

FILE NAME = W:\Projects\2016\160194\_ATCFPhaseII\Cadd\Civil\Dgn\Sh\Plat\_05.dgn

**WBK engineering**  
 WBK ENGINEERING, LLC  
 116 WEST MAIN STREET, SUITE 201  
 ST. CHARLES, ILLINOIS 60174  
 (630) 443-7755

USER NAME = nparris	DESIGNED -	REVISED -
PLOT SCALE = 1:200	DRAWN -	REVISED -
PLOT DATE = 12/4/2017	CHECKED -	REVISED -
	DATE = 12/04/17	REVISED -

**STATE OF ILLINOIS  
 DEPARTMENT OF TRANSPORTATION**

**PLAT OF HIGHWAYS  
 FOR REFERENCE ONLY**

SCALE:	SHEET NO. 5	OF 8 SHEETS	STA.	TO STA.
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F.A.U. RTE.	SECTION	COUNTY	TOTAL SHEETS	SHEET NO.
2503	16-00313-00-MS	KANE	254	79
CONTRACT NO. 61E18				
ILLINOIS FED. AID PROJECT				





PART OF THE NORTHEAST QUARTER OF SECTION 22, TWP. 38 N., R. 08 E. OF THE 3RD. P.M., IN KANE COUNTY, ILLINOIS.

**LEGEND**

SECTION / QUARTER SECTION LINE  
 PLATTED LOT LINES  
 PROPERTY (DEED) LINE  
 EXISTING CENTERLINE  
 PROPOSED CENTERLINE  
 EXISTING RIGHT OF WAY LINE  
 PROPOSED RIGHT OF WAY LINE  
 EXISTING EASEMENT  
 PROPOSED EASEMENT  
 WATER LINE

MEASURED DIMENSION  
 RECORDED DIMENSION

EXISTING BUILDING

SECTION CORNER  
 QUARTER SECTION CORNER

GRAPHIC SCALE  
 FEET  
 0 100  
 SCALE: 1" = 100'

ALL DIMENSIONS ARE MEASURED UNLESS OTHERWISE SPECIFIED.

BEARINGS AND DISTANCES SHOWN HEREON REFERENCE THE ILLINOIS STATE PLANE COORDINATE SYSTEM, EAST ZONE, NORTH AMERICAN DATUM OF 1983 (2011 ADJUSTMENT) "GRID". ALL MEASURED AND CALCULATED DISTANCES ARE "GRID" NOT "GROUND". TO OBTAIN GROUND DISTANCES, DIVIDE GRID DISTANCES SHOWN BY THE COMBINATION FACTOR OF 0.9998952584.

AREAS SHOWN ON PLAT ARE GROUND.

- IRON PIPE OR ROD FOUND      ⊕ "MAG" NAIL SET
- ⊕ CUT CROSS FOUND OR SET      ● 5 / 8" REBAR SET
- STAKING OF PROPOSED RIGHT-OF-WAY. SET DIVISION OF HIGHWAYS SURVEY MARKER TO MONUMENT THE POSITION SHOWN, IDENTIFIED BY INSCRIPTION DATA AND SURVEYORS REGISTRATION NUMBER.
- M STAKING OF PROPOSED RIGHT-OF-WAY IN CULTIVATED AREAS. BURIED 5/8 INCH METAL ROD 20 INCHES BELOW GROUND TO MARK FUTURE SURVEY MARKER POSITION IDENTIFIED BY COLORED PLASTIC BEARING SURVEYORS REGISTRATION NUMBER.
- ⊕ PERMANENT SURVEY MARKER, I.D.O.T. STANDARD 2135 (TO BE SET BY OTHERS)
- RIGHT-OF-WAY STAKING PROPOSED TO BE SET

STATE OF ILLINOIS )  
 )SS  
 COUNTY OF KANE )

THIS IS TO CERTIFY THAT I, DONALD RERICKA, AN ILLINOIS PROFESSIONAL LAND SURVEYOR, (WBK ENGINEERING, LLC, AN ILLINOIS PROFESSIONAL DESIGN FIRM LAND SURVEYING CORPORATION, NUMBER 184.007317), HAVE SURVEYED THE PLAT OF HIGHWAYS SHOWN HEREON IN SECTION 22, TOWNSHIP 38 NORTH, RANGE 08 EAST OF THE THIRD PRINCIPAL MERIDIAN, KANE COUNTY, ILLINOIS, THAT THE SURVEY IS TRUE AND COMPLETE-AS SHOWN TO THE BEST OF MY KNOWLEDGE AND BELIEF, THAT THE PLAT CORRECTLY REPRESENTS SAID SURVEY, THAT ALL MONUMENTS FOUND AND ESTABLISHED ARE OF PERMANENT QUALITY AND OCCUPY THE POSITIONS SHOWN THEREON AND THAT THE MONUMENTS ARE SUFFICIENT TO ENABLE THE SURVEY TO BE RETRACED. MADE FOR THE DEPARTMENT OF TRANSPORTATION, STATE OF ILLINOIS.

DATED AT ST. CHARLES, ILLINOIS THIS \_\_\_\_\_ DAY OF \_\_\_\_\_ 20\_\_ A.D.

ILLINOIS PROFESSIONAL LAND SURVEYOR NO. 035-003465  
 LICENSE EXPIRATION DATE: \_\_\_\_\_

THIS PROFESSIONAL SERVICE CONFORMS TO THE CURRENT ILLINOIS MINIMUM STANDARDS FOR A BOUNDARY SURVEY.


**WBK engineering** WBK ENGINEERING, LLC  
 116 WEST MAIN STREET, SUITE 201  
 ST. CHARLES, ILLINOIS 60174  
 (630) 443-7755

**PLAT OF HIGHWAYS**

STATE OF ILLINOIS  
 DEPARTMENT OF TRANSPORTATION

IL ROUTE 25  
 COUNTY: KANE  
 LIMITS: AURORA TRANSPORTATION CENTER  
 SECTION: 16-00313-00-MS JOB NO.: R-91-003-18  
 STA. TO STA.  
 SCALE: 1"=100' SHEET 9 OF 9 SHEETS

BUREAU OF LAND ACQUISITION  
 201 WEST CENTER COURT  
 SCHAMBURG, ILLINOIS 60196

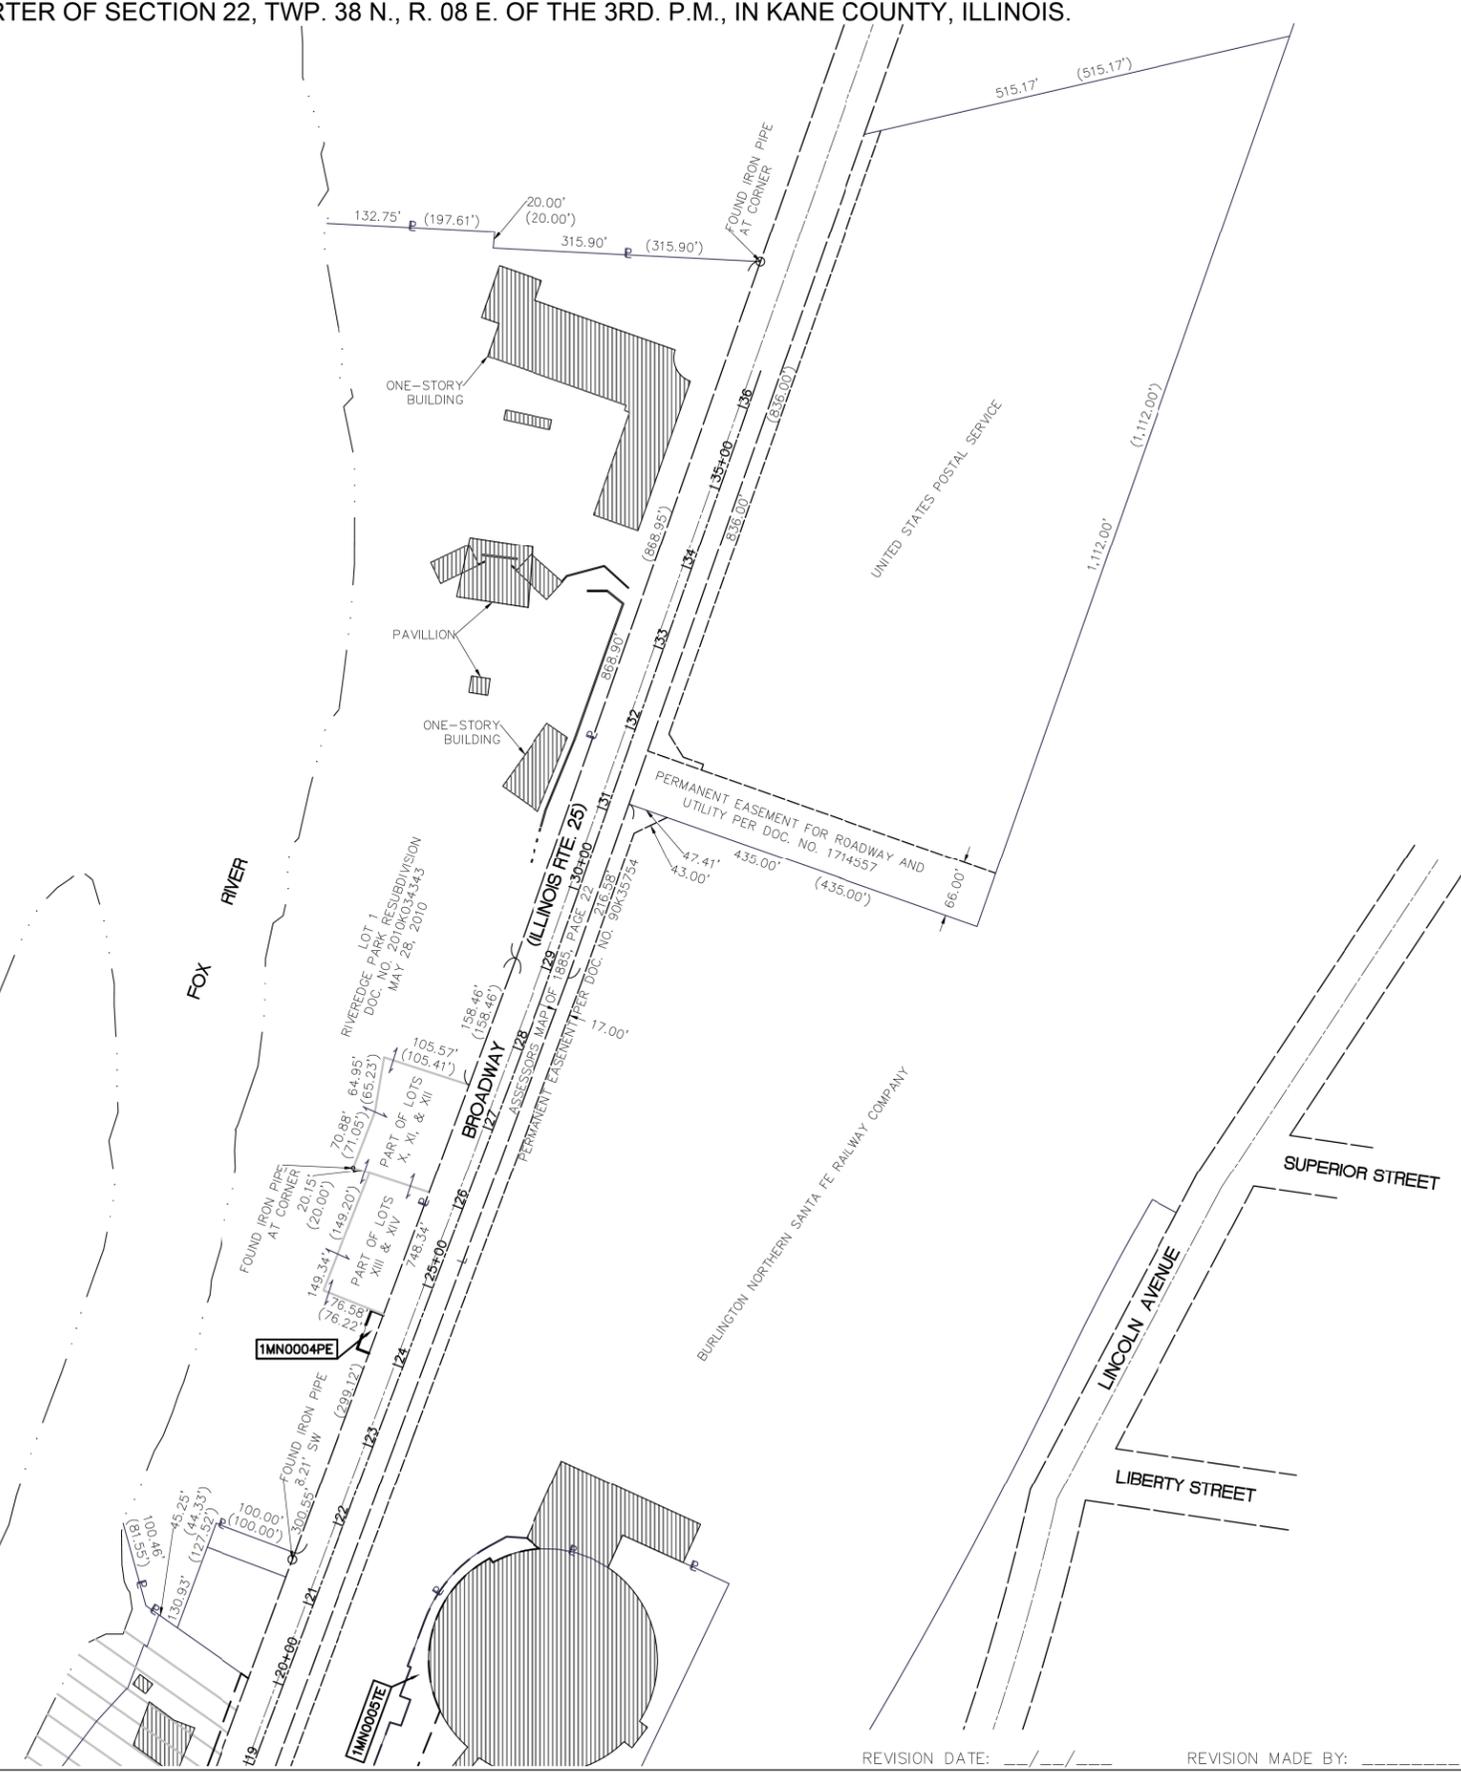

REVISION DATE: \_\_\_/\_\_\_/\_\_\_ REVISION MADE BY: \_\_\_\_\_

FILE NAME = W:\Projects\2016\160194\_ATCPhaseII\Cadd\Civil\Dgn\Sh\Plat\_08.dgn

**WBK engineering**  
 WBK ENGINEERING, LLC  
 116 WEST MAIN STREET, SUITE 201  
 ST. CHARLES, ILLINOIS 60174  
 (630) 443-7755

USER NAME = nparris	DESIGNED -	REVISED -
PLOT SCALE = 1:200	DRAWN -	REVISED -
PLOT DATE = 12/4/2017	CHECKED -	REVISED -
	DATE = 12/04/17	REVISED -


**STATE OF ILLINOIS  
 DEPARTMENT OF TRANSPORTATION**

**PLAT OF HIGHWAYS  
 FOR REFERENCE ONLY**

SCALE: SHEET NO. 8 OF 8 SHEETS STA. TO STA.


F.A.U. RTE.	SECTION	COUNTY	TOTAL SHEETS	SHEET NO.
2503	16-00313-00-MS	KANE	254	82
CONTRACT NO. 61E18				
ILLINOIS FED. AID PROJECT				



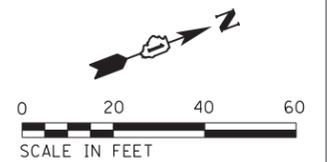


MATCH LINE SEE SHEET 83

MATCH LINE SEE SHEET 85

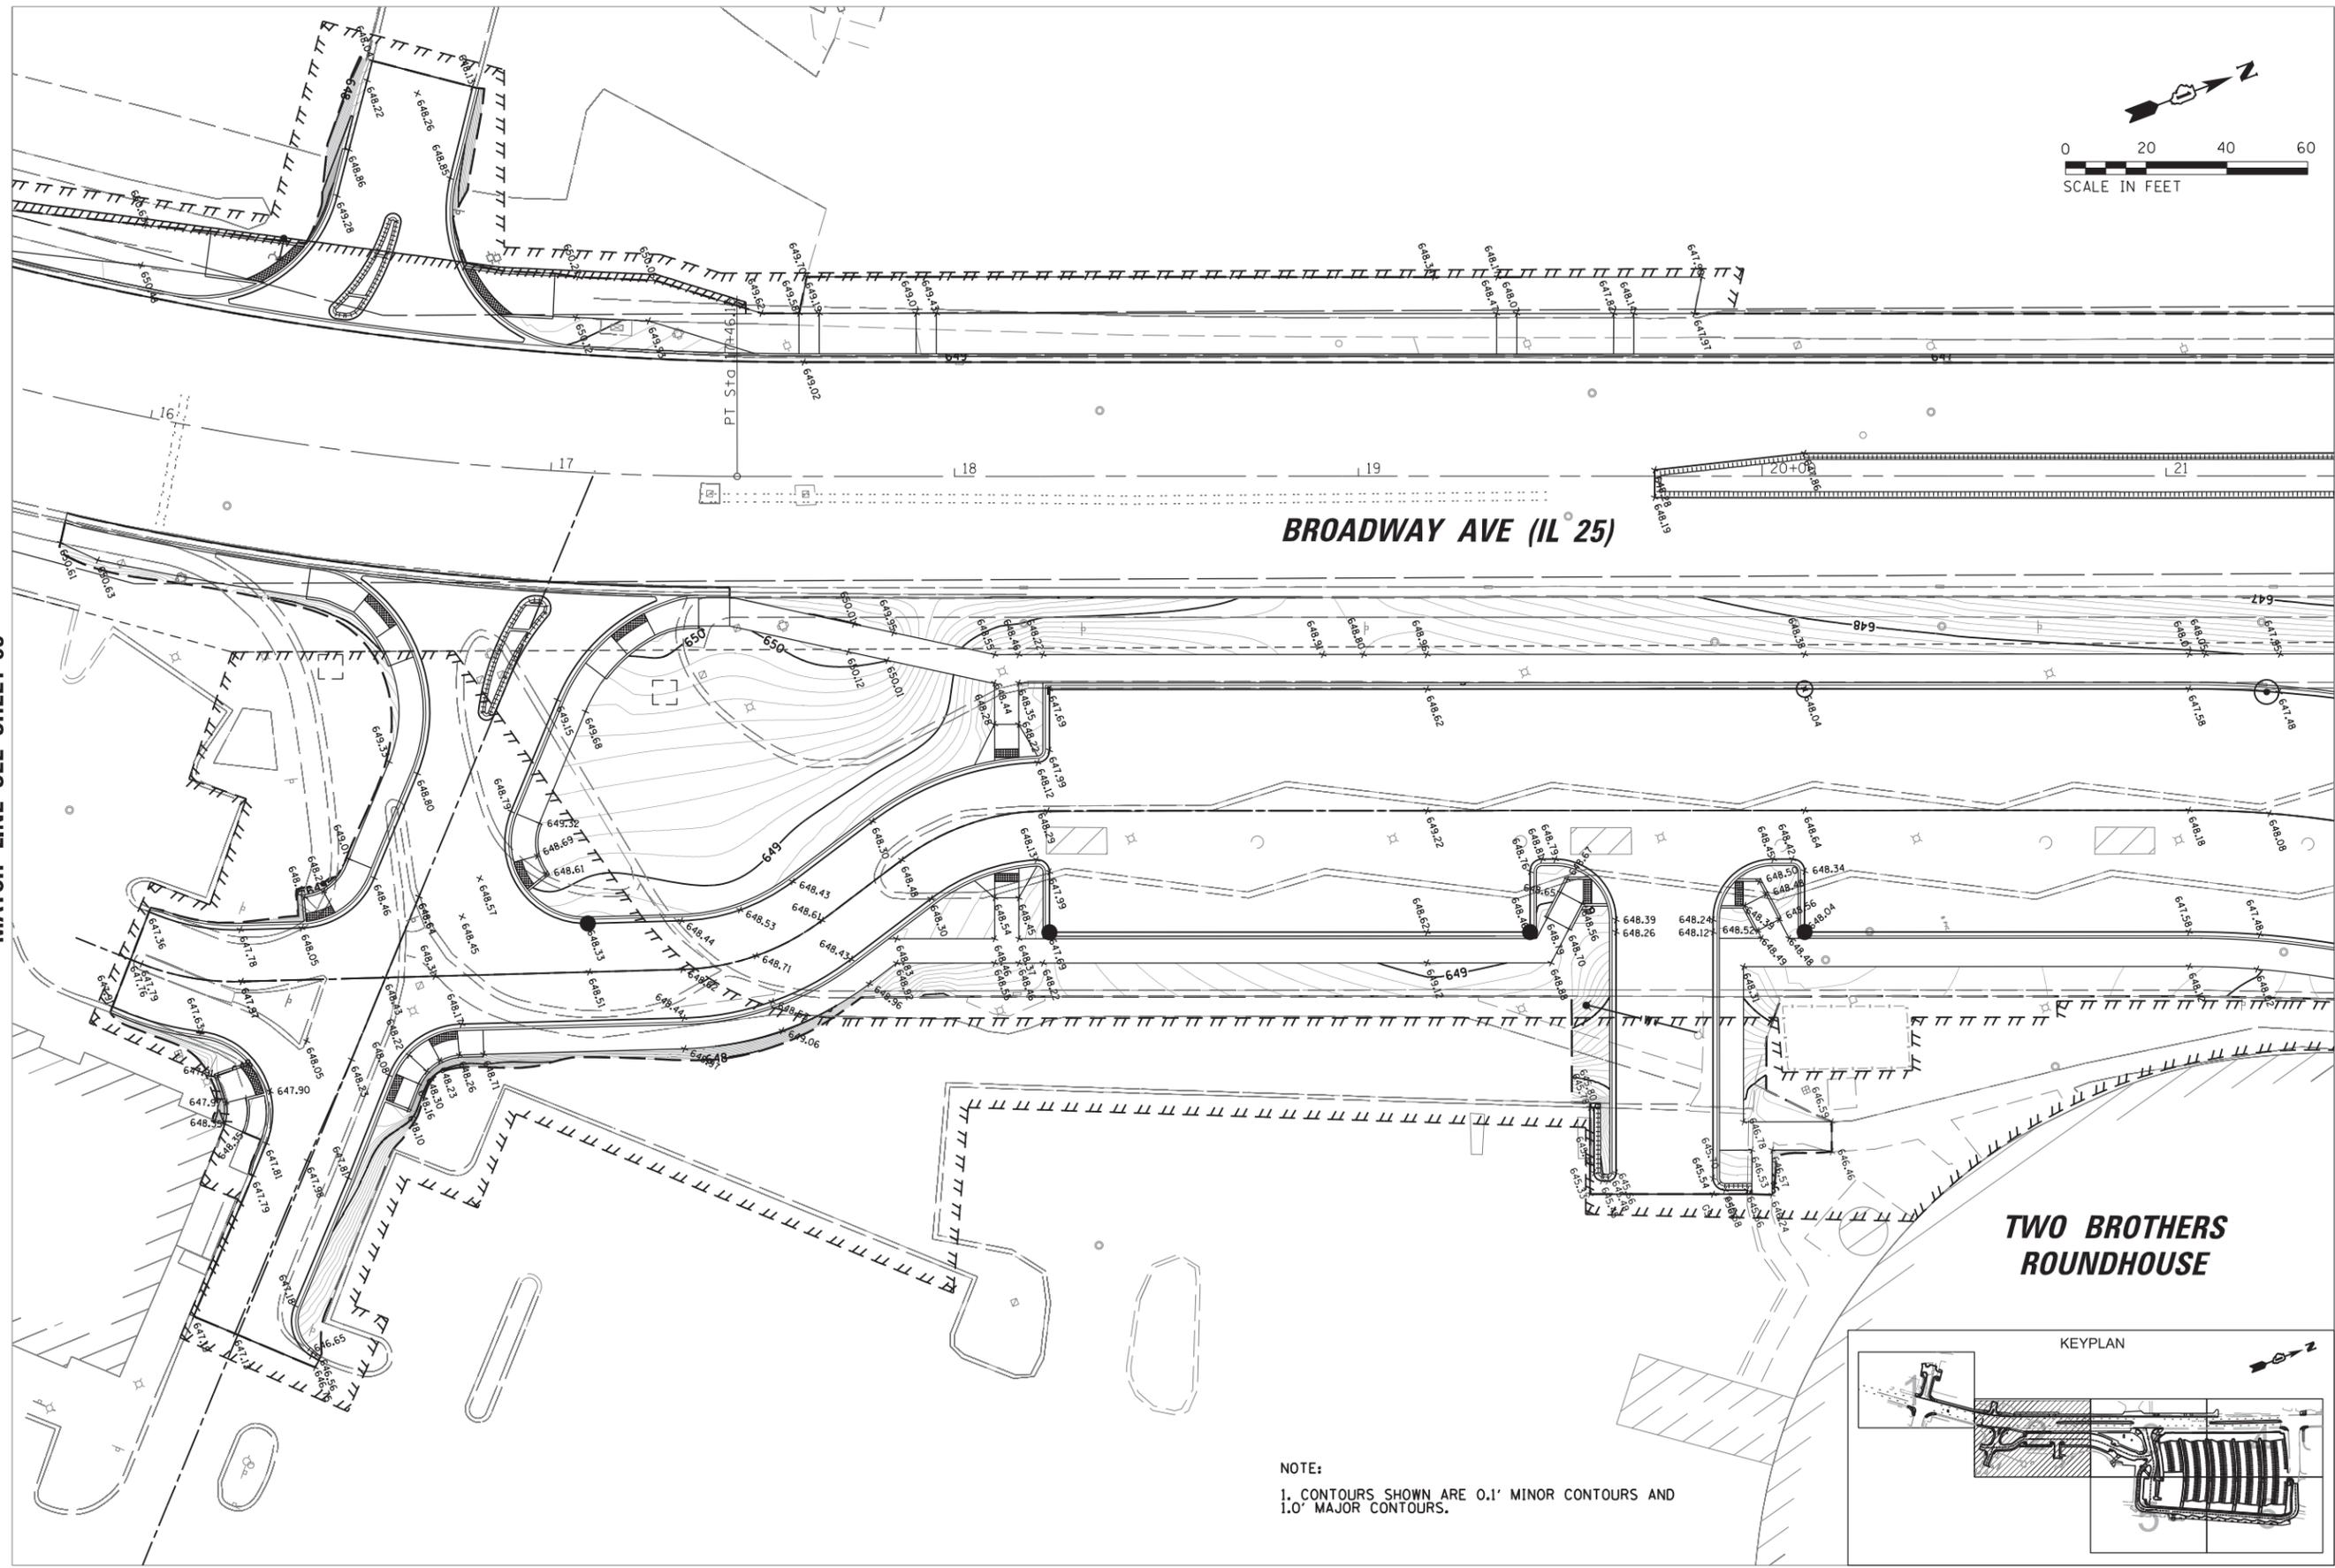

NOTE:  
 1. CONTOURS SHOWN ARE 0.1' MINOR CONTOURS AND 1.0' MAJOR CONTOURS.

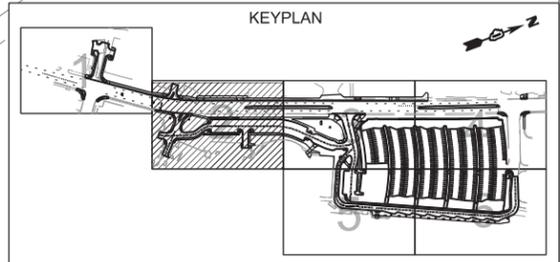

FILE NAME = N:\WBK\150077.2\Civil\GRD_150077.2_02.sht	USER NAME = bweich	DESIGNED - BMW	REVISED -	<b>STATE OF ILLINOIS</b> <b>DEPARTMENT OF TRANSPORTATION</b>	<b>AURORA TRANSIT CENTER IMPROVEMENTS</b> <b>GRADING PLAN</b>		F.A.U. R.T.E. = 2503	SECTION = 16-00313-00-MS	COUNTY = KANE	TOTAL SHEETS = 254	SHEET NO. = 84
	Default	PLOT SCALE = 48"	CHECKED - BMW				REVISED -	SCALE: 48"	SHEET OF 254 SHEETS	STA. TO STA.	CONTRACT NO. 61E18
	PLOT DATE = 10/16/2017	DATE = 10/16/2017	REVISED -				ILLINOIS FED. AID PROJECT				

**RIVEREDGE PARK  
(CITY OF AURORA PROPERTY)**

**RIVEREDGE PARK  
(CITY OF AURORA PROPERTY)**



**BROADWAY AVE (IL 25)**


MATCH LINE SEE SHEET 84

MATCH LINE SEE SHEET 86

**TWO BROTHERS  
ROUNDHOUSE**

**AURORA  
TRANSIT  
CENTER**

NOTE:  
1. CONTOURS SHOWN ARE 0.1' MINOR CONTOURS AND 1.0' MAJOR CONTOURS.

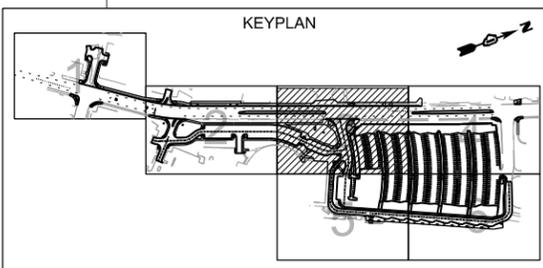

MATCH LINE SEE SHEET 87


FILE NAME = N:\WBK\150077.2\Civil\GRD_150077.2_03.sht	USER NAME = bweich	DESIGNED - BMW	REVISED -
Default	PLOT SCALE = 48"	DRAWN - PWN	REVISED -
	PLOT DATE = 12/4/2017	CHECKED - BMW	REVISED -
		DATE - 12/4/2017	REVISED -

**STATE OF ILLINOIS  
DEPARTMENT OF TRANSPORTATION**

**AURORA TRANSIT CENTER IMPROVEMENTS  
GRADING PLAN**

SCALE: 48" SHEET OF 254 SHEETS STA. TO STA.

F.A.U. RTE.	SECTION	COUNTY	TOTAL SHEETS	SHEET NO.
2503	16-00313-00-MS	KANE	254	85
CONTRACT NO. 61E18				
ILLINOIS FED. AID PROJECT				

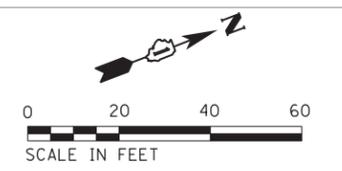


**RIVEREDGE PARK  
(CITY OF AURORA PROPERTY)**

**BROADWAY AVE (IL 25)**

MATCH LINE SEE SHEET 85

MATCH LINE SEE SHEET 88

**NOTE:**  
1. CONTOURS SHOWN ARE 0.1' MINOR CONTOURS AND 1.0' MAJOR CONTOURS.

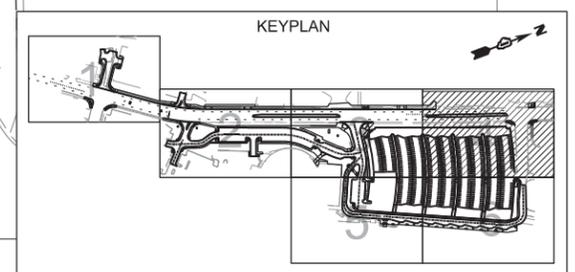

FILE NAME = N:\WBK\150077.2\Civil\GRD_150077.2_04.sht	USER NAME = bweich	DESIGNED - BMW	REVISED -
		DRAWN - PWN	REVISED -
	PLOT SCALE = 40'	CHECKED - BMW	REVISED -
Default	PLOT DATE = 10/16/2017	DATE - 10/16/2017	REVISED -

**STATE OF ILLINOIS  
DEPARTMENT OF TRANSPORTATION**

**AURORA TRANSIT CENTER IMPROVEMENTS  
GRADING PLAN**


SCALE: 40' SHEET OF 254 SHEETS STA. TO STA.

F.A.U. R.E.	SECTION	COUNTY	TOTAL SHEETS	SHEET NO.
2503	16-00313-00-MS	KANE	254	86
CONTRACT NO. 61E18				
ILLINOIS FED. AID PROJECT				



MATCH LINE SEE SHEET 86

MATCH LINE SEE SHEET 87

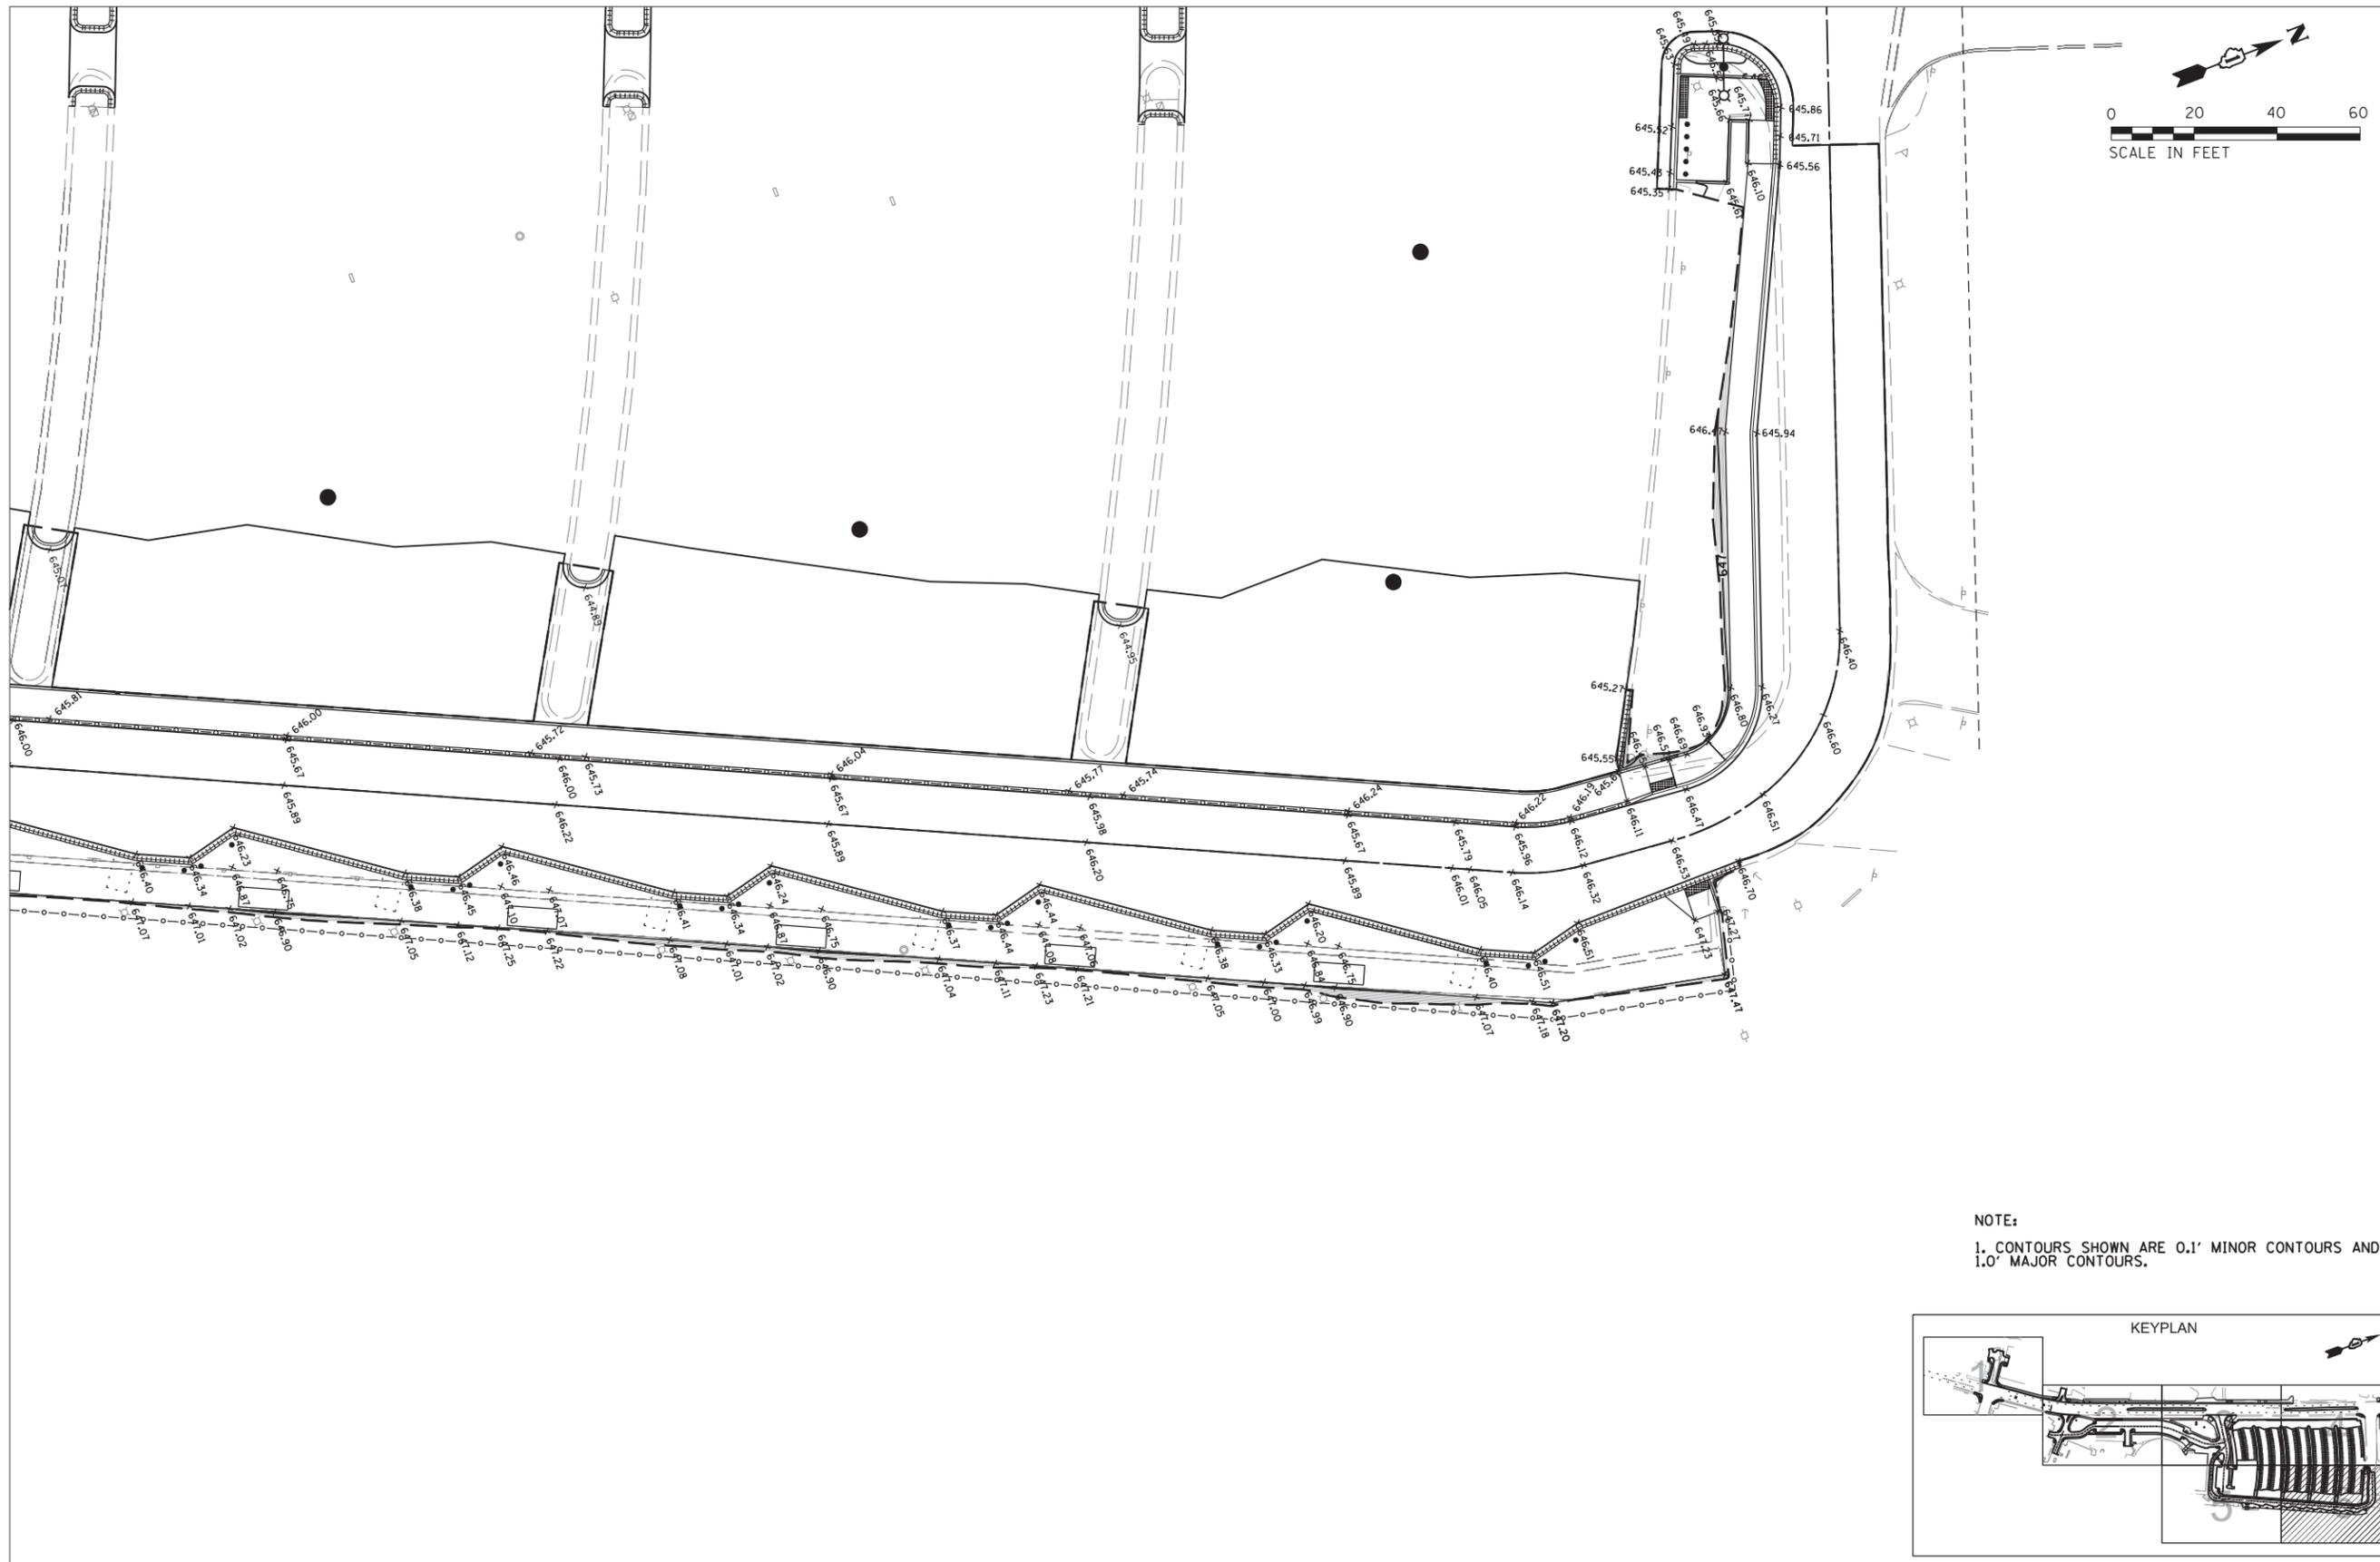

NOTE:  
1. CONTOURS SHOWN ARE 0.1' MINOR CONTOURS AND 1.0' MAJOR CONTOURS.

FILE NAME = N:\WBK\150077.2\Civil\GRD_150077.2_06.sht	USER NAME = bweich	DESIGNED - BMW	REVISED -
		DRAWN - PWN	REVISED -
Default	PLOT SCALE = 48'	CHECKED - BMW	REVISED -
	PLOT DATE = 10/16/2017	DATE - 10/16/2017	REVISED -

STATE OF ILLINOIS  
DEPARTMENT OF TRANSPORTATION

AURORA TRANSIT CENTER IMPROVEMENTS  
GRADING PLAN


SCALE: 48' SHEET OF 254 SHEETS STA. TO STA.

F.A.U. RTE.	SECTION	COUNTY	TOTAL SHEETS	SHEET NO.
2503	16-00313-00-MS	KANE	254	88
CONTRACT NO. 61E18				
ILLINOIS FED. AID PROJECT				

**STORM SEWER TABLE**

- (S1) EXIST CATCH BASIN  
RIM 636.12  
EX INV 633.04 NE  
PR INV 633.08 SW  
(CORE DRILL)
- (S2) INLET, TYPE A,  
TYPE 1 F&L, CL  
33+61.0, 162.4' RT  
RIM 637.05  
INV 634.38 SW,NE
- (S3) CATCH BASIN, TYPE A,  
4' DIA., W/ TY 8 GRATE  
(SPECIAL) (SEE DETAIL  
SHEET 242)  
32+33.8, 160.6' RT  
RIM 637.70  
INV 634.70 NW  
INV 635.03 NE
- (S4) MANHOLE, TYPE A,  
4' DIA, TY 1 F&L, CL  
32+32.1, 148.0' RT  
RIM 640.16  
INV 635.77 NE,SW  
INV 634.77 SE
- (S5) INLET, TYPE B,  
TYPE 11 F&G  
32+82.2, 144.9' RT  
RIM 639.74 (@ EOP)  
INV 636.07 NW,SW
- (S6) INLET, TYPE B,  
TYPE 1 F&L, OPEN  
32+82.1, 52.0' RT  
RIM 641.38  
INV 636.99 NE,SE
- (S7) INLET, TYPE B,  
TYPE 1 F&L, CL  
33+29.7, 52.0' RT  
RIM 641.75  
INV 637.80 NW  
INV 637.46 SW
- (S8) INLET, TYPE A,  
TYPE 1 F&L, OPEN  
33+27.5, 56.7' LT  
RIM 644.38  
INV 639.80 NW
- (S9) INLET, TYPE B,  
TYPE 11 F&G  
31+82.1, 145.0' RT  
RIM 639.71 (@ EOP)  
INV 636.07 NE,NW
- (S10) INLET, TYPE A,  
TYPE 1 F&L, OPEN  
31+82.1, 52.0' RT  
RIM 641.34  
INV 636.99 SE
- (P1) STORM SEWERS,  
CL A, TYPE 1, 12"  
65 LF @ 2.0%  
(3.1 CU YD T.B.)
- (P2) PIPE UNDERDRAIN, 8"  
127 LF @ 0.50%
- (P3) STORM SEWERS,  
CL A, TYPE 1, 18"  
12 LF @ 0.60%
- (P4) STORM SEWERS,  
CL A, TYPE 1, 18"  
50 LF @ 0.60%  
(14.1 CU YD T.B.)
- (P5) STORM SEWERS,  
CL A, TYPE 1, 15"  
92 LF @ 1.0%  
(25.9 CU YD T.B.)
- (P6) STORM SEWERS,  
CL A, TYPE 1, 12"  
47 LF @ 1.0%  
(14.6 CU YD T.B.)
- (P7) STORM SEWERS,  
CL A, TYPE 1, 12"  
108 LF @ 1.5%  
(32.3 CU YD T.B.)
- (P8) STORM SEWERS,  
CL A, TYPE 1, 18"  
50 LF @ 0.60%  
(14.1 CU YD T.B.)
- (S9) STORM SEWERS,  
CL A, TYPE 1, 12"  
92 LF @ 1.0%  
(25.6 CU YD T.B.)

- NOTES:
- REFER TO THE GEOMETRIC PLAN SHEETS FOR DIMENSIONS AND LAYOUT.
  - ALL ELEVATIONS ARE TO THE EDGE OF PAVEMENT UNLESS OTHERWISE NOTED.

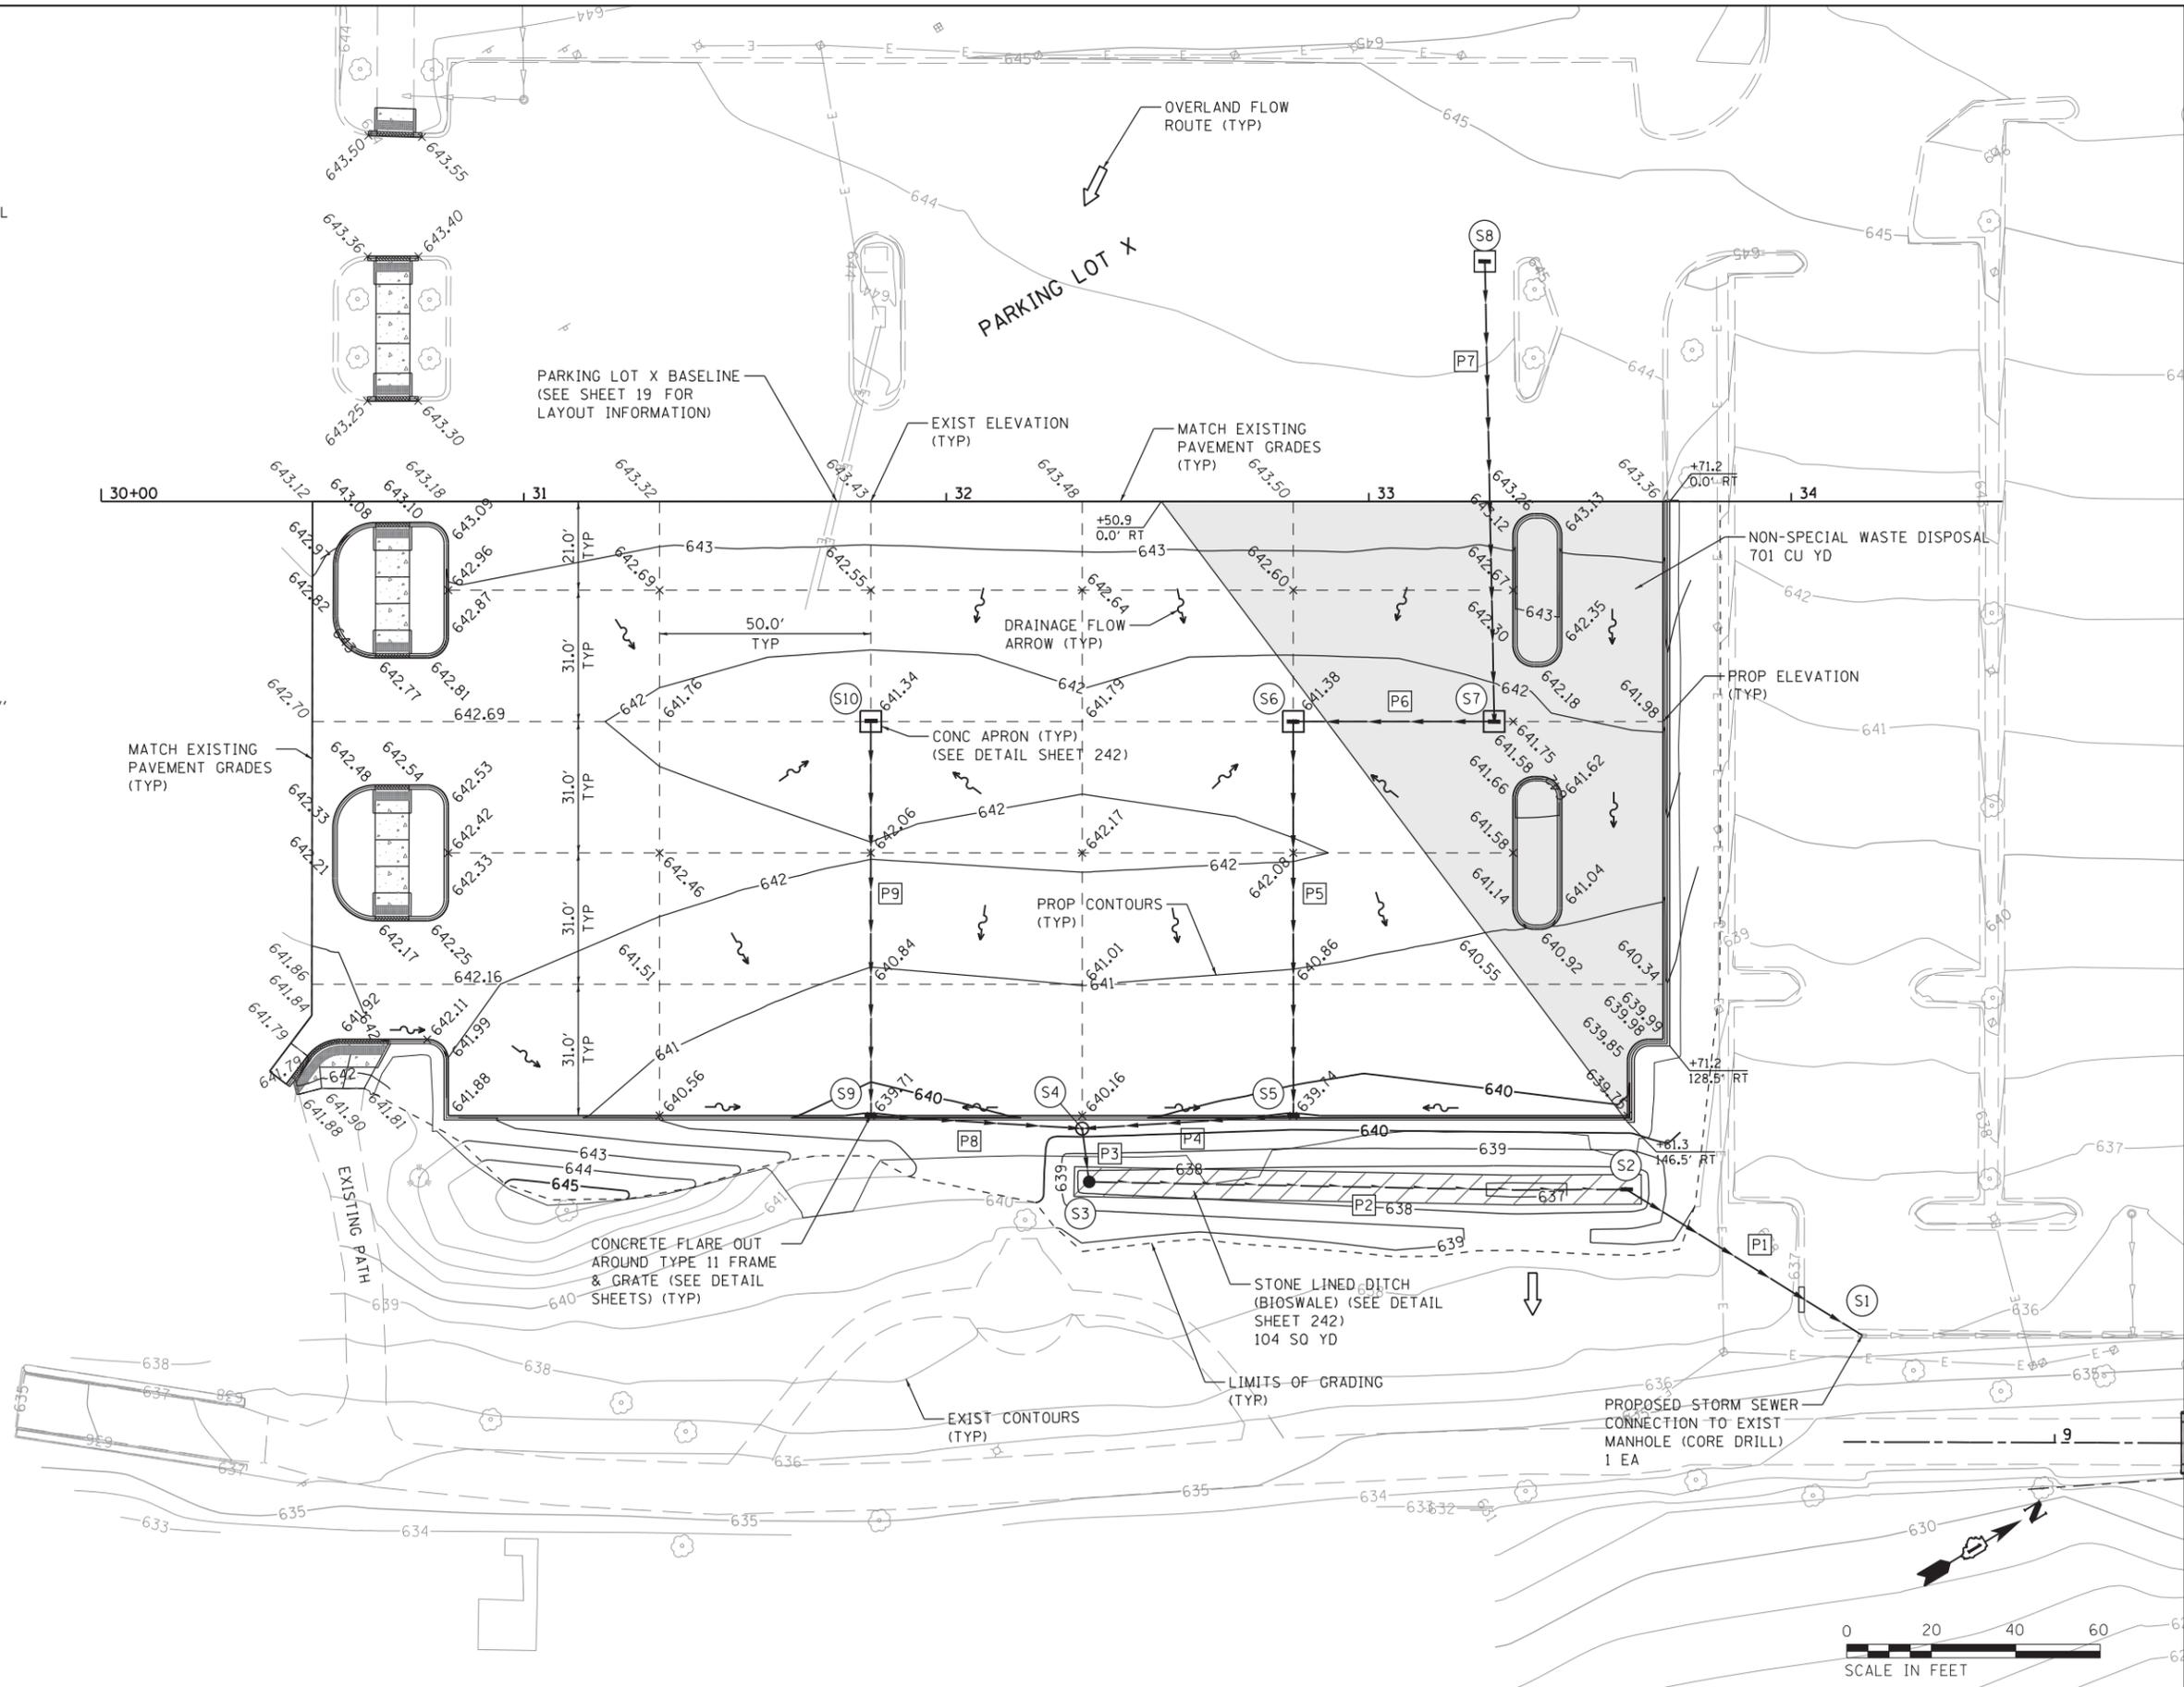

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**WBK ENGINEERING, LLC**  
116 WEST MAIN STREET, SUITE 201  
ST. CHARLES, ILLINOIS 60174  
(630) 443-7755

USER NAME = nparris  
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DRAWN - NDP  
CHECKED - MNB  
DATE - 10/17/2017

DESIGNED - MNB  
DRAWN - NDP  
CHECKED - MNB  
DATE - 10/17/2017



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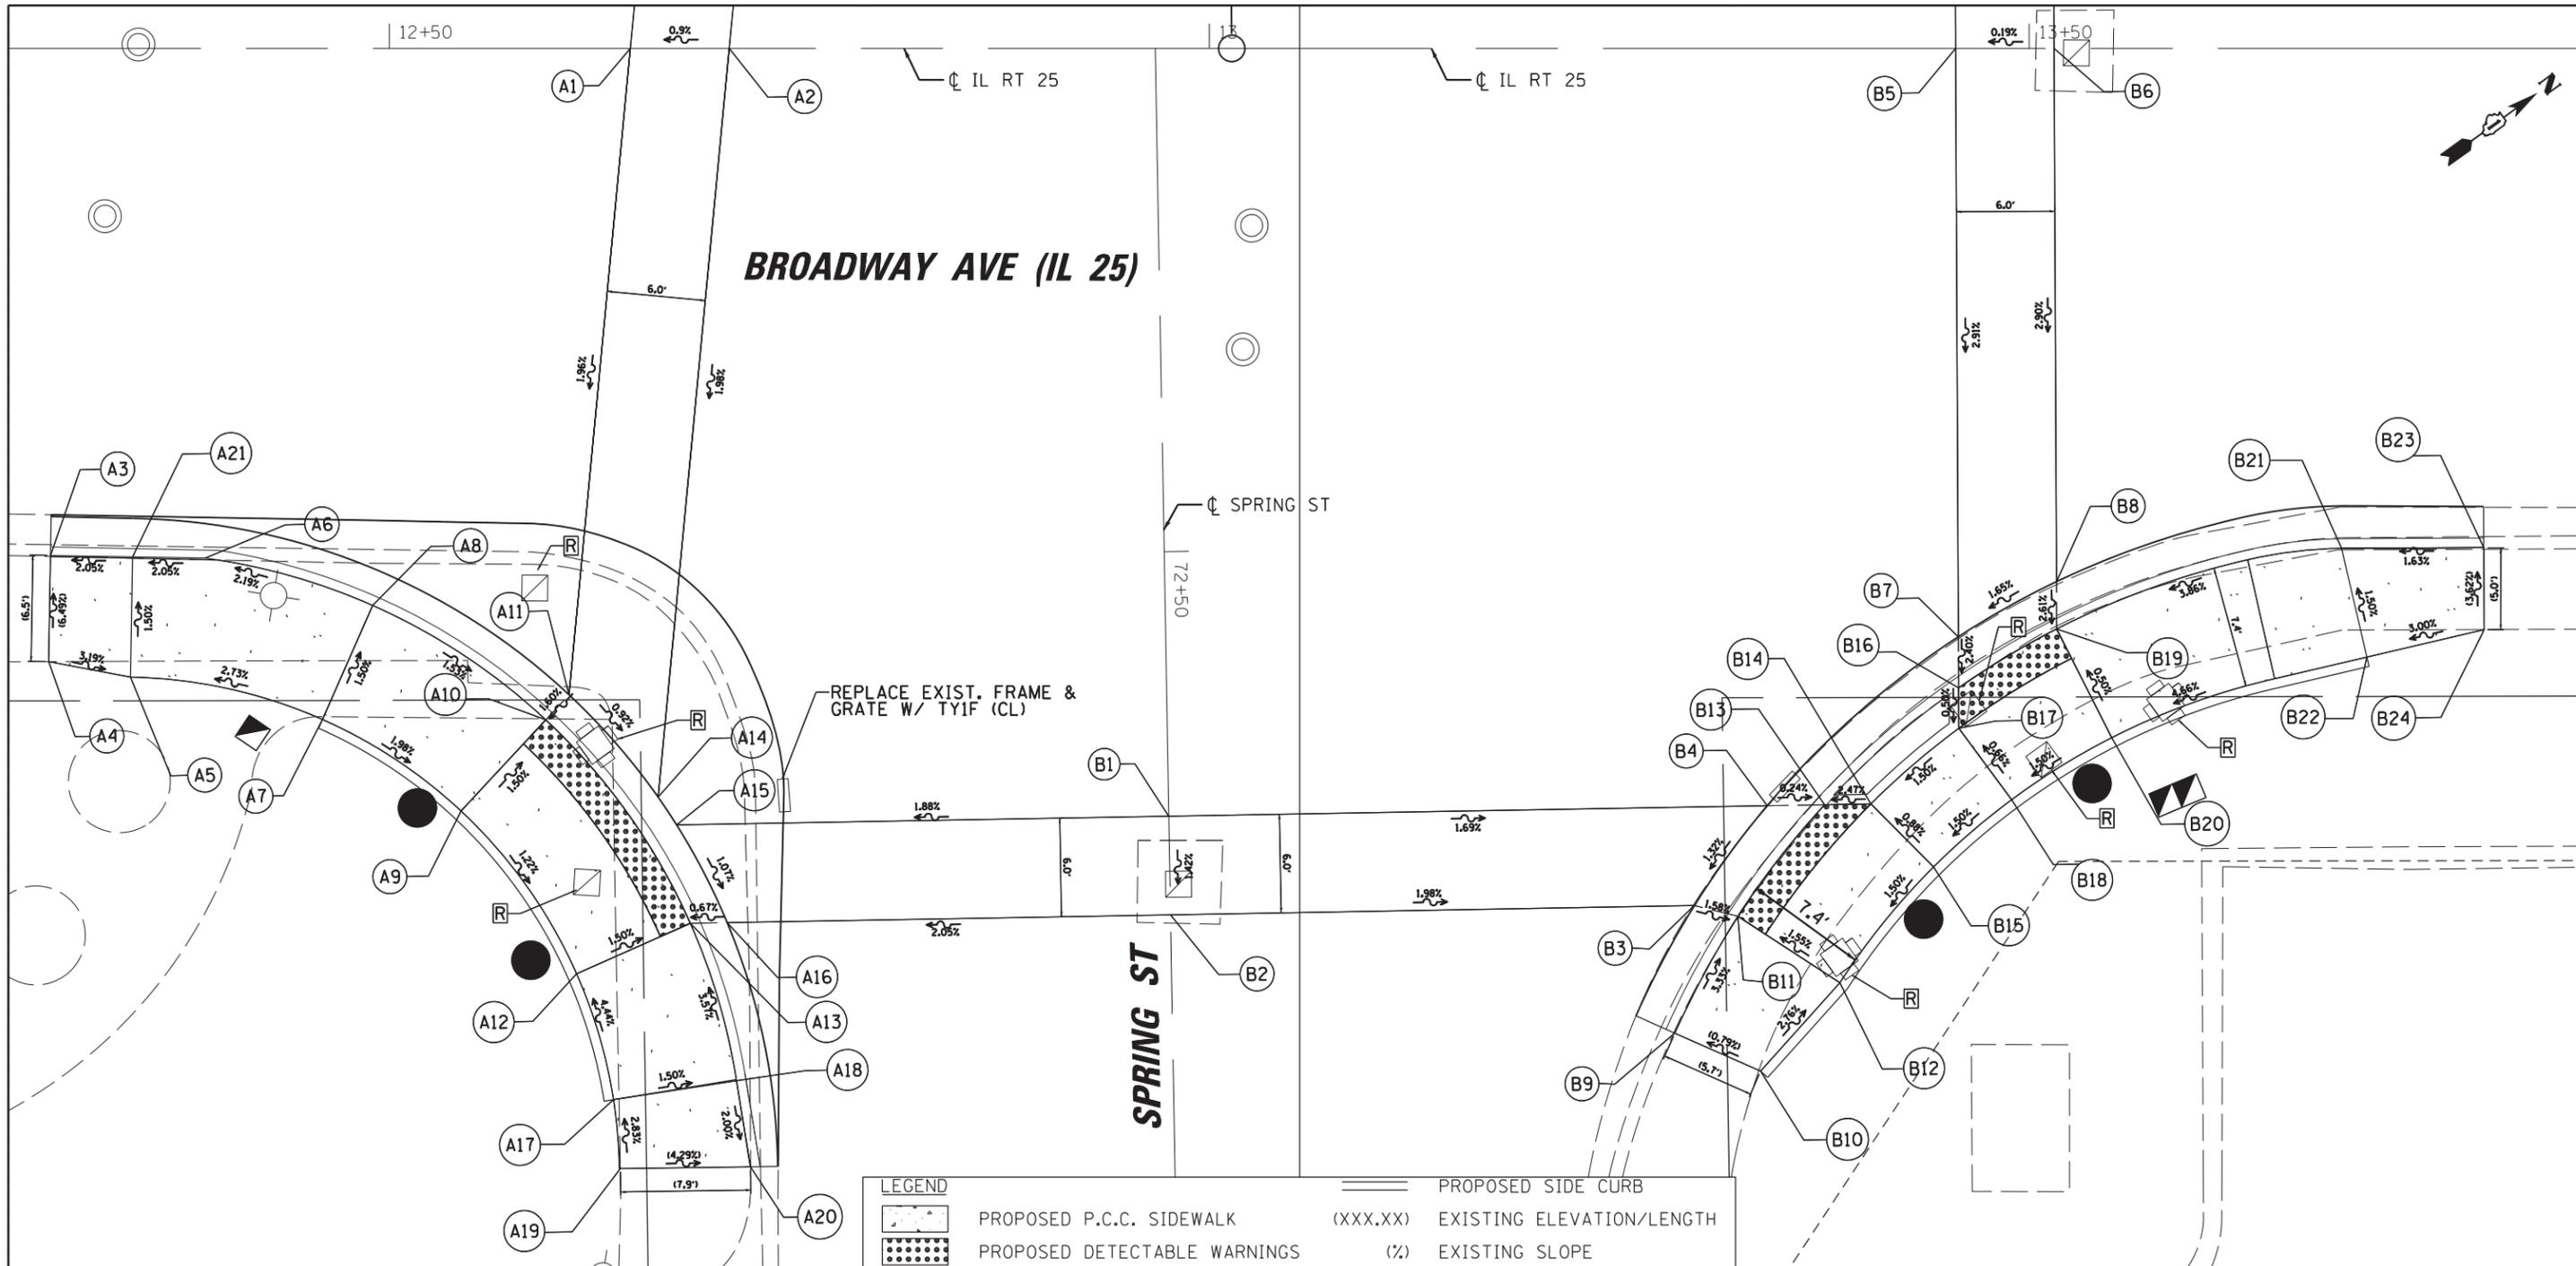
**STATE OF ILLINOIS  
DEPARTMENT OF TRANSPORTATION**

**GRADING PLAN  
PARKING LOT X**

SCALE: 1"=20' SHEET NO. 7 OF 8 SHEETS STA. TO STA.

F.A.U. RTE.	SECTION	COUNTY	TOTAL SHEETS	SHEET NO.
2503	16-00313-00-MS	KANE	254	89
CONTRACT NO. 61E18				
ILLINOIS FED. AID PROJECT				



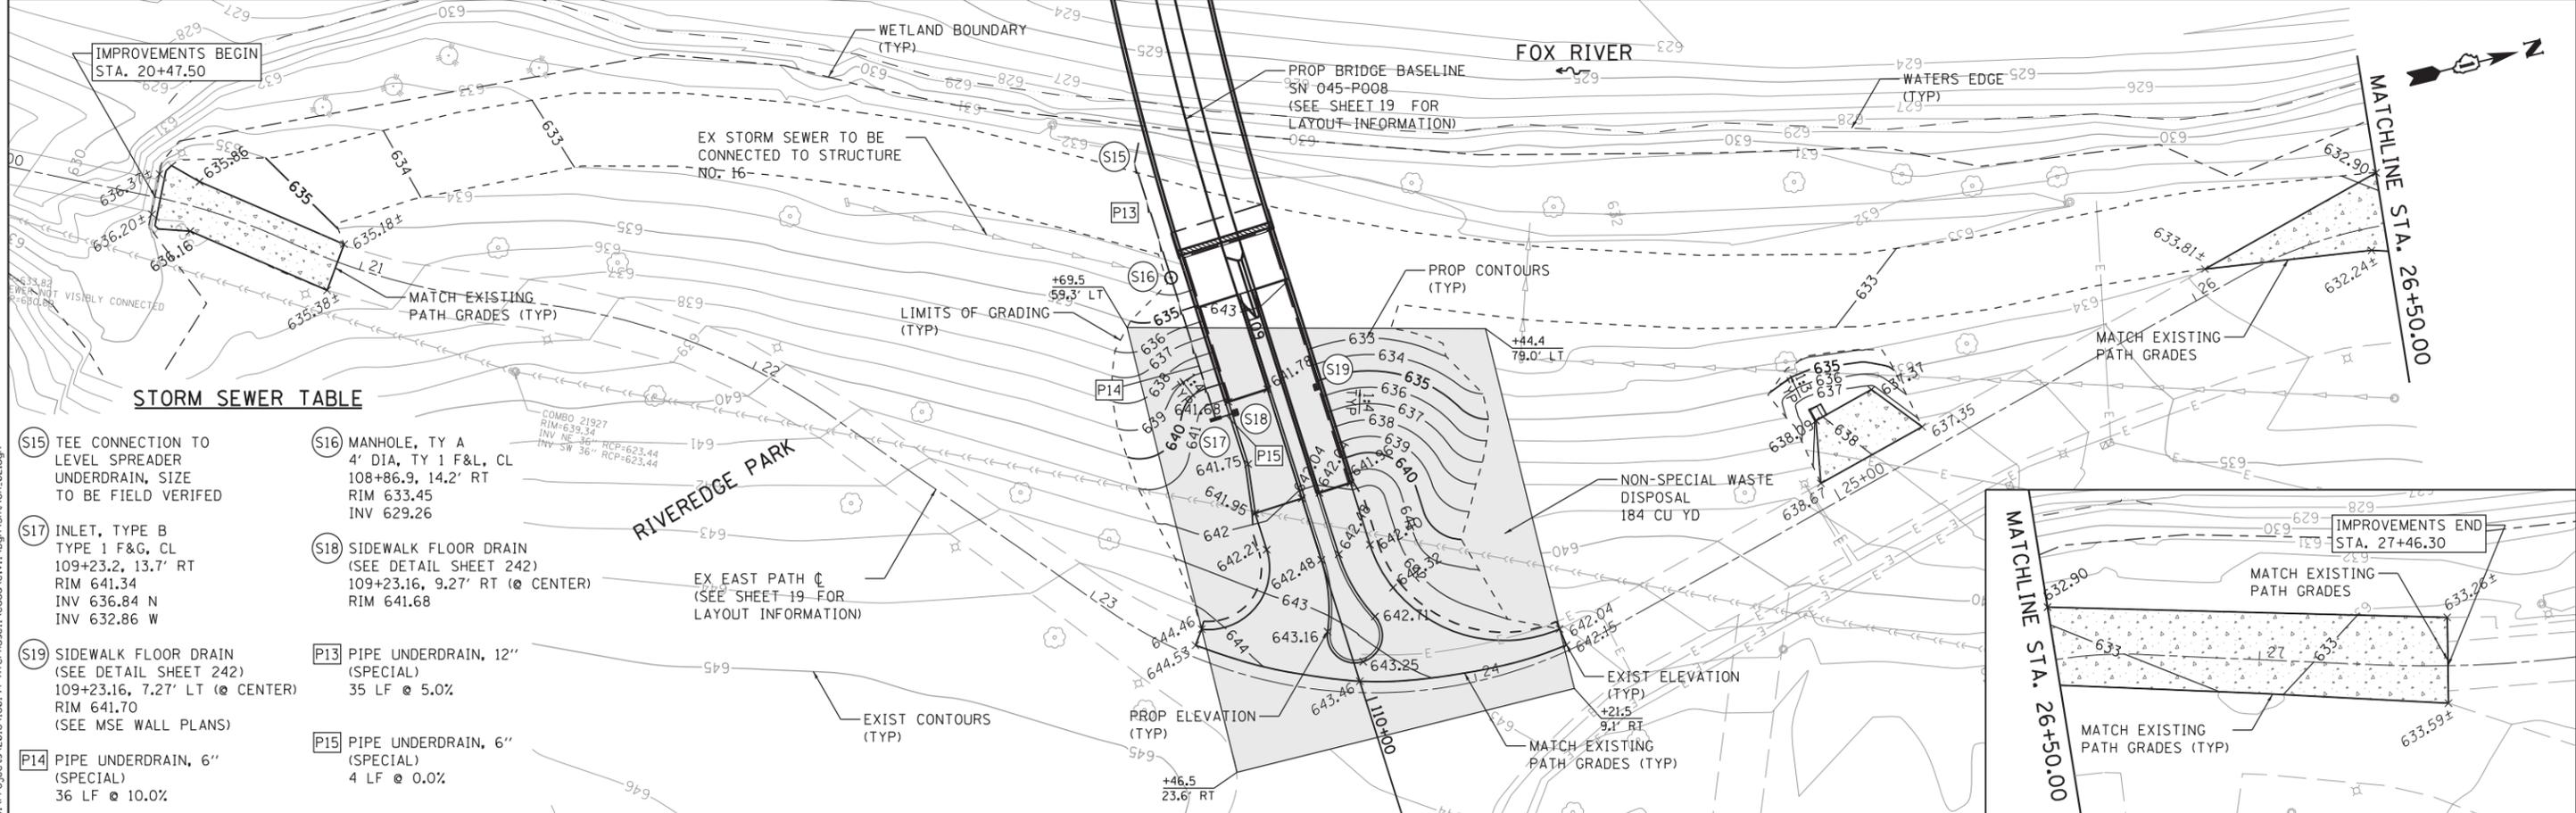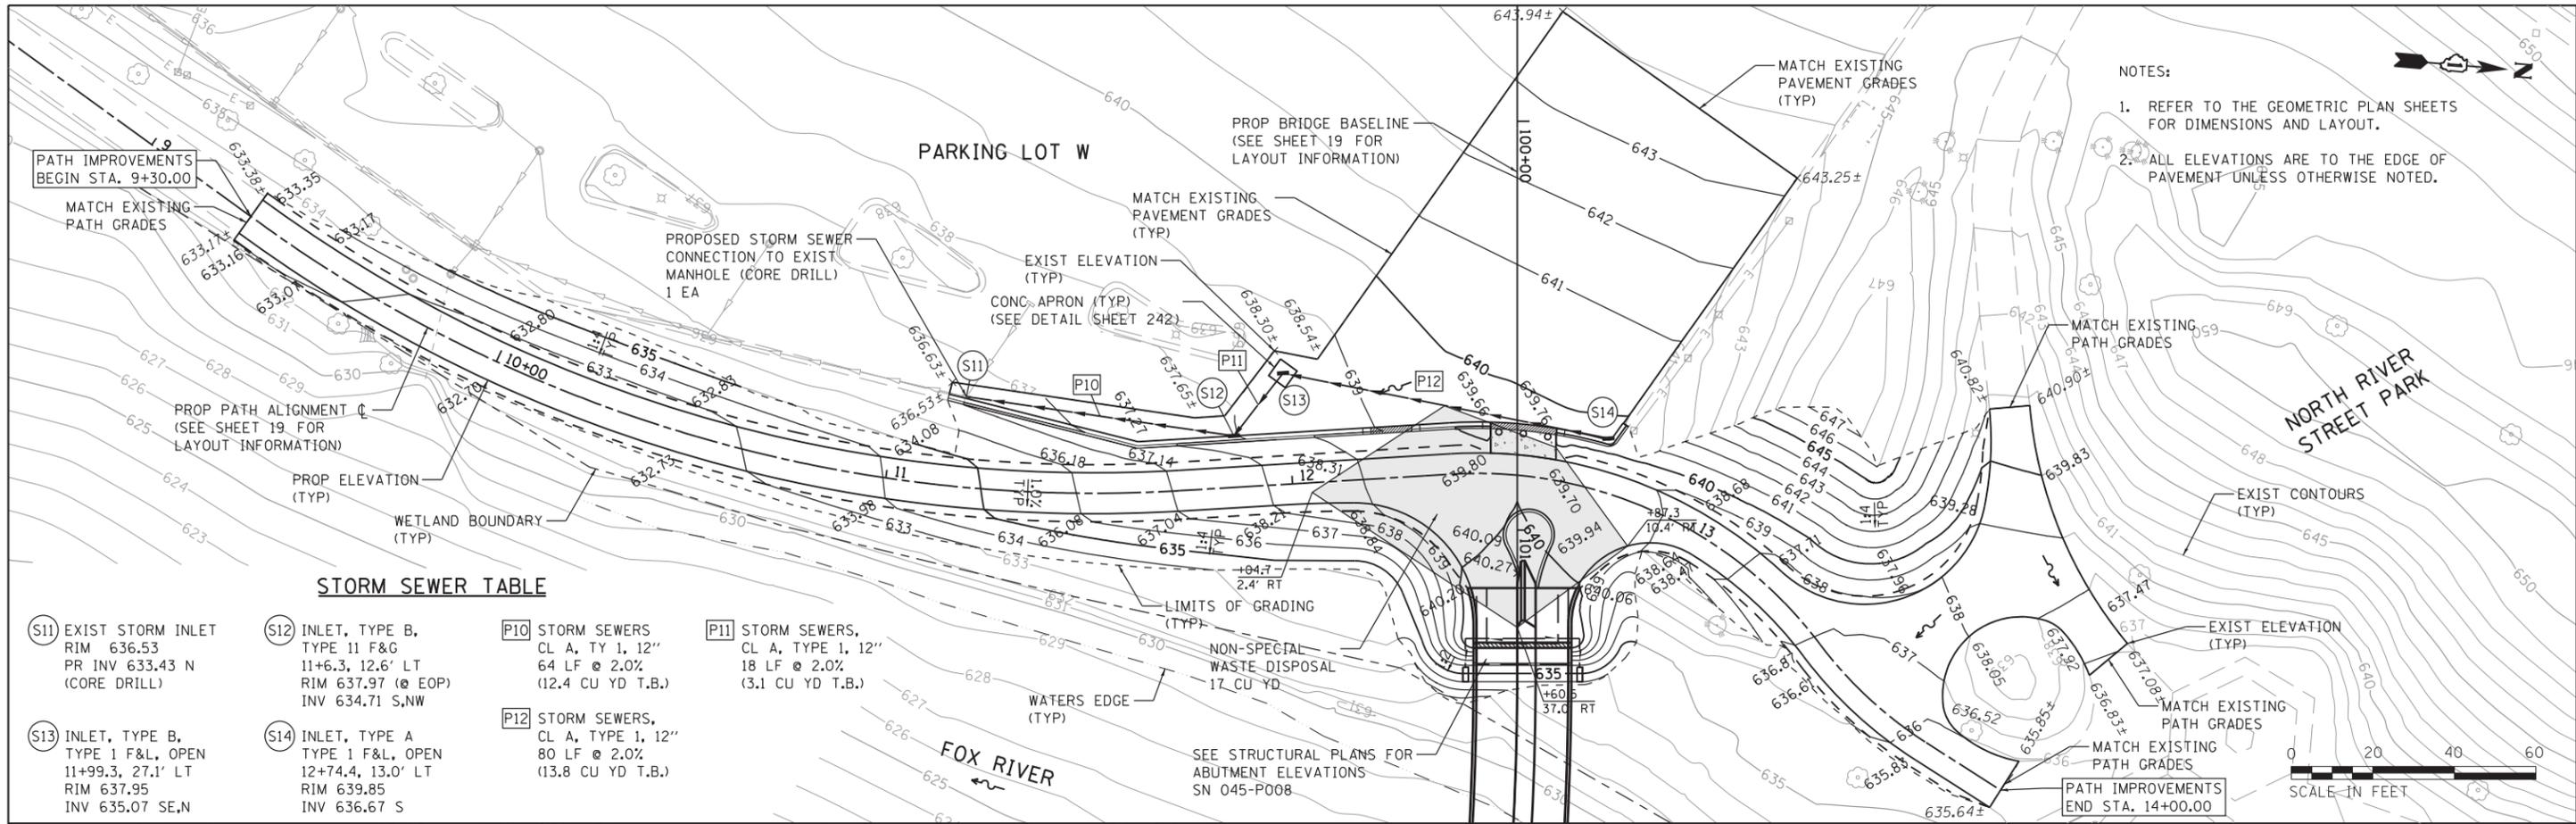

SE CORNER  
SPRING STREET

NE CORNER  
SPRING STREET

**LEGEND**

- PROPOSED P.C.C. SIDEWALK
- PROPOSED DETECTABLE WARNINGS
- NEW HANDHOLE
- REMOVE EXIST. ITEM
- PROPOSED SIDE CURB
- (XXX.XX) EXISTING ELEVATION/LENGTH
- (%) EXISTING SLOPE
- NEW SIGNAL POLE (SEE SIGNAL PLANS)

POINT	NORTHING	EASTING	ELEVATION
A1	1854788.97	990335.88	649.99
A2	1854793.85	990339.41	650.04
A3	1854742.21	990340.19	648.96
A4	1854738.36	990345.31	649.33
A5	1854741.85	990348.99	649.17
A6	1854750.35	990346.35	649.17
A7	1854749.82	990357.94	649.49
A8	1854756.37	990354.11	649.38
A9	1854753.40	990367.40	649.29
A10	1854760.84	990365.94	649.18
A11	1854762.89	990365.53	649.21
A12	1854753.31	990379.56	649.15



POINT	NORTHING	EASTING	ELEVATION
A13	1854760.73	990381.13	649.03
A14	1854763.64	990373.77	649.14
A15	1854763.56	990375.79	649.12
A16	1854762.58	990382.42	649.05
A17	1854750.64	990387.08	649.50
A18	1854757.42	990390.48	649.39
A19	1854748.52	990390.73	649.62
A20	1854755.01	990395.29	649.28
A21	1854746.19	990343.20	649.06

NOTE: THIS SHEET IS FOR USE IN LAYING OUT CURB RAMP ONLY. SEE OTHER SHEETS FOR EXISTING CONDITIONS, REMOVALS, PROPOSED IMPROVEMENTS, ETC.

POINT	NORTHING	EASTING	ELEVATION
B1	1854788.18	990392.96	649.68
B2	1854784.75	990397.88	649.60
B3	1854810.96	990416.16	648.97
B4	1854818.12	990413.84	649.07
B5	1854854.43	990383.26	650.36
B6	1854859.29	990386.78	650.38
B7	1854833.58	990412.35	649.32
B8	1854840.39	990413.15	649.44
B9	1854805.44	990421.74	649.19
B10	1854808.33	990426.69	649.24
B11	1854811.72	990418.24	648.92
B12	1854815.39	990425.16	649.04

POINT	NORTHING	EASTING	ELEVATION
B13	1854820.99	990415.84	649.06
B14	1854823.31	990417.46	649.13
B15	1854824.15	990422.81	649.18
B16	1854831.77	990414.87	649.25
B17	1854830.34	990416.87	649.23
B18	1854830.40	990422.29	649.27
B19	1854838.72	990415.48	649.34
B20	1854837.56	990422.81	649.38
B21	1854855.67	990421.69	650.04
B22	1854853.04	990427.96	650.14
B23	1854862.72	990426.74	650.18
B24	1854859.82	990430.80	650.36



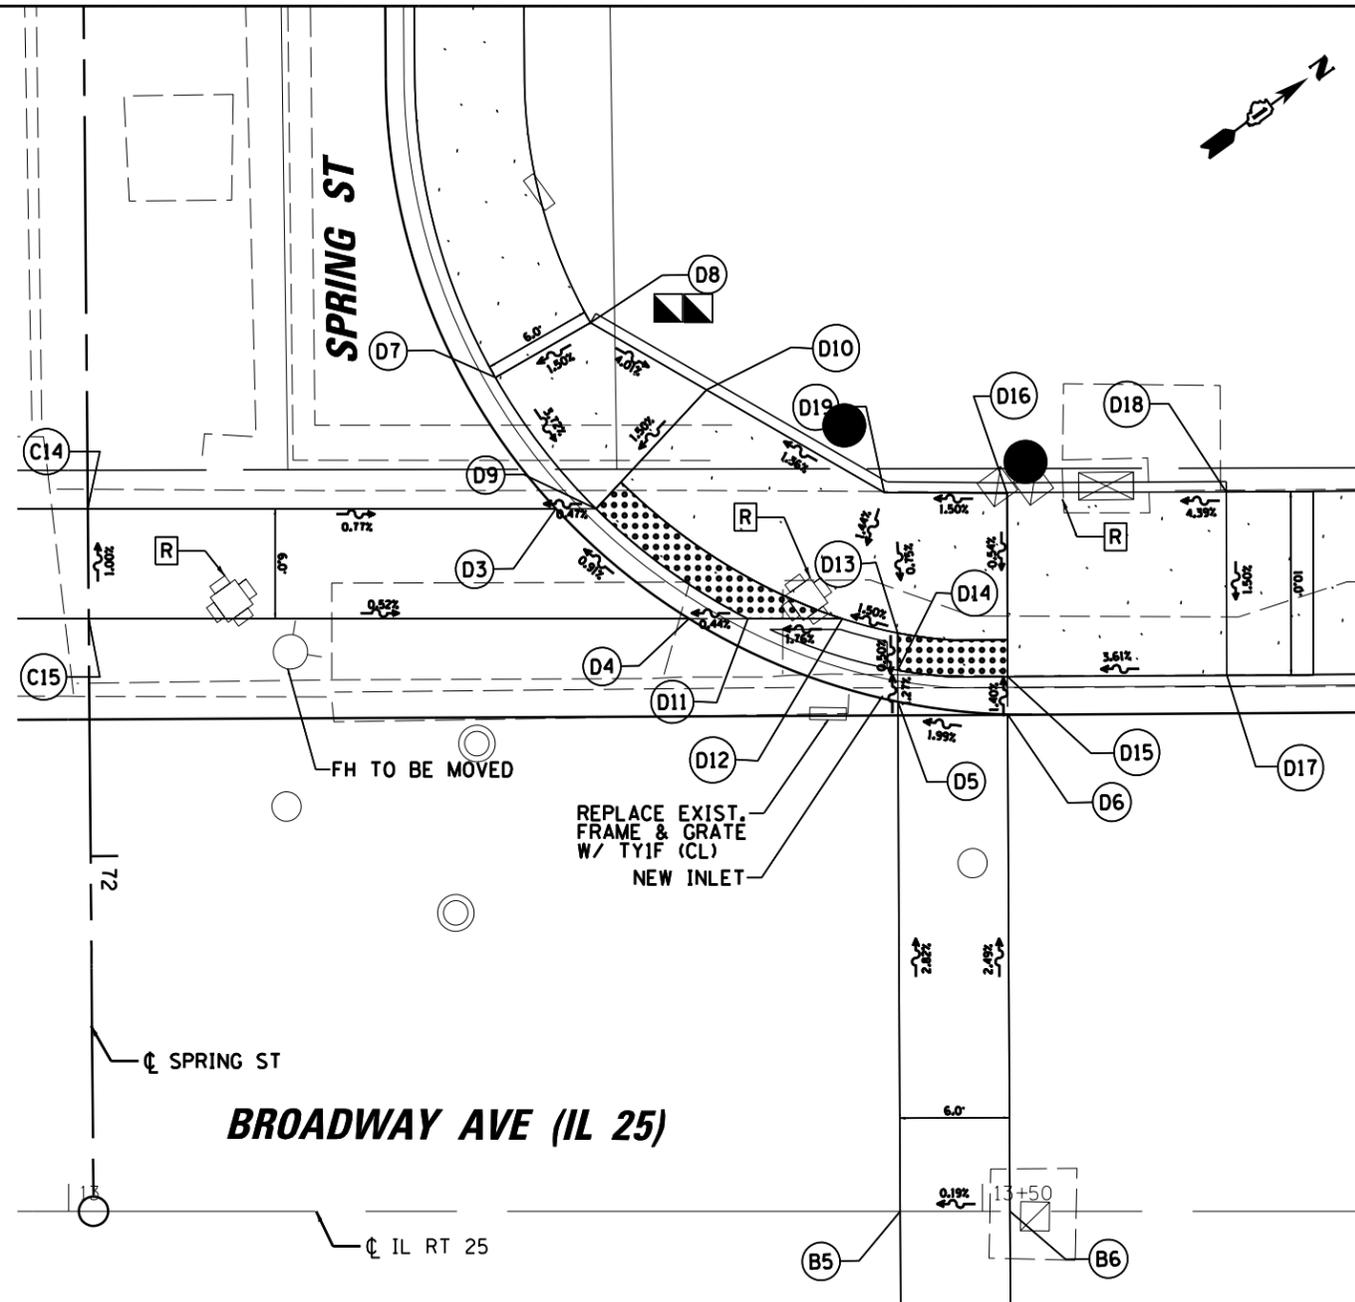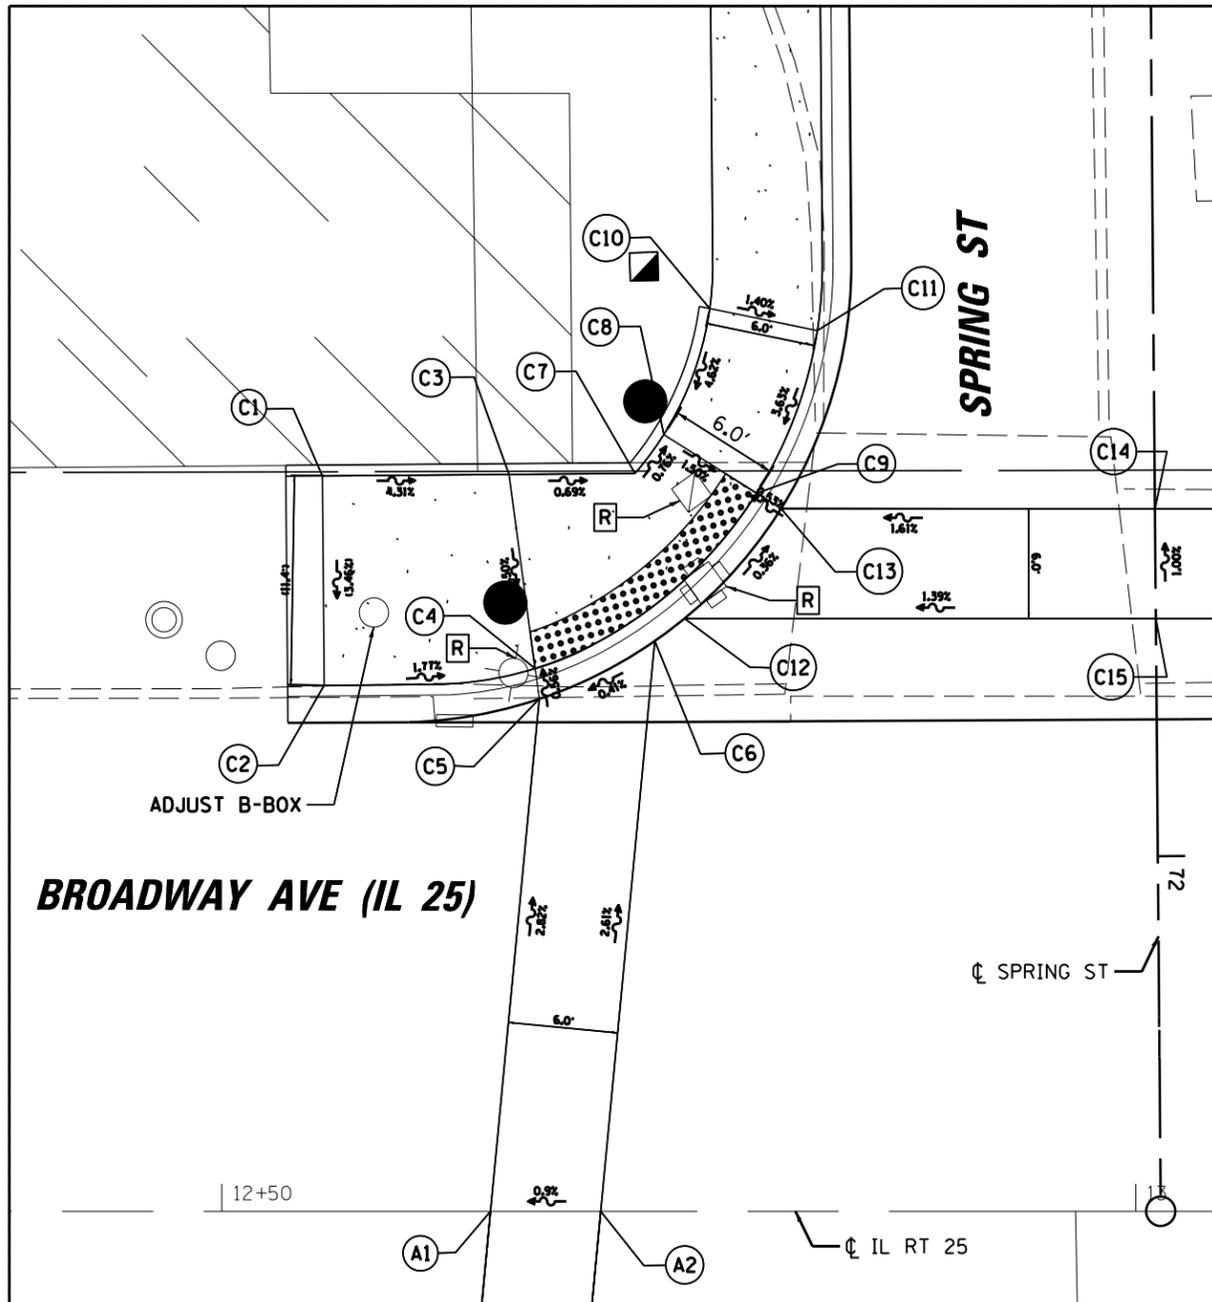

**SW CORNER**  
SPRING STREET

**NW CORNER**  
SPRING STREET

**LEGEND**

	PROPOSED P.C.C. SIDEWALK		PROPOSED SIDE CURB
	PROPOSED DETECTABLE WARNINGS	(XXX.XX)	EXISTING ELEVATION/LENGTH
	NEW HANDHOLE	(%)	EXISTING SLOPE
	REMOVE EXIST. ITEM	●	NEW SIGNAL POLE (SEE SIGNAL PLANS)



POINT	NORTHING	EASTING	ELEVATION
C1	1854803.42	990296.81	649.87
C2	1854796.80	990306.12	649.43
C3	1854813.37	990303.90	649.35
C4	1854808.31	990313.31	649.19
C5	1854807.51	990314.79	649.20
C6	1854814.50	990315.93	649.23
C7	1854818.98	990307.90	649.30
C8	1854821.50	990307.10	649.28
C9	1854823.74	990312.67	649.19
C10	1854827.57	990303.00	649.62
C11	1854831.63	990307.43	649.53
C12	1854816.53	990315.89	649.23

POINT	NORTHING	EASTING	ELEVATION
C13	1854824.33	990314.13	649.20
C14	1854840.90	990326.13	649.53
C15	1854837.42	990331.02	649.59

POINT	NORTHING	EASTING	ELEVATION
D3	1854861.64	990341.15	649.33
D4	1854864.03	990350.28	649.42
D5	1854870.63	990360.65	649.58
D6	1854875.09	990364.73	649.70
D7	1854863.17	990333.40	649.68
D8	1854869.13	990334.04	649.77
D9	1854863.43	990342.44	649.34
D10	1854872.13	990340.72	649.47
D11	1854866.64	990352.17	649.43
D12	1854870.83	990355.20	649.52
D13	1854872.82	990357.60	649.57
D14	1854871.63	990359.26	649.56

POINT	NORTHING	EASTING	ELEVATION
D15	1854876.29	990363.05	649.67
D16	1854882.14	990354.94	649.73
D17	1854886.06	990370.03	650.10
D18	1854891.91	990361.91	650.25
D19	1854876.72	990350.97	649.62

**NOTE: THIS SHEET IS FOR USE IN LAYING OUT CURB RAMP ONLY. SEE OTHER SHEETS FOR EXISTING CONDITIONS, REMOVALS, PROPOSED IMPROVEMENTS, ETC.**

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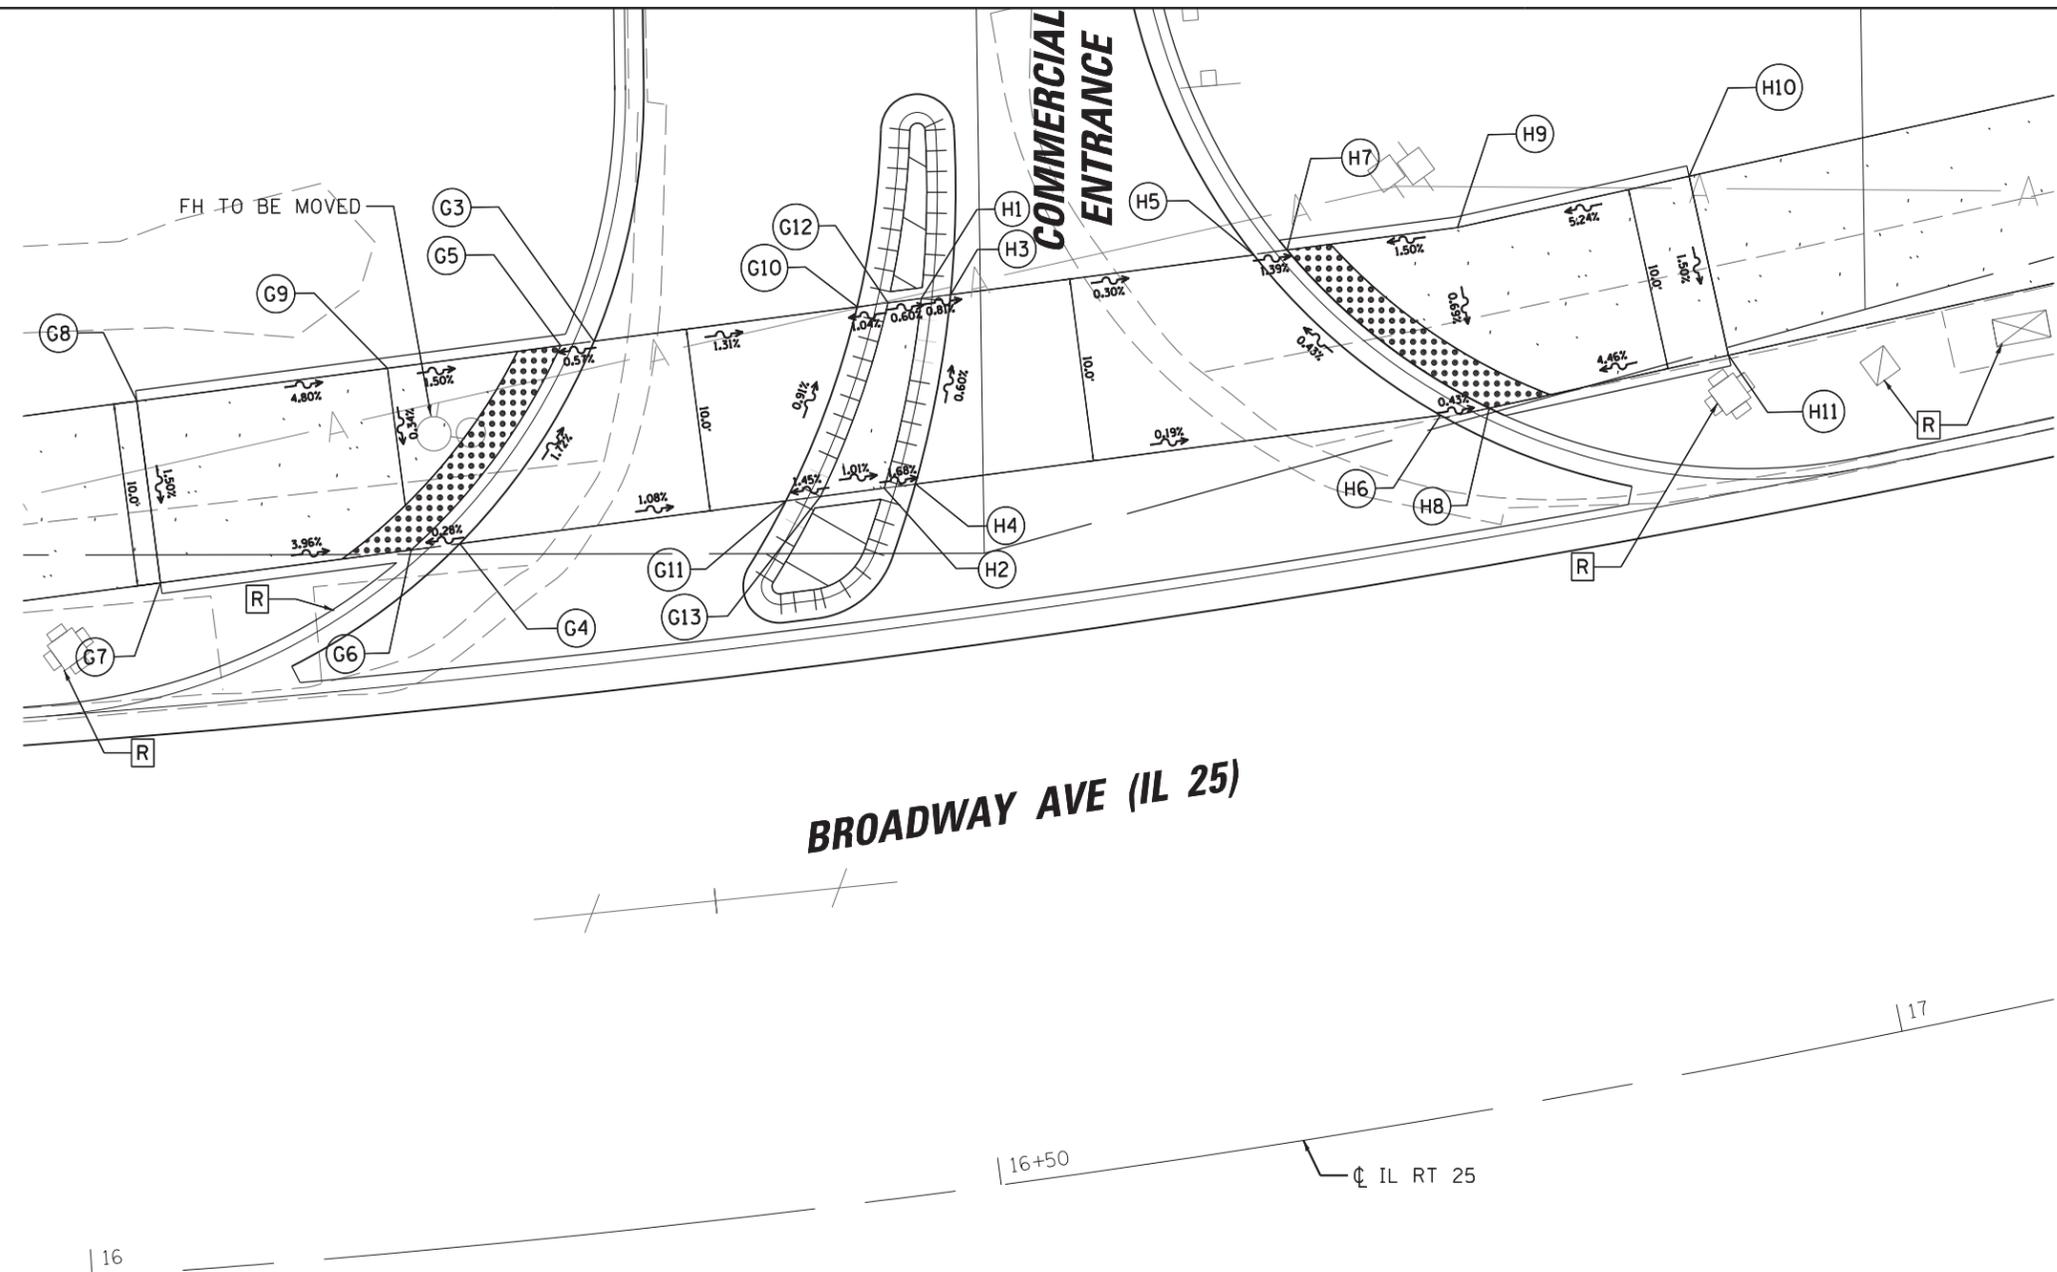
**STATE OF ILLINOIS**  
**DEPARTMENT OF TRANSPORTATION**

**AURORA TRANSIT CENTER IMPROVEMENTS**  
**SPRING STREET ADA DETAILS**

SCALE: 10" SHEET OF 254 SHEETS STA. TO STA.

F.A.U. RTE.	SECTION	COUNTY	TOTAL SHEETS	SHEET NO.
2503	16-00313-00-MS	KANE	254	92
CONTRACT NO. 61E18				
ILLINOIS FED. AID PROJECT				





**BROADWAY AVE (IL 25)**

**SW CORNER**  
COMMERCIAL ENTRANCE

**NW CORNER**  
COMMERCIAL ENTRANCE



LEGEND	
	PROPOSED P.C.C. SIDEWALK
	PROPOSED DETECTABLE WARNINGS
	REMOVE EXIST. ITEM
	PROPOSED SIDE CURB
(XXX.XX)	EXISTING ELEVATION/LENGTH
(%)	EXISTING SLOPE
	NEW SIGNAL POLE (SEE SIGNAL PLANS)
	NEW HANDHOLE

POINT	NORTHING	EASTING	ELEVATION
G3	1855113.69	990505.87	649.80
G4	1855101.26	990510.51	649.90
G5	1855112.07	990504.99	649.79
G6	1855098.90	990509.23	649.90
G7	1855086.75	990502.65	650.44
G8	1855091.51	990493.86	650.59
G9	1855103.67	990500.44	649.93
G10	1855126.46	990512.79	649.61
G11	1855117.08	990519.08	649.71
G12	1855127.94	990513.60	649.63
G13	1855118.76	990519.99	649.72

POINT	NORTHING	EASTING	ELEVATION
H1	1855129.56	990514.47	649.61
H2	1855121.86	990521.67	649.68
H3	1855130.99	990515.25	649.59
H4	1855123.37	990522.49	649.65
H5	1855145.70	990523.22	649.54
H6	1855148.84	990536.29	649.60
H7	1855147.33	990524.06	649.51
H8	1855151.23	990537.54	649.59
H9	1855155.61	990528.54	649.66
H10	1855167.51	990533.70	650.33
H11	1855163.53	990542.88	650.18

NOTE: THIS SHEET IS FOR USE IN LAYING OUT CURB RAMP ONLY. SEE OTHER SHEETS FOR EXISTING CONDITIONS, REMOVALS, PROPOSED IMPROVEMENTS, ETC.



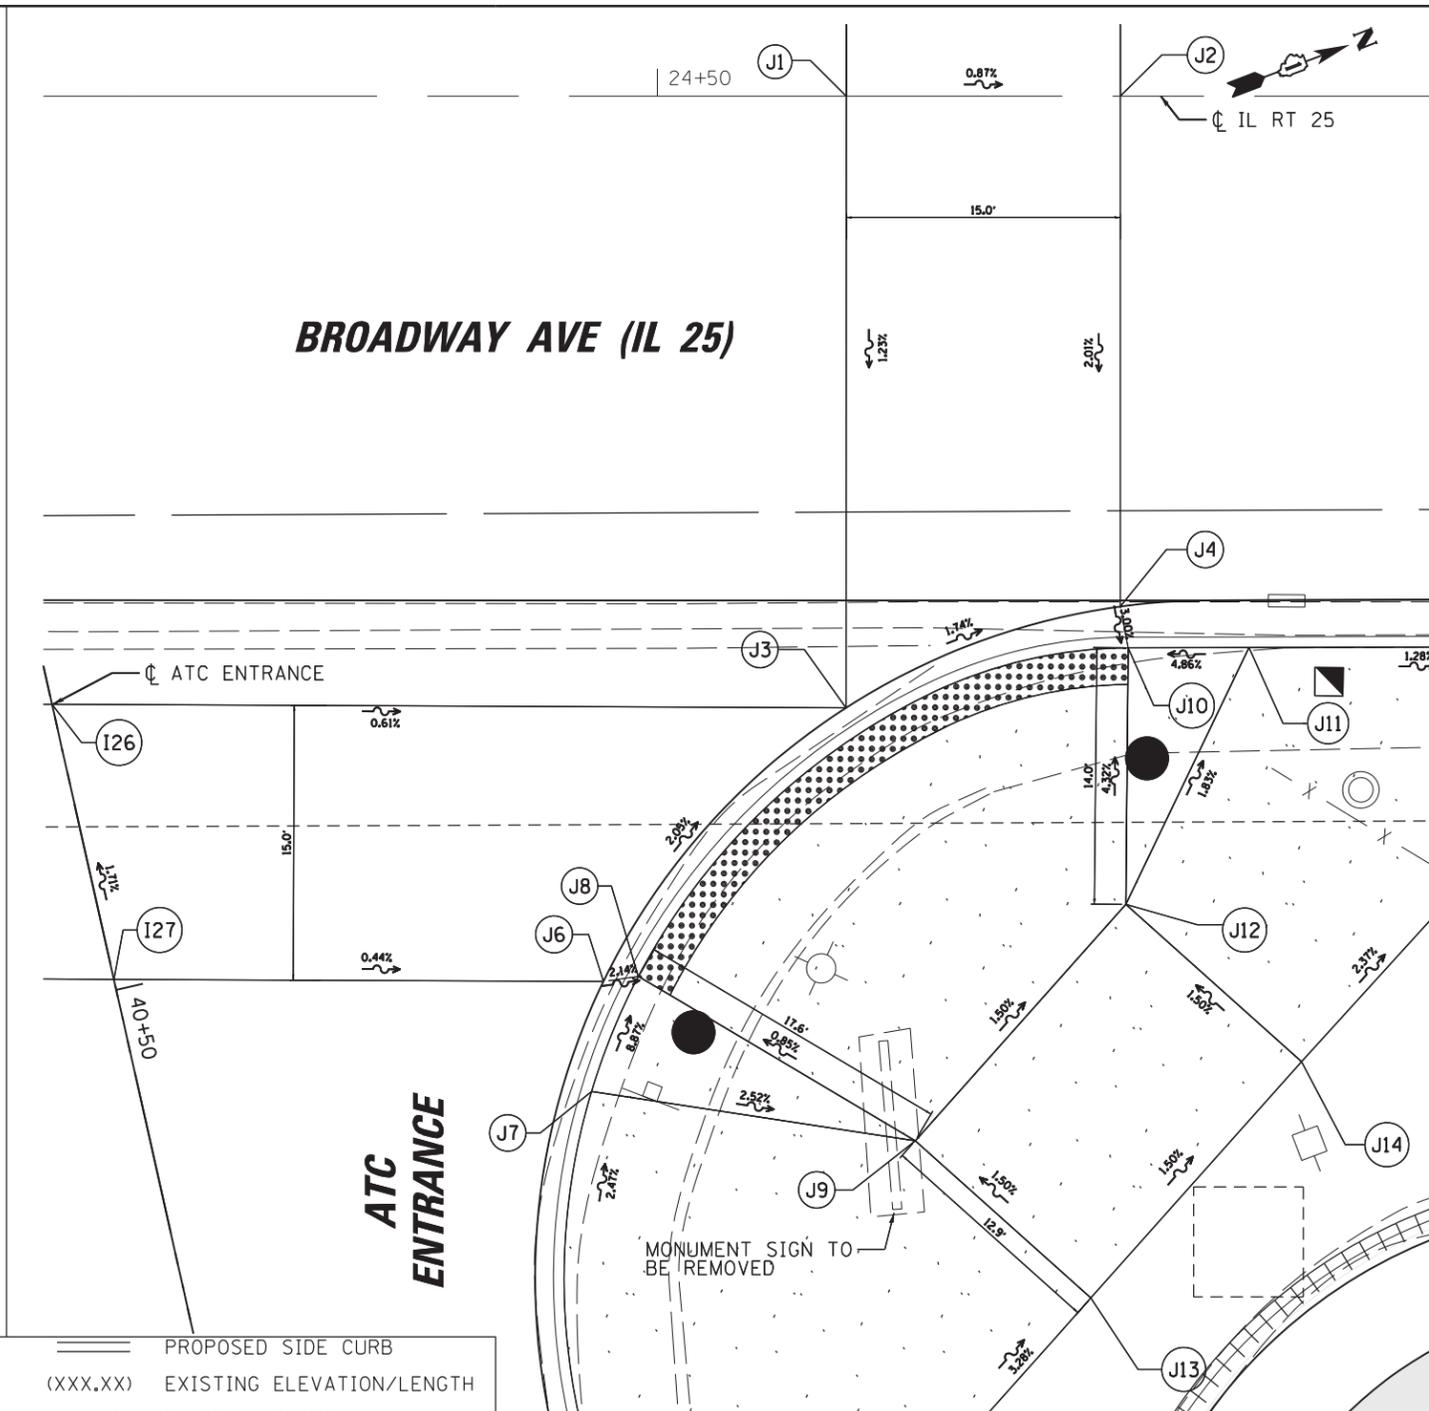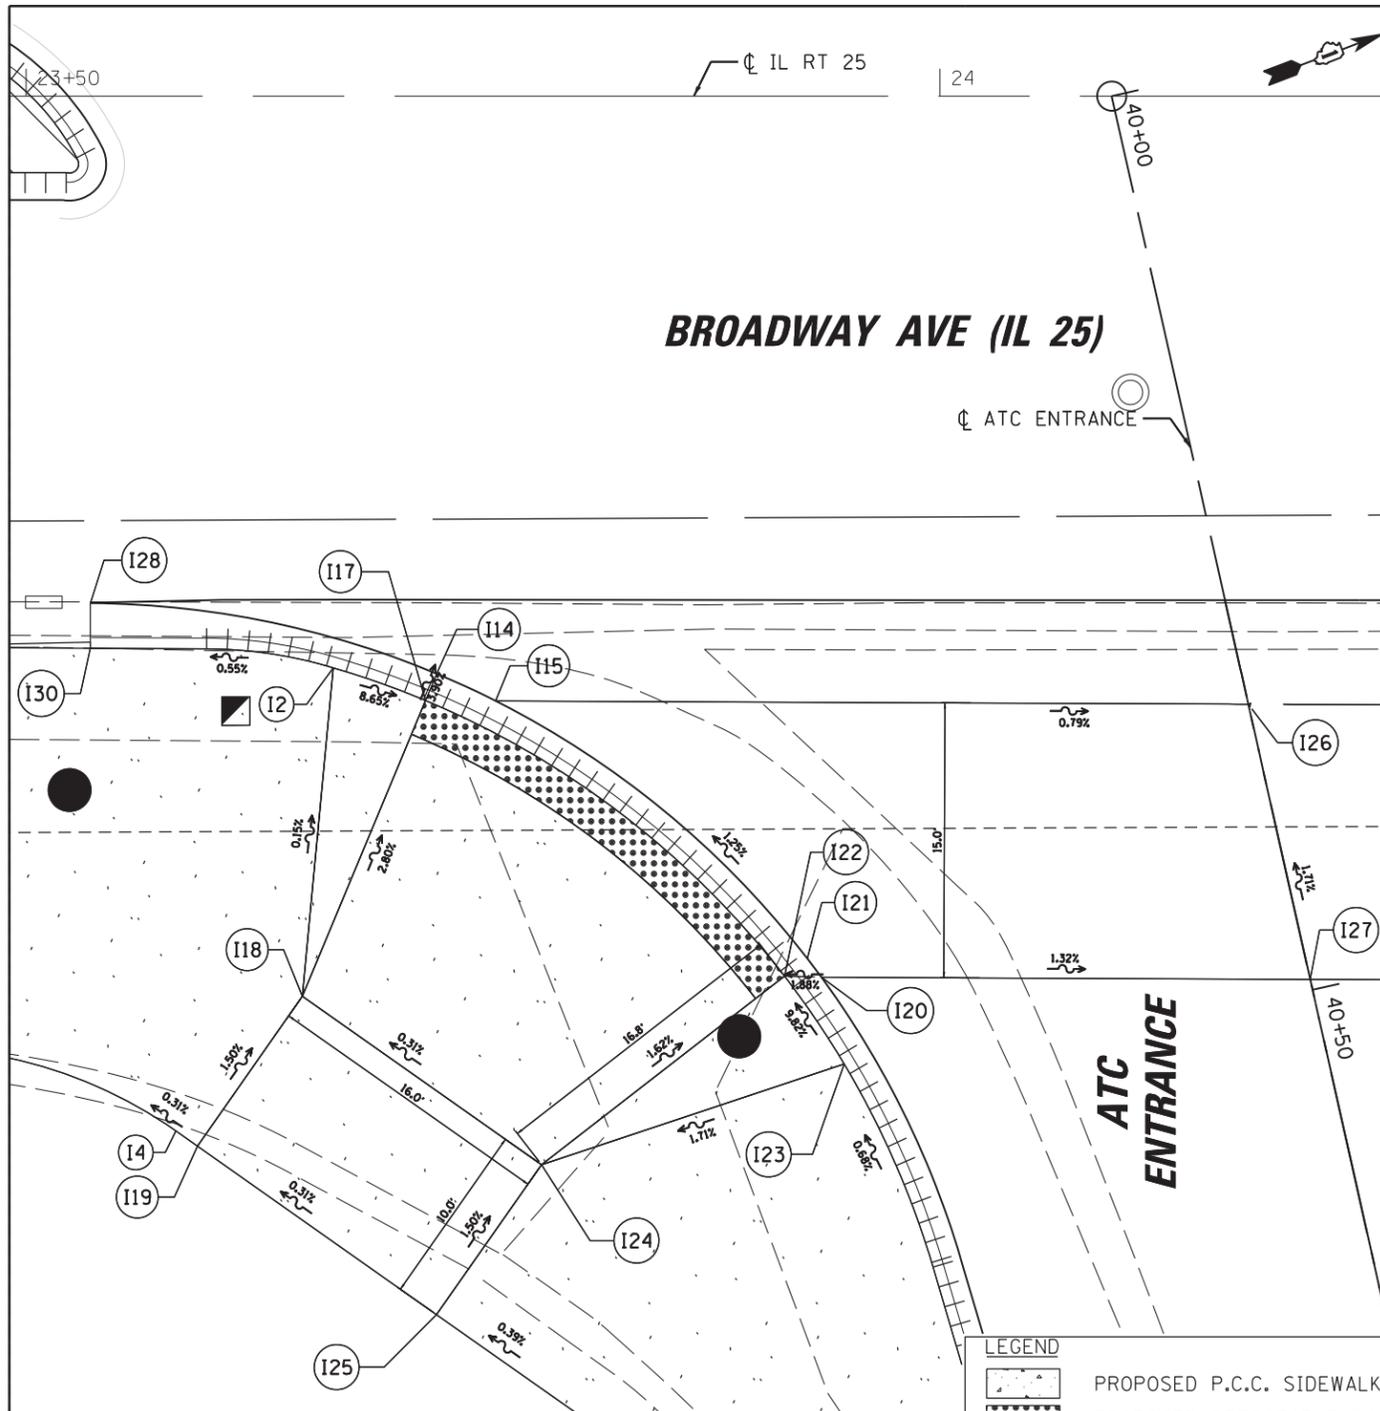

**SE CORNER**  
ATC ENTRANCE

**NE CORNER**  
ATC ENTRANCE

LEGEND		LEGEND	
	PROPOSED P.C.C. SIDEWALK		PROPOSED SIDE CURB
	PROPOSED DETECTABLE WARNINGS	(XXX.XX)	EXISTING ELEVATION/LENGTH
	NEW HANDHOLE	(%)	EXISTING SLOPE
	REMOVE EXIST. ITEM	●	NEW SIGNAL POLE (SEE SIGNAL PLANS)



POINT	NORTHING	EASTING	ELEVATION
I2	1855761.79	990844.55	644.89
I4	1855744.79	990865.15	645.06
I14	1855766.97	990846.86	644.37
I15	1855769.45	990849.38	644.37
I17	1855765.88	990848.01	644.43
I18	1855753.87	990860.73	644.92
I19	1855745.60	990866.35	645.07
I20	1855780.80	990869.79	644.66
I21	1855780.44	990868.56	644.64
I22	1855778.93	990869.02	644.70
I23	1855780.29	990874.65	645.27
I24	1855762.86	990873.95	644.97

POINT	NORTHING	EASTING	ELEVATION
I25	1855754.59	990879.57	645.12
I26	1855807.92	990864.11	644.04
I27	1855805.78	990879.35	644.31
I28	1855750.61	990836.54	644.39
I30	1855749.73	990838.85	644.82

POINT	NORTHING	EASTING	ELEVATION
J1	1855860.30	990848.42	644.19
J2	1855874.33	990853.72	644.06
J3	1855848.49	990879.64	643.78
J4	1855864.48	990879.78	643.50
J6	1855830.79	990888.93	644.19
J7	1855828.06	990894.31	644.75
J8	1855832.68	990889.34	644.15
J9	1855843.68	990903.09	644.30
J10	1855864.09	990882.04	643.43
J11	1855870.27	990884.36	643.75
J12	1855859.01	990895.09	644.04
J13	1855849.64	990914.51	644.49

POINT	NORTHING	EASTING	ELEVATION
J14	1855864.97	990906.52	644.23

**NOTE: THIS SHEET IS FOR USE IN LAYING OUT CURB RAMP ONLY. SEE OTHER SHEETS FOR EXISTING CONDITIONS, REMOVALS, PROPOSED IMPROVEMENTS, ETC.**


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**STATE OF ILLINOIS  
DEPARTMENT OF TRANSPORTATION**

**AURORA TRANSIT CENTER IMPROVEMENTS  
ATC ENTRANCE ADA DETAILS**

SCALE: 10' SHEET 41 OF 254 SHEETS STA. TO STA.

F.A.U. RTE. 2503	SECTION 16-00313-00-MS	COUNTY KANE	TOTAL SHEETS 254	SHEET NO. 95
CONTRACT NO. 61E18				
ILLINOIS FED. AID PROJECT				

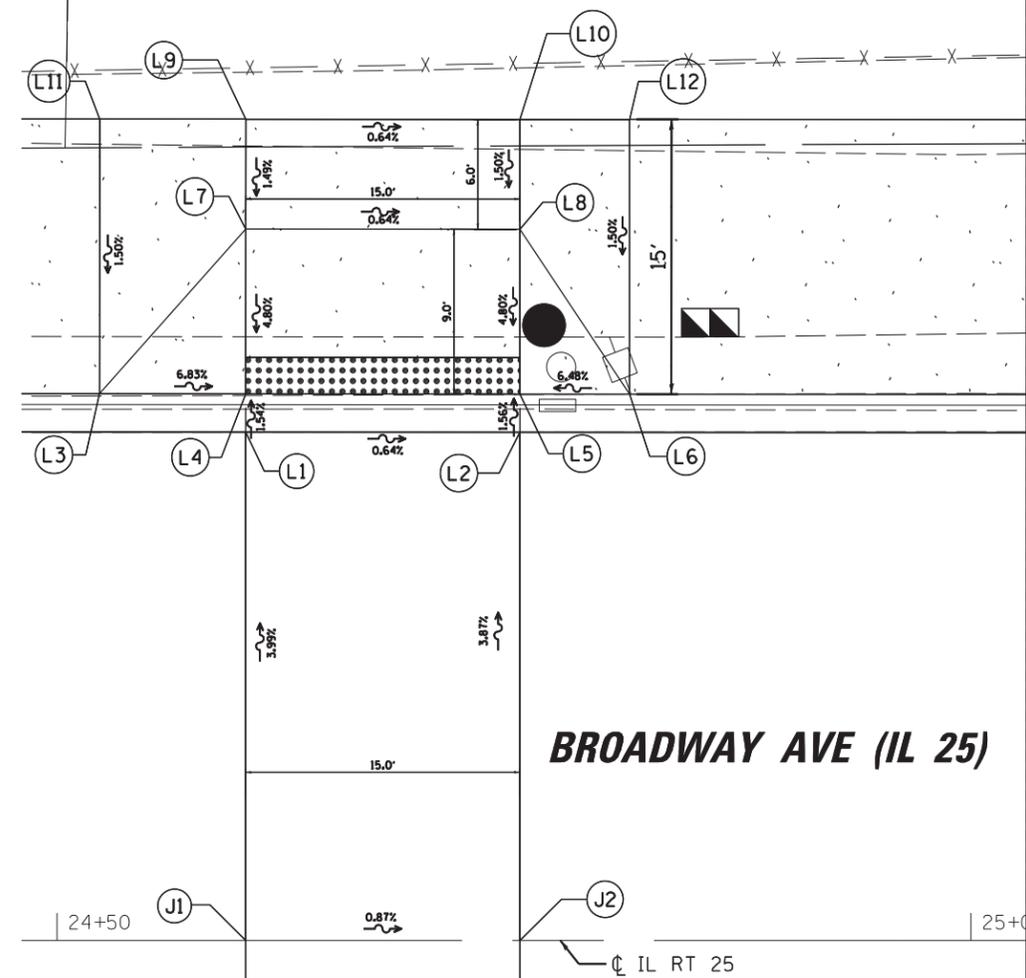

**BROADWAY AVE (IL 25)**

**NW CORNER**  
ATC ENTRANCE

LEGEND	
	PROPOSED SIDE CURB
	PROPOSED P.C.C. SIDEWALK
	PROPOSED DETECTABLE WARNINGS
	REMOVE EXIST. ITEM
	EXISTING ELEVATION/LENGTH
	EXISTING SLOPE
	NEW SIGNAL POLE (SEE SIGNAL PLANS)
	NEW HANDHOLE

NOTE: THIS SHEET IS FOR USE IN LAYING OUT CURB RAMPs ONLY. SEE OTHER SHEETS FOR EXISTING CONDITIONS, REMOVALS, PROPOSED IMPROVEMENTS, ETC.

POINT	NORTHING	EASTING	ELEVATION
L1	1855870.10	990822.47	643.08
L2	1855884.13	990827.78	642.99
L3	1855863.36	990817.69	643.60
L4	1855870.84	990820.52	643.05
L5	1855884.87	990825.83	642.96
L6	1855890.48	990827.95	643.34
L7	1855874.03	990812.10	643.48
L8	1855888.05	990817.41	643.39
L9	1855876.15	990806.49	643.57
L10	1855890.18	990811.80	643.48
L11	1855868.66	990803.66	643.82
L12	1855895.79	990813.92	643.57





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**STATE OF ILLINOIS**  
**DEPARTMENT OF TRANSPORTATION**

**AURORA TRANSIT CENTER IMPROVEMENTS**  
**ATC ENTRANCE ADA DETAILS**

SCALE: 10' SHEET 42 OF 254 SHEETS STA. TO STA.

F.A.U. RTE.	SECTION	COUNTY	TOTAL SHEETS	SHEET NO.
2503	16-00313-00-MS	KANE	254	96
CONTRACT NO. 61E18				
ILLINOIS FED. AID PROJECT				

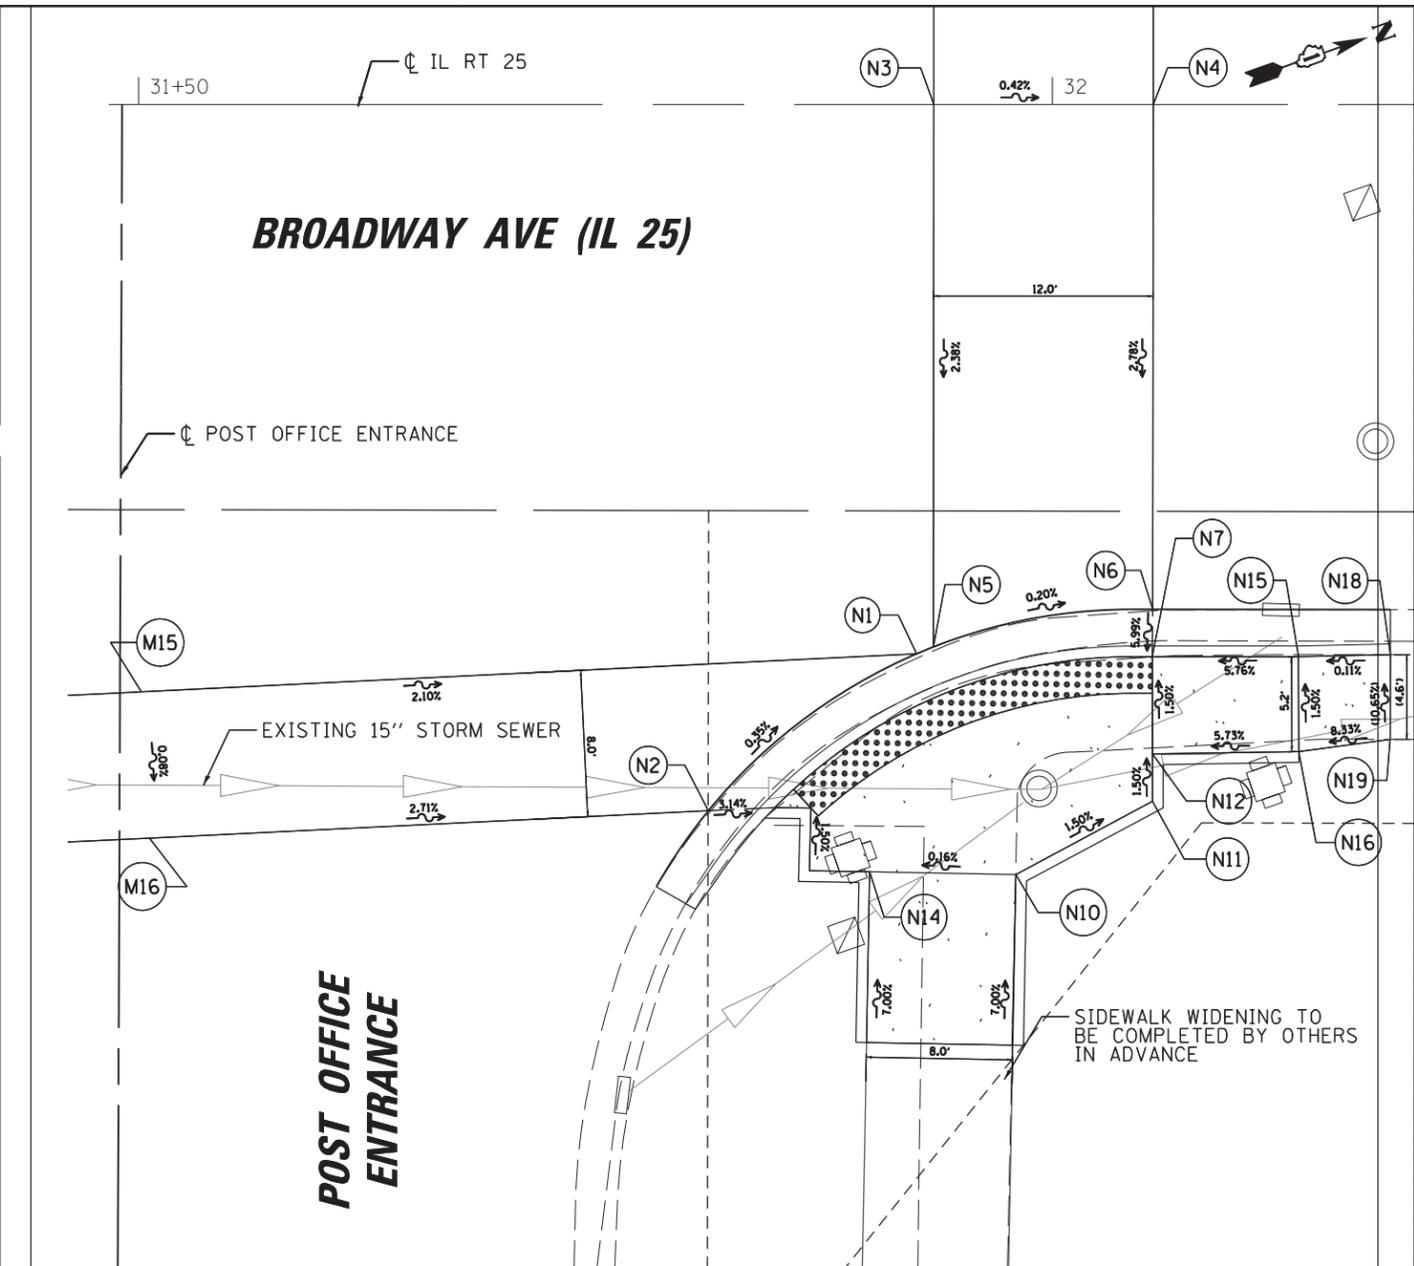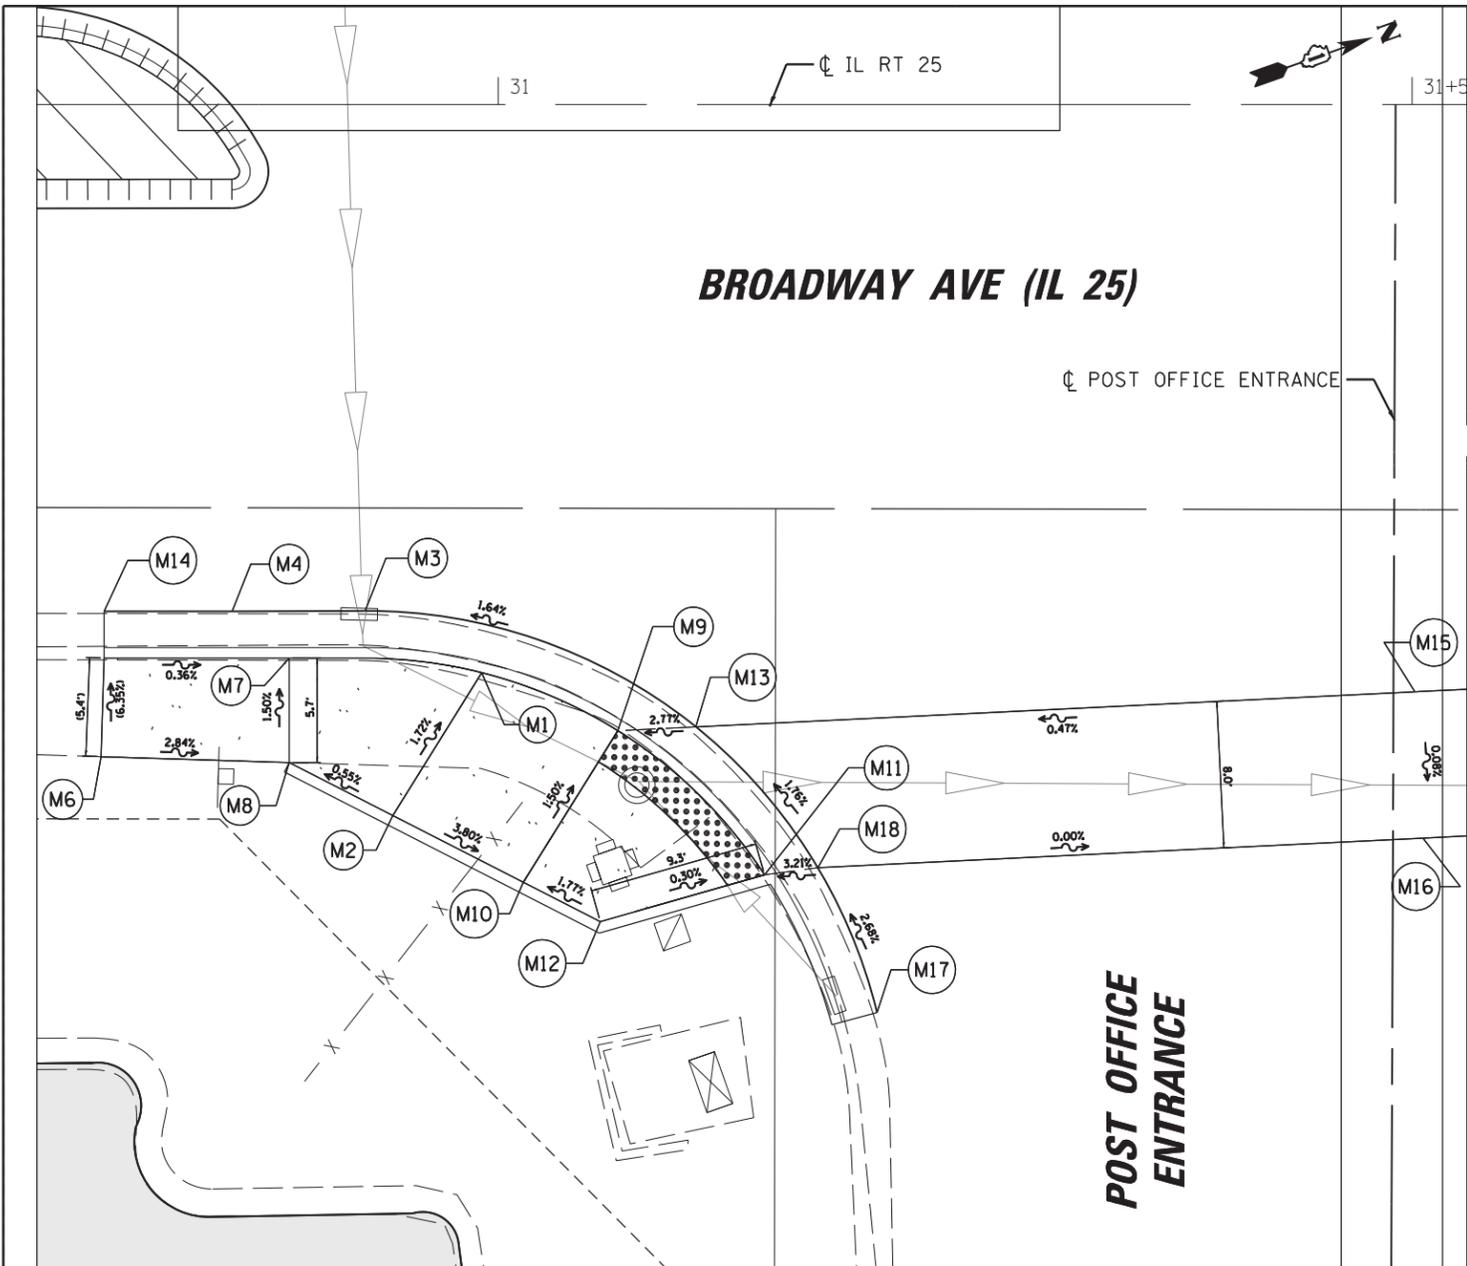

**SE CORNER**  
POST OFFICE ENTRANCE

**NE CORNER**  
POST OFFICE ENTRANCE

**LEGEND**

	PROPOSED P.C.C. SIDEWALK		PROPOSED SIDE CURB
	PROPOSED DETECTABLE WARNINGS	(XXX.XX)	EXISTING ELEVATION/LENGTH
	NEW HANDHOLE	(%)	EXISTING SLOPE
	REMOVE EXIST. ITEM	●	NEW SIGNAL POLE (SEE SIGNAL PLANS)

POINT	NORTHING	EASTING	ELEVATION
M1	1856449.58	991097.98	639.04
M2	1856442.41	991103.73	639.20
M3	1856444.68	991092.70	638.55
M4	1856437.80	991090.32	638.60
M6	1856428.41	991095.44	639.45
M7	1856439.90	991093.76	639.08
M8	1856438.02	991099.14	639.16
M9	1856455.57	991103.44	638.75
M10	1856447.96	991109.54	638.89
M11	1856460.54	991113.51	638.95
M12	1856451.22	991112.96	638.98
M13	1856459.66	991104.65	638.86

POINT	NORTHING	EASTING	ELEVATION
M14	1856431.19	991088.01	638.66
M15	1856497.43	991115.84	639.05
M16	1856495.21	991123.53	639.04
M17	1856463.87	991122.64	639.27
M18	1856463.43	991114.11	639.04

**NOTE:** THIS SHEET IS FOR USE IN LAYING OUT CURB RAMPS ONLY. SEE OTHER SHEETS FOR EXISTING CONDITIONS, REMOVALS, PROPOSED IMPROVEMENTS, ETC.


POINT	NORTHING	EASTING	ELEVATION
N1	1856538.15	991127.91	638.16
N2	1856524.56	991132.22	638.21
N3	1856548.94	991099.93	638.84
N4	1856560.27	991103.89	638.79
N5	1856539.14	991127.85	638.14
N6	1856551.14	991129.88	638.03
N7	1856550.26	991132.31	637.95
N10	1856539.30	991141.07	638.20
N11	1856547.67	991139.77	638.07
N12	1856548.52	991137.33	638.03
N14	1856531.79	991138.29	638.18
N15	1856557.82	991134.96	638.41

POINT	NORTHING	EASTING	ELEVATION
N16	1856556.12	991139.86	638.49
N17	1856525.29	991155.82	639.49
N18	1856562.60	991136.51	638.42
N19	1856561.06	991140.87	638.91
N20	1856526.94	991151.36	639.16
N21	1856532.79	991158.60	639.51






SIDWALK RAMP LAYOUT 1 (PARKING LOT X)

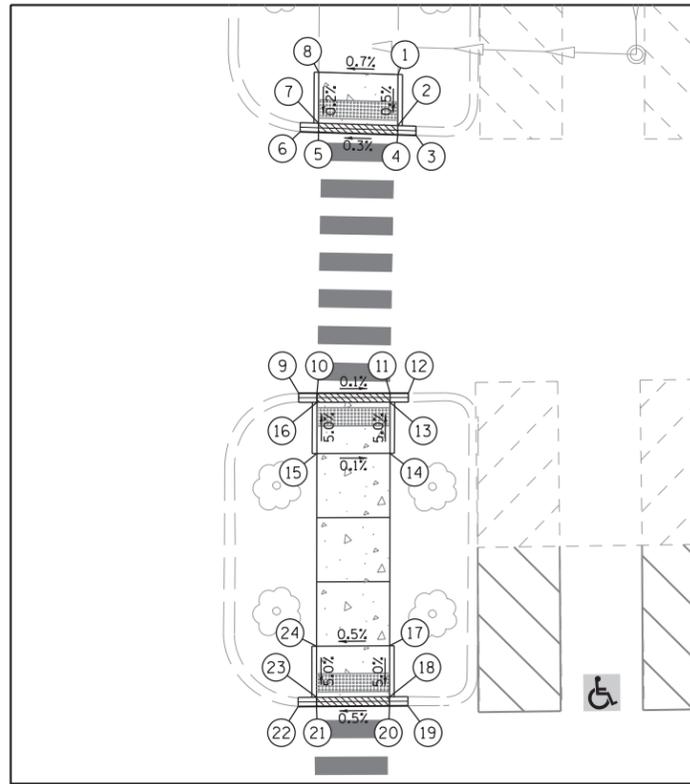

LAYOUT TABLE 1  
PARKING LOT X BASELINE

POINT	STATION/OFFSET	ELEV.
1	30+73.9, 92.6' LT	643.65
2	30+73.9, 87.1' LT	643.61
3	30+75.9, 86.0' LT	643.55
4	30+73.9, 86.1' LT	643.54
5	30+65.2, 86.3' LT	643.51
6	30+63.2, 86.4' LT	643.50
7	30+65.2, 87.3' LT	643.58
8	30+65.3, 92.9' LT	643.59
9	30+63.0, 57.8' LT	643.36
10	30+65.0, 57.9' LT	643.41
11	30+73.0, 57.9' LT	643.40
12	30+75.0, 57.9' LT	643.40
13	30+73.0, 56.9' LT	643.47
14	30+73.0, 51.3' LT	643.75
15	30+65.0, 51.3' LT	643.76
16	30+65.0, 56.9' LT	643.48
17	30+73.0, 30.3' LT	643.64
18	30+73.0, 24.7' LT	643.36
19	30+75.0, 23.7' LT	643.30
20	30+73.0, 23.7' LT	643.29
21	30+65.0, 23.7' LT	643.25
22	30+63.0, 23.7' LT	643.25
23	30+65.0, 24.7' LT	643.32
24	30+65.0, 30.2' LT	643.60


SIDWALK RAMP LAYOUT 2 (PARKING LOT X)

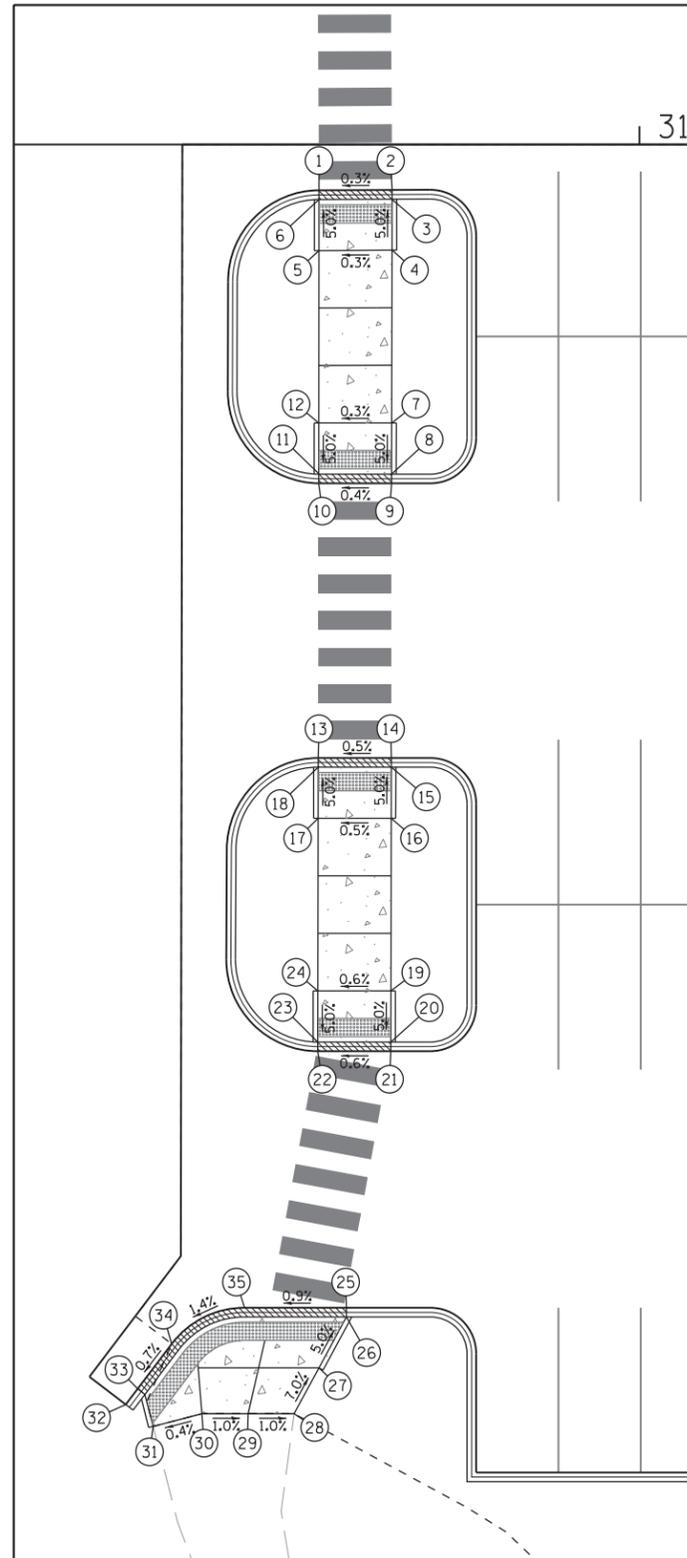

LAYOUT TABLE 2  
PARKING LOT X BASELINE

POINT	STATION/OFFSET	ELEV.
1	30+64.9, 5.0' RT	643.08
2	30+72.9, 5.0' RT	643.10
3	30+72.9, 6.0' RT	643.17
4	30+72.9, 11.5' RT	643.45
5	30+64.9, 11.6' RT	643.43
6	30+64.9, 6.0' RT	643.15
7	30+72.9, 30.4' RT	643.15
8	30+72.9, 36.0' RT	642.87
9	30+72.9, 37.0' RT	642.80
10	30+64.9, 37.0' RT	642.77
11	30+64.9, 35.9' RT	642.84
12	30+64.9, 30.4' RT	643.12
13	30+64.9, 67.0' RT	642.48
14	30+72.9, 67.0' RT	642.52
15	30+72.9, 68.0' RT	642.59
16	30+72.8, 73.5' RT	642.87
17	30+64.8, 73.5' RT	642.83
18	30+64.9, 68.0' RT	642.55
19	30+72.8, 92.4' RT	642.57
20	30+72.8, 98.0' RT	642.29
21	30+72.8, 99.0' RT	642.22
22	30+64.8, 99.0' RT	642.17
23	30+64.8, 98.0' RT	642.24
24	30+64.8, 92.4' RT	642.52
25	30+68.0, 127.0' RT	642.02
26	30+68.0, 128.0' RT	642.09
27	30+64.9, 133.5' RT	642.41
28	30+62.2, 138.5' RT	641.81
29	30+57.2, 138.5' RT	641.85
30	30+52.1, 138.5' RT	641.90
31	30+46.8, 139.9' RT	641.88
32	30+43.8, 137.5' RT	641.73
33	30+45.1, 135.8' RT	641.75
34	30+48.8, 130.9' RT	641.79
35	30+56.8, 127.0' RT	641.92

SIDWALK RAMP LAYOUT 3 (MULTI-USE PATH)

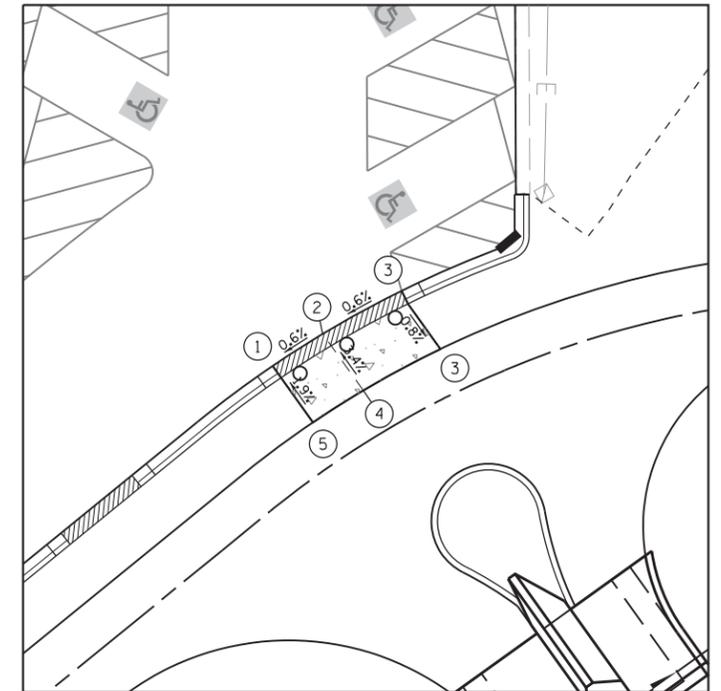

LAYOUT TABLE 3  
MULTI-USE PATH ALIGNMENT

POINT	STATION/OFFSET	ELEV.
1	12+48.4, 12.6' LT	639.66
2	12+54.2, 12.6' LT	639.70
3	12+63.0, 12.6' LT	639.76
4	12+63.9, 5.0' LT	639.70
5	12+54.8, 5.0' LT	639.97
6	12+48.6, 5.0' LT	939.80

NOTES:

- ALL STATION AND OFFSETS ARE REFERENCED TO THE ALIGNMENT OR BASELINE AS NOTED IN THE LAYOUT TABLE.
- ELEVATIONS IN THE LAYOUT TABLE ITALICIZED INDICATE THE ELEVATION SHALL MATCH THE EXISTING CONDITIONS.
- REFER TO STANDARD DETAIL 424021 FOR DEPRESSED CORNER FOR SIDEWALKS

FILE NAME = W:\Projects\2016\180194\_ATCPhaseII\cadd\Civil\Drawn\Shd\ADA\_01.dgn



WBK ENGINEERING, LLC  
116 WEST MAIN STREET, SUITE 201  
ST. CHARLES, ILLINOIS 60174  
(630) 443-7755

USER NAME = nparris  
PLOT SCALE = 1:20  
PLOT DATE = 10/17/2017

DESIGNED - MNB  
DRAWN - NDP  
CHECKED - MNB  
DATE - 10/18/17

REVISED -  
REVISED -  
REVISED -  
REVISED -

STATE OF ILLINOIS  
DEPARTMENT OF TRANSPORTATION

ADA CORNER DETAILS  
PARKING LOT X & PARKING LOT W  
SCALE: 1"=20'  
SHEET NO. 9 OF 9 SHEETS STA. TO STA.

F.A.U. RTE.	SECTION	COUNTY	TOTAL SHEETS	SHEET NO.
2503	16-00313-00-MS	KANE	254	99
CONTRACT NO. 61E18				
ILLINOIS FED. AID PROJECT				

