

018

01-18-2019 LETTING ITEM 018


STATE OF ILLINOIS
DEPARTMENT OF TRANSPORTATION

DIVISION OF HIGHWAYS

PROPOSED
HIGHWAY BRIDGE REPAIR PLANS

FAP ROUTE 404 (IL ROUTE 40)
SECTION (50B-4)BR;12[(HVB,HB)BR]BR
PROJECT NHPP-HK6S(511)
BRIDGE REHABILITATION
TAZEWELL COUNTY

C-94-054-17

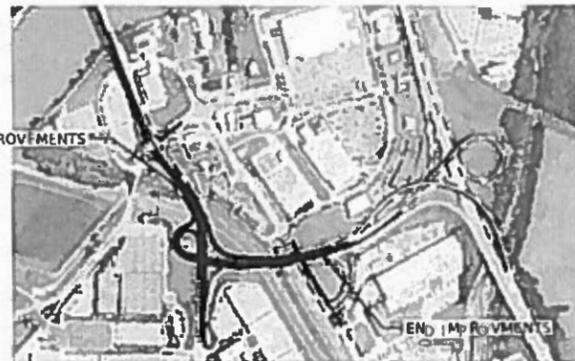


PROJECT DESCRIPTION: REHABILITATION OF STRUCTURES 080-0044, 090-0046 AND 090-0120

F.A.P. RTE.	SECTION	COUNTY	TOTAL SHEETS	SHEET NO.
404	(50B-4)BR;12[(HVB,HB)BR]BR	TAZEWELL	61	1
ILLINOIS			CONTRACT NO. 68D59	

*61 + 6 = 67 TOTAL SHEETS

D94-026-17

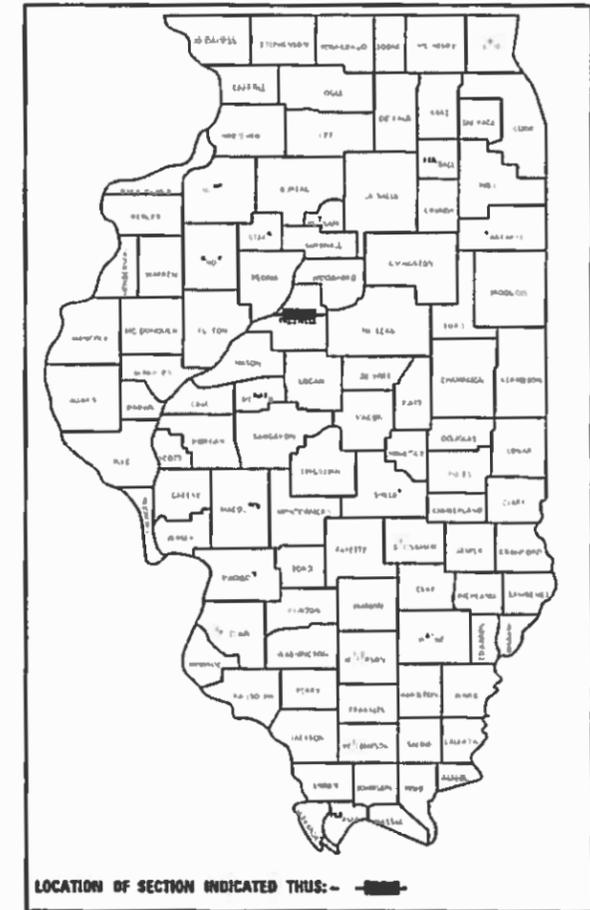

LOCATION OF SECTION INDICATED THUS: [shaded area]

FOR INDEX OF SHEETS SEE SHEET NO 2
FOR HIGHWAY STANDARDS SEE SHEET NO 2

FUNCTIONAL CLASSIFICATION
URBAN OTHER PRINCIPAL ARTERIAL

TRAFFIC DATA
IL 40/WASHINGTON STREET
EXISTING ADT=17300
S.U. = 1.5%
M.U. = 1.5%

IL 40
EXISTING ADT = 8600
S.U. = 1.5%
M.U. = 1.5%

POSTED SPEED (40)



FULL SIZE PLANS HAVE BEEN PREPARED USING STANDARD ENGINEERING SCALES. REDUCED SIZED PLANS WILL NOT CONFORM TO STANDARD SCALES. IN MAKING MEASUREMENTS ON REDUCED PLANS, THE ABOVE SCALES MAY BE USED.

J.U.L.I.E.
JOINT UTILITY LOCATION INFORMATION FOR EXCAVATION
1-800-892-0123
OR 811

PROJECT ENGINEER: MIKE LEWIS 309-671-3454
PROJECT MANAGER: MIKE MCLUCKIE 309-671-3468

CONTRACT NO. 68D59 CATALOG NO. 035477-00D



EXPIRES 11/30/2018

Bryan C. Donze
SIGNATURE

10/19/2018

DATE

1-18

SHEETS



EXPIRES 11/30/2018

Benjamin Boyce
SIGNATURE

10/19/2018

DATE

15-61

SHEETS

GROSS LENGTH = 6287.94 FT. = 1.19 MILE

NET LENGTH = 1280.21 FT. = 0.12 MILE

STATE OF ILLINOIS
DEPARTMENT OF TRANSPORTATION

SUBMITTED October 19, 2018
Kenneth A. Somerville
REGION THREE ENGINEER

Dee
ENGINEER OF DESIGN AND ENVIRONMENT

Paul P. Chit
DIRECTOR OF HIGHWAY PROJECT IMPLEMENTATION

PRINTED BY THE AUTHORITY
OF THE STATE OF ILLINOIS

INDEX OF SHEETS

1	COVER SHEET
2	INDEX OF SHEETS, HIGHWAY STANDARDS, GENERAL NOTES AND COMMENTS
3-4	SUMMARY OF QUANTITIES
5-7	TYPICAL SECTIONS
8-8A	SCHEDULES
8B-8C	MAINTENANCE OF TRAFFIC, PRE-STAGE
9-11	MAINTENANCE OF TRAFFIC, STAGE 1
12-14	MAINTENANCE OF TRAFFIC, STAGE 2
15-16	ADVANCED SIGNING
17-18	RAMP CLOSURE DETOUR ROUTES
18A	WASHINGTON ST. MEDIAN REMOVAL DETAILS
18B-18C	WASHINGTON ST. MEDIAN MODIFICATION DETAILS
19-31	SN 090-0044
32-46	SN 090-0046
47-61	SN 090-0120

HIGHWAY STANDARDS

000001-07	STANDARD SYMBOLS, ABBREVIATIONS AND PATTERNS
701456-05	PARTIAL EXIT RAMP CLOSURE, FREEWAY / EXPRESSWAY
701601-09	URBAN LANE CLOSURE, MULTILANE, 1W OR 2W WITH NONTRANSVERSABLE MEDIAN
701611-01	URBAN HALF ROAD CLOSURE, MULTILANE, 2W WITH MOUNTABLE MEDIAN
701701-10	URBAN LANE CLOSURE, MULTILANE INTERSECTION
701801-06	SIDEWALK, CORNER OR CROSSWALK CLOSURE
701901-08	TRAFFIC CONTROL DEVICES
704001-08	TEMPORARY CONCRETE BARRIER

GENERAL NOTES

PRIOR TO ROUTING TRAFFIC ONTO THE SHOULDERS AS SHOWN IN THE STAGING PLANS, THE CONTRACTOR SHALL SECURE GRATINGS ON SHOULDER INLETS AS DIRECTED BY THE ENGINEER. THIS WORK WILL NOT BE PAID FOR SEPARATELY, BUT SHALL BE INCLUDED IN THE COST OF THE TRAFFIC CONTROL PAY ITEM.

THE DEPARTMENT RESERVES THE RIGHT AT ANY TIME TO ADD ADDITIONAL TRAFFIC CONTROL SYSTEMS OR DEVICES WITHIN THE ACTIVE CONTRACT LIMITS, BY MEANS OF AN ADDITIONAL CONTRACT. ALL TERMS OF ARTICLE 105.08 OF THE STANDARD SPECIFICATIONS SHALL BE FOLLOWED BY EACH CONTRACTOR.

SIGN LOCATIONS MAY VARY FROM THE STATIONS SHOWN ON THE PLANS IN ACCORDANCE WITH DIRECTIONS FROM THE ENGINEER AT THE TIME OF CONSTRUCTION. SIGN LOCATIONS MAY BE ADJUSTED IN THE FIELD TO AVOID ANY FOUND UTILITIES.

ALL WOOD POST LOCATIONS SHALL BE VERIFIED WITH THE BUREAU OF OPERATIONS, TRAFFIC SECTION, BEFORE INSTALLATION.

TRAFFIC CONTROL ITEMS SHALL BE PAID FOR BY LUMP SUM TRAFFIC CONTROL AND PROTECTION, (SPECIAL). SEE HIGHWAY STANDARDS AND SPECIAL PROVISIONS FOR ADDITIONAL DETAILS. ALL SIGNS AND TEMPORARY PAVEMENT MARKINGS SHALL BE INCLUDED IN THE PAY ITEM.

EXISTING PAVEMENT MARKINGS IN CONFLICT WITH TEMPORARY PAVEMENT MARKINGS SHALL BE COVERED WITH PAVEMENT MARKING BLACKOUT TAPE OR HYDROBLASTED AND SHALL BE INCLUDED IN THE COST OF TRAFFIC CONTROL AND PROTECTION, (SPECIAL).

MODEL: Default
FILE NAME: P:\09-000622.IDOT.D4.MOT.Plans\10_CAD\CADD_Sheets\1468D59_41002.MOT_germanes.dgn

USER NAME = bcd	DESIGNED - BCD	REVISED - 11/21/2018	STATE OF ILLINOIS DEPARTMENT OF TRANSPORTATION	INDEX OF SHEETS, HIGHWAY STANDARDS GENERAL NOTES AND COMMENTS	F.A.P. RTE.	SECTION	COUNTY	TOTAL SHEETS	SHEET NO.	
DRAWN - GDC	CHECKED - LDC	REVISED -			404	(50B-4)BR;12[(HVB,HB)BR]BR	TAZEWELL	61	2	
PLOT SCALE = 1:50	DATE - 10/8/2018	REVISED -			CONTRACT NO.68D59					
PLOT DATE = 11/21/2018	DATE - 10/8/2018	REVISED -			SCALE:	SHEET	OF	SHEETS	STA.	TO STA.

CODE No.	ITEM	UNIT	CONSTRUCTION TYPE CODE				
			TOTAL QUANTITY	URBAN BRIDGE	URBAN BRIDGE	URBAN BRIDGE	URBAN ROADWAY
				SN-090-0044	SN 090-0046	SN 090-0120	
				0013	0013	0013	0006
70103815	TRAFFIC CONTROL SURVEILLANCE	CAL DA	120	40	40	40	
70107025	CHANGEABLE MESSAGE SIGN	CAL DA	480	160	160	160	
70400100	TEMPORARY CONCRETE BARRIER	FOOT	2400	1875		525	
70400200	RELOCATE TEMPORARY CONCRETE BARRIER	FOOT	500			500	
70600260	IMPACT ATTENUATORS, TEMPORARY (FULLY, REDIRECTIVE, NARROW), TEST LEVEL 3	EACH	2	1		1	
70600332	IMPACT ATTENUATORS, RELOCATE (FULLY, REDIRECTIVE, NARROW), TEST LEVEL 3	EACH	1			1	
78009004	MODIFIED URETHANE PAVEMENT MARKING - LINE 4"	FOOT	12105				12105
78009006	MODIFIED URETHANE PAVEMENT MARKING - LINE 6"	FOOT	1054				1054
78009008	MODIFIED URETHANE PAVEMENT MARKING - LINE 8"	FOOT	2336				2336
78009012	MODIFIED URETHANE PAVEMENT MARKING - LINE 12"	FOOT	330				330
X4402020	CONCRETE MEDIAN SURFACE REMOVAL	SQ FT	1695				1695
X5060603	CONTAINMENT AND DISPOSAL OF NON-LEAD PAINT CLEANING RESIDUES NO. 3	L SUM	1			1	
X6064500	COMBINATION CONCRETE CURB AND GUTTER, TYPE B-6.24 (TEMPORARY)	FOOT	188				188
X7010216	TRAFFIC CONTROL AND PROTECTION, (SPECIAL)	L SUM	1	0.34	0.33	0.33	
Z0001899	JACK AND REMOVE EXISTING BEARINGS	EACH	67	27	40		
Z0001905	STRUCTURAL STEEL REPAIR	POUND	2540		2540		
Z0007101	CONTAINMENT AND DISPOSAL OF LEAD PAINT CLEANING RESIDUES NO. 1	L SUM	1	1			
Z0007102	CONTAINMENT AND DISPOSAL OF LEAD PAINT CLEANING RESIDUES NO. 2	L SUM	1		1		
Z0012754	STRUCTURAL REPAIR OF CONCRETE (DEPTH EQUAL TO OR LESS THAN 5")	SQ FT	3754.9	3658.9	96		
Z0016200	DECK SLAB REPAIR (PARTIAL)	SQ YD	225.0	225.0			
Z0021920	SILICONE JOINT SEALER SPECIAL	FOOT	40	36	4		
Z0032400	JOINT REPAIR	EACH	14	11	3		
Z0062456	TEMPORARY PAVEMENT	SQ YD	230				230
Z0073200	TEMPORARY SHORING AND CRIBBING	EACH	97	57	40		

MODEL: Summary of Quantities
 FILE NAME: P:\09\06\22\DOT\DA\MOT\Plans\10_CAD\CADD_Sheets\468D59_sht004_MOT_SummaryOfQuantities_02.dgn

USER NAME = bcd	DESIGNED - BCD	REVISED - 11/21/2018
	DRAWN - GDC	REVISED -
PLOT SCALE = 1:1	CHECKED - LDC	REVISED -
PLOT DATE = 11/21/2018	DATE - 10/8/2018	REVISED -

**STATE OF ILLINOIS
DEPARTMENT OF TRANSPORTATION**

SUMMARY OF QUANTITIES

SCALE: SHEET OF SHEETS STA. TO STA.

F.A.P. RTE.	SECTION	COUNTY	TOTAL SHEETS	SHEET NO.
404	(50B-4)BR;12[(HVB,HB)BR]BR	TAZEWELL	61	4
ILLINOIS FED. AID PROJECT			CONTRACT NO.68D59	

STAGE 1

TRAFFIC

MAINTAIN A MINIMUM OF ONE LANE OF TRAFFIC IN BOTH WEST WASHINGTON STREET EB AND WEST WASHINGTON STREET WB DIRECTIONS AT ALL TIMES.


BRIDGE CONSTRUCTION

CONSTRUCT WEST WASHINGTON STREET SB DRIVING LANE.


SEE PROPOSED TYPICAL SECTION SHEETS FOR DETAILED INFORMATION.

PRIMARY IDOT STANDARDS THIS STAGE
(SEE SPECIAL PROVISIONS FOR ADDITIONAL APPLICABLE STANDARDS)

701400, 701456, 701611, 701701

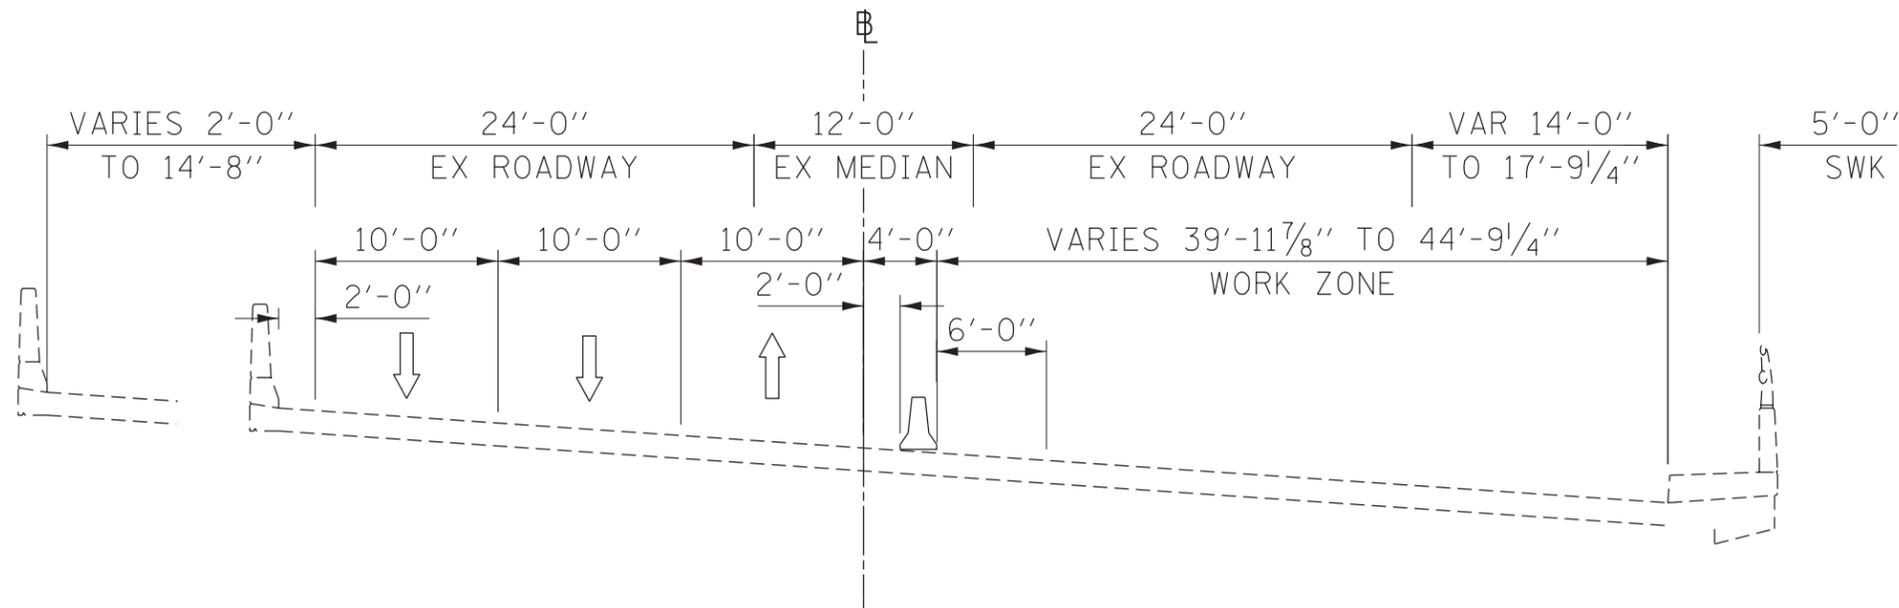

STAGE 1 - TYPICAL SECTION
WEST WASHINGTON STREET

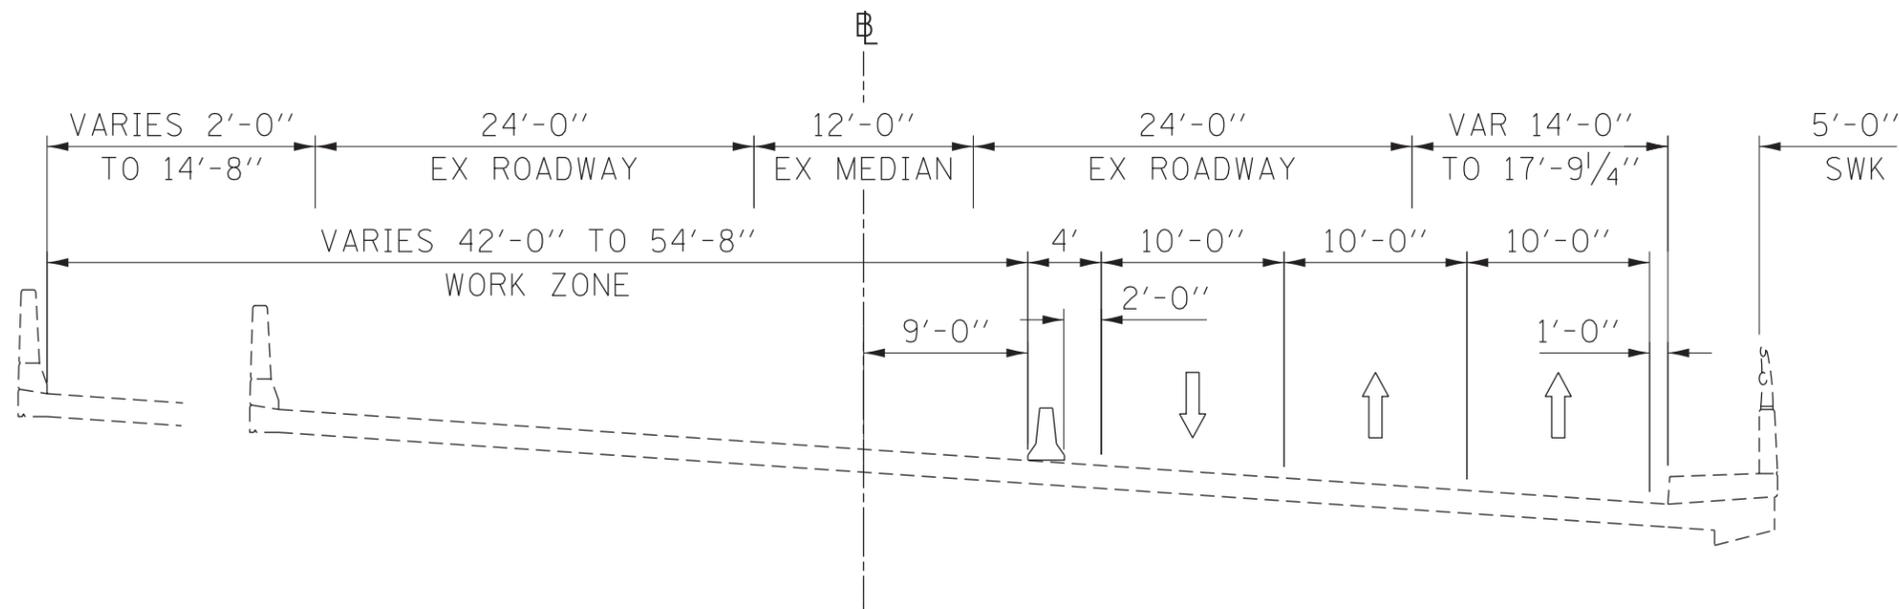

STAGE 2 - TYPICAL SECTION
WEST WASHINGTON STREET

STAGE 2

TRAFFIC

MAINTAIN A MINIMUM OF ONE LANE OF TRAFFIC IN BOTH WEST WASHINGTON STREET EB AND WEST WASHINGTON STREET WB DIRECTIONS AT ALL TIMES.

BRIDGE CONSTRUCTION

CONSTRUCT WEST WASHINGTON STREET NB.

SEE PROPOSED TYPICAL SECTION SHEETS FOR DETAILED INFORMATION.

PRIMARY IDOT STANDARDS THIS STAGE
(SEE SPECIAL PROVISIONS FOR ADDITIONAL APPLICABLE STANDARDS)

701400, 701456, 701611, 701701

SECTIONS LOOKING SOUTH

MODEL: West Washington Typical
FILE NAME: P:\090622 IDOT\DOT Plans\10 CAD\CADD Sheets\090622_017_01002_MOT_Typical.dgn

USER NAME = gdc	DESIGNED - BCD	REVISED -
	DRAWN - GDC	REVISED -
PLOT SCALE = 1:5	CHECKED - LDC	REVISED -
PLOT DATE = 10/19/2018	DATE - 10/8/2018	REVISED -

STATE OF ILLINOIS
DEPARTMENT OF TRANSPORTATION

SUGGESTED MAINTENANCE OF TRAFFIC
TYPICAL SECTIONS - SN 009-0120 OVER FARM CREEK

SCALE: 1"=5' SHEET OF SHEETS STA. TO STA.

F.A.P. RTE.	SECTION	COUNTY	TOTAL SHEETS	SHEET NO.
404	(50B-4)BR:12[(HVB,HB)BR]BR	TAZEWELL	61	5
CONTRACT NO.68D59				
ILLINOIS		FED. AID PROJECT		

STAGE 1

TRAFFIC

MAINTAIN A MINIMUM OF ONE LANE OF TRAFFIC IN BOTH RIVERFRONT DRIVE SPUR EB AND WEST WASHINGTON STREET DIRECTIONS AT ALL TIMES.


CLOSE RAMP A FROM WEST WASHINGTON TO RAMP ND

BRIDGE CONSTRUCTION

CONSTRUCT RIVERFRONT DRIVE SPUR OVER WASHINGTON STREET REPAIRS FROM WEST WASHINGTON STREET

SEE PROPOSED TYPICAL SECTION SHEETS FOR DETAILED INFORMATION.

PRIMARY IDOT STANDARDS THIS STAGE
(SEE SPECIAL PROVISIONS FOR ADDITIONAL APPLICABLE STANDARDS)
701400, 701456, 701611, 701701

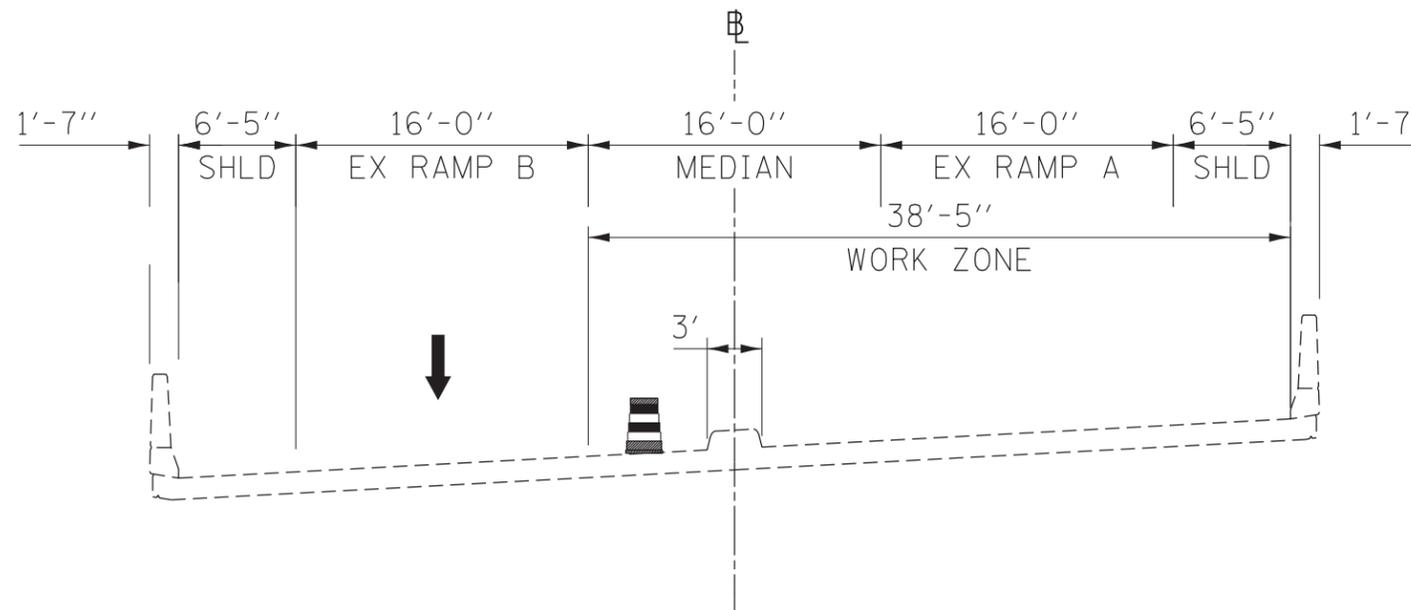

STAGE 1 - TYPICAL SECTION
RIVERFRONT DRIVE SPUR
RAMP A & RAMP B

STAGE 2

TRAFFIC


MAINTAIN A MINIMUM OF ONE LANE OF TRAFFIC IN BOTH DIRECTIONS ON RIVERFRONT DRIVE SPUR AND WEST WASHINGTON STREET. CLOSE INSIDE SHOULDERS AND MEDIAN ON RIVERFRONT DRIVE SPUR

BRIDGE CONSTRUCTION

CONSTRUCT RIVERFRONT DRIVE SPUR OVER WASHINGTON STREET REPAIRS FROM WEST WASHINGTON STREET

SEE PROPOSED TYPICAL SECTION SHEETS FOR DETAILED INFORMATION.

PRIMARY IDOT STANDARDS THIS STAGE
(SEE SPECIAL PROVISIONS FOR ADDITIONAL APPLICABLE STANDARDS)
701400, 701456, 701611, 701701

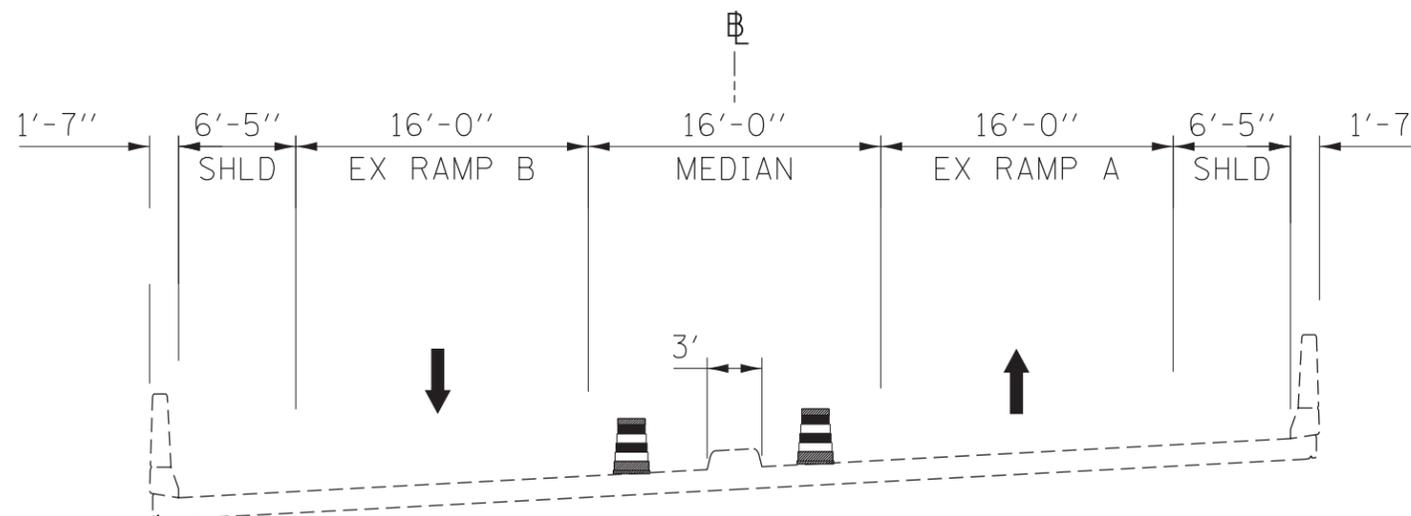

STAGE 2 - TYPICAL SECTION
RIVERFRONT DRIVE SPUR
RAMP A & RAMP B

SECTIONS LOOKING EAST

MODEL: 01_Industrial Rev_Typical.dgn
FILE NAME: P:\09-0046\22_IDOT_DI_MOT_Plans\10_CADD\CADD_Sheets\090622_17_chn003_MOT_Typical.dgn

USER NAME = gdc	DESIGNED - BCD	REVISED -
PLOT SCALE = 1:5	DRAWN - GDC	REVISED -
PLOT DATE = 10/19/2018	CHECKED - LDC	REVISED -
	DATE - 10/8/2018	REVISED -

STATE OF ILLINOIS
DEPARTMENT OF TRANSPORTATION

SUGGESTED MAINTENANCE OF TRAFFIC	
TYPICAL SECTIONS - SN 009-0046 OVER WEST WASHINGTON STREET	
SCALE: 1"=5'	SHEET OF SHEETS STA. TO STA.

F.A.P. RTE.	SECTION	COUNTY	TOTAL SHEETS	SHEET NO.
404	(50B-4)BR:12[(HVB,HB)BR]BR	TAZEWELL	61	6
CONTRACT NO.68D59				
ILLINOIS FED. AID PROJECT				

STAGE 1

TRAFFIC

MAINTAIN A MINIMUM OF ONE LANE OF TRAFFIC IN BOTH RIVERFRONT DRIVE SPUR EB AND WB AT ALL TIMES.


CLOSE RAMP A FROM WEST WASHINGTON STREET TO RAMP ND

BRIDGE CONSTRUCTION

CONSTRUCT RIVERFRONT DRIVE SPUR EB AND WB DRIVING LANE. REMOVE RAISED MEDIAN.

SEE PROPOSED TYPICAL SECTION SHEETS FOR DETAILED INFORMATION.

PRIMARY IDOT STANDARDS THIS STAGE
(SEE SPECIAL PROVISIONS FOR ADDITIONAL APPLICABLE STANDARDS)
701400, 701456, 701611, 701701

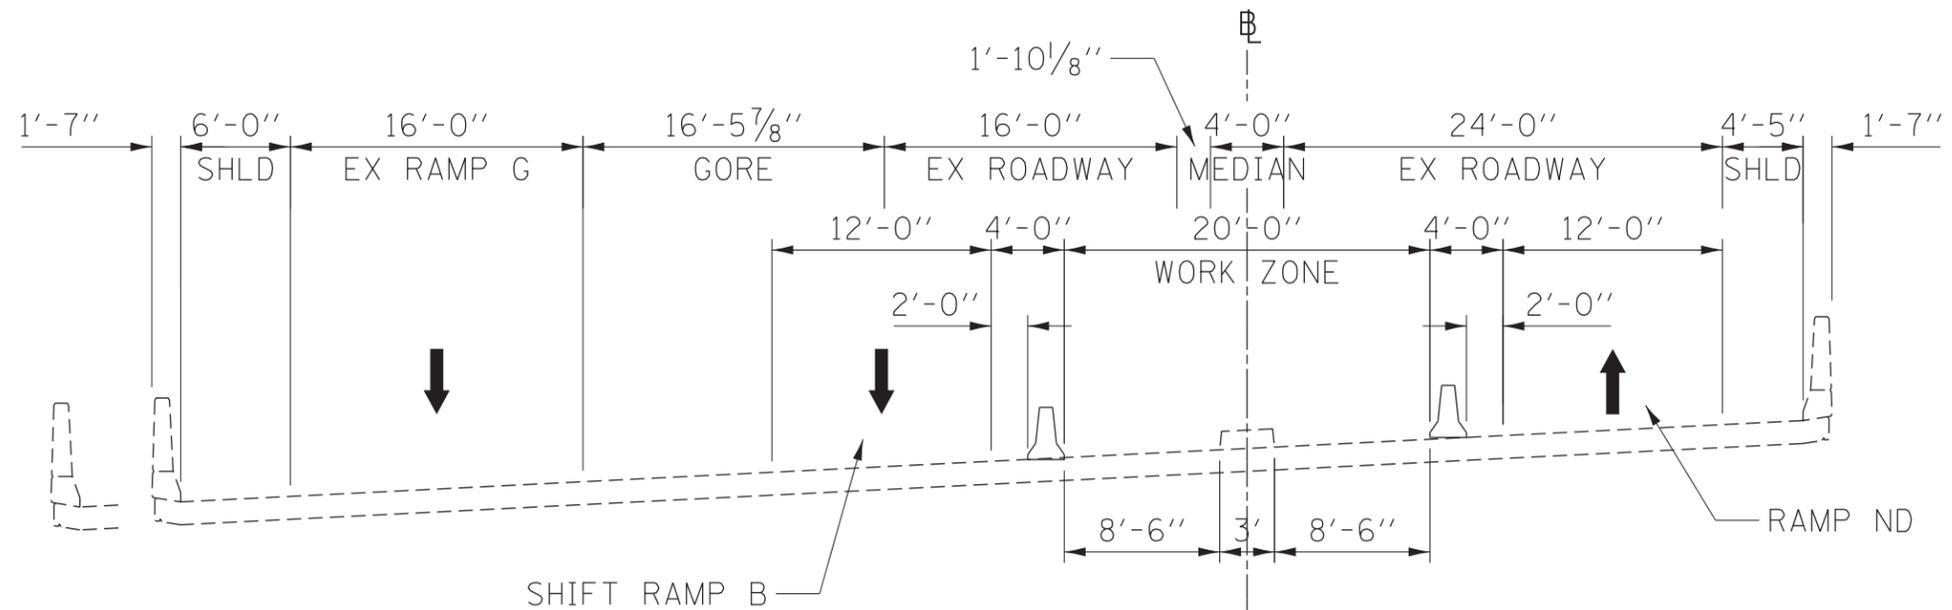

STAGE 1 - TYPICAL SECTION RIVERFRONT DRIVE SPUR

STAGE 2

TRAFFIC

MAINTAIN A MINIMUM OF ONE LANE OF TRAFFIC ON RIVERFRONT DRIVE SPUR WB TO RAMP B AND TWO LANES OF TRAFFIC ON RIVERFRONT DRIVE SPUR EB FROM RAMPS A AND ND.


CLOSE RAMP G FROM RIVERFRONT DRIVE SPUR TO WEST WASHINGTON STREET

BRIDGE CONSTRUCTION

CONSTRUCT RIVERFRONT DRIVE SPUR WB REPAIRS ALONG RAMP G

SEE PROPOSED TYPICAL SECTION SHEETS FOR DETAILED INFORMATION.

PRIMARY IDOT STANDARDS THIS STAGE
(SEE SPECIAL PROVISIONS FOR ADDITIONAL APPLICABLE STANDARDS)
701400, 701456, 701611, 701701

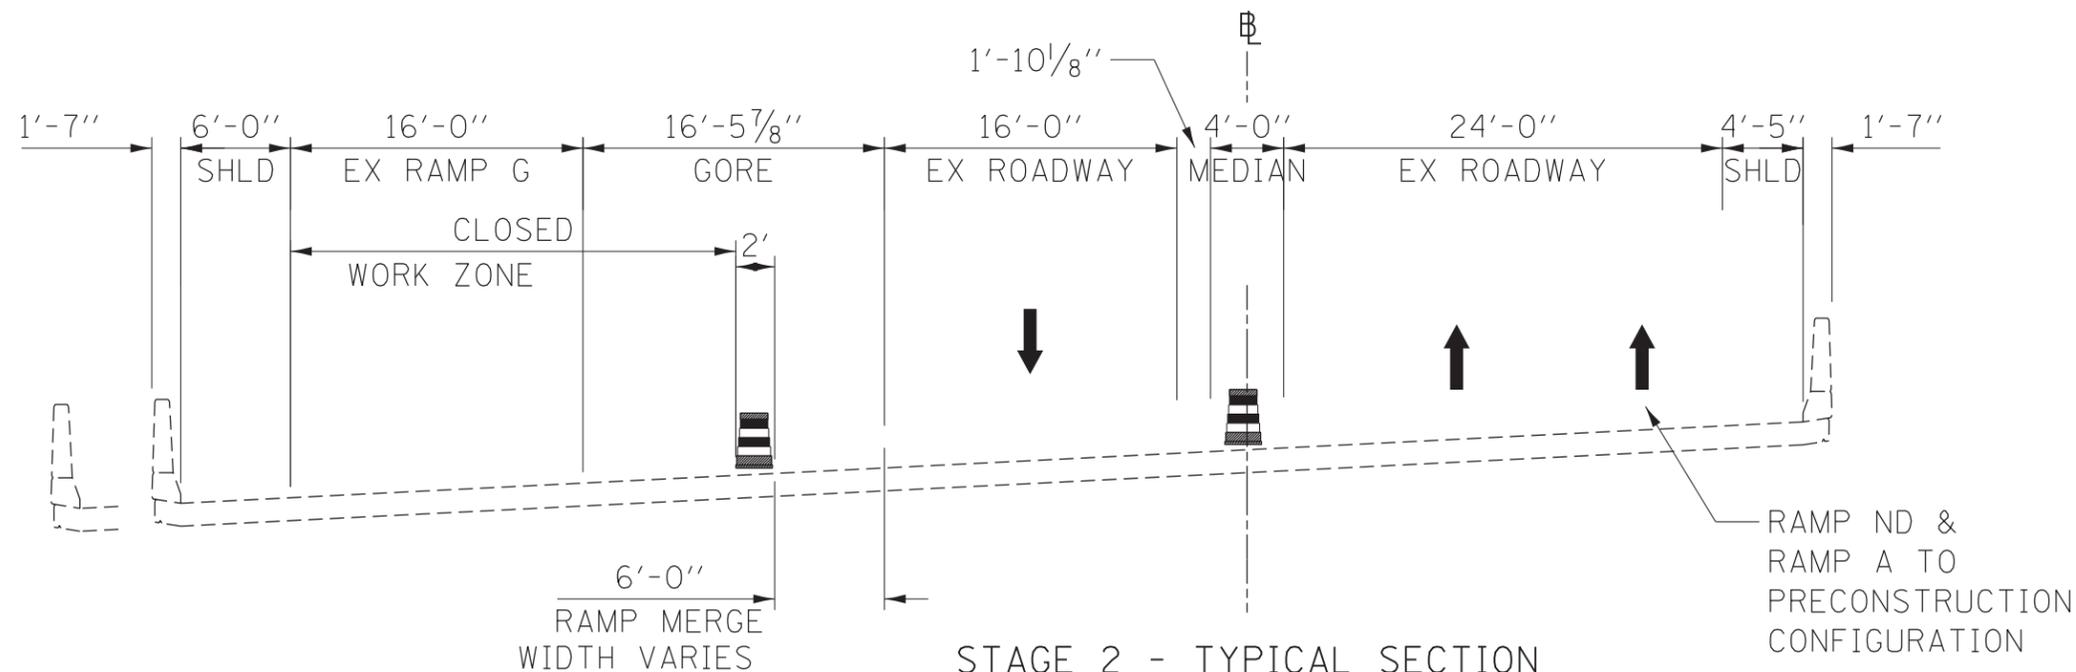

STAGE 2 - TYPICAL SECTION RIVERFRONT DRIVE SPUR

SECTIONS LOOKING EAST

MODEL: 02 - Industrial Spur Typical
FILE NAME: P:\09000221 IDOT\DOT Plans\10 CAD\CADD Sheets\09000221_eh0004_MOT_Typical.dgn

USER NAME = gdc	DESIGNED - BCD	REVISED -
DRAWN - GDC	CHECKED - LDC	REVISED -
PLOT SCALE = 1:5	DATE - 10/8/2018	REVISED -
PLOT DATE = 10/19/2018		

STATE OF ILLINOIS
DEPARTMENT OF TRANSPORTATION

SUGGESTED MAINTENANCE OF TRAFFIC			
TYPICAL SECTIONS - SN 009-0044 OVER FARM CREEK & CAMP STREET			
SCALE:	SHEET	OF SHEETS	STA. TO STA.

F.A.P. RTE.	SECTION	COUNTY	TOTAL SHEETS	SHEET NO.
404	(50B-4)BR:12[(HVB,HB)BR]BR	TAZEWELL	61	7
CONTRACT NO.68D59				
ILLINOIS		FED. AID PROJECT		

TEMPORARY CONCRETE BARRIER					
LOCATION STATION TO STATION	DESCRIPTON	TEMPORARY CONCRETE BARRIER	RELOCATE TEMPORARY CONCRETE BARRIER	IMPACT ATTENUATORS, TEMPORARY (FULLY-REDIRECTIVE NARROW)	IMPACT ATTENUATORS, RELOCATE (FULLY-REDIRECTIVE NARROW)
		70400100 FOOT	70400200 FOOT	TEST LEVEL 3 70600260 EACH	TEST LEVEL 3 7060332 EACH
WEST WASHINGTON ST					
	SN 009-0120, STAGE 1	500.0		1	
	SN 009-0120, STAGE 2	25.0	500.0		1
RIVERFRONT DRIVE SPUR					
	SN 009-0044, STAGE 1	1875.0		1	
PROJECT TOTAL		2,400.0	500.0	2	1

SCHEDULE OF MOT SIGNS

POSTED SPEED	SIGN SPACING
55	500' (150 m)
50 - 45	350' (100 m)
< 45	200' (60 m)

REFER TO SIGN SPACING TABLE FOR DISTANCES

TEMPORARY PAVEMENT MARKINGS

LOCATION STATION TO STATION	DESCRIPTION	PAVT MARK TAPE TYPE 3 OR 4, 4"		PAVT MARK TAPE TYPE 3 OR 4, 8"
		SOLID LINE 4"		DOTTED LINE 8"
		WHITE FOOT	YELLOW FOOT	WHITE FOOT
WEST WASHINGTON				
	MEDIAN MODIFICATION, PRE-STAGE	2,212		91
	SN 009-0120 & SN 009-0046, STAGE 1	3,814	1,852	
	SN 009-0120 & SN 009-0046, STAGE 2	3,184	1,737	
RIVERFRONT DRIVE SPUR				
	SN 009-0044 & SN 009-0046, STAGE 1	2,416	2,250	
	SN 009-0044 & SN 009-0046, STAGE 2	1,277	1,485	
CAMP STREET				
	SN 009-0044, STAGE 1	614		
	SN 009-0044, STAGE 2	614		
PROJECT TOTAL		14,131	7,324	91

* SCHEDULE FOR INFORMATION ONLY. PLACEMENT SHALL BE PER STANDARD OR AT THE DIRECTION OF THE ENGINEER. PAVEMENT MARKING TAPE IS INCLUDED IN THE COST OF TRAFFIC CONTROL AND PROTECTION, (SPECIAL)

MODEL: Schedule.dwg
FILE NAME: P:\09-0006-22_IDOT_D4_MOT_Plans\10_CADD\CADD_Sheets\1468D59_410008_MOT_Schedule.dgn

USER NAME = bcd	DESIGNED - BCD	REVISED - 11/21/2018
PLOT SCALE = 1:1	DRAWN - GDC	REVISED -
PLOT DATE = 11/21/2018	CHECKED - LDC	REVISED -
	DATE - 10/8/2018	REVISED -

**STATE OF ILLINOIS
DEPARTMENT OF TRANSPORTATION**

SCHEDULES AND MOT LEGEND			
SCALE:	SHEET	OF	SHEETS

F.A.P. RTE.	SECTION	COUNTY	TOTAL SHEETS	SHEET NO.
404	(50B-4)BR;12[(HVB,HB)BR]BR	TAZEWELL	61	8
CONTRACT NO.68D59				
		ILLINOIS	FED. AID PROJECT	

LOCATION	COMBINATION CURB AND GUTTER REMOVAL	PAVEMENT REMOVAL	CONCRETE MEDIAN SURFACE REMOVAL	TEMPORARY PAVEMENT	COMBINATION CONCRETE CURB AND GUTTER, TYPE B-6.24 (TEMPORARY)
	44000500	44000100	X4402020	Z0062456	X6064500
	FOOT	SQ YD	SQ FT	SQ YD	FOOT
WASHINGTON ST. MEDIAN MODIFICATION	246	56	1695	230	188
PROJECT TOTAL:	246	56	1695	230	188

NOTE: EXISTING PAVEMENT THICKNESS IS 10".
EXISTING CONCRETE MEDIAN SURFACE THICKNESS IS 4".

LOCATION	MANHOLES TO BE ADJUSTED	INLETS TO BE ADJUSTED	INLETS, TYPE A, TYPE 1 FRAME, OPEN LID	STORM SEWERS, CLASS A, TYPE 1 12"	TRENCH BACKFILL
	60255500	60260100	60234200	550A0050	20800150
	EACH	EACH	EACH	FOOT	CU YD
WASHINGTON ST. MEDIAN MODIFICATION	1	2	1	7	1
PROJECT TOTAL:	1	2	1	7	1

PERMANENT PAVEMENT MARKINGS

LOCATION	MODIFIED URETHANE PAVEMENT MARKING - LINE 4"			MODIFIED URETHANE PAVEMENT MARKING - LINE 6"	MODIFIED URETHANE PAVEMENT MARKING - LINE 8"	MODIFIED URETHANE PAVEMENT MARKING - LINE 12"
	78009004			78009006	78009008	78009012
	FOOT			FOOT	FOOT	FOOT
	WHITE	YELLOW	YELLOW- DOUBLE	WHITE-SKIP DASH	WHITE	YELLOW
WASHINGTON ST.	3052	1356	2056	784	474	330
RIVERFRONT DRIVE SPUR	1967	3674		270	1862	
PROJECT TOTAL:			12105	1054	2336	330


MODEL: \\MODEL\NAMES
FILE: \\NAME: .PLOT

USER NAME = \$USERS	DESIGNED -	REVISED -
	DRAWN -	REVISED -
PLOT SCALE = \$SCALE\$	CHECKED -	REVISED -
PLOT DATE = \$DATE\$	DATE -	REVISED -

STATE OF ILLINOIS
DEPARTMENT OF TRANSPORTATION

SCALE:		SHEET	OF	SHEETS	STA.	TO	STA.
--------	--	-------	----	--------	------	----	------

F.A.P. RTE.	SECTION	COUNTY	TOTAL SHEETS	SHEET NO.
404	(50B-4)BR:12[(HVB,HB)BR]BR	TAZEWELL	61	8A
CONTRACT NO. 68D59				
ILLINOIS FED. AID PROJECT				

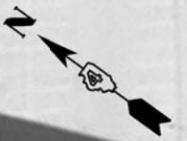

TEMPORARY PAVEMENT MARKING, 4" (SOLID WHITE)

600.00'
50:1 TAPER

LEGEND

 LANE CLOSURE

NOTE:
TRAFFIC CONTROL SHALL BE SET UP IN ACCORDANCE WITH STANDARD 701601 AND THE DETAILS ON THIS SHEET.



MODEL - 11002181000
FILE NAME - 11111

USER NAME = SUSERS	DESIGNED - IDOT	REVISED - 11/21/2018
PLOT SCALE = SCALES	DRAWN - IDOT	REVISED -
PLOT DATE = SDATES	CHECKED -	REVISED -
	DATE -	REVISED -

**STATE OF ILLINOIS
DEPARTMENT OF TRANSPORTATION**

**SUGGESTED MAINTENANCE OF TRAFFIC
PRE-STAGE**

SCALE:	SHEET 1	OF 2	SHEETS	STA.	TO STA.
--------	---------	------	--------	------	---------

F.A.P. RTE.	SECTION	COUNTY	TOTAL SHEETS	SHEET NO.
404	(50B-4)BR;12((HVB,HB)BR)BR	TAZEWELL	61	88
			CONTRACT NO. 68D59	
ILLINOIS FED. AID PROJECT				



NOTE:
TRAFFIC CONTROL SHALL BE SET UP IN ACCORDANCE WITH STANDARDS 701601, 701701 AND THE DETAILS ON THIS SHEET.

LEGEND

 CONSTRUCTION AREA (MEDIAN MODIFICATION)

 LANE CLOSURE



MODEL - 110021MMX
FILE NAME - 110021



USER NAME = SUSERS	DESIGNED - IDOT	REVISED - 11/21/2018
DRAWN - IDOT	CHECKED -	REVISED -
PLOT SCALE = SCALES	DATE -	REVISED -
PLOT DATE = SDATES		

**STATE OF ILLINOIS
DEPARTMENT OF TRANSPORTATION**

**SUGGESTED MAINTENANCE OF TRAFFIC
PRE-STAGE**

SCALE: SHEET 2 OF 2 SHEETS STA. TO STA.

F.A.P. RTE.	SECTION	COUNTY	TOTAL SHEETS	SHEET NO.
404	(50B-4)BR;12 (HVB,HB)BR	TAZEWELL	61	8C
			CONTRACT NO. 68D59	
ILLINOIS FED. AID PROJECT				

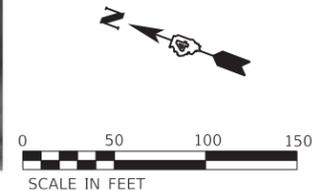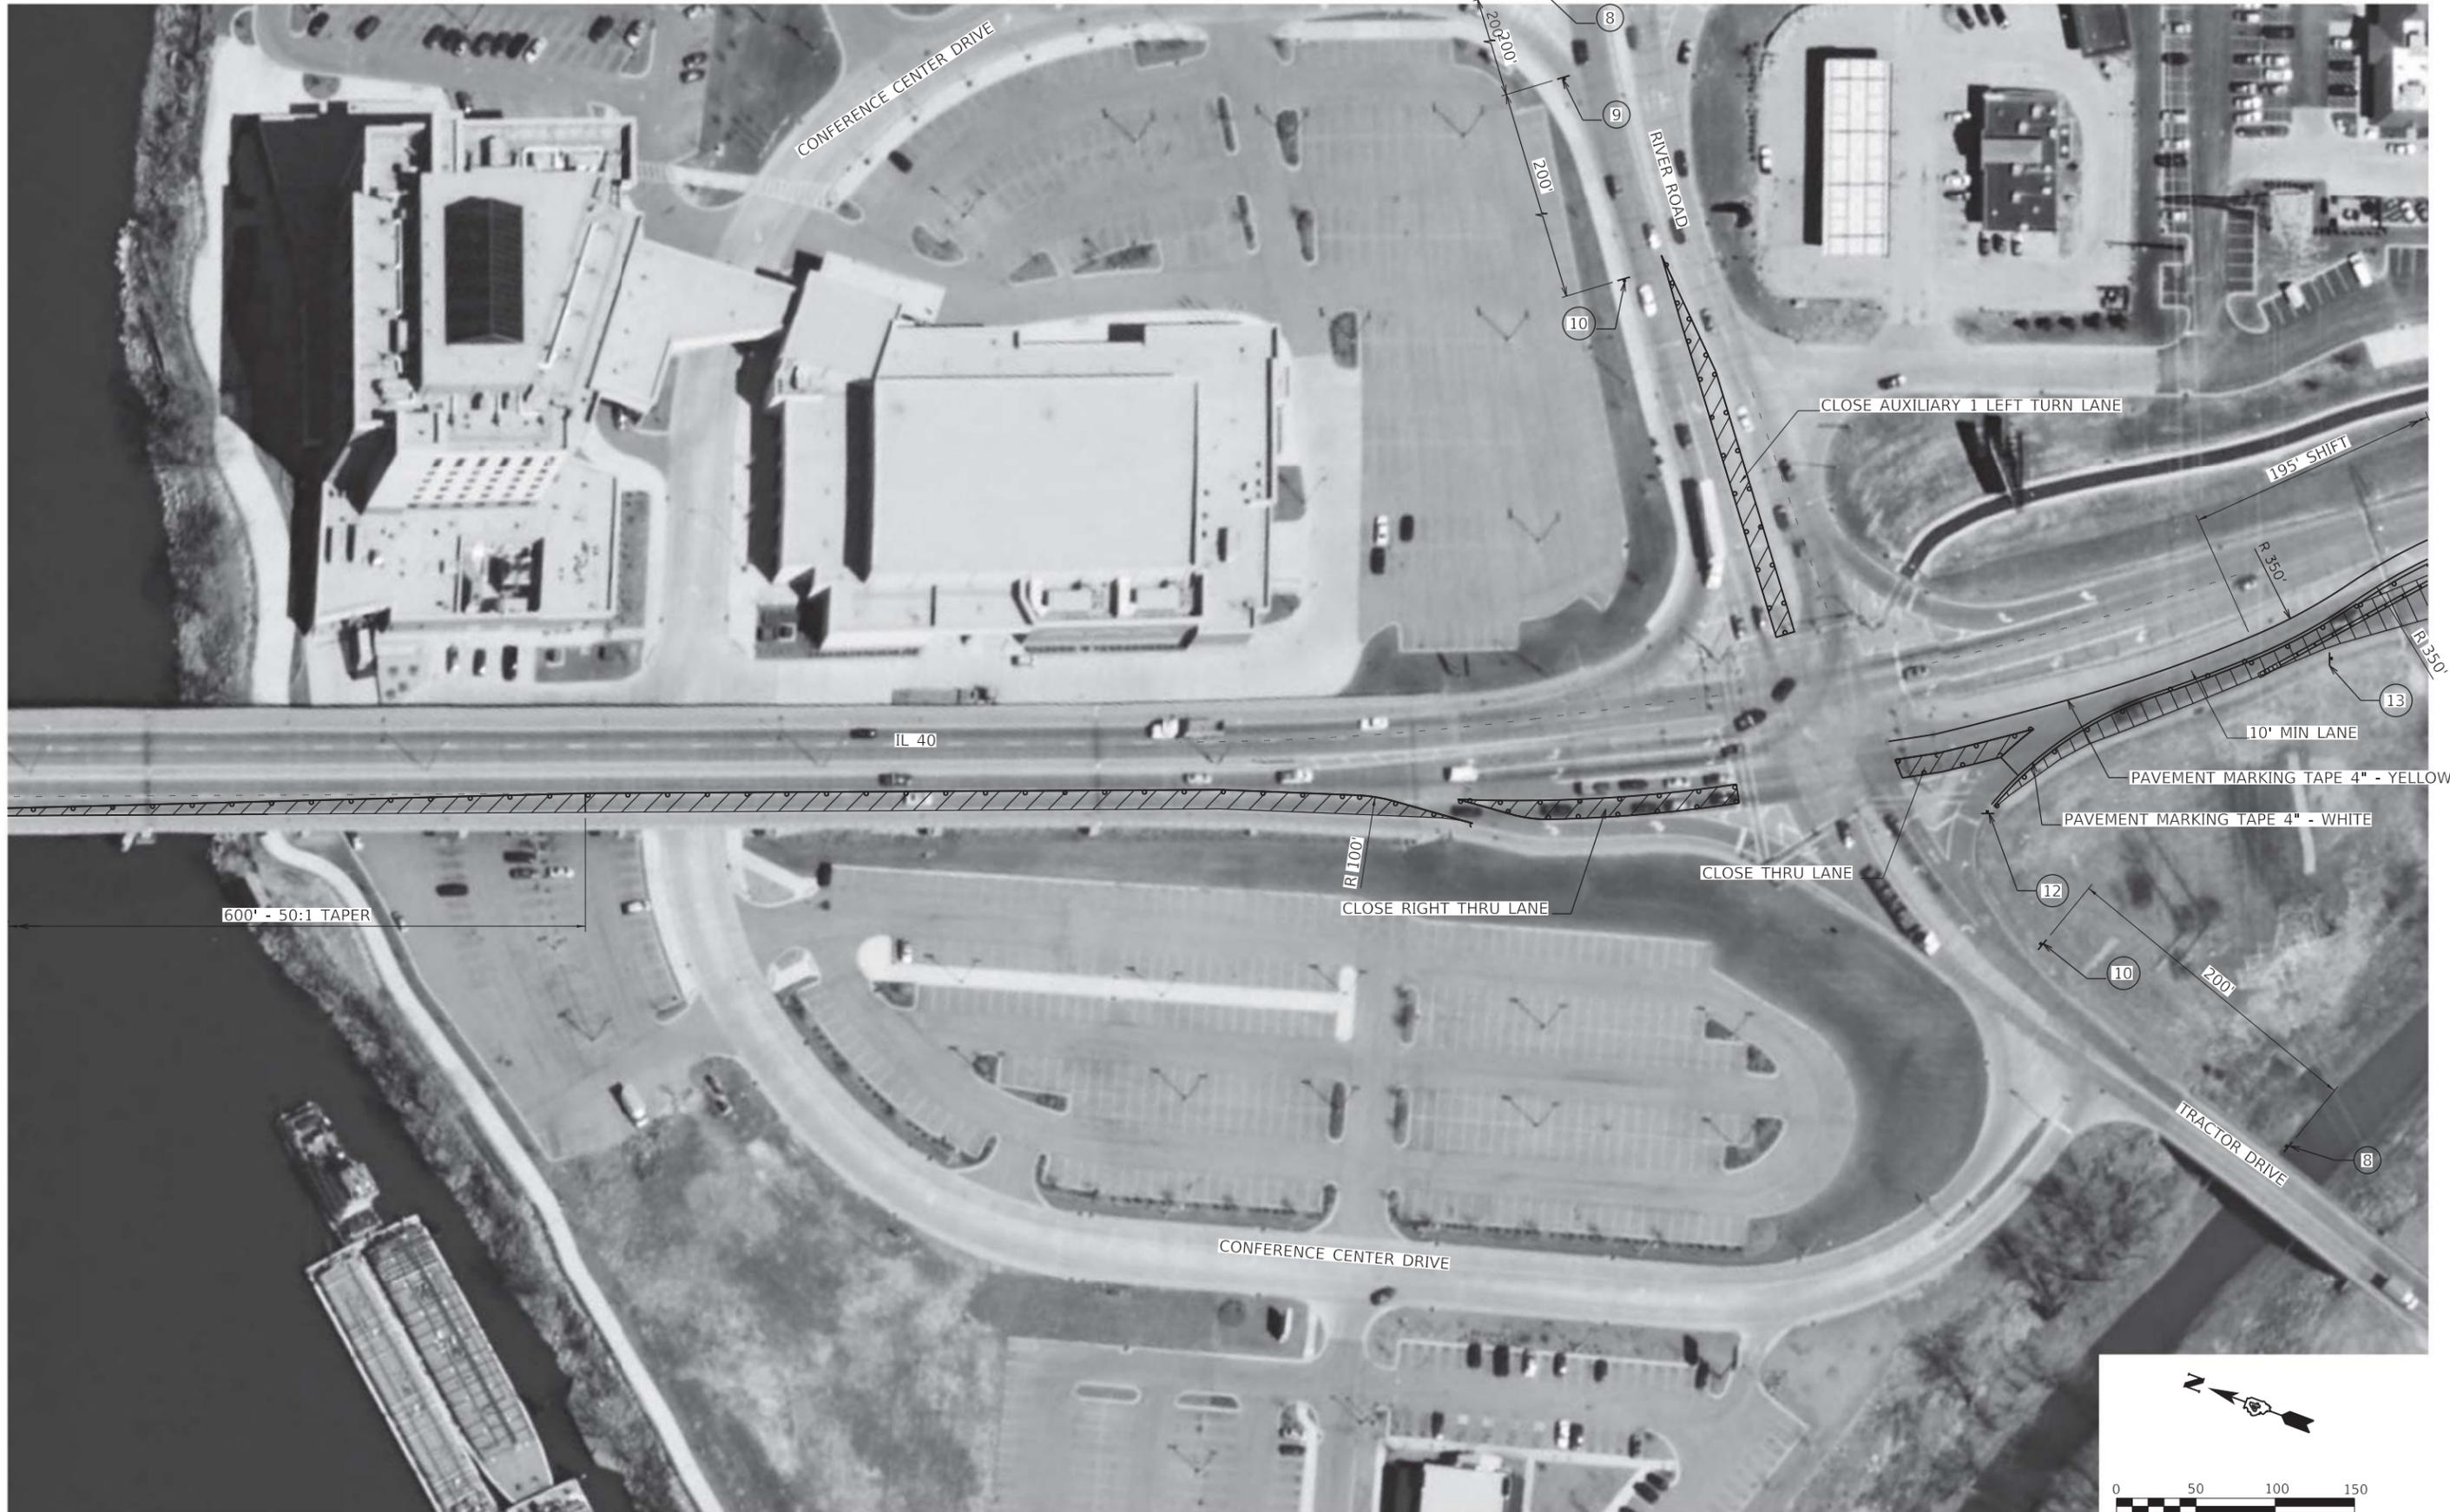

MODEL: 01 - Suggested MOT
 FILE NAME: P:\09200622\DOT\DOT Plans\10_CAD\CADD Sheets\09200622_01005_MOT_Stage_1.dgn

USER NAME = gdc	DESIGNED - BCD	REVISED -
	DRAWN - GDC	REVISED -
PLOT SCALE = 1:50	CHECKED - LDC	REVISED -
PLOT DATE = 10/19/2018	DATE - 10/8/2018	REVISED -

STATE OF ILLINOIS
DEPARTMENT OF TRANSPORTATION

SUGGESTED MAINTENANCE OF TRAFFIC
STAGE 1


SCALE: 1" = 50' SHEET OF SHEETS STA. TO STA.

F.A.P. RTE.	SECTION	COUNTY	TOTAL SHEETS	SHEET NO.
404	(50B-4)BR:12[(HVB,HB)BR]BR	TAZEWELL	61	9
CONTRACT NO.68D59				
		ILLINOIS	FED. AID PROJECT	



NOTE:
MAINTENANCE OF TRAFFIC SIGNS
PLACED AT 200' INTERVALS

NOTE:
SIGN LOCATED AT CORNER OF CLOCK TOWER DRIVE
AND WEST WASHINGTON STREET.

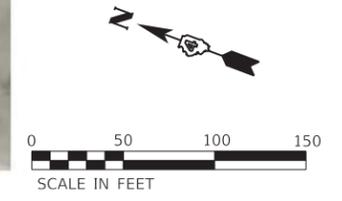


MODEL: 02 - Suggested MOT
 FILE NAME: P:\02\0622\DOT\DOT Plans\10_CAD\CADD Sheets\09\02\17_ah0006_MOT_Stage_1.dgn

USER NAME = gdc	DESIGNED - BCD	REVISED -
	DRAWN - GDC	REVISED -
PLOT SCALE = 1:50	CHECKED - LDC	REVISED -
PLOT DATE = 10/19/2018	DATE - 10/8/2018	REVISED -

STATE OF ILLINOIS
DEPARTMENT OF TRANSPORTATION


SUGGESTED MAINTENANCE OF TRAFFIC			
STAGE 1			
SCALE: 1" = 50'	SHEET	OF SHEETS	STA. TO STA.

F.A.P. RTE.	SECTION	COUNTY	TOTAL SHEETS	SHEET NO.
404	(50B-4)BR:12[(HVB,HB)BR]BR	TAZEWELL	61	10
CONTRACT NO.68D59				
		ILLINOIS	FED. AID PROJECT	

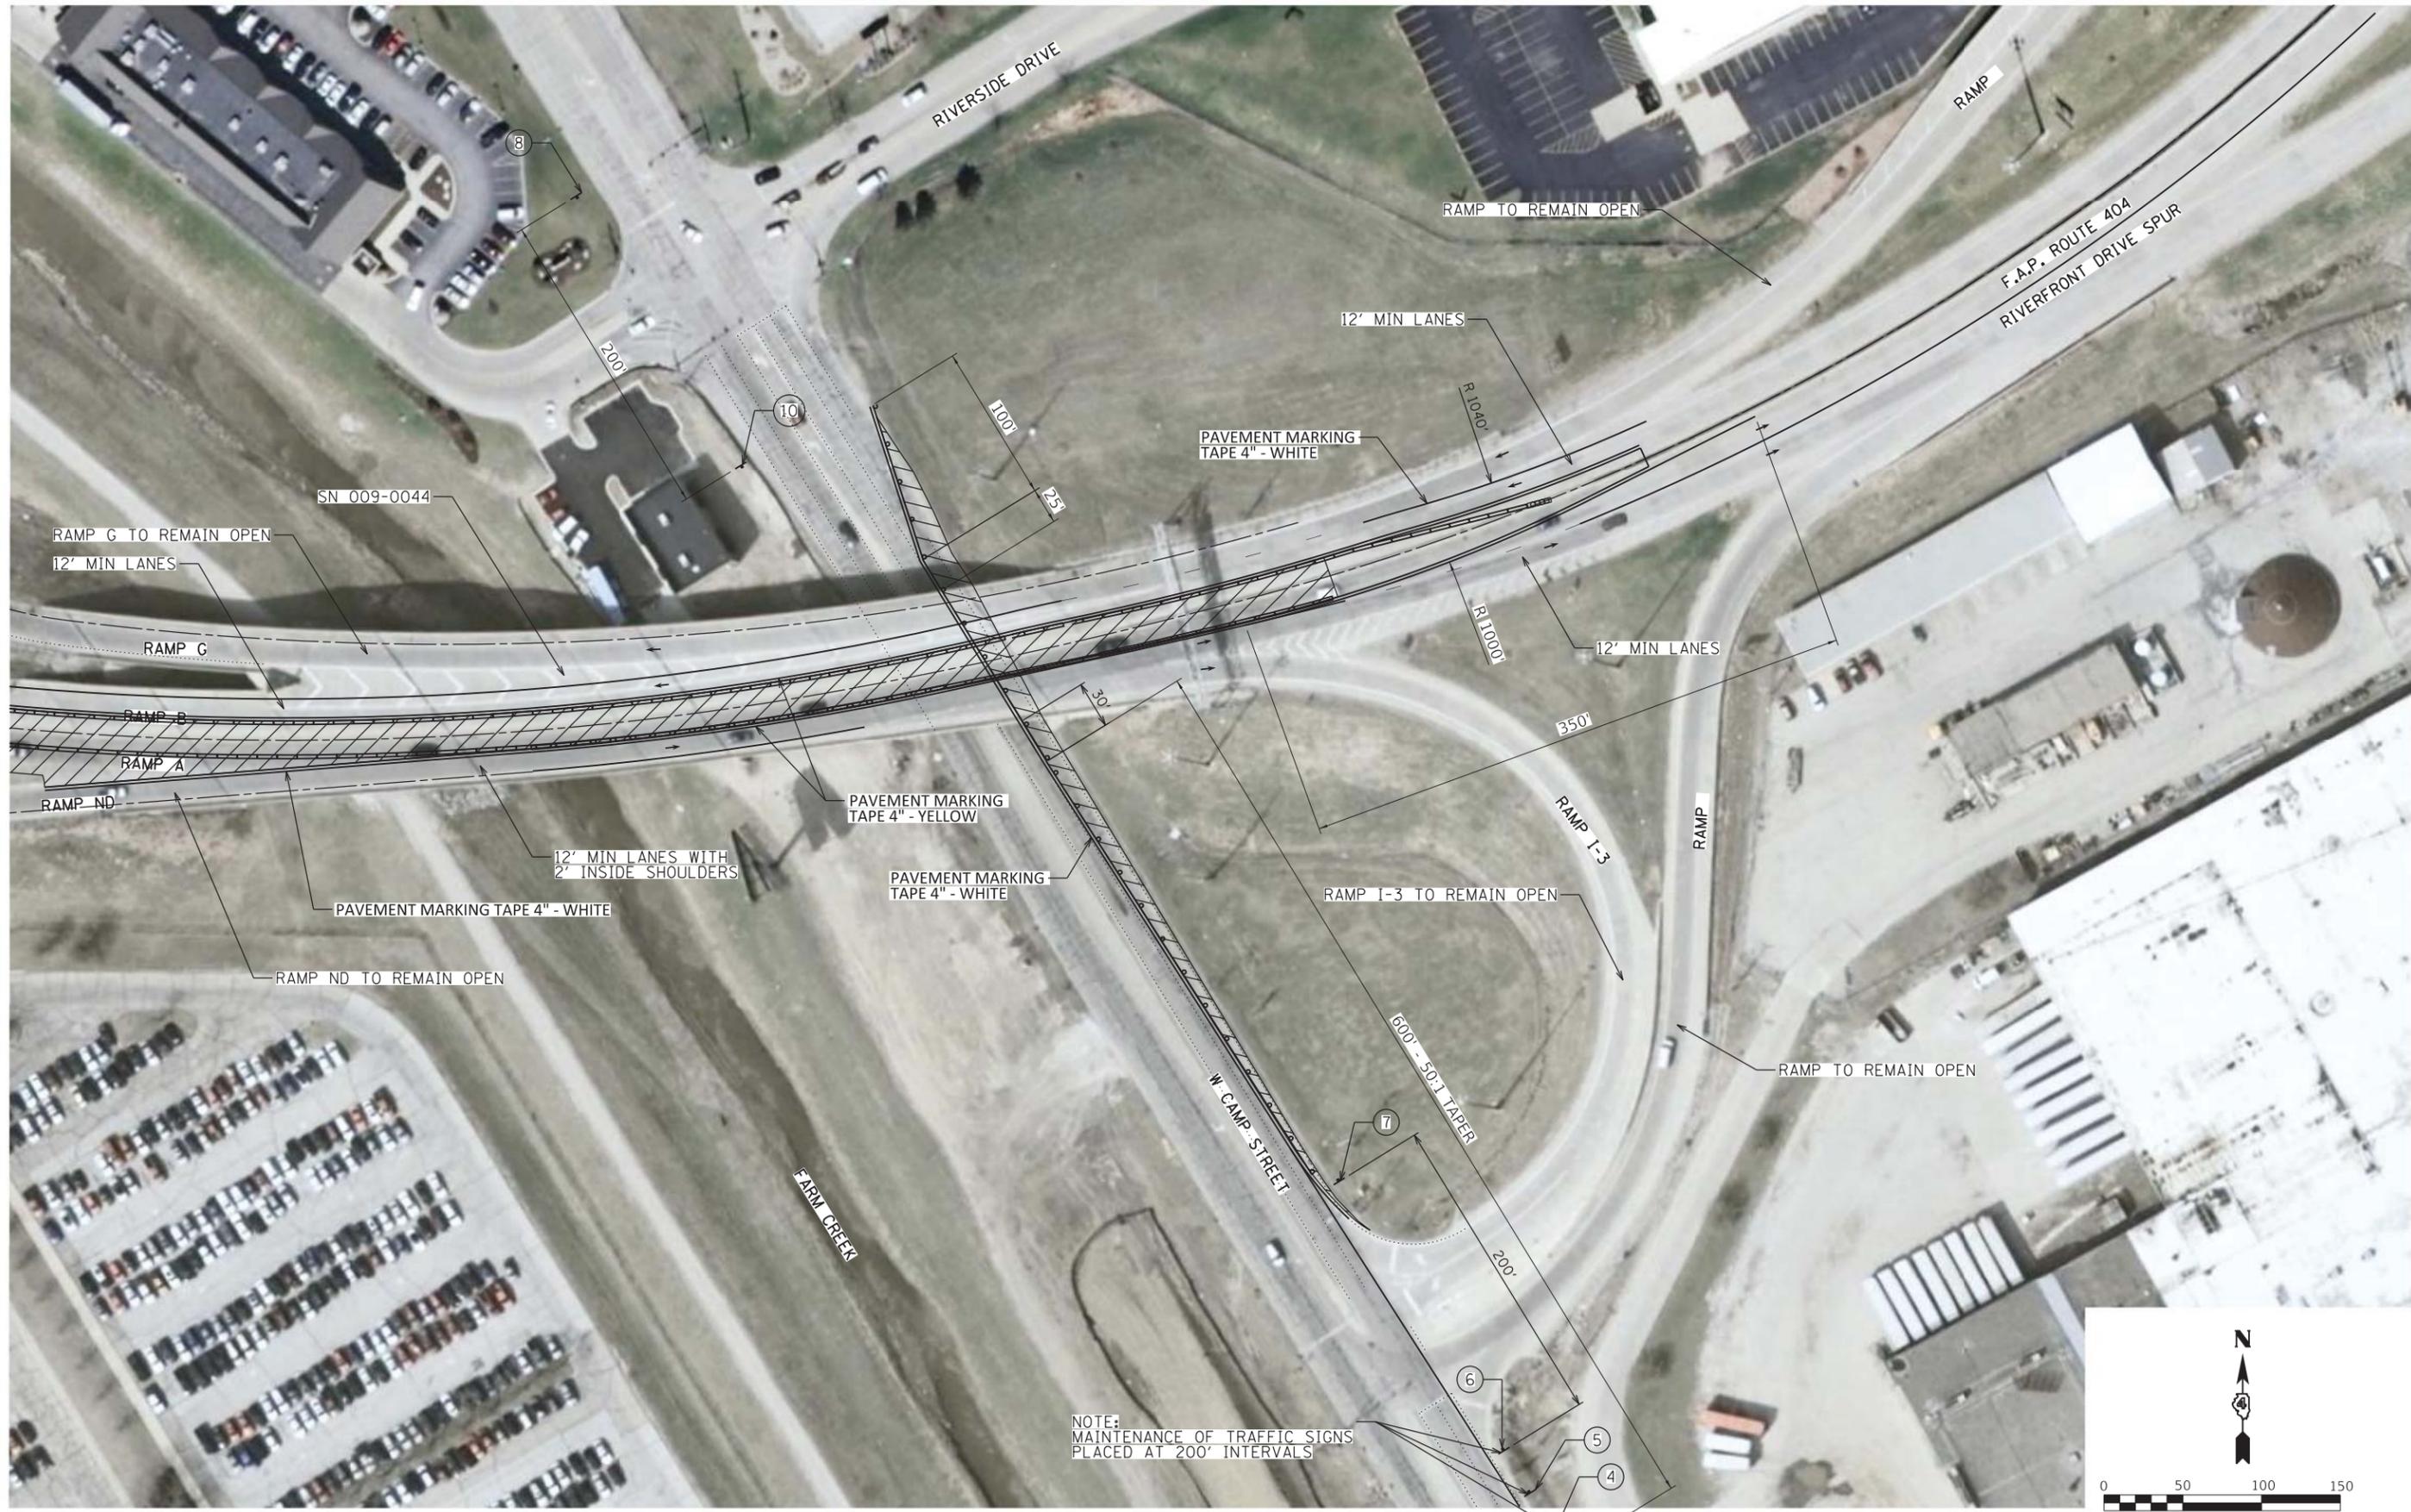

MODEL: 03 - Supplemental NOT
 FILE NAME: P:\09200622\DOT\DOT Plans\10_CADD\CADD Sheets\09200622_01007_NOT_Stage_1.dgn

NOTE:
 MAINTENANCE OF TRAFFIC SIGNS
 PLACED AT 200' INTERVALS

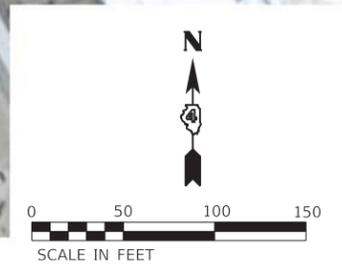


USER NAME = gdc	DESIGNED - BCD	REVISED -
	DRAWN - GDC	REVISED -
PLOT SCALE = 1:50	CHECKED - LDC	REVISED -
PLOT DATE = 10/19/2018	DATE - 10/8/2018	REVISED -

**STATE OF ILLINOIS
 DEPARTMENT OF TRANSPORTATION**

SUGGESTED MAINTENANCE OF TRAFFIC STAGE 1			
SCALE: 1"=50'	SHEET	OF SHEETS	STA. TO STA.

F.A.P. RTE. 404	SECTION (50B-4)BR:12[(HVB,HB)BR]BR	COUNTY TAZEWELL	TOTAL SHEETS 61	SHEET NO. 11
CONTRACT NO.68D59				
ILLINOIS		FED. AID PROJECT		

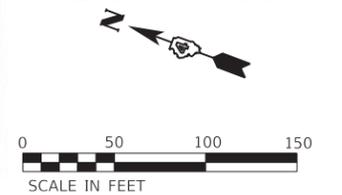

MODEL: 04 - Suggested MOT
 FILE NAME: P:\02060622\DOT\DOT Plans\10_CAD\CADD Sheets\040617_ah0008_MOT_Stage_2.dgn

USER NAME = gdc	DESIGNED - BCD	REVISED -
	DRAWN - GDC	REVISED -
PLOT SCALE = 1:50	CHECKED - LDC	REVISED -
PLOT DATE = 10/19/2018	DATE - 10/8/2018	REVISED -

STATE OF ILLINOIS
DEPARTMENT OF TRANSPORTATION


SUGGESTED MAINTENANCE OF TRAFFIC
STAGE 2

SCALE: 1" = 50' SHEET OF SHEETS STA. TO STA.

F.A.P. RTE.	SECTION	COUNTY	TOTAL SHEETS	SHEET NO.
404	(50B-4)BR:12[(HVB,HB)BR]BR	TAZEWELL	61	12
CONTRACT NO.68D59				
ILLINOIS FED. AID PROJECT				



NOTE:
MAINTENANCE OF TRAFFIC SIGNS
PLACED AT 200' INTERVALS

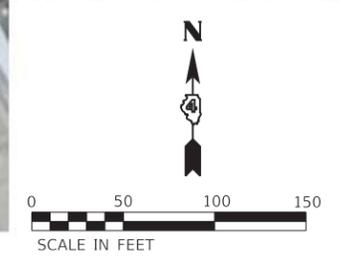


MODEL: 06 - Supermarket.MXD
 FILE NAME: P:\09200622\DOT.DA.MOT.Plans\10_CADD\CADD_Sheets\09200622_ah010.MOT_Super_2.dgn

USER NAME = gdc	DESIGNED - BCD	REVISED -
	DRAWN - GDC	REVISED -
PLOT SCALE = 1:50	CHECKED - LDC	REVISED -
PLOT DATE = 10/19/2018	DATE - 10/8/2018	REVISED -

**STATE OF ILLINOIS
DEPARTMENT OF TRANSPORTATION**

SUGGESTED MAINTENANCE OF TRAFFIC STAGE 2			
SCALE: 1" = 50'	SHEET	OF SHEETS	STA. TO STA.

F.A.P. RTE.	SECTION	COUNTY	TOTAL SHEETS	SHEET NO.
404	(50B-4)BR:12[(HVB,HB)BR]BR	TAZEWELL	61	14
CONTRACT NO.68D59				
ILLINOIS FED. AID PROJECT				

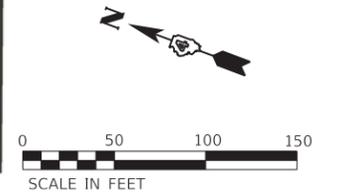


MODEL: 01_Advanced.MOT
 FILE NAME: P:\09-060622_IDOT_D4_MOT_Plans\10_CADD\CADD_Sheets\090617_ah011_MOT_Advanced_Signing.dgn

USER NAME = gdc	DESIGNED - BCD	REVISED -
	DRAWN - GDC	REVISED -
PLOT SCALE = 1:50	CHECKED - LDC	REVISED -
PLOT DATE = 10/19/2018	DATE - 10/8/2018	REVISED -

STATE OF ILLINOIS
DEPARTMENT OF TRANSPORTATION

SUGGESTED MAINTENANCE OF TRAFFIC ADVACNED SIGNING				
SCALE:	SHEET	OF	SHEETS	STA. TO STA.

F.A.P. RTE.	SECTION	COUNTY	TOTAL SHEETS	SHEET NO.
404	(50B-4)BR;12[(HVB,HB)BR]BR	TAZEWELL	61	15
CONTRACT NO.68D59				
		ILLINOIS	FED. AID PROJECT	

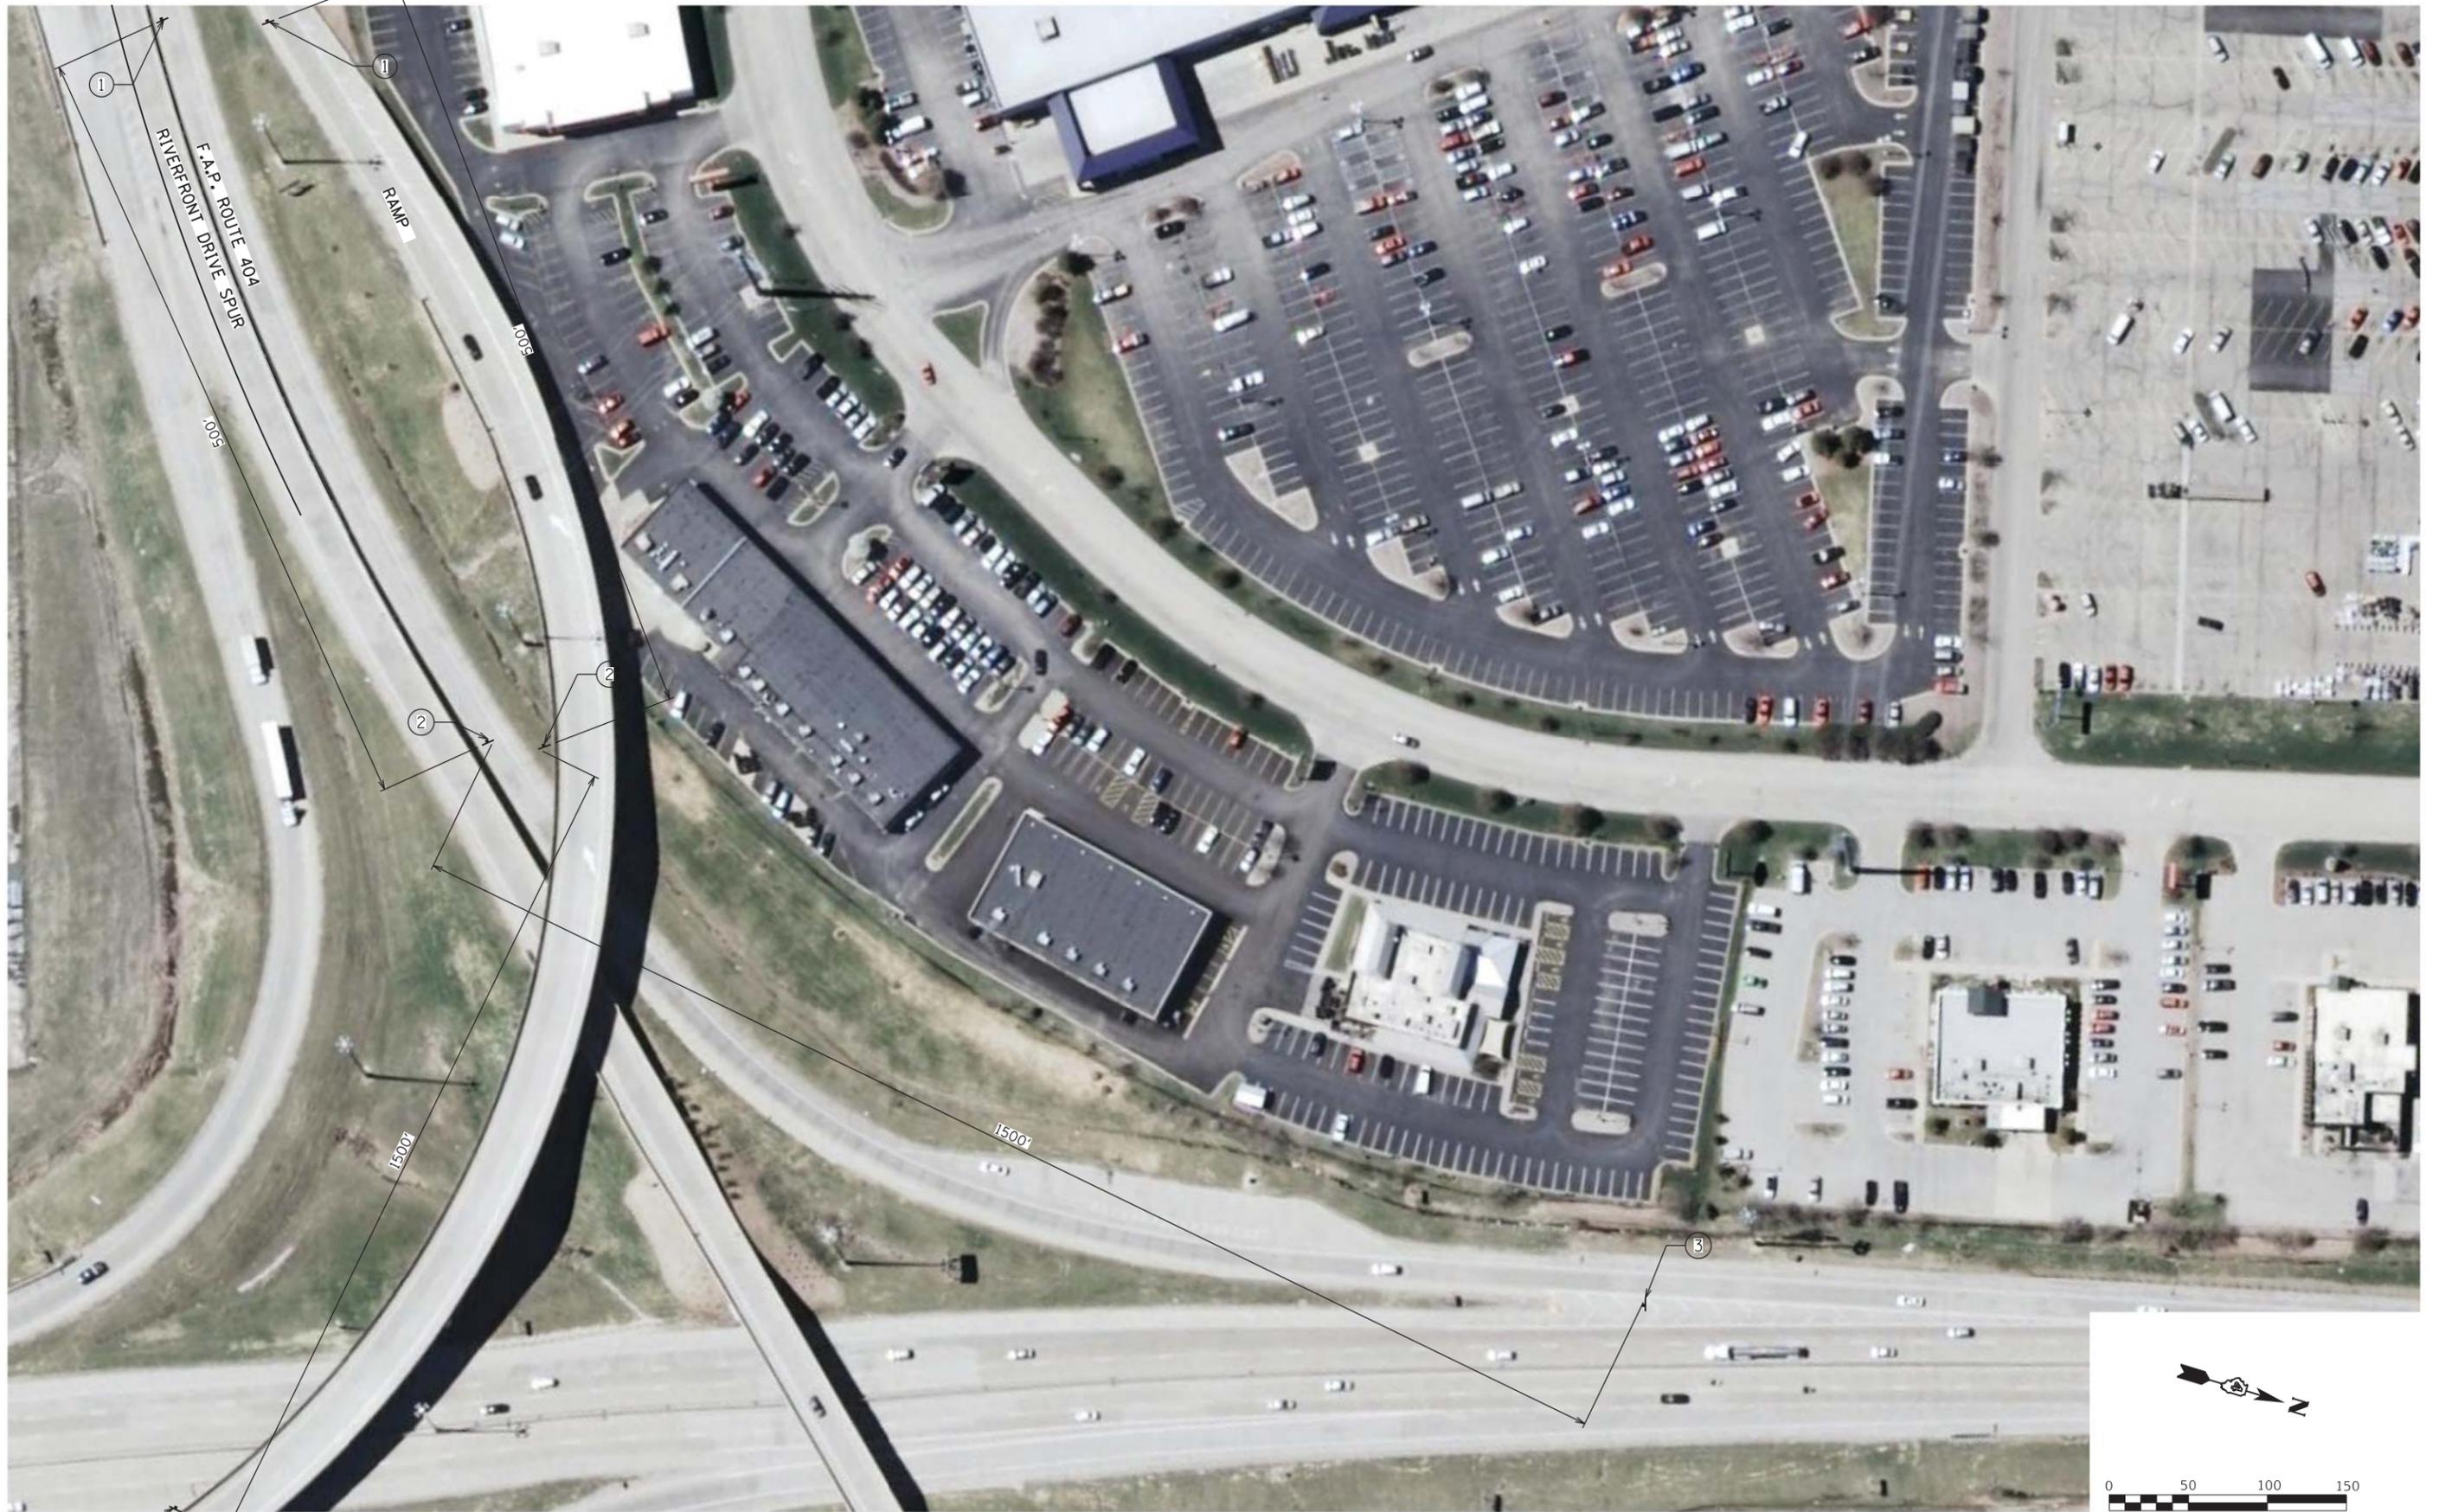

MODEL: 03_Advanced_Signing
 FILE NAME: P:\03-060622\DOT-D4_MOT_Plans\10_CADD\CADD_Sheets\0402617_ah012_MOT_Advanced_Signing.dgn




USER NAME = gdc	DESIGNED - BCD	REVISED -
PLOT SCALE = 1:50	DRAWN - GDC	REVISED -
PLOT DATE = 10/19/2018	CHECKED - LDC	REVISED -
	DATE - 10/8/2018	REVISED -

STATE OF ILLINOIS
DEPARTMENT OF TRANSPORTATION

SUGGESTED MAINTENANCE OF TRAFFIC
ADVANCED SIGNING

SCALE: SHEET OF SHEETS STA. TO STA.

F.A.P. RTE. 404	SECTION (50B-4)BR:12[(HVB,HB)BR]BR	COUNTY TAZEWELL	TOTAL SHEETS 61	SHEET NO. 16
ILLINOIS FED. AID PROJECT			CONTRACT NO.68D59	

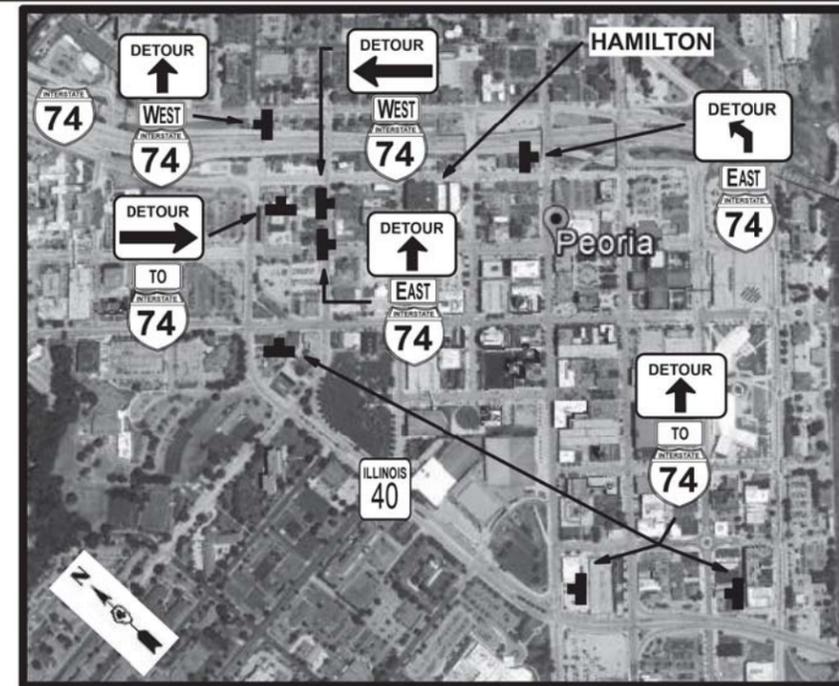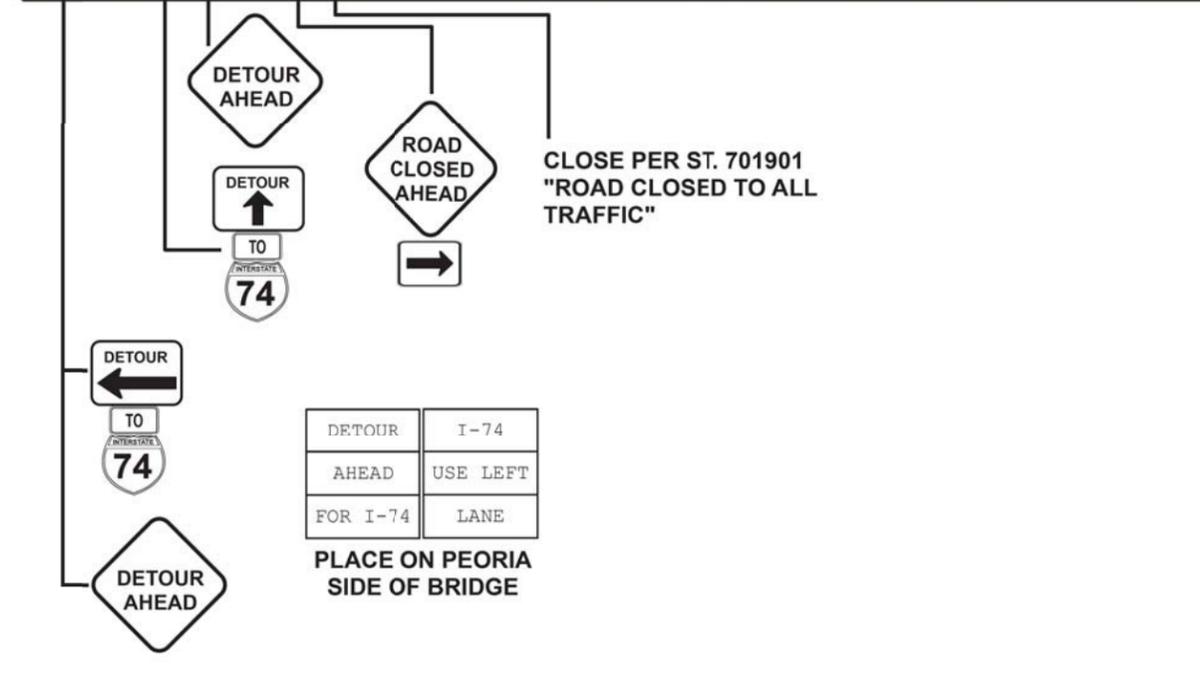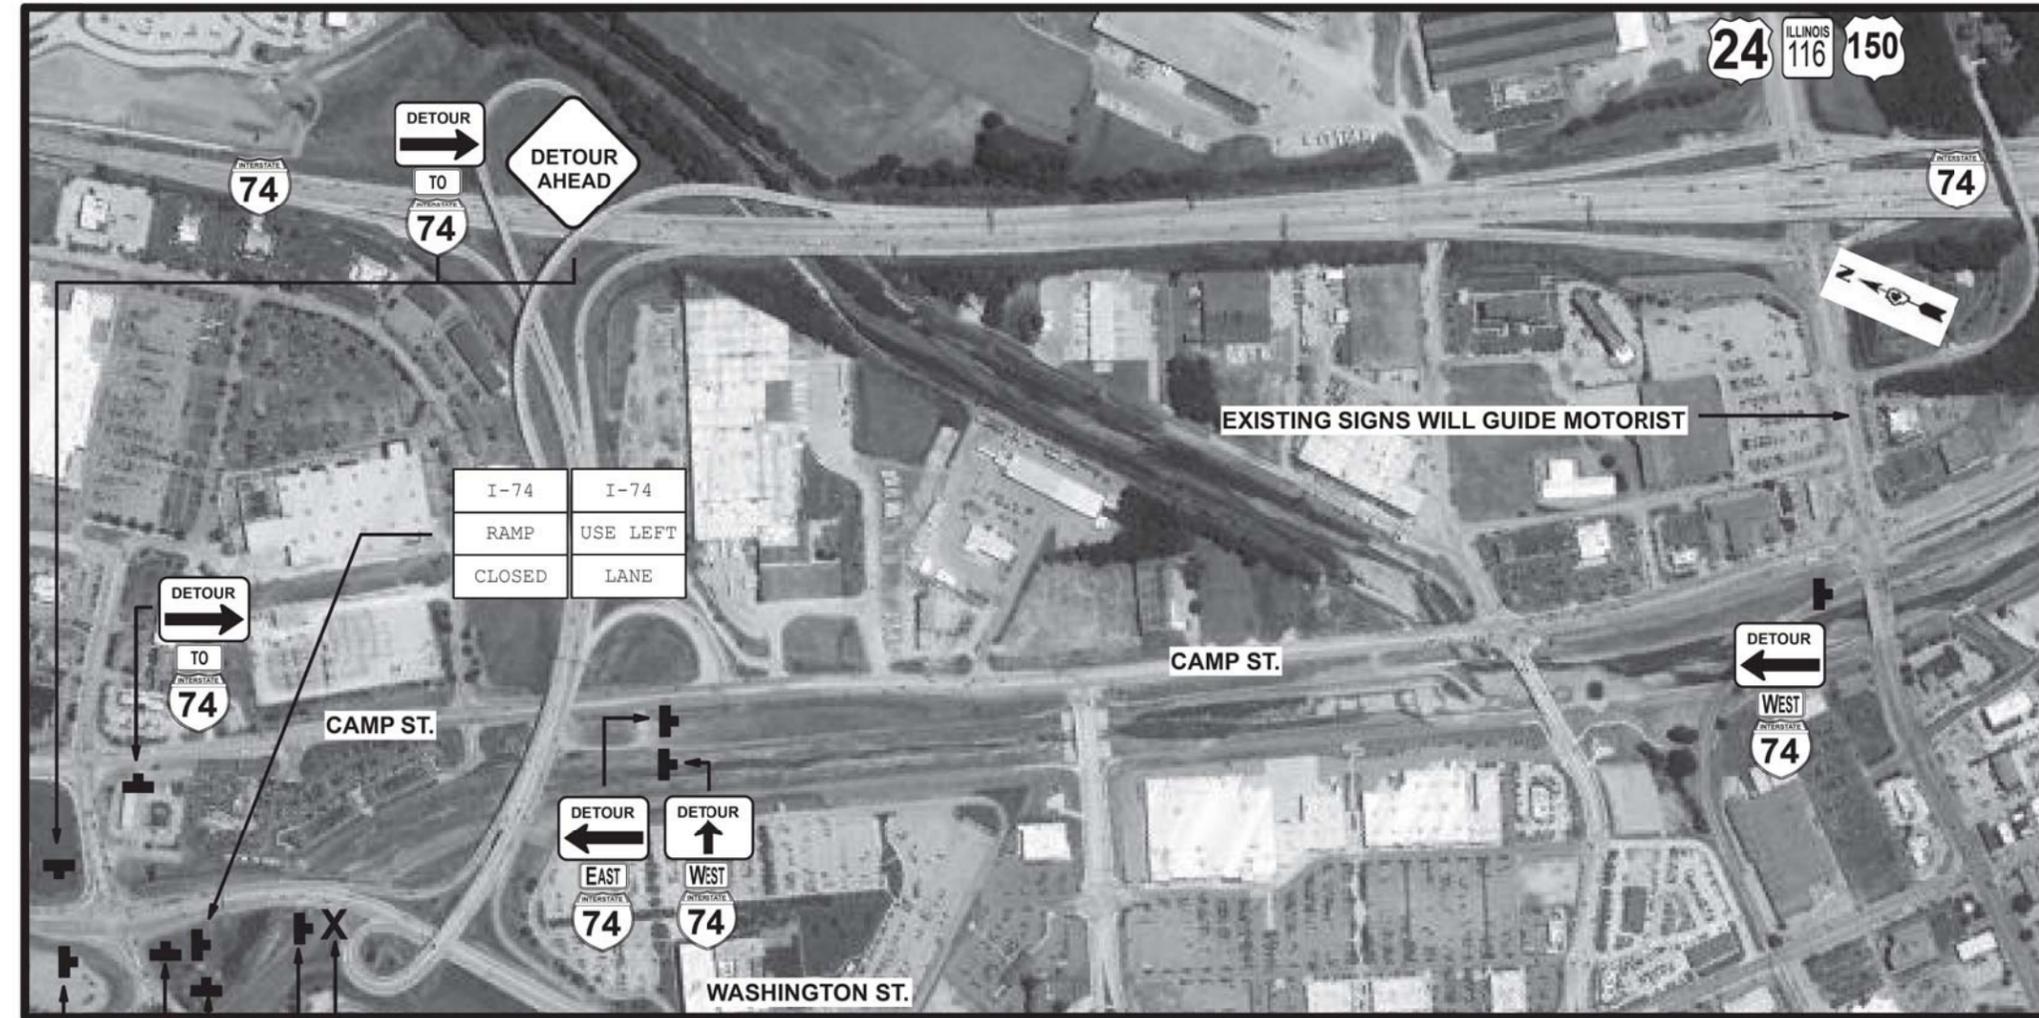

DETOUR/CLOSURE NOTES

- 1) ONE PORTABLE CHANGEABLE MESSAGE SIGN SHALL BE IN PLACE FOR FIVE DAYS TO ADVANCE WARN THE PUBLIC OF THE RAMP CLOSURE.
- 2) SIGNS SHALL BE STAND MOUNTED IN AREAS WHERE POST MOUNTING IS NOT PRACTICAL. THE RESIDENT ENGINEER SHALL APPROVE SUCH LOCATIONS.
- 3) CARDINAL DIRECTION SIGNS SHALL BE BLACK ON WHITE. DETOUR SIGNS SHALL BE BLACK ON ORANGE. EAST, WEST, AND TO SIGNS SHALL BE WHITE ON BLUE.
- 4) SIGN LOCATIONS SHALL BE DISCUSSED AT THE PRE-CONSTRUCTION MEETING.

MODEL: Default
FILE NAME: P:\09-000622 IDOT.D4.MOT.P18510.CAD\CADD Sheets\090622\17_#1017.MOT.RAMP A.DETOUR.dgn







USER NAME = gdc	DESIGNED - BCD	REVISED -
	DRAWN - GDC	REVISED -
PLOT SCALE = 1:50	CHECKED - LDC	REVISED -
PLOT DATE = 10/19/2018	DATE - 10/8/2018	REVISED -

STATE OF ILLINOIS
DEPARTMENT OF TRANSPORTATION

RAMP A CLOSURE DETOUR

SCALE: SHEET OF SHEETS STA. TO STA.

F.A.P. RTE.	SECTION	COUNTY	TOTAL SHEETS	SHEET NO.
404	(50B-4)BR:12((HVB,HB)BR)BR	TAZEWELL	61	17
CONTRACT NO.68D59				
ILLINOIS FED. AID PROJECT				

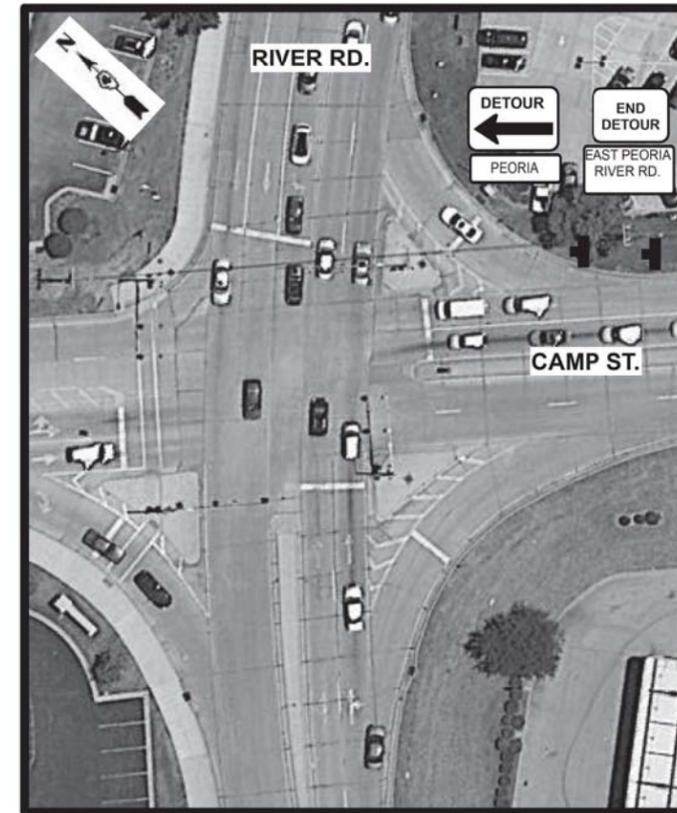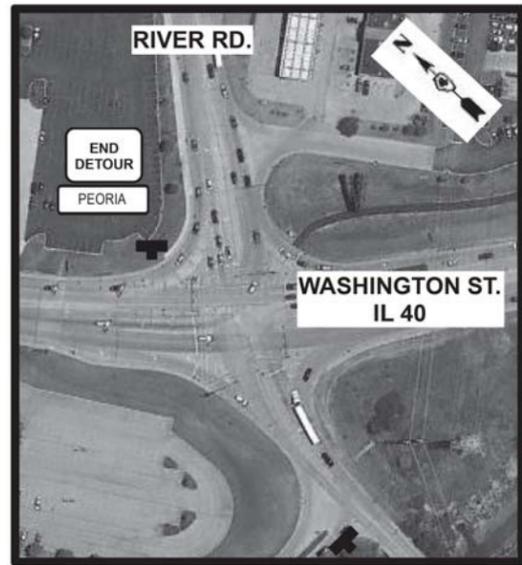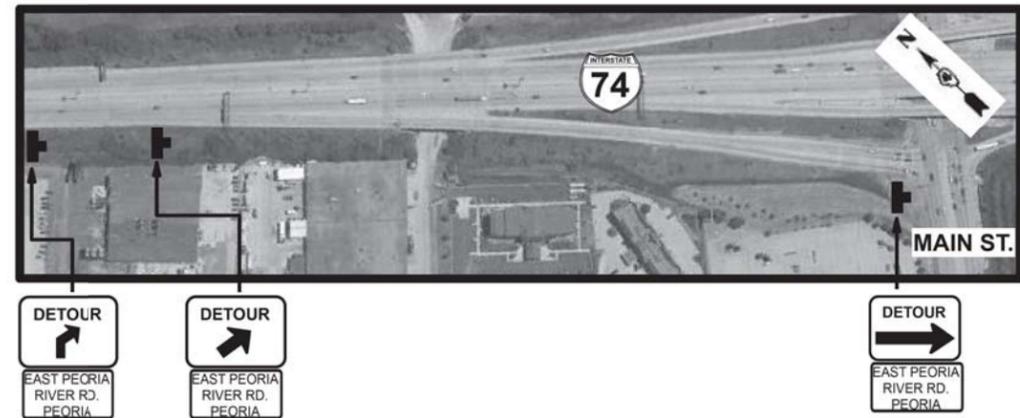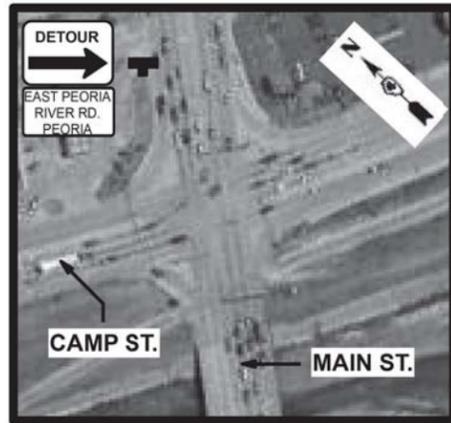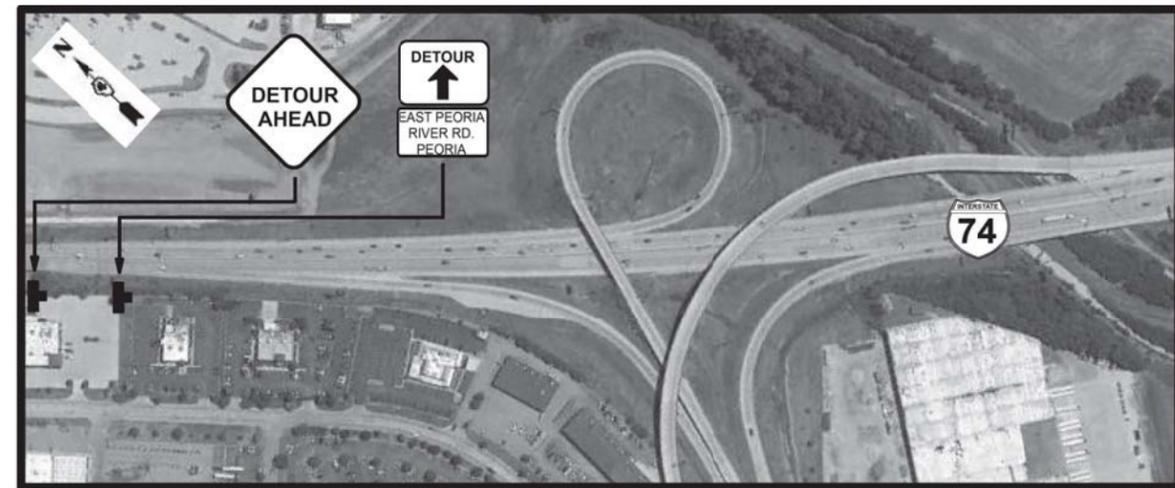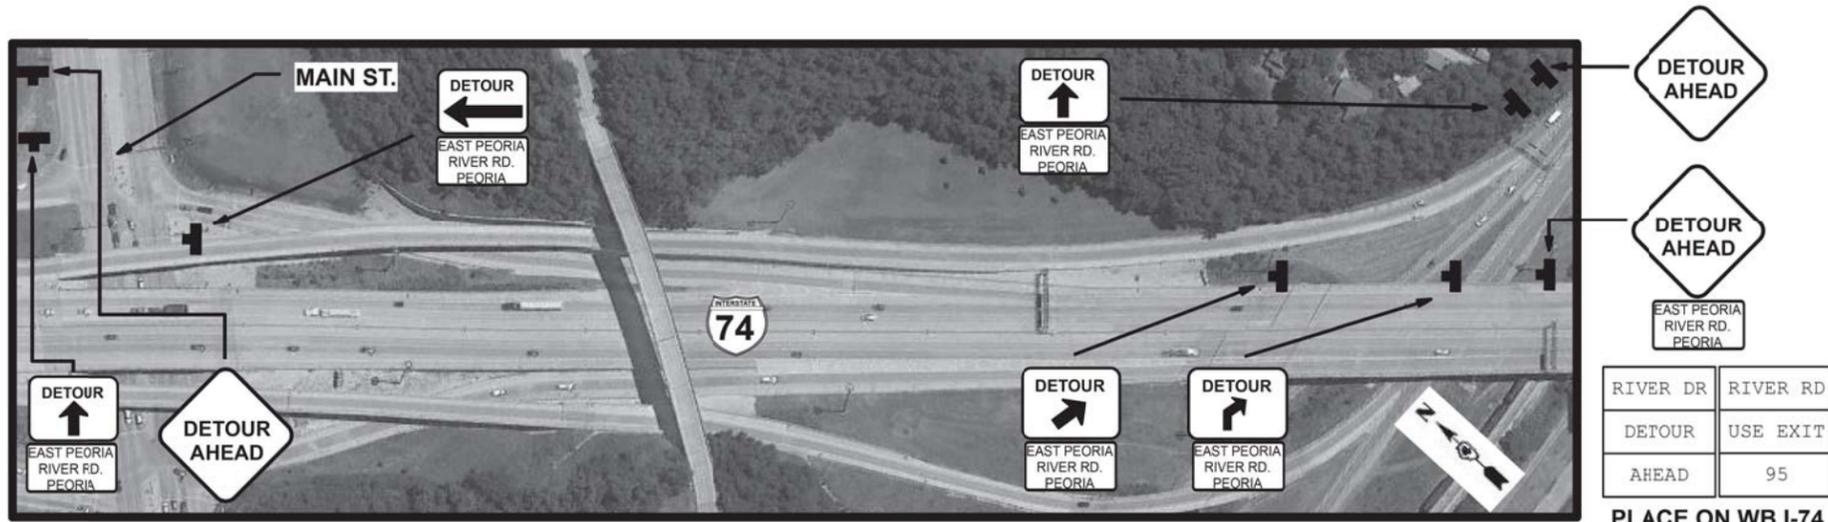

DETOUR AHEAD

DETOUR AHEAD

EAST PEORIA RIVER RD. PEORIA

RIVER DR	RIVER RD
DETOUR	USE EXIT
AHEAD	95

PLACE ON WB I-74 IN U-TURN PRIOR TO EXIT 96

DETOUR/CLOSURE NOTES

- 1) ONE PORTABLE CHANGEABLE MESSAGE SIGN SHALL BE IN PLACE FOR FIVE DAYS TO ADVANCE WARN THE PUBLIC OF THE RAMP CLOSURE.
- 2) SIGNS SHALL BE STAND MOUNTED IN AREAS WHERE POST MOUNTING IS NOT PRACTICAL. THE RESIDENT ENGINEER SHALL APPROVE SUCH LOCATIONS.
- 3) DESTINATION SIGNS SHALL BE BLACK ON WHITE. DETOUR SIGNS SHALL BE BLACK ON ORANGE.
- 4) SIGN LOCATIONS SHALL BE DISCUSSED AT THE PRE-CONSTRUCTION MEETING.
- 5) TWO ADDITIONAL PORTABLE CHANGEABLE MESSAGE SIGNS SHALL BE UTILIZED FOR THE ENTIRE DURATION OF THE CLOSURE SHOWN. THE PCMS ARE NOT SHOWN AND THE LOCATION SHALL BE DISCUSSED AT THE PRE-CONSTRUCTION MEETING.

MODEL: D:\dft\... FILE NAME: P:\09-000622 IDOT.D4.MOT.P18510.CAD\CADD_Sheets\09062217_01018.MOT.RAMP.G.DETOUR.dgn


USER NAME = gdc	DESIGNED - BCD	REVISED -
PLOT SCALE = 1:50	DRAWN - GDC	REVISED -
PLOT DATE = 10/19/2018	CHECKED - LDC	REVISED -
	DATE - 10/8/2018	REVISED -

STATE OF ILLINOIS
DEPARTMENT OF TRANSPORTATION

RAMP G CLOSURE DETOUR

SCALE: SHEET OF SHEETS STA. TO STA.

F.A.P. RTE.	SECTION	COUNTY	TOTAL SHEETS	SHEET NO.
404	(50B-4)BR:12[(HVB,HB)BR]BR	TAZEWELL	61	18
CONTRACT NO.68D59				
ILLINOIS FED. AID PROJECT				

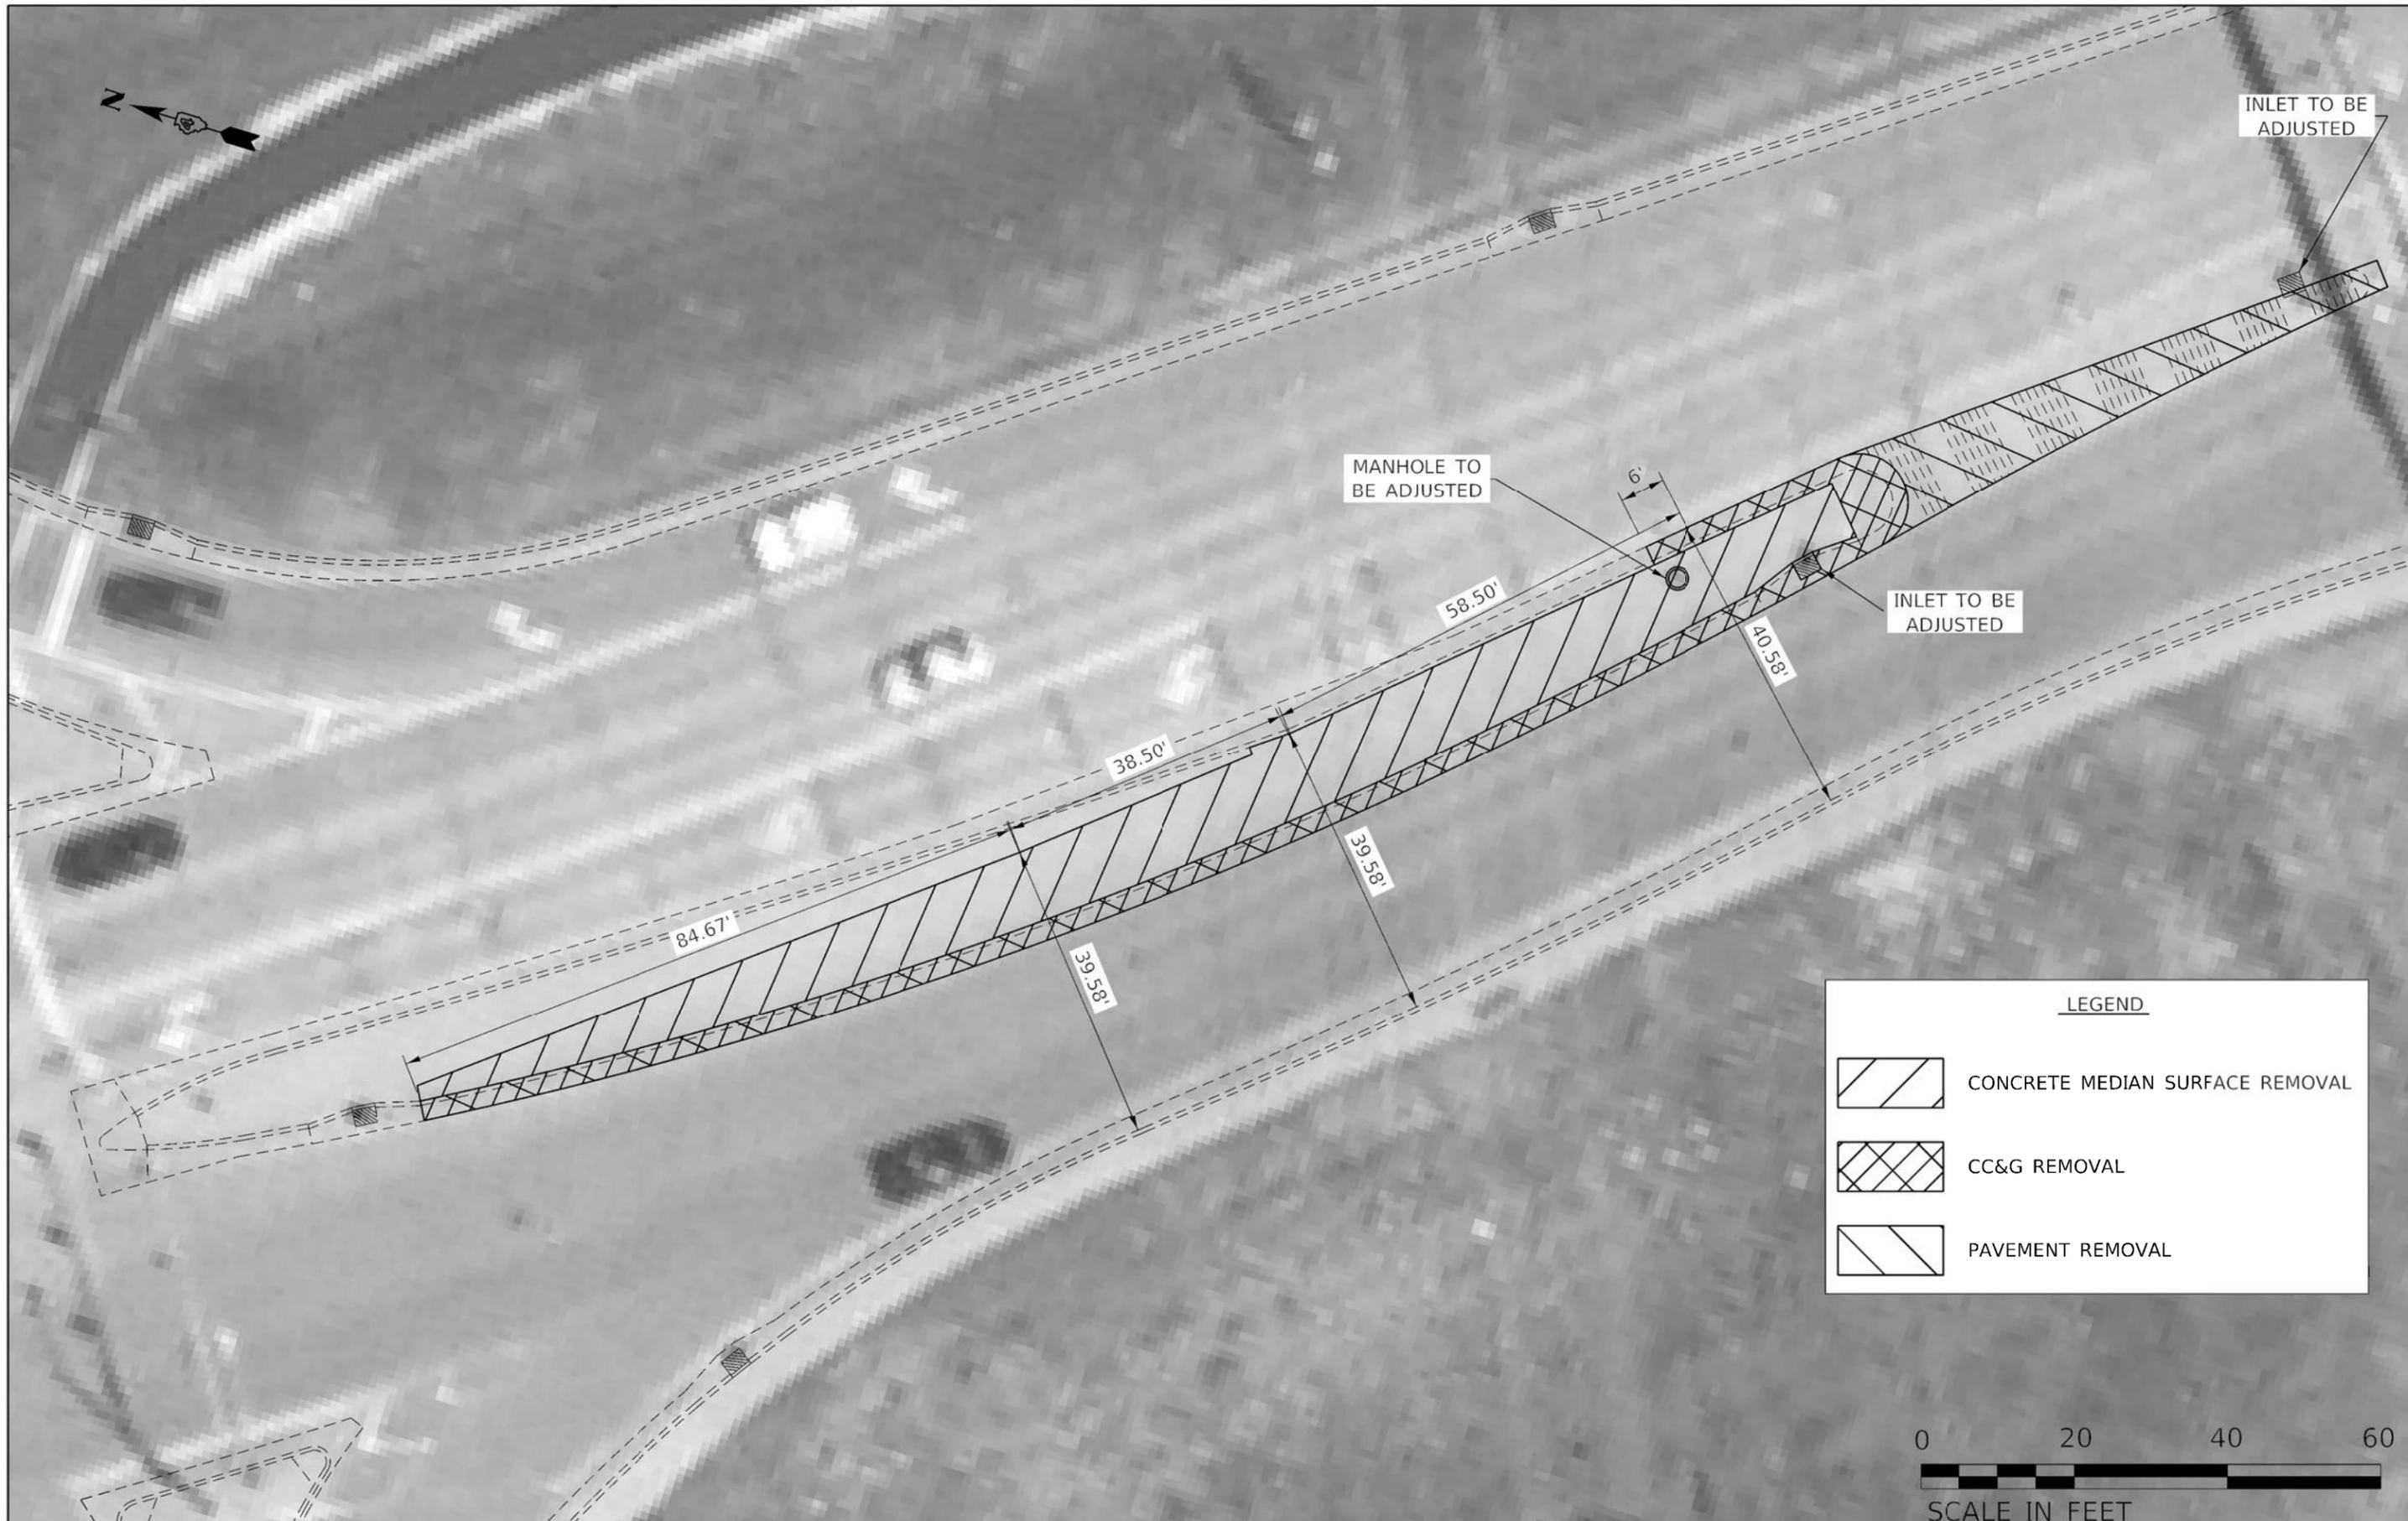

LEGEND

	CONCRETE MEDIAN SURFACE REMOVAL
	CC&G REMOVAL
	PAVEMENT REMOVAL



MODEL - SHORDBENAMES
FILE NAME - 81121


USER NAME = SUSERS	DESIGNED - IDOT	REVISED - 11/21/2018
PLOT SCALE = \$SCALE\$	DRAWN - IDOT	REVISED -
PLOT DATE = \$SDATE\$	CHECKED -	REVISED -
	DATE -	REVISED -

**STATE OF ILLINOIS
DEPARTMENT OF TRANSPORTATION**

WASHINGTON ST. MEDIAN REMOVAL DETAILS

SCALE: SHEET 1 OF 1 SHEETS STA. TO STA.

F.A.P. RTE.	SECTION	COUNTY	TOTAL SHEETS	SHEET NO.
404	(50B-4)BR;12((HVB,HB)BR)BR	TAZEWELL	61	18A
CONTRACT NO. 68D59				
ILLINOIS FED. AID PROJECT				

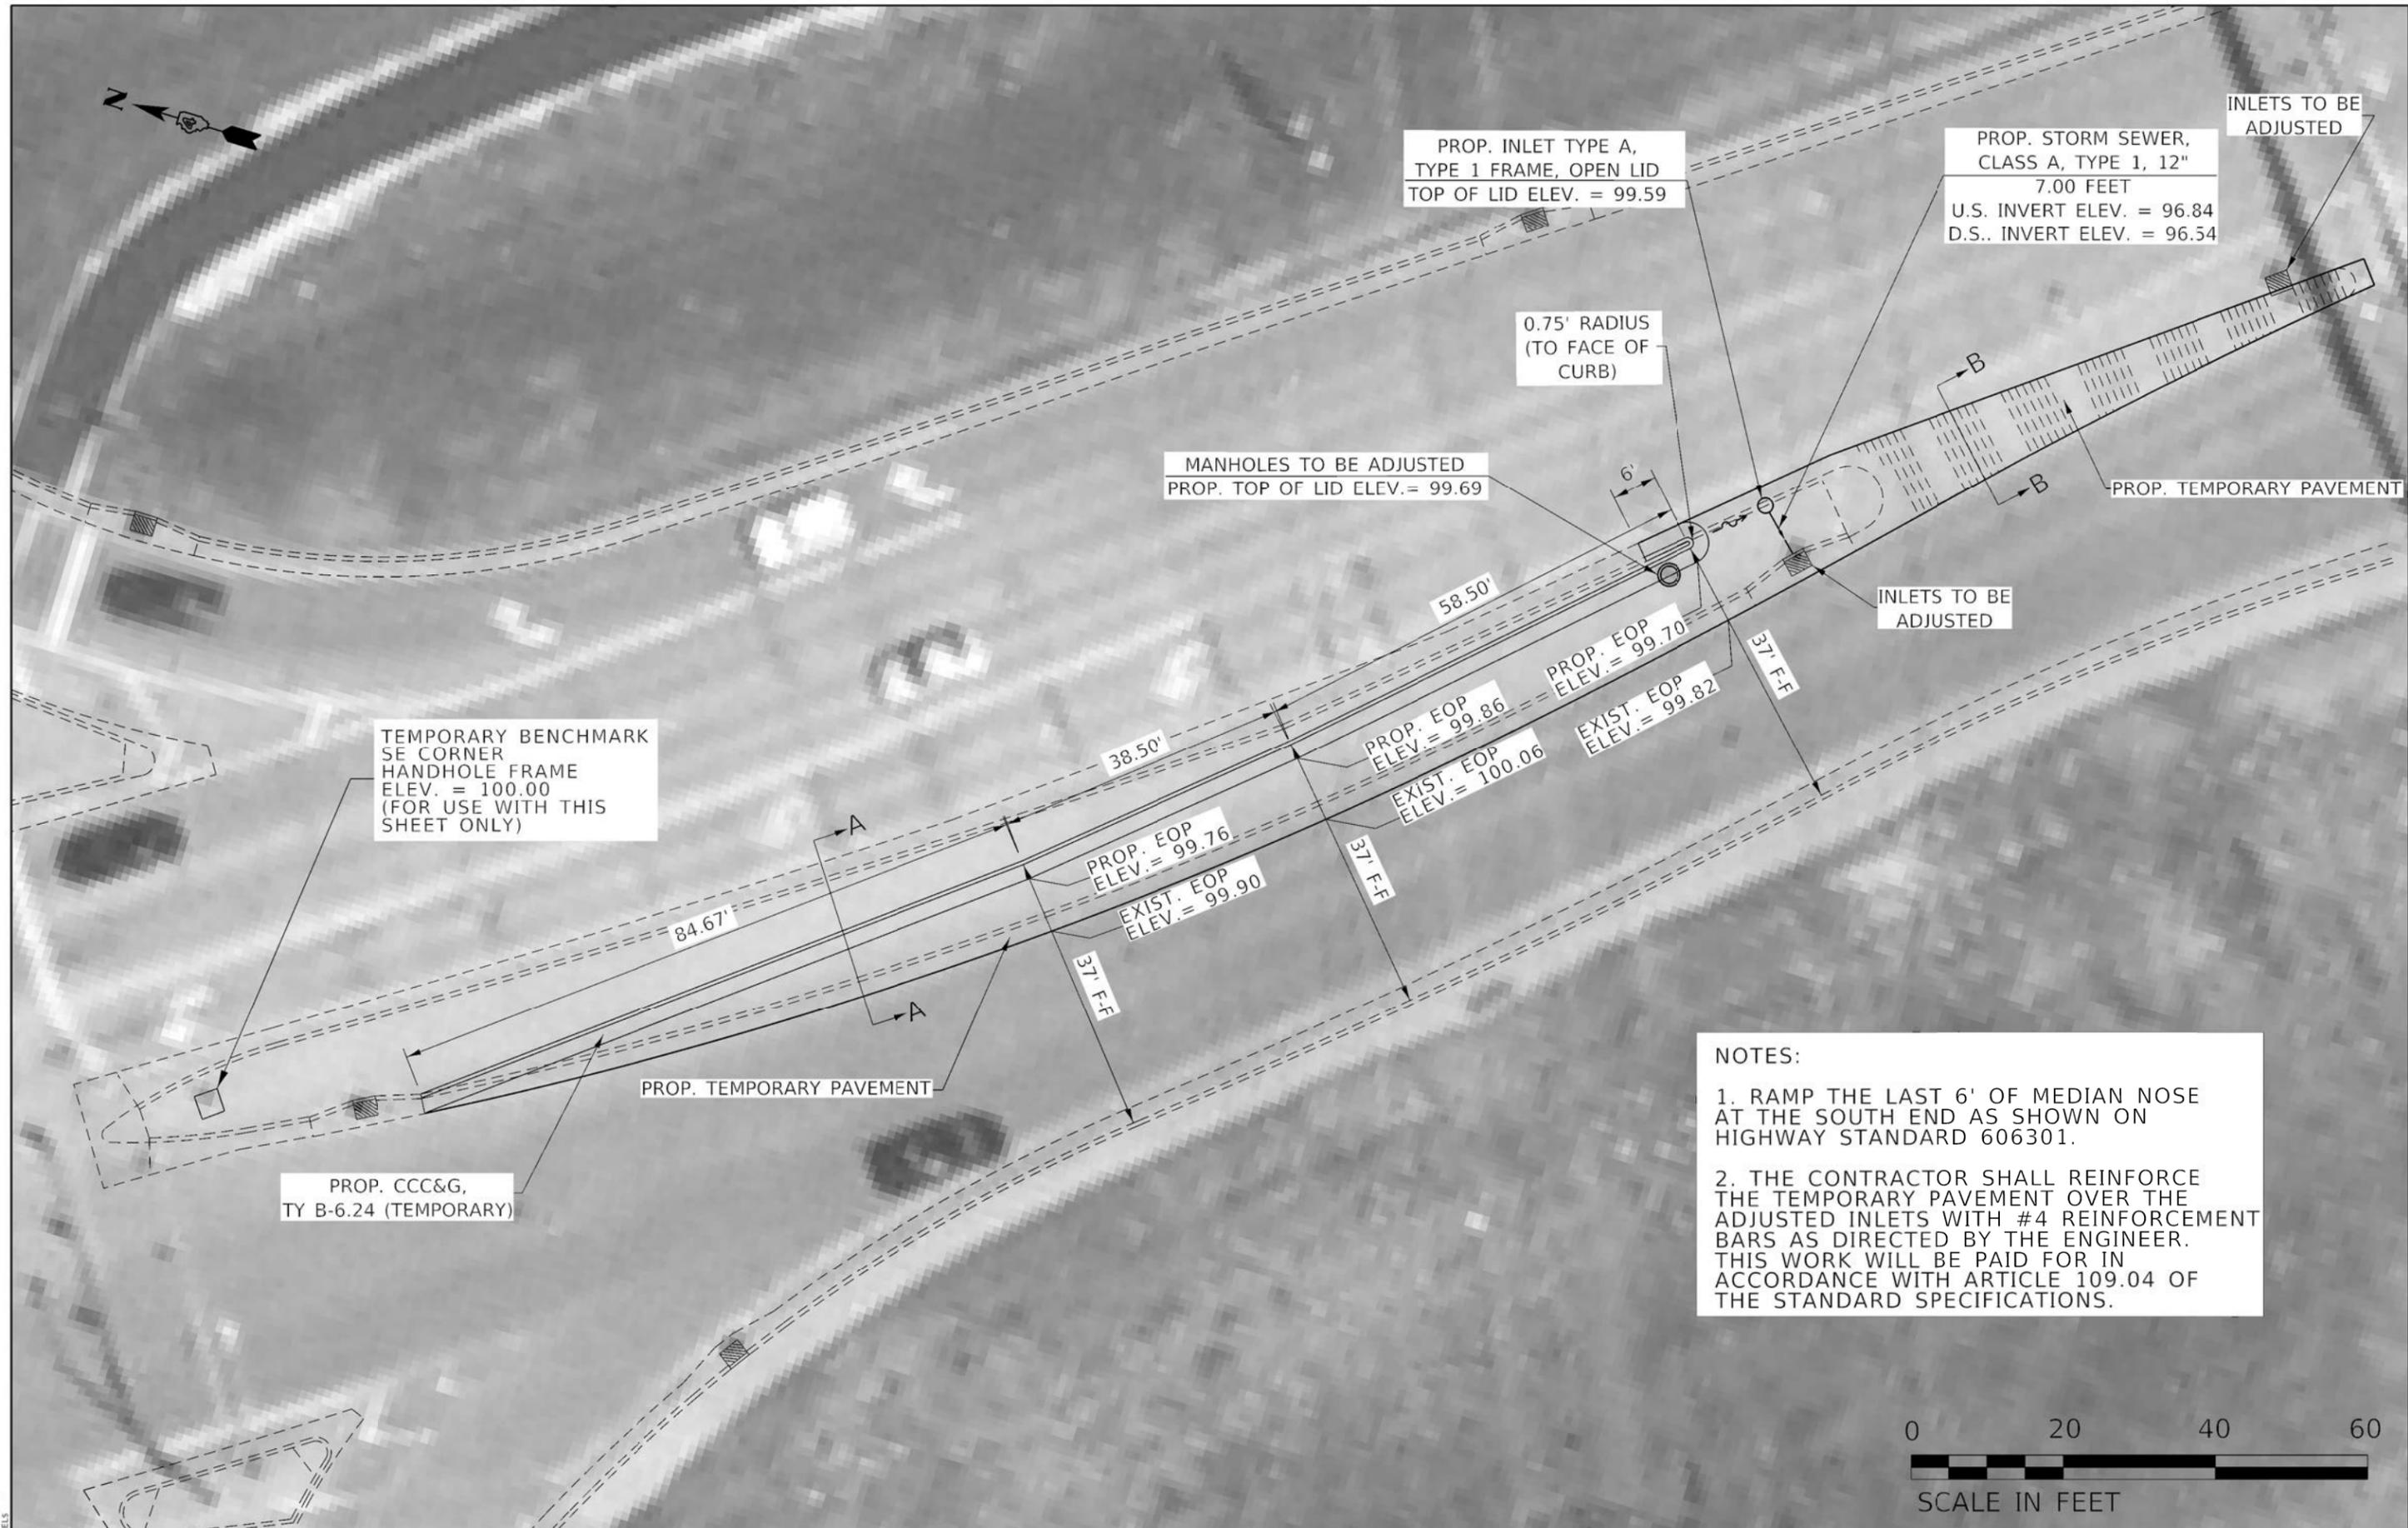

NOTES:

1. RAMP THE LAST 6' OF MEDIAN NOSE AT THE SOUTH END AS SHOWN ON HIGHWAY STANDARD 606301.
2. THE CONTRACTOR SHALL REINFORCE THE TEMPORARY PAVEMENT OVER THE ADJUSTED INLETS WITH #4 REINFORCEMENT BARS AS DIRECTED BY THE ENGINEER. THIS WORK WILL BE PAID FOR IN ACCORDANCE WITH ARTICLE 109.04 OF THE STANDARD SPECIFICATIONS.




MODEL - SHORDBENAMES
FILE NAME - ST121

USER NAME = SUSERS	DESIGNED - IDOT	REVISED - 11/21/2018
DRAWN - IDOT		
PLOT SCALE = \$SCALE\$	CHECKED -	REVISED -
PLOT DATE = \$DATE\$	DATE -	REVISED -

**STATE OF ILLINOIS
DEPARTMENT OF TRANSPORTATION**


WASHINGTON ST. MEDIAN MODIFICATION DETAILS			
SCALE:	SHEET 1	OF 2 SHEETS	STA. TO STA.

F.A.P. RTE.	SECTION	COUNTY	TOTAL SHEETS	SHEET NO.
404	(50B-4)BR;12((HVB,HB)BR)BR	TAZEWELL	61	18B
			CONTRACT NO. 68D59	
ILLINOIS FED. AID PROJECT				

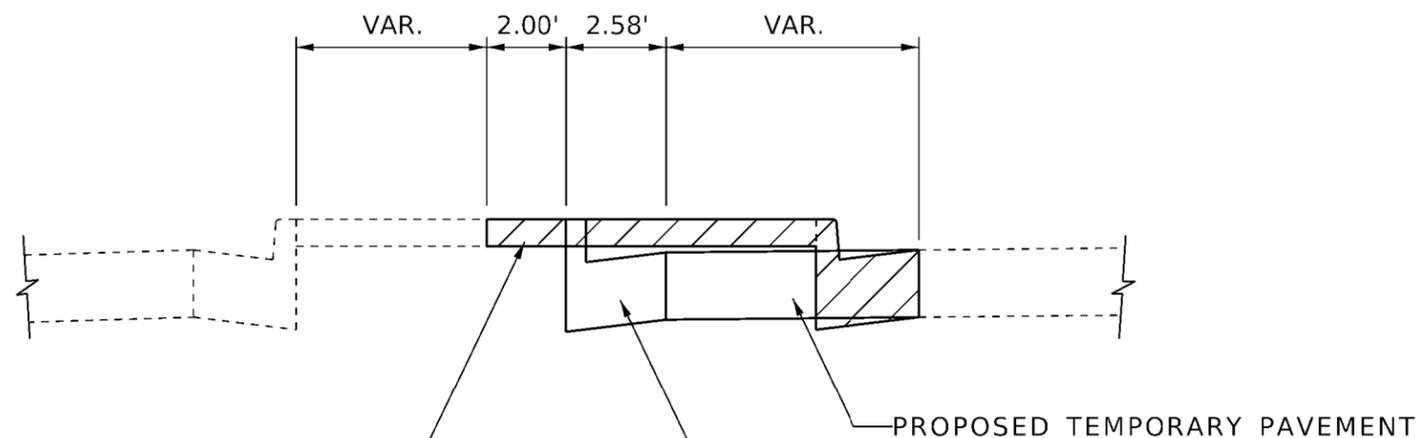

VOID SHALL BE FILLED WITH COMPACTED CA 6. THIS WORK SHALL BE INCLUDED IN THE COST OF THE PROPOSED CURB AND GUTTER.

SECTION A-A

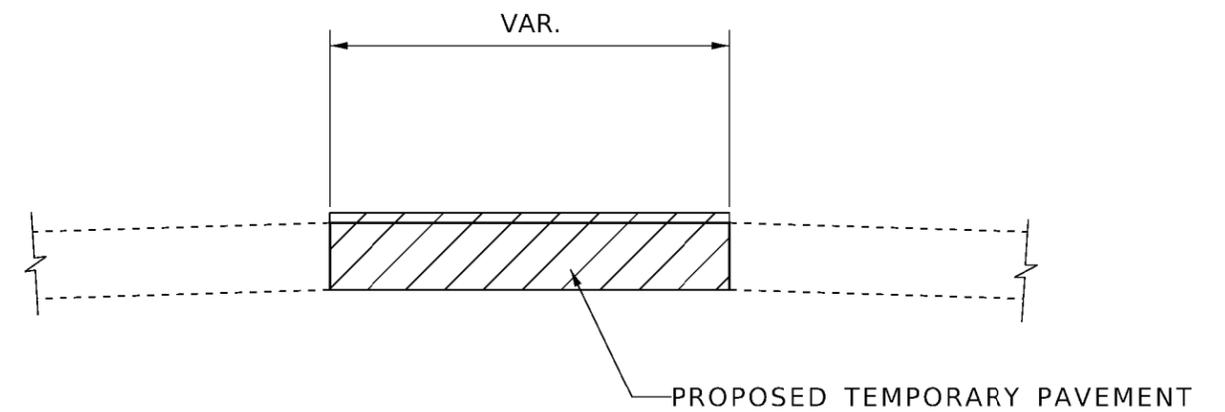

SECTION B-B

NOTE:
 ANY EARTH EXCAVATION REQUIRED SHALL BE CONSIDERED INCLUDED IN THE COST OF TEMPORARY PAVEMENT AND COMBINATION CONCRETE CURB AND GUTTER, TYPE B-6.24 (TEMPORARY).

LEGEND

 REMOVAL (SEE WASHINGTON ST. MEDIAN REMOVAL DETAILS)

MODEL: \$MODELNAME\$
FILE NAME: \$FILE\$

USER NAME = \$USERS\$	DESIGNED - IDOT	REVISED - 11/21/2018
	DRAWN - IDOT	REVISED -
PLOT SCALE = \$SCALES\$	CHECKED -	REVISED -
PLOT DATE = \$DATES\$	DATE -	REVISED -

**STATE OF ILLINOIS
 DEPARTMENT OF TRANSPORTATION**

WASHINGTON ST. MEDIAN MODIFICATION DETAILS			
SCALE:	SHEET 2	OF 2 SHEETS	STA. TO STA.

F.A.P. RTE.	SECTION	COUNTY	TOTAL SHEETS	SHEET NO.
404	(50B-4)BR;12((HVB,HB)BR)BR	TAZEWELL	61	18C
CONTRACT NO. 68D59				
ILLINOIS		FED. AID PROJECT		

Bench Mark: Chiseled cross on guard rail bolt. Station 13+35 ± 45-ft right along Existing F.A.P. Rte. 404 centerline. Elevation 484.47

Existing Structure: S.N. 090-0044 Built as F.A. Route 10(Spur), Section 12HVB in 1959. The deck was removed and the structure widened in 1993. A portion of the deck and parapet was removed and the structure widened again in 2003. The Superstructure consists of a reinforced concrete deck supported on eight spans with composite wide flange beams and plate girders. The substructure consists of pile bent abutments and multi-column piers supported by timber and driven steel piling.

Salvage: Existing Temporary Shoring

DESIGN SPECIFICATIONS

2002 AASHTO Standard Specifications for Highway Bridges
1983 AASHTO Guide Specifications for Seismic Design of Highway Bridges

LOADING HS20-44

No future wearing surface allowed.

SCOPE OF WORK:



- Clean and paint beam ends, end diaphragms.
- Perform structural repair of concrete to piers at noted areas of delamination and spalling.
- Remove and replace the bearings from the original construction at the east and west abutments with galvanized fixed bearings.
- Remove the existing median for use as temporary pavement in upcoming project.
- Repair Deck at median removal locations.
- Caulk existing joints.
- The existing steel shoring materials on Piers 1, 4, 5 and 6 are to be salvaged and remain the property of the State in accordance with Section 501.02 of the Standard Specifications. The Contractor shall fully disassemble all bolted connections and stockpile the material until the Department can arrange for pickup (contact: Mark Eckhoff - 309-671-4463). The Department will provide hauling and the Contractor shall provide loading. Cost to be included in Furnishing and Erecting Structural Steel.

INDEX OF SHEETS

- General Plan and Elevation
- General Data
- Superstructure Concrete Removal
- Framing Plan
- Bearing Details
- Pier 1 Concrete Repair Details
- Pier 2 Concrete Repair Details
- Pier 3 Concrete Repair Details
- Pier 4 Concrete Repair Details
- Pier 5 Concrete Repair Details
- Pier 6 Concrete Repair Details
- Pier 7 Concrete Repair Details
- Existing Steel Cleaning and Painting Details

DESIGN STRESSES

New Construction
 $f'_c = 4,000$ psi (Superstructure)
 $f'_c = 3,500$ psi (Concrete)
 $f_y = 60,000$ psi (Reinforcement)
 $f_y = 50,000$ psi (M270 Grade 50)

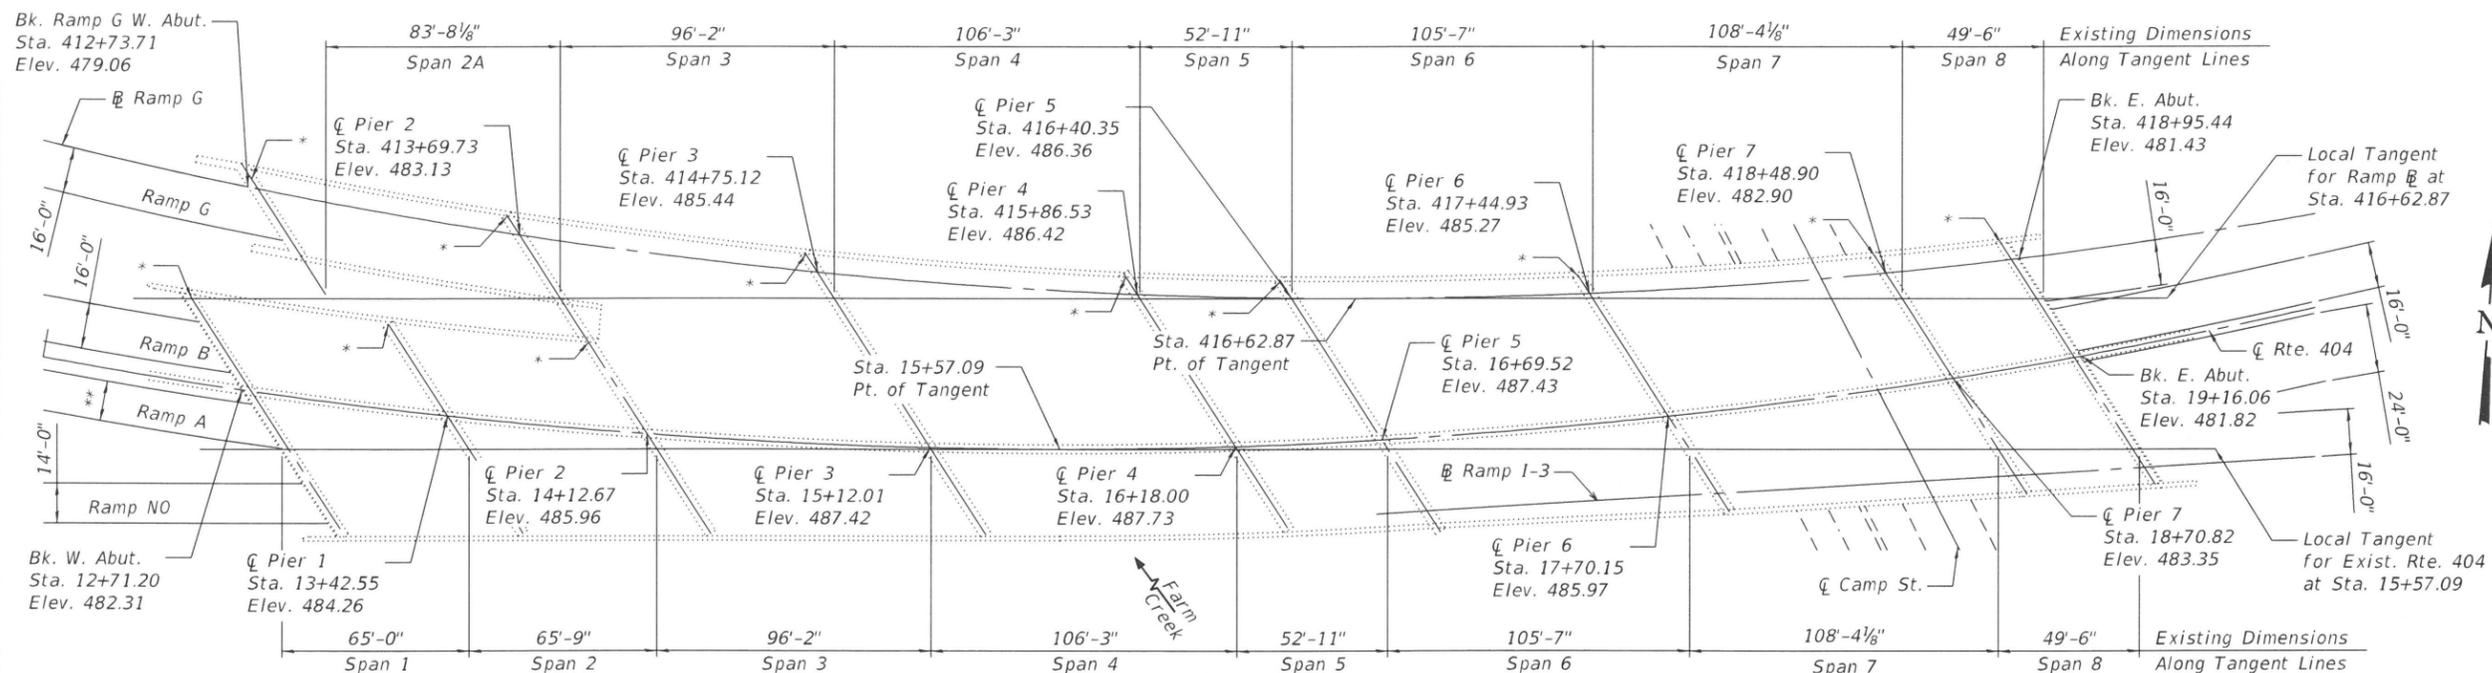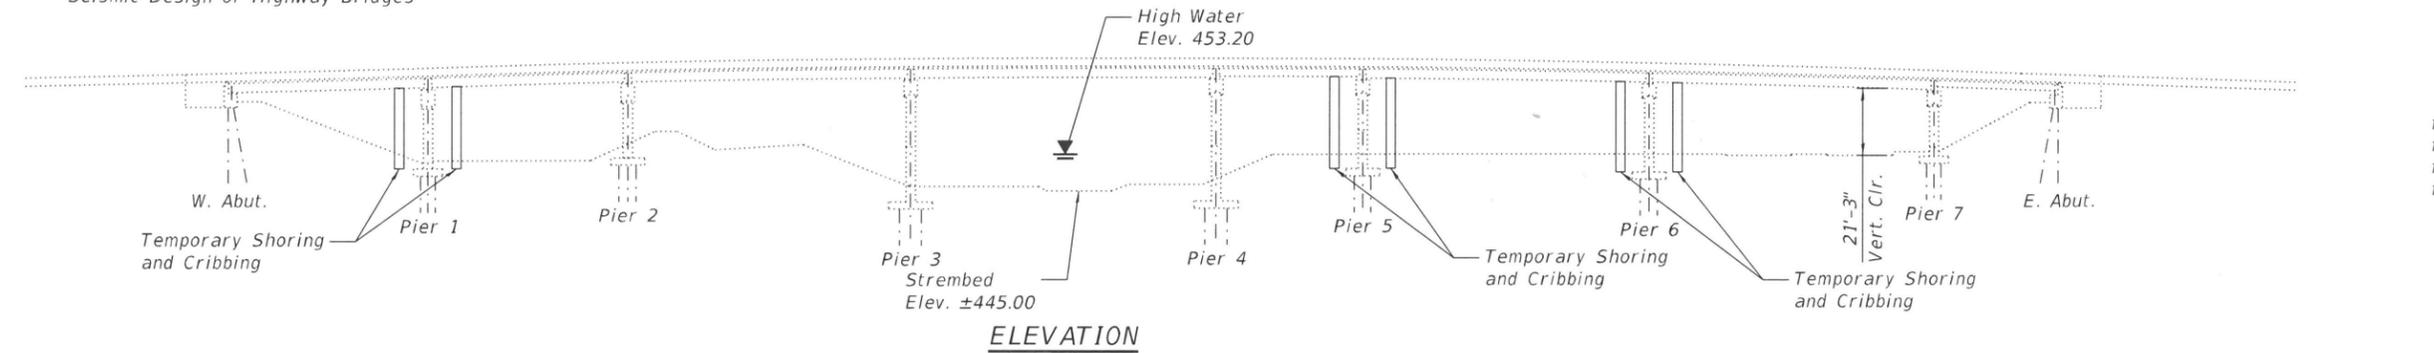


* Indicates Locations for "Joint Repair"
 ** Varies from 14'-0" to 16'-0"

PLAN



SIGNED: *Benjamin Boyce*
 DATE: 11/28/2018
 ILLINOIS STRUCTURAL ENGINEER
 NO. 081-007230
 LICENSE EXPIRES: 11-30-2020

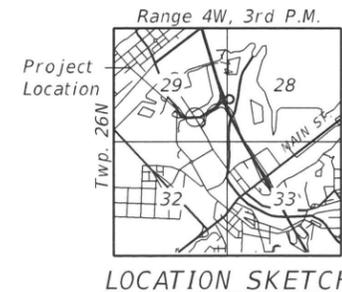

GENERAL PLAN & ELEVATION
RIVERFRONT DRIVE & RAMP I-3 OVER CAMP STREET,
FARM CREEK AND TOLEDO, PEORIA & WESTERN RR
F.A.P. ROUTE 404 - SEC. (50B-4)BR;12[(HVB,HB)BR]BR
TAZEWELL COUNTY
STATION 15+57.09
STRUCTURE NO. 090-0044

STATE OF ILLINOIS
 DEPARTMENT OF TRANSPORTATION

GENERAL PLAN AND ELEVATION
 STRUCTURE NO. 090-0044

SHEET 1 OF 13 SHEETS

F.A.P. RTE.	SECTION	COUNTY	TOTAL SHEETS	SHEET NO.
404	(50B-4)BR;12[(HVB,HB)BR]BR	TAZEWELL	61	19
CONTRACT NO. 68D59				

ILLINOIS FED. AID PROJECT




FILE NAME: P:\110-1010.18 SN0900044 Repairs\10_CADD\CADD_Sheets\0900044-68D59-001-GPE.dgn

GENERAL NOTES:

All structural steel shall be AASHTO M 270 Grade 50.
 Plan dimensions and details relative to existing plans are subject to nominal construction variations. The Contractor shall field verify existing dimensions and details affecting new construction and make necessary approved adjustments prior to construction or ordering materials. Such variations shall not be cause for additional compensation for a change in scope of work, however, the Contractor will be paid for the quantity actually furnished at the unit price bid for work.
 All new structural steel and bearing assemblies shall be hot-dipped galvanized. See special provisions for "Hot Dip Galvanizing for Structural Steel."
 Cleaning and painting of the existing structure steel shall be as specified in the special provisions for "Cleaning and Painting Existing Steel Structures". All beams, diaphragms, bearings and other structural steel within 5 ft. (measured along the beam) of either side of the deck joints shall be cleaned per Near White Blast Cleaning - SSPC-SP-10.
 The designated areas cleaned per Near White Blast Cleaning - SSPC-SP-10 shall be painted according to the requirements of Paint System 1 - OZ/E/U.
 The color of the final finish coat for all steel surfaces shall be Blue, Munsell NO. 10B 3/6.
 The existing structural steel coating contains lead. The Contractor shall take appropriate precautions to deal with the presence of lead on this project.
 Jack and remove existing bearings shall be specified in special provisions for "Jack and Remove Existing Bearings". This work shall consist of the preparation of all designated metal surfaces by the method(s) specified on the plans. This work also includes the painting of those designated surfaces with the paint system(s) specified on the plans. The Contractor shall furnish all materials, equipment, labor, and other essentials necessary to accomplish this work and all other work described herein and as directed by the Engineer.
 Containment and disposal as specified shall follow the special provisions for "Containment and Disposal of Lead Paint Cleaning Residue." The use of four air monitors will be required to monitor abrasive blasting operations.
 The painting contractor shall be SSPC-QP1 and SSPC-QP2 certified for this project and shall maintain certification throughout the duration of the project.


TOTAL BILL OF MATERIAL

ITEM	UNIT	SUPER	SUB	TOTAL
Concrete Removal	Cu. Yd.	45.3		45.3
Anchor Bolts, 1"	Each	54		54
Furnishing and Erecting Structural Steel	Pound		4420	4420
Structural Repair of Concrete (Depth equal to or less than 5')	Sq. Ft.		3658.9	3658.9
Cleaning and Painting Structural Steel, Location 1	L. Sum	1		1
Jack and Remove Existing Bearings	Each	27		27
Containment and Disposal of Lead Paint Cleaning Residues No. 1	L. Sum			1
Deck Slab Repair (Partial)	Sq. Yd.	225.0		225.0
Silicone Joint Sealer, Special	Foot	36		36
Joint Repair	Each	11		11
Temporary Shoring and Cribbing	Each	57		57

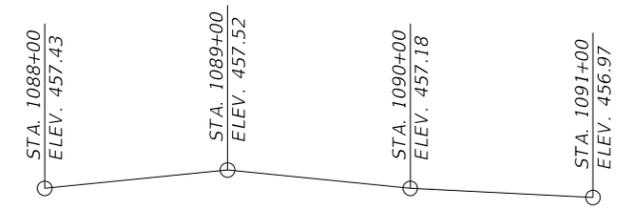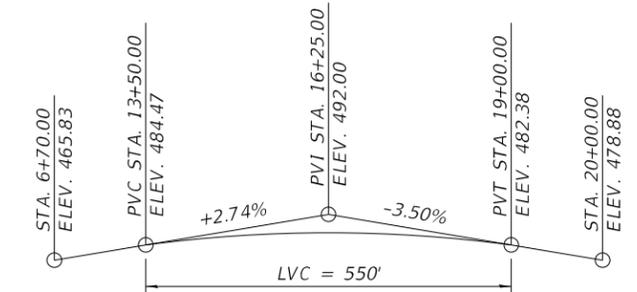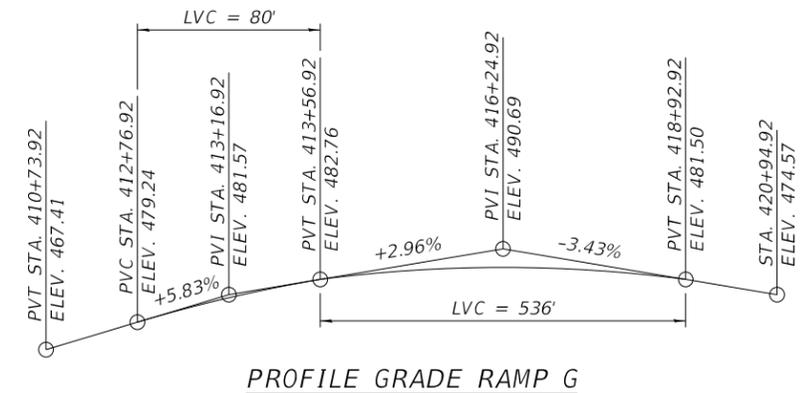

OFFSET TABLE
(All dimensions are in feet)

Location	Ramp G		C F.A.P. 404		Tangent to Ramp G		Tangent to C F.A.P. 404	
	X	Y	X	Y	X	Y	X	Y
Bk. W. Abut.	--	--	-387.950	-32.096	--	--	-374.719	-52.744
Bk. Ramp G W. Abut.	-386.524	39.135	--	--	-361.448	0.000	--	--
Pier 1	--	--	-317.175	-41.107	--	--	-309.719	-52.744
Pier 2	-292.012	22.238	-247.348	-47.468	-277.768	0.000	-243.967	-52.744
Pier 3	-187.451	9.132	-148.132	-52.230	-181.599	0.000	-147.803	-52.744
Pier 4	-76.319	1.511	-42.156	-51.805	-75.351	0.000	-41.554	-52.744
Pier 5	-22.518	0.132	9.313	-49.546	-22.434	0.000	11.862	-52.744
Pier 6	82.030	1.746	109.591	-41.267	83.149	0.000	116.945	-52.744
Pier 7	185.743	8.966	209.357	-27.887	191.488	0.000	225.284	-52.744
Bk. E. Abut.	232.009	14.008	253.942	-20.223	240.984	0.000	274.780	-52.744

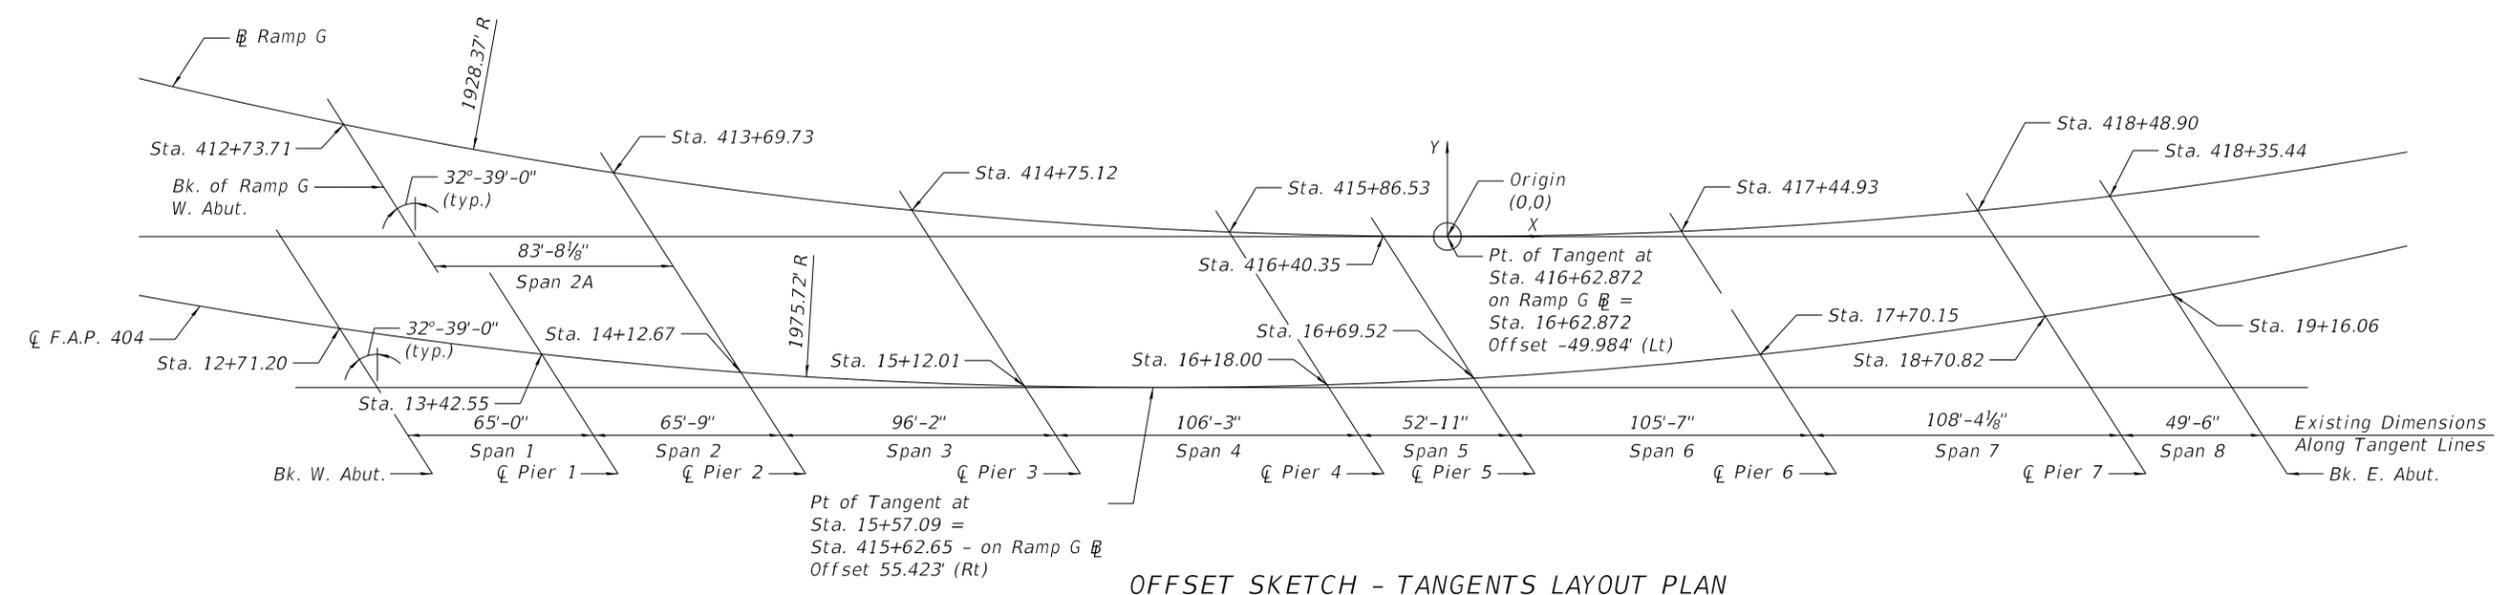

STATE OF ILLINOIS
DEPARTMENT OF TRANSPORTATION



GENERAL DATA
STRUCTURE NO. 090-0044

F.A.P. RTE.	SECTION	COUNTY	TOTAL SHEETS	SHEET NO.
404	(50B-4)BR:12((HVB,HB)BR)BR	TAZEWELL	61	20
CONTRACT NO. 68D59				



FILE NAME: P:\10-1010.18_S\09000044_Repairs\10_CAD\CADD_Sheets\09000044-68D59-002-General data.dgn




USER NAME =	DESIGNED - KS	REVISED -
PLOT SCALE =	CHECKED - BB	REVISED -
PLOT DATE =	DRAWN - KS	REVISED -
	CHECKED - BB	REVISED -

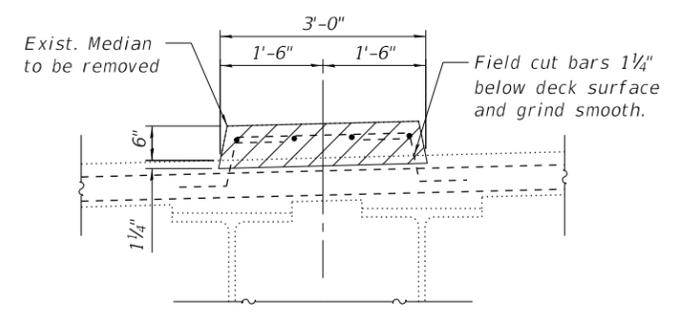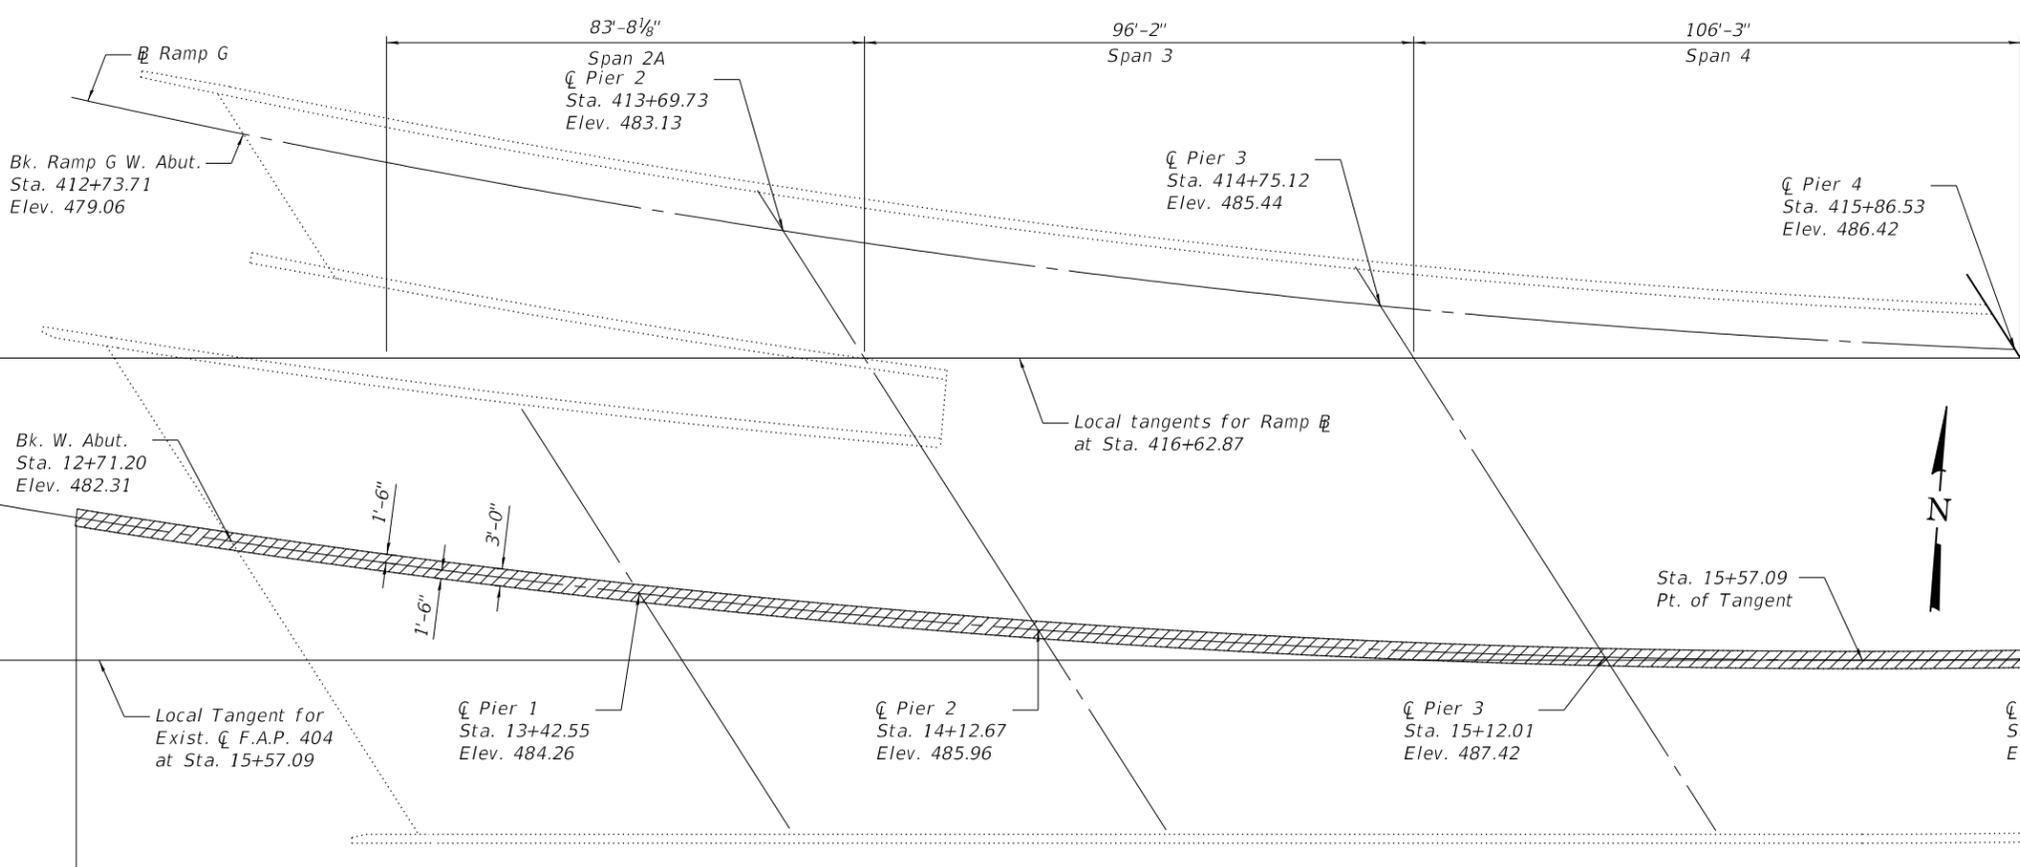

MEDIAN REMOVAL DETAIL
(Paid for as Concrete Removal)

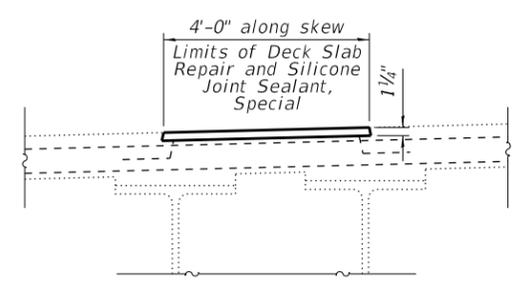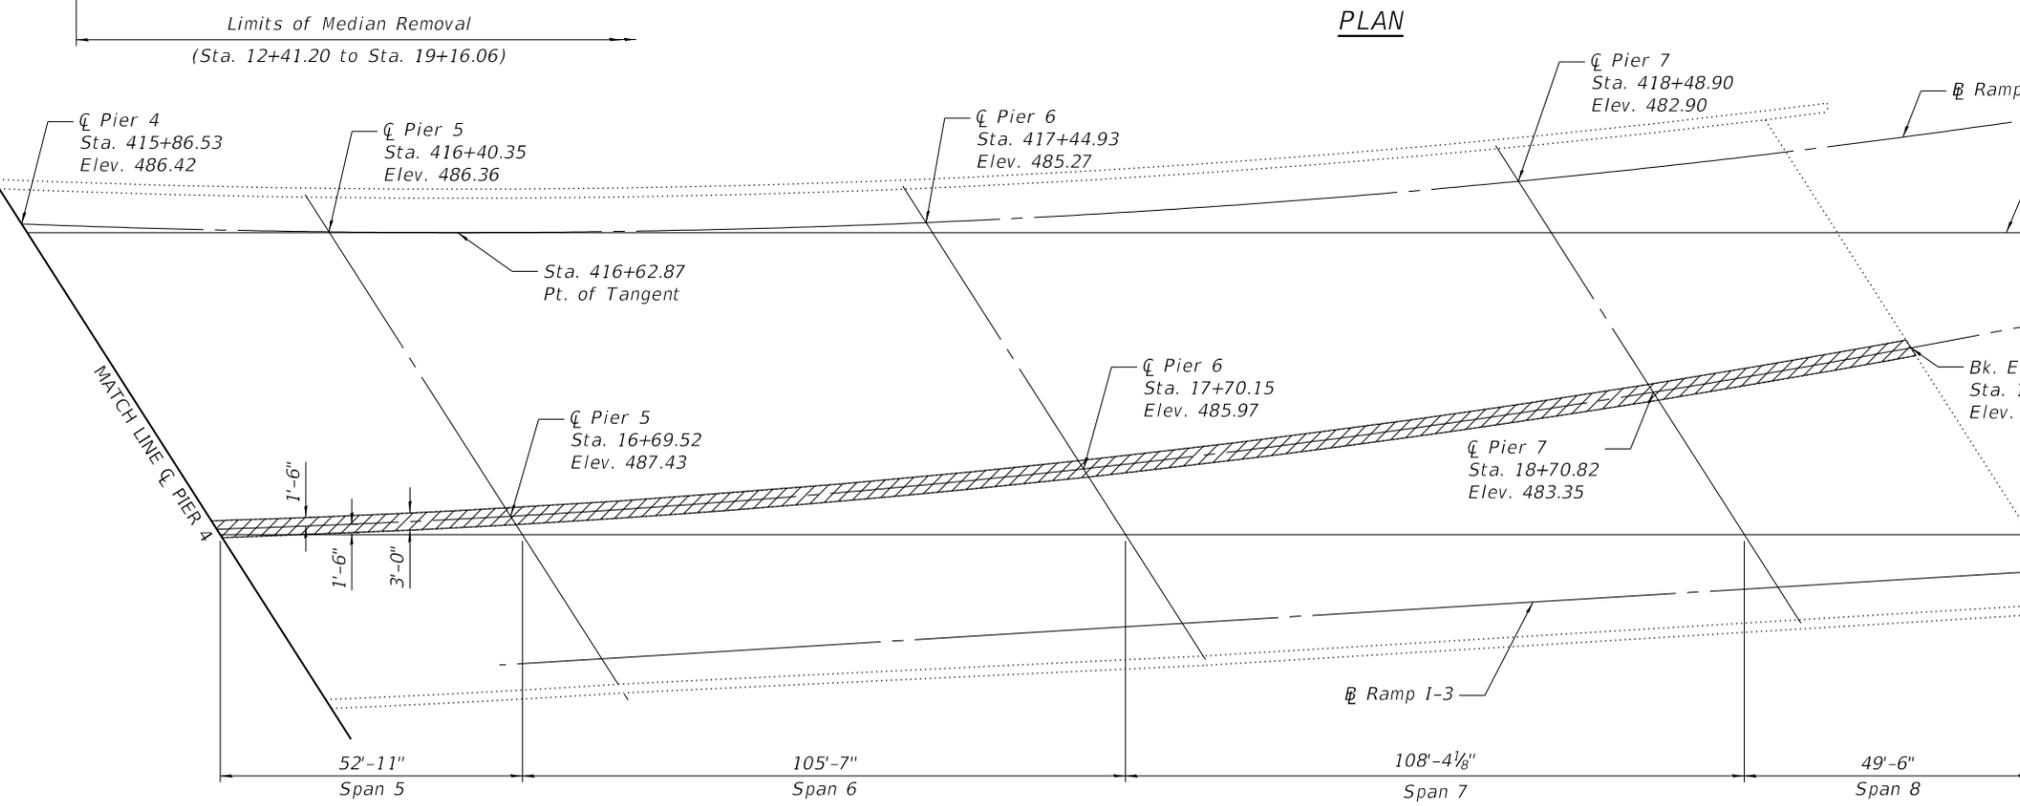

DECK REPAIR DETAIL
(Paid for as Deck Slab Repair (Partial))

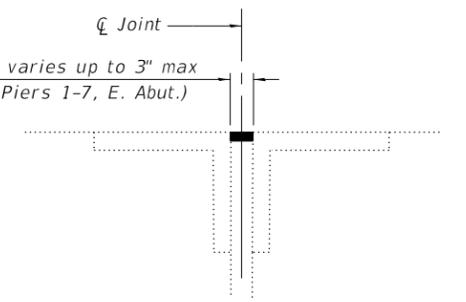

SECTION THRU MEDIAN JOINT
(Paid for as Silicone Joint Sealer, Special)

BILL OF MATERIAL

Item	Unit	Total
Concrete Removal	Cu. Yd.	45.3
Deck Slab Repair (Partial)	Sq. Yd.	225.0
Silicone Joint Sealer, Special	Foot	36

Indicates limits of Concrete Removal and Deck Slab Repair (Partial)

PLAN

PLAN

FILE NAME: P:\10-1010.18_S\09000044_Repairs\10_CAD\CADD_Sheets\09000044-68D59-003-Deck_Repairs.dgn



288 E. Main St., Suite 200
Moline, IL 61704
662.233.2877 phone
662.233.2977 fax
www.kaskaskiaeng.com
11/27/2018
10:58:56

USER NAME =	DESIGNED - KS	REVISED -
	CHECKED - BB	REVISED -
PLOT SCALE =	DRAWN - KS	REVISED -
PLOT DATE =	CHECKED - BB	REVISED -

**STATE OF ILLINOIS
DEPARTMENT OF TRANSPORTATION**

**SUPERSTRUCTURE CONCRETE REMOVAL
STRUCTURE NO. 090-0044**

SHEET 3 OF 13 SHEETS

F.A.P. RTE.	SECTION	COUNTY	TOTAL SHEETS	SHEET NO.
404	(50B-4)BR:12((HVB,HB)BR)BR	TAZEWELL	61	21
CONTRACT NO. 68D59				

ILLINOIS FED. AID PROJECT


* Indicates location of brg. replacement

DIAPHRAGM DETAILS


DESIGNATION	SHAPE	TOTAL LENGTH
D	W16X36	1206'
D1	W12X40	260'
D2	W12X36	130'
D3	W16X57	43'

PLATE GIRDER DETAILS

DESIGNATION	TOP FLANGE	WEB	BOT. FLANGE
PG2A	R 1" x 12"	R 5/8" x 39"	R 1 1/8" x 16"
PG3	R 1 3/8" x 16"	R 5/8" x 39"	R 1 1/8" x 18"
PG4	R 1 5/8" x 16"	R 5/8" x 39"	R 2 1/8" x 18"
PG6A	R 1 3/8" x 16"	R 5/8" x 39"	R 1 1/8" x 18"
PG6B	R 1 3/8" x 16"	R 5/8" x 39"	R 1 1/8" x 18"
PG7A	R 1 3/8" x 16"	R 5/8" x 39"	R 1 1/8" x 18"
PG7B	R 1 3/8" x 16"	R 5/8" x 39"	R 1 1/8" x 18"

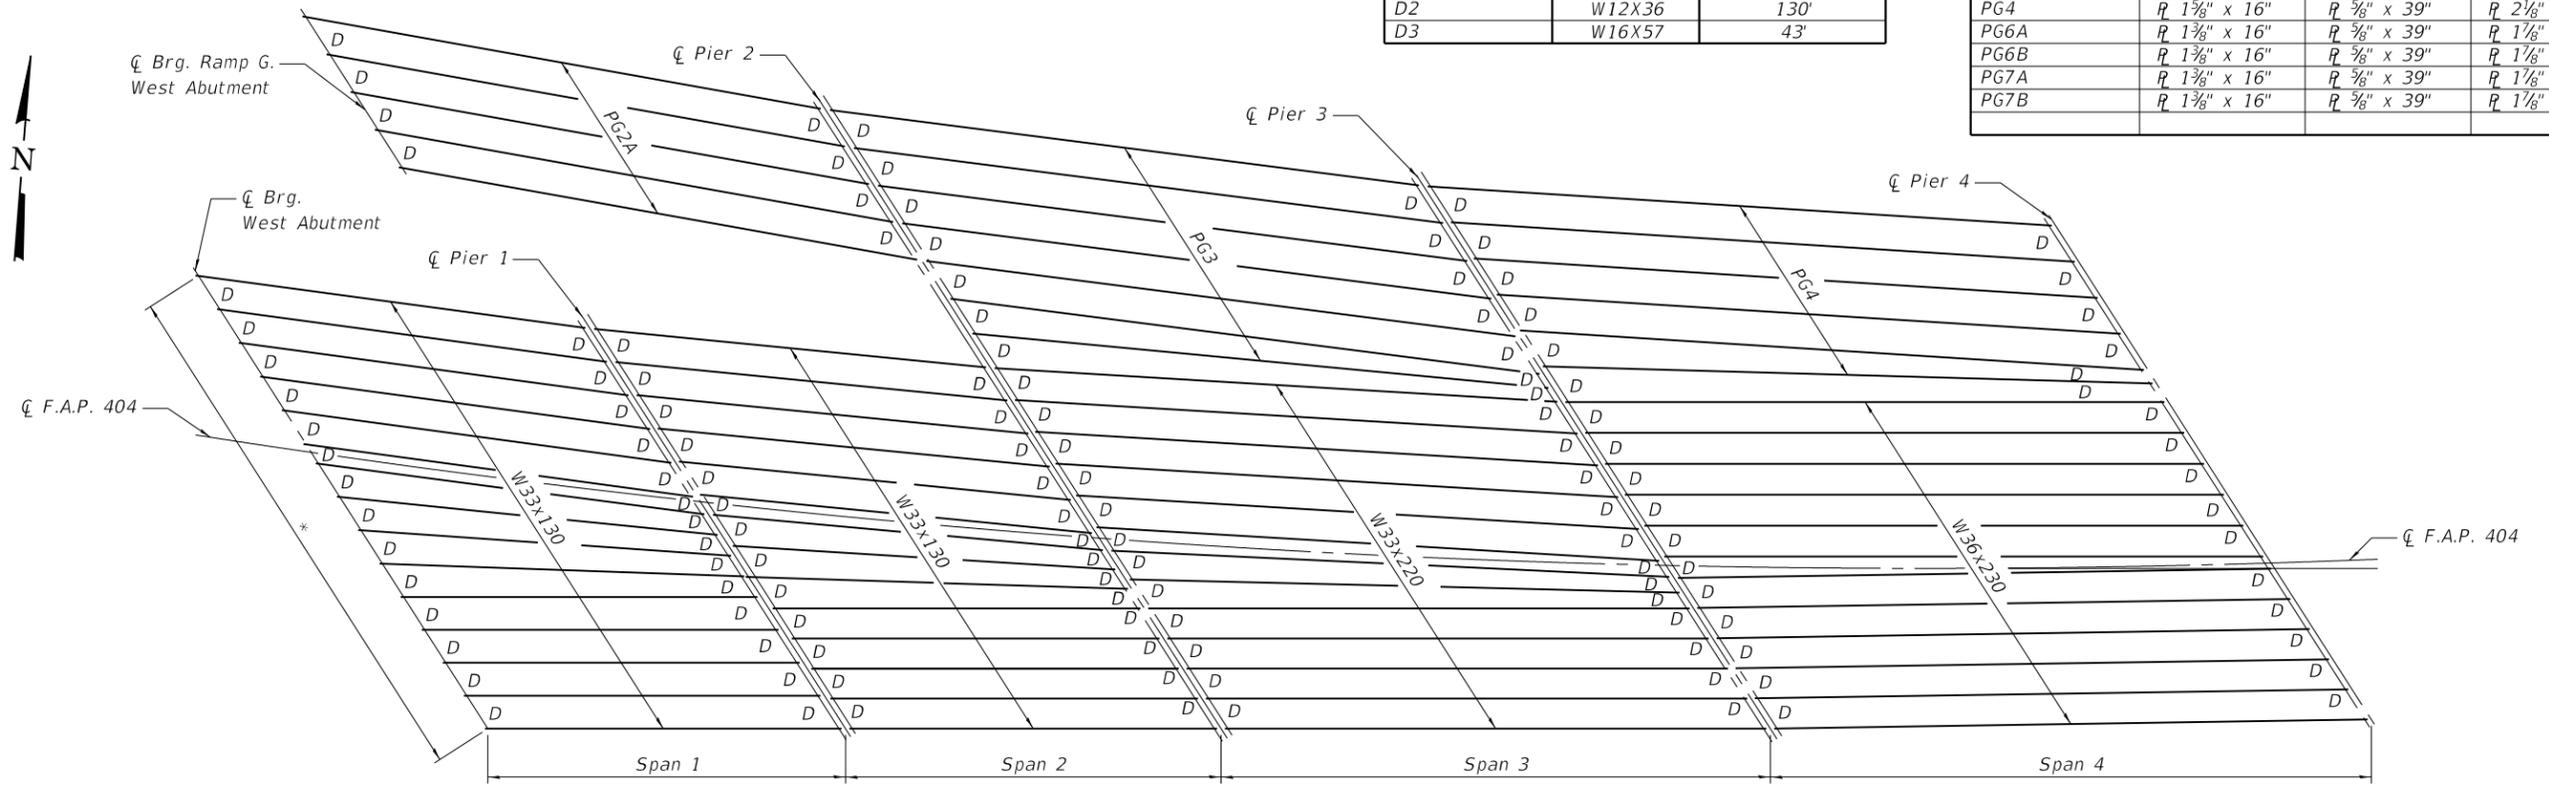

FRAMING PLAN
(Spans 1 thru 4)

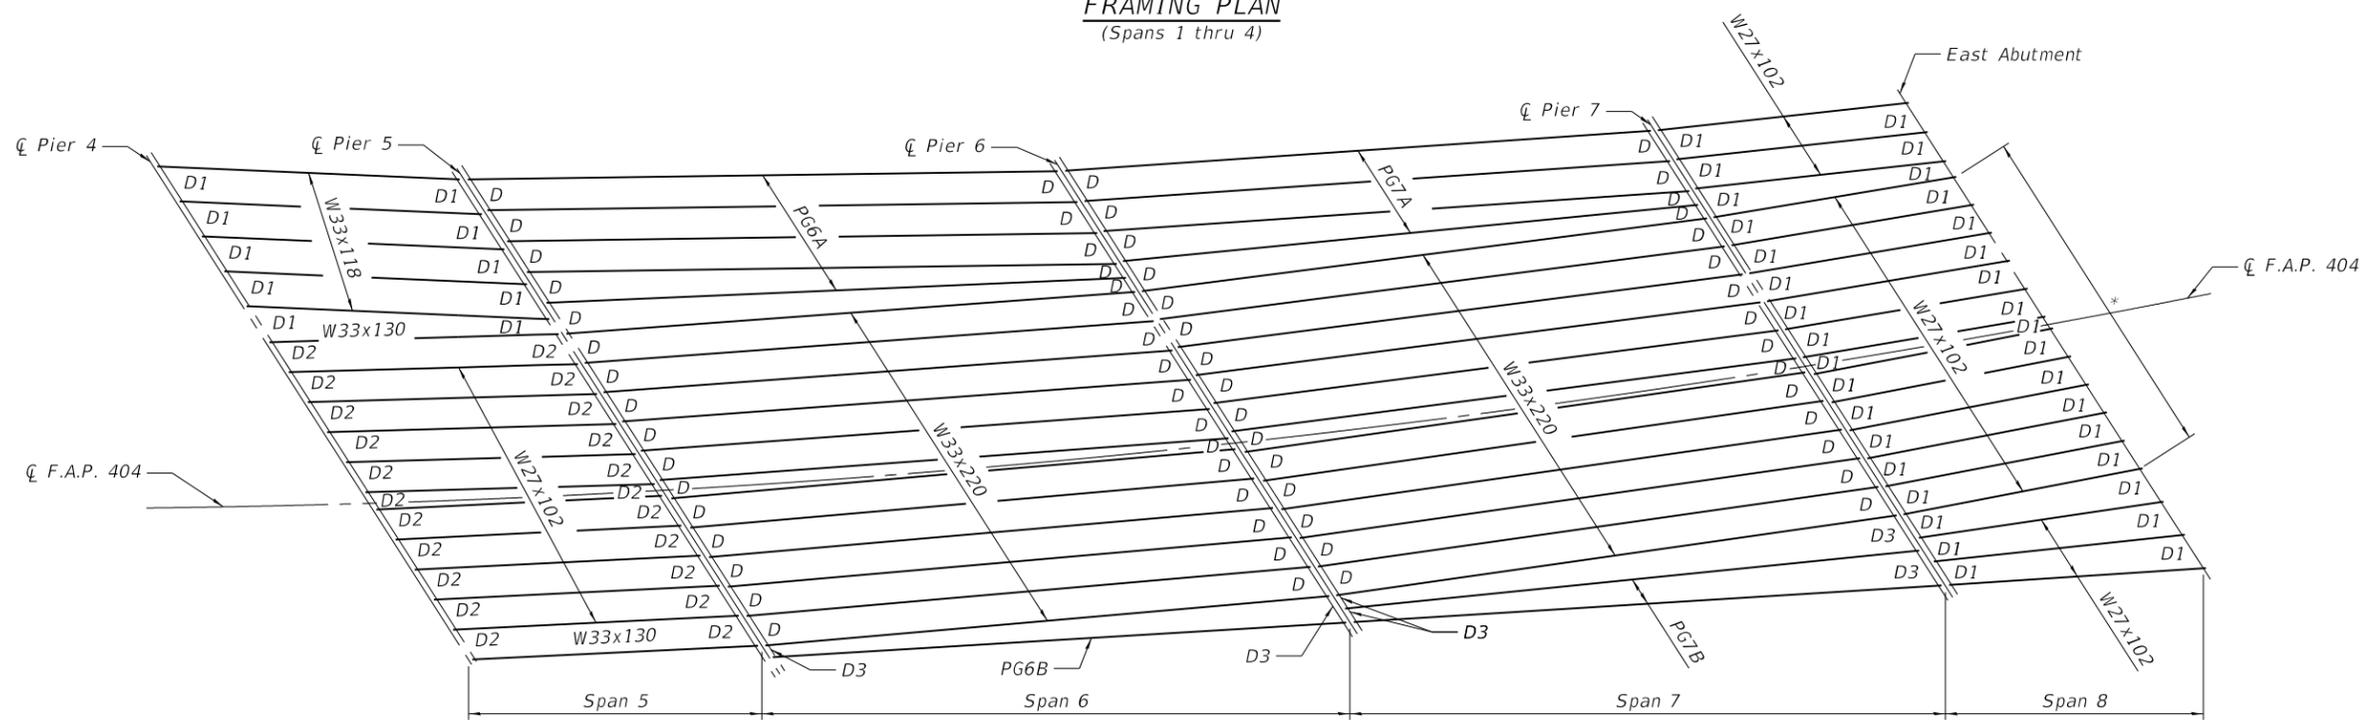

FRAMING PLAN
(Spans 5 thru 8)

FILE NAME: P:\10-1010.18_S\09000044_Repairs\10_CAD\CADD_Sheets\09000044-68D59-004-Framing_Plan.dgn

Kaskaskia
Engineering Group, LLC
Professional Engineering Group

288 E. Main St., Suite 200
Bloomington, Illinois 61702
618.233.2877 phone
618.233.2977 fax
www.kaskaskiaeng.com

11/27/2018
618.233.2877
20-088566


USER NAME =	DESIGNED - KS	REVISED -
PLOT SCALE =	CHECKED - BB	REVISED -
PLOT DATE =	DRAWN - KS	REVISED -
	CHECKED - BB	REVISED -

STATE OF ILLINOIS
DEPARTMENT OF TRANSPORTATION


FRAMING PLAN
STRUCTURE NO. 090-0044

SHEET 4 OF 13 SHEETS


F.A.U. RTE.	SECTION	COUNTY	TOTAL SHEETS	SHEET NO.
6707	(50B-4)BR:12((HVB,HB)BR)BR	TAZEWELL	61	22
CONTRACT NO. 68D59				
ILLINOIS FED. AID PROJECT				

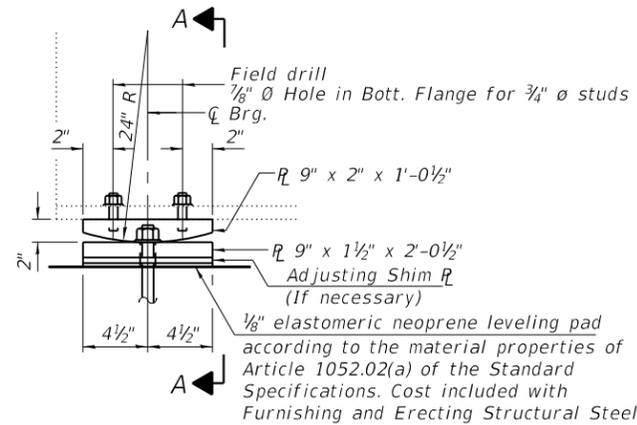


ELEVATION AT WEST ABUTMENT

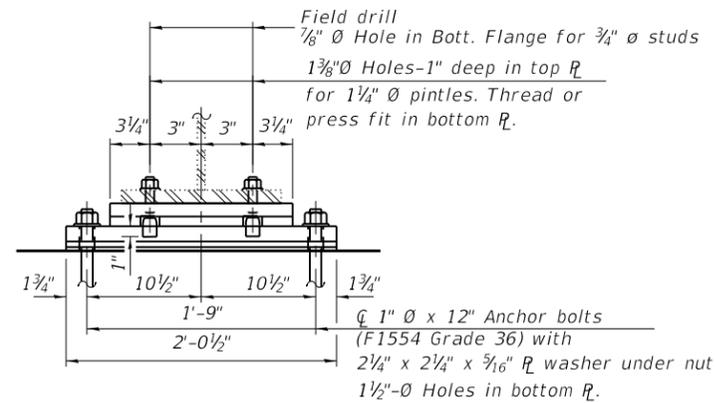

SECTION A-A

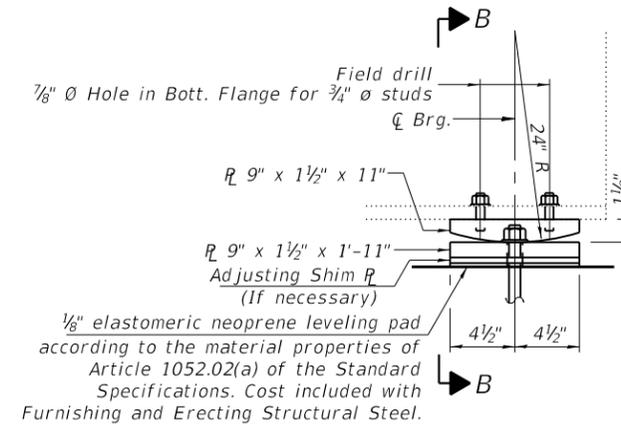


ELEVATION AT EAST ABUTMENT

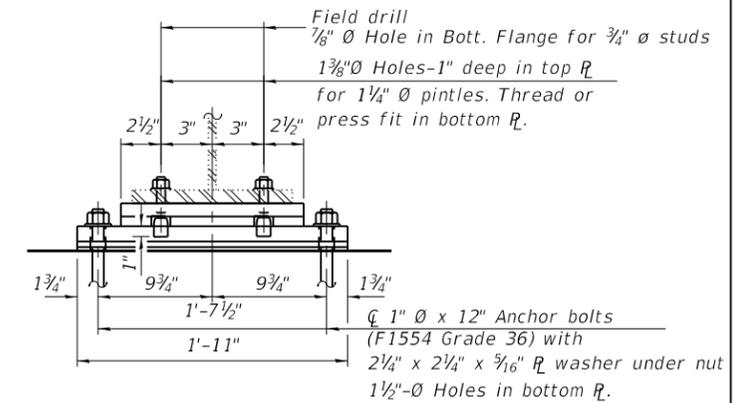


SECTION B-B

FIXED BEARING WEST ABUTMENT


FIXED BEARING EAST ABUTMENT

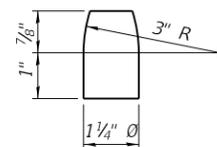


PINTLE

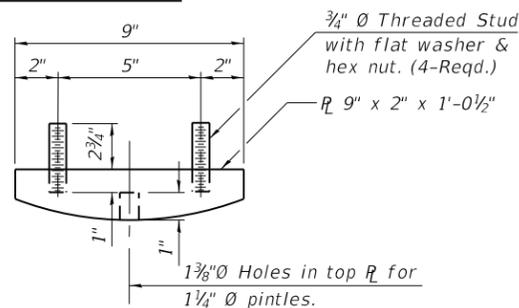

WEST ABUTMENT TOP PLATE DETAIL

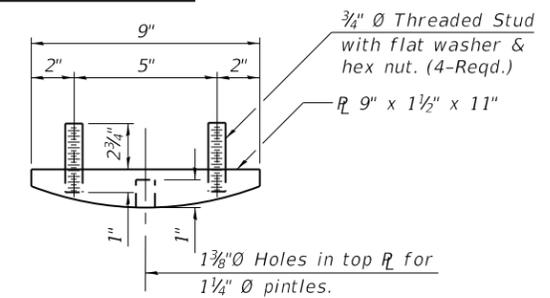

EAST ABUTMENT TOP PLATE DETAIL

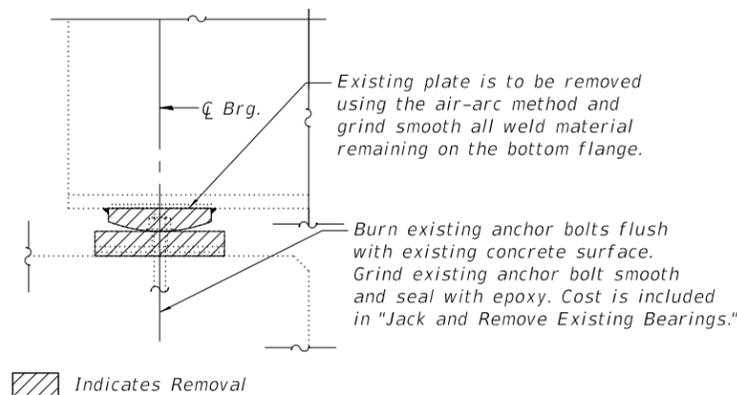

EXISTING BEARING REMOVAL DETAIL

(27 Required)
(15 at West Abut., 12 at East Abut.)

INTERIOR GIRDER REACTION TABLE			
		W. Abut.	E. Abut.
R _l	(k)	31.3	27.8
R _t	(k)	32.3	27.4
R _l	(k)	8.4	8.2
R _{Total}	(k)	72.0	63.4

Notes:
Anchor bolts shall be ASTM F1554 all-thread (or an Engineer-approved alternate material) of the grade(s) and diameter(s) specified. The corresponding specified grade of AASHTO M314 anchor bolts may be used in lieu of ASTM F1554.
Drilled and set anchor bolts shall be installed according to Article 521.06 of the Standard Specifications.
All steel for the bearings, shim plates, anchor bolts, and connection bolts shall be hot dipped galvanized.
The structural steel bearing plates for the bearings shall conform to the requirements of AASHTO M270 Grade 50.
Bearing plates, shim plates and connection bolts shall be included in Furnishing and Erecting Structural Steel.
Diaphragm removal and replacement may be required to facilitate drilling holes. Cost included in Furnishing and Erecting Structural Steel.

BILL OF MATERIAL

Item	Unit	Total
Anchor Bolts, 1"	Each	54
Furnishing and Erecting Structural Steel	Pound	4420

FILE NAME: P:\10-1010.18_S\03000044_Repairs\10_CAD\CADD_Sheets\0900044-68D59-005-Bearing_Details.dgn



288 E. Main St., Suite 200
Bellaire, MO 64608
636.253.2877 phone
636.253.2977 fax
www.kaskaskiaeng.com
Professional Engineering Group
11/27/2018
20-088266


USER NAME =	DESIGNED - KS	REVISED -
PLOT SCALE =	CHECKED - BB	REVISED -
PLOT DATE =	DRAWN - KS	REVISED -
	CHECKED - BB	REVISED -

STATE OF ILLINOIS
DEPARTMENT OF TRANSPORTATION


BEARING DETAILS
STRUCTURE NO. 090-0044

SHEET 5 OF 13 SHEETS

F.A.P. RTE.	SECTION	COUNTY	TOTAL SHEETS	SHEET NO.
404	(50B-4)BR;12(HVB,HB)BR BR	TAZEWELL	61	23
CONTRACT NO. 68D59				
ILLINOIS FED. AID PROJECT				

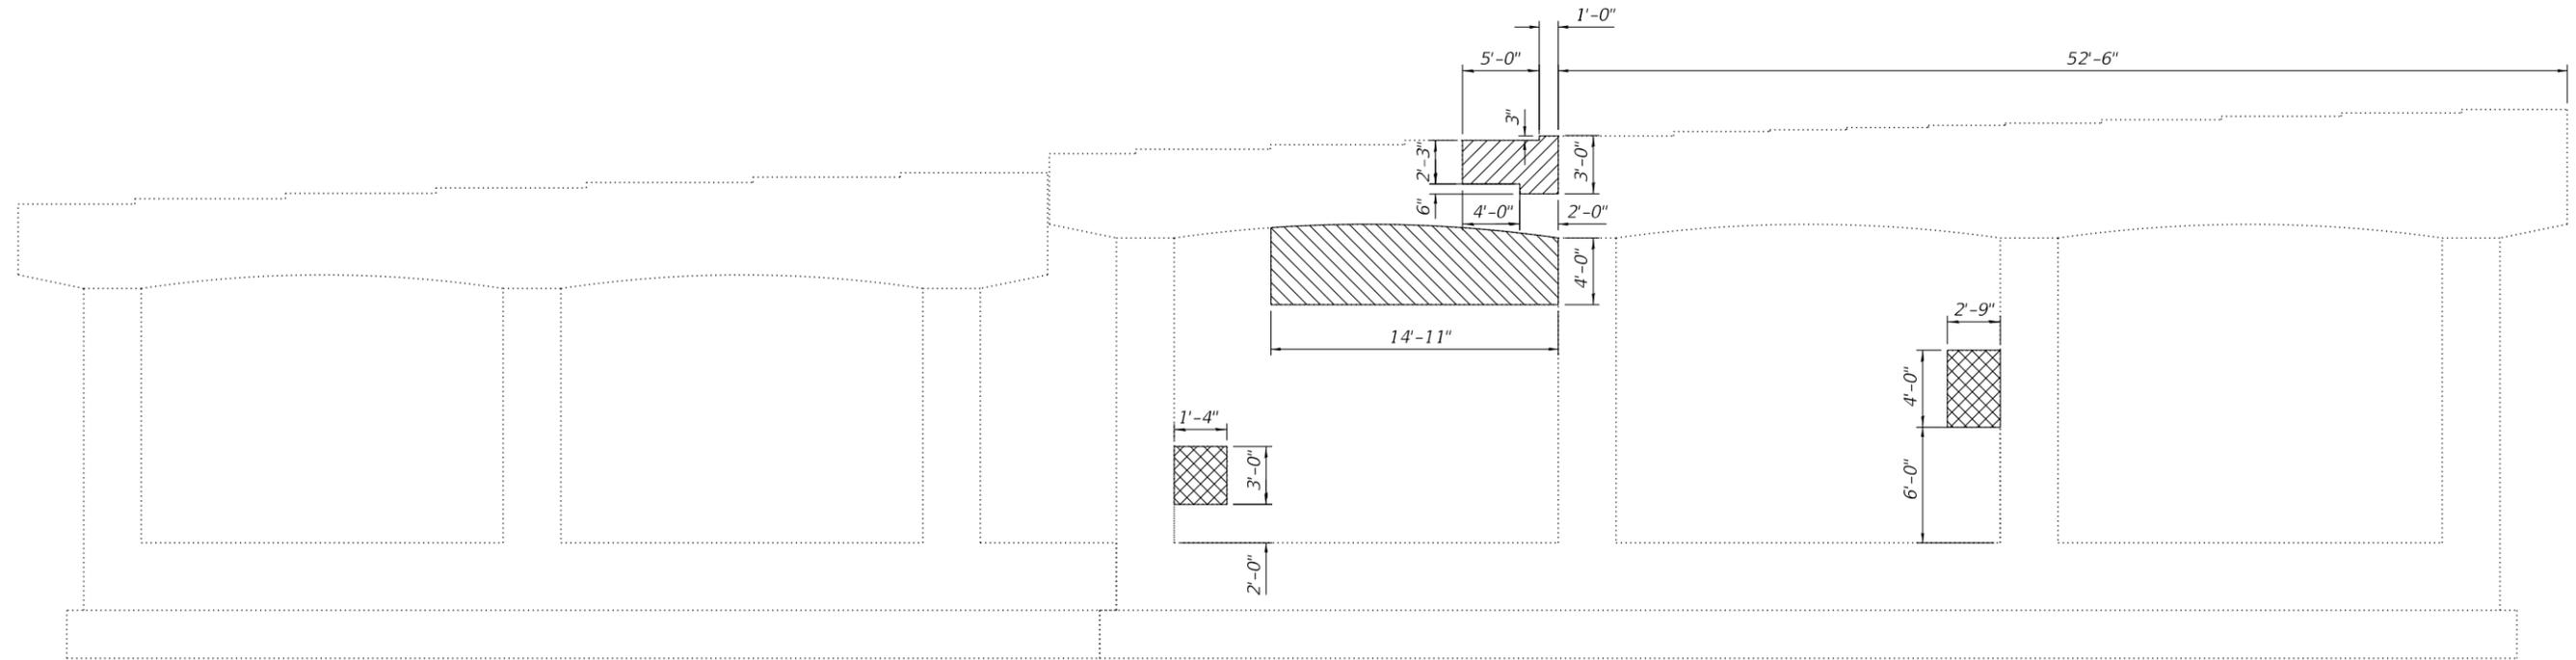

PIER 2 ELEVATION
(Looking East)

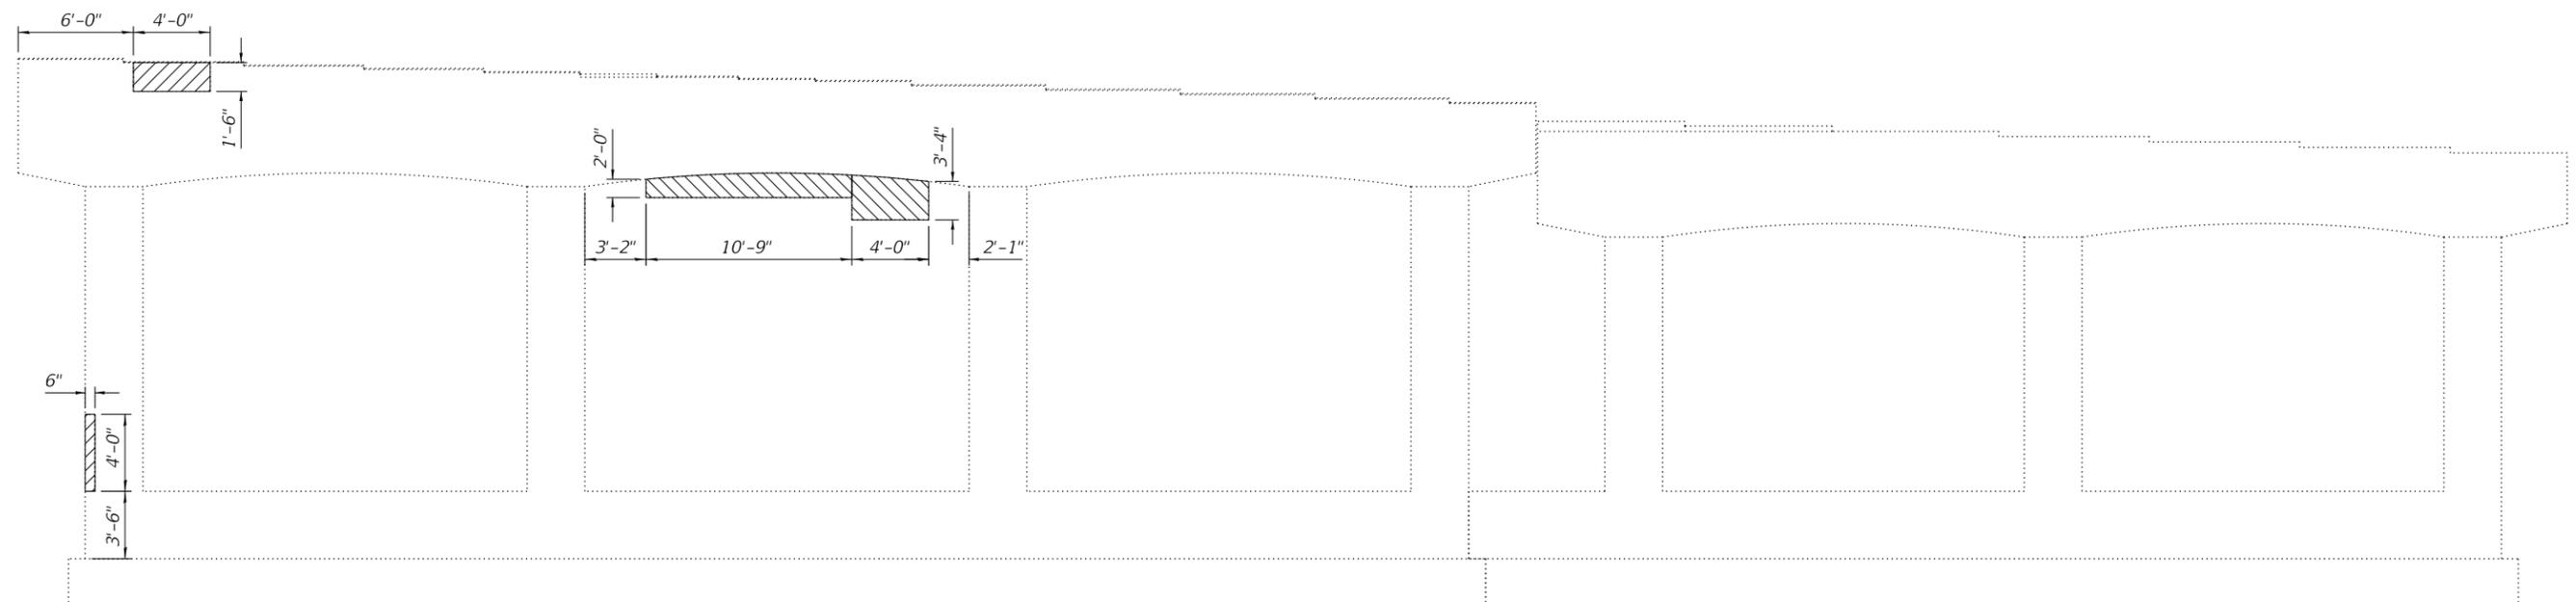

PIER 2 ELEVATION
(Looking West)

- Indicates Structural Repair of Concrete (Depth equal to or less than 5")
- Indicates Structural Repair of Concrete (Depth equal to or less than 5") on bottom of cap.
- Indicates Structural Repair of Concrete (Depth equal to or less than 5") on side of column.

BILL OF MATERIAL

ITEM	UNIT	QUANTITY
Structural Repair of Concrete (Depth Equal to or Less than 5")	Sq. Ft	133.2

FILE NAME: P:\10-1010.18_S\03000044_Repairs\10_CAD\CADD_Sheets\0900044-68D59-007-Pier 2.dgn



USER NAME =	DESIGNED - KS	REVISED -
CHECKED - BB	REVISIONS -	
PLOT SCALE =	DRAWN - KS	REVISED -
PLOT DATE =	CHECKED - BB	REVISED -

**STATE OF ILLINOIS
DEPARTMENT OF TRANSPORTATION**



**PIER 2 CONCRETE REPAIR DETAILS
STRUCTURE NO. 090-0044**

SHEET 7 OF 13 SHEETS

F.A.P. RTE.	SECTION	COUNTY	TOTAL SHEETS	SHEET NO.
404	(50B-4)BR;12((HVB,HB)BR)BR	TAZEWELL	61	25

CONTRACT NO. 68D59

ILLINOIS FED. AID PROJECT

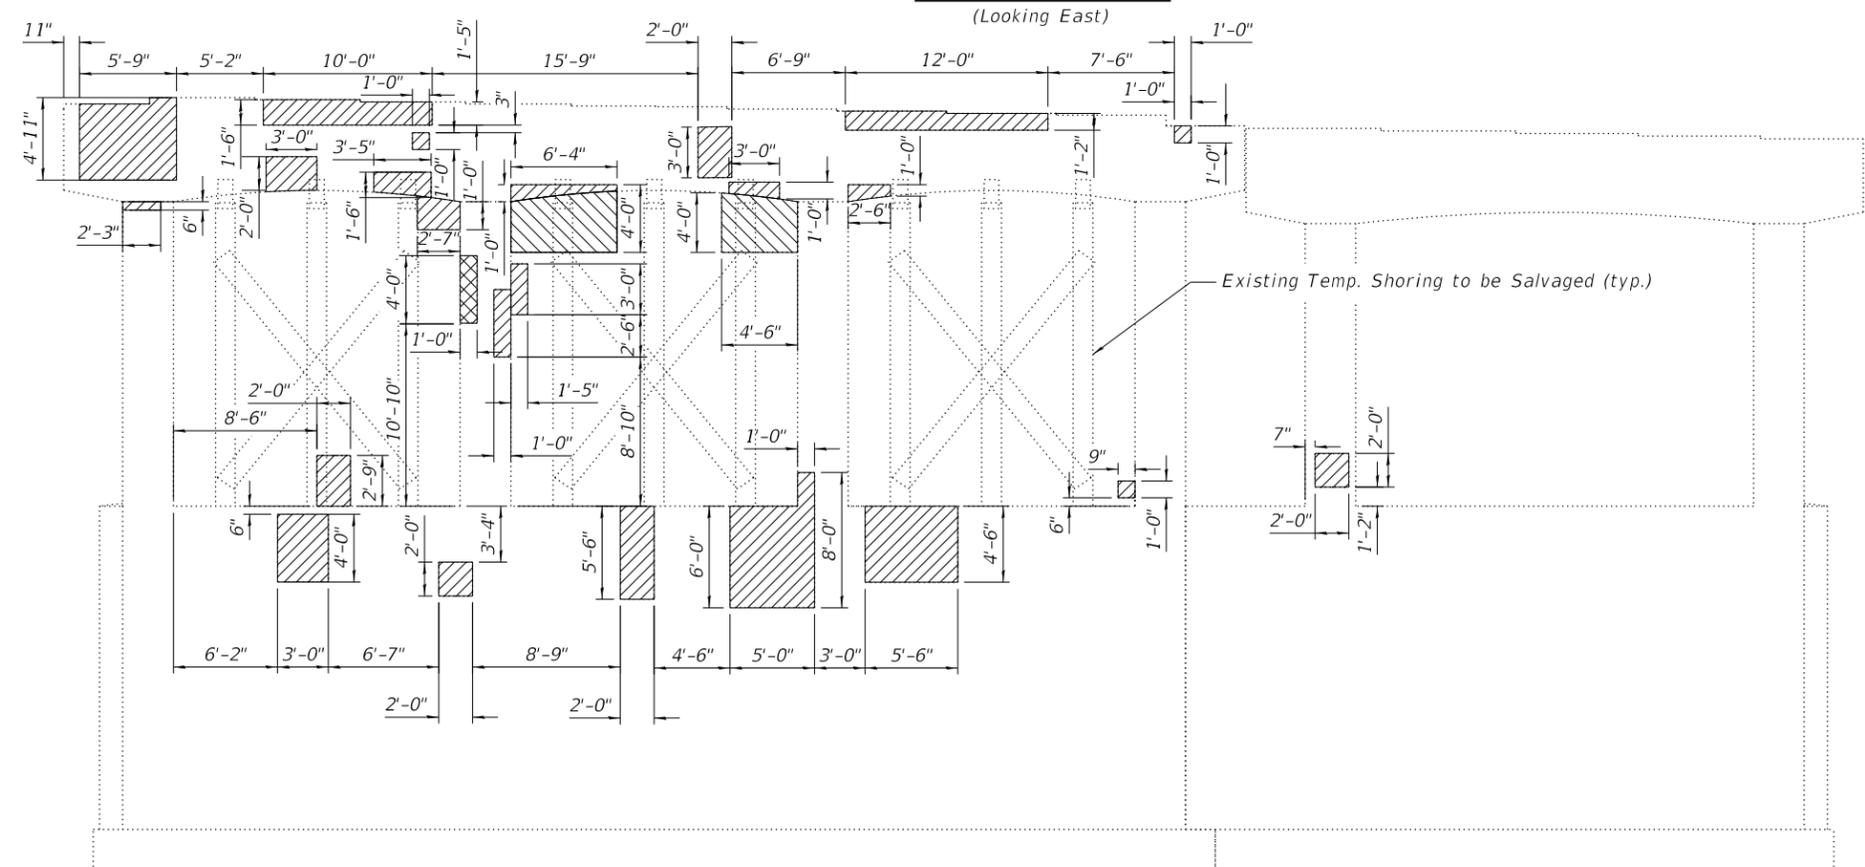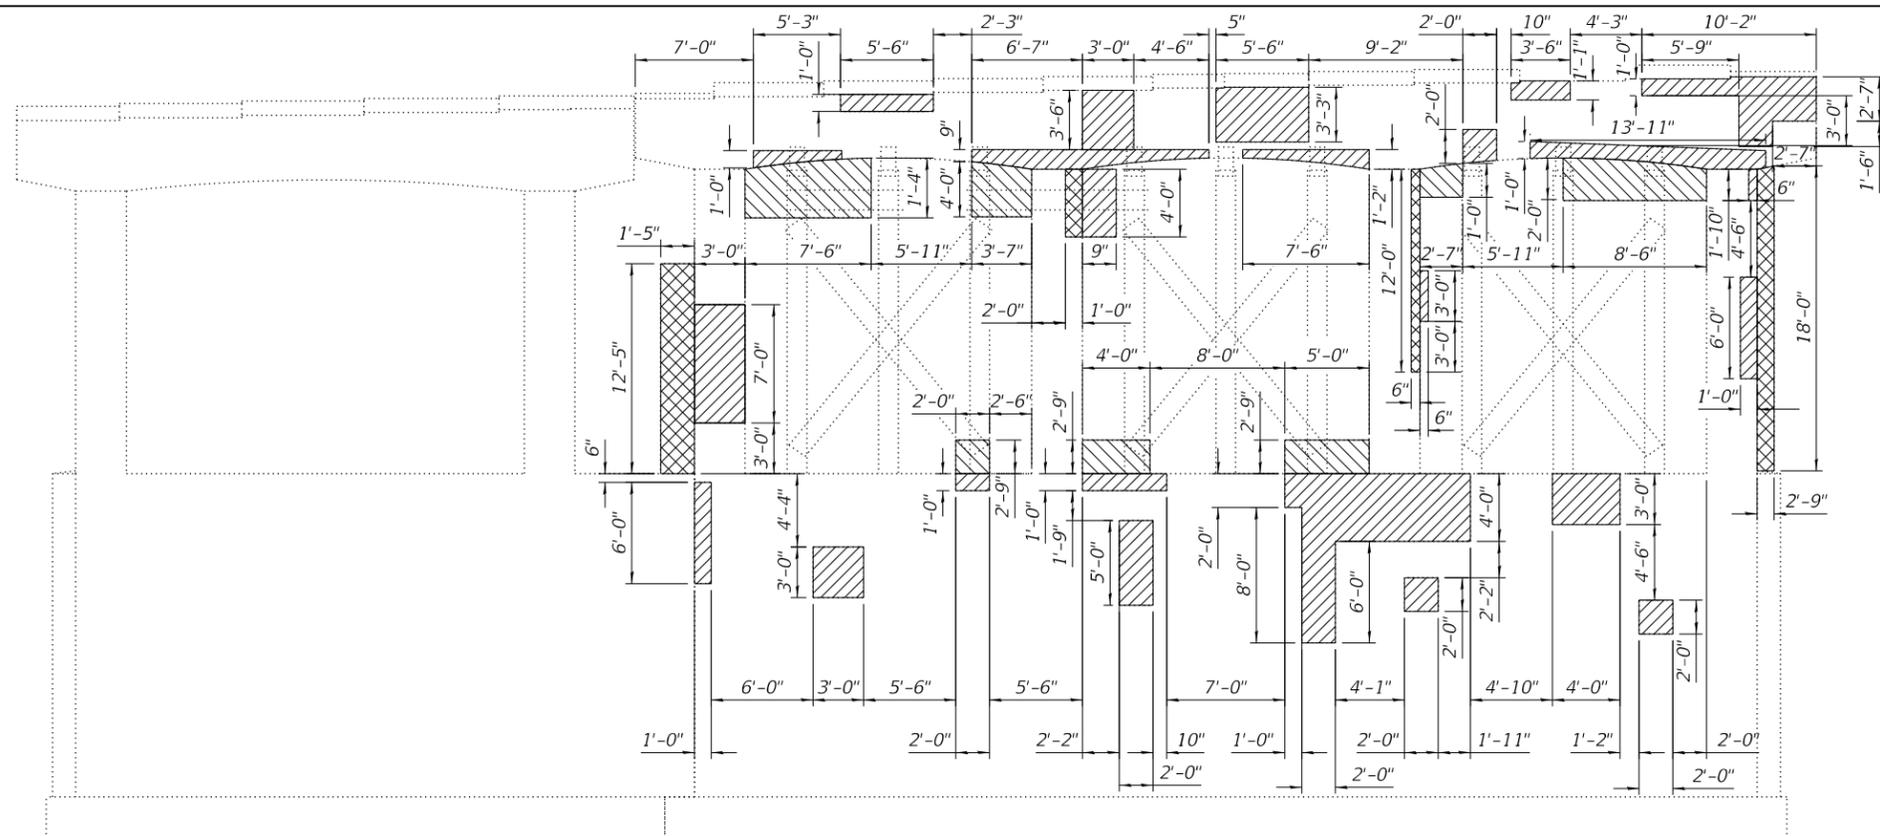

Existing Temp. Shoring to be Salvaged (typ.)

- Indicates Structural Repair of Concrete (Depth equal to or less than 5")
- Indicates Structural Repair of Concrete (Depth equal to or less than 5") on bottom of cap.
- Indicates Structural Repair of Concrete (Depth equal to or less than 5") on side of column.

BILL OF MATERIAL

ITEM	UNIT	QUANTITY
Structural Repair of Concrete (Depth Equal to or Less than 5")	Sq. Ft	627.7

FILE NAME: P:\10-1010.18_S\03000044_Repairs\10_CAD\CADD_Sheets\0900044-68D59-009-Pier_4.dgn



288 E. Main St., Suite 200
 #400 Chicago, Illinois 60602
 630.233.2877 phone
 630.233.2977 fax
 www.kaskaskiaeng.com

USER NAME =	DESIGNED - KS	REVISED -
	CHECKED - BB	REVISED -
PLOT SCALE =	DRAWN - KS	REVISED -
PLOT DATE =	CHECKED - BB	REVISED -


**STATE OF ILLINOIS
 DEPARTMENT OF TRANSPORTATION**

**PIER 4 CONCRETE REPAIR DETAILS
 STRUCTURE NO. 090-0044**

SHEET 9 OF 13 SHEETS

F.A.P. RTE.	SECTION	COUNTY	TOTAL SHEETS	SHEET NO.
404	(50B-4)BR;12(HVB,HB)BR BR	TAZEWELL	61	27
CONTRACT NO. 68D59				


ILLINOIS FED. AID PROJECT

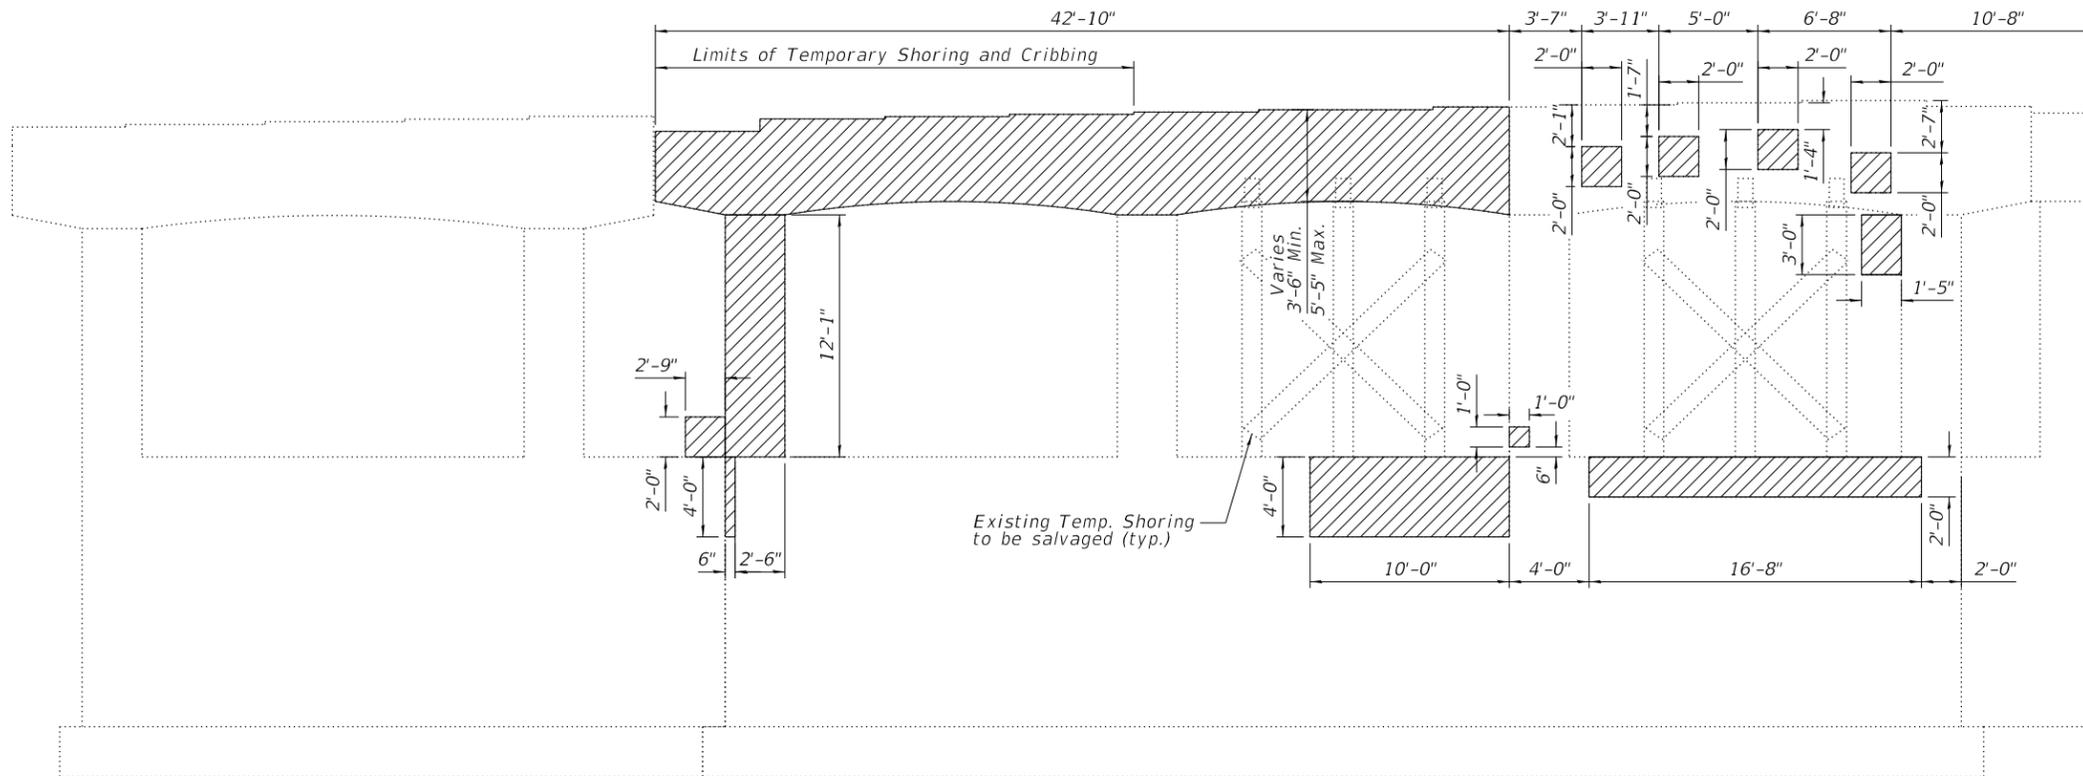

PIER 5 ELEVATION
(Looking East)

EXISTING INTERIOR BEAM REACTION TABLE

Reaction	Span 5	Span 6
DL (k)	21.2	50.8
LL (k)	28.7	32.0
IMP. (k)	8.3	7.0
Total (k)	58.2	89.8

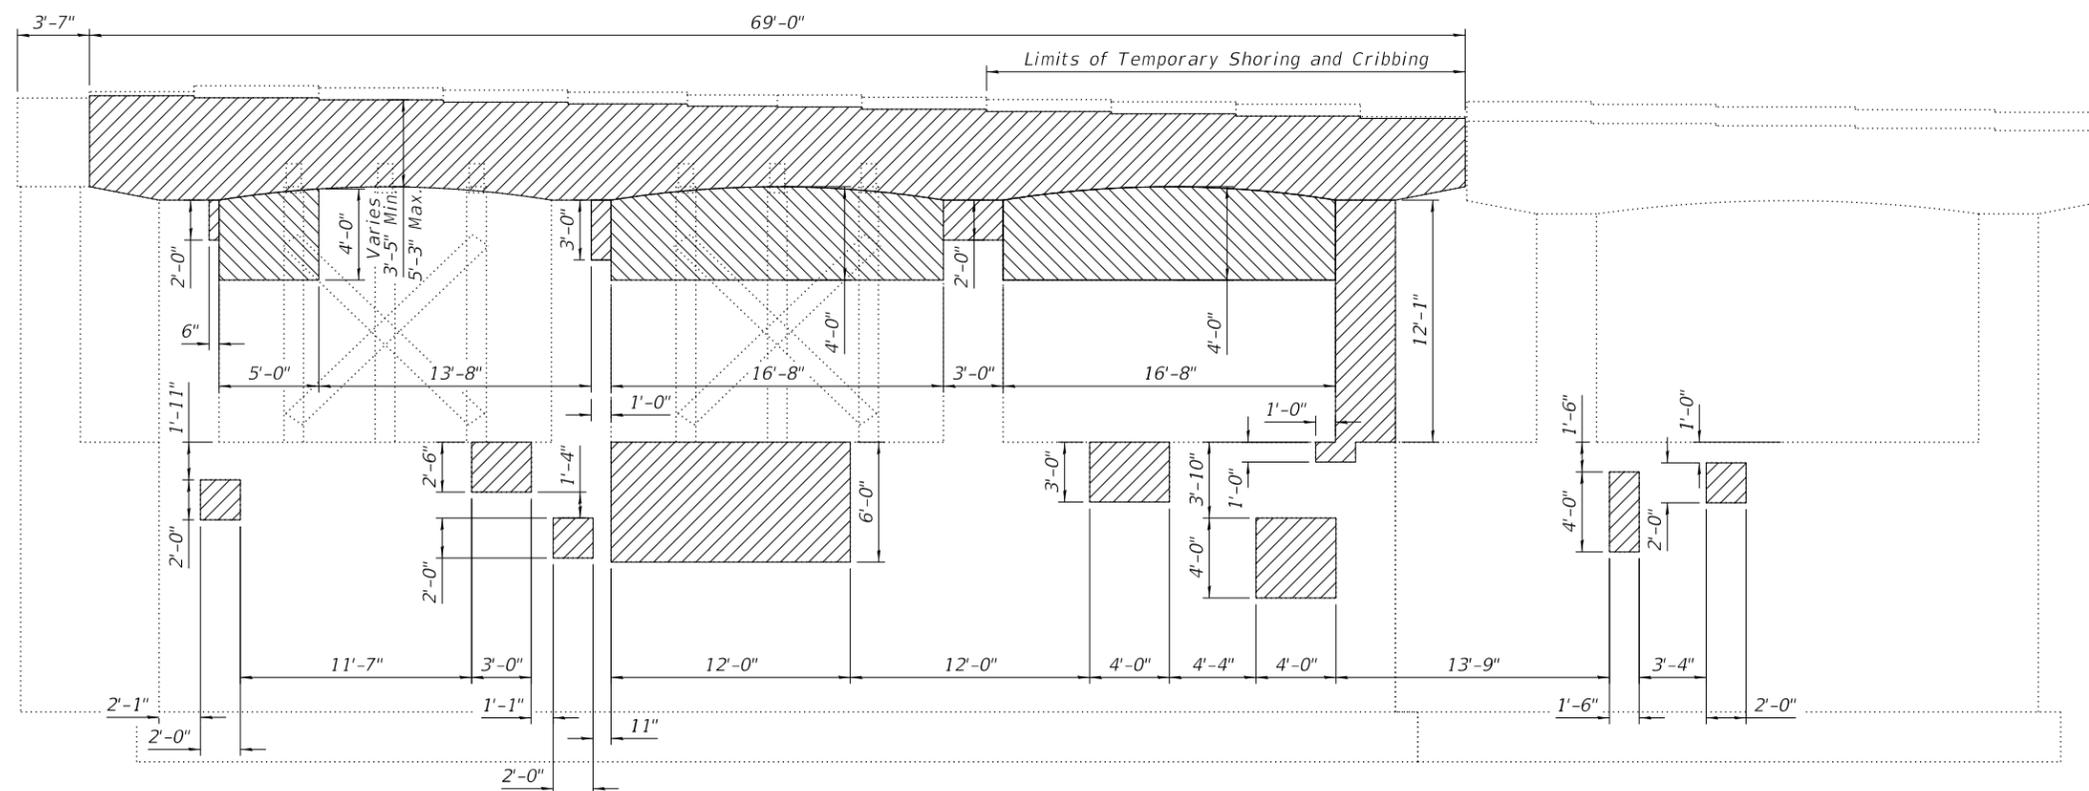

PIER 5 ELEVATION
(Looking West)

- Indicates Structural Repair of Concrete (Depth equal to or less than 5")
- Indicates Structural Repair of Concrete (Depth equal to or less than 5") on bottom of cap.
- Indicates Structural Repair of Concrete (Depth equal to or less than 5") on side of column.

BILL OF MATERIAL

ITEM	UNIT	QUANTITY
Structural Repair of Concrete (Depth Equal to or Less than 5")	Sq. Ft	952.7
Temporary Shoring And Cribbing	Each	8

FILE NAME: P:\10-1010.18_S\03000044_Repairs\10_CAD\CADD_Sheets\0900044-68D59-010-Pier_5.dgn

Kaskaskia
Engineering Group, LLC
Professional Engineering Group


USER NAME =	DESIGNED - KS	REVISED -
PLOT SCALE =	CHECKED - BB	REVISED -
PLOT DATE =	DRAWN - KS	REVISED -
	CHECKED - BB	REVISED -

STATE OF ILLINOIS
DEPARTMENT OF TRANSPORTATION


PIER 5 CONCRETE REPAIR DETAILS
STRUCTURE NO. 090-0044

SHEET 10 OF 13 SHEETS

F.A.P. RTE.	SECTION	COUNTY	TOTAL SHEETS	SHEET NO.
404	(50B-4)BR;12((HVB,HB)BR)BR	TAZEWELL	61	28
CONTRACT NO. 68D59				
ILLINOIS FED. AID PROJECT				

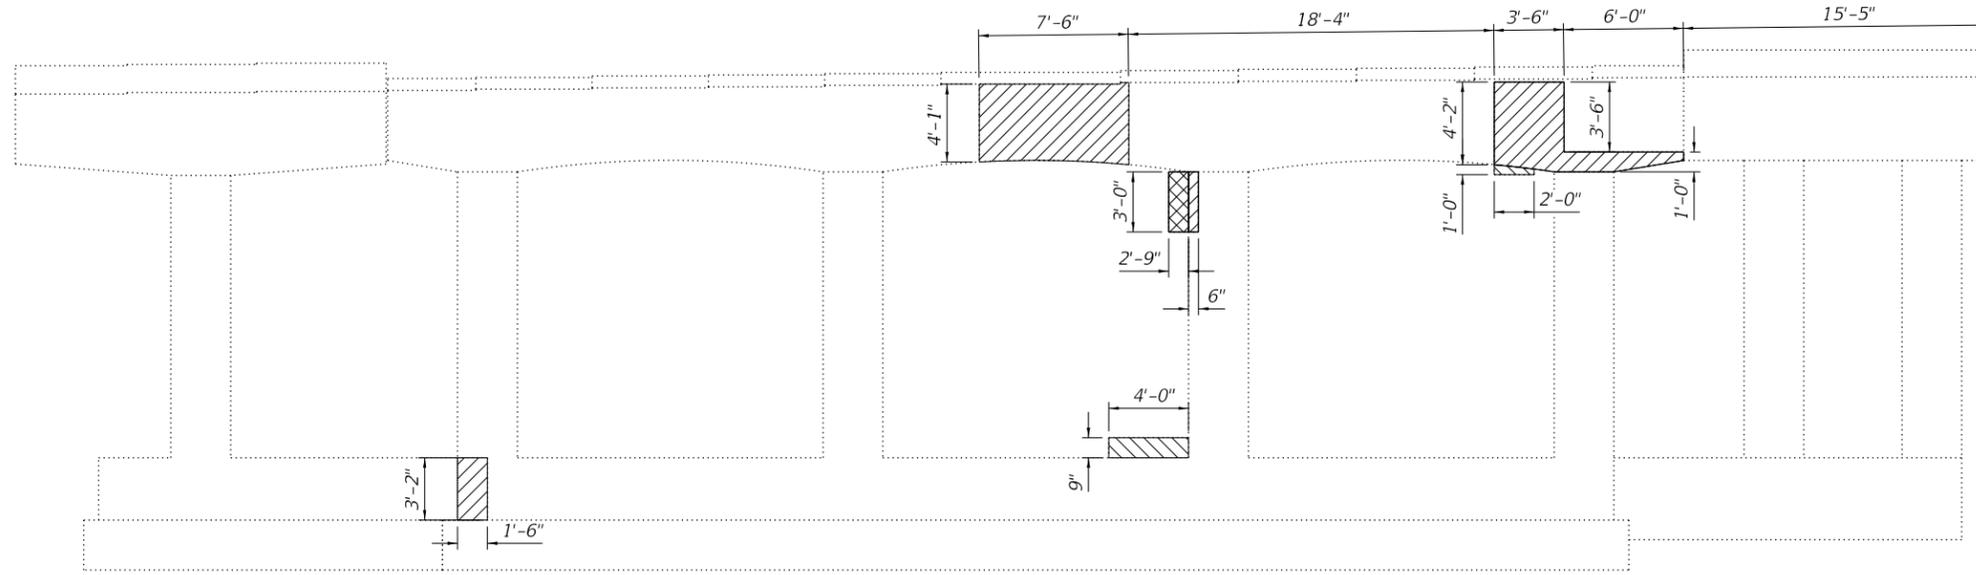

PIER 7 ELEVATION
(Looking East)

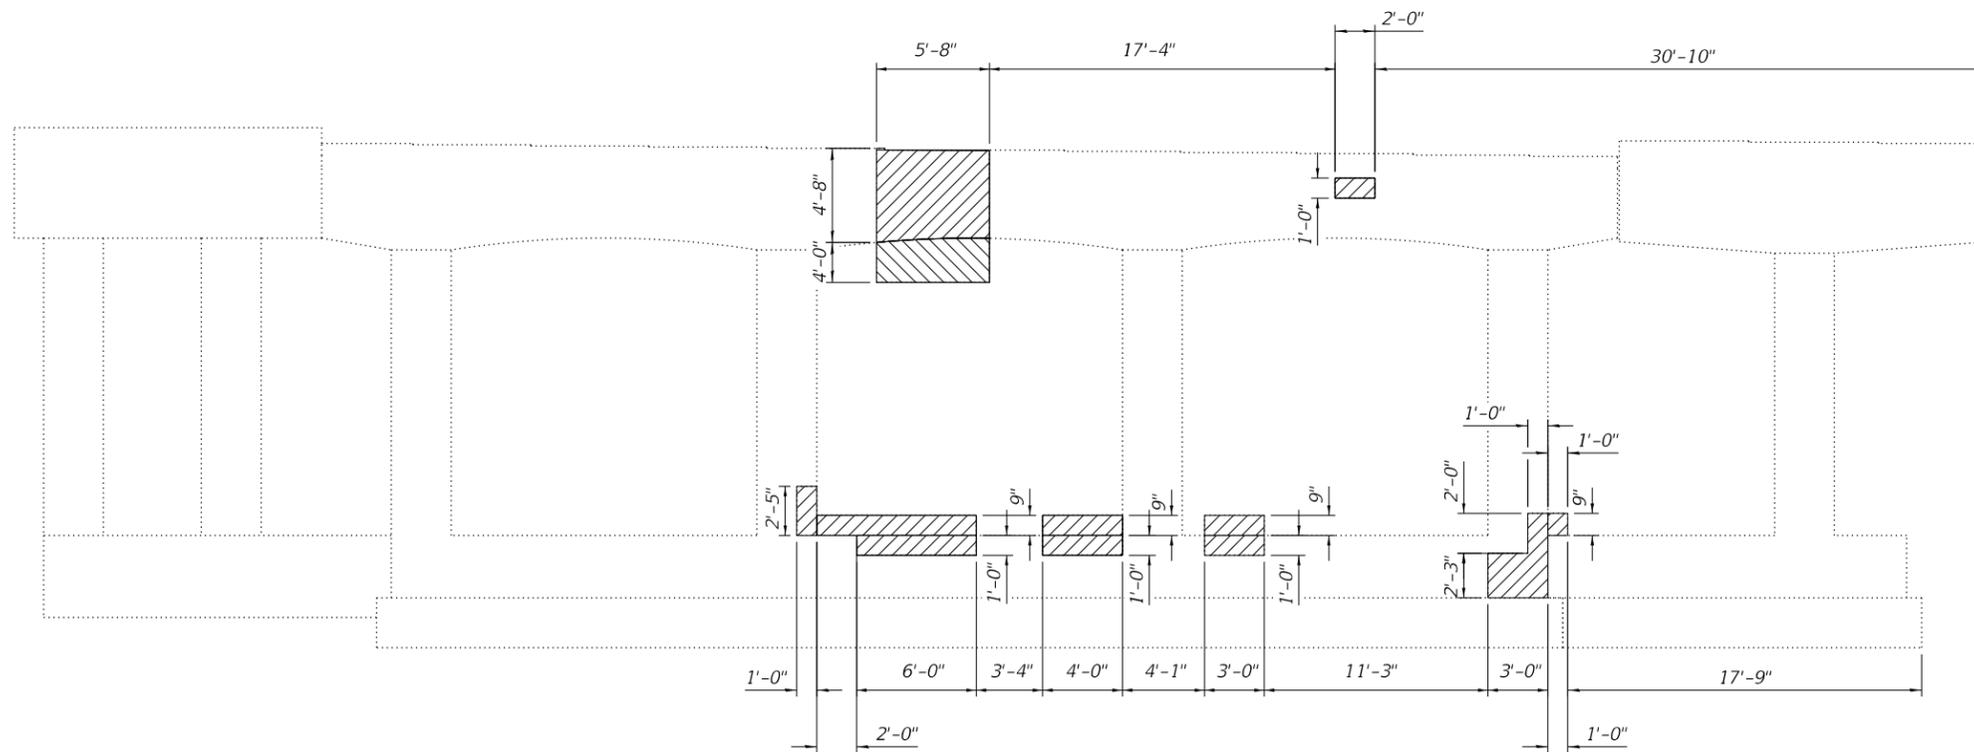

PIER 7 ELEVATION
(Looking West)

- Indicates Structural Repair of Concrete (Depth equal to or less than 5")
- Indicates Structural Repair of Concrete (Depth equal to or less than 5") on bottom of cap.
- Indicates Structural Repair of Concrete (Depth equal to or less than 5") on side of column.

BILL OF MATERIAL

ITEM	UNIT	QUANTITY
Structural Repair of Concrete (Depth Equal to or Less than 5")	Sq. Ft	158.1

FILE NAME: P:\10-1010.18_S\03000044_Repairs\10_CAD\CADD_Sheets\0900044-68D59-012-Pier 7.dgn

Kaskaskia
Engineering Group, LLC
Professional Engineering Group
117700131
30-080266

USER NAME =	DESIGNED - KS	REVISED -
	CHECKED - BB	REVISED -
PLOT SCALE =	DRAWN - KS	REVISED -
PLOT DATE =	CHECKED - BB	REVISED -


STATE OF ILLINOIS
DEPARTMENT OF TRANSPORTATION

PIER 7 CONCRETE REPAIR DETAILS
STRUCTURE NO. 090-0044


SHEET 12 OF 13 SHEETS

F.A.P. RTE.	SECTION	COUNTY	TOTAL SHEETS	SHEET NO.
404	(50B-4)BR;12((HVB,HB)BR)BR	TAZEWELL	61	30
CONTRACT NO. 68D59				

ILLINOIS FED. AID PROJECT

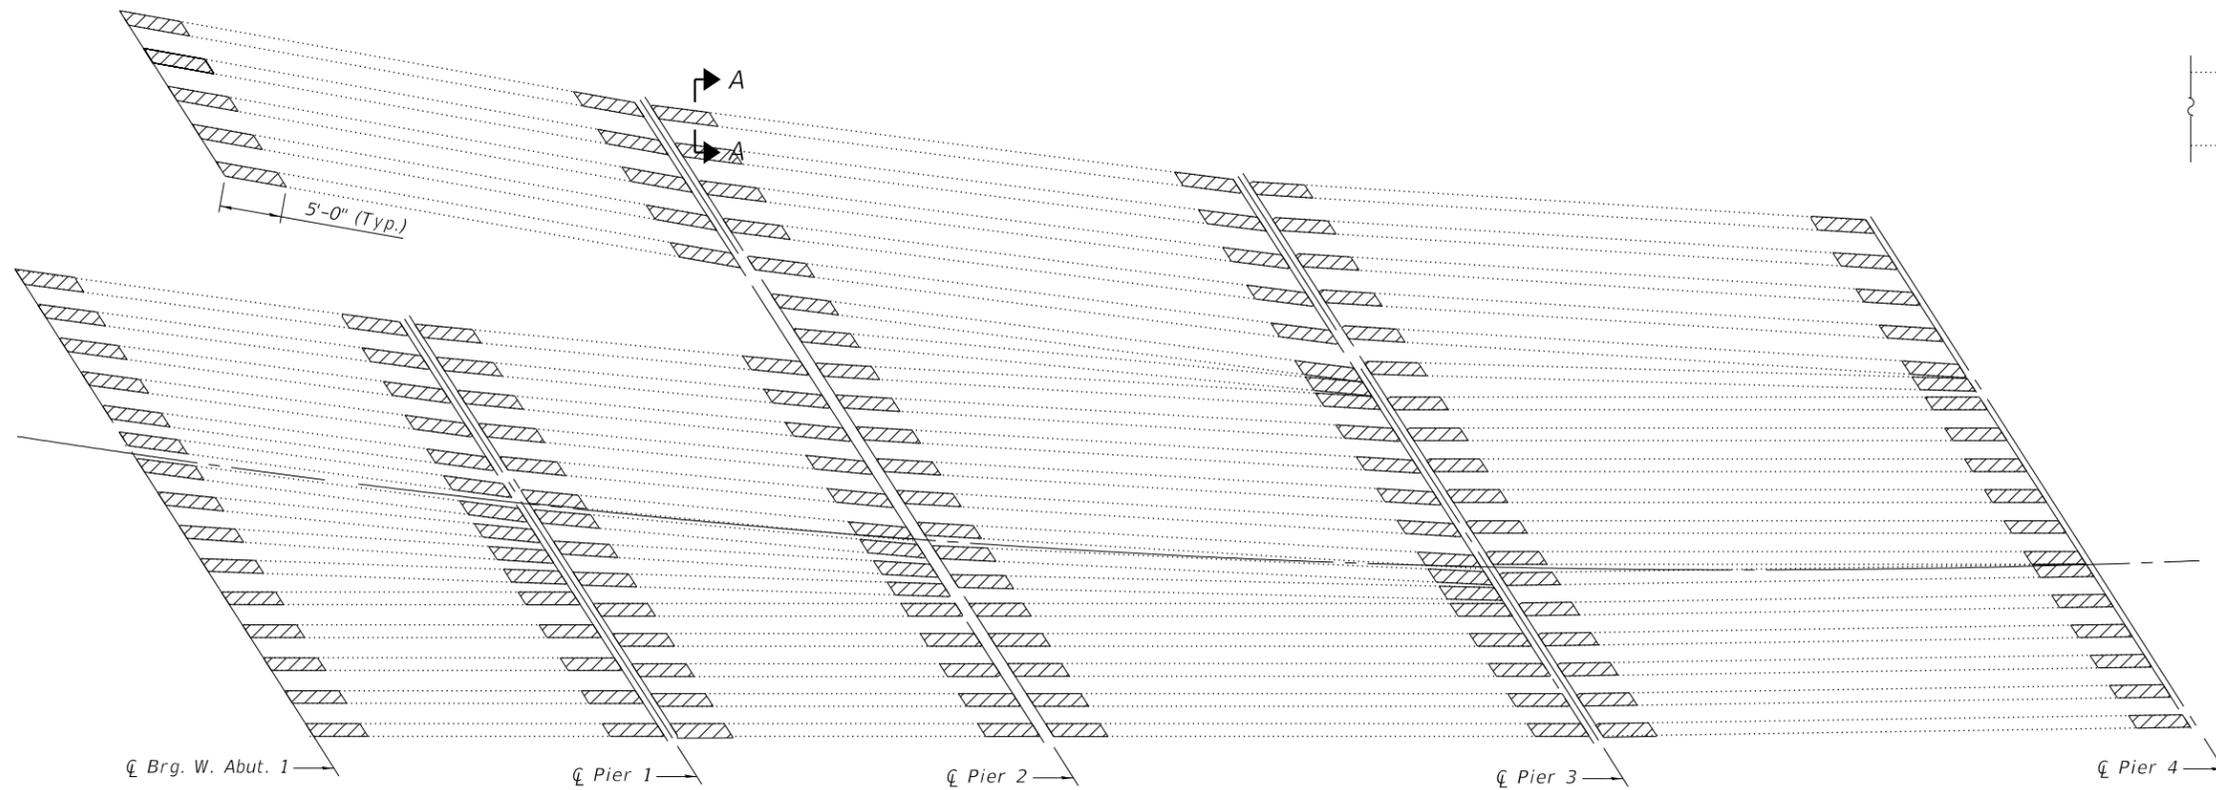


PLAN
(Spans 1 thru 4)

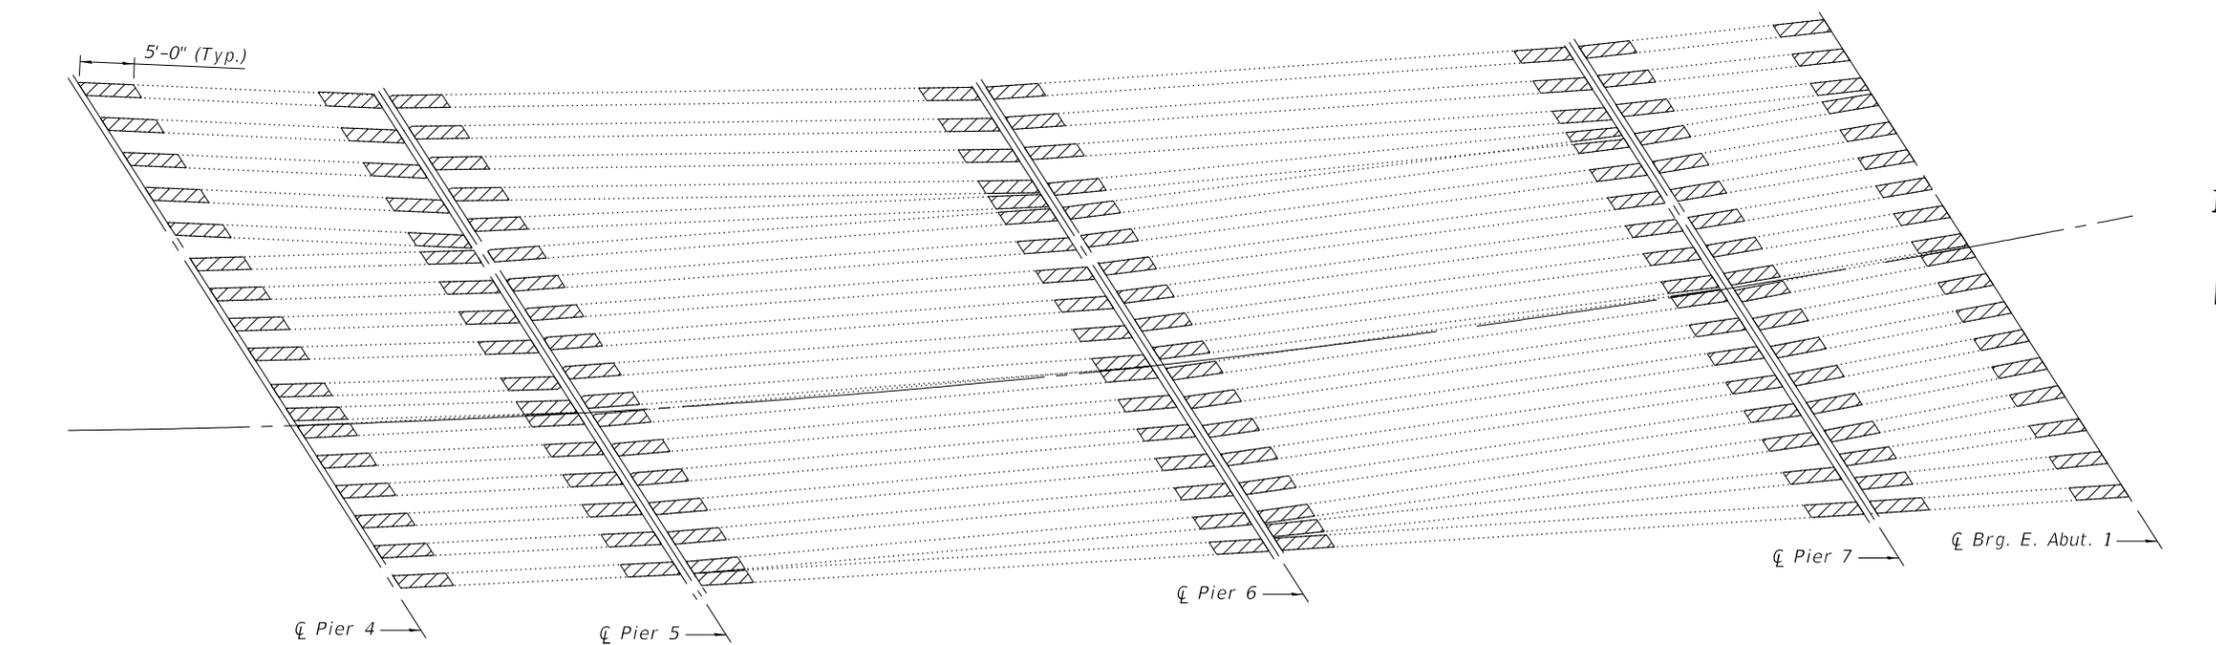

PLAN
(Spans 5 thru 8)

Indicates limits of Cleaning and Painting Steel Bridge No. 1.

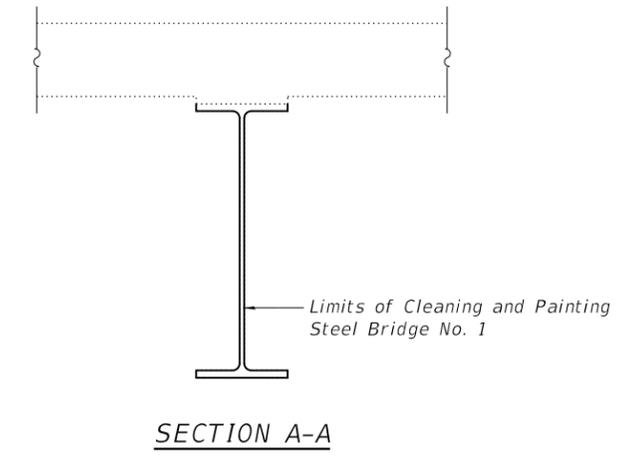

BILL OF MATERIAL

Item	Unit	Total
Cleaning and Painting Structural Steel, Location 1	L. Sum	1

Notes:
See General Notes for additional painting requirements.
For existing beam and diaphragm sizes to be cleaned and painted see Sheet 4 of 13.

FILE NAME: P:\10-1010.18_S\03000044_Repairs\10_CAD\CADD_Sheets\09000044-68D59-013-Cleaning and Painting.dgn

Kaskaskia
Engineering Group, LLC
Professional Engineering Group

USER NAME =	DESIGNED - KS	REVISED -
PLOT SCALE =	CHECKED - BB	REVISED -
PLOT DATE =	DRAWN - KS	REVISED -
	CHECKED - BB	REVISED -

STATE OF ILLINOIS
DEPARTMENT OF TRANSPORTATION

EXISTING STEEL CLEANING & PAINTING DETAILS
STRUCTURE NO. 090-0044


SHEET 13 OF 13 SHEETS

F.A.P. RTE.	SECTION	COUNTY	TOTAL SHEETS	SHEET NO.
404	(50B-4)BR;12((HVB,HB)BR)BR	TAZEWELL	61	31
CONTRACT NO. 68D59				
		ILLINOIS	FED. AID PROJECT	

Bench Mark: Chiseled cross on guard rail bolt. Station 13+35 ± 45-ft right along Existing F.A.U. Rte. 6712 centerline. Elevation 484.47

Existing Structure: Originally built in 1958 as F.A. Rt 10 (Spur) Section (12-HB) and rehabilitated in 1991 as a three span composite steel I-beam bridge having spans of 36'-3", 84'-0", and 45'-8" with a back to back abutment length of 165'-11", measured along the tangent to the horizontal curved roadway. The bridge has a skew of 12°-4'-22". The out-to-out width of the structure is 63'-8" with 1'-7" wide parapets on both sides and a 3'-0" wide raised median. The bridge is supported by driven steel pile supported abutments and multi-column piers supported on driven steel piling.

Salvage: None

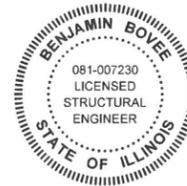

SIGNED: Benjamin Bovee
 DATE: 11/28/2018
 ILLINOIS STRUCTURAL ENGINEER
 NO. 081-007230
 LICENSE EXPIRES: 11-30-2020

INDEX OF SHEETS

1. General Plan & Elevation
2. General Data
3. Median Repair Details
4. Bearing Details
5. Bearing Details
6. Structural Steel Repair
7. Structural Steel Repair
8. Pier 1 Concrete Removal Details
9. Pier 1 Details
10. Pier 1 Details
11. Pier 2 Concrete Removal Details
12. Pier 2 Details
13. Pier 2 Details
14. Pier 2 Concrete Repair Details
15. Existing Steel Cleaning and Painting

CURVE DATA

P.I. Sta. = 16+66.65
 Δ = 45°-00'-00"
 D = 2°-54'-00"
 R = 1,975.72'
 T = 818.37'
 L = 1,551.72'
 E = 162.78'
 P.C. Sta. = 8+48.28
 P.T. Sta. = 24+00.00

DESIGN STRESSES




Existing Structure
 f'c = 3,500 psi
 fy = 60,000 psi (Reinforcement)
 fy = 36,000 psi (M183 Grade 36)
New Construction
 f'c = 4,000 psi (Superstructure)
 f'c = 3,500 psi (Substructure)
 fy = 60,000 psi (Reinforcement)
 fy = 50,000 psi (M270 Grade 50)

DESIGN SPECIFICATIONS
 2002 AASHTO Standard Specifications for Highway Bridges

LOADING HS20-44

No future wearing surface shall be installed.

* Indicates Locations for "Joint Repair"

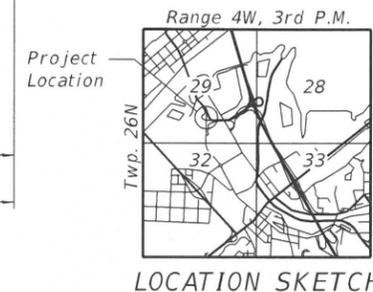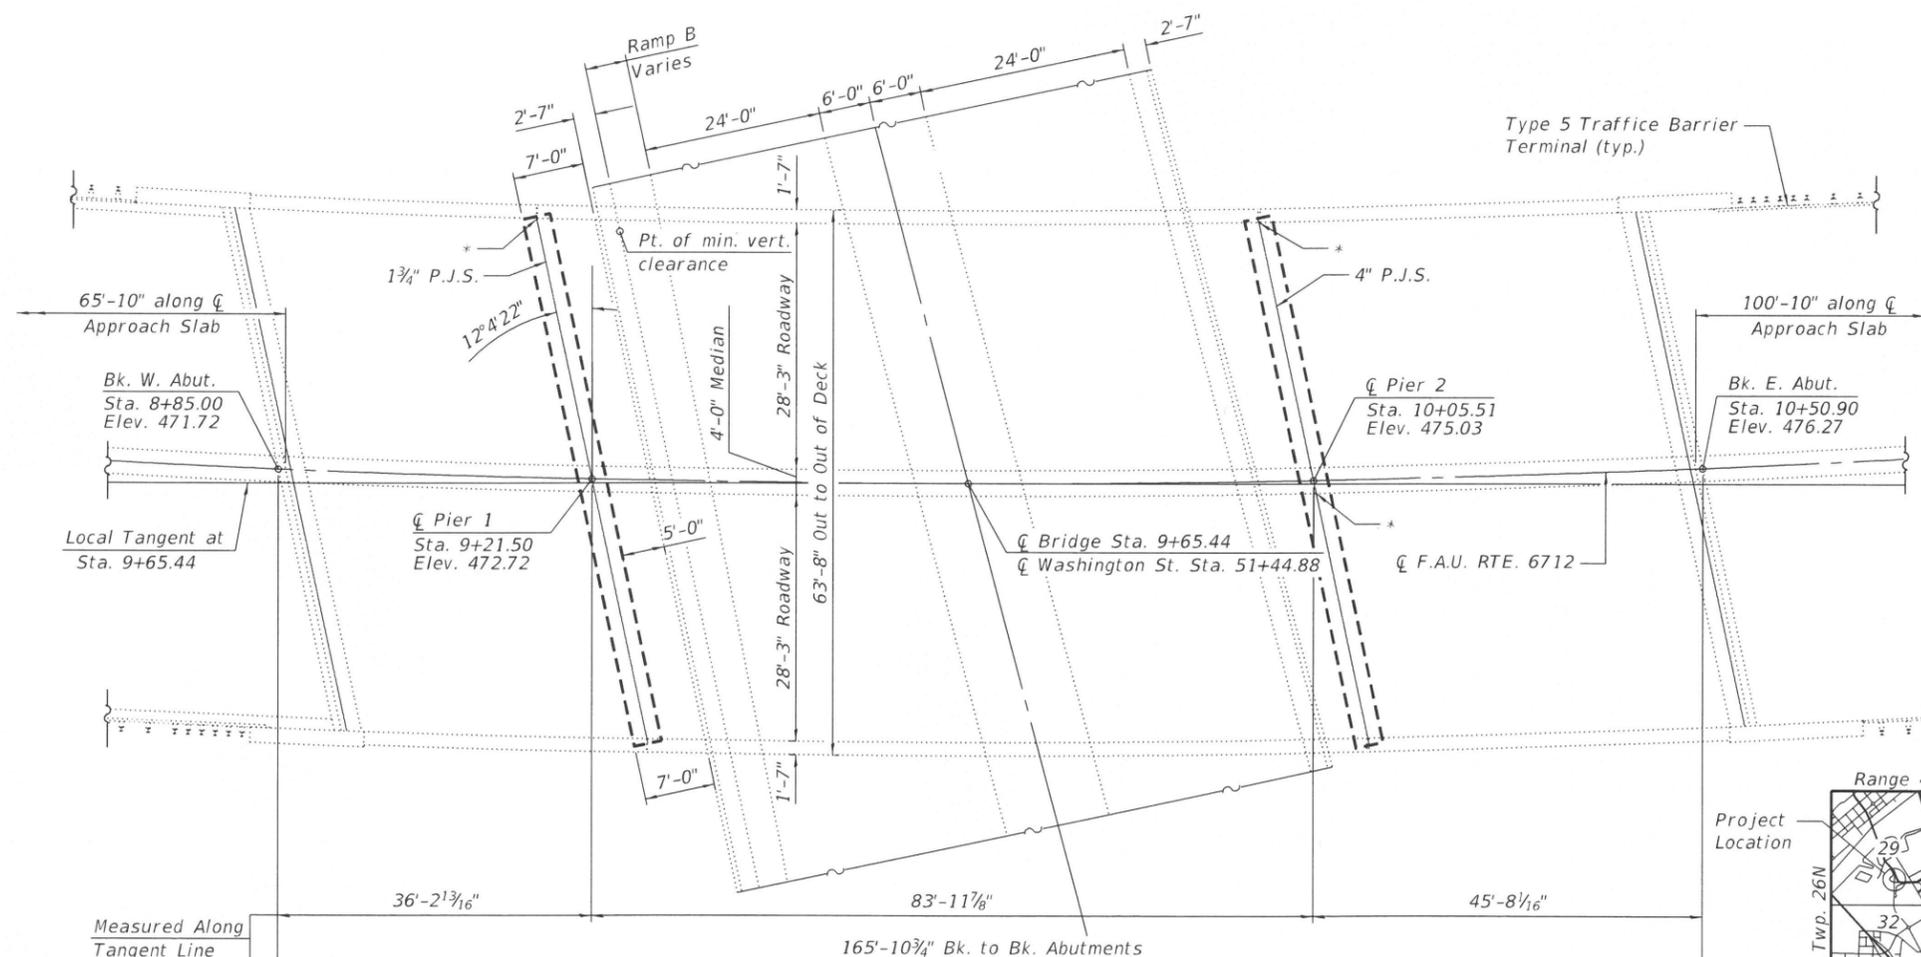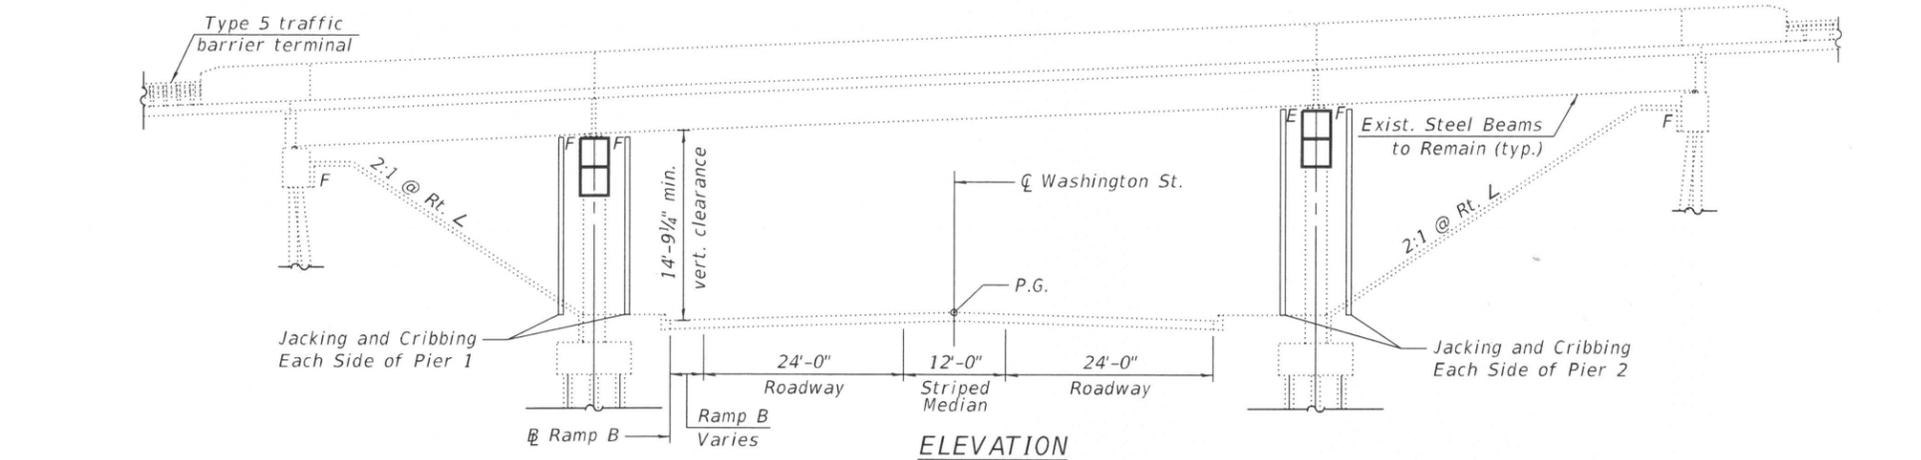

GENERAL PLAN & ELEVATION
RIVERFRONT DRIVE OVER WEST WASHINGTON ST.
F.A.U. RTE. 6712, SEC. (12-HVB)BR-1
TAZEWELL COUNTY
STATION 9+65.44
STRUCTURE NO. 090-0046

FILE NAME: P:\10-1063.08 SN 0046 0120 Repairs\10_CADD\CADD_Sheets\090-0046\0900046-68D59-01_General Plan and Elevation.dgn

Kaskaskia
 Engineering Group, LLC
 208 E. Main St., Suite 100
 Macomb, Illinois 61455
 815-233-8777
 www.kaskaskiaeng.com

USER NAME =	DESIGNED - MC	REVISOR -
PLOT SCALE =	CHECKED - BB	REVISOR -
PLOT DATE =	DRAWN - MC	REVISOR -
	CHECKED - BB	REVISOR -

STATE OF ILLINOIS
DEPARTMENT OF TRANSPORTATION

GENERAL PLAN & ELEVATION
STRUCTURE NO. 090-0046
 SHEET 1 OF 15 SHEETS

F.A.P. RTE.	SECTION	COUNTY	TOTAL SHEETS	SHEET NO.
404	(50B-4)BR:12(HVB,HB)BR	TAZEWELL	61	32
CONTRACT NO. 68D59				
ILLINOIS FED. AID PROJECT				

GENERAL NOTES



All structural steel shall be AASHTO M 270 Grade 50.
 Reinforcement bars designated (E) shall be epoxy coated.
 Prior to pouring the new concrete, all heavy or loose rust, loose mill scale, and other loose or potentially detrimental foreign material shall be removed from surfaces in contact with the concrete. Removal shall be accomplished by methods that will not damage the steel and the cost will be included with Concrete Removal.
 Plan dimensions and details relative to existing plans are subject to nominal construction variations. The Contractor shall field verify existing dimensions and details affecting new construction and make necessary approved adjustments prior to construction or ordering of materials. Such variations shall not be cause for additional compensation for a change in scope of the work, however, the Contractor will be paid for the quantity actually furnished at the unit price bid for the work.
 Bearing seat surfaces shall be constructed or adjusted to the designated elevations within a tolerance of 1/8 inch (0.01 ft.). Adjustment shall be made either by grinding the surface or by shimming the bearings.
 The existing bridge deck at the pier joints is heaving due to pack rust at the bearings. The Contractor shall adjust the bearing seat elevations as needed to bring the bridge deck to a level plane.
 All structural steel and exposed surfaces of bearings within a distance of 5 ft. each way from the deck joints shall be painted as specified in Section 506 of the Standard Specifications.
 The structural steel plates of the Bearing Assembly shall conform to the requirements of AASHTO M 270 Grade 50.
 Two 1/8 in. adjusting shims shall be provided for each bearing in addition to all other plates or shims and placed as shown on bearing details.
 Existing reinforcement shall be cleaned and incorporated into the new construction. Cost included with Concrete Removal.
 Any reinforcement bars damaged during the Concrete Removal operations shall be repaired or replaced using an approved bar splicer or anchorage system. Cost included with Concrete Removal. Joint openings shall be adjusted according to Article 520.04 of the Standard Specifications when the deck is poured at ambient temperature other than 50°F.
 The existing structural steel coating contains lead. The Contractor should take appropriate precautions to deal with the presence of lead on this project.
 Existing structural steel that will be in contact with new structural steel shall be cleaned and painted prior to erection as required by the Special Provision "Cleaning and Painting Contact Surface Areas of Existing Steel Structures".
 Cleaning and painting of the existing structural steel shall be as specified in the special provision for "Cleaning and Painting Existing Steel Structures". Areas to be cleaned and painted shall consist of all beam ends, end diaphragms and steel components of the steel bearings at the abutments and piers. Beam end painting shall extend 5 feet from the ends of the beams longitudinally. This surface preparation shall be accomplished according to the requirements of Near-White Metal Blast Cleaning SSPC-SP 10. The paint system shall be applied as specified for System 1 OZ/E/U. The color of the final finish coat shall be Blue, Munsell No. 10B 3/6.
 Containment and disposal as specified shall follow the special provision for "Containment and Disposal of Lead Paint Cleaning Residue". The use of four air monitors will be required to monitor abrasive blasting operations.
 The painting contractor shall be SSPC-QP 1 and SSPC-QP2 certified for this project and shall maintain certification throughout the duration of the project.
 Fasteners shall be high strength bolts. Bolts 7/8" open holes 1 5/16", unless otherwise noted.
 Cost of removal and re-installation of all members necessary to complete the work as detailed on the plans and as specified in the Special Provisions shall be included with Structural Steel Repair.

SCOPE OF WORK

1. Install temporary shoring to each side of Pier 1 and Pier 2.
2. Remove existing pier caps at Pier 1 & Pier 2.
3. Repair designated beam ends.
4. Construct new pier caps at Pier 1 and Pier 2.
5. Replace bearings at Pier 1 and Pier 2.
6. Complete Structural Repair of Concrete to designated areas of Pier 2.
7. Clean and Paint structure at designated locations.
8. Repair joints at existing concrete median on structure.


TOTAL BILL OF MATERIAL

ITEM	UNIT	SUPER	SUB	TOTAL
Concrete Removal	CU. YD.	-	60.1	60.1
Concrete Structures	CU. YD.	-	70.2	70.2
Reinforcement Bars (Epoxy Coated)	POUND	-	10,590	10,590
Jack and Remove Existing Bearings	EACH	40	-	40
Elastomeric Bearing Assembly, Type 1	EACH	10	-	10
Furnishing and Erecting Structural Steel	POUND	3,660	-	3,660
Cleaning and Painting Steel Bridge Location 2	L. SUM	1	-	1
Structural Repair of Concrete (Depth Equal to or Less than 5")	SQ. FT.	5.0	91.0	96.0
Silicone Joint Sealer (Special)	FOOT	4	-	4
Anchor Bolt, 3/4"	EACH	80	-	80
Temporary Shoring and Cribbing	EACH	40	-	40
Structural Steel Repair	POUND	2,540	-	2,540
Joint Repair	EACH	3	-	3
Containment and Disposal of Lead Paint Cleaning Residues No. 2	L. SUM	1	-	1

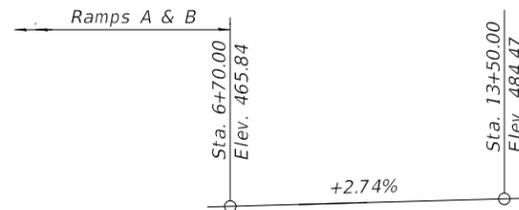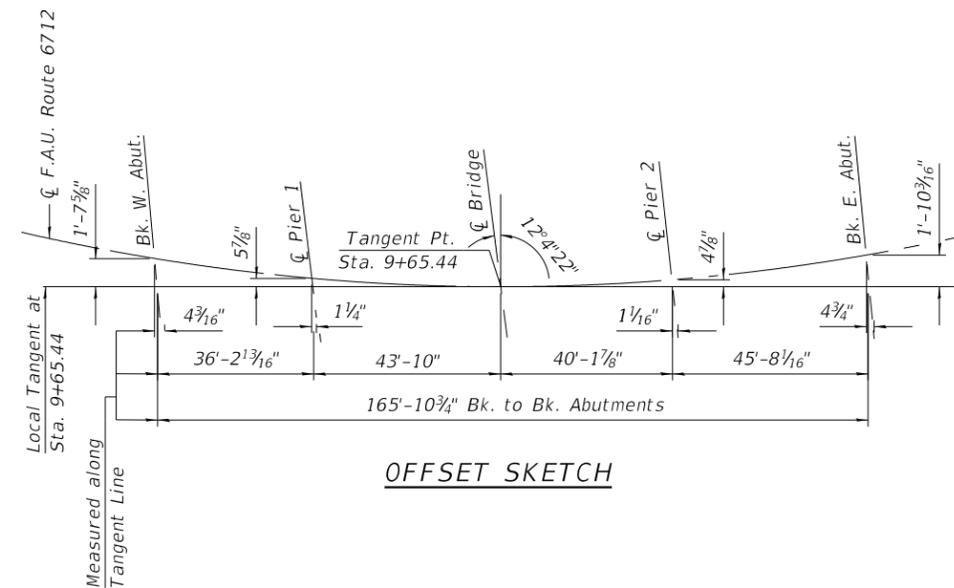

PROFILE GRADE

F.A.U. RTE. 6712
(Along C Roadway)

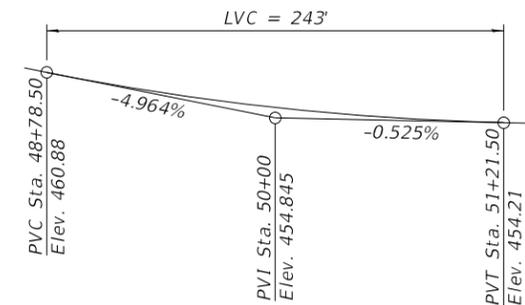

PROFILE GRADE

Washington St.
(Along C Roadway)

FILE NAME: P:\10-1063.08 SN 0046 0120 Repairs\10_CAD\CADD Sheets\090-0046-68D59-02_General Data.dgn




USER NAME =	DESIGNED - MC	REVISED -
CHECKED - BB	REVISIONS -	
PLOT SCALE =	DRAWN - MC	REVISED -
PLOT DATE =	CHECKED - BB	REVISED -

**STATE OF ILLINOIS
DEPARTMENT OF TRANSPORTATION**

**GENERAL DATA
STRUCTURE NO. 090-0046**


SHEET 2 OF 15 SHEETS

F.A.P. RTE.	SECTION	COUNTY	TOTAL SHEETS	SHEET NO.
404	(50B-4)BR:12((HVB,HB)BR)BR	TAZEWELL	61	33
CONTRACT NO. 68D59				
ILLINOIS		FED. AID PROJECT		

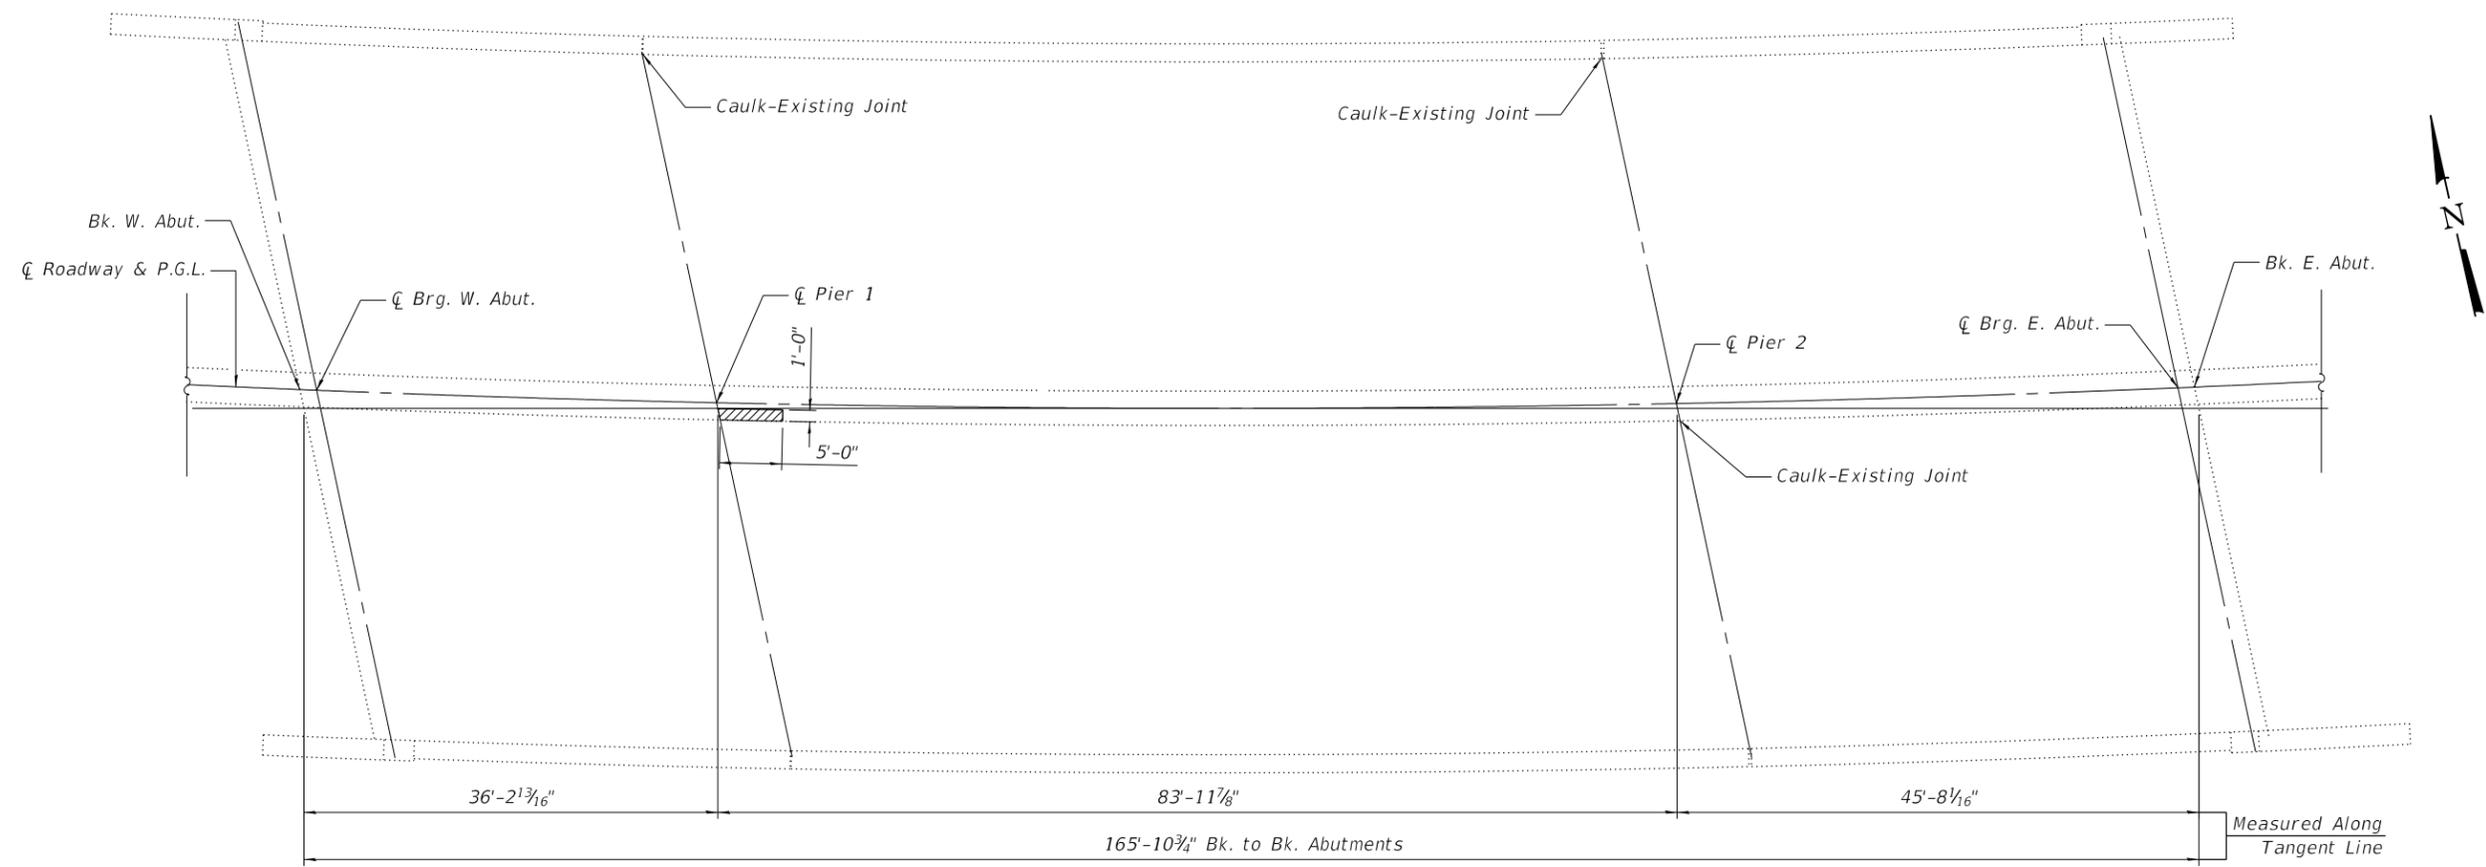


PLAN

Indicates Limits of Structural Repair of Concrete (Depth equal to or less than 5 inches)

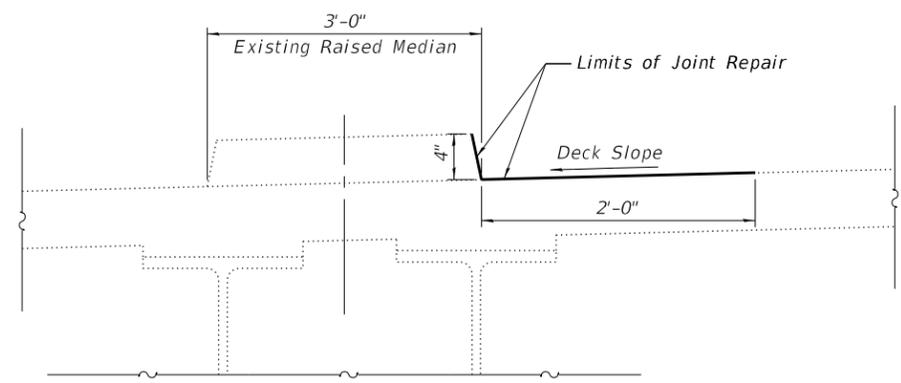

MEDIAN JOINT REPAIR DETAIL
(Pier 2 median and Pier 1 and Pier 2 North Parapet)

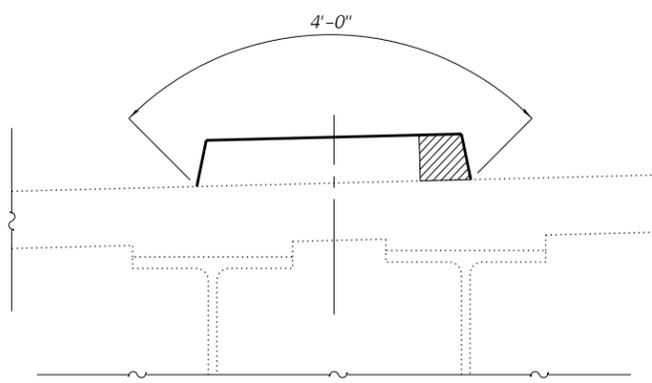

SILICONE JOINT SEALER (SPECIAL) DETAIL
(Pier 1 median)

Note:
At Pier 1, remove existing Preformed Joint Seal and replace with Silicone Joint Sealer (Special).

BILL OF MATERIAL

Item	Unit	Quantity
Silicone Joint Sealer (Special)	Foot	4
Joint Repair	Each	3
Structural Repair of Concrete (Depth Equal to or Less than 5")	SQ. FT.	5.0

FILE NAME: P:\10-1063.08 SN 0046 0120 Repairs\10_CAD\CADD Sheets\090-0046-68D59-03_Median Repair_Details.dgn

Kaskaskia
Engineering Group, LLC
Professional Engineering Group
201 E. Main St., Suite 200
Moline, IL 61704
662.233.2877
www.kaskaskiaeng.com


USER NAME =	DESIGNED - MC	REVISED -
PLOT SCALE =	CHECKED - BB	REVISED -
PLOT DATE =	DRAWN - MC	REVISED -
	CHECKED - BB	REVISED -

STATE OF ILLINOIS
DEPARTMENT OF TRANSPORTATION

MEDIAN REPAIR DETAILS
STRUCTURE NO. 090-0046

SHEET 3 OF 15 SHEETS

F.A.P. RTE.	SECTION	COUNTY	TOTAL SHEETS	SHEET NO.
404	(50B-4)BR:12((HVB,HB)BR)BR	TAZEWELL	61	34
			CONTRACT NO. 68D59	
		ILLINOIS FED. AID PROJECT		

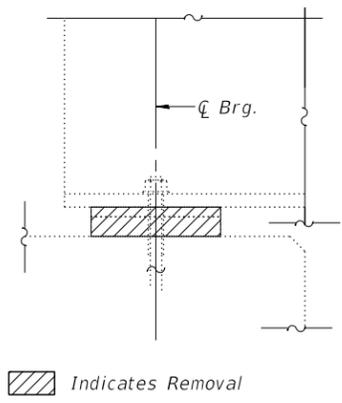


EXISTING BEARING REMOVAL DETAIL
(8 Required)
(Pier 1, Span 1 Interior Beams)

Indicates Removal

Notes:
Anchor bolts shall be ASTM F1554 all-thread (or an Engineer-approved alternate material) of the grade(s) and diameter(s) specified. The corresponding specified grade of AASHTO M314 anchor bolts may be used in lieu of ASTM F1554.
Side retainers and other steel members required for the elastomeric bearing assembly shall be included in the cost of Elastomeric Bearing Assembly, Type I.
Diaphragm removal and replacement may be required to facilitate drilling holes: Cost shall be included with Furnishing and Erecting Structural Steel.
New shim plates and pintles are included with Furnishing and Erecting Structural Steel.
Prior to ordering any material. Contractor shall verify in the field all existing bearing heights.
Two 1/8 in. adjusting shims shall be provided for each bearing in addition to all other plates or shims and placed as shown on bearing details.
Anchor bolts and side retainers at all supports shall be installed as each member is erected unless an equivalent temporary means of lateral restraint is used.

EXISTING INTERIOR BEAM REACTION TABLE


Reaction	Span 1	Span 2	Span 3
DL (k)	14.9	43.1	19.6
LL (k)	40.3	49.1	43.7
IMP. (k)	12.1	11.9	13.0
Total (k)	67.3	104.1	76.3

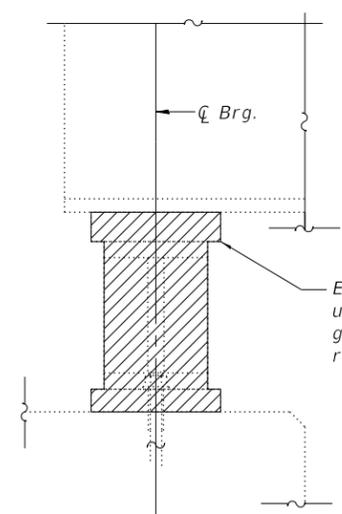


EXISTING BEARING REMOVAL DETAIL
(12 Required)
(Pier 1, Span 1 Exterior Beams & Pier 1 Span 2)

Indicates Removal

Existing plate is to be removed using the air-arc method and grind smooth all weld material remaining on the bottom flange.

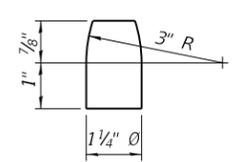


PINTLE

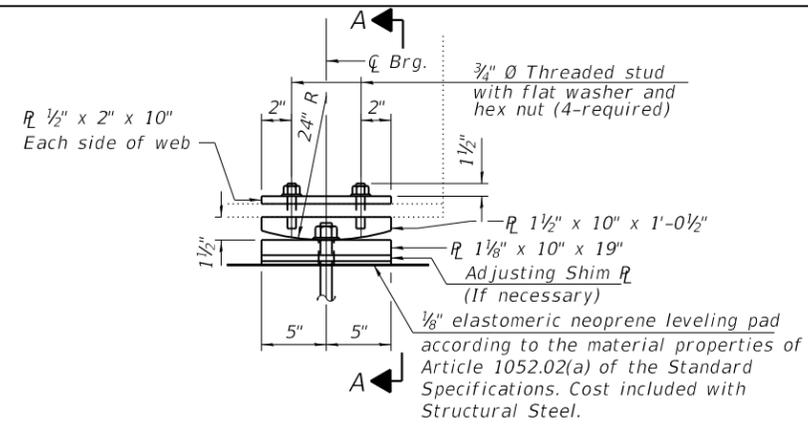


ELEVATION AT PIER

FIXED BEARING
(2 required, Pier 1 Span 1 Exterior Beams)

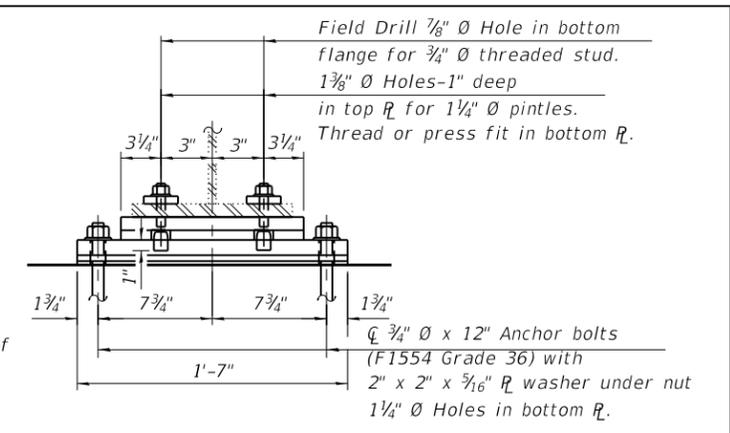


SECTION A-A

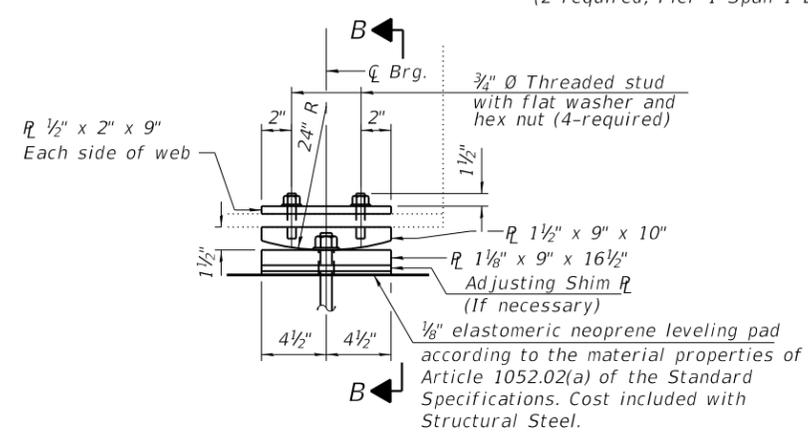


ELEVATION AT PIER

FIXED BEARING
(8 required, Pier 1 Span 1 Interior Beams)

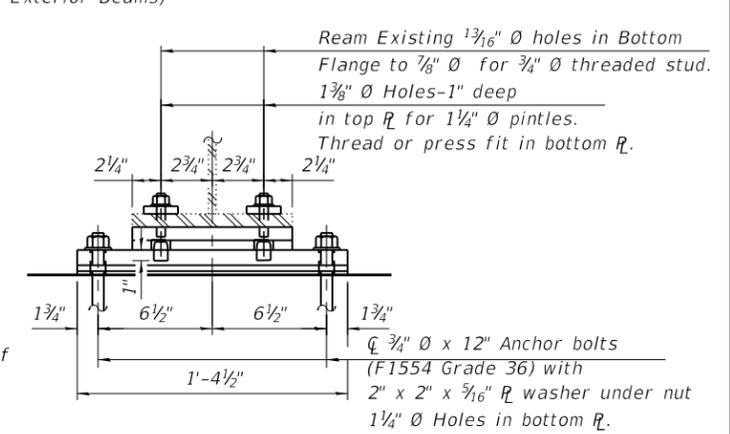


SECTION B-B

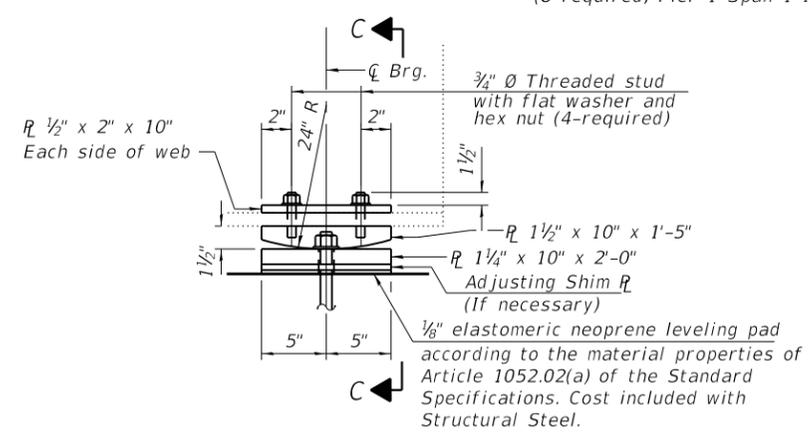

ELEVATION AT PIER

FIXED BEARING
(10 required, Pier 1 Span 2)

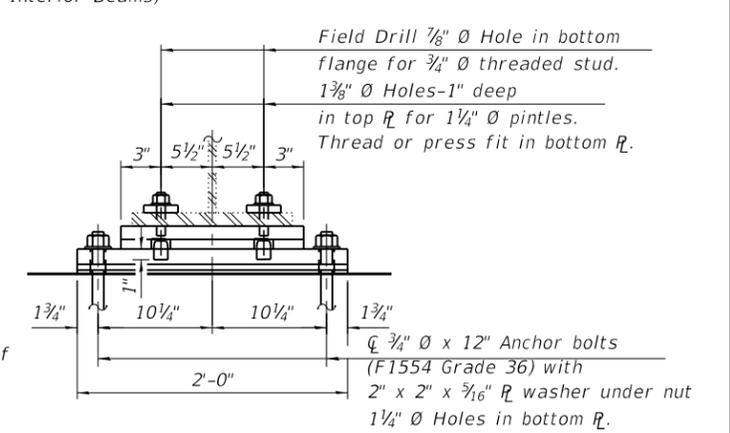

SECTION C-C

BILL OF MATERIAL

Item	Unit	Total
Furnishing and Erecting Structural Steel	Pound	2,650
Anchor Bolts, 3/4"	Each	40

FILE NAME: P:\10-1063.08 SN 0046 0120 Repairs\10_CAD\CADD Sheets\090-0046-68D59-04_Bearing_Details.dgn




USER NAME =	DESIGNED - MC	REVISED -
PLOT SCALE =	CHECKED - BB	REVISED -
PLOT DATE =	DRAWN - MC	REVISED -
	CHECKED - BB	REVISED -


STATE OF ILLINOIS
DEPARTMENT OF TRANSPORTATION

BEARING DETAILS
STRUCTURE NO. 090-0046
SHEET 4 OF 15 SHEETS


F.A.P. RTE.	SECTION	COUNTY	TOTAL SHEETS	SHEET NO.
404	(50B-4)BR;12[(HVB,HB)BR]BR	TAZEWELL	61	35
CONTRACT NO. 68D59				
ILLINOIS FED. AID PROJECT				

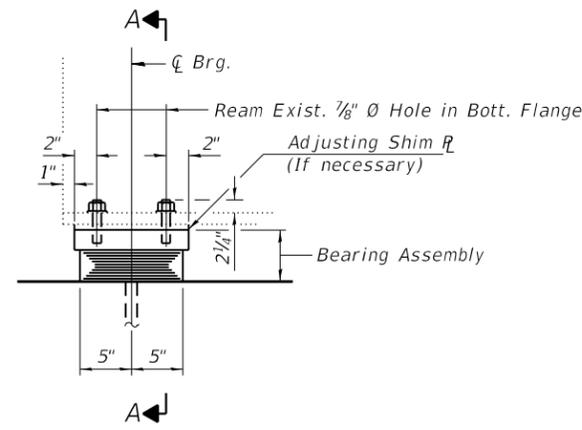


ELEVATION AT PIER

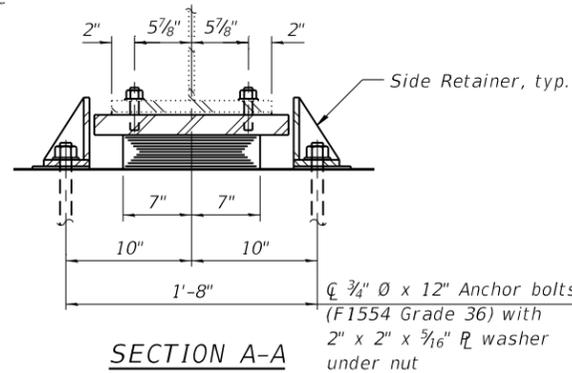

SECTION A-A

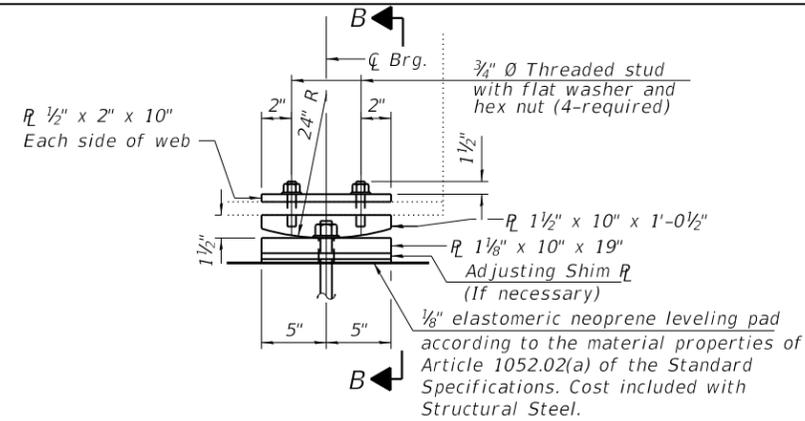


ELEVATION AT PIER

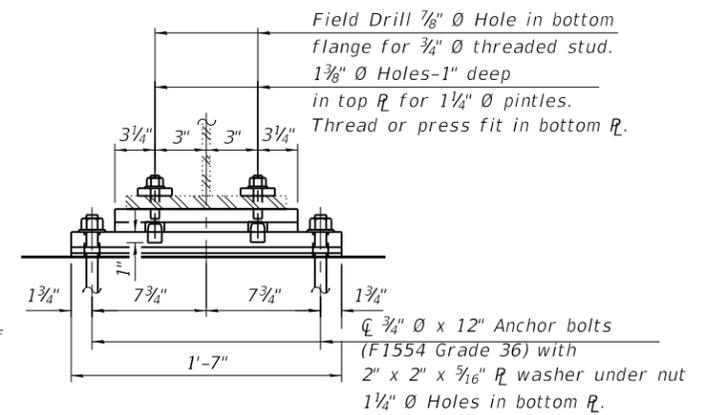


SECTION B-B

TYPE I ELASTOMERIC EXP. BRG.
(10 required, Pier 2 Span 2)

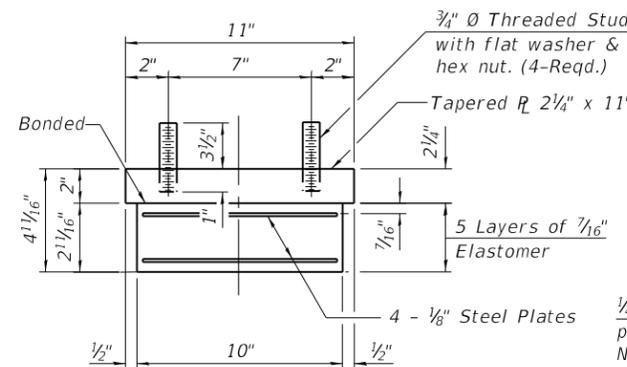


BEARING ASSEMBLY

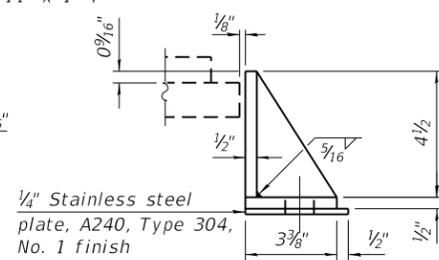


SIDE RETAINER

Equivalent rolled angle with stiffeners will be allowed in lieu of welded plates.

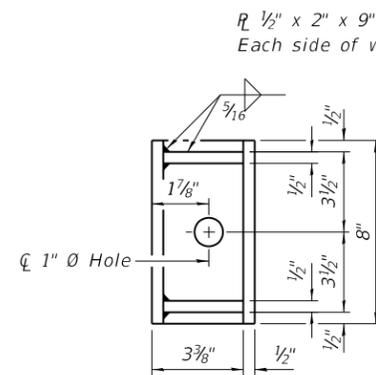

ELEVATION AT PIER

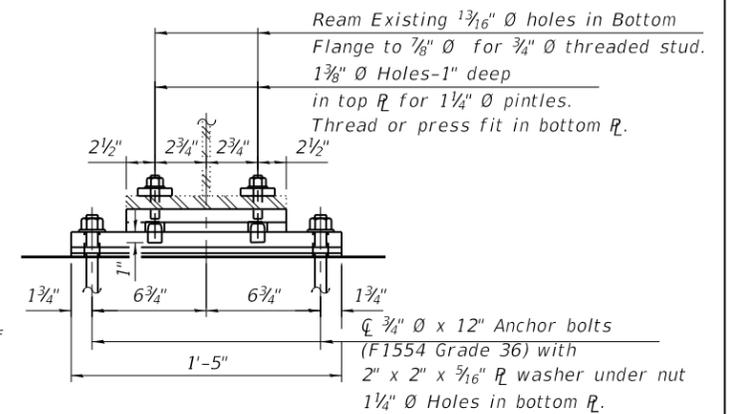


SECTION C-C


FIXED BEARING

(8 required, Pier 2 Span 3 Interior Beams)

Note:
Shim plates shall not be placed under Bearing Assembly.

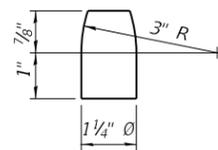


PINTLE

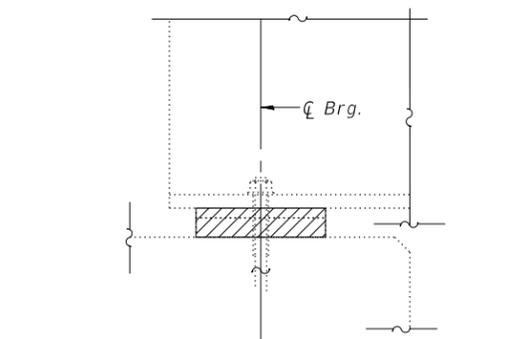


EXISTING BEARING REMOVAL DETAIL

(8 Required)
(Pier 2, Span 3 Interior Beams)

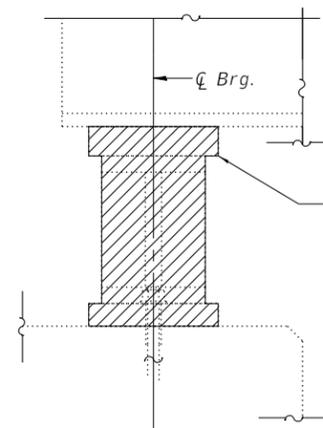

EXISTING BEARING REMOVAL DETAIL

(2 Required)
(Pier 2, Span 3 Exterior Beams)

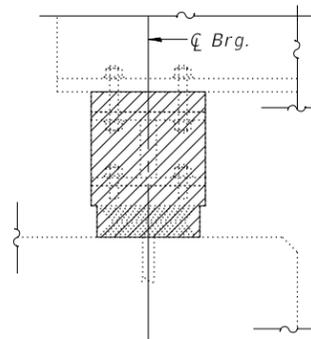

EXISTING BEARING REMOVAL DETAIL

(2 Required)
(Pier 2, Span 2)

BILL OF MATERIAL

Item	Unit	Total
Elastomeric Bearing Pad Type I	Each	10
Furnishing and Erecting Structural Steel	Pound	1,010
Anchor Bolts, 3/4"	Each	40

Notes:
See Sheet 4 of 15 for Bearing Notes.
See Sheet 4 of 15 for Interior Beam Reaction Table.

FILE NAME: P:\10-1063.08 SN 0046 0120 Repairs\10_CAD\CADD Sheets\090-0046\09000046-68D59-05_Bearing_Details.dgn


Kaskaskia
Engineering Group, LLC
Professional Engineering Group

USER NAME =	DESIGNED - MC	REVISED -
PLOT SCALE =	CHECKED - BB	REVISED -
PLOT DATE =	DRAWN - MC	REVISED -
	CHECKED - BB	REVISED -

STATE OF ILLINOIS
DEPARTMENT OF TRANSPORTATION

BEARING DETAILS
STRUCTURE NO. 090-0046
SHEET 5 OF 15 SHEETS

F.A.P. RTE.	SECTION	COUNTY	TOTAL SHEETS	SHEET NO.
404	(50B-4)BR:12[(HVB,HB)BR]BR	TAZEWELL	61	36
CONTRACT NO. 68D59				
ILLINOIS FED. AID PROJECT				






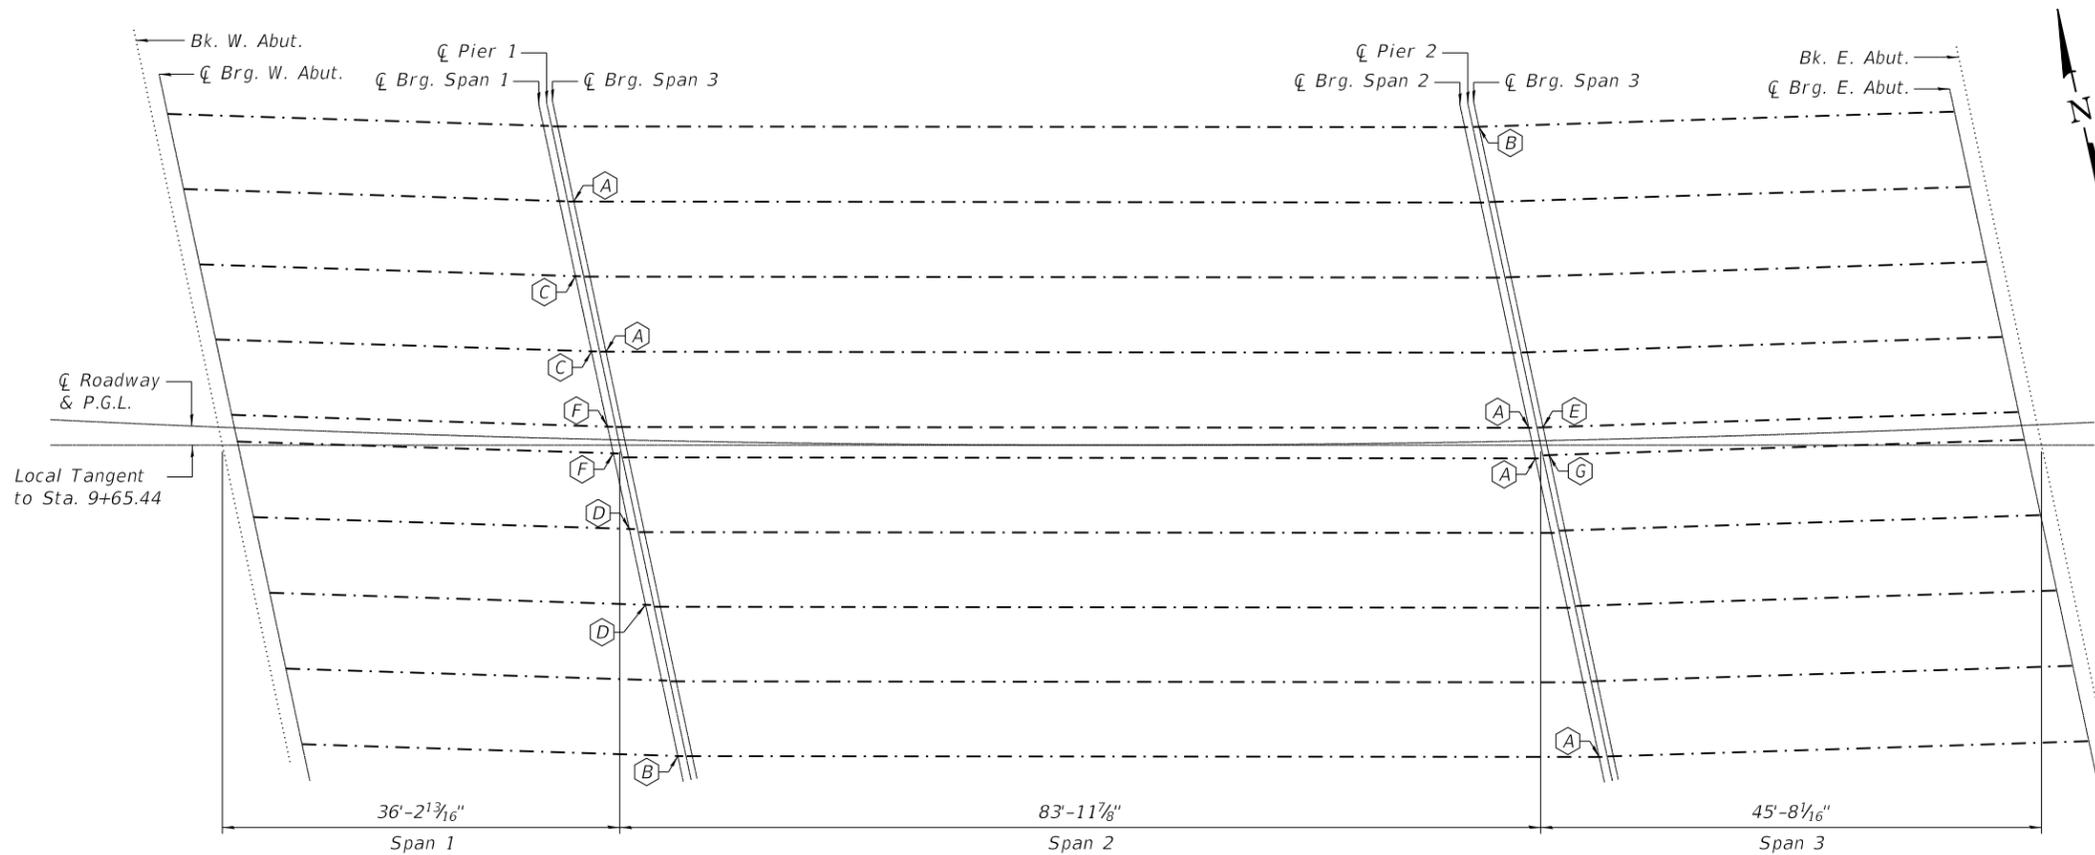


BOLT HOLE LEGEND

- - Field drill using existing steel as template
- - Shop drill holes in new steel

FRAMING PLAN

- Ⓐ REPAIR A
- Ⓑ REPAIR B
- Ⓒ REPAIR C
- Ⓓ REPAIR D
- Ⓔ REPAIR E
- Ⓕ REPAIR F
- Ⓖ REPAIR G

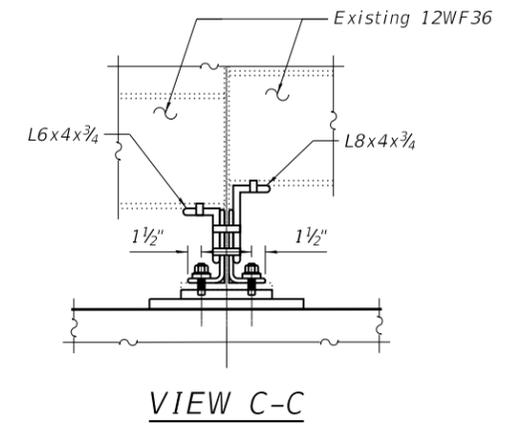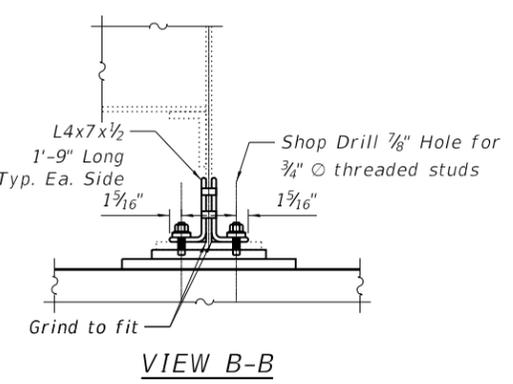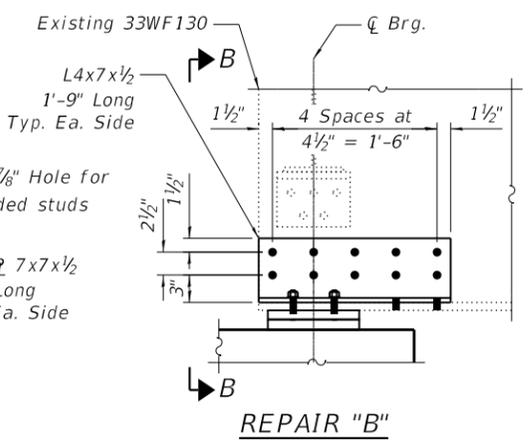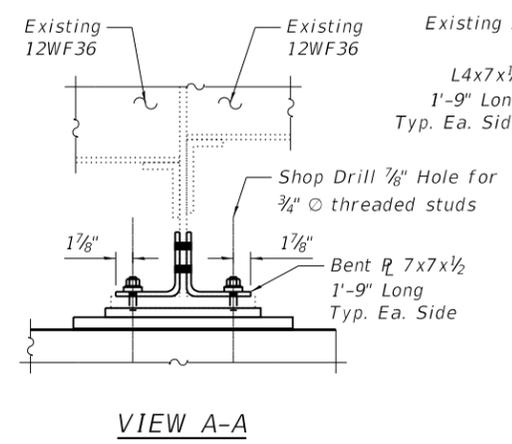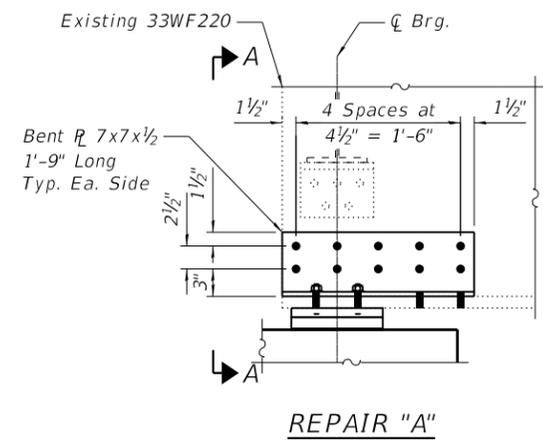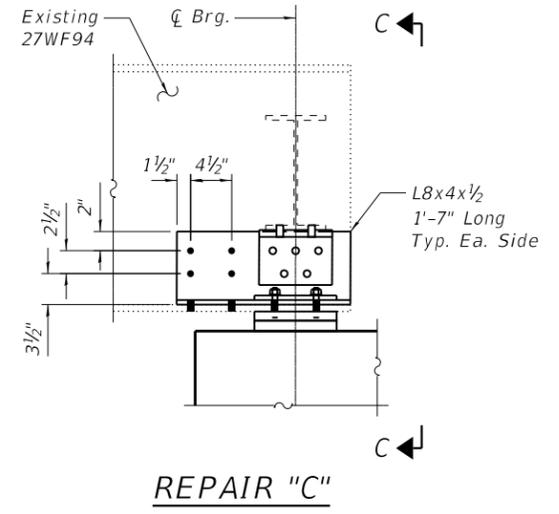

FILE NAME: P:\10-1063.08 SN 0046 0120 Repairs\10_CAD\CADD Sheets\090-0046-68D59-06_Structural Steel Repairs.dgn

Kaskaskia
Engineering Group, LLC
Professional Engineering Group

USER NAME =	DESIGNED - KS	REVISED -
CHECKED - BB	CHECKED - BB	REVISED -
DRAWN - RJO	DRAWN - RJO	REVISED -
CHECKED - BB	CHECKED - BB	REVISED -


STATE OF ILLINOIS
DEPARTMENT OF TRANSPORTATION

STRUCTURAL STEEL REPAIRS
STRUCTURE NO. 090-0046


F.A.P. RTE. 404	SECTION (50B-4)BR:12((HVB,HB)BR)BR	COUNTY TAZEWELL	TOTAL SHEETS 61	SHEET NO. 37
CONTRACT NO. 68D59				
ILLINOIS FED. AID PROJECT				

BOLT HOLE LEGEND


- - Field drill using existing steel as template
- - Shop drill holes in new steel.

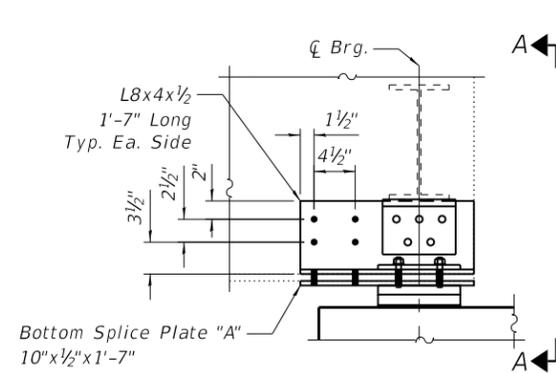


REPAIR "D"

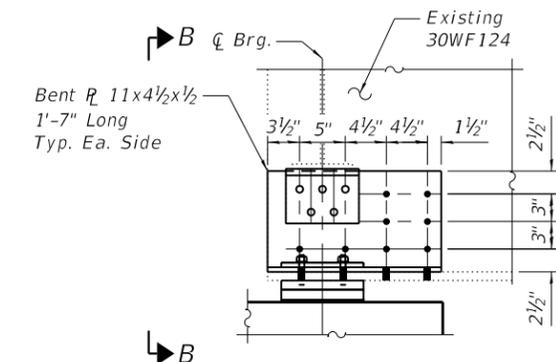


REPAIR "E"

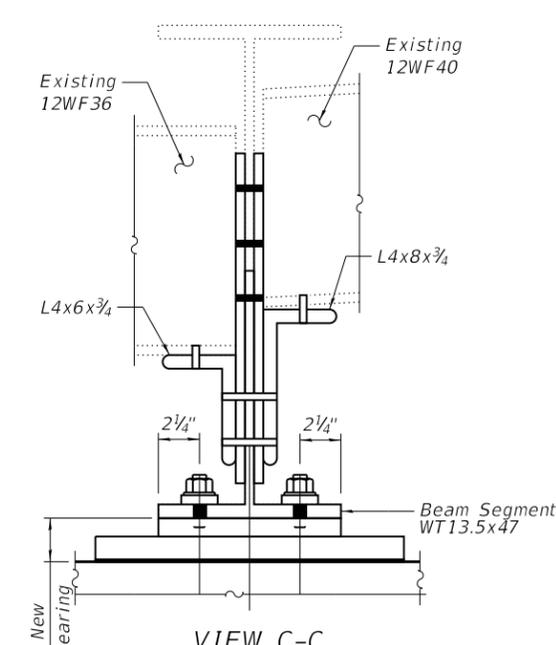

REPAIR "F"




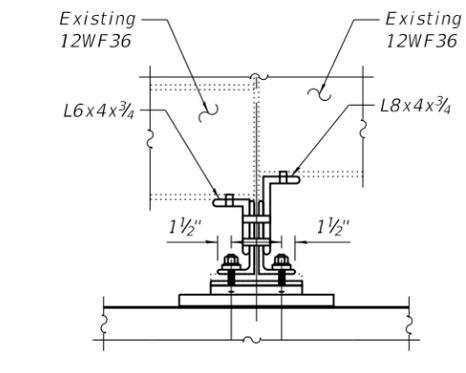


REPAIR "G"

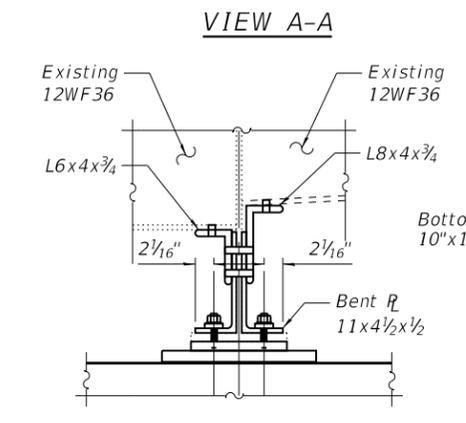


BILL OF MATERIAL

ITEM	UNIT	QUANTITY
Structural Steel Repair	Pound	2140

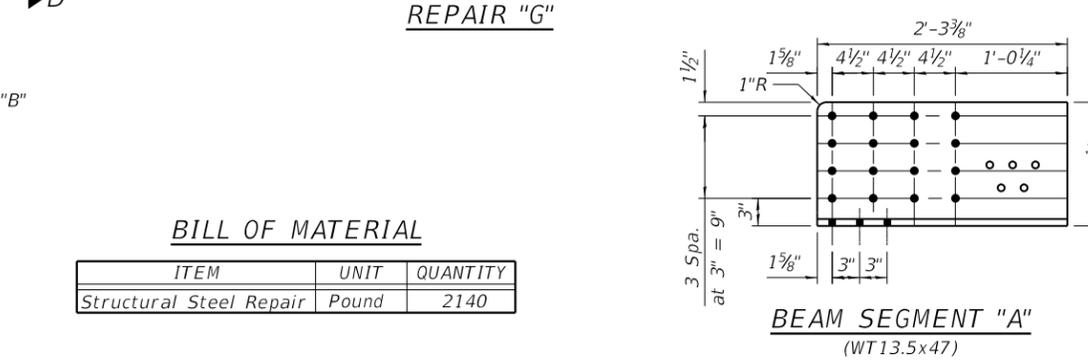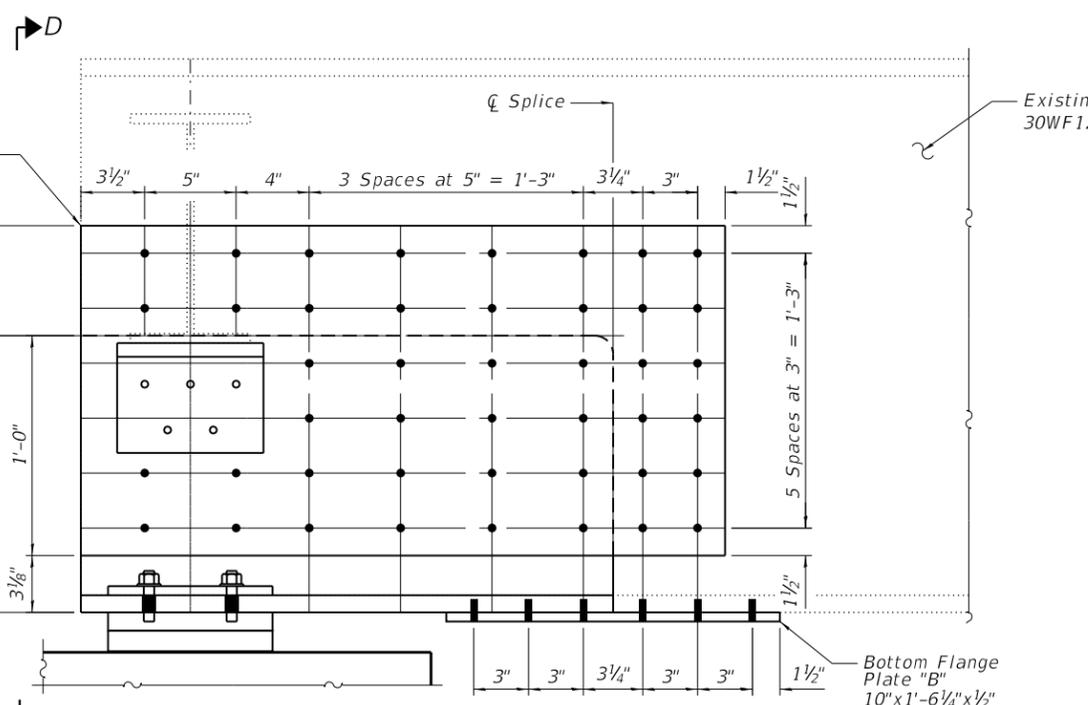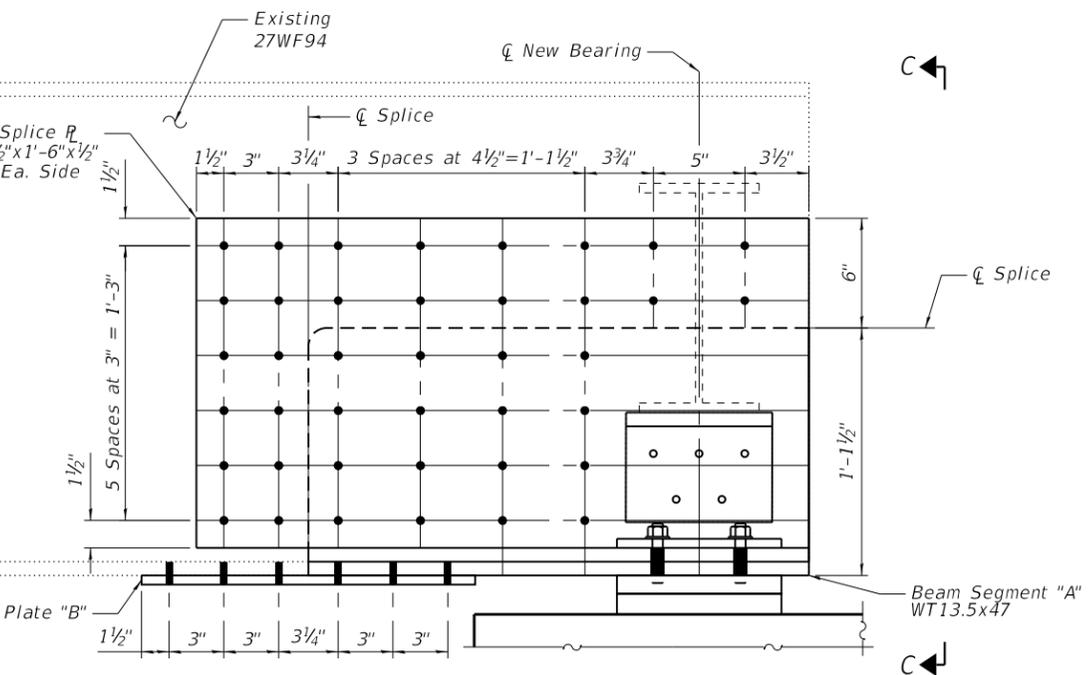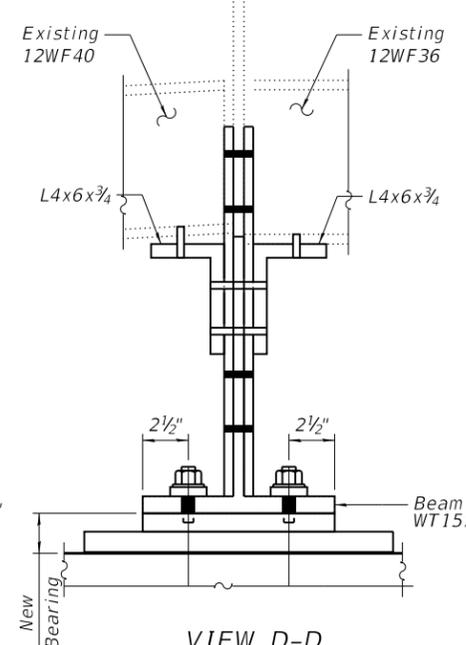


BEAM SEGMENT "A"
(WT13.5x47)

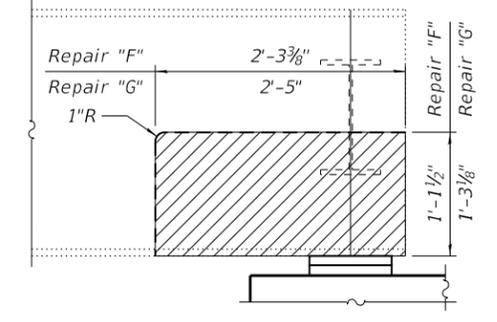


BEAM SEGMENT "B"
(WT15x62)


REMOVAL DETAIL FOR DETAILS "F" & "G"

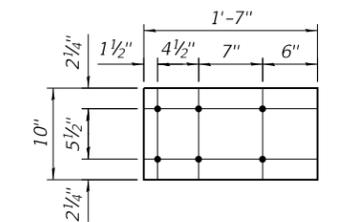

BOTTOM SPLICE PLATE "A"
(10' x 1/2' x 1'-7")

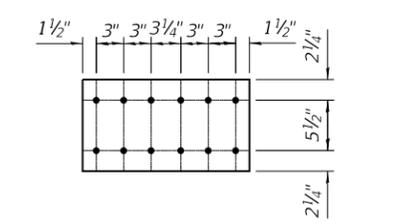

BOTTOM SPLICE PLATE "B"
(10' x 1/2' x 1'-6 1/4")

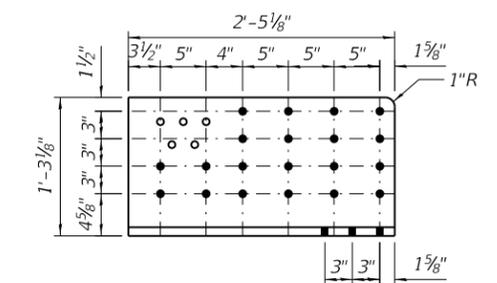

BEAM SEGMENT "B"
(WT15x62)

FILE NAME: P:\10-1063.08 SN 0046 0120 Repairs\10_CAD\CADD Sheets\090-0046-68D59-07_Structural Steel Repairs.dgn


Kaskaskia
Engineering Group, LLC
Professional Engineering Group

USER NAME =	DESIGNED - KS	REVISED -
CHECKED - BB	CHECKED - BB	REVISED -
DRAWN - RJO	DRAWN - RJO	REVISED -
CHECKED - BB	CHECKED - BB	REVISED -


STATE OF ILLINOIS
DEPARTMENT OF TRANSPORTATION

STRUCTURAL STEEL REPAIRS
STRUCTURE NO. 090-0046
SHEET 7 OF 15 SHEETS


F.A.P. RTE. 404	SECTION (50B-4)BR:12((HVB,HB)BR)BR	COUNTY TAZEWELL	TOTAL SHEETS 61	SHEET NO. 38
CONTRACT NO. 68D59			ILLINOIS FED. AID PROJECT	

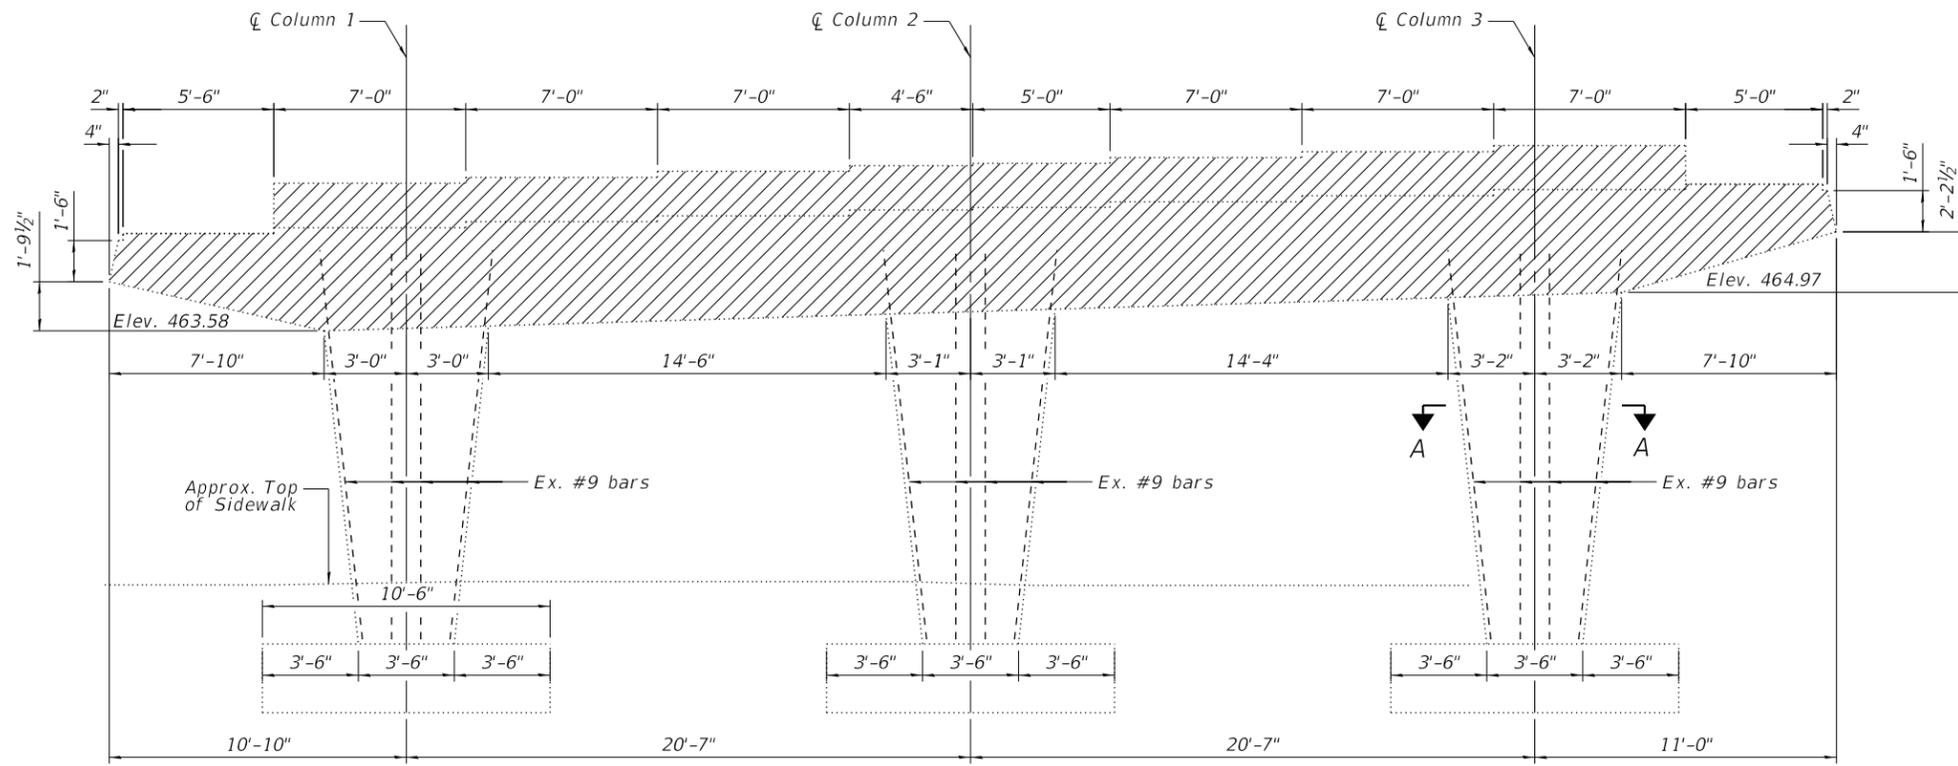

PIER 1 ELEVATION - REMOVAL
(Looking East)

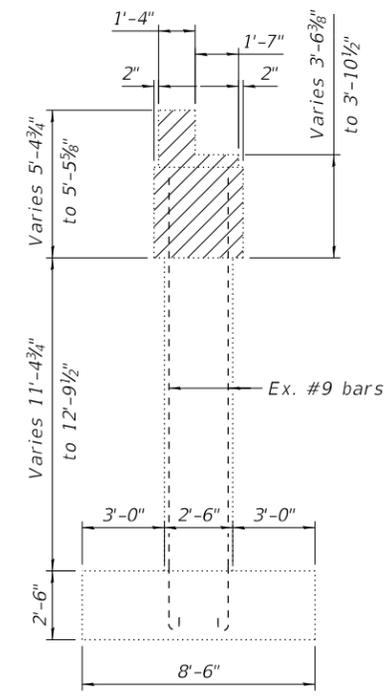

PIER 1 END VIEW
(Looking North)

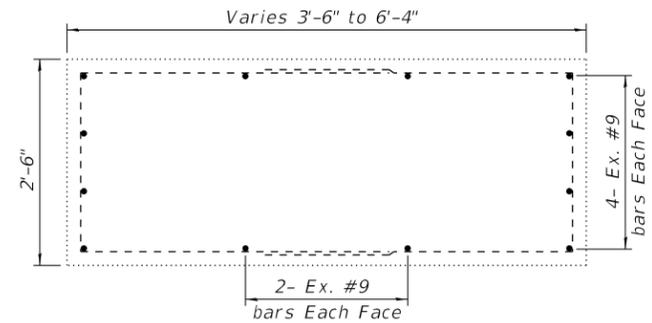

SECTION A-A

- Indicates Limits of Concrete Removal

Notes:
Existing reinforcing extending from existing columns to be incorporated into new construction shall be cleaned and straightened. Cost included with Concrete Removal.
Existing elevations and dimensions shown are taken from the 1957 bridge plans. Contractor shall field verify all elevations and dimensions shown.

BILL OF MATERIAL

ITEM	UNIT	QUANTITY
Concrete Removal	CU. YD.	30.4

FILE NAME: P:\10-1063.08 SN 0046 0120 Repairs\10_CAD\CADD Sheets\090-0046-68D59-08_Pier 1 Concrete Removal Details.dgn

Kaskaskia Engineering Group, LLC
Professional Engineering Group
208 E. Main St., Suite 200
Bloomington, Illinois 61702
618.233.2877 phone
618.233.2977 fax
www.kaskaskiaeng.com
11/27/2018
01/28/2013
20-000006


USER NAME =	DESIGNED - MC	REVISED -
	CHECKED - BB	REVISED -
PLOT SCALE =	DRAWN - MC	REVISED -
PLOT DATE =	CHECKED - BB	REVISED -

STATE OF ILLINOIS
DEPARTMENT OF TRANSPORTATION


PIER 1 CONCRETE REMOVAL DETAILS
STRUCTURE NO. 090-0046

SHEET 8 OF 15 SHEETS


F.A.P. RTE.	SECTION	COUNTY	TOTAL SHEETS	SHEET NO.
404	(50B-4)BR;12((HVB,HB)BR)BR	TAZEWELL	61	39
CONTRACT NO. 68D59				
ILLINOIS FED. AID PROJECT				

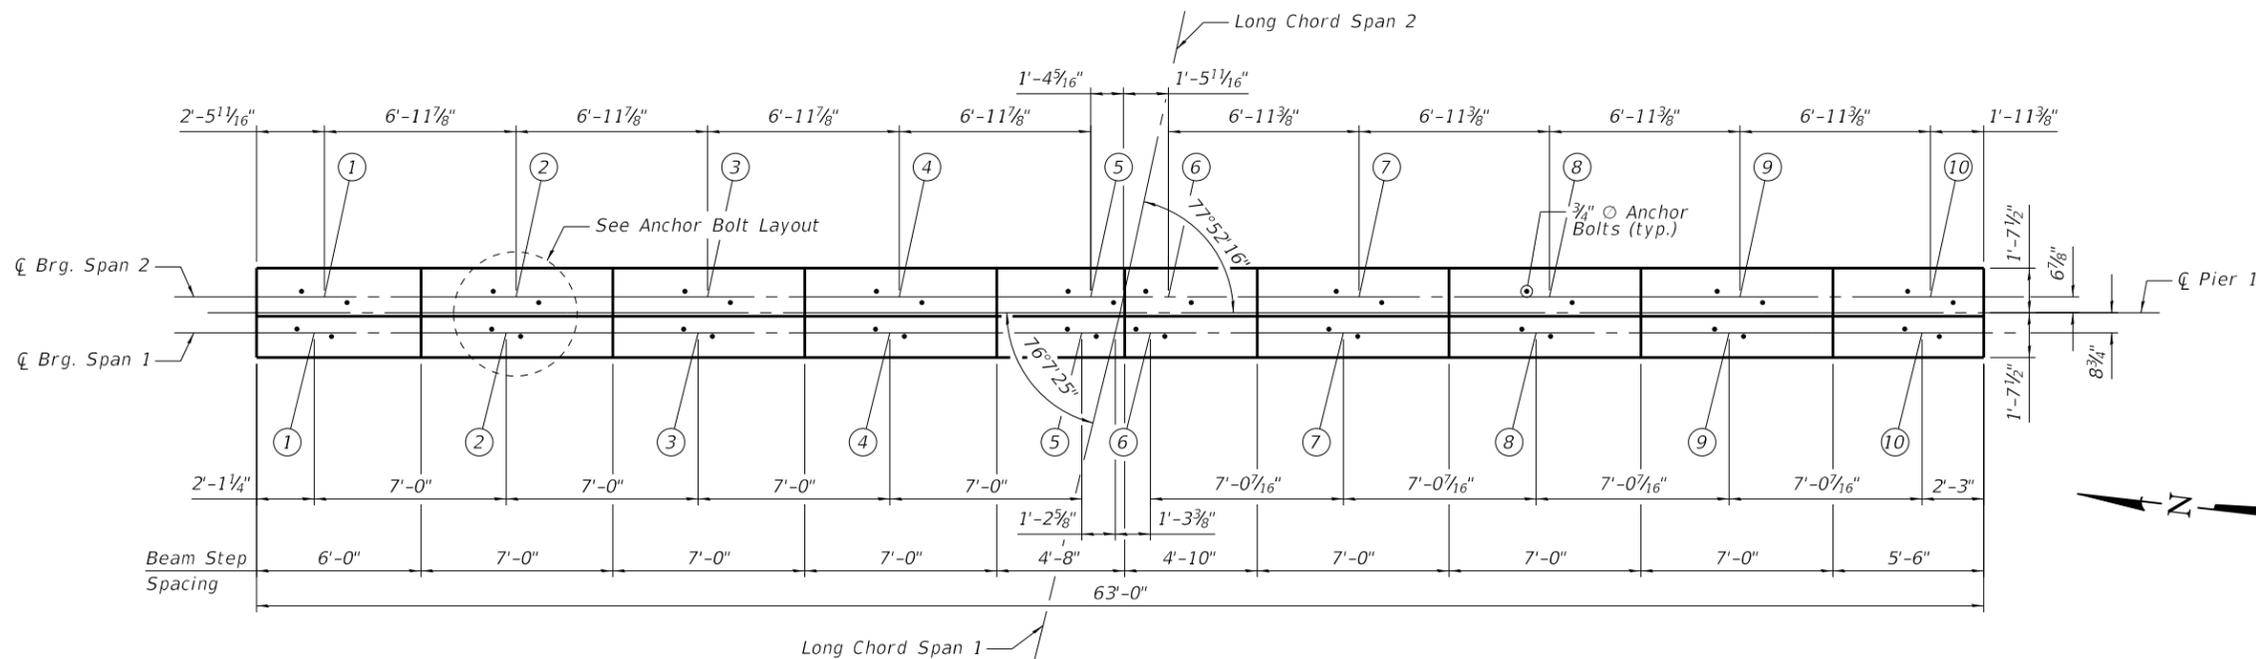

PIER 1 PLAN

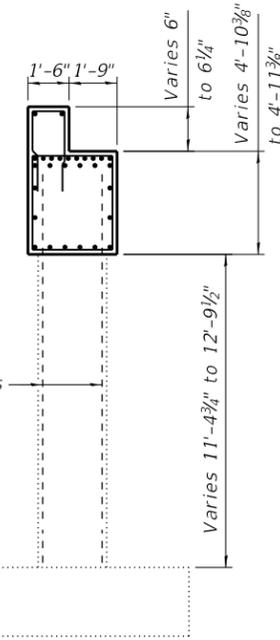

PIER 1 END ELEVATION
(Looking North)

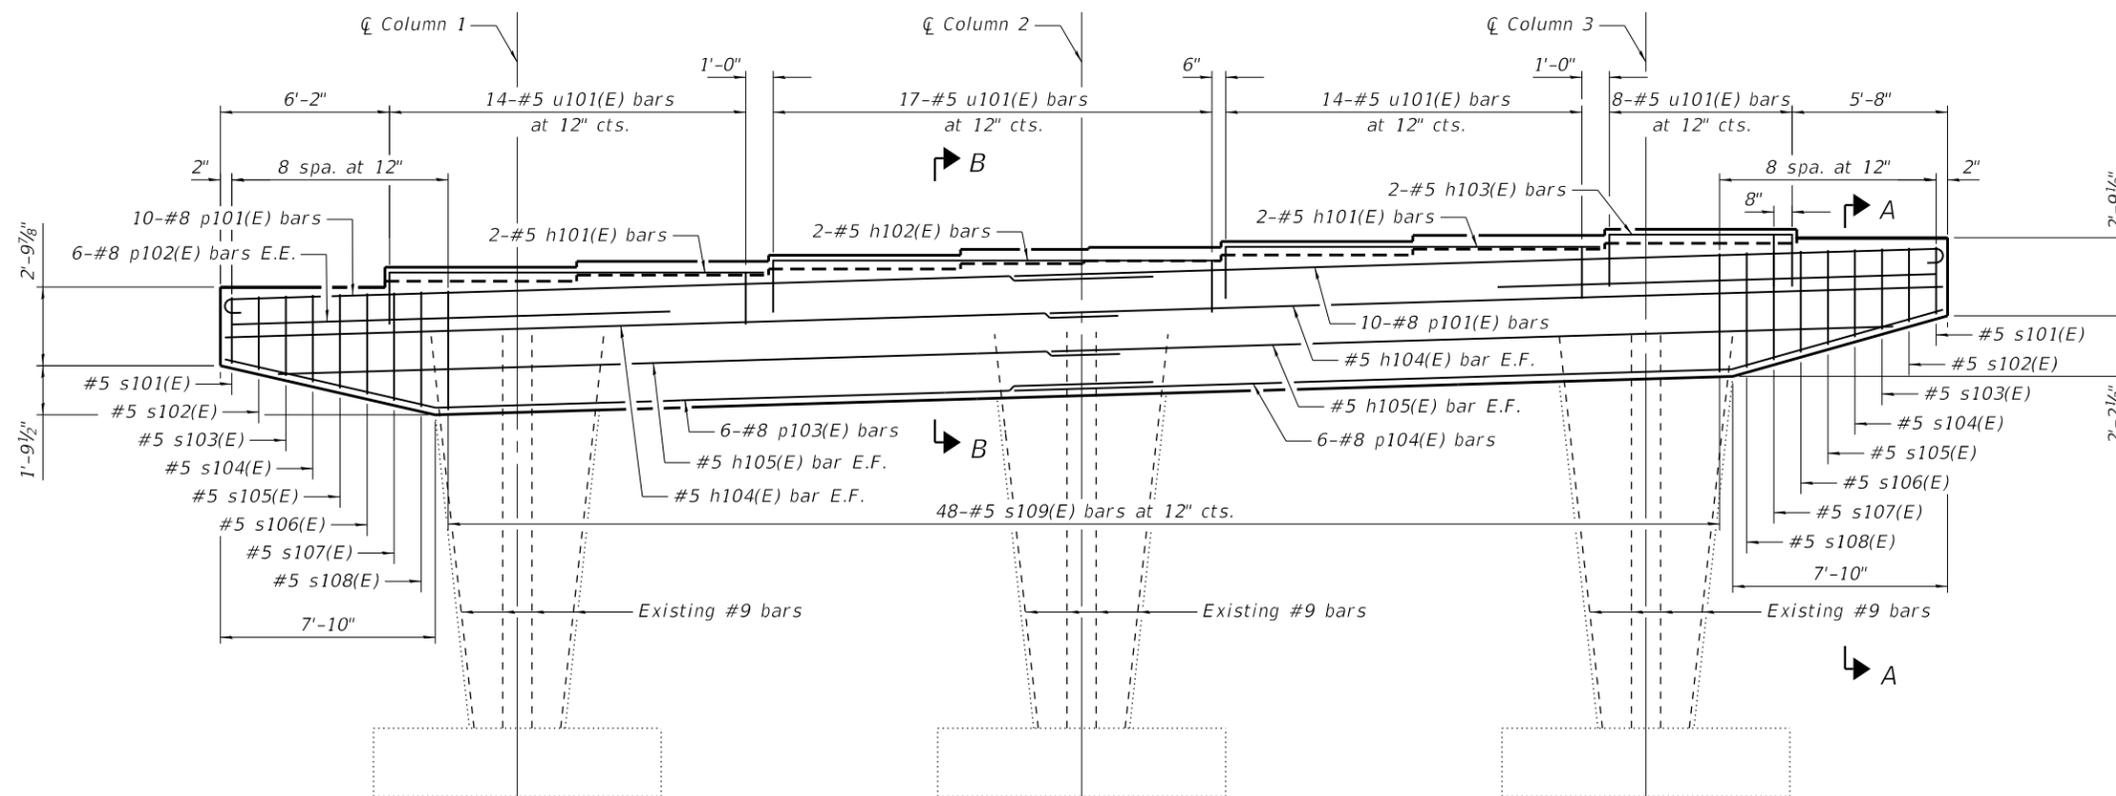

PIER 1 ELEVATION
(Looking East)

Notes:
 Existing reinforcement extending into concrete removal shall be cleaned, straightened and incorporated into the new concrete. Cost included with Concrete Removal.
 See sheet 10 of 15 for Sections A-A and B-B. Space reinforcement in cap to miss anchor bolts. Pour steps monolithically with cap.
 E.F. denotes "Each Face."
 E.E. denotes "Each End."
 See sheet 10 of 15 for Anchor Bolt Layouts.

Min. Bar Lap
 #5 bar = 5'-4"
 #8 bar = 8'-2"

FILE NAME: P:\10-1063,08 SN 0046 0120 Repairs\10_CAD\CADD Sheets\090-0046-68D59-09_Pier 1 Details_1.dgn




USER NAME =	DESIGNED - MC	REVISED -
CHECKED - BB	REVISED -	
PLOT SCALE =	DRAWN - MC	REVISED -
PLOT DATE =	CHECKED - BB	REVISED -

STATE OF ILLINOIS
 DEPARTMENT OF TRANSPORTATION


PIER 1 DETAILS
 STRUCTURE NO. 090-0046

SHEET 9 OF 15 SHEETS


F.A.P. RTE.	SECTION	COUNTY	TOTAL SHEETS	SHEET NO.
404	(50B-4)BR:12((HVB,HB)BR)BR	TAZEWELL	61	40
CONTRACT NO. 68D59				
ILLINOIS FED. AID PROJECT				

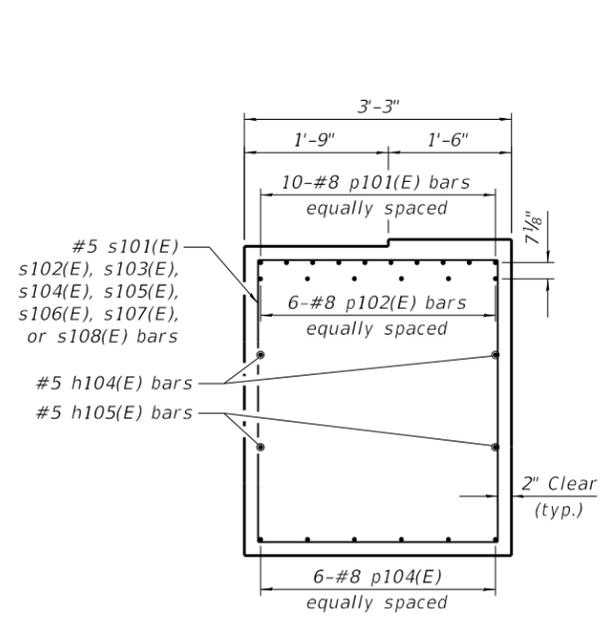


SECTION A-A

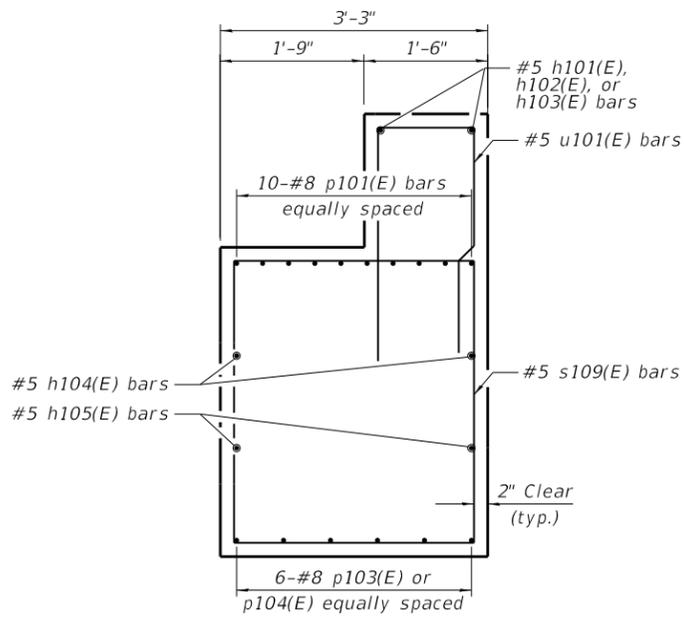


SECTION B-B

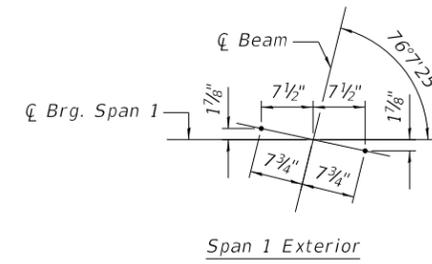

Span 1 Exterior

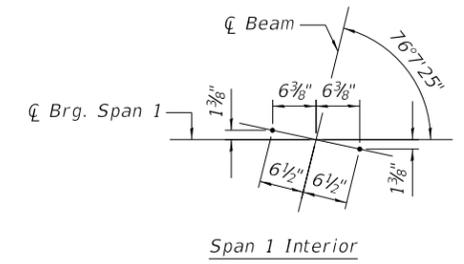


Span 1 Interior

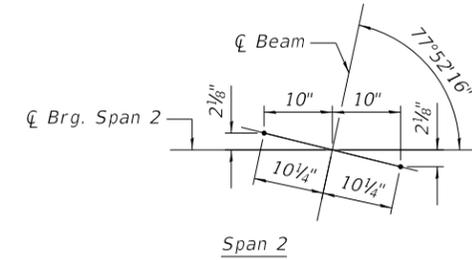


Span 2


ANCHOR BOLT LAYOUT

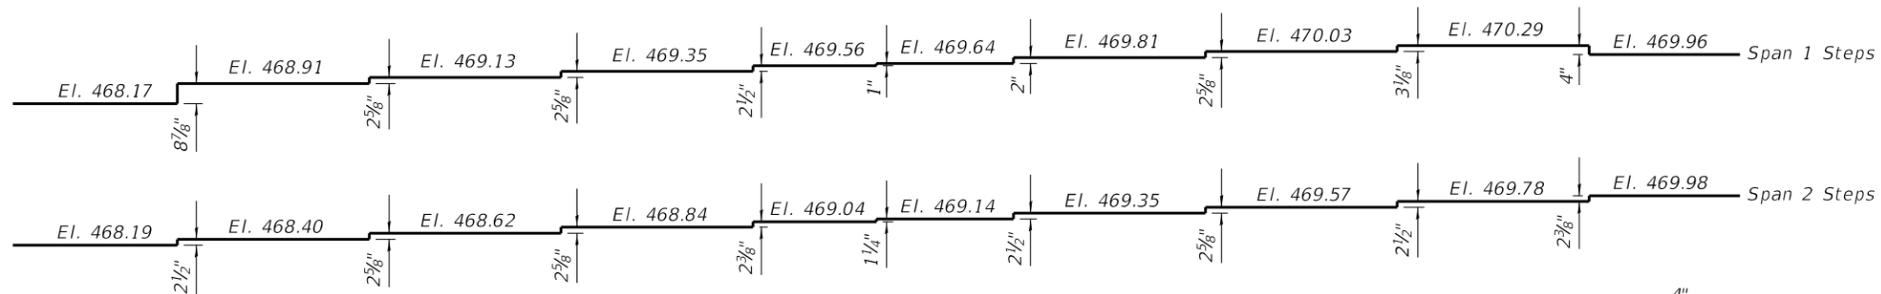


PIER 1 DETAIL OF STEPS

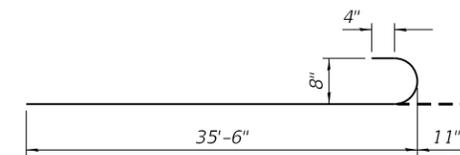


BAR p101(E)

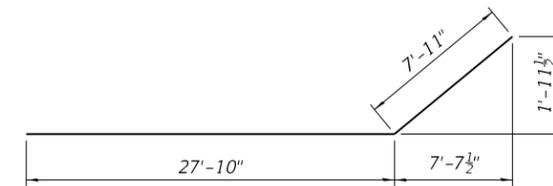


BAR p103(E)

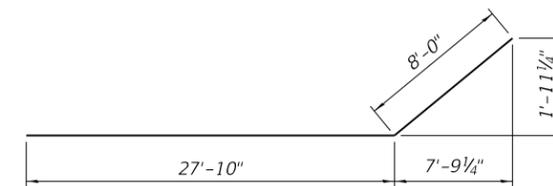

BAR p104(E)

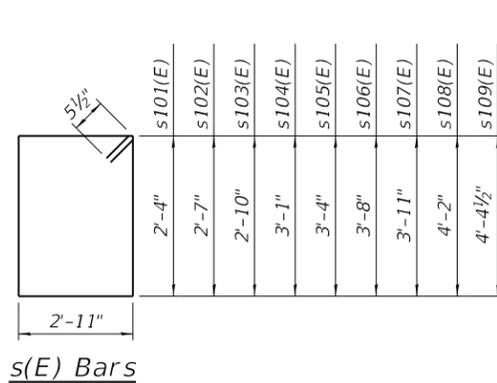

s(E) Bars

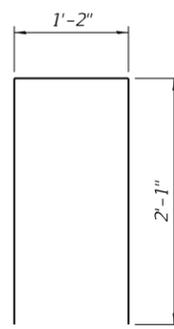

BAR u101(E)

BILL OF MATERIAL

Bar	No.	Size	Length	Shape
h101(E)	4	#5	13'-8"	—
h102(E)	2	#5	16'-2"	—
h103(E)	2	#5	6'-8"	—
h104(E)	4	#5	34'-1"	—
h105(E)	4	#5	32'-2"	—
p101(E)	20	#8	36'-5"	—
p102(E)	12	#8	16'-0"	—
p103(E)	6	#8	35'-9"	—
p104(E)	6	#8	35'-10"	—
s101(E)	2	#5	11'-5"	□
s102(E)	2	#5	11'-11"	□
s103(E)	2	#5	12'-5"	□
s104(E)	2	#5	12'-11"	□
s105(E)	2	#5	13'-5"	□
s106(E)	2	#5	14'-1"	□
s107(E)	2	#5	14'-7"	□
s108(E)	2	#5	15'-1"	□
s109(E)	48	#5	15'-6"	□
u101(E)	53	#5	5'-4"	—
Concrete Structures			Cu. Yd.	36.3
Reinforcement Bars (Epoxy Coated)			Pound	5280

FILE NAME: P:\10-1063.08 SN 0046 0120 Repairs\10_CAD\CADD Sheets\090-0046\09000046-68D59-10_Pier 1 Details_2.dgn


Kaskaskia
Engineering Group, LLC
288 E. Main St., Suite 200
Marechal, Illinois 62428
618.233.2877 phone
618.233.2977 fax
www.kaskaskiaeng.com
Professional Engineering Group
11/27/2018 11:14:15 AM

USER NAME =	DESIGNED - MC	REVISED -
CHECKED - BB	CHECKED - BB	REVISED -
DRAWN - MC	DRAWN - MC	REVISED -
CHECKED - BB	CHECKED - BB	REVISED -


STATE OF ILLINOIS
DEPARTMENT OF TRANSPORTATION

PIER 1 DETAILS
STRUCTURE NO. 090-0046
SHEET 10 OF 15 SHEETS


F.A.P. RTE. 404	SECTION (50B-4)BR:12[(HVB,HB)BR]BR	COUNTY TAZEWELL	TOTAL SHEETS 61	SHEET NO. 41
			CONTRACT NO. 68D59	
		ILLINOIS FED. AID PROJECT		

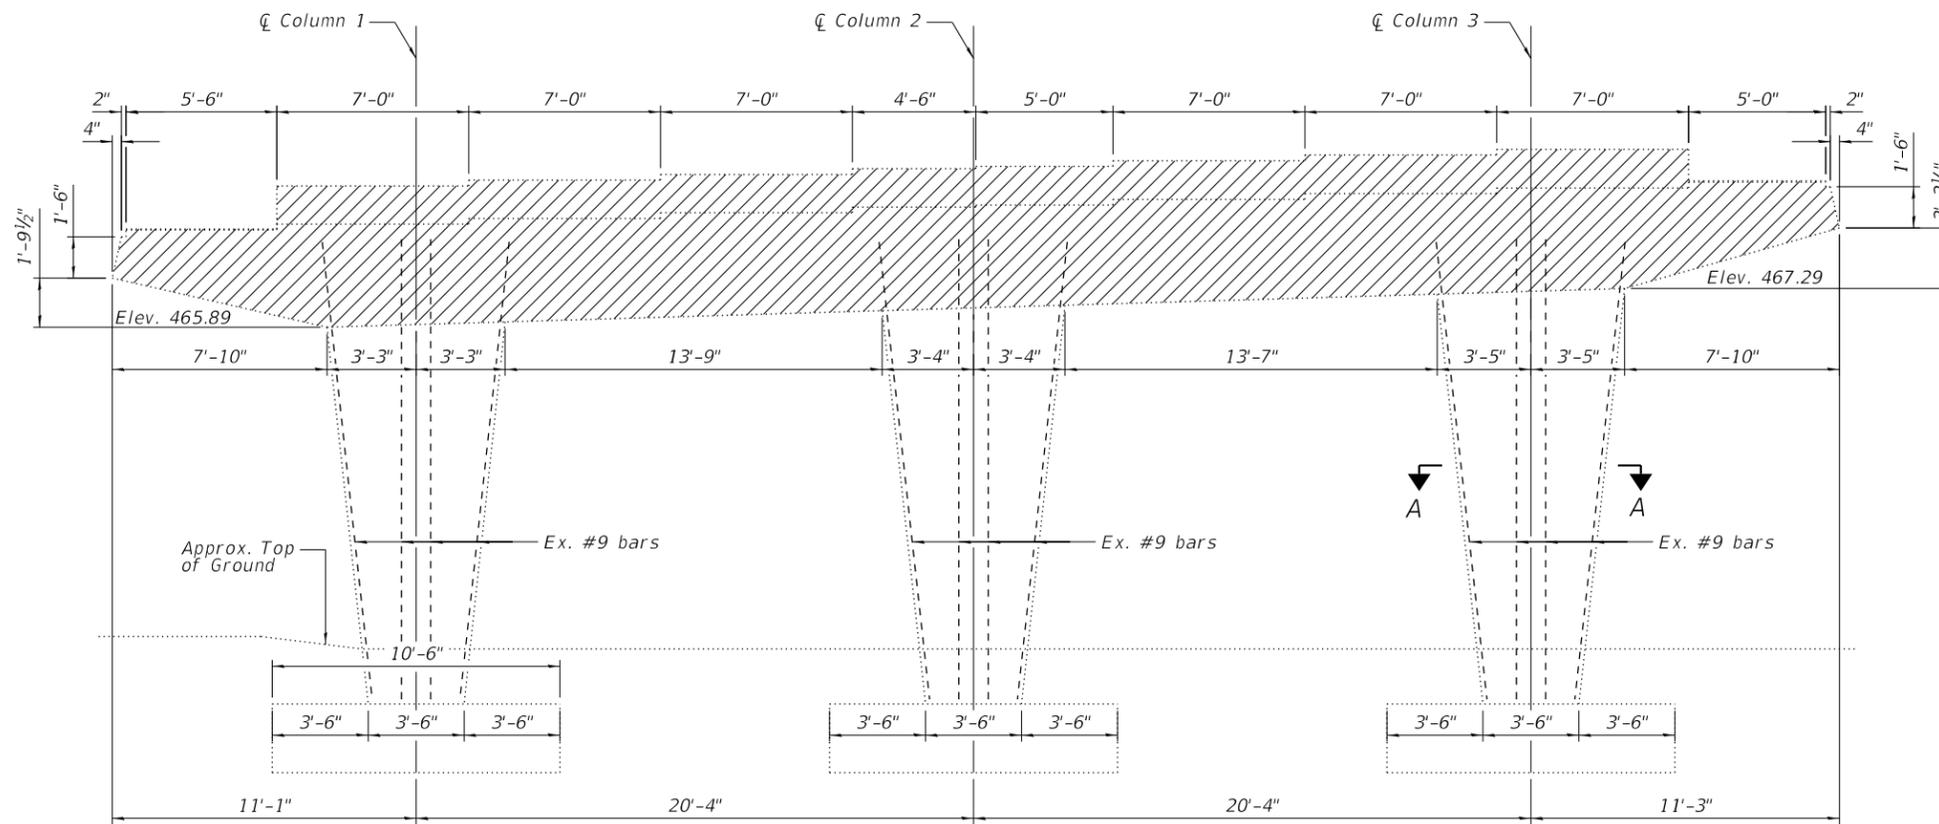

PIER 2 ELEVATION - REMOVAL
(Looking East)

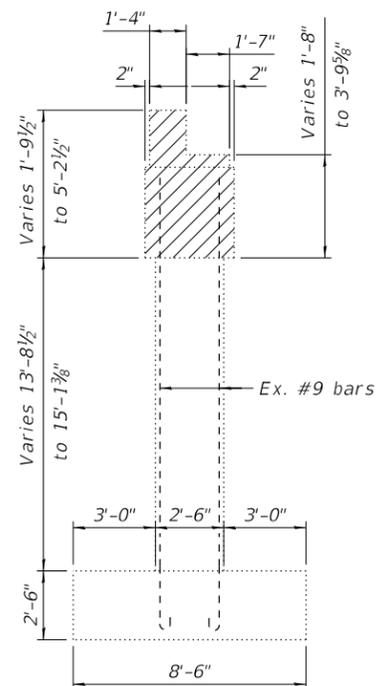

PIER 2 END VIEW
(Looking South)

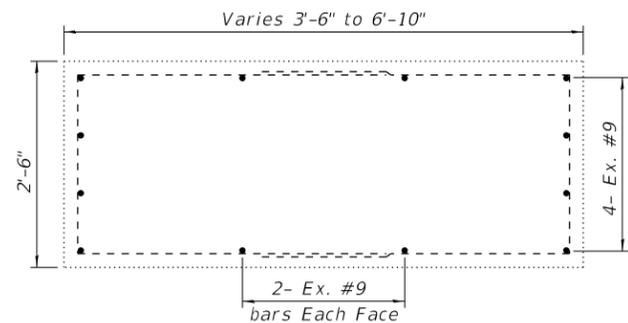

SECTION A-A

- Indicates Limits of Concrete Removal

Notes:
Existing reinforcing extending from existing columns to be incorporated into new construction shall be cleaned and straightened. Cost included with Concrete Removal.
Existing elevations and dimensions shown are taken from the 1957 bridge plans. Contractor shall field verify all elevations and dimensions shown.

BILL OF MATERIAL

ITEM	UNIT	QUANTITY
Concrete Removal	CU. YD.	29.7

FILE NAME: P:\10-1063.08 SN 0046 0120 Repairs\10_CAD\CADD Sheets\090-0046-68D59-11_Pier 2 Concrete Removal Details.dgn

Kaskaskia
Engineering Group, LLC
Professional Engineering Group
208 E. Main St., Suite 300
Bloomington, Illinois 61702
618.233.2877 phone
618.233.2977 fax
www.kaskaskiaeng.com
11/27/2018
01/08/2013
20-080266


USER NAME =	DESIGNED - MC	REVISED -
	CHECKED - BB	REVISED -
PLOT SCALE =	DRAWN - MC	REVISED -
PLOT DATE =	CHECKED - BB	REVISED -

STATE OF ILLINOIS
DEPARTMENT OF TRANSPORTATION


PIER 2 CONCRETE REMOVAL DETAILS
STRUCTURE NO. 090-0046

SHEET 11 OF 15 SHEETS


F.A.P. RTE. 404	SECTION (50B-4)BR:12((HVB,HB)BR)BR	COUNTY TAZEWELL	TOTAL SHEETS 61	SHEET NO. 42
CONTRACT NO. 68D59				
ILLINOIS FED. AID PROJECT				

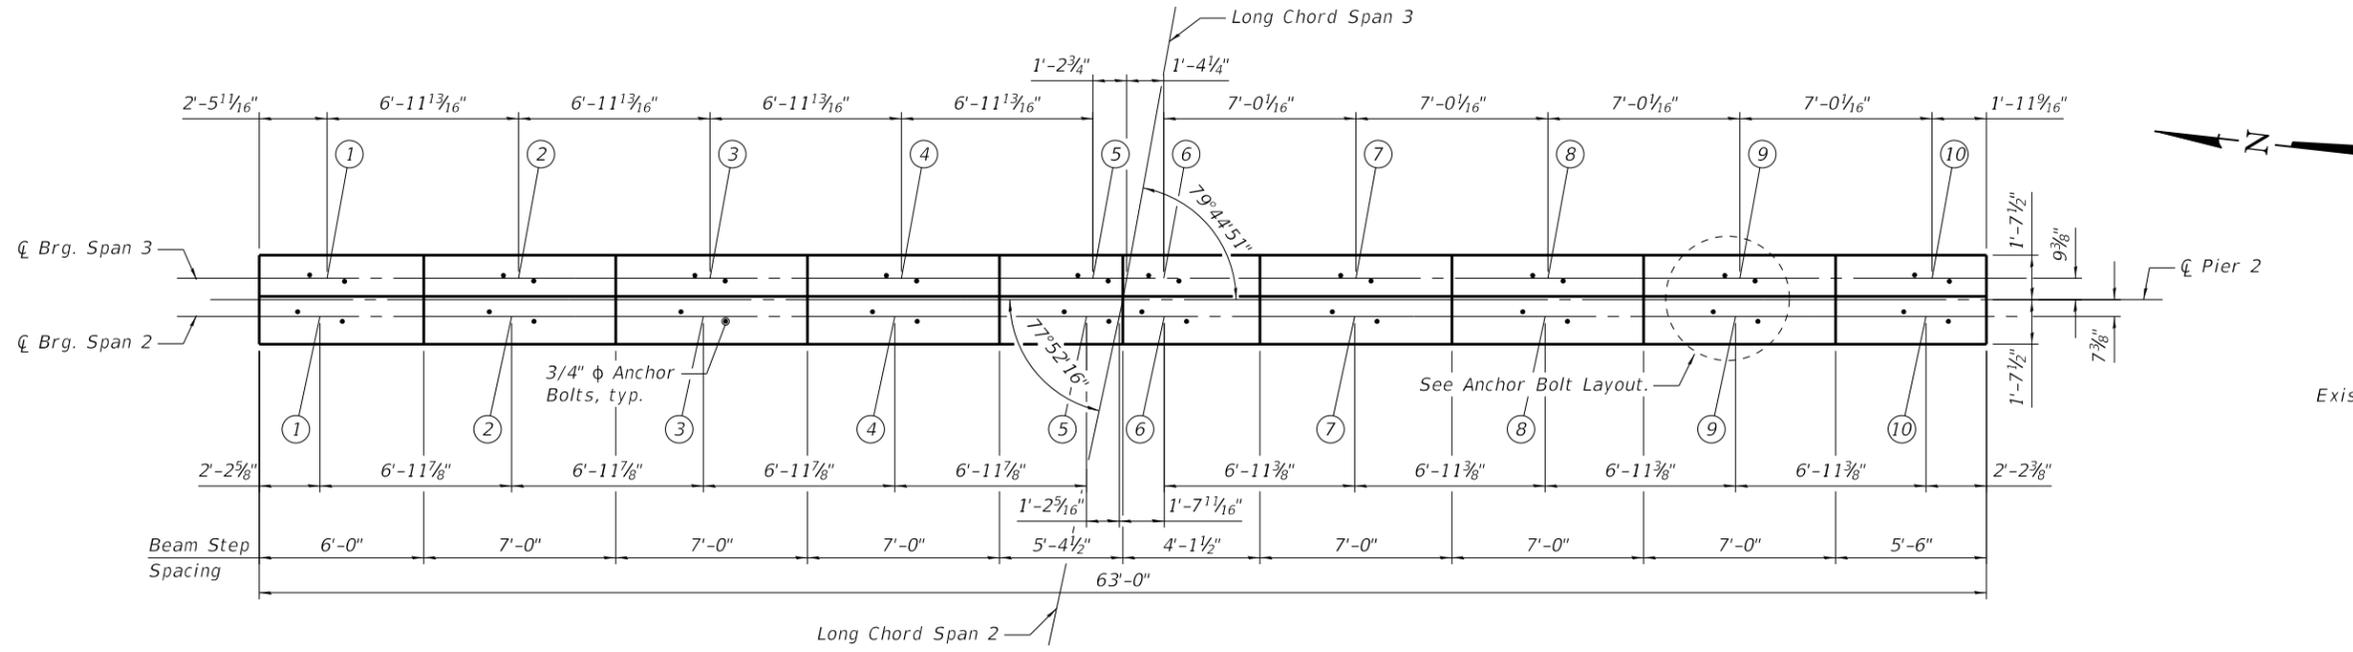

PIER 2 PLAN

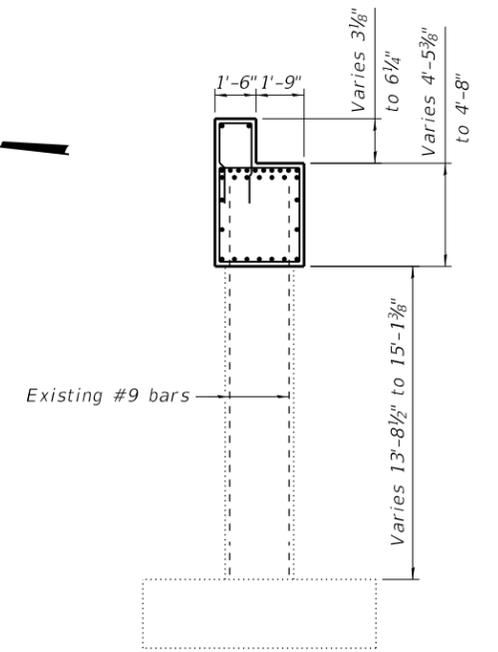

PIER 2 END ELEVATION
(Looking South)

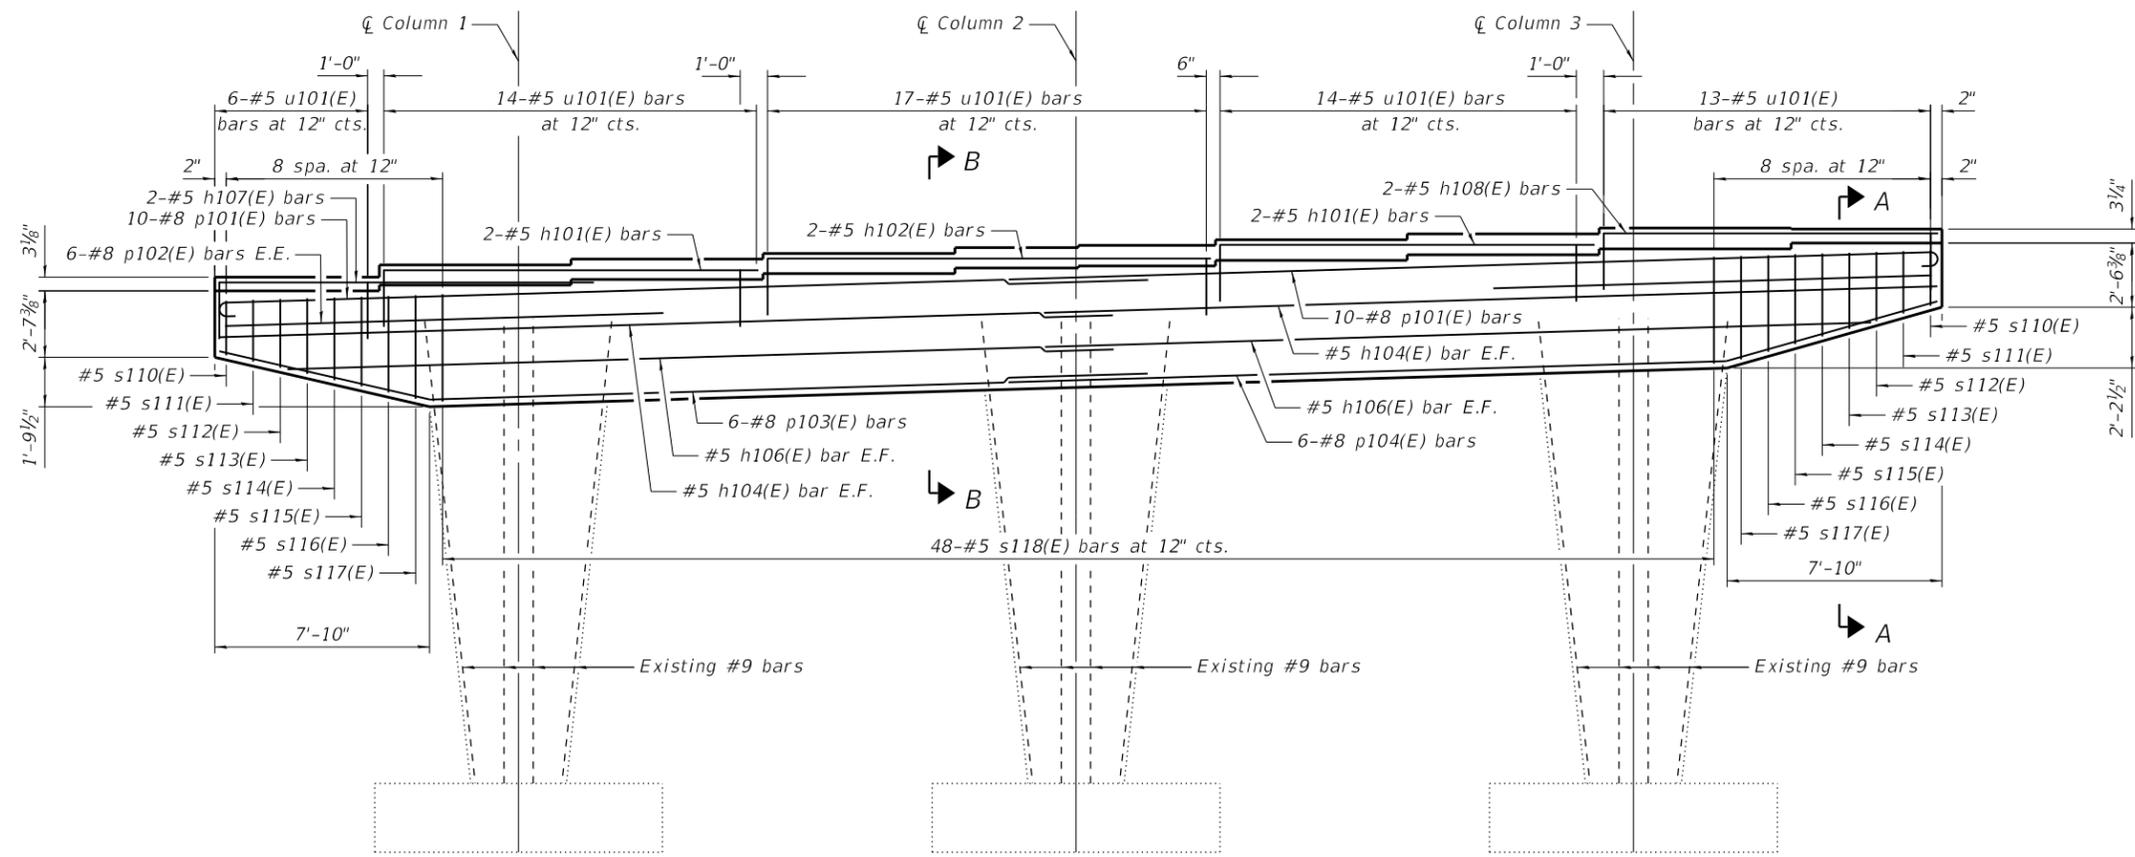

PIER 2 ELEVATION
(Looking East)

Minimum Bar Lap
 #5 bar = 5'-4"
 #8 bar = 8'-2"

Notes:
 Existing reinforcement extending into concrete removal shall be cleaned, straightened and incorporated into the new concrete. Cost included with Concrete Removal
 See sheet 13 of 15 for Sections A-A and B-B.
 Space reinforcement in cap to miss anchor bolts. Pour steps monolithically with cap.
 E.F. denotes "Each Face."
 E.E. denotes "Each End."
 See sheet 13 of 15 For Anchor Bolt Layout.

FILE NAME: P:\10-1063.08 SN 0046 0120 Repairs\10_CAD\CADD Sheets\090-0046-68D59-12_Pier 2_Details_1.dgn



288 E. Main St., Suite 300
 #480000, Ottawa, IL 62450
 618.233.2877 phone
 618.233.2977 fax
 www.kaskaskiaeng.com
 11/27/2018
 20-088266


USER NAME =	DESIGNED - MC	REVISED -
	CHECKED - BB	REVISED -
PLOT SCALE =	DRAWN - MC	REVISED -
PLOT DATE =	CHECKED - BB	REVISED -

STATE OF ILLINOIS
 DEPARTMENT OF TRANSPORTATION


PIER 2 DETAILS
 STRUCTURE NO. 090-0046

SHEET 12 OF 15 SHEETS


F.A.P. RTE.	SECTION	COUNTY	TOTAL SHEETS	SHEET NO.
404	(50B-4)BR;12((HVB,HB)BR)BR	TAZEWELL	61	43
CONTRACT NO. 68D59				
ILLINOIS FED. AID PROJECT				

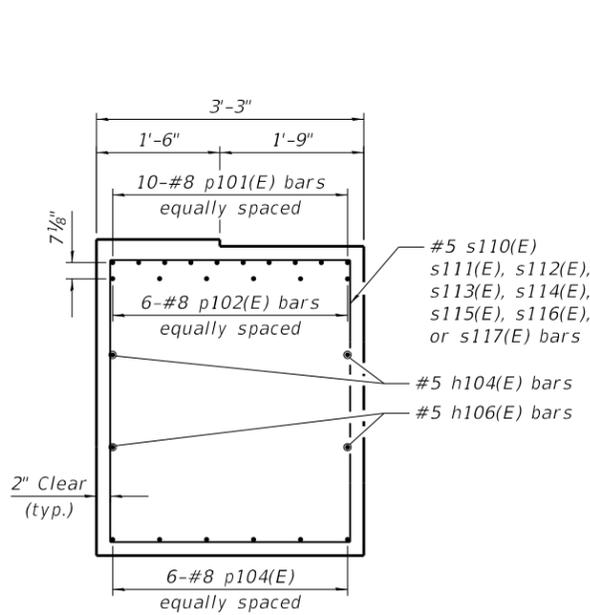


SECTION A-A

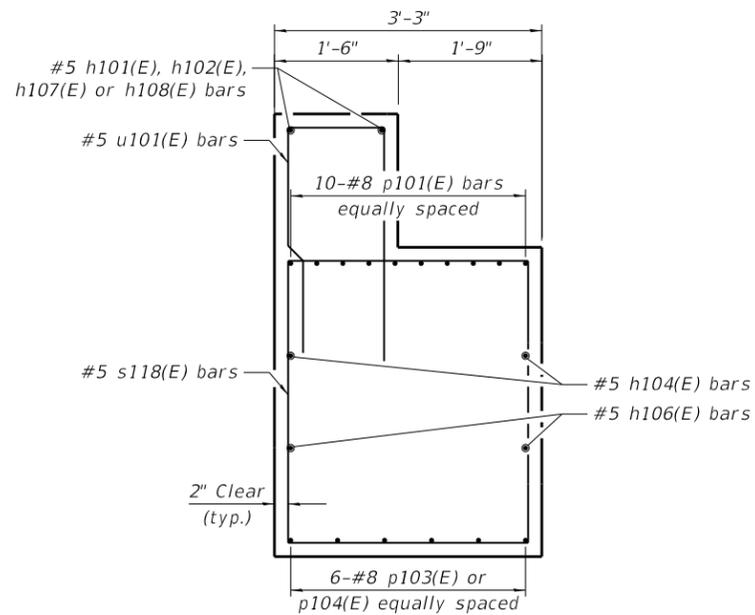


SECTION B-B

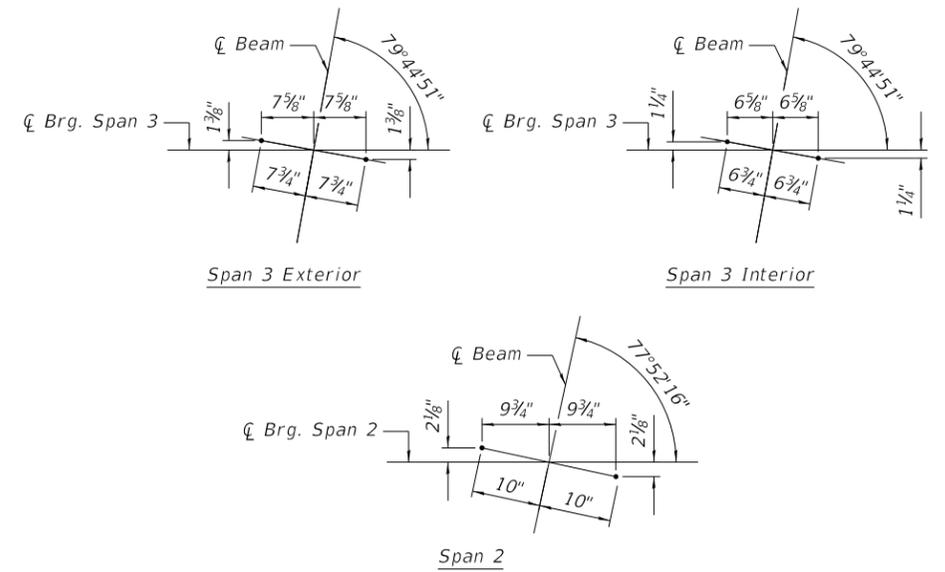


ANCHOR BOLT LAYOUT

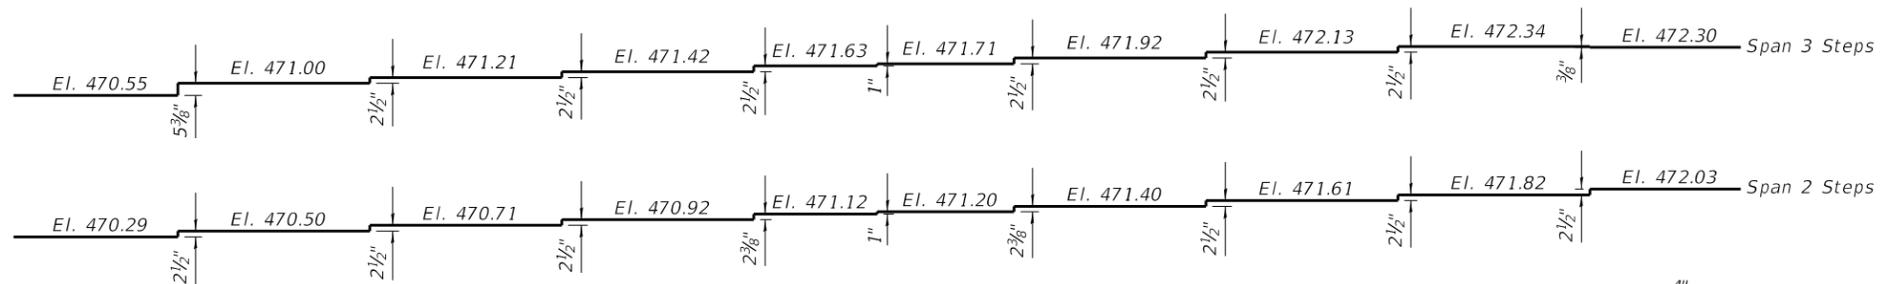


PIER 2 DETAIL OF STEPS

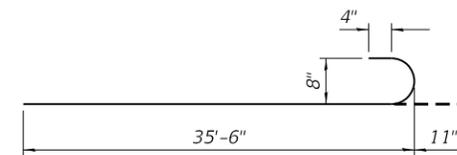


BAR p101(E)

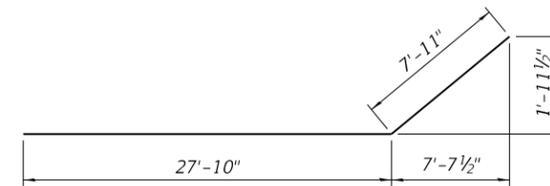


BAR p103(E)

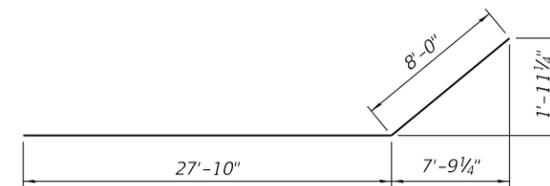

BAR p104(E)

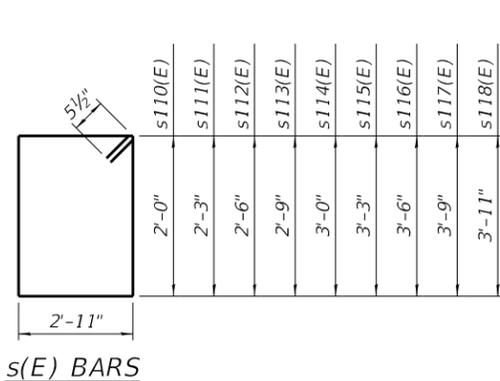

s(E) BARS

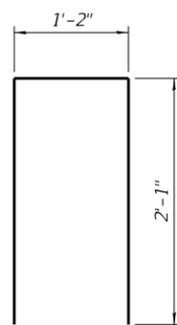

BAR u101(E)

BILL OF MATERIAL

Bar	No.	Size	Length	Shape	
h101(E)	4	#5	13'-8"	—	
h102(E)	2	#5	16'-2"	—	
h104(E)	4	#5	34'-1"	—	
h106(E)	4	#5	32'-2"	—	
h107(E)	2	#5	5'-8"	—	
h108(E)	2	#5	12'-2"	—	
p101(E)	20	#8	36'-5"	—	
p102(E)	12	#8	16'-0"	—	
p103(E)	6	#8	35'-9"	—	
p104(E)	6	#8	35'-10"	—	
s110(E)	2	#5	10'-9"	□	
s111(E)	2	#5	11'-3"	□	
s112(E)	2	#5	11'-9"	□	
s113(E)	2	#5	12'-3"	□	
s114(E)	2	#5	12'-9"	□	
s115(E)	2	#5	13'-3"	□	
s116(E)	2	#5	13'-9"	□	
s117(E)	2	#5	14'-3"	□	
s118(E)	48	#5	14'-7"	□	
u101(E)	64	#5	5'-4"	—	
Concrete Structures				Cu. Yd.	33.9
Reinforcement Bars (Epoxy Coated)				Pound	5310

Notes:
 Existing reinforcement extending into concrete removal shall be cleaned, straightened and incorporated into the new concrete. Cost included with Concrete Removal.
 Space reinforcement in cap to miss anchor bolts. Pour steps monolithically with cap.

FILE NAME: P:\10-1063.08 SN 0046 0120 Repairs\10_CAD\CADD Sheets\090-0046\09000046-68D59-13_Pier 2_Details_2.dgn

Kaskaskia
 Engineering Group, LLC
 288 E. Main St., Suite 200
 Mazon, IL 60455
 630.233.2877
 630.233.2977 Fax
 www.kaskaskiaeng.com


USER NAME =	DESIGNED - MC	REVISED -
CHECKED - BB	CHECKED - BB	REVISED -
DRAWN - MC	DRAWN - MC	REVISED -
CHECKED - BB	CHECKED - BB	REVISED -

STATE OF ILLINOIS
 DEPARTMENT OF TRANSPORTATION


PIER 2 DETAILS
 STRUCTURE NO. 090-0046

F.A.P. RTE. 404	SECTION (50B-4)BR:12((HVB,HB)BR)BR	COUNTY TAZEWELL	TOTAL SHEETS 61	SHEET NO. 44
CONTRACT NO. 68D59				
ILLINOIS FED. AID PROJECT				

SHEET 13 OF 15 SHEETS

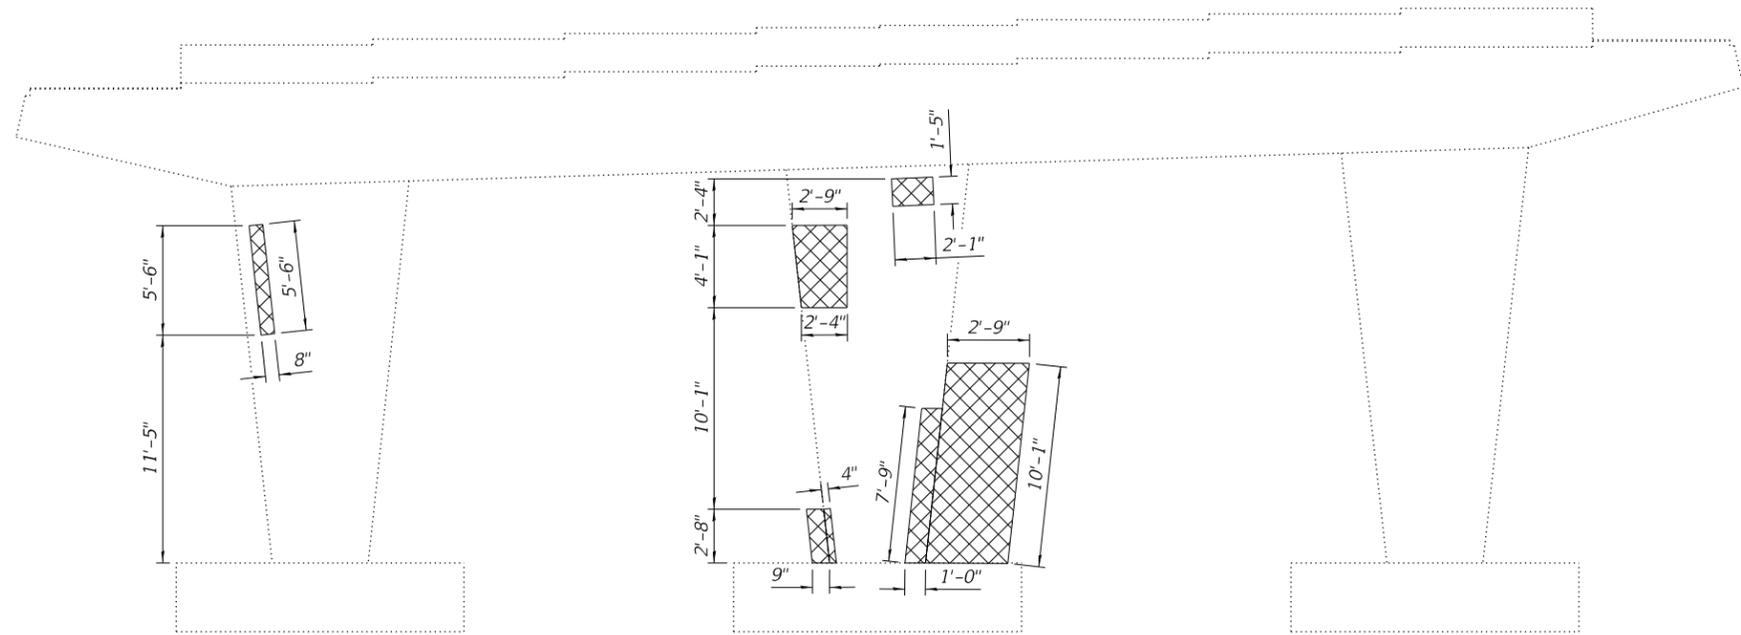

PIER 2 ELEVATION - REPAIR
(Looking East)

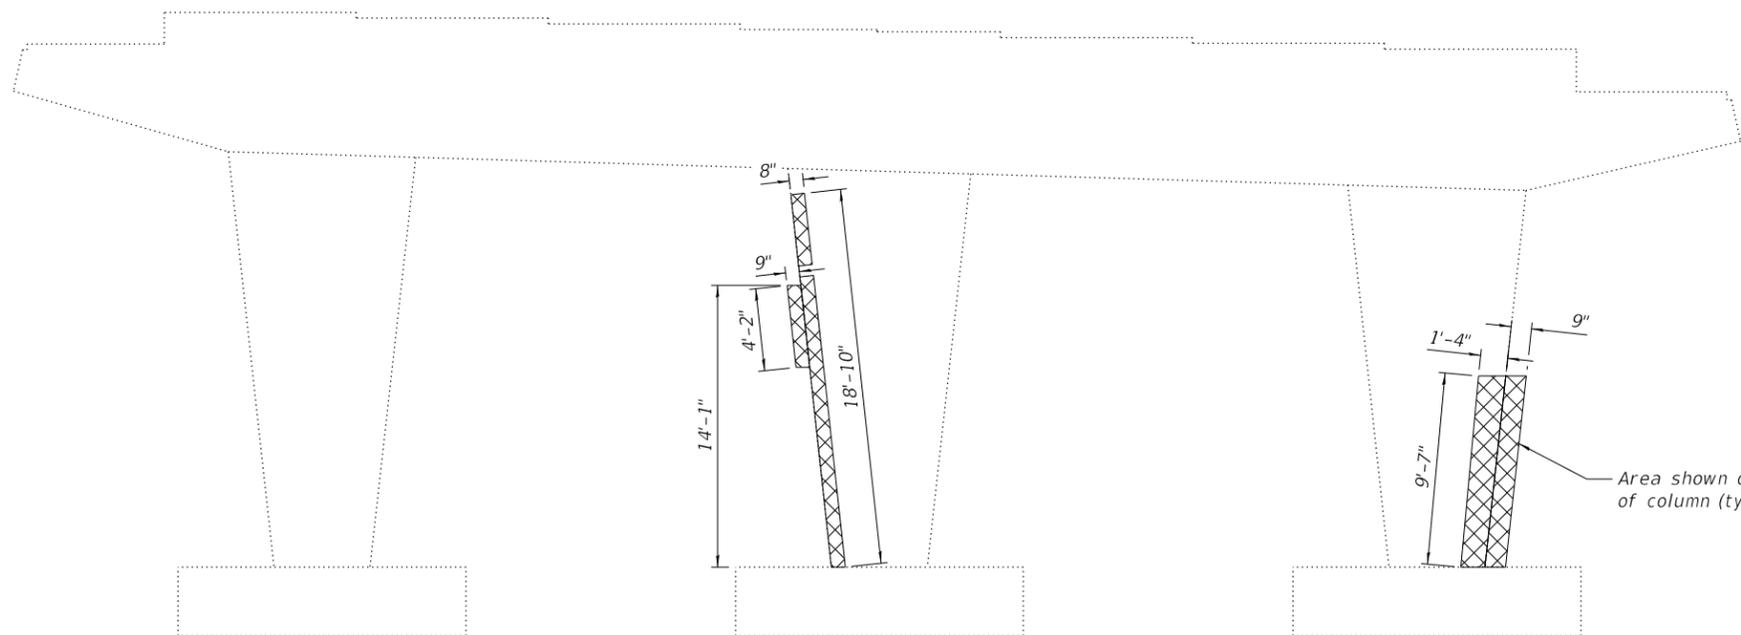

PIER 2 ELEVATION - REPAIR
(Looking West)

 - Indicates Structural Repair of Concrete (Depth equal to or less than 5")

BILL OF MATERIAL

ITEM	UNIT	QUANTITY
Structural Repair of Concrete (Depth Equal to or Less than 5")	SQ. FT	91.0

FILE NAME: P:\10-1063.08 SN 0046 0120 Repairs\10_CAD\CADD Sheets\090-0046-68D59-14_Pier 2 Concrete Repair Details.dgn

Kaskaskia
Engineering Group, LLC
Professional Engineering Group
11777 W. 117th St.
Morton, IL 62450
618.233.2877
www.kaskaskiaeng.com



USER NAME =	DESIGNED - MC	REVISED -
	CHECKED - BB	REVISED -
PLOT SCALE =	DRAWN - MC	REVISED -
PLOT DATE =	CHECKED - BB	REVISED -

STATE OF ILLINOIS
DEPARTMENT OF TRANSPORTATION

PIER 2 CONCRETE REPAIR DETAILS
STRUCTURE NO. 090-0046

SHEET 14 OF 15 SHEETS

F.A.P. RTE.	SECTION	COUNTY	TOTAL SHEETS	SHEET NO.
404	(50B-4)BR;12[(HVB,HB)BR]BR	TAZEWELL	61	45
CONTRACT NO. 68D59				
ILLINOIS FED. AID PROJECT				

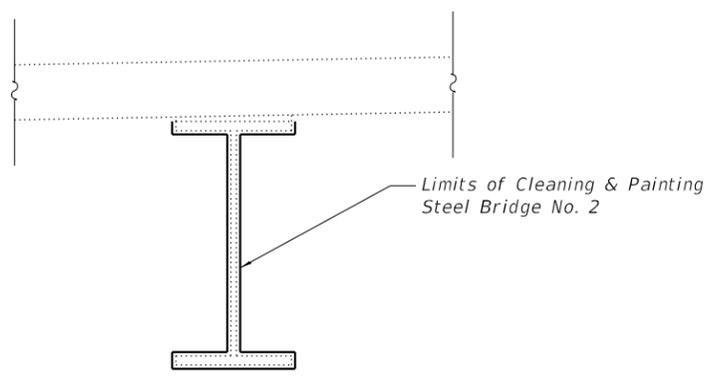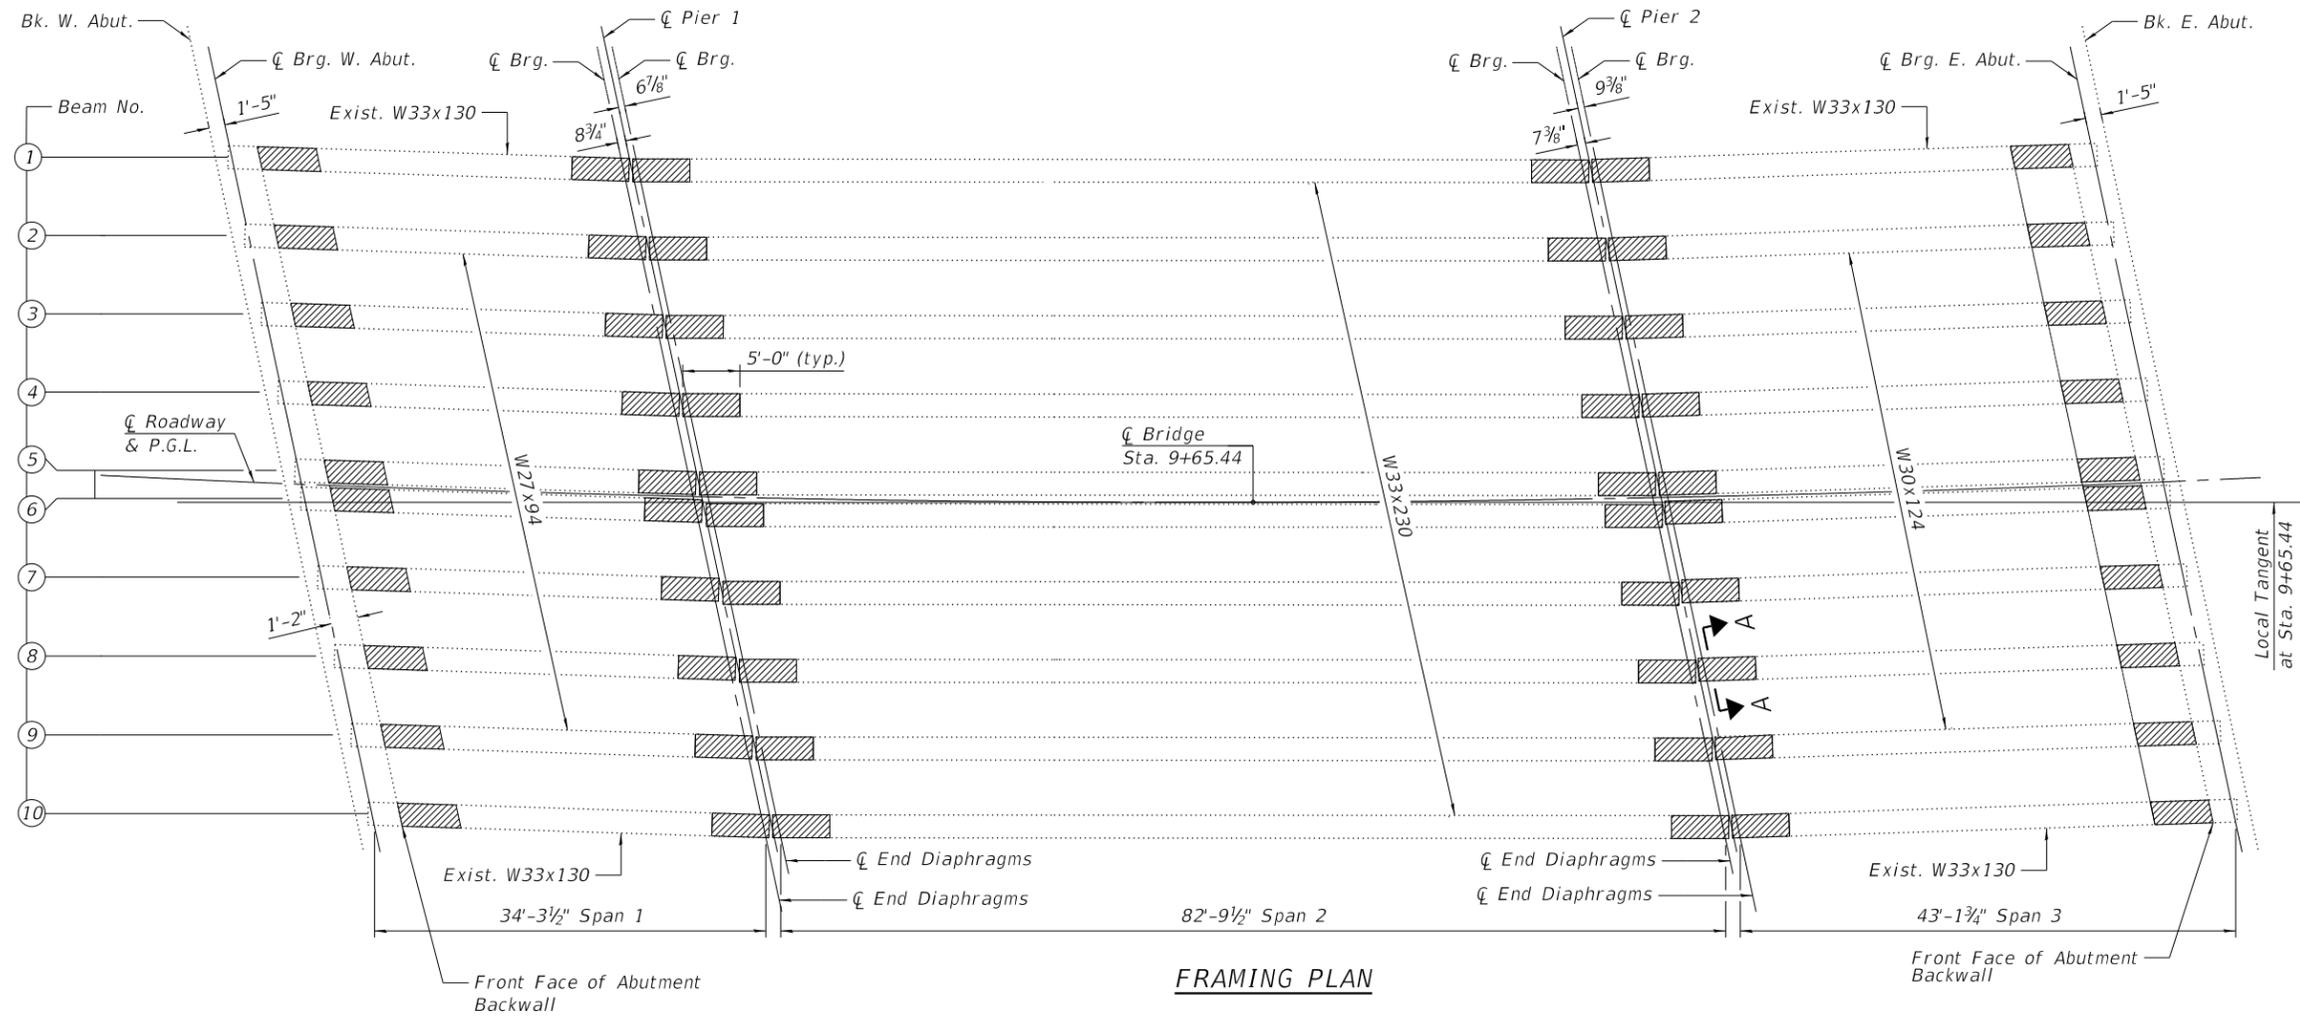

▨ - Indicates limits of Cleaning & Painting Steel Bridge No. 2.

BILL OF MATERIAL

ITEM	UNIT	QUANTITY
Cleaning & Painting Steel Bridge No. 2	L. SUM	1

FILE NAME: P:\10-1063.08 SN 0046 0120 Repairs\10_CAD\CADD Sheets\090-0046-68D59-15_Existing Steel Cleaning & Painting.dgn

Kaskaskia
Engineering Group, LLC
Professional Engineering Group
11/26/2018 3:54:10 PM

USER NAME =	DESIGNED - MC	REVISED -
	CHECKED - BB	REVISED -
PLOT SCALE =	DRAWN - MC	REVISED -
PLOT DATE =	CHECKED - BB	REVISED -

**STATE OF ILLINOIS
DEPARTMENT OF TRANSPORTATION**

**EXISTING STEEL CLEANING & PAINTING
STRUCTURE NO. 090-0046**

SHEET 15 OF 15 SHEETS

F.A.P. RTE. 404	SECTION (50B-4)BR:12[(HVB,HB)BR]BR	COUNTY TAZEWELL	TOTAL SHEETS 61	SHEET NO. 46
CONTRACT NO. 68D59			ILLINOIS FED. AID PROJECT	

Bench Mark: Chiseled cross on guard rail bolt. Station 13+35 ± 45-ft right along Existing F.A.U. Rte. 6712 centerline. Elevation 484.47

Existing Structure: SN 090-0120 originally built in 1993 as F.A.U. 6707 Section (50B-4, 50-4) as a three span steel I-beam bridge having spans of 61'-4", 87'-0", an 61'-4" with a back to back abutment length of 209'-8", measured along the tangent to the horizontal curved roadway. The bridge is skewed 38°-27'-25", left advance. The out-to-out width varies from 121'-7 $\frac{1}{8}$ " at the north abutment to 116'-5" at the south abutment. There is a 1'-0" wide parapet with aluminum railing and a 5'-0" sidewalk on the west side of the bridge. There is a 1'-7" wide parapet on the east side of the bridge. The bridge is supported by reinforced concrete pile supported abutments and solid wall piers.



Salvage: The ends of the aluminum railings shall be removed and reinstalled.

INDEX OF SHEETS

1. General Plan and Elevation
2. General Data
3. Temporary Concrete Barrier for Stage Construction
4. Concrete Removal Details
5. Superstructure
6. Superstructure
7. Superstructure Details
8. Preformed Joint Strip Seal - Sidewalk
9. Preformed Joint Strip Seal - Sidewalk
10. North Abutment Concrete Removal
11. North Abutment Concrete Repairs
12. South Abutment Concrete Removal
13. South Abutment Concrete Repairs
14. Existing Steel Cleaning and Painting Details
15. Bar Splicer Assembly and Mechanical Splicer Details

SCOPE OF WORK

- To be completed under stage construction.
1. Replace joints at both abutments.
 2. Clean and paint structural steel at designated locations.

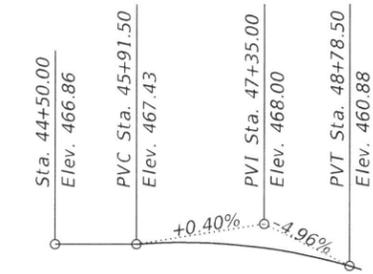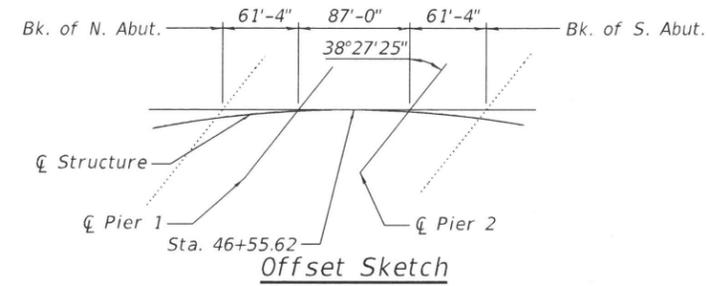

Profile Grade
Along ϕ F.A.U. Rt. 6707 (Washington St.)

DESIGN STRESSES

Existing Structure
 $f'_c = 3,500$ psi
 $f_y = 60,000$ psi (Reinforcement)
 $f_y = 36,000$ psi (M183 Grade 36)




New Construction
 $f'_c = 4,000$ psi (Superstructure)
 $f_y = 60,000$ psi (Reinforcement)
 $f_y = 36,000$ psi (M270 Grade 36)

DESIGN SPECIFICATIONS
 2002 AASHTO Standard Specifications for Highway Bridges
 1983 AASHTO Guide Specifications for Seismic Design of Highway Bridges

LOADING HS20-44
 Allow 25#/sq. ft. for future wearing surface.

SEISMIC DATA
 Seismic Performance Category (SPC) = A

GENERAL PLAN & ELEVATION
WASHINGTON STREET OVER FARM CREEK
F.A.U. 6707 - SEC. (50B-4)BR; 12[(HVB,HB)BR]BR
TAZEWELL COUNTY
STATION 46+55.62
STRUCTURE NO. 090-0120

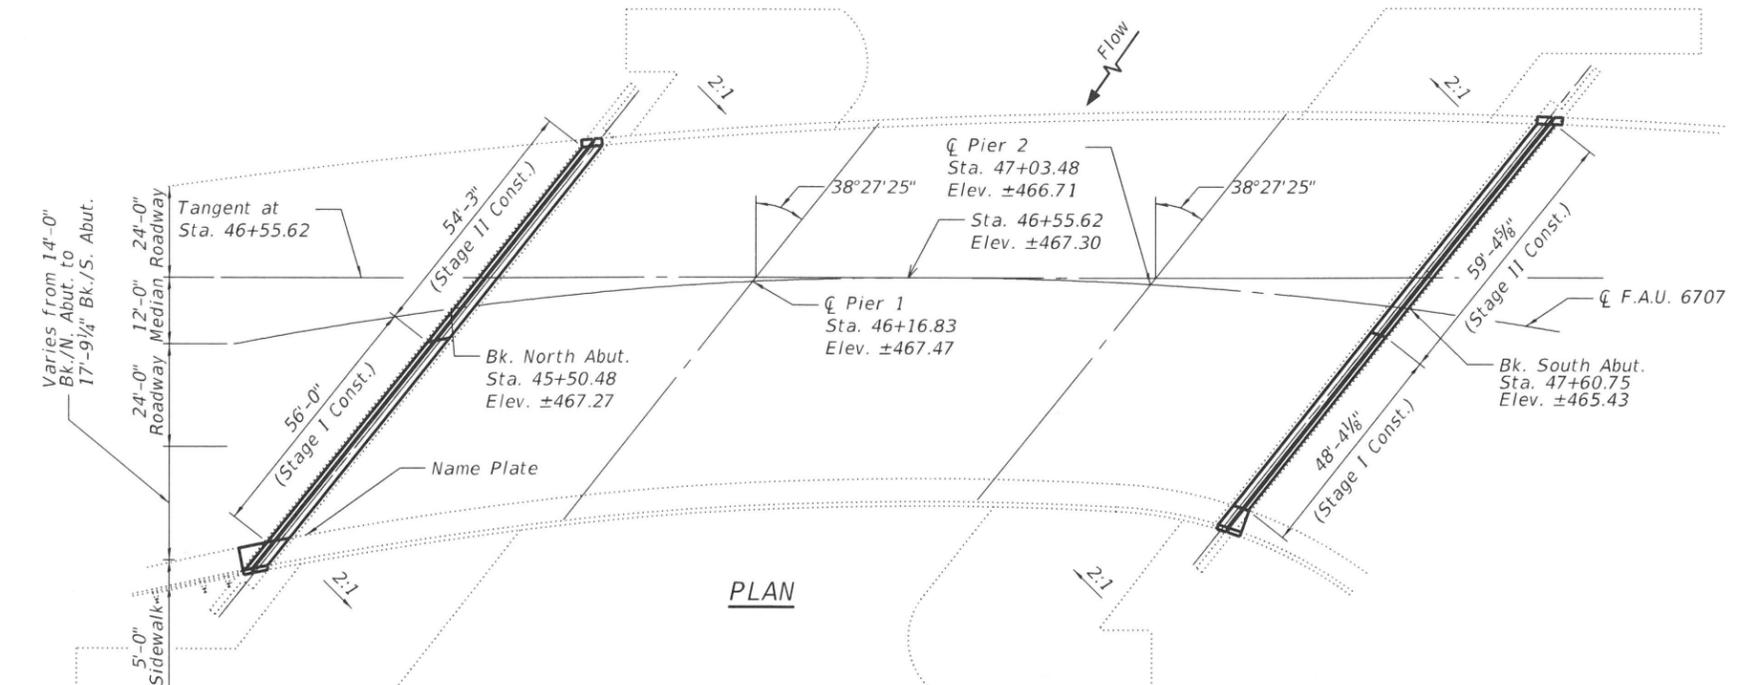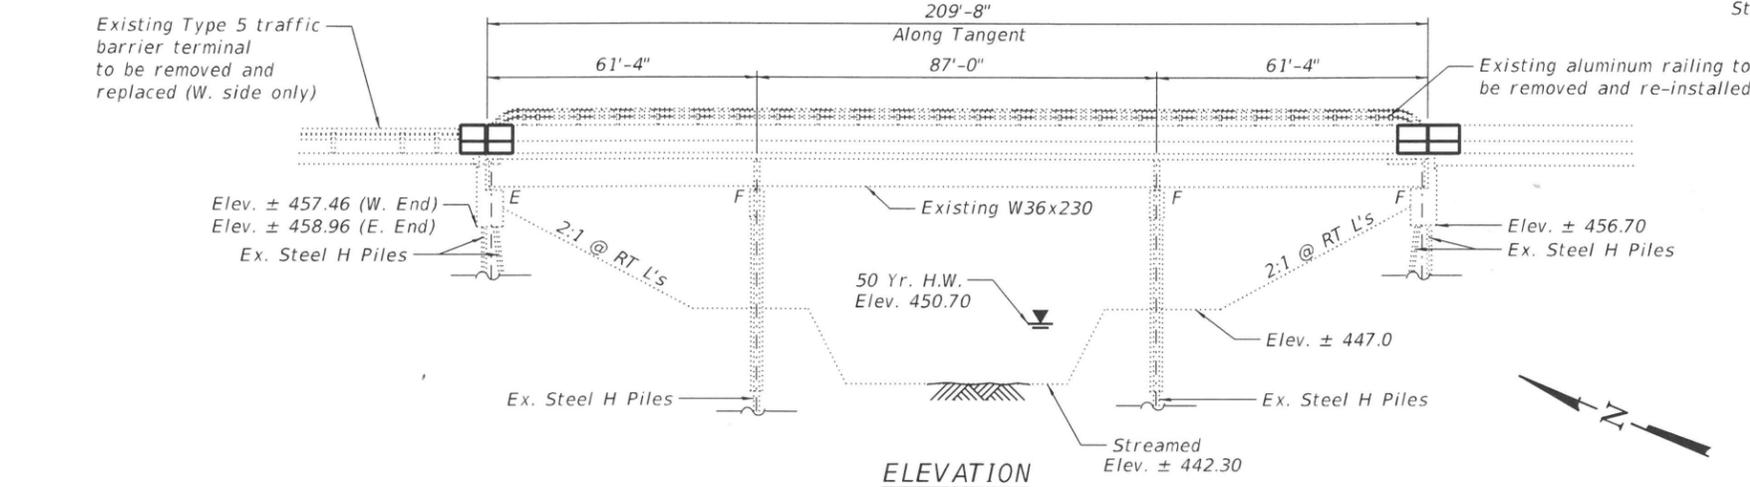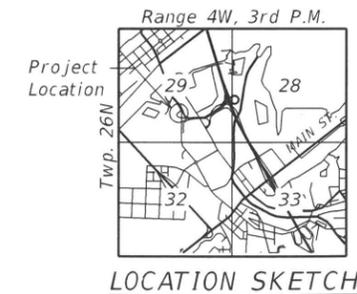

SIGNED: Benjamin Boyce
 DATE: 11/29/2018
 ILLINOIS STRUCTURAL ENGINEER
 NO. 081-007230
 LICENSE EXPIRES: 11-30-2020



FILE NAME: P:\10-1063.08 SN 0046 0120 Repairs\10_CADD\CADD Sheets\090-0120\09000120-68D59-001-GPE.dgn

 081-007230 LICENSED STRUCTURAL ENGINEER STATE OF ILLINOIS	USER NAME =	DESIGNED - KS	REVISED -	STATE OF ILLINOIS DEPARTMENT OF TRANSPORTATION	GENERAL PLAN AND ELEVATION STRUCTURE NO. 090-0120	F.A.U. RTE.	SECTION	COUNTY	TOTAL SHEETS	SHEET NO.
	PLOT SCALE =	CHECKED - BB	REVISED -			6707	(50B-4)BR; 12[(HVB,HB)BR]BR	TAZEWELL	61	47
	PLOT DATE =	DRAWN - KS	REVISED -			CONTRACT NO. 68D59				
		CHECKED - BB	REVISED -			ILLINOIS FED. AID PROJECT				

GENERAL NOTES

Reinforcement bars designated (E) shall be epoxy coated.
 Prior to pouring the new concrete deck, all heavy or loose rust, loose mill scale, and other loose or potentially detrimental foreign material shall be removed from the surfaces in contact with concrete. Tightly adhered paint may remain unless otherwise noted. Removal shall be accomplished by methods that will not damage the steel and the cost will be included in the pay item covering removal of the existing concrete. As directed by the Engineer, existing construction accessories welded to the top flange of beams shall be removed. The weld areas shall be ground flush and inspected for cracks using magnetic particle testing (MT) or dye penetrant testing (PT) by qualified personnel approved by the Engineer. Any cracks that cannot be removed by grinding 1/4 in. deep shall be identified and reported to the Bureau of Bridges and Structures for further disposition. The cost of removing welded accessories, grinding and inspecting weld areas and grinding cracks will be paid for according to Article 109.04 of the Standard Specifications.

Plan dimensions and details relative to existing plans are subject to nominal construction variations. The Contactor shall field verify existing dimensions and details affecting new construction and make necessary approved adjustments prior to construction or ordering of materials. Such variations shall not be cause for additional compensation for a change in scope of the work, however, the Contractor will be paid for the quantity actually furnished at the unit price bid for the work.

The existing structural steel does not contain lead paint.
 Joint openings shall be adjusted according to Article 520.04 of the Standard Specifications when the deck is poured at ambient temperature other than 50°F.

Cleaning and painting of the existing structure steel shall be as specified in the special provisions for "Cleaning and Painting Existing Steel Structures". All beams, bearings and other structural steel within 5 ft. (measured along the beam) of either side of the deck joints shall be cleaned per Near White Blast Cleaning - SSPC-SP-10.

The designated areas cleaned per Near White Blast Cleaning - SSPC-SP-10 shall be painted according to the requirements of Paint System 1 - OZ/E/U.



The color of the final finish coat for all steel surfaces shall be Blue, Munsell NO. 10B 3/6.

Containment and disposal of non-lead paint cleaning residues shall be as specified in special provisions for "Containment and Disposal of Non-Lead Paint Cleaning Residues". This work shall consist of the containment, collection, temporary storage, transportation and disposal of waste from non-lead paint removal projects. Waste requiring containment and control includes, but is not limited to, old paint, spent abrasives, corrosion products, mill scale, dirt, dust, grease, oil, and salts.

The painting Contractor shall be SSPC-QP1 certified for this project and shall maintain certification throughout the duration of the project.

TOTAL BILL OF MATERIAL

ITEM	UNIT	SUPER	SUB	TOTAL
Concrete Removal	Cu. Yd.	29.8		29.8
Concrete Superstructure	Cu. Yd.	29.8		29.8
Reinforcement Bars, Epoxy Coated	Pound	3170	1530	4700
Preformed Joint Strip Seal	Foot	233		233
Cleaning and Painting Steel Bridge No. 3	L. Sum	1		1
Bar Splicers	Each	16	8	24
Containment and Disposal of non-lead Paint Cleaning Residues No. 3	L. Sum	1		1
Remove and Re-erect Traffic Barrier Terminals, Type 5	Each	1		1
Aluminum Railing, Type L	Foot	9		9

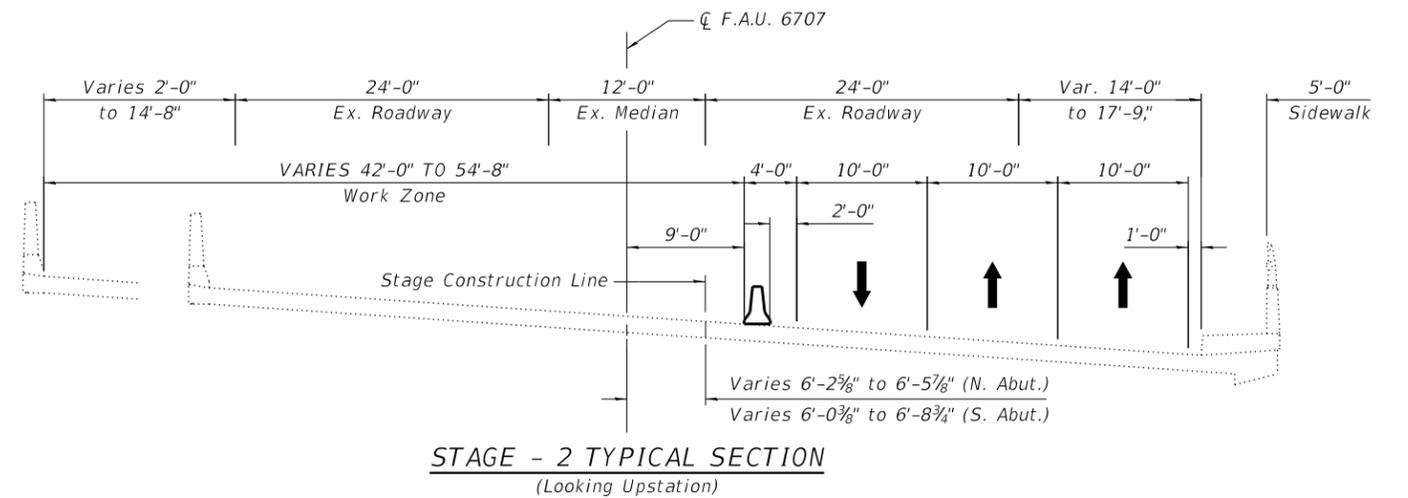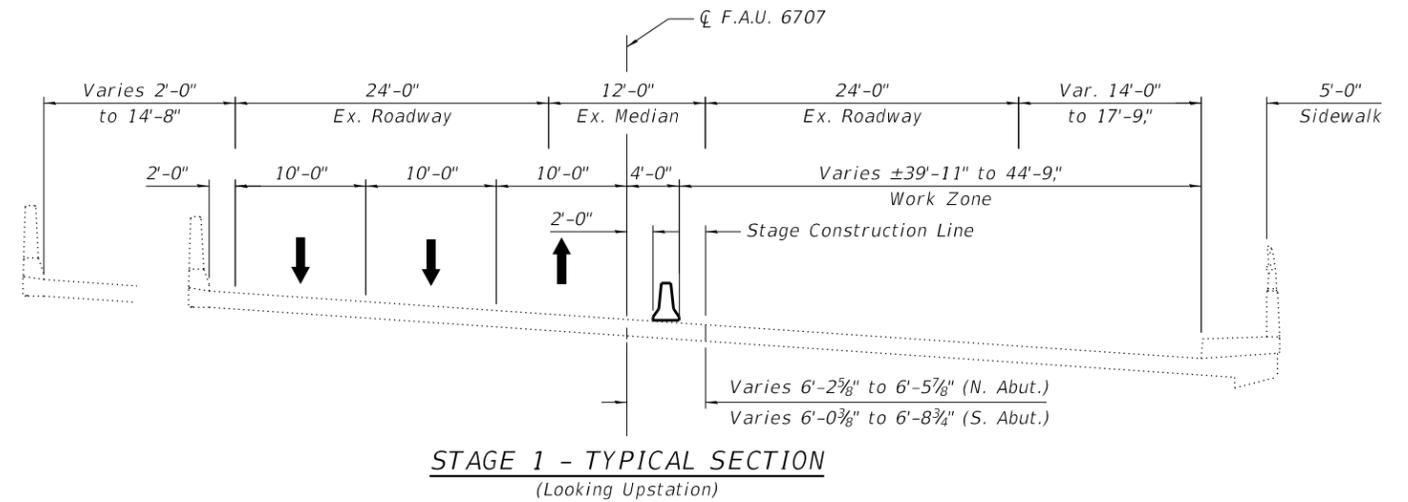

FILE NAME: P:\10-1063.08 SN 0046 0120 Repairs\10_CAD\CADD Sheets\090-0120\0900120-68D59-002-GENERAL DATA.dgn

Kaskaskia Engineering Group, LLC
 288 E. Main St., Suite 200
 Moline, IL 61704
 617.233.2877 phone
 617.233.2977 fax
 www.kaskaskiaeng.com


USER NAME =	DESIGNED - KS	REVISED -
	CHECKED - BB	REVISED -
PLOT SCALE =	DRAWN - KS	REVISED -
PLOT DATE =	CHECKED - BB	REVISED -

**STATE OF ILLINOIS
 DEPARTMENT OF TRANSPORTATION**

**GENERAL DATA
 STRUCTURE NO. 090-0120**


SHEET 2 OF 15 SHEETS

F.A.U. RTE.	SECTION	COUNTY	TOTAL SHEETS	SHEET NO.
6707	(50B-4)BR: 12(HVB,HB)BR BR	TAZEWELL	61	48
CONTRACT NO. 68D59				
ILLINOIS FED. AID PROJECT				

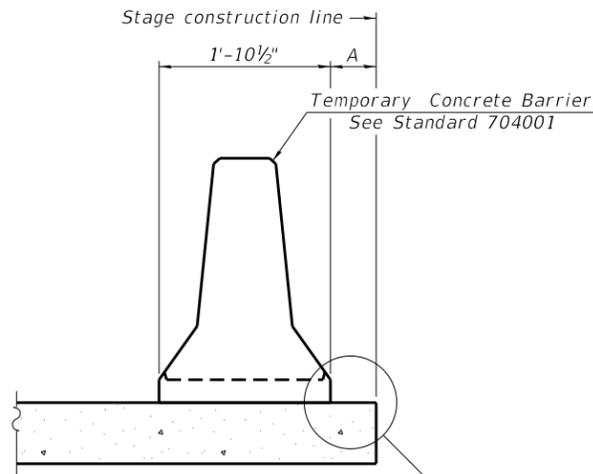

When "A" is 3'-1" or less, the temporary concrete barrier shall be restrained to the new slab according to Detail I, II or III. No restraint is required when "A" is greater than 3'-1".

NEW SLAB OR NEW DECK BEAM

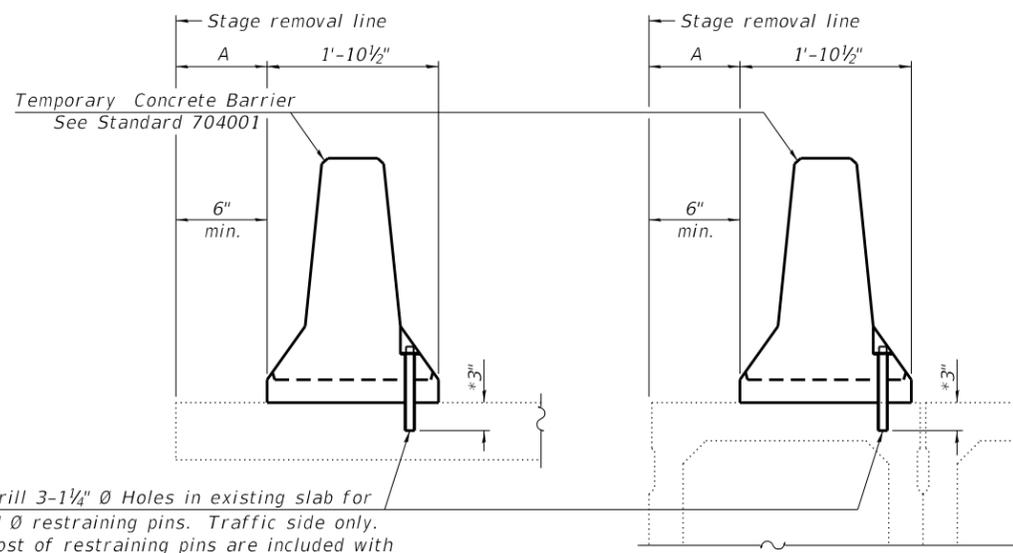


Drill 3-1/4" Ø Holes in existing slab for 1" Ø restraining pins. Traffic side only. Cost of restraining pins are included with Temporary Concrete Barrier. No restraint is required when "A" is greater than 3'-1".

EXISTING SLAB


* When hot-mix asphalt wearing surface is present, embedment shall be 3" plus the wearing surface depth.

EXISTING DECK BEAM

SECTIONS THRU SLAB OR DECK BEAM

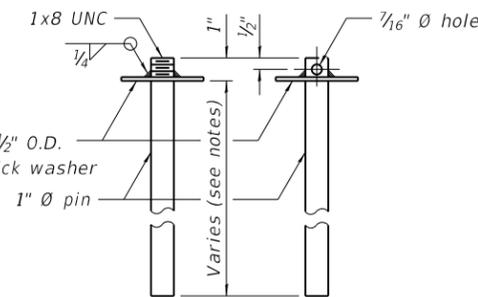


RESTRAINING PIN

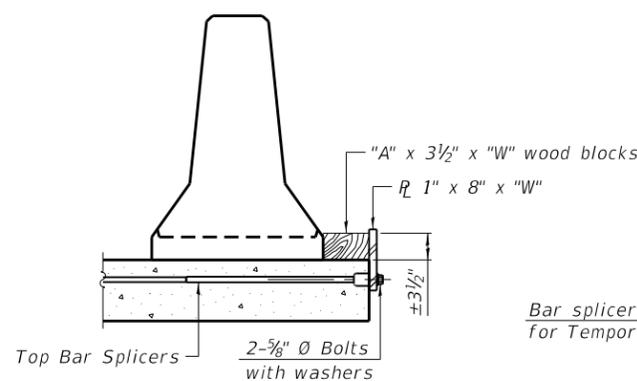


DETAIL I


Bar splicers and additional splicers for Temporary Concrete Barrier

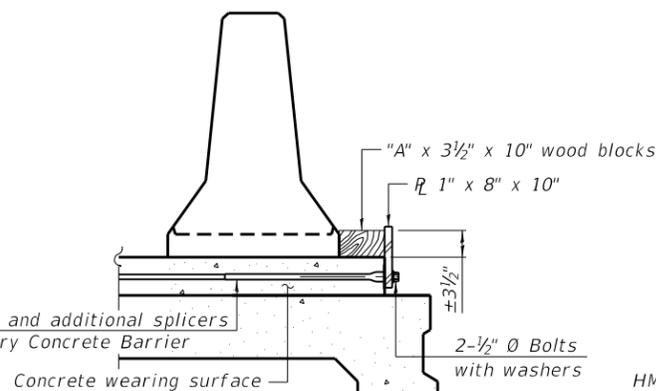


DETAIL II

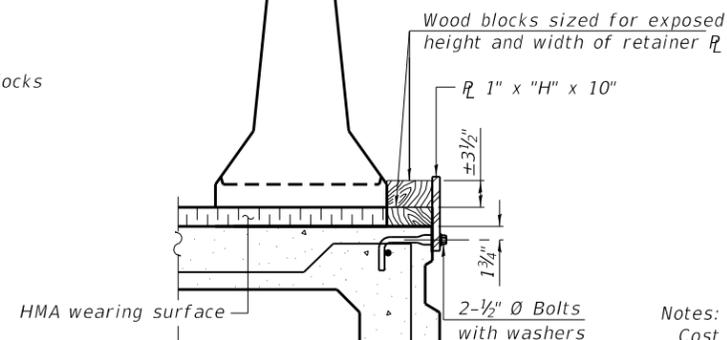


DETAIL III

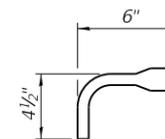

BAR SPLICER FOR #4 BAR - DETAIL III

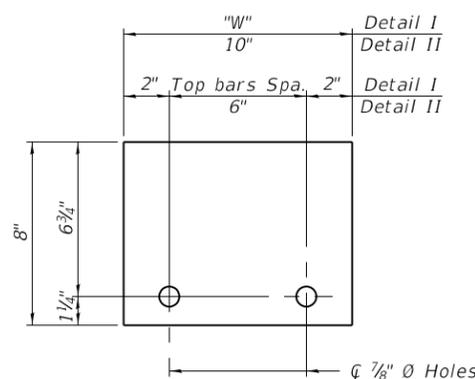

STEEL RETAINER 1" x 8" x "W"
(Detail I and II)

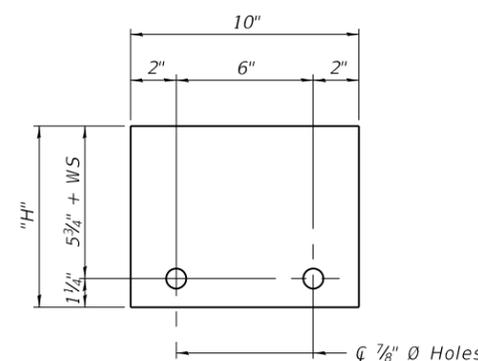

STEEL RETAINER 1" x "H" x 10"
(Detail III)

Notes:
 Cost of retainer assembly is included with Temporary Concrete Barrier.
 A retainer assembly shall be located at the approximate \bar{C} of each temporary concrete barrier.
 The retainer plate shall not be removed until the concrete on the adjacent stage is ready to be poured. For Detail III applications the retainer plate shall not be removed until just prior to placing the adjacent beam.
 When the 'A' dimension is less than 1 1/2', the wood block shall be omitted and the barrier shall be placed in direct contact with the steel retainer plate. For deck beam applications the minimum required 'A' distance is 6" to accommodate the shear key clamping device.

Detail I - Installation for a new bridge deck or bridge slab.
 Detail II - Installation for a new deck beam with an initial concrete wearing surface. Additional bar splicers shall be provided at 6'-0" centers and paired with the bar splicers of the concrete wearing surface reinforcement to accommodate the installation of the retainer assemblies. The cost of the additional bar splicers is included with the concrete wearing surface.
 Detail III - Installation for a new deck beam with no initial wearing surface or with an initial hot-mix asphalt (HMA) wearing surface present. The deck beam directly beneath the temporary concrete barrier shall be fabricated with bar splicer inserts in the side of the beam, as detailed, to accommodate the installation of the retainer assemblies. A pair of bar splicers, 6" apart, shall be placed at 6'-0" centers along the length of the beam. The cost of the bar splicers is included with the deck beam.

R-27 8-11-2017

FILE NAME: P:\10-1063,08 SN 0046 0120 Repairs\10_CAD\CADD Sheets\090-0120\0900120-68D59-003-TEMP BARRIER CURB.dgn



USER NAME =	DESIGNED - KS	REVISED -
CHECKED - BB	CHECKED - BB	REVISED -
PLOT SCALE =	DRAWN - KS	REVISED -
PLOT DATE =	CHECKED - BB	REVISED -


STATE OF ILLINOIS
DEPARTMENT OF TRANSPORTATION

TEMPORARY CONCRETE BARRIER FOR STAGE CONSTRUCTION
STRUCTURE NO. 090-0120

F.A.U. RTE.	SECTION	COUNTY	TOTAL SHEETS	SHEET NO.
6707	(50B-4)BR: 12((HVB,HB)BR)BR	TAZEWELL	61	49
CONTRACT NO. 68D59				
ILLINOIS FED. AID PROJECT				

SHEET 3 OF 15 SHEETS

FILE NAME: P:\10-1063.08 SN 0046 0120 Repairs\10_CAD\CADD Sheets\090-0120\0900120-68D59-004-SUPERSTRUCTURE CONCRETE REMOVAL.dgn

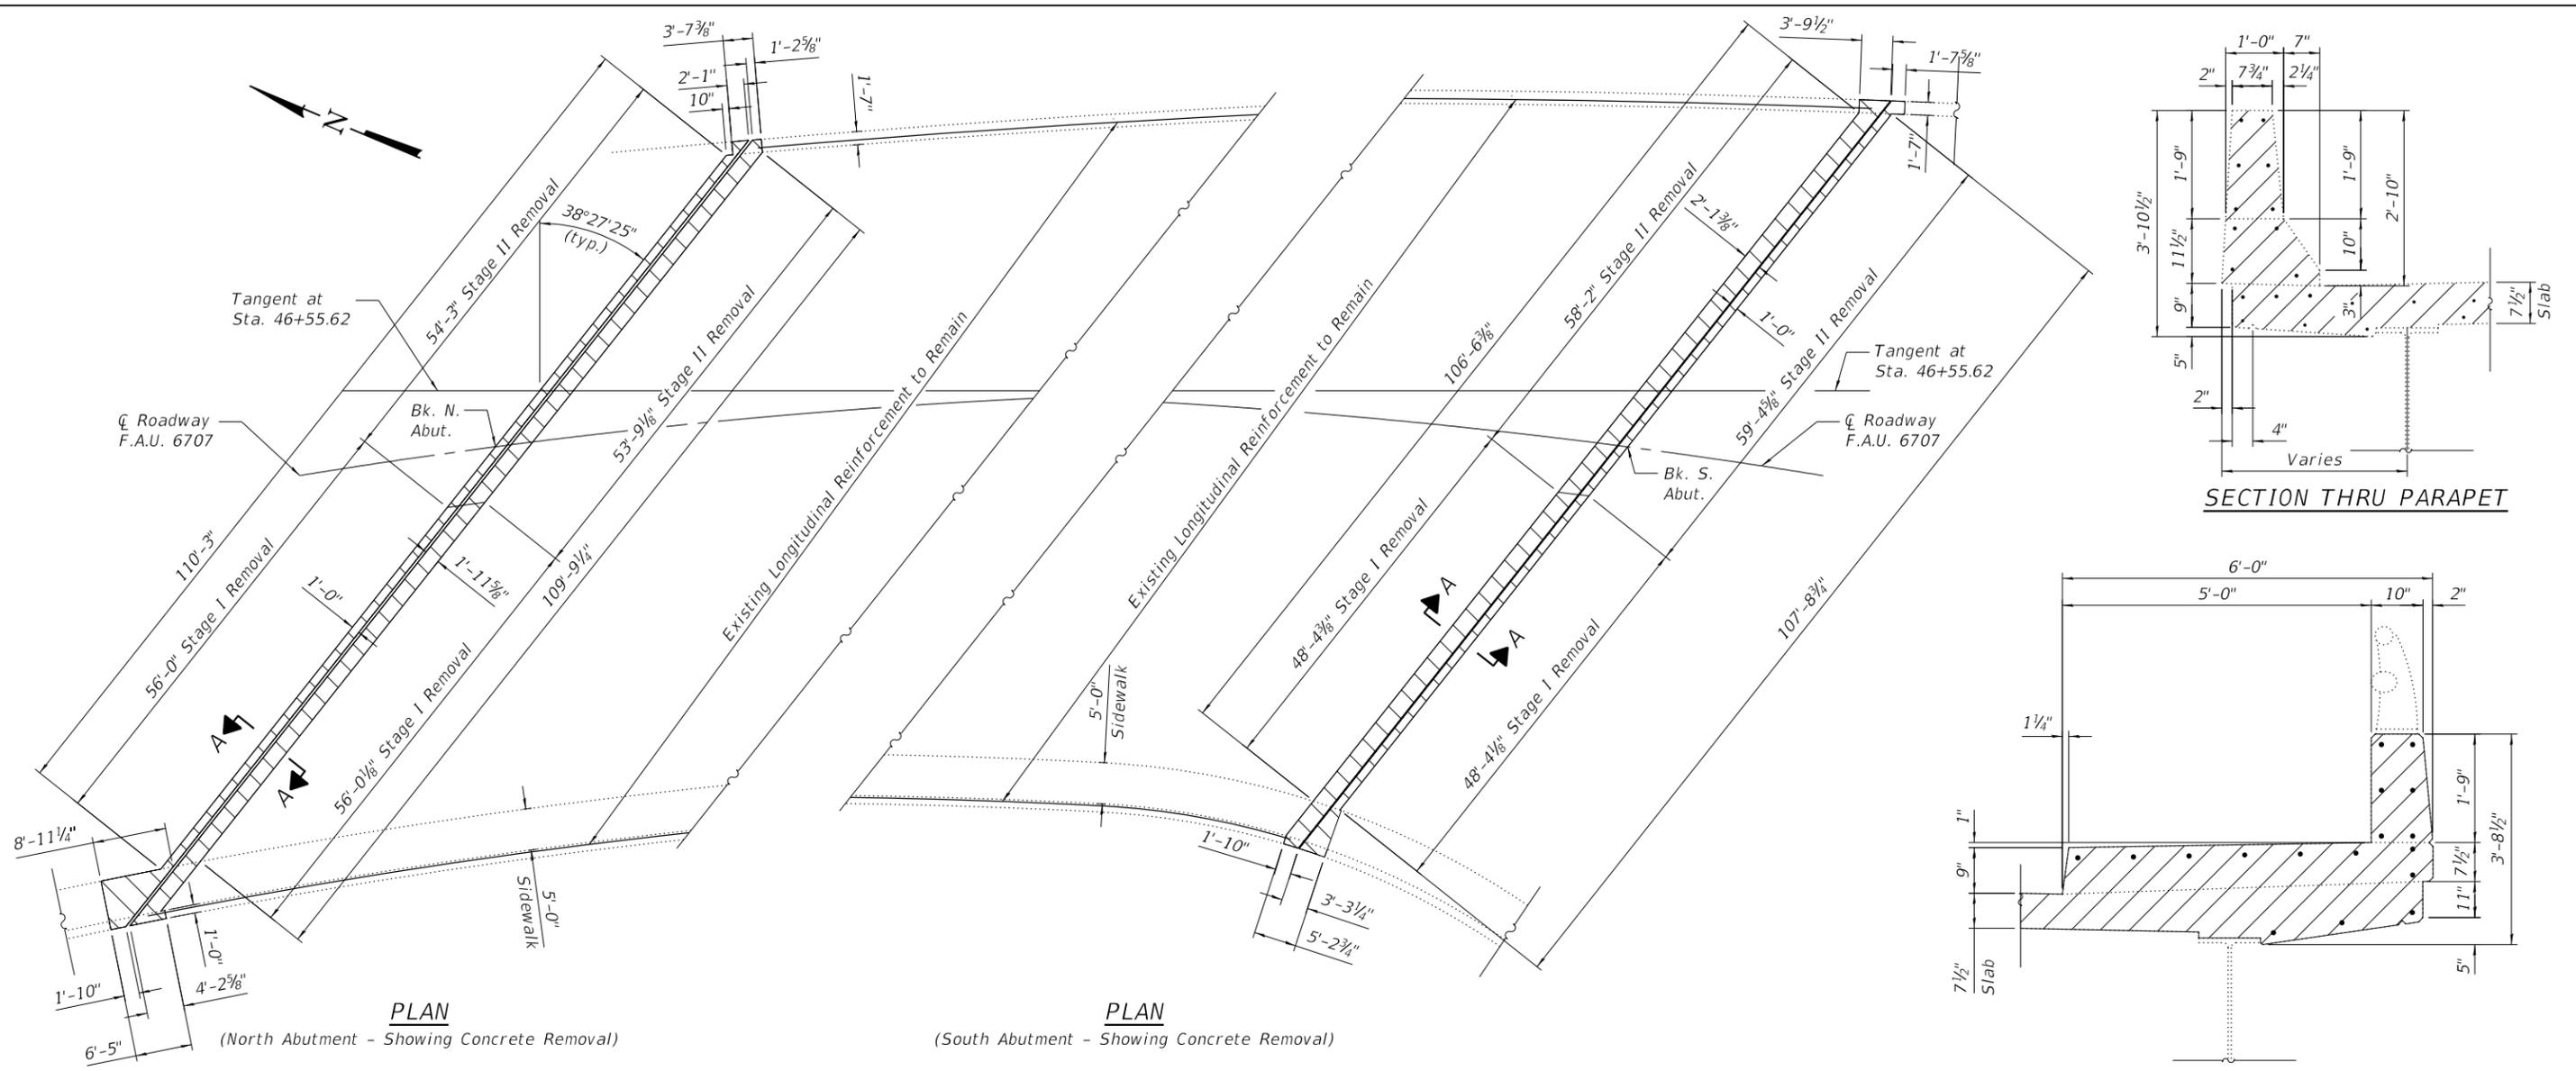

BILL OF MATERIAL

Item	Unit	Total
Concrete Removal	Cu. Yd.	17.7

Notes:


The Contractor shall use extreme care during concrete removal so as not to damage the existing steel beams.

Removal of existing expansion joint and associated material shall not be paid for separately, but shall be included in the cost of Concrete Removal.

Trim existing reinforcement to accommodate proposed expansion joint.

Existing reinforcement bars extending into the removal area shall be cleaned, straightened and incorporated into new construction. Any reinforcement bars that are damaged during concrete removal operations shall be replaced using approved bar splicer or anchorage system. Cost included in Concrete Removal.

Stud shear connectors damaged during concrete removal operations shall be removed and replaced per Section 505 of the Standard Specifications. Cost included in Concrete Removal.

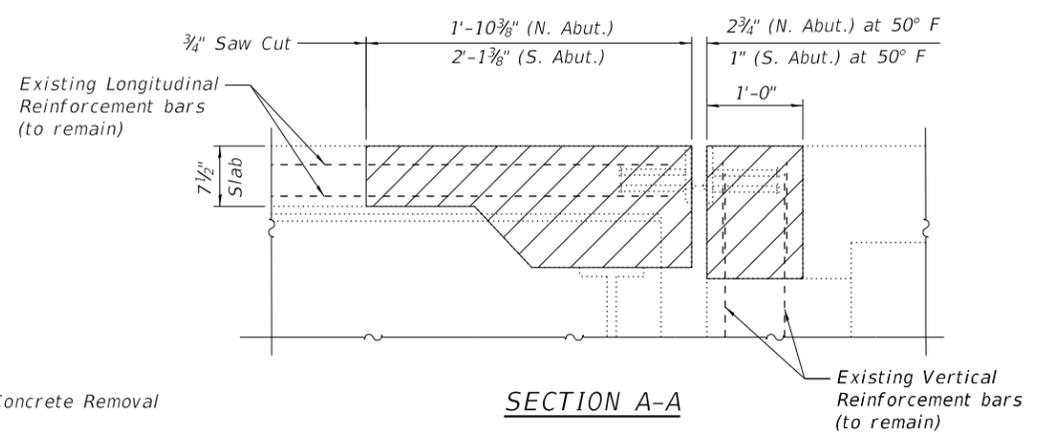

Indicates Concrete Removal



USER NAME =	DESIGNED - KS	REVISED -
CHECKED - BB	CHECKED - BB	REVISED -
DRAWN - KS	DRAWN - KS	REVISED -
CHECKED - BB	CHECKED - BB	REVISED -

**STATE OF ILLINOIS
DEPARTMENT OF TRANSPORTATION**

**CONCRETE REMOVAL DETAILS
STRUCTURE NO. 090-0120**


SHEET 4 OF 15 SHEETS

F.A.U. RTE.	SECTION	COUNTY	TOTAL SHEETS	SHEET NO.
6707	(50B-4)BR: 12(HVB,HB)BR BR	TAZEWELL	61	50
CONTRACT NO. 68D59				

ILLINOIS FED. AID PROJECT


MINIMUM BAR LAP
#5 bar = 3'-6"

Notes:
See Sheet 6 of 15 for Sections A-A and B-B.
Bars indicated thus 4 x 2-#5 etc. indicates
4 lines of bars with 2 lengths per line.

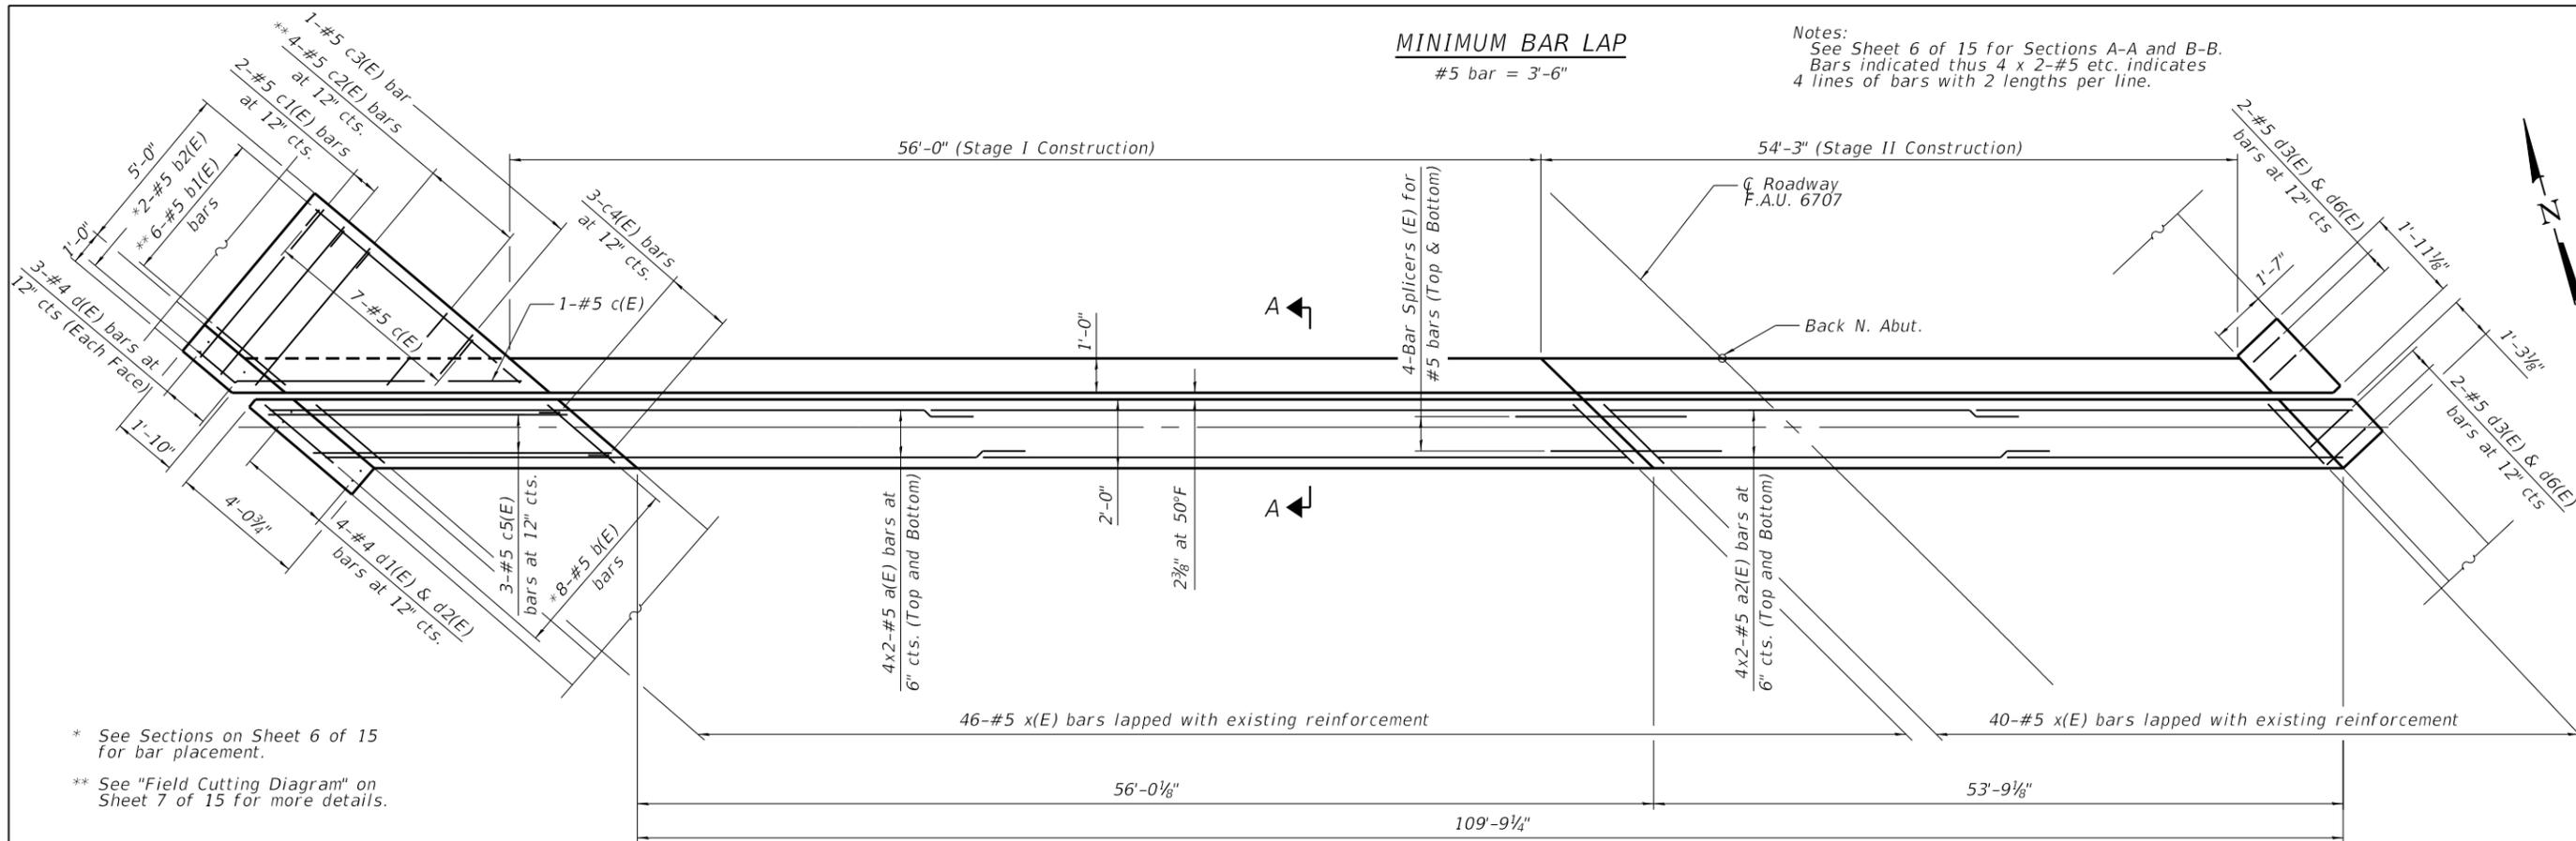

* See Sections on Sheet 6 of 15 for bar placement.
** See "Field Cutting Diagram" on Sheet 7 of 15 for more details.

PLAN
(Showing North Abutment)

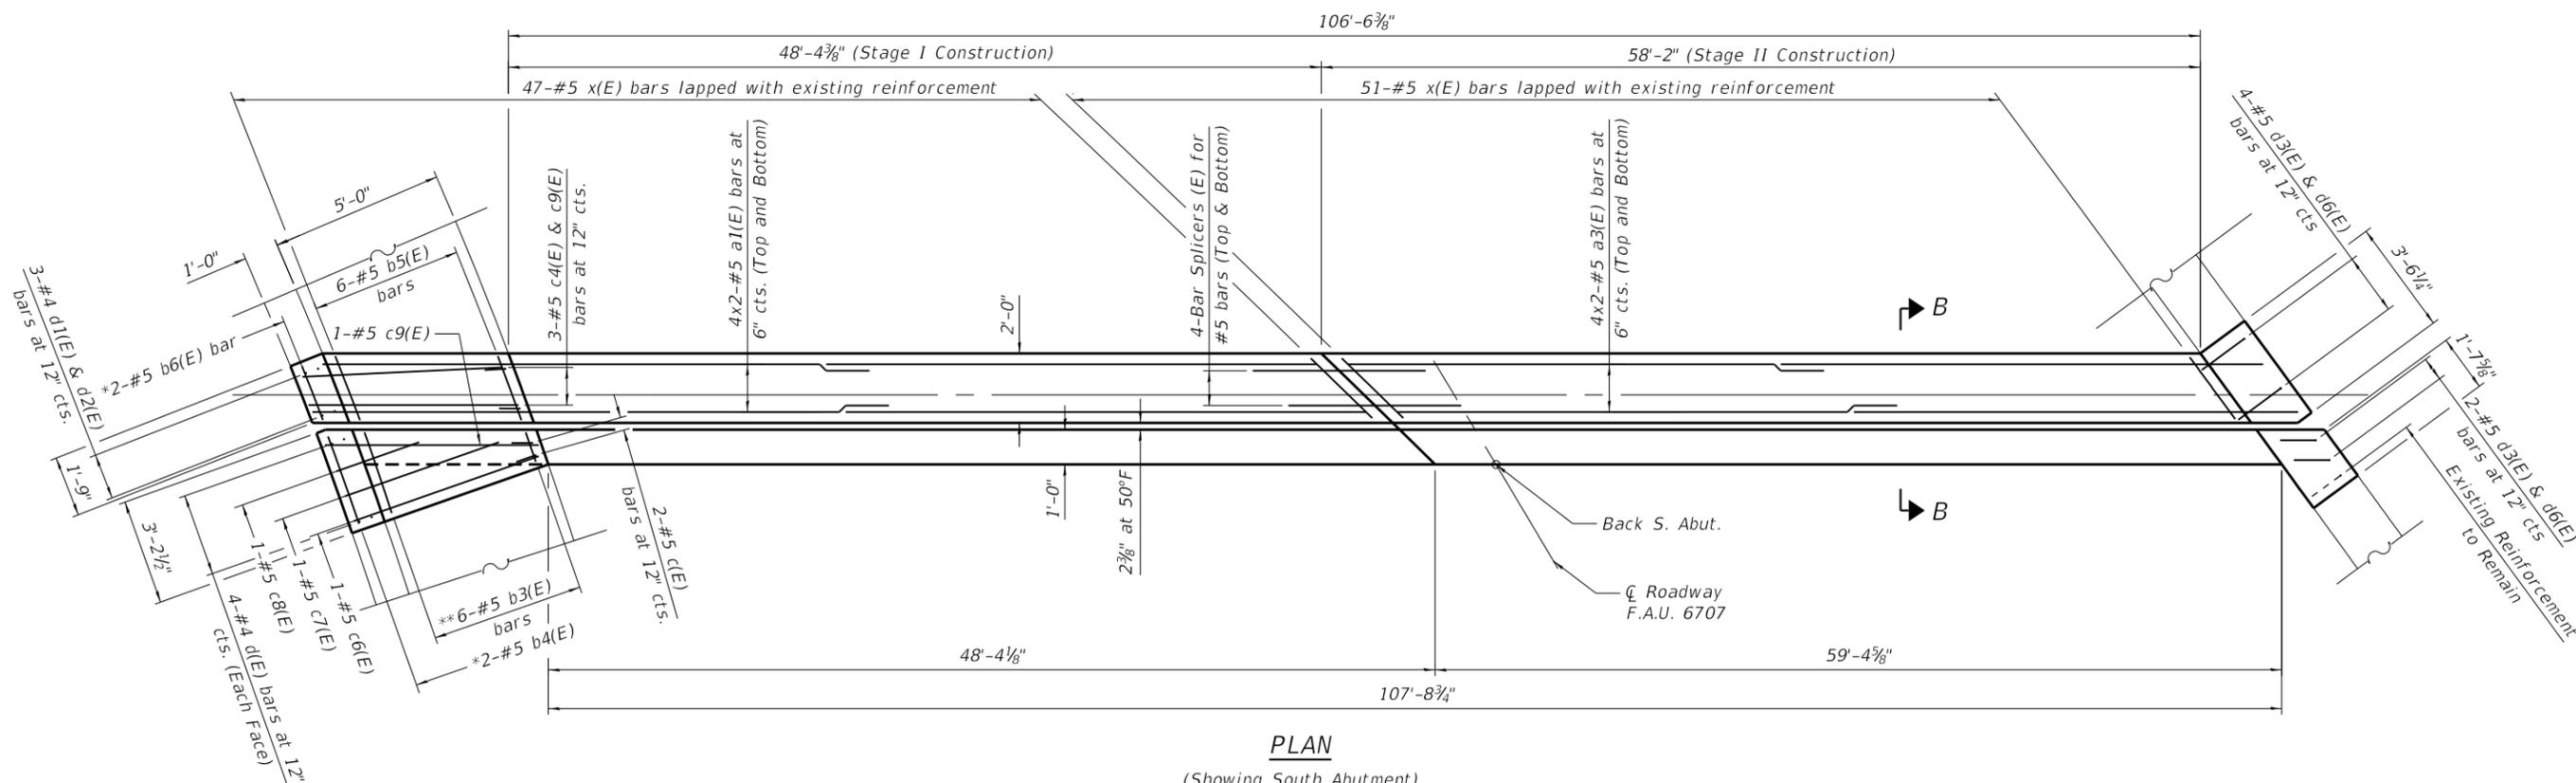

PLAN
(Showing South Abutment)

FILE NAME: P:\10-1063.08 SN 0046 0120 Repairs\10_CAD\CADD Sheets\090-0120\0900120-68D59-005-SUPERSTRUCTURE.dgn



USER NAME =	DESIGNED - KS	REVISED -
CHECKED - BB	CHECKED - BB	REVISED -
DRAWN - KS	DRAWN - KS	REVISED -
CHECKED - BB	CHECKED - BB	REVISED -


STATE OF ILLINOIS
DEPARTMENT OF TRANSPORTATION

SUPERSTRUCTURE
STRUCTURE NO. 090-0120


SHEET 5 OF 15 SHEETS

F.A.U. RTE.	SECTION	COUNTY	TOTAL SHEETS	SHEET NO.
6707	(50B-4)BR: 12((HVB,HB)BR)BR	TAZEVELL	61	51
CONTRACT NO. 68D59				


ILLINOIS FED. AID PROJECT

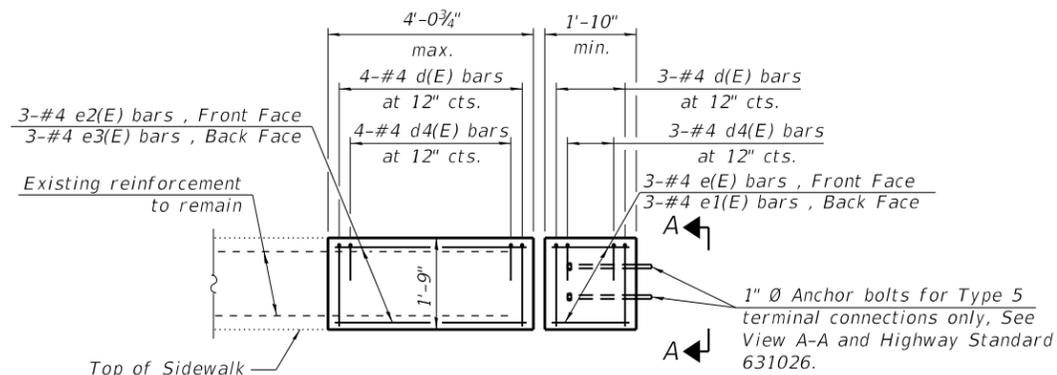


Inside Elevation - West Parapet
(North Abutment)

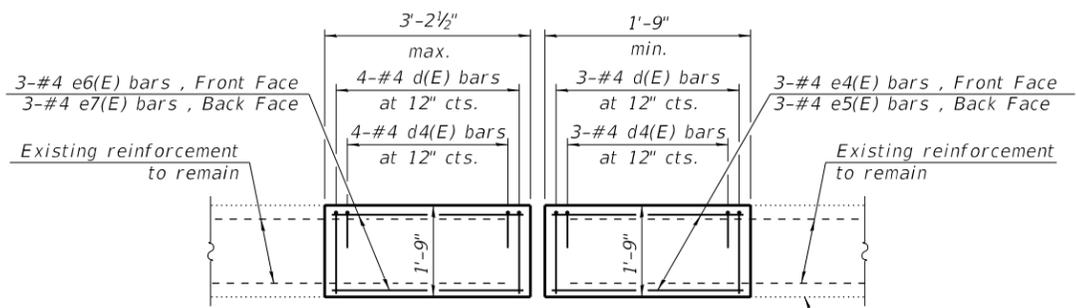


Inside Elevation - West Parapet
(South Abutment)

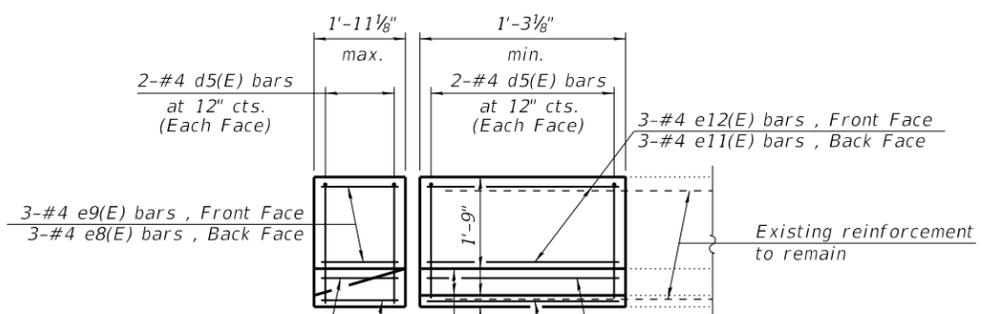



Inside Elevation - East Parapet
(North Abutment)

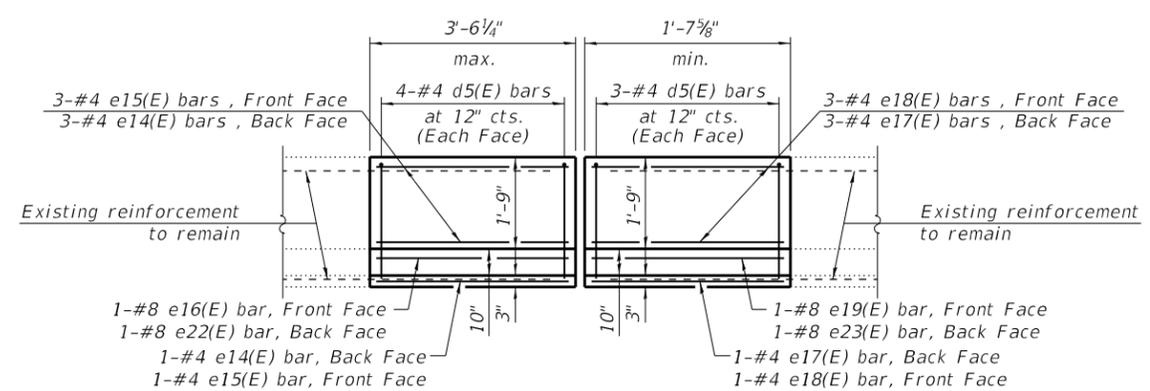


Inside Elevation - East Parapet
(South Abutment)

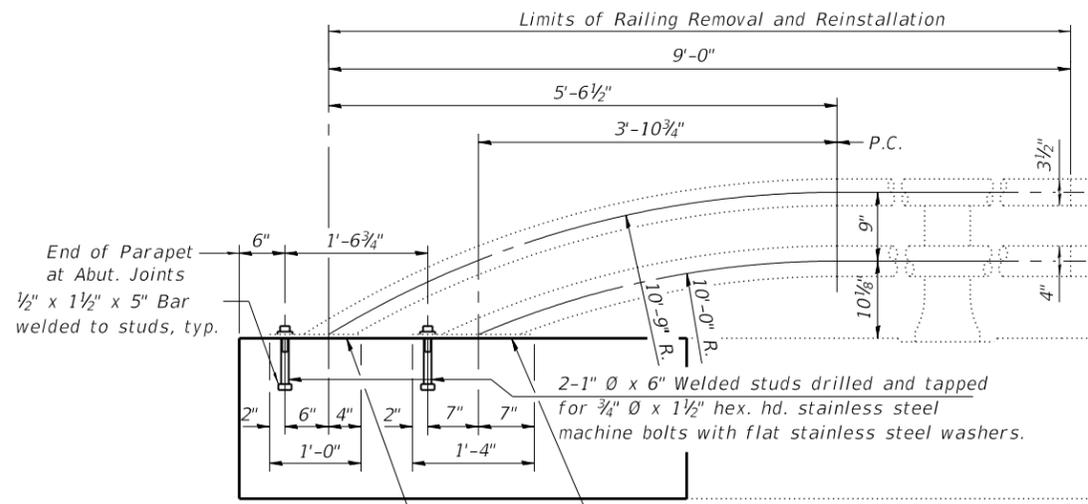


RAIL TERMINAL SECTION

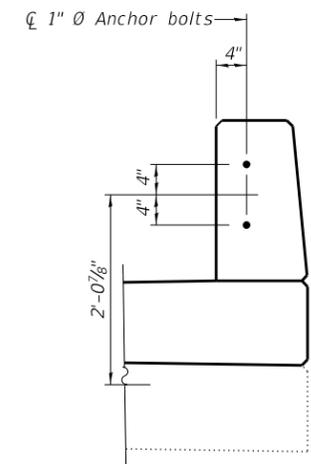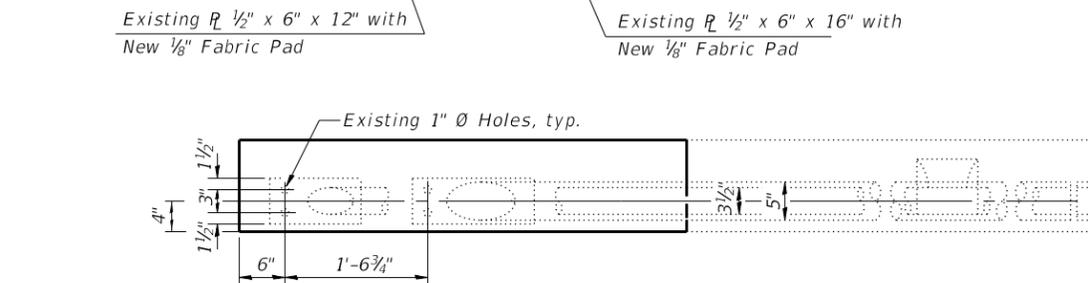

VIEW A-A

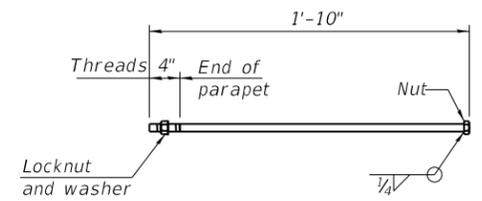

*** 1" Ø ANCHOR BOLT**
(Anchor bolt assemblies shall be galvanized according to Article 1006.09 of the Standard Specifications)

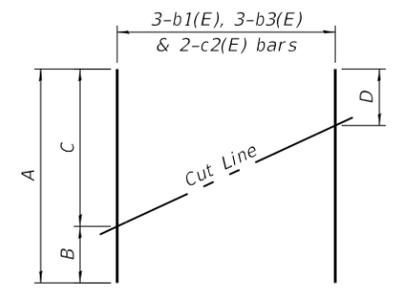

FIELD CUTTING DIAGRAM

(b1(E), b3(E) and c2(E) bars)

Bar	A	B	C	D
b1(E)	11'-0"	2'-9"	8'-3"	6'-0"
b3(E)	3'-6"	1'-7"	1'-11"	2'-6 3/4"
c2(E)	8'-2"	2'-10"	5'-4"	4'-6"

Notes:
Length of parapet shown in Parapet Elevations is taken along the back face of parapet.
See sheet 6 of 15 for Bar Bend Details.

Note: The end rail post shall be set back as required for the terminal rail section.

BILL OF MATERIAL

Bar	No.	Size	Length	Shape
a(E)	16	#5	34'-1"	—
a1(E)	16	#5	29'-0"	—
a2(E)	16	#5	29'-8"	—
a3(E)	16	#5	32'-1"	—
b(E)	8	#5	2'-6"	—
b1(E)	3	#5	11'-0"	—
b2(E)	2	#5	1'-8"	—
b3(E)	3	#5	3'-6"	—
b4(E)	2	#5	2'-10"	—
b5(E)	6	#5	1'-9"	—
b6(E)	2	#5	1'-5"	—
c(E)	9	#5	1'-11"	└
c1(E)	2	#5	5'-8"	—
c2(E)	2	#5	8'-2"	—
c3(E)	1	#5	2'-0"	—
c4(E)	6	#5	2'-5"	└
c5(E)	3	#5	8'-9"	—
c6(E)	1	#5	5'-10"	—
c7(E)	1	#5	5'-5"	—
c8(E)	1	#5	2'-6"	—
c9(E)	4	#5	6'-0"	—
d(E)	14	#4	2'-11"	—
d1(E)	7	#4	5'-0"	└
d2(E)	7	#6	3'-9"	└
d3(E)	10	#5	3'-5"	└
d4(E)	14	#4	2'-1"	—
d5(E)	22	#5	3'-0"	—
d6(E)	10	#5	2'-7"	└
x(E)	184	#5	2'-7"	└

BILL OF MATERIAL CONT'D

Bar	No.	Size	Length	Shape
e(E)	3	#4	2'-6"	—
e1(E)	3	#4	1'-8"	—
e2(E)	3	#4	2'-11"	—
e3(E)	3	#4	3'-9"	—
e4(E)	3	#4	1'-9"	—
e5(E)	3	#4	1'-5"	—
e6(E)	3	#4	2'-7"	—
e7(E)	3	#4	2'-10"	—
e8(E)	4	#4	1'-7"	—
e9(E)	4	#4	0'-5"	—
e10(E)	1	#8	0'-5"	—
e11(E)	4	#4	1'-0"	—
e12(E)	4	#4	2'-3"	—
e13(E)	1	#8	2'-3"	—
e14(E)	4	#4	3'-0"	—
e15(E)	4	#4	2'-3"	—
e16(E)	1	#8	2'-3"	—
e17(E)	4	#4	1'-4"	—
e18(E)	4	#4	2'-3"	—
e19(E)	1	#8	2'-3"	—
e20(E)	1	#8	1'-7"	—
e21(E)	1	#8	1'-0"	—
e22(E)	1	#8	3'-0"	—
e23(E)	1	#8	1'-4"	—
Concrete Superstructure		Cu. Yd.	17.7	
Reinforcement Bars, Epoxy Coated		Pound	3170	

FILE NAME: P:\10-1063.08 SN 0046 0120 Repairs\10_CAD\CADD Sheets\090-0120\0900120-68D59-007-SUPERSTRUCTURE DETAILS.dgn

Kaskaskia
Engineering Group, LLC
Professional Engineering Group


USER NAME =	DESIGNED - KS	REVISED -
PLOT SCALE =	CHECKED - BB	REVISED -
PLOT DATE =	DRAWN - KS	REVISED -
	CHECKED - BB	REVISED -

STATE OF ILLINOIS
DEPARTMENT OF TRANSPORTATION

SUPERSTRUCTURE DETAILS
STRUCTURE NO. 090-0120


SHEET 7 OF 15 SHEETS

F.A.U. RTE.	SECTION	COUNTY	TOTAL SHEETS	SHEET NO.
6707	(50B-4)BR: 12(HVB,HB)BR:BR	TAZEWELL	61	53
CONTRACT NO. 68D59				
ILLINOIS FED. AID PROJECT				

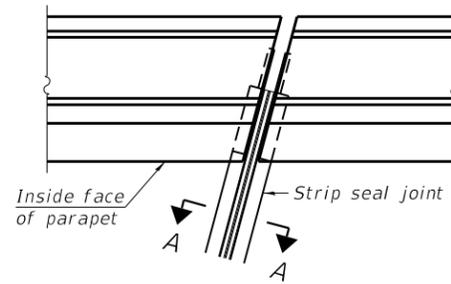


FOR SKEWS $\leq 30^\circ$

PLAN AT PARAPET

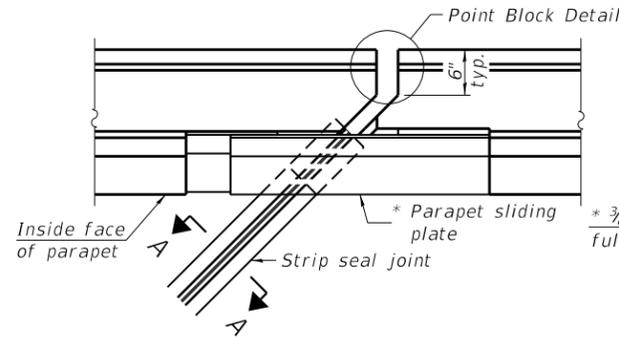


FOR SKEWS $> 30^\circ$

PLAN AT PARAPET

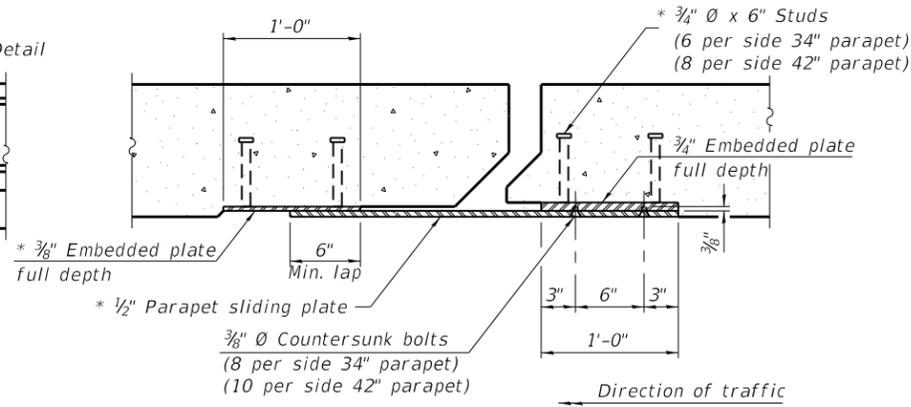


SECTION B-B

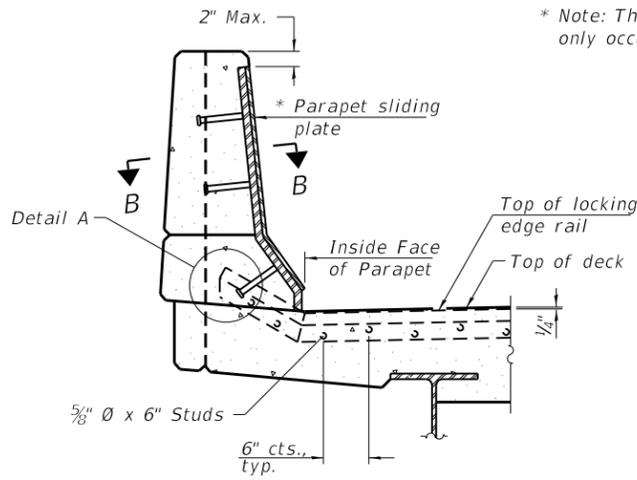


ELEVATION AT PARAPET

(Skews $> 30^\circ$ shown. Skews $\leq 30^\circ$ similar except as shown in plan view.)


* Note: The use of the sliding plate shall only occur at the south abutment, east parapet.

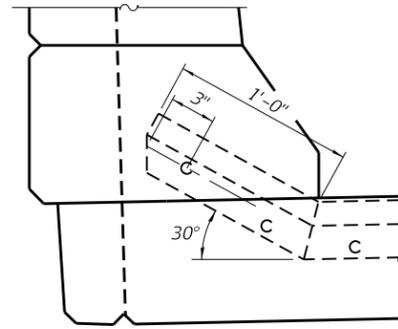

DETAIL A

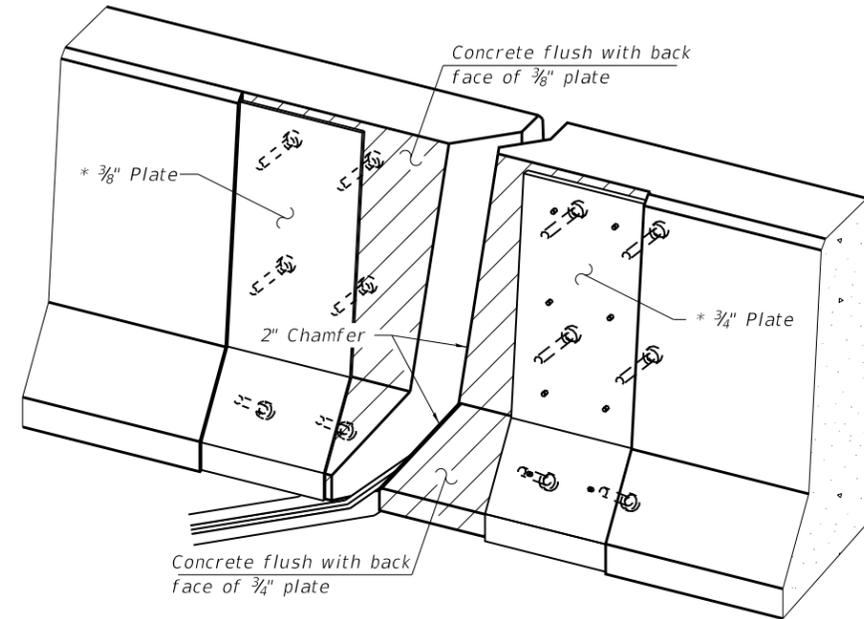

TRIMETRIC VIEW
(Showing embedded plates only)

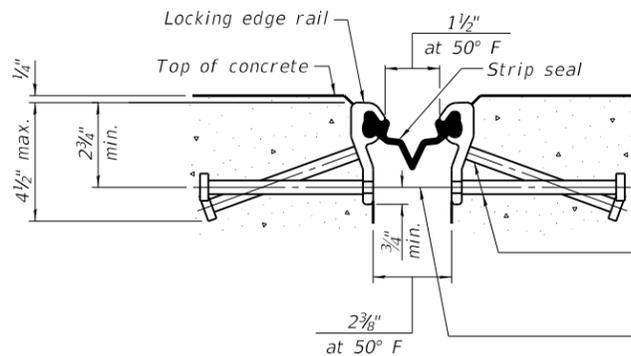


SHOWING ROLLED RAIL JOINT

** $5/8"$ ϕ x 6" studs @ 6" cts. (alternate angled/bent studs with horizontal studs)


$3/8"$ ϕ threaded rods in $7/16"$ ϕ holes at $\pm 4"-0"$ cts. for holding the proper joint opening based on the temperature during the deck pour. Place to miss studs. All rods shall be burned, or sawed off flush with the plates after concrete is set.

SECTION A-A

** Granular or solid flux filled headed studs conforming to Article 1006.32 of the Std. Specs., automatically end welded.

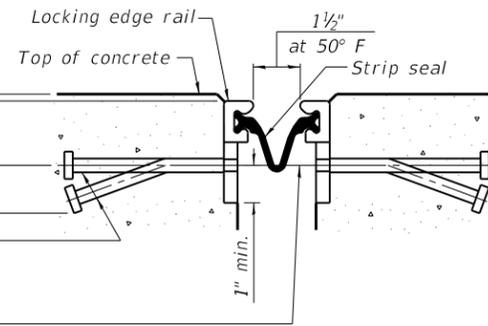


SHOWING WELDED RAIL JOINT

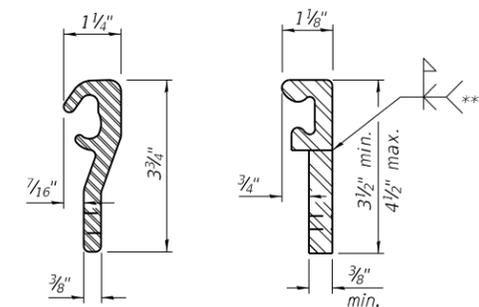

LOCKING EDGE RAILS

LOCKING EDGE RAILS

*** Back gouge not required if complete joint penetration is verified by mock-up.

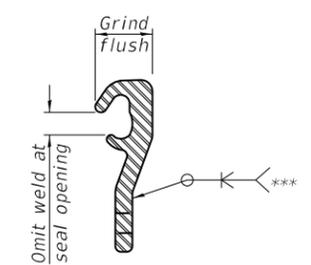

LOCKING EDGE RAIL SPLICE

The inside of the locking edge rail groove shall be free of weld residue. Rolled rail shown, welded rail similar.

BILL OF MATERIAL

Item	Unit	Total
Preformed Joint Strip Seal	Foot	233

Notes:

The strip seal shall be made continuous and shall have a minimum thickness of $1/4"$. The configuration of the strip seal shall match the configuration of the locking edge rails. Open or "webbed" strip seal gland configurations are not permitted. The gland shall be sized for a maximum rated movement of 4 inches.

The locking edge rails depicted are configured for typical applications and are conceptual only. The actual configuration of the locking edge rails and matching strip seal may vary from manufacturer to manufacturer provided they fit the application and meet the minimum anchorage shown. Flanged edge rails, however, will not be allowed. Locking edge rails may exceed the $4 1/2"$ maximum depth provided the anchorage system is revised according to the manufacturer's recommendation.

The manufacturer's recommended installation methods shall be followed.

All steel components shall be galvanized after fabrication according to Article 520.03 of the Standard Specifications.

The maximum space between locking edge rail segments shall be $3/16"$ and sealed with a suitable sealant; however, any rail joint within 10' measured perpendicular to the face of the curb or parapet shall be welded as shown in the locking edge rail splice detail.

The top surface of sidewalk sliding plates shall have a raised pattern according to ASTM A786.

Cost of sidewalk sliding plates, embedded plates, anchorage studs, and expansion anchors included with Preformed Joint Strip Seal.

The concrete opening below the strip seal will vary based on the locking edge rail chosen by the Contractor. Deck and parapet lengths shown elsewhere in the plans are dimensioned to the concrete opening, not the joint opening, and are based on the rolled locking edge rail. If the Contractor elects to use a different locking edge rail, dimensional adjustments may be required. One exception to this would be the strip seal joint at the end of the precast bridge approach slab. For these cases the pavement connector length shall be adjusted, not the length of the bridge approach slab.

FILE NAME: P:\10-1063.08 SN 0046 0120 Repairs\10_CAD\CADD Sheets\090-0120\0900120-68D59-008-P151.dgn




USER NAME =	DESIGNED - KS	REVISED -
PLOT SCALE =	CHECKED - BB	REVISED -
PLOT DATE =	DRAWN - KS	REVISED -
	CHECKED - BB	REVISED -

STATE OF ILLINOIS
DEPARTMENT OF TRANSPORTATION


PREFORMED JOINT STRIP SEAL - EAST PARAPET
STRUCTURE NO. 090-0120

SHEET 8 OF 15 SHEETS


F.A.U. RTE.	SECTION	COUNTY	TOTAL SHEETS	SHEET NO.
6707	(50B-4)BR: 12((HVB,HB)BR)BR	TAZEWELL	61	54
CONTRACT NO. 68D59				
ILLINOIS FED. AID PROJECT				

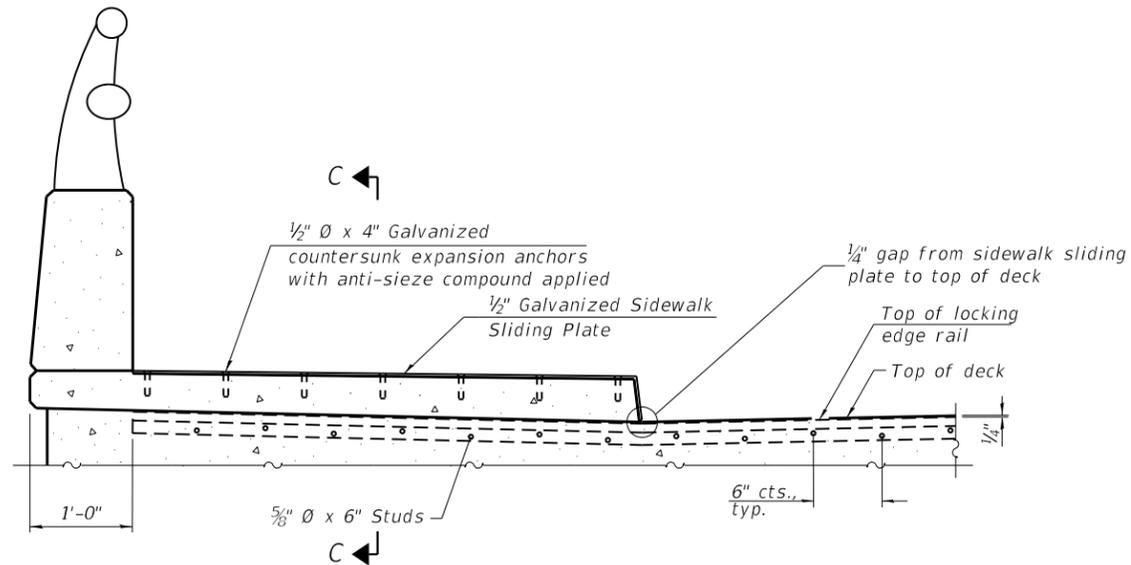


ELEVATION AT RAISED SIDEWALK

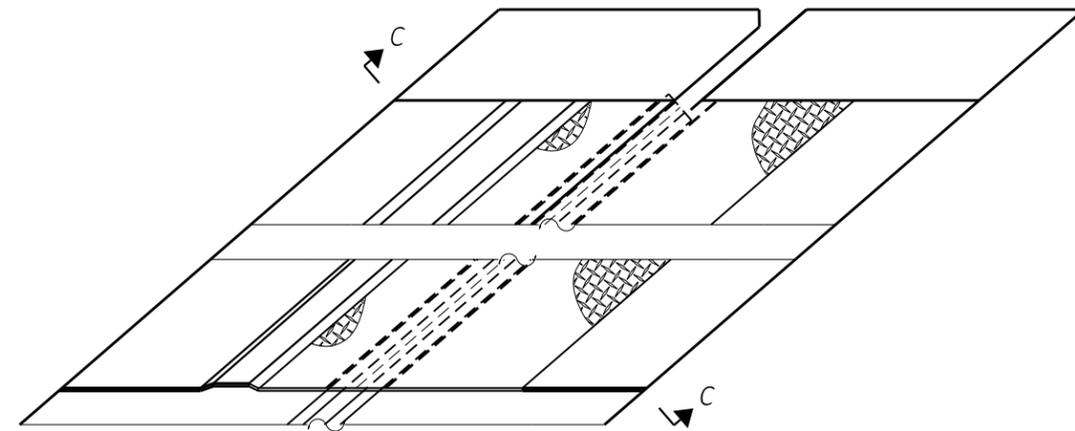

PLAN AT RAISED SIDEWALK

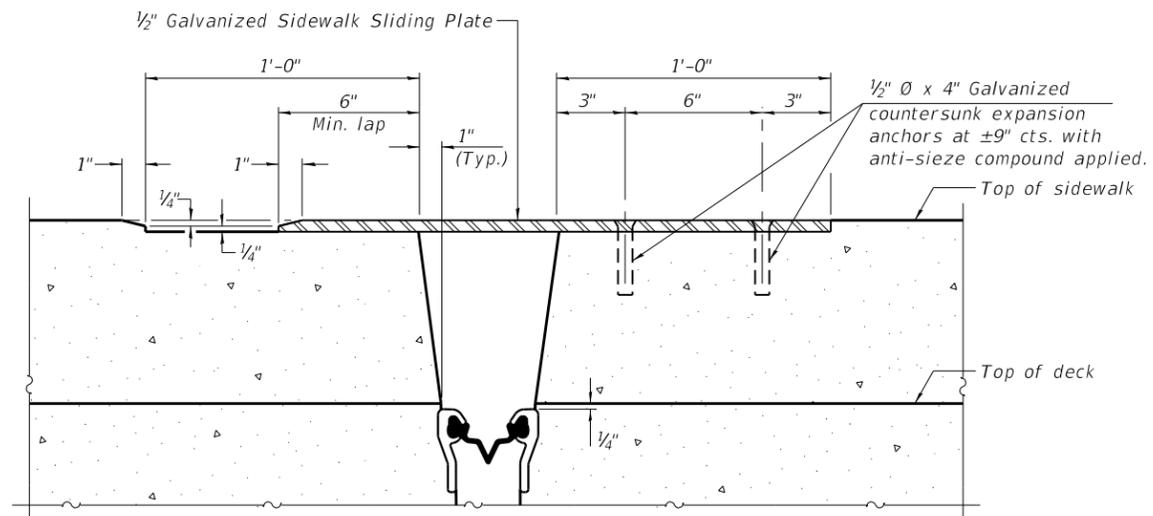

SECTION C-C

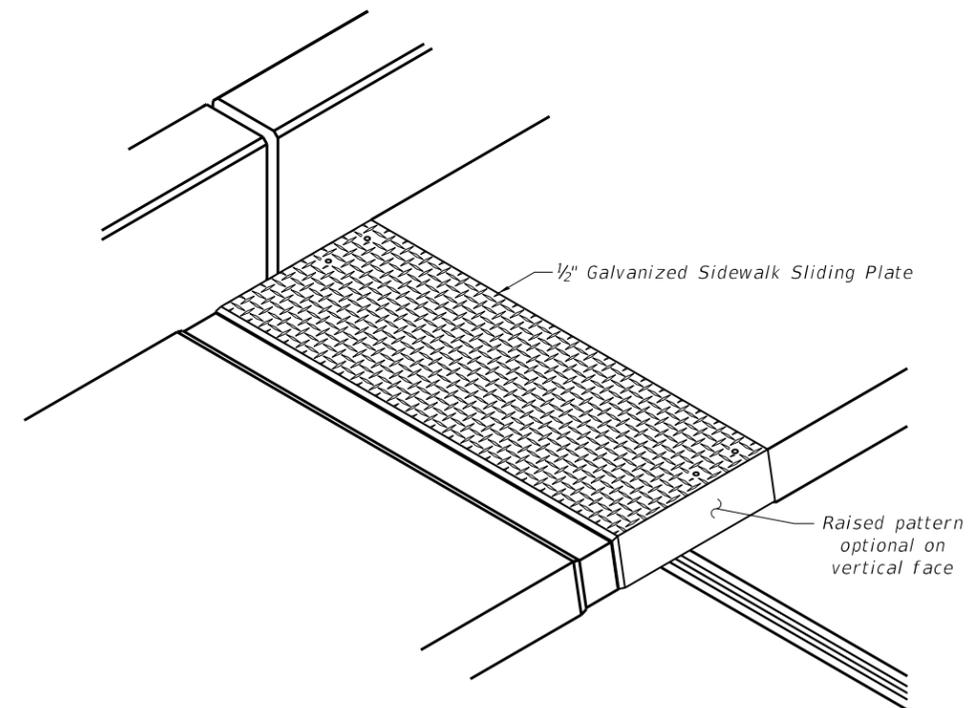

TRIMETRIC VIEW

FILE NAME: P:\10-1063.08 SN 0046 0120 Repairs\10_CAD\CADD Sheets\090-0120\0900120-68D59-005-Pls2.dgn



USER NAME =
 DESIGNED - KS
 CHECKED - BB
 PLOT SCALE =
 DRAWN - KS
 PLOT DATE =
 CHECKED - BB

DESIGNED - KS
 CHECKED - BB
 DRAWN - KS
 CHECKED - BB


REVISED -
 REVISED -
 REVISED -
 REVISED -

STATE OF ILLINOIS
DEPARTMENT OF TRANSPORTATION


PREFORMED JOINT STRIP SEAL - SIDEWALK
STRUCTURE NO. 090-0120

SHEET 9 OF 15 SHEETS


F.A.U. RTE.	SECTION	COUNTY	TOTAL SHEETS	SHEET NO.
6707	(50B-4)BR: 12(HVB,HB)BR BR	TAZEWELL	61	55
CONTRACT NO. 68D59				
ILLINOIS			FED. AID PROJECT	

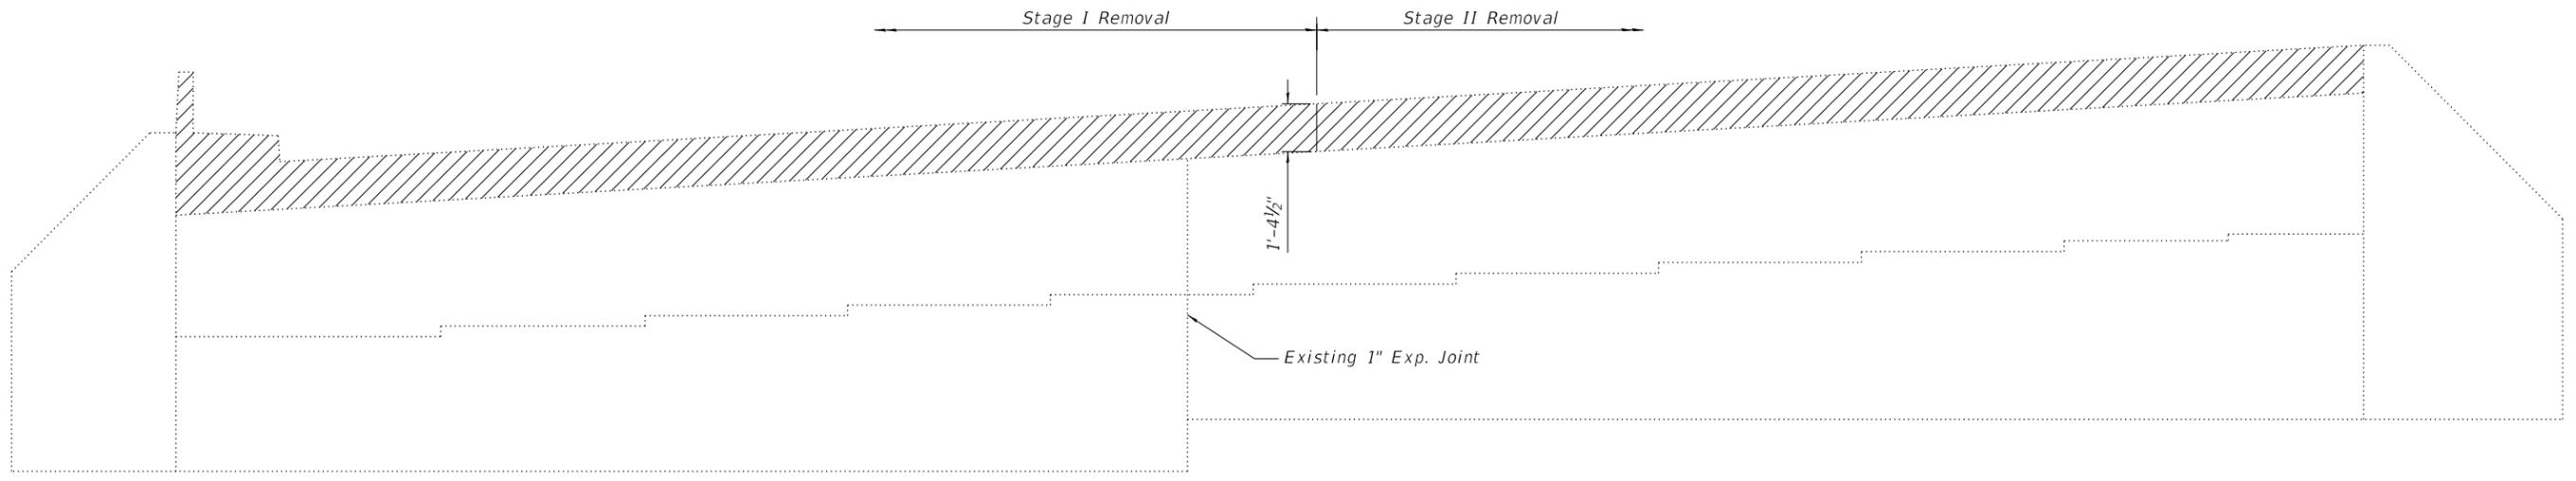

ELEVATION - REMOVAL

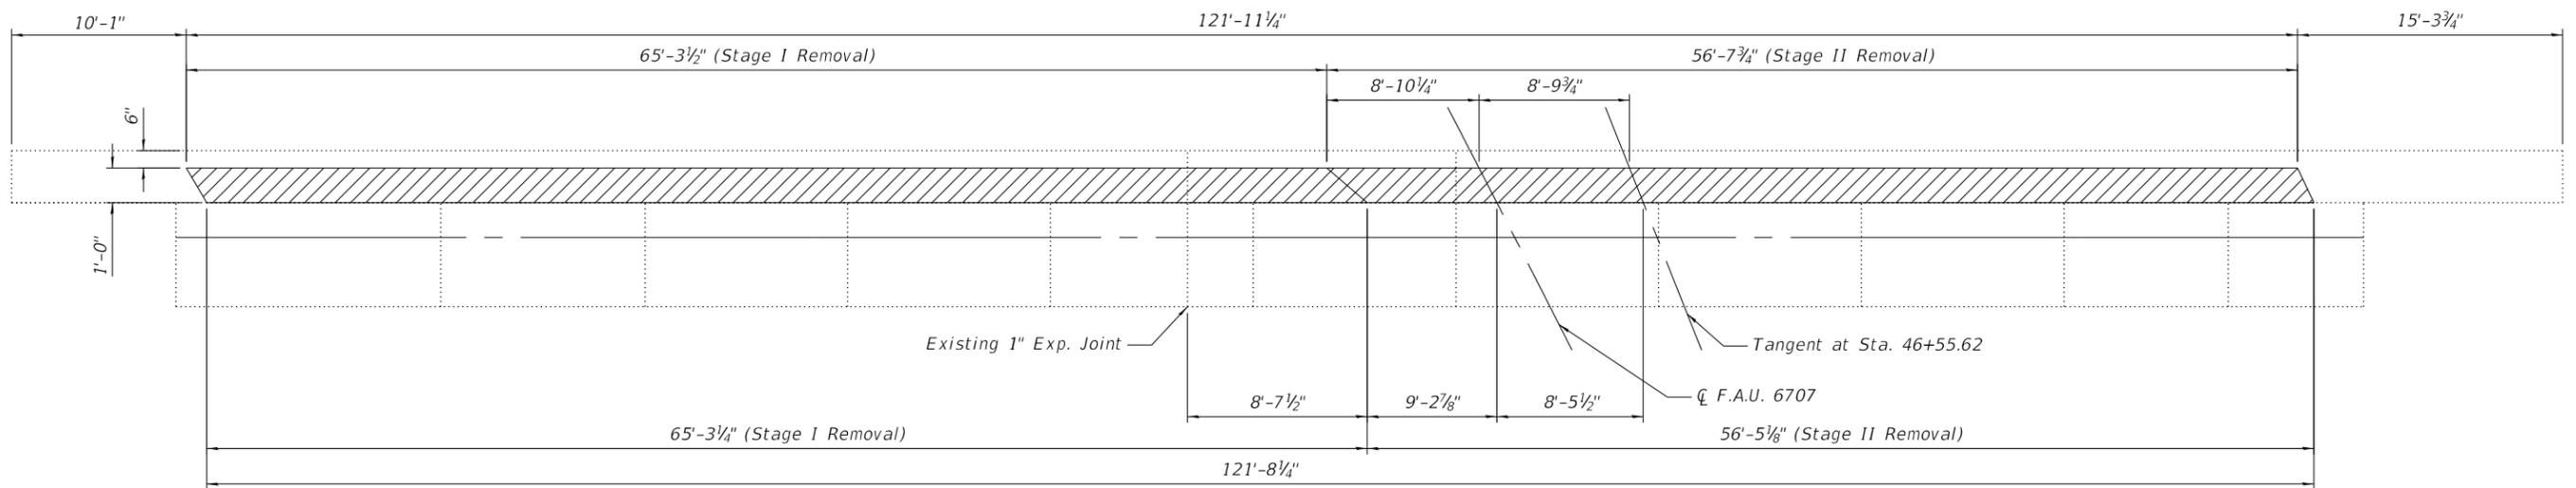

PLAN - REMOVAL

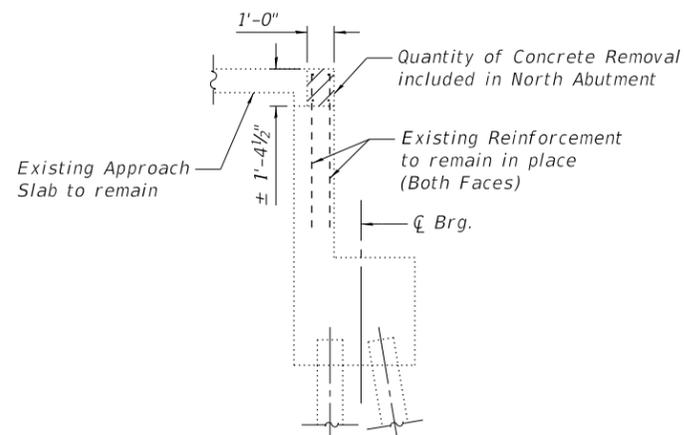

SECTION THRU ABUTMENT

Indicates Limits of Concrete Removal

BILL OF MATERIAL

ITEM	UNIT	TOTAL
Concrete Removal	CU YD	6.2

FILE NAME: P:\10-1063.08 SN 0046 0120 Repairs\10_CAD\CADD Sheets\090-0120\0900120-68D59-01C-NORTH ABUTMENT.dgn

Kaskaskia
Engineering Group, LLC
Professional Engineering Group
288 E. Main St., Suite 200
Moline, IL 61401
618.233.2877 phone
618.233.2877 fax
www.kaskaskiaeng.com
1/27/2018
618.233.2877


USER NAME =	DESIGNED - KS	REVISED -
PLOT SCALE =	CHECKED - BB	REVISED -
PLOT DATE =	DRAWN - KS	REVISED -
	CHECKED - BB	REVISED -

STATE OF ILLINOIS
DEPARTMENT OF TRANSPORTATION


NORTH ABUTMENT CONCRETE REMOVAL
STRUCTURE NO. 090-0120

SHEET 10 OF 15 SHEETS


F.A.U. RTE.	SECTION	COUNTY	TOTAL SHEETS	SHEET NO.
6707	(50B-4)BR: 12(HVB,HB)BR BR	TAZEWELL	61	56
CONTRACT NO. 68D59				
ILLINOIS FED. AID PROJECT				

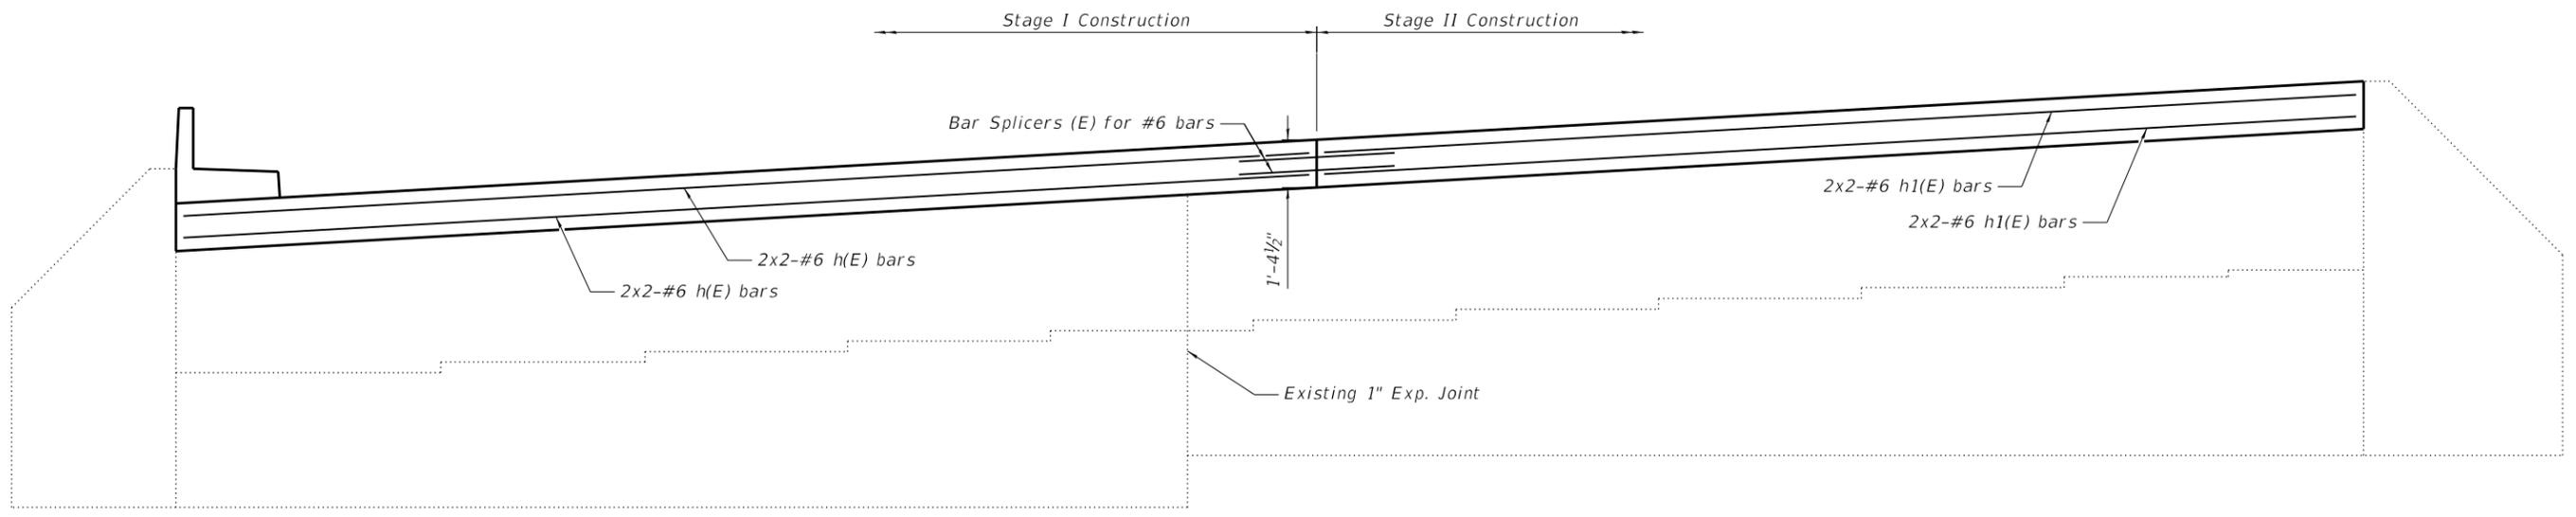


ELEVATION - REMOVAL

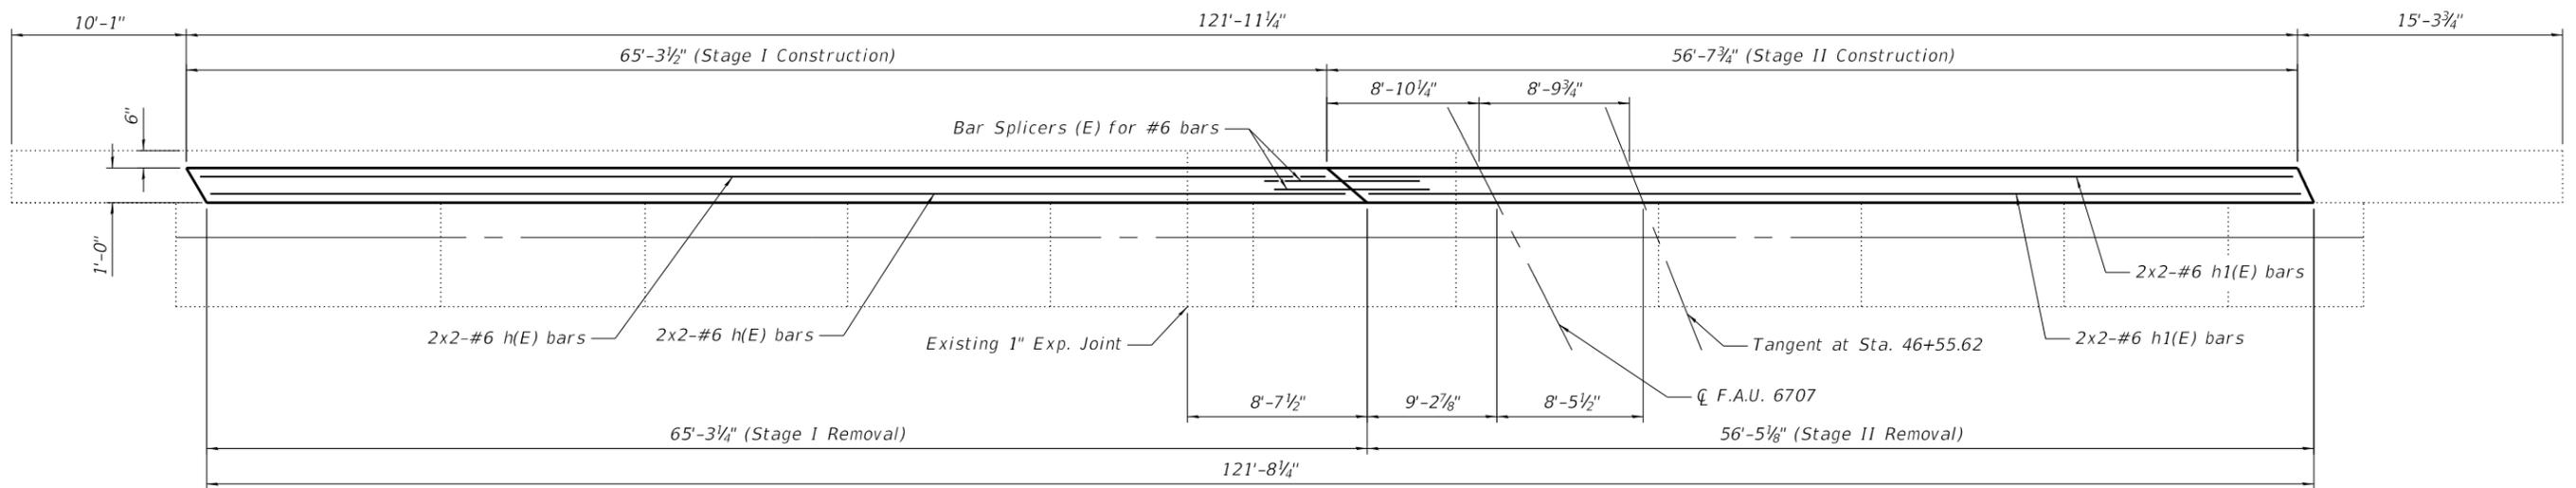

PLAN - REMOVAL

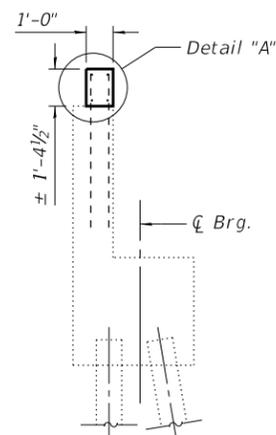

SECTION THRU ABUTMENT

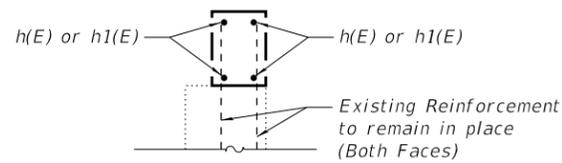

DETAIL "A"

MINIMUM BAR LAP
#6 BAR = 4'-0"

**NORTH ABUTMENT
BILL OF MATERIAL**

Bar	No.	Size	Length	Shape
h(E)	8	#6	34'-6"	—
h1(E)	8	#6	30'-3"	—
Concrete Superstructure			Cu. Yd.	6.2
Reinforcement Bars, Epoxy Coated			Pound	780

For details of Bar Splicers, see sheet 15 of 15.
See Superstructure Details for Sidewalk and parapet details and reinforcing.
Bars indicated thus 2 x 2-#6 etc. indicates 2 lines of bars with 2 lengths per line.

FILE NAME: P:\10-1063.08 SN 0046 0120 Repairs\10_CAD\CADD Sheets\090-0120\0900120-68D59-011-NORTH ABUTMENT REPAIRS.dgn


Kaskaskia
Engineering Group, LLC
Professional Engineering Group
11/27/2018 12:08:42 PM

USER NAME =	DESIGNED - KS	REVISED -
	CHECKED - BB	REVISED -
PLOT SCALE =	DRAWN - KS	REVISED -
PLOT DATE =	CHECKED - BB	REVISED -


**STATE OF ILLINOIS
DEPARTMENT OF TRANSPORTATION**

**NORTH ABUTMENT CONCRETE REPAIRS
STRUCTURE NO. 090-0120**


F.A.U. RTE.	SECTION	COUNTY	TOTAL SHEETS	SHEET NO.
6707	(50B-4)BR: 12(HVB,HB)BR BR	TAZEWELL	61	57
CONTRACT NO. 68D59				
ILLINOIS FED. AID PROJECT				

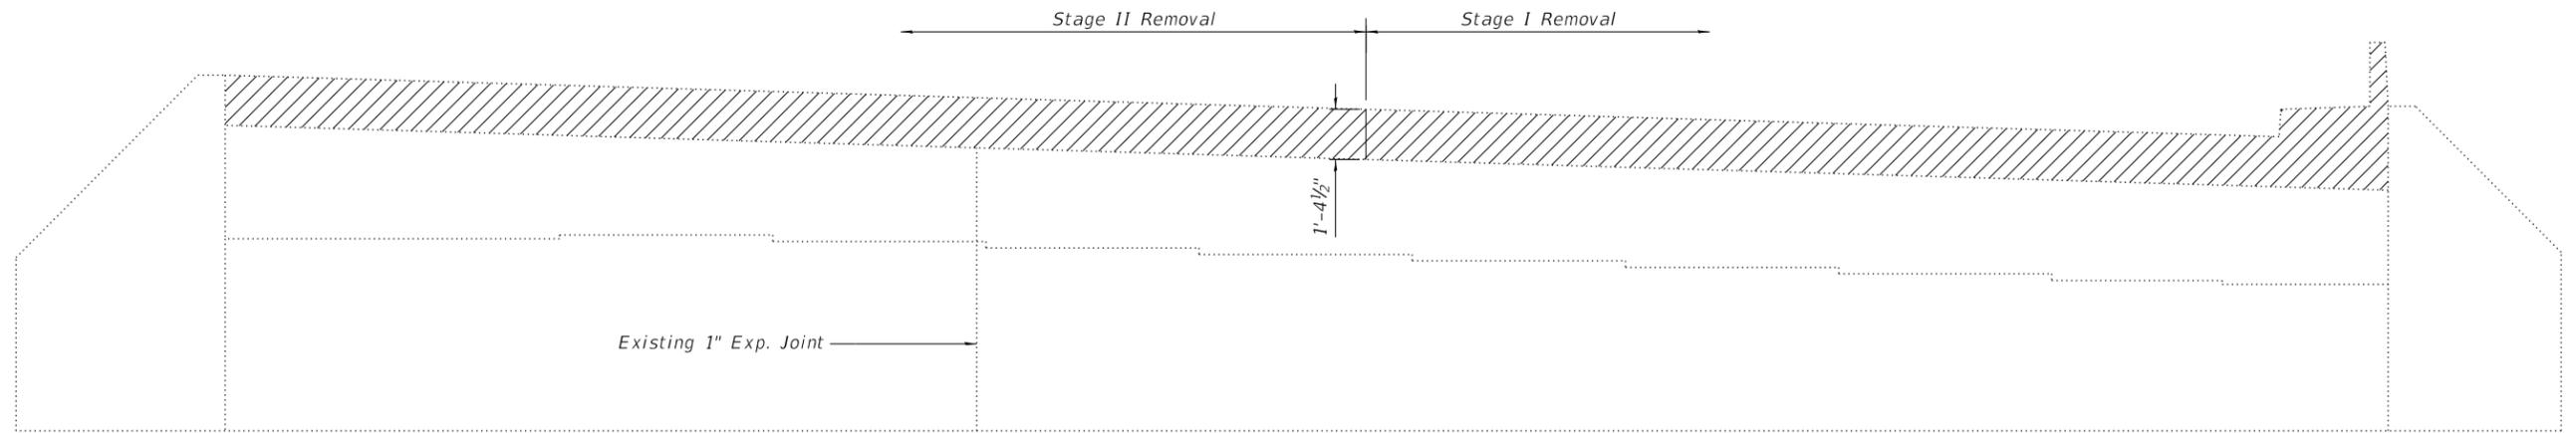

ELEVATION - REMOVAL

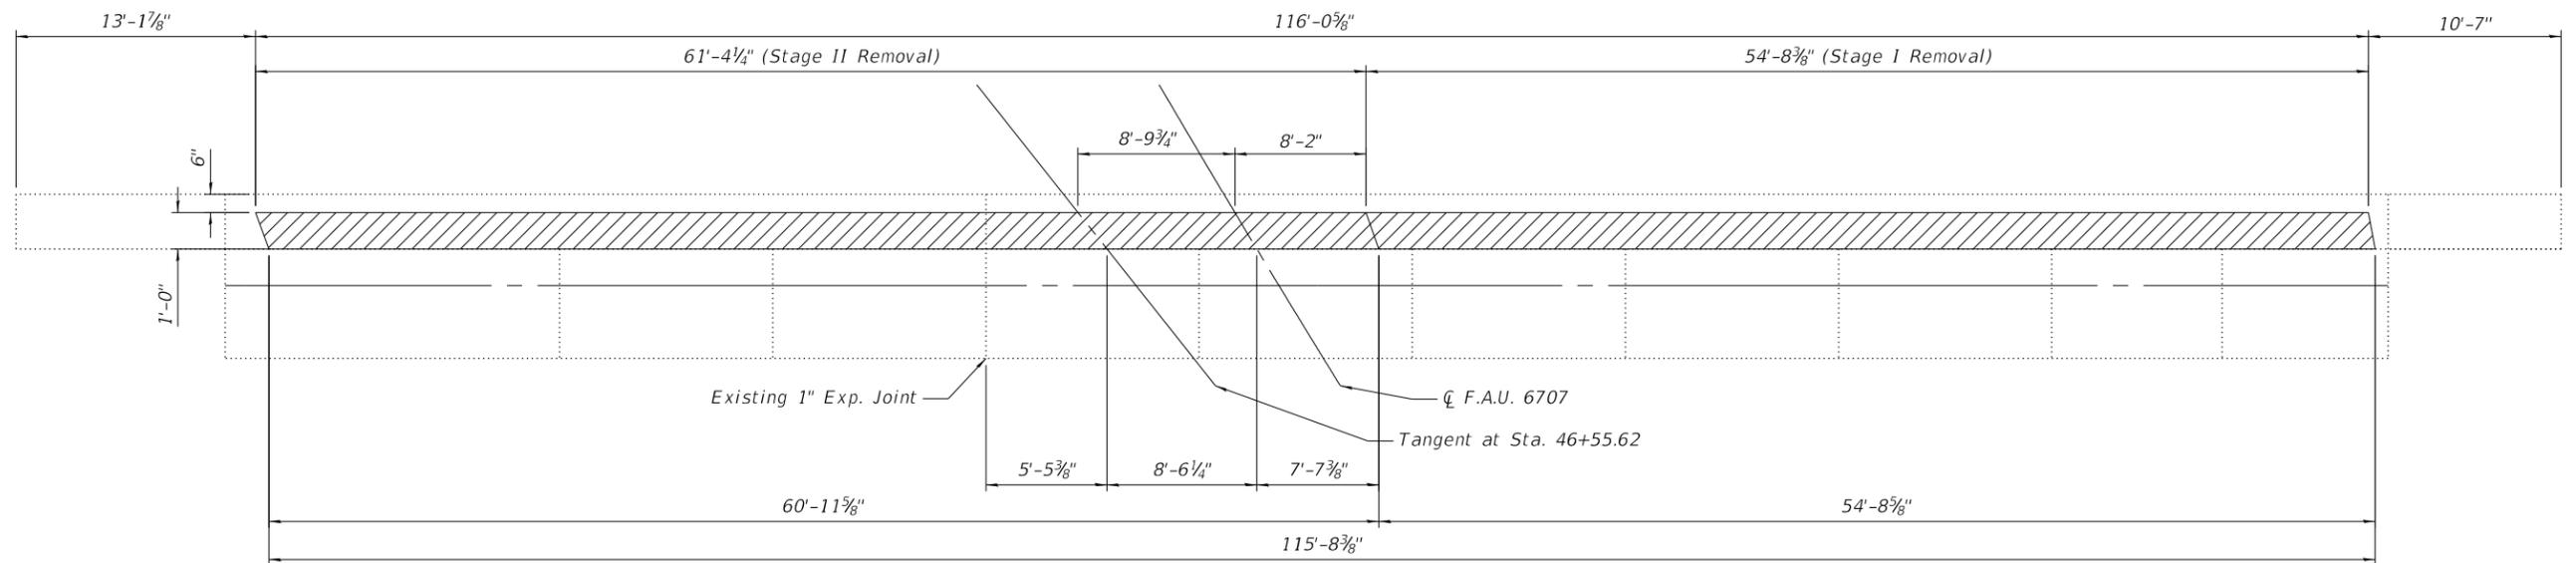

PLAN - REMOVAL

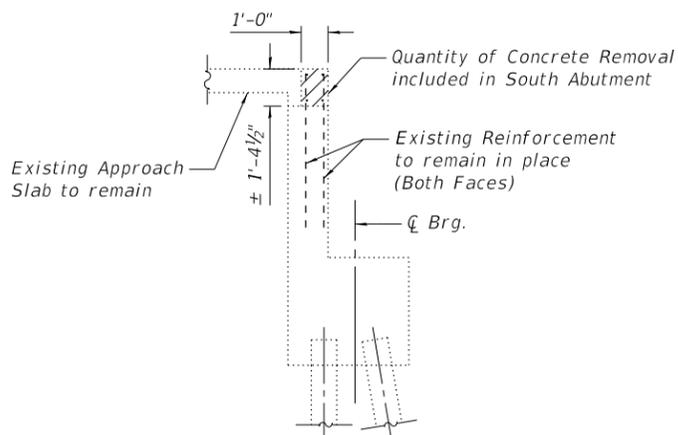

SECTION THRU ABUTMENT

Indicates Limits of Concrete Removal

BILL OF MATERIAL

ITEM	UNIT	TOTAL
Concrete Removal	CU YD	5.9

FILE NAME: P:\10-1063.08 SN 0046 0120 Repairs\10_CAD\CADD Sheets\090-0120\0900120-68D59-012-SOUTH ABUTMENT.dgn

Kaskaskia
Engineering Group, LLC
Professional Engineering Group
11777 W. 95th St.
Morton, IL 62450
618-233-2877
www.kaskaskiaeng.com

USER NAME =	DESIGNED - KS	REVISED -
PLOT SCALE =	CHECKED - BB	REVISED -
PLOT DATE =	DRAWN - KS	REVISED -
	CHECKED - BB	REVISED -


**STATE OF ILLINOIS
DEPARTMENT OF TRANSPORTATION**

**SOUTH ABUTMENT CONCRETE REMOVAL
STRUCTURE NO. 090-0120**


SHEET 12 OF 15 SHEETS

F.A.U. RTE.	SECTION	COUNTY	TOTAL SHEETS	SHEET NO.
6707	(50B-4)BR: 12((HVB,HB)BR)BR	TAZEWELL	61	58
CONTRACT NO. 68D59				


ILLINOIS FED. AID PROJECT

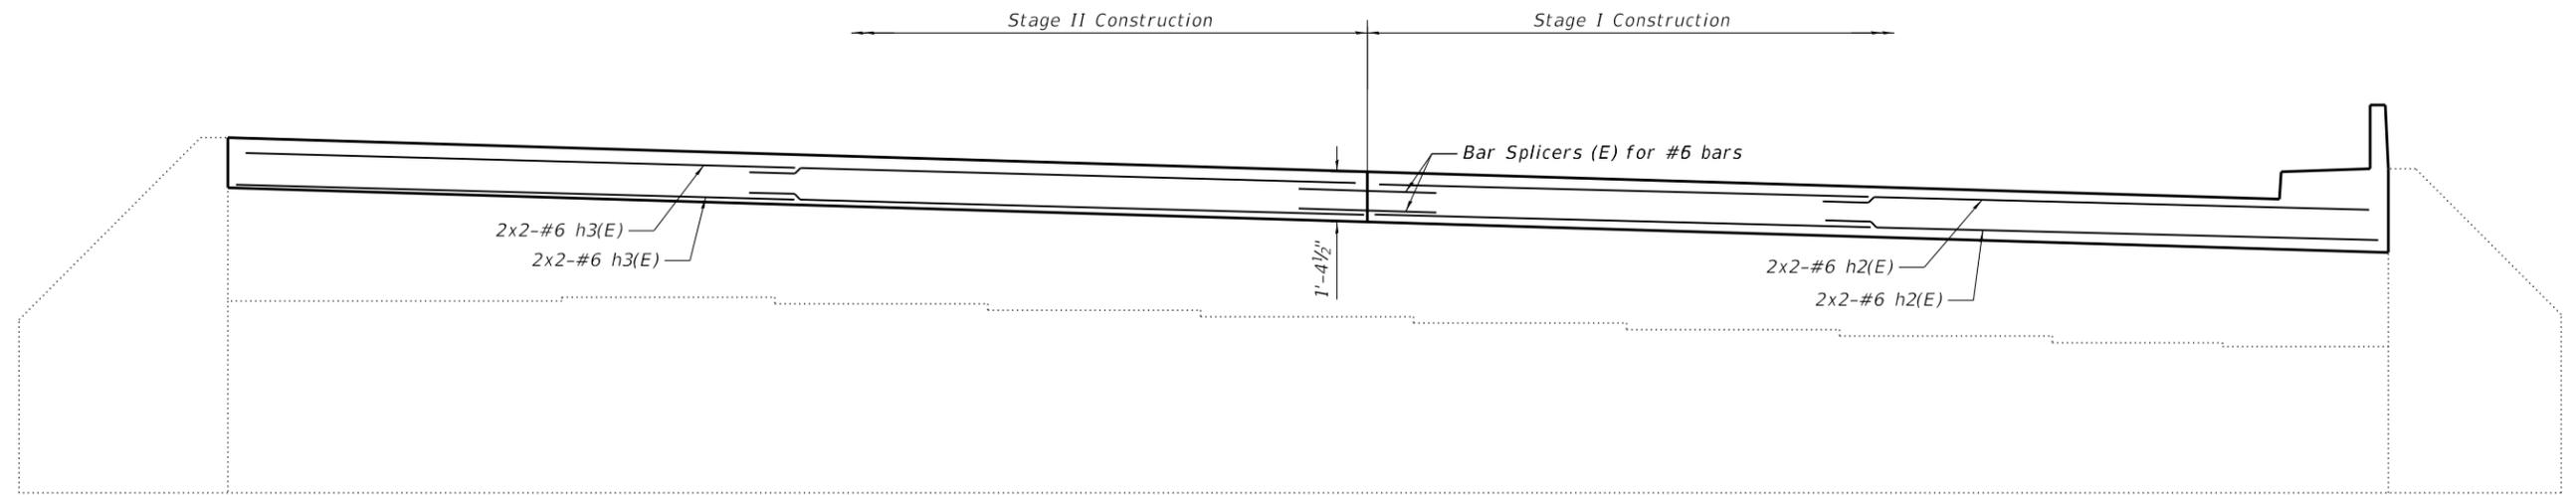


ELEVATION

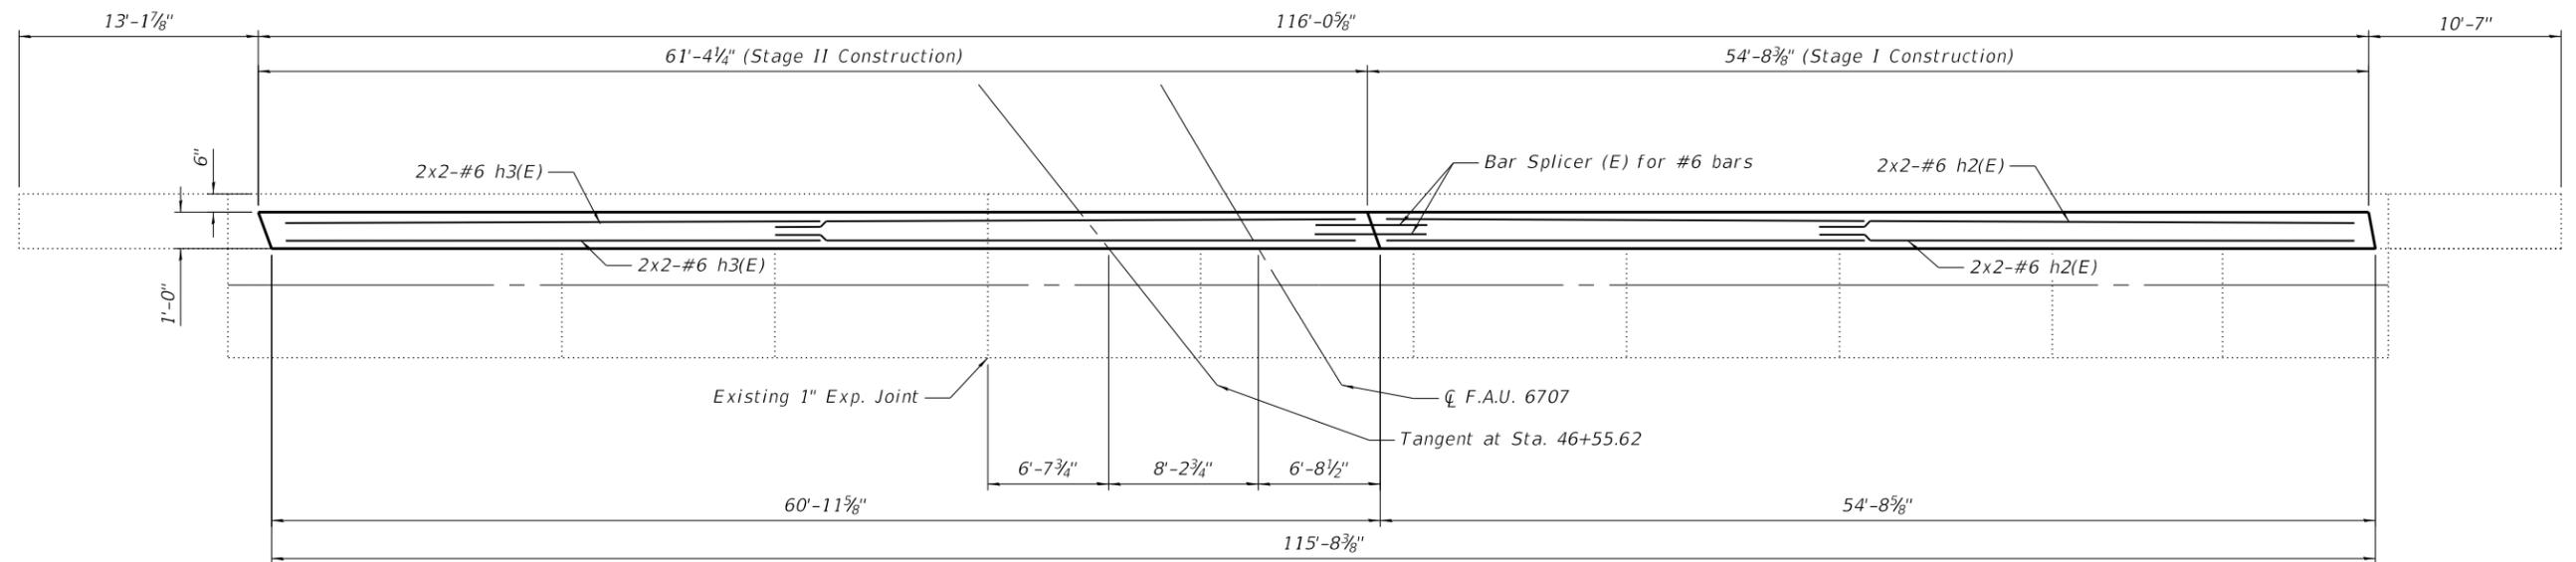

PLAN

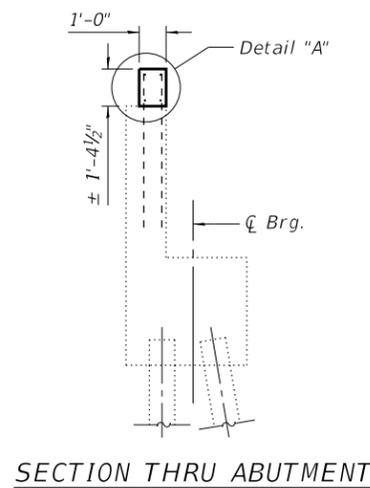

SECTION THRU ABUTMENT

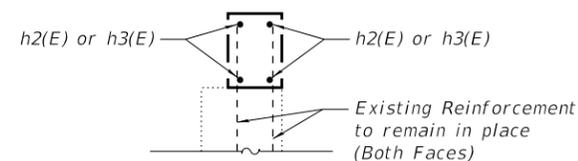

DETAIL "A"

MINIMUM BAR LAP
#6 BAR = 4'-0"

**SOUTH ABUTMENT
BILL OF MATERIAL**

Bar	No.	Size	Length	Shape
h2(E)	8	#6	29'-3"	———
h3(E)	8	#6	32'-7"	———
Concrete Superstructure			Cu. Yd.	5.9
Reinforcement Bars, Epoxy Coated			Pound	750

For details of Bar Splicers, see sheet 15 of 15.
See Superstructure Details for Sidewalk and parapet details and reinforcing.
Bars indicated thus 2 x 2-#6 etc. indicates 2 lines of bars with 2 lengths per line.

FILE NAME: P:\10-1063.08 SN 0046 0120 Repairs\10_CAD\CADD Sheets\090-0120\0900120-68D59-013-SOUTH ABUTMENT REPAIRS.dgn

Kaskaskia Engineering Group, LLC
288 E. Main St., Suite 200
Moline, IL 61401
662.233.2877 phone
662.233.2977 fax
www.kaskaskiaeng.com
Professional Engineering Group
11/27/2018
20-000056

USER NAME =	DESIGNED - KS	REVISED -
	CHECKED - BB	REVISED -
PLOT SCALE =	DRAWN - KS	REVISED -
PLOT DATE =	CHECKED - BB	REVISED -


**STATE OF ILLINOIS
DEPARTMENT OF TRANSPORTATION**

**SOUTH ABUTMENT CONCRETE REPAIRS
STRUCTURE NO. 090-0120**


SHEET 13 OF 15 SHEETS

F.A.U. RTE.	SECTION	COUNTY	TOTAL SHEETS	SHEET NO.
6707	(50B-4)BR: 12((HVB,HB)BR)BR	TAZEWELL	61	59
CONTRACT NO. 68D59				
ILLINOIS		FED. AID PROJECT		


FILE NAME: P:\10-1063.08 SN 0046 0120 Repairs\10_CAD\CADD Sheets\090-0120\0900120-68D59-014-PAINT DETAILS.dgn

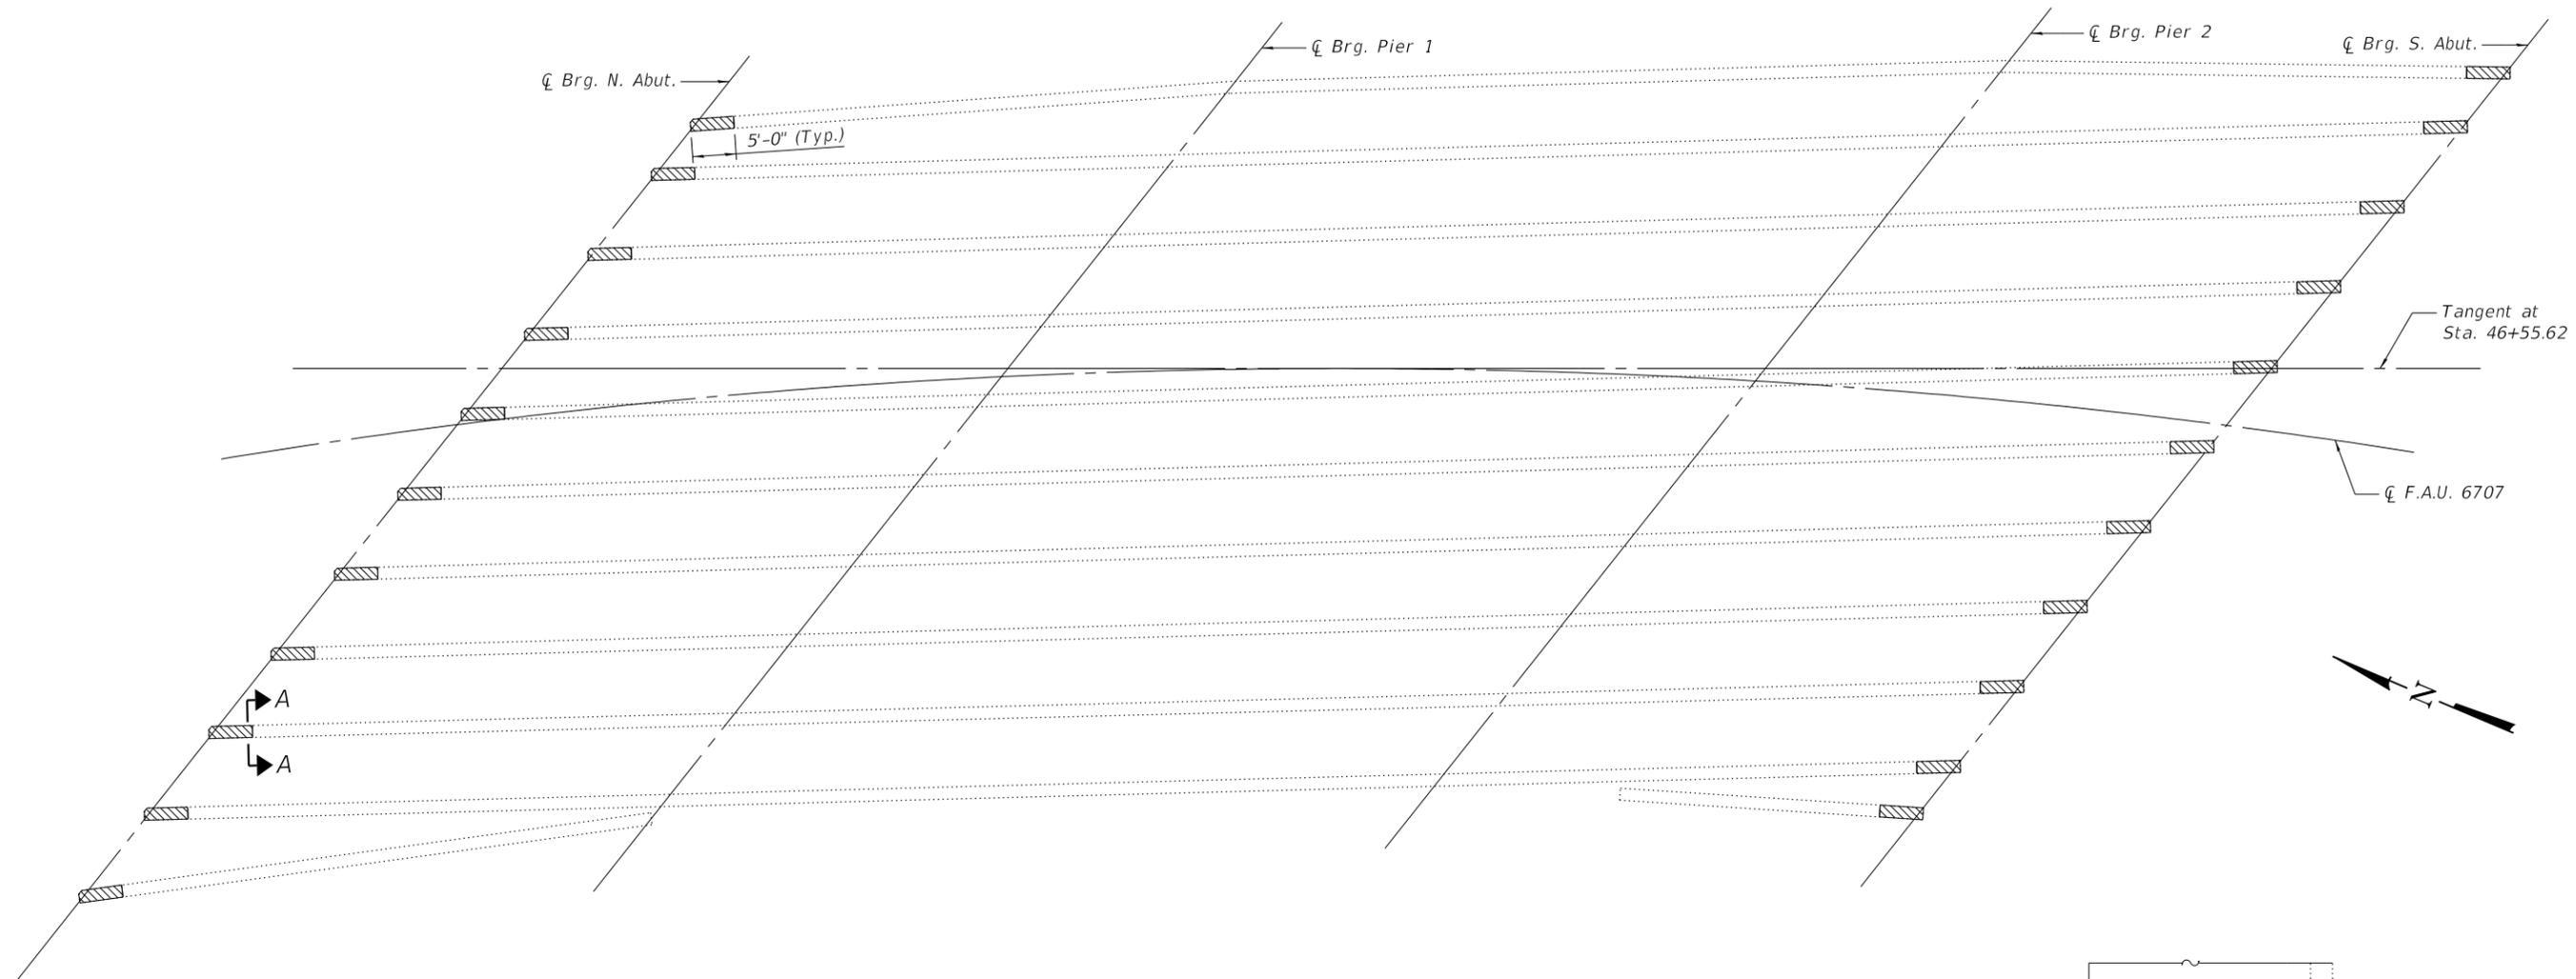


▨ Indicates limits of Cleaning and Painting Steel Bridge No. 1.

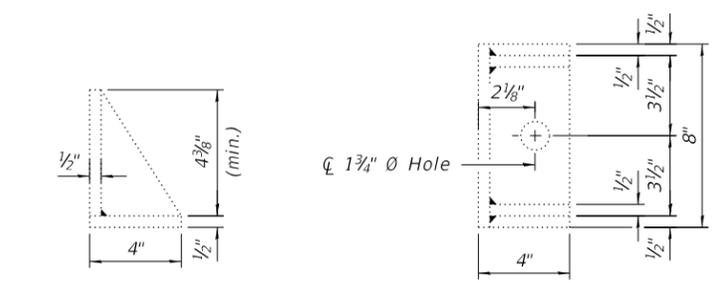


EXISTING SIDE RETAINER AT NORTH ABUTMENT
(2 Present)

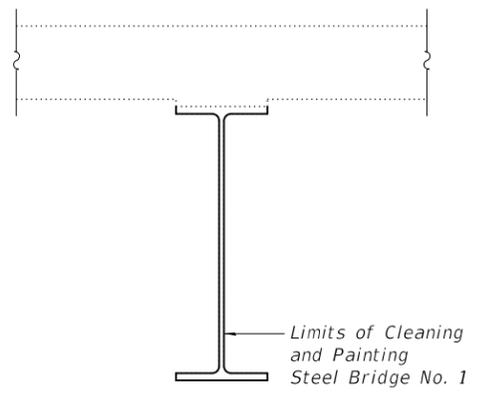

SECTION A-A

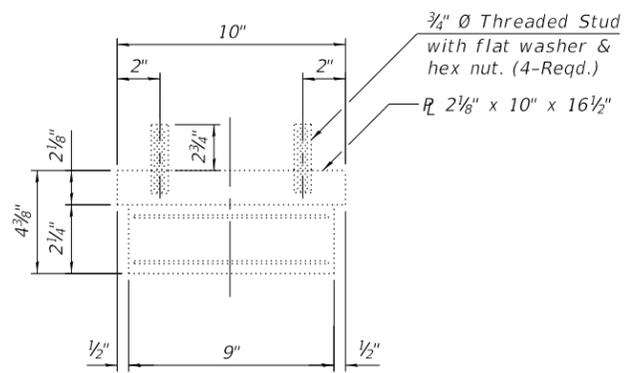

EXISTING BEARING ASSEMBLY AT NORTH ABUTMENT

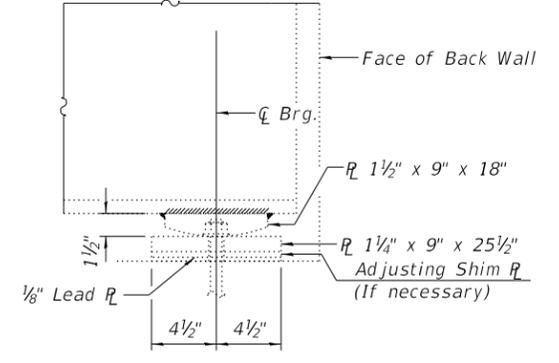

EXISTING FIXED BEARING AT SOUTH ABUTMENT

Notes:
 All beams are W36 X 230.
 All diaphragms at abutments to be cleaned and painted are W12 X 40.
 See General Notes for additional painting requirements.

Kaskaskia Engineering Group, LLC
 288 E. Main St., Suite 200
 Moline, IL 61401
 617.233.2877
 617.233.2877
 www.kaskaskiaeng.com

USER NAME =	DESIGNED - KS	REVISD -
CHECKED - BB	CHECKED - BB	REVISD -
DRAWN - KS	DRAWN - KS	REVISD -
CHECKED - BB	CHECKED - BB	REVISD -


**STATE OF ILLINOIS
 DEPARTMENT OF TRANSPORTATION**

**EXISTING STEEL CLEANING & PAINTING DETAILS
 STRUCTURE NO. 090-0120**

SHEET 14 OF 15 SHEETS

F.A.U. RTE.	SECTION	COUNTY	TOTAL SHEETS	SHEET NO.
6707	(50B-4)BR: 12(HVB,HB)BR BR	TAZEWELL	61	60
CONTRACT NO. 68D59				

ILLINOIS FED. AID PROJECT

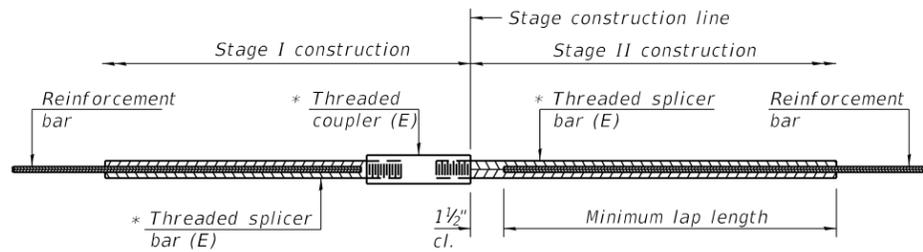


STANDARD BAR SPLICER ASSEMBLY

Threaded splicer bar length = min. lap length + 1 1/2" + thread length

* Epoxy not required on Bar Splicer Assembly components used in conjunction with black bars.

Location	Bar size	No. assemblies required	Minimum lap length
North Abutment	#6	4	4'-0"
South Abutment	#6	4	4'-0"
Deck	#5	16	3'-6"

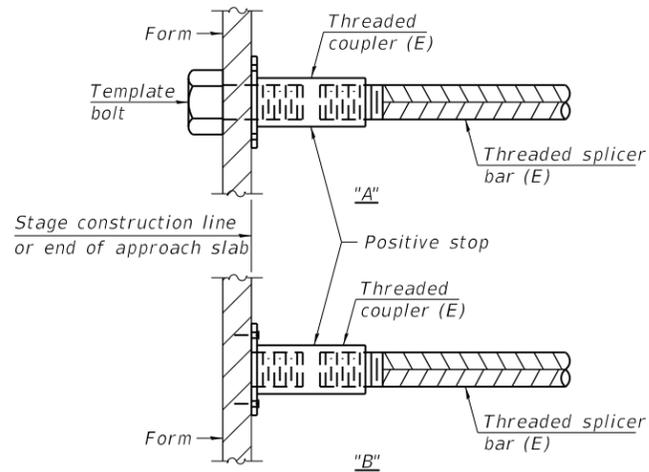


INSTALLATION AND SETTING METHODS

"A" : Set bar splicer assembly by means of a template bolt.


"B" : Set bar splicer assembly by nailing to wood forms or cementing to steel forms.

(E) : Indicates epoxy coating.

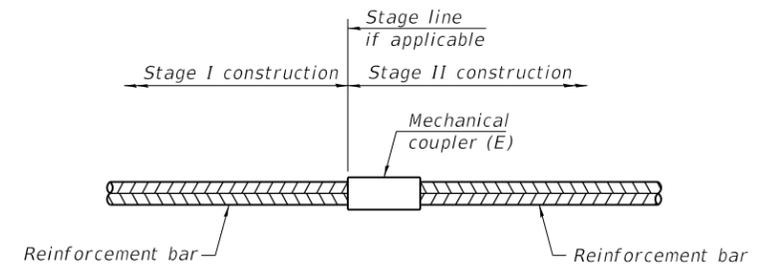

STANDARD MECHANICAL SPLICER

Location	Bar size	No. assemblies required

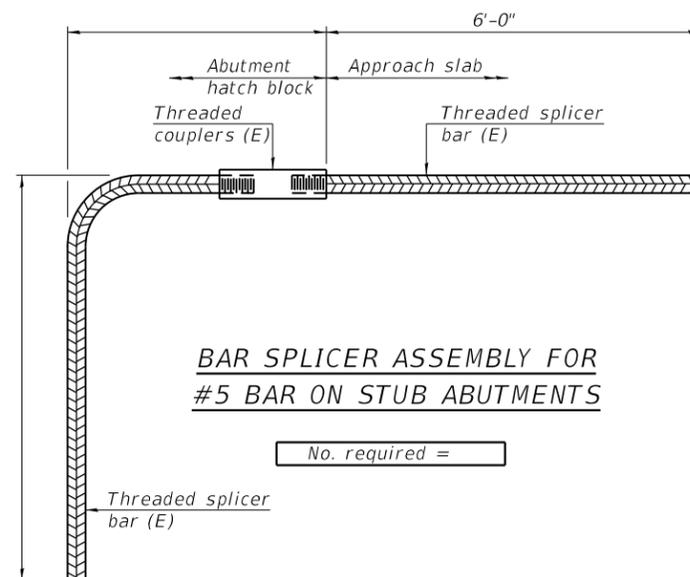

BAR SPLICER ASSEMBLY FOR #5 BAR ON STUB ABUTMENTS

No. required =

NOTES

Splicer bars shall be deformed with threaded ends and have a minimum 60 ksi yield strength.

All reinforcement shall be lapped and tied to the splicer bars. Bar splicer assemblies shall be epoxy coated according to the requirements for reinforcement bars. See Section 508 of the Standard Specifications.

See approved list of bar splicer assemblies and mechanical splicers for alternatives.

FILE NAME: P:\10-1063.08 SN 0046 0120 Repairs\10_CAD\CADD Sheets\090-0120\0900120-68D59-015-BAR SPLICER.dgn

BSD-1

2-17-2017



USER NAME =	DESIGNED - KS	REVISED -
CHECKED - BB	CHECKED - BB	REVISED -
PLOT SCALE =	DRAWN - KS	REVISED -
PLOT DATE =	CHECKED - BB	REVISED -

**STATE OF ILLINOIS
DEPARTMENT OF TRANSPORTATION**

**BAR SPLICER ASSEMBLY AND MECHANICAL SPLICER DETAILS
STRUCTURE NO. 090-0120**

SHEET 15 OF 15 SHEETS

F.A.U. RTE.	SECTION	COUNTY	TOTAL SHEETS	SHEET NO.
6707	(50B-4)BR: 12(HVB,HB)BR BR	TAZEWELL	61	61
CONTRACT NO. 68D59				

ILLINOIS FED. AID PROJECT