


SEE DETOUR 1 EROSION CONTROL PLANS
FOR EROSION CONTROL INFORMATION

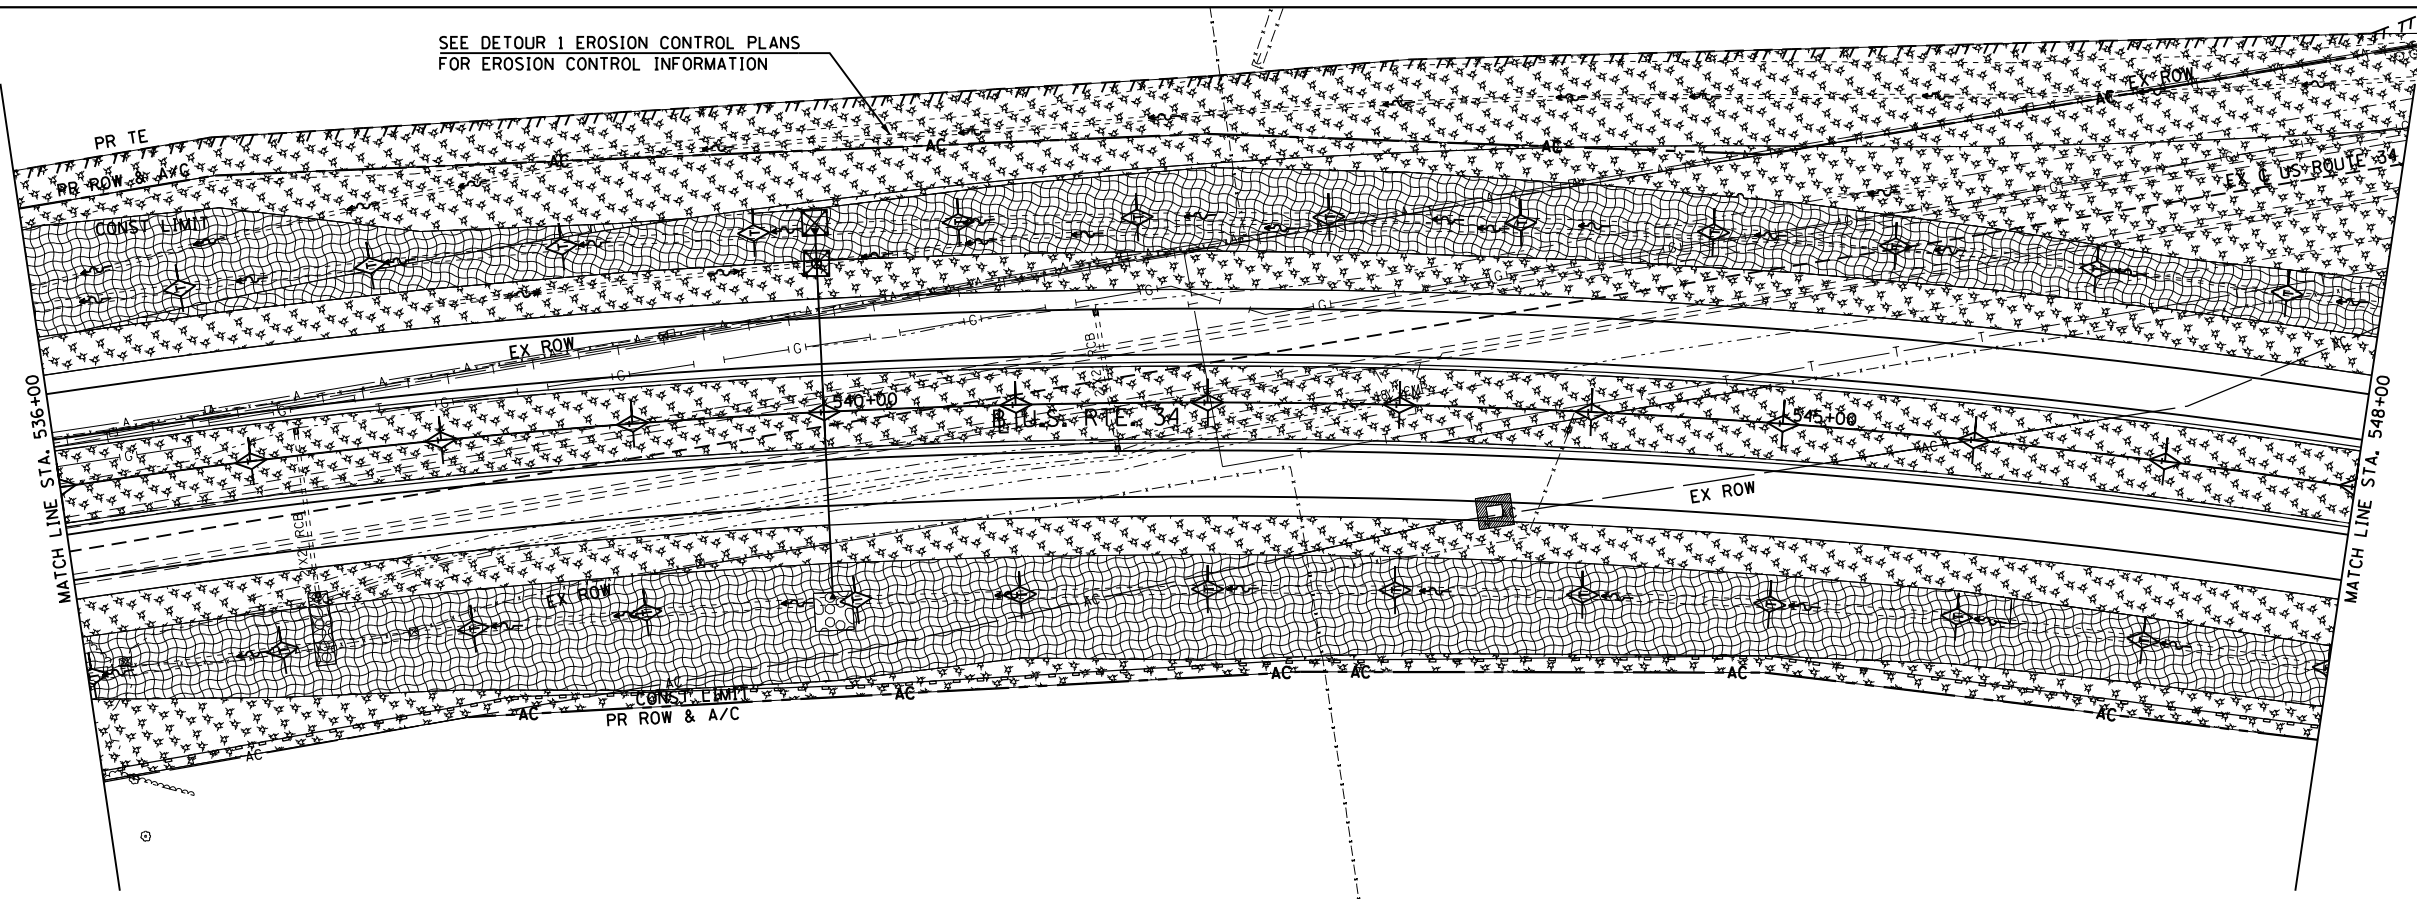


TEMPORARY EROSION CONTROL LEGEND

- INLET AND PIPE PROTECTION
- TEMPORARY DITCH CHECK
- AGGREGATE DITCH CHECK
- EROSION CONTROL BLANKET
- HEAVY DUTY EROSION CONTROL BLANKET
- MULCH METHOD 2
- PERIMETER EROSION BARRIER
- TEMPORARY SEDIMENT BASIN



SEE DETOUR 1 EROSION CONTROL PLANS
FOR EROSION CONTROL INFORMATION

SEE TR 94 EROSION CONTROL PLANS
FOR EROSION CONTROL INFORMATION

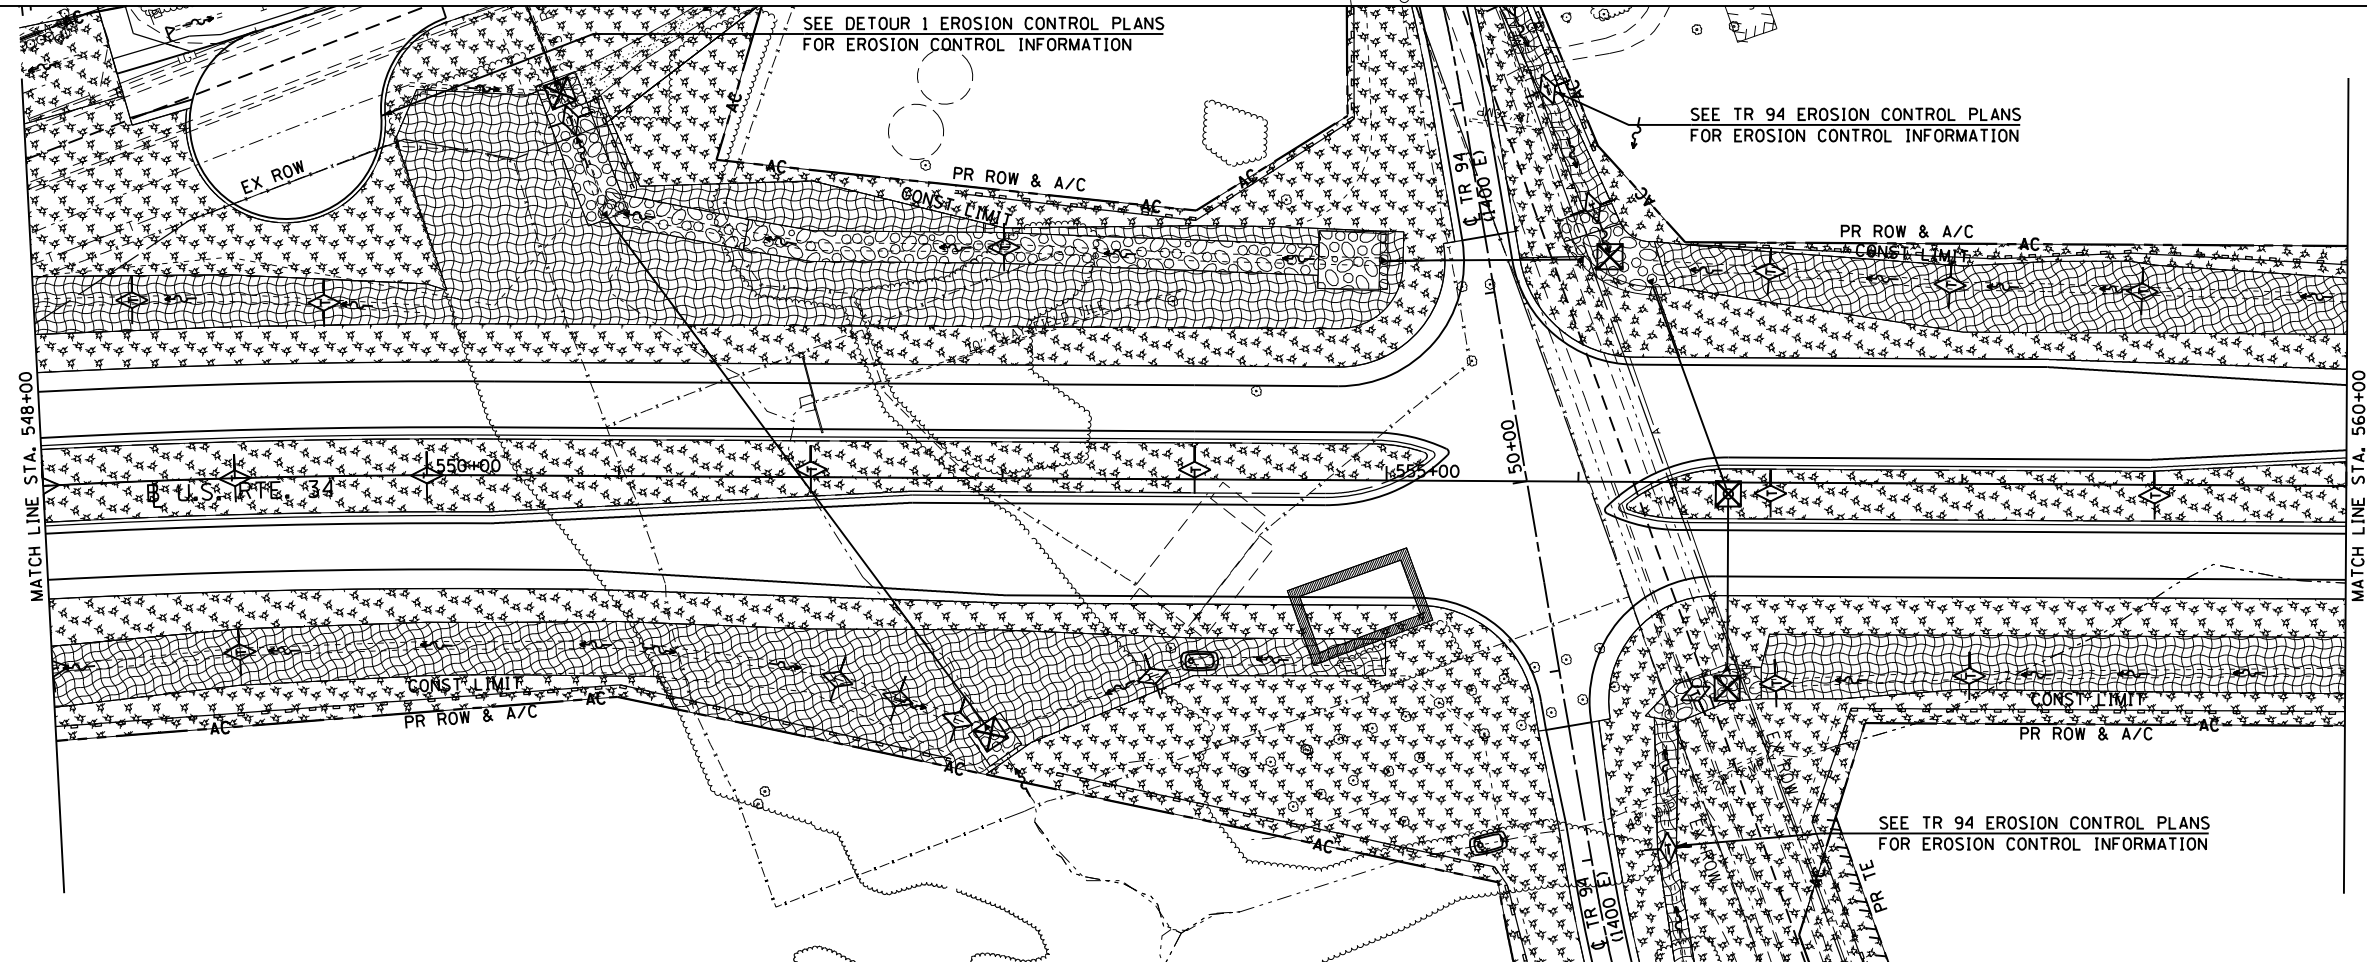

SEE TR 94 EROSION CONTROL PLANS
FOR EROSION CONTROL INFORMATION



FILE NAME =
D468409-SHT-02-EROS-US34.dgn

USER NAME = zachl
PLOT SCALE = 100.0000' / 1" =
PLOT DATE = 10/16/2012

DESIGNED - DBS
DRAWN - PSBA
CHECKED - CSB
DATE - 10/2012

REVISED -
REVISED -
REVISED -
REVISED -

STATE OF ILLINOIS
DEPARTMENT OF TRANSPORTATION

EROSION CONTROL PLANS
US ROUTE 34

SCALE: 1" = 50' SHEET NO. 2 OF 34 SHEETS STA. 536+00 TO STA. 560+00

F.A.P. RTE.	SECTION	COUNTY	TOTAL SHEETS	SHEET NO.
313	7-2 ; 6-1	HENDERSON	976	242
CONTRACT NO. 68409				
ILLINOIS FED. AID PROJECT				