DRAINAGE SHEET WILLOW ROAD STA 649+00 TO STA 661+00 LEFT SYSTEM

SHEET	STRUCTURE	STATION	OFFSET	TYPE	FDAME & CDATE	RIM				INVERT ELE	EVATIONS			
SHEET	NUMBER	STATION	OFFSET	IYPE	FRAME & GRATE	ELEVATION	NORTH	NORTHEAST	EAST	SOUTHEAST	SOUTH	SOUTHWEST	WEST	NORTHWEST
4	4-1	649+03.08	19.8' LT	MH, TYPE A, 6'-DIAMETER	TYPE 1FRAME, CLOSED LID	660.73	656.16				656.16		656.16	
4	4-2	650+08.40	33.3' LT	INLETS, TYPE A	TYPE 24 FRAME AND GRATE	660.01			656.89					
4	4-3	650+51.00	32.1' LT	MH, TYPE A, 4'-DIAMETER	TYPE 24 FRAME AND GRATE	660.07			656.39				656.49	
4	4-4	651+18.78	63.0' LT	MH, TYPE A, 6'-DIAMETER	TYPE 1FRAME, CLOSED LID	660.49			654.10 (EX)		655.10			
4	4-5	651+18.78	48.7' LT	MH, TYPE A, 4'-DIAMETER	TYPE 8 GRATE	658.43	655.18				655.43			
4	4-6	651+18.78	32.0' LT	MH, TYPE A, 4'-DIAMETER	TYPE 24 FRAME AND GRATE	660.29	655.55						655.75	
4	4-7	654+43.72	65.8' LT	MH, TYPE A, 6'-DIAMETER	TYPE 1FRAME, CLOSED LID	659.20			652.40 (EX)		655.09		652.75 (EX)	
4	4-8	654+43.72	43.0' LT	CB, TYPE C	TYPE 23 FRAME AND GRATE	659.27	655.27							
4	4-9	654+95.00	43.0' LT	CB, TYPE C	TYPE 23 FRAME AND GRATE	659.09			655.09					
4	4-10	655+45.00	43.0' LT	MH, TYPE A, 4'-DIAMETER	TYPE 23 FRAME AND GRATE	658.91			654.52				654.62	
4	4-11	655+95.00	39.7' LT	MH, TYPE A, 4'-DIAMETER	TYPE 23 FRAME AND GRATE	658.82	653.85						654.05	
4	4-12	655+95.00	62.2' LT	MH, TYPE A, 5'-DIAMETER	TYPE 1FRAME, CLOSED LID	657.88			652.03 (EX)		653.71		652.04 (EX)	
4	4-13	656+55.00	35.4' LT	INLETS, TYPE A	TYPE 23 FRAME AND GRATE	658.72			654.72					
4	4-14	657+25.77	31.3' LT	CB, TYPE A, 4'-DIAMETER	TYPE 23 FRAME AND GRATE	658.71			653.94				654.04	
4	4-15	657+36.95	58.8' LT	MH, TYPE A, 6'-DIAMETER	TYPE 1FRAME, CLOSED LID	658.29			651.68 (EX)		653.36		651.68 (EX)	
4	4-16	657+36.95	31.0' LT	CB, TYPE A, 4'-DIAMETER	TYPE 23 FRAME AND GRATE	658.72	653.57		653.95				653.87	
4	4-17	657+85.00	29.7' LT	CB, TYPE A, 4'-DIAMETER	TYPE 23 FRAME AND GRATE	658.81			654.49				654.39	
4	4-18	658+35.00	29.0' LT	INLETS, TYPE A	TYPE 23 FRAME AND GRATE	658.96							654.96	
4	4-19	660+00.72	42.3' LT	MANHOLES TO BE ADJUSTED WITH NEW	TYPE 8 GRATE	656.67			MATCH EX				MATCH EX	

NOTE:

- * DRAINAGE STRUCTURE TO BE TURNED SO THA'
 THE FRAME OR GRATE IS CLOSEST TO THE
 CENTERLINE OF THE ROAD.
 - % DRAINAGE STRUCTURE TO BE TURNED SO THAT THE FRAME OR GRATE IS FURTHEST FROM THE CENTERLINE OF THE ROAD.

DRAINAGE SHEET WILLOW ROAD STA 649+00 TO STA 661+00 RIGHT SYSTEM

OUE	STRUCTURE	CTATION	OFFOFT	TVDE	EDAME & ODATE	RIM				INVERT ELE	VATIONS			
SHE	NUMBER	STATION	OFFSET	TYPE	FRAME & GRATE	ELEVATION	NORTH	NORTHEAST	EAST	SOUTHEAST	SOUTH	SOUTHWEST	WEST	NORTHWEST
# 5	5-1A	649+02.82	34.6' RT	MH, TYPE A, 6'-DIAMETER	TYPE 1FRAME, CLOSED LID	660.71	656.13				656.13		656.13	
5	5-1B	649+02.74	49.8' RT	CB, TYPE A, 4'-DIAMETER	TYPE 8 GRATE	659.00	656.20			656.34				
5	5-2			NOT USED	NOT USED									
5	5-3	650+08.33	31.0' RT	INLETS, TYPE A	TYPE 24 FRAME AND GRATE	660.01			656.77					
5	5-4	650+51.00	31.0' RT	MH, TYPE A, 4'-DIAMETER	TYPE 24 FRAME AND GRATE	660.07			656.37				656.37	
5	5-5	651+21.43	53.9' RT	MH, TYPE A, 6'-DIAMETER	TYPE 1FRAME, CLOSED LID	660.07	655.57		654.07 (EX)				654.37 (EX)	
5	5-6	651+21.43	31.0' RT	MH, TYPE A, 4'-DIAMETER	TYPE 24 FRAME AND GRATE	660.28					655.71		655.71	
5	5-7	654+51.13	47.0' RT	MH, TYPE A, 6'-DIAMETER	TYPE 1FRAME, CLOSED LID	659.21	655.44		652.93 (EX)				653.43 (EX)	
5	5-8	654+51.13	29.5' RT	INLETS, TYPE A	TYPE 23 FRAME AND GRATE	659.55					655.55			
5	5-9	655+00.00	29.0' RT	INLETS, TYPE A	TYPE 23 FRAME AND GRATE	659.39			655.51					
5	5-10	655+50.00	29.0' RT	INLETS, TYPE A	TYPE 23 FRAME AND GRATE	659.22			654.94				655.04	
5	5-11	656+00.00	45.7' RT	MH, TYPE A, 5'-DIAMETER	TYPE 1FRAME, CLOSED LID	659.30	654.20		652.70 (EX)				652.70 (EX)	
5	5-12	656+00.00	29.0' RT	INLETS, TYPE A	TYPE 23 FRAME AND GRATE	659.04					654.28		654.48	
5	5-13	656+65.00	29.0' RT	INLETS, TYPE A	TYPE 23 FRAME AND GRATE	658.82			655.16					
5	5-14	657+25.77	29.0' RT	CB, TYPE A, 4'-DIAMETER	TYPE 23 FRAME AND GRATE	658.74			654.48				654.58	
5	5-15	657+43.58	44.5' RT	MH, TYPE A, 6'-DIAMETER	TYPE 1FRAME, CLOSED LID	658.88	653.98		MATCH EX				652.48 (EX)	
5	5-16	657+43.58	29.0' RT	CB, TYPE A, 4'-DIAMETER	TYPE 23 FRAME AND GRATE	658.75			654.37		654.05		654.35	
5	5-17	657+95.00	29.0' RT	INLETS, TYPE A	TYPE 23 FRAME AND GRATE	658.85							654.85	
5	5-18	660+21.16	29.0' RT	CB, TYPE C	TYPE 23 FRAME AND GRATE	658.52					655.02			
5	5-19	660+21.16	45.3' RT	MH, TYPE A, 6'-DIAMETER	TYPE 1FRAME, CLOSED LID	658.10	654.92		651.66 (EX)				651.76 (EX)	

DRAINAGE SHEET WILLOW ROAD STA 661+00 TO STA 672+00 LEFT SYSTEM

SHEET	STRUCTURE	STATION	OFFSET	TYPE	FRAME & CRATE	RIM				INVERT ELE	VATIONS			
SHEET	NUMBER	STATION	OFFSET	ITPE	FRAME & GRATE	ELEVATION	NORTH	NORTHEAST	EAST	SOUTHEAST	SOUTH	SOUTHWEST	WEST	NORTHWEST
6	6-1	661+20.00	42.3' LT	MH, TYPE A, 5'-DIAMETER	TYPE 1FRAME, CLOSED LID	657.88			MATCHEX		653.56		MATCH EX	
6	6-2	661+20.00	29.0' LT	CB, TYPE C	TYPE 23 FRAME AND GRATE	657.63	653.63							
6	6-3	662+46.50	40.8' LT	MH, TYPE A, 6'-DIAMETER	TYPE 1FRAME, CLOSED LID	655.33			649.91(EX)		651.89		650.16 (EX)	
6	6-4	662+46.50	29.0' LT	CB, TYPE C	TYPE 23 FRAME AND GRATE	655.96	651.96							
6	6-5	663+50.00	29.0' LT	CB, TYPE C	TYPE 23 FRAME AND GRATE	654.60			651.31					
6	6-6	664+45.00	38.6' LT	MH, TYPE A, 5'-DIAMETER	TYPE 8 GRATE	652.80			648.68 (EX)		650.18		648.71(EX)	
6	6-7	664+45.00	29.0' LT	MH, TYPE A, 4'-DIAMETER	TYPE 23 FRAME AND GRATE	653.35	650.19						650.39	
6	6-8	664+68.14	39.3' LT	MH, TYPE A, 7'-DIAMETER	TYPE 1FRAME, CLOSED LID	653.06					648.58		648.58 (EX)	
6	6-9	664+68.14	14.0' LT	MH, TYPE A, 7'-DIAMETER	TYPE 1FRAME, CLOSED LID	653.36	648.43		647.93					
6	6-10	36+95.00	28.3' LT	INLETS, TYPE A	TYPE 23 FRAME AND GRATE	652.26					648.76			
6	6-11	36+60.00	28.3' LT	CB, TYPE A, 4'-DIAMETER	TYPE 23 FRAME AND GRATE	652.45	648.44		648.44					
6	6-12A	36+60.00	10.8' RT	MH, TYPE A, 5'-DIAMETER	TYPE 1FRAME, CLOSED LID	651.86			639.99				648.06	
6	6-12B	36+57.00	20.4' RT	MH, TYPE A, 7'-DIAMETER	TYPE 23 FRAME AND GRATE	651.81	648.46 (EX)				639.93		639.93	
6	6-13	665+45.28	14.0' LT	MH, TYPE A, 7'-DIAMETER	TYPE 1FRAME, CLOSED LID	652.40	639.54		639.54		647.45		647.40	
6	6-14	666+40.00	29.0' LT	INLETS, TYPE A	TYPE 23 FRAME AND GRATE	651.11			647.11					
6	6-15	667+05.00	29.0' LT	CB, TYPE A, 4'-DIAMETER	TYPE 23 FRAME AND GRATE	650.59			646.39				646.49	
6	6-16	667+70.00	29.0' LT	CB, TYPE A, 4'-DIAMETER	TYPE 23 FRAME AND GRATE	650.07			644.93		644.63		645.78	
6	6-17			NOT USED	NOT USED									
6	6-18	668+35.00	29.0' LT	INLETS, TYPE A	TYPE 23 FRAME AND GRATE	649.55							645.55	

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STATE	OF	ILLINOIS
DEPARTMENT	0F	TRANSPORTATION

		F.A.P. RTE.	SECTION	COUNTY	TOTAL SHEETS	SHEET NO.
ı	WILLOW ROAD DRAINAGE STRUCTURE TABLES	305	(1920.01,1518,2022&1922.4B)R	COOK	919	201
ı				CONTRACT	NO. 60	T35
	SCALE: N.T.S. SHEET NO. 201 OF 919 SHEETS	FED. R	OAD DIST. NO. 1 ILLINOIS FED. AI	D PROJECT		

DRAINAGE SHEET WILLOW ROAD STA 661+00 TO STA 672+00 LEFT SYSTEM - CONTINUED

OUEET	STRUCTURE	CTATION	OFFOFT	TYPE	FRAME & ORATE	RIM				INVERT ELE	EVATIONS			
SHEET	NUMBER	STATION	OFFSET	IYPE	FRAME & GRATE	ELEVATION	NORTH	NORTHEAST	EAST	SOUTHEAST	SOUTH	SOUTHWEST	WEST	NORTHWEST
6	6-19	666+15.00	29.0' RT	INLETS, TYPE A	TYPE 23 FRAME AND GRATE	651.74			647.74					
6	6-20	667+00.00	29.0' RT	CB, TYPE A, 4'-DIAMETER	TYPE 23 FRAME AND GRATE	650.76			643.92	646.59			646.92	
6	6-21	667+10.00	38.5' RT	MH, TYPE A, 4'-DIAMETER	TYPE 1FRAME, CLOSED LID	650.83						646.67 (EX)		646.67
6	6-22	667+70.00	29.0' RT	CB, TYPE A, 4'-DIAMETER	TYPE 23 FRAME AND GRATE	649.96	643.06						643.26	
6	6-23	667+70.00	14.0' LT	MH, TYPE A, 6'-DIAMETER	TYPE 1FRAME, CLOSED LID	650.39	644.49		637.94		642.68		638.44	
6	6-24	668+35.00	29.0' RT	INLETS, TYPE A	TYPE 23 FRAME AND GRATE	649.30			645.30				645.40	
6	6-25	668+95.00	40.8' RT	INLETS, TYPE A	TYPE 8 GRATE	648.29	645.29							
6	6-26	668+95.00	28.9' RT	CB, TYPE A, 4'-DIAMETER	TYPE 23 FRAME AND GRATE	648.78	643.30		643.60		645.22		644.73	
6	6-27	668+95.00	13.9' LT	MH, TYPE A, 6'-DIAMETER	TYPE 1FRAME, CLOSED LID	649.39			637.35		642.92		637.35	
6	6-28	669+60.00	27.7' RT	CB, TYPE A, 4'-DIAMETER	TYPE 23 FRAME AND GRATE	648.25				644.41			644.21	
6	6-29	669+75.00	46.5' RT	INLETS, TYPE A	TYPE 8 GRATE	646.60								644.60
6	6-30	669+55.00	39.4' LT	INLETS, TYPE A	TYPE 23 FRAME AND GRATE	648.28			644.28					
6	6-31	670+23.51	38.6' LT	CB, TYPE A, 4'-DIAMETER	TYPE 23 FRAME AND GRATE	647.78			643.52				643.62	
6	6-32	670+35.00	38.6' LT	CB, TYPE A, 4'-DIAMETER	TYPE 23 FRAME AND GRATE	647.83					643.25		643.45	
: 6	6-33	670+35.00	11.3' LT	MH, TYPE A, 6'-DIAMETER	TYPE 1FRAME, CLOSED LID	648.28	643.03		636.68				636.68	
6	6-34	670+85.00	27.0' RT	INLETS, TYPE A	TYPE 23 FRAME AND GRATE	647.24			643.24					
6	6-35	671+20.00	27.0' RT	CB, TYPE A, 4'-DIAMETER	TYPE 23 FRAME AND GRATE	646.96			642.82				642.92	
6	6-36	671+50.00	39.0' RT	INLETS, TYPE A	TYPE 8 GRATE	646.20	643.20							
6	6-37	671+50.00	27.0' RT	CB, TYPE A, 4'-DIAMETER	TYPE 23 FRAME AND GRATE	646.59			642.37		643.13		642.57	

NOTE:

- * DRAINAGE STRUCTURE TO BE TURNED SO THAT THE FRAME OR GRATE IS CLOSEST TO THE CENTERLINE OF THE ROAD.
 - % DRAINAGE STRUCTURE TO BE TURNED SO THA THE FRAME OR GRATE IS FURTHEST FROM TH CENTERLINE OF THE ROAD.

DRAINAGE SHEET WILLOW ROAD STA 661+00 TO STA 672+00 RIGHT SYSTEM

SHEET	STRUCTURE	STATION	OFFSET	TYPE	FRAME & GRATE	RIM				INVERT EL	EVATIONS			
SHEET	NUMBER	STATION	OFFSET	ITPE	FRAINE & GRATE	ELEVATION	NORTH	NORTHEAST	EAST	SOUTHEAST	SOUTH	SOUTHWEST	WEST	NORTHWEST
7	7-1	661+00.00	29.0' RT	INLETS, TYPE A	TYPE 23 FRAME AND GRATE	657.66			653.66					
7	7-2	661+70.00	45.0' RT	MH, TYPE A, 5'-DIAMETER	TYPE 1FRAME, CLOSED LID	655.90	652.71		650.57 (EX)				650.61(EX)	
7	7-3	661+70.00	29.0' RT	CB, TYPE A, 4'-DIAMETER	TYPE 23 FRAME AND GRATE	656.85					652.79		652.99	
7	7-4	662+49.39	44.9' RT	MH, TYPE A, 6'-DIAMETER	TYPE 1FRAME, CLOSED LID	654.93	651.76		649.51(EX)				650.05 (EX)	
7	7-5	662+55.00	29.0' RT	CB, TYPE C	TYPE 23 FRAME AND GRATE	655.88					651.88			
7	7-6	663+15.00	29.0' RT	INLETS, TYPE A	TYPE 23 FRAME AND GRATE	655.19			651.27					
7	7-7	663+80.00	29.0' RT	CB, TYPE A, 4'-DIAMETER	TYPE 23 FRAME AND GRATE	654.44			650.55				650.65	
7	7-8	664+45.00	29.0' RT	CB, TYPE A, 4'-DIAMETER	TYPE 23 FRAME AND GRATE	653.69					649.74		649.94	
7	7-9	35+20.00	20.5' LT	INLETS, TYPE A	TYPE 23 FRAME AND GRATE	652.73	649.32							
7	7-10	35+31.30	22.0' LT	MH, TYPE A, 4'-DIAMETER	TYPE 23 FRAME AND GRATE	652.70			649.24		649.24			
7	7-11	664+78.63	38.8' RT	MH, TYPE A, 6'-DIAMETER	TYPE 1FRAME, CLOSED LID	653.65			648.27		649.87 (EX)		649.27 (EX)	
7	7-12	35+28.00	16.5' RT	INLETS, TYPE A	TYPE 23 FRAME AND GRATE	652.35	648.93							
7	7-13	35+39.37	16.5' RT	CB, TYPE A, 4'-DIAMETER	TYPE 23 FRAME AND GRATE	652.31	648.84				648.84		648.84	
7	7-14	665+44.61	37.5' RT	MH, TYPE A, 7'-DIAMETER	TYPE 1FRAME, CLOSED LID	652.46	647.67				648.67		647.97	

DRAINAGE SHEET WILLOW ROAD STA 672+00 TO STA 683+00

0115	STRUCTURE	OTATION	OFFOFT	TYPE	EDAME A ODATE	RIM				INVERT ELE	EVATIONS			
SHE	NUMBER	STATION	OFFSET	TYPE	FRAME & GRATE	ELEVATION	NORTH	NORTHEAST	EAST	SOUTHEAST	SOUTH	SOUTHWEST	WEST	NORTHWEST
8	8-1	672+05.00	27.0' RT	CB, TYPE A, 4'-DIAMETER	TYPE 23 FRAME AND GRATE	646.05	641.67						641.87	
# 8	8-2	672+05.00	11.3' LT	MH, TYPE A, 6'-DIAMETER	TYPE 1FRAME, CLOSED LID	647.18			635.85		641.30		635.85	
8	8-3	673+20.00	37.2' RT	INLETS, TYPE A	TYPE 8 GRATE	644.75	641.75							
8	8-4	673+20.00	27.0' RT	MH, TYPE A, 4'-DIAMETER	TYPE 23 FRAME AND GRATE	645.13			641.48		641.68			
# 8	8-5	673+55.41	52.4' LT	CB, TYPE A, 4'-DIAMETER	TYPE 8 GRATE	644.50			641.53		641.33			
# 8	8-6	673+55.41	11.3' LT	MH, TYPE A, 6'-DIAMETER	TYPE 1FRAME, CLOSED LID	645.98	640.98		635.12		641.77		635.12	
% 8	8-7	673+55.41	6.0' LT	CB, TYPE C	TYPE 11V FRAME AND GRATE	645.81	641.81							
8	8-8	674+10.00	27.0' RT	CB, TYPE A, 4'-DIAMETER	TYPE 23 FRAME AND GRATE	644.41			640.55				640.65	
8	8-9	674+00.00	63.0' LT	INLETS, TYPE A	TYPE 8 GRATE	644.98							641.98	
8	8-10	674+95.00	27.0' RT	CB, TYPE A, 4'-DIAMETER	TYPE 23 FRAME AND GRATE	643.73	639.56						639.76	
% 8	8-11	674+95.00	6.0' LT	CB, TYPE A, 4'-DIAMETER	TYPE 11V FRAME AND GRATE	644.69	639.17				639.27			
# 8	8-12	674+95.00	11.3' LT	MH, TYPE A, 6'-DIAMETER	TYPE 1FRAME, CLOSED LID	644.86			632.45		639.13		634.45	
8	8-13	676+00.00	37.2' RT	INLETS, TYPE A	TYPE 8 GRATE	642.48		639.48						
8	8-14	676+00.00	27.0' RT	CB, TYPE A, 4'-DIAMETER	TYPE 23 FRAME AND GRATE	642.89		639.31				639.41		
% 8	8-15	676+00.00	6.0' LT	CB, TYPE A, 4'-DIAMETER	TYPE 11V FRAME AND GRATE	643.85		638.92				639.02		
8	8-16	676+00.00	21.8' LT	MH, TYPE A, 6'-DIAMETER	TYPE 1FRAME, CLOSED LID	644.35				631.94		638.81	631.94	
8	8-17	677+00.00	27.0' RT	CB, TYPE C	TYPE 23 FRAME AND GRATE	642.09		638.09						
% 8	8-18	677+00.00	6.0' LT	CB, TYPE A, 4'-DIAMETER	TYPE 11V FRAME AND GRATE	643.05		637.70				637.80		
8	8-19	677+00.00	21.8' LT	MH, TYPE A, 6'-DIAMETER	TYPE 1FRAME, CLOSED LID	643.55				631.46		637.59		631.46
8	8-20	678+00.00	27.0' RT	CB, TYPE A, 4'-DIAMETER	TYPE 23 FRAME AND GRATE	641.29		636.42					636.62	
% 8	8-21	678+00.00	6.0' LT	CB, TYPE A, 4'-DIAMETER	TYPE 11V FRAME AND GRATE	642.25		636.03				636.13		
8	8-22	678+00.00	21.8' LT	MH, TYPE A, 6'-DIAMETER	TYPE 1FRAME, CLOSED LID	642.75		636.92		630.98		635.92		630.98
8	8-23	678+00.00	39.6' LT	CB, TYPE C	TYPE 8 GRATE	640.08						637.08		
% 8	8-24	678+90.00	6.0' LT	CB, TYPE C	TYPE 11V FRAME AND GRATE	641.53		637.53						
8	8-25	678+90.00	21.8' LT	MH, TYPE A, 6'-DIAMETER	TYPE 1FRAME, CLOSED LID	642.03				630.55		637.42		630.55

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	PLOT SCALE = 100.00000 '/ in.	CHECKED -	-	RCB	REVISED -	
	PLOT DATE = 11/30/2012	DATE -	-	10/31/2012	REVISED -	٦

STATE OF ILLINOIS DEPARTMENT OF TRANSPORTATION

		F.A.P. RTE.	SECTION	COUNTY	TOTAL SHEETS	SHEET NO.
ı	WILLOW ROAD DRAINAGE STRUCTURE TABLES	305	(1920.01,1518,2022&1922.4B)R	COOK	919	202
ı				CONTRACT	NO. 60	T35
	SCALE: N.T.S. SHEET NO. 202 OF 919 SHEETS	FED. F	OAD DIST. NO. 1 ILLINOIS FED. AI	D PROJECT		

DRAINAGE SHEET WILLOW ROAD STA 672+00 TO STA 683+00 - CONTINUED

SHEET	STRUCTURE	STATION	OFFSET	TYPE	FRAME & GRATE	RIM				INVERT ELE	EVATIONS			
SHEET	NUMBER	STATION	OFFSET	ITPE	FRAIVIE & GRATE	ELEVATION	NORTH	NORTHEAST	EAST	SOUTHEAST	SOUTH	SOUTHWEST	WEST	NORTHWEST
8	8-26	679+00.00	36.8' RT	CB, TYPE C	TYPE 8 GRATE	640.10			637.10					
8	8-27	679+10.00	27.0' RT	INLETS, TYPE A	TYPE 23 FRAME AND GRATE	640.41				636.41				
8	8-28	680+05.00	27.0' RT	CB, TYPE A, 4'-DIAMETER	TYPE 23 FRAME AND GRATE	639.88		635.31						635.51
8	8-29	680+05.00	21.8' LT	MH, TYPE A, 6'-DIAMETER	TYPE 1FRAME, CLOSED LID	640.51				630.00		634.87		630.00
8	8-30	680+50.00	27.0' LT	INLETS, TYPE A	TYPE 23 FRAME AND GRATE	640.02				636.02				
8	8-31	680+75.00	27.0' RT	INLETS, TYPE A	TYPE 23 FRAME AND GRATE	639.32				635.32				
8	8-32	681+00.00	27.0' LT	CB, TYPE A, 4'-DIAMETER	TYPE 23 FRAME AND GRATE	639.41				635.45				635.55
8	8-33	681+45.00	39.1' RT	CB, TYPE C	TYPE 8 GRATE	638.20		635.20						
8	8-34	681+45.00	27.0' RT	CB, TYPE A, 4'-DIAMETER	TYPE 23 FRAME AND GRATE	638.76				634.45		635.13		634.65
8	8-35	681+55.00	27.0' LT	CB, TYPE A, 4'-DIAMETER	TYPE 23 FRAME AND GRATE	638.97		635.21		634.74				634.94
8	8-36	681+55.00	36.2' LT	CB, TYPE C	TYPE 8 GRATE	638.25						635.25		
8	8-37	682+00.00	27.0' RT	CB, TYPE A, 4'-DIAMETER	TYPE 23 FRAME AND GRATE	638.32				633.84				633.94
8	8-38	682+35.00	27.0' LT	CB, TYPE A, 4'-DIAMETER	TYPE 23 FRAME AND GRATE	638.33						633.78		633.98
8	8-39	682+35.00	27.0' RT	CB, TYPE A, 4'-DIAMETER	TYPE 23 FRAME AND GRATE	638.04		632.69		632.99				633.53
8	8-40	682+35.00	4.3' LT	CB, TYPE A, 4'-DIAMETER	TYPE 23 FRAME AND GRATE	638.73		632.32				632.42		
8	8-41	682+35.00	27.0' LT	MH, TYPE A, 6'-DIAMETER	TYPE 1FRAME, CLOSED LID	638.44		633.74		628.88		632.19		628.88
8	8-42	682+95.00	27.0' RT	INLETS, TYPE A	TYPE 23 FRAME AND GRATE	637.56								633.56

NOTE:

- * DRAINAGE STRUCTURE TO BE TURNED SO THAT THE FRAME OR GRATE IS CLOSEST TO THE CENTERLINE OF THE ROAD.
- % DRAINAGE STRUCTURE TO BE TURNED SO THA THE FRAME OR GRATE IS FURTHEST FROM TH CENTERLINE OF THE ROAD.

DRAINAGE SHEET WILLOW ROAD STA 683+00 TO STA 693+00 LEFT SYSTEM

	STRUCTURE			AGE SHEET WILLOW KUA		RIM				INVERT EL	EV/ATIONS		
SHEET	NUMBER	STATION	OFFSET	TYPE	FRAME & GRATE	ELEVATION	NORTH	NORTHEAST	EAST	SOUTHEAST	SOUTH SOUTHV	EST WEST	Γ NORTHWEST
9	9-1	683+00.00	27.0' LT	INLETS, TYPE A	TYPE 23 FRAME AND GRATE	637.81				633.81			
9	9-2	683+55.00	27.0' RT	INLETS, TYPE A	TYPE 23 FRAME AND GRATE	637.37				633.37			
9	9-3	683+75.00	38.6' LT	CB, TYPE C	TYPE 8 GRATE	634.70					631.7)	
9	9-4	683+75.00	27.0' LT	CB, TYPE A, 4'-DIAMETER	TYPE 23 FRAME AND GRATE	637.12		631.63		631.33			633.09
9	9-5	684+15.00	39.5' RT	CB, TYPE C	TYPE 8 GRATE	635.50		632.50					
9	9-6	684+15.00	27.0' RT	CB, TYPE A, 4'-DIAMETER	TYPE 23 FRAME AND GRATE	636.60				632.11	632.4	1	632.80
9	9-7	684+50.00	27.0' LT	CB, TYPE A, 4'-DIAMETER	TYPE 23 FRAME AND GRATE	636.61				630.52			630.62
9	9-8	684+75.00	27.0' RT	CB, TYPE A, 4'-DIAMETER	TYPE 23 FRAME AND GRATE	636.12				631.45			631.55
9	9-9	685+30.00	27.0' LT	CB, TYPE A, 4'-DIAMETER	TYPE 23 FRAME AND GRATE	635.97					629.5	3	629.76
9	9-10	685+30.00	21.8' LT	MH, TYPE A, 6'-DIAMETER	TYPE 1FRAME, CLOSED LID	636.08		629.52		627.43	629.6	9	627.43
9	9-11	685+40.00	46.5' RT	CB, TYPE C	TYPE 8 GRATE	633.60		630.60					
9	9-12	685+30.00	27.0' RT	CB, TYPE A, 4'-DIAMETER	TYPE 23 FRAME AND GRATE	635.68		630.13			630.4	3	630.94
9	9-13	685+85.00	27.0' RT	INLETS, TYPE A	TYPE 23 FRAME AND GRATE	635.24				631.24			
9	9-14	686+10.00	36.5' LT	CB, TYPE C	TYPE 8 GRATE	634.20					631.2)	
9	9-15	686+10.00	27.0' LT	CB, TYPE A, 4'-DIAMETER	TYPE 23 FRAME AND GRATE	635.33		631.16		630.96			
9	9-16	686+95.00	27.0' LT	CB, TYPE A, 4'-DIAMETER	TYPE 23 FRAME AND GRATE	634.65					629.9	5	630.15
9	9-17	686+95.00	21.8' LT	MH, TYPE A, 7'-DIAMETER	TYPE 1FRAME, CLOSED LID	634.76		629.90		625.64	629.5	1	626.64
9	9-18	686+95.00	38.5' RT	CB, TYPE C	TYPE 8 GRATE	633.20		630.20					
9	9-19	686+95.00	27.0' RT	CB, TYPE A, 4'-DIAMETER	TYPE 23 FRAME AND GRATE	634.44		629.94		630.36	630.1	4	630.17
9	9-20	687+65.00	27.0' LT	CB, TYPE C	TYPE 23 FRAME AND GRATE	634.14					630.1	4	
9	9-21	687+65.00	21.7' LT	MH, TYPE A, 7'-DIAMETER	TYPE 1FRAME, CLOSED LID	634.25		630.10		625.41	629.7	9	625.51
9	9-22	687+65.00	6.0' RT	CB, TYPE A, 4'-DIAMETER	TYPE 11V FRAME AND GRATE	634.47		629.97		630.17			
9	9-23	687+95.34	6.0' RT	CB, TYPE C	TYPE 11V FRAME AND GRATE	634.44							630.44
9	9-24	688+52.32	27.0' LT	CB, TYPE C	TYPE 23 FRAME AND GRATE	633.67				629.67			
9	9-25	688+90.00	46.5' LT	INLETS, TYPE A	TYPE 8 GRATE	630.35					627.3	5	
9	9-26	688+83.00	27.0' LT	CB, TYPE A, 4'-DIAMETER	TYPE 23 FRAME AND GRATE	633.70		627.19			626.8	9	629.40
9	9-27	688+83.00	21.8' LT	MH, TYPE A, 7'-DIAMETER	TYPE 1FRAME, CLOSED LID	633.87		626.85		625.09			625.19
9	9-28	689+80.00	27.0' LT	CB, TYPE C	TYPE 23 FRAME AND GRATE	634.18					630.1	3	
9	9-29	689+80.00	21.7' LT	MH, TYPE A, 7'-DIAMETER	TYPE 1FRAME, CLOSED LID	634.35		630.14		624.82			624.92
9	9-30	690+90.00	21.8' LT	MH, TYPE A, 7'-DIAMETER	TYPE 1 FRAME, CLOSED LID	635.20				624.52			624.62
9	9-31	691+75.00	40.7' LT	CB, TYPE C	TYPE 8 GRATE	635.38					632.3	3	
9	9-32	691+75.00	21.7' LT	MH, TYPE A, 7'-DIAMETER	TYPE 1FRAME, CLOSED LID	635.82		632.21	624.26				624.36
9	9-33	687+07.00	27.0' RT	INLETS, TYPE A	TYPE 23 FRAME AND GRATE	634.45							630.45

DRAINAGE SHEET WILLOW ROAD STA 683+00 TO STA 693+00 RIGHT SYSTEM

	SHEET	STRUCTURE	STATION	OFFSET	TYPE	FRAME & GRATE	RIM				INVERT ELE	EVATIONS			
	SHEET	NUMBER	STATION	OFFSET	ITPE	FRAIVIE & GRATE	ELEVATION	NORTH	NORTHEAST	EAST	SOUTHEAST	SOUTH	SOUTHWEST	WEST	NORTHWEST
	10	10-1	688+58.22	39.8' RT	CB, TYPE A, 5'-DIAMETER	TYPE 8 GRATE	632.35		627.81					628.07 (EX)	
#	10	10-2	688+58.22	11.2' RT	MH, TYPE A, 7'-DIAMETER	TYPE 1FRAME, CLOSED LID	634.75				627.12		627.62		
	10	10-3	690+25.02	40.5' RT	CB, TYPE A, 4'-DIAMETER	TYPE 8 GRATE	633.25		630.64				630.74 (EX)		
# [10	10-4	690+25.02	11.2' RT	MH, TYPE A, 6'-DIAMETER	TYPE 1FRAME, CLOSED LID	635.81				626.76		630.42		626.86
# [10	10-5	691+90.00	11.3' RT	MH, TYPE A, 7'-DIAMETER	TYPE 1FRAME, CLOSED LID	636.69			625.10					626.60

FILE NAME =	USER NAME = BAWitort	DESIGNED -	JLV	REVISED	-
G:\CHII\0158\Road\Sheets\D160T35-SHT-DR	IN-101.dgn	DRAWN -	KAL	REVISED	-
	PLOT SCALE = 100.00000 '/ in.	CHECKED -	RCB	REVISED	-
	PLOT DATE = 11/30/2012	DATE -	10/31/2012	REVISED	-

	F.A.P. RTE.	SECTION	COUNTY	TOTAL SHEETS	SHEET NO.
WILLOW ROAD DRAINAGE STRUCTURE TABLES	305	(1920.01,1518,2022&1922.4B)R	COOK	919	203
			CONTRACT	NO. 60	T35
SCALE: N.T.S. SHEET NO. 203 OF 919 SHEETS	FED. R	OAD DIST. NO. 1 ILLINOIS FED. AI	D PROJECT		

DRAINAGE SHEET WILLOW ROAD STA 693+00 TO STA 704+00 LEFT SYSTEM

		STRUCTURE	07471011	055057	TVDE	EDAME A ODATE	RIM				INVERT ELE	VATIONS			
SF	IEET	NUMBER	STATION	OFFSET	TYPE	FRAME & GRATE	ELEVATION	NORTH	NORTHEAST	EAST	SOUTHEAST	SOUTH	SOUTHWEST	WEST	NORTHWEST
	11	11-1	693+46.86	39.6' LT	MH, TYPE A, 6'-DIAMETER	TYPE 1FRAME, CLOSED LID	635.45	MATCHEX				625.63			
	11	11-2	693+47.30	24.8' LT	MH, TYPE A, 9'-DIAMETER	TYPE 1FRAME, CLOSED LID	635.34	625.68		623.84		625.72		623.94	
	11	11-3	694+40.00	43.6' LT	INLETS, TYPE A	TYPE 8 GRATE	633.90					630.90			
	11	11-4	694+40.00	30.0' LT	CB, TYPE A, 4'-DIAMETER	TYPE 23 FRAME AND GRATE	634.50	630.81				630.71			
	11	11-5	694+40.00	24.8' LT	MH, TYPE A, 7'-DIAMETER	TYPE 1FRAME, CLOSED LID	634.67	630.67		623.58				623.68	
	11	11-6	695+20.00	30.0' LT	INLETS, TYPE A	TYPE 23 FRAME AND GRATE	633.91			629.91					
	11	11-7	696+00.00	30.0' LT	CB, TYPE A, 4'-DIAMETER	TYPE 23 FRAME AND GRATE	633.39					628.97		629.17	
#	11	11-8	696+00.00	14.3' LT	MH, TYPE A, 8'-DIAMETER	TYPE 1FRAME, CLOSED LID	633.84	628.88		623.18				623.28	
	11	11-9	86+59.74	17.7' LT	INLETS, TYPE A	TYPE 23 FRAME AND GRATE	632.95			628.95					
	11	11-10	86+59.74	21.1' RT	CB, TYPE A, 4'-DIAMETER	TYPE 23 FRAME AND GRATE	632.74				628.36			628.56	
	11	11-11	697+10.00	35.5' LT	CB, TYPE A, 4'-DIAMETER	TYPE 23 FRAME AND GRATE	632.67					627.92			628.12
#	11	11-12	697+10.00	14.0' LT	MH, TYPE A, 7'-DIAMETER	TYPE 1FRAME, CLOSED LID	633.09	627.77		622.88				622.98	
	11	11-13	697+75.00	29.0' LT	INLETS, TYPE A	TYPE 23 FRAME AND GRATE	632.29			628.29					
	11	11-14	698+15.00	29.0' LT	CB, TYPE A, 4'-DIAMETER	TYPE 23 FRAME AND GRATE	632.02			627.82				627.92	
	11	11-15	698+55.00	29.0' LT	CB, TYPE A, 4'-DIAMETER	TYPE 23 FRAME AND GRATE	631.78			627.36				627.46	
	11	11-16	698+95.00	29.0' LT	CB, TYPE A, 4'-DIAMETER	TYPE 23 FRAME AND GRATE	631.57			627.03		626.70		627.00	
#	11	11-17	698+95.00	14.0' LT	MH, TYPE A, 8'-DIAMETER	TYPE 1FRAME, CLOSED LID	631.89	626.62		622.02				622.52	
	11	11-18	699+35.00	29.0' LT	INLETS, TYPE A	TYPE 23 FRAME AND GRATE	631.40							627.40	
	11	11-19	699+75.00	29.0' LT	INLETS, TYPE A	TYPE 23 FRAME AND GRATE	631.26			627.26					
	11	11-20	700+15.00	29.0' LT	CB, TYPE A, 4'-DIAMETER	TYPE 23 FRAME AND GRATE	631.14			626.79				626.89	
	11	11-21	700+55.00	28.8' LT	CB, TYPE A, 4'-DIAMETER	TYPE 23 FRAME AND GRATE	631.02			626.33				626.43	
	11	11-22			NOT USED	NOT USED									
	11	11-23	701+00.00	27.8' LT	CB, TYPE A, 4'-DIAMETER	TYPE 23 FRAME AND GRATE	630.89			626.33		625.62		625.92	
#	11	11-24	701+00.00	12.8' LT	MH, TYPE A, 8'-DIAMETER	TYPE 1FRAME, CLOSED LID	631.21	625.54		621.72				621.72	
	11	11-25	701+45.00	26.9' LT	INLETS, TYPE A	TYPE 23 FRAME AND GRATE	630.75							626.75	
	11	11-26	701+85.00	26.0' LT	INLETS, TYPE A	TYPE 23 FRAME AND GRATE	630.63			626.63					
	11	11-27	702+30.00	26.0' LT	CB, TYPE A, 4'-DIAMETER	TYPE 23 FRAME AND GRATE	630.50			626.11				626.21	
	11	11-28	702+75.00	26.0' LT	CB, TYPE A, 4'-DIAMETER	TYPE 23 FRAME AND GRATE	630.38			625.60				625.70	
	11	11-29	703+00.00	26.0' LT	CB, TYPE A, 4'-DIAMETER	TYPE 23 FRAME AND GRATE	630.35			625.29				625.39	
	11	11-30	703+20.00	26.0' LT	CB, TYPE A, 4'-DIAMETER	TYPE 23 FRAME AND GRATE	630.34			625.92		624.83		625.13	
#	11	11-31	703+20.00	11.0' LT	MH, TYPE A, 8'-DIAMETER	TYPE 1FRAME, CLOSED LID	630.66	624.75		621.41				621.41	
	11	11-32	703+70.00	26.0' LT	INLETS, TYPE A	TYPE 23 FRAME AND GRATE	630.39							626.39	

NOTE:

- THE FRAME OR GRATE IS CLOSEST TO THE CENTERLINE OF THE ROAD.
- % DRAINAGE STRUCTURE TO BE TURNED SO THAT THE FRAME OR GRATE IS FURTHEST FROM THE CENTERLINE OF THE ROAD.

DRAINAGE SHEET WILLOW ROAD STA 693+00 TO STA 704+00 RIGHT SYSTEM

SHEET	STRUCTURE	CTATION	OFFOFT	TVDE	EDAME & ODATE	RIM				INVERT EL	EVATIONS			
SHEET	NUMBER	STATION	OFFSET	TYPE	FRAME & GRATE	ELEVATION	NORTH	NORTHEAST	EAST	SOUTHEAST	SOUTH	SOUTHWEST	WEST	NORTHWES
12	12-1	693+49.19	32.6' RT	MH, TYPE A, 5'-DIAMETER	TYPE 1FRAME, CLOSED LID	636.84	625.96				628.46 (EX)			
12	12-2	693+48.61	14.3' RT	MH, TYPE A, 9'-DIAMETER	TYPE 1FRAME, CLOSED LID	635.86	625.87		624.69		625.92		624.79	
12	12-3	693+64.74	39.4' RT	MH, TYPE A, 4'-DIAMETER	TYPE 1FRAME, CLOSED LID	635.53	625.12			631.67	625.32 (EX)			
12	12-4	693+64.74	14.2' RT	MH, TYPE A, 8'-DIAMETER	TYPE 1FRAME, CLOSED LID	635.75	631.41		624.18		624.97		624.68	
12	12-5	693+64.74	4.7' RT	CB, TYPE C	TYPE 11V FRAME AND GRATE	635.49					631.49			
12	12-6	694+00.00	46.7' RT	CB, TYPE C	TYPE 8 GRATE	635.02								632.02
12	12-7	694+05.00	2.1' RT	INLETS, TYPE A	TYPE 11V FRAME AND GRATE	635.14			631.14					
12	12-8	694+45.00	14.2' RT	MH, TYPE A, 8'-DIAMETER	TYPE 1FRAME, CLOSED LID	635.16	630.43		624.03				624.03	
12	12-9	694+45.00	0.5' LT	CB, TYPE A, 4'-DIAMETER	TYPE 11V FRAME AND GRATE	634.80					630.57		630.77	
12	12-10	694+90.00	1.0' LT	INLETS, TYPE A	TYPE 11V FRAME AND GRATE	634.46			630.46					
12	12-11	695+35.00	1.0' LT	CB, TYPE A, 4'-DIAMETER	TYPE 11V FRAME AND GRATE	634.13			629.94				630.04	
12	12-12	695+75.00	42.0' RT	CB, TYPE C	TYPE 8 GRATE	632.43	629.43							
12	12-13	695+75.00	14.2' RT	MH, TYPE A, 8'-DIAMETER	TYPE 1 FRAME, CLOSED LID	633.48	629.00		623.78		629.23		623.78	
12	12-14	696+75.00	1.0' LT	CB, TYPE A, 4'-DIAMETER	TYPE 11V FRAME AND GRATE	633.11			629.44		629.14		629.58	
12	12-15	696+00.00	1.0' LT	INLETS, TYPE A	TYPE 11V FRAME AND GRATE	633.66							629.66	
12	12-16	85+30.00	30.4' LT	MH, TYPE A, 6'-DIAMETER	TYPE 8 GRATE	632.10		625.11			MATCHEX			
12	12-17	85+30.04	19.6' LT	CB, TYPE A, 4'-DIAMETER	TYPE 23 FRAME AND GRATE	633.75			624.88			625.08		
12	12-18	85+30.04	12.1' RT	MH, TYPE A, 6'-DIAMETER	TYPE 1FRAME, CLOSED LID	633.65	623.80		624.80				624.30	
12	12-19	85+30.04	18.2' RT	CB, TYPE A, 4'-DIAMETER	TYPE 24 FRAME AND GRATE	633.52					MATCHEX		624.91	
12	12-20	696+83.65	14.1' RT	MH, TYPE A, 9'-DIAMETER	TYPE 1FRAME, CLOSED LID	633.21			623.58		623.58		623.58	
12	12-21	697+05.00	32.8' RT	INLETS, TYPE A	TYPE 23 FRAME AND GRATE	632.78			628.78					
12	12-22	697+70.00	29.0' RT	CB, TYPE A, 4'-DIAMETER	TYPE 23 FRAME AND GRATE	632.20	627.96						628.16	
12	12-23	697+70.00	14.0' RT	MH, TYPE A, 8'-DIAMETER	TYPE 1FRAME, CLOSED LID	632.52			623.42		627.88		623.42	
12	12-24	698+30.00	29.0' RT	INLETS, TYPE A	TYPE 23 FRAME AND GRATE	631.84			627.84					
12	12-25	698+90.00	29.0' RT	CB, TYPE A, 4'-DIAMETER	TYPE 23 FRAME AND GRATE	631.55			627.17				627.27	
12	12-26	699+50.00	40.0' RT	MH, TYPE A, 4'-DIAMETER	TYPE 8 GRATE	630.00	627.23			627.43				
12	12-27	699+50.00	29.0' RT	CB, TYPE A, 4'-DIAMETER	TYPE 23 FRAME AND GRATE	631.34	626.31				627.15		626.61	
12	12-28	699+50.00	14.0' RT	MH, TYPE A, 8'-DIAMETER	TYPE 1FRAME, CLOSED LID	631.66			623.08		626.15		623.08	
12	12-29	101+44.18	25.1' LT	PRC FLAR END SEC 12	NONE									628.05
12	12-30	101+40.74	20.1' RT	CB, TYPE A, 5'-DIAMETER	TYPE 8 GRATE	629.71	623.10				628.11(EX)			
12	12-31	700+23.62	14.0' RT	MH, TYPE A, 9'-DIAMETER	TYPE 1FRAME, CLOSED LID	631.43			622.95		622.95		622.95	
12	12-32	701+10.00	27.6' RT	INLETS, TYPE A	TYPE 23 FRAME AND GRATE	630.86			626.86					

FILE NAME =	USER NAME = BAWitort	DESIGNED	-	JLV	REVISED -
G:\CH11\0158\Road\Sheets\D160T35-SHT-DR	IN-101.dgn	DRAWN	-	KAL	REVISED -
	PLOT SCALE = 100.00000 '/ in.	CHECKED	-	RCB	REVISED -
	PLOT DATE = 11/30/2012	DATE	-	10/31/2012	REVISED -

STATE	OF	ILLINOIS	
DEPARTMENT	0F	TRANSPORTATION	01

	F.A.P. RTE.	SECTION	COUNTY	TOTAL SHEETS	SHEET NO.
WILLOW ROAD DRAINAGE STRUCTURE TABLES	305	(1920.01,1518,2022&1922.4B)R	COOK	919	204
			CONTRACT	NO. 60	T35
SCALE: N.T.S. SHEET NO. 204 OF 919 SHEETS	FED. R	OAD DIST. NO. 1 ILLINOIS FED. AI	D PROJECT		

DRAINAGE SHEET WILLOW ROAD STA 693+00 TO STA 704+00 RIGHT SYSTEM

Γ.	SHEET	STRUCTURE	CTATION	STATION OFFSET	TYPE	FRAME & GRATE	RIM				INVERT ELE	EVATIONS			
- 1,	SHEET	NUMBER	STATION	OFFSET	ITPE	FRAME & GRATE	ELEVATION	NORTH	NORTHEAST	EAST	SOUTHEAST	SOUTH	SOUTHWEST	WEST	NORTHWEST
	12	12-33	701+60.00	26.5' RT	CB, TYPE A, 4'-DIAMETER	TYPE 23 FRAME AND GRATE	630.71			626.29				626.39	
	12	12-34	702+10.00	40.0' RT	INLETS, TYPE A	TYPE 8 GRATE	629.60	626.60							
	12	12-35	702+10.00	26.0' RT	CB, TYPE A, 4'-DIAMETER	TYPE 23 FRAME AND GRATE	630.56	625.53				626.51		625.83	
#	12	12-36	702+10.00	11.0' RT	MH, TYPE A, 8'-DIAMETER	TYPE 1FRAME, CLOSED LID	630.88			622.59		625.45		622.59	
	12	12-37	702+65.00	26.0' RT	INLETS, TYPE A	TYPE 23 FRAME AND GRATE	630.40			626.40					
Г	12	12-38	702+95.00	26.0' RT	CB, TYPE A, 4'-DIAMETER	TYPE 23 FRAME AND GRATE	630.35			626.03				626.13	
	12	12-39	703+20.00	39.0' RT	MH, TYPE A, 4'-DIAMETER	TYPE 8 GRATE	629.04	626.32			626.52				
	12	12-40	703+20.00	26.0' RT	CB, TYPE A, 4'-DIAMETER	TYPE 23 FRAME AND GRATE	630.34	625.52				626.26		625.82	
#	12	12-41	703+20.00	11.0' RT	MH, TYPE A, 8'-DIAMETER	TYPE 1FRAME, CLOSED LID	630.66			621.89		625.44		622.39	
	12	12-42	111+43.58	23.3' LT	PRC FLAR END SEC 12	NONE									626.80
#	12	12-43	111+69.51	20.0' RT	MH, TYPE A, 7'-DIAMETER	TYPE 1FRAME, CLOSED LID	630.34			621.83		624.42 (EX)			

NOTE:

- * DRAINAGE STRUCTURE TO BE TURNED SO THAT THE FRAME OR GRATE IS CLOSEST TO THE CENTERLINE OF THE ROAD.
 - % DRAINAGE STRUCTURE TO BE TURNED SO THAT THE FRAME OR GRATE IS FURTHEST FROM THE CENTERLINE OF THE ROAD.

DRAINAGE SHEET WILLOW ROAD STA 704+00 TO STA 716+00 LEFT SYSTEM

				D117 1111	7.02 011221 11122011 1107	4D OIA 704 00 10 OIA 710		0.0.2.	•						
s	HEET	STRUCTURE	STATION	OFFSET	TYPE	FRAME & GRATE	RIM		T		INVERT ELE				
		NUMBER					ELEVATION	NORTH	NORTHEAST	EAST	SOUTHEAST	SOUTH	SOUTHWEST	WEST	NORTHWEST
	13	13-1	705+50.00	26.0' LT	INLETS, TYPE A	TYPE 23 FRAME AND GRATE	630.33			626.33					
	13	13-2	706+00.00	45.5' LT	INLETS, TYPE A	TYPE 8 GRATE	626.11					623.11			
	13	13-3	706+00.00	26.0' LT	CB, TYPE A, 4'-DIAMETER	TYPE 23 FRAME AND GRATE	630.12	622.97				622.77		625.86	
#	13	13-4	706+00.00	11.0' LT	MH, TYPE A, 8'-DIAMETER	TYPE 1FRAME, CLOSED LID	630.44	622.69		621.00				621.00	
	13	13-5	706+50.00	25.0' LT	INLETS, TYPE A	TYPE 23 FRAME AND GRATE	629.90			625.90					
	13	13-6	706+95.00	25.0' LT	CB, TYPE A, 4'-DIAMETER	TYPE 23 FRAME AND GRATE	629.71			625.09		624.79		625.48	
#	13	13-7	706+95.00	10.0' LT	MH, TYPE A, 8'-DIAMETER	TYPE 1FRAME, CLOSED LID	630.03	624.71		620.87				620.87	
	13	13-8	707+40.00	25.0' LT	INLETS, TYPE A	TYPE 23 FRAME AND GRATE	629.51							625.51	
	13	13-9	707+95.00	25.0' LT	INLETS, TYPE A	TYPE 23 FRAME AND GRATE	629.28			625.28					
	13	13-10	708+50.00	45.9' LT	INLETS, TYPE A	TYPE 8 GRATE	624.53					622.53			
	13	13-11	708+50.00	25.0' LT	CB, TYPE A, 4'-DIAMETER	TYPE 23 FRAME AND GRATE	629.04	622.37		622.17				624.76	
	13	13-12	708+90.00	25.0' LT	CB, TYPE A, 4'-DIAMETER	TYPE 23 FRAME AND GRATE	628.88			621.71				621.81	
	13	13-13	709+32.32	25.0' LT	CB, TYPE A, 4'-DIAMETER	TYPE 23 FRAME AND GRATE	628.82			624.63		621.03		621.33	
#	13	13-14	709+32.32	10.0' LT	MH, TYPE A, 8'-DIAMETER	TYPE 1FRAME, CLOSED LID	629.14	620.95		620.52				620.52	
	13	13-15	709+57.00	25.0' LT	INLETS, TYPE A	TYPE 23 FRAME AND GRATE	628.84							624.84	
	13	13-16	710+40.00	25.0' LT	CB, TYPE A, 4'-DIAMETER	TYPE 23 FRAME AND GRATE	629.22			625.11		624.91			
#	13	13-17	710+40.00	10.0' LT	MH, TYPE A, 8'-DIAMETER	TYPE 1FRAME, CLOSED LID	629.54	624.83		620.37				620.37	
	13	13-18	710+90.00	25.0' LT	CB, TYPE A, 4'-DIAMETER	TYPE 23 FRAME AND GRATE	629.67			625.67				625.57	
	13	13-19	711+50.00	25.0' LT	INLETS, TYPE A	TYPE 23 FRAME AND GRATE	630.24							626.24	
	13	13-20	712+10.00	25.0' LT	CB, TYPE A, 4'-DIAMETER	TYPE 23 FRAME AND GRATE	630.81			626.81		626.61			
#	13	13-21	712+10.00	10.0' LT	MH, TYPE A, 8'-DIAMETER	TYPE 1FRAME, CLOSED LID	631.13	626.53		620.13				620.13	
	13	13-22	712+70.00	25.0' LT	INLETS, TYPE A	TYPE 23 FRAME AND GRATE	631.38							627.38	
	13	13-23	713+30.00	25.0' LT	CB, TYPE A, 4'-DIAMETER	TYPE 23 FRAME AND GRATE	631.95			627.95		627.75			
#	13	13-24	713+30.00	10.0' LT	MH, TYPE A, 8'-DIAMETER	TYPE 1FRAME, CLOSED LID	632.27	627.67		619.96				619.96	
	13	13-25	713+90.00	25.0' LT	INLETS, TYPE A	TYPE 23 FRAME AND GRATE	632.52							628.52	
#	13	13-26	713+95.21	10.0' LT	MH, TYPE A, 9'-DIAMETER	TYPE 1FRAME, CLOSED LID	632.88			619.88				619.88	
	13	13-27	715+12.66	11.3' LT	PRC FLAR END SEC 42	NONE				621.20					

DRAINAGE SHEET WILLOW ROAD STA 704+00 TO STA 716+00 RIGHT SYSTEM

	SHEET	STRUCTURE	STATION	OFFOFT	TYPE	EDAME & ODATE	RIM				INVERT EL	EVATIONS			
	SHEET	NUMBER	STATION	OFFSET	IYPE	FRAME & GRATE	ELEVATION	NORTH	NORTHEAST	EAST	SOUTHEAST	SOUTH	SOUTHWEST	WEST	NORTHWEST
	14	14-1	704+20.00	26.0' RT	MH, TYPE A, 6'-DIAMETER	TYPE 23 FRAME AND GRATE	630.51	621.73						621.73	
#	14	14-2	704+20.00	11.0' RT	MH, TYPE A, 8'-DIAMETER	TYPE 1 FRAME, CLOSED LID	630.83			621.71		621.71		621.71	
	14	14-3	705+50.00	37.9' RT	INLETS, TYPE A	TYPE 8 GRATE	627.49	624.49							
	14	14-4	705+50.00	26.0' RT	CB, TYPE A, 4'-DIAMETER	TYPE 23 FRAME AND GRATE	630.33			624.22		624.42			
	14	14-5	705+95.00	26.0' RT	CB, TYPE A, 4'-DIAMETER	TYPE 23 FRAME AND GRATE	630.14			623.71				623.81	
	14	14-6	706+40.00	25.1' RT	CB, TYPE A, 4'-DIAMETER	TYPE 23 FRAME AND GRATE	629.94			623.20				623.30	
	14	14-7	706+90.00	25.0' RT	CB, TYPE A, 4'-DIAMETER	TYPE 23 FRAME AND GRATE	629.73	622.54			624.28			622.74	
#	14	14-8	706+90.00	10.0' RT	MH, TYPE A, 9'-DIAMETER	TYPE 1 FRAME, CLOSED LID	630.05			621.18		622.40		621.18	
	14	14-9	121+42.28	17.6' LT	PRC FLAR END SEC 18	NONE									625.05
	14	14-10	121+40.30	18.4' RT	MH, TYPE A, 6'-DIAMETER	TYPE 1FRAME, CLOSED LID	627.23	621.15				MATCH EX			
#	14	14-11	707+52.89	10.0' RT	MANHOLE, SPECIAL	TYPE 1 FRAME, CLOSED LID	629.78			621.08		621.08		621.08	
	14	14-12	708+75.00	25.0' RT	INLETS, TYPE A	TYPE 23 FRAME AND GRATE	628.93			624.93					
	14	14-13	709+32.32	25.0' RT	CB, TYPE A, 4'-DIAMETER	TYPE 23 FRAME AND GRATE	628.82	624.09		624.59				624.39	
#	14	14-14	709+32.32	10.0' RT	MH, TYPE A, 8'-DIAMETER	TYPE 1 FRAME, CLOSED LID	629.14			620.73		624.01		620.73	
	14	14-15	709+62.00	25.0' RT	INLETS, TYPE A	TYPE 23 FRAME AND GRATE	628.85							624.85	
	14	14-16	710+39.33	39.5' RT	MH, TYPE A, 7'-DIAMETER	TYPE 8 GRATE	625.40	620.60				MATCH EX			
#	14	14-17	710+39.33	10.0' RT	MH, TYPE A, 9'-DIAMETER	TYPE 1FRAME, CLOSED LID	629.54			620.54		620.54		620.54	
%	14	14-18	711+45.00	25.0' RT	CB, TYPE A, 4'-DIAMETER	TYPE 11V FRAME AND GRATE	630.19	625.90		626.10					
#	14	14-19	711+45.00	10.0' RT	MH, TYPE A, 8'-DIAMETER	TYPE 1 FRAME, CLOSED LID	630.51			620.34		625.85		620.34	

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	PLOT SCALE = 100.00000 '/ in.	CHECKED -	RCB	REVISED	-
	PLOT DATE = 11/30/2012	DATE -	10/31/2012	REVISED	-

	F.A.P. RTE.	SECTION	COUNTY	TOTAL SHEETS	SHEET NO.
WILLOW ROAD DRAINAGE STRUCTURE TABLES	305	(1920.01,1518,2022&1922.4B)R	COOK	919	205
			CONTRACT	NO. 60	T35
SCALE: N.T.S. SHEET NO. 205 OF 919 SHEETS	FED. R	OAD DIST. NO. 1 ILLINOIS FED. AI	D PROJECT		

DRAINAGE SHEET WILLOW ROAD STA 704+00 TO STA 716+00 RIGHT SYSTEM

CII	HEET STRUCTURE STATION	CTATION	OFFSET	TYPE	FRAME & GRATE	RIM				INVERT ELE	EVATIONS				
эп	EEI	NUMBER	STATION	OFFSET	ITPE	FRANE & GRATE	ELEVATION	NORTH	NORTHEAST	EAST	SOUTHEAST	SOUTH	SOUTHWEST	WEST	NORTHWEST
%	4	14-20A	712+00.00	25.0' RT	CB, TYPE A, 4'-DIAMETER	TYPE 11V FRAME AND GRATE	630.71			626.71				626.61	
%	4	14-20B	712+55.00	25.0' RT	INLETS, TYPE A	TYPE 11V FRAME AND GRATE	631.23							627.23	
%	4	14-21	713+10.00	25.0' RT	CB, TYPE A, 4'-DIAMETER	TYPE 11V FRAME AND GRATE	631.75	627.56		627.76					
#	4	14-22	713+10.00	10.0' RT	MH, TYPE A, 8'-DIAMETER	TYPE 1FRAME, CLOSED LID	632.07			620.03		627.51		620.03	
%	4	14-23	713+65.00	25.0' RT	INLETS, TYPE A	TYPE 11V FRAME AND GRATE	632.28							628.28	
#	4	14-24	713+95.12	10.0' RT	MH, TYPE A, 9'-DIAMETER	TYPE 1FRAME, CLOSED LID	632.88			619.87				619.87	
	4	14-25	711+50.00	46.4' RT	MH, TYPE A, 5'-DIAMETER	TYPE 8 GRATE	625.29			621.56					621.56
#	4	14-26	712+50.00	41.3' RT	MH, TYPE A, 5'-DIAMETER	TYPE 8 GRATE	624.99			621.22				621.32	
#	4	14-27	713+66.35	42.3' RT	MH, TYPE A, 6'-DIAMETER	TYPE 8 GRATE	624.64			620.94		MATCHEX		620.94	
	4	14-28	714+70.44	44.5' RT	PRC FLAR END S EQ RS 36	NONE								620.69	

NOTE:

- **DRAINAGE STRUCTURE TO BE TURNED SO THAT THE FRAME OR GRATE IS CLOSEST TO THE CENTERLINE OF THE ROAD.
- % DRAINAGE STRUCTURE TO BE TURNED SO THA THE FRAME OR GRATE IS FURTHEST FROM TH CENTERLINE OF THE ROAD.

DRAINAGE SHEET WILLOW ROAD STA 716+00 TO STA 728+00

					DITATIVAGE STILLT VVILLOV	V NUAD SIA /IU TUU IU SIA									
	SHEET	STRUCTURE	STATION	OFFSET	TYPE	FRAME & GRATE	RIM				INVERT EL				
		NUMBER					ELEVATION	NORTH	NORTHEAST	EAST	SOUTHEAST		SOUTHWEST	WEST	NORTHWEST
	15	15-1	716+00.00	25.8' LT	CB, TYPE A, 4'-DIAMETER	TYPE 23 FRAME AND GRATE	632.28			627.63		627.43			
#	15	15-2	716+00.00	11.3' LT	MH, TYPE A, 5'-DIAMETER	TYPE 1FRAME, CLOSED LID	632.59	627.33		621.30				621.30	
	15	15-3	716+15.00	27.3' RT	INLETS, TYPE A	TYPE 23 FRAME AND GRATE	632.09			628.09					
	15	15-4	716+30.00	26.8' LT	INLETS, TYPE A	TYPE 23 FRAME AND GRATE	631.90							627.90	
	15	15-5	717+00.00	43.8' RT	INLETS, TYPE A	TYPE 8 GRATE	630.93	627.43							
	15	15-6	717+00.00	30.2' RT	CB, TYPE A, 4'-DIAMETER	TYPE 23 FRAME AND GRATE	631.02	626.97				627.34		627.27	
#	15	15-7A	716+42.75	12.3' LT	MH, TYPE A, 6'-DIAMETER	TYPE 1FRAME, CLOSED LID	632.05			621.35		623.17 (EX)		621.35	
#	15	15-7B	717+00.00	12.8' LT	MH, TYPE A, 5'-DIAMETER	TYPE 1FRAME, CLOSED LID	631.34			621.41		626.55		621.41	
	15	15-8	717+32.00	26.8' LT	INLETS, TYPE A	TYPE 23 FRAME AND GRATE	631.01					627.01			
#	15	15-9	717+32.00	11.8' LT	MH, TYPE A, 5'-DIAMETER	TYPE 1FRAME, CLOSED LID	630.69	626.90		621.44				621.44	
%	15	15-10	160+56.19	30.1' LT	MH, TYPE A, 6'-DIAMETER	TYPE 23 FRAME AND GRATE	629.54	MATCHEX		622.48		622.48			
	15	15-11	718+25.00	34.3' RT	INLETS, TYPE A	TYPE 23 FRAME AND GRATE	630.07	626.07							
#	15	15-12A	717+86.23	10.0' LT	MH, TYPE A, 6'-DIAMETER	TYPE 1FRAME, CLOSED LID	630.58			621.50		623.46 (EX)		621.50	
#	15	15-12B	718+25.00	8.7' LT	MH, TYPE A, 7'-DIAMETER	TYPE 1FRAME, CLOSED LID	630.41	622.04		621.54		625.65		621.54	
	15	15-13	160+49.98	7.1' RT	MH, TYPE A, 4'-DIAMETER	TYPE 1FRAME, CLOSED LID	629.78	MATCHEX		625.48				622.94	
	15	15-14	160+47.97	19.2' RT	INLETS, TYPE A	TYPE 23 FRAME AND GRATE	629.59							625.59	
	15	15-15	719+45.00	22.0' LT	INLETS, TYPE A	TYPE 23 FRAME AND GRATE	629.56			625.56					
	15	15-16	719+98.07	33.0' LT	CB, TYPE C	TYPE 8 GRATE	629.00					626.00			
	15	15-17	719+98.07	22.0' LT	CB, TYPE A, 4'-DIAMETER	TYPE 23 FRAME AND GRATE	629.35	625.94				624.76		625.06	
	15	15-18A	719+70.00	36.0' RT	INLETS, TYPE A	TYPE 23 FRAME AND GRATE	629.51			625.51					
	15	15-18B	719+98.07	36.0' RT	CB. TYPE A. 4'-DIAMETER	TYPE 23 FRAME AND GRATE	629.40	622.65		624.65		622.95 (EX)		625.26	
#	15	15-19	719+98.07	7.0' LT	MH, TYPE A, 6'-DIAMETER	TYPE 1FRAME, CLOSED LID	629.67	624.66		621.74		622.23		621.74	
	15	15-20	720+20.00	36.0' RT	CB, TYPE A, 4'-DIAMETER	TYPE 23 FRAME AND GRATE	629.31	0200		624.92		0		624.82	
	15	15-21	720+50.00	36.0' RT	INLETS, TYPE A	TYPE 23 FRAME AND GRATE	629.19							625.19	
	15	15-22	720+70.00	24.0' LT	INLETS, TYPE A	TYPE 23 FRAME AND GRATE	629.01			625.01				020110	
	15	15-23	720+80.00	36.7' RT	INLETS, TYPE A	TYPE 23 FRAME AND GRATE	629.08			625.08					
	15	15-24A	721+05.00	24.0' LT	CB, TYPE A, 4'-DIAMETER	TYPE 23 FRAME AND GRATE	628.87			622.60		622.60		624.69	
#	15	15-24B	721+24.10	26.1'LT	MH, TYPE A, 4'-DIAMETER	TYPE 1FRAME, CLOSED LID	628.75	MATCHEX		022.00		322.33		622.90	
	15	15-25	721+05.00	37.4' RT	CB, TYPE A, 4'-DIAMETER	TYPE 23 FRAME AND GRATE	628.98	624.22		624.52				624.86	
#	15	15-26	721+05.00	7.0' LT	MH, TYPE A, 6'-DIAMETER	TYPE 1 FRAME, CLOSED LID	629.23	622.36		621.86		623.79		621.86	
	15	15-27	721+40.00	38.4' RT	INLETS, TYPE A	TYPE 23 FRAME AND GRATE	628.84	022.00		02 1.00		0200		624.84	
	15	15-28	721+70.00	22.0' LT	INLETS, TYPE A	TYPE 23 FRAME AND GRATE	628.64			624.64				021.01	
	15	15-29	721+70.00	39.3' RT	INLETS, TYPE A	TYPE 23 FRAME AND GRATE	628.73			624.73					
	15	15-30	722+00.00	31.3' LT	CB, TYPE C	TYPE 8 GRATE	628.48			02 0		625.48			
	15	15-31	722+00.00	22.0' LT	CB, TYPE A, 4'-DIAMETER	TYPE 23 FRAME AND GRATE	628.52	625.44		624.48		624.18		624.37	
	15	15-32	722+00.00	40.0' RT	CB, TYPE A, 4'-DIAMETER	TYPE 23 FRAME AND GRATE	629.03	623.95		624.25		021.10		624.46	
#	15	15-33	722+00.00	7.0' LT	MH, TYPE A, 6'-DIAMETER	TYPE 1 FRAME, CLOSED LID	628.84	624.08		622.47		623.49		621.97	
"	15	15-34	722+30.00	40.0' RT	CB, TYPE A, 4'-DIAMETER	TYPE 23 FRAME AND GRATE	628.49	02 1.00		624.60		020.10		624.50	
	15	15-35	722+40.00	22.0' LT	INLETS, TYPE A	TYPE 23 FRAME AND GRATE	628.35			3=1.00				624.85	
	15	15-36	722+60.00	40.0' RT	INLETS, TYPE A	TYPE 23 FRAME AND GRATE	628.37							624.87	
	15	15-37	190+70.84	30.5' RT	CB, TYPE C	TYPE 24 FRAME AND GRATE	627.11					624.11		0= 1.07	
#	15	15-38	723+39.85	7.0' LT	MH, TYPE A, 6'-DIAMETER	TYPE 1FRAME, CLOSED LID	628.26	623.81		622.60		5=1.11		622.60	
	15	15-39	724+25.00	22.0' LT	INLETS, TYPE A	TYPE 23 FRAME AND GRATE	627.60	020.01		022.00		624.60		022.00	
#	15	15-40	724+25.00	7.0' LT	MH, TYPE A, 6'-DIAMETER	TYPE 1 FRAME, CLOSED LID	627.92	624.50		622.68		0200		622.68	
"	15	15-41	724+45.00	40.1'RT	INLETS, TYPE A	TYPE 23 FRAME AND GRATE	627.65	02 1.00		624.65				0LL.00	
	15	15-42	724+75.00	38.7' RT	CB, TYPE A, 4'-DIAMETER	TYPE 23 FRAME AND GRATE	627.53			624.38				624.38	+
	15	15-43	724+95.00	22.0' LT	INLETS, TYPE A	TYPE 23 FRAME AND GRATE	627.31			623.81				02-1.00	+
	15	15-44	725+05.00	22.0 LT 22.0' LT	CB, TYPE A, 4'-DIAMETER	TYPE 23 FRAME AND GRATE	627.27		 	623.39		623.39	+	623.74	+
	15	15-45	725+05.00	37.3' RT	CB, TYPE A, 4'-DIAMETER	TYPE 23 FRAME AND GRATE	627.40	623.79		623.79	+	020.00	+	624.12	+
#	15	15-46	725+05.00	7.0' LT	MH. TYPE A. 6'-DIAMETER	TYPE 1FRAME, CLOSED LID	627.59	623.29	+	020.10	+	623.36	+	622.75	+
77	15	15-47	725+35.98	22.0' LT	CB, TYPE A, 4'-DIAMETER	TYPE 23 FRAME AND GRATE	627.22	020.23		623.66		020.00	 	623.66	+
	15	15-48	725+35.98	35.8' RT	CB, TYPE A, 4'-DIAMETER	TYPE 23 FRAME AND GRATE	627.28			624.07			+	624.07	+
	15	15-49	725+56.43	34.8' RT	CB, TYPE C	TYPE 23 FRAME AND GRATE	627.24			024.01			+	624.24	+
	15	15-50		25.5' LT	INLETS. TYPE A	TYPE 23 FRAME AND GRATE	627.57						 	624.24	+
		10-50	726+30.00	20.0 LT	IINLE IO, I YPE A	TIFE 23 FRAME AND GRATE	027.57							024.57	

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	PLOT SCALE = 100.00000 '/ in.	CHECKED	-	RCB	REVISED	-
	PLOT DATE = 11/30/2012	DATE	-	10/31/2012	REVISED	-

	F.A.P. RTE.	SECTION	COUNTY	TOTAL SHEETS	SHEET NO.
WILLOW ROAD DRAINAGE STRUCTURE TABLES	\$ 305 (1920.01,1518,2022&1922.		COOK	919	206
			CONTRACT	NO. 60	T35
SCALE: N.T.S. SHEET NO. 206 OF 919 SHEETS	FED. R	OAD DIST. NO. 1 ILLINOIS FED. AI	D PROJECT		

DRAINAGE SHEET WILLOW ROAD STA 728+00 TO STA 740+00

	CHEET	HEET STRUCTURE S		OFFSET	TYPE	FRAME & GRATE	RIM				INVERT ELE	EVATIONS			
	SHEET	NUMBER	STATION	OFFSET	ITE	FRAIVIE & GRATE	ELEVATION	NORTH	NORTHEAST	EAST	SOUTHEAST	SOUTH	SOUTHWEST	WEST	NORTHWEST
	16	16-1	734+55.00	28.7' RT	MH, TYPE A, 4'-DIAMETER	TYPE 24 FRAME AND GRATE	632.96				624.72				
#	16	16-2	872+76.26	38.7' RT	MH, TYPE A, 4'-DIAMETER	TYPE 1FRAME, CLOSED LID	626.87		622.87 (EX)				622.87 (EX)		623.07
	16	16-3	736+40.00	36.4' RT	INLETS, TYPE A	TYPE 8 GRATE	626.60			624.10					
	16	16-4	737+03.44	28.5' RT	MH, TYPE A, 7'-DIAMETER	TYPE 1FRAME, CLOSED LID	626.81			623.45 (EX)	MATCHEX			623.55 (EX) 623.51	

OTE:

- * DRAINAGE STRUCTURE TO BE TURNED SO THAT THE FRAME OR GRATE IS CLOSEST TO THE CENTERLINE OF THE ROAD.
 - % DRAINAGE STRUCTURE TO BE TURNED SO THAT THE FRAME OR GRATE IS FURTHEST FROM THE CENTERLINE OF THE ROAD.

DRAINAGE SHEET ILLINOIS ROUTE 43 STA 505+00 TO STA 518+00

	SHEET	STRUCTURE	STATION	OFFSET	TYPE	FRAME & GRATE	RIM				INVERT EL	EVATIONS			
	SHEET	NUMBER	STATION	OFFSET	ITPE	FRAINE & GRATE	ELEVATION	NORTH	NORTHEAST	EAST	SOUTHEAST	SOUTH	SOUTHWEST	WEST	NORTHWEST
[17	17-1	508+25.00	46.1' LT	INLETS, TYPE A	TYPE 24 FRAME AND GRATE	665.73			661.73					
#	17	17-2	508+25.00	36.7' LT	MH, TYPE A, 4'-DIAMETER	TYPE 1 FRAME, CLOSED LID	665.98	657.97 (EX)		661.48		657.93 (EX)		661.67	
[17	17-3	508+25.00	32.7' RT	CB, TYPE C	TYPE 24 FRAME AND GRATE	666.16							662.16	
%	17	17-4	509+58.00	0.2' RT	INLETS, TYPE A	TYPE 11V FRAME AND GRATE	668.20	664.20							
	17	17-5	510+23.57	49.6' LT	CB, TYPE C	TYPE 24 FRAME AND GRATE	667.83			662.37 (EX)					
	17	17-6	510+24.38	3.9' LT	CB, TYPE A, 4'-DIAMETER	TYPE 11V FRAME AND GRATE	668.75			661.86 (EX)		663.56		661.82 (EX)	
	17	17-7	510+23.74	51.3' RT	CB, TYPE C	TYPE 8 GRATE	665.89							662.89	
[17	17-8	510+23.90	37.1' RT	CB, TYPE A, 4'-DIAMETER	TYPE 24 FRAME AND GRATE	668.19			662.80				662.33 (EX)	
#	17	17-9	512+84.23	36.1' LT	MH, TYPE A, 4'-DIAMETER	TYPE 1FRAME, CLOSED LID	669.78	663.45			663.70 (EX)	663.45 (EX)			663.95 (EX)

DRAINAGE SHEET ILLINOIS ROUTE 43 STA 518+00 TO STA 530+00

	OTPHOTUPE				HOULE 43 DIA 310 1 00 10					IND/EDT EL	E) (A TIONIO			
SHEET	STRUCTURE	STATION	OFFSET	TYPE	FRAME & GRATE	RIM				INVERT EL				
0	NUMBER	017111011	011021		110 1112 21 010 112	ELEVATION	NORTH	NORTHEAST	EAST	SOUTHEAST	SOUTH	SOUTHWEST	WEST	NORTHWEST
18	18-1	518+00.00	9.0' RT	CB, TYPE A, 4'-DIAMETER	TYPE 11V FRAME AND GRATE	669.91	664.93				665.03			
18	18-2	518+30.00	39.0' RT	CB, TYPE A, 4'-DIAMETER	TYPE 24 FRAME AND GRATE	669.50	664.22				664.32			
18	18-3	518+50.00	51.0' LT	INLETS, TYPE A	TYPE 24 FRAME AND GRATE	669.08					665.08			
18	18-4	518+55.00	9.0' RT	CB, TYPE A, 4'-DIAMETER	TYPE 11V FRAME AND GRATE	670.08	664.32				664.42			
18	18-5	518+80.00	9.0' RT	CB, TYPE A, 4'-DIAMETER	TYPE 11V FRAME AND GRATE	670.15	665.36		663.81		664.11			
18	18-6	518+80.00	39.0' RT	CB, TYPE A, 4'-DIAMETER	TYPE 24 FRAME AND GRATE	669.84			663.05		663.76		663.55	
18	18-7	518+80.00	53.7' RT	CB, TYPE A, 4'-DIAMETER	TYPE 8 GRATE	668.09	662.72						662.97	
18	18-8	519+24.31	15.0' RT	CB, TYPE A, 4'-DIAMETER	TYPE 11V FRAME AND GRATE	670.28	665.86				665.76			
18	18-9	519+50.00	15.0' RT	CB, TYPE A, 4'-DIAMETER	TYPE 11V FRAME AND GRATE	670.36	666.18				666.08			
18	18-10	519+80.00	15.0' RT	INLETS, TYPE A	TYPE 11V FRAME AND GRATE	670.45					666.45			
18	18-11	520+75.00	56.3' RT	CB, TYPE A, 4'-DIAMETER	TYPE 8 GRATE	669.61	661.55				661.75			
18	18-12	522+80.00	34.9' LT	INLETS, TYPE A	TYPE 24 FRAME AND GRATE	666.46		662.46						
18	18-13	522+80.00	10.9' RT	CB, TYPE A, 4'-DIAMETER	TYPE 11V FRAME AND GRATE	667.42		661.94				662.04		
18	18-14	522+80.00	49.7' RT	CB, TYPE A, 5'-DIAMETER	TYPE 8 GRATE	666.20					660.48	661.60		655.98
18	18-15	524+00.00	8.5' RT	CB, TYPE C	TYPE 11V FRAME AND GRATE	663.91								659.91
18	18-16	524+68.89	5.5' RT	CB, TYPE A, 4'-DIAMETER	TYPE 11V FRAME AND GRATE	661.68		657.47		657.67				
18	18-17	524+68.89	50.3' RT	CB, TYPE A, 5'-DIAMETER	TYPE 8 GRATE	660.00				655.03		657.06		654.78
18	18-18	525+35.00	41.0' LT	INLETS, TYPE A	TYPE 24 FRAME AND GRATE	658.40		654.40						
18	18-19	525+35.00	47.5' RT	CB, TYPE A, 5'-DIAMETER	TYPE 24 FRAME AND GRATE	658.82				654.48		653.51		644.48
18	18-20	527+18.72	48.8' RT	CB, TYPE A, 5'-DIAMETER	TYPE 24 FRAME AND GRATE	653.16	643.38			643.58				
18	18-21	527+30.99	62.1' RT	MH, TYPE A, 6'-DIAMETER	TYPE 1FRAME, CLOSED LID	652.84					643.34	648.64 (EX)		643.24 (EX)

DRAINAGE SHEET INTERSTATE 94 RAMP A STA 811+00 TO STA 822+00

SHEET	STRUCTURE	STATION OFFSET	TYPE	FRAME & GRATE	RIM			INVERT ELI	EVATIONS				
SHEET	NUMBER	STATION	OFFSET	TIPE	FRAME & GRATE	ELEVATION	NORTH NORTHEAST	EAST	SOUTHEAST	SOUTH	SOUTHWEST	WEST	NORTHWEST
19	19-1	814+40.61	19.0' RT	CB, TYPE A, 4'-DIAMETER	TYPE 8 GRATE	624.44			618.94		MATCHEX		
19	19-2	816+06.61	19.4' RT	CB, TYPE A, 4'-DIAMETER	TYPE 8 GRATE	623.78			617.22				617.32
19	19-3	817+14.79	16.7' RT	MH, TYPE A, 6'-DIAMETER	TYPE 1 FRAME, CLOSED LID	624.10	MATCH EX		618.27				616.19
19	19-4	818+14.28	17.7' RT	CB, TYPE A, 4'-DIAMETER	TYPE 8 GRATE	623.78			619.46		MATCH EX		619.21
19	19-5	819+16.19	19.8' RT	CB, TYPE A, 4'-DIAMETER	TYPE 8 GRATE	623.45							620.45

DRAINAGE SHEET INTERSTATE 94 RAMP D STA 850+00 TO STA 862+00

SHEET	STRUCTURE STATION C	OFFSET	TYPE	FRAME & GRATE	RIM				INVERT ELI	EVATIONS				
SHEET	NUMBER	STATION	OFFSET		FRAIVIE & GRATE	ELEVATION	NORTH	NORTHEAST	EAST	SOUTHEAST	SOUTH	SOUTHWEST	WEST	NORTHWEST
20	20-1	851+74.13	24.7' RT	CB, TYPE A, 4'-DIAMETER	TYPE 8 GRATE	621.20								617.70
20	20-2	851+84.13	24.6' RT	CB, TYPE A, 4'-DIAMETER	TYPE 8 GRATE	621.32				617.64				617.39
20	20-3	852+48.97	28.2' RT	EXISTING MANHOLE	EXISTING GRATE	623.03		(EX)		616.79 (EX)		(EX)		(EX)
20	20-4	857+45.43	26.9' RT	EXISTING MANHOLE	EXISTING GRATE	623.15				(EX)				618.02 (EX)
20	20-5	857+98.00	23.7' RT	MH, TYPE A, 4'-DIAMETER	TYPE 8 GRATE	622.67				618.40				618.65
20	20-6	858+93.07	23.4' RT	MH, TYPE A, 4'-DIAMETER	TYPE 8 GRATE	622.38				619.38				

FILE NAME =	USER NAME = BAWitort	DESIGNED	-	JLV	REVISED	-
G:\CHII\0158\Road\Sheets\D160T35-SHT-DR	IN-101.dgn	DRAWN	-	KAL	REVISED	-
	PLOT SCALE = 100.00000 '/ in.	CHECKED	-	RCB	REVISED	-
	PLOT DATE = 11/30/2012	DATE	-	10/31/2012	REVISED	-

STATE OF ILLINOIS DEPARTMENT OF TRANSPORTATION

VILLOW ROAD, ILLINOIS ROUTE 43 AND INTERSTATE 94 RAMP A AND DE	F.A.P. RTE.	SECTION	COUNTY	TOTAL SHEETS	
	305	(1920.01,1518,2022&1922.4B)R	COOK	919	207
BILANAL STROUGHE TABLES			CONTRACT	NO. 60	T35
SCALE: N.T.S. SHEET NO.207 OF 919 SHEETS	FFD. R	DAD DIST. NO. 1 THE INDIS FED. AT	D PROJECT		

DRAINAGE SHEET WILLOW ROAD STA 625+00 TO STA 637+00 LEFT SYSTEM

SHEET	PIPE NUMBER	STRU	CTURE	DESCRIPTION	CLASS	TYPE	SIZE (IN)	LENGTH (FT)	SLOPE (%)	TBF
SHEET	PIPE NUMBER	FROM	ТО	DESCRIPTION	CLASS	ITPE	SIZE (IIV)	LENGIH (FI)	SLOPE (%)	(CY)
1	1-1	1-4	1-5	STORM SEWERS	Α	1	12	4.0	1.00%	0.3
1	1-2	1-7	1-6	STORM SEWERS	Α	1	12	8.0	1.00%	1.0

DRAINAGES SHEET WILLOW ROAD STA 637+00 TO STA 649+00 LEFT SYSTEM

SHEET	PIPE NUMBER	STRUG	CTURE	DESCRIPTION	CLASS	TYPE	CIZE (INI)	LENCTLI/ET)	CLODE (9/)	TBF
SHEET	PIPE NUMBER	FROM	TO	DESCRIPTION	CLASS	ITPE	SIZE (IN)	LENGTH (FT)	SLOPE (%)	(CY)
2	2-1	2-3	2-2	STORM SEWERS	Α	2	12	2.7	0.56%	0.6
2	2-2	2-6	2-5	STORM SEWERS	Α	1	12	8.4	0.56%	0.0
2	2-3	2-7	2-8	STORM SEWERS	Α	2	12	13.8	1.00%	2.1
2	2-4	18-3	2-11	STORM SEWERS	Α	2	12	103.3	1.00%	19.7
2	2-5	2-11	2-12	STORM SEWERS	Α	2	12	22.7	1.00%	5.4
2	2-6	2-12	2-13	STORM SEWERS	Α	2	15	24.9	1.00%	0.0
2	2-7	2-13	2-14	STORM SEWERS	Α	2	15	49.7	1.00%	47.0
2	2-8	2-15	18-1	STORM SEWERS	Α	2	12	52.3	1.00%	10.7
2	2-9	2-16	2-15	STORM SEWERS	Α	1	12	13.7	1.00%	1.9
2	2-10	2-18	2-17	STORM SEWERS	Α	1	12	21.1	1.00%	3.1
2	2-11	2-17	18-2	STORM SEWERS	Α	2	12	65.9	1.00%	14.6
2	2-12	2-19	2-20	STORM SEWERS	Α	1	12	26.5	1.00%	3.5
2	2-13	2-21	2-20	STORM SEWERS	Α	1	12	24.5	1.00%	3.7
2	2-14	2-20	2-23	STORM SEWERS	Α	1	15	186.0	1.75%	33.9
2	2-15	2-22	2-23	STORM SEWERS	Α	1	12	24.5	1.00%	2.5
2	2-16	2-24	2-23	STORM SEWERS	Α	1	12	13.5	1.00%	1.7
2	2-17	2-23	2-27	STORM SEWERS	Α	1	15	206.0	1.75%	32.3
2	2-18	2-25	2-26	STORM SEWERS	Α	1	12	6.7	1.00%	0.0
2	2-19	2-26	2-27	STORM SEWERS	Α	1	12	15.5	1.00%	1.3
2	2-20	2-27	4-1	STORM SEWERS	Α	1	18	98.1	0.75%	17.5

DRAINAGE SHEET WILLOW ROAD STA 637+00 TO STA 649+00 RIGHT SYSTEM

SHEET	PIPE NUMBER	STRUC	CTURE	DESCRIPTION	CLASS	TYPE	SIZE (IN)	LENGTH (FT)	SLOPE (%)	TBF
SHEET	PIPE NUMBER	FROM	TO	DESCRIPTION	CLASS	ITPE	SIZE (IIV)	LENGIH (FI)	SLOPE (%)	(CY)
3	3-1	3-2	3-1	STORM SEWERS	Α	1	12	23.5	1.00%	2.5
3	3-2	3-1	3-3	STORM SEWERS	Α	1	12	14.6	1.00%	2.1
3	3-3	3-3	17-9	STORM SEWERS	А	2	18	176.8	0.55%	58.8
3	3-4	3-5	3-3	STORM SEWERS	Α	2	15	19.6	0.50%	4.1
3	3-5	3-4	3-5	STORM SEWERS	Α	1	12	13.2	1.00%	1.8
3	3-6	3-6	3-5	STORM SEWERS, RG	Α	2	15	60.0	0.50%	12.1
3	3-7	3-7	3-6	STORM SEWERS (WM REQ)			12	31.0	0.50%	3.8
3	3-8	3-8	3-7	STORM SEWERS (WM REQ)			12	20.8	0.50%	2.0
3	3-9	3-9	3-10	STORM SEWERS, RG	Α	1	12	13.8	1.00%	0.3
3	3-10	3-10	3-12	STORM SEWERS	А	1	15	196.0	1.75%	0.0
3	3-11	3-11	3-12	STORM SEWERS, RG	Α	1	12	13.8	1.00%	0.3
3	3-12	3-12	3-14	STORM SEWERS, RG	Α	1	15	196.0	1.75%	0.0
3	3-13	3-13	3-14	STORM SEWERS, RG	А	1	12	13.8	1.00%	0.2
3	3-14	3-14	5-1A	STORM SEWERS (WM REQ)			18	98.5	0.50%	2.9

DRAINAGE SHEET WILLOW ROAD STA 649+00 TO STA 661+00 LEFT SYSTEM

SHEET	PIPE NUMBER	STRUC		DESCRIPTION	CLASS	TYPE	SIZE (IN)	LENGTH (FT)	SLOPE (%)	TBF
OTTLE !	THE HOMBER	FROM	TO	BESSIAI FISH	02,100		OILL (III)	LENGIII (I I)	O201 2 (70)	(CY)
4	4-1	4-2	4-3	STORM SEWERS	A	1	12	39.6	1.00%	3.3
4	4-2	4-3	4-6	STORM SEWERS	A	1	12	63.8	1.00%	10.3
4	4-3	4-5	4-4	STORM SEWERS	Α	1	15	8.4	1.00%	0.0
4	4-4	4-6	4-5	STORM SEWERS	A	1	12	11.7	1.00%	0.0
4	4-5	4-8	4-7	STORM SEWERS	A	1	12	17.8	1.00%	0.4
4	4-6	4-9	4-10	STORM SEWERS	Α	1	12	47.0	1.00%	7.7
4	4-7	4-10	4-11	STORM SEWERS	A	2	12	46.3	1.00%	9.6
4	4-8	4-11	4-12	STORM SEWERS	A	2	12	14.5	1.00%	0.0
4	4-9	4-13	4-14	STORM SEWERS	A	2	12	67.8	1.00%	12.6
4	4-10	4-14	4-16	STORM SEWERS	A	2	12	7.2	1.00%	1.3
4	4-11	4-16	4-15	STORM SEWERS	А	2	12	20.9	1.00%	0.0
4	4-12	4-17	4-16	STORM SEWERS	A	2	12	44.1	1.00%	9.2
4	4-13	4-18	4-17	STORM SEWERS	A	1	12	47.0	1.00%	7.8

DRAINAGE SHEET WILLOW ROAD STA 649+00 TO STA 661+00 RIGHT SYSTEM

SHEET	PIPE NUMBER	STRUG	CTURE	DESCRIPTION	CLASS	TYPE	SIZE (IN)	LENGTH (FT)	SLOPE (%)	TBF
SHEET	PIPE NUMBER	FROM	TO	DESCRIPTION	CLASS	ITPE	SIZE (IIV)	LENGIH (FI)	SLOPE (%)	(CY)
5	5-1	5-1B	5-1A	STORM SEWERS, RG	Α	1	12	7.2	1.00%	0.0
5	5-2	N/A	5-1B	STORM SEWERS	Α	1	12	13.9	0.06%	0.0
5	5-3	5-3	5-4	STORM SEWERS (WM REQ)			12	39.7	1.00%	3.8
5	5-4	5-4	5-6	STORM SEWERS (WM REQ)			12	66.4	1.00%	10.9
5	5-5	5-6	5-5	STORM SEWERS, RG	Α	2	12	13.9	1.00%	0.0
5	5-6	5-8	5-7	STORM SEWERS, RG	Α	1	12	11.2	1.00%	0.4
5	5-7	5-9	5-10	STORM SEWERS (WM REQ)			12	47.0	1.00%	7.1
5	5-8	5-10	5-12	STORM SEWERS (WM REQ)			12	46.0	1.00%	8.8
5	5-9	5-12	5-11	STORM SEWERS, RG	А	2	12	8.7	1.00%	0.0
5	5-10	5-13	5-14	STORM SEWERS (WM REQ)			12	57.8	1.00%	8.2
5	5-11	5-14	5-16	STORM SEWERS (WM REQ)			12	13.8	1.00%	2.2
5	5-12	5-16	5-15	STORM SEWERS, RG	Α	2	12	6.5	1.00%	0.0
5	5-13	5-17	5-16	STORM SEWERS (WM REQ)			12	48.4	1.00%	8.1
5	5-14	5-18	5-19	STORM SEWERS, RG	Α	1	12	10.1	1.00%	0.0

DRAINAGE SHEETS WILLOW ROAD STA 661+00 TO STA 672+00 LEFT SYSTEM

SHEET	PIPE NUMBER	STRUG	CTURE	DESCRIPTION	CLASS	TYPE	SIZE (IN)	LENGTH (FT)	SLOPE (%)	TBF
SHEET	PIPE NUMBER	FROM	TO	DESCRIPTION	CLASS	ITPE	SIZE (IIV)	LENGIH (FI)	SLOPE (%)	(CY)
6	6-1	6-2	6-1	STORM SEWERS (WM REQ)			12	7.3	1.00%	0.5
6	6-2	6-4	6-3	STORM SEWERS	Α	1	12	6.9	1.00%	0.4
6	6-3	6-5	6-7	STORM SEWERS	Α	1	12	92.0	1.00%	5.7
6	6-4	6-7	6-6	STORM SEWERS	Α	1	12	1.6	1.00%	0.0
6	6-5	6-8	6-9	STORM SEWERS	Α	1	EQ RS 30	20.3	0.75%	4.3
6	6-6	6-9	6-13	STORM SEWERS	А	1	EQ RS 30	70.1	0.75%	18.4
6	6-7A	6-10	6-11	STORM SEWERS	А	1	12	32.0	1.00%	3.9
6	6-7B	6-11	6-12A	STORM SEWERS	Α	1	12	38.1	1.00%	5.3
6	6-8A	6-12A	6-12B	STORM SEWERS, RG	Α	2	30	5.6	1.00%	6.7
6	6-8B	6-12B	6-13	STORM SEWERS (WM REQ)			30	39.5	1.00%	73.8
6	6-9	6-13	6-23	STORM SEWERS, RG	Α	2	48	218.2	0.50%	468.1
6	6-10	6-14	6-15	STORM SEWERS	Α	1	12	62.0	1.00%	9.7
6	6-11	6-15	6-16	STORM SEWERS	А	2	12	61.0	1.00%	10.7
6	6-12	6-18	6-16	STORM SEWERS	А	2	12	62.0	1.00%	12.9
6	6-13			NOT USED						
6	6-14	6-16	6-23	STORM SEWERS	Α	2	12	14.0	1.00%	4.0
6	6-15	6-19	6-20	STORM SEWERS (WM REQ)			12	82.0	1.00%	11.8
6	6-16	6-21	6-20	STORM SEWERS, RG	А	1	12	7.9	1.00%	0.0
6	6-17	6-20	6-22	STORM SEWERS (WM REQ)			15	66.0	1.00%	45.5
6	6-18	6-22	6-23	STORM SEWERS	А	2	15	38.0	1.00%	28.9
6	6-19	6-23	6-27	STORM SEWERS, RG	А	2	48	119.0	0.50%	247.9
6	6-20	6-24	6-26	STORM SEWERS (WM REQ)			12	57.0	1.00%	8.7
6	6-21	6-25	6-26	STORM SEWERS (WM REQ)			12	6.9	1.00%	0.0
6	6-22	6-26	6-27	STORM SEWERS (WM REQ)			15	37.9	1.00%	9.8
6	6-23	6-28	6-26	STORM SEWERS (WM REQ)			12	61.0	1.00%	13.0
6	6-24	6-29	6-28	STORM SEWERS (WM REQ)			12	19.5	1.00%	2.2
6	6-25	6-27	6-33	STORM SEWERS, RG	А	2	48	134.0	0.50%	263.4
6	6-26	6-30	6-31	STORM SEWERS	Α	1	12	65.5	1.00%	10.4
6	6-27	6-31	6-32	STORM SEWERS	Α	2	12	7.5	1.00%	1.0
6	6-28	6-32	6-33	STORM SEWERS	Α	2	12	22.3	1.00%	5.1
6	6-29	6-33	8-2	STORM SEWERS	Α	2	48	165.0	0.50%	308.5
6	6-30	6-34	6-35	STORM SEWERS (WM REQ)			12	32.0	1.00%	4.7
6	6-31	6-35	6-37	STORM SEWERS (WM REQ)			12	25.5	1.00%	3.9
6	6-32	6-36	6-37	STORM SEWERS, RG	Α	1	12	7.0	1.00%	0.0
6	6-33	6-37	8-1	STORM SEWERS (WM REQ)			12	49.3	1.00%	8.4

FILE NAME =	USER NAME = BAWitort	DESIGNED	-	JLV	REVISED -
G:\CH11\0158\Road\Sheets\D160T35-SHT-DR	IN-102.dgn	DRAWN	-	KAL	REVISED -
	PLOT SCALE = 100.00000 '/ in.	CHECKED	-	RCB	REVISED -
	PLOT DATE = 11/30/2012	DATE	-	10/31/2012	REVISED -

		F.A.P. RTE.	SECTION	COUNTY	TOTAL SHEETS	SHEET NO.
	WILLOW ROAD DRAINAGE PIPE TABLES	305	(1920.01,1518,2022&1922.4B)R	COOK	919	208
				CONTRACT	NO. 60	T35
N.T.S.	SHEET NO. 208 OF 919 SHEETS	FED. R	OAD DIST. NO. 1 ILLINOIS FED. A	D PROJECT		

DRAINAGE SHEETS WILLOW ROAD STA 661+00 TO STA 672+00 RIGHT SYSTEM

QUEET	DIDE VIIIADED	STRU	CTURE	DECODIDETON	01.400	T) (DE	0175 (11)		01.00= (0/)	TBF
SHEET	PIPE NUMBER	FROM	TO	DESCRIPTION	CLASS	TYPE	SIZE (IN)	LENGTH (FT)	SLOPE (%)	(CY)
7	7-1	7-1	7-3	STORM SEWERS, RG	Α	1	12	67.0	1.00%	9.6
7	7-2	7-3	7-2	STORM SEWERS, RG	Α	1	12	8.0	1.00%	0.0
7	7-3	7-5	7-4	STORM SEWERS, RG	Α	1	12	12.7	1.00%	0.0
7	7-4	7-6	7-7	STORM SEWERS	Α	1	12	62.0	1.00%	8.4
7	7-5	7-7	7-8	STORM SEWERS	Α	1	12	61.0	1.00%	8.1
7	7-6	7-8	N/A	STORM SEWERS, RG	Α	1	12	5.8	1.00%	0.0
7	7-7	7-9	7-10	STORM SEWERS	Α	1	12	8.3	1.00%	0.6
7	7-8	7-10	7-13	STORM SEWERS (WM REQ)			12	39.3	1.00%	3.7
7	7-9	7-11	7-14	STORM SEWERS	Α	1	EQ RS 30	59.6	0.50%	16.1
7	7-10	7-12	7-13	STORM SEWERS (WM REQ)			12	8.4	1.00%	0.6
7	7-11	7-13	7-14	STORM SEWERS (WM REQ)			12	17.0	1.00%	1.8
7	7-12	7-14	6-13	STORM SEWERS	Α	1	EQ RS 30	43.8	0.50%	11.4

DRAINAGE SHEET WILLOW ROAD STA 672+00 TO STA 683+00

SHEET	PIPE NUMBER	STRUG	CTURE	DESCRIPTION	CLASS	TYPE	SIZE (IN)	LENGTH (FT)	SLOPE (%)	TBF
SHEET	FIPE NUMBER	FROM	TO	DESCRIPTION	CLASS		SIZE (IIV)	LENGIH (FI)	SLUPE (%)	(CY)
8	8-1	8-1	8-2	STORM SEWERS, RG	Α	2	12	37.3	1.00%	9.7
8	8-2	8-2	8-6	STORM SEWERS	Α	2	48	146.4	0.50%	257.8
8	8-3	8-3	8-4	STORM SEWERS, RG	Α	1	12	7.2	1.00%	0.0
8	8-4	8-4	8-8	STORM SEWERS (WM REQ)			12	83.2	1.00%	10.1
8	8-5	8-5	8-6	STORM SEWERS	Α	1	12	35.2	1.00%	2.1
8	8-6	8-7	8-6	STORM SEWERS	Α	1	12	4.3	1.00%	0.4
8	8-7	8-9	8-5	STORM SEWERS	Α	1	12	45.3	1.00%	2.5
8	8-8	8-6	8-12	STORM SEWERS, RG	Α	2	48	135.4	0.50%	220.3
8	8-9	8-8	8-10	STORM SEWERS (WM REQ)			12	78.3	1.00%	11.2
8	8-10	8-10	8-11	STORM SEWERS, RG	Α	2	12	29.0	1.00%	5.7
8	8-11	8-11	8-12	STORM SEWERS	Α	2	12	4.3	1.00%	0.8
8	8-12	8-12	8-16	STORM SEWERS	Α	2	48	101.0	0.50%	185.8
8	8-13	8-13	8-14	STORM SEWERS, RG	Α	1	12	7.2	1.00%	0.0
8	8-14	8-14	8-15	STORM SEWERS, RG	Α	2	12	29.0	1.00%	4.3
8	8-15	8-15	8-16	STORM SEWERS	Α	2	12	10.8	1.00%	2.5
8	8-16	8-16	8-19	STORM SEWERS	Α	2	48	96.1	0.50%	199.5
8	8-17	8-17	8-18	STORM SEWERS, RG	Α	2	12	29.0	1.00%	5.3
8	8-18	8-18	8-19	STORM SEWERS	Α	2	12	10.8	1.00%	2.9
8	8-19	8-19	8-22	STORM SEWERS	Α	2	48	96.1	0.50%	190.8
8	8-20	8-20	8-21	STORM SEWERS, RG	Α	2	12	29.0	1.00%	7.5
8	8-21	8-21	8-22	STORM SEWERS	Α	2	12	10.8	1.00%	5.8
8	8-22	8-23	8-22	STORM SEWERS	Α	2	12	15.9	1.00%	1.4
8	8-23	8-22	8-25	STORM SEWERS	Α	2	48	85.9	0.50%	162.7
8	8-24	8-24	8-25	STORM SEWERS	Α	2	12	10.8	1.00%	1.7
8	8-25	8-25	8-29	STORM SEWERS	Α	2	48	110.6	0.50%	190.7
8	8-26	8-26	8-20	STORM SEWERS (WM REQ)			12	48.1	1.00%	6.4
8	8-27	8-27	8-28	STORM SEWERS (WM REQ)			12	90.3	1.00%	12.9
8	8-28	8-28	8-29	STORM SEWERS, RG	Α	2	12	43.8	1.00%	11.5
8	8-29	8-29	8-41	STORM SEWERS	Α	2	48	224.0	0.50%	328.0
8	8-30	8-30	8-32	STORM SEWERS	Α	1	12	47.0	1.00%	6.7
8	8-31	8-31	8-34	STORM SEWERS (WM REQ)			12	67.0	1.00%	10.5
8	8-32	8-32	8-35	STORM SEWERS	A	1	12	51.0	1.00%	7.6
8	8-33	8-33	8-34	STORM SEWERS, RG	Α	1	12	7.1	1.00%	0.0
8	8-34	8-36	8-35	STORM SEWERS	Α	1	12	4.2	1.00%	0.0
8	8-35	8-35	8-38	STORM SEWERS	Α	2	12	76.0	1.00%	13.8
8	8-36	8-34	8-37	STORM SEWERS (WM REQ)			12	51.0	1.00%	9.4
8	8-37	8-37	8-39	STORM SEWERS (WM REQ)			12	31.0	1.00%	6.0
8	8-38	8-38	8-41	STORM SEWERS	Α	2	12	4.3	1.00%	0.5
8	8-39	8-40	8-41	STORM SEWERS	А	2	12	12.5	1.00%	6.6
8	8-40	8-39	8-40	STORM SEWERS, RG	А	2	12	27.3	1.00%	8.3
8	8-41	8-42	8-39	STORM SEWERS (WM REQ)			12	57.0	1.00%	11.6
8	8-42	8-41	9-10	STORM SEWERS	Α	2	48	289.0	0.50%	346.6

DRAINAGE SHEET WILLOW ROAD STA 683+00 TO STA 693+00 LEFT SYSTEM

SHEET	PIPE NUMBER	STRUC	CTURE	DESCRIPTION	CLASS	TYPE	SIZE (IN)	LENGTH (FT)	SLOPE (%)	TBF
SHEET	FIFE NOWIDER	FROM	TO	DESCRIF HON	CLASS	IIFE	SIZE (IIV)	LENGTH (FT)	SLOFE (76)	(CY)
9	9-1	9-1	9-4	STORM SEWERS	Α	1	12	72.0	1.00%	11.0
9	9-2	9-2	9-6	STORM SEWERS (WM REQ)			12	57.0	1.00%	8.0
9	9-3	9-3	9-4	STORM SEWERS	Α	2	12	6.6	1.00%	0.0
9	9-4	9-4	9-7	STORM SEWERS	Α	2	12	71.0	1.00%	24.4
9	9-5	9-5	9-6	STORM SEWERS, RG	Α	1	12	9.5	1.00%	0.0
9	9-6	9-6	9-8	STORM SEWERS (WM REQ)			12	56.0	1.00%	11.4
9	9-7	9-7	9-9	STORM SEWERS	Α	2	12	76.0	1.00%	28.2
9	9-8	9-8	9-12	STORM SEWERS (WM REQ)			12	51.0	1.00%	11.2
9	9-9	9-9	9-10	STORM SEWERS	Α	2	12	4.3	1.00%	1.5
9	9-10	9-11	9-12	STORM SEWERS, RG	Α	1	12	17.2	1.00%	3.4
9	9-11	9-12	9-10	STORM SEWERS, RG	Α	2	15	43.8	1.00%	14.3
9	9-12	9-10	9-17	STORM SEWERS	Α	2	48	158.5	0.50%	156.3
9	9-13	9-13	9-19	STORM SEWERS (WM REQ)			12	107.0	1.00%	17.8
9	9-14	9-14	9-15	STORM SEWERS	Α	1	12	4.5	1.00%	0.0
9	9-15	9-15	9-16	STORM SEWERS	Α	2	12	81.0	1.00%	15.9
9	9-16	9-16	9-17	STORM SEWERS	Α	2	12	4.3	1.00%	0.5
9	9-17	9-18	9-19	STORM SEWERS (WM REQ)			12	6.5	1.00%	0.0
9	9-18	9-19	9-17	STORM SEWERS, RG	Α	2	12	42.8	1.00%	9.4
9	9-19	9-17	9-21	STORM SEWERS	Α	2	60	64.0	0.20%	63.8
9	9-20	9-23	9-22	STORM SEWERS	Α	1	12	27.4	1.00%	4.4
9	9-21	9-20	9-21	STORM SEWERS	Α	1	12	4.3	1.00%	0.4
9	9-22	9-22	9-21	STORM SEWERS	Α	2	12	17.8	1.00%	2.7
9	9-23	9-21	9-27	STORM SEWERS	Α	2	60	108.8	0.20%	103.9
9	9-24	9-24	9-26	STORM SEWERS	Α	1	12	26.8	1.00%	4.2
9	9-25	9-25	9-26	STORM SEWERS	Α	2	12	15.7	1.00%	2.3
9	9-26	9-26	9-27	STORM SEWERS	A	2	12	4.3	1.00%	1.7
9	9-27	9-27	9-29	STORM SEWERS	Α	2	60	88.0	0.20%	93.5
9	9-28	9-28	9-29	STORM SEWERS	Α	1	12	4.3	1.00%	0.4
9	9-29	9-29	9-30	STORM SEWERS	Α	2	60	100.7	0.20%	138.6
9	9-30	9-30	9-32	STORM SEWERS, RG	Α	2	60	76.2	0.20%	129.3
9	9-31	9-31	9-32	STORM SEWERS	Α	1	12	17.0	1.00%	3.4
9	9-32	9-32	11-2	STORM SEWERS	Α	2	60	160.4	0.20%	297.7
9	9-33	9-33	9-19	STORM SEWERS (WM REQ)			12	9.0	1.00%	1.1

DRAINAGE SHEET WILLOW ROAD STA 683+00 TO STA 693+00 RIGHT SYSTEM

SHEET	PIPE NUMBER	STRUC	CTURE	DESCRIPTION	CLASS	TYPE	PE SIZE (IN) LENGTH	LENGTH (FT)	SLOPE (%)	TBF
SHEET	PIPE NUMBER	FROM	TO	DESCRIPTION	CLASS	TYPE	SIZE (IIV)	LENGIH (FI)	SLOPE (%)	(CY)
10	10-1	10-1	10-2	STORM SEWERS, RG	A	1	36	18.6	1.00%	3.5
10	10-2	10-2	10-4	STORM SEWERS	A	2	42	162.5	0.10%	163.4
10	10-3	10-3	10-4	STORM SEWERS, RG	A	1	12	21.2	1.00%	2.0
10	10-4	10-4	10-5	STORM SEWERS, RG	Α	2	42	160.7	0.10%	216.1
10	10-5	10-5	12-2	STORM SEWERS	A	2	60	153.3	0.20%	276.8

DRAINAGE SHEET WILLOW ROAD STA 693+00 TO STA 704+00 LEFT SYSTEM

SHEET	PIPE NUMBER	STRUG	CTURE	DESCRIPTION	CLASS	TYPE	SIZE (IN)	LENGTH (FT)	SLOPE (%)	TBF
SHEET	FIFE NUMBER	FROM	TO	DESCRIPTION	CLASS	ITE	SIZE (IIV)	LENGIH (FI)	SLOPE (%)	(CY)
11	11-1	12-1	11-1	STORM SEWERS (WM REQ)			42	66.2	0.50%	91.1
11	11-2	11-2	11-5	STORM SEWERS	Α	2	60	82.4	0.20%	144.8
11	11-3	11-3	11-4	STORM SEWERS	Α	1	12	8.6	1.00%	1.5
11	11-4	11-4	11-5	STORM SEWERS	Α	1	12	4.3	1.00%	0.3
11	11-5	11-5	11-8	STORM SEWERS	Α	2	60	149.0	0.20%	244.2
11	11-6	11-6	11-7	STORM SEWERS	Α	1	12	74.3	1.00%	12.1
11	11-7	11-7	11-8	STORM SEWERS	Α	2	12	8.8	1.00%	1.6
11	11-8	11-8	11-12	STORM SEWERS, RG	А	2	60	102.4	0.20%	152.1
11	11-9	11-9	11-10	STORM SEWERS	Α	1	12	38.8	1.00%	6.1
11	11-10	11-10	11-11	STORM SEWERS (WM REQ)			12	24.1	1.00%	4.5
11	11-11	11-11	11-12	STORM SEWERS (WM REQ)			12	15.2	1.00%	3.5
11	11-12	11-12	11-17	STORM SEWERS	Α	2	60	177.5	0.20%	231.0
11	11-13	11-13	11-14	STORM SEWERS	Α	1	12	37.0	1.00%	5.6
11	11-14	11-14	11-15	STORM SEWERS	Α	2	12	36.0	1.00%	6.2
11	11-15	11-15	11-16	STORM SEWERS	Α	2	12	36.0	1.00%	7.1
11	11-16	11-16	11-17	STORM SEWERS	Α	2	12	8.0	1.00%	1.6
11	11-17	11-18	11-16	STORM SEWERS	Α	2	12	37.0	1.00%	6.4
11	11-18	11-17	11-24	STORM SEWERS	Α	2	66	197.0	0.15%	234.2
11	11-19	11-19	11-20	STORM SEWERS	Α	1	12	37.0	1.00%	5.9
11	11-20	11-20	11-21	STORM SEWERS	Α	2	12	36.0	1.00%	7.0

FILE NAME =	USER NAME = BAWitort	DESIGNED	-	JLV	REVISED -
G:\CHII\0158\Road\Sheets\D160T35-SHT-DR	IN-102.dgn	DRAWN	-	KAL	REVISED -
	PLOT SCALE = 100.00000 '/ in.	CHECKED	-	RCB	REVISED -
	PLOT DATE = 11/30/2012	DATE	-	10/31/2012	REVISED -

SCALE: N.T.S.

	F.A.P. RTE.	SECTION	COUNTY	TOTAL SHEETS	SHEET NO.
WILLOW ROAD DRAINAGE PIPE TABLES	305	(1920.01,1518,2022&1922.4B)R	COOK	919	209
			CONTRACT	NO. 60	T35
SHEET NO. 209 OF 919 SHEETS	FFD R	DAD DIST NO 1 THE INDIS FED AT	D PROJECT		

DRAINAGE SHEET WILLOW ROAD STA 693+00 TO STA 704+00 LEFT SYSTEM - CONTINUED

SHEET	PIPE NUMBER	STRUG	CTURE	DESCRIPTION	CLASS	TYPE	SIZE (IN)	LENGTH (FT)	SLOPE (%)	TBF
SHEET	PIPE NUMBER	FROM	TO	DESCRIPTION	CLASS	1175	SIZE (IIV)	LENGIH (FI)	SLOPE (%)	(CY)
11	11-21	11-21	11-23	STORM SEWERS	Α	2	12	41.0	1.00%	9.5
11	11-22			NOT USED						
11	11-23	11-23	11-24	STORM SEWERS	Α	2	12	8.0	1.00%	1.9
11	11-24	11-25	11-23	STORM SEWERS	Α	2	12	42.0	1.00%	7.4
11	11-25	11-24	11-31	STORM SEWERS	Α	2	66	212.0	0.15%	217.1
11	11-26	11-26	11-27	STORM SEWERS	Α	1	12	42.0	1.00%	6.8
11	11-27	11-27	11-28	STORM SEWERS	Α	2	12	41.0	1.00%	8.3
11	11-28	11-28	11-29	STORM SEWERS	Α	2	12	21.0	1.00%	4.7
11	11-29	11-29	11-30	STORM SEWERS	Α	2	12	16.0	1.00%	3.8
11	11-30	11-32	11-30	STORM SEWERS	Α	2	12	47.0	1.00%	8.0
11	11-31	11-30	11-31	STORM SEWERS	Α	2	12	8.0	1.00%	2.0
11	11-32	11-31	13-4	STORM SEWERS	Α	2	66	272.0	0.15%	292.6

DRAINAGE SHEET WILLOW ROAD STA 693+00 TO STA 704+00 RIGHT SYSTEM

		STRUC	CTURE						21 222 (21)	TBF
SHEET	PIPE NUMBER	FROM	TO	DESCRIPTION	CLASS	TYPE	SIZE (IN)	LENGTH (FT)	SLOPE (%)	(CY)
12	12-1	12-2	12-4	STORM SEWERS	Α	2	60	7.8	0.20%	10.2
12	12-2	12-3	12-4	STORM SEWERS (WM REQ)			18	15.2	1.00%	15.6
12	12-3	12-5	12-4	STORM SEWERS	Α	2	12	8.6	1.00%	1.1
12	12-4	12-6	12-3	STORM SEWERS (WM REQ)			12	34.8	1.00%	0.0
12	12-5	12-4	12-8	STORM SEWERS	Α	2	66	73.7	0.20%	128.6
12	12-6	12-7	12-9	STORM SEWERS	А	1	12	37.1	1.00%	5.5
12	12-7	12-9	12-8	STORM SEWERS	Α	2	12	13.7	1.00%	2.4
12	12-8	12-8	12-13	STORM SEWERS	Α	2	66	124.3	0.20%	178.8
12	12-9	12-10	12-11	STORM SEWERS	Α	1	12	41.9	1.00%	6.4
12	12-10	12-11	12-14	STORM SEWERS	Α	1	12	35.9	1.00%	4.8
12	12-11	12-12	12-13	STORM SEWERS, RG	Α	1	12	19.8	1.00%	1.3
12	12-12	12-14	12-13	STORM SEWERS	Α	2	12	14.3	1.00%	2.2
12	12-13	12-15	12-14	STORM SEWERS	Α	1	12	22.0	1.00%	2.8
12	12-14	12-13	12-20	STORM SEWERS	Α	2	66	100.8	0.20%	118.1
12	12-15	12-16	12-17	STORM SEWERS	Α	2	12	1.8	2.00%	0.0
12	12-16	12-17	12-18	STORM SEWERS (WM REQ)			12	28.7	2.00%	28.6
12	12-17	12-18	12-20	STORM SEWERS (WM REQ)			42	45.0	0.50%	60.5
12	12-18	12-19	12-18	STORM SEWERS	Α	2	18	5.1	2.00%	3.3
12	12-19	12-20	12-23	STORM SEWERS, RG	Α	2	66	77.9	0.20%	82.7
12	12-20	12-21	12-22	STORM SEWERS (WM REQ)			12	61.6	1.00%	9.4
12	12-21	12-22	12-23	STORM SEWERS, RG	Α	2	12	8.0	1.00%	1.2
12	12-22	12-23	12-28	STORM SEWERS	Α	1	66	172.0	0.20%	153.5
12	12-23	12-24	12-25	STORM SEWERS (WM REQ)			12	57.0	1.00%	9.4
12	12-24	12-25	12-27	STORM SEWERS (WM REQ)			12	56.0	1.00%	11.5
12	12-25	12-26	12-27	STORM SEWERS, RG	А	1	12	4.0	2.00%	0.0
12	12-26	12-27	12-28	STORM SEWERS, RG	А	2	15	8.0	2.00%	1.8
12	12-27	12-29	12-26	PIPE CULVERTS	Α	1	12	24.7	2.00%	1.7
12	12-28	12-28	12-31	STORM SEWERS	А	1	66	65.1	0.20%	50.0
12	12-29	12-30	12-31	STORM SEWERS, RG	А	2	36	35.3	0.42%	22.4
12	12-30	12-31	12-36	STORM SEWERS	Α	1	66	177.9	0.20%	130.4
12	12-31	12-32	12-33	STORM SEWERS (WM REQ)			12	47.0	1.00%	7.8
12	12-32	12-33	12-35	STORM SEWERS (WM REQ)			12	46.0	1.00%	9.5
12	12-33	12-34	12-35	STORM SEWERS, RG	Α	1	12	9.0	1.00%	0.0
12	12-34	12-35	12-36	STORM SEWERS, RG	Α	2	12	8.0	1.00%	1.7
12	12-35	12-36	12-41	STORM SEWERS	Α	1	66	102.0	0.20%	70.4
12	12-36	12-37	12-38	STORM SEWERS (WM REQ)			12	27.0	1.00%	4.2
12	12-37	12-38	12-40	STORM SEWERS (WM REQ)			12	21.0	1.00%	3.8
12	12-38	12-39	12-40	STORM SEWERS, RG	Α	1	12	6.0	1.00%	0.0
12	12-39	12-40	12-41	STORM SEWERS, RG	Α	2	15	8.0	1.00%	1.6
12	12-40	12-42	12-39	PIPE CULVERTS	А	1	12	22.3	1.00%	1.5
12	12-41	12-41	14-2	STORM SEWERS	Α	1	72	91.5	0.20%	73.8
12	12-42	12-43	14-1	STORM SEWERS (WM REQ)			36	24.5	0.40%	25.5

DRAINAGE SHEET WILLOW ROAD STA 704+00 TO STA 716+00 LEFT SYSTEM

SHEET	PIPE NUMBER	STRU	CTURE	DESCRIPTION	CLASS	TYPE	SIZE (IN)	LENGTH (FT)	SLOPE (%)	TBF
SHEET	PIPE NUMBER	FROM	ТО	DESCRIPTION	CLASS	ITPE	SIZE (IIV)	LENGIH (FI)	SLOPE (%)	(CY)
13	13-1	13-1	13-3	STORM SEWERS	A	1	12	47.0	1.00%	7.6
13	13-2	13-2	13-3	STORM SEWERS	Α	2	12	14.5	1.00%	3.8
13	13-3	13-3	13-4	STORM SEWERS	Α	2	12	8.0	1.00%	4.9
13	13-4	13-4	13-7	STORM SEWERS	Α	2	66	87.0	0.15%	90.6
13	13-5	13-5	13-6	STORM SEWERS	Α	1	12	42.0	1.00%	6.7
13	13-6	13-6	13-7	STORM SEWERS	Α	2	12	8.0	1.00%	1.6
13	13-7	13-8	13-6	STORM SEWERS	Α	2	12	42.0	1.00%	7.5
13	13-8	13-7	13-14	STORM SEWERS	Α	1	66	229.3	0.15%	209.2
13	13-9	13-9	13-11	STORM SEWERS	Α	1	12	52.0	1.00%	8.5
13	13-10	13-10	13-11	STORM SEWERS	Α	2	12	15.9	1.00%	2.0
13	13-11	13-11	13-12	STORM SEWERS	Α	2	12	36.0	1.00%	24.8
13	13-12	13-12	13-13	STORM SEWERS	Α	2	12	38.3	1.00%	28.5
13	13-13	13-13	13-14	STORM SEWERS	Α	2	12	8.0	1.00%	5.4
13	13-14	13-15	13-13	STORM SEWERS	Α	1	12	21.7	1.00%	3.3
13	13-15	13-14	13-17	STORM SEWERS, RG	Α	1	66	99.7	0.15%	90.1
13	13-16	13-16	13-17	STORM SEWERS	Α	2	12	8.0	1.00%	1.3
13	13-17	13-18	13-16	STORM SEWERS	Α	1	12	46.0	1.00%	7.3
13	13-18	13-19	13-18	STORM SEWERS	Α	1	12	57.0	1.00%	8.6
13	13-19	13-17	13-21	STORM SEWERS	Α	2	66	162.0	0.15%	215.1
13	13-20	13-20	13-21	STORM SEWERS	Α	2	12	8.0	1.00%	1.2
13	13-21	13-22	13-20	STORM SEWERS	Α	1	12	57.0	1.00%	8.6
13	13-22	13-21	13-24	STORM SEWERS	Α	2	66	112.0	0.15%	209.2
13	13-23	13-23	13-24	STORM SEWERS	Α	2	12	8.0	1.00%	1.2
13	13-24	13-25	13-23	STORM SEWERS	Α	1	12	57.0	1.00%	8.6
13	13-25	13-24	13-26	STORM SEWERS	Α	2	66	56.7	0.15%	123.4
13	13-26	15-2	13-27	STORM SEWERS, RG	Α	2	42	76.7	0.12%	141.3

DRAINAGE SHEET WILLOW ROAD STA 704+00 TO STA 716+00 RIGHT SYSTEM

SHEET	PIPE NUMBER	STRUG	CTURE	DESCRIPTION	CLASS	TYPE	SIZE (IN)	LENGTH (FT)	SLOPE (%)	TBF
SHEET	PIPE NUMBER	FROM	ТО	DESCRIPTION	CLASS	ITE	SIZE (IIV)	LENGIH (FI)	SLOPE (%)	(CY)
14	14-1	14-1	14-2	STORM SEWERS, RG	Α	2	36	7.0	0.40%	6.0
14	14-2	14-2	14-8	STORM SEWERS	Α	1	72	261.0	0.20%	218.5
14	14-3	14-3	14-4	STORM SEWERS, RG	Α	2	12	6.9	1.00%	0.0
14	14-4	14-4	14-5	STORM SEWERS (WM REQ)			12	41.0	1.00%	15.2
14	14-5	14-5	14-6	STORM SEWERS (WM REQ)			12	41.0	1.00%	25.7
14	14-6	14-6	14-7	STORM SEWERS (WM REQ)			12	46.0	1.00%	31.3
14	14-7	14-7	14-8	STORM SEWERS, RG	Α	2	18	7.0	2.00%	4.2
14	14-8	14-9	14-7	PIPE CULVERTS	Α	1	18	32.5	2.00%	5.0
14	14-9	14-8	14-11	STORM SEWERS	Α	1	72	54.4	0.20%	40.1
14	14-10	14-10	14-11	STORM SEWERS, RG	Α	2	42	39.0	0.20%	29.4
14	14-11	14-11	14-14	STORM SEWERS	Α	1	72	171.0	0.20%	114.6
14	14-12	14-12	14-13	STORM SEWERS (WM REQ)			12	54.3	1.00%	9.3
14	14-13	14-13	14-14	STORM SEWERS, RG	Α	2	12	8.0	1.00%	1.5
14	14-14	14-15	14-13	STORM SEWERS (WM REQ)			12	26.7	1.00%	4.1
14	14-15	14-14	14-17	STORM SEWERS, RG	Α	1	72	98.5	0.20%	70.9
14	14-16	14-16	14-17	STORM SEWERS, RG	Α	2	36	15.5	0.40%	6.3
14	14-17	14-17	14-19	STORM SEWERS	Α	2	72	97.2	0.20%	101.5
14	14-18	14-18	14-19	STORM SEWERS, RG	Α	2	12	5.5	1.00%	0.7
14	14-19A	14-20A	14-18	STORM SEWERS (WM REQ)			12	51.0	1.00%	8.1
14	14-19B	14-20B	14-20A	STORM SEWERS	Α	2	12	52.0	1.00%	7.8
14	14-20	14-19	14-22	STORM SEWERS	Α	2	72	157.0	0.20%	253.9
14	14-21	14-21	14-22	STORM SEWERS	Α	2	12	5.5	1.00%	0.7
14	14-22	14-23	14-21	STORM SEWERS	Α	1	12	52.0	1.00%	7.8
14	14-23	14-22	14-24	STORM SEWERS	Α	2	72	76.6	0.20%	162.1
14	14-24	14-25	14-26	STORM SEWERS	Α	1	EQ RS 36	95.0	0.25%	0.0
14	14-25	14-26	14-27	STORM SEWERS	Α	1	EQ RS 36	110.9	0.25%	0.0
14	14-26	14-27	14-28	STORM SEWERS	Α	1	EQ RS 36	93.1	0.25%	0.0

DRAINAGE SHEET WILLOW ROAD STA 716+00 TO STA 728+00

SHEET	PIPE NUMBER	STRUG	CTURE	DESCRIPTION	CLASS	CLASS TYPE SIZE (IN	CIZE (INI)	LENGTH (FT)	SLOPE (%)	TBF
SHEET	PIPE NUMBER	FROM	TO	DESCRIPTION	THE SIZE (III) ELINGTH (III) SLOPE (TIPE SIZE (IIV) LENGTH (FT) SLOPE (%)		(CY)	
15	15-1	15-1	15-2	STORM SEWERS, RG	Α	2	12	10.5	1.00%	2.3
15	15 - 2	15-4	15-1	STORM SEWERS, RG	Α	2	12	27.0	1.00%	4.7
15	15-3A	15-7A	15-2	STORM SEWERS	А	2	42	37.3	0.12%	61.6
15	15-3B	15-7B	15-7A	STORM SEWERS	Α	2	42	52.3	0.12%	78.6
15	15-4	15-3	15-6	STORM SEWERS (WM REQ)			12	82.1	1.00%	11.4
15	15-5	15-5	15-6	STORM SEWERS, RG	Α	1	12	8.6	1.00%	1.7
15	15-6	15-6	15-7B	STORM SEWERS, RG	Α	2	12	42.0	1.00%	8.0

FILE NAME =	USER NAME = BAWitort	DESIGNED	-	JLV	REVISED	-
G:\CHII\0158\Road\Sheets\D160T35-SHT-DR	IN-102.dgn	DRAWN	-	KAL	REVISED	-
	PLOT SCALE = 100.00000 '/ in.	CHECKED	-	RCB	REVISED	-
	PLOT DATE = 11/30/2012	DATE	-	10/31/2012	REVISED	-

	F.A.P. RTE.	SECTION	COUNTY	TOTAL SHEETS	SHEET NO.
WILLOW ROAD DRAINAGE PIPE TABLES	305	(1920.01,1518,2022&1922.4B)R	COOK	919	210
			CONTRACT	NO. 60	T35
SHEET NO. 210 OF 919 SHEETS!	EEU D	OAD DIST NO 1 THE INDIS EED AT	n ppn iect		

DRAINAGE SHEET WILLOW ROAD STA 716+00 TO STA 728+00 - CONTINUED

SHEET	PIPE NUMBER	STRU	CTURE	DESCRIPTION	CLASS	TYPE	SIZE (IN)	LENGTH (FT)	SLOPE (%)	TBF
SHEET	PIPE NUMBER	FROM	ТО	DESCRIPTION	CLASS		` ,	LENGIH (FI)	SLOPE (%)	(CY)
15	15-7	15-9	15-7B	STORM SEWERS	Α	2	42	27.0	0.12%	34.2
15	15-8	15-8	15-9	STORM SEWERS	Α	1	12	11.0	1.00%	1.3
15	15-9A	15-12A	15-9	STORM SEWERS	Α	2	42	48.8	0.12%	58.6
15	15-9B	15-12B	15-12A	STORM SEWERS	Α	2	42	32.3	0.12%	36.4
15	15-10	15-10	15-12B	STORM SEWERS	Α	2	15	29.7	1.50%	24.2
15	15-11	15-11	15-12B	STORM SEWERS, RG	Α	2	12	42.0	1.00%	7.8
15	15-12	15-13	15-10	STORM SEWERS, RG	Α	2	15	30.5	1.50%	21.1
15	15-13	15-14	15-13	STORM SEWERS, RG	Α	1	12	11.2	1.00%	1.6
15	15-14	15-19	15-12B	STORM SEWERS, RG	Α	2	42	166.8	0.12%	172.6
15	15-15	15-15	15-17	STORM SEWERS	Α	1	12	50.2	1.00%	8.2
15	15-16	15-16	15-17	STORM SEWERS	Α	1	12	6.0	1.00%	0.0
15	15-17	15-17	15-19	STORM SEWERS	Α	2	12	10.0	1.00%	1.9
15	15-18A	15-18A	15-18B	STORM SEWERS (WM REQ)			12	25.0	1.00%	3.7
15	15-18B	15-18B	15-19	STORM SEWERS, RG	Α	2	18	42.0	1.00%	31.2
15	15-19	15-26	15-19	STORM SEWERS	Α	2	42	101.0	0.12%	83.8
15	15-20	15-20	15-18B	STORM SEWERS (WM REQ)			12	17.8	1.00%	3.6
15	15-21	15-21	15-20	STORM SEWERS (WM REQ)			12	26.9	1.00%	4.4
15	15-22	15-22	15-24A	STORM SEWERS	Α	1	12	32.1	1.00%	5.0
15	15-23	15-23	15-25	STORM SEWERS (WM REQ)			12	21.9	1.00%	3.2
15	15-24A	15-24A	15-26	STORM SEWERS	Α	2	18	12.0	2.00%	6.8
15	15-24B	15-24B	15-24A	STORM SEWERS	Α	2	18	15.2	2.00%	5.2
15	15-25	15-25	15-26	STORM SEWERS, RG	Α	2	12	43.4	1.00%	11.2
15	15-26	15-33	15-26	STORM SEWERS	Α	2	42	89.1	0.12%	61.3
15	15-27	15-27	15-25	STORM SEWERS (WM REQ)			12	31.9	1.00%	5.4
15	15-28	15-28	15-31	STORM SEWERS	А	1	12	27.1	1.00%	4.1
15	15-29	15-29	15-32	STORM SEWERS (WM REQ)			12	27.0	1.00%	4.6
15	15-30	15-30	15-31	STORM SEWERS	А	1	12	4.3	1.00%	0.0
15	15-31	15-32	15-33	STORM SEWERS, RG	A	2	12	46.0	1.00%	12.5
15	15-32	15-31	15-33	STORM SEWERS	A	2	12	10.0	1.00%	1.7
15	15-33	15-35	15-31	STORM SEWERS	А	1	12	37.1	1.00%	4.6
15	15-34	15-34	15-32	STORM SEWERS (WM REQ)			12	25.9	1.00%	4.7
15	15-35	15-38	15-33	STORM SEWERS, RG	A	1	36	133.9	0.10%	43.5
15	15-36	15-36	15-34	STORM SEWERS (WM REQ)			12	26.9	1.00%	3.1
15	15-37	15-37	15-38	STORM SEWERS	Α	1	12	59.5	0.50%	7.3
15	15-38	15-40	15-38	STORM SEWERS	Α	1	EQ RS 36	79.1	0.10%	50.2
15	15-39	15-39	15-40	STORM SEWERS, RG	A	1	12	10.0	1.00%	0.6
15	15-40	15-46	15-40	STORM SEWERS	Α	1	EQ RS 36	73.8	0.10%	40.2
15	15-41	15-41	15-42	STORM SEWERS	Α	1	12	27.2	1.00%	1.5
15	15-42	15-42	15-45	STORM SEWERS	A	1	12	26.2	1.00%	1.8
15	15-43	15-43	15-44	STORM SEWERS (WM REQ)	- · ·	<u> </u>	12	7.0	1.00%	0.5
15	15-44	15-44	15-46	STORM SEWERS, RG	Α	1	12	10.0	1.00%	1.3
15	15-45	15-45	15-46	STORM SEWERS	A	1	12	43.3	1.00%	6.1
15	15-46	15-47	15-44	STORM SEWERS (WM REQ)	, ,	_	12	26.9	1.00%	3.1
15	15-47	15-48	15-45	STORM SEWERS	Α	1	12	27.2	1.00%	2.4
15	15-48	15-50	15-47	STORM SEWERS (WM REQ)	, ,	 '	12	90.7	1.00%	7.1
		1000	10 77	I O I OI WIN OF AMELING (AMINI LICE)		1	1 12	00.7	1.00/0	, ,,,

DRAINAGE SHEET WILLOW ROAD STA 728+00 TO STA 740+00

SHEET	PIPE NUMBER	STRUCTURE		DESCRIPTION	CLASS	TYPE	SIZE (IN)	LENGTH (FT)	SLOPE (%)	TBF
SHEET	PIPE NUMBER	FROM	TO	DESCRIPTION	CLASS	ITPE	SIZE (IIV)	LENGIH (FI)	SLOPE (%)	(CY)
16	16-1	16-1	16-2	STORM SEWERS	Α	2	12	82.4	2.00%	18.6
16	16-2	16-3	16-4	STORM SEWERS	Α	1	12	59.1	1.00%	8.7

DRAINAGE SHEET ILLINOIS ROUTE 43 STA 505+00 TO STA 518+00

SHEET	PIPE NUMBER	STRUCTURE		DESCRIPTION	CLASS	CLASS TYPE	SIZE (IN)	LENGTH (FT)	SLOPE (%)	TBF
SHEET	FIFE NUMBER	FROM	TO	DESCRIPTION	CLASS		SIZE (IIV)	LENGIH (FI)	SLOPE (%)	(CY)
17	17-1	17-1	17-2	STORM SEWERS	Α	1	12	6.4	1.00%	8.0
17	17-2	17-3	17-2	STORM SEWERS, RG	Α	2	12	68.4	1.00%	12.1
17	17-3	17-4	17-6	STORM SEWERS	Α	2	12	63.6	1.00%	13.4
17	17-4	17-7	17-8	STORM SEWERS, RG	Α	2	12	9.2	1.00%	0.0

DRAINAGE SHEET ILLINOIS ROUTE 43 STA 518+00 TO STA 530+00

SHEET	PIPE NUMBER	STRUC	CTURE	DESCRIPTION	CLASS	TYPE	SIZE (IN)	LENGTH (FT)	SLOPE (%)	TBF
SHEET	PIPE NUMBER	FROM	TO	DESCRIPTION	CLASS	ITPE	SIZE (IIV)	LENGIH (FI)	SLOPE (%)	(CY)
18	18-1	18-1	18-4	STORM SEWERS	A	2	12	51.0	1.00%	14.4
18	18-2	18-4	18-5	STORM SEWERS	A	2	12	21.0	1.00%	6.7
18	18-3	18-2	18-6	STORM SEWERS	Α	2	12	46.0	1.00%	14.6
18	18-4	18-5	18-6	STORM SEWERS	A	2	12	26.0	1.00%	15.0
18	18-5	18-6	18-7	STORM SEWERS	A	2	15	7.7	1.00%	0.0
18	18-6	18-8	18-5	STORM SEWERS	А	2	12	40.4	1.00%	8.6
18	18-7	18-7	18-11	STORM SEWERS	A	2	18	195.1	0.50%	0.0
18	18-8	18-9	18-8	STORM SEWERS	A	2	12	21.7	1.00%	3.8
18	18-9	18-10	18-9	STORM SEWERS	Α	1	12	27.0	1.00%	4.1
18	18-10	18-11	18-14	STORM SEWERS	A	2	18	213.3	0.50%	0.0
18	18-11	18-12	18-13	STORM SEWERS	A	2	12	41.7	1.00%	8.2
18	18-12	18-13	18-14	STORM SEWERS	Α	2	12	34.8	1.00%	7.3
18	18-13	18-14	18-17	STORM SEWERS	Α	2	24	189.7	0.50%	0.0
18	18-14	18-15	18-16	STORM SEWERS	A	1	12	65.9	3.40%	18.5
18	18-15	18-16	18-17	STORM SEWERS	Α	1	12	40.8	1.00%	4.1
18	18-16	18-17	18-19	STORM SEWERS	Α	1	24	60.8	0.50%	8.3
18	18-17	18-18	18-19	STORM SEWERS	Α	2	12	88.5	1.00%	19.4
18	18-18	18-19	18-20	STORM SEWERS	Α	2	30	179.0	0.50%	332.0
18	18-19	18-20	18-21	STORM SEWERS	А	2	30	8.9	0.50%	3.3


DRAINAGE SHEET INTERSTATE 94 RAMP A STA 811+00 TO STA 822+00

SHEET	PIPE NUMBER	STRU	CTURE	DESCRIPTION	CLASS	TYPE	SIZE (IN)	LENGTH (FT)	SLOPE (%)	TBF
SHEET	PIPE NUMBER	FROM	TO	DESCRIPTION	CLASS	ITPE	SIZE (IIV)	LENGIH (FI)	SLOPE (%)	(CY)
19	19-1	19-1	19-2	STORM SEWERS	A	2	18	162.0	1.00%	0.0
19	19-2	19-2	19-3	STORM SEWERS	Α	2	18	103.5	1.00%	52.9
19	19-3	19-4	19-3	STORM SEWERS	A	2	18	94.5	1.00%	61.6
19	19-4	19-5	19-4	STORM SEWERS	Α	1	15	98.9	1.00%	0.0

DRAINAGE SHEET INTERSTATE 94 RAMP D STA 850+00 TO STA 862+00

SHEET	PIPE NUMBER	STRU	CTURE DESCRIPTION		CLASS	TYPE	SIZE (IN)	LENGTH (FT)	SLOPE (%)	TBF
SHEET	PIPE NUMBER	FROM	TO	DESCRIPTION	CLASS	ITPE	SIZE (IIV)	LENGIH (FI)	SLOPE (%)	(CY)
20	20-1	20-1	20-2	STORM SEWERS	A	1	15	6.0	1.00%	0.0
20	20-2	20-2	20-3	STORM SEWERS	Α	2	18	59.9	1.00%	0.0
20	20-3	20-5	20-4	STORM SEWERS	А	1	18	47.6	0.80%	0.0
20	20-4	20-6	20-5	STORM SEWERS	A	1	15	91.1	0.80%	0.0

FILE NAME =	USER NAME = BAWitort	DESIGNED -	JLV	REVISED -
G:\CH11\0158\Road\Sheets\D160T35-SHT-DR	HII\0I58\Road\Sheets\DI60T35-SHT-DR#IN-I02.dgn		KAL	REVISED -
	PLOT SCALE = 100.00000 '/ in.	CHECKED -	RCB	REVISED -
	PLOT DATE = 11/30/2012	DATE -	10/31/2012	REVISED -

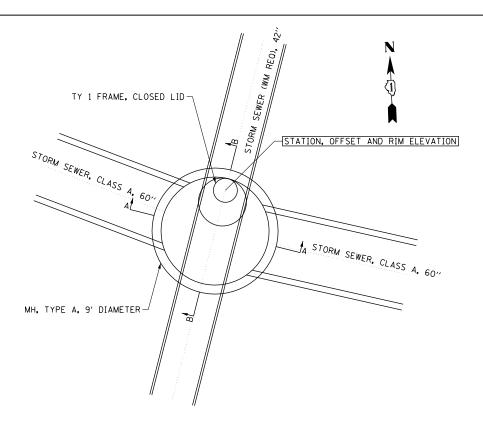

PLAN VIEW STRUCTURE NO. 11-2

SECTION A-A

FILE NAME = DESIGNED - JLV REVISED USER NAME = BAWitort g:\ch11\0158\road\Sheets\D160T35-SHT-DRNDET-01.dgn DRAWN KAI REVISED PLOT SCALE = 40.000 '/ in. CHECKED RCB REVISED 10/31/2012 PLOT DATE = 11/1/2012 DATE REVISED


STATE OF ILLINOIS DEPARTMENT OF TRANSPORTATION

SCALE: N.T.S.

NOTES


- 1. STRUCTURE SHALL BE PRECAST REINFORCED CONCRETE AND IN ACCORDANCE WITH HIGHWAY STANDARD 602421-03.
- 2. SEE HIGHWAY STANDARDS 602601-02, 602701-02 AND 604001-03 FOR ADDITIONAL INFORMATION AND REQUIREMENTS.
- 3. THE CONTRACT UNIT PRICE FOR EACH SHALL INCLUDE ALL EXCAVATION, BACKFILL, CONCRETE, REINFORCEMENT, FRAME, LID AND OTHER INCIDENTALS AS SPECIFIED ON THIS DETAIL AND AS DIRECTED BY THE ENGINEER.
- 4. ALL INVERTS AND ELEVATIONS SHALL BE FIELD VERIFIED BY THE CONTRACTOR PRIOR TO ORDERING MATERIALS AND PREFABRICATION. THIS WORK WILL NOT BE PAID FOR SEPARATELY, BUT SHALL BE INCLUDED WITHIN THE CONTRACT UNIT PRICE FOR EACH STRUCTURE.
- 5. STATION, OFFSET AND RIM ELEVATION PROVIDED ARE AT THE CENTER OF THE PROPOSED FRAME AND LID.


A FULLY ENCLOSED, CONTINUOUS SEGMENT OF 42" STORM SEWER (WM REQ) PIPE SHALL PASS THROUGH THE STRUCTURE AS SHOWN IN THIS DETAIL. THIS PIPE SHALL NOT DISCHARGE INTO THE STRUCTURE, BUT RATHER SHALL REMAIN FULLY INDEPENDENT AND SEPARATE FROM THE PROPOSED WILLOW ROAD MAINLINE STORM SEWER. THE PRECAST OPENINGS IN THE STRUCTURE WALLS SHALL BE TIGHTLY SEALED AFTER INSTALLATION OF THE 42" PIPE TO THE SATISFACTION OF THE ENGINEER. THIS WORK WILL NOT BE PAID FOR SEPARATELY, BUT SHALL BE INCLUDED IN THE CONTRACT UNIT PRICE FOR EACH STRUCTURE.

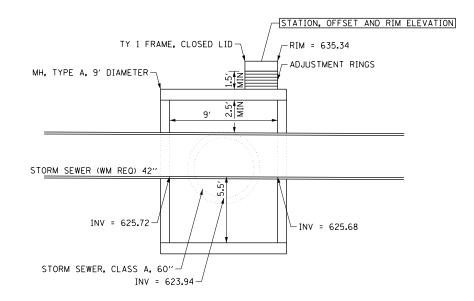

SECTION B-B

DRAINAGE DETAILS	F.A.P. RTE.	SECTION	COUNTY	TOTAL SHEETS	SHEET NO.
STRUCTURE NUMBER 11–2	305	(1920.01,1518,2022&1922.4B)R	COOK	919	212
OTHOUTONE NOMBER 11 E			CONTRACT	NO. 60	T35
SHEET NO. 212 OF 919 SHEETS	FED. R	DAD DIST. NO. 1 ILLINOIS FED. AI	D PROJECT		

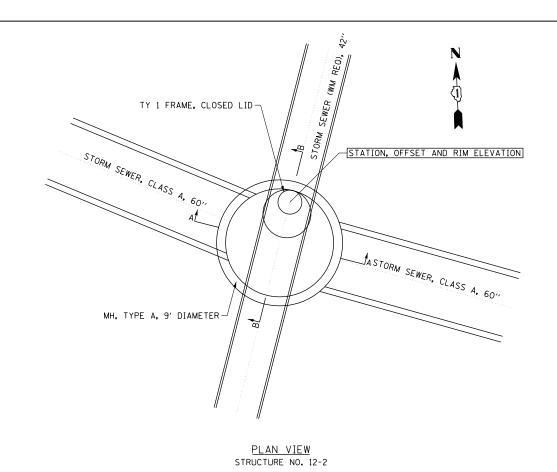

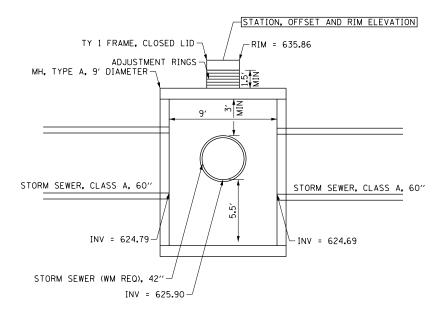


SECTION A-A

<u>NOTES</u>


- 1. STRUCTURE SHALL BE PRECAST REINFORCED CONCRETE AND IN ACCORDANCE WITH HIGHWAY STANDARD 602421-03.
- 2. SEE HIGHWAY STANDARDS 602601-02, 602701-02 AND 604001-03 FOR ADDITIONAL INFORMATION AND REQUIREMENTS.
- 3. THE CONTRACT UNIT PRICE FOR EACH SHALL INCLUDE ALL EXCAVATION, BACKFILL, CONCRETE, REINFORCEMENT, FRAME, LID AND OTHER INCIDENTALS AS SPECIFIED ON THIS DETAIL AND AS DIRECTED BY THE ENGINEER.
- 4. ALL INVERTS AND ELEVATIONS SHALL BE FIELD VERIFIED BY THE CONTRACTOR PRIOR TO ORDERING MATERIALS AND PREFABRICATION. THIS WORK WILL NOT BE PAID FOR SEPARATELY, BUT SHALL BE INCLUDED WITHIN THE CONTRACT UNIT PRICE FOR EACH STRUCTURE.
- 5. STATION, OFFSET AND RIM ELEVATION PROVIDED ARE AT THE CENTER OF THE PROPOSED FRAME AND LID.

A FULLY ENCLOSED, CONTINUOUS SEGMENT OF 42" STORM SEWER (WM REQ) PIPE SHALL PASS THROUGH THE STRUCTURE AS SHOWN IN THIS DETAIL. THIS PIPE SHALL NOT DISCHARGE INTO THE STRUCTURE, BUT RATHER SHALL REMAIN FULLY INDEPENDENT AND SEPARATE FROM THE PROPOSED WILLOW ROAD MAINLINE STORM SEWER. THE PRECAST OPENINGS IN THE STRUCTURE WALLS SHALL BE TIGHTLY SEALED AFTER INSTALLATION OF THE 42" PIPE TO THE SATISFACTION OF THE ENGINEER. THIS WORK WILL NOT BE PAID FOR SEPARATELY, BUT SHALL BE INCLUDED IN THE CONTRACT UNIT PRICE FOR EACH STRUCTURE.

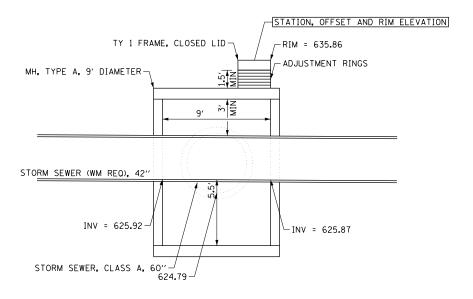


SECTION B-B

FILE NAME =	USER NAME = BAWitort	DESIGNED - JLV	REVISED -		DRAINAGE DETAILS	F.A.P. SECTION COUNTY TOTAL SHEET
g:\chl1\0158\road\Sheets\D160T35-SHT-DRNDET-01.dgn		DRAWN - KAL RE		STATE OF ILLINOIS	STRUCTURE NUMBER 12-2	305 (1920.01,1518,2022&1922.4B)R COOK 919 213
	PLOT SCALE = 40.000 '/ in.	CHECKED - RCB	REVISED -	DEPARTMENT OF TRANSPORTATION		CONTRACT NO. 60T35
	PLOT DATE = 11/1/2012	DATE - 10/31/2012	REVISED -		SCALE: N.T.S. SHEET NO. 213 OF 919 SHEETS	FED. ROAD DIST. NO. 1 ILLINOIS FED. AID PROJECT

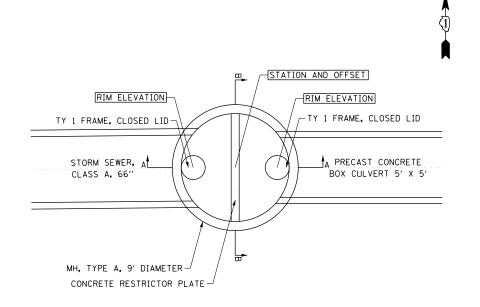

PLAN VIEW STRUCTURE NO. 13-26

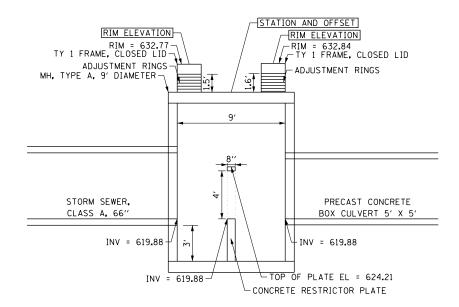


NOTES:

- 1. STRUCTURE SHALL BE PRECAST REINFORCED CONCRETE AND IN ACCORDANCE WITH HIGHWAY STANDARD 602421-03.
- 2. SEE HIGHWAY STANDARDS 602601-02, 602701-02 AND 604001-03 FOR ADDITIONAL INFORMATION AND REQUIREMENTS.
- 3. THE CONTRACT UNIT PRICE FOR EACH SHALL INCLUDE ALL EXCAVATION, BACKFILL, CONCRETE, REINFORCEMENT, FRAME, LID AND OTHER INCIDENTALS AS SPECIFIED ON THIS DETAIL AND AS DIRECTED BY THE ENGINEER.
- 4. ALL INVERTS AND ELEVATIONS SHALL BE FIELD VERIFIED BY THE CONTRACTOR PRIOR TO ORDERING MATERIALS AND PREFABRICATION. THIS WORK WILL NOT BE PAID FOR SEPARATELY, BUT SHALL BE INCLUDED WITHIN THE CONTRACT UNIT PRICE FOR EACH STRUCTURE.
- 5. STATION AND OFFSET PROVIDED ARE AT THE CENTER OF THE PROPOSED STRUCTURE. RIM ELEVATIONS PROVIDED ARE AT THE CENTER OF THE PROPOSED FRAME AND LID.
- 6. CONCRETE FOR THE RESTRICTOR PLATE SHALL CONSIST OF CLASS SI CONCRETE.

BILL OF MATERIAL

BAR	NO.	SIZE	LENGTH	SHAPE
h ₅ (E)	18	#4	2'-2''	
h ₆ (E)	9	#4	8'-9''	
∨ ₄ (E)	10	#4	2'-2''	
∨ ₅ (E)	10	#4	7'-7''	
∨ ₆ (E)	8	#4	5′-4′′	
CONCRE:	TE STRU	ICTURES	CU YD	1.5
REINFOF EPOXY	RCEMENT COATED	BARS,	POUND	180

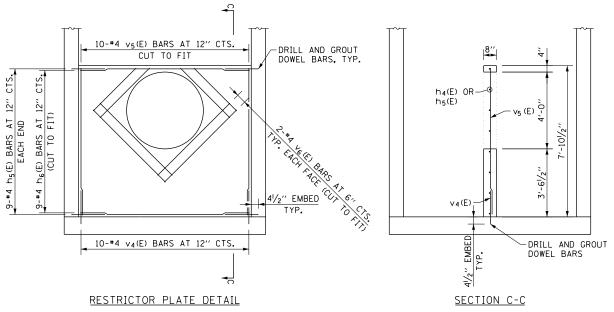

RIM ELEVATION

STATION AND OFFSET

RIM = 632.84

TY 1 FRAME, CLOSED LID

ADJUSTMENT RINGS

PRECAST CONCRETE BOX CULVERT 5' X 5'

9'


TOP OF PLATE EL = 624.21

CONCRETE RESTRICTOR PLATE

INV = 619.88

SECTION A-A

FILE NAME =	USER NAME = BAWitort	DESIGNED - JLV	REVISED -	2 2- 1111112	DRAINAGE DETAILS	F.A.P. SECTION	COUNTY	TOTAL SHEET SHEETS NO.
	illoci briogri	DRAWN - KAL	REVISED -	STATE OF ILLINOIS	STRUCTURE NUMBER 13–26	305 (1920.01,1518,2022&1922.4B)R	COOK	919 214
	PLOT SCALE = 40.000 '/ in.	CHECKED - RCB	REVISED -	DEPARTMENT OF TRANSPORTATION			CONTRACT	NO. 60T35
	PLOT DATE = 11/30/2012	DATE - 10/31/2012	REVISED -		SCALE: N.T.S. SHEET NO. 214 OF 919 SHEETS	FED. ROAD DIST. NO. 1 ILLINOIS FED. AID	PROJECT	

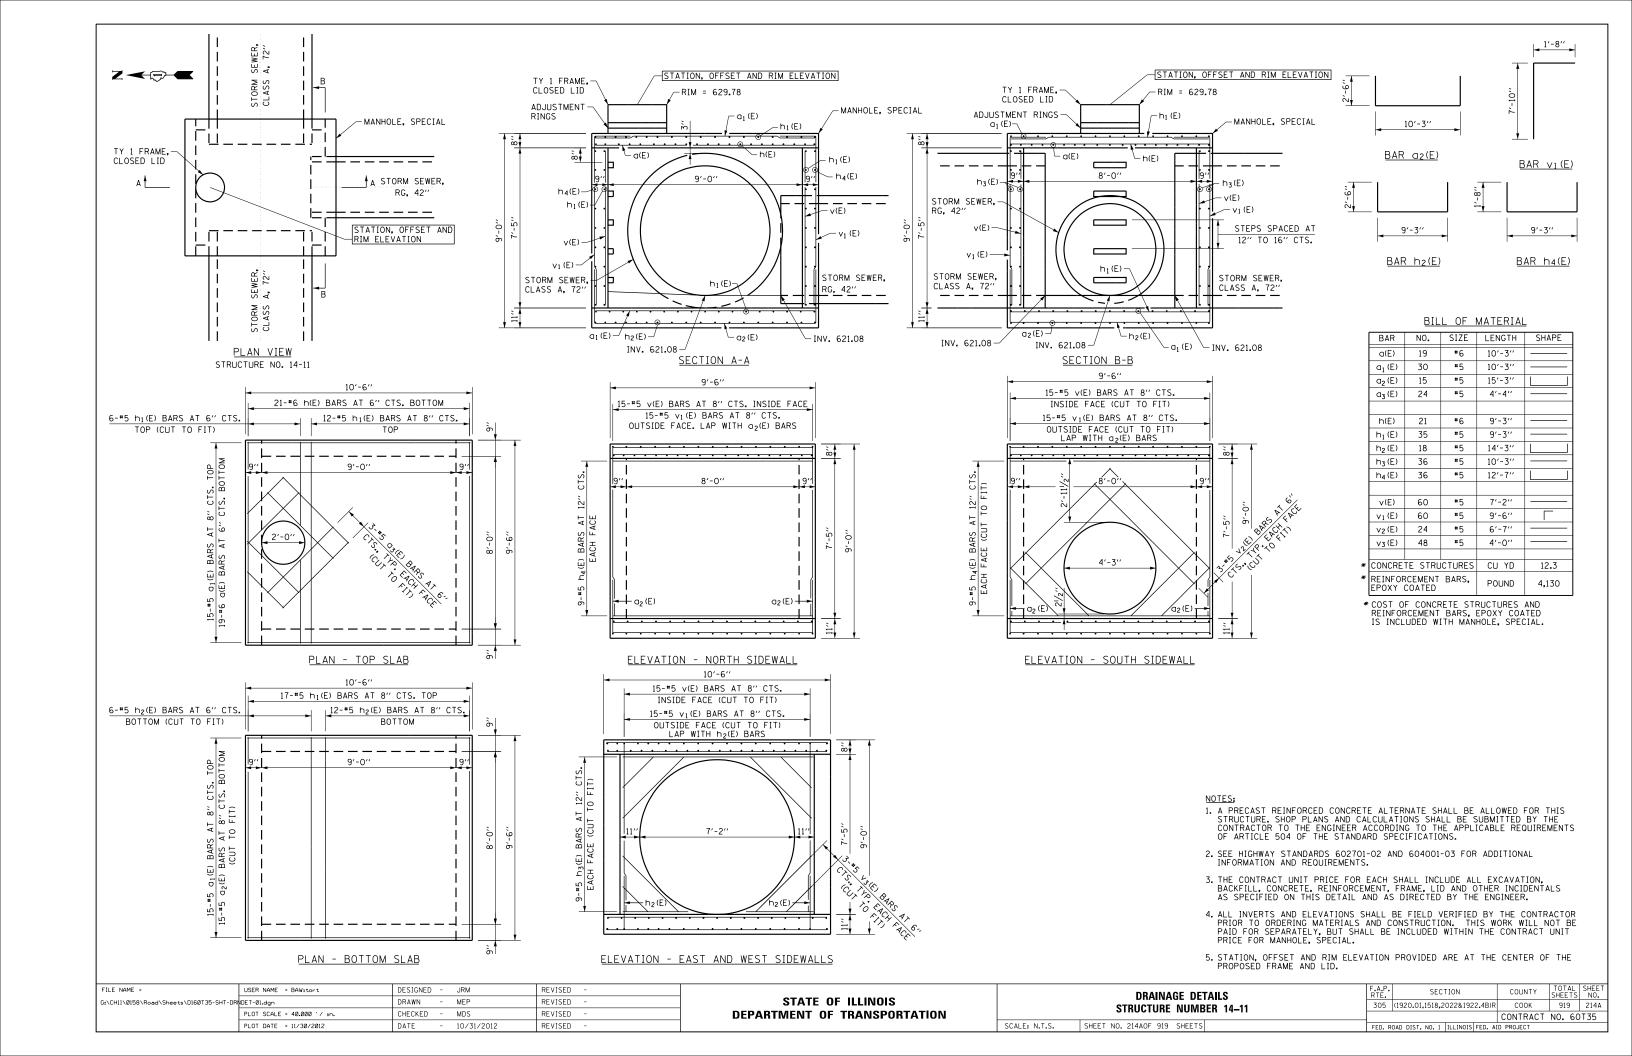

GENERAL NOTES

- 1. THE ILLINOIS DEPARTMENT OF TRANSPORTATION "STANDARD SPECIFICATIONS FOR ROAD AND BRIDGE CONSTRUCTION" LATEST EDITION, THE "STANDARD SPECIFICATIONS FOR WATER AND SEWER MAIN CONSTRUCTION IN ILLINOIS" LATEST EDITION, PROJECT SPECIFICATIONS, ALL APPLICABLE REQUIREMENTS OF THE ILLINOIS ENVIRONMENTAL PROTECTION AGENCY, THE VILLAGE OF NORTHFIELD, ALL APPLICABLE REQUIREMENTS OF THE ORDINANCES OF AUTHORITIES HAVING JURISDICTION AND ALL ADDENDA THERETO SHALL GOVERN THIS WORK.
- 2. THE STANDARD SPECIFICATIONS, PROJECT SPECIFICATIONS, CONSTRUCTION PLANS AND SUBSEQUENT DETAILS ARE ALL TO BE CONSIDERED AS PART OF THE CONTRACT, INCIDENTAL ITEMS OR ACCESSORIES NECESSARY TO COMPLETE THIS WORK MAY NOT BE SPECIFICALLY NOTED BUT ARE TO BE CONSIDERED A PART OF THE CONTRACT.
- 3. PRIOR TO COMMENCEMENT OF CONSTRUCTION, THE CONTRACTOR SHALL VERIFY ALL DIMENSIONS AND CONDITIONS AFFECTING THEIR WORK WITH THE ACTUAL CONDITIONS AT THE JOB SITE. IN ADDITION, THE CONTRACTOR MUST VERIFY THE ENGINEER'S LINE AND GRADES. IF THERE ARE ANY DISCREPANCIES FROM WHAT IS SHOWN ON THE CONSTRUCTION PLANS, STANDARD SPECIFICATIONS AND/OR SPECIAL DETAILS, THE CONTRACTOR SHALL SECURE WRITTEN INSTRUCTION FROM THE ENGINEER PRIOR TO PROCEEDING WITH ANY PART OF THE WORK AFFECTED BY DISCREPANCIES. FAILING TO SECURE SUCH INSTRUCTION, THE CONTRACTOR WILL BE CONSIDERED TO HAVE PROCEEDED AT HIS OWN RISK AND EXPENSE. IN THE EVENT OF ANY DOUBT OR QUESTION ARISING WITH RESPECT TO THE TRUE MEANING OF THE CONSTRUCTION PLANS OR SPECIFICATIONS, THE DECISION OF THE ENGINEER SHALL BE FINAL AND CONCLUSIVE.
- 4. BEFORE ACCEPTANCE BY THE VILLAGE AND FINAL PAYMENT, ALL WORK SHALL BE INSPECTED AND APPROVED BY THE VILLAGE OR HIS REPRESENTATIVES. FINAL PAYMENT WILL BE MADE AFTER ALL OF THE CONTRACTOR'S WORK HAS BEEN APPROVED AND ACCEPTED.
- 5. WHENEVER THE PERFORMANCE OF WORK IS INDICATED ON THE PLANS AND NO ITEM IS INCLUDED IN THE CONTRACT FOR PAYMENT, THE WORK SHALL BE CONSIDERED INCIDENTAL TO THE CONTRACT, AND NO ADDITIONAL COMPENSATION WILL BE ALLOWED.
- 6. ALL CONSTRUCTION WILL BE INSPECTED BY THE ENGINEER AND/OR THE VILLAGE. SPECIFICALLY ALL TRENCHES AND PIPE SHALL BE LEFT OPEN (BUT SAFELY BARRICADED) UNTIL INSPECTED AND APPROVED.
- 7. IT SHALL BE THE RESPONSIBILITY OF THE CONTRACTOR TO REMOVE FROM THE SITE ANY AND ALL MATERIALS AND DEBRIS WHICH RESULT FROM HIS CONSTRUCTION OPERATIONS AT NO ADDITIONAL EXPENSE TO THE DEPARTMENT.
- 8. WHEN A CONFLICT BETWEEN PLANS AND SPECIFICATIONS OR NOTES OCCURS, THE ENGINEER SHALL DECIDE WHICH GOVERNS. GENERALLY, THE MORE RESTRICTIVE, MORE SPECIFIC, OR STRICTER PROVISION SHALL GOVERN.
- 9. CONTRACTOR IS RESPONSIBLE FOR RETURNING ALL AREAS AFFECTED BY EQUIPMENT OR LABORERS TO EXISTING CONDITIONS. CONTRACTOR IS ALSO RESPONSIBLE FOR PROTECTING ALL NEW WORK UNTIL COMPLETION OF THIS CONTRACT.
- 10. EXISTING UTILITIES: WHEN THE PLANS OR SPECIAL PROVISIONS INCLUDE INFORMATION PERTAINING TO THE LOCATION OF UNDERGROUND UTILITY FACILITIES, SUCH INFORMATION REPRESENTS ONLY THE OPINION OF THE ENGINEER AS TO THE LOCATION OF SUCH UTILITIES AND IS ONLY INCLUDED FOR THE CONVENIENCE OF THE CONTRACTOR. THE ENGINEER AND DEPARTMENT ASSUME NO RESPONSIBILITY WHATSOEVER IN RESPECT TO THE SUFFICIENCY OR ACCURACY OF THE INFORMATION SHOWN ON THE PLANS RELATIVE TO THE LOCATION OF UNDERGROUND UTILITY FACILITIES OR THE MANNER IN WHICH THEY ARE TO BE REMOVED OR ADJUSTED. IT SHALL BE THE CONTRACTOR'S RESPONSIBILITY TO DETERMINE THE ACTUAL LOCATION OF ALL SUCH FACILITIES. HE SHALL ALSO OBTAIN FROM THE RESPECTIVE UTILITY COMPANIES, JULLIE., THE RESPECTIVE VILLAGE, DETAILED INFORMATION RELATIVE TO THE LOCATION OF THEIR FACILITIES AND THE WORKING SCHEDULES OF THE UTILITY COMPANIES FOR REMOVING OR ADJUSTING THEM
- 11. EASEMENTS FOR THE EXISTING UTILITIES, BOTH PUBLIC AND PRIVATE, AND UTILITIES WITHIN PUBLIC RIGHTS-OF-WAY ARE SHOWN ON THE PLANS ACCORDING TO AVAILABLE RECORDS. THE CONTRACTOR SHALL BE RESPONSIBLE FOR DETERMINING THE EXACT LOCATION IN THE FIELD OF THESE UTILITY LINES AND THEIR PROTECTION FROM DAMAGE DUE TO CONSTRUCTION OPERATIONS. IF EXISTING UTILITY LINES OF ANY NATURE ARE ENCOUNTERED WHICH CONFLICT IN LOCATION WITH NEW CONSTRUCTION, THE CONTRACTOR SHALL NOTIFY THE ENGINEER SO THAT THE CONFLICT MAY BE RESOLVED.

UTILITY/IEPA NOTES

- THE CONTRACTOR SHALL PROVIDE A LIST OF WATER SERVICE MEASUREMENTS TO THE VILLAGE AND TO THE ENGINEER AT THE CONCLUSION OF THE JOB.
- THE CONTRACTOR SHALL NOTIFY THE ENGINEER AND THE VILLAGE OF NORTHFIELD AT (847) 441-3810 AT LEAST 3 WORKING DAYS PRIOR TO BEGINNING ANY WORK ON THE WATER MAIN.
- 3. UNDERGROUND WORK SHALL INCLUDE TRENCHING, DEWATERING, INSTALLATION OF PIPE, CASTINGS, STRUCTURES, BACKFILLING OF TRENCHES AND COMPACTION, AND TESTING AS SHOWN ON THE CONSTRUCTION PLANS, FITTINGS AND ACCESSORIES NECESSARY TO COMPLETE THE WORK MAY NOT BE SPECIFIED BUT SHALL BE CONSIDERED AS INCIDENTAL TO THE COST OF THE CONTRACT, CONTRACTOR SHALL PROVIDE "AS BUILT" DRAWINGS OF ALL WATERMAIN INSTALLATIONS.
- 4. DFW NON-SHEAR COUPLINGS AS MANUFACTURED BY NDS COMPANY OR APPROVED EQUAL SHALL BE USED FOR CONNECTIONS OF NEW PIPE TO EXISTING PIPE, AND WHERE DISSIMILAR PIPE AND JOINT MATERIALS ARE ENCOUNTERED. COUPLINGS SHALL BE A MINIMUM OF 8 INCHES LONG FOR CONNECTIONS OF 4-INCH THROUGH 8-INCH PIPE AND A MINIMUM OF 12 INCHES LONG FOR CONNECTIONS ON LARGER PIPES (THESE ARE SPECIAL ORDER ITEMS). NO STAINLESS STEEL SHEAR RINGS WILL BE ALLOWED.
- 6. ALL WATERMAIN TRENCHES BENEATH PROPOSED OR EXISTING
 UTILITIES, PROPOSED OR EXISTING PAVEMENT, DRIVEWAYS, SIDEWALKS AND WITHIN THE
 ZONE OF INFLUENCE OF SUCH IMPROVEMENTS, AND/OR WHEREVER ELSE SHOWN ON
 THE CONSTRUCTION PLAN SHALL BE BACKFILLED WITH TRENCH BACKFILL
 AND THOROUGHLY COMPACTED IN ACCORDANCE WITH THE SPECIFICATIONS.
- 7. ALL STRUCTURE SECTIONS AND ADJUSTING RINGS SHALL BE SECURELY SEALED TO EACH OTHER OR TO THE FRAME, CONE SECTION OF THE STRUCTURE USING RESILIENT, FLEXIBLE, NON-HARDENING, PREFORMED, BITUMINOUS MASTIC (RAM-NEK, OR APPROVED EQUAL.) THIS MASTIC SHALL BE APPLIED IN SUCH A MANNER THAT NO SURFACE WATER OR GROUND WATER INFLOW CAN ENTER THE STRUCTURE THROUGH GAPS BETWEEN BARREL SECTIONS OR CONE SECTIONS AND ADJUSTING RINGS.
- 8. THE CONTRACTOR IS RESPONSIBLE FOR CONTACTING JULIE AS WELL AS LOCAL CABLE TV COMPANIES AND THE VILLAGE FOR LOCATION OF EXISTING UNDERGROUND UTILITIES. THE FACILITIES SHALL BE LOCATED PRIOR TO ANY WORK WITHIN ANY EASEMENT, R.O.W. OR SUSPECTED UTILITY LOCATION.
- ALL EXISTING STRUCTURES SHALL BE ADJUSTED AS NECESSARY TO MATCH PROPOSED GRADES & LANDSCAPING.
- 10. ALL UTILITIES SHALL BE INSTALLED ON CRUSHED STONE BEDDING
 (CA-11) WITH A MINIMUM THICKNESS OF 4 INCHES. THE BEDDING MATERIAL
 SHALL BE PLACED AND COMPACTED TO 12" ABOVE THE TOP OF PIPE.
 BLOCKING OF ANY KIND FOR GRADE IS NOT PERMITTED.
- 11. WATERMAIN COVER SHALL BE 5.5 FEET FROM FINISHED GRADE TO TOP OF PIPE.
- 12. SEE PROJECT DOCUMENTS FOR WATERMAIN MATERIAL SPECIFICATIONS.

HORIZONTAL DIRECTIONAL DRILLING METHOD

- 1. CONTRACTOR SHALL EXAMINE THE SITE(S) INDICATED. THE LIMITS OF SURFACE EXCAVATION SHALL BE LOCATED AT VALVE VAULTS, FITTINGS AND INTERCONNECTIONS AS SHOWN ON THE DRAWINGS. CONTRACTOR SHALL BE RESPONSIBLE FOR LOCATING THE BORFHOLE AND RECEIVING HOLE SUFFICIENTLY BACK FROM THE LIMITS OF EXCAVATION TO ALLOW CONNECTION TO THE HORIZONTALLY DRILLED PIPE. PITS SHALL BE OF LENGTH AND WIDTH NECESSARY TO INSTALL PIPES AND SIZED TO FIT AREAS AVAILABLE FOR WORK.
- PROVIDE ALL REQUIRED SEDIMENT AND EROSION CONTROL MEASURES TO PREVENT DRILLING FLUID AND BOREHOLE CUTTINGS FROM ENTERING ADJACENT STORM DRAINAGE DITCHES OR PIPING.
- 3. THE DIRECTIONAL DRILLING EQUIPMENT SHALL CONSIST OF A DIRECTIONAL DRILLING RIG OF SUFFICIENT CAPACITY TO PERFORM THE BORE AND PULLBACK THE PIPE, A DRILLING FLUID MIXING AND DELIVERY SYSTEM OF SUFFICIENT CAPACITY TO SUCCESSFULLY COMPLETE THE CROSSING, A GUIDANCE SYSTEM TO ACCURATELY GUIDE BORING OPERATIONS AND TRAINED AND COMPETENT PERSONNEL TO OPERATE THE SYSTEM. ALL EQUIPMENT SHALL BE IN GOOD, SAFE OPERATING CONDITION WITH SUFFICIENT SUPPLIES, MATERIALS, AND SPARE PARTS ON HAND TO MAINTAIN THE SYSTEM IN GOOD WORKING ORDER FOR THE DURATION OF THE PROJECT.
- 4. THE DIRECTIONAL DRILLING MACHINE SHALL CONSIST OF A HYDRAULICALLY POWERED SYSTEM TO ROTATE, PUSH AND PULL HOLLOW DRILL PIPE INTO THE GROUND AT A VARIABLE ANGLE WHILE DELIVERING A PRESSURIZED FLUID MIXTURE TO GUIDABLE DRILL (BORE) HEAD. THE MACHINE SHALL BE ANCHORED TO THE GROUND TO WITHSTAND THE PULLING, PUSHING, AND ROTATING PRESSURE REQUIRED TO COMPLETE THE INSTALLATION. THE HYDRAULIC POWER SYSTEM SHALL BE SELF CONTAINED WITH SUFFICIENT PRESSURE AND VOLUME TO POWER DRILLING OPERATIONS. HYDRAULIC SYSTEM SHALL BE FREE OF LEAKS, RIG SHALL HAVE A SYSTEM TO MONITOR AND RECORD MAXIMUM PULLBACK PRESSURE DURING PULLBACK OPERATIONS. THE RIG SHALL BE GROUNDED DURING DRILLING AND PULLBACK OPERATIONS.

HORIZONTAL DIRECTIONAL DRILLING METHOD (CONTINUED)

- THE DRILL HEAD SHALL BE STEERABLE BY CHANGING ITS ORIENTATION AND SHALL PROVIDE THE NECESSARY CUTTING SURFACES AND DRILLING FLUID JETS.
- 6. PILOT HOLE SHALL ESTABLISH THE HORIZONTAL PLANS OF THE PIPELINE.
 A PLOT OF LENGTH VERSUS ELEVATION VERSUS LEFT/RIGHT VARIANCE WILL
 DICTATE THE ACTUAL AS-BUILT PLAN AND PROFILE OF THE PIPELINE. DATA
 FEEDBACK AND ELECTRONIC GUIDANCE SYSTEMS AND SUPPLEMENTAL SURFACE
 TRACKING SYSTEMS SHALL BE USED TO PROVIDE CONFIRMATION OF POSITION.
 MINIMUM DEPTHS ARE INDICATED ON THE DRAWINGS. PIPES SHALL BE INSTALLED
 AT GREATER DEPTHS, IF NECESSARY, TO PERMIT MOVEMENT OF TRAPPED AIR TO
 AIR RELEASE HIGH POINTS. AVOID UNDERGROUND OBSTRUCTIONS BY STEERING
 HORIZONTALLY AROUND THEM. PIPE MAY BE INSTALLED AT GREATER DEPTHS TO
 FACILITATE THE INSTALLATION IF THE PROPOSED GREATER DEPTH IS REVIEWED
 AND APPROVED BY ENGINEER BEFORE INSTALLATION.
- 7. REAMING SHALL CONSIST OF USING AN APPROPRIATE TOOL TO OPEN THE PILOT HOLE TO A SLIGHTLY LARGER DIAMETER THAN THE CARRIER PIPELINE. THE PERCENTAGE OVER SIZE SHALL DEPEND ON SOIL TYPES, SOIL STABILITIES, DEPTH, DRILLING FLUID HYDROSTATIC PRESSURE, ETC. NORMAL OVERSIZING SHALL BE FROM 120 TO 150 PERCENT OF THE CARRIER PIPE DIAMETER, DRILLING FLUID SHALL BE FORCED DOWN THE HOLE TO STABILIZE THE HOLE AND TO REMOVE SOIL CUTTINGS.
- 8. PULL BACK THE ENTIRE PIPELINE LENGTH IN ONE SEGMENT BACK THROUGH THE DRILLING FLUID ALONG THE REAMED HOLE PATHWAY. PROPER PIPE HANDLING, CRADLING, BENDING MINIMIZATION, SURFACE FORCE READINGS, CONSTANT INSERTION VELOCITY, DRILLING FLUID FLOW CIRCULATION/EXIT RATE, AND FOOTAGE LENGTH INSTALLED SHALL BE RECORDED. THE PULL-BACK SPEED SHALL BE WITHIN THE PIPE MANUFACTURER'S RECOMMENDATIONS. ANY BITS, DRILLS, REAMERS, OR OTHER TOOLS LOST OR STUCK IN THE HOLE SHALL BE REMOVED AT CONTRACTOR'S EXPENSE. IF TOOLS CANNOT BE READILY REMOVED, CONTRACTOR MAY, AT CONTRACTORS OPTION, ABANDON THE HOLE. NO PAYMENT SHALL BE MADE FOR ANY LOST EQUIPMENT, MATERIAL, OR WORK ON ABANDONED HOLES.
- AS-BUILT DRAWINGS SHALL BE SUBMITTED BY THE CONTRACTORS BASED UPON HIS PIPE LOG DATA. AS-BUILT DRAWINGS SHALL BE CERTIFIED AS TO ACCURACY BY THE CONTRACTOR.
- 10. A VARIATION GREATER THAN 6-INCHES FROM THE HORIZONTAL PLAN OR DESIGNATED GRADE IS SUFFICIENT REASON FOR REJECTION OF THE PIPE, AND PIPE SHALL BE RE-BORED TO PROPER GRADE IF SO DIRECTED BY ENGINEER AT NO COST TO DEPARTMENT.
- 11. DRILLING FLUID TO BE USED TO FACILITATE INSTALLATION OF THE PIPE SHALL BE ADJUSTED WITHIN ACCEPTABLE LIMITS SUCH THAT GROUND HEAVING AND SUBSURFACE CAVITY FORMATION THROUGH EROSION ARE PREVENTED. DRILLING FLUID SHALL BE BENTONITE CLAY MIXTURE. CONTRACTOR MAY USE A POLYMER ADDITIVE AT CONTRACTOR'S OPTION. FLUID AND ADDITIVES SHALL NOT BE HAZARDOUS TO THE ENVIRONMENT.
- 12. CONTRACTOR SHALL TAKE APPROPRIATE PRECAUTIONS TO PREVENT DAMAGE TO EXISTING UTILITIES WHERE THEY CROSS EITHER ABOVE OR BELOW THE PROPOSED HORIZONTAL DIRECTIONALLY DRILLED PIPE. EXPOSING THE EXISTING UTILITY PRIOR TO INSTALLING THE DIRECTIONALLY DRILLED PIPE MAY BE NECESSARY TO VERIFY APPROPRIATE SEPARATION IS BEING MAINTAINED AND THAT NO DAMAGE WILL OCCUR TO THE EXISTING UTILITY. THE COST FOR THESE EXPLORATORY EXCAVATIONS IS INCIDENTAL.
- 13. SPENT DRILLING FLUID AND CUTTING SHALL BE CONFINED TO VICINITY OF DRILLING RIG. ANY DRILLING FLUID WHICH ENTERS THE PIPE SHALL BE REMOVED BY FLUSHING OR OTHER SUITABLE MEANS. CONTRACTOR SHALL BE RESPONSIBLE FOR CLEAN-UP AND RESTORATION, SHOULD THERE BE A BOREHOLE BLOW OUT DUE TO EXCESSIVE PRESSURE IN THE DRILLING FLUID. NO ADDITIONAL PAYMENT SHALL BE MADE FOR CLEAN-UP COSTS REQUIRED BY DEPARTMENT, ENGINEER, OR REGULATORY AGENCIES DUE TO A LOSS OF DRILLING FLUID. THIS MAY INCLUDE A FULL TIME VAC TRUCK TO COLLECT CUTTINGS, LEAVINGS, OR DRILLING FLUID.
- 14. PITS EXCAVATED TO PERMIT CONNECTION OF BORED PIPE SHALL BE BACKFILLED, AND DISTURBED SURFACE SHALL BE RESTORED.

SCALE: N.T.S.

15. LOGS SHALL BE KEPT GIVING THE HORIZONTAL AND VERTICAL POSITION OF THE WATER MAIN AT 50-FOOT INTERVALS ALONG THE PIPE POINTS TO CONFIRM ITS CONFORMANCE TO SPECIFIED DEPTH AND LINE SHOWN ON THE DRAWINGS. NO PAYMENT FOR ANY LENGTH OF PIPE SHALL BE MADE WITHOUT A LOG ACCOMPANYING IT. LOG SHALL ALSO CONTAIN A SUMMARY OF STRESSES ON PIPE DURING INSTALLATION.

DIRECTIONAL DRILLING CONTINGENCY PLAN


PRIOR TO STARTING ANY DIRECT DRILLING MOBILIZATION, THE CONTRACTOR SHALL PROVIDE THE FOLLOWING INFORMATION TO THE ENGINEER: THIS INFORMATION WILL THEN BE FORWARDED TO VILLAGE FOR THEIR REVIEW.


GENERAL INFORMATION REQUIREMENTS


- NAME, ADDRESS AND PHONE NUMBER OF ONSITE DRILLING COMPANY REPRESENTATIVE:
- 2. MATERIAL SAFETY DATA SHEETS (MSDS) FOR DRILLING MUD CONSTITUENTS;
- 3. NAME, ADDRESS AND PHONE NUMBER OF ANIONIC POLYMER VENDOR;
- 4. CATALOG CUT SHEETS FOR EACH RECOMMENDED POLYMER, DIRECTIONS FOR USE AND ANY LIMITATIONS NOTE, CATIONIC POLYMERS ARE TOXIC TO FRESHWATER AQUATIC LIFE AND WILL NOT BE PERMITTED ON THIS PROJECT. ANIONIC POLYMERS WILL BE REQUIRED. POLYMERS ARE REQUIRED TO BE AVAILABLE ONSITE IF DRILLING WILL BE UNDER OR NEAR STREAMS OR OTHER WETLANDS;
- 5. A BRIEF NARRATIVE DISCUSSING THE DIRECTIONAL DRILLING OPERATION, IDENTIFICATION OF LIKELY PROBLEM LOCATIONS AND PROPOSED METHODS OF ENSURING THAT FRAC OUTS DO NOT OCCUR OR ARE PROPERLY CONTAINED.


OPERATIONAL REQUIREMENTS


- AT LEAST ONE VACUUM TRUCK MUST BE ONSITE DURING ALL DRILLING OPERATIONS AND AT LEAST ONE ADDITIONAL VACUUM TRUCK SHALL BE READILY AVAILABLE OR ON STAND-BY AT A NEARBY LOCATION, AS APPROPRIATE.
- 2. AT LEAST ONE FULL TIME PERSON TO WALK THE DRILLING ROUTE AND IDENTIFY FRAC OUTS AND COORDINATE REMEDIATION.
- 3. IF A FRAC OUT IS IDENTIFIED, THE CONTRACTOR SHALL IMMEDIATELY STOP DRILLING, WAIT AT LEAST 30 MINUTES, INJECT A QUANTITY OF DRILLING FLUID WITH A VISCOSITY EXCEDING 120 SECONDS AS MEASURED BY A MARCH FUNNEL AND THEN WAIT ANOTHER 30 MINUTES. IF MUD FRACTURE OR RETURNS LOSS CONTINUES, CONTRACTOR WILL CEASE OPERATIONS AND NOTIFY ENGINEER. CONTRACTOR SHALL PROCEED TO CONTAIN FRAC OUT MATERIAL USING SILT FENCE, PLASTIC OR OTHER ACCEPTABLE BARRIER MATERIAL AND PROVIDE ADEQUATE VACUUM TRUCKS TO CONTAIN AND REMOVE MATERIAL FROM THE SITE, WITHIN WATER WAYS THE CONTRACTOR SHALL PROVIDE A TURBIDITY BARRIER OR CONTAINMENT BOX, AS APPROPRIATE.
- 4. VERIFICATION OF ADEQUATE POLYMER STORED ONSITE TO TREAT AT LEAST ONE RELEASE INTO WETLANDS OR STREAMS WITH THE UNDERSTANDING THAT ADDITIONAL POLYMER WILL BE PROCURED IF THE FIRST IS USED.
- 5. FRAC OUTS IN UPLAND AREAS THAT DO NOT AFFECT WETLANDS OR OTHER SENSITIVE AREAS ARE TO BE SUMMARIZED IN A WEEKLY REPORT TO THE ENGINEER DETAILING THE AMOUNT OF DRILLING MUD RELEASED, THE METHOD OF CONTAINMENT, REMEDIATION METHOD USED AND ANY ADDITIONAL RELEVANT INFORMATION.
- 6. THE ENGINEER MUST BE CONTACTED IMMEDIATELY IF A FRAC OUT AFFECTS WETLAND AREAS. APPROPRIATE TELEPHONE NUMBERS SHOULD BE A PART OF THE CONTINGENCY PLAN, EACH FRAC OUT MUST BE SUMMARIZED IN DAILY REPORTS TO THE ENGINEER DETAILING THE AMOUNT OF DRILLING MUD RELEASED, THE METHOD OF CONTAINMENT, REMEDIATION METHOD USED AND ANY ADDITIONAL RELEVANT INFORMATION.

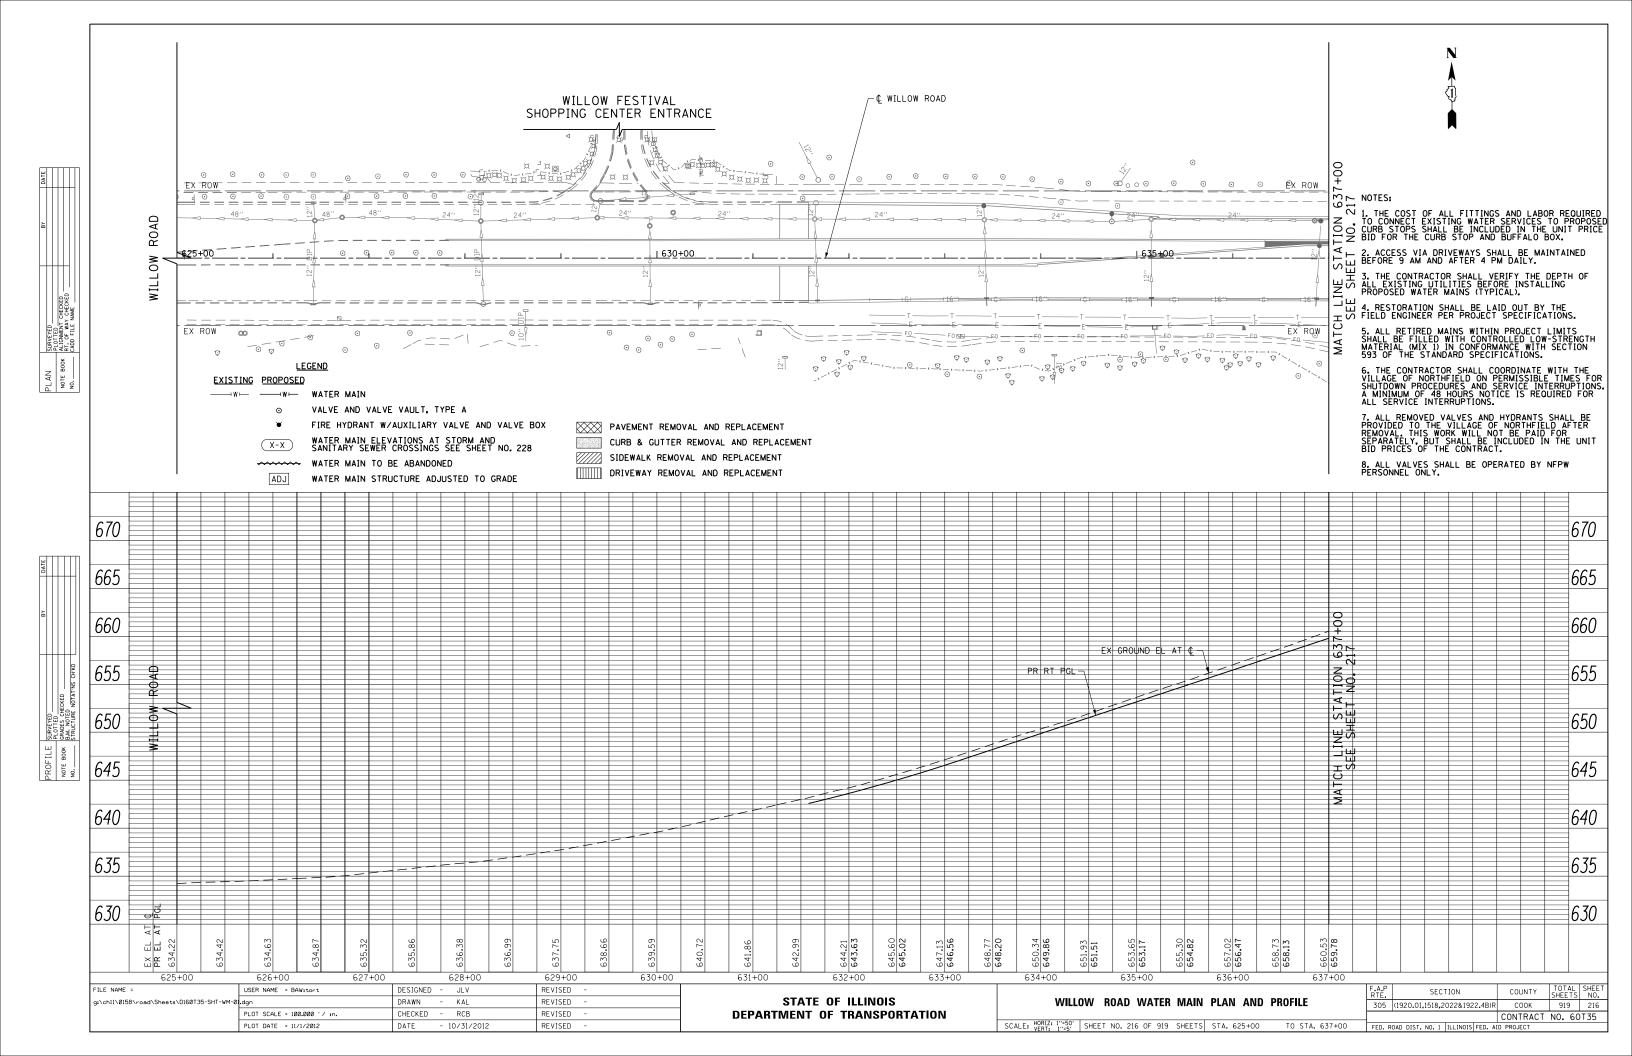


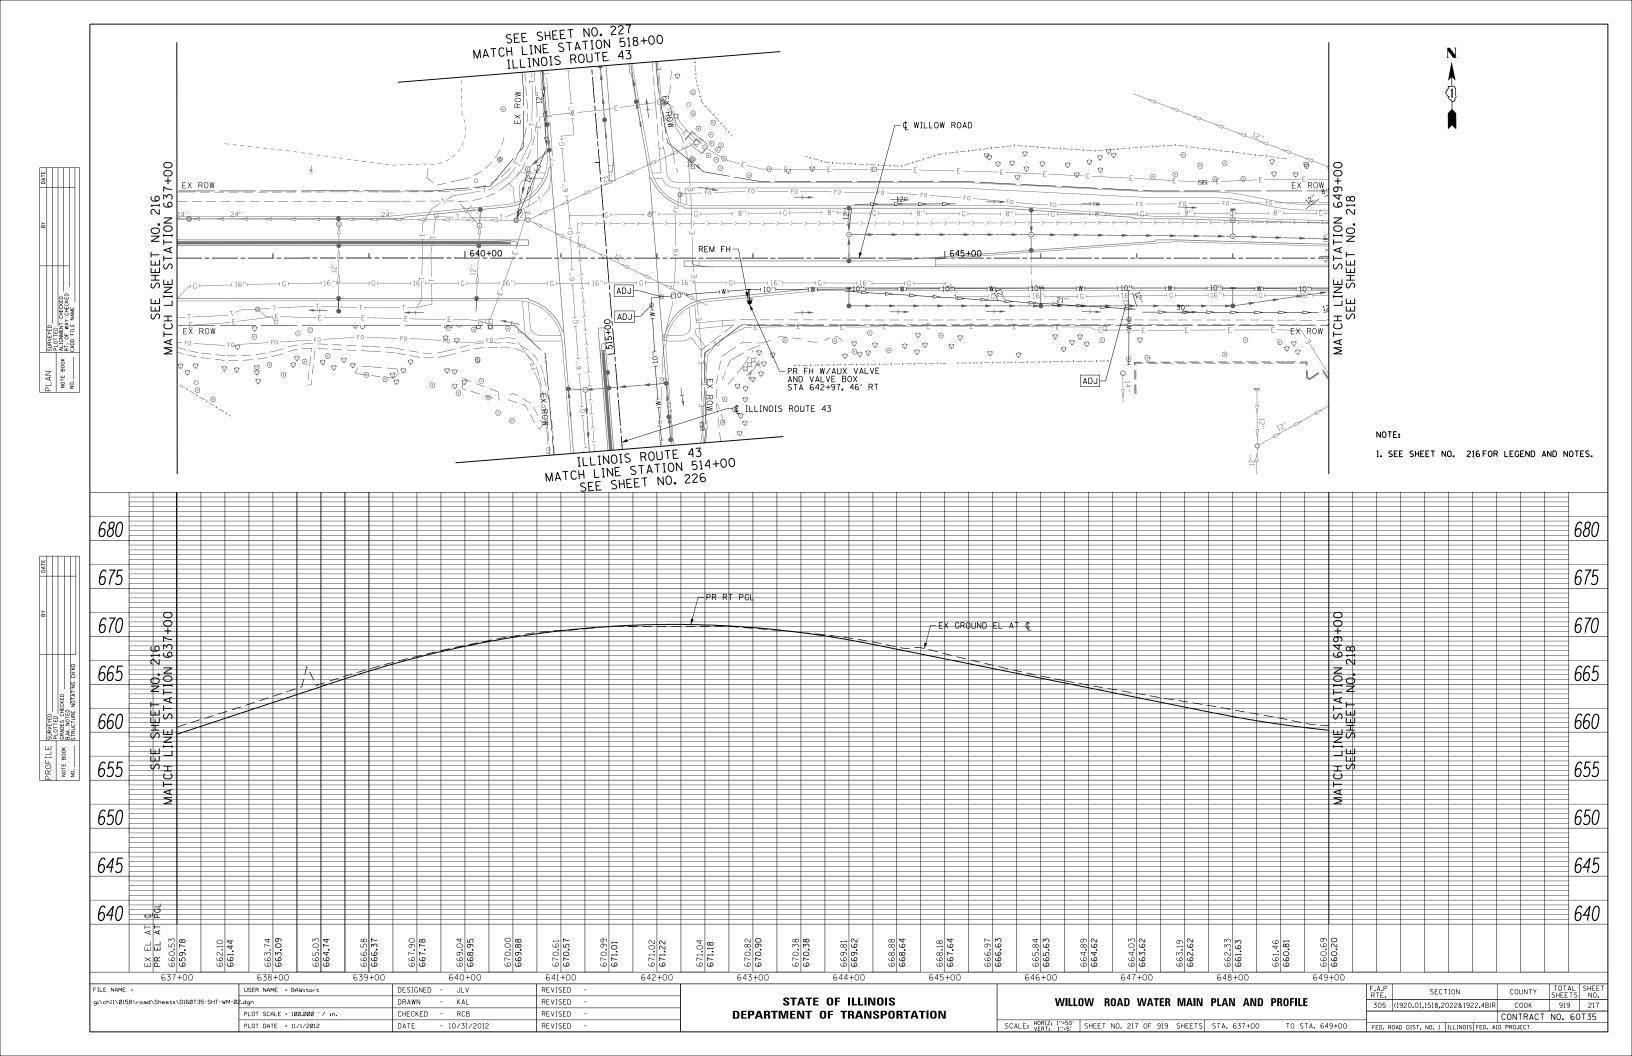


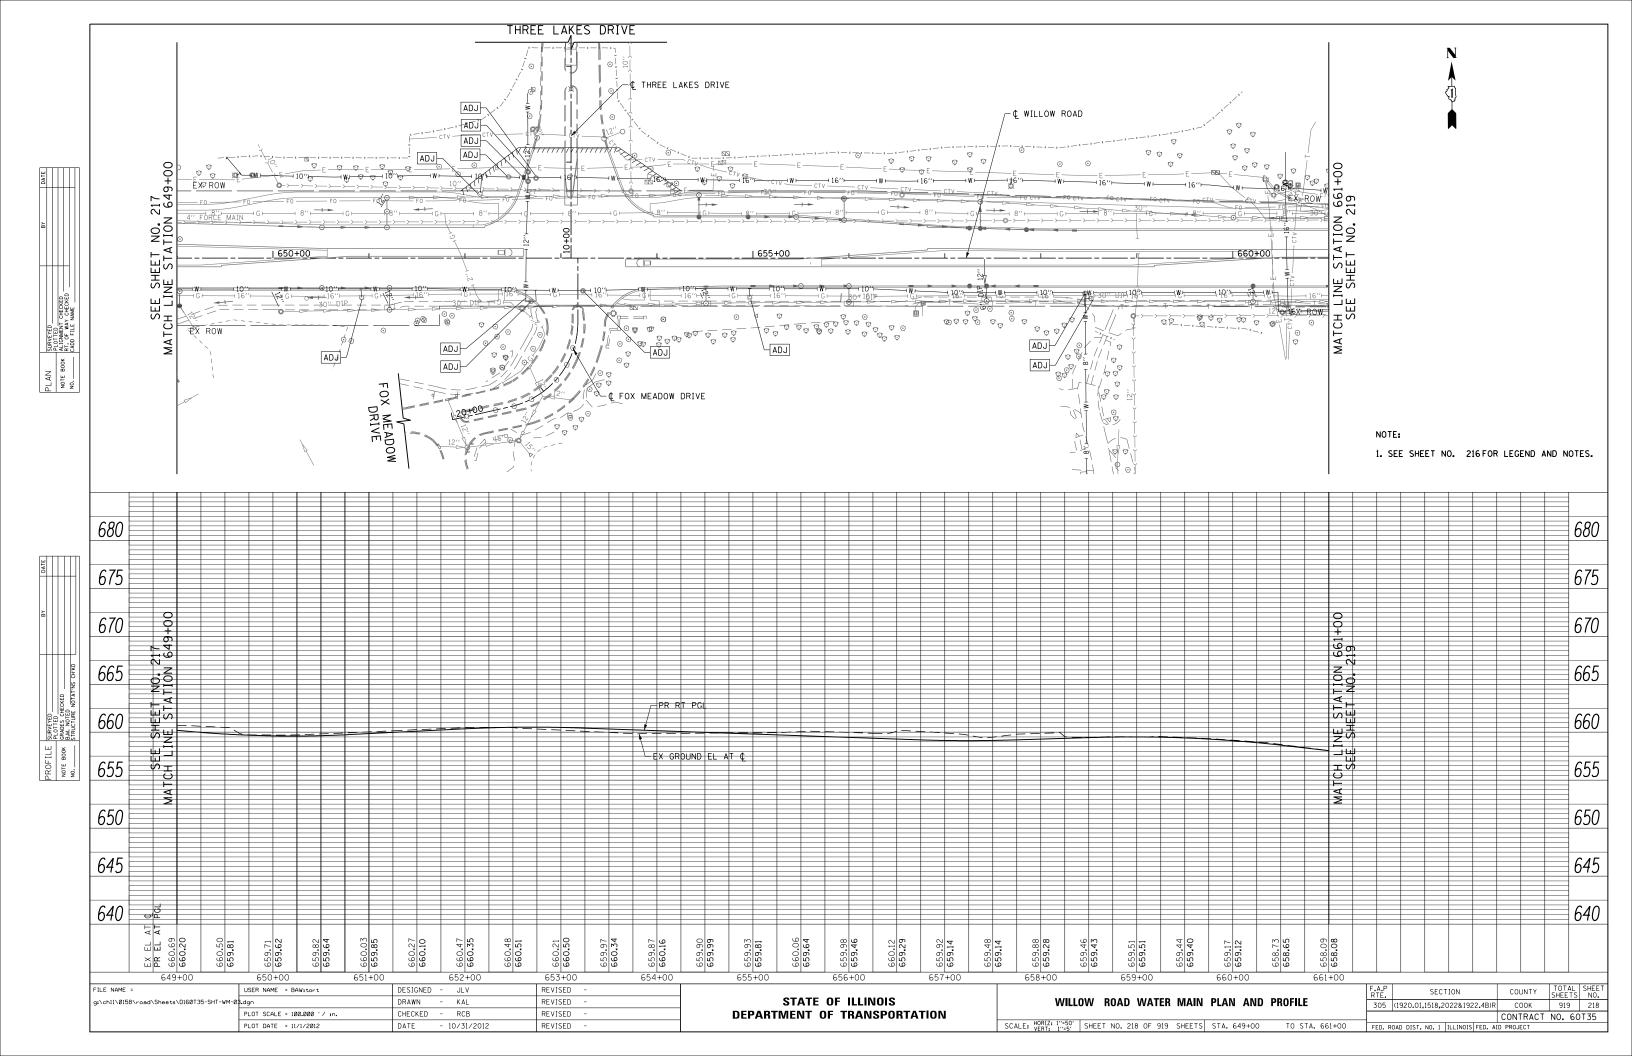


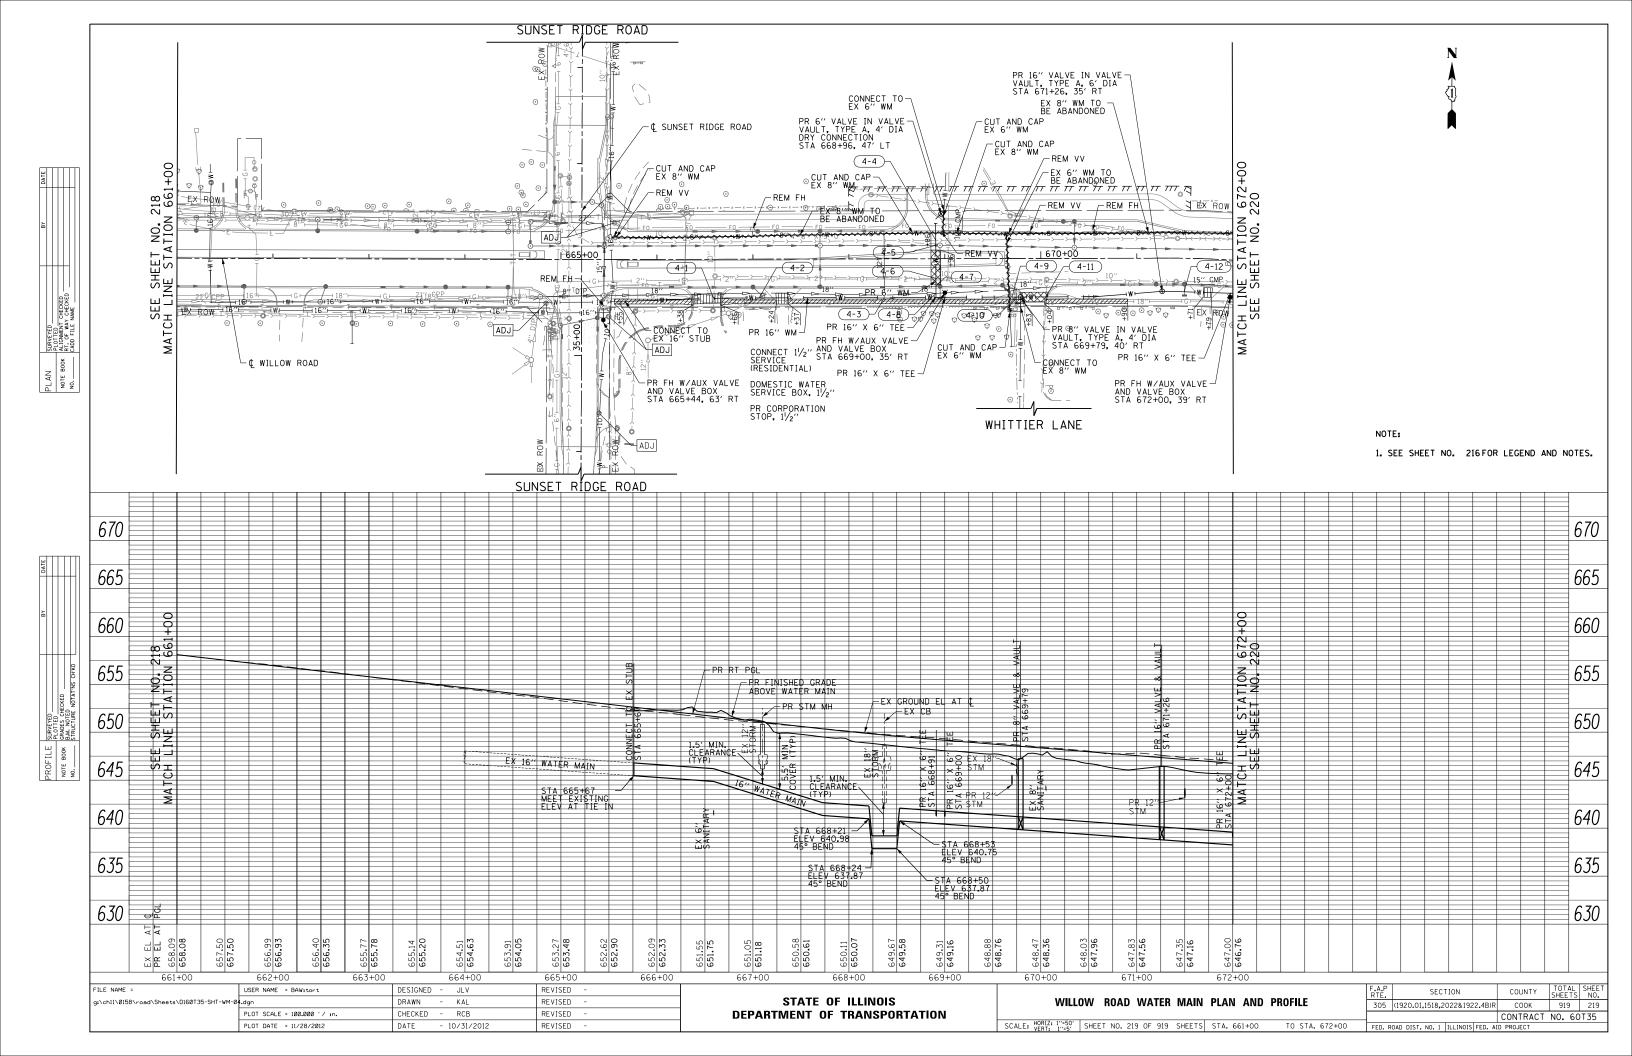


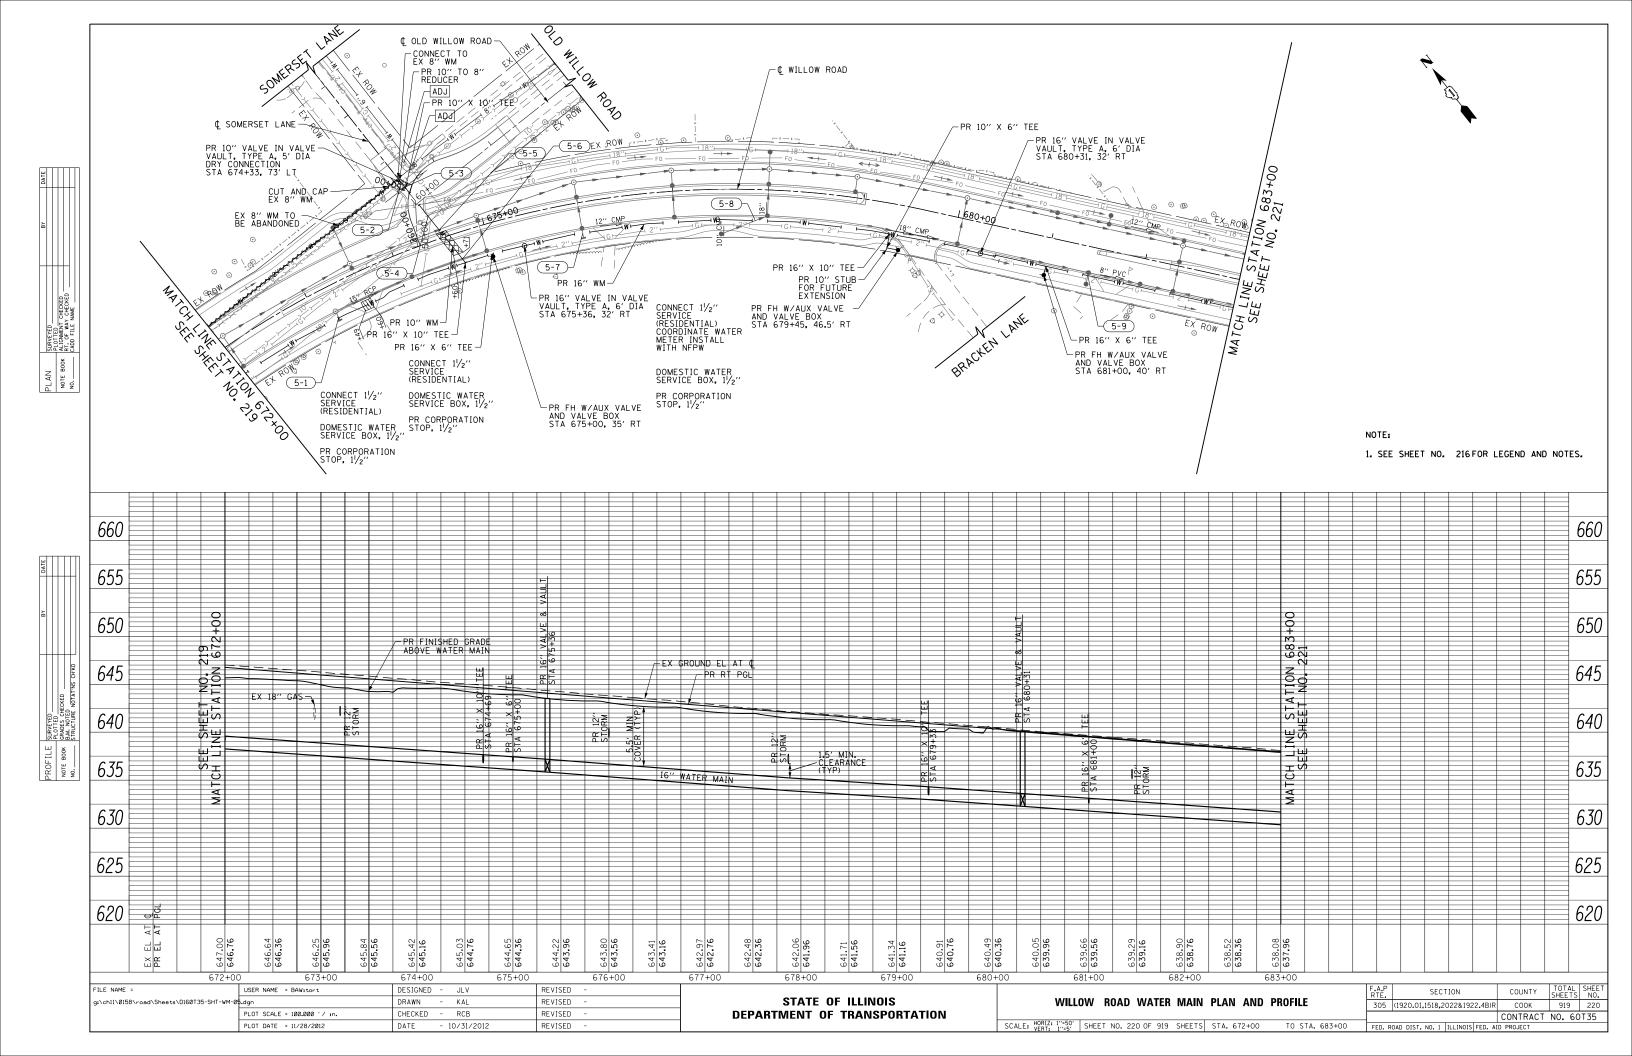


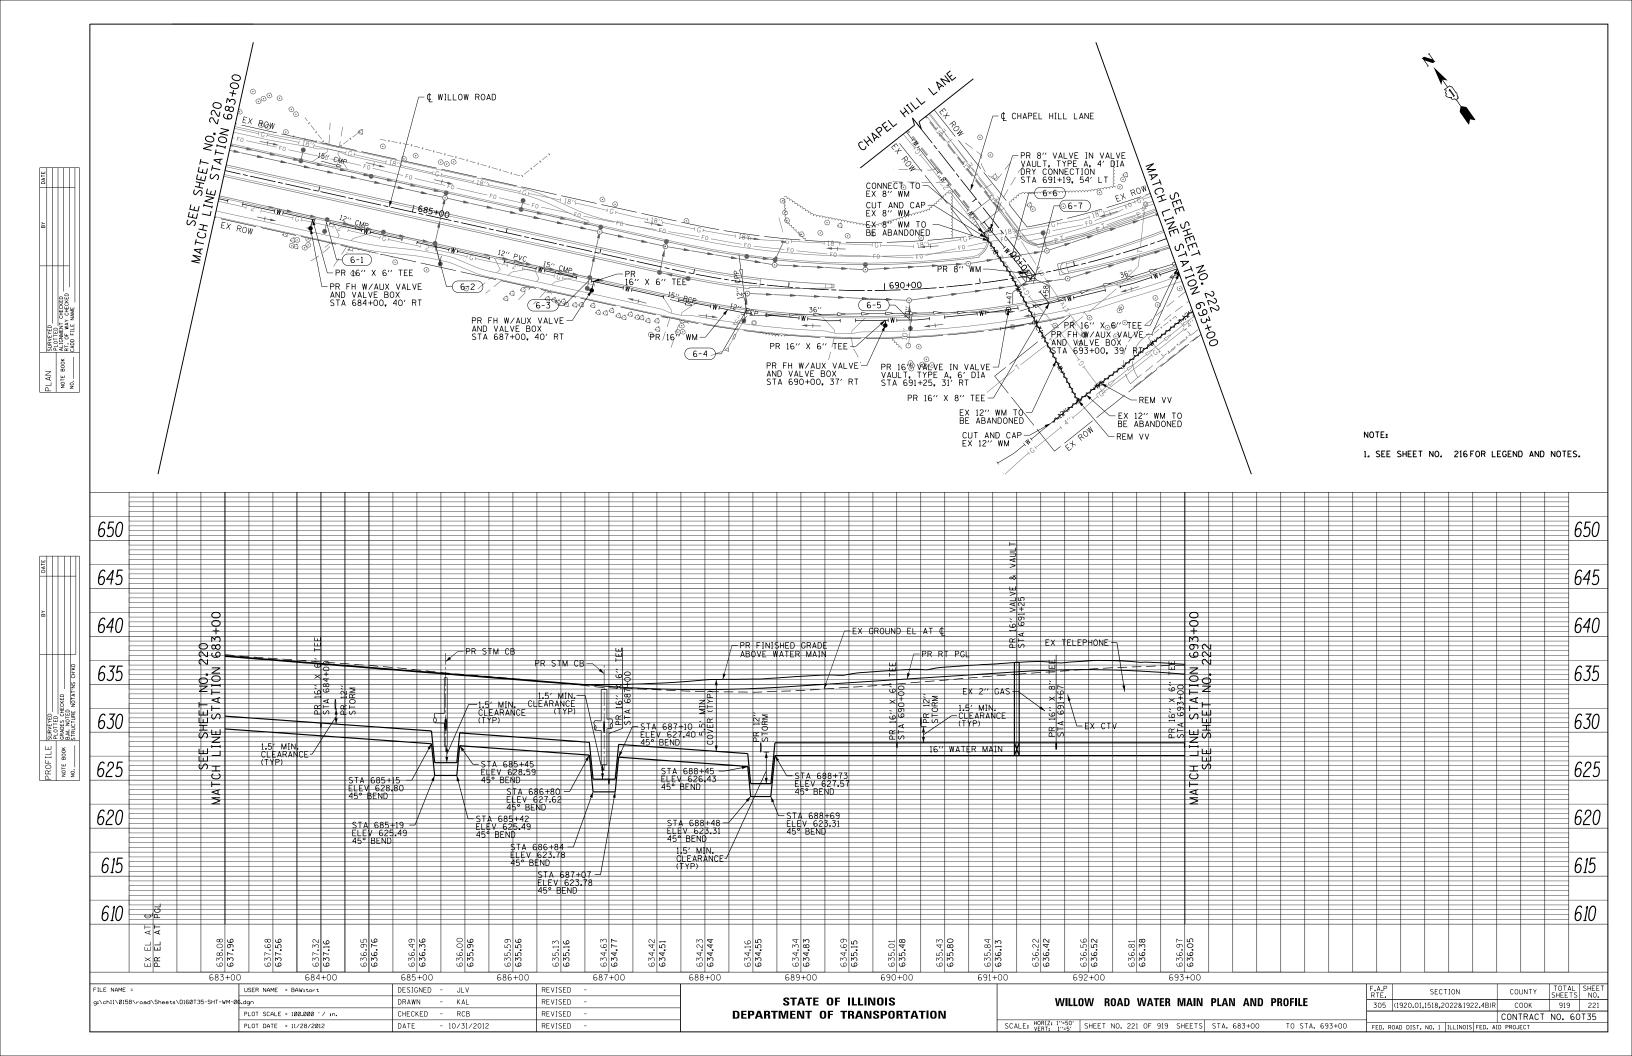


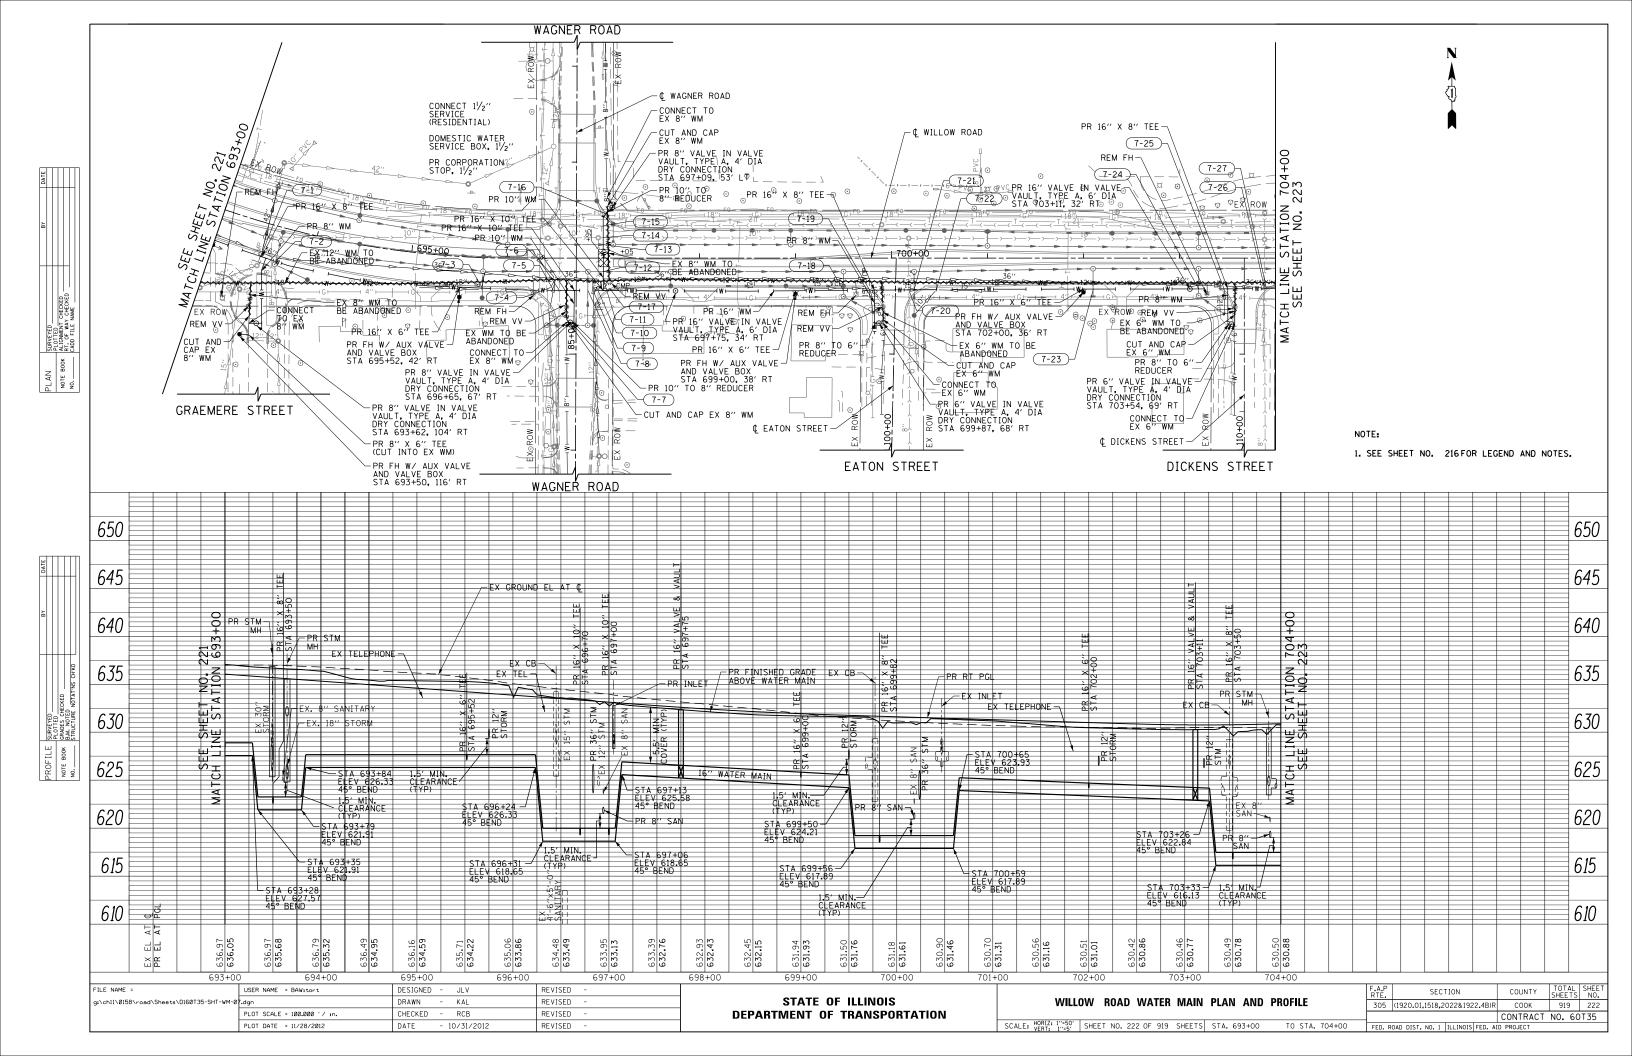


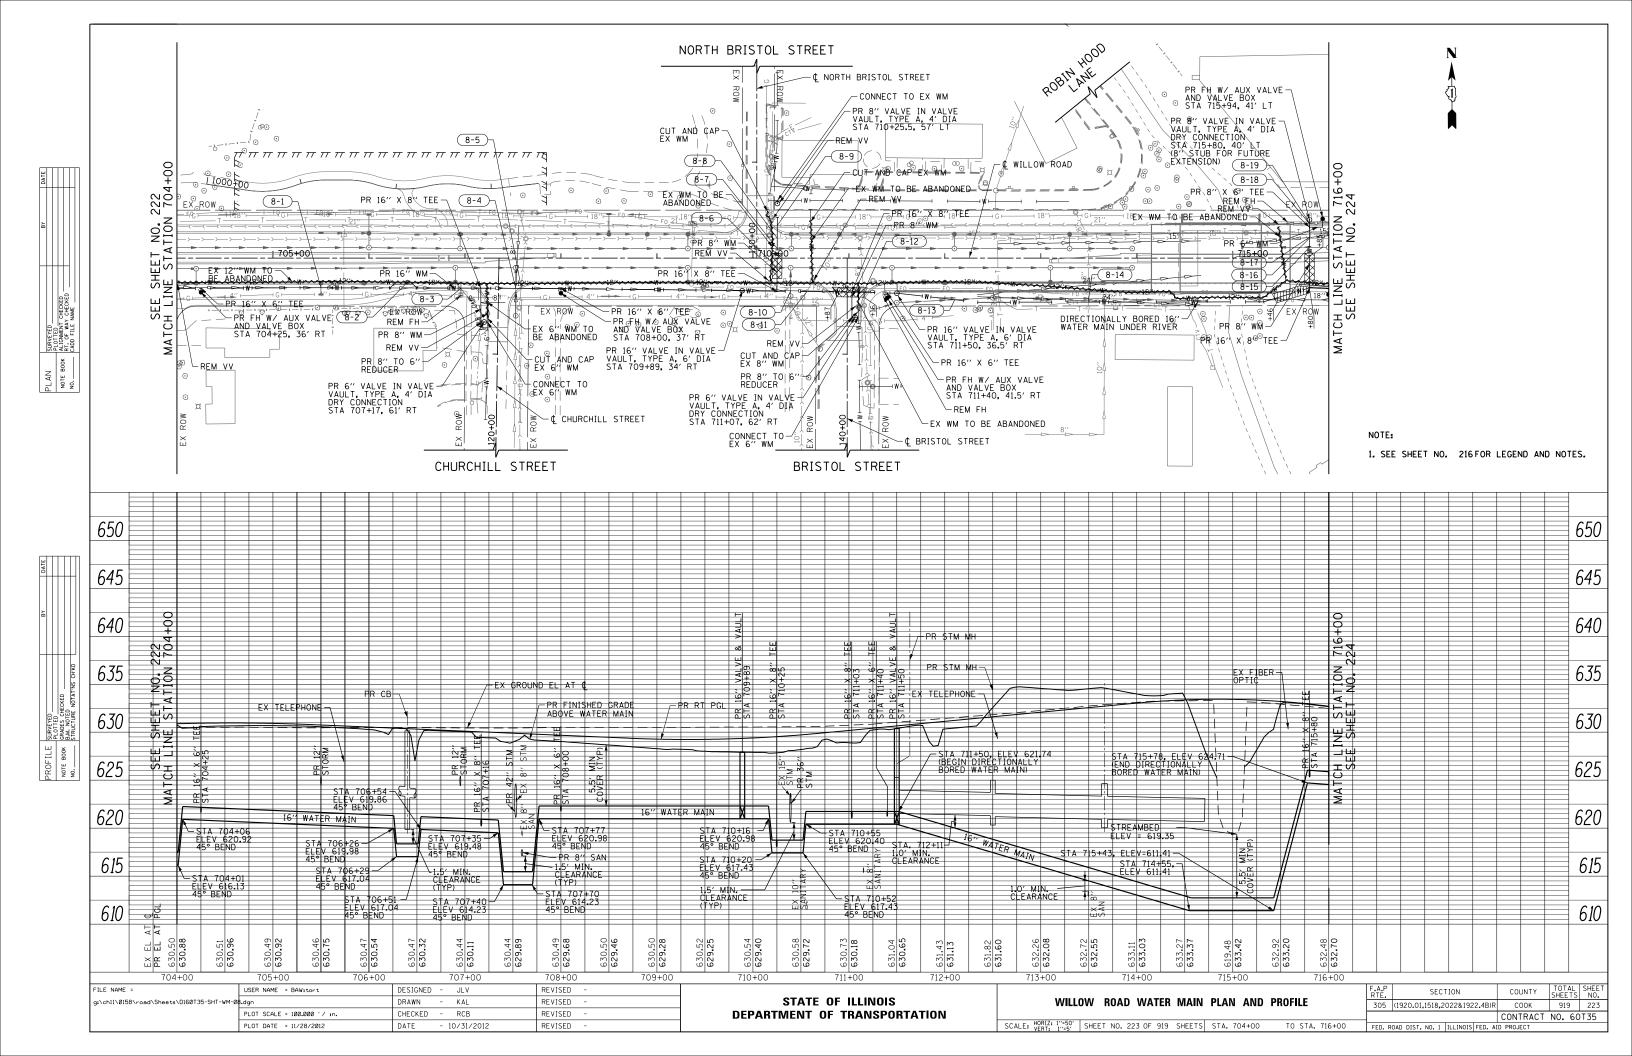

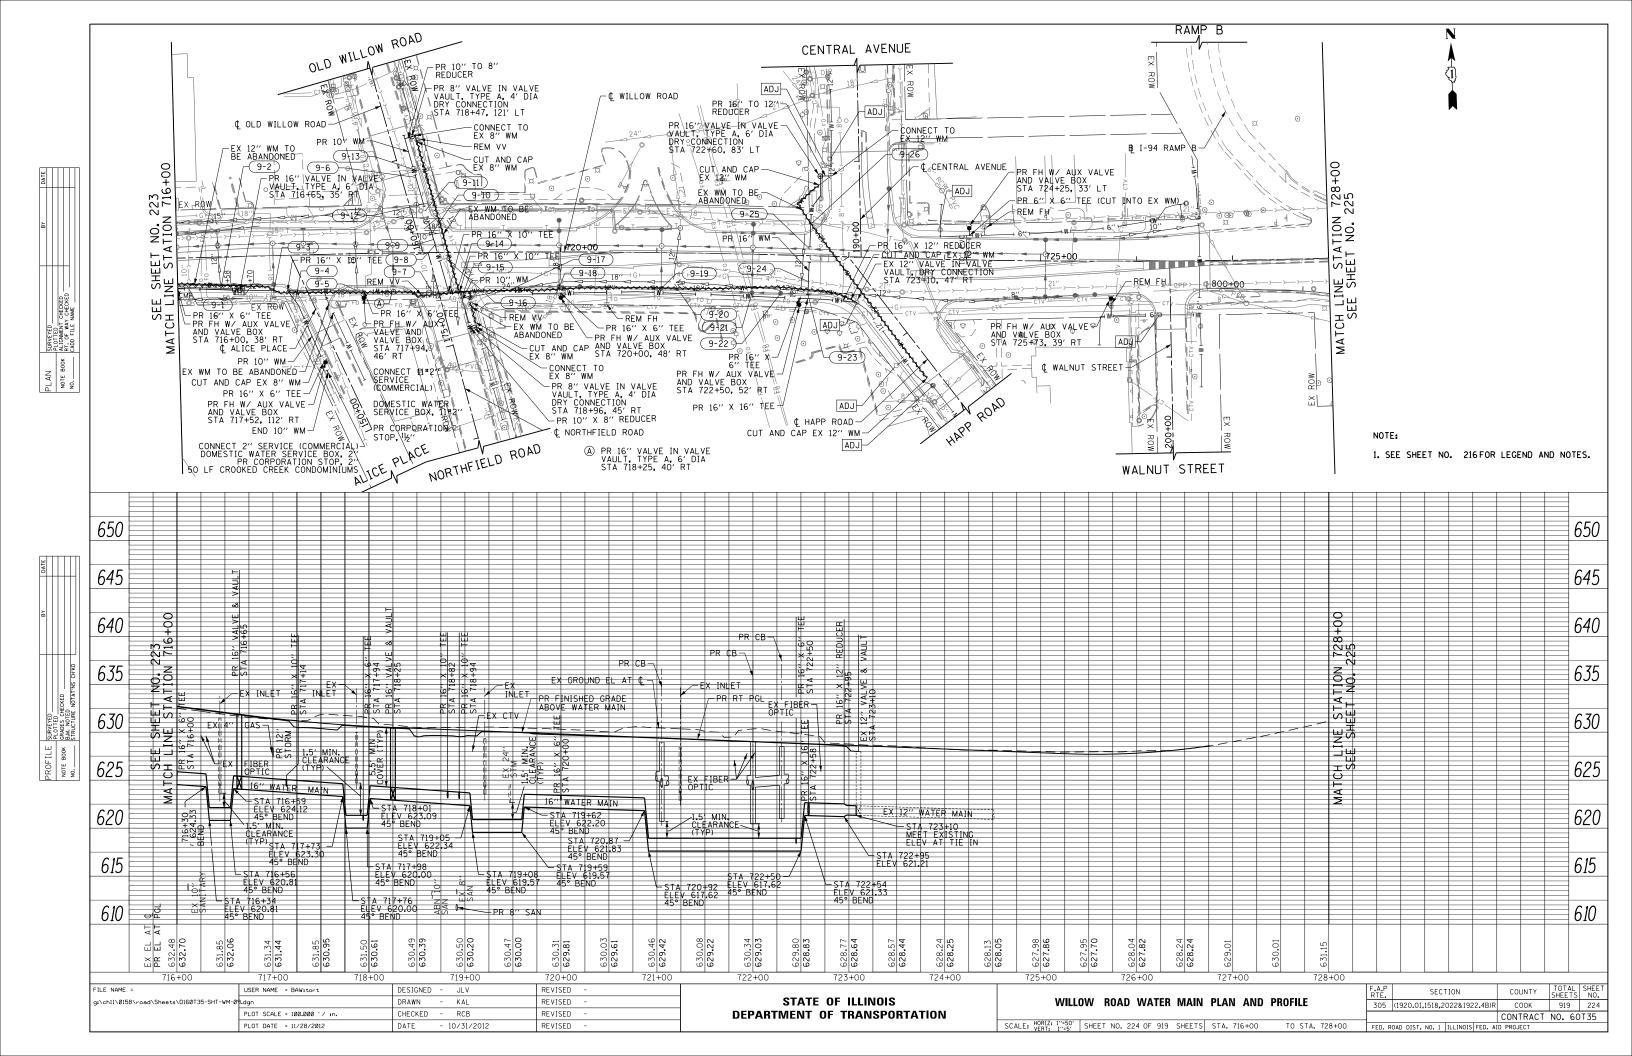

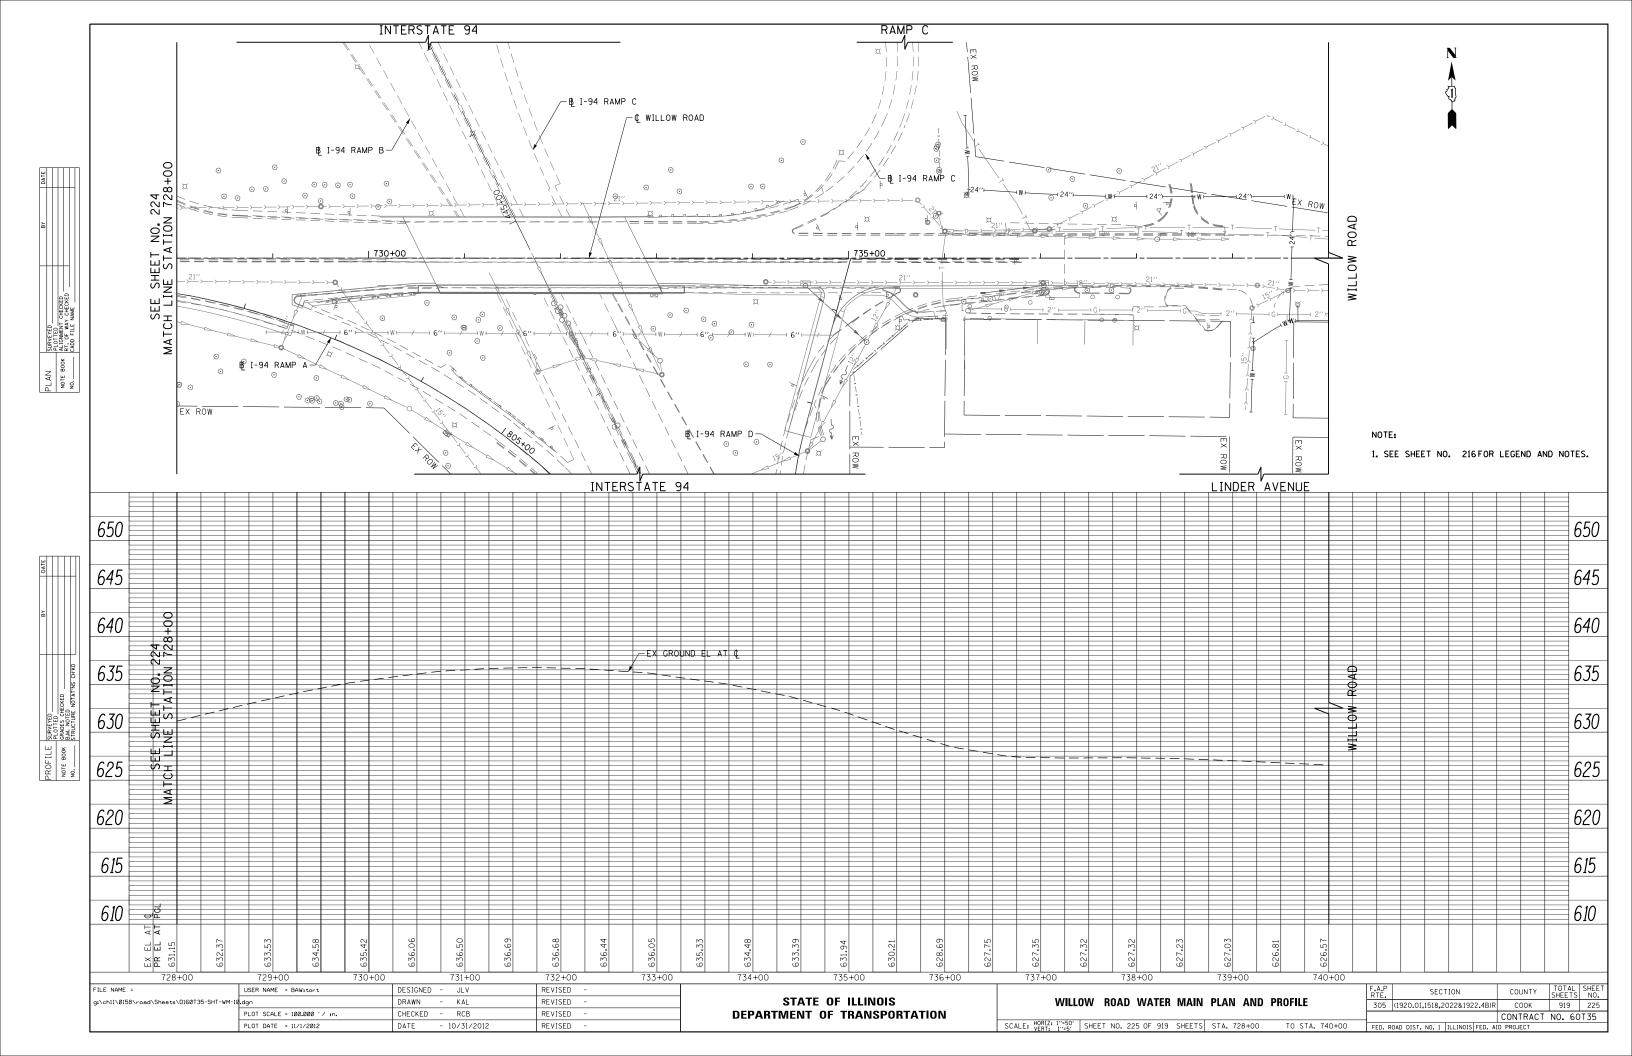

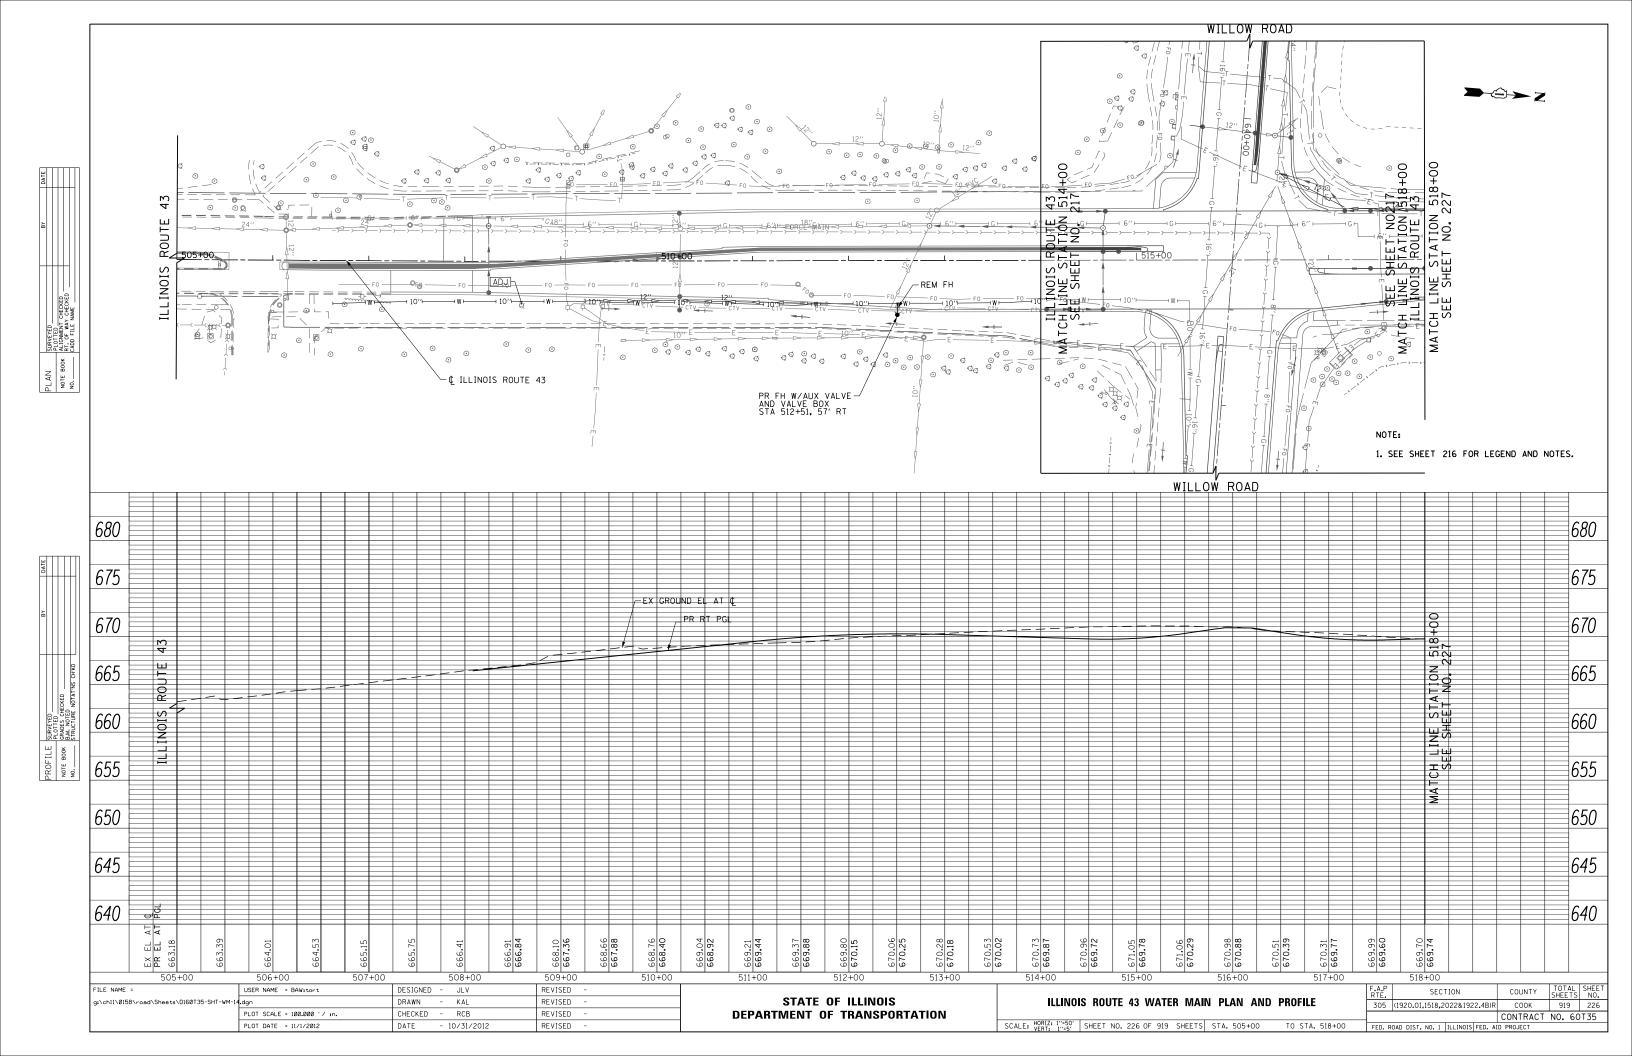

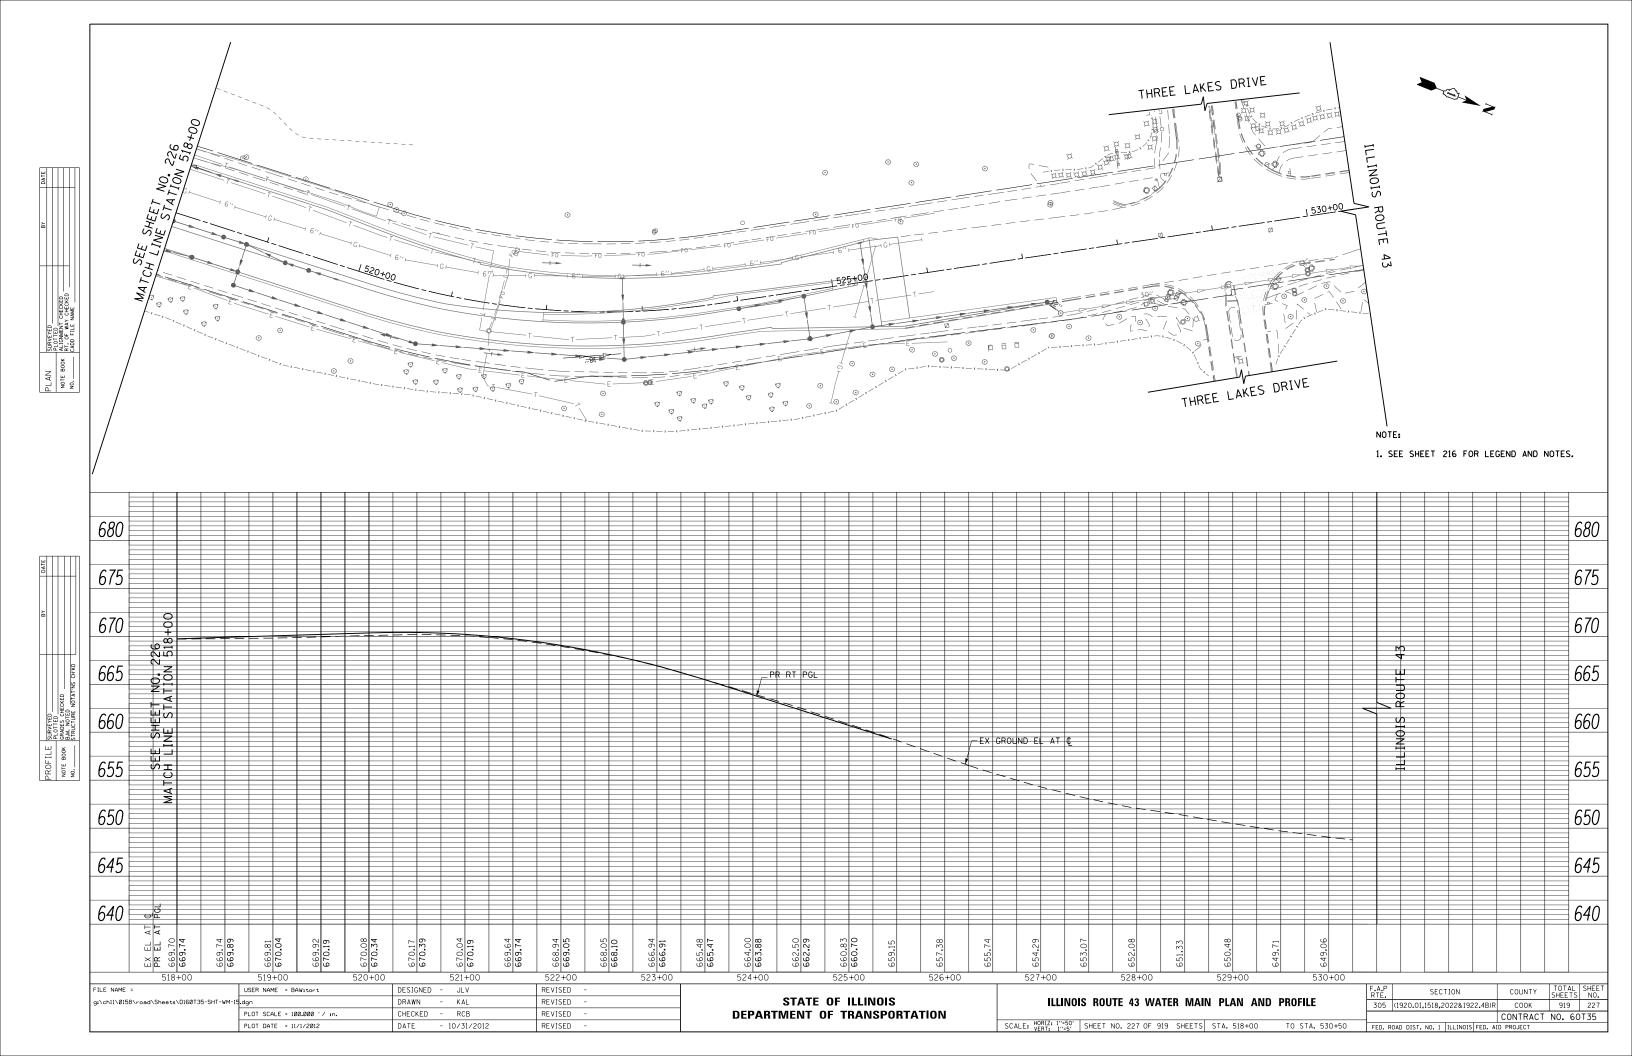

PROPOSED WATER MAIN ELEVATIONS WILLOW ROAD STA 661+00 TO STA 672+00

SHEET	CROSSING NUMBER	FINISH GRADE	TOP OF WATER MA I N	BOTTOM OF WATER MAIN	INVERT OF STORM / SANITARY		TTOM OF SANITARY	CLEARANCE
4	4-1	652.06	646.19	644.73	641.24	641.78	T / SAN	2.95
4	4-2	651.15	644.67	643.21	646.67	646.50	B/STM	1.83
4	4-3	648.69	639.20	637.74	645.96	642.63	B / EX CB	3.43
4	4-4	649.31	643.81	643.27	VERIFY IN FIELD			
4	4-5	649.42	643.92	643.38	637.36	641.78	T / STM	1.60
4	4-6	649.00	641.81	641.27	634.10	635.02	T / SAN	6.25
4	4-7	648.82	641.81	641.27	644.75	644.58	B/STM	2.77
4	4-8	648.86	641.81	641.27	645.81	645.60	B/STM	3.79
4	4-9	647.36	641.24	639.78	644.53	644.36	B/STM	3.12
4	4-10	647.16	641.20	639.74	VERIFY IN FIELD			
4	4-11	647.87	640.99	639.53	VERIFY IN FIELD			
4	4-12	646.04	639.95	638.49	643.17	643.00	B/STM	3.05

PROPOSED WATER MAIN ELEVATIONS WILLOW ROAD STA 672+00 TO STA 683+00

SHEET	CROSSING NUMBER	FINISH GRADE	TOP OF WATER MAIN	BOTTOM OF WATER MAIN	INVERT OF STORM / SANITARY	TOP/BO STORM/S	TTOM OF SANITARY	CLEARANCE
5	5-1	644.64	638.72	637.26	641.72	641.55	B/STM	2.83
5	5-2	645.75	639.75	638.83	VERIFY IN FIELD			
5	5-3	645.87	639.87	638.95	VERIFY IN FIELD			
5	5-4	645.74	639.74	638.82	632.05	632.93	T / SAN	5.90
5	5-5	645.14	632.73	631.81	634.65	634.23	B / STM	1.50
5	5-6	643.88	637.65	636.73	640.00	639.83	B/STM	2.18
5	5-7	643.08	636.71	635.25	639.44	639.27	B/STM	2.56
5	5-8	641.48	635.07	633.61	636.74	636.57	B/STM	1.50
5	5-9	639.13	632.79	631.33	635.14	634.97	B/STM	2.18

PROPOSED WATER MAIN ELEVATIONS WILLOW ROAD STA 683+00 TO STA 693+00

SHEET	CROSSING NUMBER	FINISH GRADE	TOP OF WATER MAIN	BOTTOM OF WATER MAIN	INVERT OF STORM / SANITARY	TOP/BOTTOM OF STORM/SANITARY		CLEARANCE
6	6-1	636.97	630.75	629.29	632.42	632.25 B / STM		1.50
6	6-2	636.05	626.82	625.36	630.46	628.55	B/CB	1.73
6	6-3	634.95	625.11	623.65	630.16	626.61	B/CB	1.50
6	6-4	635.55	624.64	623.18	627.77	627.60	B/STM	2.96
6	6-5	636.53	628.90	627.44	630.57	630.40	B/STM	1.50
6	6-6	635.53	622.43	621.71	624.43	623.93	B/STM	1.50
6	6-7	636.53	624.76	624.04	626.63	626.26 B / STM		1.50

PROPOSED WATER MAIN ELEVATIONS WILLOW ROAD STA 693+00 TO STA 704+00

SHEET	CROSSING NUMBER	FINISH GRADE	TOP OF WATER MA I N	BOTTOM OF WATER MAIN	INVERT OF STORM / SANITARY	TOP/BO STORM/S	TTOM OF SANITARY	CLEARANCE
7	7-1	636.68	623.25	621.79	628.40	625.36	B/MH	2.11
7	7-2	636.60	623.25	621.79	625.10	624.82	B/MH	1.57
7	7-3	635.14	627.66	626.20	629.33	629.16	B / STM	1.50
7	7-4	633.69	619.99	618.53	628.75	625.42	B/CB	5.43
7	7-5	633.58	619.99	618.53	629.44	629.25	B/STM	9.26
7	7-6	633.57	619.99	618.53	609.00	613.75	T / SAN	4.78
7	7-7	633.89	628.39	627.47	624.53	625.70	T / STM	1.78
7	7-8	633.18	619.99	618.53	623.64	623.31	B/STM	3.32
7	7-9	633.08	619.99	618.53	624.40	624.23	B/STM	4.24
7	7-10	633.09	619.99	618.53	621.52	621.49	B / SAN	1.50
7	7-11	632.95	619.99	619.07	624.40	624.07	B/STM	4.08
7	7-12	633.06	619.99	619.07	623.55	623.01	B/STM	3.02
7	7-13	633.17	619.44	618.52	623.00	622.50	B/STM	3.06
7	7-14	633.05	619.44	618.52	620.98	620.94	B / SAN	1.50
7	7-15	632.90	626.58	625.66	VERIFY IN FIELD			
7	7-16	633.19	626.58	625.66	628.25	628.08	B/STM	1.50
7	7-17	632.78	619.99	618.53	628.78	628.28	B/INL	8.29
7	7-18	631.62	625.52	624.06	627.19	627.02	B/STM	1.50
7	7-19	631.21	619.23	617.77	626.09	622.76	B/CB	3.53
7	7-20	630.88	619.23	617.77	620.92	620.88	B / SAN	1.65

PROPOSED WATER MAIN ELEVATIONS WILLOW ROAD STA 693+00 TO STA 704+00

SHEET	CROSSING NUMBER	FINISH GRADE	TOP OF WATER MAIN	BOTTOM OF WATER MAIN	INVERT OF STORM / SANITARY	TOP/BOTTOM OF STORM/SANITARY		CLEARANCE
7	7-21	630.93	619.23	617.77	623.00	622.67 B/STM		3.44
7	7-22	631.43	619.23	617.77	626.94	626.44	B / INL	7.21
7	7-23	630.44	624.66	623.20	626.53	626.36	B/STM	1.70
7	7-24	630.29	624.20	622.74	626.29	626.12	B/STM	1.92
7	7-25	630.14	617.47	616.01	626.56	619.78 B / CB		2.31
7	7-26	630.14	617.47	616.01	619.01	618.97	B / SAN	1.50
7	7-27	630.34	617.47	616.01	624.42	623.59 B / MH		6.12

PROPOSED WATER MAIN ELEVATIONS WILLOW ROAD STA 704+00 TO STA 716+00

SHEET	CROSSING NUMBER	FINISH GRADE	TOP OF WATER MAIN	BOTTOM OF WATER MAIN	INVERT OF STORM / SANITARY		TTOM OF SANITARY	CLEARANCE
8	8-1	630.57	621.64	620.18	624.44	624.27 B / STM		2.63
8	8-2	630.14	618.37	616.91	623.20 619.87 B / CB		B / CB	1.50
8	8-3	630.06	621.02	619.56	624.35	624.18	B/STM	3.16
8	8-4	629.11	615.57	614.11	621.11	620.74	B/STM	5.16
8	8-5	629.47	615.57	614.11	617.11	617.07	B/SAN	1.50
8	8-6	629.44	618.35	617.63	620.57	619.99	B/STM	1.64
8	8-7	629.44	618.35	617.63	620.39	619.85 B / STM		1.50
8	8-8	629.22	618.35	617.63	613.96	615.27	T / SAN	2.36
8	8-9	629.57	624.07	623.35	610.02	611.85	T / SAN	11.49
8	8-10	628.08	618.76	617.30	620.59	620.26	B/STM	1.50
8	8-11	628.30	621.74	620.28	611.55	612.43	T / SAN	7.86
8	8-12	629.39	621.74	620.28	615.25	615.96	T / SAN	4.32
8	8-13	625.11	619.94	618.48	621.31	620.94	B/STM	1.00
8	8-14	634.52	615.91	614.45	VERIFY IN FIELD			
8	8-15	632.80	626.84	626.12	621.28	624.61	T / STM	1.50
8	8-16	632.61	626.84	626.12	611.65	612.94	T / SAN	13.18
8	8-17	632.58	626.84	626.12	VERIFY IN FIELD			
8	8-18	632.78	626.84	626.12	610.74	612.53	T / SAN	13.59
8	8-19	632.76	626.84	626.12	VERIFY IN FIELD			


PROPOSED WATER MAIN ELEVATIONS WILLOW ROAD STA 716+00 TO STA 728+00


SHEET	CROSSING NUMBER	FINISH GRADE	GRADE WATER MAIN WATER MAIN STORM/S		INVERT OF STORM / SANITARY	TOP/BO STORM/		
9	9-1	632.50	625.80	624.34	613.40	614.28	T / SAN	10.94
9	9-2	632.07	622.14	620.68	624.14	623.64	B / INL	1.50
9	9-3	631.37	625.16	623.70	627.36	627.19	B/STM	2.03
9	9-4	630.94	625.44	624.52	621.16	622.04	T / SAN	2.49
9	9-5	630.62	621.33	619.87	625.20	624.70	B / INL	3.37
9	9-6	630.20	623.45	622.53	625.10	624.95	B/STM	1.50
9	9-7	629.67	623.96	622.50	VERIFY IN FIELD			
9	9-8	630.22	619.76	618.84	621.59	621.26	B/STM	1.50
9	9-9	630.15	619.76	618.84	611.08	611.77	T / SAN	7.07
9	9-10	630.05	619.76	618.84	VERIFY IN FIELD			
9	9-11	629.72	623.45	622.53	612.45	614.01	T / SAN	8.52
9	9-12	629.66	623.45	622.53	625.52	625.35	B/STM	1.90
9	9-13	630.24	623.45	622.53	625.30	625.18	B/STM	1.72
9	9-14	629.64	623.77	622.31	611.41	612.10	T / SAN	10.21
9	9-15	629.29	621.00	620.08	622.75	622.50	B/STM	1.50
9	9-16	630.08	620.90	619.44	624.06	623.56	B / INL	2.66
9	9-17	630.09	620.90	619.44	622.65	622.40	B/STM	1.50
9	9-18	629.72	621.26	619.80	622.97	622.76	B/STM	1.50
9	9-19	628.98	618.95	617.49	624.22	621.05	B/CB	2.10
9	9-20	629.29	618.95	617.49	623.41	622.91	B / INL	3.96
9	9-21	629.03	618.95	617.49	623.95	620.45	B/CB	1.50
9	9-22	628.49	618.95	617.49	624.50	621.00	B/CB	2.25
9	9-23	628.37	622.65	621.19	624.87	624.37	B / INL	1.72
9	9-24	628.67	622.65	621.19	VERIFY IN FIELD			
9	9-25	628.60	620.70	619.24	622.53	622.20	B/STM	1.50
9	9-26	628.86	623.36	621.90	610.72	610.89	T / SAN	11.02


FILE NAME =	USER NAME = BAWitort	DESIGNED -	JLV	REVISED	-
g:\ch11\0158\road\Sheets\D160T35-SHT-WM	EL.dgn	DRAWN -	KAL	REVISED	-
	PLOT SCALE = 100.00000 '/ in.	CHECKED -	RCB	REVISED	-
	PLOT DATE = 11/28/2012	DATE -	10/31/2012	REVISED	-

	F.A.P. SECTION		COUNTY	TOTAL SHEETS	SHEET NO.
WILLOW ROAD WATER MAIN ELEVATIONS		(1920.01,1518,2022&1922.4B)R	COOK	919	228
			CONTRACT	NO. 60	T35
SHEET NO. 228 OF 919 SHEETS	EEU D	OAD DIST NO 1 THE INDISPED AT	n ppn iert		

TYPICAL SIDE STREET CONNECTION NOT TO SCALE

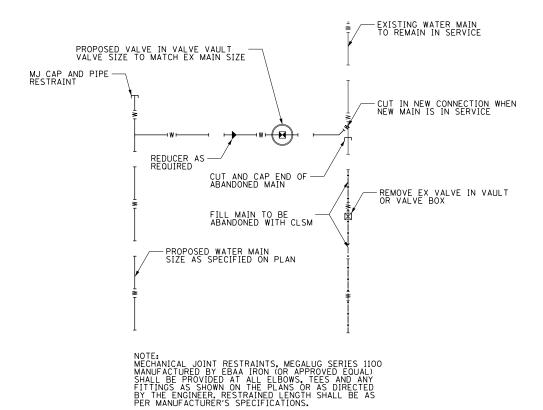

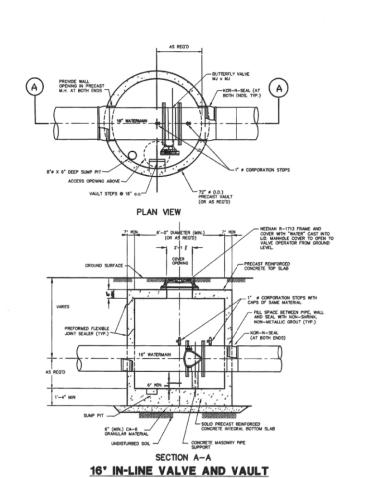

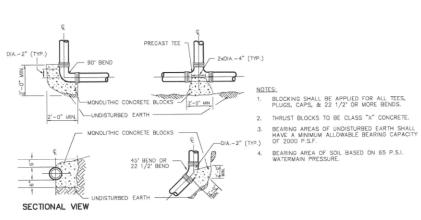

RESTRAINED	RESTRAINED LENGTH - EACH WAY					
TYPE METHOD	8"	10"	12"	24"		
DEAD END/TEE	17'-0"	21'-0"	25'-0"	45'-0"		
90° BEND	13'-0"	16'-0"	19'-0"	35'-0"		
45° BEND	6'-0"	7'-0"	8'-0"	15'-0"		
22 1/2° BEND	3'-0"	4'-0"	4'-0"	7'-0"		
11 1/4" BEND	2'-0"	2'-0"	2'-0"	4'-0"		
VERTICAL OFFSET UPPER/LOWER	9/4	11/5	20/6	35/10		
FIRE HYDRANT	ALL JOINTS	RESTRAINED FROM	MAIN TO MJ SHOE			

NOTES:
JOINT RESTRAINT FOR FITTINGS/CONFIGURATIONS NOT SHOWN SHALL BE PER MANUFACTURER'S RECOMEDATIONS.
ALL BENDS, TEES, ELBOWS, REDUCERS, ETC. SHALL BE MJ WITH RETAINING GLANDS AND USING MEGALUG SERIES
1100 RESTRAINT SYSTEM AS MANUFACTURED BY EBAA IRON.

THRUST BLOCKING AND RESTRAINED LENGTH TABLE

NOTES:

- PIPE OPENINGS CAST INTO WALL.
- PRECAST REINFORCED CONCRETE SECTIONS WITH PREFORMED BITUMINOUS JOINTS AND INTEGRAL PRECAST BOTTOMS.
- 3. FRAME TO BE LAID IN 3/4" MASTIC BED.
- 4. ADJUSTING RINGS NOT TO EXCEED 8".
- CONCENTRIC CONE.
- . CONCENTRIC CONE.
- NEENAH R-1713 FRAME AND COV WITH "WATER" IMPRINTED IN LID.
- 2" CORPORATION STOP REQUIRE
- ON BOTH SIDES OF VALVE.
- 8. RESILIENT WEDGE GATE VALVE WITH NON RISING STEM AND MECHANICAL JOINT. (SIZE AS LABELED)


8"-12" VALVE AND VAULT

SEAL SPACE WITH MASONRY


CONCRETE SUPPORTS

·41

5" FOR 10" & 12" VALVE 6' FOR 14" & 16" VALVE

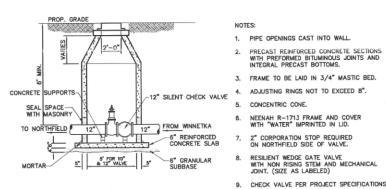


12" VALVE AND VAULT W/CHECK VALVE

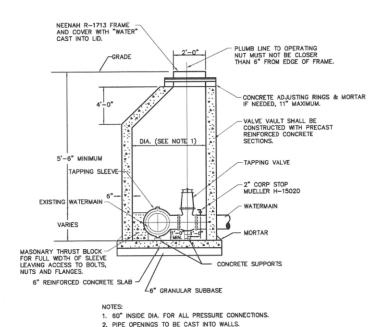

4. USE PRECAST ECCENTRIC MH CONE. TAPPING VALVE AND VAULT

3. BACKFILL MATERIAL SHALL BE TRENCH BACKFILL (TBF)

FILE NAME =	USER NAME = BAWitort	DESIGNED - JLV	REVISED -				F.A.P. SECTION	COUNTY TOTAL SHEET
g:\chl1\0158\road\Sheets\D160T35-SHT-WM	STD-NORTHFIELD.dgn	DRAWN - KAL	REVISED -	STATE OF ILLINOIS		WATER MAIN DETAILS	305 (1920.01,1518,2022&1922.4B)F	R COOK 919 229
	PLOT SCALE = 100.0000 ' / in.	CHECKED - RCB	REVISED -	DEPARTMENT OF TRANSPORTATION				CONTRACT NO. 60T35
1	PLOT DATE = 11/1/2012	DATE - 10/31/2012	REVISED -		SCALE: N.T.S. SHEET NO. 229 OF 919 SHEETS		FED. ROAD DIST. NO. 1 ILLINOIS FED. A	AID PROJECT

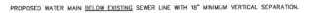

NOTE: COMPACTION REQUIREMENTS REFER TO 20-2.208

GUIDELINES

1. OMIT SELECT GRANULAR EMBEDMENT AND GRANULAR BACKFILL TO ONE (1) FOOT OVER TOP OF WATER MAIN AND USE SELECT EXCAVATED MATERIAL (CLASS IV) AND COMPACT THE LENGTH OF "L".


OMPACT THE LENGTH OF "L".

SELECT GRANULAR BACKFILL EXISTS,
MOVE WITHIN WIDTH OF EXISTING SEWER


 IF SELECT GRANULAR BACKFILL EXISTS, REMOVE WITHIN WIDTH OF EXISTING SEI LINE TRENCH AND REPLACE WITH SELE EXCAVATED MATERIAL (CLASS IV) AND COMPACT.

PROVIDE ADEQUATE SUPPORT FO EXISTING SEWER LINE TO PREVEN DAMAGE DUE TO SETTLEMENT.

 USE "L" FEET OF WAINE OF PROOF MAIN MATERIAL FOR CASING OF PROOF

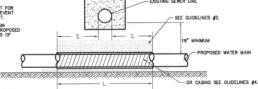

PLACEMENT OF WATER MAIN **BELOW EXISTING** OR PROPOSED SEWER LINE **WITH LESS** THAN 18" MINIMUM VERTICAL SEPARATION. **NOT ALLOWED***

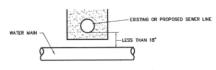


NOT ALLOWED*

MUST MAINTAIN 18" VERTICAL SEPARATION

WATER AND SEWER SEPARATION REQUIREMENTS

PROPOSED WATER MAIN ABOVE EXISTING SEWER LINE WITH LESS THAN 18" VERTICAL SEPARATION.

NOTE: COMPACTION REQUIREMENTS REFER TO 20-2.20B

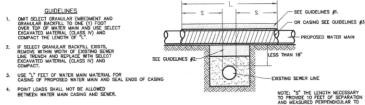


WATER AND SEWER SEPARATION REQUIREMENTS

WHEN PROPOSED SEWER (OR WATER) IS LOCATED 10 FEET OR MORE FROM EXISTING WATER (OR SEWER), NO SPECIAL CONSTRUCTION REQUIRED.



WHEN <u>PROPOSED</u> SEWER (OR WATER) IS LOCATED <u>LESS THAN 10 FEET</u> FROM EXISTING WATER (OR SEWER), DETAILS BELOW SHALL APPLY.


SEE SECTION 41-2.018 (2)

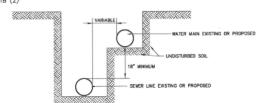

WATER AND SEWER SEPARATION REQUIREMENTS


PROPOSED SEWER LINE <u>WITH 18*MINIMUM VERTICAL SEPARATION ABOVE</u> EXISTING WATER MAIN.

NOTE: COMPACTION REQUIREMENTS REFER TO 20-2.20B

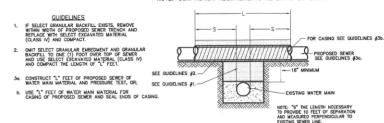


WATER AND SEWER SEPARATION REQUIREMENTS


PROPOSED SEWER LINE BELOW EXISTING WATER MAIN WITH 18" MINIMUM VERTICAL SEPARATION.

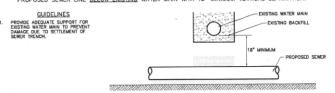

PROPOSED SEWER LINE BELOW EXISTING WATER MAIN WITH LESS THAN 18" VERTICAL SEPARATION.

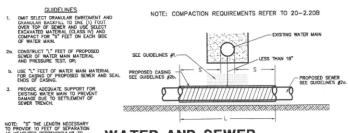


HONGE TO FEET OF SEPARATION WATER MAIN. WATER AND SEWER SEPARATION REQUIREMENTS

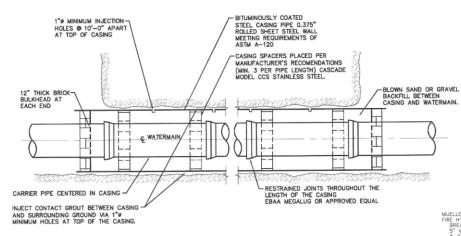


CASING PIPE INSTALLATION

NOT TO SCALE

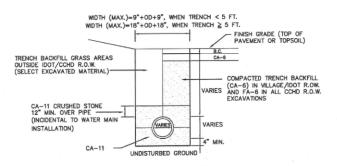

WATERMAIN TRENCH

SCALE: N.T.S.

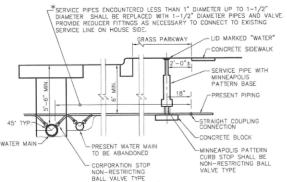

NOTES:


1. EXISTING SERVICE PIPES MAY BE OF VARYING SIZES AND MATERIALS. CONTRACTOR SHALL FURNISH SUITABLE CONNECTOR TO COPPER PIPE AND FITTINGS.


2. ALL CORP AND CURB STOPS SHALL BE FLARE TYPE CONNECTIONS.

3. THE EXISTING SERVICE BOX SHALL BE REMOVED AND THE NEW SERVICE BOX PLACED AS CLOSE AS POSSIBLE TO THE ORIGINAL LOCATION.


4. SERVICE TAP SHALL INCLUDE SMITH-BLAIR 317

TYPICAL WATER SERVICE CONNECTION

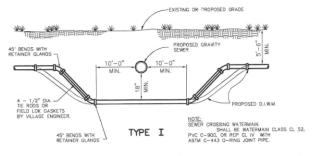

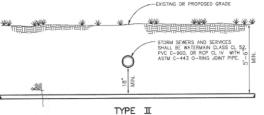


WATERMAIN CROSSING

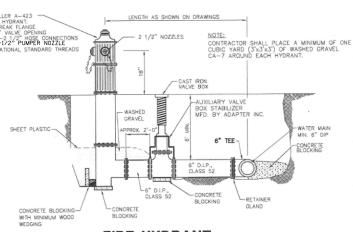



FIRE HYDRANT


STATE OF ILLINOIS DEPARTMENT OF TRANSPORTATION


	MATER MAIN RETAILS		F.A.P. RTE.	SECTION	COUNTY	TOTAL SHEETS	SHEE NO.
WATER MAIN DETAILS		305	(1920.01,1518,2022&1922.4B)F	COOK	919	230	
					CONTRACT	NO. 60)T35
	SHEET NO. 230 OF 919 SHEETS		FED. R	OAD DIST. NO. 1 ILLINOIS FED. A	ID PROJECT		

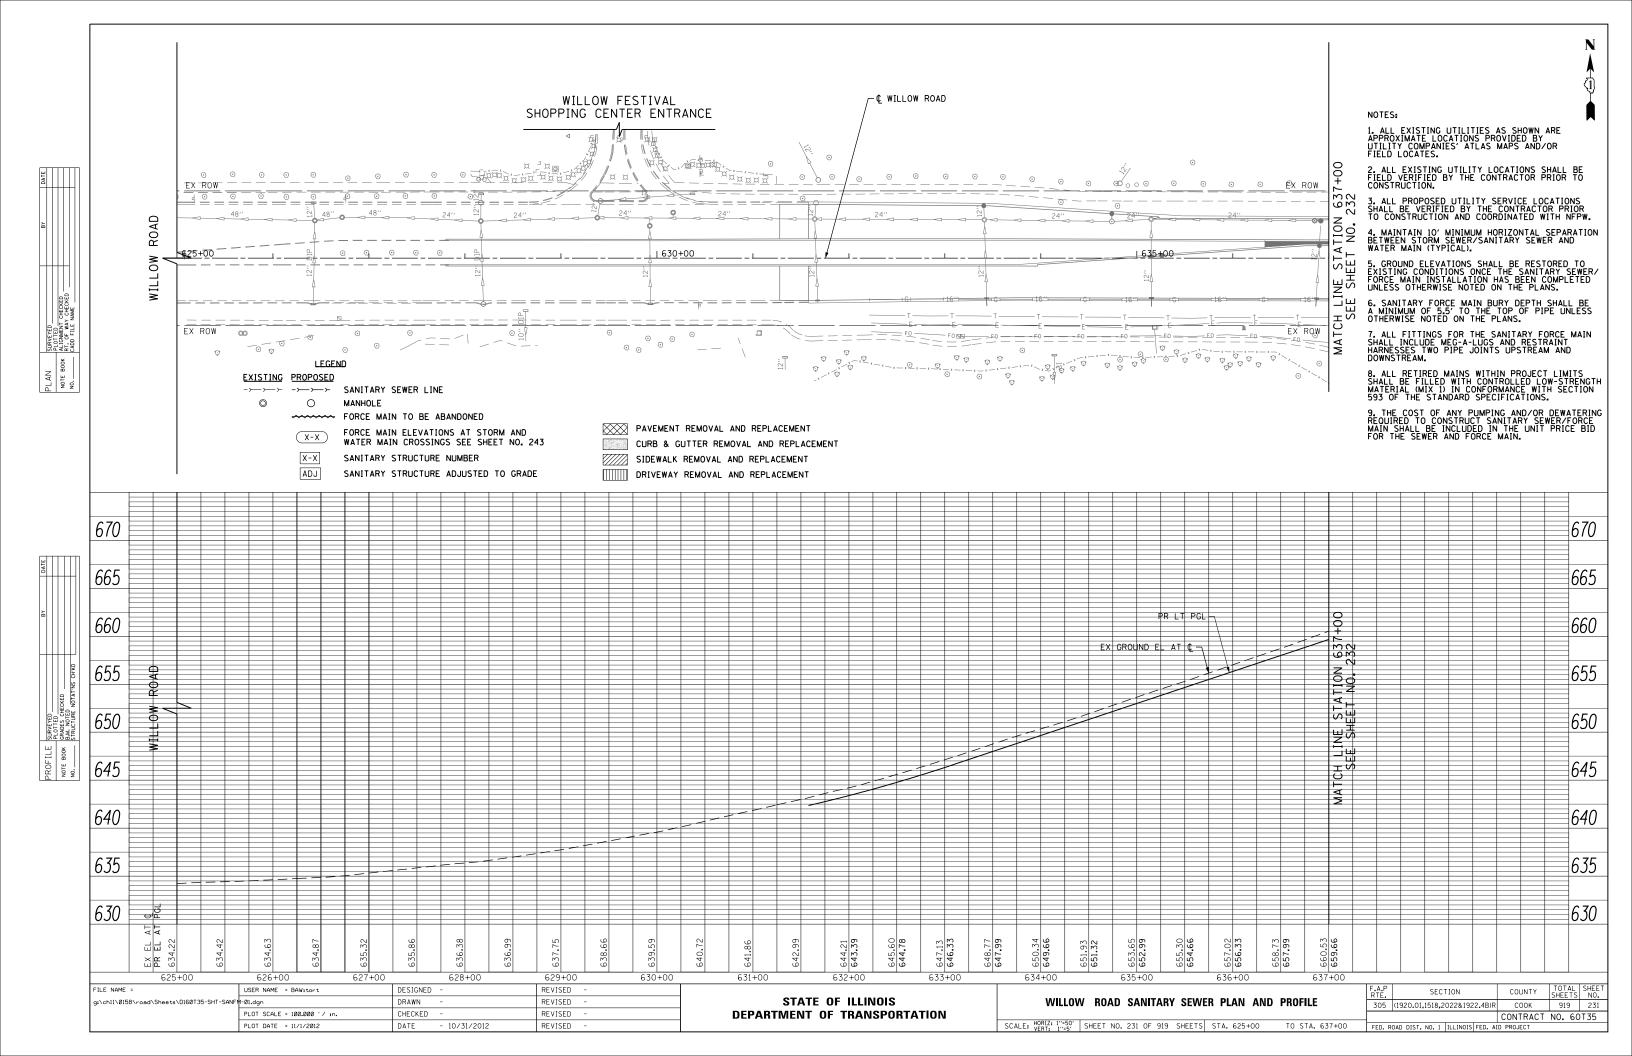


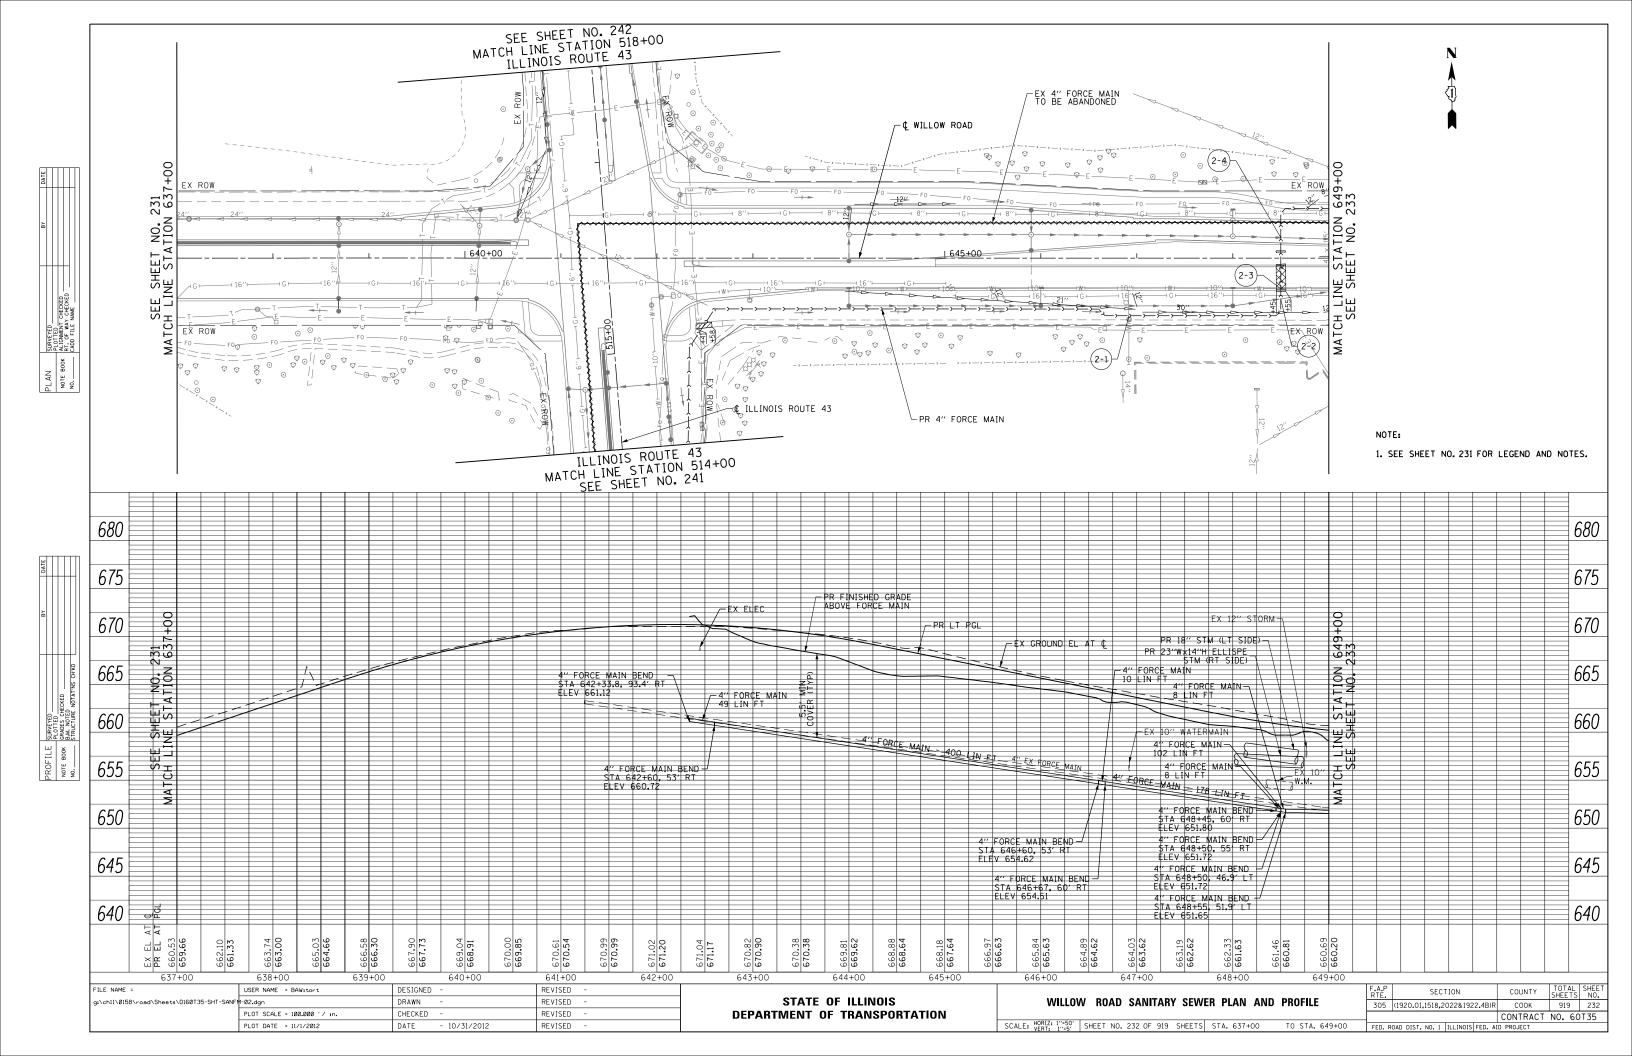


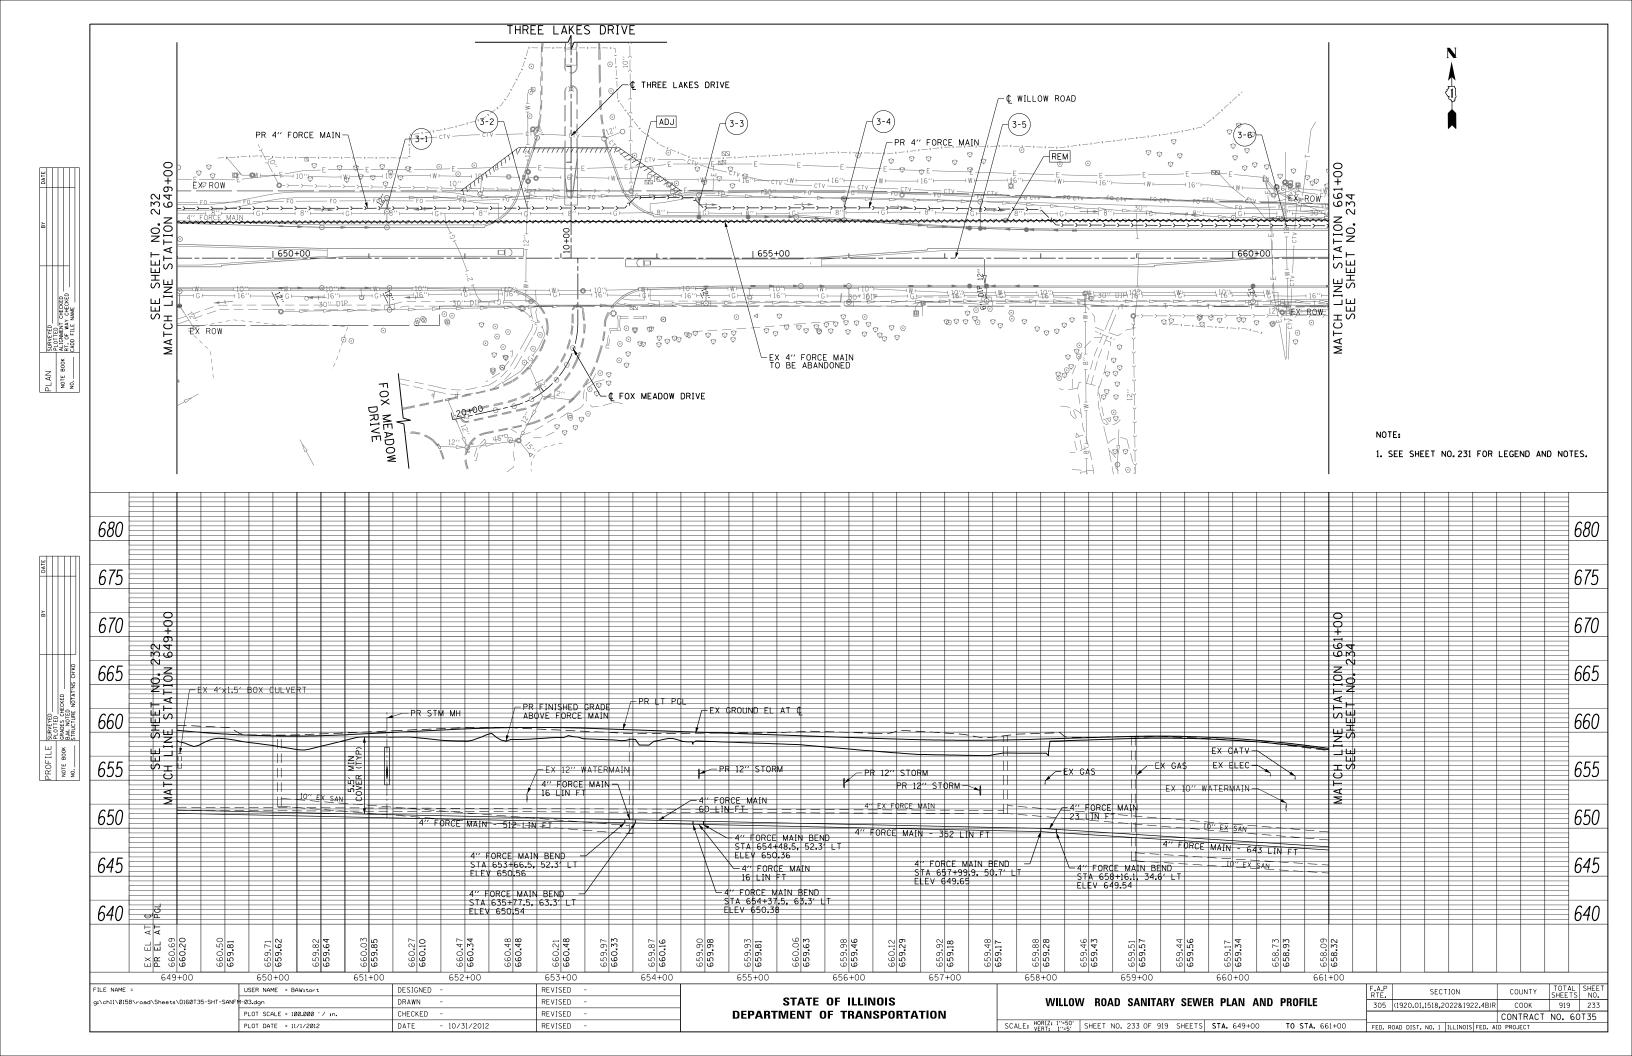


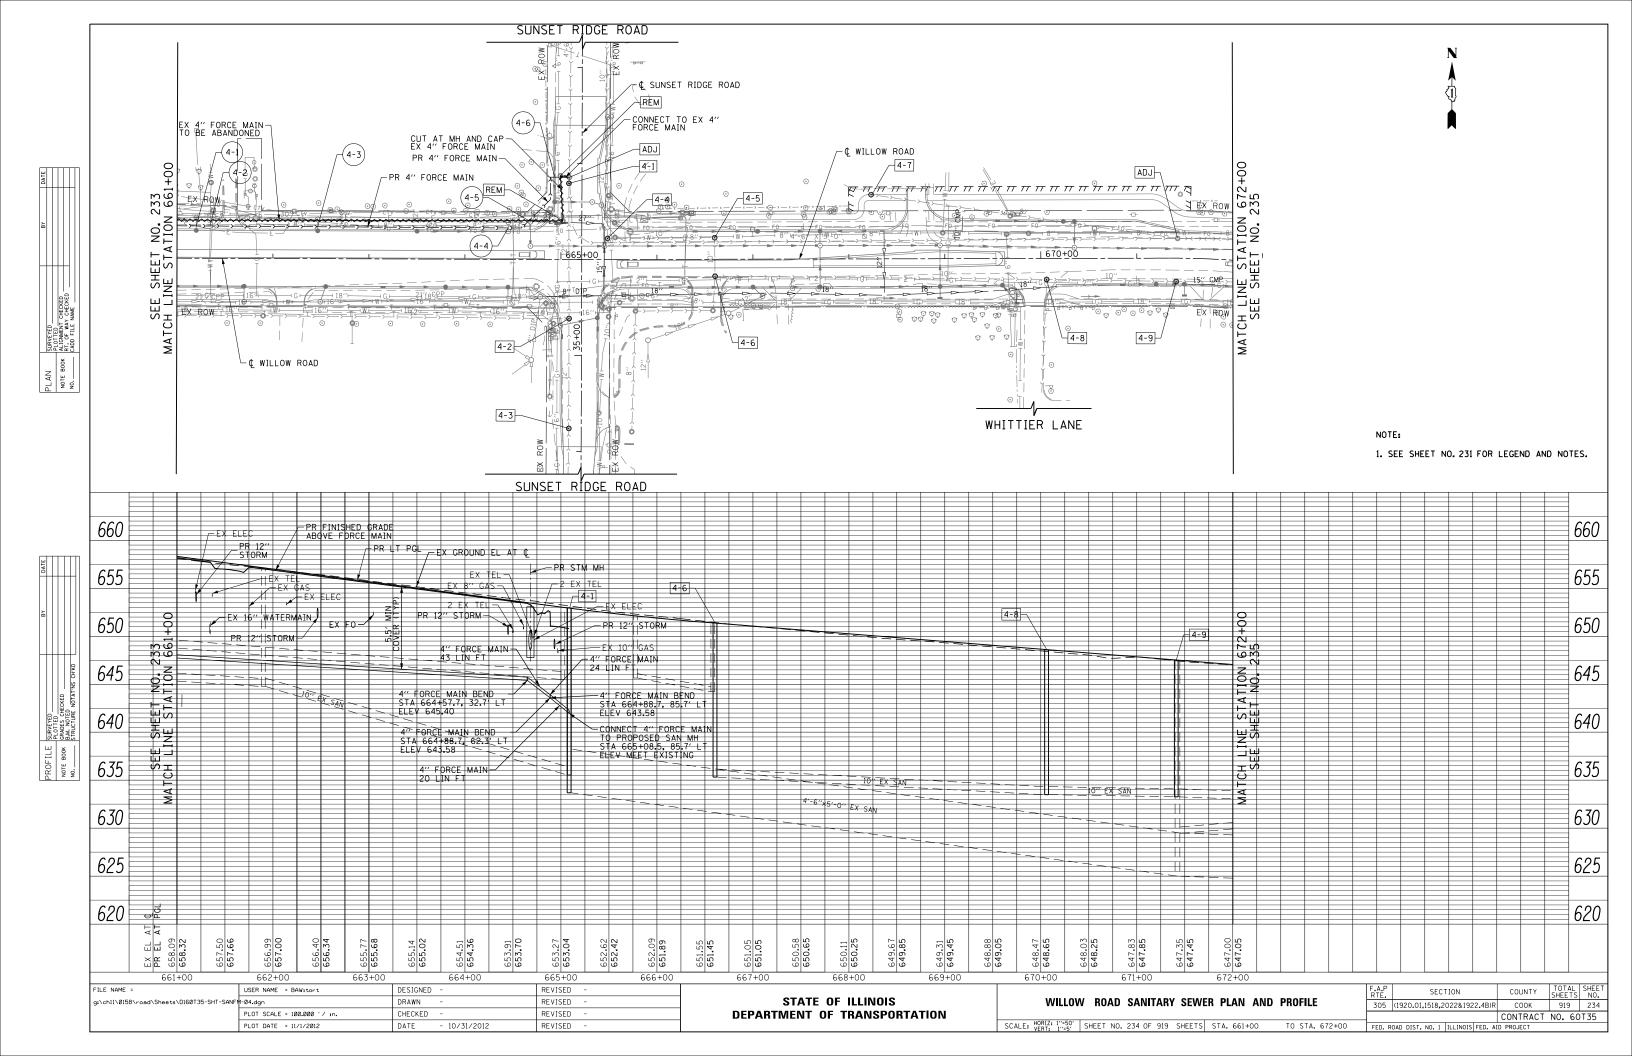


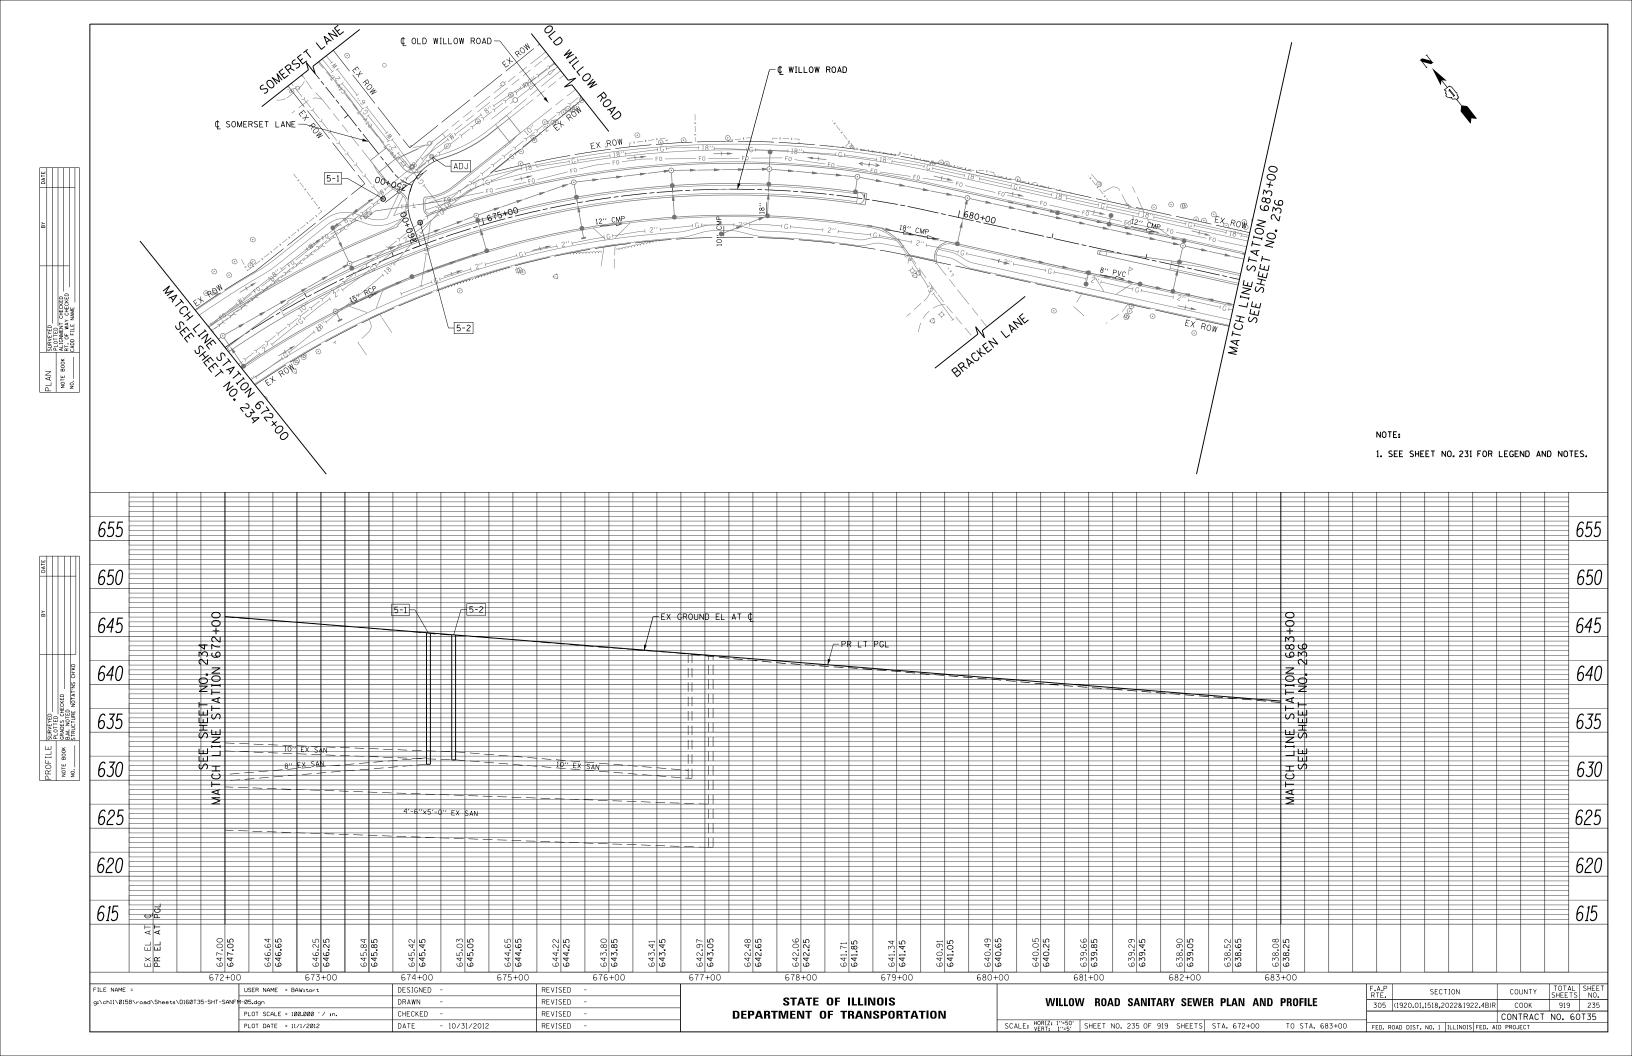


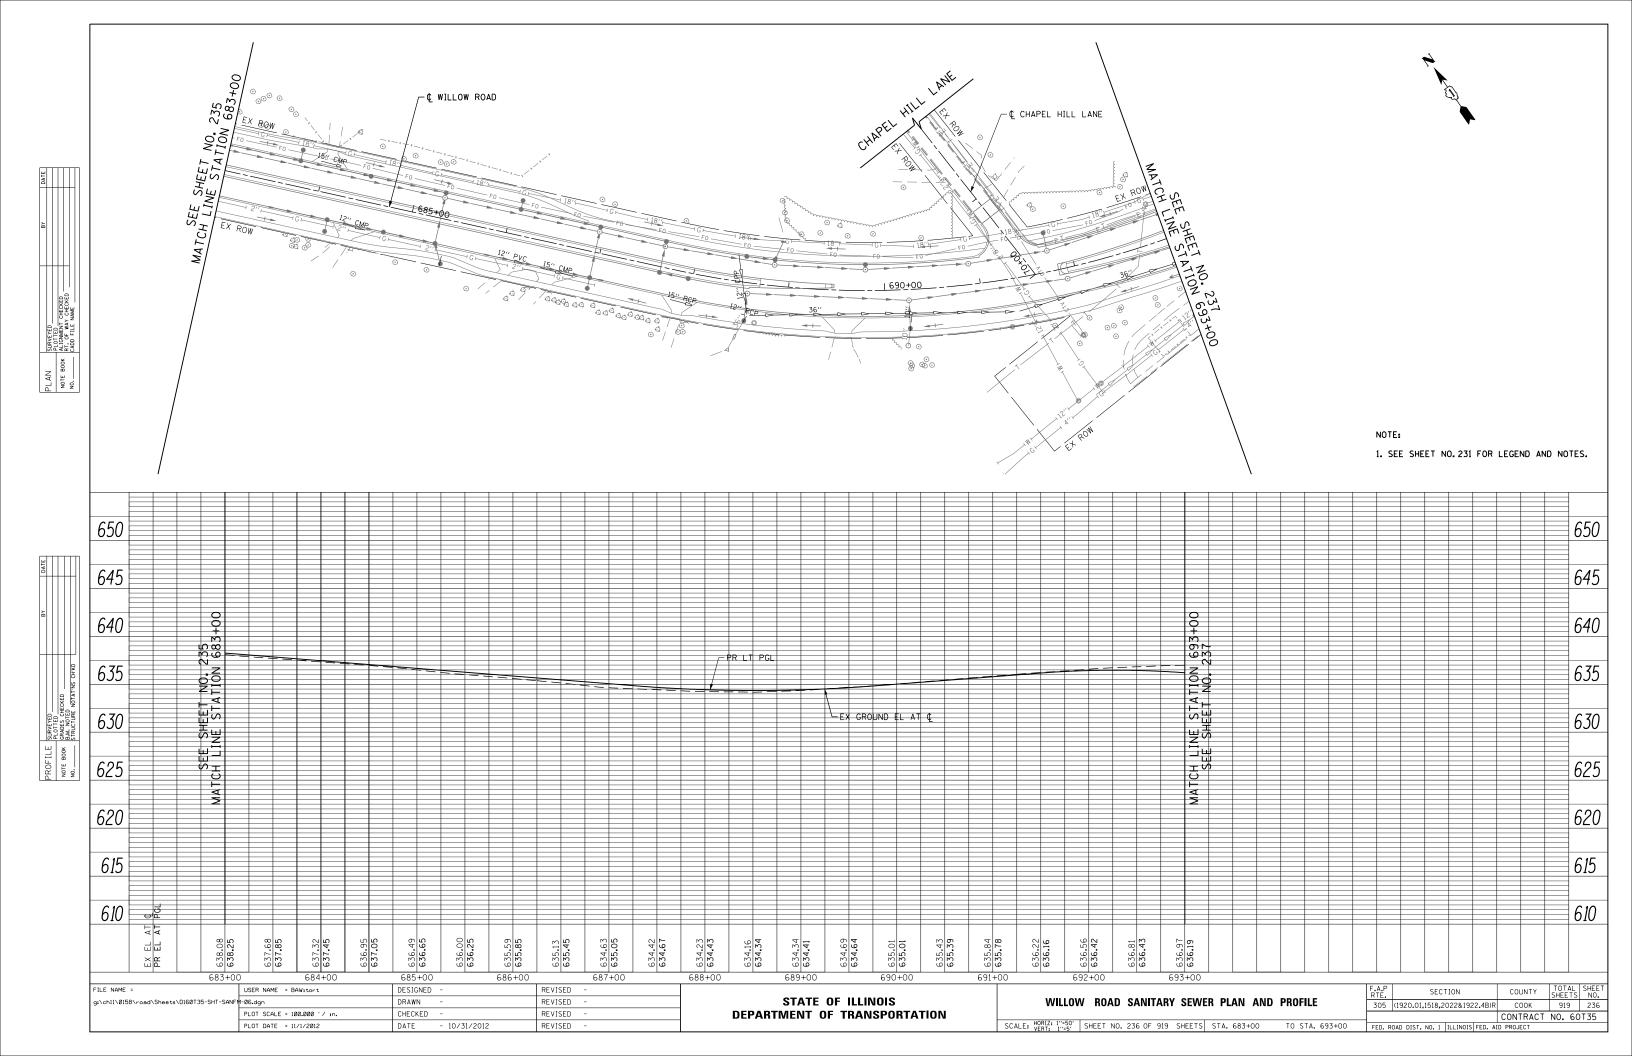


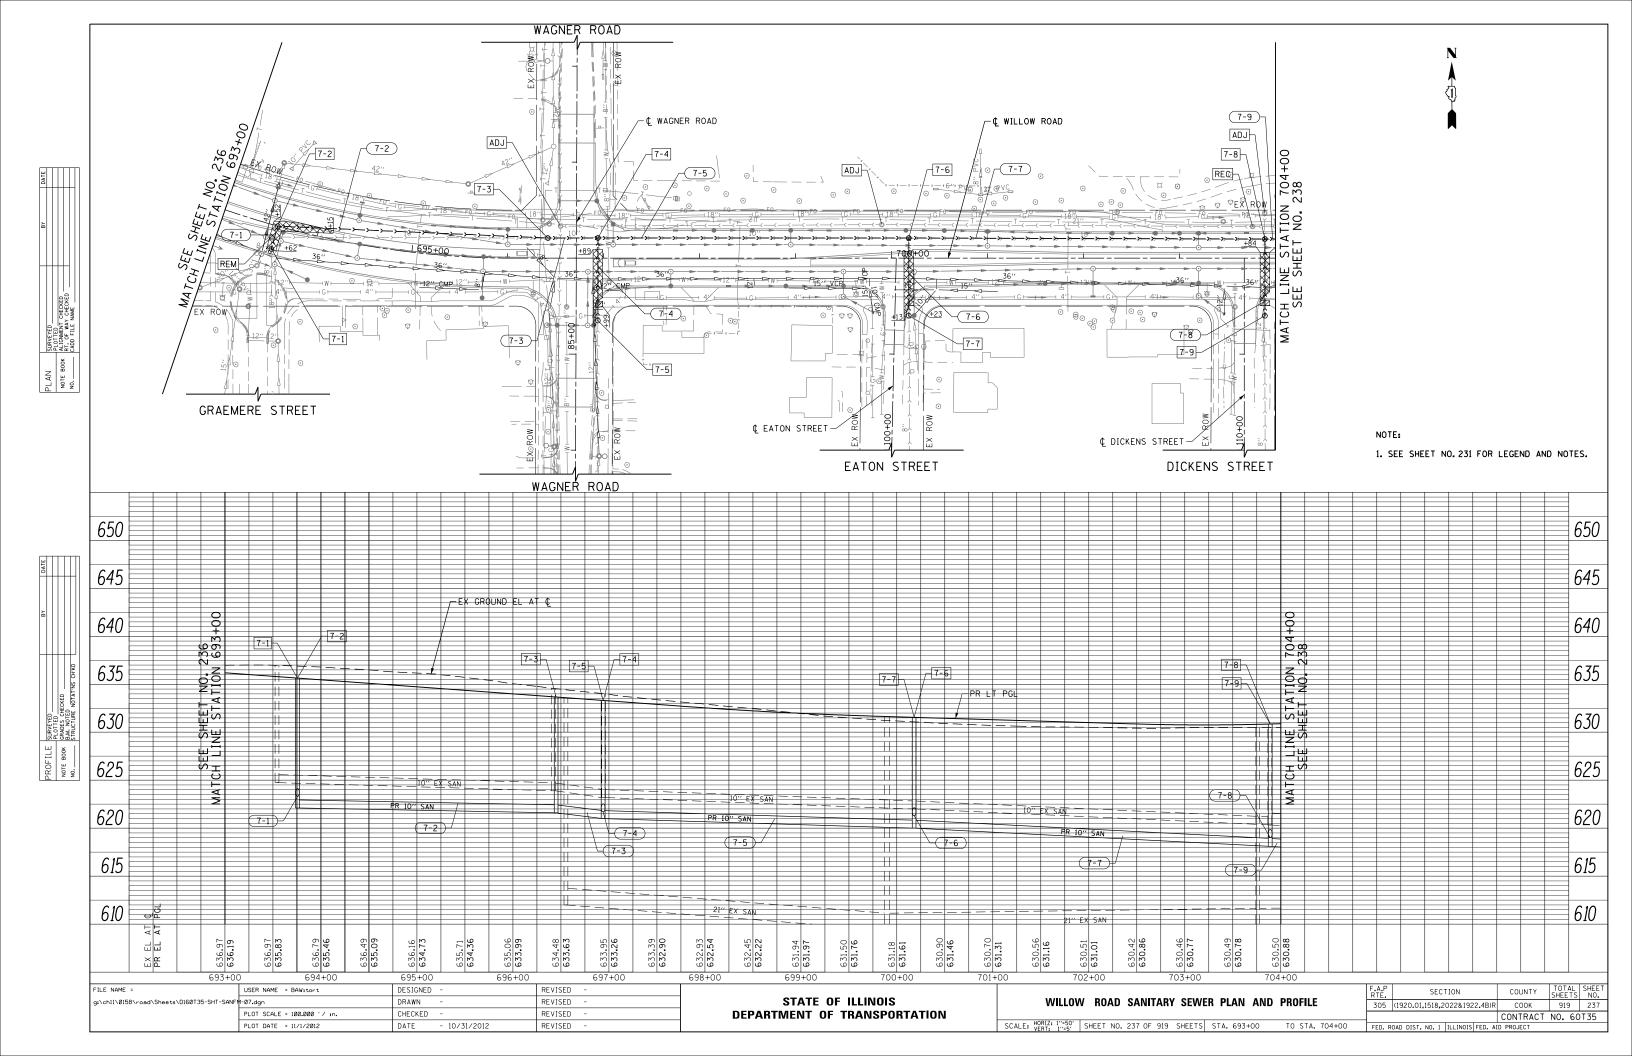


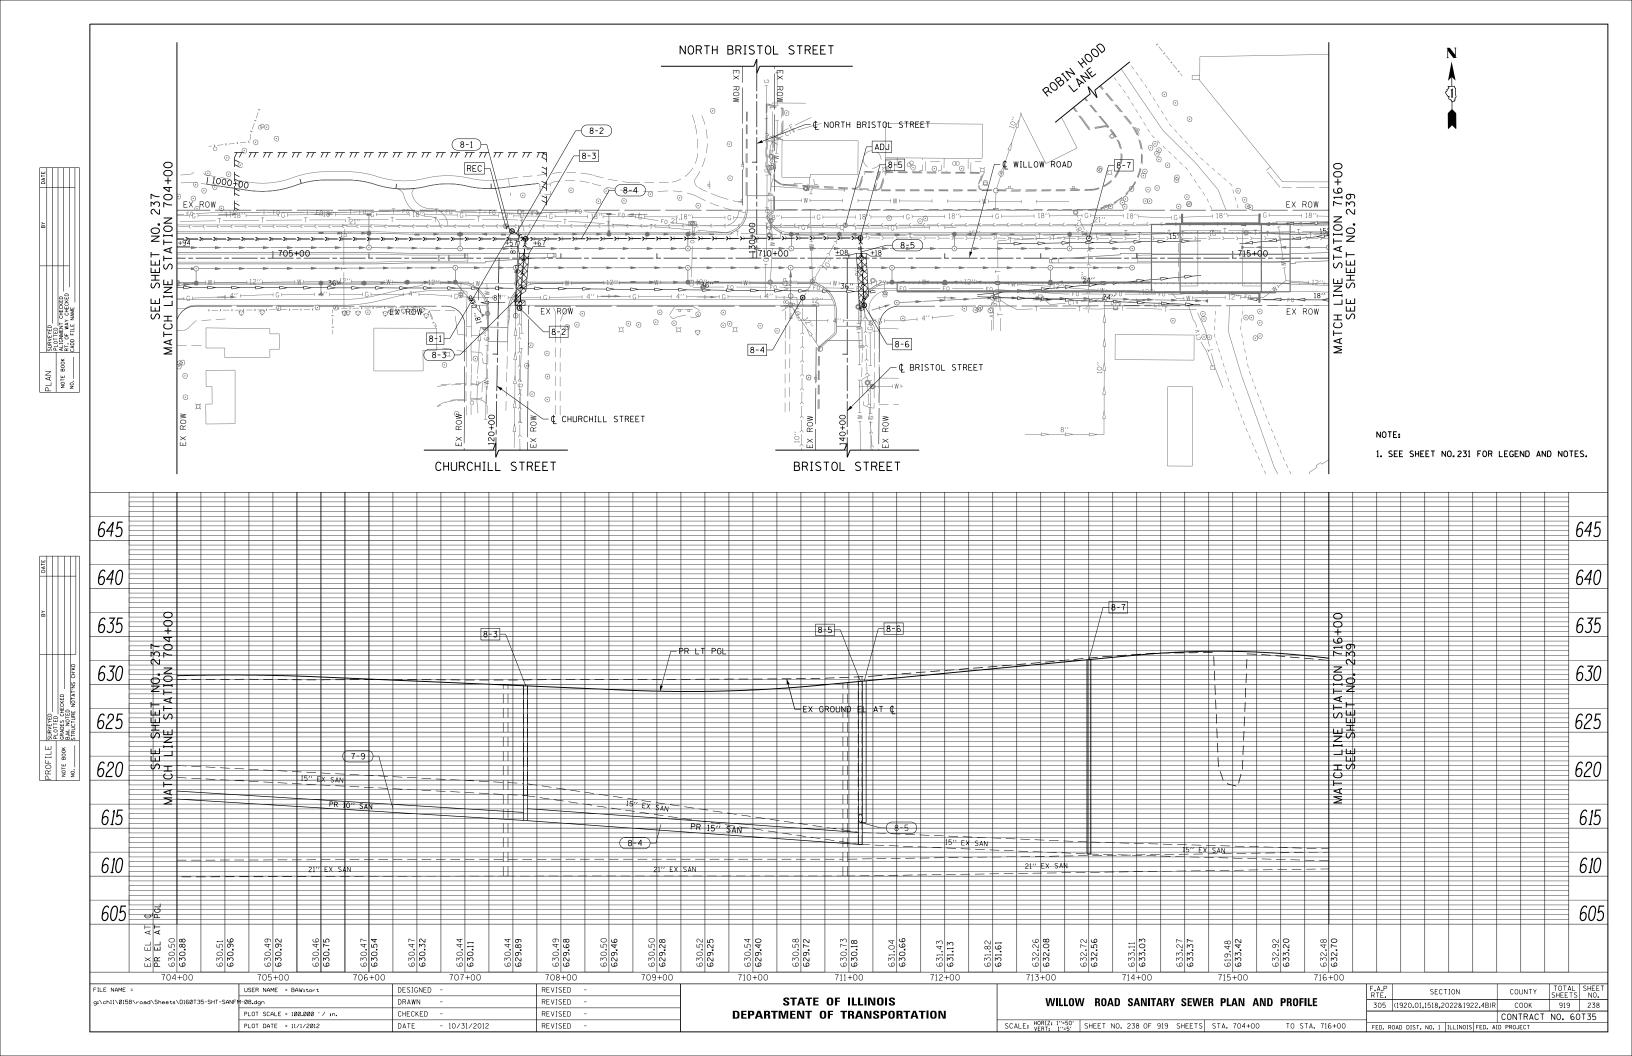

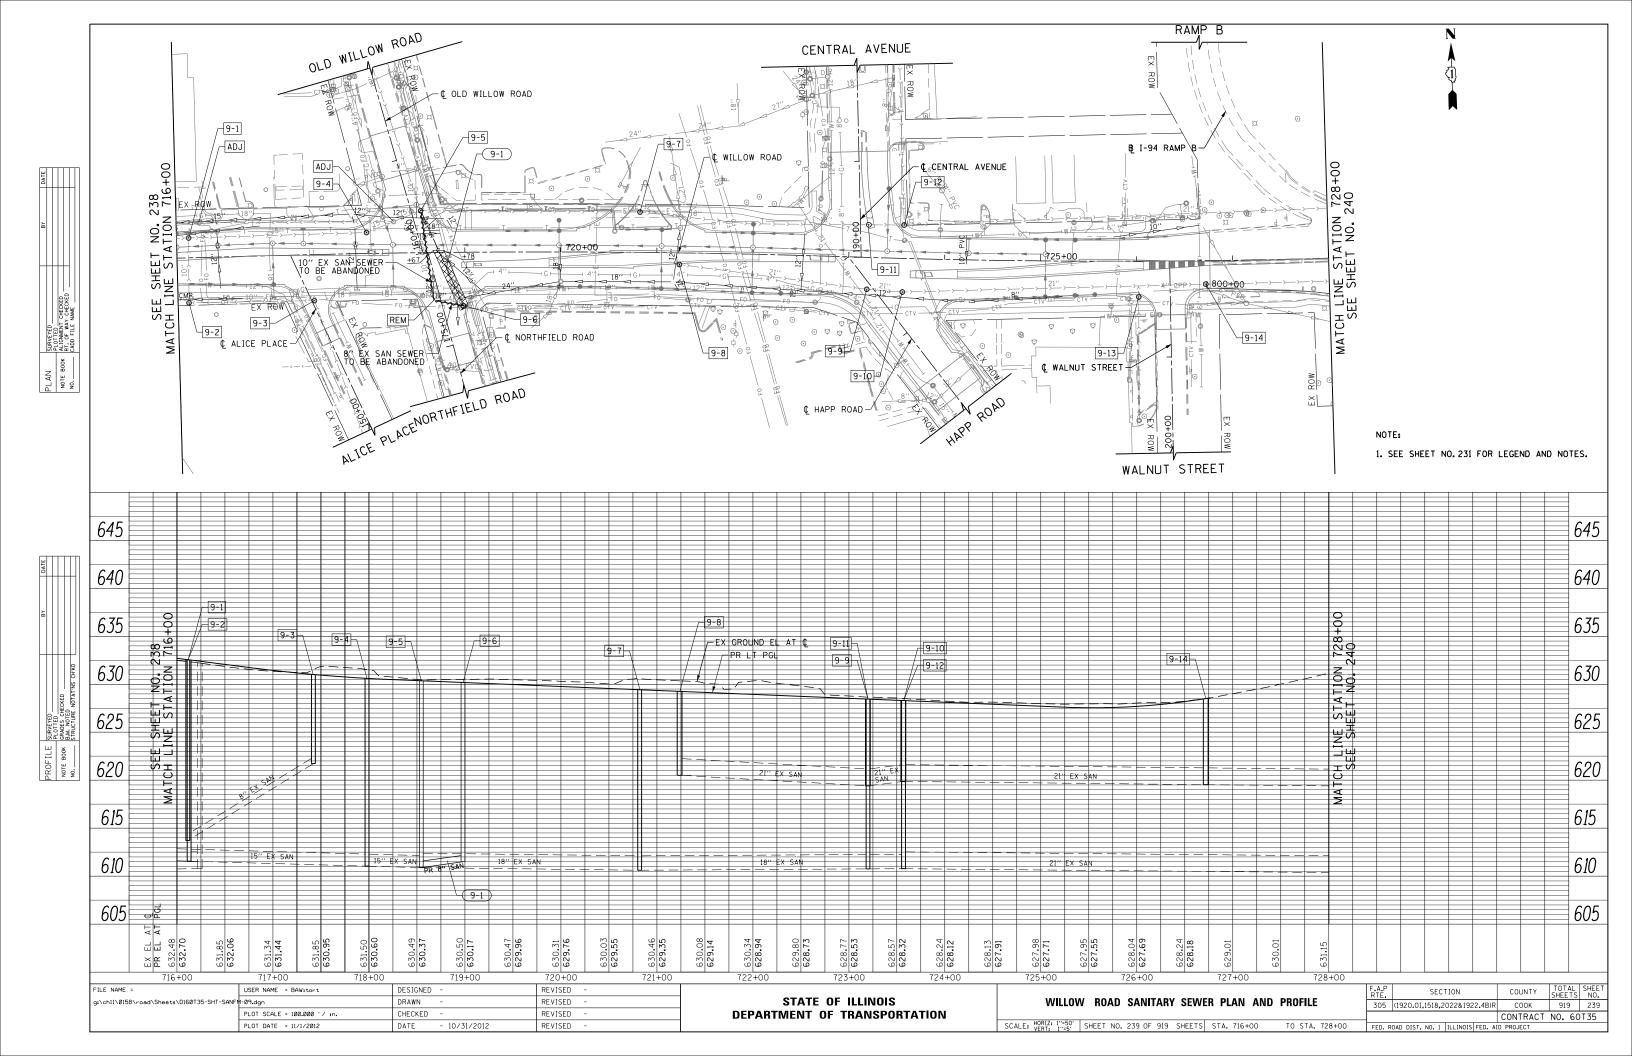

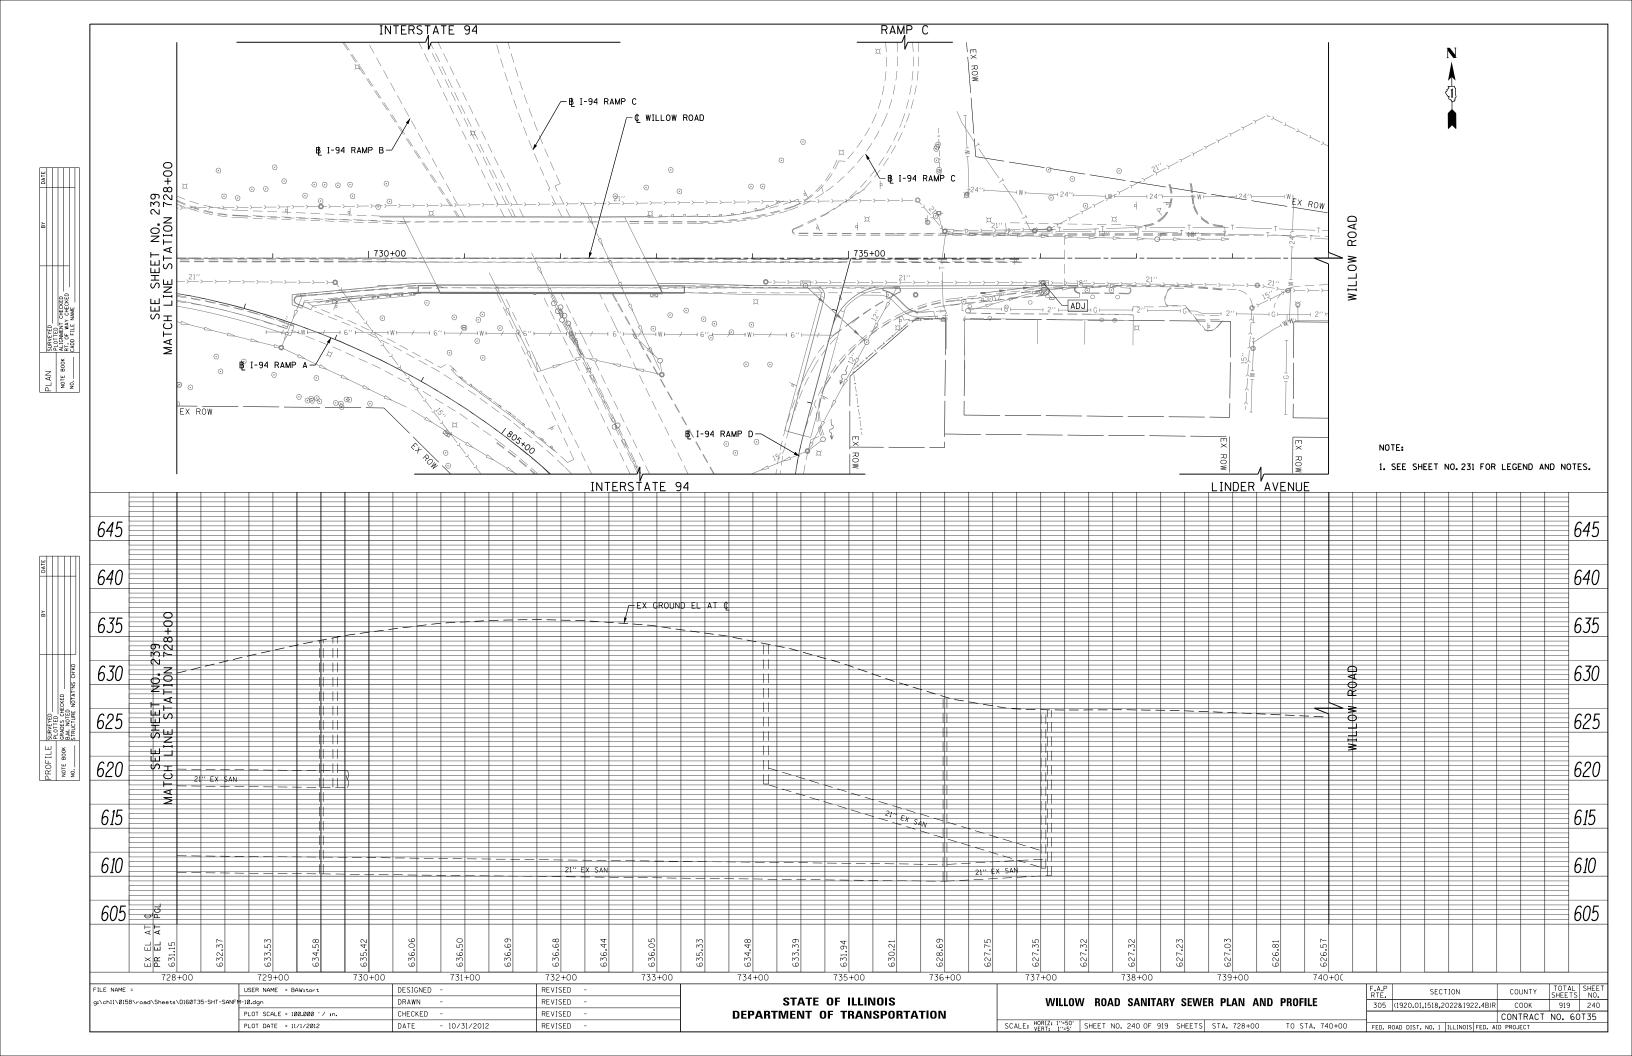

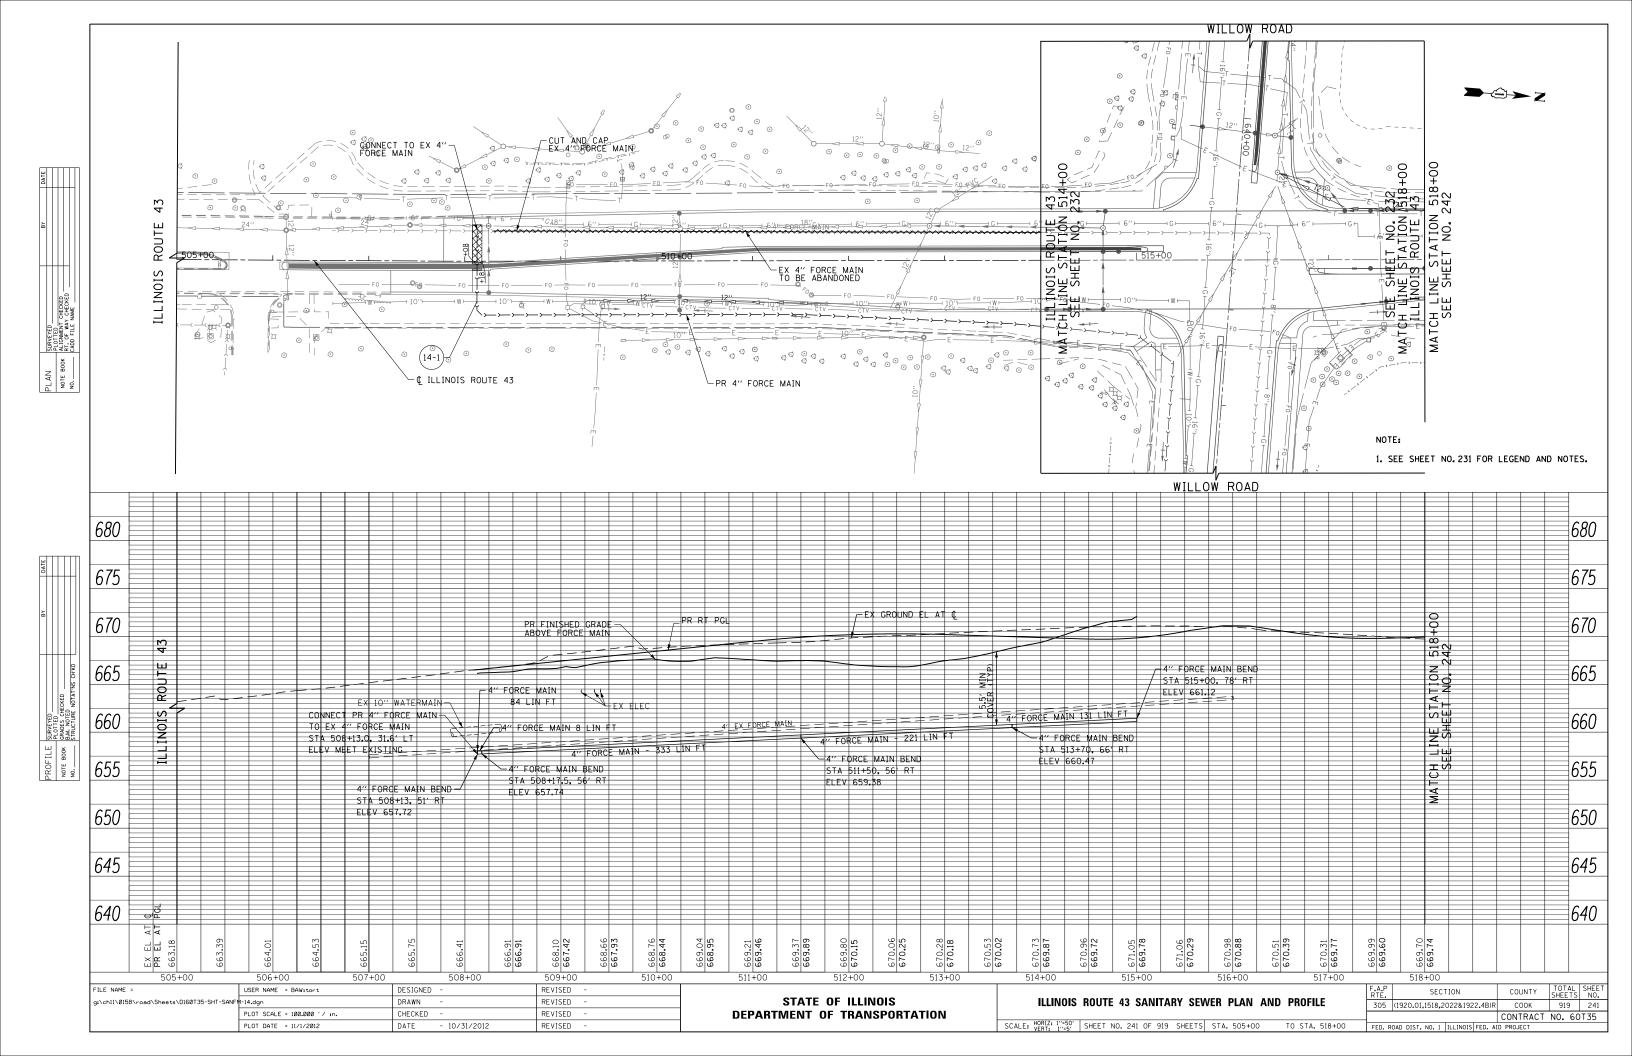

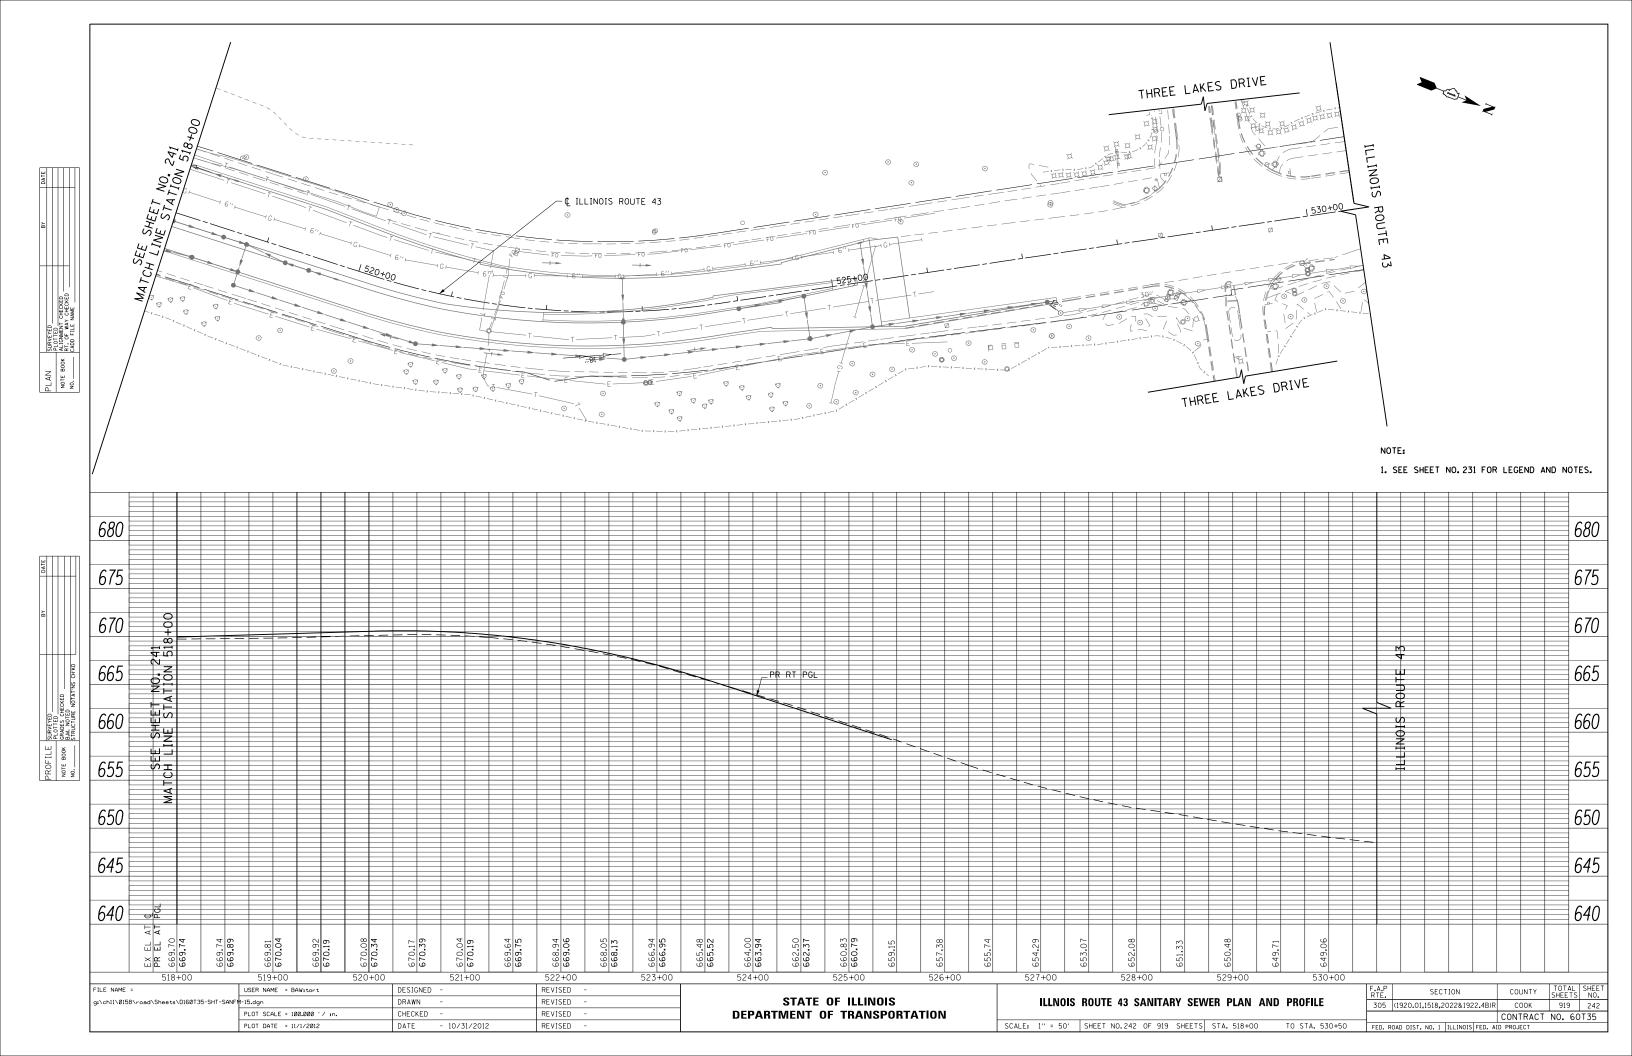

WILLOW ROAD SANITARY ELEVATIONS STA 637+00 TO STA 649+00

SHEET	CROSSING NUMBER	FINISH GRADE	TOP OF FORCE MAIN	BOTTOM OF FORCE MAIN	INVERT OF STORM/WATER	TOP / BOTTOM OF STORM / WATER MAIN	CLEARANCE (FOOT)
2	2-1	665.31	654.44	654.11	655.99	655.95 (B/WTR)	1.51
2	2-2	661.84	652.06	651.72	656.38	656.07 (B/STM)	4.01
2	2-3	662.26	652.06	651.72	654.04	654.00 (B/WTR)	1.94
2	2-4	662.70	652.06	651.72	657.25	657.04 (B/STM)	4.98

WILLOW ROAD SANITARY ELEVATIONS STA 649+00 TO STA 661+00

SHEET	CROSSING NUMBER	FINISH GRADE	TOP OF FORCE MAIN	BOTTOM OF FORCE MAIN	INVERT OF STORM/WATER	TOP / BOTTOM OF STORM / WATER MAIN	CLEARANCE (FOOT)
3	3-1	659.00	651.42	651.09	655.18	654.52 (B/MH)	3.10
3	3-2	659.11	651.11	650.78	652.66	652.62 (B/WTR)	1.51
3	3-3	658.81	650.73	650.40	655.16	654.99 (B/STM)	4.26
3	3-4	658.28	650.41	650.08	654.20	654.03 (B/STM)	3.62
3	3-5	657.61	650.11	649.78	653.42	653.25 (B/STM)	3.14
3	3-6	658.58	648.35	648.01	651.79	651.75 (B/WTR)	3.40

WILLOW ROAD SANITARY ELEVATIONS STA 661+00 TO STA 672+00

SHEET	CROSSING NUMBER	FINISH GRADE	TOP OF FORCE MAIN	BOTTOM OF FORCE MAIN	INVERT OF STORM/WATER	TOP / BOTTOM OF STORM / WATER MAIN	CLEARANCE (FOOT)
4	4-1	657.92	647.94	647.60	653.61	653.44 (B/STM)	5.50
4	4-2	657.73	647.84	647.51	650.13	650.07 (B/WTR)	2.23
4	4-3	656.28	647.13	646.79	651.93	651.76 (B/STM)	4.63
4	4-4	653.76	645.86	645.53	650.19	650.02 (B/STM)	4.16
4	4-5	652.99	645.49	645.16	648.58	647.77 (B/MH)	2.28
4	4-6	652.30	643.54	643.23	648.68	648.51 (B/STM)	4.97

ILLINOIS ROUTE 43 SANITARY ELEVATIONS STA 505+00 TO STA 518+00

SHEET	CROSSING NUMBER	FINISH GRADE	TOP OF FORCE MAIN	BOTTOM OF FORCE MAIN	INVERT OF STORM/WATER	TOP / BOTTOM OF STORM / WATER MAIN	CLEARANCE (FOOT)
14	14-1	666.07	658.05	657.72	659.78	659.74 (B/WTR)	1.69

FILE NAME =	USER NAME = BAWitort	DESIGNED -	JLV	REVISED -	Γ
G:\CHII\0158\Road\Sheets\D160T35-SHT-SAM	IFM-EL.dgn	DRAWN -	KAL	REVISED -	
	PLOT SCALE = 100.00000 '/ in.	CHECKED -	RCB	REVISED -	
	PLOT DATE = 11/1/2012	DATE -	10/31/2012	REVISED -	

	F.A.P. SECTION COUNTY TOTAL SHE
WILLOW ROAD SANITARY FORCE MAIN ELEVATIONS	305 (1920.01,1518,2022&1922.4B)R COOK 919 24
	CONTRACT NO. 60T35
SCALE: N.T.S. SHEET NO. 243 OF 919 SHEETS	FED. ROAD DIST. NO. 1 ILLINOIS FED. AID PROJECT

PROPOSED SANITARY STRUCTURE TABLE WILLOW ROAD STA 661+00 TO STA 672+00

CHE	STI	RUCTURE	STATION	OFFSET	TYPE	FRAME & GRATE	RIM						INVERT EI	EVATIONS					
SHE	-' N	NUMBER	STATION	OFFSEI	I TIPE	FRAME & GRATE	ELEVATION	NO	RTH	NORTH	HEAST E	AST	SOUTHEAST	so	UTH	SOUTHWEST	WE	ST	NORTHWEST
4		4-1	665+08.08	79.4' LT	MAN SAN, 4'-DIAMETER	TYPE 1 FRAME, CLOSED LID	652.35	633.69 (EX)	12" PVC					633.69 (EX)	12" PVC				
4		4-2	665+08.65	61.5' RT	MAN SAN, 4'-DIAMETER	TYPE 1 FRAME, CLOSED LID	652.76	635.54 (EX)	10" PVC					635.54 (EX)	10" PVC		636.49 (EX)	10" PVC	
4		4-3	665+08.85	176.0' RT	MAN SAN, 4'-DIAMETER	TYPE 1 FRAME, CLOSED LID	653.68	636.08 (EX)	10" PVC					636.08 (EX)	10" PVC		636.63 (EX)	10" PVC	
4		4-4	665+48.56	21.8' LT	MAN SAN, 4'-DIAMETER	TYPE 1 FRAME, CLOSED LID	652.22	636.72 (EX)	10" PVC		636.72 (EX)	10" PVC							
4		4-5	666+60.27	22.5' LT	MAN SAN, 4'-DIAMETER	TYPE 1 FRAME, CLOSED LID	650.88							VERIFY	IN FIELD		VERIFY	N FIELD	
4		4-6	666+60.51	17.7' RT	MAN SAN, 4'-DIAMETER	TYPE 1 FRAME, CLOSED LID	651.45	636.12 (EX)	10" VCP		635.32 (EX)	12" VCP		635.82 (EX)	6" PVC		635.32 (EX)	12" VCP	
4		4-7	668+23.30	66.9' LT	MAN SAN, 4'-DIAMETER	TYPE 1 FRAME, CLOSED LID	647.41	637.21(EX)	6" VCP		637.01(EX)	6" VCP							
4		4-8	670+06.05	21.8' RT	MAN SAN, 4'-DIAMETER	TYPE 1 FRAME, CLOSED LID	647.98				633.49 (EX)	12" VCP		643.79 (EX)	8" VCP		633.49 (EX)	12" VCP	
4		4-9	671+41.10	24.3' RT	MAN SAN, 4'-DIAMETER	TYPE 1 FRAME, CLOSED LID	646.79				633.27 (EX)	12" VCP					633.27 (EX)	12" VCP	

PROPOSED SANITARY STRUCTURE TABLE WILLOW ROAD STA 672+00 TO STA 683+00

CHE	ە ب	TRUCTURE	STATION	OFFSET	TYPE	FRAME & GRATE	RIM						INVERT ELEVATIONS				
SHE	NUMBER	STATION	OFFSET	ITPE	FRAME & GRATE	ELEVATION	NOF	RTH NOF	RTHEAST	EAST	SOUTI	HEAST SO	JTH SOUT	HWEST WE	ST N	ORTHWEST	
5	;	5-1	674+12.04	59.3' LT	MAN SAN, 4'-DIAMETER	TYPE 1FRAME, CLOSED LID	644.66	631.66 (EX)	8" VCP						631.66 (EX)	8" VCP	
5	j	5-2	674+38.21	22.7' LT	MAN SAN, 4'-DIAMETER	TYPE 1 FRAME, CLOSED LID	645.69			632.12 (I	X) 1	10" VCP			632.22 (EX)	10" VCP	

PROPOSED SANITARY STRUCTURE TABLE WILLOW ROAD STA 693+00 TO STA 704+00

SHEET	STRUCTURE	STATION	OFFSET	TYPE	FRAME & GRATE	RIM								INVERT ELEVATIO	NS							
SHEET	NUMBER	STATION	OFFSET	TIPE	FRAME & GRATE	ELEVATION	NO	RTH	NORTH	HEAST	E <i>P</i>	AST	SOUT	HEAST	SOU	TH	SOUTH	HWEST	WE	ST	NORTH	HWEST
7	7-1	693+57.50	24.8' RT	MAN SAN, 4'-DIAMETER	TYPE 1 FRAME, CLOSED LID	636.13			623.30	10" PVC				625.2	20 (EX)	10" VCP						
7	7-2	693+57.50	0.0' LT	MAN SAN, 4'-DIAMETER	TYPE 1 FRAME, CLOSED LID	636.37					622.10	10" PVC	625.20 (EX)	10" VCP			623.20	10" PVC			625.15 (EX)	10" VCP
7	7-3	696+42.00	21.0' LT	MAN SAN, 4'-DIAMETER	TYPE 1 FRAME, CLOSED LID	633.42			624.50 (EX)	12" VCP	621.20	10" PVC							621.25	10" PVC		
7	7-4	696+94.00	21.0' LT	MAN SAN, 4'-DIAMETER	TYPE 1 FRAME, CLOSED LID	633.12					621.00	10" PVC		62	1.20	8" PVC			621.05	10" PVC		
7	7-5	696+94.00	65.0' RT	MAN SAN, 4'-DIAMETER	TYPE 1 FRAME, CLOSED LID	632.47	621.70	8" PVC						623.6	60 (EX)	8" VCP						
7	7-6	700+18.00	21.0' LT	MAN SAN, 4'-DIAMETER	TYPE 1 FRAME, CLOSED LID	631.30					620.00	10" PVC		62	0.20	8" PVC			620.05	10" PVC		
7	7-7	700+18.00	60.0' RT	MAN SAN, 4'-DIAMETER	TYPE 1 FRAME, CLOSED LID	630.08	621.30	8" PVC						623.2	20 (EX)	8" VCP						
7	7-8	703+89.00	20.0' LT	MAN SAN, 4'-DIAMETER	TYPE 1 FRAME, CLOSED LID	630.56					618.10	10" PVC		61	8.30	8" PVC			618.15	10" PVC		
7	7-9	703+89.00	60.0' RT	MAN SAN, 4'-DIAMETER	TYPE 1 FRAME, CLOSED LID	628.92	619.40	8" PVC						621.3	30 (EX)	8" VCP						

PROPOSED SANITARY STRUCTURE TABLE WILLOW ROAD STA 704+00 TO STA 716+00

													7000							
CHEET	STRUCTURE	STATION	OFFSET	TYPE	FRAME & GRATE	RIM							INVERT E	LEVATIONS						
SHEET	NUMBER	STATION	OFFSET	I TIPE	FRAME & GRATE	ELEVATION	NC	RTH	NORT	HEAST	EA	ST	SOUTHEAST	SO	JTH	SOUTHWEST	W	EST	NORTH	HWEST
8	8-1	707+49.00	28.3' LT	MAN SAN, 4'-DIAMETER	TYPE 1 FRAME, CLOSED LID	629.92							618.25 8" PVC						612.35	8" PVC
8	8-2	707+57.00	52.0' RT	MAN SAN, 4'-DIAMETER	TYPE 1 FRAME, CLOSED LID	627.74	617.70	8" PVC						619.60 (EX)	8" VCP					
8	8-3	707+63.00	20.0' LT	MAN SAN, 4'-DIAMETER	TYPE 1 FRAME, CLOSED LID	629.53					615.80	15" PVC		616.30	8" PVC		616.20	10" PVC	618.45	8" PVC
8	8-4	710+51.92	41.0' RT	MAN SAN, 4'-DIAMETER	TYPE 1 FRAME, CLOSED LID	626.27			611.65 (EX)	12" VCP				611.65 (EX)	12" VCP					
8	8-5	711+12.00	21.0' LT	MAN SAN, 4'-DIAMETER	TYPE 1 FRAME, CLOSED LID	629.96					613.30 (EX)	15" VCP		613.80	8" PVC		613.35	15" PVC		
8	8-6	711+16.00	49.0' RT	MAN SAN, 4'-DIAMETER	TYPE 1 FRAME, CLOSED LID	628.31	615.60	8" PVC						616.10 (EX)	8" VCP					
8	8-7	713+50.12	20.6' LT	MAN SAN, 4'-DIAMETER	TYPE 1 FRAME, CLOSED LID	632.23					612.31(EX)	15" VCP		612.76 (EX)	12" VCP				612.31(EX)	12" VCP

PROPOSED SANITARY STRUCTURE TABLE WILLOW ROAD STA 716+00 TO STA 728+00

OUEET	STRUCTURE	OTATION	OFFSET	TVDE	EDAME & ODATE	RIM						INVER	T ELEVATIONS							
SHEET	NUMBER	STATION	OFFSET	TYPE	FRAME & GRATE	ELEVATION	NOF	RTH	NORTHEAST	EA	ST	SOUTHEAST	SOL	JTH	SOUTH	HWEST	WE:	ST	NORTH'	WEST
9	9-1	716+12.65	20.7' LT	MAN SAN, 4'-DIAMETER	TYPE 1 FRAME, CLOSED LID	632.24	614.66 (EX)	8" VCP		611.56 (EX)	15" VCP		612.26 (EX)	10" VCP			611.56 (EX)	15" VCP		
9	9-2	716+11.31	46.9' RT	MAN SAN, 4'-DIAMETER	TYPE 1 FRAME, CLOSED LID	632.16	613.71(EX)	10" VCP		618.41(EX) 613.71(EX)	8" VCP 8" VCP		618.81(EX)	8" VCP						
9	9-3	717+42.15	47.9' RT	MAN SAN, 4'-DIAMETER	TYPE 1 FRAME, CLOSED LID	630.45							623.93 (EX)	8" VCP	621.83 (EX)	8" VCP	621.73 (EX)	10" VCP		
9	9-4	717+97.92	21.9' LT	MAN SAN, 4'-DIAMETER	TYPE 1 FRAME, CLOSED LID	630.25	616.05 (EX)	6" VCP		611.05 (EX)	15" VCP						611.05 (EX)	15" VCP		
9	9-5	718+54.50	43.8' LT	MAN SAN, 4'-DIAMETER	TYPE 1 FRAME, CLOSED LID	629.77	VERIFY	IN FIELD		612.49 (EX)	18" VCP		610.90	8" PVC			611.09 (EX)	15" VCP		
9	9-6	718+98.03	55.7' RT	MAN SAN, 4'-DIAMETER	TYPE 1 FRAME, CLOSED LID	629.08	611.50	8" PVC					613.37 (EX)	8" VCP						
9	9-7	720+82.06	42.0' LT	MAN SAN, 4'-DIAMETER	TYPE 1 FRAME, CLOSED LID	629.56				610.62 (EX)	18" VCP						610.62 (EX)	18" VCP		
9	9-8	721+23.67	12.1' RT	MAN SAN, 4'-DIAMETER	TYPE 1 FRAME, CLOSED LID	629.58				VERIFY	N FIELD						620.50 (EX)	21" VCP		
9	9-9	723+19.82	33.2' RT	MAN SAN, 4'-DIAMETER	TYPE 1 FRAME, CLOSED LID	628.36				VERIFY	N F I ELD						620.06 (EX)	21" VCP		
9	9-10	723+56.78	35.0' RT	MAN SAN, 4'-DIAMETER	TYPE 1 FRAME, CLOSED LID	628.19				619.87 (EX)	21" VCP						619.87 (EX)	21" VCP		
9	9-11	723+19.76	34.0' LT	MAN SAN, 4'-DIAMETER	TYPE 1 FRAME, CLOSED LID	627.79				VERIFY	N FIELD						VERIFY I	N FIELD		
9	9-12	723+56.92	34.8' LT	MAN SAN, 4'-DIAMETER	TYPE 1 FRAME, CLOSED LID	627.88	611.48 (EX)	15" VCP		610.78 (EX)	21" VCP						610.78 (EX)	18" VCP		
9	9-13	726+02.07	37.2' RT	MAN SAN, 4'-DIAMETER	TYPE 1 FRAME, CLOSED LID	627.79	621.59 (EX)	8" VCP					621.59 (EX)	8" VCP	621.84 (EX)	8" VCP				
9	9-14	726+71.80	24.5' RT	MAN SAN, 4'-DIAMETER	TYPE 1 FRAME, CLOSED LID	628.13				619.65 (EX)	21" VCP						619.65 (EX)	21" VCP		

FILE NAME = G:\CHII\0158\Road\Sheets\D160T35-SHT-SAM	USER NAME = BAWitort IFM-TABLE.dgn PLOT SCALE = 100.0000 '/ in.	DESIGNED - JLV DRAWN - KAL CHECKED - RCB	REVISED - REVISED - REVISED -	STATE OF ILLINOIS DEPARTMENT OF TRANSPORTATION	w	ILLOW ROAD SANITARY S	STRUCTU
	PLOT DATE = 11/1/2012	DATE - 10/31/2012	REVISED -	DEFAILTIER OF THAIRD OFFATION	SCALE: N.T.S.	SHEET NO. 244 OF 919 SHEETS	

WILLOW ROAD SANITARY STRUCTURE TABLE		SECTION	COUNTY	TOTAL SHEETS	SHEET NO.
		(1920.01,1518,2022&1922.4B)R	COOK	919	244
			CONTRACT	NO. 60	T35
SHEET NO. 244 OF 919 SHEETS	FED. RO	OAD DIST. NO. 1 ILLINOIS FED. AI	D PROJECT		

PROPOSED SANITARY PIPE TABLE WILLOW ROAD STA 693+00 TO STA 704+00

SHEET	PIPE NUMBER	STRUC	CTURE	DESCRIPTION	TYPE	SIZE (IN)	LENCTH (ET)	CLODE (9/)	TBF
SHEET	PIPE NUMBER	FROM	TO	DESCRIPTION	ITPE	SIZE (IIV)	LENGTH (FT)	SLOPE (%)	(CY)
7	7-1	7-1	7-2	SANITARY SEWERS	PVC (D3034) SDR-26	10	24.6	0.40%	32.9
7	7-2	7-2	7-3	SANITARY SEWERS	PVC (D3034) SDR-26	10	281.8	0.30%	466.9
7	7-3	7-3	7-4	SANITARY SEWERS	PVC (D3034) SDR-26	10	52	0.30%	75.7
7	7-4	7-5	7-4	SANITARY SEWERS	DIP (ANSI A21.51)	8	86	0.60%	112.8
7	7-5	7-4	7-6	SANITARY SEWERS	PVC (D3034) SDR-26	10	324	0.30%	465.0
7	7-6	7-7	7-6	SANITARY SEWERS	DIP (ANSI A21.51)	8	81	1.30%	89.8
7	7-7	7-6	7-8	SANITARY SEWERS	PVC (D3034) SDR-26	10	371	0.50%	542.5
7	7-8	7-9	7-8	SANITARY SEWERS	PVC (D3034) SDR-26	8	80	1.40%	99.5
7	7-9	7-8	8-3	SANITARY SEWERS	PVC (D3034) SDR-26	10	374	0.50%	606.2

PROPOSED SANITARY PIPE TABLE WILLOW ROAD STA 704+00 TO STA 716+00

SHEET	PIPE NUMBER	STRU	CTURE	DESCRIPTION	TVDE	TYPE SIZE (IN)		SLODE (9/)	TBF
SHEET	PIPE NUMBER	FROM	TO	DESCRIPTION	IIFE	SIZE (IIV)	LENGTH (FT)	SLOPE (%)	(CY)
8	8-1	8-1	EX MH	SANITARY SEWERS	PVC (D3034) SDR-26	8	8.3	1.00%	
8	8-2	8-3	8-1	SANITARY SEWERS	PVC (D3034) SDR-26	8	16.3	1.20%	19.3
8	8-3	8-2	8-3	SANITARY SEWERS	PVC (D3034) SDR-26	8	72.3	1.90%	97.4
8	8-4	8-3	8-5	SANITARY SEWERS	PVC (D3034) SDR-26	15	349.0	0.70%	750.1
8	8-5	8-6	8-5	SANITARY SEWERS	PVC (D3034) SDR-26	8	70.1	2.60%	122.2


PROPOSED SANITARY PIPE TABLE WILLOW ROAD STA 716+00 TO STA 728+00

SHEET	PIPE NUMBER	STRU	CTURE	DESCRIPTION	TYPE	SIZE (IN)	LENGTH (FT)	SLOPE (%)	TBF
SHEET	PIPE NUMBER	FROM	ТО	DESCRIPTION	IIFE	SIZE (IIV)	LENGIH(FI)	SLOPE (%)	(CY)
9	9-1	9-7	9-6	SANITARY SEWERS	PVC (D3034) SDR-26	8	108.6	0.60%	250.2


G:\CHII\0158\Road\Sheets\DI60135-SHI-SANEM-IABLE.don DRAWN - KAL REVISED -	
G:\CHII\0I58\Road\Sheets\DI60T35-SHT-SANFM-TABLE.dgn DRAWN - KAL REVISED -	
PLOT SCALE = 100.0000 '/ 10. CHECKED - RCB REVISED -	
PLOT DATE = 11/1/2012 DATE - 10/31/2012 REVISED -	

WILLOW ROAD SANITARY PIPE TABLE		F.A.P. SECTION		TOTAL SHEETS	SHEET NO.
		(1920.01,1518,2022&1922.4B)R	соок	919	245
			CONTRACT	NO. 60	T35
SHEET NO 245 OF 919 SHEETS	FF0 F	OAD DICT NO 1 THE INDIC SED AT	D DDO IECT		


- 1. EXTERIOR NEOPRENE CHIMNEY SEAL REQUIRED ON ALL SANITARY MANHOLE RIMS.
- 2. PIPE OPENINGS TO BE PRECAST INTO WALLS.
- 3. PRECAST REINFORCED CONCRETE SECTIONS WITH PREFORMED BITUMINOUS JOINTS AND INTEGRAL PRECAST BOTTOMS
- 4. FRAME TO BE LAID IN 3/4" MASTIC BED.
- 5. ADJUSTING RINGS NOT TO EXCEED 8".
- 6. STEPS TO BE STEEL REINFORCED PLASTIC OR APPROVED EQUAL.
- 7. STEPS TO BE IMBEDDED INTO WALL A MINIMUM OF 3".
- STEPS TO BE AT 16" CENTERS. FIRST STEP TO BE 8" BELOW FRAME.
- 9. CAST IN RESILIENT WATERTIGHT SLEEVE CLAMPED WITH A STAINLESS BAND FOR ALL SANITARY MANHOLES.
- 10. INVERT TO BE FORMED WITH HALF-PIPE POUR PCC BENCH TO TROUGH.
- 11. PCC BENCH SHALL EXTEND TO CROWN AND SLOPE 3" TO OUTSIDE WALL-SMOOTH FINISH.
- 12. FRAME TO BE NEENAH R-1772-C LID TO BE SELF-SEALING WITH "SANITARY" IMPRINTED ON COVER AND BLIND PICK

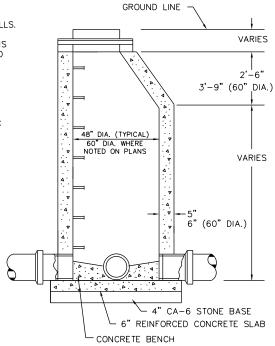

SANITARY MANHOLE

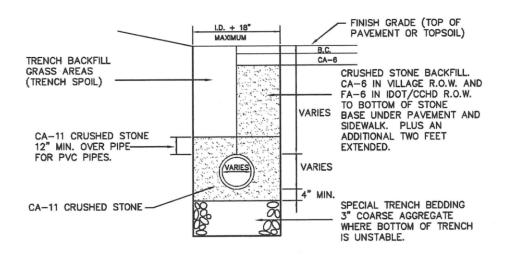

SANITARY TRENCH

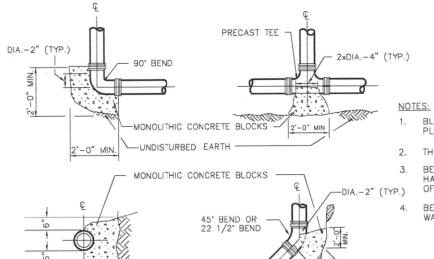

UNDISTURBED EARTH -

SECTIONAL VIEW


- BLOCKING SHALL BE APPLIED FOR ALL TEES, PLUGS, CAPS, & 22 1/2' OR MORE BENDS.
- THRUST BLOCKS TO BE CLASS "X" CONCRETE.
- BEARING AREAS OF UNDISTURBED EARTH SHALL HAVE A MINIMUM ALLOWABLE BEARING CAPACITY OF 2000 P.S.F.
- BEARING AREA OF SOIL BASED ON 65 P.S.I.


TYPE RESTRAINED		RESTRAINED LENG	TH - EACH WAY	
OF FITTING METHOD	8"	10"	12"	24"
DEAD END/TEE	17'-0"	21'-0"	25'-0"	45'-0"
90° BEND	13'-0"	16'-0"	19'-0"	35'-0"
45° BEND	6'-0"	7'-0"	8'-0"	15'-0"
22 1/2° BEND	3'-0"	4'-0"	4'-0"	7'-0"
11 1/4° BEND	2'-0"	2'-0"	2'-0"	4'-0"
VERTICAL OFFSET UPPER/LOWER	9/4	11/5	20/6	35/10
FIRE HYDRANT	ALL JOINTS I	RESTRAINED FROM	MAIN TO MJ SHOE	

JOINT RESTRAINT FOR FITTINGS/CONFIGURATIONS NOT SHOWN SHALL BE PER MANUFACTURER'S RECOMEDATIONS. ALL BENDS, TEES, ELBOWS, REDUCERS, ETC. SHALL BE MJ WITH RETAINING GLANDS AND USING MEGALUG SERIES 1100 RESTRAINT SYSTEM AS MANUFACTURED BY EBAA IRON.

THRUST BLOCKING AND RESTRAINED LENGTH TABLE

FILE NAME =	USER NAME = BAWitort	DESIGNED -	REVISED -				F.A.P. RTE.	SECTION	COUNTY	TOTAL	SHEET S NO.
g:\ch11\0158\road\Sheets\D160T35-SHT-SAI	FM-STD-NORTHFIELD.dgn	DRAWN -	REVISED -	STATE OF ILLINOIS		SANITARY SEWER DETAILS	305 (1920	.01,1518,2022&1922.4B)R	соок	919	246
	PLOT SCALE = 100.0000 '/ in.	CHECKED -	REVISED -	DEPARTMENT OF TRANSPORTATION					CONTRACT	NO. 60	OT35
	PLOT DATE = 11/1/2012	DATE - 10/31/2012	REVISED -		SCALE: N.T.S.	SHEET NO. 246 OF 919 SHEETS	FED. ROAD DI		ID PROJECT		

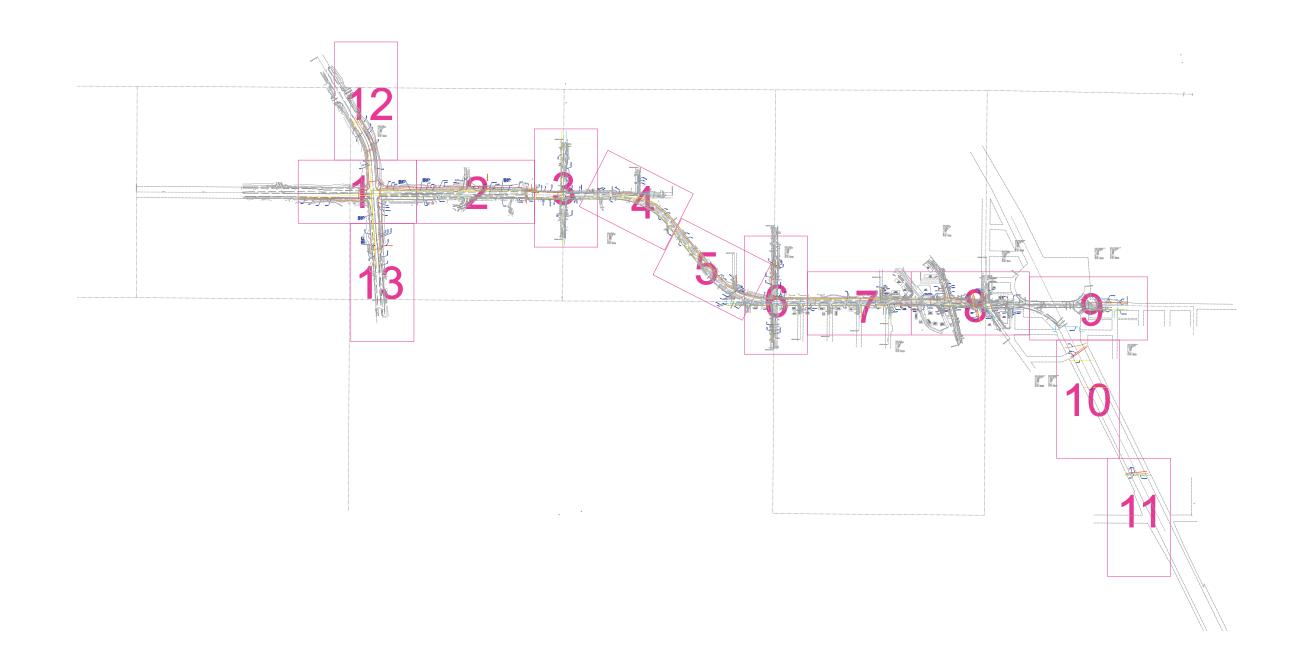

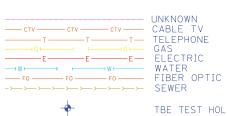

TBE TEST HOLE

Utility Quality Level "A" : visually verified Test Hole
Utility Quality Level "B" : Designating/non Visually Verified Test Hole Utility Quality Level "C": Research with Survey Utility Quality Level "D": Records Research

AT&T = TELEPHONE AT&T = FIBER OPTIC NICOR = GAS COMCAST = CABLE TV COMCAST = FIBER OPTIC COMED = ELECTRIC SPRINT = FIBER OPTIC NORTHFIELD = WATER

UTILITY OWNERS

OWEST = FIBER OPTIC
EXCELON-COMED = FIBER OPTIC
SUNSET VILLAGE MOBILE HOMES - FORCE MAIN

Utilities shown on these plans as depicted in the legend have been investigated by Cardno TBE in accordance with SUE Industry Standards. All other information shown has been provided to Cardno TBE by others. Cardno TBE's OL'B'' SUE field investigation was performed 1/16/12 through 2/18/12. Changes to utilities after 2/18/12 may have been made and therefore may result in variances from this plan. Consideration should be given to updating this plan if deemed advisable prior to final design and construction.

ALL UTILITIES SHOWN QUALITY LEVEL "B" UNLESS NOTED OTHERWISE.




DESIGNED LP REVISED **STATE OF ILLINOIS** DRAWN KLC REVISED CHECKED KFS
DATE 3/27/12 REVISED **DEPARTMENT OF TRANSPORTATION** REVISED

Willow Road along I–94 Northfield, Illinois

					JOE TIGHT	ago. co	V () (
A. TE.	SECTION				COUNTY	TOTAL SHEETS	SHE	
	N/A				Cook			
Contract No. N/A								
-0 0	DAD DICT	NO	THE TMOTE	IDOT	Destant No.			



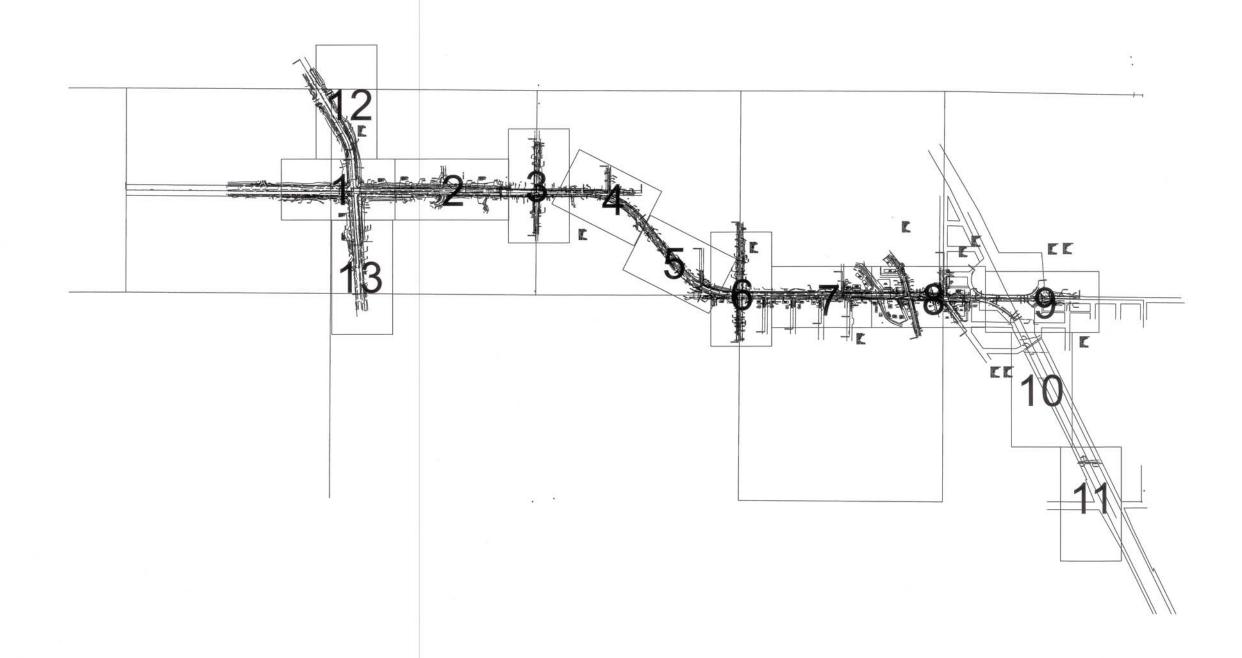

UNKNOWN

CABLE TV

T T T T TELEPHONE

GAS

E E E E E ELECTRIC

WATER

FO FO FO FO SEWER

TBE TEST HOLE

Utility Quality Level "A": visually verified Test Hole
Utility Quality Level "B": Designating/non Visually Verified Test Hole
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SPRINT = FIBER OPTIC
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SUNSET VILLAGE MOBILE HOMES - FORCE MAIN

DESIGNED LP
REVISED
DRAWN KLC
REVISED

REVISED

REVISED

UTILITY OWNERS

AT&T = TELEPHONE

AT&T = FIBER OPTIC NICOR = GAS COMCAST = CABLE TV

CHECKED KFS

DATE 3/27/12

COMCAST = FIBER OPTIC COMED = ELECTRIC Utilities shown on these plans as depicted in the legend have been investigated by Cardno TBE in accordance with SUE Industry Standards. All other information shown has been provided to Cardno TBE by others, Cardno TBE's OL'B' SUE field investigation was performed 1/16/12 through 2/18/12. Changes to utilities after 2/18/12 may have been made and therefore may result in variances from this plan. Consideration should be given to updating this plan If deemed advisable prior to final design and construction.

ALL UTILITIES SHOWN QUALITY LEVEL "B" UNLESS NOTED OTHERWISE.






CIVIL ENGINEERING * TRANSPORTATION * ENVIRONMENTAL * PLANNING * UTILITY ENGINEERING/LOCATING


TBE Job No. IL09510464, 465 SUE Plan Page: Cover


TE.	SE	CTION	COUNTY	TOTAL	SHEET NO.
	N/	Ą	Cook		
			Contract N	lo. N/A	
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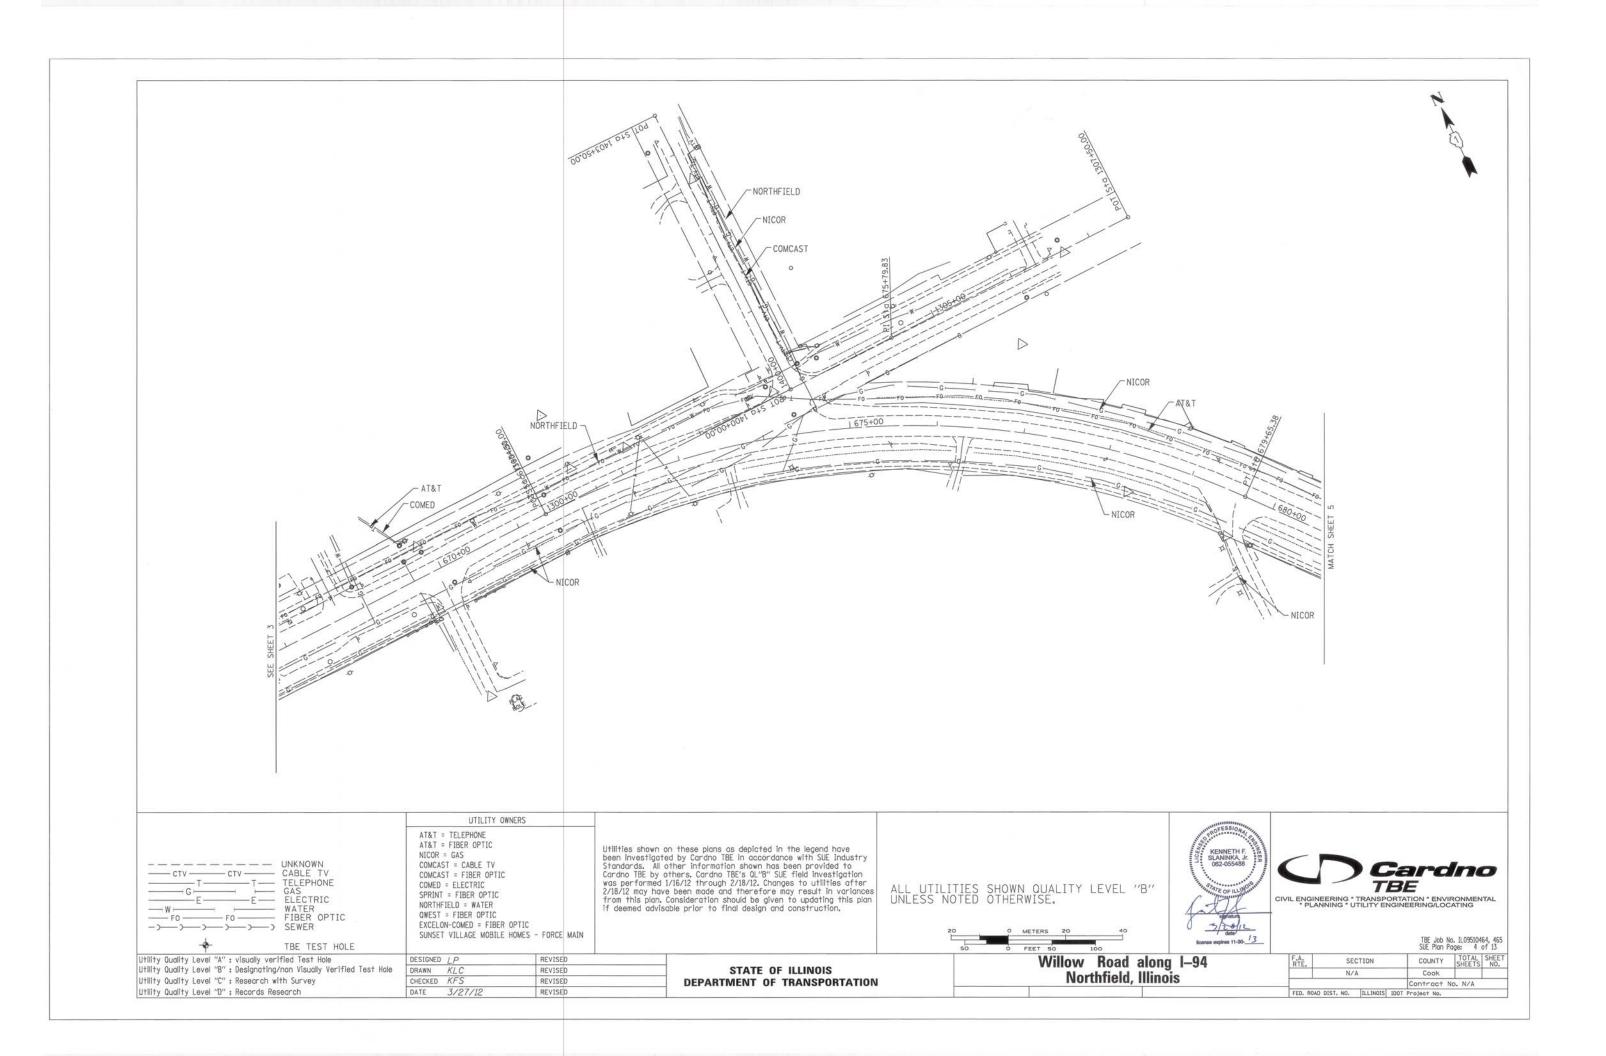
STATE OF ILLINOIS
DEPARTMENT OF TRANSPORTATION


Willow Road along I–94 Northfield, Illinois




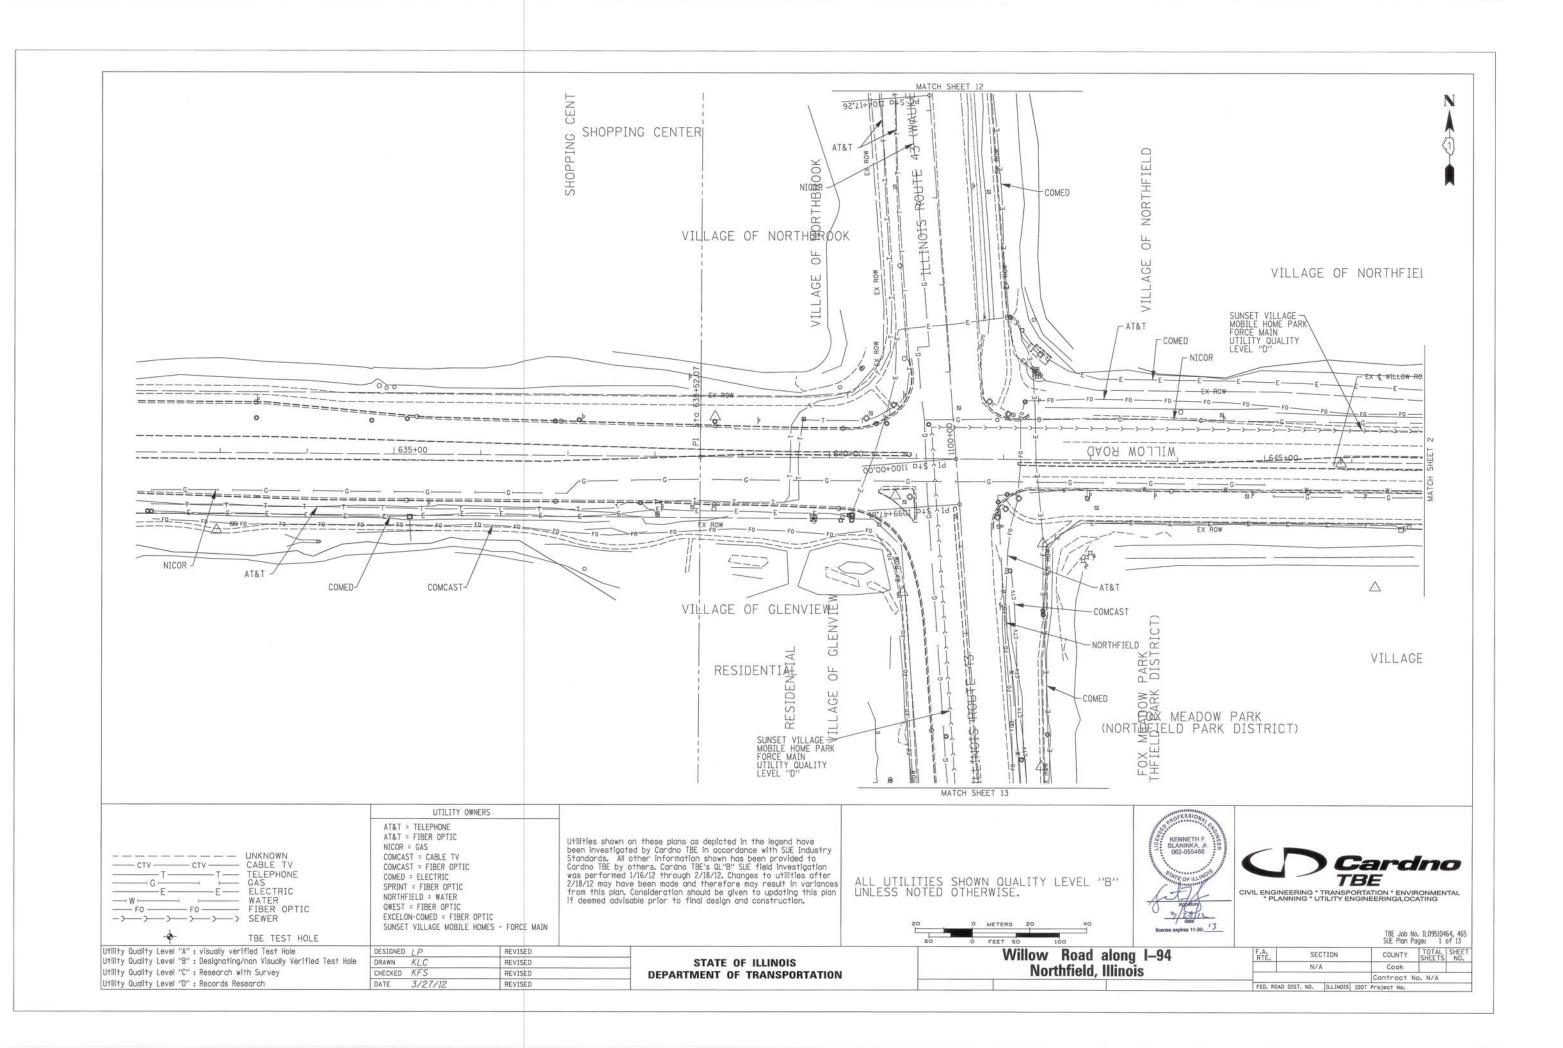


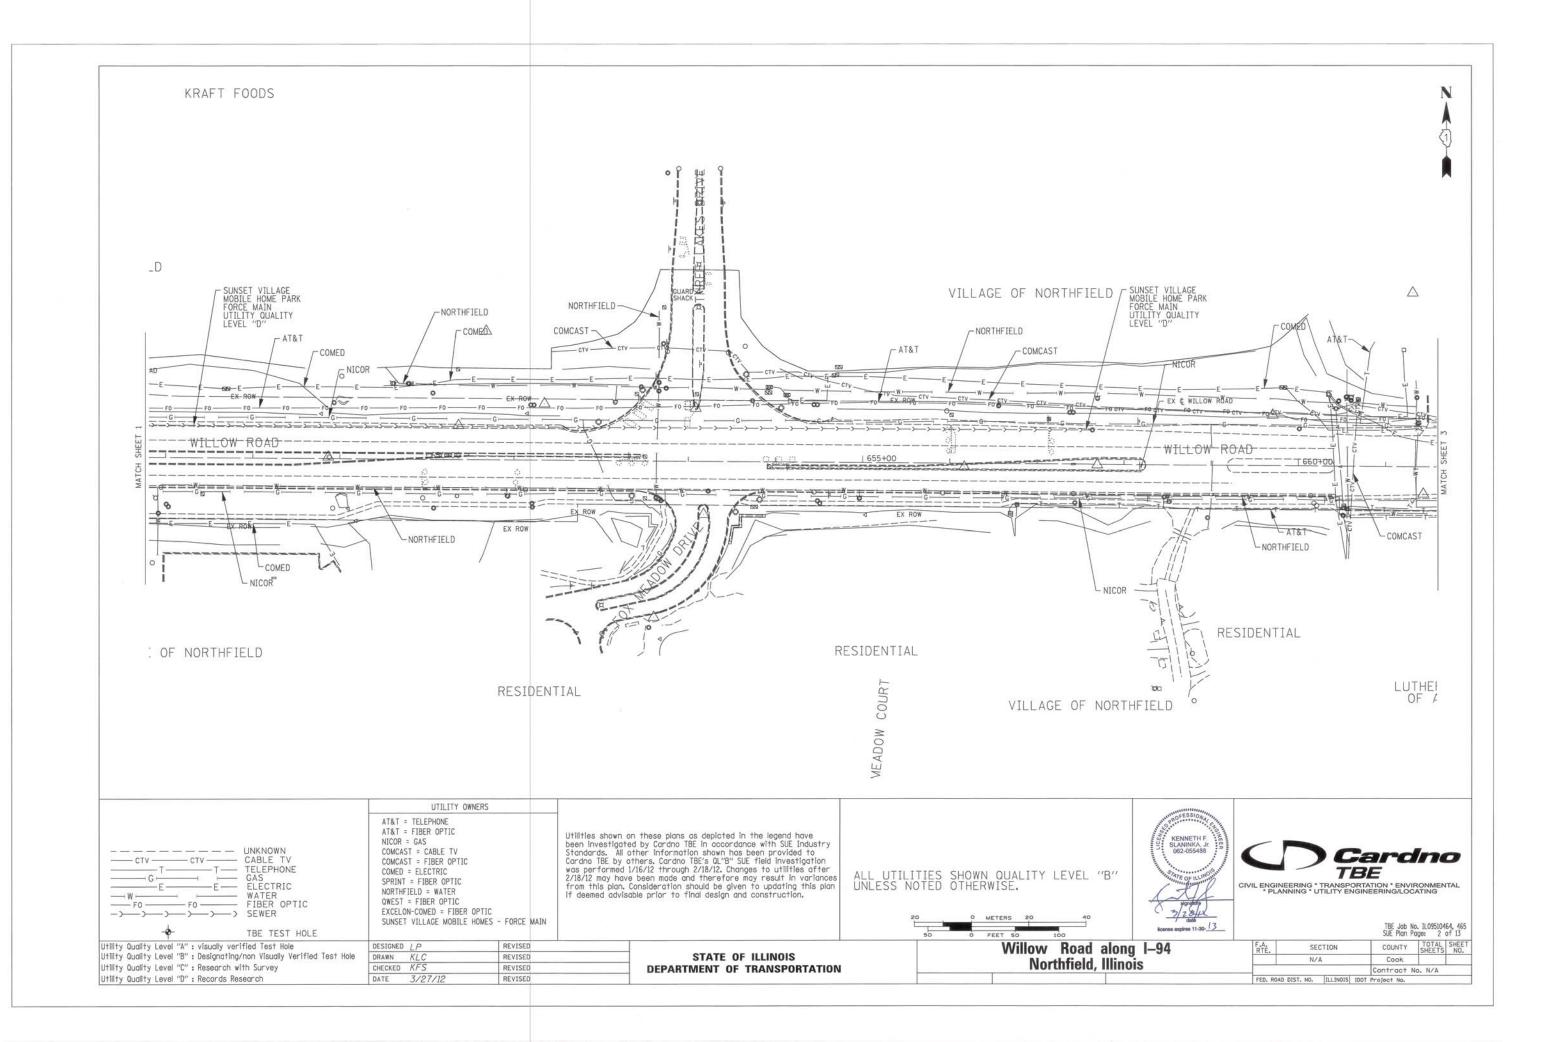


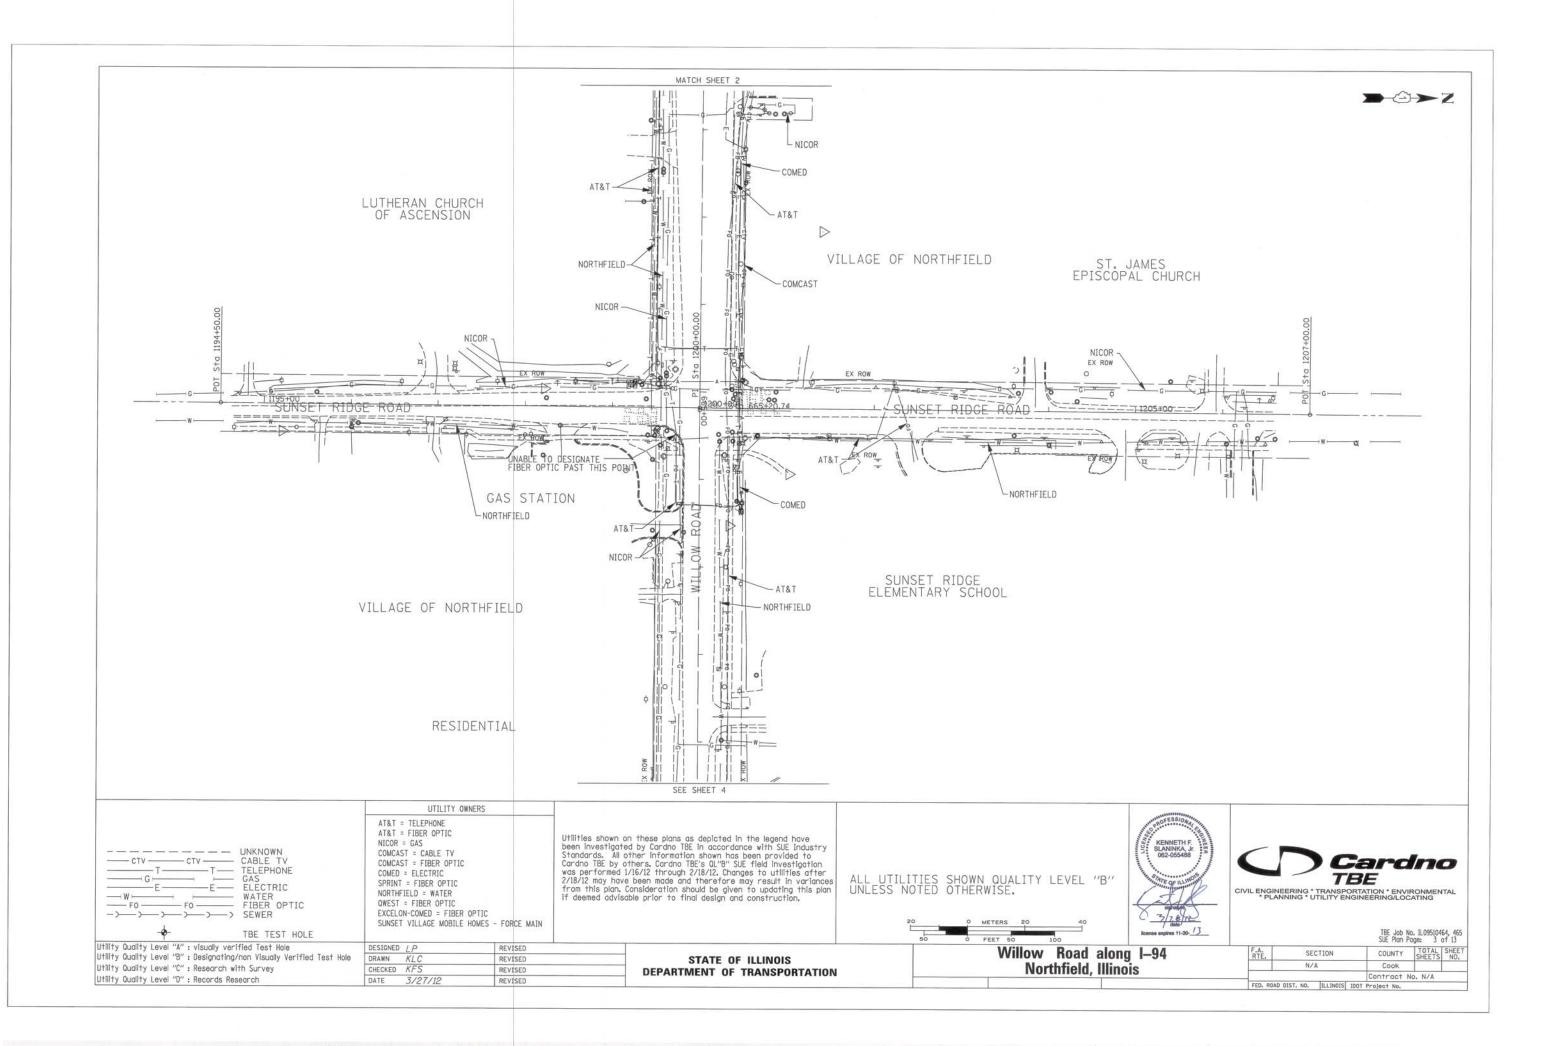


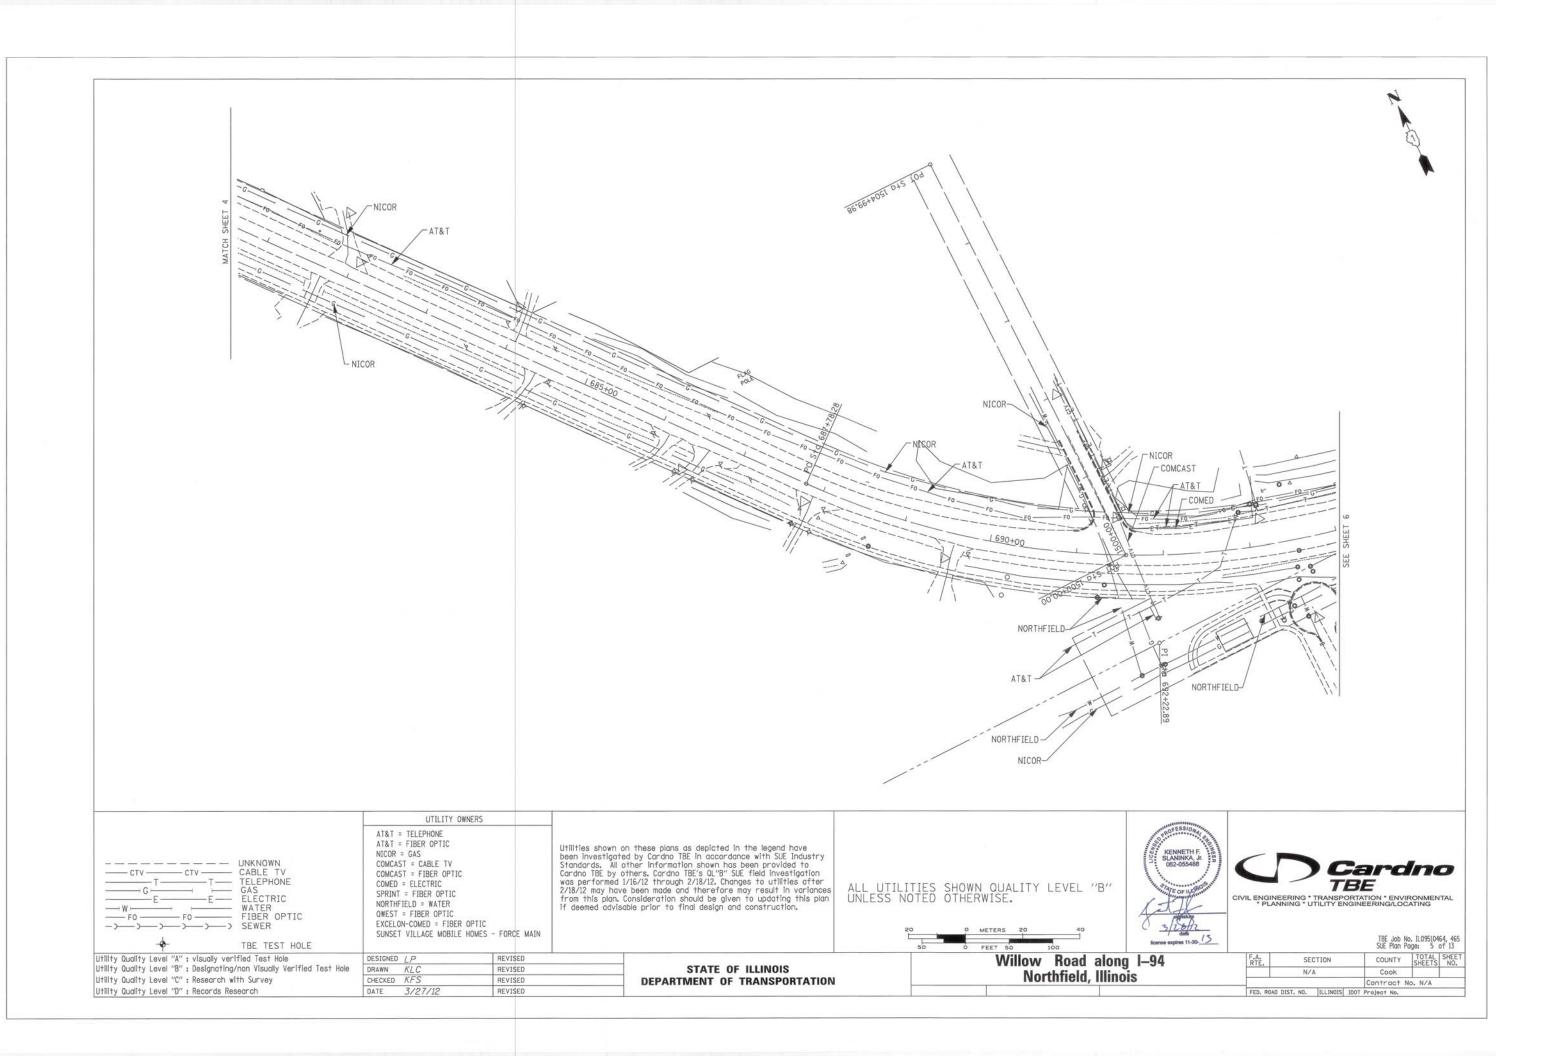


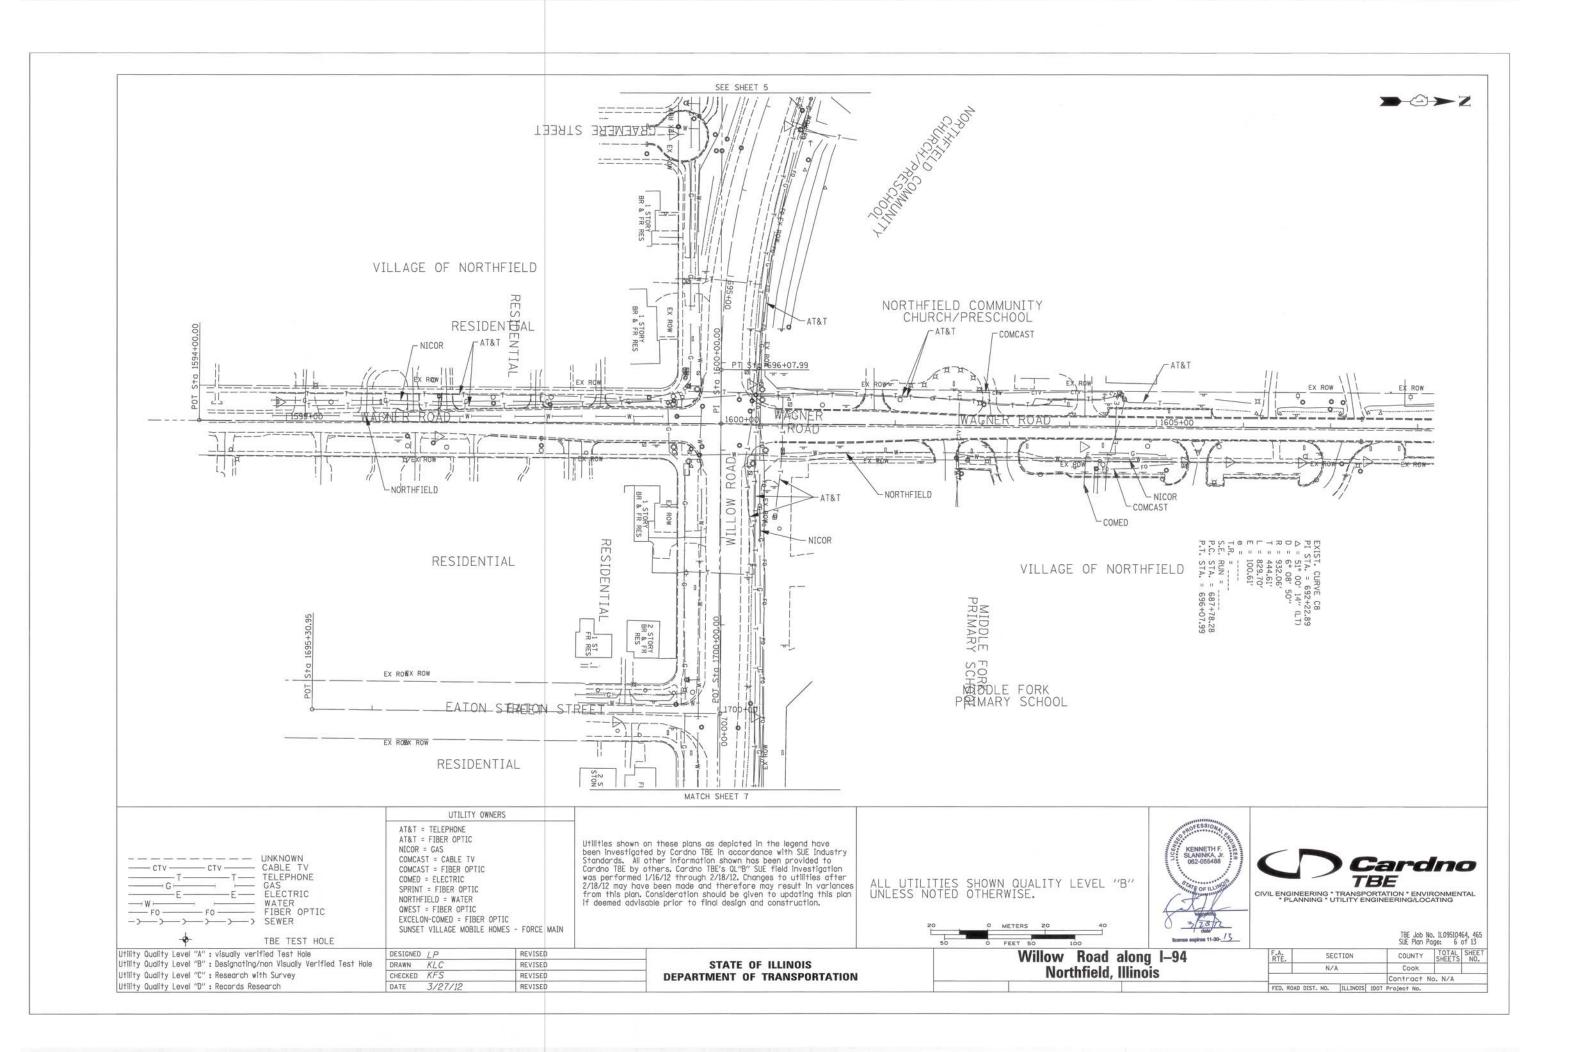


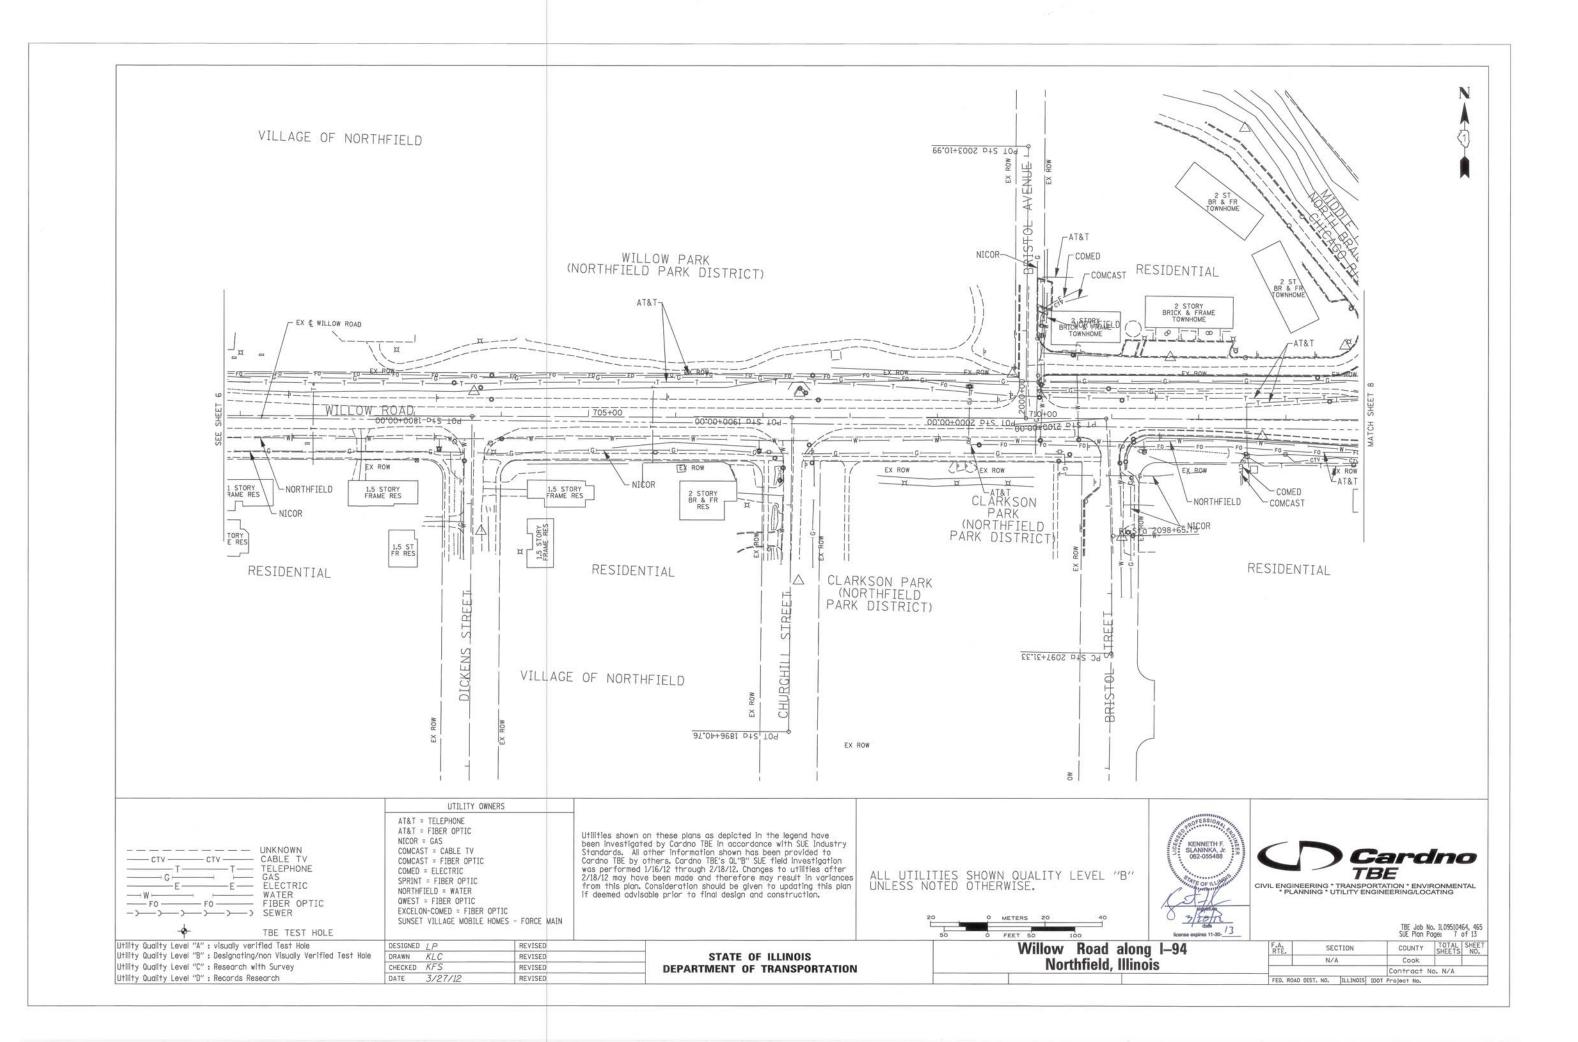


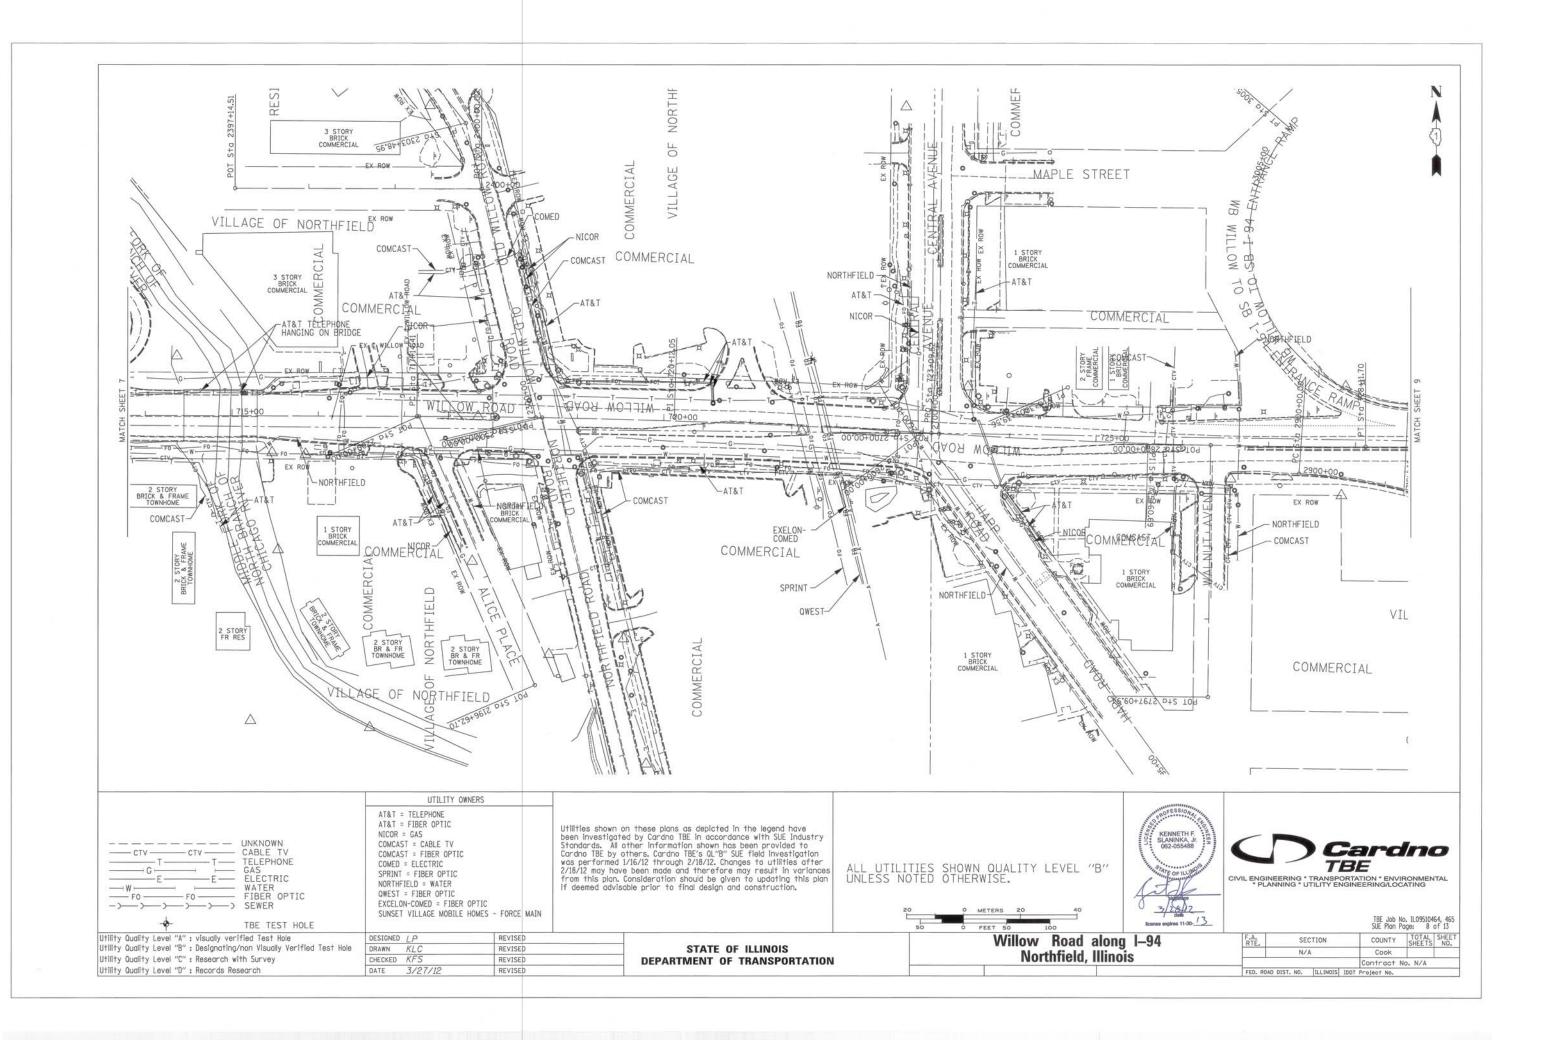

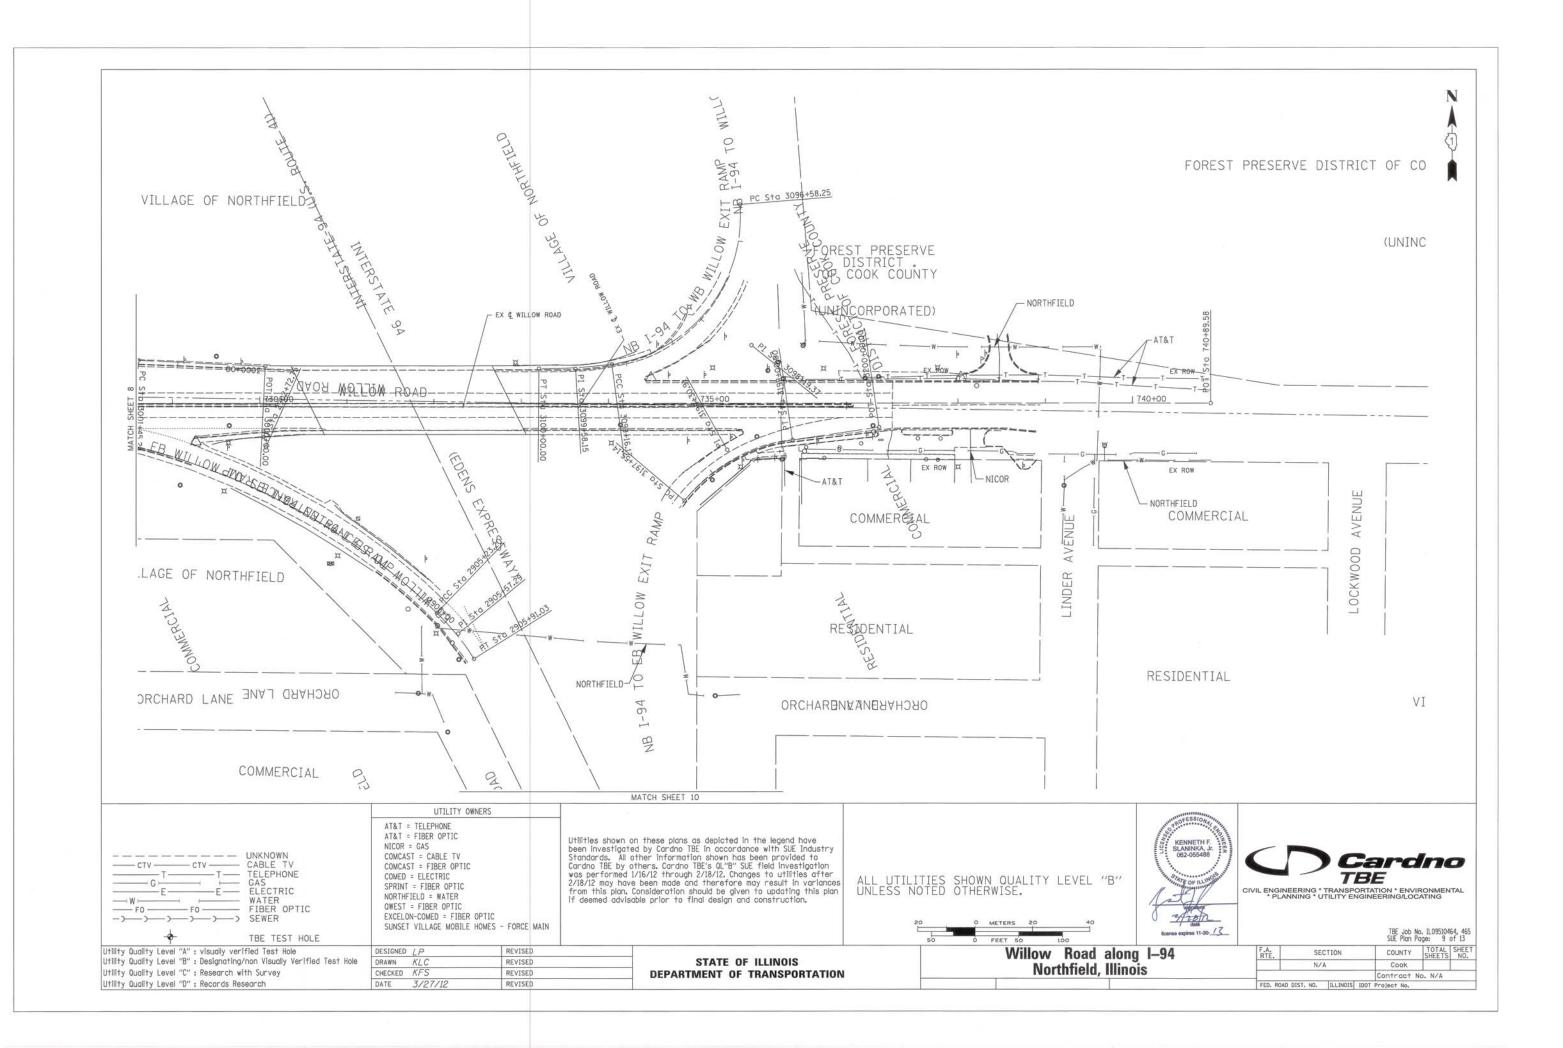

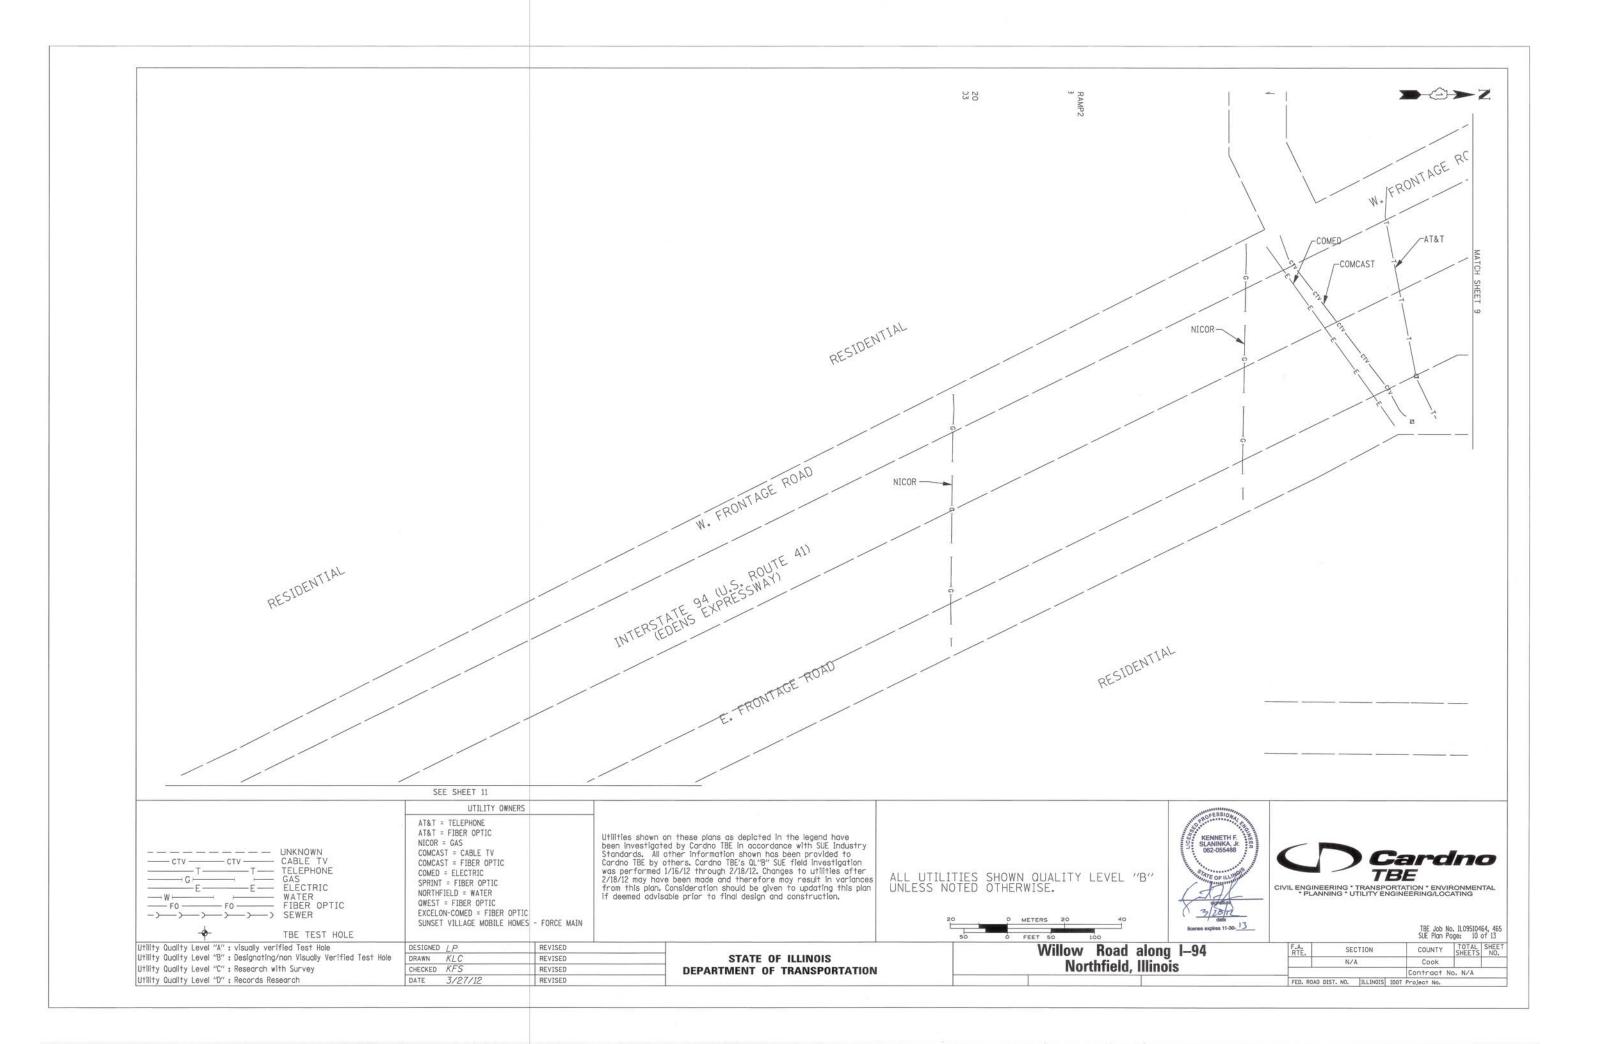

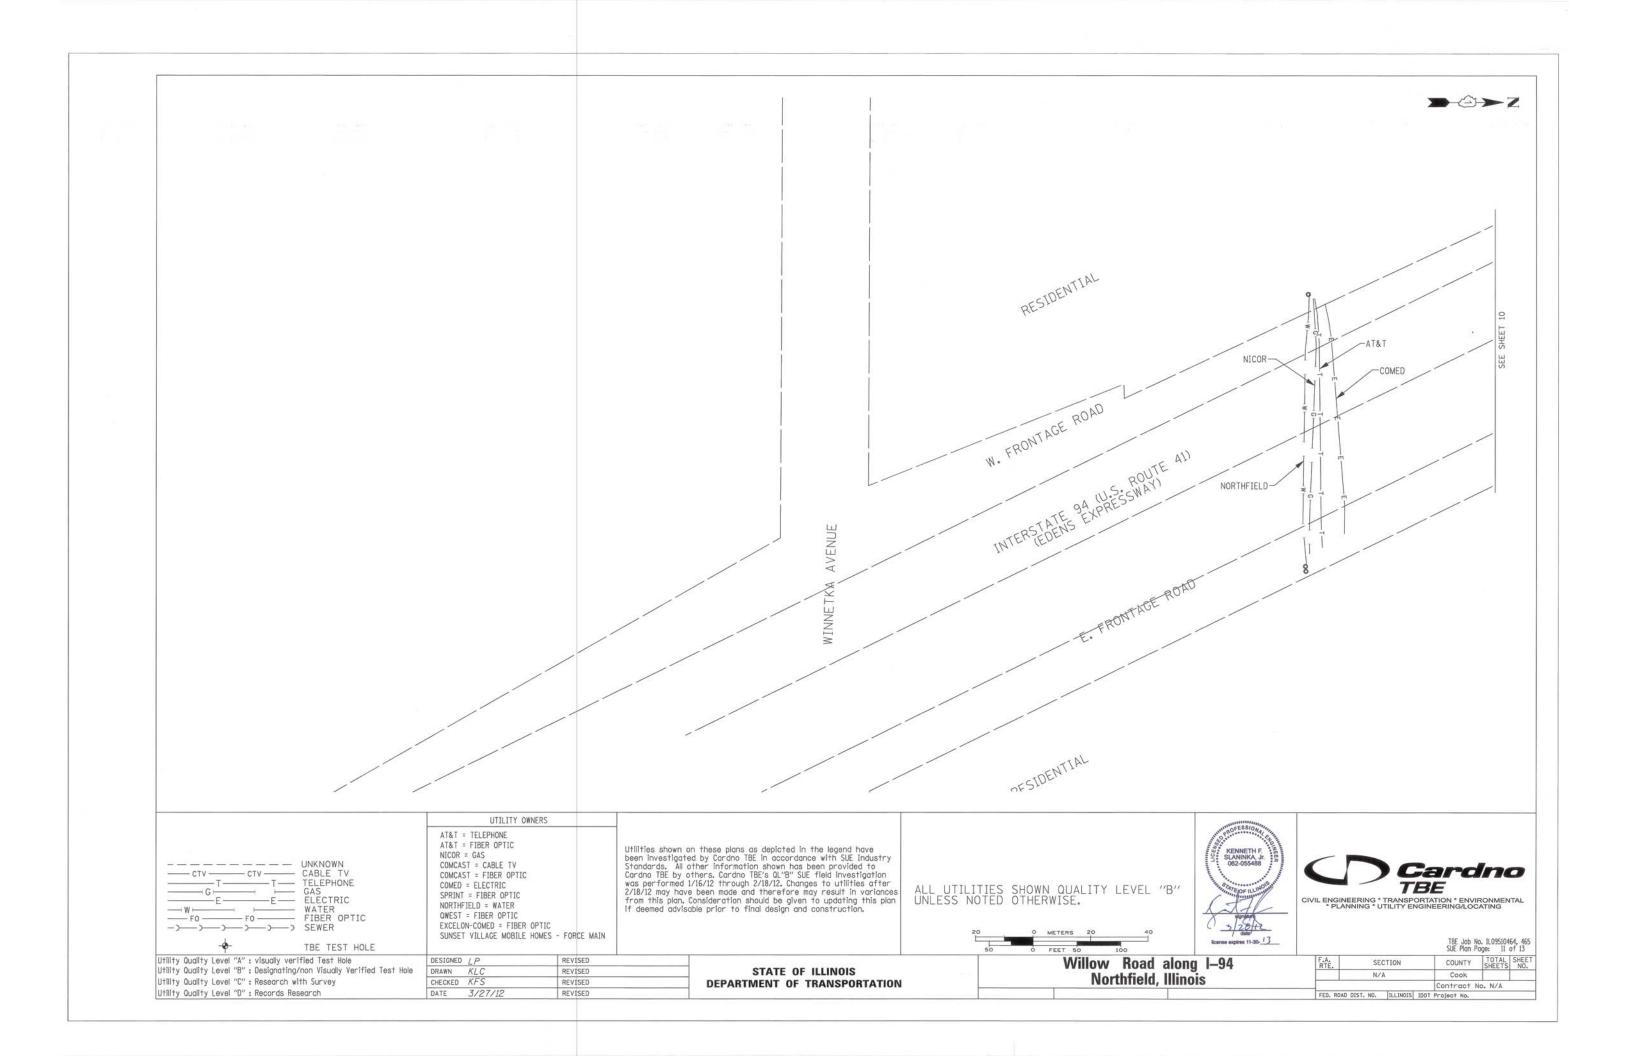

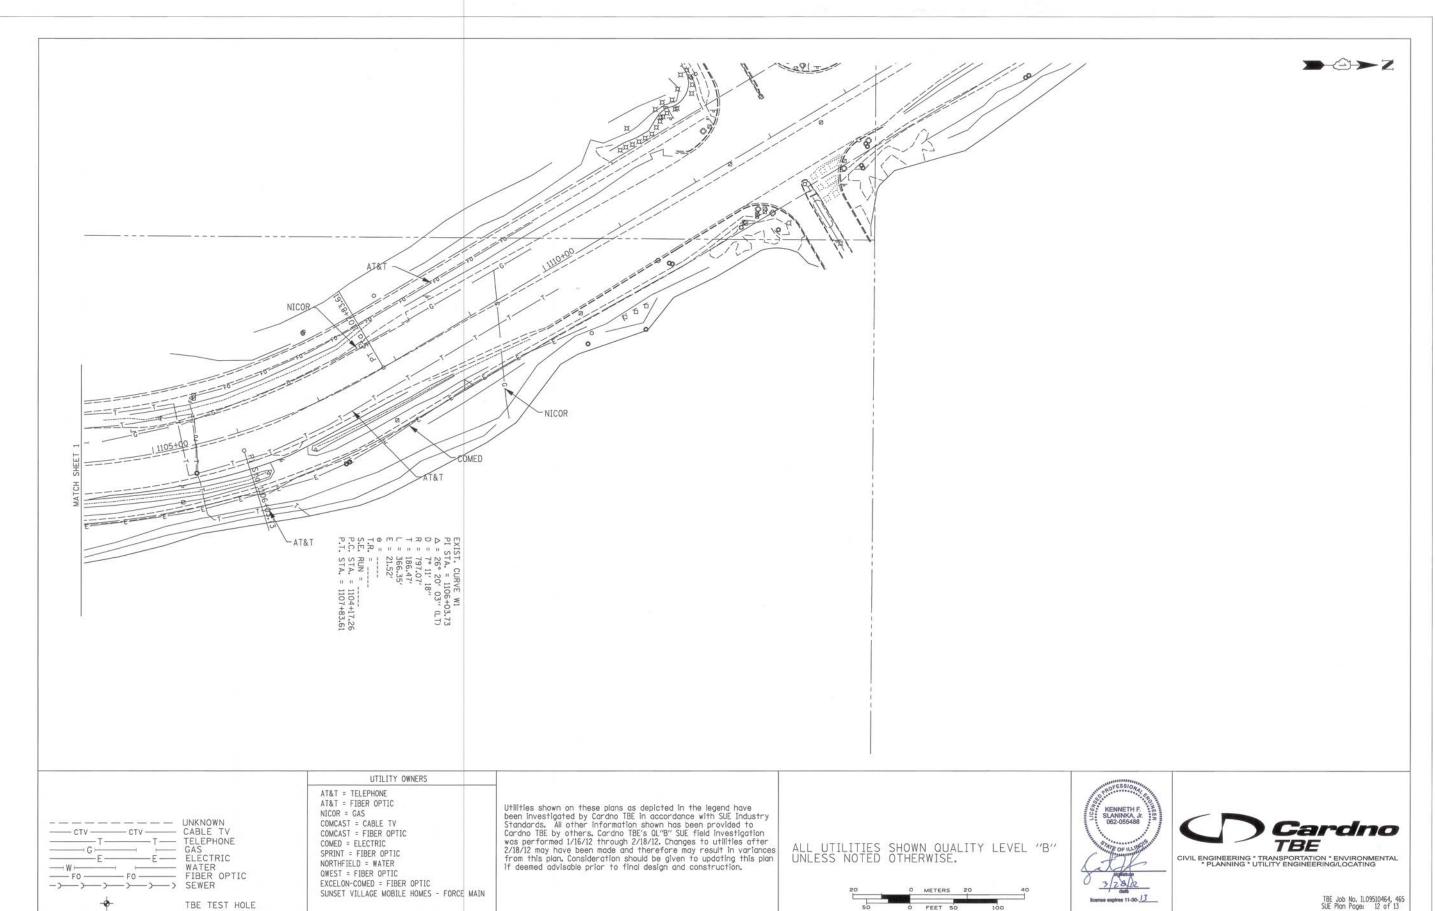

STATE OF ILLINOIS

DEPARTMENT OF TRANSPORTATION

Utility Quality Level "A": visually verified Test Hole
Utility Quality Level "B": Designating/non Visually Verified Test Hole

Utility Quality Level "C": Research with Survey Utility Quality Level "D": Records Research

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DRAWN KLC

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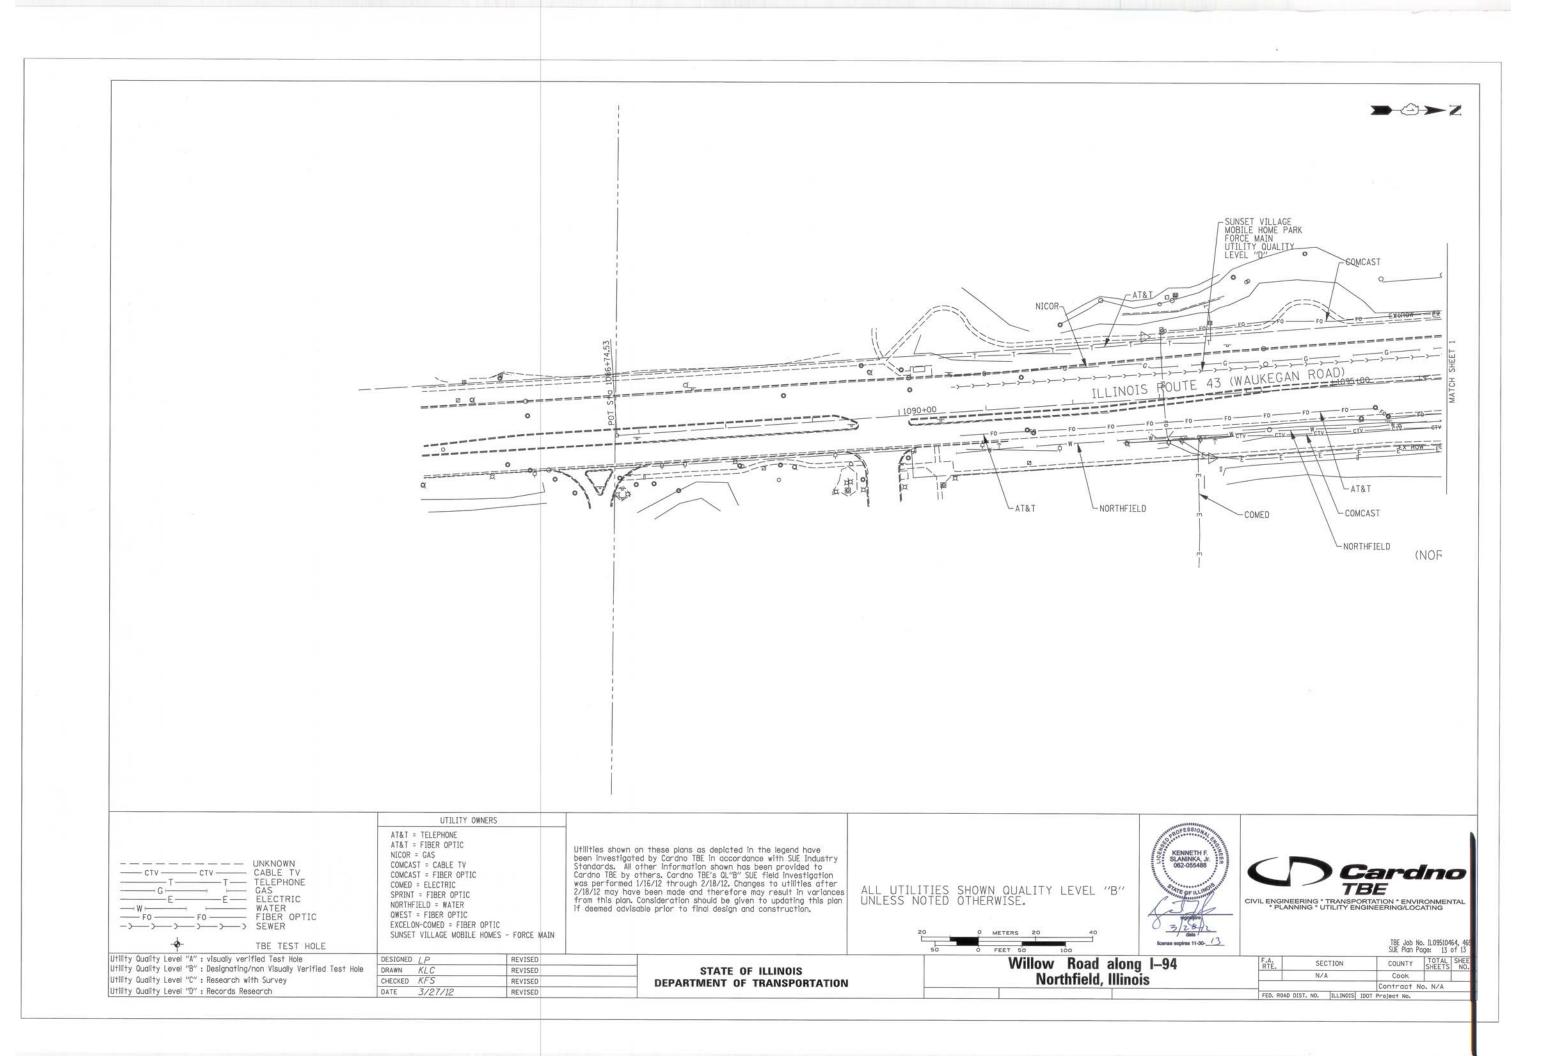
DATE 3/27/12


Willow Road along I—94
Northfield, Illinois


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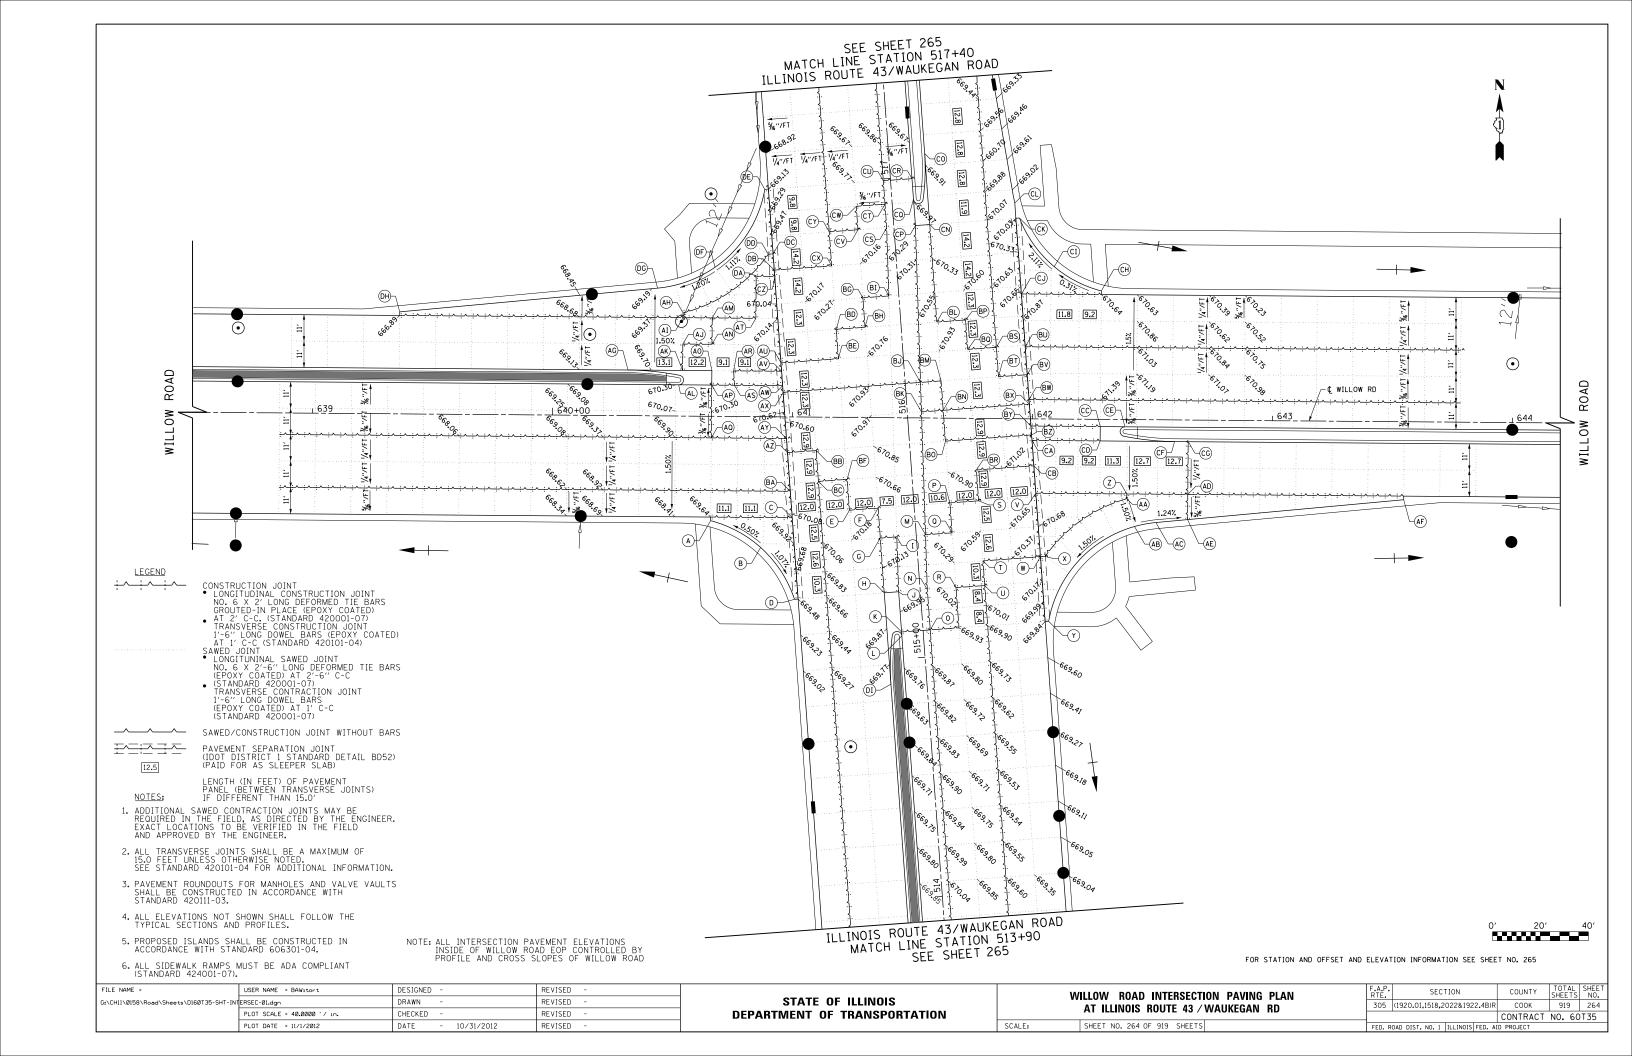
N/A Cook
Contract No. N/A


FED. BOAD DIST, NO. ILL NOTE BEFORE NO. N/A





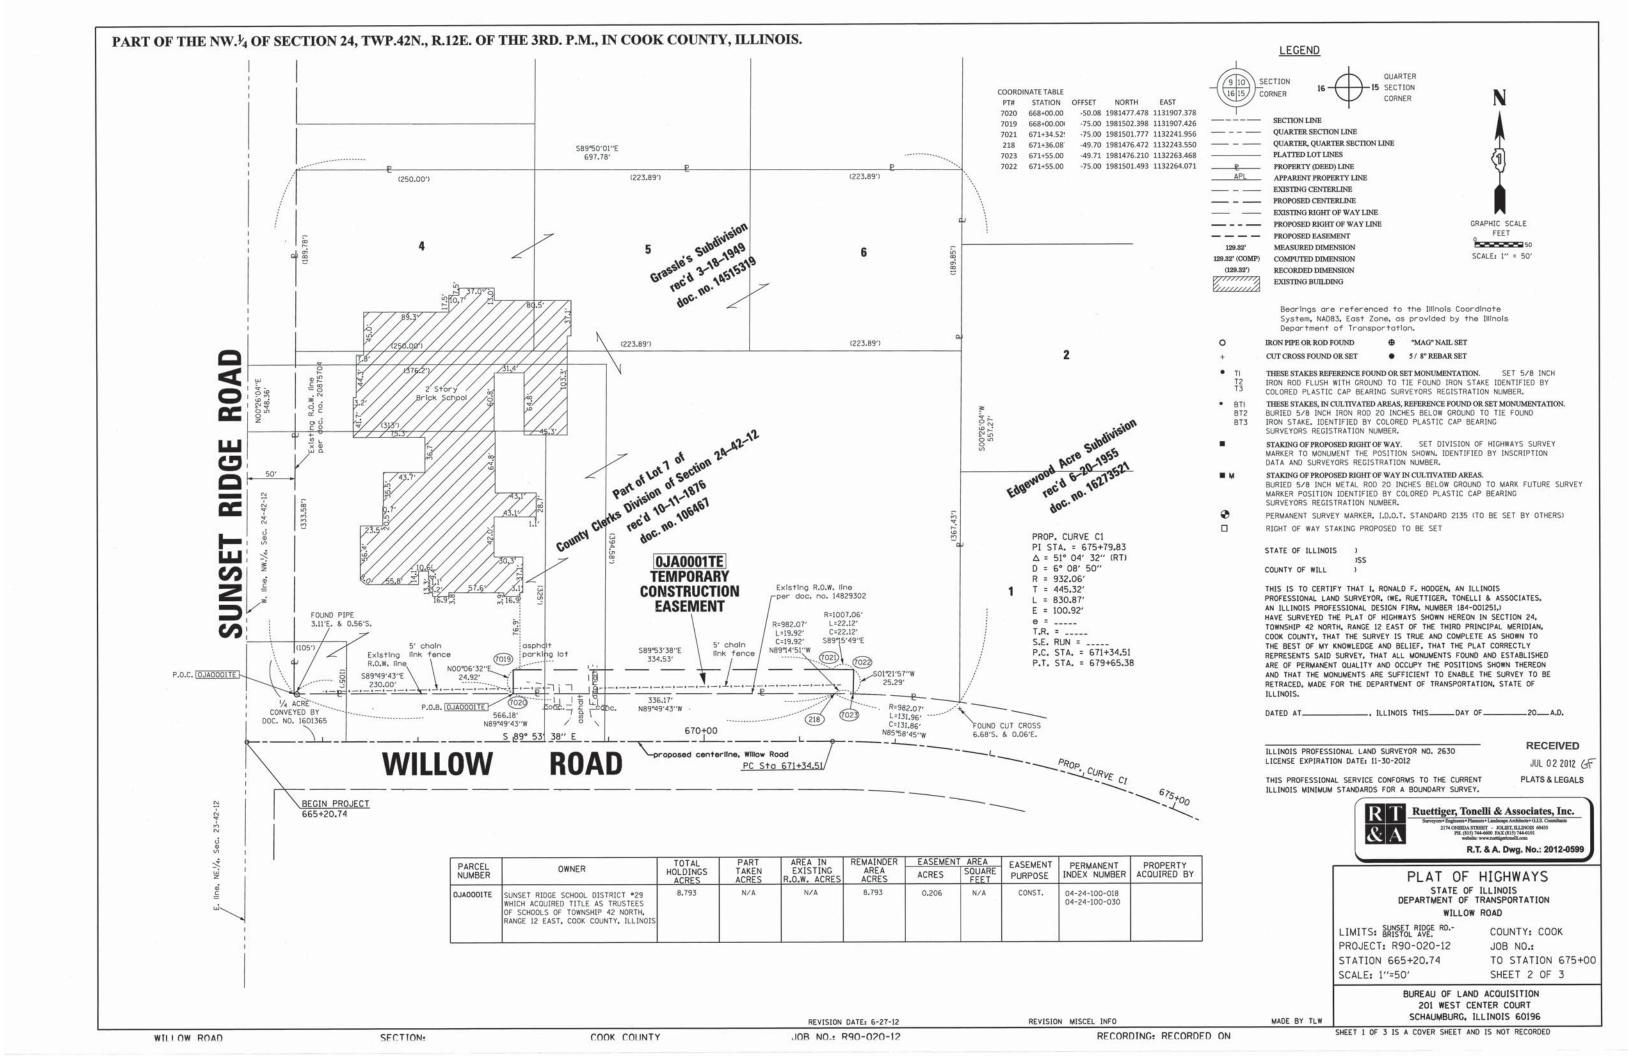

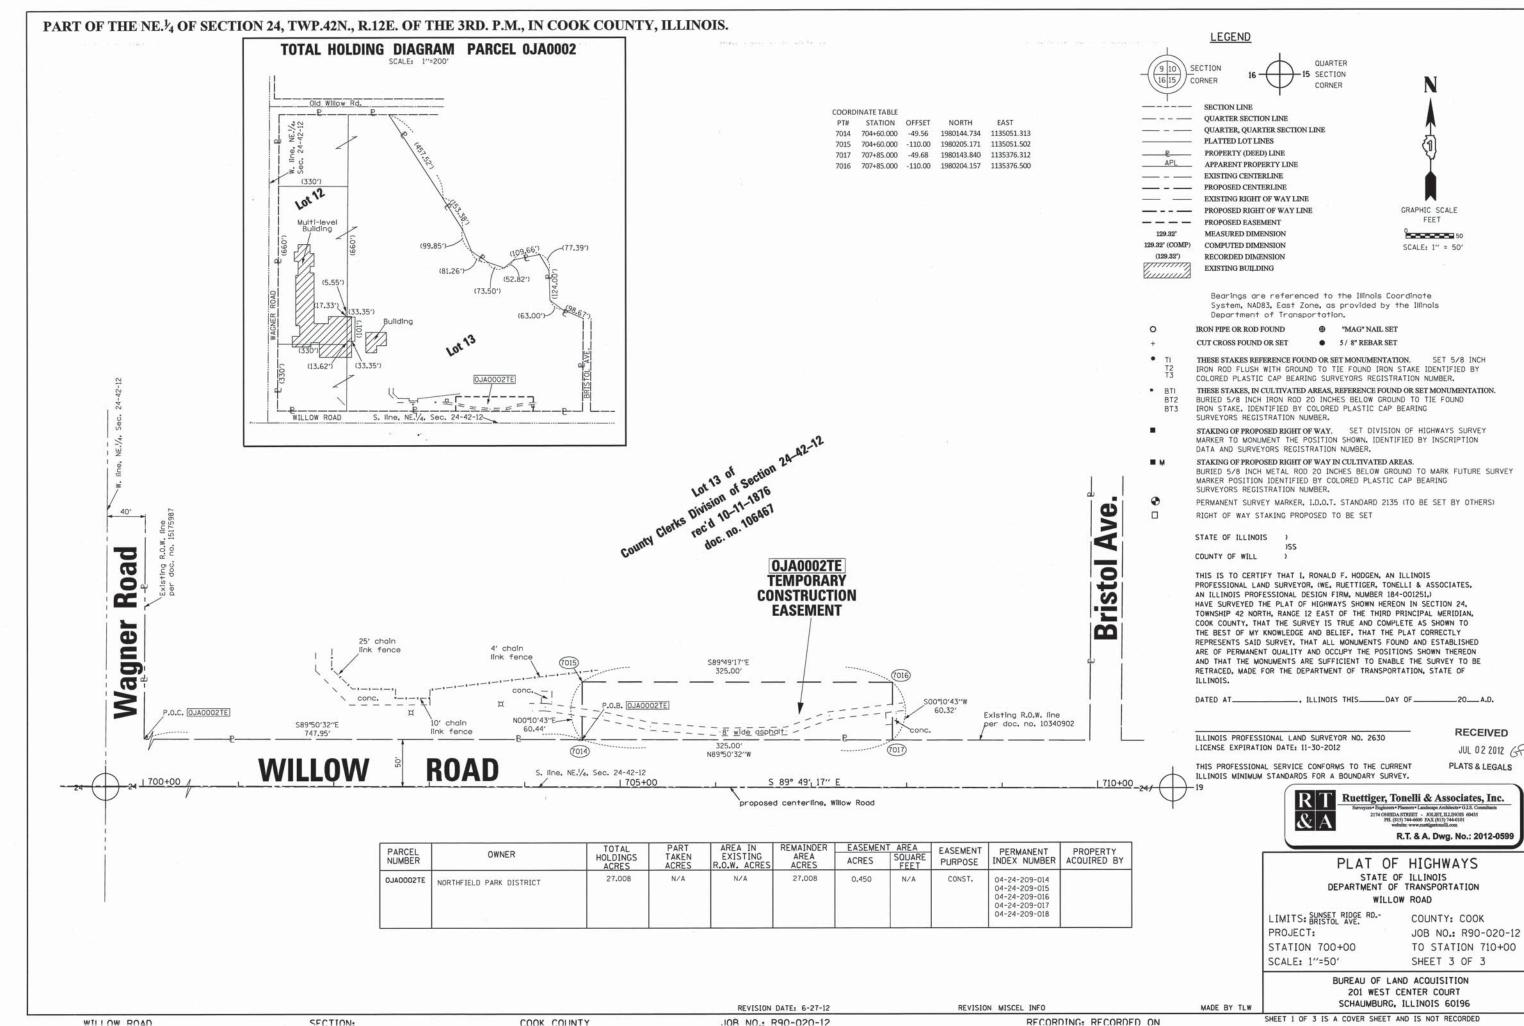

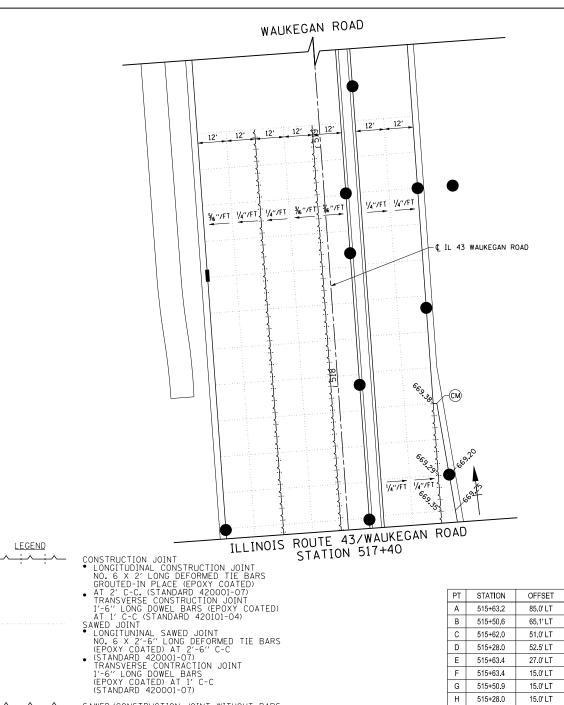

STATION 513+90 ILLINOIS ROUTE 43/WAUKEGAN ROAD £15.1 • WAUKEGAN ROAD

→ SAWED/CONSTRUCTION JOINT WITHOUT BARS

PAVEMENT SEPARATION JOINT (IDOT DISTRICT 1 STANDARD DETAIL BD52) (PAID FOR AS SLEEPER SLAB) LENGTH (IN FEET) OF PAVEMENT PANEL (BETWEEN TRANSVERSE JOINTS) IF DIFFERENT THAN 15.0'

12.5 NOTES:

- 1. ADDITIONAL SAWED CONTRACTION JOINTS MAY BE REQUIRED IN THE FIELD, AS DIRECTED BY THE ENGINEER. EXACT LOCATIONS TO BE VERIFIED IN THE FIELD AND APPROVED BY THE ENGINEER.
- 2. ALL TRANSVERSE JOINTS SHALL BE A MAXIMUM OF 15.0 FEET UNLESS OTHERWISE NOTED. SEE STANDARD 420101-04 FOR ADDITIONAL INFORMATION.
- 3. PAVEMENT ROUNDOUTS FOR MANHOLES AND VALVE VAULTS SHALL BE CONSTRUCTED IN ACCORDANCE WITH STANDARD 420111-03.
- 4. ALL ELEVATIONS NOT SHOWN SHALL FOLLOW THE TYPICAL SECTIONS AND PROFILES.
- 5. PROPOSED ISLANDS SHALL BE CONSTRUCTED IN ACCORDANCE WITH STANDARD 606301-04.
- 6. ALL SIDEWALK RAMPS MUST BE ADA COMPLIANT (STANDARD 424001-07).

PT	STATION	OFFSET	ELEVATION
Α.	515+63.2	85.0' LT	669.62
В	515+50.6	65.1'LT	669.74
С	515+62.0	51,0'LT	670.08
D	515+28.0	52.5' LT	669.46
Е	515+63.4	27.0' LT	670.36
F	515+63.4	15.0' LT	670.48
G	515+50.9	15.0' LT	670.30
Н	515+28.0	15.0' LT	670.01
ı	515+50.9	8.1' LT	670.36
J	515+40.7	4.6' LT	670.03
K	515+11.2	9.0' LT	669.88
L	515+09.5	9.0' LT	669.87
М	515+50.9	3.9' RT	671.48
N	515+28.0	3.0' RT	670.08
0	515+11.2	3.0' RT	669.92
Р	515+63.4	15.0' RT	670.71
Q	515+50.9	15.0' RT	670.51
R	515+28.0	15.0' RT	670.13
S	515+63.4	27.0' RT	670.78
Т	515+38.3	27.0' RT	670.33
U	515+28.0	27.0' RT	670.14
٧	515+64.8	51.0' RT	670.89
W	515+38.3	51.0' RT	670.40
Χ	515+38.3	53.0' RT	670.40
Υ	515+11.2	52.5' RT	669.83
Z	642+39.6	31.0' RT	670.88

PT	STATION	OFFSET	ELEVATION
AA	642+39.7	33.0' RT	670.58
AB	642+42.9	44.5' RT	670.67
AC	642+51.8	42.8' RT	670.54
AD	642+65.0	31.0' RT	670.66
AE	642+42.9	44.5' RT	670.67
AF	643+55.0	32.5' RT	669.82
AG	640+31.3	19.0' LT	669.52
AH	640+54.1	43.0' LT	669.55
Al	640+54.1	41.0' LT	669.58
AJ	640+54.1	30.0' LT	669.42
AK	640+54.1	19.0' LT	669.91
AL	640+52.5	13.0' LT	669.92
AM	640+66.2	41.0' LT	669.77
AN	640+66.2	30.0' LT	669.60
AO	640+66.2	19.0' LT	670.10
AP	640+66.2	13.0' LT	670.13
AQ	640+66.2	9.0' LT	370.13
AR	640+75.3	19.0' LT	670.23
AS	640+75.3	13.0' LT	670.27
AT	640+84.4	41.0' LT	670.02
AU	640+95.0	22.5' LT	670.43
ΑV	640+95.3	19.0' LT	670.49
AW	640+95.8	13.0' LT	670.56
AX	640+96.0	10.2' LT	670.59
AY	640+97.6	9.0' RT	670.54
ΑZ	640+98.0	14.9' RT	670.46

PT	STATION	OFFSET	ELEVATION
BA	640+99.3	31.0' RT	670.23
ВВ	641+10.0	13.9' RT	670.60
ВС	641+11.0	26.8' RT	670.42
BD	641+18.0	36.7' LT	670.47
BE	641+19.0	24.4' LT	670.66
BF	641+23.0	25.8' RT	670.55
BG	641+29.0	49.9' LT	670.37
ВН	641+29.9	37.6' LT	670.56
ВІ	641+39.8	50.7' LT	670.44
BJ	641+53.3	14.8' LT	671.06
BK	641+53.8	2.5' LT	671.11
BL	641+59.9	40.0' LT	670.73
ВМ	641+61.8	15.5' LT	671.11
BN	641+62.8	3.3' LT	671.18
во	641+63.8	9.6' RT	671.08
BP	641+71.8	670.98	670.79
BQ	641+72.8	28.7' LT	670.98
BR	641+76.8	21.5' RT	670.97
BS	641+84.8	29.7' LT	671.01
ВТ	641+85.7	17.4' LT	671.19
BU	641+96.8	30.0' LT	671.03
BV	641+97.7	18.4' LT	671.19
BW	641+98.5	8.0' LT	671.30
вх	641+98.7	6.1'LT	671.30
BY	641+99.4	3.0' RT	671.28
BZ	641+99.7	6.7' RT	671.24

SCALE:


PT	STATION	OFFSET	ELEVATION
CA	641+99.9	9.0' RT	671.22
СВ	642+00.8	19.6' RT	671.06
СС	642+28.3	3.0' RT	671.22
CD	642+28.3	9.0' RT	671.23
CE	642+38.6	3.0' RT	671.20
CF	642+59.3	9.0' RT	671.15
CG	642+65.0	9.0' RT	671.12
СН	516+46.9	84.3' RT	670.62
CI	516+58.4	65.5' RT	670.55
CJ	516+79.7	52.5' RT	670.70
CK	516+79.7	52.5' RT	670.02
CL	516+86.1	51.0' RT	669.91
СМ	517+90.0	40.5' RT	669.35
CN	516+79.7	15.0' RT	670.14
СО	517+09.4	15.0' RT	669.87
CP	516+79.7	9.0' RT	670.10
CQ	516+90.7	9.0' RT	669.95
CR	516+99.3	9.0' RT	669.84
cs	516+79.7	3.0' LT	670.14
СТ	516+89.5	3.0' LT	670.05
CU	516+99.3	3.0' LT	669.96
CV	516+79.7	15.0' LT	669.97
CW	516+89.5	3.0' LT	669.86
СХ	516+65.4	27.0' LT	670.03
CY	516+79.7	27.0' LT	669.80
CZ	516+62.8	51.0' LT	669.81

DA 516+63.4 58.7'LT 669.72 DB 516+65.4 51.0'LT 669.76 DC 516+72.2 51.0'LT 669.61 DD 516+72.2 53.0'LT 669.59 DE 516+99.3 52.5'LT 669.10 DF 516+68.4 75.5'LT 669.54 DG 516+61.4 100.0'LT 669.23 DH 516+93.3 207.0'LT 668.85	PT	STATION	OFFSET	ELEVATION
DC 516+72.2 51.0'LT 669.61 DD 516+72.2 53.0'LT 669.59 DE 516+99.3 52.5'LT 669.10 DF 516+68.4 75.5'LT 669.54 DG 516+61.4 100.0'LT 669.23	DA	516+63.4	58.7'LT	669.72
DD 516+72.2 53.0'LT 669.59 DE 516+99.3 52.5'LT 669.10 DF 516+68.4 75.5'LT 669.54 DG 516+61.4 100.0'LT 669.23	DB	516+65.4	51.0'LT	669.76
DE 516+99.3 52.5'LT 669.10 DF 516+68.4 75.5'LT 669.54 DG 516+61.4 100.0'LT 669.23	DC	516+72.2	51.0'LT	669.61
DF 516+68.4 75.5'LT 669.54 DG 516+61.4 100.0'LT 669.23	DD	516+72.2	53.0' LT	669.59
DG 516+61.4 100.0'LT 669.23	DE	516+99.3	52.5' LT	669.10
	DF	516+68.4	75.5' LT	669.54
DH 516+59.3 207.9'LT 666.85	DG	516+61.4	100.0' LT	669.23
201.0 21	DH	516+59.3	207.9' LT	666.85
DI 514+89.8 15.0'LT 669.73	DI	514+89.8	15.0' LT	669.73

FILE NAME =	USER NAME = BAWitort	DESIGNED -	REVISED -
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	PLOT DATE = 12/6/2012	DATE - 10/31/2012	REVISED -

STATE OF ILLINOIS **DEPARTMENT OF TRANSPORTATION**

WILLOW ROAD INTERSECTION PAVING PLAN AT ILLINOIS ROUTE 43 / WAUKEGAN RD		SECTION	COUNTY	TOTAL SHEETS	SHEET NO.
		(1920.01,1518,2022&1922.4B)R	COOK	919	265
			CONTRACT	NO. 60	T35
SHEET NO. 265 OF 919 SHEETS	FED. ROAD DIST. NO. 1 ILLINOIS FED. AID PROJECT				

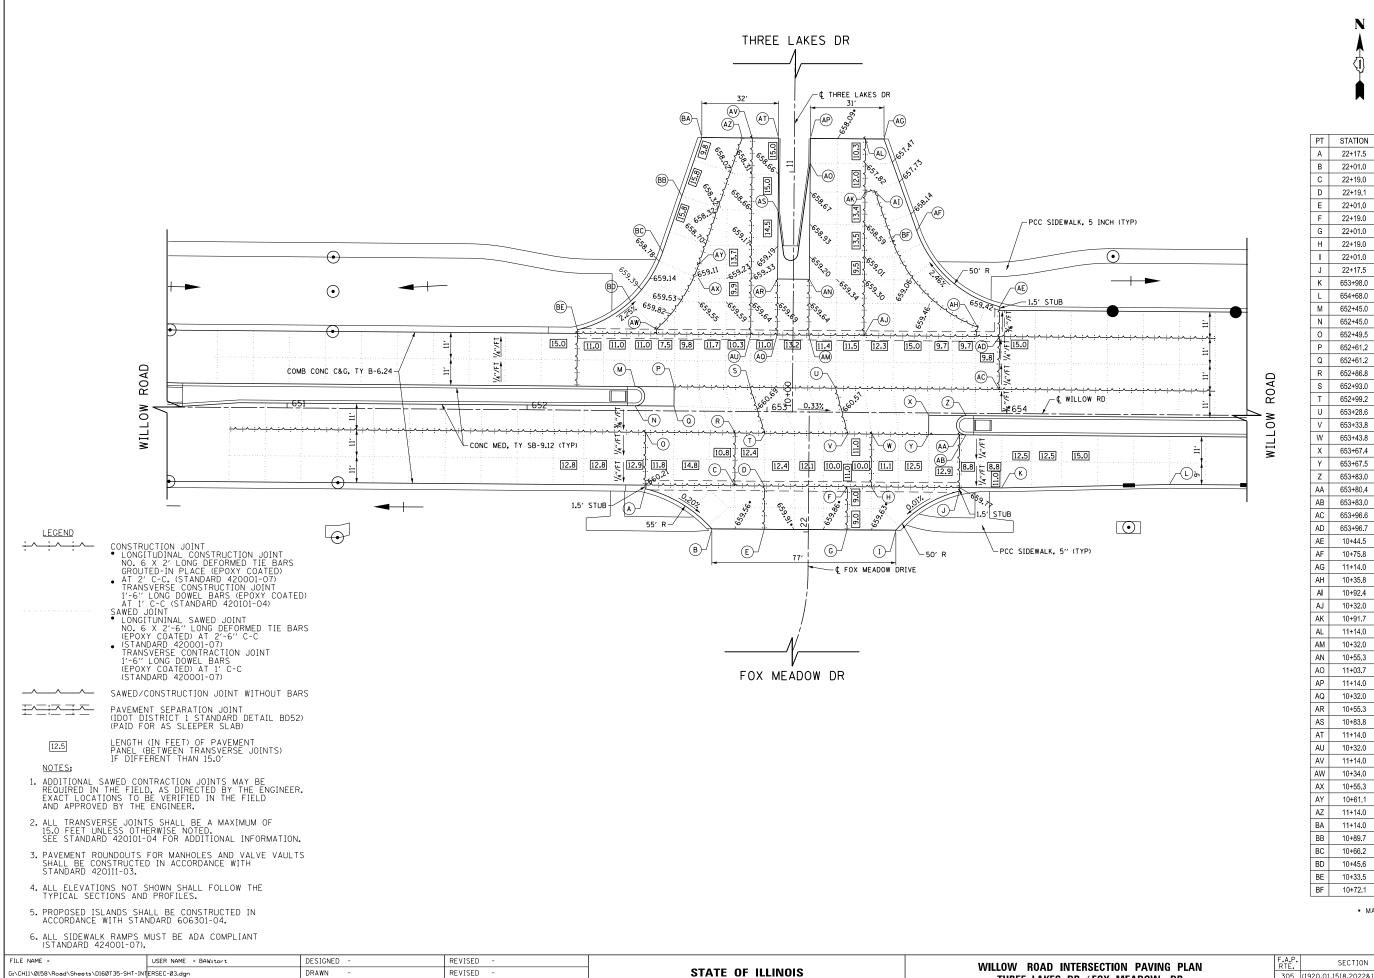

DEPARTMENT OF TRANSPORTATION

CHECKED

10/31/2012

DATE

PLOT DATE = 12/6/2012

REVISED

REVISED

COUNTY 305 (1920.01,1518,2022&1922.4B)R COOK 919 266 CONTRACT NO. 60T35

OFFSET

68.1'LT

40.2' LT

30.8' LT

18.4' LT

18.4' LT

16.1' RT

16.1'RT

26.1' RT

36.5' RT

62.8' RT

31 0' RT

29.0' RT

10.0' LT

2.0' LT

9.0' RT

10.0' LT

2.0' LT

9.0' RT

10.0' LT

9.0' RT

10.0' LT

9.0' RT

9.0' RT

1.0' RT

9.0' RT

1.0' RT

9.0' RT

9.0' RT

10.0' LT

32.0'LT

86.1' RT

61.3' RT

37.3' RT

76.9' RT

33 5' RT

29.6' RT

29.6' RT

29.6' RT

6.6' RT

6.6' RT

6.6' RT

6.6' LT

6.6' LT

6.6' LT

6.6' LT

17.6' LT

17.6' LT

56.8' LT

39.6' LT

39.5' LT

21.8' LT

38.6' LT

46.7' LT

54.6' LT

67.7' LT

89.9'LT

40.9' RT

* MATCH EXISTING

10+44.5

10+75.8

11+14.0

10+35.8

10+32.0

10+91.7

11+14.0

10+32.0

10+55.3

11+03.7

11+14.0

10+32.0

10+55.3

10+83.8

11+14.0

10+34.0

10+55.3

10+61.1

11+14.0

10+89.7

10+66.2

10+45.6

10+33.5

THREE LAKES DR / FOX MEADOW DR

SHEET NO. 266 OF 919 SHEETS

SCALE:

22+19.0

22+19.1

22+19.0

22+01.0

ELEVATION

660.17

659.50*

660.10

660.05

659 75*

659.93

659.74*

659.90

659.68*

659.73

659 71

659.50

660.70

660.87

660.67

660.65

660.82

660.56

660.53

660.51

660.41

660.39

660.39

660.44

660.27

660.39

660.23

660.22

660 17

659.71

659.38

658.35

657.18*

659.61

658 06 659.91

658.18

657.50*

659.99

659.38

658 44

658.24*

660.04

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658.92

658.39*

660.07

657.96*

660.16

659.13

658.95

657.89*

657.28*


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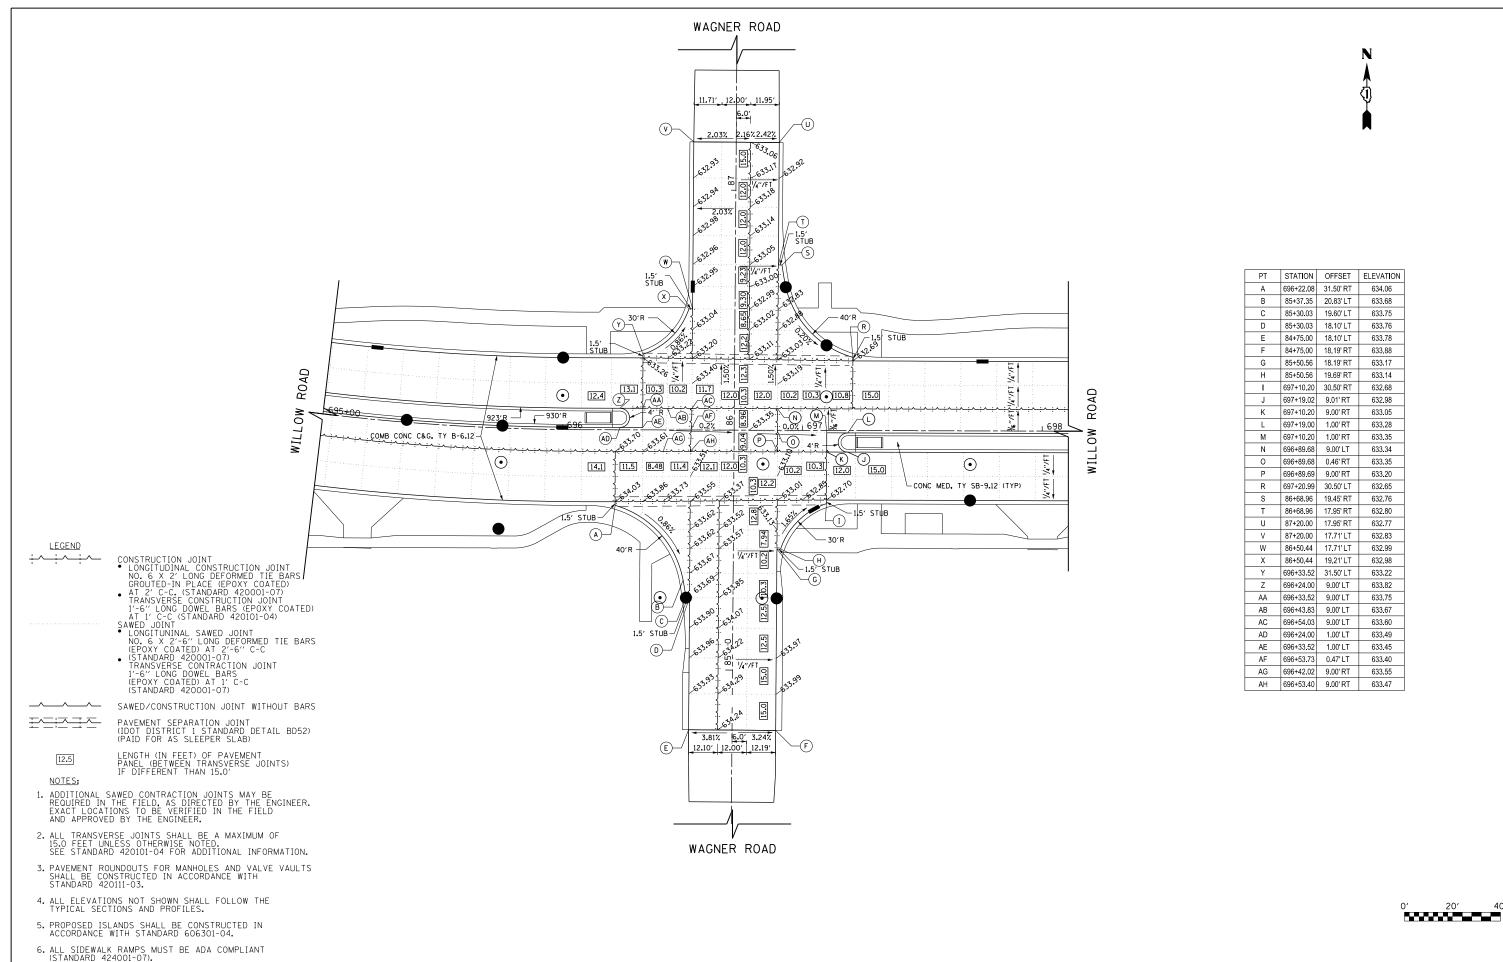
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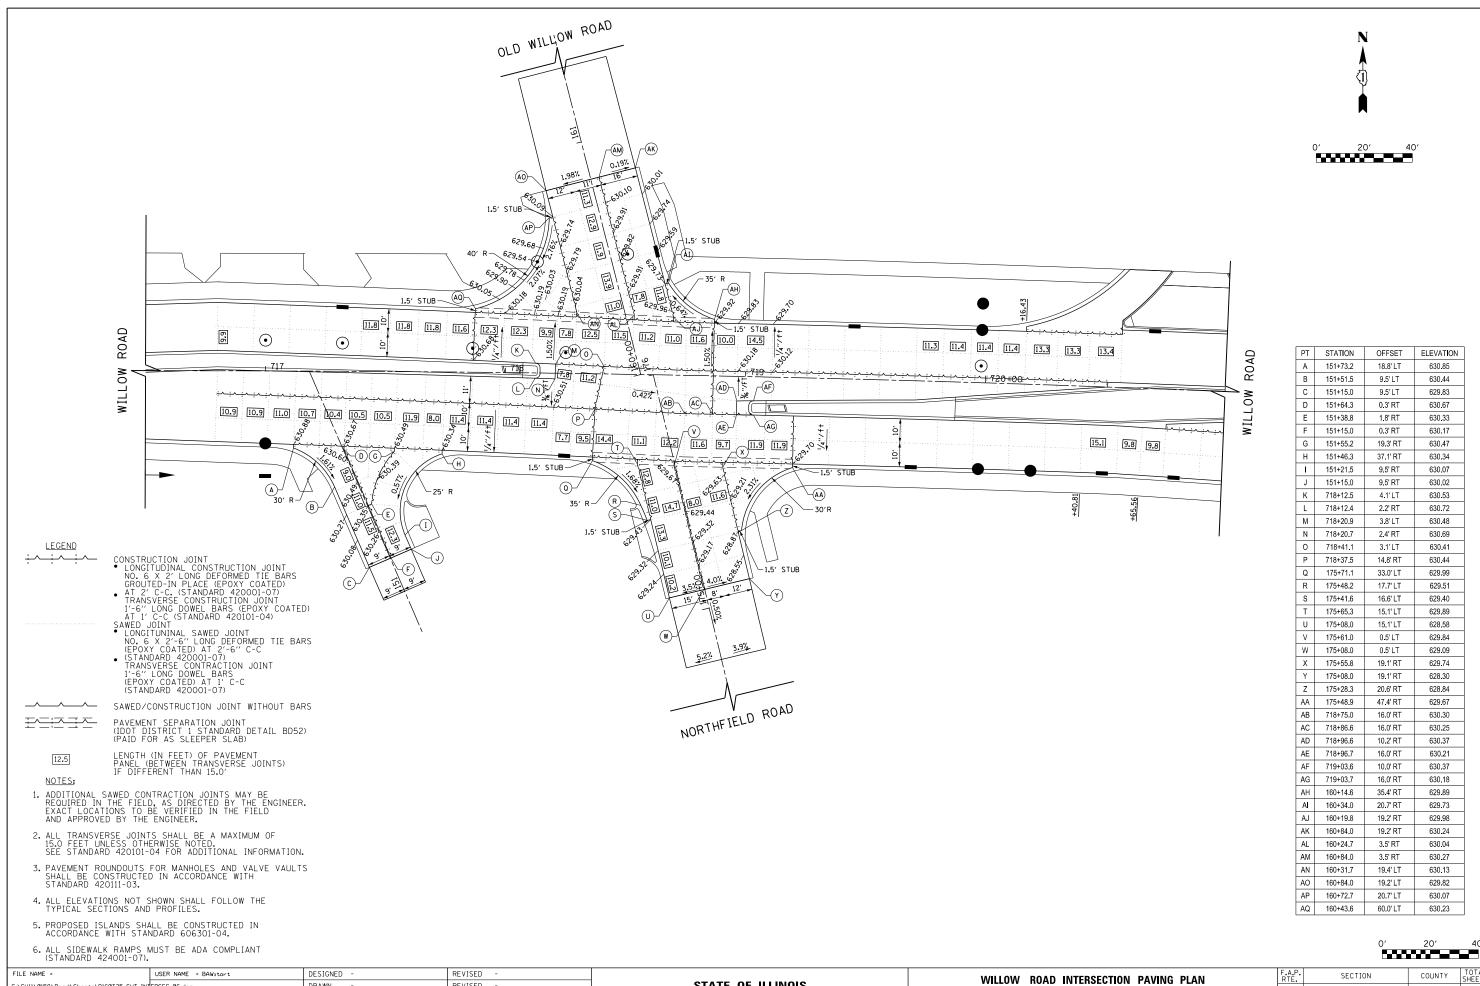
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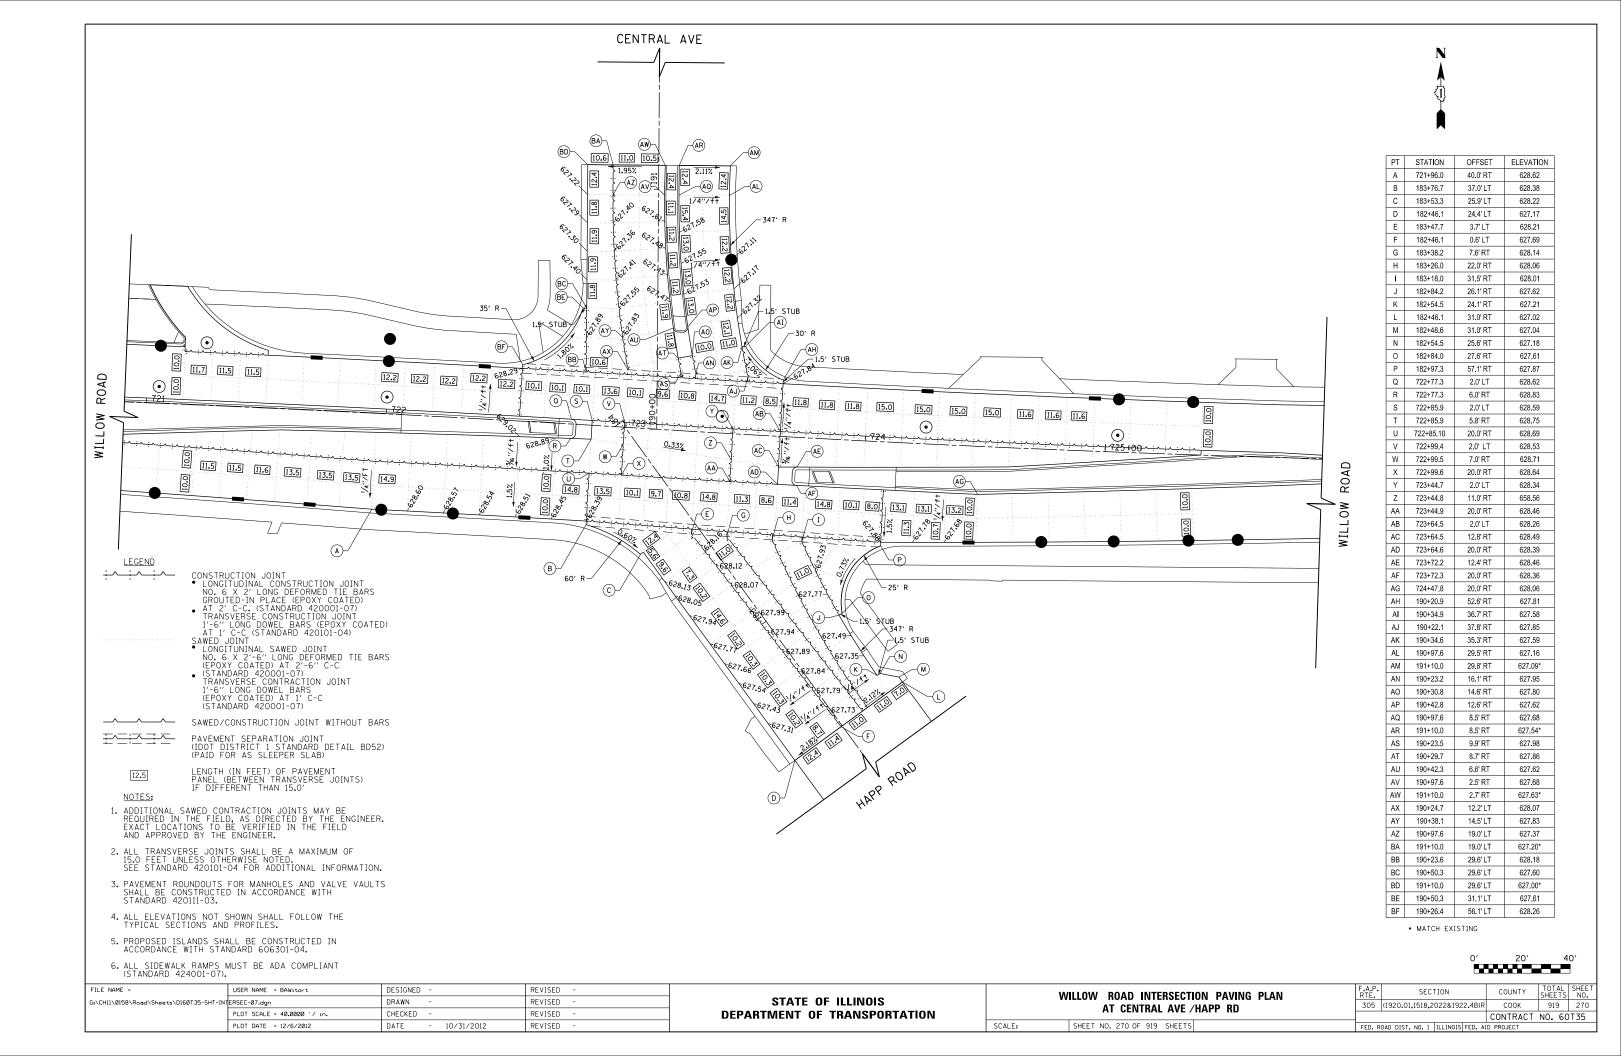






DESIGNED REVISED SECTION COUNTY WILLOW ROAD INTERSECTION PAVING PLAN STATE OF ILLINOIS G:\CHII\0158\Road\Sheets\D160T35-SHT-INTERSEC-05.dgn DRAWN REVISED COOK 919 268 305 (1920.01,1518,2022&1922.4B)R AT WAGNER RD CHECKED REVISED **DEPARTMENT OF TRANSPORTATION** CONTRACT NO. 60T35 SCALE: SHEET NO. 268 OF 919 SHEETS DATE 10/31/2012 REVISED PLOT DATE = 12/6/2012




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FILE NAME =	USER NAME = BAWitort	DESIGNED -	REVISED -			WILLOW ROAD INTERSECTION PAVING PLAN	F.A.P.	SECTION	COUNTY	TOTAL SHE	ĒΤ
G:\CH11\0158\Road\Sheets\D160T35-SHT-IN	ERSEC-06.dgn	DRAWN -	REVISED -	STATE OF ILLINOIS		AT OLD WILLOW RD / NORTHFIELD RD	305 (1920.0)	1.1518.2022&1922.4B)R	соок	919 26	69
	PLOT SCALE = 40.0000 ' / in.	CHECKED -	REVISED -	DEPARTMENT OF TRANSPORTATION		AT OLD WILLOW ND / NUNTHFIELD ND			CONTRACT	NO. 60T35	5
	PLOT DATE = 12/6/2012	DATE - 10/31/2012	REVISED -		SCALF:	SHEET NO. 269 OF 919 SHEETS	FED ROAD DIST	NO 1 THE INOIS FED A	ID PROJECT		

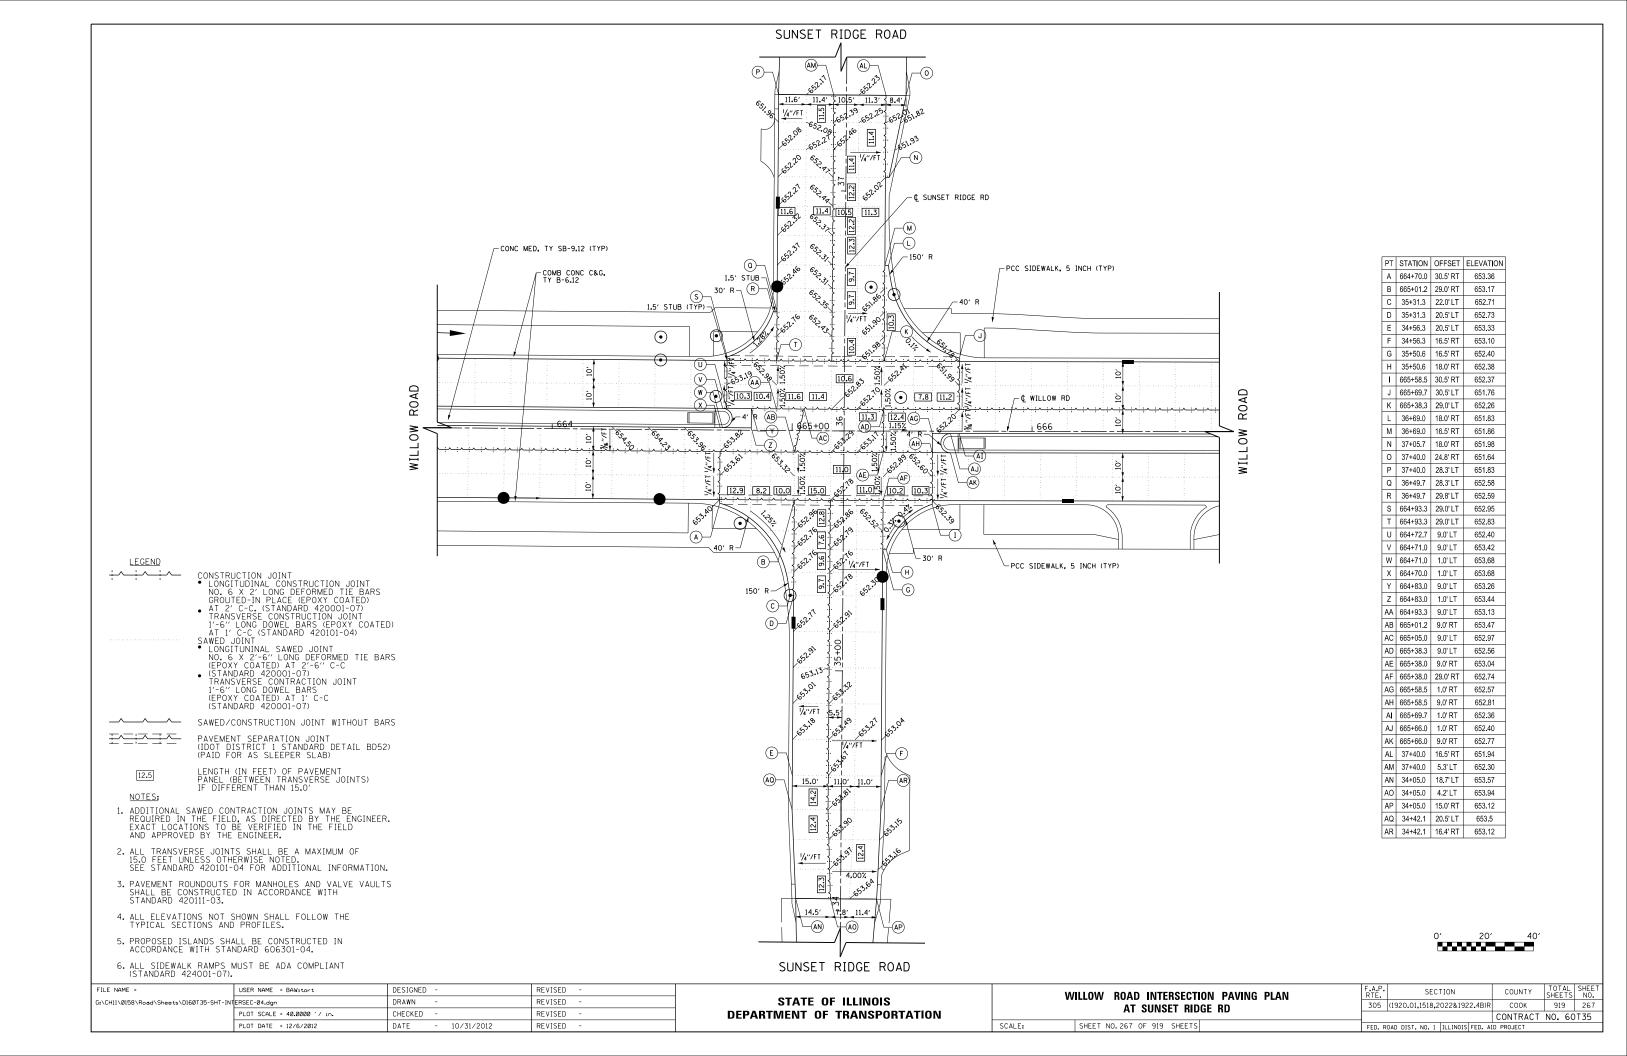

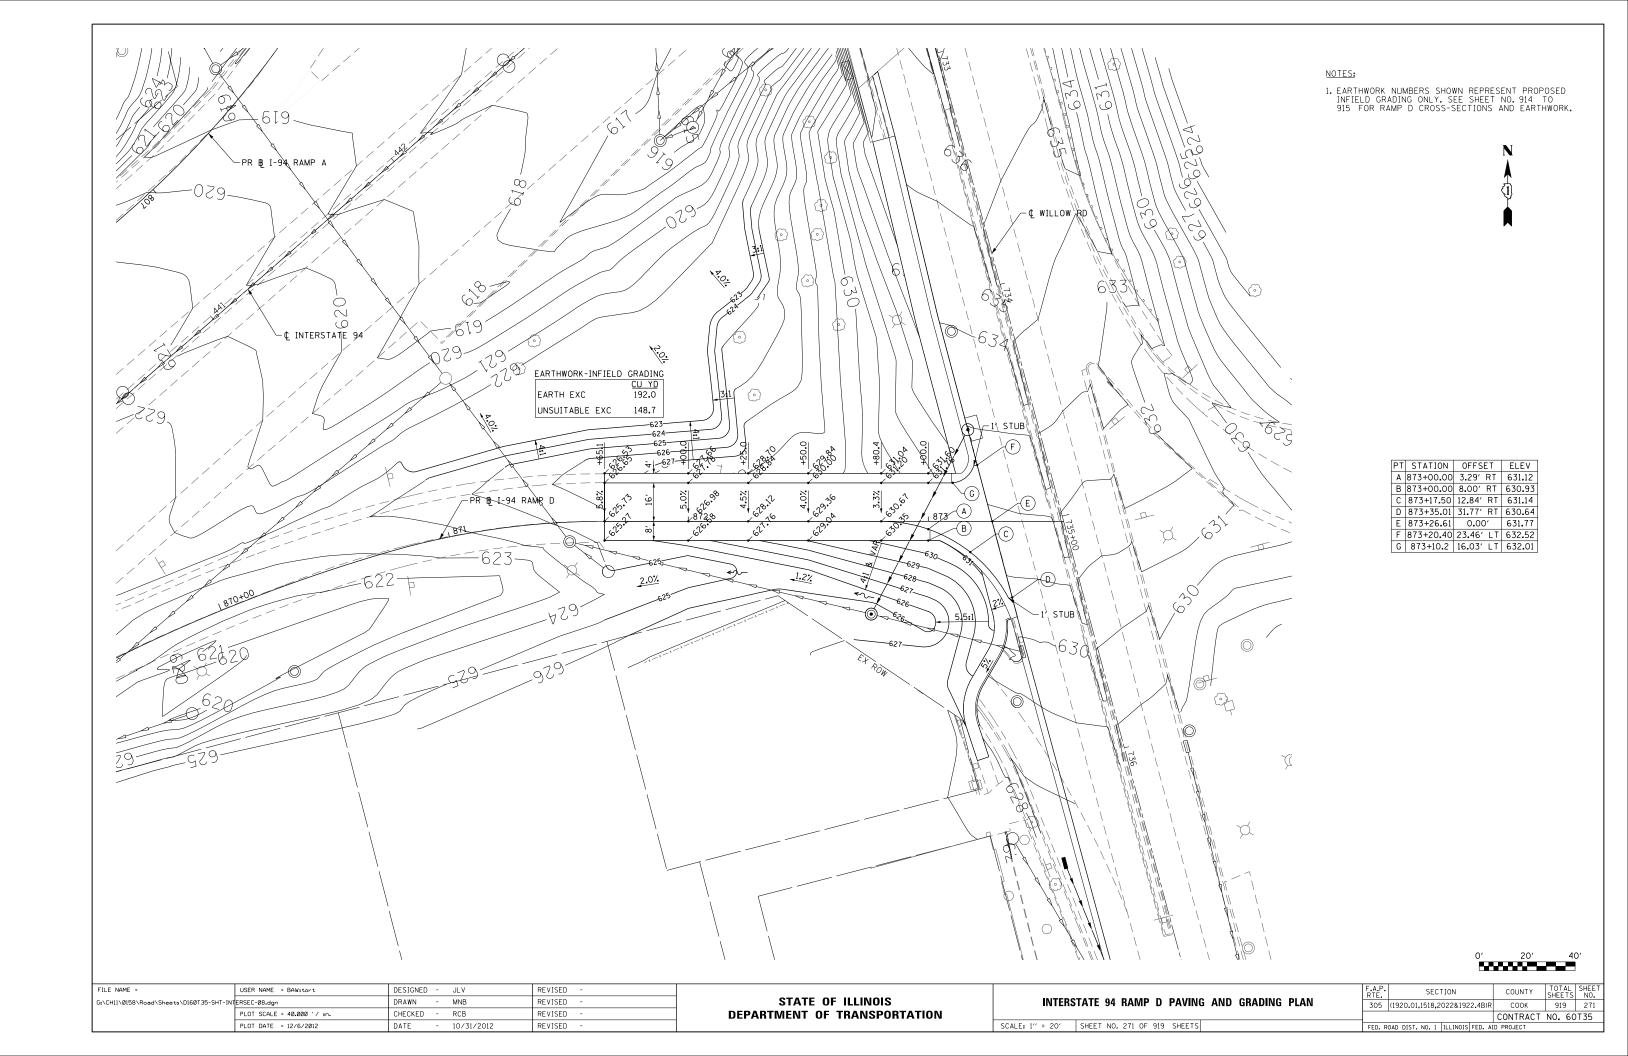


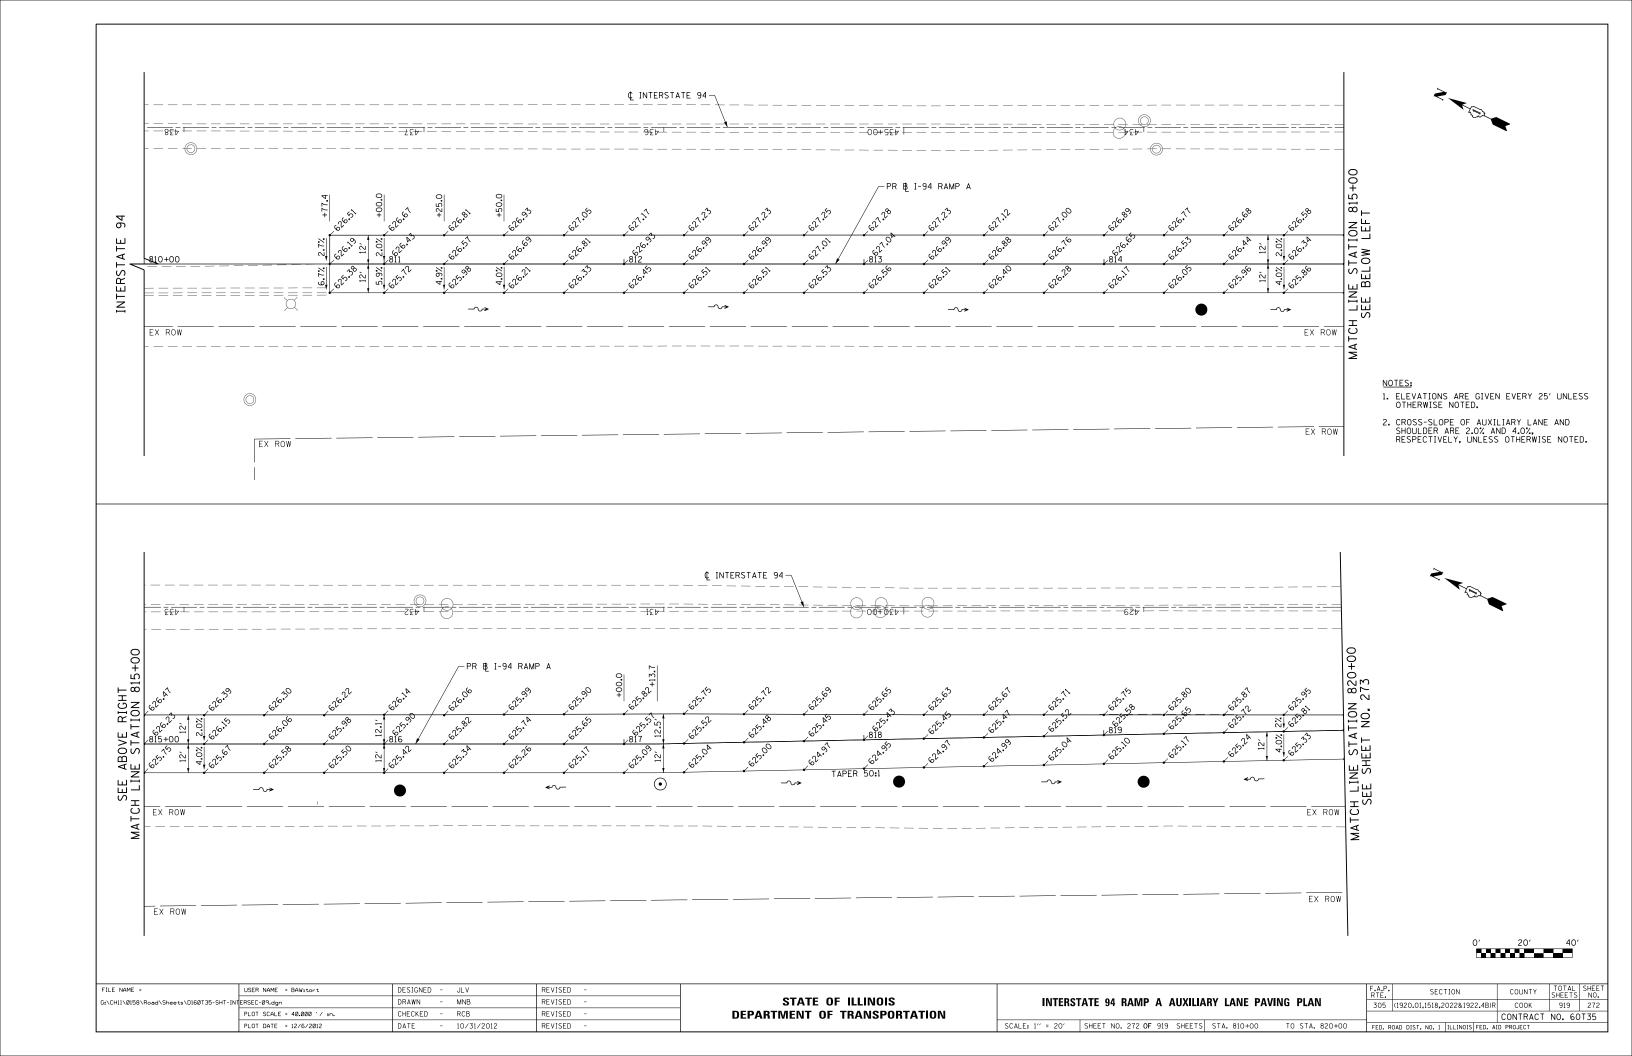


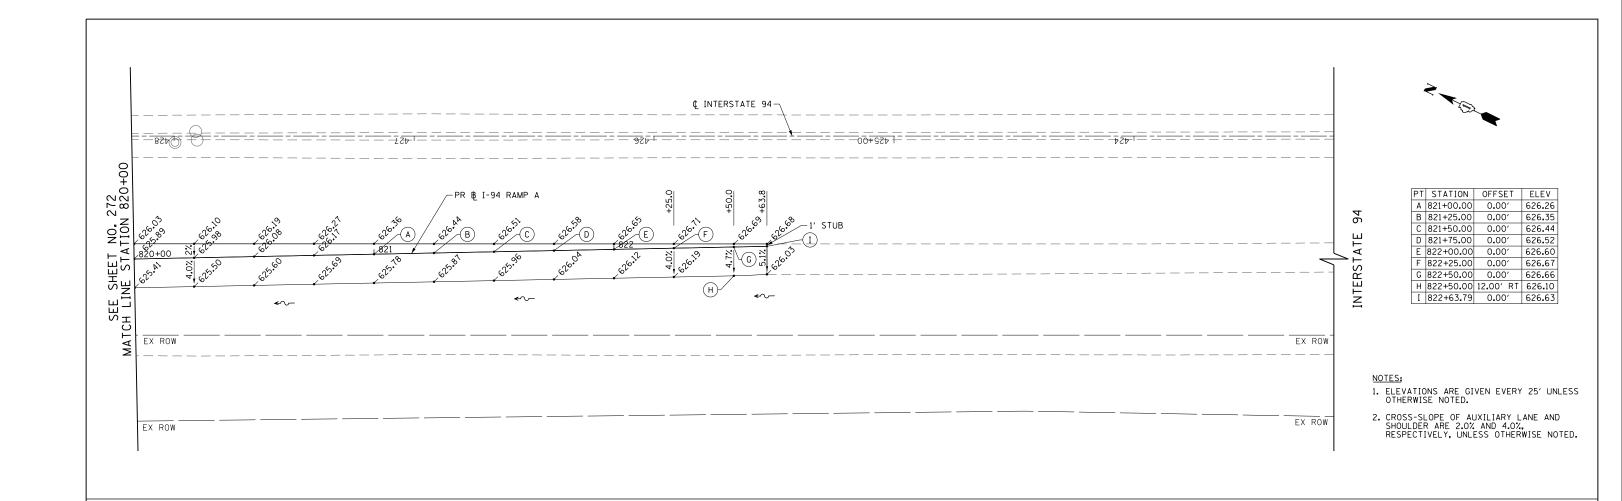

0′	20′	40′


FILE NAME =	USER NAME = BAWitort	DESIGNED - JLV	REVISED -			F.A.P.	SECTION	COUNTY	TOTAL SHEET
G:\CHII\0158\Road\Sheets\D160T35-SHT-IN1	ERSEC-10.dgn	DRAWN - MNB	REVISED -	STATE OF ILLINOIS	INTERSTATE 94 RAMP A AUXILIARY LANE PAVING PLAN	305	(1920.01,1518,2022&1922.4B)R	СООК	919 273
	PLOT SCALE = 40.000 '/ in.	CHECKED - RCB	REVISED -	DEPARTMENT OF TRANSPORTATION				CONTRACT	NO. 60T35
	PLOT DATE = 12/6/2012	DATE - 10/31/2012	REVISED -		SCALE: 1" = 20' SHEET NO. 273 OF 919 SHEETS STA. 820+00 TO STA. 822+64	FED. RO	OAD DIST. NO. 1 ILLINOIS FED. AID	PROJECT	

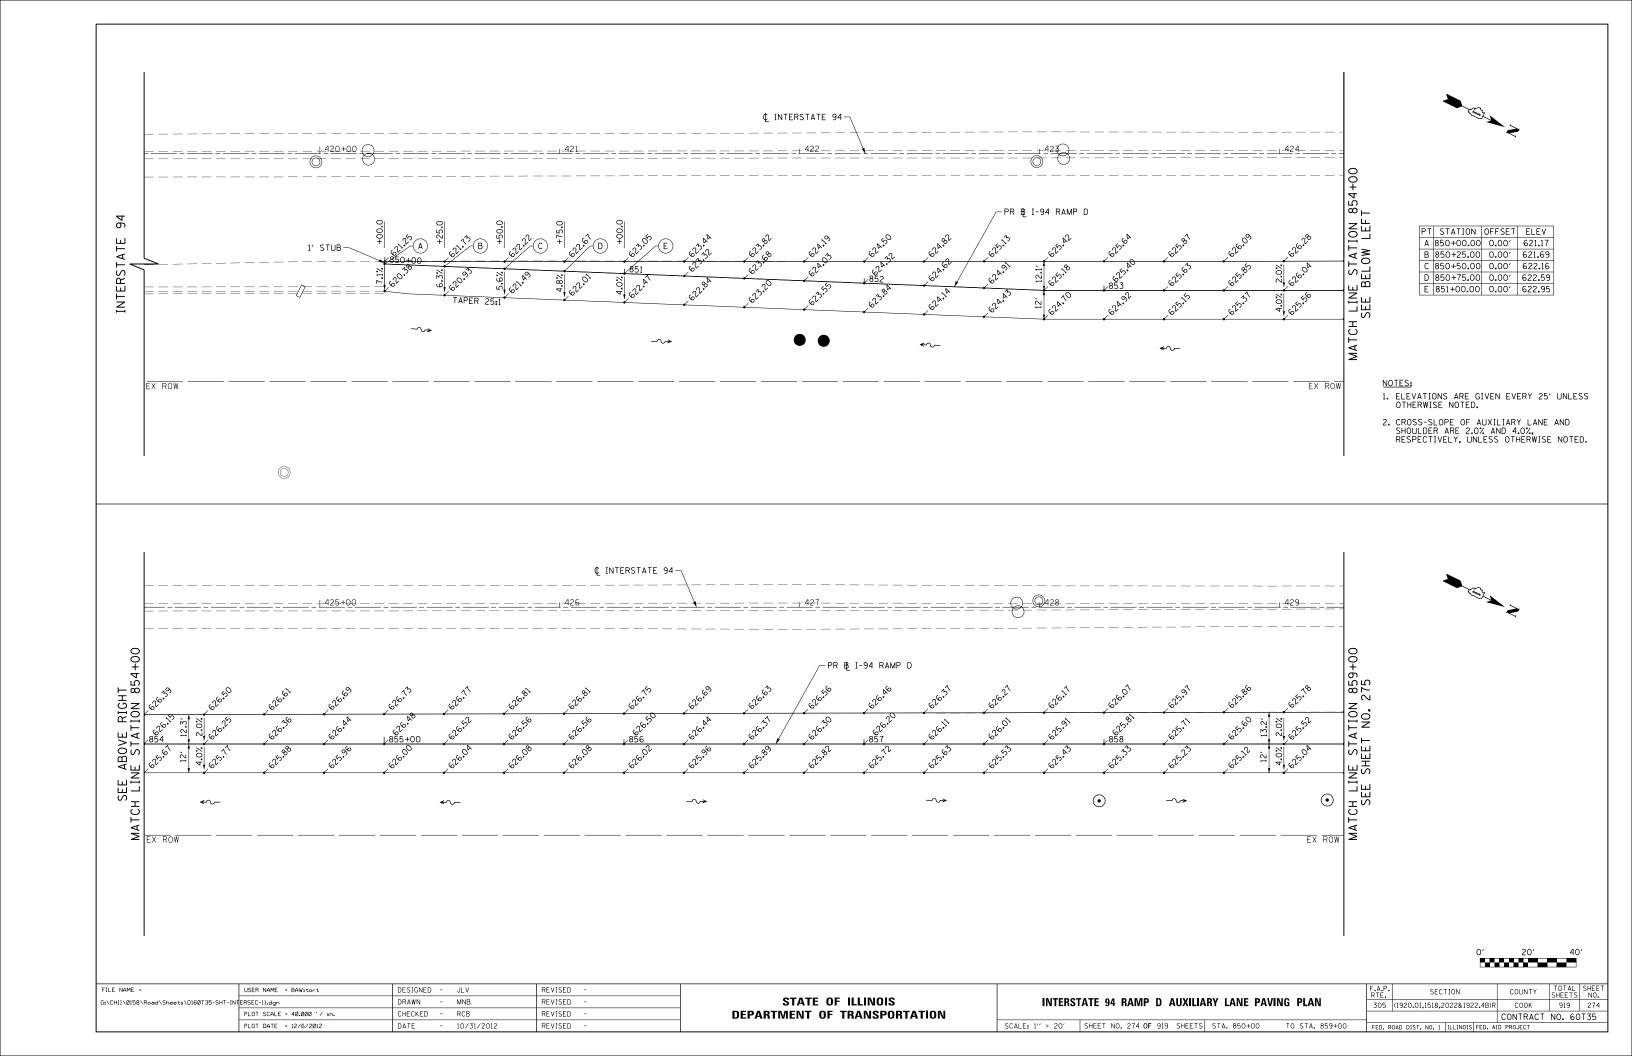


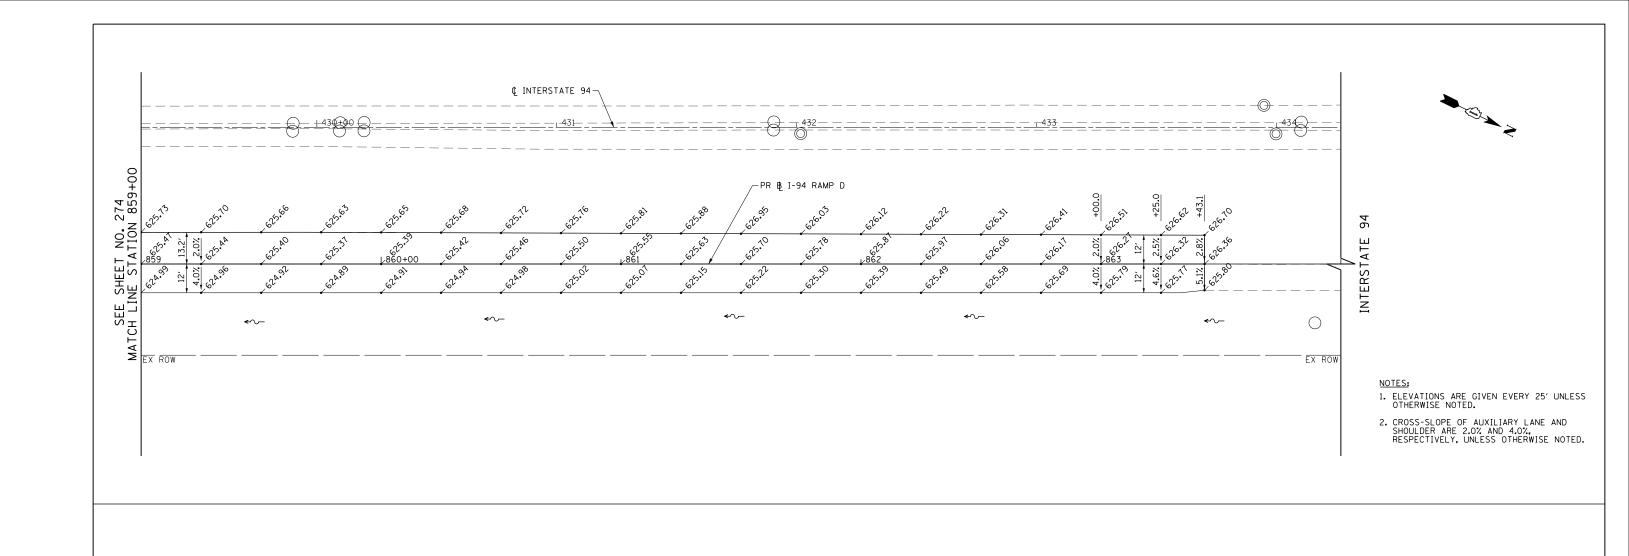



0′	20′	40'


FILE NAME =	USER NAME = BAWitort	DESIGNED	JLV	REVISED -			F.A.P.	SECTION	COUNTY	TOTAL	SHEET NO.
G:\CHII\0158\Road\Sheets\D160T35-SHT-IN	TERSEC-12-dgn	DRAWN - N	MNB	REVISED -	STATE OF ILLINOIS	INTERSTATE 94 RAMP D AUXILIARY LANE PAVING PLAN	305	(1920.01,1518,2022&1922.4B)R	COOK	919	275
	PLOT SCALE = 40.000 '/ in.	CHECKED - F	RCB	REVISED -	DEPARTMENT OF TRANSPORTATION				CONTRACT	T NO. 60	T35
	PLOT DATE = 12/6/2012	DATE - 1	10/31/2012	REVISED -		SCALE: 1" = 20' SHEET NO. 275 OF 919 SHEETS STA. 859+00 TO STA. 864+00	FED.	ROAD DIST. NO. 1 ILLINOIS FED. AID	PROJECT		

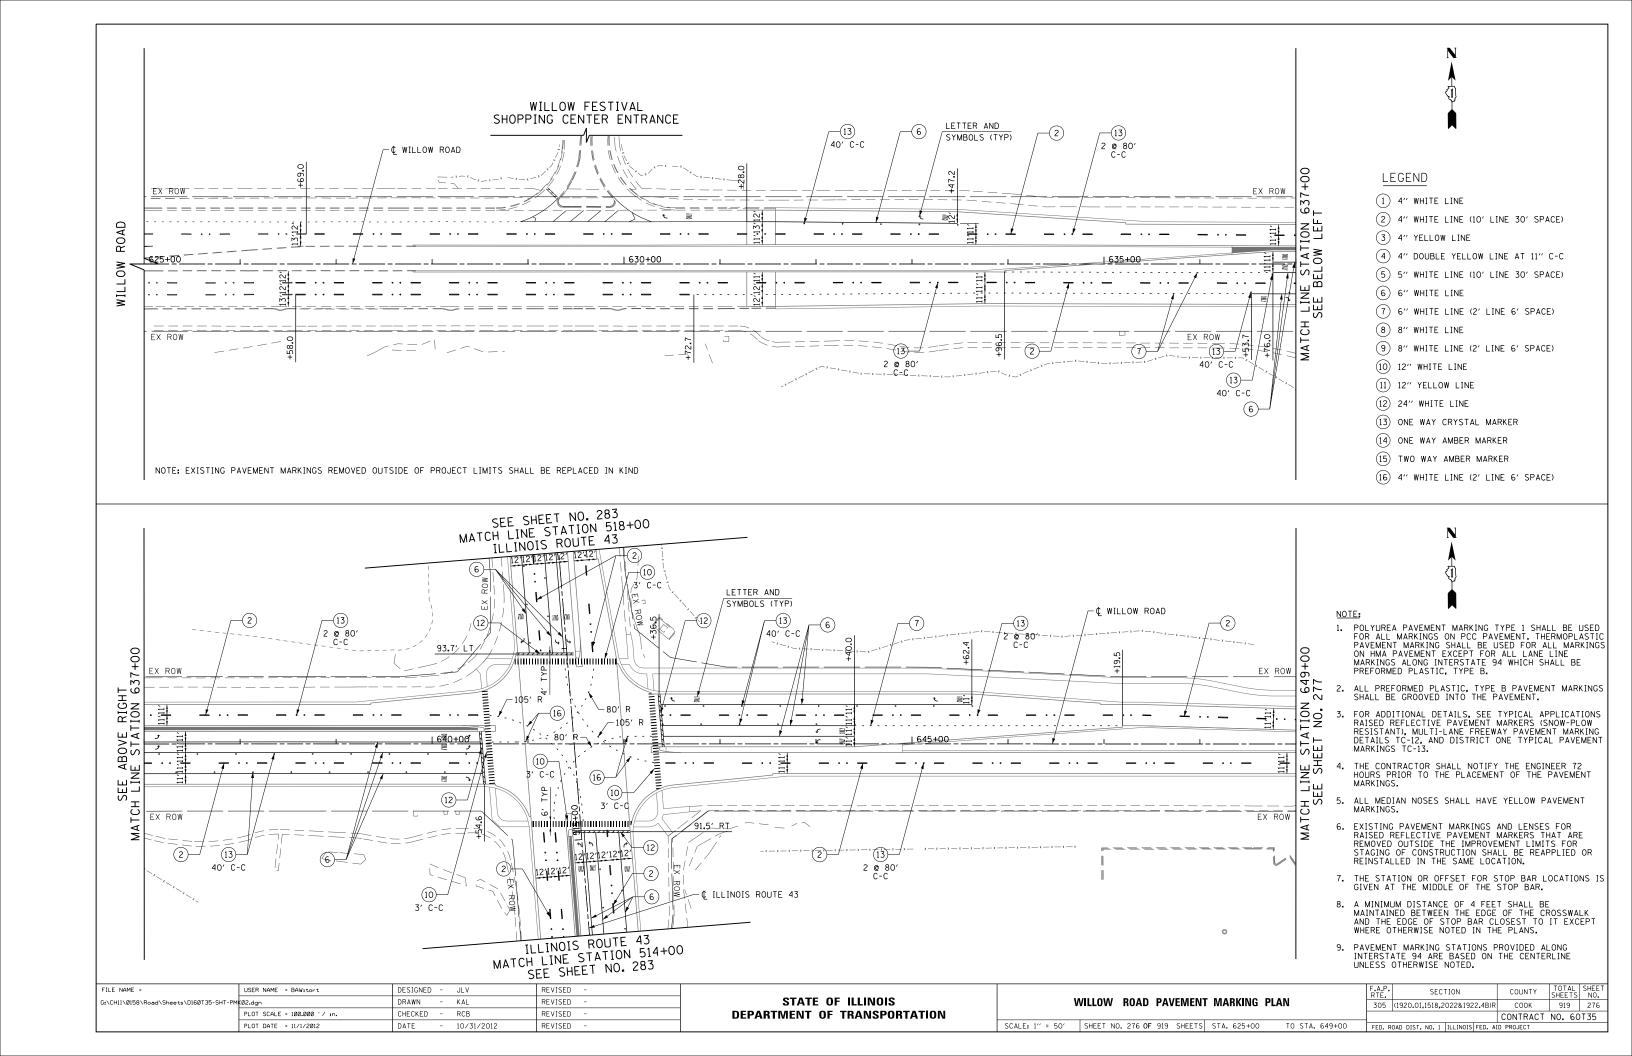


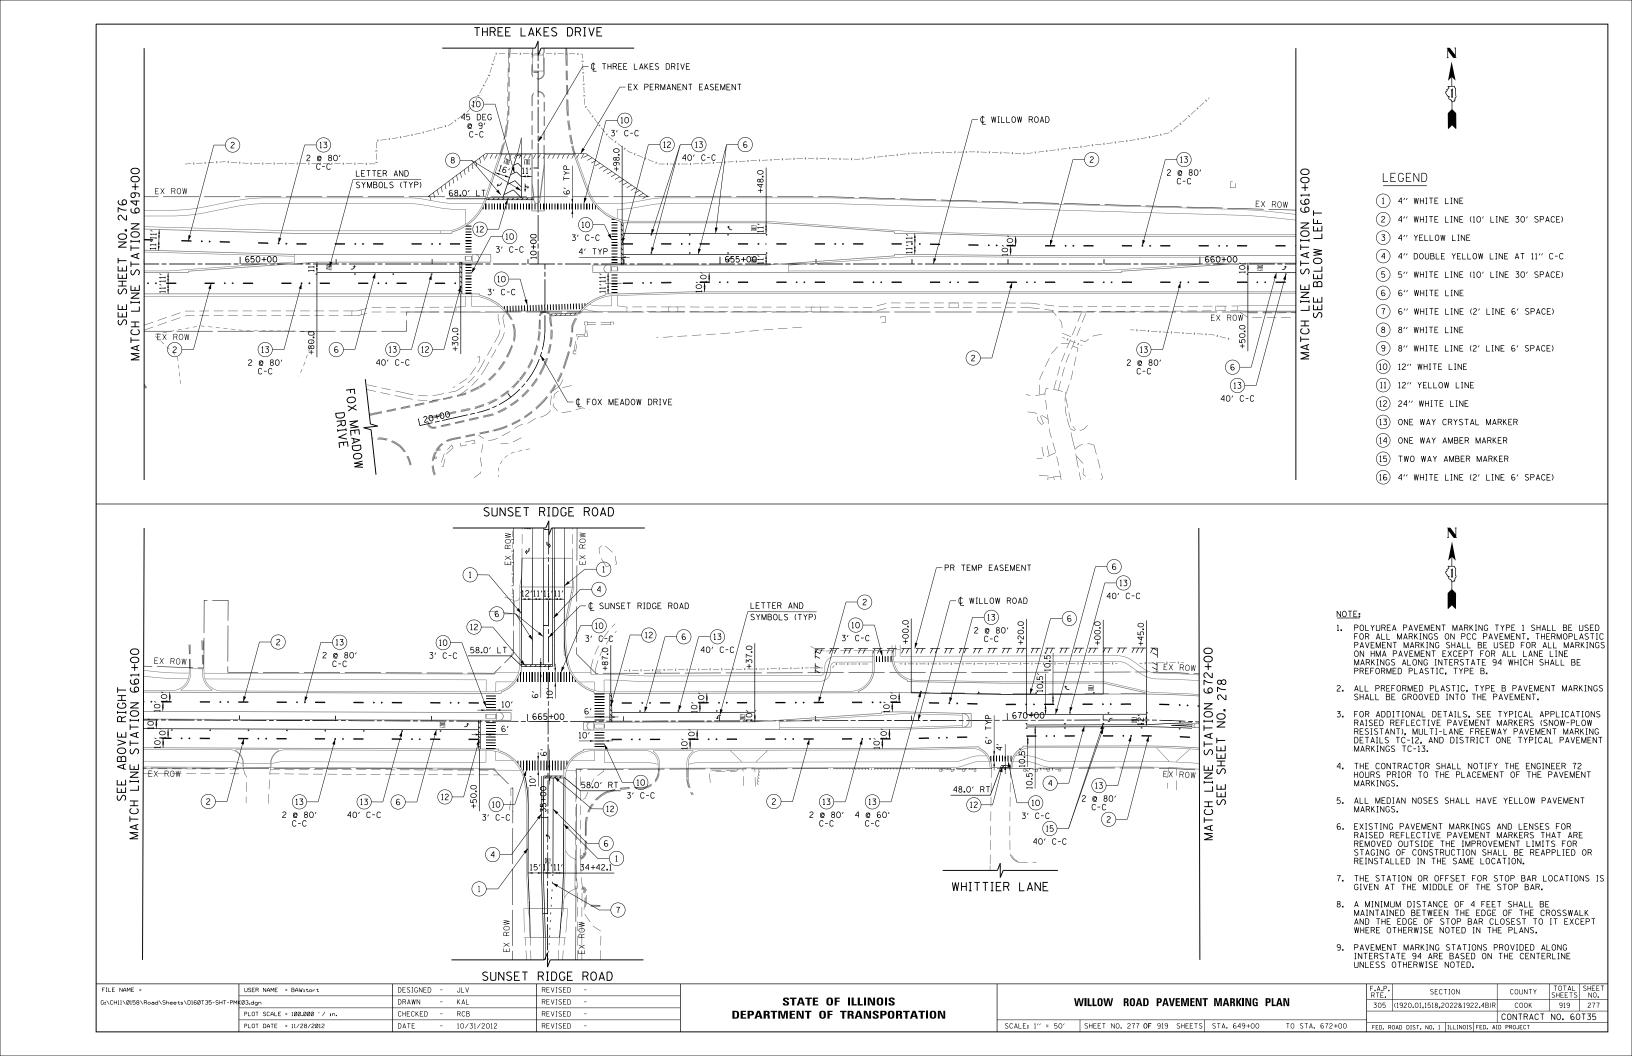

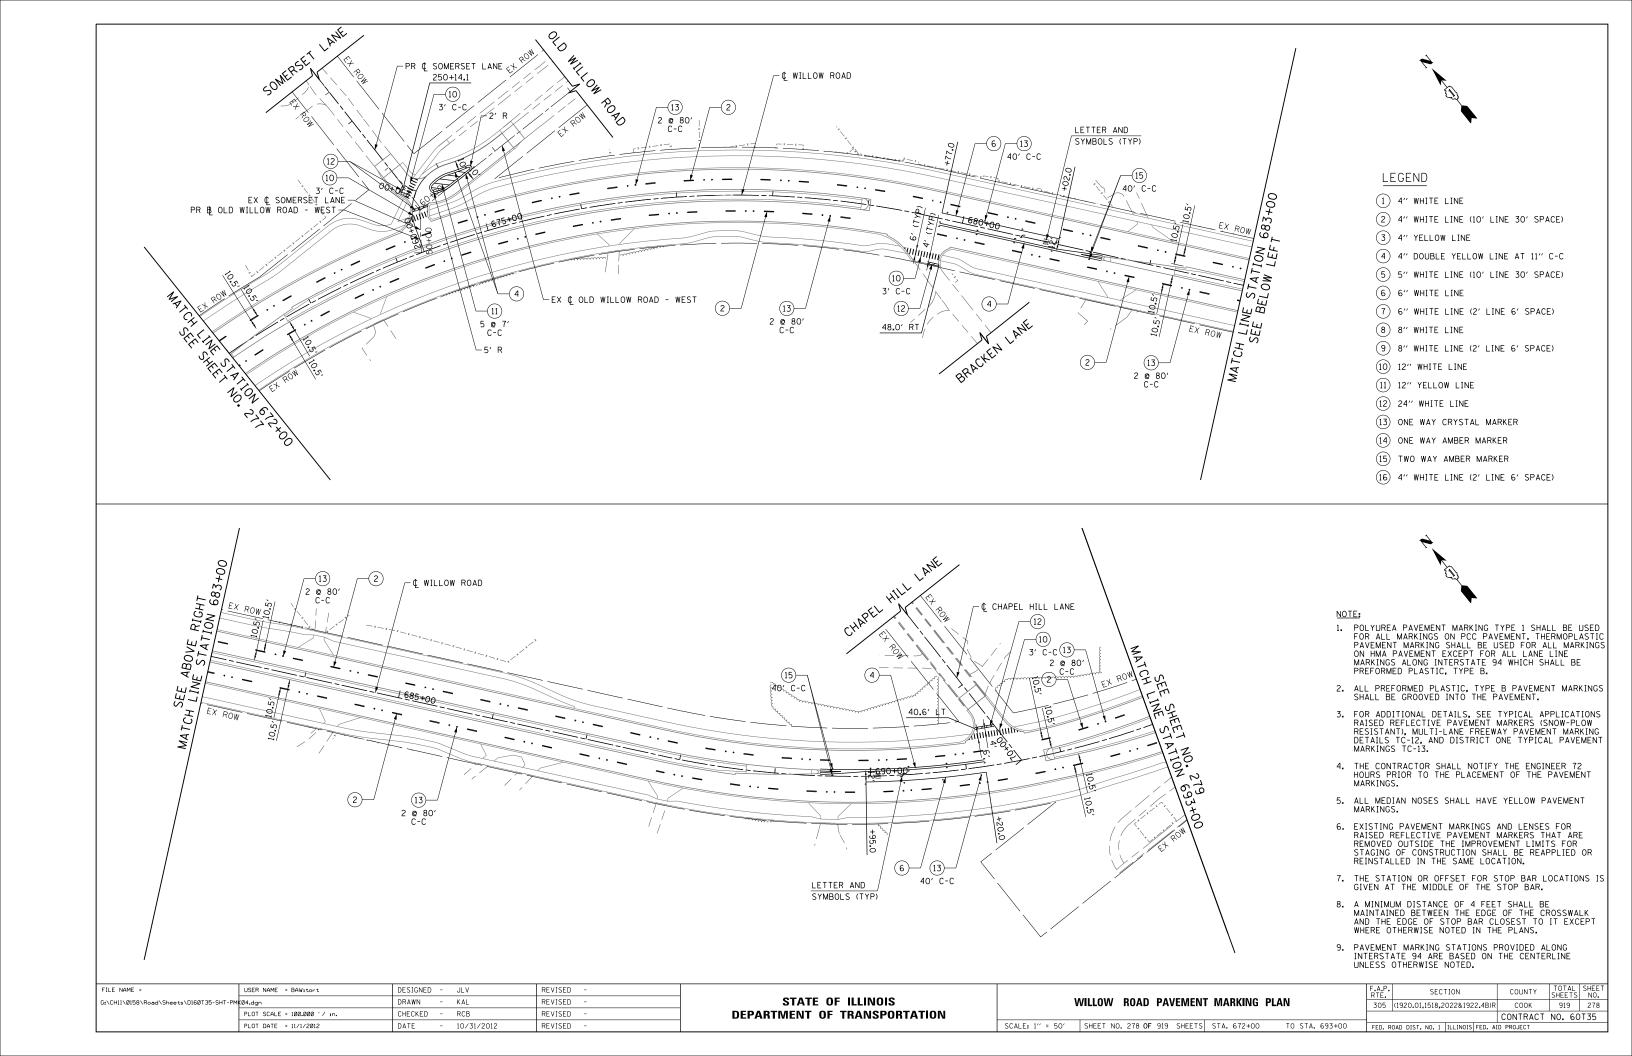

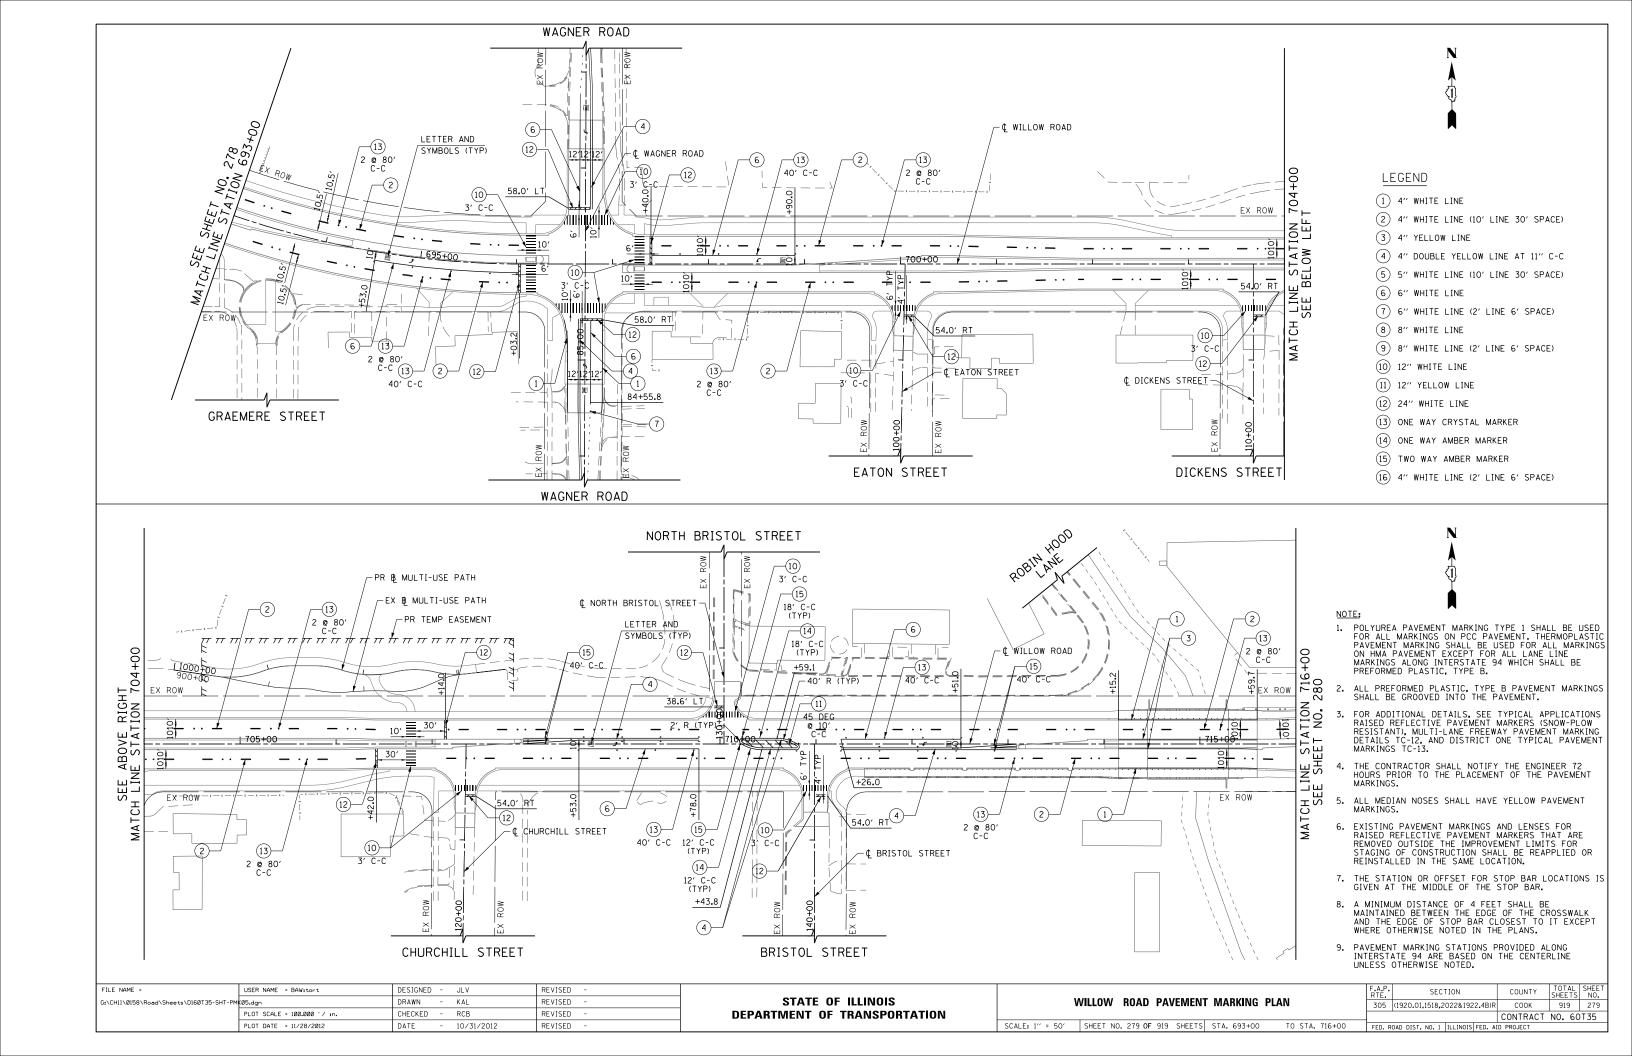

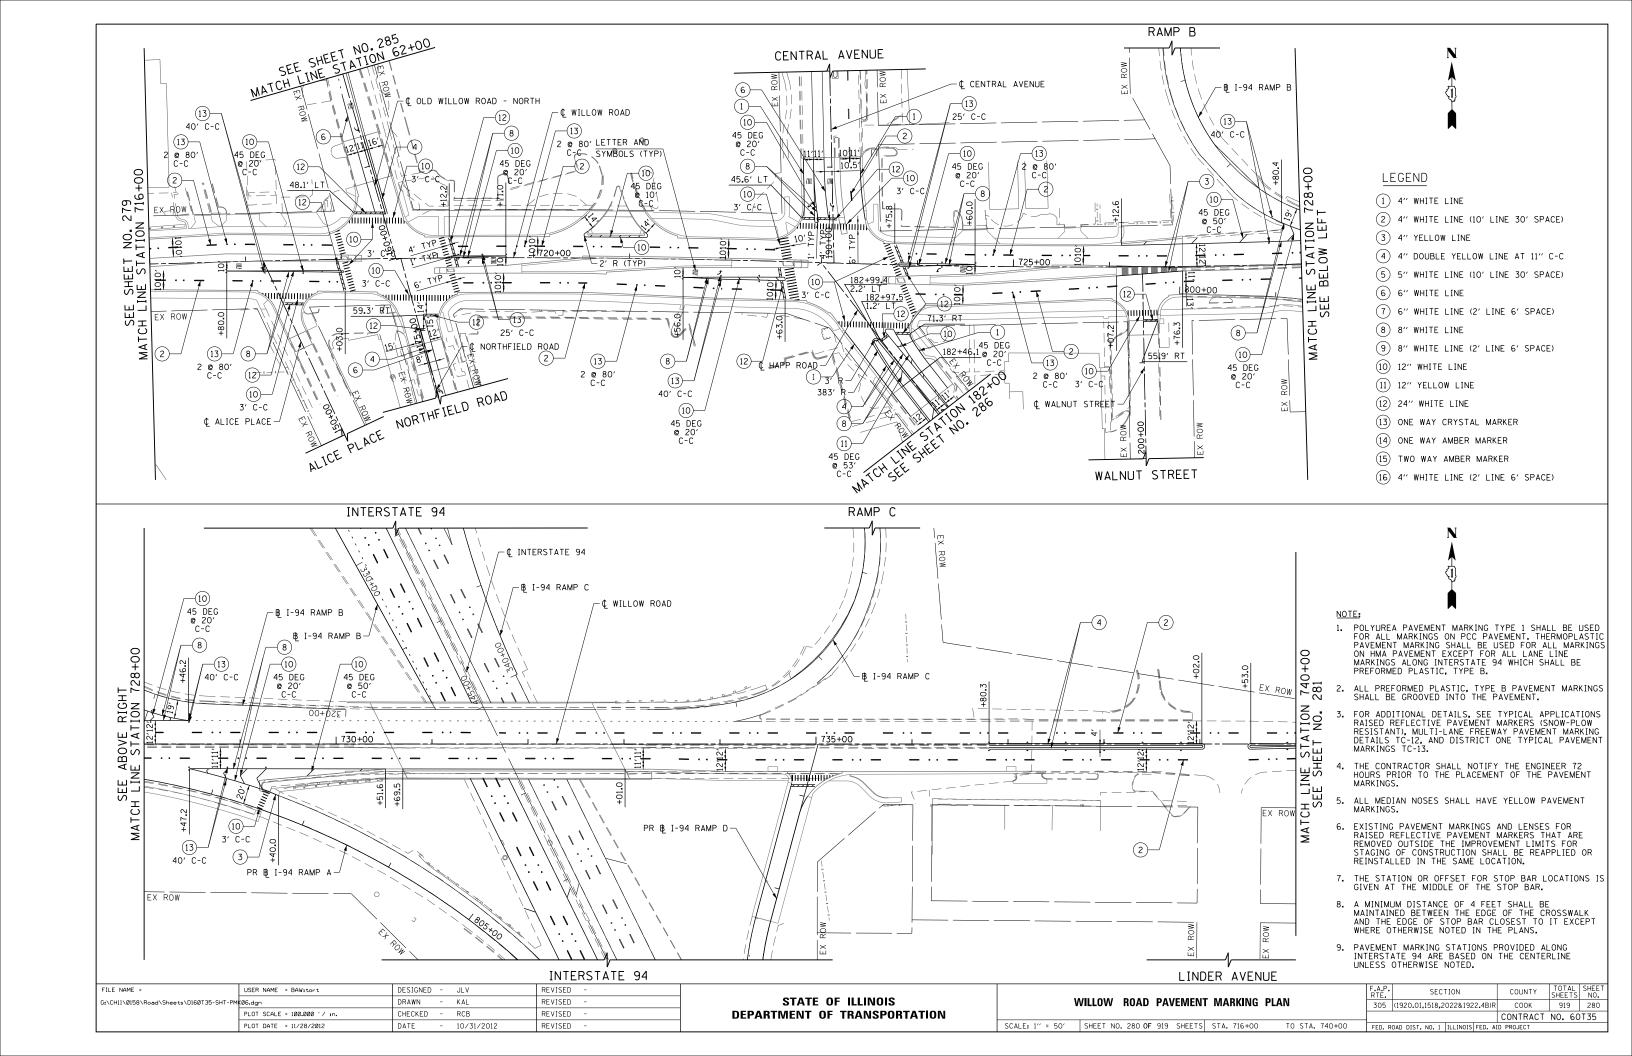

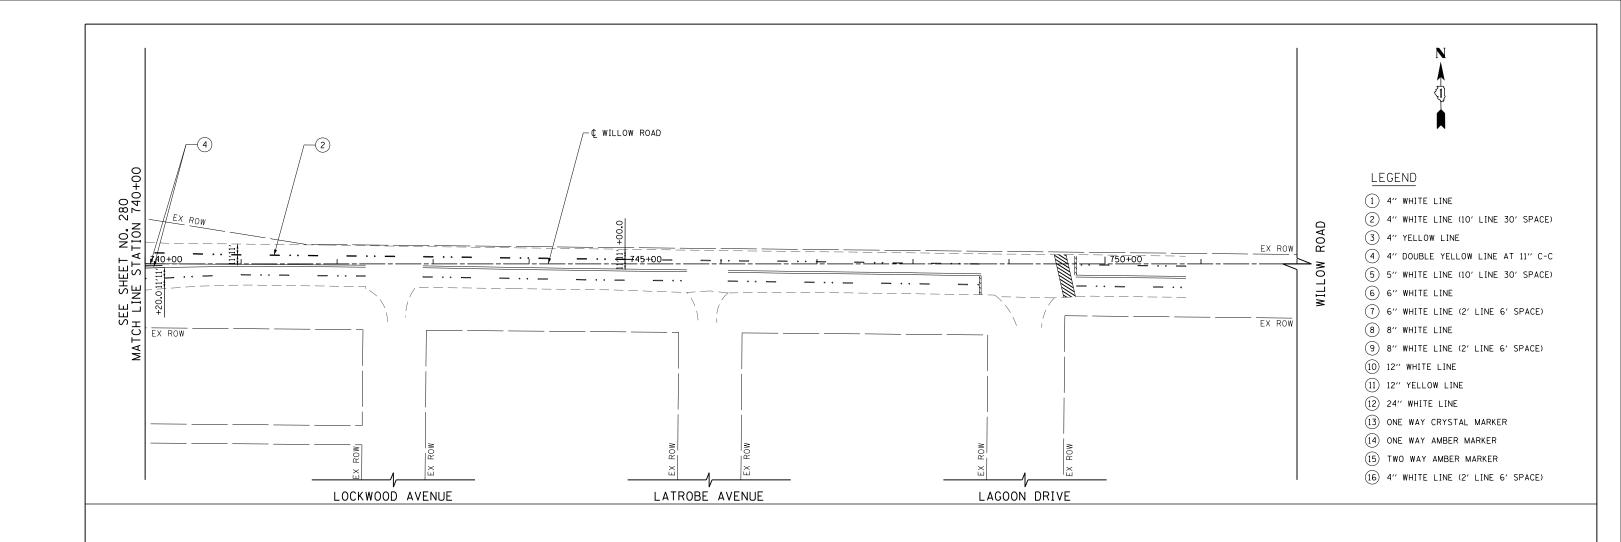


NOT

- 1. POLYUREA PAVEMENT MARKING TYPE 1 SHALL BE USED FOR ALL MARKINGS ON PCC PAVEMENT. THERMOPLASTIC PAVEMENT MARKING SHALL BE USED FOR ALL MARKINGS ON HMA PAVEMENT EXCEPT FOR ALL LANE LINE MARKINGS ALONG INTERSTATE 94 WHICH SHALL BE PREFORMED PLASTIC, TYPE B.
- 2. ALL PREFORMED PLASTIC, TYPE B PAVEMENT MARKINGS SHALL BE GROOVED INTO THE PAVEMENT.
- 3. FOR ADDITIONAL DETAILS, SEE TYPICAL APPLICATIONS RAISED REFLECTIVE PAVEMENT MARKERS (SNOW-PLOW RESISTANT), MULTI-LANE FREEWAY PAVEMENT MARKING DETAILS TC-12, AND DISTRICT ONE TYPICAL PAVEMENT MARKINGS TC-13.
- 4. THE CONTRACTOR SHALL NOTIFY THE ENGINEER 72 HOURS PRIOR TO THE PLACEMENT OF THE PAVEMENT MARKINGS.
- 5. ALL MEDIAN NOSES SHALL HAVE YELLOW PAVEMENT MARKINGS.
- 6. EXISTING PAVEMENT MARKINGS AND LENSES FOR RAISED REFLECTIVE PAVEMENT MARKERS THAT ARE REMOVED OUTSIDE THE IMPROVEMENT LIMITS FOR STAGING OF CONSTRUCTION SHALL BE REAPPLIED OR REINSTALLED IN THE SAME LOCATION.
- 7. THE STATION OR OFFSET FOR STOP BAR LOCATIONS IS GIVEN AT THE MIDDLE OF THE STOP BAR.
- 8. A MINIMUM DISTANCE OF 4 FEET SHALL BE MAINTAINED BETWEEN THE EDGE OF THE CROSSWALK AND THE EDGE OF STOP BAR CLOSEST TO IT EXCEPT WHERE OTHERWISE NOTED IN THE PLANS.
- 9. PAVEMENT MARKING STATIONS PROVIDED ALONG INTERSTATE 94 ARE BASED ON THE CENTERLINE UNLESS OTHERWISE NOTED.

FILE NAME =	USER NAME = BAWitort	DESIGNED - JLV	REVISED -			F.A.P. SECTION	COUNTY	TOTAL	SHEET
G:\CH11\Ø158\Road\Sheets\D160T35-SHT-F	PMK07.dgn	DRAWN - KAL	REVISED -	STATE OF ILLINOIS	WILLOW ROAD PAVEMENT MARKING PLAN	305 (1920,01,1518,2022&1922,4B)	г соок	919	281
	PLOT SCALE = 100.000 '/ in.	CHECKED - RCB	REVISED -	DEPARTMENT OF TRANSPORTATION			CONTRACT		OT35
	PLOT DATE = 11/1/2012	DATE - 10/31/2012	REVISED -		SCALE: 1" = 50' SHEET NO. 281 OF 919 SHEETS STA. 740+00 TO STA. 752+00	FED. ROAD DIST. NO. 1 ILLINOIS FED.	AID PROJECT		

LEGEND

- 1) 4" WHITE LINE
- 2 4" WHITE LINE (10' LINE 30' SPACE)
- (3) 4" YELLOW LINE
- 4) 4" DOUBLE YELLOW LINE AT 11" C-C
- 5 5" WHITE LINE (10' LINE 30' SPACE)
- 6 6" WHITE LINE
- 7 6" WHITE LINE (2' LINE 6' SPACE)
- 8 8" WHITE LINE
- 9 8" WHITE LINE (2' LINE 6' SPACE)
- (10) 12" WHITE LINE
- 11) 12" YELLOW LINE
- (12) 24" WHITE LINE
- (13) ONE WAY CRYSTAL MARKER
- (14) ONE WAY AMBER MARKER
- (15) TWO WAY AMBER MARKER
- (16) 4" WHITE LINE (2' LINE 6' SPACE)

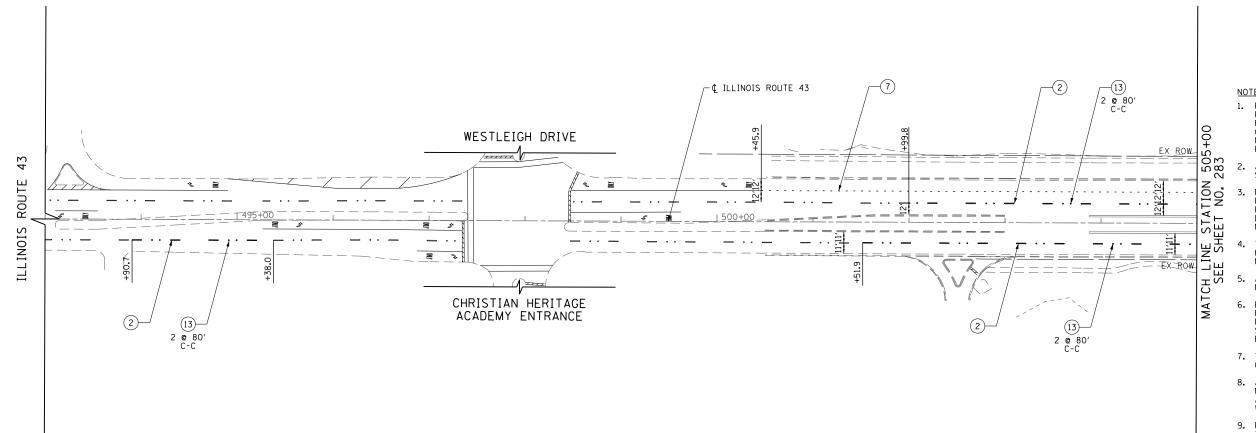





- 1. POLYUREA PAVEMENT MARKING TYPE 1 SHALL BE USED FOR ALL MARKINGS ON PCC PAVEMENT. THERMOPLASTIC PAVEMENT MARKING SHALL BE USED FOR ALL MARKINGS ON HMA PAVEMENT EXCEPT FOR ALL LANE LINE MARKINGS ALONG INTERSTATE 94 WHICH SHALL BE PREFORMED PLASTIC, TYPE B.
- 2. ALL PREFORMED PLASTIC, TYPE B PAVEMENT MARKINGS SHALL BE GROOVED INTO THE PAVEMENT.
 - FOR ADDITIONAL DETAILS, SEE TYPICAL APPLICATIONS RAISED REFLECTIVE PAVEMENT MARKERS (SNOW-PLOW RESISTANT), MULTI-LANE FREEWAY PAVEMENT MARKING DETAILS TC-12, AND DISTRICT ONE TYPICAL PAVEMENT MARKINGS TC-13.
- 4. THE CONTRACTOR SHALL NOTIFY THE ENGINEER 72 HOURS PRIOR TO THE PLACEMENT OF THE PAVEMENT MARKINGS.
- 5. ALL MEDIAN NOSES SHALL HAVE YELLOW PAVEMENT MARKINGS.
- 6. EXISTING PAVEMENT MARKINGS AND LENSES FOR RAISED REFLECTIVE PAVEMENT MARKERS THAT ARE REMOVED OUTSIDE THE IMPROVEMENT LIMITS FOR STAGING OF CONSTRUCTION SHALL BE REAPPLIED OR REINSTALLED IN THE SAME LOCATION.
- 7. THE STATION OR OFFSET FOR STOP BAR LOCATIONS IS GIVEN AT THE MIDDLE OF THE STOP BAR.
- 8. A MINIMUM DISTANCE OF 4 FEET SHALL BE MAINTAINED BETWEEN THE EDGE OF THE CROSSWALK AND THE EDGE OF STOP BAR CLOSEST TO IT EXCEPT WHERE OTHERWISE NOTED IN THE PLANS.
- 9. PAVEMENT MARKING STATIONS PROVIDED ALONG INTERSTATE 94 ARE BASED ON THE CENTERLINE UNLESS OTHERWISE NOTED.

FILE NAME =	USER NAME = BAWitort	DESIGNED - JLV	REVISED -		1	
G:\CH11\0158\Road\Sheets\D160T35-SHT-PMI	k08.dgn	DRAWN - KAL	REVISED -	STATE OF ILLINOIS	j ILf	LINOIS ROUTE
	PLOT SCALE = 100.000 '/ in.	CHECKED - RCB	REVISED -	DEPARTMENT OF TRANSPORTATION	1	
	PLOT DATE = 11/1/2012	DATE - 10/31/2012	REVISED -		SCALE: 1" = 50'	SHEET NO. 282

												F.A.P. RTE.	SECTION		COUNTY	TOTAL SHEETS	SHEET NO.
ILLINOIS ROUTE 43 PAVEMENT MARKING PLAN				305	(1920.01,1518,2022&1922.	4B)R	соок	919	282								
															CONTRACT	NO. 60	T35
)'	SHEET	NO.	282	OF	919	SHEETS	STA.	493+00	TO	STA.	505+00	FED. R	ROAD DIST. NO. 1 ILLINOIS F	ED. A	ID PROJECT		

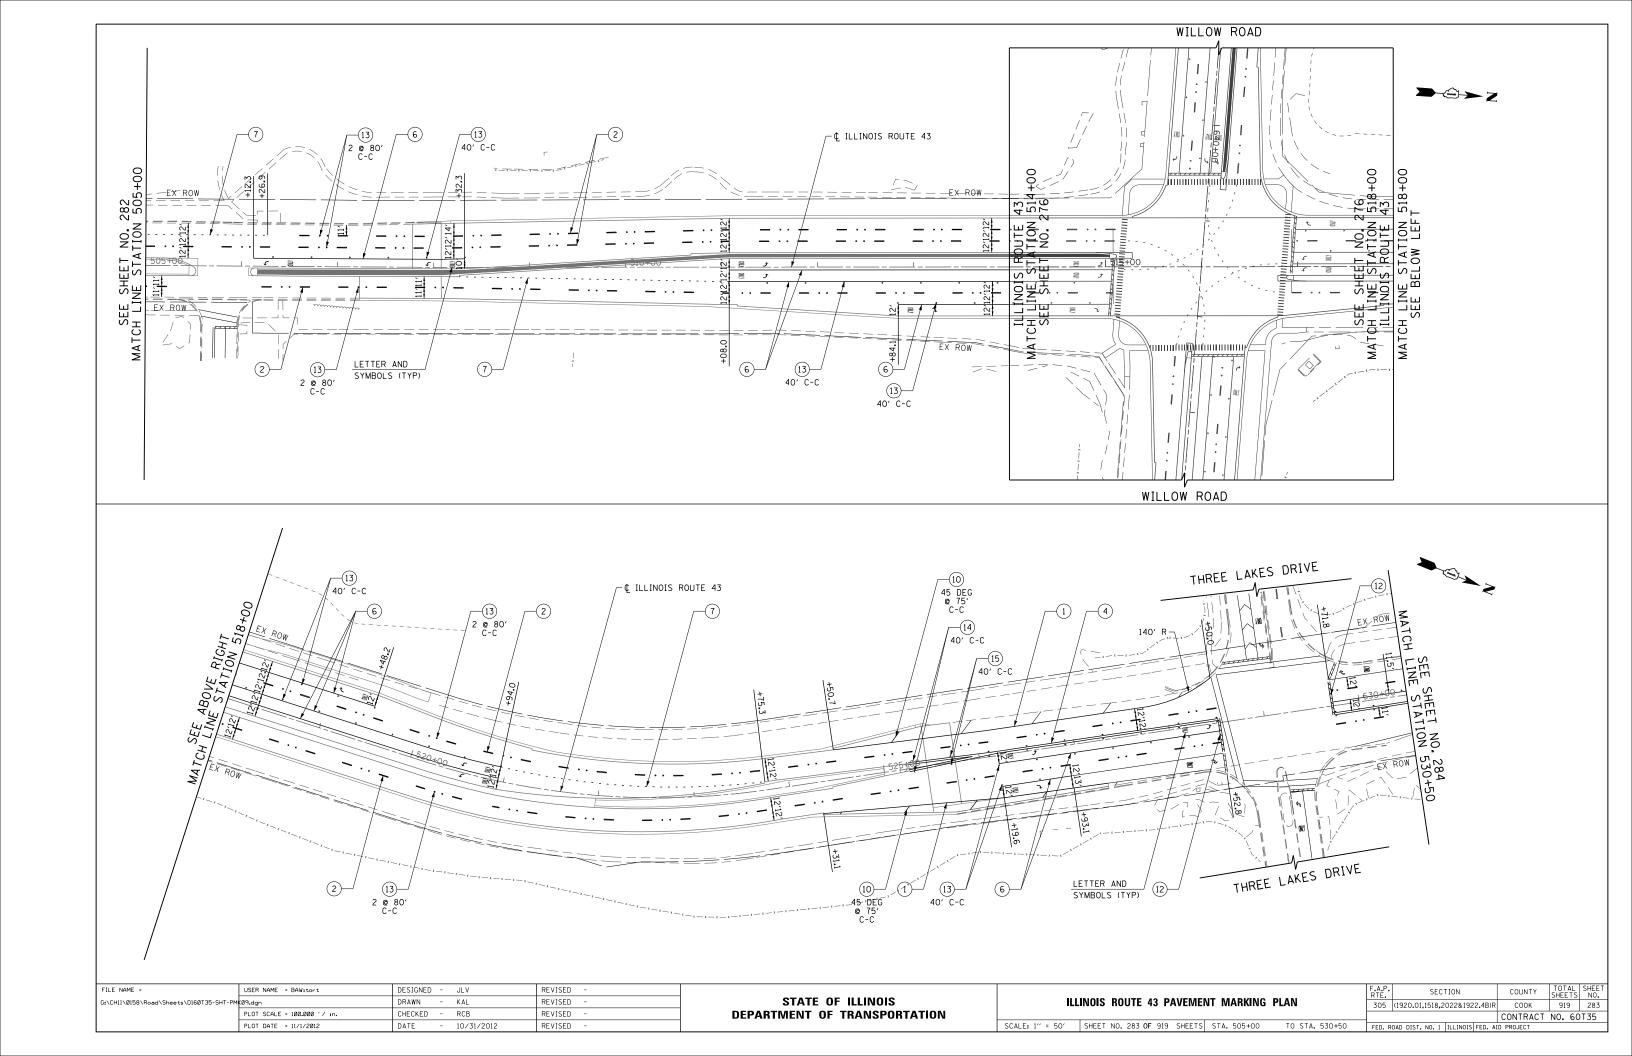

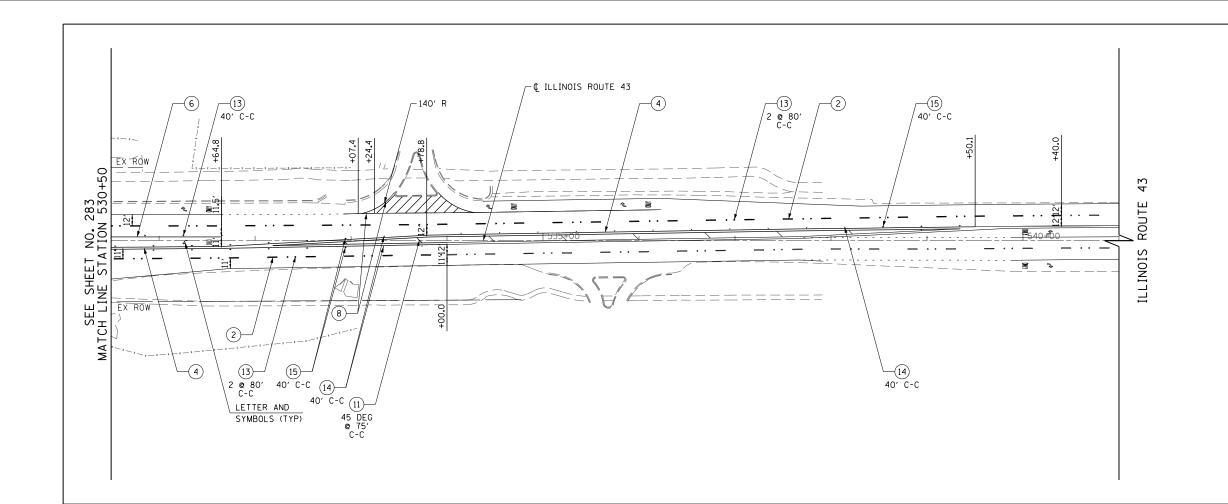




LEGEND

- 1) 4" WHITE LINE
- 2 4" WHITE LINE (10' LINE 30' SPACE)
- (3) 4" YELLOW LINE
- 4) 4" DOUBLE YELLOW LINE AT 11" C-C
- 5) 5" WHITE LINE (10' LINE 30' SPACE)
- 6 6" WHITE LINE
- 7) 6" WHITE LINE (2' LINE 6' SPACE)
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- 9) 8" WHITE LINE (2' LINE 6' SPACE)
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- 1. POLYUREA PAVEMENT MARKING TYPE 1 SHALL BE USED FOR ALL MARKINGS ON PCC PAVEMENT. THERMOPLASTIC PAVEMENT MARKING SHALL BE USED FOR ALL MARKINGS ON HMA PAVEMENT EXCEPT FOR ALL LANE LINE MARKINGS ALONG INTERSTATE 94 WHICH SHALL BE PREFORMED PLASTIC, TYPE B.
- 2. ALL PREFORMED PLASTIC, TYPE B PAVEMENT MARKINGS SHALL BE GROOVED INTO THE PAVEMENT.
- 3. FOR ADDITIONAL DETAILS, SEE TYPICAL APPLICATIONS RAISED REFLECTIVE PAVEMENT MARKERS (SNOW-PLOW RESISTANT), MULTI-LANE FREEWAY PAVEMENT MARKING DETAILS TC-12, AND DISTRICT ONE TYPICAL PAVEMENT MARKINGS TC-13.
- 4. THE CONTRACTOR SHALL NOTIFY THE ENGINEER 72 HOURS PRIOR TO THE PLACEMENT OF THE PAVEMENT MARKINGS.
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- 7. THE STATION OR OFFSET FOR STOP BAR LOCATIONS IS GIVEN AT THE MIDDLE OF THE STOP BAR.
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- 9. PAVEMENT MARKING STATIONS PROVIDED ALONG INTERSTATE 94 ARE BASED ON THE CENTERLINE UNLESS OTHERWISE NOTED.

FILE NAME =	USER NAME = BAWitort	DESIGNED - JLV	REVISED -			F.A.P. SECTION	COUNTY	TOTAL SHEET
G:\CH11\0158\Road\Sheets\D160T35-SHT-PMK	0.dgn	DRAWN - KAL	REVISED -	STATE OF ILLINOIS	ILLINOIS ROUTE 43 PAVEMENT MARKING PLAN	305 (1920.01.1518.2022&1922.4B)F	R COOK	919 284
	PLOT SCALE = 100.000 '/ in.	CHECKED - RCB	REVISED -	DEPARTMENT OF TRANSPORTATION			CONTRACT	NO. 60T35
	PLOT DATE = 11/1/2012	DATE - 10/31/2012	REVISED -		SCALE: 1" = 50' SHEET NO. 284 OF 919 SHEETS STA. 530+50 TO STA. 541+00	FED. ROAD DIST, NO. 1 ILLINOIS FED. /	AID PROJECT	

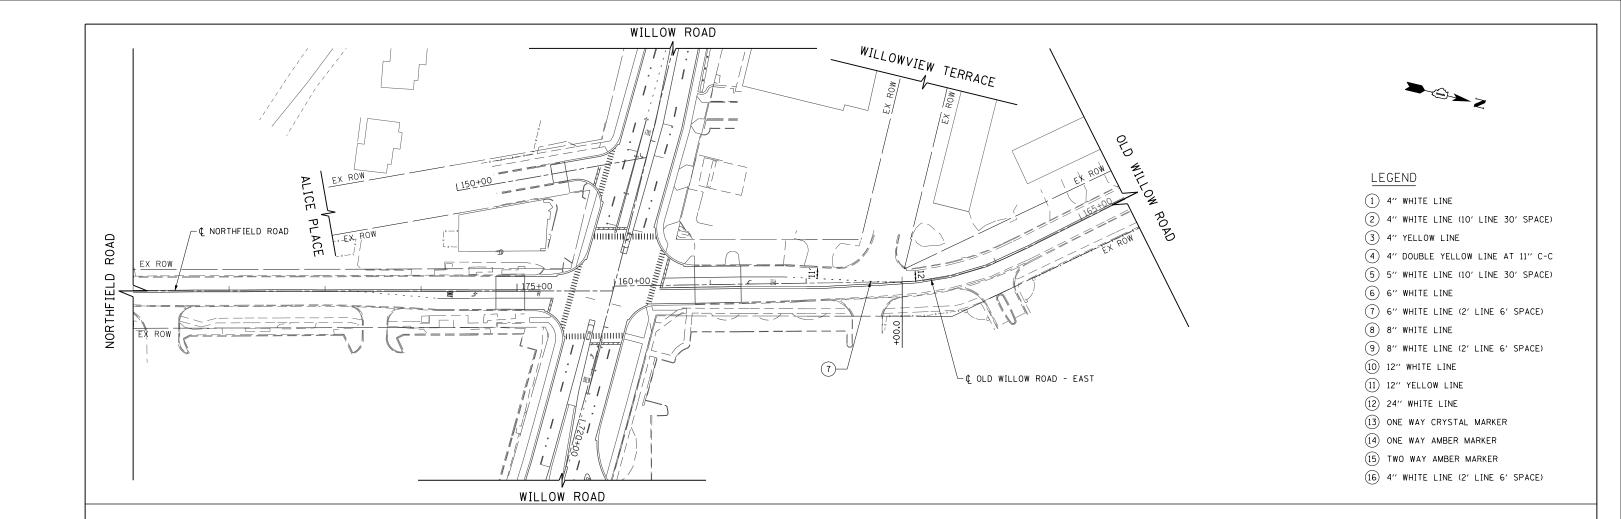

NOTE


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FILE NAME =	USER NAME = BAWitort	DESIGNED	-	JLV	REVISED	-
G:\CH11\0158\Road\Sheets\D160T35-SHT-PMI	(12A.dgn	DRAWN	-	KAL	REVISED	-
	PLOT SCALE = 100.000 '/ in.	CHECKED	-	RCB	REVISED	-
	PLOT DATE = 11/1/2012	DATE	-	10/31/2012	REVISED	-

STATE OF ILLINOIS
DEPARTMENT OF TRANSPORTATION


NORTHFIELD ROAD / OLD WILLOW ROAD PAVEMENT MARKING PLAN


SCALE: 1" = 50' SHEET NO. 285 OF 919 SHEETS STA. 165+50 TO STA. 171+00

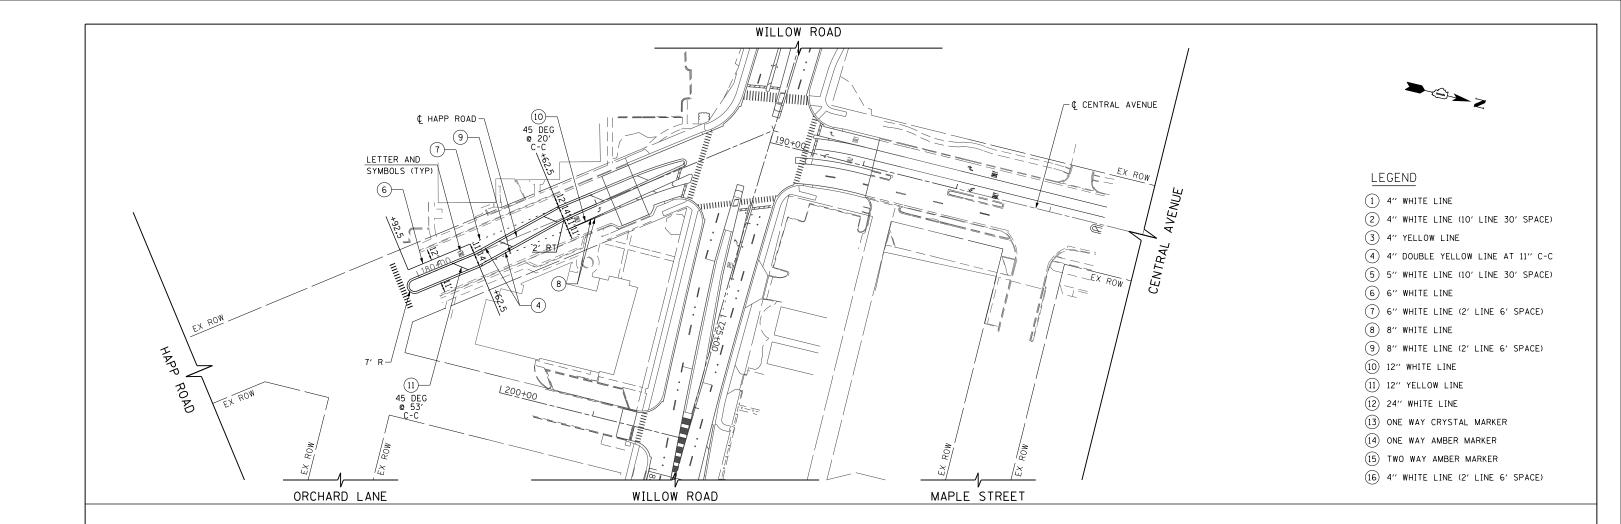

- 1. POLYUREA PAVEMENT MARKING TYPE 1 SHALL BE USED FOR ALL MARKINGS ON PCC PAVEMENT. THERMOPLASTIC PAVEMENT MARKING SHALL BE USED FOR ALL MARKINGS ON HMA PAVEMENT EXCEPT FOR ALL LANG LINE MARKINGS ALONG INTERSTATE 94 WHICH SHALL BE PREFORMED PLASTIC, TYPE B.
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FILE NAME =	USER NAME = BAWitort	DESIGNED - JLV	REVISED -			F.A.P. SECTION	COUNTY	TOTAL	L SHEE
G:\CH11\0158\Road\Sheets\D160T35-SHT-PM	(13.dgn	DRAWN - KAL	REVISED -	STATE OF ILLINOIS	HAPP ROAD / CENTRAL AVENUE PAVEMENT MARKING PLAN	305 (1920.01.1518.2022&1922.4B)F	я соок	919	286
	PLOT SCALE = 100.000 '/ in.	CHECKED - RCB	REVISED -	DEPARTMENT OF TRANSPORTATION			CONTRAC	T NO. 6	60T35
	PLOT DATE = 11/1/2012	DATE - 10/31/2012	REVISED -		SCALE: 1" = 50' SHEET NO. 286 OF 919 SHEETS STA. 180+00 TO STA. 194+00	FED. ROAD DIST. NO. 1 JULINOIS FED. /	AID PROJECT		



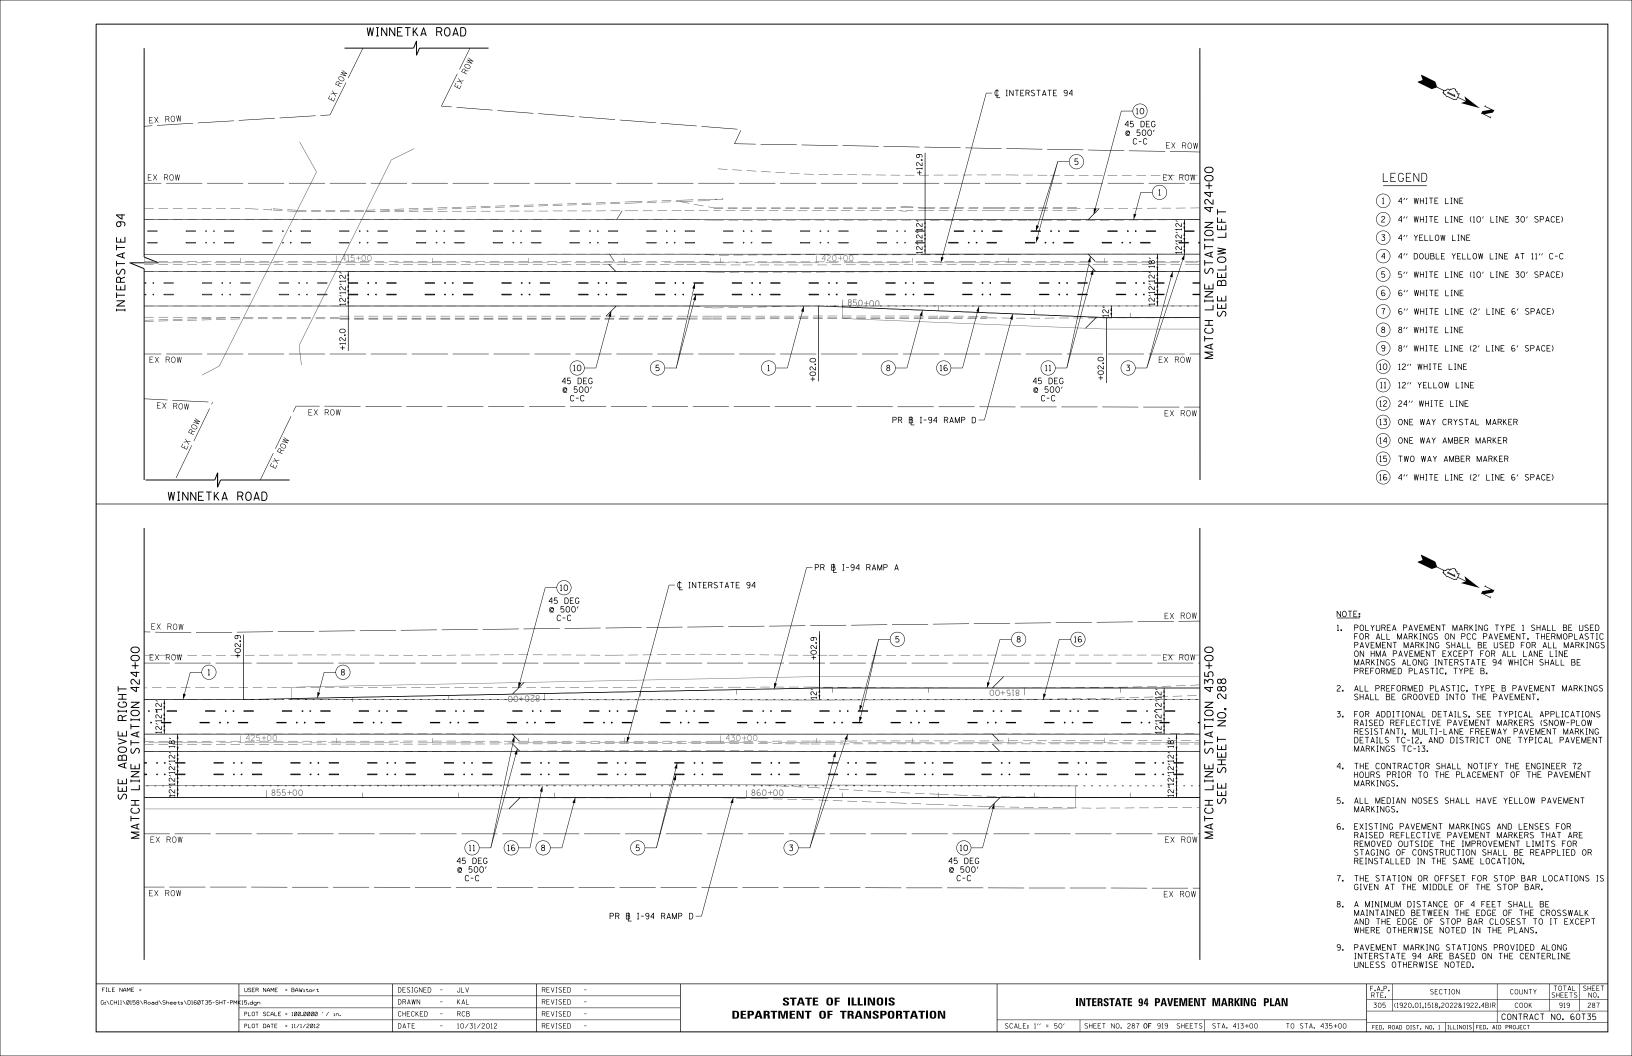

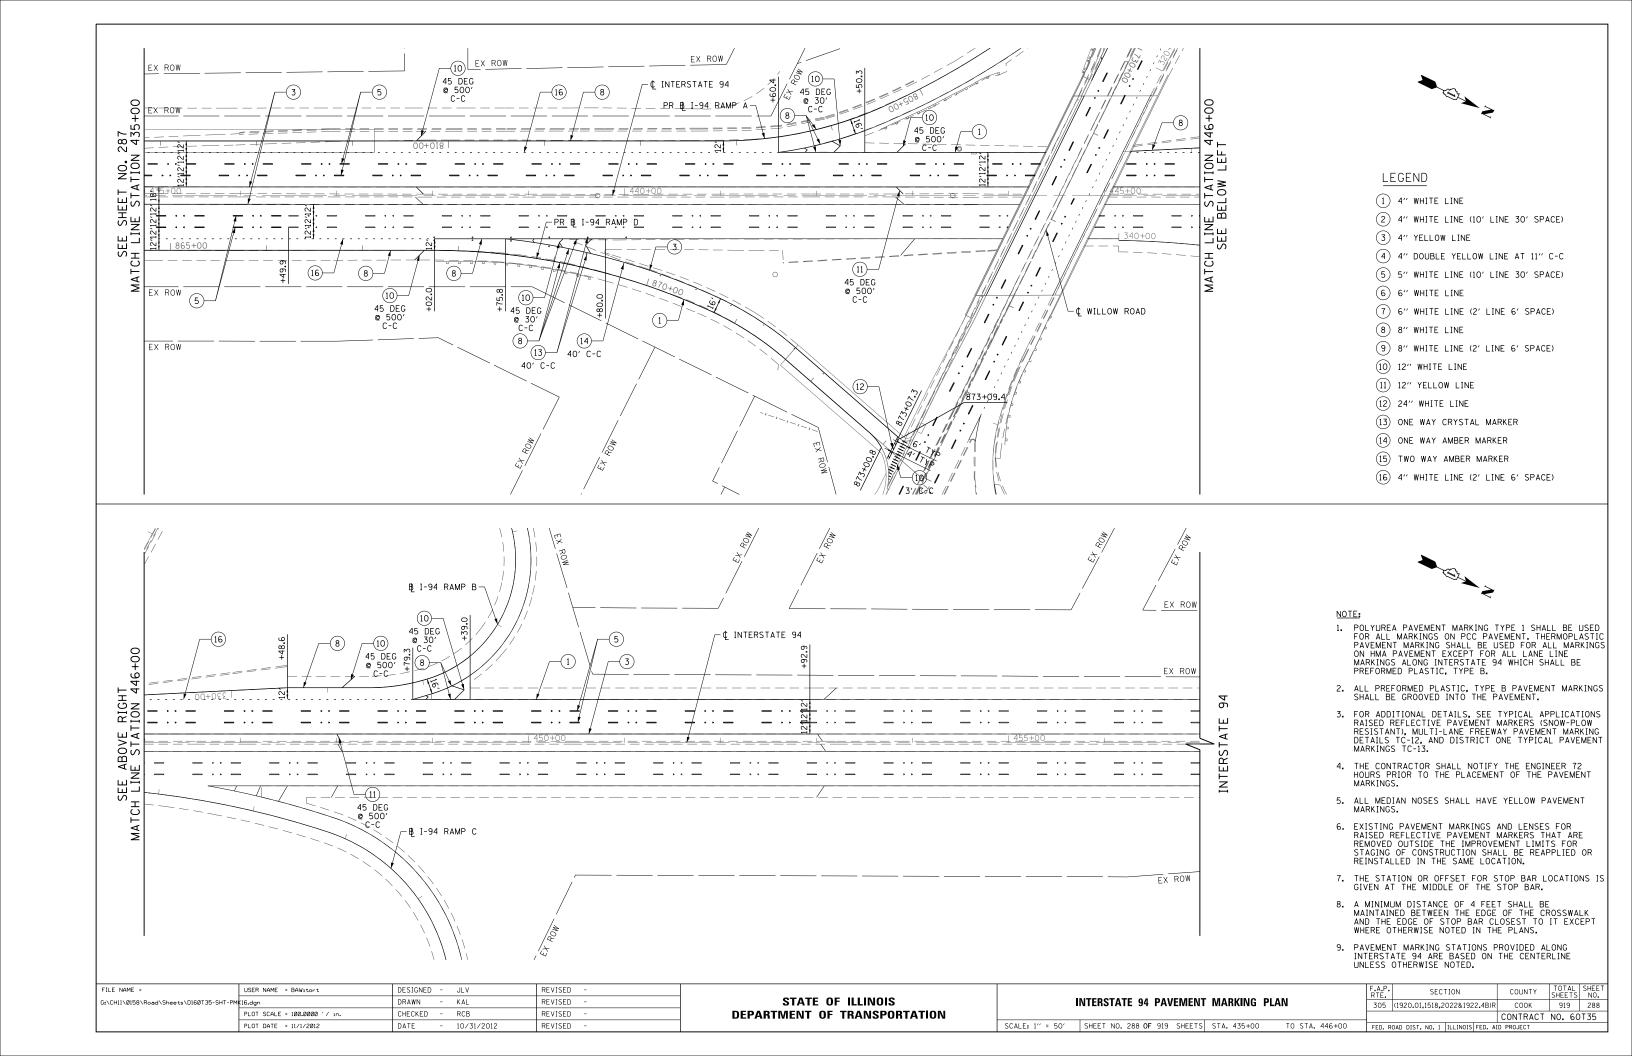SECONDARY PROFESSION PROF	EXISTING SIGN NUMBER	PANEL DESCRIPTION	SIGN SUPPORT	STATION	OFFSET	Г	FACING TRAFFIC	ACTION		MENS W x F	
PACE	VILLOW ROAD (STA 625+00 TO STA 637+00)									
STATE STAT		LEFT TURN ONLY	` '	625+07	2.8'		WB		30"	Х	36"
DECEMP		RIGHT TURN ONLY	POST MOUNTED (GROUND)	625+17	62.0'	LT	WB	SIGN AND POST TO REMAIN	30"	Х	36"
STREAM, DETRINACE O.A., SOMEONS S.P. B.P. T.		RIGHT LANE MUST TURN RIGHT	POST MOUNTED (GROUND)	626+75	61.8'		WB	SIGN AND POST TO REMAIN	36"	Х	36"
BIRCH BIRC		ONE WAY	POST MOUNTED (LANDSCAPED MEDIAN)	628+64	13.9'	LT	SB	SIGN PANEL ASSEMBLY TO BE RELOCATED	30"	Х	36"
STOPPING	1-5	STRIP MALL ENTRANCE	DUAL STONE POSTS	628+76	88.6'	LT	EB/WB	SIGN AND POST TO REMAIN	27"	Х	60"
Fig. Sept.	1-6	(SHARED POST)	POST MOUNTED (GROUND)	629+14	81.1'	LT		POST TO REMAIN			
1-1-	E1-6a	STOP SIGN					SB	SIGN TO REMAIN	36"	Х	36"
1-15 SIMPHALL INFERRICE DUAS FOOR POINTS 63-46 88 11 8408 SOURCE POINTS 27 27 27 27 27 27 27 2	E1-6b	RIGHT TURN ONLY					SB	SIGN TO REMAIN	30"	Х	36"
	1-7	SPEED LIMIT 40	POST MOUNTED (GROUND)	630+44	49.0'	RT	EB	SIGN PANEL ASSEMBLY TO BE REMOVED	30"	Х	36"
BIRTH TURNOLY	1-8	STRIP MALL ENTRANCE	DUAL STONE POSTS	630+46	88.8'	LT	EB/WB	SIGN AND POST TO REMAIN	27"	Х	60"
STATE STAT	1-9	RIGHT LANE MUST TURN RIGHT	POST MOUNTED (GROUND)	631+98	50.3'	RT	EB	SIGN PANEL ASSEMBLY TO BE REMOVED	36"	х	36"
MILLOW RED PORT PICE I NOUNTED PROUND S71" M.S. L. SCHYMBL ASSEMBLY TO BE RELOCATED	1-10	RIGHT TURN ONLY	POST MOUNTED (GROUND)	633+43	61.9'	LT	WB	SIGN PANEL ASSEMBLY TO BE RELOCATED	30"	Х	36"
Service Problem Post NOMINED ORGANION 187-18 445 LT SOUTHMEN ASSIGNATION 187-18 145 LT SOUTHMEN ASSIGNATION 187-18 145 LT SOUTHMEN ASSIGNATION 187-18 145 LT SOUTHMEN ASSIGNATION 187-18 187	1-11	RIGHT LANE MUST TURN RIGHT	POST MOUNTED (GROUND)	635+41	55.8'	RT	EB	SIGN PANEL ASSEMBLY TO BE REMOVED	36"	Х	36"
Service Problem Post NOMINED ORGANION 187-18 445 LT SOUTHMEN ASSIGNATION 187-18 145 LT SOUTHMEN ASSIGNATION 187-18 145 LT SOUTHMEN ASSIGNATION 187-18 145 LT SOUTHMEN ASSIGNATION 187-18 187	VILLOW ROAD (STA 637+00 TO STA 649+00)		<u> </u>				1	1		
EAST COVER THE LAND OF LINCOLD Control Price Control P			POST MOUNTED (GROUND)	637+18	44.6'	LT		SIGN PANEL ASSEMBLY TO BE RELOCATED			
25-16 CAPPEA-A-GRIPMY							WB		30"		36"
CEP-16 REPER LIMINOSE CLAM										Х	18"
ROFF TURN ONLY										X	25"
SAME PAST PAST PAST MUNITED (SROUND) SAME SEE LT			POST MOUNTED (GROUND)	638+00	56.2'	RT				x	36"
Page							LD		30		
Page		7	FOST MODIVIED (GROUND)	030140	91.0		\A/D		16"		12"
SPEEDLIME 46											12"
ADDED LANE			POOT MOUNTED (OPOUND)	000.40	40.01					Х	
Part			1 /							Х	36"
POST MOUNTED (GROUND)			, ,							Х	36"
Page							WB		48"	X	30"
Page			POST MOUNTED (GROUND)	640+51	117.4'	LT					
MOUNTEO M. SIGNAL POST MOUNTED M. SIGNAL P		NO SWIMMING						SIGN TO REMAIN		X	12"
Page SHARED POST MOUNTED ON RED LIGHT CAMERA POST 840-78 83.8" LT CAMERA POST TO BE REMOVED BY OTHERS 52.8" SIGNAPABLE, TOSE REMOVED 30.7" E249 RIGHT TURN ONLY SS SIGNAPABLE, ASSERBILY TO SE RELOCATED ON NEW SIGNAL, POST 2.0" POST MOUNTED (GROUND) 640-68 73.1" LT SS SIGNAPABLE, ASSERBILY TO SE RELOCATED ON NEW SIGNAL, POST 2.0" POST MOUNTED (GROUND) 640-68 73.1" LT SS SIGNAPABLE, ASSERBILY TO SE RELOCATED ON NEW SIGNAL, POST 2.0" POST MOUNTED (GROUND) 640-68 73.1" LT SS SIGNAPABLE, ASSERBILY TO SE RELOCATED ON NEW SIGNAL, POST 3.0" POST MOUNTED (GROUND) 640-68 73.1" LT SS SIGNAPABLE, ASSERBILY TO SE RELOCATED ON NEW SIGNAL, POST 3.0" POST MOUNTED (GROUND) 640-68 73.1" LT SS SIGNAPABLE, ASSERBILY TO SE RELOCATED ON NEW SIGNAL, POST 3.0" POST MOUNTED (GROUND) 640-68 73.1" LT SS SIGNAPABLE, ASSERBILY TO SE RELOCATED ON NEW SIGNAL POST 3.0" POST MOUNTED (GROUND) 640-69 43.9" RT SIGNAPABLE TO SE RELOCATED ON NEW SIGNAL POST 3.0" POST MOUNTED (GROUND) 640-69 43.9" RT SIGNAPABLE TO SE RELOCATED ON NEW SIGNAL POST 3.0" POST MOUNTED (GROUND) 640-69 43.9" RT SIGNAPABLE TO SE RELOCATED ON NEW SIGNAL POST 3.0" POST MOUNTED (GROUND) 640-69 43.9" RT SIGNAPABLE TO SE REMOVED BY THE SERVICE OF THE		NO SWIMMING					SB	SIGN TO REMAIN	16"	Х	12"
22-96 NO TURNON RED	2-8	NO TURN ON RED	MOUNTED ON SIGNAL POST	640+73	61.0'	LT	SB	SIGN PANEL TO BE REMOVED	30"	Х	30"
E2-80 RIGHT TURN ONLY	2-9	(SHARED POST)	MOUNTED ON RED LIGHT CAMERA POST	640+78	83.8'	LT		CAMERA POST TO BE REMOVED BY OTHERS			
REDUCHT PHOTO ENFORCED WOOD POST MOUNTED (GROUND) 640-68 71.74 LT SB SIN PANEL, ASSEMBLY TO BE REMOVED BY OTHERS 397	E2-9a	NO TURN ON RED					SB	SIGN PANEL TO BE REMOVED	30"	Х	30"
FOLDED STOP SIGN	E2 - 9b	RIGHT TURN ONLY					SB	SIGN PANEL ASSEMBLY TO BE RELOCATED ON NEW SIGNAL POST	30"	х	36"
E-12	2-10	RED LIGHT PHOTO ENFORCED	WOOD POST MOUNTED (GROUND)	640+85	117.4'	LT	SB	SIGN PANEL ASSEMBLY TO BE REMOVED BY OTHERS	36"	Х	36"
SHARED POST NOUNTED ON SIGNAL POST (ISLAND) 640+93 43.9" RT SIGN PAMEL ASSEMBLY TO BE RELOCATED ON NEW SIGNAL POST 247	2-11	FOLDED STOP SIGN	POST MOUNTED (GROUND)	640+86	73.1'	LT	SB	SIGN PANEL ASSEMBLY TO BE RELOCATED	36"	Х	36"
E2126		(SHARED POST)	MOUNTED ON SIGNAL POST (ISLAND)	640+93	43.9'	RT		SIGN PANEL ASSEMBLY TO BE RELOCATED ON NEW SIGNAL POST			
E2-12b DOUBLE ARROW		,					EB	SIGN PANEL TO BE RELOCATED WITH ASSEMBLY	24"	х	24"
E2-13										Х	15"
E2-13											36"
E2-13a			MOUNTED ON SIGNAL POST (ISLAND)	640+93	43.9'	RT			- 1	<u>~</u>	
E2-13b RED LIGHT PHOTO ENFORCED		,	mostries artalantier act (last tras)	010100	10.0		SB		44"	Х	18"
E2-136										X	36"
E2-13d NO TURNONRED POS MOUNTED (GROUND) 641+77 162.2" LT SIGN PANEL TO BE REMOVED WITH ASSEMBLY 24"										X	36"
E2-14											24"
E2-14a NORTH			POST MOUNTED (CROUND)	044.77	400.01	1.7	30		24	Х	
E2-14b ILLINOIS 43 NB SIGN PANEL TO BE RELOCATED WITH ASSEMBLY 24"		7	POST MOUNTED (GROUND)	041+77	162.2	LI	NB		0.411		
E2-15											12"
E2-15a WILLOW RD							NB		24"	Χ	24"
E2-15b RED LIGHT PHOTO ENFORCED NO TURN ON RED NB SIGN PANEL TO BE REMOVED BY OTHERS 36"		,	MOUNTED ON SIGNAL POST	641+83	65.9'	LT					
E2-15c NO TURN ON RED NB SIGN PANEL TO BE REMOVED 24"		WILLOW RD						SIGN PANEL TO BE REMOVED			18"
E2-15d ILLINOIS 43 WB SIGN PANEL TO BE RELOCATED WITH ASSEMBLY 24" E2-15e DOUBLE ARROW WB SIGN PANEL TO BE RELOCATED WITH ASSEMBLY 21" E2-16 (SHARED POST) MOUNTED ON SIGNAL POST 641+94 66.7" RT SIGN PANEL ASSEMBLY TO BE RELOCATED ON NEW SIGNAL POST E2-16a NO TURN ON RED BEL-16b FOLDED STOP SIGN NEW SIGN PANEL ASSEMBLY TO BE RELOCATED ON NEW SIGNAL POST 36" E2-17 RED LIGHT PHOTO ENFORCED WOOD POST MOUNTED (GROUND) 641+99 168.0" RT NB SIGN PANEL ASSEMBLY TO BE RELOCATED ON NEW SIGNAL POST 36" E2-18a RIGHT TURN ONLY E2-18b FOLDED STOP SIGN WOUNTED ON SIGNAL POST WB SIGN PANEL ASSEMBLY TO BE RELOCATED WITH ASSEMBLY TO BE RELOCATED ON NEW SIGNAL POST WB SIGN PANEL ASSEMBLY TO BE RELOCATED WITH ASSEMBLY TO BE RELOCATED WIT	E2-15b	RED LIGHT PHOTO ENFORCED					NB	SIGN PANEL TO BE REMOVED BY OTHERS	36"	Х	36"
E2-15e DOUBLE ARROW	E2-15c	NO TURN ON RED					NB	SIGN PANEL TO BE REMOVED			
E2-16 (SHARED POST) MOUNTED ON SIGNAL POST 641+94 66.7° RT SIGN PANEL ASSEMBLY TO BE RELOCATED ON NEW SIGNAL POST 36°	E2-15d	ILLINOIS 43					WB	SIGN PANEL TO BE RELOCATED WITH ASSEMBLY	24"	Х	24"
E2-16a NO TURN ON RED NB SIGN PANEL TO BE REMOVED 36"	E2-15e	DOUBLE ARROW					WB	SIGN PANEL TO BE RELOCATED WITH ASSEMBLY	21"	Х	15"
E2-16b FOLDED STOP SIGN	2-16	(SHARED POST)	MOUNTED ON SIGNAL POST	641+94	66.7'	RT		SIGN PANEL ASSEMBLY TO BE RELOCATED ON NEW SIGNAL POST			
RED LIGHT PHOTO ENFORCED WOOD POST MOUNTED (GROUND) 641+99 168.0 RT NB SIGN PANEL ASSEMBLY TO BE REMOVED BY OTHERS 36"	E2-16a	NO TURN ON RED					NB	SIGN PANEL TO BE REMOVED	36"	Х	36"
E2-17 RED LIGHT PHOTO ENFORCED WOOD POST MOUNTED (GROUND) 641+99 168.0' RT NB SIGN PANEL ASSEMBLY TO BE REMOVED BY OTHERS 36"	E2-16b	FOLDED STOP SIGN					NB	SIGN PANEL ASSEMBLY TO BE RELOCATED ON NEW SIGNAL POST	36"	Х	36"
E2-18	2-17	RED LIGHT PHOTO ENFORCED	WOOD POST MOUNTED (GROUND)	641+99	168.0'	RT	NB	SIGN PANEL ASSEMBLY TO BE REMOVED BY OTHERS	36"	Х	36"
E2-18a RIGHT TURN ONLY WB SIGN PANEL TO BE RELOCATED WITH ASSEMBLY 30" E2-18b FOLDED STOP SIGN WB SIGN PANEL TO BE RELOCATED WITH ASSEMBLY 36" E2-19 ILL ROUTE 43 / WAUKEGAN RD MOUNTED ON SIGNAL POST 642+18 44.7" RT EB SIGN PANEL TO BE REMOVED 48" E2-20 KRAFT SIGN STONE BASE 642+39 99.5" LT EB SIGN AND BASE TO REMAIN 97"			` '								
E2-18b FOLDED STOP SIGN WB SIGN PANEL TO BE RELOCATED WITH ASSEMBLY 36" E2-19 ILL ROUTE 43 / WAUKEGAN RD MOUNTED ON SIGNAL POST 642+18 44.7" RT EB SIGN PANEL TO BE REMOVED 48" E2-20 KRAFT SIGN STONE BASE 642+39 99.5" LT EB SIGN AND BASE TO REMAIN 97"		, ,					WB		30"		36"
E2-19 ILL ROUTE 43 / WAUKEGAN RD MOUNTED ON SIGNAL POST 642+18 44.7' RT EB SIGN PANEL TO BE REMOVED 48" E2-20 KRAFT SIGN STONE BASE 642+39 99.5' LT EB SIGN AND BASE TO REMAIN 97"											
E2-20 KRAFT SIGN STONE BASE 642+39 99.5' LT EB SIGN AND BASE TO REMAIN 97"			MOUNTED ON SIGNAL POST	6/2+18	44.7'	РT					30"
10" 10"											
E2-22 NORTHFIELD SIGN DUAL STONE POSTS 643+01 115.4' RT EB SIGN AND POST TO REMAIN 164"			, ,								

FILE NAME =		USER NAME = BAWitort	DESIGNED	-	JLV	REVISED	-
g:\ch11\0158\	road\Sheets\D160T35-SHT-SIC	N-SCHØl.dgn	DRAWN	-	MTS	REVISED	-
		PLOT SCALE = 40.000 '/ in.	CHECKED	-	RCB	REVISED	-
		PLOT DATE = 11/1/2012	DATE	-	10/31/2012	REVISED	-

STATE OF ILLINOIS DEPARTMENT OF TRANSPORTATION

SCALE: N.T.S

	F.A.P. RTE.	SECTION	COUNTY	TOTAL SHEETS	SHEE'
SIGN SCHEDULE	305	(1920.01,1518,2022&1922.4B)R	COOK	919	289
			CONTRACT	NO. 60	T35
SHEET NO. 289 OF 919 SHEETS	FED. R	OAD DIST. NO. 1 ILLINOIS FED. AI	D PROJECT		

- 1. SIGN SHALL BE RE-ERECTED ACCORDING TO ARTICLE 107.25 OF THE STANDARD SPECIFICATION (PROTECTION AND RESTORATION OF TRAFFIC SIGNS). ADDITIONAL SIGNS THAT HAVE NOT BEEN SURVEYED BUT ARE OBSCURED BY CONSTRUCTION OPERATIONS SHALL ALSO BE RE-ERECTED ACCORDING TO ARTICLE 107.25.
- 2. ALL EXISTING PRIVATE SIGNS WITHIN THE STATE ROW THAT INTERFERE WITH CONSTRUCTION OPERATIONS WILL BE REMOVED AND REPLACED BY OTHERS. THE CONTRACTOR SHALL NOTIFY THE OWNERS PRIOR TO THE START OF CONSTRUCTION.
- 3. EXISTING SIGN PANEL AND ASSEMBLY TO BE REMOVED SHALL BE DELIVERED TO AN IDOT MAINTENANCE YARD SPECIFIED BY THE ENGINEER.

EXISTING SIGN NUMBER	PANEL DESCRIPTION	SIGN SUPPORT	STATION	OFFSET	Т	FACING TRAFFIC	ACTION	DIMEN W >	
E2-23	(SHARED POST)	POST MOUNTED (GROUND)	643+75	39.3'	RT		SIGN PANEL ASSEMBLY TO BE RELOCATED		
E2-23a	NO PARKING SNOW ROUTE					EB	SIGN PANEL TO BE RELOCATED WITH ASSEMBLY	24" x	x 30"
E2-23b	NO PARKING ON ANY VILLAGE STREET HOURS					EB	SIGN PANEL TO BE RELOCATED WITH ASSEMBLY	30" x	x 36"
E2-24	RIGHT TURN LANE	POST MOUNTED (GROUND)	644+53	49.9'	LT	WB	SIGN PANEL ASSEMBLY TO BE REMOVED	24" x	x 24"
E2-25	(SHARED POST)	POST MOUNTED (GROUND)	644+87	37.2'	RT		SIGN PANEL ASSEMBLY TO BE RELOCATED		
E2-25a	LOVE THE LAND OF LINCOLN					EB	SIGN PANEL TO BE RELOCATED WITH ASSEMBLY	30" x	x 36"
E2-25b	ADOPT-A-HIGHWAY					EB	SIGN PANEL TO BE RELOCATED WITH ASSEMBLY	30" x	x 18"
E2-25c	KEEP ILLINOIS CLEAN	EB SIGN PANEL TO BE RELOCATED WITH ASSEMBLY		50" x	x 25"				
E2-26	BUCKLE UP	DUAL POST MOUNTED (GROUND)	646+16	37.0'	RT	EB	SIGN PANEL ASSEMBLY TO BE REMOVED	30" x	x 30"
WILLOW ROAD (S	STA 649+00 TO STA 661+00)	·	•						
E3-1	(SHARED POST)	POST MOUNTED (GROUND)	651+67	142.7'	RT		POST TO REMAIN		
E3-1a	STOP SIGN					WB	SIGN TO REMAIN	30" x	x 30"
E3-1b	2-WAY					WB	SIGN TO REMAIN	18" x	x 6"
E3-2	NEIGHBORHOOD SPEED 20	POST MOUNTED (GROUND)	651+91	143.1'	RT	WB	SIGN AND POST TO REMAIN	18" x	x 30"
E3-3	(SHARED POST)	MOUNTED ON SIGNAL POST MAST	651+97	44.2'	LT		SIGN PANEL ASSEMBLY TO BE REMOVED		
E3-3a	THREE LAKES DRIVE					EB	SIGN PANEL TO BE REMOVED WITH ASSEMBLY	48" x	x 30"
E3-3b	THREE LAKES DRIVE					WB	SIGN PANEL TO BE REMOVED WITH ASSEMBLY	48" x	
E3-4	KEEP RIGHT	MOUNTED ON DECORATIVE STREET LIGHT POLE	652+02	164.7'	RT	EB	SIGN AND POLE TO REMAIN	24" x	
E3-5	(SHARED POST)	POST MOUNTED (CONCRETE MEDIAN)	652+33	5.9'	LT		SIGN PANEL ASSEMBLY TO BE RELOCATED		
E3-5a	LEFT TURN ONLY	1 OOT MICONTED (CONCINETE MEDIAN)	032133	3.3		EB	SIGN PANEL TO BE RELOCATED WITH ASSEMBLY	24" x	x 30"
E3-5a	KEEP RIGHT					WB	SIGN PANEL TO BE RELOCATED WITH ASSEMBLY		x 30" x 30"
		MOUNTED ON GIONAL POOT	050.00	40.01	DT	VVB		Z4 X	30
E3-6	(SHARED POST)	MOUNTED ON SIGNAL POST	652+36	40.0'	RT		SIGN PANEL ASSEMBLY TO BE RELOCATED ON NEW SIGNAL POST	0.411	
E3-6a	DO NOT BLOCK INTERSECTION					EB	SIGN PANEL TO BE RELOCATED WITH ASSEMBLY	24" x	
E3-6b	FOLDED STOP SIGN					EB	SIGN PANEL TO BE RELOCATED WITH ASSEMBLY	30" x	x 30"
E3-7	(SHARED POST)	POST MOUNTED (GROUND)	652+43	73.1'	LT		SIGN PANEL ASSEMBLY TO BE REMOVED		
E3-7a	THREE LAKES DR					WB	SIGN PANEL TO BE REMOVED WITH ASSEMBLY	36" x	
E3-7b	WILLOW RD					SB	SIGN PANEL TO BE REMOVED WITH ASSEMBLY	36" x	
E3-8	FOLDED STOP SIGN	MOUNTED ON SIGNAL POST	652+47	81.2'	LT	SB	SIGN PANEL ASSEMBLY TO BE RELOCATED	30" x	x 30"
E3-9	WILLOW RD	MOUNTED ON SIGNAL POST MAST	652+60	52.5'	RT	SB	SIGN PANEL TO BE REMOVED	36" x	x 12"
E3-10	(SHARED POST)	POST MOUNTED (GROUND)	652+63	97.6'	LT		SIGN PANEL ASSEMBLY TO BE RELOCATED		
E3-10a	FIRE LANE					WB	SIGN PANEL TO BE RELOCATED WITH ASSEMBLY	24" x	x 30"
E3-10b	FOR ACCESS TO THIS AREA					WB	SIGN PANEL TO BE RELOCATED WITH ASSEMBLY	24" x	x 30"
E3-11	AREA MONITORED	POST MOUNTED (GROUND)	652+75	135.5'	LT	SB	SIGN AND POST TO REMAIN	18" x	x 24"
E3-12	KRAFT ENTRANCE SIGN	DUAL POST MOUNTED (LANDSCAPED MEDIAN)	653+13	111.5'	LT	NB	SEE NOTE 2	20" x	x 36"
E3-13	(SHARED POST)	DECORATIVE POST MOUNTED (LANDSCAPED MEDIAN)	653+19	67.6'	RT		POST TO REMAIN		-
E3-13a	FOX MEADOW					EB	SIGN TO REMAIN	32" x	x 37"
E3-13b	TO EDGEWOOD LN					EB	SIGN TO REMAIN	32" x	x 18"
E3-14	FOLDED STOP SIGN	MOUNTED ON SIGNAL POST	653+55	57.5'	RT	NB	SIGN PANEL TO BE RELOCATED	36" x	x 36"
E3-15	WILLOW RD	MOUNTED ON SIGNAL POST MAST	653+65	99.9'	LT	NB	SIGN PANEL TO BE REMOVED	36" x	x 12"
E3-16	DO NOT BLOCK INTERSECTION	MOUNTED ON SIGNAL POST	653+82	43.2'	RT	EB	SIGN PANEL TO BE RELOCATED ON NEW SIGNAL POST	24" x	
E3-17	(SHARED POST)	MOUNTED ON SIGNAL POST	654+06	61.8'	LT		SIGN PANEL ASSEMBLY TO BE RELOCATED ON NEW SIGNAL POST		
E3-17a	RIGHT TURN ONLY	INCOMPED ON ORGANIZATION	001100	01.0		WB	SIGN PANEL TO BE RELOCATED WITH ASSEMBLY	30" x	x 36"
E3-17b	FOLDED STOP SIGN					WB	SIGN PANEL TO BE RELOCATED WITH ASSEMBLY	30" x	
E3-178	(SHARED POST)	POST MOUNTED (CONCRETE MEDIAN)	654+14	5.6'	RT	VVD	SIGN PANEL ASSEMBLY TO BE RELOCATED		. 30
E3-18a	KEEP RIGHT	POST MICONTED (CONCINETE MEDIAN)	034114	3.0	17.1	EB	SIGN PANEL TO BE RELOCATED WITH ASSEMBLY	24" x	x 30"
E3-18b	LEFT TURN ONLY						SIGN PANEL TO BE RELOCATED WITH ASSEMBLY		x 30"
		DOST MOUNTED (CROUND)	CEA1CO	27.41	DT	WB			
E3-19	LANE ENDS	POST MOUNTED (GROUND)	654+62	37.1'	RT	EB	SIGN PANEL ASSEMBLY TO BE REMOVED		x 36"
E3-20	DIVIDED HIGHWAY ENDS	POST MOUNTED (GROUND)	656+61	38.1'	RT	EB	SIGN PANEL ASSEMBLY TO BE REMOVED		x 36"
E3-21	RIGHT TURN LANE	POST MOUNTED (GROUND)	657+13	51.2'	LT	WB	SIGN PANEL ASSEMBLY TO BE RELOCATED		x 24"
E3-22	SPEED LIMIT 40	CIRCULAR POST MOUNTED (GROUND)	658+16	49.7'	LT	WB	SIGN PANEL ASSEMBLY TO BE REMOVED		x 36"
E3-23	KEEP RIGHT	CIRCULAR POST MOUNTED (LANDSCAPED MEDIAN)	658+19	0.8'	RT	WB	SIGN PANEL ASSEMBLY TO BE REMOVED		x 30"
E3-24	SPEED LIMIT 35	POST MOUNTED (GROUND)	658+28	38.2'	RT	EB	SIGN PANEL ASSEMBLY TO BE REMOVED		x 36"
E3-25	SCHOOL CROSSING	POST MOUNTED (GROUND)	660+31	37.8'	RT	EB	SIGN PANEL ASSEMBLY TO BE RELOCATED	36" x	x 36"
WILLOW ROAD (S	STA 661+00 TO STA 672+00)								
E4-1	STOP SIGN	MOUNTED ON METAL GATE	661+54	79.9'	LT	NB	SIGN TO REMAIN	30" x	x 30"
E4-2	SPEED LIMIT 35	POST MOUNTED (GROUND)	664+02	46.5'	LT	WB	SIGN PANEL ASSEMBLY TO BE REMOVED	30" x	x 36"
E4-3	LUTHERAN CHURCH OF THE ASCENSION	NONE - SIGN IS A STONE BLOCK	664+34	106.9'	RT	SB	SIGN TO REMAIN	197" x	37"
	(SHARED POST)	MOUNTED ON SIGNAL POST	664+60	46.6'	LT		SIGN PANEL ASSEMBLY TO BE RELOCATED ON NEW SIGNAL POST		
E4-4						WB	SIGN PANEL TO BE REMOVED	60" x	18"
E4-4 E4-4a	SUNSET RIDGE RD		II.					1 - "	
E4-4a						WB	SIGN PANEL TO BE RELOCATED WITH ASSEMBLY	24" x	: 24"
E4-4a E4-4b	NO TURN ON RED					WB WB	SIGN PANEL TO BE RELOCATED WITH ASSEMBLY SIGN PANEL TO BE RELOCATED WITH ASSEMBLY		x 24"
E4-4a		POST MOUNTED (GROUND)	664+66	30.8'	RT	WB WB EB	SIGN PANEL TO BE RELOCATED WITH ASSEMBLY SIGN PANEL TO BE RELOCATED WITH ASSEMBLY SIGN PANEL ASSEMBLY TO BE RELOCATED	24" x	x 24" x 12" x 18"

	FILE NAME =	USER NAME = BAWitort	DESIGNED	-	JLV	REVISED	-
١	g:\chll\0158\road\Sheets\D160T35-SHT-S1G	N-SCHØ2.dgn	DRAWN	-	MTS	REVISED	-
١		PLOT SCALE = 40.000 '/ in.	CHECKED	-	RCB	REVISED	-
		PLOT DATE = 11/1/2012	DATE	-	10/31/2012	REVISED	-
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STATE OF ILLINOIS DEPARTMENT OF TRANSPORTATION

	01011 0011	I RT	A.P.	SECTION	COUNTY	TOTAL SHEETS	SHEET NO.
	SIGN SCHED	JLE 30	305	(1920.01,1518,2022&1922.4B)R	COOK	919	290
					CONTRACT	NO. 60	T35
SCALE: N.T.S	SHEET NO. 290 OF 919 SHEETS	FEC	ED. RO	DAD DIST. NO. 1 ILLINOIS FED. AI	D PROJECT		

- 1. SIGN SHALL BE RE-ERECTED ACCORDING TO ARTICLE 107.25 OF THE STANDARD SPECIFICATION (PROTECTION AND RESTORATION OF TRAFFIC SIGNS). ADDITIONAL SIGNS THAT HAVE NOT BEEN SURVEYED BUT ARE OBSCURED BY CONSTRUCTION OPERATIONS SHALL ALSO BE RE-ERECTED ACCORDING TO ARTICLE 107.25.
- 2. ALL EXISTING PRIVATE SIGNS WITHIN THE STATE ROW THAT INTERFERE WITH CONSTRUCTION OPERATIONS WILL BE REMOVED AND REPLACED BY OTHERS. THE CONTRACTOR SHALL NOTIFY THE OWNERS PRIOR TO THE START OF CONSTRUCTION.
- 3. EXISTING SIGN PANEL AND ASSEMBLY TO BE REMOVED SHALL BE DELIVERED TO AN IDOT MAINTENANCE YARD SPECIFIED BY THE ENGINEER.

Feb. Section	EXISTING SIGN NUMBER	PANEL DESCRIPTION	SIGN SUPPORT	STATION	OFFSET	FACIN TRAFF		DIMENSION W x H
EACH SAFEWAY SAFEWAY		,	MOUNTED ON SIGNAL POST	664+89	52.1' L	_		
Description	E4-7a	SCHOOL CROSSING				SB	SIGN PANEL TO BE RELOCATED WITH ASSEMBLY	30" x 30"
The								24" x 12"
EAST COLORS COL								24" x 30"
Section Page Page						_		30" x 30"
SAME DAY DESCRIPTIONS PRESENT SAME		,	MOUNTED ON SIGNAL POST	665+42	48.4' F			
E-8- NO.T.BM.9.GREWARD PEGETINNO RESOLT								30" x 30"
E-6-14 PACCESTEP SIGN						_		24" x 12"
March Septem Priss Priss Priss Septem Priss Pris								24" x 30"
SAMP								30" x 30"
24-03 CELESTRUS SELLESTRUS SE		,	POST MOUNTED (GROUND)	665+51	137.7' L			
ELECTROMOSPHIC INTERVALENCE TOPOLOGIC ETTA POSTS (SCOLO) 864-93 568 87 10 SINAMPACT TO SCHAMP						_		24" x 30"
EAST SARRE RODGE RO								18" x 18"
SPANEDURS								- x -
EA-72		SUNSET RIDGE RD	MOUNTED ON SIGNAL POST	665+74		_	SIGN PANEL TO BE REMOVED	60" x 18"
EA-75 PARRON		(SHARED POST)	POST MOUNTED (GROUND)	665+74	23.6' F	T.	SIGN PANEL ASSEMBLY TO BE RELOCATED	
E4-19	E4-12a	SCHOOL CROSSING				EB	SIGN PANEL TO BE RELOCATED WITH ASSEMBLY	36" x 36"
E-15	E4-12b	ARROW				EB	SIGN PANEL TO BE RELOCATED WITH ASSEMBLY	24" x 12"
E-1-15 ORBOVINED	E4-13	(SHARED POST)	MOUNTED ON SIGNAL POST	665+72	28.7' L	Т	SIGN PANEL ASSEMBLY TO BE RELOCATED ON NEW SIGNAL POST	
E4-56	E4-13a	SCHOOL CROSSING				WB	SIGN PANEL TO BE RELOCATED WITH ASSEMBLY	36" x 36"
E-15	E4-13b	ARROW				WB	SIGN PANEL TO BE RELOCATED WITH ASSEMBLY	21" x 15"
EA-14	E4-13c	NO TURN ON RED				WB	SIGN PANEL TO BE RELOCATED WITH ASSEMBLY	24" x 24"
EA-14		ON SCHOOL DAY WHEN CHILDREN ARE PRESENT				WB	SIGN PANEL TO BE RELOCATED WITH ASSEMBLY	24" x 12"
E4-15 SHR-QPORT								36" x 36"
E4-15 SEARED POST)			DECORATIVE POST MOUNTED (GROUND)	665+78	43.6' L			24" x 30"
E4-15 SPEED_LIATE SPEED_LIATE E8 SIGN PAREL TO BE REMOVED WITH ASSEMBLY 12						_		2. x 33
E4-19 NO PARRING ALONG HIGHWAY POST MOUNTED (GROUAD) 667-42 2.9 E. B. SIGN PARIL, TO BE REMOVED WITH ASSEMBLY 10 PER REMOVED 17		,	1 GOT MIGGITTED (GITGGITE)	000100	21.0			30" x 36"
E-1-9 NO PARKING ALONG HIGHWAY POST MOUNTED (ROUND) 667-92 32.9" LT WB SIGNAPARE, ASSEMBLY TO BE REMOVED 1.2								12" x 18"
E4-19 NO PARRING ALOMA HIGHWAY POST MOLINTED (GROUND) 687-75 29.4 8.7 E SIGN PAREL ASSEMBLY TO BE RELOCATED 12			POST MOUNTED (GROUND)	667+52	32 9'	_		12" x 18"
E4-19 SIAMED POST POST MOUNTED (GROUND) 686-76 22 Z RT SIAMEN POST SIAMEN TO BE RELOCATED						_		12" x 18"
E4-198			, ,					12 / 10
E4-198		,	1 001 MICONTED (ONCOME)	000170	29.2			30" x 30"
E4-19 GHARED POST)						_		12" x 18"
E4-19			POST MOLINTED (CROLIND)	660+00	22.21			12 10
E4-19		,	FOST MODINTED (GROUND)	009+09	23.3 L			42" x 34"
E4-20								
E4-21 STOP SIGN			DECORATIVE POST MOUNTED (CROUND)	660176	20.71	_		
E4-22 SPEED LIMIT 35 POST MOUNTED (GROUND) 671-01 2.4" RT EB SIGN PANEL ASSEMBLY TO BE REMOVED 30								
MILLOW ROAD (STA 672-00) TO STA 683+00)			, ,			_		
E5-1			POST MOUNTED (GROUND)	0/1+01	22.4 F	II EB	SIGN PAINEL ASSEMBLY TO BE REMOVED	30 X 30
E5-19 NOLEFT TURN EB SIGN PANEL TO BE REMOVED WITH ASSEMBLY 38		,	POST MOUNTED (ODOUND)	070+00	40.01	т I	CION DANIEL ACCEMBLY TO BE DEMOVED	
E5-16 NOLEFT TURN HOURS FOST MOUNTED (GROUND) 673+90 42.2" LT SIGN PARKEL ASSEMBLY TO BE REMOVED WITH ASSEMBLY 36		, ,	POST MOUNTED (GROUND)	0/2+39	19.0			201 201
E5-22 (SHARED POST)						_		
E5-2a NO LEFT TURN			POOT MOUNTED (OPOUND)	070.00	40.01			36" x 36"
E5-2b NO LEFT TURN HOURS EB SIGN PANEL TO BE REMOVED WITH ASSEMBLY 30		,	POST MOUNTED (GROUND)	673+90	42.2 L			2011 2011
E5-2c OLD WILLOW RD WITH ARROW EB SIGN PANEL TO BE REMOVED WITH ASSEMBLY 300								30" x 30"
E5-2d STOP SIGN (BLACK FRAME AROUND 1ST 3 LETTERS) E5-3 SOMERSET LANE DECORATIVE POST MOUNTED (GROUND) 674+08 70.6' LT WB SER NOTE 2 24						_		30" x 24"
E5-3 SOMERSET LANE DECORATIVE POST MOUNTED (GROUND) 674+08 70.6° LT WB SEE NOTE 2 24								
E5-4 (SHARED POST)								30" x 30"
E5-4a STOP SIGN SB SIGN PANEL TO BE RELOCATED WITH ASSEMBLY 24			` '			_		24" x 48"
E5-4b SLOW CHILDREN NB SIGN PANEL TO BE RELOCATED WITH ASSEMBLY 18		,	POST MOUNTED (GROUND)	674+17	78.1' L			
E5-5 NO OUTLET								24" x 24"
E5-6 (SHARED POST)						_		18" x 24"
E5-6a NO LEFT TURN			POST MOUNTED (GROUND)	674+39			SIGN PANEL ASSEMBLY TO BE RELOCATED	30" x 30"
E5-6b NO LEFT TURN HOURS SIGN PANEL TO BE REMOVED WITH ASSEMBLY 300		(SHARED POST)	POST MOUNTED (GROUND)	674+75	38.4' L	T		
E5-7 SPEED LIMIT 20 POST MOUNTED (GROUND) 675+24 62.1' LT EB SIGN PANEL ASSEMBLY TO BE RELOCATED 24' E5-8 DO NOT DRIVE ON SHOULDER POST MOUNTED (GROUND) 675+47 20.9' RT EB SIGN PANEL ASSEMBLY TO BE REMOVED 30' E5-9 SPEED LIMIT 35 POST MOUNTED (GROUND) 679+22 27.6' LT WB SIGN PANEL ASSEMBLY TO BE REMOVED 30' E5-10 BRACKEN LANE DECORATIVE POST MOUNTED (GROUND) 679+60 53.8' RT EB SIGN AND POST TO REMAIN 48' E5-11 STOP SIGN POST MOUNTED (GROUND) 679+89 48.9' RT NB SIGN PANEL ASSEMBLY TO BE RELOCATED 30' WILLOW ROAD (STA 683+00 TO STA 693+00) STA 693+00 STA								30" x 30"
E5-8 DO NOT DRIVE ON SHOULDER POST MOUNTED (GROUND) 675+47 20.9' RT EB SIGN PANEL ASSEMBLY TO BE REMOVED 30'						_		30" x 24"
E5-9 SPEED LIMIT 35 POST MOUNTED (GROUND) 679+22 27.6' LT WB SIGN PANEL ASSEMBLY TO BE REMOVED 300			POST MOUNTED (GROUND)	675+24				24" x 30"
E5-10 BRACKEN LANE DECORATIVE POST MOUNTED (GROUND) 679+60 53.8' RT EB SIGN AND POST TO REMAIN 48 E5-11 STOP SIGN POST MOUNTED (GROUND) 679+89 48.9' RT NB SIGN PANEL ASSEMBLY TO BE RELOCATED 30 WILLOW ROAD (STA 683+00 TO STA 693+00) FOST MOUNTED (GROUND) 684+52 24.2' LT WB SIGN PANEL ASSEMBLY TO BE RELOCATED 30'	E5-8	DO NOT DRIVE ON SHOULDER	POST MOUNTED (GROUND)	675+47	20.9' F	T EB	SIGN PANEL ASSEMBLY TO BE REMOVED	30" x 24"
E5-11 STOP SIGN POST MOUNTED (GROUND) 679+89 48.9' RT NB SIGN PANEL ASSEMBLY TO BE RELOCATED 30' WILLOW ROAD (STA 683+00 TO STA 693+00) E6-1 HORIZONTAL ALIGNMENT CURVE POST MOUNTED (GROUND) 684+52 24.2' LT WB SIGN PANEL ASSEMBLY TO BE RELOCATED 30'	E5-9	SPEED LIMIT 35	POST MOUNTED (GROUND)	679+22	27.6' L	T WB	SIGN PANEL ASSEMBLY TO BE REMOVED	30" x 36"
E5-11 STOP SIGN POST MOUNTED (GROUND) 679+89 48.9' RT NB SIGN PANEL ASSEMBLY TO BE RELOCATED 30' WILLOW ROAD (STA 683+00 TO STA 693+00) E6-1 HORIZONTAL ALIGNMENT CURVE POST MOUNTED (GROUND) 684+52 24.2' LT WB SIGN PANEL ASSEMBLY TO BE RELOCATED 30'	E5-10	BRACKENLANE	DECORATIVE POST MOUNTED (GROUND)	679+60	53.8' F	T EB	SIGN AND POST TO REMAIN	48" x 32"
WILLOW ROAD (\$TA 683+00 TO \$TA 693+00) E6-1 HORIZONTAL ALIGNMENT CURVE POST MOUNTED (GROUND) 684+52 24.2' LT WB SIGN PANEL ASSEMBLY TO BE RELOCATED 30'	E5-11	STOP SIGN	POST MOUNTED (GROUND)	679+89	48.9' F	T NB	SIGN PANEL ASSEMBLY TO BE RELOCATED	30" x 30"
E6-1 HORIZONTAL ALIGNMENT CURVE POST MOUNTED (GROUND) 684+52 24.2' LT WB SIGN PANEL ASSEMBLY TO BE RELOCATED 30'						'		'
		· · · · · · · · · · · · · · · · · · ·	POST MOUNTED (GROUND)	684+52	24.2' L	T WB	SIGN PANEL ASSEMBLY TO BE RELOCATED	30" x 30"
1 DO TO		DO NOT DRIVE ON SHOULDER	POST MOUNTED (GROUND)	686+45		_		30" x 24"
			, ,					30" x 36"

FILE NAME =	USER NAME = BAWitort	DESIGNED	-	JLV	REVISED	-
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	PLOT SCALE = 40.000 '/ in.	CHECKED	-	RCB	REVISED	-
	PLOT DATE = 11/1/2012	DATE	-	10/31/2012	REVISED	-

STATE OF ILLINOIS DEPARTMENT OF TRANSPORTATION

		F.A.P. RTE.	SECT	ION	COUNTY	TOTAL SHEETS	SHEE NO.
SIGN SCHEDULE		305	(1920.01,1518,20)22&1922.4B)R	COOK	919	291
					CONTRACT	NO. 60	T35
SCALE: N.T.S	SHEET NO. 291 OF 919 SHEETS	FED. F	ROAD DIST. NO. 1	ILLINOIS FED. AI	D PROJECT		

- 1. SIGN SHALL BE RE-ERECTED ACCORDING TO ARTICLE 107.25 OF THE STANDARD SPECIFICATION (PROTECTION AND RESTORATION OF TRAFFIC SIGNS). ADDITIONAL SIGNS THAT HAVE NOT BEEN SURVEYED BUT ARE OBSCURED BY CONSTRUCTION OPERATIONS SHALL ALSO BE RE-ERECTED ACCORDING TO ARTICLE 107.25.
- 2. ALL EXISTING PRIVATE SIGNS WITHIN THE STATE ROW THAT INTERFERE WITH CONSTRUCTION OPERATIONS WILL BE REMOVED AND REPLACED BY OTHERS. THE CONTRACTOR SHALL NOTIFY THE OWNERS PRIOR TO THE START OF CONSTRUCTION.
- 3. EXISTING SIGN PANEL AND ASSEMBLY TO BE REMOVED SHALL BE DELIVERED TO AN IDOT MAINTENANCE YARD SPECIFIED BY THE ENGINEER.

E6-4	MBLY 36" x 10" 30" x 30" 36" x 36" MBLY 33" x 33"
E6-4b STOP SIGN SB SIGN PANEL TO BE REMOVED E6-5 SCHOOL CROSSING POST MOUNTED (GROUND) 691+18 22.7' RT EB SIGN PANEL ASSEMBLY TO BE RELOCATED E6-6 (SHARED POST) POST MOUNTED (GROUND) 691+46 56.5' LT SIGN PANEL ASSEMBLY TO BE RELOCATED WITH ASSEMBLY TO BE REMOVED BY ASSEMBLY TO BE REMOVED BY ASSEMBLY TO BE REMOVED BY THE PROVINCE OF	30" x 30" 36" x 36" MBLY 33" x 33"
E6-5 SCHOOL CROSSING POST MOUNTED (GROUND) 691+18 22.7' RT EB SIGN PANEL ASSEMBLY TO BE RELOCATED	36" x 36" MBLY 33" x 33"
E6-6 (SHARED POST) POST MOUNTED (GROUND) 691+46 56.5' LT SIGN PANEL ASSEMBLY TO BE RELOCATED E6-6a NO OUTLET NB SIGN PANEL TO BE RELOCATED WITH ASSEMBLY TO BE REMOVED BY WILLOW ROAD (STA 693+00 TO STA 704+00) F7-1 RED LIGHT PHOTO ENFORCED WOOD POST MOUNTED (GROUND) 694+99 24.6' RT EB SIGN PANEL ASSEMBLY TO BE REMOVED BY	MBLY 33" x 33"
E6-6a NO OUTLET NB SIGN PANEL TO BE RELOCATED WITH ASSEMBLE TO BE REMOVED BY WILLOW ROAD (STA 693+00 TO STA 704+00) FT.1 RED LIGHT PHOTO ENFORCED WOOD POST MOUNTED (GROUND) 694+99 24.6' RT EB SIGN PANEL ASSEMBLY TO BE REMOVED BY	MBLY 33" x 33"
E6-6b SLOW CHILDREN NB SIGN PANEL TO BE RELOCATED WITH ASSEMULLOW ROAD (STA 693+00 TO STA 704+00) E7-1 RED LIGHT PHOTO ENFORCED WOOD POST MOUNTED (GROUND) 694+99 24.6' RT EB SIGN PANEL ASSEMBLY TO BE REMOVED BY	
WILLOW ROAD (STA 693+00 TO STA 704+00) E7-1 RED LIGHT PHOTO ENFORCED WOOD POST MOUNTED (GROUND) 694+99 24.6' RT EB SIGN PANEL ASSEMBLY TO BE REMOVED BY	MBLY 18" x 24"
E7-1 RED LIGHT PHOTO ENFORCED WOOD POST MOUNTED (GROUND) 694+99 24.6' RT EB SIGN PANEL ASSEMBLY TO BE REMOVED BY	
E7-2 NORTHFIELD COMMUNITY NURSERY SCHOOL DUAL POST MOUNTED (GROUND) 695+59 67.7' LT NB SIGN AND POST TO REMAIN	66" x 30"
E7-3 SPEED LIMIT 35 POST MOUNTED (GROUND) 695+61 32.5' LT WB SIGN PANEL ASSEMBLY TO BE REMOVED	30" x 36"
E7-4 NORTHFIELD COMMUNITY CHURCH STONE BASE 696+13 65.8' LT WB SIGN AND POST TO REMAIN	128" x 79"
E7-5 FOLDED STOP SIGN MOUNTED ON SIGNAL POST 696+30 27.5' RT EB SIGN PANEL TO BE RELOCATED ON NEW SIGN	
E7-6 (SHARED POST) MOUNTED ON SIGNAL POST 696+31 47.1' LT SIGN PANEL ASSEMBLY TO BE RELOCATED.	
E7-6a RED LIGHT PHOTO ENFORCED WB SIGN PANEL TO BE REMOVED BY OTHERS	30" x 30"
E7-6b NO TURN ON RED WB SIGN PANEL TO BE RELOCATED WITH ASSEN	
E7-6c ON SCHOOL DAY WHEN CHILDREN ARE PRESENT WB SIGN PANEL TO BE RELOCATED WITH ASSEN	
E7-7 (SHARED POST) MOUNTED ON SIGNAL POST 696+42 47.3' LT SIGN PANEL ASSEMBLY TO BE RELOCATED.	
E7-7a NO TURN ON RED SB SIGN PANEL TO BE RELOCATED WITH ASSEN	
E7-7b ON SCHOOL DAY WHEN CHILDREN ARE PRESENT SB SIGN PANEL TO BE RELOCATED WITH ASSEN	
E7-7c FOLDED STOP SIGN SB SIGN PANEL TO BE RELOCATED WITH ASSEN	
E7-8 SPEED LIMIT 35 DUAL POST MOUNTED (GROUND) 696+46 105.5' RT SB SIGN PANEL ASSEMBLY TO BE RELOCATED	30" x 36"
E7-9 NO PARKING THIS SIDE OF STREET POST MOUNTED (GROUND) 696+49 143.6' LT SB SIGN AND POST TO REMAIN	12" x 18"
E7-10 (SHARED POST) POST MOUNTED (GROUND) 696+95 74.3' RT SIGN PANEL ASSEMBLY TO BE RELOCATED	
E7-10a SCHOOL CROSSING NB SIGN PANEL TO BE RELOCATED WITH ASSEN	MBLY 36" x 36"
E7-10b AHEAD NB SIGN PANEL TO BE RELOCATED WITH ASSEN	MBLY 24" x 12"
E7-11 SCHOOL SPEED LIMIT 20 POST MOUNTED (GROUND) 696+96 136.6' LT NB SIGN AND POST TO REMAIN	24" x 48"
E7-12 (SHARED POST) MOUNTED ON SIGNAL POST 696+96 54.3' RT SIGN PANEL ASSEMBLY TO BE RELOCATED	
E7-12a NO TURN ON RED NB SIGN PANEL TO BE RELOCATED WITH ASSEN	MBLY 24" x 24"
E7-12b FOLDED STOP SIGN NB SIGN PANEL TO BE RELOCATED WITH ASSEN	MBLY 30" x 30"
E7-13 SPEED LIMIT 20 POST MOUNTED (GROUND) 696+97 94.6' LT NB SIGN PANEL ASSEMBLY TO BE RELOCATED	18" x 24"
E7-14 (SHARED POST) MOUNTED ON SIGNAL POST 697+00 51.3' LT SIGN PANEL ASSEMBLY TO BE REMOVED	
E7-14a NO TURN ON RED NB SIGN PANEL TO BE REMOVED WITH ASSEMB	BLY 24" x 24"
E7-14b ON SCHOOL DAY WHEN CHILDREN ARE PRESENT NB SIGN PANEL TO BE REMOVED WITH ASSEMB	BLY 24" x 12"
E7-15 (SHARED POST) MOUNTED ON SIGNAL POST 697+13 36.9' RT SIGN PANEL ASSEMBLY TO BE REMOVED	
E7-15a WAGNER RD EB SIGN PANEL TO BE REMOVED WITH ASSEMB	BLY 44" x 18"
E7-15b RED LIGHT PHOTO ENFORCED EB SIGN PANEL TO BE REMOVED BY OTHERS	36" x 36"
E7-16 (SHARED POST) MOUNTED ON SIGNAL POST 697+15 36.9' LT SIGN PANEL ASSEMBLY TO BE RELOCATED	ON NEW SIGNAL POST
E7-16a NO TURN ON RED WB SIGN PANEL TO BE RELOCATED WITH ASSEN	MBLY 24" x 24"
E7-16b ON SCHOOL DAY WHEN CHILDREN ARE PRESENT WB SIGN PANEL TO BE RELOCATED WITH ASSEN	MBLY 24" x 12"
E7-16c FOLDED STOP SIGN WB SIGN PANEL TO BE RELOCATED WITH ASSEN	MBLY 30" x 30"
E7-17 (SHARED POST) POST MOUNTED (GROUND) 697+19 32.5' LT SIGN PANEL ASSEMBLY TO BE RELOCATED	
E7-17a SCHOOL CROSSING WB SIGN PANEL TO BE RELOCATED WITH ASSEN	MBLY 36" x 36"
E7-17b ARROW WB SIGN PANEL TO BE RELOCATED WITH ASSEN	
E7-17c STOP HERE ON RED WB SIGN PANEL TO BE REMOVED	24" x 30"
E7-18 (SHARED POST) POST MOUNTED (GROUND) 697+20 26.8' RT SIGN PANEL ASSEMBLY TO BE RELOCATED	
E7-18a SCHOOL CROSSING EB SIGN PANEL TO BE RELOCATED WITH ASSEN	
E7-18b ARROW EB SIGN PANEL TO BE RELOCATED WITH ASSEN	
E7-19 WILLOW PARK DUAL STONE POSTS 697+45 57.0' LT EB SIGN AND POST TO REMAIN	58" x 21"
E7-20 (SHARED POST) POST MOUNTED (GROUND) 698+28 23.8' RT SIGN PANEL ASSEMBLY TO BE REMOVED	
E7-20a SPEED LIMIT 35 EB SIGN PANEL TO BE REMOVED WITH ASSEMB	
E7-20b NO PARKING ANY TIME EB SIGN PANEL TO BE REMOVED WITH ASSEMB	
E7-21 NO PARKING ANY TIME CIRCULAR POST MOUNTED (GROUND) 698+31 35.5' LT WB SIGN PANEL ASSEMBLY TO BE REMOVED	12" x 18"
E7-22 RED LIGHT PHOTO ENFORCED WOOD POST MOUNTED (GROUND) 698+47 31.4' LT WB SIGN PANEL ASSEMBLY TO BE REMOVED BY	Y OTHERS 36" x 36"
E7-23 NO PARKING ANY TIME CIRCULAR POST MOUNTED (GROUND) 699+71 32.4' LT WB SIGN PANEL ASSEMBLY TO BE REMOVED	12" x 18"
E7-24 (SHARED POST) POST MOUNTED (GROUND) 699+77 29.5' RT SIGN PANEL ASSEMBLY TO BE RELOCATED	
E7-24a WILLOW RD (2 SIGN PANELS BACK TO BACK) NB/SB SIGN PANEL TO BE RELOCATED WITH ASSEN	
E7-24b EATON ST (2 SIGN PANELS BACK TO BACK) EB/WB SIGN PANEL TO BE RELOCATED WITH ASSEN	
E7-25 SPEED LIMIT 20 POST MOUNTED (GROUND) 699+89 76.4' RT SB SIGN PANEL ASSEMBLY TO BE RELOCATED	
E7-26 STOP SIGN POST MOUNTED (GROUND) 700+19 54.2' RT NB SIGN PANEL ASSEMBLY TO BE RELOCATED	
E7-27 (SHARED POST) POST MOUNTED (GROUND) 701+56 24.7' LT SIGN PANEL ASSEMBLY TO BE RELOCATED	
E7-27a SCHOOL CROSSING WB SIGN PANEL TO BE RELOCATED WITH ASSEN	
E7-27b NO PARKING ANY TIME WB SIGN PANEL TO BE REMOVED	12" x 18"
E7-28 NO PARKING ANY TIME POST MOUNTED (GROUND) 701+60 24.5' RT EB SIGN PANEL ASSEMBLY TO BE REMOVED	12" x 18"
E7-29 WARNING UNDERGROUND CABLE POST MOUNTED (GROUND) 702+02 37.9' LT NB SIGN PANEL ASSEMBLY TO BE REMOVED BY	Y OTHERS 4" x 8"

-	FILE NAME =	USER NAME = BAWitort	DESIGNED	-	JLV	REVISED	-
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		PLOT SCALE = 40.000 '/ in.	CHECKED	-	RCB	REVISED	-
- [PLOT DATE = 11/1/2012	DATE	-	10/31/2012	REVISED	-
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STATE OF ILLINOIS DEPARTMENT OF TRANSPORTATION

		Alon Acustus	F.A.P. RTE.	SECTION	COUNTY	TOTAL SHEETS	SHEET NO.
	SIGN SCHEDULE			(1920.01,1518,2022&1922.4B)R	COOK	919	292
ı					CONTRACT	NO. 60	T35
	SCALE: N.T.S	SHEET NO. 292 OF 919 SHEETS	FED. F	OAD DIST. NO. 1 ILLINOIS FED. AI	D PROJECT		

- 1. SIGN SHALL BE RE-ERECTED ACCORDING TO ARTICLE 107.25 OF THE STANDARD SPECIFICATION (PROTECTION AND RESTORATION OF TRAFFIC SIGNS). ADDITIONAL SIGNS THAT HAVE NOT BEEN SURVEYED BUT ARE OBSCURED BY CONSTRUCTION OPERATIONS SHALL ALSO BE RE-ERECTED ACCORDING TO ARTICLE 107.25.
- 2. ALL EXISTING PRIVATE SIGNS WITHIN THE STATE ROW THAT INTERFERE WITH CONSTRUCTION OPERATIONS WILL BE REMOVED AND REPLACED BY OTHERS. THE CONTRACTOR SHALL NOTIFY THE OWNERS PRIOR TO THE START OF CONSTRUCTION.
- 3. EXISTING SIGN PANEL AND ASSEMBLY TO BE REMOVED SHALL BE DELIVERED TO AN IDOT MAINTENANCE YARD SPECIFIED BY THE ENGINEER.

EXISTING SIGN NUMBER	PANEL DESCRIPTION	SIGN SUPPORT	STATION	OFFSE ⁻	Т	FACING TRAFFIC	ACTION	DIMENSIC W x H	
E7-30	(SHARED POST)	POST MOUNTED (GROUND)	703+24	23.4'	RT		SIGN PANEL ASSEMBLY TO BE REMOVED		
E7-30a	NO PARKING ANY TIME					EB	SIGN PANEL TO BE REMOVED WITH ASSEMBLY	12" x	18"
E7-30b	NO PASSING ZONE					WB	SIGN PANEL TO BE REMOVED WITH ASSEMBLY	42" x	34"
E7-31	NO PARKING ANY TIME	CIRCULAR POST MOUNTED (GROUND)	703+26	21.0'	LT	WB	SIGN PANEL ASSEMBLY TO BE REMOVED		18"
E7-32	SPEED LIMIT 20	POST MOUNTED (GROUND)	703+54	73.8'	RT	SB	SIGN PANEL ASSEMBLY TO BE RELOCATED		30"
E7-33	(SHARED POST)	POST MOUNTED (GROUND)	703+84	54.1'	RT		SIGN PANEL ASSEMBLY TO BE RELOCATED		
E7-33a	WILLOW RD (2 SIGN PANELS BACK TO BACK)	TOOT MOONTED (GROOND)	703104	34.1	13.1	NB/SB	SIGN PANEL TO BE RELOCATED WITH ASSEMBLY	24" x	10"
	DICKENS ST (2 SIGN PANELS BACK TO BACK)								
E7-33b						EB/WB	SIGN PANEL TO BE RELOCATED WITH ASSEMBLY		10"
E7-33c	STOP SIGN					NB	SIGN PANEL TO BE RELOCATED WITH ASSEMBLY	30" x	30"
	(STA 704+00 TO STA 716+00)								
E8-1	NO PARKING ANY TIME	CIRCULAR POST MOUNTED (GROUND)	705+91	23.3'	LT	WB	SIGN PANEL ASSEMBLY TO BE REMOVED	12" x	18"
E8-2	SPEED LIMIT 20	POST MOUNTED (GROUND)	707+20	73.4'	RT	SB	SIGN PANEL ASSEMBLY TO BE RELOCATED	24" x	30"
E8-3	STOP SIGN	POST MOUNTED (GROUND)	707+50	53.6'	RT	NB	SIGN PANEL ASSEMBLY TO BE RELOCATED	30" x	30"
E8-4	(SHARED POST)	POST MOUNTED (GROUND)	707+58	38.6'	RT		SIGN PANEL ASSEMBLY TO BE RELOCATED		
E8-4a	WILLOW RD (2 SIGN PANELS BACK TO BACK)	(NB/SB	SIGN PANEL TO BE RELOCATED WITH ASSEMBLY	24" x	10"
E8-4b	CHURCHILL ST (2 SIGN PANELS BACK TO BACK)					EB/SB	SIGN PANEL TO BE RELOCATED WITH ASSEMBLY		10"
E8-5		POCT MOUNTED (OPOUND)	700.00	00.51	ВΤ				
	NO PARKING ANY TIME	POST MOUNTED (GROUND)	709+02	22.5'	RT	EB	SIGN PANEL ASSEMBLY TO BE REMOVED		18"
E8-6	CLARKSON PARK	DUAL STONE POSTS	709+29	54.7'	RT	SB	SIGN AND POST TO REMAIN		21"
E8-7	WILLOW PARK	DUAL WOOD POSTS	709+54	76.1'	LT	WB	SIGN AND POST TO REMAIN		24"
E8-8	NO PARKING ANY TIME	POST MOUNTED (GROUND)	709+64	21.4'	LT	WB	SIGN PANEL ASSEMBLY TO BE REMOVED	12" x	18"
E8-9	SPEED LIMIT 35	POST MOUNTED (GROUND)	709+70	21.4'	LT	WB	SIGN PANEL ASSEMBLY TO BE REMOVED	30" x	36"
E8-10	(SHARED POST)	POST MOUNTED (GROUND)	709+85	27.1'	LT		SIGN PANEL ASSEMBLY TO BE RELOCATED		
E8-10a	N. BRISTOL ST (2 SIGN PANELS BACK TO BACK)	, commonnes (encome)	700 00			EB/WB	SIGN PANEL TO BE RELOCATED WITH ASSEMBLY	36" x	10"
E8-10b	TO ROBINHOOD LN (2 SIGN PANELS BACK TO BACK)					EB/WB	SIGN PANEL TO BE RELOCATED WITH ASSEMBLY	30" x	8"
	· · · · · · · · · · · · · · · · · · ·								
E8-10c	STOP SIGN					SB	SIGN PANEL TO BE RELOCATED WITH ASSEMBLY		30"
E8-11	NO PARKING STANDING OR UNLOADING	POST MOUNTED (GROUND)	709+89	96.5'	LT	WB	SIGN AND POST TO REMAIN		18"
E8-12	ATHLETIC DROP OFF PROHIBITED	POST MOUNTED (GROUND)	709+89	60.1'	LT	NB	SIGN AND POST TO REMAIN		18"
E8-13	NO PARKING STANDING OR UNLOADING	POST MOUNTED (GROUND)	709+88	164.7'	LT	WB	SIGN AND POST TO REMAIN	12" x	18"
E8-14	RESERVED PARKING	POST MOUNTED (GROUND)	710+31	81.4'	LT	NB	SIGN AND POST TO REMAIN	16" x	16"
E8-15	RESIDENT PARKING ONLY	POST MOUNTED (GROUND)	710+33	151.3'	LT	EB	SIGN AND POST TO REMAIN	16" x	16"
E8-16	RESIDENT PARKING ONLY	POST MOUNTED (GROUND)	710+33	166.7'	LT	EB	SIGN AND POST TO REMAIN		16"
E8-17	NO PARKING HOURS	POST MOUNTED (GROUND)	710+65	125.0'	RT	WB	SIGN AND POST TO REMAIN		18"
						VVD			
E8-18	(SHARED POST)	POST MOUNTED (GROUND)	710+73	32.0'	RT		SIGN PANEL ASSEMBLY TO BE RELOCATED		
E8-18a	BRISTOL ST (2 SIGN PANELS BACK TO BACK)					EB/WB	SIGN PANEL TO BE RELOCATED WITH ASSEMBLY		10"
E8-18b	WILLOW RD (2 SIGN PANELS BACK TO BACK)					NB/SB	SIGN PANEL TO BE RELOCATED WITH ASSEMBLY		10"
E8-19	SPEED LIMIT 20	POST MOUNTED (GROUND)	710+81	72.7'	RT	SB	SIGN PANEL ASSEMBLY TO BE RELOCATED	24" x	30"
E8-20	NO PARKING FIRE LANE	MOUNTED ON WOODEN FENCE	710+90	49.5'	LT	SB	SIGN AND POST TO REMAIN	24" x	24"
E8-21	RESERVED PARKING	POST MOUNTED (GROUND)	711+07	79.4'	LT	NB	SIGN AND POST TO REMAIN	16" x	16"
E8-22	STOP SIGN	POST MOUNTED (GROUND)	711+16	54.5'	RT	NB	SIGN PANEL ASSEMBLY TO BE REMOVED	30" x	30"
E8-23	DO NOT DRIVE ON SHOULDER	POST MOUNTED (GROUND)	711+49	25.0'	LT	WB	SIGN PANEL ASSEMBLY TO BE REMOVED		24"
E8-24	NO PARKING FIRE LANE	MOUNTED ON WOODEN FENCE	711+53	49.4'	LT	SB	SIGN AND POST TO REMAIN		18"
E8-25	SPEED LIMIT 35	POST MOUNTED (GROUND)	711+56	20.2'	RT	EB	SIGN PANEL ASSEMBLY TO BE REMOVED		36"
E8-26	NO PARKING FIRE LANE	MOUNTED ON WOODEN FENCE	712+19	49.2'	LT	SB	SIGN AND POST TO REMAIN	12" x	18"
E8-27	PRIVATE PROPERTY TOW AWAY ZONE	POST MOUNTED (GROUND)	712+67	73.8'	LT	NB	SIGN AND POST TO REMAIN	12" x	18"
E8-28	PRIVATE PROPERTY TOW AWAY ZONE	POST MOUNTED (GROUND)	713+34	73.7'	LT	NB	SIGN AND POST TO REMAIN	12" x	18"
E8-29	NO PARKING FIRE LANE	MOUNTED ON WOODEN FENCE	713+63	51.8'	LT	SB	SIGN AND POST TO REMAIN	12" x	18"
E8-30	NO PARKING FIRE LANE	POST MOUNTED (GROUND)	714+01	133.7'	LT	EB	SIGN AND POST TO REMAIN		18"
	(STA 716+00 TO STA 728+00)		1 ,,,,,,,,				Joseph Maria Para Para Para Para Para Para Para		
E9-1	LANE ENDS	DOST MOUNTED (CROUND)	716+26	26.11	1.7	WB	CICN DANIEL ASSEMBLY TO BE DEMOVED	36" x	26"
		POST MOUNTED (GROUND)		36.1'	LT		SIGN PANEL ASSEMBLY TO BE REMOVED		36"
E9-2	NEW RETAIL SPACE FOR LEASE	POST MOUNTED (GROUND)	717+00	54.0'	RT	SB	SIGN AND POST TO REMAIN	96" x	
E9-3	LEFT TURN LANE	POST MOUNTED (LANDSCAPED MEDIAN)	717+52	0.8'	LT	EB	SIGN PANEL ASSEMBLY TO BE REMOVED	24" x	30"
E9-4	(SHARED POST)	POST MOUNTED (GROUND)	717+62	54.4'	RT		SIGN PANEL ASSEMBLY TO BE RELOCATED		
E9-4a	WILLOW RD (2 SIGN PANELS BACK TO BACK)					NB/SB	SIGN PANEL TO BE RELOCATED WITH ASSEMBLY	24" x	10"
E9-4b	ALICE PL (2 SIGN PANELS BACK TO BACK)					EB/WB	SIGN PANEL TO BE RELOCATED WITH ASSEMBLY	24" x	10"
E9-4c	NO OUTLET					EB	SIGN PANEL TO BE RELOCATED WITH ASSEMBLY	24" x	
E9-4d	STOP SIGN					NB			
		DOCT MOUNTED (CDOUND)	747.00	140.01	рт	IND	SIGN PANEL TO BE RELOCATED WITH ASSEMBLY	3U X	
E9-5	(SHARED POST)	POST MOUNTED (GROUND)	717+68	148.6'	RT		POST TO REMAIN		
E9-5a	1HR PARKING HOURS					WB	SIGN TO REMAIN		18"
E9-5b	NO PARKING HOURS					WB	SIGN TO REMAIN	12" x	18"
E9-6	(SHARED POST)	POST MOUNTED (GROUND)	717+68	53.2'	RT		POST TO REMAIN		
E9-6a	RESERVED PARKING HANDICAP	,				NB	SIGN TO REMAIN	12" x	18"
E9-6b	\$250 FINE					NB	SIGN TO REMAIN		
E9-7	STOP SIGN	POST MOUNTED (GROUND)	717+78	183.4'	LT	EB	SIGN AND POST TO REMAIN	30" x	
		` /							
E9-8 E9-9	ADVANCE INTERSECTION LANE CONTROL	POST MOUNTED (GROUND)	717+84	174.6'	LT	SB	SIGN AND POST TO REMAIN	36" x	
	SHELL GAS SIGN	STONE BASE	717+83	56.2'	LT	WB	SIGN AND POST TO REMAIN	96" x	65"

١	FILE NAME =	USER NAME = BAWitort	DESIGNED	-	JLV	REVISED	-
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		PLOT DATE = 11/30/2012	DATE	-	10/31/2012	REVISED	-
ı		1001 DATE - 11/36/2012	DAIL		107 317 2012	IVE ATOED	

STATE OF ILLINOIS DEPARTMENT OF TRANSPORTATION

SCALE: N.T.S

	F.A.P. RTE.	SECTION	COUNTY	TOTAL SHEETS	SHEET NO.
SIGN SCHEDULE		(1920.01,1518,2022&1922.4B)R	COOK	919	293
			CONTRACT	NO. 60	T 35
SHEET NO. 293 OF 919 SHEETS	FED. R	OAD DIST. NO. 1 ILLINOIS FED. A	D PROJECT		

- 1. SIGN SHALL BE RE-ERECTED ACCORDING TO ARTICLE 107.25 OF THE STANDARD SPECIFICATION (PROTECTION AND RESTORATION OF TRAFFIC SIGNS). ADDITIONAL SIGNS THAT HAVE NOT BEEN SURVEYED BUT ARE OBSCURED BY CONSTRUCTION OPERATIONS SHALL ALSO BE RE-ERECTED ACCORDING TO ARTICLE 107.25.
- 2. ALL EXISTING PRIVATE SIGNS WITHIN THE STATE ROW THAT INTERFERE WITH CONSTRUCTION OPERATIONS WILL BE REMOVED AND REPLACED BY OTHERS. THE CONTRACTOR SHALL NOTIFY THE OWNERS PRIOR TO THE START OF CONSTRUCTION.
- 3. EXISTING SIGN PANEL AND ASSEMBLY TO BE REMOVED SHALL BE DELIVERED TO AN IDOT MAINTENANCE YARD SPECIFIED BY THE ENGINEER.

EXISTING SIGN NUMBER	PANEL DESCRIPTION	SIGNSUPPORT	STATION	OFFSE	ΞT	FACING TRAFFIC	ACTION		MENS W x F	
E9-10	NORTHFIELD RD / OLD WILLOW RD	MOUNTED ON SIGNAL POST MAST	717+95	35.8'	LT	WB	SIGN PANEL TO BE REMOVED	64"	Х	30"
E9-11	(SHARED POST)	POST MOUNTED (LANDSCAPED MEDIAN)	718+04	0.2'	LT		SIGN PANEL ASSEMBLY TO BE RELOCATED			
E9-11a	LEFT TURN ONLY					EB	SIGN PANEL TO BE RELOCATED WITH ASSEMBLY	24"	Х	30"
E9-11b	KEEP RIGHT					WB	SIGN PANEL TO BE RELOCATED WITH ASSEMBLY	24"	Х	30"
E9-12	FOLDED STOP SIGN	MOUNTED ON SIGNAL POST	718+09	49.1'	LT	SB	SIGN PANEL TO BE RELOCATED ON NEW LIGHT POLE	36"	Х	36"
E9-13	FOLDED STOP SIGN	MOUNTED ON SIGNAL POST	718+30	44.7'	RT	EB	SIGN PANEL TO BE RELOCATED ON NEW LIGHT POLE	36"	Х	36"
E9-14	NO PARKING ANY TIME	POST MOUNTED (GROUND)	718+72	122.0'	RT	SB	SIGN AND POST TO REMAIN	12"	Х	18"
E9-15	WALGREENS SIGN	STONE BASE	718+93	70.5'	LT	EB/WB	SIGN AND POST TO REMAIN	72"	x	50"
E9-16	(SHARED POST)	MOUNTED ON SIGNAL POST	719+01	41.3'	LT		SIGN PANEL ASSEMBLY TO BE RELOCATED ON NEW SIGNAL POST			
E9-16a	RIGHT TURN ONLY					WB	SIGN PANEL TO BE REMOVED	36"	Х	36"
E9-16b	FOLDED STOP SIGN					WB	SIGN PANEL TO BE RELOCATED WITH ASSEMBLY	30"	Х	
E9-17	(SHARED POST)	POST MOUNTED (LANDSCAPED MEDIAN)	719+03	14.2'	RT		SIGN PANEL ASSEMBLY TO BE RELOCATED			
E9-17a	KEEP RIGHT	Too mooning (Entropy and Entropy and	110 00			EB	SIGN PANEL TO BE RELOCATED WITH ASSEMBLY	24"	х	30"
E9-17b	LEFT TURN ONLY					WB	SIGN PANEL TO BE RELOCATED WITH ASSEMBLY	24"	X	
E9-18	FOLDED STOP SIGN	MOUNTED ON SIGNAL POST	719+06	63.5'	RT	NB	SIGN PANEL TO BE RELOCATED ON NEW LIGHT POLE		X	
E9-19			719+21	50.3'	RT	IND	SIGN PANEL ASSEMBLY TO BE RELOCATED ON NEW SIGNAL POST	30		
	(SHARED POST)	MOUNTED ON SIGNAL POST	7 19721	50.5	ΚI	ED		0.4"		40"
E9-19a	TO					EB	SIGN PANEL TO BE RELOCATED WITH ASSEMBLY	24"	Х	
E9-19b	WEST					EB	SIGN PANEL TO BE RELOCATED WITH ASSEMBLY	24"	Х	
E9-19c	INTERSTATE 94					EB	SIGN PANEL TO BE RELOCATED WITH ASSEMBLY	24"	Х	
E9-19d	ADVANCE TURN ARROW					EB	SIGN PANEL TO BE RELOCATED WITH ASSEMBLY	21"	Х	
E9-20	DOMINICK'S SIGN	DUAL STONE POSTS	719+38	71.6'	RT	EB	SIGN AND POST TO REMAIN	96"	Х	
E9-21	SPEED LIMIT 35	MOUNTED ON STREET LIGHT POLE	720+26	43.4'	LT	WB	SIGN PANEL TO BE REMOVED	30"	Х	36"
E9-22	POST OFFICE / LIBRARY DIRECTION	MOUNTED ON STREET LIGHT POLE	720+36	45.0'	RT	EB	SIGN PANEL TO BE RELOCATED ON NEW LIGHT POLE	24"	Х	18"
E9-23	ONE WAY	POST MOUNTED (LANDSCAPED MEDIAN)	720+48	5.5'	RT	SB	SIGN PANEL ASSEMBLY TO BE REMOVED	24"	Х	30"
E9-24	STOP SIGN	POST MOUNTED (GROUND)	720+65	67.7'	LT	SB	SIGN AND POST TO REMAIN	30"	Х	30"
E9-25	RIGHT TURN ONLY	POST MOUNTED (LANDSCAPED ISLAND)	720+88	70.0'	LT	SB	SIGN AND POST TO REMAIN	24"	X	30"
E9-26	(SHARED POST)	POST MOUNTED (GROUND)	721+67	77.8'	LT		POST TO REMAIN			
E9-26a	DANGER UNDERGROUND FIBER OPTIC CABLE	(**************************************				EB	SIGN TO REMAIN	9"	Х	12"
E9-26b	DANGER UNDERGROUND FIBER OPTIC CABLE					WB	SIGN TO REMAIN	9"	Х	
E9-27	EMPTY POST	POST (GROUND)	721+68	77.3'	LT	-	SIGN AND POST TO REMAIN	_	X	
E9-28	WARNING FIBER OPTIC CABLE BURIED	POST MOUNTED (GROUND)	721+70	76.9'	LT	NB	SIGN AND POST TO REMAIN	4"	X	12"
E9-29	(SHARED POST)	POST MOUNTED (GROUND)	721+83	73.3'	RT	IND	POST TO REMAIN			
E9-29a	,	FOOT MODIVIED (GROUND)	721+03	13.3	KI	EB	SIGN TO REMAIN	10"		14"
E9-29b	WARNING NO DIGGING					WB		10"		
	WARNING NO DIGGING	DOOT MOUNTED (ODOUND)	700.44	05.01	D.T.	VVD	SIGN TO REMAIN	10	Х	
E9-30	(SHARED POST)	POST MOUNTED (GROUND)	722+14	65.3'	RT		POST TO REMAIN			
E9-30a	DANGER UNDERGROUND FIBER OPTIC CABLE					EB	SIGN TO REMAIN	9"	Х	
E9-30b	DANGER UNDERGROUND FIBER OPTIC CABLE					WB	SIGN TO REMAIN	9"	Х	
E9-31	WARNING FIBER OPTIC CABLE BURIED	POST MOUNTED (GROUND)	722+18	64.1'	RT	SB	SIGN AND POST TO REMAIN	4"	Х	12"
E9-32	(SHARED POST)	POST MOUNTED (LANDSCAPED MEDIAN)	722+69	2.4'	RT		SIGN PANEL ASSEMBLY TO BE RELOCATED			
E9-32a	LEFT TURN ONLY					EB	SIGN PANEL TO BE RELOCATED WITH ASSEMBLY	24"	Х	30"
E9-32b	KEEP RIGHT					WB	SIGN PANEL TO BE RELOCATED WITH ASSEMBLY	24"	Х	30"
E9-33	NO PARKING ANY TIME	MOUNTED ON DECORATIVE STREET LIGHT POLE	722+72	110.5'	LT	WB	SIGN AND POLE TO REMAIN	24"	Х	30"
E9-34	(SHARED POST)	MOUNTED ON SIGNAL POST	722+73	50.8'	LT		SIGN PANEL ASSEMBLY TO BE RELOCATED ON NEW SIGNAL POST			
E9-34a	EAST					SB	SIGN PANEL TO BE RELOCATED WITH ASSEMBLY	24"	Х	12"
E9-34b	INTERSTATE 94					SB	SIGN PANEL TO BE RELOCATED WITH ASSEMBLY	24"	Х	24"
E9-34c	DIRECTIONAL ARROW					SB	SIGN PANEL TO BE RELOCATED WITH ASSEMBLY	21"	x	15"
E9-34d	NO TURN ON RED					SB	SIGN PANEL TO BE REMOVED			30"
E9-34e	FOLDED STOP SIGN					SB	SIGN PANEL TO BE RELOCATED WITH ASSEMBLY		Х	
E9-35	(SHARED POST)	POST MOUNTED (GROUND)	723+02	65.7'	RT		POST TO REMAIN			
E9-35a	TO		. 20.02	1 30.7		EB	SIGN TO REMAIN	24"		12"
E9-35b	EAST					EB	SIGN TO REMAIN			12"
E9-350	INTERSTATE 94					EB	SIGN TO REMAIN			24"
E9-35d	DIRECTIONAL ARROW					EB	SIGN TO REMAIN	21"		
	(SHARED POST)	MOUNTED ON SIGNAL POST	700.44	65.01	рт	ED		21"		10
E9-36	(INIOUNTED ON SIGNAL POST	723+11	65.3'	RT		SIGN PANEL ASSEMBLY TO BE RELOCATED ON NEW SIGNAL POST	0.45		
E9-36a	TO					EB	SIGN PANEL TO BE RELOCATED WITH ASSEMBLY			12"
E9-36b	WEST					EB	SIGN PANEL TO BE RELOCATED WITH ASSEMBLY			12"
E9-36c	INTERSTATE 94					EB	SIGN PANEL TO BE RELOCATED WITH ASSEMBLY		Х	
E9-36d	DIRECTIONAL ARROW					EB	SIGN PANEL TO BE RELOCATED WITH ASSEMBLY		Х	
E9-36e	FOLDED STOP SIGN					EB	SIGN PANEL TO BE RELOCATED WITH ASSEMBLY			36"
E9-37	NO PARKING STOPPING OR STANDING	MOUNTED ON DECORATIVE STREET LIGHT POLE	723+36	193.3'	LT	WB	SIGN AND POLE TO REMAIN	24"	х	30"
E9-38	LANE ENDS	MOUNTED ON DECORATIVE STREET LIGHT POLE	723+39	155.9'	LT	NB	SIGN AND POLE TO REMAIN	36"	Х	36"
E9-39	CENTRAL (POOR QUALITY, COULD NOT READ)	MOUNTED ON SIGNAL POST	723+62	45.7'	LT	WB	SIGN PANEL TO BE REMOVED	30"	Х	15"
E9-40	CIRCULAR STARBUCKS SIGN	POST MOUNTED (GROUND)	723+72	46.6'	LT	EB/WB	SIGN AND POST TO REMAIN	52"		52"

-	FILE NAME =	USER NAME = BAWitort	DESIGNED	-	JLV	REVISED	-
-	g:\chll\0158\road\Sheets\D160T35-SHT-SIG	N-SCHØ6.dgn	DRAWN	-	MTS	REVISED	-
-		PLOT SCALE = 40.000 '/ in.	CHECKED	-	RCB	REVISED	-
-[PLOT DATE = 11/1/2012	DATE	-	10/31/2012	REVISED	-
L							

STATE OF ILLINOIS DEPARTMENT OF TRANSPORTATION

		I R	.A.P.	SECTION	COUNTY	TOTAL	SHEET NO.
SIGN SCHEDULE				(1920.01,1518,2022&1922.4B)R	COOK	919	294
					CONTRACT	NO. 60	T35
SCALE: N.T.S	SHEET NO. 294 OF 919 SHEETS	FE	FED. RO	DAD DIST. NO. 1 ILLINOIS FED. AI	D PROJECT		

- 1. SIGN SHALL BE RE-ERECTED ACCORDING TO ARTICLE 107.25 OF THE STANDARD SPECIFICATION (PROTECTION AND RESTORATION OF TRAFFIC SIGNS). ADDITIONAL SIGNS THAT HAVE NOT BEEN SURVEYED BUT ARE OBSCURED BY CONSTRUCTION OPERATIONS SHALL ALSO BE RE-ERECTED ACCORDING TO ARTICLE 107.25.
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- 3. EXISTING SIGN PANEL AND ASSEMBLY TO BE REMOVED SHALL BE DELIVERED TO AN IDOT MAINTENANCE YARD SPECIFIED BY THE ENGINEER.

EACH CARREST NAME CARREST TOPP	EXISTING SIGN NUMBER	PANEL DESCRIPTION	SIGN SUPPORT	STATION	OFFSET		FACING TRAFFIC	ACTION		MENSION W x H	١
Design	E9-41	(SHARED POST)	MOUNTED ON PARKING LOT LIGHT POLE	723+72	116.3'	LT		POLE TO REMAIN			
PACE SERVICE PACE	E9-41a	NO LEFT TURN					NB	SIGN TO REMAIN	36"	х 3	36"
19-25 10	E9-41b	ONE WAY					NB	SIGN TO REMAIN	24"	х :	30"
Fig.	E9-42	(SHARED POST)	MOUNTED ON SIGNAL POST	723+73	34.0'	LT		SIGN PANEL ASSEMBLY TO BE RELOCATED ON NEW SIGNAL POST			
MISSPETER	E9-42a	ТО					WB	SIGN PANEL TO BE RELOCATED WITH ASSEMBLY	24"	X	12"
BESTERM AMENON	E9-42b	WEST					WB	SIGN PANEL TO BE RELOCATED WITH ASSEMBLY	24"	x	12"
Part	E9-42c	INTERSTATE 94					WB	SIGN PANEL TO BE RELOCATED WITH ASSEMBLY	24"	х .:	24"
Section Sect	E9-42d	DIRECTIONAL ARROW					WB	SIGN PANEL TO BE RELOCATED WITH ASSEMBLY	21"	х ′	15"
Section Part	E9-42e	FOLDED STOP SIGN					WB	SIGN PANEL TO BE RELOCATED WITH ASSEMBLY	30"	х :	30"
Beach	E9-43	(SHARED POST)	MOUNTED ON PARKING LOT LIGHT POLE	723+78	147.6'	LT		POLE TO REMAIN			
Part	E9-43a	ONE WAY ARROW					NB	SIGN TO REMAIN	54"	x í	36"
General Content	E9-43b	NO LEFT TURN					NB	SIGN TO REMAIN	36"	х 3	36"
E8-48 REPRINTED NATE	E9-43c	NO PARKING ANY TIME					NB	SIGN TO REMAIN	12"	X ´	18"
Sept Decoration Decoratio		(SHARED POST)	POST MOUNTED (LANDSCAPED MEDIAN)	723+82	14.7'	RT		SIGN PANEL ASSEMBLY TO BE RELOCATED			
Section Sect	E9-44a	KEEP RIGHT					EB	SIGN PANEL TO BE RELOCATED WITH ASSEMBLY	24"	х 3	30"
B-45	E9-44b	LEFT TURN ONLY					WB	SIGN PANEL TO BE RELOCATED WITH ASSEMBLY	24"	х :	30"
EA-56 PERCENTION MONTED ON SOME POST 73-19 15	E9-45	(SHARED POST)	MOUNTED ON SIGNAL POST	723+98	68.4'	RT		SIGN PANEL ASSEMBLY TO BE RELOCATED ON NEW LIGHT POLE			
SHARED POINT MOUNTED OR SIGNAL POST 724-19 51.5 RT SINNAMEL ASSISTANT TORS READYD RESISTANT TORS REA	E9-45a	NO TURN ON RED WHEN PEDESTRIANS PRESENT					NB	SIGN PANEL TO BE REMOVED	24"	х	30"
EP-49 CRITINA, MAY S. HAPPINO	E9-45b	FOLDED STOP SIGN					NB	SIGN PANEL TO BE RELOCATED WITH ASSEMBLY	30"	х :	30"
EAST SPEED MAIR 5 EB SCHAPMENT OB EREXIVED WITH ASSEMBLY SZ KE NAME ASSEMBLY OB EREXIVED WITH ASSEMBLY OB EREXIV	E9-46	(SHARED POST)	MOUNTED ON SIGNAL POST	724+13	51.5'	RT		SIGN PANEL ASSEMBLY TO BE REMOVED			
EAST PRILEASE DUA POST MONATED GROUND 774-11 32.5 LT 80 SER NOTE 2 17 8 8 8 8 8 8 8 8 8	E9-46a	CENTRAL AVE / S. HAPP RD					EB	SIGN PANEL TO BE REMOVED WITH ASSEMBLY	48"	х :	30"
BEH-9 SRIFT TURNONLY NOUNTED OND ECONOMY STREET LIGHT POLE 7414 96.71 81 81 81 81 81 81 81	E9-46b	SPEED LIMIT 35					EB	SIGN PANEL TO BE REMOVED WITH ASSEMBLY	30"	x :	36"
E946 SHAMED DOST OQUATED ON STREET LIGHT POLE 72417 \$2.1" IT SIGN PAPEL ASSEMILY TO BE RELOCATED WITH ASSEMILY 30" x	E9-47	FOR LEASE	DUAL POST MOUNTED (GROUND)	724+11	32.8'	LT	NB	SEE NOTE 2	72"	х 4	48"
EM-98	E9-48	RIGHT TURN ONLY	MOUNTED ON DECORATIVE STREET LIGHT POLE	724+14	90.1'	RT	NB	SIGN PANEL ASSEMBLY TO BE REMOVED	24"	х :	30"
E9-58 ADDPTA-HIGHWAY	E9-49	(SHARED POST)	MOUNTED ON STREET LIGHT POLE	724+17	32.1'	LT		SIGN PANEL ASSEMBLY TO BE RELOCATED ON NEW LIGHT POLE			
19-96	E9-49a	LOVE THE LAND OF LINCOLN					WB	SIGN PANEL TO BE RELOCATED WITH ASSEMBLY	30"	x :	36"
B9-50 RIGHT TURNONLY MOUNTED ON PARINGLOT LIGHT POLE 724-40 54.6 LT 58 SION AND POLE TO REMAN 21.7 x	E9-49b	ADOPT-A-HIGHWAY					WB	SIGN PANEL TO BE RELOCATED WITH ASSEMBLY	30"	χ .	18"
ES-51 NOEMT TO SOUTHPOUND HAPP ROAD OST MOUNTED (ROLLAND) 724-44 45.2 LT 58 SIGN AND POST TO ERLAND 50" X	E9-49c	KEEP ILLINOIS CLEAN					WB	SIGN PANEL TO BE RELOCATED WITH ASSEMBLY	50"	х '	25"
E3-52 ADVANCE MERSECTION LANE CONTROL MOUNTED ON DECORATIVE STREET LIGHT POLE 724-47 114.5 RT NB SIGN-PANEL ASSEMBLY TO BE REMOVED 24° x 2	E9-50	RIGHT TURN ONLY	MOUNTED ON PARKING LOT LIGHT POLE	724+40	54.4'	LT	SB	SIGN AND POLE TO REMAIN	24"	x :	30"
E9-59 ONE WAY	E9-51	NO EXIT TO SOUTHBOUND HAPP ROAD	POST MOUNTED (GROUND)	724+44	45.2'	LT	SB	SIGN AND POST TO REMAIN	60"	x :	36"
69-54 ONE WAY	E9-52	ADVANCE INTERSECTION LANE CONTROL	MOUNTED ON DECORATIVE STREET LIGHT POLE	724+47	134.5'	RT	NB	SIGN PANEL ASSEMBLY TO BE REMOVED	42"	x :	30"
E9-54 ORREN PICKEL DESIGN SHOWNOOM DUAL WOOD POSTS 725-95 36 /67 LT W8 SIGN AND POST TO REMAN 90" x	E9-53	ONE WAY	POST MOUNTED (LANDSCAPED MEDIAN)	724+61		_	SB	SIGN PANEL ASSEMBLY TO BE REMOVED	24"	х 3	30"
E9-56 PEGESTRIAN CROSSING		ORREN PICKELL DESIGN SHOWROOM	,	725+05		_	WB		60"	x :	36"
E9-67 RICHTTURN ONLY POST MOUNTED (GROUND) 725-75 34.8" LT 88 SIGN-PAREL ASSEMBLY TO BE RELOCATED 19-86 19	E9-55	ONE WAY	POST MOUNTED (LANDSCAPED MEDIAN)	725+59	3.9'	RT	SB	SIGN PANEL ASSEMBLY TO BE REMOVED	24"	x :	30"
E9-88 SHARED POST)	E9-56	PEDESTRIAN CROSSING	POST MOUNTED (GROUND)	725+65	41.4'	RT	EB	SIGN PANEL ASSEMBLY TO BE REMOVED	30"	x :	30"
E9-88	E9-57	RIGHT TURN ONLY	POST MOUNTED (GROUND)	725+75	34.8'	LT	SB	SIGN PANEL ASSEMBLY TO BE RELOCATED	30"	x :	36"
E9-88	E9-58	(SHARED POST)	POST MOUNTED (GROUND)	725+78	29.9'	LT		SIGN PANEL ASSEMBLY TO BE RELOCATED			
E9-860 CENTRALAVE	E9-58a	POST OFFICE / LIBRARY DIRECTION					WB	SIGN PANEL TO BE RELOCATED WITH ASSEMBLY	24"	x	18"
E9-96 20 MIN-PARKING POST MOUNTED (GROUND) 725-94 102.3" RT WB SIGNAND POST TO REMAIN 12" x	E9-58b	HAPP RD					WB	SIGN PANEL TO BE RELOCATED WITH ASSEMBLY	27"	x	9"
E9-60 POLICE PARKING ONLY	E9-58c	CENTRAL AVE					WB	SIGN PANEL TO BE RELOCATED WITH ASSEMBLY	36"	x	9"
E9-61 POLICE PARKING ONLY	E9-59	20 MIN PARKING	POST MOUNTED (GROUND)	725+93	87.8'	RT	WB	SIGN AND POST TO REMAIN	12"	х ′	18"
POLICE PARKING ONLY	E9-60	POLICE PARKING ONLY	POST MOUNTED (GROUND)	725+94	103.3'	RT	WB	SIGN AND POST TO REMAIN	12"	х .	18"
E9-63	E9-61	POLICE PARKING ONLY	POST MOUNTED (GROUND)	725+94	162.1'	RT	WB	SIGN AND POST TO REMAIN	12"	X ·	18"
E9-63a KEEP RIGHT	E9-62	POLICE PARKING ONLY	POST MOUNTED (GROUND)	725+94	135.3'	RT	WB	SIGN AND POST TO REMAIN	12"	х .	18"
E9-83b NO UTURN	E9-63	(SHARED POST)	POST MOUNTED (LANDSCAPED MEDIAN)	725+99	3.6'	RT		SIGN PANEL ASSEMBLY TO BE RELOCATED			
E9-63c NO U TURN	E9-63a	KEEP RIGHT					WB	SIGN PANEL TO BE RELOCATED WITH ASSEMBLY	24"	x :	30"
E9-64 NORTHFIELD POLICE DEPARTMENT DUAL WOOD POSTS 726+07 62.4" RT SB SIGN AND POST TO REMAIN 60" x	E9-63b	NO U TURN					WB	SIGN PANEL TO BE RELOCATED WITH ASSEMBLY	24"	x :	24"
E9-65 NO LEFT TURN	E9-63c	NO U TURN					EB	SIGN PANEL TO BE RELOCATED WITH ASSEMBLY	24"	x :	24"
E9-66 (SHARED POST) POST MOUNTED (GROUND) 726+54 50.7' RT SIGN PANEL ASSEMBLY TO BE RELOCATED E9-66a WILLOW RD (2 SIGN PANELS BACK TO BACK) E9-66b WALNUT ST (2 SIGN PANELS BACK TO BACK) E9-66b WALNUT ST (2 SIGN PANELS BACK TO BACK) E9-66c STOP SIGN E9-66d NO LEFT TURN E9-66d NO PARKING ANY TIME POST MOUNTED (GROUND) 726+55 114.0' RT EB SIGN PANEL TO BE REMOVED 30" x E9-67 NO PARKING ANY TIME POST MOUNTED (GROUND) 726+55 114.0' RT EB SIGN AND POST TO REMAIN 12" x E9-68 PEDESTRIAN CROSSING MOUNTED (GROUND) 727+23 35.5' RT SIGN PANEL TO BE REMOVED 30" x E9-69 (SHARED POST) POST MOUNTED (GROUND) 727+23 35.5' RT SIGN PANEL TO BE RELOCATED WITH ASSEMBLY 24" x E9-69b INTERSTATE 94 E9-69c DIRECTIONAL ARROW EB SIGN PANEL TO BE RELOCATED WITH ASSEMBLY 24" x E9-69c DIRECTIONAL ARROW EB SIGN PANEL TO BE RELOCATED WITH ASSEMBLY 24" x E9-69d SHARE THE DRIVE E9-70a SIGNAL AHEAD E9-70a SIGNAL AHEAD FOST MOUNTED (GROUND) 727+46 37.5' LT WB SIGN PANEL TO BE RELOCATED WITH ASSEMBLY 21" x SIGN PANEL TO BE RELOCATED WITH ASSEMBLY 21" x E9-70a SIGNAL AHEAD FOST MOUNTED (GROUND) 727+46 37.5' LT WB SIGN PANEL TO BE RELOCATED WITH ASSEMBLY 21" x SIGN PANEL TO BE RELOCATED WITH ASSEMBLY 21" x E9-70a SIGNAL AHEAD	E9-64	NORTHFIELD POLICE DEPARTMENT	DUAL WOOD POSTS	726+07	62.4'	RT	SB	SIGN AND POST TO REMAIN	60"	x :	30"
E9-66a WILLOW RD (2 SIGN PANELS BACK TO BACK) NB/SB SIGN PANEL TO BE RELOCATED WITH ASSEMBLY 24" x	E9-65	NO LEFT TURN	POST MOUNTED (GROUND)	726+38	33.5'	LT	NB	SIGN PANEL ASSEMBLY TO BE RELOCATED	30"	x :	30"
E9-66b WALNUT ST (2 SIGN PANELS BACK TO BACK) EB/WB SIGN PANEL TO BE RELOCATED WITH ASSEMBLY 24" x	E9-66	(SHARED POST)	POST MOUNTED (GROUND)	726+54	50.7'	RT		SIGN PANEL ASSEMBLY TO BE RELOCATED			
E9-66c STOP SIGN NB SIGN PANEL TO BE RELOCATED WITH ASSEMBLY SOW X	E9-66a	WILLOW RD (2 SIGN PANELS BACK TO BACK)					NB/SB	SIGN PANEL TO BE RELOCATED WITH ASSEMBLY	24"	x	10"
E9-66d NO LEFT TURN	E9-66b	WALNUT ST (2 SIGN PANELS BACK TO BACK)					EB/WB	SIGN PANEL TO BE RELOCATED WITH ASSEMBLY	24"	χ .	10"
F9-67 NO PARKING ANY TIME POST MOUNTED (GROUND) 726+55 114.0' RT EB SIGN AND POST TO REMAIN 12" x	E9-66c	STOP SIGN					NB	SIGN PANEL TO BE RELOCATED WITH ASSEMBLY			_
E9-68 PEDESTRIAN CROSSING MOUNTED ON STREET LIGHT POLE 726+93 39.6" LT WB SIGN PANEL ASSEMBLY TO BE REMOVED 30" x	E9-66d	NO LEFT TURN					NB	SIGN PANEL TO BE REMOVED	30"	x :	30"
E9-68 PEDESTRIAN CROSSING MOUNTED ON STREET LIGHT POLE 726+93 39.6" LT WB SIGN PANEL ASSEMBLY TO BE REMOVED 30" x			POST MOUNTED (GROUND)	726+55	114.0'	RT					
E9-69 (SHARED POST)			` '			_					
E9-69a EAST EB SIGN PANEL TO BE RELOCATED WITH ASSEMBLY 24" x											\neg
E9-69b INTERSTATE 94 EB SIGN PANEL TO BE RELOCATED WITH ASSEMBLY 24" x x x x x x x x x x		,	` '				EB		24"	χ .	12"
E9-69c DIRECTIONAL ARROW EB SIGN PANEL TO BE RELOCATED WITH ASSEMBLY 21" x E9-69d SHARE THE DRIVE EB SIGN PANEL TO BE RELOCATED WITH ASSEMBLY 36" x E9-70 (SHARED POST) POST MOUNTED (GROUND) 727+46 37.5" LT POST TO REMAIN E9-70a SIGNAL AHEAD WB SIGN TO REMAIN 36" x		1				-					
E9-69d SHARE THE DRIVE EB SIGN PANEL TO BE RELOCATED WITH ASSEMBLY 36" x E9-70 (SHARED POST) POST MOUNTED (GROUND) 727+46 37.5" LT POST TO REMAIN E9-70a SIGNAL AHEAD WB SIGN TO REMAIN 36" x						_					
E9-70 (SHARED POST) POST MOUNTED (GROUND) 727+46 37.5' LT POST TO REMAIN E9-70a SIGNAL AHEAD WB SIGN TO REMAIN 36" x											
E9-70a SIGNAL AHEAD WB SIGN TO REMAIN 36" x			POST MOUNTED (GROUND)	727+46	37.5'	LT					
		,		12			WB		36"		36"
THE PARTY OF THE P	E9-70b	S. HAPP RD / CENTRAL AVE	1			-+	WB	SIGN TO REMAIN			_

-	FILE NAME =	USER NAME = BAWitort	DESIGNED	-	JLV	REVISED	-
	g:\ch11\0158\road\Sheets\D160T35-SHT-S1G	N-SCHØ7.dgn	DRAWN	-	MTS	REVISED	-
		PLOT SCALE = 40.000 '/ in.	CHECKED	-	RCB	REVISED	-
		PLOT DATE = 11/1/2012	DATE	-	10/31/2012	REVISED	-
-							

STATE OF ILLINOIS DEPARTMENT OF TRANSPORTATION

SCALE: N.T.S

	F.A.P. RTE.	SECTION	COUNTY	TOTAL SHEETS	SHEET NO.
SIGN SCHEDULE		(1920.01,1518,2022&1922.4B)R	COOK	919	295
			CONTRACT	NO. 60	T 35
SHEET NO. 295 OF 919 SHEETS	FED. R	OAD DIST. NO. 1 ILLINOIS FED. AI	D PROJECT		

- 1. SIGN SHALL BE RE-ERECTED ACCORDING TO ARTICLE 107.25 OF THE STANDARD SPECIFICATION (PROTECTION AND RESTORATION OF TRAFFIC SIGNS). ADDITIONAL SIGNS THAT HAVE NOT BEEN SURVEYED BUT ARE OBSCURED BY CONSTRUCTION OPERATIONS SHALL ALSO BE RE-ERECTED ACCORDING TO ARTICLE 107.25.
- 2. ALL EXISTING PRIVATE SIGNS WITHIN THE STATE ROW THAT INTERFERE WITH CONSTRUCTION OPERATIONS WILL BE REMOVED AND REPLACED BY OTHERS. THE CONTRACTOR SHALL NOTIFY THE OWNERS PRIOR TO THE START OF CONSTRUCTION.
- 3. EXISTING SIGN PANEL AND ASSEMBLY TO BE REMOVED SHALL BE DELIVERED TO AN IDOT MAINTENANCE YARD SPECIFIED BY THE ENGINEER.

EXISTING SIGN NUMBER	PANEL DESCRIPTION	SIGN SUPPORT	STATION	OFFSET		FACING TRAFFIC	ACTION		MENS W x I	
E9-71	(SHARED POST)	DUAL WOOD POSTS	727+56	43.0'	LT		SIGN PANEL ASSEMBLY TO BE RELOCATED			
E9-71a	ТО					WB	SIGN PANEL TO BE RELOCATED WITH ASSEMBLY	24"	х	12"
E9-71b	WEST					WB	SIGN PANEL TO BE RELOCATED WITH ASSEMBLY	24"	Х	12"
E9-71c	INTERSTATE 94					WB	SIGN PANEL TO BE RELOCATED WITH ASSEMBLY	24"	х	24"
E9-71d	DIRECTIONAL ARROW					WB	SIGN PANEL TO BE RELOCATED WITH ASSEMBLY	21"	х	15"
E9-71e	EAST INTERSTATE 94 / SOUTH 41 / CHICAGO					WB	SIGN PANEL TO BE REMOVED	96"	х	60"
E9-72	BUCKLE UP	MOUNTED ON STREET LIGHT POLE	727+94	52.1'	RT	EB	SIGN AND POLE TO REMAIN	48"	х	60"
	(STA 728+00 TO STA 740+00)		1 121 11	5=1.						
E10-1	BUCKLE UP	MOUNTED ON STREET LIGHT POLE	728+08	74.8'	LT	WB	SIGN AND POLE TO REMAIN	48"	Х	60"
E10-2	RAMP 20 MPH	POST MOUNTED (GROUND)	729+14	49.8'	LT	WB	SIGN AND POST TO REMAIN	36"	Х	48"
E10-3	RAMP 30 MPH	MOUNTED ON STREET LIGHT POLE	729+59	99.9'	RT	EB	SIGN AND POLE TO REMAIN	36"	X	48"
E10-4	(SHARED POST)	POST MOUNTED (GROUND)	729+79	47.8'	LT		POST TO REMAIN	- 00		
E10-4a	EAST	1 OUT MICONTED (OROUND)	120.10	41.0		WB	SIGN TO REMAIN	24"	Х	12"
E10-4b	INTERSTATE 94					WB	SIGN TO REMAIN	24"	X	24"
E10-4c	DIRECTIONAL ARROW					WB	SIGN TO REMAIN	21"	X	15"
E10-40	(SHARED POST)	POST MOUNTED (METAL FENCE)	732+67	43.7'	LT	VVD	POST TO REMAIN	21		
	, ,	POST MOUNTED (METAL PENCE)	132+01	43.7	LI	WD		24"		401
E10-5a	EAST					WB	SIGN TO REMAIN		Х	12"
E10-5b	INTERSTATE 94					WB	SIGN TO REMAIN	24"	Х	24"
E10-5c	ADVANCE TURN ARROW					WB	SIGN TO REMAIN	21"	Х	15"
E10-6	YIELD	POST MOUNTED (GROUND)	734+55	66.5'	LT	WB	SIGN AND POST TO REMAIN	36"	Х	31"
E10-7	(SHARED POST)	POST MOUNTED (GROUND)	734+67	31.5'	LT		POST TO REMAIN			
E10-7a	DO NOT ENTER					EB	SIGN TO REMAIN	30"	Х	30"
E10-7b	YIELD					WB	SIGN TO REMAIN	36"	Х	31"
E10-8	MERGE	POST MOUNTED (GROUND)	734+91	42.3'	RT	EB	SIGN PANEL ASSEMBLY TO BE REMOVED	36"	Х	36"
E10-9	WRONG WAY	MOUNTED ON STREET LIGHT POLE	734+92	110.1'	LT	WB	SIGN AND POLE TO REMAIN	36"	Х	36"
E10-10	MERGE	POST MOUNTED (OUT OF GROUND)	735+08	32.8'	LT	WB	SIGN PANEL ASSEMBLY TO BE REMOVED	36"	Х	36"
E10-11	WRONG WAY	POST MOUNTED (GROUND)	735+34	76.6'	LT	EB	SIGN AND POST TO REMAIN	36"	Х	36"
E10-12	(SHARED POST)	POST MOUNTED (GROUND)	735+40	38.5'	RT		SIGN PANEL ASSEMBLY TO BE RELOCATED			
E10-12a	STOP SIGN					NB	SIGN PANEL TO BE REMOVED	36"	х	36"
E10-12b	DO NOT ENTER					EB	SIGN PANEL TO BE RELOCATED WITH ASSEMBLY	36"	х	36"
E10-13	AUTHORIZED VEHICLES ONLY	DUAL POST MOUNTED (GROUND)	735+52	73.9'	RT	NB	SIGN PANEL ASSEMBLY TO BE RELOCATED	36"	Х	24"
E10-14	(SHARED POST)	POST MOUNTED (GROUND)	735+54	64.9'	RT		SIGN PANEL ASSEMBLY TO BE RELOCATED ON NEW LIGHT POLE	- 35		
E10-14a	STOP SIGN	1 OOT MICORTED (ORGONE)	700.01	01.0		NB	SIGN PANEL TO BE RELOCATED WITH ASSEMBLY	36"	Х	36"
E10-14b	DO NOT ENTER					WB	SIGN PANEL TO BE RELOCATED WITH ASSEMBLY	36"	X	36"
E10-145	(SHARED POST)	POST MOUNTED (GROUND)	735+72	63.5'	RT	VVD	SIGN PANEL ASSEMBLY TO BE RELOCATED	30		
E10-15	RESERVED PARKING HANDICAP	1 OST MODIVIED (GROUND)	100112	00.0	13.1	NB	SIGN PANEL TO BE RELOCATED WITH ASSEMBLY	12"		18"
E10-15a	\$250 FINE					NB	SIGN PANEL TO BE RELOCATED WITH ASSEMBLY	12"		6"
	140	POOT MOUNTED (ODOUND)	705.04	40.51					Х	6"
E10-16		POST MOUNTED (GROUND)	735+81	40.5'	LT	WB	SIGN AND POST TO REMAIN	12"	Х	
E10-17	(SHARED POST)	POST MOUNTED (GROUND)	735+91	61.8'	RT		SIGN PANEL ASSEMBLY TO BE RELOCATED	400		
E10-17a	RESERVED PARKING HANDICAP					NB	SIGN PANEL TO BE RELOCATED WITH ASSEMBLY		Х	
E10-17b	\$250 FINE					NB	SIGN PANEL TO BE RELOCATED WITH ASSEMBLY	12"		6"
E10-18	NO PARKING ANY TIME	POST MOUNTED (GROUND)	736+40	43.2'	RT	NB	SIGN PANEL ASSEMBLY TO BE RELOCATED	12"	X	18"
E10-19	(SHARED POST)	MOUNTED ON STREET LIGHT POLE	736+46	39.7'	LT		POLE TO REMAIN			
E10-19a	JCT					WB	SIGN TO REMAIN	24"	Х	
E10-19b	EAST					WB	SIGN TO REMAIN	24"	Х	12"
E10-19c	INTERSTATE 94					WB	SIGN TO REMAIN	24"	Х	24"
E10-20	ONE WAY	POST MOUNTED (GROUND)	736+96	35.7'	RT	NB	SIGN PANEL ASSEMBLY TO BE RELOCATED	24"	Х	30"
E10-21	NO PARKING	POST MOUNTED (GROUND)	737+02	36.5'	RT	NB	SIGN PANEL ASSEMBLY TO BE REMOVED	12"	Х	18"
E10-22	ERICKSON WOODS	DUAL WOOD POSTS	737+99	54.6'	LT	WB	SIGN AND POST TO REMAIN	96"	Х	25"
E10-23	STOP SIGN	POST MOUNTED (GROUND)	738+32	57.0'	LT	SB	SIGN AND POST TO REMAIN	30"	х	30"
E10-24	5 STAR IMPORTS AUTO REPAIR	STONE BASE	738+75	71.3'	RT	EB	SIGN AND POST TO REMAIN			49"
E10-25	SPEED LIMIT 35	MOUNTED ON STREET LIGHT POLE	739+10	38.6'	RT	EB	SIGN AND POLE TO REMAIN			36"
E10-26	(SHARED POST)	POST MOUNTED (GROUND)	739+14	42.4'	RT		POST TO REMAIN	1		
E10-26a	WILLOW RD (2 SIGN PANELS BACK TO BACK)					NB/SB	SIGN TO REMAIN	24"		10"
E10-26b	LINDER AVE (2 SIGN PANELS BACK TO BACK)					EB/WB	SIGN TO REMAIN	24"		
	43 (STA 493+00 TO STA 505+00)	I						- '		
E11-1	NO LEFT TURN	POST MOUNTED (LANDSCAPED ISLAND)	502+52	58.5'	RT	WB	SIGN AND POST TO REMAIN	36"	Х	36"
E11-2	HOLY SPIRIT MISSIONARY SISTERS	DUAL POST MOUNTED (GROUND)	502+77	67.3'	RT	NB	SIGN AND POST TO REMAIN	126"		
E11-2 E11-3		,				WB				
	STOP SIGN	POST MOUNTED (GROUND)	502+86	46.4'	RT		SIGN AND POST TO REMAIN			
E11-4	ONE WAY	POST MOUNTED (LANDSCAPED MEDIAN)	502+96	4.0'	RT	WB	SIGN AND POST TO REMAIN	36"	Х	
E11-5	RIGHT LANE MUST TURN RIGHT	POST MOUNTED (GROUND)	503+65	48.0'	LT	SB	SIGN AND POST TO REMAIN	30"	X	30"

FILE NAME =	USER NAME = BAWitort	DESIGNED	-	JLV	REVISED	-
g:\ch11\0158\road\Sheets\D160T35-SHT-S1G	N-SCHØ8.dgn	DRAWN	-	MTS	REVISED	-
	PLOT SCALE = 40.000 '/ in.	CHECKED	-	RCB	REVISED	-
	PLOT DATE = 11/1/2012	DATE	-	10/31/2012	REVISED	-

STATE OF ILLINOIS DEPARTMENT OF TRANSPORTATION

RION COUEDINE		SECT	TION	COUNTY	TOTAL SHEETS	SHEET NO.	
SIGN SCHEDULE			(1920.01,1518,2	022&1922 . 4B)R	COOK	919	296
			•		CONTRACT	NO. 60	T35
SCALE: N.T.S	SHEET NO. 296 OF 919 SHEETS	FED.	ROAD DIST. NO. 1	ILLINOIS FED. AI	D PROJECT		

- 1. SIGN SHALL BE RE-ERECTED ACCORDING TO ARTICLE 107.25 OF THE STANDARD SPECIFICATION (PROTECTION AND RESTORATION OF TRAFFIC SIGNS). ADDITIONAL SIGNS THAT HAVE NOT BEEN SURVEYED BUT ARE OBSCURED BY CONSTRUCTION OPERATIONS SHALL ALSO BE RE-ERECTED ACCORDING TO ARTICLE 107.25.
- 2. ALL EXISTING PRIVATE SIGNS WITHIN THE STATE ROW THAT INTERFERE WITH CONSTRUCTION OPERATIONS WILL BE REMOVED AND REPLACED BY OTHERS. THE CONTRACTOR SHALL NOTIFY THE OWNERS PRIOR TO THE START OF CONSTRUCTION.
- 3. EXISTING SIGN PANEL AND ASSEMBLY TO BE REMOVED SHALL BE DELIVERED TO AN IDOT MAINTENANCE YARD SPECIFIED BY THE ENGINEER.

EXISTING SIGN NUMBER	PANEL DESCRIPTION	SIGN SUPPORT	STATION	OFFSE	ΞT	FACING TRAFFIC	ACTION	DIMENSION W x H
	43 (STA 505+00 TO STA 514+00)	LUQUE GIOLIGA OTOUE PLOOV					Total Aug Book to British	1,000
E12-1	COLLEGE OF AMERICAN PATHOLOGISTS	NONE - SIGN IS A STONE BLOCK	505+45	57.7'	RT	NB	SIGN AND POST TO REMAIN	120" x 54"
E12-2	(SHARED POST)	POST MOUNTED (LANDSCAPED MEDIAN)	505+45	5.2'	RT	ND	SIGN PANEL ASSEMBLY TO BE RELOCATED	0.411
	NO U TURN					NB CD	SIGN PANEL TO BE RELOCATED WITH ASSEMBLY	24" x 24"
E12-2b E12-3	KEEP RIGHT STOP SIGN	DOCT MOUNTED (CDOUND)	E00+00	E2 4!	рт	SB	SIGN PANEL TO BE RELOCATED WITH ASSEMBLY SIGN AND POST TO REMAIN	24" x 30" 36" x 36"
E12-3	DO NOT BLOCK DRIVEWAY	POST MOUNTED (GROUND) POST MOUNTED (GROUND)	506+00 506+13	53.4' 40.9'	RT RT	WB NB	SIGN AND POST TO REMAIN	36" x 36" 24" x 30"
	PACE BUS STOP	MOUNTED ON BUS SHELTER	506+19	51.0'	LT	SB	SIGN TO REMAIN	18" x 18"
E12-5	(SHARED POST)	POST MOUNTED (CONCRETE MEDIAN)	506+47	6.0'	RT	30	SIGN PANEL ASSEMBLY TO BE RELOCATED	10 X 10
E12-6a	KEEP RIGHT	FOST MICONTED (CONCRETE MEDIAN)	300+47	0.0	N1	NB	SIGN PANEL TO BE RELOCATED WITH ASSEMBLY	24" x 30"
E12-6b	LEFT TURN ONLY					SB	SIGN PANEL TO BE RELOCATED WITH ASSEMBLY	24" x 30" 24" x 30"
E12-7	PACE BUS STOP	MOUNTED ON BUS SHELTER	506+56	61.2'	RT	NB	SIGN AND POST TO REMAIN	18" x 18"
E12-7	RIGHT LANE MUST TURN RIGHT	POST MOUNTED (GROUND)	506+60	47.3'	LT	SB	SIGN AND POST TO REMAIN	30" x 30"
E12-9			509+82	57.8'	LT	36	SIGN PANEL ASSEMBLY TO BE RELOCATED	30 X 30
	(SHARED POST)	POST MOUNTED (GROUND)	309*02	37.0	LI	SB	SIGN PANEL TO BE RELOCATED WITH ASSEMBLY	24" x 12"
E12-9a E12-9b						SB	SIGN PANEL TO BE RELOCATED WITH ASSEMBLY SIGN PANEL TO BE RELOCATED WITH ASSEMBLY	
	ILLINOIS 43	DOST MOUNTED (CDOUND)	511+28	38.7'	рт	NB	SIGN PANEL TO BE RELOCATED WITH ASSEMBLY SIGN PANEL ASSEMBLY TO BE RELOCATED	
E12-10	ILLINOIS TOLLWAY	POST MOUNTED (GROUND)		5.9'	RT LT	NB NB		
E12-11	LEFT TURN ONLY	POST MOUNTED (CONCRETE MEDIAN)	512+06			INB	SIGN PANEL ASSEMBLY TO BE REMOVED	30" x 36"
E12-12	(SHARED POST)	POST MOUNTED (GROUND)	512+04	57.6'	LT	CD.	SIGN PANEL ASSEMBLY TO BE RELOCATED	40" , 04"
E12-12a	GLENVIEW POPULATION					SB	SIGN PANEL TO BE RELOCATED WITH ASSEMBLY	48" x 24"
	SPEED LIMIT 40					SB	SIGN PANEL TO BE RELOCATED WITH ASSEMBLY	30" x 36"
	43 (STA 518+00 TO STA 530+00)	DOOT MOUNTED (ODOUBLE)	F10:11	00.01			CION DANIEL ACCEMBLY TO DE DEL COATES	
E13-1	(SHARED POST)	POST MOUNTED (GROUND)	519+11	39.9'	RT	. i e	SIGN PANEL ASSEMBLY TO BE RELOCATED	2011
E13-1a	HORIZONTAL ALIGNMENT CURVE					NB	SIGN PANEL TO BE RELOCATED WITH ASSEMBLY	30" x 30"
	40 M.P.H.					NB	SIGN PANEL TO BE RELOCATED WITH ASSEMBLY	18" x 18"
	SPEED LIMIT 40	POST MOUNTED (GROUND)	521+15	41.3'	LT	SB	SIGN PANEL ASSEMBLY TO BE RELOCATED	30" x 36"
E13-3	SPEED LIMIT 45	POST MOUNTED (GROUND)	521+25	40.0'	RT	NB	SIGN PANEL ASSEMBLY TO BE RELOCATED	30" x 36"
E13-4	NOTICE OF PUBLIC HEARING	DUAL POST MOUNTED (GROUND)	521+43	80.0'	LT	WB	SIGN AND POST TO REMAIN	45" x 31"
E13-5	(SHARED POST)	POST MOUNTED (GROUND)	522+37	42.8'	RT		SIGN PANEL ASSEMBLY TO BE RELOCATED	
E13-5a	LOVE THE LAND OF LINCOLN					NB	SIGN PANEL TO BE RELOCATED WITH ASSEMBLY	30" x 36"
E13-5b	ADOPT-A-HIGHWAY					NB	SIGN PANEL TO BE RELOCATED WITH ASSEMBLY	30" x 18"
E13-5c	KEEP ILLINOIS CLEAN					NB	SIGN PANEL TO BE RELOCATED WITH ASSEMBLY	50" x 25"
E13-6	(SHARED POST)	POST MOUNTED (GROUND)	524+69	47.4'	LT		SIGN PANEL ASSEMBLY TO BE RELOCATED	
E13-6a	ADVANCE TRAFFIC CONTROL					SB	SIGN PANEL TO BE RELOCATED WITH ASSEMBLY	30" x 30"
E13-6b	WILLOW RD					SB	SIGN PANEL TO BE RELOCATED WITH ASSEMBLY	36" x 12"
E13-7	STRIP MALL ENTRANCE	DUAL STONE POSTS	528+13	90.0'	LT	NB/SB	SIGN AND POST TO REMAIN	27" x 60"
E13-8	THREE LAKES DR	MOUNTED ON SIGNAL POST MAST	528+38	51.2'	LT	SB	SIGN AND SIGNAL TO REMAIN	48" x 12"
E13-9	(SHARED POST)	MOUNTED ON SIGNAL POST	528+48	57.6'	RT		SIGNAL POST TO REMAIN	
E13-9a	RIGHT TURN ONLY					NB	SEE NOTE 1	30" x 36"
E13-9b	FOLDED STOP SIGN					NB	SIGN TO REMAIN	36" x 36"
E13-10	ILL ROUTE 43 / WAUKEGAN RD	MOUNTED ON SIGNAL POST MAST	528+60	70.0'	RT	EB	SIGN TO REMAIN	48" x 30"
E13-11	FOLDED STOP SIGN	POST MOUNTED (GROUND)	528+60	64.8'	LT	EB	SIGN AND POST TO REMAIN	36" x 36"
E13-12	KRAFT SIGN	DUAL POST MOUNTED (LANDSCAPED MEDIAN)	529+07	135.3'	RT	EB	SIGN AND POST TO REMAIN	36" x 24"
E13-13	(SHARED POST)	POST MOUNTED (GROUND)	529+47	83.7'	RT		POST TO REMAIN	
E13-13a	THREE LAKES DR					WB	SIGN TO REMAIN	36" x 10"
E13-13b	WAUKEGANRD					WB	SIGN TO REMAIN	36" x 10"
E13-14	FOLDED STOP SIGN	MOUNTED ON SIGNAL POST	529+56	67.4'	RT	WB	SIGN AND SIGNAL TO REMAIN	36" x 36"
E13-15	ILL ROUTE 43 / WAUKEGAN RD	MOUNTED ON SIGNAL POST MAST	529+63	71.7'	LT	WB	SIGN AND SIGNAL TO REMAIN	48" x 30"
E13-16	RIGHT TURN ONLY	MOUNTED ON SIGNAL POST	529+75	58.4'	LT	SB	SIGN AND SIGNAL TO REMAIN	30" x 36"
	FOLDED STOP SIGN	POST MOUNTED (GROUND)	529+88	47.9'	LT	SB	SIGN AND POST TO REMAIN	36" x 36"
	THREE LAKES DR	MOUNTED ON SIGNAL POST MAST	529+96	54.2'	RT	NB	SIGN AND SIGNAL TO REMAIN	48" x 12"
	43 (STA 530+50 TO STA 542+50)							
E14-1	(SHARED POST)	POST MOUNTED (GROUND)	532+39	48.2'	LT		POST TO REMAIN	
E14-1a	HORIZONTAL ALIGNMENT CURVE	, commonned (encomp)		, , , , ,		SB	SIGN TO REMAIN	30" x 30"
E14-1b	40 M.P.H.					SB	SIGN TO REMAIN	24" x 24"
E14-2	DO NOT ENTER	POST MOUNTED (GROUND)	533+25	55.2'	LT	WB	SIGN AND POST TO REMAIN	30" x 30"
E14-3	(SHARED POST)	POST MOUNTED (GROUND)	533+44	81.4'	LT	****	POST TO REMAIN	00 × 30
E14-3a	STOP SIGN	, con modified (choolid)	333,44	01.7		EB	SIGN TO REMAIN	30" x 30"
E14-3a	RIGHT TURN ONLY		 			EB	SIGN TO REMAIN	24" x 30"
E14-30	NO LEFT TURN	DOST MOUNTED // ANDSCADED ISLAND)	522.70	55.4'	1 =	NB		
		POST MOUNTED (LANDSCAPED ISLAND)	533+70 534+65	34.9'	LT RT	NB NB	SIGN AND POST TO REMAIN	36" x 36" 30" x 36"
	SPEED LIMIT 45	MOUNTED ON POWER POLE					SIGN AND POLE TO REMAIN	
E14-6	NO LEFT TURN	POST MOUNTED (CANDSCAPED ISLAND)	535+68	45.0'	RT	SB	SIGN AND POST TO REMAIN	24" x 24"
E14-7	STOP SIGN	POST MOUNTED (GROUND)	536+00	51.4'	RT	WB	SIGN AND POST TO REMAIN	30" x 30"
E14-8	RIGHT TURN ONLY	POST MOUNTED (GROUND)	536+21	57.6'	LT	SB	SEE NOTE 1	24" x 30"
E14-9	(SHARED POST)	POST MOUNTED (GROUND)	537+37	28.9'	RT		POST TO REMAIN	00"
E14-9a	INTERSECTION WARNING KAMP DR / ROYAL RIDGE DR					NB	SIGN TO REMAIN	30" x 30"
E14-9b						NB	SIGN TO REMAIN	36" x 15"

-	FILE NAME =	USER NAME = BAWitort	DESIGNED	-	JLV	REVISED -
-	g:\chll\0158\road\Sheets\D160T35-SHT-S1G	N-SCHØ9.dgn	DRAWN	-	MTS	REVISED -
-		PLOT SCALE = 40.000 '/ in.	CHECKED	-	RCB	REVISED -
		PLOT DATE = 11/1/2012	DATE	-	10/31/2012	REVISED -
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STATE OF ILLINOIS DEPARTMENT OF TRANSPORTATION

GION CONFOUR		F.A.P. RTE.	SECTION	COUNTY	TOTAL SHEETS	SHEET NO.
	SIGN SCHEDULE		(1920.01,1518,2022&1922.4B)R	COOK	919	297
				CONTRACT	NO. 60	T 35
	SCALE: N.T.S SHEET NO. 297 OF 919 SHEETS		OAD DIST. NO. 1 ILLINOIS FED. A	D PROJECT		

- 1. SIGN SHALL BE RE-ERECTED ACCORDING TO ARTICLE 107.25 OF THE STANDARD SPECIFICATION (PROTECTION AND RESTORATION OF TRAFFIC SIGNS). ADDITIONAL SIGNS THAT HAVE NOT BEEN SURVEYED BUT ARE OBSCURED BY CONSTRUCTION OPERATIONS SHALL ALSO BE RE-ERECTED ACCORDING TO ARTICLE 107.25.
- 2. ALL EXISTING PRIVATE SIGNS WITHIN THE STATE ROW THAT INTERFERE WITH CONSTRUCTION OPERATIONS WILL BE REMOVED AND REPLACED BY OTHERS. THE CONTRACTOR SHALL NOTIFY THE OWNERS PRIOR TO THE START OF CONSTRUCTION.
- 3. EXISTING SIGN PANEL AND ASSEMBLY TO BE REMOVED SHALL BE DELIVERED TO AN IDOT MAINTENANCE YARD SPECIFIED BY THE ENGINEER.

EXISTING SIGN NUMBER	PANEL DESCRIPTION	SIGN SUPPORT	STATION	OFFSE	:T	FACING TRAFFIC	ACTION	DIMENSION W x H
	ROAD (STA 30+50 TO STA 34+50)							
E15-1	(SHARED POST)	POST MOUNTED (GROUND)	32+03	15.4'	RT		POST TO REMAIN	
E15-1a	SCHOOL CROSSING					NB	SIGN TO REMAIN	30" x 30"
E15-1b	AHEAD					NB	SIGN TO REMAIN	24" x 12"
E15-1c	FIRE HYDRANT					NB	SIGN TO REMAIN	6" x 12"
E15-2	NO TRUCKS ALLOWED	POST MOUNTED (GROUND)	33+19	58.6'	LT	WB	SIGN AND POST TO REMAIN	24" x 30"
E15-3	LUTHERAN CHURCH OF THE ASCENSION	DECORATIVE POST MOUNTED (GROUND)	33+20	41.5'	LT	NB	SIGN AND POST TO REMAIN	48" x 30"
E15-4	SPEED LIMIT 35	DUAL POST MOUNTED (GROUND)	33+46	22.1'	LT	SB	SIGN AND POST TO REMAIN	30" x 36"
E15-5	WILLOW RD	DUAL POST MOUNTED (GROUND)	33+84	23.7'	RT	NB	SIGN PANEL ASSEMBLY TO BE RELOCATED	48" x 18"
E15-6	NO SEMI TRUCKS ALLOWED	POST MOUNTED (GROUND)	34+23	36.5'	RT	EB	SIGN AND POST TO REMAIN	24" x 18"
	ROAD (STA 37+50 TO STA 43+00)					1		
E15-7	SUNSET RIDGE SCHOOL	DUAL WOOD POSTS	38+05	58.0'	RT	NB/SB	SIGN AND POST TO REMAIN	85" x 24"
E15-8	ONE WAY	POST MOUNTED (GROUND)	38+64	31.6'	RT	NB	SIGN AND POST TO REMAIN	24" x 30"
E15-9	TEMPLE JEREMIAH	POST MOUNTED (GROUND)	38+74	29.0'	LT	SB	SIGN AND POST TO REMAIN	24" x 30"
E15-10	WILLOW RD	DUAL POST MOUNTED (GROUND)	39+03	25.4'	LT	SB	SIGN AND POST TO REMAIN	48" x 18"
E15-11	(SHARED POST)	POST MOUNTED (GROUND)	39+07	26.3'	RT		POST TO REMAIN	
E15-11a	SCHOOL CROSSING					NB	SIGN TO REMAIN	30" x 30"
E15-11b	AHEAD					NB	SIGN TO REMAIN	24" x 12"
E15-12	(SHARED POST)	POST MOUNTED (GROUND)	39+95	27.0'	RT		POST TO REMAIN	
E15-12a	SCHOOL SPEED LIMIT 20					NB	SIGN TO REMAIN	24" x 48"
E15-12b	FIRE HYDRANT					NB	SIGN TO REMAIN	6" x 12"
E15-13	(SHARED POST)	POST MOUNTED (GROUND)	40+00	29.4'	LT		POST TO REMAIN	
E15-13a	ONE WAY					NB	SIGN TO REMAIN	18" x 24"
E15-13b	ONE WAY					SB	SIGN TO REMAIN	18" x 24"
E15-14	ST. JAMES THE LESS CHURCH	DUAL WOOD POSTS	40+53	31.4'	LT	SB	SIGN AND POST TO REMAIN	70" x 61"
E15-15	(SHARED POST)	POST MOUNTED (GROUND)	41+04	39.8'	RT		POST TO REMAIN	
E15-15a	DO NOT ENTER					EB	SIGN TO REMAIN	30" x 30"
E15-15b	STOP SIGN					WB	SIGN TO REMAIN	30" x 30"
E15-16	(SHARED POST)	POST MOUNTED (GROUND)	41+09	29.6'	RT		POST TO REMAIN	
E15-16a	ONE WAY					NB	SIGN TO REMAIN	18" x 24"
E15-16b	ONE WAY					SB	SIGN TO REMAIN	18" x 24"
E15-17	(SHARED POST)	POST MOUNTED (GROUND) - YELLOW REFLECTOR STRIP	41+42	25.5'	RT		POST TO REMAIN	
E15-17a	SCHOOL CROSSING					NB	SIGN TO REMAIN	30" x 30"
E15-17b	ARROW					NB	SIGN TO REMAIN	24" x 12"
E15-18	(SHARED POST)	POST MOUNTED (GROUND)	41+54	30.6'	RT		POST TO REMAIN	
E15-18a	ONE WAY					NB	SIGN TO REMAIN	18" x 24"
E15-18b	ONE WAY					SB	SIGN TO REMAIN	18" x 24"
E15-19	(SHARED POST)	POST MOUNTED (GROUND)	42+04	21.9'	LT		POST TO REMAIN	
E15-19a	ONE WAY					NB	SIGN TO REMAIN	18" x 24"
E15-19b	ONE WAY					SB	SIGN TO REMAIN	18" x 24"
E15-20	MARTIN LANE	MOUNTED ON DECORATIVE STREET LIGHT POLE	42+07	45.7'	RT	NB	SIGN AND POLE TO REMAIN	24" x 6"
E15-21	(SHARED POST)	POST MOUNTED (GROUND) - YELLOW REFLECTOR STRIP	42+25	10.1'	LT		POST TO REMAIN	
E15-21a	SCHOOL CROSSING					SB	SIGN TO REMAIN	30" x 30"
E15-21b	ARROW					SB	SIGN TO REMAIN	24" x 12"
WAGNER ROAD	(STA 80+00 TO STA 84+50)							
E16-1	(SHARED POST)	POST MOUNTED (GROUND)	80+16	20.6'	RT		POST TO REMAIN	
E16-1a	SCHOOL CROSSING					NB	SIGN TO REMAIN	36" x 36"
E16-1b	AHEAD					NB	SIGN TO REMAIN	12" x 10"
E16-2	WILLOW RD	DUAL POST MOUNTED (GROUND)	82+29	20.6'	RT	NB	SIGN AND POST TO REMAIN	48" x 18"
WAGNER ROAD	(STA 87+50 TO STA 92+00)	•						
E16-3	(SHARED POST)	POST MOUNTED (GROUND)	88+29	40.0'	RT		POST TO REMAIN	
E16-3a	HANDICAP PARKING	, , ,				WB	SIGN TO REMAIN	12" x 18"
E16-3b	\$250 FINE					WB	SIGN TO REMAIN	12" x 6"
E16-4	NORTHFIELD COMMUNITY CHURCH	DUAL WOOD POSTS	88+67	42.4'	LT	SB	SIGN AND POST TO REMAIN	96" x 22"
E16-5	STOP SIGN	POST MOUNTED (GROUND)	88+73	46.7'	RT	WB	SIGN AND POST TO REMAIN	30" x 30"
E16-6	SLOW CHILDREN	POST MOUNTED (GROUND)	89+04	22.0'	RT	WB	SIGN AND POST TO REMAIN	41" x 41"
E16-7	(SHARED POST)	POST MOUNTED (GROUND)	89+18	54.7'	RT		POST TO REMAIN	
E16-7a	TURN OFF ENGINE / NO CELL PHONE		1			EB	SIGN TO REMAIN	24" x 30"
E16-7b	NO PARKING FIRE LANE		1			EB	SIGN TO REMAIN	12" x 18"
E16-8	CHURCH ENTRANCE	DUAL WOOD POSTS	89+19	37.9'	LT	SB	SIGN AND POST TO REMAIN	26" x 16"
E16-9	(SHARED POST)	POST MOUNTED (GROUND)	89+90	50.3'	RT	05	POST TO REMAIN	25 10
E16-9a	HANDICAP PARKING PERMIT REQUIRED	. 301 110011125 (01100115)	33.00	50.0		WB	SIGN TO REMAIN	12" x 18"
E16-9b	VAN ACCESSIBLE					WB	SIGN TO REMAIN	12" x 6"
E16-9c	\$250 FINE		+			WB	SIGN TO REMAIN	12" x 6"
L10-36	WEOO I HAE		1	1		NAD.	OIGH TO NEIMAIN	12 X 0

11	FILE NAME =	USER NAME = BAWitort	DESIGNED	-	JLV	REVISED	-
9	g:\chll\0158\road\Sheets\D160T35-SHT-SIG	N-SCHl0.dgn	DRAWN	-	MTS	REVISED	-
		PLOT SCALE = 40.000 '/ in.	CHECKED	-	RCB	REVISED	-
		PLOT DATE = 11/1/2012	DATE	-	10/31/2012	REVISED	-

STATE OF ILLINOIS DEPARTMENT OF TRANSPORTATION

SCALE: N.T.S

SIGN SCHEDULE		F.A.P. RTE.	SECTION	COUNTY	TOTAL SHEETS	SHEE NO.
		305 (1920.01,1518,2022&1922.4B)		COOK	919	298
				CONTRACT	NO. 60	T35
	SHEET NO. 298 OF 919 SHEETS	FED. R	OAD DIST. NO. 1 ILLINOIS FED. AI	D PROJECT		

- 1. SIGN SHALL BE RE-ERECTED ACCORDING TO ARTICLE 107.25 OF THE STANDARD SPECIFICATION (PROTECTION AND RESTORATION OF TRAFFIC SIGNS). ADDITIONAL SIGNS THAT HAVE NOT BEEN SURVEYED BUT ARE OBSCURED BY CONSTRUCTION OPERATIONS SHALL ALSO BE RE-ERECTED ACCORDING TO ARTICLE 107.25.
- 2. ALL EXISTING PRIVATE SIGNS WITHIN THE STATE ROW THAT INTERFERE WITH CONSTRUCTION OPERATIONS WILL BE REMOVED AND REPLACED BY OTHERS. THE CONTRACTOR SHALL NOTIFY THE OWNERS PRIOR TO THE START OF CONSTRUCTION.
- 3. EXISTING SIGN PANEL AND ASSEMBLY TO BE REMOVED SHALL BE DELIVERED TO AN IDOT MAINTENANCE YARD SPECIFIED BY THE ENGINEER.

EXISTING SIGN NUMBER	PANEL DESCRIPTION	SIGN SUPPORT	STATION	OFFSI	ΞT	FACING TRAFFIC		DIME W	ENSI V x H	
E16-10	MIDDLEFORK SCHOOL	DUAL WOOD POSTS	90+05	45.1'	RT	NB/SB	SIGN AND POST TO REMAIN	58"	Х	33"
E16-11	RESERVED / VISITOR PARKING	POST MOUNTED (GROUND)	90+18	51.6'	RT	WB	SIGN AND POST TO REMAIN	12"	Х	18"
E16-12	NO PARKING THIS SIDE OF STREET	POST MOUNTED (GROUND)	90+40	16.5'	LT	SB	SIGN AND POST TO REMAIN	12"	Х	18"
E16-13	RESERVED / VISITOR PARKING	POST MOUNTED (GROUND)	90+40	51.6'	RT	WB	SIGN AND POST TO REMAIN		Х	18"
E16-14	NO PARKING BUS STOP	POST MOUNTED (GROUND)	90+45	26.7'	LT	WB	SIGN AND POST TO REMAIN		Х	24"
E16-15	RESERVED / VISITOR PARKING	POST MOUNTED (GROUND)	90+62	51.6'	RT	WB	SIGN AND POST TO REMAIN		Χ	18"
E16-16	RESERVED / VISITOR PARKING	POST MOUNTED (GROUND)	90+85	51.3'	RT	WB	SIGN AND POST TO REMAIN		Χ	18"
E16-17	DO NOT BLOCK DRIVE	POST MOUNTED (GROUND)	90+94	14.1'	RT	NB	SIGN AND POST TO REMAIN		Х	18"
E16-18	RESERVED / VISITOR PARKING	POST MOUNTED (GROUND)	91+06	51.6'	RT	WB	SIGN AND POST TO REMAIN		Χ	18"
E16-19	DO NOT ENTER	POST MOUNTED (CONCRETE ISLAND)	91+48	25.3'	RT	EB	SIGN AND POST TO REMAIN		Х	30"
E16-20	NO PARKING BUS STOP	POST MOUNTED (GROUND)	91+52	26.2'	LT	WB	SIGN AND POST TO REMAIN	12"	Х	24"
E16-21	(SHARED POST)	POST MOUNTED (GROUND)	91+67	62.3'	RT		POST TO REMAIN			
E16-21a	SLOW CHILDREN					NB	SIGN TO REMAIN		Χ	24"
E16-21b	5 MPH					NB	SIGN TO REMAIN		Х	6"
E16-22	RESERVED / VISITOR PARKING	POST MOUNTED (GROUND)	91+98	51.1'	RT	WB	SIGN AND POST TO REMAIN	12"	Х	18"
NORTHFIELD RO	DAD (STA 171+00 TO STA 174+50)									
E17-1	(SHARED POST)	POST MOUNTED (GROUND)	171+09	18.2'	LT		POST TO REMAIN			
E17-1a	PEDESTRIAN CROSSING					SB	SIGN TO REMAIN	30"	Х	30"
E17-1b	ARROW					SB	SIGN TO REMAIN	24"	х	12"
E17-2	STOP SIGN	POST MOUNTED (GROUND)	171+49	32.3'	RT	WB	SIGN AND POST TO REMAIN	30"	х	30"
E17-3	STOP SIGN	POST MOUNTED (GROUND)	171+61	18.1'	LT	SB	SIGN AND POST TO REMAIN	30"	Х	30"
E17-4	(SHARED POST)	POST MOUNTED (GROUND)	171+74	18.0'	RT		POST TO REMAIN			
E17-4a	NO PARKING					EB	SIGN TO REMAIN	12"	х	18"
E17-4b	FIRE HYDRANT					EB	SIGN TO REMAIN	6"	х	12"
E17-5	NO PARKING	POST MOUNTED (GROUND)	172+43	18.9'	RT	EB	SIGN AND POST TO REMAIN	12"	x	18"
E17-6	(SHARED POST)	POST MOUNTED (GROUND)	172+88	18.6'	LT		POST TO REMAIN			
E17-6a	SPEED LIMIT 30	(5.65.65)				SB	SIGN TO REMAIN	24"	Х	30"
E17-6b	NO PARKING ANY TIME					SB	SIGN TO REMAIN		Х	18"
E17-7	STOP SIGN	POST MOUNTED (GROUND)	173+76	23.8'	RT	NB	SIGN AND POST TO REMAIN		Х	30"
E17-8	EMPTY POST	POST MOUNTED (GROUND)	173+82	23.8'	RT	_	POST TO REMAIN		X	
	DAD (STA 162+20 TO STA 165+50)	COT MODITIES (CITOCIES)	110.02	20.0			, oor to telling.			
E17-9	(SHARED POST)	POST MOUNTED (GROUND)	162+41	20.5'	LT		POST TO REMAIN		—	
E17-9a	OLD WILLOW RD (2 SIGN PANELS BACK TO BACK)	T COT MICONTED (CINCOND)	102.41	20.0		EB/WB	SIGN TO REMAIN	42"	х	10"
E17-9b	WILLOW VIEW TER (2 SIGN PANELS BACK TO BACK)					NB/SB	SIGN TO REMAIN		x	10"
E17-90	NO OUTLET (2 SIGN PANELS BACK TO BACK)					NB/SB	SIGN TO REMAIN		<u>х</u>	8"
E17-90	STOP SIGN					EB	SIGN TO REMAIN		X	30"
E17-90	STOP SIGN	POST MOUNTED (GROUND)	162+80	20.41	RT	WB	SIGN AND POST TO REMAIN			30"
		, ,	163+05	39.1' 51.9'	LT	NB			X	18"
E17-11	NO PARKING ANY TIME	POST MOUNTED (GROUND)					SIGN AND POST TO REMAIN		Х	
E17-12	WILLOW GREEN	DUAL WOOD POSTS	163+27	43.6'	LT	WB	SIGN AND POST TO REMAIN		Х	45"
E17-13	SPEED LIMIT 30	POST MOUNTED (GROUND)	164+88	21.6'	RT	NB	SIGN AND POST TO REMAIN	24"	Х	30"
· ·	A 180+00 TO STA 182+00)			0=01						
E18-1	(SHARED POST)	POST MOUNTED (GROUND)	180+62	35.8'	LT		POST TO REMAIN			
E18-1a	NO PARKING					WB	SIGN TO REMAIN	12"		18"
E18-1b	WILBUS STOP					WB	SIGN TO REMAIN	12"	_X	18"
E18-2	(SHARED POST)	POST MOUNTED (GROUND)	180+77	33.0'	LT		POST TO REMAIN			
E18-2a	PEDESTRIAN CROSSING					SB	SIGN TO REMAIN	30"		
E18-2b	AHEAD					SB	SIGN TO REMAIN	24"		12"
E18-3	ADVANCE INTERSECTION LANE CONTROL	POST MOUNTED (GROUND)	181+97	33.0'	LT	SB	SIGN AND POST TO REMAIN	30"	Х	30"
CENTRAL AVEN	UE (STA 192+16 TO STA 194+00)									
E18-4	DO NOT ENTER	MOUNTED ON DECORATIVE STREET LIGHT POLE	192+53	35.4'	RT	SB	SIGN AND POLE TO REMAIN		Х	36"
E18-5	2 HR PARKING	POST MOUNTED (GROUND)	192+74	120.5'	RT	SB	SIGN AND POST TO REMAIN	12"	х	18"
E18-6	2 HR PARKING / NO PARKING ANY TIME	POST MOUNTED (GROUND)	192+74	81.5'	RT	SB	SIGN AND POST TO REMAIN	24"	х	18"
E18-7	NO OUTLET	POST MOUNTED (GROUND)	192+75	61.2'	RT	EB	SIGN AND POST TO REMAIN	30"	х	30"
E18-8	NO PARKING ANY TIME	MOUNTED ON DECORATIVE STREET LIGHT POLE	193+00	35.9'	LT	WB	SIGN AND POLE TO REMAIN	24"	х	30"
E18-9	2 HR PARKING	POST MOUNTED (GROUND)	193+15	134.1'	RT	NB	SIGN AND POST TO REMAIN	12"	х	18"
E18-10	2 HR PARKING	POST MOUNTED (GROUND)	193+15	89.5'	RT	NB	SIGN AND POST TO REMAIN	12"		18"
E18-11	(SHARED POST)	POST MOUNTED (GROUND)	193+17	52.9'	RT		POST TO REMAIN			
E18-11a	MAPLE ST	, , , ,				WB	SIGN TO REMAIN	36"	Х	10"
E18-11b	CENTRAL AV					WB	SIGN TO REMAIN			10"
E18-11c	STOP SIGN					WB	SIGN TO REMAIN	30"		
E18-12	DO NOT ENTER	POST MOUNTED (GROUND)	193+36	72.9'	RT	NB	SIGN AND POST TO REMAIN	24"		
E18-13	MUNICIPAL LOT DIRECTION	MOUNTED ON DECORATIVE STREET LIGHT POLE	193+30	36.8'	RT	NB	SIGN AND POLE TO REMAIN			
E18-14	EXIT ONLY	POST MOUNTED (GROUND)	193+38	40.6'	LT	WB	SIGN AND POST TO REMAIN		X	30"
	(STA 413+00 TO STA 424+00)	ן פאן אוסטויובט (טולסטויט)	190*00	1 70.0		1 440	STORT AND LOCAL TO ITEMPAIR			
E19-1	SPEED LIMIT 55	POST MOUNTED (GROUND)	420+23	61.2'	LT	SB	SIGN PANEL ASSEMBLY TO BE RELOCATED	48"		60"
=19-1 =19-2		, , ,	420+23			NB		48"		
	TRUCKS USE 2 RIGHT LANES	WOOD POST MOUNTED (GROUND)		63.6'	RT		SIGN PANEL ASSEMBLY TO BE RELOCATED			
E19-3	TRUCKS USE 2 RIGHT LANES	WOOD POST MOUNTED (GROUND)	422+68	60.8'	LT	SB	SIGN PANEL ASSEMBLY TO BE RELOCATED	48"	Х	60"

FILE NAME =	USER NAME = BAWitort	DESIGNED -	JLV	REVISED -
g:\chll\0158\road\Sheets\D160T35-SHT-SIG	N-SCH11.dgn	DRAWN -	MTS	REVISED -
	PLOT SCALE = 40.000 '/ in.	CHECKED -	RCB	REVISED -
	PLOT DATE = 11/30/2012	DATE -	10/31/2012	REVISED -

STATE OF ILLINOIS DEPARTMENT OF TRANSPORTATION

I RT		F.A.P. RTE.	SECTION	COUNTY	TOTAL SHEETS	SHEET NO.		
	SIGN SCHEDULE		305	(1920.01,1518,2022&1922.4B)R	COOK	919	299	
				CONTRACT	NO. 60	T35		
	SCALE: N.T.S	SCALE: N.T.S SHEET NO. 299 OF 919 SHEETS		FED. R	OAD DIST. NO. 1 ILLINOIS FED. AI	D PROJECT		

- 1. SIGN SHALL BE RE-ERECTED ACCORDING TO ARTICLE 107.25 OF THE STANDARD SPECIFICATION (PROTECTION AND RESTORATION OF TRAFFIC SIGNS). ADDITIONAL SIGNS THAT HAVE NOT BEEN SURVEYED BUT ARE OBSCURED BY CONSTRUCTION OPERATIONS SHALL ALSO BE RE-ERECTED ACCORDING TO ARTICLE 107.25.
- 2. ALL EXISTING PRIVATE SIGNS WITHIN THE STATE ROW THAT INTERFERE WITH CONSTRUCTION OPERATIONS WILL BE REMOVED AND REPLACED BY OTHERS. THE CONTRACTOR SHALL NOTIFY THE OWNERS PRIOR TO THE START OF CONSTRUCTION.
- 3. EXISTING SIGN PANEL AND ASSEMBLY TO BE REMOVED SHALL BE DELIVERED TO AN IDOT MAINTENANCE YARD SPECIFIED BY THE ENGINEER.

EXISTING SIGN NUMBER	PANEL DESCRIPTION	SIGN SUPPORT	STATION	N OFFSET FACING TRAFFIC ACTION		ACTION	DIMENSION W x H
INTERSTATE 94	(STA 424+00 TO STA 435+00)		I		1	1	
E20-1	KOHL CHILDREN'S MUSEUM	WOOD POST MOUNTED (GROUND)	425+89	65.9' RT	NB	SIGN PANEL ASSEMBLY TO BE REMOVED	48" x 60"
E20-2	(SHARED POST)	POST MOUNTED (GROUND)	426+67	62.0' LT		SIGN PANEL ASSEMBLY TO BE RELOCATED	
E20-2a	EAST				SB	SIGN PANEL TO BE RELOCATED WITH ASSEMBLY	15" x 30"
E20-2b	94 SHIELD				SB	SIGN PANEL TO BE RELOCATED WITH ASSEMBLY	36" x 36"
E20-2c	SOUTH				SB	SIGN PANEL TO BE RELOCATED WITH ASSEMBLY	15" x 30"
E20-2d	RTE 41				SB	SIGN PANEL TO BE RELOCATED WITH ASSEMBLY	36" x 36"
E20-3	41 SOUTH / SKOKIE ROAD / EXIT 34A	DUAL POST MOUNTED (GROUND)	432+44	72.4' LT	SB	SIGN PANEL, POSTS AND FOUNDATIONS TO BE REMOVED	168" x 150"
INTERSTATE 94	(STA 435+00 TO STA 446+00)	·		•			
E21-1	RAMP 25 MPH	MOUNTED ON LIGHT POLE	437+72	77.3' RT	NB	SIGN AND POLE TO REMAIN	48" x 60"
E21-2	EXIT 30A-B / DUNDEE ROAD	TRUSS MOUNTED	439+47	23.0' RT	NB	SIGN PANEL TO BE REMOVED	174" x 144"
E21-3	EXIT 33A / WEST WILLOW ROAD	TRUSS MOUNTED	439+47	39.5' RT	NB	SIGN PANEL TO BE REMOVED	168" x 144"
E21-4	EXIT 33B / EAST WILLOW ROAD	TRUSS MOUNTED	439+47	63.0' RT	NB	SIGN PANEL TO BE REMOVED	210" x 144"
E21-5	EXIT 33B	WOOD POST MOUNTED (GROUND)	440+17	62.9' RT	NB	SIGN PANEL AND POST TO BE REMOVED	90" x 60"
E21-6	STOP SIGN AHEAD	POST MOUNTED (GROUND)	870+80	15.8' RT	NB	SIGN AND POST TO REMAIN	36" x 36"
E21-7	STOP SIGN AHEAD	POST MOUNTED (GROUND)	870+83	30.3' LT	NB	SIGN AND POST TO REMAIN	36" x 36"
E21-8	WRONG WAY	POST MOUNTED (GROUND)	872+09	10.8' RT	SB	SIGN PANEL ASSEMBLY TO BE RELOCATED	36" x 24"
E21-9	WRONG WAY	POST MOUNTED (GROUND)	872+13	24.1' LT	SB	SIGN PANEL ASSEMBLY TO BE RELOCATED	36" x 24"
E21-10	EXIT 33A / WEST WILLOW ROAD	MOUNTED ON BRIDGE	443+91	42.0' RT	NB	SIGN PANEL TO BE REMOVED	210" x 96"
E21-11	14FT 4IN	MOUNTED ON BRIDGE	444+03	27.0' RT	NB	SIGN PANEL TO BE RELOCATED ON BRIDGE	78" x 24"
E21-12	EAST INTERSTATE 94 / SOUTH 41 / CHICAGO	DUAL WOOD POSTS	802+89	32.3' LT	SB	SIGN PANEL AND POSTS TO BE REMOVED	96" x 60"
E21-13	MERGE	WOOD POST MOUNTED (GROUND)	442+90	61.3' LT	SB	SIGN AND POST TO REMAIN	48" x 48"

NOTE:

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FILE NAME =	USER NAME = BAWitort	DESIGNED	-	JLV	REVISED	-
g:\chll\0158\road\Sheets\D160T35-SHT-S1G	N-SCH12.dgn	DRAWN	-	MTS	REVISED	-
	PLOT SCALE = 40.000 '/ in.	CHECKED	-	RCB	REVISED	-
	PLOT DATE = 11/1/2012	DATE	-	10/31/2012	REVISED	-

STATE OF ILLINOIS DEPARTMENT OF TRANSPORTATION

	CION COMEDINE		F.A.P. RTE.	SECTION	COUNTY	TOTAL SHEETS	SHEET NO.	
			305	(1920.01,1518,2022&1922.4B)R	COOK	919	300	
				•		CONTRACT	NO. 60	T35
	SCALE: N.T.S SHEET NO. 300 OF 919 SHEETS		FED. RO	DAD DIST. NO. 1 ILLINOIS FED. AI	D PROJECT			