


GENERAL NOTES

- THE CONTRACTOR SHALL MAINTAIN A MINIMUM OF ONE 11' THRU LANE IN EACH DIRECTION FOR TWO-WAY TRAFFIC FLOW ALONG WILLOW RD AND ILLINOIS ROUTE 43, AND A MINIMUM OF THREE 11' THROUGH LANES OF TRAFFIC IN EACH DIRECTION FOR I-94 EDENS EXPRESSWAY UNLESS OTHERWISE SPECIFIED. A MINIMUM OF 3' SHALL BE MAINTAINED AT ALL TIMES BETWEEN TRAFFIC AND CONSTRUCTION WORK ZONE UNLESS OTHERWISE NOTED ON THE PLANS.
- 2. ON INTERSTATE 94 ALL TEMPORARY CONCRETE BARRIER SHALL HAVE A MINIMUM 2' SEPARATION FROM THE TRAVEL LANE.
- 3. A 3'-6" DEFLECTION AREA IS REQUIRED FROM THE BACK SIDE OF THE TEMPORARY CONCRETE BARRIER WALL TO ANY OBSTRUCTION OR DROP OFF IN THE WORK ZONE. IF THIS 3'-6" DEFLECTION AREA CANNOT BE MAINTAINED, THE TEMPORARY CONCRETE BARRIER WALL SHALL BE ANCHORED TO THE PAVEMENT (EXCLUDING BRIDGE DECKS) THROUGH THE 3 ANCHORING HOLES ON THE TRAFFIC SIDE OF THE TEMPORARY CONCRETE BARRIER WALL. THIS WORK SHALL NOT BE PAID FOR SEPARATELY, BUT SHALL BE CONSIDERED INCIDENTAL TO THE TEMPORARY ONCRETE BARRIER WALL PAY ITEM.
- THE CONTRACTOR SHALL MAINTAIN TRAFFIC IN ACCORDANCE WITH THE SPECIAL PROVISIONS, STATE STANDARDS, STANDARDS, SPECIFICATIONS AND AS DIRECTED BY THE ENGINEER.
- 5. THE ENGINEER SHALL BE INFORMED 48 HOURS IN ADVANCE OF ANY CHANGE IN CONSTRUCTION STAGING.
- 6. THE CONTRACTOR SHALL CONTACT THE ILLINOIS DEPARTMENT OF TRANSPORTATION ARTERIAL TRAFFIC CONTROL SUPERVISOR AT (847) 705-4470 AND THE VILLAGE OF NORTHFIELD CHIEF OF POLICE AT (847) 441-3849 A MINIMUM OF 72 HOURS IN ADVANCE OF RECENSING WORK
- 7. THE CONTRACTOR SHALL NOTIFY MWRD
 (312-751-3236) A MINIMUM OF 72 HOURS IN ADVANCE
 OF ANY CONSTRUCTION ACTIVITIES IMPACTING MWRD
 FACILITIES. ALL MWRD FACILITIES SHALL BE
 PROTECTED AND 24-HOUR ACCESS MAINTAINED
 THROUGHOUT THE DURATION OF CONSTRUCTION AND UPON
 COMPLETION OF THE PROJECT.

TEMPORARY RAISED REFLECTIVE PAVEMENT MARKERS

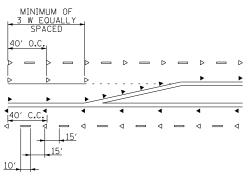

- ▷ ONE-WAY CRYSTAL MARKER
- ► ONE-WAY AMBER MARKER

GENERAL NOTES (CONTINUED)

- 8. TEMPORARY LANE CLOSURES ALONG WILLOW RD AND ILLINOIS ROUTE 43, FOR ANY REASON, SHALL BE RESTRICTED TO THE WEEKDAY HOURS OF 9:00AM TO 3:30 PM, AS APPROVED IN ADVANCE BY THE ENGINEER. TEMPORARY LANE CLOSURES ALONG EDENS EXPRESSWAY SHALL FOLLOW SPECIAL PROVISION "KEEPING EXPRESSWAY OPEN TO TRAFFIC".
- 9. ALL DRIVEWAYS SHALL BE OPEN FOR TRAFFIC DURING CONSTRUCTION UNLESS OTHERWISE SHOWN ON THE
- 10. WET REFLECTIVE TEMPORARY TAPE TYPE III
 PAVEMENT MARKINGS SHALL BE USED ON ALL FINAL
 PAVEMENT WEARING SURFACES INCLUDING 1-94 EDENS
 EXPRESSWAY, TEMPORARY PAVEMENT MARKING PAINT SHALL BE USED ELSEWHERE.
- 11. BARRIER WALL MARKERS, TYPE C SHALL BE PLACED AT 25'C-C ALONG THE EDENS EXPRESSWAY EXISTING CONCRETE MEDIAN BARRIER WITHIN THE PROJECT LIMITS AS SHOWN IN STD. 704001.
- 12. THE CONTRACTOR SHALL BE REQUIRED TO REMOVE ALL EXISTING PAVEMENT MARKINGS WHICH CONFLICT WITH THE DESIGNATED TRAFFIC CONTROL PLAN. TH WORK SHALL BE PAID FOR AS PAVEMENT MARKING
- 13. THE CONTRACTOR SHALL BE REQUIRED TO REMOVE AND REPLACE ALL REFLECTORS FROM EXISTING RAISED REFLECTIVE PAVEMENT MARKERS WHICH CONFLICT WITH THE DESIGNATED TRAFFIC CONTROL PLAN. THIS WORK SHALL BE PAID FOR AS RAISED REFLECTIVE PAVEMENT MARKER, REFLECTOR REMOVAL.
- 14. ALL TEMPORARY PAVEMENT MARKINGS SHOWING DETERIORATION AFTER 7 DAYS SHALL BE REPLACED BY THE CONTRACTOR AS DIRECTED BY THE ENGINEER. SUFFICIENT QUANTITIES FOR ONE PLACEMENT AND ONE REPLACEMENT HAVE BEEN PROVIDED FOR EACH STAGE. ALL MARKINGS THAT REQUIRE REPLACEMENT PRIOR TO 7 DAYS OF SERVICE OR REPLACEMENT AFTER THE THIRD REPLACEMENT SHALL BE REPLACED BY THE CONTRACTOR AT HIS OWN EXPENSE.
- 15. TEMPORARY PAVEMENT SHALL ADHERE TO THE TEMPORARY PAVEMENT SPECIAL PROVISION. TEMPORARY PAVEMENT SHALL CONSIST OF 8 INCHES OF PCC PAVEMENT OR 8 INCHES OF HMA BINDER COURSE. THE SELECTED ALTERNATIVE SHALL BE PLACED ON 4 INCHES OF AGGREGATE SUBGRADE IMPROVEMENT, WHICH WILL NOT BE PAID FOR SEPERATELY, BUT SHALL BE INCLUDED IN THE UNIT CONTRACT PRICE FOR TEMPORARY PAVEMENT.
- 16. THE FURNISHING, INSTALLING, AND RELOCATION OF ALL TRAFFIC SIGNS SHALL BE IN ACCORDANCE WITH THE MANUAL ON UNIFORM TRAFFIC CONTROL DEVICES AND THE STANDARD SPECIFICATIONS. THIS WORK SHALL BE INCLUDED IN THE COST FOR TRAFFIC CONTROL AND PROTECTION, (SPECIAL). ALL CONFLICTING TRAFFIC SIGNS SHALL BE COVERED AS DIRECTED BY THE ENGINEER. THIS WORK SHALL BE INCLUDED IN THE COST OF TRAFFIC CONTROL AND PROTECTION, (SPECIAL).

GENERAL NOTES (CONTINUED)

- 17. THE CONTRACTOR SHALL BE RESPONSIBLE FOR ENSURING DRAINAGE OF THE ROADWAY DURING ALL STAGES OF CONSTRUCTION. A QUANTITY OF 20 INLETS, TYPE A, TYPE 8 GRATE AND 500' OF STORM SEWERS, CLASS A, TYPE 1 12" HAS BEEN PROVIDED FOR TEMPORARY USE. REMOVAL OF THESE ITEMS SHALL BE INCLUDED IN THEIR COST.
- 18. THE CONTRACTOR SHALL MAINTAIN EXISTING AND/OR PROPOSED ROADWAY LIGHTING DURING THE DURATION OF THE PROJECT.
- 19. DURING CONSTRUCTION, THE CONTRACTOR SHALL PROVIDE A SAFE WAITING AREA AND ACCESS TO BUS LANDING AREA FOR PEDESTRIANS DURING CONSTRUCTION. THE COST OF THIS WORK WILL NOT BE PAID FOR SEPARATELY, BUT SHALL BE INCLUDED IN THE CONTRACT UNIT PRICE FOR "PCC SIDEWALK, 5 INCH".
- 20. ALL CONSTRUCTION SIGNS, BARRICADES, AND OTHER DEVICES REQUIRED TO CONTROL TRAFFIC SHALL BE FURNISHED, INSTALLED, AND MAINTAINED BY THE
- 21. ALL TRAFFIC CONTROL DEVICES SHALL BE REMOVED, COVERED OR TURNED AWAY FROM THE TRAFFIC IMMEDIATELY WHEN THEY ARE NO LONGER NECESSARY. WHEN A SIGN IS COVERED, ITS POST SHALL HAVE A REFLECTIVE 3 INCH X 6 INCH DELINEATOR INSTALLED.
- 22. FOR PROPERTIES THAT MAINTAIN TWO DRIVEWAYS IN THEIR EXISTING CONDTION, THE CONTRACTOR SHALL PROVIDE ACCESS TO THE PROPERTY THRU ONE DRIVEWAY WHILE THE SECOND DRIVEWAY IS BEING CONSTRUCTED.
- 23. THE CONTRACTOR SHALL REPLACE ANY TEMPORARY RAISED REFLECTIVE PAVEMENT MARKER THAT IS DAMAGED OR AS DIRECTED BY THE ENGINEER. THIS WORK SHALL BE INCIDENTAL TO THE ORIGINAL TEMPORARY RAISED REFLECTIVE PAVEMENT MARKER.
- 24. THE CONTRACTOR SHALL MAINTAIN ACCESS TO COMMERCIAL DRIVEWAYS AND SIDE STREETS AT ALL TIMES AND STAGES OF CONSTRUCTION UNLESS OTHERWISE NOTED IN THE PLANS. THE CONTRACTOR SHALL COORDINATE ANY SHORT TERM DRIVEWAY CLOSURES WITH THE ENGINEER AND THE IMPACTED BUSINESS OWNER.


BOXED ITEMS ARE INCLUDED IN THE COST OF THE CONTRACT.

FILE NAME =	USER NAME = BAWitort	DESIGNED -	DBC	REVISED -	Т
G:\CH11\0158\Road\Road-GV\Sheets\D160T3	-SHT-STAGING-TYPICALS.dgn	DRAWN -	FY	REVISED -	٦
	PLOT SCALE = 100.00000 '/ in.	CHECKED -	RCB	REVISED -	7
	PLOT DATE = 11/29/2012	DATE -	10/31/2012	REVISED -	7


STATE OF ILLINOIS **DEPARTMENT OF TRANSPORTATION**

SCALE: N.T.S.

su	GGESTED CONSTRUCTION PROCEDURES AND	GENERAL NOTES REL	COUNTY	TOTAL SHEETS	SHEET NO.	
MAINTENANCE OF TRAFFIC GENERAL NOTES	305	(1920.01,1518,2022&1922.4B)R	COOK	919	104	
	MAINTENANCE OF THAT TO GENERAL MOTEO			CONTRACT	NO. 60	T35
	CHEET NO 104 OF 010 CHEETC					

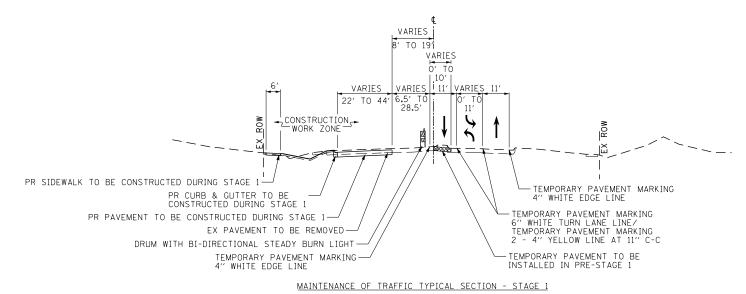


WILLOW ROAD STATION 631+27.95 TO STATION 658+08.00

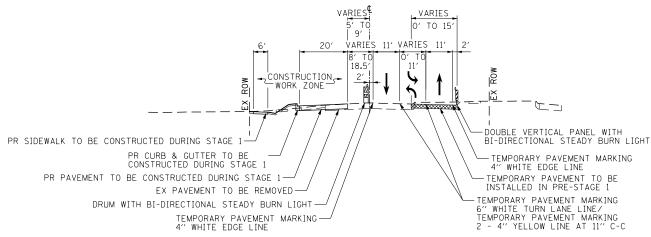

MAINTENANCE OF TRAFFIC TYPICAL SECTION - STAGE 1

WILLOW ROAD STATION 658+08.00 TO STATION 668+92.00 STATION 696+71.61 TO STATION 715+60.00

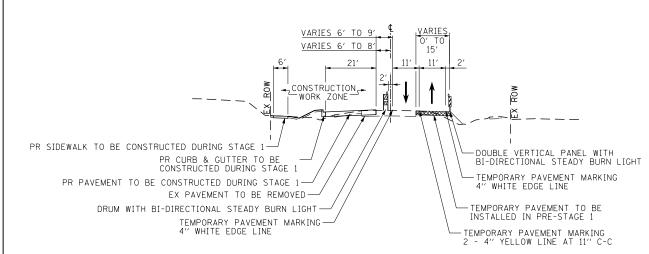

MAINTENANCE OF TRAFFIC TYPICAL SECTION - STAGE 1

WILLOW ROAD STATION 668+92.00 TO STATION 696+71.61


PRE-STAGE 1

- 1. MAINTAIN TWO-WAY TRAFFIC FLOW ON WILLOW ROAD.
- 2. THE FOLLOWING SHALL BE COMPLETED USING STANDARD 701421-05, 701501-06, 701601-07, 701606-08, OR 701701-08 AS NEEDED FOR DAYTIME A MINIMUM OF ONE LANE SHALL BE MAINTAINED IN EACH DIRECTION.
 - a. REMOVE EXISTING MEDIAN AND REPLACE WITH TEMPORARY PAVEMENT ALONG WILLOW AS SHOWN ON THE PLANS (SEE SHEETS NO. 113 TO 119). SEE SHEET NO. 111 FOR GUIDANCE ON TEMPORARY PAVEMENT CROSS SLOPES.
 - REMOVE EXISTING CORNER ISLAND AND REPLACE WITH TEMPORARY PAVEMENT AT THE WILLOW ROAD INTERSECTION OF ILLINOIS ROUTE 43.
- c. CONSTRUCT THE PROPOSED RETAINING WALL ALONG THE SOUTH SIDE OF WILLOW ROAD FROM STA 711+98 TO
- d. REMOVE EXISTING PAVED SHOULDER ALONG THE SOUTH SIDE OF WILLOW ROAD FROM STA 661+00 TO STA 714+15. CONSTRUCT TEMPORARY PAVEMENT ALONG THE SOUTH EDGE OF PAVEMENT AS SHOWN ON THE STAGE I TYPICAL SECTIONS AND STAGING PLANS (SEE SHEETS NO. 113 TO 119).
- e. CONSTRUCT THE TEMPORARY ACCESS FROM GRAEMERE STREET FOR THE DRIVEWAY ON THE SOUTH SIDE OF WILLOW ROAD AT STA 695+18.
- f. CONSTRUCT THE PROPOSED FORCE MAIN ALONG THE SOUTH SIDE OF WILLOW ROAD FROM STATION 642+60 TO
- CONSTRUCT THE WATER MAIN AND SERVICES FROM STATION 665+67 TO STATION 675+36. PRESSURE TEST AND CHLORINATE THE PROPOSED WATER MAIN AND TRANSFER SERVICES FROM THE EXISTING WATER MAIN TO THE PROPOSED WATER MAIN.
- CONSTRUCT THE WATER MAIN FROM STATION 709+89
 TO STATION 716+65. THIS INCLUDES THE PORTION OF
 WATER MAIN TO BE DIRECTIONALLY BORED UNDER THE
 MIDDLE FORK NORTH BRANCH OF THE CHICAGO RIVER.
 PRESSURE TEST AND CHLORINATE THE PROPOSED WATER
 MAIN WITHIN THIS STATION RANGE AND TRANSFER
 SERVICES FROM THE EXISTING WATER MAIN TO THE
 PROPOSED WATER MAIN. CONNECT EXISTING WATER MAIN
 TO PROPOSED WATER MAIN.
- 3. INSTALL TEMPORARY TRAFFIC SIGNALS ALONG
 WILLOW ROAD AT THE FOLLOWING INTERSECTIONS;
 ILLINOIS ROUTE 43, THREE LAKES DRIVE/FOX MEADOW
 DRIVE, SUNSET RIDGE ROAD, WAGNER ROAD, OLD WILLOW
 ROAD/NORTHFIELD ROAD, AND CENTRAL AVENUE/HAPP
- 4. SEE SHEETS 146 TO 147 FOR THE WILLOW ROAD AT ILLINOIS ROUTE 43 INTERSECTION MAINTENANCE OF TRAFFIC.

SCALE: N.T.

STAGE 1

- 1. USE STAGE 1 STAGING PLAN SHEETS (SEE SHEETS NO. 113 TO 119).
- 2. ESTABLISH TWO-WAY TRAFFIC FLOW ALONG THE SOUTH SIDE OF WILLOW ROAD. MAINTAIN TWO 11' THROUGH LANES FOR EASTBOUND TRAFFIC AND ONE 11' THROUGH LANE FOR THE WESTBOUND TRAFIC FROM BEGINNING OF PROJECT TO STA 633+50. THE RIGHT EASTBOUND THROUGH LANE BECOMES A RIGHT TURN ONLY LANE AT THE INTERSECTION OF WILLOW ROAD AND ILLINOIS 43. MAINTAIN A MINIMUM OF ONE 11' THRU LANE IN EACH DIRECTION THROUGHOUT THE ENTIRE REST OF THE PROJECT LENGTH. AN 11' LEFT TURN LANE SHALL BE PROVIDED AT ALL SIGNALIZED INTERSECTION LOCATIONS UNLESS OTHERWISE SHOWN. (SEE SHEETS NO. 113 TO 119).
- 3. REMOVE EXISTING PAVEMENT AND SHOULDER OR CURB AND GUTTER ALONG THE NORTH SIDE OF WILLOW ROAD FROM STA 631+58 TO STA 726+76.
- 4. REMOVE THE PORTION OF LATERAL STORM SEWER AND CULVERTS WITHIN THE STAGE 1 CONSTRUCTION WORK ZONE AND THE EXISTING LONGITUDINAL STORM SEWER SYSTEM ALONG THE NORTH SIDE OF WILLOW ROAD AS SHOWN ON THE DRAINAGE PLANS (SEE SHEETS NO. 172
- 5. WITHIN THE STAGE 1 CONSTRUCTION WORK ZONE, CONSTRUCT ALL OF THE MAINLINE STORM SEWER AND THE LATERALS BETWEEN STA 631+58 AND STA 726+76. CONSULT THE DRAINAGE PLANS (SEE SHEETS NO. 179 TO 199) AND EROSION AND SEDIMENT CONTROL PLANS STAGE 1 (SEE SHEETS NO. 156 TO 171). A QUANTITY OF CLASS D PATCHES HAS BEEN PROVIDED FOR PATCHING TRENCHES QUISTIPE OF THE STAGE 1 CONSTRUCTION WORK ZONE OUTSIDE OF THE STAGE 1 CONSTRUCTION WORK ZONE.
- 6. CONSTRUCT THE WESTBOUND THRU LANES, RIGHT TURN LANES, OUTSIDE CURB AND GUTTER AND SIDEWALK ALONG THE NORTH SIDE OF WILLOW ROAD.
- 7. CONSTRUCT THE NORTH HALF OF THE WILLOW ROAD BRIDGE OVER THE MIDDLE FORK NORTH BRANCH OF THE CHICAGO RIVER.
- 8. CONSTRUCT THE NORTH PORTIONS OF THE INTERSECTIONS ALONG WILLOW ROAD BY ALTERNATELY CLOSING THESE INTERSECTIONS AND DETOURING LOCAL TRAFFIC TO ADJACENT INTERSECTIONS. THE CLOSING OF THE INTERSECTIONS WILL BE LIMITED TO A LONG WEEKEND CLOSURE (I.E. FRIDAY TO TUESDAY). ALL CLOSURES SHALL BE COORDINATED WITH THE VILLAGE OF NORTHFIELD AT LEAST TWO WEEKS IN ADVANCE OF THE
- 9. CONSTRUCT ALL DRIVEWAYS ALONG THE NORTH SIDE OF WILLOW ROAD. DRIVEWAYS ARE TO REMAIN OPEN THROUGHOUT CONSTRUCTION UNLESS OTHERWISE SHOWN ON THE PLANS. PCC DRIVEWAYS SHALL BE CONSTRUCTED ONE LANE AT A TIME WHILE PROVIDING TWO LANES FOR TRAFFIC. HMA DRIVEWAYS SHALL BE CONSTRUCTED ONE HALF AT A TIME WHILE UTILIZING TEMPORARY ACCESS FOR TRAFFIC.
- 10. INSTALL PERMANENT LIGHTING ALONG THE NORTH SIDE OF WILLOW ROAD.
- 11. CONSTRUCT THE WATER MAIN AND SERVICES BETWEEN STATION 675+36 AND 709+89, AND EAST OF STATION 716+65, LOCATED WITHIN THE STAGE 1 CONSTRUCTION WORK ZONE AS SHOWN ON THE WATER MAIN PLANS (SEE SHEETS NO. 215 TO 230).
- 12. CONSTRUCT THE SANITARY SEWER, THE FORCE MAIN AND SERVICES WITHIN THE STAGE 1 CONSTRUCTION ZONE. CONSTRUCT THE FORCE MAIN CROSSING AT
- 13. COMPLETE LANDSCAPING ALONG THE NORTH SIDE OF WILLOW ROAD. (SEE SHEETS NO. 334 TO 342).

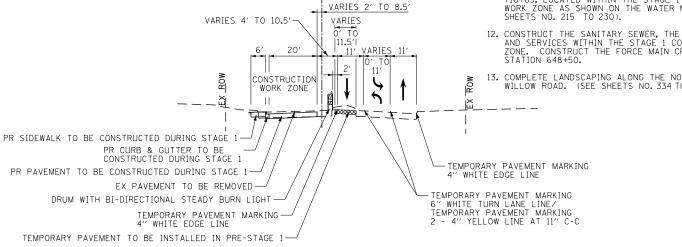


MAINTENANCE OF TRAFFIC TYPICAL SECTION - STAGE 1

WILLOW ROAD STATION 715+60.00 TO STATION 726+76.26


FILE NAME =	USER NAME = BAWitort	DESIGNED	-	DBC	REVISED -
G:\CH11\0158\Road\Road-GV\Sheets\D160T3	-SHT-STAGING-TYPICALS.dgn	DRAWN	-	FY	REVISED -
	PLOT SCALE = 100.00000 '/ in.	CHECKED	-	RCB	REVISED -
	PLOT DATE = 11/29/2012	DATE	-	10/31/2012	REVISED -

STATE OF ILLINOIS **DEPARTMENT OF TRANSPORTATION**

	SUGGESTED CONSTRUCTION PROCEDURES AND MINTENANCE OF TRAFFIC TYPICAL SECTIONS AND NOTES WILLOW ROAD S. SHEET NO. 105 OF 919 SHEETS		F.A.P. RTE.	SECTION	COUNTY	TOTAL SHEETS	SHEET NO.
MAINTEN	MAINTENANCE OF TRAFFIC TYPICAL SECTIONS AND NOTES		305	(1920.01,1518,2022&1922.4B)R	COOK	919	105
	WILLOW ROAD				CONTRACT	NO. 60	T35
: N.T.S.	SHEET NO. 105 OF 919 SHEETS		FFD. R	OAD DIST, NO. 1 THE INDIS FED. AT	D PROJECT		

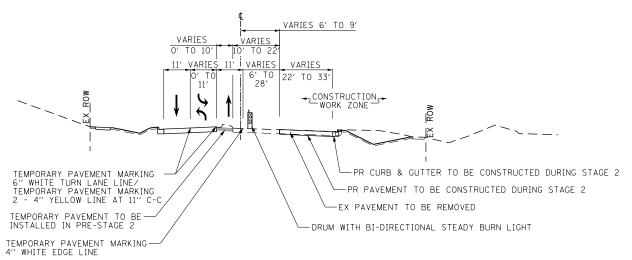


WILLOW ROAD STATION 631+27.95 TO STATION 658+08.00

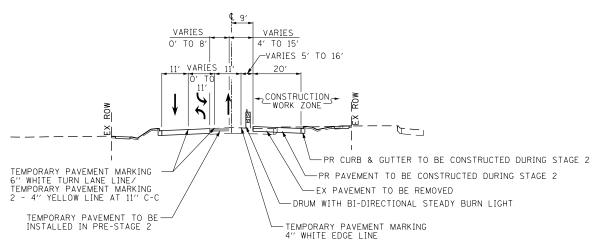

MAINTENANCE OF TRAFFIC TYPICAL SECTION - STAGE 2

WILLOW ROAD STATION 658+08.00 TO STATION 668+92.00 STATION 696+71.61 TO STATION 715+60.00

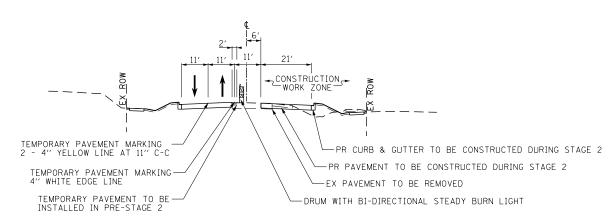

MAINTENANCE OF TRAFFIC TYPICAL SECTION - STAGE 2

WILLOW ROAD STATION 668+92.00 TO STATION 696+71.61

POST-STAGE

- 1. MAINTAIN MINIMUM OF ONE 11' THROUGH LANE FOR EASTBOUND TRAFFIC ON WILLOW ROAD AS ESTABLISHED IN STAGE 1 CONSTRUCTION. SHIFT WESTBOUND TRAFFIC TO THE OUTSIDE WESTBOUND LANE CONSTRUCTED IN STAGE 1. REALIGN TEMPORARY TRAFFIC SIGNALS.
- 2. CONSTRUCT TEMPORARY PAVEMENT AT THE LOCATIONS SHOWN ON THE STAGE 2 PLAN SHEETS (123 TO 129) TO TIE THE PAVEMENT THAT WAS CONSTRUCTED IN STAGE 1 TO THE EXISTING PAVEMENT, AND TO PATCH OVER THE DRAINAGE LATERALS THAT NEED TO BE CONSTRUCTED AFTER STAGE 1 BUT PRIOR TO STAGE 2. SEE SHEET NO. 111 FOR GUIDANCE ON TEMPORARY PAVEMENT CROSS SLOPES. WHEN LANE CLOSURES ARE REQUIRED, STANDARD 701421-05, 701501-06, 701601-07, 701606-08, OR 701701-08 AS NEEDED FOR DAYTIME LANE CLOSURES SHALL BE USED. A MINIMUM OF ONE LANE SHALL BE MAINTAINED IN EACH DIRECTION.
- 3. CLOSE THE WESTBOUND TEMPORARY LEFT TURN LANES INSTALLED DURING STAGE 1 CONSTRUCTION ALTERNATELY TO CONSTRUCT THE PROPOSED WESTBOUND LEFT TURN LANES AT THE SIGNALIZED INTERSECTIONS ALONG WILLOW ROAD.

VARIES 5.5' TO 20' VARIES VARIES 0' TO 14' 6' TO 20' VARIES 5' TO 20' VARIES 22' CONSTRUCTION WORK ZONE TEMPORARY PAVEMENT MARKING PR CURB & GUTTER TO BE CONSTRUCTED DURING STAGE 2 6" WHITE TURN LANE LINE/ TEMPORARY PAVEMENT MARKING └─PR PAVEMENT TO BE CONSTRUCTED DURING STAGE 2 4" YELLOW LINE AT 11" C-C -EX PAVEMENT TO BE REMOVED -DRUM WITH BI-DIRECTIONAL STEADY BURN LIGHT TEMPORARY PAVEMENT TO BE INSTALLED IN PRE-STAGE 2 TEMPORARY PAVEMENT MARKING 4" WHITE EDGE LINE

MAINTENANCE OF TRAFFIC TYPICAL SECTION - STAGE 2

WILLOW ROAD STATION 715+60.00 TO STATION 726+76.26

SCALE: N.T.S


FILE NAME =	USER NAME = BAWitort	DESIGNED	-	DBC	REVISED -
G:\CHII\0158\Road\Road-GV\Sheets\D160T3	5-SHT-STAGING-TYPICALS.dgn	DRAWN	-	FY	REVISED -
	PLOT SCALE = 100.0000 ' / in.	CHECKED	-	RCB	REVISED -
	PLOT DATE = 11/29/2012	DATE	-	10/31/2012	REVISED -

STATE OF ILLINOIS DEPARTMENT OF TRANSPORTATION


	GGESTED CONSTRUCTION		F.A.P. RTE.	SECTION	COUNTY	TOTAL SHEETS	SHEET NO.
MAINTENANCE OF TRAFFIC TYPICAL SECTIONS AND NOTES		305	(1920.01,1518,2022&1922.4B)R	COOK	919	106	
WILLOW ROAD					CONTRACT	NO. 60	T35
N.T.S. SHEET NO. 106 OF 919 SHEETS FED. ROAD DIST, NO. 1 ILLINOIS FED. AID PROJECT							

STAGE

- 1. USE STAGE 2 STAGING PLAN SHEETS (SEE SHEETS NO. 123 TO 129).
- 2. ESTABLISH TWO-WAY TRAFFIC FLOW ALONG THE NORTH SIDE OF WILLOW ROAD. MAINTAIN A MINIMUM OF ONE 11' THRU LANE IN EACH DIRECTION THROUGHOUT THE ENTIRE PROJECT LENGTH. AN 11' LEFT TURN LANE SHALL BE PROVIDED AT ALL SIGNALIZED INTERSECTION LOCATIONS. REALIGN TEMPORARY TRAFFIC SIGNALS.
- 3. REMOVE EXISTING PAVEMENT AND CURB AND GUTTER ALONG THE SOUTH SIDE OF WILLOW ROAD FROM STA 631+58 TO STA 726+76.
- 4. REMOVE THE PORTION OF LATERAL STORM SEWER AND CULVERTS WITHIN THE STAGE 2 CONSTRUCTION WORK ZONE AND THE EXISTING LONGITUDINAL STORM SEWER SYSTEM ALONG THE SOUTH SIDE OF WILLOW ROAD AS SHOWN ON THE DRAINAGE PLANS (SEE SHEETS NO. 172 TO 178).
- 5. WITHIN THE STAGE 2 CONSTRUCTION WORK ZONE CONSTRUCT ALL OF THE REMAINING MAINLINE STORM SEWER AND LATERALS. CONSULT THE DRAINAGE PLANS (SEE SHEETS NO. 179 TO 199) AND EROSION AND SEDIMENT CONTROL PLANS STAGE 2 (SEE SHEETS NO. 156 TO 171). A QUANTITY OF CLASS D PATCHES HAS BEEN PROVIDED FOR PATCHING TRENCHES OUTSIDE OF THE STAGE 2 CONSTRUCTION WORK ZONE.
- 6. CONSTRUCT THE EASTBOUND THRU LANES, RIGHT TURN LANES, OUTSIDE CURB AND GUTTER AND SIDEWALK ALONG THE SOUTH SIDE OF WILLOW ROAD.
- 7. CONSTRUCT THE SOUTH HALF OF THE WILLOW ROAD BRIDGE OVER THE MIDDLE FORK NORTH BRANCH OF THE CHICAGO RIVER.
- 8. CONSTRUCT THE SOUTH PORTIONS OF THE INTERSECTIONS ALONG WILLOW ROAD BY ALTERNATELY CLOSING THESE INTERSECTIONS AND DETOURING LOCAL TRAFFIC TO ADJACENT INTERSECTIONS. THE CLOSING OF THE INTERSECTIONS WILL BE LIMITED TO A LONG WEEKEND CLOSURE (I.E. FRIDAY TO TUESDAY). ALL CLOSURES SHALL BE COORDINATED WITH THE VILLAGE OF NORTHFIELD AT LEAST TWO WEEKS IN ADVANCE OF THE CLOSURF.
- O. CONSTRUCT ALL DRIVEWAYS ALONG THE SOUTH SIDE
 OF WILLOW ROAD. DRIVEWAYS ARE TO REMAIN OPEN
 THROUGHOUT CONSTRUCTION UNLESS OTHERWISE SHOWN ON
 THE PLANS. PCC DRIVEWAYS SHALL BE CONSTRUCTED
 ONE LANE AT A TIME WHILE PROVIDING TWO LANES FOR
 TRAFFIC. HMA DRIVEWAYS SHALL BE CONSTRUCTED ONE
 HALF AT A TIME WHILE UTILIZING TEMPORARY ACCESS
 FOR TRAFFIC.
- 10. CONSTRUCT BRIDGE WORK ALONG THE SOUTH SIDEWALK AND PARAPET AT THE WILLOW ROAD BRIDGE OVER INTERSTATE 94.
- 11. CONSTRUCT THE RAMP WORK AT THE INTERSTATE 94 EXIT AND ENTRANCE RAMPS JUNCTIONS ALONG WILLOW ROAD.
- 12. INSTALL PERMANENT LIGHTING ALONG THE SOUTH SIDE OF WILLOW ROAD.
- 13. CONSTRUCT THE WATER MAIN AND SERVICES BETWEEN STATION 675+36 AND 709+89, AND EAST OF STATION 716+65, LOCATED WITHIN THE STAGE 2 CONSTRUCTION WORK ZONE AS SHOWN ON THE WATER MAIN PLANS (SEE SHEETS NO. 215 TO 230). DIRECTIONALLY BORE THE WATER SERVICES OUTSIDE THE STAGE 2 CONSTRUCTION WORK ZONE. PRESSURE TEST AND CHLORINATE THE PROPOSED WATER MAIN AND TRANSFER SERVICES FROM THE EXISTING WATER MAIN TO THE PROPOSED WATER MAIN.
- 14. COMPLETE LANDSCAPING ALONG THE SOUTH SIDE OF WILLOW ROAD. (SEE SHEETS NO. 334 TO 342).

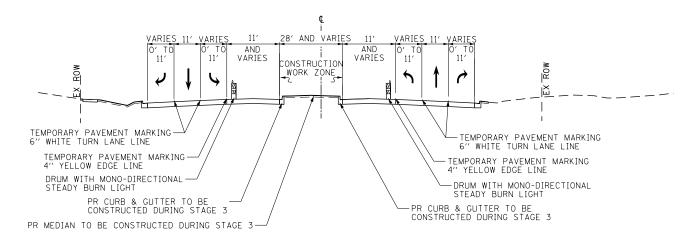


WILLOW ROAD STATION 631+27.95 TO STATION 653+10.00

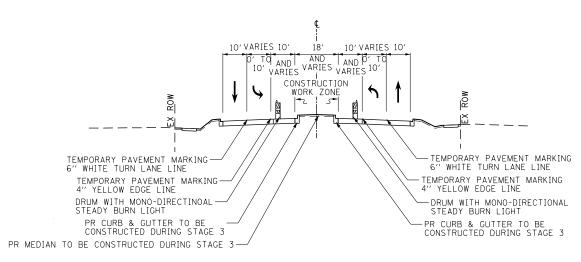

MAINTENANCE OF TRAFFIC TYPICAL SECTION - STAGE 3

WILLOW ROAD STATION 653+10.00 TO STATION 668+92.00 STATION 696+71.61 TO STATION 715+60.00

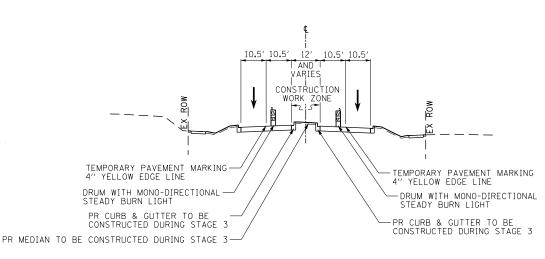

MAINTENANCE OF TRAFFIC TYPICAL SECTION - STAGE 3

WILLOW ROAD STATION 668+92.00 TO STATION 696+71.61

REVISED

REVISED

REVISED

REVISED

DESIGNED - DBC

FY

RCB

10/31/2012

DRAWN

DATE

HECKED

USER NAME = BAWitort

PLOT DATE = 11/29/2012

G:\CHII\@I58\Road\Road-GV\Sheets\DI6@T35-SHT-STAGING-TYPICALS.dgn

FILE NAME :

STATE OF ILLINOIS

DEPARTMENT OF TRANSPORTATION

PRE-STAGE 3


USE STAGE 3 STAGING PLAN SHEETS (SEE SHEETS NO. 136 TO 142).

2. MAINTAIN MINIMUM OF ONE 10' THROUGH LANE FOR WESTBOUND TRAFFIC ON WILLOW ROAD AS ESTABLISHED FOR STAGE 2 CONSTRUCTION. SHIFT EASTBOUND TRAFFIC TO THE OUTSIDE EASTBOUND LANE CONSTRUCTED

TRAFFIC TO THE OUTSIDE EASTBOUND LANE CONSTRUCTED IN STAGE 2. A MINIMUM 10' LEFT TURN LANE SHALL BE PROVIDED AT ALL SIGNALIZED INTERSECTION LOCATIONS SHOWN ON THE STAGE 3 STAGING PLAN SHEETS. A RIGHT TURN LANE SHALL BE PROVIDED AT THE INTERSECTION OF WILLOW ROAD WITH ILLINOIS ROUTE 43 AND THE INTERSECTION OF WILLOW ROAD WITH THREE LAKES DRIVE WESTBOUND. REALIGN TEMPORARY TRAFFIC SIGNALS. CLOSE TEMPORARY LEFT TURN LANES ALTERNATELY TO CONSTRUCT THE REMAINING PROPOSED LEFT TURN LANES ALONG WILLOW ROAD.

STAGE 3


- REMOVE REMAINING PAVEMENT, MEDIAN AND STORM SEWER ALONG WILLOW ROAD FROM STA 631+58 TO STA 726+76 AS SHOWN ON THE ROADWAY AND DRAINAGE REMOVAL PLANS (SEE SHEETS NO. 57 TO 61 AND 172 TO
- 2. WITHIN THE STAGE 3 CONSTRUCTION WORK ZONE
 CONSTRUCT THE REMAINING MAINLINE STORM SEWER.
 CONSTRUCT THE PORTION OF THE LATERALS FROM STA
 631+58 TO STA 726+76 WITHIN THE STAGE 3
 CONSTRUCTION WORK ZONE. CONSULT THE DRAINAGE
 PLANS (SEE SHEETS NO. 179 TO 199) AND EROSION AND
 SEDIMENT CONTROL PLANS STAGE 3 (SEE SHEETS NO. 156
 TO 171)
- 3. FILL REMAINING STORM SEWERS THAT WILL NO LONGER BE IN USE AS SHOWN ON THE DRAINAGE PLANS (SEE SHEETS NO. 179 TO 199).
- 4. CONSTRUCT ALL REMAINING PAVEMENT ALONG WILLOW ROAD.
- 5. CONSTRUCT THE MEDIAN ALONG WILLOW ROAD FROM STA 631+58 TO STA 726+76 AS SHOWN ON THE STAGE 3 STAGING PLAN (SEE SHEETS NO. 136 TO 142).
- 6. COMPLETE MEDIAN LANDSCAPING ALONG WILLOW ROAD.
- 7. PLACE PERMANENT PAVEMENT MARKINGS (SEE SHEETS NO. 276 TO 288) ALONG WILLOW ROAD.
- 8. PLACE PERMANENT TRAFFIC SIGNALS.
- 9. OPEN ROADWAY TO TWO-WAY FOUR-LANE TRAFFIC FLOW.

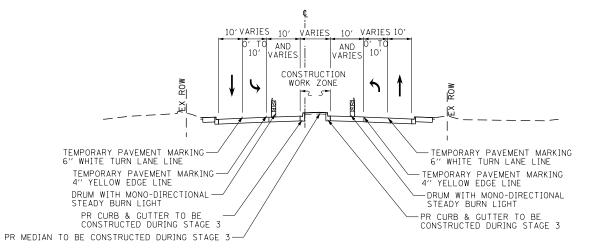


MAINTENANCE OF TRAFFIC TYPICAL SECTION - STAGE 3

WILLOW ROAD STATION 715+60.00 TO STATION 726+76.26

SUGGESTED CONSTRUCTION PROCEDURES AND COUNTY MAINTENANCE OF TRAFFIC TYPICAL SECTIONS AND NOTES 305 (1920.01,1518,2022&1922.4B)R COOK 919 | 107 WILLOW ROAD CONTRACT NO. 60T35 SHEET NO. 107 OF 919 SHEETS

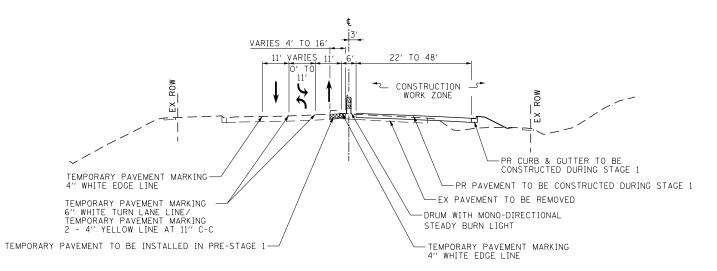

ILLINOIS ROUTE 43
STATION 507+23.00 TO STATION 516+00.00

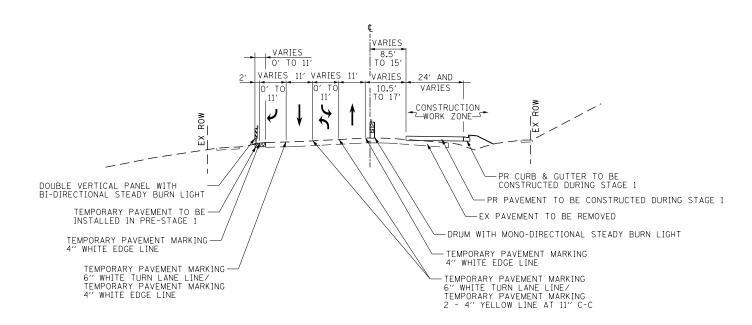

MAINTENANCE OF TRAFFIC TYPICAL SECTION - STAGE 1

ILLINOIS ROUTE 43 STATION 516+00.00 TO STATION 527+28.72

FILE NAME =	USER NAME = BAWitort	DESIGNED -	DBC	REVISED -	
G:\CHII\ØI58\Road\Road-GV\Sheets\DI60T3	S-SHT-STAGING-TYPICALS.dgn	DRAWN -	FY	REVISED -	
	PLOT SCALE = 100.00000 '/ in.	CHECKED -	RCB	REVISED -	
	PLOT DATE = 11/29/2012	DATE -	10/31/2012	REVISED -	

STATE OF ILLINOIS DEPARTMENT OF TRANSPORTATION

SUGGESTED CONSTRUCTION PROCEDURES AND MAINTENANCE OF TRAFFIC TYPICAL SECTIONS AND NOTES **ILLINOIS ROUTE 43** SCALE: N.T.S. SHEET NO. 108 OF 919 SHEETS

SECTION COUNTY 305 (1920.01,1518,2022&1922.4B)R COOK 919 | 108 CONTRACT NO. 60T35

- MAINTAIN TWO-WAY TRAFFIC FLOW ON ILLINOIS
- 2. THE FOLLOWING SHALL BE COMPLETED USING STANDARD 701421-05, 701501-06, 701601-07, 701606-08, OR 701701-08 AS NEEDED FOR DAYTIME LANE CLOSURES. A MINIMUM OF ONE LANE SHALL BE MAINTAINED IN EACH DIRECTION.


PRE-STAGE 1

ROUTE 43.


- d. REMOVE THE EXISTING MEDIAN ALONG ILLINOIS ROUTE 43 FROM STA 503+88 TO STA 515+46 AND REPLACE WITH TEMPORARY PAVEMENT. SEE SHEET NO. 112 FOR GUIDANCE ON TEMPORARY PAVEMENT CROSS
- b. REMOVE EXISTING CORNER ISLAND AND REPLACE WITH TEMPORARY PAVEMENT AT THE INTERSECTION OF WILLOW ROAD AND ILLINOIS ROUTE 43 (STATED IN PRE-STAGE 1 CONSTRUCTION NOTES FOR WILLOW ROAD).
- c. CONSTRUCT TEMPORARY PAVEMENT ALONG THE WEST EDGE OF PAVEMENT ON ILLINOIS ROUTE 43 FROM STA 519+19 TO STA 524+38 AS SHOWN ON THE STAGE 1 TYPICAL SECTION AND STAGING PLANS (SEE SHEETS NO.
- 3. INSTALL TEMPORARY TRAFFIC SIGNALS AT THE INTERSECTION OF ILLINOIS ROUTE 43 AND THREE LAKES DRIVE. THE INSTALLATION OF TEMPORARY TRAFFIC SIGNAL AT THE INTERSECTION OF WILLOW ROAD AND ILLINOIS ROUTE 43 WAS STATED IN PRE-STAGE 1 CONSTRUCTION NOTES FOR WILLOW ROAD.
- SEE SHEETS NO.146 TO 147 FOR THE WILLOW RD AT ILLINOIS ROUTE 43 INTERSECION MAINTENANCE OF TRAFFIC.

STAGE 1

- 1. USE THE STAGE 1 STAGING PLAN SHEETS (SEE SHEETS NO. 120 TO 122).
- 2. ESTABLISH TWO-WAY TRAFFIC FLOW ALONG THE WEST SIDE OF ILLINOIS ROUTE 43. MAINTAIN A MINIMUM OF ONE 11' THRU LANE IN EACH DIRECTION. AN 11' LEFT TURN LANE SHALL BE PROVIDED AT ALL SIGNALIZED INTERSECTION LOCATIONS. (SEE SHEETS NO. 120
- 3. REMOVE EXISTING PAVEMENT AND SHOULDER OR CURB AND GUTTER ALONG THE EAST SIDE OF WILLOW ROAD FROM STA 507+23 TO STA 527+29.
- REMOVE THE PORTION OF LATERAL STORM SEWER AND CULVERTS WITHIN THE STAGE I CONSTRUCTION WORK ZONE AND THE EXISTING LONGITUDINAL STORM SEWER SYSTEM ALONG THE EAST SIDE OF ILLINOIS ROUTE 43 AS SHOWN ON THE DRAINAGE PLANS (SEE SHEETS NO. 172 TO 178).
- 5. WITHIN THE STAGE 1 CONSTRUCTION WORK ZONE, CONSTRUCT ALL OF THE MAINLINE STORM SEWER AND THE LATERALS BETWEEN STA 507+23 AND STA 527+29. CONSULT THE DRAINAGE PLANS (SEE SHEETS NO. 179 TO 199) AND EROSION AND SEDIMENT CONTROL PLANS STAGE 1 (SEE SHEETS NO. 156 TO 171). A QUANTITY OF CLASS D PATCHES HAS BEEN PROVIDED FOR PATCHING TRENCHES OUTSIDE OF THE STAGE 1 CONSTRUCTION WORK ZONE.
- 6. CONSTRUCT THE NORTHBOUND THRU LANES, RIGHT TURN LANES, OUTSIDE CURB AND GUTTER AND SIDEWALK ALONG THE EAST SIDE OF ILLINOIS ROUTE 43.
- 7. CONSTRUCT THE FORCE MAIN WITHIN THE STAGE 1 CONSTRUCTION ZONE.
- 8. COMPLETE LANDSCAPING ALONG THE EAST SIDE OF ILLINOIS ROUTE 43. (SEE SHEETS NO. 334 TO 342).
- 9. AFTER STAGE 1 CONSTRUCTION IS COMPLETE, TEMPORARY PAVEMENT IS TO BE PLACED AT THE LOCATIONS SHOWN ON THE STAGE 2 PLAN SHEETS (120 TO 122) TO TIE THE PAVEMENT THAT WAS CONSTRUCTED IN STAGE 1 TO THE EXISTING PAVEMENT, AND TO PATCH OVER THE DRAINAGE LATERALS THAT NEED TO BE CONSTRUCTED AFTER STAGE 1 BUT PRIOR TO STAGE 2. SEE SHEET NO. 112 FOR GUIDANCE ON TEMPORARY PAVEMENT CROSS SLOPES.

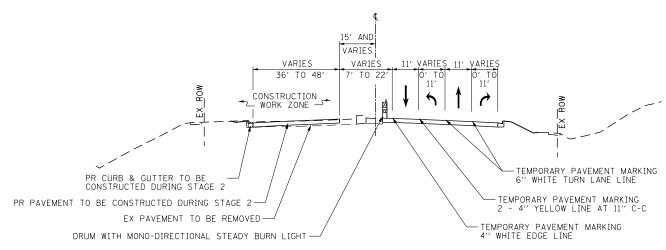


ILLINOIS ROUTE 43 STATION 507+78.00 TO STATION 516+00.00

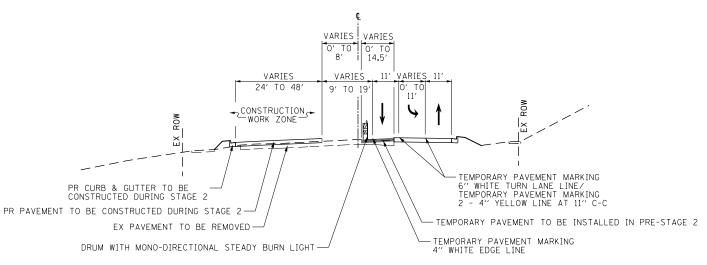

MAINTENANCE OF TRAFFIC TYPICAL SECTION - STAGE 2

ILLINOIS ROUTE 43 STATION 516+00.00 TO STATION 525+74.72

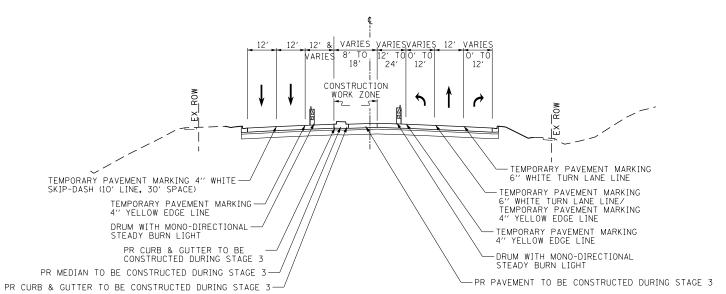

MAINTENANCE OF TRAFFIC TYPICAL SECTION - STAGE 3

ILLINOIS ROUTE 43 STATION 503+00.00 TO STATION 516+00.00

FILE NAME =	USER NAME = BAWitort	DESIGNED -	- [DBC	REVISED	-
G:\CHII\@I58\Road\Road-GV\Sheets\DI6@T3	S-SHT-STAGING-TYPICALS.dgn	DRAWN -	- 1	FY	REVISED	-
	PLOT SCALE = 100.0000 ' / in.	CHECKED -	- 1	RCB	REVISED	-
	PLOT DATE = 11/29/2012	DATE -	- 1	10/31/2012	REVISED	-

STATE OF ILLINOIS DEPARTMENT OF TRANSPORTATION


STAGE 2

- 1. USE THE STAGE 2 STAGING PLAN SHEETS (SEE SHEETS NO. 130 TO $\,$ 132).
- 2. ESTABLISH TWO-WAY TRAFFIC FLOW ALONG THE EAST SIDE OF ILLINOIS ROUTE 43. MAINTAIN A MINIMUM OF ONE 11' THRU LANE IN EACH DIRECTION. AN 11' LEFT TURN LANE SHALL BE PROVIDED AT ALL SIGNALIZED INTERSECTION LOCATIONS SHOWN ON THE STAGE 2 STAGING PLAN SHEFTS.
- 3. REMOVE EXISTING PAVEMENT AND CURB AND GUTTER ALONG THE WEST SIDE OF WILLOW ROAD FROM STA 507+78 TO STA 525+75.
- 4. REMOVE THE PORTION OF LATERAL STORM SEWER WITHIN THE STAGE 2 CONSTRUCTION WORK ZONE AND THE EXISTING LONGITUDINAL STORM SEWER SYSTEM ALONG THE WEST SIDE OF ILLINOIS ROUTE 43 AS SHOWN ON THE DRAINAGE PLANS (SEE SHEETS NO. 172 TO 178).
- 5. CONSTRUCT ALL OF THE REMAINING STORM SEWER AND LATERALS WITHIN THE STAGE 2 CONSTRUCTION WORK ZONE. CONSULT THE DRAINAGE PLANS (SEE SHEETS NO. 179 TO 199) AND EROSION AND SEDIMENT CONTROL PLANS STAGE 2 (SEE SHEETS NO. 156 TO 171). A QUANTITY OF CLASS D PATCHES HAS BEEN PROVIDED FOR PATCHING TRENCHES OUTSIDE OF THE STAGE 2 CONSTRUCTION WORK TONE.
- 6. CONSTRUCT THE SOUTHBOUND THROUGH LANES, RIGHT TURN LANES, OUTSIDE CURB AND GUTTER AND SIDEWALK ALONG THE WEST SIDE OF ILLINOIS ROUTE 43.
- 7. COMPLETE LANDSCAPING ALONG THE WEST SIDE OF ILLINOIS ROUT 43. (SEE SHEETS NO. 334 TO 342).
- 8. REALIGN TEMPORARY TRAFFIC SIGNALS.

SCALE: N.

STAGE 3


- 1. USE THE STAGE 3 STAGING PLAN SHEETS (SEE SHEETS NO. 143 TO 145).
- 2. ESTABLISH TWO-WAY TRAFFIC FLOW ALONG THE OUTSIDE LANES OF ILLINOIS ROUTE 43. MAINTAIN A MINIMUM OF ONE 12' THRU LANE IN EACH DIRECTION. THE NORTHBOUND THROUGH LANE SHOULD BE LOCATED ON THE OUTSIDE NORTHBOUND LANE THAT WAS CONSTRUCTED IN STAGE 1 AND THE SOUTHBOUND THROUGH LANE SHOULD BE LOCATED ON THE OUTSIDE SOUTHBOUND THROUGH LANE THAT WAS CONSTRUCTED IN STAGE 2. A 12' LEFT TURN LANE AND A 12' RIGHT TURN LANE SHALL BE PROVIDED AT ALL SIGNALIZED INTERSECTION LOCATIONS (SEE SHEETS NO. 143 TO 145).
- 3. REMOVE REMAINING PAVEMENT, MEDIAN AND STORM SEWER ALONG ILLINOIS ROUTE 43 FROM STA 507+78 TO STA 525+75 AS SHOWN ON THE ROADWAY AND DRAINAGE PLANS (SEE SHEETS NO. 57 TO 61 AND 172 TO 178).
- 4. WITHIN THE STAGE 3 CONSTRUCTION WORK ZONE CONSTRUCT THE REMAINING STORM SEWER. CONSTRUCT THE PORTION OF THE LATERALS FROM STA 507+78 TO STA 525+75 WITHIN THE STAGE 3 CONSTRUCTION WORK ZONE. CONSULT THE DRAINAGE PLANS (SEE SHEETS NO. 179 TO 199) AND EROSION AND SEDIMENT CONTROL PLANS STAGE 3 (SEE SHEETS NO. 156 TO 171).
- 5. FILL REMAINING STORM SEWERS THAT WILL NO LONGER BE IN USE AS SHOWN ON THE DRAINAGE PLANS (SEE SHEETS NO. 179 TO 199).
- 6. CONSTRUCT ALL REMAINING PAVEMENT ALONG ILLINOIS ROUTE 43.
- 7. CONSTRUCT THE MEDIAN ALONG ILLINOIS ROUTE 43 FROM STA 507+78 TO STA 525+75 AS SHOWN ON THE STAGE 3 STAGING PLAN (SEE SHEETS NO. 143 TO 145).
- 8. COMPLETE MEDIAN LANDSCAPING ALONG ILLINOIS ROUTE 43. (SEE SHEETS NO. 334 TO 342).
- 9. PLACE PERMANENT PAVEMENT MARKINGS (SEE SHEETS NO. 276 TO 288) ALONG ILLINOIS ROUTE 43.
- 10. PLACE PERMANENT TRAFFIC SIGNALS.
- 11. OPEN ROADWAY TO TWO-WAY FOUR-LANE TRAFFIC FLOW.

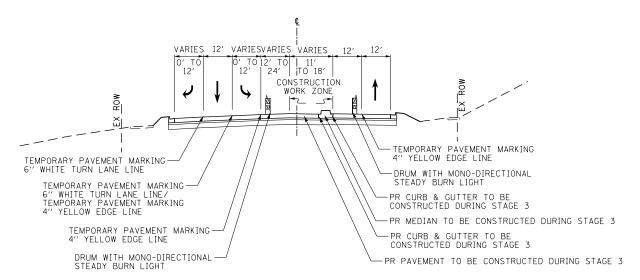


MAINTENANCE OF TRAFFIC TYPICAL SECTION - STAGE 3

ILLINOIS ROUTE 43 STATION 516+00.00 TO STATION 525+74.72

SUGGESTED CONSTRUCTION PROCEDURES AND	F.A.P. RTE.	SECTION	COUNTY	TOTAL SHEETS	SHEET NO.
MAINTENANCE OF TRAFFIC TYPICAL SECTIONS AND NOTES	305	(1920.01,1518,2022&1922.4B)R	COOK	919	109
ILLINOIS ROUTE 43			CONTRACT	NO. 60	T35
N.T.S. SHEET NO. 109 OF 919 SHEETS	FED. R	OAD DIST. NO. 1 ILLINOIS FED. AI	D PROJECT		

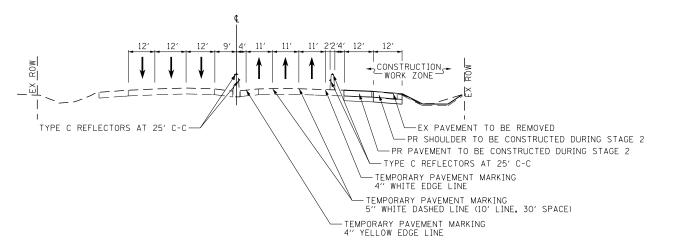


INTERSTATE 94 STATION 420+27.00 TO STATION 425+53.00

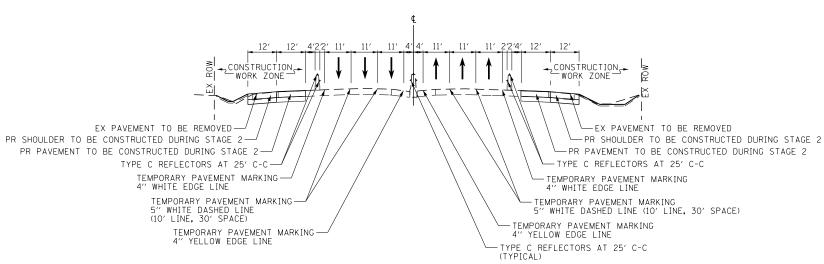

MAINTENANCE OF TRAFFIC TYPICAL SECTION - STAGE 2

INTERSTATE 94 STATION 425+53.00 TO STATION 433+70.00

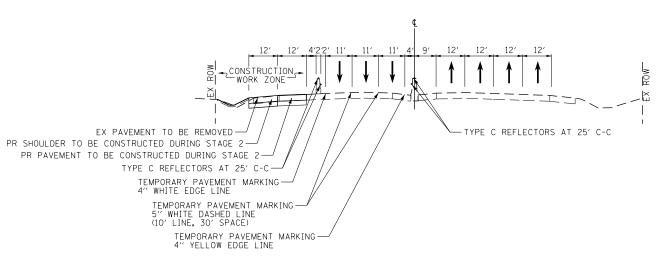

MAINTENANCE OF TRAFFIC TYPICAL SECTION - STAGE 2

INTERSTATE 94
STATION 433+70.00 TO STATION 437+39.00

FILE NAME =	USER NAME = BAWitort	DESIGNED -	REVISED -	
G:\CHII\0158\Road\Sheets\D160T35-SHT-ST	GING-TYPICALS_94.dgn	DRAWN -	REVISED -	
	PLOT SCALE = 100.0000 '/ in.	CHECKED -	REVISED -	
	PLOT DATE = 11/29/2012	DATE - 10/31/2012	REVISED -	

STATE OF ILLINOIS DEPARTMENT OF TRANSPORTATION

SUGGESTED CONSTRUCTION PROCEDURES AND MAINTENANCE OF TRAFFIC TYPICAL SECTIONS AND NOTES INTERSTATE 94 LE: N.T.S. SHEET NO. 110 OF 919 SHEETS SECTION 305 (1920.01,1518,2022&1922.4B)R FFD. ROAD DIST. NO. 1 ILLINOIS/FED. ADD FFD. ROAD DIST. NO. 1 ILLINOIS/FED. ADD			
MAINTENANCE OF TRAFFIC TYPICAL SECTIONS AND NOTES INTERSTATE 94	Ξ		
INTERSTATE 94			C
SCALE: N.T.S. SHEET NO. 110 OF 919 SHEETS	FED. R	OAD DIST, NO. 1 ILLINOIS FED. AI	D_


STAGE 2


- 1. USE STAGE 2 STAGING PLAN SHEETS (SEE SHEETS NO. 133 TO 135).
- 2. ESTABLISH TRAFFIC FLOW ON EASTBOUND AND WESTBOUND I-94 EDENS LANES WITH 3 LANES IN EACH DIRECTION. TRAFFIC SHALL SHIFT AND TAPER FROM 12' TO 11' ENTERING CONSTRUCTION LIMITS. LANES WILL SHIFT AND TAPER BACK TO EXISTING CONFIGURATION EXITING CONSTRUCTION LIMITS. ACCESS TO RAMP A SHALL BE MAINTAINED AT ALL TIMES. ACCESS TO RAMP D SHALL BE MAINTAINED EXCEPT DURING APPROVED DETOUR. RAMP D PAVEMENT SHALL BE COMPLETED DURING DETOUR (SEE SHEET NO. 135 FOR APPROVED DETOUR ROUTE). CONTRACTOR MAY BEGIN PAVEMENT CONSTRUCTION AND GRADING PRIOR TO DETOUR BUT ANY AND ALL ACTIVITIES SHALL NOT IMPACT RAMP D TRAFFIC.
- 3. REMOVE PAVEMENT, SHOULDER, CURB AND GUTTER, AND ALL DRAINAGE ITEMS ALONG EAST AND WEST SIDES OF INTERSTATE 94.
- 4. GRADE DITCHES AND SIDESLOPES ALONG BOTH SIDES OF INTERSTATE 94 AS SHOWN IN PLANS.
- 5. INSTALL STORM SEWER AND STRUCTURES ALONG BOTH SIDES OF INTERSTATE 94.
- 6. INSTALL PERMANENT LIGHTING ALONG BOTH SIDES OF INTERSTATE 94.
- 7. CONSTRUCT PAVEMENT AND SHOULDERS FOR AUXILIARY LANE EXTENSIONS.
- 8. PLACE PERMANENT PAVEMENT MARKINGS ALONG EASTBOUND AND WESTBOUND LANES.
- 9. COMPLETE LANDSCAPING ALONG BOTH SIDES OF INTERSTATE 94.
- 10. COMPLETE STEEL BEAM REPAIRS ON THE WILLOW ROAD BRIDGE OVER INTERSTATE 94. THE CONTRACTOR SHALL PROVIDE A MAINTENANCE OF TRAFFIC PLAN FOR THIS WORK. THE MAINTENANCE OF TRAFFIC PLAN SHALL BE SUBMITTED TO THE ENGINEER FOR APPROVAL. THIS MAINTENANCE OF TRAFFIC PLAN SHALL BE INCLUDED IN THE COST OF TRAFFIC CONTROL AND PROTECTION (EXPRESSWAYS).

COUNTY

COOK 919 110

CONTRACT NO. 60T35

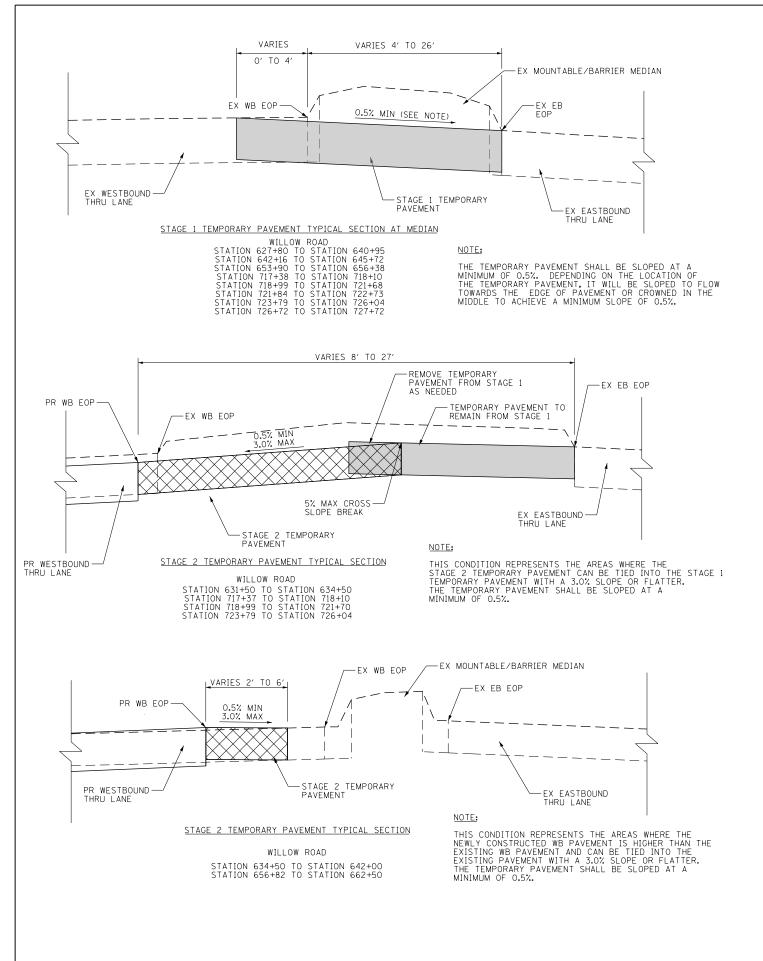

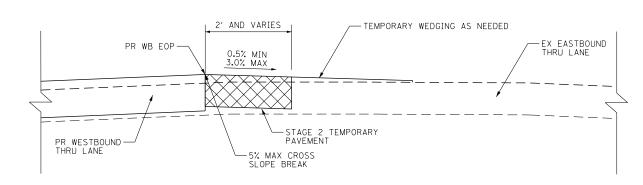


STAGE 2 TEMPORARY PAVEMENT TYPICAL SECTION

WILLOW ROAD

STATION 645+35 TO STATION 654+50 STATION 666+00 TO STATION 671+70 STATION 679+50 TO STATION 689+50 STATION 698+40 TO STATION 706+50 STATION 715+60 TO STATION 717+00

NOTE:

THIS CONDITION REPRESENTS THE AREAS WHERE THE NEWLY CONSTRUCTED WB PAVEMENT IS HIGHER THAN THE EXISTING WB PAVEMENT AND CANNOT BE TIED INTO THE EXISTING PAVEMENT WITH A 3.0% SLOPE OR FLATTER. THE TEMPORARY PAVEMENT SHALL BE SLOPED AT A MINIMUM OF 0.5%.

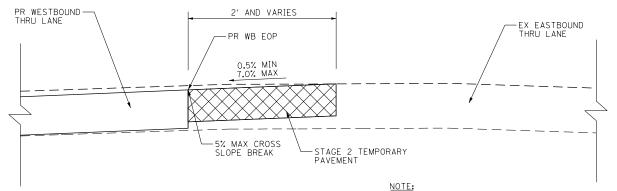


STAGE 2 TEMPORARY PAVEMENT TYPICAL SECTION

WILLOW ROAD

STATION 662+50 TO STATION 666+00 STATION 672+00 TO STATION 674+00 STATION 721+70 TO STATION 723+79

THIS CONDITION REPRESENTS THE AREAS WHERE THE NEWLY CONSTRUCTED WB PAVEMENT IS LOWER THAN THE EXISTING WB PAVEMENT AND CAN BE TIED INTO THE EXISTING PAVEMENT WITH A 7.0% SLOPE OR FLATTER. THE TEMPORARY PAVEMENT SHALL BE SLOPED AT A MINIMUM OF 0.5%.

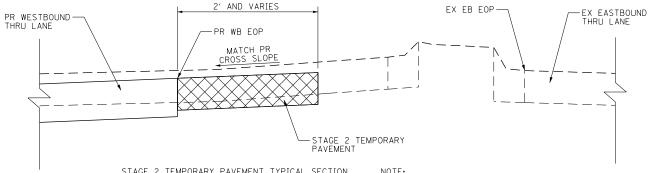

STAGE 2 TEMPORARY PAVEMENT TYPICAL SECTION

WILLOW ROAD

STATION 674+50 TO STATION 678+00 STATION 692+00 TO STATION 698+00 STATION 706+50 TO STATION 714+00

THIS CONDITION REPRESENTS THE AREAS WHERE THE NEWLY CONSTRUCTED WB PAVEMENT IS LOWER THAN THE EXISTING WB PAVEMENT AND CANNOT BE TIED INTO THE EXISTING PAVEMENT WITH A 7.0% SLOPE OR FLATTER. THE PAVEMENT SHALL BE SLOPED AT A MINIMUM OF 0.5%.

GENERAL NOTES:

- 1. THE DROP OFF POLICY (SAFETY 4-08, UPDATED 8/27/10) MUST BE FOLLOWED FOR ALL STAGES.
- 2. IN ALL CONDITIONS, THE MAXIMUM CROSS SLOPE BREAK IS 5% WITHIN THE TRAVELWAY.

FILE NAME : DESIGNED -DBC REVISED USER NAME = BAWitort G:\CHII\@I58\Road\Road-GV\Sheets\DI6@T35-SHT-STAGING-TYPICALS.dgn DRAWN FY REVISED PLOT SCALE = 100.0000 '/ 10. CHECKED RCB REVISED

PLOT DATE = 11/29/2012


DATE

10/31/2012

REVISED

STATE OF ILLINOIS **DEPARTMENT OF TRANSPORTATION**

SUGGESTED CONSTRUCTION PROCEDURES AND	F.A.P. RTE.	SECTION	COUNTY	TOTAL SHEETS	SHEET NO.
MAINTENANCE OF TRAFFIC TYPICAL SECTIONS AND NOTES	305	(1920.01,1518,2022&1922.4B)R	COOK	919	111
TEMPORARY PAVEMENT – WILLOW ROAD			CONTRACT	NO. 60	T35
SCALE: N.T.S. SHEET NO. 111 OF 919 SHEETS	FED. R	OAD DIST, NO. 1 ILLINOIS FED. AI	D PROJECT		$\overline{}$

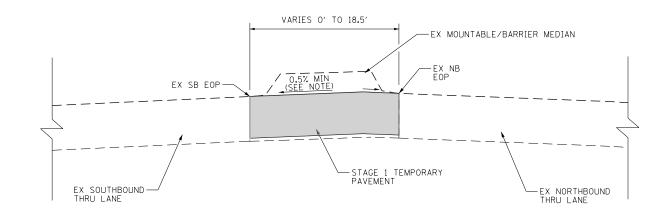


STAGE 1 TEMPORARY PAVEMENT TYPICAL SECTION AT MEDIAN

ILLINOIS ROUTE 43

STATION 503+88 TO STATION 505+53
STATION 506+10 TO STATION 515+46

NOTE:

THE TEMPORARY PAVEMENT SHALL BE SLOPED AT A MINIMUM OF 0.5%. DEPENDING ON THE LOCATION OF THE TEMPORARY PAVEMENT, IT WILL BE SLOPED TO FLOW TOWARDS THE EDGE OF PAVEMENT OR CROWNED IN THE MIDDLE TO ACHIEVE A MINIMUM SLOPE OF 0.5%.

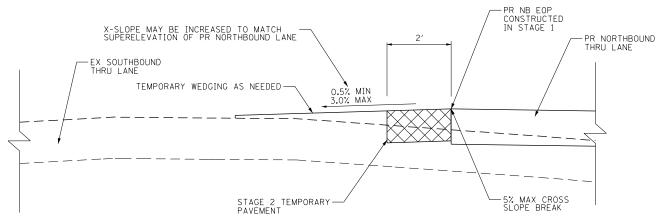


STAGE 2 TEMPORARY PAVEMENT TYPICAL SECTION

ILLINOIS ROUTE 43
STATION 517+60 TO STATION 521+50

NOTE:

THIS CONDITION REPRESENTS THE AREAS WHERE THE NEWLY CONSTRUCTED NB PAVEMENT IS HIGHER THAN THE EXISTING PAVEMENT AND CANNOT BE TIED INTO THE EXISTING PAVEMENT WITH A 3.0% SLOPE OR FLATTER.

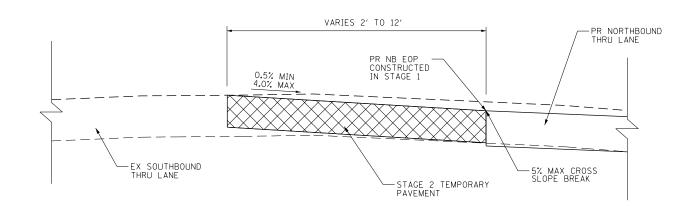


STAGE 2 TEMPORARY PAVEMENT TYPICAL SECTION

ILLINOIS ROUTE 43

STATION 516+00 TO STATION 517+60 STATION 524+50 TO STATION 525+45

NOTE:

THIS CONDITION REPRESENTS THE AREAS WHERE THE NEWLY CONSTRUCTED NB PAVEMENT IS LOWER THAN THE EXISTING PAVEMENT AND CAN BE TIED INTO THE EXISTING PAVEMENT WITH A 4.0% SLOPE OR FLATTER. THE TEMPORARY PAVEMENT SHALL BE SLOPED AT A MINIMUM OF 0.5%.

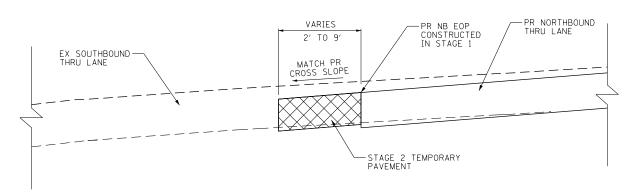

STAGE 2 TEMPORARY PAVEMENT TYPICAL SECTION

ILLINOIS ROUTE 43 STATION 521+50 TO STATION 524+50

NOTE

THIS CONDITION REPRESENTS THE AREAS WHERE THE NEWLY CONSTRUCTED NB PAVEMENT IS LOWER THAN THE EXISTING PAVEMENT AND CANNOT BE TIED INTO THE EXISTING PAVEMENT WITH A 3.0% SLOPE OR FLATTER.


GENERAL NOTES:


- 1. THE DROP OFF POLICY (SAFETY 4-08, UPDATED 8/27/10) MUST BE FOLLOWED FOR ALL STAGES.
- 2. IN ALL CONDITIONS, THE MAXIMUM CROSS SLOPE BREAK IS 5% WITHIN THE TRAVELWAY.


FILE NAME =	USER NAME = BAWitort	DESIGNED	-	DBC	REVISED	-
G:\CHII\@I58\Road\Road-GV\Sheets\DI6@T3	S-SHT-STAGING-TYPICALS.dgn	DRAWN	-	FY	REVISED	-
	PLOT SCALE = 100.00000 '/ in.	CHECKED	-	RCB	REVISED	-
	PLOT DATE = 11/29/2012	DATE	-	10/31/2012	REVISED	-


STATE OF ILLINOIS DEPARTMENT OF TRANSPORTATION


SUGGESTED CONSTRUCTION PROCEDURES AND		F.A.P. RTE.	SECTION	COUNTY	TOTAL	SHEET NO.	
MAINTENANCE OF TRAFFIC TYPICAL SECTIONS AND NOTES			(1920.01,1518,2022&1922.4B)F	COOK	919	112	
TEMPORARY PAVEMENT – ILLINOIS ROUTE 43					CONTRACT	NO. 60	T35
SC	CALE: N.T.S.	SHEET NO. 112 OF 919 SHEETS	FED. F	ROAD DIST. NO. 1 ILLINOIS FED. /	AID PROJECT		

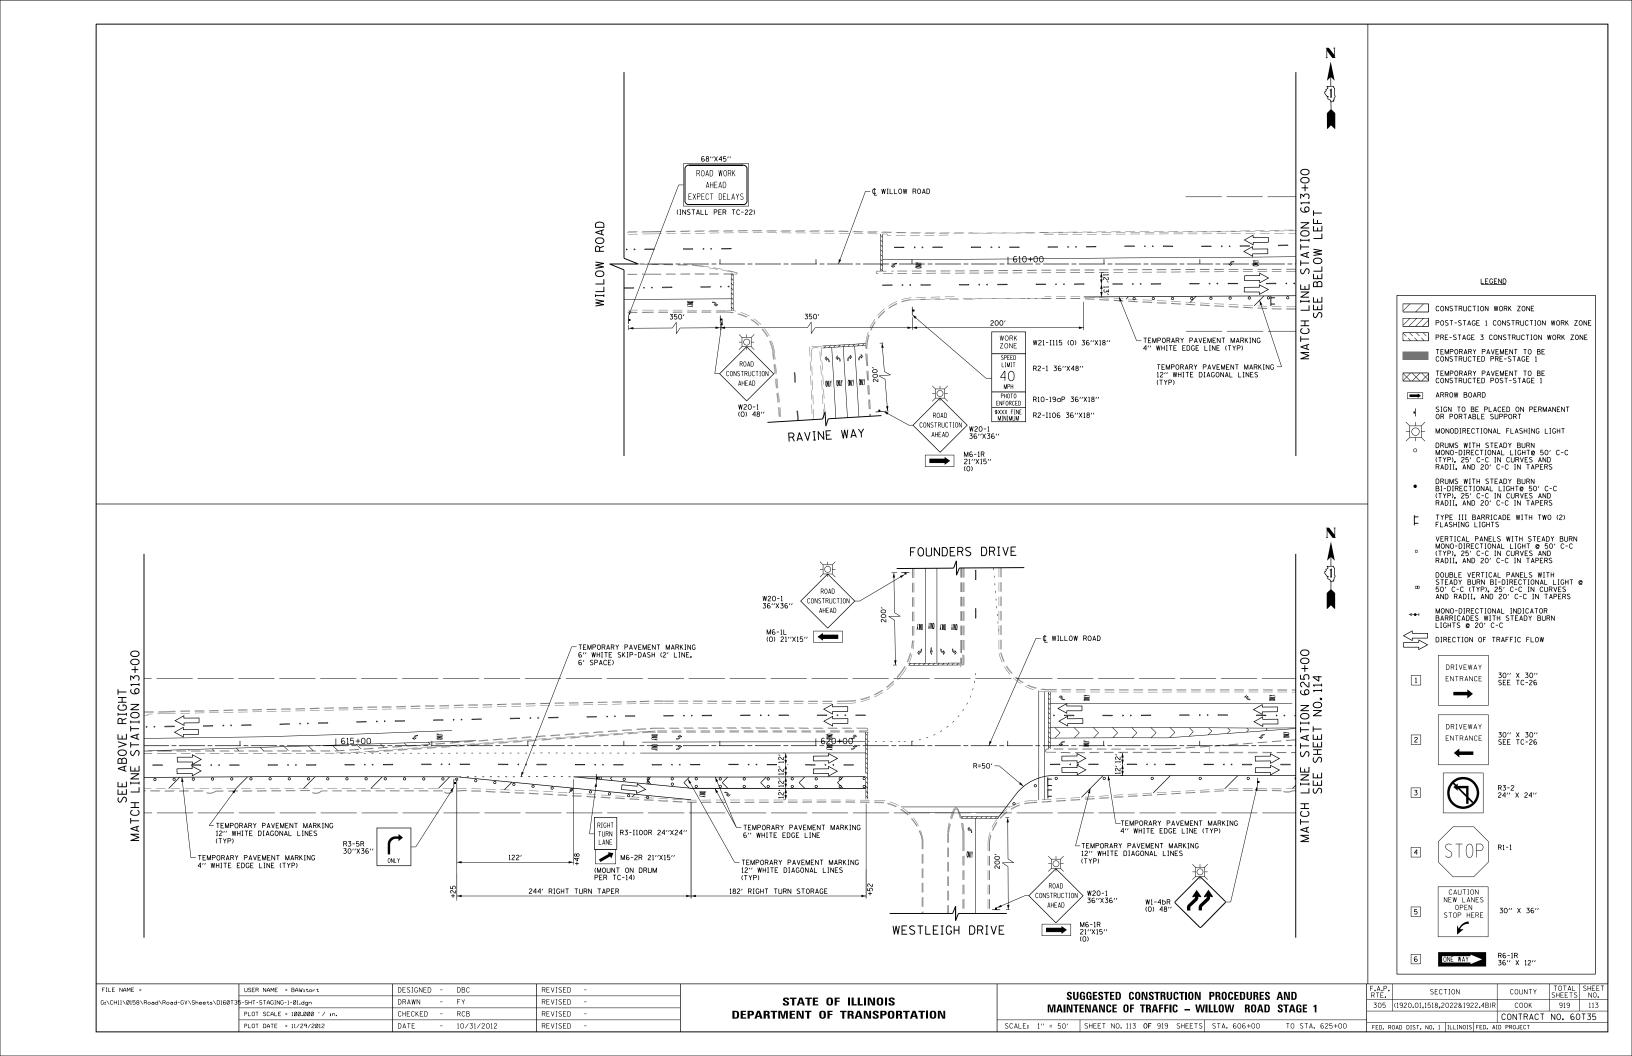


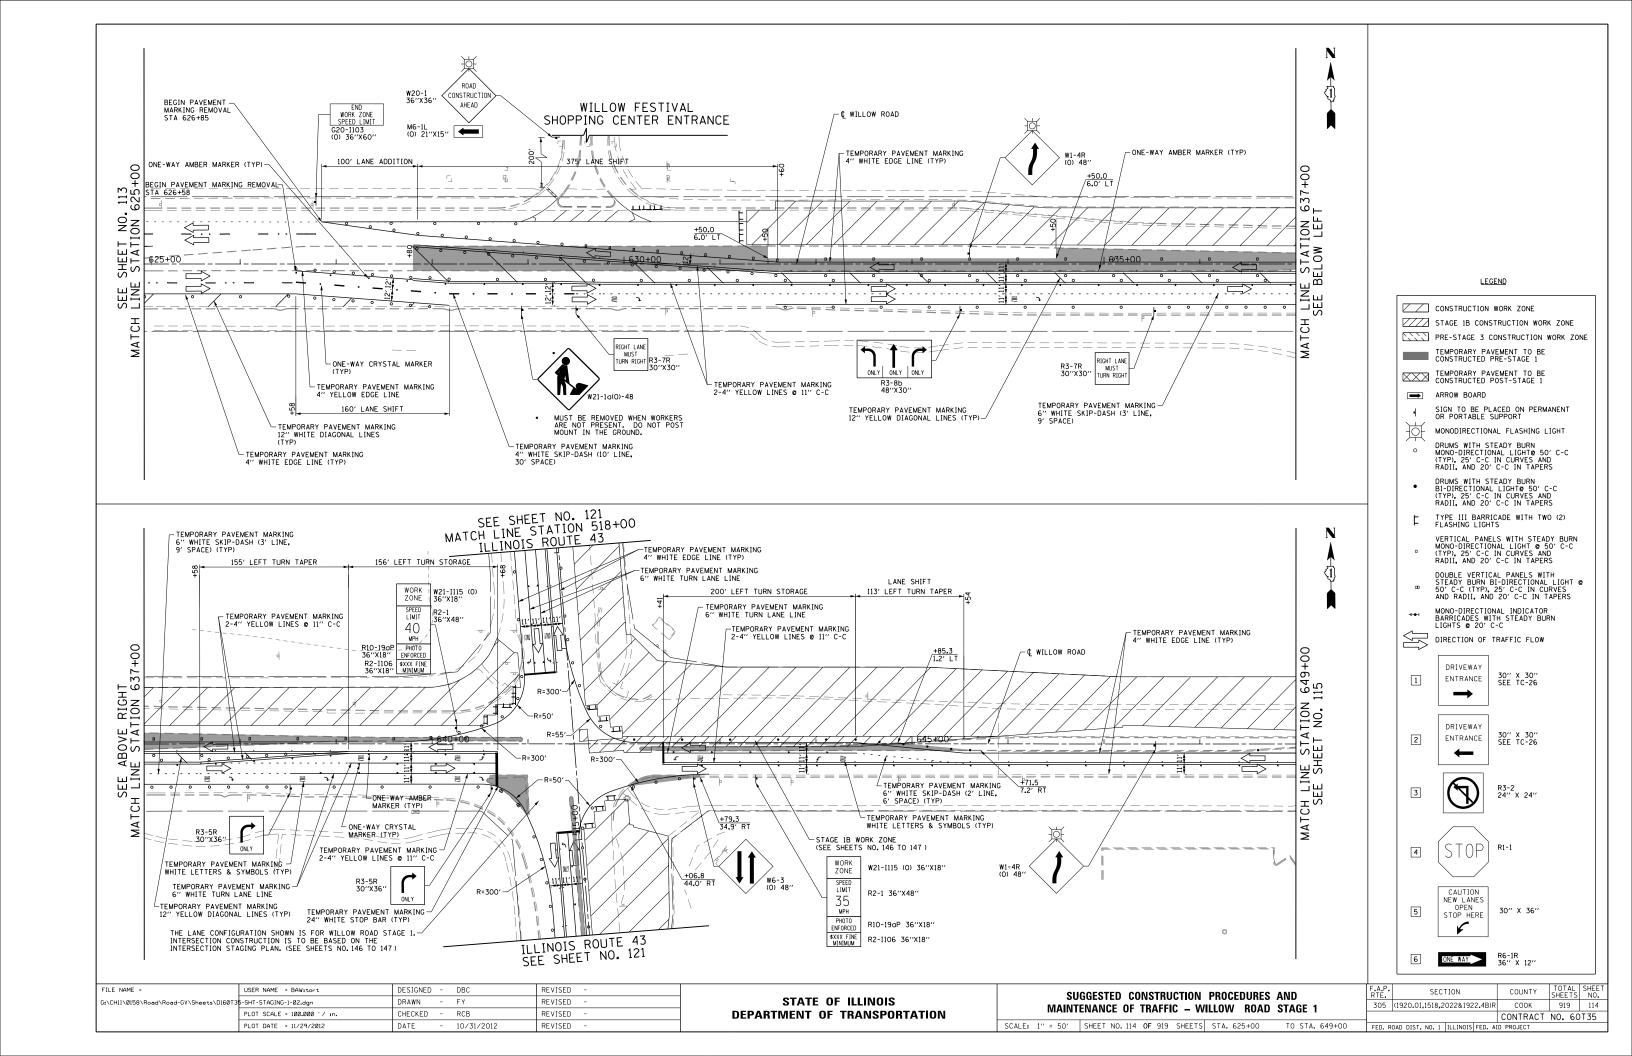


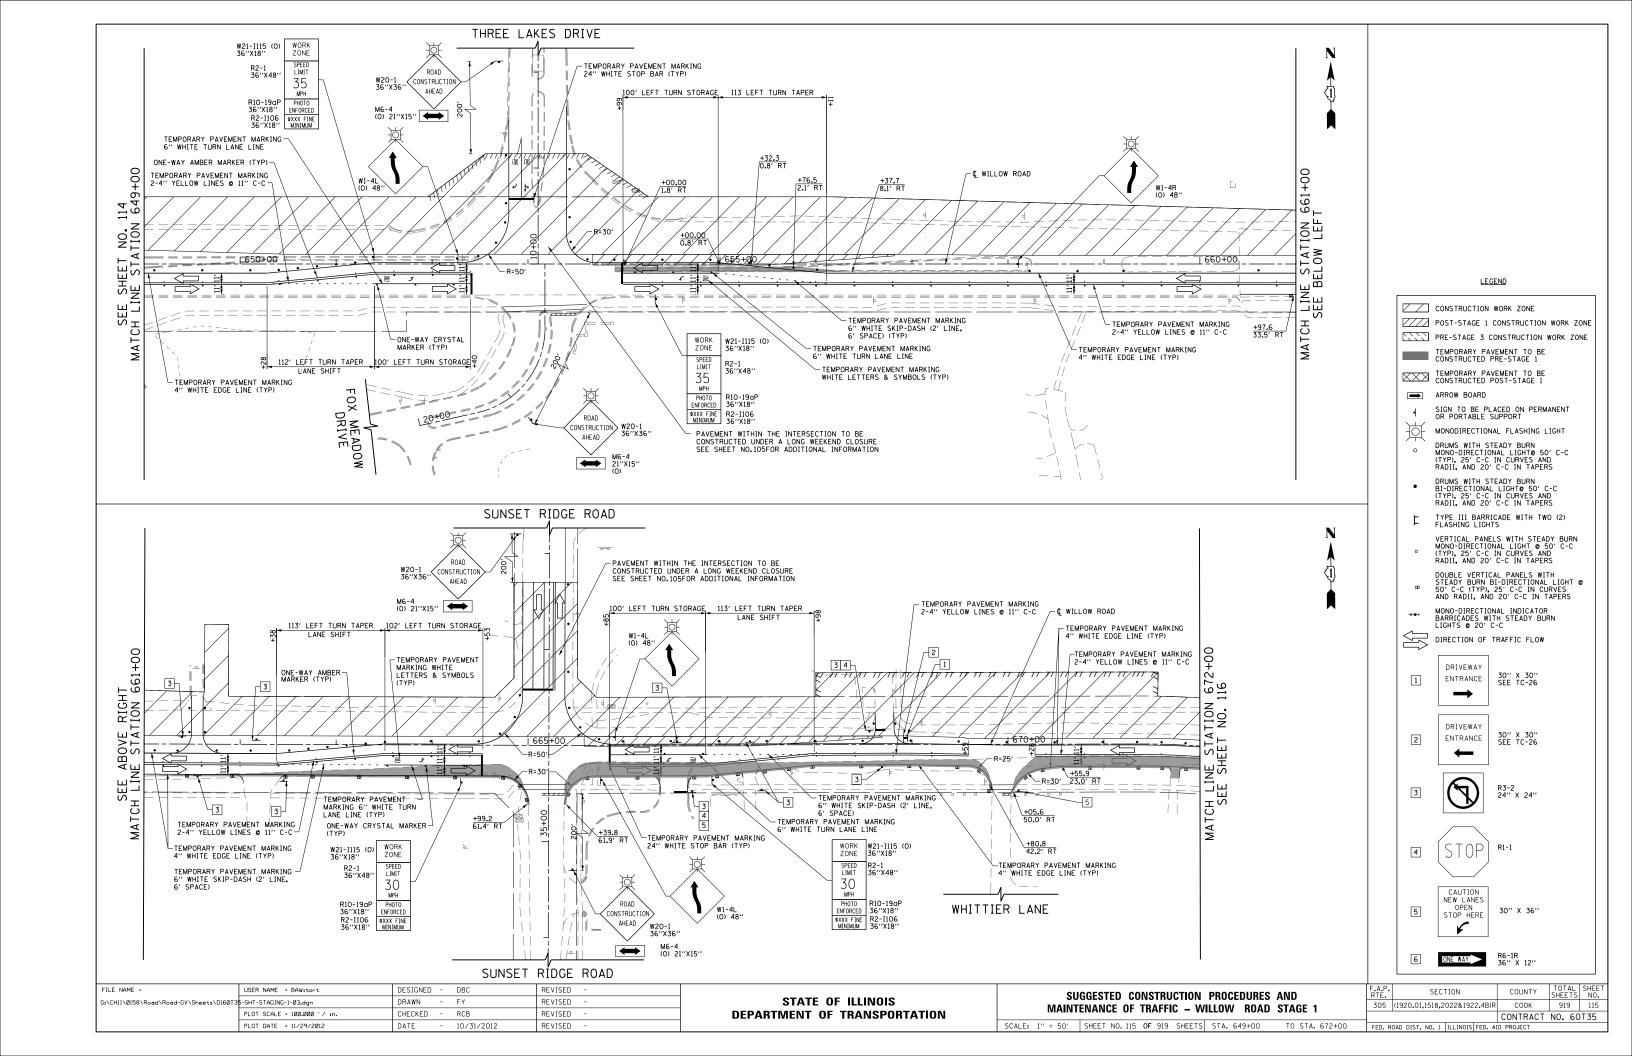


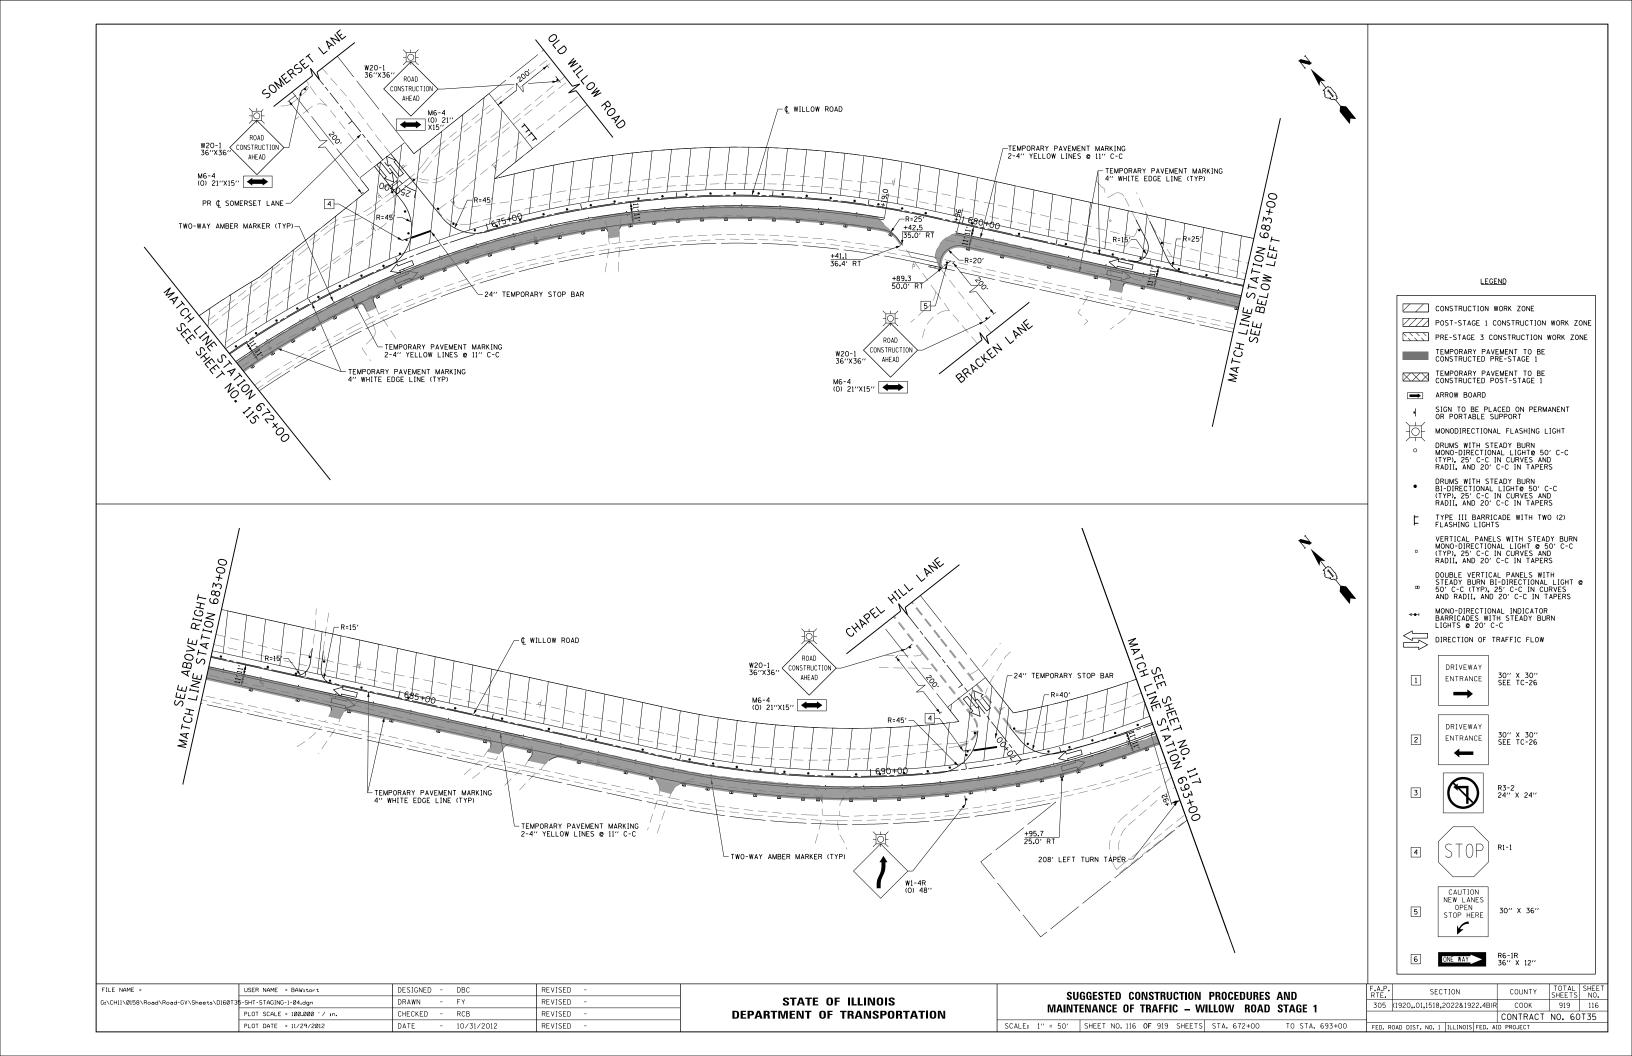


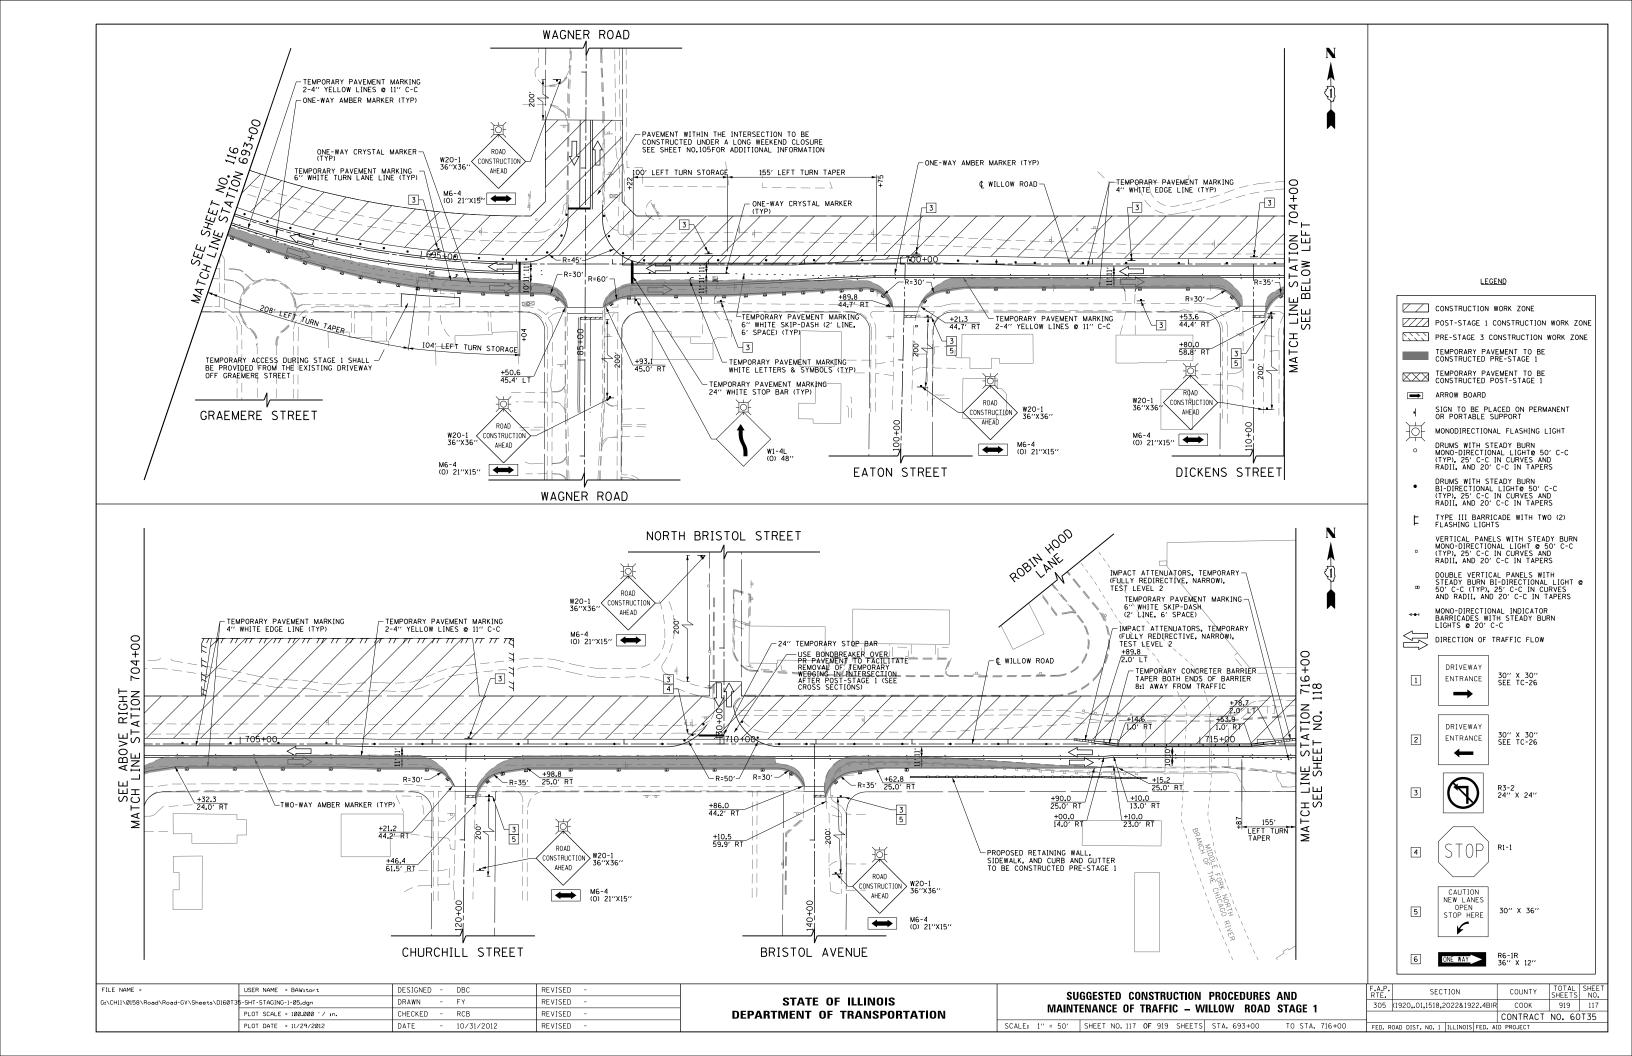


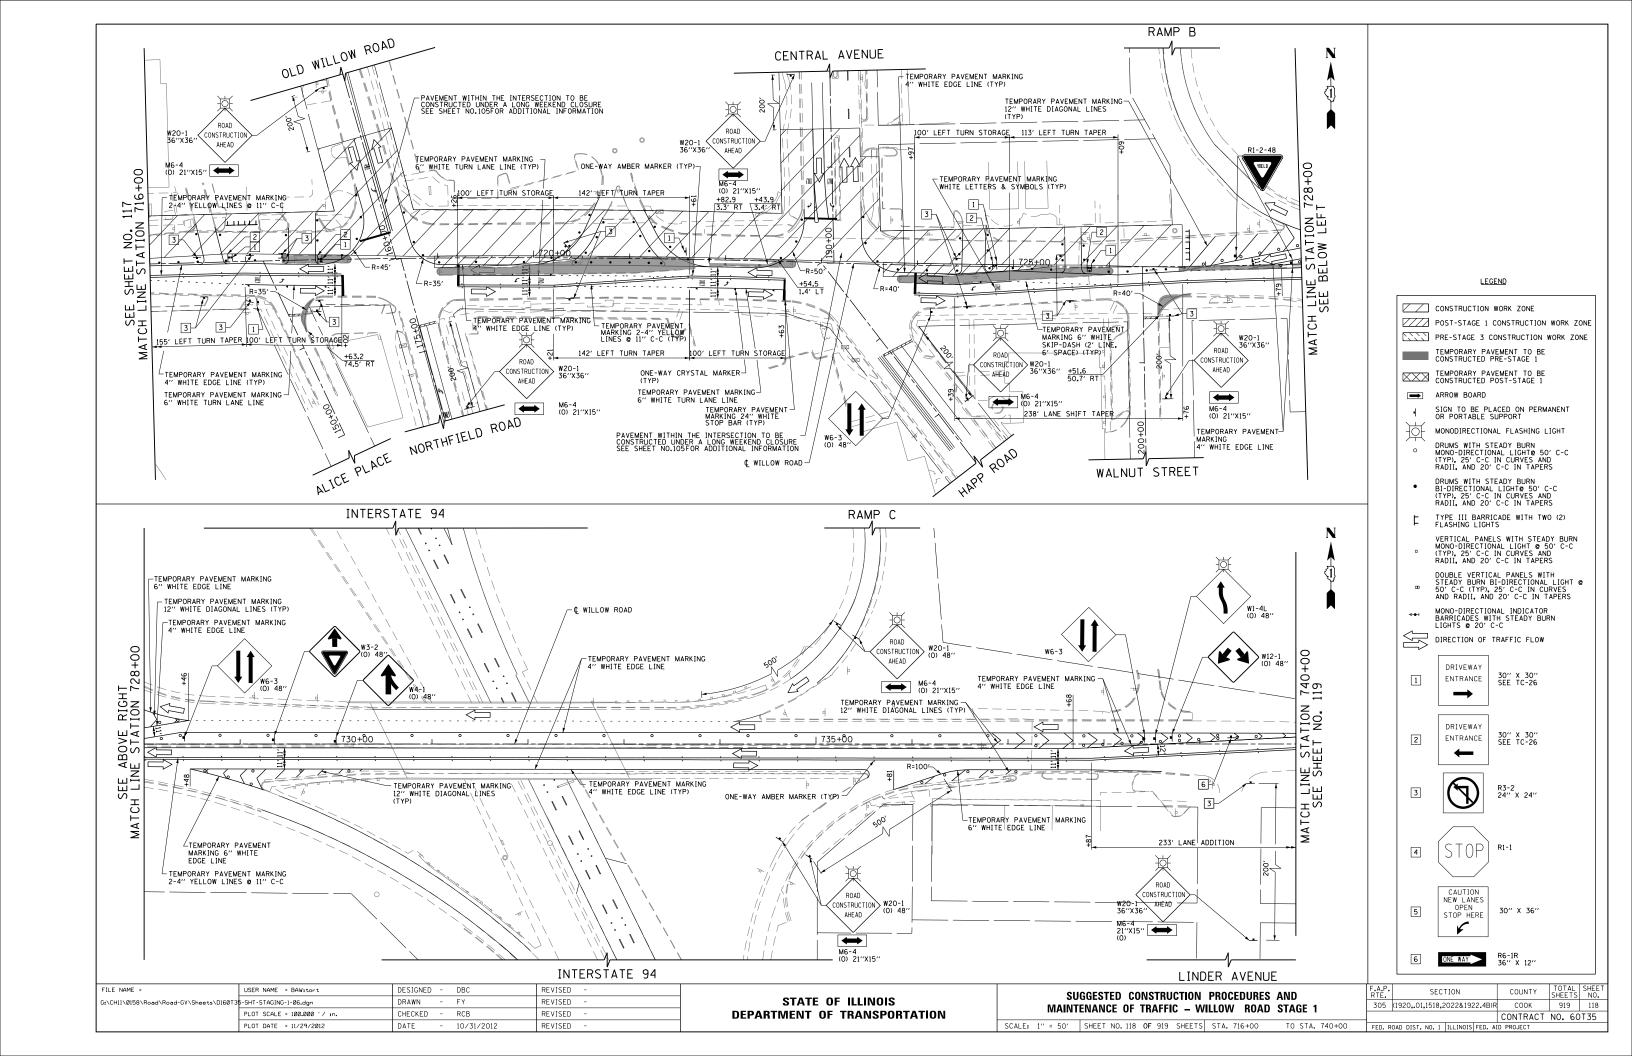


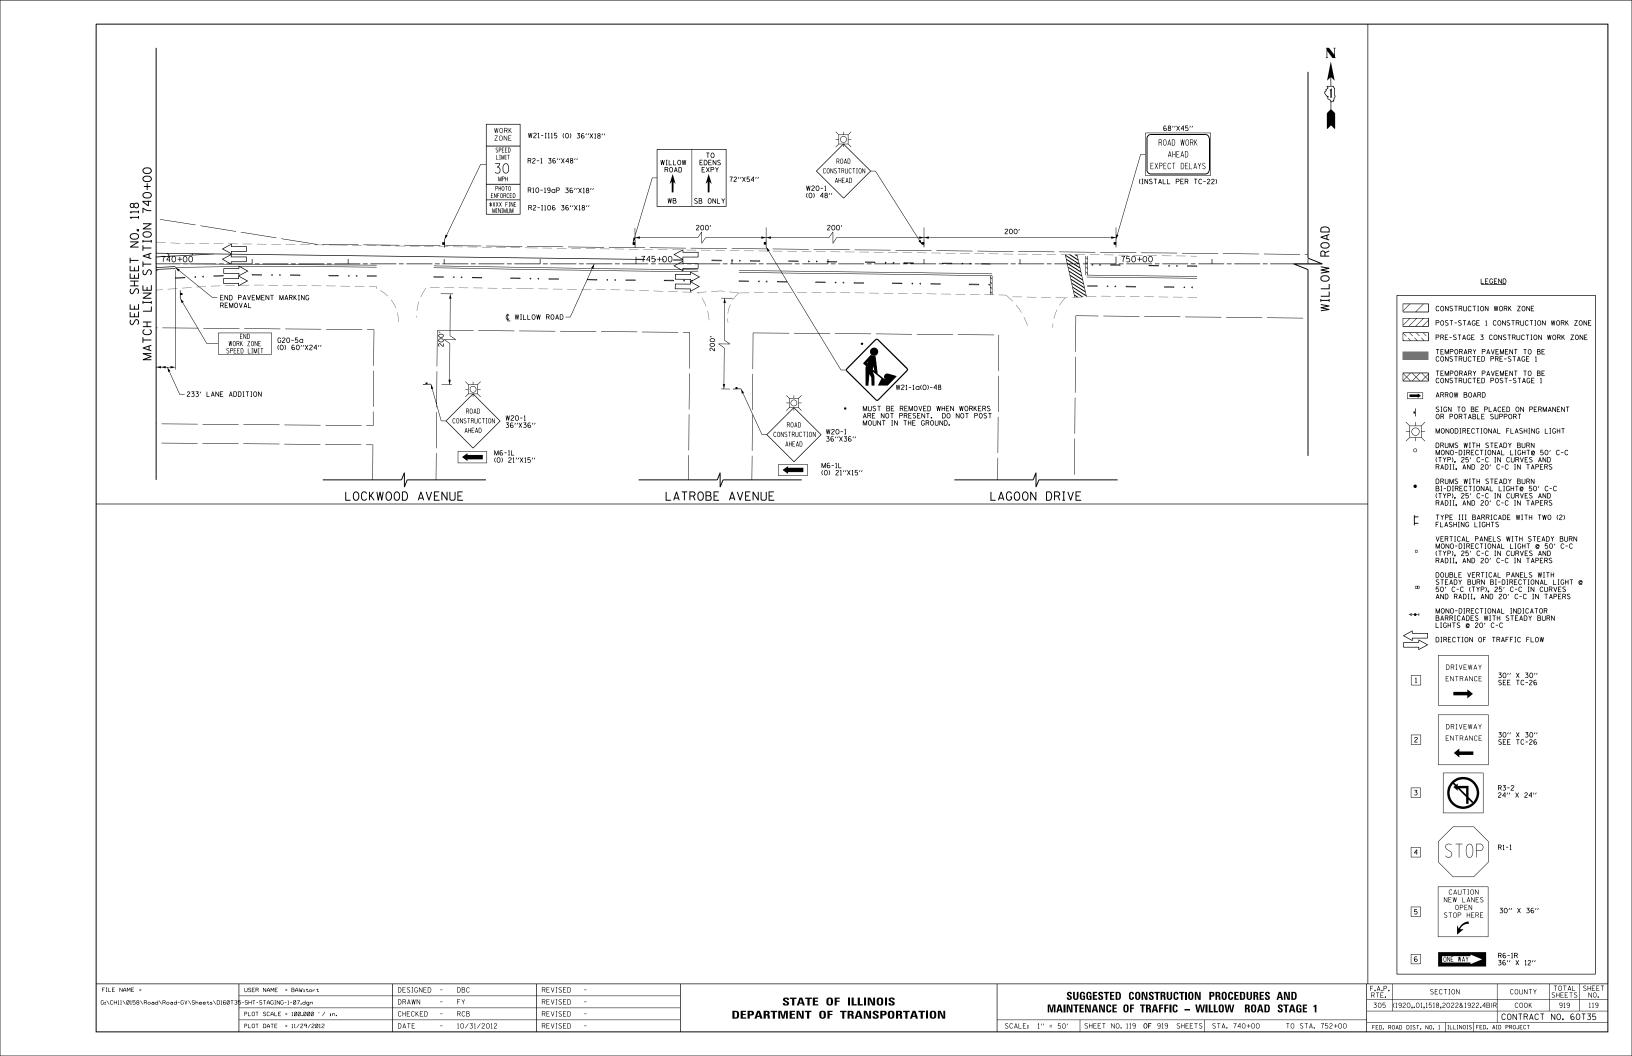


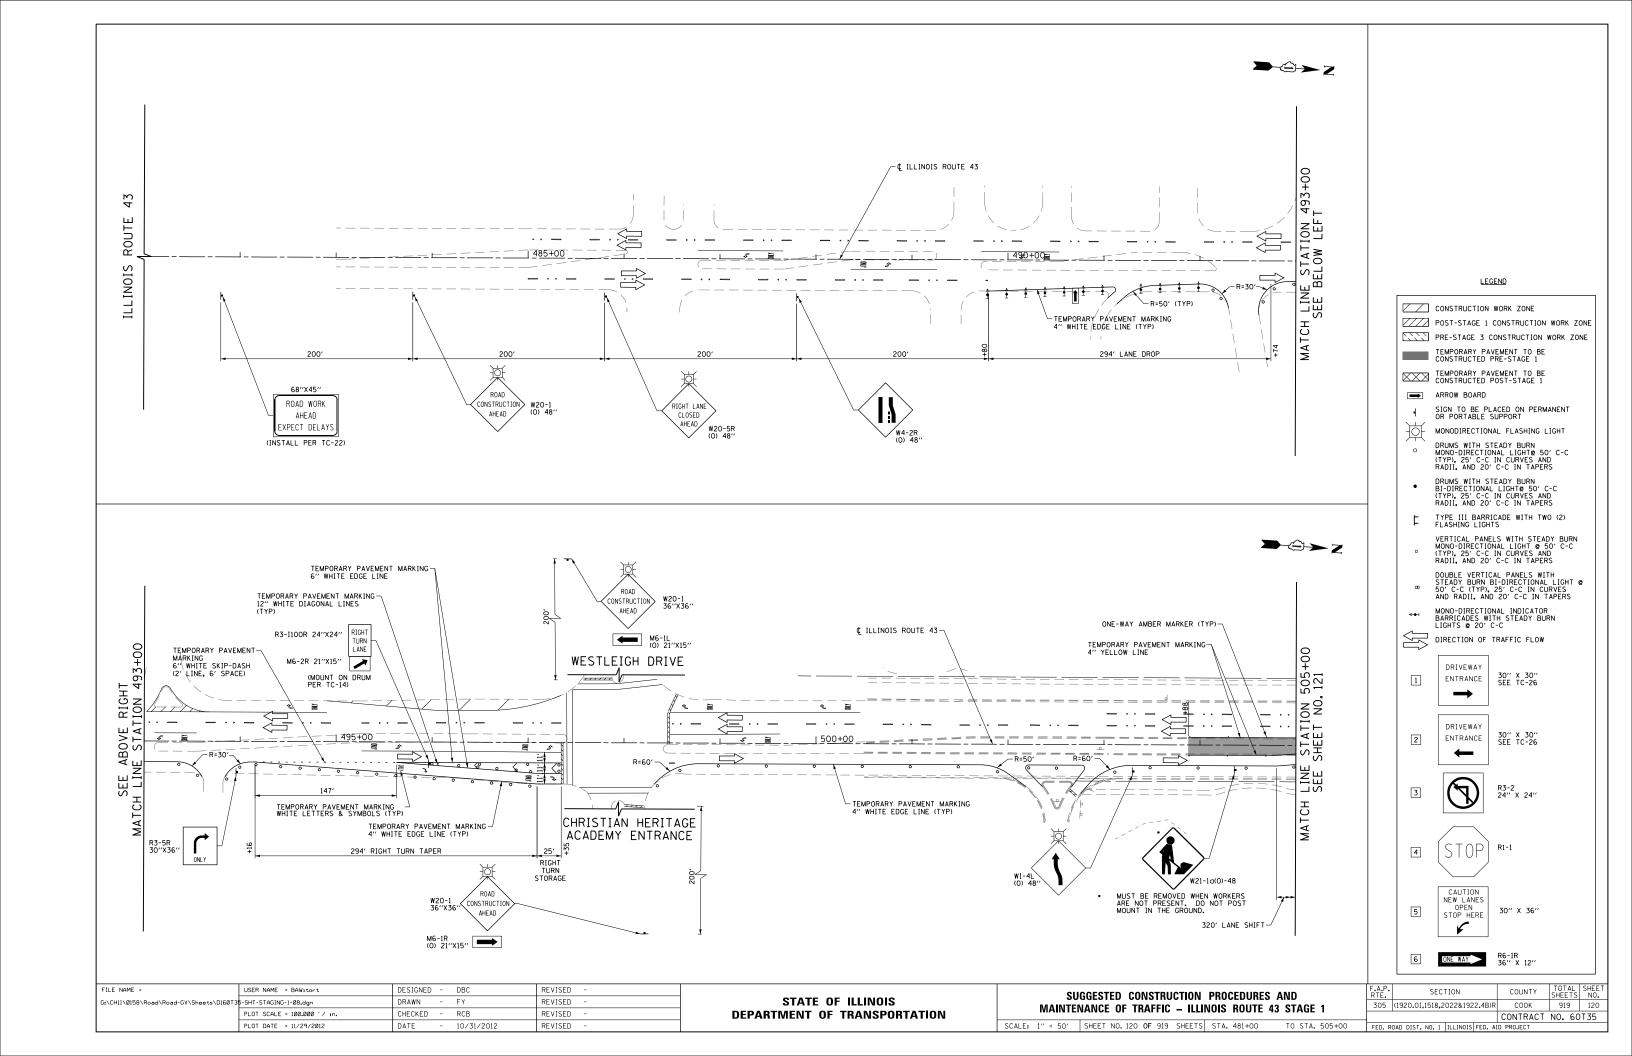


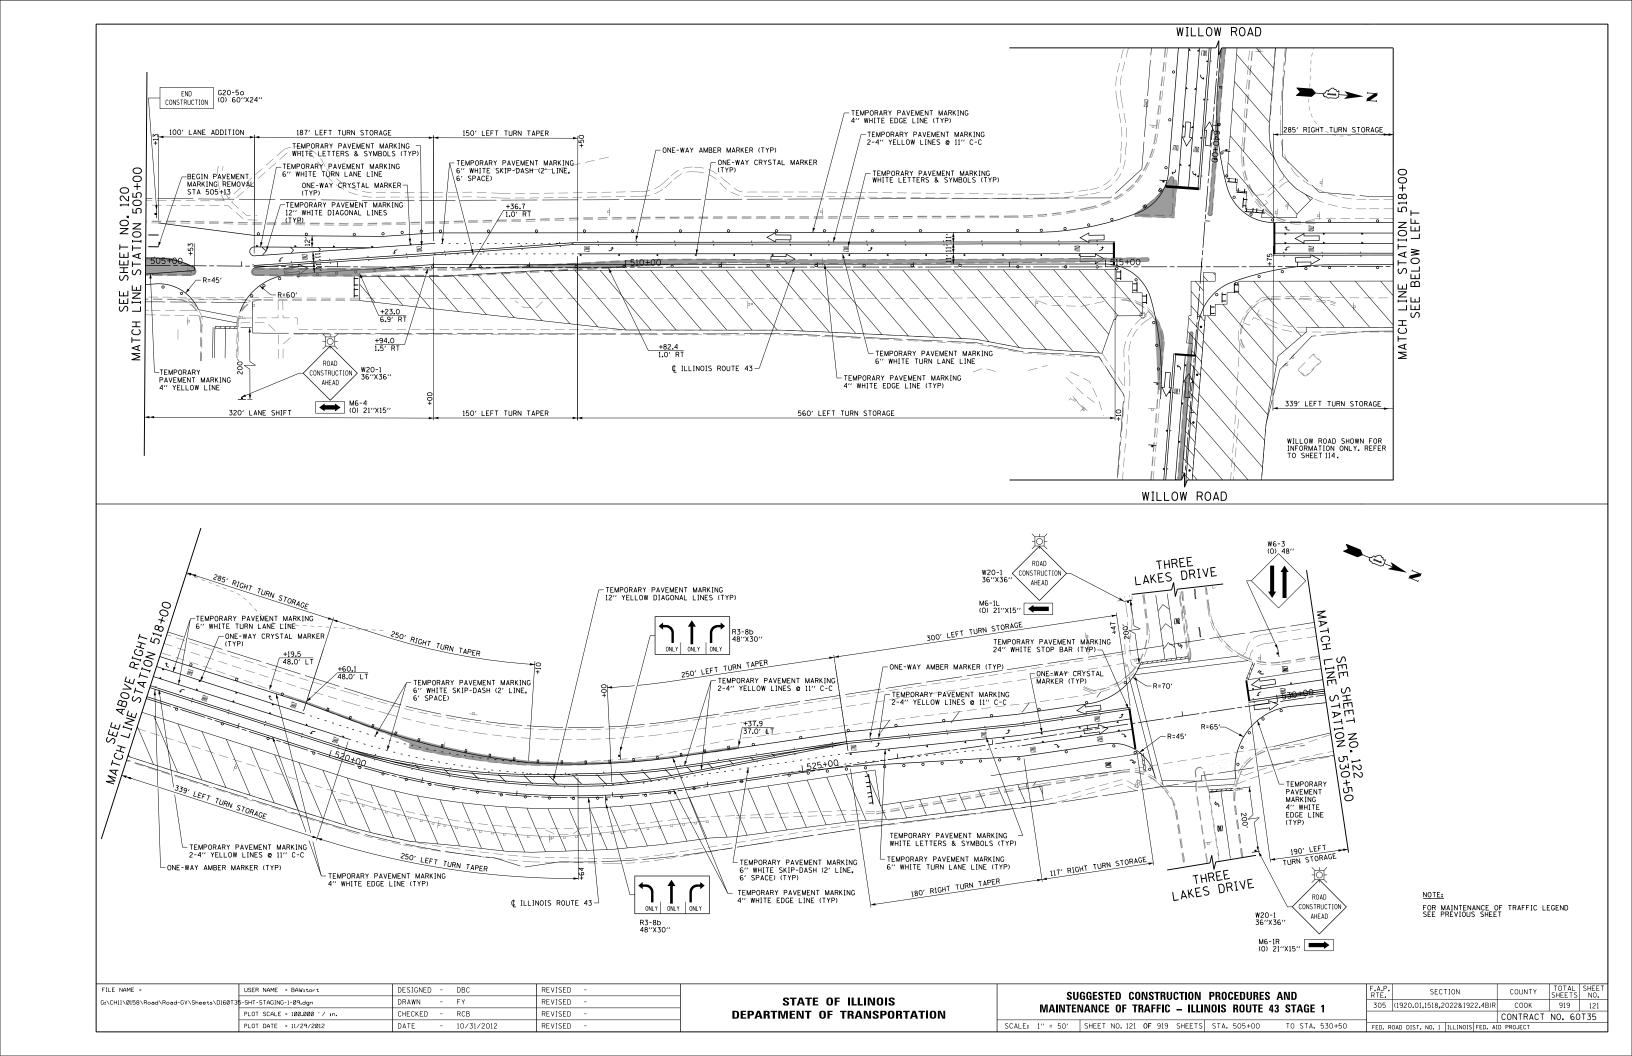


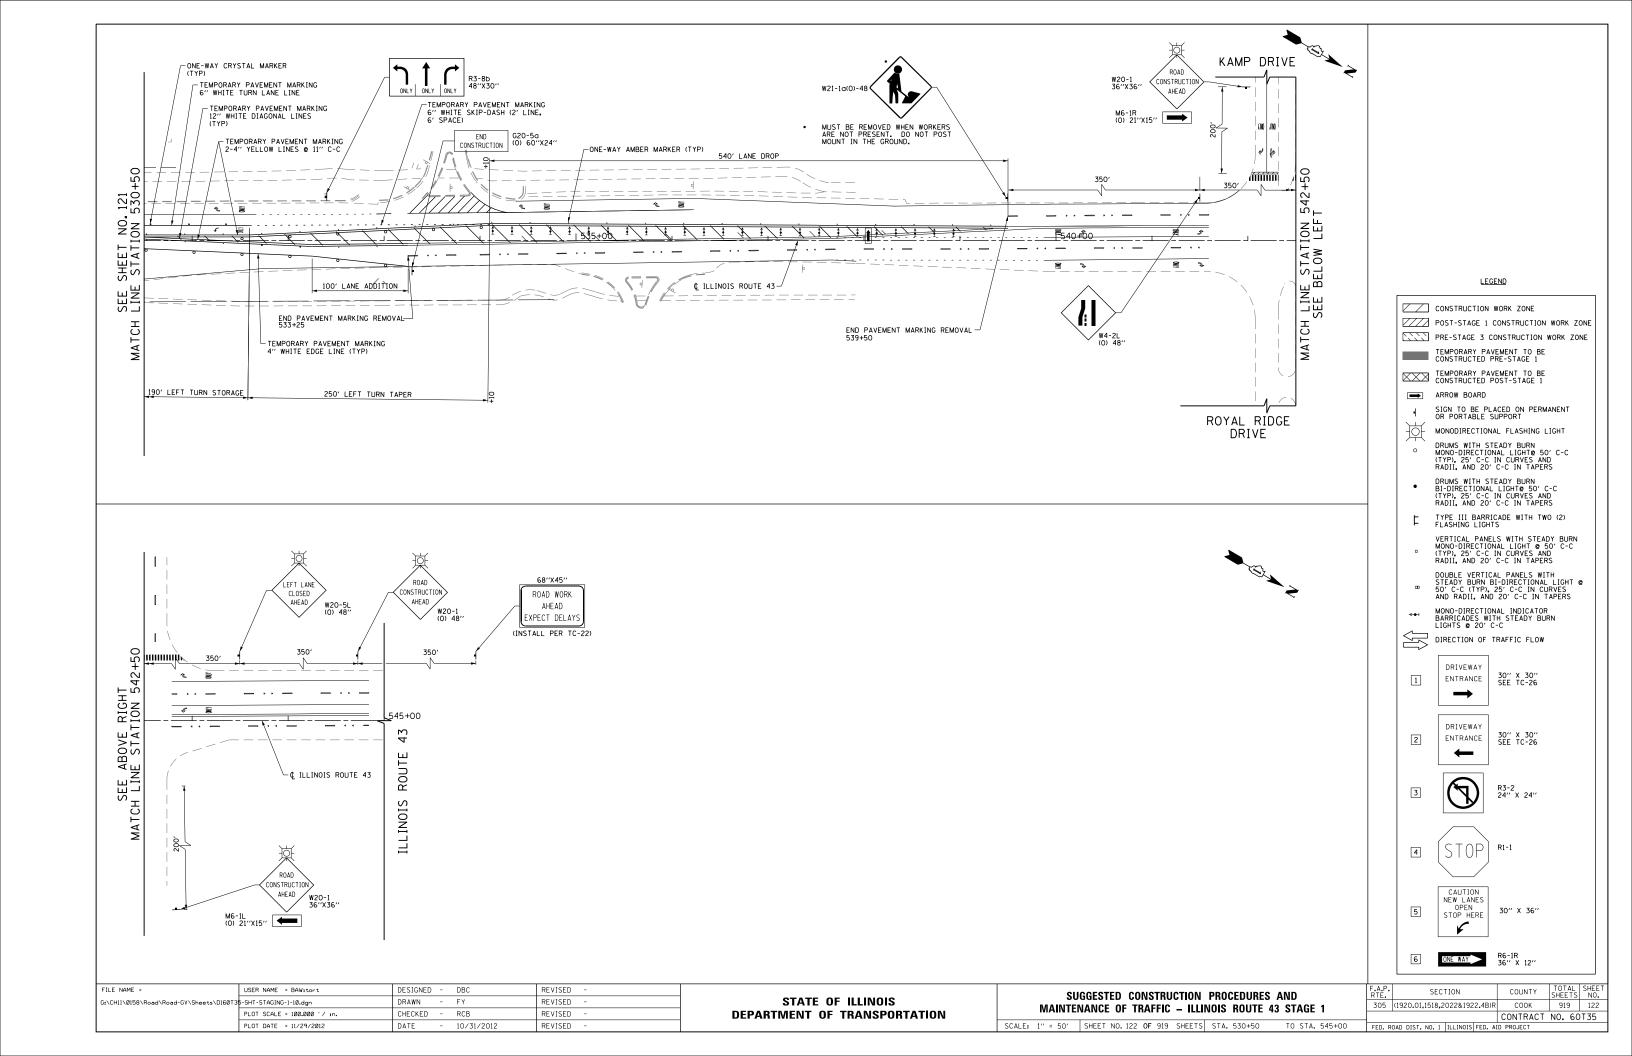


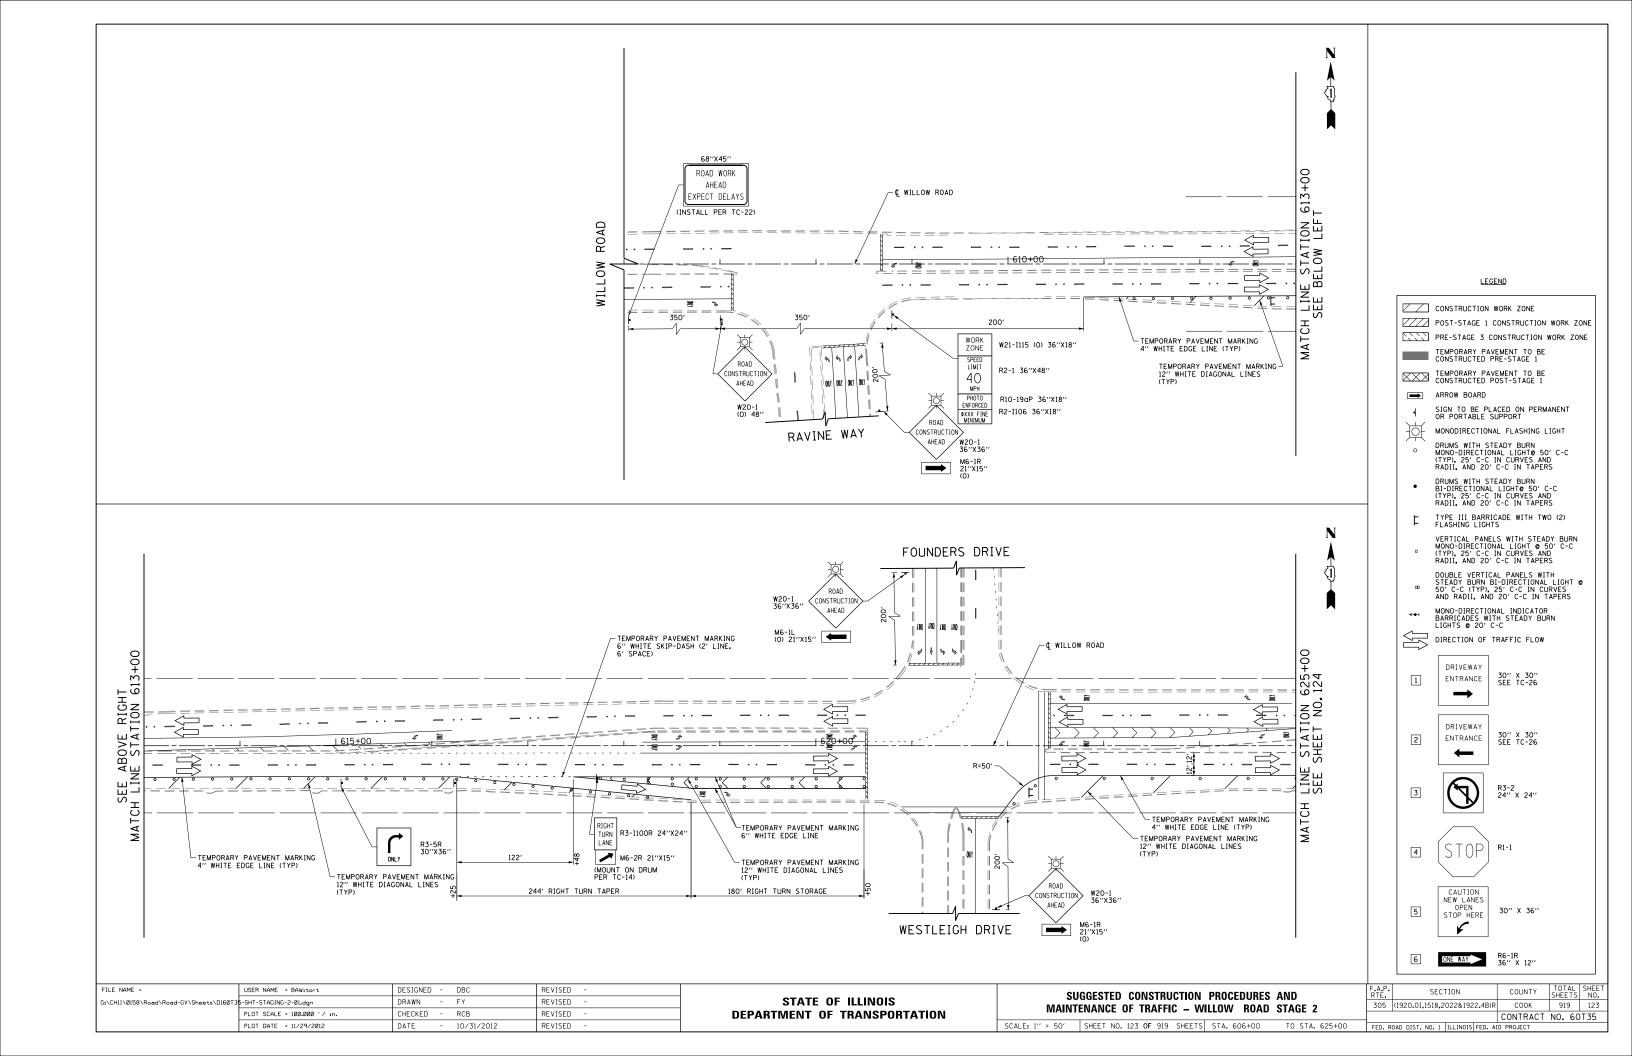


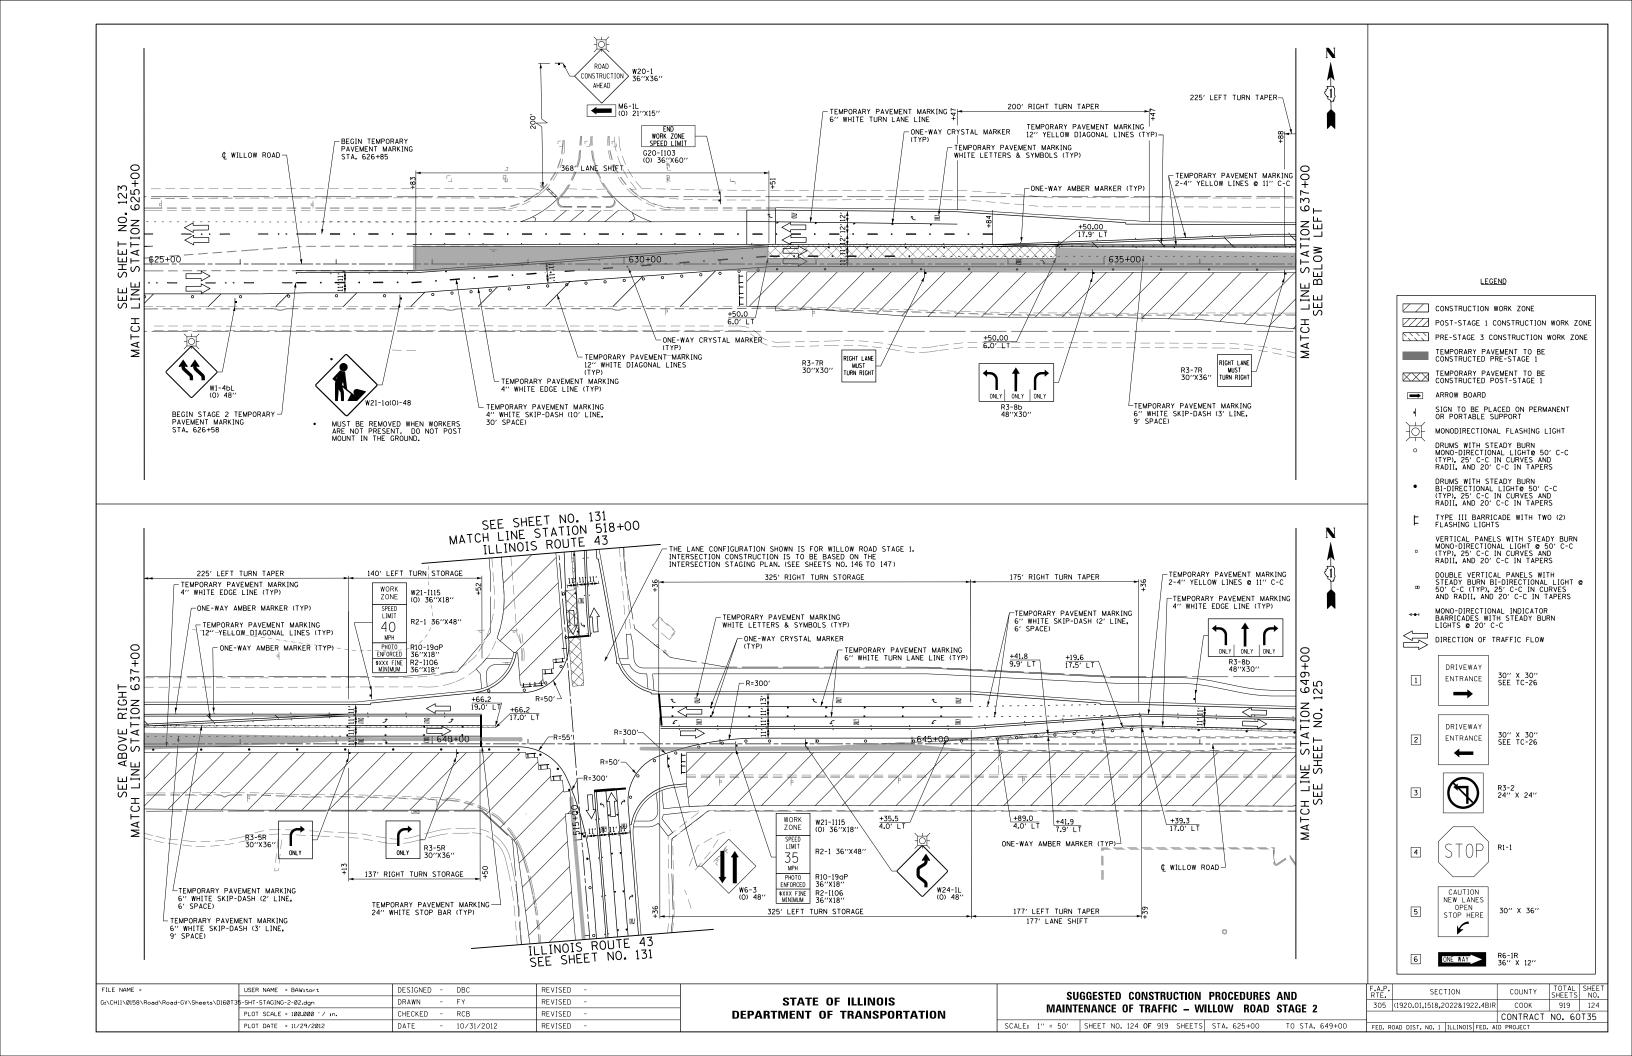


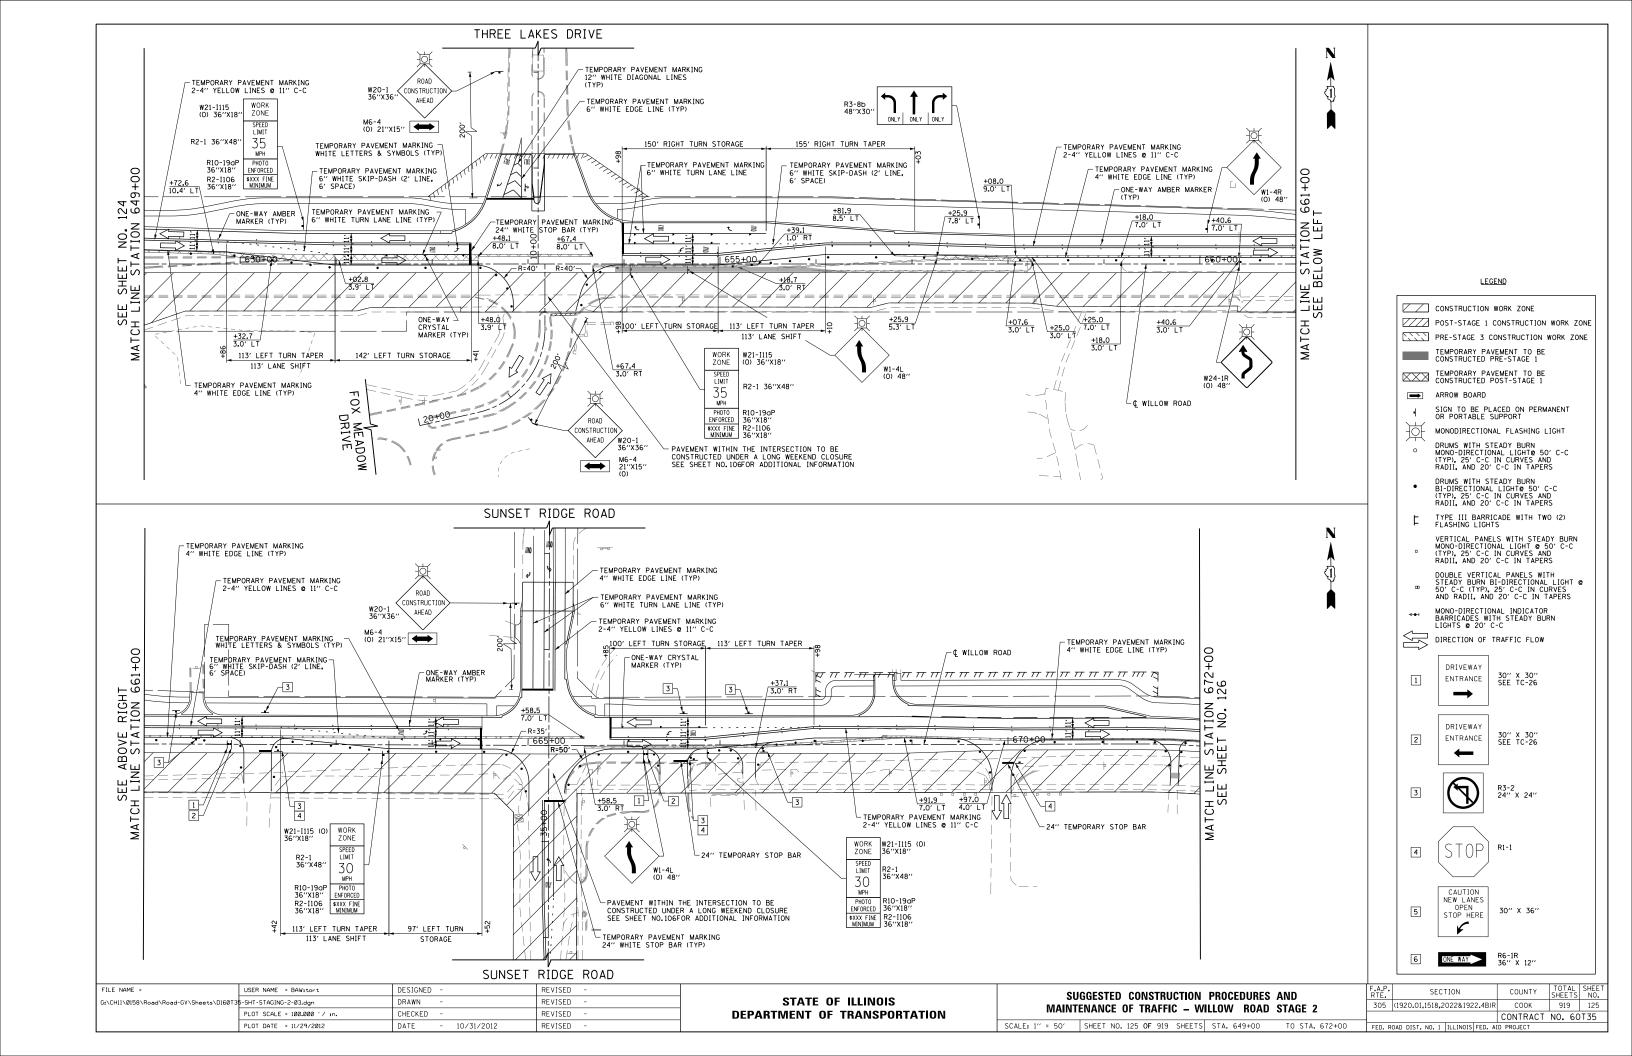


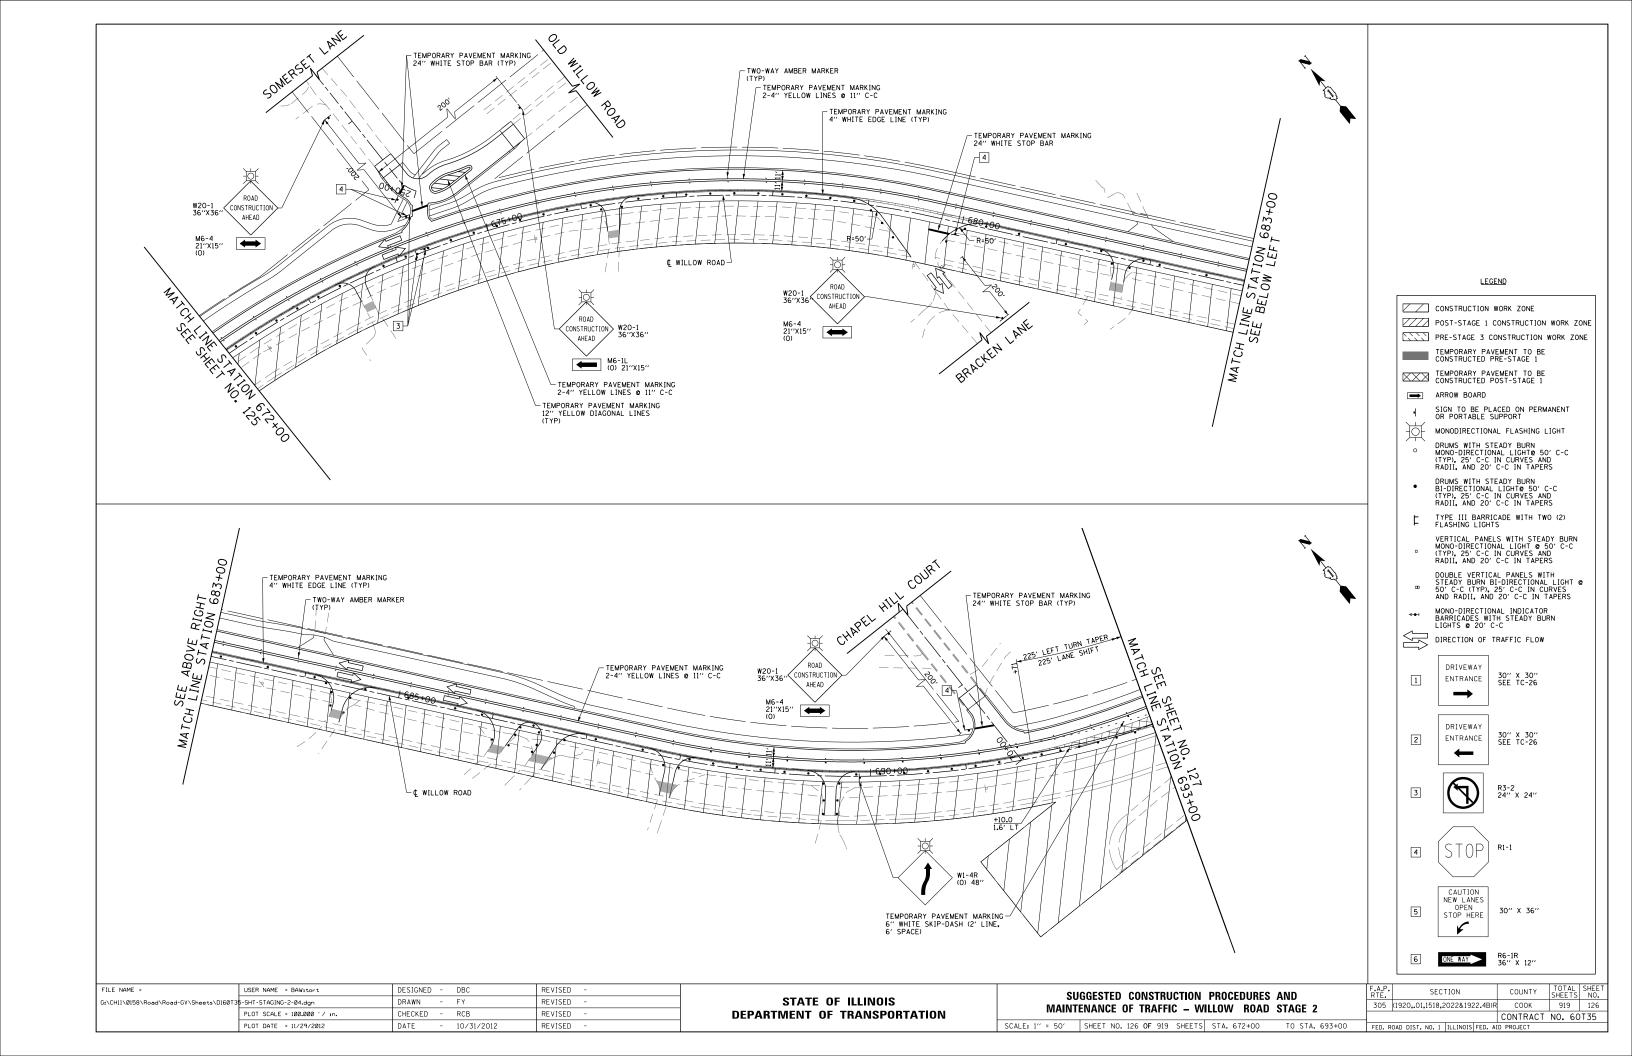


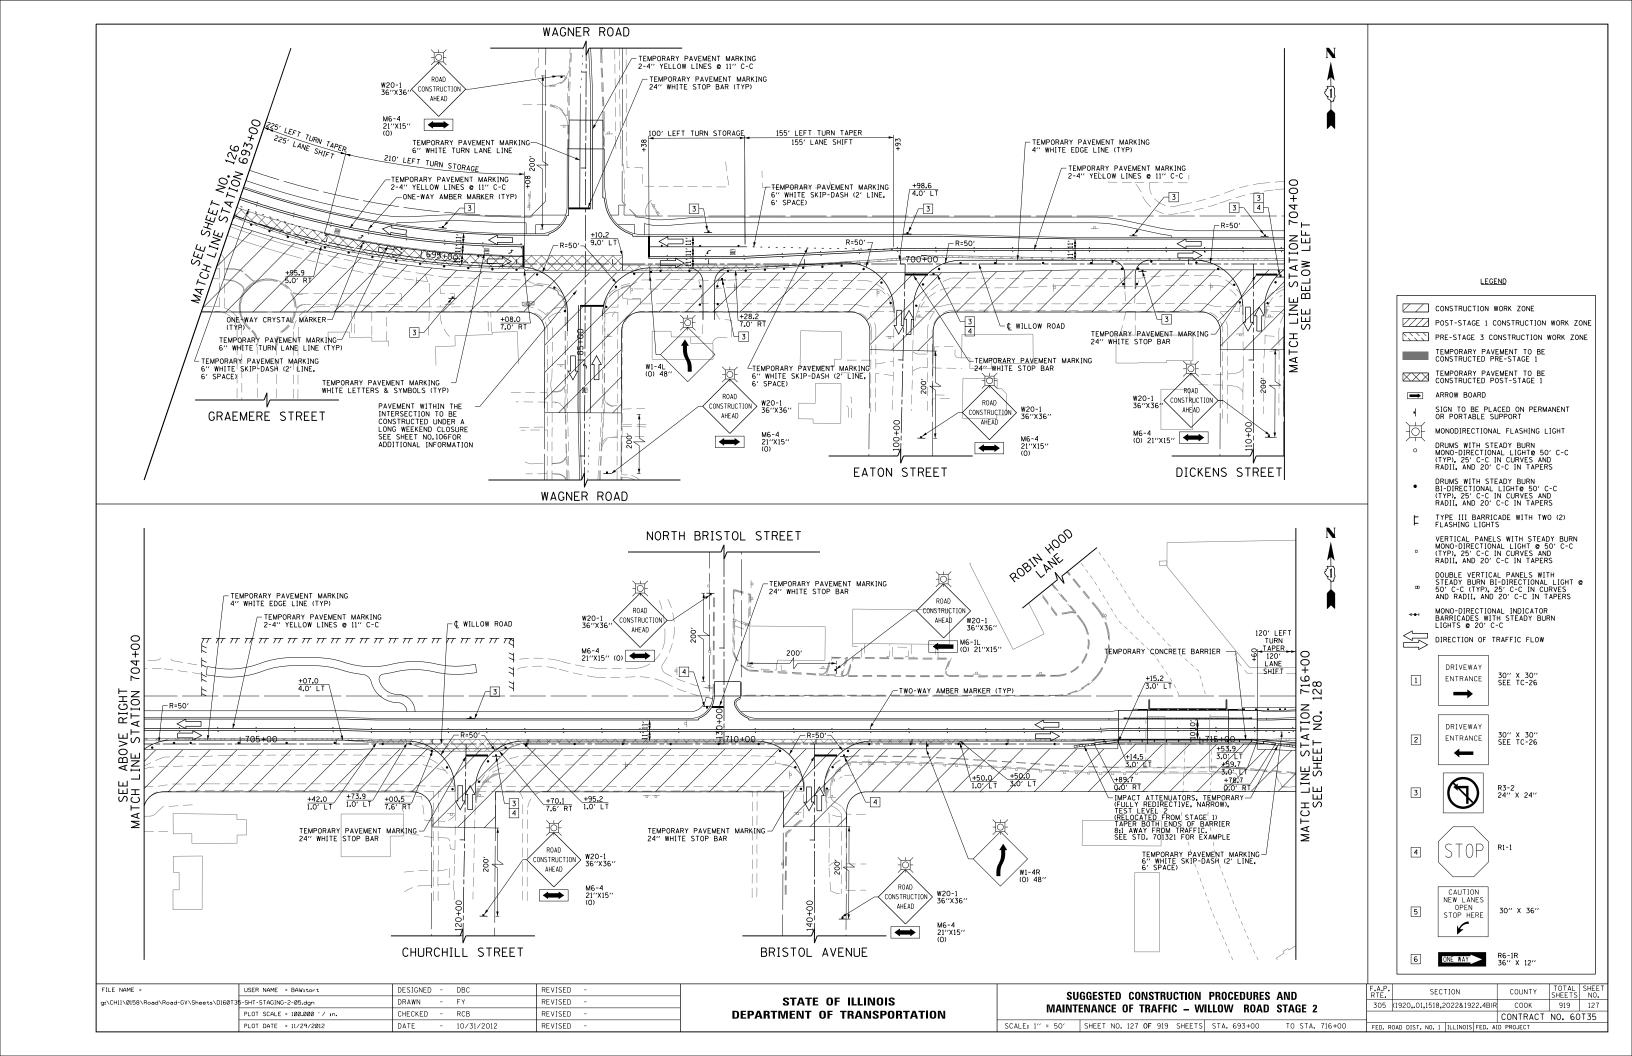


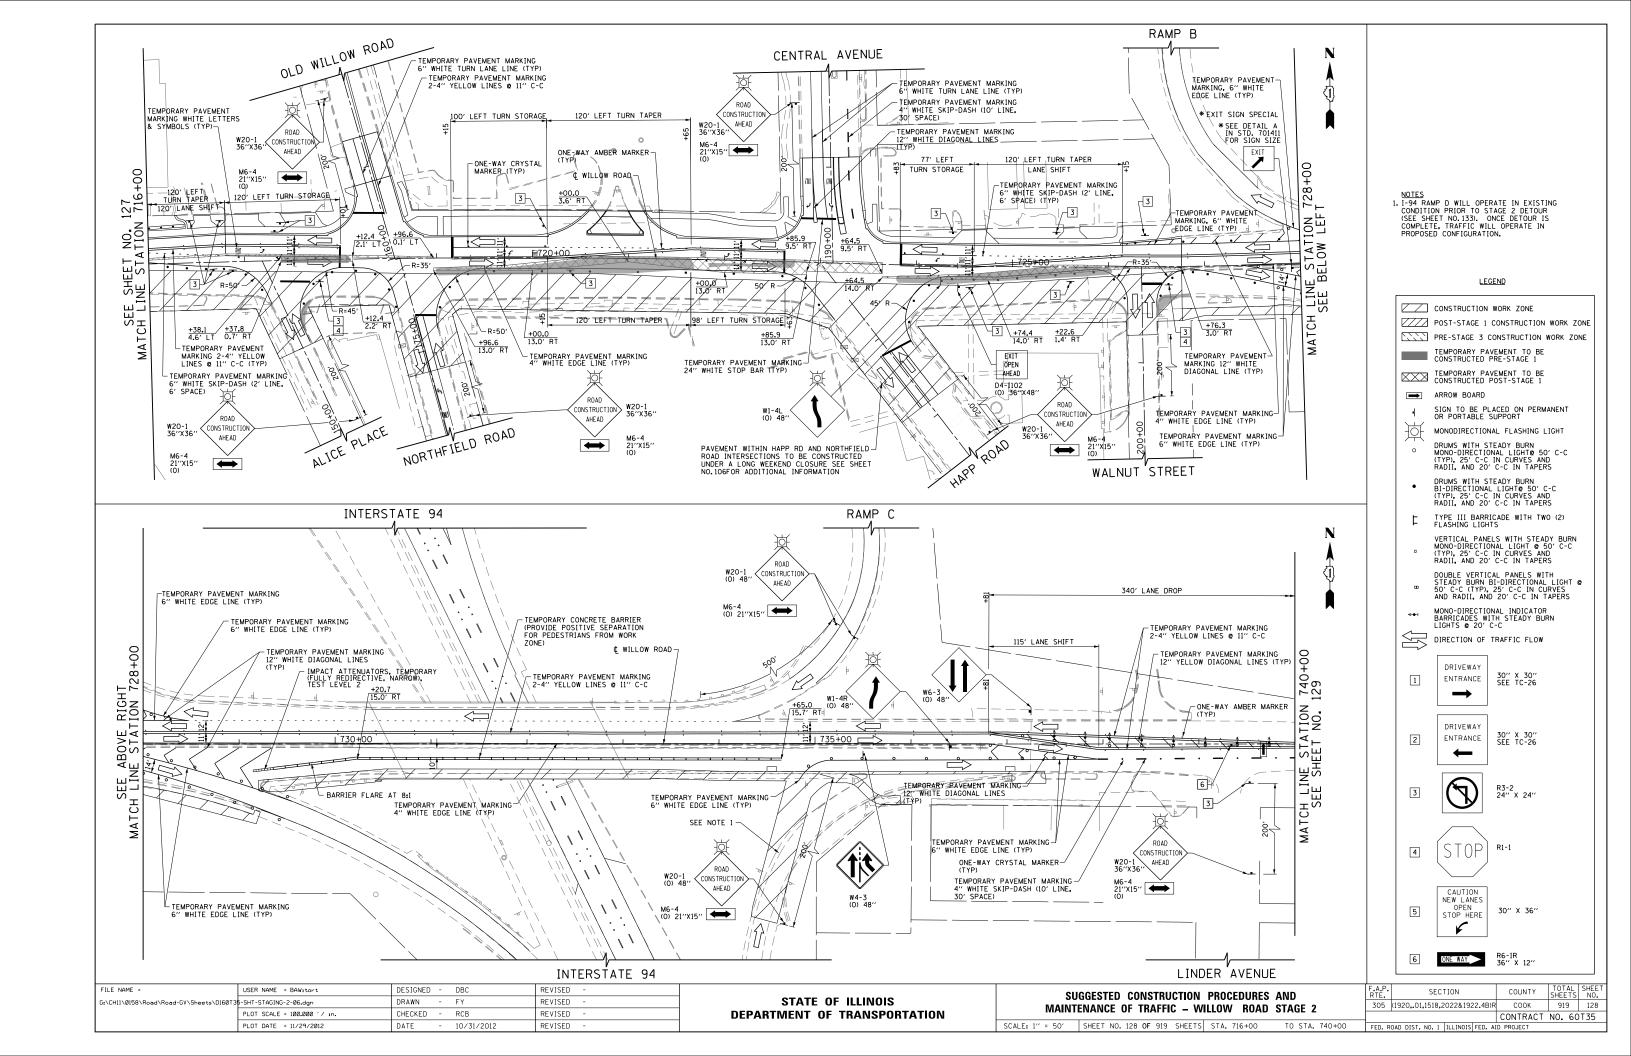


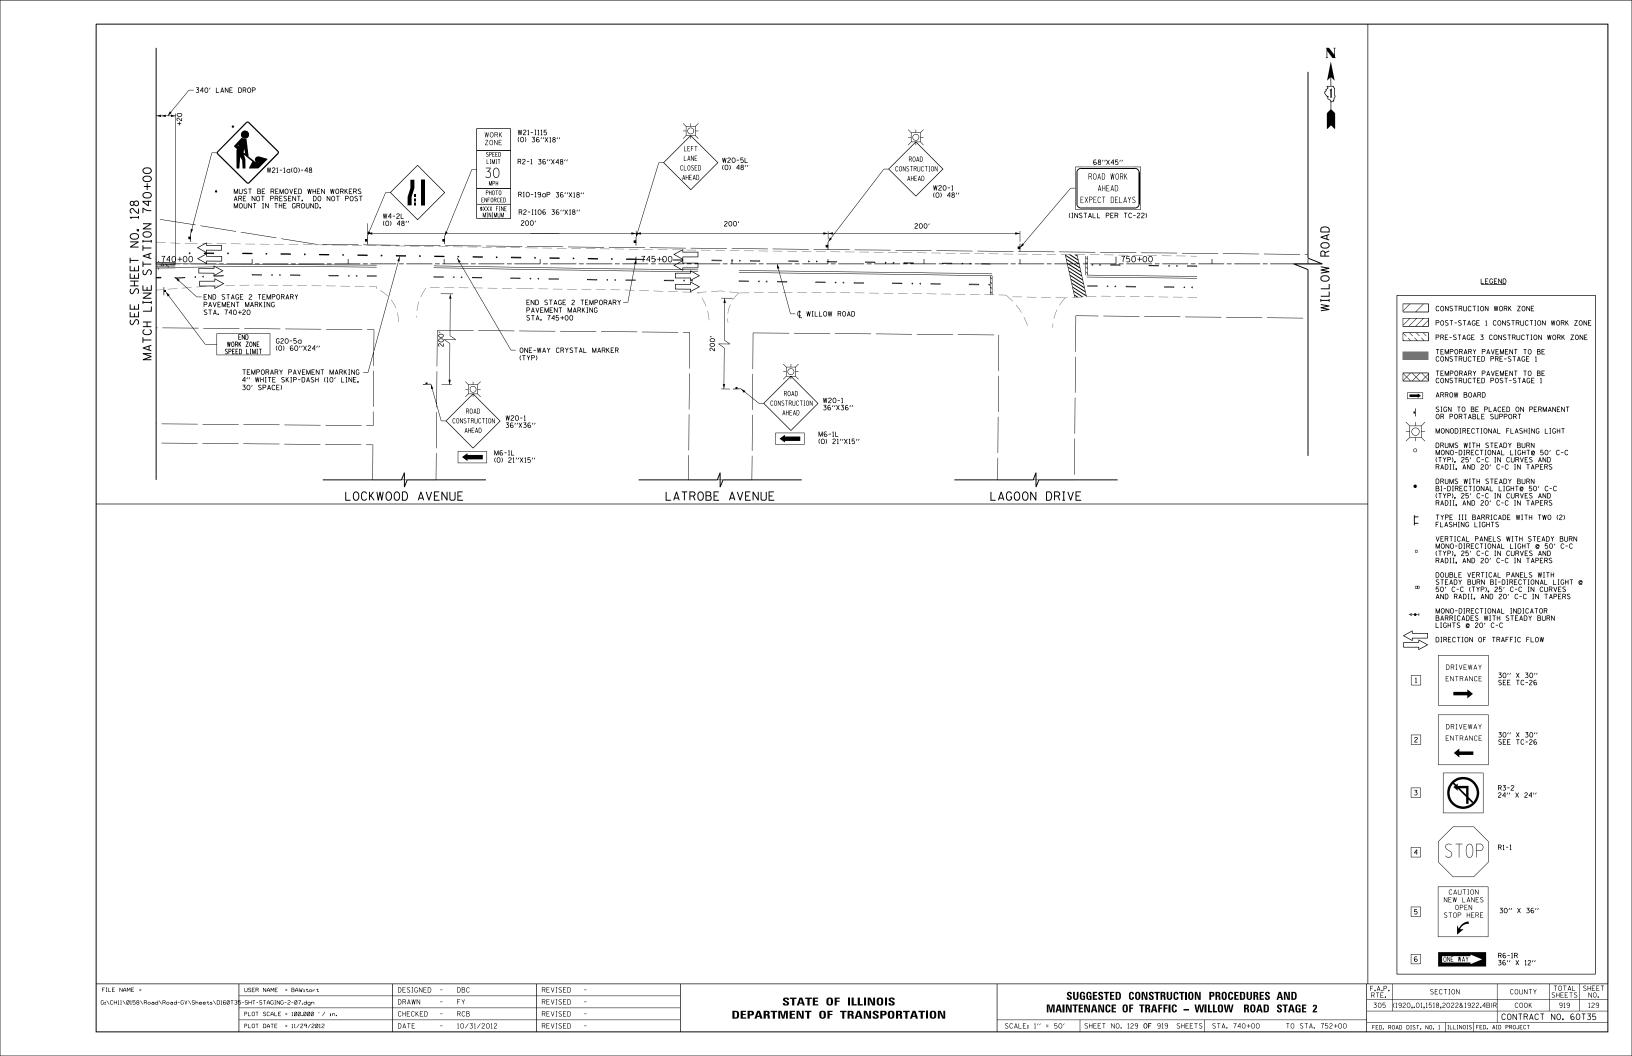


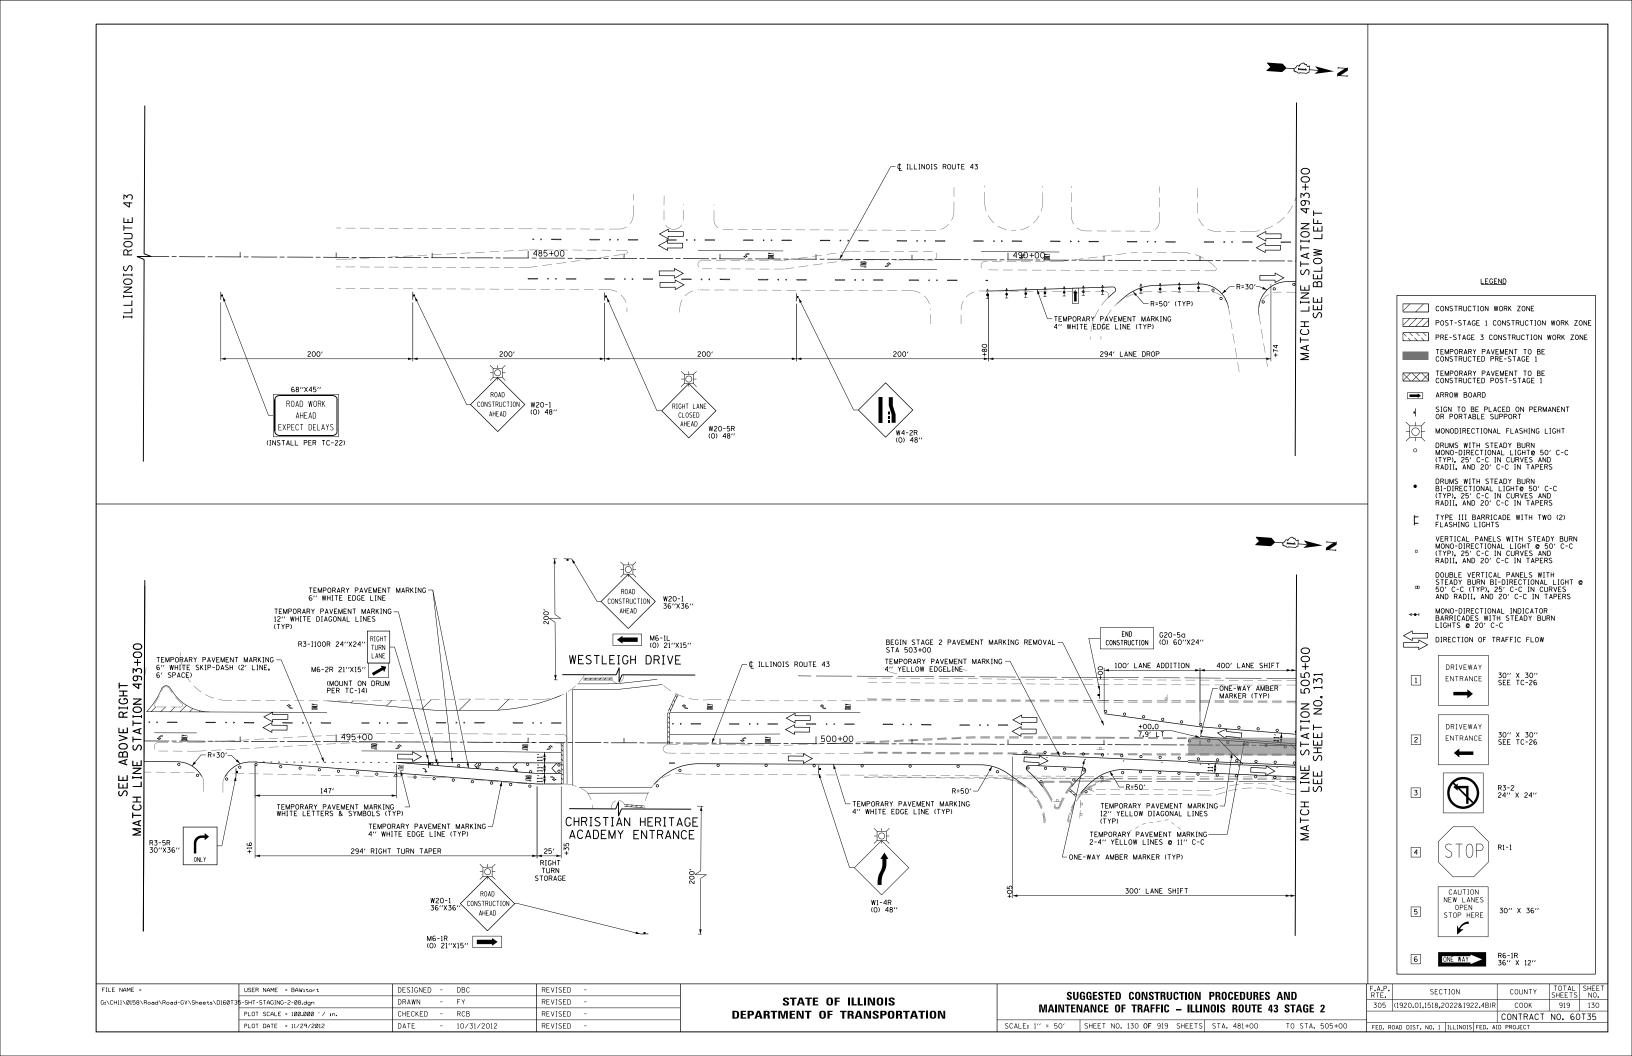


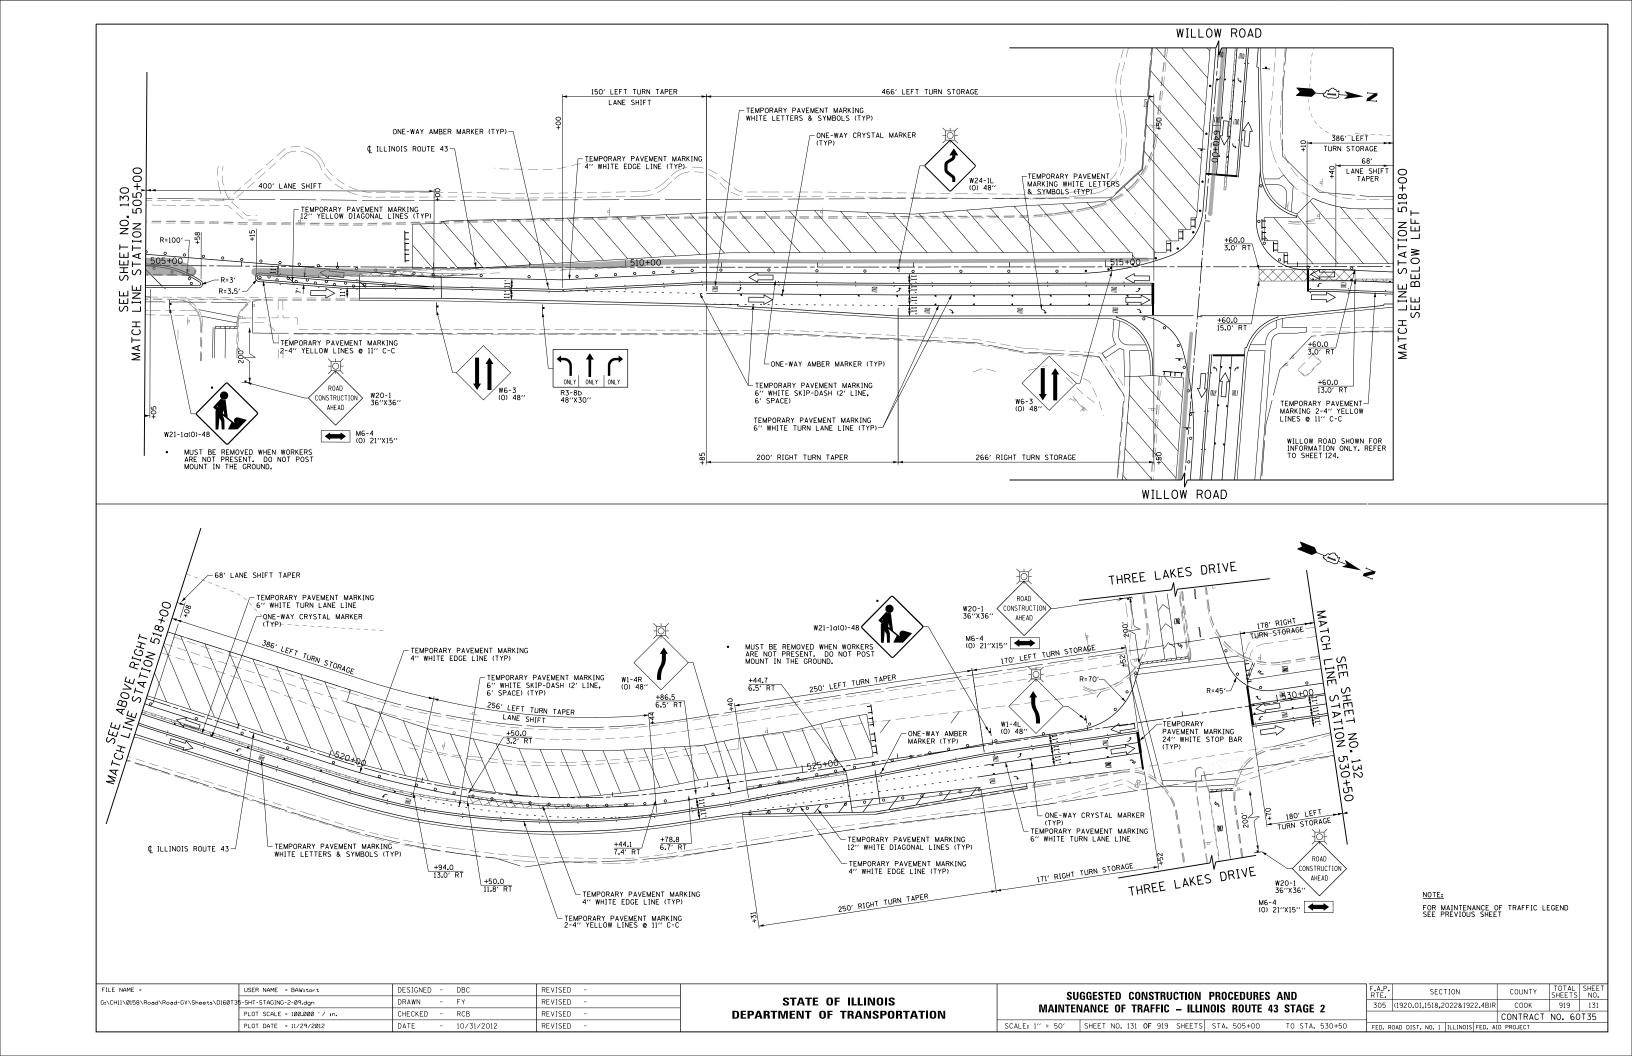


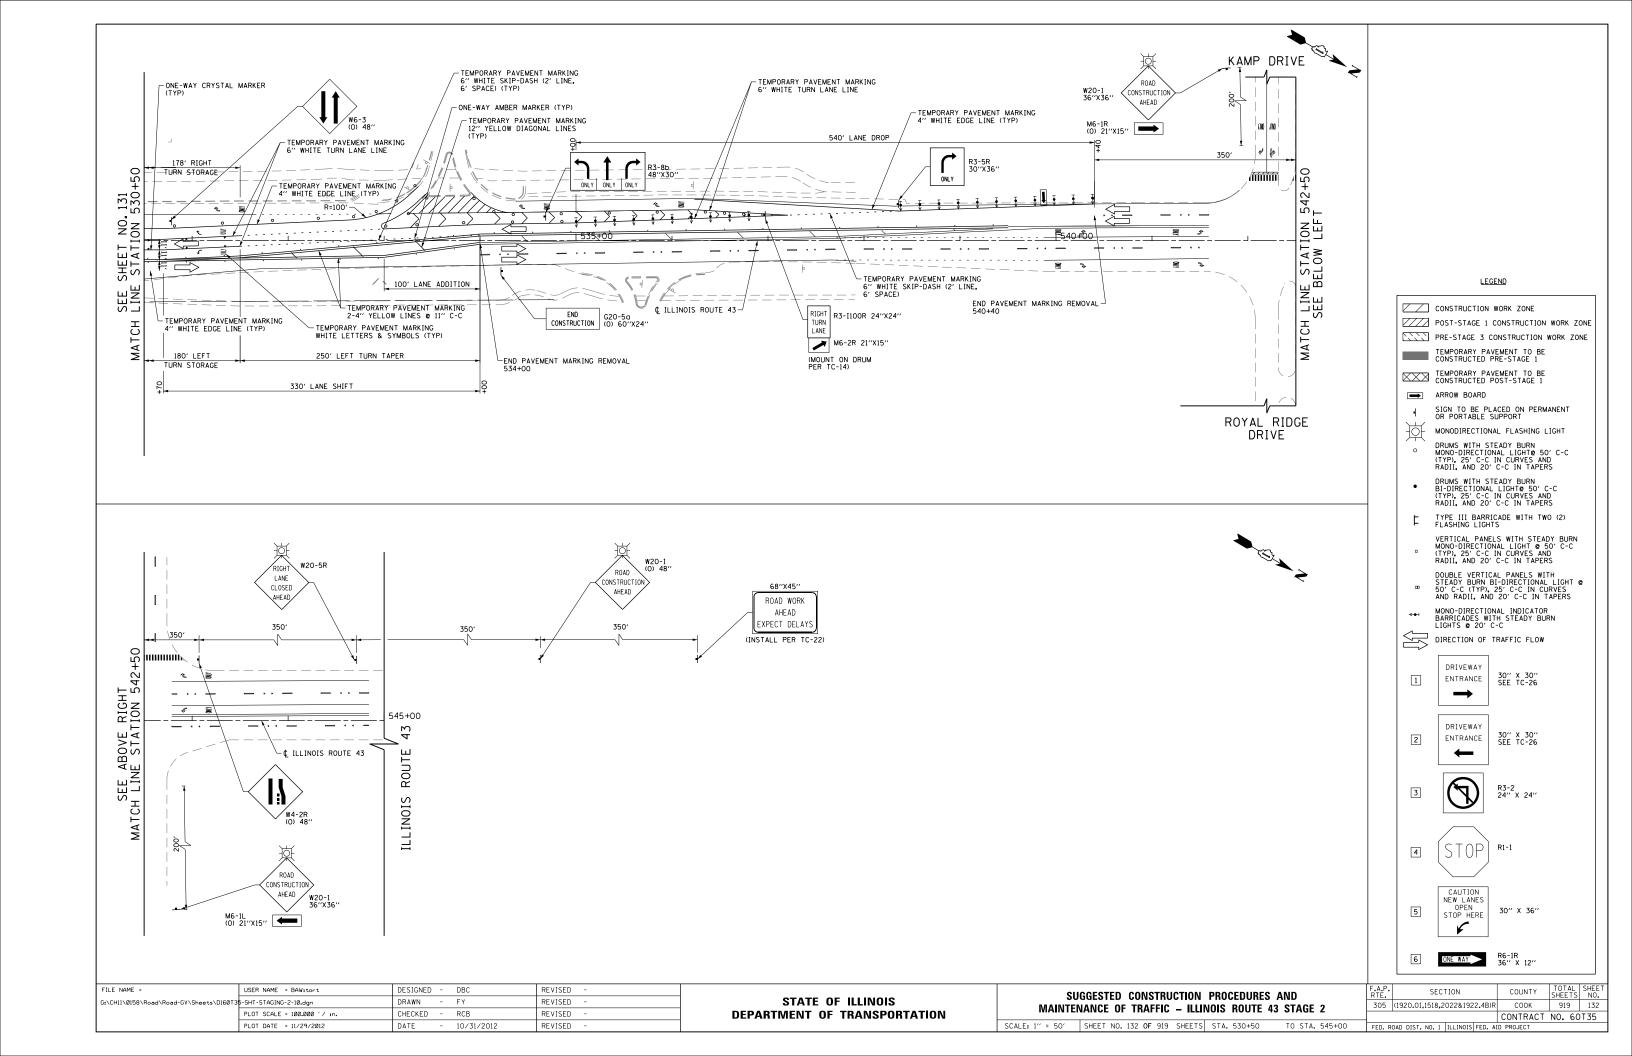


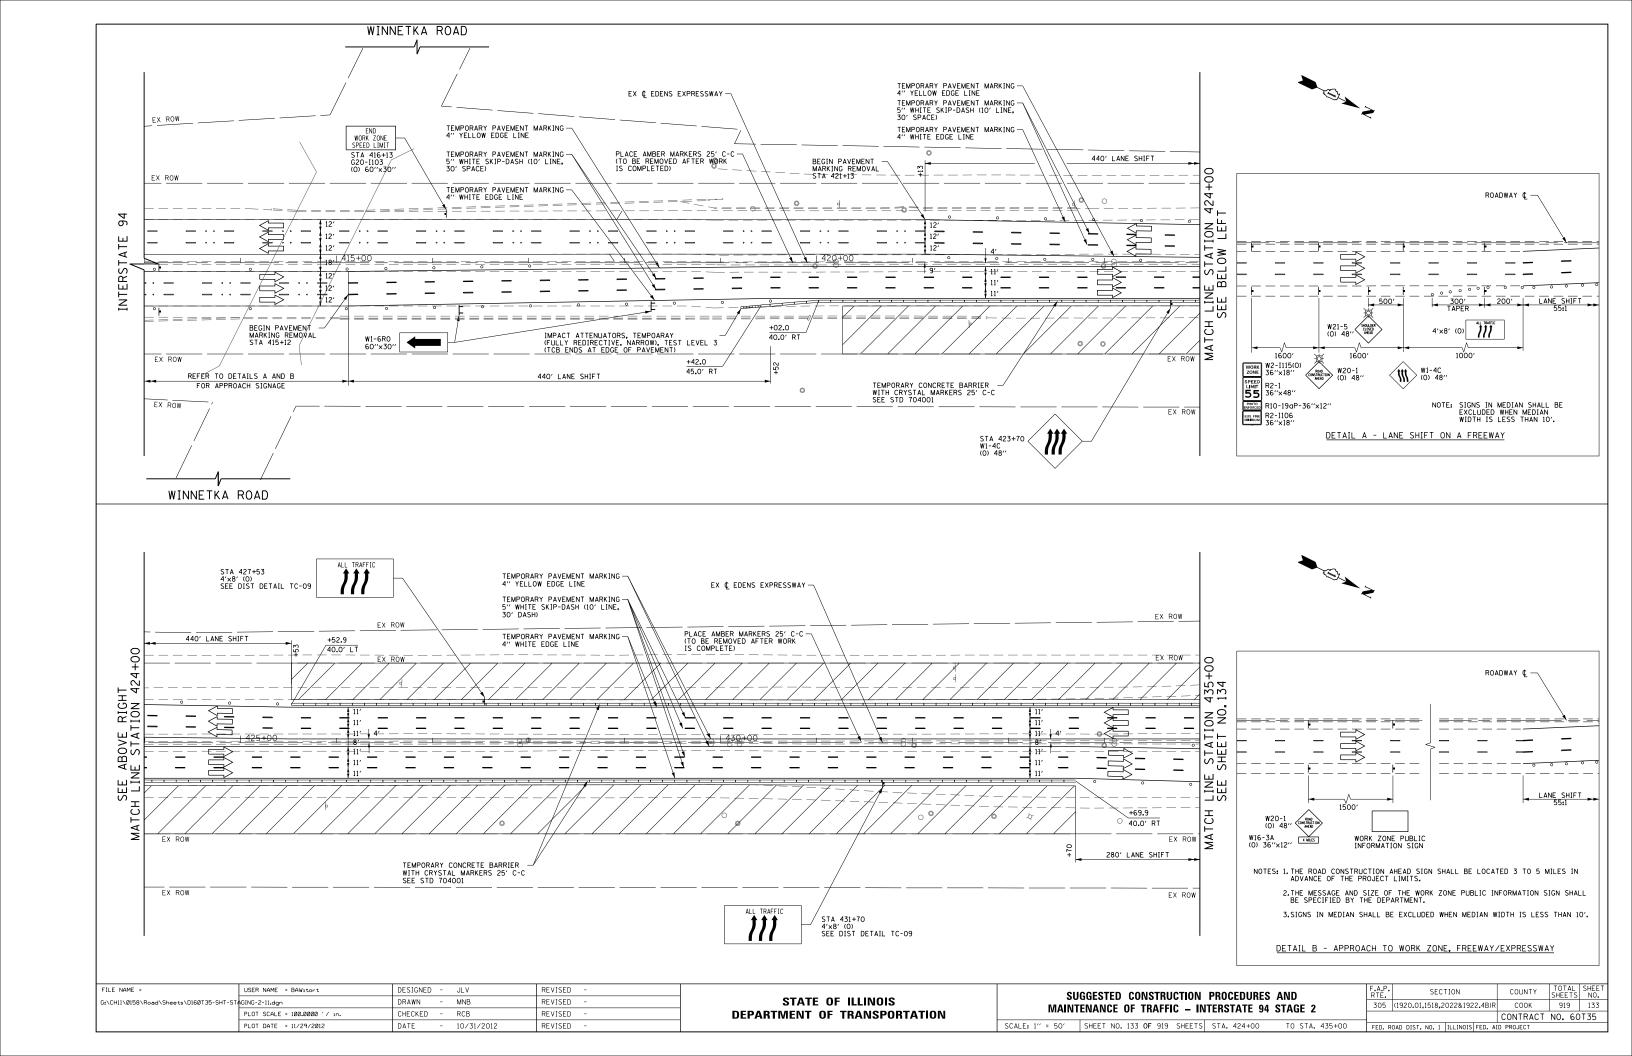


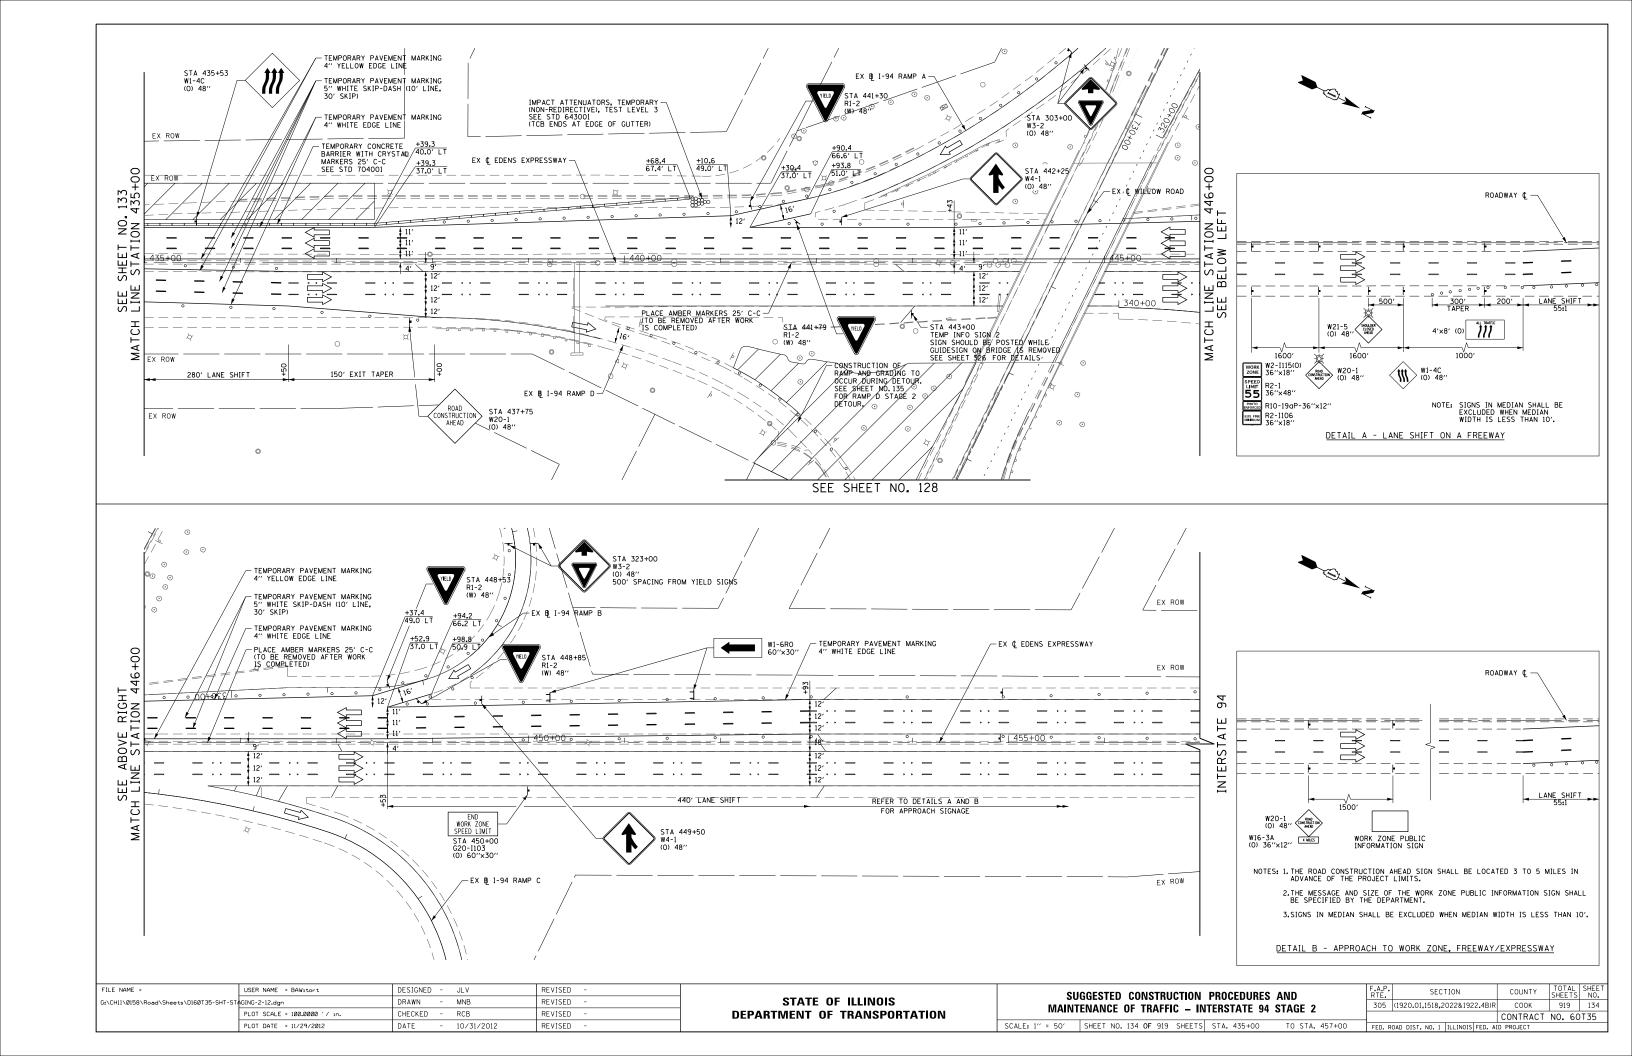


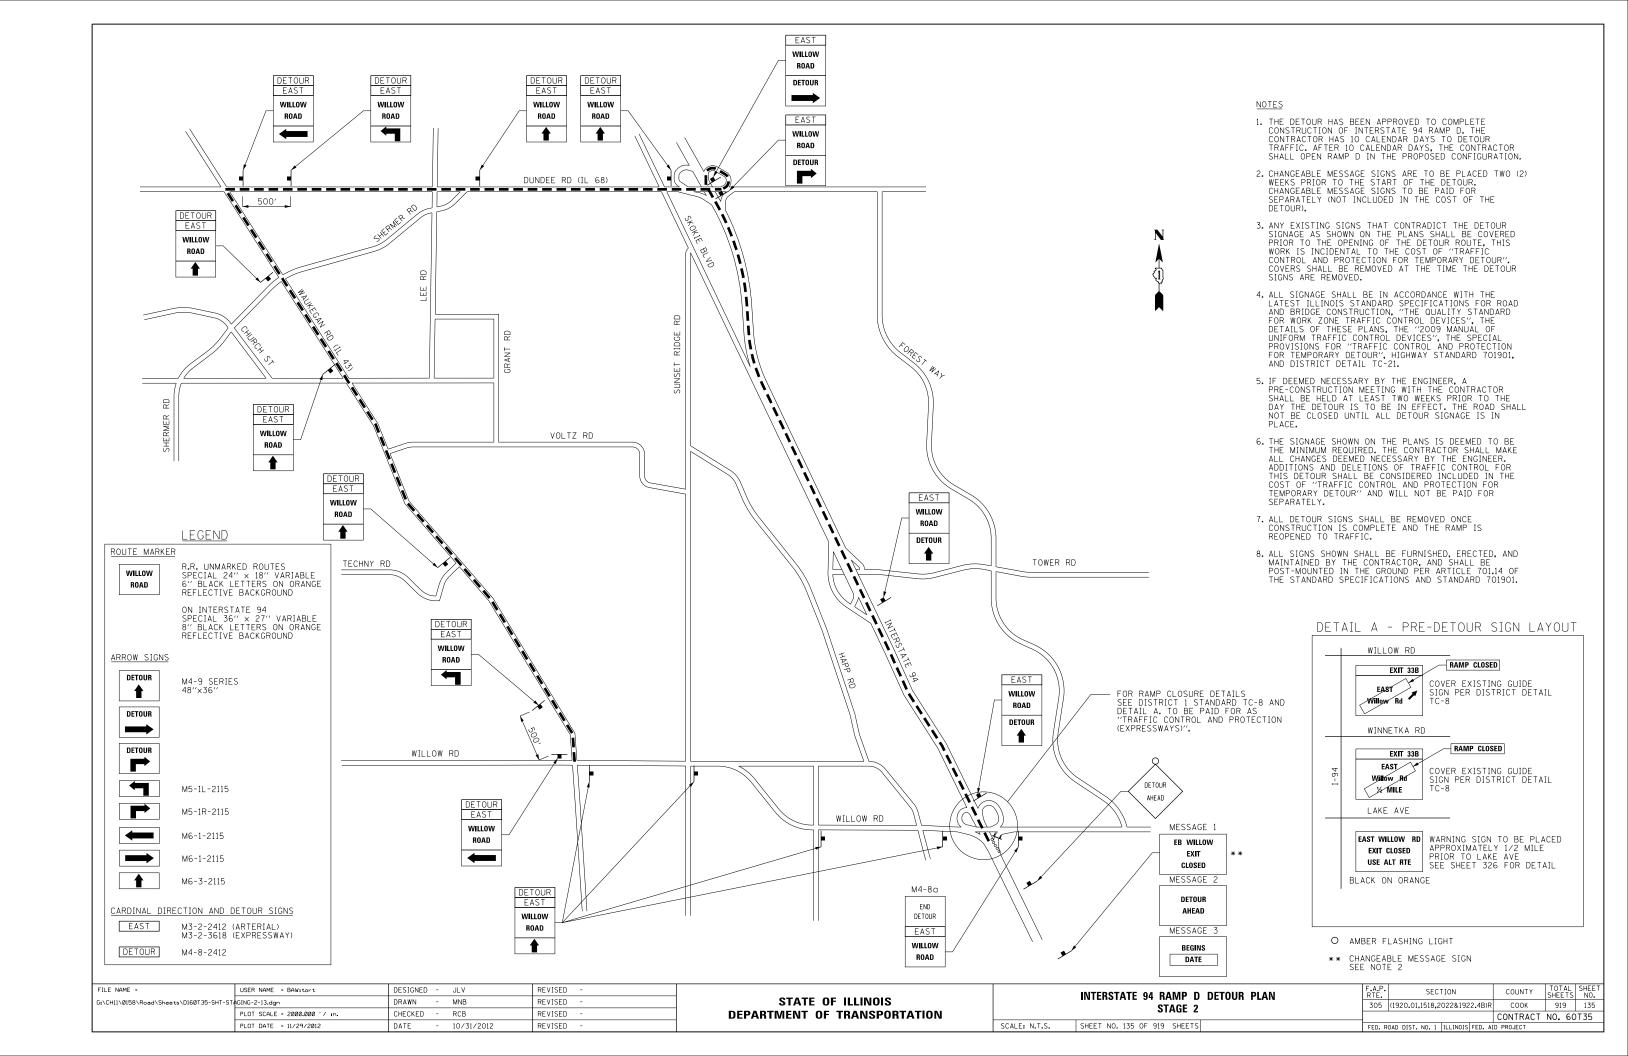


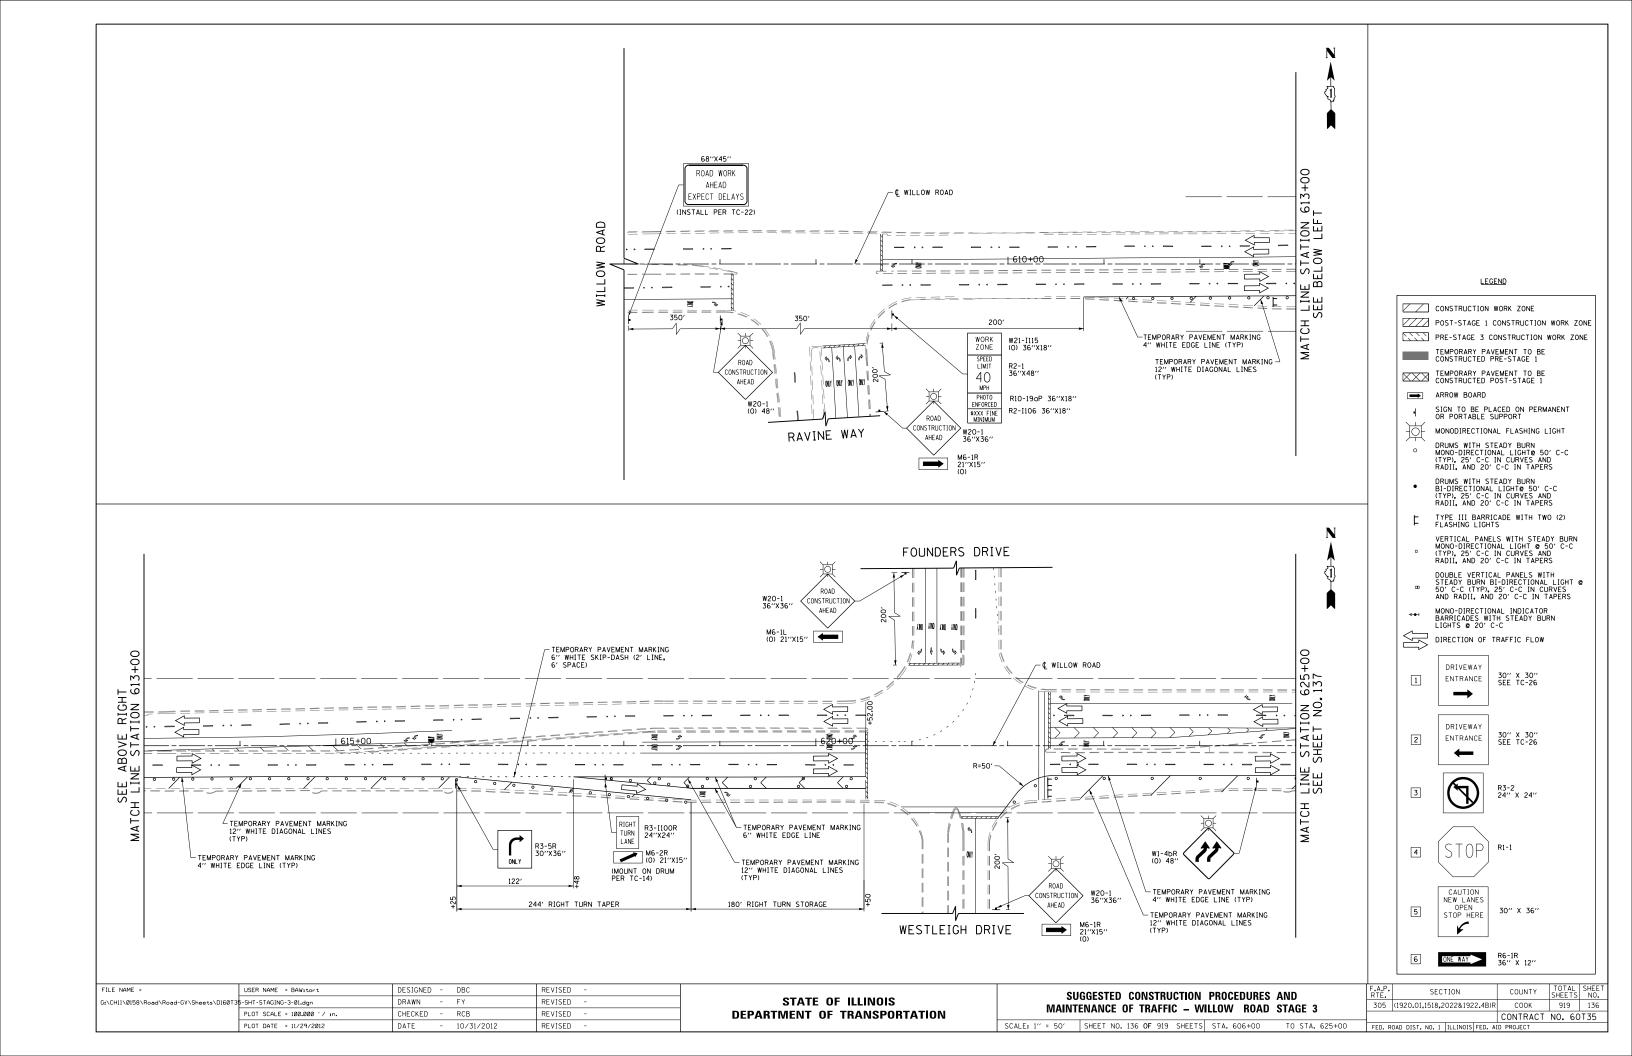


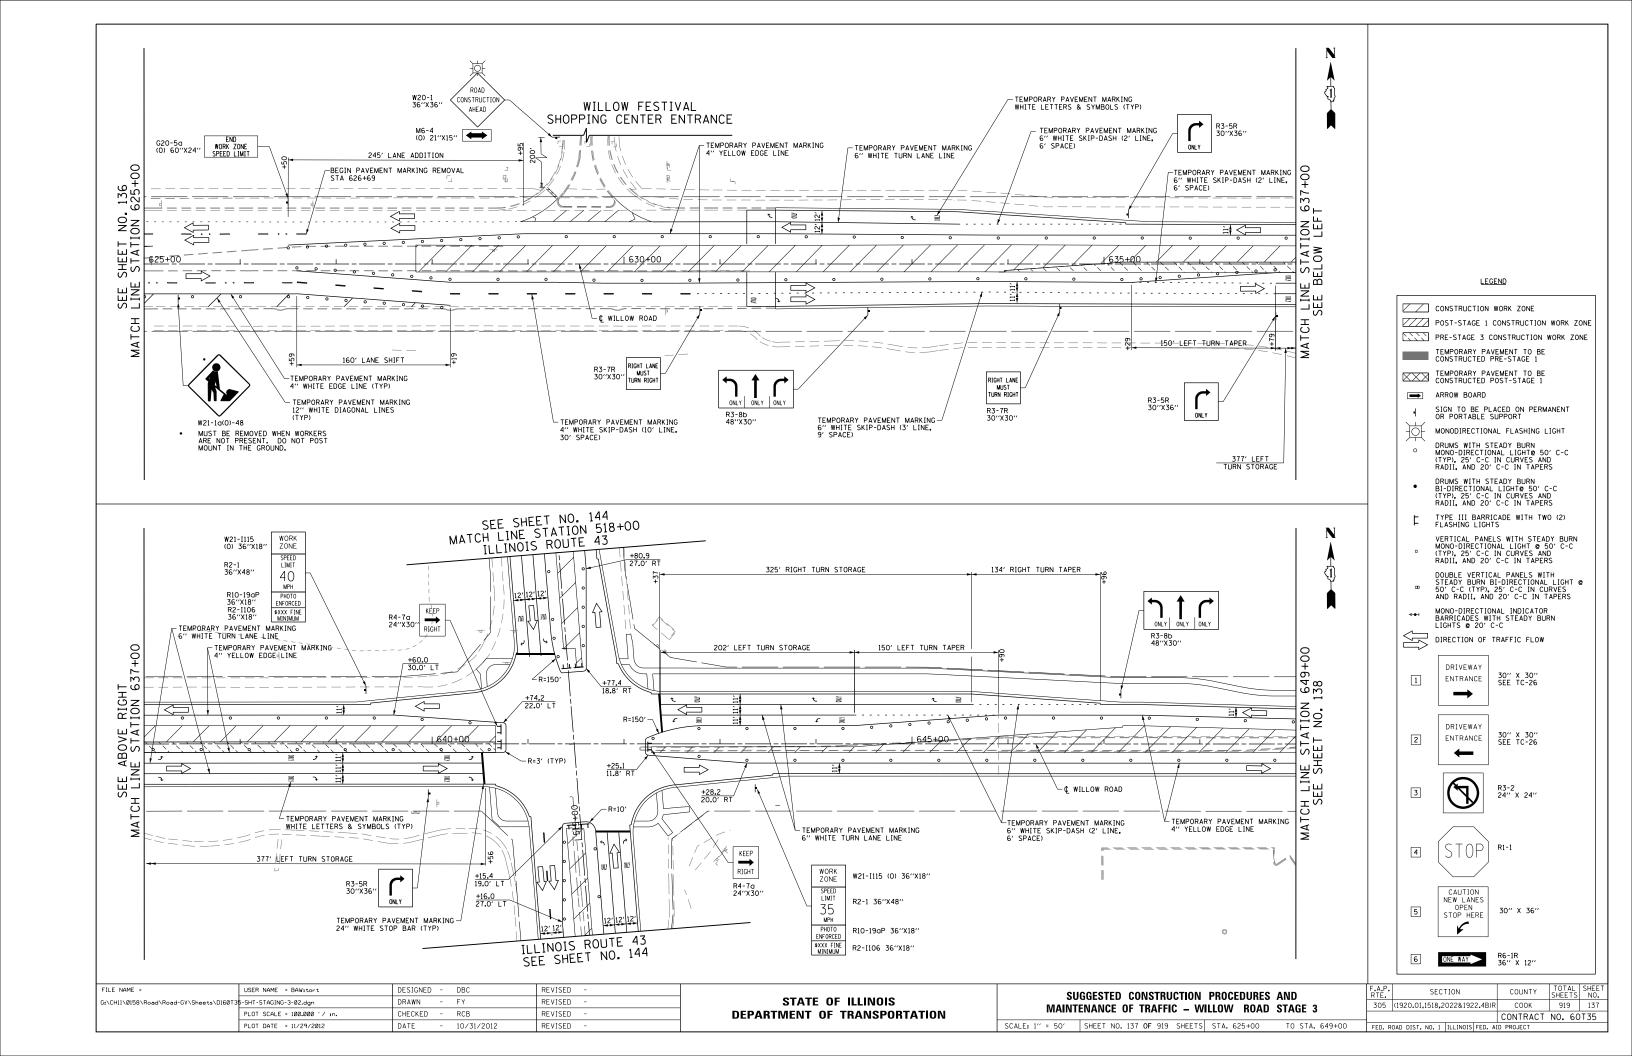


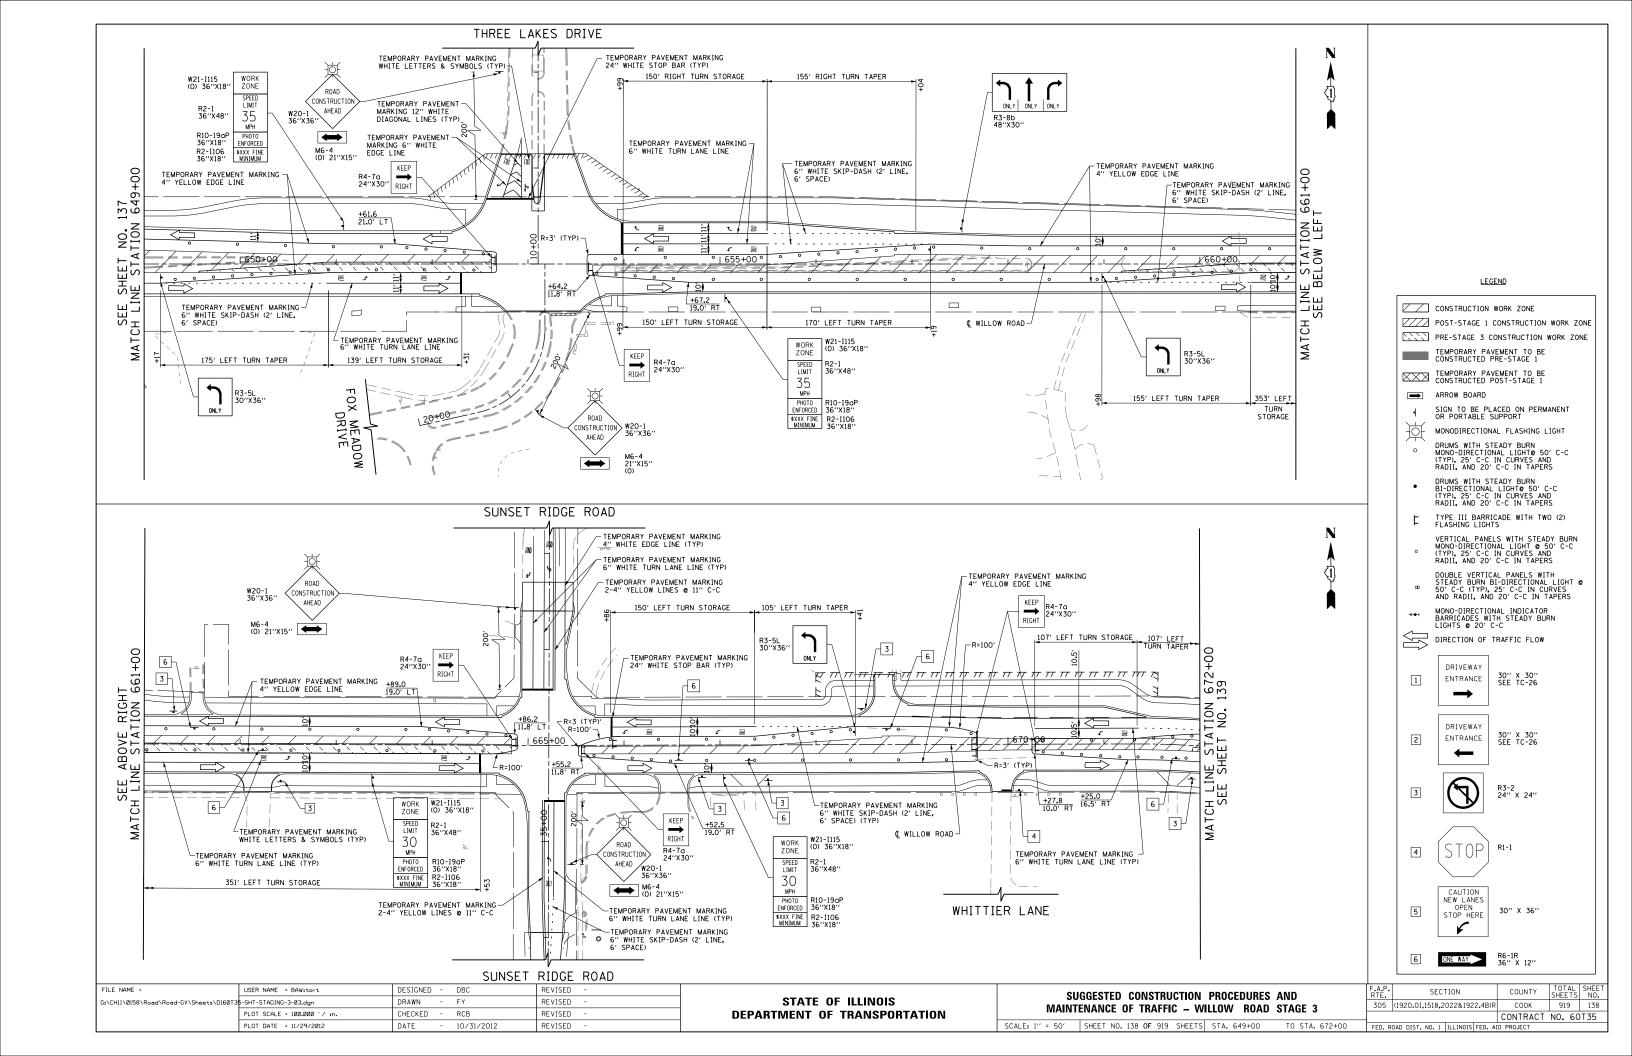


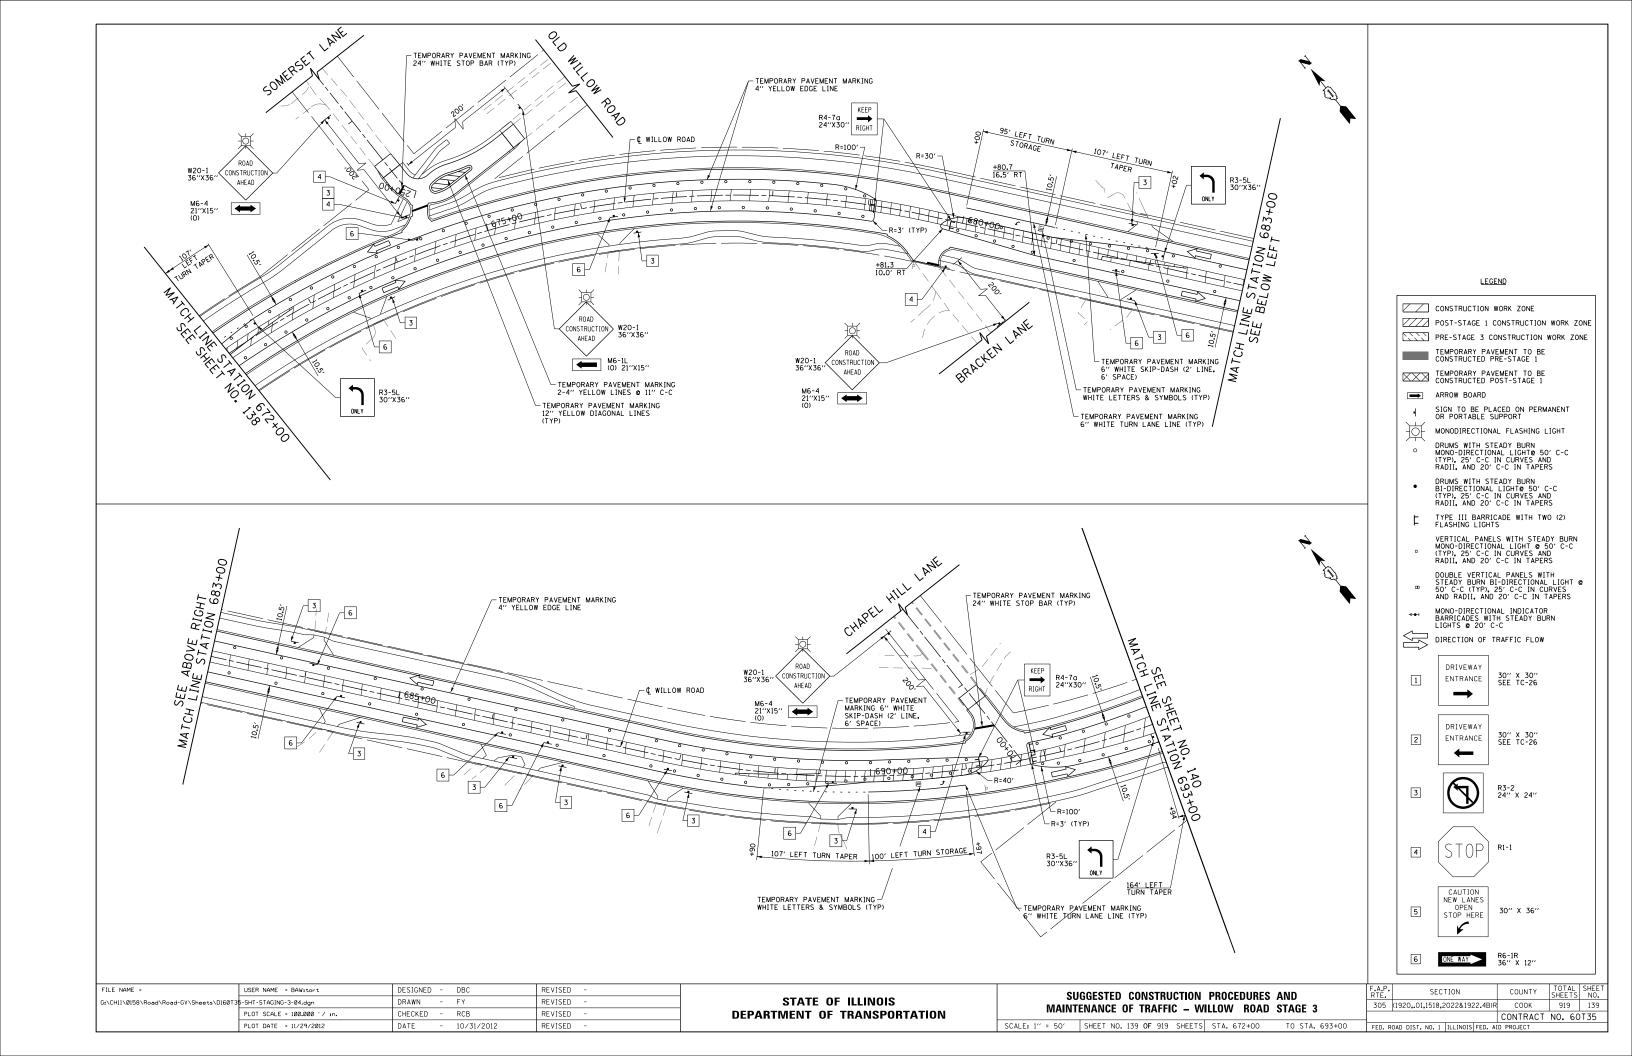


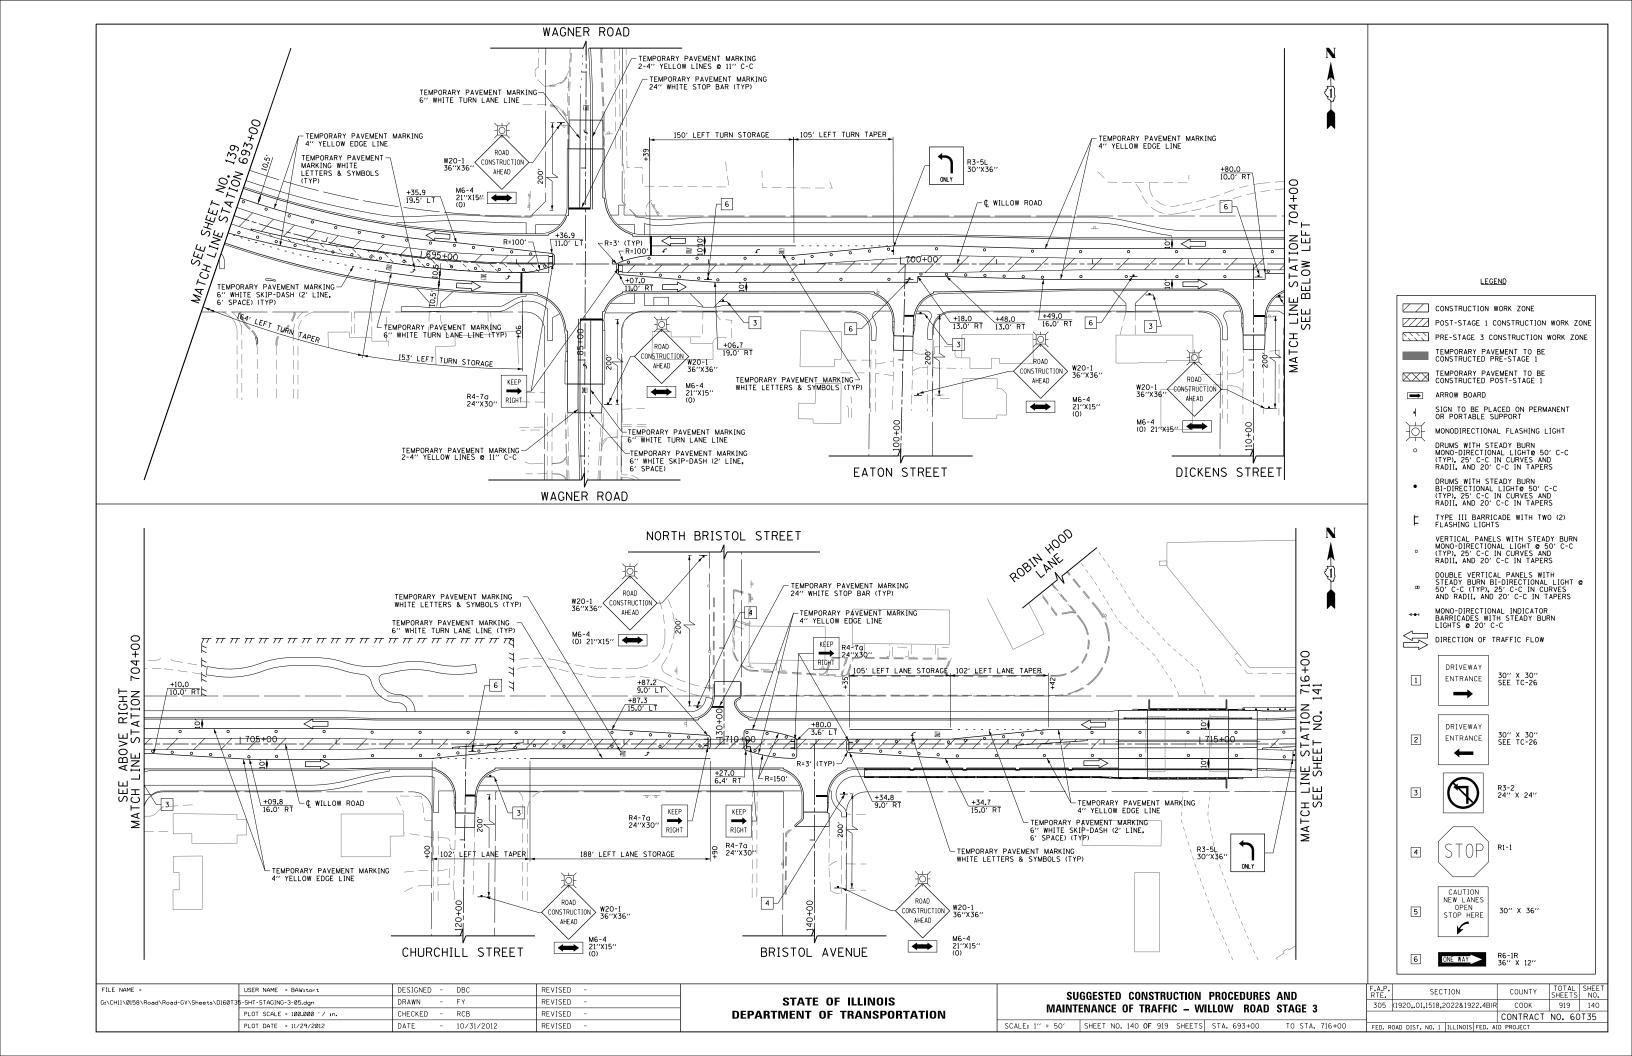


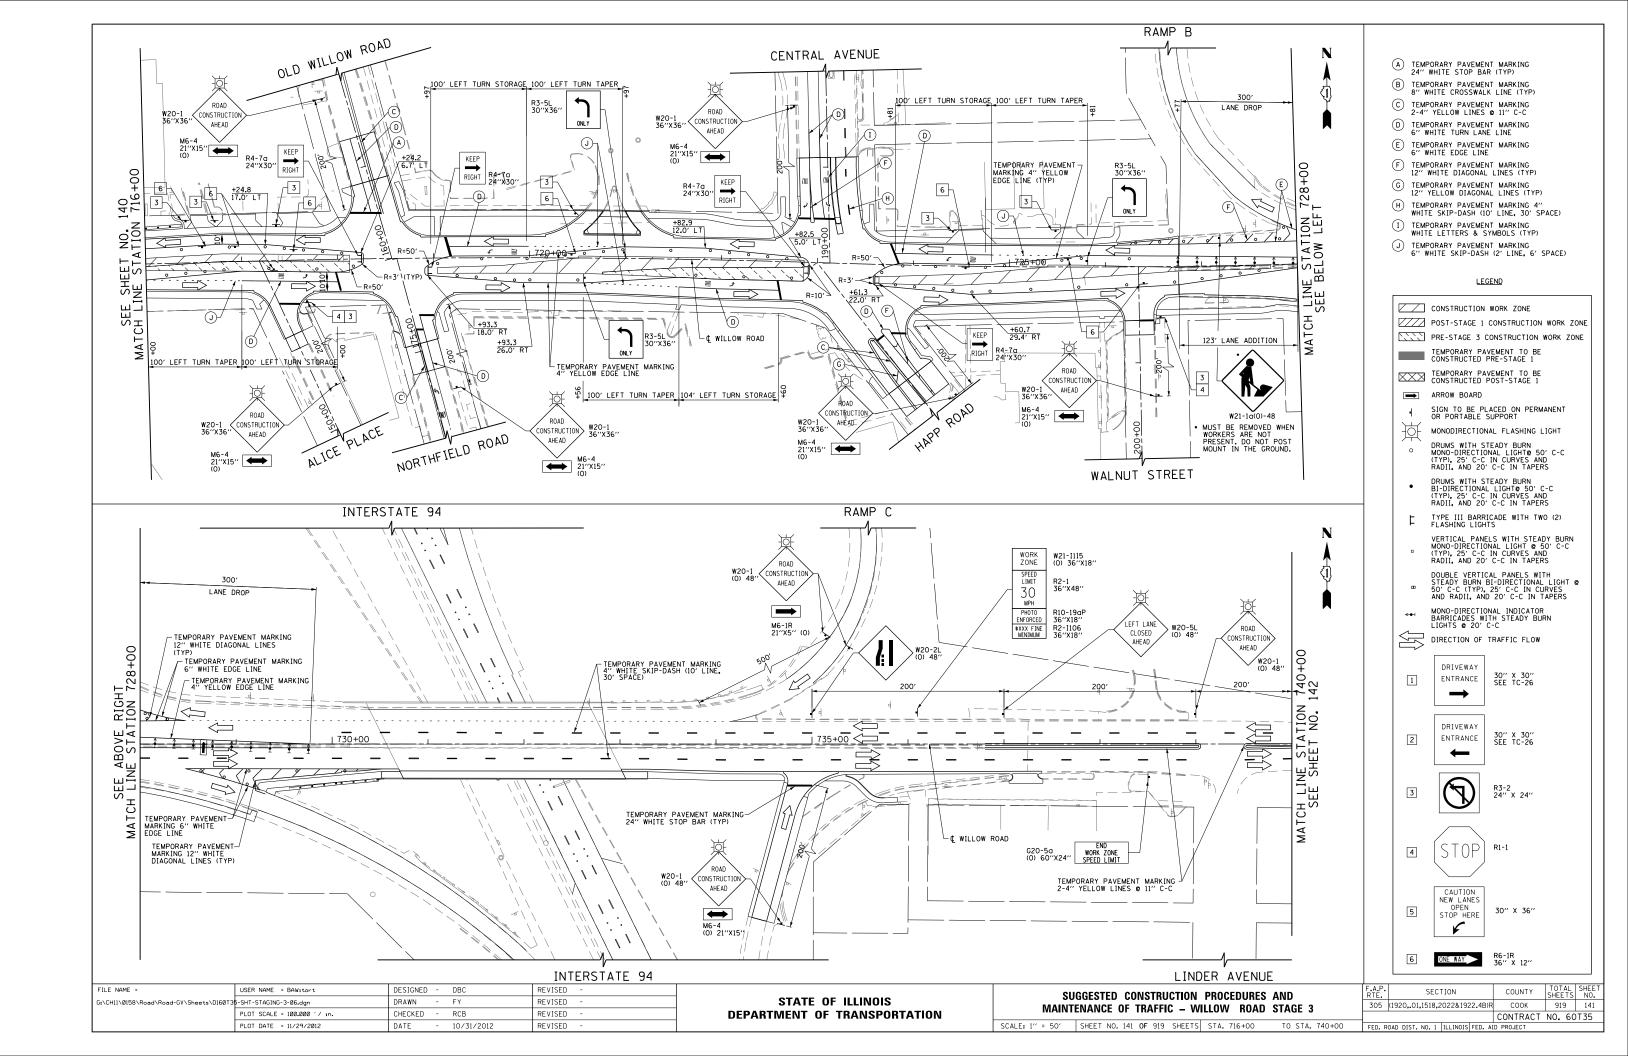

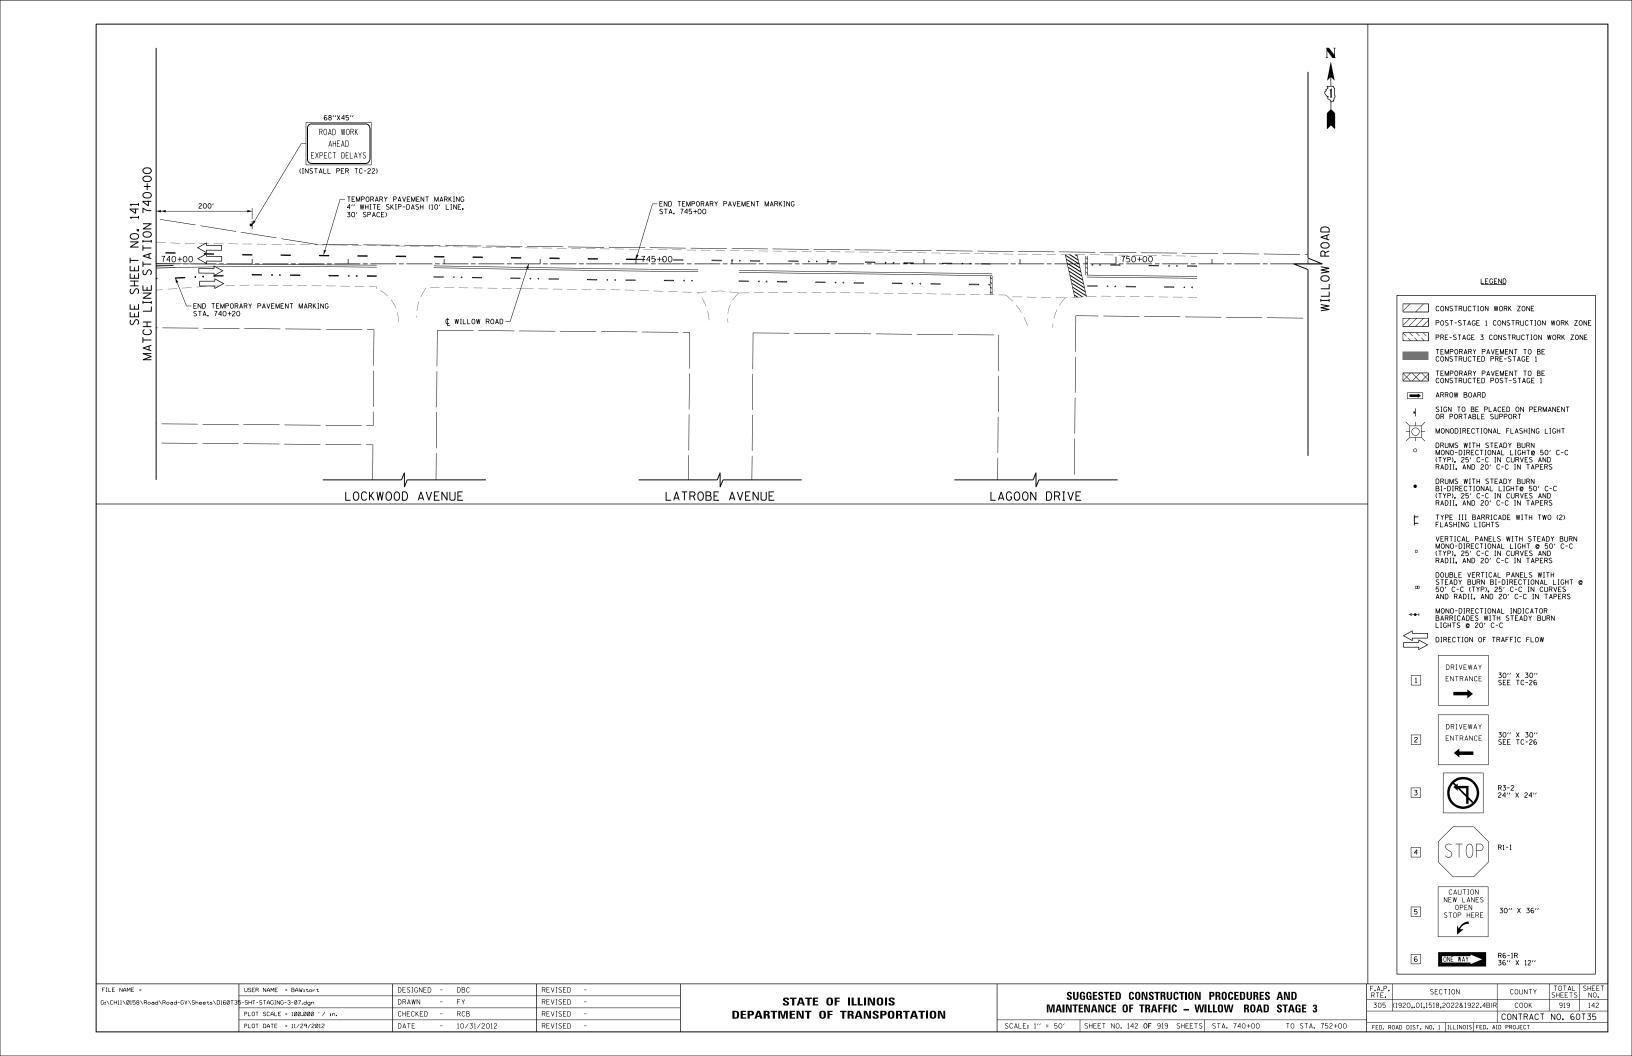

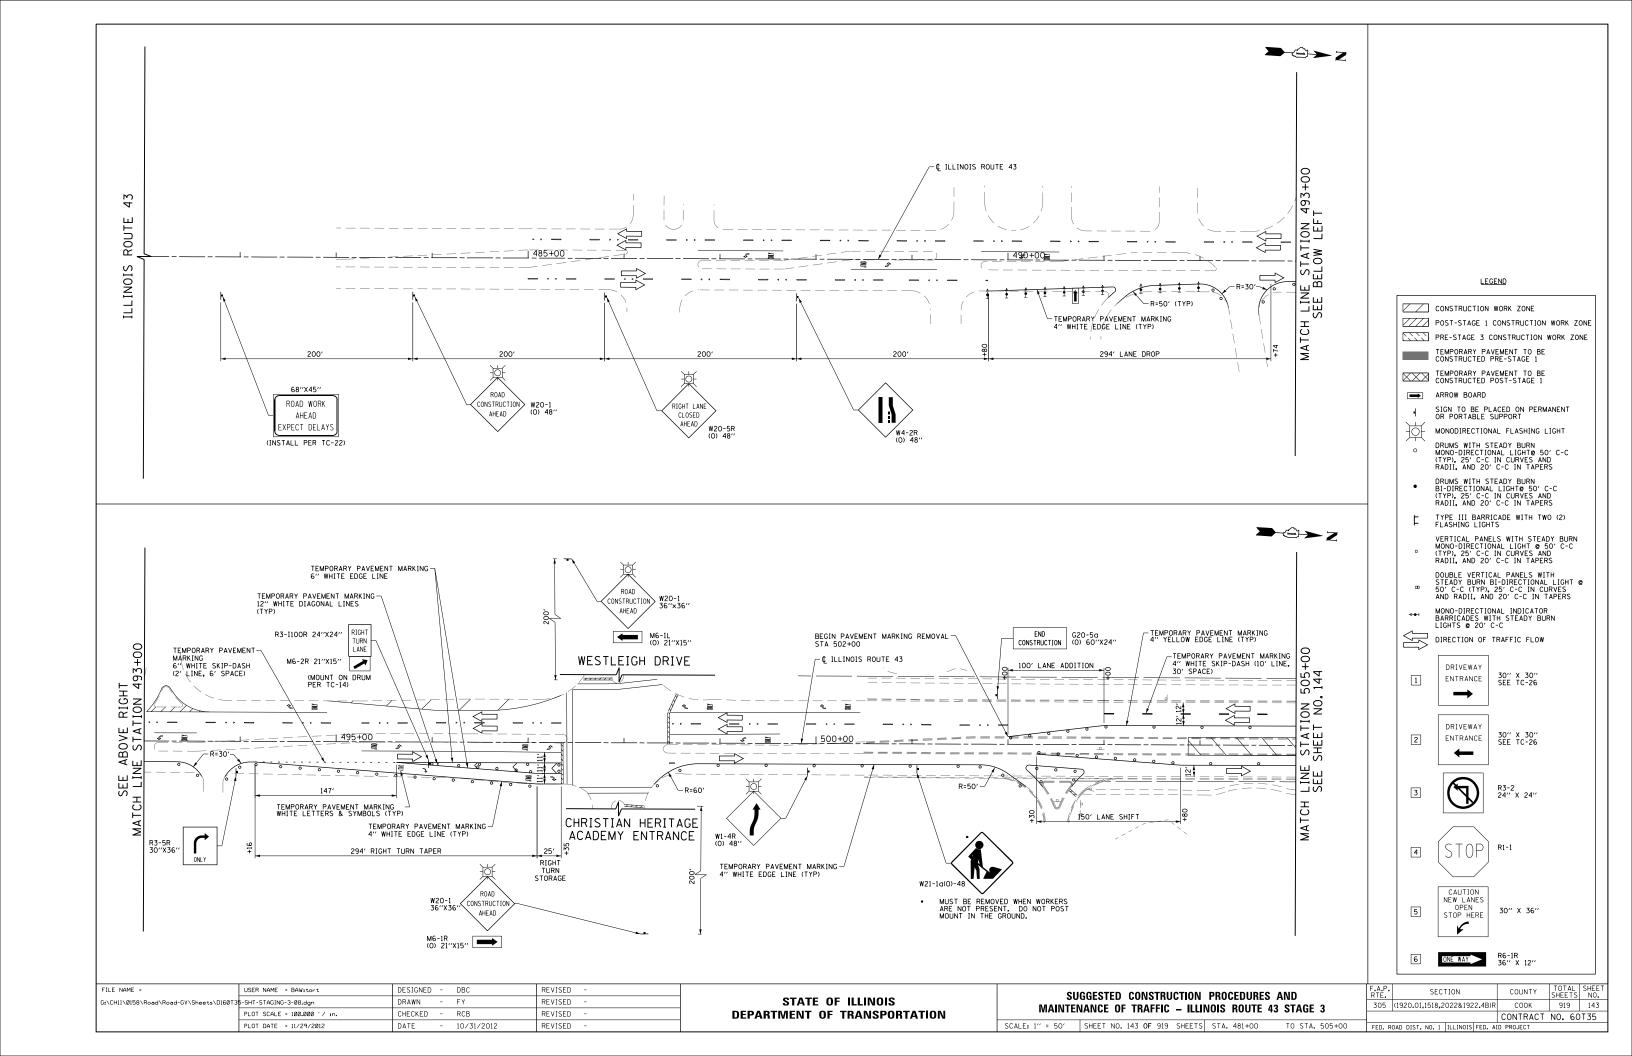

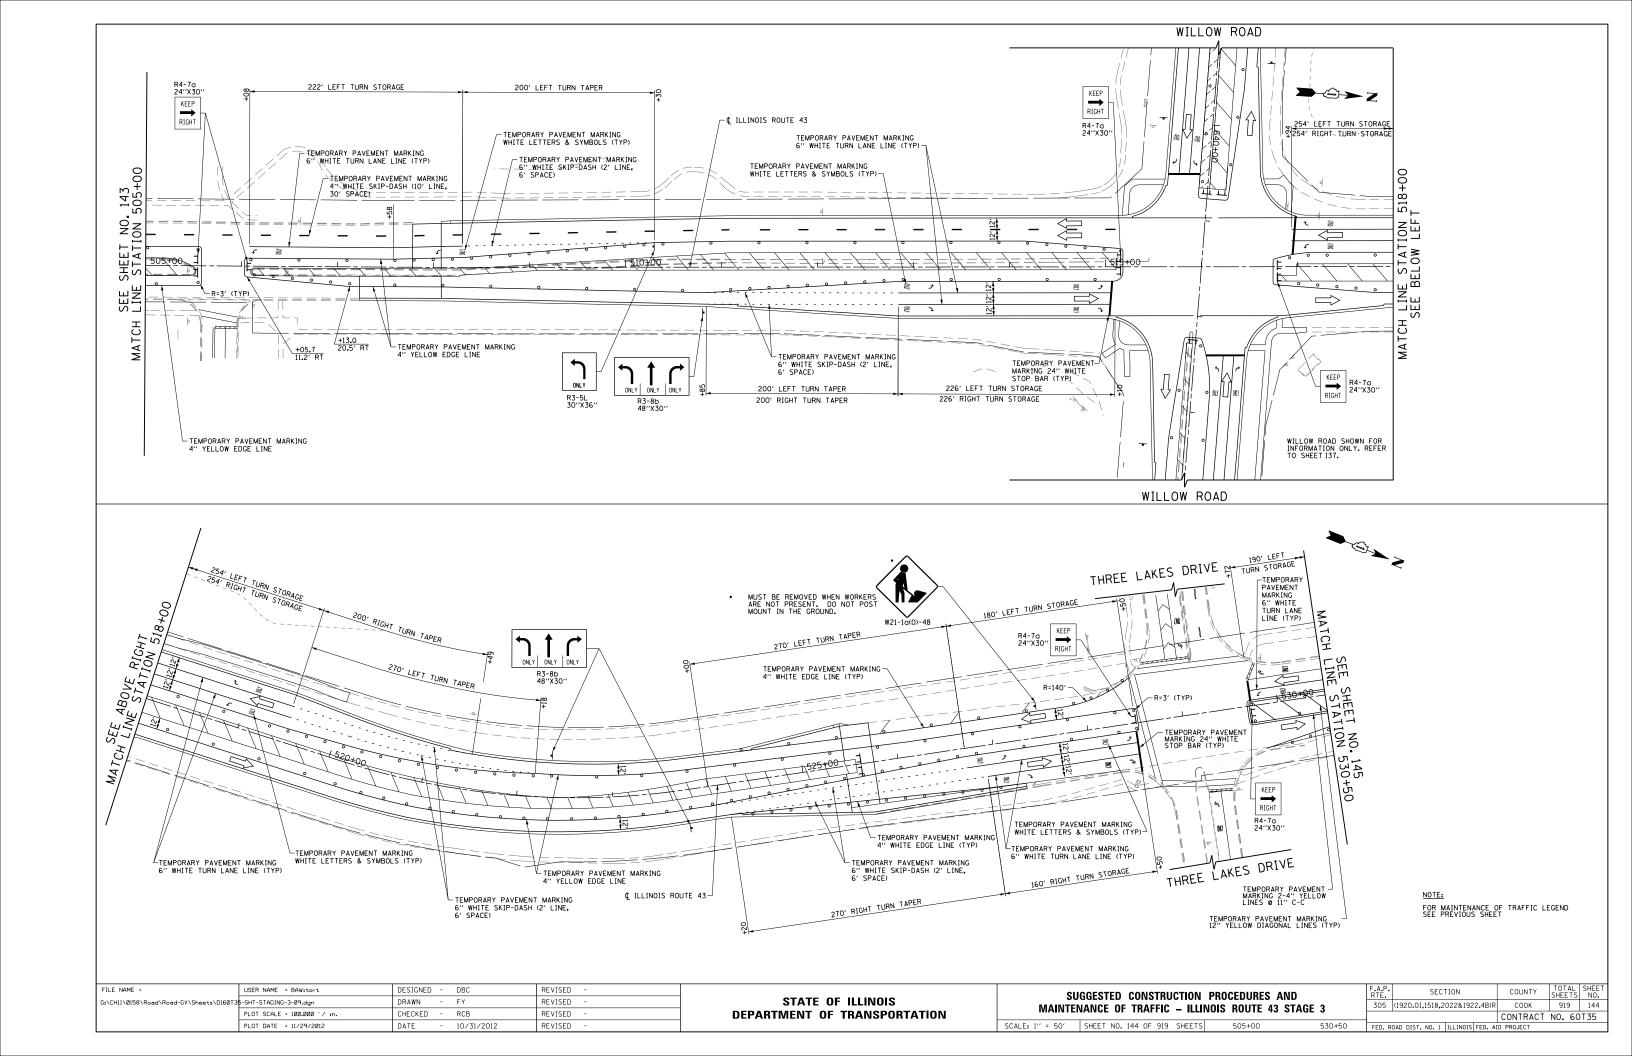

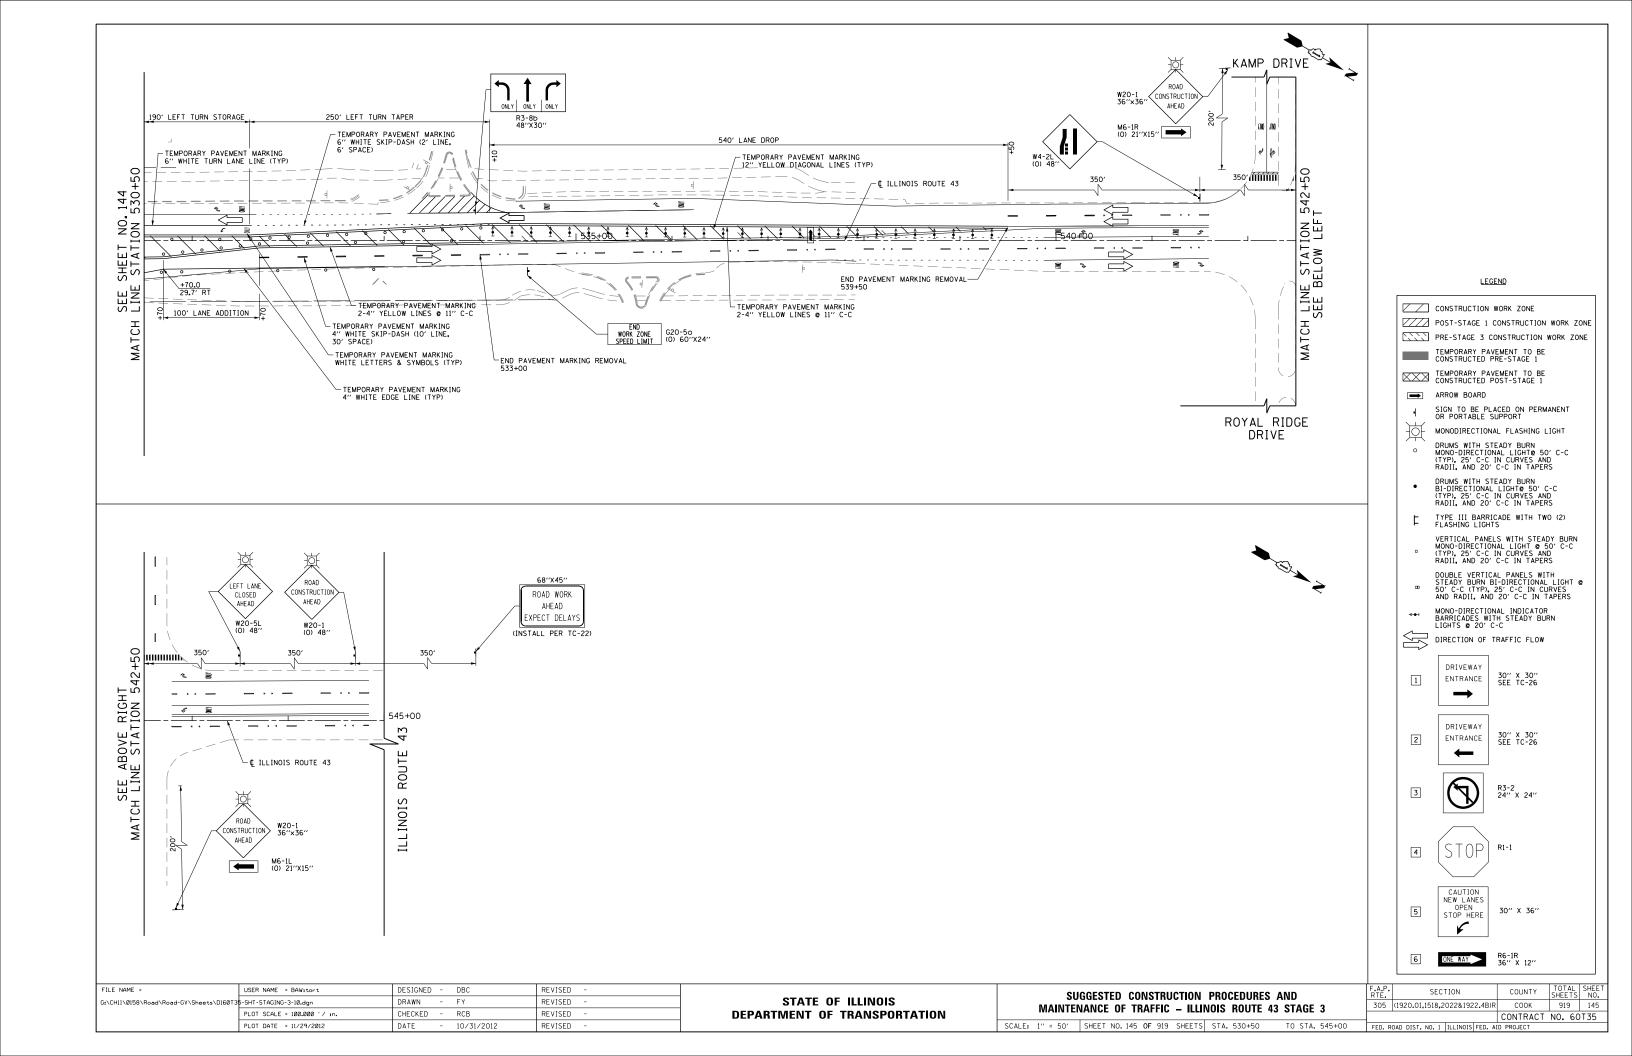

SUGGESTED SEQUENCE OF CONSTRUCTION FOR THE INTERSECTION OF WILLOW ROAD AND ILLINOIS ROUTE 43

CONTRACTOR SHALL ENSURE PEDESTRIANS ARE PROTECTED THROUGH THE CONSTRUCTION AREAS.

ANY CHANGES TO THE SUGGESTED CONSTRUCTION SEQUENCING SHALL BE COORDINATED WITH THE ENGINEER PRIOR TO IMPLEMENTATION.

PRF-STAGE

- MAINTAIN TWO-WAY TRAFFIC FLOW ON WILLOW ROAD. LEFT TURN, THROUGH, AND RIGHT TURN MOVEMENTS SHALL BE MAINTAINED FOR EACH APPROACH.
- 2. REFER TO SUGGESTED CONSTRUCTION PROCEDURES ON SHEET 105 FOR ADDITIONAL WORK.
- 3. MAINTAIN TWO-WAY TRAFFIC FLOW ON ILLINOIS ROUTE 43. LEFT TURN, THROUGH, AND RIGHT TURN MOVEMENTS SHALL BE MAINTAINED FOR EACH APPROACH.
- REFER TO SUGGESTED CONSTRUCTION PROCEDURES ON SHEET 108 FOR ADDI-TIONAL WORK.

STAGE 1

- 1. MAINTAIN TWO-WAY TRAFFIC FLOW ON WILLOW ROAD AND ILLINOIS ROUTE 43. REFER TO SHEETS 113 AND 122. LEFT TURN, THROUGH, AND RIGHT TURN MOVEMENTS SHALL BE MAINTAINED FOR EACH APPROACH.
- 2. REFER TO SUGGESTED CONSTRUCTION PROCEDURES ON SHEETS 105 AND 108.
- CONSTRUCT PAVEMENT AREAS LABELED "STAGE 1" AS SHOWN ON SHEET 147. INSTALL TEMPORARY PAVEMENT REQUIRED FOR USE DURING STAGE 1A.

STAGE 1A

- 1. MAINTAIN STAGE 1 TRAFFIC PATTERNS WITH THE FOLLOWING CHANGES:
 - a. PROHIBIT WESTBOUND RIGHT TURNS AT THE STOP LINE.
 - D. CREATE A WESTBOUND RIGHT TURN ONLY LANE UPSTREAM OF STOP LINE TO CHANNEL RIGHT TURNING VEHICLES ONTO NEWLY CONSTRUCT-ED STAGE 1 PAVEMENT AND AROUND STAGE 1A CONSTRUCTION AREA. PROVIDE A MINIMUM 11-FOOT LANE FOR RIGHT TURN MOVEMENT.
 - C. MERGE RIGHT TURNING TRAFFIC INTO THE NORTHBOUND TRAFFIC LANE ALONG ILLINOIS ROUTE 43. COORDINATE WITH ENGINEER FOR THE TRAFFIC CONTROLS REQUIRED FOR THIS MERGE.
- CONSTRUCT PAVEMENT AREA LABELED "1A" AS SHOWN ON SHEET 147. INSTALL TEMPORARY PAVEMENT REQUIRED FOR USE DURING STAGE 1B.

STAGE 18

- 1. MAINTAIN STAGE 1 TRAFFIC PATTERNS ALONG ILLINOIS ROUTE 43.
- 2. MAINTAIN EASTBOUND WILLOW ROAD TRAFFIC AS IN STAGE 1.
- SHIFT WESTBOUND WILLOW ROAD TRAFFIC TO THE NORTHSIDE OF WILLOW ROAD. PROVIDE A MINIMUM OF A SINGLE LEFT TURN LANE AND A SINGLE THROUGH/RIGHT LANE ON APPROACH.
- 4. CONSTRUCT PAVEMENT AREAS LABELED "1B" AS SHOWN ON SHEET 147. INSTALL TEMPORARY PAVEMENT REQUIRED FOR USE DURING STAGE 1C.

STAGE 1C

- 1. MAINTAIN STAGE 1B TRAFFIC PATTERNS ALONG ILLINOIS ROUTE 43.
- MAINTAIN WESTBOUND WILLOW ROAD TRAFFIC ON THE NORTHSIDE OF WILLOW ROAD. REFER TO TRAFFIC CONTROL FOR STAGE 2, SHEET 124.
- 3. SHIFT EASTBOUND WILLOW ROAD TRAFFIC TO THE NORTHSIDE OF WILLOW ROAD. REFER TO TRAFFIC CONTROL FOR STAGE 2, SHEET 124.
- CONSTRUCT PAVEMENT AREAS LABELED "1C" AS SHOWN ON SHEET 147. INSTALL TEMPORARY PAVEMENT REQUIRED FOR USE DURING STAGE 1D.

STAGE 1

- 1. MAINTAIN STAGE IC TRAFFIC PATTERNS ALONG ILLINOIS ROUTE 43 WITH THE FOLLOWING CHANGES:
 - a. PROHIBIT NORTHBOUND RIGHT TURNS AT THE STOP LINE.
 - CREATE A NORTHBOUND RIGHT TURN ONLY LANE UPSTREAM OF STOP LINE TO CHANNEL RIGHT TURNING VEHICLES ONTO NEWLY CONSTRUCTED STAGE 1 AND STAGE 1B PAVEMENT SECTIONS AND AROUND STAGE 1D CONSTRUCTION AREA. PROVIDE A MINIMUM 11-FOOT LANE FOR RIGHT TURN MOVEMENT.
 - c. MERGE RIGHT TURNING TRAFFIC INTO THE EASTBOUND TRAFFIC LANE ALONG WILLOW ROAD. COORDINATE WITH ENGINEER FOR THE TRAFFIC CONTROLS REQUIRED FOR THIS MERGE.
- 2. CONSTRUCT PAVEMENT AREA LABELED "1D" AS SHOWN ON SHEET 147.

STAGE 2

- 1. MAINTAIN TWO-WAY TRAFFIC FLOW ON WILLOW ROAD AND WAUKEGAN ROAD (RTE 43), REFER TO SHEETS 124 AND 131. LEFT TURN, THROUGH, AND RIGHT TURN MOVEMENTS SHALL BE MAINTAINED FOR EACH DIRECTION.
- 2. REFER TO SUGGESTED CONSTRUCTION PROCEDURES ON SHEETS 106 AND 109.
- 3. CONSTRUCT PAVEMENT AREAS LABELED "STAGE 2" AS SHOWN ON SHEET 147. INSTALL TEMPORARY PAVEMENT REQUIRED FOR USE DURING STAGE 2A.

STAGE 2A

- 1. MAINTAIN STAGE 2 TRAFFIC PATTERNS ALONG ILLINOIS ROUTE 43 WITH THE FOLLOWING CHANGE:
 - a. MODIFY THE NORTHBOUND APPROACH OF WAUKEGAN ROAD RTE 43 TRAFFIC LANES TO PROVIDE A SINGLE LEFT TURN LANE AND A SHARED THROUGH/RIGHT LANE.
- 2. SHIFT WILLOW ROAD TRAFFIC TO THE SOUTHSIDE OF WILLOW ROAD. PROVIDE A MINIMUM OF A SINGLE LEFT TURN LANE AND A SINGLE THROUGH/RIGHT LANE ON THE APPROACHES.
- 3. CONSTRUCT PAVEMENT AREA LABELED "2A" AS SHOWN ON SHEET 147.

STAGE 2B

- 1. MAINTAIN STAGE 2A TRAFFIC PATTERNS ALONG ILLINOIS ROUTE 43 WITH THE FOLLOWING CHANGES:
 - D. TAPER THE SOUTHBOUND APPROACH OF ILLINOIS ROUTE 43
 TRAFFIC LANES TO ALIGN WITH NORTHBOUND ILLINOIS ROUTE 43
 LANES. PROVIDE A SINGLE LEFT TURN LANE AND A SHARED THROUGH/
 RIGHT LANE
 - b. PROHIBIT SOUTHBOUND RIGHT TURNS AT THE STOP LINE.
 - CREATE A SOUTHBOUND RIGHT TURN ONLY LANE UPSTREAM OF STOP LINE TO CHANNEL RIGHT TURNING VEHICLES ONTO NEWLY CONSTRUCTED STAGE 1, STAGE 2, AND STAGE 2A PAVEMENT SECTIONS AROUND STAGE 2B CONSTRUCTION AREA. PROVIDE A MINIMUM 11-FOOT LANE FOR RIGHT TURN MOVEMENT.
 - d. MERGE RIGHT TURNING TRAFFIC INTO THE WESTBOUND TRAFFIC LANE ALONG WILLOW ROAD, COORDINATE WITH ENGINEER FOR THE TRAFFIC CONTROLS REQUIRED FOR THIS MERGE.
- 2. CONSTRUCT PAVEMENT AREA LABELED "2B" AS SHOWN ON SHEET 147.

STAGE 2C

- MAINTAIN STAGE 2B TRAFFIC PATTERN FOR THE NORTHBOUND APPROACH OF ILLINOIS ROUTE 43.
- 2. MAINTAIN STAGE 2B TRAFFIC PATTERN FOR THE SOUTHBOUND APPROACH OF ILLINOIS ROUTE 43. CONTRACTOR CAN ADJUST LANES IF RE-OUTED BY THE FNOINFER
- 3. SHIFT WILLOW ROAD TRAFFIC TO THE NORTHSIDE OF WILLOW ROAD WITH THE FOLLOWING CHANGES:
 - g. PROVIDE A SINGLE LEFT TURN LANE AND A SHARED THROUGH/RIGHT LANE FOR THE WESTBOUND APPROACH.
 - b. PROVIDE A SINGLE LEFT TURN LANE AND A SINGLE THROUGH ONLY LANE FOR THE EASTBOUND APPROACH.
 - c. PROHIBIT EASTBOUND RIGHT TURNS AT THE STOP LINE.
 - d. CREATE AN EASTBOUND RIGHT TURN ONLY LANE UPSTREAM OF STOP LINE TO CHANNEL RIGHT TURNING VEHICLES ONTO NEWLY CONSTRUCT-ED STAGE 2 PAVEMENT AROUND STAGE 2C CONSTRUCTION AREA. PRO-VIDE A MINIMUM 11-FOOT LANE FOR RIGHT TURN MOVEMENT.
 - e. MERGE RIGHT TURNING TRAFFIC INTO THE SOUTHBOUND TRAFFIC LANE ALONG ILLINOIS ROUTE 43. COORDINATE WITH ENGINEER FOR THE TRAFFIC CONTROLS REQUIRED FOR THIS MERGE.
- 4. CONSTRUCT PAVEMENT AREA LABELED "2C" AS SHOWN ON SHEET 147.


STAGE 3


- MAINTAIN TWO-WAY TRAFFIC FLOW ON WILLOW ROAD AND ILLINOIS ROUTE 43. REFER TO SHEETS 137 AND 144. LEFT TURN, THROUGH, AND RIGHT TURN MOVEMENTS SHALL BE MAINTAINED FOR EACH APPROACH.
- 2. REFER TO SUGGESTED CONSTRUCTION PROCEDURES ON SHEETS 107 AND 109.
- 3. CONSTRUCT MEDIAN ISLAND AREAS LABELED "STAGE 3" AS SHOWN ON SHEFT 147.


STATE OF ILLINOIS
DEPARTMENT OF TRANSPORTATION


SUGGESTED CONSTRUCTION PROCEDURES AND MAINTENANCE OF TRAFFIC – NOTES WILLOW ROAD AT ILLINOIS ROUTE 43


SCALE: 1" = 20' SHEET NO. 146 OF 919 SHEETS

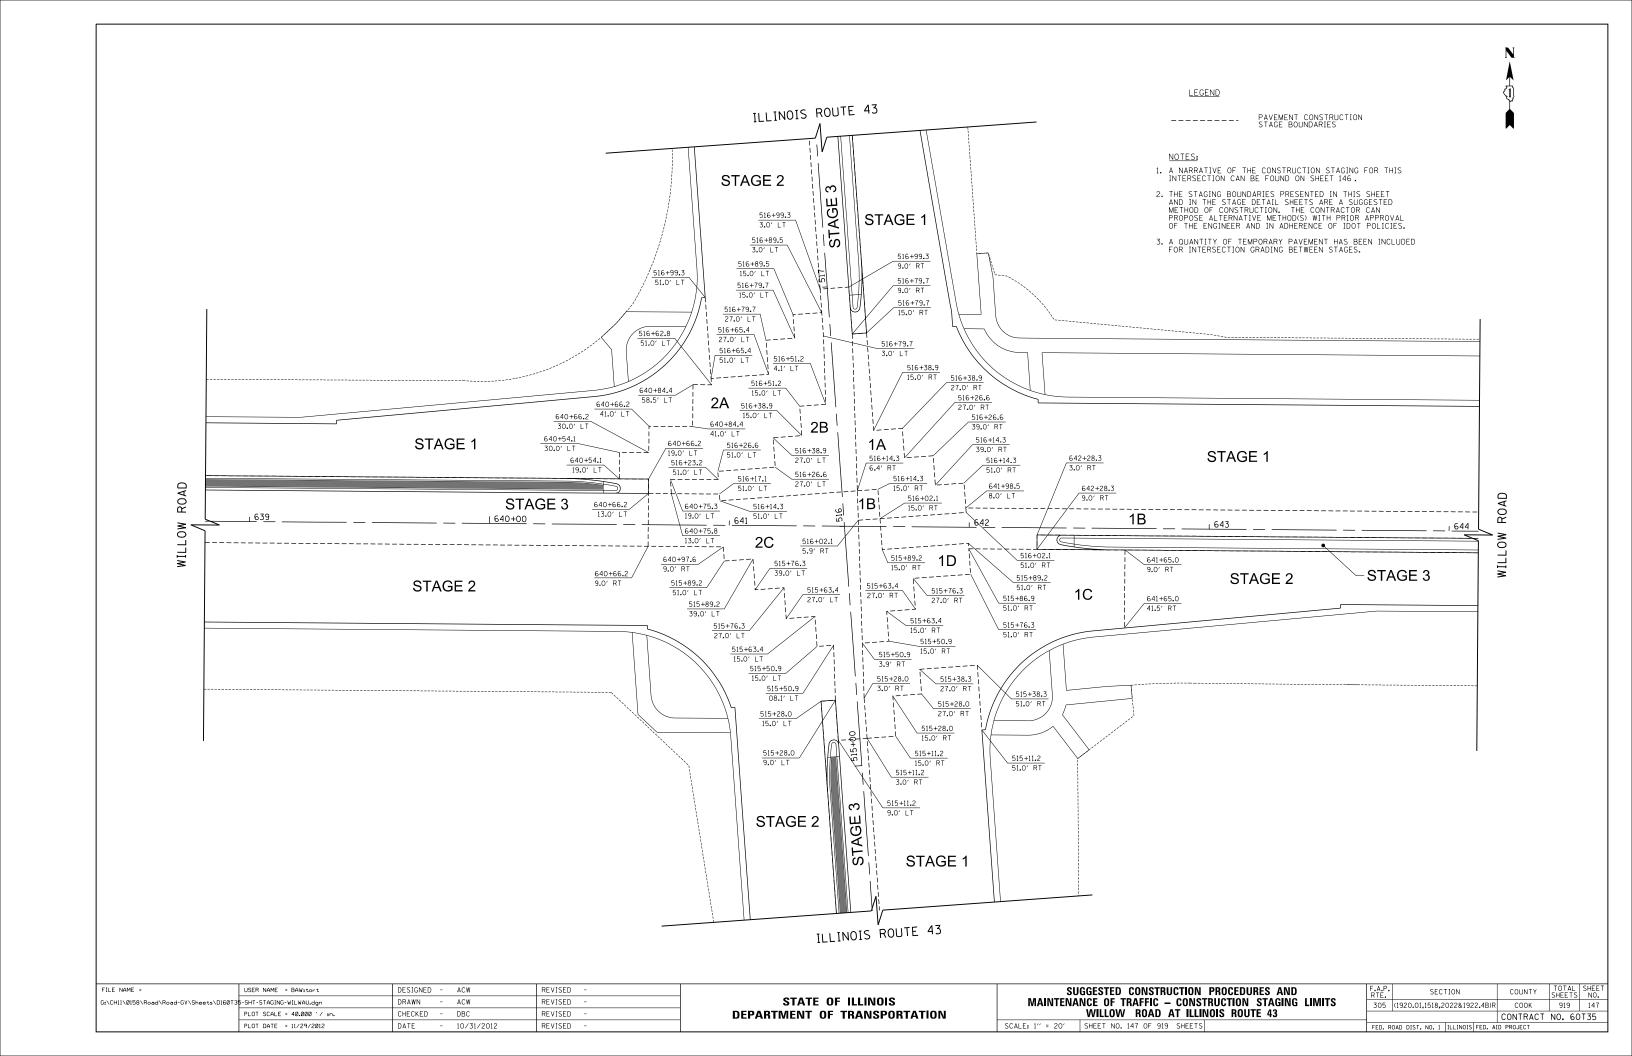


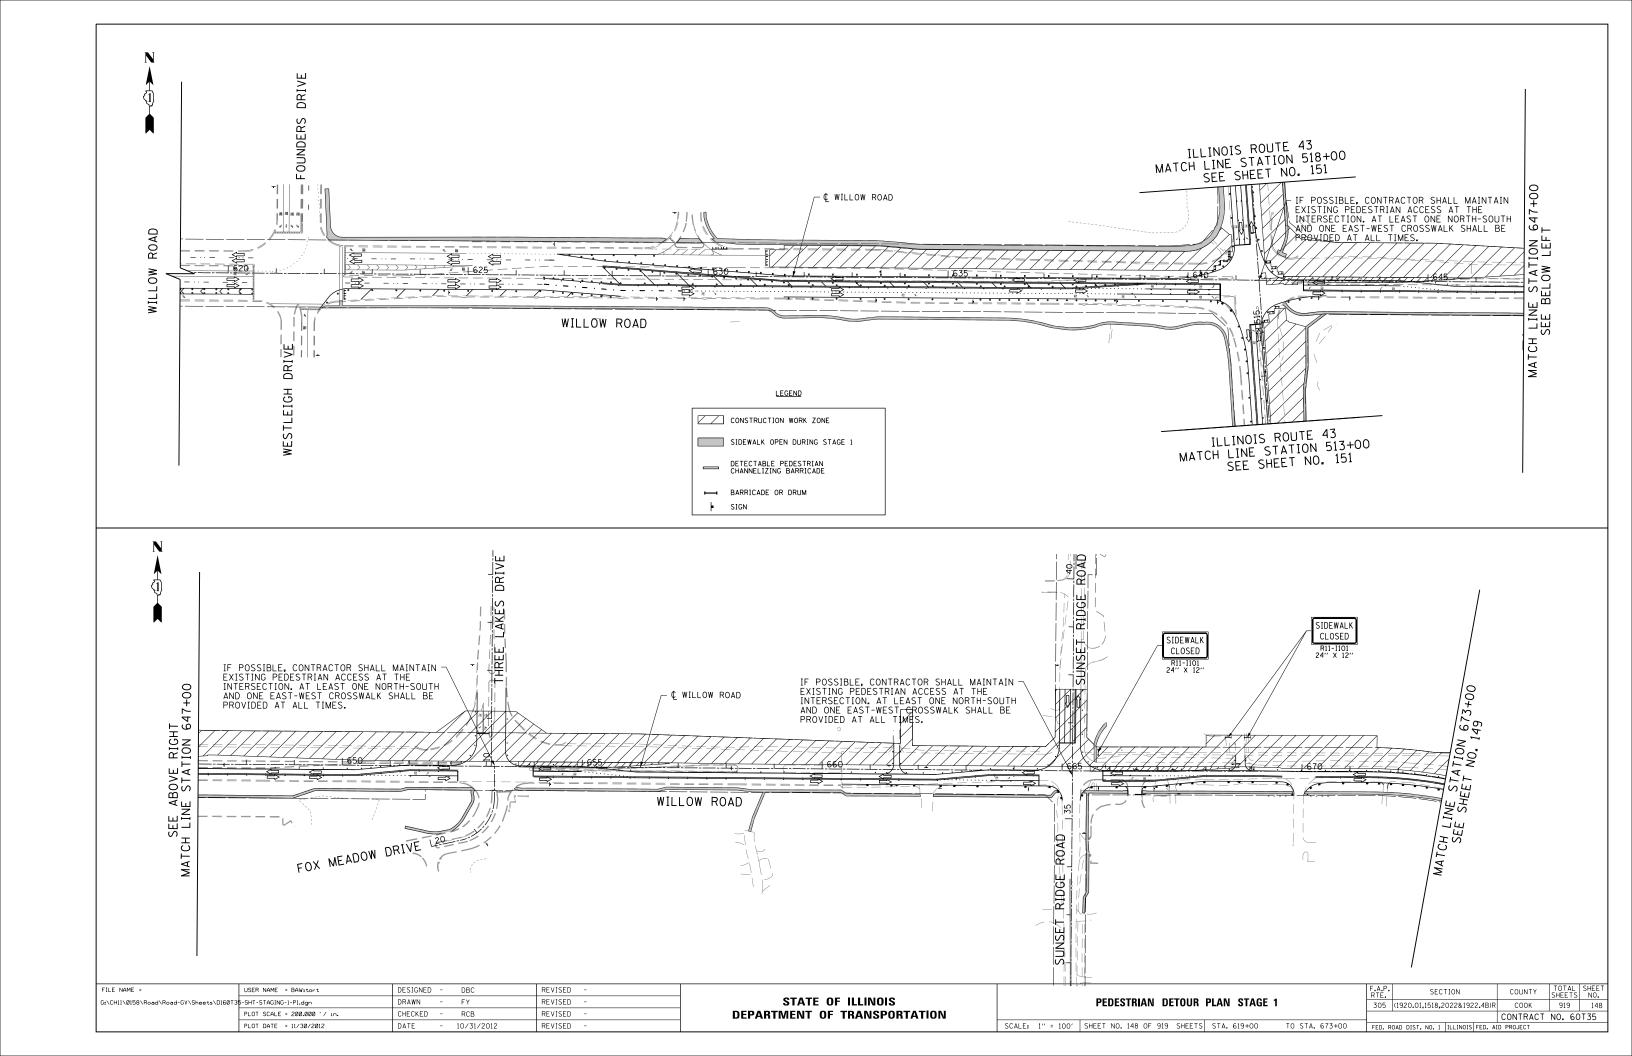


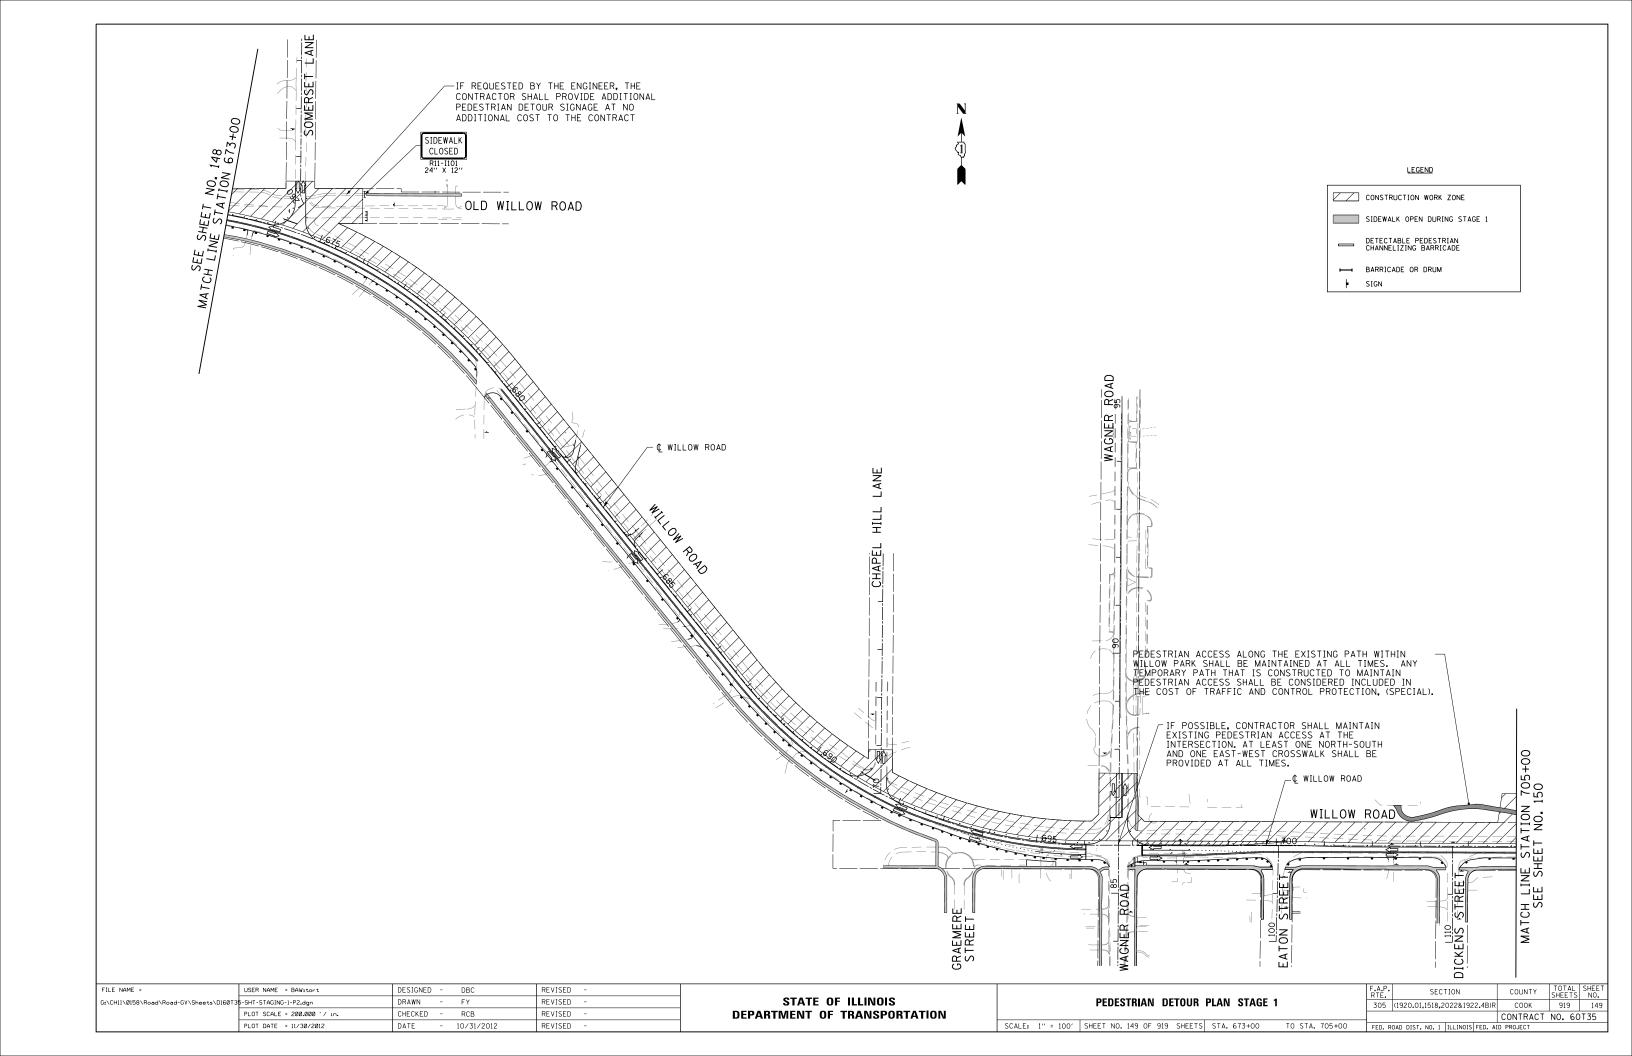


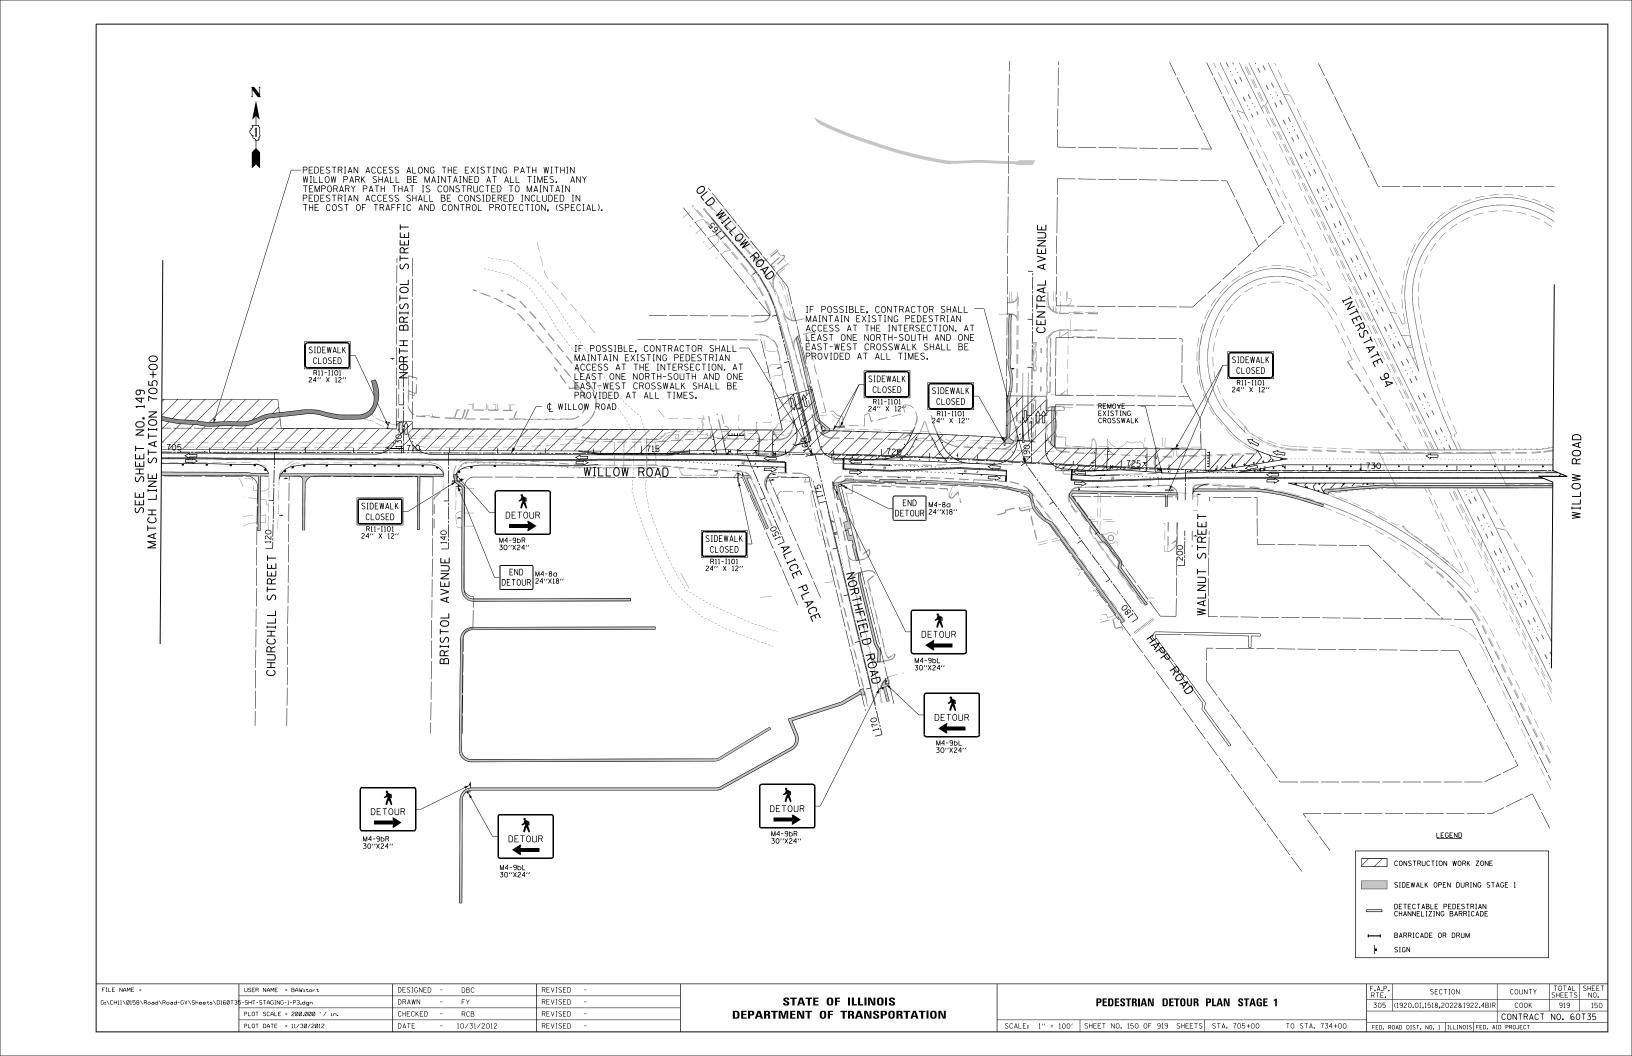


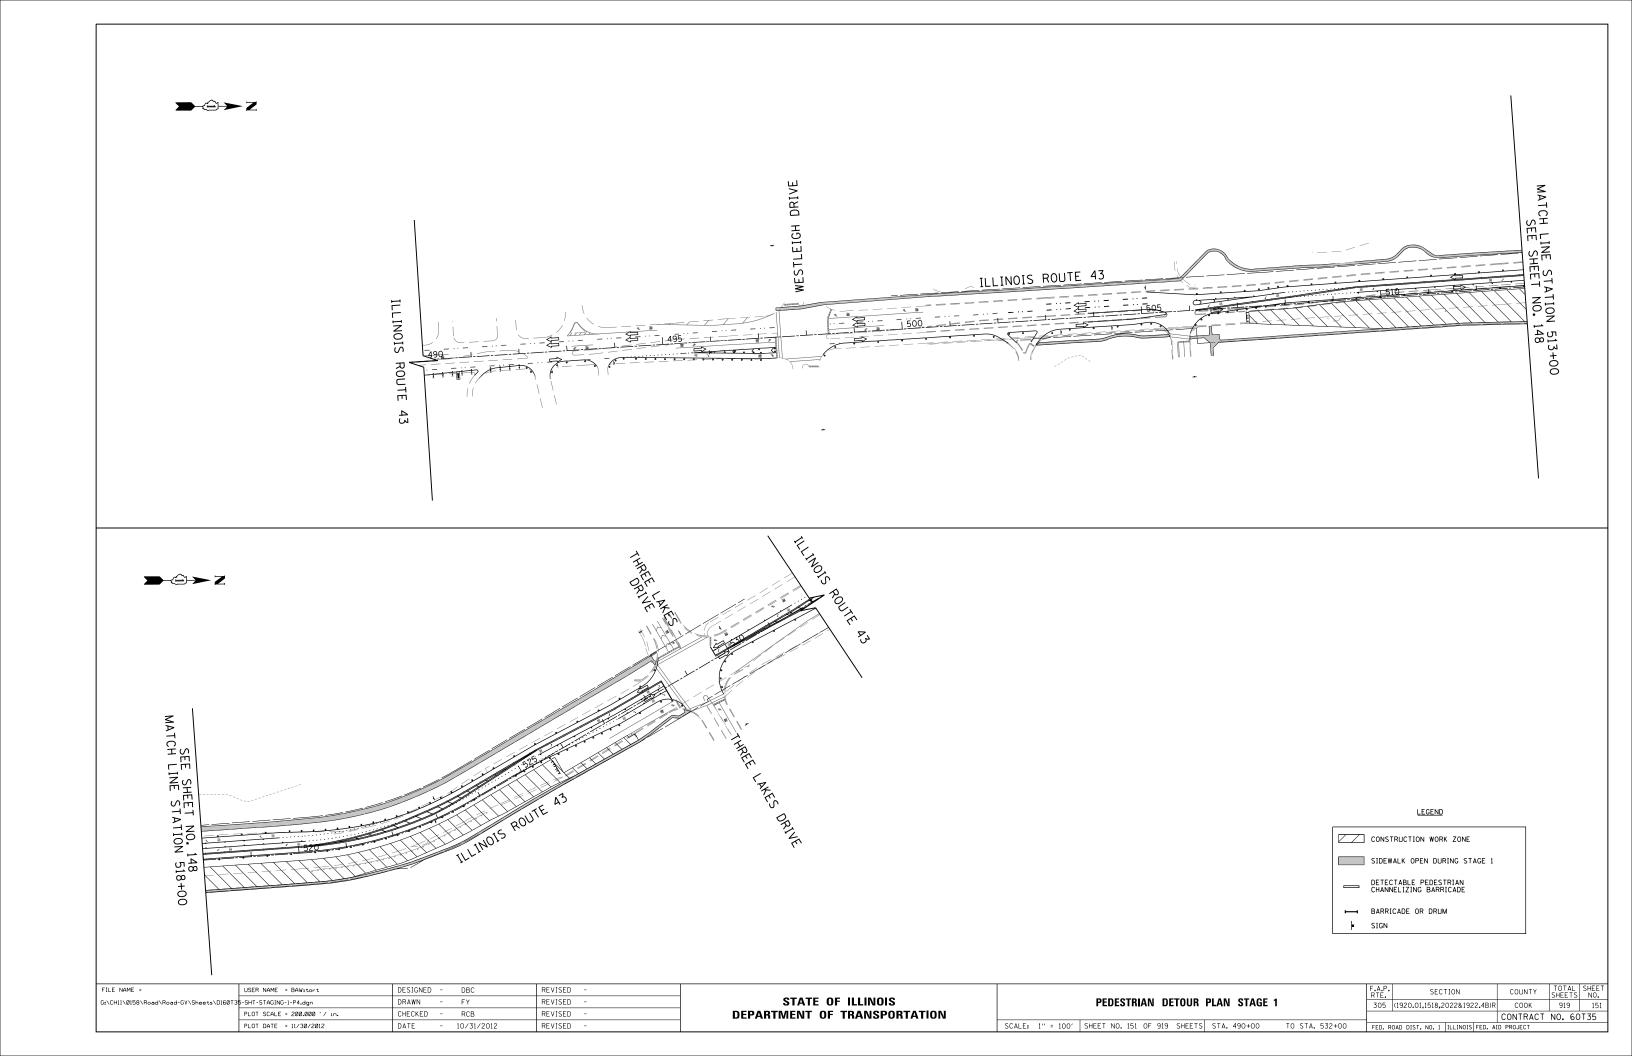


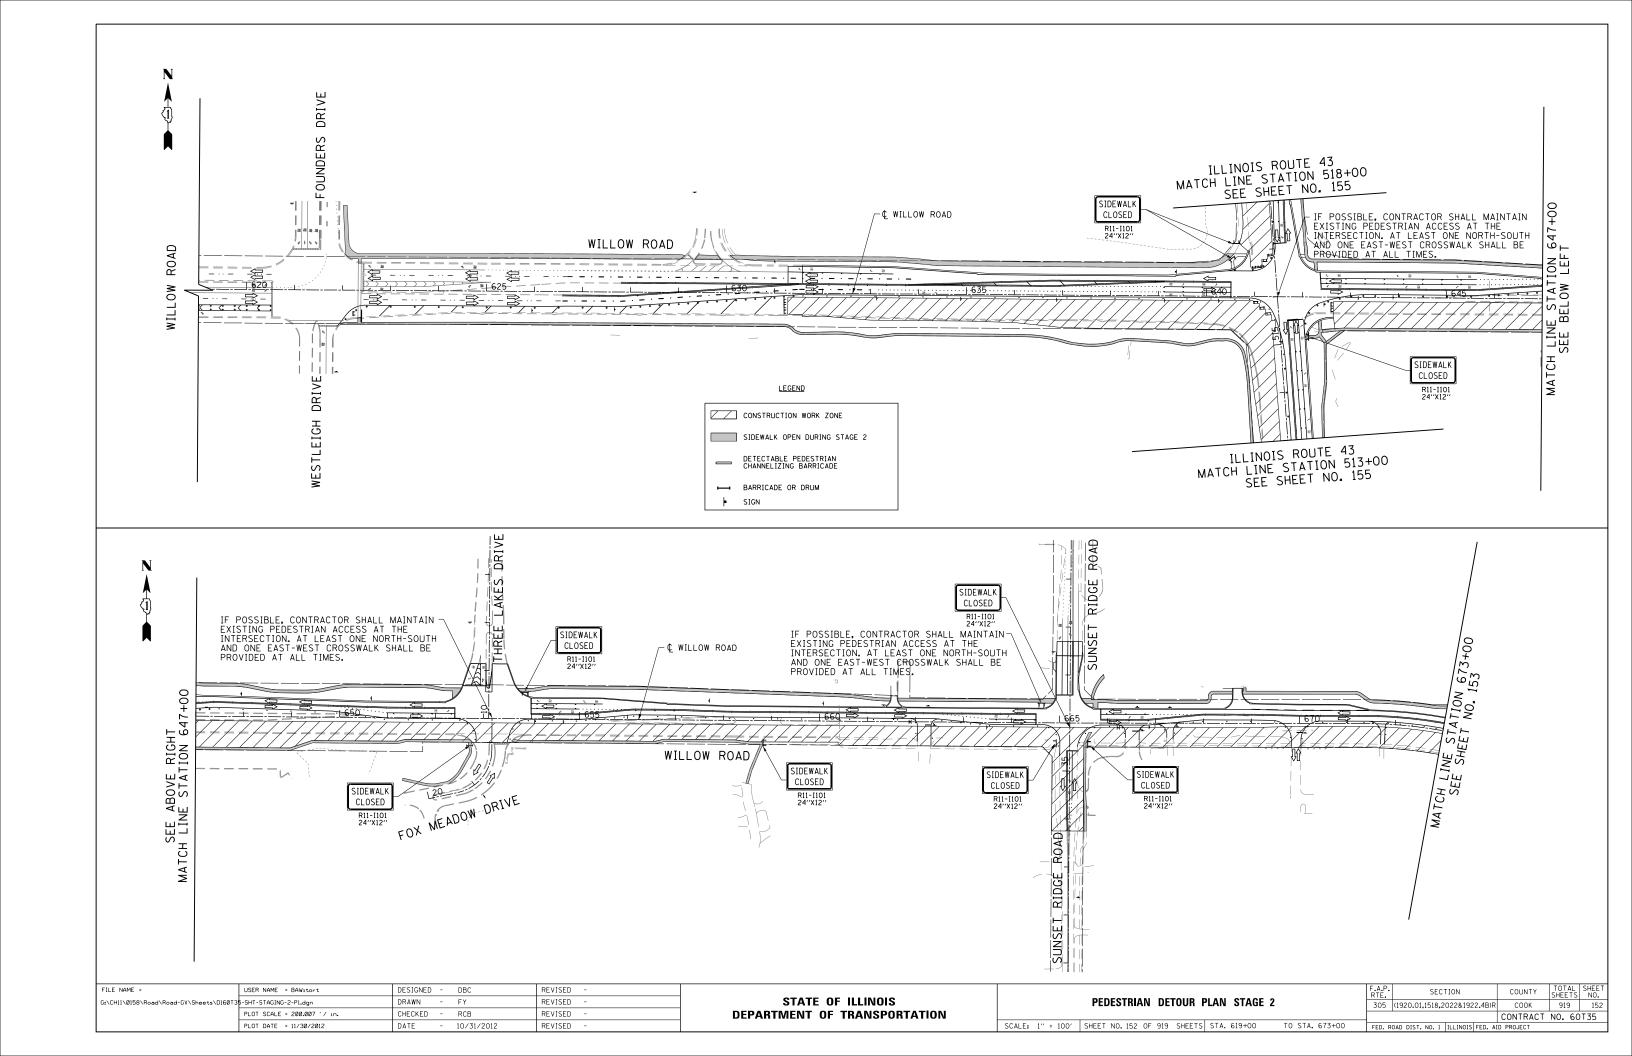


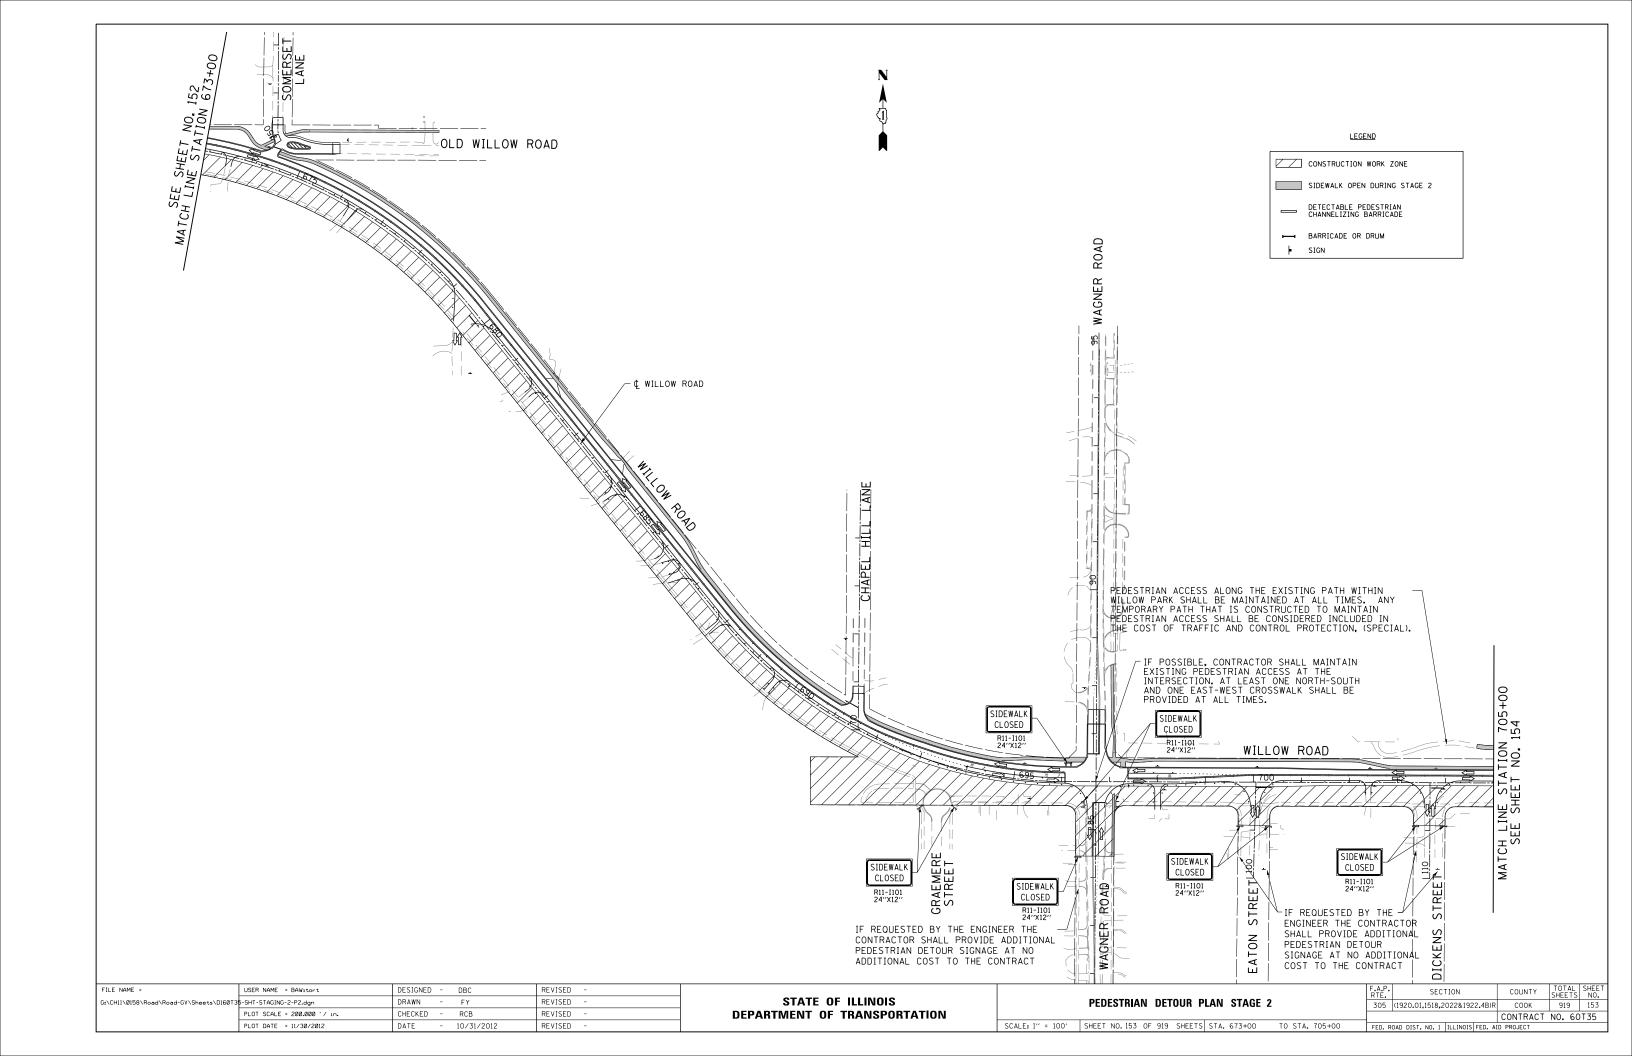


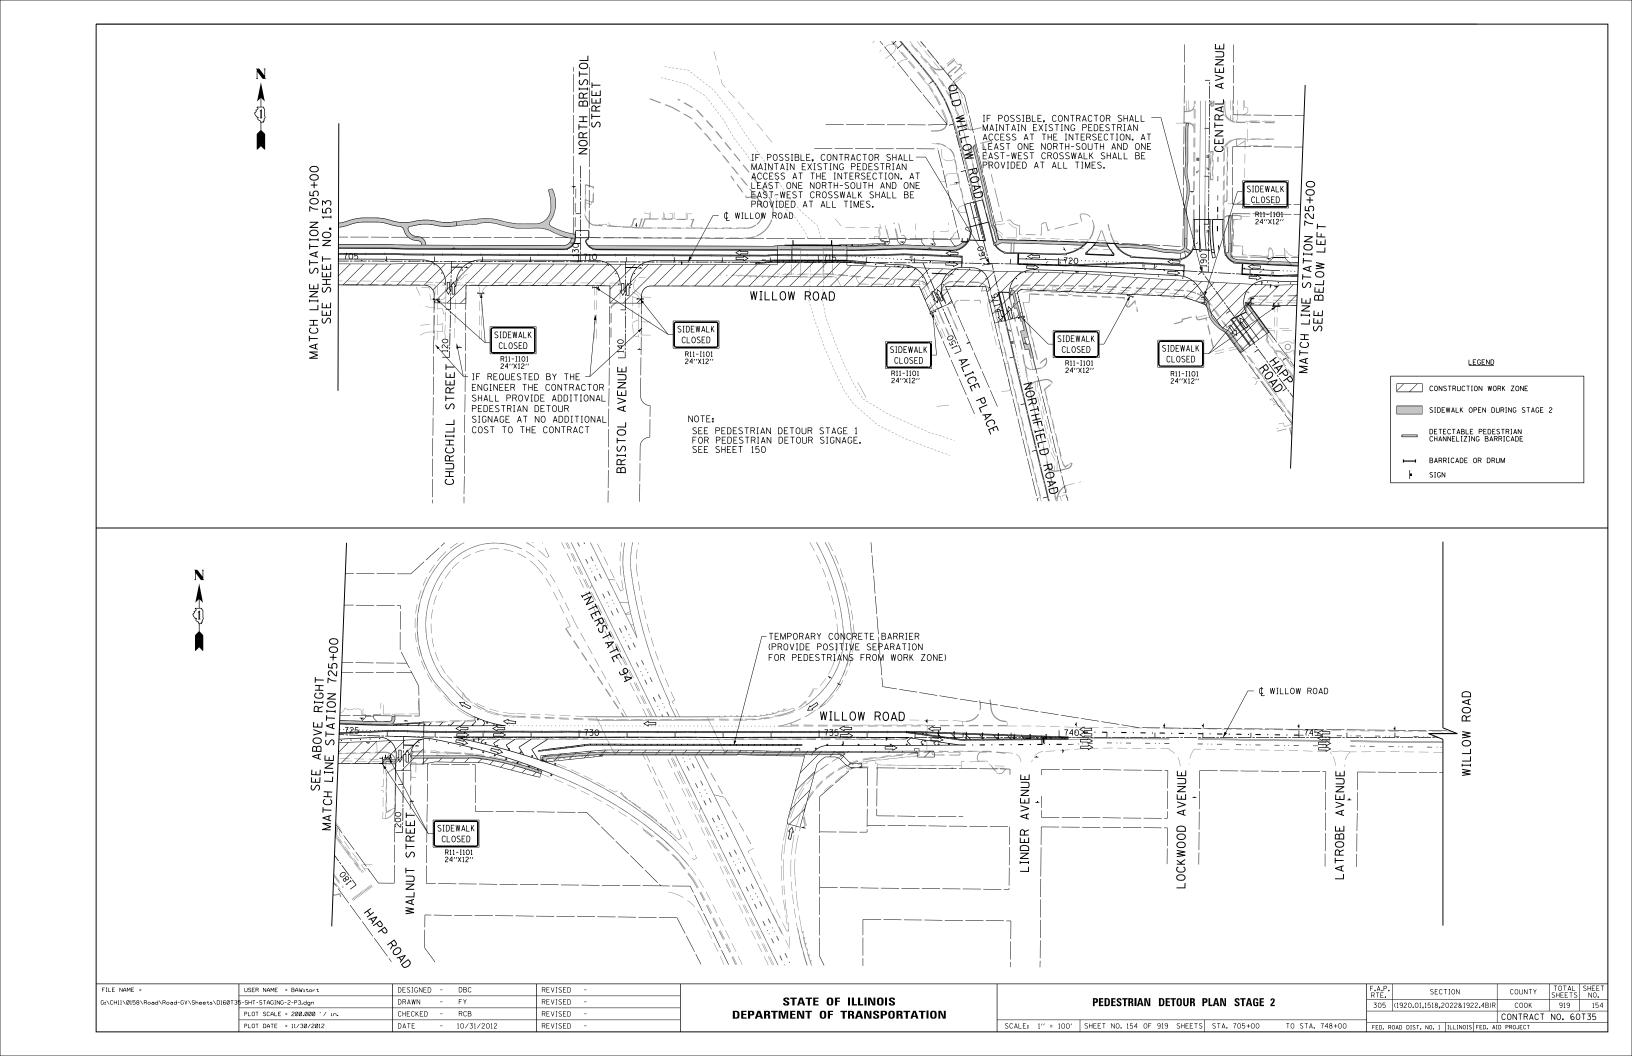


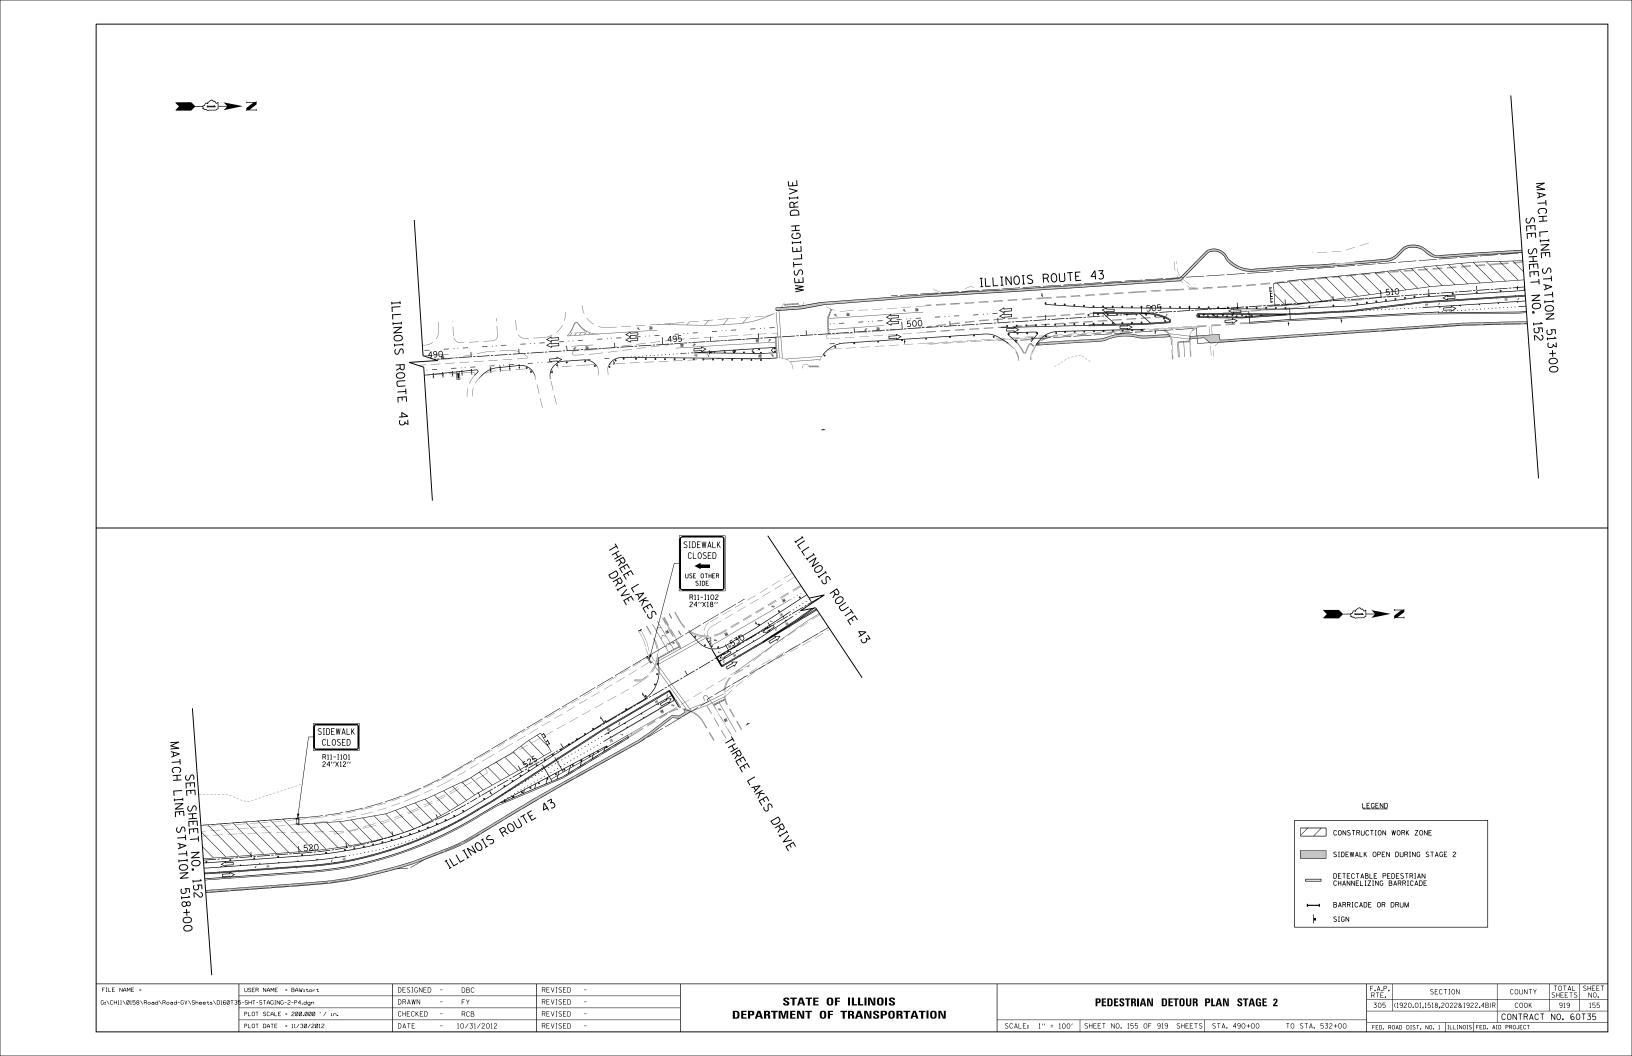


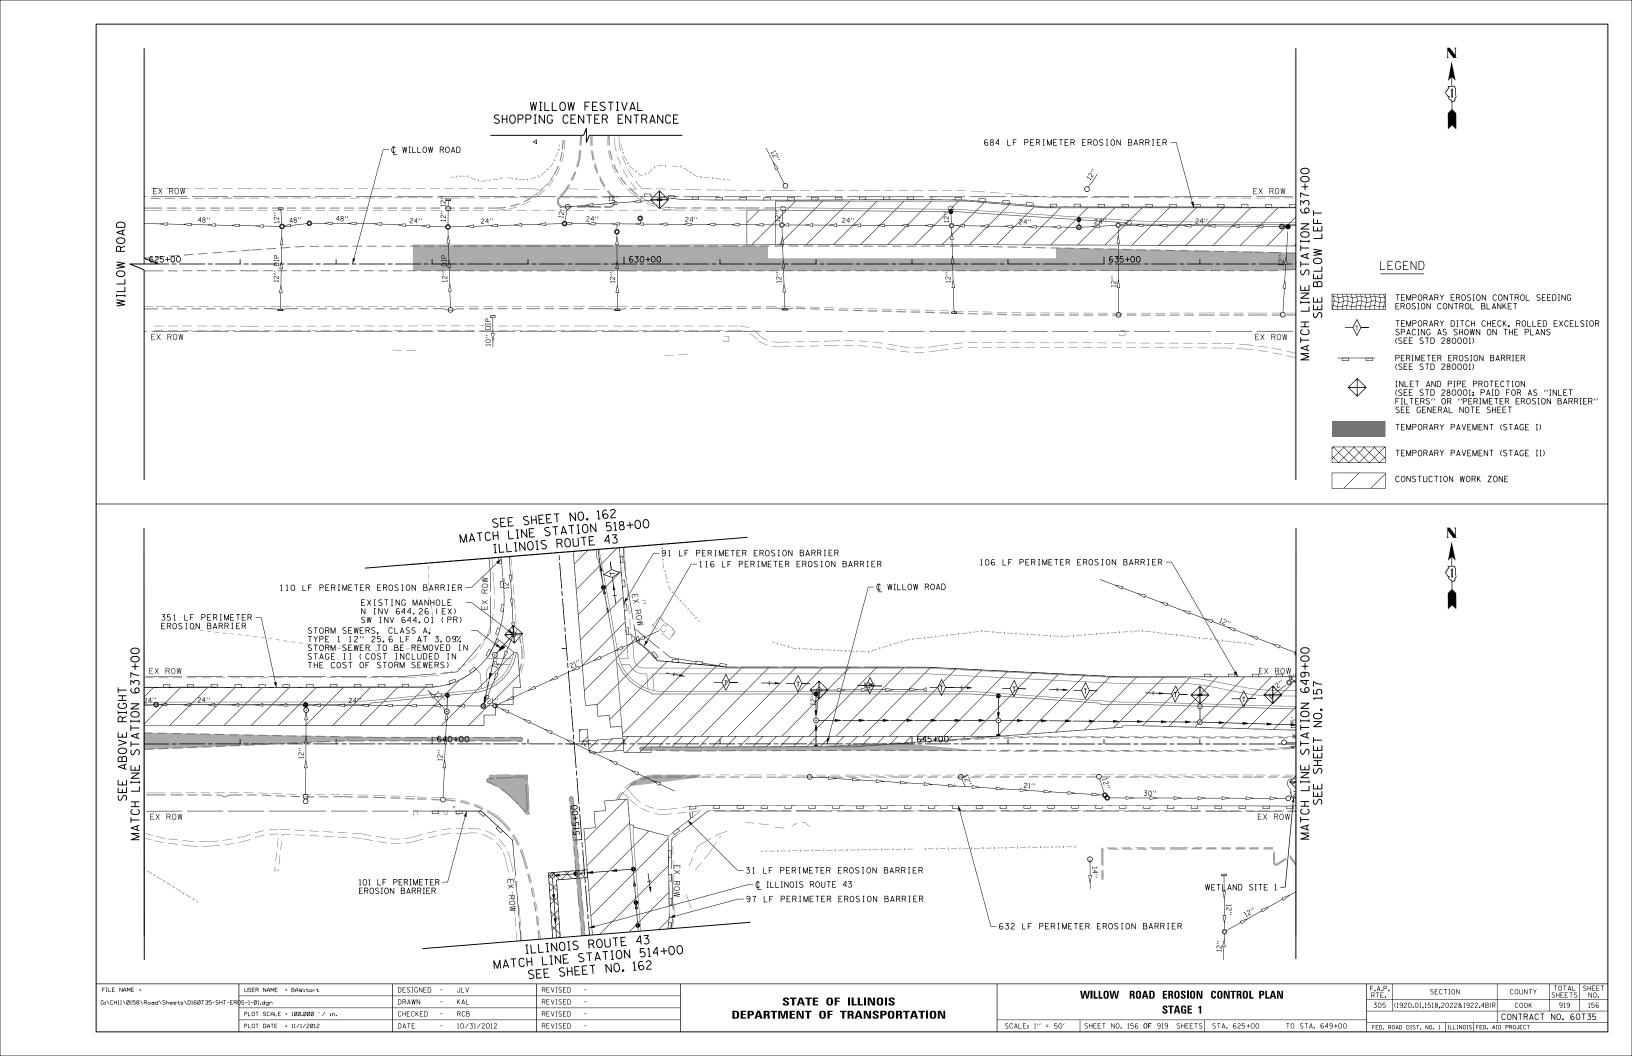

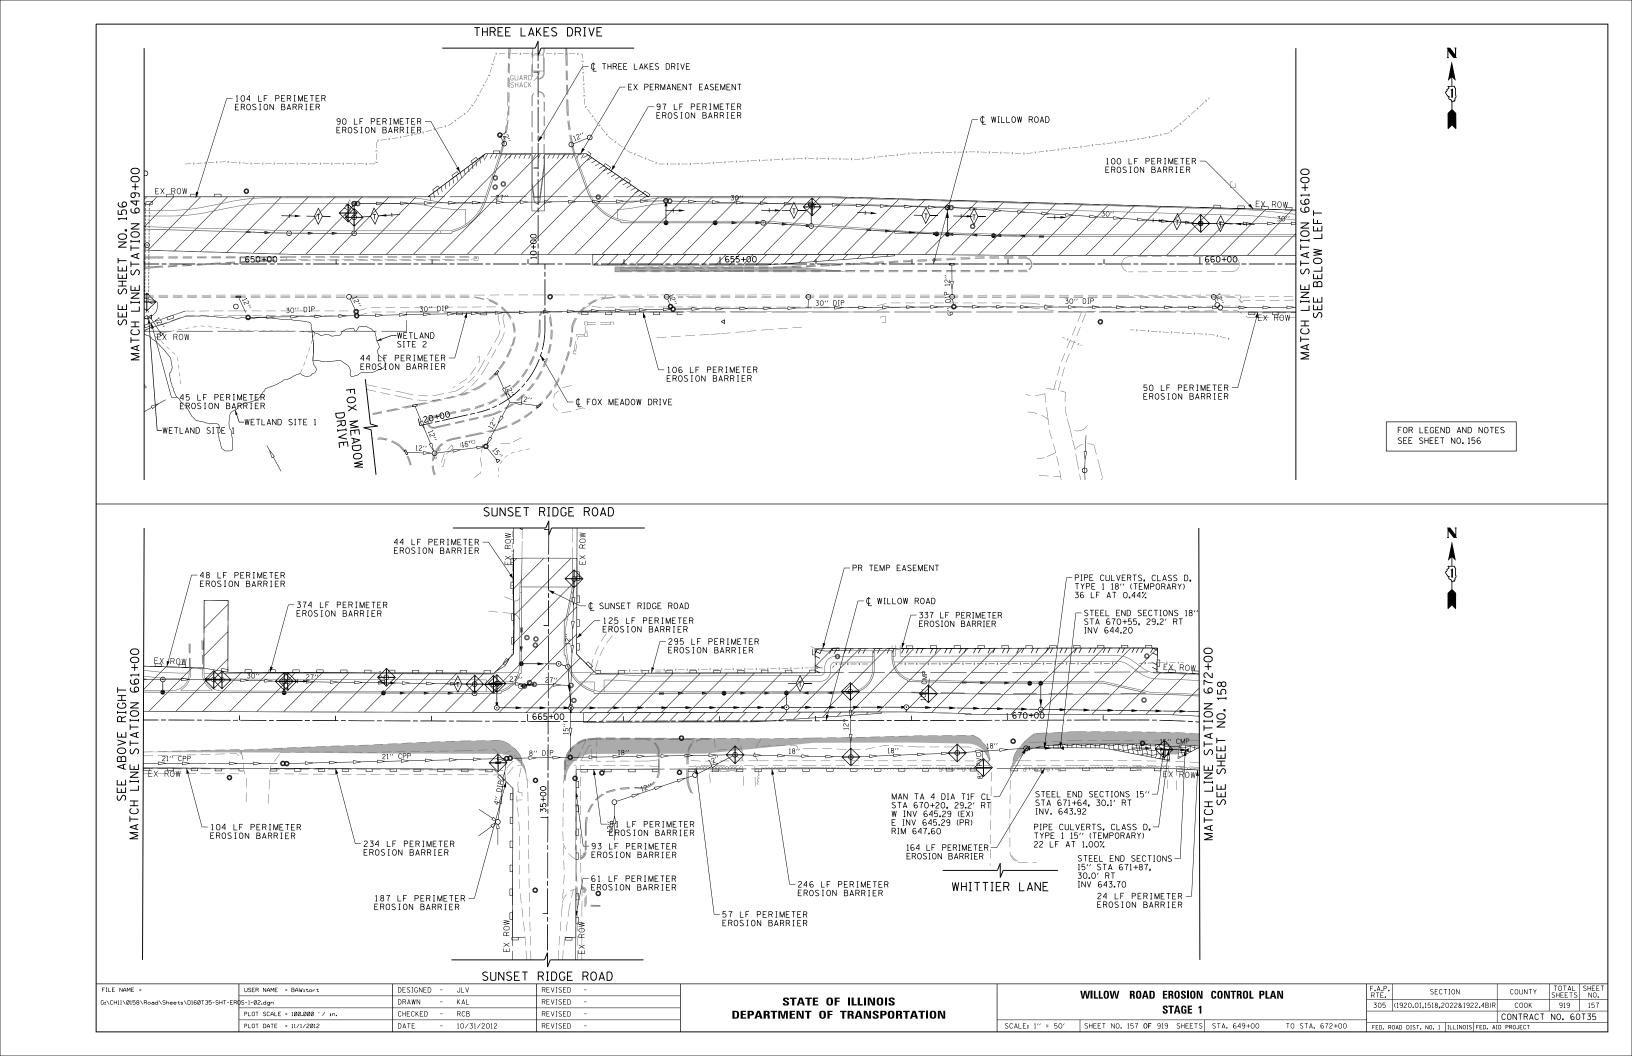

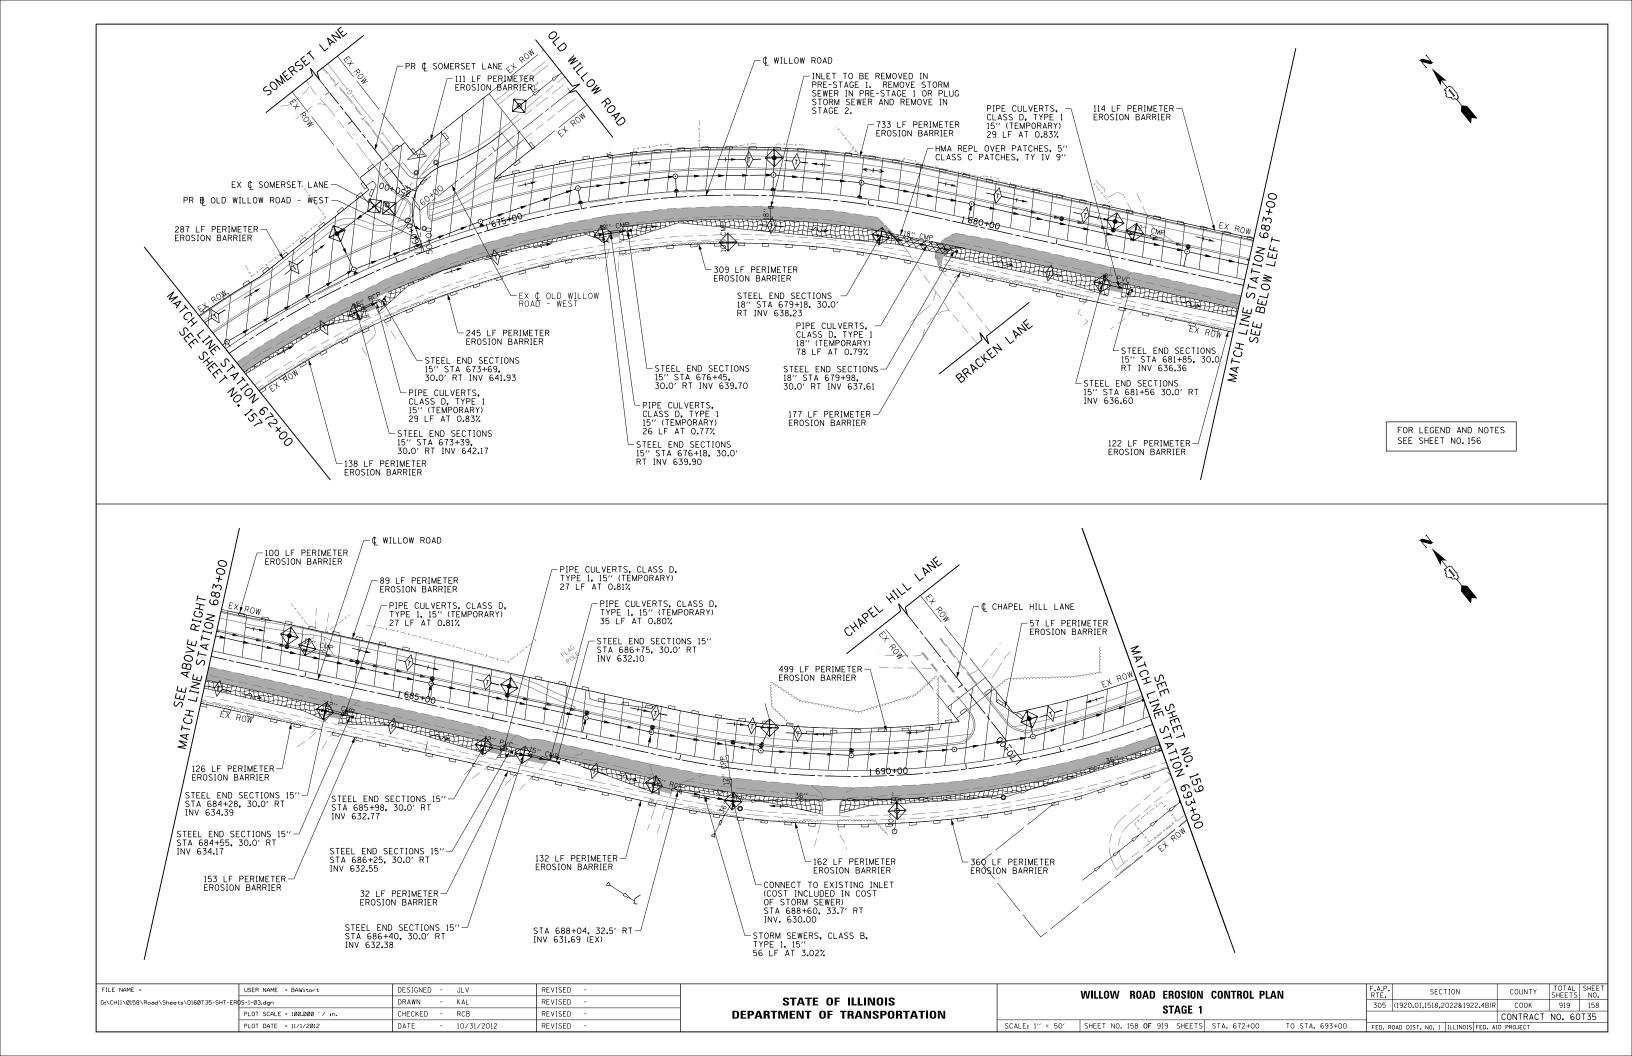


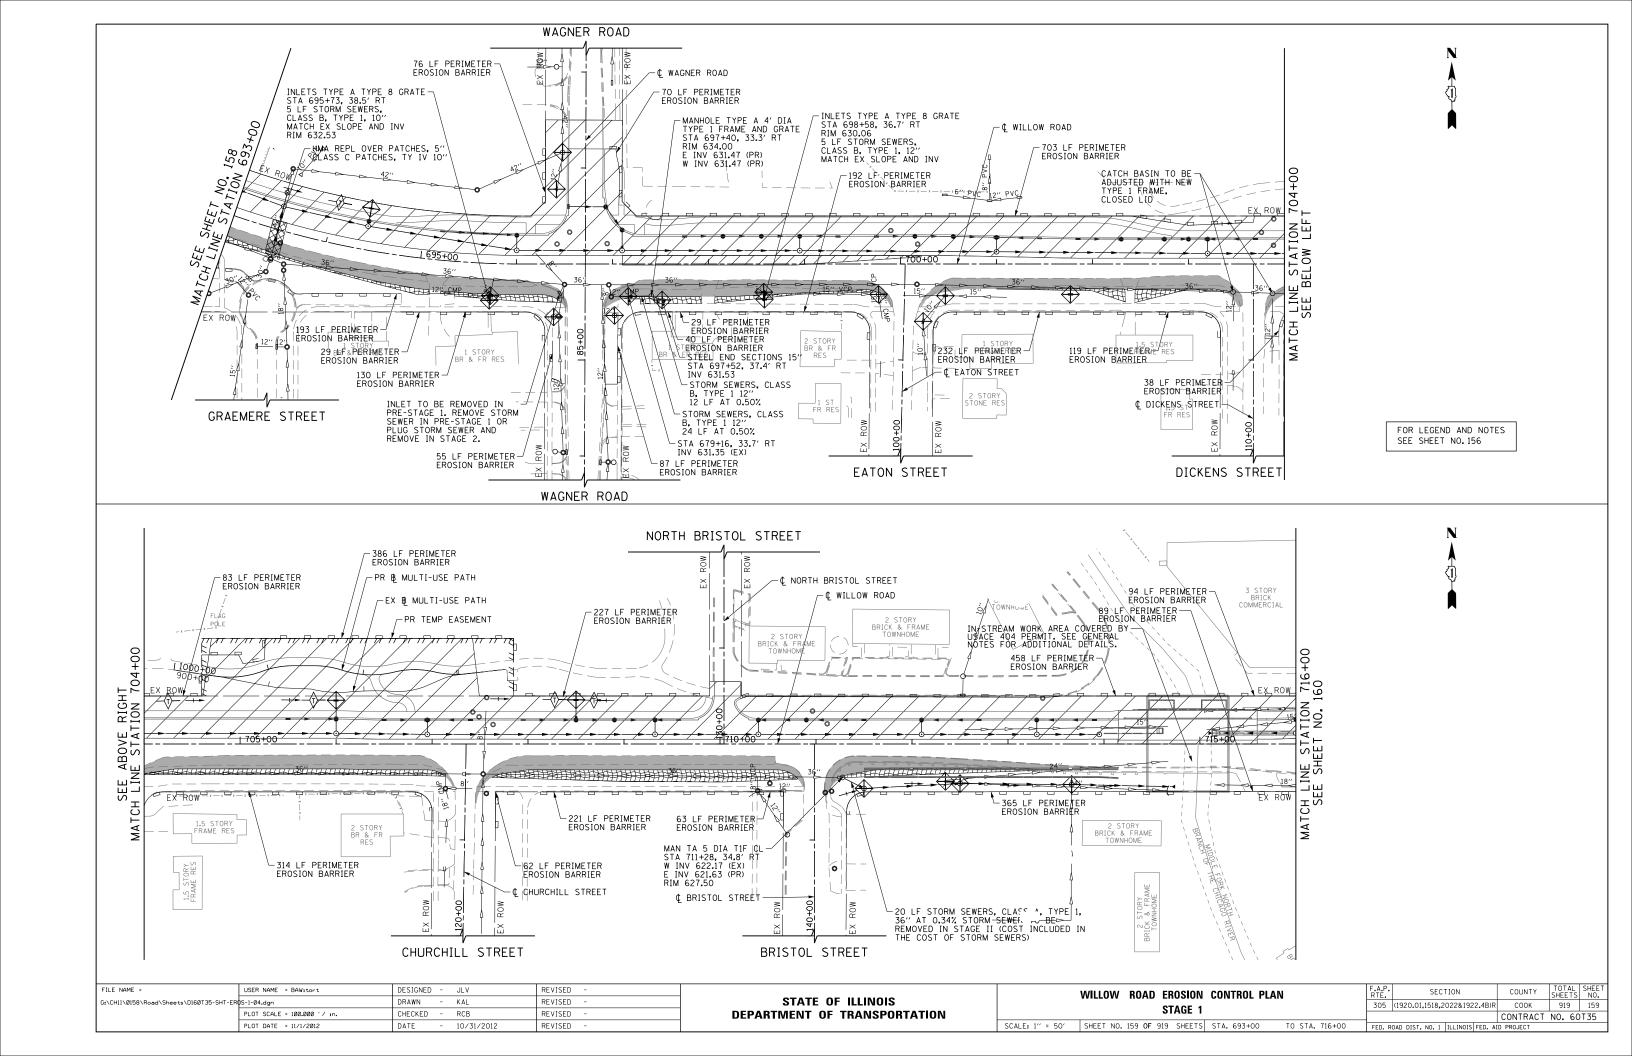


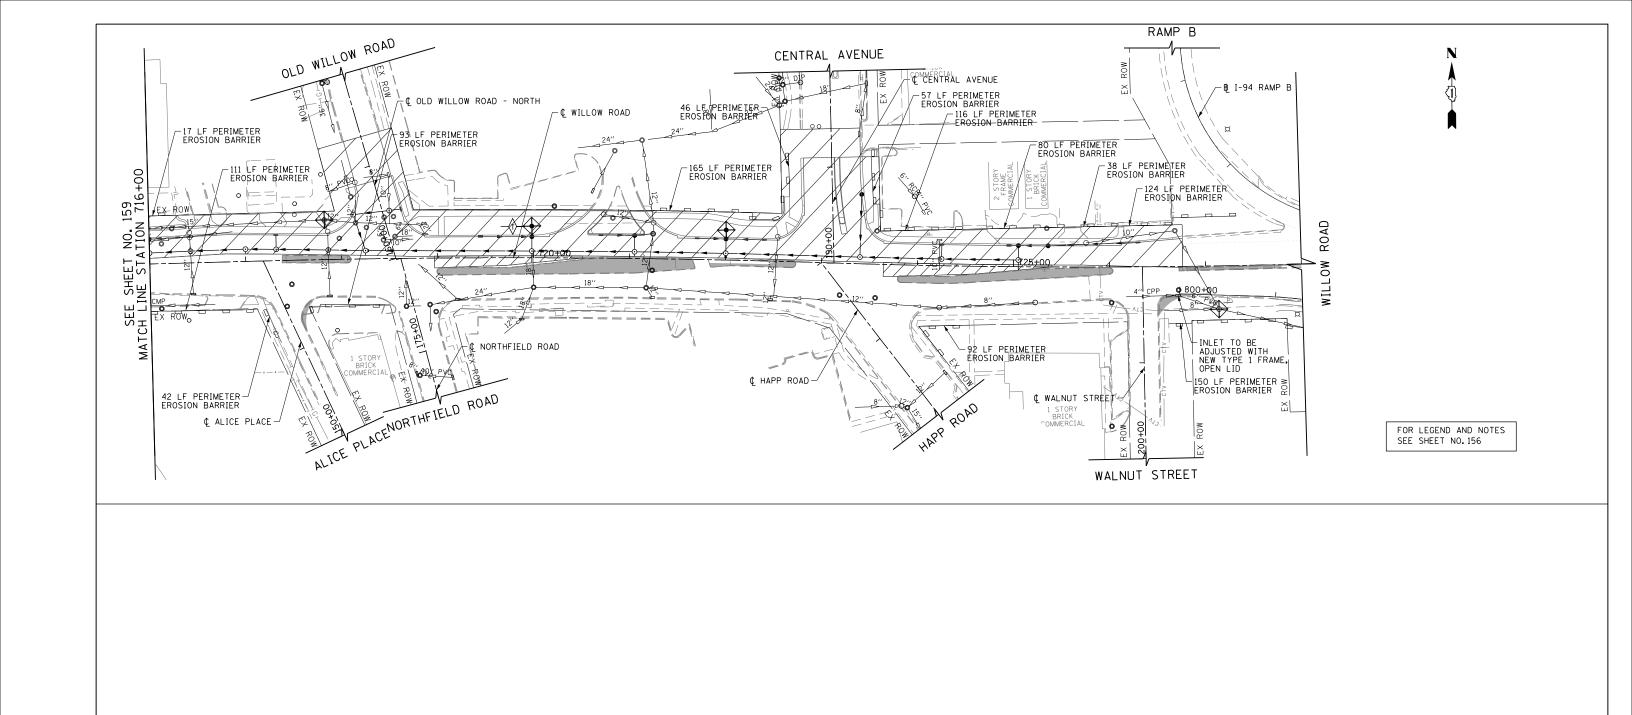



FILE NAME =	USER NAME = BAWitort	DESIGNED - JLV	REVISED -			WILLOW ROAD EROSION CONTROL PLA		F.A.P. SECTION	COUNTY TOTAL SHEET
G:\CH11\0158\Road\Sheets\D160T35-SHT-ER	95-1-05 . dgn	DRAWN - KAL	REVISED -	STATE OF ILLINOIS	STAGE 1			305 (1920.01,1518,2022&1922.4B)F	R COOK 919 160
	PLOT SCALE = 100.000 ' / in.	CHECKED - RCB	REVISED -	DEPARTMENT OF TRANSPORTATION				'	CONTRACT NO. 60T35
	PLOT DATE = 11/1/2012	DATE - 10/31/2012	REVISED -	SC		SHEET NO. 160 OF 919 SHEETS STA. 716+00	TO STA. 728+00	FED. ROAD DIST. NO. 1 ILLINOIS FED. A	AID PROJECT


FOR LEGEND AND NOTES SEE SHEET NO.156 WESTLEIGH DRIVE 43 ROUTE ILLINOIS CHRISTIAN HERITAGE ACADEMY ENTRANCE FILE NAME = USER NAME = BAWitort DESIGNED - JLV REVISED STATE OF ILLINOIS DRAWN - KAL REVISED **DEPARTMENT OF TRANSPORTATION** PLOT SCALE = 100.000 '/ in. CHECKED - RCB REVISED PLOT DATE = 11/1/2012 DATE - 10/31/2012 REVISED

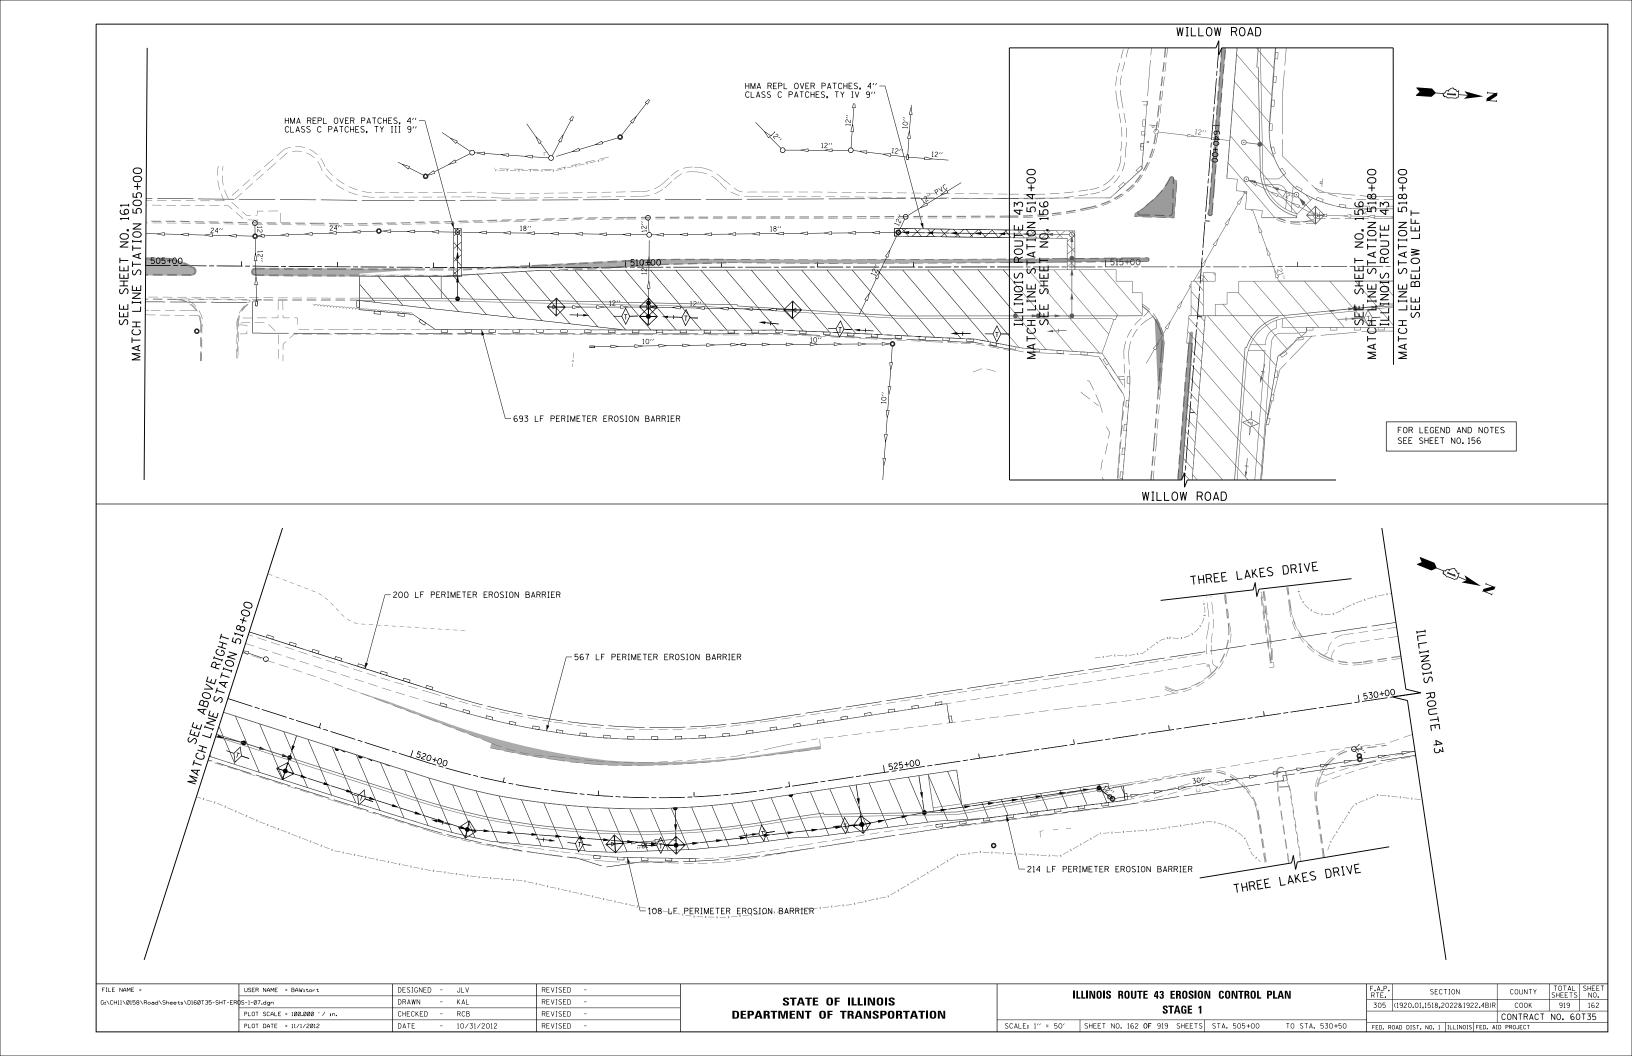


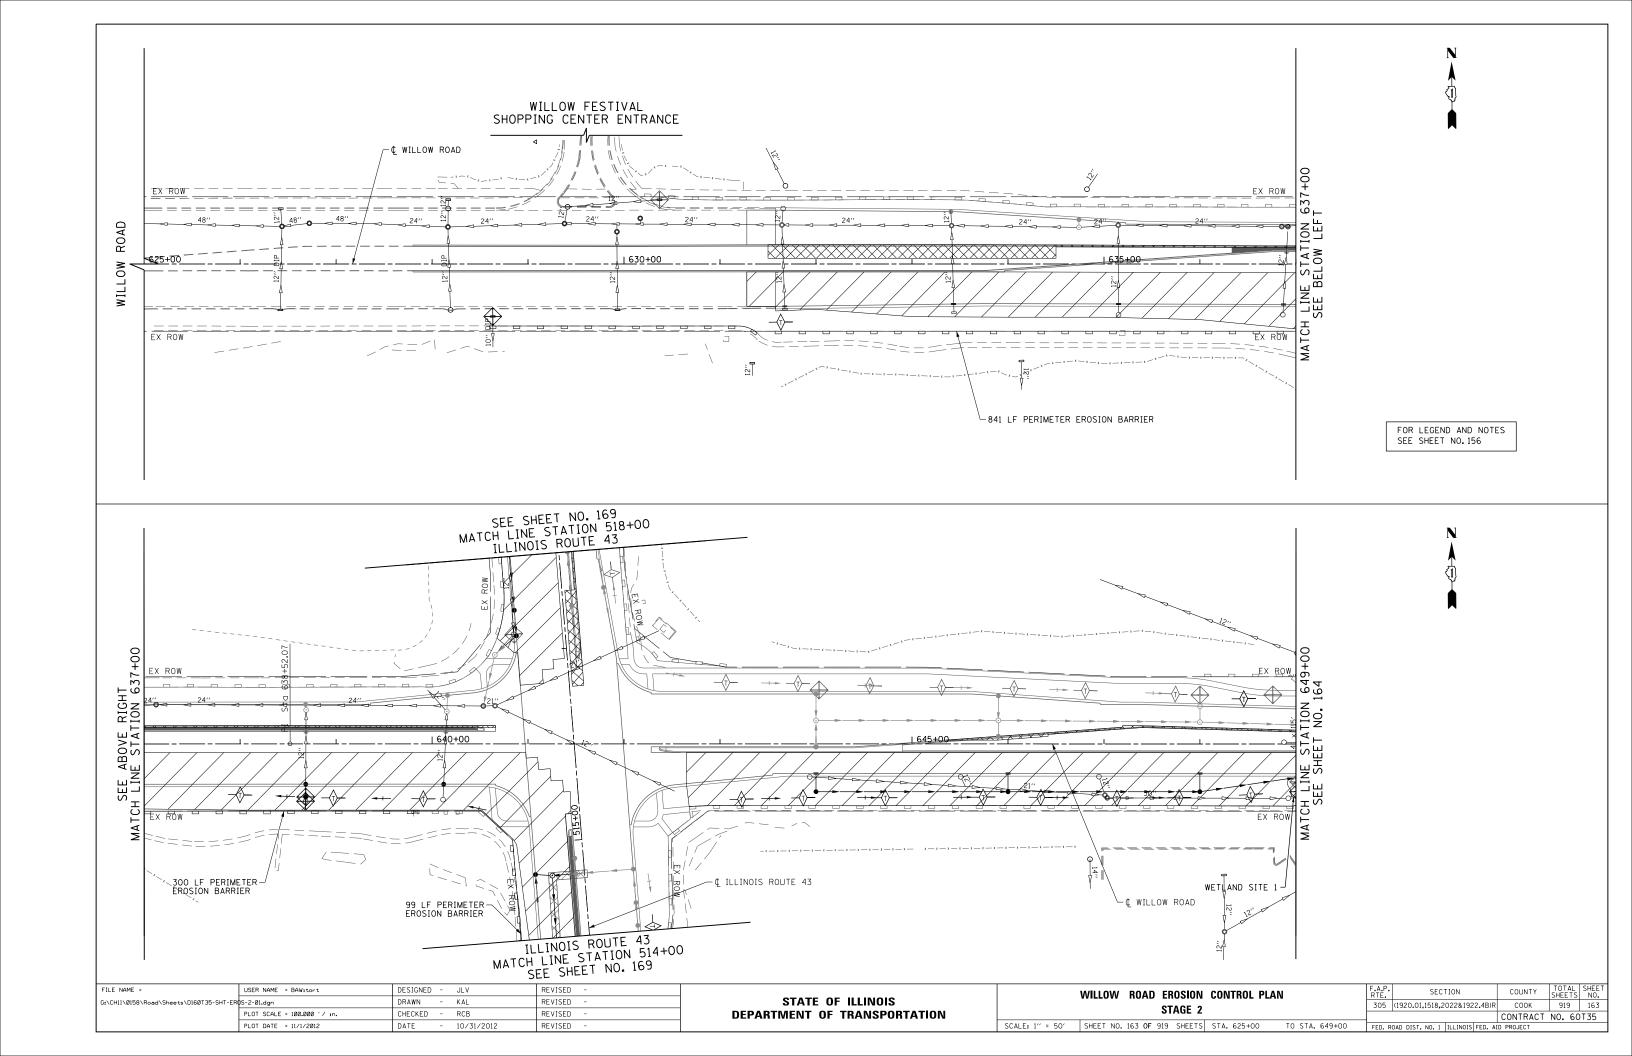

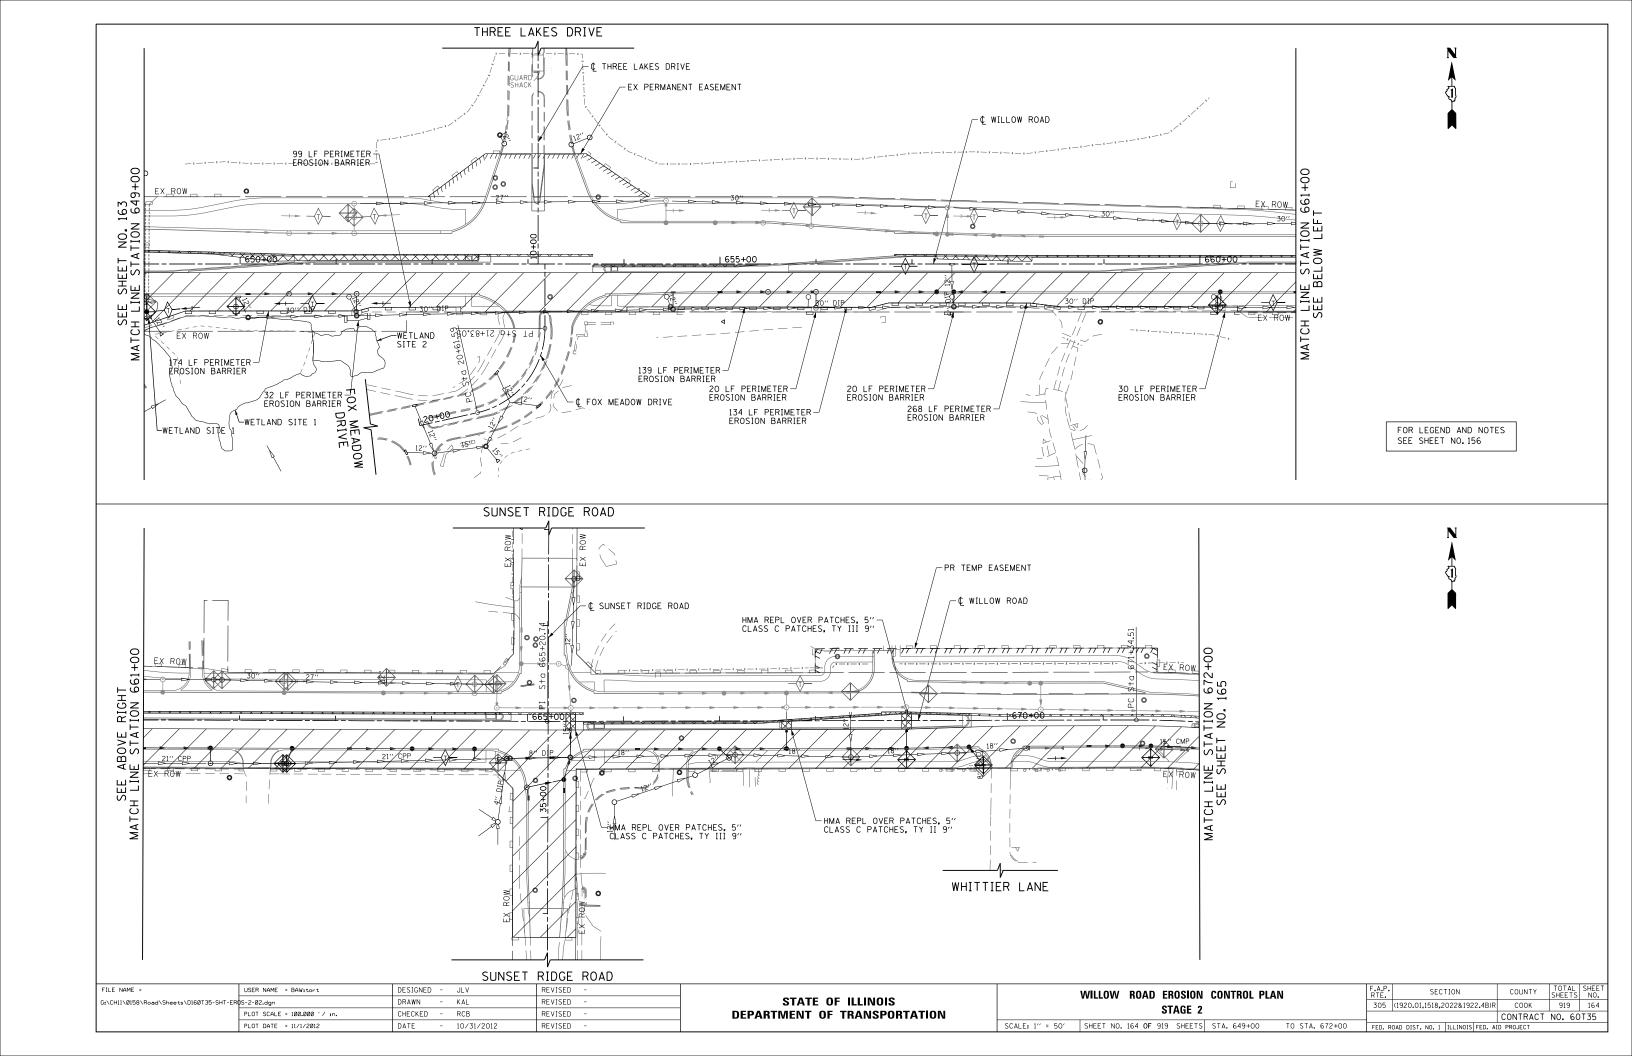


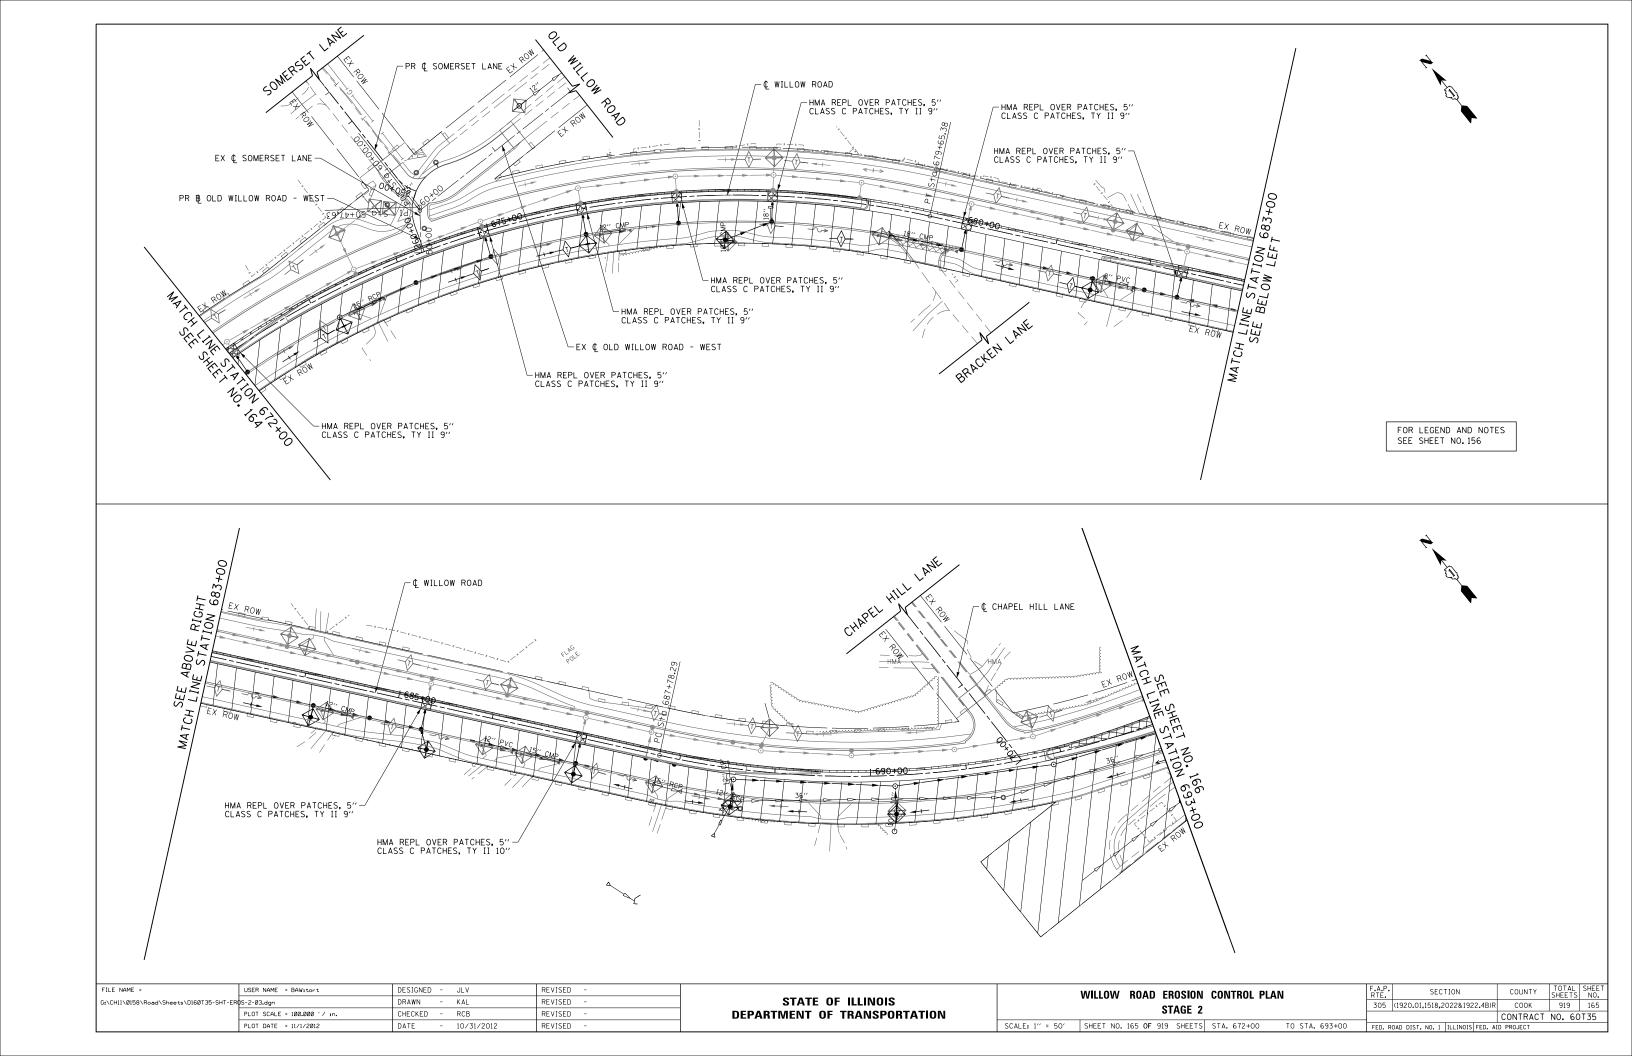


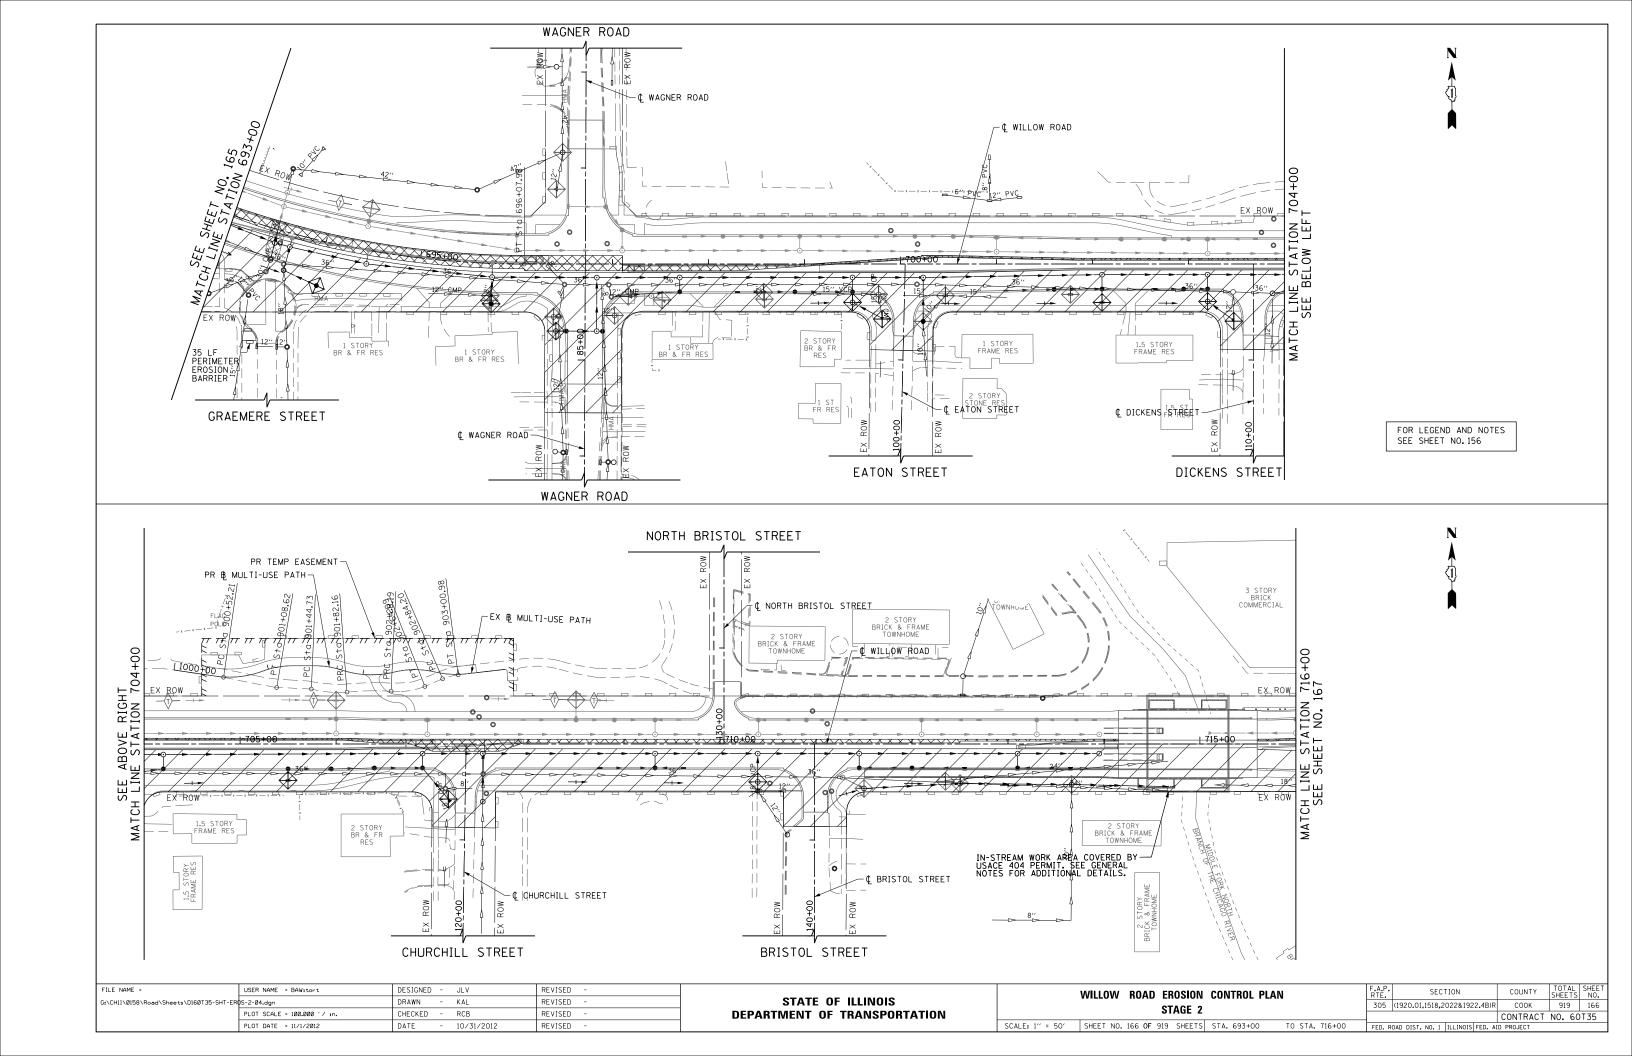


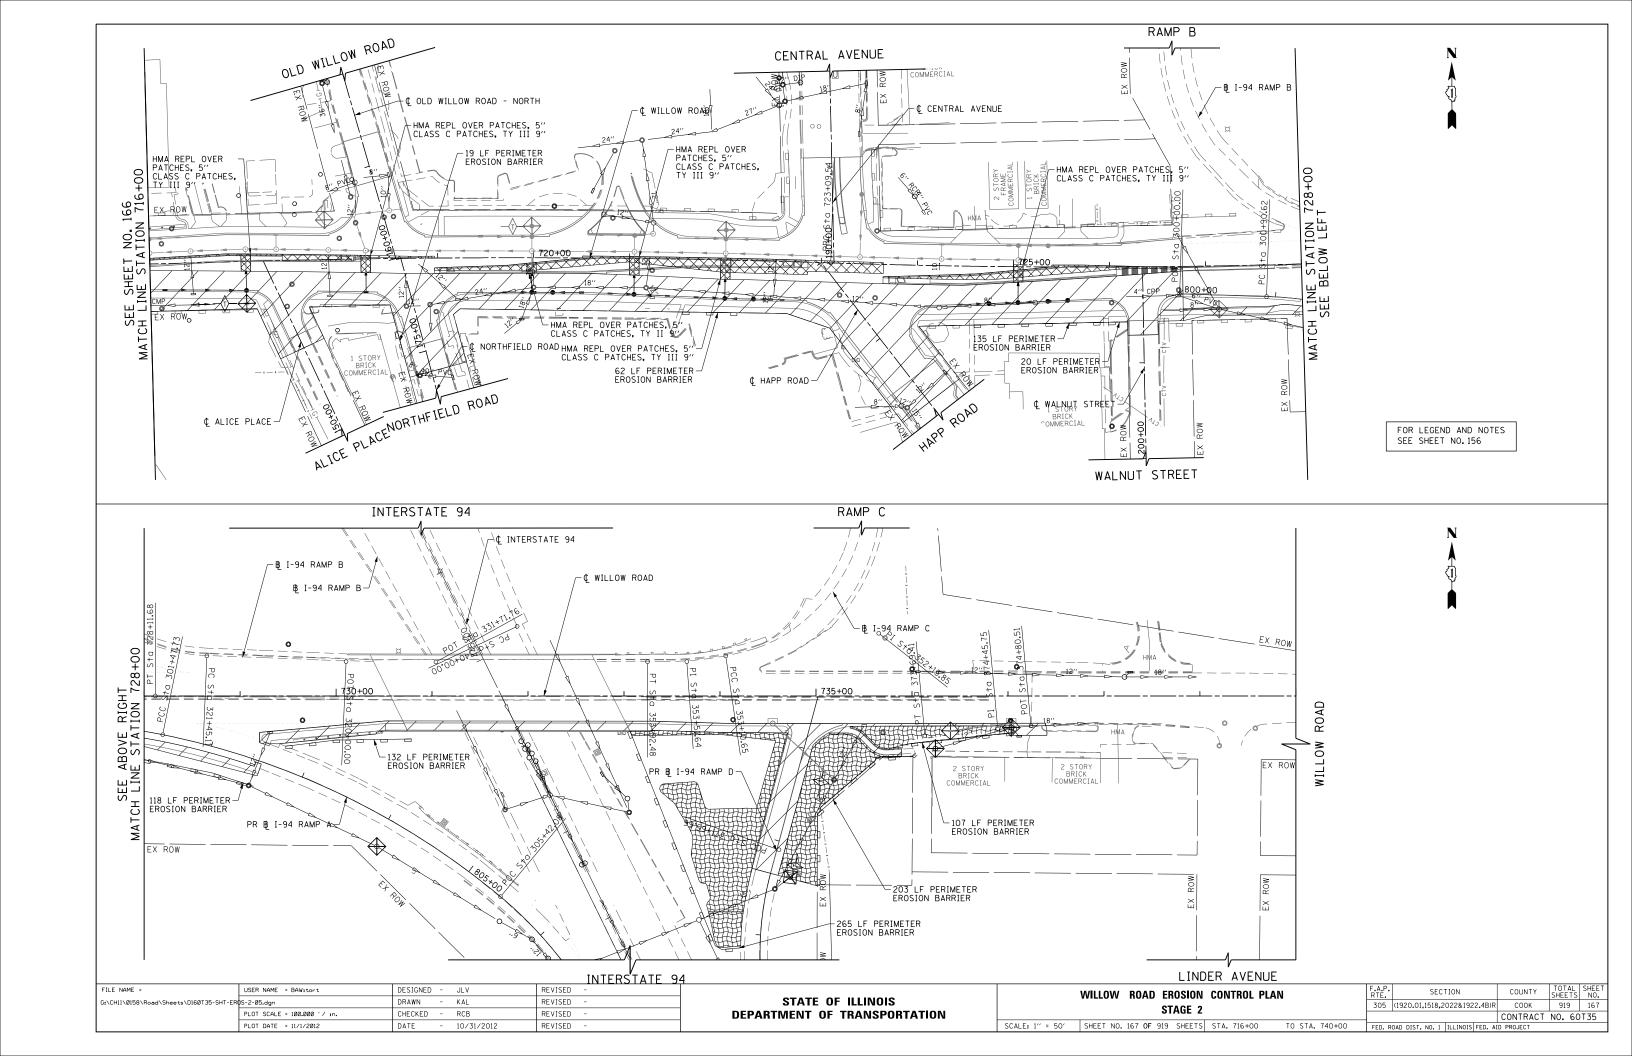


FOR LEGEND AND NOTES SEE SHEET NO.156 WESTLEIGH DRIVE 43 ROUTE ILLINOIS CHRISTIAN HERITAGE ACADEMY ENTRANCE FILE NAME = USER NAME = BAWitort DESIGNED - JLV REVISED STATE OF ILLINOIS DRAWN - KAL REVISED PLOT SCALE = 100.000 '/ in. **DEPARTMENT OF TRANSPORTATION** CHECKED - RCB REVISED PLOT DATE = 11/1/2012 DATE - 10/31/2012 REVISED

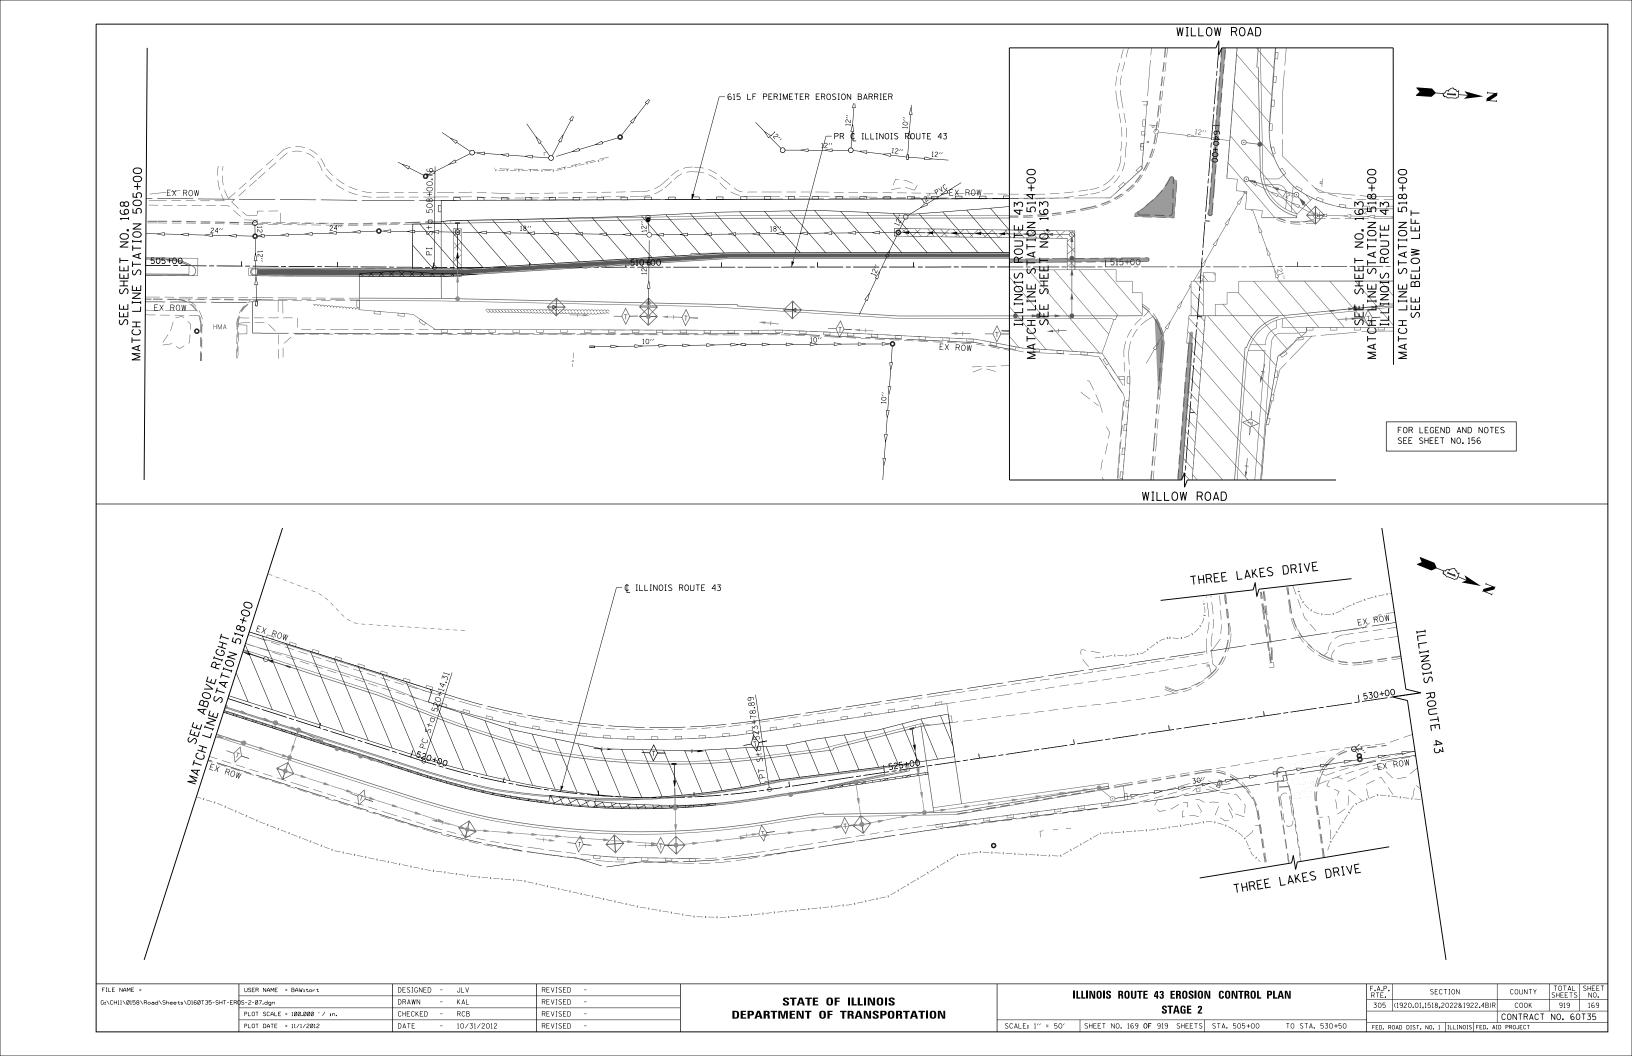


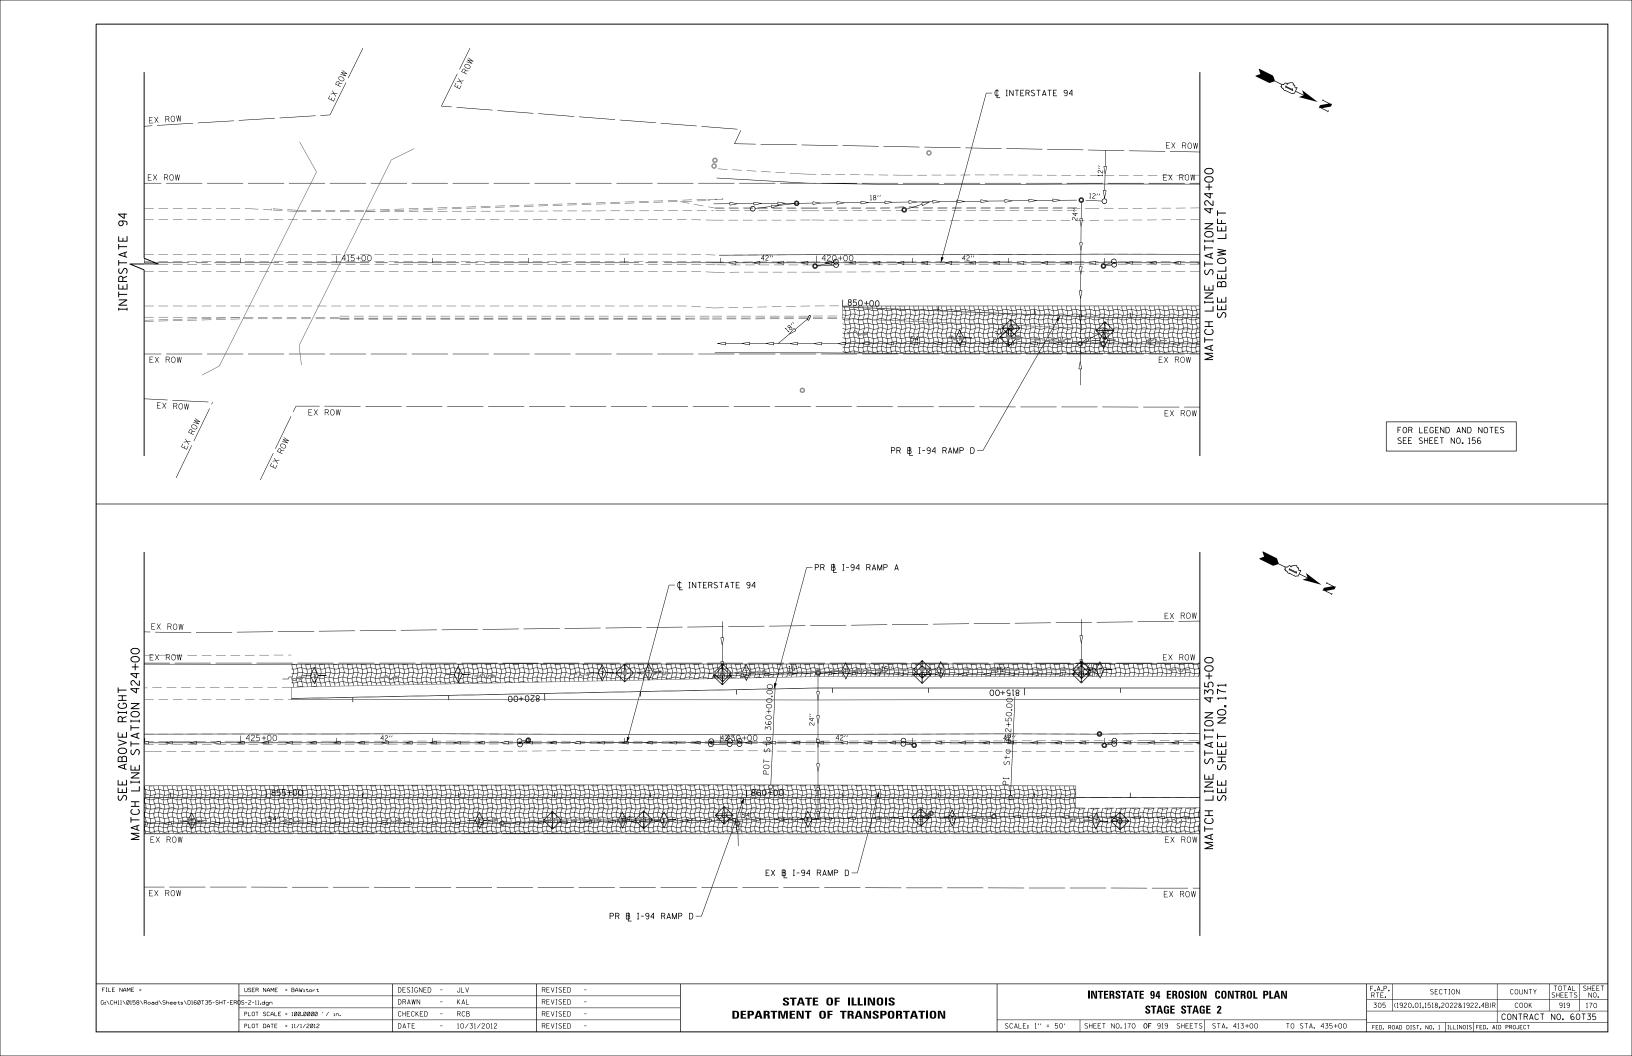


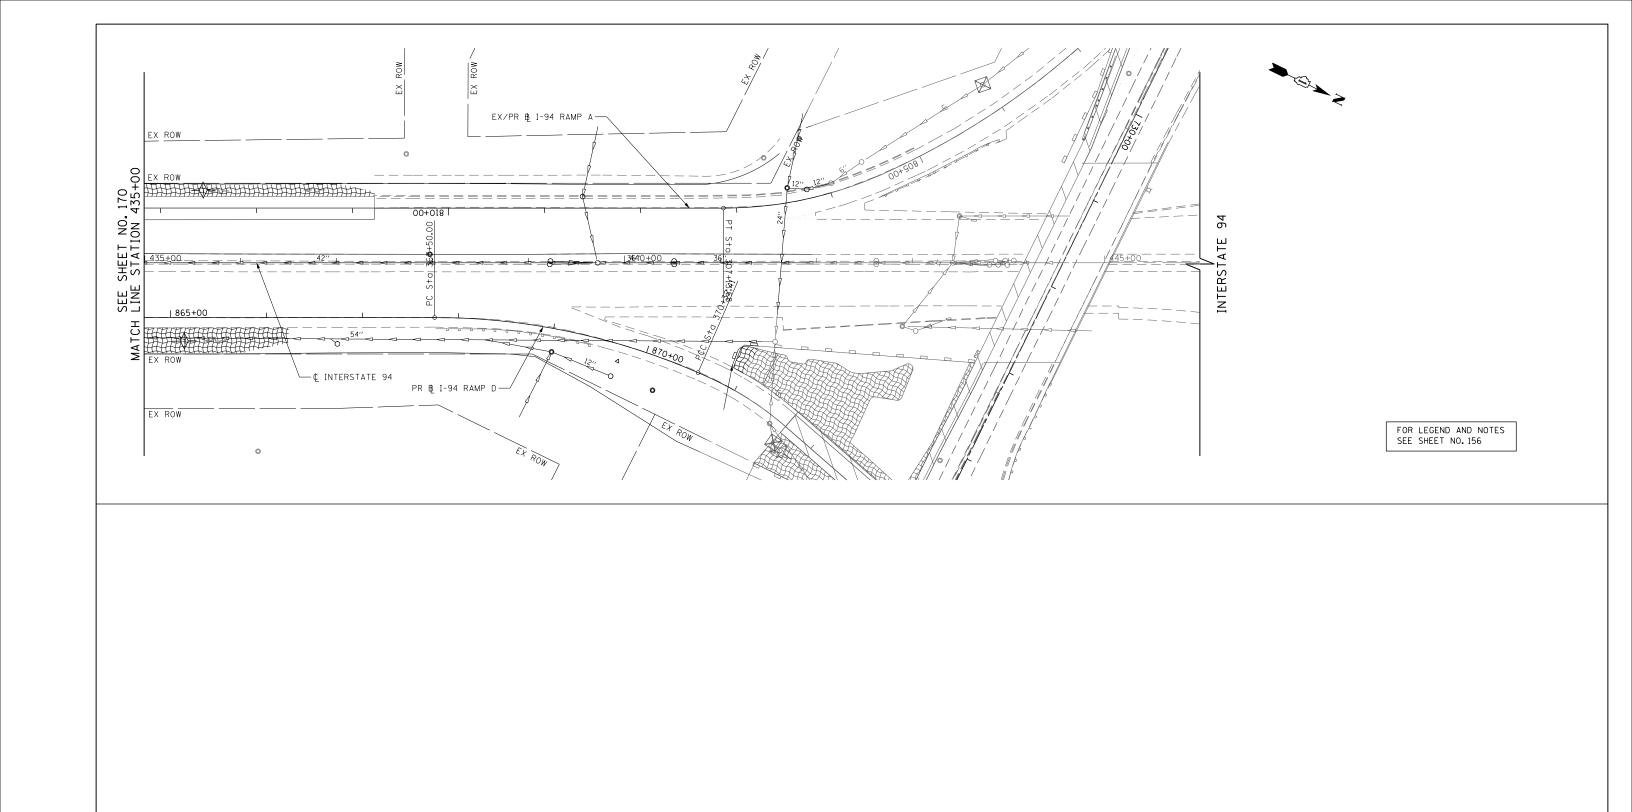



FILE NAME =	USER NAME = BAWitort	DESIGNED - JLV	REVISED -		INTERSTATE 94 EROSION CONTROL PLAN	F.A.P. RTE.	SECTION	COUNTY	TOTAL SHEET SHEETS NO.		
	DS-2-12.dgn	DRAWN - KAL	REVISED -	STATE OF ILLINOIS	STAGE 2	305	(1920.01,1518,2022&1922.4B)R	COOK	919 171		
	PLOT SCALE = 100.0000 '/ in.	CHECKED - RCB	REVISED -	DEPARTMENT OF TRANSPORTATION	STAUL Z		CONTRACT NO. 60T35				
	PLOT DATE = 11/1/2012	DATE - 10/31/2012	REVISED -		SCALE: 1" = 50' SHEET NO.171 OF 919 SHEETS STA. 435+00 TO STA. 446+00	FED. R	FED. ROAD DIST. NO. 1 ILLINOIS FED. AID PROJECT				

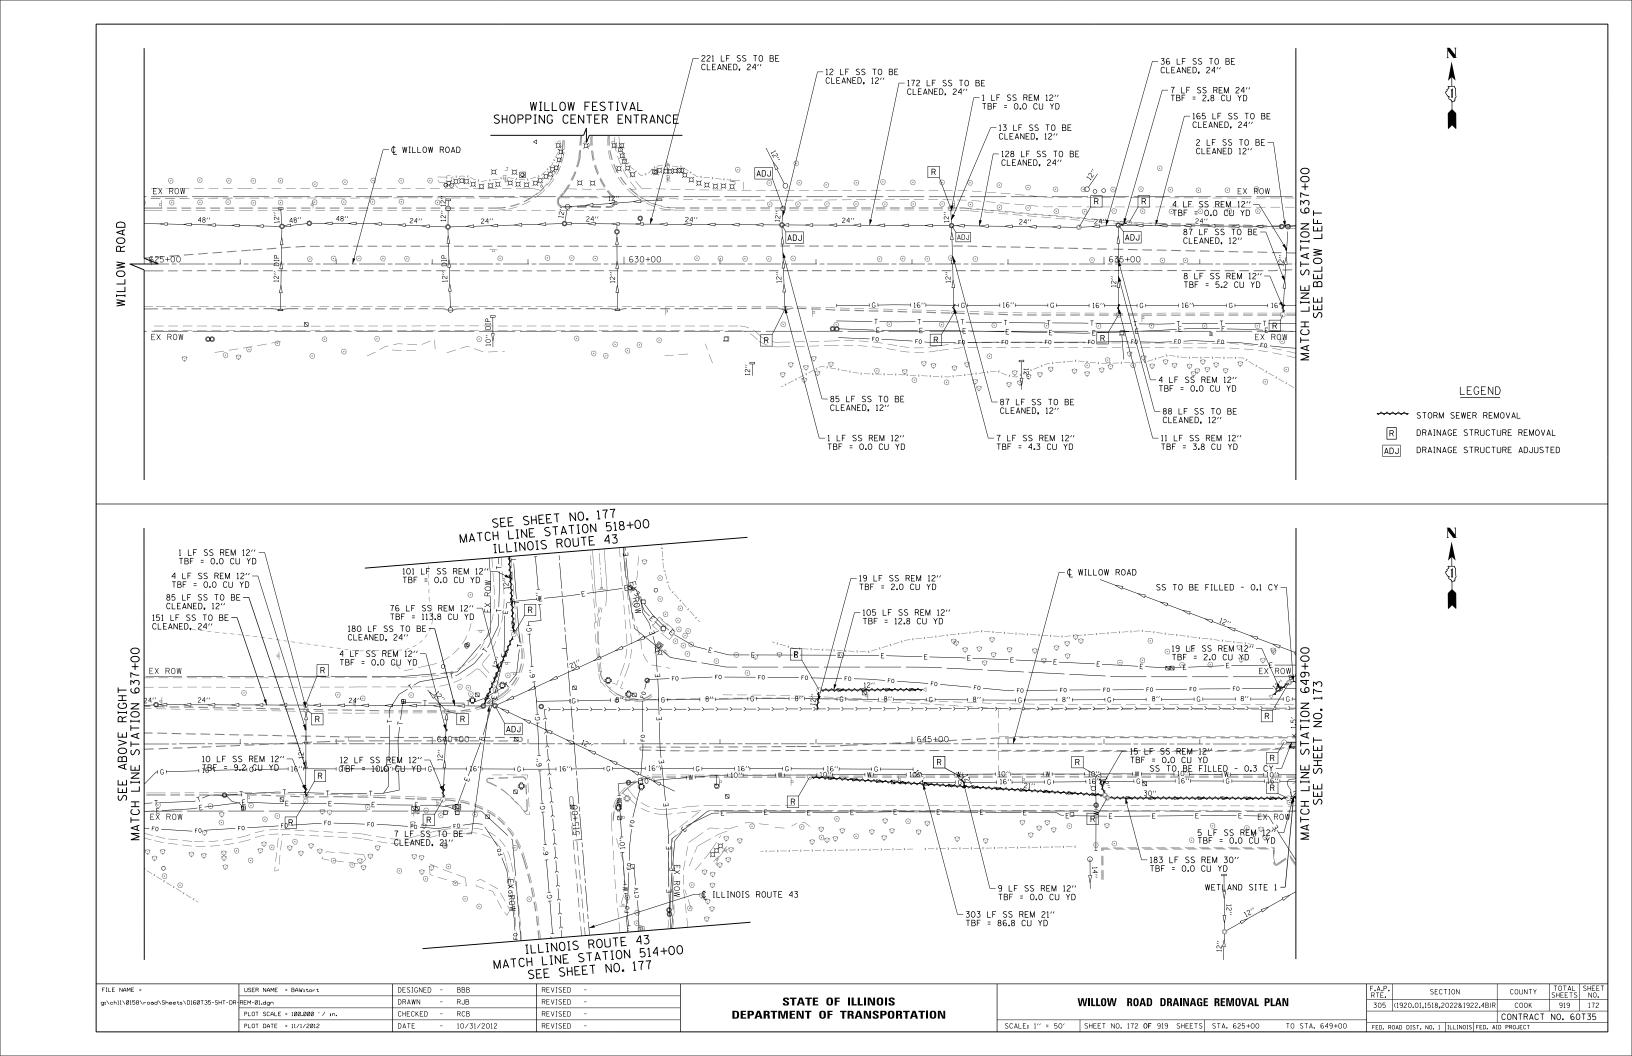


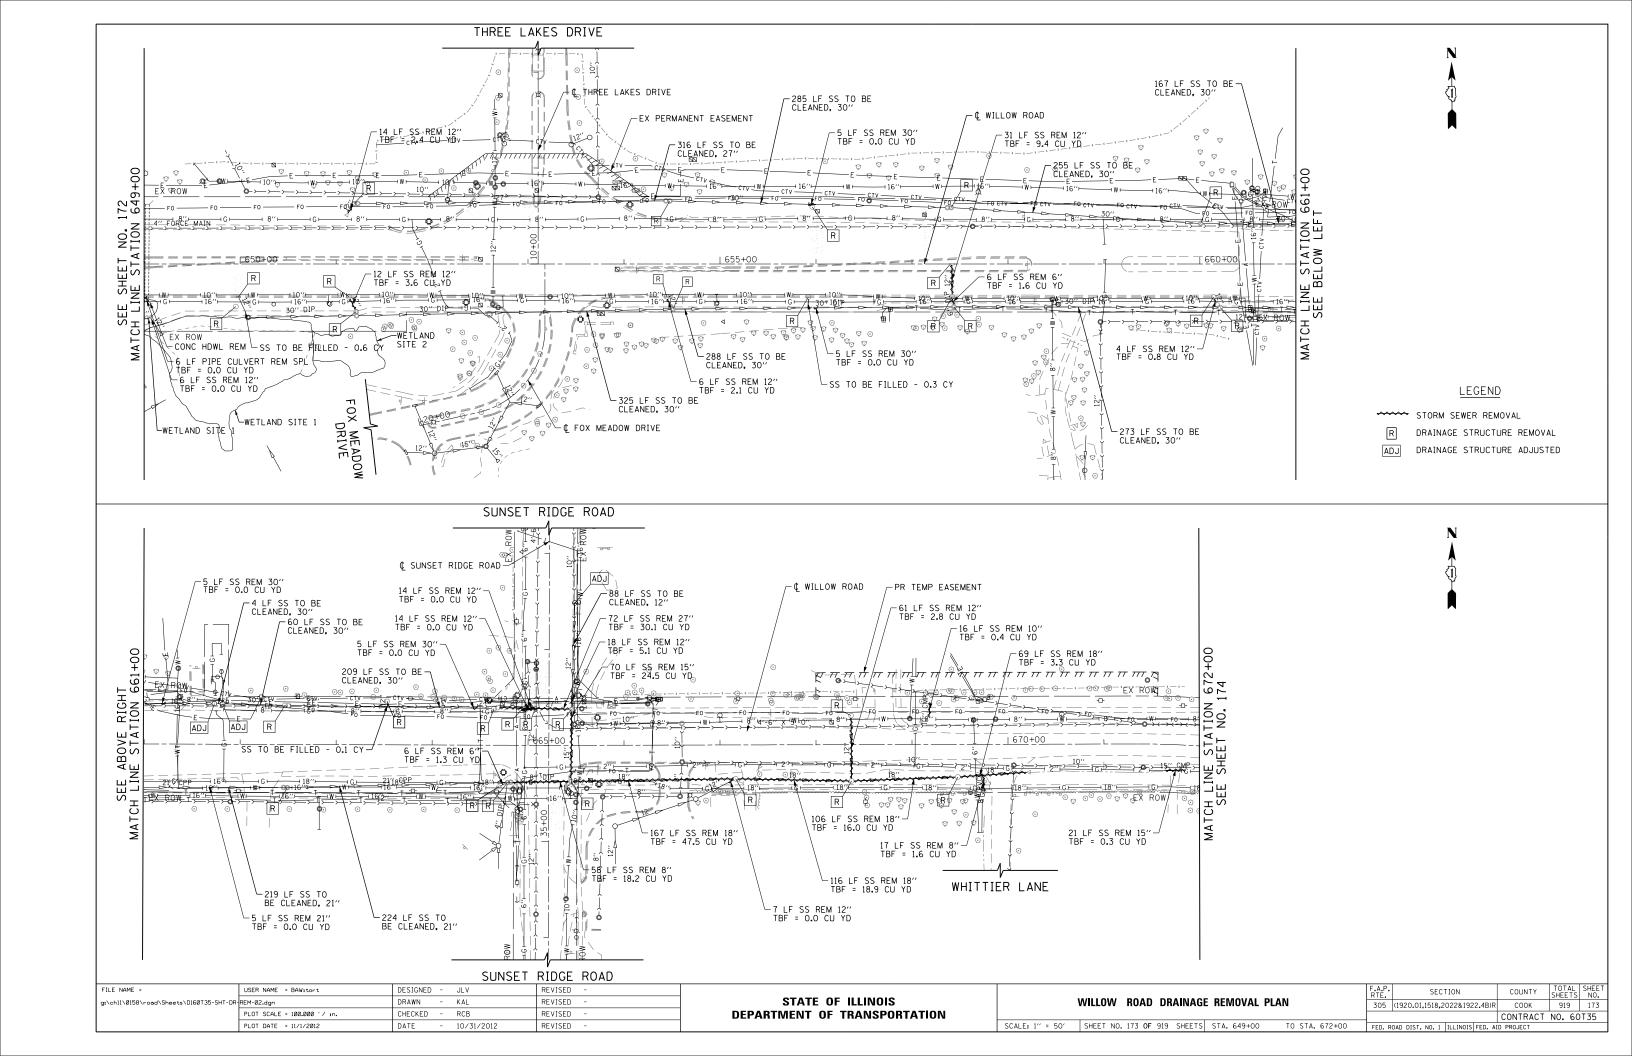


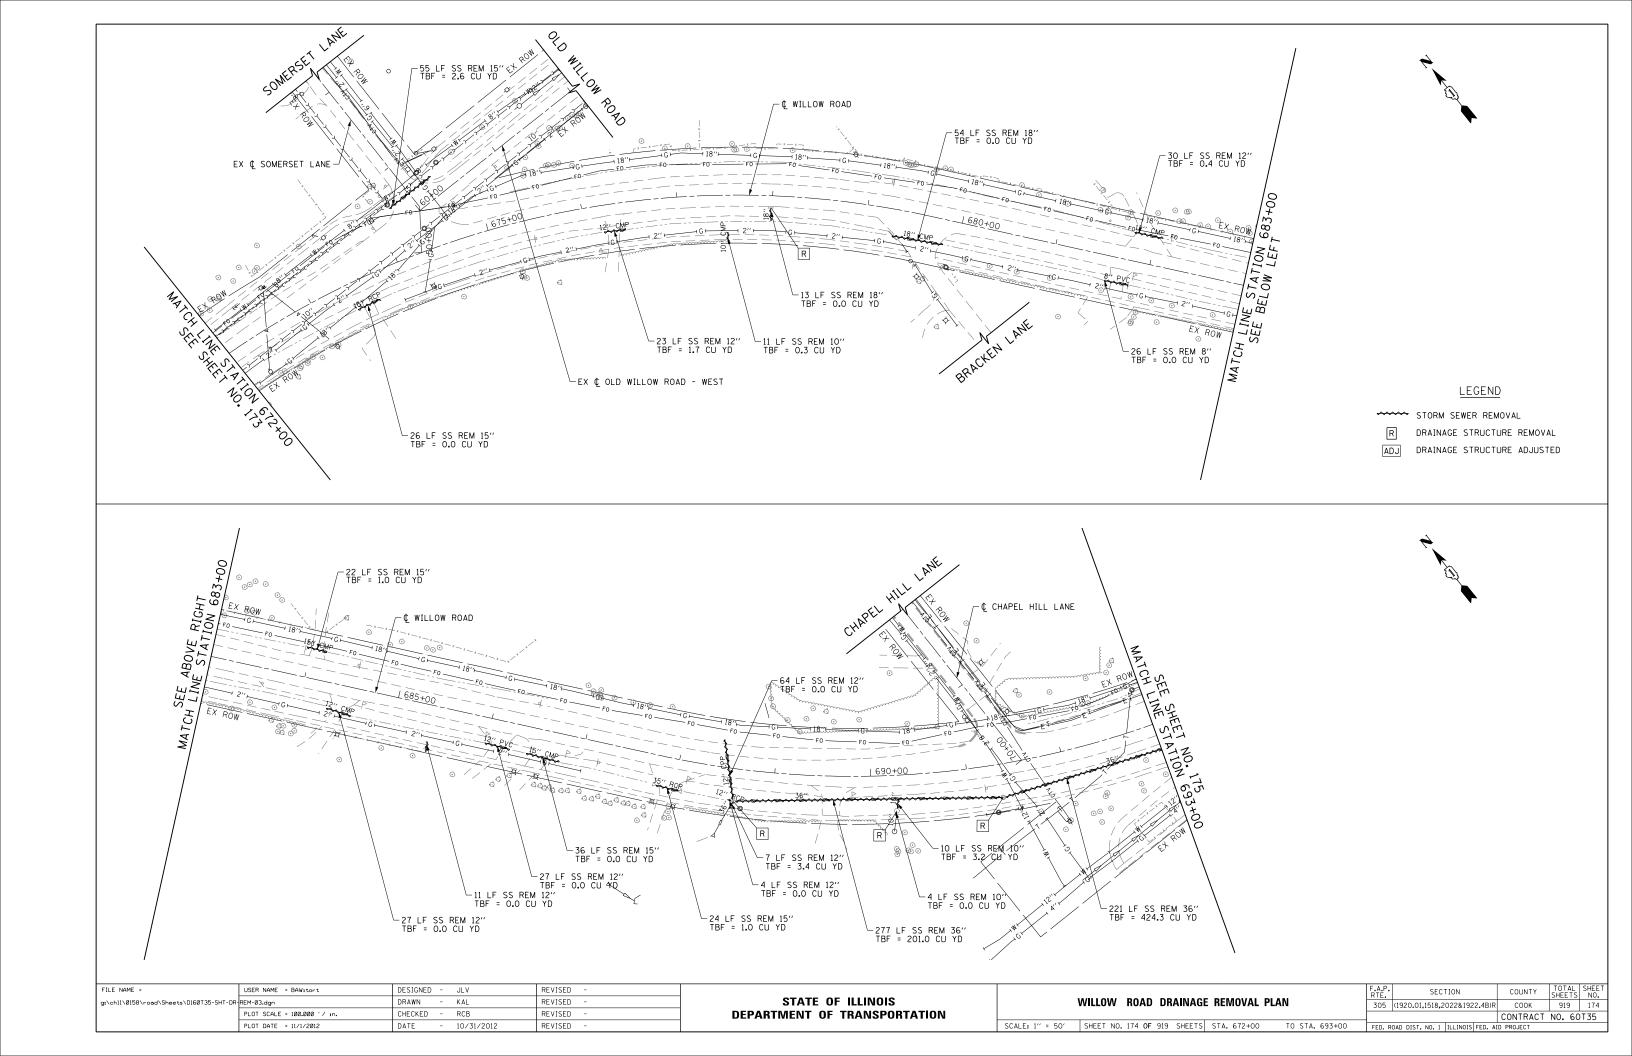


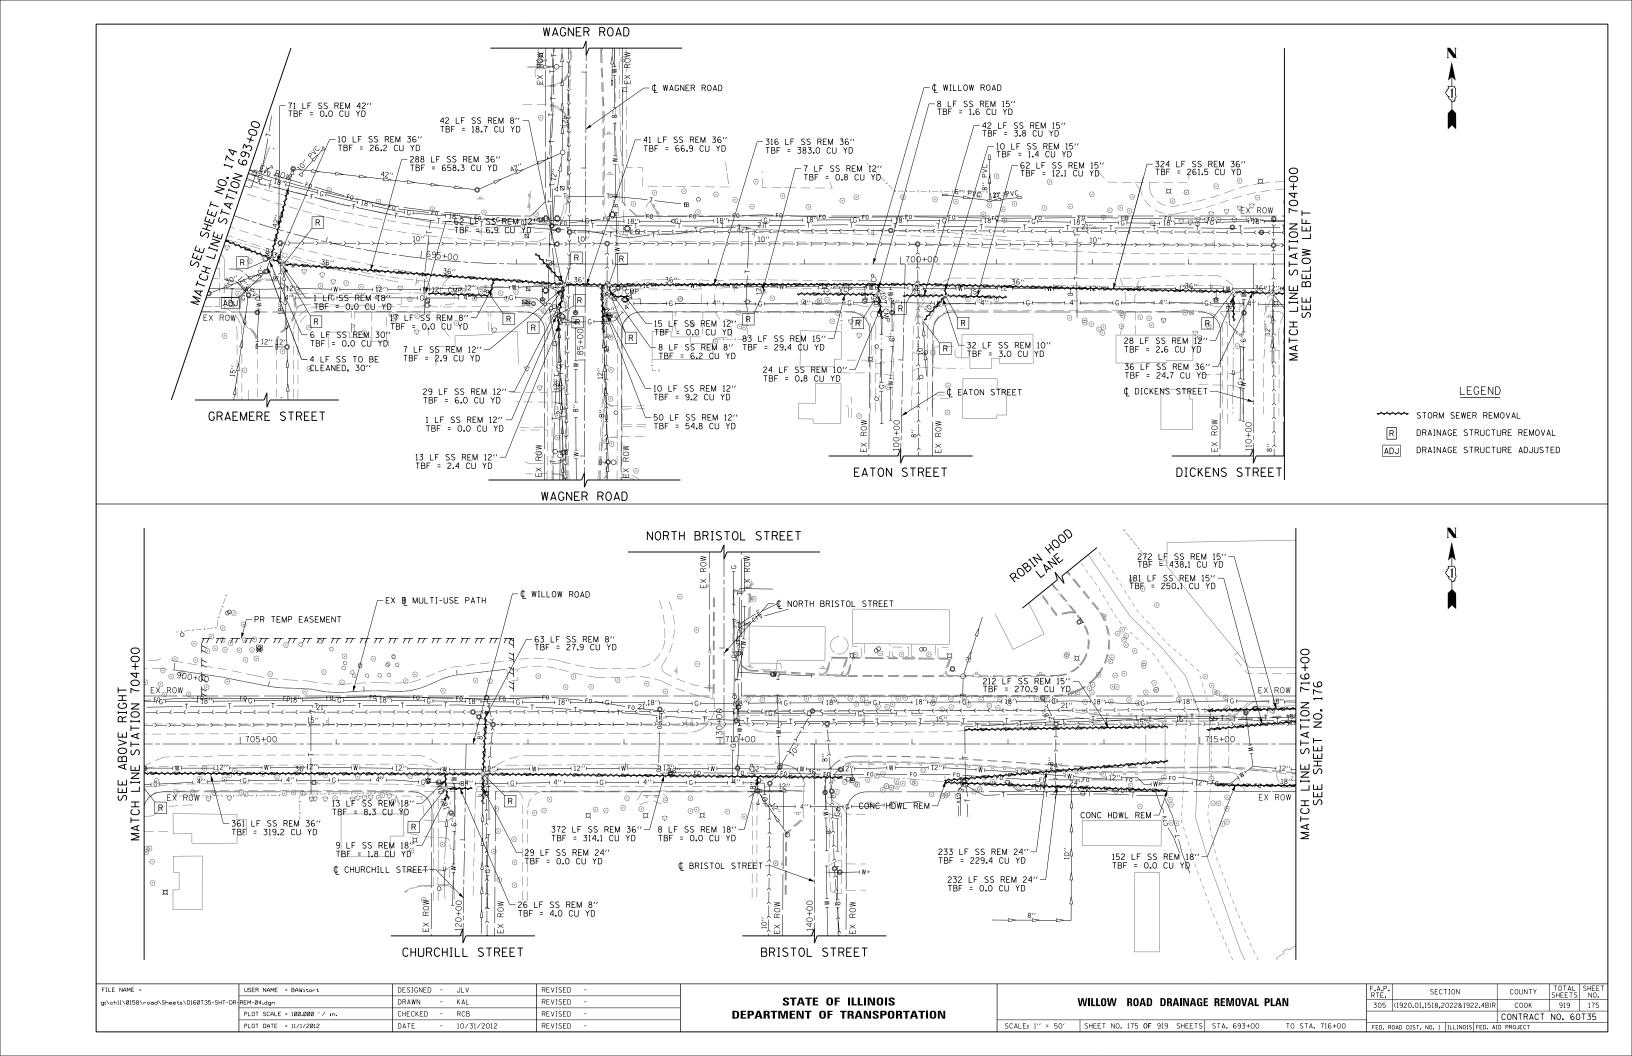


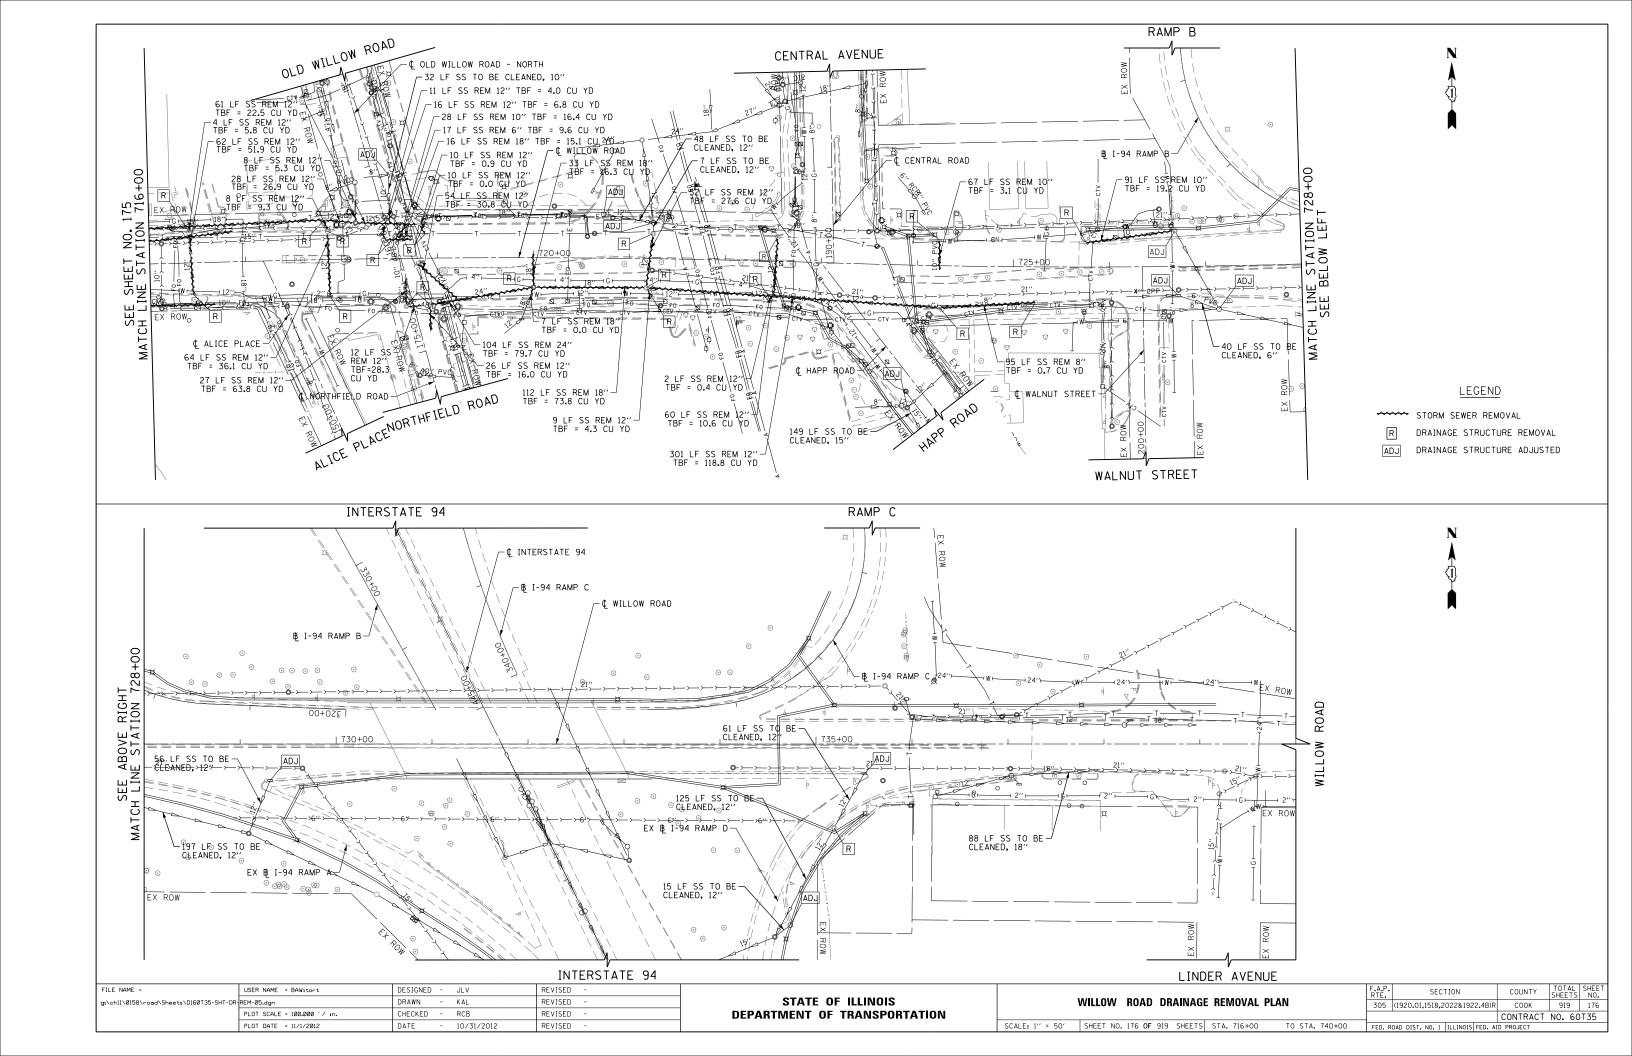


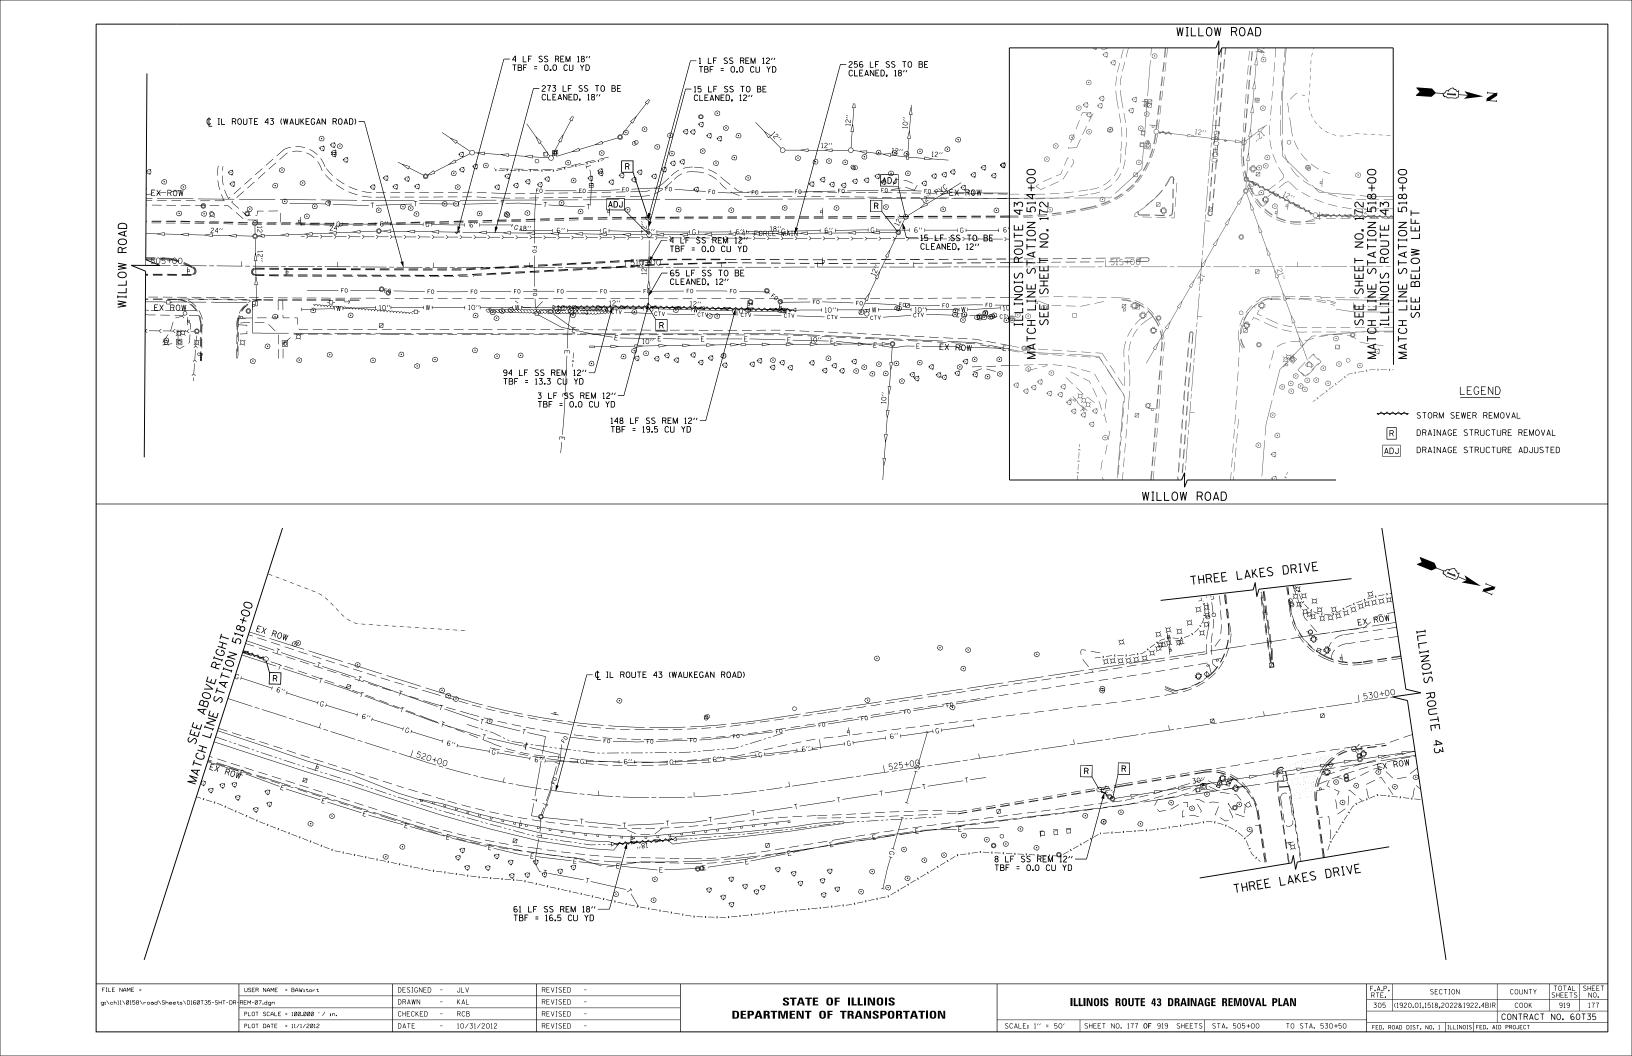


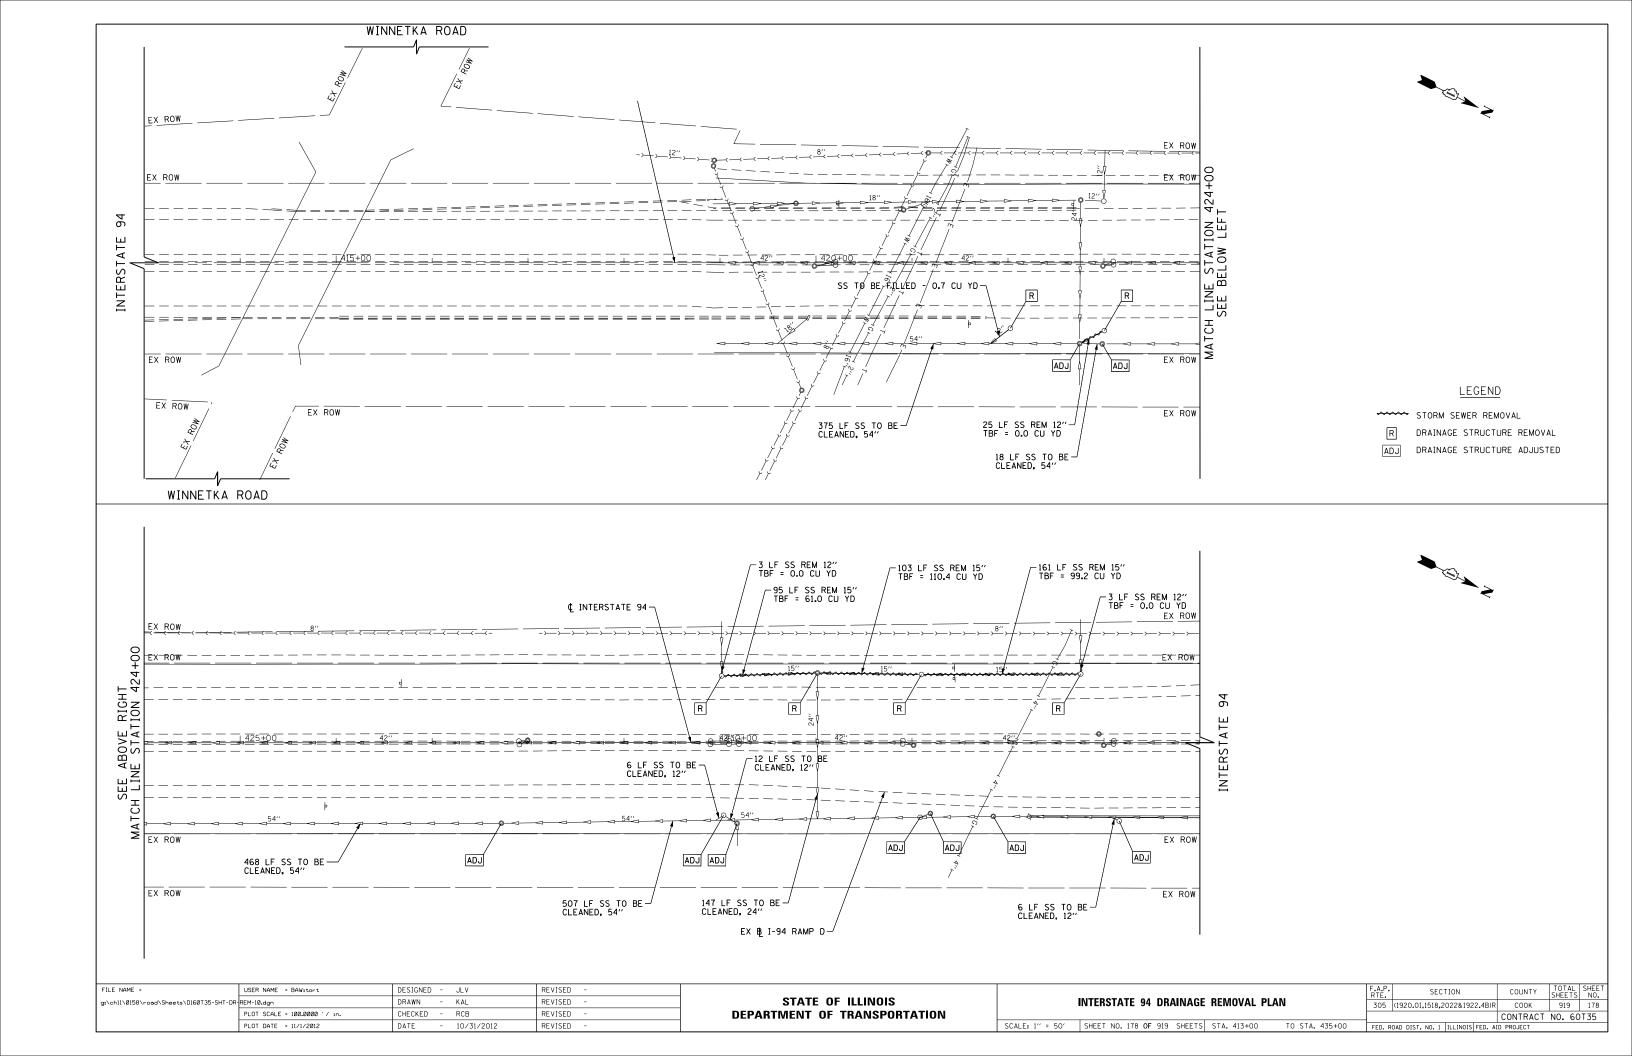


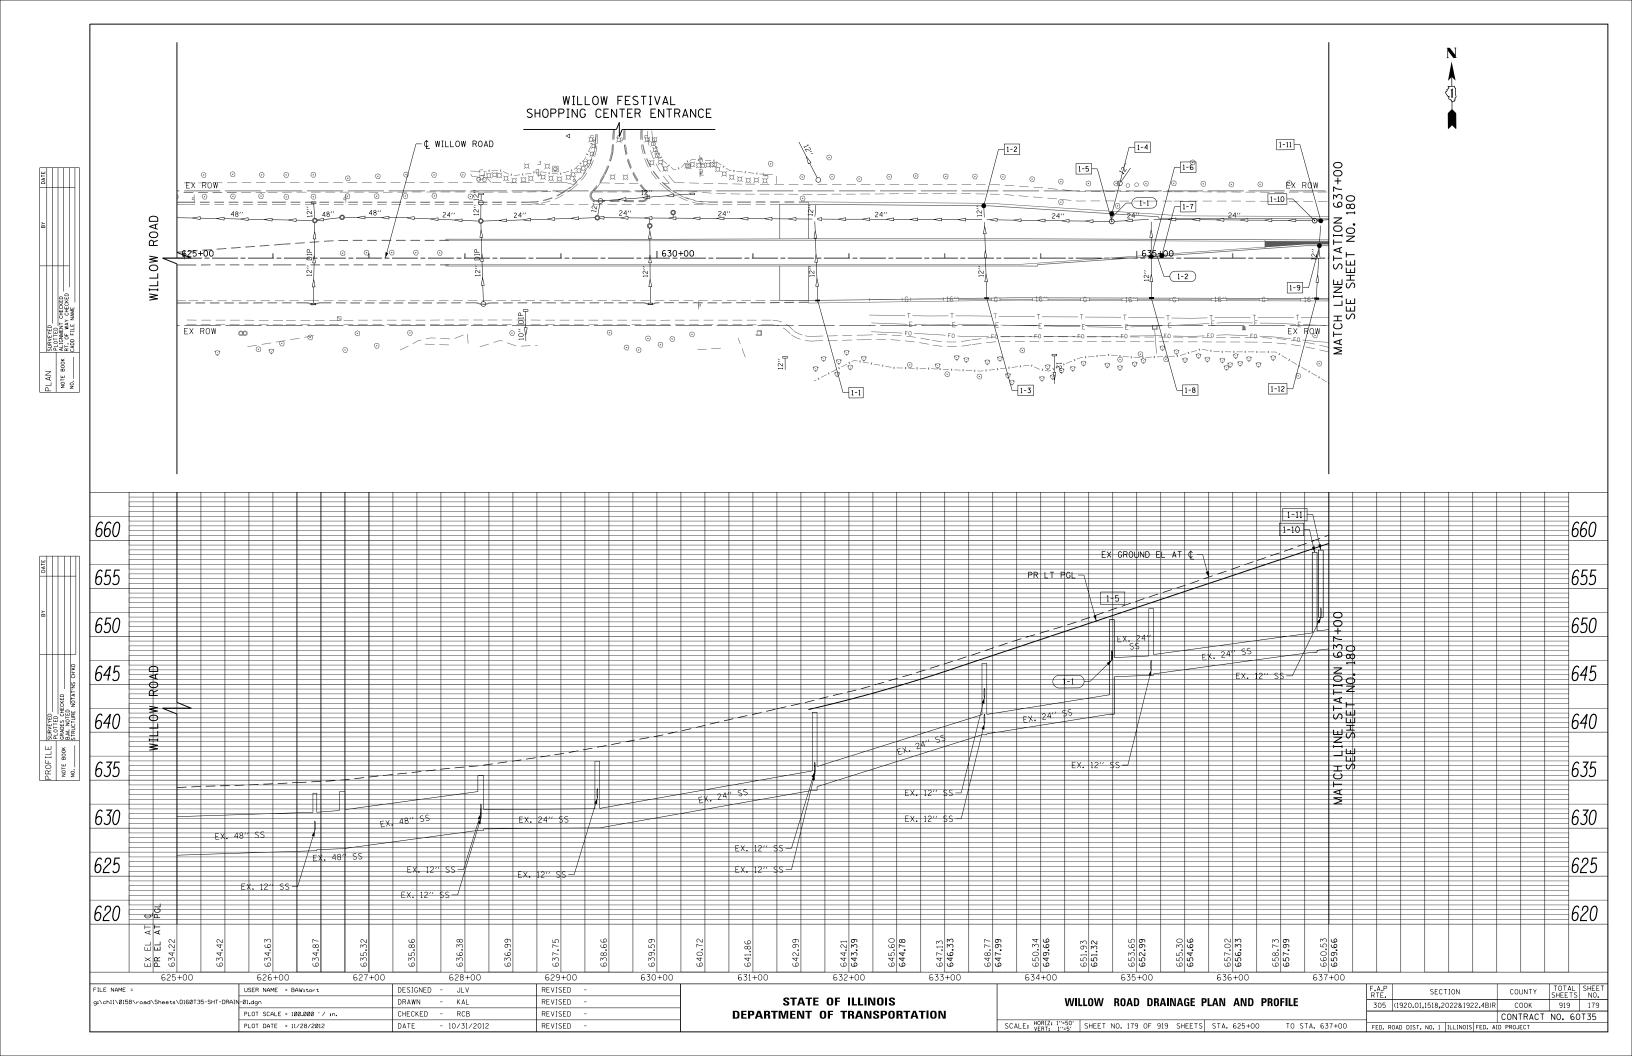


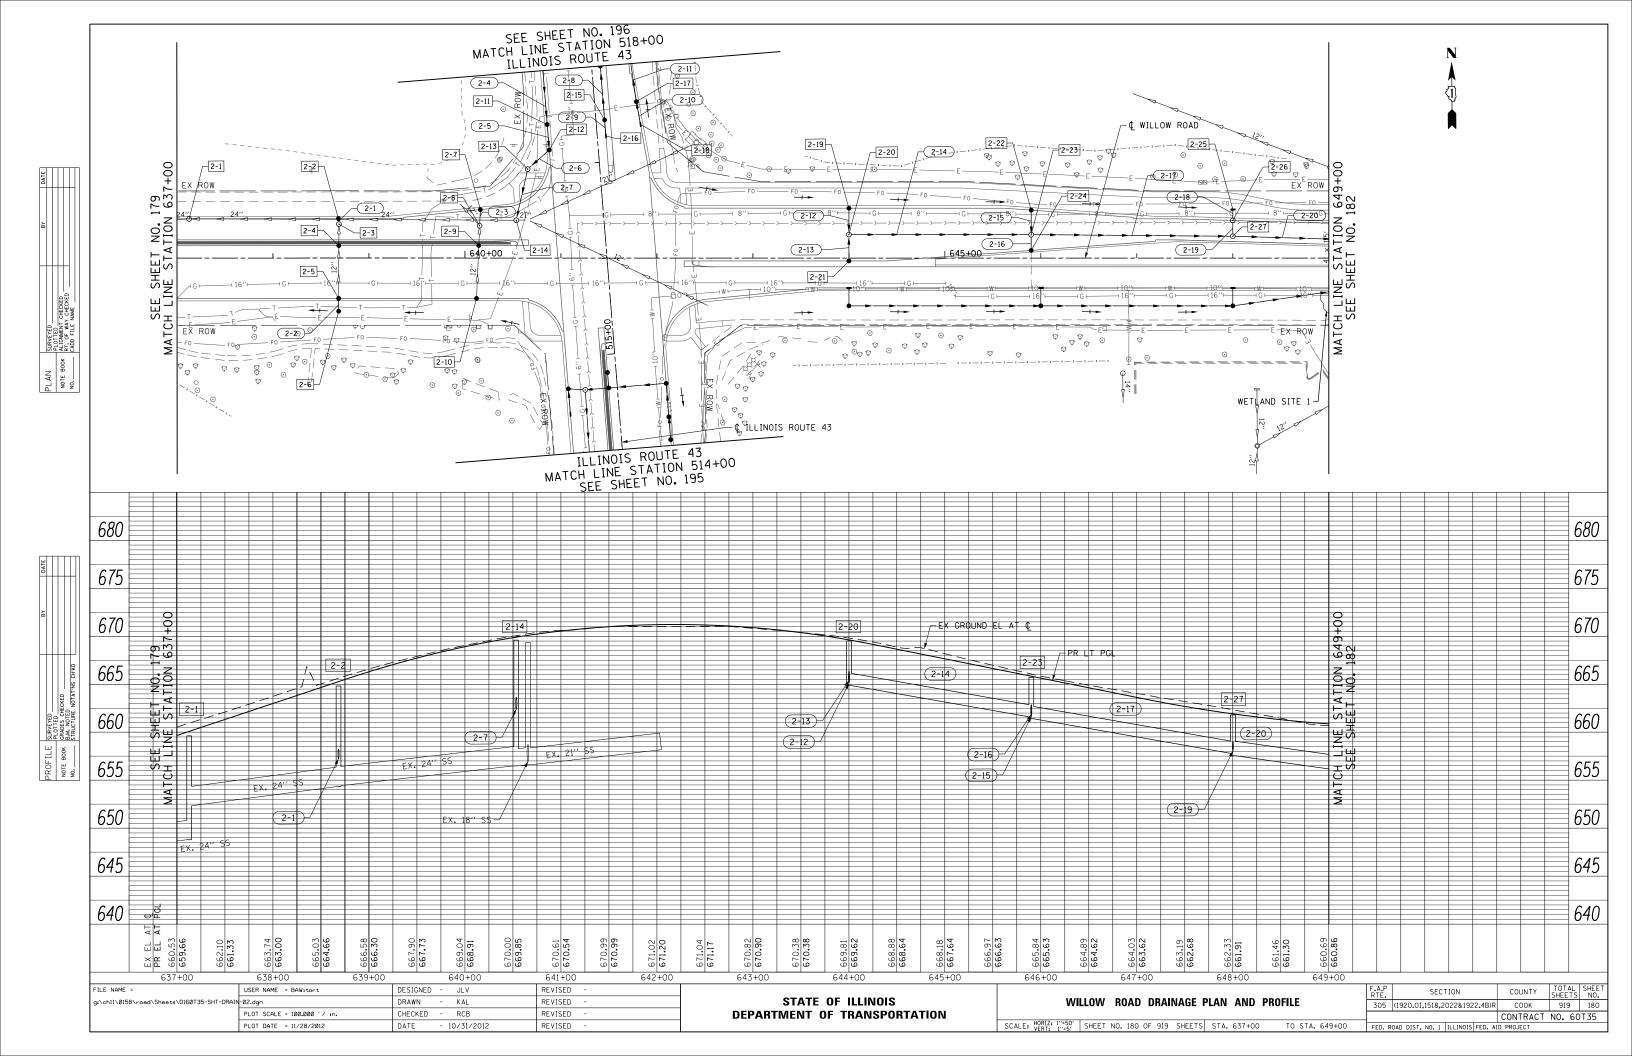


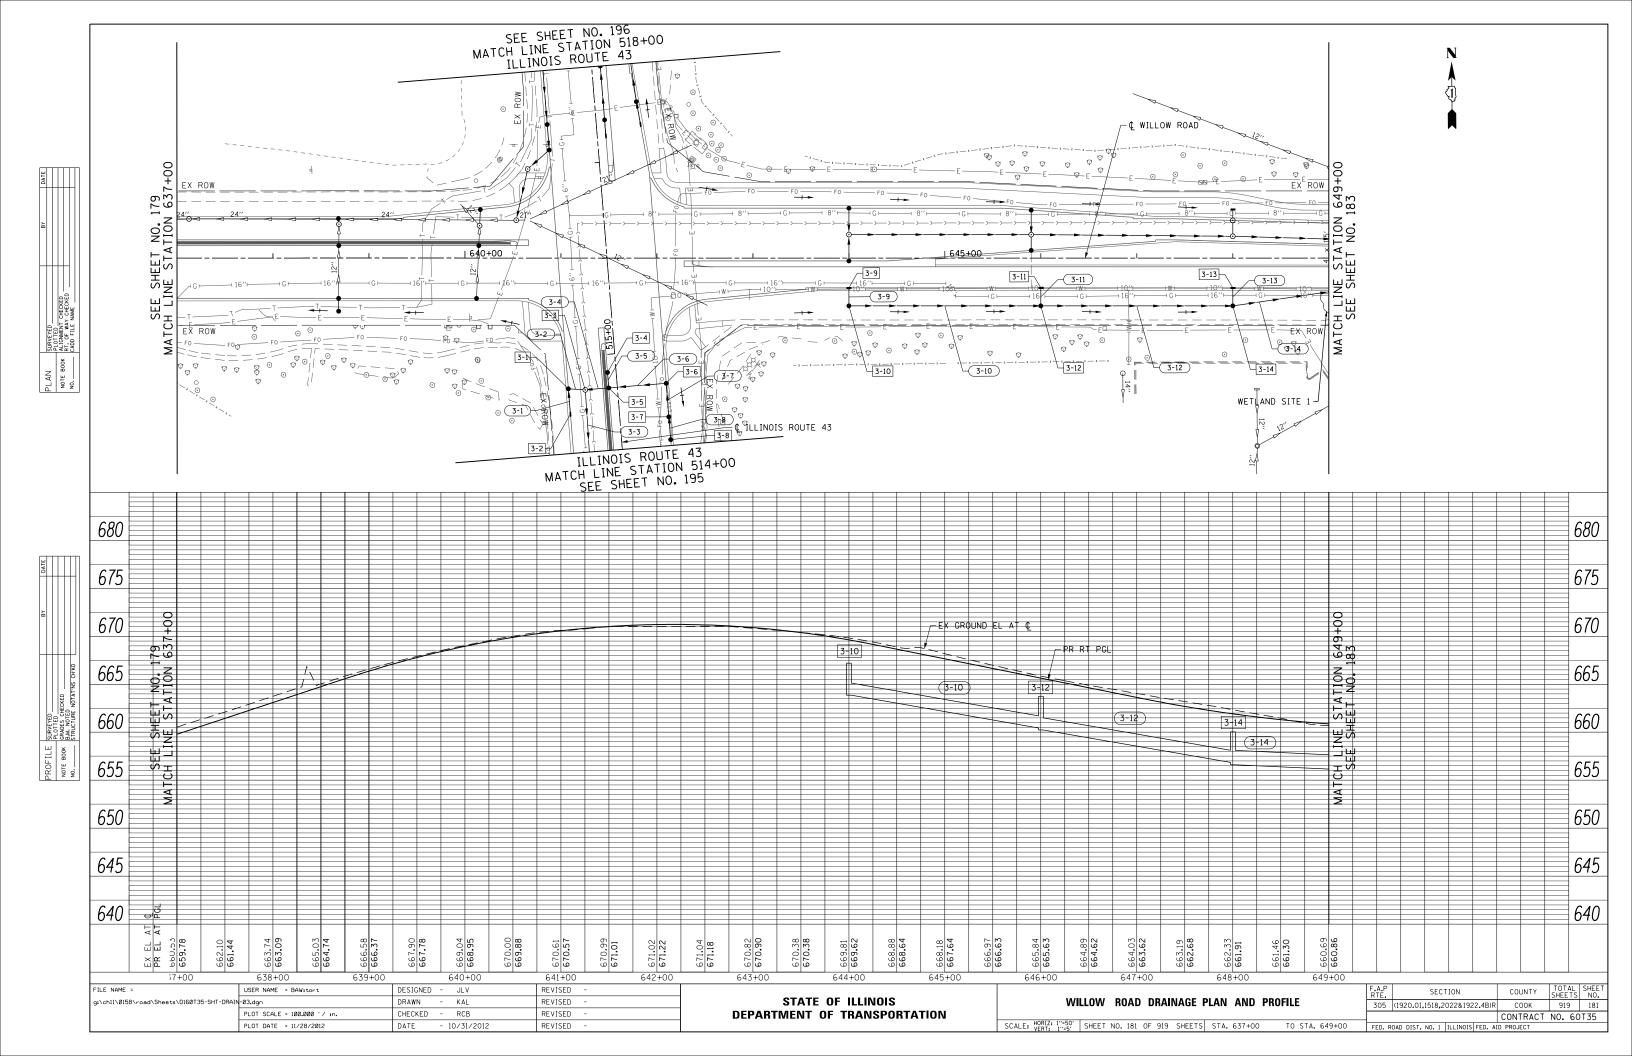


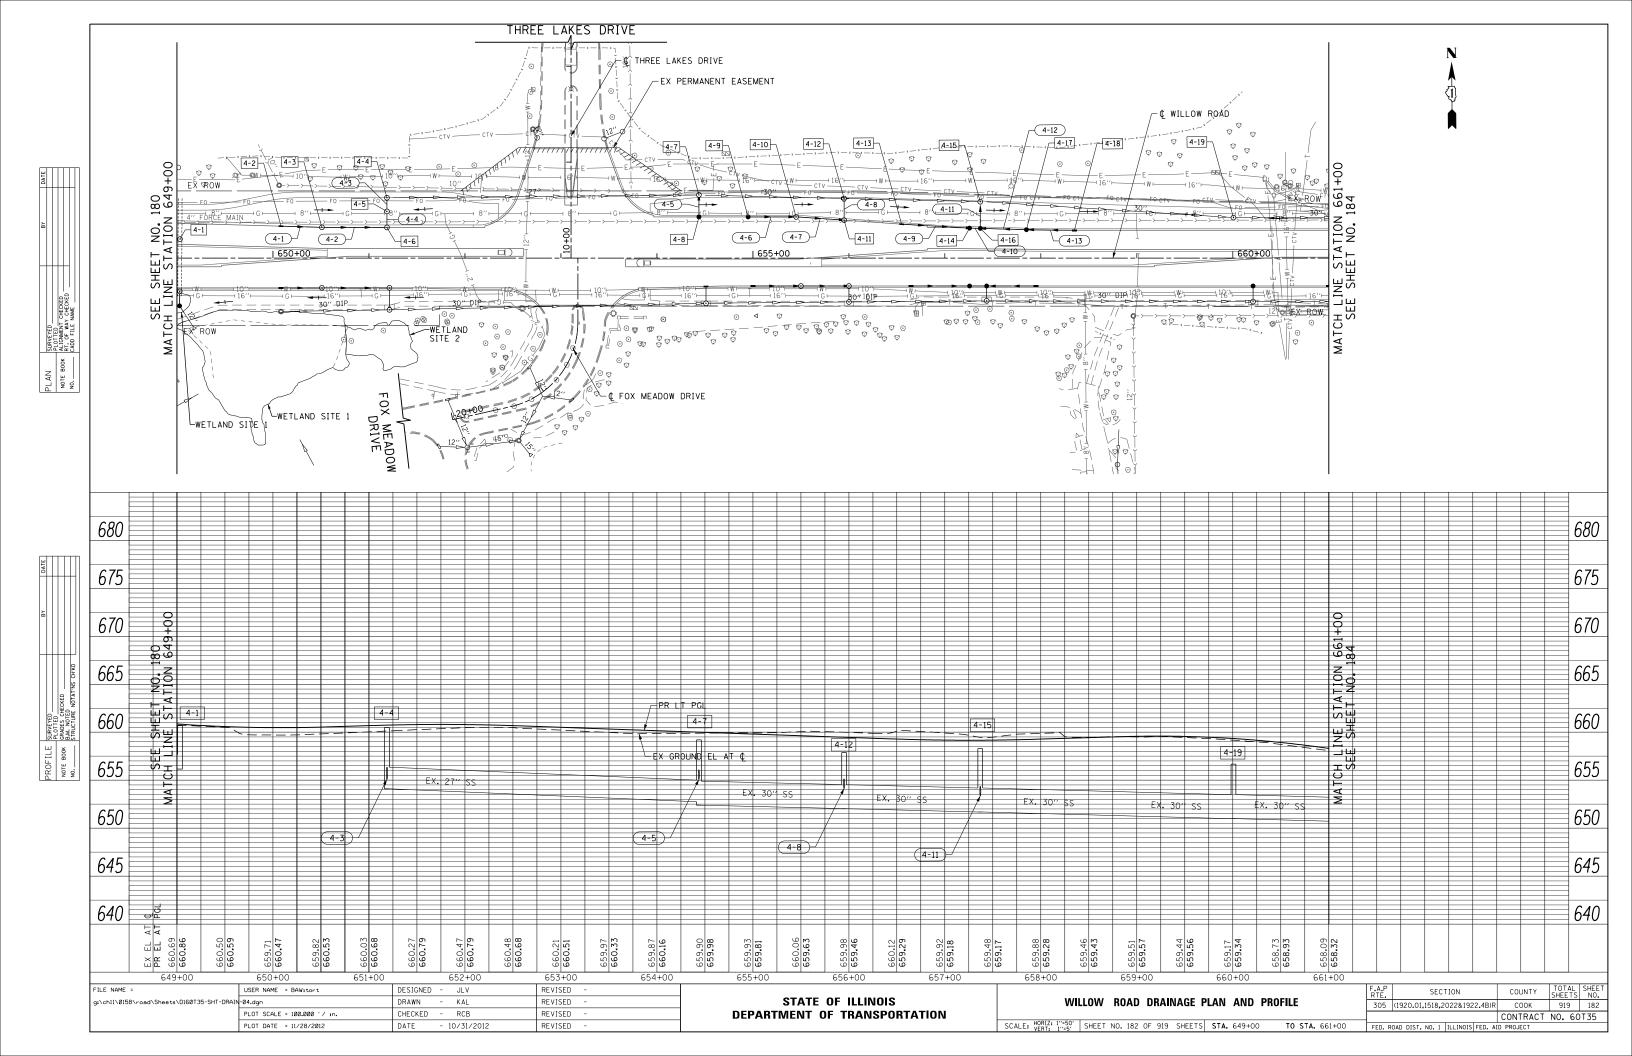


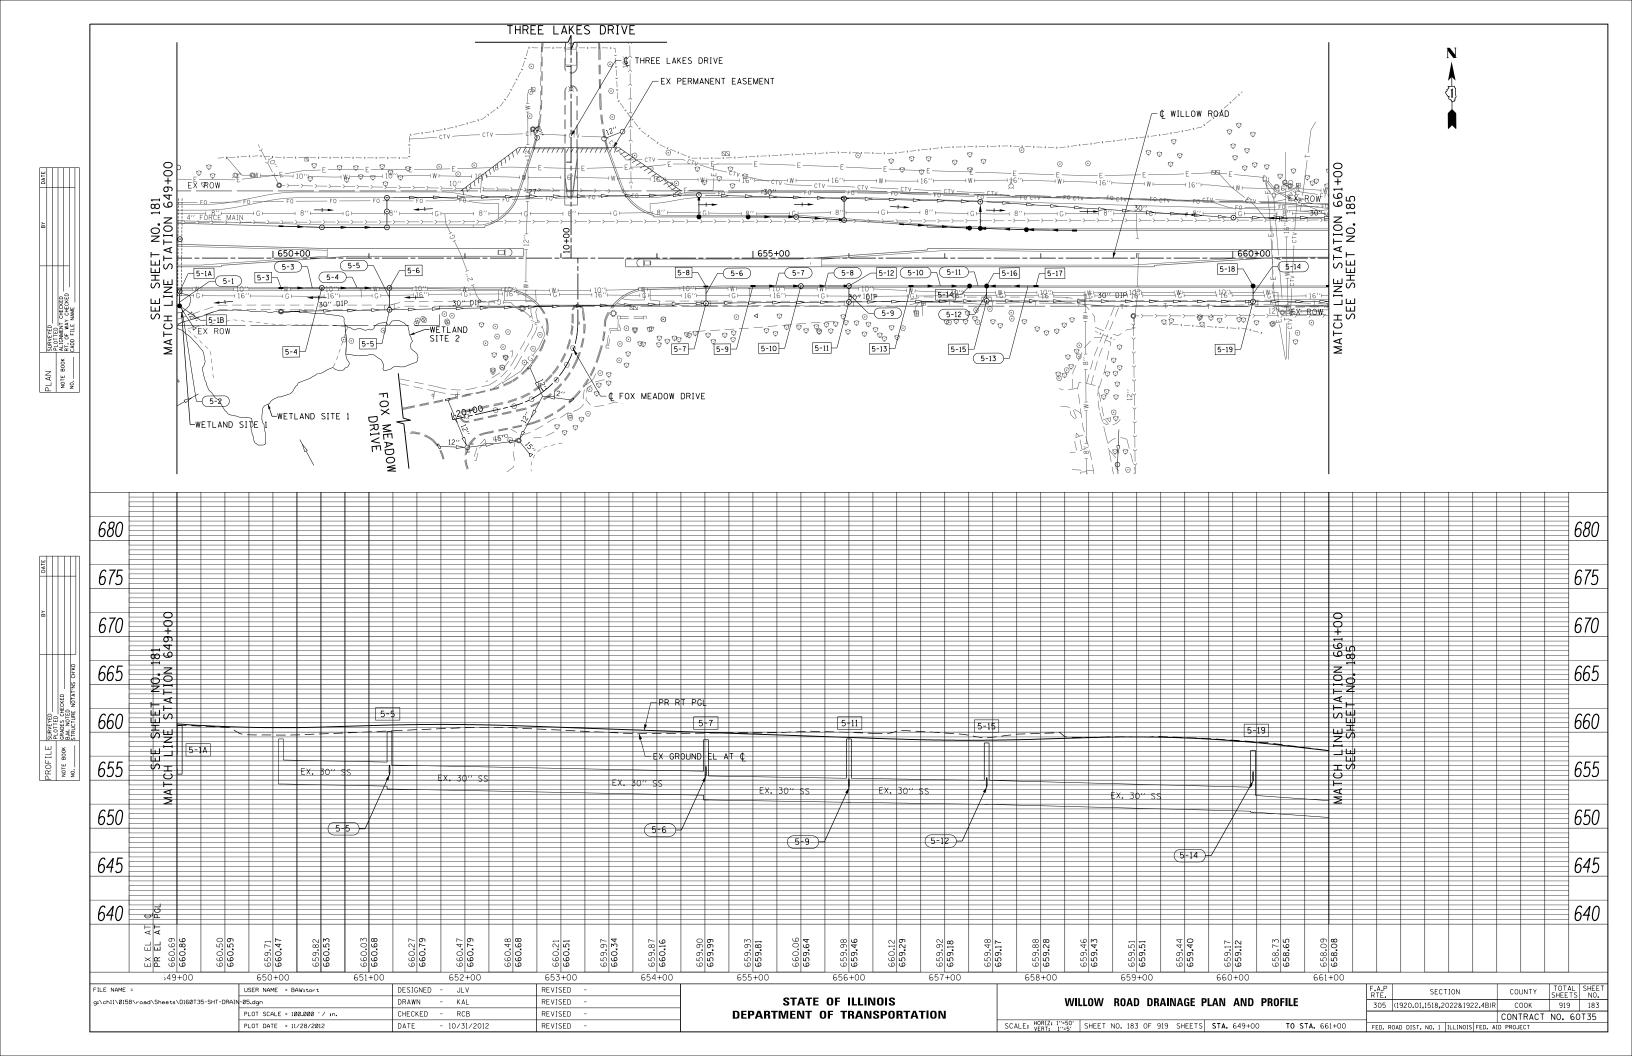


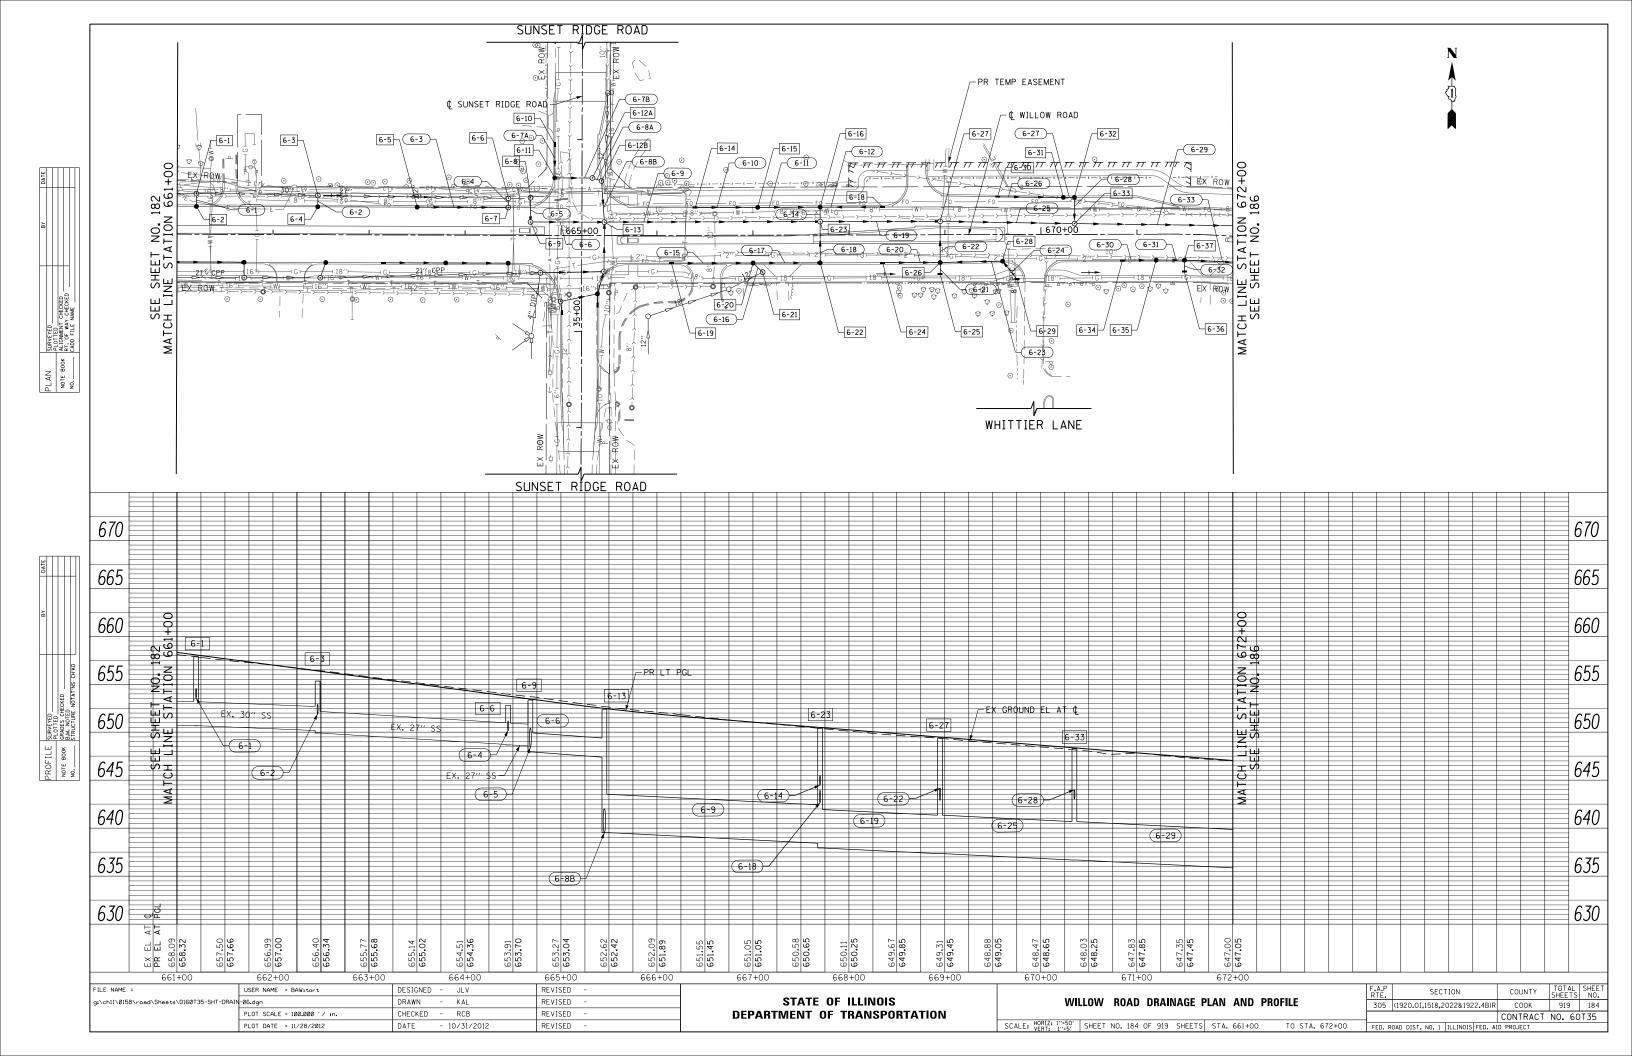


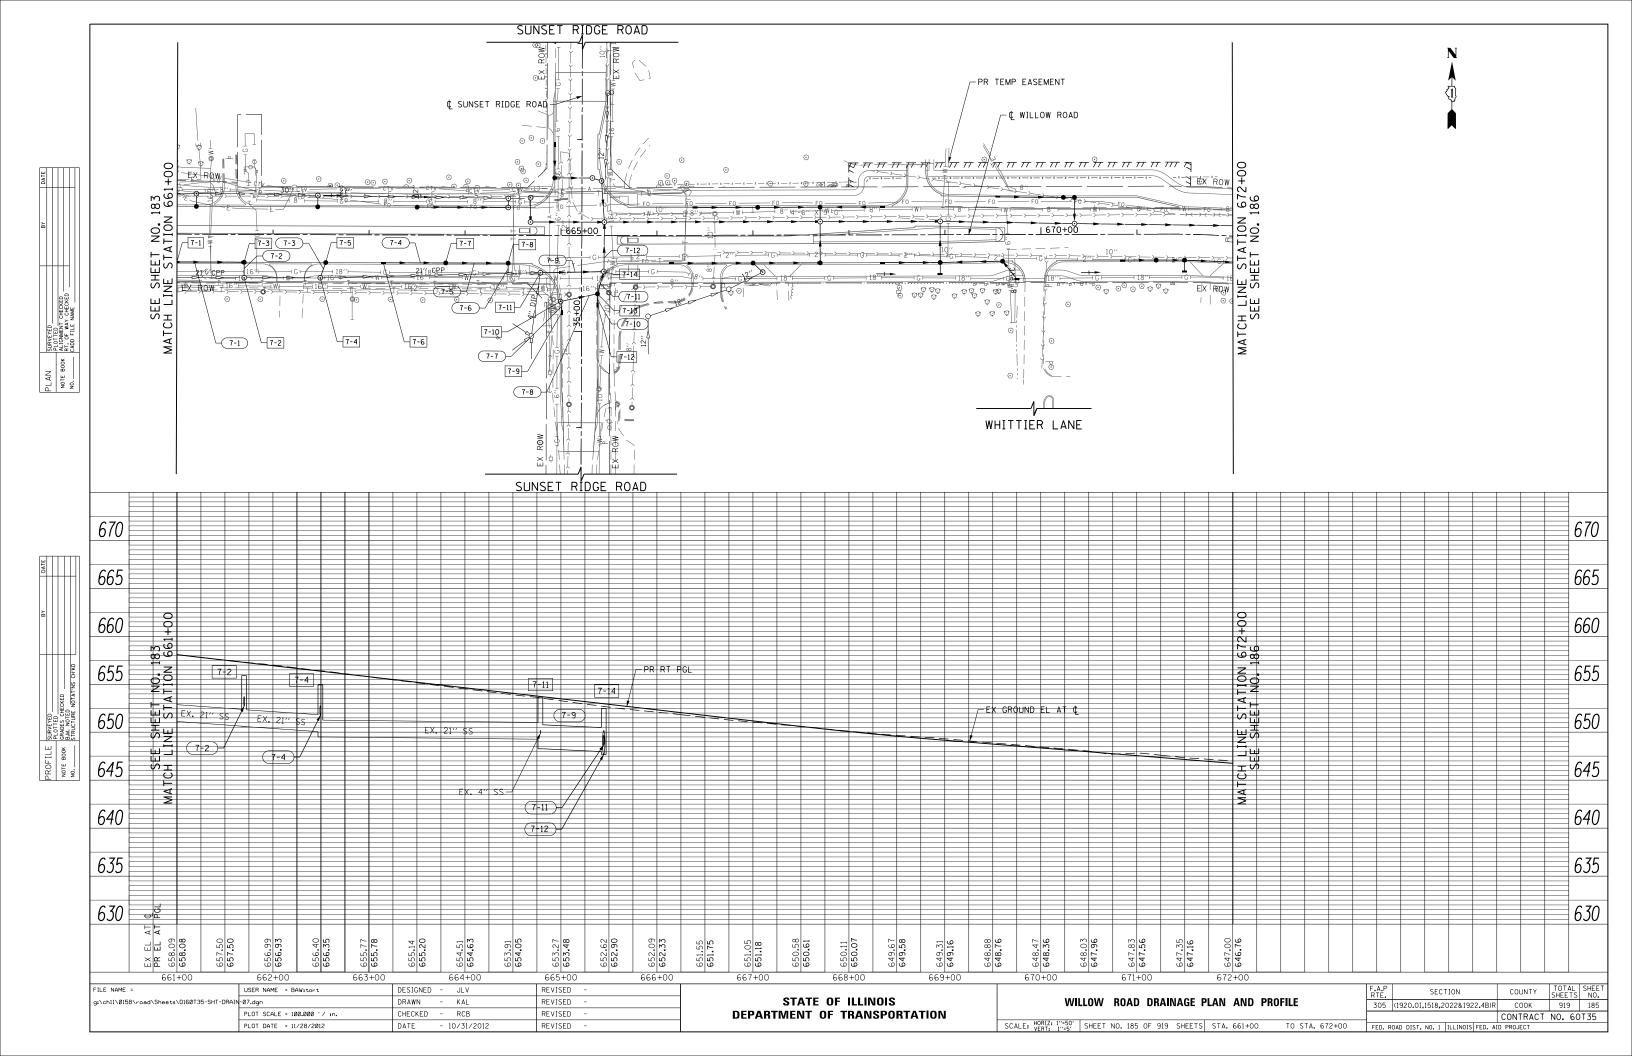


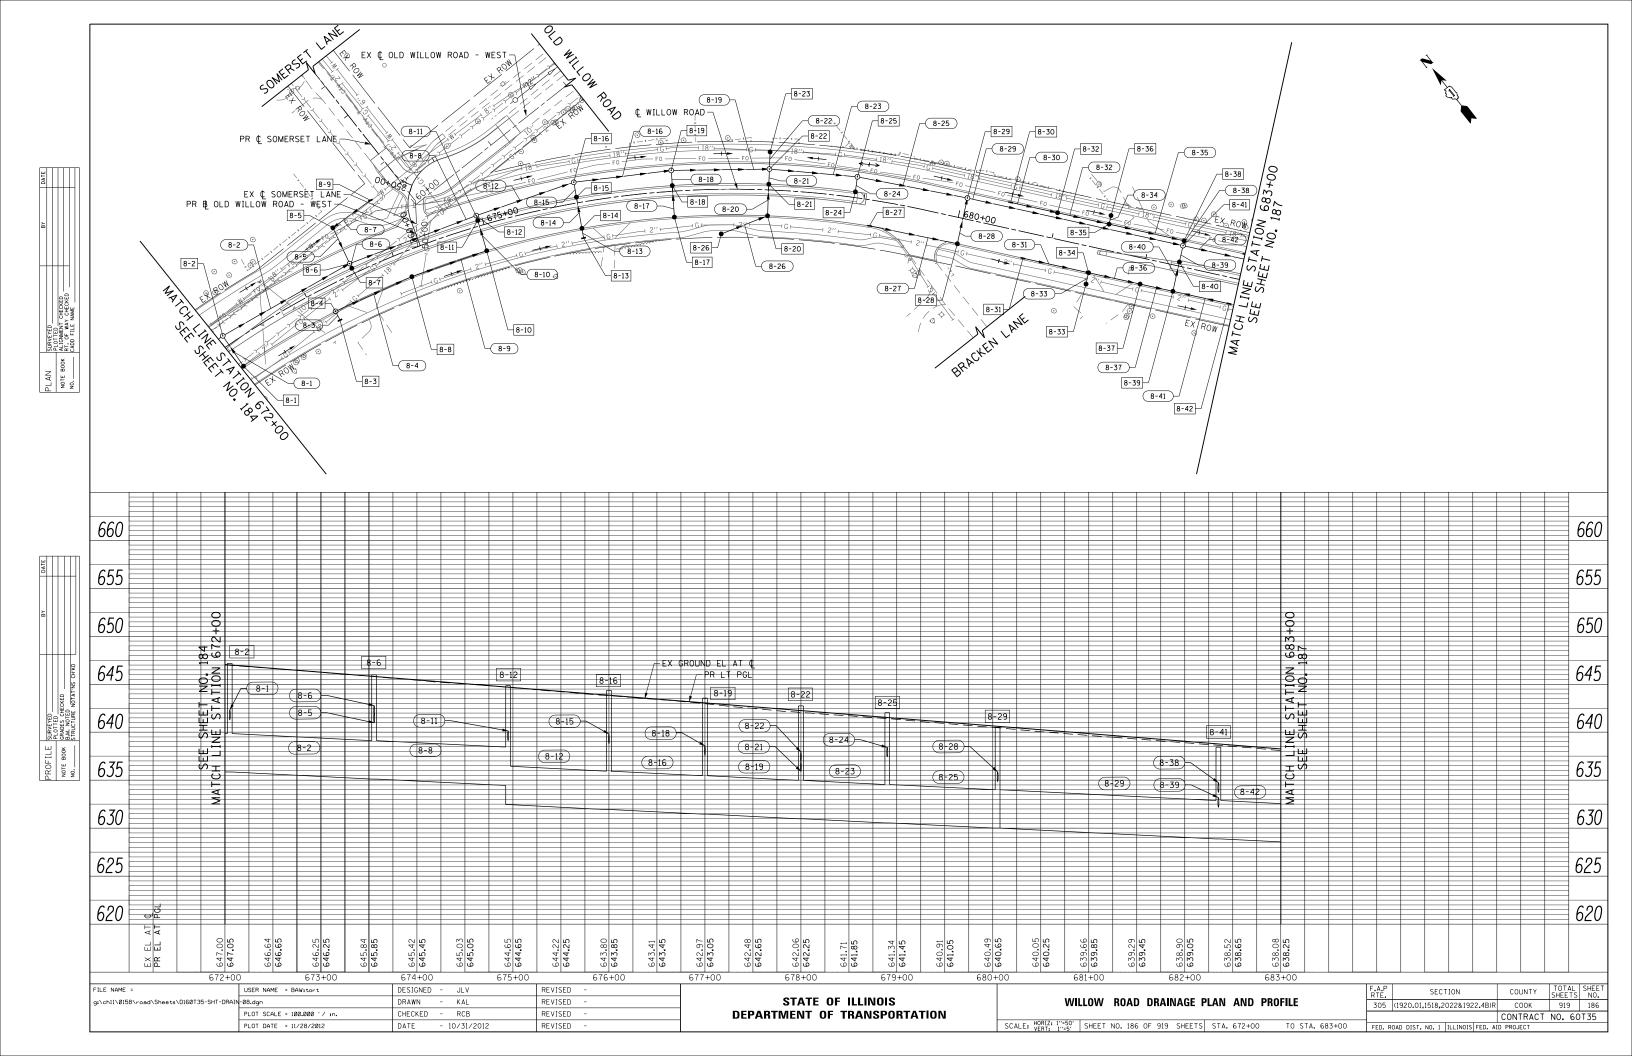


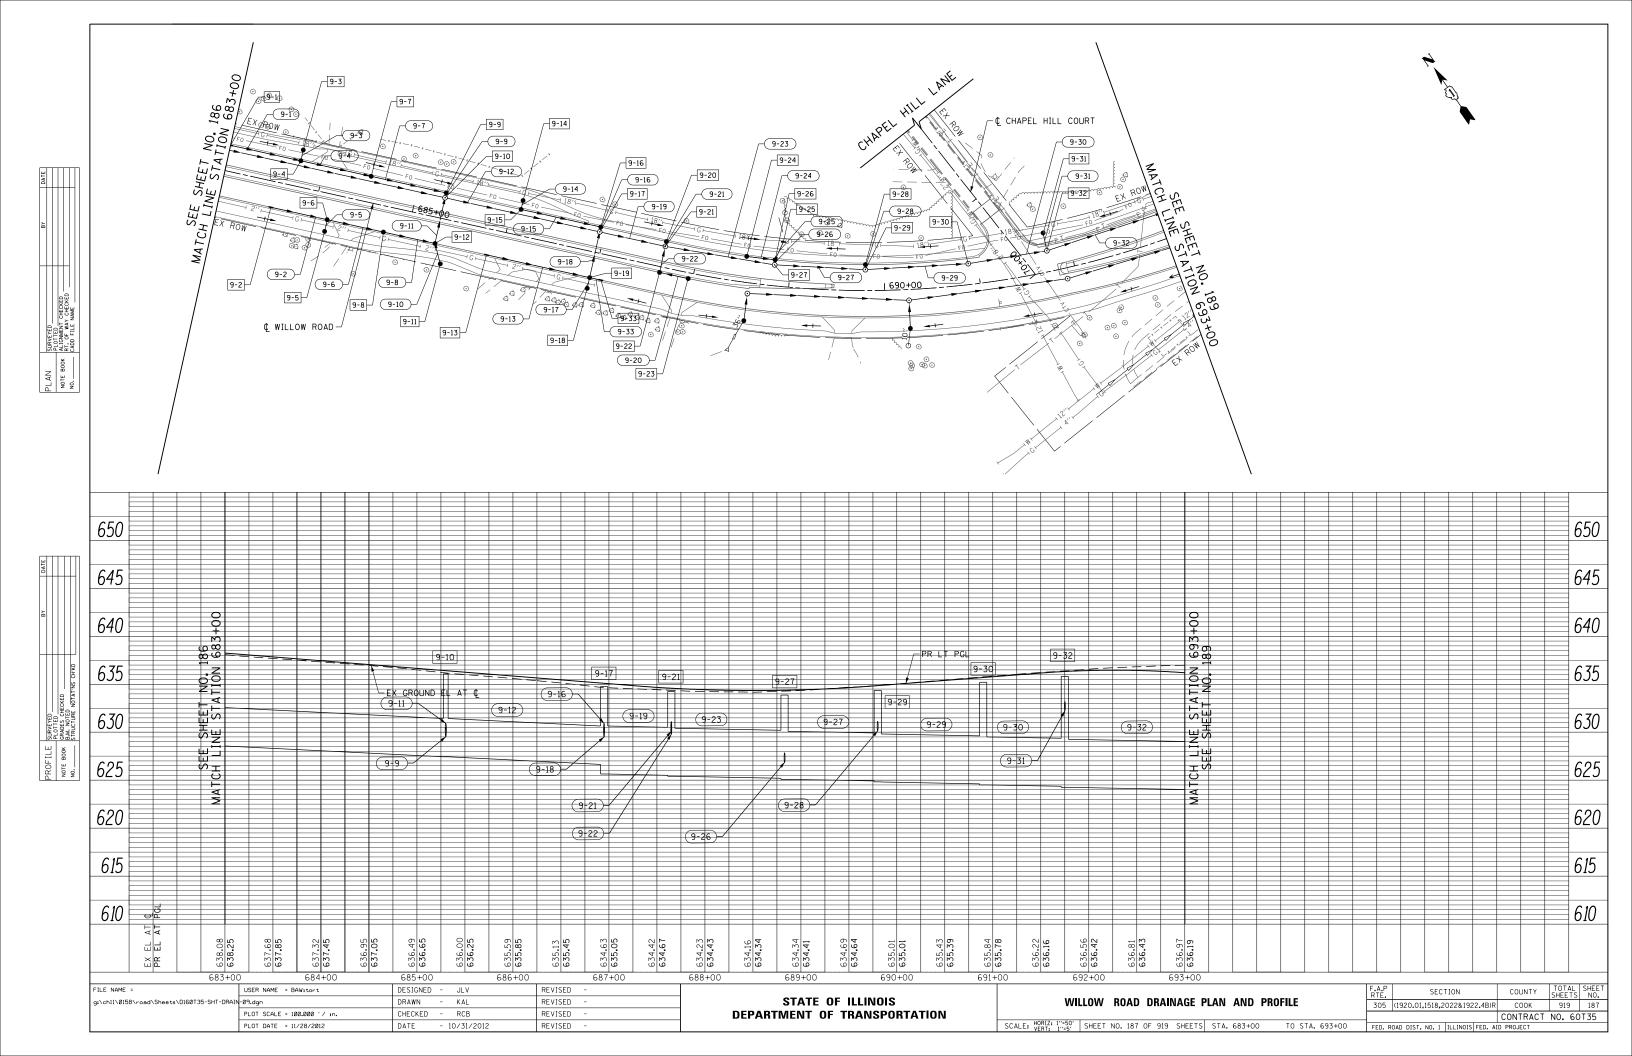


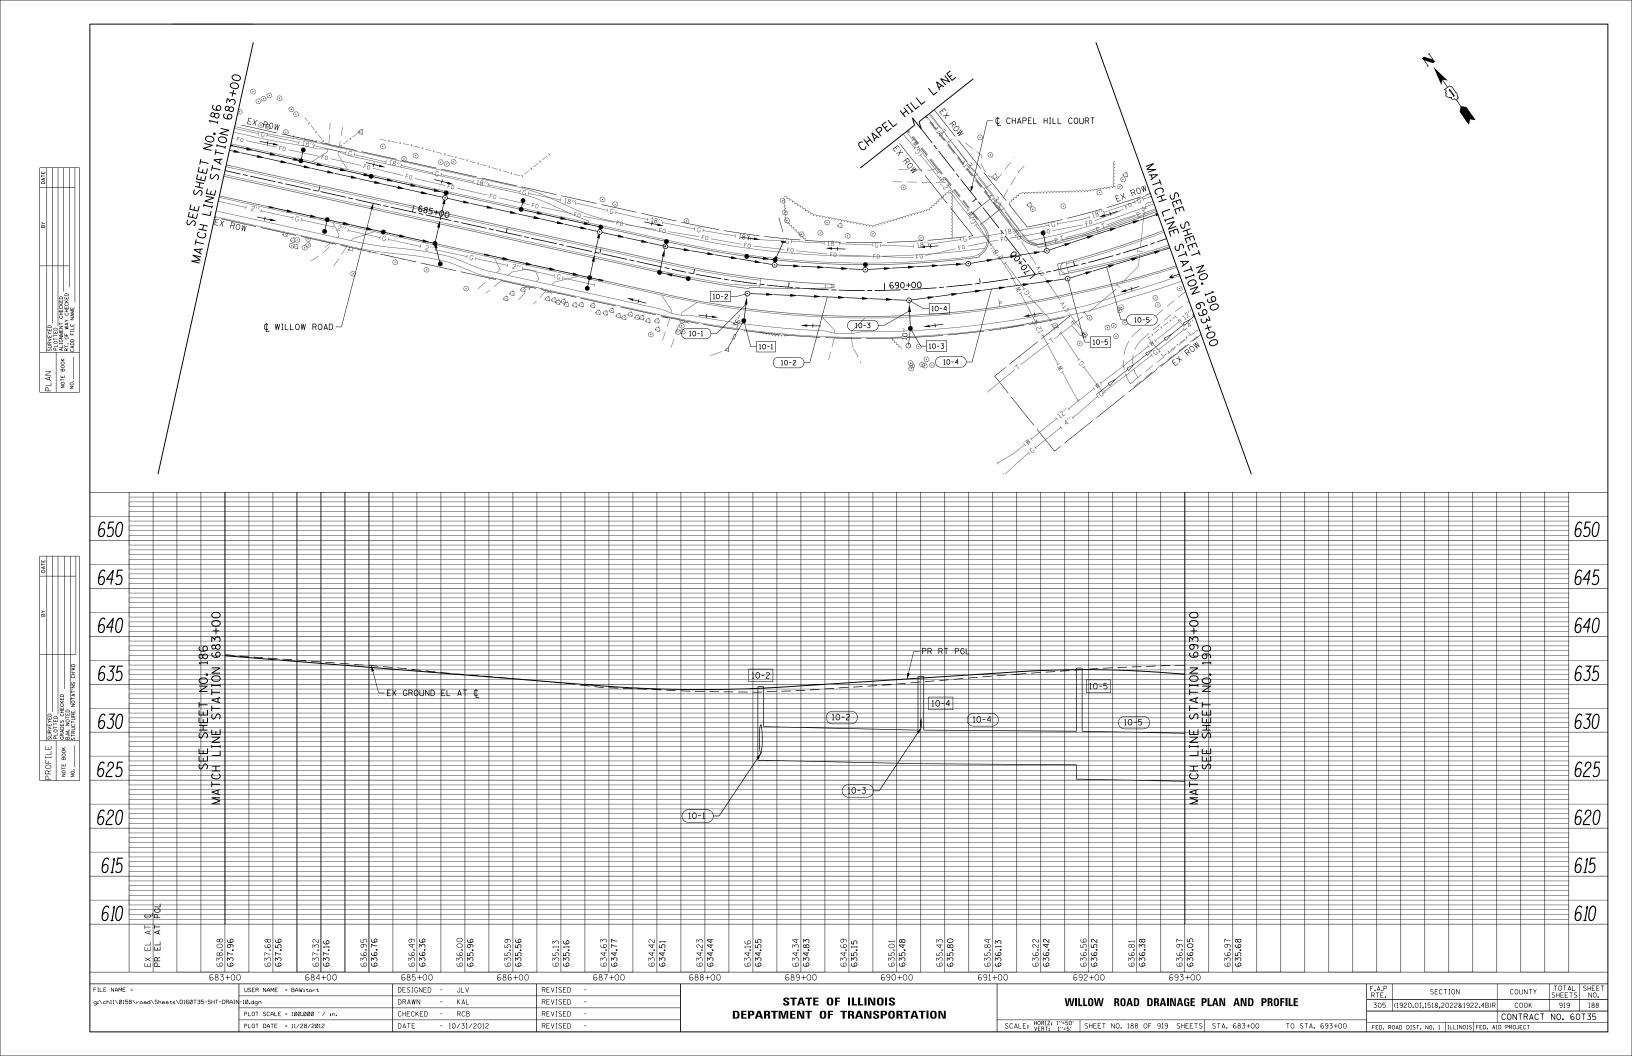


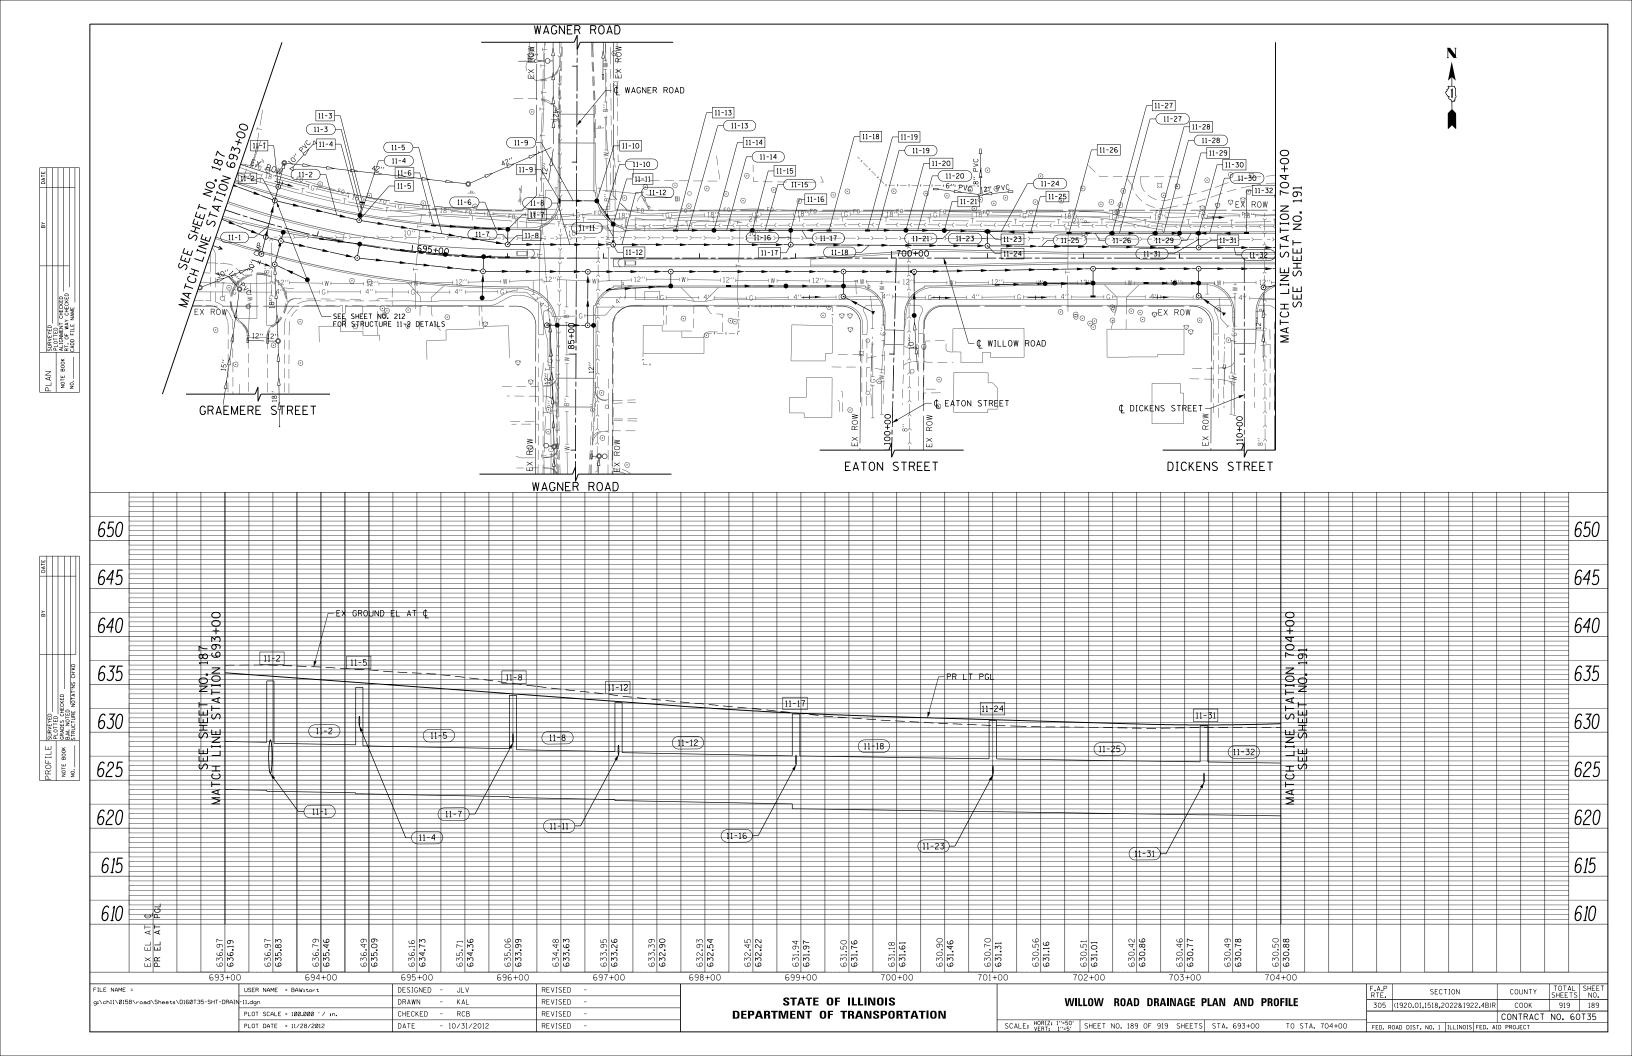


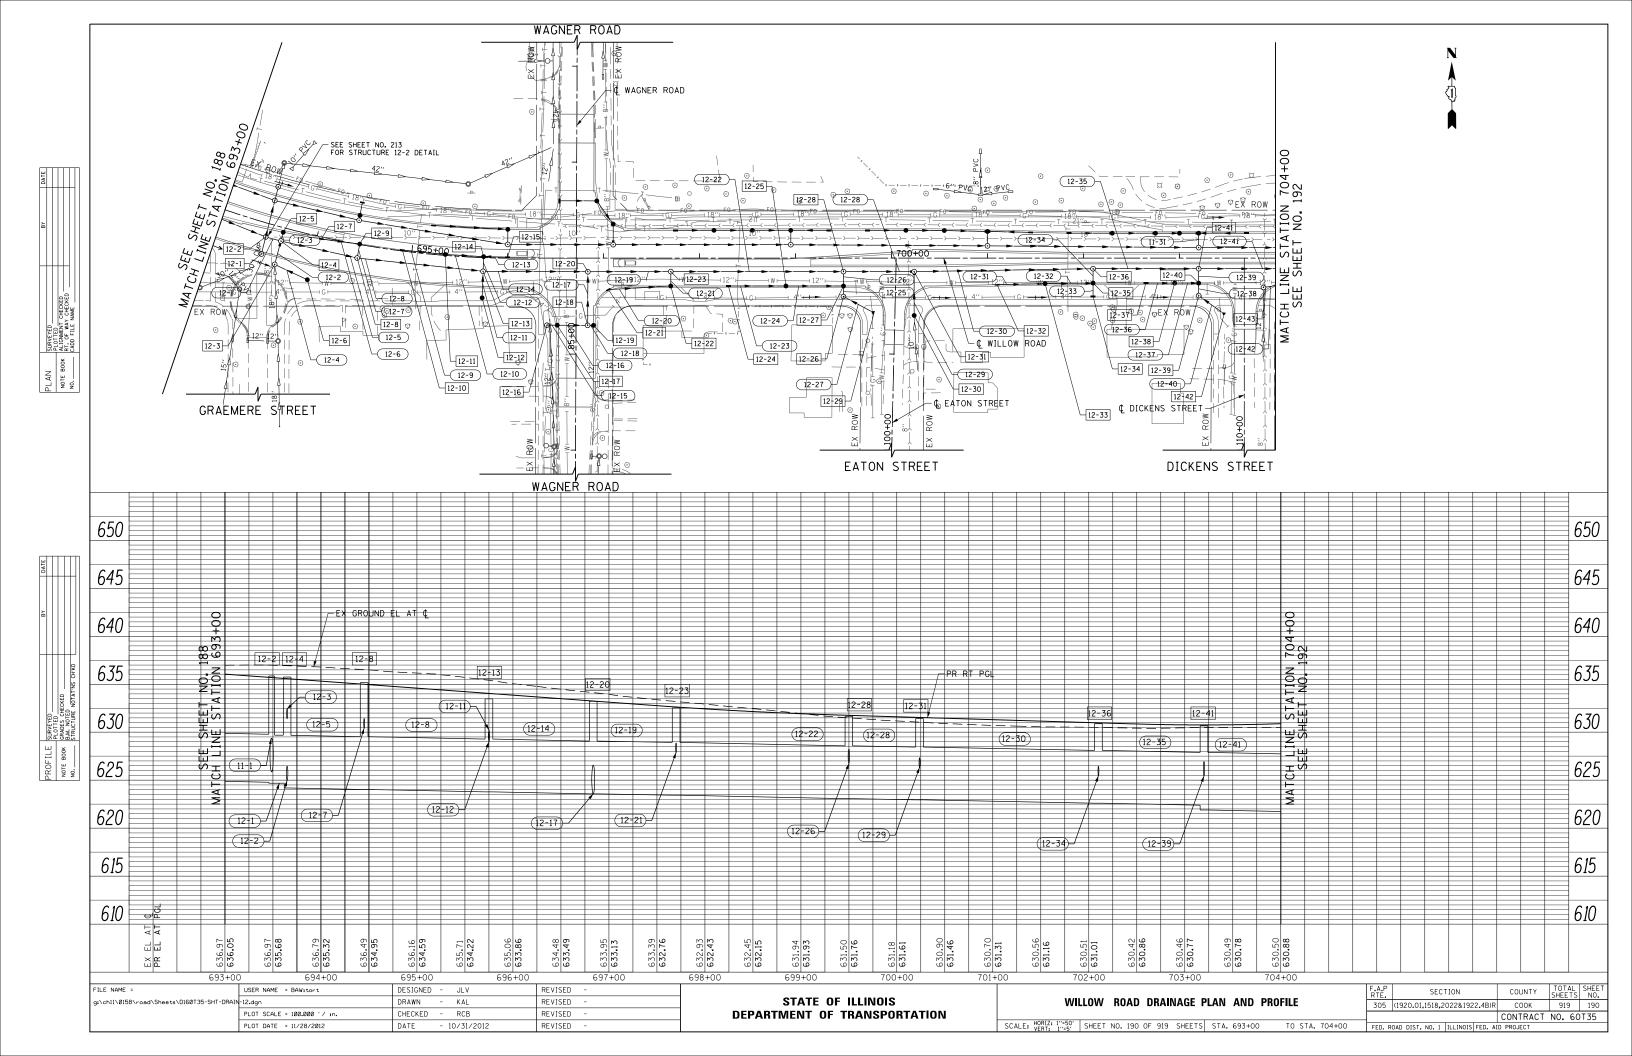


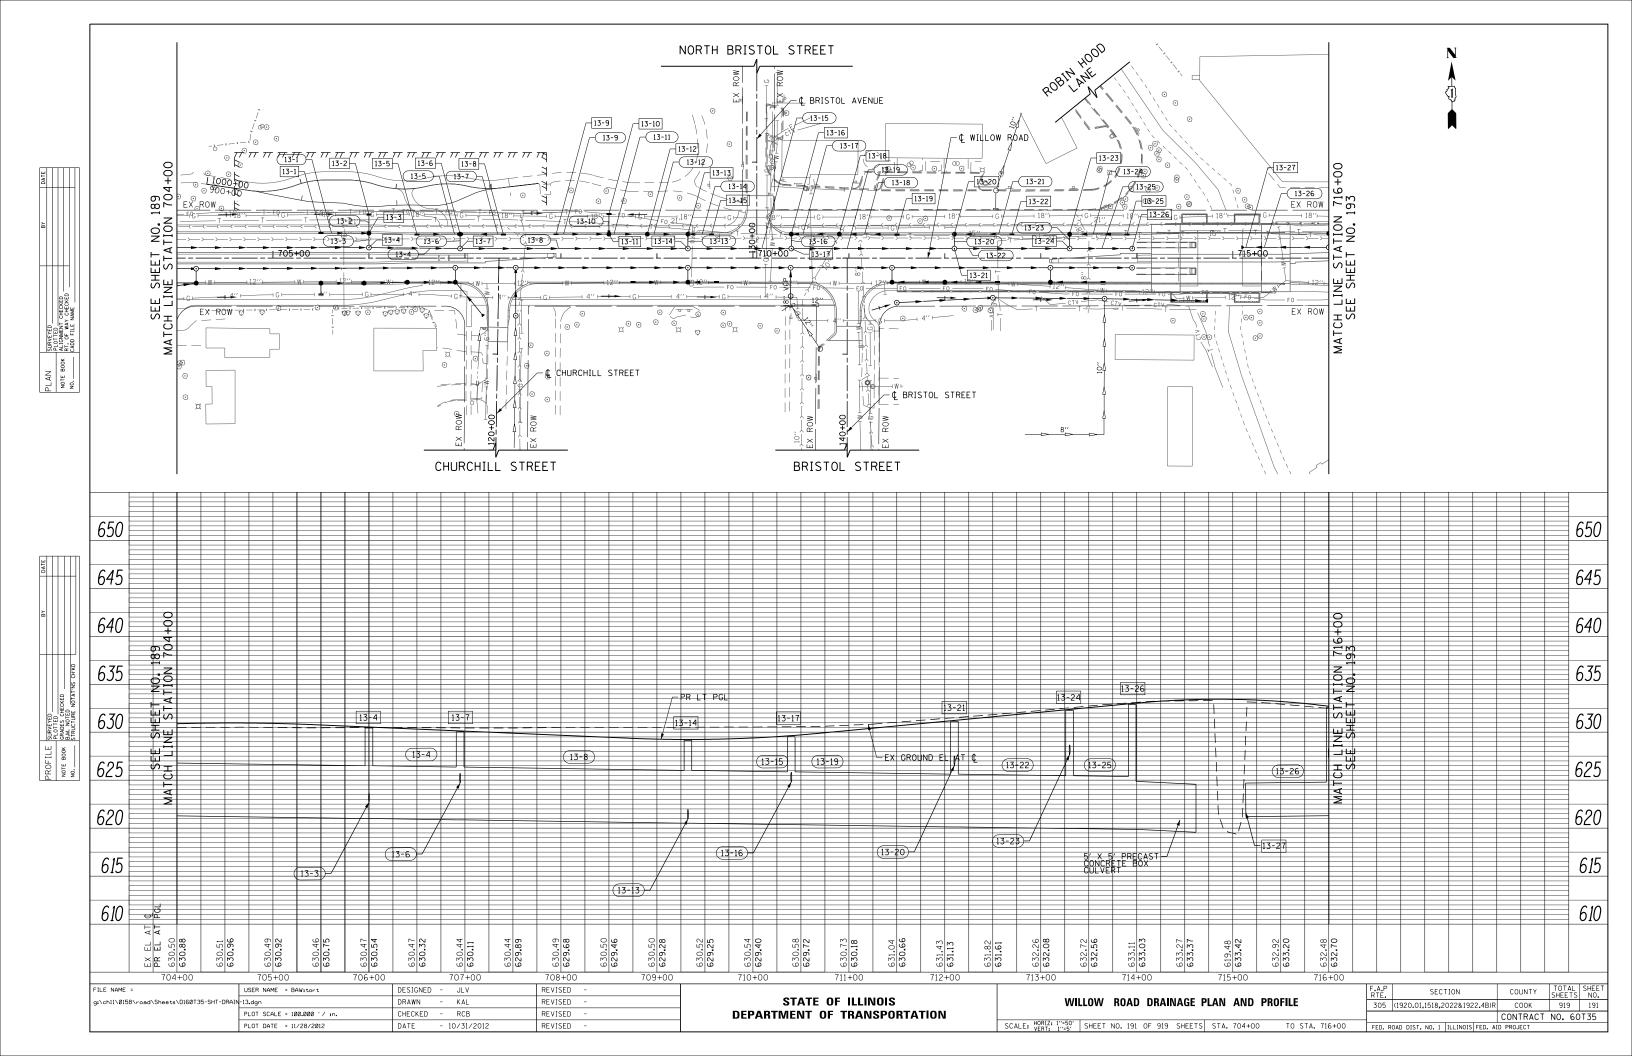


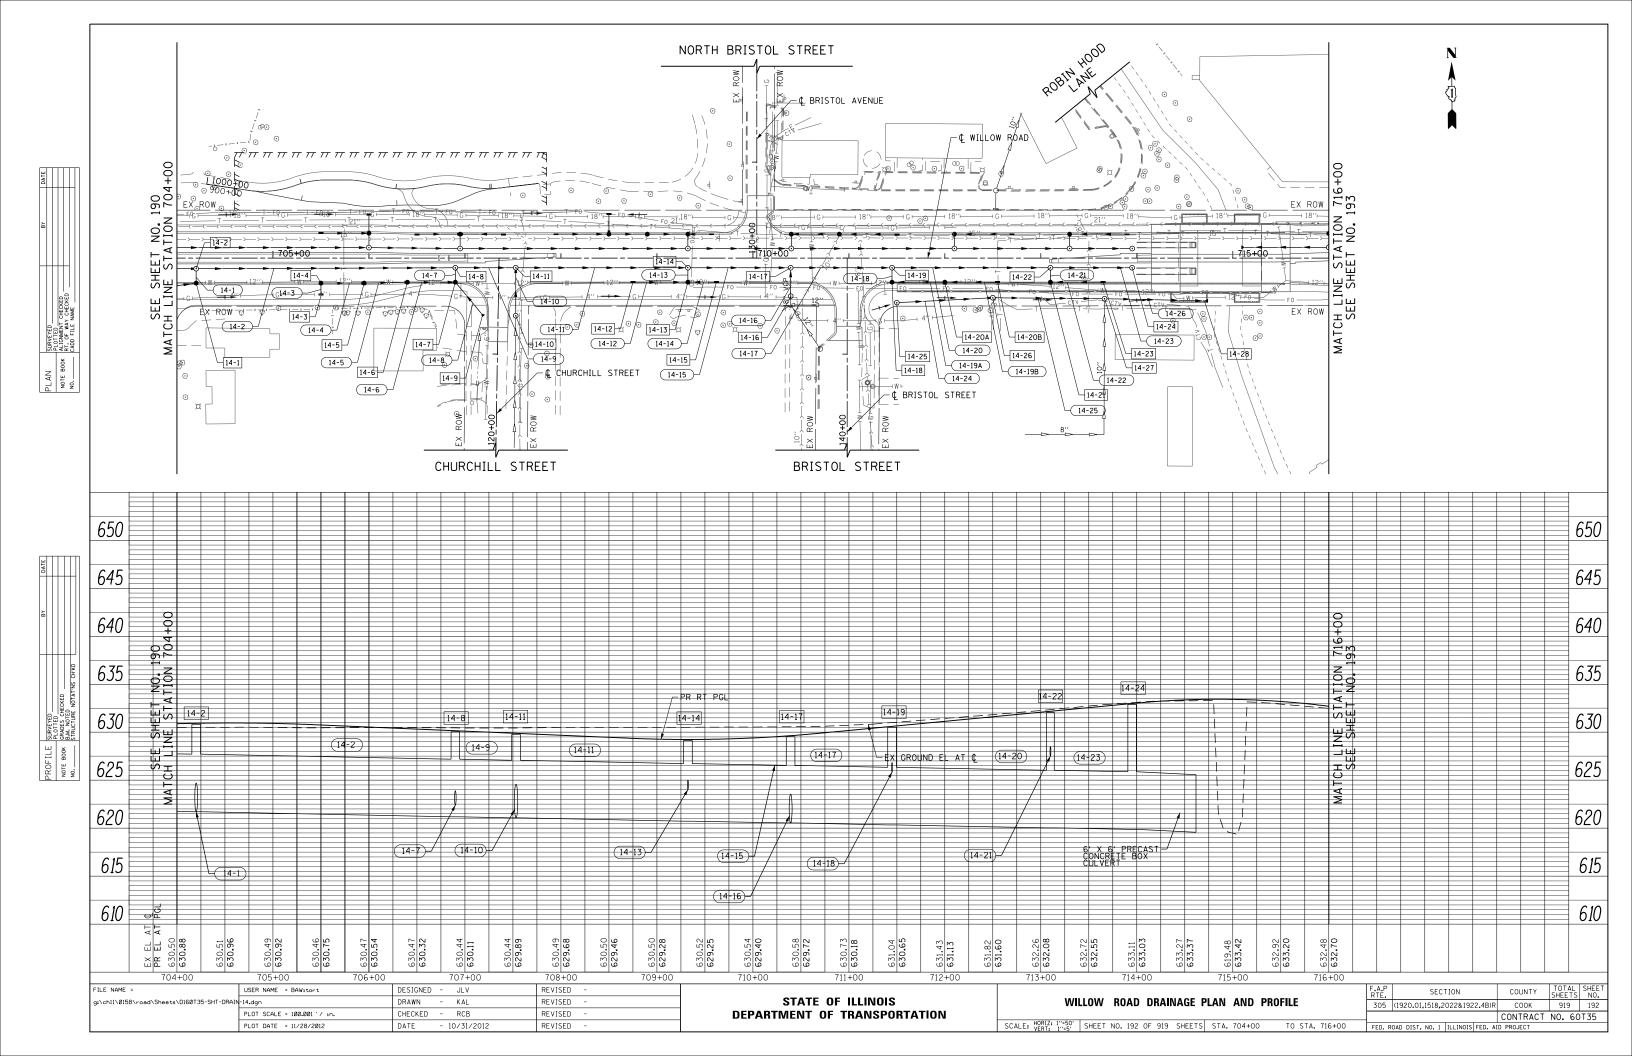


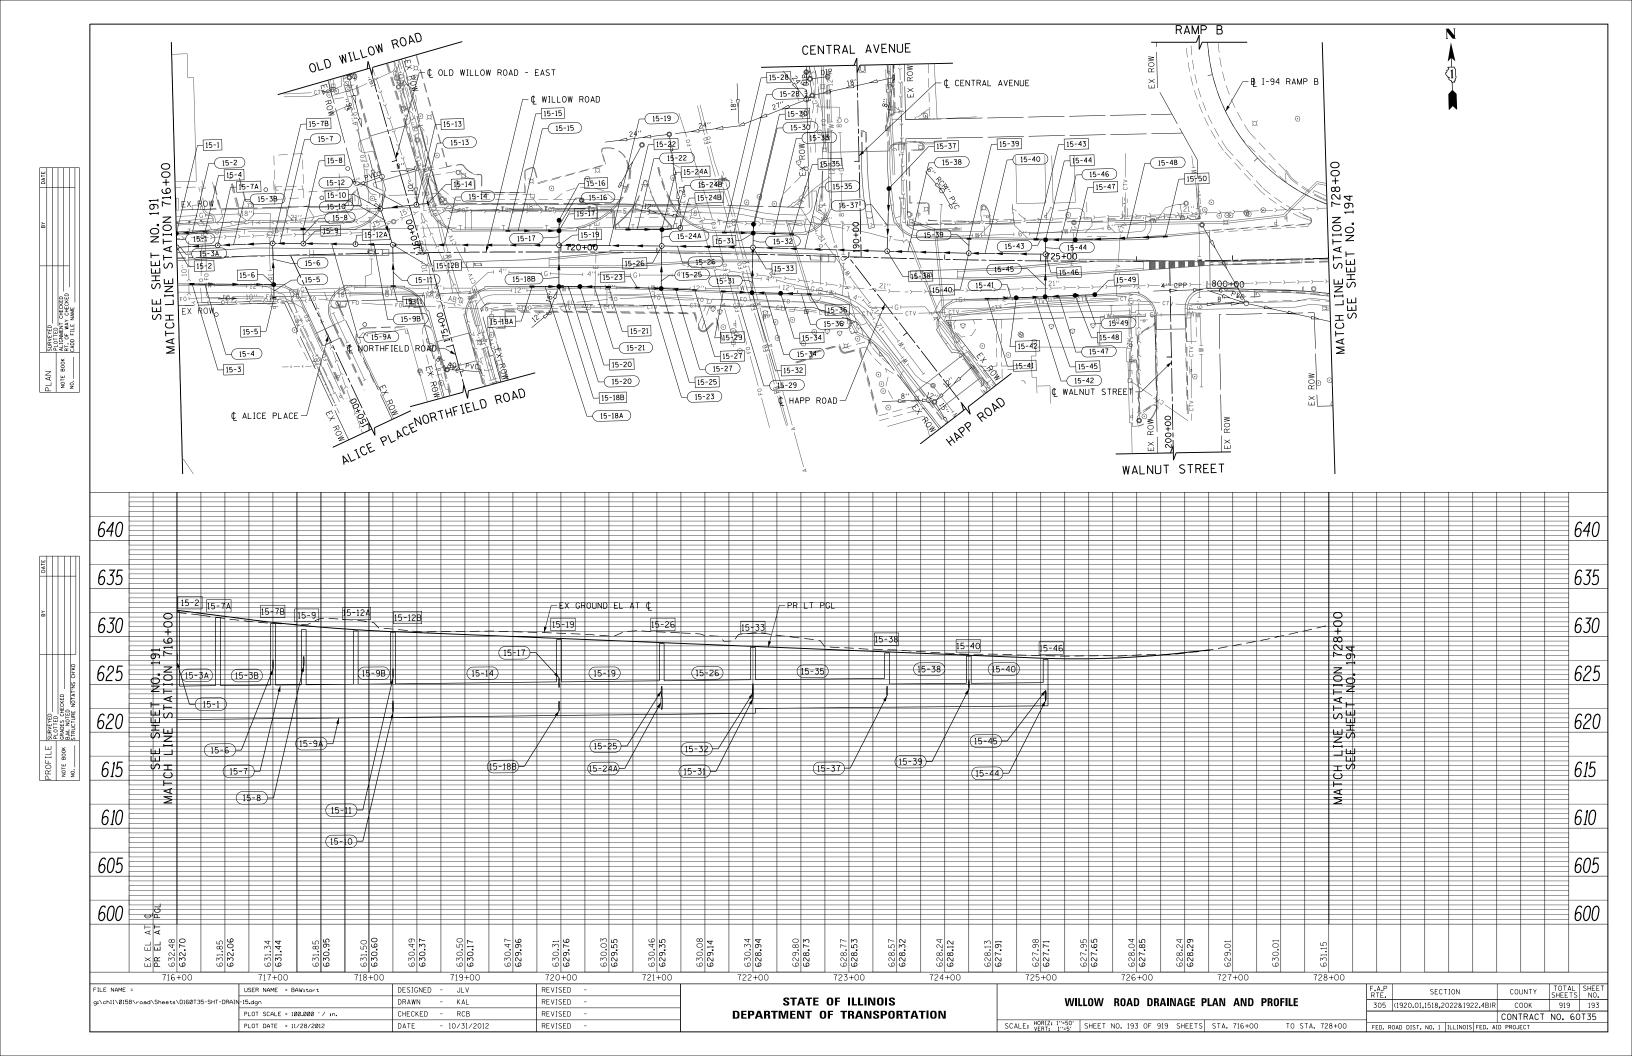


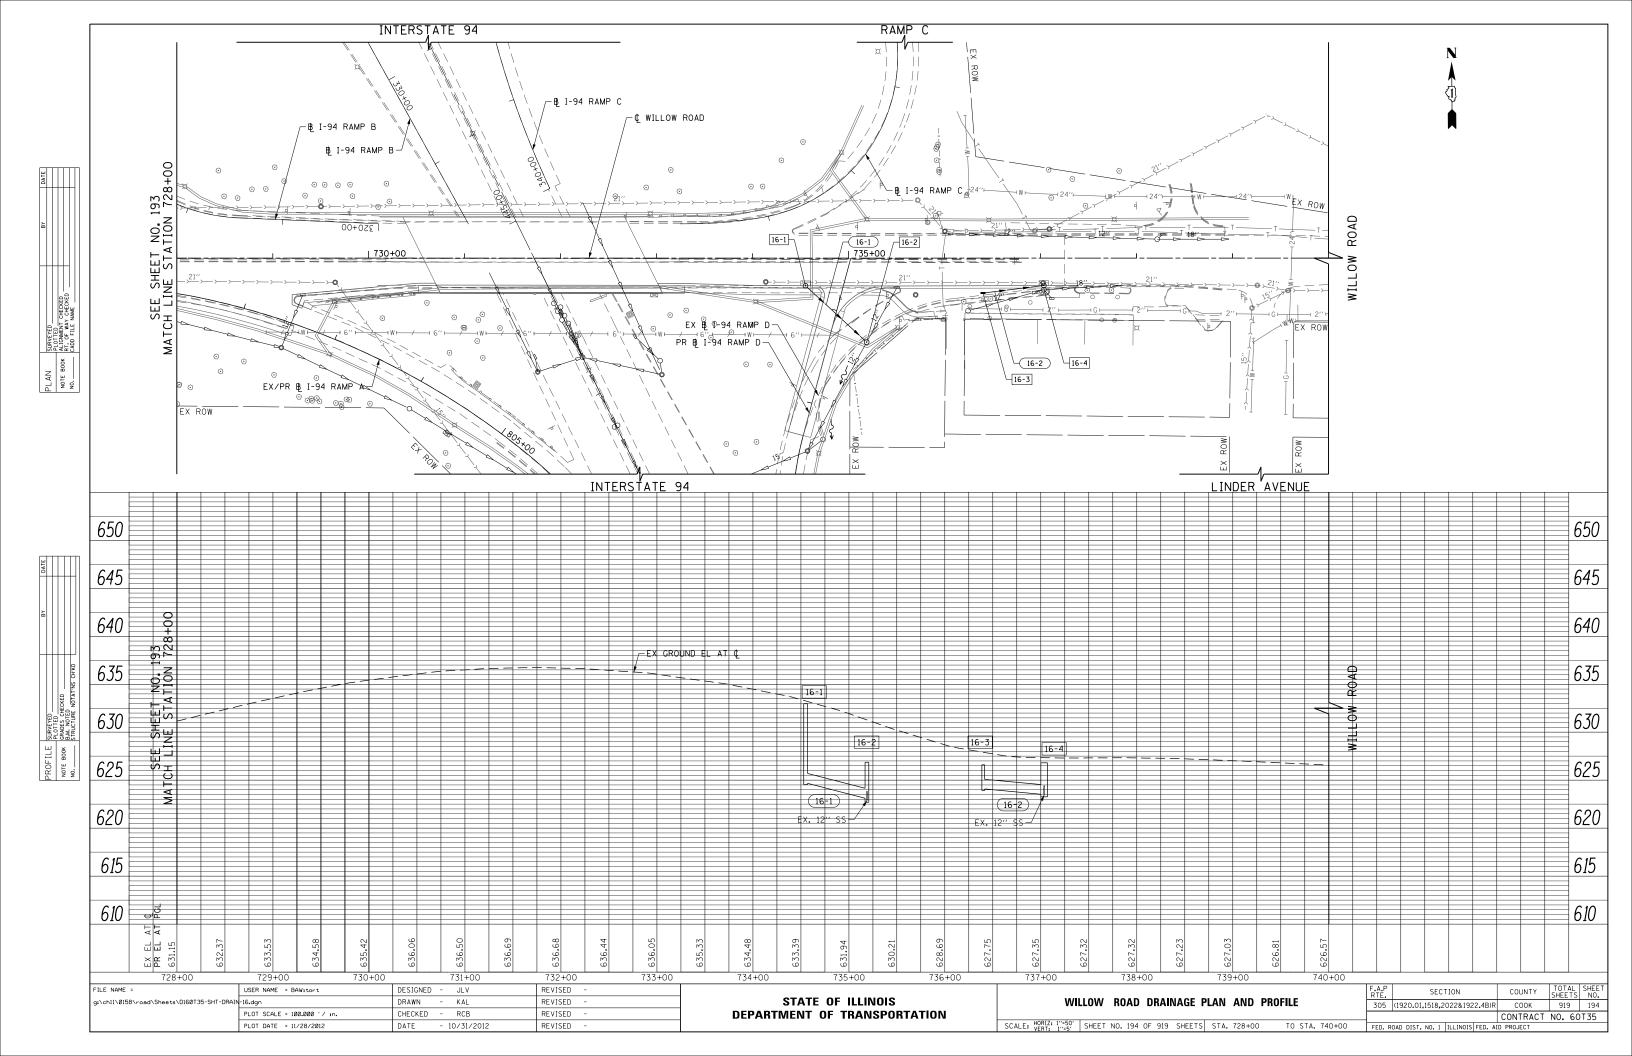


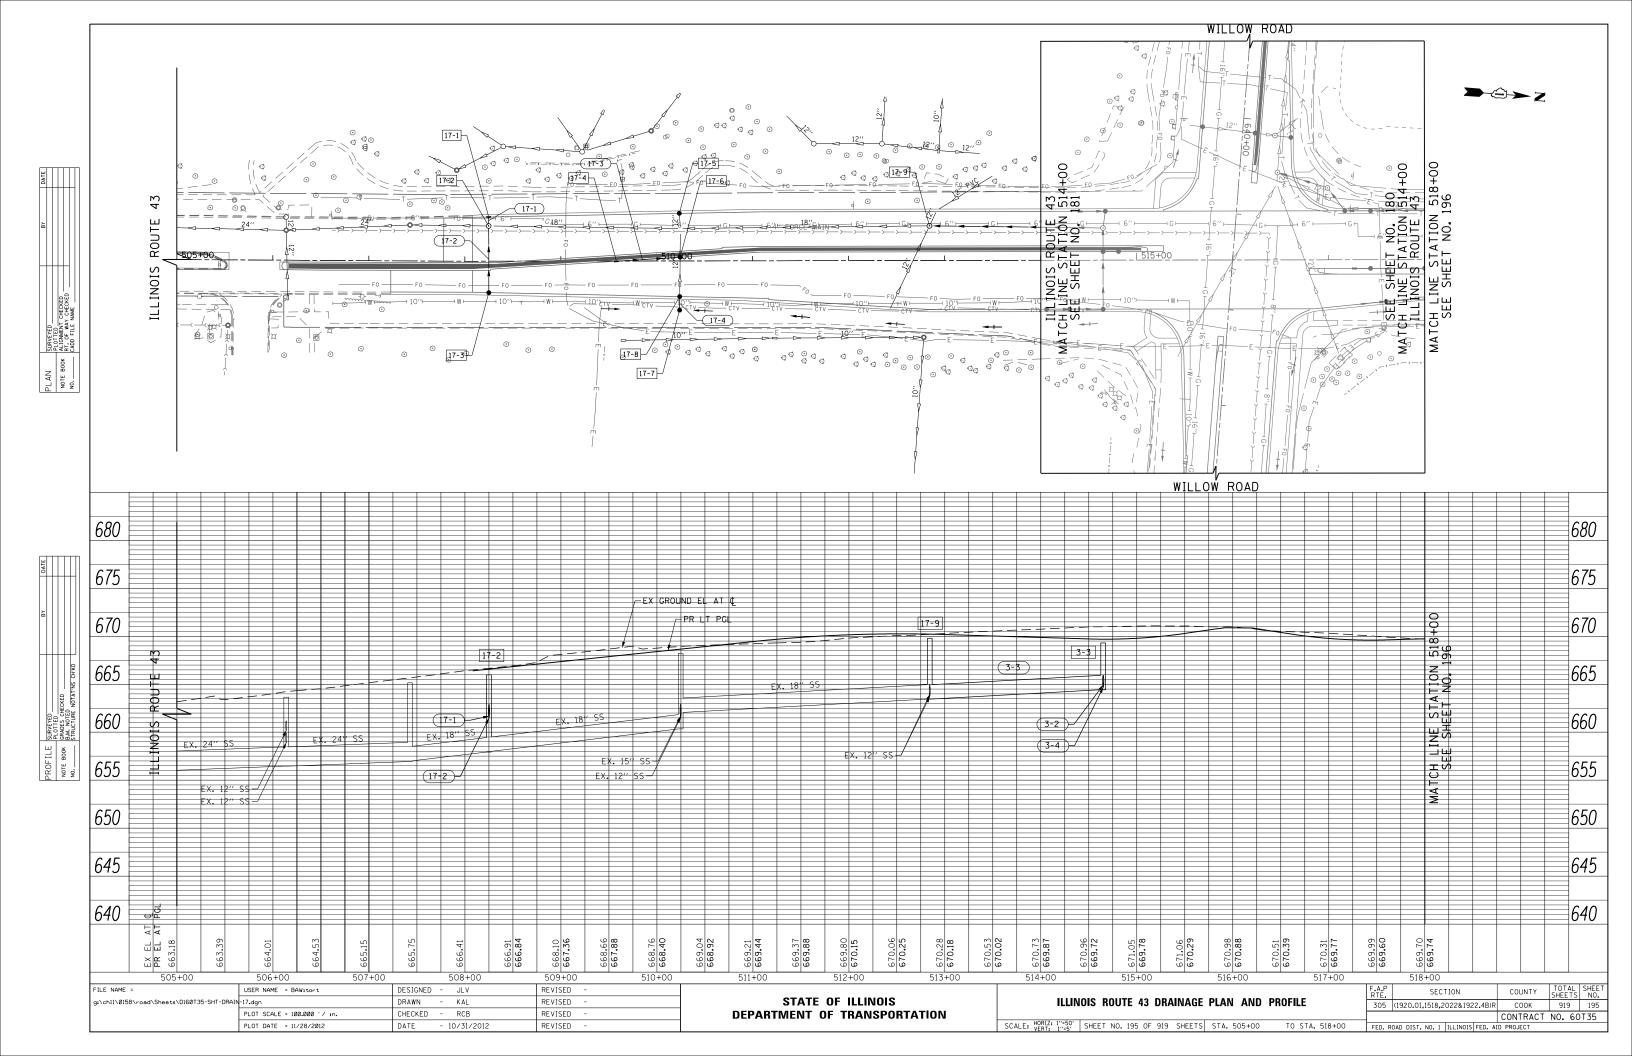

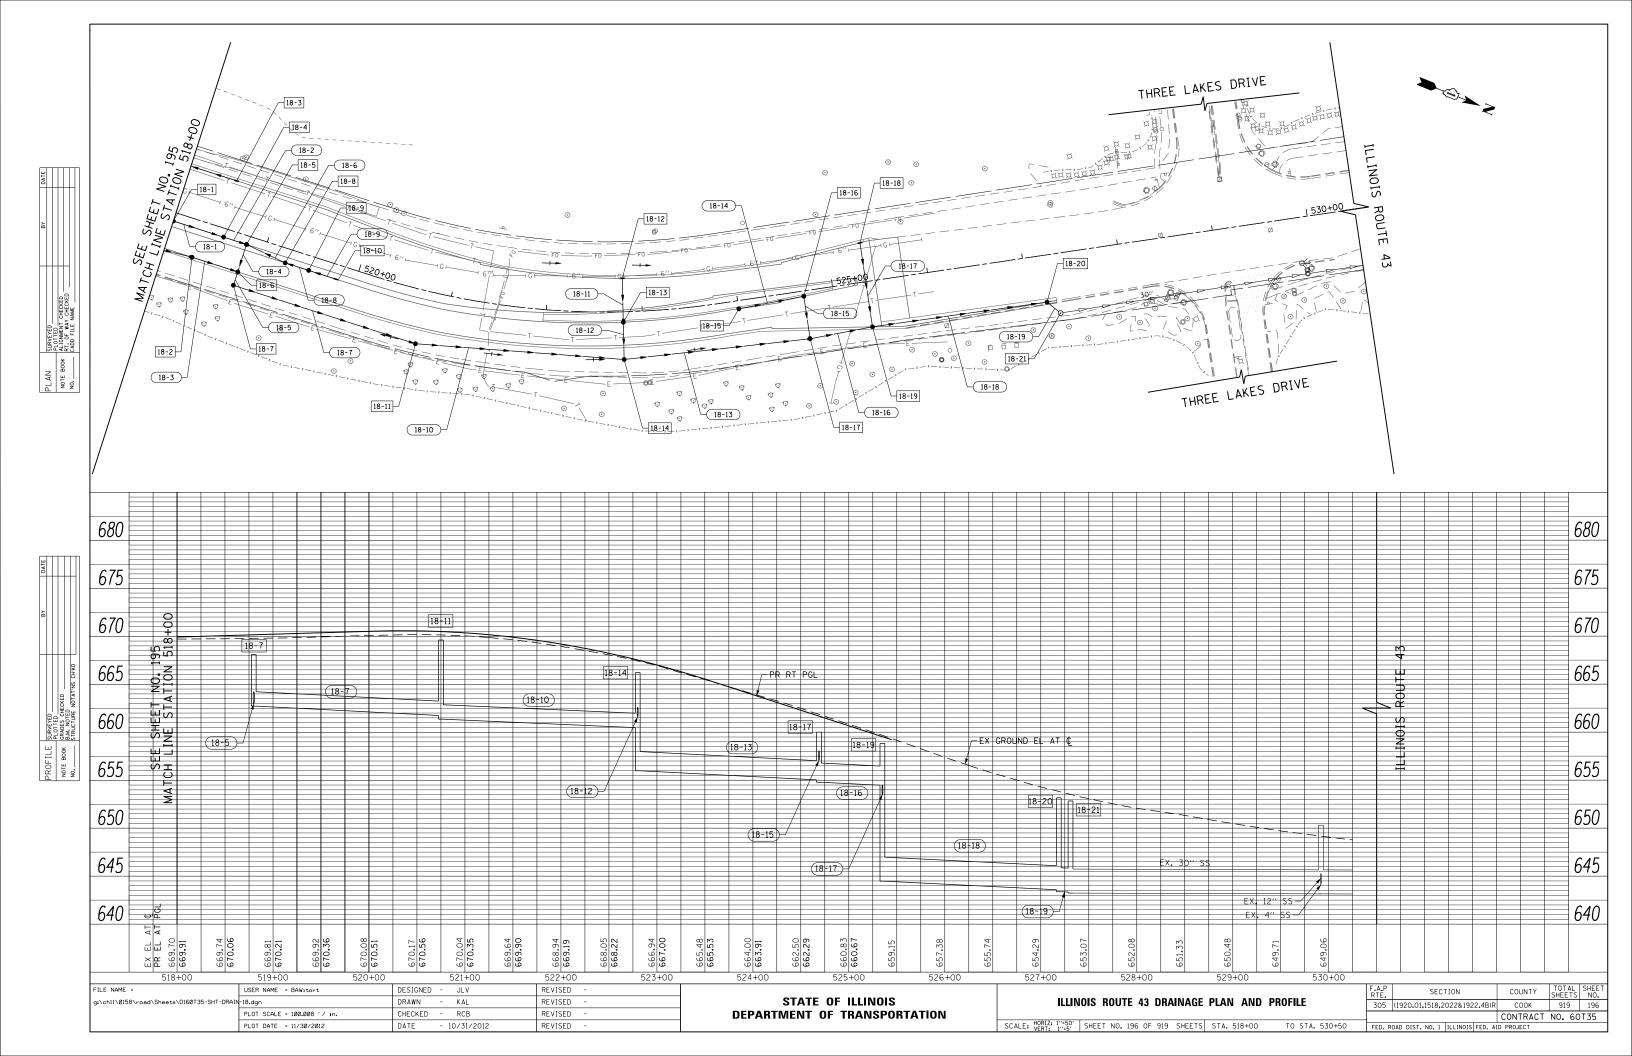

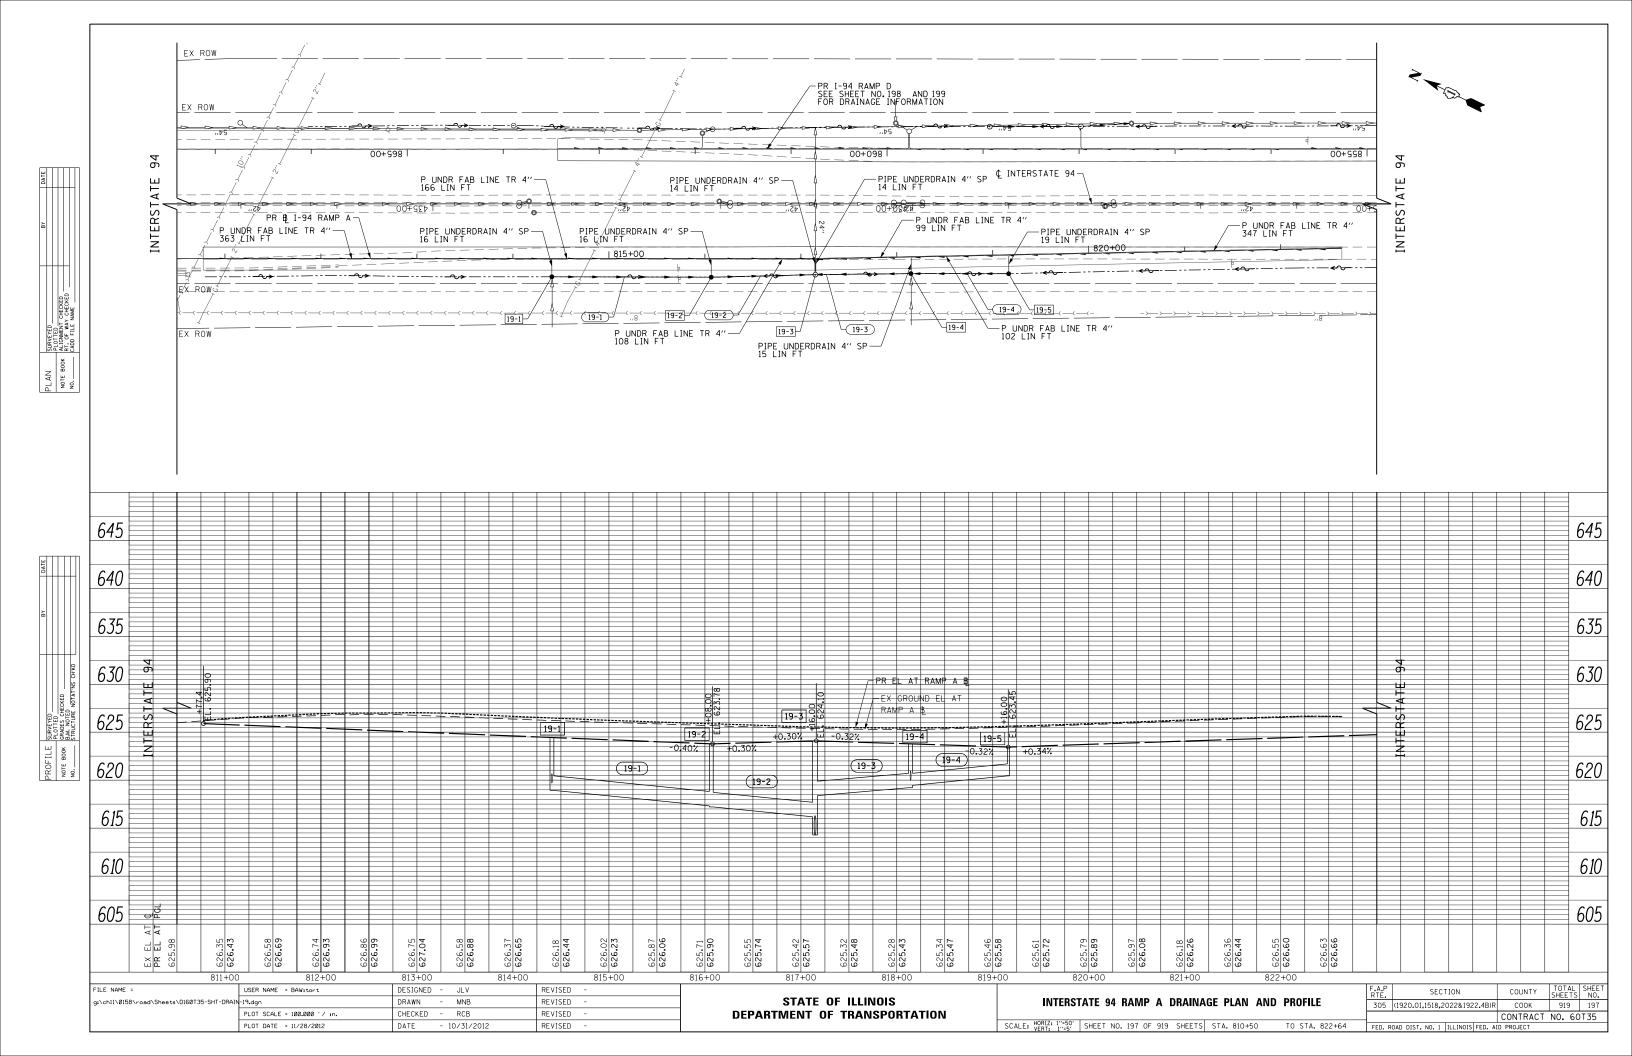

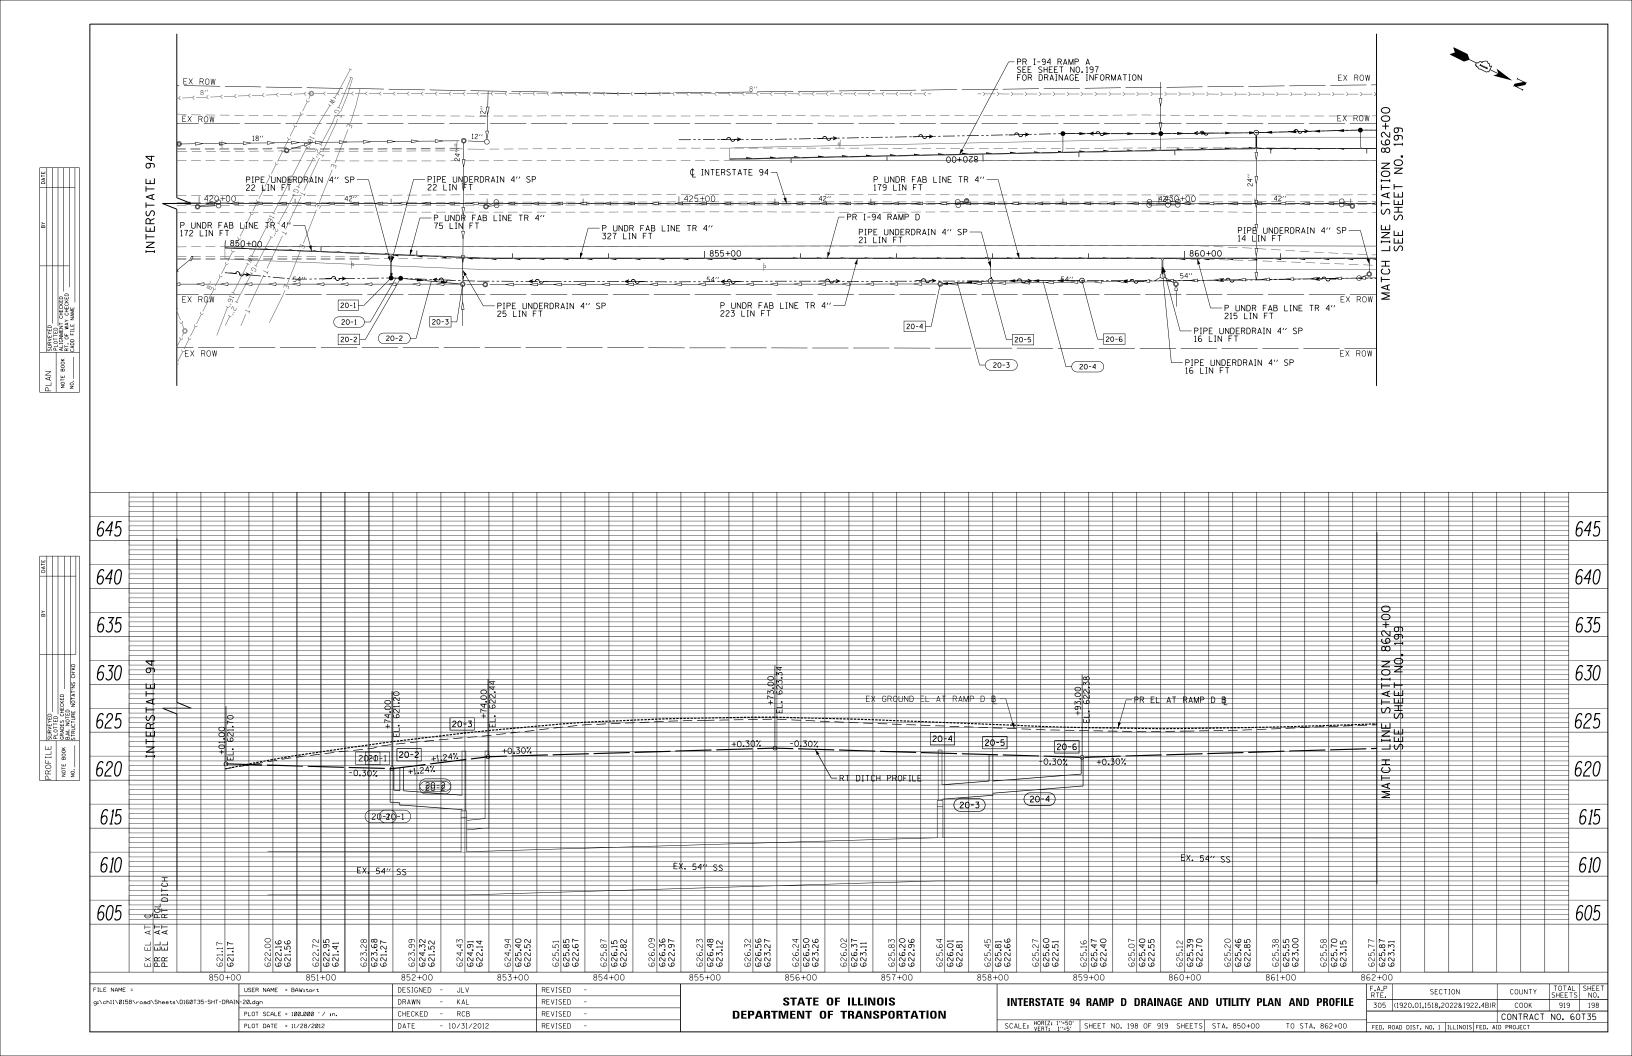

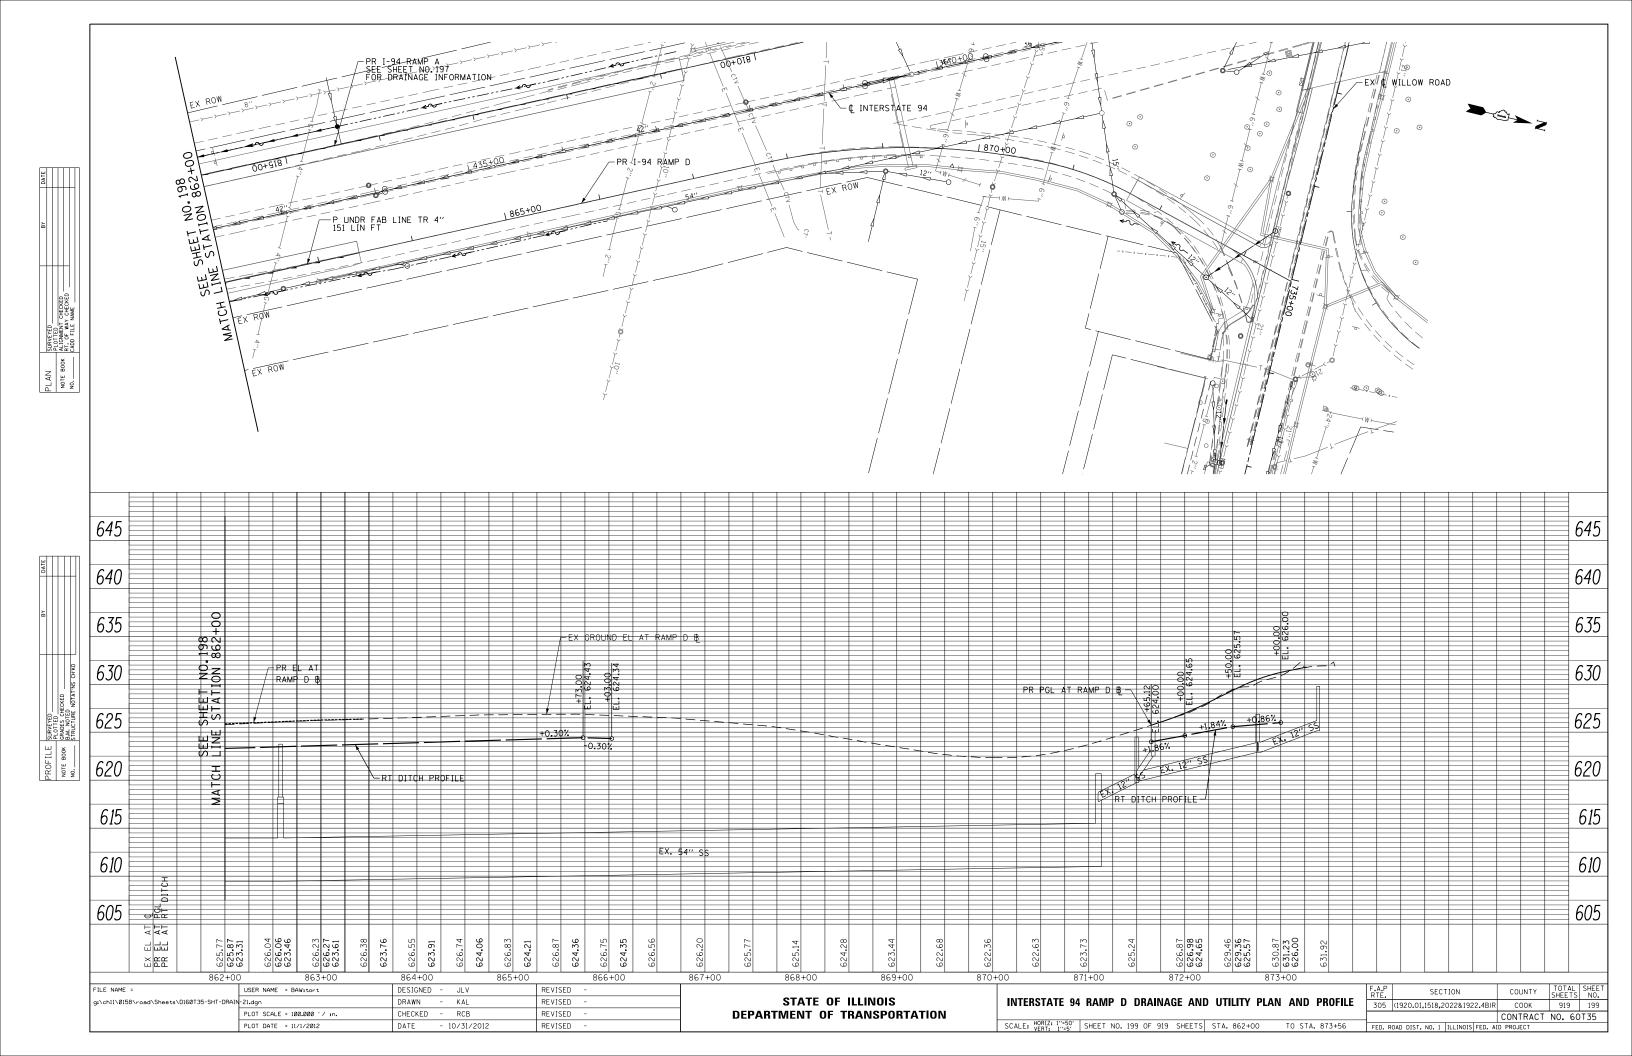

DRAINAGE SHEET WILLOW ROAD STA 625+00 TO STA 637+00

SHEET	STRUCTURE	STATION	ON OFFSET TYPE FRAME & GRATE RIM		INVERT ELEVATIONS									
SHEET	NUMBER	STATION	OFFSET	ITPE	FRAINE & GRATE	ELEVATION	NORTH	NORTHEAST	EAST	SOUTHEAST	SOUTH	SOUTHWEST	WEST	NORTHWEST
1	1-1	631+67.51	44.0' RT	INLETS, TYPE A	TYPE 24 FRAME AND GRATE	641.96	639.62 (EX)							
1	1-2	633+40.55	54.5' LT	CB, TYPE C	TYPE 24 FRAME AND GRATE	646.90					643.77 (EX)			
1	1-3	633+43.56	41.6' RT	INLETS, TYPE A	TYPE 24 FRAME AND GRATE	647.23	642.26 (EX)							
1	1-4	634+73.94	46.3' LT	CB, TYPE C	TYPE 24 FRAME AND GRATE	651.55					647.55			
1	1-5	634+73.94	38.2' LT	MH, TYPE A, 5'-DIAMETER	TYPE 1 FRAME, CLOSED LID	651.74	647.51		645.77 (EX)				641.87 (EX)	
1	1-6	635+15.03	1.6' LT	CB, TYPE A, 4'-DIAMETER	TYPE 11V FRAME AND GRATE	653.65	647.12 (EX)		649.58		647.20 (EX)			
1	1-7	635+26.00	2.4' LT	CB, TYPE C	TYPE 11V FRAME AND GRATE	653.66							649.66	
1	1-8	635+15.15	41.6' RT	INLETS, TYPE A	TYPE 24 FRAME AND GRATE	652.93	648.05 (EX)							
1	1-9	636+90.22	13.0' LT	CB, TYPE A, 4'-DIAMETER	TYPE 11V FRAME AND GRATE	659.34	652.32 (EX)				652.39 (EX)			
1	1-10	636+85.22	39.1' LT	MANHOLES TO BE ADJUSTED WITH NEW	TYPE 1FRAME, CLOSED LID	658.75			648.53 (EX) 652.88 (EX)				648.33 (EX)	
1	1-11	636+91.74	38.9' LT	CATCH BASINS TO BE ADJUSTED WITH NEW	TYPE 1FRAME, CLOSED LID	658.97					651.96 (EX)		651.96 (EX)	
1	1-12	636+87.00	42.0' RT	INLETS, TYPE A	TYPE 24 FRAME AND GRATE	658.61	653.39 (EX)							

NOTE:

- * DRAINAGE STRUCTURE TO BE TURNED SO THAT THE FRAME OR GRATE IS CLOSEST TO THE CENTERLINE OF THE ROAD.
 - % DRAINAGE STRUCTURE TO BE TURNED SO THA THE FRAME OR GRATE IS FURTHEST FROM TH CENTERLINE OF THE ROAD.

DRAINAGE SHEET WILLOW ROAD STA 637+00 TO STA 649+00 LEFT SYSTEM

SHEET STRUCTURE STATION			OFFSET	TYPE	FRAME & GRATE	RIM	INVERT ELEVATIONS							
SHEE	NUMBER	STATION	OFFSET	IYPE	FRAME & GRATE	ELEVATION	NORTH	NORTHEAST	EAST	SOUTHEAST	SOUTH	SOUTHWEST	WEST	NORTHWEST
2	2-1	637+12.58	40.9' LT	MANHOLES TO BE ADJUSTED WITH NEW	TYPE 24 FRAME AND GRATE	659.62			652.34 (EX)				648.79 (EX)	
2	2-2	638+68.22	41.0' LT	CB, TYPE A, 5'-DIAMETER	TYPE 24 FRAME AND GRATE	664.81			654.43 (EX)		657.23		654.33 (EX)	
2	2-3	638+68.74	35.3' LT	MH, TYPE A, 4'-DIAMETER	TYPE 1FRAME, CLOSED LID	664.95	657.25				657.35 (EX)			
2	2-4	638+68.64	13.0' LT	CB, TYPE A, 4'-DIAMETER	TYPE 11V FRAME AND GRATE	665.29	657.44 (EX)				657.46 (EX)			
2	2-5	638+68.39	42.0' RT	CB, TYPE A, 4'-DIAMETER	TYPE 24 FRAME AND GRATE	664.61	657.77 (EX)				660.45			
2	2-6	638+68.39	55.4' RT	CB, TYPE C	TYPE 8 GRATE	663.50	660.50							
2	2-7	640+16.03	50.5' LT	CB, TYPE C	TYPE 24 FRAME AND GRATE	668.56					664.56			
2	2-8	640+15.32	33.8' LT	MH, TYPE A, 4'-DIAMETER	TYPE 1FRAME, CLOSED LID	668.92	664.42				661.76 (EX)			661.26 (EX)
2	2-9	640+14.43	13.0' LT	CB, TYPE A, 4'-DIAMETER	TYPE 11V FRAME AND GRATE	669.20	661.82 (EX)				661.84 (EX)			
2	2-10	640+12.09	42.0' RT	CB, TYPE C	TYPE 24 FRAME AND GRATE	668.48	662.07 (EX)							
2	2-11	517+43.71	51.0' LT	CB, TYPE A, 4'-DIAMETER	TYPE 24 FRAME AND GRATE	668.78	664.04				663.94			
2	2-12	517+17.00	51.0' LT	CB, TYPE A, 4'-DIAMETER	TYPE 24 FRAME AND GRATE	668.90	663.72					663.47		
2	2-13	516+99.00	75.0' LT	MH, TYPE A, 4'-DIAMETER	TYPE 1FRAME, CLOSED LID	669.99		663.22			663.02			
2	2-14	640+53.41	39.4' LT	MANHOLES TO BE ADJUSTED WITH NEW	TYPE 1FRAME, CLOSED LID	669.59	662.52		656.49 (EX)				656.49 (EX)	
2	2-15	517+43.71	9.0' RT	CB, TYPE A, 4'-DIAMETER	TYPE 11V FRAME AND GRATE	669.77	665.55				665.65			
2	2-16	517+27.00	9.0' RT	INLETS, TYPE A	TYPE 11V FRAME AND GRATE	669.79	665.79							
2	2-17	517+60.00	43.5' RT	CB, TYPE A, 4'-DIAMETER	TYPE 24 FRAME AND GRATE	669.20	664.98				665.08			
2	2-18	517+36.00	45.9' RT	INLETS, TYPE A	TYPE 24 FRAME AND GRATE	669.29	665.29							
2	2-19	644+00.00	52.0' LT	CB, TYPE C	TYPE 24 FRAME AND GRATE	668.88					665.44			
2	2-20	644+00.00	24.5' LT	MH, TYPE A, 4'-DIAMETER	TYPE 1FRAME, CLOSED LID	669.51	665.17		664.92		665.38			
2	2-21	644+00.00	3.0' RT	CB, TYPE C	TYPE 11V FRAME AND GRATE	669.62	665.62							
2	2-22	645+90.00	50.0' LT	CB, TYPE C	TYPE 24 FRAME AND GRATE	665.14					661.96			
2	2-23	645+90.00	24.5' LT	MH, TYPE A, 4'-DIAMETER	TYPE 1FRAME, CLOSED LID	665.72	661.72		661.47		661.87		661.67	
6 2	2-24	645+90.00	8.0' LT	CB, TYPE C	TYPE 11V FRAME AND GRATE	666.00	662.00							
2	2-25	648+00.00	50.9' LT	INLETS, TYPE A	TYPE 8 GRATE	660.47					658.43			
2	2-26	648+00.00	39.3' LT	MH, TYPE A, 4'-DIAMETER	TYPE 24 FRAME AND GRATE	661.45	658.37				658.27			
2	2-27	648+00.00	22.8' LT	MH, TYPE A, 4'-DIAMETER	TYPE 1FRAME, CLOSED LID	661.80	658.11		657.61				657.86	

DRAINAGE SHEET WILLOW ROAD STA 637+00 TO STA 649+00 RIGHT SYSTEM

SHEET	STRUCTURE	STATION	OFFSET	TYPE	FRAME & GRATE	RIM				INVERT ELE	VATIONS			
SHEET	NUMBER	STATION	OFFSET	ITPE	FRAINE & GRATE	ELEVATION	NORTH	NORTHEAST	EAST	SOUTHEAST	SOUTH	SOUTHWEST	WEST	NORTHWEST
3	3-1	514+67.47	51.0' LT	CB, TYPE A, 4'-DIAMETER	TYPE 24 FRAME AND GRATE	668.88			665.07		665.17			
3	3-2	514+41.00	51.0' LT	INLETS, TYPE A	TYPE 24 FRAME AND GRATE	668.93	665.41							
3	3-3	514+65.00	33.6' LT	MH, TYPE A, 4'-DIAMETER	TYPE 1FRAME, CLOSED LID	669.30			664.68		664.43		664.93	
3	3-4	514+81.17	9.0' LT	CB, TYPE C	TYPE 11V FRAME AND GRATE	669.64					665.64			
3	3-5	514+65.00	9.0' LT	CB, TYPE A, 4'-DIAMETER	TYPE 11V FRAME AND GRATE	669.65	665.50		664.77				664.77	
3	3-6	514+65.00	51.0' RT	CB, TYPE A, 4'-DIAMETER	TYPE 24 FRAME AND GRATE	669.26					665.32		665.07	
3	3-7	514+30.00	51.0' RT	CB, TYPE A, 4'-DIAMETER	TYPE 24 FRAME AND GRATE	669.09	665.48				665.48			
3	3-8	514+06.17	51.0' RT	INLETS, TYPE A	TYPE 24 FRAME AND GRATE	669.04	665.58							
3	3-9	644+00.00	31.0' RT	INLETS, TYPE A	TYPE 24 FRAME AND GRATE	669.16					664.32			
3	3-10	644+00.00	49.8' RT	CB, TYPE A, 4'-DIAMETER	TYPE 1FRAME, CLOSED LID	667.19	664.18		663.93					
3	3-11	646+00.00	31.0' RT	INLETS, TYPE A	TYPE 24 FRAME AND GRATE	665.17					660.69			
3	3-12	646+00.00	49.8' RT	CB, TYPE A, 4'-DIAMETER	TYPE 1FRAME, CLOSED LID	663.75	660.55		660.30				660.50	
3	3-13	648+00.00	31.0' RT	INLETS, TYPE A	TYPE 24 FRAME AND GRATE	661.45					657.26			
3	3-14	648+00.00	49.8' RT	CB, TYPE A, 4'-DIAMETER	TYPE 1FRAME, CLOSED LID	660.03	657.12		656.62				656.87	

FILE NAME =	USER NAME = BAWitort	DESIGNED	-	JLV	REVISED -	
G:\CH11\0158\Road\Sheets\D160T35-SHT-DR#IN-101.dgn				KAL	REVISED -	
	PLOT SCALE = 100.00000 '/ in.	CHECKED	-	RCB	REVISED -	
	PLOT DATE = 11/30/2012	DATE	-	10/31/2012	REVISED -	\Box

STATE	OF	ILLINOIS
DEPARTMENT	0F	TRANSPORTATION

	F.A.P. RTE.	SECTION	COUNTY	TOTAL SHEETS	SHEET NO.			
WILLOW ROAD DRAINAGE STRUCTURE TABLES		(1920.01,1518,2022&1922.4B)R	COOK	919	200			
			CONTRACT NO. 60T35					
SCALE: N.T.S. SHEET NO. 200 OF 919 SHEETS	FED. R	OAD DIST. NO. 1 ILLINOIS FED. AI	D. AID PROJECT					