01-17-2025 LETTING ITEM 088 FOR INDEX OF SHEETS, SEE SHEET NO. 2 FOR INDEX OF HIGHWAY STANDARDS, SEE SHEET NO. 2

**FUNCTIONAL CLASSIFICATION GRAND BOULEVARD - MAJOR COLLECTOR BROOKFIELD AVENUE - MINOR COLLECTOR** 

TRAFFIC DATA **GRAND BOULEVARD** ADT (2022) = 3,250, ADT

**BROOKFIELD AVENUE ADT (2022) = 800, ADT** 

**POSTED SPEED LIMIT GRAND BOULEVARD = 25 MPH BROOKFIELD AVENUE = 25 MPH** 


**DESIGN SPEED LIMIT GRAND BOULEVARD = 30 MPH BROOKFIELD AVENUE = 30 MPH** 



Civil Engineers

 Municipal Consultants Established 1911

Wistcheiter 8, 60154-2790 Phone 708-865-7309

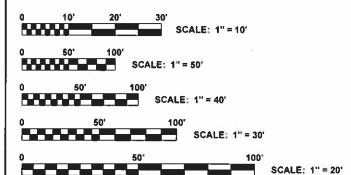

FULL SIZE PLANS HAVE BEEN PREPARED USING STANDARD ENGINEERING SCALES. REDUCED SIZED PLANS WILL NOT CONFORM TO STANDARD SCALES. IN MAKING MEASUREMENTS ON REDUCED PLANS, THE ABOVE SCALES MAY BE USED.



Know what's below. Call before you dig.

Contact the Metropolitan **Water Reclamation District** of Greater Chicago 2 days before starting work.

P (708) 588-4055 ■ WMOjobStart@mwrd.org

CONTRACT NO. 61K86

### STATE OF ILLINOIS **DEPARTMENT OF TRANSPORTATION**


# PLANS FOR PROPOSED **FEDERAL AID HIGHWAY**

**FAU ROUTE 1694 (GRAND BOULEVARD) GRANT AVENUE TO BROOKFIELD AVENUE FAU ROUTE 1408 (BROOKFIELD AVENUE) PRAIRIE AVE TO WASHINGTON AVENUE** RESURFACING

**SECTION NO.: 21-00134-00-RS** PROJECT NO.: AQ4W(052)

VILLAGES OF BROOKFIELD AND RIVERSIDE

**COOK COUNTY** 

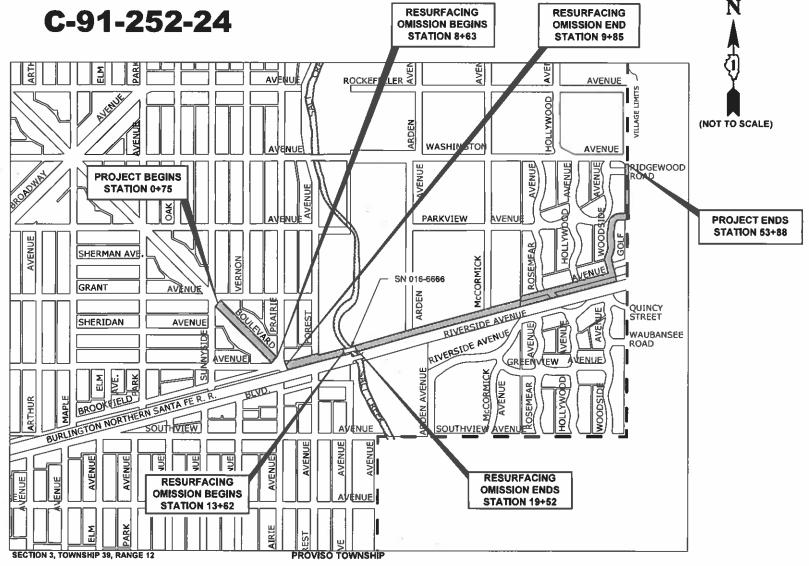


- AREA OF IMPROVEMENT GROSS LENGTH OF IMPROVEMENT = 5,313 FT = 1,006 MI NET LENGTH OF IMPROVEMENT = 4,601 FT = 0.871 MI

1694/1408 21-00134-00-RS COOK ILLINOIS PROJECT AQ4W(052) 61K86



INDICATED THUS:

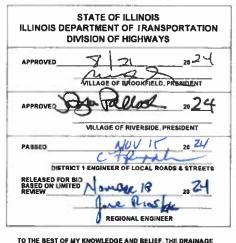

TO THE BEST OF MY KNOWLEDGE AND BELIEF, THE DRAINAGE OF SURFACE WATERS WILL NOT BE CHANGED BY THE PROPOSED DEVELOPMENT, IF ANY DRAINAGE PATTERNS WILL BE CHANGED, REASONABLE PROVISIONS HAVE BEEN MADE FOR THE COLLECTION AND DYPERSION OF SUCH SUFFACE WATERS IN TO THE PUBLIC AREA, OR DRAINS APPROVED FOR THE USE BY THE MUNICIPAL ENGINEER, AND THAT SUCH SURFACE WATERS ARE PLANNED FOR IN ACCORDANCE WITH GENERALLY
ACCEPTED ENGINEERING PRACTICES SO AS TO REDUCE THE
LIKELIHOOD OF DAMAGES TO ADJOINING PROPERTIES



PRINTED BY THE AUTHORITY OF THE STATE OF ILLINOIS

F.H.F. PROJECT NO. 125-21-005-8

SHEET NO.	DESCRIPTION			
1	TITLE SHEET, LOCATION MAP			
2	INDEX OF SHEETS AND LEGEND OF SYMBOLS			
3	GENERAL NOTES			
4	M.W.R.D.G.C. GENERAL NOTES			
5-14	SUMMARY OF QUANTITIES			
15-18	EXISTING AND PROPOSED TYPICAL SECTIONS			
19-24	PAVING AND UTILITY PLAN			
25-29	PAVING AND UTILITY DETAILS			
30-37	MAINTENANCE OF TRAFFIC AND STAGING PLAN			
38-40	DETOUR PLAN			
41-43	EROSION CONTROL PLANS AND SWPPP			
44	ROUTE OUTLET MAP			
45-48	PAVING MARKING AND SIGNING PLAN			
49-51	LANDSCAPING PLAN			
52-53	STREET LIGHTING PLAN			
54-55	STREET LIGHTING WIRING DIAGRAM			
56-59	LIGHTING DETAILS			
60-68	IDOT DISTRICT ONE DETAILS			

EXISTING	PROPOSED	DESCRIPTION	EXISTIN
Ø	<b>96</b>	POWER POLE	
Δ		GAS VALVE	++++
<b>♦</b> >>	<b>~</b>	STREET LIGHT	
Ø	•	WATER MAIN BUFFALO BOX	——((—
$\otimes$	8	WATER MAIN VALVE BOX	
(\$)		SPRINKLER	
		WATER MAIN VALVE VAULT	w
	-	STORM INLET	——-E⊢—
Я	A	FIRE HYDRANT	———G⊢—
$\boxtimes_{RM}$		EXISTING STRUCTURE TO BE REMOVED	——т—
×		EXISTING STRUCTURE TO BE FILLED	====:
⊠ <sub>RM</sub> ⊠ <sub>F</sub> ⊗ <sub>RM</sub>		TREE TO BE REMOVED	
O KM		BUSH	
	•	NEW TREE	
$\odot$		TREE	
5°-2		EVERGREEN TREE	\(\sum_{xxx}\)
2/-	TP	TREE TRUNK PROTECTION	XXXX
	RP	ROOT PRUNING	XXX
7777		NON-SPECIAL WASTE DISPOSAL	
		EXISTING CONCRETE SIDEWALK TO BE REMOVED	XXX
		EXISTING CONCRETE DRIVEWAY TO BE REMOVED	
		EARTH EXCAVATION	
		PROPOSED CONCRETE PAVEMENT/SIDEWALK	
		PROPOSED HOT MIX ASPHALT PAVING	.643.9 ×
		PROPOSED HOT MIX ASPHALT PAVING	

<del></del>	<del></del>	STORM SEWER PIPE
<del></del> (	—— <b>«</b> ——	COMBINATION SEWER PIPE
		SANITARY SEWER PIPE
	<del></del> .	UNDERDRAIN
		WATER MAIN
———E———		ELECTRIC LINE
———G⊢——		GAS LINE
——т——		TELECOMMUNICATION LINE
======	4	CURB AND GUTTER
		EXISTING CURB AND GUTTER TO BE REMOVED
		DIRECTION OF FLOW
	<b>-\$-</b>	DRAINAGE SUMMIT
XXXX	627.75	WATER MAIN VALVE VAULT RIM AND TOP OF PIPE ELEVATION
XXX	4' DIA. MH R:622.05 617.35 8"N	COMBINATION MANHOLE RIM AND INVERT ELEVATION
XXX	4' DIA. MH R:622.05 617.35 8"N	STORM SEWER MANHOLE/CATCHBASIN RIM AND INVERT ELEVATION
	Α	STRUCTURE TO BE ADJUSTED
	1C	TYPE 1 FRAME & CLOSED LID
	1P	TYPE 1 FRAME & OPEN LID
	RC	RECONSTRUCT EXISTING STRUCTURE
643.90 ×	632.25 <sub>×</sub>	GROUND ELEVATIONS

PROPOSED

**DESCRIPTION** 

STORM SEWER TO BE REMOVED

### **DISTRICT ONE DETAILS**

TRAFFIC CONTROL AND PROTECTION FOR SIDE ROADS, INTERSECTIONS, AND DRIVEWAYS (TC-10) DISTRICT ONE TYPICAL PAVEMENT MARKINGS (TC-13) SHORT TERM PAVEMENT MARKING LETTERS AND SYMBOLS (TC-16) DETOUR SIGNING FOR CLOSING STATE HIGHWAYS (TC-21) ARTERIAL ROAD INFORMATION SIGN (TC-22) DRIVEWAY ENTRANCE SIGNING (TC-26) FRAMES AND LIDS ADJUSMENT WITH MILLING (BD-08) BUTT JOINTS AND HMA TAPER DETAILS (BD-32) MISC. ELECTRICAL DETAILS, SHEET A (BE-702)

STANDARD NO.	TITLE OR DESCRIPTION	STANDARD NO	)
000001-08	STANDARD SYMBOLS, ABBREVIATIONS AND PATTERNS	720001-01	9
280001-07	TEMPORARY EROSION CONTROL SYSTEMS	720006-04	S
424001-12	PERPENDICULAR CURB RAMPS FOR SIDEWALKS	720011-01	N
424016-06	MID-BLOCK CURB RAMPS FOR SIDEWALKS	720016-04	M
424026-04	ENTRANCE ALLEY PEDESTRIAN CROSSINGS	728001-01	7
442101-09	CLASS B PATCHES	729001-01	P
442201-03	CLASS C & D PATCHES	731001-01	В
601001-05	PIPE UNDERDRAINS	780001-05	Т
602601-06	PRECAST REINFORCED CONCRETE FLAT SLAB TOP	805001-01	E
701006-05	OFF-RD OPERATIONS, 2L, 2W, 15' (4.5M) TO 24"(600MM) FROM PAVEMENT EDGE	814001-03	H
701011-04	OFF-RD MOVING OPERATIONS, 2L, 2W, DAY ONLY	814006-03 838001-01	D B
701301-04	LANE CLOSURE, 2L, 2W, SHORT TIME OPERATIONS	636001-01	
701311-03	LANE CLOSURE, 2L, 2W, MOVING OPERATIONS-DAY ONLY		
701501-06	URBAN LANE CLOSURE, 2L, 2W, UNDIVIDED		
701801-06	SIDEWALK, CORNER OR CROSSWALK CLOSURE		

TRAFFIC CONTROL DEVICES

TITLE OR DESCRIPTION
SIGN PANEL MOUNTING DETAILS
SIGN PANEL ERECTION DETAILS
METAL POSTS FOR SIGNS, MARKERS AND DELINEATORS
MAST ARM MOUNTED STREET NAME SIGNS
TELESCOPING STEEL SIGN SUPPORT
APPLICATIONS OF TYPES A&B METAL POSTS
BASE FOR TELESCOPING STEEL SIGN SUPPORT
TYPICAL PAVEMENT MARKINGS
ELECTRICAL SERVICE INSTALLATION DETAILS
HANDHOLES
DOUBLE HANDHOLES
BREAK AWAY DEVICES

HANCOCK ENGINEERING
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9 0	<ul> <li>CMI Engineers</li> </ul>
34	<ul> <li>CMI Engineers</li> <li>M Nicipal Consultants</li> </ul>
\$ N	<ul><li>Established 1911</li></ul>

	9933 Rocsevell Road
,	Westchaster, IL, 60154-2780
	Phone: 708-665-0300
	www.ehancock.com

reft Road	DESIGNED -	O <del>f</del>
154-2780	DRAWN -	ECW, SB, GD, DMM, L
ALS-020D	CHECKED -	e <del>l</del>
ock,com	DATE -	11-7-24

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	DATE - 11-7-24	REVISED -	

701901-10

STATE OF ILLINOIS
DEPARTMENT OF TRANSPORTATION

	INDEX OF CHEETS AND LEGEND OF COMPOSE		F.A.U. RTE.	SECTION	COUNTY	TOTAL	SHE			
	INDEX OF SHEETS AND LEGEND OF SYMBOLS			1694/140	21-00134-00-RS	COOK	68	2		
l,		,		,				CONTRACT	NO.	61K86
ij	SCALE: NONE	SHEET NO. 1 OF	1 SHEETS	STA.	TO STA.	FED.	ROAD DIST. NO. 1   ILLINOIS	FED. AID PRO	JECT	

- ANY REFERENCE TO STANDARDS THROUGHOUT THE PLANS OR SPECIAL PROVISIONS SHALL BE INTERPRETED TO BE THE LATEST STANDARD OF THE ILLINOIS DEPARTMENT OF TRANSPORTATION AS SHOWN ON THE INDEX OF SHEETS IN THE PLANS. ALL CONSTRUCTION SHALL BE DONE IN ACCORDANCE WITH THE "STANDARDS SPECIFICATIONS FOR ROAD AND BRIDGE CONSTRUCTION" ADOPTED JANUARY 1, 2022, AND THE "SUPPLEMENTAL SPECIFICATIONS AND RECURRING SPECIAL PROVISIONS" ADOPTED JANUARY 1, 2025. THE "ILLINOIS MANUAL ON UNIFORM TRAFFIC AND CONTROL DEVICES FOR STREETS AND HIGHWAYS," 11TH EDITION, THE "SPECIAL PROVISIONS" INCLUDED IN THE CONTRACT DOCUMENTS THE VILLAGE OF BROOKFIELD MUNICIPAL CODE. THE METROPOLITAN WATER RECLAMATION DISTRICT OF GREATER CHICAGO (MWRD) WATERSHED MANAGEMENT ORDINANCE AND TECHNICAL GUIDANCE MANUAL, AND THE "DETAILS" IN THE PLANS. IN CASE OF CONFLICT BETWEEN THE APPLICABLE ORDINANCES NOTED, THE MORE STRINGENT SHALL TAKE PRECEDENCE AND SHALL CONTROL ALL
- 2. WHEN WORK COMMENCES, THE CONTRACTOR SHALL ASSUME THE MAINTENANCE OF ANY PAVEMENT, SHOULDERS, DRAINAGE FACILITIES, TRAFFIC CONTROL SIGNS, PAVEMENT MARKINGS, AND OTHER APPURTENANCES ON ROADWAYS WITHIN THE LIMITS OF THE CONTRACT THAT ARE TO BE USED BY THE PUBLIC DURING CONSTRUCTION AND TO RETAIN THIS MAINTENANCE RESPONSIBILITY UNTIL PROJECT COMPLETION. SNOW AND ICE CONTROL OR REMOVAL WILL BE DONE BY OTHERS.
- CONTRACTOR SHALL TAKE PRECAUTION BY PRESERVING EXISTING TREES WITHIN THE RIGHT OF WAY. IF ANY DAMAGE OCCURS, TREE SHALL BE REPLACED IN KIND PER ARTICLE 201.07 REPAIR OR REPLACEMENT OF EXISTING PLANT MATERIAL REQUIREMENTS STATED HEREIN
- 4. THE CONTRACTOR WILL NOT BE ALLOWED TO SET UP A YARD OR FIELD OFFICE ON STATE OR VILLAGE PROPERTY WITHOUT WRITTEN PERMISSION FROM THE ENGINEER
- THE CONTRACTOR SHALL MAINTAIN ACCESS FOR EMERGENCY VEHICLES AND GARBAGE TRUCKS AT ALL TIMES. IF THE GARBAGE TRUCKS ARE NOT ABLE TO HAVE ACCESS TO ALL OF THE PROPERTIES WITHIN THE PROJECT LIMITS, THEN THE CONTRACTOR SHALL PLACE ANY GARBAGE THAT IS AFFECTED IN A LOCATION WHERE THE GARBAGE TRUCKS CAN PICK IT UP. THE CONTRACTOR SHALL RETURN THE GARBAGE CANS TO THE PARKWAY OF THE RESPECTIVE PROPERTY BY THE END OF THE DAY.
- 6. THE CONTRACTOR WILL BE RESPONSIBLE FOR PROVIDING WRITTEN NOTICE TO ALL RESIDENCES AND/OR PLACES OF BUSINESS IN THE WORK ZONE AT LEAST ONE (1) WORKING DAY PRIOR TO PERFORMING ANY CONSTRUCTION ACTIVITY THAT WILL ELIMINATE ACCESS TO THEIR PROPERTY. THE WRITTEN NOTICE SHALL BE APPROVED BY THE ENGINEER AND COORDINATED WITH THE VILLAGE PRIOR
- IT IS THE CONTRACTOR'S SOLE RESPONSIBILITY TO COORDINATE WITH THE BNSF RAILROAD WHENEVER CONSTRUCTION ACTIVITY IS WITHIN 25 FEET OF THE RAILROAD OR WITHIN BNSF ROW. THE CONTRACTOR SHALL RETAIN FLAGMEN EMPLOYED AND DESIGNATED BY THE BNSF RAILROAD TO MONITOR ON-COMING TRAIN TRAFFIC, AND ADVISE CONTRACTOR PERSONNEL WHEN ACTIVITY ON OR NEAR THE RAILROAD ROW MAY PROCEED. THIS ITEM WILL BE PAID FOR ACCORDING TO ARTICLE 107.12 AND WILL BE REIMBURSDED ACCORDING TO ARTICLE 109.05.
- BEFORE STARTING ANY EXCAVATION, THE CONTRACTOR SHALL CALL "JULIE" AT 811 FOR FIELD LOCATIONS OF BURIED ELECTRICAL, TELEPHONE AND GAS FACILITIES. (48 HOURS NOTIFICATION IS
- 9. THE LOCATIONS OF THE UNDERGROUND UTILITIES IF SHOWN ON THE PLANS HAVE BEEN OBTAINED BY FIELD SURVEYS AND SEARCHES OF AVAILABLE RECORDS. THE VILLAGE OF BROOKFIELD, THE ILLINOIS DEPARTMENT OF TRANSPORTATION AND/OR OTHER OFFICES AND AGENCIES ASSOCIATED WITH THE DEVELOPMENT OF THESE PLANS DO NOT GUARANTEE THEIR ACCURACY OR COMPLETENESS. THE CONTRACTOR SHALLL BE REQUIRED TO VERIFY THE EXACT LOCATION OF EACH FACILITY WITH THE UTILITY COMPANY, AND SHALL TAKE DUE CARE IN ALL PHASES OF THE CONSTRUCTION TO PROTECT ANY SUCH FACILITIES WHICH MAY BE AFFECTED BY THE WORK, ANY DAMAGE TO EXISTING UTILITIES DURING CONSTRUCTION ACTIVITIES SHALL BE REPAIRED OR REPLACED TO THE SATISFACTION OF THE
- 10. THE CONTRACTOR SHALL COORDINATE CONSTRUCTION ACTIVITIES WITH UTILITY COMPANIES AND THE VILLAGE OF BROOKFIELD.
- 11. ADJUSTMENTS REQUIRED BY UTILITY COMPANIES WILL BE PERFORMED BY THE COMPANY INVOLVED OR ITS CONTRACTOR, BUT WILL BE COORDINATED BY GENERAL CONTRACTOR.

THE CONTRACTOR SHALL USE EXTREME CAUTION IN THE REMOVAL OF ABANDONED EXISTING GAS LINES SINCE RESIDUAL MATERIALS CONTAINED THEREIN ARE HIGHLY EXPLOSIVE, FLAMMABLE, AND TOXIC. ONCE THE MAINS ARE ABANDONED BY THE OWNER. THE CONTRACTOR SHALL ASSUME ALL RESPONSIBILITY FOR ANY DAMAGE AND/OR INJURY OCCURRING ON THE PROJECT DUE TO HIS/HER OPERATIONS NEXT TO THE MAINS AND/OR THE METHOD OF REMOVAL OF THE ABANDONED MAINS.

12. THE VILLAGE WILL PASS OUT A LETTER REQUESTING THAT ALL RESIDENTS WITH SPRINKLER SYSTEMS IN THE PARKWAY NOTIFY THE VILLAGE PRIOR TO CONSTRUCTION. THE VILLAGE WILL THEN MARK THE SPRINKLER HEADS ON THESE SYSTEMS. THE CONTRACTOR WILL BE RESPONSIBLE FOR ALL COSTS FOR REPAIRING ANY DAMAGE THAT IS DONE TO EXISTING SPRINKLER SYSTEMS THAT HAVE BEEN LOCATED

### **CONSTRUCTION NOTES**

- THE SUBGRADE STABILITY WILL BE VERIFIED BY PROOF ROLLING WITH A FULLY LOADED TANDEM-AXLE TRUCK.
- GEOTECHNICAL FABRIC FOR GROUND STABILIZATION AND/OR AGGREGATE SUBGRADE IMPROVEMENT (CU YD) HAVE BEEN PROVIDED FOR USE AT THE LOCATIONS INDICATED FOR SOILS THAT TEND TO BE UNSTABLE AND/OR UNSUITABLE. THE ACTUAL NEED FOR REMOVAL AND REPLACEMENT WITH ABOVE ITEM WILL BE DETERMINED IN THE FIELD AT THE TIME OF CONSTRUCTION BY THE ENGINEER. ALL POTENTIALLY UNSTABLE SOILS SHOULD BE TESTED WITH A STATIC OR DYNAMIC CONE
  PENETROMETER AND TREATED IN ACCORDANCE WITH ARTICLE 301.04 OF THE SSRBC AND IDOT SUBGRADE STABILITY MANUAL. IF UNSTABLE AND/OR UNSUITABLE SOILS ARE NOT ENCOUNTERED, THEN THE QUANTITY SHALL BE DEDUCTED AND NO ADDITIONAL COMPENSATION WILL BE DUE TO THE
- ANY AGGREGATE SUBGRADE IMPROVEMENT CONTAMINATED AND/OR DAMAGED BY THE CONTRACTOR'S VEHICLES AND/OR EQUIPMENTS IS TO BE REMOVED AND REPLACED AS DIRECT BY THE ENGINEER AT CONTRACTOR EXPENSE.
- 4. WHEN REMOVING PAVEMENT AND/OR OTHER STRUCTURES, THE CONTRACTOR SHALL NOT USE ANY TYPE OF CONCRETE BREAKERS SUCH AS DROP HAMMERS, THAT MIGHT DAMAGE UNDERGROUND PUBLIC OR PRIVATE UTILITIES.
- THE CONTRACTOR SHALL SAW CUT ASPHALT PAVEMENT AS INDICATED ON THE PLANS TO SEPARATE THE EXISTING PAVEMENT TO BE REMOVED BY APPROVED MEANS OR AN APPROVED CONCRETE SAW TO A DEPTH AS DIRECTED BY THE ENGINEER. SUITABLE GUIDELINES OR DEVICES SHALL BE USED TO ASSURE CUTTING A NEAT, STRAIGHT LINE AS SHOWN ON THE PLANS. CARE SHALL BE TAKEN BY THE CONTRACTOR AS NOT TO DAMAGE THE REMAINING PAVEMENT DIRECTLY ADJACENT TO THE PAVEMENT TO BE REMOVED. ANY DAMAGE TO THE EXISTING PAVEMENT RESULTING FROM PAVEMENT REMOVAL OPERATIONS SHALL BE REPAIRED TO THE SATISFACTION OF THE ENGINEER.
- 6. A BUTT JOINT WILL BE INSTALLED AT THE ENDS OF ALL RESURFACING (WHERE RESURFACING MEETS EXISTING PAVEMENT) IN ACCORDANCE WITH THE "BUTT JOINT AND HMA TAPER DETAILS" SHEET INCLUDED IN THE PLANS, UNLESS OTHERWISE SPECIFIED.
- 7. WHEN MILLED PAVEMENT IS OPEN TO TRAFFIC THE MAXIMUM GRADE DIFFERENTIAL BETWEEN PASSES OF THE MILLING MACHINE SHALL NOT EXCEED 1½ INCHES (40 MM) WHERE THE SPEED LIMIT IS 45 MPH (80 KM/H) OR LESS AND 1 INCH (25 MM) WHERE THE SPEED LIMIT IS GREATER THAN 45 MPH (80 KM/H). WITH WRITTEN APPROVAL FROM THE ENGINEER, A MAXIMUM GRADE DIFFERENTIAL OF 3 INCHES (75 MM) MAY BE ALLOWED IF THE EDGE OF THE MILLING IS SLOPED A MINIMUM 1:3 (V:H).
- THE CONTRACTOR WILL BE REQUIRED TO SCHEDULE THEIR OPERATIONS SO THAT NO SECTIONS OF PAVEMENT ALONG THE CENTERLINE WILL HAVE A COLD JOINT OVERNIGHT.
- LOCATIONS OF CLASS B OR D PATCHES ON PLANS ARE APPROXIMATE. EXACT LOCATIONS WILL BE DETERMINED IN THE FIELD BY ENGINEER. CLASS B OR D PATCHES LOCATED WITHIN THE THROUGH LANES SHALL BE MADE ACCESSIBLE TO TRAFFIC AT THE END OF EACH WORK DAY.
- 10. PAVEMENT PATCHING SHALL BE STAGED TO MAINTAIN TWO-WAY TRAFFIC AT ALL TIMES.
- 11. IT SHALL BE THE CONTRACTOR'S RESPONSIBILITY TO TAKE PRECAUTIONS SO AS NOT TO DAMAGE EXISTING SIDEWALKS, DRIVEWAYS, AND PAVEMENTS OUTSIDE THE LIMITS OF RESTORATION. THE GENERAL LIMITS OF RESTORATION ARE SHOWN ON THE PLANS. THE ENGINEER WILL MARK OUT THE EXACT LIMITS OF REMOVAL FOR THESE ITEMS PRIOR TO THE COMMENCEMENT OF WORK. THE CONTRACTOR SHALL BE RESPONSIBLE FOR RESTORING ANY DAMAGE TO SIDEWALKS, DRIVEWAYS, AND PAVEMENTS OUTSIDE OF THESE LIMITS TO THE SATISFACTION OF THE ENGINEER AND THE VILLAGE AT HIS OWN EXPENSE.
- 12. LOCATIONS OF CURB AND GUTTER AND SIDEWALK REPLACEMENT ARE APPROXIMATE. XACT LOCATIONS WILL BE DETERMINED DURING CONSTRUCTION.

### UNDERGROUND NOTES

- 1. SANITARY SEWER SERVICE CONNECTION LENGTHS SHOWN ON PLAN ARE ESTIMATED, CONTRACTOR TO VERIFY IN FIELD SERVICE PIPE QUALITY AND GRADE WHEN MAKING CONNECTIONS TO EXISTING PIPE. SPECIAL ATTENTION SHOULD BE PAID TO CROSSINGS AT PURPOSED STORM SEWER PIPE. UNLESS SHOWN OTHERWISE ON PLAN, ASSUMED SANITARY SERVICE PIPE LENGTH TO COMPLETE
- 2. THE TYPE OF THE FRAMES AND GRATES REQUIRED FOR ALL CATCH BASINS AND MANHOLE LISTED IN THE SUMMARY OF QUANTITIES MAY BE FOUND ON THE PLANS AT THEIR RESPECTIVE LOCATIONS. WHERE LIDS ARE CALLED FOR ON THE PLANS, THEY SHALL BE IN ACCORDANCE WITH ARTICLE 604.01 OF TH STANDARD SPECIFICATIONS AND THE TERM LID IS USED IN LIEU OF GRATE.
- THE WORD "WATER", "SANITARY", OR "STORM" SHALL BE CAST INTO THE LID OF EACH RESPECTIVE
- 3. ON ALL IMPROVEMENTS. THE FRAMES AND LIDS OF EXISTING CATCH BASINS, INLETS, MANHOLES, AND VALVE VAULTS WHICH ARE TO BE ABANDONED DUE TO CONSTRUCTION OF THIS IMPROVEMENT ARE TO REMAIN THE PROPERTY OF THE VILLAGE OF BROOKFIELD AND BE SALVAGED. THE CONTRACTOR SHALL DELIVER FRAMES AND LIDS TO THE VILLAGE OF BROOKFIELD LOCATED AT 4545 EBERLY AVE, BROOKFIELD, IL 60513 (708) 485-7344.
- THE CONTRACTOR SHALL CONDUCT OPERATIONS AS TO MAINTAIN AT ALL TIMES FLOW THROUGH EXISTING STORM AND SAN ITARY SEWER SYSTEMS. THE CONTRACTOR SHALL ALSO PROVIDE AND MAINTAIN AN EFFICIENT PUMPING PLANT IF NECESSARY AND A TEMPORARY OUTLET AND BE PREPARED AT ALL TIMES TO DISPOSE OF THE WATER COLLECTED IN A SAFE MANNER WITHOUT DAMAGE OF ANY KIND TO ADJACENT PROPERTIES. THE ENDS OF EXISTING DRAINAGE LINES THAT ARE NOT TO BE INCORPORATED INTO THE PROJECT SHALL BE SEALED AS SPECIFIED IN THE SPECIAL PROVISIONS. EXISTING STRUCTURES ARE TO BE INSPECTED BEFORE CONSTRUCTION STARTS - ANY ACCUMULATION OF MATERIAL IN THE STRUCTURE DUE TO CONSTRUCTION OPERATIONS SHALL BE REMOVED BY THE CONTRACTOR.
- 5. ALL ABANDONED SANITARY SEWERS SHALL BE PLUGGED AT BOTH ENDS WITH AT LEAST 2 FEET LONG NON-SHRINK CONCRETE OR MORTAR PLUG. THIS WORK SHALL NOT BE PAID FOR SEPARATELY, BUT SHALL BE INCLUDED IN THE PAY ITEMS FOR REMOVING AND/OR FILLING THE VARIOUS TYPES OR
- THE CONTRACTOR SHALL BE RESPONSIBLE FOR BACKFILLING THE TRENCHES WITH CRUSHED STONE TO A LEVEL EQUAL TO THAT OF ADJACENT EXISTING PAVEMENTS BY THE END OF EACH WORK DAY. THE STONE SHALL BE LEVELED OFF AND COMPACTED TO THE SATISFACTION OF THE ENGINEER AND THE VILLAGE TO PERMIT TEMPORARY PEDESTRIAN AND VEHICULAR TRAFFIC.
- WHEN DURING THE CONSTRUCTION OPERATIONS, ANY LOOSE MATERIAL IS DEPOSITED IN THE FLOW LINE OF ANY GUTTERS AND DRAINAGE STRUCTURE SO THAT THE NATURAL FLOW OF WATER IS OBSTRUCTED, IT SHALL BE REMOVED AT THE CLOSE OF EACH WORKING DAY. AT THE CONCLUSION OF THE CONSTRUCTION OPERATIONS, ALL DRAINAGE FACILITIES SHALL BE CLEAN AND FREE OF ALL OBSTRUCTIONS DUE TO CONSTRUCTION OPERATIONS.
- 8. FIGURES SHOWN AT SEWER REPAIRS INDICATED DISTANCE FROM CENTER OF MANHOLE.
- 9. BACKFILLING STORM SEWER CONSTRUCTED UNDER THE ROADWAY SPECIFIED UNDER ART, 550,07 (B.C) OF THE SSRBC WILL NOT BE ALLOWED.

### COMMITMENTS

- TREES THREE (3) INCHES IN DIAMETER AT BREAST HEIGHT SHALL NOT BE CLEARED FROM APRIL 1ST THROUGH SEPTEMBER 30TH
- ALL LIGHTING SHALL BE INSTALLED UTILIZING THE ILLUMINATING ENGINEERING SOCIETY'S BUG (BACKLIGHT, UPLIGHT, AND GLARE) SYSTEM

TO STA.



 CIVII Engineers Municipal Consultants

Vesichester, IL, 60154-2780

DESIGNED - -REVISED -DRAWN REVISED CHECKED -REVISED DATE -11-7-24 REVISED

STATE OF ILLINOIS **DEPARTMENT OF TRANSPORTATION**  **GENERAL NOTES** 

SHEET NO. 1 OF 1 SHEETS STA. -

SCALE: NONE

SECTION SHEETS CONTRACT NO. 61K86 FED ROAD DIST NO 1 ILLINOIS

- 1. ALL CONSTRUCTION SHALL BE IN ACCORDANCE WITH THE APPLICABLE SECTIONS OF THE FOLLOWING,
- ALL CONSTRUCTION SHALL BE IN ACCORDANCE WITH THE APPLICABLE SECTIONS OF THE FOLLOWING, EXCEPT AS MODIFIED HEREIN OR ON THE PLANS:

  \* STANDARD SPECIFICATIONS FOR ROAD AND BRIDGE CONSTRUCTION (LATEST EDITION), BY THE ILLINOIS DEPARTMENT OF TRANSPORTATION (IDOT SS) FOR ALL IMPROVEMENTS EXCEPT SANITARY SEWER AND WATER MAIN CONSTRUCTION;

  \* STANDARD SPECIFICATIONS FOR WATER AND SEWER MAIN CONSTRUCTION IN ILLINOIS, LATEST EDITION (SSWS) FOR SANITARY SEWER AND WATER MAIN CONSTRUCTION;

  \* VILLAGE OF BROOKFIELD MUNICIPAL CODE;

  \* THE METROPOLITAN WATER RECLAMATION DISTRICT OF GREATER CHICAGO (MWRD) WATERSHED MANAGEMENT OF DIVINANCE AND TECHNICAL GUIDANCE MANUAL.

- MANAGEMENT ORDINANCE AND TECHNICAL GUIDANCE MANUAL;
  \* IN CASE OF CONFLICT BETWEEN THE APPLICABLE ORDINANCES NOTED, THE MORE STRINGENT SHALL TAKE PRECEDENCE AND SHALL CONTROL ALL CONSTRUCTION.

### **B. NOTIFICATIONS**

- 1. THE MWRD LOCAL SEWER SYSTEMS SECTION FIELD OFFICE MUST BE NOTIFIED AT LEAST TWO (2) WORKING DAYS PRIOR TO THE COMMENCEMENT OF ANY WORK (CALL 708-588-4055 OR SEND EMAIL NOTIFICATION WITH PROJECT NAME, LOCATION AND PERMIT NUMBER TO WMOJOBSTART@MWRD.ORG).
- 2. THE VILLAGE OF BROOKFIELD ENGINEERING DEPARTMENT AND PUBLIC MUST BE NOTIFIED AT LEAST 24 HOURS PRIOR TO THE START OF CONSTRUCTION AND PRIOR TO EACH PHASE OF WORK, CONTRACTOR SHALL DETERMINE ITEMS REQUIRING INSPECTION PRIOR TO START OF CONSTRUCTION OR EACH WORK PHASE.
- 3. THE CONTRACTOR SHALL NOTIFY ALL UTILITY COMPANIES PRIOR TO BEGINNING CONSTRUCTION FOR THE EXACT LOCATIONS OF UTILITIES AND FOR THEIR PROTECTION DURING CONSTRUCTION. IF EXISTING UTILITIES ARE ENCOUNTERED THAT CONFLICT IN LOCATION WITH NEW CONSTRUCTION, IMMEDIATELY NOTIFY THE ENGINEER SO THAT THE CONFLICT CAN BE RESOLVED, CALL J.U.L.I.E. AT 1-800-892-0123.

### C. GENERAL NOTES

- 1. ALL ELEVATIONS SHOWN ON PLANS REFERENCE THE NORTH AMERICAN VERTICAL DATUM OF 1988 (NAVD88). CONVERSION FACTOR IS 0 FT.
- 2. MWRD, THE MUNICIPALITY AND THE OWNER OR OWNER'S REPRESENTATIVE SHALL HAVE THE AUTHORITY TO INSPECT, APPROVE, AND REJECT THE CONSTRUCTION IMPROVEMENTS.
- 3. THE CONTRACTOR(S) SHALL INDEMNIFY THE OWNER, ENGINEER, MUNICIPALITY, MWRD, AND THEIR AGENTS, ETC., FROM ALL LIABILITY INVOLVED WITH THE CONSTRUCTION, INSTALLATION, OR TESTING OF THIS WORK
- 4. THE PROPOSED IMPROVEMENTS MUST BE CONSTRUCTED IN ACCORDANCE WITH THE ENGINEERING PLANS AS APPROVED BY MWRD AND THE MUNICIPALITY UNLESS CHANGES ARE APPROVED BY MWRD, THE MUNICIPALITY, OR AUTHORIZED AGENT. THE CONSTRUCTION DETAILS, AS PRESENTED ON THE PLANS, MUST BE FOLLOWED. PROPER CONSTRUCTION TECHNIQUES MUST BE FOLLOWED ON THE IMPROVEMENTS
- 5. THE LOCATION OF VARIOUS UNDERGROUND UTILITIES WHICH ARE SHOWN ON THE PLANS ARE FOR INFORMATION ONLY AND REPRESENT THE BEST KNOWLEDGE OF THE ENGINEER. VERIFY LOCATIONS AND ELEVATIONS PRIOR TO BEGINNING THE CONSTRUCTION OPERATIONS.
- 6. ANY EXISTING PAVEMENT, SIDEWALK, DRIVEWAY, ETC., DAMAGED DURING CONSTRUCTION OPERATIONS AND NOT CALLED FOR TO BE REMOVED SHALL BE REPLACED AT THE EXPENSE OF THE CONTRACTOR.
- 7. MATERIAL AND COMPACTION TESTING SHALL BE PERFORMED IN ACCORDANCE WITH THE REQUIREMENTS OF THE MUNICIPALITY, MWRD, AND OWNER.
- 8. THE UNDERGROUND CONTRACTOR SHALL MAKE ALL NECESSARY ARRANGEMENTS TO NOTIFY ALL
- 9. ALL NEW AND EXISTING UTILITY STRUCTURES ON SITE AND IN AREAS DISTURBED DURING CONSTRUCTION SHALL BE ADJUSTED TO FINISH GRADE PRIOR TO FINAL INSPECTION.
- 10. RECORD DRAWINGS SHALL BE KEPT BY THE CONTRACTOR AND SUBMITTED TO THE ENGINEER AS SOON AS UNDERGROUND IMPROVEMENTS ARE COMPLETED. FINAL PAYMENTS TO THE CONTRACTOR SHALL BE HELD UNTIL THEY ARE RECEIVED. ANY CHANGES IN LENGTH, LOCATION OR ALIGNMENT SHALL BE SHOWN IN RED. ALL WYES OR BENDS SHALL BE LOCATED FROM THE DOWNSTREAM MANHOLE. ALL VALVES, B-BOXES, TEES OR BENDS SHALL BE TIED TO A FIRE HYDRANT.

### D. SANITARY SEWER

- 1. THE CONTRACTOR SHALL TAKE MEASURES TO PREVENT ANY POLLUTED WATER, SUCH AS GROUND AND SURFACE WATER, FROM ENTERING THE EXISTING SANITARY SEWERS.
- 2. A WATER-TIGHT PLUG SHALL BE INSTALLED IN THE DOWNSTREAM SEWER PIPE AT THE POINT OF SEWER CONNECTION PRIOR TO COMMENCING ANY SEWER CONSTRUCTION. THE PLUG SHALL REMAIN IN PLACE UNTIL REMOVAL IS AUTHORIZED BY THE MUNICIPALITY AND/OR MWRD AFTER THE SEWERS HAVE BEEN TESTED AND ACCEPTED.
- 3. DISCHARGING ANY UNPOLLUTED WATER INTO THE SANITARY SEWER SYSTEM FOR THE PURPOSE OF SEWER FLUSHING OF LINES FOR THE DEFLECTION TEST SHALL BE PROHIBITED WITHOUT PRIOR APPROVAL
- FROM THE MUNICIPALITY OR MWRD.
  4. ALL SANITARY SEWER CONSTRUCTION SHALL BE IN ACCORDANCE WITH THE STANDARD SPECIFICATIONS OR WATER AND SEWER MAIN CONSTRUCTION IN ILLINOIS (LATEST EDITION).
- 5. ALL FLOOR DRAINS SHALL DISCHARGE TO THE SANITARY SEWER SYSTEM.
- 6. ALL DOWNSPOUTS AND FOOTING DRAINS SHALL DISCHARGE TO THE STORM SEWER SYSTEM.
- 7. ALL SANITARY SEWER PIPE MATERIALS AND JOINTS (AND STORM SEWER PIPE MATERIALS AND JOINTS IN A COMBINED SEWER AREA) SHALL CONFORM TO THE FOLLOWING:

PIPE MATERIAL	PIPE SPECIFICATIONS	JOINT SPECIFICATIONS
VITRIFIED CLAY PIPE	ASTM C-700	ASTM C-425
REINFORCED CONCRETE SEWER PIPE	ASTM C-76	ASTM C-443
CAST IRON SOIL PIPE	ASTM A-74	ASTM C-564
DUCTILE IRON PIPE	ANSI A21.51	ANSI A21.11
POLYVINYL CHLORIDE (PVC) PIPE 6-INCH TO 15-INCH DIAMETER SDR 26 18-INCH TO 27-INCH DIAMETER F/DY=46	ASTM D-3034 ASTM F-679	ASTM D-3212 ASTM D-3212
HIGH DENSITY POLYETHYLENE (HDPE)	ASTM D-3350 ASTM D-3035	ASTM D-3261,F-2620 (HEAT FUSION ASTM D-3212,F-477 (GASKETED)
WATER MAIN QUALITY PVC 4-INCH TO 36-INCH 4-INCH TO 12-INCH 14-INCH TO 48-INCH	ASTM D-2241 AWWA C900 AWWA C905	ASTM D-3139 ASTM D-3139 ASTM D-3139

THE FOLLOWING MATERIALS ARE ALLOWED ON A QUALIFIED BASIS SUBJECT TO DISTRICT REVIEW AND APPROVAL PRIOR TO PERMIT ISSUANCE. A SPECIAL CONDITION WILL BE ADDED TO THE PERMIT WHEN THE PIPE MATERIAL BELOW IS USED FOR SEWER CONSTRUCTION OR A CONNECTION IS MADE.

<u>PIPE MATERIAL</u> POLYPROPYLENE (PP) PIPE	PIPE SPECIFICATIONS	JOINT SPECIFICATIONS
12-INCH TO 24-INCH DOUBLE WALL	ASTM F-2736	D-3212, F-477
30-INCH TO 60-INCH TRIPLE WALL	ASTM F-2764	D3212, F-477

- 8. ALL SANITARY SEWER CONSTRUCTION (AND STORM SEWER CONSTRUCTION IN COMBINED SEWER AREAS) REQUIRES STONE BEDDING WITH STONE ¼ "TO 1" IN SIZE, WITH MINIMUM BEDDING THICKNESS EQUAL TO ¼ THE OUTSIDE DIAMETER OF THE SEWER PIPE, BUT NOT LESS THAN FOUR (4) INCHES NOR MORE THAN EIGHT (8) INCHES. MATERIAL SHALL BE CA-7, CA-11 OR CA-13 AND SHALL BE EXTENDED AT LEAST 12" ABOVE THE TOP OF THE PIPE WHEN USING PVC.
- NON-SHEAR FLEXIBLE-TYPE COUPLINGS SHALL BE USED IN THE CONNECTION OF SEWER PIPES OF DISSIMILAR PIPE MATERIALS.
- 10. ALL MANHOLES SHALL BE PROVIDED WITH BOLTED, WATERTIGHT COVERS. SANITARY LIDS SHALL BE CONSTRUCTED WITH A CONCEALED PICKHOLE AND WATERTIGHT GASKET WITH THE WORD "SANITARY" CAST INTO THE LID.
- 11. WHEN CONNECTING TO AN EXISTING SEWER MAIN BY MEANS OTHER THAN AN EXISTING WYE, TEE, OR AN EXISTING MANHOLE, ONE OF THE FOLLOWING METHODS SHALL BE USED:
  - a) A CIRCULAR SAW-CUT OF SEWER MAIN BY PROPER TOOLS AND PROPER INSTALLATION OF HUBWYE SADDLE OR HUB-TEE SADDLE.
  - b) REMOVE AN ENTIRE SECTION OF PIPE (BREAKING ONLY THE TOP OF ONE BELL) AND REPLACE WITH A WYE OR TEE BRANCH SECTION.
  - c) WITH PIPE CUTTER, NEATLY AND ACCURATELY CUT OUT DESIRED LENGTH OF PIPE FOR INSERTION OF PROPER FITTING, USING APPROVED COUPLINGS TO HOLD IT FIRMLY IN PLACE.
- 12. WHENEVER A SANITARY/COMBINED SEWER CROSSES UNDER A WATERMAIN, THE MINIMUM VERTICAL DISTANCE FROM THE TOP OF THE SEWER TO THE BOTTOM OF THE WATERMAIN SHALL BE 18 INCHES. FURTHERMORE, A MINIMUM HORIZONTAL DISTANCE OF 10 FEET BETWEEN SANITARY/COMBINED SEWERS AND WATERMAINS SHALL BE MAINTAINED UNLESS: THE SEWER IS LAID IN A SEPARATE TRENCH, KEEPING A MINIMUM 18" VERTICAL SEPARATION; OR THE SEWER IS LAID IN THE SAME TRENCH WITH THE WATERMAIN LOCATED AT THE OPPOSITE SIDE ON A BENCH OF UNDISTURBED EARTH, KEEPING A MINIMUM 18" VERTICAL SEPARATION. IF EITHER THE VERTICAL OR HORIZONTAL DISTANCES DESCRIBED CANNOT BE MAINTAINED, OR THE SEWER CROSSES ABOVE THE WATER MAIN, THE SEWER SHALL BE CONSTRUCTED TO WATER MAIN STANDARDS OR IT SHALL BE ENCASED WITH Á WATER MAIN QUALITY CARRIER PIPE WITH THE ENDS SEALED.
- 13. ALL EXISTING SEPTIC SYSTEMS SHALL BE ABANDONED. ABANDONED TANKS SHALL BE FILLED WITH GRANULAR MATERIAL OR REMOVED.
- 14. ALL SANITARY MANHOLES, (AND STORM MANHOLES IN COMBINED SEWER AREAS), SHALL HAVE A MINIMUM INSIDE DIAMETER OF 48 INCHES, AND SHALL BE CAST IN PLACE OR PRE-CAST REINFORCED CONCRETE.
- 15. ALL SANITARY MANHOLES, (AND STORM MANHOLES IN COMBINED SEWER AREAS), SHALL HAVE PRECAST "RUBBER BOOTS" THAT CONFORM TO ASTM C-923 FOR ALL PIPE CONNECTIONS. PRECAST SECTIONS SHALL CONSIST OF MODIFIED GROOVE TONGUE AND RUBBER GASKET TYPE JOINTS.
- 16. ALL ABANDONED SANITARY SEWERS SHALL BE PLUGGED AT BOTH ENDS WITH AT LEAST 2 FEET LONG NON-SHRINK CONCRETE OR MORTAR PLUG.
- 17. EXCEPT FOR FOUNDATION/FOOTING DRAINS PROVIDED TO PROTECT BUILDINGS, OR PERFORATED PIPES ASSOCIATED WITH VOLUME CONTROL FACILITIES, DRAIN TILES/FIELD TILES/UNDERDRAINS/PERFORATED PIPES ARE NOT ALLOWED TO BE CONNECTED TO OR TRIBUTARY TO COMBINED SEWERS, SANITARY SEWERS, OR STORM SEWERS TRIBUTARY TO COMBINED SEWERS IN COMBINED SEWER AREAS.
  CONSTRUCTION OF NEW FACILITIES OF THIS TYPE IS PROHIBITED: AND ALL EXISTING DRAIN TILES AND PERFORATED PIPES ENCOUNTERED WITHIN THE PROJECT AREA SHALL BE PLUGGED OR REMOVED, AND SHALL NOT BE CONNECTED TO COMBINED SEWERS, SANITARY SEWERS, OR STORM SEWERS TRIBUTARY
- 18. A BACKELOW PREVENTER IS REQUIRED FOR ALL DETENTION BASINS TRIBUTARY TO COMBINED SEWERS REQUIRED BACKFLOW PREVENTERS SHALL BE INSPECTED AND EXERCISED ANNUALLY BY THE PROPERTY OWNER TO ENSURE PROPER OPERATION, AND ANY NECESSARY MAINTENANCES SHALL BE PERFORMED TO ENSURE FUNCTIONALITY. IN THE EVENT OF A SEWER SURCHARGE INTO AN OPEN DETENTION BASIN TRIBUTARY TO COMBINED SEWERS, THE PERMITTEE SHALL ENSURE THAT CLEAN UP AND WASH OUT OF SEWAGE TAKES PLACE WITHIN 48 HOURS OF THE STORM EVENT.

### E. EROSION AND SEDIMENT CONTRO

- THE CONTRACTOR SHALL INSTALL THE EROSION AND SEDIMENT CONTROL DEVICES AS SHOWN ON THE APPROVED EROSION AND SEDIMENT CONTROL PLAN.
- 2. EROSION AND SEDIMENT CONTROL PRACTICES SHALL BE FUNCTIONAL PRIOR TO HYDROLOGIC DISTURBANCE OF THE SITE.
- 3. ALL DESIGN CRITERIA, SPECIFICATIONS, AND INSTALLATION OF EROSION AND SEDIMENT CONTROL PRACTICES SHALL BE IN ACCORDANCE WITH THE ILLINOIS URBAN MANUAL
- 4. A COPY OF THE APPROVED EROSION AND SEDIMENT CONTROL PLAN SHALL BE MAINTAINED ON THE SITE AT ALL TIMES.
- 5. INSPECTIONS AND DOCUMENTATION SHALL BE PERFORMED, AT A MINIMUM: a) UPON COMPLETION OF INITIAL EROSION AND SEDIMENT CONTROL MEASURES, PRIOR TO ANY
- b) ONCE EVERY SEVEN (7) CALENDAR DAYS AND WITHIN 24 HOURS OF THE END OF A STORM EVENT WITH GREATER THAN 0.5 INCH OF RAINFALL OR LIQUID EQUIVALENT PRECIPITATION.
- 6. SOIL DISTURBANCE SHALL BE CONDUCTED IN SUCH A MANNER AS TO MINIMIZE FROSION IF STRIPPING, CLEARING, GRADING, OR LANDSCAPING ARE TO BE DONE IN PHASES, THE CO-PERMITTEE SHALL PLAN FOR APPROPRIATE SOIL EROSION AND SEDIMENT CONTROL MEASURES.
- 7. A STABILIZED MAT OF CRUSHED STONE MEETING THE STANDARDS OF THE ILLINOIS URBAN MANUAL SHALL BE INSTALLED AT ANY POINT WHERE TRAFFIC WILL BE ENTERING OR LEAVING A CONSTRUCTION SITE. SEDIMENT OR SOIL REACHING AN IMPROVED PUBLIC RIGHT-OF-WAY, STREET, ALLEY OR PARKING AREA SHALL BE REMOVED BY SCRAPING OR STREET CLEANING AS ACCUMULATIONS WARRANT AND TRANSPORTED TO A CONTROLLED SEDIMENT DISPOSAL AREA.
- 8. CONCRETE WASHOUT FACILITIES SHALL BE CONSTRUCTED IN ACCORDANCE WITH THE ILLINOIS URBAN MANUAL AND SHALL BE INSTALLED PRIOR TO ANY ON SITE CONSTRUCTION ACTIVITIES INVOLVING
- 9. MORTAR WASHOUT FACILITIES SHALL BE CONSTRUCTED IN ADDITION TO CONCRETE WASHOUT FACILITIES FOR ANY BRICK AND MORTAR BUILDING ENVELOPE CONSTRUCTION ACTIVITIES.
- 10. TEMPORARY DIVERSIONS SHALL BE CONSTRUCTED AS NECESSARY TO DIRECT ALL RUNOFF FROM HYDROLOGICALLY DISTURBED AREAS TO AN APPROPRIATE SEDIMENT TRAP OR BASIN. VOLUME CONTROL FACILITIES SHALL NOT BE USED AS TEMPORARY SEDIMENT BASINS.
- 11. DISTURBED AREAS OF THE SITE WHERE CONSTRUCTION ACTIVITIES HAVE TEMPORARILY OF PERMANENTLY CEASED SHALL BE STABILIZED WITH TEMPORARY OR PERMANENT MEASURES WITHIN
- 12. ALL FLOOD PROTECTION AREAS AND VOLUME CONTROL FACILITIES SHALL, AT A MINIMUM, BE PROTECTED WITH A DOUBLE-ROW OF SILT FENCE (OR EQUIVALENT).
- 13. VOLUME CONTROL FACILITIES SHALL NOT BE CONSTRUCTED UNTIL ALL OF THE CONTRIBUTING DRAINAGE AREA HAS BEEN STABILIZED.
- 14. SOIL STOCKPILES SHALL, AT A MINIMUM, BE PROTECTED WITH PERIMETER SEDIMENT CONTROLS. SOIL STOCKPILES SHALL NOT BE PLACED IN FLOOD PROTECTION AREAS OR THEIR BUFFERS.
- 15. EARTHEN EMBANKMENT SIDE SLOPES SHALL BE STABILIZED WITH APPROPRIATE EROSION CONTROL
- 16. STORM SEWERS THAT ARE OR WILL BE FUNCTIONING DURING CONSTRUCTION SHALL BE PROTECTED BY APPROPRIATE SEDIMENT CONTROL MEASURES.
- 17. THE CONTRACTOR SHALL EITHER REMOVE OR REPLACE ANY EXISTING DRAIN TILES AND INCORPORATE THEM INTO THE DRAINAGE PLAN FOR THE DEVELOPMENT. DRAIN TILES CANNOT BE TRIBUTARY TO A SANITARY OR COMBINED SEWER. DRAIN TILES ALLOWED IN COMBINED SEWER AREA FOR GREEN INFRASTRUCTURE PRACTICES.
- 18. IF DEWATERING SERVICES ARE USED, ADJOINING PROPERTIES AND DISCHARGE LOCATIONS SHALL BE PROTECTED FROM EROSION AND SEDIMENTATION. DEWATERING SYSTEMS SHOULD BE INSPECTED DAILY DURING OPERATIONAL PERIODS. THE SITE INSPECTOR MUST BE PRESENT AT THE COMMENCEMENT OF DEWATERING ACTIVITIES.
- 19. THE CONTRCTOR SHALL BE RESPONSIBLE FOR TRENCH DEWATERING AND EXCAVATION FOR THE INSTALLATION OF SANITARY SEWERS, STORM SEWERS, WATERMAINS AS WELL AS THEIR SERVICES AND OTHER APPURTENANCES. ANY TRENCH DEWATERING, WHICH CONTAINS SEDIMENT SHALL PASS THROUGH A SEDIMENT SETTLING POND OR EQUALLY EFFÉCTIVE SEDIMENT CONTROL DEVICE. ALTERNATIVES MAY INCLUDE DEWATERING INTO A SUMP PIT, FILTER BAG OR EXISTING VEGETATED UPSLOPE AREA. SEDIMENT LADEN WATERS SHALL NOT BE DISCHARGE TO WATERWAYS, FLOOD PROTECTION AREAS OR THE COMBINED SEWER SYSTEM.
- 20. ALL PERMANENT EROSION CONTROL PRACTICES SHALL BE INITIATED WITHIN SEVEN (7) DAYS FOLLOWING THE COMPLETION OF SOIL DISTURBING ACTIVITIES.
- 21. ALL EROSION AND SEDIMENT CONTROL MEASURES SHALL BE MAINTAINED AND REPAIRED AS NEEDED ON A YEAR-ROUND BASIS DURING CONSTRUCTION AND ANY PERIODS OF CONSTRUCTION SHUTDOWN UNTIL PERMANENT STABILIZATION IS ACHIEVED.
- 22. ALL TEMPORARY EROSION AND SEDIMENT CONTROL MEASURES SHALL BE REMOVED WITHIN HIRTY (30) DAYS AFTER PERMANENT SITE STABILIZATION.
- 23. THE EROSION AND SEDIMENT CONTROL MEASURES SHOWN ON THE PLANS ARE THE MINIMUM REQUIREMENTS. ADDITIONAL MEASURES MAY BE REQUIRED, AS DIRECTED BY THE ENGINEER, SITE INSPECTOR, OR MWRD.



Municipal Consultants

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ck.com	DATE -	11-7-24	REVISED	_

STATE OF ILLINOIS **DEPARTMENT OF TRANSPORTATION** 

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SCALE: NONE	SHEET NO.	1 OF	1	SHEETS	STA.	TO STA.

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S.I.	Code No.	Item	Unit	Quantity	0005	0021	0042	
					URBAN	URBAN	URBAN	
	20101100	TREE TRUNK PROTECTION	EACH	40	40			
x	20101200	TREE BOOT BRIDING						
^	20101200	TREE ROOT PRUNING	EACH	8	8			
$\dashv$	20200100	EARTH EXCAVATION	CU YD	1050	1050			
		Approvided to	COTE	1000				
	20201200	REMOVAL AND DISPOSAL OF UNSUITABLE MATERIAL	CU YD	60	60			
$\dashv$	20800150	TRENCH BACKFILL	CUYD	325	325			
						H.		
-	21101615	TOPSOIL FURNISH AND PLACE, 4"	SQ YD	2500	2500			
	25000400	NITROGEN FERTILIZER NUTRIENT	POUND	50	50			
	25000500	PHOSPHORUS FERTILIZER NUTRIENT	POUND	50	50			
	25000600	POTASSIUM FERTILIZER NUTRIENT	POUND	50	50			
	25200110	SODDING, SALT TOLERANT	SQ YD	2500	2500		-	
	25200200	SUPPLEMENTAL WATERING	UNIT	25	25	The transfer of the second		
1	28000510	INLET FILTERS	EACH	82	82			
-	30300001	AGGREGATE SUBGRADE IMPROVEMENT	CU YD	60	60			
		111111111111111111111111111111111111111						
	35300060	PORTLAND CEMENT CONCRETE BASE COURSE, 4"	SQ YD	750	750			
	35800200	AGGREGATE BASE REPAIR	TON	950	950			
+	40201000	AGGREGATE FOR TEMPORARY ACCESS	TON	35	35			

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DESIGNED - - REVISED - DRAWN - ECW, SB, GD, DMM, LW REVISED - CHECKED - REVISED - DATE REVISEO -

STATE OF ILLINOIS **DEPARTMENT OF TRANSPORTATION** 

**SUMMARY OF QUANTITIES** SCALE: NONE SHEET NO. 1 OF 10 SHEETS STA.

CONSTRUCTION CODE

S.I.	Code No.	ltem	Unit	Total Quantity	ROADWAY 0005 URBAN	LIGHTING 0021 URBAN	TRAINEES 0042 URBAN
	40600290	BITUMINOUS MATERIALS (TACK COAT)	POUND	14500	14500	UNDAIN	URDAN
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	40600370	LONGITUDINAL JOINT SEALANT	FOOT	10250	10250		
	40600400	MIXTURE FOR CRACKS, JOINTS, AND FLANGEWAYS	TON	25	25	_	
<u> </u>		19-900 Milliotheddon ou marks fair o					
	40600982	HOT-MIX ASPHALT SURFACE REMOVAL - BUTT JOINT	SQ YD	400	400		
	40600985	PORTLAND CEMENT CONCRETE SURFACE REMOVAL - BUTT JOINT	SQ YD	25	25		
	40602978	HOT-MIX ASPHALT BINDER COURSE, IL-9.5, N50	TON	2400	2400		
	40604060	HOT-MIX ASPHALT SURFACE COURSE, IL-9.5, MIX "D", N50	TON	2750	2750		
	40800050	INCIDENTAL HOT-MIX ASPHALT SURFACING	TON	15	15		
<u> </u>							
<u> </u>	42000300	PORTLAND CEMENT CONCRETE PAVEMENT 8"	SQ YD	100	100		
<b></b>	42001300	PROTECTIVE COAT	SQ YD	3000	3000		
	42001000	THOILDING SOAT	30 10	3000	3000		
	42300300	PORTLAND CEMENT CONCRETE DRIVEWAY PAVEMENT, 7 INCH	SQ YD	175	175	van de la constanta de la cons	
	42400200	PORTLAND CEMENT CONCRETE SIDEWALK 5 INCH	SQ FT	26000	26000		
	42400800	DETECTABLE WARNINGS	SQ FT	335	335		
			······································				
	44000100	PAVEMENT REMOVAL	SQ YD	100	100		
	44000200	DRIVEWAY PAVEMENT REMOVAL	SQ YD	175	175		•
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	44000500	COMBINATION CURB AND GUTTER REMOVAL	FOOT	2250	2250		

DRAWN - ECW, SB, GD, DMM, LW REVISED -CHECKED - -REVISED -

STATE OF ILLINOIS **DEPARTMENT OF TRANSPORTATION** 

**SUMMARY OF QUANTITIES** SHEET NO. 2 OF 10 SHEETS STA.

COUNTY TOTAL SHEE NO.
COOK 68 6 SECTION 21-00134-00-RS CONTRACT NO. 61K86
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				Total	ROADWAY	LIGHTING	TRAINEES
S.I.	Code No.	Item	Unit	Quantity	0005 URBAN	0021 URBAN	0042 URBAN
	44000600	SIDEWALK REMOVAL	SQ FT	29250	29250	UNDAIN	UNDAN
	44200929	CLASS B PATCHES, TYPE I, 8 INCH	SQ YD	125	125		
	44200934	CLASS B PATCHES, TYPE II, 8 INCH	SQ YD	225	225		
	44200942	CLASS B PATCHES, TYPE III, 8 INCH	SQ YD	325	325		
	44200944	CLASS B PATCHES, TYPE IV, 8 INCH	SQ YD	425	425		
	44201713	CLASS D PATCHES, TYPE I, 6 INCH	SQ YD	150	150		
	44201717	CLASS D PATCHES, TYPE II, 6 INCH	SQYD	275	275		
	44201721	CLASS D PATCHES, TYPE III, 6 INCH	SQ YD	400	400		
	77404724	DEAGO D'ENTONEO, TELEM, O MOST	3015	400	400		•
	44201723	CLASS D PATCHES, TYPE IV, 6 INCH	SQ YD	525	525		
	44213200	ŞAW CUTS	FOOT	4750	4750		
	44213202	TIE BARS 1"	EACH	1300	1300		
	550B0330	STORM SEWERS, CLASS B, TYPE 2, 10"	FOOT	10	10		
	56500600	DOMESTIC WATER SERVICE BOXES TO BE ADJUSTED	EACH	10	10		
	60108106	PIPE UNDERDRAINS, TYPE 1, 6"	FOOT	1450	1450		
	60200105	CATCH BASINS, TYPE A, 4'-DIAMETER, TYPE 1 FRAME, OPEN LID	EACH	1	1		
	60206905	CATCH BASINS, TYPE C, TYPE 1 FRAME, OPEN LID	EACH	1	1		

CONSTRUCTION CODE

X SPECIALTY ITEM

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S.I.	Code No.	ltem	Unit	Total Quantity	ROADWAY 0005	LIGHTING 0021	TRAINEES 0042
	60218400	MANHOLES, TYPE A, 4'-DIAMETER, TYPE 1 FRAME, CLOSED LID	EACH	1	URBAN 1	URBAN	URBAN
	00210400	TARRIOLLS, THEA, 4 -DIAMETER, TIPE IT RAME, GLOSED EID	EAGIT		1		
	60234200	INLETS, TYPE A, TYPE 1 FRAME, OPEN LID	EACH	1	1		
		·					
	60250400	CATCH BASINS TO BE ADJUSTED WITH NEW TYPE 1 FRAME, OPEN LID	EACH	2	2		
	60248900	VALVE VAULTS, TYPE A, 5'-DIAMETER, TYPE 1 FRAME, CLOSED LID	EACH	1	1		
	60255800	MANHOLES TO BE ADJUSTED WITH NEW TYPE 1 FRAME, CLOSED LID	EACH	2	2		
	60257900	MANHOLES TO BE RECONSTRUCTED	EACH	3	3		
	60265900	VALVE VAULTS TO BE ADJUSTED WITH NEW TYPE 1 FRAME, CLOSED LID	EACH	1	1		
	60300305	FRAMES AND LIDS TO BE ADJUSTED	EACH	37	37	THE PARTY OF THE P	
	60600605	CONCRETE CURB, TYPE B	FOOT	200	200		
	60603800	COMBINATION CONCRETE CURB AND GUTTER, TYPE B-6.12	FOOT	125	125		
	60604100	COMBINATION CONCRETE CURB AND GUTTER, TYPE B-6.12 (MODIFIED)	FOOT	2000	2000		
Х	66900200	NON-SPECIAL WASTE DISPOSAL	CU YD	350	350		
Х	66900530	SOIL DISPOSAL ANALYSIS	EACH	1	1		
		1 - Matter			***************************************	*************	
Х	66901001	REGULATED SUBSTANCES PRE-CONSTRUCTION PLAN	L SUM	1	1		
Х	66901003	REGULATED SUBSTANCES FINAL CONSTRUCTION REPORT	L SUM	1	1		
Х	66901006	REGULATED SUBSTANCES MONITORING	CAL DA	5	5		

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DESIGNED - - REVISEO -DRAWN -- ECW, SB, GD, DMM, LW REVISED --CHECKED - -REVISEO -

STATE OF ILLINOIS **DEPARTMENT OF TRANSPORTATION** 

SUMMARY OF QUANTITIES SHEET NO. 4 OF 10 SHEETS STA. TO STA. COUNTY SHEETS NO.

21-00134-00-RS COOK 68 8

CONTRACT NO. 61K86

FED. ROAD DIST. NO. 1 | ILLINOIS | FED. AID | PROJECT |
E.H.E. | PROJECT NO. 62K86

						BINDCHONC	V
						STP FUNDS	
					80% FI	DERAL / 20%	LOCAL
			¥	Total	ROADWAY	LIGHTING	TRAINEES
S.I.	Code No.	Item	Unit		0005	0021	0042
}			Name of the state	Quantity	URBAN	URBAN	URBAN
	67100100	MOBILIZATION	L SUM	1	1	ONDAIN	UNDAN
}	07100100	HOBILIZATION	13017		<u> </u>		
$\vdash$							
	70107025	CHANGEABLE MESSAGE SIGN	CAL DA	60	60		
			Plate and the second se				
Х	70300100	SHORT TERM PAVEMENT MARKING	FOOT	4250	4250		
Х	70300150	SHORT TERM PAVEMENT MARKING REMOVAL	SO FT	1500	1500		
					***************************************		
Х	72000100	SIGN PANEL - TYPE 1	SQ FT	625	625		
<u> </u>	72000100	OOR PARELL TIPE I	301	623	623		
<b>—</b>							
Х	72800100	TELESCOPING STEEL SIGN SUPPORT	FOOT	350	350		
					-		
Х	72900100	METAL POST - TYPE A	FOOT	550	550		
Х	72900200	METAL POST - TYPE B	FOOT	600	600		
			1				
Х	73100100	BASE FOR TELESCOPING STEEL SIGN SUPPORT	EACH	35	25		
	73100100	DAGE FOR TELESCOPING STEEL SIGN SUPPORT	EACH	ან	35		
Х	78000100	THERMOPLASTIC PAVEMENT MARKING - LETTERS AND SYMBOLS	SQ FT	150	150		····
X	78000200	THERMOPLASTIC PAVEMENT MARKING - LINE 4"	FOOT	20750	20750		
х	78000400	THERMOPLASTIC PAVEMENT MARKING - LINE 6"	FOOT	1300	1300		***************************************
			1.55.		1555		
х	78000600	THERMOPLASTIC PAVEMENT MARKING - LINE 12"					
<del>  ^  </del>	7600000	INENTIOPEASTIC PAVEITENT PIANNING - LINE 12	FOOT	575	575		***************************************
Х	78000650	THERMOPLASTIC PAVEMENT MARKING - LINE 24"	FOOT	350	350		
Х	78300201	PAVEMENT MARKING REMOVAL - GRINDING	SQ FT	300	300		
X	80400100	ELECTRIC SERVICE INSTALLATION	EACH	2		2	
<del> </del>			LAOII				***************************************
					l		

	HANCOCK ENGINEERING		•
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CMI Engineers Municipal Consultants

REVISEO -DRAWN - ECW, SB, GD, DMM, LW REVISED -CHECKED - -REVISED -DATE - 11-7-24

STATE OF ILLINOIS **DEPARTMENT OF TRANSPORTATION** 

**SUMMARY OF QUANTITIES** SHEET NO. 5 OF 10 SHEETS STA. TO STA.

SCALE: NONE

CONSTRUCTION CODE

COUNTY TOTAL SHEET SHO.

COOK 68 9 SECTION 21-00134-00-RS CONTRACT NO. 61k86

FED. ROAD DIST. NO. 1 ILLINOIS FED. AID PROJECT

E.H.E. PROJECT NO. 1252100501

CONSTRUCTION CODE						
STP FUNDS						
80% FEDERAL / 20% LOCAL						
DOADMAY	LICHTING	TOAINE				

_	Code No.	ltem	Unit	Total	ROADWAY	LIGHTING	TRAINEES
S.I.				Quantity	0005	0021	0042
х	80400200	ELECTRIC UTILITY SERVICE CONNECTION	L SUM	1	URBAN	URBAN 1	URBAN
				<del></del>		_	
Х	81028200	UNDERGROUND CONDUIT, GALVANIZED STEEL, 2" DIA.	FOOT	250		250	
Х	81028250	UNDERGROUND CONDUIT, GALVANIZED STEEL, 5" DIA.	FOOT	250		250	
Х	81400100		EACH	2		2	
	81400100	TANDROLE	EAGH				
Х	81400300	DOUBLE HANDHOLE	EACH	3		3	
Х	81603051	UNIT DUCT, 600V, 3-1C NO. 6, 1/C NO. 8 GROUND, (XLP-TYPE USE), 1 1/4" DIA.	FOOT	5150		5150	
Х	81603598	UNIT DUCT, 600V, 6-1C NO. 6, 1/C NO. 8 GROUND, (XLP-TYPE USE), 1 1/2" DIA.	FOOT	1500	J	1500	
X	81702400	ELECTRIC CABLE IN CONDUIT, 600V (XLP-TYPE USE) 3-1/C NO. 2	FOOT	50		50	
х	82500350	LIGHTING CONTROLLER, BASE MOUNTED, 240VOLT, 100AMP	EACH	1		1	
	62300330	EIGHTING CONTROLLER, BASE PICONTED, 240VOLT, 100APTF	EACH	<u> </u>		<u> </u>	
Х	82500370	LIGHTING CONTROLLER, BASE MOUNTED, 240VOLT, 200AMP	EACH	1		1	
Х	83600200	LIGHT POLE FOUNDATION, 24" DIAMETER	FOOT	285		285	
х	84200600	REMOVAL OF LIGHTING UNIT, NO SALVAGE	EACH	37		37	
	64200000	REPOVAL OF EIGHTING UNIT, NO SALVAGE	EMUN	3/		37	
Х	84200804	REMOVAL OF POLE FOUNDATION	EACH	37		37	
Х	89502380	REMOVE EXISTING HANDHOLE	EACH	5		5	
	X0323868	DRAINAGE RESTRICTOR	EACH	6	6		
							,
	X0324050	BOLLARD, LED	EACH	4		4	
<u> </u>							

| 9931 Roomwell Rood | DESIGNED - | NEVISED | DRAWN - ECW, SB, GD, DMM, LW | REVISED - | DATE - 11-7-24 | REVISED - | REVISED -

STATE OF ILLINOIS **DEPARTMENT OF TRANSPORTATION**  **SUMMARY OF QUANTITIES** 

SCALE: NONE SHEET NO. 6 OF 10 SHEETS STA.

| FAU | SECTION COUNTY | SHEETS NO. | TSH41488 | 21-00134-09-RS COOK | 58 10 | TSH41488 | CONTRACT NO. | S1K85 | FED. ROAD DIST. NO. 1 | ILLINOIS | FED. AID | PROJECT |

						STP FUNDS	
					90% 5		OCAL
			<u> </u>		ROADWAY	EDERAL / 20% I	
S.I.	Code No.	Item	Unit	Total		LIGHTING	TRAINEES
"	ocac ito.	, item	Oilit	Quantity	0005	0021	0042
$\vdash$					URBAN	URBAN	URBAN
$\vdash \vdash$				,,,			
	X0327611	REMOVE AND REINSTALL BRICK PAVER	SQFT	3350	3350		
	X1200046	STORM SEWERS, CLASS B, TYPE 2, 8"	FOOT	55	55		
					:		
	X1200160	CONNECTION TO EXISTING DRAINAGE STRUCTURE	EACH	2	2		
X	X1400210	LIGHT POLE, SPECIAL, 12'	EACH	50		50	
	X2530008	TREE GRATES	EACH	23	23		
	X2530009	TREE GRATE REMOVAL	EACH	9	9		
			EAQ11				
	X4021000	TEMPORARY ACCESS (PRIVATE ENTRANCE)	EACH	25	25		
<del>                                     </del>	71172244	tern ostati noozoo (timente zenamoz)	LAGI		23		
$\vdash$	X4240430	PORTLAND CEMENT CONCRETE SIDEWALK 5 INCH, SPECIAL	COFF	750	750		
	X424U43U	PORTLAND CEITENT CONCRETE SIDEWALK STINCH, SPECIAL	SQFT	750	750		
	V4040000	DETECTABLE IMARABANA (OPERALA)					
<u> </u>	X4240800	DETECTABLE WARNINGS (SPECIAL)	SQFT	50	50		
$\vdash \!$	X4400100	PORTLAND CEMENT CONCRETE SURFACE REMOVAL (VARIABLE DEPTH)	SQ YD	250	250		
	X4401198	HOT-MIX ASPHALT SURFACE REMOVAL, VARIABLE DEPTH	SQYD	21500	21500		
	X4420210	TEMPORARY PATCHING	SQYD	250	250		
	X5510010	STORM SEWER CONNECTION .	EACH	2	2		
	X5610001	CLEANOUTS	EACH	6	6		
<del> </del>			21011				
	X6020399	CONNECTION TO EXISTING MANHOLE	EACH	5	5		
		OSTATE DATE TO ENGINE PROPERTY.	EACH	<u> </u>	3		

HANCOCK | See Section | Se

9933 Roosevet Road Westcherter, E. 60154-2780 Phone; 708-845-0300 www.ehoncock.com

DESIGNED - -
 DRAWN
 ECW, SB, GD, DMM, LW, SA
 REVISED
 —

 CHECKED
 REVISED
 —

 DATE
 12-4-24
 REVISED
 —

STATE OF ILLINOIS **DEPARTMENT OF TRANSPORTATION** 

**SUMMARY OF QUANTITIES** SHEET NO. 7 OF 10 SHEETS STA. TO STA.

SCALE: NONE

CONSTRUCTION CODE

Dec 04, 2024 - 2:29pm
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12521005 - Brooklield And 3700 Block of Grand LAFD\Summary o
ok of Grand 1
and 3700 Bloc
<ul> <li>Brooklield A</li> </ul>
12521005 -

					COV	ISTRUCTION C	ODE
					90% 5	STP FUNDS EDERAL / 20% I	OCAL
I		·			ROADWAY	LIGHTING	TRAINEES
S.I.	Code No.	Item	Unit	Total	0005	0021	0042
				Quantity	URBAN	URBAN	URBAN
	X6030310	FRAMES AND LIDS TO BE ADJUSTED (SPECIAL)	EACH	45	45		,
	X6640104	FENCE REMOVAL	FOOT	250	250		
		•					
	X7010216	TRAFFIC CONTROL AND PROTECTION, (SPECIAL)	LSUM	1	1		
$\dashv$	Y7040000	DEMOVE AND OF EDECT EVICTING CLOSE					
	X7240600	REMOVE AND RE-ERECT EXISTING SIGN	EACH	45	45		
	XX000541	EXPLORATORY EXCAVATION	CUYD	400	100		
	77000341	EXPLORATION EXCAVATION	COYD	100	100		
х	XX003803	SANITARY SEWER SERVICE 6"	FOOT	36	36		
			1001		- 30		
	XX004688	BRICK PAVER SIDEWALK	SQ FT	3500	3500		
	XX005283	BRICK PAVER CROSSWALK	SQFT	200	200		
	XX005634	12" X 6" PVC SEWER SERVICE CONNECTIONS	EACH	5	5		
Х	XX006449	PVC COMBINED SEWER PIPE REPLACEMENT, 12"	FOOT	38	38		
<del>.</del>	171/200			***************************************			
X	XX006450	PVC COMBINED SEWER PIPE REPLACEMENT, 15"	FOOT	64	64		
x	XX006452	15" X 6" PVC SEWER SERVICE CONNECTIONS	FAOU				
	AAUUU432	10 NO FVO SERVER SERVICE CONNECTIONS	EACH	2	2		
х	XX006834	ELECTRICAL CONNECTION TO EXISTING LIGHTING SYSTEM	EACH	3			
			LAGII	<b></b>		3	
	XX006994	8" X 4" CATCH BASIN TRAP AND RESTRICTOR	EACH	9	9		
	XX007079	CONCRETE RIBBON	FOOT	600	600		

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\*\*Municipal Consultants\*\*

\*\*Batabilished 1911\*\*

9933 Roomvett Road Westchester, IL 60(54-2780 Phone; 708-845-0300 www.ehoncock.com

DESIGNED - -DRAWN - ECW, SB, GD, DMM, LW, SA REVISED -CHECKED - -REVISED -DATE -- 12-4-24 REVISED -

STATE OF ILLINOIS **DEPARTMENT OF TRANSPORTATION** 

**SUMMARY OF QUANTITIES** SCALE: NONE SHEET NO. 8 OF 10 SHEETS STA. TO STA. 

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2018/2016/2016	Brookfield .
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						STRUCTION C	
5.1.	Code No.	Code No. Item	Unit	Total	ROADWAY 0005	DERAL / 20% I LIGHTING 0021	TRAINEES 0042
4				Quantity	URBAN	URBAN	URBAN
<	XX007203	24" X 6" PVC SEWER SERVICE CONNECTIONS	EACH	2	2		
1	XX007729	DETECTABLE WARNINGS, SPECIAL	SQFT	50	50		A TO LANGE
1	XX007899	MASONRY WALL	FOOT	30	30		
1	XX008159	PORTLAND CEMENT CONCRETE BAND FOR PAVER BRICKS	FOOT	65	65	0.00	
4	XX008284	ORNAMENTAL LIGHT POLE, ALUMINUM, WITH CONTEMPORARY ARM	EACH	4		4	WIII W
1	XX008356	STRUCTURAL SOIL	CUYD	1150	1150		
	XX008536	PREPARATION OF BASE (SPECIAL)	SQ YD	12250	12250	10°	
<b>(</b>	XX008994	COMBINED SEWERS, CLASS B, TYPE 3, 24"	FOOT	132	132		
	XX009601	10" X 6" CATCH BASIN TRAP AND RESTRICTOR	EACH	4	4		
+	Z0004544	HOT-MIX ASPHALT DRIVEWAY PAVEMENT REMOVAL	SQ YD	50	50		
1	Z0018700	DRAINAGE STRUCTURE TO BE REMOVED	EACH	1	1		Here y
	Z0019600	DUST CONTROL WATERING	UNIT	50	50		
+	Z0030850	TEMPORARY INFORMATION SIGNING	SQFT	175	175		
4	Z0033028	MAINTENANCE OF LIGHTING SYSTEM	CAL MO	9		9	
$\pm$	Z0048665	RAILROAD PROTECTIVE LIABILITY INSURANCE	LSUM	1	1	11	

HANCOCK | See See Civil Engineers | See Consultants | See Consulta

9933 Rooseyett Rood Wellcharter, R. 60154-2780 Phone: 709-645-0300 www.sekoncock.com

DISIGNED - -REVISED -DRAWN - ECW, SB, GD, DMM, LW, SA REVISED -CHECKED - -REVISED -DATE - 12-4-24 REVISED -

STATE OF ILLINOIS **DEPARTMENT OF TRANSPORTATION** 

**SUMMARY OF QUANTITIES** SCALE: NONE SHEET NO. 9 OF 10 SHEETS STA.

COUNTY TOTAL SHEE SHEETS NO.

21-00134-00-RS COOK 68 13

CONTRACT NO. 61K86

FED. ROAD DIST. NO. 1 ILLINOIS FED. AND PROJECT

E.H.E. PROJECT

						STP FUNDS	
			T		80% FEDERAL / 20% LOCA		
				Total	ROADWAY	LIGHTING	TRAINEES
S.I.	Code No.	ltem Ur	Unit	Quantity	0005	0021	0042
				Quarter	URBAN	URBAN	URBAN
	Z0076600	TRAINEES	HOUR	500			500
	Z0076604	TRAINEES TRAINING PROGRAM GRADUATE	HOUR	500			500
							,
	XX009689	STORM SEWERS, CLASS B, TYPE 2, 6"	FOOT	30	30		
Х	XX009690	CHECK VALVE, 8"	EACH	2	2		
				-			

HANCOCK | See Section | Se

DESIGNED - -REVISED -DRAWN - EGW, SB, GD, DMM, LW, SA REVISED -CHECKED - 
DATE - 12-4-24 REVISED —

STATE OF ILLINOIS **DEPARTMENT OF TRANSPORTATION** 

**SUMMARY OF QUANTITIES** SHEET NO. 10 OF 10 SHEETS STA.

CONSTRUCTION CODE

**EXISTING TYPICAL SECTION GRAND BOULEVARD** (STA 0+75 TO STA 8+63)


\* ITEM TO BE REMOVED \*\* INTERMITTEMT REMOVAL

NORTHEAST SOUTHWEST 10.5 59.0 B-B **9**\*  $\langle 4 \rangle$ PARKING THRU LANE THRU LANE PARKING (NW BOUND) (SE BOUND)  $\langle 3 \rangle$  $\langle H \rangle$ 

### PROPOSED TYPICAL SECTION **GRAND BOULEVARD** (STA 0+75 TO STA 8+63)

**★** ITEM TO BE REMOVED

\*\* INTERMITTEMT REMOVAL

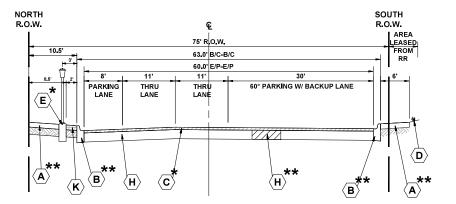

### NORTH SOUTH R.O.W. R.O.W. 75' R O.W. EASED FROM 63.0' B/C-B/C 60.0' E/P-E/P PARKING 60° PARKING W/ BACKUP LANE \_\_\_\_\_\_**\*** (5) $\langle 3 \rangle$ $\langle$ 2angle

## **EXISTING TYPICAL SECTION BROOKFIELD AVENUE**

(STA 9+85 TO STA 13+62) **★** ITEM TO BE REMOVED \*\* INTERMITTEMT REMOVAL

SOUTH R.O.W. R.O.W. SS' POW AREA LEASED FROM RR 57.5' B/C-B/C 54.5' E/P-E/P 11.5' 60° PARKING W/ BACKUP LANE  $\langle \mathbf{D} \rangle$ 


### **EXISTING TYPICAL SECTION BROOKFIELD AVENUE** (STA 19+52 TO STA 23+08)

**★** ITEM TO BE REMOVED \*\* INTERMITTEMT REMOVAL

### PROPOSED TYPICAL SECTION **BROOKFIELD AVENUE** (STA 9+85 TO STA 13+62)

\* ITEM TO BE REMOVED

\*\* INTERMITTEMT REMOVAL

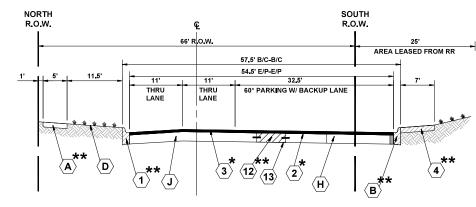

### PROPOSED TYPICAL SECTION **BROOKFIELD AVENUE** (STA 19+52 TO STA 23+08)

\* ITEM TO BE REMOVED

\*\* INTERMITTEMT REMOVAL

### TYPICAL SECTION LEGEND

### **EXISTING**

PORTLAND CEMENT CONCRETE SIDEWALK, 5"

EXISTING COMBINATION CONCRETE CURB AND GUTTER B TYPE B-6,12 (MODIFIED)

 $\langle c \rangle$ HOT-MIX ASPHALT BINDER AND SURFACE COURSE, 2" - 4"

 $\langle \mathbf{D} \rangle$ SODDED PARKWAY

(E) 15' POST TOP LIGHT POLE

 $\langle$  F $\rangle$ 4' x 4' TREE GRATE

 $\langle {f G} 
angle$ TREE

 $\langle H \rangle$ AGGREGATE BASE COURSE, ± 12"

 $\langle \, {\scriptscriptstyle \, \bf I} \, 
angle$ PORTLAND CEMENT CONCRETE RIBBON CURB

 $\langle {f J} 
angle$ PORTLAND CEMENT CONCRETE BASE COURSE, ± 8"

 $\langle \mathbf{K} \rangle$ BRICK PAVER SIDEWALK

 $\langle L \rangle$ EARTH EXCAVATION

CONCRETE BARRIER CURB

### PROPOSED

COMBINATION CONCRETE CURB AND GUTTER, TYPE B-6.12 (MODIFIED)

 $\langle 2 \rangle$ HOT-MIX ASPHALT BINDER COURSE, IL-9.5, N50, 1.5"

 $\langle \mathbf{3} \rangle$ HOT-MIX ASPHALT SURFACE COURSE, IL-9.5, N50, 2"

 $\langle \mathbf{4} \rangle$ PORTLAND CEMENT CONCRETE SIDEWALK, 5"

REMOVE AND RESET BRICK PAVERS

PORTLAND CEMENT CONCRETE RIBBON CURB

PENDENT LIGHT WITH 2' MAST ARM

4' x 4' TREE GRATE

BRICK PAVER SIDEWALK

STRUCTURAL SOIL

 $\langle 11 \rangle$ CLASS D PATCH

**12** CLASS B PATCH

DEFORMED TIE BARS

MIXTURE TYPE	AIR VOIDS @ Ndes	QMP
HOT-MIX ASPHALT SURFACING - BUTT JOINT		
HOT-MIX ASPHALT SURFACE COURSE, MIX "D", N50, 2" (IL 9.5mm)	4% @ 50 Gyr.	LR 1030-
INCIDENTAL HOT-MIX ASPHALT SURFACING - HMA	RIVEWAYS	
HOT-MIX ASPHALT SURFACE COURSE, MIX "D", N50, 3" (2 LIFTS) (IL 9.5mm)	4% @ 50 Gyr.	LR 1030
PAVEMENT RESURFACING		
HOT-MIX ASPHALT SURFACE COURSE, MIX "D", N50, 2" (IL 9.5mm)	4% @ 50 Gyr.	LR 1030
HOT-MIX ASPHALT BINDER COURSE, IL-9.5, N50,1.5"	4% @ 50 Gyr.	LR 1030
TEMPORARY PATCHING		
HOT-MIX ASPHALT SURFACE COURSE, MIX "D", N50,2" (IL 9.5 MM)	4% @ 50 Gyr.	LR 1030
QMP DESIGNATION: QUALITY CONTROL/ QUALITY ASSURANCE (QC/QA) PER L	R1030-2.	
CLASS D PATCHING		
HOT-MIX ASPHALT BINDER COURSE, IL-9.5, N50, 6" (IL 9.5 MM)	4% @ 50 Gyr.	LR 1030

THE UNIT WEIGHT USED TO CALCULATE ALL HMA SURFACE MIXTURE QUANTITIES IS 112 LBS/SQ YD/IN.

THE "AC TYPE" FOR POLYMERIZED HMA MIXES SHALL BE "SBS/SBR PG 76-22" AND FOR NON-POLYMERIZED HMA THE "AC TYPE" SHALL BE "PG 64-22" UNLESS MODIFIED BY RECLAIMED MATERIALS SPECIFICATIONS.

TO STA. -

THE LONGITUDINAL JOINT SEALANT SHALL BE PLACED ON THE HMA BINDER COURSE: HOT-MIX ASPHALT BINDER COURSE, IL-9.5, N50, 1.5".



 CMI Engineer Municipal Consultant Established 1911

DRAWN

DESIGNED -REVISED ECW, SB, GD, DMM, LW CHECKED -REVISED -11-7-24 REVISED


**STATE OF ILLINOIS DEPARTMENT OF TRANSPORTATION** 

EXISTING	AND	PROPOSED	TYPICAL	SECTIONS

SHEET NO. 1 OF 4 SHEETS STA. -


SCALE: NONE

F.A.U. RTE.		ç	SECTI	ON		C	OUNTY	TOTAL	SHEE NO.
1694/140	8	21-0	00134	-00-	RS	(	соок	68	15
						COI	NTRACT	NO. 6	1K86
EED	POAD	DIST	NΟ	1	ILL INIOIS	EED	AID DDO	JECT	

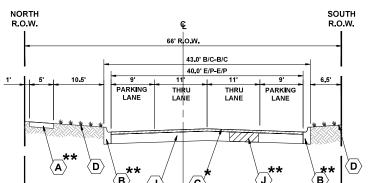


### **EXISTING TYPICAL SECTION BROOKFIELD AVENUE** (STA 23+08 TO STA 29+64)

\* ITEM TO BE REMOVED

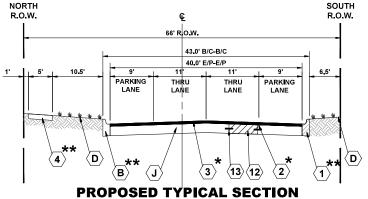

## **BROOKFIELD AVENUE** (STA 23+08 TO STA 29+64)

**★** ITEM TO BE REMOVED \*\* INTERMITTEMT REMOVAL

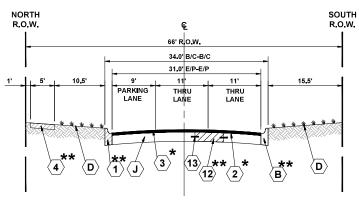

### **PROPOSED TYPICAL SECTION BROOKFIELD AVENUE** (STA 29+64 TO STA 33+28)


\* ITEM TO BE REMOVED \*\* INTERMITTEMT REMOVAL

\*\* INTERMITTEMT REMOVAL

### R.O.W. R.O.W. 66' R O.W. 34.0' B/C-B/C 31.0' E/P-E/P 10.5 15.5' PARKING THRU LANE $\langle \mathsf{D} \rangle$


### **EXISTING TYPICAL SECTION BROOKFIELD AVENUE** (STA 29+64 TO STA 33+28)

\* ITEM TO BE REMOVED \*\* INTERMITTEMT REMOVAL

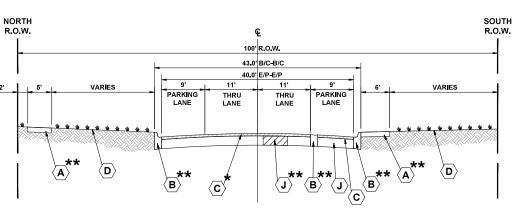

### **EXISTING TYPICAL SECTION BROOKFIELD AVENUE** (STA 33+28 TO STA 35+88)

\* ITEM TO BE REMOVED \*\* INTERMITTEMT REMOVAL

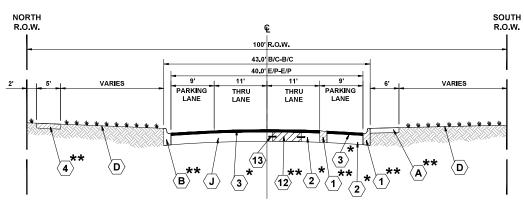

### PROPOSED TYPICAL SECTION **BROOKFIELD AVENUE** (STA 33+28 TO STA 35+88)

\* ITEM TO BE REMOVED \*\* INTERMITTEMT REMOVAL

# HANCOCK

 CMI Engineer Municipal Consultor

sd S	DESIGNED -	-	REVISED	-
<del>~</del>	DRAWN -	ECW, SB, GD, DMM, LW	REVISED	-
00	CHECKED -	-	REVISED	-
m	DATE -	11-7-24	REVISED	-

### **STATE OF ILLINOIS DEPARTMENT OF TRANSPORTATION**

EXISTI	NG AND P	PROP	OSED	TYPICAL SI	ECTIONS
SCALE: NONE	SHEET NO. 2	OF 4	SHEETS	STA	TO STA

21-00134-00-RS соок 68 16

### **EXISTING**

PORTLAND CEMENT CONCRETE SIDEWALK, 5" EXISTING COMBINATION CONCRETE CURB AND GUTTER, TYPE B-6.12 (MODIFIED)  $\langle \mathbf{B} \rangle$ 

 $\langle \mathbf{c} \rangle$ HOT-MIX ASPHALT BINDER AND SURFACE COURSE, 2" - 4"

 $\langle \mathtt{D} 
angle$ SODDED PARKWAY

 $\langle \mathtt{E} \rangle$ 15' POST TOP LIGHT POLE

 $\langle$  F $\rangle$ 4' x 4' TREE GRATE

 $\langle {f G} 
angle$ 

AGGREGATE BASE COURSE, ± 12"

PORTLAND CEMENT CONCRETE RIBBON CURB

 $\langle$  J  $\rangle$ PORTLAND CEMENT CONCRETE BASE COURSE, ± 8"

 $\langle \mathsf{K} 
angle$ BRICK PAVER SIDEWALK

 $\langle L \rangle$ EARTH EXCAVATION

CONCRETE BARRIER CURB

PROPOSED

COMBINATION CONCRETE CURB AND GUTTER, TYPE B-6.12 (MODIFIED)

HOT-MIX ASPHALT BINDER COURSE, IL-9.5, N50, 1.5"

 $\langle \mathbf{3} \rangle$ HOT-MIX ASPHALT SURFACE COURSE, IL-9.5, N50, 2"

 $\langle \mathbf{4} \rangle$ PORTLAND CEMENT CONCRETE SIDEWALK, 5" REMOVE AND RESET BRICK PAVERS

PORTLAND CEMENT CONCRETE RIBBON CURB

 $\langle \mathbf{7} \rangle$ PENDENT LIGHT WITH 2' MAST ARM

 $\langle 8 \rangle$ 4' x 4' TREE GRATE

 $\langle \mathbf{5} \rangle$ 

**TYPICAL SECTION LEGEND** 

 $\langle$  9  $\rangle$ BRICK PAVER SIDEWALK

**(10)** STRUCTURAL SOIL

**(11)** CLASS D PATCH

**12** CLASS B PATCH

**(13)** DEFORMED TIE BARS

## **EXISTING TYPICAL SECTION BROOKFIELD AVENUE**


(STA 35+88 TO STA 41+70)

\* ITEM TO BE REMOVED \*\* INTERMITTEMT REMOVAL

## WEST EAST R.O.W. R.O.W. 25.0' B/C-B/C 22.0' E/P-E/P $\langle H \rangle \langle C \rangle$ $\langle \mathbf{B} \rangle$

### **EXISTING TYPICAL SECTION BROOKFIELD AVENUE / WOODSIDE AVENUE** (STA 41+70 TO STA 44+20)

\* ITEM TO BE REMOVED \*\* INTERMITTEMT REMOVAL

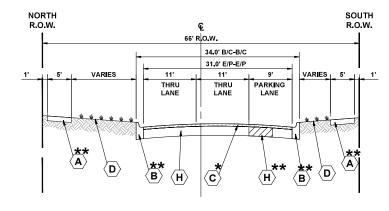


### **EXISTING TYPICAL SECTION WOODSIDE AVENUE** (STA 44+20 TO STA 47+50)

**★** ITEM TO BE REMOVED \*\* INTERMITTEMT REMOVAL


### PROPOSED TYPICAL SECTION **BROOKFIELD AVENUE** (STA 35+88 TO STA 41+70)

\* ITEM TO BE REMOVED \*\* INTERMITTEMT REMOVAL

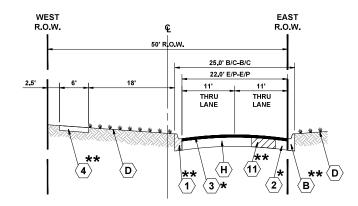

### PROPOSED TYPICAL SECTION **BROOKFIELD AVENUE / WOODSIDE AVENUE** (STA 41+70 TO STA 44+20)

**★** ITEM TO BE REMOVED \*\* INTERMITTEMT REMOVAL

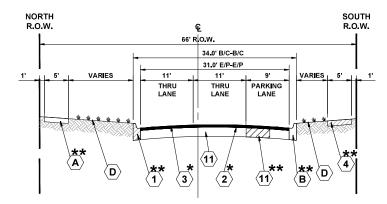

### PROPOSED TYPICAL SECTION **WOODSIDE AVENUE** (STA 44+20 TO STA 47+50)

**★** ITEM TO BE REMOVED

\*\* INTERMITTEMT REMOVAL

### **TYPICAL SECTION LEGEND**

### EXISTING

- PORTLAND CEMENT CONCRETE SIDEWALK, 5"
- EXISTING COMBINATION CONCRETE CURB AND GUTTER TYPE B-6.12 (MODIFIED)  $\langle {f B} \rangle$
- $\langle c \rangle$ HOT-MIX ASPHALT BINDER AND SURFACE COURSE, 2" - 4"
- $\langle \mathbf{D} \rangle$ SODDED PARKWAY
- $\langle \mathbf{E} \rangle$ 15' POST TOP LIGHT POLE
- $\langle {f F} 
  angle$ 4' x 4' TREE GRATE
- $\langle {f G} 
  angle$
- $\langle \mathsf{H} \rangle$ AGGREGATE BASE COURSE, ± 12"
- $\langle \mathbf{1} \rangle$ PORTLAND CEMENT CONCRETE RIBBON CURB
- $\langle {f J} 
  angle$ PORTLAND CEMENT CONCRETE BASE COURSE, ± 8"
- $\langle \mathbf{K} \rangle$ BRICK PAVER SIDEWALK
- $\langle \mathtt{L} \rangle$ EARTH EXCAVATION

SCALE: NONE

CONCRETE BARRIER CURB

### PROPOSED


- COMBINATION CONCRETE CURB AND GUTTER,
- $\langle \mathbf{2} \rangle$ HOT-MIX ASPHALT BINDER COURSE, IL-9.5, N50, 1.5"
- $\langle \mathbf{3} \rangle$ HOT-MIX ASPHALT SURFACE COURSE, IL-9.5, N50, 2"
  - PORTLAND CEMENT CONCRETE SIDEWALK, 5"
- REMOVE AND RESET BRICK PAVERS
- PORTLAND CEMENT CONCRETE RIBBON CURB
- $\langle \mathbf{7} \rangle$ PENDENT LIGHT WITH 2' MAST ARM
- 4' x 4' TREE GRATE
- BRICK PAVER SIDEWALK
- **(10)** STRUCTURAL SOIL
- $\langle 11 \rangle$ CLASS D PATCH
- (12) CLASS B PATCH

**EXISTING AND PROPOSED TYPICAL SECTIONS** 21-00134-00-RS соок 68 17 CONTRACT NO. 61K86 SHEET NO. 3 OF 4 SHEETS STA. -TO STA. -

-	
	4


## **EXISTING TYPICAL SECTION PARKVIEW AVENUE** (STA 47+50 TO STA 49+25)

\* ITEM TO BE REMOVED \*\* INTERMITTEMT REMOVAL

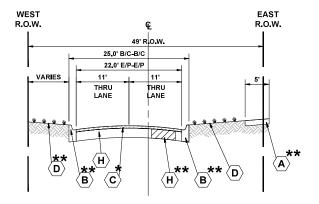


### **EXISTING TYPICAL SECTION GOLF ROAD** (STA 49+25 TO STA 53+88)

\* ITEM TO BE REMOVED \*\* INTERMITTEMT REMOVAL

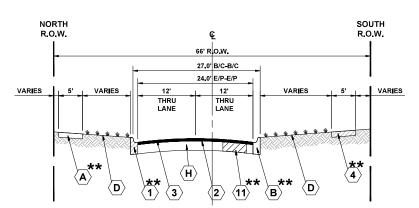

### PROPOSED TYPICAL SECTION **PARKVIEW AVENUE** (STA 47+50 TO STA 49+25)

\* ITEM TO BE REMOVED \*\* INTERMITTEMT REMOVAL

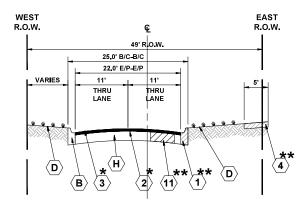

### **PROPOSED TYPICAL SECTION GOLF ROAD** (STA 49+25 TO STA 53+88)

**★** ITEM TO BE REMOVED \*\* INTERMITTEMT REMOVAL

### **TYPICAL SECTION LEGEND**

### **EXISTING**

- PORTLAND CEMENT CONCRETE SIDEWALK, 5"
- EXISTING COMBINATION CONCRETE CURB AND GUTTER. (B) TYPE B-6.12 (MODIFIED)
- $\langle \mathbf{c} \rangle$ HOT-MIX ASPHALT BINDER AND SURFACE COURSE, 2" - 4"
- $\langle \mathtt{D} \rangle$ SODDED PARKWAY
- $\langle \mathbf{E} \rangle$ 15' POST TOP LIGHT POLE
- $\langle \mathsf{F} \rangle$ 4' x 4' TREE GRATE
- $\langle \mathbf{G} \rangle$ TREE
- AGGREGATE BASE COURSE, ± 12"
- PORTLAND CEMENT CONCRETE RIBBON CURB
- $\langle {f J} 
  angle$ PORTLAND CEMENT CONCRETE BASE COURSE, ± 8"
- BRICK PAVER SIDEWALK
- $\langle L \rangle$ EARTH EXCAVATION
- CONCRETE BARRIER CURB

### PROPOSED

- COMBINATION CONCRETE CURB AND GUTTER, TYPE B-6.12 (MODIFIED)
- HOT-MIX ASPHALT BINDER COURSE, IL-9.5, N50, 1.5"
- $\langle \mathbf{3} \rangle$ HOT-MIX ASPHALT SURFACE COURSE, IL-9.5, N50, 2"
- $\langle \mathbf{4} \rangle$ PORTLAND CEMENT CONCRETE SIDEWALK, 5"
- $\langle \mathbf{5} \rangle$ REMOVE AND RESET BRICK PAVERS
- PORTLAND CEMENT CONCRETE RIBBON CURB
- $\langle \mathbf{7} \rangle$ PENDENT LIGHT WITH 2' MAST ARM
- **8** 4' x 4' TREE GRATE
- BRICK PAVER SIDEWALK
- (10) STRUCTURAL SOIL
- **(11)** CLASS D PATCH
- (12) CLASS B PATCH

HANCOCK ENGINEERING ## + Established 1911


 CMI Engineers Municipal Consultants


DESIGNED -REVISED DRAWN -ECW, SB, GD, DMM, LW REVISED CHECKED - -REVISED -11-7-24 REVISED

**STATE OF ILLINOIS DEPARTMENT OF TRANSPORTATION** 

**EXISTING AND PROPOSED TYPICAL SECTIONS** SCALE: NONE SHEET NO. 4 OF 4 SHEETS STA. -TO STA. -

F.A.U. RTE.	SECTION	COUNTY	TOTAL SHEETS	SHEET NO.
1694/1408	21-00134-00-RS	соок	68	18
		CONTRACT	NO. 61	K86
FFD I	ROAD DIST NO 1 ILLINOIS	FED. AID. PRO.	IECT	

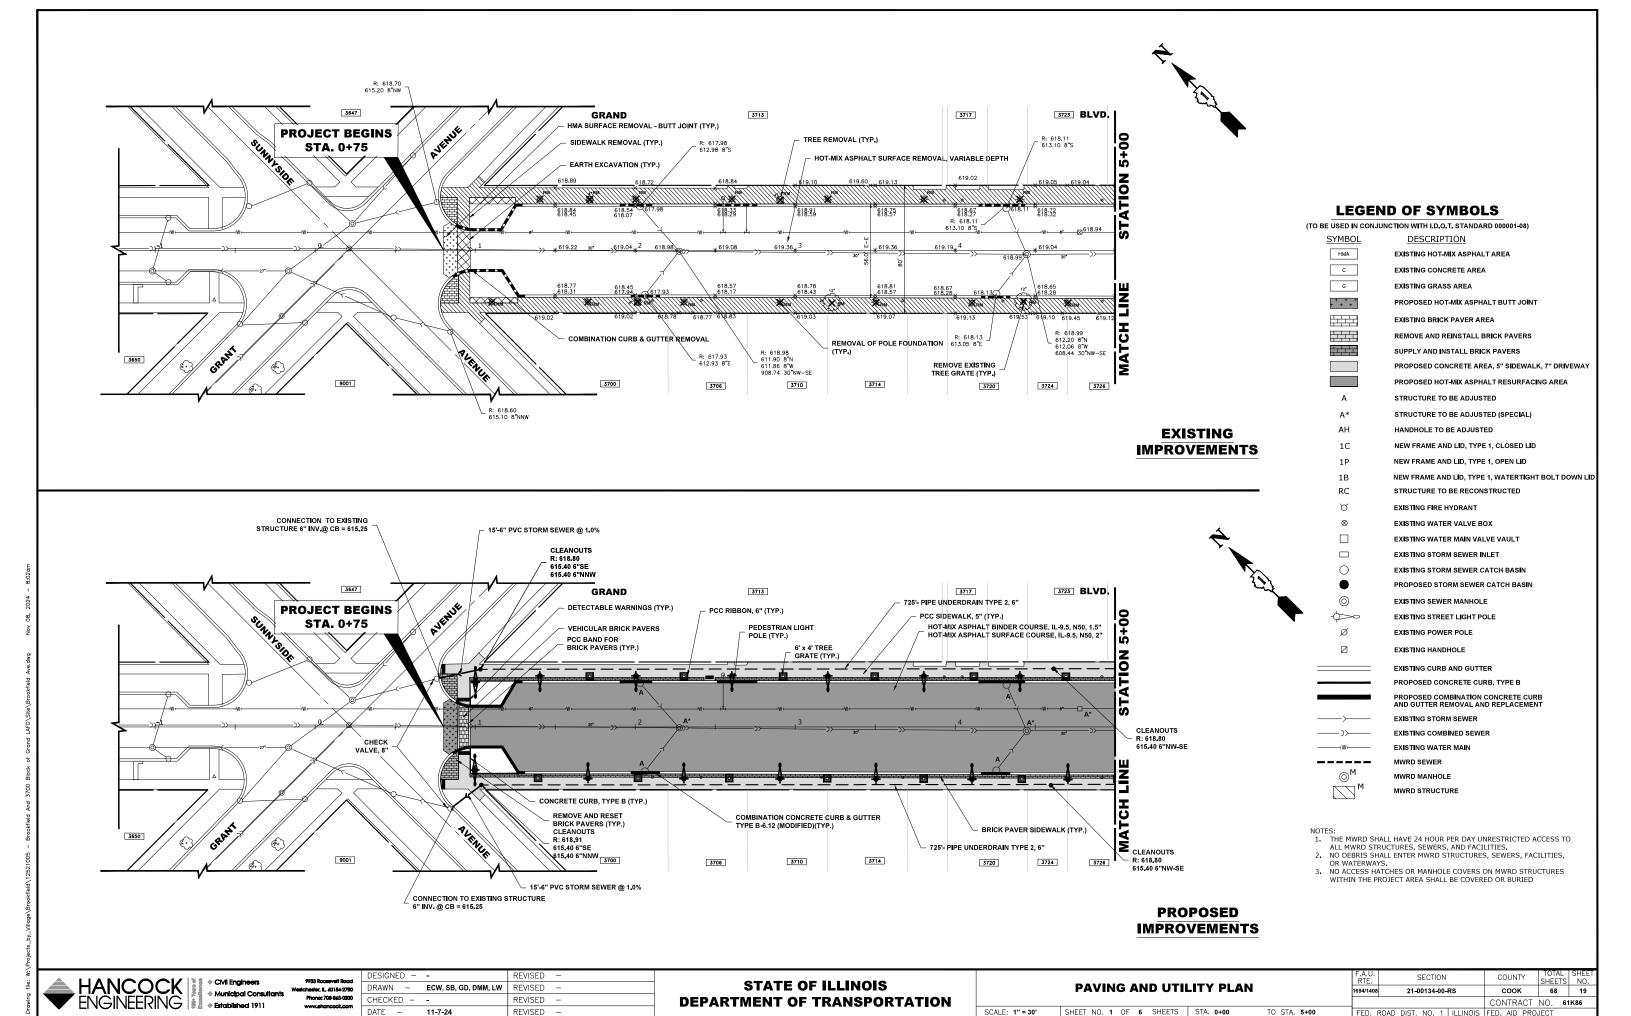


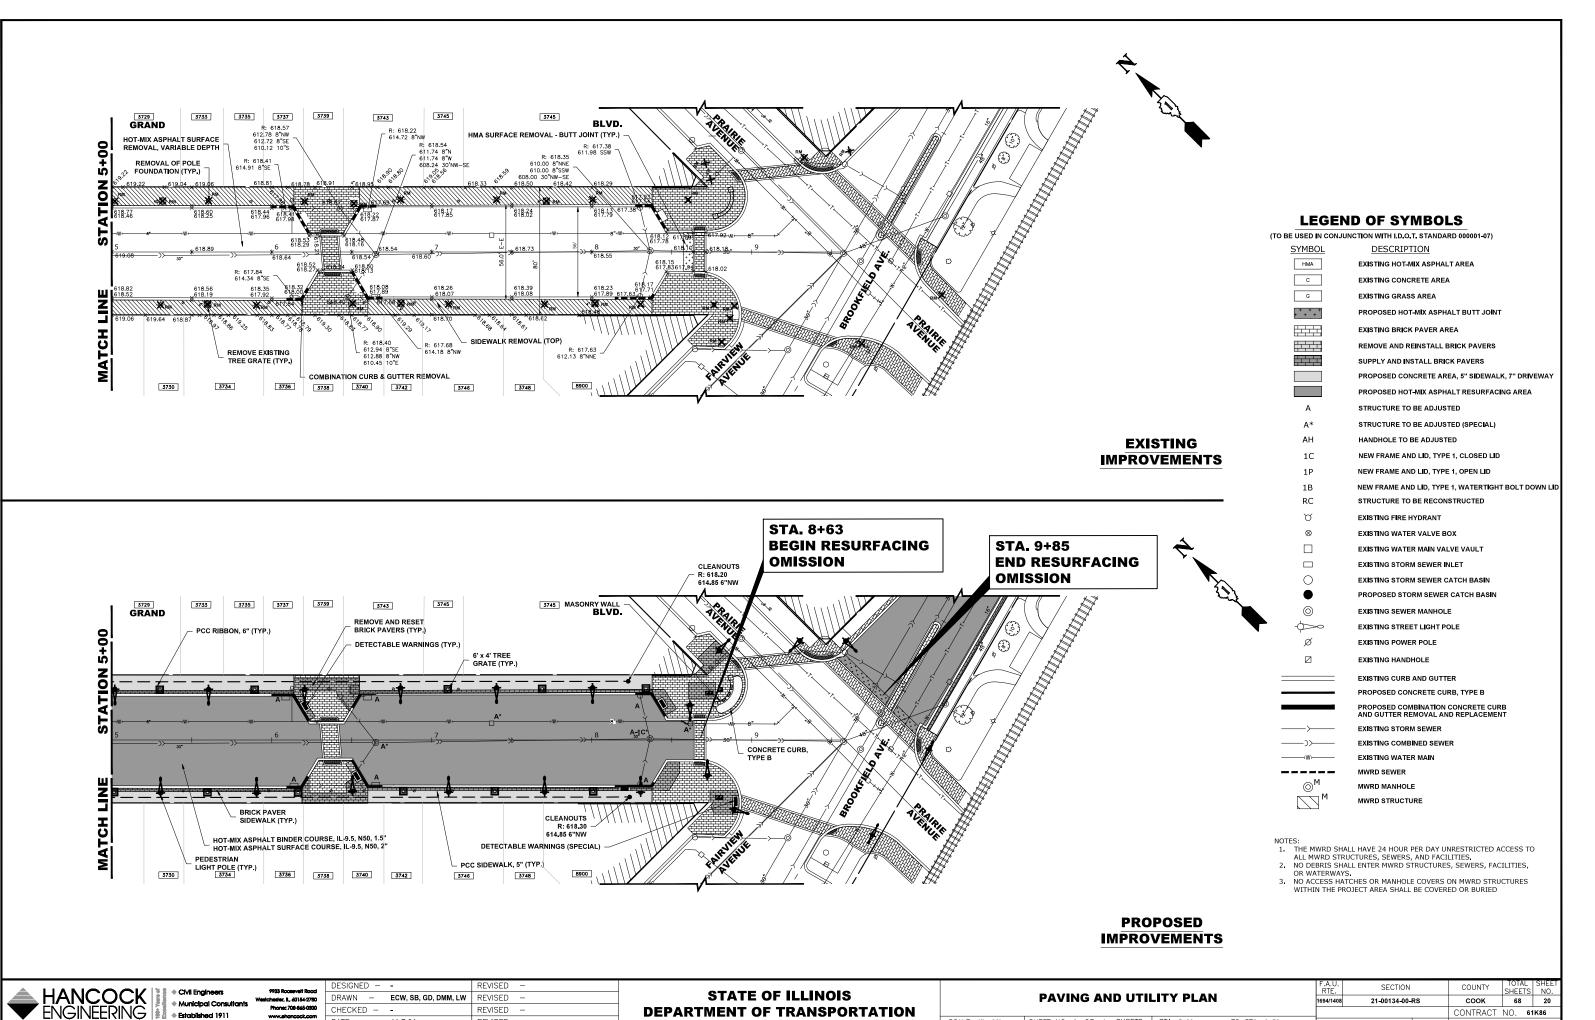


SCALE: 1" = 30'


SHEET NO. 2 OF 6 SHEETS STA. 5+00

TO STA. 9+50

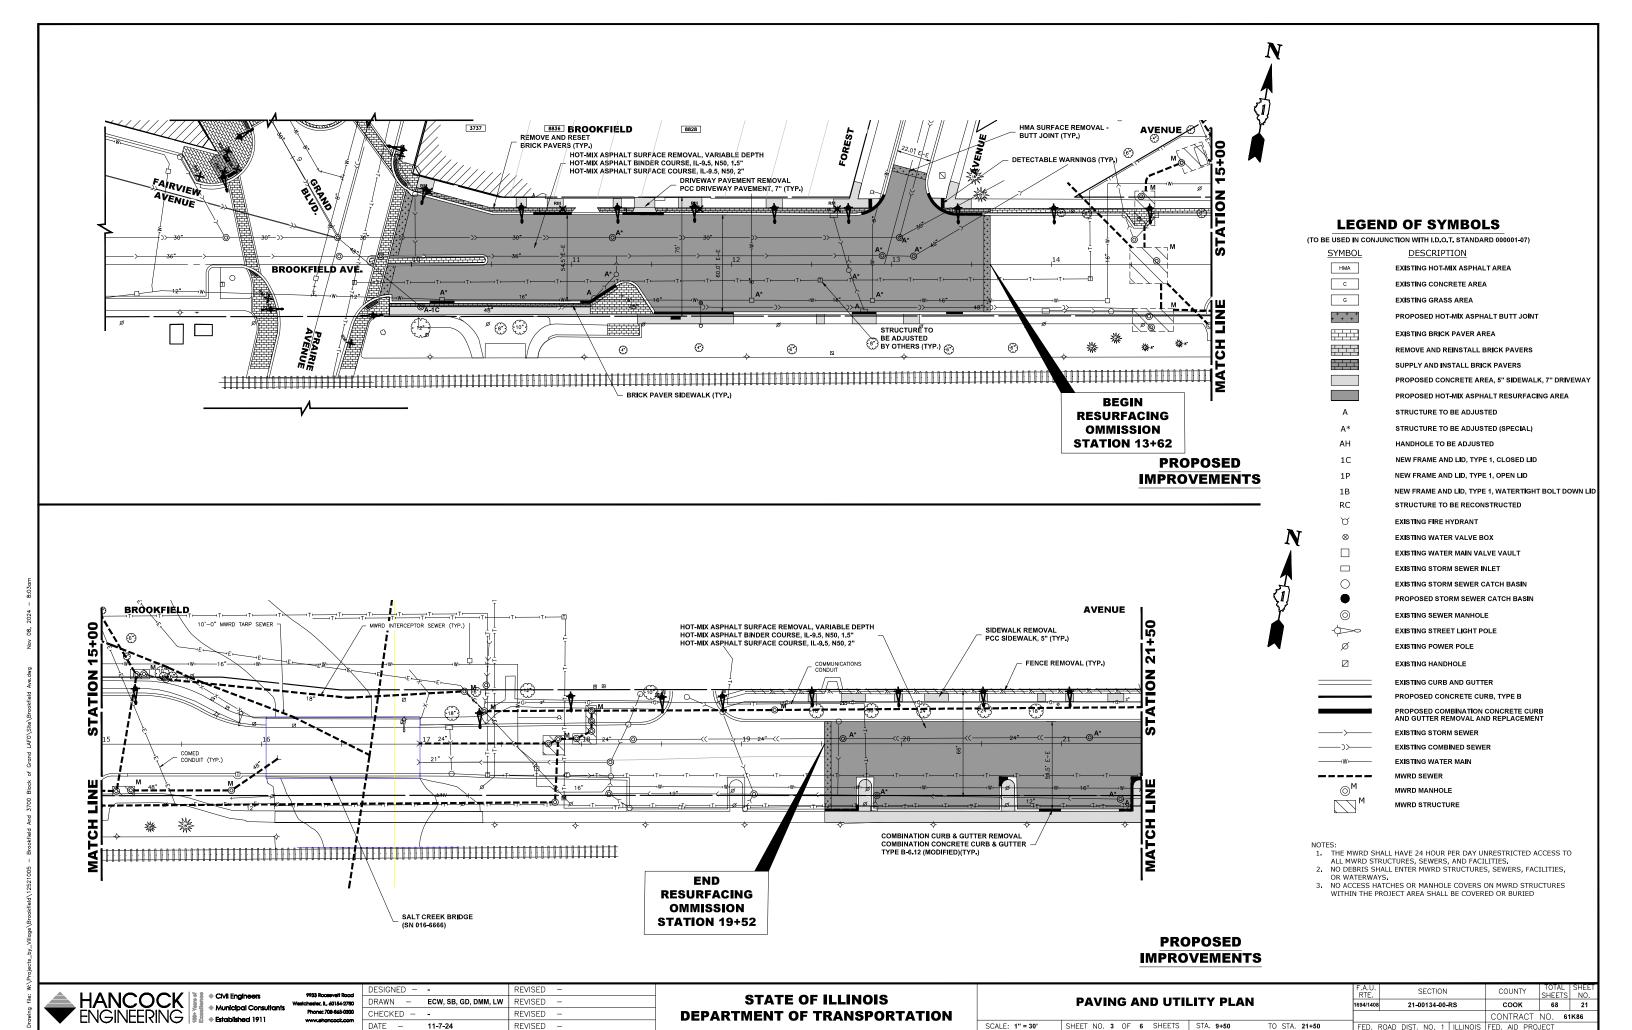

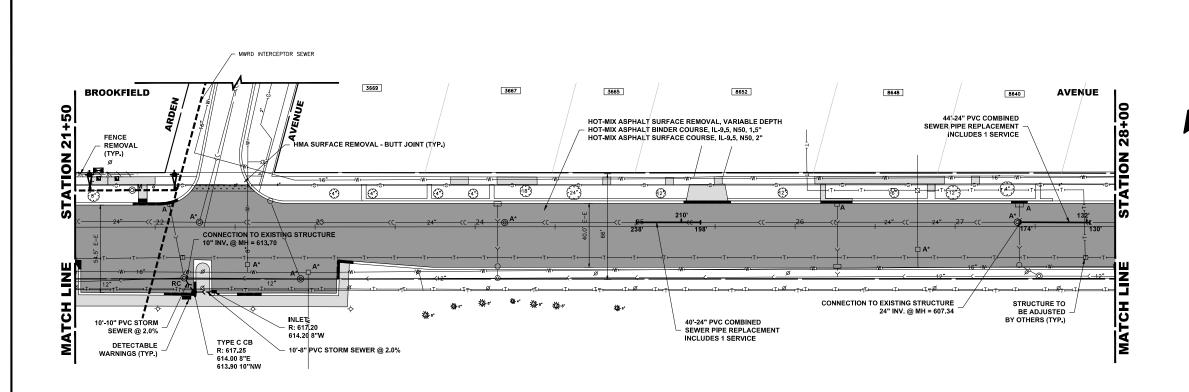

### **PROPOSED IMPROVEMENTS**

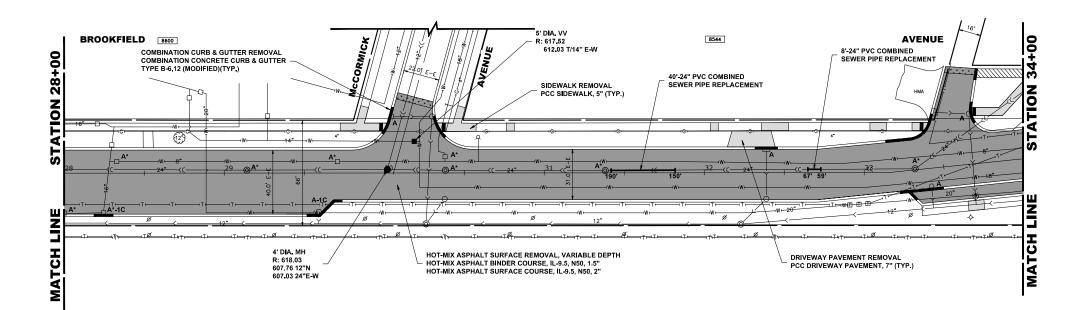

### **LEGEND OF SYMBOLS**

(TO BE USED IN CONJUNCTION WITH I.D.O.T. STANDARD 000001-07)

DESCRIPTION

HMA	EXISTING HOT-MIX ASPHALT AREA
С	EXISTING CONCRETE AREA
G	EXISTING GRASS AREA
+ + + +	PROPOSED HOT-MIX ASPHALT BUTT JOINT
	EXISTING BRICK PAVER AREA
	REMOVE AND REINSTALL BRICK PAVERS
	SUPPLY AND INSTALL BRICK PAVERS
	PROPOSED CONCRETE AREA, 5" SIDEWALK, 7" DRIVEWAY
	PROPOSED HOT-MIX ASPHALT RESURFACING AREA
Α	STRUCTURE TO BE ADJUSTED
A*	STRUCTURE TO BE ADJUSTED (SPECIAL)
АН	HANDHOLE TO BE ADJUSTED
1C	NEW FRAME AND LID, TYPE 1, CLOSED LID
1P	NEW FRAME AND LID, TYPE 1, OPEN LID
1B	NEW FRAME AND LID, TYPE 1, WATERTIGHT BOLT DOWN LID
RC	STRUCTURE TO BE RECONSTRUCTED
Q	EXISTING FIRE HYDRANT
$\otimes$	EXISTING WATER VALVE BOX
	EXISTING WATER MAIN VALVE VAULT
	EXISTING STORM SEWER INLET
$\circ$	EXISTING STORM SEWER CATCH BASIN
•	PROPOSED STORM SEWER CATCH BASIN
<b>(a)</b>	EXISTING SEWER MANHOLE
<del></del>	EXISTING STREET LIGHT POLE
Ø	EXISTING POWER POLE
	EXISTING HANDHOLE

TO STA. 34+00

NOTES:

1. THE MWRD SHALL HAVE 24 HOUR PER DAY UNRESTRICTED ACCESS TO ALL MWRD STRUCTURES, SEWERS, AND FACILITIES.

2. NO DEBRIS SHALL ENTER MWRD STRUCTURES, SEWERS, FACILITIES, OR WATERWAYS.

EXISTING CURB AND GUTTER PROPOSED CONCRETE CURB, TYPE B PROPOSED COMBINATION CONCRETE CURB AND GUTTER REMOVAL AND REPLACEMENT

EXISTING STORM SEWER EXISTING COMBINED SEWER EXISTING WATER MAIN MWRD SEWER MWRD MANHOLE MWRD STRUCTURE

- 3. NO ACCESS HATCHES OR MANHOLE COVERS ON MWRD STRUCTURES WITHIN THE PROJECT AREA SHALL BE COVERED OR BURIED

### **PROPOSED IMPROVEMENTS**

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 Civil Engineers Municipal Consultants ◆ Established 1911


DESIGNED -DRAWN - ECW, SB, GD, DMM, LW REVISED CHECKED - -

**STATE OF ILLINOIS DEPARTMENT OF TRANSPORTATION**  **PAVING AND UTILITY PLAN** 

SHEET NO. 4 OF 6 SHEETS STA. 21+50


SCALE: 1" = 30'

SECTION 21-00134-00-RS COOK 68 22 CONTRACT NO. 61K86

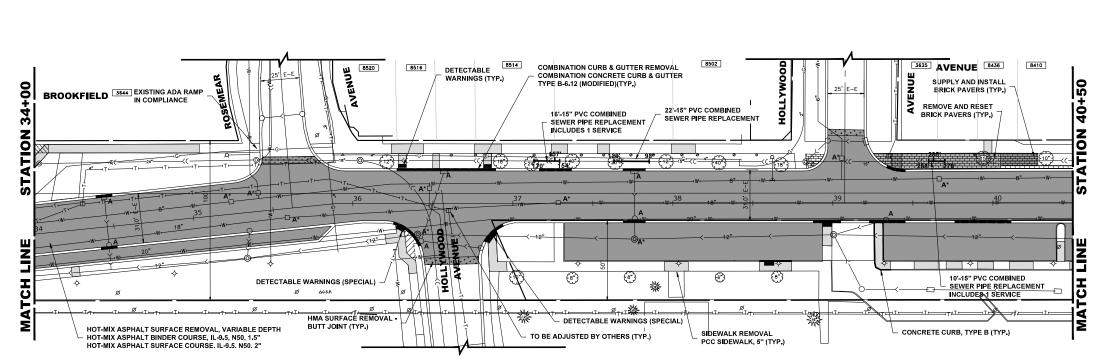

# **PROPOSED**

**IMPROVEMENTS** 

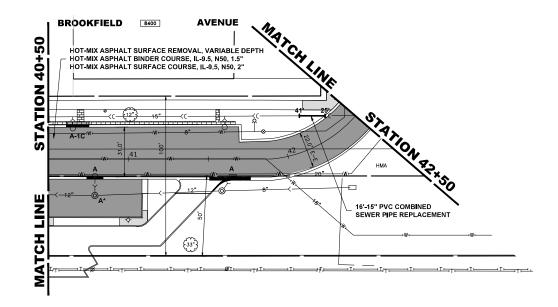

### **LEGEND OF SYMBOLS**

(TO BE USED IN CONJUNCTION WITH I.D.O.T. STANDARD 000001-07)

SYMBOL	DESCRIPTION
НМА	EXISTING HOT-MIX ASPHALT AREA
С	EXISTING CONCRETE AREA
G	EXISTING GRASS AREA
+ + + +	PROPOSED HOT-MIX ASPHALT BUTT JOINT
	EXISTING BRICK PAVER AREA
	REMOVE AND REINSTALL BRICK PAVERS
	SUPPLY AND INSTALL BRICK PAVERS
	PROPOSED CONCRETE AREA, 5" SIDEWALK, 7" DRIVEWA
	PROPOSED HOT-MIX ASPHALT RESURFACING AREA
Α	STRUCTURE TO BE ADJUSTED
A*	STRUCTURE TO BE ADJUSTED (SPECIAL)
АН	HANDHOLE TO BE ADJUSTED
1C	NEW FRAME AND LID, TYPE 1, CLOSED LID
1P	NEW FRAME AND LID, TYPE 1, OPEN LID
1B	NEW FRAME AND LID, TYPE 1, WATERTIGHT BOLT DOWN
RC	STRUCTURE TO BE RECONSTRUCTED
A	EXISTING FIRE HYDRANT
$\otimes$	EXISTING WATER VALVE BOX
	EXISTING WATER MAIN VALVE VAULT
	EXISTING STORM SEWER INLET
0	EXISTING STORM SEWER CATCH BASIN
•	PROPOSED STORM SEWER CATCH BASIN
<b>(a)</b>	EXISTING SEWER MANHOLE
$\Leftrightarrow$	EXISTING STREET LIGHT POLE
Ø	EXISTING POWER POLE
	EXISTING HANDHOLE
	EXISTING CURB AND GUTTER
	PROPOSED CONCRETE CURB, TYPE B
	PROPOSED COMBINATION CONCRETE CURB AND GUTTER REMOVAL AND REPLACEMENT
	EXISTING STORM SEWER
>	EXISTING COMBINED SEWER
W⊢	EXISTING WATER MAIN
	MWRD SEWER

- NOTES:

  1. THE MWRD SHALL HAVE 24 HOUR PER DAY UNRESTRICTED ACCESS TO ALL MWRD STRUCTURES, SEWERS, AND FACILITIES.

  2. NO DEBRIS SHALL ENTER MWRD STRUCTURES, SEWERS, FACILITIES, OR WATERWAYS.

MWRD MANHOLE MWRD STRUCTURE

NO ACCESS HATCHES OR MANHOLE COVERS ON MWRD STRUCTURES WITHIN THE PROJECT AREA SHALL BE COVERED OR BURIED

### **PROPOSED IMPROVEMENTS**

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g file:	<b>HANCOCK</b>	a de la constant de l	
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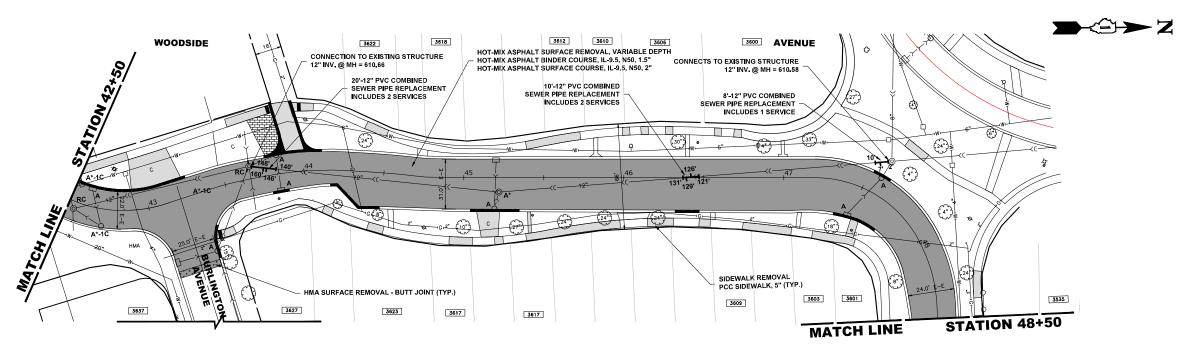
 Civil Engineers Municipal Consultants Established 1911

DESIGNED - -DRAWN - ECW, SB, GD, DMM, LW REVISED CHECKED - -

**STATE OF ILLINOIS DEPARTMENT OF TRANSPORTATION**  **PAVING AND UTILITY PLAN** 


SCALE: 1" = 30' SHEET NO. 5 OF 6 SHEETS STA. 34+00

SECTION 21-00134-00-RS COOK 68 23 CONTRACT NO. 61K86



### **PROPOSED IMPROVEMENTS**

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### **PROPOSED IMPROVEMENTS**
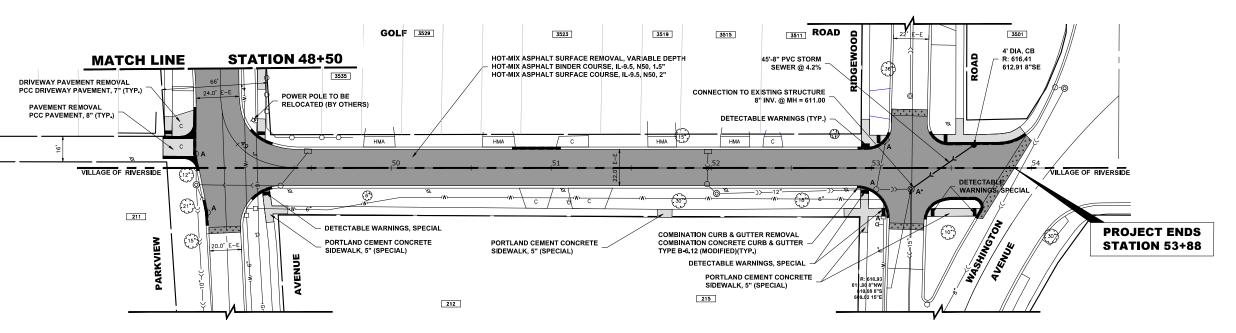
### **LEGEND OF SYMBOLS**

HMA

С

G

+ + + +

DESCRIPTION

EXISTING CONCRETE AREA

EXISTING GRASS AREA

EXISTING HOT-MIX ASPHALT AREA

PROPOSED HOT-MIX ASPHALT BUTT JOINT

	EXISTING BRICK PAVER AREA
	REMOVE AND REINSTALL BRICK PAVERS
	SUPPLY AND INSTALL BRICK PAVERS
	PROPOSED CONCRETE AREA, 5" SIDEWALK, 7" DRIVEWA
	PROPOSED HOT-MIX ASPHALT RESURFACING AREA
Α	STRUCTURE TO BE ADJUSTED
A*	STRUCTURE TO BE ADJUSTED (SPECIAL)
AH	HANDHOLE TO BE ADJUSTED
1C	NEW FRAME AND LID, TYPE 1, CLOSED LID
1P	NEW FRAME AND LID, TYPE 1, OPEN LID
1B	NEW FRAME AND LID, TYPE 1, WATERTIGHT BOLT DOWN
RC	STRUCTURE TO BE RECONSTRUCTED
A	EXISTING FIRE HYDRANT
$\otimes$	EXISTING WATER VALVE BOX
	EXISTING WATER MAIN VALVE VAULT
	EXISTING STORM SEWER INLET
0	EXISTING STORM SEWER CATCH BASIN
•	PROPOSED STORM SEWER CATCH BASIN
<b>(a)</b>	EXISTING SEWER MANHOLE
<b>\( \)</b>	EXISTING STREET LIGHT POLE
Ø	EXISTING POWER POLE
	EXISTING HANDHOLE
	EXISTING CURB AND GUTTER
	PROPOSED CONCRETE CURB, TYPE B
	PROPOSED COMBINATION CONCRETE CURB AND GUTTER REMOVAL AND REPLACEMENT
$\longrightarrow \!$	EXISTING STORM SEWER
——>>——	EXISTING COMBINED SEWER

- NOTES:

  1. THE MWRD SHALL HAVE 24 HOUR PER DAY UNRESTRICTED ACCESS TO ALL MWRD STRUCTURES, SEWERS, AND FACILITIES.

  2. NO DEBRIS SHALL ENTER MWRD STRUCTURES, SEWERS, FACILITIES, OR WATERWAYS.

EXISTING WATER MAIN MWRD SEWER

MWRD MANHOLF MWRD STRUCTURE

- 3. NO ACCESS HATCHES OR MANHOLE COVERS ON MWRD STRUCTURES WITHIN THE PROJECT AREA SHALL BE COVERED OR BURIED

TO STA. **54+00** 

HANCOCK		
		100+ Years of

 Civil Engineers Municipal Consultants ◆ Established 1911


DESIGNED -DRAWN - ECW, SB, GD, DMM, LW REVISED CHECKED - -REVISED

**STATE OF ILLINOIS DEPARTMENT OF TRANSPORTATION**  **PAVING AND UTILITY PLAN** 


SCALE: 1" = 30' SHEET NO. 6 OF 6 SHEETS STA. 42+50

SECTION 21-00134-00-RS COOK 68 24 CONTRACT NO. 61K86

### **COMBINATION CONCRETE CURB & GUTTER TYPE B-6.12**

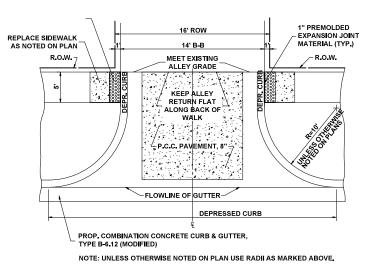


### **ALLEY RETURN**

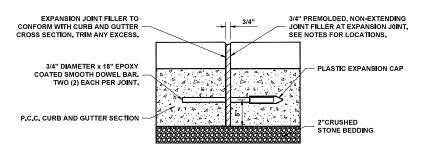

1. EXPANSION JOINTS ARE TO BE CONSTRUCTED AT ALL PC'S & PT'S OF INTERSECTION RETURNS AND ALL OTHER SHORT RADIUS SECTIONS. CONSTRUCTION JOINTS, EVERY 50' ON TANGENT SECTIONS, AND AS DIRECTED BY THE ENGINEER.


### **TYPICAL CURB AND GUTTER EXPANSION JOINT**

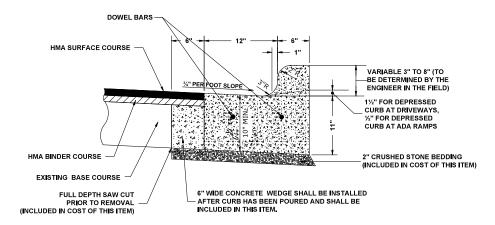


### NOTES:

- PROVIDE 2 3/4" DIAMETER, 18" LONG EPOXY COATED SMOOTH BARS WITH PLASTIC EXPANSION CAPS AT EACH EXPANSION JOINT.
- CONTRACTION JOINT 2" DEEP CONTRACTION JOINTS SHALL BE SAWED AT EQUAL SPACES (NOT EXCEEDING 15 FEET) BETWEEN NORMAL EXPANSION JOINTS, IN THE UPPER 1/3 OF CURB & GUTTERS WITHIN 24 HOURS OF PLACEMENT.


### **COMBINATION CONCRETE CURB & GUTTER TYPE B-6.12 (MODIFIED)**

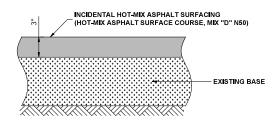


**INCIDENTAL HOT-MIX ASPHALT SURFACING** 

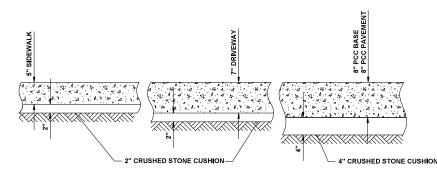

TYPICAL P.C.C. SIDEWALK, DRIVEWAY, **PAVEMENT AND BASE** 

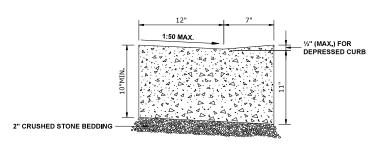


### **CURB AND GUTTER AT A.D.A. RAMPS**

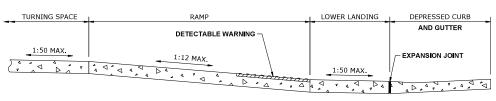


THE RUNNING SLOPE OF THE CURB RAMP SHALL NOT REQUIRE THE CURB LENGTH TO EXCEED 15'.

### **ADA RAMP**

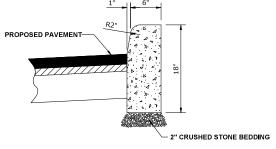

**BARRIER CURB** 

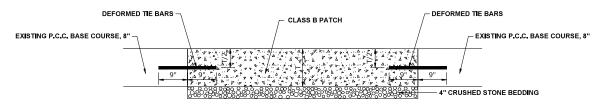

**PAVEMENT PATCH FOR CONCRETE BASE PAVEMENT** 

9933 Roosevelt Road Phone: 708-845-0300


DESIGNED -ECW, SB, GD, DMM, LW REVISED DRAWN -CHECKED -REVISED

STATE OF ILLINOIS **DEPARTMENT OF TRANSPORTATION**  **PAVING AND UTILITY DETAILS** 


SECTION COUNTY COOK 68 25 21-00134-00-RS CONTRACT NO. 61K86

SHEET NO. 1 OF 5 SHEETS STA. SCALE: NONE


ENGINEERING | # # # Established 1911 DATE 11-7-24 REVISED

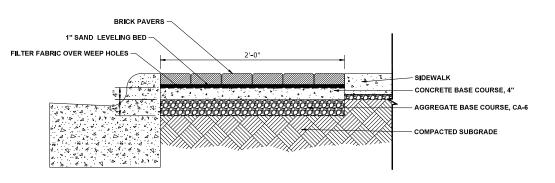


### **BRICK PAVER SIDEWALK** (CROSS SECTION)

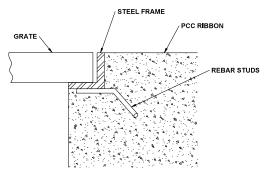

TREE GRATE FRAME MOUNTING

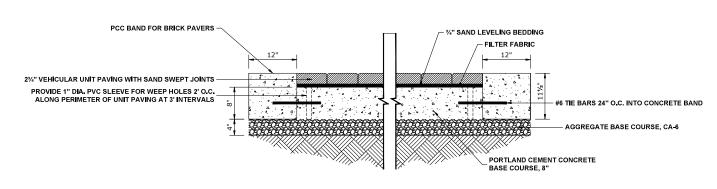


**BRICK PAVER CROSS WALK** (CROSS SECTION)

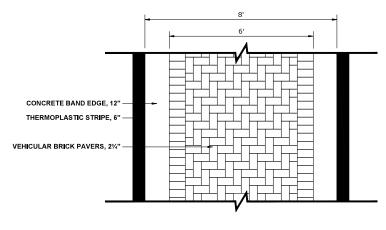



**BRICK PAVER CROSS WALK** (PLAN VIEW)

SCALE: NONE

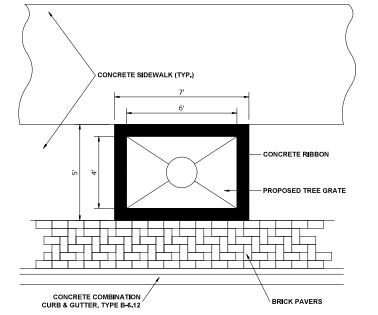

TREE GRATE ASSEMBLY (PLAN VIEW)

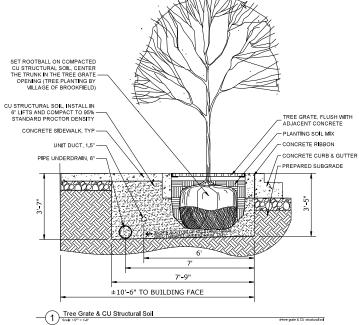

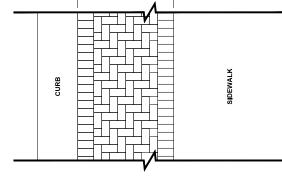


**BRICK PAVER SIDEWALK** (PLAN VIEW)



DESIGNED -	-	KEVISED -
DRAWN -	ECW, SB, GD, DMM, LW	REVISED -
CHECKED -	-	REVISED -
DATE -	11-7-24	REVISED -

**STATE OF ILLINOIS DEPARTMENT OF TRANSPORTATION** 

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tchester, IL, 60154-2780 Phone: 708-845-0300

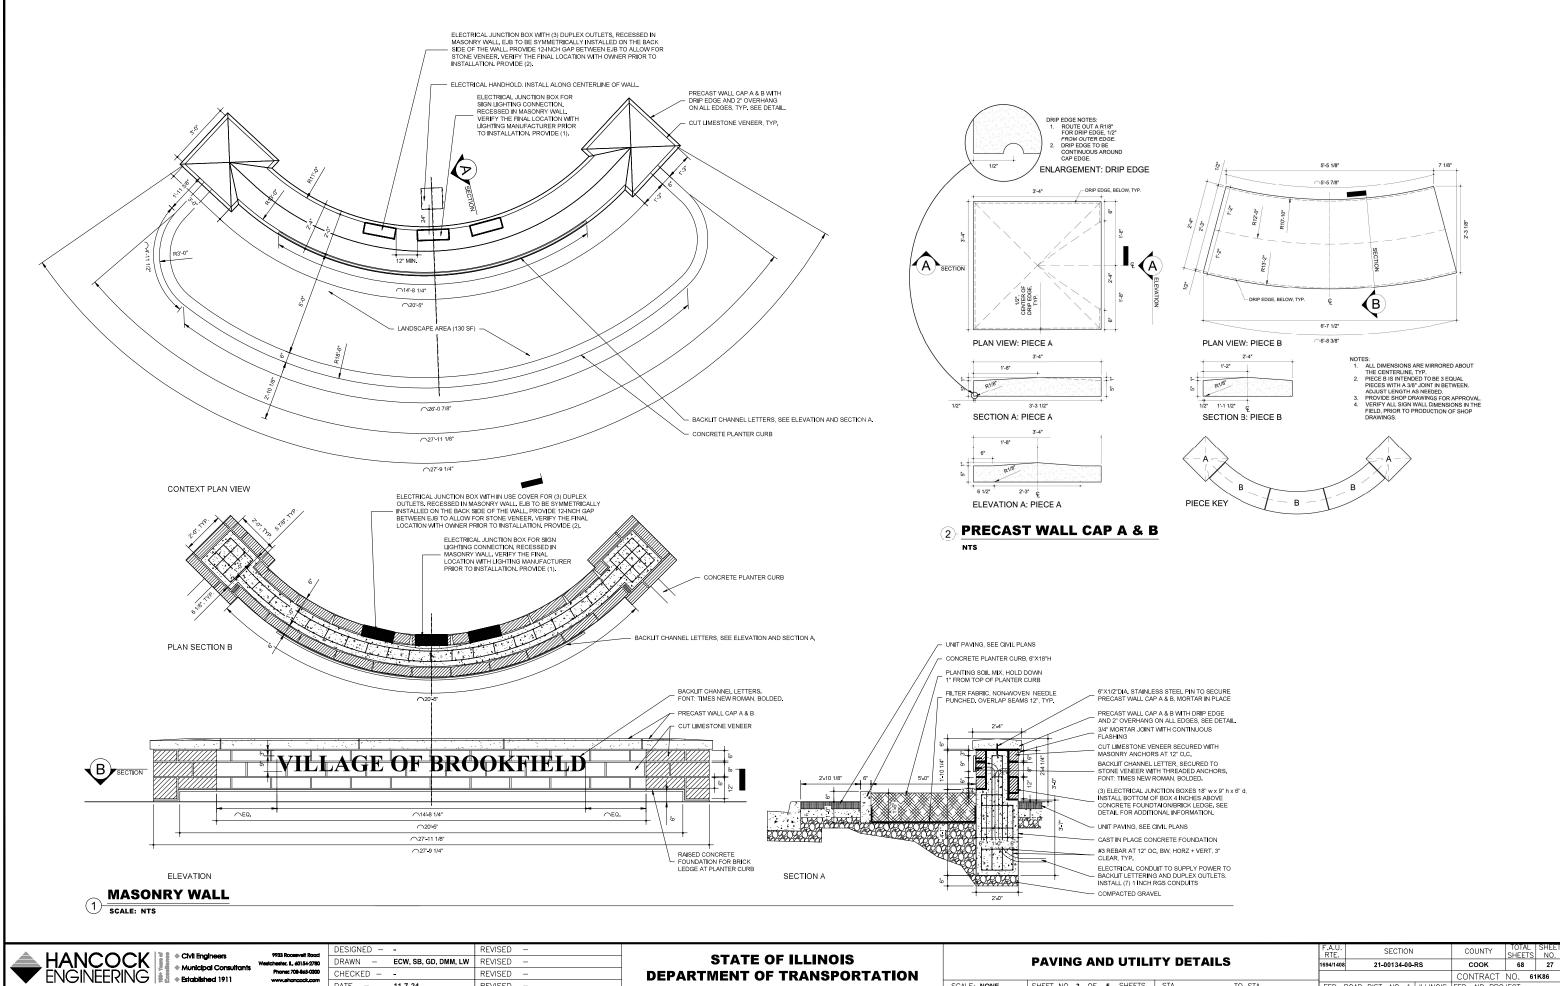CHECKED -REVISED DATE -REVISED

**DEPARTMENT OF TRANSPORTATION** 


SCALE: NONE

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SHEET NO. 3 OF	5	SHEETS	STA.	T	O STA.	FED.	ROAD	DIST.	NO.	П	ILLINOIS	FED.	AID F	PRO.	JECT		

STRUCTURE ADJUSTMENT



**STANDARD VALVE VAULT** 

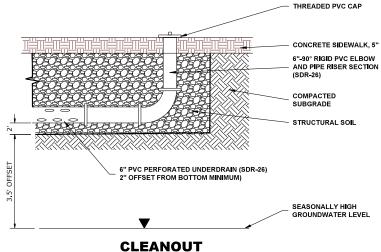

CAST IRON MANHOLE FRAME & SELF-SEALING

PRECAST REINFORCED CONCRETE SECTIONS

FABRICATED IN ACCORDANCE WITH A.S.T.M.

PRECAST REINFORCED CONCRETE
FLOOR FABRICATED IN ACCORDANCE WITH

A.S.T.M. DESIG. C-478, WITH 4" TRENCH BACKFILL MATERIAL AS CUSHION.


LID, WITH WORD "WATER" CAST INTO LID

MINIMUM OF 2" AND MAXIMUM 6" OF


ONE 1" CORPORATION STOP.

WITHIN VAULT: 2 PER VAULT

CONCRETE BLOCK SUPPORT

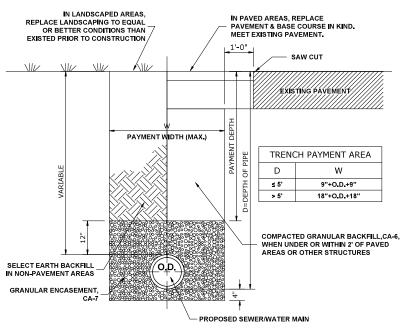

### **TYPICAL SEWER AND WATER MAIN TRENCH**

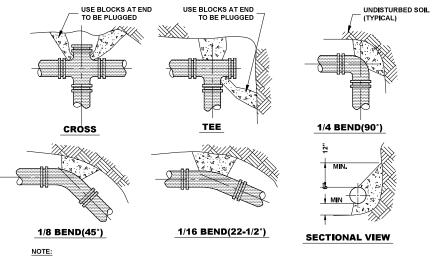

1. THRUST BLOCKS TO BE USED AT 1/16(22-1/2°) OR GREATER BENDS & AT ALL ENDS TO BE PLUGGED. 2. PRECAST CONCRETE THRUST BLOCKS TO BE PLACED AGAINST FIRM, UNDISTURBED SOIL.

THRUST BLOCK

**DRAINAGE AND UTILITIES NOTES** 

THE LOCATIONS OF EXISTING DRAINAGE STRUCTURES, STORM SEWERS, COMBINED SEWERS, TELEPHONE LINES, COMMUNICATION LINES, ELECTRIC LINES, GAS MAINS, AND WATER SERVICES ARE APPROXIMATE AND THEIR SPECIFIC LOCATIONS ARE TO BE DETERMINED IN THE FIELD AT NO COMPENSATION TO THE CONTRACTOR.

COORDINATION OF ALL UTILITY WORK INVOLVED WITHIN THE CONSTRUCTION AREAS SHALL BE SUBJECT TO DISCUSSION AND CLARIFICATION AT A PRECONSTRUCTION MEETING.

WHEN EXISTING DRAINAGE FACILITIES ARE DISTURBED. THE CONTRACTOR SHALL PROVIDE AND MAINTAIN TEMPORARY OUTLETS AND CONNECTIONS FOR ALL PRIVATE OR PUBLIC DRAINAGE STRUCTURES OR SEWERS UNTIL PERMANENT CONNECTIONS TO SEWERS ARE BUILT AND IN SERVICE. THIS WORK SHALL BE PAID FOR AS TEMPORARY DRAINAGE CONNECTIONS.

IF, DURING CONSTRUCTION OPERATIONS, ANY LOOSE MATERIALS ARE DEPOSITED IN THE FLOW LINES OF GUTTERS OR DRAINAGE STRUCTURES SO THAT THE NATURAL FLOW OF WATER IS OBSTRUCTED, THE OBSTRUCTING MATERIALS SHALL BE REMOVED AT THE CLOSE OF EACH WORK DAY. AT THE CONCLUSION OF THE CONSTRUCTION OPERATIONS, ALL DRAINAGE STRUCTURES ARE TO BE FREE OF ALL DIRT, DEBRIS, AND OBSTRUCTING MATERIALS. THE WORK SPECIFIED ABOVE WILL NOT BE PAID FOR SEPARATELY, BUT SHALL BE INCLUDED IN THE COST OF PROPOSED ITEMS BEING CONSTRUCTED.

THE CONTRACTOR SHALL VERIFY THE TYPE OF ALL WATER MAIN HARDWARE INCLUDING VALVES, FIRE HYDRANTS, VALVE BOXES, CORPORATION STOPS, CURB STOPS, AND WATER SERVICES BOXES WITH THE UTILITY SUPERINTENDENT PRIOR TO ORDERING SUCH MATERIAL.

ON ALL IMPROVEMENTS, THE FRAMES AND LIDS OF EXISTING CATCH BASINS, INLETS, MANHOLES, AND VALVE VAULTS WHICH ARE TO BE ABANDONED DUE TO CONSTRUCTION OF THIS IMPROVEMENT ARE TO REMAIN THE PROPERTY OF THE VILLAGE OF BROOKFIELD AND BE SALVAGED. THE CONTRACTOR IS TO DELIVER FRAMES AND LIDS TO THE VILLAGE OF BROOKFIELD PUBLIC WORKS DEPARTMENT.

ANY COSTS FOR SHEETING OR SHORING REQUIRED FOR SEWER INSTALLATION OR OTHER CONSTRUCTION ELEMENTS REQUIRING RELATIVELY DEEP EXCAVATIONS SHALL BE INCLUDED IN THE PARTICULAR PAYMENT ITEM AND NO ADDITIONAL COMPENSATION WILL BE ALLOWED FOR ANY SUPPLEMENTAL WORK ASSOCIATED WITH THE MAINTENANCE OF TRENCH SIDES OR OTHER EXCAVATED AREAS.

ALL ABANDONED SEWERS SHALL BE PLUGGED AT BOTH ENDS WITH AT LEAST 2 FEET LONG NON-SHRINK CONCRETE OR MORTAR PLUG. THIS WORK SHALL NOT BE PAID FOR SEPARATELY, BUT SHALL BE INCLUDED IN THE PAY ITEMS FOR REMOVING AND/OR FILLING THE VARIOUS TYPES OF STRUCTURES.

SEWER PIPE INSTALLED ON THIS PROJECT SHALL CONFORM TO THE FOLLOWING STANDARD:

MATERIAL STANDARD	JOINT STANDAR
ASTM C-76	ASTM C-443
ASTM D-2241	ASTM D-3139
ASTM A-21.51	ASTM A-21.11
	ASTM C-76 ASTM D-2241

Phone: 708-845-0300

DESIGNED -ECW. SB. GD. DMM. LW REVISED DRAWN -CHECKED -REVISED


STATE OF ILLINOIS **DEPARTMENT OF TRANSPORTATION** 

SCALE: NONE


**PAVING AND UTILITY DETAILS** 

SECTION COUNTY SHEETS NO 21-00134-00-RS COOK 68 28 CONTRACT NO. 61K86 SHEET NO. 4 OF 5 SHEETS STA. FED. ROAD DIST. NO. 1 JILLINOIS




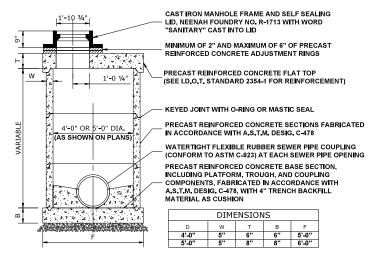



### RESTRICTED DEPTH (COMBINED) **SANITARY MANHOLE**

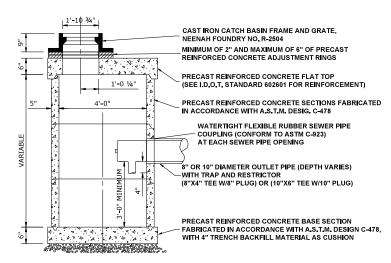


### **RESTRICTED DEPTH CATCH BASIN**

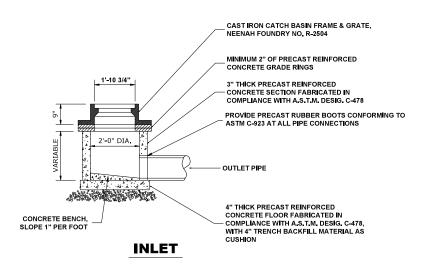


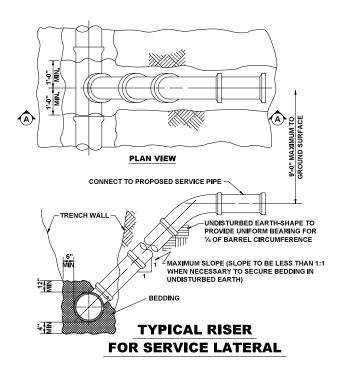

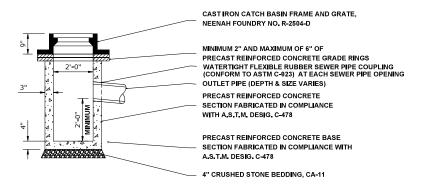


### CATCH BASIN, TYPE C

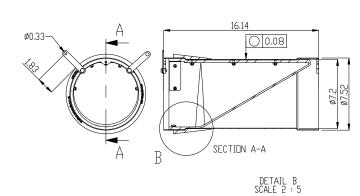


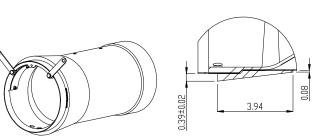

### **CHECK VALVE, 8"**

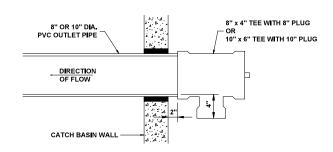

### 8"X4"/10"X6" CATCH BASIN TRAP AND RESTRICTOR

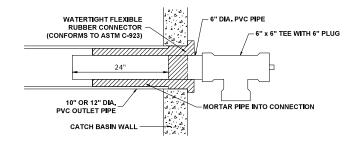

### **DRAINAGE RESTRICTOR**



Ichester, IL, 60154-2780 Phone: 708-845-0300

DESIGNED - -ECW. SB. GD. DMM. LW REVISED DRAWN -CHECKED -REVISED DATE REVISED

STATE OF ILLINOIS **DEPARTMENT OF TRANSPORTATION** 

COUNTY SHEETS NO. 21-00134-00-RS COOK 68 29 CONTRACT NO. 61K86 FED. AID PROJECT

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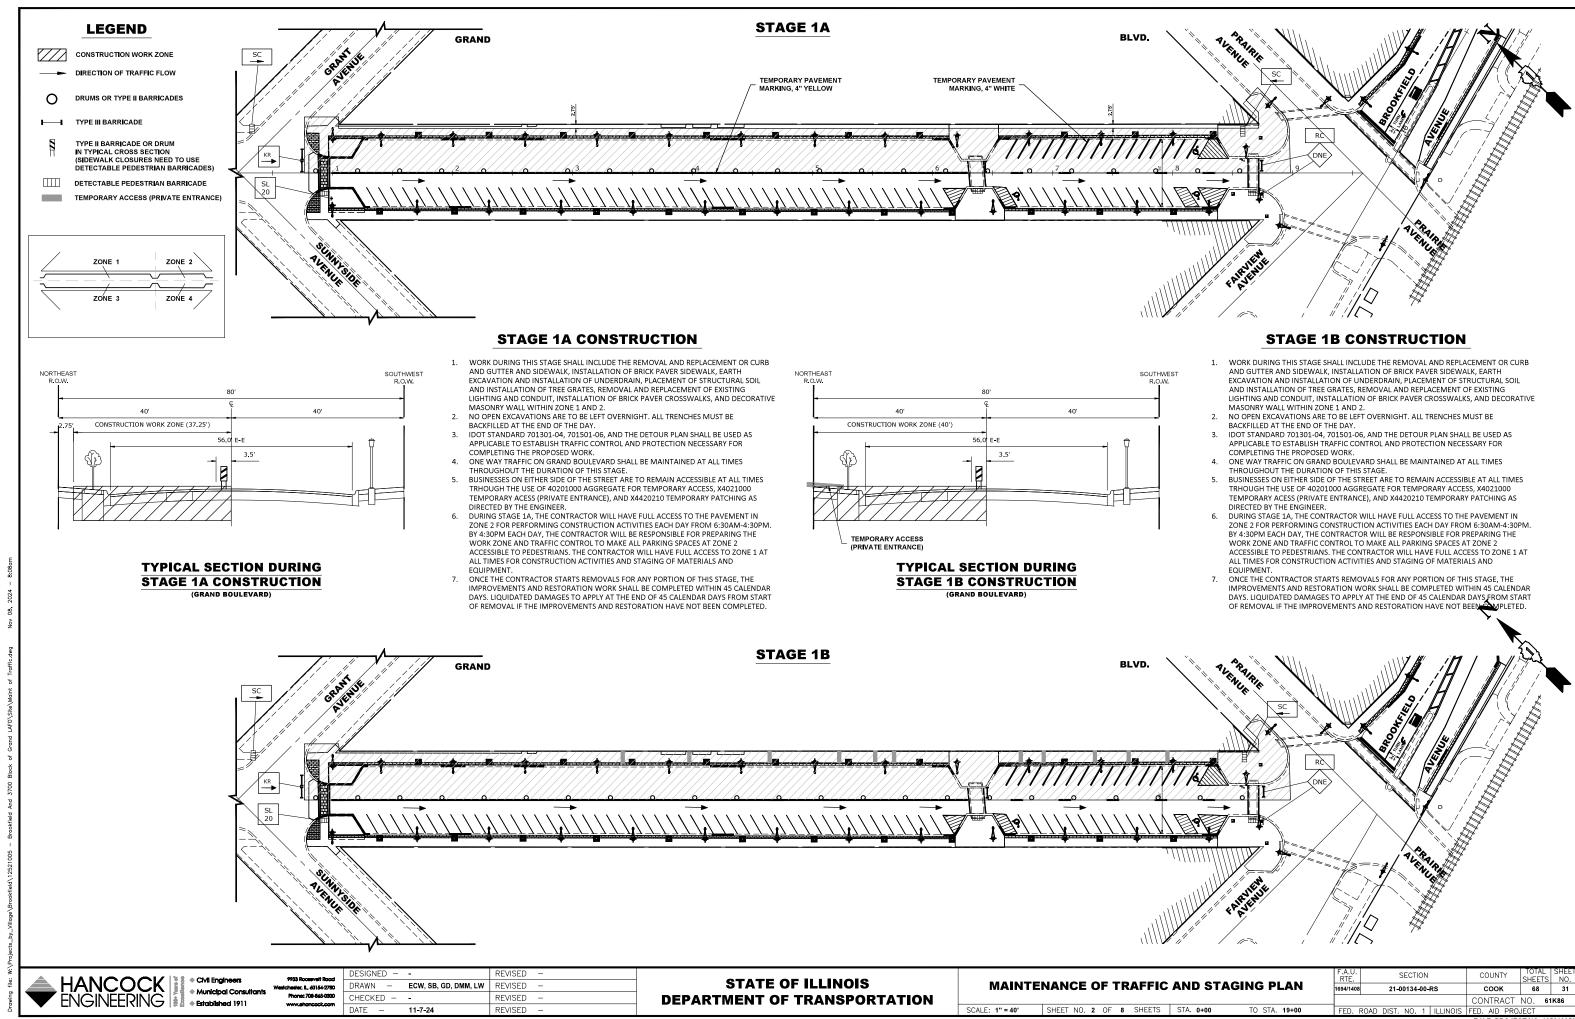
Municipal Consultants


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п	DATE -	11-7-24	REVISED	=


STATE OF ILLINOIS **DEPARTMENT OF TRANSPORTATION** 


MAINTENANCE OF TRAFFIC AND STAGING PLAN SCALE: NONE SHEET NO. 1 OF 8 SHEETS STA.


SECTION COOK 68 30 21-00134-00-RS CONTRACT NO. 61K86 FED. AID PROJECT



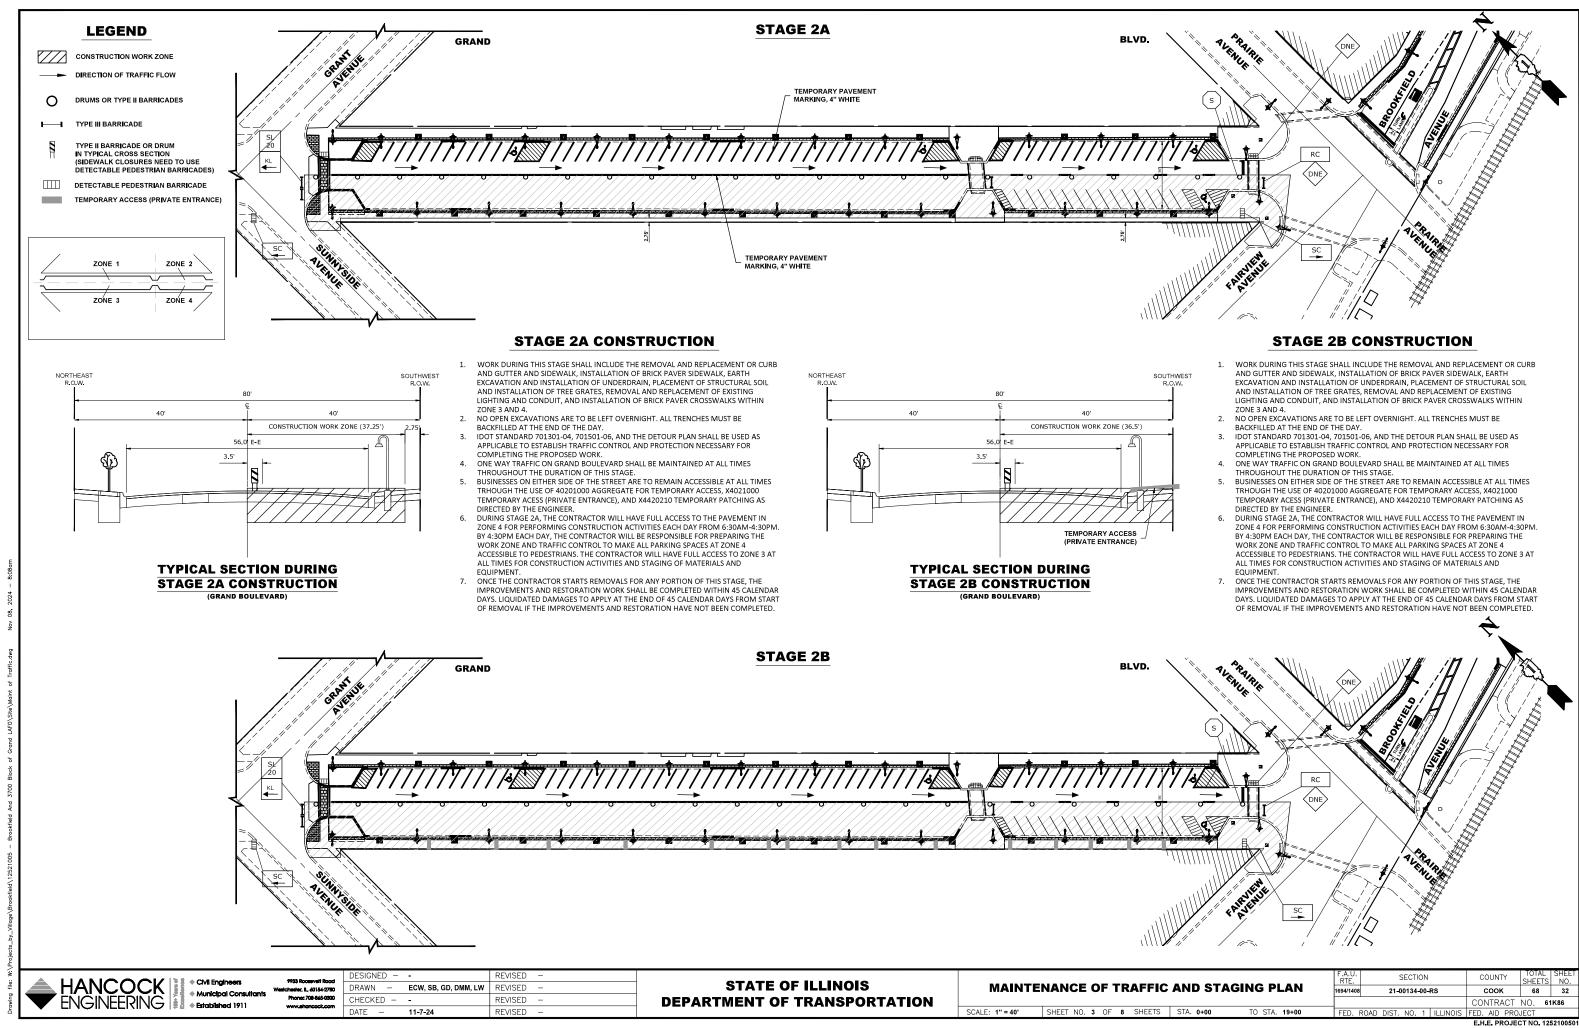

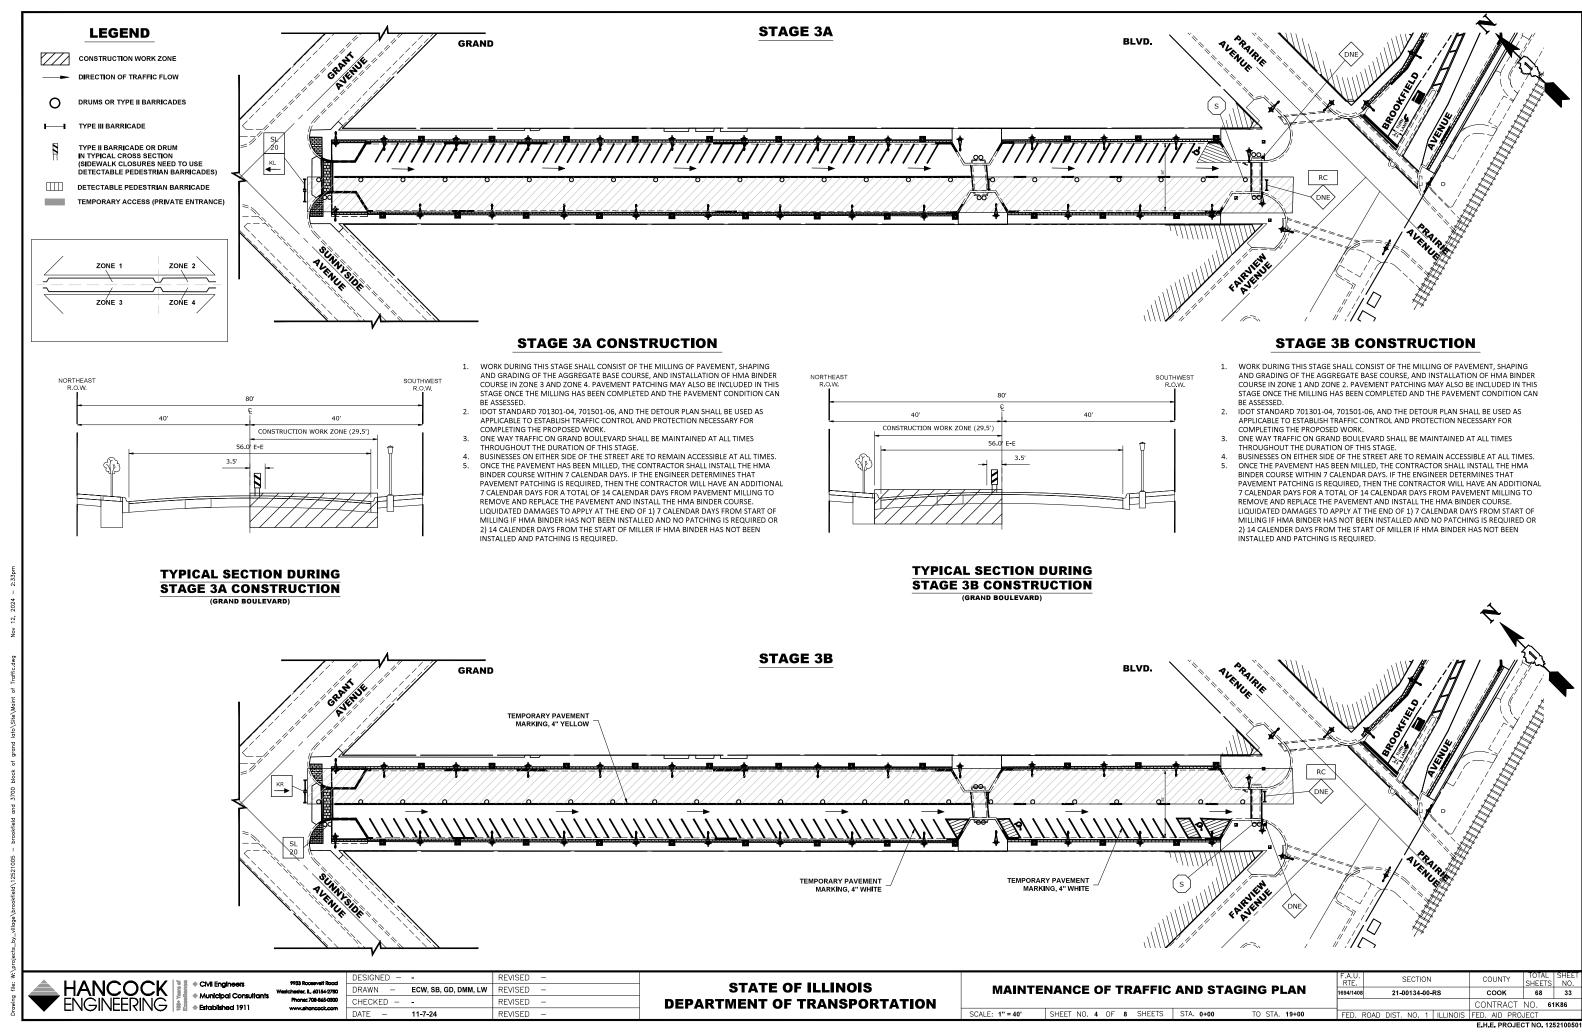

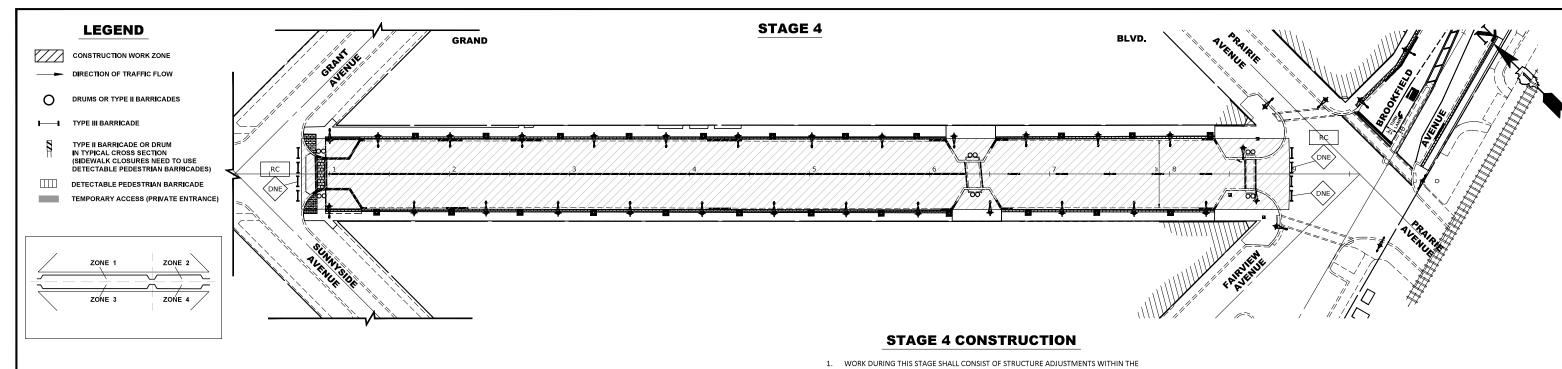

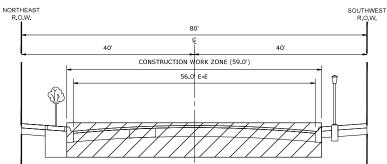

**TYPICAL SECTION DURING STAGE 4 CONSTRUCTION** 

- PAVEMENT, HMA SURFACE INSTALLATION, AND PAVEMENT MARKINGS FOR ZONE 1, 2, 3, AND 4
- 2. IDOT STANDARD 701301-04, 701501-06, AND THE DETOUR PLAN SHALL BE USED AS APPLICABLE TO ESTABLISH TRAFFIC CONTROL AND PROTECTION NECESSARY FOR COMPLETING THE PROPOSED WORK.
- THE CONTRACTOR MAY KEEP THE ROAD CLOSED IN THE CONSRUCTION WORK ZONE DURING THE DAY WHILE CONSTRUCTION ACTIVITIES ARE TAKING PLACE BUT SHALL MAINTAIN ACCESSIBILITY TO LOCAL TRAFFIC AT ALL OTHER TIMES.
- 4. BUSINESSES ON EITHER SIDE OF THE STREET ARE TO REMAIN ACCESSIBLE AT ALL TIMES. 5. ONCE WORK HAS BEEN COMPLETED ON STAGE 3B, THE CONTRACTOR WILL HAVE 7 CALENDAR DAYS TO COMPLETE ALL WORK ASSOCIATED WITH THE STAGE. LIQUIDATED DAMAGES TO APPLY AT THE END OF 7 CALENDAR DAYS FROM COMPLETION OF STAGE 3B IF THE PAVEMENT MARKINGS HAVE NOT BEEN INSTALLED.


Municipal Consultants

DESIGNED	REVISED -
DRAWN - ECW, SB, GD, DMM, LW	REVISED -
CHECKED	REVISED -
DATE - 11-7-24	REVISED -

**STATE OF ILLINOIS DEPARTMENT OF TRANSPORTATION** 

**MAINTENANCE OF TRAFFIC AND STAGING PLAN** SCALE: 1" = 40' SHEET NO. 5 OF 8 SHEETS STA. 0+00

21-00134-00-RS CONTRACT NO. 61K86

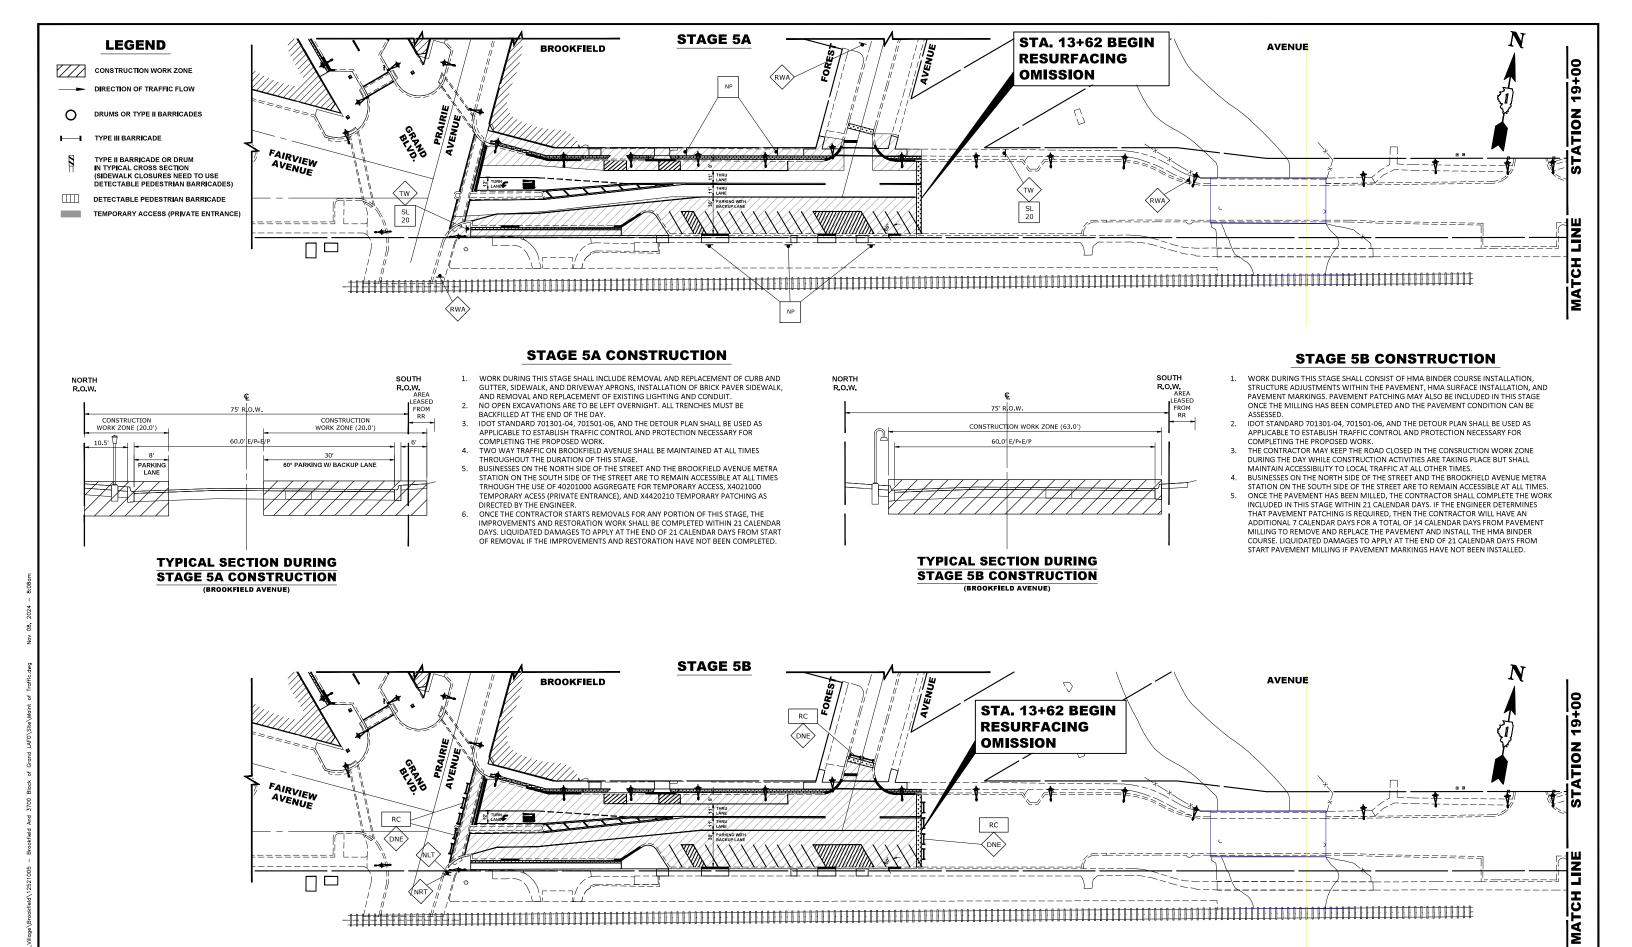


Municipal Consultants

DESIGNED -DRAWN - ECW. SB. GD. DMM. LW REVISED CHECKED -REVISED REVISED

STATE OF ILLINOIS **DEPARTMENT OF TRANSPORTATION**  **MAINTENANCE OF TRAFFIC AND STAGING PLAN** SHEET NO. 6 OF 8 SHEETS STA. 0+00

21-00134-00-RS COOK 68 35 CONTRACT NO. 61K86

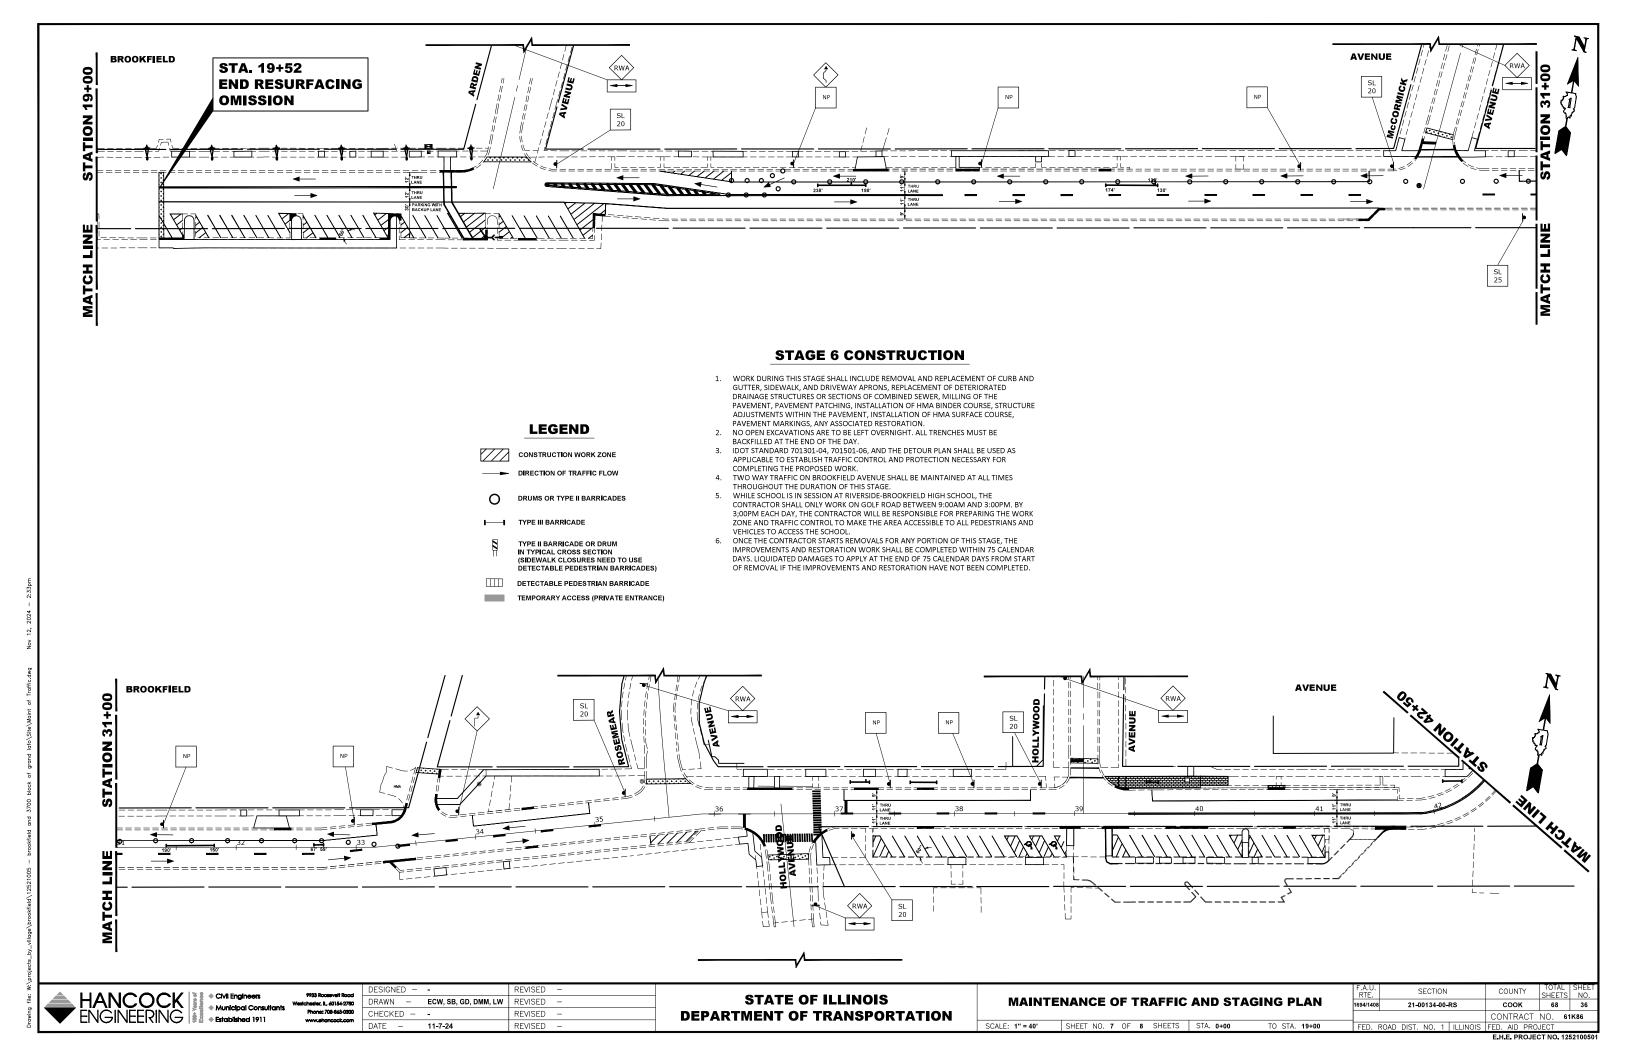

#### **STAGE 6 CONSTRUCTION**

- 1. WORK DURING THIS STAGE SHALL INCLUDE REMOVAL AND REPLACEMENT OF CURB AND GUTTER, SIDEWALK, AND DRIVEWAY APRONS, REPLACEMENT OF DETERIORATED DRAINAGE STRUCTURES OR SECTIONS OF COMBINED SEWER, MILLING OF THE PAVEMENT, PAVEMENT PATCHING, INSTALLATION OF HMA BINDER COURSE, STRUCTURE ADJUSTMENTS WITHIN THE PAVEMENT, INSTALLATION OF HMA SURFACE COURSE, PAVEMENT MARKINGS, ANY ASSOCIATED RESTORATION.
- NO OPEN EXCAVATIONS ARE TO BE LEFT OVERNIGHT. ALL TRENCHES MUST BE BACKFILLED AT THE END OF THE DAY.
- IDOT STANDARD 701301-04, 701501-06, AND THE DETOUR PLAN SHALL BE USED AS APPLICABLE TO ESTABLISH TRAFFIC CONTROL AND PROTECTION NECESSARY FOR COMPLETING THE PROPOSED WORK.
- TWO WAY TRAFFIC ON BROOKFIELD AVENUE SHALL BE MAINTAINED AT ALL TIMES THROUGHOUT THE DURATION OF THIS STAGE.
- WHILE SCHOOL IS IN SESSION AT RIVERSIDE-BROOKFIELD HIGH SCHOOL, THE CONTRACTOR SHALL ONLY WORK ON GOLF ROAD BETWEEN 9:00AM AND 3:00PM. BY 3;00PM EACH DAY, THE CONTRACTOR WILL BE RESPONSIBLE FOR PREPARING THE WORK ZONE AND TRAFFIC CONTROL TO MAKE THE AREA ACCESSIBLE TO ALL PEDESTRIANS AND
- ONCE THE CONTRACTOR STARTS REMOVALS FOR ANY PORTION OF THIS STAGE, THE IMPROVEMENTS AND RESTORATION WORK SHALL BE COMPLETED WITHIN 75 CALENDAR DAYS. LIQUIDATED DAMAGES TO APPLY AT THE END OF 75 CALENDAR DAYS FROM START OF REMOVAL IF THE IMPROVEMENTS AND RESTORATION HAVE NOT BEEN COMPLETED.

#### **LEGEND**

CONSTRUCTION WORK ZONE

DIRECTION OF TRAFFIC FLOW


DRUMS OR TYPE II BARRICADES

TYPE III BARRICADE

TYPE II BARRICADE OR DRUM DETECTABLE PEDESTRIAN BARRICADES)

DETECTABLE PEDESTRIAN BARRICADE

TEMPORARY ACCESS (PRIVATE ENTRANCE)

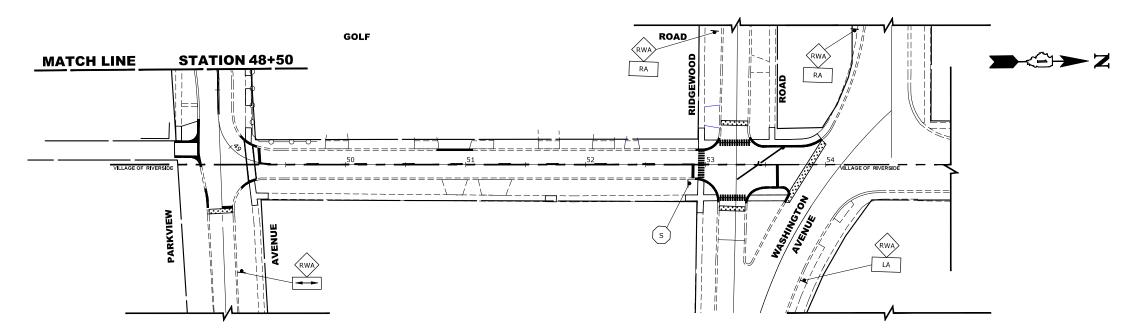

HANCOCK

Municipal Consult
ENGINEERING

CMI Engineers

Municipal Consult
Established 1911

Municipal Consultants


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**STATE OF ILLINOIS DEPARTMENT OF TRANSPORTATION** 

**MAINTENANCE OF TRAFFIC AND STAGING PLAN** SCALE: 1" = 40' SHEET NO. 8 OF 8 SHEETS STA. 42+50

| SHEETS | NO. | COOK | 68 | 37 21-00134-00-RS CONTRACT NO. 61K86



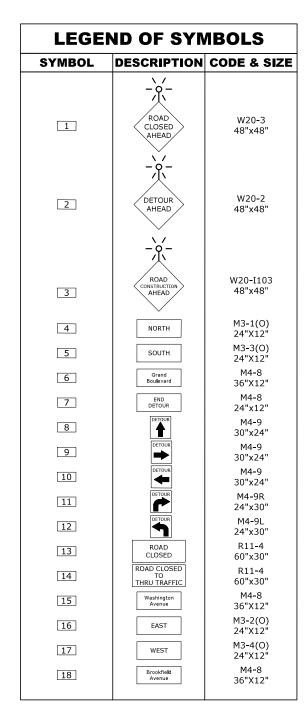

- 1. ALL LOCAL DETOURS SHALL BE APPROVED BY THE ENGINEER AT LEAST 48 HOURS PRIOR TO INSTALLATION.
- 2. GRAND BOULEVARD TO BE DETOURED.
- 2. GRAND BOULEVARD IN SE DETOURED.
  3. TEMPORARY ACCESS TO INTERSECTIONS AND RESIDENTIAL DRIVEWAYS TO BE MAINTAINED AT ALL TIMES UNLESS DIRECTLY IMPACTED BY CONSTRUCTON
  4. ONE-WAY TRAFFIC TO BE MAINTAINED AT ALL TIMES ON GRAND BOULEVARD.
  5. DETOUR SIGNAGE SHALL BE CONSIDERED INCLUDED IN THE COST FOR TEMPORARY TRAFFIC

- CONTROL AND PROTECTION (SPECIAL) EXCEPT AS OTHERWISE NOTED.

  6. THE CONTRACTOR SHALL NOT OBSTRUCT ANY EXISTING SIGN WITH THE PLACEMENT OF DETOUR
- SIGNAGE.
  7. SEE DETAIL TC-21 FOR TYPICAL SIGN SPACING.
- 7. SEE DETAIL TOZETFOR ETFICAL SIGN SPACING.

  8. A MINIMUM OF 14 DAYS IN ADVANCE OF THE START OF THE PROJECT, THE CONTRACTOR SHALL PLACE 1 ARTERIAL ROAD INFORMATION SIGN AT EACH END OF THE PROJECT AS DIRECTED AND AT A LOCATION DESIGNATED BY THE ENGINEER. THIS SHALL BE PAID FOR AS TEMPORARY INFORMATION SIGNING. ADDITIONALLY, CHANGEABLE MESSAGE SIGNS SHALL BE PLACED AT EACH END OF ANY ROAD CLOSURES 7 DAYS IN ADVANCE OF WHEN THE CLOSURE WILL TAKE PLACE.

  9. ALL DETOUR SIGNAGE TO BE BAGGED OR COVERED WHEN NOT IN USE.

TO STA.



Civil Engineers Municipal Consultants

Phone: 708-865-030

9933 Rogsevelt Rogs


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**STATE OF ILLINOIS DEPARTMENT OF TRANSPORTATION** 

**DETOUR PLAN STAGE 1, 2, AND 3** SHEET NO. 1 OF 3 SHEETS STA.

SCALE: NTS

SECTION COUNTY 21-00134-00-RS CONTRACT NO. 61K86

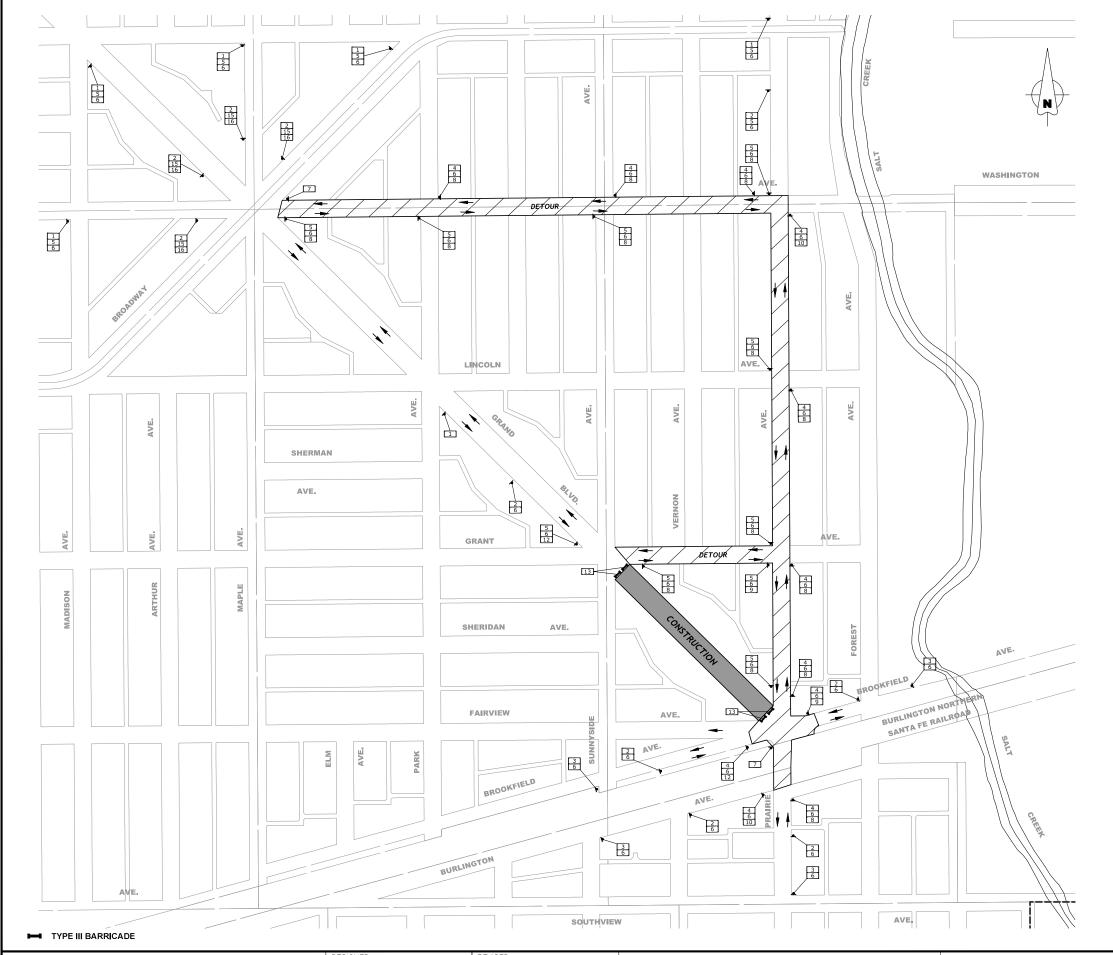

LEGEN	ID OF SYN	<b>IBOLS</b>
SYMBOL	DESCRIPTION	CODE & SIZE
1	ROAD CLOSED	W20-3
	AHEAD	48"x48"
2	DETOUR AHEAD	W20-2 48"x48"
3	ROAD CONSTRUCTION AHEAD	W20-I103 48"x48"
4	NORTH	M3-1(O) 24"X12"
5	SOUTH	M3-3(O) 24"X12"
6	Grand Boulevard	M4-8 36"X12"
7	END DETOUR	M4-8 24"x12"
8	DETOUR	M4-9 30"x24"
9	DETOUR	M4-9 30"x24"
10	DETOUR	M4-9 30"x24"
11	DETOUR	M4-9R 24"x30"
12	DETOUR	M4-9L 24"x30"
13	ROAD CLOSED	R11-4 60"x30"
14	ROAD CLOSED TO THRU TRAFFIC	R11-4 60"x30"
15	Washington Avenue	M4-8 36"X12"
16	EAST	M3-2(O) 24"X12"
17	WEST	M3-4(O) 24"X12"
18	Brookfie <b>l</b> d Avenue	M4-8 36"X12"

- 1. ALL LOCAL DETOURS SHALL BE APPROVED BY THE ENGINEER AT LEAST 48 HOURS PRIOR TO INSTALLATION.
- 2. GRAND BOULEVARD TO BE DETOURED.
  3. TEMPORARY ACCESS TO INTERSECTIONS AND RESIDENTIAL DRIVEWAYS TO BE MAINTAINED AT ALL TIMES UNLESS DIRECTLY IMPACTED BY CONSTRUCTON

- ALL TIMES UNLESS DIRECTLY IMPACTED BY CONSTRUCTION

  4. DETOUR SIGNAGE SHALL BE CONSIDERED INCLUDED IN THE COST FOR TEMPORARY TRAFFIC CONTROL AND PROTECTION (SPECIAL) EXCEPT AS OTHERWISE NOTED.

  5. THE CONTRACTOR SHALL NOT OBSTRUCT ANY EXISTING SIGN WITH THE PLACEMENT OF DETOUR SIGNAGE.
- 6. SEE DETAIL TC-21 FOR TYPICAL SIGN SPACING.
  7. A MINIMUM OF 14 DAYS IN ADVANCE OF THE START OF THE PROJECT, THE CONTRACTOR SHALL PLACE 1 ARTERIAL ROAD INFORMATION SIGN AT EACH END OF THE PROJECT AS DIRECTED AND AT A LOCATION DESIGNATED BY THE ENGINEER. THIS SHALL BE PAID FOR AS TEMPORARY INFORMATION SIGNING. ADDITIONALLY, CHANGEABLE MESSAGE SIGNS SHALL BE PLACED AT EACH END OF ANY ROAD CLOSURES 7 DAYS IN ADVANCE OF WHEN THE CLOSURE WILL TAKE PLACE.
- 8. ALL DETOUR SIGNAGE TO BE BAGGED OR COVERED WHEN NOT IN USE.

	+ HANCOCK ENGINEERING	
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Civil Engineers Municipal Consultants ◆ Established 1911

9933 Rogsevelt Rogs Phone: 708-865-0300

DATE -


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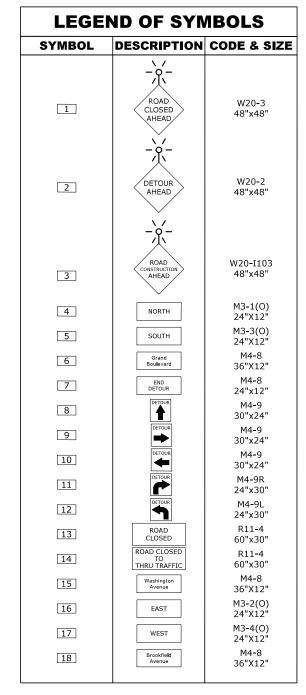
**STATE OF ILLINOIS DEPARTMENT OF TRANSPORTATION** 

**DETOUR PLAN** STAGE 4 SHEET NO. 2 OF 3 SHEETS STA.

SCALE: NTS

SECTION COUNTY 21-00134-00-RS CONTRACT NO. 61K86 Fed. aid project



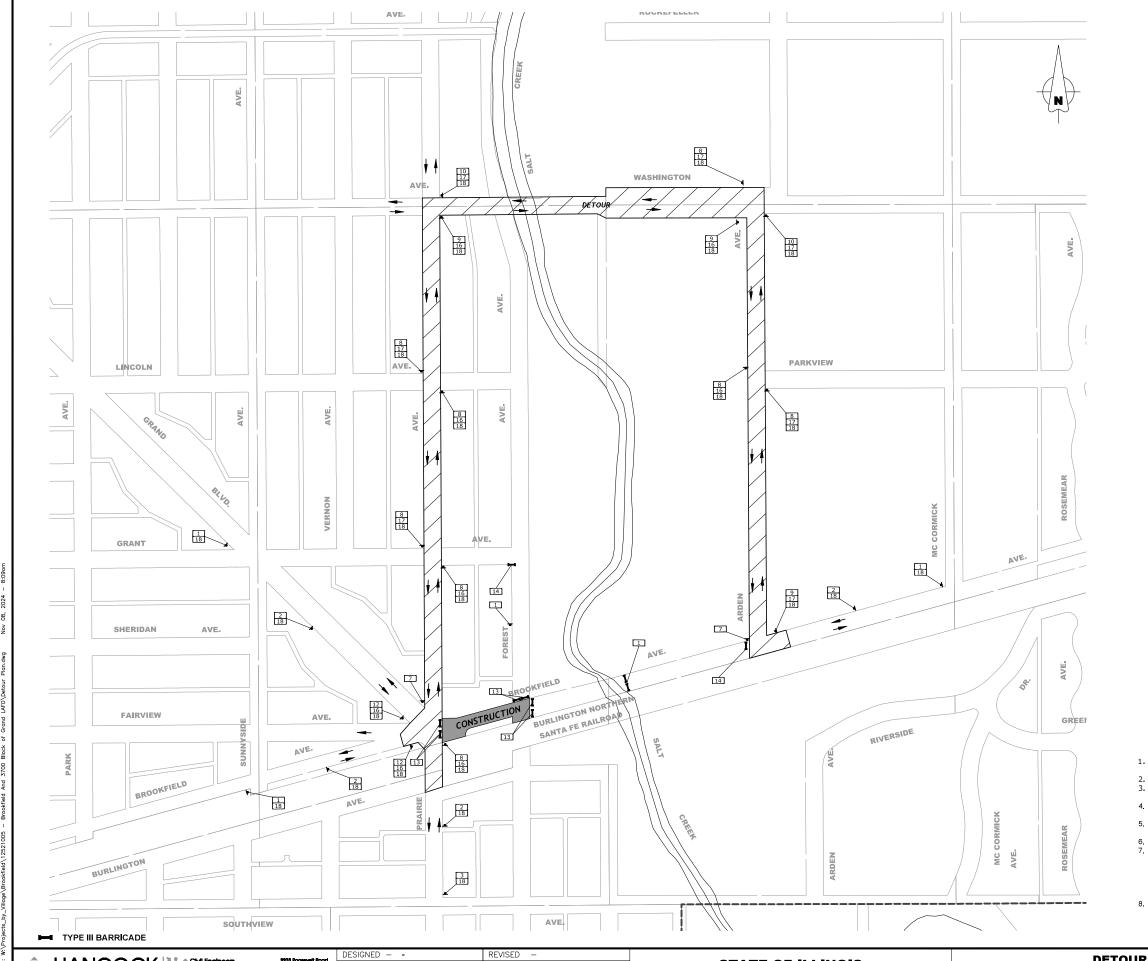

- 1. ALL LOCAL DETOURS SHALL BE APPROVED BY THE ENGINEER AT LEAST 48 HOURS PRIOR TO
- INSTALLATION.

  2. BROOKFIELD AVENUE TO BE DETOURED.
- 2. BKOUKFIELD AVENUE 10 BE DETOURED.

  3. TEMPORARY ACCESS TO INTERSECTIONS AND RESIDENTIAL DRIVEWAYS TO BE MAINTAINED AT ALL TIMES UNLESS DIRECTLY IMPACTED BY CONSTRUCTON.

  4. DETOUR SIGNAGE SHALL BE CONSIDERED INCLUDED IN THE COST FOR TEMPORARY TRAFFIC CONTROL AND PROTECTION (SPECIAL) EXCEPT AS OTHERWISE NOTED.

- 5. THE CONTRACTOR SHALL NOT OBSTRUCT ANY EXISTING SIGN WITH THE PLACEMENT OF DETOUR SIGNAGE.
- SEE DETAIL TC-21 FOR TYPICAL SIGN SPACING.
   A MINIMUM OF 14 DAYS IN ADVANCE OF THE START OF THE PROJECT, THE CONTRACTOR SHALL PLACE 1 ARTERIAL ROAD INFORMATION SIGN AT EACH END OF THE PROJECT AS DIRECTED AND AT A LOCATION DESIGNATED BY THE ENGINEER. THIS SHALL BE PAID FOR AS TEMPORARY INFORMATION SIGNING. ADDITIONALLY, CHANGEABLE MESSAGE SIGNS SHALL BE PLACED AT EACH END OF ANY ROAD CLOSURES 7 DAYS IN ADVANCE OF WHEN THE CLOSURE WILL TAKE
- 8. ALL DETOUR SIGNAGE TO BE BAGGED OR COVERED WHEN NOT IN USE.

SECTION COUNTY HANCOCK **DETOUR PLAN**  Civil Engineers 9933 Rogsevelt Rogs **STATE OF ILLINOIS** ECW, SB, GD, DMM, LW REVISED DRAWN -21-00134-00-RS Municipal Consultants STAGE 5 Phone: 708-865-030 CHECKED - -REVISED **DEPARTMENT OF TRANSPORTATION** ENGINEERING | \* Established 1911 CONTRACT NO. 61K86 SCALE: NTS SHEET NO. 4 OF 4 SHEETS STA. TO STA. REVISED

#### NARRATIVE DESCRIPTION OF EXISTING CONDITIONS AND PROPOSED DEVELOPMENT THE PROJECT WILL COMPLY WITH THE APPLICABLE SOIL EROSION AND SEDIMENT CONTROL REQUIREMENTS OF ALL CITY ORDINANCES AND THE IEPA NPDES. THE EXISTING SITE IS PRIMARILY AN

IMPERVIOUS R.O.W. SOILS ARE PRIMARILY SILTY CLAY AND ARE DESIGNATED AS TYPE 533 ON THE NRCS REPORT. THE SOILS AFTER DEVELOPMENT WILL REMAIN THE SAME. THE SITE IS NOT WITHIN THE FLOOD PROTECTION AREA OR FLOOD ZONE. ALL STORM WATER WILL BE DISCHARGED TO THE EXISTING CITY STORM SEWER ALONG WASHINGTON BOULEVARD.

#### DESCRIPTION OF STABILIZATION PRACTICES AT THE BEGINNING OF CONSTRUCTION (WHERE APPLICABLE):

A) AT LOCATIONS WHERE WATER DRAINS AWAY FROM THE PROJECT, INLET PROTECTION SHALL BE INSTALLED AROUND EXISTING INLETS OR CATCH BASINS.

#### DESCRIPTION OF STABILIZATION PRACTICES DURING CONSTRUCTION (WHERE APPLICABLE):

- 1) DURING CONSTRUCTION, AREAS OUTSIDE THE CONSTRUCTION AREA AS OUTLINED PREVIOUSLY SHALL BE PROTECTED FROM DAMAGE EFFECTS OF CONSTRUCTION. THE CONTRACTOR SHALL NOT USE THIS AREA FOR STAGING (EXCEPT AS DESIGNATED ON THE PLANS OR DIRECTED BY THE ENGINEER), PARKING VEHICLES OR CONSTRUCTION EQUIPMENT, STORAGE OF MATERIALS, OR OTHER CONSTRUCTION RELATED ACTIVITIES
- A) WITHIN THE CONSTRUCTION ZONE, CRITICAL AREAS WHICH HAVE HIGH ELOWS OF WATER AS DETERMINED BY THE ENGINEER SHALL REMAIN UNDISTURBED UNTIL FULL SCALE CONSTRUCTION IS UNDERWAY TO PREVENT UNNECESSARY SOIL EROSION.
- B) TOP SOIL AND EARTH STOCKPILES SHALL BE TEMPORARILY SEEDED IF THEY ARE TO REMAIN UNUSED FOR MORE THAN FOURTEEN DAYS
- C) AS THE CONTRACTOR CONSTRUCTS THE UNDERGROUND IMPROVEMENTS, THEY SHALL ADHERE TO THE FOLLOWING STEPS AS DIRECTED BY THE ENGINEER:
- I. PLACE TEMPORARY EROSION CONTROL SYSTEMS AT LOCATIONS WHERE WATER LEAVES AND
- D) THE CONTRACTOR SHALL IMMEDIATELY FOLLOW MAJOR EARTH MOVING OPERATIONS WITH FINAL GRADING EQUIPMENT. AFTER MAJOR EARTH SPREAD OPERATION HAS MOVED TO A NEW LOCATION, FINAL GRADING SHALL BE COMPLETED WITHIN FOURTEEN DAYS. IF GRADING IS NOT COMPLETED WITHIN FOURTEEN DAYS, ALL MAJOR EARTH MOVING OPERATIONS WILL BE STOPPED, AS DIRECTED BY THE ENGINEER, UNTIL DISTRIBUTED AREAS ARE FINAL GRADED AND SEEDED
- E) EXCAVATED AREAS AND EMBANKMENT SHALL BE PERMANENTLY SEEDED WHEN FINAL GRADED IF NOT, THEY SHALL BE TEMPORARILY SEEDED AS STATED IN THE SPECIAL PROVISION "TEMPORARY **EROSION CONTROL SEEDING**<sup>3</sup>
- F) CONSTRUCTION EQUIPMENT SHALL BE STORED AND FUELED ONLY AT DESIGNATED LOCATIONS. ALL NECESSARY MEASURES SHALL BE TAKEN TO CONTAIN ANY FUEL OR POLLUTION RUN-OFF IN COMPLIANCE WITH EPA WATER QUALITY REGULATIONS LEAKING EQUIPMENT OR SUPPLIES SHALL BE IMMEDIATELY REPAIRED OR REMOVED FROM THE SITE.
- G) THE RESIDENT ENGINEER SHALL INSPECT THE PROJECT DAILY DURING ACTIVITIES AND WEEKLY OF AFTER LARGE RAINS DURING THE WINTER SHUTDOWN PERIOD. THIS PROJECT SHALL ADDITIONALLY BE INSPECTED BY THE CONSTRUCTION FIELD ENGINEER ON A BIWEEKLY BASIS TO DETERMINE THAT EROSION CONTROL EFFORTS ARE IN PLACE AND EFFECTIVE AND IF OTHER CONTROL WORK IS
- H) SEDIMENT COLLECTED DURING CONSTRUCTION BY THE VARIOUS TEMPORARY EROSION CONTROL SYSTEM SHALL BE DISPOSED OF ON SITE ON A REGULAR BASIS AS DIRECTED BY THE ENGINEER. THE COST OF MAINTENANCE IS INCIDENTAL TO THE CONTRACT.
- I) THE TEMPORARY EROSION CONTROL SYSTEM SHALL BE REMOVED AS DIRECTED BY THE ENGINEER AFTER IT'S USE IS NO LONGER NEEDED OR NO LONGER FUNCTIONING.

#### **NOTES**

- 1. SEE IDOT STANDARD 280001-07 FOR TEMPORARY EROSION CONTROL SYSTEMS.
- 2. THE CONTRACTOR SHALL ENSURE THAT ADJACENT PROPERTIES REMAIN PROTECTED
- 3. SOIL STOCKPILES SHALL BE PROTECTED WITH PERIMETER EROSION BARRIER OR OTHER EROSION PROTECTION SPECIFIED BY THE RESIDENT ENGINEER. THE COST SHALL BE INCLUDED IN THE UNIT PRICE FOR THE INDIVIDUAL SOIL MATERIALS.
- 4. WHEREVER CONSTRUCTION VEHICLE ACCESS ROUTES INTERSECT PAVED PUBLIC ROADS. PROVISIONS SHALL BE MADE TO MINIMIZE THE TRANSPORT OF SEDIMENT BY RUNOFF OR VEHICLE TRACKING ONTO THE PAVED SURFACE. THE PROVISIONS MAY INCLUDE SPRAYING VEHICLE WHEELS TO CLEAR SEDIMENT BEFORE EXITING THE CONSTRUCTION SITE OR OTHER MEASURES APPROVED BY THE ENGINEER. THE COST OF ABOVE WORK WILL BE INCLUDED IN COST OF TRAFFIC CONTROL AND PROTECTION (SPECIAL)
- 5. INLET FILTER SHALL BE INSTALLED PRIOR TO CONSTRUCTION AND SHALL BE REMOVED AFTER CONSTRUCTION IS COMPLETED. FILTERS WILL BE INSPECTED WEEKLY AND THE CONTRACTOR WILL BE NOTIFIED OF ANY CORRECTIVE MEASURES THAT WILL BE REQUIRED TO BE MADE BY THE CONTRACTOR.

#### DOCUMENTATION

- 1) A REPORT SUMMARIZING THE SCOPE OF INSPECTION, NAME(S) AND QUALIFICATIONS OF THE PERSONNEL MAKING THE INSPECTION DATE(S) OF THE SECTION MAJOR OBSERVATIONS RELATING TO THE IMPLANTATION OF THE STORM WATER POLLUTION PREVENTION PLAN, AND ACTION TAKEN IN ACCORDANCE WITH SECTION 4.B, SHALL BE MADE AND RETAINED AS PART OF THE PLAN FOR AT LEAST THREE YEARS AFTER THE DATE OF INSPECTION. THE REPORT SHALL BE SIGNED IN ACCORDANCE WITH PART VI.G, OF THE GENERAL PERMIT.
- 2) IF ANY VIOLATION OF THE PROVISIONS OF THIS PLAN IS IDENTIFIED DURING THE CONDUCT OF THE CONSTRUCTION WORK COVERED BY THIS PLAN, THE RESIDENT ENGINEER OR RESIDENT TECHNICIAN SHALL COMPLETE AND FILE AN "INCIDENT OF NONCOMPLIANCE (ION)" REPORT FOR THE IDENTIFIED VIOLATION. THE RESIDENT ENGINEER OR RESIDENT TECHNICIAN SHALL USE FORMS PROVIDED BY THE ILLINOIS ENVIRONMENTAL PROTECTION AGENCY AND SHALL INCLUDE SPECIFIC INFORMATION ON THE NONCOMPLIANCE, ACTIONS WHICH WERE TAKEN TO PREVENT ANY FURTHER CAUSES OF NONCOMPLIANCE. ALL REPORTS OF NONCOMPLIANCE SHALL BE SIGNED BY A RESPONSIBLE AUTHORITY IN ACCORDANCE WITH PART VI.G. OF THE GENERAL PERMIT. THE REPORT ID NONCOMPLIANCE SHALL BE MAILED TO THE FOLLOWING ADDRESS:

ILLINOIS ENVIRONMENTAL PROTECTION AGENCY DIVISION OF WATER POLLUTION CONTROL COMPLIANCE ASSURANCE SECTION #19 POST OFFICE BOX 19276 SPRINGFIELD, IL 62794-9276

#### DESCRIPTION OF INTENDED SEQUENCE OF MAJOR CONSTRUCTION ACTIVITIES WHICH WILL DISTURB EARTH AND LEAD TO POSSIBLE EROSION FOR MAJOR PORTIONS OF THE CONSTRUCTION SITE

- 1) EXCAVATION AND REMOVAL OF EXISTING STRUCTURES AND PAVED SURFACES WILL BE COMPLETED AT LOCATIONS AS INDICATED ON THE PLANS OR DIRECTED BY THE ENGINEER.
- 2) DRAINAGE STRUCTURES WILL BE INSTALLED BEFORE AND/OR DURING THE EXCAVATION AND REMOVAL OF THE EXISTING STRUCTURES TO ALLOW FOR PROPER DRAINAGE OF THE SITE
- 3) PLACEMENT, MAINTENANCE, REMOVAL AND PROPER CLEANUP OF TEMPORARY EROSION CONTROL SUCH AS EROSION CONTROL FENCE, HAY OR STRAW BALE DITCH CHECKS, INLET PROTECTION, AND TEMPORARY SEEDING AND MULCHING.
- 4) FINAL GRADING AND PLACEMENT OF PERMANENT EROSION CONTROL SEEDING AND MULCHING.


#### AREA OF DISTURBED GROUND


THE FOLLOWING PLAN WAS ESTABLISHED AND INCLUDED IN THESE PLANS TO DIRECT THE CONTRACTOR IN THE PLACEMENT OF TEMPORARY EROSION CONTROL SYSTEM AND TO PROVIDE A STORM WATER POLLUTION PREVENTION PLAN FOR COMPLIANCE UNDER NPDES. THE CONTRACTOR SHALL ABIDE TO ALL REQUIREMENTS WITHIN THIS PLAN AS PART OF THE CONTRACT.

ALL DISTURBED AREAS HAVING HIGH POTENTIAL FOR EROSION, AS DETERMINED BY THE ENGINEER, SHALL BE PERMANENTLY SEEDED AS SOON AS POSSIBLE.

#### MAINTENANCE AFTER CONSTRUCTION (WHERE APPLICABLE):


- 1) CONSTRUCTION IS COMPLETE AFTER ACCEPTANCE IS RECEIVED AT THE FINAL INSPECTION.
- 2) AREAS WILL BE INSPECTED ON A REGULAR BASIS BY THE ENGINEER AND THE VILLAGE.
- 3) MAINTENANCE CREWS WILL ALSO AID IN ANY DRAINAGE PROBLEMS
- 4) ALL MAINTENANCE WILL BE CONDUCTED AT TIMES WHEN WEATHER CONDITIONS WILL NOT CAUSE
- 5) CONTRACTORS SHALL COMPLY WITH ALL TERMS AND CONDITIONS OF IEPA NPDES PERMIT ILR 10. RESTORATION SHALL OCCUR WITHIN 7 DAYS OF DISTURBANCE.
- 6) CONTRACTORS SHALL SUBMIT INSPECTION REPORTS TO THE VILLAGE AT LEAST ONCE PER SEVEN DAYS AND AFTER RAINFALL EVENTS OF HALF INCH (OR EQUIVALENT SNOW FALL).
- 7) THE CONTRACTOR IS RESPONSIBLE FOR HAVING THE SWPPP ON SITE AT ALL TIMES.
- 8) TECHNIQUES SHALL BE EMPLOYED BY THE CONTRACTOR TO PREVENT THE BLOWING OF DUST OR SEDIMENT FROM THE SITE.
- 9) DAILY REMOVAL OF SEDIMENT AND DEBRIS FROM THE STREET SHALL BE REQUIRED OF THE CONTRACTOR

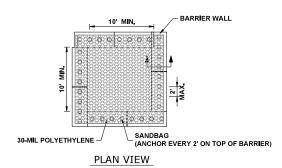

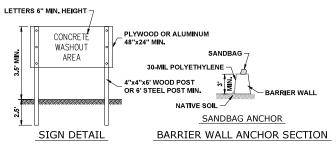

- 1. MAINTAINING TEMPORARY CONCRETE FACILITIES SHALL INCLUDE REMOVING AND DISPOSING OF HARDENED CONCRETE AND/OR SLURRY AND RETURNING THE FACILITIES TO A FUNCTIONAL CONDITION.
- 2. FACILITY SHALL BE CLEANED OR RECONSTRUCTED IN A NEW AREA ONCE WASHOUT BECOMES TWO-THIRDS FULL.

**CONCRETE WASHOUT** (BARRIER WALL)

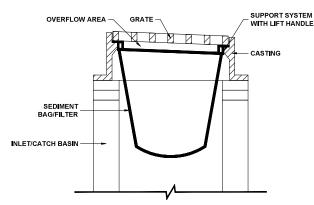

#### **INLET/CATCH BASIN PROTECTION** DETAIL

(DROP-IN PROTECTION

- CLEAN OUT AFTER EVERY RAIN EVENT.
- 2. INSTALL BEFORE BEGINNING ANY WORK.



# Municipal Consultant





9933 Roceavelt Road	
	Т
Westchester, IL, 60154-2760	
Phone: 708-865-0300	
www.ehancock.com	


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L, 60154-2780	DRAWN -	ECW, SB, GD, DMM, LW	REVISED -	
708-845-0300	CHECKED -	-	REVISED -	
nancack.com	DATE -	11-7-24	REVISED -	

STATE OF ILLINOIS **DEPARTMENT OF TRANSPORTATION** 

				F.A.U. RTE.		SECTION		COU	NTY	TOTAL SHEETS	SHEET NO.
:R	OSION CONTROL PI	AN AND S	WPPP	1694/1408	2	1-00134-00-	RS	cod	ЭK	68	41
								CONT	RACT	NO. 6	IK86
	SHEET NO 1 OF 3 SHEETS	STA.	TO STA	EED E	SUVU DIS.	T NO 1	SIUNINUIS	EED AL	n ppn	IECT	

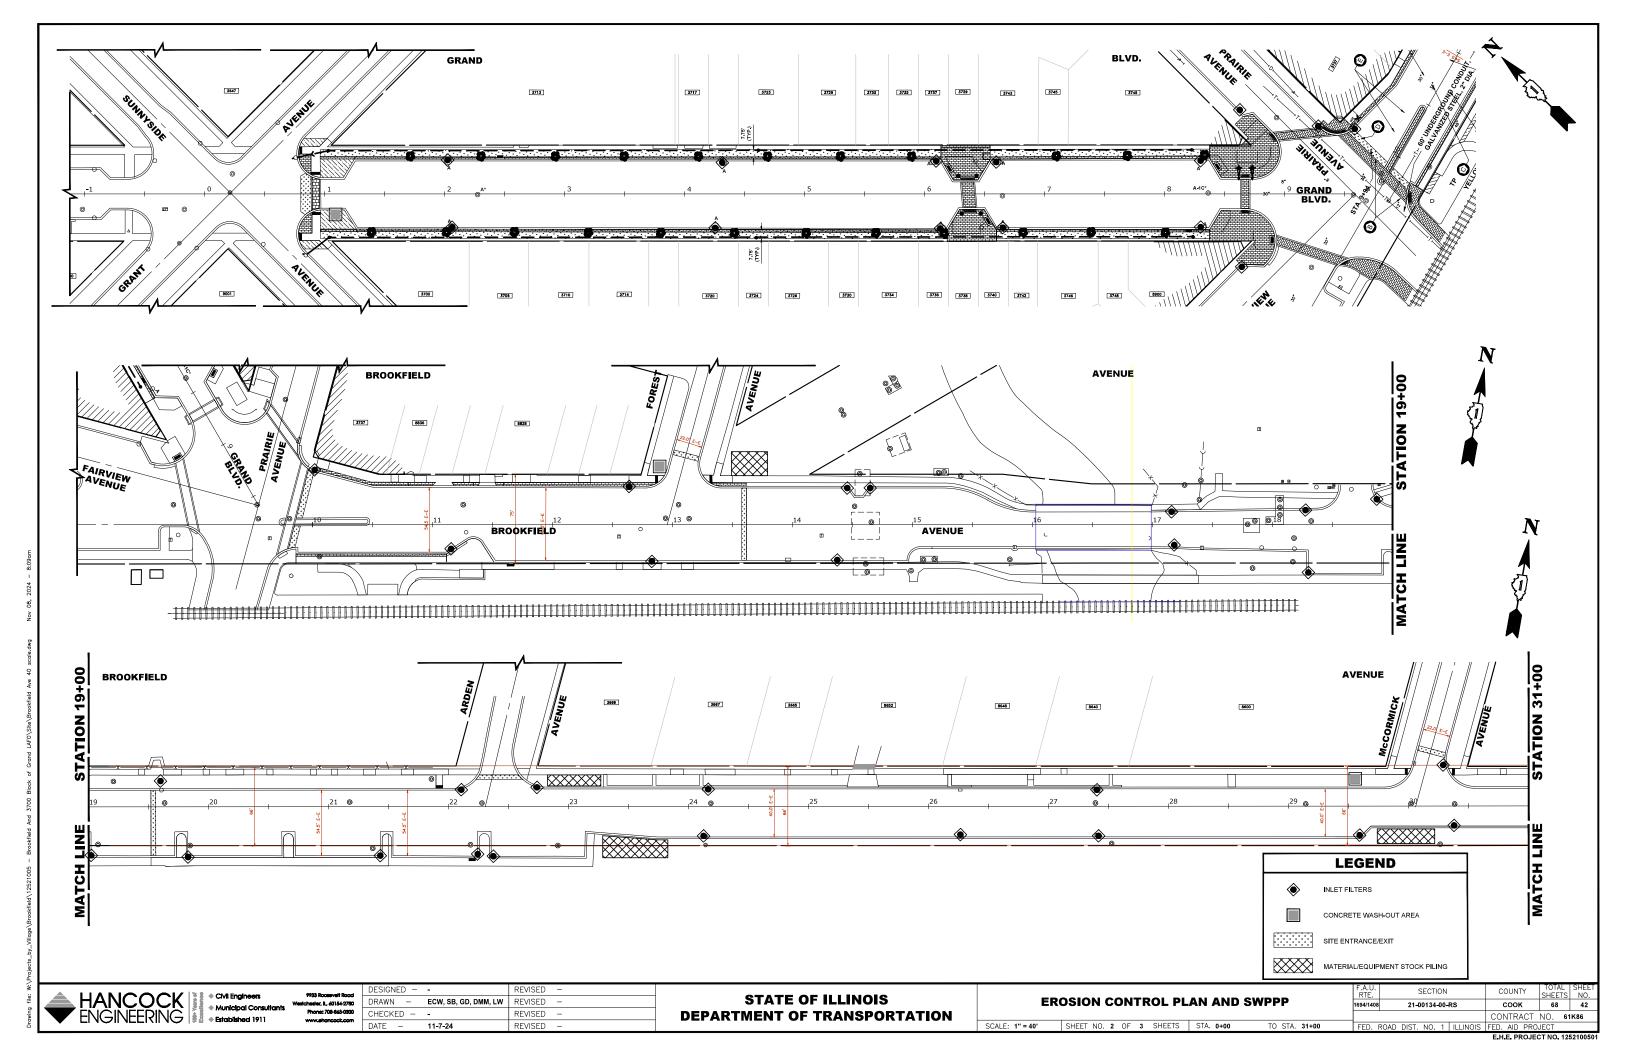

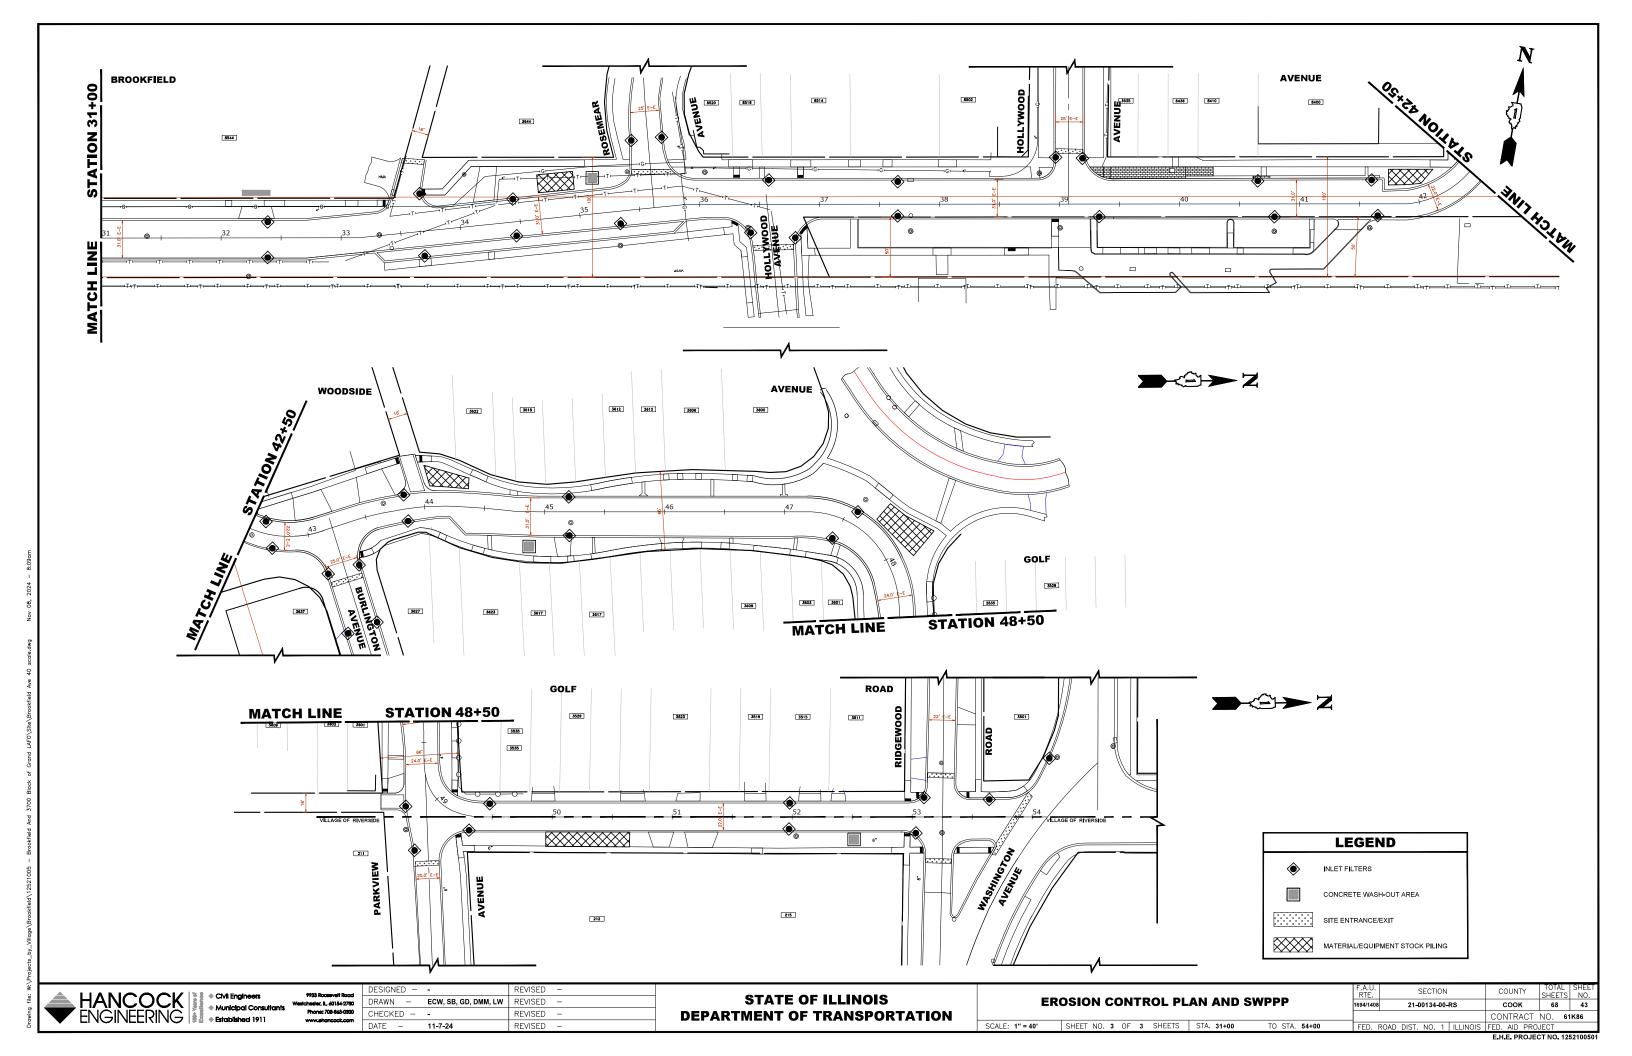

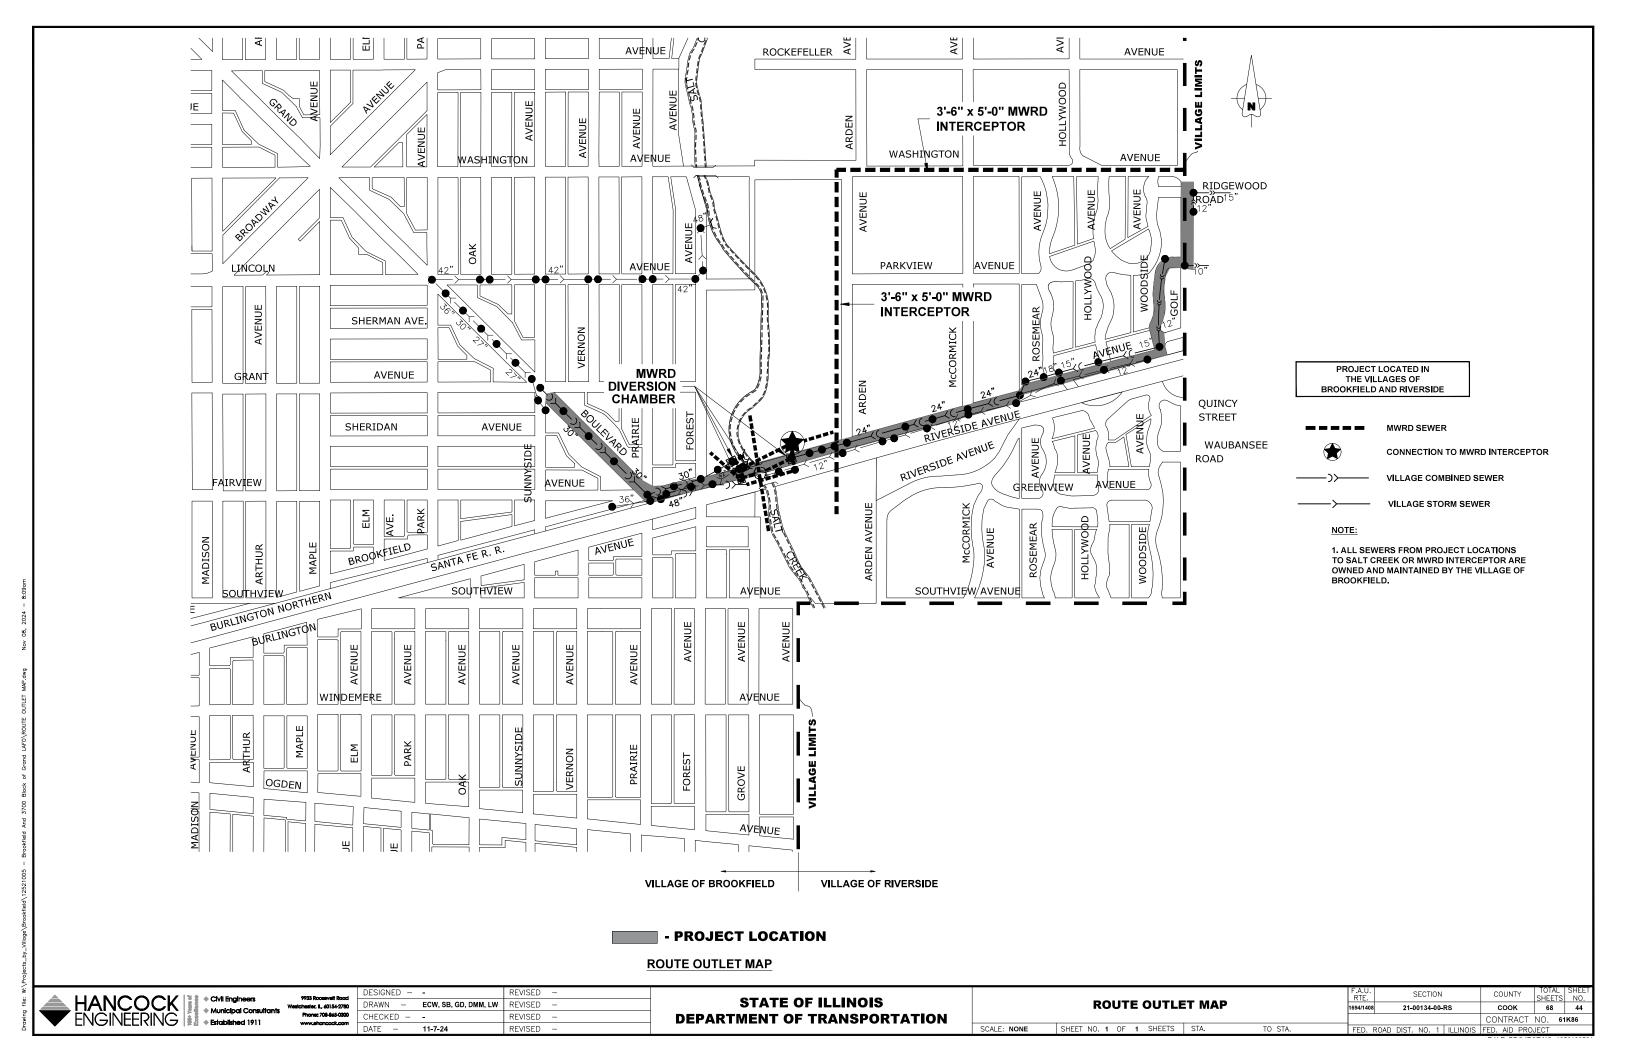

JOB-SITE	SIGNING CODES	AND SIZES	JOB-SITE SIGNING CODES AND SIZES			JOB-SITE SIGNING CODES AND SIZ			
SYMBOL	SIGN	CODE & SIZE	SYMBOL	SIGN	CODE & SIZE	SYMBOL	SIGN	CODE & SIZE	
s	STOP	R1-1 30"x30"	NPT3	NO * PARKING 2:00 AM TO 6:00 AM	R7-2a* 12"x18"	OCT DNS	ONCOMING TRAFFIC DOES NOT STOP	W4-4bP 24"x12"	
AW	ALL-WAY	R1-3P 18"x6"	NPT4	NO PARYING SIGN ELECTRICY NO PARYING STREET (LEARNIS	R7-203* 12"x18"	TFL DNS	TRAFFIC FROM LEFT DOES NOT STOP	W4-4aP 24"x12"	
20	SPEED LIMIT <b>20</b>	R2-1 24"x30"	2HRP	2 HRPARING * BUL-PHI ECCPT SMARTS AND HOLDAYS	R7-108* 12"x18"	TFR DNS	TRAFFIC FROM RIGHT DOES NOT STOP	W4-4aP 24"x12"	
25	SPEED LIMIT 25	R2-1 24"x30"	4HRP	4 HR PARVING  AUL FRI  EUST  SINUS NO  HOLDRIS	R7-108* 12"x18"	CT DNS	CROSS TRAFFIC DOES NOT STOP	W4-4P 24"x12"	
LTO	ONLY	R3-5 30"x36"	15MP	15 MNUTE PARKING	R7-5* 12"x18"	RR		W10-3R 30"x30"	
KR	KEEP	R4-7a 24"x30"	HIPO	HEAD IN * PARKING OILLY	R7-10* 12"x18"	RR	4	W10-3L 30"x30"	
НР	RIGHT	R7-8 12"x18"	PPO	PARALLEL PARKING ONLY	R7-10* 12"x18"	PG	474	W15-1 30"x30"	
FINE	\$250 FINE	R7-I101P 18"x9"	СР	COMMUTER * PARKING PERNIT REQUIRED	R7-22* 12"x18"	47	4	W16-6P 21"x15"	
NPAT	NO PARKING ANY TIME	R7-1 12"x18"	RPPO	RESIDENT * PENIIT PARNIGONY B BELLA REGURED	R7-22* 12"x18"	[*		W16-6P 21"x15"	
NPHTC	NO PARMING * HERE TO CORNER	R7-1* 12"x18"	BPDR	BUSINESS * PARKING DECAL REQUIRED	R7-22* 12"x18"	\$\hat{\phi}\$		W1-2R 30"x30"	
NPFL	NO PARKING * FRE LANE	R7-1* 12"x18"	DNBI	DO NOT Block Ntersection	R10-7 24"x30"	<b>S</b>	<b>5</b>	W1-2L 30"x30"	
NPT1	NO PARMING * IND-179 229.44,TO 659.44,AD SS SSHAREDS 18944,TO THAIL	R7-2a* 12"x18"	cc		S1-1 36"x36"	20 MPH	<b>20</b> M.P.H.	W13-1P 18"x18"	
NPT2	NO PARKING 2:00 AM TO 5:00 AM	R7-2a* 12"×18"							

: SIGNS WITH SPECIFIC PARKING REGULATIONS THAT ARE NOT DIRECTLY REFERENCED IN THE MUTCD AND " STANDARD HIGHWAY SIGNS" PUBLICATION HAVE BEEN ASSIGNED A CODE DESIGNATION OF THE SIMILAR, STANDARD PARKING SIGN, WITH THE ACTUAL REGULATIONS SPECIFIED IN THE LEGEND. THE SIGNS SHALL BE CONSISTENT WITH THE SIGNS THAT

#### **SIGNING NOTES:**

DESIGN: AASHTO STANDARD SPECIFICATIONS FOR STRUCTURAL

SUPPORTS FOR HIGHWAY SIGNS, LUMINAIRES, AND

TRAFFIC SIGNALS, 2013.

CURRENTS STANDARD SPECIFICATIONS FOR TRAFFIC CONSTRUCTION: CONTROL ITEMS, AND APPLICABLE SPECIAL PROVISIONS.

FOR 80 MPH WIND VELOCITY WITH 30% GUST FACTOR,

NORMAL TO SIGN.

SOIL PRESSURE: MINIMUM ALLOWABLE SOIL PRESSURE = 1.25 TSF.

MATERIALS: POSTS SHALL CONFORM TO THE REQUIREMENTS OF

ARTICLE 1006.29, STANDARD SPECIFICATIONS FOR ROAD AND BRIDGE CONSTRUCTION, STATE OF ILLINOIS.

HARDWARE FOR ATTACHING SIGN PANELS TO POSTS

SHALL BE CADIUM OR ZINC COATED STEEL, STAINLESS STEEL, OR ALUMINUM, AND SHALL CONFORM

TO THE FOLLOWING SPECIFICATIONS: CADIUM OR ZINC

COATED STEEL: BOLTS, NUTS, AND WASHERS:

ASTM A165, TYPE NS.

ZINC COATED IN ACCORDANCE WITH AASHTO M-232

OR ASTM A164, TYPE GS.

STAINLESS STEEL: BOLTS: ASTM A193, CLASS I, GRADE B8,

NUTS: ASTM A194, GRADE 8 OR 8F

WASHERS: ASTM A240, TYPE 302 OR 304.

BOLTS: ASTM B211 ALLOY 6061-T6 OR 2024-T4, NUTS: ASTM B211 ALLOY 6061-T6 OR 6262-T9,

WASHERS: ASTM B209 ALCLAD 2024-T4.

PER 2009 MUTCD SECTION 2D.43, PARAGRAPH 03, STREET NAME SIGNS ARE TO BE MIXED CASE FONT.

#### **NOTES:**

ALUMINUM:

- 1. EXISTING SIGNS AND POSTS ARE TO BE REMOVED BY THE CONTRACTOR PRIOR TO CONSTRUCTION. AS DESIGNATED BY ENGINEER, THE CONTRACTOR SHALL REINSTALL OR REPLACE SIGNS AFTER COMPLETION OF PROJECT. REMOVAL AND INSTALLATION OF SIGNS AND THEIR POSTS ARE TO BE DETERMINED BY THE ENGINEER. (COST IS TO BE INCLUDED IN THE "REMOVE AND RE-ERECT EXISTING SIGN " OR "SIGN PANEL - TYPE 1" AND "METAL POST - TYPE A OR B"
- 2. ALL SIGNS AND POSTS TO BE SAFELY STORED BY THE CONTRACTOR FOR THE DURATION OF THE PROJECT.
- 3. ALL POSTS TO BE TYPE A UNLESS OTHERWISE NOTED.
- 4. CONTRACTOR TO VERIFY LOCATIONS OF ALL SIGNAGE.
- 5. SIGNS SHALL FOLLOW THE ASSIGNED CODE DESIGNATION AND SIZE IN ACCORDANCE WITH THE MANUAL ON UNIFORM TRAFFIC CONTROL DEVICES (MUTCD) AND "STANDARD HIGHWAY SIGNS" PUBLICATION.
- 6. ALL PROPOSED SIGNAGE AND PAVEMENT MARKING INSTALLATION LOCATIONS MUST COMPLY WITH ALL PROWAG REQUIREMENTS.

SYMBOL	DESCRIPTION
•	METAL POST - TYPE
<b>∮</b> <sub>B</sub>	METAL POST - TYPE
d	EXISTING POST




Municipal Consultants


elt Road	DESIGNED -	-	REVISED -	
154-2780	DRAWN -	ECW, SB, GD, DMM, LW	REVISED -	
845-0300	CHECKED -	-	REVISED -	
ockcom	DATE -	11-7-24	REVISED -	


STATE OF ILLINOIS **DEPARTMENT OF TRANSPORTATION** 

PAVE	MENT	MAR	KI	NG AN	ID SIGNING	3 PLAN
SCALE: 1" = 40'	SHEET NO.	1 OF	4	SHEETS	STA. 0+00	TO STA, 19+00

 $<sup>^{**}</sup>$ : NO CURRENT STANDARD EXISTS. SIGN PANEL SHALL RESEMBLE THE APPROXIMATE SIZE AND DISPLAY SHOWN.

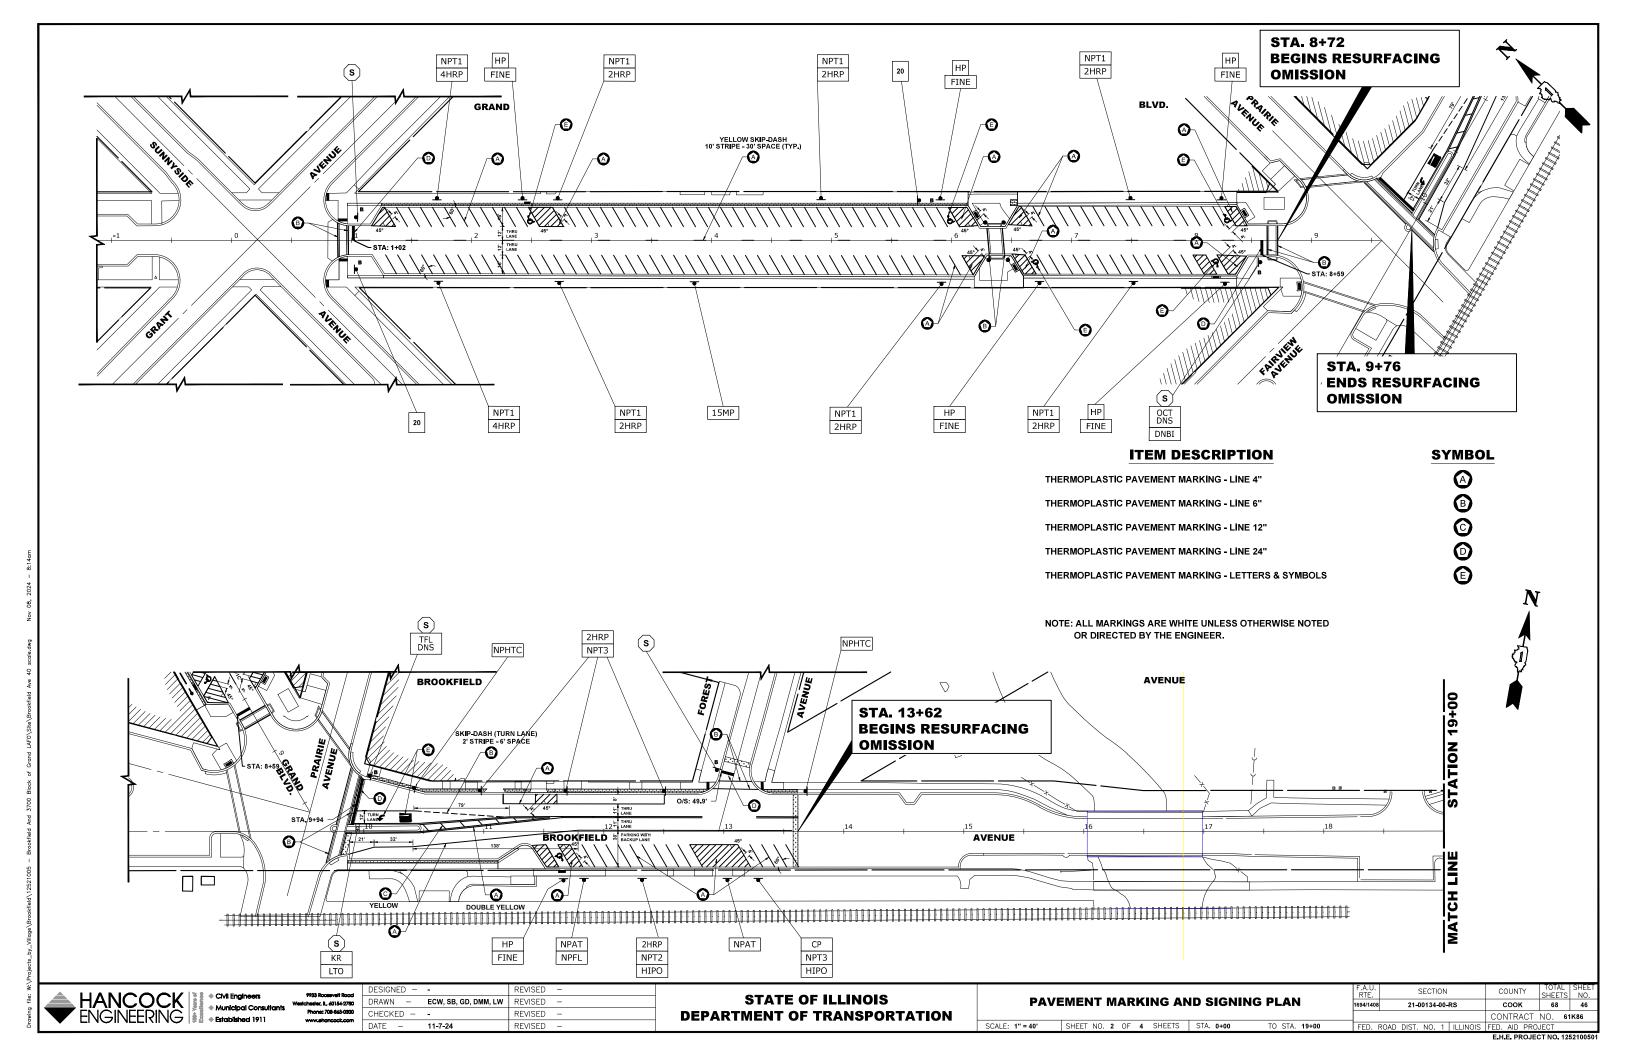

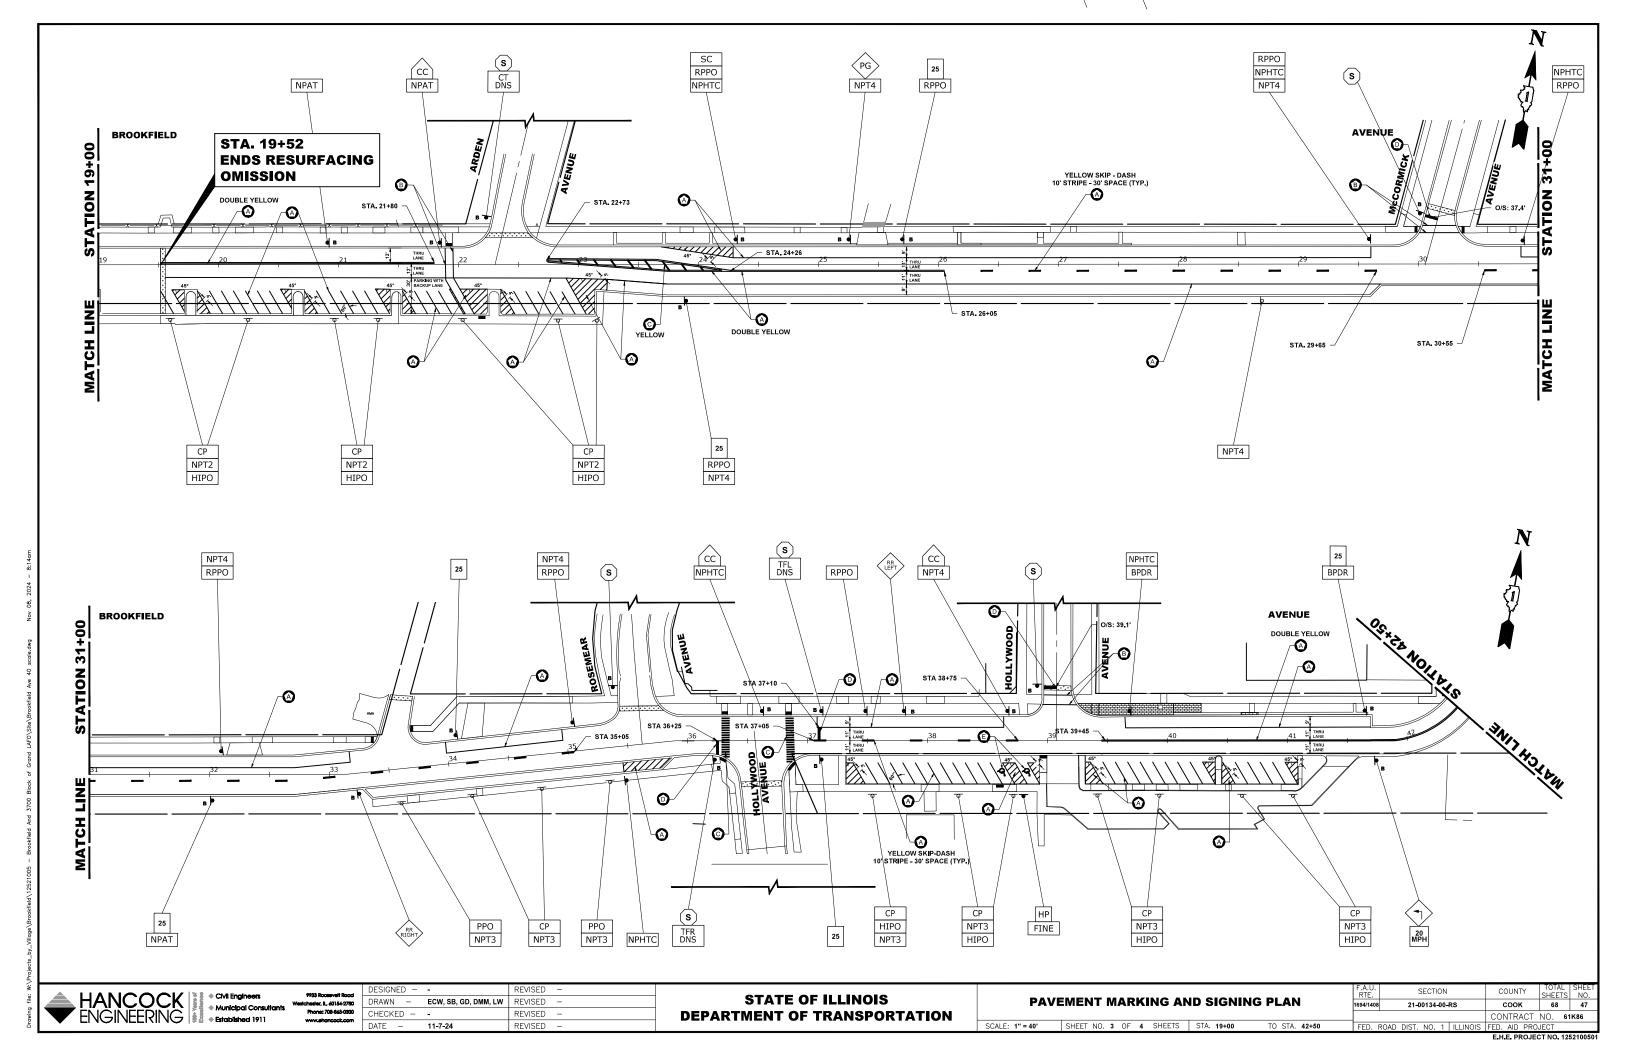

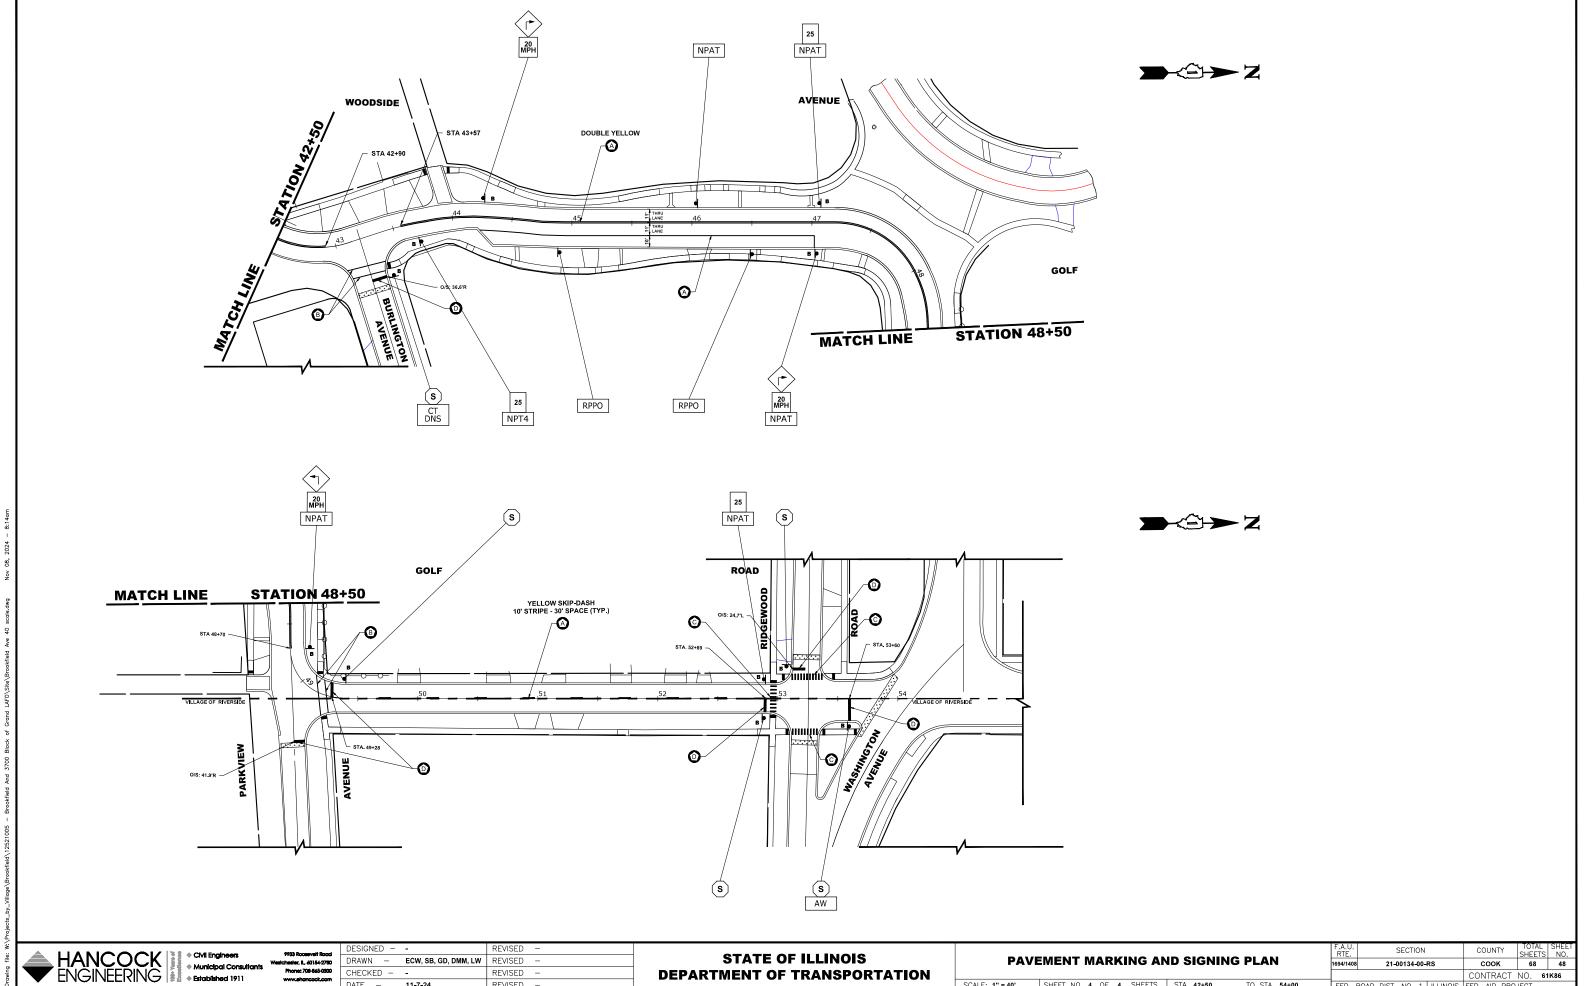

**DEPARTMENT OF TRANSPORTATION** 

SCALE: 1" = 40' SHEET NO. 4 OF 4 SHEETS STA. 42+50


CONTRACT NO. 61K86 FED. AID PROJECT


E.H.E. PROJECT NO. 1252100501


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#### **LANDSCAPING NOTES**

#### SODDING:

ALL DISTURBED AREAS INDICATED ON CROSS SECTION OR LANDSCAPING PLANS TO BE SODDED, INCLUDING FERTILIZER NUTRIENTS' AND SUPPLEMENTAL WATERING WHICH IS TO BE USED AFTER THE INITIAL WATERING (AS SPECIFIED AND AS DIRECTED BY THE ENGINEER) AT THE RATE OF 27 GALLONS PER SQUARE YARD SODDING, SODDED SLOPES WHICH ARE 2:1 OR STEEPER SHALL BE STAKED. (PROVIDE A 3" STRIP AROUND CATCH BASINS IN SEEDED AREAS).
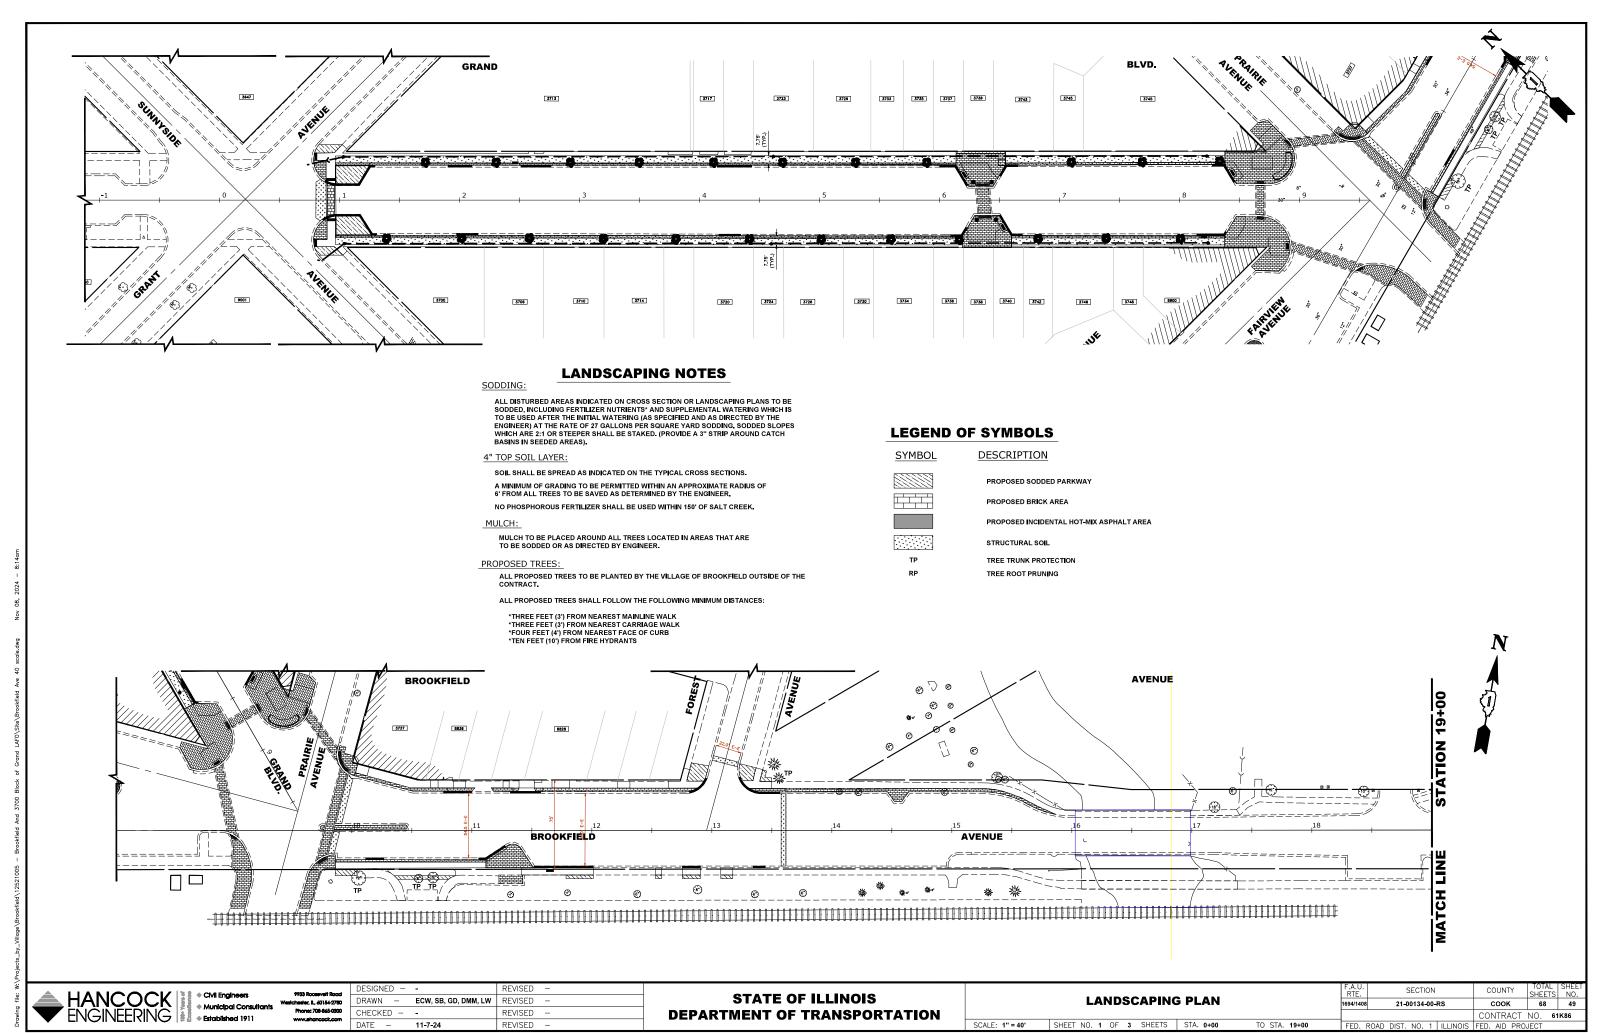
#### 4" TOP SOIL LAYER:

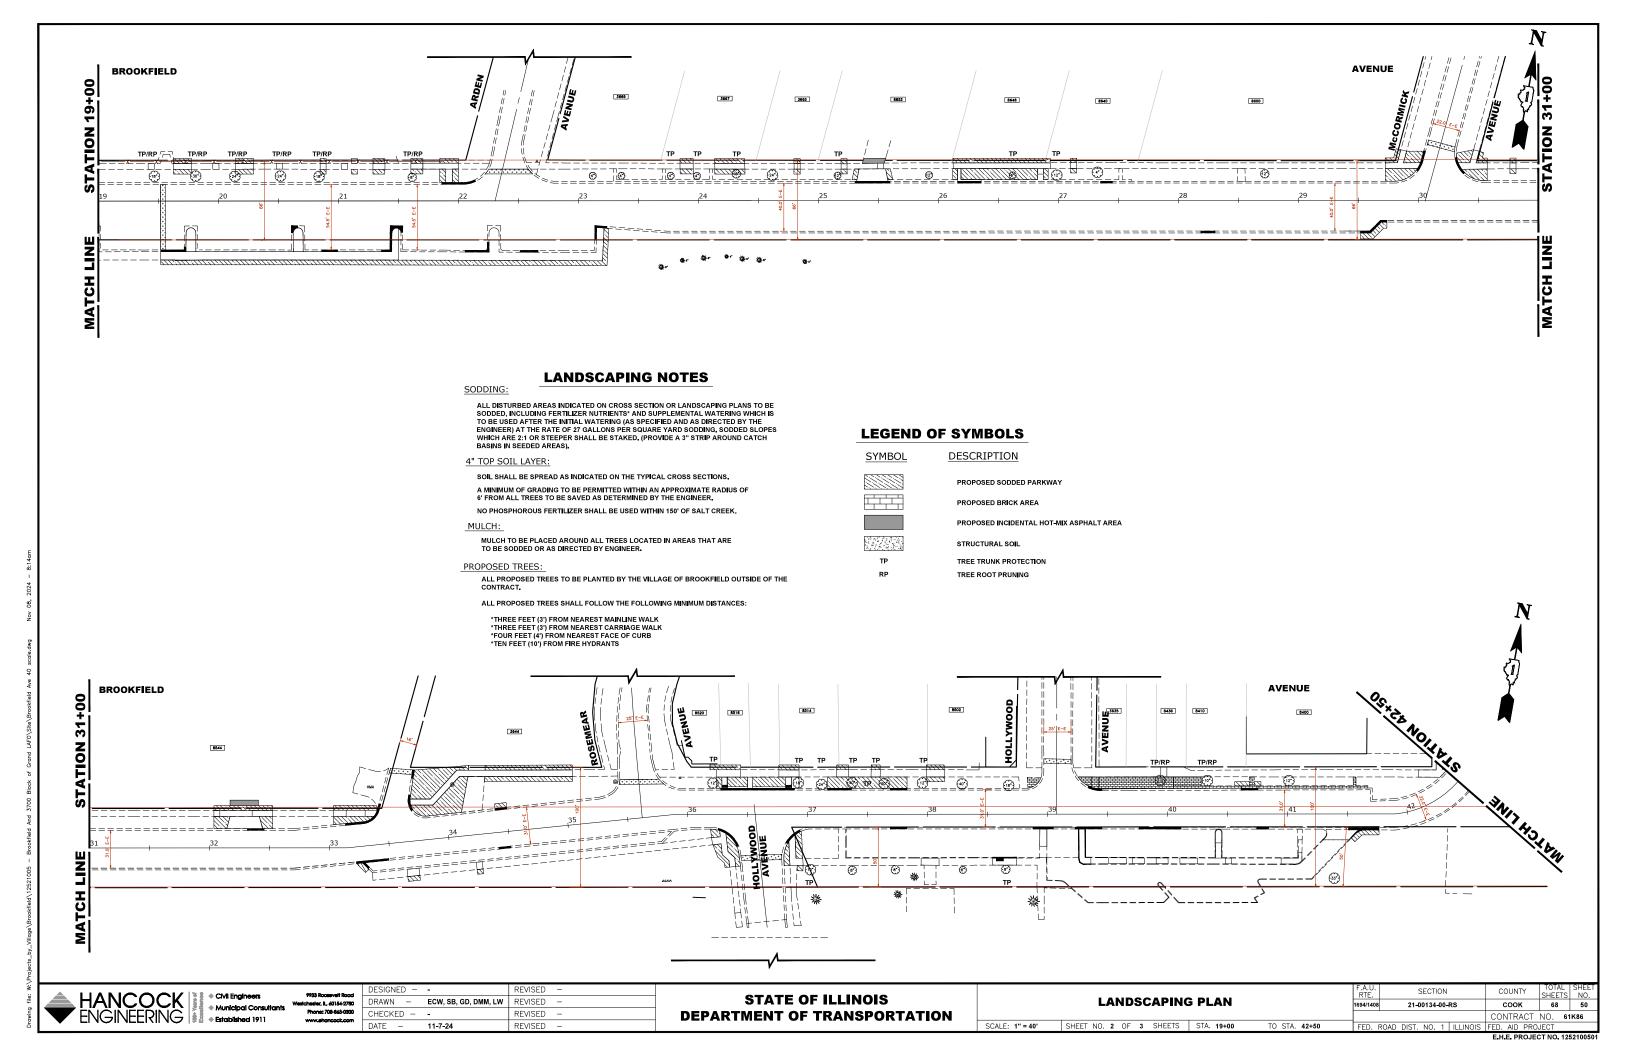SOIL SHALL BE SPREAD AS INDICATED ON THE TYPICAL CROSS SECTIONS.

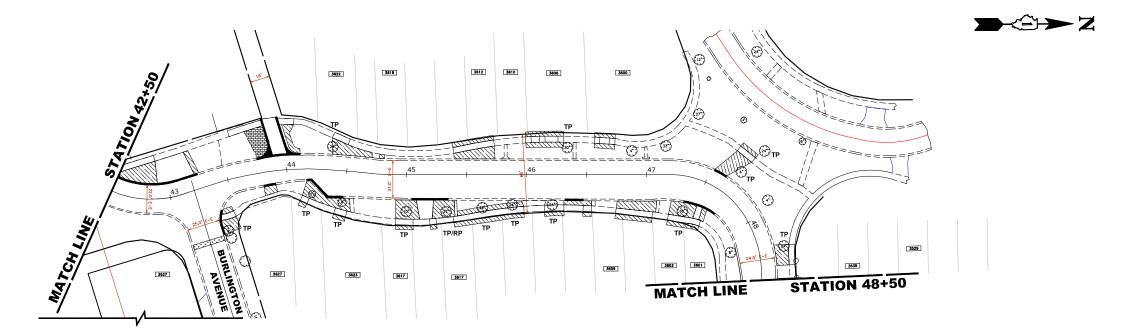A MINIMUM OF GRADING TO BE PERMITTED WITHIN AN APPROXIMATE RADIUS OF 6' FROM ALL TREES TO BE SAVED AS DETERMINED BY THE ENGINEER. NO PHOSPHOROUS FERTILIZER SHALL BE USED WITHIN 150' OF SALT CREEK.

MULCH TO BE PLACED AROUND ALL TREES LOCATED IN AREAS THAT ARE TO BE SODDED OR AS DIRECTED BY ENGINEER.

#### PROPOSED TREES:

ALL PROPOSED TREES TO BE PLANTED BY THE VILLAGE OF BROOKFIELD OUTSIDE OF THIS CONTRACT.

#### ALL PROPOSED TREES SHALL FOLLOW THE FOLLOWING MINIMUM DISTANCES:

- \*THREE FEET (3') FROM NEAREST MAINLINE WALK \*THREE FEET (3') FROM NEAREST CARRIAGE WALK
  \*FOUR FEET (4') FROM NEAREST FACE OF CURB
  \*TEN FEET (10') FROM FIRE HYDRANTS

#### **LEGEND OF SYMBOLS**

**DESCRIPTION SYMBOL** PROPOSED SODDED PARKWAY

PROPOSED BRICK AREA

STRUCTURAL SOIL

PROPOSED INCIDENTAL HOT-MIX ASPHALT AREA

TREE TRUNK PROTECTION TREE ROOT PRUNING

GOLF ROAD **STATION 48+50 MATCH LINE** (21-) 211 (B) 215 212

HANCOCK ENGINEERING | \* \* \* Established 1911

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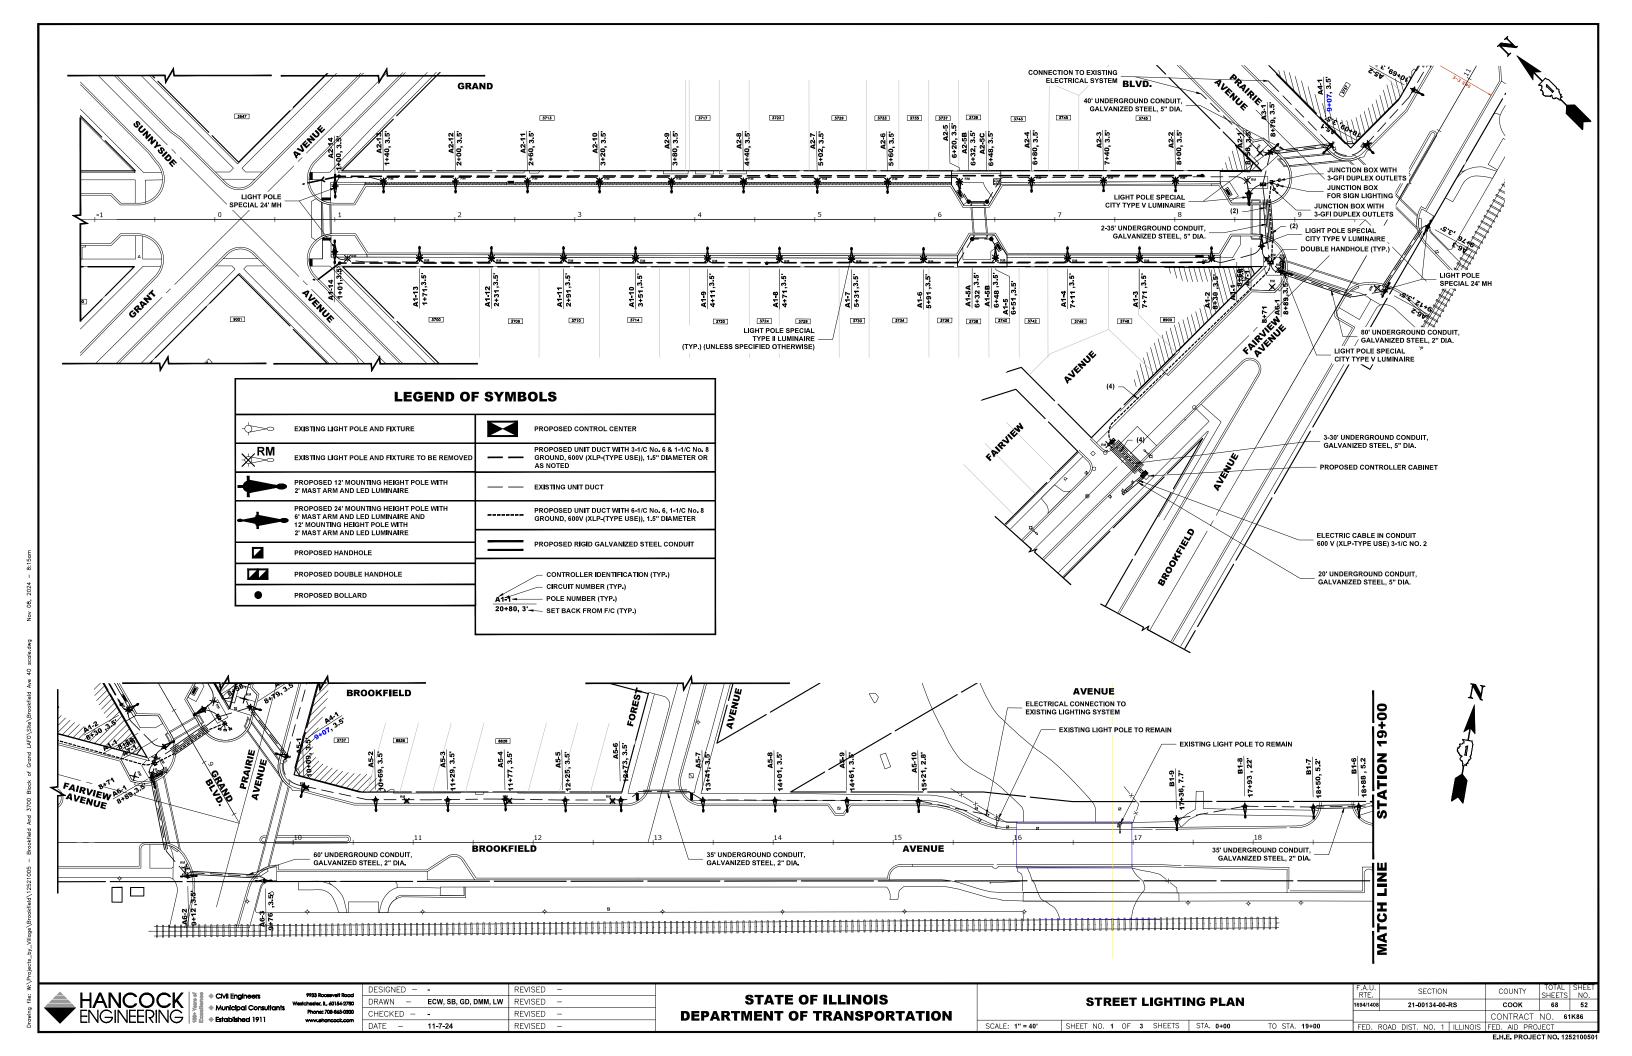
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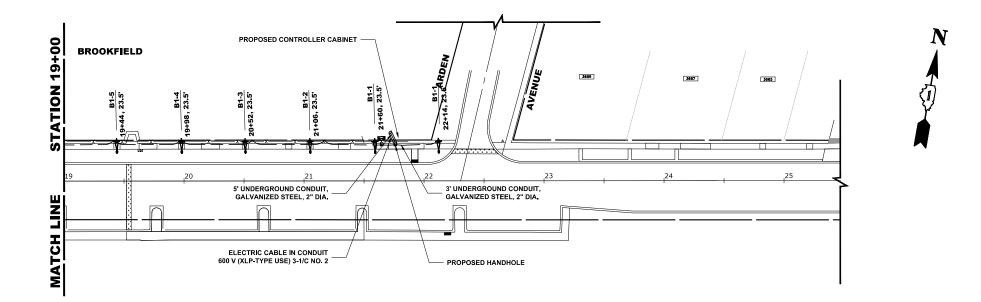
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**STATE OF ILLINOIS DEPARTMENT OF TRANSPORTATION** 

LANDSCAPING PLAN SCALE: 1" = 40' SHEET NO. 3 OF 3 SHEETS STA. 42+50 TO STA. **54+00** 

SECTION 21-00134-00-RS CONTRACT NO. 61K86





	LEGEND OF	SYMB	ols
<b>♦</b> ∞	EXISTING LIGHT POLE AND FIXTURE	$\blacksquare$	PROPOSED CONTROL CENTER
₩RM	EXISTING LIGHT POLE AND FIXTURE TO BE REMOVED		PROPOSED UNIT DUCT WITH 3-1/C No. 6 & 1-1/C No. 8 GROUND, 600V (XLP-(TYPE USE)), 1.5" DIAMETER OR AS NOTED
<b>-</b>	PROPOSED 12' MOUNTING HEIGHT POLE WITH 2' MAST ARM AND LED LUMINAIRE		EXISTING UNIT DUCT
-	PROPOSED 24' MOUNTING HEIGHT POLE WITH 6' MAST ARM AND LED LUMINAIRE AND 12' MOUNTING HEIGHT POLE WITH 2' MAST ARM AND LED LUMINAIRE		PROPOSED UNIT DUCT WITH 6-1/C No. 6, 1-1/C No. 8 GROUND, 600V (XLP-(TYPE USE)), 1.5" DIAMETER
	PROPOSED HANDHOLE		PROPOSED RIGID GALVANIZED STEEL CONDUIT
	PROPOSED DOUBLE HANDHOLE		CONTROLLER IDENTIFICATION (TYP.)
•	PROPOSED BOLLARD	A1=1 - 20+80, 3	CIRCUIT NUMBER (TYP.)  POLE NUMBER (TYP.)  SET BACK FROM F/C (TYP.)

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REVISED -

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HANCOCK Multiplication of the control of the contro

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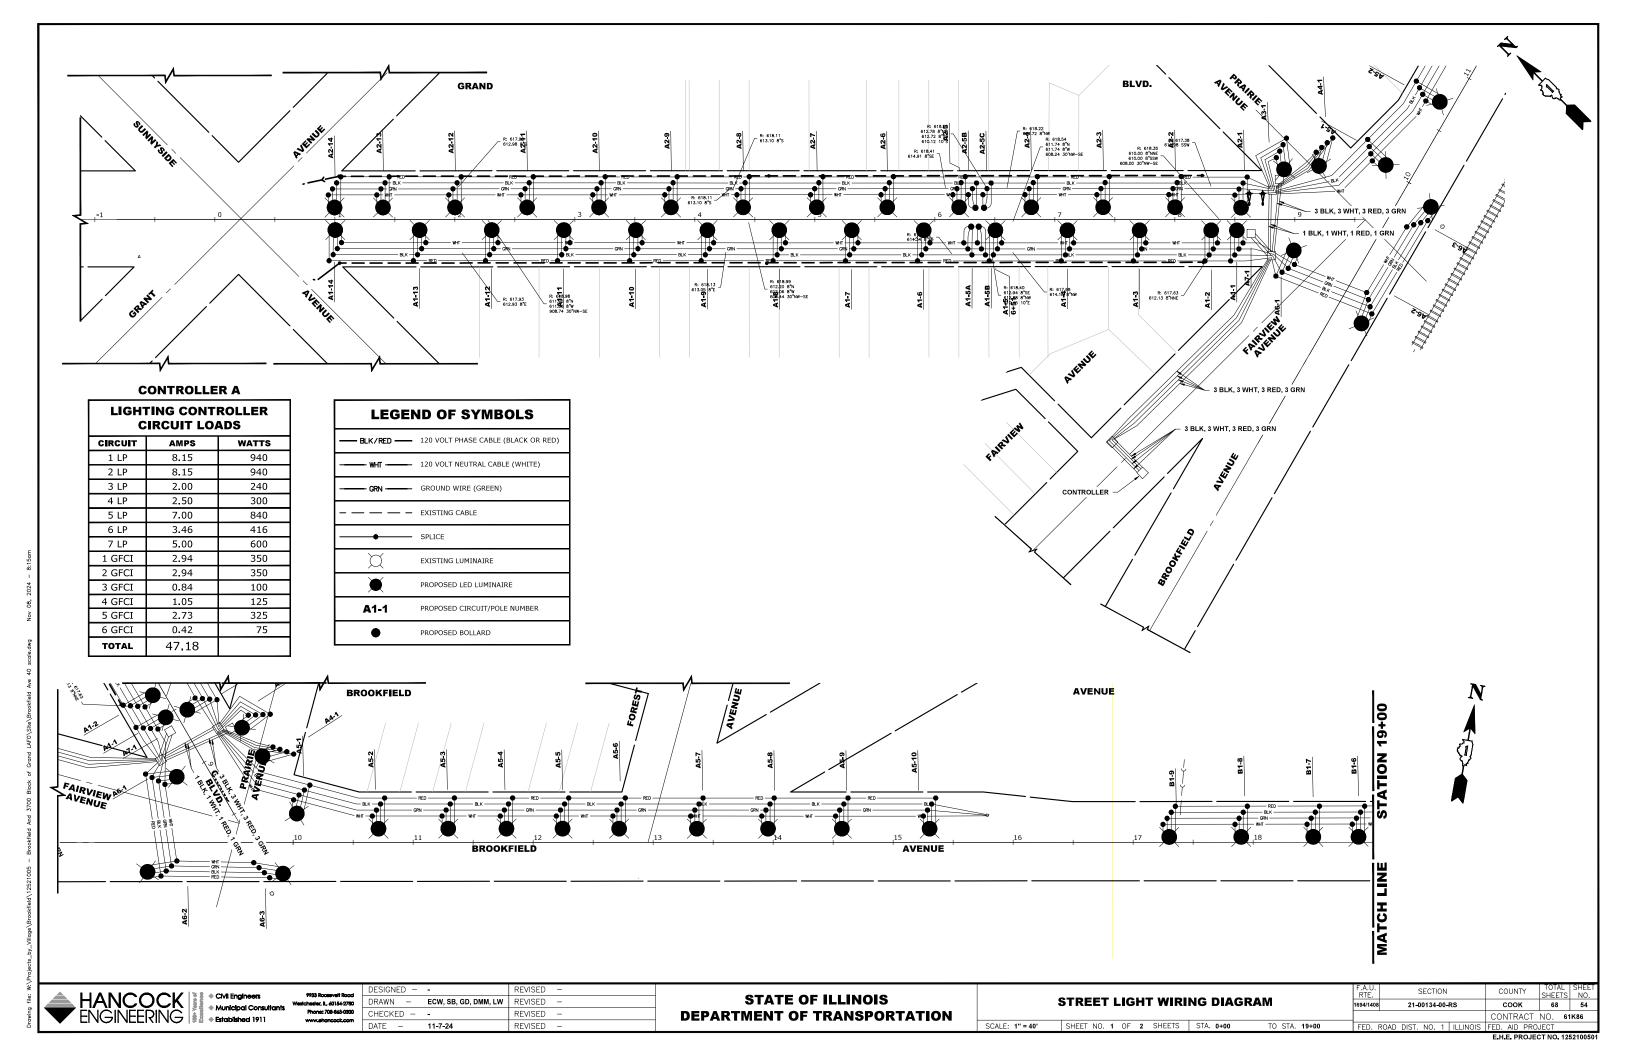
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**STATE OF ILLINOIS DEPARTMENT OF TRANSPORTATION** 

STREET LIGHTING PLAN SCALE: 1" = 40' SHEET NO. 2 OF 2 SHEETS STA. 19+00

TO STA. 25+00

SECTION COOK 68 53 21-00134-00-RS CONTRACT NO. 61K86 FED. AID PROJECT



#### **CONTROLLER B**

LIGHTING CONTROLLER CIRCUIT LOADS						
CIRCUIT	AMPS	WATTS				
1 LP	4.5	540				
1 GFCI	1.89	225				
<b>TOTAL</b> 6.39						

LEGEN	ND OF SYMBOLS
BLK/RED	120 VOLT PHASE CABLE (BLACK OR RED)
—— wнт ——	120 VOLT NEUTRAL CABLE (WHITE)
GRN	GROUND WIRE (GREEN)
	EXISTING CABLE
	SPLICE
X	EXISTING LUMINAIRE
<b>(</b>	PROPOSED LED LUMINAIRE
A1-1	PROPOSED CIRCUIT/POLE NUMBER
•	PROPOSED BOLLARD

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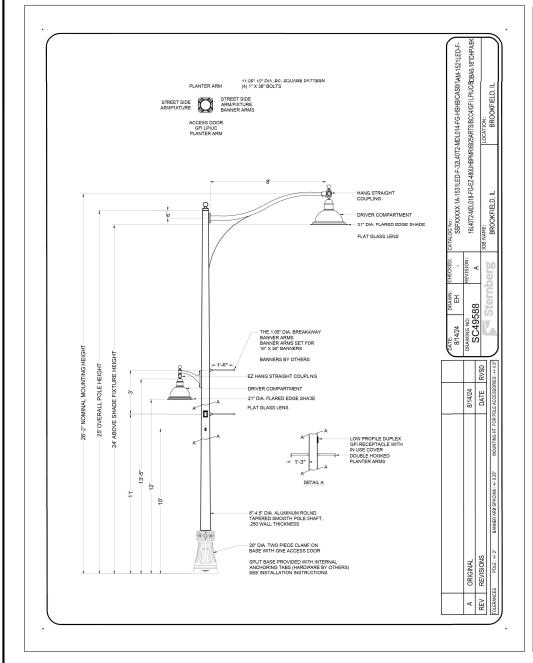
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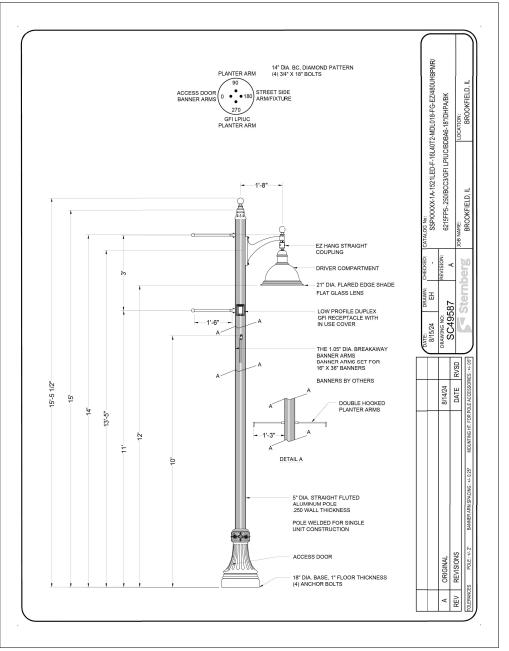
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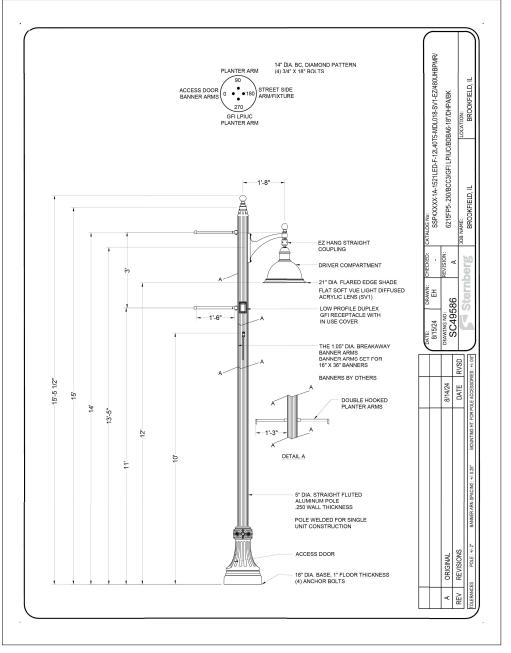
**STATE OF ILLINOIS DEPARTMENT OF TRANSPORTATION** 

STREET LIGHT WIRING DIAGRAM SCALE: 1" = 40' SHEET NO. 1 OF 3 SHEETS STA. 0+00 TO STA. 19+00

SECTION COOK 68 55 21-00134-00-RS CONTRACT NO. 61K86
FED. AID PROJECT







LIGHT POLE, ALUMINUM WITH CONTEMPORARY ARM

LIGHT POLE, SPECIAL 12'
(TYPE II DISTRIBUTION

LIGHT POLE, SPECIAL 12'
(TYPE V DISTRIBUTION



9933 Roosevett Ro
Westchester, IL, 40154-27
Phone: 708-845-03
Www.ehancock.co

Priore: 708-845-0300
www.ehancock.com

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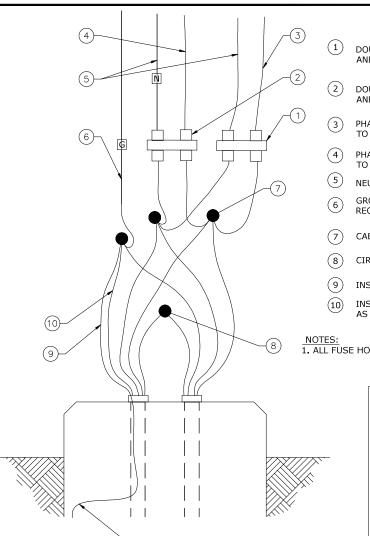
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STATE OF ILLINOIS
DEPARTMENT OF TRANSPORTATION

LIGHTING DETAILS

| SHEET NO. 1 OF 4 SHEETS | STA.

SCALE: NONE



TO GROUND ROD

**POLE BASE WIRING DIAGRAM** (NOT TO SCALE)

DOUBLE POLE FUSE HOLDER (HEX) WITH ONE 10 AMP FUSE AND ONE NEUTRAL SOLID SLUG TO LUMINAIRES.

DOUBLE POLE FUSE HOLDER (HEX) WITH ONE 10 AMP FUSE AND ONE NEUTRAL SOLID SLUG TO RECEPTACLE

PHASE CONDUCTORS SINGLE, 10 AWG, CU 600 V TO LUMINAIRES

PHASE CONDUCTORS SINGLE, 10 AWG, CU 600 V TO RECEPTACLE

NEUTRAL CONDUCTOR SINGLE, 10 AWG, CU 600 V

GROUND CONDUCTOR TO LUMINAIRES AND RECEPTACLE, 10 AWG


CABLE SPLICE (TYPICAL)

CIRCUIT TO NEXT POLE (AS APPLICABLE)

INSULATED GREEN GROUND CONDUCTOR TO GROUNDING ROD

INSULATED GROUND CONDUCTOR SIZE AS SHOWN ON PLANS

1. ALL FUSE HOLDERS SHALL INCLUDE BOOTS

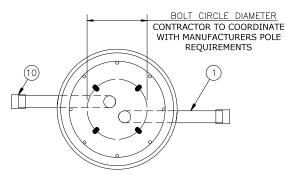

FOUN	<b>DATION D</b>	ESIGN CH	IART			
TYPE OF SOIL	DESIGN DEPTH OF FOUNDATION	REINFORCE FOUNDA				
	"D"	VERT. BARS	SPIRAL			
SOFT CLAY	11'-0"	8-#6 x 10'-0"	#4 x 157'			
MEDIUM CLAY	9'-0"	8-#6 x 8'-0"	#4 x 110'			
STIFF CLAY	7'-6"	8-#6 x 6'-6"	#4 x 78'			
LOOSE CLAY	9'-6"	8-#6 x 8'-6"	#4 x 102'			
MEDIUM SAND	9'-3"	8-#6 x 8'-3"	#4 x 88'			
DENSE SAND	8'-0"	8-#6 x 7'-0"	#4 x 78'			
ROCK OR SOLIDIFIED SLAG	5'-0"	NONE	NONE			

2-1/2" DIA. P.V.C. ELBOW RACEWAYS

MANUFACTURER TO FURNISH TEMPLATE DRAWING FOR SETTING OF ANCHOR BOLTS

1" CHAMFER

(4) 1"-8NC GALV. STL. ANCHOR BOLTS, AASHTO M314-90 GRADE 55, 10" OF THREADED END GALV PER ASTM A153 (4) 1"-8NC GALV STL. HEX. NUTS (4) 1" GALV. STL. LOCK WASHERS

(4) 1" GALV. STL. FLAT WASHERS

%" x 10' GROUND ROD CONNECTED TO GROUND WIRE WITH EXOTHERMIC WELD AT LOCATIONS NOTED ON PLAN SHEETS (INCLUDED IN COST OF FOUNDATION)


8-#6 REINFORCING BARS EQUALLY SPACED AROUND AN 18" DIA. CIRCLE, FOR SIZE, SEE FOUNDATION DESIGN CHART

#4 SPIRAL TIE BARS WITH 6" PITCH

CLASS SI CONCRETE

FOUNDATION LOCATIONS AS SHOWN ON PLAN SHEETS

FLEXIBLE DUET UL LISTED FITTING TO UNIT DUCT

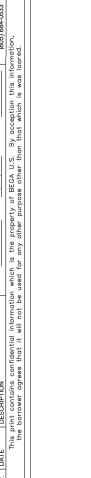

NOTE: SYSTEM BOLLARD HEAD # 99 727- SEE SPECIFICATIONS 1½" 71/4" 1½" ∘ ⊚ ∘ 53/8" APPROVAL SUBMITTAL 99 727 shown on Bollard Tube 99 622 (SCALE 1:2)

## **BOLLARD, LED**

# HANCOCK Municipal Consul ENGINEERING CM Engineers Municipal Consul Established 1911

Municipal Consultant

	DESIGNED -	-	REVISED	_
	DRAWN -	ECW, SB, GD, DMM, LW	REVISED	=
0	CHECKED -	-	REVISED	-
	DATE -	11-7-24	REVISED	_

**STATE OF ILLINOIS DEPARTMENT OF TRANSPORTATION** 

SCALE: NONE

								RTE
		LIC	GH	I	NG DE	TAILS	5	1694/14
CHEET	NO	-	ΛE	4	SHEETS	ATS.	TO STA	EED

F.A.U. RTE.		5	SECTI	ON		cour		TOTAL S SHEETS		
1694/140	8 21-00134-00-RS				cod	68		57		
						CONTR	RACT	NO.	61	K86
FED.	ROAD	DIST.	NO.	1	ILLINOIS	FED. All	) PRO	JECT		

**LIGHT POLE FOUNDATION** 

CONCRETE

QUANTITY

(A)

COMMONWEALTH EDISON METER		DOOR FACING AWAY FROM STREET PLATE WITH "STREET LIGHTING
AIR VENT		VILLAGE OF BROOKFIELD"  ENCLOSURE (SEE SPECIFICATIONS)
SEAL ENDS OF CONDUIT AGAINST ENTRANCE OF MOISTURE		" DIAMETER X 12"
GRADE —	4	ANCHOR BOLTS  P.C.C. SIDEWALK, 5"  PAD BETWEEN SIDEWALK AND CONTROLLER
		EXOTHERMIC WELD #6 GROUND WIRE
2" GALVANIZED STEEL CONDIUT TO COMMONWEALTH		GROUND STRAP
EDISON SERVICE	+	3" X 10' COPPERCLAD GROUND ROD
2-½" PVC CONDUITS	ELEVATION	CONCRETE

**DEVICE SCHEDULE** 

600V FRAME, NON-INTERCHANGABLE TRIP, BOLT ON TYPE.

DESCRIPTION 200 AMP CIRCUIT BREAKER, MOLDED CASE, THERMAL MAGNETIC, 2-POLE, SINGLE THROW,

## (R) 120/240V, 1 PHASE, (B) 3 WIRE FROM (W) COMMONWEALTH EDISON E (j) (J #2/O GROUND CONDUCTOR #2 AWG Lighting 1 CB CB Lighting 2 Lighting 3 ĊВ CB 9 OSW\* Lighting 4 ĊВ CB 10 OSW\* ĊВ Lighting 5 CB 11 OSW\* ĊВ Lighting 6 CB 12 OSW\* ĊВ Spare CB 13 OSW\* ĊВ Spare CB 14 OSW\* 15 OSW\* CB 16 OSW\* CB CB 17 OSW\* CB 18 OSW\* CB 19 OSW\* CB 20 OSW\* \* OUTLETS IN SEAT WALL 120/240 VOLT 200 AMP CONTROLLER PANEL WIRING DIAGRAM

HANCOCK -NGINEERING | # # Established 1911

Municipal Consultants

Phone: 708-865-0300

DRAWN - ECW. SB. GD. DMM. LW REVISED -CHECKED -REVISED

**STATE OF ILLINOIS DEPARTMENT OF TRANSPORTATION** 

**LIGHTING DETAILS** SHEET NO. 3 OF 4 SHEETS STA. TO STA.

SCALE: NONE

SECTION COUNTY 21-00134-00-RS 68 58 COOK CONTRACT NO. 61K86 FED ROAD DIST NO 1 HILINOIS FED AID PROJECT





COMMONWEALTH EDISON METER

AIR VENT

SEAL ENDS OF CONDUIT


GRADE

2" GALVANIZED STEEL CONDIUT TO COMMONWEALTH EDISON SERVICE

2-1 PVC CONDUITS

AGAINST ENTRANCE OF MOISTURE



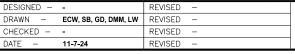

**ELEVATION LIGHTING CONTROLLER & FOUNDATION** 

\_DOOR FACING AWAY FROM STREET

(SEE SPECIFICATIONS)

½" DIAMETER X 12" ANCHOR BOLTS

\_PLATE WITH "STREET LIGHTING VILLAGE OF BROOKFIELD"

P.C.C. SIDEWALK, 5" - PAD BETWEEN SIDEWALK AND CONTROLLER

GROUND STRAP


CONCRETE

FOUNDATION

EXOTHERMIC WELD

3" X 10' COPPERCLAD GROUND ROD



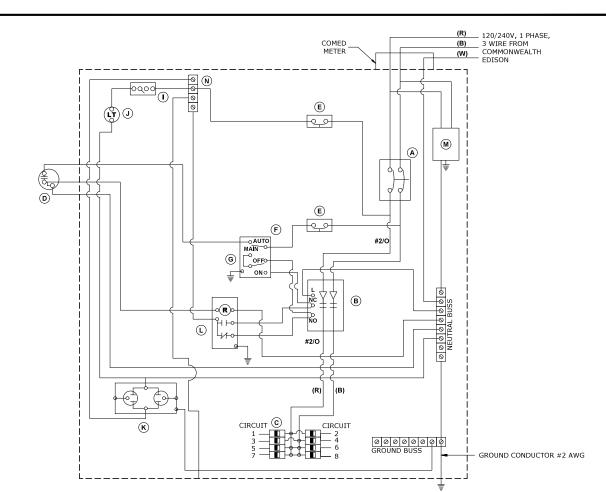


		DEVICE SCHEDULE
	QUANTITY	DESCRIPTION
A	1	100 AMP CIRCUIT BREAKER, MOLDED CASE, THERMAL MAGNETIC, 2-POLE, SINGLE THROW, 600V FRAME, NON-INTERCHANGABLE TRIP, BOLT ON TYPE.
В	1	100 AMP, ELECTRICALLY OPERATED AND MECHANICALLY HELD LIGHTING CONTRACTOR, 2-POLE, 600 VOLT WITH 120 V COIL
©	8	120/240 VOLT 1 PHASE PANEL BOARD WITH 100 AMP COPPER MAINS SINGLE POLE, 30 AMP, 120 VOLT BOLT ON BRANCH CIRCUIT BREAKERS
D	1	PHOTO-ELECTRIC CELL, 120 VOLT, MOUNT ON UNDERSIDE OF VENT ON CONTROLLER
E	2	THERMAL MAGNETIC, MOLDED CASE CIRCUIT BREAKER, 1 POLE, 15 AMP, 120 VOLT BOLT ON TYPE
F	1	CONTROL SWITCH, MOMENTARY CONTACT, SPDT, 15 AMP, 120 VOLT
G	1	CONTROL SWITCH, TOGGLE TYPE, SPDT, 20 AMP, 120 VOLT SPECIAL GRADE
1	1	MICRO SWITCH (MOUNTED WITH ACTUATOR TO SWITCH WHEN DOOR IS OPEN) 120 VOLT, 20 AMP
J	1	LED LIGHT FIXTURE VAPOR TIGHT WITH GLOBE, GUARD, AND MOUNTING BOX
ĸ	1	120 VOLT, 20 AMP RECEPTACLE, SPECIFICATION GRADE IN NEMA 5-15R WEATHER PROOF BOX WITH FLAP-TYPE COVER, OUTLET TO BE GFI-TYPE.
L	1	POWER RELAY WITH 25 AMP CONTACTS RATED FOR CONTRACTOR INRUSH CURRENT - 120 VOLT COIL
M	1	SURGE ARRESTOR, 5 WIRE EDCO "4803 OR EQUAL
N	1	TERMINAL BLOCK, 120 VOLT, 50 AMP MAXIMUM WITH NUMBER OF TERMINALS AS INDICATED

#### NOTES:

- 1. ALL CIRCUIT BREAKERS SHALL HAVE AN INTERRUPT RATING OF 18,000 AMPS
  2. UL LISTED DEVICES/COMPONENTS SHALL BE USED
  3. NO SPICIES OF WIRES IN CABINET
  4. CONTROL WIRE TO BE #12 MTW

- POWER WIRE SHALL BE RATED RHH/RHW 600 VOLTS OF SIZE INDICATED
   LIGHTING CONTROLLER SHALL BE SERVICE ENTRANCE RATED
   PANEL SHALL BE DEAD FRONT TO ALLOW OPERATION OF HOA SWITCH

#### 120/240 VOLT 100 AMP CONTROLLER PANEL WIRING DIAGRAM

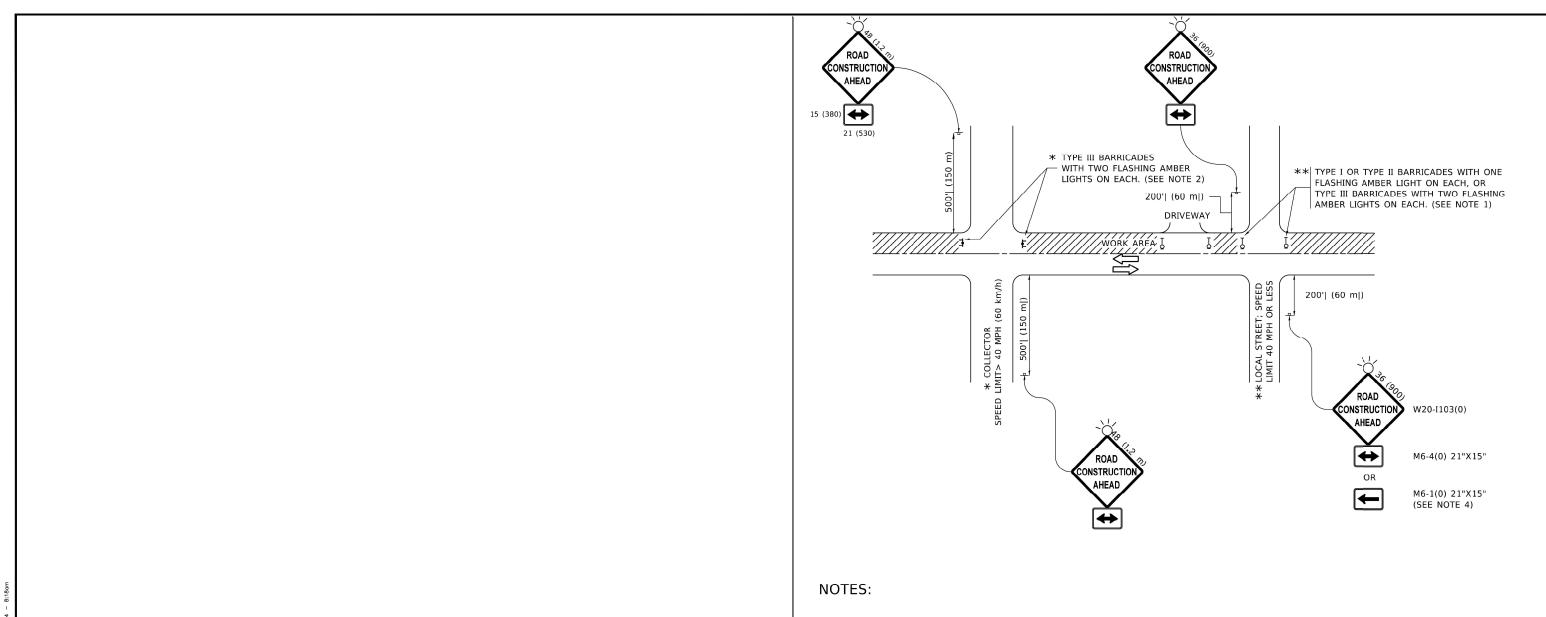

- 1. SIDE ROAD WITH A SPEED LIMIT OF 40 MPH (60 km/h) OR LESS AS SHOWN ON THE DRAWING AND AS DIRECTED BY THE ENGINEER:
- a) ONE "ROAD CONSTRUCTION AHEAD" SIGN 36 x 36 (900x900) WITH A FLASHER MOUNTED ON IT APPROXIMATELY 200' (60 m) IN ADVANCE OF THE MAIN ROUTE.
- b) THE CLOSED PORTION OF THE MAIN ROUTE SHALL BE PROTECTED BY BLOCKING WITH TYPE I. TYPE II OR TYPE III BARRICADES, 1/3 OF THE CROSS SECTION OF THE CLOSED PORTION.
- SIDE ROAD WITH A SPEED LIMIT GREATER THAN 40 MPH (60 km/h) AS SHOWN ON THE DRAWING AND AS DIRECTED BY THE ENGINEER:
- a) ONE "ROAD CONSTRUCTION AHEAD" SIGN 48 x 48 (1.2 m x 1.2 m) WITH A FLASHER MOUNTED ON IT APPROXIMATELY 500' (150 m) IN ADVANCE OF THE MAIN ROUTE.
- THE CLOSED PORTION OF THE MAIN ROUTE SHALL BE PROTECTED BY
  b) BLOCKING WITH TYPE III BARRICADES, 1/2 OF THE CROSS SECTION
  OF THE CLOSED PORTION.
- 3. CONES MAY BE SUBSTITUTED FOR BARRICADES OR DRUMS AT HALF THE SPACING DURING DAY OPERATIONS. CONES SHALL BE A MINIMUM OF 28 (710) IN HEIGHT.
- WHEN THE SIDE ROAD LIES BETWEEN THE BEGINNING OF THE MAINLINE
  4. SIGNING AND THE WORK ZONE, A SINGLE HEADED ARROW (M6-1) SHALL
  BE USED IN LIEU OF THE DOUBLE HEADED ARROW (M6-4).

- 5. WHEN WORK IS BEING PERFORMED ON A SIDE ROAD OR DRIVEWAY, FOLLOW THE APPLICABLE STANDARD(S). THE DIRECTIONAL ARROW (M6-1 OR M6-4) SHALL BE COVERED OR REMOVED WHEN NO LONGER CONSISTENT WITH THE TRAFFIC CONTROL SET-UP.
- 6. ADVANCE WARNING SIGNS ARE TO BE OMITTED ON DRIVEWAYS UNLESS OTHERWISE SPECIFIED IN THE PLANS OR BY THE ENGINEER.
- 7. THE TRAFFIC CONTROL AND PROTECTION FOR SIDE ROADS, INTERSECTIONS, AND DRIVEWAYS SHALL BE INCLUDED IN THE COST OF SPECIFIED TRAFFIC CONTROL STANDARDS OR ITEMS.


All dimensions are in inches (millimeters) unless otherwise shown.

USER NAME = Lawrence.DeManche	DESIGNED - L.H.A.	REVISED - T. RAMMACHER 01-06-00
	DRAWN -	REVISED - A. SCHUETZE 07-01-13
PLOT SCALE = 100.0000 ' / in.	CHECKED -	REVISED - A. SCHUETZE 09-15-16
PLOT DATE = 5/3/2024	DATE - 06-89	REVISED - D. SENDERAK 05-03-24

STATE	OF	ILLINOIS
DEPARTMENT	<b>OF</b>	TRANSPORTATION

	TRAFF	IC	CONTR	10	L AND F	PROTEC	TION FOR
SI	DE RO	AD	S, INTE	R	SECTIONS	S, AND	DRIVEWAYS
	SHEET	1	OF	1	SHEETS	STA.	TO

F.A.U. RTE.		SECTION					COUNTY				
1694/140	8	21-0	0134-	-00	RS	COOP	(	68	1		
		TC-10				CONTRA	ACT	NO. 6	1K86		
FED.	ROAD	DIST.	NO.	1	ILLINOIS	FED. AID	PRO	JECT			

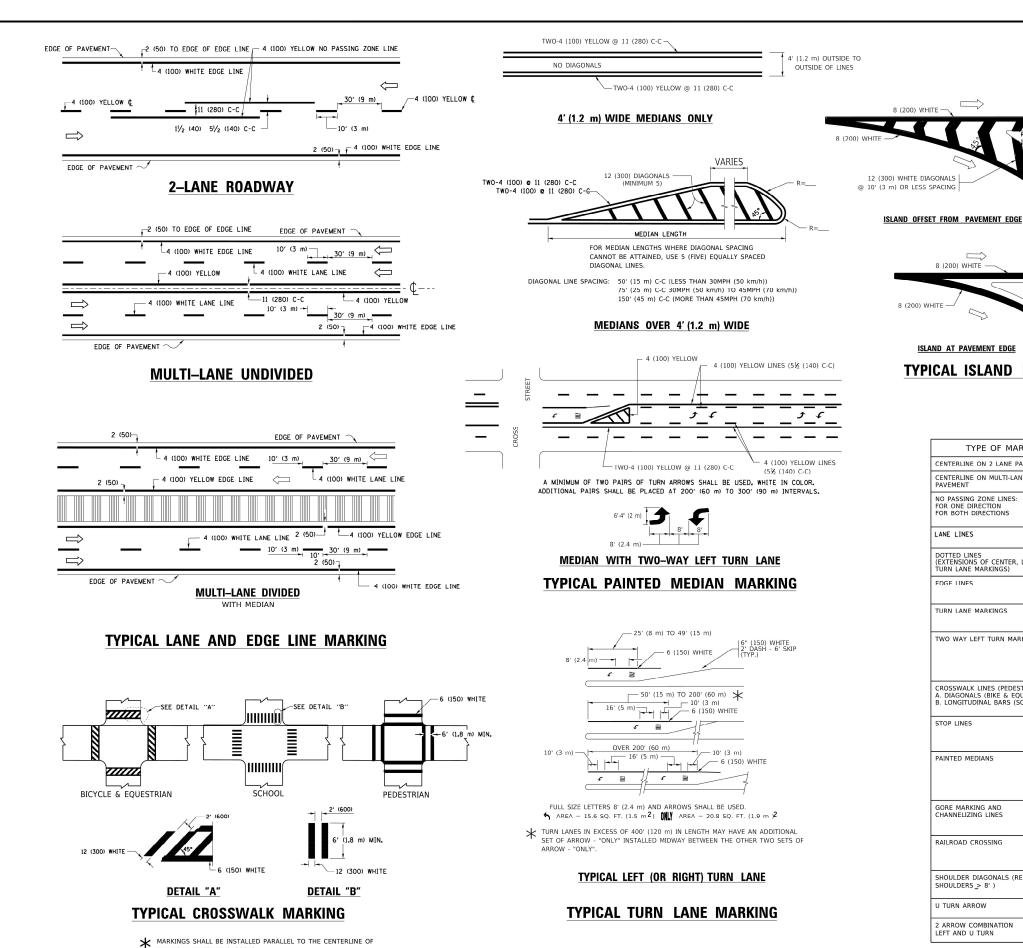

THE ROAD WHICH IT CROSSES

40 (1020) 64 (1620) COMBINATION LEFT AND U-TURN - 2 (50) 5'-4" (1620) RAISED ISLAND = 32 R (810) 2 (50) 20 (510) TYPICAL ISLAND MARKING LANE REDUCTION TRANSITION \* LANE REDUCTION ARROWS REQUIRED AT SPEEDS OF 45 MPH OR GREATER OR WHEN SPECIFIED IN PLANS. U-TURN TYPE OF MARKING WIDTH OF LINE PATTERN SPACING / REMARKS COLOR CENTERLINE ON 2 LANE PAVEMENT 4 (100) SKIP-DASH YELLOW 10' (3 m) LINE WITH 30' (9 m) SPACE CENTERLINE ON MULTI-LANE UNDIVIDED PAVEMENT 2 @ 4 (100) SOLID YELLOW 11 (280) C-C (100) 2 @ 4 (100) 5½ (140) C-C FROM SKIP-DASH CENTERLINE 11 (280) C-C YELLOW MIT SKIP-DASH CENTERLINE BETWEEN 4 (100) 5 (125) ON FREEWAYS SKIP-DASH SKIP-DASH 10' (3 m) LINE WITH 30' (9 m) SPACE SAME AS LINE BEING EXTENDED SKIP-DASH SAME AS LINE BEING EXTENDED 2' (600) LINE WITH 6' (1.8 m) SPACE DOTTED LINES (EXTENSIONS OF CENTER, LANE OR 4 (100) SOLID OUTLINE MEDIANS IN YELLOW WHITE-RIGHT 6 (150) LINE; FULL SIZE LETTERS & SOLID WHITE SEE TYPICAL TURN LANE MARKING DETAIL YMBOLS (8' (2.4m) TWO WAY LEFT TURN MARKING 2 @ 4 (100) SKIP-DASH YELLOW 10' (3 m) LINE WITH 30' (9 m) SPACE FOR SKIP-DASH; 5½ (140) C-C BETWEEN SOLID LINE AND SKIP-DASH LINE SEE TYPICAL TWO-WAY LEFT TURN MARKING DETAIL EACH DIRECTION AND SOLIC 8' (2.4m) LEFT ARROW WHITE CROSSWALK LINES (PEDESTRIAN) 2 @ 6 (150) NOT LESS THAN 6' (1.8 m) APART 2' (600) APART 2' (600) APART SEE TYPICAL CROSSWALK MARKING DETAILS. A. DIAGONALS (BIKE & FOLIESTRIAN) WHITE B. LONGITUDINAL BARS (SCHOOL) 12 (300) @ 90 SOLID PLACE 4' (1.2 m) IN ADVANCE OF AND
PARALLEL TO CROSSWALK, IF PRESENT.
OTHERWISE, PLACE AT DESIRED STOPPING
POINT. PARALLEL TO CROSSROAD CENTERLINE, WHERE
POSSIBLE 24 (600) SOLID WHITE

36 (910)

STANDARD SPECIFICATIONS FOR ROAD AND BRIDGE CONSTRUCTION AND STATE STANDARD 780001.

2 @ 4 (100) WITH 12 (300) DIAGONALS

NO DIAGONALS USED FO 4' (1.2 m) WIDE MEDIAN:

8 (200) WITH 12 (300)

24 (600) TRANSVERSE LINES; "RR" IS 6' (1.8 m) LETTERS; 16 (400) LINE FOR "X"

12 (300) @ 45°

SEE DETAIL

SEE DETAIL

SOLID

SOLID

SOLID

SOLID

SOLID

SOLID

YELLOW: TWO WAY TRAFFIC

WHITE: ONE WAY TRAFFIC

WHITE

WHITE

WHITE

WHITE

WHITE - RIGHT YELLOW - LEFT

8 (200) WHITE

ISLAND AT PAVEMENT EDGE

NO PASSING ZONE LINES FOR ONE DIRECTION FOR BOTH DIRECTIONS

TURN LANE MARKINGS)

TURN LANE MARKINGS

LANE LINES

EDGE LINES

STOP LINES

PAINTED MEDIANS

GORE MARKING AND

RAILROAD CROSSING

SHOULDERS > 8')

2 ARROW COMBINATION LEFT AND U TURN

U TURN ARROW

SHOULDER DIAGONALS (REQUIRED FOR

unless otherwise shown.

DIAGONALS: 15' (4.5 m) C-C (LESS THAN 30MPH (50 km/h)) 20' (6 m) C-C 30MPH (50 km/h) TO 45MPH (70 km/h)) 30' (9 m) C-C (OVER 45MPH (70 km/h))

50' (15 m) C-C (LESS THAN 30MPH (50 km/h)) 75' (25 m) C-C (30 MPH (50 km/h) TO 45MPH (70 km/h)) 150' (45 m) C-C (OVER 45MPH (70 km/h))

11 (280) C-C FOR THE DOUBLE LINE SEE TYPICAL PAINTED MEDIAN MARKING.

SEE STATE STANDARD 780001 AREA OF:
"R"=3.6 SQ. FT. (0.33 m )<sup>2</sup> EACH
"X"=54.0 SQ. FT. (5.0 m )<sup>2</sup>

16.3 SF

30.4 SF


SPEED LIMIT

500 580

665


750

USER NAME = footemj	DESIGNED - EVERS	REVISED - C. JUCIUS 09-0			F.A.U.	SECTION	COUNTY	TOTAL '	SHEET		
	DRAWN -	REVISED - C. JUCIUS 07-0	STATE OF ILLINOIS					21-00134-00-RS	соок	68	61
PLOT SCALE = 50.0000 ' / in.	CHECKED -	REVISED - C. JUCIUS 12-2	DEPARTMENT OF TRANSPORTATION		TYPICAL PAVEMENT MARKINGS			TC-13	CONTRACT	NO. 61K	K86
PLOT DATE = 3/4/2019	DATE - 03-19-90	REVISED - C. JUCIUS 04-1	16	SCALE: NONE SHEET 1 OF 1 SHEETS STA. TO STA.			FED. ROAD	DIST. NO. 1 ILLINOIS	FED. AID PRO	JECT	
									E.H.E. PROJE	CT NO. 125'	2100501

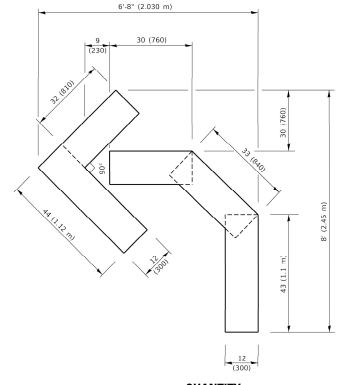


#### QUANTITY

4 (100) LINE = 45.5 ft. (13.9 m)15.2 sq. ft. (1.41 sq. m)

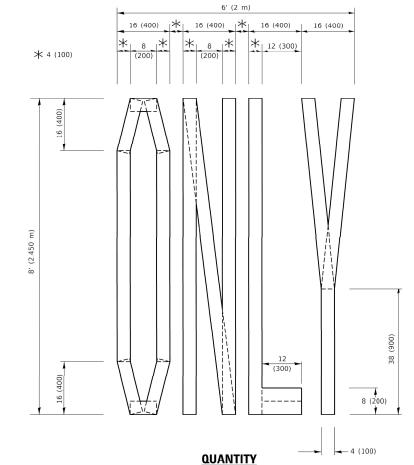

4 (100) LINE = 64.1 ft. (19.5 m) 21.4 sq. ft. (1.99 sq. m)

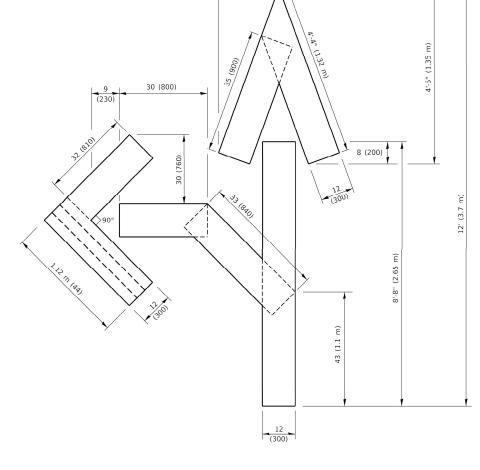


1'-8" (500)

### QUANTITY

4 (100) LINE = 82.5 ft. (25.1 m) 27.5 sq. ft. (2.53 sq. m)

### NOTE:

ALL QUANTITIES OF PLACEMENT ARE REPRESENTED IN LINEAR FEET OF 4" LINES TO MATCH THE 4" TEMPORARY TAPE PAY ITEM AND REPRESENTS THE TOTAL QUANTITY OF 4" TAPE REQUIRED.

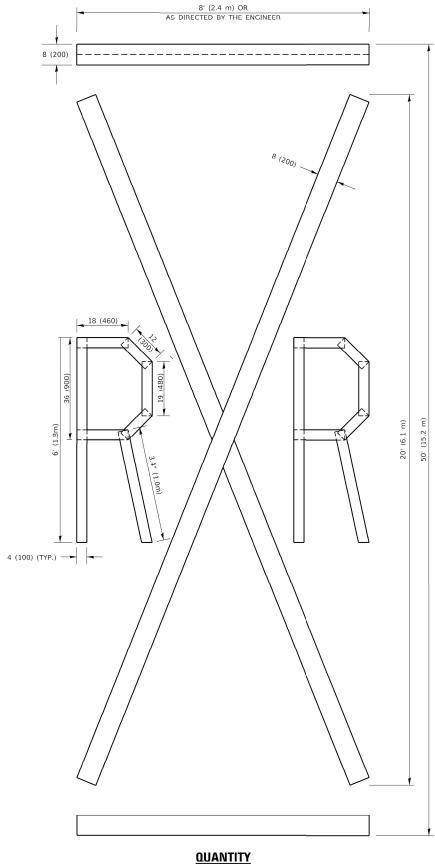

4 (100) LINE = 225.9 ft. (68.9 m) 75.3 sq. ft. (6.99 sq. m)


> All dimensions are in inches (millimeters) unless otherwise shown.

USER NAME = footemj	DESIGNED -	REVISED - I. RAMMACHER 03-02-98
	DRAWN -	REVISED - E. GOMEZ 08-28-00
PLOT SCALE = 50.0068 ' / in.	CHECKED -	REVISED - E. GOMEZ 08-28-00
PLOT DATE = 3/4/2019	DATE - 09-18-94	REVISED - A. SCHUETZE 09-15-16


STATE OF ILLINOIS **DEPARTMENT OF TRANSPORTATION** 

SHORT TERM PAVEMENT MARKING LETTERS AND SYMBOLS SCALE: NONE SHEET 1 OF 1 SHEETS STA. TO STA.

SECTION 21-00134-00-RS COOK 68 62 TC-16 CONTRACT NO. 61K86

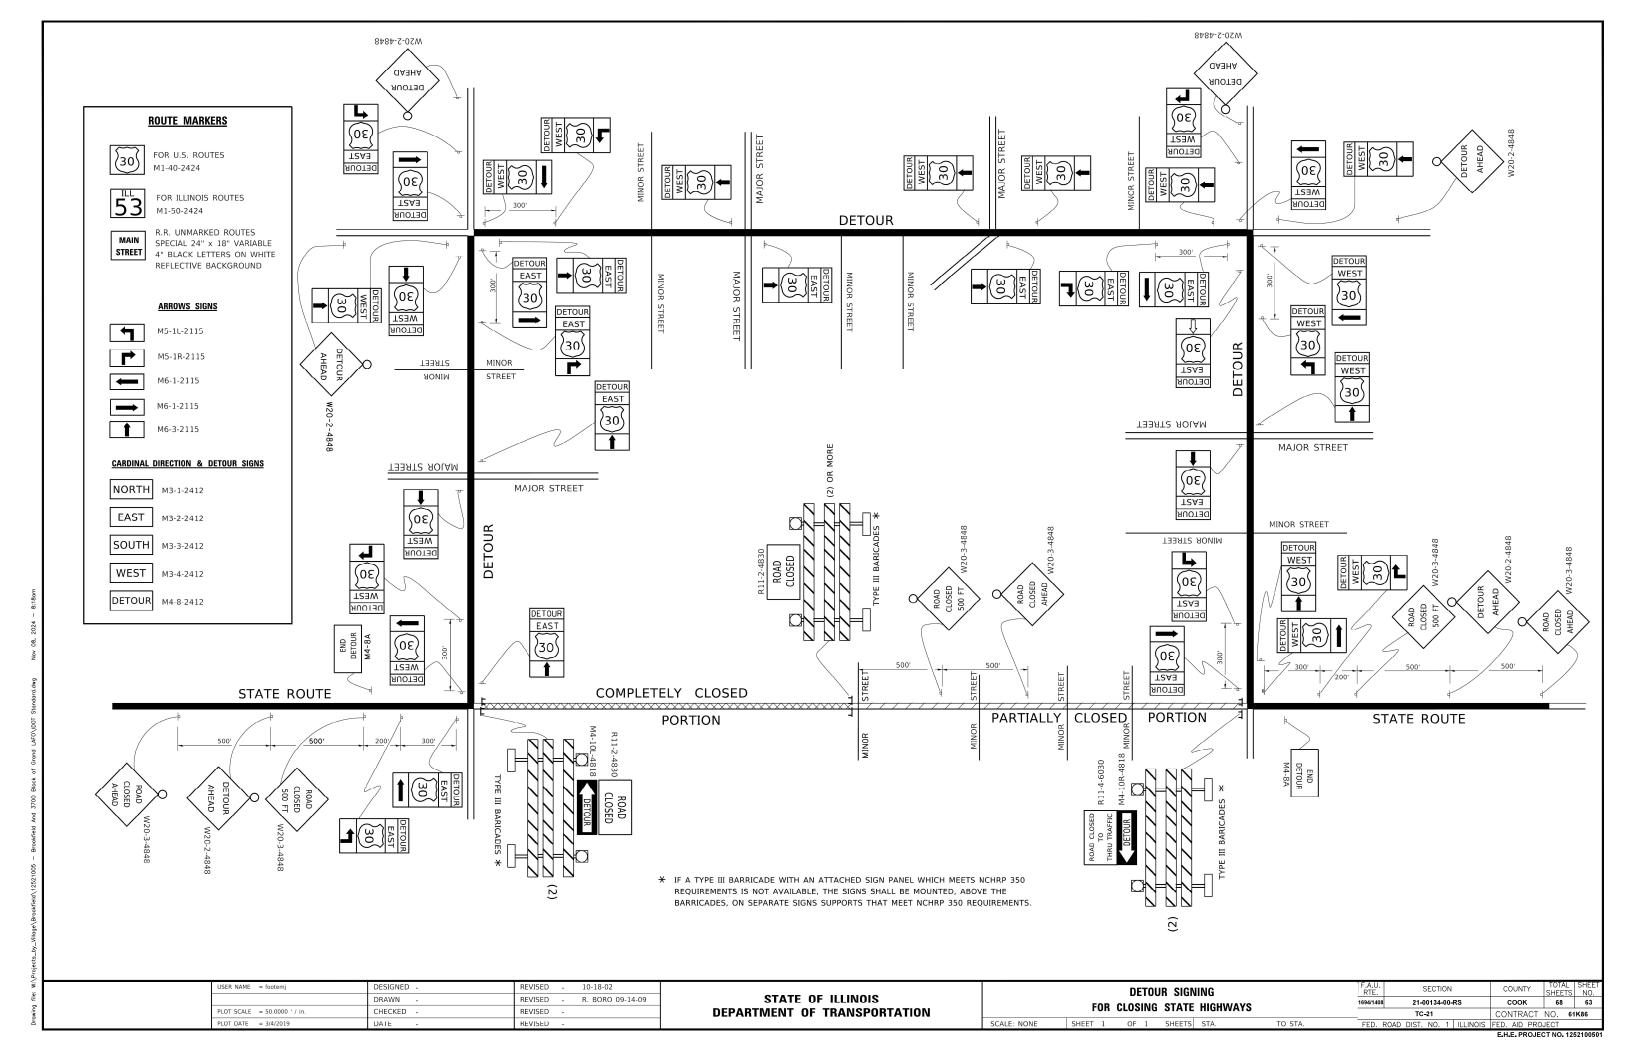



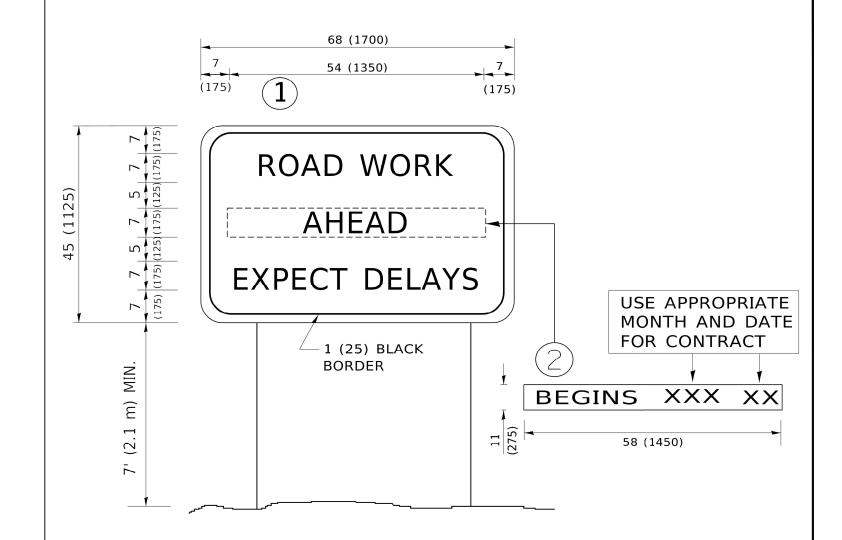

- 1. USE BLACK LETTERING ON ORANGE BACKGROUND.
- 2. ERECT SIGNS IN ADVANCE OF THE LOCATION FOR THE "ROAD CONSTRUCTION AHEAD" SIGN AT LOCATIONS AS DIRECTED BY THE ENGINEER.
- 3. ERECT SIGN 1 WITH INSTALLED PANEL 2 ONE WEEK PRIOR TO THE START OF CONSTRUCTION.
- 4. REMOVE PANEL(2)SOON AFTER THE START OF CONSTRUCTION.
- 5. SEE SPECIAL PROVISION FOR "TEMPORARY INFORMATION SIGNING" FOR ADDITIONAL INFORMATION.
- 6. ONE SIGN ASSEMBLY EQUALS 25.70 SQ. FT. (2.3 SQ. M.)
- 7. SHALL BE PAID FOR AS TEMPORARY INFORMATION SIGNING.

ALL DIMENSIONS ARE IN INCHES (MILLIMETERS) UNLESS OTHERWISE SHOWN.

USER NAME = footemj	DESIGNED -	REVISED - R. MIRS 09-15-97				ΔRTE	ERIAL R	ΠΔΠ		F.A.U. RTF	SECTION	COUNTY	TOTAL	SHEET
	DRAWN -	REVISED - R. MIRS 12-11-97	STATE OF ILLINOIS							1694/1408	21-00134-00-RS	соок	68	64
PLOT SCALE = 50.0000 ' / in.	CHECKED -	REVISED -T. RAMMACHER 02-02-99	DEPARTMENT OF TRANSPORTATION			INFURI	VIATION	SIGN			TC-22	CONTRACT	NO. 6	61K86
PLOT DATE = 3/4/2019	DATE -	REVISED - C. JUCIUS 01-31-07		SCALE: NONE	SHEET 1	OF 1	SHEETS	STA.	TO STA.	FED. ROAD	DIST. NO. 1 ILLINO	S FED. AID PR	OJECT	

3.0" RADIUS, 0.5" BORDER, WHITE ON GREEN; REFLECTORIZED "DRIVEWAY" D; "ENTRANCE" D; STANDARD ARROW CUSTOM 12.0" x 5.0"

### NOTES:

- 1. HALF OF THE SIGNS WILL REQUIRE A LEFT HAND FACING ARROW.
- 2. TWO SIGNS SHALL BE USED AT EACH COMMERCIAL ENTRANCE PLACED BACK-TO-BACK: ONE WITH A RIGHT HAND ARROW (SHOWN) SHALL BE PLACED ON THE NEAR RIGHT SIDE THE DRIVEWAY AND ONE WITH A LEFT HAND ARROW SHALL BE PLACED ON THE FAR LEFT SIDE OF THE DRIVEWAY.
- 3. SIGNS TO BE PAID FOR AS ITEM "TEMPORARY INFORMATION SIGNING".

STATE OF ILLINOIS
DEPARTMENT OF TRANSPORTATION

DRIVEWAY ENTRANCE SIGNING

SCALE: NONE SHEET 1 OF 1 SHEETS STA. TO


F.A.U. SECTION COUNTY TOTAL SHEET NO.


1694/1408 21-00134-00-RS COOK 68 65

TC-26 CONTRACT NO. 61K86

FFD. ROAD DIST. NO. 1 ILLINOIS FFD. AID PROJECT



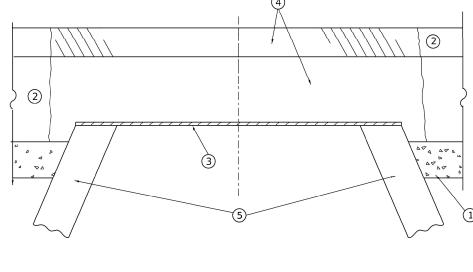

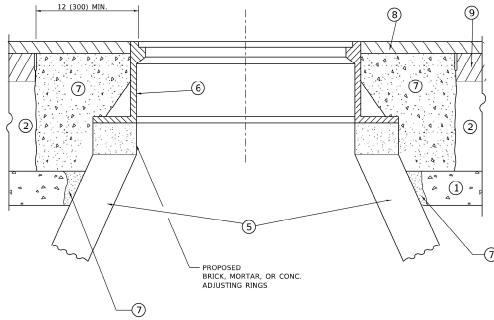

# **DETAILS FOR FRAMES AND LIDS ADJUSTMENT**

#### **NOTES**

- 1. EXISTING BROKEN FRAMES AND LIDS SHALL BE REMOVED AND DISPOSED OF BY THE CONTRACTOR AND SHALL BE REPLACED AS DIRECTED BY THE ENGINEER. REPLACEMENT FRAMES AND LIDS WILL BE PAID FOR IN ACCORDANCE WITH ARTICLE 109.04 OF THE STANDARD SPECIFICATIONS UNLESS A SEPARATE PAY ITEM HAS BEEN PROVIDED.
- 2. IF THE EXISTING LIDS ARE OPEN. THE FRAME WILL BE ADJUSTED TO THE ELEVATION OF THE MILLED PAVEMENT SURFACE PRIOR TO THE MILLING OPERATION. THE FRAME WILL NOT BE REMOVED AND COVERED BY THE METAL PLATE.
- 3. CITY OF CHICAGO CASTINGS ARE THE PROPERTY OF THE CITY AND THE CONTRACTOR SHALL NOTIFY THE CITY FOR REMOVAL AND DISPOSITION OF THE CASTINGS.
- 4. THE METAL PLATE USED TO COVER THE STRUCTURE SHALL REMAIN THE PROPERTY OF THE CONTRACTOR.
- 5. THE CONTRACTOR SHALL REMOVE ALL TRAFFIC CONTROL DEVICES BY THE END OF EACH WORK SHIFT.

# WITH MILLING

#### **CONSTRUCTION PROCEDURES**

#### STAGE 1 (BEFORE PAVEMENT MILLING)

- A) REMOVE A MINIMUM OF 12 (300) OF THE PAVEMENT FROM AROUND THE STRUCTURE.
- B) REMOVE THE EXISTING FRAME AND LID FROM THE STRUCTURE.
- C) COVER THE STRUCTURE OPENING WITH A 36 (900) DIAMETER METAL PLATE.
- D) BACKFILL WITH CRUSHED STONE AND HMA SURFACE MIX APPROVED BY THE ENGINEER. (MIN. 3 (80) HMA TO REMAIN AFTER MILLING).

#### STAGE 2 (AFTER PAVEMENT MILLING)

- A) REMOVE THE HMA SURFACE MIX AND CRUSHED STONE.
- B) INSTALL THE FRAME AND LID; ADJUST THE FRAME TO ITS FINAL SURFACE ELEVATION.
- C) THE SURROUNDING SPACE SHALL BE FILLED WITH CLASS PP-2\* CONCRETE TO THE ELEVATION OF THE SURFACE OF THE EXISTING BASE COURSE OR THE BINDER COURSE.
- \*UNLESS OTHERWISE SPECIFIED IN THE PLANS.

THE PROCEDURE EXPLAINED ABOVE SHALL CONFORM TO THE APPLICABLE PORTIONS OF SECTIONS 353, 406, 602, AND 603 OF THE STANDARD SPECIFICATIONS EXCEPT THAT "THE CONTRACTOR SHALL ADJUST THE STRUCTURES TO THE FINISHED PAVEMENT ELEVATION NO MORE THAN 5 CALENDAR DAYS PRIOR TO PLACEMENT OF THE FINAL LIFT OF SURFACE UNLESS APPROVED BY THE ENGINEER."

#### **LEGEND**

- ① SUB-BASE GRANULAR MATERIAL
- (6) FRAME AND LID (SEE NOTES)
- 2 EXISTING PAVEMENT
- 7 CLASS PP-2\* CONCRETE
- 3 36 (900) DIAMETER METAL PLATE
  - - (8) PROPOSED HMA SURFACE COURSE
- PROPOSED CRUSHED STONE AND HMA SURFACE MIX
- (5) EXISTING STRUCTURE
- (9) PROPOSED HMA BINDER COURSE

#### **LOCATION OF STRUCTURES**

THE CONTRACTOR WILL BE REQUIRED TO KEEP A RECORD OF THE LOCATIONS OF THE BURIED STRUCTURES ACCORDING TO THE STATION AND DISTANCE LEFT OR RIGHT OF THE CENTERLINE OF PAVEMENT. UPON COMPLETION OF THE WORK. THE CONTRACTOR WILL DELIVER THE RECORD TO THE ENGINEER.

#### **BASIS OF PAYMENT**


- 1. REMOVING FRAMES AND LIDS ON DRAINAGE AND UTILITY STRUCTURES IN THE PAVEMENT PRIOR TO MILLING, AND ADJUSTING TO FINAL GRADE PRIOR TO PLACING THE SURFACE COURSE, WILL BE PAID FOR AT THE CONTRACT UNIT PRICE EACH FOR "FRAMES AND LIDS TO BE ADJUSTED (SPECIAL)."
- 2. THIS WORK WILL NOT BE PAID FOR WHEN DRAINAGE AND UTILITY STRUCTURES ARE SPECIFIED FOR PAYMENT AS STRUCTURE RECONSTRUCTION.
- 3. NEW FRAMES AND LIDS, WHEN SPECIFIED, WILL BE PAID FOR SEPARATELY.
- 4. WHEN STRUCTURES ARE TO BE ADJUSTED OR RECONSTRUCTED, THE LOWERING AND RAISING OF THE FRAMES AND LIDS WILL NOT BE PAID FOR SEPARATELY BUT WILL BE INCLUDED IN THE COST OF THE CORRESPONDING PAY ITEM.

ALL DIMENSIONS ARE IN INCHES (MILLIMETERS) UNLESS OTHERWISE SHOWN

USER NAME = Lawrence.DeManche	DESIGNED - R. SHAH	REVISED - R. BORO 03-09-11		DETAILS FOR	F.A.U.	SECTION	COUNTY	TOTAL	SHEET
	DRAWN -	REVISED - R. BORO 12-06-11	STATE OF ILLINOIS		1694/1408	21-00134-00-RS	соок	68 68	66
PLOT SCALE = 100.0000 ' / in.	CHECKED -	REVISED - K. SMITH 11-18-22	DEPARTMENT OF TRANSPORTATION	FRAMES AND LIDS ADJUSTMENT WITH MILLING		BD600-03 (BD-8)	CONTRACT	NO. 61K	(86
PLOT DATE = 9/15/2023	DATE - 10-25-94	REVISED - K. SMITH 09-15-23		SCALE: NONE SHEET 1 OF 1 SHEETS STA. TO STA.	FED. ROA	D DIST. NO. 1 ILLIN	IOIS FED. AID PRO	JECT	

### OPTION 1

(FOR BUTT JOINT AND HMA TAPER SEE DETAIL BELOW)

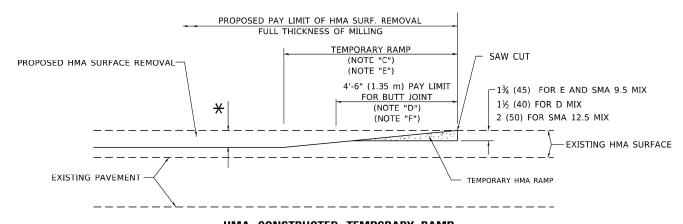


#### HMA CONSTRUCTED TEMPORARY RAMP


(FOR BUTT JOINT AND HMA TAPER SEE DETAIL BELOW)


#### OPTION 2

# **TYPICAL TEMPORARY RAMP**

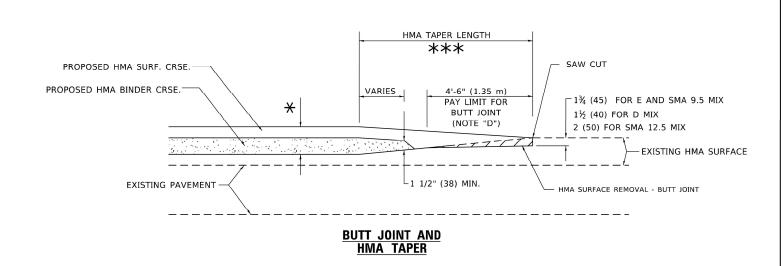

# TYPICAL BUTT JOINT AND HMA TAPER FOR MILLING AND RESURFACING

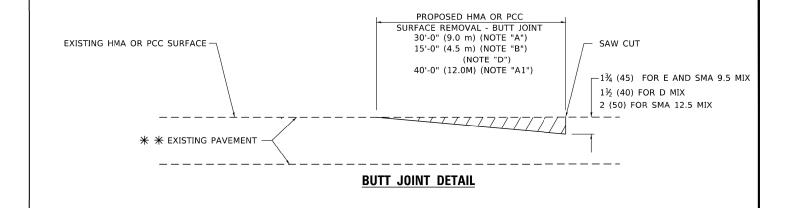

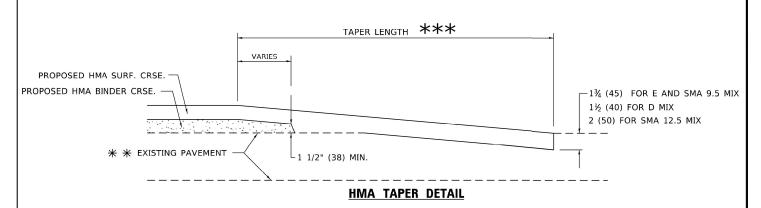

# TYPICAL BUTT JOINT AND HMA TAPER FOR RESURFACING ONLY

\*\* PC CONCRETE, HMA OR HMA RESURFACED PAVEMENT.

#### **GENERAL NOTES**

- A. MAINLINE ARTERIAL ROADWAYS AND MAJOR SIDE ROADS.
- A1. INTERSTATES
- B. MINOR SIDE ROADS.
- C. THE TEMP. RAMP SHALL BE CONSTRUCTED IMMEDIATELY UPON REMOVAL OF THE EXISTING HMA SURFACE.
- D. THE BUTT JOINT SHALL BE CONSTRUCTED IMMEDIATELY PRIOR TO PLACING THE PROPOSED HMA COURSES.
- E. TAPER THE TEMP. RAMP AT A RATE OF 3' 4" (1.02m) PER 1 INCH (25 mm) OF MILLING THICKNESS.

igstar SEE TYPICAL SECTIONS FOR MILLING THICKNESS

F. SEE ARTICLE 406.08 AND 406.14 OF THE STANDARD SPECIFICATIONS FOR "HMA AND/OR PCC SURFACE REMOVAL, BUTT JOINT".

\*\*\* 20'-0" (6.1 m) PER 1 (25) RESURFACING (NOTE "A") 10'-0" (3.0 m) PER 1 (25) RESURFACING (NOTE "B")

#### **BASIS OF PAYMENT**

- THE BUTT JOINT WILL BE PAID FOR AT THE CONTRACT UNIT PRICE PER SOUARE YARD (SOUARE METER) FOR "HOT-MIX ASPHALT SURFACE REMOVAL - BUTT JOINT" OR FOR "PORTLAND CEMENT CONCRETE SURFACE REMOVAL- BUTT JOINT".
- 2. THE TEMPORARY RAMP AND SAW CUT SHALL BE INCLUDED IN THE UNIT COST FOR HMA OR PCC SURFACE REMOVAL-BUTT JOINT.

ALL DIMENSIONS ARE IN INCHES (MILLIMETERS) OTHERWISE SHOWN.

USER NAME = Lawrence.DeManche	DESIGNED - M. DE YONG	REVISED - A. ABBAS 03-21-97		BUTT JOINT AND	F.A.U. SECTION	COUNTY TOTAL SHEET
	DRAWN -	REVISED - M. GOMEZ 04-06-01	STATE OF ILLINOIS		1694/1408 21-00134-00-RS	COOK 68 67
PLOT SCALE = 100.0000 ' / in.	CHECKED -	REVISED - R. BORO 01-01-07	DEPARTMENT OF TRANSPORTATION	HMA TAPER DETAILS	BD400-05 BD32	CONTRACT NO. 61K86
PLOT DATE = 11/18/2022	DATE - 06-13-90	REVISED - K. SMITH 11-18-22		SCALE: NONE SHEET 1 OF 1 SHEETS STA. TO ST.	A. FED ROAD DIST NO 1 ILLINOIS	FED AID PROJECT

