01-17-2025 LETTING ITEM 057

FOR INDEX OF SHEETS, SEE SHEET NO. 2

STATE OF ILLINOIS DEPARTMENT OF TRANSPORTATION

 FA I RTE.
 SECTION
 COUNTY
 TOTAL SHEETS
 SHEET NO.

 55
 2023-927-RS,SW
 DUPAGE
 24
 1

 ILLINOIS
 CONTRACT NO. 62W49

D-91-133-24

PROPOSED HIGHWAY PLANS

FAI ROUTE 55: I-55 FRONTAGE ROAD
CASS AVENUE TO CLARENDON HILLS ROAD
SECTION 2023-927-RS,SW
DESIGNED OVERLAY, ADA IMPROVEMENTS
DUPAGE COUNTY

C-91-153-24


R 11 E

THIS PROJECT IS LOCATED IN THE CITY OF DARIEN.

TRAFFIC DATA:

I-55 (FRONTAGE RD) CLARENDON HILLS RD TO CASS AVE ADT (2021) = 3000 VPD SPEED LIMIT = 35 - 40 MPH

Functional Class: LOCAL ROAD

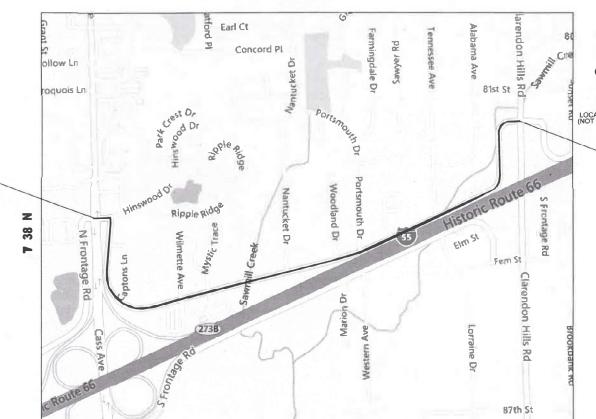

DOWNERS GROVE TOWNSHIP

GROSS & NET LENGTH = 7,407 FT. = 1.40 MILES

STATE OF ILLINOIS
DEPARTMENT OF TRANSPORTATION

SUBMITTED

December 6, 2024

ENGINEER OF DESIGN AND ENVIRO
December 6, 2024

LOCATION OF SECTION INDICATED THUS: -

PROJECT ENDS STA. 87+59

PRINTED BY THE AUTHORITY OF THE STATE OF ILLINOIS

PROJECT BEGINS
STA. 15+36

PROJECT BEGINS
STA. 15+36

100' 200' 300' — 1"= 100'
50' 100' 1"= 40'
100' — 1"= 40'
100' — 1"= 30'
100' — 1"= 20'

FULL SIZE PLANS HAVE BEEN PREPARED USING STANDARD
ENGINEERING SCALES. REDUCED SIZED PLANS WILL NOT
CONFORM TO STANDARD SCALES. IN MAKING MEASUREMENTS
ON REDUCED PLANS, THE ABOVE SCALES MAY BE USED.

J.U.L.I.E. JOINT UTILITY LOCATION INFORMATION FOR EXCAVATION 1-800-892-0123 OR 811

PROJECT ENGINEER: VESELIN VELICHKOV (847-705-4432)
PROJECT MANAGER: FAWAD AQUEEL

CONTRACT NO. 62W49

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INDEX OF SHEETS

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1 2	COVER SHEET INDEX OF SHEETS, STATE STANDARDS, AND GENERAL NOTES	424021-07 DEPRESSED CORNER
3-4	SUMMARY OF QUANTITIES	442201-03 CLASS C AND D PATCHES
5-6	EXISTING AND PROPOSED TYPICAL SECTIONS	604001-05 FRAME AND LIDS, TYPE 1
7-10	PROPOSED ROADWAY AND PAVEMENT MARKING PLANS	604061-03 FRAME AND GRATE, TYPE 12
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12 13	DETAILS FOR FRAMES AND LIDS ADJUSTMENTS WITH MILLING (BD-08) PAVEMENT PATCHING FOR HMA SURFACED PAVEMENT (BD-22)	701001-02 OFF ROAD OPERATIONS, 2L, 2W, MORE THAN 15' (4.5m) AWAY
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15	BUTT JOINT AND HMA TAPER DETAILS (BD-32)	701011-04 OFF-ROAD MOVING OPERATIONS, 2L, 2W - DAY ONLY
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17	PROJECT DETAIL FOR SINGLE PERPENDICULAR CURB RAMPS (PD-02)	701311-03 LANE CLOSURE 2L, 2W, MOVING OPERATIONS - DAY ONLY
18	PROJECT DETAIL FOR SINGLE PERPENDICULAR CURB RAMPS (PD-03)	701501-06 URBAN LANE CLOSURE, 2L, 2W, UNDIVIDED
19	PROJECT DETAIL FOR DOUBLE PERPENDICULAR CURB RAMPS (PD-04)	701301-00 ONDAN LANE GEOSONE, ZE, ZW, UNDIVIDED
20	TRAFFIC CONTROL AND PROTECTION FOR SIDE ROADS, INTERSECTIONS, AND DRIVEWAYS (TC-10)	701701-10 URBAN LANE CLOSURE, MULTILANE INTERSECTIONS
21	TYPICAL APPLICATIONS RAISED REFLECTIVE PAVEMENT MARKERS (SNOW-PLOW RESISTANT) (TC-11)	701801-06 SIDEWALK, CORNER OR CROSSWALK CLOSURE
22	DISTRICT ONE TYPICAL PAVEMENT MARKINGS (TC-13)	701901-10 TRAFFIC CONTROL DEVICES
23	SHORT TERM PAVEMENT MARKING LETTERS AND SYMBOLS (TC-16)	780001-05 TYPICAL PAVEMENT MARKINGS
24	ARTERIAL ROAD INFORMATION SIGNING (TC-22)	781001-04 TYPICALAPPLICATIONS FOR RAISED REFLECTIVE PAVEMENT MARKERS

STATE STANDARDS

000001-08 STANDARD SYMBOLS, ABBREVIATIONS AND PATTERNS

GENERAL NOTES:

- 1) BEFORE STARTING ANY EXCAVATION THE CONTRACTOR SHALL CALL "JULIE" AT 800-892-0123 FOR FIELD LOCATIONS OF BURIED ELECTRIC, TELEPHONE AND GAS FACILITIES, (48 HOURS NOTIFICATION IS REQUIRED)
- 2) TEN (10) FOOT TRANSITION SHALL BE USED TO MATCH PROPOSED CURB AND GUTTER AND MEDIAN ITEMS OF WORK TO EXISTING CURBS AND GUTTERS AND MEDIANS IN THE FIELD, UNLESS OTHERWISE SHOWN. THE TRANSITION SHALL BE PAID FOR AT THE CONTRACT UNIT PRICE FOR THE PROPOSED ITEMS OF WORK SPECIFIED.
- 3) THE CONTRACTOR SHALL COORDINATE CONSTRUCTION ACTIVITIES WITH THE UTILITY COMPANIES AND THE CITY OF DARIEN.
- 4) THE CONTRACTOR WILL NOT BE ALLOWED TO SET UP A YARD OR FIELD OFFICE ON STATE PROPERTY WITHOUT WRITTEN PERMISSION FROM THE DEPARTMENT
- 5) ANY PAVEMENT MARKINGS AND RAISED REFLECTIVE PAVEMENT MARKERS OBLITERATED BY MILLING AND RESURFACING OPERATIONS ON SIDE STREETS AND ENTRANCES SHALL BE REPLACED AND PAID FOR IN KIND.
- 6) ALL DAMAGE TO EXISTING PAVEMENT MARKINGS OR RAISED REFLECTIVE PAVEMENT MARKERS OUTSIDE THE REMOVAL LINE SHOWN ON THE PLANS SHALL BE REPLACED AT NO ADDITIONAL COST TO THE DEPARTMENT.
- 7) ALL PAVEMENT PATCHING LOCATIONS WILL BE DETERMINED IN THE FIELD BY THE ENGINEER
- 8) LOCATION OF COMBINATION CONCRETE CURB AND GUTTER REMOVAL AND REPLACEMENT [OR COMBINATION CURB AND GUTTER (THE TYPE SPECIFIED ON THE PLANS)], WILL BE DETERMINED IN THE FIELD BY THE ENGINEER.
- 9) DRAINAGE ADJUSTMENT OR RECONSTRUCTION LOCATIONS WILL BE DETERMINED IN THE FIELD BY THE ENGINEER.
- 10) IT SHALL BE THE CONTRACTORS RESPONSIBILITY TO VERIFY ALL DIMENSIONS AND EXISTING CONDITIONS IN THE FIELD PRIOR TO CONSTRUCTION AND ORDERING OF MATERIALS.
- 11) FRAMES AND GRATES ADJUSTMENT OF PRIVATE UTILITIES WITHIN THE LIMITS OF THE IMPROVEMENT SHALL BE DONE BY THEIR RESPECTIVE OWNERS AND ARE NOT IN PART OF THIS CONTRACT.
- 12) BEFORE BEGINNING ANY WORK, THE CONTRACTOR SHALL RETAIN AND RECORD FOR FUTURE REFERENCE, ALL EXISTING PAVEMENT MARKING LINES (RAISED REFLECTIVE PAVEMENT MARKERS) IN ORDER THAT THESE LOCATIONS CAN BE RE-ESTABLISHED FOR STRIPING. EXACT LOCATIONS OF ALL PAVEMENT MARKINGS SHALL BE AS SHOWN ON THE PLANS OR AS DIRECTED BY THE ENGINEER.
- 13) WHEN THE MILLED PAVEMENT IS OPEN TO TRAFFIC THE MAXIMUM GRADE DIFFERENTIAL BETWEEN PASSES OF THE MILLING MACHINE SHALL NOT EXCEED12 INCHES (40 mm) WHERE THE SPEED LIMIT IS 40 MPH (80 km/ h) OR LESS AND 1 INCH (25 mm) WHERE THE SPEED LIMIT IS GREATER THAN 40 MPH (80 km/h), WITH WRITTEN APPROVAL OF THE ENGINEER, A MAXIMUM GRADE DIFFERENTIAL OF 3 INCHES (75 mm) MAY BE ALLOWED IF THE EDGE OF THE MILLING MACHINE IS SLOPED A
- 14) THE CONTRACTOR SHALL CONTACT KALPANA-KANNAN-HOUSADRUG, THE DISTRICT ONE TRAFFIC CONTROL SUPERVISOR AT KALPANA.KANNAN-HOUSADURGA@ILLINOIS.GOV A MINIMUM OF 72 HOURS IN ADVANCE OF BEGINNING WORK.
- 15) PERMANENT PAVEMENT MARKINGS SHALL BE THERMOPLASTIC (OF THE EXTRUDED TYPE) AND SHOULD BE PLACED IN ACCORDANCE WITH THE "DISTRICT ONE TYPICAL PAVEMENT MARKINGS" DÉTAIL. (TC-13)
- 16) THE RESIDENT ENGINEER SHALL CONTACT MR. ERIC CAMPOS , AREA TRAFFIC FIELD ENGINEER, AT ERIC.CAMPOS@ILLINOIS.GOV, A MINIMUM OF TWO (2) WEEKS PRIOR TO THE PLACEMENT OF PERMANENT PAVEMENT MARKINGS
- 17) THE CONTRACTOR SHALL MAINTAIN PEDESTRIAN ACCESS AT ALL TIMES DURING CONSTRUCTION.
- 18) THE CONTRACTOR SHALL CONTACT THE ROADSIDE DEVELOPMENT UNIT AT (847) 705-4171 AT LEAST TWO WEEKS PRIOR TO BEGINNING LANDSCAPE AND FORESTRY WORK FOR LAYOUT
- 19) PAVEMENT MARKING TAPE, TYPE III SHALL BE USED FOR SHORT-TERM PAVEMENT MARKINGS ON ALL FINAL SURFACES.
- 20) ALL MILLED SURFACES SHALL BE AT A UNIFORM CROSS SLOPE PER LANE AND FREE OF RIDGES BETWEEN PASSES. ANY DEVIATIONS SHALL BE CORRECTED AT NO COST TO THE DEPARTMENT.
- 21) THE "ROAD CONSTRUCTION AHEAD" SIGNS SHALL REMAIN INSTALLED UNTIL THE COMPLETION OF THE PROJECT OR WHEN NO ROADWAY HAZARDS REMAIN WITHIN THE WORK ZONE.
- 22) NO REMOVAL OF TREES MEASURING THREE (3) INCHES IN DIAMETER OR GREATER AT BREAST HEIGHT SHALL OCCUR BETWEEN APRIL 1 AND OCTOBER 31 OF ANY GIVEN YEAR TO CONSERVE THE THREATEN AND ENDANGERED NORTHERN LONG-FARED BAT (NLFB).
- 23) IT WILL BE THE RESPONSIBILITY OF THE CONTRACTOR TO CONTACT ROADSIDE DEVELOPMENT UNIT AT 847.705.4171 TO SCHEDULE A WALK THROUGH TO DETERMINE TREE PROTECTION, TREE REMOVAL, SELECTIVE CLEARING, AND OTHER FORESTRY WORK A MINIMUM OF 14 DAYS PRIOR TO THE COMMENCEMENT OF CONSTRUCTION. AT NO TIME SHALL THE CONTRACTOR PRUNE OR REMOVE ANY TREES UNLESS SPECIFICALLY DIRECTED BY THE ROADSIDE DEVELOPMENT UNIT
- 24) EXISTING VEGETATED AREAS (TREES, SHRUBS, VEGETATIVE BUFFERS, TURF AREAS, ETC.) WHERE DISTURBANCE IS NOT OCCURING (INCLUDING AREAS OUTSIDE THE PROJECT LIMITS) SHALL NOT BE DISTURBED TO ENSURE THAT EXISTING VEGETATION IS PRESERVED HEALTHY TO MINIMIZE SOIL EROSION AND TO ELIMINATE SOIL COMPACTION. NO MATERIALS ARE TO BE STORED OR VEHICLES DRIVEN OR PARKED WITHIN THESE UNDISTURBED AREAS AT ANY TIME
- 25) PHOSPHORUS FERTILIZER HAS BEEN INTENTIONALLY OMITTED FROM CONTRACT BECAUSE IT WOULD BE DETRIMENTAL TO NEARBY SAWMILL CREEK. A PHOSPHORUS-FREE FERTILIZER SHALL BE USED (MIDDLE NUMBER SHOULD EQUAL 0).

			_
user name = Zaid.Salah	DESIGNED =	REVISED =	
	DRAWN =	REVISED =	
PLOT SCALE = 0.16666633 ' / in	CHECKED -	REVISED -	
PLOT DATE = 10/30/2024	DATE	REVISED =	

STATE OF ILLINOIS **DEPARTMENT OF TRANSPORTATION**

INDEX OF SHEETS, STATE STANDARDS & GENERAL NOTES I-55 N. FRONTAGE RD. (CASS AVE. TO CLARENDON HILLS RD.) SHEET 1 OF 1 SHEETS STA. SCALE:

REV-SEP

Code No.	ITEM	UNIT	TOTAL QUANTITIES	STND OVERLAY 100% STATE 0005	
20200100	EARTH EXCAVATION	CU YD	20	20	
21101615	TOPSOIL FURNISH AND PLACE, 4"	SQ YD	25	25	
25200110	SODDING, SALT TOLERANT	SQ YD	25	25	
40600290	BITUMINOUS MATERIALS (TACK COAT)	POUND	17800	17800	
40600370	LONGITUDINAL JOINT SEALANT	FOOT	7410	7410	
40600400	MIXTURE FOR CRACKS, JOINTS, AND FLANGEWAYS	TON	40	40	
40600982	HOT-MIX ASPHALT SURFACE REMOVAL - BUTT JOINT	SQ YD	265	265	
40601005	HOT-MIX ASPHALT REPLACEMENT OVER PATCHES	TON	250	250	
40602978	HOT-MIX ASPHALT BINDER COURSE, IL-9.5, N50	TON	2951	2951	
40604060	HOT-MIX ASPHALT SURFACE COURSE, IL-9.5, MIX "D", N50	TON	2582	2582	
42001300	PROTECTIVE COAT	SQ YD	105	105	
42400200	PORTLAND CEMENT CONCRETE SIDEWALK 5 INCH	SQ FT	775	775	
42400800	DETECTABLE WARNINGS	SQ FT	95	95	
44000164	HOT-MIX ASPHALT SURFACE REMOVAL, 3 3/4"	SQ YD	26340	26340	
44000500	COMBINATION CURB AND GUTTER REMOVAL	FOOT	295	295	
44000600	SIDEWALK REMOVAL	SQ FT	775	775	
44002215	HOT-MIX ASPHALT REMOVAL OVER PATCHES, 3 3/4"	SQ YD	1195	1195	
44201777	CLASS D PATCHES, TYPE II, 11 INCH	SQ YD	630	630	
44201781	CLASS D PATCHES, TYPE III, 11 INCH	SQ YD	110	110	
44201783	CLASS D PATCHES, TYPE IV, 11 INCH	SQ YD	455	455	

	Code No.	ITEM	UNIT	TOTAL QUANTITIES	STND OVERLAY 100% STATE 0005	
	48102100	AGGREGATE WEDGE SHOULDER, TYPE B	TON	97	97	
	60603800	COMBINATION CONCRETE CURB AND GUTTER, TYPE B-6.12	FOOT	245	245	
-	60605000	COMBINATION CONCRETE CURB AND GUTTER, TYPE B-6.24	FOOT	50	50	
*	66900200	NON-SPECIAL WASTE DISPOSAL	CU YD	20	20	
*	66900530	SOIL DISPOSAL ANALYSIS	EACH	3	3	
*	66901001	REGULATED SUBSTANCES PRE-CONSTRUCTION PLAN	L SUM	1	1	
_	66004002	DECLIFATED STREETANCES SINAL CONSTRUCTION DEPORT	LOUM	1	4	
*	66901003	REGULATED SUBSTANCES FINAL CONSTRUCTION REPORT	L SUM	1	1	
*	66901006	REGULATED SUBSTANCES MONITORING	CAL DA	6	6	
	67100100	MOBILIZATION	L SUM	1	1	
	70102620	TRAFFIC CONTROL AND PROTECTION, STANDARD 701501	L SUM	1	1	
	70102635	TRAFFIC CONTROL AND PROTECTION, STANDARD 701701	L SUM	1	1	
-	7070200					
	70102640	TRAFFIC CONTROL AND PROTECTION, STANDARD 701801	L SUM	1	1	
-	70300100	SHORT TERM PAVEMENT MARKING	FOOT	67765	67765	
+	70300150	SHORT TERM PAVEMENT MARKING REMOVAL	SQ FT	16945	16945	
+						
	70300211	TEMPORARY PAVEMENT MARKING LETTERS AND SYMBOLS - PAINT	SQ FT	70	70	
-	70300221	TEMPORARY PAVEMENT MARKING - LINE 4"- PAINT	FOOT	23796	23796	
+	70300221	I LIWI CIVANT FAVEWENT WANNING - LINE 4 - PAINT		23/90	23/30	
	70300241	TEMPORARY PAVEMENT MARKING - LINE 6"-PAINT	FOOT	215	215	
-	70300261	TEMPORARY PAVEMENT MARKING - LINE 12"- PAINT	FOOT	1180	1180	
-						
	70300281	TEMPORARY PAVEMENT MARKING - LINE 24"- PAINT	FOOT	235	235	

* = SPECIALITY ITEM

	USER NAME = Zaid.Salah	DESIGNED -	REVISED -
		DRAWN -	REVISED -
		CHECKED	REVISED -
-	PLOT DATE = 10/24/2024	DATE	REVISED =

STATE OF ILLINOIS DEPARTMENT OF TRANSPORTATION

SUMMARY OF QUANTITIES						
	I-55 N. FF	RONTAGE	RD. (CAS	S AVE. T	O CLAF	RENDON HILLS RD.)
	SCALE:	SHEET	OF	SHEETS	STA.	TO STA.

	Code No.	ITEM	UNIT	TOTAL QUANTITIES	STND OVERLAY 100% STATE 0005	
1	70307120	TEMPORARY PAVEMENT MARKING - LINE 4" - TYPE IV TAPE	FOOT	5290	5290	6
-L	78000100	THERMOPLASTIC PAVEMENT MARKING - LETTERS AND SYMBOLS	SQ FT	70	70	
*	78000100	THERMOPLASTIC PAVEMENT MARKING - LETTERS AND STIMBOLS	SQFI	70	70	
*	78000200	THERMOPLASTIC PAVEMENT MARKING - LINE 4"	FOOT	23796	23796	
*	78000400	THERMOPLASTIC PAVEMENT MARKING - LINE 6"	FOOT	215	215	
*	78000600	THERMOPLASTIC PAVEMENT MARKING - LINE 12"	FOOT	1180	1180	
*	78000650	THERMOPLASTIC PAVEMENT MARKING - LINE 24"	FOOT	235	235	
*	78100100	RAISED REFLECTIVE PAVEMENT MARKER	EACH	235	235	
	78300200	RAISED REFLECTIVE PAVEMENT MARKER REMOVAL	EACH	235	235	
*	X8860105	DETECTOR LOOP REPLACEMENT	FOOT	222	222	
	X0320050	CONSTRUCTION LAYOUT (SPECIAL)	L SUM	1	1	
	X2020110	GRADING AND SHAPING SHOULDERS	UNIT	49	49	
	X5537800	STORM SEWERS TO BE CLEANED 12"	FOOT	150	150	
	X6700407	ENGINEER'S FIELD OFFICE, TYPE A (D1)	CAL MO	12	12	
	Z0018500	DRAINAGE STRUCTURES TO BE CLEANED	EACH	10	10	
-	Z0030850	TEMPORARY INFORMATION SIGNING	SQ FT	52	52	
-	X2010350	TREE REMOVAL, ACRE (SPECIAL)	ACRE	0.45	0.45	
	X2010514	SELECTIVE CLEARING	ACRE	0.50	0.50	
	25000210	SEEDING, CLASS 2A	ACRE	0.93	0.93	
	25100630	EROSION CONTROL BLANKET	SQ YD	4512	4512	
Ī	25000400	NITROGEN FERTILIZER NUTRIENT	POUND	56	56	
Ī	25000600	POTASSIUM FERTILIZER NUTRIENT	POUND	56	56	


* = SPECIALITY ITEM

	USER NAME = Nedal.Qarut	DESIGNED	REVISED	
}		DRAWN _	REVISED _	
		CHECKED	REVISED .	
	PLOT DATE = 10/25/2024	DATE	REVISED	

STATE OF ILLINOIS DEPARTMENT OF TRANSPORTATION

	I-55 N.			Y OF QUANTITI SS AVE. TO CLA	ES (RENDON HILLS RD.)	
1	SCALE:	SHEET	OF	SHEETS STA.	TO STA.	


I-55 (FRONTAGE ROAD)

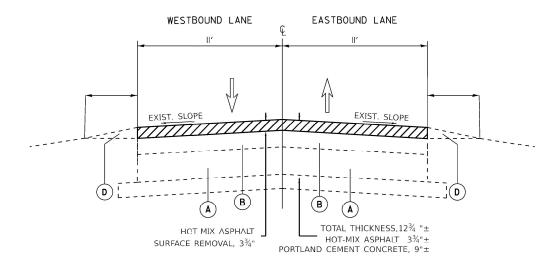

EXISTING TYPICAL

STA 15+36 TO STA 34+30 STA 59+85 TO STA 87+59

I-55 (FRONTAGE ROAD)

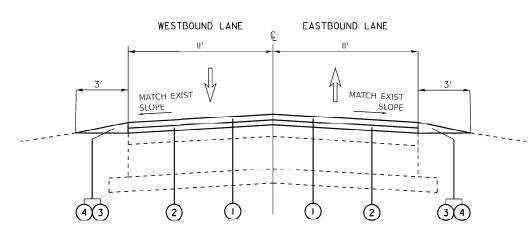

PROPOSED TYPICAL

STA 15+36 TO STA 34+30 STA 59+85 TO STA 87+59

LEGEND – **EXISTING**

- A PORTLAND CEMENT CONCRETE PAVEMENT 9"±
- B HOT-MIX ASPHALT PAVEMENT 3¾"
- C HOT-MIX ASPHALT SHOULDER 8"±
- D AGGREGATE SHOULDER 6"±

LEGEND - PROPOSED

- 1 HOT-MIX ASPHALT SURFACE COURSE, MIX "D", IL-9.5, N50, I 34"
- 2 HOT-MIX ASPHALT BINDER COURSE, IL-9,5, N50, 2*
- 3 GRADING AND SHAPING SHOULDERS
- 4 AGGREGATE WEDGE SHOULDER, TYPE B

NOTES:

NOTE I: THE CONTRACTOR SHALL PATCH FIRST, THEN MILL.

NOTE 2: LONGITUDINAL JOINT SEALANT SHALL BE PLACED OVER THE HMA BINDER COURSE IL-9.5.

HOT-MIX ASPHALT MIXTURE REQUIREMENT	<u> </u>	OUALITY MANAGEMENT PROGRAM (OMP)	
MIXTURE TYPE	AIR VOIDS(%) @ Ndes	I ISOURAM COME?	
PAYEMENT			
HOT-MIX ASPHALT SURFACE COURSE, MIX 'D', IL-9.5, N50, I %	4.0% @ 50 GYR.	OCP	
HOT-MIX ASPHALT BINDER COURSE, IL-9.5, N50, 2*	3.5% @ 50 GYR.	OCP	
PATCHING			
CLASS D PATCHES (HMA BINDER IL-19 MM)	4% c 70 GYR.	OC/QA	
HOT-MIX ASPHALT REPLACEMENT OVER PATCHES (HMA BINDER IL-19 MM)	4% e 70 GYR.	OC/QA	

- THE UNIT WEIGHT USED TO CALCULATE ALL HOT-MIX ASPHALT SURFACE MIXTURE OUANTATIES IS 112 LBS/SO YD/IN.
- THE 'AC TYPE'FOR POLYMERIZED HMA MIXES SHALL BE 'SBS/SBR PG 76 -22" AND AND FOR NON-POLYMERIZED HMA THE 'AC TYPE' SHALL BE 'PG 64 -22" UNLESS MODIFIED BY RECLAIMED MATERIALS SPECIFICATIONS.


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	DRAWN -	REVISED -
PLOT SCALE = 100.000 ' / in.	CHECKED -	REVISED -
PLOT DATE = 10/25/2024	DATE _	REVISED -

STATE OF ILLINOIS
DEPARTMENT OF TRANSPORTATION

I 55 N. FR	ONTAGE		AL SECT S AVE. T		RENDON HILLS RD.)
SCALE:	SHEET	OF	SHEETS	STA.	TO STA.

F.A.I. RTE.	SECTION		COUNTY	TOTAL SHEETS	SHEET NO.
55	2023-927-RS,SW	DUPAGE	24	5	
		CONTRACT	10. 62W4	.9	
	ILLINOIS	PROJECT			


I-55 (FRONTAGE ROAD)

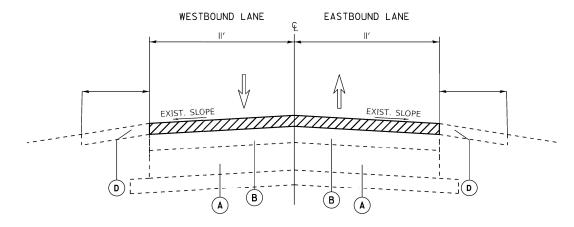

EXISTING TYPICAL

STA 34+30 - STA 59+85 STA 73+20 - STA 77+00 - SHOULDER RESURFACING

I-55 (FRONTAGE ROAD)

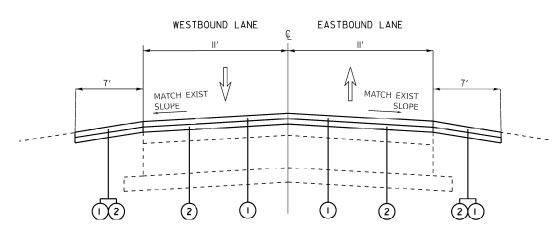

PROPOSED TYPICAL

STA 34+30 - STA 59+85 STA 73+20 - STA 77+00 - SHOULDER RESURFACING

STATE OF ILLINOIS DEPARTMENT OF TRANSPORTATION

LEGEND – **EXISTING**

- A PORTLAND CEMENT CONCRETE PAVEMENT 9"±
- B HOT-MIX ASPHALT PAVEMENT 33/4"
- C HOT-MIX ASPHALT SHOULDER 8"±
- D AGGREGATE SHOULDER 6"±

LEGEND – PROPOSED


1 HOT-MIX ASPHALT SURFACE COURSE, MIX "D", IL-9.5, N50, I 34"


COUNTY TOTAL SHEETS

CONTRACT NO. 62W49

DUPAGE 24 6

- 2 HOT-MIX ASPHALT BINDER COURSE, IL-9.5, N50, 2*
- 3 GRADING AND SHAPING SHOULDERS
- 4 AGGREGATE WEDGE SHOULDER, TYPE B

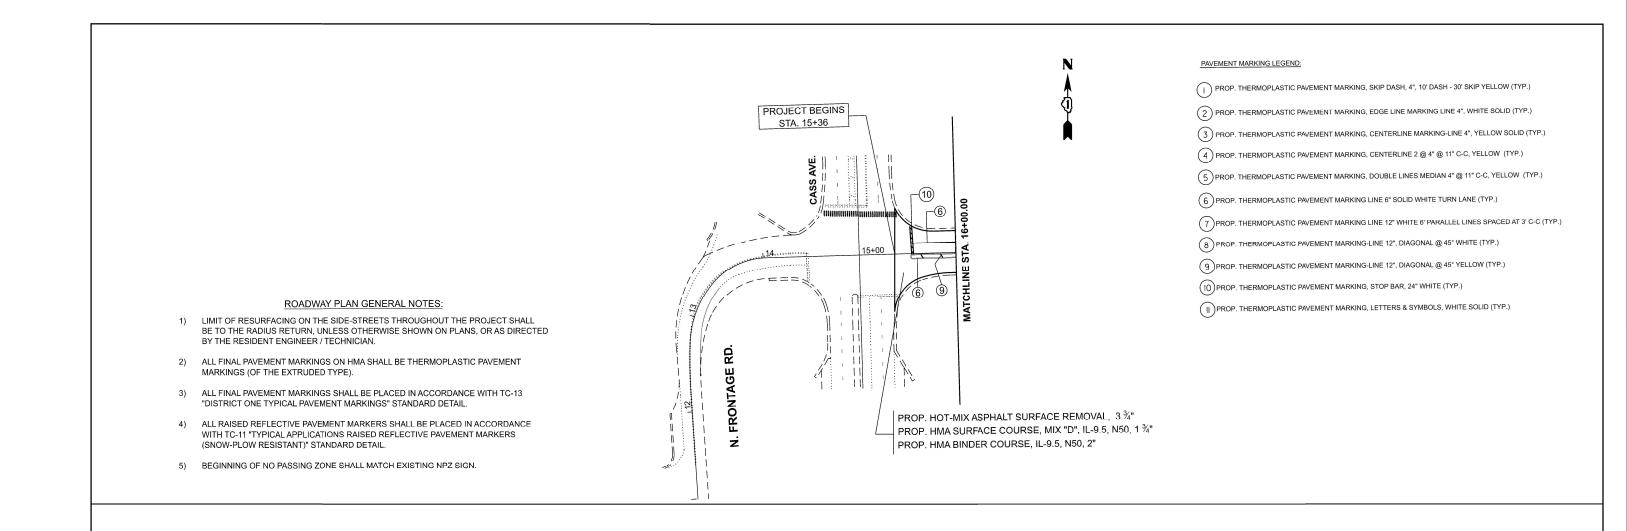

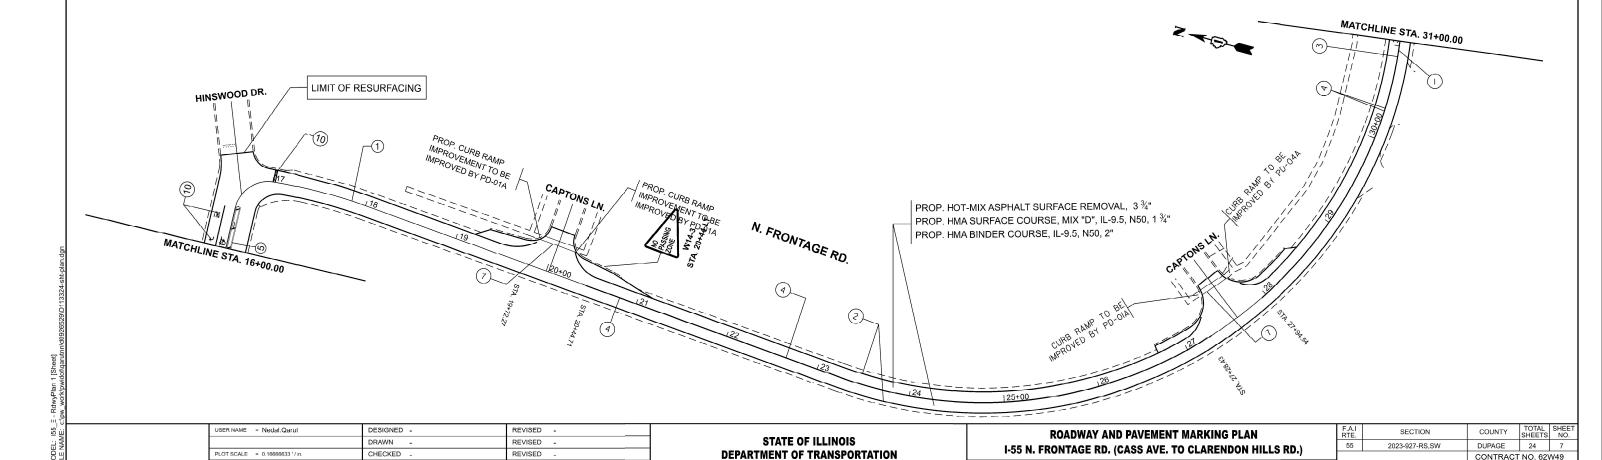



PLOT DATE = 11/27/2024

DATE

CONTRACT NO. 62W49

SHEET 1 OF 4 SHEETS STA. 10+00.00

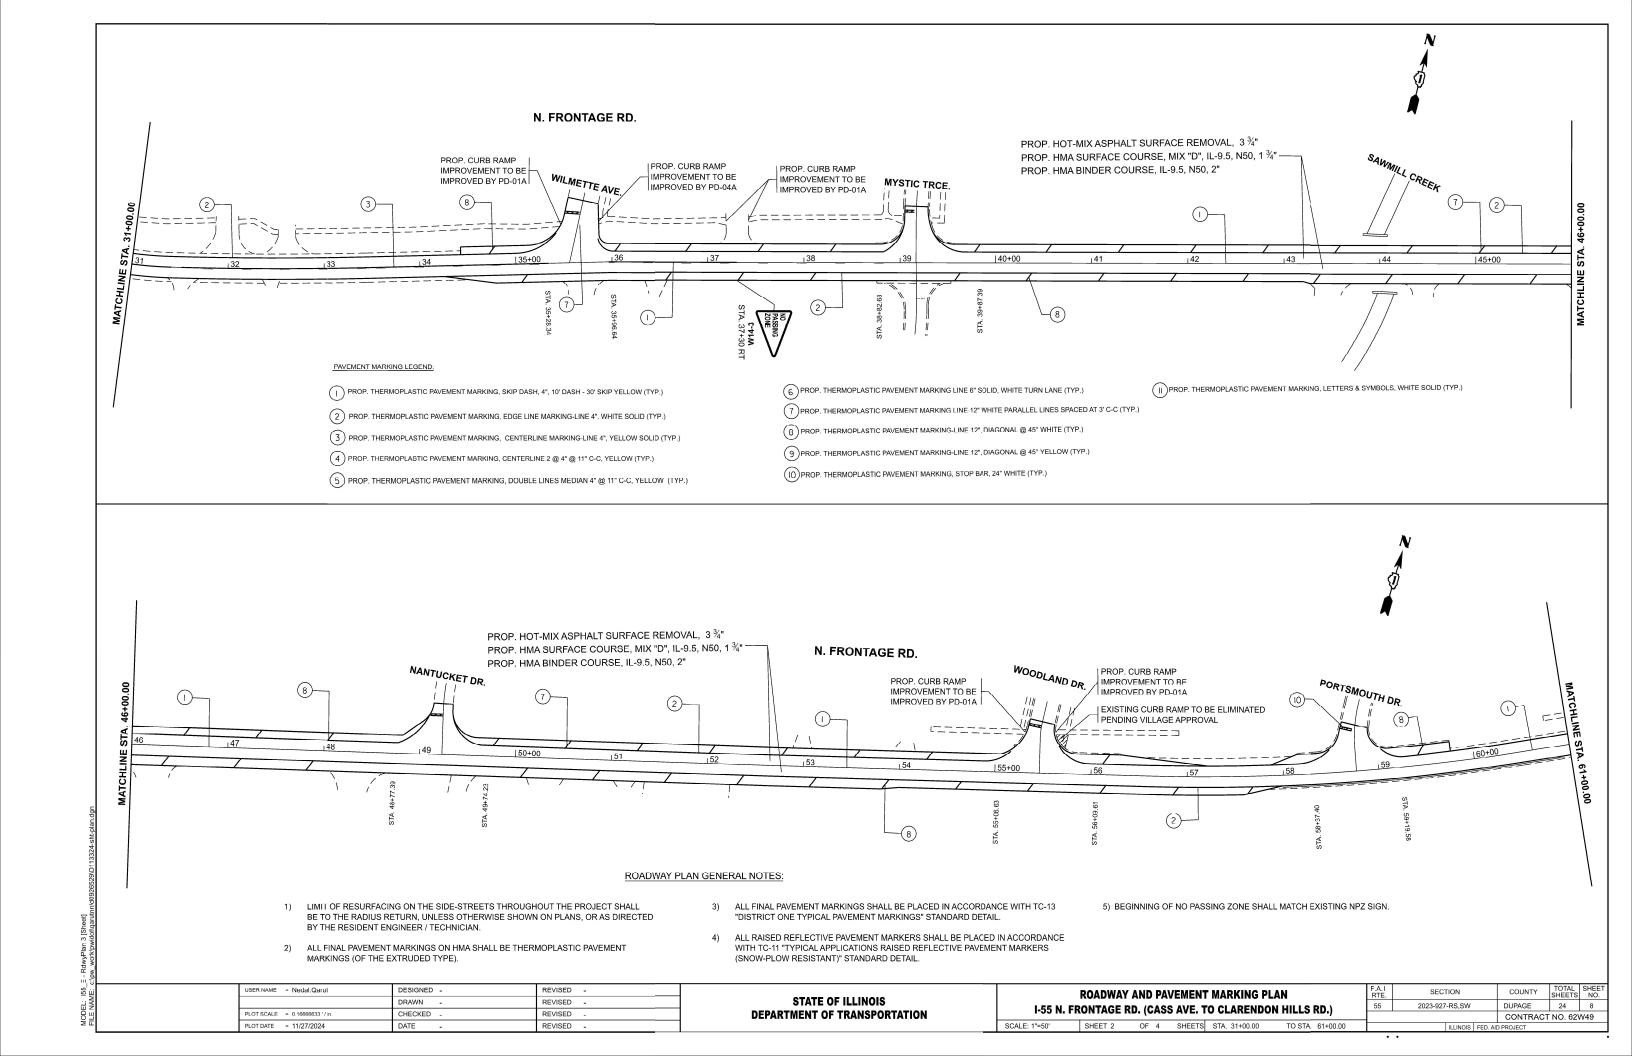


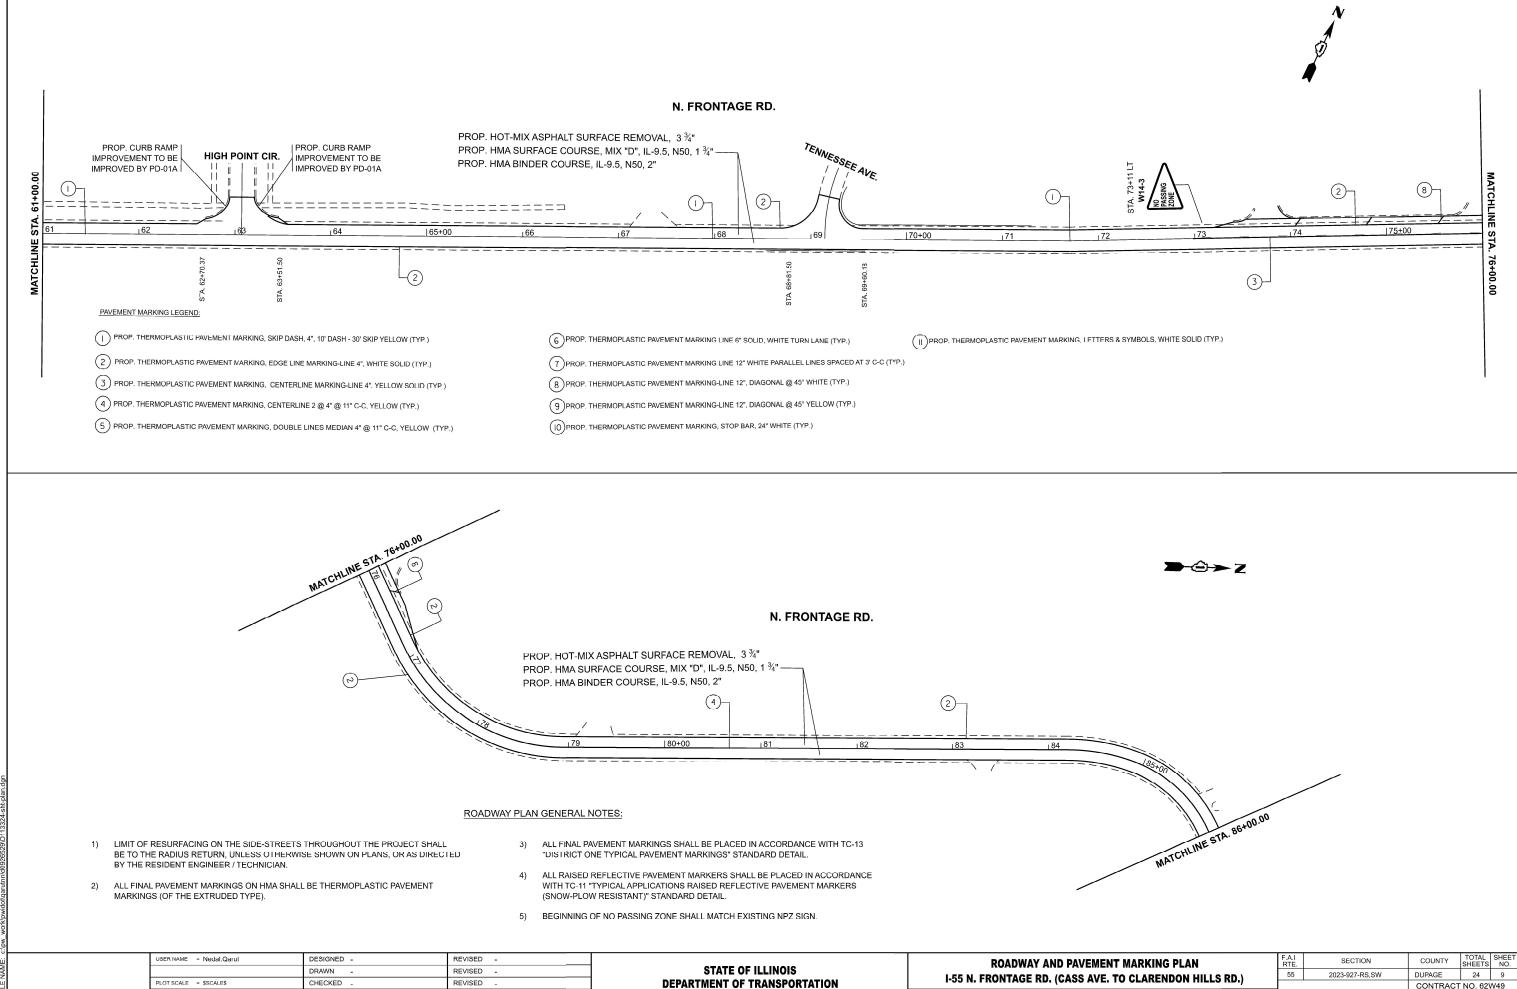

PLOT DATE = 11/27/2024

DATE

I-55 N. FRONTAGE RD. (CASS AVE. TO CLARENDON HILLS RD.) SCALE: 1"=50' SHEET 3 OF 4 SHEETS STA. 61+00.00 TO STA, 86+00.00 CONTRACT NO. 62W49

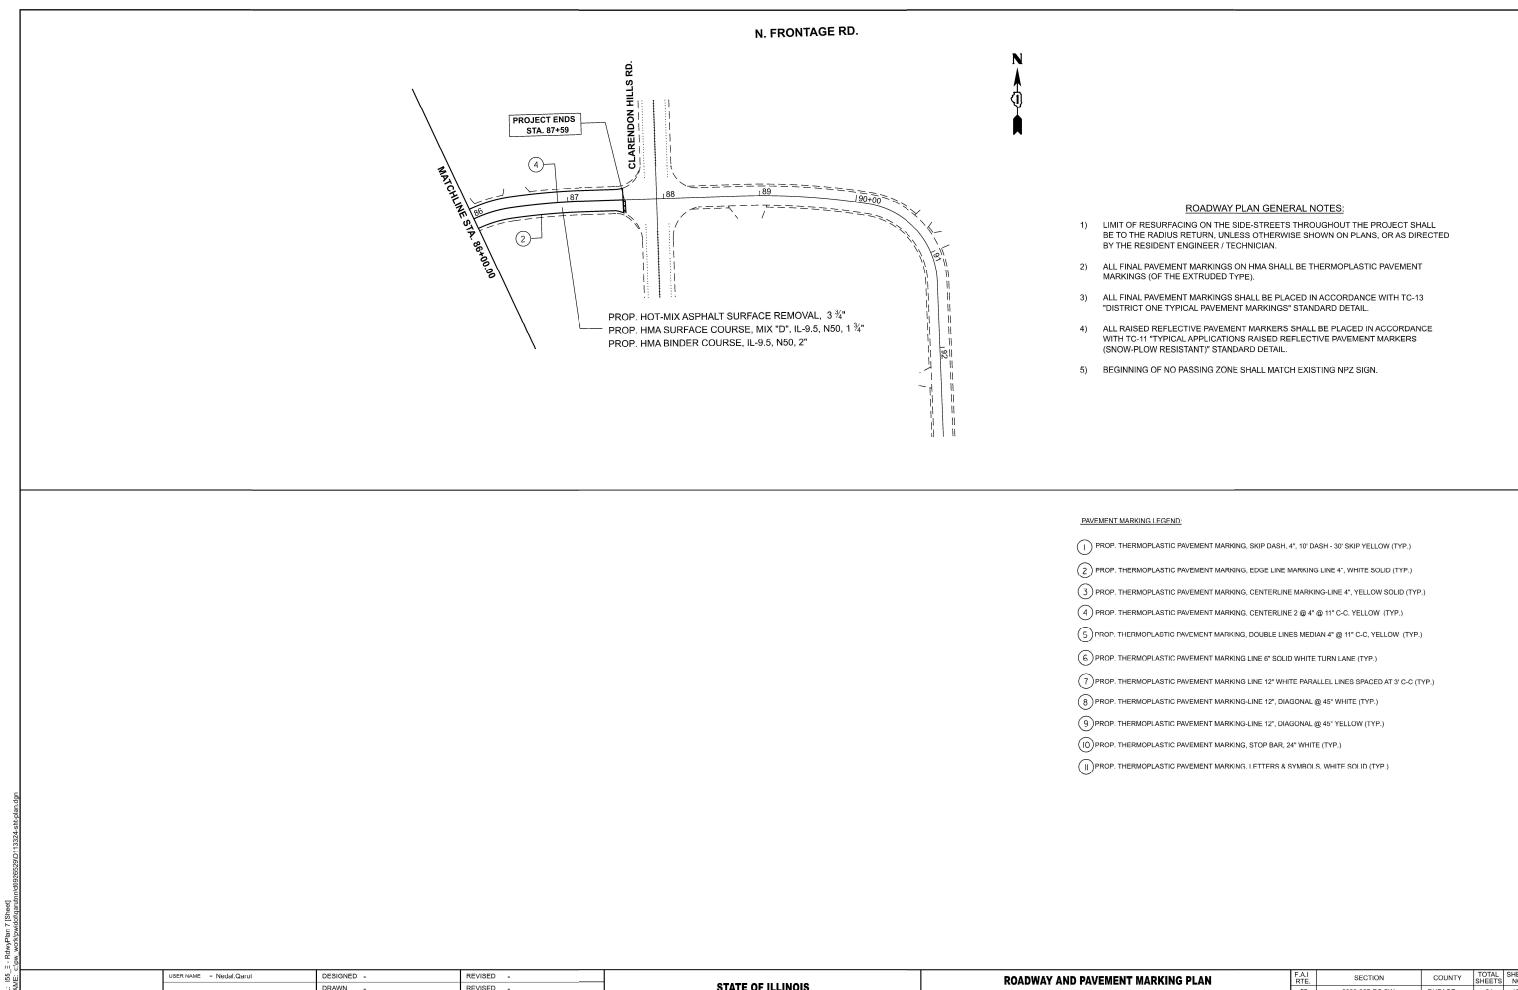

PLOT SCALE = \$SCALE\$

PLOT DATE = 11/27/2024

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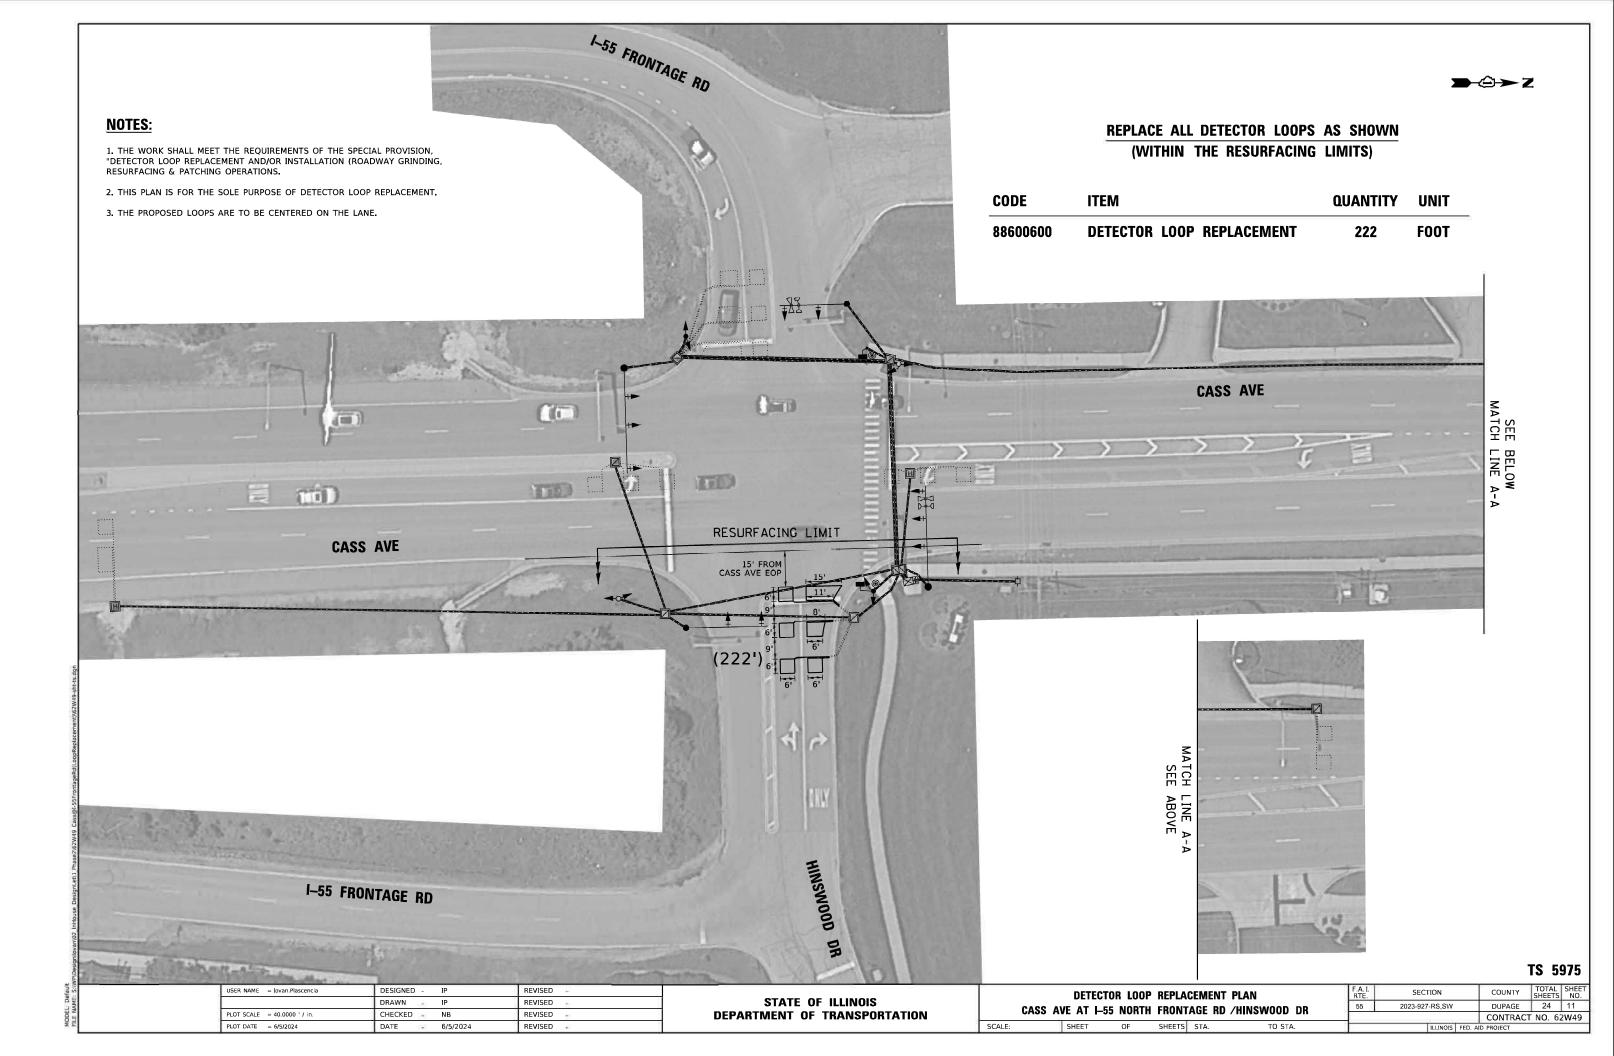
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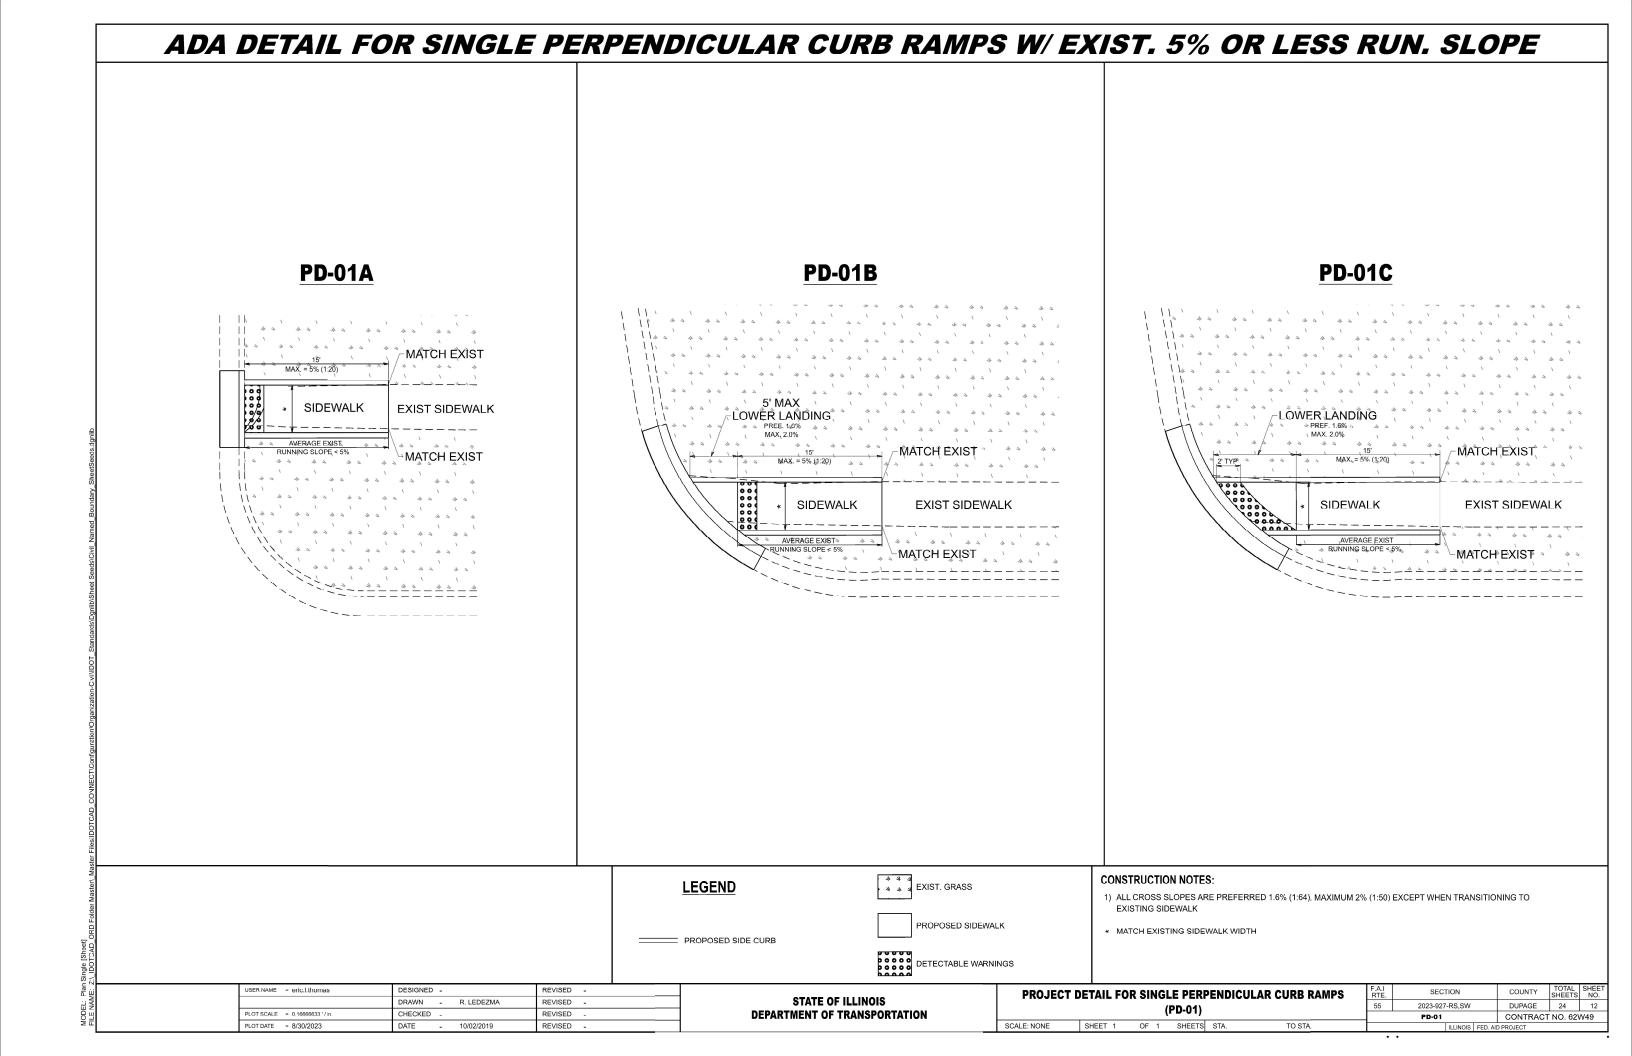
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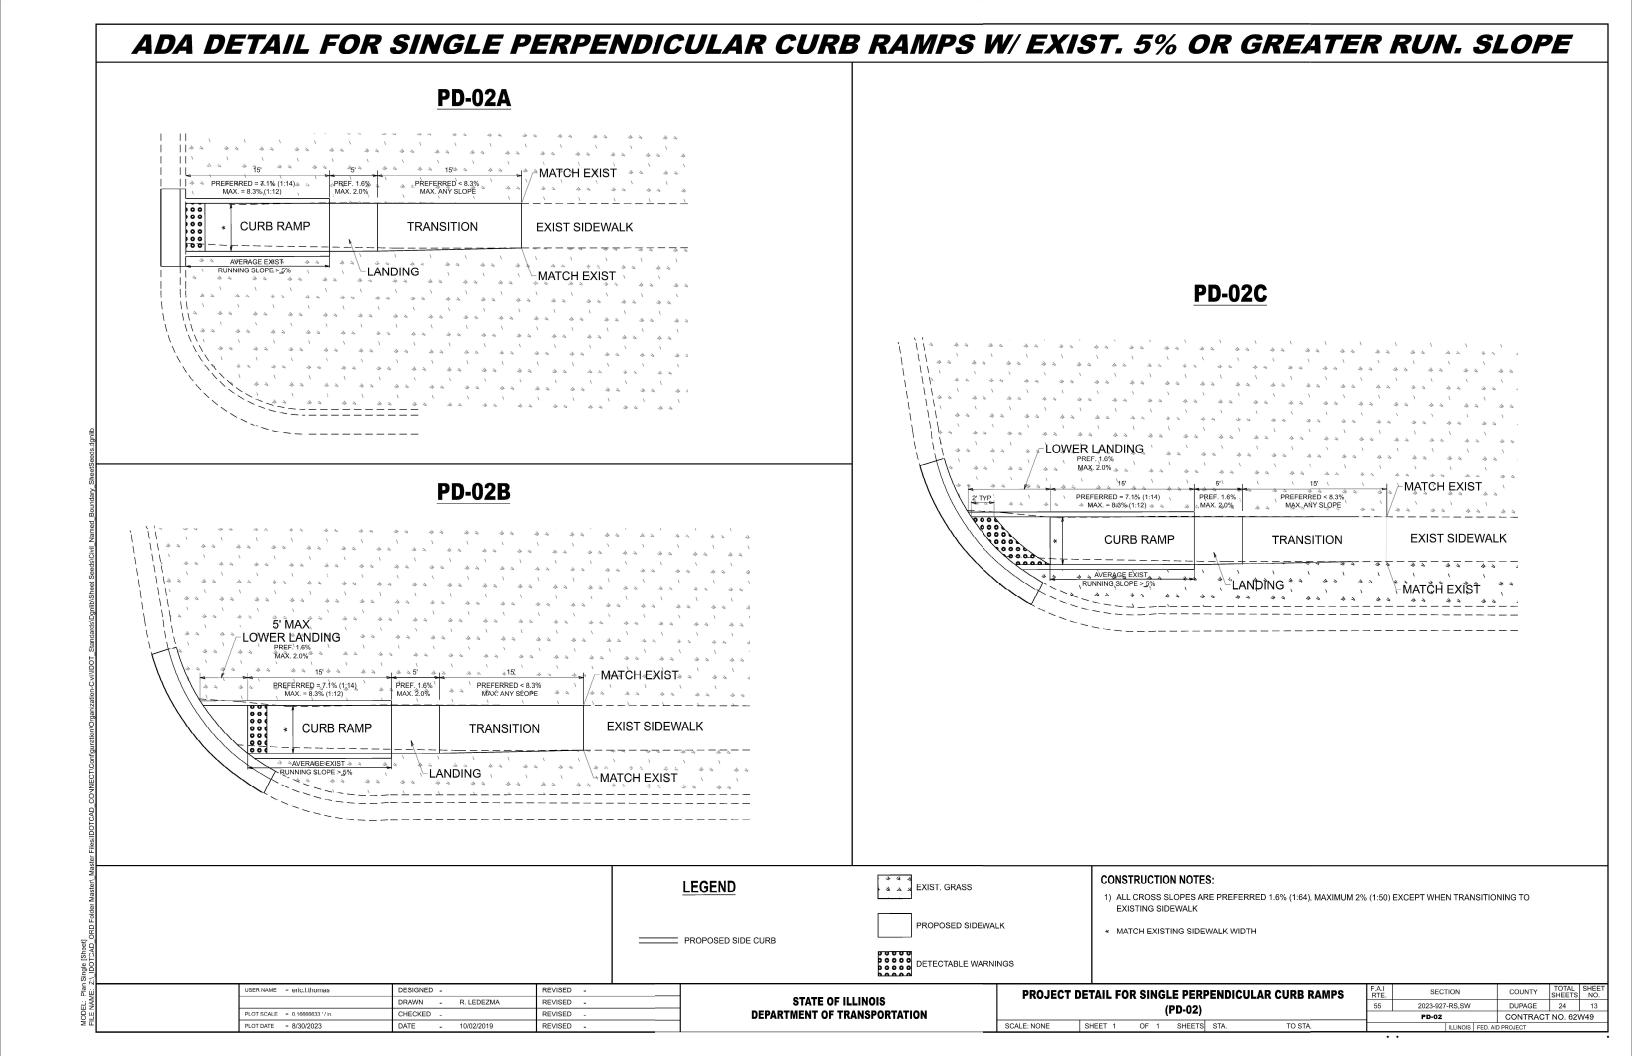
STATE OF ILLINOIS **DEPARTMENT OF TRANSPORTATION**


ROADWAY AND PAVEMENT MARKING PLAN I-55 N. FRONTAGE RD. (CASS AVE. TO CLARENDON HILLS RD.) SCALE: 1"=50' SHEET 4 OF 4 SHEETS STA. 86+00.00 TO STA. 101+00.00


SECTION 2023-927-RS,SW DUPAGE 24 10 CONTRACT NO. 62W49








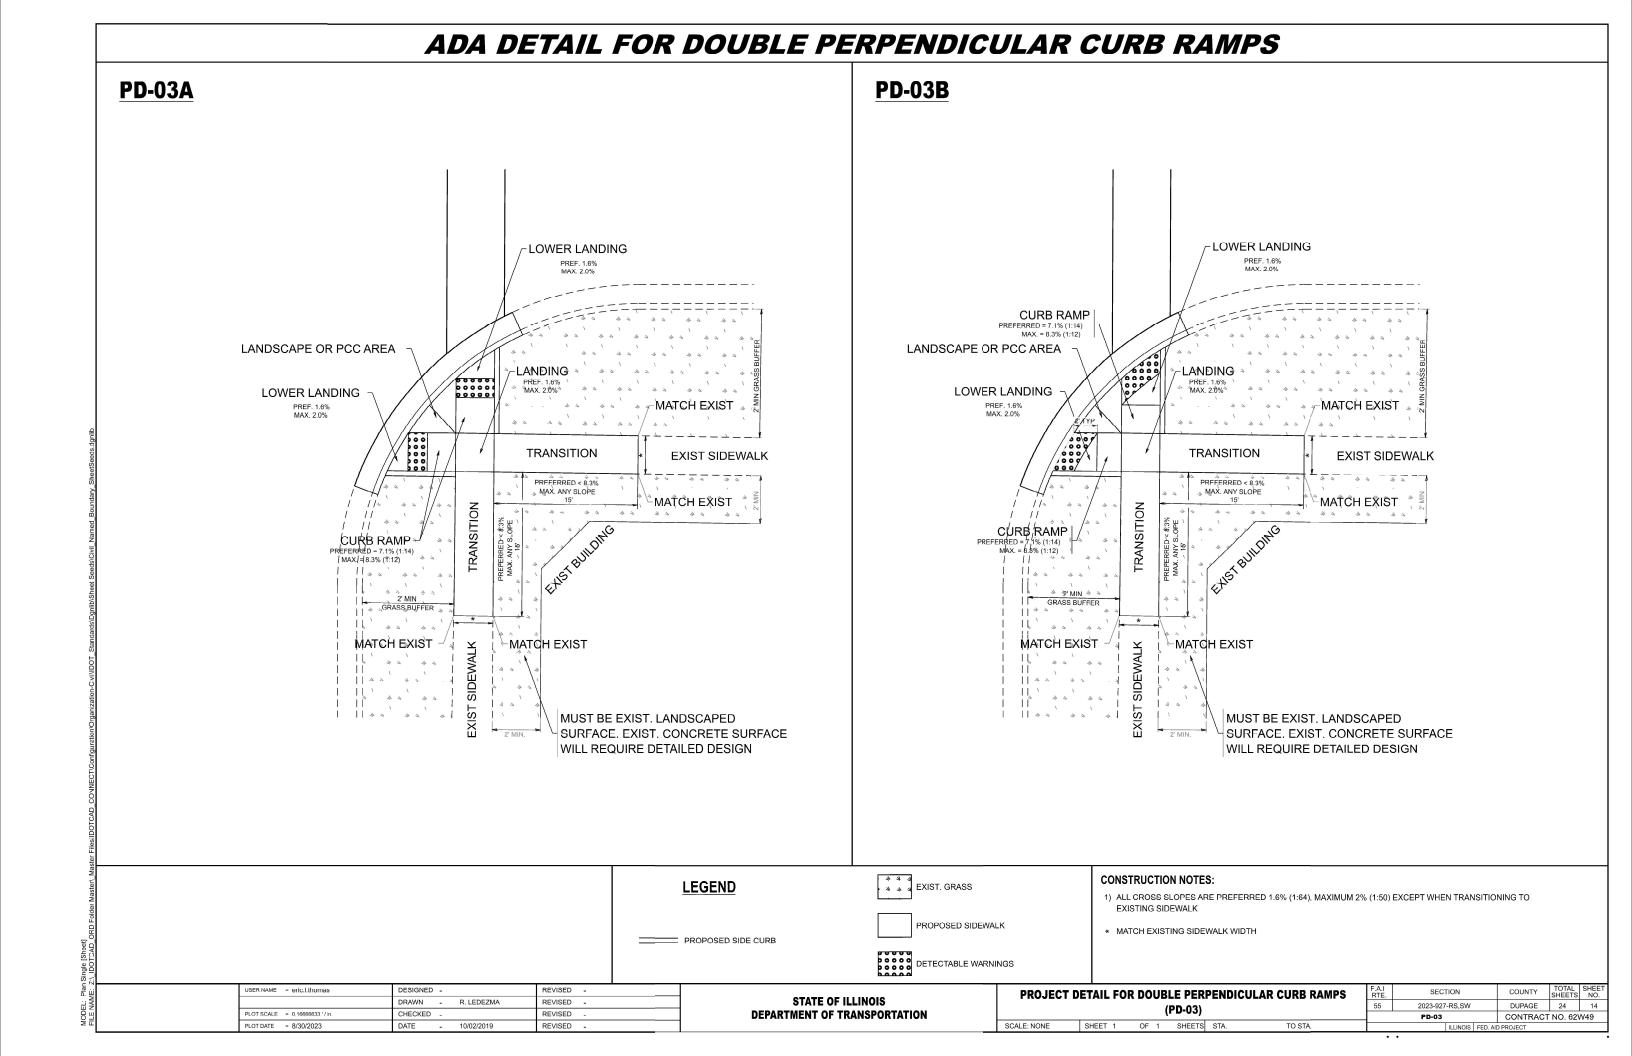

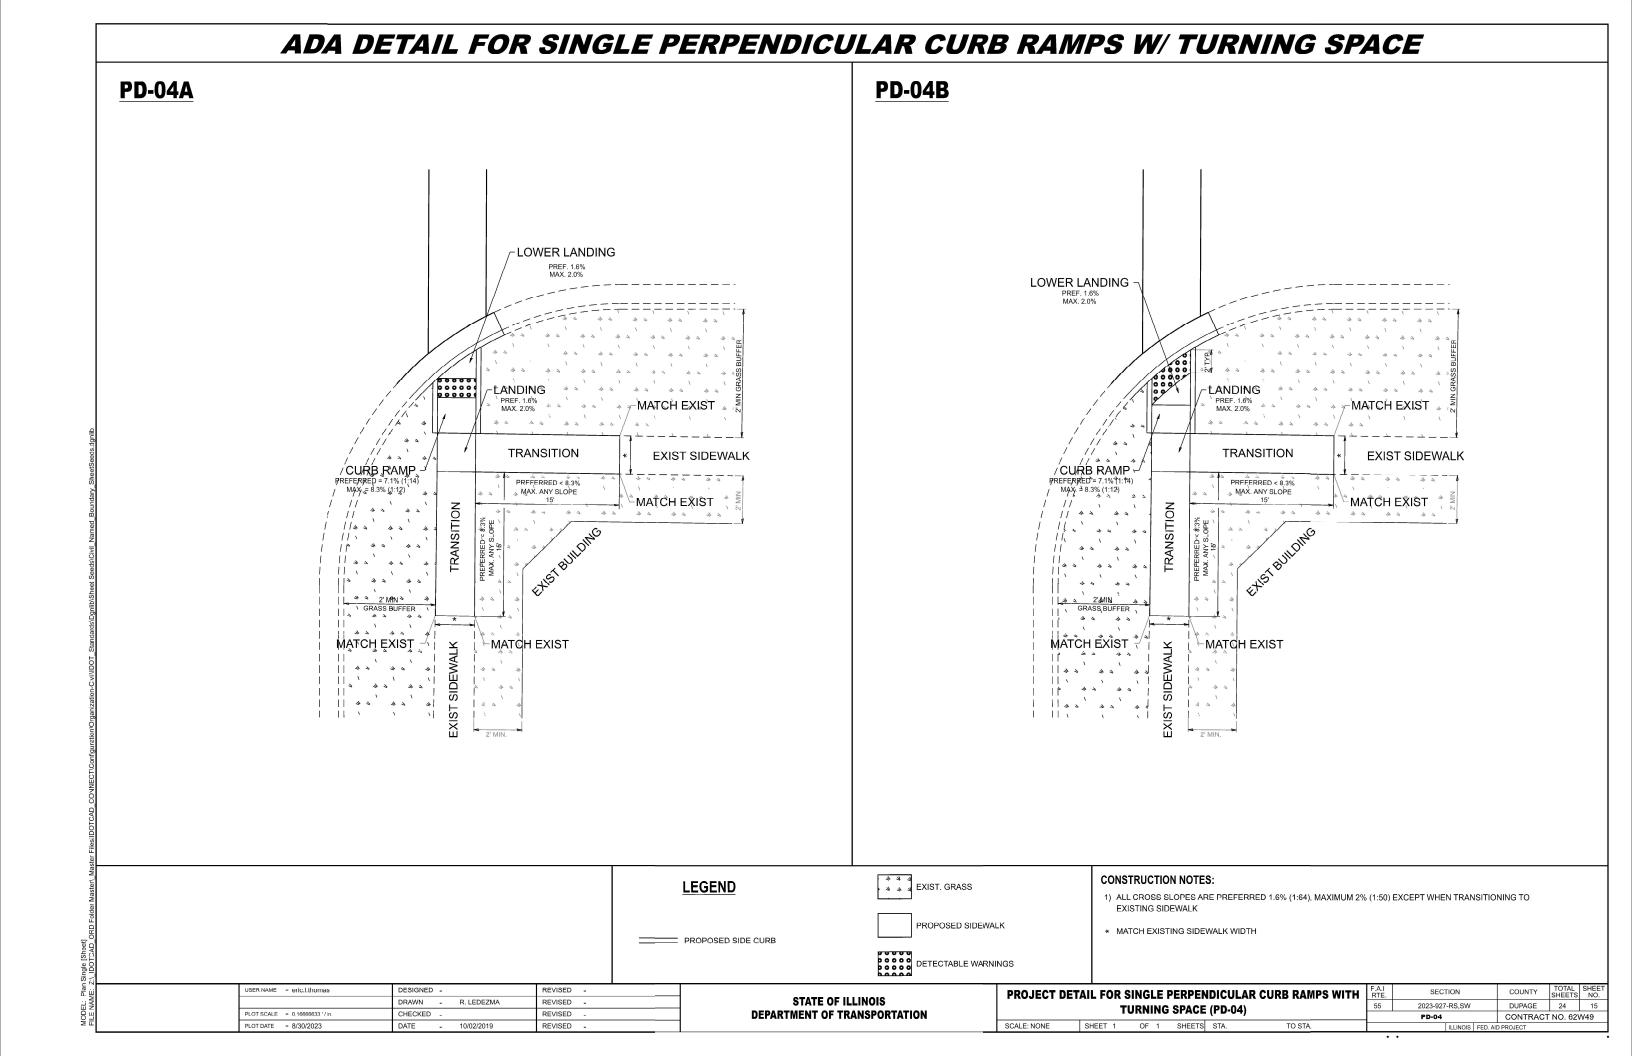

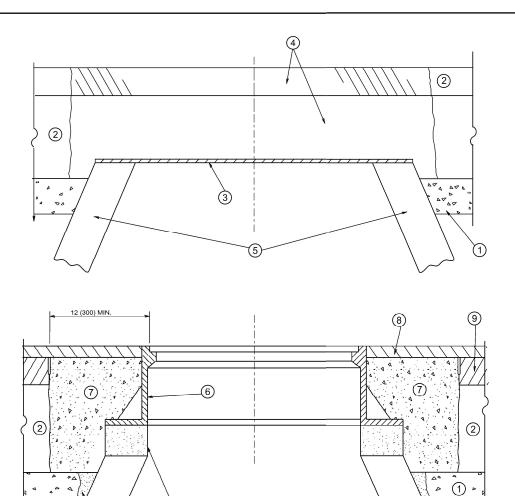

DETAILS FOR FRAMES AND LIDS ADJUSTMENT

BRICK MORTAR OR CONC.

<u>NOTES</u>

- 1. EXISTING BROKEN FRAMES AND LIDS SHALL BE REMOVED AND DISPOSED OF BY THE CONTRACTOR AND SHALL BE REPLACED AS DIRECTED BY THE ENGINEER. REPLACEMENT FRAMES AND LIDS WILL BE PAID FOR IN ACCORDANCE WITH ARTICLE 109.04 OF THE STANDARD SPECIFICATIONS UNLESS A SEPARATE PAY ITEM HAS BEEN PROVIDED.
- 2. IF THE EXISTING LIDS ARE OPEN, THE FRAME WILL BE ADJUSTED TO THE ELEVATION OF THE MILLED PAVEMENT SURFACE PRIOR TO THE MILLING OPERATION. THE FRAME WILL NOT BE REMOVED AND COVERED BY THE METAL PLATE.
- 3. CITY OF CHICAGO CASTINGS ARE THE PROPERTY OF THE CITY AND THE CONTRACTOR SHALL NOTIFY THE CITY FOR REMOVAL AND DISPOSITION OF THE CASTINGS.
- 4. THE METAL PLATE USED TO COVER THE STRUCTURE SHALL REMAIN THE PROPERTY OF THE CONTRACTOR.
- 5. THE CONTRACTOR SHALL REMOVE ALL TRAFFIC CONTROL DEVICES BY THE END OF EACH WORK SHIFT.

WITH MILLING

CONSTRUCTION PROCEDURES

STAGE 1 (BEFORE PAVEMENT MILLING)

A) REMOVE A MINIMUM OF 12 (300) OF THE PAVEMENT FROM AROUND THE STRUCTURE.

B) REMOVE THE EXISTING FRAME AND LID FROM THE STRUCTURE. C) COVER THE STRUCTURE OPENING WITH A 36 (900) DIAMETER METAL PLATE.

D) BACKFILL WITH CRUSHED STONE AND HMA SURFACE MIX APPROVED BY THE ENGINEER. (MIN. 3 (80) HMA TO REMAIN AFTER MILLING).

STAGE 2 (AFTER PAVEMENT MILLING)

A) REMOVE THE HMA SURFACE MIX AND CRUSHED STONE.

- B) INSTALL THE FRAME AND LID; ADJUST THE FRAME TO ITS FINAL SURFACE ELEVATION.
- C) THE SURROUNDING SPACE SHALL BE FILLED WITH CLASS PP-2 * CONCRETE TO THE ELEVATION OF THE SURFACE OF THE EXISTING BASE COURSE OR THE BINDER COURSE.
- * UNLESS OTHERWISE SPECIFIED IN THE PLANS.

THE PROCEDURE EXPLAINED ABOVE SHALL CONFORM TO THE APPLICABLE PORTIONS OF SECTIONS 353, 406, 602, AND 603 OF THE STANDARD SPECIFICATIONS EXCEPT THAT "THE CONTRACTOR SHALL ADJUST THE STRUCTURES TO THE FINISHED PAVEMENT ELEVATION NO MORE THAN 5 CALENDAR DAYS PRIOR TO PLACEMENT OF THE FINAL LIFT OF SURFACE UNLESS APPROVED BY THE ENGINEER."

LEGEND

1 SUB-BASE GRANULAR MATERIAL

(6) FRAME AND LID (SEE NOTES)

2 EXISTING PAVEMENT

(7) CLASS PP-2* CONCRETE

3 36 (900) DIAMETER METAL PLATE

8 PROPOSED HMA SURFACE COURSE

4 PROPOSED CRUSHED STONE AND HMA SURFACE MIX

(5) EXISTING STRUCTURE

9 PROPOSED HMA BINDER COURSE

LOCATION OF STRUCTURES

THE CONTRACTOR WILL BE REQUIRED TO KEEP A RECORD OF THE LOCATIONS OF THE BURIED STRUCTURES ACCORDING TO THE STATION AND DISTANCE LEFT OR RIGHT OF THE CENTERLINE OF PAVEMENT. UPON COMPLETION OF THE WORK, THE CONTRACTOR WILL DELIVER THE RECORD TO THE ENGINEER.

BASIS OF PAYMENT

- 1. REMOVING FRAMES AND LIDS ON DRAINAGE AND UTILITY STRUCTURES IN THE PAVEMENT PRIOR TO MILLING, AND ADJUSTING TO FINAL GRADE PRIOR TO PLACING THE SURFACE COURSE, WILL BE PAID FOR AT THE CONTRACT UNIT PRICE EACH FOR "FRAMES AND LIDS TO BE ADJUSTED (SPECIAL)."
- 2. THIS WORK WILL NOT BE PAID FOR WHEN DRAINAGE AND UTILITY STRUCTURES ARE SPECIFIED FOR PAYMENT AS STRUCTURE RECONSTRUCTION.
- 3. NEW FRAMES AND LIDS, WHEN SPECIFIED, WILL BE PAID FOR SEPARATELY.
- 4. WHEN STRUCTURES ARE TO BE ADJUSTED OR RECONSTRUCTED. THE LOWERING AND RAISING OF THE FRAMES AND LIDS WILL NOT BE PAID FOR SEPARATELY BUT WILL BE INCLUDED IN THE COST OF THE CORRESPONDING PAY ITEM.

ALL DIMENSIONS ARE IN INCHES (MILLIMETERS) UNLESS OTHERWISE SHOWN

DESIGNED - R. SHAH REVISED - R. BORO 03-09-11 JSER NAME = eric.l.thornas DRAWN REVISED - R. BORO 12-06-11 CHECKED REVISED - K. SMITH 11-18-22 PLOT DATE = 8/30/2023 DATE 10-25-94 REVISED - K. SMITH 09-15-23

STATE OF ILLINOIS **DEPARTMENT OF TRANSPORTATION**


1			DE	TAILS F	OR .		F.A. RTE		SECTION		COUNTY	TOTAL SHEETS	SHEE NO.
	FRAMES AND LIDS ADJUSTMENT WITH MILLING						55	5	2023-927-RS,SW		DUPAGE 24		
	I IVA	INIES AND	LIDO A	D000111		TITI WILLING			BD600-03 (BD-08)		CONTRACT	NO. 62\	N49
	SCALE: NONE	SHEET 1	OF 1	SHEETS	STA.	TO STA.			ILLINOIS	FED. All	D PROJECT		

METHOD OF MEASUREMENT

REFER TO SECTION 442 OF THE STANDARD SPECIFICATIONS FOR ROAD AND BRIDGE CONSTRUCTION AND THE RECURRING SPECIAL PROVISION "PATCHING WITH HOT-MIX ASPHALT OVERLAY REMOVAL."

BASIS OF PAYMENT

- 1. REFER TO SECTION 442 OF THE STANDARD SPECIFICATIONS FOR ROAD AND BRIDGE CONSTRUCTION AND THE RECURRING SPECIAL PROVISION "PATCHING WITH HOT-MIX ASPHALT OVERLAY REMOVAL."
- SAW CUT/SCORING OF EXISTING HMA OVERLAY IS INCLUDED IN THE COST OF PAVEMENT PATCHING.
- 3. SAW CUT/SCORING OF EXISTING PAVEMENT IS INCLUDED IN THE COST OF PAVEMENT PATCHING.

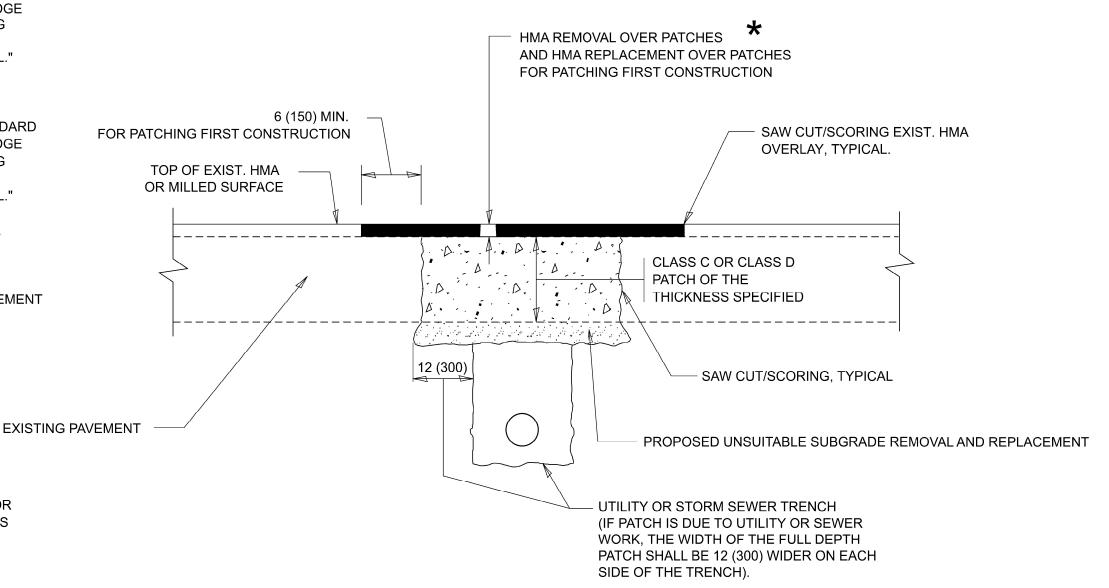

SEQUENCE OF CONSTRUCTION (PATCHING FIRST)

1. REMOVE THE EXISTING HMA MATERIAL OVER THE AREA TO BE PATCHED.

SEE TYPICAL SECTIONS FOR

THICKNESS AND MATERIALS


- 2. REMOVE AND REPLACE WITH CLASS C OR D PATCH.
- 3. REPLACE HMA MATERIAL OVER THE AREA TO BE PATCHED.

SEQUENCE OF CONSTRUCTION (MILLING FIRST)

- 1. MILL HMA FIRST IF THERE IS AT LEAST 4 ½ INCHES OR MORE OF HMA MATERIAL ON TOP OF THE EXISTING PAVEMENT OR IF THE PAVEMENT IS FULL DEPTH HMA. A MINIMUM OF 2 INCHES OF HMA MATERIAL SHALL BE IN PLACE AFTER MILLING.
- 2. REMOVE AND REPLACE WITH FULL DEPTH CLASS D PATCHES TO TOP OF MILLED SURFACE.

ALL DIMENSIONS ARE IN INCHES (MILLIMETERS) UNLESS OTHERWISE SHOWN.

USER NAME = eric.l.thomas	DESIGNED - R. SHAH	REVISED - R. BORO 01-01-07			PAVEMENT PATCHING FOR		F.A.I RTE.	SECTION	COUNTY	TOTAL	SHEET NO.
	DRAWN -	REVISED - R. BORO 09-04-07	STATE OF ILLINOIS		HMA SURFACED PAVEMENT		55	2023-927-RS,SW	DUPAGE	24	17
PLOT SCALE = \$SCALE\$	CHECKED -	REVISED - K. ENG 10-27-08	DEPARTMENT OF TRANSPORTATION		HIMA SURFACED FAVEINERT			BD400-04 (BD-22)	CONTRAC	T NO. 62	W49
PLOT DATE = 8/30/2023	DATE - 10-25-94	REVISED - K. SMITH 11-18-22		SCALE: NONE	SHEET 1 OF 1 SHEETS STA.	TO STA.		ILLINOIS FED A	D PROJECT		

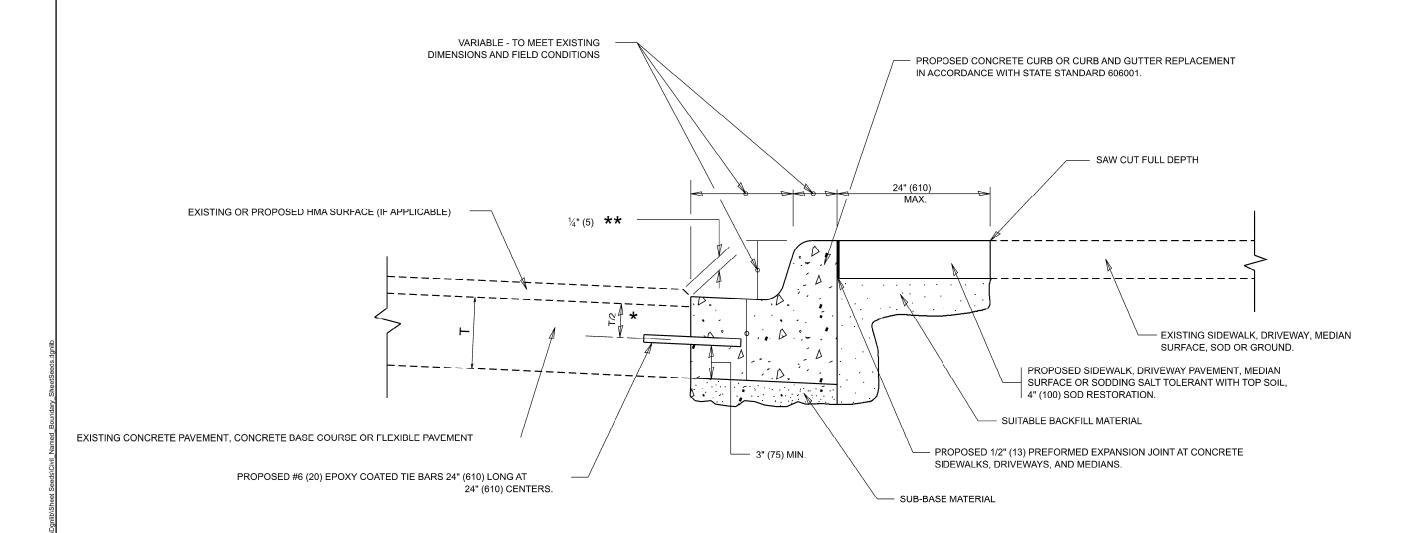


- ★ 3" (75) MINIMUM FROM TOP AND BOTTOM OF THE CONCRETE PAVEMENT OR BASE COURSE.
- ** IF THE FINAL SURFACE OF THE PAVEMENT IS CONCRETE, THE GUTTER IS TO BE FLUSH WITH THE PAVEMENT.

CURB OR CURB AND GUTTER REMOVAL AND REPLACEMENT

ALL DIMENSIONS ARE IN INCHES (MILLIMETERS) UNLESS OTHERWISE SHOWN.


USER NAME = eric.l.thornas	DESIGNED - A. HOUSEH	REVISED - A. ABBAS 03-21-97			CUR	B OR C	URB AN	D GUTTER		F.A.I RTE.	SECT	ION	COUN
	DRAWN -	REVISED - M. GOMEZ 01-22-01	STATE OF ILLINOIS					LACEMENT		55	2023-927	-RS,SW	DUPAG
PLOT SCALE = \$SCALE\$	CHECKED -	REVISED - R. BORO 12-15-09	DEPARTMENT OF TRANSPORTATION		KEIVI	OVAL A	ND KEP	LACEIVIENI		_ i	BD600-06 (B	D-24)	CONTR
PLOT DATE = 8/30/2023	DATE - 03-11-94	REVISED - K. SMITH 07-11-19		SCALE: NONE	SHEET 1	OF 1	SHEETS	STA.	TO STA.		•	ILLINOIS F	FED. AID PROJECT

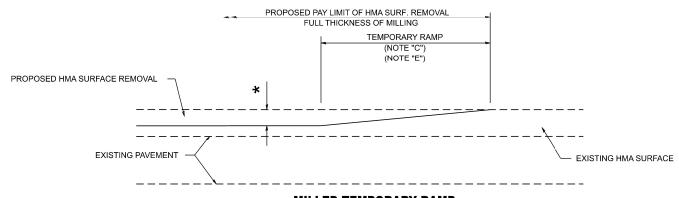

MILLED TEMPORARY RAMP

(FOR BUTT JOINT AND HMA TAPER SEE DETAIL BELOW)

OPTION 1

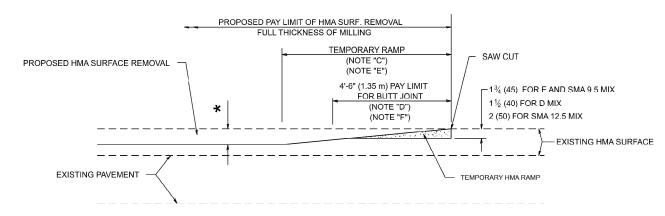


HMA CONSTRUCTED TEMPORARY RAMP


(FOR BUTT JOINT AND HMA TAPER SEE DETAIL BELOW)


OPTION 2

TYPICAL TEMPORARY RAMP

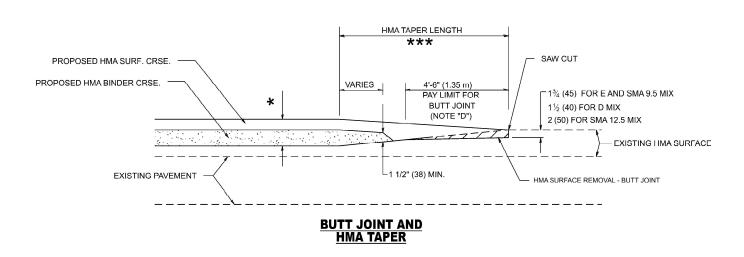

TYPICAL BUTT JOINT AND HMA TAPER FOR MILLING AND RESURFACING

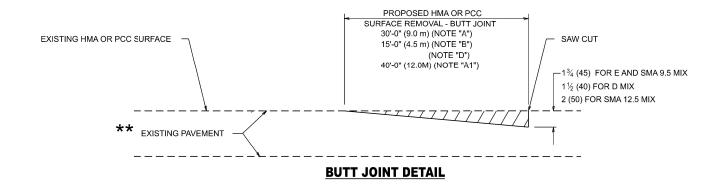

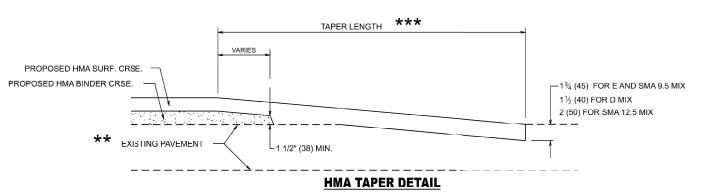

TYPICAL BUTT JOINT AND HMA TAPER FOR RESURFACING ONLY

 $\star\star$ PC CONCRETE, HMA OR HMA RESURFACED PAVEMENT.

GENERAL NOTES


- A. MAINLINE ARTERIAL ROADWAYS AND MAJOR SIDE ROADS.
- A1. INTERSTATES
- B. MINOR SIDE ROADS.
- C. THE TEMP. RAMP SHALL BE CONSTRUCTED IMMEDIATELY UPON REMOVAL OF THE EXISTING HMA SURFACE.
- D. THE BUTT JOINT SHALL BE CONSTRUCTED IMMEDIATELY PRIOR TO PLACING THE PROPOSED HMA COURSES.
- E. TAPER THE TEMP. RAMP AT A RATE OF 3' 4" (1.02m) PER 1 INCH (25 mm) OF MILLING THICKNESS.
 - ★ SEE TYPICAL SECTIONS FOR MILLING THICKNESS.
- F. SEE ARTICLE 406.08 AND 406.14 OF THE STANDARD SPECIFICATIONS FOR "HMA AND/OR PCC SURFACE REMOVAL, BUTT JOINT".
- *******20'-0" (6.1 m) PER 1 (25) RESURFACING (NOTE "A")
 10'-0" (3.0 m) PER 1 (25) RESURFACING (NOTE "B")

BASIS OF PAYMENT

- THE BUTT JOINT WILL BE PAID FOR AT THE CONTRACT UNIT PRICE PER SQUARE YARD (SQUARE METER)
 FOR "HOT-MIX ASPHALT SURFACE REMOVAL - BUTT JOINT" OR FOR "PORTI AND CFMENT CONCRETE SURFACE REMOVAL - BUTT JOINT".
- 2. THE TEMPORARY RAMP AND SAW CUT SHALL BE INCLUDED IN THE UNIT COST FOR HMA OR PCC SURFACE REMOVAL-BUTT JOINT.

ALL DIMENSIONS ARE IN INCHES (MILLIMETERS) UNLESS

USER NAME = eric.l.thornas	DESIGNED - M. DE YONG	REVISED - A. ABBAS 03-21-97		BUTT JOINT AND	F.A.I RTE.	SECTION	COUNTY	TOTAL	SHEET NO.
	DRAWN -	REVISED - M. GOMEZ 04-06-01	STATE OF ILLINOIS	HMA TAPER DETAILS	55	2023-927-RS,SW	DUPAGE	24	19
PLOT SCALE = \$SCALE\$	CHECKED -	REVISED - R. BORO 01-01-07	DEPARTMENT OF TRANSPORTATION	HIMA TAPER DETAILS	j ,	BD400-05 BD-32	CONTRACT	T NO. 62V	N49
PLOT DATE = 8/30/2023	DATE - 06-13-90	REVISED - K. SMITH 11-18-22		SCALE: NONE SHEET 1 OF 1 SHEETS STA. TO STA	\vdash	ILLINOIS FED A	VID PROJECT		-

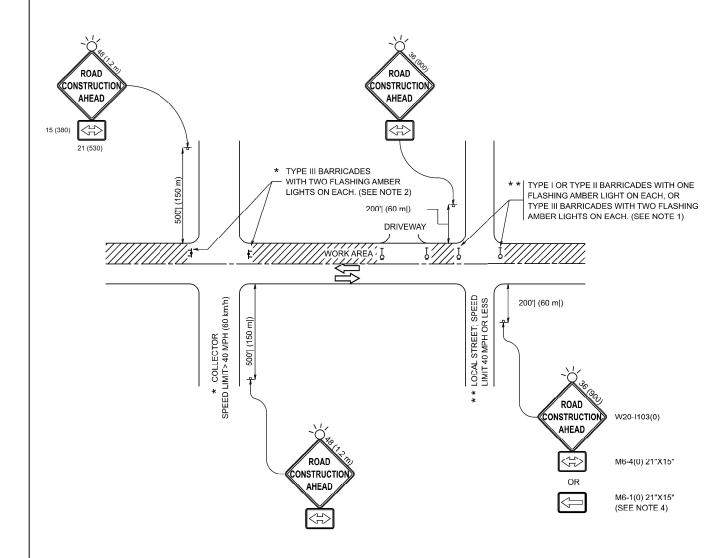

NOTES:

- 1. SIDE ROAD WITH A SPEED LIMIT OF 40 MPH (60 km/h) OR LESS AS SHOWN ON THE DRAWING AND AS DIRECTED BY THE ENGINEER:
- a) ONE "ROAD CONSTRUCTION AHEAD" SIGN 36 x 36 (900x900) WITH A FLASHER MOUNTED ON IT APPROXIMATELY 200' (60 m) IN ADVANCE OF THE MAIN ROUTE.
- b) THE CLOSED PORTION OF THE MAIN ROUTE SHALL BE PROTECTED BY BLOCKING WITH TYPE I, TYPE II OR TYPE III BARRICADES, 1/3 OF THE CROSS SECTION OF THE CLOSED PORTION.
- SIDE ROAD WITH A SPEED LIMIT GREATER THAN 40 MPH (60 km/h)
 AS SHOWN ON THE DRAWING AND AS DIRECTED BY THE ENGINEER:
- a) ONE "ROAD CONSTRUCTION AHEAD" SIGN 48 x 48 (1.2 m x 1.2 m) WITH A FLASHER MOUNTED ON IT APPROXIMATELY 500' (150 m) IN ADVANCE OF THE MAIN ROUTS.
- b) THE CLOSED PORTION OF THE MAIN ROUTE SHALL BE PROTECTED BY BLOCKING WITH TYPE III BARRICADES, 1/2 OF THE CROSS SECTION OF THE CLOSED PCRTION.
- 3. CONES MAY BE SUBSTITUTED FOR BARRICADES OR DRUMS AT HALF THE SPACING DURING DAY OPERATIONS. CONES SHALL BE A MINIMUM OF 28 (710) IN HEIGHT
- WHEN THE SIDE ROAD LIES BETWEEN THE BEGINNING OF THE MAINLINE SIGNING AND THE WORK ZONE, A SINGLE HEADED ARROW (M6-1) SHALL BE USED IN LIEU OF THE DOUBLE HEADED ARROW (M6-4).


- 5. WHEN WORK IS BEING PERFORMED ON A SIDE ROAD OR DRIVEWAY, FOLLOW THE APPLICABLE STANDARD(S). THE DIRECTIONAL ARROW (M6-1 OR M6-4) SHALL BE COVERED OR REMOVED WHEN NO LONGER CONSISTENT WITH THE TRAFFIC CONTROL SET-UP.
- 6. ADVANCE WARNING SIGNS ARE TO BE OMITTED ON DRIVEWAYS UNLESS OTHERWISE SPECIFIED IN THE PLANS OR BY THE ENGINEER.
- 7. THE TRAFFIC CONTROL AND PROTECTION FOR SIDE ROADS, INTERSECTIONS, AND DRIVEWAYS SHALL BE INCLUDED IN THE COST OF SPECIFIED TRAFFIC CONTROL STANDARDS OR ITEMS.

All dimensions are in inches (millimeters) unless otherwise shown.

STATE OF ILLINOIS
DEPARTMENT OF TRANSPORTATION

TRAFFIC CONTROL AND PROTECTION FOR SIDE ROADS, INTERSECTIONS, AND DRIVEWAYS

SHEET OF SHEETS STA. TO STA.

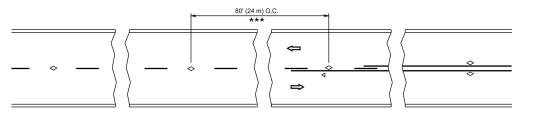


*** REDUCE TO 40' (12 m) O.C. ON CURVES WITH POSTED OR ADVISORY SPEED 45 M.P.H. (70 km/h) OR LESS.

3 @ 40' (12 m) O.C.


SEE FIGURE 3B-14 MUTCD

LANE REDUCTION TRANSITION

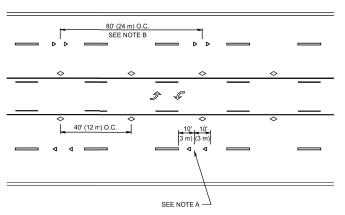


TWO-WAY LEFT TURN

TWO-LANE/TWO-WAY

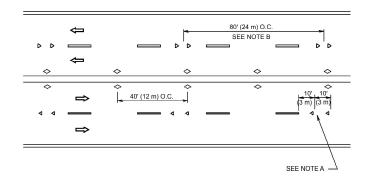


MULTI-LANE/UNDIVIDED

3 @ 40' (12 m)

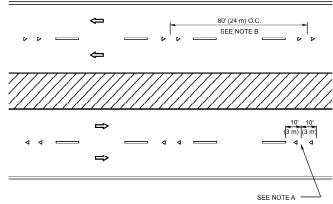

MULTI-LANE/DIVIDED

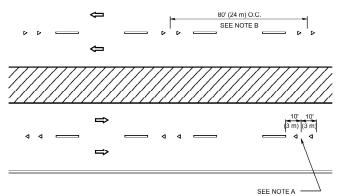

MINIMUM OF 3 W 3 @ 80' (24 m) O.C. EQUALLY SPACED 3 @ 40' (12 m) O.C. \Rightarrow 40' (12 m) O.C. * SEE TWO-LANE/TWO-WAY WHERE MARKERS CONTINUE ** WHERE THE MEDIAN WIDTH IS 6' (2 m) OR LESS USE TWO-WAY MARKERS.

TURN LANES

GENERAL NOTES

- 1. MARKERS USED WITH DASHED LINES SHALL BE CENTERED IN THE GAP BETWEEN SEGMENTS.
- 2. MARKERS USED ADJACENT TO SOLID LINES SHALL BE OFFSET 2 TO 3 (50 TO 75) TOWARD TRAFFIC AS SHOWN
- 3. MARKERS THROUGH TANGENTS LESS THAN 500' (150 m) IN LENGTH BETWEEN CURVES SHALL BE INSTALLED AT THE LESSER OF THE TWO CURVE SPACINGS.
- 4. MARKERS ARE TO BE USED ADJACENT TO BOTH SOLID WHITE LINES IN DUAL LEFT TURN LANES

SYMBOLS

YELLOW STRIPE

── WHITE STRIPE

ONE-WAY AMBER MARKER

ONE-WAY CRYSTAL MARKER (W/O)

TWO-WAY AMBER MARKER

LANE MARKER NOTES

A. USE DOUBLE LANE LINE MARKERS SPACED AS SHOWN.

B. REDUCE TO 40' (12 m) O.C. ON CURVES WHERE ADVISORY SPEEDS ARE 10 M.P.H (20 km/h) LOWER THAN POSTED SPEEDS.

DESIGN NOTES

- 1. DOUBLE LANE LINE MARKERS SHALL BE USED UNLESS SPECIFIED OTHERWISE.
- 2. EXCEPT AS SHOWN ON THE LANE REDUCTION TRANSITION AND FREEWAY EXIT RAMP DETAIL, MARKERS ARE NOT TO BE SPECIFIED ON RIGHT EDGE LINES.
- 3. THE EXACT MARKER LIMITS, SPACING, AND COLOR SHALL BE INCLUDED IN
- 4. MARKERS SHOULD NOT BE USED ALONGSIDE CURBS EXCEPT FOR EXTREMELY SHORT SECTIONS OF CURBS WHERE NOT MORE THAN TWO MARKERS WOULD BE INVOLVED.

All dimensions are in inches (millimeters) unless otherwise shown

DESIGNED -JSER NAME = eric.l.thornas REVISED - T. RAMMACHER 03-12-99 DRAWN REVISED - T. RAMMACHER 01-06-00 CHECKED REVISED C. JUCIUS 09-09-09 C. JUCIUS 07-01-13 PLOT DATE = 8/30/2023 DATE REVISED -


_ 40' (12 m) _


STATE OF ILLINOIS **DEPARTMENT OF TRANSPORTATION**

TYPICAL APPLICATIONS RAISED REFLECTIVE PAVEMENT MARKERS (SNOW-PLOW RESISTANT) SHEET 1 OF 1 SHEETS STA.


SECTION COUNTY DUPAGE 2023-927-RS,SW 24 21 TC-11 CONTRACT NO. 62W49

3 @ 80' (24 m) O.C.

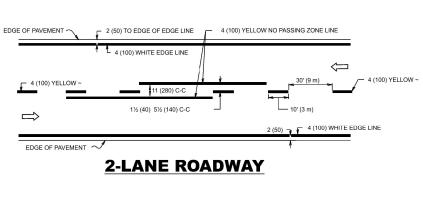


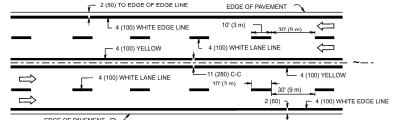

MULTI-LANE UNDIVIDED

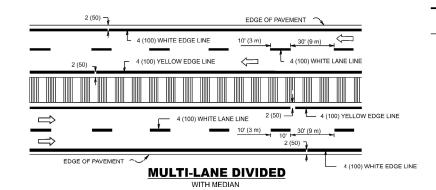

TYPICAL LANE AND EDGE LINE MARKING

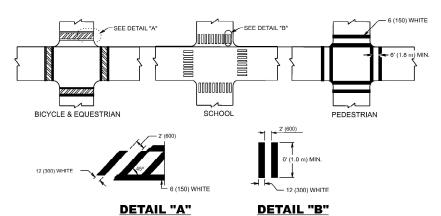


TYPICAL CROSSWALK MARKING

★ MARKINGS SHALL BE INSTALLED PARALLEL TO THE CENTERLINE OF THE ROAD WHICH IT CROSSES

TWO-4 (100) YELLOW @ 11 (280) C-C NO DIAGONALS 4' (1.2 m) OUTSIDE TO OUTSIDE OF LINES

4' (1.2 m) WIDE MEDIANS ONLY

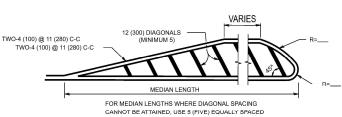


DIAGONAL LINES.


SPACING: 50' (15 m) C-C (I ESS THAN 30MPH (50 km/h))
75' (25 m) C-C 30MPH (50 km/h) TO 45MPH (70 km/h))

MEDIANS OVER 4' (1.2 m) WIDE


150' (45 m) C-C (MORE THAN 45MPH (70 km/h))

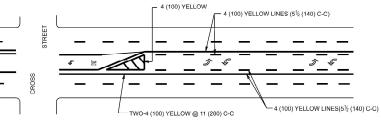

A MINIMUM OF TWO PAIRS OF TURN ARROWS SHALL BE USED, WHITE IN COLOR. ADDITIONAL PAIRS SHALL BE PLACED AT 200' (60 m) TO 300' (90 m) INTERVALS.

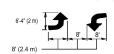

MEDIAN WITH TWO-WAY LEFT TURN LANE TYPICAL PAINTED MEDIAN MARKING

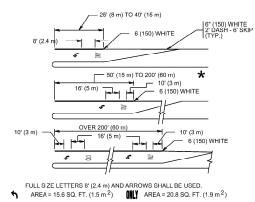

TURN LANES IN EXCESS OF 400' (120 m) IN LENGTH MAY HAVE AN ADDITIONAL SET OF ARROW - "ONLY" INSTALLED MIDWAY BETWEEN THE OTHER TWO SETS OF

TYPICAL LEFT (OR RIGHT) TURN LANE

TYPICAL TURN LANE MARKING

8 (200) WHITE DIAGONALS (© 10' (3 m) OR LESS SPACING ISLAND AT PAVEMENT EDGE TYPICAL ISLAND MARKING 340 R (1020) 340 R (1020) 40 R

U-TURN

★ LANE REDUCTION ARROWS REQUIRED AT SPEEDS OF 45 MPH OR GREATER OR WHEN SPECIFIED IN PLANS.

TRANSITION

D(FT)


SPEED LIMIT


				GREATER OR WHEN SPECIFIED IN PLANS.
TYPE OF MARKING	WIDTH OF LINE	PATTERN	COLOR	SPACING / REMARKS
CENTERLINE ON 2 LANE PAVEMENT	4 (100)	SKIP-DASH	YELLOW	10' (3 m) LINE WITH 30' (9 m) SPACE
CENTERLINE ON MULTI-LANE UNDIVIDED PAVEMENT	2 @ 4 (100)	SOLID	YELLOW	11 (280) C-C
NO PASSING ZONE LINES: FOR ONE DIRECTION FOR BOTH DIRECTIONS	4 (100) 2 @ 4 (100)	SOLID SOLID	YELLOW YELLOW	5½ (140) C-C FROM SKIP-DASH CENTERLINE 11 (280) C-C OMIT SKIP-DASH CENTERLINE BETWEEN
LANE LINES	4 (100) 5 (125) ON FREEWAYS	SKIP-DASH SKIP-DASH	WHITE WHITE	10' (3 m) LINE WITH 30' (9 m) SPACE
DOTTED LINES (EXTENSIONS OF CENTER, LANE OR TURN LANE MARKINGS)	SAME AS LINE BEING EXTENDED	SKIP-DASH	SAME AS LINE BEING EXTENDED	2' (600) LINE WITH 6' (1.8 m) SPACE
EDGE LINES	4 (100)	SOLID	YELLOW-LEFT WHITE-RIGHT	OUTLINE MEDIANS IN YELLOW
TURN LANE MARKINGS	6 (150) LINE: FULL SIZE LETTERS & SYMBOLS (8' (2.4m))	SOLID	WHITE	SEE TYPICAL TURN LANE MARKING DETAIL
TWO WAY LEFT TURN MARKING	2 @ 4 (100) EACH DIRECTION 8' (2.411) LEFT ARROW	SKIP-DASH AND SOLID IN PAIRS	YELLOW	10' (3 m) LINE WITH 30' (9 m) SPACE FOR SKIP-DASH; 5'/2 (140) C-C BETWEEN SOLID LINE AND SKIP-DASH LINE SEE TYPICAL TWO-WAY LEFT TURN MARKING DETAIL
CROSSWALK LINES (PEDESTRIAN) A. DIAGONALS (BIKE & EQUESTRIAN) B. LONGITUDINAL BARS (SCHOOL)	2 @ 6 (150) 12 (300) @ 45° 12 (300) @ 90°	SOLID SOLID SOLID	WHITE WHITE WHITE	NOT LESS THAN 6' (1.8 m) APART 2' (600) APART 2' (500) APARI 2' (500) APARI SEE TYPICAL CROSSWALK MARKING DETAILS.
STOP LINES	24 (600)	SOLID	WHITE	PLACE 4' (1.2 m) IN ADVANCE OF AND PARALLEL TO GROSSWALK, IF PRESENT. OTHERWISE, PLACE AT DESIRED STOPPING POINT. PARALLEL TO GROSSROAD CENTERLINE, WHERE POSSIBLE
PAINTED MEDIANS	2 @ 4 (100) WITH 12 (300) DIAGONALS @ 45° NO DIAGONALS USED FOR 4' (1.2 m) WIDE MEDIANS	SOLID	YELLOW: TWO WAY TRAFFIC WHITE: ONE WAY TRAFFIC	11 (280) C-C FOR THE DOUBLE LINE SEE TYPICAL PAINTED MEDIAN MARKING.
GORE MARKING AND CHANNELIZING LINES	8 (200) WITH 12 (300) DIAGONALS @ 45°	SOLID	WHITE	DIAGONALS: 15' (4.5 m) C-C (LESS THAN 30MPH (50 km/h)) 20' (6 m) C-C 30MPH (50 km/h) TO 45MPH (70 km/h)) 30' (9 m) C-C (OVER 45MPH (70 km/h))
RAILROAD CROSSING	24 (600) TRANSVERSE LINES; "RR" IS 6' (1.8 m) LETTERS; 16 (400) LINE FOR "X"	SOLID	WHITE	SEE STATE STANDARD 780001 AREA OF: "x"=3.6 SQ. FT. (0.33 m ²) EACH "X"=54.0 SQ. FT. (5.0 m ²)
SHOULDER DIAGONALS (REQUIRED FOR SHOULDERS ≥ 8')	12 (300) @ 45°	SOLID	WHITE - RIGHT YELLOW LEFT	50' (15 m) C-C (LESS THAN 30MPH (50 km/h)) 76' (26 m) C C (30 MPH (50 km/h) TO 45MPH (70 km/h)) 150' (45 m) C-C (OVER 45MPH (70 km/h))
U TURN ARROW	SEE DETAIL	SOLID	WHITE	16.3 SF
2 ARROW COMBINATION LEFT AND U TURN	SEE DETAIL	SOLID	WHITE	30.4 SF

FOR FURTHER DETAILS ON PAVEMENT MARKING REFER TO STANDARD SPECIFICATIONS FOR ROAD AND BRIDGE CONSTRUCTION AND STATE STANDARD 780001. All dimensions are in inches (millimeters


USER NAME = eric.l.thornas	DESIGNED - EVERS	REVISED -	C. JUCIUS 09-09-09
	DRAWN -	REVISED -	C. JUCIUS 07-01-13
PLOT SCALE = \$SCALE\$	CHECKED -	REVISED -	C. JUCIUS 12-21-15
PLOT DATE = 8/30/2023	DATE - 03-19-90	REVISED -	C. JUCIUS 04-12-16

STATE OF ILLINOIS
DEPARTMENT OF TRANSPORTATION

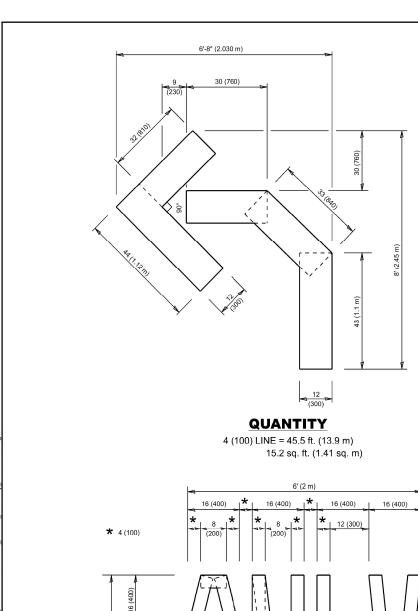

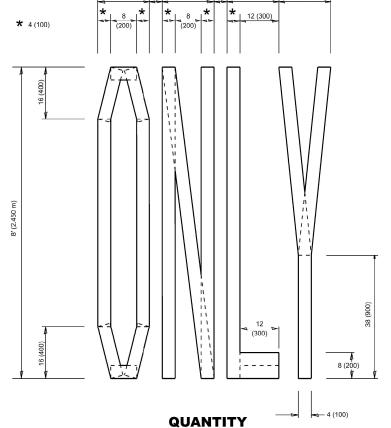

4 (100) LINE = 64.1 ft. (19.5 m)

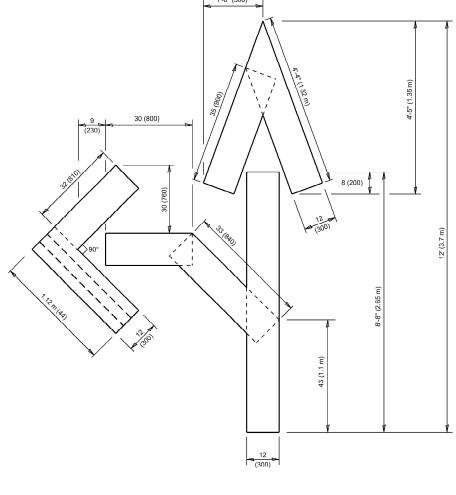


QUANTITY

4 (100) LINE = 82.5 ft. (25.1 m) 27.5 sq. ft. (2.53 sq. m)

NOTE:

ALL QUANTITIES OF PLACEMENT ARE REPRESENTED IN LINEAR FEET OF 4" LINES TO MATCH THE 4" TEMPORARY TAPE PAY ITEM AND REPRESENTS THE TOTAL QUANTITY OF 4" TAPE REQUIRED.

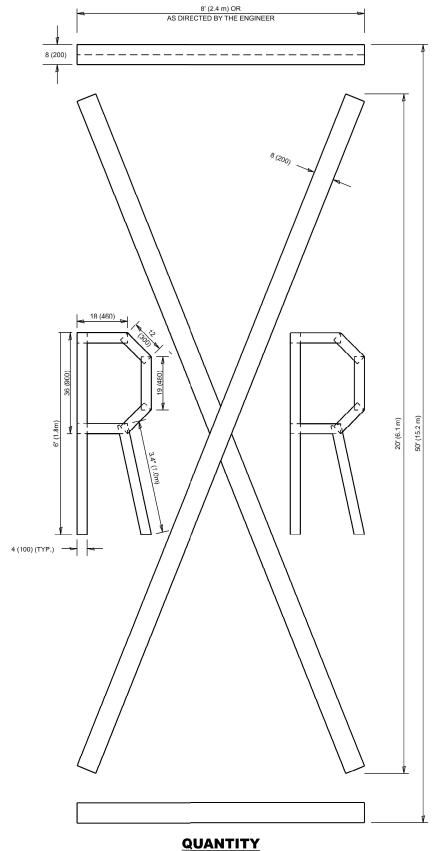

4 (100) LINE = 225.9 ft. (68.9 m) /5.3 sq. ft. (6.99 sq. m)


> All dimensions are in inches (millimeters) unless otherwise shown.

USER NAME = eric.l.thornas	DESIGNED -		REVISED	- T. RAMMACHER 03-02-98
	DRAWN -		REVISED	- E. GOMEZ 08-28-00
PLOT SCALE = \$SCALE\$	CHECKED -		REVISED	- E. GOMEZ 08-28-00
PLOT DATE = 8/30/2023	DATE -	09-18-94	REVISED	- A. SCHUETZE 09-15-16

21.4 sq. ft. (1.99 sq. m)

STATE OF ILLINOIS **DEPARTMENT OF TRANSPORTATION**

SHORT TER	RM PAVEN	IENT	MARKIN	G LET	TERS AND SYMBOLS	F.A.I RTE.	SECTION	COUNTY	TOTAL SHEETS	SHEET NO.
								DUPAGE	24	23
							TC-16	CONTRAC	T NO. 62	W49
SCALE: NONE	SHEET 1	OF	1 SHEETS	STA.	TO STA.	ILLINOIS FED. AID PROJECT				

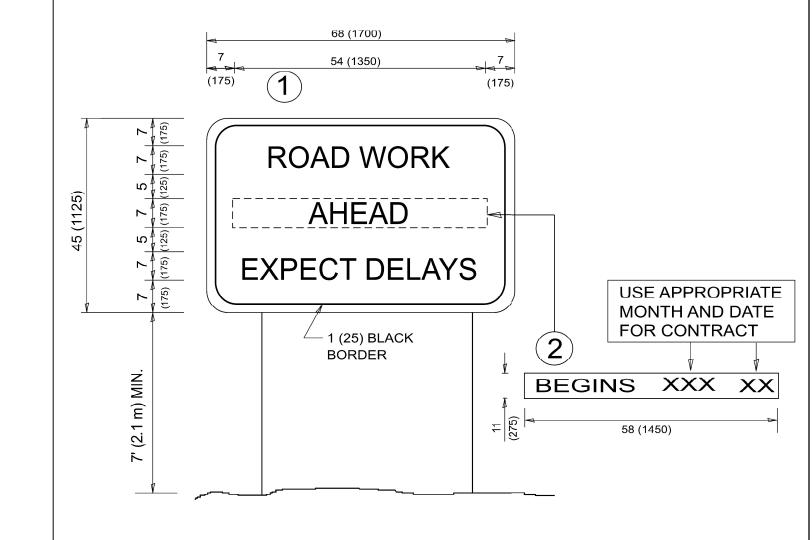

NOTES:

- 1. USE BLACK LETTERING ON ORANGE BACKGROUND.
- 2. ERECT SIGNS IN ADVANCE OF THE LOCATION FOR THE "ROAD CONSTRUCTION AHEAD" SIGN AT LOCATIONS AS DIRECTED BY THE ENGINEER.
- 3. ERECT SIGN 1) WITH INSTALLED PANEL 2) ONE WEEK PRIOR TO THE START OF CONSTRUCTION.
- 4. REMOVE PANEL 2) SOON AFTER THE START OF CONSTRUCTION.
- 5. SEE SPECIAL PROVISION FOR "TEMPORARY INFORMATION SIGNING" FOR ADDITIONAL INFORMATION.
- 6. ONE SIGN ASSEMBLY EQUALS 25.70 SQ. FT. (2.3 SQ. M.)
- 7. SHALL BE PAID FOR AS TEMPORARY INFORMATION SIGNING.

ALL DIMENSIONS ARE IN INCHES (MILLIMETERS) UNLESS OTHERWISE SHOWN.

 DuPage
 24
 24

 CONTRACT NO. 62W49

-	USER NAME = eric.l.thornas	DESIGNED -	REVISED - R. MIRS 09-15-97				ART	ERIAL R	OAD		F.A.I RTE.	SECTION
		DRAWN -	REVISED - R. MIRS 12-11-97	STATE OF ILLINOIS			INFOR	MATION	SIGN		55	2023-927-RS,SW
	PLOT SCALE = \$SCALE\$	CHECKED -	REVISED - T. RAMMACHER 02-02-99	DEPARTMENT OF TRANSPORTATION			INFOR	MATION	SIGN			TC-22
	PLOT DATE = 8/30/2023	DATE -	REVISED - C. JUCIUS 01-31-07		SCALE: NONE	SHEET 1	OF 1	SHEETS	STA.	TO STA.		ILLINOIS FED.