FOR INDEX OF SHEETS, SEE SHEET NO. 2

THE PROJECT IS LOCATED IN THE CITY OF CHICAGO

TRAFFIC DATA

FAI 290/CONGRESS PARKWAY

ADT (2012) = 66,000POSTED SPEED LIMIT 45 MPH

FAI 90/94

 $\circ$ 

0

ADT (2012) = 191,300

POSTED SPEED LIMIT 45 MPH

STATE OF ILLINOIS


**DEPARTMENT OF TRANSPORTATION** 

**DIVISION OF HIGHWAYS** 

# **PROPOSED HIGHWAY PLANS**

FAI 90/94 AT I-290/CONGRESS PARKWAY(CIRCLE INTERCHANGE) & AT SOUTH BRANCH CHICAGO RIVER **SURVEILLANCE** SECTION 2013-026-I **COOK COUNTY** C-91-306-13

PROJECT NO.: ACNHPP-DOOS (956)

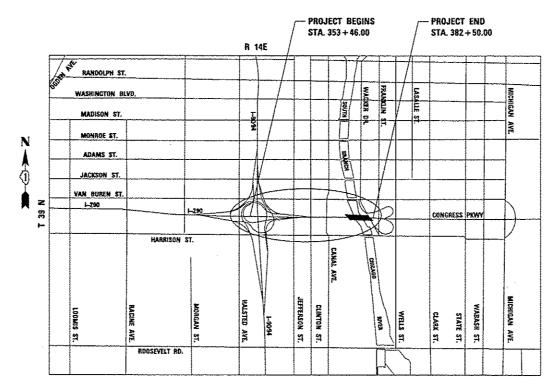

LOCATION MAP TOTAL GROSS AND NET LENGTH OF PROJECT = 2904 FT. = .550 MI

**PARSONS BRINCKERHOFF** 


230 WEST MONROE STREET, SUITE 900 CHICAGO, ILLINOIS 60606 TEL: 312-782-8150 FAX: 312-782-1684

SECTION COUNTY TOTAL SHEE 2013-026-1

X37 41 = 38

D-91-306-13



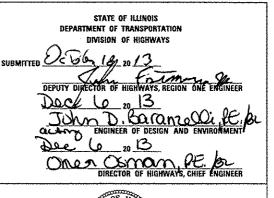



AHMAD M. HAMMAD, S.E., P.E. LICENSE NO.: 081-005467 EXPIRES: November 30, 2014

PRINTED BY THE AUTHORITY OF THE STATE OF ILLINOIS

FULL SIZE PLANS HAVE BEEN PREPARED USING STANDARD ENGINEERING SCALES. REDUCED SIZED PLANS WILL NOT CONFORM TO STANDARD SCALES. IN MAKING MEASUREMENTS

DIGGER - CHICAGO UTILITY ALERT NETWORK 1-312-744-7000

ON REDUCED PLANS, THE ABOVE SCALES MAY BE USED.

**CONTRACT NO. 60W49** 

 $\circ$ 

0

INDEX OF SHEETS, GENERAL NOTES AND STATE STANDARDS

GENERAL ELECTRICAL NOTES

ELECTRICAL NOTES

ELECTRICAL SYMBOLS AND ABBREVIATIONS

6.44 SUMMARY OF QUANTITIES

ALIGNMENT AND BENCHMARKS SHEET 1 OF 2

ALIGNMENT AND BENCHMARKS SHEET 2 OF 2

KEY PLAN

10. CCTV SYSTEM BLOCK DIAGRAM

II. HALSTED STREET AND HARRISON STREET - ITS PLANS PROPOSED ITS

12. CCTV FIRER OPTIC PLAN SHEET 1 OF 2

13. CCTV FIBER OPTIC PLAN SHEET 2 OF 2

14. EAST SIDE DOCK LEVEL

15. EAST SIDE MEZZANINE LEVEL AND OPERATOR'S ROOM

16. EAST SIDE SIDEWALK LEVEL

17. WEST SIDE DOCK LEVEL

18. WEST SIDE MEZZANINE LEVEL

19. WEST SIDE SIDEWALK LEVEL 20. CCTV DETAIL AT JEFFERSON STREET

21. CCTV CAMERA ATTACHED TO BRIDGE HOUSE

22. PANEL SCHEDULES

23. TWELVE FIBER LATERAL CABLE FIBER ASSIGNMENTS

24. TRUNK CABLE FIBER ASSIGNMENTS

25. TRUNK CABLE FIBER ASSIGNMENTS

26. PUMP STATION DETAILS

27. TRUNK CABLE FIBER ASSIGNMENTS

28. DISTRIBUTION CABLE FIBER ASSIGNMENTS

29. TWELVE FIBER LATERAL CABLE FIBER ASSIGNMENTS

30. TOWER FOUNDATION PLANS LOF 2

31. TOWER FOUNDATION PLANS 2 OF 2

32 THRU 36 DISTRICT 1 STANDARDS 37. BRIDGE HOUSES AND ENGLOSURES

### STATE STANDARDS

701400-07

701101-C4 OFF-ROAD OPERATIONS, MULTILANE, 15' (4.5 m) TO

24" (600 mm) FROM PAVEMENT EDGE

OFF-ROAD OPERATIONS, MULTILANE, MORE THAN 701106-02

> 15' (4,5 m) AWAY APPROACH TO LANE CLOSURE, FREEWAY/EXPRESSWAY

701401-08 LANE CLOSURE, FREEWAY/EXPRESSWAY

701422-06 LANE CLOSURE MULTI LANE 45-55MPH

701411-08 LANE CLOSURE MULTI LANE - ENTR OR EXIT RAMPS 45MPH+ 701301-03

TRAFFIC CONTROL DEVICES

701426-06 LANE CLOSURE, MULTI LANE INTERMITTENT OR MOVING

OPERATION FOR SPEEDS 2 45 MPH

TRAFFIC CONTROL. SETUP AND REMOVAL 701428 FREEWAY/EXPRESSWAY

# DISTRICT 1 STANDARDS-Plan Sheets 32-36

SINGLE AND MULTI-LANE WEAVE

TC-10 TRAFFIC CONTROL AND PROJECTION FOR SIDEROADS.

INTERSECTIONS AND DRIVEWAYS

TC-17 PARTIAL RAMP OR SHOULDER CLOSURE TC~18 SIGNING FOR FLAGGING OPERATIONS AT WORK ZONE

ARTERIAL ROAD INFORMATION SIGN TC~22

# GENERAL NOTES:

- ALL ELEVATIONS SHOWN ON THE PLANS ARE BASED ON THE CHICAGO CITY DATUM. THE CONVERSION EQUATION FROM CCD TO NAVD 88 IS: NAVO 88 ELEVATION=CCO + 579.19.
- ALL DIMENSIONS ARE IN FEET UNLESS OTHERWISE NOTED.
- ALL WORK SHALL BE PERFORMED IN ACCORDANCE WITH THE LATEST CODES. STANDARDS AND THE 100T STANDARD SPECIFICATIONS FOR ROAD AND BRIDGE CONSTRUCTION ADOPTED JANUARY 1, 2014, AND SUPPLEMENTAL SPECIFICATIONS AND RECURRING SPECIAL PROVISIONS.

# GENERAL NOTES CONT'D:

- BEFORE STARTING ANY EXCAVATION, THE CONTRACTOR SHALL CALL "JULIE" AT 800-892-0123 OR BLI FOR FIELD LOCATIONS OF BURIED ELECTRIC, TELEPHONE, AND GAS FACILITIES. (48 HOUR NOTIFICATION IS REQUIRED.)
- THE LOCATION OF EXISTING FACILITIES, AS SHOWN ON THE DRAWINGS, REPRESENT DATA RECEIVED FROM VARIOUS SOURCES. IT IS NOT GUARANTEED TO BE CORRECT OR ALL INCLUSIVE. THE CONTRACTOR SHALL CONDUCT HIS OWN INVESTIGATION INTO THE LOCATION, SIZE, CONFIGURATION AND NATURE OF ANY AND ALL EXISTING FACILITIES WHICH MAY INTERFERE WITH THE WORK UNDER THIS CONTRACT. ANY EXISTING FACILITIES (FIBER OPTIC CABLE, ELECTRIC OR ANY OTHER COMMUNICATIONS CABLES OR EQUIPMENT) MEAR PROPOSED WORK AREAS WHICH ARE TO REMAIN IN SERVICE SHALL BE RECONFIGURED AND BE FULLY PROTECTED BY THE CONTRACTOR, ANY DAMAGE CAUSED BY THE CONSTRUCTION OPERATIONS SHALL BE IMMEDIATELY REPAIRED AT NO ADDITIONAL COST TO 100T TO THE SATISFACTION OF THE ENGINEER.
- THE CHICAGO TRANSIT AUTHORITY HAS EXISTING AND/OR ABANDONED FACILITIES IN THE AREA, SUCH FACILITIES MAY INCLUDE ELEVATED RAIL TRACKS, SUBWAYS, UNDERGROUND DUCT LINES, AND/OR FORMER STREETCAR TRACKS, COPIES OF DRAWINGS WILL BE SUBMITTED TO THE OUC OFFICE, CAUTION SHOULD BE EXERCISED WHEN EXCAVATING NEAR STREETCAR TRACKS, MEMBERS OF THE CHICAGO AREA JOINT ELECTROLYSIS COMMITTEE MAY USE STREETCAR TRACKS AND NEGATIVE CABLE. PLEASE CONTACT MR. YOUSEF TABLE OF COMED BEFORE CUTTING OR REMOVING ANY BURIED STREETCAR RAILS. HE MAY BE REACHED AT (630) 576-6952. THE CONTRACTOR SHALL ALSO COORDINATE WITH MR. DAVID HEARD AT 312-681-3862 FOR TRANSIT TUNNELS AND ADJACENT APPURTENANCES.
- 7. THE CONTRACTOR SHALL COORDINATE CONSTRUCTION ACTIVITIES WITH AFFECTED UTILITY COMPANIES AND MUNICIPALITIES. THE CONTRACTOR SHALL USE ALL NECESSARY PRECAUTIONS AND PROTECTIVE MEASURES REQUIRED TO MAINTAIN EXISTING UTILITIES AND THEIR OPERATION.
- THE CONTRACTOR WILL NOT BE ALLOWED TO SET UP A YARD OR FIELD OFFICE ON STATE PROPERTY WITHOUT WRITTEN PERMISSION FROM THE DEPARTMENT.
- WHEN ARTIFICIAL LIGHTING IS USED IN NIGHT OPERATIONS THE CONTRACTOR SHALL EXERCISE THE UTMOST PRECAUTIONS IN PREVENTING ADVERSE VISIBILITY TO THE MOTORING PUBLIC AND ADJOINING RESIDENTIAL AREAS.
- 10. ALL FRAMES, CRATES, PAVEMENT, FENCES, DELINEATORS AND APPURTENANCES DAMAGED BY THE CONTRACTOR DURING CONSTRUCTION WILL BE REPLACED BY THE CONTRACTOR AT THEIR EXPENSE
- THE CONTRACTOR SHALL REQUEST AND GAIN APPROVAL FROM THE ILLINOIS DEPARTMENT OF TRANSPORTATION'S EXPRESSWAY TRAFFIC OPERATIONS ENGINEER AT www.ldotics.com TWENTY-FOUR (24) HOURS IN ADVANCE OF ALL DAILY LANE, RAMP AND SHOULDER CLOSURES AND ONE WEEK IN ADVANCE OF ALL PERMANENT AND WEEKEND CLOSURES ON ALL FREEWAYS AND/OR EXPRESSWAYS IN DISTRICT ONE.
- 12. THE CONTRACTOR SHALL CONTACT THE EXPRESSWAYS TRAFFIC CONTROL SUPERVISOR AT (847) 705-4155 AND THE ARTERIALS SUPERVISOR AT 1847) TOS-4470 A MINIMUM OF 72 HOURS PRIOR TO THE START OF WORK,
- 13. IT IS THE CONTRACTOR'S RESPONSIBILITY TO VERIFY ALL DIMENSIONS, ELEVATIONS, AND EXISTING FIELD CONDITIONS PRIOR TO BIDDING, ORDERING MATERIALS, OR BEGINNING OF CONSTRUCTION ON THIS PROJECT, SPECIFICIALLY AS THEY RELATE TO LUMP SUM ITEMS.
- 14. ALL DAMAGE TO DEPARTMENT OWNED UNDERGROUND FACILITIES CAUSED BY THE CONTRACTOR, SHALL BE REPAIRED TO THE SATISFACTION OF THE DEPARTMENT AT THE CONTRACTOR'S EXPENSE, THIS SHALL INCLUDE ALL TEMPORARY REPAIRS REQUIRED TO KEEP THE FACILITY OPERATIONAL WHILE MATERIAL IS BEING OBTAINED TO MAKE PERMANENT REPAIRS. SPLICING OF FIBER OPTIC CABLE SHALL NOT BE ALLOWED. FIBER OPTIC CABLE SHALL BE REPLACED FROM COMMUNICATION VALLE TO COMMUNICATION VALLET.
- 15. FLUGRESCENT VESTS AND HARD HATS: ALL CONSTRUCTION PERSONNEL WILL BE REQUIRED TO WEAR FLUGRESCENT GRANCE, FLUGRESCENT YELLOW/GREEN OR A COMBINATION OF FLUGRESCENT GRANCE AND FLUORESCENT YELLOW/GREEN VESTS AND HARD HATS AT ALL TIMES WHILE ON THE CONSTRUCTION SITE.
- 16. DURING CONSTRUCTION OPERATIONS THE CONTRACTOR SHALL TAKE NECESSARY PRECAUTIONS TO PROTECT ADJACENT EQUIPMENT FROM DAMAGE OR INTERFERENCE, THE CONTRACTOR SHALL ALSO BE RESPONSIBLE FOR KEEPING THE WORK AREA FREE FROM DEBRIS. THIS WORK SHALL BE INCIDENTAL TO
- 17. THE STANDARD DRAWINGS LISTED IN THE PLANS INDEX ARE INTENDED TO BE THE LATEST REVISIONS AND SHALL TAKE PRECEDENCE OVER EARLIER REVISIONS THAT MAY BE REFERRED TO ELSEWHERE IN THE PLANS OR SPECIAL PROVISIONS
- 18. ANY EXCAVATION REQUIRED ON THE PROJECT FROM THE EXISTING BRIDGE HOUSES TO THE WEST SIDE OF DES PLAINES STREET WILL REMAIN ON THE PROJECT SITE, TAKEN TO THE CIRCLE INTERCHANGE AT A LOCATION AS DIRECTED BY THE ENGINEER AND GRADED ACCORDINGLY
- 19. EXCAVATION WEST OF DES PLAINES FOR SURVEILLANCE TOWERS, TRENCHES AND OTHER EXCAVATION WILL BE HANDLED AS POTENTIAL SPECIAL WASTE AS STIPULATED IN THE SUMMARY OF QUANTITIES.
- 20. A FIELD OFFICE IS NOT INCLUDED AS PART OF THIS PROJECT, THE CONTRACTOR WILL BE PROVIDED OFFICE SPACE AT THE IDOT FACILITY AT 900 SOUTH DES PLAINES STREET, CHICAGO IL. 60607.

NOTE: BOXED ITEMS ARE INCLUDED IN THE COST OF THE CONTRACT.

### TRAFFIC CONTROL PLAN NOTES:

TRAFFIC CONTROL AND PROTECTION SHALL CONSIST OF SHOULDER AND LANE CLOSURES AND RAMP TAPER MODIFICATIONS, SIDE ROAD LANE REDUCTIONS AND PARKING PROHIBITIONS TO ALLOW WORK ALONG ROADWAYS, IN ACCORDANCE WITH FOLLOWING IDOT HIGHWAY STANDARDS AND DISTRICT ONE STANDARDS FOR TRAFFIC CONTROL.

OFF-ROAD OPERATIONS, MULTILANE, 15' (4.5 m) TO 24" (600 mm) FROM PAVEMENT EDGE 701101-03 701106-02

OFF-ROAD OPERATIONS, MULTILANE, MORE THAN 15' (4.5 m) AWAY APPROACH TO LANE CLOSURE, FREEWAY/EXPRESSWAY

701401-08 LANE CLOSURE, FREEWAY/EXPRESSWAY 701422-06 LANE CLOSURE MULTI LANE 45-55MPH

LANE CLOSURE MULTI LANE - ENTR OR EXIT RAMPS 45MPH+

701426-02 LANE CLOSURE, MULTI LANE INTERMITTENT OR MOVING OPERATION FOR SPEEDS > 45 MPH 701428

TRAFFIC CONTROL, SETUP AND REMOVAL FREEWAY/EXPRESSWAY SINGLE AND MULTI-LANE WEAVE

TC-10 TRAFFIC CONTROL AND PROJECTION FOR SIDEROADS, INTERSECTIONS AND DRIVEWAYS

PARTIAL RAMP OR SHOULDER CLOSURE SIGNING FOR FLAGGING OPERATIONS AT WORK ZONE TC-17

TC-22 ARTERIAL ROAD INFORMATION SIGN

701901-02 TRAFFIC CONTROL DEVICES

THESE STANDARDS WILL NOT BE PAID FOR AS SEPARATELY BUT WILL BE INCLUDED IN THE PRICE FOR

- TRAFFIC CONTROL AND PROTECTION (EXPRESSWAYS) AS A LUMP SUM PAY ITEM. 2. THE CONTRACTOR SHALL MAINTAIN TRAFFIC IN ACCORDANCE WITH 1001 SPECIAL PROVISIONS, IDOT HIGHWAY
- 3. THE CONTRACTOR SHALL COORDINATE CONSTRUCTION STAGING AND TRAFFIC CONTROL WORK WITH ADJOINING OR OVERLAPPING CONTRACTS. THE COST OF ANY ADDITIONAL TRAFFIC CONTROL AND/OR TEMPORARY CONSTRUCTION ITEMS REQUIRED FOR SUCH COORDINATION WILL NOT BE PAID FOR SEPARATELY BUT SHALL BE INCLUDED IN THE CONTRACT UNIT PRICE FOR "TRAFFIC CONTROL AND PROTECTION (EXPRESSWAYS)."

STANDARDS, 100T STANDARD SPECIFICATIONS, PLAN SPECIFICATIONS, AND AS DIRECTED BY THE ENGINEER.

- THE TRAFFIC CONTROL PLAN SHALL SERVE AS A GUIDE FOR SAFE DIVERSION OF TRAFFIC DURING EXECUTION OF THIS CONTRACT. HOWEVER, THE CONTRACTOR MAY IMPROVE OR MODIFY THE TRAFFIC CONTROL PLAN TO MEET CONSTRUCTION NEEDS BUT NOT AT THE EXPENSE OF PUBLIC SAFETY OR CONVENIENCE. ANY CHANGES TO THE TRAFFIC CONTROL PLAN SHALL BE SUBMITTED TO THE ENGINEER FOR APPROVAL.
- 5. THE ENGINEER SHALL BE INFORMED 21 DAYS IN ADVANCE OF ANY CHANGE TO THE TRAFFIC CONTROL PLAN.
- TRAFFIC CONDITIONS, ACCIDENTS AND OTHER UNFORSEEN EMERGENCY CONDITIONS MAY REQUIRE THE ENGINEER TO RESTRICT, MODIFY OR REMOVE LANE CLOSURES OR CHANNELIZATIONS PER THE TRAFFIC CONTROL PLAN. THE CONTRACTOR SHALL MAKE THE NECESSARY ADJUSTMENTS DIRECTED BY THE ENGINEER WITHOUT DELAY. THE CONTRACTOR SHALL RESPOND WITHIN 30 MINUTES FROM THE TIME OF NOTIFICATION BY THE ENGINEER TO ANY REQUEST MADE BY THE ENGINEER FOR CORRECTION, IMPROVEMENT, OR MODIFICATION OF THE MAINTENANCE OF TRAFFIC CONTROL DEVICES.
- ALL TRAFFIC CONTROL DEVICES USED FOR TRAFFIC CONTROL AND PROTECTION SHALL BE REFLECTORIZED PRIOR TO INSTALLATION AND CLEANED AS SPECIFIED IN TRAFFIC CONTROL AND PROTECTION SPECIAL PROVISIONS OR AS DIRECTED BY THE ENGINEER.
- 8. THE CONTRACTOR SHALL COVER OR REMOVE ALL CONFLICTING EXISTING SPEED LIMIT SIGNS, GUIDE SIGNS, OR ANY OTHER CONFLICTING SIGNS FOR THE DURATION OF THE CONSTRUCTION. THE CONTRACTOR SHALL SUBMIT THE METHOD IN WHICH THE SIGNS WILL BE COVERED TO THE ENGINEER FOR APPROVAL.
- 9. LOCATIONS OF CHANGEABLE MESSAGE SIGNS SHALL BE DETERMINED BY THE ENGINEER.
- 10. DRUMS OR TYPE II BARRICADES AND VERTICAL PANELS SHALL BE EQUIPPED WITH MONODIRECTIONAL STEADY BURN LIGHTS AND SHALL BE PLACED AT 100' INTERVALS ALONG WORK ZONES, AT 50' INTERVALS IN CURVES, AND AT 50' INTERVALS IN TAPER SECTIONS AS INDICATED IN THE 100T HICHWAY STANDARDS OR AS DIRECTED BY THE ENGINEER.
- 11. THE FURNISHING, INSTALLING, AND RELOCATION OF ALL TRAFFIC SIGNS SHALL BE IN ACCORDANCE WITH THE MANUAL ON UNIFORM TRAFFIC CONTROL DEVICES FOR STREETS AND HIGHWAYS (MUTCD), ILLINOIS SUPPLEMENT TO THE MUTCD, IDOT SPECIAL PROVISIONS, IDOT HIGHWAY STANDARDS, IDOT STANDARD SPECIFICATIONS, CONTRACT SPECIFICATIONS, AND AS DIRECTED BY THE ENGINEER. ALL CONFLICTING TRAFFIC SIGNS SHALL BE COVERED AS DIRECTED BY THE ENGINEER. THIS WORK SHALL BE INCLUDED IN THE COST FOR TRAFFIC AND PROTECTION (EXPRESSWAYS).
- 12. THE CONTRACTOR SHALL PROVIDE ADVANCE NOTICE OF CONSTRUCTION SIGNING. SIGNS SHALL BE ERECTED ONE WEEK IN ADVANCE OF THE START OF CONSTRUCTION AND SHALL BE REMOVED OR COVERED WHEN PROTECTION IS NOT REQUIRED.
- 13. ALL ARROW BOARDS SHALL HAVE SOLAR POWER CAPABILITY.
- 14. ALL TRAFFIC CONTROL DEVICES SHALL BE REMOVED, COVERED OR TURNED AWAY FROM THE TRAFFIC IMMEDIATELY WHEN THEY ARE NO LONGER NECESSARY. WHEN A SIGN IS COVERED, ITS POST SHALL HAVE A REFLECTIVE 3" BY 6" DELINEATOR INSTALLED.

  15. LOCAL ROADS, DRIVEWAYS AND PROPERTY ACCESS DRIVES ADJACENT TO CONGRESS PARKWAY (S. TILDEN
- STREET, WACKER DRIVE) MUST REMAIN OPEN TO TRAFFIC AT ALL TIMES DURING CONSTRUCTION, SHOULD A TEMPORARY CLOSURE BE NECESSARY, THE CONTRACTOR SHALL NOTIFY THE STATE AND THE AFFECTED PROPERTY OWNER TWENTY-FOUR (24) HOURS IN ADVANCE OF SUCH CLOSURE, CONSTRUCTION ACTIVITIES SHALL BE EXPEDITED AND ACCESS RESTORED WITHIN AN ADEQUATE TIME FRAME AS DIRECTED BY THE ENGINEER.

PARSONS BRINCKERHOFF USER NAME : poteto DESIGNED - SH REVISED FILE HOVE DRAWN - DCP REVISED -PLOT SCALE : NONE CHECKED - SN REVISED -PLOT DATE : 10/28/2013 DATE - 10/18/2013 REVISED

STATE OF ILLINOIS DEPARTMENT OF TRANSPORTATION

CCTV SYSTEM, I-9094 TO CONGRESS PARKWAY INDEX OF SHEETS, GENERAL NOTES AND STATE STANDARDS SCALE: NONE SHEET NO. OF SHEETS STA. 353+46.00 TO STA. 382+50.00

Rev SECTION COUNTY TOTAL SHEE 389 2013-026-COOK 37 2 CONTRACT NO. 60W49

ŧ œ,

 INDOOR ELECTRICAL CONTROL CABINETS SHALL HAVE A MINIMUM NEMA-12 RATING OR AS INDICATED. ALL OUTDOOR CABINETS SHALL BE STAINLESS STEEL TYPE 316, AND SHALL BE NEMA 4X RATED UNLESS OTHERWISE NOTED.

3. LOCATIONS AND DIMENSIONS OF ELECTRICAL EQUIPMENT AND ASSOCIATED DEVICES AND CONDUIT RUNS ARE APPROXIMATE BASED ON EXISTING CONDITIONS AND BEST AVAILABLE PERTIMENT INFORMATION AND PLANS. HOWEVER, THE CONTRACTOR SHALL BE RESPONSIBLE FOR FIELD VERIFYING EXACT LOCATIONS AND PROPOSED EQUIPMENT DIMENSIONS AS PART OF THE CONSTRUCTION AND SHOP DRAWING SUBMITTAL PROCESS. AS-BUILT-DRAWINGS SHALL BE BASED ON APPROVED SHOP DRAWINGS AND ON ACTUAL FIELD SURVEYS, MEASUREMENTS, AND APPROVED INSTALLED EQUIPMENT ONLY.

4. FURNISH AND INSTALL ALL REQUIRED CONDUIT, WIRE AND CABLE, FITTINGS. BOXES, HARDWARE, ETC. IN ORDER TO MAKE A COMPLETE ELECTRICAL/ COMMUNICATION SYSTEM READY FOR OPERATION, DRAWINGS FOR APPROVAL SHOWING LAYOUT DETAILS SHALL BE SUBMITTED PRIOR TO ANY INSTALLATION WORK,

5. ALL CONDUIT AND WIRING FURNISHED AND INSTALLED UNDER THIS CONTRACT SHALL BE NEW AND MEET NEC AND AASHTO CODE REQUIREMENTS. EXISTING WIRING NOT USED SHALL BE DISCONNECTED AND CLEARLY MARKED AS SUCH. CONDUIT NOT REMOVED AND NOT USED SHALL BE CAPPED. ALL CONDUIT AND FITTINGS SHALL BE HOT- DIP GALVANIZED RIGID STEEL. ADDITIONALLY, ALL EXTERNAL CONDUITS SHALL BE PVC-COATED. MOUNT ALL CONDUIT RUNS ON PVC-COATED GALVANIZED STEEL UNISTRUT (KINDORF) CHANNELS OR APPROVED EQUAL. MOUNTING HARDWARE SHALL BE STAINLESS STEEL. TYPE 316.

6. EXACT CONDUITS, JUNCTION AND PULL BOX LOCATIONS, MOUNTING HARDWARE AND SUPPORTS, AND STUB-UP LOCATIONS ARE TO BE DETERMINED BASED ON FIELD CONDITIONS AS SPECIFIED AND SHOWN ON THE PLANS.

 PROVIDE EXPANSION AND DEFLECTION CONDUIT FITTINGS OF THE APPROVED TYPE AT THE LOCATIONS WHERE CONDUIT PASSES THROUGH STRUCTURAL EXPANSION JOINTS OTHER CRITICAL LOC-ATIONS, OR MINIMUM EVERY 300 FEET ON STRAIGHT RUNS.

 PITCH CONDUIT RUNS TOWARD PULL BOXES TO PREVENT MOISTURE ACCUMULATION. ON LOWEST POINT OF ALL BOXES AND OTHER ELECTRICAL EQUIPMENT SUBJECT TO WATER ACCUMULATION. PROVIDE NECESSARY DRAIN OPENINGS, FITTINGS, CONDUITS, ETC.

9. PERFORM ALL CUTTING, DRILLING AND CORE DRILLING AS NECESSARY
TO PROVIDE PENETRATIONS THROUGH WALLS AND FLOORS FOR ELECTRICAL INSTALLATION WORK, CORE DRILL DIAMETER SHALL NOT BE
MORE THAN 25 PERCENT LARGER THAN THE CONDUIT OUTSIDE DIAMETER. ALL CONDUITS PENETRATING WALLS AND FLOORS SHALL BE INSTALLED IN A GALVANIZED STEEL SLEEVE WITH FLOOR SUPPORTS. PATCH
AND RESTORE SURPOUNDING AREA OF PENETRATIONS TO ITS ORIGINAL
CONDITION TO THE SATISFACTION OF THE ENGINEER, OPENINGS
THROUGH SLAB AND WALL FOR CONDUITS SHALL BE FIRE STOPPED
IN AN APPROVED MANNER UTILIZING "3M" COMPANY SEALING SYSTEM
"7904 SERIES OR APPROVED EDUAL."

10. ALL EQUIPMENT CABINETS SHALL BE FURNISHED WITH ONE THERMOSTATICALLY-CONTROLLED STRIP HEATER, AND 125V, 20A RATED DUPLEX RECEPTACLE.

 CONTRACTOR SHALL NOTIFY IDOT FOR EXISTENCE OF ASBESTOS AFFECTED BY THE INSTALLATION OF ELECTRICAL AND CONTROL SYSTEMS.

12. FURNISH AND INSTALL TAGS FOR CONDUITS AND CABLES TO BE INSTALLED UNDER THIS CONTRACT. TAG IDENTIFICATIONS SHALL BE IN ACCORDANCE WITH THE CONTRACT DRAWINGS, OR AS DIRECTED BY THE ENGINEER.

13. PRIOR TO COMMENCEMENT OF WORK, SUBMIT DETAILED STAGING PLANS TO THE ENGINEER FOR APPROVAL, COORDINATE WITH THE ENGINEER ALL CONSTRUCTION ACTIVITIES THAT MAY AFFECT OPERATIONS.

14. COMPLETE ELECTRICAL INSTALLATION SHALL BE PERMANENTLY AND EFFECTIVELY GROUNDED TO GROUND ROOS AND/OR STRUCTURAL STEEL IN ACCORDANCE WITH NATIONAL ELECTRICAL CODE AND AASHTO CODE ROUIREMENTS. WHETHER OR NOT SUCH CONNECTIONS ARE SPECIFICALLY IDENTIFIED, MEASURED RESISTANCE TO GROUND TO BE 5 OHMS MAXIMUM.

5. ALL 600V POWER AND CONTROL CABLE SHALL BE TYPES RHH, RHW, XHHW-2 OR USE. THE CABLE SHALL RATED AT A MINIMUM OF 90°C DRY AND 75°C WET AND SHALL BE SUITABLE FOR INSTALLATION IN WET AND DRY LOCATIONS, AND SHALL BE RESISTANT TO 01LS AND CHEMICALS, SHALL CONSIST OF STRANDED COPPER CONDUCTORS INSULATED WITH CHEMICALLY CROSS-LINKED POLYETHYLENE, XLPE.

16. THE CONTRACTOR SHALL PERFORM FULL CONTINUITY, INSULATION AND GROUNDING INTEGRITY TESTS UPON COMPLETION OF THE ELECTRICAL INSTALLATIONS. THE CONTRACTOR SHALL PERFORM FULL ACCEPTANCE TESTS OF ALL INDIVIOUAL NEW CCTV SYSTEM COMPONENTS, THE FULL SYSTEM'S INTEGRATION TO EXISTING IDOT CCTV MONITORING SYSTEM, AND ALL AUXILIARY EQUIPMENT. THE CONTRACTOR SHALL ALSO PERFORM FULL CONTINUITY TEST ON REMAINING SPARE FIBER OPTIC STRANDS IN EACH INSTALLED F.O. CABLE.

17. FOR ADDITIONAL INFORMATION REGARDING EXISTING ROADWAY, BRIDGE, AND OTHER INFRASTRUCTURE AND SYSTEMS, REFER TO BRIDGE'S ROADWAY AND VARIOUS ROOMS CONTRACT - WEST CONGRESS STREET BRIDGE OVER SOUTH BRANCH - CHICAGO RIVER. THE CONTRACTOR SHALL FIELD VERIFY ALL EXISTING INSTALLATIONS, AND SHALL PREPARE CONSTRUCTION DOCUMENTATION BASED ON VERIFIED FIELD MEASUREMENTS AND INSTALLATIONS.

 ALL POWER EQUIPMENT SHALL BE GROUNDED, COPPER GROUNDING TERMINATION DETAILS, AS INDICATED ON DRAWINGS AND SPECIFICATIONS.

19. SUBMIT DETAIL DRAWINGS OF ALL EQUIPMENT PRIOR TO FABRICATION.

 ALL EQUIPMENT SHOULD BE ARRANGED TO PERMIT EASY ACCESS FOR OPERATION AND MAINTENANCE.


 ALL SURFACES DAMAGED IN THE COURSE OF WORK SHALL BE RESTORED TO THE ORIGINAL CONDITION AT NO ADDITIONAL COSTS TO THE OWNER.

22. UPON REMOVAL OF ANY EQUIPMENT, REMOVE ALL SUPPORTS AND HANGERS ASSOCIATED WITH THE EQUIPMENT AND RESTORE THE SURFACE TO MATCH THE SURROUNDING AREAS.

23. REMOVAL OF HAZARDOUS MATERIALS SHALL FOLLOW PROCEDURES
APPROVED BY JOOT AND OTHER LOCAL AUTHORITIES HAVING
HUBISDICTION

 ELECTRICAL EQUIPMENT SHALL NOT BE INSTALLED DIRECTLY OVER HEAT PRODUCING EQUIPMENT SUCH AS WALL/SPACE HEATERS AND TRANSFORMERS.

 ALL SALVAGABLE EQUIPMENT SHALL BE RETURNED TO IDOT AT NO ADDITIONAL COST.

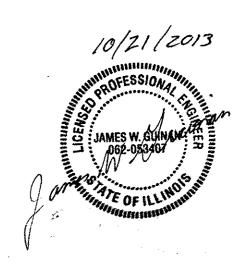

James William Guinan IL PE 062.053407

# **Parsons Brinckerhoff**

Applicable to drawing sheets 3 through 10 And 12 through 25

PARSONS BRINCKERHOFF

Chicago, 2, 60606

STATE OF ILLINOIS
DEPARTMENT OF TRANSPORTATION

CCTV SYSTEM, I-9094 TO CONGRESS PARKWAY
GENERAL ELECTRICAL NOTES

SCALE: AS SHOWN SHEET NO. OF SHEETS STA. 353+46.00 TO STA. 382+50.00

JCIYAFiles from NYA9-17-2013816843A-CCTV-E01-06\_NotesGen\_DwgIndex.dgn

#### ELECTRICAL NOTES:

#### B. CONDUIT & FITTINGS

- USE FACTORY APPLIED POLYURETHANE COATED HOT DIPPED GALVANIZED RIGID CONDUIT AND FITTINGS IN AREAS WHERE CONDUITS ARE EXPOSED TO WATER CONDITIONS, AND FOR ALL OUTDOOR INSTALLATIONS INCLUDING CONTROL AND COMMUNICATION SYSTEMS.
- 2. ALL CONDUIT SHALL BE RIGID CALVANIZED STEEL UNLESS OTHERWISE NOTED. CONDUITS SHALL NOT BE LESS THAN  $\frac{1}{4}$ " WHERE EXPOSED. AND NOT LESS THAN 1" WHERE CONCEALED, CONCRETE-ENCASED, OR BURIED.
- ALL CONDUIT CONNECTIONS SHALL BE WATERTIGHT AND ALL CONDUITS ENTERING ENCLOSURES SHALL BE PROVIDED WITH WATERTIGHT HUBS AND CONDUIT SEALING BUSHINGS THROUGHOUT. ALL OPENINGS FOR CONDUIT PENETRATIONS SHALL BE SLEEVED, AND SHALL BE WATERPROOFED AND FIRE PROOFED.
- 4. INSTALL MOCUL CONDULETS WHERE CONDUIT RUN EXCEEDS 180 FEET BETWEEN CABLE PULLING POINTS. CONDUIT RUNS BETWEEN ANY TWO PULL POINTS SHALL NOT CONTAIN MORE THAN THE EQUIVALENT OF THREE RIGHT ANGLE BENDS. PROVIDE EXPANSION FITTINGS IN CONDUIT RUN WHERE IT CROSSES STRUCTURAL EXPANSION JOINT AND OR EVERY 300 FEET IN ALL EXPOSED CONDUIT RUNS.
- 5. WHERE STRUCTURAL OPENINGS ARE NOT AVAILABLE, SLEEVES SHALL BE INSTALLED AS REQUIRED TO PERMIT PASSAGE OF CONDUITS. AFTER INSTALLATION, ALL OPENINGS SHALL BE FILLED WITH 2 HOUR FIRE RATED COMPOUND AND WATERPROOFED TO MATCH THE SURROUNDING AREAS.
- 6. EXPOSED CONDUIT SUPPORTS MINIMUM SPACING, CENTER TO CENTER, SHALL BE NOT MORE THAN:
  -- 7/<sub>2</sub> FEET ON CONCRETE OR MASONRY, AS PERMITTED BY NEC FOR THE CONDUIT SIZE
  -- 5 FEET ON STEEL STRUCTURES
- 7. WHEREVER A CONDUIT RUN MEETS AN OBSTRUCTION (DRAIN PIPE, VERTICAL PIPE, DRIP PAN, ETC.) CONDUIT SHALL BE OFFSET AS REQUIRED.
- 8. ALL SPARE DUCTS AND CONDUITS SHALL BE SEALED WITH HEAVY DUCT CAPS.
- 9. CHASE WALLS AND FLOORS AS REQUIRED AND APPROVED AND PATCH ALL OPENINGS, FLOOR CHASING OR HOLES WHICH HAVE BEEN CAUSED BY THE INSTALLATION AND REMOVAL OF THE EQUIPMENT.
- 10. THE NUMBER AND SIZES OF CONDUITS, BOXES, CABINETS, WIRES AND CABLES SHOWN ON THE CONTRACT PLANS SCHEMATIC LAYOUT DIAGRAMS AND SCHEDULES ARE THE MINIMUM PERMISSIBLE FOR THE POWER AND CONTROL CIRCUITS OF THE SYSTEMS SHOWN ON THESE CONTRACT PLANS. THE CONTRACTOR SHALL PROVIDE CONDUITS, CONDUCTORS AND CABLES OF SUFFICIENT NUMBER AND SIZE, INCLUDING SPARES, AS MAY BE REQUIRED FOR THE INSTALLATION IN ACCORDANCE WITH THE FINAL WIRING DIAGRAMS ON THE APPROVED WORKING DRAWINGS, AND IN COMPLIANCE WITH NEC AND ALL OTHER APPLICABLE CODES.
- II. THE CONTRACTOR SHALL NUMBER AND TAG SPARE CONDUCTORS AS SUCH, AND SPARE CONDUCTORS SHALL BE SHOWN ON ALL SHOP AND RECORD DRAWINGS. THE SCHEMATIC CONDUIT DIAGRAMS ON THE CONTRACT PLANS AND ALL ASSOCIATED TABLES, SCHEDULES AND DETAILS DO NOT PURPORT TO SHOW ALL PULL AND TERMINAL BOXES, JUNCTION BOXES, MOUNTING HARDWARE AND SUPPORTS ASSOCIATED WITH THE COMPLETE AND FINAL INSTALLATION OF ALL ELECTRICAL SYSTEMS. THE CONTRACTOR SHALL FURNISH AND INSTALL ANY ADDITIONAL BOXES, SUPPORTS AND OTHER HARDWARE REQUIRED TO COMPORM TO THESE ITEMS CONSTRUCTION AND INSTALLATION SPECIFICATIONS, IN COMPLIANCE WITH ALL APPLICABLE CODES AND NYCT DESIGN GUIDELINES.
- 12. FLEXIBLE CONDUIT SECTIONS, HARDWARE AND SUPPORTS REQUIRED FOR CONNECTIONS TO CCTV EQUIPMENT ARE NOT INDICATED ON THE CONTRACT PLANS.
- 13. THE SCHEMATIC CONDUIT DIAGRAMS DO NOT PURPORT TO SHOW THE EXACT PHYSICAL LAYOUT AND LOCATIONS OF THE EQUIPMENT OR OF THE ASSOCIATED CONDUIT, WIRING, BOXES AND OTHER HARDWARE, AND SHOULD NOT BE USED FOR SUCH PURPOSES AS SUBSTITUTES FOR WORKING OR INSTALLATION DRAWINGS. THE CONTRACTOR SHALL SUBMIT SUCH COMPLETE CONDUIT PHYSICAL LAYOUT DRAWINGS APART OF THE SHOP DRAWING SUBMITTAL PROCESS FOR THE ENGINEER'S APPROVAL PRIOR TO PERFORMING THE ACTUAL WORK, THE CONTRACTOR IS SOLELY RESPONSIBLE TO PRODUCE AND SUBMIT FOR THE ENGINEER'S APPROVAL SUCH DRAWINGS AS SPECIFIED HEREIN AND UNDER OTHER RELATED NOTES AND SPECIFICATION SECTIONS.
- 14. FITTINGS, MOUNTING SUPPORTS, BRACKETS, ETC. ARE NOT SHOWN ON THE CONDUIT AND WIRING SCHEMATIC DIAGRAMS,

### C. ELECTRIC POWER

- I. ALL SPARE DUCTS SHALL BE SEALED WITH HEAVY DUCT CAPS AT BOTH ENDS.
- 2. A FRAMEWORK OF KINDORF CHANNEL OR APPROVED EQUAL SHALL BE INSTALLED TO SUPPORT ENCLOSURES. KINDORF CHANNELS MOUNTED VERTICALLY ON THE WALL SHALL HAVE  ${\cal H}''$  SPACERS.
- ALL REQUIRED CONDUIT, WIRE, CABLE, FITTINGS, BOXES, HARDWARE ETC. SHALL BE FURNISHED AND INSTALLED IN ORDER TO MAKE A COMPLETE ELECTRICAL SYSTEM READY FOR OPERATION. NO SPLICING OF WIRE AND CABLE IS ACCEPTABLE UNLESS OTHERWISE INDICATED ON THE CONTRACT DRAWINGS.

### D. ELECTRICAL DEMOLITION

- REMOVE AND/OR RELOCATE ALL EXISTING ELECTRICAL WORK WHICH INTERFERES WITH THE ELECTRICAL LAYOUTS AND SCHEMES IN FULL COORDINATION WITH ALL OTHER DEMOLITION WORK, ALL EQUIPMENT WHICH IS NO LONGER REQUIRED SHALL BE DE-ENERGIZED AND DISCONNECTED AT THE SOURCE OF POWER SUPPLY, AND REMOVED, WHEN REMOVING EMPTY CONDUITS, PATCH SURFACES BEHIND THEM ON THE WALLS, CEILINGS AND OTHER STRUCTURAL ELEMENTS THAT ARE TO REMAIN.
- MAINTAIN SERVICE TO EXISTING EQUIPMENT THAT IS OPERATIONAL, PROVIDE COVERING AND PATCHING OF ALL OPENINGS CREATED BY ELECTRICAL EQUIPMENT REMOVALS, ON ALL WALLS, CEILINGS AND OTHER STRUCTURES TO REMAIN. THE REMAINING ELECTRICAL EQUIPMENT SHALL BE RECONNECTED AND RESTORED TO THEIR CURRENT FUNCTIONS AS PART OF THE ELECTRICAL SYSTEMS WORK.
- 3. NOTIFY IDOT AND THE FACILITY GENERAL MANAGER THRU THE ENGINEER AT THE APPROPRIATE TIME AND FOLLOWING THE APPROPRIATE PROCEDURES FOR THE PROJECTED DEMOLITION. EQUIPMENT PROTECTION AND CONSTRUCTION PHASING SHALL BE CARRIED OUT IN ACCORDANCE WITH THE CONTRACT REQUIREMENTS AND AS AGREED WITH THE IDOT AND OTHER LOCAL AUTHORITIES, FOLLOW THE APPROVED DEMOLITION AND PHASING SCHEDULE AND PROCEED IN THE SPECIFIED SEQUENCE AS APPLICABLE TO ANY POWER SHUTDOWN.
- 4. CONTRACTOR SHALL SUBMIT ALL MATERIAL REMOVALS FOR REVIEW AND APPROVAL 30 DAYS PRIOR TO ANY DEMOLITION WORK, AT NO TIME THE CONTRACTOR SHALL PERFORM ANY DEMOLITION WORK, RELOCATION, REPAIR OR REROUTING OF EXISTING CABLES, CONDUITS, RACEWAYS, JUNCTION BOXES OR EQUIPMENT IN AN AREA WITHOUT THE ENGINEER'S APPROVAL FOR THE AREA AS CLEAR OF ANY HAZARDOUS MATERIALS.

PARSONS
BRINCKERHOFF
200 West Marrier Street

STATE OF ILLINOIS
DEPARTMENT OF TRANSPORTATION

| CCTV SYSTEM, 1-9094 TO CONGRESS PARKWAY | F.A.P | SECTION | COUNTY SHEETS NO. | SHEETS STAL 153+46.00 TO STAL 382+50.00 | FED. ROAD DIST, NO. 1 | ILLINOIS|FED. AID PROSECT

WEATHERPROOF

ELECTRICAL SYMBOLS

(LIGHT LINE INDICATES EXISTING CONDUIT, CABLE AND EQUIPMENT. HAVY LINE INDICATES NEW WORK).

CONDUIT RUN EXPOSED.

CONDUIT TURNING UP OR TOWARD OBSERVER.

CONDUIT TURNING DOWN OR AWAY FROM OBSERVER.

UNDERGROUND POWER (GOOV AND BELOW), CONCRETE ENCASED CONDUIT OR DUCTBANK.

SUBMARINE CABLE. <del>----</del>S-----

 $\times\!\!\times\!\!\times\!\!\times$ 

<del>-- J/||/- >--</del>

GFC1

STACE 2 - EXISTING EQUIPMENT, CONDUIT, OR CABLE TO BE REMOVED.

HOME RUN, DESIGNATION INDICATES PANEL AND CIRCUIT NUMBERS HATCHMARK INDICATES NUMBER OF \*12 PHASE WIRE, UON. HATCHMARK WITH STRIKE INDICATES \*12 NEUTRAL WIRE, UON. HATCHMARK WITH TAIL INDICATES\*12 GROUND WIRE, UON. LP-E1-1,3,5

208/120V, 3P, 4W DISTRIBUTION PANELBOARD. 

EQUIPMENT BOX

TB PB \$8 TERMINAL, PULL OR SPLICE BOX AS SHOWN.

**(** JUNCTION BOX.

FLUSH MOUNTED DUPLEX CONVENIENCE RECEPTACLE, 20A, 125V, 3W GROUNDING TYPE WITH GROUND FAULT CIRCUIT INTERRUPTER.

GFCI

WALL MOUNTED DUPLEX CONVENIENCE RECEPTACLE, 20A, 125V, 3W GROUNDING TYPE WITH GROUND FAULT CIRCUIT INTERRUPTER IN WEATHERPROOF, ENCLOSURE

FOR SINGLE LINE AND CONTROL WIRING DIAGRAMS

MAGNETIC STARTER OR CONTACTOR COLL WITH IDENTIFICATION 0

R1 ‡

®XX RELAY COIL WITH IDENTIFICATION

CONTACT, NORMALLY OPEN INSTANTLY ON ENERGIZING "RI" - INDICATES CONTACT OF RELAY RI

CONTACT, NORMALLY CLOSED SUBSCRIPTS HAVE SAME MEANING AS ABOVE Ri ∦

FULL-VOLTAGE NON-REVERSING STARTER CONTACTOR, 3 POLE 3 ± "3" - INDICATES STARTER SIZE RATING

(BLOCK DIAGRAM)

PAN TILT ZOOM CCTV CAMERA, OUTDOOR

CCTV-E03-08 NYB9-17-2013B16843A-

USER NAME + potold PARSONS DESIGNEO - O, DRAKULICH REVISED BRINCKERHOFF FILE NAME DRAWN - E. MALUSEL REVISED PLOT SCALE 4 NONE CHECKED - S. STERN REVISED . PLOT DATE + 10/18/2013 - 10/18/2013

						TO CON				
ELECTRICAL SYMBOLS AND ABBREVIATIONS										
SCALE:	AS		SHEET		0F	SHEETS	STA.	53+46.00	TO STA	. 382+50.00

F.A.P RTE.	SECTION	COUNTY	TOTAL SHEETS	SHEET NO.
389	2013-026-1	COOK	37	5
		CONTRACT	NO. 60	OW49
PED, R	DAD DIST, NO. 1 ILLINOIS FED. A	ID PROJECT		

PROJECT: FAP 389 - CCTV SYSTEM - I-90/94 TO CONGRESS PARKWAY - CONTRACT NO. 60W49 COOK COUNTY

CONSTR. TYPE CODE ELECTRICAL TOTAL 90% FED CODE NO. ITEM UNIT 10% STATE QUANTITY 0021 67100100 MOBILIZATION L SUM 70106800 CHANGEABLE MESSAGE SIGN CAL MO 0.5 0.5 UNDERGROUND CONDUIT, GALVANIZED STEEL, 2" DIA. FOOT 38 81028200 38 81028220 UNDERGROUND CONDUIT, GALVANIZED STEEL, 3" DIA. FOOT 102 102 81028370 UNDERGROUND CONDUIT, PVC, 3" DIA. FOOT 560 560 81100300 CONDUIT ATTACHED TO STRUCTURE, 1" DIA., GALVANIZED STEEL FOOT 120 120 81100320 CONDUIT ATTACHED TO STRUCTURE, 1" DIA., PVC COATED GALVANIZED STEEL FOOT 210 210 81100400 CONDUIT ATTACHED TO STRUCTURE, 1 1/4" DIA., GALVANIZED STEEL FOOT 110 110 CONDUIT ATTACHED TO STRUCTURE, 1 1/4" DIA., PVC COATED GALVANIZED STEEL FOOT 40 40 81100420 FOOT 81100600 CONDUIT ATTACHED TO STRUCTURE, 2" DIA., GALVANIZED STEEL 10 CONDUIT ATTACHED TO STRUCTURE, 2" DIA., PVC COATED GALVANIZED STEEL FOOT 700 81100605 700 40 CONDUIT ATTACHED TO STRUCTURE, 3" DIA., PVC COATED GALVANIZED STEEL FOOT 40 81100805 JUNCTION BOX, STAINLESS STEEL, ATTACHED TO STRUCTURE, 12" X 12" X 6" EACH 4 81300550 EACH 3 3 81300960 JUNCTION BOX, STAINLESS STEEL, ATTACHED TO STRUCTURE, 42" X 36" X 12" 81702441 ELECTRIC CABLE IN CONDUIT. 600V (XLP-TYPE USE) 2-12/C, 1-12/C GROUND FOOT 224 224 87000885 ELECTRIC CABLE ASSEMBLY IN CONDUIT, 600V (XLP-TYPE TC) 2/C NO. 6 AND NO. 8 FOOT 1455 1455 87900200 DRILL EXISTING HANDHOLE EACH 3 3

!!6843A@CCTV&CADD&60#49~sh1,.03~soq. :NNV-2013 14:23

PARSONS BRINCKERHOFF 230 West Montous Street Suite 900

USER NAME * poteld	DESIGNEO	-	SN	REVISED -
FILE NAME	DRAWN	-	OCP .	REVISED -
PLOT SCALE . NONE	CHECKED	_	SN	REVISEO -
PLOT DATE : 11/1/2010	DATE	~	10/18/2013	REVISED -

STATE OF ILLINOIS
DEPARTMENT OF TRANSPORTATION

CCT	V SY	STEM,	1-90/9	4 TO	ÇOI	NGRE	SS	PARK	W	Įγ		
		SUMM	ARY	OF I	QUA	NTI	TIES	5				
	SHEET	NO.	0F	SHE	ETS	STA.	3534	46,00	ΤQ	STA.	382+5	0.00

SCALE: NONE

	F.A.P RTE.		SEC	TION		COUNTY	TOTAL SHEETS	SHEET NO.
1	389		2013-	1-850	COOK	37	6	
4						CONTRACT	NO. 60	W49
1	FED.	ROAD DIST.	NO. I	ILLINGIS	FED. AL	O PROJECT		

PROJECT: FAP 389 - CCTV SYSTEM - I-90/94 TO CONGRESS PARKWAY - CONTRACT NO. 60W49 COOK COUNTY

	1 30/34 TO CONGRESS PARKWAY - CONTRACT	NO. 60W49 C	OUR COUNTY	CONST
CODE NO.	ITEM		TOTAL	TYPE C ELECTR 90% F
V0.70.70.00		UNIT	QUANTITY	10% ST 002
X0323898	CLOSED CIRCUIT TELEVISION DOME CAMERA	EACH	10	10
X0323914	FIBER OPTIC CABLE SPLICE - LATERAL	EACH	3	3
V0704507				
X0324597	CLOSED CIRCUIT TELEVISION CABINET	EACH	5	5
X0326945	CLOSED CIRCUIT TELEVISION CAMERA EQUIPMENT	EACH	10	10
X0326946	CLOSED CIRCUIT TELEVISION CAMERA INSTALLATION	EACH	6	6
V070450				
X0327561	BUDGETARY ALLOWANCE FOR CCTV INTEGRATION	L SUM	1	1
X0783300	PUMP STATION ELECTRICAL WORK	L SUM	1	1
X7011015	TRAFFIC CONTROL AND PROTECTION (EXPRESSWAYS)	L SUM	1	1
X8710012	FIBER OPTIC CABLE IN CONDUIT (INSTALLONLY)	FOOT	670	670 .
X8710036	FIBER OPTIC CABLE 12 FIBERS, SINGLE MODE			010
	TOOK OF TO CAULT 12 TIBERS, STRULE MUDE	FOOT	629	629
Z0010614	CLEANING EXISTING MANHOLE OR HANDHOLE	EACH	2	2
20013798	CONSTRUCTION LAYOUT	L SUM	1	1
Z0030850	TEMPORARY INFORMATION SIGNING	00.55		
		S0 FT	24	24
(8710047	FIBER OPTIC CABLE AERIAL SELF. SUPPORTING 24 FIBERS, SINGLE MODE	FOOT	2837	2837
(0327683	CLOSED CIRCUIT TELEVISION CAMERA STRUCTURE, GALVANIZED STEEL, 100 FT. MOUNTING HEIGHT	EACH	2	2
		Transact Harris		
				·····
SPECIALTY ITE	V			**************************************

D NP-100% STATE

PARSONS BRINCKERHOFF 230 West Shaves Street 5-de 900 CHC490, N. 47495

USER NAME - poteld
FILE NAME: DESIGNED - SN

DRAWN - DCP


CHECKED - SN


DATE - 10/18/2013 REVISED -REVISED . . PLOT SCOLE : HOME REVISED -PLO1 DAFE 3 07172013

STATE OF ILLINOIS DEPARTMENT OF TRANSPORTATION

SCALE; NONE SHEET NO. OF SHEETS STA. 353+46.00 TO STA. 382+50.00

REAL SECTION COUNTY SHEETS NO. SHEETS NO. 37 60 COUNTY SHEETS NO. 37 60 COUNTRACT NO. 60W49

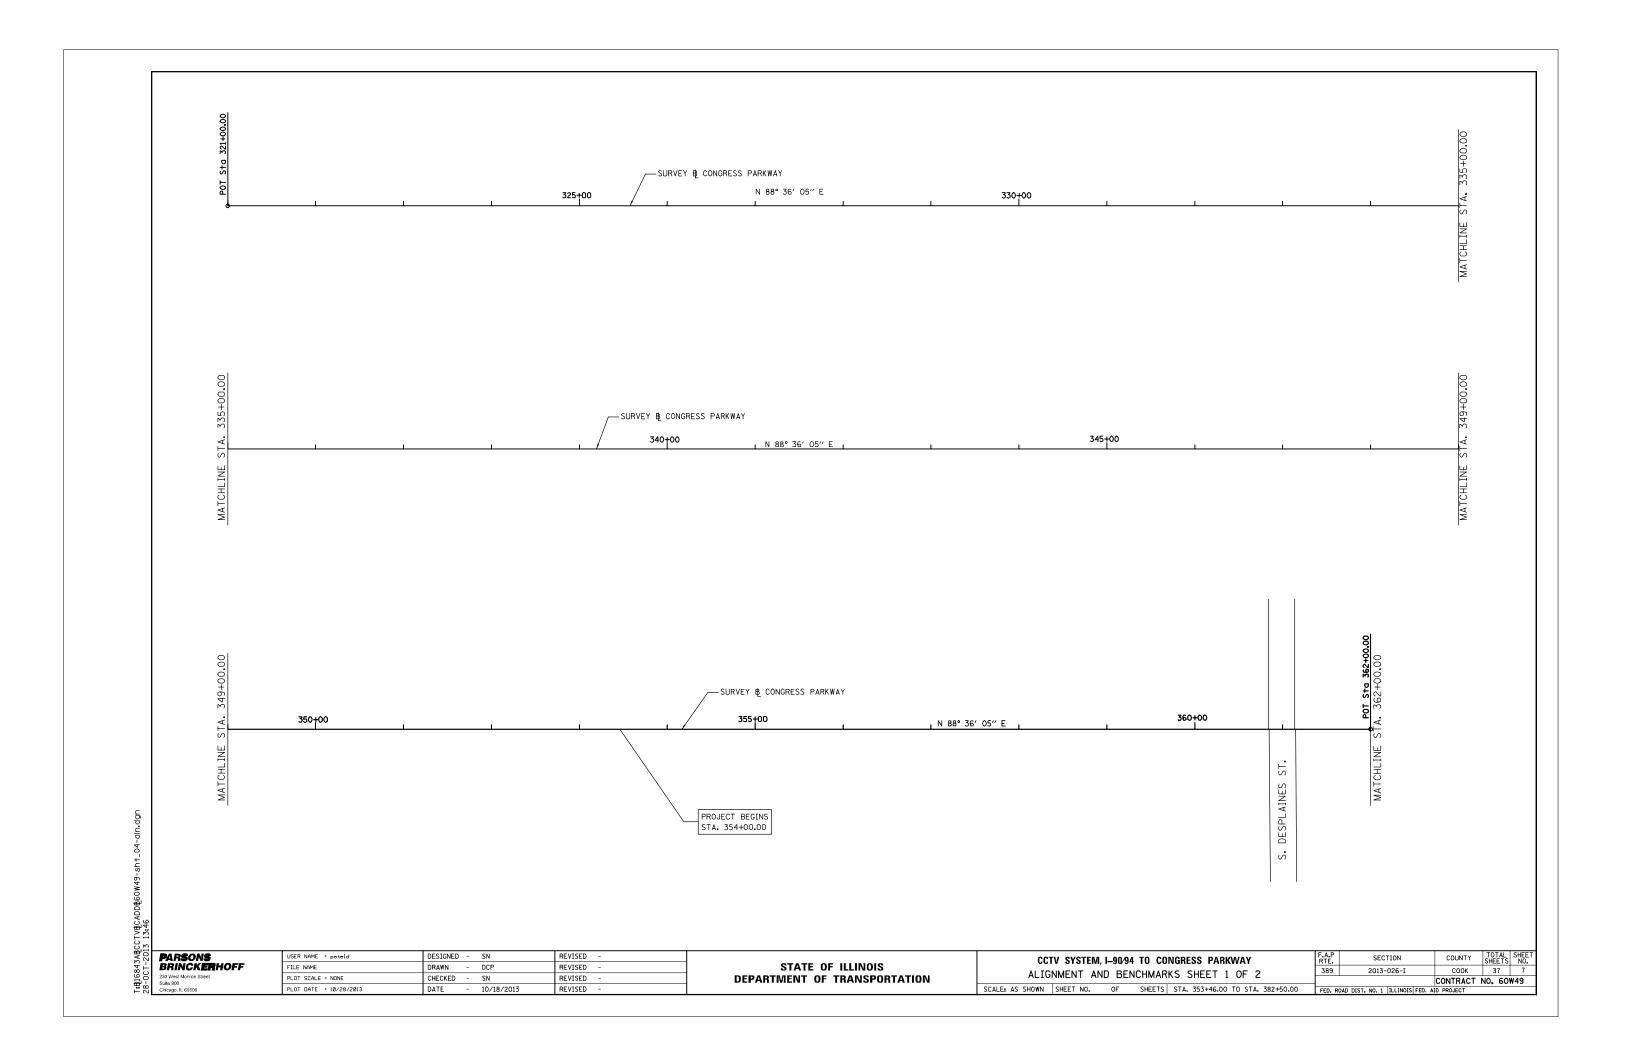

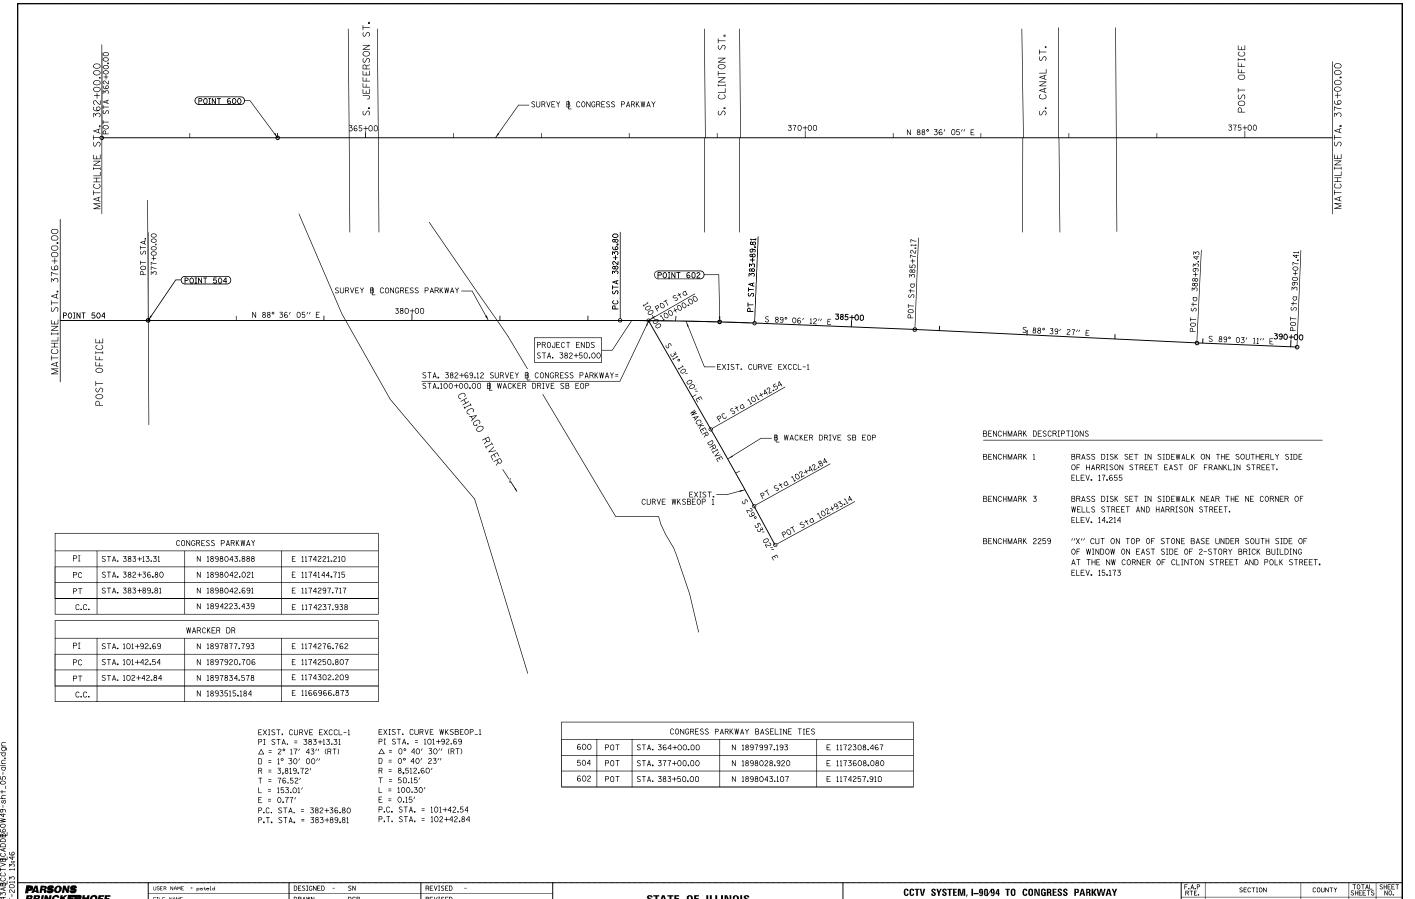

BRINCKERHOFF

FILE NAME DRAWN - DCP REVISED PLOT SCALE = NONESØ' CHECKED - SN REVISED PLOT DATE = 10/28/2013 REVISED

STATE OF ILLINOIS **DEPARTMENT OF TRANSPORTATION** 

ALIGNMENT AND BENCHMARKS SHEET 2 OF 2 SCALE: AS SHOWN SHEET NO. OF SHEETS STA. 353+46.00 TO STA. 382+50.00

COUNTY TOTAL SHEE SHEETS NO. COOK 37 8 389 2013-026-I FED. ROAD DIST. NO. 1 |ILLINOIS | FED. AID PROJECT

FOR THIS AREA REFER TO DRAWING 11

FOR THIS AREA REFER TO DRAWING 12

FOR THIS AREA REFER TO DRAWING 13


KEY PLAN


TiB16843ABCCTVBFIles from NYB9-17-2013B16843A-CCTV-f 28-0CT-2013 13:46


PARSONS BRINCKERHOFF 230 West Monroe Street Suite 900

USER NAME = pateld	DESIGNED	-	D. DRAKULICH	REVISED -
FILE NAME	DRAWN	-	E. MALUSEL	REVISED -
PLOT SCALE = NONE	CHECKED	-	S. STERN	REVISED -
PLOT DATE = 10/18/2013	DATE	-	10/18/2013	REVISED -

STATE OF ILLINOIS DEPARTMENT OF TRANSPORTATION

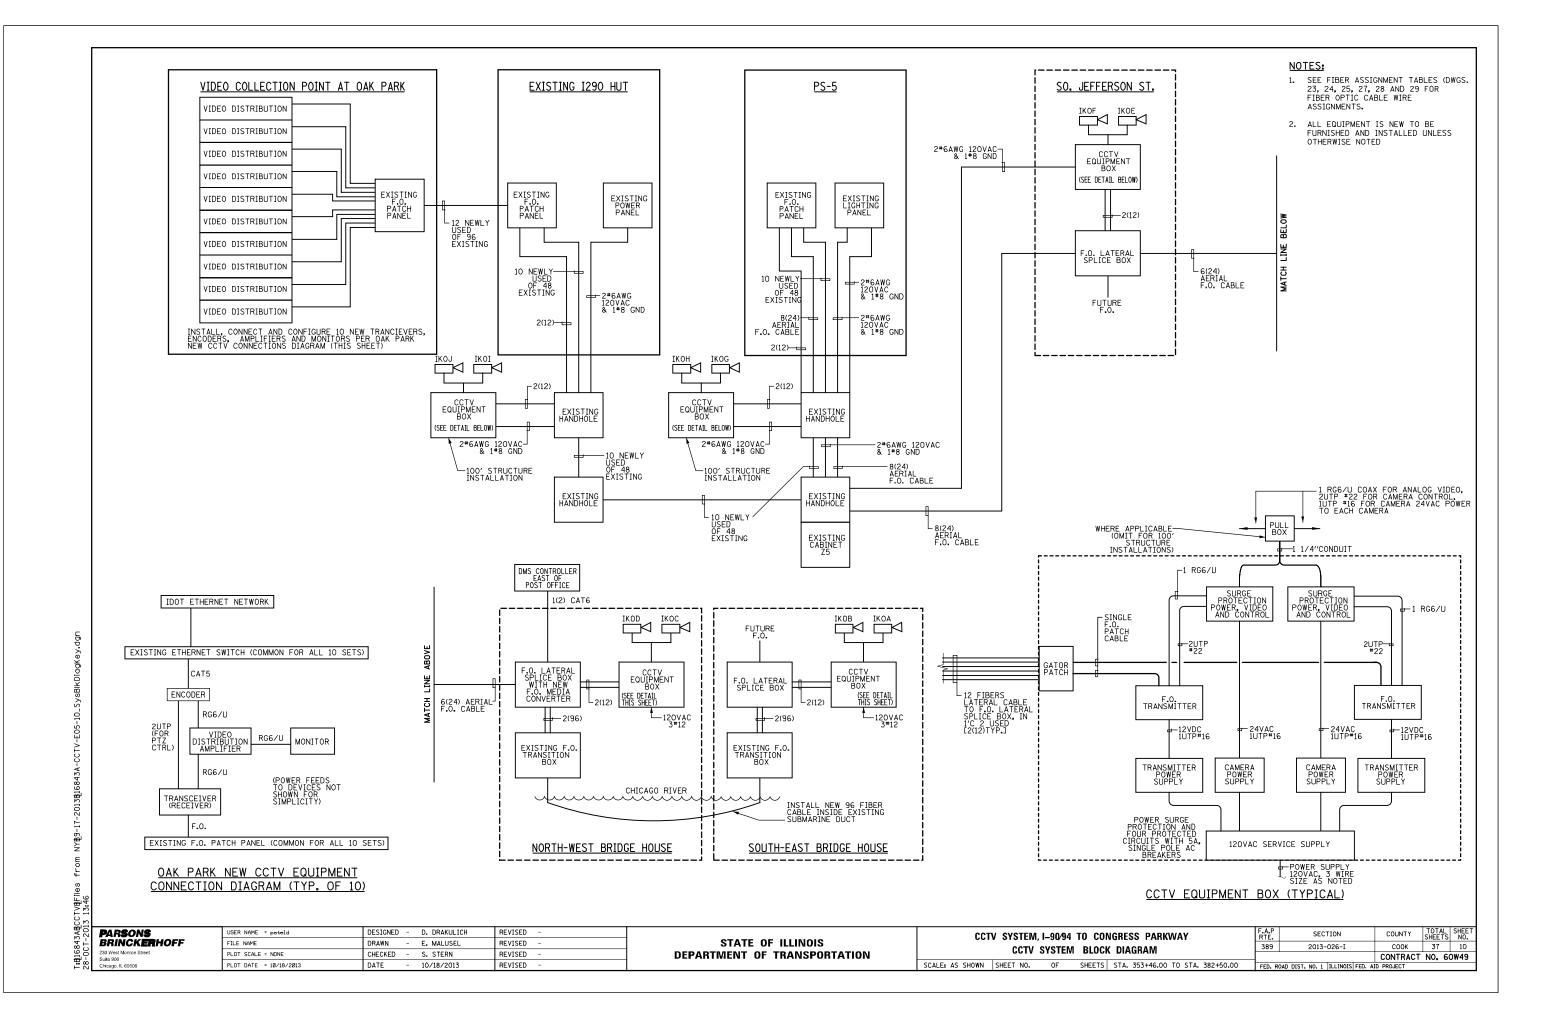


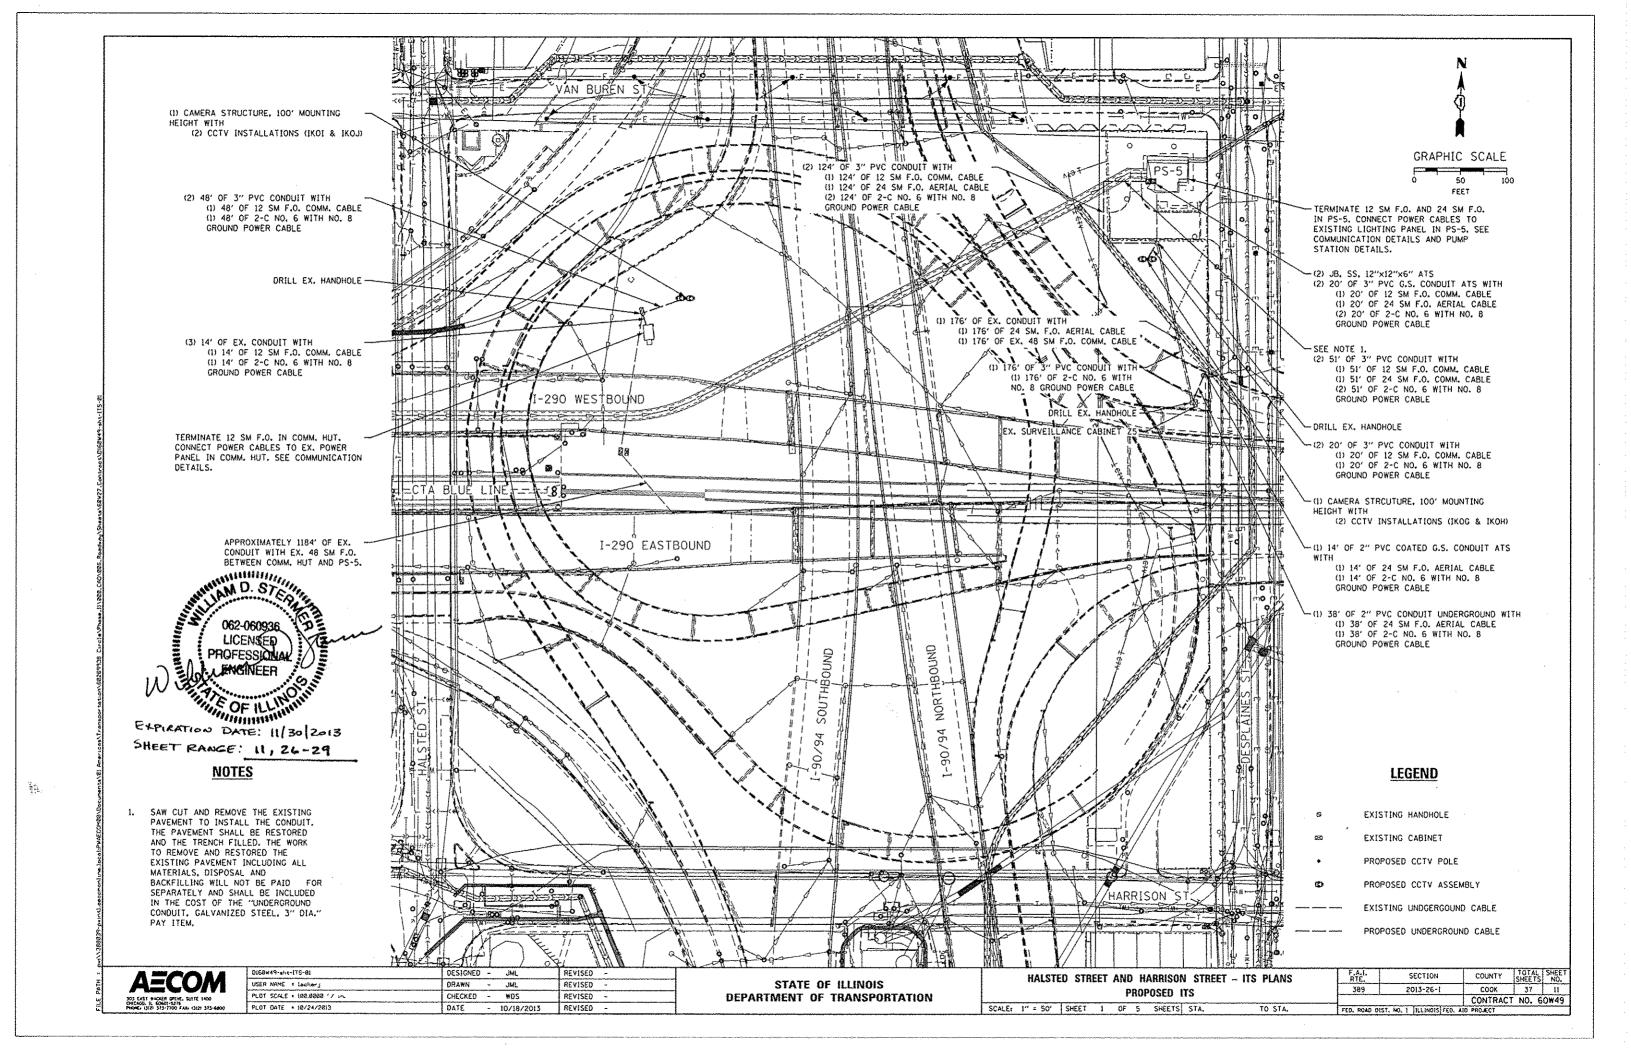

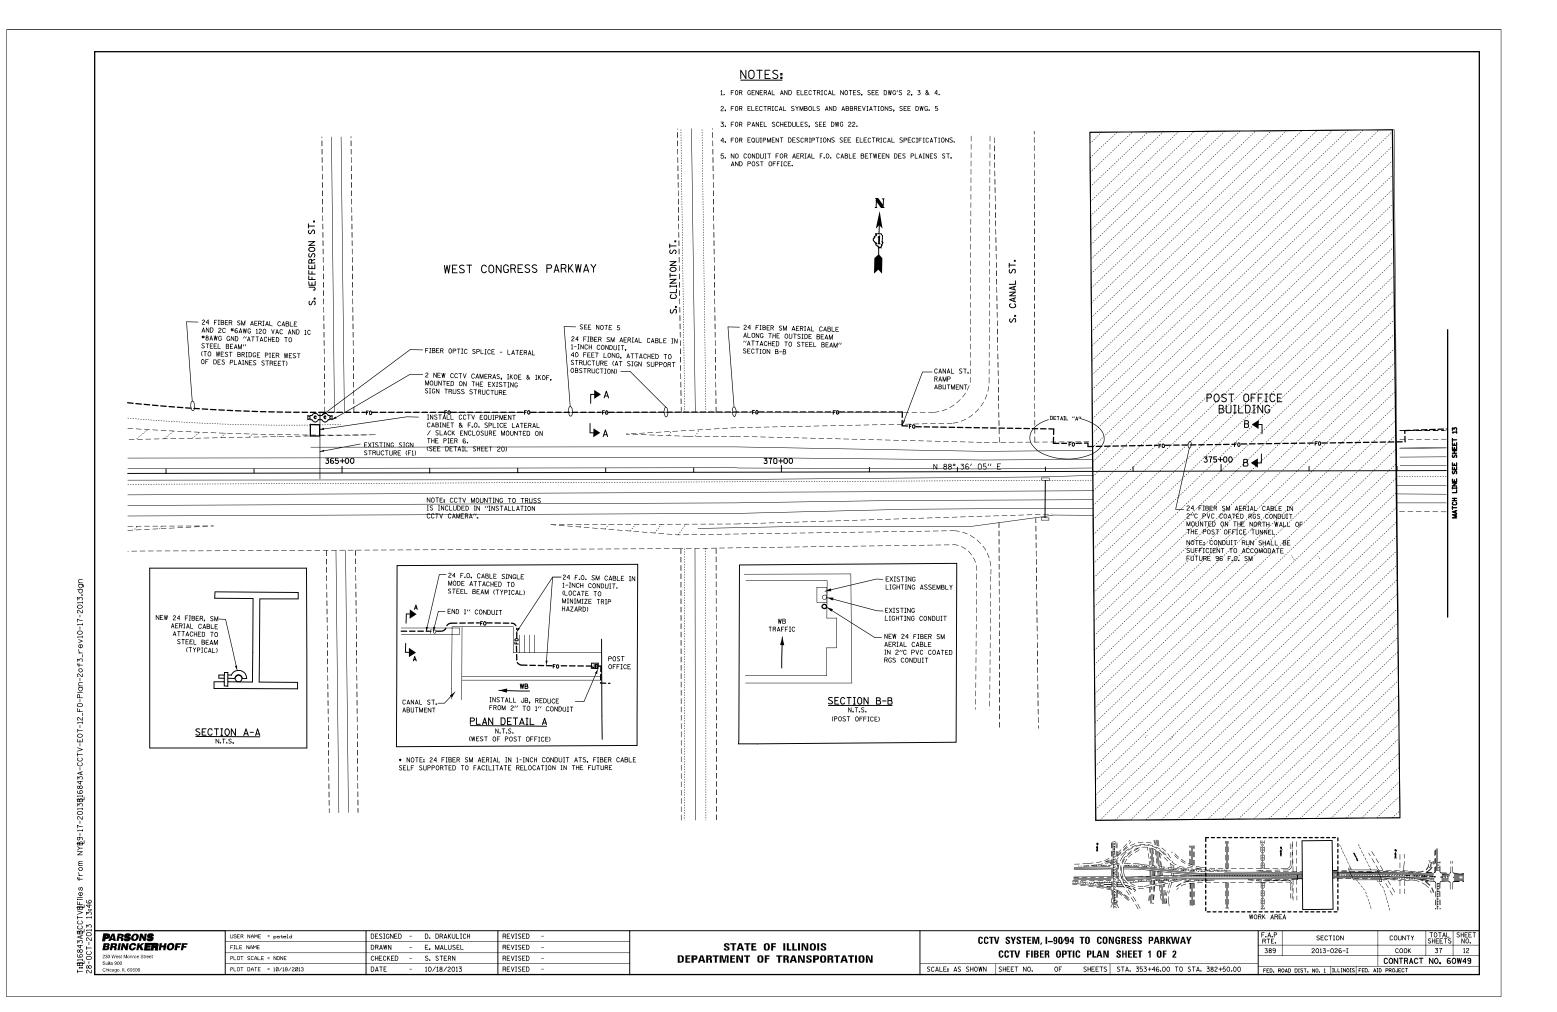

# NOTES:

- 1. FOR GENERAL AND ELECTRICAL NOTES, SEE DWG'S 2, 3 & 4.
- 2. FOR ELECTRICAL SYMBOLS AND ABBREVIATIONS, SEE DWG. 5
- 3. FOR PANEL SCHEDULES, SEE DWG 22.
- 4. FOR EQUIPMENT DESCRIPTIONS SEE ELECTRICAL SPECIFICATIONS.

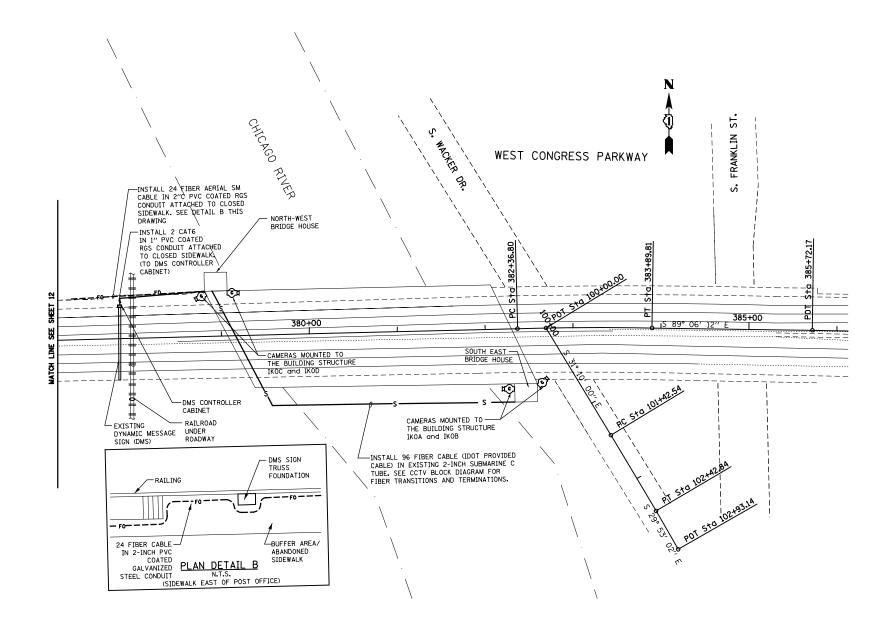

WORK AREA

PARSONS BRINCKERHOFF	
230 West Monroe Street	

USER NAME = pateld	DESIGNED	-	D. DRAKULICH	REVISED -	
FILE NAME	DRAWN	-	E. MALUSEL	REVISED -	
PLOT SCALE = NONE	CHECKED	-	S. STERN	REVISED -	
PLOT DATE = 10/18/2013	DATE	-	10/18/2013	REVISED -	L

STATE OF ILLINOIS
DEPARTMENT OF TRANSPORTATION

CCTV SYSTEM, I-90/94 TO CONGRESS PARKWAY


CCTV FIBER OPTIC PLAN SHEET 2 OF 2

SCALE: AS SHOWN SHEET NO. OF SHEETS STA. 353+46.00 TO STA. 382+50.00


A.P TE.	SECTION						COUNTY	TOTAL SHEETS		SHEET NO.	
89	2013-026-I					C00K 37			13		
							CONTRACT	NO.	60	)W49	
-	OAD DICT	NO	1	THE TMATE	EED	۸١	IN DONIECT				

-2013 13:46

CCTVRFILES from NYR9

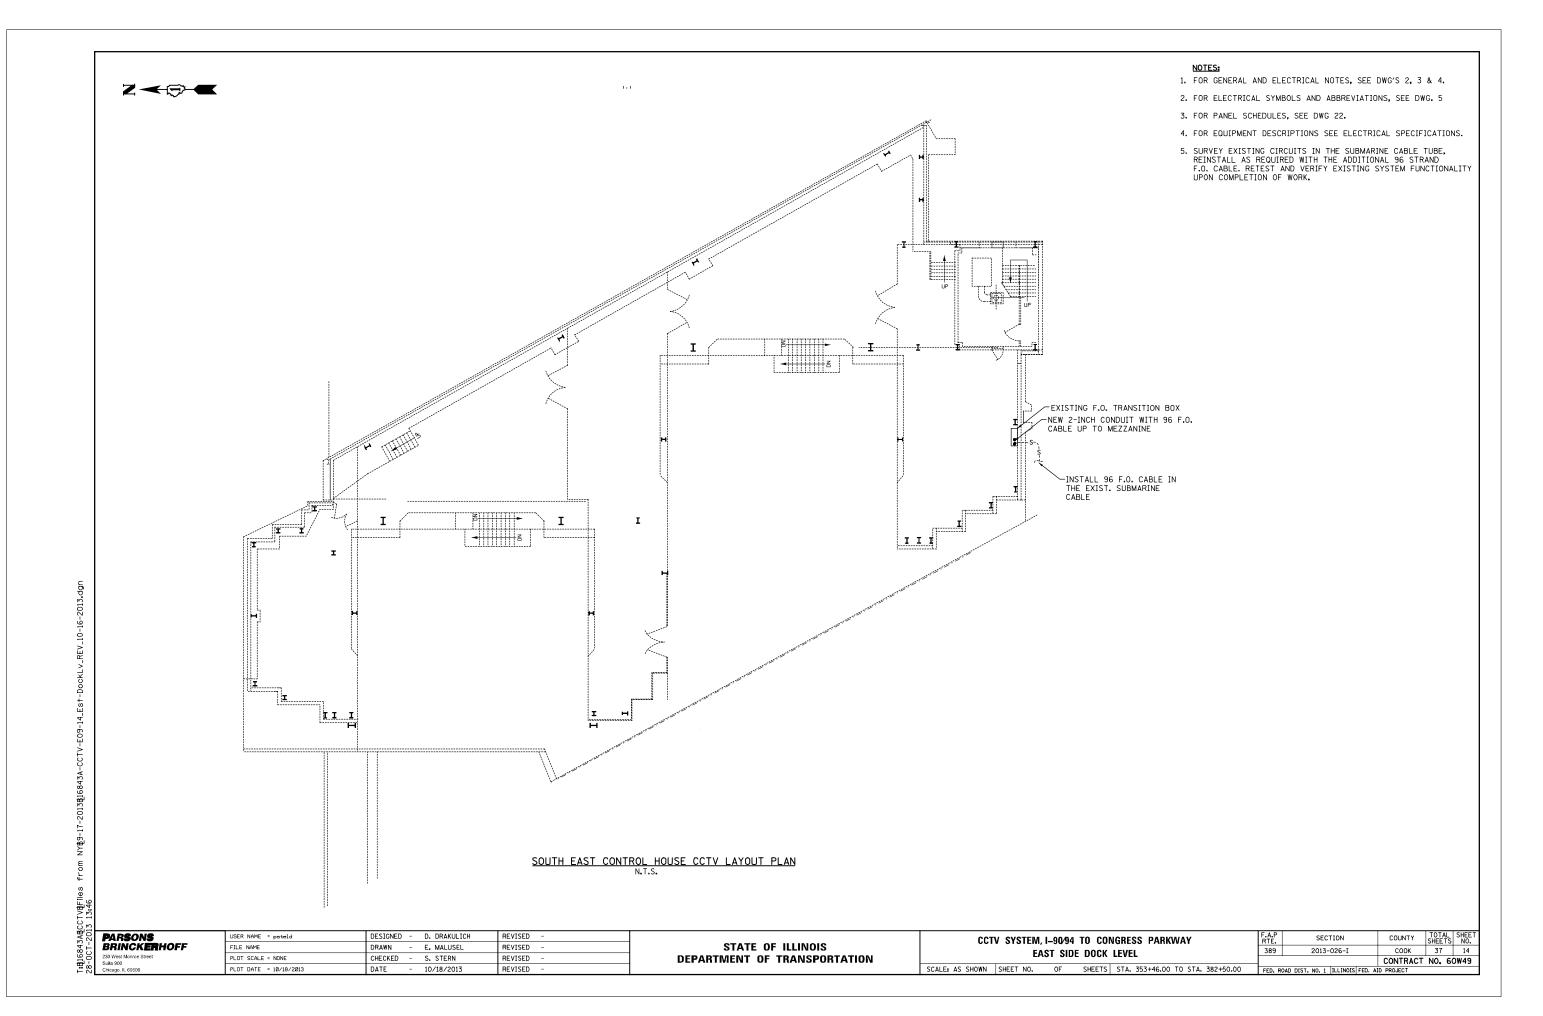

- 1. FOR GENERAL AND ELECTRICAL NOTES, SEE DWG'S 2, 3 & 4.
- 2. FOR ELECTRICAL SYMBOLS AND ABBREVIATIONS, SEE DWG. 5
- 3. FOR PANEL SCHEDULES, SEE DWG 22.
- 4. FOR EQUIPMENT DESCRIPTIONS SEE ELECTRICAL SPECIFICATIONS.

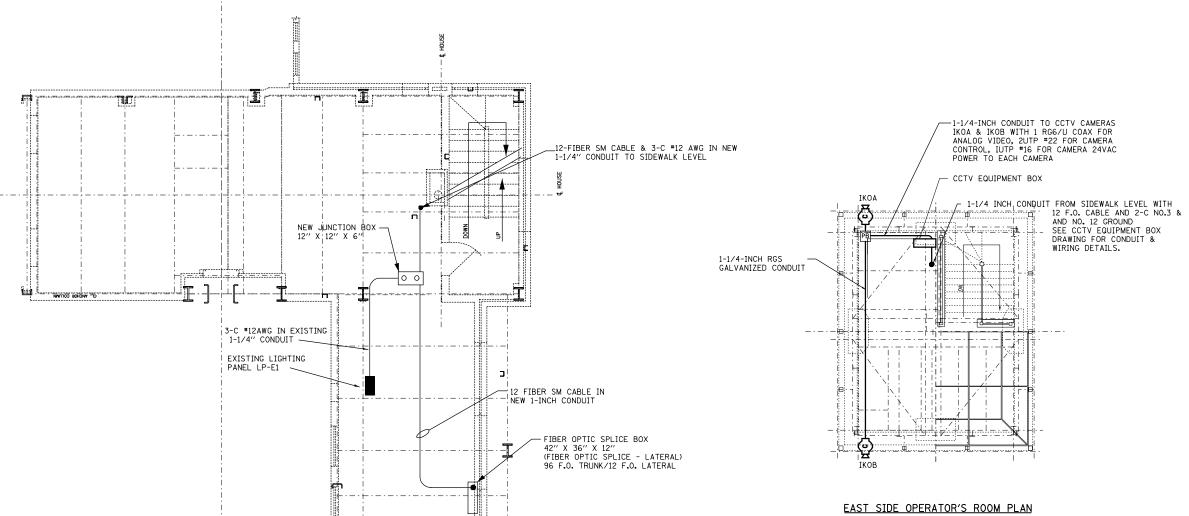

N.T.S.

PARSONS BRINCKERHOFF 230 West Monroe Street Stille 900
230 West Monroe Street

USER NAME = pateld	DESIGNED	-	D. DRAKULICH	REVISED -	Г
FILE NAME	DRAWN	-	E. MALUSEL	REVISED -	ı
PLOT SCALE = NONE	CHECKED	-	S. STERN	REVISED -	ı
PLOT DATE = 10/18/2013	DATE	-	10/18/2013	REVISED -	

III

CL. TRUNNION


STATE OF ILLINOIS DEPARTMENT OF TRANSPORTATION


SOUTH EAST MEZZANINE LEVEL CONTROL HOUSE CCTV LAYOUT PLAN N.T.S.


			I TO CONGRESS PARKWAY LEVEL AND OPERATOR'S ROOM	
SCALE: AS SHOWN	SHEET NO.	OF	SHEETS STA. 353+46.00 TO STA. 382+50.00	

F.A.P RTE.	SECT	TION		COUNTY	TOTAL SHEETS	SHEET NO.			
389	2013-	026-I		COOK	37	15			
				CONTRACT	NO. 6	OW49			
FED. R	FED. ROAD DIST. NO. 1   ILLINOIS   FED. AID PROJECT								

เซิโ6843ABCCTV&Files from NY®9-17-2013฿ฺ16843A-CCTV-E10-15\_Est-N

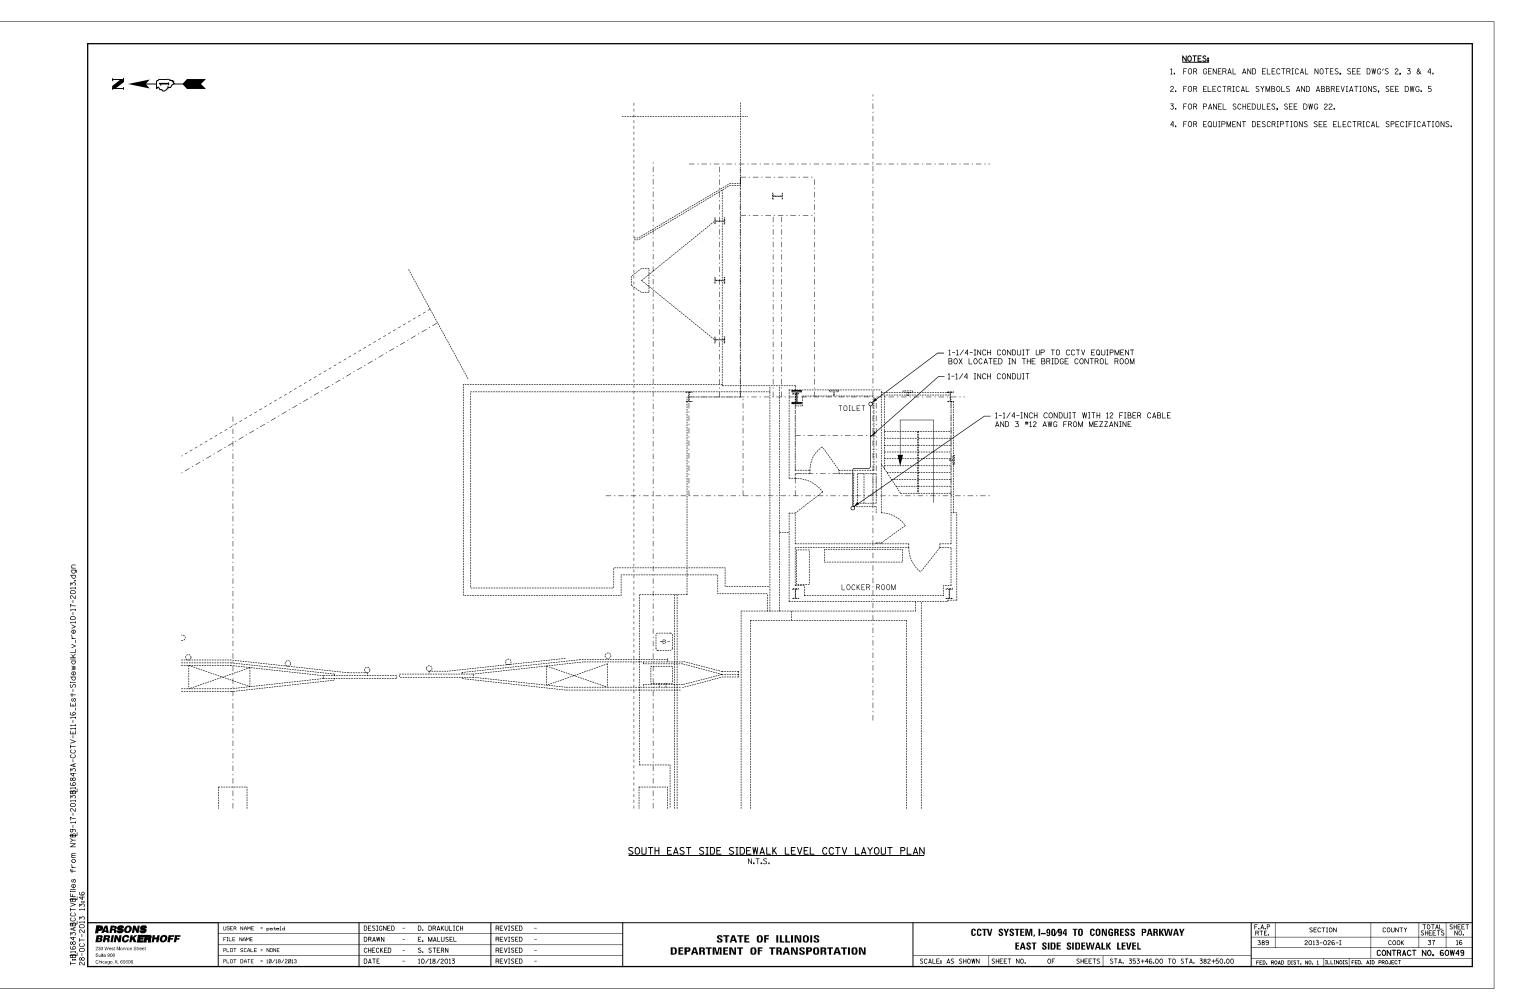

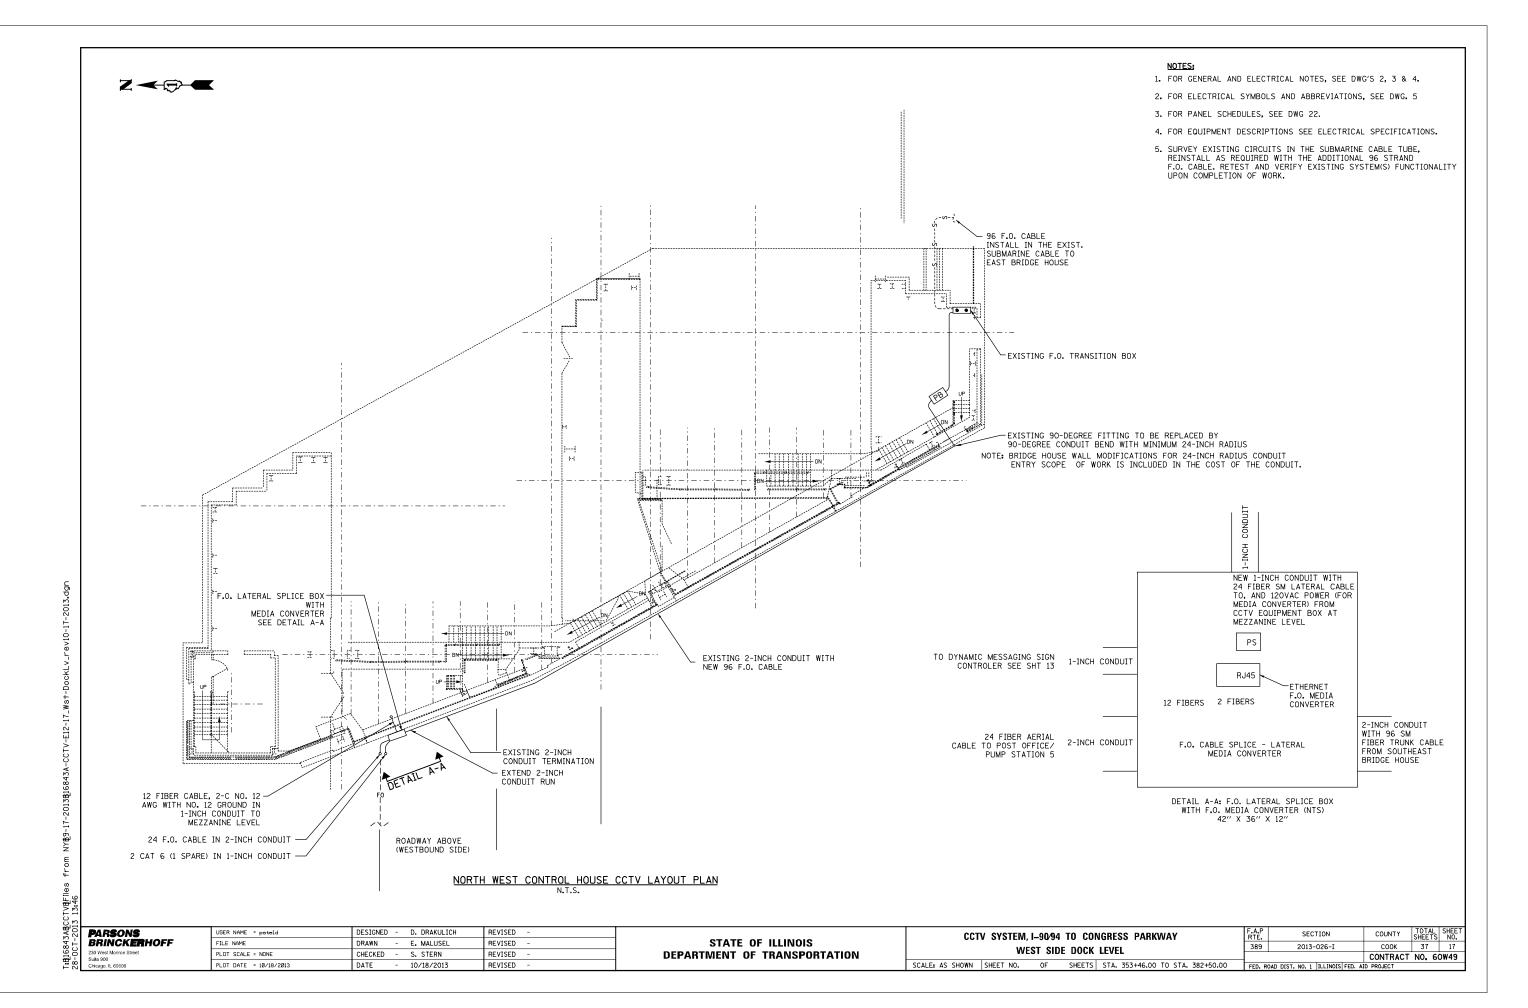

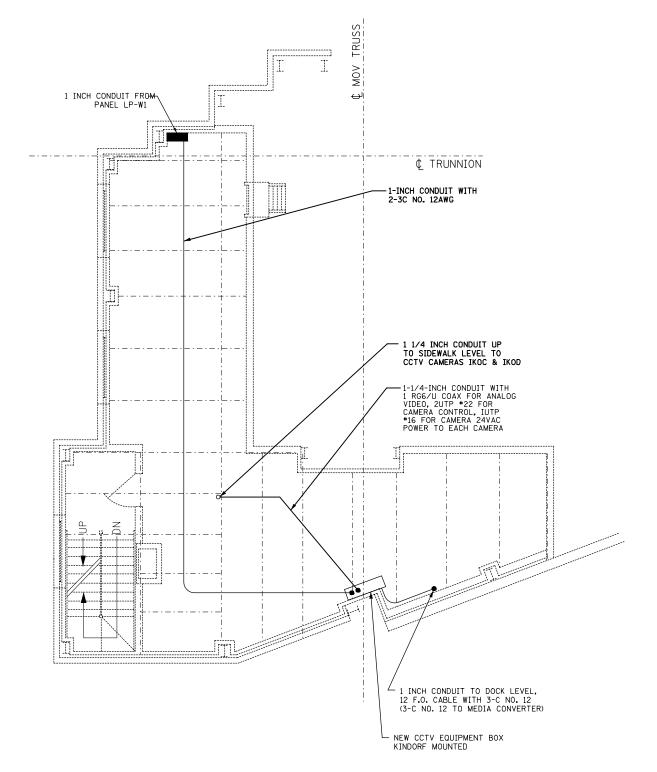

NORTH WEST SIDE MEZZANINE LEVEL CONTROL HOUSE CCTV LAYOUT PLAN N.T.S.

PARSONS BRINCKERHOFF 230 West Monroe Street Suite 900

STATE OF ILLINOIS
DEPARTMENT OF TRANSPORTATION

CCTV SYSTEM, I-90/94 TO CONGRESS PARKWAY

WEST SIDE MEZZANINE LEVEL

SCALE: AS SHOWN SHEET NO. OF SHEETS STA. 353+46.00 TO STA. 382+50.00 FED. ROAD DIS

NOTES:

FOR GENERAL AND ELECTRICAL NOTES, SEE DWG'S 2, 3 & 4.
 FOR ELECTRICAL SYMBOLS AND ABBREVIATIONS, SEE DWG. 5

4. FOR EQUIPMENT DESCRIPTIONS SEE ELECTRICAL SPECIFICATIONS.

3. FOR PANEL SCHEDULES, SEE DWG 22.

343AECCTVEFIles from NYE9-17-2013E16843A-CCTV-E13-18\_Wst-MezzLv\_rev10-17-201 T 2013 13.46

1-INCH CONDUIT

### NOTES:

- 1. FOR GENERAL AND ELECTRICAL NOTES, SEE DWG'S 2, 3 & 4.
- 2. FOR ELECTRICAL SYMBOLS AND ABBREVIATIONS, SEE DWG. 5
- 3. FOR PANEL SCHEDULES, SEE DWG 22.
- 4. FOR EQUIPMENT DESCRIPTIONS SEE ELECTRICAL SPECIFICATIONS.

 $\underset{N.T.S.}{\textbf{NORTH WEST SIDE SIDEWALK LEVEL CCTV LAYOUT PLAN}}$ 

**P**AR**S**ON**S** Brinck**er**hoff

DESIGNED - D. DRAKULICH REVISED FILE NAME DRAWN - E. MALUSEL REVISED -PLOT SCALE = NONE CHECKED - S. STERN REVISED PLOT DATE = 10/18/2013 10/18/2013

IKOD


LOCKER ROOM


STATE OF ILLINOIS **DEPARTMENT OF TRANSPORTATION** 

CCTV SYSTEM, I-90/94 TO CONGRESS PARKWAY
WEST SIDE SIDEWALK LEVEL
SCALE: AS SHOWN SHEET NO. OF SHEETS STA. 353+46.00 TO STA. 382+50.00

SCALE: AS SHOWN SHEET NO. OF SHEETS STA. 353+46.00 TO STA. 382+50.00

FED. ROAD DIST. NO. 1 |ILLINOIS|FED. AID PROJECT

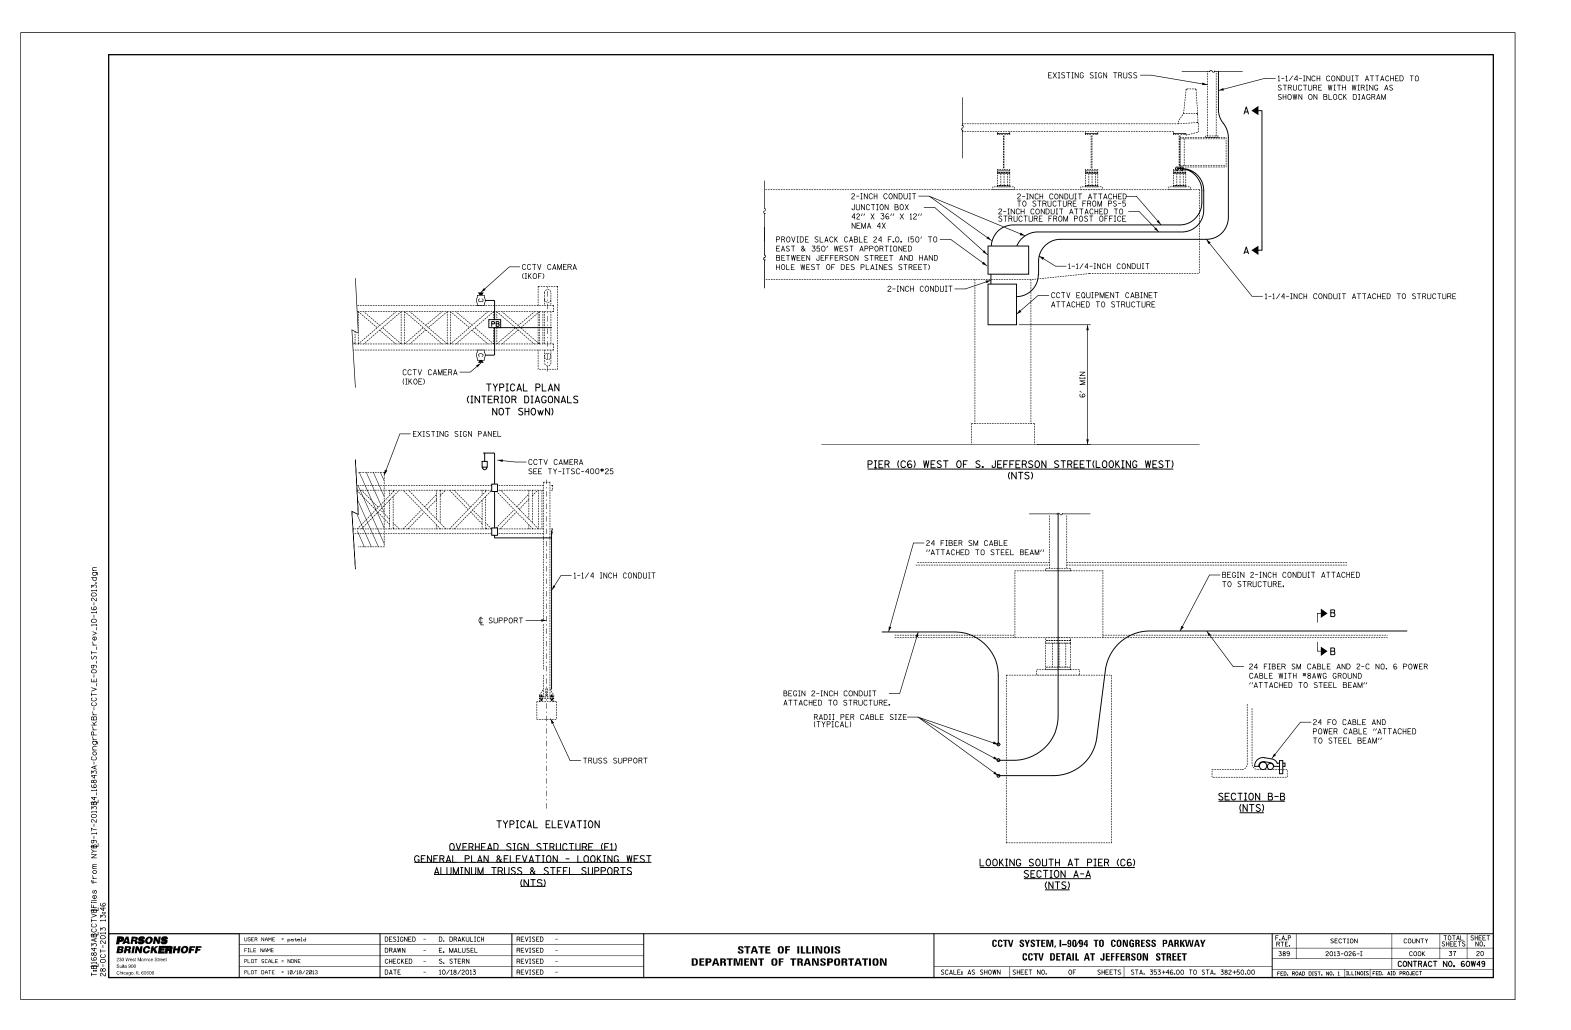

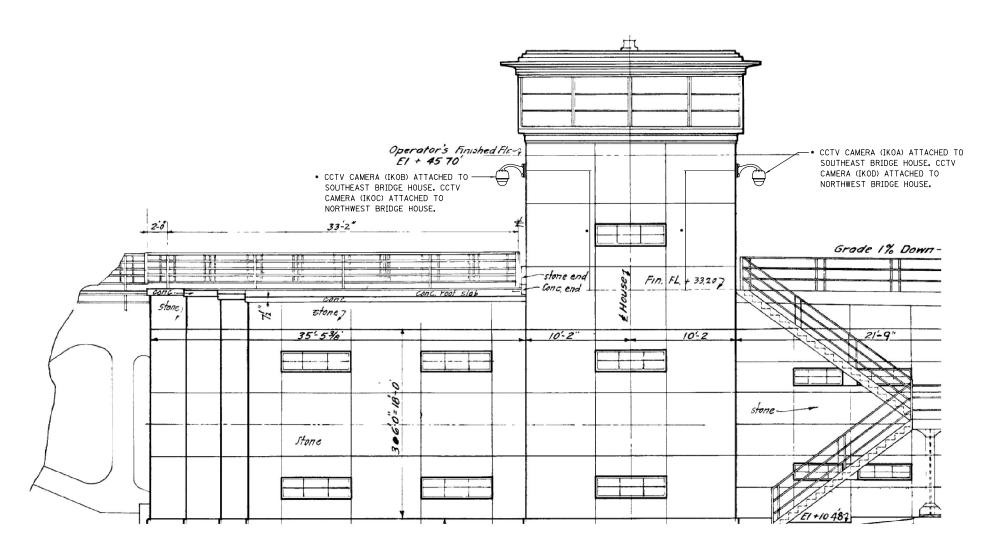

### SOUTH ELEVATION OF SOUTHEAST BRIDGE HOUSE

NORTH ELEVATION OF NORTHWEST BRIDGE HOUSE SIMILAR EXCEPT STAIRS ARE OMITTED

# NOTES:

- CONTRACTOR SHALL SUBMIT MOUNTING BRACKET DETAIL TO THE ENGINEER FOR APPROVED.
   DAMAGE TO THE EXISTING STONE DURING THE INSTALLATION OF THE MOUNTING BRACKET AND CCTV.
- 2. CAMERA SYSTEM SHALL BE THE CONTRACTOR RESPONSIBILITY AND DAMAGED AND DAMAGED STONE SHALL BE REPLACED AT NO COST TO IDOT.
- 3. MOUNTING BRACKET AND ACCESSORIES FOR CCTV CAMERA IS INCLUDED IN THE COST OF CCTV CAMERA INSTALATION.

• CONTRACTOR SHALL VERIFY LOCATION (HORIZONTALLY AND VERTICALLY) WITH ENGINEER PRIOR TO INSTALLATION.

T:距16843A像CCTV像CADD像4\_16843A-CongrPrkBr-C 28-007-2013 13:46

BRINCKERHOF	F
230 West Monroe Street	•
Suite 900	
Chicago II 60606	

USER NAME = pateld	DESIGNED	-	SN	REVISED	-
FILE NAME	DRAWN	-	DCP	REVISED	-
PLOT SCALE = NONE	CHECKED	-	SN	REVISED	-
PLOT DATE = 10/28/2013	DATE	-	10/18/2013	REVISED	-
			-		

CCTV SYSTEM, I-90/94 TO CONGRESS PARKWAY	F.A.P RTE.	SECTION	COUNTY	TOTAL SHEETS	SHEET NO.
CCTV CAMERA ATTACHED TO BRIDGE HOUSE	389	2013-026-I	COOK	37	21
			CONTRACT	NO. 60	W49
SCALE: AS SHOWN   SHEET NO. OF SHEETS   STA. 353+46.00 TO STA. 382+50.00	FED. R	OAD DIST. NO. 1   ILLINOIS FED. A	ID PROJECT		

PANEL DESIGNATION: LP-	-E1											VC	I TAGE	208	1201	/ 3P	н 4	W, 60HZ
LOCATION: FAST SIDE N		A NIT NI	-											T BRK				150AT. 3POLE
TYPE:  FLUSH		SURF											AINS:		AMP,			BOTTOM, MLO
LOAD		AKER		VA		_			$\overline{}$	_	_			VA	,	BRE/		
		TRIP	Α	В	C	CKT		€-	$\in$ $\subset$		- 1	CKT	Λ	В	С	TRIP		
MEZZ LEVEL LIGHTING	1	20	520	۲		1	<u>_</u> _	H	$\pm$	⇉	┧	2	696			20	1 011	DOCK LEVEL LIGHTING
MEZZ LEVEL LIGHTING	1	20	520	520		3	$\bot \frown$	ш	ш	⊥∕	┧	4	030	696		20	Ė	DOCK LEVEL LIGHTING
EXIT LIGHT	1	20		320		5	-	ш	11	┵	┧	6		030	1071	20	H	STAIR LIGHTING
DOCK LEVEL LIGHTING	1	20	924			7		⇊	ш	⊥∕	┧	8	1271		1011	20	Ħ	DOCK LEVEL RECEPTACLES
DOCK LEVEL LIGHTING	1	20		924		9	$\perp \smallfrown$	ш	₩	Д^	ᅺ	10		1059		20	i	DOCK LEVEL RECEPTACLES
FIRE ALARM CONTROL PANEL	1	20			600	11	$\vdash \smallfrown$	Н	11	4	ᅿ	12				20	Ħ	SPARE
DOCK LEVEL LIGHTING	1	20	924			13		₩	Н	┵	ᅿ		1059			20	Ť	MEZZ RECEPTACLES
DOCK LEVEL LIGHTING	1	20		693		15	<b>├</b> へ-	Н	₩	┵	뇌	16		847		20		MEZZ RECEPTACLES
SPARE	1	20				17	$\vdash \smallfrown$	Н	+	┯	$\forall$	18				20		SPARE
EMER BATT UNIT DOCK LEVEL	1	20	276			19	<b>├</b> へ-	₩	+	—∕	H	20	924			20	Т	DOCK LEVEL LIGHTING
EMER BATT UNIT DOCK LEVEL	1	20		276		21	<b>├</b> ^-	Н	₩	—∕	$\forall$	22		924		20	1	DOCK LEVEL LIGHTING
SPARE	1	20				23	┝╲╌	Н	+	┯	Ч	24				20	_	SPARE
CCTV CAMERA POWER SUPPLY	1	20	200			25	├^-	₩	+	+	H	26	237			20	_	EMERG BAT UNIT
SPARE	1	20		-		27	<b>├</b> ^-	Н	┿	+	H	28		237		20	_	EMERG BAT UNIT
RECEPTACLES	1	20			720	29	┝╲╌	Н	+	┯	Ч	30			609	20	_	LTG VERTICAL CORE
SPACE	1					31	├^-	₩	+	+	H	32					_	SPACE
SPACE	1					33	}-^-	Н	┿	十	H	34					_	SPACE
SPACE	1					35	┝╲╴	Н	+	┰	Ή	36					_	SPACE
SPACE	1					37	<u>├</u> ़	┰	+	+	Ή	38						SPACE
SPACE	1					39	├^-	Н	┿	+	Ή	40					_	SPACE
SPACE	1					41	$\sim$	$\pm$	$\pm$	$\pm$	$\exists$	42						SPACE
							^	1			_ G							
VOLT AMPS:		PH ,	4 = 7	031				PΗ	В :	6,1	76				PH C	= 3,	.000	
TOTAL VOLT AMPS = 16,2	207				AMPS	= 4	5			AIC	-RN	AS =	22,00	00				@ 208VAC, 3PHASE

PANEL DESIGNATION: LP	-W1											V	DLTAG	E: 208	3/120	/, 3P	Н, 4	W, 60HZ
LOCATION: WEST SIDE N	<b>IEZZ</b>	ANINE	Ξ									M	AIN CK	T BRK	: 2	225AF		150AT, 3POLE
TYPE:  FLUSH	X	SURF	ACE									M	AINS:	225	MΡ,	X	TOP,	☐ BOTTOM, ☐ MLO
LOAD	BRE	AKER		VA		OI/ T		7		,		A		VA		BRE/	KER	
DESCRIPTION	POLE	TRIP	Α	В	С	CKT		[	77	٦.		CKT	Α	В	С	TRIP	POLE	DESCRIPTION
MEZZ LEVEL LIGHTING	1	20	433			1	}-^-	П	Н	F	<del>├</del> ╲-	2	609			20		DOCK LEVEL LIGHTING
MEZZ LEVEL LIGHTING	1	20		520		3	}-^-	Н	₩	┿	+^-	4		522		20	$\perp$	DOCK LEVEL LIGHTING
EXIT LIGHT	1	20				5	}^-	Н	H	┿	+^-	6			609	20	_	STAIR LIGHTING
DOCK LEVEL LIGHTING	1	20	693			7	╌	Н	₩	┰	╀╲╌	8	1059			20	_	DOCK LEVEL RECEPTACLES
DOCK LEVEL LIGHTING	1	20		462		9	}-^-	Н	₩	┿	+^-	10		1270		20		DOCK LEVEL RECEPTACLES
FIRE ALARM CONTROL PANEL	1	20			600	11	}^-	Н	Н	┿	+^-	12				20		SPARE
DOCK LEVEL LIGHTING	1	20	693			13	┢╲╌	Н	₩	╫	╀╲╌	14	847			20	_	MEZZ LEVEL RECEPTACLES
DOCK LEVEL LIGHTING	1	20		693		15	}^-	Н	₩	┿	+^-	16		1059		20	_	MEZZ LEVEL RECEPTACLES
SPARE	1	20				17	}^-	Н	Н	┿	+^-	18				20		SPARE
EMER BATT UNIT DOCK LEVEL	1	20	276			19	┢╲╌	Н	₩	┿	╆╲╌	20	693			20	- 1	DOCK LEVEL LIGHTING
EMER BATT UNIT DOCK LEVEL	1	20		276		21	<b>├</b> ^-	Н	₩	┿	+^-	22		693		20		DOCK LEVEL LIGHTING
SPARE	1	20				23	}^-	Н	Н	┿	+^-	24				20		SPARE
CCTV CAMERA POWER SUPPLY	1	20	200			25	┢╲╌	Н	Н	┿	╀╲╌	26	237			20	_	EMERG BAT UNIT
HEATER & F.O. MEDIA CONVERTER	1	20		400		27	<b>├</b> ^-	Н	⊢	┿	+^-	28		237		20		EMERG BAT UNIT
RECPTACLE	1	20			720	29	}^-	Н	Н	┿	+^-	30			609	20		LTG VERTICAL CORE
SPACE						31	┢╲╌	Н	Н	┿	╀╲╌	32					_	SPACE
SPACE						33	}^-	Н	₩	┿	+^-	34						SPACE
SPACE						35	}^-	Н	Н	┿	+^-	36						SPACE
SPACE						37	}^-	Н	₩	┿	<del>-</del> ∽	38						SPACE
SPACE						39	}^-	Н	⊢┼	┰	┵	40						SPACE
SPACE						41	}^-	Н	₩	┿	+^-	42						SPACE
							N	1				;	1					
VOLT AMPS:	VOLT AMPS: PH A = 5,740					PH B = 6,132				PH C = 2,538								
TOTAL VOLT AMPS = 14,410 A					AMPS	= 4	10			Α	IC-R	MS =	22,0	00				@ 208VAC, 3PHASE

∄j6843AβCCTV&Files from NY®9-17-2013&j6843A-CCTV-E15-20\_PanelSche

PARSONS BRINCKERHOFF 230 West Monroe Street Suite 900

USER NAME = pateld	DESIGNED	-	D. DRAKULICH	REVISED -
FILE NAME	DRAWN	-	E. MALUSEL	REVISED -
PLOT SCALE = NONE	CHECKED	-	S. STERN	REVISED -
PLOT DATE = 10/18/2013	DATE	-	10/18/2013	REVISED -

ССТ	V SYSTEM,	, I–90⁄94	TO COI	NGRESS PARKWAY	F.A.P RTE.	SECTION	COUNTY	TOTAL SHEETS	SHEET NO.
		PANFI	SCHEDU	IIFS	389	2013-026-I	COOK	37	22
			0011220				CONTRACT	NO. 6	OW49
SCALE: AS SHOWN	SHEET NO.	OF	SHEETS	STA. 353+46.00 TO STA. 382+50.00	FED. RO	DAD DIST. NO. 1   ILLINOIS FED. A	D PROJECT		

LATERAL CABLE FIB	LATERAL CABLE FIBER ASSIGNMENTS							
LCF-WBH								
FIBER NO	FUNCTION	CONNECTION						
1	CCTV CAMERA IKOC (at Northwest Bridge House)	Fiber #3 of 24-strand cable						
2	CCTV CAMERA IKOD (at Northwest Bridge House)	Fiber #4 of 24-strand cable						
3	DARK							
4	DARK							
5	DARK							
6	DARK							
7	DARK							
8	DARK							
9	DARK							
10	DARK							
11	DARK							
12	DARK							

LATERAL CABLE F	LATERAL CABLE FIBER ASSIGNMENTS									
LCF-SJS										
FIBER NO	FUNCTION	CONNECTION								
1	CCTV CAMERA IKOE (at So. JEfferson St.)	Fiber #7 of 24-strand cable								
2	CCTV CAMERA IKOF (at So. JEfferson St.)	Fiber #8 of 24-strand cable								
3	DARK									
4	DARK									
5	DARK									
6	DARK									
7	DARK									
8	DARK									
9	DARK									
10	DARK									
11	DARK									
12	DARK									

LATERAL CABLE FIBER ASSIGNMENTS								
LCF-								
FIBER NO	FUNCTION	CONNECTION						
1								
2								
3								
4								
5								
6								
7								
8								
9								
10								
11								
12								

T:@16843ABCCTV@Files from NY@9-17-2013@12-strand-late

PARSONS BRINCKERHOFF 230 West Monroe Street Suite 900

USER NAME = pateld	DESIGNED	-	D. DRAKULICH	REVISED -
FILE NAME	DRAWN	-	E. MALUSEL	REVISED -
PLOT SCALE = NONE	CHECKED	-	S. STERN	REVISED -
PLOT DATE = 10/18/2013	DATE	-	10/18/2013	REVISED -

	CCTV SYSTEM, I-90/94 TO CONGRESS PARKWAY									
		TV	VELVE FIBER	LATERAL	CABLE	FIBER	ASSIGNMENTS			
E-	۸C	CHOMN	CHEET NO	ΛE	CHEETC	СТА	3E3+4C 00 TO C	LV 3031EU UU	_	

L.P E.		S	EC.	TION		COUNTY	TOTAL SHEETS	SHEET NO.	
39	2013-026-I						соок	37	23
							CONTRACT	NO. 6	OW49
n D	NAD DIET	NO	1	THE TMATE	EED	Α1	IN DOMEST		

7-2013824-strand trunk	
from NY\$9-17-20	
Table843ABCCTVBF11es	8-0CT-2013 13:40

<b>P</b> AR <b>S</b> ON <b>S</b> BRINCK <b>ER</b> HOFF
230 West Monroe Street
Suite 900

USER NAME = pateld	DESIGNED	-	D. DRAKULICH	REVISED -	
FILE NAME	DRAWN	-	E. MALUSEL	REVISED -	
PLOT SCALE = NONE	CHECKED	-	S. STERN	REVISED -	
PLOT DATE = 10/18/2013	DATE	-	10/18/2013	REVISED -	

**DEPARTMENT OF TRANSPORTATION** 

CCT	CCTV SYSTEM, I–9094 TO CONGRESS PARKWAY 24 FIBER TRUNK CABLE FIBER ASSIGNMENTS	F.A.P RTE.	SEC	TION	COUNTY	TOTAL SHEETS	SHEE1						
	24 FIDER TRUNK CARLE FIRER ACCIONMENTS						389	2013-026-I		COOK	37	24	
											CONTRACT	NO. 6	OW49
SCALE: AS SHOWN	SHEET NO.	OF	SHEETS	STA.	353+46.00	TO STA	. 382+50.00	FED. R	DAD DIST, NO. 1	ILLINOIS FED. AT	D PROJECT		


STATE OF ILLINOIS

CARLE DESTO	NATION TCF-96	Setrand			DESTINATIO	)NI	
		T	LOCATON VENT	DUSTED TUDE			ACCIONNENT.
UFFER TUBE	FIBER	FIBER NO	ASSIGNMENT	BUFFER TUBE	FIBER NO	FIBER NO	ASSIGNMENT
	Blue 1	1	CCTV CAMERA IKOA (at Souteast Bridge House)		Blue 1	49	DARK
	Orange 2	2	CCTV CAMERA IKOB (at Souteast Bridge House)		Orange 2	50	DARK
	Green 3	3	DARK		Green 3	51	DARK
	Brown 4	4	DARK		Brown 4	52	DARK
	Slate 5	5	DARK		Slate 5	53	DARK
BLUE	White 6	6	DARK	SLATE	White 6	54	DARK
	Red 7	7	DARK		Red 7	55	DARK
	Black 8		DARK		Black 8	56	DARK
	Yellow 9	-	DARK		Yellow 9	57	DARK
	Violet 10		DARK		Violet 10	58	DARK
	Rose 11	11	DARK		Rose 11	59	DARK
	Aqua 12		DARK		Aqua 12	60	DARK
	Blue 1		DARK		Blue 1	61	DARK
	Orange 2	14	DARK		Orange 2	62	DARK
	Green 3	15	DARK		Green 3	63	DARK
	Brown 4	16	DARK		Brown 4	64	DARK
	Slate 5	17	DARK		Slate 5	65	DARK
ORANGE	White 6	18	DARK	WHITE	White 6	66	DARK
	Red 7	19	DARK		Red 7	67	DARK
	Black 8	20	DARK		Black 8	68	DARK
	Yellow 9	21	DARK		Yellow 9	69	DARK
	Violet 10		DARK		Violet 10	70	DARK
	Rose 11		DARK		Rose 11	71	DARK
	Aqua 12	_	DARK		Aqua 12	72	DARK
	Blue 1	25	DARK		Blue 1	73	DARK
	Orange 2	26	DARK		Orange 2	74	DARK
	Green 3	27	DARK		Green 3	75	DARK
	Brown 4	28	DARK		Brown 4	76	DARK
	Slate 5	29	DARK		Slate 5	77	DARK
GREEN	White 6	30	DARK	RED	White 6	78	DARK
	Red 7	31	DARK		Red 7	79	DARK
	Black 8	32	DARK		Black 8	80	DARK
	Yellow 9		DARK		Yellow 9	81	DARK
	Violet 10		DARK		Violet 10	82	DARK
	Rose 11		DARK		Rose 11	83	DARK
	Aqua 12	_	DARK		Aqua 12	84	DARK
	Blue 1	37	DARK		Blue 1	85	DARK
	Orange 2	38	DARK		Orange 2	86	DARK
	Green 3	39	DARK		Green 3	87	DARK
	Brown 4	40	DARK		Brown 4	88	DARK
	Slate 5	41	DARK		Slate 5	89	DARK
BROWN	White 6	42	DARK	BLACK	White 6	90	DARK
	Red 7	43	DARK		Red 7	91	DARK
	Black 8	44	DARK		Black 8	92	DARK
	Yellow 9	45	DARK		Yellow 9	93	DARK
	Violet 10		DARK		Violet 10	94	DARK
	Rose 11		DARK		Rose 11	95	DARK
	Aqua 12	48	DARK		Aqua 12	96	DARK


PARSONS BRINCKERHOFF
230 West Monroe Street
Suite 900
011 # 00000

USER NAME = pateld	DESIGNED	-	D. DRAKULICH	REVISED -
FILE NAME	DRAWN	-	E. MALUSEL	REVISED -
PLOT SCALE = NONE	CHECKED	-	S. STERN	REVISED -
PLOT DATE = 10/18/2013	DATE	-	10/18/2013	REVISED -

ССТ	F.A.P RTE.	SECTION								
	389	2013-026-I								
	96 FIBER TRUNK CABLE FIBER ASSIGNMENTS									
SCALE: AS SHOWN	SHEET NO.	OF	SHEETS	STA. 353+46.00 TO STA. 382+50.0	O FED.	ROAD DIST. NO. 1 ILLINOIS				

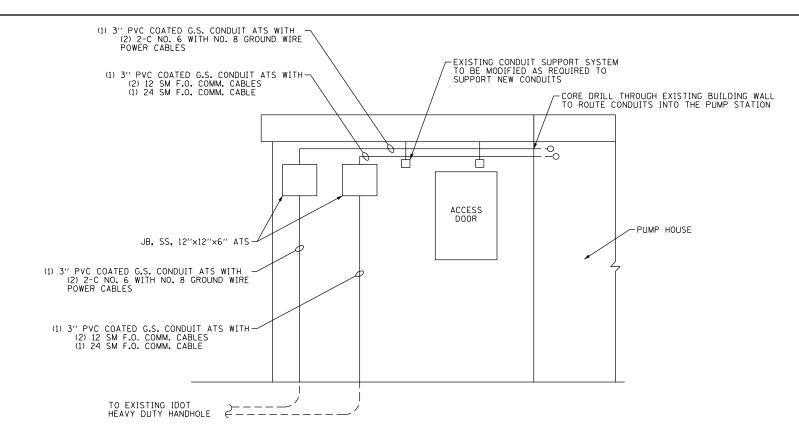

# IDOT PUMP STATION NO. 5 - PARTIAL ELEVATION VIEW (LOOKING NORTH)

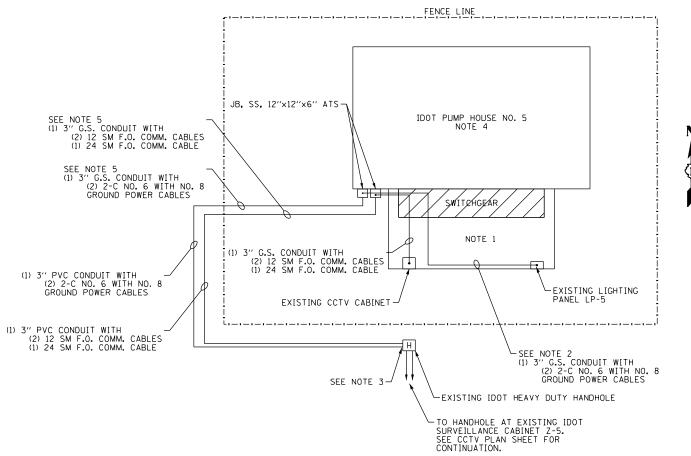

# **IDOT PUMP STATION NO. 5 – PLAN VIEW**

#### 0160W49-sht-ITS-02 DESIGNED -WDS REVISED -USER NAME = lacherj DRAWN - CAM REVISED -PLOT SCALE = 2.0000 '/ in. CHECKED - WDS REVISED PLOT DATE = 10/21/2013 DATE REVISED

STATE OF ILLINOIS **DEPARTMENT OF TRANSPORTATION** 

		CCTV S				94 CON		PARKWAY S
SCALE:	NONE	SHEET	2	OF	5	SHEETS	STA.	TO STA.

#### COUNTY TOTAL SHEET NO. COOK 37 26 SECTION 389 2013-26-I CONTRACT NO. 60W49

1. ALL WORK TO INSTALL THE POWER AND FIBER OPTIC CABLES IN CONDUIT FROM THE NEW JUNCTION BOXES TO THE CCTV CABINET AND LIGHTING PANEL SHALL BE INCLUDED IN THE LUMP SUM "PUMP STATION ELECTRICAL WORK" PAY ITEM.

2. CONNECT THE CCTV CAMERA POWER CABLES TO TWO EXISTING SPARE 1-POLE, 20 AMP CIRCUIT BREAKERS LOCATED IN THE EXISTING LIGHTING PANEL.

3. THE CONTRACTOR SHALL DRILL THROUGH THE EXISTING HEAVY DUTY HANDHOLE WALL TO CONNECT THE NEW 3" CONDUITS AS SHOWN.

4. ALL WORK SHALL BE COORDINATED WITH IDOT PUMP STATION MAINTENANCE PERSONNEL.

5. SAW CUT AND REMOVE THE EXISTING PAVEMENT TO INSTALL THE CONDUIT. THE PAVEMENT SHALL BE RESTORED AND THE TRENCH FILLED. THE WORK TO REMOVE AND RESTORED THE EXISTING PAVEMENT INCLUDING ALL MATERIALS, DISPOSAL AND BACKFILLING WILL NOT BE PAID FOR SEPARATELY AND SHALL BE INCLUDED IN THE COST OF THE "UNDERGROUND CONDUIT, GALVANIZED STEEL, 3" DIA." PAY ITEM.

**NOTES:** 

**AECOM** 

JNK CABLE FIBER	ASSIGNMENT	ΓS				ORI	GINATIC	N CIRCLE I	NTERCHANGE COMM. HUT
JNK CABLE DESIGN	NATION TCF	- I-290	EAST			DES	TINATIC	N OAK PARK	< TSC
BUFFER TUBE	FIBER	F	IBER NO	ASSIGNMENT	BUFFER TUBE	FIBER	NO	FIBER NO	ASSIGNMENT
	Blue	1	1	I-290 CCTV		Blue	1	49	Kennedy PTZ Cameras 1,2,3 BLD A to HUB
	Orange	2	2	I-290 CCTV		0range	2	50	PS-5 Cameras 1,2,3 PS-5 to HUB
	Green	3	3	I-290 CCTV		Green	3	51	Microwave Hut Cameras 1,2,3,4 Microwave Hut to HUB
	Brown	4	4	I-290 CCTV		Brown	4	52	Microwave Hut Cameras 5,6,7 Microwave Hut to HUB
	Slate	5	5	COMM. HUT CCTV FIBER #1 (IKOI) TO TSC FIBER #5		Slate	5	53	Homeland Security to I-290 hut to Bld A (Optelicom)
	White	6	6	COMM. HUT CCTV FIBER #2 (IKOJ) TO TSC FIBER #6		White	6	54	Dark
BLUE	Red	7	7	PS-5 FIBER #13 (IKOG) TO TSC FIBER #7	SLATE	Red	7	55	Dark
	Black	8	8	PS-5 FIBER *14 (IKOH) TO TSC FIBER *8		Black	8	56	Dark
	Yellow	9	9	Dark		Yellow	9	57	ITS GigE Switch
	Violet	10	10	Dark		Violet	10	58	ITS GigE Switch
	-	11	11	IMC media converter (Revlac Alarm Screen)		Rose	11	59	Dark
	-	12	12	IMC media converter (Revlac Alarm Screen)		Aqua	12	60	Dark
	Blue	1	13	Dark		Blue	1	61	I-57 Imux T1 Chassis
	Orange	2	14	Dark		0range	2	62	I-57 Imux T1 Chassis
		3	15	Dark		Green	3	63	Dark
		4	16	Dark		Brown	4	64	Dark
		5	17	Dark		Slate	5	65	Polk AIS CCTV
	-	6	18	Dark		White	6	66	Dark
ORANGE	-	7	19	I-55 T1 SURVEILLANCE DATA KING DRIVE TO TRI-STATE TRANSMIT CIRCUIT	WHITE	Red	7	67	Dark
		8	20	I-55 TI SURVEILLANCE DATA KING DRIVE TO TRI-STATE RECEIVE CIRCUIT		Black	8	68	Dark
	-	9	21	KIDS camera 13,14,15		Yellow	9	69	Dark
		10	22	Dark		Violet	10	70	Dark
		11	23	Dark			11	71	Dark
		12	24	Kennedy PTZ Cameras 1,2,3 Blue Tube,Fiber #3		Rose	12	72	Dark
	Aqua Blue	1	25	Dark		Aqua Blue	12	73	CISCO 15454 OC-48 DVS
	Orange	2	26	Dark			2	74	CISCO 15454 OC-48 DVS
		3	27	Kennedy Core Imux RX port #27		Orange	3	75	CISCO 15454 OC-48 DVS
		4	28	Kennedy Core Imux TX port #28		Green	4	76	CISCO 15454 OC-48 DVS
			29	Dark		Brown	5	77	C15CU 15454 UC-48 DVS  Dark
		5				Slate			
GREEN		6	30	Dark	RED	White	6	78	Dark
		7	31	Touhy Ave. DMS		Red	1	79	Dark
		8	32	Touhy Ave. DMS		Black	8	80	Dark
		9	33	PS-5 FIBER *21 (IKOE) TO TSC FIBER *33		Yellow	9	81	Dark
	-	10	34	PS-5 FIBER #22 (IKOF) TO TSC FIBER #34		Violet	10	82	Dark DEW AC Botto
		11	35	Dark		Rose	11	83	REVLAC Data
	<u> </u>	12	36	Dark		Aqua	12	84	REVLAC Data
	Blue	1	37	PUMP STATION SYSTEM		Blue	1	85	Dark
	0range		38	PUMP STATION SYSTEM		0range		86	Dark
		3	39	PUMP STATION SYSTEM		Green	3	87	Dark
		4	40	PUMP STATION SYSTEM		Brown	4	88	Dark
		5	41	Addison Camera		Slate	5	89	REVLAC DATA
BROWN		6	42	PS-5 FIBER *15 (IKOA) TO TSC FIBER *42	BLACK	White	6	90	REVLAC DATA
	Red	7	43	PS-5 FIBER *16 (IKOB) TO TSC FIBER *43		Red	7	91	Homeland Security to Hillside Hub
	Black	8	44	PS-5 FIBER #17 (IKOC) TO TSC FIBER #44		Black	8	92	Dark
	Yellow	9	45	PS-5 FIBER *18 (IKOD) TO TSC FIBER *45		Yellow	9	93	Dark
	Violet	10	46	PS-5 FIBER #19 (DMS TX) TO TSC FIBER #46		Violet	10	94	Dark
	Rose	11	47	PS-5 FIBER #20 (DMS RX) TO TSC FIBER #47		Rose	11	95	Dark
	Aqua	12	48	Dark		Aqua	12	96	Temp Video Bld A to Hub

<b>AECOM</b>
303 EAST WACKER DRIVE, SUITE 1400 CHICAGO, IL 60601-5276

D160W49-sht-ITS-03	DESIGNED - JML	REVISED -
USER NAME = lacherj	DRAWN - JML	REVISED -
PLOT SCALE = 100.0000 ' / 10.	CHECKED - WDS	REVISED -
PLOT DATE = 10/21/2013	DATE - 10/18/2013	REVISED -

	CCTV SYSTEM, I–90/94 TO CONGRESS PARKWAY TRUNK CABLE FIBER ASSIGNMENTS							F.A.I. RTE.	S	ECTION	COUNTY	TOTAL SHEETS	SHEET NO.		
								389	20	)13-26-I	соок	37	27		
	THUNK CABLE FIBER ASSIGNMENTS								BE-210	0	CONTRACT	NO. 6	OW49		
	SCALE:	NONE	SHEET	3	OF	5	SHEETS	STA.	TO STA.	FED. ROAD D	IST. NO. 1	ILLINOIS FED. AI	ID PROJECT		

<b>AECOM</b>
303 EAST WACKER DRIVE, SUITE 1400 CHICAGO, IL 60601-5276 PHONE: (312) 373-7700 FAX: (312) 373-6800

D160W49-sht-ITS-04	DESIGNED - JML REVISED -	
USER NAME = lacherj	DRAWN - JML REVISED -	
PLOT SCALE = 100.0000 ' / 10.	CHECKED - WDS REVISED -	
PLOT DATE = 10/21/2013	DATE - 10/18/2013 REVISED -	

SCALE: NONE

CCTV SYSTEM, I-90/94 TO CONGRESS PARKWAY							F.A.I. RTE.		
	DISTRIBUTION CABLE FIBER ASSIGNMENTS							389	
									BE-2
	SHEET	4	OF	5	SHEETS	STA.	TO STA.	FED. ROAD D	IST. NO.


F.A.I. RTE.	S	ECTION			COUNTY	TOTAL SHEETS	SHEE NO.
389	20	)13-26-I			C00K 37		28
	BE-211		CONTRACT	NO. 6	OW49		
FED. ROAD D	IST. NO. 1	ILLINOIS	FED. A	ID	PROJECT		

LATERAL CABLE FIBER ASSIGNMENTS							
LCF- PS-5 HIGH MAST CCTV CAMERAS TO PS-5 48 STRAND FIBER DISTRIBUTION CABLE							
FIBER NO	FUNCTION	CONNECTION					
1	VIDEO AND CAMERA CONTROL	CCTV IKOG					
2	VIDEO AND CAMERA CONTROL	CCTV IKOH					
3	DARK	DARK					
4	DARK	DARK					
5	DARK	DARK					
6	DARK	DARK					
7	DARK	DARK					
8	DARK	DARK					
9	DARK	DARK					
10	DARK	DARK					
11	DARK	DARK					
12	DARK	DARK					


F-		
FIBER NO	FUNCTION	CONNECTION
1		
2		
3		
4		
5		
6		
7		
8		
9		
10		
11		
12		

LATERAL CABLE FIBER ASSIGNMENTS						
LCF-						
FIBER NO	FUNCTION	CONNECTION				
1						
2						
3						
4						
5						
6						
7						
8						
9						
10						
11						
12						

D160W49-sht-ITS-05	DESIGNED - JML	REVISED -
USER NAME = lacherj	DRAWN - JML	REVISED -
PLOT SCALE = 100.0000 ' / 10-	CHECKED - WDS	REVISED -
PLOT DATE = 10/21/2013	DATE - 10/18/2013	REVISED -

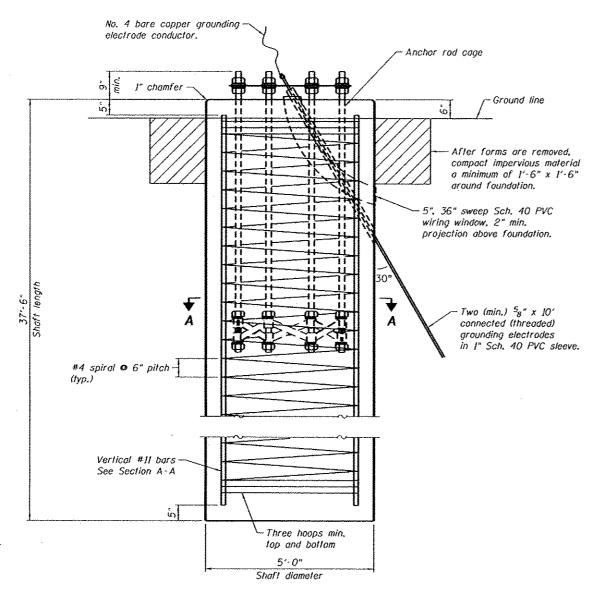

# FOUNDATION ELEVATION

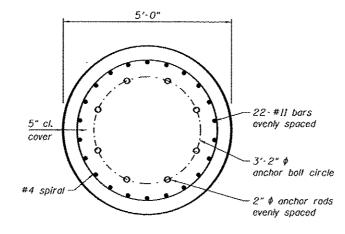

# SECTION A-A

REVISED

REVISED

REVISED

REVISED

DESIGNED - DEV

CHECKED - ATB


DRAWN


CHECKED

# STATE OF ILLINOIS **DEPARTMENT OF TRANSPORTATION**

# NOTES:

- 1. The shaft length(s) are based on nearest available soil borings. If different soils are encountered, the engineer shall be notified to provide a revised length.
- 2. Anchor rod quantity, diameter and length shall be determined by the tower manufacturer and approved by the Engineer. Each foundation shall have a minimum of 8 anchor rods.
- 3. All foundation reinforcement steel shall be epoxy coated.
- 4. The cost of the foundation is incidental to the cost of the CCTV Tower.
- 5. Steel anchor rod forms shall not be removed for a minimum of 3 days after concrete is poured. The tower shall not be set for a minimum of 7 days or as approved by the Engineer.
- 6. The foundation shall be poured monolithically and shall have no
- 7. Grounding electrodes shall be installed in an access well when there is a conflict in using the method shown.
- 8. Coordinate the rod circle diameter of the tower with the diameter of the anchor rod cage.

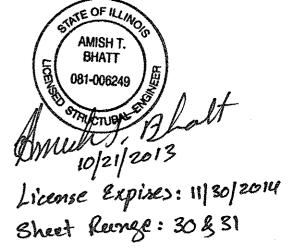

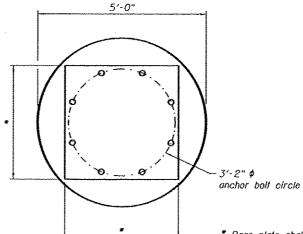

\* Base plate shall be designed by the tower manufacturer and approved by the Engineer.


# BASE PLATE LAYOUT

CCTV SYSTEM, I-90/94 TO CONGRESS PARKWAY	F.A.P. RTE.	SECTION	COUNTY	TOTAL	SHEE NO.
TOWER FOUNDATION PLANS 1 OF 2		2013-026-1	COOK	37	30
				NO.	60W4
SHEET NO. S-1 OF S-2 SHEETS		ILLINOIS FEO. AID PROJECT			


USER NAME : bhatta

PLOT DATE : 10/18/2013


PLOT SCALE . N.T.S.

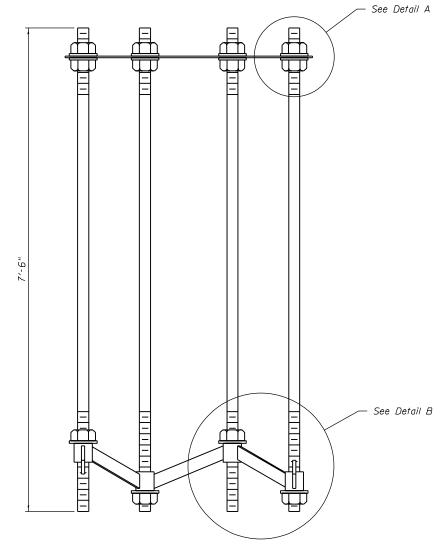


<u>SECTION B-B</u>

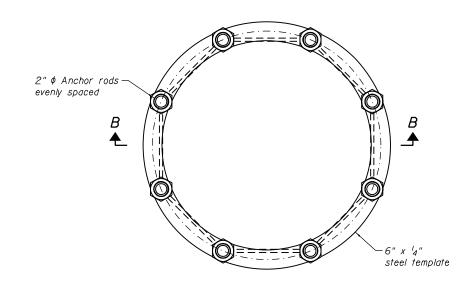

ANCHOR ROD CAGE (PLAN)

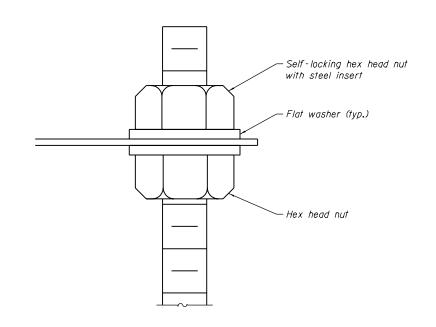



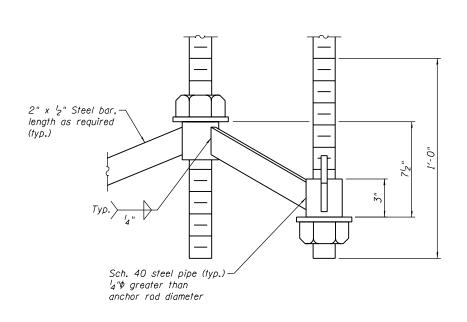


<u>DETAIL B</u>

**AECOM** 


USER NAME = lacherj	DESIGNED - DEV	REVISED
	CHECKED - ATB	REVISED
PLOT SCALE = N.T.S.	DRAWN - MRK	REVISED
PLOT DATE = 10/18/2013	CHECKED - JML	REVISED

STATE OF ILLINOIS
DEPARTMENT OF TRANSPORTATION

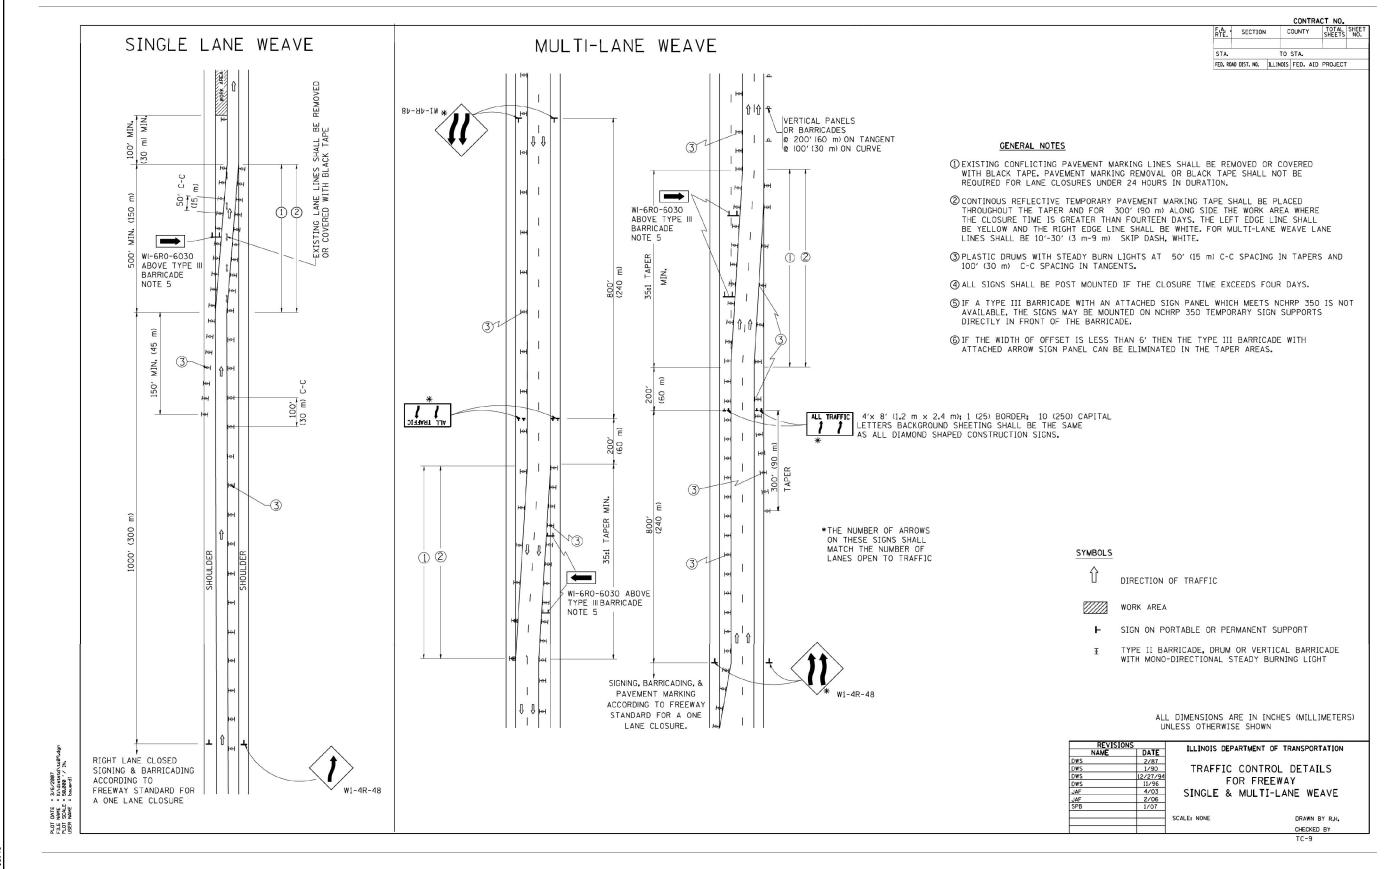

T#B16843ABCCTVBCADDB60W49-sht\_33-std 28-0CT-2013 13:46

**P**AR**S**ON**S** USER NAME = pateld DESIGNED -SN REVISED SECTION COUNTY TOTAL SHEE CCTV SYSTEM, I-90/94 TO CONGRESS PARKWAY BRINCKERHOFF STATE OF ILLINOIS FILE NAME DRAWN - DCP REVISED COOK 37 32 389 2013-026-I SINGLE AND MULTI-LANE WEAVE PLOT SCALE = NONE CHECKED - SN REVISED **DEPARTMENT OF TRANSPORTATION** CONTRACT NO. 60W49 PLOT DATE = 10/28/2013 REVISED SHEET NO. OF SHEETS STA. 353+46.00 TO STA. 382+50.00 FED. ROAD DIST. NO. 1 | ILLINOIS | FED. AID PROJECT

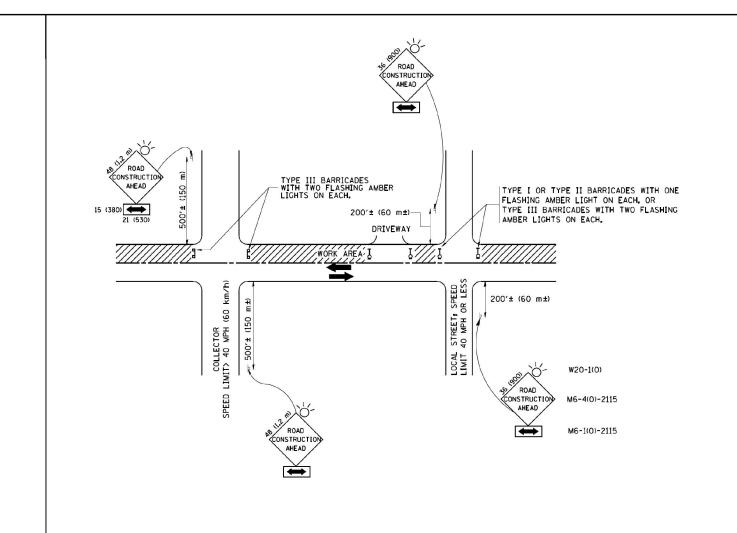

# TRAFFIC CONTROL AND PROTECTION FOR SIDE ROADS, INTERSECTIONS, AND DRIVEWAYS

### NOTES:

- A. FOR NO LANE RESTRICTION ON THE SIDE ROAD OR DRIVEWAYS
- 1. SIDE ROAD WITH A SPEED LIMIT OF 40 MPH (60 km/h) OR LESS AS SHOWN ON THE DRAWING AND AS DIRECTED BY THE ENGINEER:
- $^{\rm cl}$  one road construction ahead sign 36  $\times$  36 (900×900) With a flasher and flag mounted on 11 approximately 200' (60 m) in advance of the main route.
- b) THE CLOSED PORTION OF THE MAIN ROUTE SHALL BE PROTECTED BY BLOCKING WITH TYPE I. TYPE II OR TYPE III BARRICADES, 1/3 OF THE CROSS SECTION OF THE CLOSED PORTION.
- 2. SIDE ROAD WITH A SPEED LIMIT GREATER THAN 40 MPH (60 km/h)
  AS SHOWN ON THE DRAWING AND AS DIRECTED BY THE ENGINEER:
- O) ONE ROAD CONSTRUCTION AHEAD SIGN 48 x 48 (1.2 m x 1.2 m) WITH A FLASHER MOUNTED ON IT APPROXIMATELY 500' (150 m) IN ADVANCE OF THE MAIN ROUTE.
- b) THE CLOSED PORTION OF THE MAIN ROUTE SHALL BE PROTECTED BY BLOCKING WITH TYPE III BARRICADES, 1/2 OF THE CROSS SECTION OF THE CLOSED PORTION.
- 3. WHEN THE SIDE ROAD LIES BETWEEN THE BEGINNING OF THE MAINLINE SIGNING AND THE WORK ZONE, A SINGLE HEADED ARROW (MG-1) SHALL BE USED IN LIEU OF THE DOUBLE HEADED ARROW (MG-4).

### B. FOR A LANE CLOSURE ON A SIDE ROAD OR DRIVEWAY:

USE APPLICABLE PORTIONS OF THE TYPICAL APPLICATION OF TRAFFIC CONTROL DEVICES (STD. 701501, STD. 701606 OR THE APPROPRIATE STANDARD). THE SPACING OF SIGNS AND BARRICADES SHALL BE ADJUSTED FOR FIELD CONDITIONS AS DIRECTED BY THE ENGINEER. THE DIRECTIONAL ARROW SHALL BE COVERED OR REMOVED WHEN NO LONGER CONSISTENT WITH THE SIDE ROAD LANE CLOSURE.

- C. ADVANCE WARNING SIGNS ARE TO BE OMITTED ON DRIVEWAY UNLESS OTHERWISE NOTED.
- D. THE TRAFFIC CONTROL AND PROTECTION FOR SIDE ROADS, INTERSECTIONS, AND DRIVEWAYS SHALL BE INCIDENTAL TO THE COST OF SPECIFIED TRAFFIC CONTROL STANDARDS OR ITEMS.

All dimensions are in millimeters (inche unless otherwise shown.

PARSONS
BRINCKERHOFF
230 West Monroe Street

 USER NAME
 = poteId
 DESIGNED
 SN
 REVISED

 FILE NAME
 DRAWN
 DCP
 REVISED

 PLOT SCALE = NONE
 CHECKED
 SN
 REVISED

 PLOT DATE
 = 10/28/2013
 DATE
 10/18/2013
 REVISED

STATE OF ILLINOIS
DEPARTMENT OF TRANSPORTATION


CCTV SYSTEM, I-90/94 TO CONGRESS PARKWAY

TRAFFIC CONTROL AND PROTECTION FOR SIDE ROADS

LE: NONE | SHEET NO. OF SHEETS | STA. 353+46.00 TO STA. 382+50.00


| FAP | SECTION | COUNTY | TOTAL SHEE | SHOOT | | SHOT | SHOOT | SHOT |

T:@16843A@CCTV@CADD@60W49-sh+\_3 28-0CT-2013 13.47

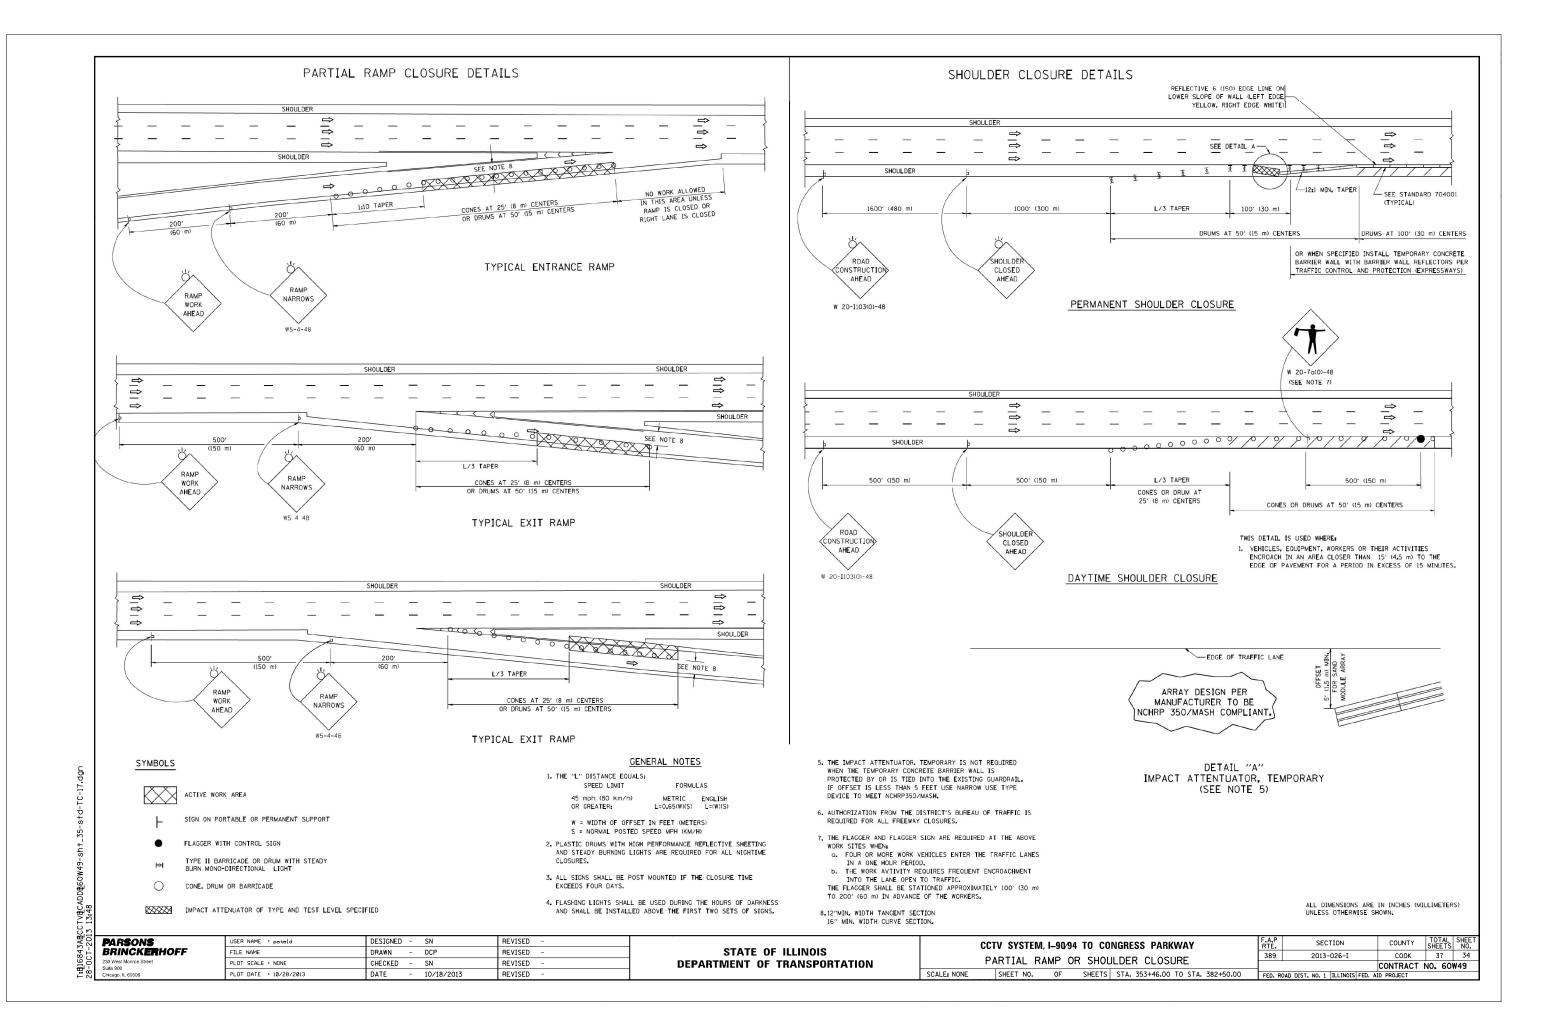


# SIGNING FOR FLAGGING OPERATIONS AT WORK ZONE OPENINGS

### WORK ZONE EXIT OPENING

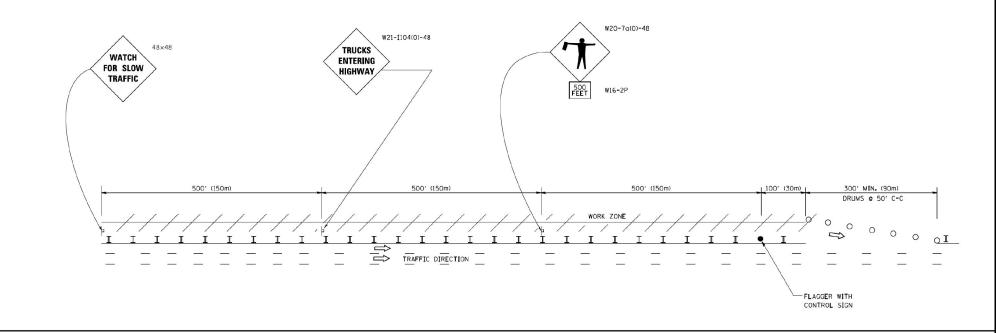

### WORK ZONE ENTRY OPENING

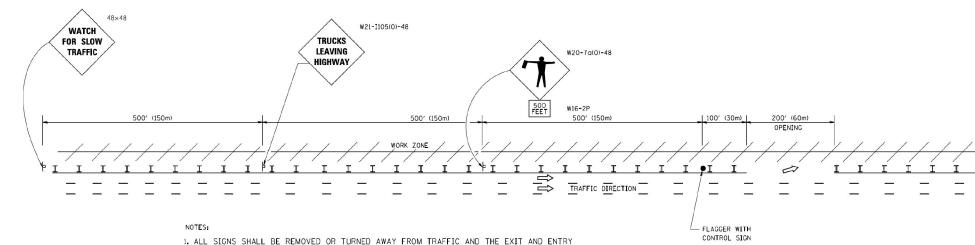

1. ALL SIGNS SHALL BE REMOVED OR TURNED AWAY FROM TRAFFIC AND THE EXIT AND ENTRY OPENINGS SHALL BE CLOSED WHEN THE FLAGGING OPERATION CEASES. NON OPERATING EQUIPMENT SHALL COMPLY WITH ARTICLE 701.11

2. WORK ZONE OPENINGS SHALL BE A MINIMUM OF ONE HALF MILE APART AND A MINIMUM OF ONE QUARTER MILE FROM ALL ENTRANCE AND EXIT RAMPS.

3, EXITING THE WORK ZONE AT ANY PLACE OTHER THAN AT A WORK ZONE EXIT OPENING WILL BE PROHIBITED.

4. ALL VEHICLES SHALL ENTER THE WORK ZONE AT ENTRY OPENINGS, USING THEIR TURN SIGNALS TO WARN MOTORISTS

5. FLAGGERS SHALL NOT STOP TRAFFIC OR DIRECT TRAFFIC INTO AN ADJACENT LANE.

ALL DIMENSIONS ARE IN INCHES (MILLIMETERS)
UNLESS OTHERWISE SHOWN

**P**AR**S**ON**S** Brinck**er**hoff

DESIGNED - SN REVISED FILE NAME DRAWN - DCP REVISED PLOT SCALE = NONE CHECKED - SN REVISED PLOT DATE = 10/28/2013 REVISED

STATE OF ILLINOIS **DEPARTMENT OF TRANSPORTATION** 

CCTV SYSTEM, I-90/94 TO CONGRESS PARKWAY SIGNING FOR FLAGGING OPERATIONS AT WORK ZONE SCALE: NONE SHEET NO. OF SHEETS STA. 353+46.00 TO STA. 382+50.00

SECTION COUNTY TOTAL SHEETS NO. COOK 37 35 389 2013-026-I CONTRACT NO. 60W49

