

- PARTIAL FOUNDATION KEY NOTES:

 1. EXISTING 18" DRILLED SHAFT TO REMAIN.
 2. EXISTING 48" DRILLED SHAFT TO REMAIN.
- EXISTING WF12 COLUMN TO REMAIN.
- NEW PC-2 PILE CAP WITH 48"Ø DRILLED SHAFT. T/ PILE CAP = B/EXISTING
- LONGITUDINAL CONCRETE PLATFORM BEAM 5. NEW ELEVATOR PIT MAT FOUNDATION.
- NEW 48"Ø DRILLED SHAFT.
- NEW W12 COLUMN ABOVE.
- NEW W12 COLUMN.. 9" ELEVATOR PIT WALL, (3) SIDES.
- 10. NEW 8" ALUMINUM POST ABOVE.



PARTIAL PLATFORM FOUNDATION PLAN

SCALE: 1/4"=1'-0"



GRAPHIC SCALE

1/4" = 1'-0"

PRELIMINARY NOT FOR CONSTRUCTION


Tram Systems

USER NAME = MAC	DESIGNED — KLT	REVISED
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PLOT SCALE =	DRAWN — MAC	REVISED
PLOT DATE = 10/28/13	CHECKED — AFK	REVISED

STATE OF ILLINOIS **DEPARTMENT OF TRANSPORTATION**

PEORIA STREET STATION PARTIAL PLATFORM FOUNDATION PLAN SHEET NO. S-100 OF 117 SHEETS

TOTAL SHEET NO.
356 201 MUN SECTION COUNTY 2090 2013-011R COOK CONTRACT NO. 60W29 ILLINOIS FED. AID PROJECT FED. AID PROJECT

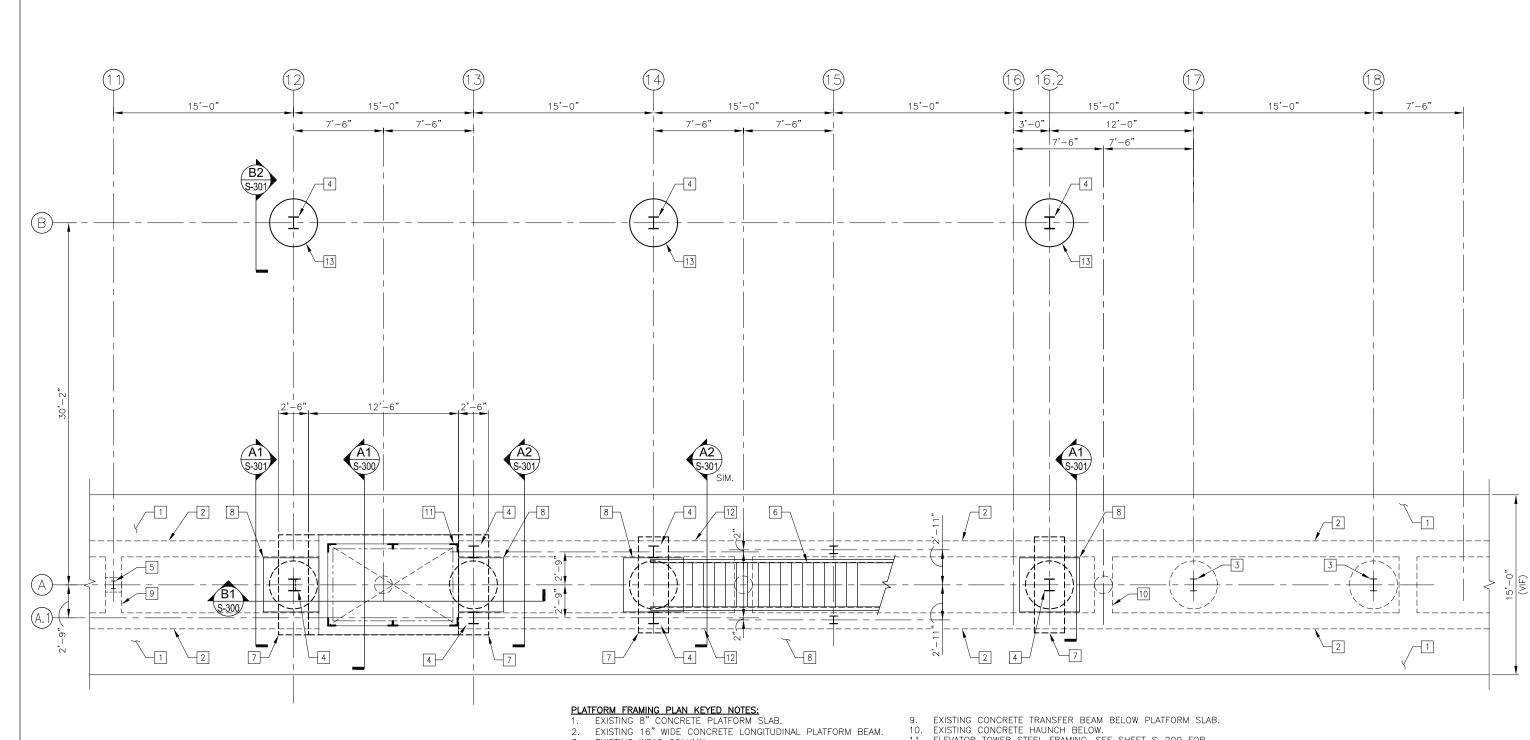



CHECKED — AFK

REVISED

Tram Systems

PLOT SCALE =

PLOT DATE = 10/28/13

- EXISTING WF12 COLUMN.
 NEW W12 COLUMN FOR STATION STRUCTURE ABOVE. (9) LOCATIONS
- EXISTING ALUMINUM CANOPY POST. EXISTING STAIR REINSTALLED.
- PC-2 PILE CAP BELOW.
- NEW CONCRETE INFILL.

- EXISTING CONCRETE TRANSFER BEAM BELOW PLATFORM SLAB. EXISTING CONCRETE HAUNCH BELOW.
- ELEVATOR TOWER STEEL FRAMING. SEE SHEET S-200 FOR
- ELEVATIONS.
- 12. NEW 8" ALUMINUM POST FOR CANOPY STRUCTURE ABOVE. 13. NEW 48"Ø DRILLED SHAFT. SEE SECTION FOR T/ SHAFT.

SHEET NO. S-110 OF 117 SHEETS

GRAPHIC SCALE

0 1' 2' 1/4" = 1'-0"

SECTION

2013-011R

PRELIMINARY NOT FOR CONSTRUCTION TOTAL SHEET NO. 356 202

COUNTY

COOK


ILLINOIS FED. AID PROJECT FED. AID PROJECT

CONTRACT NO. 60W29

USER NAME = MAC DESIGNED - KLT REVISED MUN PEORIA STREET STATION STATE OF ILLINOIS CHECKED — AFK REVISED 2090 PARTIAL PLATFORM FRAMING PLAN REVISED **DEPARTMENT OF TRANSPORTATION** DRAWN - MAC

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Lega Cyptomo		CHECKED — AFK	REVISED	STATE OF ILLINOIS	PARTIAL PLATFORM CANOPY FRAMING PLAN	2090	2013-011R	COOK 356 203
" STEETH SYSTEMS >	PLOT SCALE =	DRAWN — MAC	REVISED	DEPARTMENT OF TRANSPORTATION	PARTIAL PLATFURIN GANUPT FRAINING PLAN			CONTRACT NO. 60W29
	PLOT DATE = 10/28/13	CHECKED — AFK	REVISED		SHEET NO. S-120 OF 117 SHEETS		ILLINOIS FEI	D. AID PROJECT FED. AID PROJECT

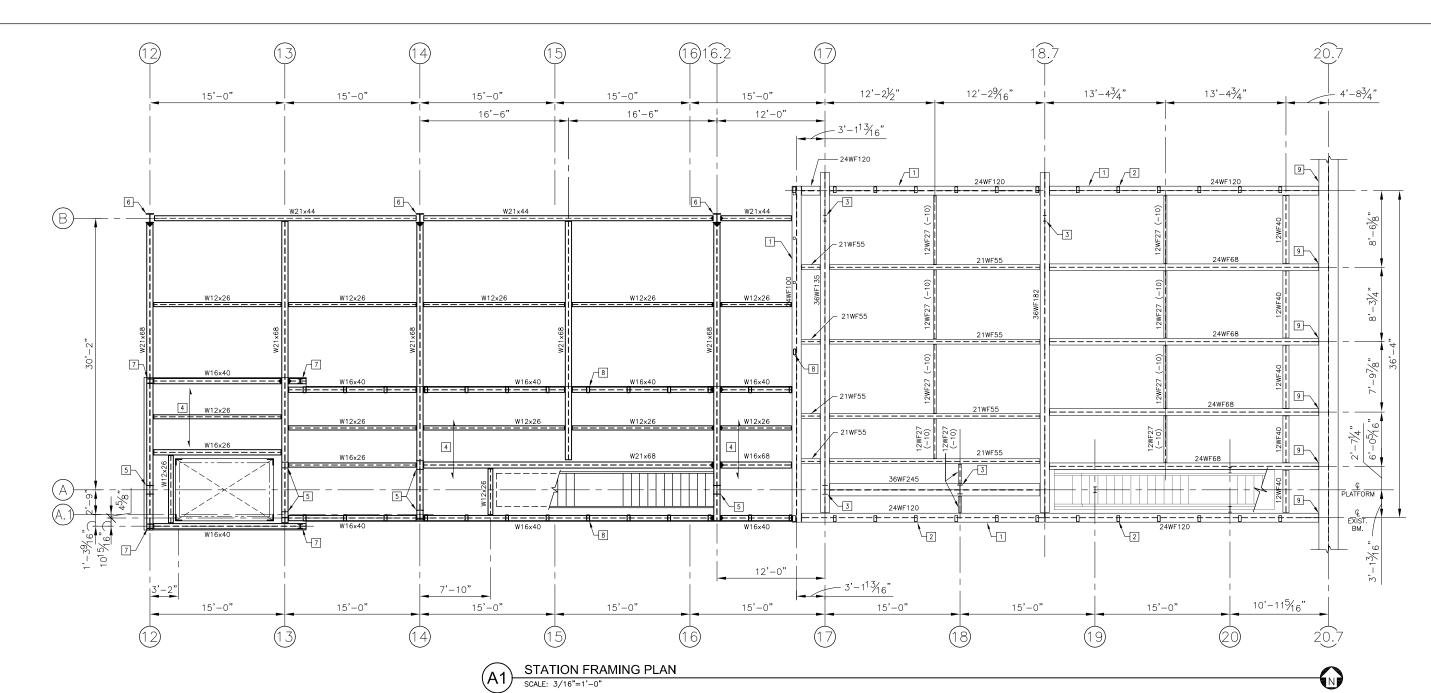

SHEET NOTES:

ALL EXISTING DIMENSIONS ARE SHOWN FOR REFERENCE
 ONLY AND SHALL BE VERIFIED PRIOR TO COMMENCEMENT
 OF CONSTRUCTION TO DETERMINE ANY CRITICAL DIMENSIONS.

- ALL EXISTING MEMBERS AND DIMENSIONS TO AND BETWEEN EXISTING MEMBERS SHALL BE VERIFIED PRIOR TO FABRICATION OF ANY NEW MEMBERS CONNECTING TO OR BETWEEN EXISTING MEMBERS.
- SEE SHEETS S-001 AND S-002 FOR GENERAL NOTES AND ABBREVIATIONS.
- 4. ASD DESIGN BEAM SHEARS SHOWN THUS:



- 5. MOMENT CONNECTIONS SHOWN THUS:
- 6. PROVIDE BEAM SHEAR CONNECTIONS FOR ASD DESIGN BEAM SHEARS INDICATED IN ACCORDANCE WITH THE TYPICAL DETAILS SHOWN ON SHEET S-600.
- 7. EXPOSED FRAMING OVER WEST BOUND TRACKS HAVE BEEN DESIGNED FOR A POSSIBLE FUTURE EXPANSION TO THE STATION. SDL = 125 PSF, SLL = 100 PSF, RLL = 20 PSF AND RSL = 25 PSF. ALL LOADS ARE UNFACTORED ALLOWABLE STRESS LOADS.

KEYED NOTES:

- 1. EXISTING STEEL FLOOR FRAMING.
- 2. EXISTING HSS8x4 FRAME.
- 3. EXISTING WF12 COLUMN BELOW.
- 4. 6" TOTAL CONCRETE DECK OVER
 1½", 20 GAGE CONFORM DECK.
 REINF WITH (1) LAYER
 6x6-W4.0xW4.0 WWR.
- 5. NEW W12 COLUMN BELOW.
- NEW W12 COLUMN.
- 7. NEW W6 COLUMN UP TO HIGH ROOF ABOVE.
- 8. NEW HSS8x4x5/6 FRAME AT 4'-6"
- 9. SEE NEW BRIDGE DESIGN
 DOCUMENTS FOR CONNECTION TO
 THE NEW BRIDGE.

GRAPHIC SCALE



PRELIMINARY NOT FOR CONSTRUCTION

Tran Systems

USER NAME = MAC	DESIGNED — K	(LT	REVISED	
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STATE OF ILLINOIS
DEPARTMENT OF TRANSPORTATION


PEORIA STREET STATION
STATION FRAMING PLAN
SHEET NO. S-130 OF 117 SHEETS


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 TOTAL SHEETS NO.
 SHEET NO.

 2090
 2013–011R
 COOK
 356
 204

 CONTRACT NO.
 60W29

 ILLINOIS FED. AID PROJECT FED. AID PROJECT

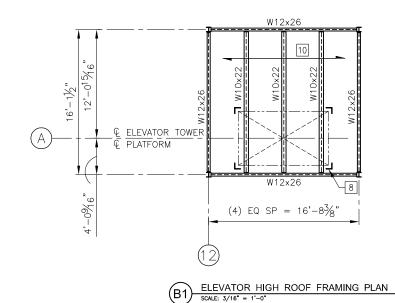

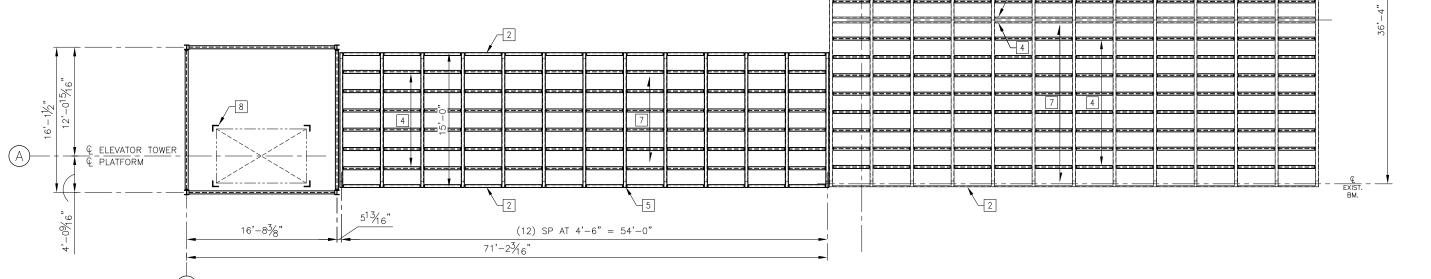

SHEET NOTES:
1. ALL EXISTING DIMENSIONS ARE SHOWN FOR REFERENCE ONLY AND SHALL BE VERIFIED PRIOR TO COMMENCEMENT OF CONSTRUCTION TO DETERMINE ANY CRITICAL DIMENSIONS.

- 2. ALL EXISTING MEMBERS AND DIMENSIONS TO AND BETWEEN EXISTING MEMBERS SHALL BE VERIFIED PRIOR TO FABRICATION OF ANY NEW MEMBERS CONNECTING TO OR BETWEEN EXISTING MEMBERS.
- 3. SEE SHEETS S-001 AND S-002 FOR GENERAL NOTES AND ABBREVIATIONS.

KEYED NOTES:

1. EXISTING HSS8x4 FRAME AT 4'-6".

- 2. EXISTING ¼" BENT & AT EAVE BETWEEN HSS8x4 FRAMES.
- 3. EXISTING DBL C4 AT RIDGE.
- 4. NEW WT4x6.5 AT 24" ON CENTER, MAXIMUM
- 5. NEW HSS8x4x5/6 FRAME AT (13) LOCATIONS ALONG CONNECTOR WALKWAY.
- 6. NEW HSS4x2x5/16 EAVE MEMBER.
- 7. NEW POLYCARBONATE ROOF DECKING.
- 8. ELEVATOR TOWER STRUCTURE.
- 9. ELEVATOR TOWER STRUCTURE BELOW.
- 10. WR20 ROOF DECK.

STATION ROOF FRAMING PLAN SCALE: 3/16" = 1'-0"

GRAPHIC SCALE

31'-5³/₄"


3/16" = 1'-0"


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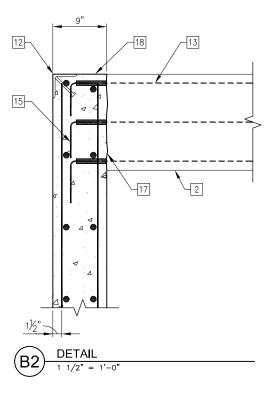
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24'-51/16"





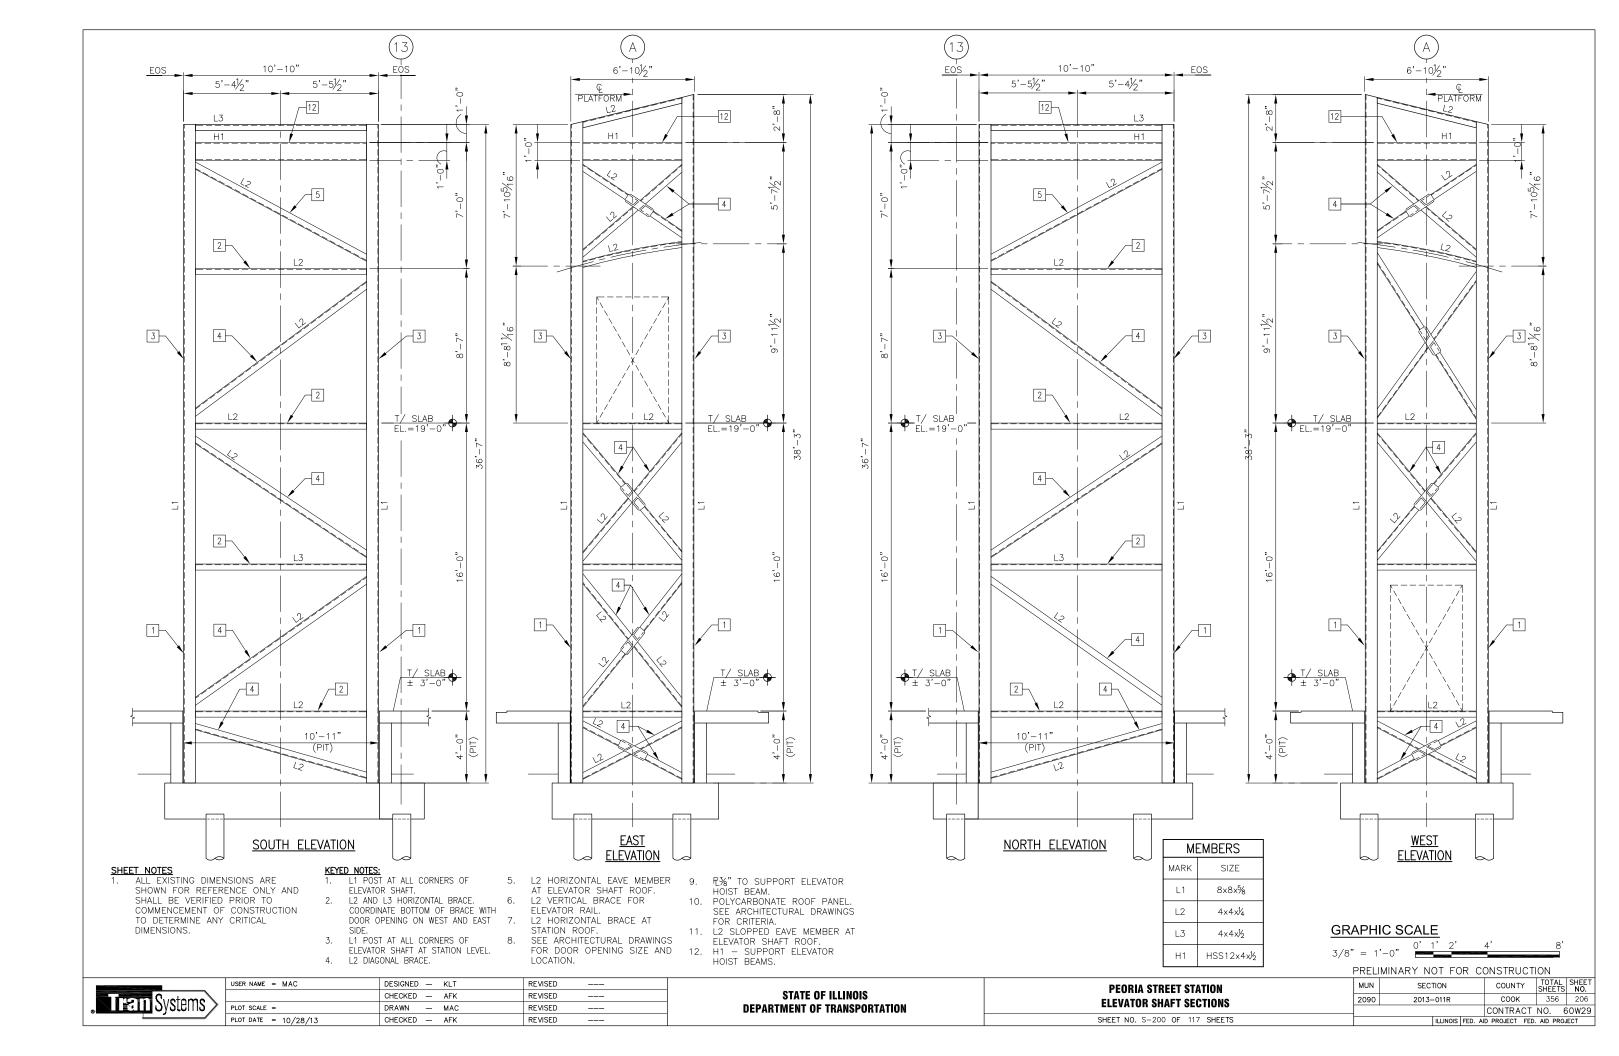


SHEET NOTES:

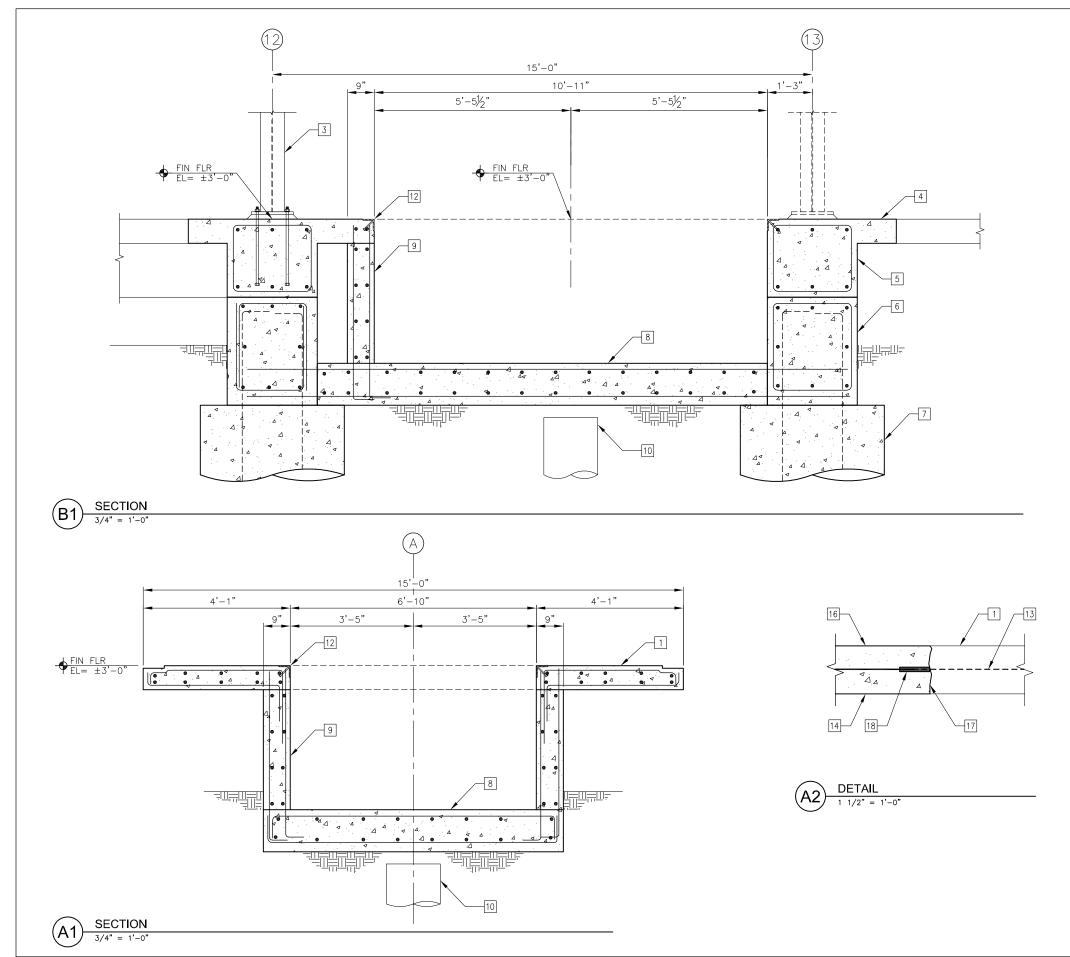1. ALL EXISTING DIMENSIONS ARE SHOWN FOR REFERENCE ONLY AND SHALL BE VERIFIED PRIOR TO COMMENCEMENT OF CONSTRUCTION TO DETERMINE ANY CRITICAL DIMENSIONS.

- KEYED NOTES:
 1. EXISTING PLATFORM SLAB.
 2. EXISTING LONGITUDINAL PLATFORM BEAM. NEW WF STEEL COLUMN, SEE PLAN FOR SIZE.
- INFILL SLAB.
- INFILL CONCRETE.
- P-2 PILE CAP.
- DRILLED SHAFT.
- ELEVATOR MAT SLAB. REINF. W/ #6 AT 12" O.C., EA. WAY, TOP AND BOTTOM.

 9" THICK ELEVATOR PIT WALL. REINF. W/ #5 AT 12"
- O.C., EA. WAY, EA. SIDE.
- EXISTING DRILLED SHAFT. REMOVE TO 3" BELOW BOTTOM OF NEW ELEVATOR MAT SLAB.

 NEW 8" ALUMINUM POST, EACH SIDE OF PLATFORM.
- L4x4x3 CONTINUOUS WITH 36"Øx4" HCA AT 12" O.C. EXISTING SLAB OR BEAM REINF. EXPOSE SUFFICIENTLY
- TO INSTALL MECHANICAL SPLICE.
 PROVIDE REINFORCING TO MATCH EXISTING SLAB REINFORCING.
- SPLICE EXISTING BEAM REINFORCING AND PROVIDE STD.
- 16. NEW 8" THICK CONCRETE PLATFORM SLAB.
- 17. ROUGHEN EXISTING CONCRETE TO ¼" AMPLITUDE AND APPLY CONCRETE BONDING AGENT IN ACCORDANCE WITH THE MANUFACTURER'S CRITERIA PRIOR TO NEW CONCRETE PLACEMENT.
- 18. PROVIDE MECHANICAL REINF. SPLICE AT ALL EXISTING REINFORCING.

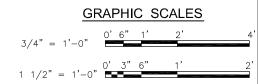


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STATE OF ILLINOIS **DEPARTMENT OF TRANSPORTATION**

PEORIA STREET STATION **FOUNDATION SECTIONS AND DETAILS** SHEET NO. S-300 OF 117 SHEETS

MUN SECTION COUNTY 2090 COOK 356 207 CONTRACT NO. 60W29 ILLINOIS FED. AID PROJECT FED. AID PROJECT



15'-0"

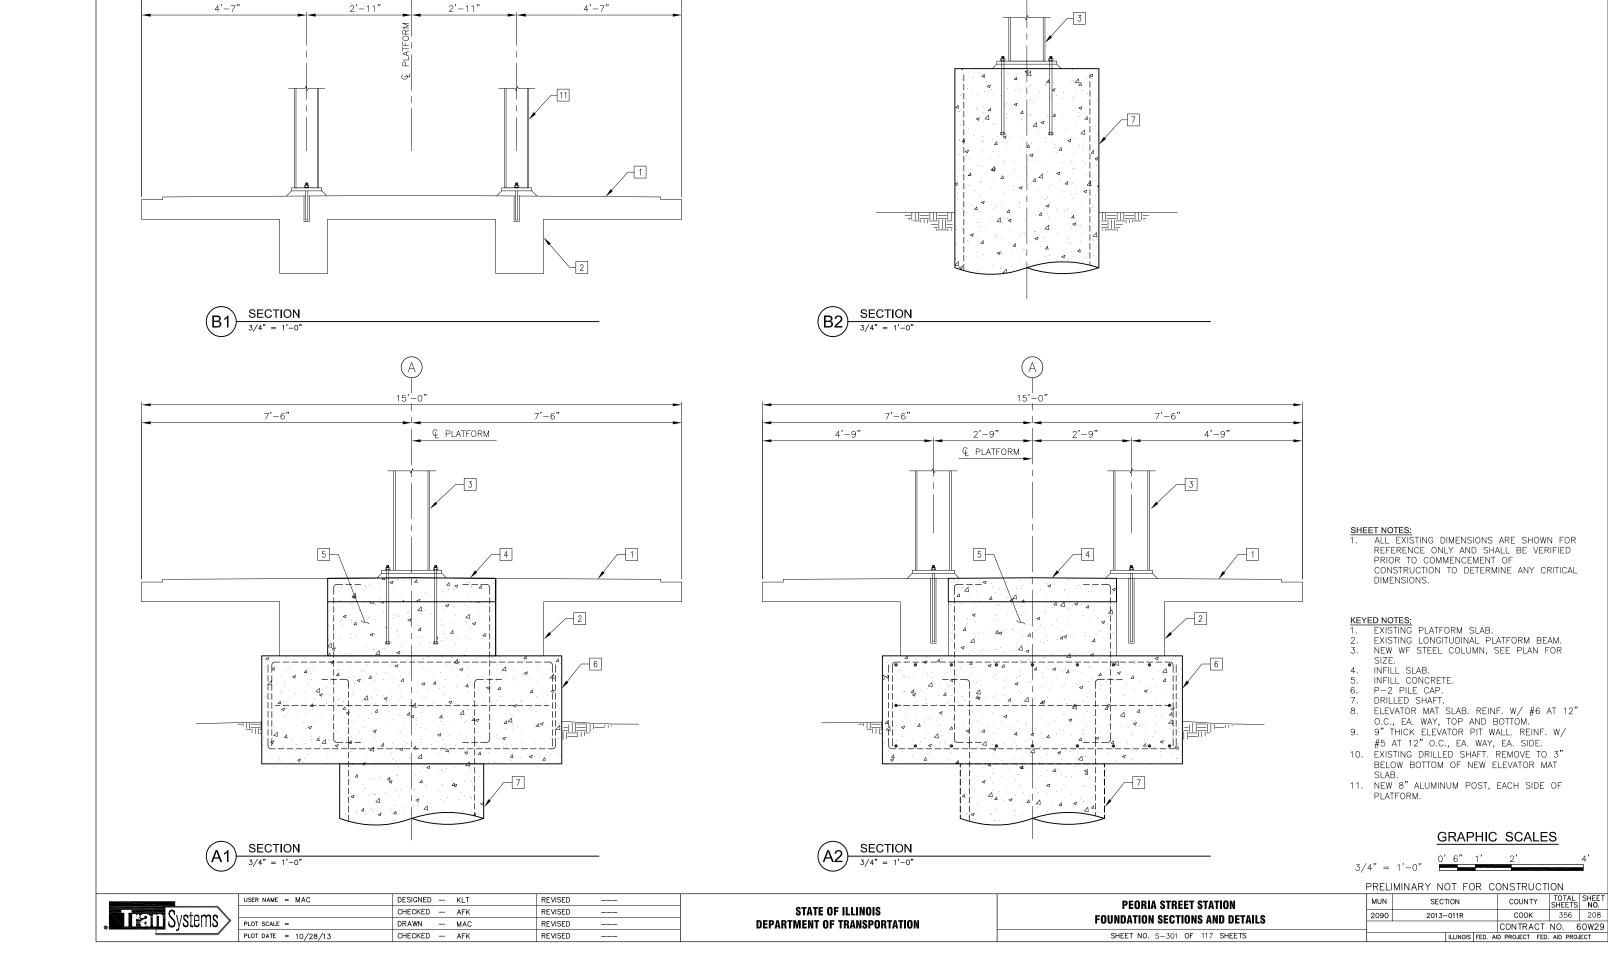7'-6"

7'-6"

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GRAPHIC SCALE

PRELIMINARY NOT FOR CONSTRUCTION


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STATE OF ILLINOIS
DEPARTMENT OF TRANSPORTATION

PEORIA STREET STATION
STATION ROOF SECTIONS AND DETAILS

SHEET NO. S-502 OF 117 SHEETS



BEAM DEPTH	N	L (IN)	V (KIP)
W8	2	5½	40.8
W10, W12, W14	3	8½	63.6
W16	4	11½	83.9
W18	5	14½	104
W21	6	17½	124
W24, W27	7	20½	145
W30	8	23½	165
W33	9	26½	185
W36	19	29½	205
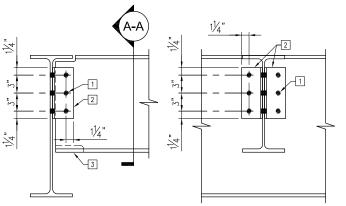
<u>DETAILED KEYED NOTES:</u>
1. SEE SCHEDULE FOR NUMBER, N, OF 34" ϕ , A325—N BOLTS. 2. L3 $\frac{1}{2}$ x $3\frac{1}{2}$ x $\frac{5}{6}$ x "L" 3. COPE BOTTOM FLANGE AS REQUIRED.


SECTION A-A

- NOTES:

 1. APPLICABLE FOR CONNECTIONS
 WITH SKEW ANGLE LESS THAN 5'.


 2. BEND TO SKEW REQ'D FOR SKEW
 ANGLE LESS THAN 5'.

 3. SHEAR CAPACITIES, V, INDICATED
 ARE UNFACTORED, ASD
 CONNECTION CAPACITIES.

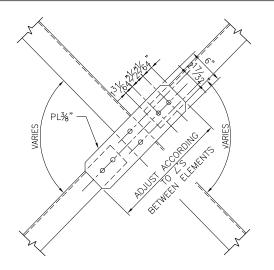

DETAIL 1 1/2" = 1'-0"

ALL-BOLTED DOUBLE ANGLE CONNECTION TYPICAL DETAIL

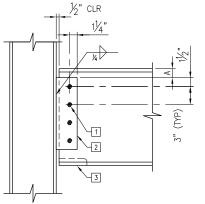

BOLT SCHEDULE									
BEAM DEPTH	A (IN)	L (IN)	N	V (KIP)					
W8, W10	1	5½	2	14.6					
W12	1½	8½	3	32.1					
W14	1½	1 1½	3	53.3					
W16	1½	14½	4	76.4					
W18	11/2	17½	5	100					
W21	2	20½	5	125					
W24	8	231/2	6	149					
W27	9	26½	6	173					
W30	10	29½	7	197					

NOTES:


1. SHEAR CAPACITIES, V, INDICATED ARE UNFACTORED, ASD CONNECTION CAPACITIES.

DETAIL KEYED NOTES:

- SEE SCHEDULE FOR NUMBER, N, OF 3/4"ø, A325-N BOLTS.
- 2. P 3/4 x L. SEE SCHEDULE FOR LENGTH, L, REQUIRED.
 3. COPE BOTTOM FLANGE AS REQUIRED.

BEAM CONNECTION TO BEAM OR COLUMN (B1)

GRAPHIC SCALE

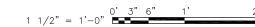

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PLOT SCALE =	DRAWN — MAC	REVISED
PLOT DATE = $10/28/13$	CHECKED — AFK	REVISED

STATE OF ILLINOIS **DEPARTMENT OF TRANSPORTATION**

PEORIA STREET STATION SCHEDULES AND DETAILS SHEET NO. S-600 OF 117 SHEETS

COUNTY TOTAL SHEET NO.
COOK 356 213 MUN SECTION COUNTY 2090 CONTRACT NO. 60W29 ILLINOIS FED. AID PROJECT FED. AID PROJECT

DEMOLITION

- I. THE CONTRACTOR IS FULLY RESPONSIBLE FOR THE MEANS AND METHODS OF DEMOLITION AND THE INTEGRITY AND STABILITY OF THE EXISTING STRUCTURE DURING DEMOLITION UNTIL THE WORK IS COMPLETED. THE CONTRACOTR SHALL PROVIDE SHORING IN REQUIRED LOCATIONS WHERE EXITING CONSTRUCTION IS TO REMAIN WILL BE AFFECTED BY DEMOLITION. SEE SHORING SPEC.
- 2. THE EXISTING STRUCTURE IS INDICATED FOR REFERENCE ONLY AND IS TO BE FIELD VERIFED BY THE CONTRACTOR. THE EXACT EXTENT OF DEMOLITION SHALL BE VERIFIED AT THE SITE. DETERMINE THE NATURE AND EXTENT OF DEMOLITION THAT WILL BE NECESSARY BY COMPARING THE DRAWINGS WITH THE EXISTING CONSTRUCTION.
- 3. THE CONTRACTOR SHALL USE THESE DRAWINGS IN CONJUNCTION WITH THE ARCHITECTURAL, STRUCTURAL, MECHANICAL, AND ELECTRICAL DEMOLITION DRAWINGS. IN THE EVENT OF CONFLICT, THE CONTRACTOR SHALL IMMEDIATELY NOTIFY IDOT.
- 4. THE CONTRACTOR SHALL USE QUALIFIED, EXPERIENCED PERSONNEL FOR DEMOLITION AND REMOVAL OPERATIONS. DEMOLITION AND REMOVAL OPERATIONS SHALL BE PERFORMED IN A CAREFUL AND ORDERLY MANNER TO PREVENT HAZARDS TO PERSONS, DAMAGE TO PROPERTY, AND THE SPREADING OF DUST AND DEBRIS USING VACUUM SYSTEM AND OR WET METHODS.
- 5. NO PORTION OF THE STRUCTURE SHALL BE PERMITTED TO FALL NOR SHALL ANY DEBRIS BE DROPPED EXCEPT BY METHODS WHICH WILL ENSURE INTEGRITY OF THE STRUCTURE.
- 6. PRIOR TO THE START OF WORK, VERIFY THAT THE SCOPE OF DEMOLITION INDICATED ON THE DRAWINGS SHALL NOT DAMAGE, CUT OR DISRUPT SERVICE TO ANY MECHANICAL SYSTEM, COMMUNICATION SYSTEM, ELECTRICAL SYSTEM OR UTILITY EMBEDDED IN THE EXISTING STRUCTURE OR BELOW THE TRAIN PLATFORM.
- 7. DO NOT REMOVE MORE OF THE EXISTING STRUCTURE THAN INDICATED ON DRAWING. DO NOT DAMAGE, MAR, CUT, OF DEFACE THE REMAINING STRUCTURE TO REMAIN, OR MATERIALS TO BE REUSED.
- 8. THE CONTRACTOR SHALL INCLUDE IN HIS BID THE COST OF REMOVING AND LEGALLY DISOSING OF DEMOLISHED MATERIALS FROM THE SITE IN ACCORDANCE WITH ALL APPLICABLE LAWS, CODES, AND REGULATIONS.
- 9. WHERE NEW OPENINGS IN EXISTING CONCRETE SLABS ARE TO BE CREATED, THE DEMOLITION CONTRACTOR SHALL CORE HOLES AT THE OUTSIDE CORNERS OF THE NEW OPENING PRIOR TO DEMOLITION. SAW-CUTTING SHALL BE STRAIGHT AND SHALL NOT EXTEND INTO THE EXISTING SLAB TO REMAIN NOR BEYOND THE HOLES CORED AT THE CORNERS OF THE NEW OPENING.
- 10. A DEMOLITION PLAN IS TO BE SUBMITTED TO IDOT FOR APPROVAL. DEMOLITION SHALL NOT COMMENCE UNTIL THE CONTRACTOR HAS RECEIVED WRITTEN APPROVAL FROM IDOT.
- 11. IF DEMOLITION IS PERFORMED IN EXCESS OF THAT REQUIRED, RESTORE AFFECTED AREAS AT NO COST TO THE OWNER.
- 12. REMOVE DESIGNATED EQUIPMENT, COMPONENTS, PARTITIONS, ETC. AS REQUIRED FOR NEW WORK.
- I3. REMOVE FROM SITE REGULARLY AND LEGALLY DISPOSE OF REFUSE, DEBRIS, RUBBISH, AND OTHER MATERIAL RESULTING FROM DEMOLITION OPERATIONS.

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STATE OF ILLINOIS
DEPARTMENT OF TRANSPORTATION


PEORIA STREET STATION
DEMOLITION GENERAL NOTES

SHEET NO.AD-0010F 117 SHEETS

 MUN
 SECTION
 COUNTY
 TOTAL SHEETS NO.

 2090
 2013-011R
 COOK
 356
 214

 CONTRACT NO. 60W29

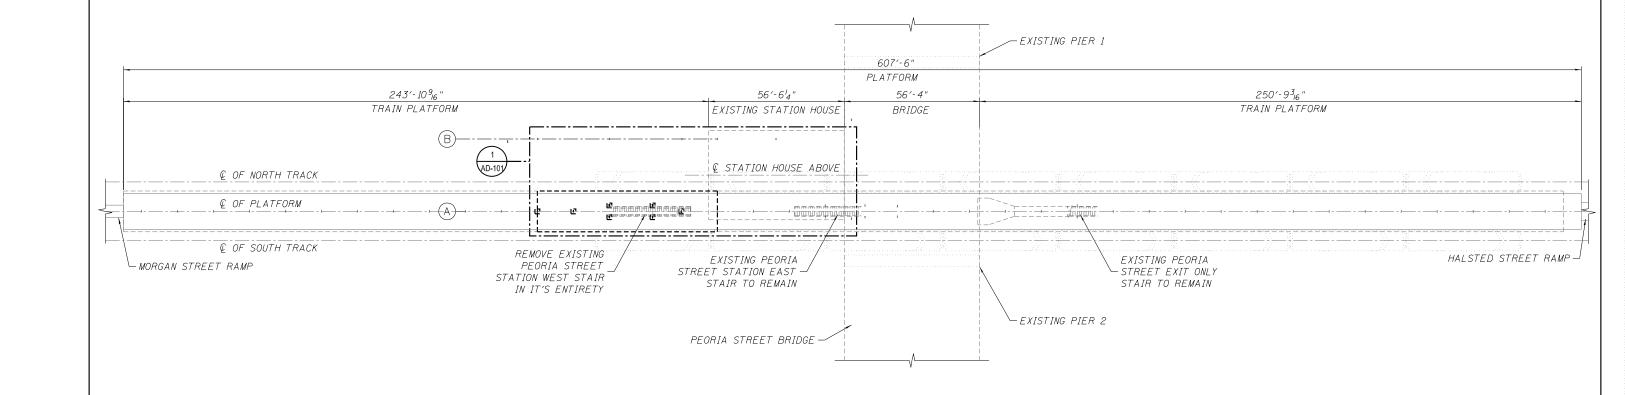

DEMOLITION OVERALL PLATFORM FLOOR PLAN SCALE: 1" = 20'-0"


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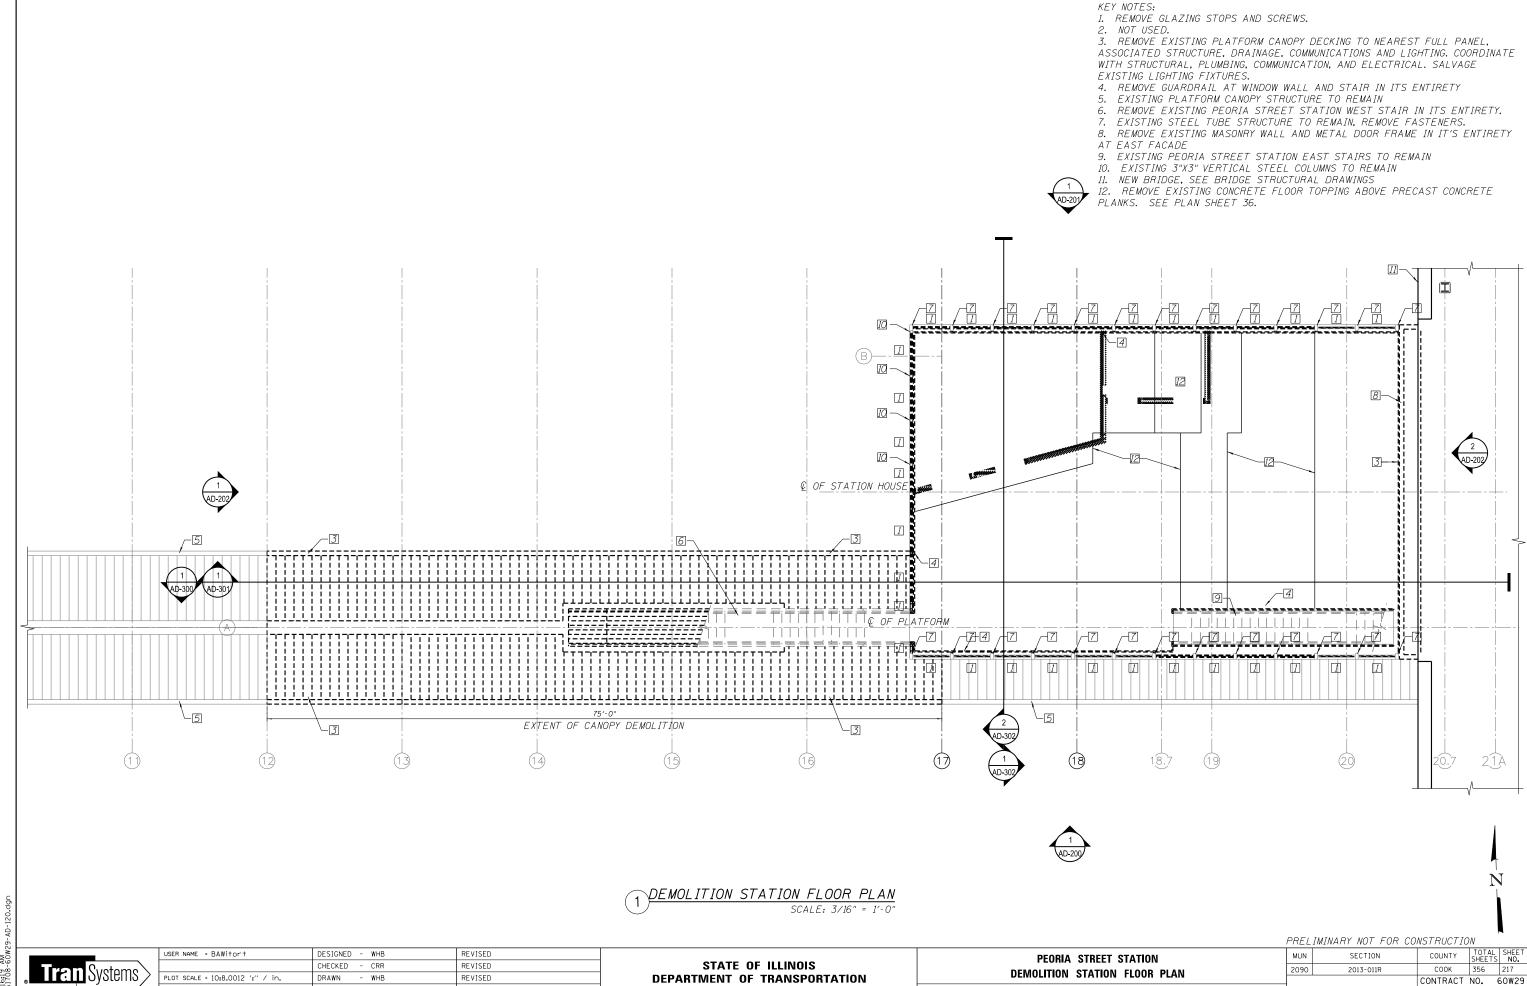
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STATE OF ILLINOIS **DEPARTMENT OF TRANSPORTATION**

PEORIA STREET STATION				
DEMOLITION OVERALL PLATFORM FLOOR PLAN				
SHEET NO.AD-1000F 117 SHEETS				

PRELIMINARY NOT FOR CONSTRUCTION COUNTY TOTAL SHEET NO.
COOK 356 215
CONTRACT NO. 60W29 MUN SECTION 2013-011R 2090



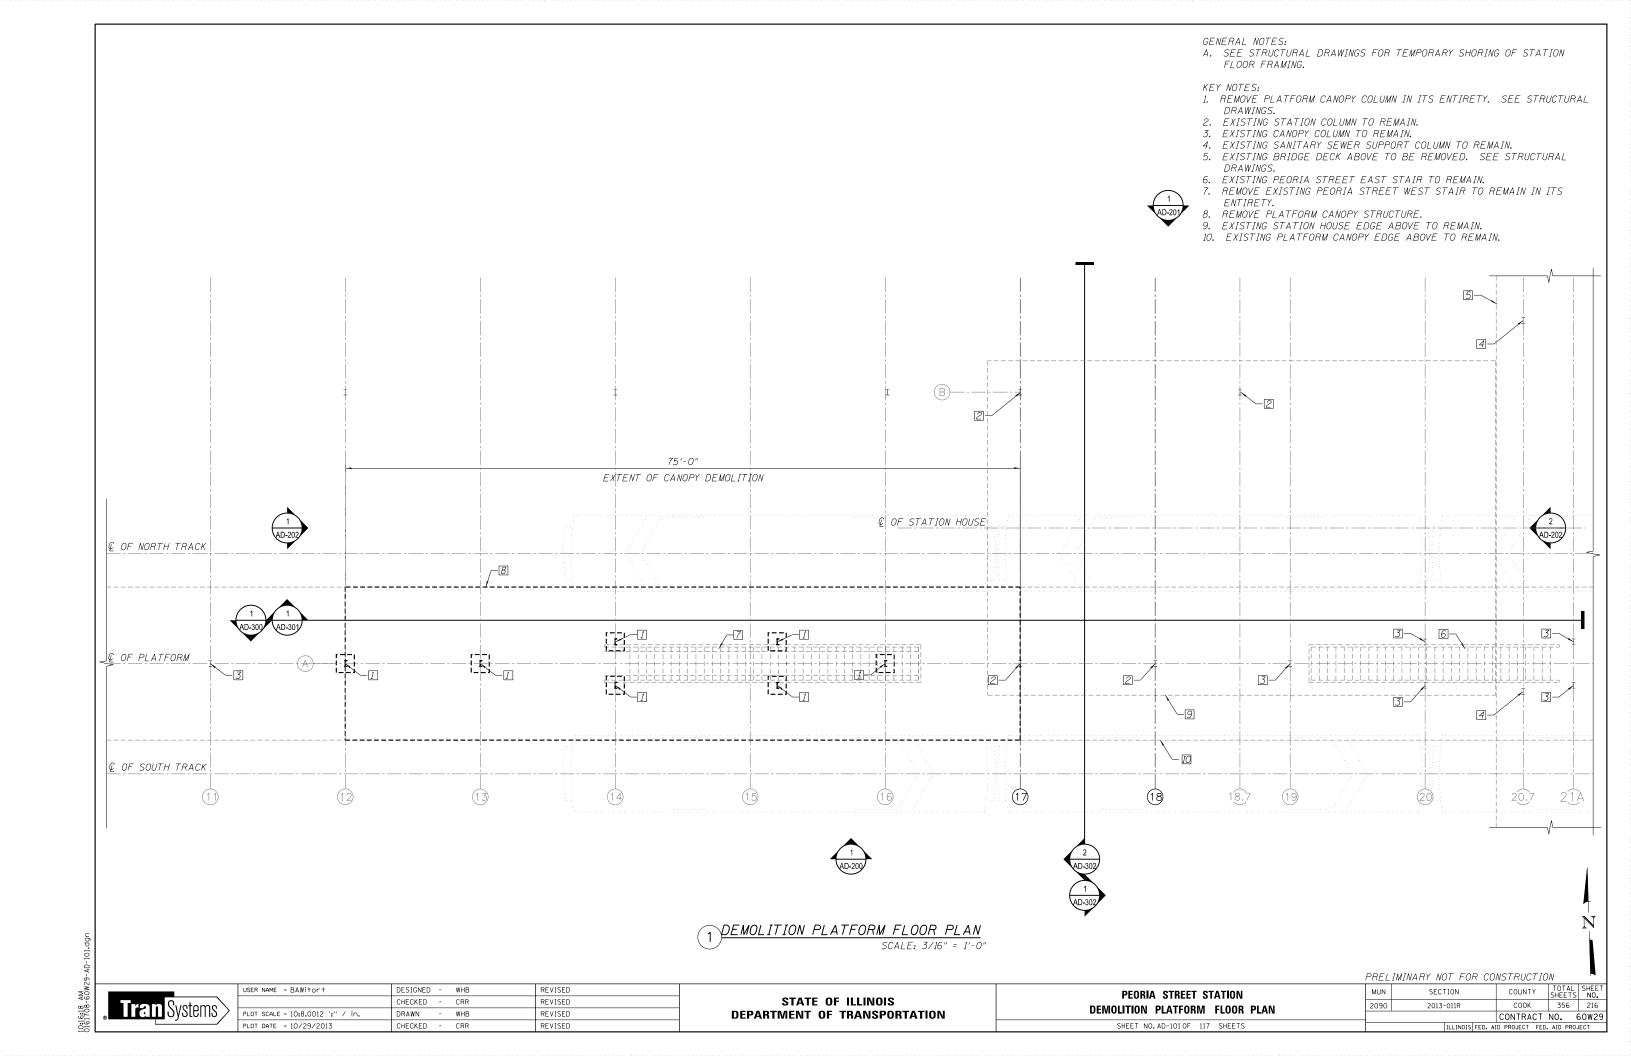

SHEET NOAD-120 OF 117 SHEETS


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REVISED

PLOT DATE = 10/29/2013

- KEY NOTES:
 1. REMOVE GLAZING, GLAZING STOPS & SCREWS.
- NOT USED.
- REMOVE STEEL ANGLES WELDED TO MAIN SUPPORT MEMBERS.
 EXISTING STEEL TUBE STRUCTURE TO REMAIN.
 EXISTING STEEL TEE TO REMAIN.

- 6. EXISTING STEEL CHANNELS TO REMAIN.
- 7. EXISTING STEEL BENT PLATE TO REMAIN.

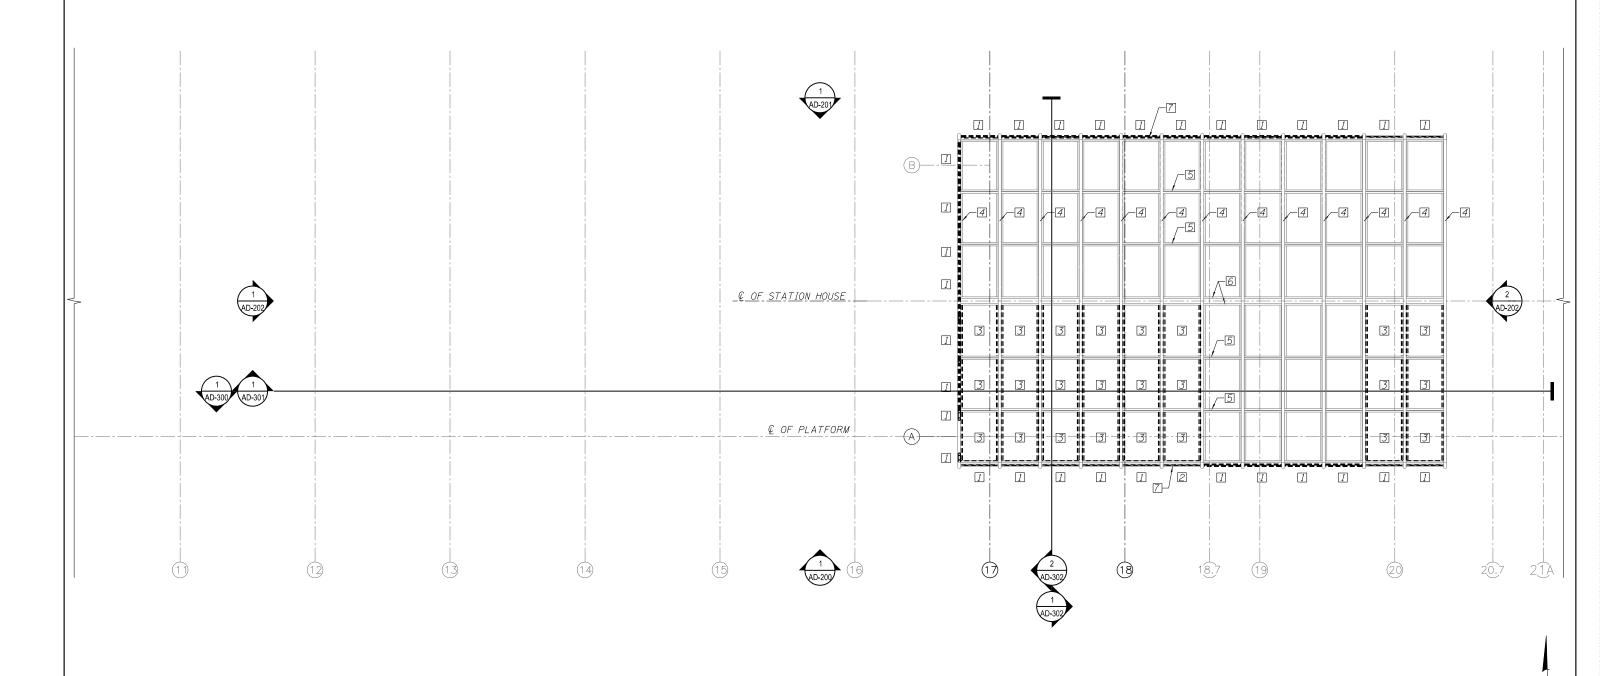

1 PEMOLITION STATION REFLECTED CEILING PLAN SCALE: 3/16" = 1'-0"

Tran Systems

USER NAME = BAWitort DESIGNED - WHB REVISED CHECKED - CRR REVISED PLOT SCALE = 10:8.0012 ':" / in. DRAWN WHB REVISED PLOT DATE = 10/29/2013 CHECKED - CRR REVISED


STATE OF ILLINOIS **DEPARTMENT OF TRANSPORTATION**

PEORIA STREET STATION DEMOLITION STATION REFLECTED CEILING PLAN SHEET NO. AD-121 OF 117 SHEETS

PRELIMINARY NOT FOR CONSTRUCTION COUNTY TOTAL SHEET NO.

COOK 356 218 MUN SECTION 2090 2013-011R CONTRACT NO. 60W29

- KEY NOTES: 1. REMOVE SKYLIGHT UNITS AND SCREWS IN THEIR ENTITY, TYP.
- 2. EXISTING STRUCTURALFRAMING TO REMAIN, TYP.
- 3. EXISTING STEEL TUBE STRUCTURE TO REMAIN
- 4. REMOVE STAIR ROOF IN ITS ENTIRETY

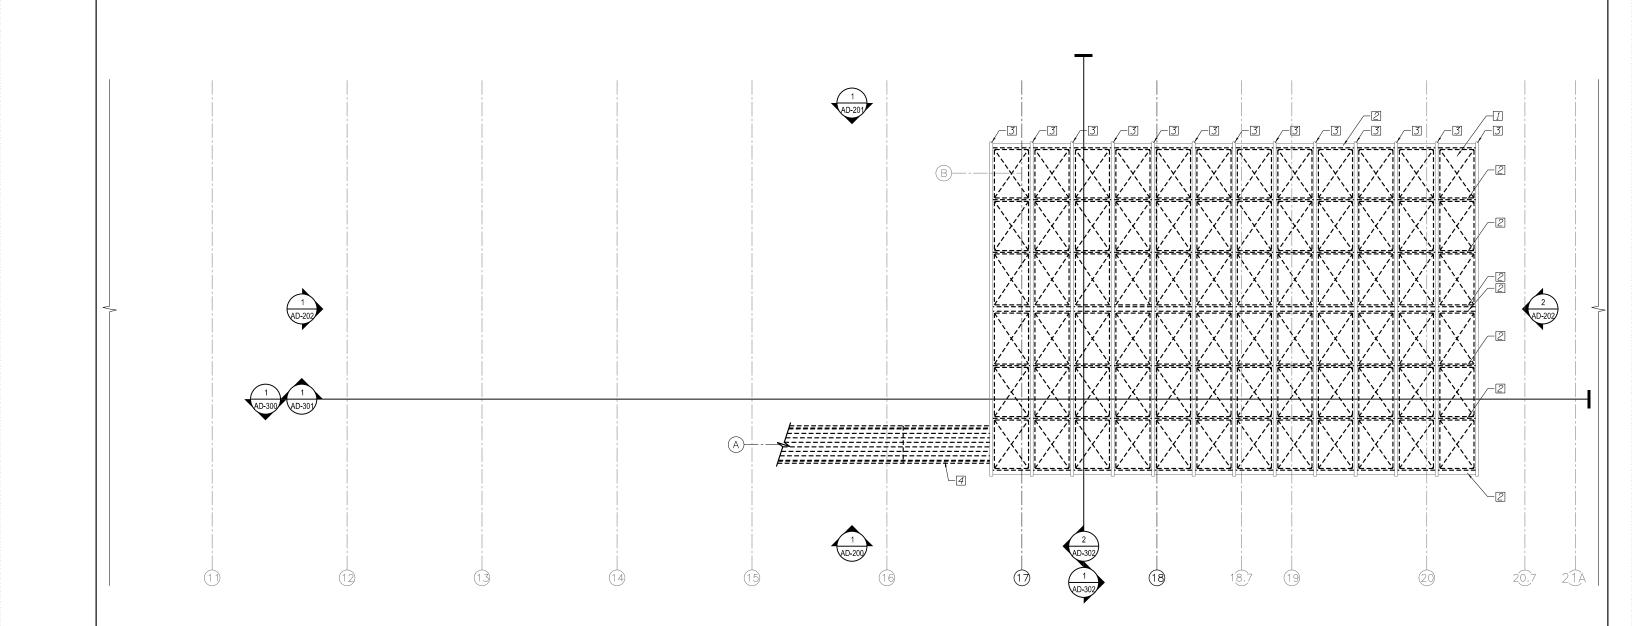

DEMOLITION STATION ROOF PLAN SCALE: 3/16" = 1'-0"

Tran Systems


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	PLOT DATE = 10/29/2013	CHECKED	-	CRR	REVISED

PEORIA	STREET S	TATION	
DEMOLITION	STATION	ROOF PLAN	
SHEET NO. A	AD-130 OF 117	' SHEETS	

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2090	2013-011R	COOK	356	2
		CONTRACT	NO. 6	50W
	ILLINOIS FED. AI	D PROJECT FED.	AID PROJ	JECT

- REMOVE GLAZING AND FRAMEGLAZING STOPS & SCREWS.
- NOT USED.
- REMOVE PLATFORM CANOPY COLUMN IN ITS ENTIRETY -
- SEE STRUCTURAL DRAWINGS. EXISTING STATION COLUMN TO REMAIN.
- 5. EXISTING STRUCTURAL FRAMING TO REMAIN, TYP.
- REMOVE SKYLIGHT UNITS AND SCREWS IN THEIR ENTIRETY, TYP.
- 6. REMOVE SKYLIGHT UNITS AND SCREWS IN THEIR LAND.
 7. EXISTING STEEL TUBE STRUCTURE TO REMAIN, TYP.
 8. NOT USED.

- 10. PLATFORM LEVEL.
- 11. EXISTING STEEL BEAM TO REMAIN.
- 12. FINISH GRADE.
- 13. EXISTING PEORIA STREET STATION EAST STAIRS TO REMAIN REMOVE EXISTING PEORIA STREET STATION WEST STAIR IN ITS ENTIRETY.
- 14. EXISTING PLATFORM CANOPY DASHED FOR CLARITY.

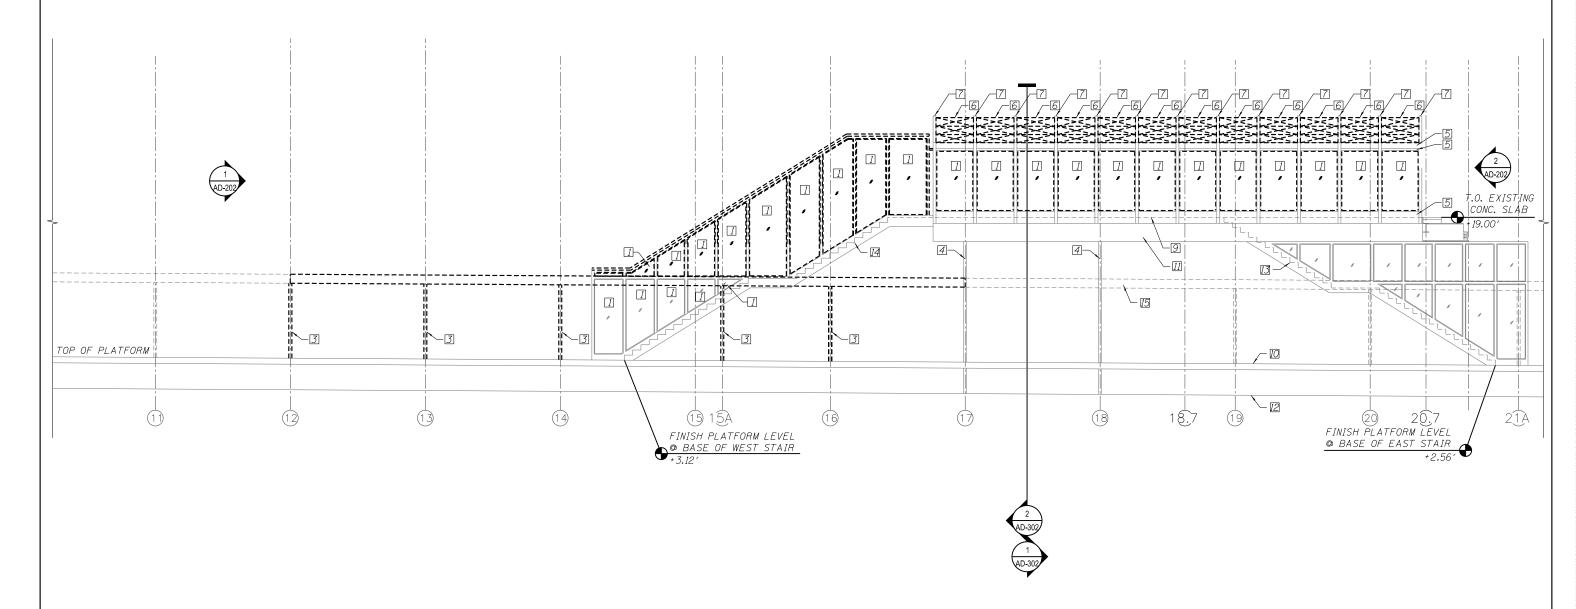

DEMOLITION STATION SOUTH ELEVATION SCALE: 3/16" = 1'-0

Tran Systems

USER NAME = BAWitort DESIGNED - WHB REVISED CHECKED -CRR REVISED PLOT SCALE = 10:8.0000 ':" / in. DRAWN WHB REVISED PLOT DATE = 10/29/2013 CHECKED -CRR REVISED

STATE OF ILLINOIS **DEPARTMENT OF TRANSPORTATION**

PEORIA STREET STATION **DEMOLITION STATION ELEVATIONS** SHEET NO.AD-2000F 117 SHEETS

PRELIMINARY NOT FOR CONSTRUCTION MUN SECTION COUNTY COOK 356 220 2090 2013-011R CONTRACT NO. 60W29

KEY NOTES

1. REMOVE GLAZING AND GLAZING STOPS AND SCREWS.

NOT USED.

REMOVE CANOPY COLUMN IN ITS ENTIRETY - SEE STRUCTURAL DRAWINGS.

4. EXISTING STATION COLUMN TO REMAIN.

REMOVE SKYLIGHT UNITS AND SCREWS IN ITS ENTIRETY.

6. NOT USED.

7. EXISTING STEEL TUBE STRUCTURE TO REMAIN, TYP.


PLATFORM LEVEL.

9. FINISH GRADE.

10. FINISH FLOOR LEVEL.

II. EXISTING STRUCTURAL STEEL BEAM TO REMAIN.
REMOVE EXISTING PEORIA STREET STATION WEST STAIR IN ITS ENTIRETY.
12. EXISTING PEORIA STREET STATION EAST STAIR TO REMAIN.

13. PLATFORM CANOPY DASHED FOR CLARITY.

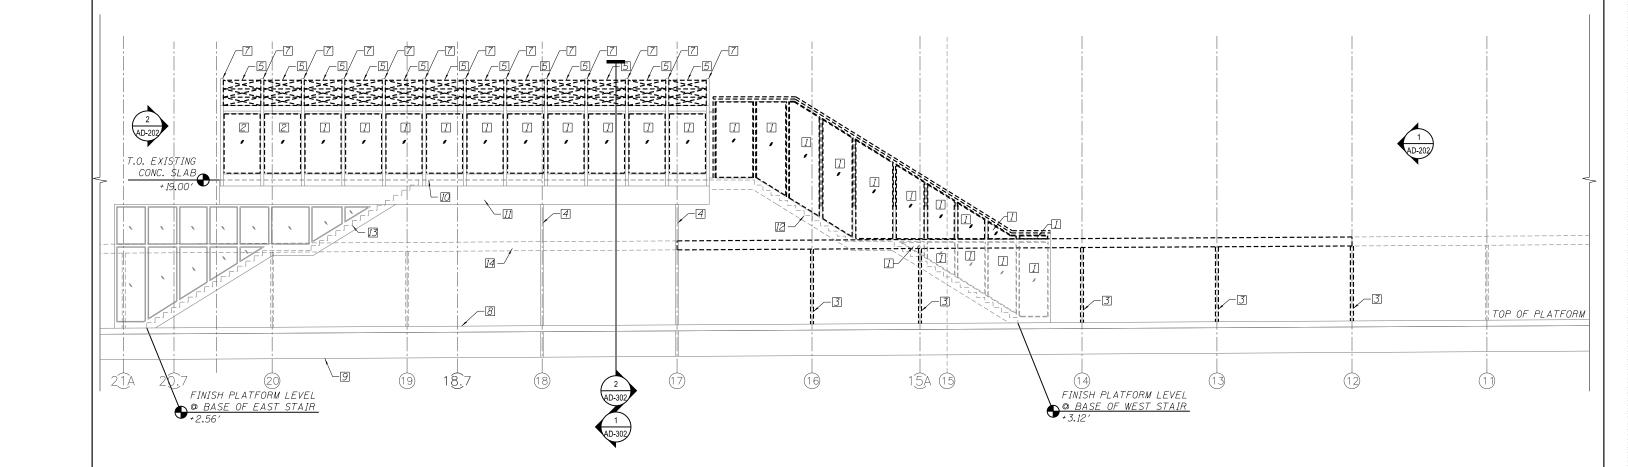

<u> DEMOLITION STATION NORTH ELEVATION</u> SCALE: 3/16" = 1'=0"

Tran Systems

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	CHECKED - CRR	REVISED
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PLOT DATE = 10/29/2013	CHECKED - CRR	REVISED


PEORIA STREET STATION			
DEMOLITION STAT	TON ELEVATIONS		
SHEET NO.AD-201	OF 117 SHEETS		


	PRELIMINARY NOT FOR CONSTRUCTION					W	
	MUN	UN SECTION			Υ	TOTAL SHEETS	SHEE NO.
	2090 2013-011R			COOK		356	221
				CONTRA	СТ	NO. 6	50W2
		ILLINOI	S FED. A	ID PROJECT	FED.	AID PROJ	ECT

KEY NOTES:

- REMOVE GLAZING, GLAZING STOPS AND SCREWS.
- NOT USED.
- REMOVE SKYLIGHT UNITS IN THEIR ENTIRETY.
- EXISTING STEEL TUBE STRUCTURE TO REMAIN. FINISH GRADE. FINISH FLOOR LEVEL.

- PLATFORM CANOPY & STRUCTURE.
- 8. PLATFORM LEVEL.
 9. EXISTING STATION COLUMN TO REMAIN.
- 10. EXISTING STRUCTURAL STEEL BEAM TO REMAIN.
- 11. EXISTING STRUCTURAL FRAMING TO REMAIN, TYP.
- 12. EXISTING 3" X 3" STRUCTURAL COLUMN TO REMAIN, TYP.
 13. REMOVE 3" X 3" STRUCTURAL COLUMN.
- 14. EXISTING 3" X 3" STRUCTURAL BEAM TO REMAIN.
- 15. EXISTING STAIR DASHED FOR CLARITY.
- 16. EXISTING STAIR TO BE REMOVED, DASHED FOR CLARITY.

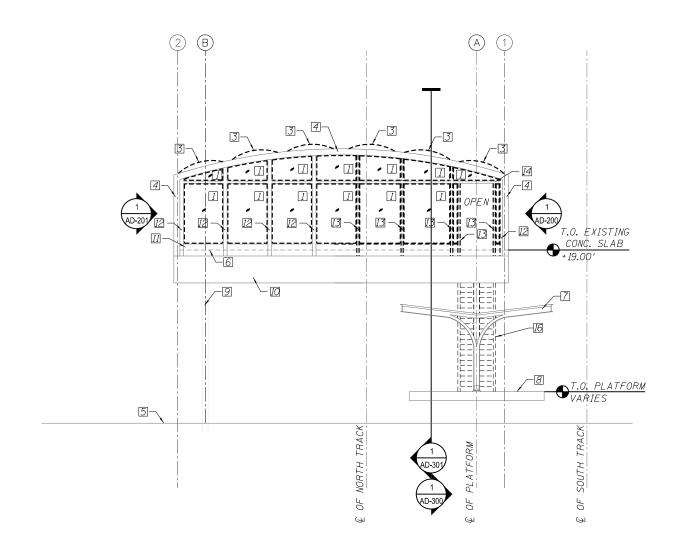

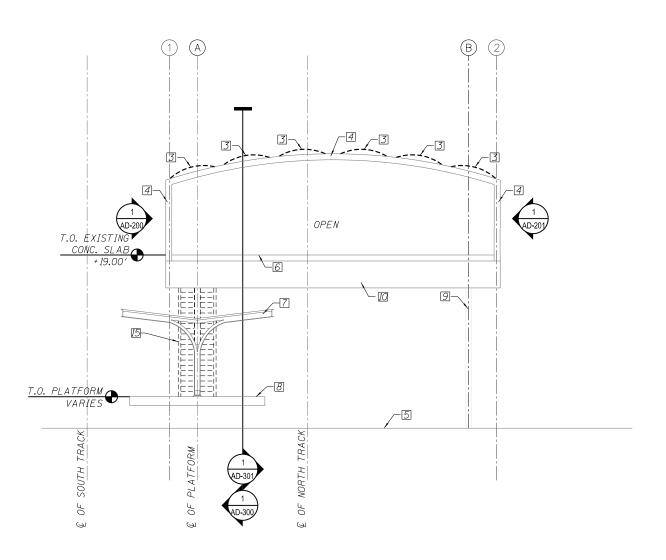

<u> DEMOLITION STATION WEST ELEVATION</u>


SCALE: 3/16" = 1'-0" *STAIR NOT SHOWN FOR CLARITY 2 DEMOLITION STATION EAST ELEVATION




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PEORIA DEMOLITION	STREET ST		
SHEET NO.A	D-2020F 117	SHEETS	

/ / \ L L	IMINANT NOT TON	CUI	1311100110	/V	
MUN	SECTION		COUNTY	TOTAL SHEETS	SHEET NO.
2090	2013-011R		COOK	356	222
			CONTRACT	NO. 6	50W29
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DEMOLITION STATION SECTION LOOKING SOUTH SCALE: 3/16" = 1'-0"

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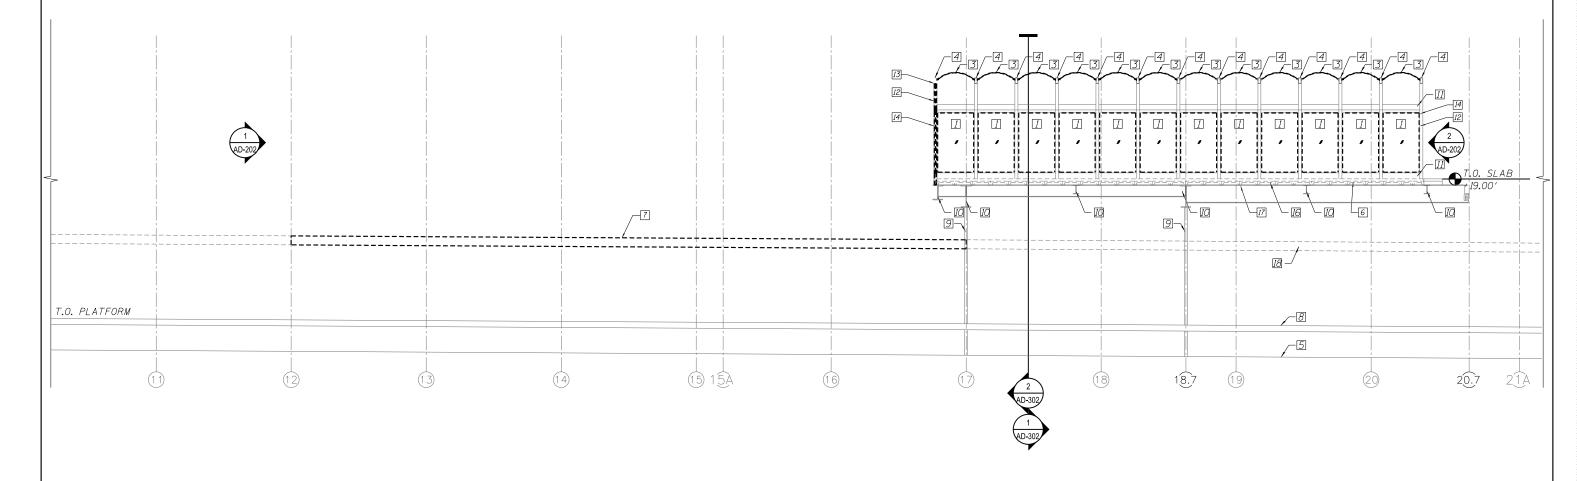
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PLOT DATE = 10/29/2013	CHECKED -	-	CRR	REVISED	

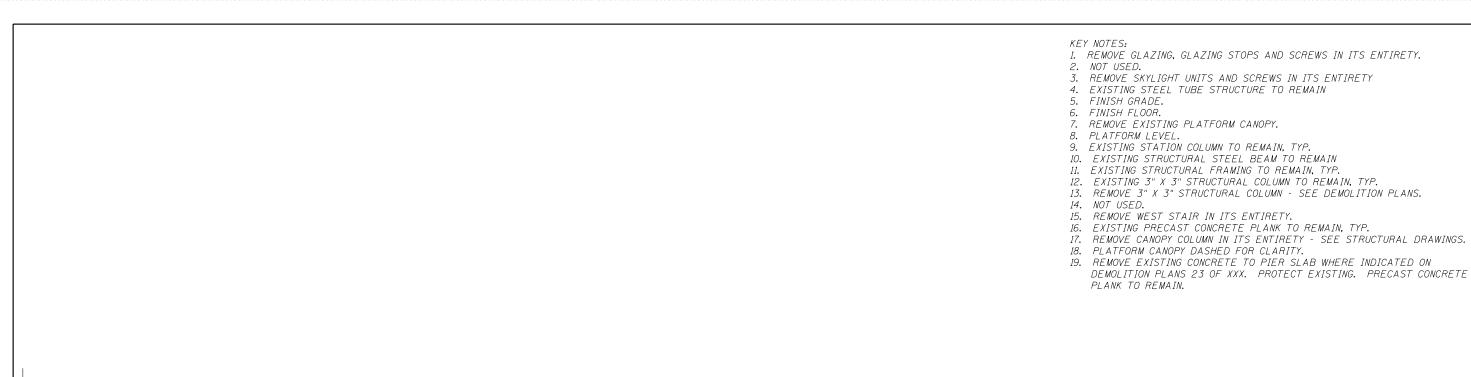PEORIA STREET STATION					
DEMOLITION STATI	ON SECTIONS				
SHEET NO.AD-3000F	117 SHEETS				

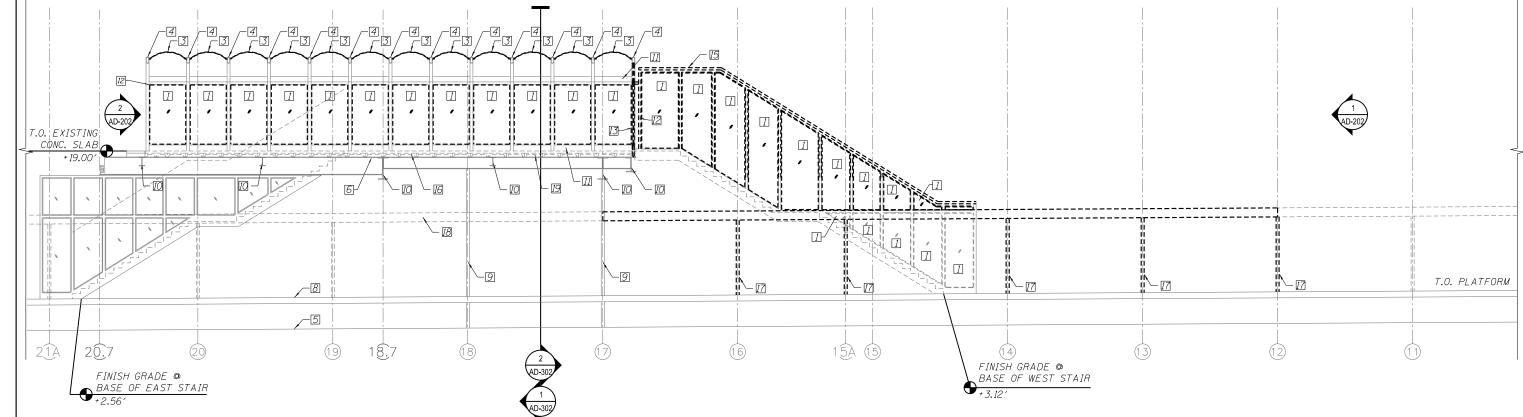PREL	IMINARY NOI FOF	7 CO	NSTRUCT	10	W.	
MUN	SECTION		COUNTY	,	TOTAL SHEETS	SHEI NO
2090	2013-011R		COOK		356	22
			CONTRAC	CT	NO. 6	50W2
	ILLINOIS	FED. AI	D PROJECT	FED.	AID PRO	JECT

10:16:25 0161708-

KEY NOTES:
1. REMOVE GLAZING, GLAZING STOPS AND SCREWS. NOT USED. 3. REMOVE SKYLIGHT UNITS AND SCREWS IN THEIR ENTIRETY.
4. EXISTING STEEL TUBE STRUCTURE TO REMAIN. FINISH GRADE. 6. FINISH FLOOR. 7. REMOVE EXISTING PLATFORM CANOPY. 8. PLATFORM LEVEL. 9. EXISTING STATION COLUMN TO REMAIN. 10. EXISTING STRUCTURAL STEEL BEAM TO REMAIN.
11. EXISTING STRUCTURAL FRAMING TO REMAIN, TYP.
12. EXISTING 3" X 3" STRUCTURAL COLUMN TO REMAIN, TYP. 13. REMOVE 3" X 3" STRUCTURAL COLUMN (SEE DEMOLITION PLAN). 14. EXISTING 3" X 3" STRUCTURAL BEAM TO REMAIN 15. NOT USED. 16. EXISTING PRECAST CONCRETE PLANK TO REMAIN, TYP.
17. REMOVE EXISTING CONCRETE TOPPING SLAB WHERE INDICATED ON DEMOLITION PLAN 23 OF 111. PROTECT EXISTING PRECAST CONCRETE PLANK, TO REMAIN. 18. CANOPY DASHED FOR CLARITY




DEMOLITION STATION SECTION LOOKING NORTH SCALE: 3/16" = 1'-0"

Tran Systems

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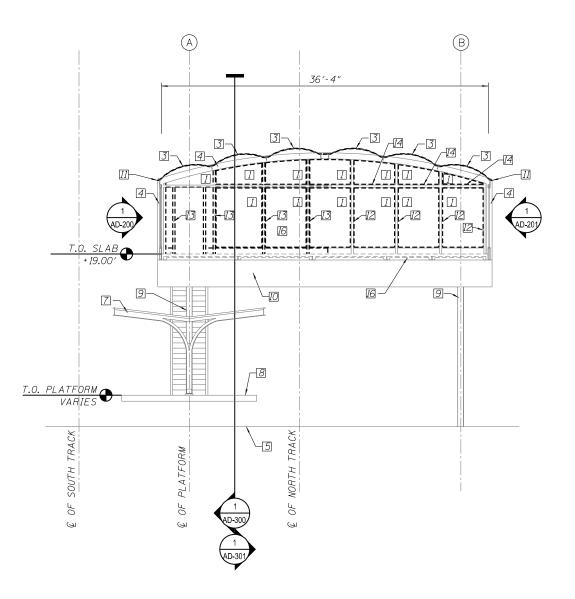
PEORIA STREET STATION					
DEMOLITION STATION SECTIONS					
CHEET NO AD 7010E	117	CHEETC			

PREL	RELIMINARY NOT FOR CONSTRUCTION						
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			CONTRA	СТ	NO. 6	SOW	
	ILLINOIS	FED. A	D PROJECT	FED.	AID PROJ	ECT	



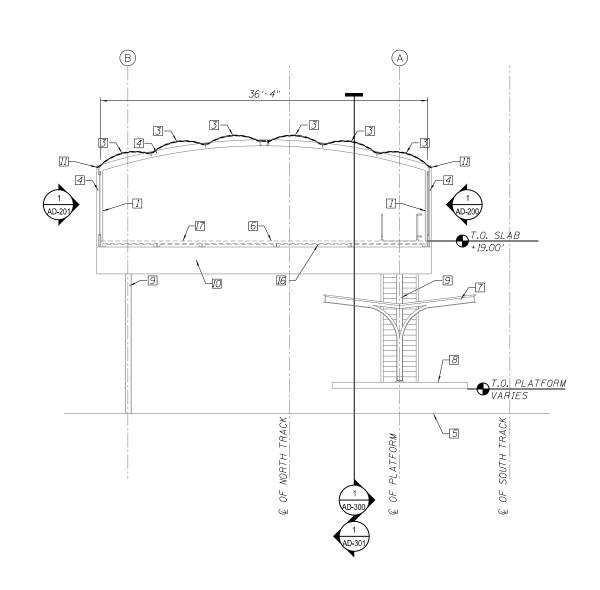

- KEY NOTES:
 1. REMOVE GLAZING, GLAZING STOPS AND SCREWS.
 2. NOT USED.
- REMOVE SKYLIGHT UNIT IN ITS ENTIRETY. EXISTING STEEL TUBE STRUCTURE TO REMAIN.
- FINISH GRADE.
- FINISH FLOOR.
- PLATFORM CANOPY.
- PLATFORM LEVEL.
- EXISTING STATION COLUMN TO REMAIN
- EXISTING STRUCTURAL STEEL BEAM TO REMAIN
- 11. EXISTING STRUCTURAL FRAMING TO REMAIN, TYP.
 12. EXISTING 3" X 3" STRUCTURAL COLUMN TO REMAIN, TYP.
 13. REMOVE 3" X 3" STRUCTURAL COLUMN
- EXISTING 3" X 3" STRUCTURAL BEAM TO REMAIN
- 15. NOT USED.
- EXISTING PRECAST CONCRETE PLANK TO REMAIN, TYP.
- REMOVE EXISTING CONCRETE TOPPING SLAB WHERE INDICATED ON DEMOLITION PLAN 23. PROTECT EXISTING PRECAST CONCRETE PLANK,



STATION SECTION LOOKING EAST

SCALE: 3/16" = 1'-0" * ROADWAY BRIDGE NOT SHOWN FOR CLARITY

2 STATION SECTION LOOKING WEST SCALE: 3/16" = 1'-0"



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PEORIA STREET STATION DEMOLITION STATION SECTIONS		SECTION	COUNTY	SH
		2013-011R	COOK	3
			CONTRACT	NO
SHEET NO.AD-3020F 117 SHEETS		ILLINOIS FED. AI	D PROJECT FED	. AIC

COUNTY COOK 356 225 CONTRACT NO. 60W29



EXISTING FARE COLLECTION MACHINES

SCALE: NTS



 $\frac{\textit{EXISTING TURNSTYLES}}{\textit{SCALE: NTS}}$



EXISTING TURNSTYLES AND GATE

SCALE: NTS




EXISTING BENCH SCALE: NTS


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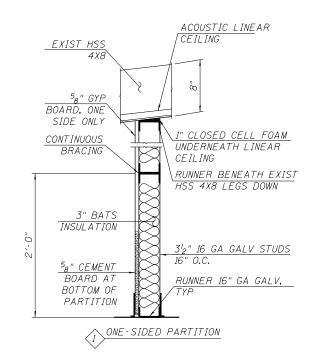
10:16:28 AM 0161708-60W29-AD-700.dgn


GENERAL NOTES

- I. IDOT EXPRESSLY DISCLAIMS ANY RESPONSIBILITY ARISING FROM ANY UNAUTHORIZED USE OF THESE DRAWINGS PLANS, AND NOTES. ANY AUTHORIZATION MUST BE IN WRITING. THESE DRAWINGS MAY HAVE BEEN REPRODUCED AT A SIZE DIFFERENT THATN ORIGINALLY DRAWN. OWNER AND ARCHITECT ASSUME NO RESPONSIBILITY FOR USE OF INCORRECT SCALE.
- 2. ALL CONSTRUCTION SHALL COMPLY WITH THE CURRENT CHICAGO BUILDING CODE, ALL APPLICABLE MUNICIPAL, STATE AND FEDERAL REGULATIONS HAVING JURISDICTION, INCLUDING THE STATE OF ILLINOIS ACCESIBILITY STANDARDS AND ADA REQUIREMENTS.
- 3. FINISH FLOOR ELEVATIONS NOTED ARE BASED ON THE CHICAGO CITY DATUM, UNLESS NOTED OTHERWISE.
- 4. IT IS IMPERATIVE THAT THE CONTRACTOR FULLY FAMILIARIZED ITSELF WITH ALL EXISTING SITE CONDITIONS, SURVEYS, AND REPORTS. THE CONTRACTOR MUST VERIFY ALL FIELD DIMENSIONS AND CONDITIONS SHOWN OR DESCRIBED TO BE EXISTING BY ITS OWN FIELD SURVEY PRIOR TO THE START OF SHOP DRAWING PREPARATION, FABRICATION, OR SITE CONSTRUCTION. NOTIFY THE ARCHITECT OF DISCREPENCIES IN WRITING BEFORE PROCEEDING WITH WORK.
- 5. CONTRACTOR SHALL BE RESPONSIBLE FOR PROVIDING ALL REQUIRED BLOCKING, SUPPORTS, AND BRACING REQUIRED TO ACHEIVE SPECIFICLLY INDICATED OR NOT.
- 6. ALL EXPOSED STEEL TO BE PREPARED AND PAINTED UNLESS OTHERWISE NOTED.
- 7. NEW STEEL TO BE GALVANIZED UNLESS OTHERWISE NOTED.
- 8. REFER TO STRUCTURAL DRAWINGS FOR ALL DIMENSIONS THAT ESTABLISH LOCATIONS OF STRUCTURAL ELEMENTS AND THEIR LOCATION ON THE SITE. DIMENSIONS OF THE ITEMS IN THE ARCHITECTURAL SET ARE FOR REFERENCE ONLY.



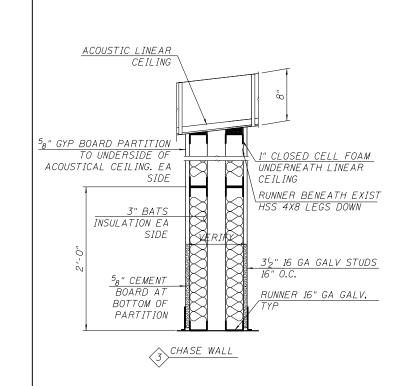

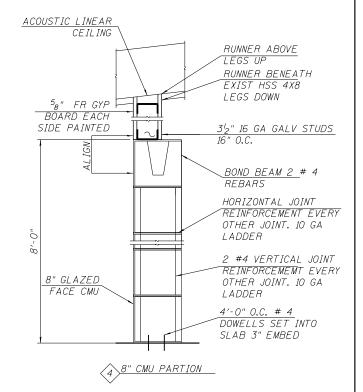

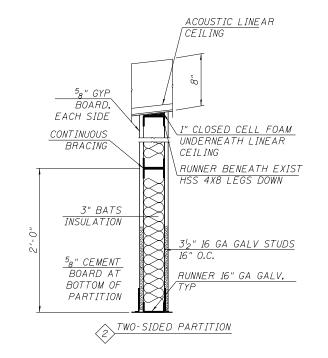

• Tran Systems

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STATE OF ILLINOIS
DEPARTMENT OF TRANSPORTATION

 PEORIA STREET STATION GENERAL NOTES
 MUN
 SECTION 2090
 2013-0


 SHEET NO. A-001 OF 117 SHEETS
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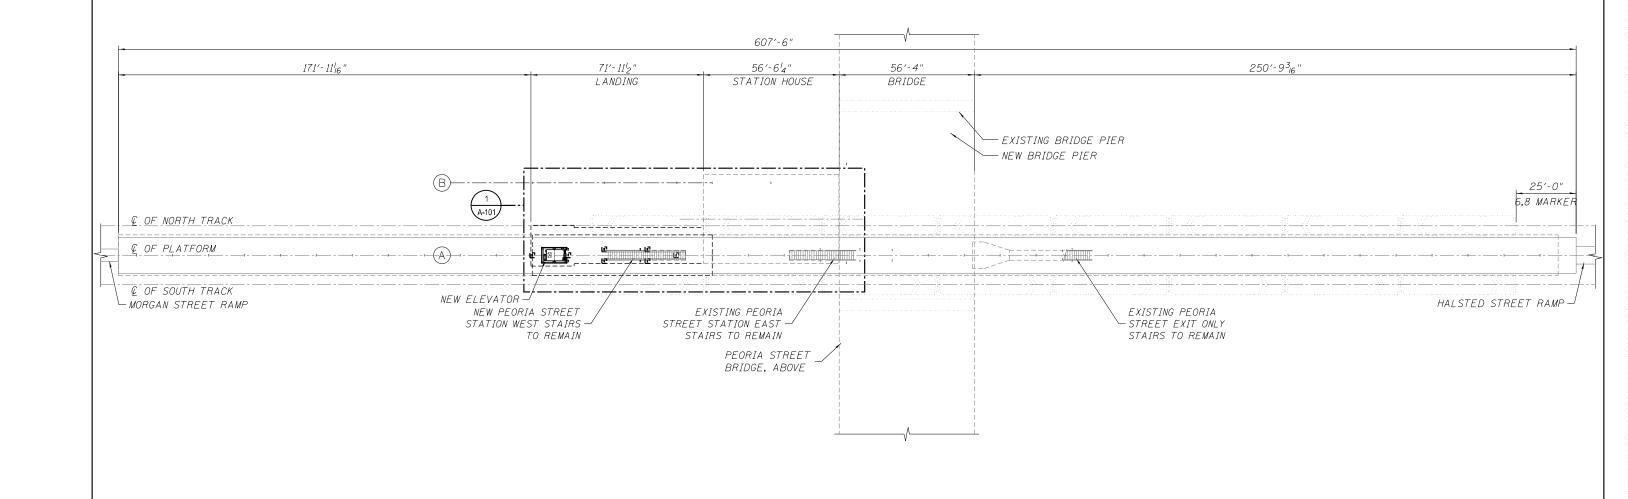
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 SECTION
 COUNTY SHEETS
 TOTAL SHEETS NO.

 2090
 2013-011R
 COOK
 356
 227

 CONTRACT NO. 60W29

 IILLINOIS FED. AID PROJECT FED. AID PROJECT



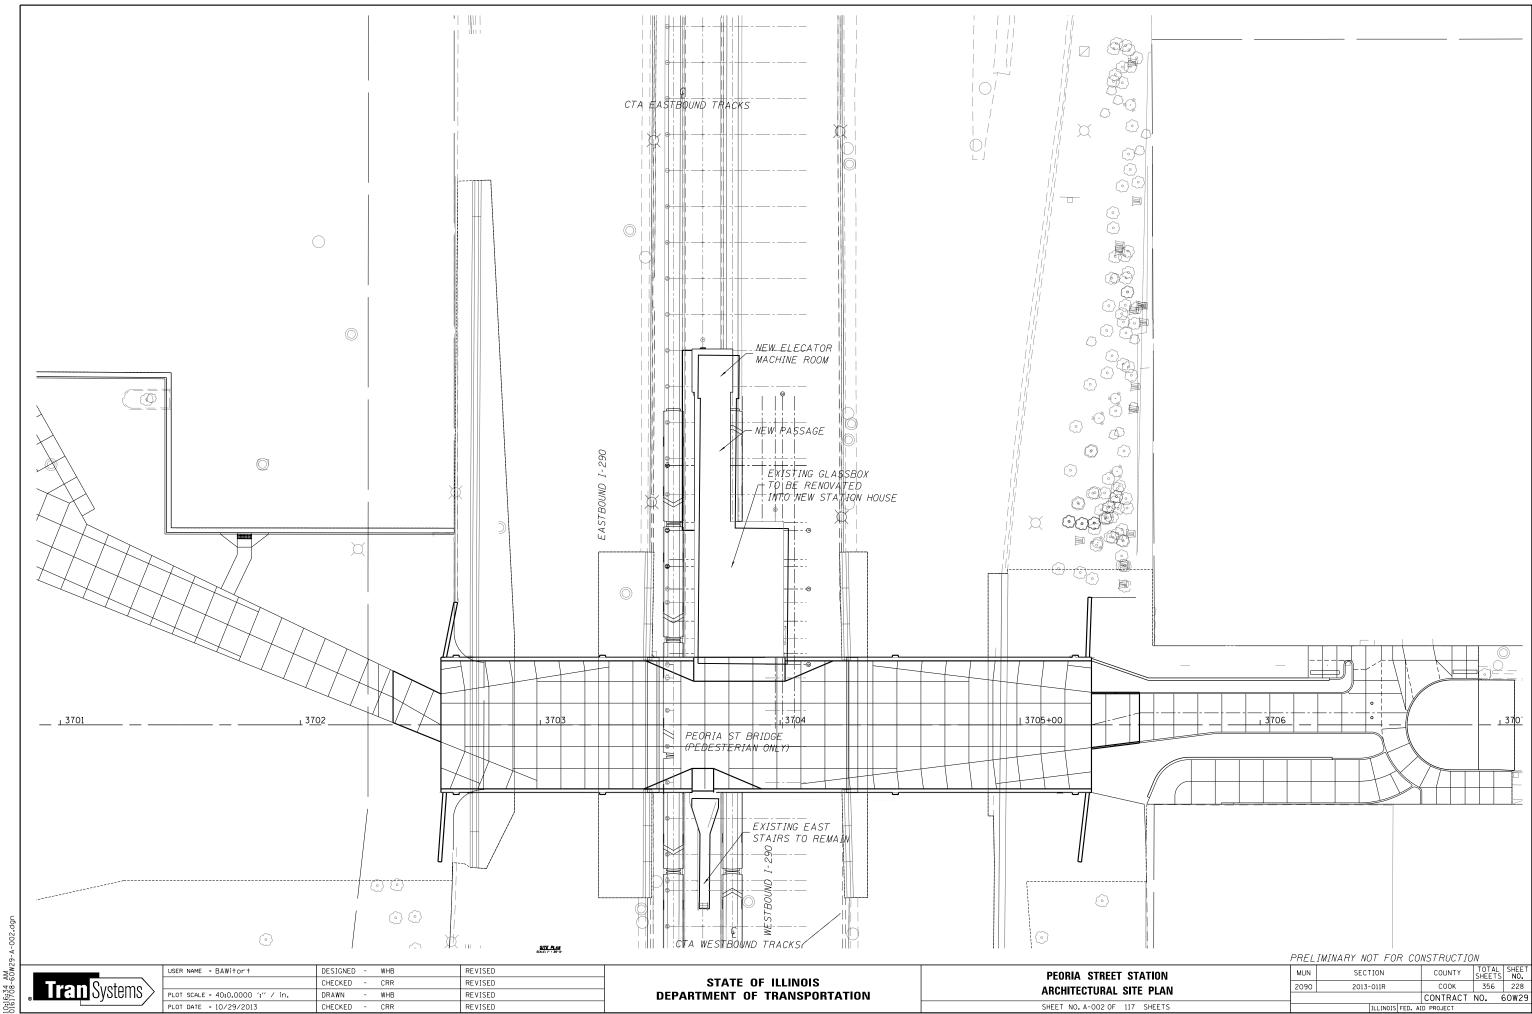

OVERALL PLATFORM PLAN SCALE: 1" = 20'-0"

Tran Systems

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STATE OF ILLINOIS **DEPARTMENT OF TRANSPORTATION**


PEORIA STREET STATION OVERALL PLATFORM FLOOR PLAN SHEET NO. A-100 OF 117 SHEETS

PRELIMINARY NOT FOR CONSTRUCTION COUNTY TOTAL SHEET NO.
COOK 356 229
CONTRACT NO. 60W29 MUN SECTION 2090 2013-011R

- KEY NOTES: 1. PLATFORM CANOPY ABOVE. 2. PLATFORM EDGE.

- 2. FLATION LOGE.
 3. EXISTING STATION COLUMN TO REMAIN.
 4. EXISTING PLATFORM CANOPY COLUMN TO REMAIN, TYP.
 5. NEW PLATFORM CANOPY COLUMN.
 6. EXISTING CANE RAIL.

- 7. NEW CAN RAIL. MATCH EXISTING CANE RAIL. 8. RELOCATE EXISTING STEEL STAIR STRINGERS AND TUBE FRAME AND GLAZING. PREP / PAINT ALL STEEL. NEW CAST

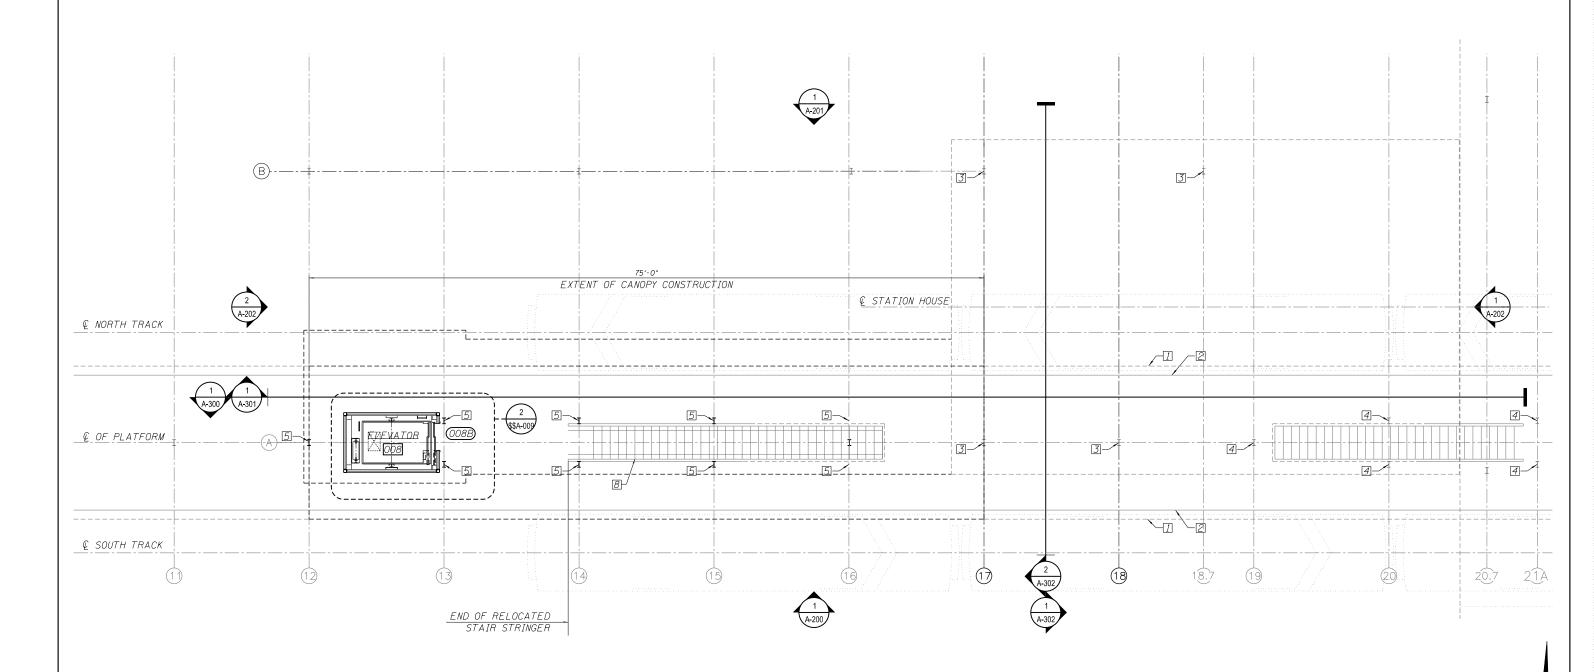

EXTENT OF PLATFORM CONSTRUCTION

1 OVERALL PLATFORM FLOOR PLAN SCALE: 3/16" = 1'-0"

Tran	Systems >
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	USER NAME = BAWitort	DESIGNED	-	WHB	REVISED	
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	PLOT DATE = 10/29/2013	CHECKED	-	CRR	REVISED	

STATE OF ILLINOIS **DEPARTMENT OF TRANSPORTATION**

PEORIA STREET STATION OVERALL PLATFORM FLOOR PLAN SHEET NO. A-101 OF 117 SHEETS

PRELIMINARY NOT FOR CONSTRUCTION SECTION COUNTY 2090 COOK 356 230 2013-011R CONTRACT NO. 60W29

10:16:37 0161708-1

BILL OF MATERIAL

ITEM	UNIT	TOTAL QUANTITY
CONCRETE (CTA)	L. SUM	1
DEMOLITION (CTA)	L. SUM	1
STRUCTURAL STEEL AND METAL DECK (CTA)	L. SUM	1
MASONRY (CTA)	L. SUM	1
ELEVATOR (CTA)	L. SUM	1
MECHANICAL AND PLUMBING WORK (CTA)	L. SUM	1
ELECTRICAL AND COMMUNICATIONS WORK (CTA)	L. SUM	1
EARTHWORK, EXTERIOR IMPROVEMENTS AND UTILITES WORK (CTA)	L. SUM	1

^{*} MASONRY, METALS, CARPENTRY, THERMAL, AND MOISTURE PROTECTION, OPENINGS, FINISHES, SPECIALTIES, EQUIPMENT, FURNISHINGS, SPECIAL CONSTRUCTION WORK (CTA)

GENERAL NOTES:

1. CONTRACTOR TO INSTALL ITEMS SUPPLIED BY CTA

KEY NOTES:

1. NOT USED

2. GENERATOR TAP BOX

BOLLARD

FARE VENDING MACHINE PROVIDED BY FARE VENDOR

POLYCARBONATE WALL SYSTEM TO MATCH ROOF COLOR

MOP BASIN

FLOOR DRAIN

CONTROL JOINT

AUTOMATED TELLER MACHINE

10. TRASH RECEPTICLE

11. EXTERIOR INSULATED METAL PANEL

TRANSIT BOARD

13. POWER-OPERATED DOOR

14. UIC PHONE

15. PEDESTAL MOUNT DOOR ACTUATOR

17. STAINLESS STEEL GATE

STANDARD TURNSTILE PROVIDED BY FARE VENDOR

TWO-WAY ACCESSIBLE TURNSTILE

20. STAINLESS STEEL ROTOGATE


STAINLESS STEEL BARRIER

23. CANOPY ABOVE

24. EXPOSED STRUCTURAL FRAME - SEE STRUCTURAL

26. EXPANSION JOINT - SEE STRUCTURAL PLANS.

27. RECESSED STONE TILES

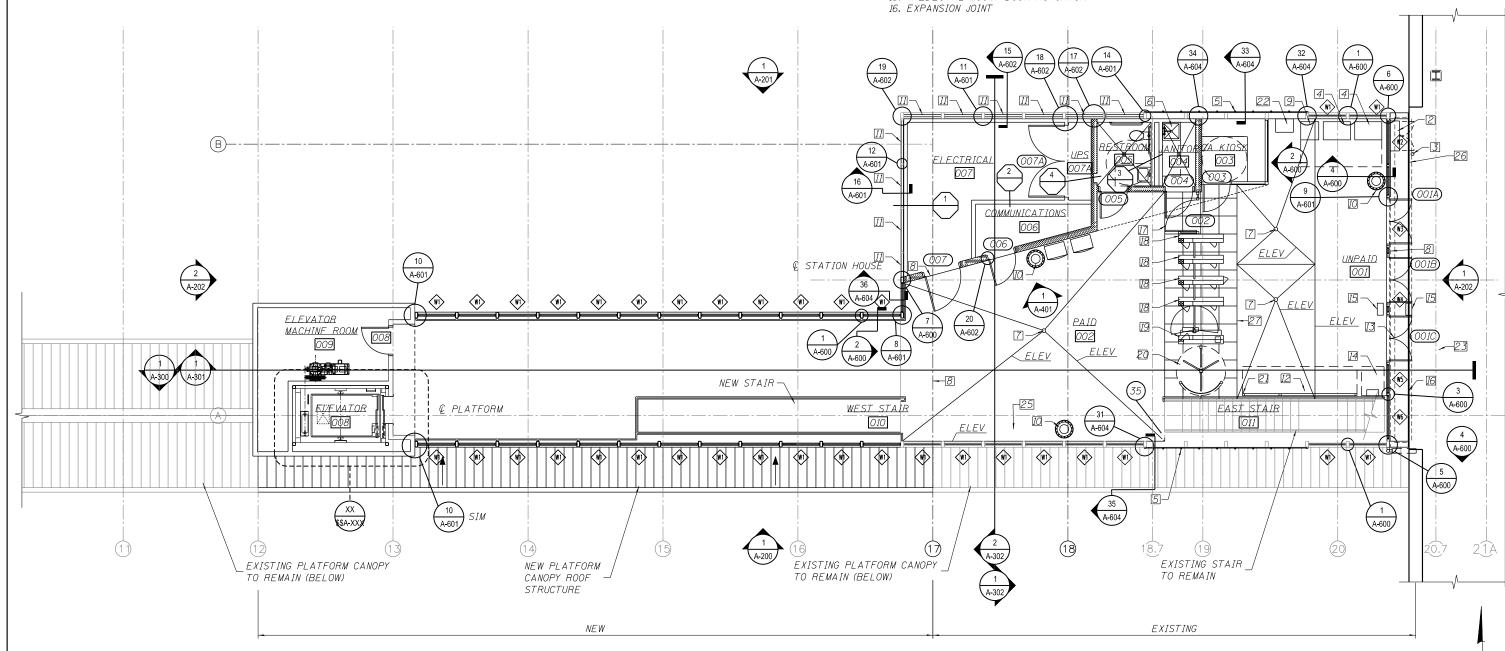




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2090 2013-011R			COOK		356	231	
				CONTRA	СТ	NO. (50W29
		ILLINOIS	FED. A	ID PROJECT	FED.	AID PRO	ECT



DEPARTMENT OF TRANSPORTATION

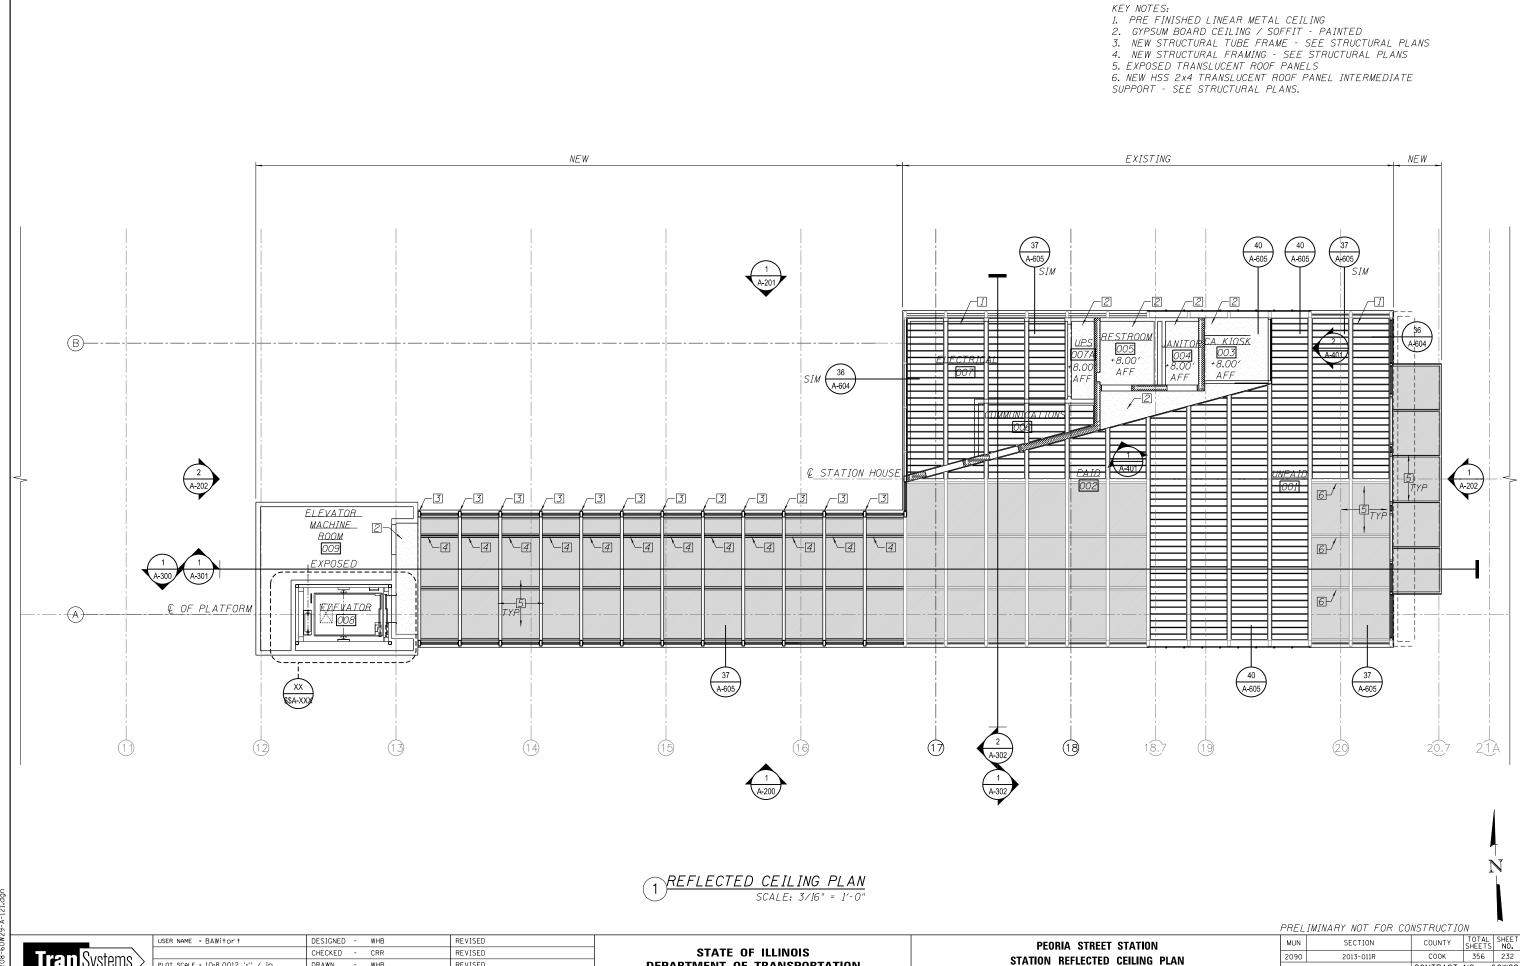2090

STATION REFLECTED CEILING PLAN

SHEET NO. A-121 OF 117 SHEETS

2013-011R

CONTRACT NO. 60W29

Tran Systems

CHECKED - CRR

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PLOT SCALE = 10:8.0012 ':" / in.

PLOT DATE = 10/29/2013

REVISED

REVISED

REVISED

KEY NOTES: I. POLYCARBONATE STANDING SEAM ROOF SYSTEM 2. EX SINGLE PLY ROOF
3. ROOF DRAINS
4. STAINLESS STEEL COPING 131'-9" 18′-0" 53′-10½" 59'-10¹2" 37 A-605 SIM 36 A-604 + \square 38 A-605 ROOF HIGH POINT 36 A-604

STATION ROOF PLAN SCALE: 3/16" = 1'-0"

113′-9"

Tran Systems

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>	PLOT SCALE = 10:8.0015 ft:in / in.	DRAWN	-	WHB	REVISED	
	PLOT DATE = 10/29/2013	CHECKED	-	CRR	REVISED	

18′-0"

STATE OF ILLINOIS **DEPARTMENT OF TRANSPORTATION**

PEORIA	STREET	STA	TION	
STAT	ON RO)F PL	.AN	
SHEET NO	Δ-130 OF	117	SHEETS	

40 A-605


SECTION 2090 2013-011R

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PRELIMINARY NOT FOR CONSTRUCTION

MUN

37 A-605

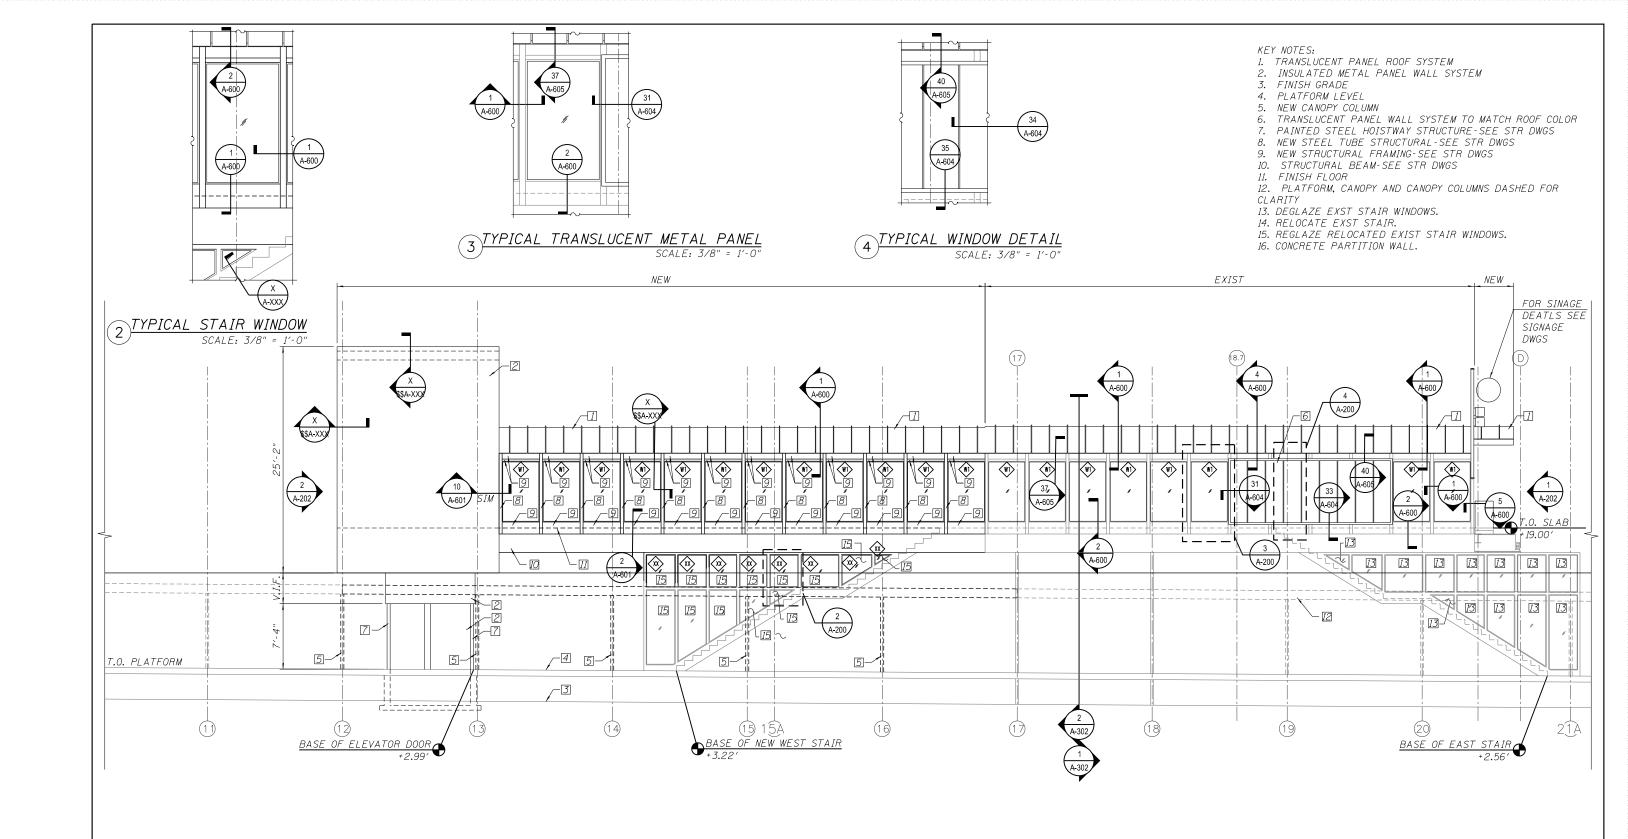

STATION SOUTH ELEVATION SCALE: 3/16" = 1'-0"

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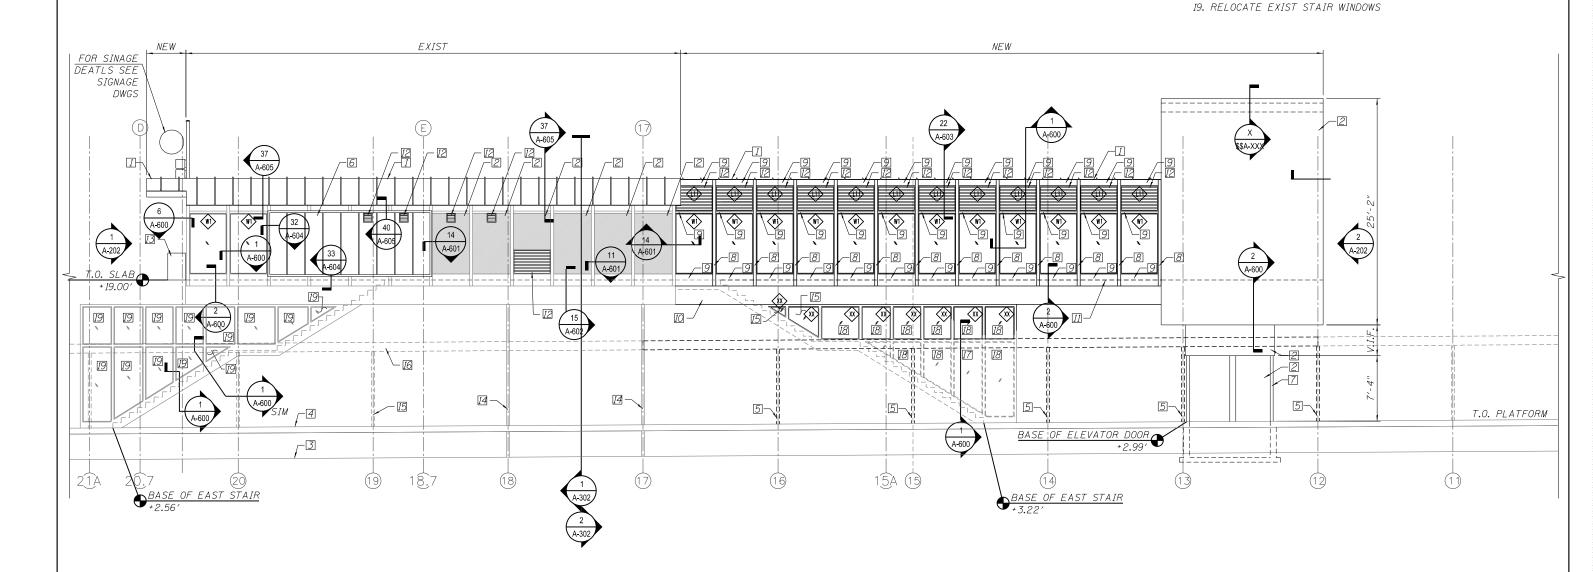
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PLOT SCALE = 10:8.0012 ':" / in.	DRAWN -	WHB	REVISED
PLOT DATE = 10/29/2013	CHECKED -	CRR	REVISED

PEORIA STREET STATION STATION ELEVATION						
SHEET NO. A-2	00 OF	117	SHEETS			

PRELIMINARY NOT FOR CONSTRUCTION MUN SECTION COUNTY COOK 356 234 2090 2013-011R CONTRACT NO. 60W29 ILLINOIS FED. AID PROJECT FED. AID PROJECT

10:16:41 AM 0161708-60W

KEY NOTES: 1. TRANSLUCENT PANEL ROOF SYSTEM 2. INSULATED METAL PANEL WALL SYSTEM 3. FINISH GRADE 4. PLATFORM LEVEL 5. NEW CANOPY COLUMN TRANSLUCENT PANEL WALL SYSTEM TO MATCH ROOF-SEE STR DWGS 7. PAINTED STEEL HOISTWAY STRUCTURE-SEE STR DWGS 8. NEW STEEL TUBE STRUCTURAL-SEE STR DWGS 9. NEW STRUCTURAL FRAMING-SEE STR DWGS 10. STRUCTURAL BEAM-SEE STR DWGS 11. FINISH FLOOR
12. LOUVER 13. CONCRETE BARRIER WALL 14. EXISTING STATION COLUMN TO REMAIN
15. EXISTING CANOPY COLUMN TO REMAIN
16. PLATFORM CANOPY AND CANOPY COLUMNS DASHED FOR CLARITY 17. ERELOCATED EXST STAIR



<u>STATION NORTH ELEVATION</u> SCALE: 3/16" = 1'-0"

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Tran Systems	

10:16:42 AM 0161708-60W29-

USER NAME = BAWitort	DESIGNED	-	WHB	REVISED
	CHECKED	-	CRR	REVISED
PLOT SCALE = 10:8.0012 ':" / in.	DRAWN	-	WHB	REVISED
PLOT DATE = 10/29/2013	CHECKED	-	CRR	REVISED

PEORIA STREET STATION						
S	ΓΑΤ	ION	ELE	VATI	ION	
SHEET	NO.	A-201	OF	117	SHEETS	

PRELIMINARY NOT FOR CONSTRUCTION								
MUN	SECTION	COUNTY		TOTAL SHEETS	SHE			
2090	2013-011R		COOK 356		356	23		
			CONTRA	СТ	NO. 6	SOW		
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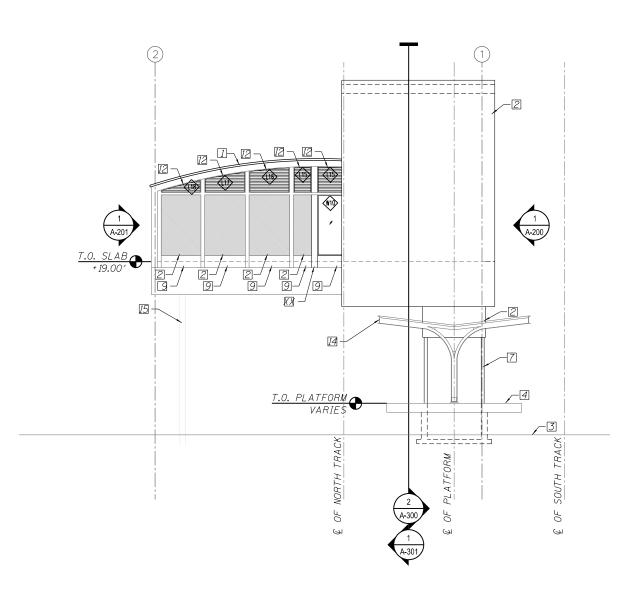
18. REGLAZE RELOCATED EXIST STAIR WINDOWS



A-201

+ 19.00′

- [15



KEY NOTES:

*NEW ROADWAY BRIDGE NOT SHOWN FOR CLARITY

- <u>18|18|</u> –

(A-601)

T.O. PLATFORM VARIES

2 STATION WEST ELEVATION

SCALE: 3/16" = 1'-0"

*STAIRS NOT SHOWN FOR CLARITY

PRELIMINARY NOT FOR CONSTRUCTION



7-2-

 USER NAME = BAWitort
 DESIGNED - WHB
 REVISED

 CHECKED - CRR
 REVISED

 PLOT SCALE = 10:8.0012 ':' / in.
 DRAWN - WHB
 REVISED

 PLOT DATE = 10/29/2013
 CHECKED - CRR
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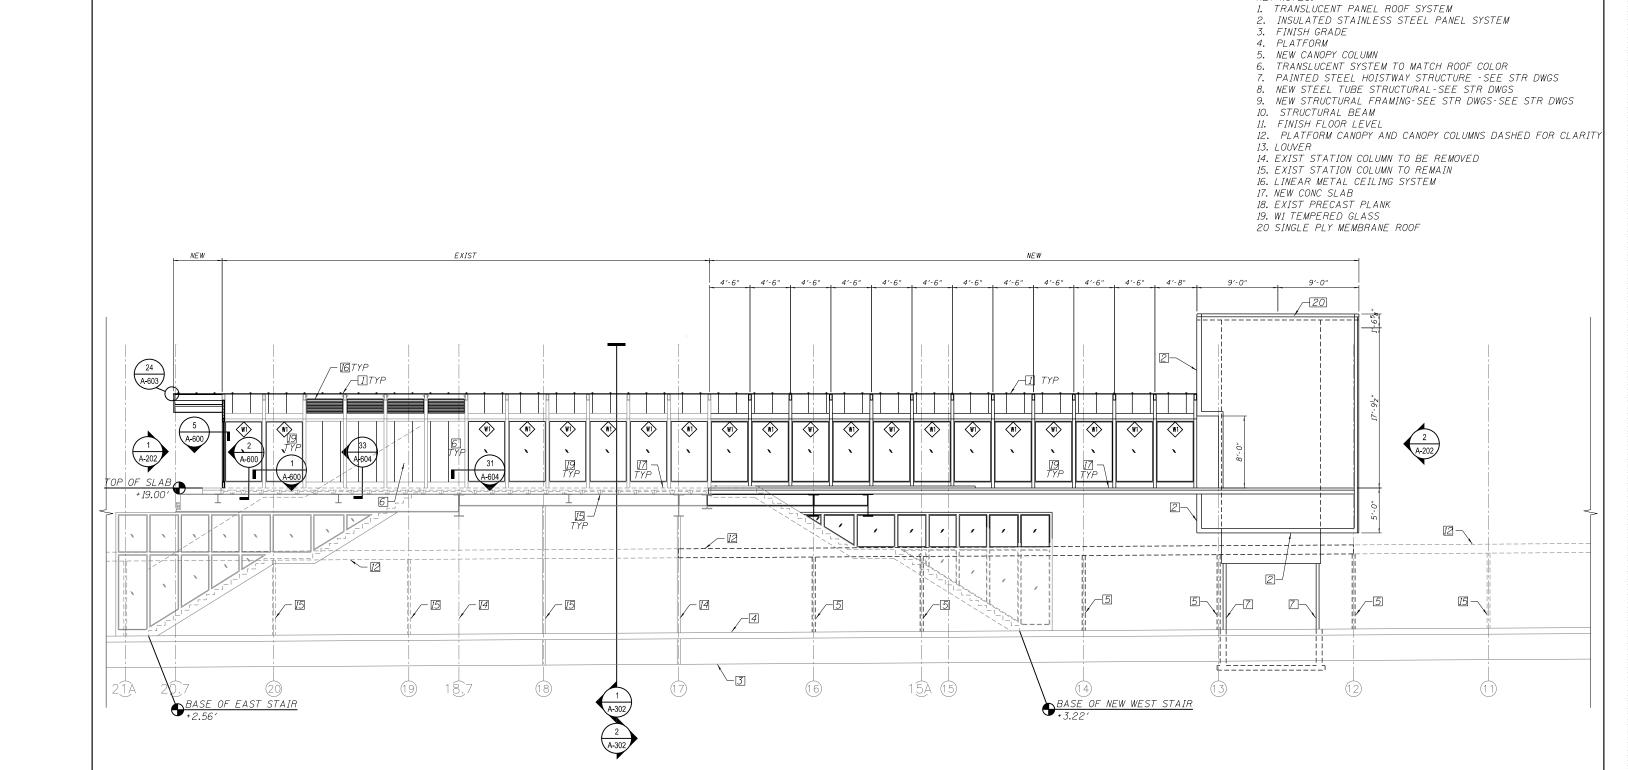
STATE OF ILLINOIS
DEPARTMENT OF TRANSPORTATION

PEORIA STREET STATION
STATION ELEVATIONS
SHEET NO. A-202 OF 117 SHEETS

 MUN
 SECTION
 COUNTY
 TOTAL SHEETS NO.

 2090
 2013-011R
 COOK
 356
 236

 CONTRACT NO. 60W29



STATION SECTION LOOKING SOUTH

SCALE: 3/16" = 1'-0"

*STAIR RAILINGS NOT SHOWN FOR CLARITY

. Tran Systems

USER NAME = BAWitort	DESIGNED - WHB	REVISED
	CHECKED - CRR	REVISED
PLOT SCALE = 10:8.0012 ':" / in.	DRAWN - WHB	REVISED
PLOT DATE = 10/29/2013	CHECKED - CRR	REVISED


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S	TAT	ION	SEC	CIT	NS	
SHEET	NO.	4-300	OF	117	SHEETS	

KEY NOTES:

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	MUN	SECTION			COUNT	Y	TOTAL SHEETS	SHE
	2090	2013-011R			COOK		356	2:
					CONTRA	СТ	NO.	60W
		TI LINOIC	EED	A T	D DDO IECT	550	410 DD0	FOT

PRELIMINARY NOT FOR CONSTRUCTION

.44 AM 08-60W29-A-300.dç

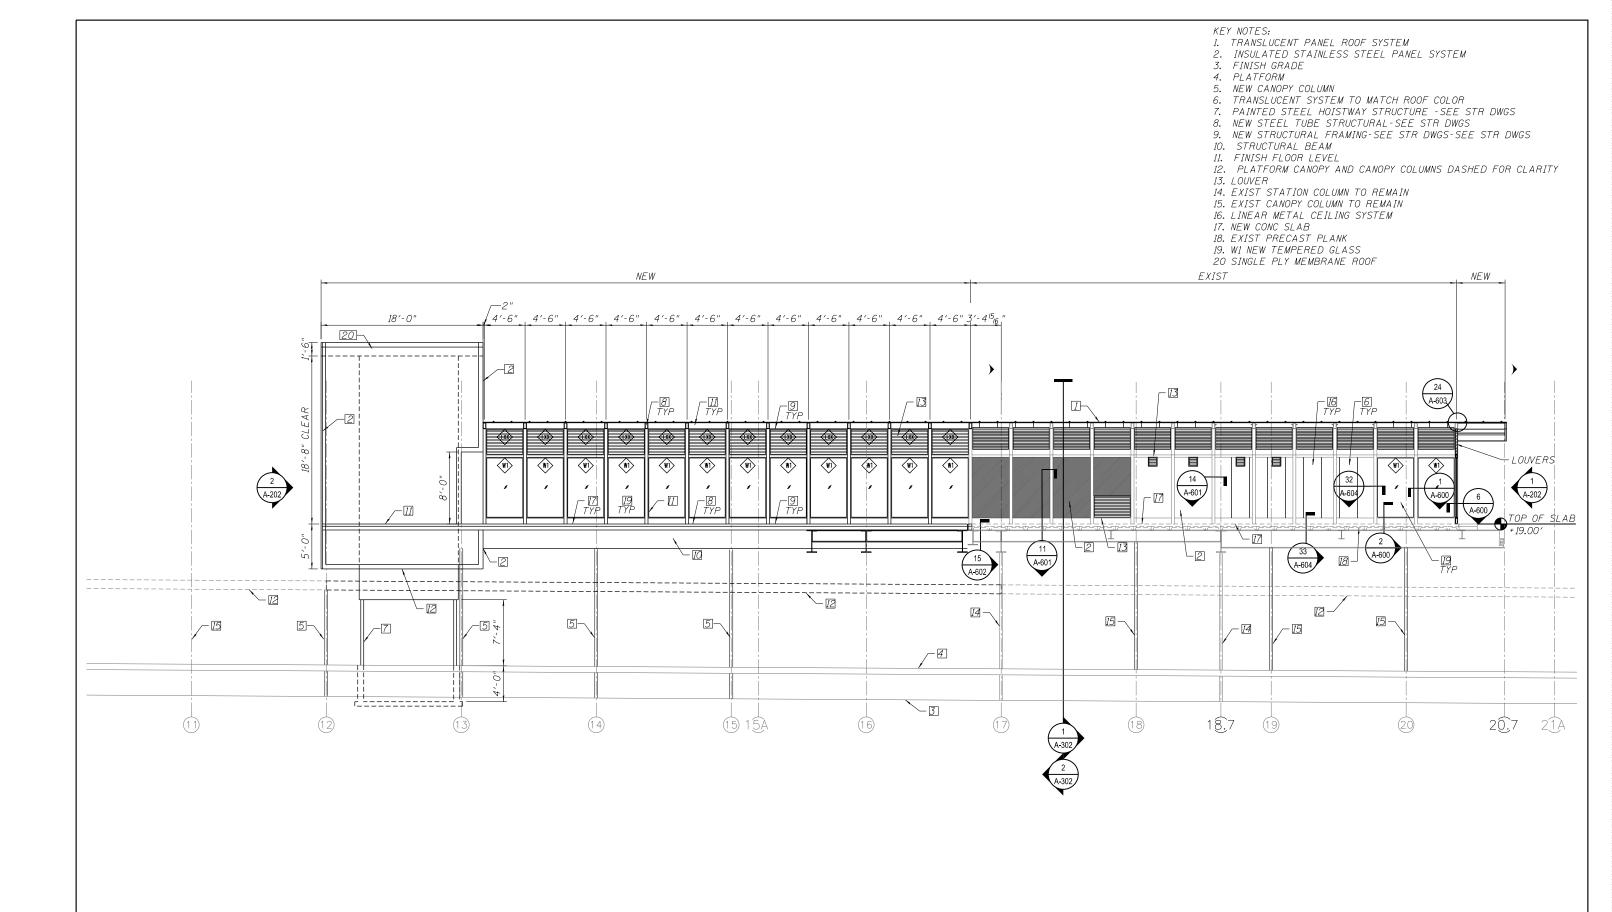

STATION SECTION LOOKING NORTH

*INTERIOR PARTITION AND EQUIPMENT NOT SHOWN FOR CLARITY

Tran Systems

USER NAME = BAWitort	DESIGNED	-	WHB	REVISED
	CHECKED	-	CRR	REVISED
PLOT SCALE = 10:8.0012 ':" / in.	DRAWN	-	WHB	REVISED
PLOT DATE = 10/29/2013	CHECKED	-	CRR	REVISED


STATE OF ILLINOIS	
DEPARTMENT OF TRANSPORTATION	

PEORIA STREET STATION											
;	STA	TION	SI	CTI	ON						
SHEET	NO.	Δ-301	ΩF	117	SHEETS						

PREL	IMINARY NOT FOR CO	NSTRUCTIO	N	
MUN	SECTION	COUNTY	TOTAL SHEETS	SH 1
2090	2013-011R	COOK	356	2
		CONTRACT	NO. 6	٥٥١
	ILLINOIS FED. A	ID PROJECT FED.	AID PROJ	ECT

KEY NOTES:

- 1. TRANSLUCENT PANEL ROOF SYSTEM
 2. INSULATED STAINLESS STEEL PANEL SYSTEM
- 3. FINISH GRADE
- 4. PLATFORM
- 5. NEW STEEL TUBE STRUCTURAL-SEE STR DWGS
 6. STRUCTURAL BEAM
- 7. FINISH FLOOR LEVEL
- 8. LOUVER
- 9. EXIST STATION COLUMN TO REMAIN
- 10. LINEAR METAL CEILING SYSTEM
 11. NEW STRUCTURAL FRAMING
- 12. NEW CONC SLAB
 13. EXIST PRECAST PLANK
- 14. W1 NEW TEMPERED GLASS

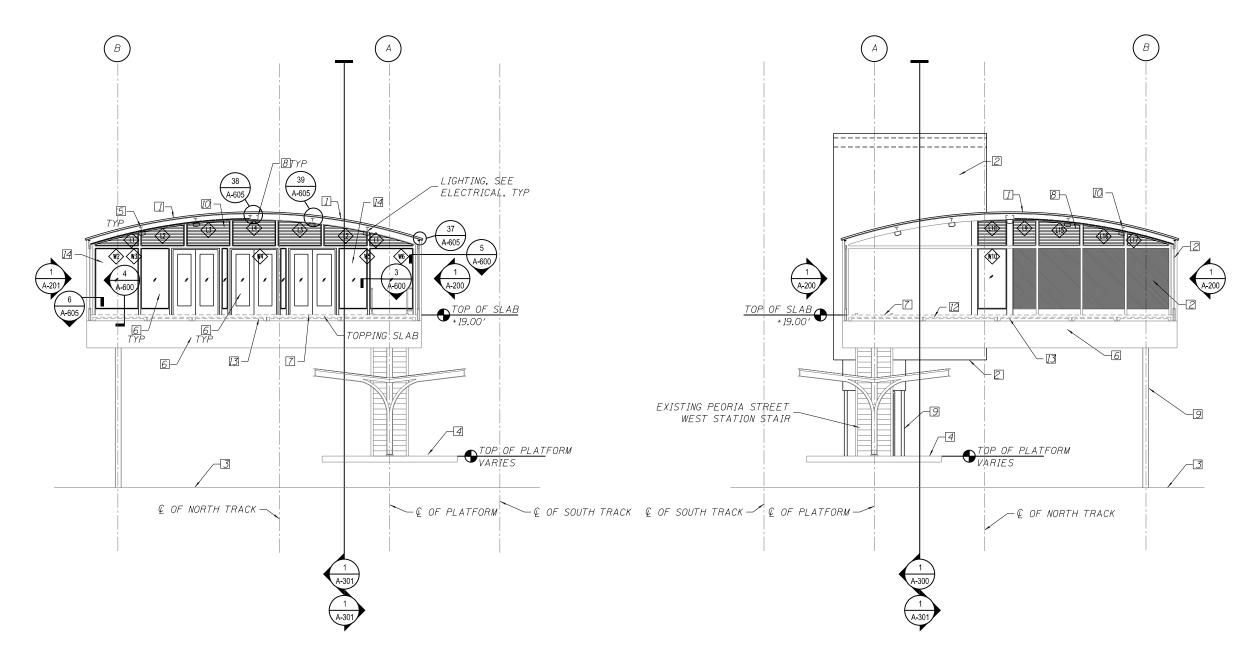

STATION SE<u>CTION LOOKING EAST</u> SCALE: 3/16" = 1'-0" 2)STATION SECTION LOOKING WEST




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	CHECKED	-	CRR	REVISED	
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PLOT DATE = 10/29/2013	CHECKED	-	CRR	REVISED	


STATE OF ILLINOIS **DEPARTMENT OF TRANSPORTATION**


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:	STA	ΙT	ION S	ECTI	ON	
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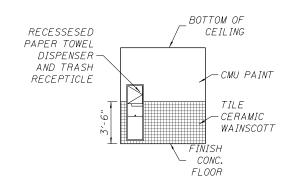
PRELIMINARY NOT FOR CONSTRUCTION COUNTY TOTAL SHEET NO.

COOK 356 239 MUN SECTION COUNTY 2090 2013-011R CONTRACT NO. 60W29



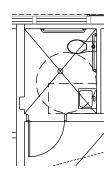

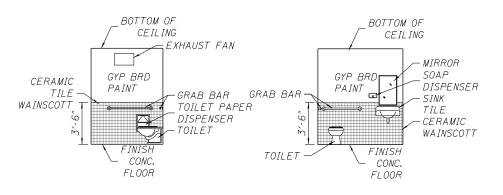

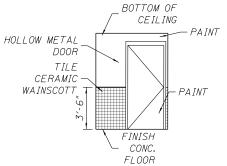

1 RESTROOM ENLARGED PLAN

SCALE: 1/4" = 1'-0"

2 NORTH ELEVATION SCALE: 1/4" = 1'-0"

3 <u>EAST ELEVATION</u> SCALE: 1/4" = 1'-0" 4 SOUTH ELEVATION
SCALE: 1/4" = 1'-0"

5 WEST ELEVATION
SCALE: 1/4" = 1'-0"

• Tran Systems

USER NAME = BAWITOr+ DESIGNED - WHB REVISED

CHECKED - CRR REVISED

PLOT SCALE = 8:0.0009 ':" / in. DRAWN - WHB REVISED

PLOT DATE = 10/29/2013 CHECKED - CRR REVISED

STATE OF ILLINOIS
DEPARTMENT OF TRANSPORTATION

PRELIMINARY NOT FOR CONSTRUCTION

PENLARGED RESTROOM

AND AGENT KIOSK PLANS, ELEVATIONS, & DETAILS

SHEET NO. A-400 OF 117 SHEETS


SHEET NO. A-400 OF 117 SHEETS


PRELIMINARY NOT FOR CONSTRUCTION

MUN SECTION COUNTY SHEETS NO.

2090 2013-011R COOK 356 240

CONTRACT NO. 60W29

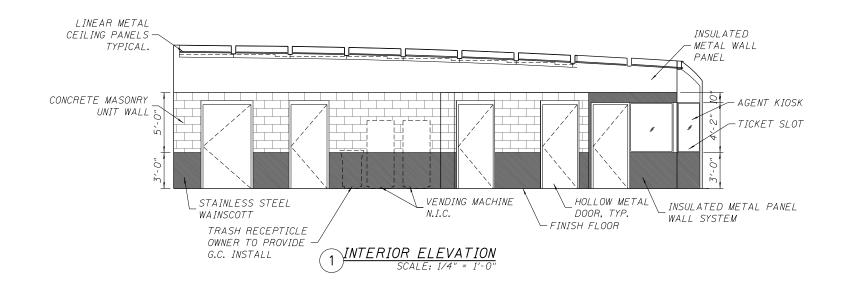

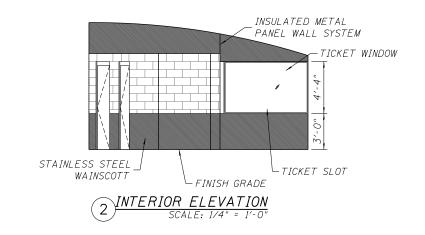

USER NAME = BAWitort	DESIGNED - WHB	REVISED	
	CHECKED - CRR	REVISED	
PLOT SCALE = 8:0.0000 ':" / in.	DRAWN - WHB	REVISED	
PLOT DATE = 10/29/2013	CHECKED - CRR	REVISED	

STATE OF ILLINOIS
DEPARTMENT OF TRANSPORTATION

					ATION EVATIONS	
SHEET	NO.	A-401	OF	117	SHEETS	

 MUN
 SECTION
 COUNTY SHEETS NO.

 2090
 2013-011R
 COOK
 356
 241

 CONTRACT NO. 60W29

 IILLINOIS|FED. AID PROJECT



USER NAME = BAWitort DESIGNED - WHB REVISED CHECKED - CRR REVISED PLOT SCALE = 8:0.0009 ':" / in. DRAWN WHB REVISED PLOT DATE = 10/29/2013 CHECKED - CRR REVISED

STATE OF ILLINOIS **DEPARTMENT OF TRANSPORTATION**

PEORIA STREET STATION STATION ELEVATOR PLANS, SECTIONS, & ELEVATIONS SHEET NO. A-500 OF 117 SHEETS

CONTRACT NO.



USER NAME = BAWitort DESIGNED - WHB REVISED CHECKED - CRR REVISED PLOT SCALE = 8:0.0009 ':" / in. DRAWN WHB REVISED PLOT DATE = 10/29/2013 CHECKED - CRR REVISED

STATE OF ILLINOIS **DEPARTMENT OF TRANSPORTATION**

PEORIA STREET STATION **ELEVATOR CAB PLANS & ELEVATIONS** SHEET NO. A-501 OF 117 SHEETS

CONTRACT NO.



USER NAME = BAWitort DESIGNED - WHB REVISED CHECKED - CRR REVISED DRAWN WHB REVISED PLOT DATE = 10/29/2013 CHECKED - CRR REVISED

STATE OF ILLINOIS **DEPARTMENT OF TRANSPORTATION**

PEORIA STREET STATION **ELEVATOR HOISTWAY PLANS, SECTIONS & ELEVATIONS** PRELIMINARY NOT FOR CONSTRUCTION CONTRACT NO.

SHEET NO. A-502 OF 117 SHEETS



STATE OF ILLINOIS
DEPARTMENT OF TRANSPORTATION

PEORIA STREET STATION
ELEVATOR HOISTWAY DETAILS

SHEET NO. A-503 OF 117 SHEETS

 MUN
 SECTION
 COUNTY SHEETS NO
 TOTAL SHEET NO
 SHEET NO

 2090
 2013-011R
 COOK
 356
 245

 CONTRACT NO. 60W2

 [ILLINOIS] FED. AID PROJECT



 USER NAME = BAWITOr †
 DESIGNED - WHB
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 CHECKED - CRR
 REVISED

 PLOT SCALE = 96:0.0011 in:in / in.
 DRAWN - WHB
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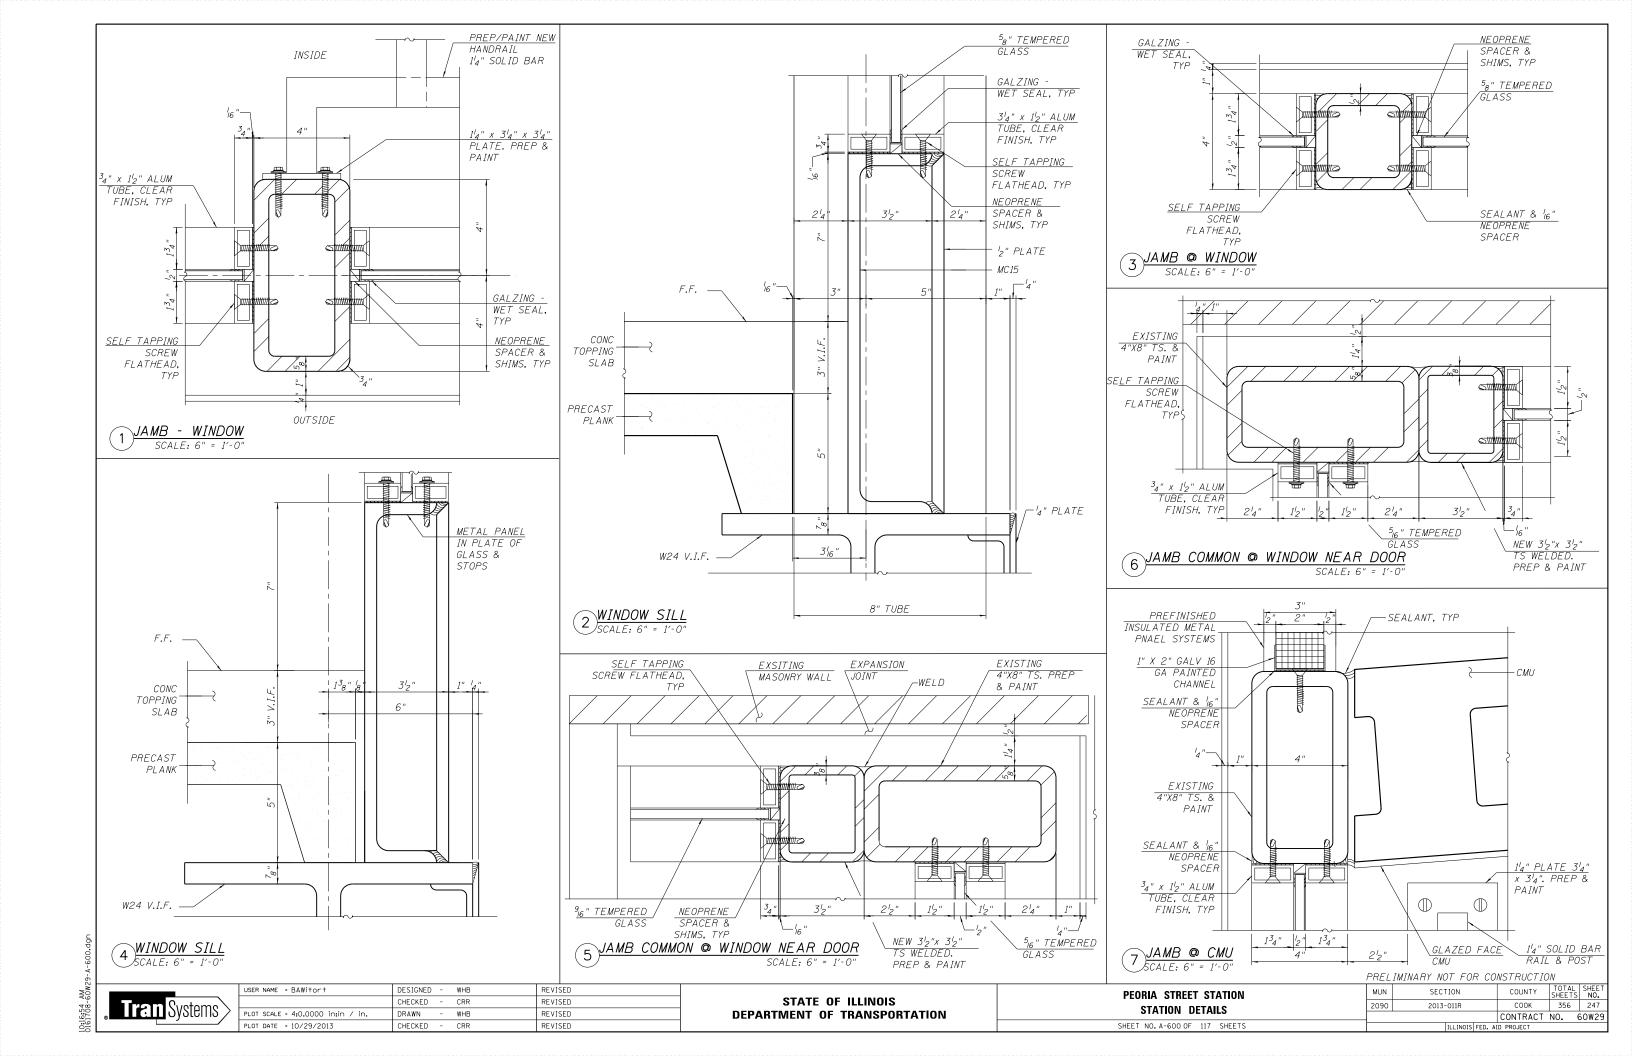
 PLOT DATE = 10/29/2013
 CHECKED - CRR
 REVISED


STATE OF ILLINOIS
DEPARTMENT OF TRANSPORTATION

PEORIA STREET STATION

STATION WEST STAIR PLAN, SECTIONS, ELEVATIONS, & DETAILS

SHEET NO. A-510 OF 117 SHEETS



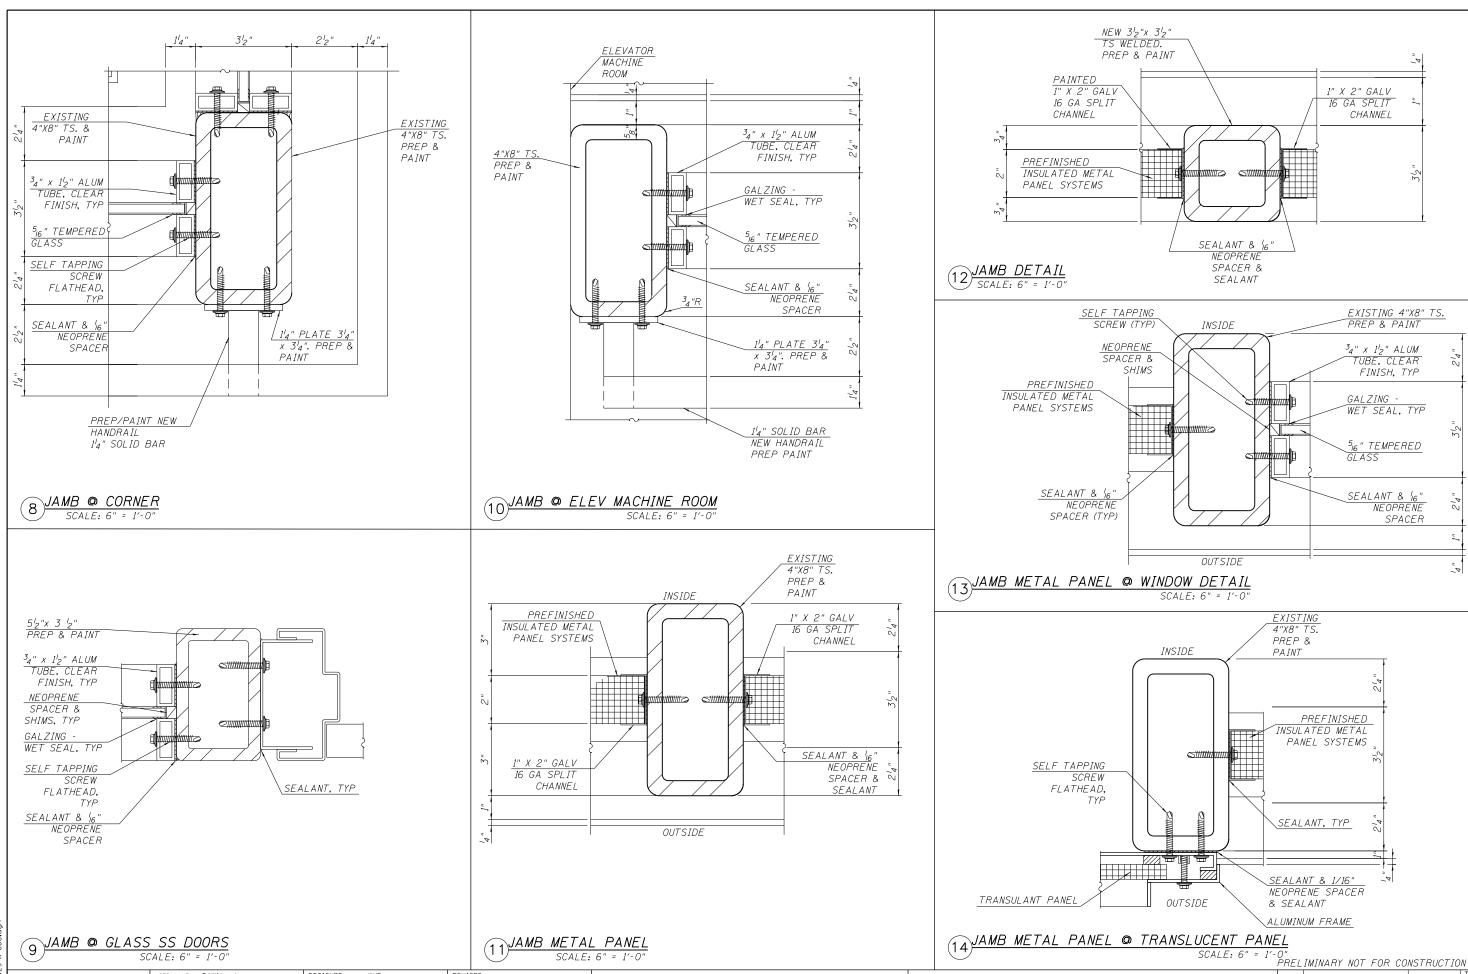

STATE OF ILLINOIS

DEPARTMENT OF TRANSPORTATION

1" X 2" GALV

16 GA SPLIT

CHANNEL

EXISTING 4"X8" TS.

PREP & PAINT

³4" x 1¹2" ALUM

GALZING -

TUBE, CLEAR

FINISH, TYP

WET SEAL, TYP

5₁₆" TEMPERED GLASS

SEALANT & 16" NEOPRENE

PANEL SYSTEMS

SECTION

2013-011R

2090

PEORIA STREET STATION

STATION DETAILS

SHEET NO. A-601 OF 117 SHEETS

SPACER

COUNTY TOTAL SHEETS NO. COOK 356 248

CONTRACT NO. 60W29

COUNTY

Tran Systems

USER NAME = BAWitort

PLOT DATE = 10/29/2013

PLOT SCALE = 4:0.0000 in:in / in.

DESIGNED -

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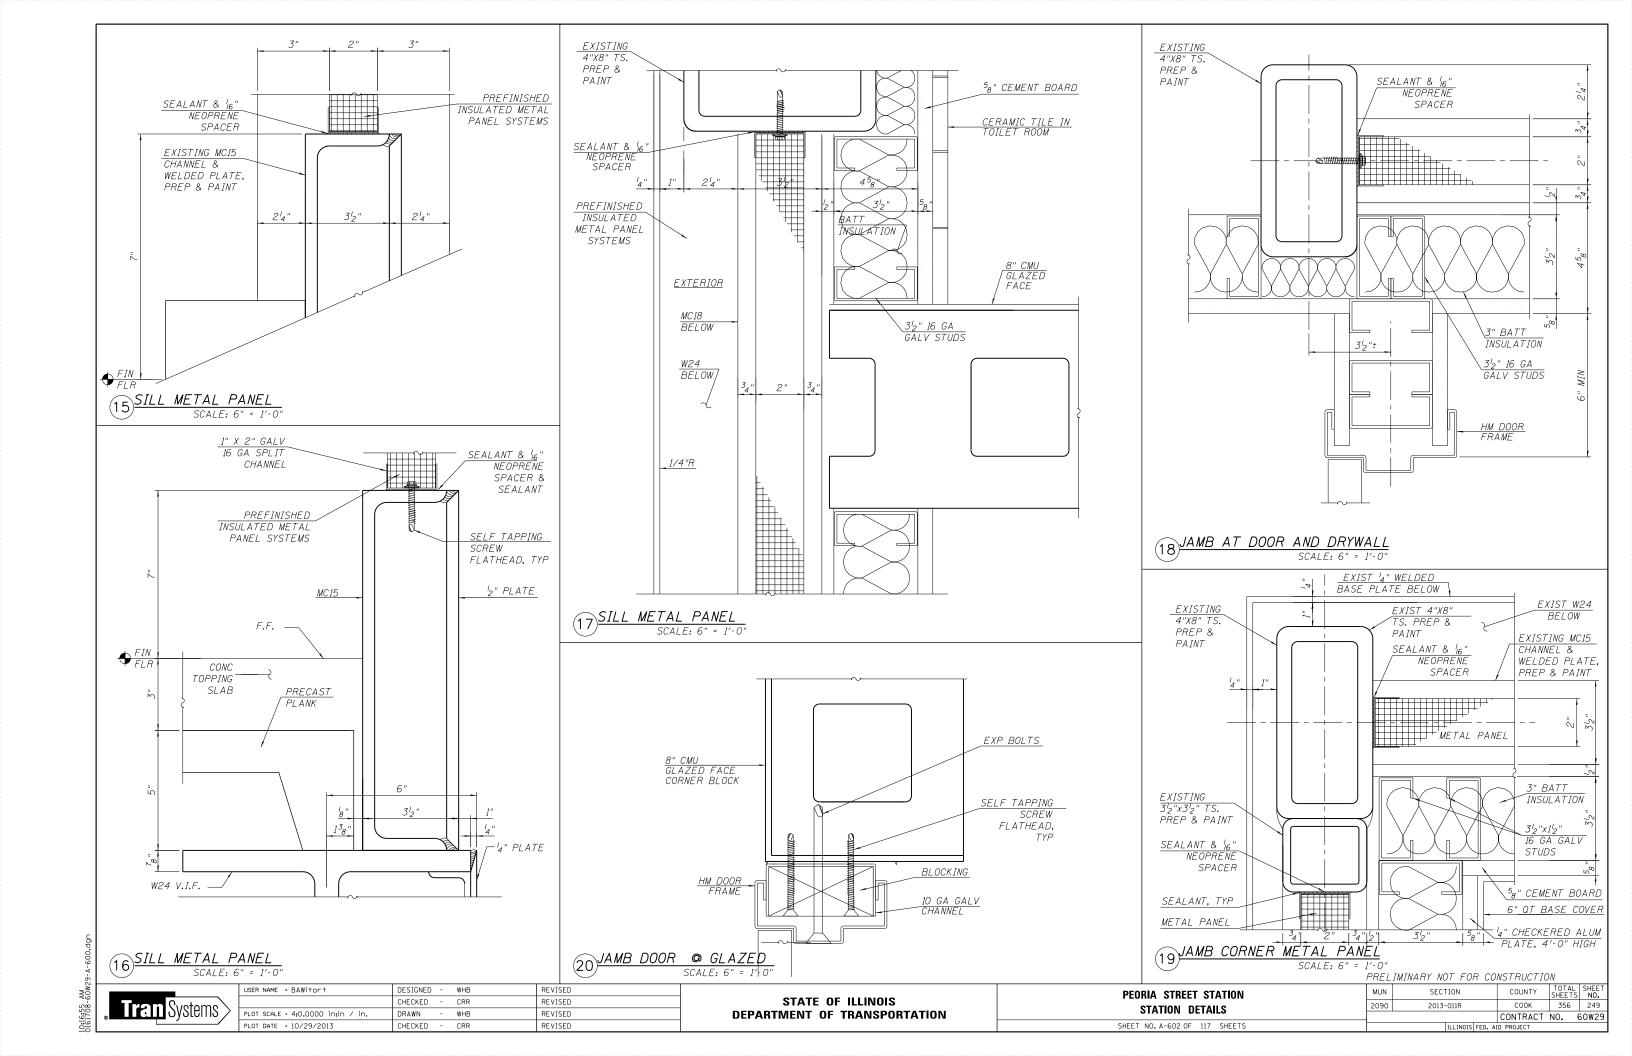
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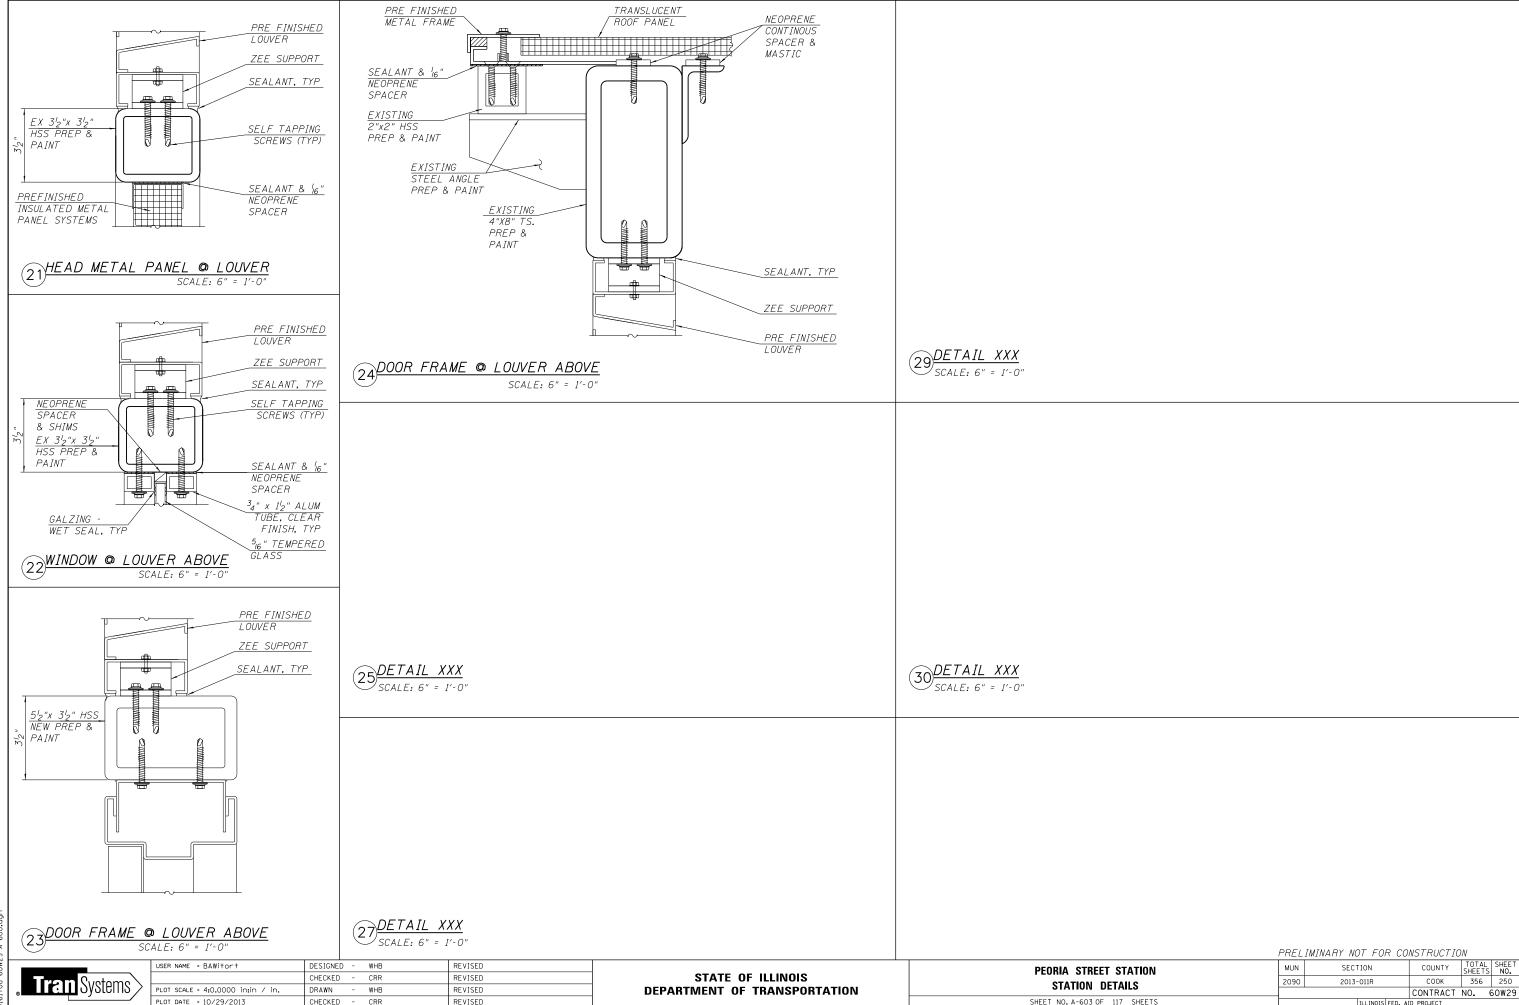
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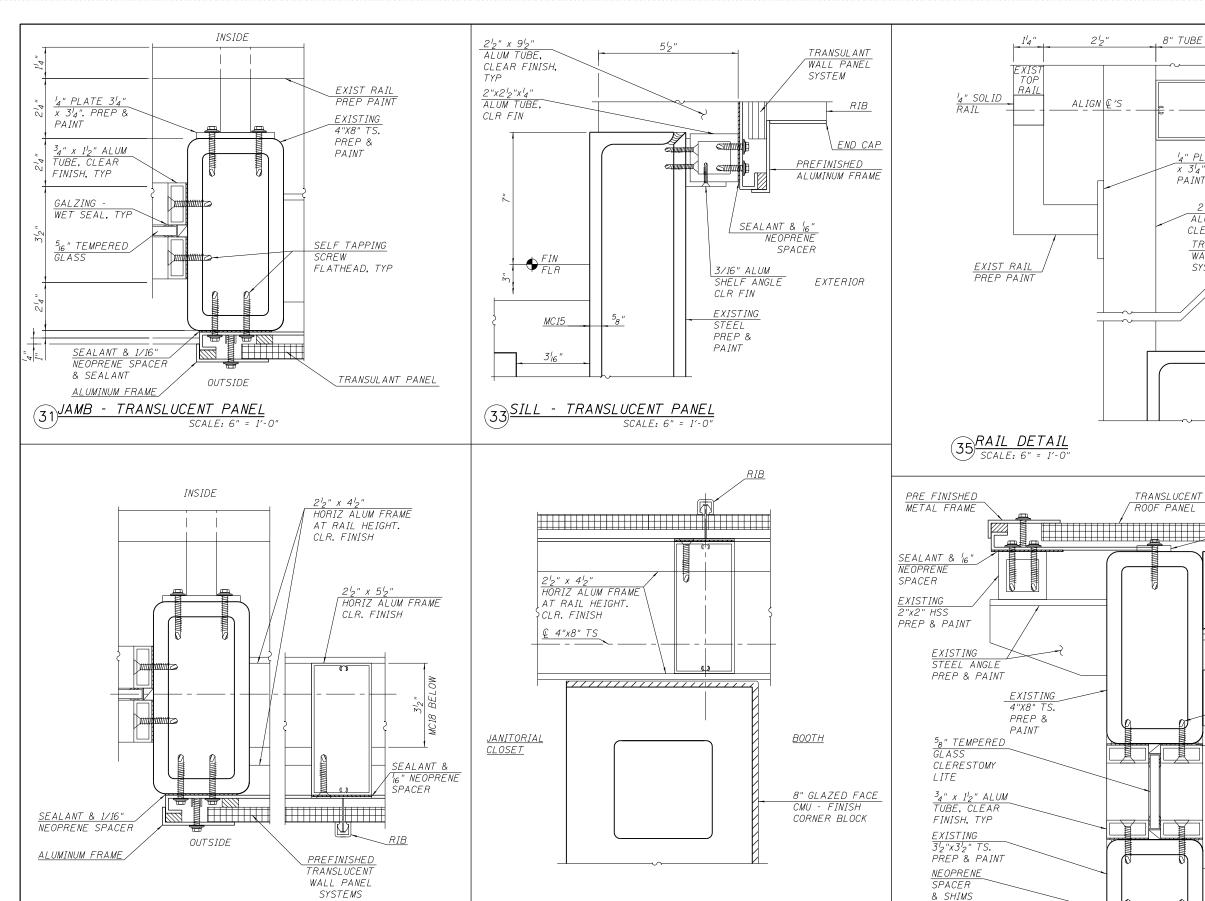
REVISED

REVISED






10:16:55 AM



34) JAMB CMU @ TRANSLUCENT PANEL

SCALE: 6" = 1'-0"

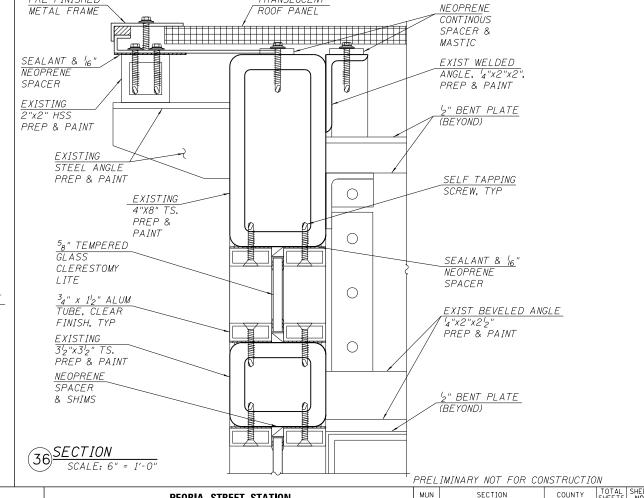

8" TUBE STEEL (BEYOND)

14" PLATE 314" x 314" PREP &

ALUM FRAME,

CLEAR FINISH

TRANSULANT

WALL PANEL

RIB

END CAP

SYSTEM




32 JAMB - TRANSLUCENT PANEL

SCALE: 6" = 1'-0"

DESIGNED - WHB USER NAME = BAWitort REVISED CHECKED - CRR REVISED WHB REVISED PLOT DATE = 10/29/2013 CHECKED - CRR REVISED

STATE OF ILLINOIS **DEPARTMENT OF TRANSPORTATION**

MUN COUNTY PEORIA STREET STATION COOK 356 251 2090 2013-011R STATION DETAILS CONTRACT NO. 60W29 SHEET NO. A-604 OF 117 SHEETS

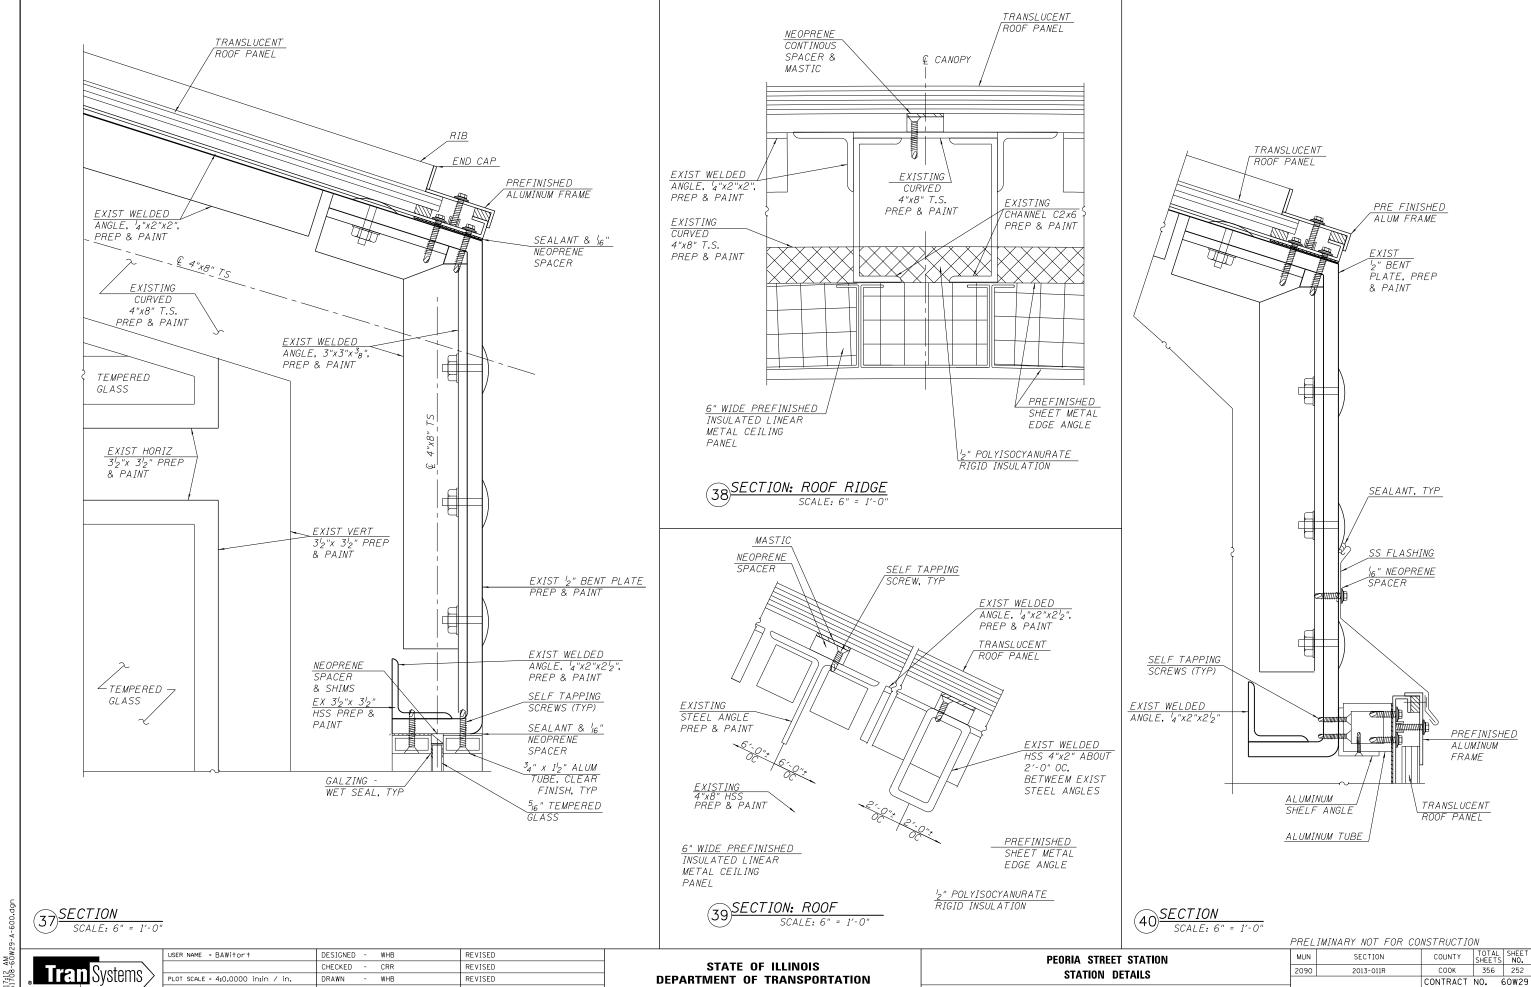

SHEET NO. A-605 OF 117 SHEETS

PLOT DATE = 10/29/2013

CHECKED -

CRR

REVISED



 USER NAME = BAWITOr †
 DESIGNED - WHB
 REVISED

 CHECKED - CRR
 REVISED

 PLOT SCALE = 8:0.0009 ':" / in.
 DRAWN - WHB
 REVISED

 PLOT DATE = 10/29/2013
 CHECKED - CRR
 REVISED

STATE OF ILLINOIS DEPARTMENT OF TRANSPORTATION PEORIA STREET STATION
WINDOWS, DOORS, LOUVER SCHEDULE
SHEET NO. A-610 OF 117 SHEETS




USER NAME = BAWitort DESIGNED - WHB REVISED CHECKED - CRR REVISED PLOT SCALE = 8:0.0009 ':" / in. DRAWN WHB REVISED PLOT DATE = 10/29/2013 CHECKED - CRR REVISED

STATE OF ILLINOIS **DEPARTMENT OF TRANSPORTATION**

PEORIA STREET STATION TACTILE PANEL PLAN, SECTION AND DETAILS SHEET NO. A-620 OF 117 SHEETS

CONTRACT NO.

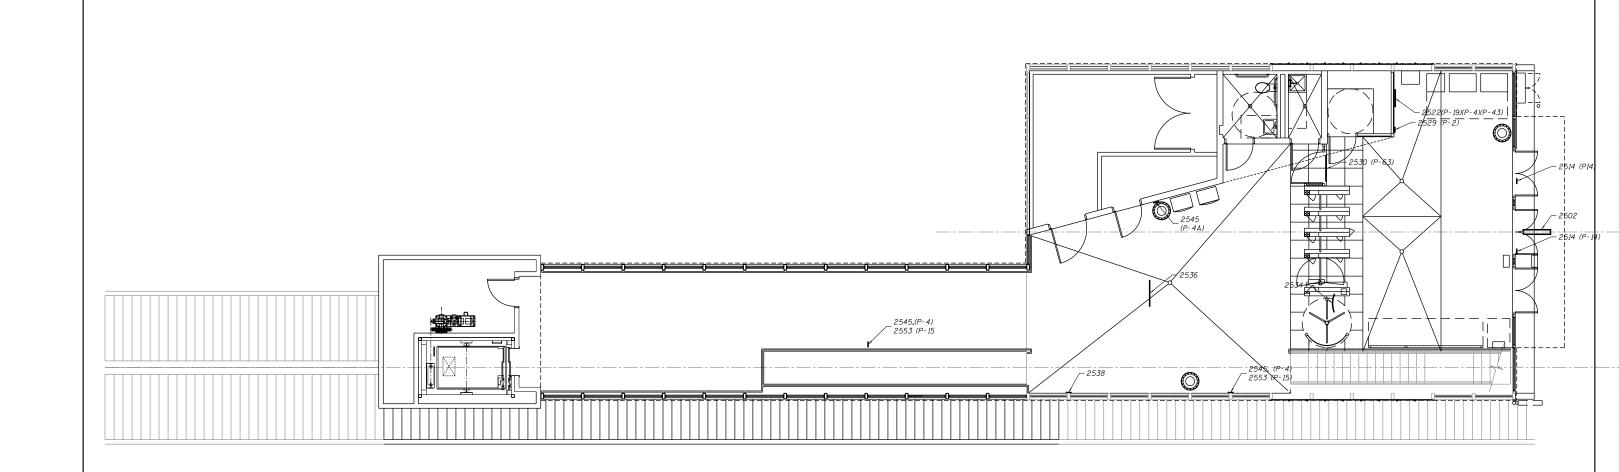

10:21:09 AM 0161708-60W29-A-700.dgn

Tran Systems

1 STATION SIGNAGE FLOOR PLAN SCALE: 1/4" - 1'-0"

USER NAME = BAWifort DESIGNED - WHB REVISED

CHECKED - CRR REVISED

PLOT SCALE = 128:0.0015 in:in / in. DRAWN - WHB REVISED

PLOT DATE = 10/29/2013 CHECKED - CRR REVISED

DEPARTMENT OF TRANSPORTATION

REVISED

PEORIA STREET STATION

STATION SIGNAGE FLOOR PLAN

SHEET NO. A-700 OF 117 SHEETS

 MUN
 SECTION
 COUNTY SHEETS NO.

 2090
 2013-011R
 COOK
 356
 255

 CONTRACT NO. 60W29

 IILLINDISTED. AID PROJECT

SIGN TYPES	ARTWORK	DESIGN NUMBER	INSTALLATION LOCATION	SIGN MESSAGE	MOUNTING DETAIL DRAWING SHEET	GRAPHIC COLOR(S)	BACKGROUND COLOR	DRILLING PATTERN	OVERALL SIGN SIZE	SIGN MATERIAL	SIGN QUANTITY	NOTES
	LUMINATED SIGNAGE		233.171011									
P-2		OP - 5560	P-4	NO LOITERING DIAL 911	\$\$AS-004	BLACK COPY WHITE COPY RED PMS 200	WHITE	"C" FOR P-2 "W" FOR P-2A	(F1 P0	ALUMINUM (.063) CORPLAST (4MM) BERGLASS (.180) PRCELAIN (16 GA)	XX	EXISTING
P-4				NO SMOKING	\$\$AS-004	BLACK COPY RED PMS 200	WHITE	"C" FOR P-2 "W" FOR P-2A	(F1 P0	ALUMINUM (.063) CORPLAST (4MM) BERGLASS (.180) PRCELAIN (16 GA) FAINLESS (16 GA)		EXISTING
P-4				NO SMOKING	\$\$AS-004	BLACK COPY RED PMS 200	WHITE	"C" FOR P-2 "W" FOR P-2A	() F1 P0	ALUMINUM (.063) CORPLAST (4MM) BERGLASS (.180) PRCELAIN (16 GA) FAINLESS (16 GA)		NEW
P- 14		0P - 7362		HOLD ON TO YOUR CHILDREN	\$\$AS-004	YELLOW COPY RED PMS 200 BLACK SYMBOLS	YELLOW	P-14-"C" P-14A-"W"		16 FIBERGLASS 194 PORCELAIN		EXISTING
P-15		OP - 7368		STAY ON PLATFORM	\$\$AS-004	YELLOW COPY RED PMS 200 BLACK SYMBOLS BLACK COPY	YELLOW	P- 15 - "C" P- 15A - "W"		616 FIBERGLASS 694 PORCELAIN		EXISTING
P-17												NEW
P- 18												NEW
P- 19		FE - 7861		SYSTEM MAP	\$\$AS-004	CMYK LITHOGRAPHIC PROCESS PREFERRED DIGITAL PROCESS CAN USE CMYKLCLM CTA ROUTE COLORS	WHITE	NONE		O GRAM DOUBLE SIDED MATTE PAPER WITH OVERLAMINTURE		EXISTING
												NEW
P-20 P-26				HANDICAP	\$\$AS-004	BLUE PMS 300	WHITE	PORCELAIN ISA (0.5(13MM) FROM CORNER-4 HOLES COMPLETE WITH GROMMETS	F	MODUCAL (4MM) PLASTIGRAPHIX (10MM) DRCELAIN (16GA)		NEW
P-27				HANNDICAP ELEVATOR	\$\$AS-004	BLUE PMS 300	WHITE	"C"	FI PC	ALUMINUM (.063) BERGLASS (.180) RCELAIN (16 GA) AINLESS (16 GA)		NEW
		0P-9011		SURVEILLANCE CAMREAS ON	\$\$AS-004	RED PMS 200	WHITE	"W"		BERGLASS (.180) RCELAIN (16 GA)		EXISTING
P-43 P-44		0P-8989		PREMISES DO NOT FEED THE BIRDS	\$\$AS-004	PMS 161C BROWN PMS 200C RED PMS 712C FLESH PMS 877C SILVER PMS 300C L0G0 BLACK COPY	WHITE	"B"	FI	BERGLASS (.180)		NEW
P-45		OP-8311		ELEVATOR	\$\$AS-004	PMS 300	WHITE COPY	"B"	PC	RCELAIN (16 GA)		NEW
P-45 P-63		0P-8312		ELEVATOR	\$\$AS-004	PMS 300	WHITE COPY	"B"		RCELAIN (16 GA)		NEW
P-63 P-63				PURCHASE FARECARDS HERE	\$\$AS-004	BLACK	WHITE COPY	"C"	FI	LUMINUM (.063) BERGLASS (.180) RCELAIN (16 GA)		NEW
				STATION ELEVATOR STATUS	\$\$AS-004	CTA ROUTE COLORS BLACK COPY	WHITE	NONE	MA	KROLON AR (1/8")		EXISTING
P-76				CTA	\$\$AS-004	PMS 200 RED PMS 300C BLUE	OOPAQUE WHITE COPY	SUPPLIED TEMPLATE		LULOSE ACETATI BUTYRATE (CAB) PLASTEDELIM		NEW CONSTRUCTION
Witort	DESIGNED	WIID	REVISED					PEORIA STREET S		MUN MUN	SECTION	CONSTRUCTION TO

STATE OF ILLINOIS DEPARTMENT OF TRANSPORTATION PEORIA STREET STATION
STATION SIGNAGE SCHEDULE (1 OF 1)

SHEET NO. A-701 OF 117 SHEETS

, ,,	111111111111111111111111111111111111111		100,10		
MUN	SECTION		COUNTY	TOTAL SHEETS	SHEE NO.
2090	2013-011R		COOK	356	256
			CONTRACT	NO. 6	50W2
	ILLINOIS	FED. A	D PROJECT		

SIGN TYPES	ARTWORK	DESIGN NUMBER	INSTALLATION LOCATION	SIGN MESSAGE	MOUNTING DETAIL DRAWING SHEET	GRAPHIC COLOR(S)	BACKGROUND COLOR	DRILLING PATTERN	OVERALL SIGN SIZE	SIGN MATERIAL	SIGN QUANTITY	NOTES
	VATED SIGNAGE	xx	P-4	ELEVATOR	\$\$A - 004	4 COLOR CMYK PROCESS, VINYL APPLICATION	XX	NONE	XX	FIBERGLASS (.180) ACRYLIC (.125) PLEXIGALSS (.125) POLYCARBONATE	XX	XX
E - 22Ha E - 22Ha				ELEVATOR	\$\$A-004	4 COLOR CMYK PROCESS, VINYL APPLICATION		NONE		(.125) FIBERGLASS (.180) ACRYLIC (.125) PLEXIGALSS (.125) POLYCARBONATE		
P-4										(.125)		
P-14												
P-15												
P-17												
P-18												
P-19												
P-20												
P-26												
P-27												
P-43												
P-44												
P-45												
P-45 P-63												
P-63												
P-76												

 USER NAME = BAWITOr†
 DESIGNED - WHB
 REVISED

 CHECKED - CRR
 REVISED

 PLOT SCALE = 0:2.0000 ':" / In.
 DRAWN - WHB
 REVISED

 PLOT DATE = 10/29/2013
 CHECKED - CRR
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STATE OF ILLINOIS
DEPARTMENT OF TRANSPORTATION


PEORIA STREET STATION
STATION SIGNAGE SCHEDULE (2 OF 2)

 MUN
 SECTION
 COUNTY
 TOTAL SHEET NO.

 2090
 2013-011R
 COOK
 356
 257

 CONTRACT NO. 60W29

 ILLINOIS FED. AID PROJECT

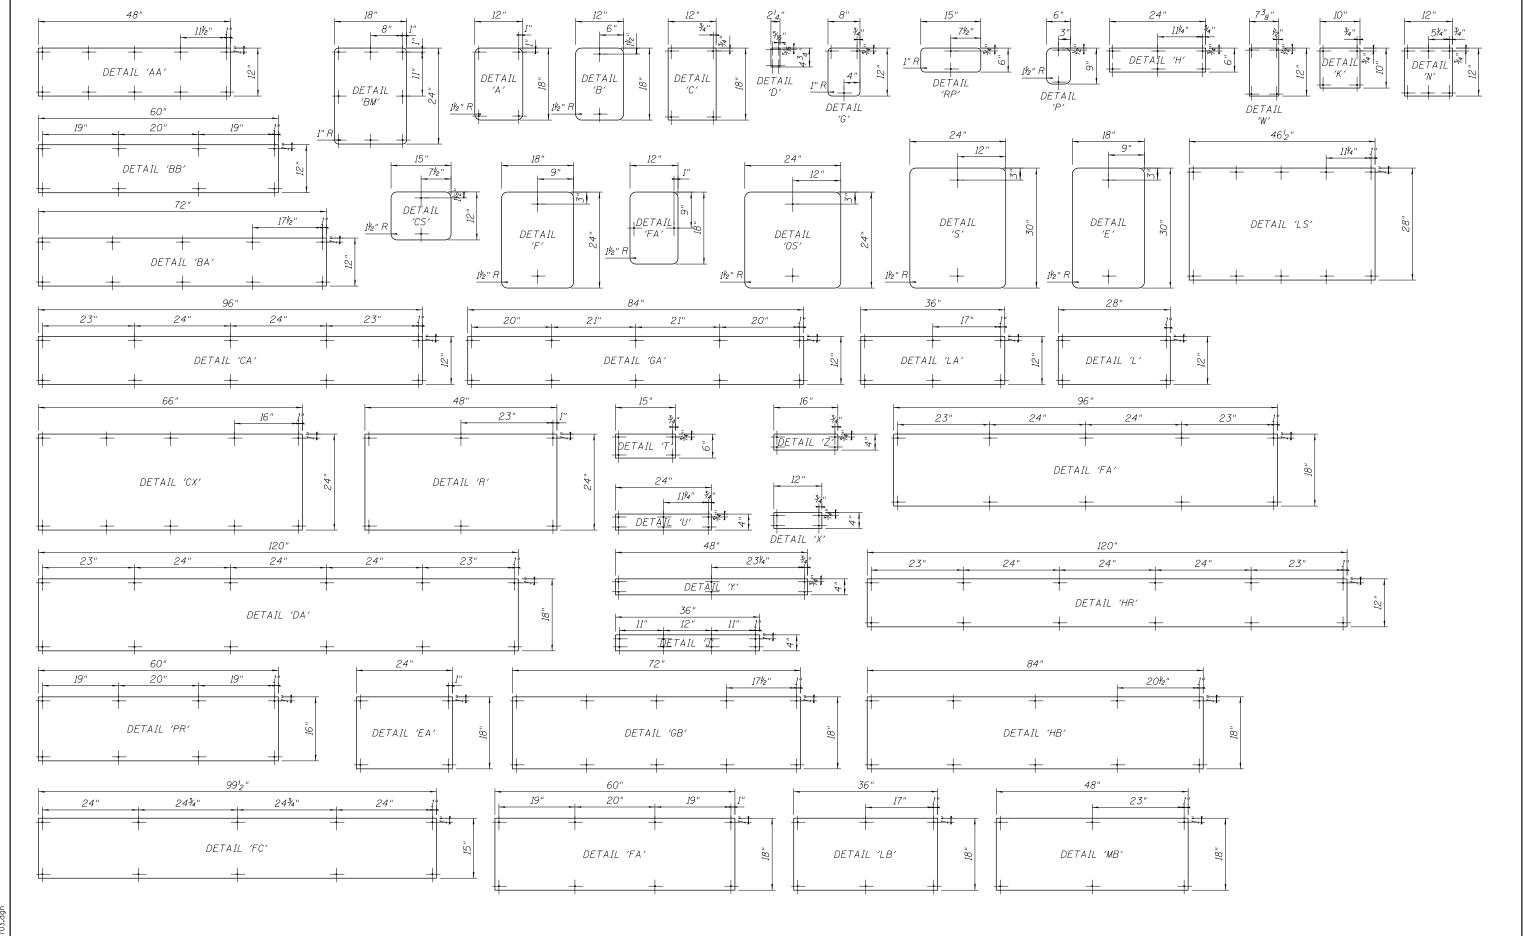

STATE OF ILLINOIS
DEPARTMENT OF TRANSPORTATION

PEORIA STREET STATION
STATION SIGNAGE MOUNTING DETAILS
SHEET NO. A-703 OF 117 SHEETS

 MUN
 SECTION
 COUNTY SHEETS NO.

 2090
 2013-011R
 COOK
 356
 258

 CONTRACT NO. 60W29

 | ILLINOIS| FED. AID PROJECT



1 SIGNAGE 2502 SCALE: NTS



2 SIGNAGE 2514 SCALE: NTS



4 SIGNAGE 2522 SCALE: NTS



5 SIGNAGE 2529 SCALE: NTS



6 SIGNAGE 2530 SCALE: NTS



3 SIGNAGE 2560 SCALE: NTS


7 SIGNAGE 2534 SCALE: NTS



8 SIGNAGE 2536 SCALE: NTS



9 SIGNAGE 2538 SCALE: NTS

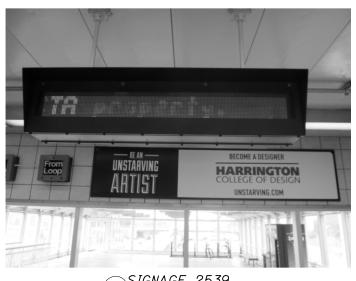

10 SIGNAGE 2539 SCALE: NTS



SIGNAGE 2541
SCALE: NTS



12 SIGNAGE 2545 SCALE: NTS

PRELIMINARY NOT FOR CONSTRUCTION



USER NAME = BAWitort	DESIGNED - WHB	REVISED
	CHECKED - CRR	REVISED
PLOT SCALE = 2:0.0000 in:in / in.	DRAWN - WHB	REVISED
PLOT DATE = 10/29/2013	CHECKED - CRR	REVISED

STATE OF ILLINOIS
DEPARTMENT OF TRANSPORTATION

PEORIA STREET STATION

STATION EXISTING SIGNAGE PHOTOS (1 OF 2)

SHEET NO. A-704 OF 117 SHEETS



1 SIGNAGE 2553 SCALE: NTS

USER NAME = BAWitort	DESIGNED - WHB	REVISED	
	CHECKED - CRR	REVISED	
PLOT SCALE = 2:0.0000 in:in / in.	DRAWN - WHB	REVISED	
PLOT DATE = 10/29/2013	CHECKED - CRR	REVISED	

STATE OF ILLINOIS
DEPARTMENT OF TRANSPORTATION

STATION	PEORIA STREET STATION EXISTING SIGNAGE PHOTOS (2 OF 2)	
	SHEET NO. A-705 OF 117 SHEETS	



USER NAME = BAWitort DESIGNED - WHB REVISED CHECKED - CRR REVISED PLOT SCALE = 8:0.0009 ':" / in. DRAWN WHB REVISED PLOT DATE = 10/29/2013 CHECKED - CRR REVISED


STATE OF ILLINOIS **DEPARTMENT OF TRANSPORTATION**

PEORIA STREET STATION STATION EXISTING SINGAGE PHOTOS SHEET NO. A-706 OF 117 SHEETS

PRELIMINARY NOT FOR CONSTRUCTION CONTRACT NO.

NOTES:

- 1. EXHAUST FANS EF-3, EF-4 & EF-7 TO BE BEHIND THE ARCHED LOUVERS ABOVE WINDOWS. BLANK OFF UNUSED LOUVERS. INSTALL MOTORIZED DAMPERS BETWEEN LOUVER AND FANS. WHEN FANS ARE ACTIVATED, DAMPERS TO OPEN IF FANS ARE NOT OPERATING; DAMPERS TO REMAIN CLOSED.
- EXHAUST FANS EF-1, EF-2, EF-5, EF-6, EF-8 & EF-9 TO BE MOUNTED JUST BELOW CEILING. PROVIDE LOUVER AND MOTORIZED DAMPER TO ACCOMMODATE SIZE OF FAN BEING INSTALLED. IF FANS ARE ACTIVATED, DAMPERS TO OPEN. IF FANS ARE INACTIVE, DAMPERS TO REMAIN CLOSED.

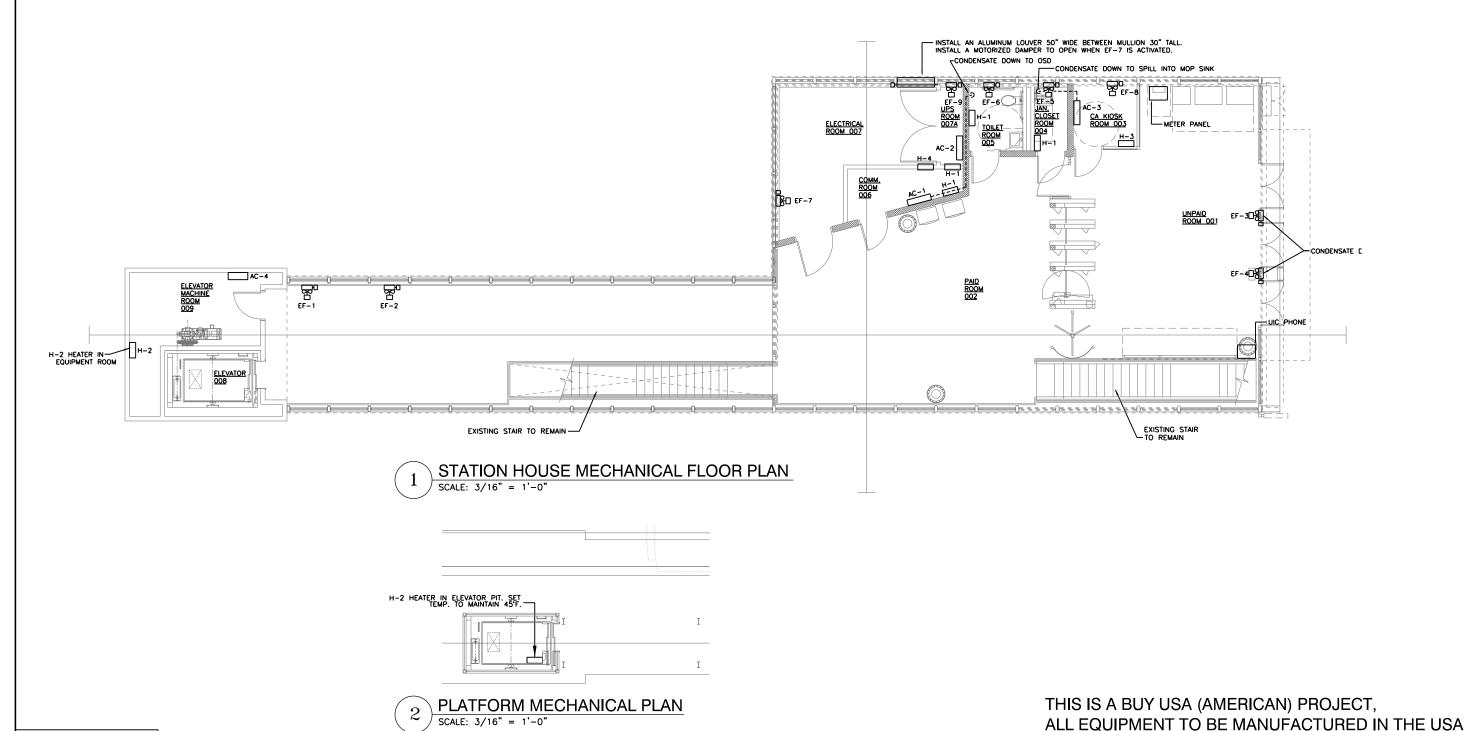

AAA ENGINEERING **Tran** Systems

USER NAME = habib DESIGNED REVISED CHECKED REVISED PLOT SCALE = 10:8 ':" / in. DRAWN REVISED PLOT DATE = 10/28/2013 CHECKED REVISED

STATE OF ILLINOIS **DEPARTMENT OF TRANSPORTATION**

PEORIA STREET STATION MECHANICAL STATION HOUSE & PARTIAL PLATFORM PLANS SHEET NO. 71 OF 117 SHEETS

PRELIMINARY NOT FOR CONSTRUCTION COUNTY TOTAL SHEETS NO. COOK 356 262 MUN SECTION 2090 2013-011R CONTRACT NO. 60W29

							EXI	HAUS	ST FA	AN SCI	HEDI	ULE							
QTY.	TAG	AREA SERVED	LOCATION	СҒМ	S.P. (IN. H20)	RPM	AMPS	WATTS	HP	VOLTS	PHASE	CYCLE	DRIVE	SONES	WEIGHT (LBS)	SIZE (LxWxH)	MANUF.	MODEL	REMARKS
1	EF-1	PAID	-	6100	.25	725	-	-	1 2	120	1	60	BELT	15.5	95	30°DIA	GREENHECK	SBE-1H305	3 5 6
1	EF-2	UNPAID	-	6100	.25	725	-	-	1/2	120	1	60	BELT	15.5	95	30"DIA	GREENHECK	SBE-1H305	3 5 6
1	EF-3	UNPAID	-	6100	.25	725	-	-	1 2	120	1	60	BELT	15.5	95	30"DIA	GREENHECK	SBE-1H305	3 5 6
1	EF-4	UNPAID	-	6100	.25	725	-	-	1/2	120	1	60	BELT	15.5	95	30"DIA	GREENHECK	SBE-1H305	3 5 6
1	EF-5	JAN CLOSET	_	200	.25	1650	-	.78	-	120	1	60	DIRECT	5.2	20	10"DIA	GREENHECK	SE-1-10-428P	1 4 5
1	EF-6	TOILET	-	200	.25	1650	-	.78	-	120	1	60	DIRECT	5.2	20	10"DIA	GREENHECK	SE-1-10-428P	1 4 5
1	EF-7	ELECTRICAL	-	2600	.25	829	-	-	3	120	1	60	BELT	14.8	140	24"DIA	GREENHECK	SBE-1H24-3	2 5 6
1	EF-8	CA KIOSK	-	200	.25	1650	-	.78	-	120	1	60	DIRECT	5.2	20	10"DIA	GREENHECK	SE-1-10-428P	1 3 5
1	EF-9	UPS	ı	200	.25	1650	-	.78	-	120	1	60	DIRECT	5.2	20	10"DIA	GREENHECK	SE-1-10-428P	1 3 5

EQUIVALENT EQUIPMENT BY COOK AND PENNBARRY ARE ACCEPTABLE.

NOTES:

- 1. EXHAUST FAN TO BE PROVIDED WITH BACKDRAFT DAMPER, INTERNAL DISCONNECT, AND WALL COLLAR MOUNTING OPTION.
- 2. CONTROLLED BY SPACE THERMOSTAT AND SPACE INTERFACE RELAY.
- 3. PROVIDE CONTROL THROUGH ON-DUTY/OFF-DUTY SWITCH. EQUIPMENT CANNOT BE STARTED WHEN SWITCH IS TURNED TO OFF-DUTY DURING OCCUPIED MODE, SWITCH WILL BE TURNED TO ON-DUTY AND WINTER/SUMMER THERMOSTAT WILL MAINTAIN DESIRED TEMPERATURE.
- 4. FAN TO BE CONTROLLED BY LIGHT SWITCH TO ENGAGE WHEN OCCUPIED.
- 5. EXHAUST FANS TO BE PROVIDED WITH REMOVABLE WIRE MESH SCREEN TO PROTECT PERSONNEL.
- 6. EXHAUST FAN TO BE PROVIDED WITH BACKDRAFT DAMPER, AND INTERNAL DISCONNECT

			VEN	ITILAT	ION S	SCHE	DULE					
							INANCE IREMENTS	ACTUAL	PROVIDED	EQUIF	PMENT	
ROOM NO.	ROOM NAME (PLAN)	ROOM PURPOSE (PER TABLE 403.3)	FLOOR AREA (SQ.FT.)		NATURAL LIGHT VENT		HANICAL TILATION CFM)	MECHANICAL VENTILATION (CFM)		TAG OF EQUIPMENT SUPPLYING	TAG OF EQUIPMENT EXHAUSTING	REMARKS
				GLASS AREA			(FROM RM) EXH. AIR	SUPPLY AIR		AIR TO THE	E AIR FROM THE ROOM	
1	ELECTRICAL ROOM	INACTIVE STORAGE	205	-	-	0	0	-	2600	-	E-7	
2	сомм. коом	INACTIVE STORAGE	54	-	_	0	0	280	-	AC-1	-	
3	UPS	INACTIVE STORAGE	22	-	_	0	0	280	200	AC-2	E-9	
4	TOILET ROOM	TOILET	43	-	-	-	94	_	200	-	E-6	
5	JAN. CLOSET	JAN. CLOSET	26	-	_	-	52	-	200	-	E-5	
6	CA KIOSK	OFFICE	50	-	-	50	50	300	200	AC-3	E-8	
7	UNPAID	CORRIDOR	585	-	-	NR	NR	-	12,200	-	E-3, E-4	
8	PAID	CORRIDOR	1329	-	-	NR	NR	-	12,200	-	E-1, E-2	
9	ELEV. EQUIP	ELEV EQUIP	150	-	1	NR	NR	635	-	AC-4	-	

	ELECTRIC HEATING EQUIPMENT SCHEDULE													
QTY.	TAG	TYPE	KW	BUT/HOUR	VOLTS	PHASE	AMPS	BLOW	CFM	WEIGHT (LBS)	SIZE (WxHxD)	MANUFACTURER	MODEL	REMARKS
4	H-1	WALL HEATER	3.0	10,239	208	1	14.4	HORIZ.	245	55	144x2316x44	MARKEL	F3453T	NOTES 1,3
2	H-2	WALL HEATER	5.0	17,065	208	3	13.9	HORIZ.	245	55	144x2316x44	MARKEL	J3455T	NOTES 1,2
1	H-3	WALL HEATER	3.0	10,239	208	1	14.4	HORIZ.	245	55	144x2316x44	MARKEL	F3453T	NOTES 1,2
1	H-4	WALL HEATER	5.0	17,065	208	3	13.9	HORIZ.	245	55	144x2316x44	MARKEL	J3455T	NOTES 1,3

NOTES:

- 1. WALL HEATERS TO BE PROVIDED WITH BUILT-IN THERMOSTAT CONTROL AND DISCONNECT.
- 2. WALL HEATER TO BE SURFACE MOUTND IN ELEVATOR SHAFT, ELEVATOR EQUIP. ROOM & CA KIOSK.
- 3. WALL HEATER TO BE RECESSED IN WALL. PROVIDE MOUNTING SLEEVE.

MECHANICAL ABBREVIATION LIST

AC AIR CONDITIONER

ACD AUTOMATIC CONTROL DAMPER

BTU BRITISH THERMAL UNIT

CFM CUBIC FEET PER MINUTE

CFM CUBIC FEET PER IN

CU CONDENSING UNIT

DN DOW

DS DUCTLESS SPLIT SYSTEM

EF EXHAUST FAN

EUH ELECTRIC UNIT HEATER
EWH ELECTRIC WALL HEATER

FD FIRE DAMPER

FT FEET HORIZ HORIZONTAL

HP HORSEPOWER

HR HOUR
IH INFRARED HEATERS

W KILOWATT LOUVER

LBS POUNDS
MANUF MANUFACTURER

NTS NOT TO SCALE
OAI OUTSIDE AIR INTAKE

A ROOM

RPM REVOLUTIONS PER MINUTE

SF SUPPLY FAN SQ.FT. SQUARE FEET

TEMP TEMPERATURE
SYM SYMMETRIC
TYP TYPICAL

VERT VERTICAL WH WALL HEATER

MECHANICAL SYMBOL LIST

ELECTRIC UNIT HEATER

EXHAUST FAN

— ├── MOTORIZED DAMPER

DUCTWORK

S SWITCH

THERMOSTAT

	REFRIGERATION SCHEDULE												
TAG	NO. OF COMPR.	COMPR. TONS	COMPR. HP	REF	WT. REF.	REMOTE	SELF CONTAINED	LOCATION	AIR COOLED	WATER COOLED	COOLING TOWER	GLYCOL CHILLER	SPECIAL
AC-1	0	0	0	R-410	-	YES	NO	COMM. RM. WALL	YES	NO	NO	NO	1 QUANT.
AC-2	0	0	0	R-410	-	YES	NO	UPS CLOS. WALL	YES	NO	NO	NO	1 QUANT.
AC-3	0	0	0	R-410	_	YES	NO	CA KIOSK WALL	YES	NO	NO	NO	1 QUANT.
AC-4	0	0	0	R-410	-	YES	NO	ELEV. EQUIP ROOM	YES	NO	NO	NO	1 QUANT.
CU-1	1	4	4	R-410	8.8 LBS.	YES	NO	BELOW STATION HOUSE ABOVE PLATFORM COVERING	YES	NO	NO	NO	1 QUANT.

- AC-1 EVAPORATOR TO BE DAIKEN AC MODEL FXAQO9PVJU, 208-230/1/60 POWER CONSUMPTION LESS THEN 2 AMPS. COOLING CAPACITY 9,500 BTU/H, 280 CFM. UNIT WEIGHT 26 LBS. CONTROLLER TO BE BRC2A71 SIMPLIFIED CONTROLLER.
- AC-2 EVAPORATOR TO BE DAIKEN AC MODEL FXAQ09PVJU, 208-230/1/60 POWER CONSUMPTION LESS THEN 2 AMPS. COOLING CAPACITY 9,500 BTU/H, 280 CFM. UNIT WEIGHT 26 LBS. CONTROLLER TO BE BRC2A71 SIMPLIFIED CONTROLLER.
- AC-3 EVAPORATOR TO BE DAIKEN AC MODEL FXAQ12PVJU, 208-230/1/60 POWER CONSUMPTION LESS THEN 2 AMPS. COOLING CAPACITY 12,000 BTU/H, 300 CFM. UNIT WEIGHT 26 LBS. CONTROLLER TO BE BRC2A71 SIMPLIFIED CONTROLLER.
- AC-4 EVAPORATOR TO BE DAIKEN AC MODEL FXAQ024PVJU, 208-230/1/60 POWER CONSUMPTION LESS THEN 4 AMPS. COOLING CAPACITY 24,000 BTU/H, 635 CFM. UNIT WEIGHT 31 LBS. CONTROLLER TO BE BRC2A71 SIMPLIFIED CONTROLLER.
- CONDENSER TO BE DAIKEN AC VRVIII—S RXYMQ36PVJU, 208-230/1/60 MOCP 30.0A, MCA 27.0A COMPRESSOR IS SCROLL TYPE WITH A CU-1 COOLING CAPACITY OF 47,500 BTU/HR. SEER 15.10, CAN CONNECT UP TO 8 EVAPORATOR UNITS. TEMPERATURE OPERATING RANGE IS 23'-115'F.

EQUIVALENT EQUIPMENT AS MANUFACTURED BY TRANE OR CARRIER ARE ACCEPTABLE.

THIS IS A BUY USA (AMERICAN) PROJECT, ALL EQUIPMENT TO BE MANUFACTURED IN THE USA

PRELIMINARY NOT FOR CONSTRUCTION

STATE OF ILLINOIS
DEPARTMENT OF TRANSPORTATION

PEORIA STREET STATION
DETAILS, NOTES AND SYMBOL LIST


SHEET NO. 72 OF 117 SHEETS


 MUN
 SECTION
 COUNTY SHEETS NO.
 TOTAL SHEETS NO.

 2090
 2013-011R
 COOK
 356
 263


 CONTRACT NO. 60W29

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ELECTRIC WALL HEATER (EWH) DETAIL

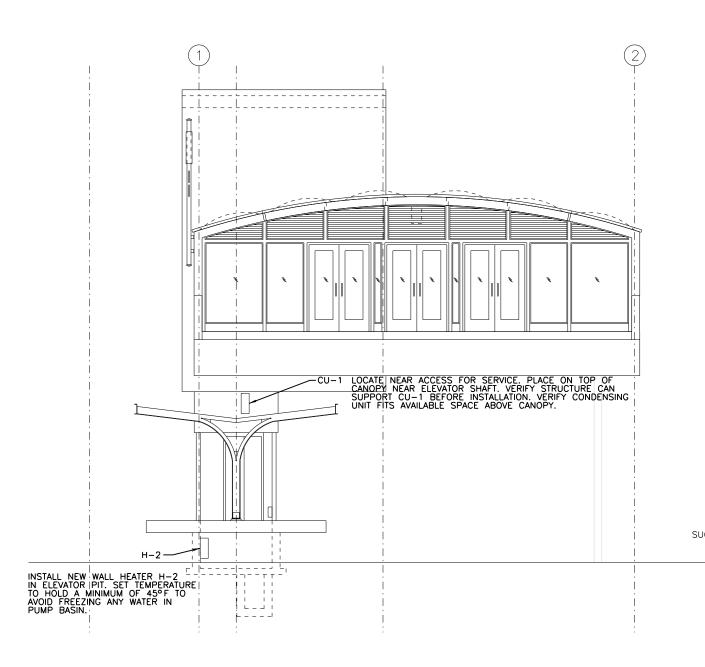

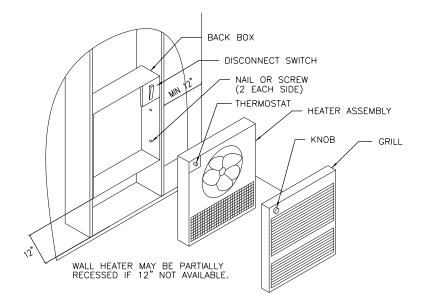REFRIGERATION NOTES:

- 1. REMOVE EXPANSION VALVES, DEVICES, AND CONNECTIONS FROM THE AIR STREAM. INSTALL PRESSURE RELIEF VALVE ON HIGH PRESSURE SIDE OF SYSTEM. UPSTREAM FROM ANY LIQUID LINE SHUT-OFF VALVES.
- 2. REMOTE REFRIGERATION PIPING TO BE K-COPPER.
- 3. ALL JOINTS SHALL BE BRAZED.
- 4. ALL REFRIGERATION PIPING AND ACCESSORIES TO BE INSTALLED IN COMPLETE ACCORDANCE WITH MANUFACTURER'S RECOMMENDATIONS.

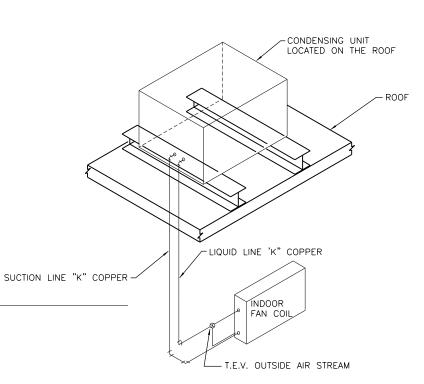REFRIGERATION PIPING & COMPONENT DIAGRAM




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COUNTY TOTAL SHEETS NO. COOK 356 264 SECTION PEORIA STREET STATION 2090 2013-011R **MECHANICAL ELEVATOR ELEVATION** CONTRACT NO. 60W29 SHEET NO. 73 OF 117 SHEETS



USER NAME = habib DESIGNED REVISED CHECKED REVISED DRAWN REVISED PLOT DATE = 10/28/2013 CHECKED REVISED

STATE OF ILLINOIS DEPARTMENT OF TRANSPORTATION

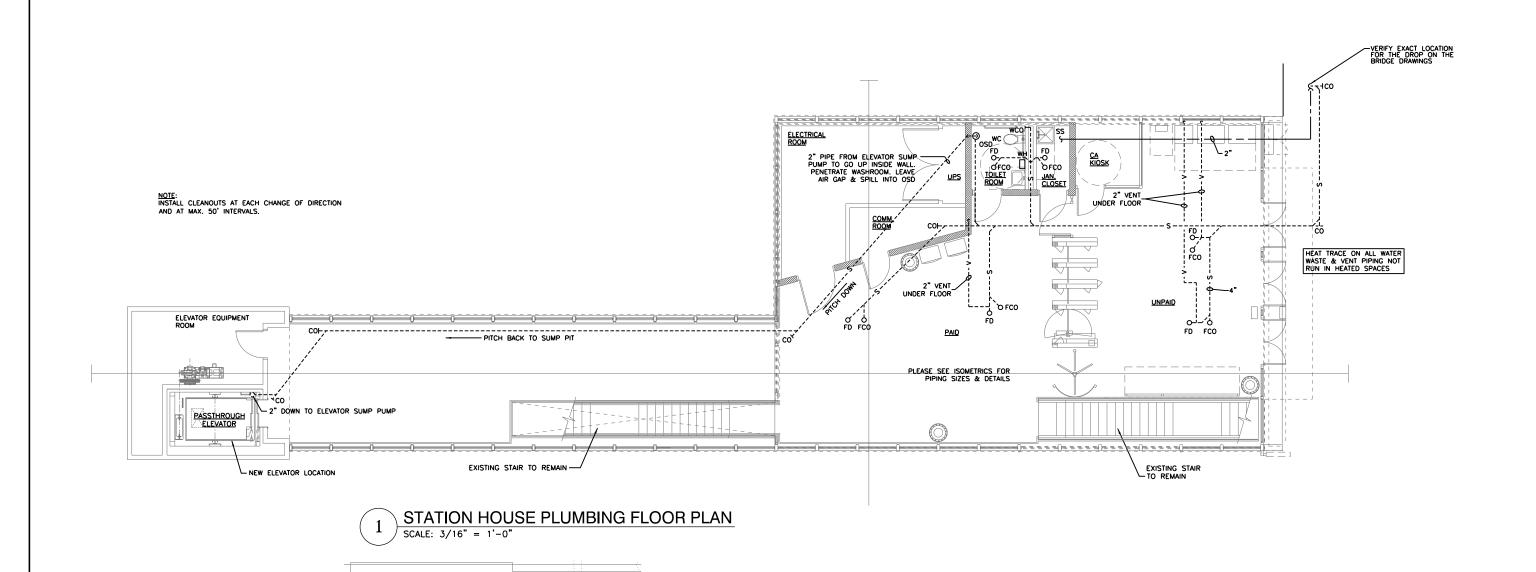

PLATFORM PLUMBING PLAN
SCALE: 3/16" = 1'-0"

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36"x24"x24" DEEP_ ELEVATOR SUMP PIT

STATE OF ILLINOIS **DEPARTMENT OF TRANSPORTATION** PEORIA STREET STATION PLUMBING STATION HOUSE & PARTIAL PLATFORM PLANS SHEET NO. 74 OF 117 SHEETS

COUNTY TOTAL SHEETS NO.

COOK 356 265 SECTION MUN 2090 2013-011R CONTRACT NO. 60W29

PLUMBING FIXTURE SCHEDULE MOUNTING STOP **SUPPLY** MANUFACTURER COLOR QTY. **FIXTURE** SYMBOL SIZE TYPE MODEL NO. MATERIAL TRAP CARRIER REMARKS FITTING **HEIGHT** VALVE FAUCET HOLES ON 8" CENTERS. LAVATORY TO BE ADA COMPLIANT, PIPE ACCORDINGLY. PAIR -1/4" C.P. "P" TRAP J.R. SMITH CHICAGO FAUCETS LAVATORY LAV 20"x18-1/4" WALL MOUNTED AMERICAN STANDARD 0356.015 WHITE VITREOUS CHINA 34" TO RIM HICAGO FAUCET WITH ESCUTHEON 0750 404-VE-2805CF 1005-CP WATER CLOSET TO BE ADA COMPLIANT. SEAT TO BE CHURCH #2955SSC WITH WATER CLOSET 31-3/4"x19-1/2" WALL MOUNTED AMERICAN STANDARD 3351.001 WHITE VITREOUS CHINA 17" TO RIM SLOAN 115-1.6 INTEGRAL WC INTEGRAL 0230 OPEN FRONT, WITHOUT COVER. MOP SINK TO BE PROVIDED WITH VACUUM BREAKER (MTD 7'-6" AFF). 3" C.P. "P" TRAP CHICAGO FAUCETS FLOOR MOUNTED MOP SINK MS 24"x24"x12" FIAT TSBC-1610 GRAY CEMENT ON FLOOR INTEGRAL INCLUDE FIAT #832-AA HOSE W/BRACKET AND FIAT #889-CC MOP HANGER. WITH ESCUTHEON 911-ISCP

2x4 VTF

KOHLER, ELJER, AND CRANE ARE APPROVED EQUALS FOR LAVATORIES AND WATER CLOSETS. FLORESTONE, CREATIVE INDUSTRIES, AND ELSMERE ARE APPROVED EQUALS FOR MOP SINKS.

				DR	AIN FITTING SO	CHEDULE
SYM.	TYPE	SIZE	MANUFACTURER	MODEL NO.	TOP FINISH	REMARKS
FD	FLOOR DRAIN	4"	J.R. SMITH	2010-B-U	8" SQUARE NICKEL-BRONZE	GALVANIZED BODY; 2" CAST IRON "P" TRAP; CLAMPING RING.
со	CLEAN OUT	4"	J.R. SMITH	4420		CAST IRON CLEANOUT FERRULE, BRONZE COUNTERSUNK PLUG.
FCO	FLOOR CLEAN OUT	4"	J.R. SMITH	4023	SATIN NIKALOY	CAST IRON CLEANOUT FERRULE, BRONZE COUNTERSUNK PLUG.
wco	WALL CLEAN OUT	4"	J.R. SMITH	4422	5-1/2" ROUND STAINLESS STEEL	ACCESS COVER, CENTER SCREW, COATED CAST IRON CLEANOUT FERRULE WITH NO-HUB CONNECTION AND BRONZE COUNTERSUNK PLUG.
OSD	OPEN SITE DRAIN	4"	J.R. SMITH	3824	5" FUNNEL INLET	DEEP SEAL "P" TRAP WITH INDIRECT WASTE FUNNEL AND SIDE OUTLET THREADED CONNECTION.

JOSAM, ZURN, AND WADE ARE APPROVED EQUALS. CLEANOUTS TO BE ADDED AS NEEDED, AT INTERVALS NO LARGER THAN FIFTY FEET AND ANY CHANGE IN DIRECTION.



BRADFORD

WATER HEATER

EFC-8300-2-S-10

3/4" UNION

3/4" BALL

VALVE (TYP)

PIPE TO


CLOSEST OSD OR FD


(TYP)

(QTY. 1) INSTANTANEOUS ELECTRIC WATER HEATER SUMP PUMP (SP) TO BE METROPOLITAN MODEL (WH) TO BE BRADFORD WHITE MODEL "STORM-PRO" BA501 HEAVY-DUTY SUBMERSIBLE EFC-8300-2-S-10 OR APPROVED EQUAL. 208 PUMP, WITH STAINLESS STEEL HOUSING AND PUMP VOLTS, 1 PHASE, 8.3KW, 39.0 AMPS. CAPABLE OF STRAINER, NON-CLOGGING VORTEX CAST IRON HEATING 0.75 GPM AT A TEMPERATURE RISE OF 76°F IMPELLER, STAINLESS STEEL SHAFT, BUNA-N O-RINGS. UNIT TO HAVE ABS UL 94 VO RATED COVER. HEATER DUAL MECHANICAL, TYPE 21 OIL LUBRICATED SEALS, BODY AND ELEMENT TO BE GLASS REINFORCED UPPER & LOWER BEARINGS (SINGLE ROW BALL, OIL NORYL. ELEMENT TO BE REPLACABLE CARTRIDGE LUBRICATED). MOTOR TO BE 1/2-HP, 115-VOLT, INSERT. UNIT TO HAVE A REPLACABLE FILTER IN THE 1-PH, 5.8-AMP DRAW. DISCHARGE TO BE 2", AND THE INLET CONNECTOR. ELEMENT TO BE IRON FREE, PUMP IS TO BE CAPABLE OF 15 GPM@26 FT. HD. NICKEL - CHROME MATERIAL HEATER TO BE FITTED SUMP PUMP TO BE PROVIDED WITH A STAINLESS STEEL WITH 1/8" COMPRESSION NUTS AND SLEEVES TO NEMA 12 BOX. ACCEPTABLE ALTERNATIVES STAINLESS

SUMP PUMPS (SP)

WATER HEATER (WH)

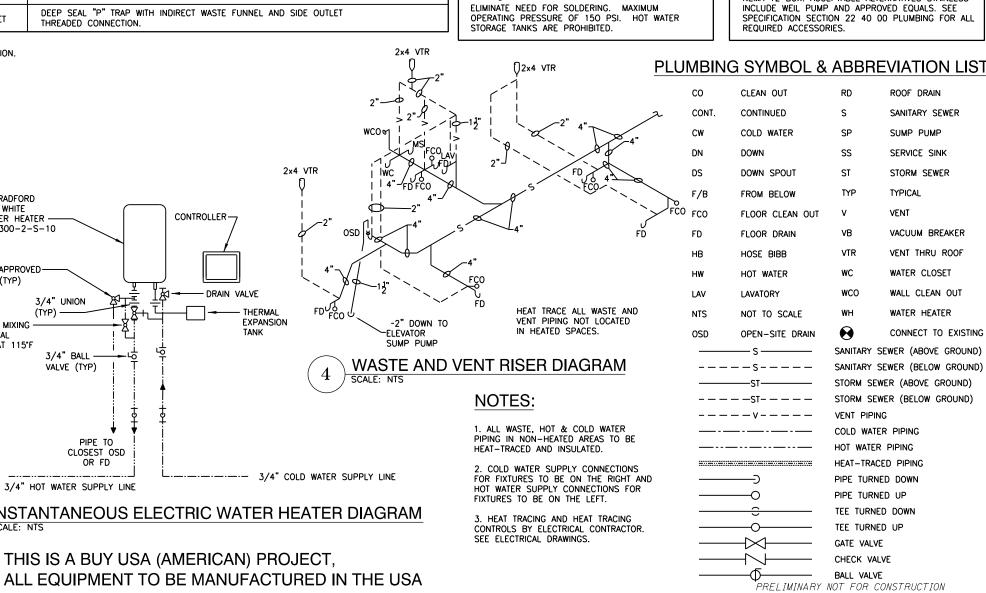

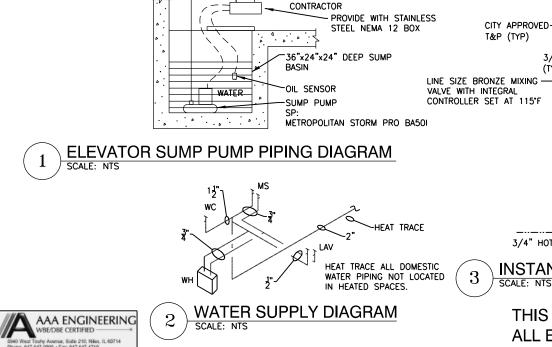

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PLOT DATE = 10/28/2013

√ UP TO 2" SANITARY BELOW

2" CHECK VALVE

CONTROL PANEL

2" GALVANIZED STEEL PIPE

HARD-WIRED BY ELECTRICAL

STATION HOUSE

3/4" HOT WATER SUPPLY LINE INSTANTANEOUS ELECTRIC WATER HEATER DIAGRAM THIS IS A BUY USA (AMERICAN) PROJECT,

CONTROLLER-

- DRAIN VALVE

THERMAI


EXPANSION

DESIGNED REVISED STATE OF ILLINOIS CHECKED REVISED DRAWN REVISED **DEPARTMENT OF TRANSPORTATION** CHECKED REVISED

PEORIA STREET STATION PLUMBING NOTES, DIAGRAMS AND SYMBOL LIST SHEET NO. 75 OF 117 SHEETS

MUN SECTION COUNTY СООК 2090 2013-011R 356 266 CONTRACT NO. 60W29

Tran Systems

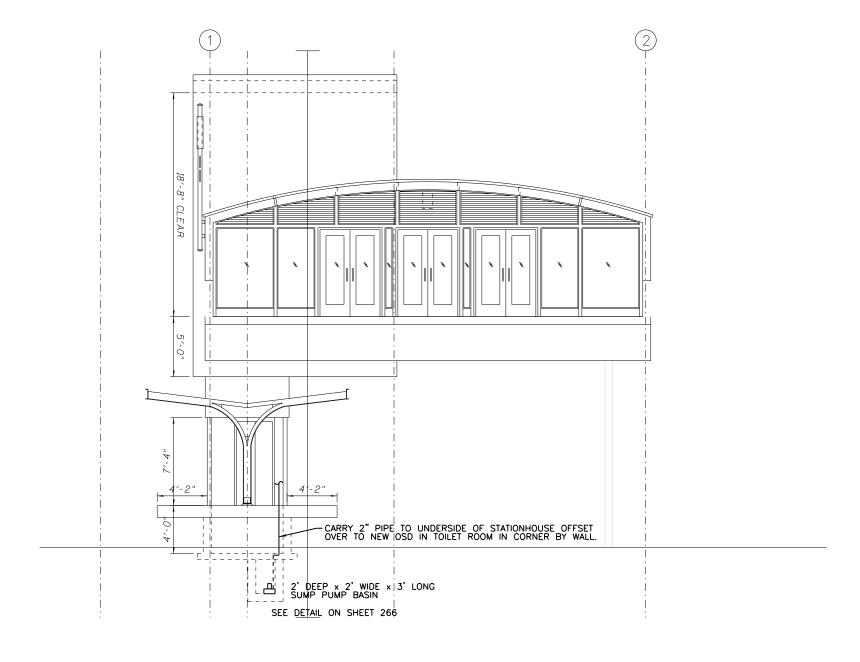



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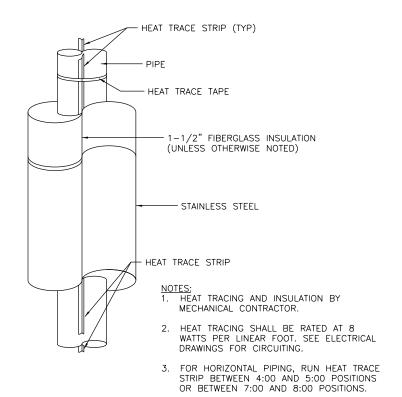
AAA ENGINEERING
WBE/DBE CERTIFIED
SINO West Toutry Avenue, Butle 210, Nike, IL 60714
Prices: 647-647-900 - Fac 647-647-4719


Train Systems

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PLOT DATE = 10/28/2013	CHECKED -	REVISED

STATE OF ILLINOIS
DEPARTMENT OF TRANSPORTATION

PEORIA STREET STATION						
PLUMBING	EL	EVA	TOR	ELE	VATION	
SHEET	NΩ	76	ΩF	117	SHEETS	




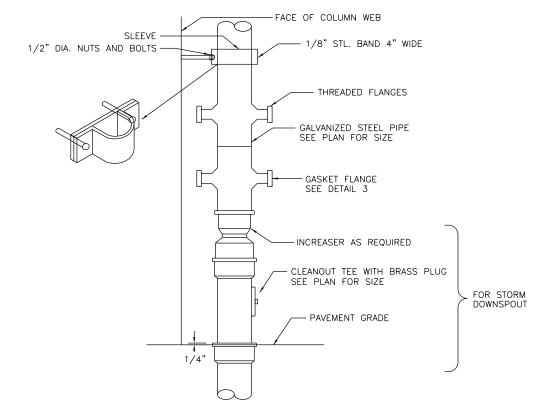

TYPICAL DETAIL OF PIPING WITH HEAT TRACE AND INSULATION

SCALE: NONE

2 DOUBLE INSULATED FLANGE DETAIL
SCALE: NONE

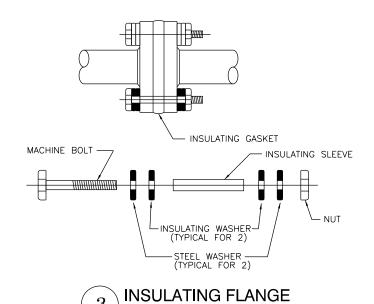

NOTE:
THERE IS TO BE NO PIPING WITH DIRECT CONNECTION TO GROUND.
ALL PIPING TO HAVE A DIELECTRIC FITTING BEFORE CONNECTING TO GROUND.

THIS IS A BUY USA (AMERICAN) PROJECT, ALL EQUIPMENT TO BE MANUFACTURED IN THE USA


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9940 Weet Torby Avenue, State 210, Nikes, It. 60714
Phone: 647-647-9900 - Fac 647-647-4719

Systems

AAA ENGINEERING
WBE/DBE CERTIFIED

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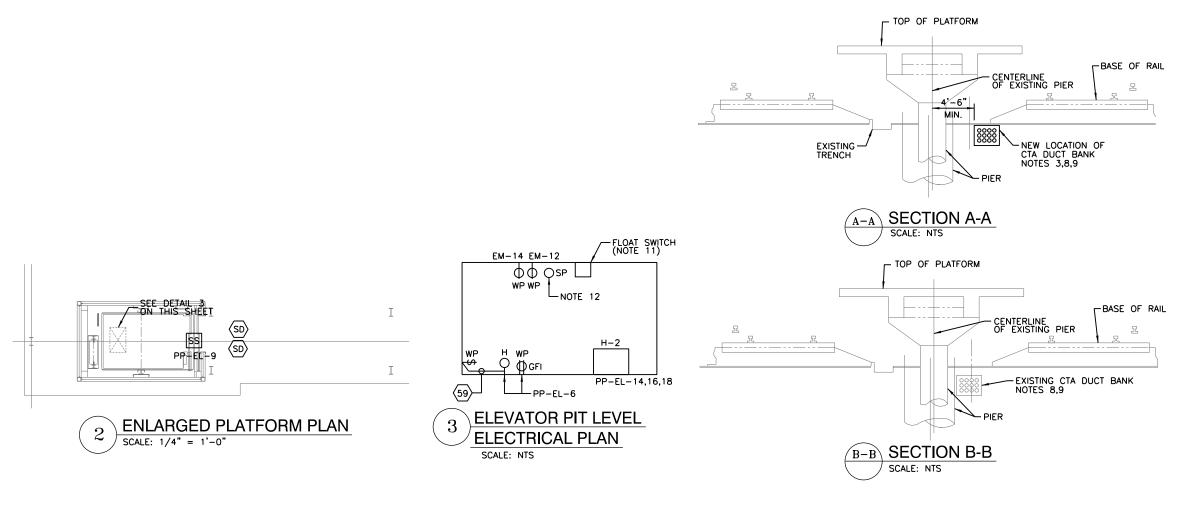


SHEET NO.78 OF 117 SHEETS

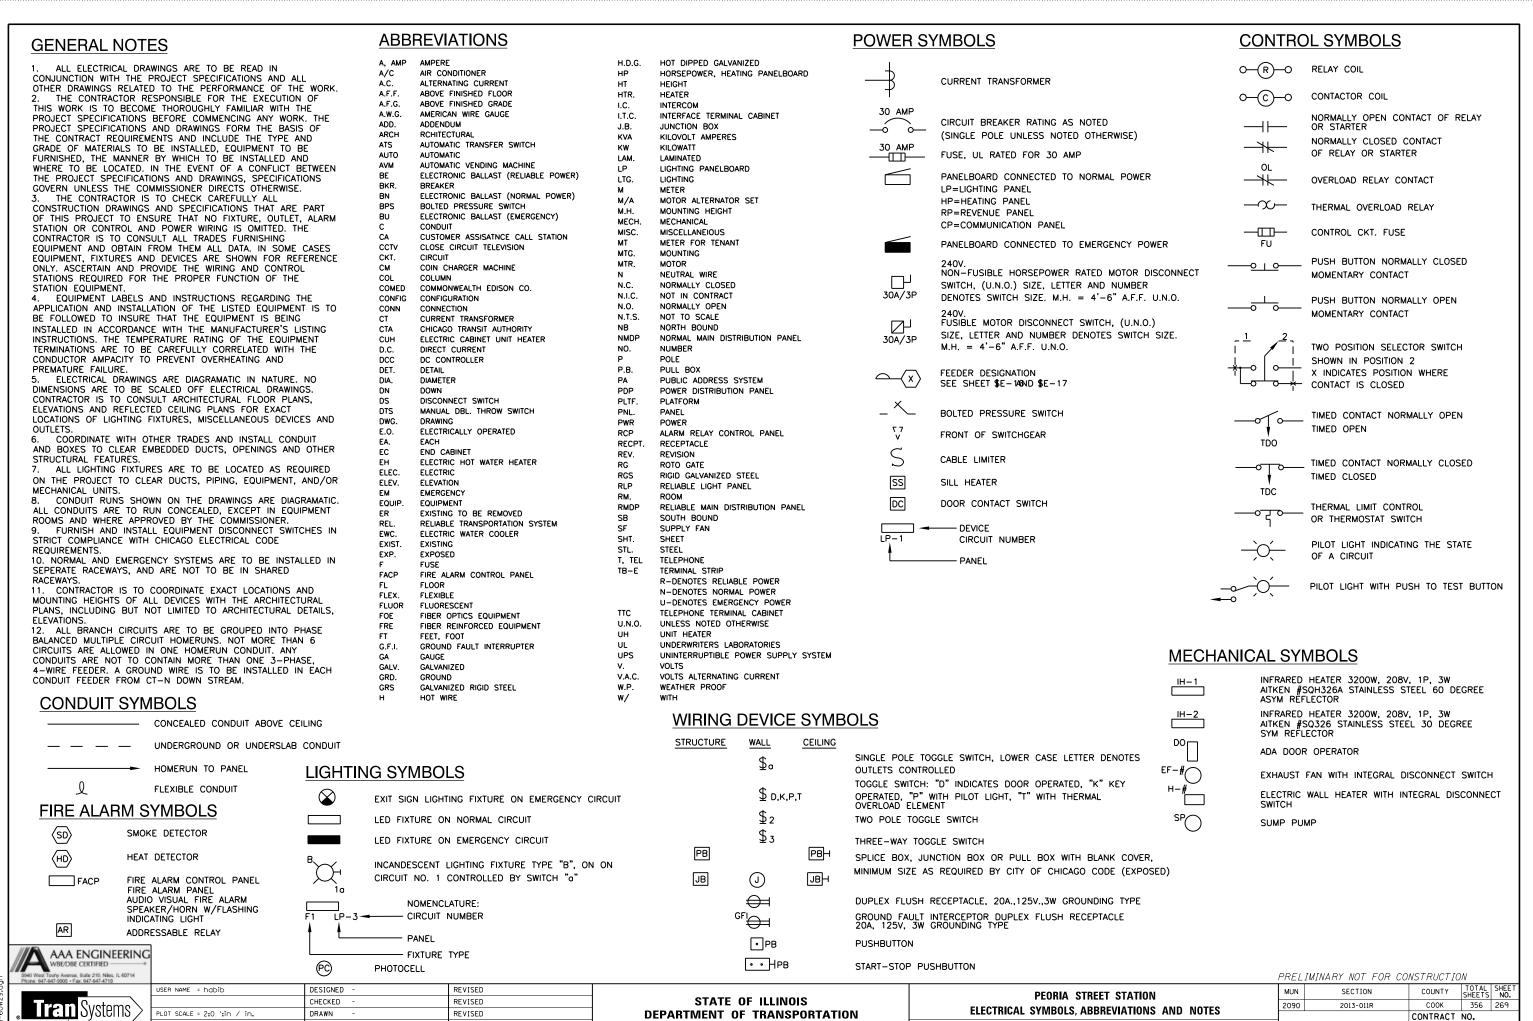7:37:57 PM


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REVISED



NOTES:

- REPLACE THREE EXISTING WINDBREAK INFRARED HEATERS. CONNECT TO NEW HEATER PANEL HP-1. SEE SHEET 287 FOR CONTROL DIAGRAM.
- 2. SECTION OF EXISTING DUCTBANK TO BE RELOCATED.
- 3. SECTION OF NEW DUCTBANK TO MATCH EXISTING.
- 4. INTERCEPT EXISTING DUCTBANK AND REPLACE SECTION AS SHOWN AFTER INSTALLATION AND TESTING OF TEMPORARY CABLING.
- 5. TOTAL OF 6 (IH-1) INFRARED HEATERS FOR WINDBREAK.
- 6. AIR CONDITIONING UNIT AC-1. FED FROM PANEL PP-EL-21,23.
- 7. WALL HEATER H-3. FED FROM PANEL PP-EL-17,19.
- 8. PROVIDE NEW COMMUNICATION, DC RETURN AND FO CABLES.
- 9. CONTRACTOR TO RE-ROUTE DUCTBANK AS SHOWN COORDINATE WORK WITH CTA.
- 10. PROVIDE TEMPORARY CTA CABLES ROUTED ALONG PLATFORM FROM NEAREST MANHOLE AT PEORIA ST. TO NEXT MANHOLE TOWARDS MORGAN ST. CTA STATION.
- 11. FLOAT SWITCH TO BE POWERED BY EM-14 AND CONNECTED TO RELAY PANEL IN ELECTRICAL ROOM.
- 12. SUMP PUMP. PROVIDE LOCAL DISCONNECT SWITCH AND CONNECT TO CIRCUIT EM-12.

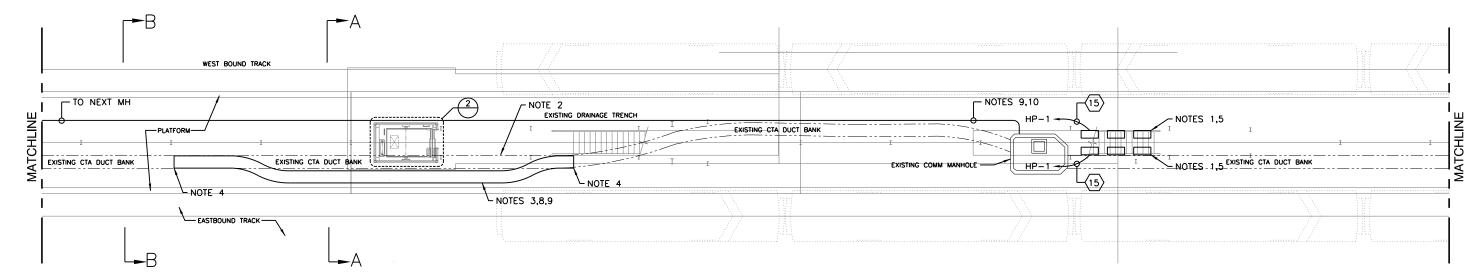

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5940 West Toutry Avenue, Suite 210, Niss, IL 60714
Phone 647-647-9900 - Fax: 647-647-4710

US

Train Systems

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 CHECKED - REVISED

 PLOT SCALE = 16:0 ':" / in.
 DRAWN - REVISED

 PLOT DATE = 10/28/2013
 CHECKED - REVISED

STATE OF ILLINOIS
DEPARTMENT OF TRANSPORTATION

PLATFORM PLAN
SCALE: 1/8" = 1'-0"

PEORIA STREET STATION
ELECTRICAL PLATFORM LEVEL POWER PLAN
SHEET NO. 79 OF 117 SHEETS

 MUN
 SECTION
 COUNTY SHEETS NO.
 TOTAL SHEET NO.
 SHEET NO.

 2090
 2013-011R
 COOK
 356
 270


 CONTRACT NO.
 60W29


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270-60W29.dgn

NOTES:

1. EXISTING LIGHTING FIXTURES MOUNTED DOWN CENTER OF CANOPY TO BE REMOVED WITHIN NEW ELEVATOR ENCROACHMENT. PROVIDE NEW CONDUIT AND CABLE TO MAINTAIN EXISTING LIGHTING.



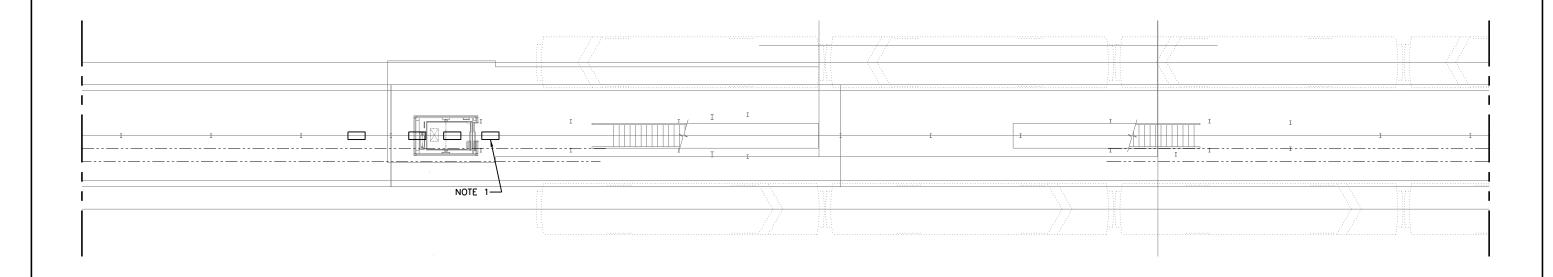

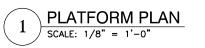


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PLOT DATE = 10/28/2013	CHECKED -	REVISED	

STATE OF ILLINOIS
DEPARTMENT OF TRANSPORTATION

PEORIA STREET STATION					
ELECTRICAL PLATFOR	M LEVE	L POWER	PLAN		
SHEET NO. 8Ø	OF 117	SHEETS			

RELIMINARY NOT FOR CONSTRUCTION						
MUN	SECT	ION		COUNTY	TOTAL SHEETS	SHEE NO.
2090	2013-011R		COOK	356	271	
				CONTRACT	NO. 6	50W2
ILLINOIS FED. AID PROJECT						

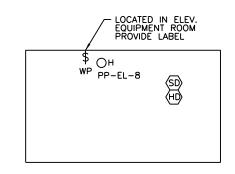


2 ELEVATOR ROOF LEVEL ELECTRICAL PLAN SCALE: NTS

NOTES:

- GENERATOR TAP BOX, SEE SHEET 290 FOR DETAILS.
- 2. ADA DOOR OPERATOR.
- EXHAUST FAN MOUNTED AT TOP OF ELEVATOR SHAFT.
- 4. FURNISH AND INSTALL 60A, 2P, 250V NONFUSED DISCONNECT ROUTED TO PANEL HP-1 CIRCUITS 19,21 WITH 2#6AWG AND 1#8AWG, 1"C GRS.
- 5. FURNISH AND INSTALL 100A, 3P, 250V NEMA 4X NONFUSED DISCONNECT SWITCH. FOR LOCAL DISCONNECT FOR ELEVATOR MACHINE AT ROOF LEVEL OF ELEVATOR SHAFT.
- 6. CONTINUOUS DIVIDED WIREWAY MOUNTED ON EXISTING STRUCTURAL TUBING ABOVE DOOR PAINTED TO MATCH EXISTING STRUCTURE.
- 7. COMED METER IN CABINET. PROVIDE 1 CONDUIT DOWN THROUGH FLOOR TO ELECTRICAL ROOM TO CT-N.

- B. PROVIDE HEAT TRACE, POWER, AND CONTROLS FOR ALL PLUMBING PIPING (SUMP PUMP, WATER, SANITARY, AND VENT). REFER TO SHEET 265 FOR EXACT LOCATIONS ROUTING OF PIPING. MAXIMUM LENGTH OF HEAT TRACE PER CIRCUIT TO BE 200 LF. SEE SHEET 277 FOR CIRCUITING.
- 9. PROVIDE 2-2" CONDUITS
 BETWEEN EACH TURNSTYLE AND
 END CABINET THAT ARE TO BE
 ROUTED BELOW THE FLOOR.
 PROVIDE 2-3/4" CONDUITS BACK
 TO KIOSK. PROVIDE 2-1" CONDUITS
 BACK TO COMM ROOM.
- 10. ALL CONDUITS TO BE ROUTED BELOW FLOOR SLAB.
- 11. PROVIDE 1" CONDUIT FROM EACH VENTRA AND ATM TO COMM ROOM.

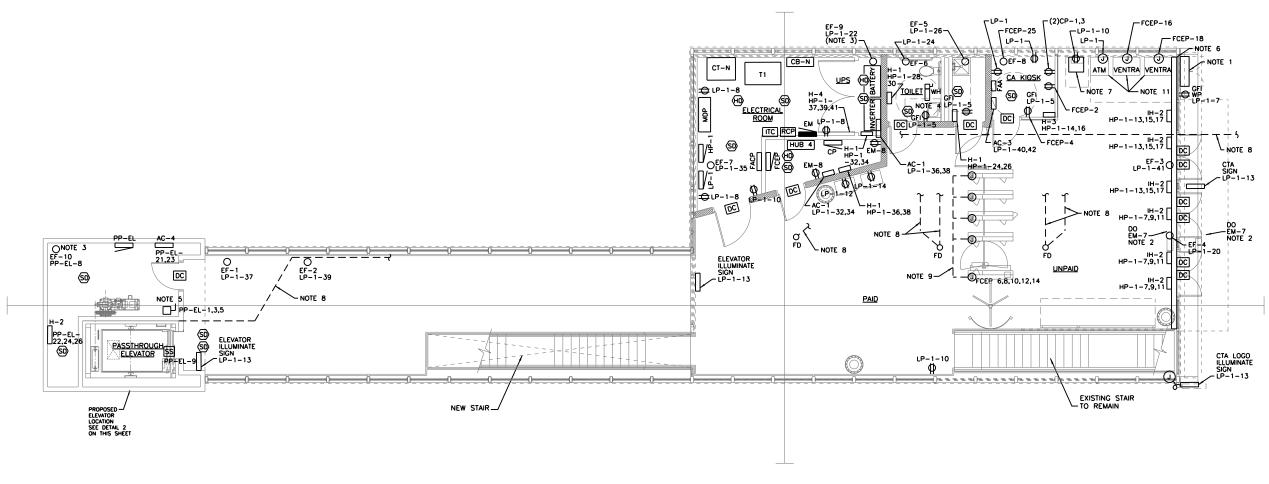

1 ELECTRICAL POWER PLAN
SCALE: 3/16" = 1'-0"

AAA ENGINEERING
WBE/DBE CERTIFIED

5040 West Tority Avenue, Suste 210, Nac., IL 60714

Phone: 647-647-9000 - Fas: 647-647-4710

USt

Tran Systems

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PLOT DATE = 10/28/2013	CHECKED -	REVISED	

STATE OF ILLINOIS
DEPARTMENT OF TRANSPORTATION

PEORIA STREET STATION


ELECTRICAL STATION HOUSE POWER PLAN

SHEET NO. 81 OF 117 SHEETS

 MUN
 SECTION
 COUNTY SHEETS
 TOTAL SHEETS
 NO.

 2090
 2013-011R
 COOK
 356
 272

 CONTRACT NO. 60W29

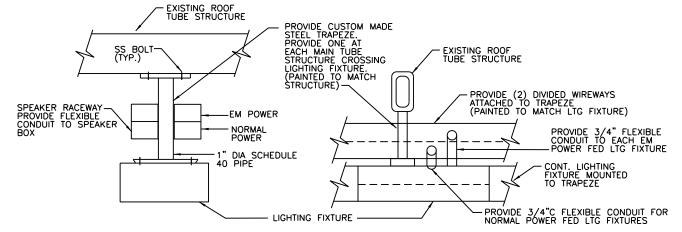

SCALE: NTS

LIGHTING FIXTURE MOUNTING DETAIL


NOTES:

- 1. DASHED LINES REPRESENT SS METAL FILLER BETWEEN LIGHTING FIXTURES. FILLER TO HAVE SAME WIDTH AND HIEGHT AS ADJACENT LIGHT FIXTURE TO FORM A CONTINUOUS ROW OF LIGHTING.
- 2. PROVIDE PERFERATIONS FOR PA SYSTEM SPEAKER AND PRE-DRILL HOLES FOR MOUNTING SPEAKER BOX. COORDINATE WORK WITH SPEAKER MANUFACTURER
- 3. SEE SHEET 278 FOR LIGHT FIXTURE SCHEDULE.
- 4. CONTINUOUS DIVIDED WIREWAY MOUNTED ON EXISTING STRUCTURAL TUBING ABOVE POURWAY.
- 5. ROUTE ALL LIGHTING, SPEAKER, CCTV AND SIGN CONDUIT AND CABLE HOME RUNS CONCEALED ABOVE CEILING. REFER TO ARCHITECTUAL PLANS FOR CEILING LAYOUT.



A EM-5

REPLACE EXISTING FIXTURE

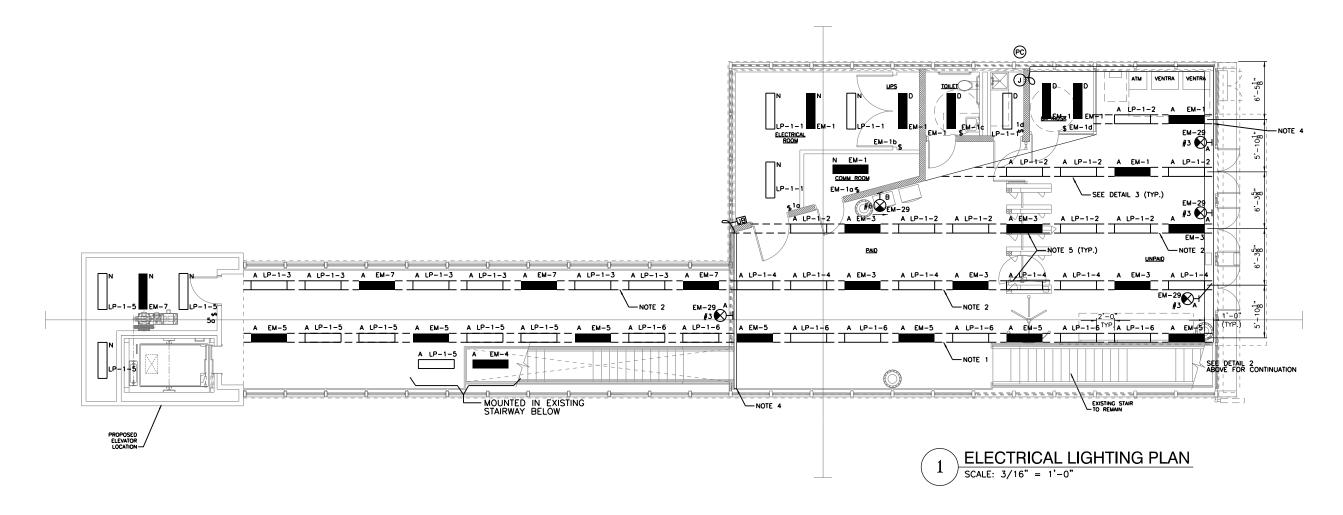

AAA ENGINEERING
WBE/DBE CERTIFIED

5940 Weer Toutry Avenue, State 210, Nike, IL 60714
Phone: 647-647-9000 - Fax: 647-647-4710

US

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STATE OF ILLINOIS
DEPARTMENT OF TRANSPORTATION

PEORIA STREET STATION
ELECTRICAL STATION HOUSE LIGHTING PLAN
SHEET NO. 82 OF 117 SHEETS

PRELIMINARY NOT FOR CONSTRUCTION


MUN SECTION COUNTY TOTAL SHEETS NO.

2090 2013-011R COOK 356 273


CONTRACT NO. 60W29

NOTES:

- 1. DASHED LINES REPRESENT SS METAL FILLER BETWEEN LIGHTING FIXTURES. FILLER TO HAVE SAME WIDTH AND HIEGHT AS ADJACENT LIGHT FIXTURE TO FORM A CONTINUOUS ROW OF LIGHTING.
- 2. PROVIDE PERFERATIONS FOR PA SYSTEM SPEAKER AND PRE-DRILL HOLES FOR MOUNTING SPEAKER BOX. COORDINATE WORK WITH SPEAKER MANUFACTURER.
- 3. SEE SHEET 278 FOR LIGHT FIXTURE SCHEDULE.
- 4. CONTINUOUS DIVIDED WIREWAY MOUNTED ON EXISTING STRUCTURAL TUBING ABOVE POURWAY.
- ROUTE ALL LIGHTING, SPEAKER, CCTV AND SIGN CONDUIT AND CABLE HOME RUNS CONCEALED ABOVE CEILING. REFER TO ARCHITECTUAL PLANS FOR CEILING LAYOUT.

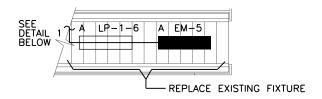



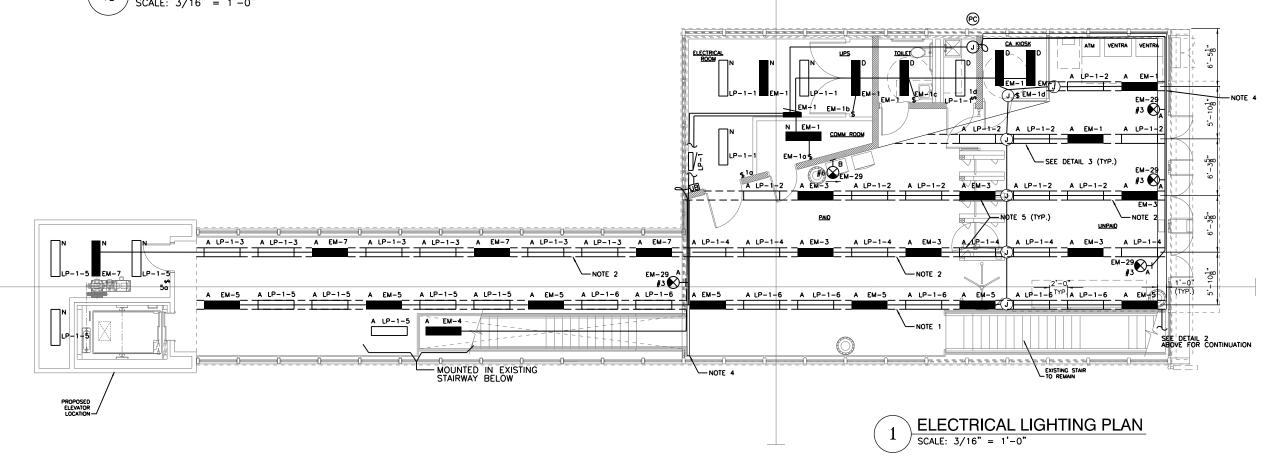




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PLOT DATE = 10/28/2013	CHECKED -	REVISED

STATE OF ILLINOIS
DEPARTMENT OF TRANSPORTATION

	PEORI/	A S	TRE	ET S	TAT	ION	
ELECTRICAL	STATI	ON	НО	USE	EM	ERGENCY	PLAN
	SHEET	NO.	83	OF	117	SHEETS	

PREL	IMINARY NOT FO	R CO.	NSTRUCTIC	W	
MUN	SECTION		COUNTY	TOTAL SHEETS	SHEE NO.
2090	2013-011R		COOK	356	274
			CONTRACT	NO. 6	50W2
	ILLINOIS	FED. A	D PROJECT		

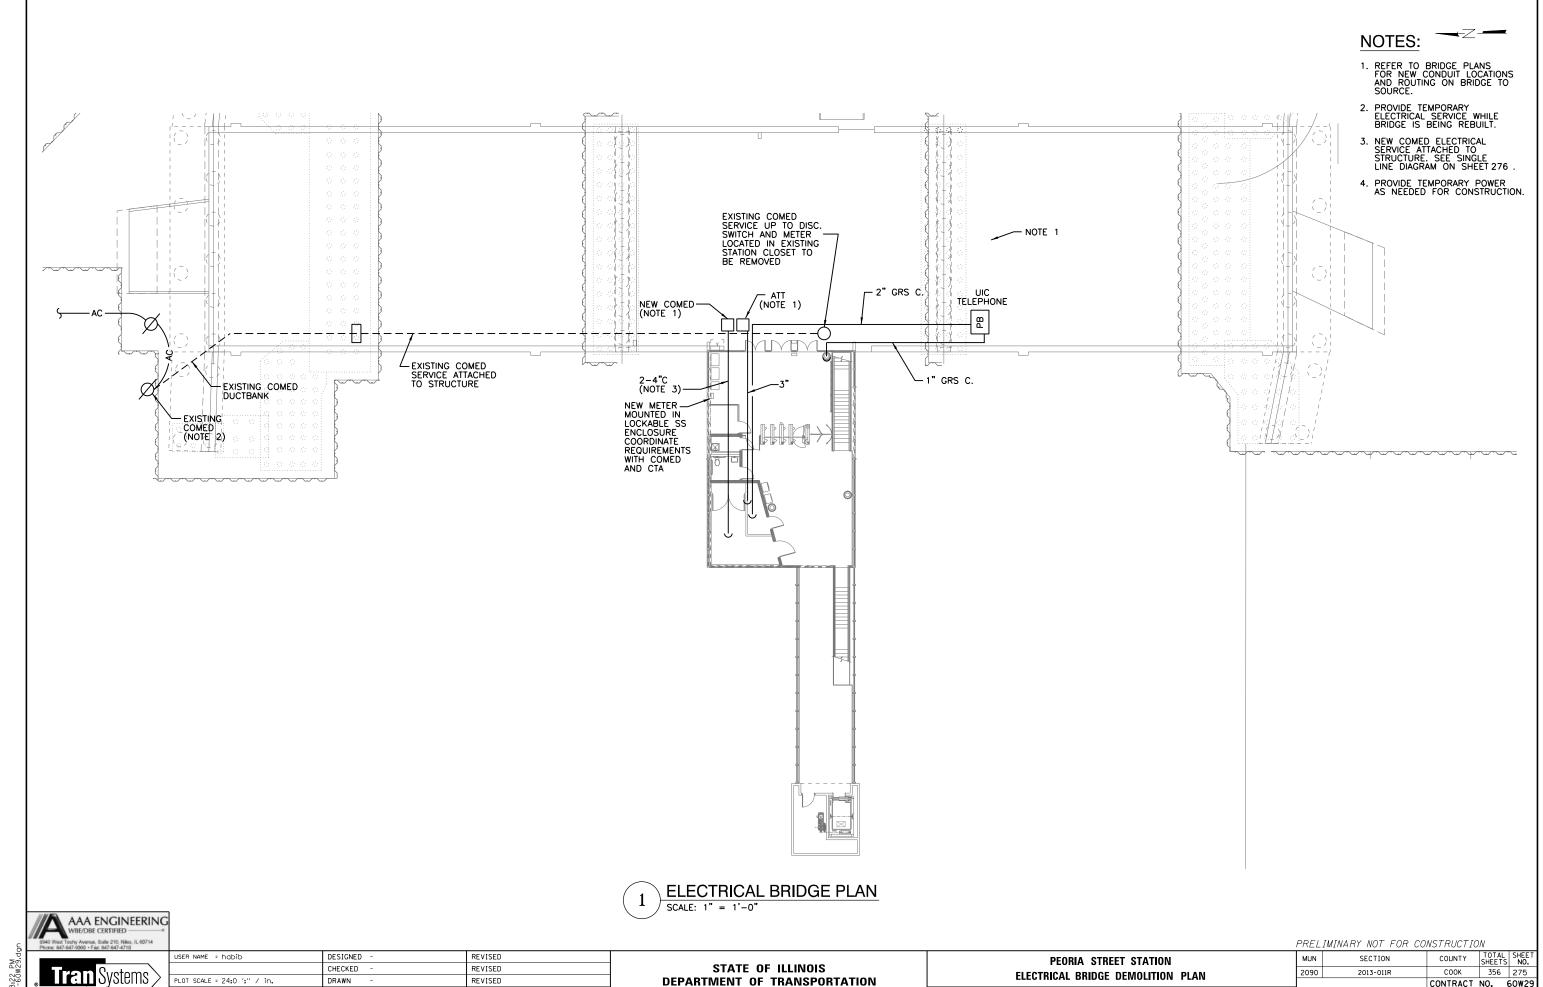

PLOT SCALE = 24:0 ':" / in.

PLOT DATE = 10/28/2013

DRAWN


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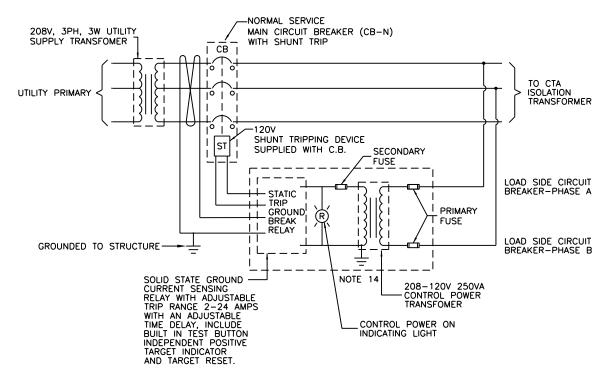
STATE OF ILLINOIS **DEPARTMENT OF TRANSPORTATION** **ELECTRICAL BRIDGE DEMOLITION PLAN** SHEET NO. 84 OF 117 SHEETS

COUNTY TOTAL SHEETS NO. COOK 356 275 2090 2013-011R CONTRACT NO. 60W29




SCALE NTS



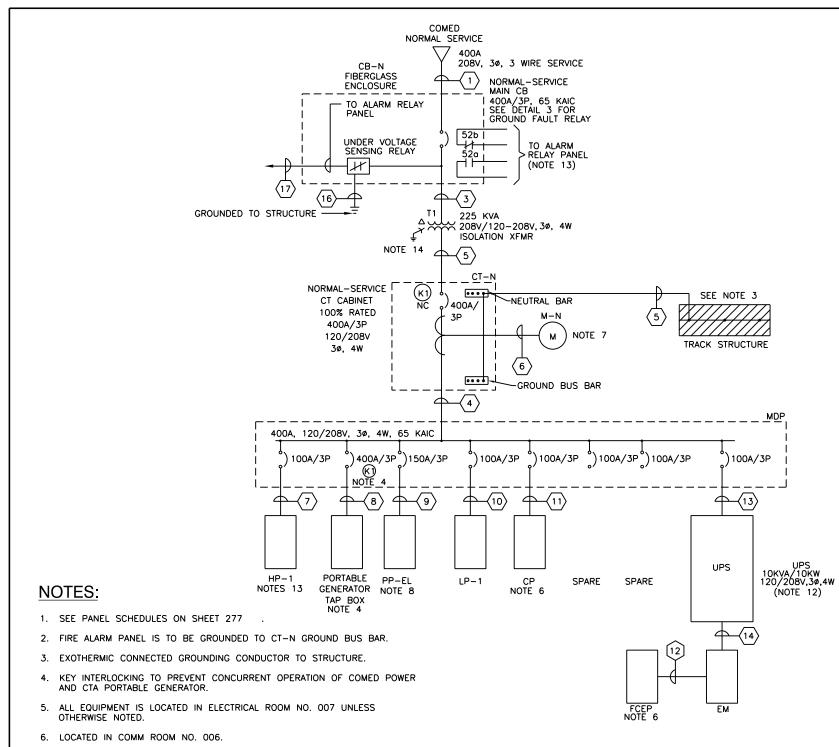

GROUND FAULT RELAY 3 SCALE NTS

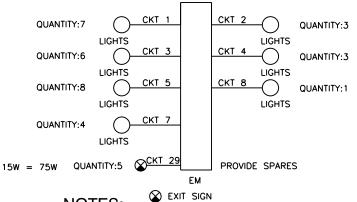

NOTES:

- A. EXIT SIGNS ARE FED USING 2-#10 AWG THHN/THWN COPPER CABLE.
- ONLY WIRE SERVING EMERGENCY LIGHTING MUST BE INSTALLED IN CONDUIT AND JUNCTION BOXES SERVING THE BATTERY UNITS.
- C. WIRE SERVING EXIT SIGNS ARE NOT TO BE IN CONDUIT WITH NORMAL POWER OR LIGHTING.

MUN

2090

- D. CONTRACTOR IS TO INSTALL A 4 HOUR BATTERY BACK UP LIGHT FOR EACH ELEVATOR.
- E. SEE SHEET 277 FOR EM COMPLETE PANEL SCHEDULE

EMERGENCY LIGHTING SINGLE LINE

14. TRANSFORMER GROUND TO BE CONNECTED TO STRUCTURE. AAA ENGINEERING

Tran Systems

LOCATED IN UNPAID AREA.

8. LOCATED IN ELEVATOR MACH ROOM.

PAD WITH A 4" LIP. SEE SPECIFICATIONS.

RATED BREAKERS ARE NOT ALLOWED. 12. LOCATED IN UPS ROOM NO. 007A. 13. CONTINUED ON SHEET 282

9. SEE SHEETS 279 AND 280 FOR CONDUIT/CABLE SCHEDULE.

10. CT-N, MDP, LP-1, HP-1, AND T1 TO BE INSTALLED ON A 4" CONCRETE

11. ALL PANEL BOARDS ARE TO HAVE A MINIMUM RATING OF 65KAIC. SERIES

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STATE OF ILLINOIS **DEPARTMENT OF TRANSPORTATION**

PEORIA STREET STATION **ELECTRICAL SINGLE LINE DIAGRAM** SHEET NO. 85 OF 117 SHEETS

PRELIMINARY NOT FOR CONSTRUCTION SECTION COUNTY СООК 356 276 2013-011R CONTRACT NO.

PANEL:CP VOLTAGE: 120/208V, 3P, 4W										MAIN MOUNTING BUS	100A SURF 100A	ACE	
	BREAK	(ERS		LOAD (VA)					LOAD (VA	.)	BREA	KERS	
CIRCUITUSE	TRIP	POLE	Α	В	С	CK	Τ#	Α	В	O	TRIP	POLE	CIRCUITUSE
RM RECEPT	20	1	360			- 1	2				30	2	SPARE
RM RECEPT	20	1		360		3	4						
AUDIO/VISUAL CONS (KIOSK)	20	1			1200	5	6				30	2	SPARE
MONITOR, CPU (KIOSK)	20	1	1200			7	8						
SPARE	20	1				9	10				20	1	SPARE
SPARE	20	1				11	12				20	1	SPARE
RM LTG	20	1	120			13	14				20	1	SPARE
SPARE	20	1				15	16				20	1	SPARE
SPARE	20	1				17	18				20	1	SPARE
SPARE	20	1				19	20				20	1	SPARE
SPARE	20	1				21	22				20	1	SPARE
SPARE	20	1				23	24				20	1	SPARE
SPARE	20	1				25	26				20	1	SPARE
SPARE	20	1				27	28				20	1	SPARE
SPARE	20	1				29	30				20	1	SPARE
SPARE	20	1				31	32				20	1	SPARE
SPARE	20	1				33	34				20	1	SPARE
SPARE	20	1				35	36				20	1	SPARE
SPARE	20	1				37	38	680			20	1	EF-5, DAMPERS
SPARE	20	1				39	40		2185		35	2	AC-1
SPARE	20	1				41	42			2185			
TOTALS			1680	360	1200	П		680	2185	2185			
PHASE A:	2,340	VA	•	•				•					
PHASE B:	2,545	VA				(1)	LOC	KABLE BRI	AKER				
PHASE C:	3,385	VA				(2)	GFC	I PROTECT	ION ARTIC	LE 680 OF C	EC		
TOTAL CONNECTED VA	8,270	VA				(3)	BRE	AKERS FE	EDING ME	CHANICAL, I	PLUM	BING A	ND MOTORS
AMPS	23	A	CONNECTE	ED.		Ι΄.	TO E	BE OF HAC	R TYPE				
1.25XAMPS	29							I RECEPTA					

/OLTAGE: 120/208V, 3P, 4W										MOUNTING	SURF	ACE	
										BUS	100A		
	FUS	ES	- 1	OAD (VA)					LOAD (VA)	FU	SES	
CIRCUIT USE	TRIP	POLE	A	В	С	CK	Τ#	A	В	С	TRIP	POLE	CIRCUIT USE
(IOSK LIGHTING	20	1	140			- 1	2	210			20	1	ELEC,COMM & UPS ROOM LIGHTING
STATION LIGHTING	20	1		580		3	4		210		20	1	WEST STAIRS LIGHTING
STATION LIGHTING	20	1			490	- 5	6			140		1	EAST STAIRS LIGHTING
DOOR OPERATOR - DO	20	1	200			- 7	8	240			20	1	COMM & UPS ROOM RECEPTACLE
SPARE	20	1				9			750		20		ELEVATOR EQUIPMENT ROOM LIGHTNIG
SPARE	20	1				11	12			900			ELEVATOR SUMP PUMP
SPARE	20	1				13	1.7	400			20	1	ELEVATOR PIT ALARM
JPS ROOM RECEPT	20	1		200		15			560		20	1	ATM
FIRE ALARM PANEL	20	1			1500	17	18				20	1	SPARE
SPARE	20	1				19	20	450			20	1	SPARE
SPARE	20	1				21	22		450		20	1	SPARE
SPARE	20	1				23	24			600	20	1	SPARE
SPARE	20	1				25	26	6890			60	3	PANEL FCEP
SPARE	20	1				27	28		5090				
STATION HOUSE EXIT SIGN	20	1			60	29	30			4290			
TOTAL			340	760	2050			8190	7060	5930			
PHASE A:	8,530	VA											
PHASE B:	7,820	VA				(1)	ALL	BREAKERS	S TO BE O	F LOCKABL	E TYP	E	
PHASE C:	7,980	VA				(2)	CON	NECTEDIT	O LIGHTING	CONTACT	OR. CO	ONTRO	LLED BY PHOTOCELL
TOTAL CONNECTED VA	24,330	VA				(3)	ALL	BREAKERS	S TO COMP	LY WITH O	EC FO	R EM F	PANELS
AMPS	6	3 A	CONNECTE	D									
.25X AMPS	8-	1 A				1							

PANEL: HP-1 VOLTAGE: 120/208V, 3P, 4W										MAIN MOUNTING BUS	100A SURF 100A	ACE	
	BREA	KERS		OAD (VA)			\neg		LOAD (VA	1	BREA	KERS	
CIRCUIT USE	TRIP	POLE	A	B	С	ск	т# 1	A	B	C	_	POLE	CIRCUIT USE
PLATFORM HEATER	40	3	3200			1	2	3200		_	40	3	PLATF OR M HEATER
				3200		3	4		3200				
					3200	5	- 6			3200			
STATION ENTRY HEATERS	40	3	3200			7	8	1600			20	1	HEAT TRACE #1
				3200		9	10		1600		20	1	HEAT TRACE #2
					3200	11	12			1600	20	1	HEAT TRACE #3
STATION ENTRY HEATERS	40	3	3200			13	14	1500			20	2	KIOSK HEATER H-3
				3200		15	16		1500				
					3200	17	18				20	1	SPARE
WATER HEATER WH	50	2	4150			19	20				20	1	SPARE
				4150		21	22				20	1	SPARE
HEAT TRACE #4	20	1			1600	23	24			1,500	20	2	JANITORS CLOSET HEATER H-1
HEAT TRACE #5	20	1	1600			25	26	1500					
HEAT TRACE #8	20	1		1600		27	28		1500		20	2	TOILET ROOM HEATER H-1
HEAT TRACE #7	20	1			1600	29	30			1500			
SPARE	20	1				31	32	1500			20	2	UPS ROOM HEATER H-1
SPARE	20	1				33	34		1500				
SPARE	20	1				35	36			1500	20	2	COMMUNICATION ROOM HEATER H-1
ELECTRICAL ROOM HEATER-4	20	3	1687			37	38	1500					
				1667		39	40						
					1687	41	42						
TOTALS	_		17017	17017	14487			10800	9300	9300			
PHASE A:	27,817												
PHASE B:	26,317	VA				(1)	LOC	KABLE BRE	AKER				
PHASE C:	23,767	VA				(2)	GFC	PROTECTI	ON ARTIC	LE 680 OF C	EC		
TOTAL CONNECTED VA	77,901	VA				(3) BREAKERS FEEDING MECHANICAL, PLUMBING AND MOTORS							
AMPS	216		CONNECTE	:D		TO BE OF HACR TYPE							
1.25X AMPS	270) A				(4)	GFC	RECEPTAG	CLE				

PANEL: LP-1 VOLTAGE: 120/208V, 3P, 4W										MAIN MOUNTING BUS	MLO SURF 100A	ACE	
	BREAL	ŒRS	l	OAD (VA)					LOAD (VA	()	BREA	KERS	
CIRCUITUSE	TRIP	POLE	A	В	O	CK	Τ#	A	В	С	TRIP	POLE	CIRCUIT USE
ELEC, TOILET, JAN CL.R.M. LTG	20	1	350			1	2	630			20	1	STATION LIGHTING
WEST STAIR LIGHTING	20	1		210		3	- 4		630		20	1	STATION LIGHTING
TOILET AND JAN CL. OUTLET	20	1			360	5	6			280	20	1	STATION LIGHTING
OUTDOOR OUTLET	20	1	180			7	8	540			20	1	ELECTRICAL ROOM OUTLETS
OUTDOOR LIGHTING	20	1				9	10		540		20	1	STATION OUTLETS
EAST STAIR LIGHTING	20	1			210	11	12	2		1200	20	1	VENDING
ELEV/CTA SKU	20	1	900			13	14	1200			20	1	VENDING
DAS	20	1		1200		15	16		540		20	1	KIOSK RECEPT
SPARE	20	1				17				050	20	1	KIOSK, EF-0, DAMPERS
SPARE	20	1				19					20	1	STATION EXHAUST FAN EF-4
SPARE	20	1				21		2	4150		20	1	UPS ROOM EXHAUST FAN EF-9
SPARE	20	1				23					20	1	TOILET ROOM EXHAUST FAN EF-8
SPARE	20	1				25					20	1	JANITORS CLOSET EXHAUST FAN EF-5
SPARE	20	1				27	28	3	2810		30	2	CONDENSER CU-1
SPARE	20	1				29	30			2810			
SPARE	20	1				31	32	120			20	2	COMMUNICATION ROOM AC-1
SPARE	20	1				33	34	4	120				
ELEC.RM.EXHAUST FAN EF-7	20	1			900	35	36	3		120	20	2	UPS ROOM AC-2
STATION EXHAUST FAN EF-1	20	1	1200			37							
STATION EXHAUST FAN EF-2	20	1		1200		39			120		20	2	KIOSK AC-2
STATION EXHAUST FAN EF-5	20	1			1200	41	42			120			
TOTALS			2630	2610	2670			6760	8910	5180			
PHASE A:	9,390	VA											
PHASE B:	11,520	VA				(1)	LO	CKABLE	BREAKE	R			
PHASE C:	7,850	VA				(2)	GF	CIPROTE	CTION A	RTICLE 68	30 OF	CEC	
TOTAL CONNECTED VA	28,760	VA				(3)	BR	EAKERS	FEEDIN	G M ECHAN	NICAL	, PLU	IMBING AND MOTORS
AMPS	80	Α	CONNECTE	D			TO	BE OF HA	CR TYP	E			
1.25X AMPS	100	Α				(4)	GF	CIRECEP	TACLE				

PANEL: FCEP VOLTAGE: 120/208V, 3P, 4W										MAIN MOUNTING BUS	100A		
	BREAK	KERS		LOAD (VA)		_			LOAD (VA	()	BREA		
CIRCUITUSE	TRIP	POLE	Α	В	С	CK	T#	A	В	С	TRIP	POLE	CIRCUIT USE
RCP	15	1	250			1	2	360			20	1	KIOSK RECEPT
SPARE	20	1				3			360		20	1	KIOSK RECEPT
SPARE	20	1				5	6			500	20	1	TUNSYSTLE END CABINET
SPARE	20	1				7	8	500			20	1	TURNSTYLE END CABINET
SPARE	20	1				9	10		500		20	1	TURNSTYLE END CABINET
SPARE	20	1				11	12			500	20	1	TURNSTYLE END CABINET
SPARE	20	1				13	14	500			20	1	TURNSTYLE END CABINET
SPARE	20	1				15	16		1200		20	1	VENTRA
SPARE	20	1				17	18			1200	20	1	VENTRA
SPARE	20	1				19	20				20	1	SPARE
SPARE	20	1				21	22				20	1	SPARE
SPARE	20	1				23	24				20	1	SPARE
SPARE	20	1				25	26	100			20	1	KIOSK EXHAUST FAN E-8
SPARE	20	1				27	28				20	1	SPARE
SPARE	20	1				29	30				20	1	SPARE
SPARE	20	1				31	32				20	1	SPARE
SPARE	20	1				33	34				20	1	SPARE
SPARE	20	1				35	36				20	1	SPARE
SPARE	20	1				37	38				20	1	SPARE
SIC/PIU/CA- KIOSK	20	1		500		39	40				20	1	SPARE
						41	42				20	1	SPARE
TOTALS			250	500	0			1460	2060	2200			
PHASE A:	1,710	VA											
PHASE B:	2,560	VA				(1)	LO	KABLE BRE	AKER				
PHASE C:	2,200	VA				(2)	GF	CIPROTECTI	ON ARTIC	LE 680 OF 0	CEC		
TOTAL CONNECTED VA	6,470	VA				(3)	BRE	AKERS FEE	EDING ME	CHANICAL,	PLU ME	BING A	ND MOTORS
AMPS	18	А	CONNECT	ED]	то	BE OF HACE	TYPE				
1.25X AMPS	22	Α				(4)	GF	CIRECEPTA	CLE				

PANEL: PP-EL VOLTAGE: 120/208V, 3P, 4W										MAIN MOUNTING BUS	150A SURF 150A	ACE		
	BREAK	ŒRS		LOAD (VA)					LOAD (VA))	BREA	KERS		
CIRCUITUSE	TRIP	POLE	A	В	С	CK	Τ#	Α	В	С	TRIP	POLE	CIRCUIT USE	
ELEVATOR	90	3	5000			1	2	550			20	1	ELEVATOR RM LIGHTING & EX. FAN	
				5000		3	4		180		20	1	ELEVATOR RM RECEPT	
					5000	5	6			250	20		PIT LTG AND RECEPT	
SPARE	20	1				7	8	250			20	1	ELEVATOR ROOF LTG AND EF-10	
SILLHEATERS	20	1		1200		9					20	1	SPARE	
SPARE	20	1				11	12				20	1	SPARE	
ELEV. RM LOUVERS	20	1	800			13	14	1666			20	3	ELEV. PIT HTR H-2	
SPARE	20	1				15	16		1668					
ELEV. EQUIP. RM HTR H-3	20	2			1500	17	18			1667				
			1500			19		360			20	1	ELEV. EQUIP. ROOM RECEPTACLE	
ELEV. EQUIP. RM AC-4	20	2		120		21	22		1,666		20	3	ELEV.ROOF LEVEL HEATER H-3	
					120					1,686	20			
SPARE	20	1				25	26	1667			20			
SPARE	20	1				27					20	1	SPARE	
SPARE	20	1				29	30				20	1	SPARE	
TOTALS			7300	6320	6620			4493	3512	3583				
PHASE A:	11,793	VA												
PHASE B:	9,832	VA				(1)	LOC	KABLE BRE	AKER					
PHASE C:	10,203	VA				(2)	GFC	PROTECTI	ON ARTICI	LE 680 OF 0	EC			
TOTAL CONNECTED VA	31,828	VA				(3) BREAKERS FEEDING MECHANICAL, PLUMBING AND MOTORS								
AMPS	88	А	CONNECT	ED				E OF HACE						
1.25X AMPS	111	Α				(4)	GEC	RECEPTA	CLE					

AAA ENGINEERING
WBe/DBE CERTIFIED

5940 Weet Toutry Avenue, Buth 210, Nies, II. 60714
Phone: 647-647-9000 - Fax: 647-647-4710

USER NAME = habib	DESIGNED -	REVISED
	CHECKED -	REVISED
PLOT SCALE = 0:2 ':in / in.	DRAWN -	REVISED
PLOT DATE = 10/28/2013	CHECKED -	REVISED

STATE OF ILLINOIS DEPARTMENT OF TRANSPORTATION

PEORIA STREET STATION **ELECTRICAL PANEL SCHEDULES** PRELIMINARY NOT FOR CONSTRUCTION | CONTRACT | NO. | COW29 | ILLINOIS | FED. AID | PROJECT | CONTRACT | COW29 | CONTRACT | SECTION 2090 2013-011R

LIGHTING FIXTURE SCHEDULE

TYPE	SYMBOL	DESCRIPTION	MANUFACTURER & CATALOG NUMBER	NUMBER OF LAMPS	LAMP TYPE & WATTAGE	VOLTAGE	MOUNTING	MOUNTING HEIGHT	NOTES
Α		18 GAUGE # 304 STAINLESS STEEL, ONE PIECE CONSTRUCTION WITH CORNER SEAM WELDED AND GROUND SMOOTH, NO.4 FINISH	KENALL: CTA-99-308-FUSE LED (50L40K) TYPE B-LED OR APPROVED EQUAL	(4) 12-LED BOARDS, 5000K 70-CRI	LED 70W	120 V	SURFACE	SEE ARCH. DWGS	1
В	0	18 GAUGE TYPE 304 STAINLESS STEEL BRUSHED(STD), .050" ALUMINUM, SEAM WELDED CONSTRUCTION. EXTERNAL EXTRUDED ALUMINUM HEAT SINK.	KENALL: TDL6VL230L40KDV5BRGFS OR APPROVED EQUAL	LED ARRAY	LED 30W	120 V	RECESSED	SEE ARCH. DWGS	1
С		18 GAUGE TYPE 304, NO.4 FINISH DIE FORMED, SEAM WELDED AND GROUND SMOOTH.	KENALL: CTA TYPE C-LED, CTA-99-301-FUSED 50L40K-LED OR APPROVED EQUAL	(4) 12-LED BOARDS, 5000K 70-CRI	LED 70W	120 V	SURFACE CORNER MT.	SEE ARCH. DWGS	1
D		ONE PIECE SEAM WELDED 16-GAUGE TYPE 304 STAINLESS STEEL CONSTRUCTION	KENALL: TES848250L40KDV5HCP OR APPROVED EQUAL	LED ARRAY	LED 70W	120 V	SURFACE/ PENDANT	SEE ARCH. DWGS	1
D1	0	ONE PIECE 20-GAUGE #304 STAINLESS STEEL BASE WITH WELDED ENDS AND SPOTWELDED STAINLESS STEEL PIANO HINGE, FINISH IS A # 4 BRUSH. LENS IS POSITIONED IN HOUSING CHANNELS AND RETAINED WITH STAINLESS STEEL FASTENERS	KENALL: CDOT-99-366-LED 50L40K TYPE CX-LED OR APPROVED EQUAL	(4) 12-LED BOARDS, 5000K 70-CRI	LED 70W	120 V	SURFACE CORNER MT.	SEE ARCH. DWGS	1
E		18 GAUGE # 304 STAINLESS STEEL, DIE FORMED AND SEAM WELDED	KENALL: CTA TYPE E, CAT # CTA-99-300 FUSE OR APPROVED EQUAL	LED ARRAY	LED 70W	120 V	SURFACE	SEE ARCH. DWGS	1
F	α	ONE-PIECE SEAM WELDED .063" 3003 ALUMINUM ALLOY CONSTRUCTION .156" PRISMATIC C73 TEMPERED GLASS LENS.	KENALL: DLD1220-108L50K-DCC-DV-FS OR APPROVED EQUAL	LED ARRAY	LED 108W	120 V	SURFACE	SEE ARCH. DWGS	1
Н	9	CAST ALUMINUM HOUSING WITH CORROSION RESISTANT PAINT IN AN INDUSTRIAL GREY FINISH, VAPOR TIGHT.	LITHONIA: OLVTWM OR APPROVED EQUAL	LED ARRAY	LED 70W	120 V	WALL	SEE ARCH. DWGS	1
М		LED WALL MOUNT LIGHT WITH PHOTOCELL CONTROL, WIREGUARD, FUSE, DIE CAST ALUMINUM HOUSING, POLYCARBONATE LENS.	LITHONIA: TWP-LED-30C-50K-T3M-120-PE-SF-WG OR APPROVED EQUAL	LED ARRAY	LED 67W	120 V	SURFACE	SEE ARCH. DWGS	1
N		INDUSTRIAL STRIP LIGHT FIXTURE WITH WIRE GUARD	LITHONIA: EJSA-2-32-120-GEB10IS-WGL OR APPROVED EQUAL	2	F32T8/TL741 32W	120 V	SURFACE/ PENDANT	SEE ARCH. DWGS	1,2

JE COLJEDIJI E

NOTES: 1. SEE SPECIFICATIONS FOR ADDITIONAL REQUIREMENTS.

2.	INPUT WATTAGE OF FIXTUR
	IS 59W, FURNISH -20°F
	BALLAST WITH FIXTURE.

EMERGENCY/EXIT SYMBOL LIST

	EMERICENOT/EXIT OTMBOE EIGT									
TYPE	SYMBOL	DESCRIPTION	MANUFACTURER & CATALOG NUMBER	NUMBER OF LAMPS	LAMP TYPE & WATTAGE	VOLTAGE	MOUNTING	MOUNTING HEIGHT	NOTES	
А	&	EXIT SIGN, ELECTRIC, 120 VOLT, LED LIGHT SOURCE, GLASS PANEL, CHICAGO CODE APPROVED, EMERGENCY BACK-UP POWER	BIG BEAM: ECXLN2RWW-SS-TP-HTR12?-TM OR APPROVED EQUAL	LED ARRAY	LED 3.7W	120	CEILING/ WALL/ PENDANT	SEE ARCH. DWGS	1	
В	<u>S</u>	EXIT SIGN, ELECTRIC, 120 VOLT, LED LIGHT SOURCE, RIGHT ARROW, GLASS PANEL, CHICAGO CODE APPROVED, EMERGENCY BACK-UP POWER	BIG BEAM: ECXLN2RWW-SS-TP-HTR12?-TM-AR OR APPROVED EQUAL	LED ARRAY	LED 3.7W	120	CEILING/ WALL/ PENDANT	SEE ARCH. DWGS	1	
С	(EXIT SIGN, ELECTRIC, 120 VOLT, LED LIGHT SOURCE, LEFT ARROW, GLASS PANEL, CHICAGO CODE APPROVED, EMERGENCY BACK-UP POWER	BIG BEAM: ECXLN2RWW-SS-TP-HTR12?-TM-AL OR APPROVED EQUAL	LED ARRAY	LED 3.7W	120	CEILING/ WALL/ PENDANT	SEE ARCH. DWGS	1	
D	•	EXIT SIGN, ELECTRIC, 120 VOLT, LED LIGHT SOURCE, DOUBLE-FACE ARROW, GLASS PANEL. CHICAGO CODE APPROVED, EMERGENCY BACK-UP POWER	BIG BEAM: ECXLN2RWW-SS-TP-HTR12?-TM-ARAL/ARAR OR APPROVED EQUAL	LED ARRAY	LED 3.7W	120	CEILING/ WALL/ PENDANT	SEE ARCH. DWGS	1	

AAA ENGINEERING
W8E/DBE CERTIFIED

SIMO West Toutry Avenue, Suite 210, Nikes, IL 60714
Phone: 647-647-0900 - Faic 647-647-4710

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STATE OF ILLINOIS DEPARTMENT OF TRANSPORTATION

PEORIA STREET STATION							
ELECTRICAL LIGHTI	NG FIXTURE	SCHEDULES					
SHEET NO.87	OF 117 SI	HEETS					

REL	ELIMINARY NOT FOR CONSTRUCTION									
IUN	SECTION	COUNTY	TOTAL SHEETS	SHEET NO.						
090	2013-011R	COOK	356	278						
		CONTRACT	NO. (60W29						
	ILLINOIS FED. AID PROJECT									

LEGEND	CABLE DESCRIPTION	CONDUIT SIZE	FROM	то	REMARKS
1	3-500 KCMIL	(INCHES) 3-1/2	COMED	CB-N	NOTE 1
2	3-500 KCMIL	3-1/2	CB-N	T1	NOTE 1
3	4-600 KCMIL, 1-#3/0 AWG (G)	4	TI	CT-N	
4	4-600 KCMIL, 1-#3/0 AWG (G)	4	CT-N	MDP	
5	1-#3/0 AWG	1	CT-N	TRACK	NOTE 2
6	13-#10 AWG	1	CT-N	M-N	
7	4-#2 AWG, 1-#4 AWG (G)	1-1/2	MDP	HP-1	
	4-350 KCMIL, 1-#1/0 AWG (G)	3-1/2		GEN.	
8	4-350 KCMIL, 1-#1/0 AWG (G)	3-1/2	MDP	TAP BOX	
9	4-#3/0 AWG, 1-#4 AWG (G)	2	MDP	PP-EL	
(10)	4-#2 AWG, 1-#4 AWG (G)	1-1/2	MDP	LP-1	
(11)	4-#2 AWG, 1-#4 AWG (G)	1-1/2	MDP	СР	
(12)	4-#2 AWG, 1-#4 AWG (G)	1-1/2	ЕМ	FCEP	
(13)	4-#4 AWG, 1-#8 AWG (G)	1-1/2	MDP	BATTERY INVERTER	
(14)	4-#4 AWG, 1-#8 AWG (G)	1-1/2	BATTERY INVERTER	ЕМ	
(15)	3-#8 AWG, 1-#10 AWG (G)	1	HP-1	INFRARED HEATERS	
	2-#10 AWG (CONTROL)			TILATERS	
(16)	1-#10 AWG	3/4	RELAY	TRACK	
17>	2-#12 AWG, 1-#12 AWG	3/4	RELAY	TO RCP	
18	NOT USED				
19	NOT USED				
20>	NOT USED				
21>	NOT USED				
22	NOT USED				
23>	NOT USED				
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	CABLE / CONI	DUIT SCHE	EDULE			NOTES:
LEGEND	CABLE DESCRIPTION	CONDUIT SIZE (INCHES)	FROM	то	REMARKS	FRE CONDUIT. GROUND, EXOTI CONNECTION TO STRUCTURE.
24>	NOT USED					3. CONTROL.
25>	NOT USED					
26>	NOT USED					
27>	NOT USED					
28>	NOT USED					
29>	NOT USED					
30>	NOT USED					
31	SPARE	1	ELEC RM	COMM RM		
32	SPARE	1	ELEC RM	COMM RM		
33>	8-#8 AWG, 1-#10 AWG (G)	1	LP-2	SOUTH PLATFORM CONDUIT TRAY	CKTS 2,4,6,8,10,12	
34	8-#8 AWG, 1-#10 AWG (G)	1	LP-2	SOUTH PLATFORM /GROUND LIGHTING	CKTS 14,16,18,20,22,24	
35	6-#8 AWG, 1-#10 AWG (G)	1	RS	SOUTH PLATFORM LIGHTING/ SIGNAGE	CKTS 32,34,36,38,40	
(36)	8-#8 AWG, 1-#10 AWG (G)	1	ЕМ	SOUTH PLATFORM LIGHTING/ SIGNAGE	CKTS 20,22,24,26,28,30	
37	2-#8 AWG, 1-#10 AWG (G)	3/4	LP-1	SOUTH PLATFORM RECEPT.	СКТ 38	
38	3-#8 AWG, 2-#12, 1-10 AWG (G)	1	IR-CP	SOUTH IR-HTRS PLATFORM	CKTS 2,4,6	
39>	5-#8 AWG, 1-10 AWG (G)	1	HP-1	SOUTH IR-HTRS GROUND	CKTS 8,10,12,14,16	
40>	4-#8 AWG, 1-10 AWG (G)	1	HP-1	SOUTH KIOSK HEATERS	CKTS 18,20,22,24	
41>	4-#8 AWG, 1-10 AWG (G)	1	HP-1	SOUTH JAN. CLO. HEATER BATHRM	CKTS 26,28,30,32	
42>	8-#10 AWG, 1-10 AWG (G)	3/4	LP-1	SOUTH STATION	CKTS 2,4,6,8,10,12	
43>	7-#10 AWG, 1-10 AWG (G)	1	RS	SOUTH STATION LIGHTING	CKTS 2,4,6,8,10	
44>	6-#10 AWG, 1-10 AWG (G)	3/4	ЕМ	SOUTH STATION	CKTS 4,6,8,10	
\(\frac{1}{2} \)	4-#10 AWG, 1-#10 AWG (G)	1	10.4	SOUTH	CVTS 14 16 19 20 22	
45	2-#6 AWG, 1-#8 AWG (G)	1	- LP−1	SOUTH STATION	CKTS 14,16,18,20,22	
46>	2-#10 AWG, 1-#10 AWG (G)	3/4	HT-CP	SOUTH HEAT TRACING STATION	CKT 3	





REL	IMINARY NOI FOR	COL	VS / RUC / 10	/V	
MUN	SECTION		COUNTY	TOTAL SHEETS	SHEE NO.
2090	2013-011R		COOK	356	279
			CONTRACT	NO.	
	ILLINOIS F	ED. AI	D PROJECT		

GROUND, EXOTHERMIC CONNECTION TO STRUCTURE.


CABLE / CONDUIT SCHEDULE								
LEGEND	CABLE DESCRIPTION	CONDUIT SIZE (INCHES)	FROM	то	REMARKS			
47	2-#14 AWG, 1-#10 AWG (G)	3/4	FACP	SOUTH MEZZANINE ELEVATOR ROOM				
48>	8-#12 AWG, 1-10 AWG (G)	3/4	KIOSK	IR-CP	NOTE 3			
49	70-#14 AWG, 1-#12 AWG (G)	2	ELEC RM	сомм км				
(50)	SPARE	1	ELEC RM	сомм км				
(51)	SPARE	1	ELEC RM	сомм км				
(52)	SPARE	1	ELEC RM	сомм км				
(53)	24-#14 AWG, 1-#12 AWG (G)	1	SOUTH MEZZANINE	RELAY PANEL/ ITC CABINET				
(54)	4-#10 AWG, 1-#10 AWG (G)	3/4	FCP		CKTS 1,3,5			
(55)	6-#10 AWG, 1-#10 AWG (G)	3/4	FCP	ELEC RM	CKTS 7,9,11,13			
(56)	2-#10 AWG, 1-#10 AWG (G)	3/4	LP-1	LED FIXTURES (SIGN)				
(57)	4-#10 AWG, 1-#10 AWG (G)	1	HP-1	SOUTH KIOSK AC	CKTS 8,10,34,36			
(58)	2-#8 AWG, 1-#10 AWG (G)	3/4	RS	PLATFORM LIGHT POLE	CKT 12			
(59)	2-#10 AWG, 1-#10 AWG (G)	3/4	ELEVATOR PIT	PP-EL CKT 6				
60>	TBD	TBD	TBD	TBD				
61	TBD	TBD	TBD	TBD				
62	TBD	TBD	TBD	TBD				
63	TBD	TBD	TBD	TBD				
64	TBD	TBD	TBD	TBD				
65	TBD	TBD	TBD	TBD				
66	TBD	TBD	TBD	TBD				
67	TBD	TBD	TBD	TBD				
68	TBD	TBD	TBD	TBD				
69	TBD	TBD	TBD	TBD				
70	TBD	TBD	TBD	TBD				

	CABLE / CONI	DUIT SCHE	DULE			NOTES:
LEGEND	CABLE DESCRIPTION	CONDUIT SIZE (INCHES)	FROM	то	REMARKS	1. FRE CONDUIT. 2. GROUND, EXOT CONNECTION TO STRUCTURE.
71	TBD	TBD	TBD	TBD		3. CONTROL.
72	TBD	TBD	TBD	TBD]
73	TBD	TBD	TBD	TBD]
74	тво	TBD	TBD	TBD		
75	TBD	TBD	TBD	TBD]
76	TBD	TBD	TBD	TBD		1
77	TBD	TBD	TBD	TBD		1
78	TBD	TBD	TBD	TBD		1
79	TBD	TBD	TBD	TBD		1
80	TBD	TBD	TBD	TBD		
(81)	TBD	TBD	TBD	TBD		1
82	TBD	TBD	TBD	TBD		1
(83)	TBD	TBD	TBD	TBD		1
84	TBD	TBD	TBD	TBD]
85	TBD	TBD	TBD	TBD]
86	TBD	TBD	TBD	TBD		
87	TBD	TBD	TBD	TBD		
(88)	TBD	TBD	TBD	TBD]
(89)	2-#8 AWG, 1-#10 AWG (G)	3/4	нт-ср	HEAT TRACE CKT 1		1
90>	2-#8 AWG, 1-#10 AWG (G)	3/4	нт-ср	HEAT TRACE CKT 2		1
91	2-#8 AWG, 1-#10 AWG (G)	3/4	нт-ср	HEAT TRACE CKT 3		1
92	2-#8 AWG, 1-#10 AWG (G)	3/4	нт-ср	HEAT TRACE CKT 4		1
93	2-#8 AWG, 1-#10 AWG (G)	3/4	HT-CP	HEAT TRACE CKT 5		1
94	2-#8 AWG, 1-#10 AWG (G)	3/4	HT-CP	HEAT TRACE CKT 6		1





GROUND, EXOTHERMIC CONNECTION TO STRUCTURE.

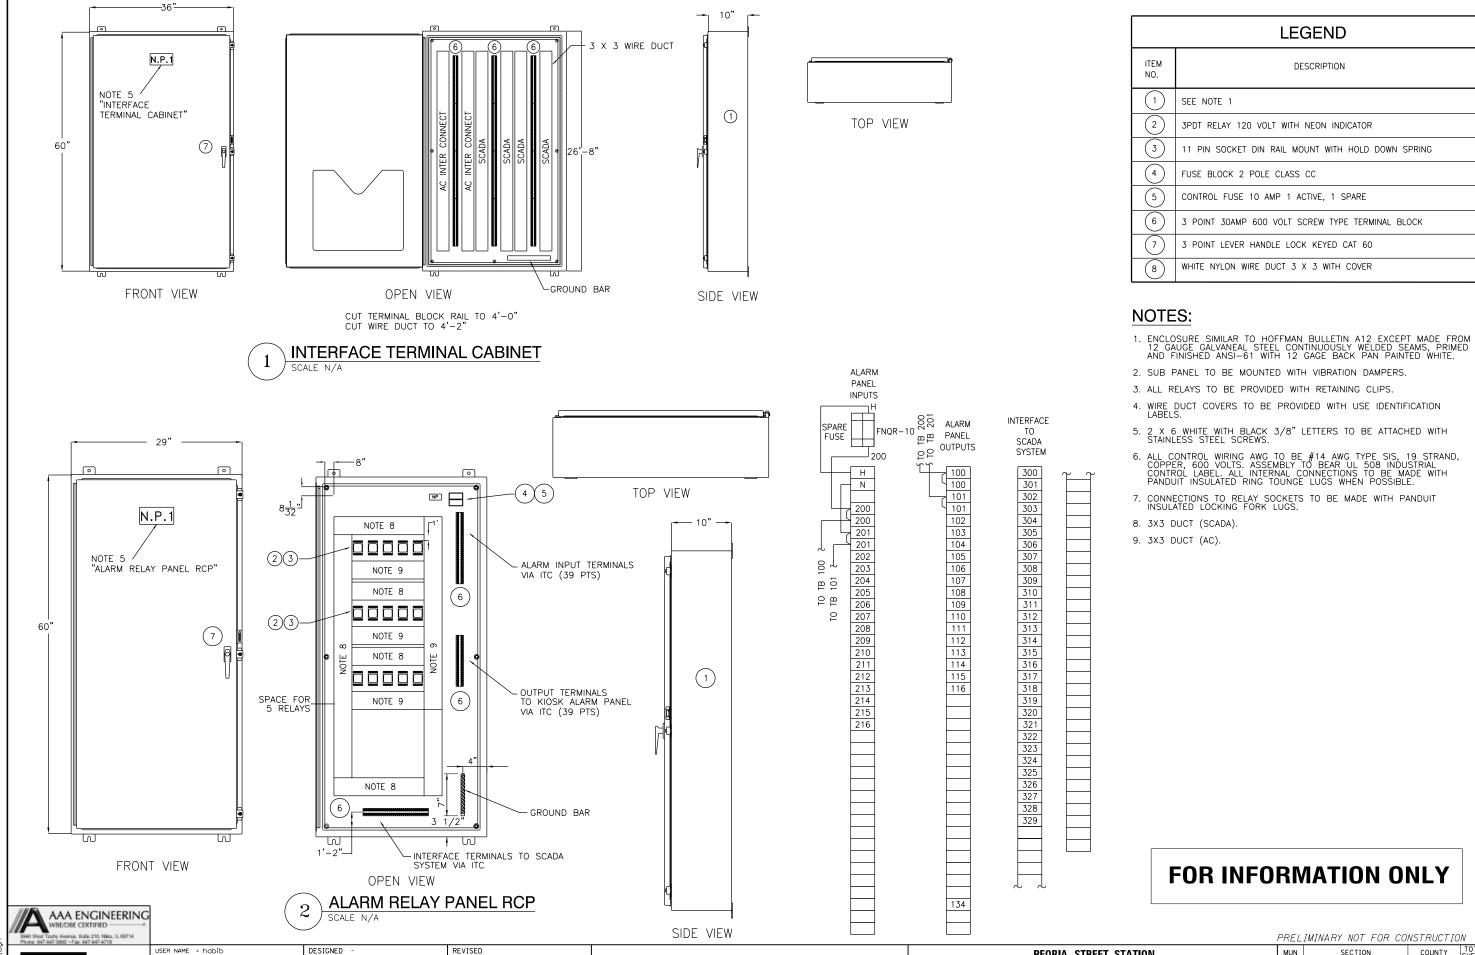

STATE OF ILLINOIS

DEPARTMENT OF TRANSPORTATION

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PLOT DATE = 10/28/2013

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PRELIMINARY NOT FOR CONSTRUCTION

COUNTY TOTAL SHEE NO.
COOK 356 281 SECTION COUNTY ELECTRICAL INTERFACE TERMINAL CABINET & ALARM RELAY PANEL RCP 2090 2013-011R CONTRACT NO. 60W29

SHEET NO.90 OF 117 SHEETS

PEORIA STREET STATION

INTERFACE TERMINAL CABINET (ITC)

"TROUBLE"


FAP 400 401

FAP 402 403

SEE NOTE 2

1 0 410 1 0 411 1 0 412 1 0 413

SEE NOTE 2

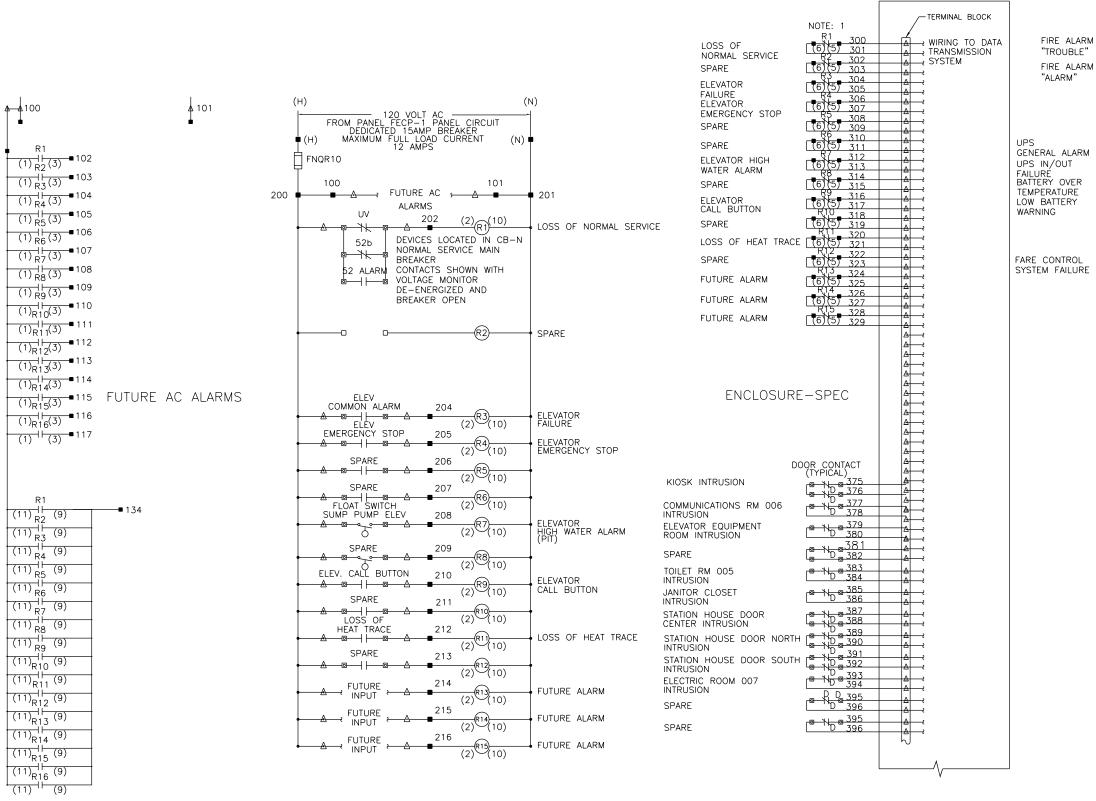

- TERMINAL IN INTERFACE TERMINAL COMPARTMENT

TERMINAL OR DEVICE IN ALARM RELAY CONTROL PANEL

→ WIRING TO DATA

A → TRANSMISSION A → SYSTEM

O - TERMINAL AT RESPECTIVE REMOTE DEVICE

D - DOOR SWITCH CONTACT (INTRUSION ALARM)

CONTROL PANEL TO HAVE

U/L 508 INDUSTRIAL CONTROL LABEL

NOTES:

- MAXIMUM CONTACT RATING 120 VOLT AC, 10 FULL LOAD AMPS
 MAKE: 1200 VA
 BREAK: 360 VA
 CIRCUIT BREAKER OR FUSED DISCONNECT AS
 REQUIRED BY NEC.

 CONFIRM THAT FIRE ALARM AND UPS CONTACTS
 ARE NORMALLY CLOSED AND OPEN ON ALARM OR
 FAULT.

- ARE NORMALLY CLOSED AND OPEN ON ALARM OR FAULT.

 ITC CABINET AND RELAY PANEL ARE LOCATED IN ELECTRICAL ROOM.

 CONNECT ALL RELAY NC & NO CONTACTS TO ITC PANEL.
- PANEL.
 WIRING FROM TERMINALS IN ITC CABINET TO
 TERMINALS IN RCP PANEL AND FIELD WIRING FROM
 REMOTE DEVICES TO ITC CABINET OR RCP PANEL TO
 BE #14 AWG IN 3/4" CONDUIT.

RELAY CONTROL PANEL WIRING DIAGRAM SCALE N/A

ITC ALARM CONTACT WIRING DIAGRAM SCALE N/A




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STATE OF ILLINOIS **DEPARTMENT OF TRANSPORTATION**

PEORIA STREET STATION CONTROL DIAGRAMS ITC AND RCP PANELS SHEET NO.91 OF 117 SHEETS

PRELIMINARY NOT FOR CONSTRUCTION SECTION MUN COUNTY COOK 356 282 2090 2013-011R CONTRACT NO. 60W29

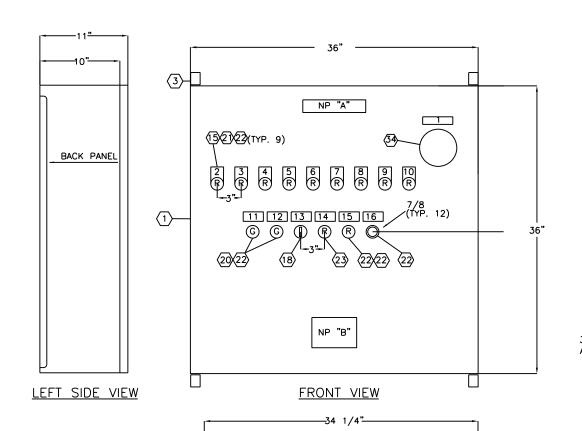

3 X 3 DUCT

(FIELD)

DUCT

۲ ×

NP"C"

DUCT

×

3 X 3 DUCT

BACK PANEL

(6)(10)(11)

6/9/11>

6 7 8 9 1 1 1 2

(TYP. 5) (24)(27)-

(TYP. 3) (25)(28)

(TYP. 6) (24)(27)-

(16)(17)

NAMEPLATE (NP) "A"

1 1/4"X 7" WHITE LAMINATED PHENOLIC WITH BLACK CORE LETTERS. ATTACHED WITH STAINLESS STEEL SCREWS. 1/4" LETTER SIZE N.T.S.

NAMEPLATE (NP) "B"

4\(5\)

- PANELBOARD LUGS

- SEE POWER WIRING DIAGRAM FOR CIRCUIT BREAKER TYPE AND SIZE

34 1/4"

MCB

DUCT

CB2 CB4 CB6

MATERIAL:
3 1/2"X 4" WHITE LAMINATED PHENOLIC WITH BLACK CORE LETTERS.
ATTACHED WITH STAINLESS STEEL SCREWS. 1/8" AND 1/4" LETTER SIZE N.T.S.

USE 75°C MINIMUM COPPER CONDUCTORS FOR FIELD WIRE

1"X 2" WHITE LAMINATED PHENOLIC WITH BLACK CORE LETTERS. ATTACHED WITH STAINLESS STEEL SCREWS. 3/16" LETTER SIZE N.T.S.

NAMEPLATE (NP) "C"

TERMINAL TAGGING SCHEDULE						
NP	FIRST LINE	SECOND LINE	THIRD LINE			
1	TB1	FUSE FU1 5 AMP	CONTROL POWER			
2	TB2	AMBIENT THERMOSTAT	INPUT			
3	TB3	ALARM	OUTPUT			
4	TB4	LOAD POWER				

\bigcirc	LEGEND
ITEM	DESCRIPTION
1	36" HIGH X 36" WIDE X 10" DEEP, NEMA 12, CARBON STEEL ENCLOSURE
2	34 1/4" HIGH X 34 1/4" WIDE BACK PANEL
3	MOUNTING FOOT KIT
4	3 POLE, 100 AMP RESISTIVE, 120 VOLT COIL, 600 VOLT, IEC CONTACTOR
(5)	1-NO AND NC AUXILIARY CONTACT BLOCK
6	TYPE SCHT5, LABEL HOLDER AND CLEAR COVER
7	TYPE WSI 6/2 LED, 600 VAC, 16 AMP, FUSE TERMINAL BLOCK
8	TYPE WAP 2/5-10, FUSE END SECTION
9	TYPE WDU4, 600 VAC, 35 AMP, #22 - #10 AWG, WEMID, TERMINAL
10	TYPE WDU10, 600 VAC, 65 AMP, # 18 - #6 AWG, WEMID, TERMINAL BLOCK
(1)	TYPE WEW 35/2, WEMID END SECTION/ END BRACKET
(12)	5 AMP, 250 VOLT, 1/4" X 1 1/4" FUSE
(13)	2" WIDE X 3" HIGH WHITE WIRE DUCT WITH COVER
14	3" WIDE X 3" HIGH WHITE WIRE DUCT WITH COVER
(15)	GRAVOPLY LEGEND PLATE
(16)	RELAY SOCKET MOUNTING RAIL
17	END CLAMP
18	3 POSITION, MAINTAINED, FINGER-SAFE SELECTOR SWITCH
(19)	1 NO., BLACK, MOMENTARY, FINGER-SAFE PUSH BUTTON
20	120 VOLT AC, GREEN LED, PILOT LIGHT
21	120 VOLT AC, RED LED, PILOT LIGHT
22	COVER FOR "APW" PILOT LIGHT
23	120 VOLT AC, RED LED, MOMENTARY, FINGER-SAFE ILLUMINATED PUSH BUTTON
24	DPDT, 10 AMP, 120 VOLT AC COIL, BLADE TYPE RELAY
25	4PDT, 3 AMP, 120 VOLT AC COIL, BLADE TYPE RELAY
(26)	DPDT, 5 AMP, 120 VOLT AC COIL, ADJUSTABLE 3 SEC TO 30 MIN TIME RANGE, ON DELAY, TIMER
27	250 VOLT, 10 AMP, 8 BLADE, FINGER-SAFE SOCKET
28	250 VOLT, 7 AMP, 14 BLADE, FINGER-SAFE SOCKET
29	30 CIRCUIT, 225 AMP, EQUIPMENT GROUND BAR WITH ONE #1- #4/0 LUGS
(30)	3 POLE, 100 AMP, 22,000 AIC, 240 VOLT, THERMAL MAGNETIC MAIN CIRCUIT BREAKER
(31)	240 VOLT, 3 PHASE, 4 WIRE, 100 AMP, MAIN LUGS ONLY, COPPER BUS, 12 SPACE, PANELBOARD
(32)	1 POLE, 20 AMP, 120 VOLT, BOLT-ON, 30 MILLIAMP GROUND FAULT TRIP, CIRCUIT
(33)	1 POLE CIRCUIT BREAKER HANDLE PADLOCK
(34)	DOOR-MOUNTED CIRCUIT BREAKER OPERATING MECHANISM

NP FIRST LINE SECOND LINE THIRD LI	
	NE
1 TB1 FUSE FU1 5 AMP CONTROL PO)WER
2 TB2 AMBIENT THERMOSTAT INPUT	
3 TB3 ALARM OUTPUT	
4 TB4 LOAD POWER	

NAMEPLATE SCHEDULE					
NP	NP FIRST LINE SECOND LINE		NP	FIRST LINE	SECOND LINE
1	MAIN DISCONNECT		9	CIRCUIT BREAKER	NO. 8 OFF
2	CIRCUIT BREAKER	NO. 1 OFF	10	CIRCUIT BREAKER	NO. 9 OFF
3	CIRCUIT BREAKER	NO. 2 OFF	11	POWER ON	
4	CIRCUIT BREAKER	NO. 3 OFF	12	HEAT TRACE CONTACTOR	ENERGIZED
5	CIRCUIT BREAKER	NO. 4 OFF	13	HEAT TRACE	HAND OFF AUTO
6	CIRCUIT BREAKER	NO. 5 OFF	14	COMMON ALARM	PUSH TO ACKNOWLEDGE
7	CIRCUIT BREAKER	NO. 6 OFF	15	HEAT TRACE CONTACTOR	FAILURE ALARM
8	CIRCUIT BREAKER	NO. 7 OFF	16	LAMP TEST	






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STATE OF ILLINOIS DEPARTMENT OF TRANSPORTATION

PEORIA STREET STATION **ELECTRICAL HEAT TRACE FREEZE PROTECTION PANEL (HTC-1)** SHEET NO. 92 OF 117 SHEETS

PRELIMINARY NOT FOR CONSTRUCTION COUNTY TOTAL SHEETS NO. COOK 356 283 SECTION 2090 2013-011R CONTRACT NO. 60W29

NOTES: 1. DASHED LINES INDICATE FIELD WIRING 2. SEE SHEET 277 FOR HP-1 SCHEDULE.

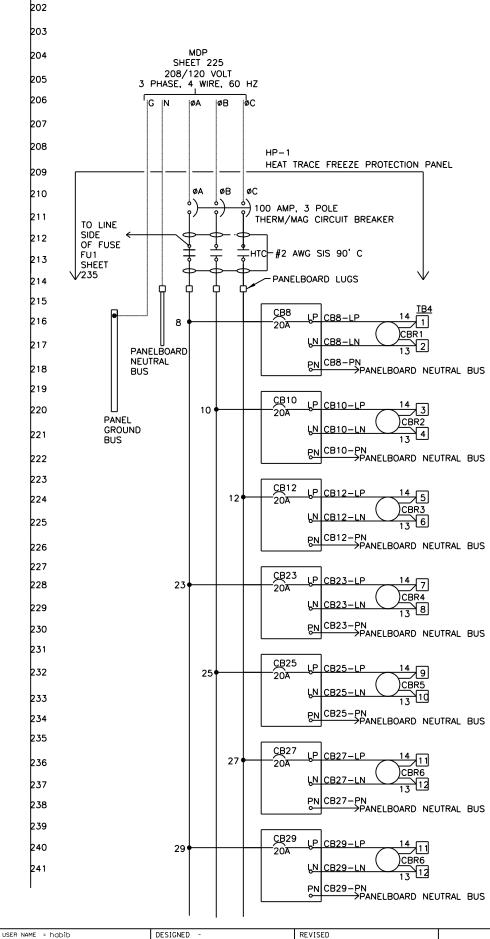

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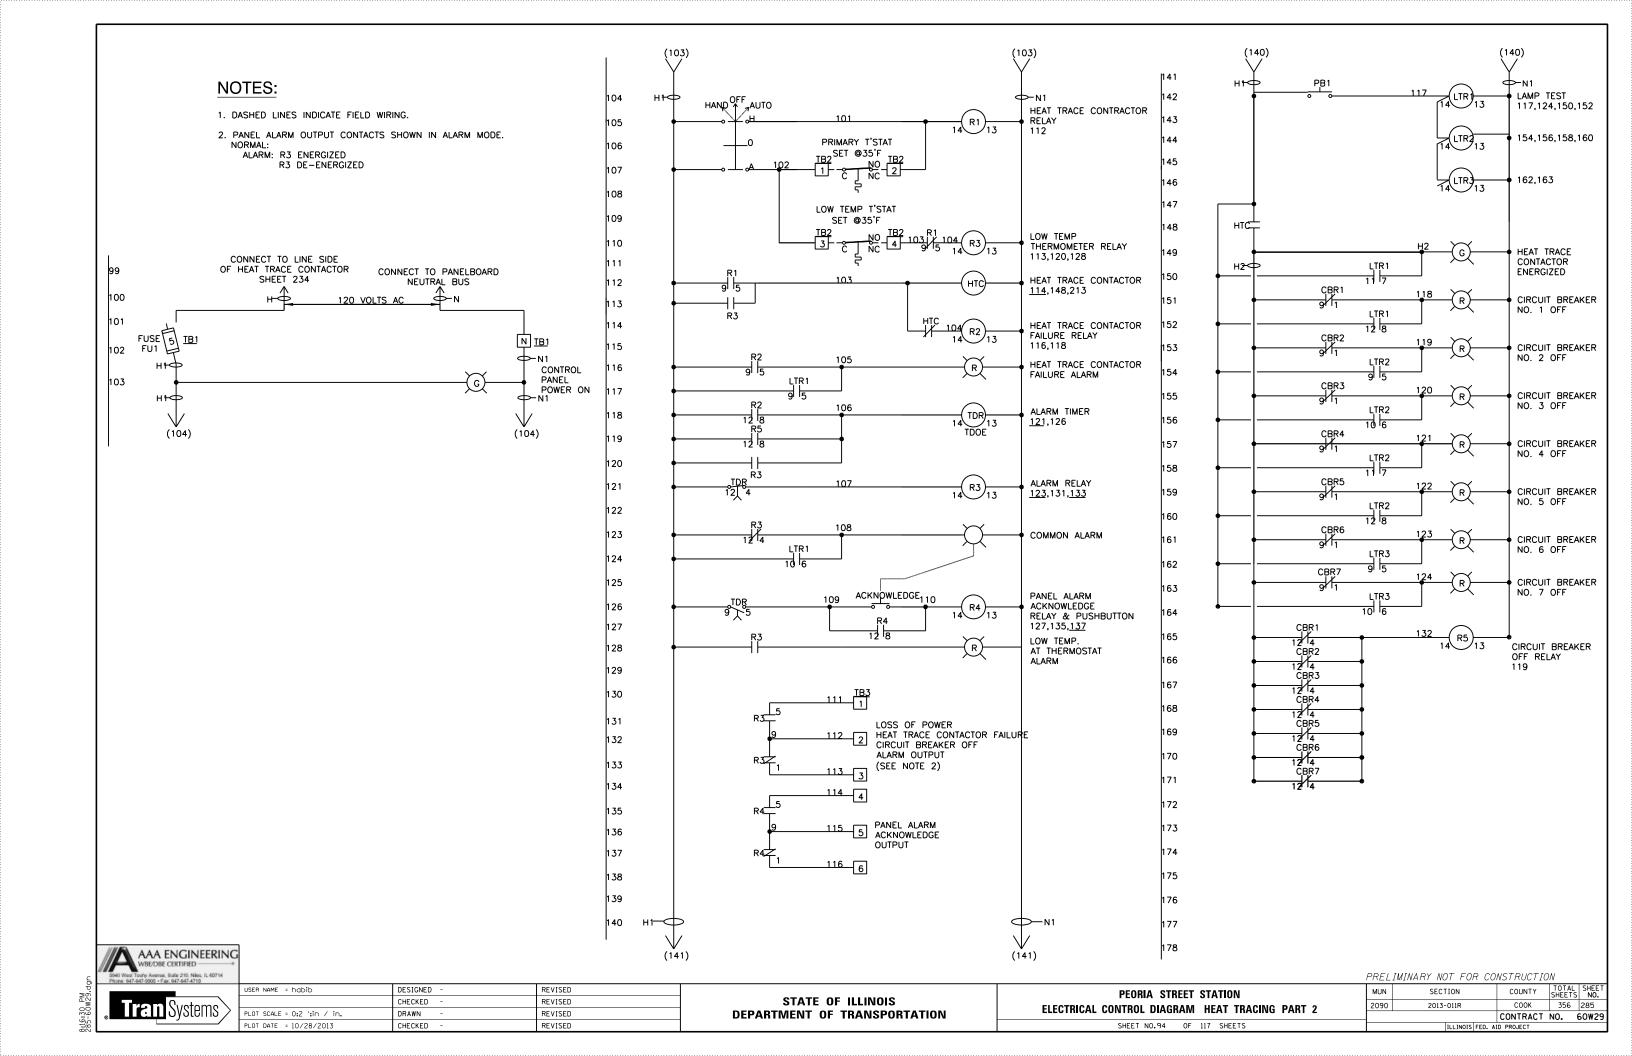
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NOTES:


- 1. PCR, FS LOCATED IN LCP ARE TO BE POTTER BRUMFIELD KRPA 1AAN120, SOCKET AND HOLD DOWN SPRING.
- 2. CN AND CE ARE TO BE SQUARE D ELECTRICALLY HELD 3 AMP TYPE LD WITH NORMALLY CLOSED CONTACTS COIL BURDEN 180VA IN RUSH, 35VA
- 3. LIGHTING CONTRACTORS DE-ENERGIZED TO TURN LIGHTS ON IN NORMAL OPERATION OR PHOTO CELL FAILURE OR TEST.
- 4. DEVICES ARE TO BE MOUNTED IN ENCLOSURE (LCP).
- 5. DEVICES AND PANEL ARE TO BE PROVIDED BY ILLINOIS SWITCHBOARD OR APPROVED EQUAL.
- 6. CONTACTORS ARE TO BE MOUNTED AT THE BOTTOM OF ASSOCIATED LIGHTING PANEL UNDER SEPARATE DOOR AND COVER ARE TO BE SEPARATED FROM PANELBOARD AND WIRING BREAKERS, BUS WORK PANELBOARD.
- 7. PHOTO CELL LOCATED ON STATION HOUSE AS SHOWN ON THE SHEETS.

EM PANEL

EM PANEL 20A CE1 LOCATED UNDER SEPERATE DOOR AND COVER IN EM PANEL ASSIGNED CIRCUITS IN TO EMERGENCY EM PANEL LIGHTING LOADS (8 POLES MAX)

CN1 LOCATED UNDER SEPERATE DOOR AND COVER IN LP-1 PANEL CN1 ASSIGNED CIRCUITS IN LP-1 PANEL TO NORMAL

LIGHTING LOADS (8 POLES MAX)

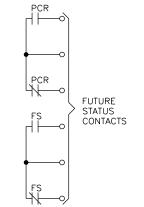


LIGHTING NEUTRAL CONTROL ĹΤ. TEST. -(PC) PHOTO CELL NOTE 7 LIGHTING CONTROL (PCR) RELAY NOTE 7 NOTE 1 (FS FAILSAFE RELAY NOTE 1 (CE1) EMERGENCY LIGHTING CONTACTOR NOTES 2,6 -(CE2) EMERGENCY LIGHTING CONTACTOR NOTES 2,6 -(CN1) NORMAL LIGHTING CONTACTOR NOTES 2,6 (CN2) NORMAL LIGHTING CONTACTOR NOTES 2,6 -(CN3)-NORMAL LIGHTING CONTACTOR NOTES 2,6 (CN4) NORMAL LIGHTING CONTACTOR NOTES 2,6

SCALE N/A

PLATFORM LIGHTING PHOTOCELL CONTROL

NOTES:

A. EACH DEVICE TO BE FED WITH WITH 2-#14 AWG, 1-#14 AWG GRD, IN 3/4" GRS CONDUIT.

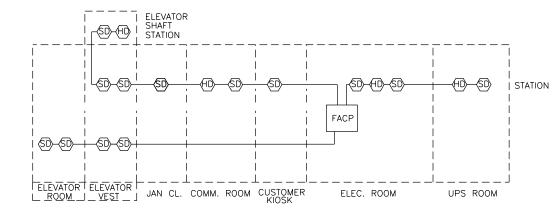




AAA ENGINEERING Tran Systems

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STATE OF ILLINOIS
DEPARTMENT OF TRANSPORTATION

PEORIA STREET STATION
ELECTRICAL CONTROL DIAGRAMS PART 1
SHEET NO 95 OF 117 SHEETS


PRELIMINARY NOT FOR CONSTRUCTION					
MUN	SECTION		COUNTY	TOTAL SHEETS	SHEET NO.
2090	2013-011R		COOK	356	286
CONTRACT NO. 60W2					50W29
ILLINOIS FED. AID PROJECT					

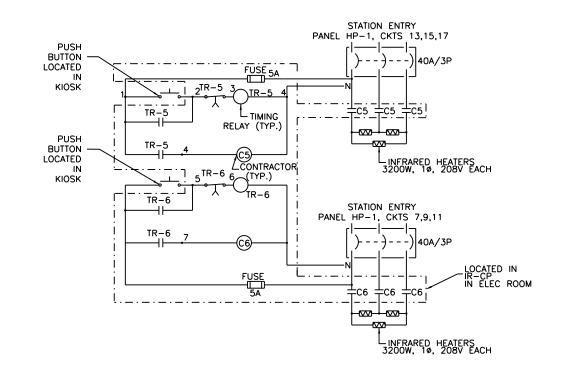

	NAME PLATES					
	1	2	3	4	5	
	0	0	0	\$	\$	
•	PUSH	PUSH	PUSH	SWITCH	SWITCH	


NAME PLATES				
1 STATION HEATER		(2)		
2	STATION HEATER	(O)		
3	TURNSTILE HEATER	<u>(S)</u>		
4	EX FAN			
5	LIGHT			

IN KIOSK CONTROL STATION SCALE N/A

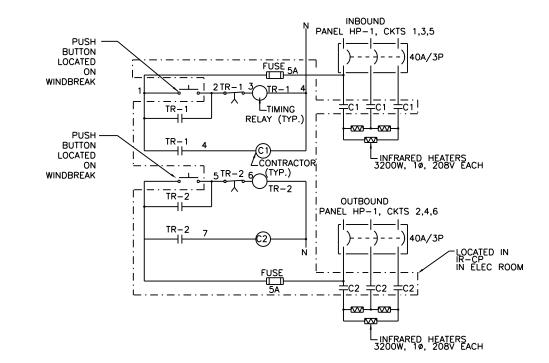


PLATFORM WINDBREAK HEATER CONTROL DIAGRAM

STATION HEATER CONTROL DIAGRAM SCALE N/A

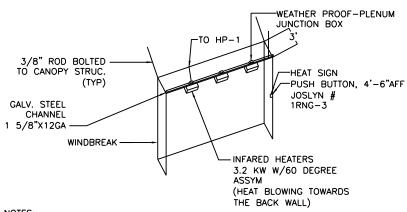

NOTES:
A. INSTALLATION SHOWN IS DIAGRAMATIC. COORDINATE WITH EXISTING FIELD CONDITIONS.

TYPICAL PLATFORM WINDBREAK HEATER INSTALLATION SCALE N/A

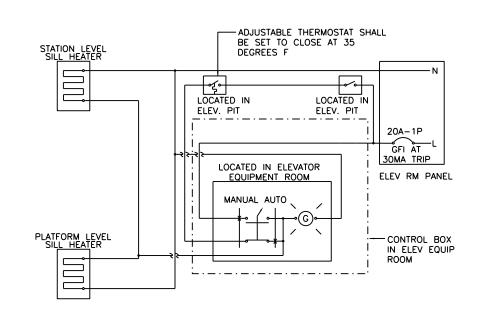

ELEVATOR DOOR SILL FREEZE PROTECTION - WIRING DIAGRAM (TYP.) 5 SCALE N/A


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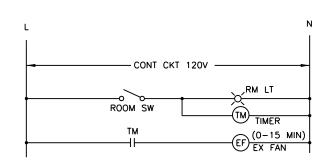
STATE OF ILLINOIS **DEPARTMENT OF TRANSPORTATION**

PEORIA STREET STATION **ELECTRICAL CONTROL DIAGRAMS PART 2** SHEET NO.96 OF 117 SHEETS


PRELIMINARY NOT FOR CONSTRUCTION COUNTY TOTAL SHEETS NO.
COOK 356 287 MUN SECTION 2090 2013-011R CONTRACT NO. 60W29



1 ELEVATOR ROOM EXHAUST FAN CONTROL DIAGRAM
SCALE N/A

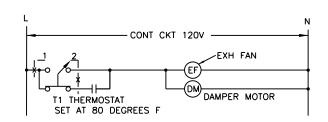


3 TOILET ROOM CONTROL DIAGRAM

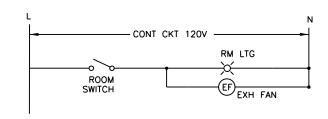

JANITOR AND COMMUNICATION ROOM

2 EXHAUST FAN CONTROL DIAGRAM

SCALE N/A

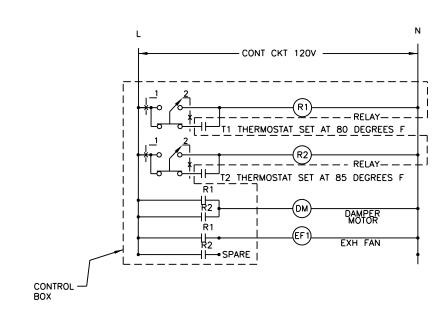

4 ELECTRICAL ROOM EXHAUST FAN CONTROL DIAGRAM

AAA ENGINEERING
WBE/DBE CERTIFED

5940 West Toutry Avenue, State 210 Nikes, IL-60714
Phone: 847-647-5900 - Fax: 847-647-4710

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STATE OF ILLINOIS DEPARTMENT OF TRANSPORTATION PEORIA STREET STATION

ELECTRICAL CONTROL DIAGRAMS PART 3


SHEET NO.97 OF 117 SHEETS

 MUN
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 COUNTY SHEETS NO.
 TOTAL SHEETS NO.
 SHEET NO.

 2090
 2013-011R
 COOK
 356
 288

 CONTRACT NO.
 60W29


 | ILLINOIS| FED. AID PROJECT

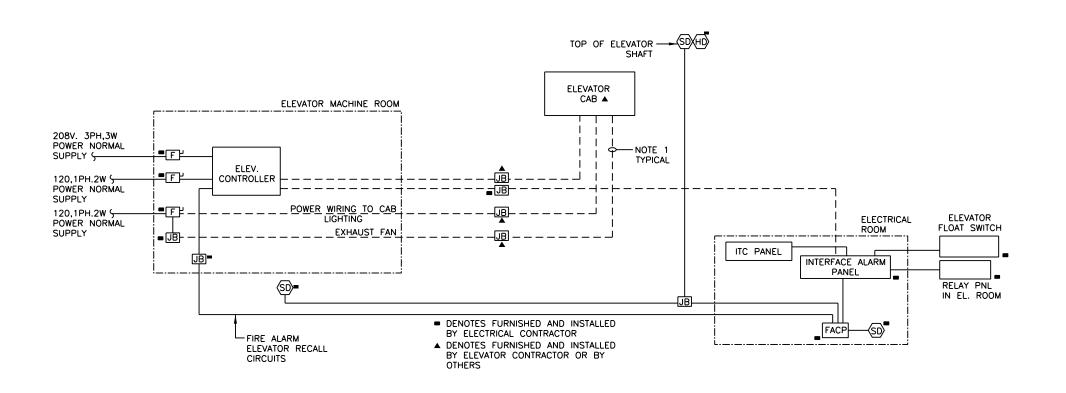

ELEVATOR INTERFACE/RELAY PANELS WIRING BLOCK DIAGRAM

NOTES:

- ALL CONDUITS AND WIRING SHOWN WITH "DASHED" LINES WILL BE DESIGNED, FURNISHED AND INSTALLED BY ELEVATOR CONTRACTOR.
- 2. CONTRACTOR IS TO FURNISH AND INSTALL ALL OTHER CONDUITS AND WIRING.
- THE CONDUITS, ELECTRICAL ENCLOURES, AND ALL OTHER ELECTICAL CONPONENTS ARE TO BE ELECTRICALLY ISOLATED FROM EARTH GROUND.
- 4. FOR FEEDER AND CONDUIT SCHEDULES SEE OTHER PLANS AND DETAILS.
- 5. ELEVATOR BLOCK DIAGRAM IS TYPICAL FOR ALL ELEVATORS.
- 6. EACH DEVICE TO BE CONNECTED TO EITHER ITC OR RCP WITH 2-#14 AWG, 1 #14 AWG (G), IN 3/4" GRS CONDUIT.

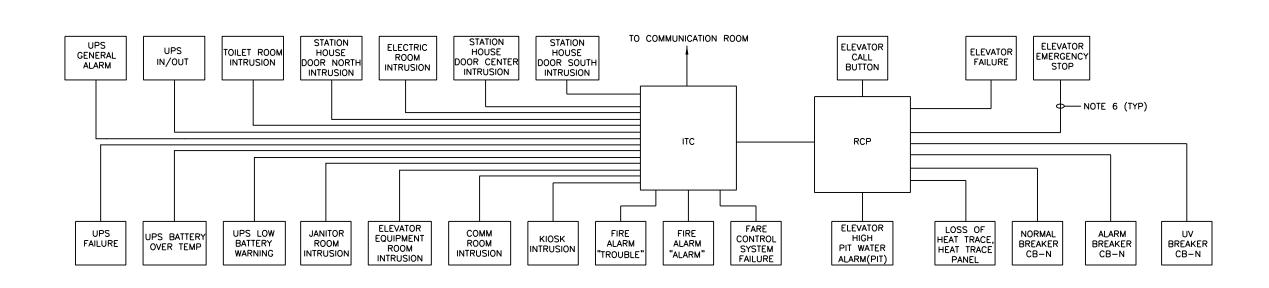

Tran Systems

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SCALE N/A

STATE OF ILLINOIS DEPARTMENT OF TRANSPORTATION


SCALE N/A

ITC/RCP PANEL WIRING BLOCK DIAGRAM


PEORIA STREET STATION **ELECTRICAL BLOCK DIAGRAMS** SHEET NO.98 OF 117 SHEETS

TOTAL SHEET NO. 356 289 MUN SECTION COUNTY СООК 2090 2013-011R CONTRACT NO. 60W29

PRELIMINARY NOT FOR CONSTRUCTION

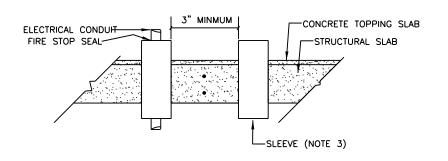




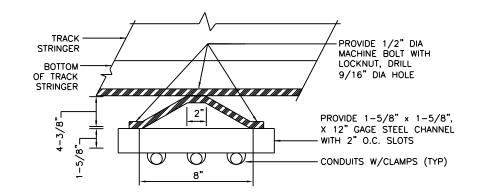

2 CONDUITS CROSSING GIRDER SCALE: NTS



- FOR 400 AMP APPLICATIONS
 BUS DETAIL 2" X 1/4" COPPER
 (1) SET OF LUGS PER PHASE
- 2. FOR 800 AMP APPLICATIONS BUS DETAIL 4" X 1/4" COPPER (2) SETS OF LUGS PER PHASE
- 3. SIZE OF SLEEVE TO BE 1" LARGER THEN THE SIZE OF THE INSERTED CONDUIT.
- 4. 1/4" X 2" SILVER PLATED COPPER GROUND BUS BONDED TO ENCLOSURE WITH (1) 2 HOLE LONG BARREL COMPRESSION LUG #1/0 AWG PANDUIT #LCC 1/0 MECHANICAL LINE LUG FOR EXTRA FLEX CABLE #6 AWG TO ONE 250KCMIL ILSCO #SLUH-225

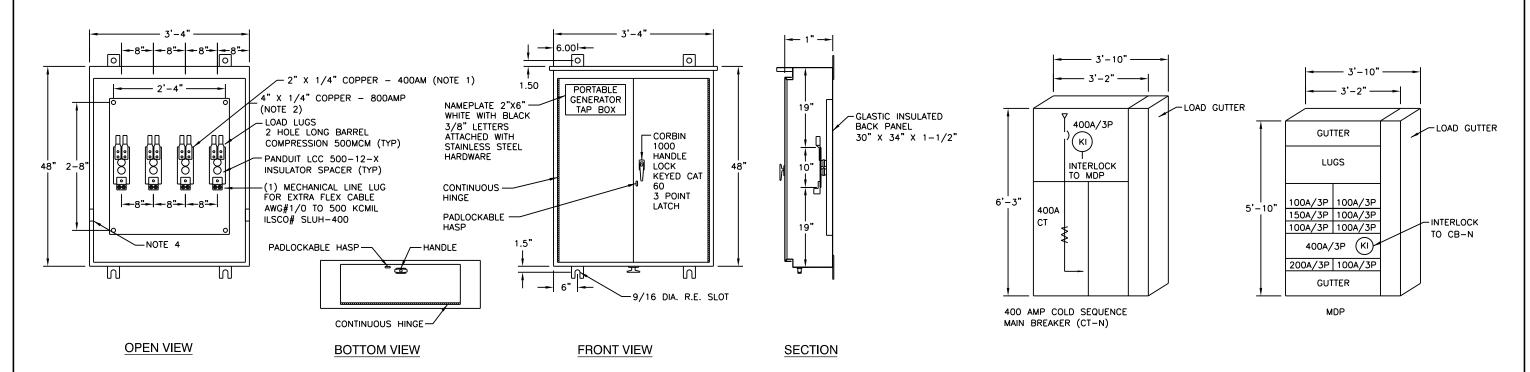

PORTABLE GENERATOR TAP BOX
SCALE: 1"=1'-0"

4 CT-N AND MDP ELEVATIONS
SCALE: NTS



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STATE OF ILLINOIS DEPARTMENT OF TRANSPORTATION

PE	ORIA ST	REET S	TATION	
	ELECTRIC	CAL DET	TAILS	
CHEE	T NO GO	OF 117	CHEETC	

 MUN
 SECTION
 COUNTY SHEETS NO.
 TOTAL SHEETS NO.
 SHEETS NO.

 2090
 2013-011R
 COOK
 356
 290

 CONTRACT NO.
 60W29

 | ILLINOIS|FED. AID PROJECT

CHICAGO FLUORESCENT EXITS

ECXP



Series Features
120 VAC Operation Standard
Maximum Input Rating:
(120 VAC) 30 Watts Standard
Energy Saving Compact Fluorescent
[2] 120 VAC, 7 Wart Lamps .
Open Face Glass Parci
Slik Screen Lettors
Ceiling, Endier Back Mount
Canopy
Enwirlight
White Powder-coat Finish
15 GA Stainless Staal Housing [-\$8]
Camp_shel[-DMP]
Siticone Gasketing (-SG)
LLS24 Listed
Chicago Code Approved

Chicago Code Approved

ADDITIONAL EMERGENCY UNIT FEATURES

Integrated Solid State System
Multi-Fable, Centrollari, Automatic Charger—
No Manual Battery Recycling
Brownout Scraithrity
Low Voltage Battery Cutoff
Low Cott, Astomatic Battery Connect)
Single Voltage Transformer for
120 VPC Operation
Maximum Inpul Rating
(120 or 277 VPC) 29 Welfs
[2] 6 VPC, 6 Welf Long Life, noon-descrit Lamps
Seeled Lose Co. dum Cettery
3 Volt Operation
Mainte nance Fire
Test Switch
Red (Power Cr.) LCD Indicato:

2ECXP2RWW-SS-DMP-SG

BIG SEAM Emergency Systems Inc. 290 E. Froille Street PO Res 518 Crysta' Lake. III. 80433-0518 USA Sales. (315) 493-3145 / Em. (815) 483-5126 vvvv.tigbeam.com



LOAD CALCULATION F	OR BUILDING SER	VICE (NORMAL SE	RVICE)			
Dranama Dur	AAA ENGINEERIN	ıc				
Prepared By:	5940 W. TOUHY					
	SUITE 210	AVE.				
	NILES, ILLINOIS	60714				
				_		
Building Description	CTA ELEVATED S	STATION AT 430 S	PEORIA STREE	Г		
Available Fault Current	65KIC @ 208V					
Type of Electrical Service:	208V, 3 PHASE, 3	WIRE UNGROUN	DED			
Size of Service Entrance Conductors	SEE DRAWING S					
Size of Grounding Electrode:	SEE DRAWING S					
Size of O.C.P.	400A/3P					
GENERAL LIGHTING LOAD CALCULATION:	Sq-Ft/Unit	Units	VA/SF		Sub Totals	
General Lighting Load:	34-FUUIIIL	Ullits	VA/SF		Sub Totals	
Lighting Load	3000	1	4		12,000.00	VA
						VA
				Total 1/A		
				Total VA	12,000.00	VA
SECTION 1						
GENERAL LIGHTING LOAD DEMAND FACTOR:						
ALL AT 100%				Total VA	12,000.00	VA
SECTION 2						
STATION LOAD:						
		Units/Quantity	VA	Demand Fact		
ELEVATOR		1		0.95		
H-1		1		1	3,000.00	
H-2		1		1	5,000.00	
H-3		1		1	3,000.00	
H-4		1		1	5,000.00	
IH-1 (PLATE)		3		1		
IH-2 (STATION)		6		1		
EXHUAST FANS & LOUVERS		1		1		
HEAT TRACING		8		1	14,400.00	
REVENUE EQUIPMENT		1		1	5,000.00	
COMMUNICATION EQUIP		1		1		
WATER HEATER (WH)		1		1	8,300.00	
SUMP PUMPS		1	1200	1	1,200.00	VA
Since Heating overall building is larger load w	e do not take into	account		Total 1/A	400 050 00	\/A
Cooling loads				Total VA	100,950.00	VA
SECTION 3						
25% Continous Load (Lighting)			12,000.00	0.25		
25% of Largest Motor (Elevator)			15000			
				Total VA	6,750.00	VA
		Total From Section	on 1		12,000.00	VA
		Total From Section Total From Section	on 2		100,950.00 6,750.00	VA
			TOTAL VA		119,700.00	
					-,	
On a 120/208V, 3 phase, 4 Wire System			TOTAL AMPS		332.26	

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WBE/DBE CERTIFIED

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STATE OF ILLINOIS **DEPARTMENT OF TRANSPORTATION**

MUN PEORIA STREET STATION 2090 CITY LOAD CALCS AND EXIT LTG CATALOG CUT SHEET NO. 100 OF 117 SHEETS

PRELIMINARY NOT FOR CONSTRUCTION COUNTY TOTAL SHEETS NO.
COOK 356 291 SECTION 2013-011R

CONTRACT NO. 60W29

ABBREVIATIONS

2 WIRE FOREIGN EXCHANGE OFFICE 2W FXS 2 WIRE FOREIGN EXCHANGE SUBSCRIBER 4W E&M 4 WIRF F&M AMERICANS WITH DISABILITIES ACT ADA AWG AMERICAN WIRE GAUGE AT&T AMERICAN TELEPHONE & TELEGRAPH **AMPERE** AMPERE HOUR ΑН AUX. AUXII IARY BENT CAB. CABINET CABLE CTR CENTER CENTER LINE CENTRAL UNIT PBX CÚ PBX CB CHANNEL BANK CHICAGO TRANSIT AUTHORITY CTA CONDUIT CONTINUOUS, CONTROLLER CONT CONTROL CENTER CC COPPER CU. CUSTOMER ASSISTANT CAS CUSTOMER ASSISTANCE STATION DPP DATA PATCH PANEL D.E. DEAD END DIAMETER DACS DIGITAL ACCESS AND CROSSCONNECT SWITCH DIGITAL SIGNAL CROSSCONNECT PANEL FOR DS - 1 SWITCH DSX -DS - 0 DIGITAL SIGNAL RATE 0 (64 Kbps) DIGITAL SIGNAL RATE 1 (1.544 Mbps) DIMENSION DIRECT CURRENT DIM. DC DRAWING DWG FΑ FACH EQ EQUIPMENT FDF FDP FO FIBER DISTRIBUTION FRAME FIBER DISTRIBUTION PANEL FIBER OPTIC CABLE IN INNERDUCT FID FIBER OPTIC COMMUNICATION SYSTEM **FOCS** FIBER SLACK ENCLOSURE FSE FIBERGLASS EPOXY CONDUIT FIN. FL. FINISHED FLOOR FTG FITTING FL, FLR FLOOR GALV GALVANIZED GRS GALVANIZED RIGID STEEL GRD GROUND HTR **HEATER** ΙB INBOUND J.B. JUNCTION BOX LK, LAK LAKE LTG LIGHTING

CABLE LEGEND

LONG

A. CAT 6 4PR#22 AWG UTP B. CAT 6 4PR#22 AWG & 1PR#18 AWG C. 1PR#16 AWG SHIELDED D. 3PR#22 AWG IND. SHIELDED E. 1PR#18 AWG F. 2 STRAND MULTIMODE OPTICAL CABLE G. 6 STRAND MULTIMODE OPTICAL CABLE H. MANHATTAN 2PR#18 AWG CABLE J. CAT 6 4PR F/UTP K. 50 PR#22 AWG CAT3

NOTE: NUMBER PRECEDING LETTER CHARACTER INDICATES QUANTITY OF CABLES.

ABBREVIATIONS (CONTINUED)

MFD MAIN DISTRIBUTION FRAME MANHOLE M.H MFGR MANUFACTURER MB MIC. MTD NES N.I.C. MEASURED BUSINESS TELEPHONE LINE SERVICE MICROPHONE MOUNTED NODAL EQUIPMENT SHELTER NOT IN CONTRACT NOM. NOMINAL N.B. NORTH BOUND NOT TO SCALE
OFFICE CHANNEL UNIT/DATA PROCESSOR
OPTICAL CARRIER RATE 1 (51 Mbps)
OPTICAL CARRIER RATE 3 (155 Mbps) N.T.S OCU/DP OC - 1 OC - 3 OB PR OUTBOUND PNL PTE PANEL PATCH TO EQUIPMENT PRIMARY PBX PRIVATE BRANCH EXCHANGE PUBLIC ACCESS READY ACCESS SPLICE CLOSURE (COPPER) RELAY HOUSE RTU REMOTE TERMINAL UNIT RINGDOWN TELEPHONE RD TEL ROOM SECONDARY SHEET NUMBER SHP SHOP S.B. SOUTH BOUND SU PBX SOUTH UNIT PBX SPLICE CABINET STD. STANDARD STA. STATION SS SCADA SUBSTATION, STAINLESS STEEL SUPERVISORY CONTROL AND DATA ACQUISITION SINGLE MODE SONET SYNCHRONOUS OPTICAL NETWORK TELEPHONE - TYPEWRITER **TELEPHONE** TELEPHONE INSTRUMENT
TELEPHONE TERMINAL CABINET TEL TTC TB TIP TERMINAL BLOCK TERMINATE IN PANEL TO TRANSMIT ONLY TRANS **TRANSPORTATION** TRK. TRACK TX TWP TRANSMITTER TWISTED WIRE PAIR TYP. VARIABLE MESSAGE SIGN - PA ADA VISUAL SIGN VMS

VAC VOLTS ALTERNATING CURRENT

VDC VOLTS DIRECT CURRENT

WATT

CONDUIT LEGEND

A	3/4" GRS
B	1" GRS
©	1-1/2" GRS
(D)	2" GRS
Œ	1-1/2" POLYDUCT
(F)	2" POLYDLICT

DI ANI OVA 4DOLO

 \bigcirc

<u>PLAN SY</u>	<u>PLAN SYMBOLS</u>				
lacktriangle	TELEPHONE - CTA PBX SYSTEM				
▼ TP	PUBLIC PAY TELEPHONE				
\mathbf{T}	VOICE/DATA JACK				
cc	ELEVATOR CAB CALL PHONE				
DC	DOOR CONTACT				
HC	ELEVATOR HALL CALL PHONE				
PA	PA AMPLIFIER & CONTROL EQUIPMENT				
М	MICROPHONE (AUDIO/VISUAL CONSOLE)				
MIC	MICROPHONE				
CA	CUSTOMER ASSISTANCE PUSHBUTTON				
PID	PASSENGER INFORMATION DISPLAY				
MON	MONITOR				
EMV	EXPRESS VENDING MACHINE				
TCVM	TICKET CARD VENDING MACHINE				
CAM #	NEW CAMERA, # INDICATES CAMERA NUMBER				

EXISTING CAMERA, # INDICATES CAMERA NUMBER

CAM # (PTZ) CAMERA WITH PAN TILT ZOOM, # INDICATES CAMERA NUMBER CAM #

 \mathfrak{S} PA SPEAKER - TYPE I

(S) RECESSED HOUSING WITH CONE SPEAKER - TYPE II S SURFACE MOUNTED HOUSING WITH CONE SPEAKER - TYPE II

CONDUIT OR CABLE TURNING AWAY OR DOWN

JUNCTION BOX RTU DATA TRANSMISSION SYSTEM REMOTE TERMINAL UNIT EXPOSED CONDUIT OR CABLE

BURIED OR CONCEALED CONDUIT IN FLOOR

BURIED OR CONCEALED CONDUIT IN CEILING OR WALLS

CONDUIT OR CABLE TURNING UPWARD CONDUIT CAPPED OR CABLE DEAD END

FIBER SLACK ENCLOSURE SIGNAL JUNCTION BOX

РВ PULL BOX $\langle MH \rangle$ MANHOLE

362+00 STATIONING OR STATION CHAINING

TWISTED PAIR ф DIAMETER

PLAN SYMBOLS (CONTINUED)

NS AMBIENT NOISE SENSOR

*)- WAP WIRELESS ACCESS POINT WITH DIRECTIONAL ANTENNA

WIRELESS ACCESS POINT WITH OMNI ANTENNA

DYNAMIC MESSAGE SIGN

HUB COMMUNICATION HUB

HPT HELP POINT TELEPHONE

(BL) BLUE LIGHT

DMS

TELEPHONE

INFORMATION TOUCH SCREEN SIGN ISIGN

SVT SECURITY VIDEO TERMINAL

ITC INTERFACE TERMINAL CABINET

IDF INTERMEDIATE DISTRIBUTION FRAME

DAS DIGITAL ADVERTISING SIGN

IDS INTRUSION DETECTION SENSOR

CONDUIT TAG, REFER TO CONDUIT LEGEND ON THIS SHEET FOR CONDUIT SIZE AND DESCRIPTION

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Tran Systems

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DT SCALE = 2.00000 / in.	DRAWN -	REVISED
DT DATE = 10/28/2013	CHECKED -	REVISED



PEORIA STREET STATION					
	FEU	וס אוחע	UEEI 9	IAIIUN	
C	COMMUNICATION SYMBOLS, CONDUIT				
U	DIVITATION	ICATION	1 311110	OLO, GUINE	,011
VND	CARIE	LEGENIE	UNV SI	ABBREVI	2MNITA
AIND	OADLL	LEGENE	UI AIND	ADDITEVI	AIIUNU
	CHEET	T NO 101	OF 117	CHEETC	

GENERAL NOTES:

- 1. ALL CONDUIT AND CABLE PLACEMENT SHOWN ON THE CONTRACT DRAWINGS IS CONDUIT AND SCHEMATIC ONLY THE CONTRACTOR IS TO MAKE APPROPRIATE ADJUSTMENTS TO CLEAR OBSTRUCTIONS IN THE PATH.
- 2. IT IS THE CONTRACTOR'S RESPONSIBILITY TO LOCATE AND IDENTIFY ALL EXISTING CONDUITS, CABLES AND UTILITIES BEFORE COMMENCEMENT OF CONSTRUCTION
- 3. THERE IS NO MID SPAN SPLICING OF THE FIBER OPTIC CABLE. ALL CABLE RUNS ARE TO BE CONTINUOUS BETWEEN STATIONS UNLESS DIRECTED OTHERWISE BY THE COMMISSIONER.
- 4. SHOULD THERE BE ANY EXISTING EQUIPMENT THE CONTRACTOR IS TO REMOVE, THE EXISTING COPPER CABLE AND TELEPHONE JUNCTION BOXES AFTER CUT-OVER TO THE NEW CABLES.
- 5. THE CONTRACTOR IS TO REQUEST IN WRITING TO CTA ANY AND ALL SERVICE INTERRUPTIONS.
- 6. THE CONTRACTOR IS RESPONSIBLE TO ENSURE THAT THE PUBLIC ADDRESS (PA) SYSTEM REMAINS OPERATIONAL 24 HOURS DAILY. EXCEPTION MAY OCCUR WHEN THE CONSTRUCTION SITE IS CLOSED. ANY INTERRUPTION OF PA SERVICE IS TO BE COORDINATED WITH THE CTA. THE CONTRACTOR IS TO PROVIDE A WRITTEN NOTICE REQUEST FOR APPROVAL TO THE CTA 10 DAYS IN ADVANCE FOR ANY COMMUNICATION SHUTDOWN OR CUT-OVER PRIOR TO INTERRUPTION OF SERVICE.
- 7. THE CONTRACTOR IS TO WORK WITH CTA DESIGNATED REPRESENTATIVE TO IDENTIFY EQUIPMENT TO BE REMOVED, BEFORE ACTUAL REMOVAL OF SUCH EQUIPMENT. REMOVED DEVICES ARE TO BE INVENTORIED AND RETURNED TO THE CTA STORAGE FACILITY.
- 8. IF DURING THE COURSE OF THE CONTRACT WORK, IT IS NECESSARY TO RELOCATE EXISTING FIBER AND/OR COPPER CABLES, THE CONTRACTOR IS TO PROTECT SUCH CABLES AND KEEP THEM OPERATIONAL DURING CONSTRUCTION.
- 9. FOR FIBER CONNECTORS INSTALLED UNDER THIS CONTRACT, THE CONTRACTOR IS RESPONSIBLE FOR PROVIDING COMPLETE OPERATIONAL OPTICAL LINKS AS REQUIRED TO TRANSPORT SIGNALS TO THE CTA'S CENTRAL CORE NODES. THE COMPLETE LINK, INCLUDING PORTIONS OF EXISTING CABLE IS TO BE MEASURED AND TESTED FOR OPTICAL PERFORMANCE AND LOSS BY CONTRACTOR. SUCH OPTICAL TIME-DOMAIN REFLECTOMETER (OTDR) TESTS WILL BE WITNESSED BY CTA DESIGNATED REPRESENTATIVE AND TEST RECORDS ARE TO BE SUBMITTED TO CTA FOR THE RECORD. IF FIBER 20. THE CONTRACTOR IS TO PERFORM ALL WORK IN ACCORDANCE WITH THE FAILS THE OTDR TEST, CONTRACTOR IS TO PROVIDE NEW FIBER OPTIC CABLE AS NECESSARY AND RETEST UNTIL ALL FIBER CABLES PASS THE TEST SUCCESSFULLY AT NO ADDITIONAL COST TO THE CTA. ALL LINKS NEED TO PASS THE NECESSARY TESTS.
- 10. THE CCTV CONDUIT PLAN IS A SCHEMATIC REPRESENTATION OF THE CONDUIT LAYOUT IN THE PLATFORM AND STATION, THE CONTRACTOR IS TO FIELD VERIFY ALL SPECIFIC CAMERA LOCATIONS, HEIGHT OF IP CAMERA AND HAVE IT APPROVED BY THE CTA DESIGNATED REPRESENTATIVE. ORIENTATION OF EVERY CAMERA IS TO BE ADJUSTED UNTIL CAMERA VISUAL COVERAGE IS ACCEPTABLE TO CTA AUTHORITIES. CONTRACTOR IS TO COORDINATE WITH THE COMMISSIONER THE FINAL FIELD OF VIEW POSITIONS FOR EACH CAMERA. A SNAPSHOT OF THE FINAL FIELD OF VIEW IS TO BE PROVIDED BY CONTRACTOR AS PART OF THE AS-BUILT RECORDS.
- 11. FINAL CAMERA CONDUIT INFRASTRUCTURE INSTALLATION DETAILS ARE TO BE PROVIDED BY THE CONTRACTOR. ALL CAT6 CABLE TERMINATIONS INSIDE HUB AND AT PATCH PANELS (e.g. CISCO 3000 SWITCH) ARE TO BE LABELED BY THE CONTRACTOR.
- 12. CONTRACTOR TO ENSURE ALL CAMERA HEATER CIRCUITS ARE POWERED UP FROM HUB/POWER SUPPLY.


- 13. CONTRACTOR IS NOT TO INTRODUCE ANY NEW SPLICES IN ANY EXISTING COMMUNICATION CABLES. IF DURING THE COURSE OF WORK, THE CONTRACTOR DAMAGES ANY EXISTING FIBER OPTIC CABLE. THE CONTRACTOR IS TO REPLACE IN KIND WITH NEW FIBER OPTIC CABLE AT NO ADDITIONAL COSTS TO CTA.
- 14. WHERE THE CONTRACTOR IS TO BE USING EXISTING CABLE AND SUCH CABLE IS OBSERVED TO NOT HAVE SUFFICIENT SLACK, THE CONTRACTOR IS TO PROVIDE AND INSTALL NEW CABLE FOR THAT SECTION WHEN NECESSARY SLACK IS REQUIRED.
- 15. COORDINATE PROPOSED CONDUIT RUNS WITH EXISTING CONDUITS, RISERS RACEWAYS WHERE POSSIBLE. ALL CONDUITS ARE TO BE CONCEALED, AS MUCH AS POSSIBLE. ENSURE ALL JUNCTION BOXES ARE SIZED PER CODE AND CONDUIT FILL RATE IS NOT TO EXCEED 40 PERCENT.
- 16. ALL EXISTING PAINTED SURFACES DAMAGED OR PATCHED UNDER THIS PROJECT ARE TO BE PAINTED TO MATCH EXISTING ADJACENT COLOR, TEXTURE AND FINISH, EXISTING PAINT, COLOR, TEXTURE AND FINISH IS TO BE VERIFIED BY CONTRACTOR IN FIELD AND APPROVED BY THE COMMISSIONER AFTER CONSTRUCTION IS COMPLETED.
- 17. DURING THE COURSE OF THE CONTRACT WORK, THE CONTRACTOR IS TO ADOPT ALL MEASURES TO PROTECT EXISTING FACILITY, ARCHITECTURAL, STRUCTURAL, MECHANICAL AND ELECTRICAL IN AND AROUND THE AREA OF WORK, IF DUE TO NEGLIGENCE ANY OF THE ABOVE FEATURES ARE DAMAGED, THE CONTRACTOR IS TO REPLACE IN KIND AT NO ADDITIONAL COST TO CTA.
- 18. THE CONTRACTOR IS TO BE RESPONSIBLE FOR INSPECTING ALL EQUIPMENT WHEN IT ARRIVES ON SITE, ANY DAMAGED EQUIPMENT IS TO BE REJECTED AND THE CONTRACTOR IS TO RETURN DAMAGED EQUIPMENT TO CTA AND ARRANGE REPLACEMENT OF SAME WITH NEW EQUIPMENT TO BE DELIVERED TO SITE FOR INSTALLATION BY THE CONTRACTOR WITHIN PROJECT TIME SCHEDULE.
- 19. AT THE COMPLETION OF THE CONTRACT, THE CONTRACTOR IS TO PERFORM A SITE INSPECTION TO VERIFY THAT ALL EQUIPMENT SUPPLIED IS IN OPERABLE CONDITION AND NO PHYSICAL DAMAGES ARE OBSERVED. ANY PIECE OF EQUIPMENT DEEMED INOPERABLE IS TO BE MADE OPERABLE BY THE CONTRACTOR AND VERIFIED BY CTA REPRESENTATIVE PRIOR TO RELEASE OF RETENTION FUNDS.
- LATEST EDITION OF THE CITY OF CHICAGO ELECTRICAL CODE AND NEC.
- 21. ALL CONDUITS THAT PENETRATE WALL OR ROOF SLABS ARE TO BE INSTALLED IN A MANNER THAT IS TO PRESERVE FIRE RESISTIVE STRUCTURE INTEGRITY AND WATER TIGHT FEATURE OF ROOF/SLAB WALL. FIRESTOP ALL WALL/ROOF SLAB PENETRATIONS TO MATCH ORIGINAL HOURLY RATING OF WALL/ROOF SLAB WHERE SUCH PENETRATIONS OCCUR.
- 22. THE CONTRACTOR IS SOLELY RESPONSIBLE FOR QUALITY CONTROL, INCLUDING CONSTRUCTION MEANS, METHODS, TECHNIQUES AND SEQUENCE PHASING, PROCEDURES AND SAFETY PRECAUTIONS FOR WORKERS AND PUBLIC DURING COURSE OF HIS PROJECT RELATED WORK ACTIVITES.
- 23. ALL CAT6 CABLES ARE TO BE TESTED TO TIA/568 B.2 OR LATEST STANDARDS. CABLES ARE TO BE TESTED FOR INSERTION LOSS, NEAR END CROSS TALK, POWER SUM NEAR END CROSS TALK, POWER SUM ATTENUATION TO CROSS TALK RATIO-NEAR END. FAR END CROSS TALK. ATTENUATION TO CROSS TALK RATIO, RETURN LOSS, WIRE MAP, PROPAGATION DELAY, DELAY SKEW AND LENGTH, PASS/FAIL SUBMISSIONS ARE NOT TO BE ACCEPTED, ONLY THE COMPLETE TEST REPORT INDICATING ALL OF THE PARAMETERS IS TO BE ACCEPTED BY CTA. CONTRACTOR IS TO SUBMIT A ELECTRONIC VERSION ON CD TO CTA DESIGNER OF RECORD FOR REVIEW. ALL CABLES ARE TO PASS AND CONTRACTOR AT THEIR EXPENSE REPAIR OR REPLACE SUCH CABLE/S THAT FAIL.

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NOTES:

- 1. SEE SHEET 292 FOR CONDUIT \(\sum_{\text{legend.}}\) LEGEND.
- 2. PROTECT EXISTING SPEAKER CONDUIT.
- RE-ROUTE NS CONDUIT TO NORTH EDGE OF PLATFORM AND REPLACE CABLE PRIOR TO DEMOLITION WORK.
- RE-ROUTE CONDUIT TO NORTH EDGE OF PLATFORM AND REPLACE ALL CCTV CABLES PRIOR TO DEMOLITION WORK.
- 5. EXISTING EQUIPMENT TO REMAIN SHOWN FOR INFORMATION ONLY. ACTUAL LOCATION MAY VARY.



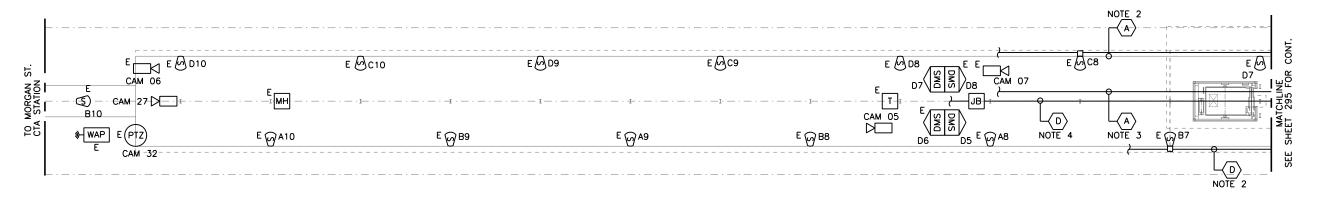

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WBE/DBE CERTIFIED
S940 West Toutry Avenue, Butle 210 Niles, IL 60714
Phone, 647-647-5000 - Fax: 647-647-4710

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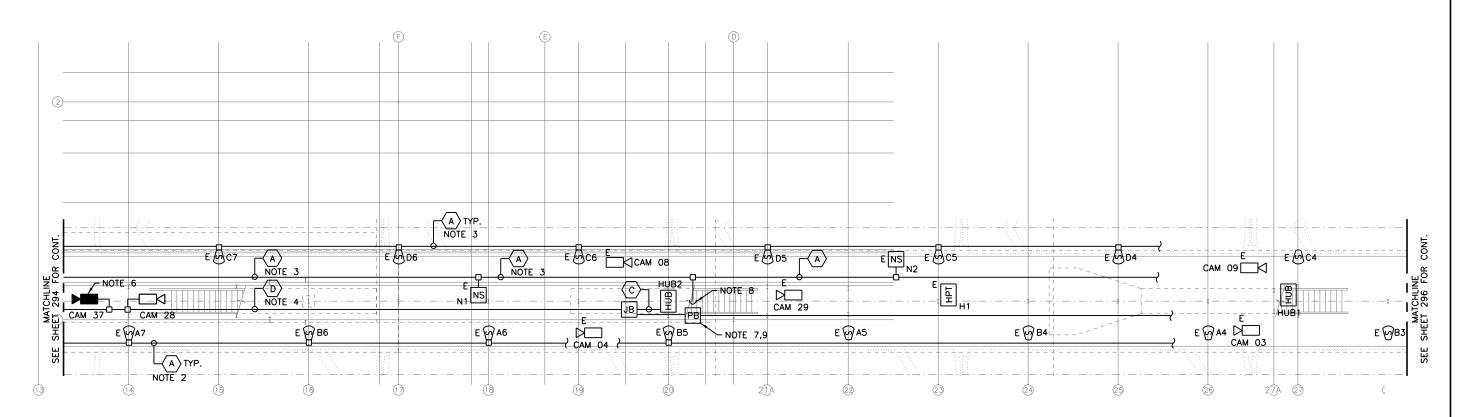
STATE OF ILLINOIS DEPARTMENT OF TRANSPORTATION PEORIA STREET STATION

COMMUNICATION PLATFORM LEVEL CENTER TO WEST EQUIPMENT PLAN

SHEET NO. 103 OF 117 SHEETS

NOTES:

- 1. SEE SHEET 292 FOR CONDUIT \(\sum_{\text{legend.}} \) LEGEND.
- 2. PROTECT EXISTING SPEAKER CONDUIT.
- 3. RE-ROUTE NS CONDUIT TO NORTH EDGE OF PLATFORM AND REPLACE CABLE PRIOR TO DEMOLITION WORK.
- 4. RE-ROUTE CONDUIT TO NORTH EDGE OF PLATFORM AND REPLACE ALL CCTV CABLES PRIOR TO DEMOLITION.
- 5. EXISTING EQUIPMENT TO REMAIN SHOWN FOR INFORMATION ONLY. ACTUAL LOCATION MAY VARY.
- 6. PROVIDE NEW FIXED CCTV CAMERA.
- 7. EXISTING RISER TO EXISTING COMMUNICATION CLOSET. REMOVE AND ROUTE NEW RISER TO NEW COMMUNICATION ROOM LOCATION AT STATION LEVEL.
- 8. EXISTING CONDUIT UP TO EXISTING NOISE SENSOR N4 LOCATEDMIN PEORIA ST. STATION. NOISE SENSOR N4 IS TO BE RELOCATED. PROVIDE NEW CONDUIT FROM PULL BOX AT PLATFORM TO NEW LOCATION. PROVIDE TEMP CABLE AS REQUIRED.
- 9. PROVIDE TEMPORARY CONNECTIONS FOR CABLING TO REMAIN.





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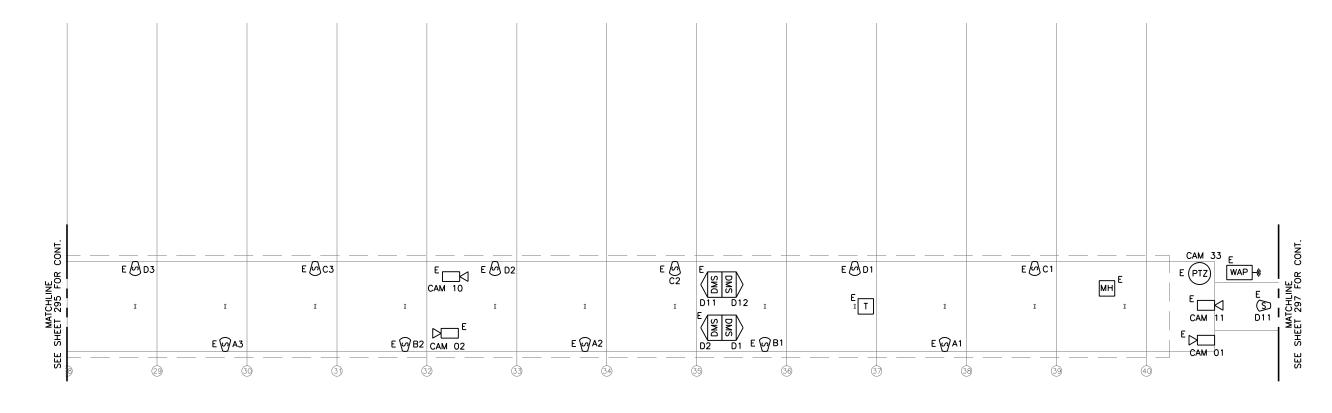
S940 Weet Toutry Avenue, Butle 210, Niles, IL 60714
Phone, 647-647-5000 - Fax. 647-647-4710

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STATE OF ILLINOIS
DEPARTMENT OF TRANSPORTATION

PEORIA STREET STATION					
COMMUNICATION	PLATFORM	LEVE	EL (CENTER	EQUIPMENT PLAN
	SHEET NO. 104	OF	117	SHEETS	

MUN SECTION COUNTY SHEETS					
MUN SECTION COUNTY SHEETS					295
	MUN	SECTION	COUNTY	TOTAL SHEETS	SHEE





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DEPARTMENT OF TRANSPORTATION

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PEORIA STREET STATION	MUN
COMMUNICATION PLATFORM LEVEL CENTER TO EAST EQUIPMENT PLAN	2090
SHEET NO. 105 OF 117 SHEETS	


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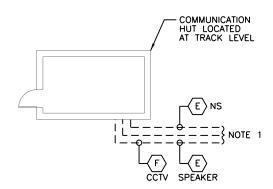
MUN SECTION COUNTY TOTAL SHEET NO. 2090 2013-011R COOK 356 296

CONTRACT NO. | ILLINOIS | FED. AID PROJECT

NOTES:

- EXISTING POLYDUCTS FOR SPEAKER, NS, CCTV, AND DMS CIRCUITS TO HALSTED ST. STATION.
- 2. SEE SHEET 292 FOR CONDUIT \(\sum_{\text{legend.}}\) LEGEND.



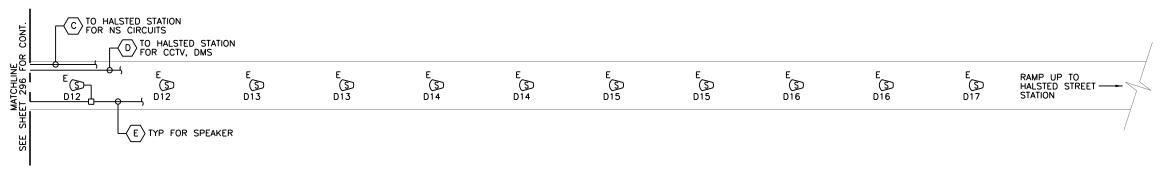

1 PLATFORM PLAN
SCALE: 1/8" = 1'-0"



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STATE OF ILLINOIS DEPARTMENT OF TRANSPORTATION

PEORIA STREET STATION

COMMUNICATION PLATFORM LEVEL EAST EQUIPMENT PLAN

SHEET NO. 106 OF 117 SHEETS

PRELIMINARY NOT FOR CONSTRUCTION

MUN SECTION COUNTY TOTAL SHEETS NO.
2090 2013-011R COOK 356 297

CONTRACT NO.

| ILLINOIS|FED. AID PROJECT

		NAMEPLATES	
NAME PLATE	ENGRAVING		
NP 1	LINE 1 LINE 2	CONTROL POWER AVAILABLE	
NP 2	LINE 1 LINE 2	SERVICE 1 FAILURE	
NP 3	LINE 1	FIRE ALARM TROUBLE	
NP 4	LINE 1	FIRE ALARM	
NP 5	LINE 1 LINE 2	ELEVATOR PIT HIGH WATER	
NP 6	LINE 1	INTRUSION	
NP 7	LINE 1	_	
NP 8	LINE 2 LINE 1	COMMON ALARM	
NP 9	LINE 1 LINE 2	ON OFF DUTY DUTY	
NP 10	LINE 1	ALARM RESET	
NP 11	LINE 1 LINE 2	ALARM SILENCE	


NAMEPLATES 1" X 2" WHITE WITH BLACK 1/8" LETTERS ATTACHED WITH STAINLESS STEEL HARDWARE

BILL OF MATERIAL					
ITEM NO.	QTY.	MANUFACTURER	CATALOG NUMBER	DESCRIPTION	
1	1	ILLINOIS SWITCHBOARD	BY DESCRIPTION	GASKETTED CONSOLET STYLE ENCLOSURE SIMILAR TO HOFFMANN C-12C16 EXCEPT MADE FROM 304 STAINLESS STEEL BRUSH FINISH	
2	6	EATON	10250T297LRP2A	FULL VOLTAGE PUSH TO TEST INDICATING LIGHT LIGHT WITH RED LENS AND RED LED	
3	1	EATON	10250T297LGP2A	FULL VOLTAGE PUSH TO TEST INDICATING LIGHT WITH GREEN LENS AND GREEN LED	
4	1	EATON	10250T297LAP2A	FULL VOLTAGE PUSH TO TEST INDICATING LIGHT WITH AMBER LENS AND AMBER PUSH TO TEST	
5	1	EATON	10250T3011 10250T53	BLACK LEVER OPERATED 2 POSITION SELECTOR SWITCH 1 N.O. CONTACT BLOCK	
6	1	EATON	10250T101 10250T53	BLACK PUSH BUTTON OPERATOR 1 N.O. CONTACT BLOCK	
7	1	EATON	10250T101 10250T51	BLACK PUSHBUTTON OPERATOR 1 N.C. CONTACT BLOCK	
8	1	MALLORY	SC110R	SONALERT ALARM BUZZER CONTINUOUS TONE 120V AC 80dB	
9	3	SQD	8501NR61	11 PIN SOCKET DIN RAIL MOUNT	
10	3	SQD	RUMC3AB2F7	3 PDT RELAY FULL FEATURE 120 VOLT AC COIL	
11	3	SQD	RUZC200	RELAY HOLD DOWN CLIP	
12	11	USD	NSS3	3 POINT 30 AMP 600 VOLT, SCREW TYPE TERMINAL BLOCK	

ALL CONTROL WIRING AWG #14 TYPE SIS ASSEMBLY TO BEAR UL INDUSTRIAL CONTROL LABEL

NOTES:

- PROVIDE NEW CCTV CAMERAS. REMOVE EXISTING CAMERAS AND HAND OVER TO CTA.
- 2. NEW CAMERA, INSTALL AT LOCATION AS SHOWN.
- 3. NEW SPEAKER INSTALL AT LOCATION AS SHOWN.
- 4. NEW EQUIPMENT. INSTALL AT LOCATION AS SHOWN.
- 5. SPEAKER MOUNTED IN FILLER SECTION OF CONTINUOUS LTG. PROVIDE INSULATED BACK BOX. REFER TO LIGHTING PLAN FOR EXACT LOCATION.
- 6. EXISTING EQUIPMENT IN RELOCATED POSITION.
- 7. PROVIDE WALL FIELD WITH PUNCH DOWN TERMINAL BLOCKS.
- 8. PROVIDE 3/4" EMPTY CONDUIT TO COMM. ROOM. SEE ELECTRICAL SITE PLAN FOR ADDITIONAL WORK.

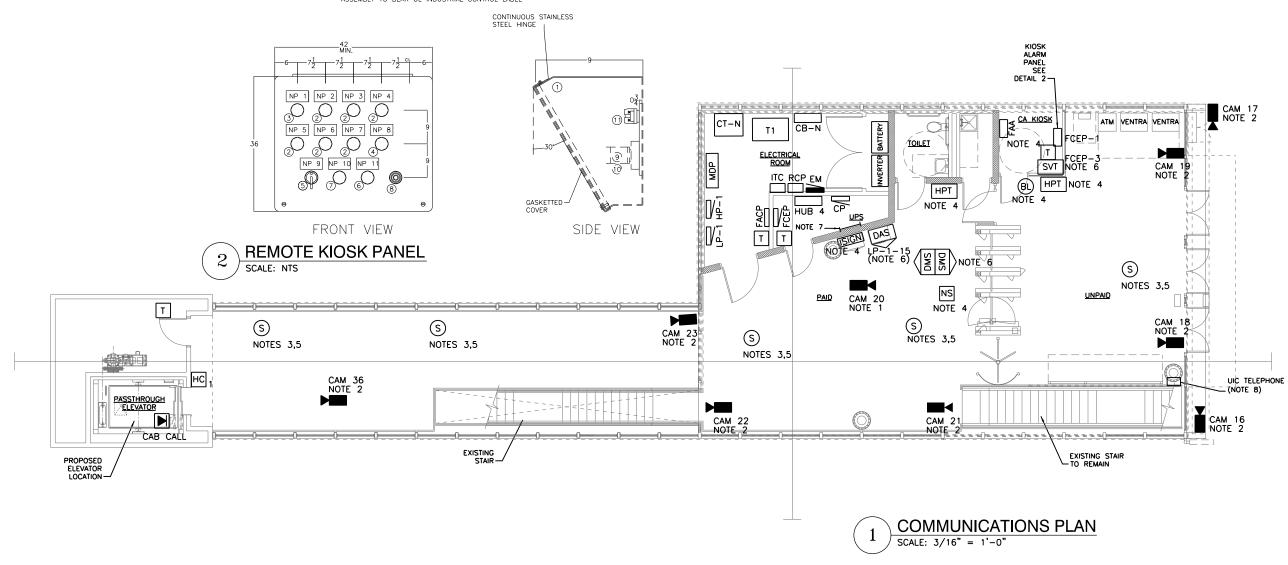


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STATE OF ILLINOIS DEPARTMENT OF TRANSPORTATION

PEORIA STREET STATION **COMMUNICATION STATION LEVEL EQUIPMENT PLAN** SHEET NO. 107 OF 117 SHEETS

PRELIMINARY NOT FOR CONSTRUCTION COUNTY TOTAL SHEETS NO. COOK 356 298 MUN SECTION 2090 2013-011R CONTRACT NO. 60W29



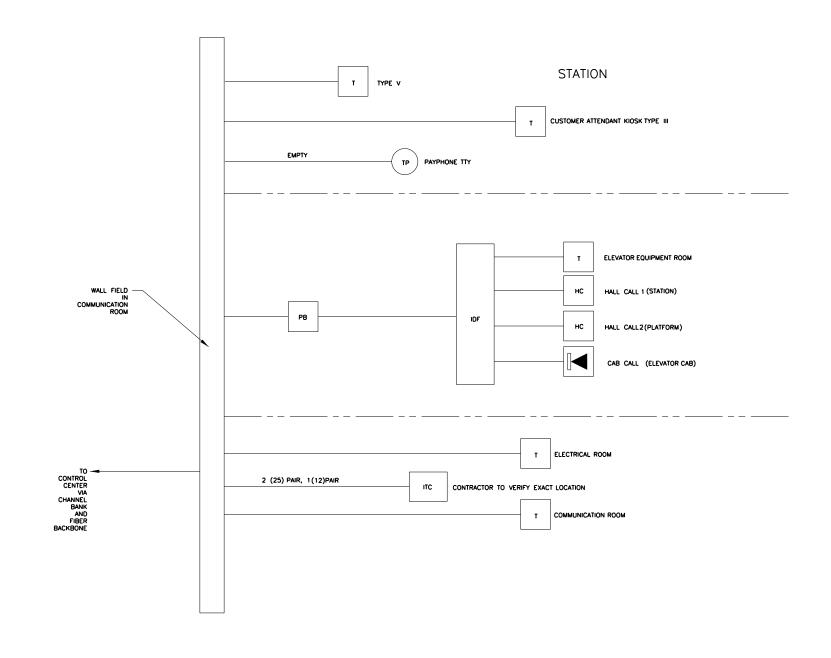

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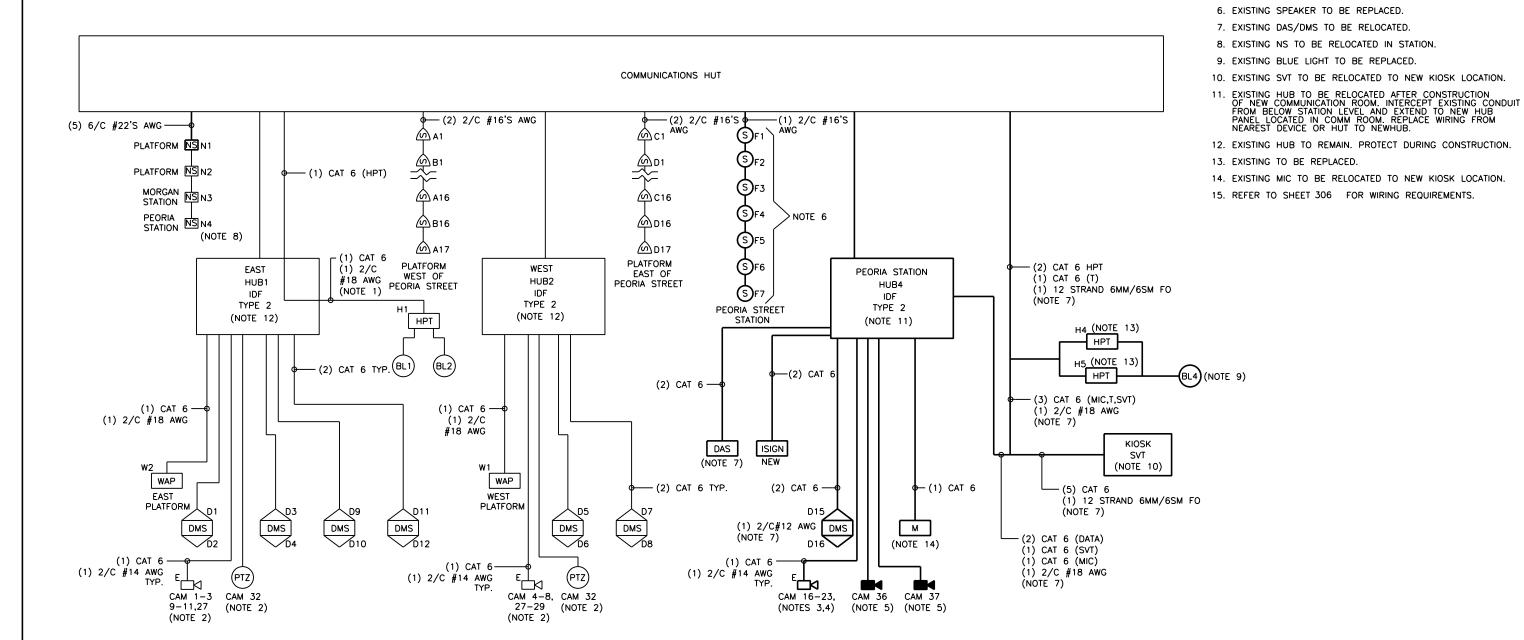
STATE OF ILLINOIS
DEPARTMENT OF TRANSPORTATION

PEORIA STREET STATION COMMUNICATION TELEPHONE SYSTEM BLOCK DIAGRAM SHEET NO.108 OF 117 SHEETS

PRELIMINARY NOT FOR CONSTRUCTION MUN SECTION 2090 2013-011R

COUNTY TOTAL SHEETS NO.
COOK 356 299 CONTRACT NO. 60W29

ILLINOIS FED. AID PROJECT



EXISTING EQUIPMENT WIRING DIAGRAM SCALE: NOT TO SCALE



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STATE OF ILLINOIS DEPARTMENT OF TRANSPORTATION

PEORIA STREET STATION COMMUNICATION EXISTING EQUIPMENT WIRING DIAGRAM SHEET NO. 109 OF 117 SHEETS

NOTES:

1. FOR TYPICAL HPT CABLING.

2. EXISTING CCTV CAMERAS LOCATED ON PLATFORM TO REMAIN.

4. TURN OVER EXISTING EQUIPMENT TO CTA.

EXISTING CCTV CAMERAS LOCATED IN PEORIA STREET STATION TO BE REPLACED.

5. NEW CCTV CAMERAS LOCATED IN PEORIA STREET STATION.

MUN SECTION COUNTY COOK 356 300 2090 2013-011R CONTRACT NO. 60W29

PRELIMINARY NOT FOR CONSTRUCTION