


ELEVATOR ROOF LEVEL ELECTRICAL PLAN SCALE: NTS

NOTES:

- GENERATOR TAP BOX, SEE SHEET 290 FOR DETAILS.
- 2. ADA DOOR OPERATOR.
- 3. EXHAUST FAN MOUNTED AT TOP OF ELEVATOR SHAFT.
- 4. FURNISH AND INSTALL 60A, 2P, 250V NONFUSED DISCONNECT ROUTED TO PANEL HP-1 CIRCUITS 19,21 WITH 2#6AWG AND 1#8AWG, 1"C GRS.
- 5. FURNISH AND INSTALL 100A, 3P, 250V NEMA 4X NONFUSED DISCONNECT SWITCH. FOR LOCAL DISCONNECT FOR ELEVATOR MACHINE AT ROOF LEVEL OF ELEVATOR SHAFT.
- 6. CONTINUOUS DIVIDED WIREWAY MOUNTED ON EXISTING STRUCTURAL TUBING ABOVE DOOR PAINTED TO MATCH EXISTING STRUCTURE.
- COMED METER IN CABINET. PROVIDE 1" CONDUIT DOWN THROUGH FLOOR TO ELECTRICAL ROOM TO CT-N.

- PROVIDE HEAT TRACE, POWER, AND CONTROLS FOR ALL PLUMBING PIPING (SUMP PUMP, WATER, SANITARY, AND VENT). REFER TO SHEET 265 FOR EXACT LOCATIONS ROUTING OF PIPING. MAXIMUM LENGTH OF HEAT TRACE PER CIRCUIT TO BE 200 LF. SEE SHEET 277 FOR CIRCUITING.
- PROVIDE 2-2" CONDUITS
 BETWEEN EACH TURNSTYLE AND
 END CABINET THAT ARE TO BE
 ROUTED BELOW THE FLOOR.
 PROVIDE 2-3/4" CONDUITS BACK
 TO KIOSK. pROVIDE 2-1" CONDUITS
 BACK TO COMM ROOM.
- 10. ALL CONDUITS TO BE ROUTED BELOW FLOOR SLAB.
- 11. PROVIDE 1" CONDUIT FROM EACH VENTRA AND ATM TO COMM ROOM.

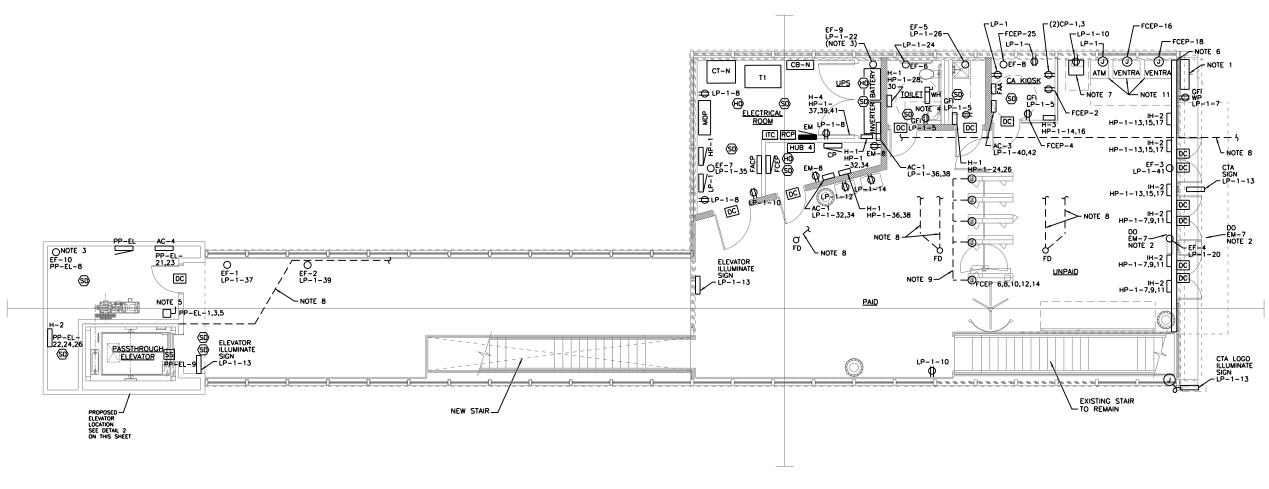

ELECTRICAL POWER PLAN SCALE: 3/16" = 1'-0"

AAA ENGINEERING
WBE/DBE CERTIFIED **Tran** Systems

SER NAME = habib	DESIGNED -	REVISED	_
	CHECKED -	REVISED	
LOT SCALE = 10:8 ':" / in.	DRAWN -	REVISED	
LOT DATE = 10/28/2013	CHECKED -	REVISED	

STATE OF ILLINOIS DEPARTMENT OF TRANSPORTATION

PEORIA STREET STATION **ELECTRICAL STATION HOUSE POWER PLAN** SHEET NO.81 OF 117 SHEETS

PRELIMINARY NOT FOR CONSTRUCTION COUNTY TOTAL SHEETS NO. COOK 356 272 MUN SECTION 2090 2013-011R CONTRACT NO. 60W29