STATE OF ILLINOIS
DEPARTMENT OF TRANSPORTATION
DIVISION OF HIGHWAYS

PLANS FOR PROPOSED FEDERAL AID HIGHWAY

FAU ROUTE 1004 (BLUFF AVENUE)
SECTION 08-00079-01-FP
COSSITT AVENUE (FAU ROUTE 1365) TO
BURLINGTON AVENUE (FAU ROUTE 3557)
PROJECT NO. M-9003 (113)
COOK COUNTY

C-91-107-09

BENTON

PROJECT STAGE 1

FOR INDEX OF SHEETS SEE SHEET NO. 2

PROJECT LOCATED IN THE VILLAGE OF LA GRANGE

SECTION 4, TOWNSHIP 38N, RANGE 12E LYONS TOWNSHIP

100' 200' 300' 1"= 100' 10' 20' 30' 1"= 10' 50' 100' 1"= 50' 1"= 50' 100' 1"= 40' 100' - 1"= 30' 100' - 1"= 20'

FULL SIZE PLANS HAVE BEEN PREPARED USING STANDARD ENGINEERING SCALES; REDUCED SIZED PLANS WILL NOT CONFORM TO STANDARD SCALES. IN MAKING MEASUREMENTS ON REDUCED PLANS, THE ABOVE SCALES MAY BE USED.

FOR UTILITY INFORMATION CALL J.U.L.I.E. 1-800-892-0123

CONTRACT NO. 63007

TRAFFIC DATA 4,157 ADT BLUFF AVENUE (2025 EST.) SPEED LIMIT = 25 MPH

GROSS LENGTH OF PROJECT = 1,572.32 LINEAL FEET = 0.298 MILES NET LENGTH OF PROJECT = 1,572.32 LINEAL FEET = 0.298 MILES

FAU 1488

THESE PLANS WERE PREPARED BY HEUER AND ASSOCIATES, P.C. UNDER THE DIRECT SUPERVISION OF PAUL F. HARRING, P.E., A REGISTERED PROFESSIONAL ENGINEER OF THE STATE OF ILLINOIS.

PAUL F. HARRING, P.E.
REGISTRATION NO. 62-040352
EXPIRATION DATE: 11/30/09


VILLAGE OF LA GRANGE LIMITS


PROJECT LOCATION

PROJECT ENDS STATION 45+53.65

> OSEADO 082 040352 REGISTERED PROFESSIONAL ENGINEER OF

DATE: 8.29.2008

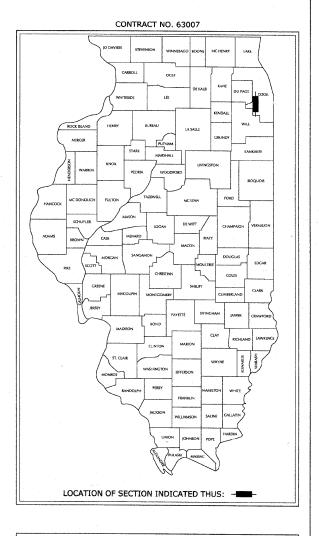

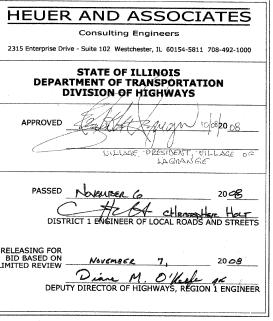

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DATE		
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BY DATE						
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	SURVEYED	PLOTTED	GRADES CHECKED	B.M. NOTED	STRUCTURE NOT	

EXISTING SYMBOL	PROPOSED SYMBOL	DESCRIPTION
හි	0	DECIDUOUS TREE
貘	***	EVERGREEN TREE
Ø	2	HANDHOLE, TYPE A
	•	CONCRETE LIGHTPOLE - ARM TYPE
× ×)	LIGHTPOLE - LA GRANGE RESIDENTIAL STANDARD
ø		POWER POLE
0	•	MANHOLE
0	•	CATCHBASIN
- 🗆	•	INLET
\otimes	•	VALVE & VAULT
\otimes	8	VALVE BOX
Δ	▼	В-ВОХ
Ø.	₩ .	FIRE HYDRANT
E	, ·	ELECTRICAL VAULT
		TELEPHONE VAULT
— Е ——		ELECTRIC CABLE
G		GAS MAIN
— T ——		TELEPHONE CABLE/DUCT
W		WATER MAIN
—<(-	 (COMBINATION SEWER
		SANITARY SEWER
		STORM SEWER
-		SEWER SERVICE
		WATER SERVICE
MANHOLE RIM=704.99 INV=692.51 N INV=692.51 S	STRUCTURE # RIM: 600.00 INV: 595.00	STRUCTURE RIM AND INVERTS
		COMBINATION CURB AND GUTTER
		PROPOSED P.C.C. DRIVEWAY
		PROPOSED P.C.C. SIDEWALK
×+	,	PROPOSED TRANSITION PATCH
		PROPOSED HMA SURFACE COURSE
	V	- BUTT JOINT PROPOSED DETECTABLE

Consulting Engineers

TO STA. 2315 Enterprise Drive - Suite 102 Westchester, IL 60154-5811 708-492-1000 FED. ROAD DIST. NO. 1 ILLINOIS FED. AID PROJECT

CONTRACT No. 63007

INDEX OF SHEETS						
SHEET NUMBER						
1 2 3 4 5-6 7 8 9 10 11 12-14 15-17 18-20 21-23 24-26 27-29 30-32 33-38 39-46						

 S	TATE STANDARDS
STANDARD No.	DRAWING TITLE
280001-05 701501-05 701801-04 7049-01-01 729001-01 780001-02	TEMPORARY EROSION CONTROL SYSTEMS URBAN LANE CLOSURE, 2L, 2W UNDIVIDED SIDEWALK CLOSURE TRAFFIC CONTROL DEVICES APPLICATIONS OF TYPES A & B METAL POSTS FOR SIGNS AND MARKERS TYPICAL PAVEMENT MARKINGS
 DISTRICT 1 STANDARDS	
 TC 11 TC 13	RAISED REFLECTIVE PAVEMENT MARKERS TYPICAL PAVEMENT MARKING

REVISIONS	,,,,,,,,,,,,,,,,,,,,,,,,,,,,,,,,,,,,,,,	ILLINOIS DEDARTMENT	OF TRANSPORTATION
NAME	DATE		
		BLUFF AVENUE	IMPROVEMENTS
		1	GE 1
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		INDEX OF SHEETS	STATE STANDARDS
		AND	EGEND
		ANDL	EGEND
		SCALE:	
			DRAWN BY H&A
		DATE 07/18/2008	CHECKED BY PFH

GENERAL NOTES

- 1. ALL CONSTRUCTION SHALL BE COMPLETED IN ACCORDANCE WITH THE SPECIFICATIONS, GENERAL CONDITIONS, SPECIAL PROVISIONS, AND OTHER CONTRACT REQUIREMENTS OF THE OWNER; CODES, STANDARDS, AND ORDINANCES OF THE VILLAGE OF LA GRANGE; PLANS, DETAILS, AND SPECIFICATIONS ISSUED BY THE ENGINEER; THE APPLICABLE PROVISIONS OF THE 2007 EDITION OF THE "STANDARD SPECIFICATIONS FOR ROAD AND BRIDGE CONSTRUCTION"; THE 2003 EDITION OF THE "LILINOIS MANUAL OF UNIFORM TRAFFIC CONTROL DEVICES FOR STREETS AND HIGHWAYS"; THE 1996 EDITION OF THE "STANDARD SPECIFICATIONS FOR WATER AND SEWER MAIN CONSTRUCTION IN ILLINOIS"; AND THE 1999 EDITION OF THE "MANUAL OF PROCEDURES FOR THE ADMINISTRATION OF A SEWER PERMIT ORDINANCE"; INCLUDING ALL APPLICABLE SUPPLEMENTAL SPECIFICATIONS AND REVISIONS. SUPPLEMENTAL SPECIFICATIONS AND REVISIONS.
- 2. THE CONTRACTOR SHALL BE RESPONSIBLE FOR DETERMINING THE LOCATION 2. THE CONTACTOR SHALL BE RESPONSIBLE FOR DETERMINING THE LOCATION OF ALL UNDERGROUND UTILITIES AND SHALL CONTACT J.U.L.I.E. (1-800-892-0123), THE OWNER, AND EACH OF THE OTHER MUNICIPAL, GOVERNMENTAL AND/OR PRIVATE UTILITY COMPANIES, WHICH MAY HAVE THEIR FACILITIES LOCATED WITHIN THE LIMITS OF THE PROPOSED IMPROVEMENTS TO AID IN THE LOCATION OF FACILITIES. THE CONTRACTOR SHALL PROVIDE THE OWNER AND ALL PERMITTING AGENCIES AT LEAST TWO (2) WORKING DAYS OF NOTICE PROPOSED THE COMPANIES OF CONTRACTOR MORTUSTED. NOTICE PRIOR TO THE COMMENCEMENT OF CONSTRUCTION ACTIVITIES.
- 3. THE CONTRACTOR SHALL INDEMNIFY AND HOLD HARMLESS THE OWNER, AND THE ENGINEER FROM AND AGAINST ALL CLAIMS, DAMAGES, LOSSES, AND EXPENSES, DIRECT, INDIRECT, OR CONSEQUENTIAL, ARISING OUT OF, OR FROM THE PERFORMANCE OF THE WORK.
- 4. ALL FENCES, BUILDINGS, WALKWAYS, TREES, LANDSCAPING, AND OTHER EXISTING FEATURES IN PRIVATE PROPERTY AREAS ADJACENT TO THE PROJECT LIMITS SHALL BE PROTECTED FROM DAMAGE DURING THE COURSE OF CONSTRUCTION, UNLESS OTHERWISE SPECIFIED BY THE OWNER. DAMAGED PROPERTY SHALL BE RESTORED BY THE CONTRACTOR TO THE SATISFACTION OF THE OWNER WITHOUT ADDITIONAL COMPENSATION.
- 5. ALL SAW CUTTING REQUIRED TO DEFINE PAVEMENT REMOVAL LIMITS OR TO CUT OTHER MATERIALS REQUIRED IN THE CONSTRUCTION OF THE PAVING IMPROVEMENTS SHALL BE CONSIDERED AS INCIDENTAL TO THE PAVING WORK.
- 6. THE CONTRACTOR SHALL PROTECT PAVEMENTS, WALKS, CURBS, BURIED STRUCTURES, AND OTHER SUCH FEATURES WITHIN AND ADJACENT TO THE PAVEMENT WORK ZONE NOT DESIGNATED FOR REMOVAL. DAMAGED MATERIALS SHALL BE REPLACED AT THE SOLE EXPENSE OF THE CONTRACTOR.
- 7. ALL TRENCHES SHALL BE EXCAVATED AT THE MINIMAL WIDTH REQUIRED TO INSTALL THE SEWER PIPE, AS INDICATED IN THE PLAN DETAILS. THE CONTRACTOR SHALL MAKE ALLOWANCES FOR ANY SHEETING, SHORING, BRACING, TRENCH BOXES, OR OTHER MEASURES REQUIRED TO INSTALL THE SEWER AND MAINTAIN MINIMAL TRENCH WIDTHS. THE CONTRACTOR SHALL MAKE PROVISIONS TO MANAGE GROUND WATER OR SEWER FLOW BY PUMPING OR FLUMING THROUGH THE WORK ZONE DURING THE COURSE OF CONSTRUCTION. ALL TRENCH SUPPORT OR WATER MANAGEMENT MEASURES REQUIRED SHALL BE CONSIDERED AS INCIDENTAL TO THE SEWER WORK INCIDENTAL TO THE SEWER WORK.
- 8. THE CONTRACTOR SHALL MANAGE THE PLACEMENT AND HANDLING OF ALL NEW MATERIALS AND WASTE MATERIALS GENERATED BY THE CONSTRUCTION OPERATIONS. CONSTRUCTION ACCESS POINTS TO THE SITE SHALL BE PROTECTED IN SUCH A WAY AS TO PREVENT TRACKING OF SOIL AND AGGREGATE ONTO PUBLIC THOROUGHFARES. AT THE END OF EACH WORK DAY THE CONTRACTOR SHALL PERFORM SITE MAINTENANCE REMOVING AND/OR RELOCATING MATERIALS WHICH INTERFERE WITH PUBLIC USE OF AREAS ADJACENT TO THE WORK ZONE, KEEPING SIDEWALKS, ROADWAYS, AND OTHER PASSAGE-WAYS FREE OF ACCEMENTATION OF MATERIAL OF MATERIALS OF MATERIAL OF MATERIALS OF MATERIAL DEPRIS OF ACCUMULATIONS OF WATER, MUD, SPOIL, AND OTHER CONSTRUCTION DEBRIS.
- 9. ALL DISTURBED LANDSCAPE AREAS SHALL BE RESTORED WITH THE SPECIFIED LANDSCAPE MATERIALS IN ACCORDANCE WITH SEASONAL AND PROJECT PLANTING SCHEDULES. A MINIMUM OF FOUR INCHES OF TOPSOIL SHALL BE PLACED ON CLEAN PREPARED SOILS WHERE LANDSCAPE AREAS ARE TO BE ESTABLISHED. PROVISIONS SHALL BE MADE FOR WATERING AND MAINTENANCE UNTIL PLANTING MATERIALS HAVE BECOME ESTABLISHED AS OUTLINED IN SECTION 253 OF THE IDOT STANDARD SPECIFICATIONS.
- 10. THE CONTRACTOR SHALL RECORD DIMENSIONS AND ELEVATIONS OF CONSTRUCTED UTILITIES AND MAINTAIN A COPY OF THE SUCH RECORDS ON MARKED DRAWINGS TO DOCUMENT CHANGES. THE RECORD DRAWINGS SHALL BE PROVIDED TO THE ENGINEER AT THE COMPLETION OF THE CONSTRUCTION WORK.

MWRD GENERAL NOTES

- 1. THE METROPOLITAN WATER RECLAMATION DISTRICT OF GREATER CHICAGO (MWRDGC), LOCAL SEWER SYSTEMS SECTION, FIELD OFFICE SHALL BE NOTIFIED AT LEAST TWO (2) WORKING DAYS PRIOR TO THE COMMENCEMENT OF SEWER WORK TO COORDINATE INSPECTION SERVICES, (708-588-4055)
- 2. THE PLAN ELEVATIONS ARE BASED UPON A USGS DATUM ELEVATION. THE CITY OF CHICAGO STANDARD DATUM IS 579.48 FEET LOWER THAN THE PLAN
- 3. ALL FLOOR DRAINS SHALL DISCHARGE TO THE SANITARY SEWER SYSTEM.
- 4. ALL DOWNSPOUTS AND FOOTING DRAINS SHALL DISCHARGE TO THE GROUND SURFACE OR STORM WATER DRAINAGE SYSTEM.
- 5. ALL SANITARY SEWER PIPE MATERIALS AND JOINTS (AND STORM SEWER PIPE MATERIALS AND JOINTS IN COMBINED SEWER AREAS) SHALL CONFORM TO FOLLOWING LISTED SPECIFICATIONS:

MATERIAL: POLY VINYL CHLORIDE (PVC) CYLINDER SPECIFICATION: SDR 26, ASTM D-3034 JOINT SPECIFICATION: ASTM D-3212

MATERIAL: CEMENT LINED CAST DUCTHE IRON (DI CYLINDER SPECIFICATION: CLASS 52, ANSI A-21.51 JOINT SPECIFICATION: ANSI A-21.11

MATERIAL: REINFORCED CONCRETE PIPE (RCP)
CYLINDER SPECIFICATION: ASTM C-76
JOINT SPECIFICATION: ASTM C-443 OR ASTM D-=361

- 6. ALL SANITARY SEWER CONSTRUCTION, AND STORM SEWER CONSTRUCTION IN COMBINED SEWER AREAS, REQUIRES STONE BEDDING WITH A 1/4 INCH TO 1 INCH GRADATION WITH A MINIMUM BEDDING THICKNESS EQUAL TO ONE QUARTER OF THE OUTSIDE DIAMETER OF THE SEWER PIPE, BUT NOT LESS THAN 4 INCHES NOR MORE THAN 8 INCHES IN THICKNESS. THE BEDDING MATERIAL SHALL ALSO BEING PLACED TO A DEPTH OF AT LEAST 12 INCHES ABOVE THE TOP OF THE SEWER PIPE WHEN USING PVC SEWER MATERIAL. ALL BEDDING MATERIAL SHALL CONSIST OF CRUSHED LIMESTONE, CONFORMING TO IDOT GRADATION CA-11 OR CA-13. GRADATION CA-11 OR CA-13.
- 7. NON-SHEAR TYPE FLEXIBLE TYPE COUPLINGS, FERNCO, BAND-SEAL, OR EQUAL SHALL BE USED IN THE CONNECTION OF SEWER PIPES OF DISSIMILAR MATERIALS, AND TO JOIN NEW AND OLD PIPE OR SIMILAR COMPOSITION WHEN POINT REPAIRS ARE REQUIRED.
- 8. WHEN CONNECTING TO AN EXISTING SEWER MAIN BY MEANS OTHER THAN AN EXISTING WYE, TEE, OR MANHOLE, THE CONNECTION CAN BE MADE BY (A) INSTALLING A NEW MANHOLE TO ACCEPT THE PROPOSED BRANCH SEWER; OR INSTALLING A NEW MANHOLE TO ACCEPT THE PROPOSED BRANCH SEWER; OR (B) BY CIRCULAR SAW-CUTTING THE SEWER MAIN WITH A PROPER TAPPING MACHINE AND THE INSTALLATION OF AN APPROVED HUB WYE SADDLE OR HUB TEE SADDLE IN ACCORDANCE WITH MANUFACTURERS RECOMMENDATION; OR (C) BY REMOVING AN ENTIRE SECTION OF PIPE AND INSTALLING A MANUFACTURED WYE OR TEE FITTING. WHEN REMOVING THE PIPE SECTION A PIPE CUTTER, SHALL BE USED TO NEATLY AND ACCURATELY CUT OUT A DESIRED LENGTH OF PIPE FOR INSERTION OF THE PROPER FITTING. BAND-SEAL OR SIMILAR FLEXIBLE COUPLINGS ARE TO BE USED TO FASTEN AND SECURE THE INSERTED FITTING AND PIPE TO THE EXISTING SEWER.
- 9. WHEREVER A SANITARY OR COMBINED SEWER CROSSES UNDER A WATERMAIN, THE MINIMUM VERTICAL DISTANCE FROM THE TOP OF THE SEWER TO THE BOTTOM OF THE WATERMAIN SHALL BE 18 INCHES. FURTHERMORE, A MINIMUM HORIZONTAL DISTANCE OF 10 FEET BETWEEN THE SEWERS AND WATER MAINS SHALL BE MAINTAINED UNLESS THE SEWER IS LAID IN A SEPARATE TRENCH, KEEPING A MINIMUM OF 18 INCHES VERTICAL SEPARATION; OR THE SEWER IS LAID SO THAT THE WATERMAIN IS LOCATED IN THE SAME TRENCH ON A BENCH OF UNDISTURBED EARTH, KEEPING A MINIMUM 18 INCH VERTICAL SEPARATION. IF EITHER THE VERTICAL OR HORIZONTAL DISTANCES DESCRIBED ABOVE CANNOT BE MAINTAINED, OR THE SEWER CROSSES ABOVE THE WATERMAIN, THE SEWER SHALL BE CONSTRUCTED TO WATER MAIN STANDARDS.
- 10. ALL EXISTING SEPTIC TANKS SHALL BE ABANDONED. ABANDONED TANKS SHALL BE FILLED WITH GRANULAR MATERIAL OR REMOVED.
- 11. ALL SANITARY MANHOLES, AND ALSO STORM MANHOLES IN COMBINED SEWER AREAS, SHALL HAVE A MINIMUM INSIDE DIAMETER OF 48 INCHES AND SHALL BE CAST IN PLACE OR PRECAST REINFORCED CONCRETE. ALL SANITARY SEWER PIPE CONNECTIONS TO MANHOLES SHALL BE CONSTRUCTED USING RESILIENT CONNECTORS OR COUPLINGS CONFORMING TO ASTM C923 TO MAINTAIN A WATERTIGHT SEAL.
- 12. ALL SEWER CONSTRUCTION SHALL CONFORM TO THE PLANS, OR REVISED PLANS, AS APPROVED UNDER THE PERMIT ISSUED BY THE MWRDGC.
- 13. THE MAXIMUM ALLOWABLE RATE OF INFILTRATION FOR SANITARY SEWERS SHALL NOT EXCEED 100 HUNDRED GALLONS PER TWENTY-FOUR HOURS, PER MILE, PER INCH-DIAMETER OF PIPE.
- 14. ALL SANITARY SEWERS SHALL BE INSPECTED AND TESTED IN ACCORDANCE WITH THE REQUIREMENTS OF THE MWRD
- 15. ABANDONED PIPES OR CONDUITS, SHALL BE REMOVED AND/OR SECURELY PLUGGED WITH CONCRETE EXTENDING A MINIUM LENGTH OF 2 FEET.

HEUER AND ASSOCIATES

Consulting Enginee

2315 Enterprise Drive - Suite 102 Westchester, IL 60154-5811 708-492-1000

TOTAL SHEET SHEETS No. 1004 08-00079-01-FP соок 46 3 STA TO STA FED. ROAD DIST. NO. 1 ILLINOIS FED. AID PROJECT

COUNTY

SECTION

CONTRACT No. 63007

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REVISIO		HELINIOIS	DEPARTMENT C	F TRANSPORTATION	
NAME	DATE				
		BLUFF	AVENUE II	MPROVEMENTS	
			GENERAL	NOTES	
		SCALE:		DRAWN BY H&A	
		DATE 07/18/:	2008	CHECKED BY PFH	

Consulting Engineers

2315 Enterprise Drive - Suite 102 Westchester, IL 60154-5811 708-492-1000

1004 08-00079-01-FP COOK 46 4	F.A.U. RTE.	SECTION		COUNTY	TOTAL SHEETS	SHEET No.	
STA TO STA	1004	08-00079-0	L-FP	соок	46	4	
151A. 1551A.	STA. TO STA.						

CONTRACT No. 63007

		,	SUMMARY OF QUANTITIES				
#	CODE #		CONTRACT ITEM	QTY	UNIT	STU 1000	NON- PART
1	20101400	7	NITROGEN FERTILIZER NUTRIENT	27	POUND	27	
2	20101500	100	PHOSPHORUS FERTILIZER NUTRIENT	27	POUND	27	
3	20101600	a,	POTASSIUM FERTILIZER NUTRIENT	27	POUND	27	
4	20101700		SUPPLEMENTAL WATERING	30	UNIT	30	
5	20200100		EARTH EXCAVATION	886	CU YD	886	:
6	20200200		ROCK EXCAVATION	25	CU YD	25	
7	21001000		GEOTECHNICAL FABRIC FOR GROUND STABILIZATION	5,786	SQ YD	5,786	
8	21101615	3.	TOPSOIL FURNISH AND PLACE, 4"	2,201	SQ YD	2,201	
9	25200650		SODDING, SALT TOLERANT, SPECIAL	2,201	SQ YD	2,201	
10	28000510		INLET FILTERS	18	EACH	18	
11	31101000	Γ	SUB-BASE GRANULAR MATERIAL, TYPE B	1,505	TON	1,505	
12	40201000		AGGREGATE FOR TEMPORARY ACCESS	36	TON	36	:
13	40600100		BITUMINOUS MATERIALS (PRIME COAT)	2,264	GALLON	2,264	
14	40600300		AGGREGATE (PRIME COAT)	10	TON	10	
15	40600982		HOT-MIX ASPHALT SURFACE REMOVAL - BUTT JOINT	264	SQ YD	264	
16	40701921		HOT-MIX ASPHALT PAVEMENT (FULL DEPTH), 12"	5,031	SQ YD	5,031	
17	42001300		PROTECTIVE COAT		SQ YD	2,350	
18	42300300		PORTLAND CEMENT CONCRETE DRIVEWAY PAVEMENT, 7 INCH		SQ YD	446	
19	42400200		PORTLAND CEMENT CONCRETE SIDEWALK 5 INCH		SQ FT	10,763	
20	44001900	_	COMBINATION CURB AND GUTTER REMOVAL (SPECIAL)		FOOT	3,179	
21	44004400	_	PAVEMENT REMOVAL (SPECIAL)		SQ YD	5,396	
22	44004700		SIDEWALK REMOVAL (SPECIAL)	, , , ,	SQ FT	11,309	
23	550B0320	-	STORM SEWERS, CLASS B, TYPE 2 8"		FOOT	253	
24	550B0330	45	STORM SEWERS, CLASS B, TYPE 2 10"		FOOT	81	
25	550B0340		STORM SEWERS, CLASS B, TYPE 2 12"		FOOT	443	
26	550B0360	-	STORM SEWERS, CLASS B, TYPE 2 15"		FOOT	22	
27		*	DUCTILE IRON WATER MAIN 6"		FOOT		
28	56103100		DUCTILE IRON WATER MAIN 8"		FOOT		
29			DUCTILE IRON WATER MAIN 12"		FOOT		
30			WATER VALVES 12"		EACH		
31	56400500		FIRE HYDRANT TO BE REMOVED	1 2			
32			FIRE HYDRANT WITH AUXILIARY VALVE AND VALVE BOX	2			
33	60201330	-	CATCH BASINS, TYPE A, 4'-DIAMETER, TYPE 23 FRAME AND GRATE	7		7	
34	60218400	-	MANHOLES, TYPE A, 4'-DIAMETER, TYPE 1 FRAME, CLOSED LID	4		4	
35	60237460	-	INLETS, TYPE A, TYPE 23 FRAME AND GRATE	5		5	
36	60248900		VALVE VAULTS, TYPE A, 5'-DIAMETER, TYPE 1 FRAME, CLOSED LID	3		3	
37	60250200	-	CATCH BASINS TO BE ADJUSTED	7	EACH	7	
38	60255500	-	MANHOLES TO BE ADJUSTED		EACH	2	
39	60255800	-	MANHOLES TO BE ADJUSTED WITH NEW TYPE 1 FRAME, CLOSED LID	2		2	
40	60500040	-	REMOVING MANHOLES	1		- 4	
41	60500040	-	REMOVING CATCH BASINS	8		8	
41	80300030	<u> </u>	INCHIOVING CATCH DASINS	1 8	EACH	- 8	

#	CODE #		CONTRACT ITEM	QΤΥ	UNIT	STU IOOO	NON- PART
42	60500060	5,7	REMOVING INLETS	2	EACH	2	
43	60600605		CONCRETE CURB, TYPE B	140	FOOT	140	
44	60604400		COMBINATION CONCRETE CURB AND GUTTER, TYPE B-6.18	3,181	FOOT	3,181	
45	66700095		PERMANENT SURVEY MARKERS	1	EACH	1	
46	67100100		MOBILIZATION	1	L SUM	1	
47	70101700		TRAFFIC CONTROL AND PROTECTION	1	L SUM	1	
48	70101900		TRAFFIC CONTROL AND PROTECTION (DETOUR 1)	1	L SUM	1	
49	72000100	7	SIGN PANEL - TYPE 1	109	SQ FT	109	
50	72800100	*	TELESCOPING STEEL SIGN SUPPORT	225	FOOT	225	
51	78000100	*	THERMOPLASTIC PAVEMENT MARKING, LETTERS & SYMBOLS	16	SQ FT	16	
52	78000200		THERMOPLASTIC PAVEMENT MARKING - LINE 4"	315		315	
53	78000400		THERMOPLASTIC PAVEMENT MARKING - LINE 6"	80		80	
54	78000600		THERMOPLASTIC PAVEMENT MARKING - LINE 12"	54	FOOT	54	
55	78000650		THERMOPLASTIC PAVEMENT MARKING - LINE 24"	86	FOOT	86	
56	78100100		RAISED REFLECTIVE PAVEMENT MARKER	70		70	
57	X0322917	-	PROPOSED STORM SEWER CONNECTION TO EXISTING MANHOLE	3	EACH	3	
58	XX000717		STORM SEWER CONNECTION, SPECIAL	2	EACH	2	
59		*	VALVE VAULTS TO BE ABANDONED	2	EACH		
60	XX001109		PORTLAND CEMENT CONCRETE ALLEY PAVEMENT, 8"	42		42	
61	XX002981	*	BUFFALO BOX ADJUSTMENT, SPECIAL	12			1
62	XX003037	-	DUCTILE IRON FITTINGS AND ACCESSORIES		POUND		4,10
63	XX003057	-	CAST IRON VAPOR TRAPS	7	EACH	7	
64			WATER SERVICE CONNECTION 1"	19			1
65			SANITARY SEWER SERVICE, 6"	264		264	
66	XX003303		PRESSURE TESTING AND DISINFECTION	1			
67	XX004384		SHUT DOWN CONNECTION	2	EACH		
68	XX005314	-	BITUMINOUS DRIVEWAY REMOVAL	204		204	
69	XX006698	-	TREE PROTECTION AND PRESERVATION	49		49	
70		_	CLASS C PATCHES (SPECIAL)	24		24	
71	XX007357		CLASS D PATCHES (SPECIAL)		SQ YD	58	
72	X4420132		COPPER WATER SERVICE IN TRENCH, 1"		FOOT	- 30	59
		<u> </u>	DETECTABLE WARNINGS. SPECIAL				
	XX007729	*	DETECTABLE WARNINGS, SPECIAL GULFBOX TO BE ADJUSTED	160	SQ FT EACH	<i>160</i>	
		_			SQ YD	264	
	XX000405		BUTT JOINTS, SPECIAL	48		48	
76	XXanro		MULCH PLACEMENT, SPECIAL	48	EACH		
	Cata	*	A CONTRACTOR OF THE PROPERTY O		- FACIL	1	
			RELOCATE EXISTING LIGHTING YNIT	100			
79	XX007754	*	TRENCH BACKFILL, CA-11 TRENCH BACKFILL, CA-6		CU YD	78 371	51 51

* = DENOTES SPECIALTY ITEM

REVISIONS NAME D	AIE I	ENT OF TRANSPORTATION
		JE IMPROVEMENTS TAGE 1
	SUMMARY	OF QUANTITIES
	SCALE:	DRAWN BY H&A
	DATE 08/28/2008	CHECKED BY PFH

HEUER AND ASSOCIATES

Consulting Engineers

Consulting Engineers 5TA.
2315 Enterprise Drive - Suite 102 Westchester, IL 60154-5811 708-492-1000 FFD. ROAD INT

F.A.U. RTE.	SECTION		COUNTY	TOTAL SHEETS	SHEET No.
1004	08-00079-0	1-FP	соок	46	5
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CONTRACT No. 63007

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		PAY ITEM CODE			\$6400500 *	* 60250200	60255500 *	60255800 *	* 60500040	* 60500050	* 60500060	XX001047 *	56105200 *	56400820 *	60201330 *	60218400 *	60237460 *	60248900 *	*
	ST	RUCTURE	INFO			L	EX	ISTING	PAY I	TEM	L	i		1	PROPO	SED PA	Y ITEN	4	
SHEET	STR. NO.	STATION	OFFSET	BASE LINE	FH REMOVE	CB ADJUST	MH ADJUST	MH ADJUST, TY 1 F&CL	MH REMOVE	CB REMOVE	INL REMOVE	VV ABANDON, REM CN F&L	12" VALVE	FH AUX VALVE & BOX	CB TY A TY 23 F&G	MH TY A TY 1 F&CL	INL TY A TY 23 F&G	VV TY A TY 1 F&CL	STREET LIGHT RELOCATE
24	2995	29+95.00		5									1					1	
21		29+99.38	12.30'R	5		1													
21		30+04.49	14.18'L	5		1			ļ				ļ	ļ	ļ	ļ	ļ		
21 21	3169	31+68.98 32+00.00	2.51'L 13.50'L	5 5	ļ			1	ļ			ļ	ļ	 	·				
21	3200	32+00.00	13.50 L	5	<u> </u>		 						 		1	 	1	-	
24		32+70.00	20.00'R	5		 	 			,		-	ļ	1	 	<u> </u>			
24	3334		17.00'R	5	1							İ	 	 	 	 		 	
21	3359	33+59.36	11.97'R	5				 		1		 			-	 			
21	3360	33+59.72	15.53'L	5						1			l	İ	T				
22	3402	34+02.00	13.50'L	5													1		
22		34+02.00		5											1				
28	3555	35+55.00	18.00'R	5															1
25	3607	36+07.00	20.00'R	5										1					
25				5		<u> </u>	<u> </u>					1							
25		36+22.00		5		<u> </u>	ļ	ļ					1					1	
25	3627		17.59'R	5	1		ļ									ļ			
22	3641	36+40.89		5		1	<u> </u>						ļ						
22 22	3659	36+59.00 36+66.39	13.50'L 4.40'R	5			ļ		ļ	ļ			ļ	<u> </u>	1	 			
25	2672	36+72.49	7.52'R	5		ļ	_	1		ļ	ļ		 	ļ					
22		36+75.13	16.75'R	5		1			<u> </u>	ļ		1	ļ	ļ	-	 			
22		36+75.27	15.22'L	5.		 	 	ļ		1		 			 	 	 		
25		36+88.00	27.00'R	5	 	 	 						1		-		 	1	
22	3871	38+71.14	16.34'L	5		 	1			<u> </u>		 	 	 	-	 			
22	3881	38+81.19	17.70'L	5		1	 	 	 	 		 	 	 	 . 	 			
22	3882	38+81.44	14.71'L	5					<u> </u>		1		 	†	 	 	 	 	
23			14.22'L	5		 			·	1			l					 	
23	3978	39+80.00	18.50'L	5		T	1						l		 	1			
23	3986	39+85.70	33.07'R	5		1									<u> </u>				
23		40+13.29	23.77'L	5												1			
23	4014	40+14.06	32.99'R	5		1													
23	4055	40+55.00	13.50'L	5	ļ	<u> </u>						ļ		<u> </u>	1	<u> </u>			
23		40+55.00		5		<u> </u>	ļ	ļ						ļ.:	ļ	ļ	1		
23	4182	41+82.00	18.50'L	5	 		 	ļ	1			ļ	L	 	ļ			ļ	
23		43+06.00 43+06.00		5 5	 	 		_	ļ		ļ	ļ	ļ	 	1	<u> </u>	 		
23		43+32.19		5		 	 	-		1		 	ļ	 	<u> </u>	 	1		
23		43+34.42		5		 		 	 	$\frac{1}{1}$		 	ļ	 	 	 			
23		43+46.00		5	-	 	 			 		 	ļ	 	 	1	 	 	
23		43+61.35		5		 	 			<u> </u>		 		 	 	1	 		
23		43+65.86		5	l	†				 				†	1	 	 		
23		44+61.57		5		T									<u> </u>	1			
23		45+06.00		5						1		1	····		1		1		
23		45+06.00		5													1		
23		45+25.17		5						1									
23		45+30.27		5							1								
23	4531	45+30.49	18.00'R	5 51	2	7		2		1 8	2	2			7	4	5	3	1
		OTALS					2		1				3	2					

	, , , , , , , , , , , , , , , , , , ,	SCHE	DULE	OF (QUAN	TITI	ES - 9	SEWE	R PI	PE	Υ
					-	*	*	*	*	*	*
			PAY ITEM CODE			550B0320	550B0330	55080340	55080360		
	U	NDERG	ROUND 1	NFO			PR	OPOSEI	PAY I	TEM	
SHEET	UPSTREAM STRUCTURE # or (STATION)	UPSTREAM DEPTH	DOWNSTREAM STRUCTURE # or (STATION)	DOWNSTREAM DEPTH	AVERAGE DEPTH	8" PVC STORM	10" PVC COMBINATION	12" PVC COMBINATION	15" PVC COMBINATION	TRENCH BACKFILL CA-6, CY	TRENCH BACKFILL CA-11, CY
21	3200	3.00	3201	3.02	3.0	28				4.1	2.2 1.5
21	3201	3.12	(3210)	5.20	4.2	19				4.9	1.5
22	3402	3.00	3403	2.98	3.0	28				4.1	2.2
22	3403	3.09	(3408)	4.00	3.0 3.5 3.3 3.3	14				2.8	1.1
22	3659	3.00	3666	3.65	3.3	19				3.5 3.3	1.5
22	(3663)	3.00	(3658)	3.65	3.3				22	3.3	2.9
23	3978	3.40	4013	5.11	4.3			33		22.5	3.6
23	4013	5.21	4361	6.22	5.7 3.3			348		237.3	38.3 2.2
23	4056	3.00	4055	3.52	3.3	28				5.2	2.2
23	4055	3.62	(4064)	5.00	4.3	14				3.8	1.1
23	4307	3.00	4306	3.52	3.3	28				5.2	2.2
23	4306	3.62	(4315)	4.28	4.0	14				3.3	1.1
23	4361	6.32	4346	6.30	6.3			62		46.3	6.8
23	4366	3.00	4346	3.78	3.4	26				4.8	2.1
23	4462	4.75	(4542)	6.00	5.4		81			13.4	1.1 2.2 1.1 6.8 2.1 6.5 2.2
23	4507	2.97	4506	3.49	3.2	28			L	4.6	2.2
23	4506	4.36	(4512)	5.00	4.7	7				1.9	0.6
		TO	OTALS			253	81	443	22	371	78

	S	CHED	ULE O	F QUA	NTIT	IES - V	WATE	R MAI	N	
						*	*	*	*	*
		PAY ITEM	CODE		56103000	56103100	56103300			
	U	NDERGRO	OUND INF	0			PROP	OSED PA	Y ITEM	
SHEET STRUCTURE # or (STATION) DEPTH Or (STATION) DEPTH AVERAGE DEPTH							8" DIP	12" DIP	TRENCH BACKFILL CA-6, CY	TRENCH BACKFILL CA-11, CY
24	(2966)	5.50	2995	5.50	5.5			30	20.5	3.3
24	2995	5.50	(3270)	5.50	5.5			274	186.9	30.1
24	(3270)	5.50	3270	5.50	5.5	- 6			4.2	0.4
25	(3270)	5.50	(3607)	5.50	5.5			337	229.8	37.1
25	(3607)	5.50	3607	5.50	5.5	6			4.2	0.4
25	(3607)	5.50	3623	5.50	5.5			15	10.2	1.7
25	3623	5.50	(3644)	5.50	5.5			22	15.0	2.4
25	(3644)	5.50	(3644)	5.50	5.5		10		6.5	1.1
25	(3644)	5.50	3688	5.50	5.5			44	30.0	4.8
25	3688	5.50 TO 1	(3700) FALS	5.50	5.5	12	10	10 732	6.8 514	1.1 82

* = DENOTES SPECIALTY ITEM

	REVISIONS	DATE	ILLINOIS DEPARTME	ENT OF TRANSPORTATION
	NAME	DATE		E IMPROVEMENTS FAGE 1
				OF QUANTITIES
-		L	SCALE:	DRAWN BY H&A
			DATE 08/28/2008	CHECKED BY PFH

SCHEDULE OF QUANTITIES - ROADWAY REMOVAL												
	40600982	44001900	44004400	44004700	XX005314							
STATION	HOT-MIX ASPHALT SURFACE REMOVAL BUTT JOINT	COMBINATION CURB AND GUTTER REMOVAL (SPECIAL)	PAVEMENT REMOVAL (SPECIAL)	SIDEWALK REMOVAL, SPECIAL	BITUMINOUS DRIVEWAY REMOVAL	PORTLAND CEMENT CONCRETE DRIVEWAY REMOVAL, SPECIAL						
	SQ YD	FOOT	SQ YD	SQ FT	SQ YD	SQ YD						
29+81.33 TO 34+00	40	808	1,213	4,909	33	106						
34+00 TO 39+60	62	1,125	1,846	4,859	54	120						
39+60 TO 45+53.65	162	1,246	2,017	1,541	117	94						
TOTAL	264	3,179	5,076	11,309	204	320 💥						

	SCHE	DULE OF QUAN	NTITIES - BITU	MINOUS PAVE	MENT	
	21001000	31101000	40600100	40600300	40701921	
STATION	GEOTECHNICAL FABRIC FOR GROUND STABILIZATION	SUB-BASE GRANULAR MATERIAL, TYPE B	BITUMINOUS MATERIALS (PRIME COAT)	AGGREGATE (PRIME COAT)	HOT-MIX ASPHALT PAVEMENT (FULL DEPTH), 12"	HOT-MIX ASPHALT SURFACE COURSE - BUTT JOINT
	SQ YD	TON	GALLON	TON	SQ YD	SQ YD
29+81.33 TO 34+00	1,416	368	554	2	1,231	40
34+00 TO 39+60	2,094	545	819	4	1,821	62
39+60 TO 45+53.65	2,276	592	891	4	1,979	162
TOTAL	5,786	1,505	2,264	10	5,031	264

SCHE	DULE OF QUAN	TITIES - ALLE	YS AND DRIVI	EWAYS
	42300300	XX001109		
STATION	PORTLAND CEMENT CONCRETE DRIVEWAY PAVEMENT, 7 INCH	PORTLAND CEMENT CONCRETE ALLEY PAVEMENT, 8"	CLASS C PATCH (CONCRETE)	CLASS D PATCH (ASPHALT)
	SQ YD	SQ YD	SQ YD	SQ YD
29+81.33 TO 34+00	134	0	1	11
34+00 TO 39+60	177	21	16	14
39+60 TO 45+53.65	135	21	7	33
TOTAL	446	42	24	58

SCHE	42400200	60600605	60604400	XX007729
STATION	PORTLAND CEMENT CONCRETE SIDEWALK 5 INCH	CONCRETE CURB, TYPE B	COMBINATION CONCRETE CURB AND GUTTER, TYPE B-6.18	DETECTABLE WARNINGS, SPECIAL
	SQ FT	FOOT	FOOT	SQ FT
29+81.33 TO 34+00	4,528	0	818	8
34+00 TO 39+60	4,837	0	1,133	88
39+60 TO 45+53.65	1,398	140	1,230	64
TOTAL	10,763	140	3,181	160

EARTH EX	CAVATION
	20200100
STATION	UNSUITABLE EXCAVATION
	CUYD
29+81.33 TO 34+00	245
34+00 TO 39+60	206
39+60 TO 45+53.65	435
TOTAL	886

Consulting Engineers

Enterprise Drive - Suite 102 Westchester, IL 60154-5811 708-492-1000

5	RTE.	SECTION	COUNTY	SHEETS	No.
==	1004	08-00079-01-FP	соок	46	6
	STA.		TO STA.		
1000	FED. RO	OAD DIST. NO. 1 ILLIN	OIS FED. A	ID PROJE	CT

CONTRACT No. 63007

* To be measured and paid For as Pavement Removal (Special), See PCC Driveway Removal Special Provision,

REVISIONS
NAME DATE
BLUFF AVENUE IMPROVEMENTS
STAGE 1

SCHEDULE OF QUANTITIES


SCALE: DRAWN BY H&A


DATE 08/28/2008 CHECKED BY PFH

TOTAL SHEET SHEETS No. SECTION COUNTY **HEUER AND ASSOCIATES** 1004 05-00079-01-FP соок TO STA. 2315 Enterprise Drive - Suite 102 Westchester, IL 60154-5811 708-492-1000 FED. ROAD DIST. NO. 1 ILLINOIS FED. AID PROJECT CONTRACT No. 63007 WEST R.O.W. BASELINE PAVEMENT **DESIGN DATA** CLASSIFICATION OF ROADWAY: CLASS II ROADWAY
DESIGN PERIOD: 20 YEARS
PROJECTED AVERAGE DAILY TRAFFIC: 4157
% OF PASSENGER VEHICLES (PV): 99%
% OF SINGLE UNIT TRUCKS (SU): 0.5%
% OF MULTI UNIT TRUCKS (MU): 0.5%
SUBGRADE SUPPORT RATING (SSR): FAIR 66.0 FT. ROW 10.7 30.0' F-F 15' DRIVING LANE 15' DRIVING LANE PARKING ALLOWED ON EAST CHECKED SIDE (NON-CONTINUOUS) VARIABLE VARIABLE RATES OF APPLICATION VARIABLE VARIABLE THE FOLLOWING RATES OF APPLICATION HAVE BEEN ASSUMED IN CALCULATING PLAN QUANTITIES: EXISTING P.C.C. SIDEWAL EXISTING P.C.C. SIDEWALK 112 LBS/SY/IN . 1.8 TON/CY . 0.35 GAL/SY EXISTING GRASS PARKWAY EXISTING GRASS PARKWAY EXISTING BARRIER CURB EXISTING BARRIER CURB 0.10 GAL/SY - EXISTING BITUMINOUS CONCRETE SURFACE 5" ± EXISTING P.C.C. BASE 5" ± EXISTING SUBGRADE HOT-MIX ASPHALT MIXTURE REQUIREMENTS **EXISTING TYPICAL SECTION MIXTURE TYPE AC TYPE AIR VOIDS** STA 29+90.55 - STA 45+53.65 **COSSITT AVENUE TO BURLINGTON AVENUE FULL DEPTH PAVEMENT**; HOT-MIX ASPHALT SURFACE COURSE MIX "C", N50 (IL 9.5mm) 4% @ 50 GYR HOT-MIX ASPHALT BINDER COURSE IL-9.0, N50 PG 64-22 * 4% @ 50 GYR HOT-MIX ASPHALT BASE COURSE, (HMA BINDER IL-19mm) PG 64-22 * 4% @ 50 GYR **PATCHING** 13.5' DRIVING LANE WIDTH 13.5' DRIVING CLASS D PATCHES (HMA BINDER IL-19mm) PG 64-22 * 4% @ 70 GYR PROFILE GRADE LINE * WHEN RAP EXCEEDS 20%, THE NEW ASPHALT BINDER IN THE MIX SHALL BE PG 58-22 VARIABLE, 2% TYPICAL VARIABLE, 2% TYPICAL VARIABLE, 2% TYPICAL VARIABLE, 2% TYPICAL THE UNIT WEIGHT USED TO CALCULATE ALL HAM SURFACE MIXTURE QUANTITIES IS 112 LBS . 40/12 RESTORE WITH TOPSOIL FURNISHED AND PLACED (4") AND SODDING (SALT TOLERANT) AS REQUIRED RESTORE WITH TOPSOIL FURNISHED AND PLACED (4")
AND SODDING (SALT TOLERANT) AS REQUIRED P.C.C. SIDEWALK, 5" WITH SUB-BASE GRANULAR — MATERIAL, TYPE B, 2" (INCIDENTAL TO THE COST OF THE P.C.C. SIDEWALK, 5") HOT-MIX ASPHALT SURFACE P.C.C. SIDEWALK, 5" WITH SUB-BASE GRANULAR MATERIAL, TYPE B, 2" (INCIDENTAL TO THE COST OF THE P.C.C. SIDEWALK, 5") - HOT-MIX ASPHALT BINDER COURSE, 2-1/4" RESTORE WITH TOPSOIL FURNISHED AND PLACED (4")—AND SODDING (SALT TOLERANT) AS REQUIRED RESTORE WITH TOPSOIL FURNISHED AND PLACED (4")
 AND SODDING (SALT TOLERANT) AS REQUIRED BITUMINOUS MATERIAL (PRIME COAT) COMBINATION CONCRETE -CURB AND GUTTER, TYPE B-6.18
ON BEDDING AGGREGATE (2" MIN)
(INCIDENTAL TO THE CONCRETE - HOT-MIX ASPHALT BASE COURSE, N50, 7-3/4" COMBINATION CONCRETE
CURB AND GUTTER, TYPE 8-6.18 CURB AND GUTTER, TYPE B-6.18) SUBBASE GRANULAR MATERIAL, TYPE B, 6" ILLINOIS DEPARTMENT OF TRANSPORTATION GEOTECHNICAL FABRIC FOR GROUND STABILIZATION BEDDING AGGREGATE (THICKNESS **BLUFF AVENUE IMPROVEMENTS** TO MATCH SUBBASE DEPTH)
(INCIDENTAL TO THE CONRETE
CURB AND GUTTER, TYPE B-6.18) STAGE 1 PROPOSED TYPICAL SECTION STA 29+90.55 - STA 45+53.65 **COSSITT AVENUE TO BURLINGTON AVENUE** TYPICAL SECTIONS SCALE: NTS DRAWN BY H&A

DATE 07/18/2008

CHECKED BY PFH

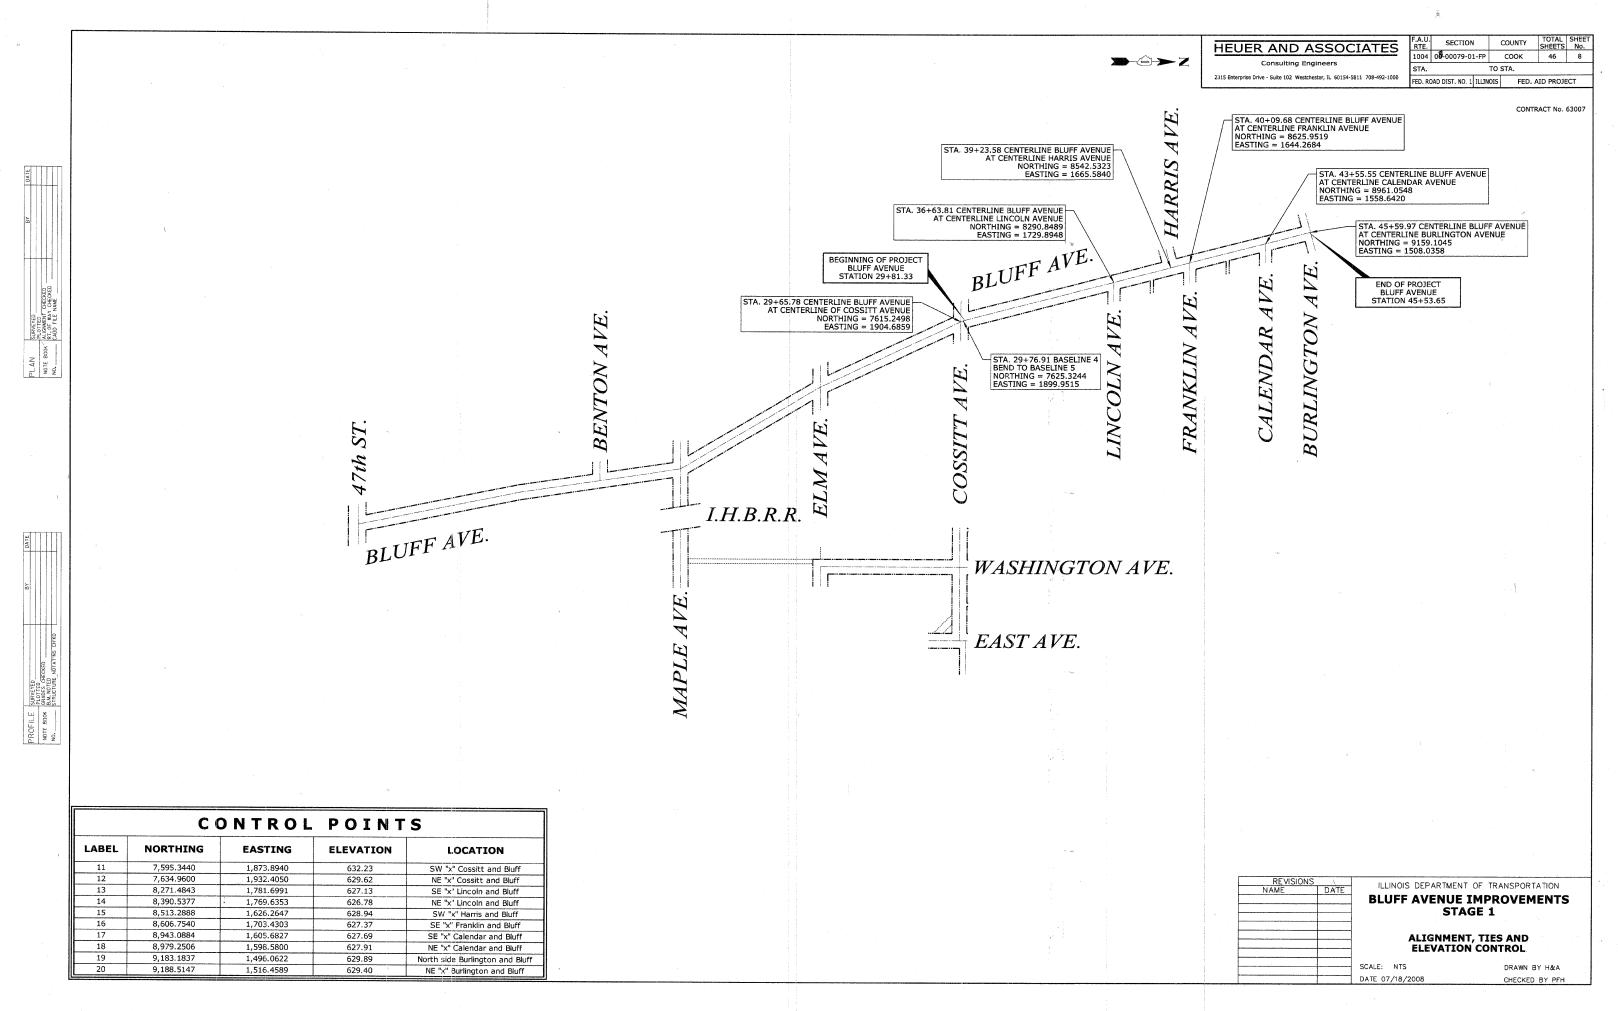

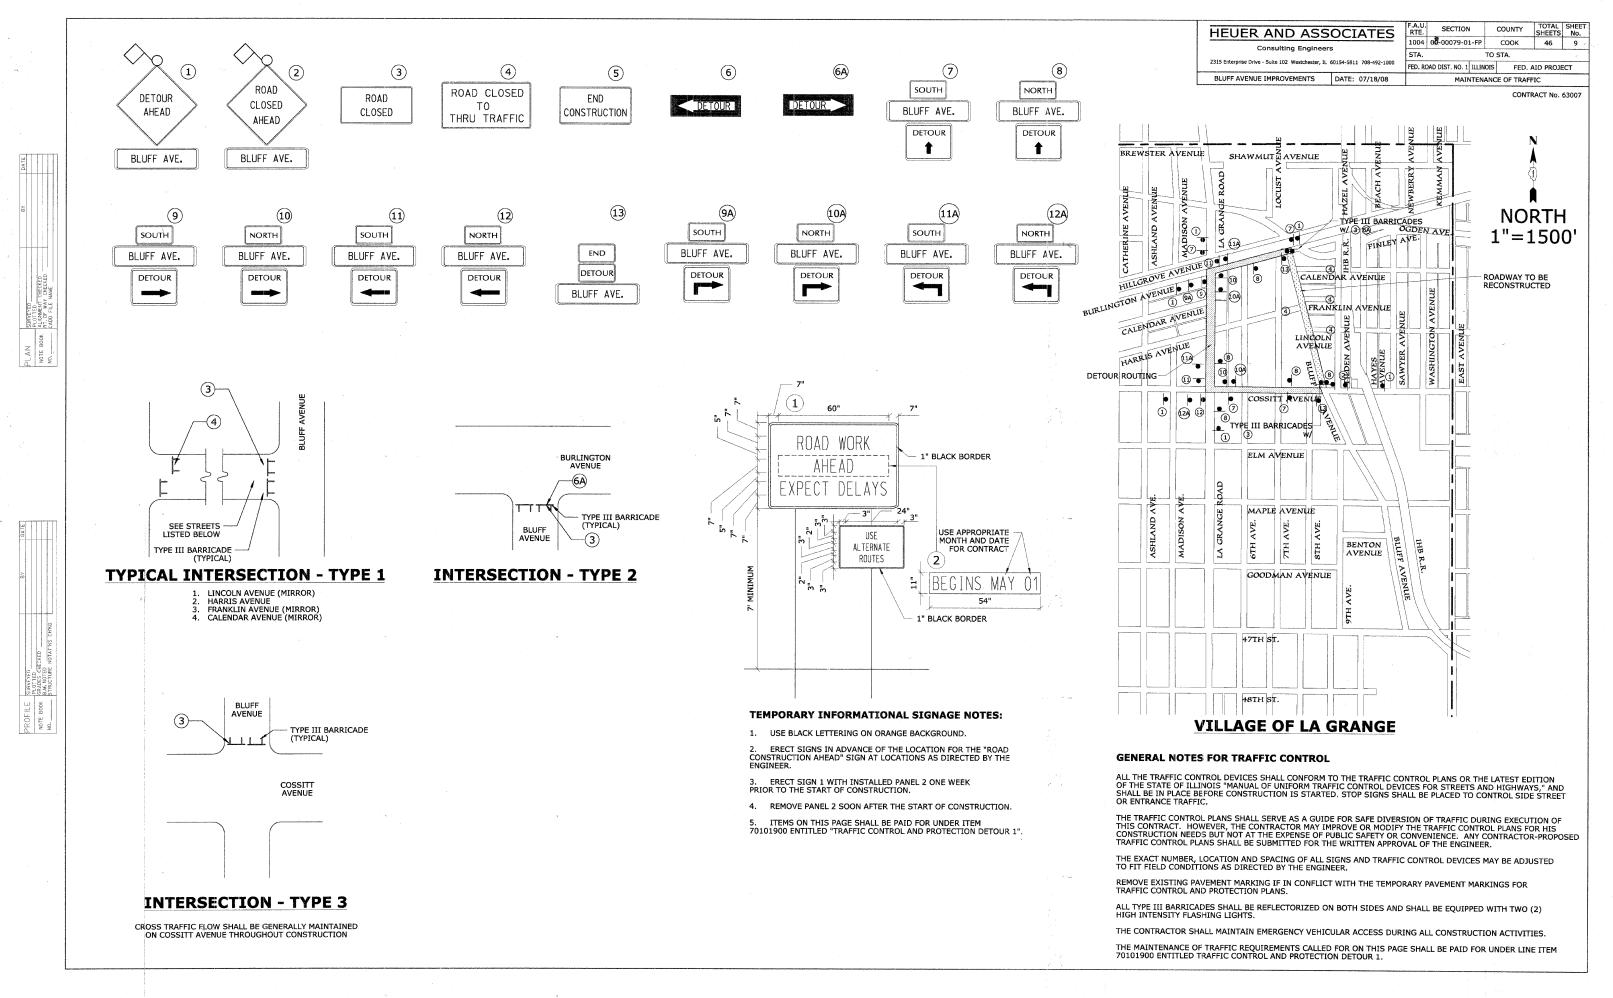

GENERAL PROVISIONS

THE FOLLOWING PLAN IS ESTABLISHED AND INCORPORATED IN THE PROJECT TO DIRECT THE CONTRACTOR IN THE PLACEMENT OF TEMPORARY EROSION CONTROL SYSTEMS AND TO PROVIDE A STORM SEWER WATER POLLUTION PREVENTION PLAN FOR COMPLIANCE UNDER NPDES.

THE PURPOSE OF THIS PLAN IS TO MINIMIZE EROSION WITHIN THE CONSTRUCTION SITE AND TO LIMIT SEDIMENTS FROM LEAVING THE CONSTRUCTION SITE BY UTILIZING PROPER TEMPORARY EROSION CONTROL SYSTEMS AND PROVIDING GROUND COVER WITHIN A REASONABLE AMOUNT OF TIME.

CERTAIN EROSION CONTROL FACILITIES SHALL BE INSTALLED BY THE CONTRACTOR AT THE BEGINNING OF CONSTRUCTION. OTHER ITEMS SHALL BE INSTALLED BY THE CONTRACTOR AS IDENTIFIED BY THE ENGINEER ON A CASE BY CASE SITUATION DEPENDING ON THE CONTRACTOR'S SEQUENCE OF ACTIVITIES, TIME OF YEAR, AND EXPECTED WEATHER CONDITIONS.

THE CONTRACTOR SHALL INSTALL PERMANENT EROSION CONTROL SYSTEMS AND SEEDING WITHIN A TIME FRAME SPECIFIED HEREIN AND AS OUTLINED BY THE ENGINEER, THEREFORE MINIMIZING THE AMOUNT OF AREA SUSCEPTIBLE TO EROSION AND REDUCING THE AMOUNT OF TEMPORARY SEEDING. THE ENGINEER WILL DETERMINE IF ANY TEMPORARY EROSION CONTROL SYSTEMS SHOWN IN THE PLAN CAN BE DELETED AND IF ANY ADDITIONAL TEMPORARY EROSION CONTROL SYSTEMS, WHICH ARE NOT INCLUDED IN THIS PLAN, SHALL BE ADDED. THE CONTRACTOR SHALL PERFORM ALL WORK AS STIPULATED BY THE ENGINEER AND AS SHOWN IN IDOT STANDARD 280001 WHICH SUPPLEMENTS THIS PLAN. THE TEMPORARY EROSION CONTROL PROVISIONS OUTLINED IN SECTION 280 OF THE IDOT STANDARD SPECIFICATIONS ADDITIONALLY SUPPLEMENT THIS PLAN.

DESCRIPTION OF SITE AND PLANNED CONSTRUCTION ACTIVITIES

- 1. THE PROJECT IS LOCATED IN THE COOK COUNTY, ILLINOIS. THE PROJECT SITE ENCOMPASSES BLUFF AVENUE FROM 47th STREET TO BURLINGTON AVENUE.
- 2. THE AREA DISTURBED BY CONSTRUCTION ACTIVITIES WILL ENCOMPASS THE ENTIRE PROJECT SITE.
- 3. THE PROJECT INVOLVES WATER MAIN REPLACEMENT, SEWER REPLACEMENT, DRAINAGE STRUCTURE REPAIR AND REPLACEMENT, LANDSCAPE RESTORATION, ROADWAY REMOVAL AND REPLACEMENT AND OTHER MISCELLANEOUS RELATED IMPROVEMENTS.

SEQUENCE FOR MAJOR CONSTRUCTION ACTIVITIES

THE FOLLOWING DESCRIBES THE PROJECTED SEQUENCE OF MAJOR CONSTRUCTION ACTIVITIES WHICH WILL DISTURB SOILS WITHIN THE PROJECT AREA.

- 1. INSTALLATION OF TEMPORARY EROSION CONTROL MEASURES REQUIRED TO LIMIT SOIL MIGRATION DURING SITE CLEARING, GRADING, FILLING, AND SUBSEQUENT DEVELOPMENT ACTIVITIES. MEASURES MAY INCLUDE PERIMETER EROSION CONTROL BARRIER, TEMPORARY DITCH CHECKS, INLET AND PIPE PROTECTION, RIP-RAP, EROSION CONTROL BLANKETS, TEMPORARY SEEDING, AND OTHER SIMILAR MEASURES. THE MEASURES ARE TO BE ADJUSTED IN KEEPING WITH SITE WORK PROGRESS.
- 2. WATER MAIN REPLACEMENT, SEWER REPLACEMENT AND DRAINAGE STRUCTURE REPAIR AND OR REPLACEMENT.
- 3. CURB AND GUTTER REMOVAL.
- 4. EXISTING PAVEMENT REMOVAL.
- 5. INSTALLATION OF REPLACEMENT CURB AND GUTTER.
- 6. INSTALLATION OF REPLACEMENT PAVEMENT
- 7. FINISHED GRADING AND LANDSCAPE RESTORATION.
- 8. MAINTENANCE, REMOVAL, AND PROPER CLEAN-UP OF TEMPORARY EROSION CONTROL MEASURES.

EROSION AND SEDIMENT CONTROL PRACTICES

THE DRAWINGS, SPECIFICATIONS AND SPECIAL PROVISIONS HAVE BEEN PLANNED TO ENSURE THAT EXISTING VEGETATION IS PRESERVED WHERE FEASIBLE, AND DISTURBED PORTIONS OF THE SITE ARE STABILIZED. STABILIZATION PRACTICES INCLUDE TEMPORARY SEEDING, PERMANENT SEEDING, MULCHING, PROTECTION OF TREES, PRESERVATION OF NATURAL VEGETATION, AND OTHER APPROPRIATE MEASURES AS IDENTIFIED BY THE ENGINEER. STABILIZATION MEASURES SHALL BE INITITATED AS SOON AS PRACTICABLE IN PORTIONS OF THE SITE WHERE CONSTRUCTION ACTIVITIES HAVE TEMPORARILY OR PERMANENTLY CEASED, BUT IN NO CASE MORE THAN 7 DAYS AFTER THE CONSTRUCTION ACTIVITY IN THAT PORTION OF THE SITE HAS TEMPORARILY OR PERMANENTLY CEASED.

- AREAS OF EXISTING VEGETATION, WOOD AND GRASSLANDS, OUTSIDE THE PROPOSED CONSTRUCTION LIMITS SHALL BE IDENTIFIED BY THE ENGINEER FOR PRESERVATION AND SHALL BE PROTECTED FROM CONSTRUCTION ACTIVITIES.
- 2. DEAD, DISEASED, UNSUITABLE, OR CONFLICTING VEGETATION WITHIN THE SITE SHALL BE REMOVED AS DIRECTED BY THE ENGINEER, ALONG WITH REQUIRED TREE REMOVAL.
- 3. AS SOON AS REASONABLE ACCESS IS AVAILABLE TO ALL LOCATIONS WHERE WATER DRAINS AWAY FROM THE PROJECT, TEMPORARY DITCH CHECKS, INLET AND PIPE PROTECTION, AND PERIMETER EROSION BARRIER SHALL BE INSTALLED AS CALLED OUT IN THIS PLAN AND DIRECTED BY THE ENGINEER.
- 4. BARE AND SPARSELY VEGETATED GROUND IN HIGH ERODABLE AREAS AS DETERMINED BY THE ENGINEER SHALL BE TEMPORARILY SEEDED AT THE BEGINNING OF CONSTRUCTION WHERE NO CONSTRUCTION ACTIVITIES ARE EXPECTED WITHIN SEVEN (7) DAYS.
- 5. IMMEDIATELY AFTER TREE REMOVAL IS COMPLETED, AREAS WHICH ARE HIGHLY ERODIBLE AS DETERMINED BY THE ENGINEER, SHALL BE TEMPORARILY SEEDED WHEN NO CONSTRUCTION ACTIVITIES ARE EXPECTED WITHIN SEVEN (7) DAYS.
- 6. AT LOCATIONS WHERE A SIGNIFICANT AMOUNT OF WATER DRAINS INTO THE CONSTRUCTION ZONE FROM OUTSIDE AREAS ON ADJACENT LANDOWNERS, TEMPORARY DITCH CHECKS SHALL BE UTILIZED TO LOCALLY DIVERT WATER, REDUCE FLOW RATES, AND COLLECT OUTSIDE SILTATION INSIDE THE RIGHT-OF-WAY LINE.
- 7. DURING CONSTRUCTION, AREAS OUTSIDE THE CONSTRUCTION LIMITS INDICATED ON THE PLANS SHALL BE PROTECTED FROM DAMAGE. THE CONTRACTOR SHALL NOT USE THESE AREAS FOR STAGING, PARKING OF VEHICLES OF CONSTRUCTION EQUIPMENT, STORAGE OF MATERIALS OR OTHER CONSTRUCTION RELATED ACTIVITIES EXCEPT AS DESCRIBED ON THE PLANS AND INDICATED BY THE ENGINEER.
- 8. WITHIN THE CONSTRUCTION LIMITS, AREAS WHICH MAY BE SUSCEPTIBLE TO EROSION SHALL REMAIN UNDISTURBED UNTIL THE STAGE OF CONSTRUCTION IS INITIATED TO AVOID UNNECESSARY SOIL EROSION.
- EARTH STOCKPILES SHALL BE TEMPORARILY SEEDED IF THEY ARE TO REMAIN UNUSED FOR MORE THAN DURTEEN (14) DAYS.
- 10. AS CONSTRUCTION PROCEEDS, THE CONTRACTOR SHALL PLACE TEMPORARY EROSION CONTROL FACILITIES AT LOCATIONS SHOWN ON THE PLANS. THE ERODIBLE EXPOSED EARTH SURFACES SHALL BE TEMPORARILY SEEDED ON A WEEKLY BASIS TO MINIMIZE THE AMOUNT OF EROSION THAT WILL OCCUR WITHIN THE PROJECT LIMITS. THE ROADSIDE DITCHES WITHIN THE PROJECT LIMITS SHALL BE MAINTAINED OR CONSTRUCTED AS REQUIRED TO LIMIT EROSION. TEMPORARILY DIVERT WATER AROUND PROPOSED CULVERT LOCATIONS UNTIL EROSION CONTROL MEASURES ARE IN PLACE.
- 11. CONSTRUCTION EQUIPMENT SHALL BE STORED AND FUELED ONLY AT DESIGNATED LOCATIONS. ALL NECESSARY MEASURES SHALL BE TAKEN TO CONTAIN ANY FUEL OR OTHER POLLUTANT IN ACCORDANCE WITH EPA WATER QUALITY REGULATIONS. LEAKING EQUIPMENT OR SUPPLIES SHALL BE IMMEDIATELY REPAIRED OR REMOVED FROM THE SITE.
- 12. THE CONTRACTOR SHALL INSPECT THE PROJECT DAILY DURING CONSTRUCTION ACTIVITIES. INSPECTION SHALL ALSO BE DONE WEEKLY AND AFTER RAINS OF 1/2-INCH OR GREATER OR EQUIVALENT SNOWFALL AND DURING THE WINTER SHUTDOWN PERIOD. THE PROJECT SHALL ADDITIONALLY BE INSPECTED BY THE WORK SITE CONSTRUCTION MANAGER ON A BI-WEEKLY BASIS TO ETERMINE THAT EROSION CONTROL EFFORTS ARE IN PLACE AND EFFECTIVE AND IF OTHER EROSION CONTROL WORK IS NECESSARY.
- 13. SEDIMENT COLLECTED DURING CONSTRUCTION OF THE VARIOUS TEMPORARY EROSION CONTROL SYSTEMS SHALL BE DISPOSED OF ON THE SITE ON A REGULAR BASIS AS IDENTIFIED BY THE ENGINEER. THE COST OF THIS MAINTENANCE SHALL BE INCLUDED IN THE UNIT BID PRICE FOR EACH EXCAVATION FOR EROSION CONTROL.
- 14. THE TEMPORARY EROSION CONTROL SYSTEMS SHALL BE REMOVED WHERE INDICATED BY THE ENGINEER AFTER USE IS NO LONGER NEEDED OR NO LONGER FUNCTIONING.
- 15. TEMPORARY DITCH CHECKS SHALL BE LOCATED AT EVERY 1 FOOT FALL OR RISE IN DITCH GRADE OR AS STIPULATED ON THE PLAN.
- $16.\,$ Where required the temporary erosion control seeding shall be applied at a rate of 100 LBs per acre of area.
- 17. STRAW BALES, HAY BALES, PERIMETER EROSION BARRIER AND SILT FENCES WILL NOT BE PERMITTED FOR TEMPORARY OR PERMANENT DITCH CHECKS. DITCH CHECKS SHALL BE COMPOSED OF AGGREGATE.
- 18. SEDIMENT COLLECTED DURING CONSTRUCTION BY THE VARIOUS TEMPORARY EROSION CONTROL SYSTEMS SHALL BE DISPOSED OF ON THE SITE ON A REGULAR BASIS, AS DIRECTED BY THE ENGINEER. THE COST OF THIS MAINTENANCE SHALL BE PAID FOR AT THE CONTRACT UNIT PRICE PER CUBIC YARD FOR EARTH EXCAVATION FOR EROSION CONTROL.
- 19. ALL EROSION CONTROL PRODUCTS FURNISHED SHALL BE SPECIFICALLY RECOMMENDED BY THE MANUFACTURER FOR THE USE SPECIFIED IN THE EROSION CONTROL PLAN. PRIOR TO THE APPROVAL AND USE OF THE PROJECT, THE CONTRACTOR SHALL SUBMIT TO THE ENGINEER A NOTARIZED CERTIFICATION BY THE PRODUCER STATING THE INTENDED USE OF THE PRODUCT AND THAT THE PHYSICAL PROPERTIES REQUIRED FOR THE APPLICATION ARE MET OR EXCEEDED. THE CONTRACTOR SHALL PROVIDE MANUFACTURER INSTALLATION PROCEDURES TO FACILITATE THE ENGINEER IN CONSTRUCTION INSPECTION.
- 20. WATER PUMPED FROM EXCAVATIONS SHALL BE DIRECTED INTO THE SEDIMENT BASIN. THE SEDIMENT BASIN SHALL BE MAINTAINED AT A DEPTH BETWEEN 2 AND 3 FEET AND CLEARED OF SEDIMENT AS REQUIRED. SEDIMENT SHALL BE DISPOSED OF IN A MANNER NOT TO INCREASE SOIL MIGRATION.

HEUER AND ASSOCIATES

Consulting Engineers

2315 Enterprise Drive - Suite 102 Westchester, IL 60154-5811 708-492-1000

CONTRACT No. 63007

OTHER REPORTS, STUDIES, PLANS, SPECIFICATIONS WHICH ARE REFERENCED DOCUMENTS OF THE STORM WATER POLLUTION PREVENTION PLAN

- 1. INFORMATION CONCERNING THE SOILS CHARACTER AND TERRAIN WITHIN THE SITE WAS OBTAINED FROM TOPOGRAPHIC SURVEYS AND GEO-TECHNICAL SURVEYS THAT WERE UTILIZED FOR THE DEVELOPMENT OF THE PROPOSED TEMPORARY EROSION CONTROL SYSTEMS.
- 2. PROJECT SPECIFICATIONS, SPECIAL PROVISIONS, AND DRAWINGS INDICATING DRAINAGE PATTERNS AND APPROXIMATE SLOPES ANTICIPATED AFTER GRADING ACTIVITIES, WERE UTILIZED FOR THE PROPOSED PLACEMENT OF THE TEMPORARY EROSION CONTROL SYSTEMS.
- 3. ILLINOIS URBAN MANUAL FOR SOIL EROSION CONTROL GUIDANCE AND CONTROL MEASURES.
- 4. IDOT STANDARD SPECIFICATIONS FOR ROAD AND BRIDGE CONSTRUCTION FOR SOIL EROSION CONTROL MATERIALS AND INSTALLATION GUIDANCE

MAINTENANCE AFTER CONSTRUCTION

- 1. THE CONSTRUCTION WILL BE CONSIDERED TO BE COMPLETE AFTER ACCEPTANCE BY THE MUNICIPAL AGENCY WITH JURISDICTION OVER THE IMPROVEMENTS. MAINTENANCE OF EROSION MEASURES AS WELL AS THE SITE IMPROVEMENTS WILL BE THE RESPONSIBILITY OF THE CONTRACTOR UNTIL THE DATE OF ACCEPTANCE.
- TEMPORARY EROSION CONTROL SYSTEMS SHALL BE LEFT IN PLACE WITH PROPER MAINTENANCE UNTIL PERMANENT EROSION CONTROL IS IN PLACE AND WORKING PROPERLY AND ALL PROPOSED SEEDED OR SODDED AREAS HAVE BEEN ESTABLISHED.
- 3. ONCE PERMANENT EROSION CONTROL SYSTEMS AS PROPOSED IN THE PLANS ARE FUNCTIONAL AND ESTABLISHED, TEMPORARY ITEMS SHALL BE REMOVED, CLEANED UP, AND DISTURBED SURFACES RESTORED.

CERTIFICATION

THIS PLAN HAS BEEN PREPARED TO COMPLY WITH THE PROVISIONS OF THE NPDES PERMIT NUMBER ILR10 ISSUED BY THE ILLINOIS ENVIRONMENTAL PROTECTION AGENCY FOR STORM WATER DISCHARGES FROM CONSTRUCTION SITE ACTIVITIES.

I CERTIFY UNDER PENALTY OF LAW THAT THIS DOCUMENT AND ALL ATTACHMENTS WERE PREPARED UNDER MY DIRECTION OR SUPERVISION IN ACCORDANCE WITH A SYSTEM DESIGNED TO ASSURE THAT QUALIFIED PERSONNEL PROPERLY GATHERED AND EVALUATED THE INFORMATION SUBMITTED. BASED ON MY INQUIRY OF THE PERSON OR PERSONS WHO MANAGE THE SYSTEM, OR THOSE PERSON DIRECTLY RESPONSIBLE FOR GATHERING THE INFORMATION, THE INFORMATION SUBMITTED IS TO THE BEST OF MY KNOWLEDGE AND BELIEF, TRUE, ACCURATE AND COMPLETE. I AM AWARE THAT THERE ARE SIGNIFICANT PENALTIES FOR SUBMITTING FALSE INFORMATION, INCLUDING THE POSSIBILITY OF FINE AND IMPRISONMENT FOR KNOWING VIOLATIONS.

MIKE BOJOVIC, ACTING DIRECTOR


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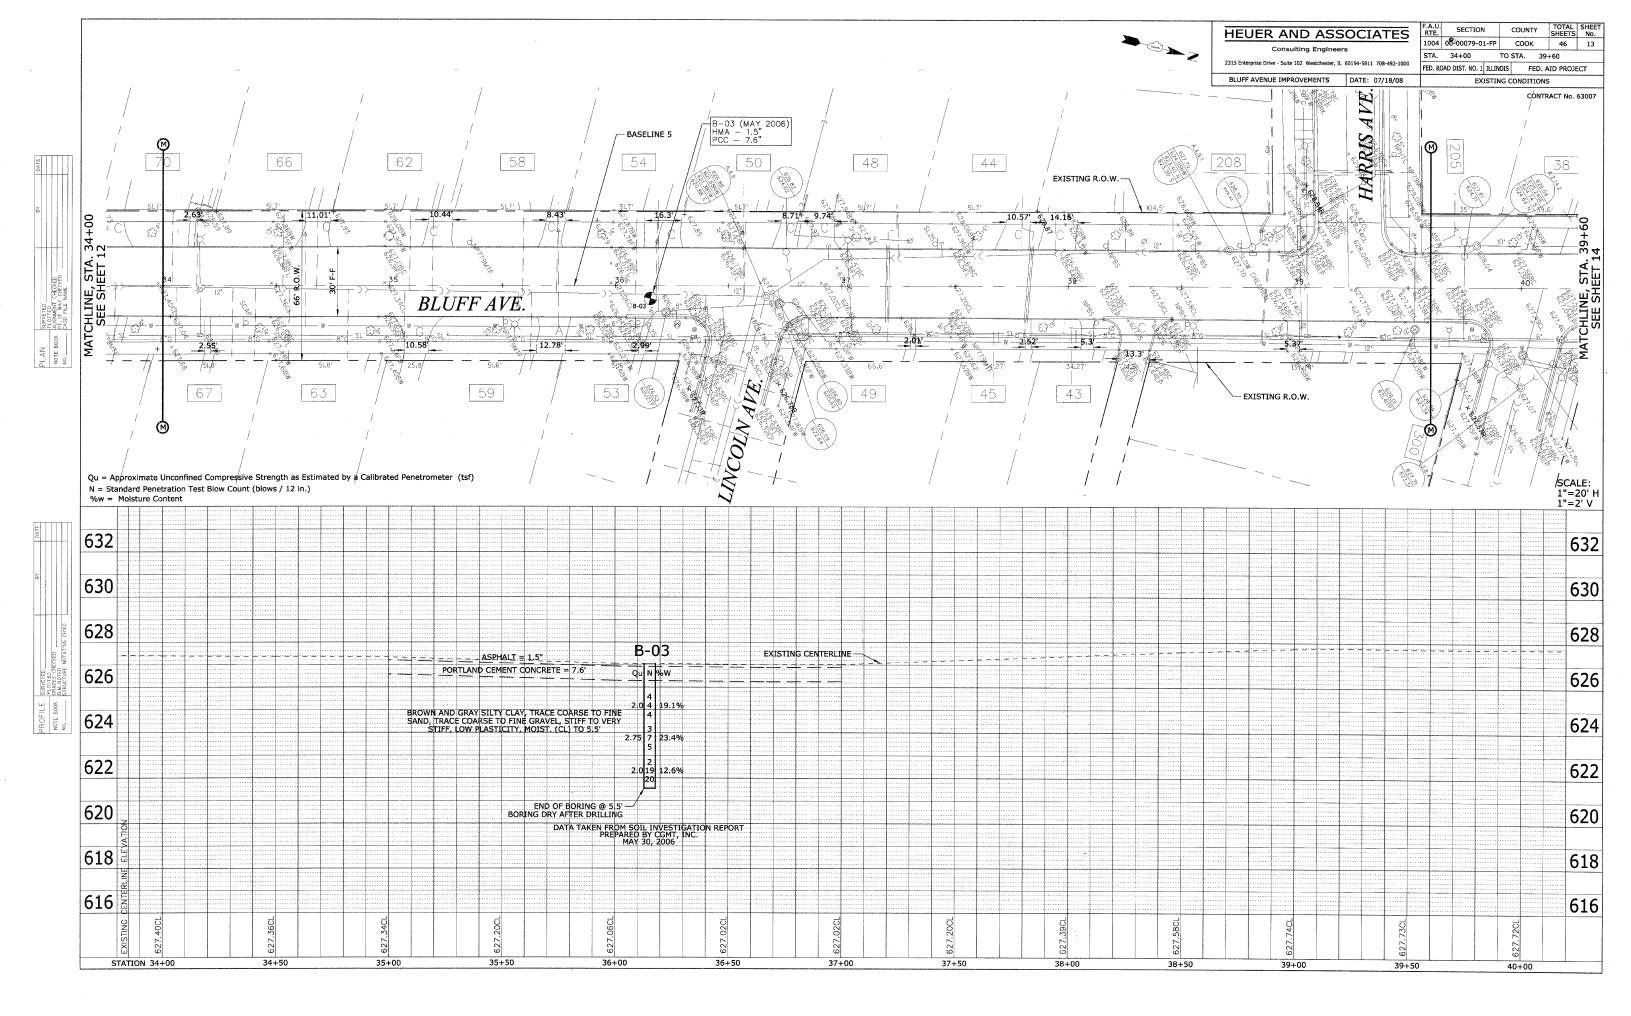
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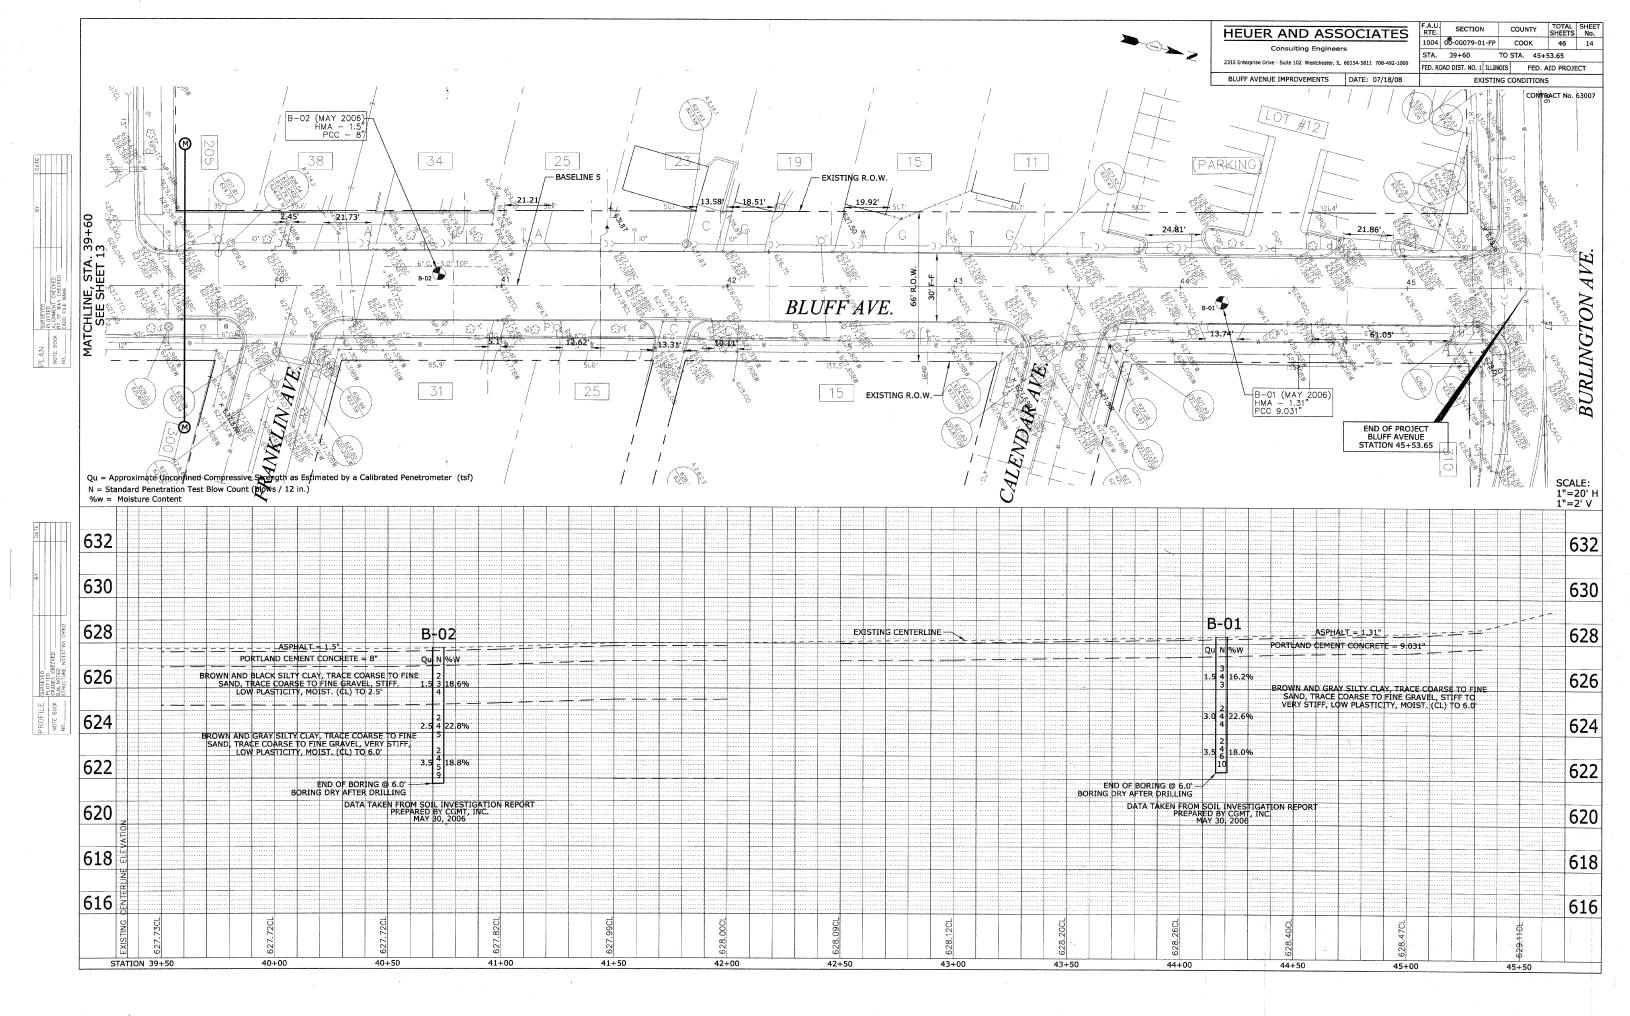
- 1. SEE DETAIL PLAN SHEETS FOR EROSION CONTROL DETAILS.
- 2. REFER TO PLAN INDEX FOR LOCATION.


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		SCALE: NTS	DRAWN BY H&A
		DATE 07/18/2008	CHECKED BY PFH


TOTAL SHEET No. SECTION COUNTY HEUER AND ASSOCIATES 1004 00-00079-01-FP соок TO STA. 2315 Enterprise Drive - Suite 102 Westchester, IL 60154-5811 708-492-1000 FED. ROAD DIST. NO. 1 ILLINOIS FED. AID PROJECT CONTRACT No. 63007 MWRD INTERCEPTOR (SALT CREEK NO. 2) EXISTING 20" COMBINATION SEWER EXISTING 72"
COMBINATION SEWER BROOKFIELD MWRD 13A - EXT CONSTRUCTION SHAFT #1 40th STREET EXISTING 15" COMBINATION SEWER MWRD 13A - EXT PROPOSED 10" SEWER (REPLACE EXISTING COMBINATION SEWER) - EXISTING 72" COMBINATION SEWER EXISTING 72" OUTFALL COMBINATION SEWER PROPOSED 12" SEWER (REPLACE EXISTING COMBINATION SEWER) EXISTING 12" COMBINATION SEWER NOTES: REPLACE EXISTING INLETS/CATCHBASINS (TYPICAL) THE VILLAGE OF LA GRANGE OWNS AND MAINTAINS THE COMBINATION SEWER SYSTEM FROM THE PROJECT LOCATION TO THE MWRD INTERCEPTOR. PROJECT LOCATION **VILLAGE** OF LA GRANGE ILLINOIS DEPARTMENT OF TRANSPORTATION **BLUFF AVENUE IMPROVEMENTS** 48th STREET STAGE 1 **ROUTE OUTLET MAP** SCALE: NTS DRAWN BY H&A DATE 07/18/2008 CHECKED BY PFH







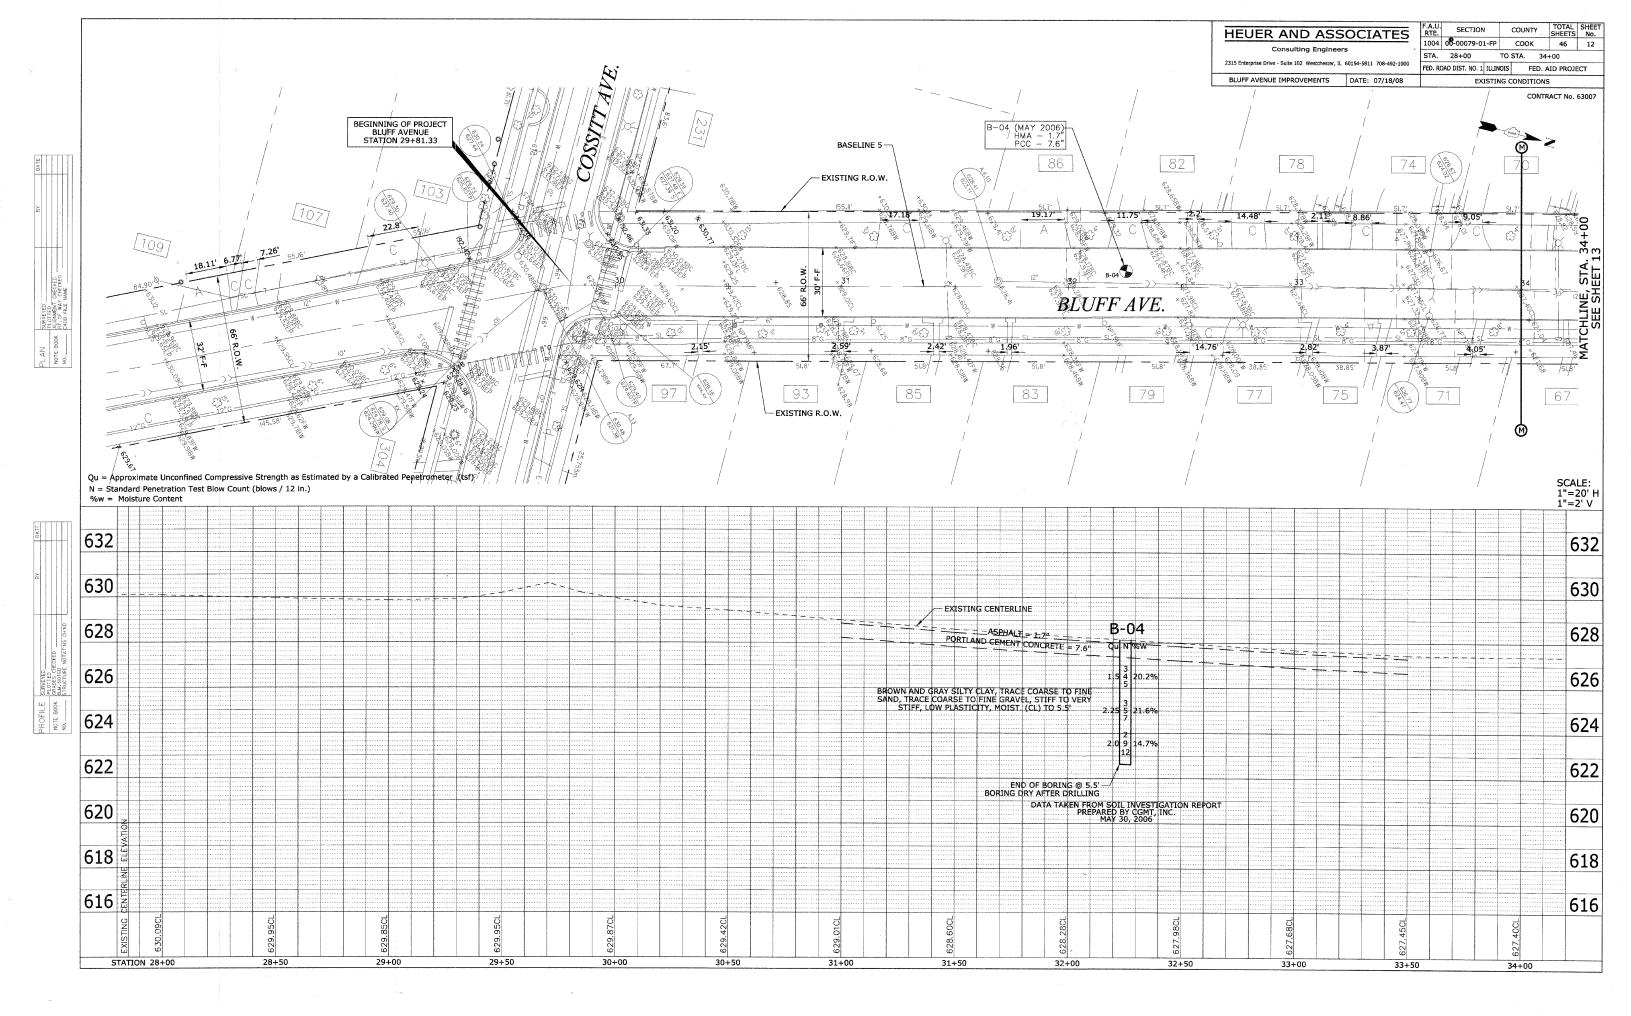


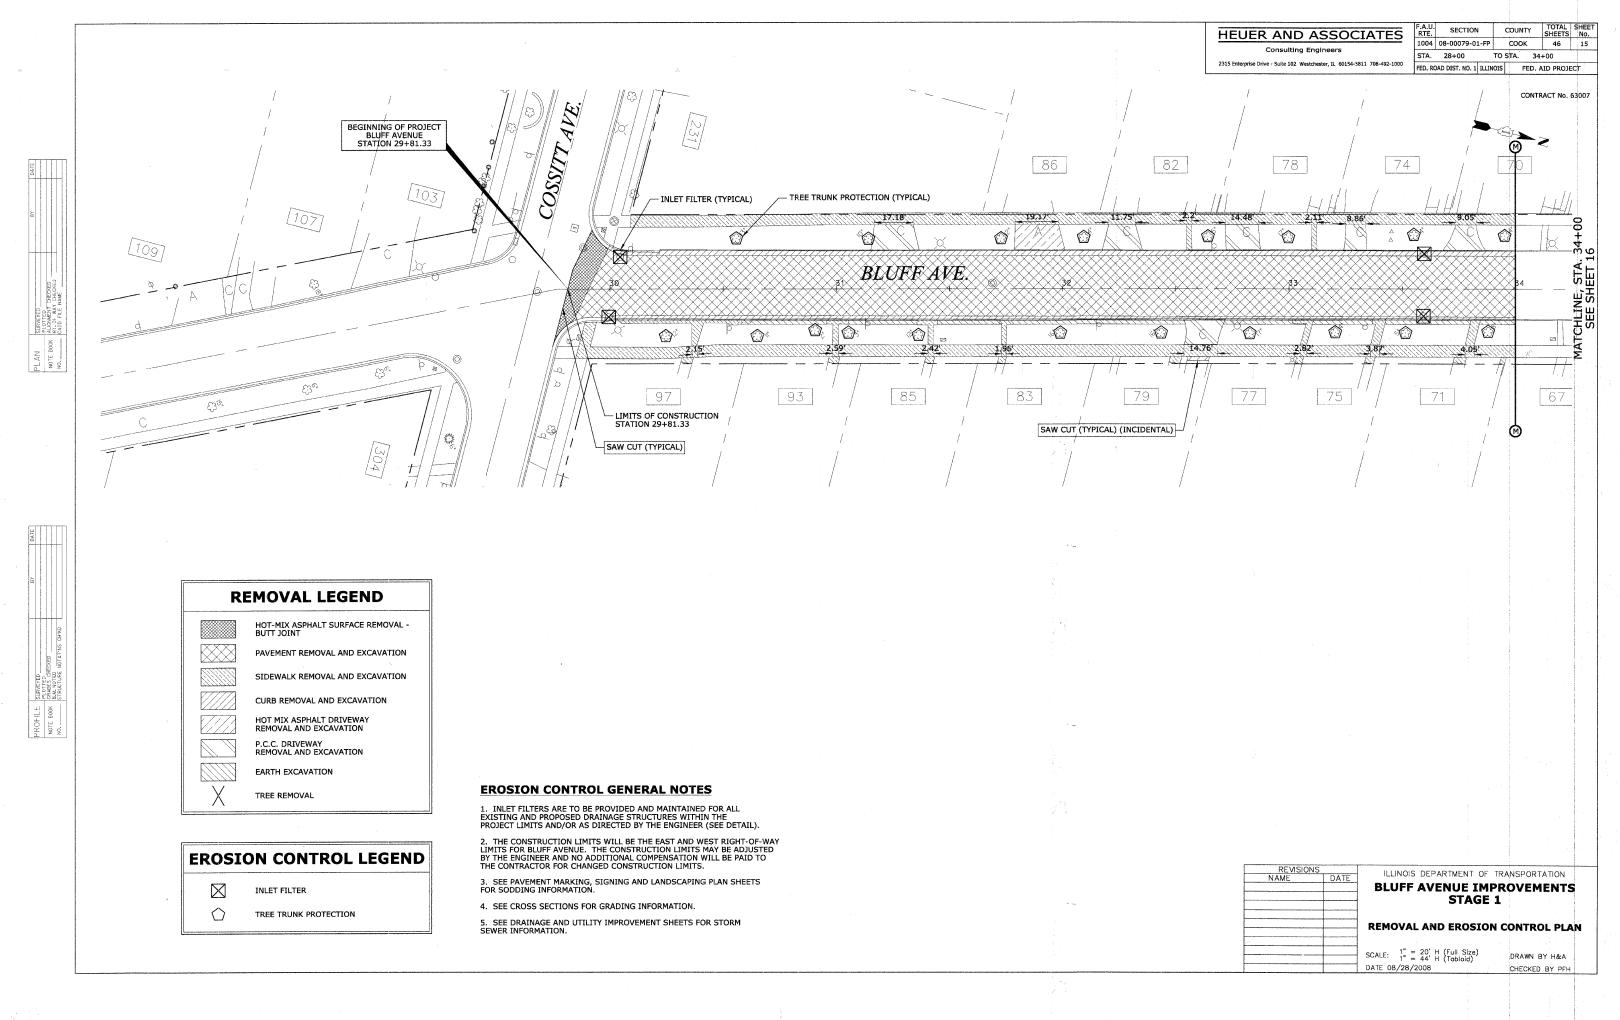


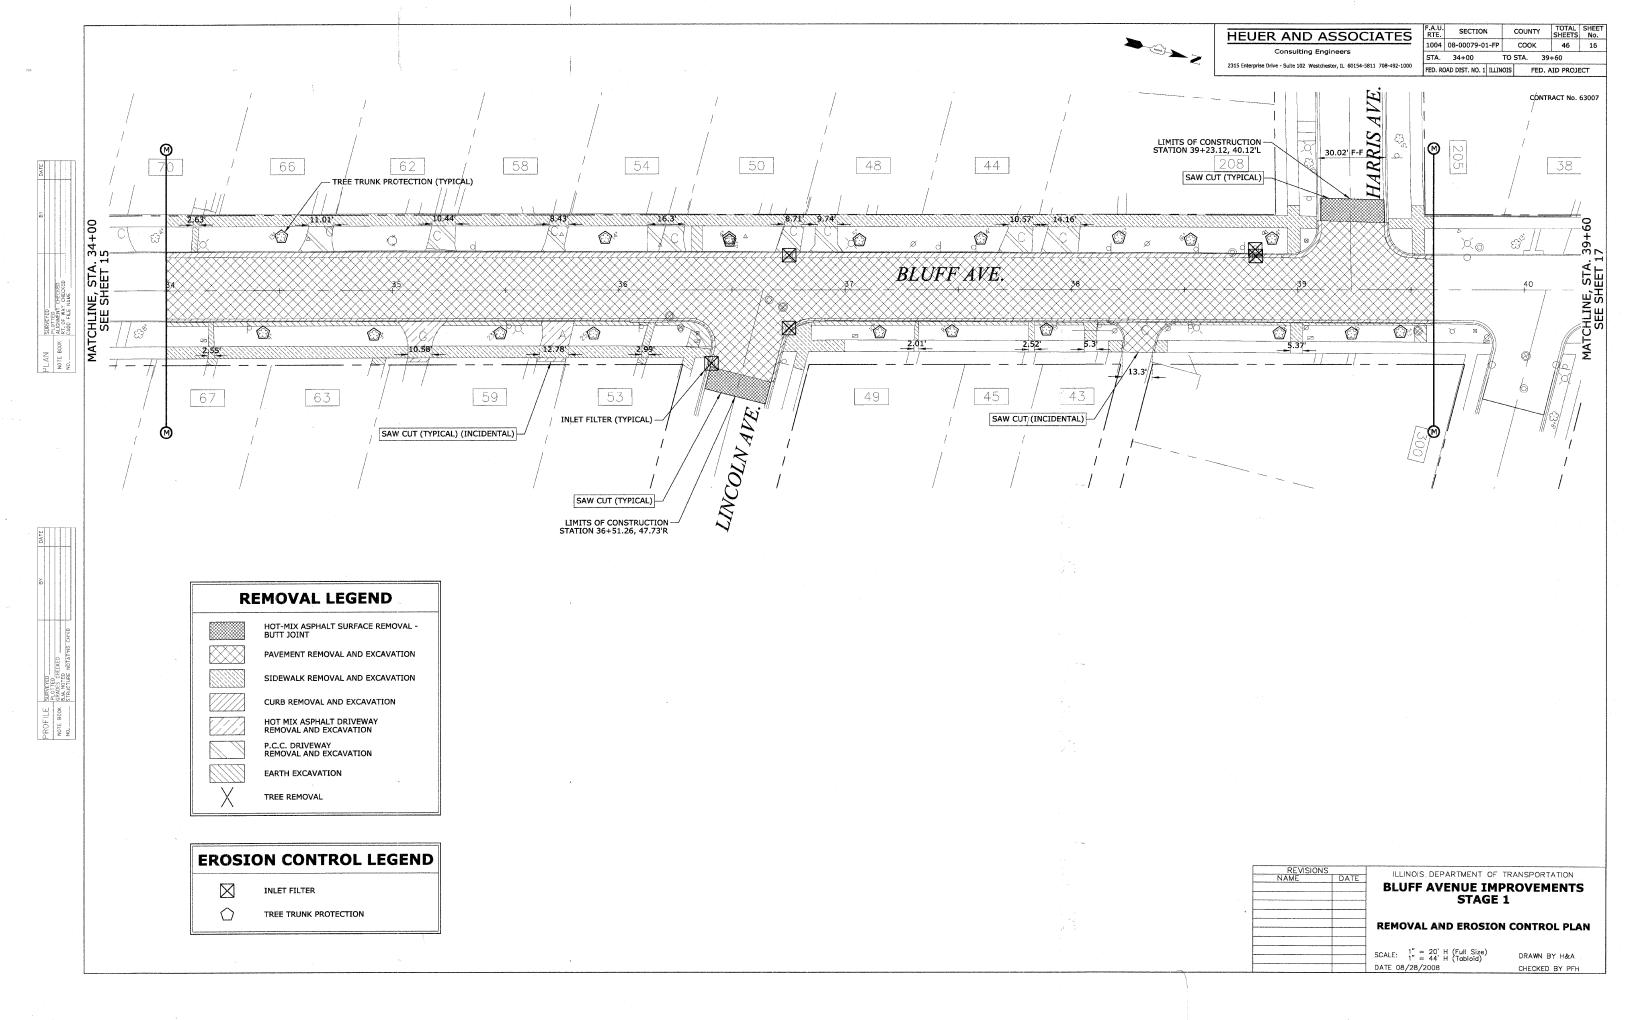


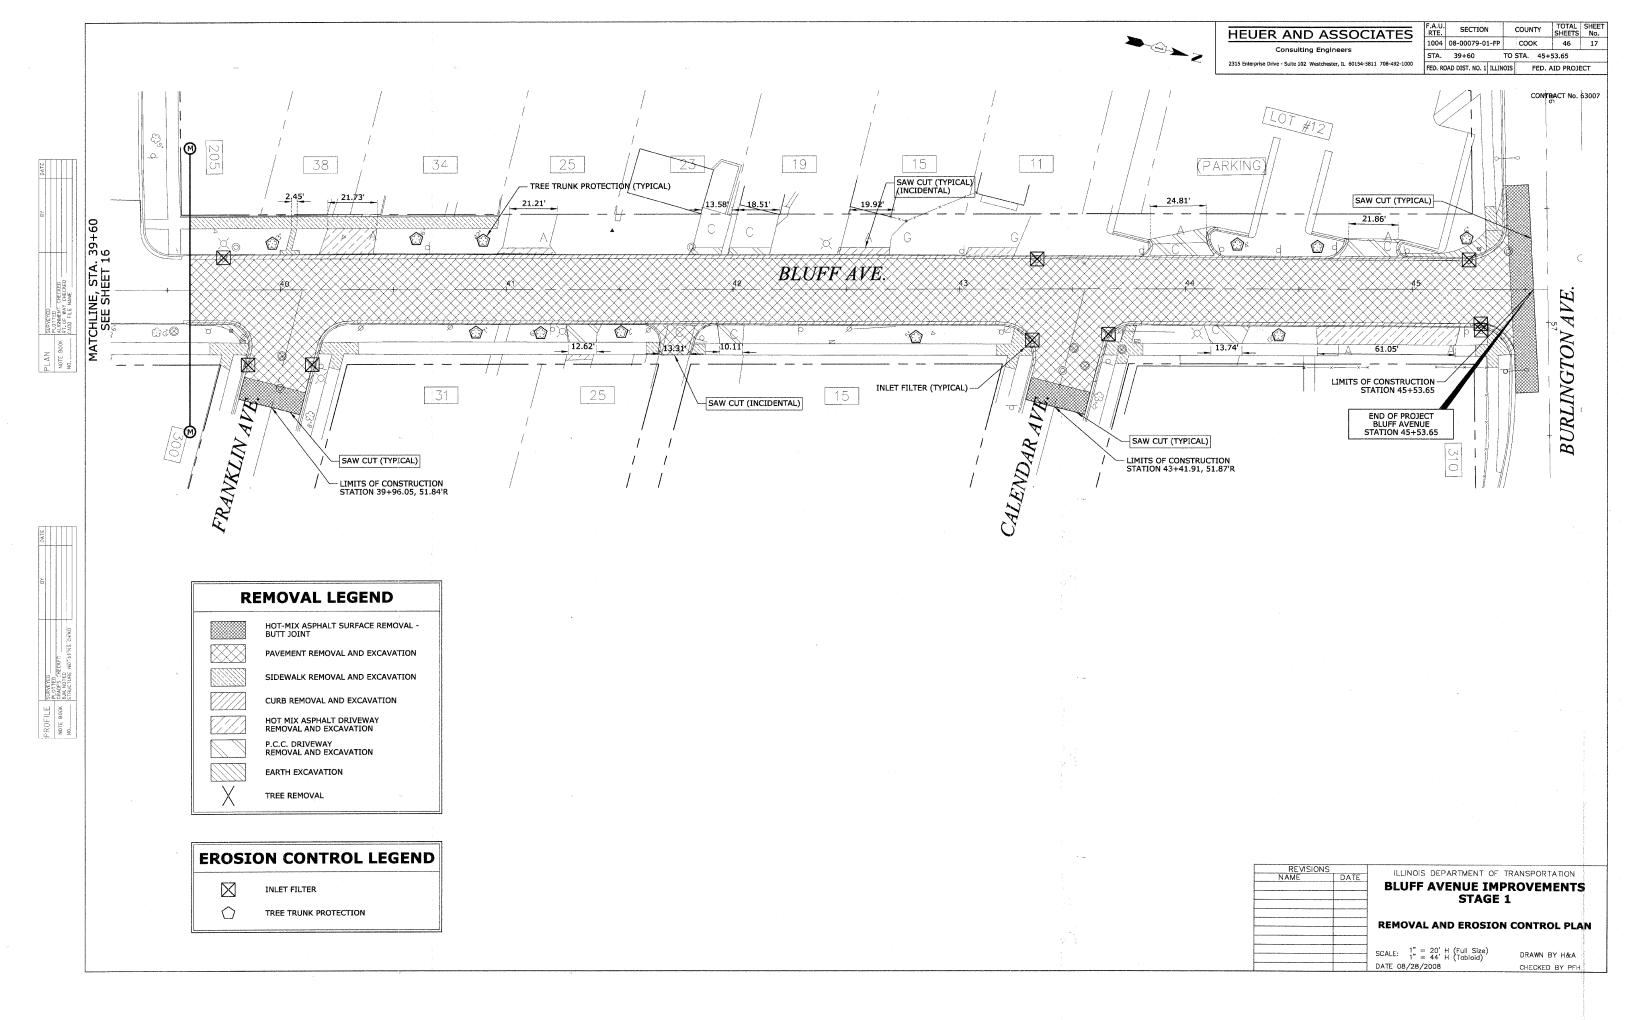


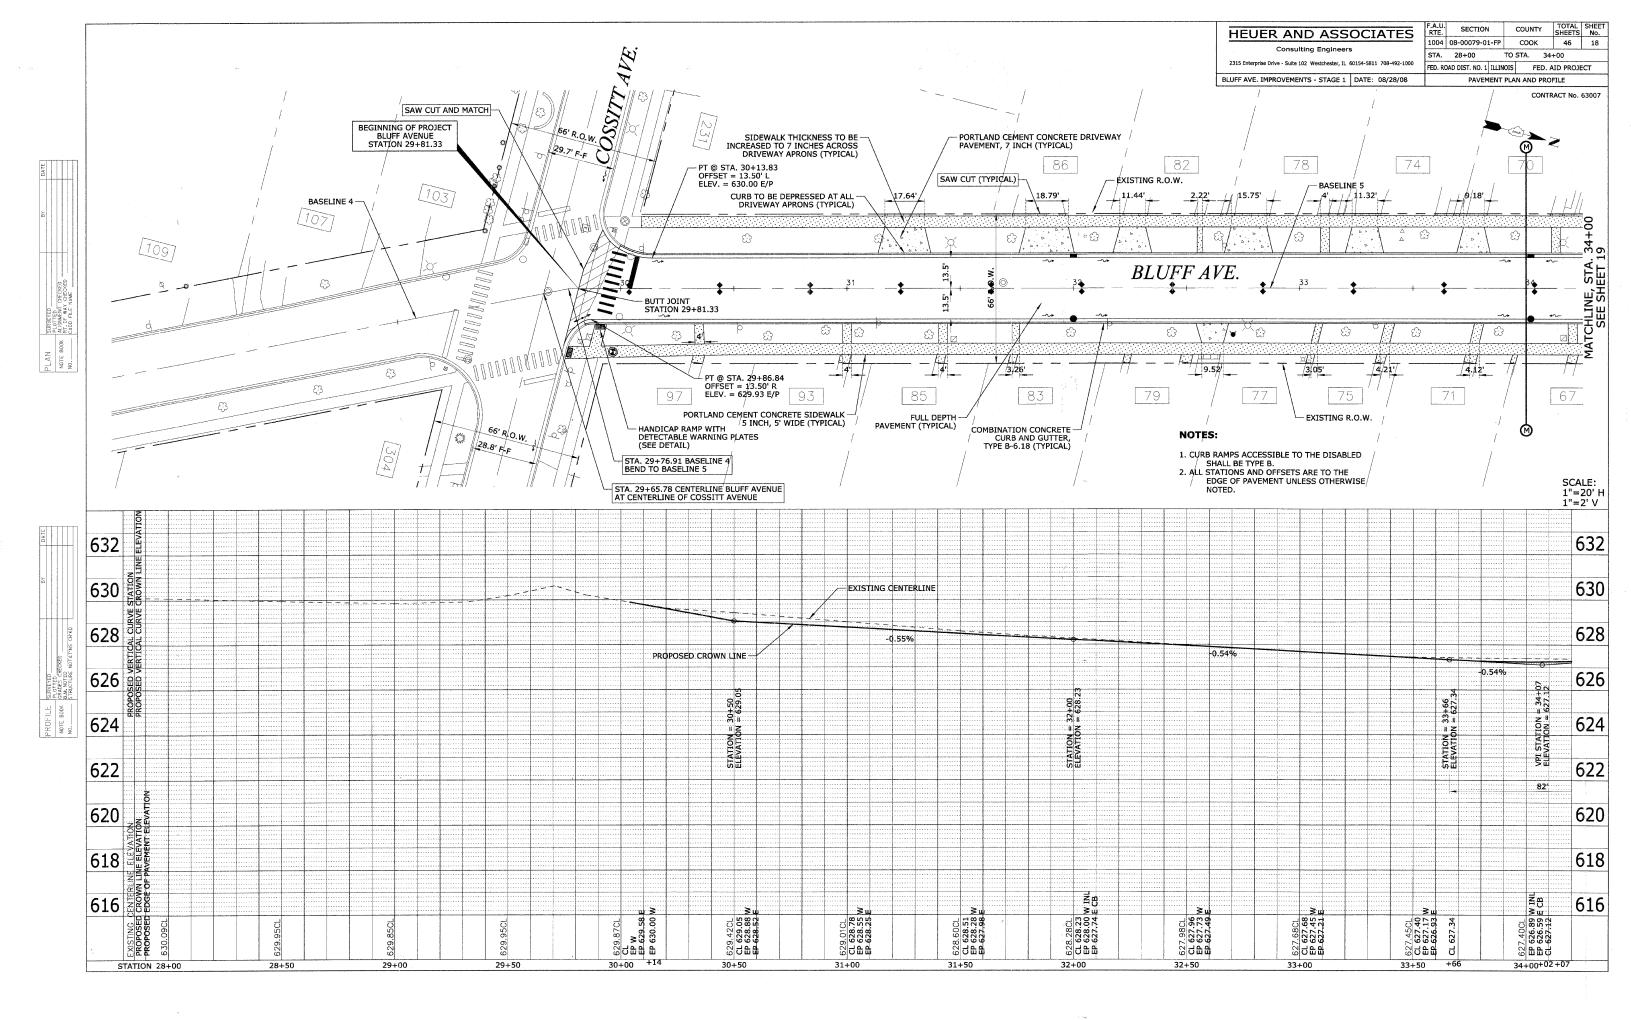


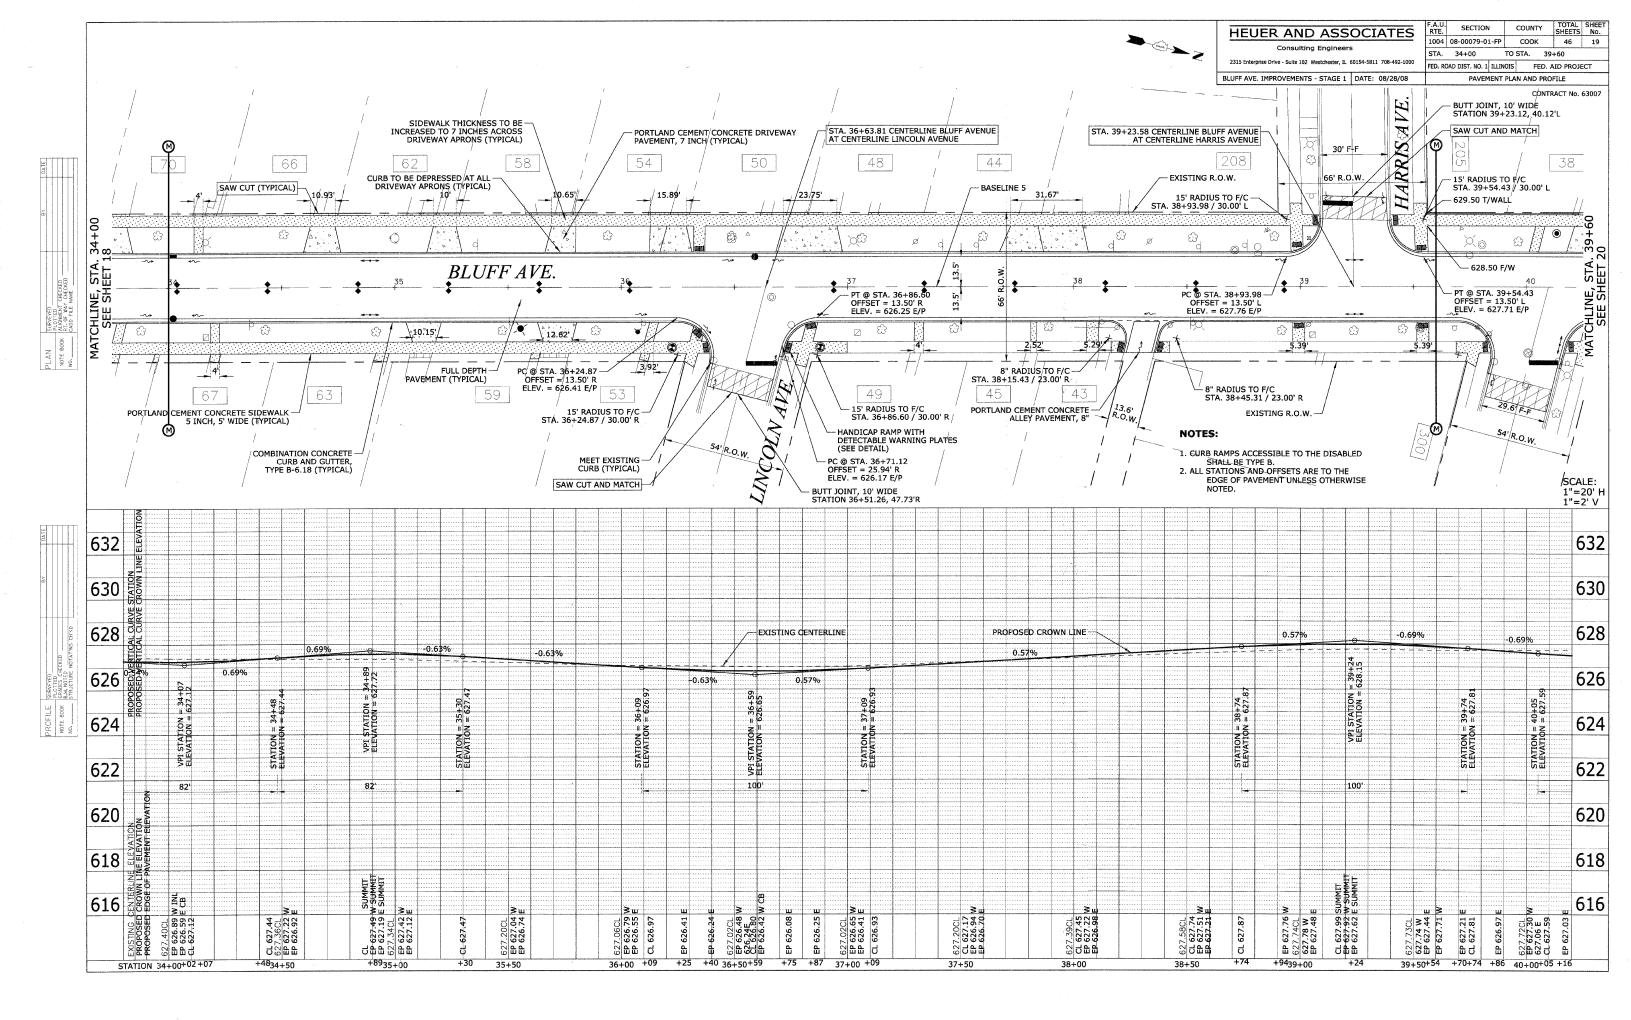


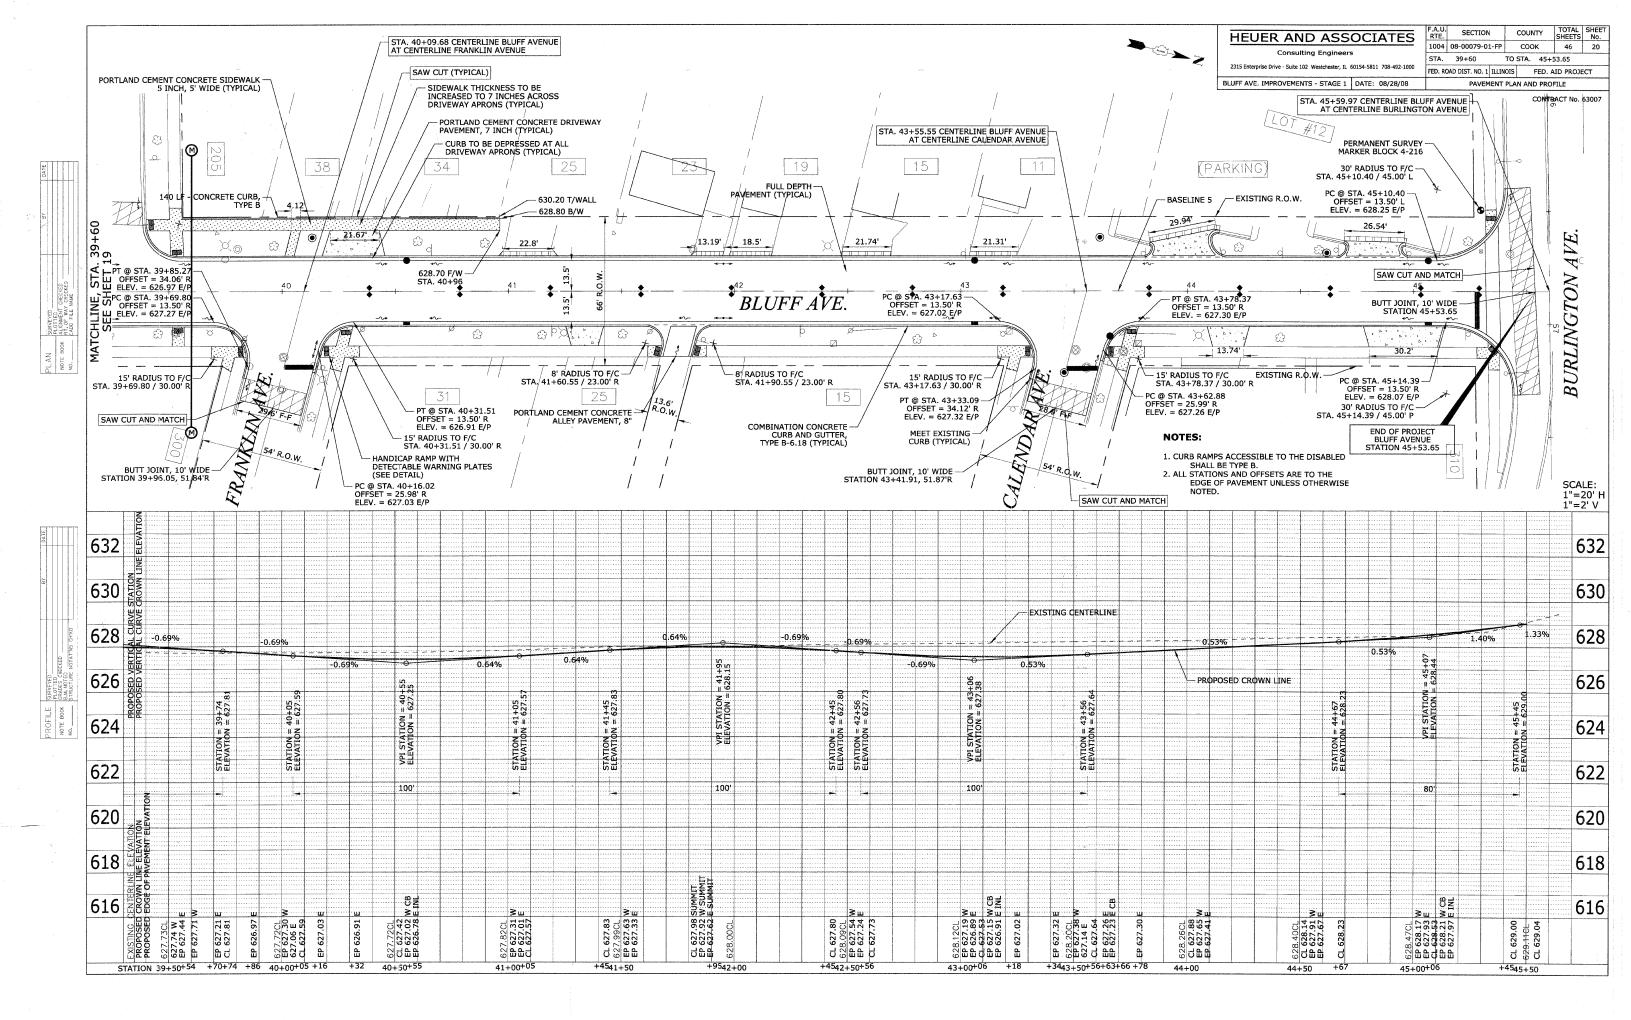


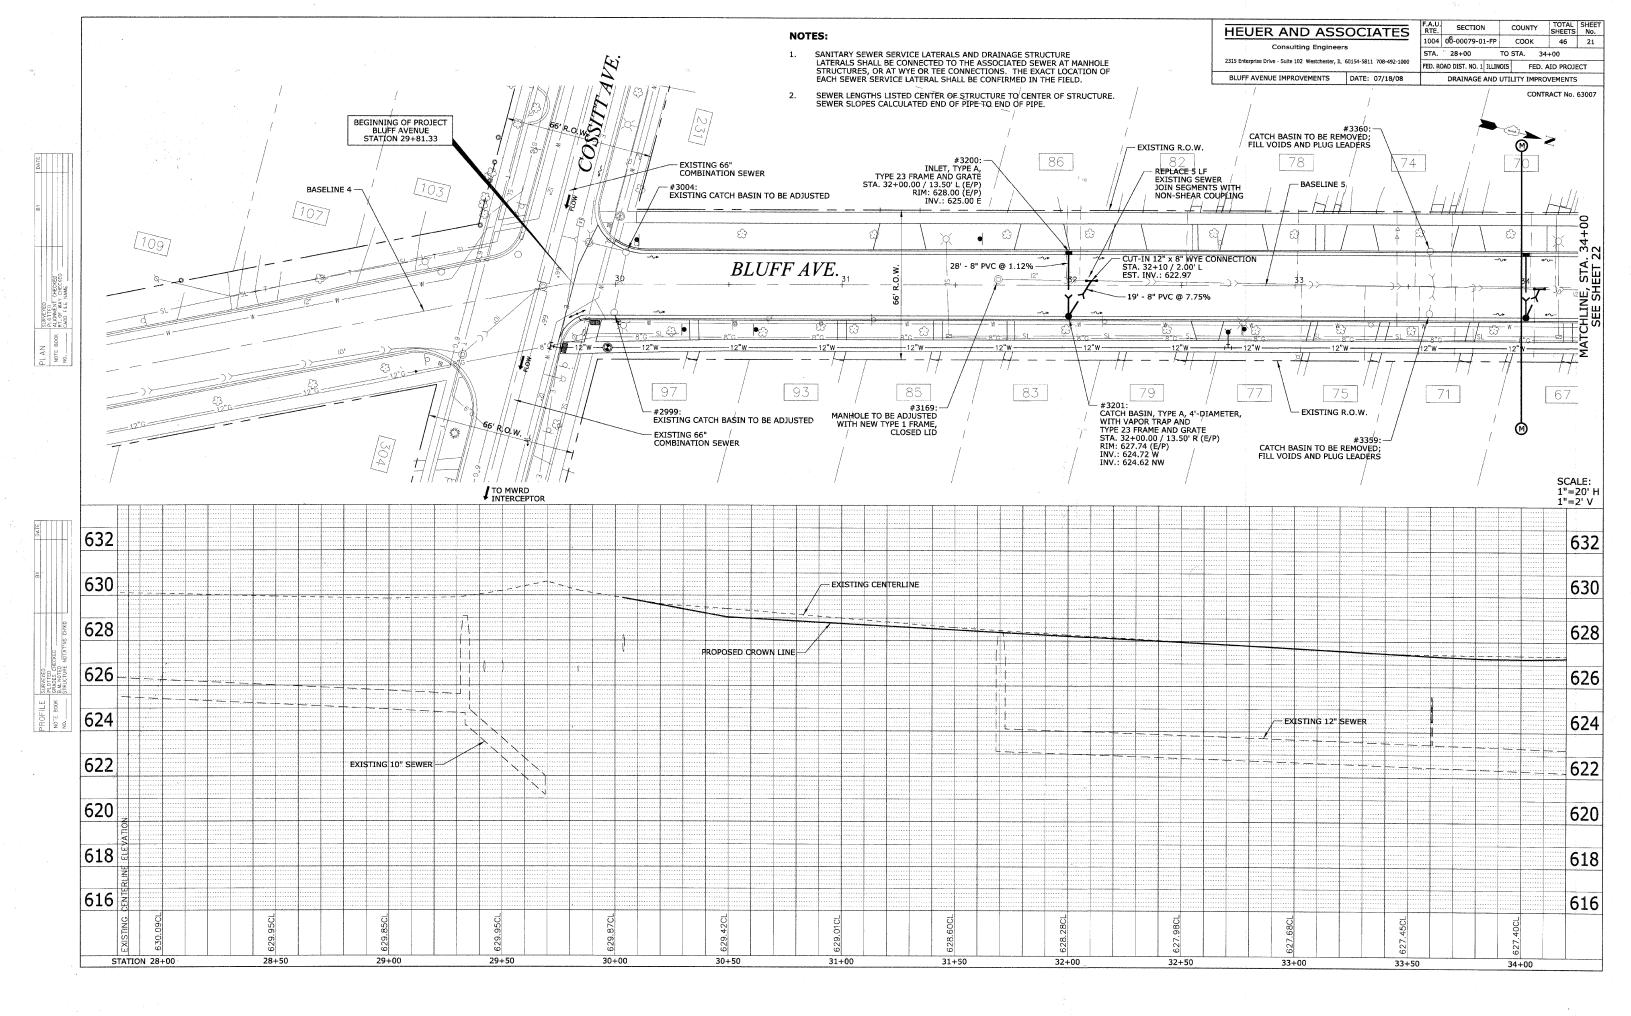


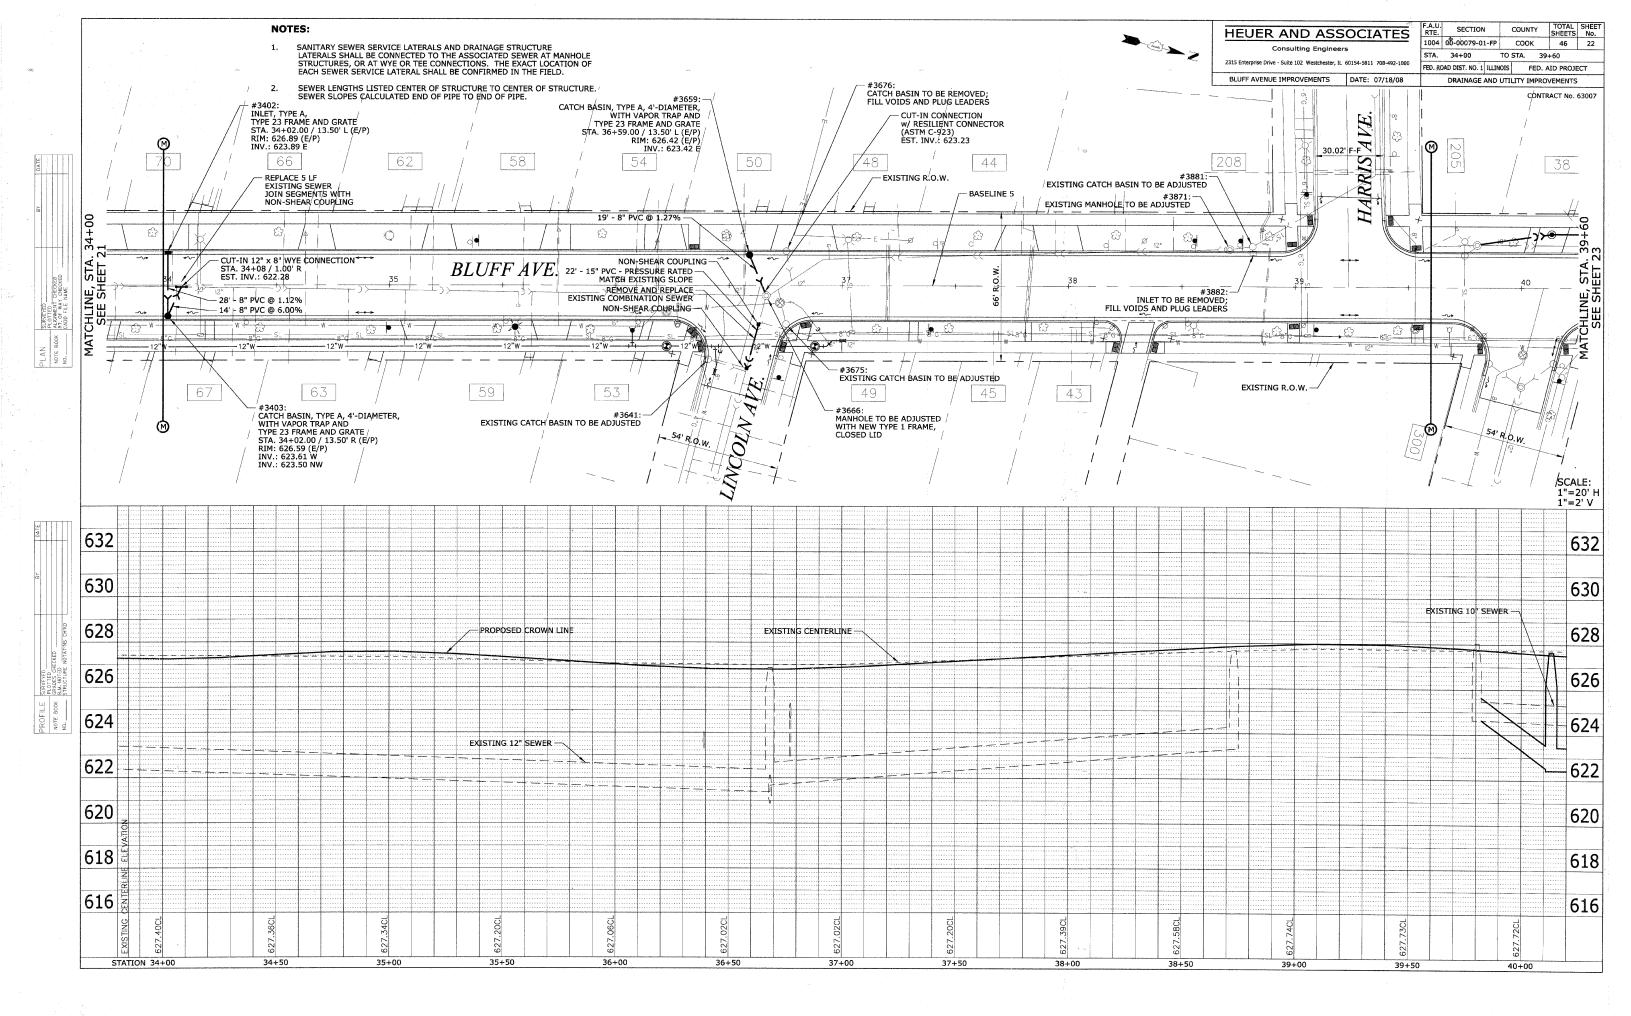


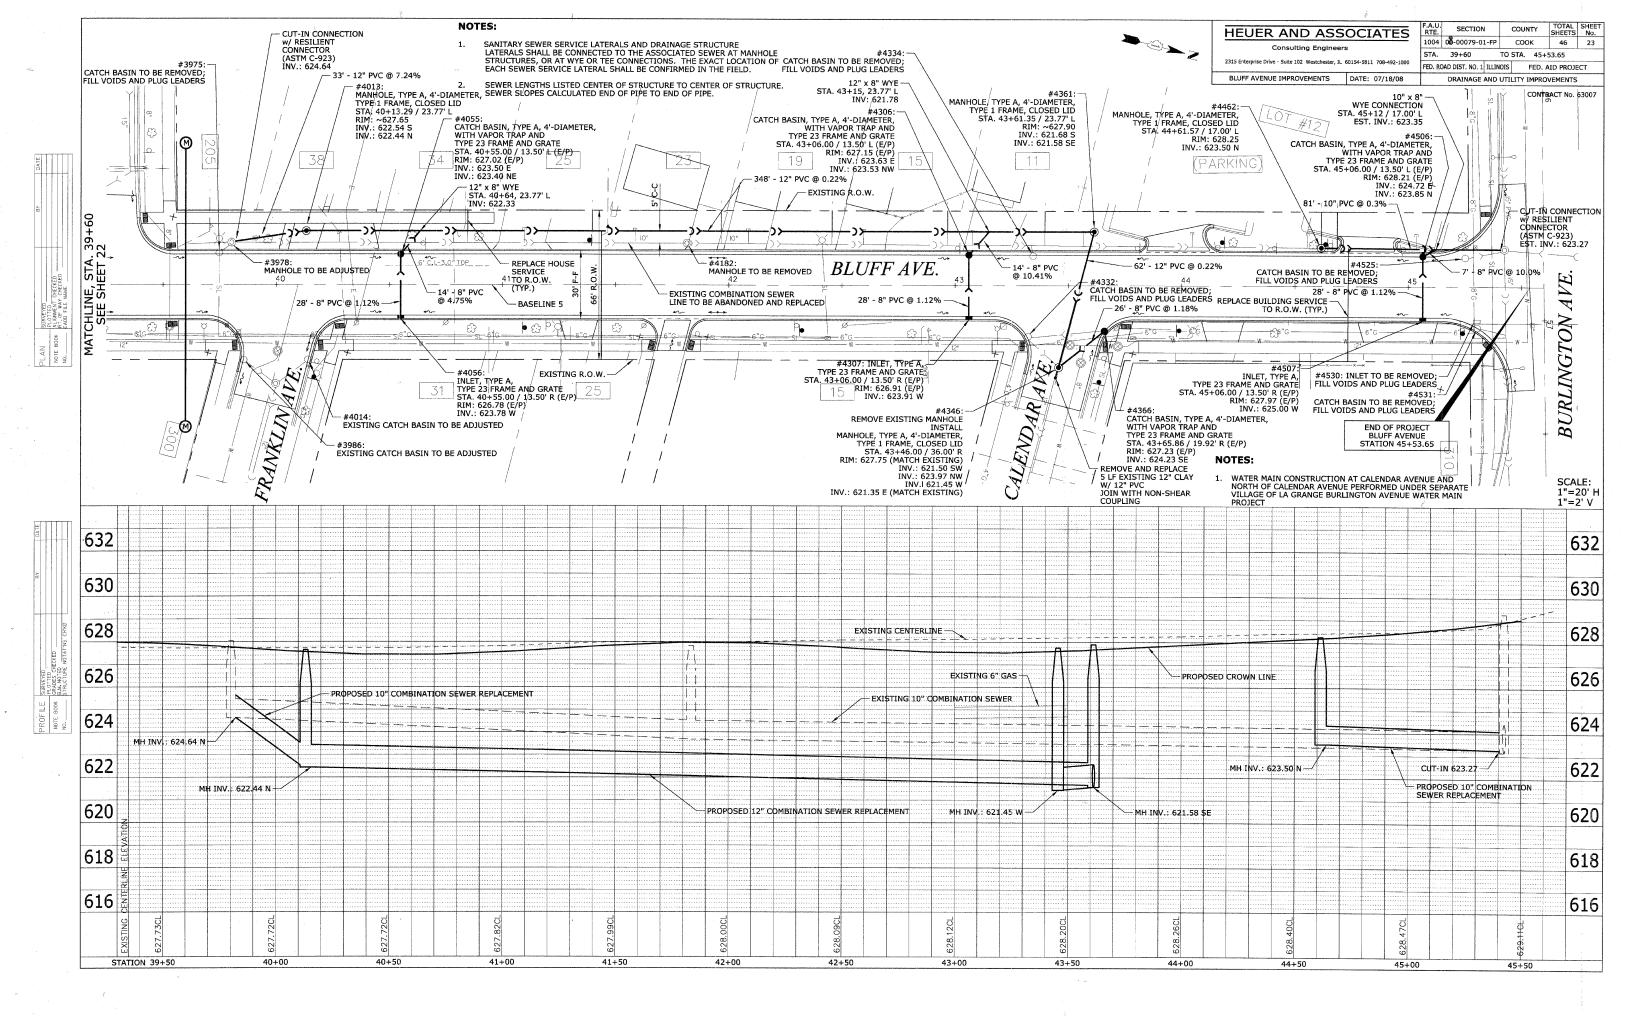


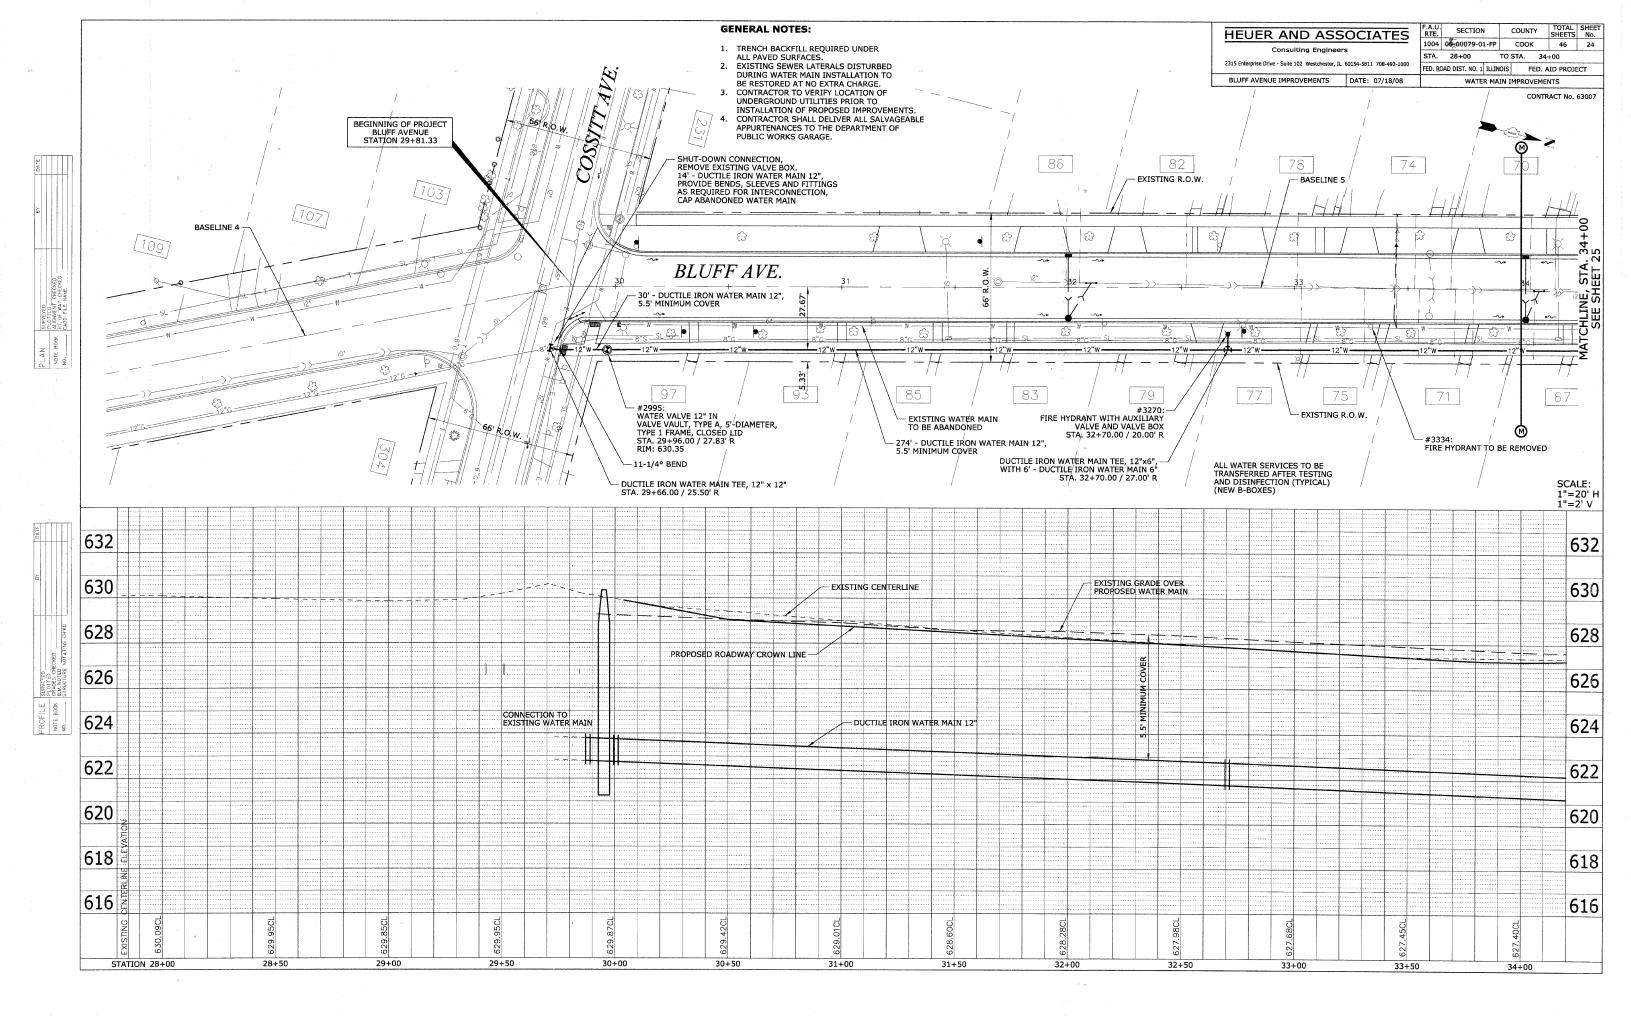


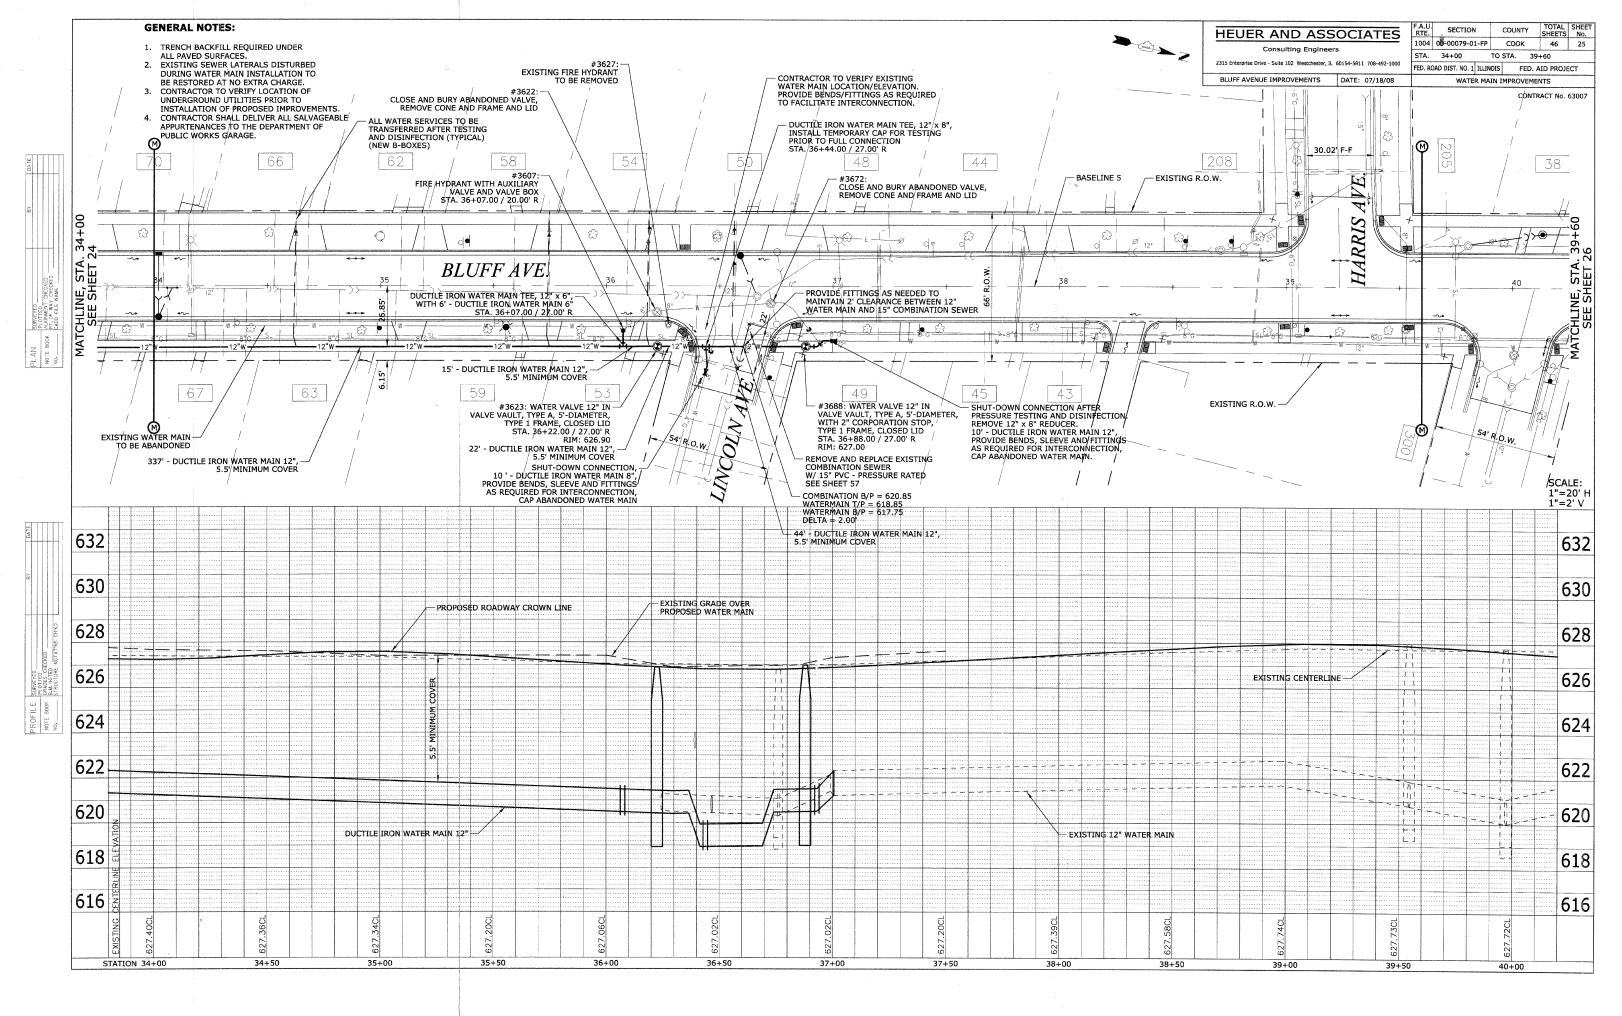


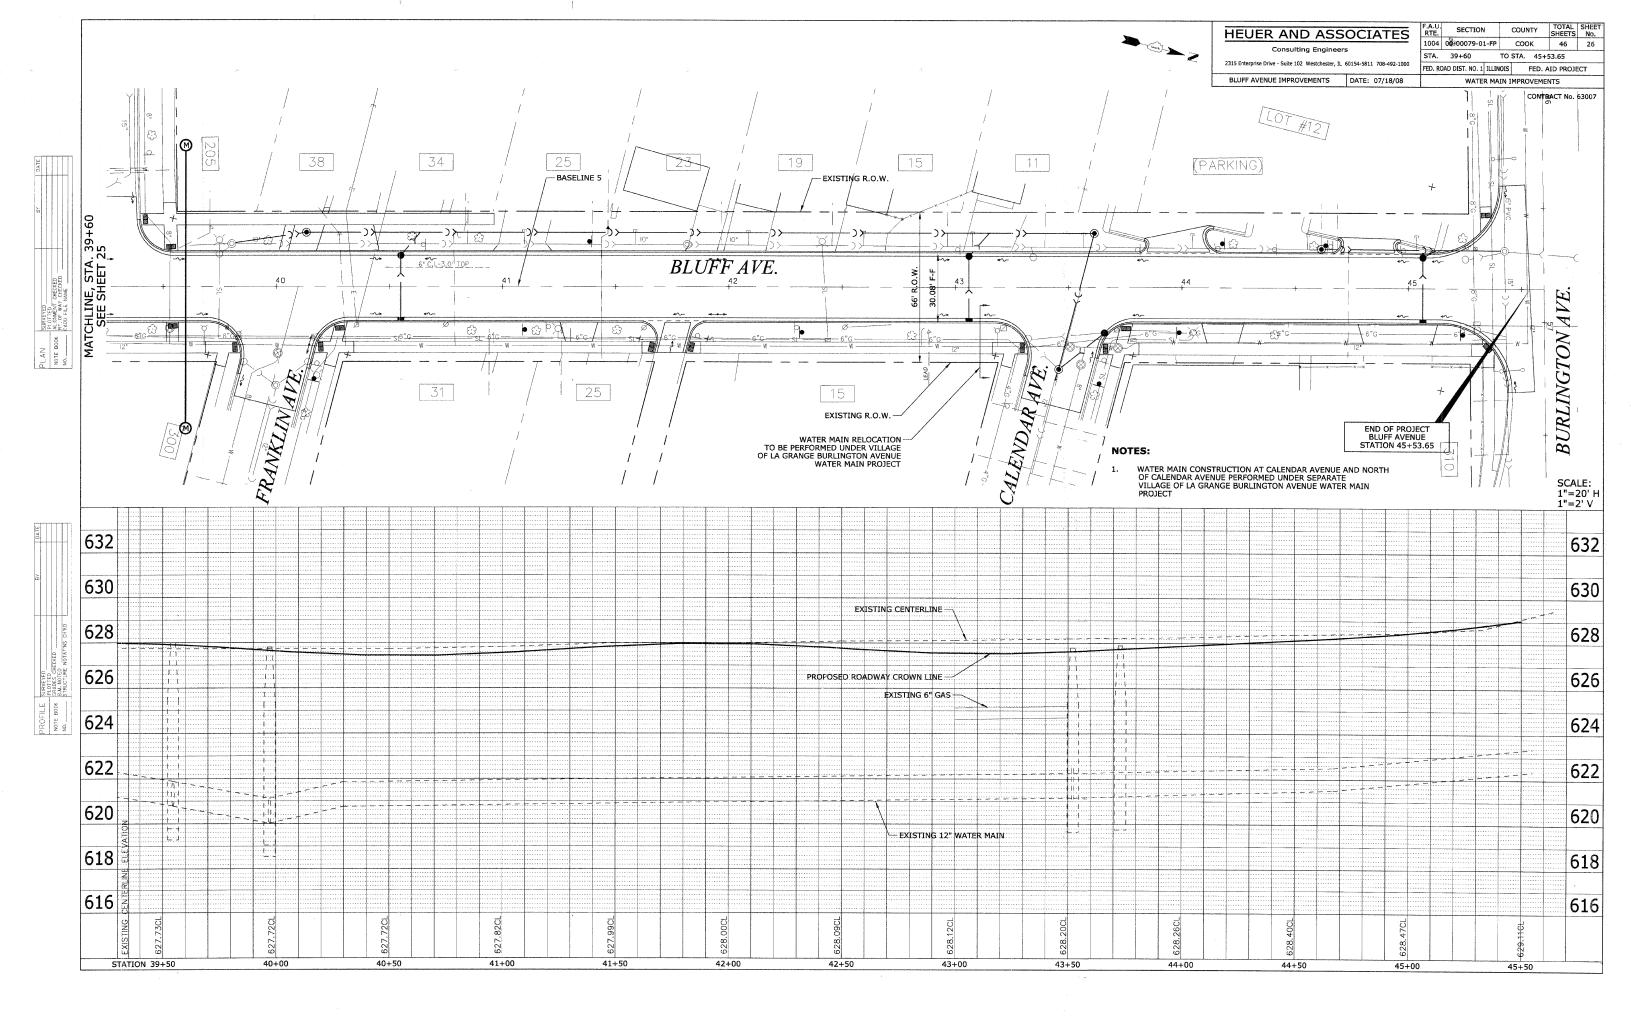


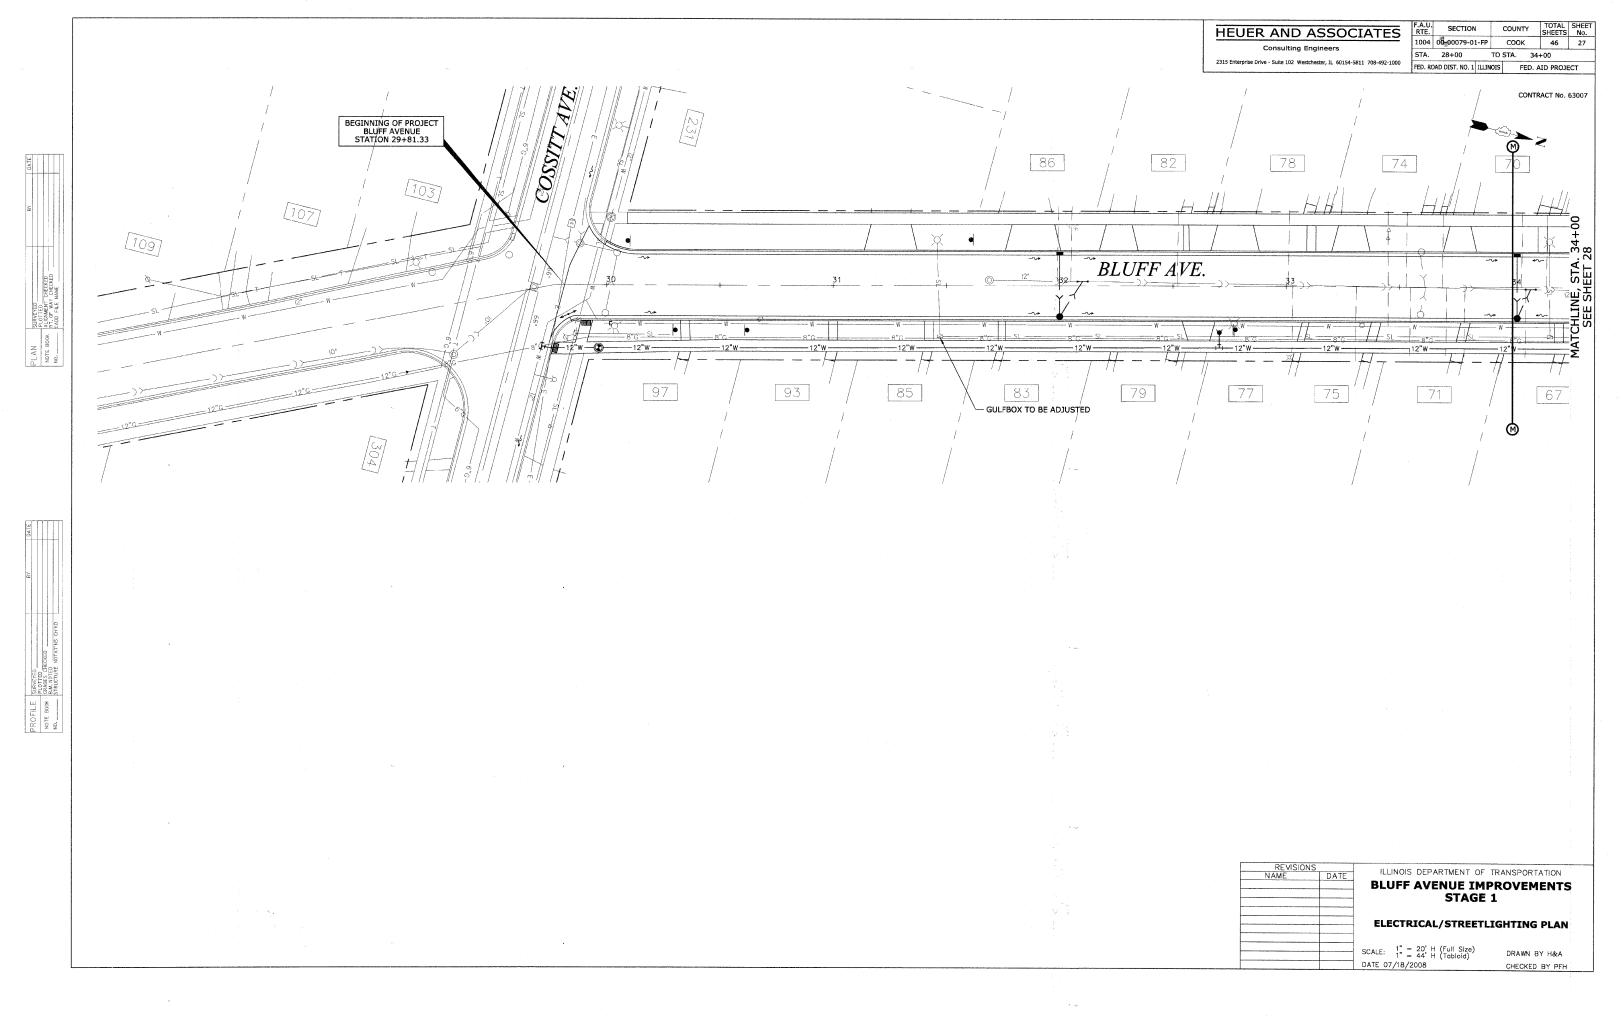


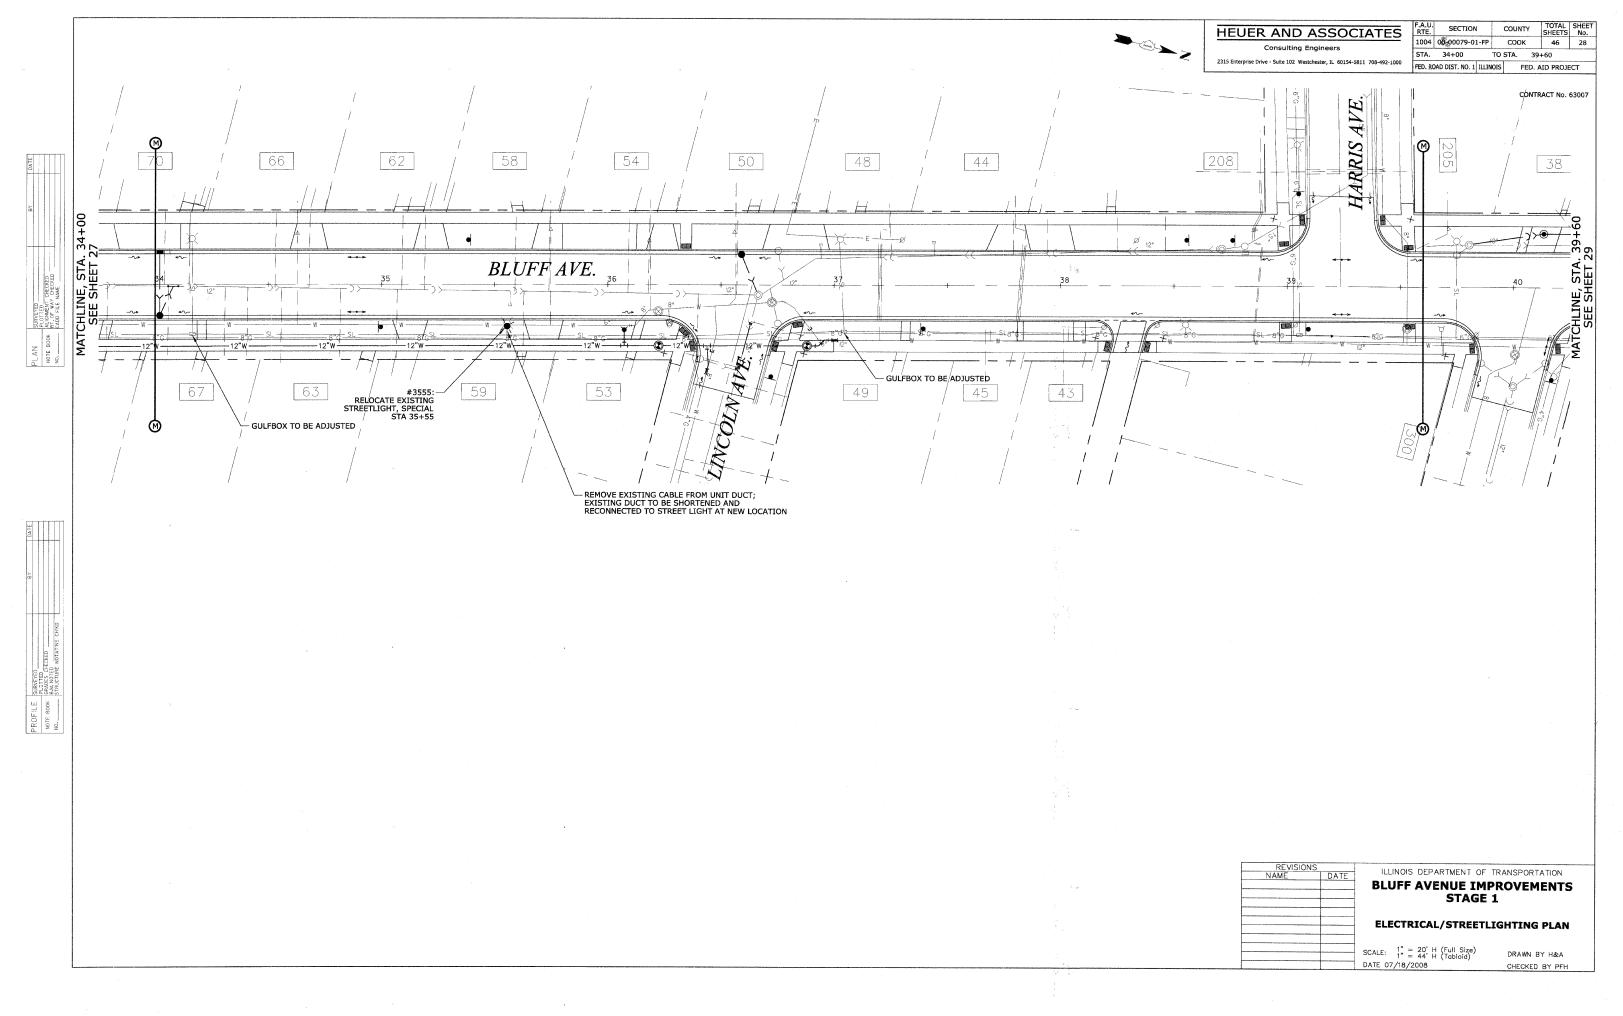


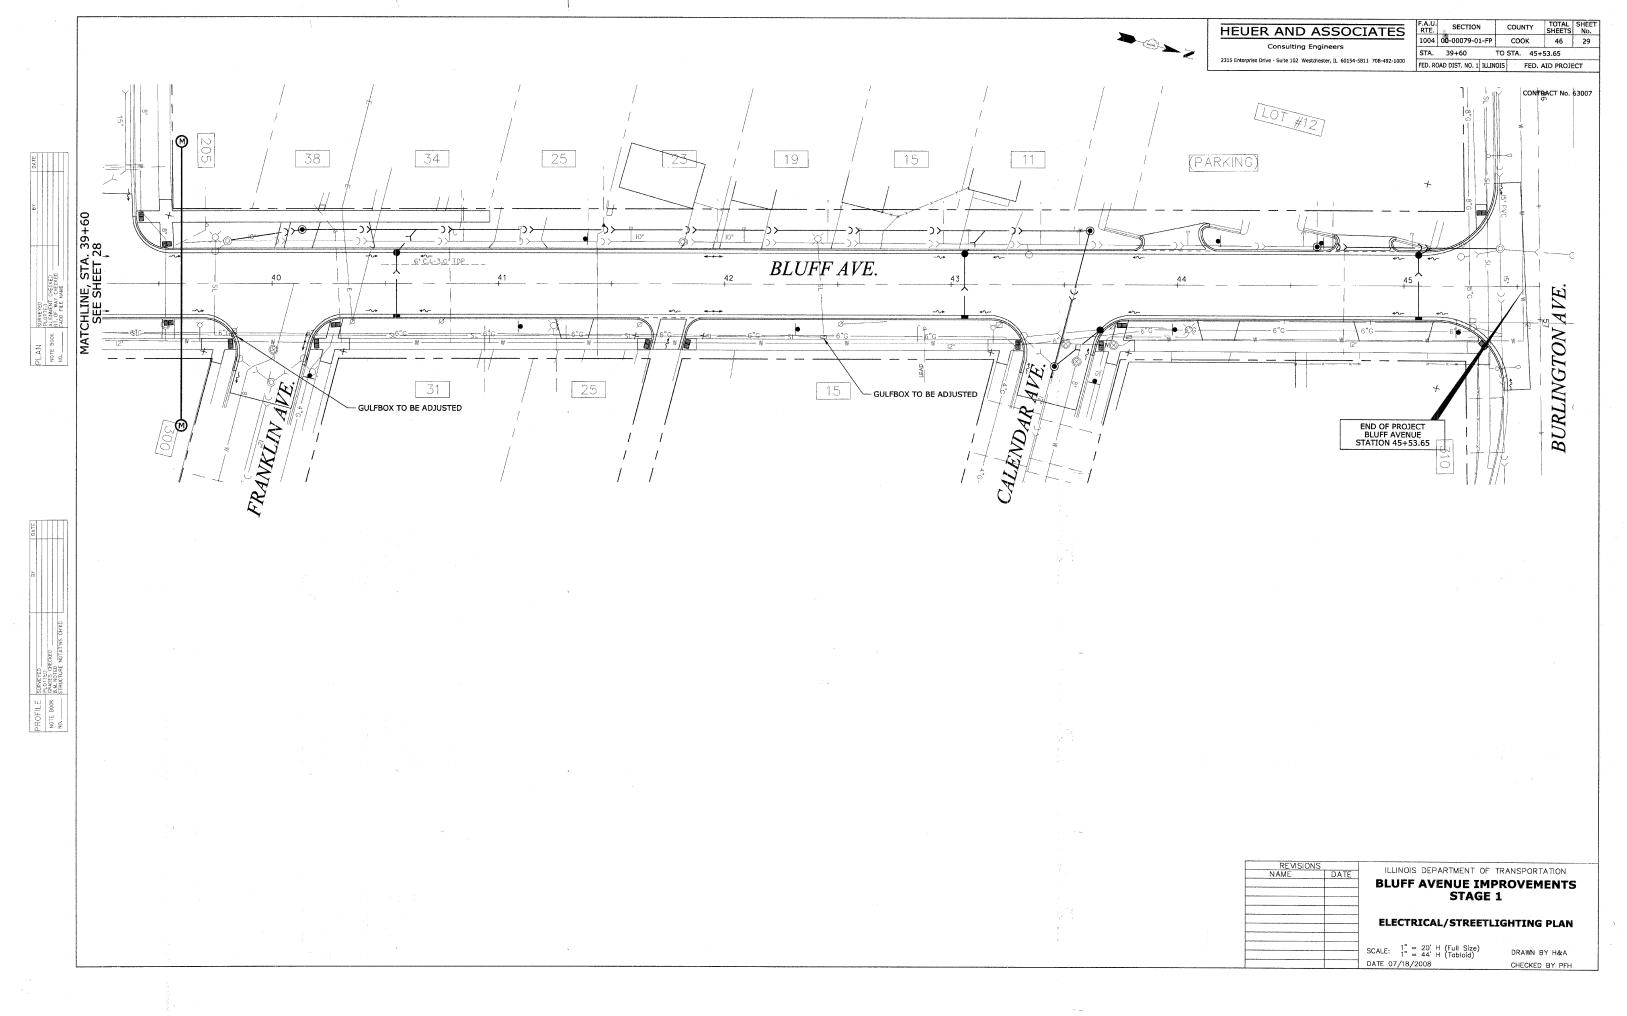


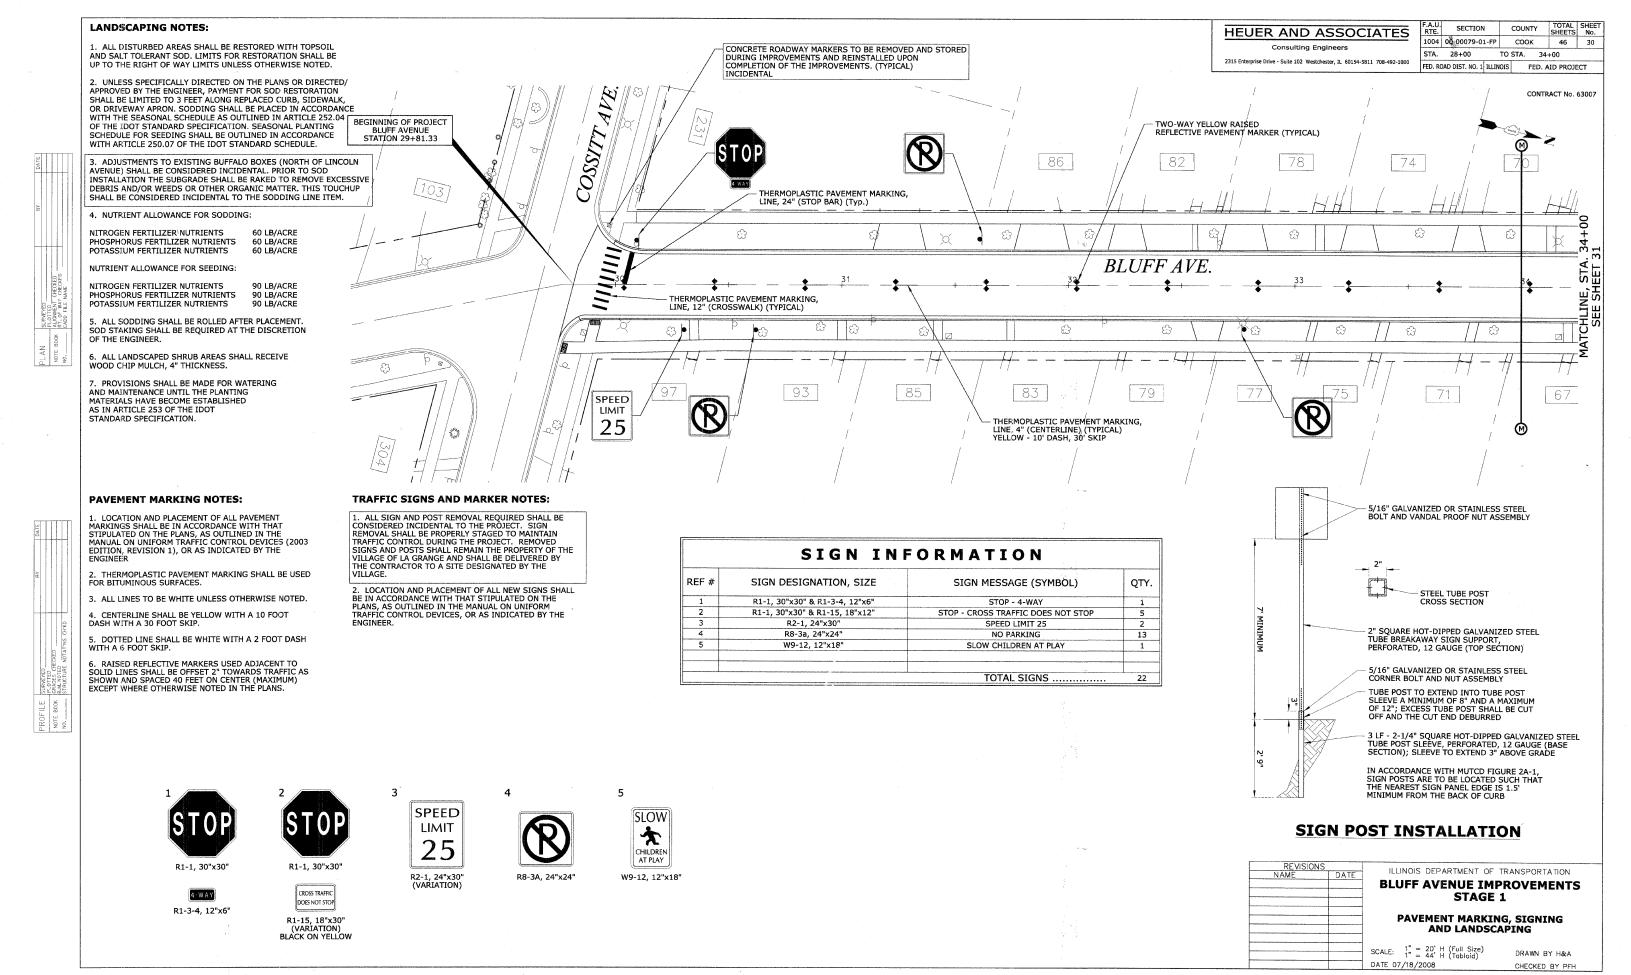


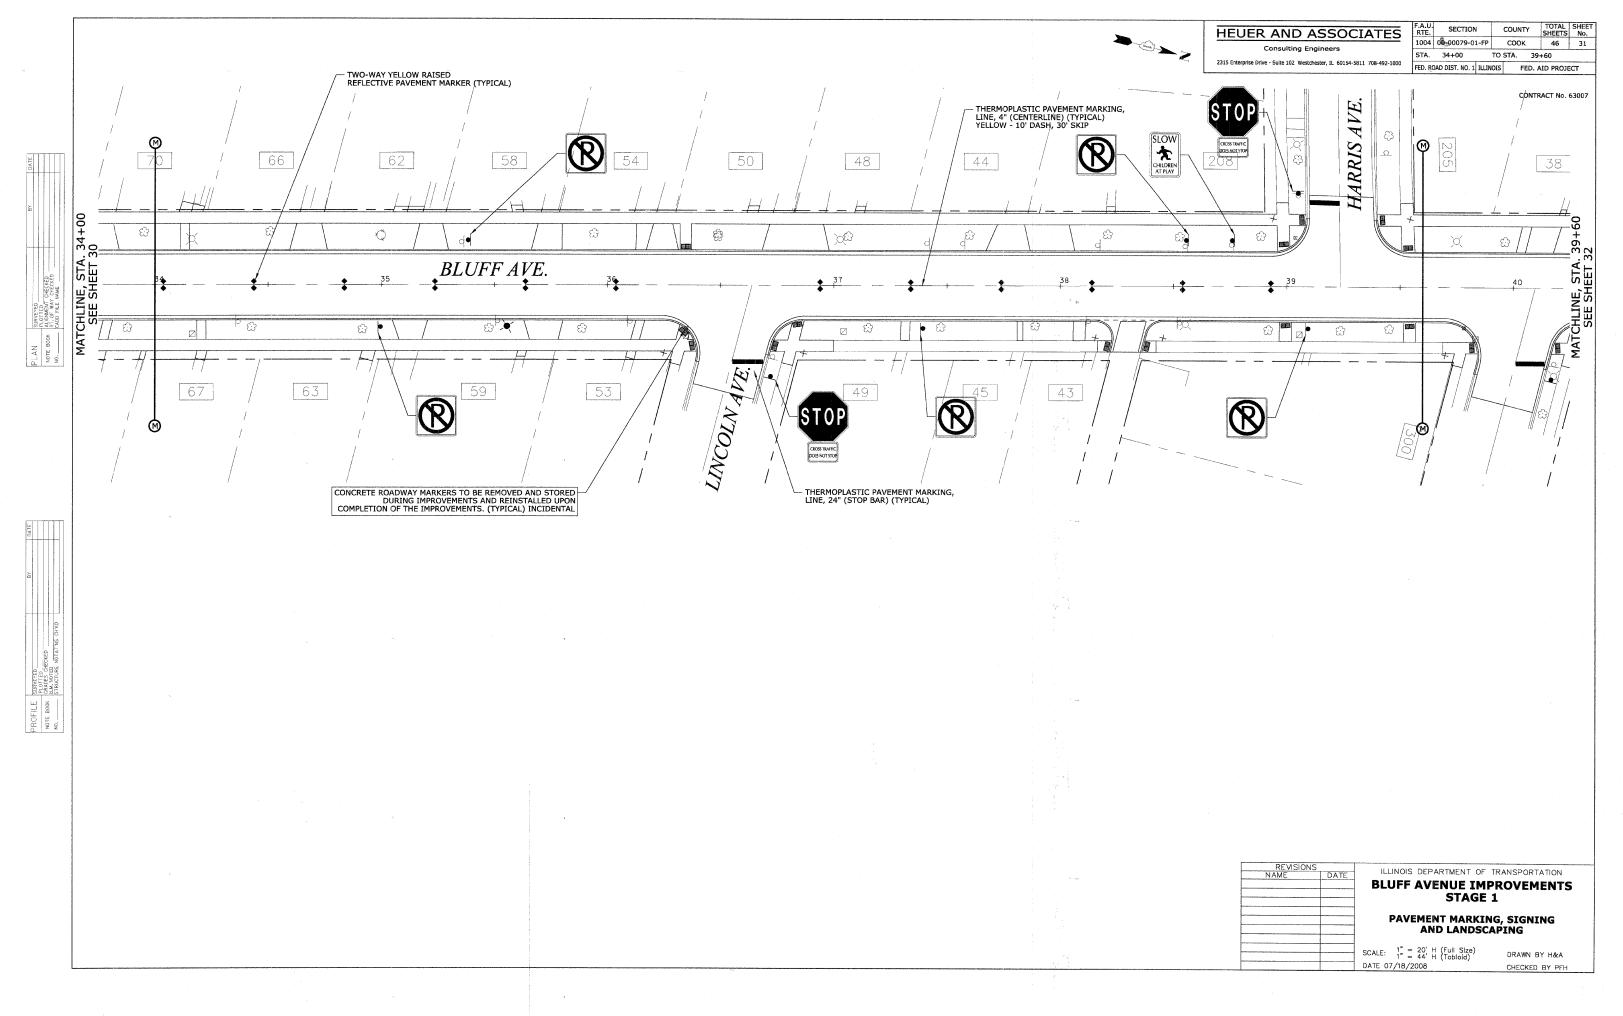


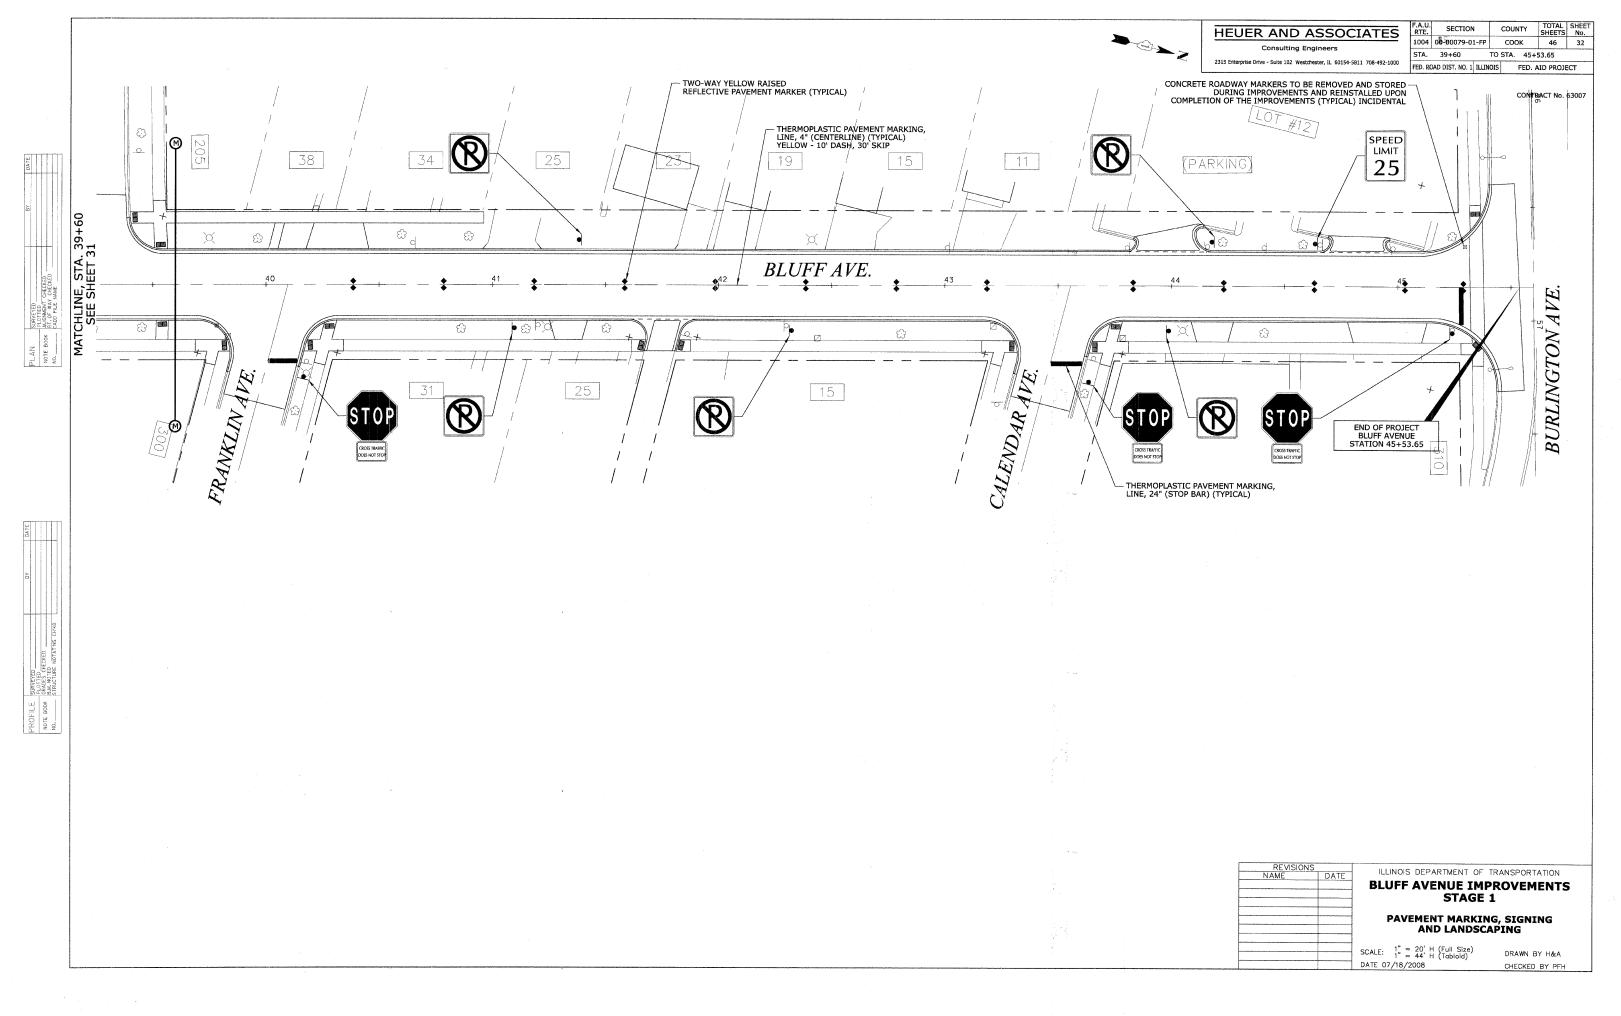


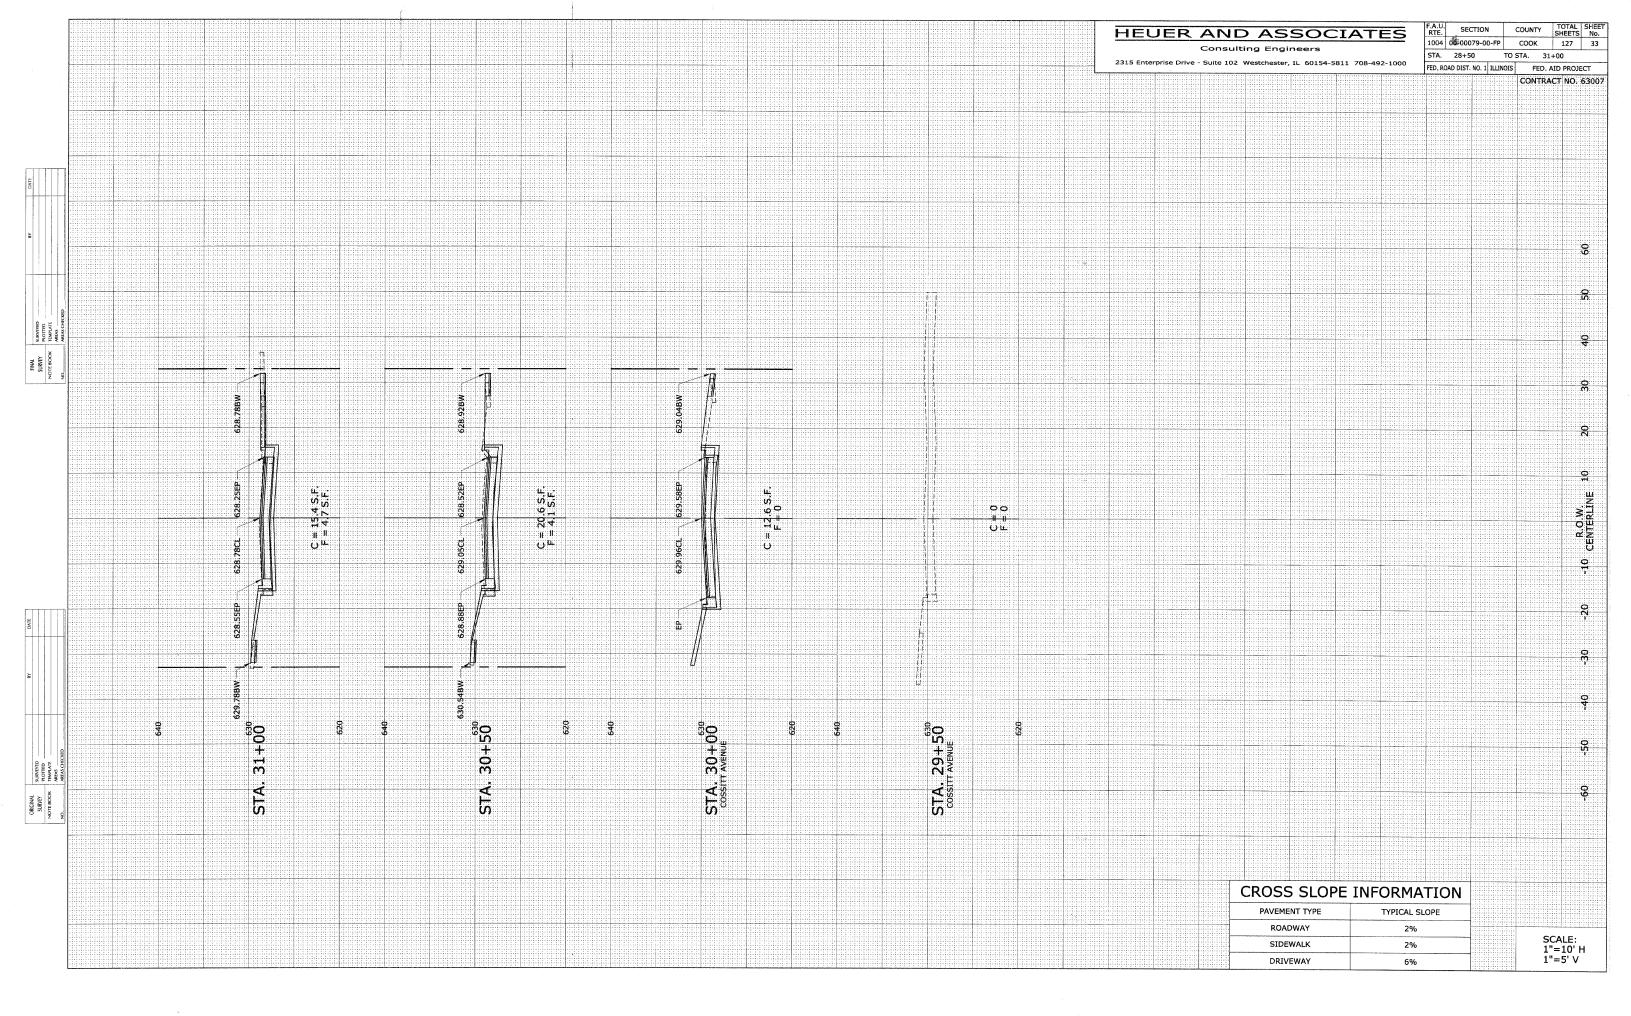


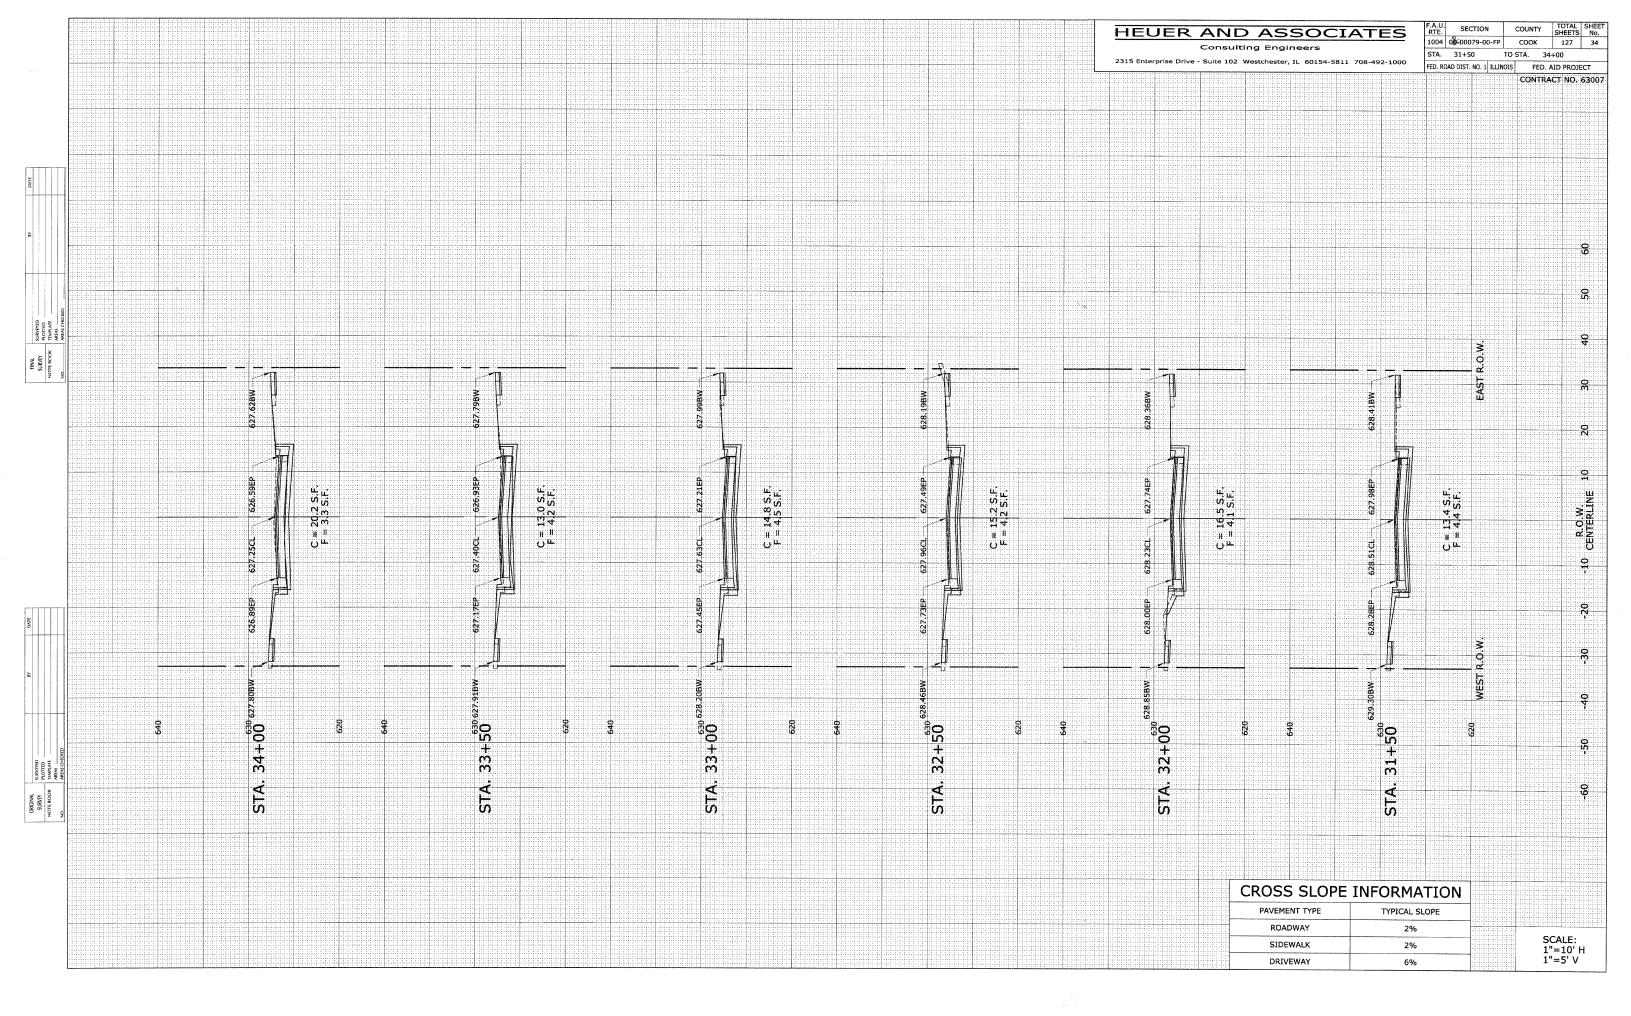


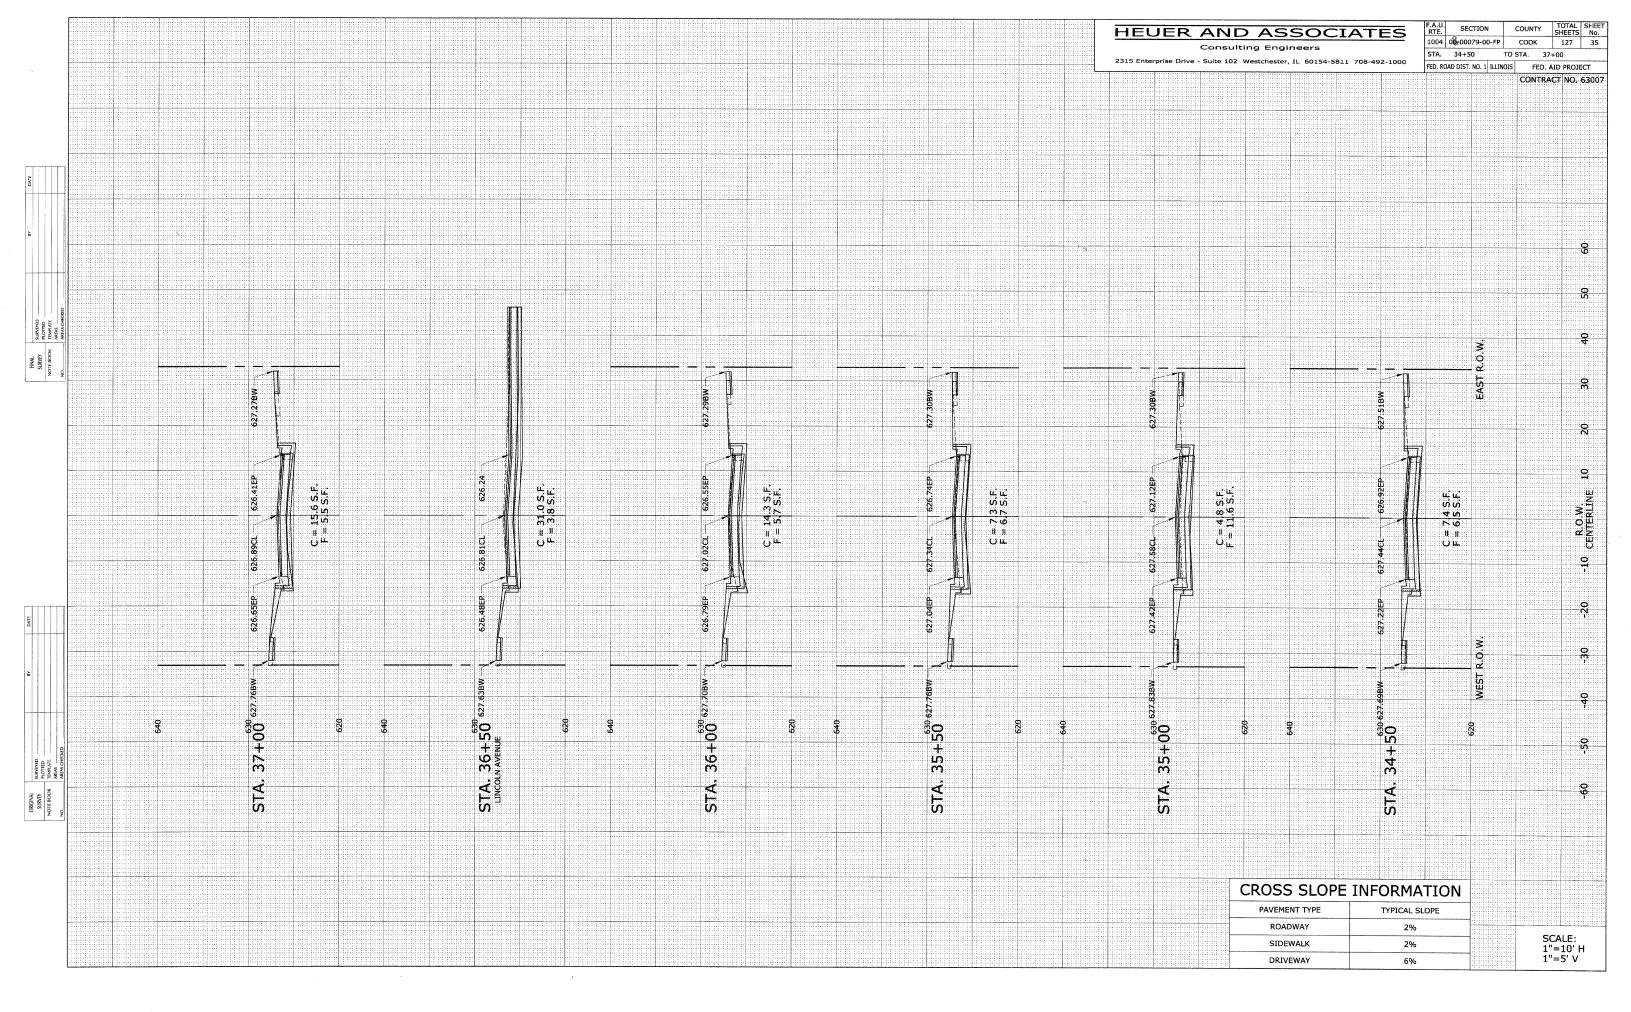

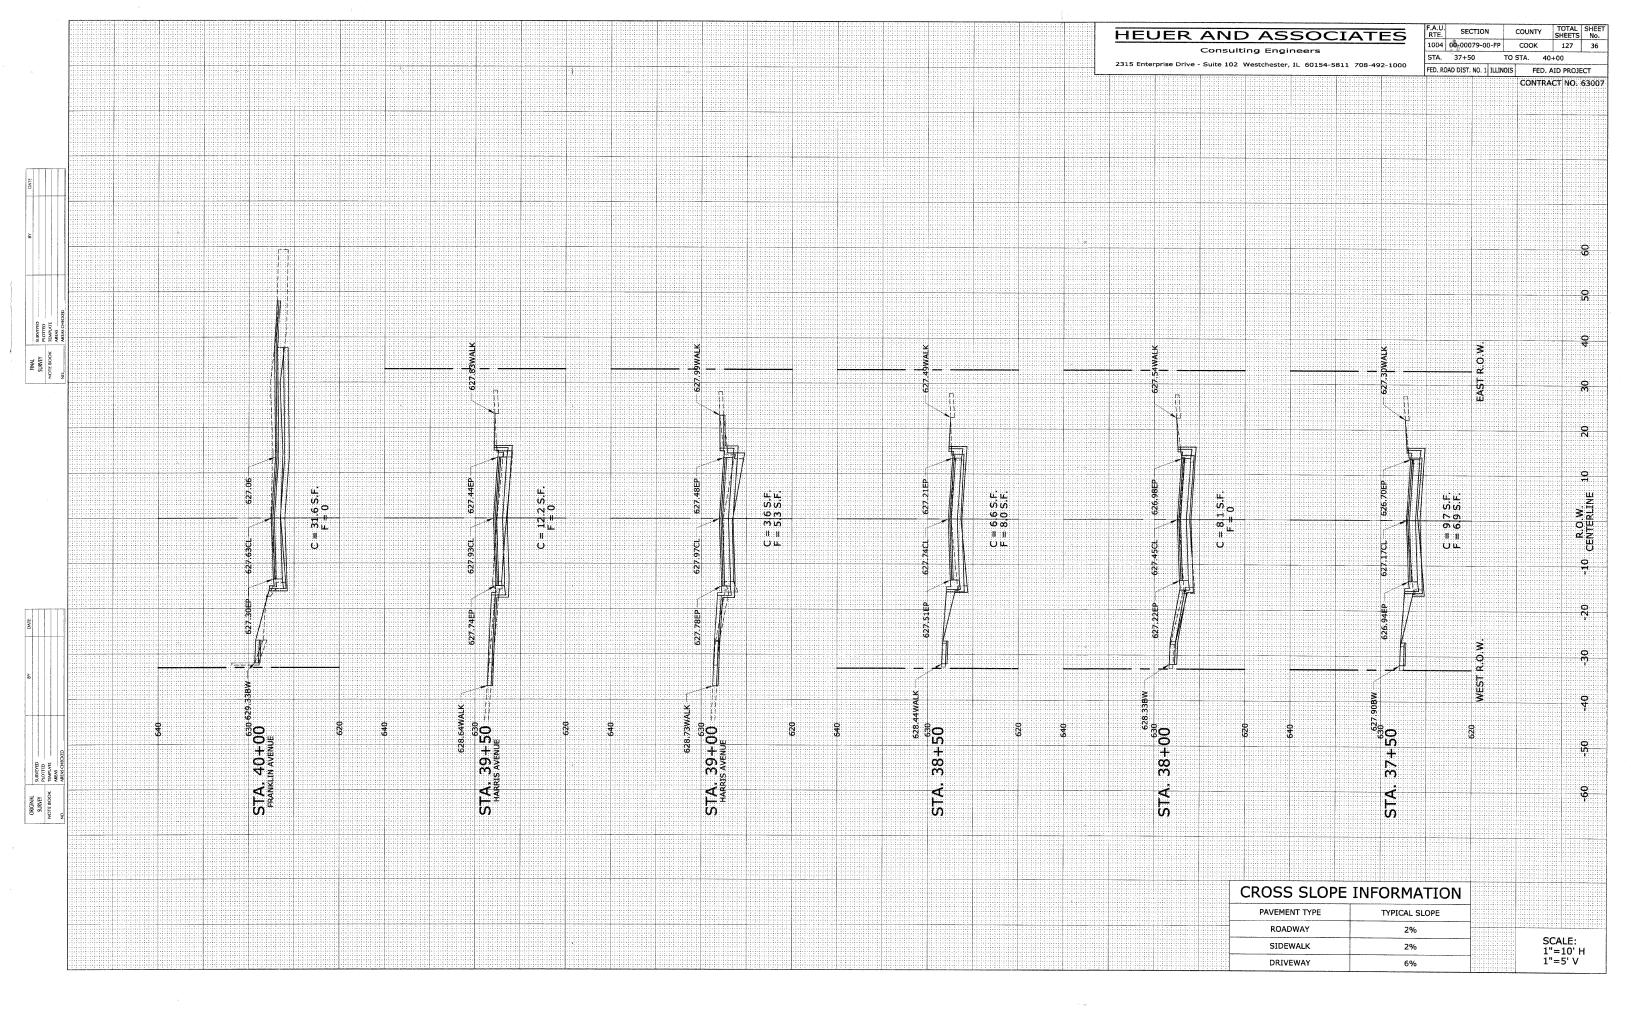


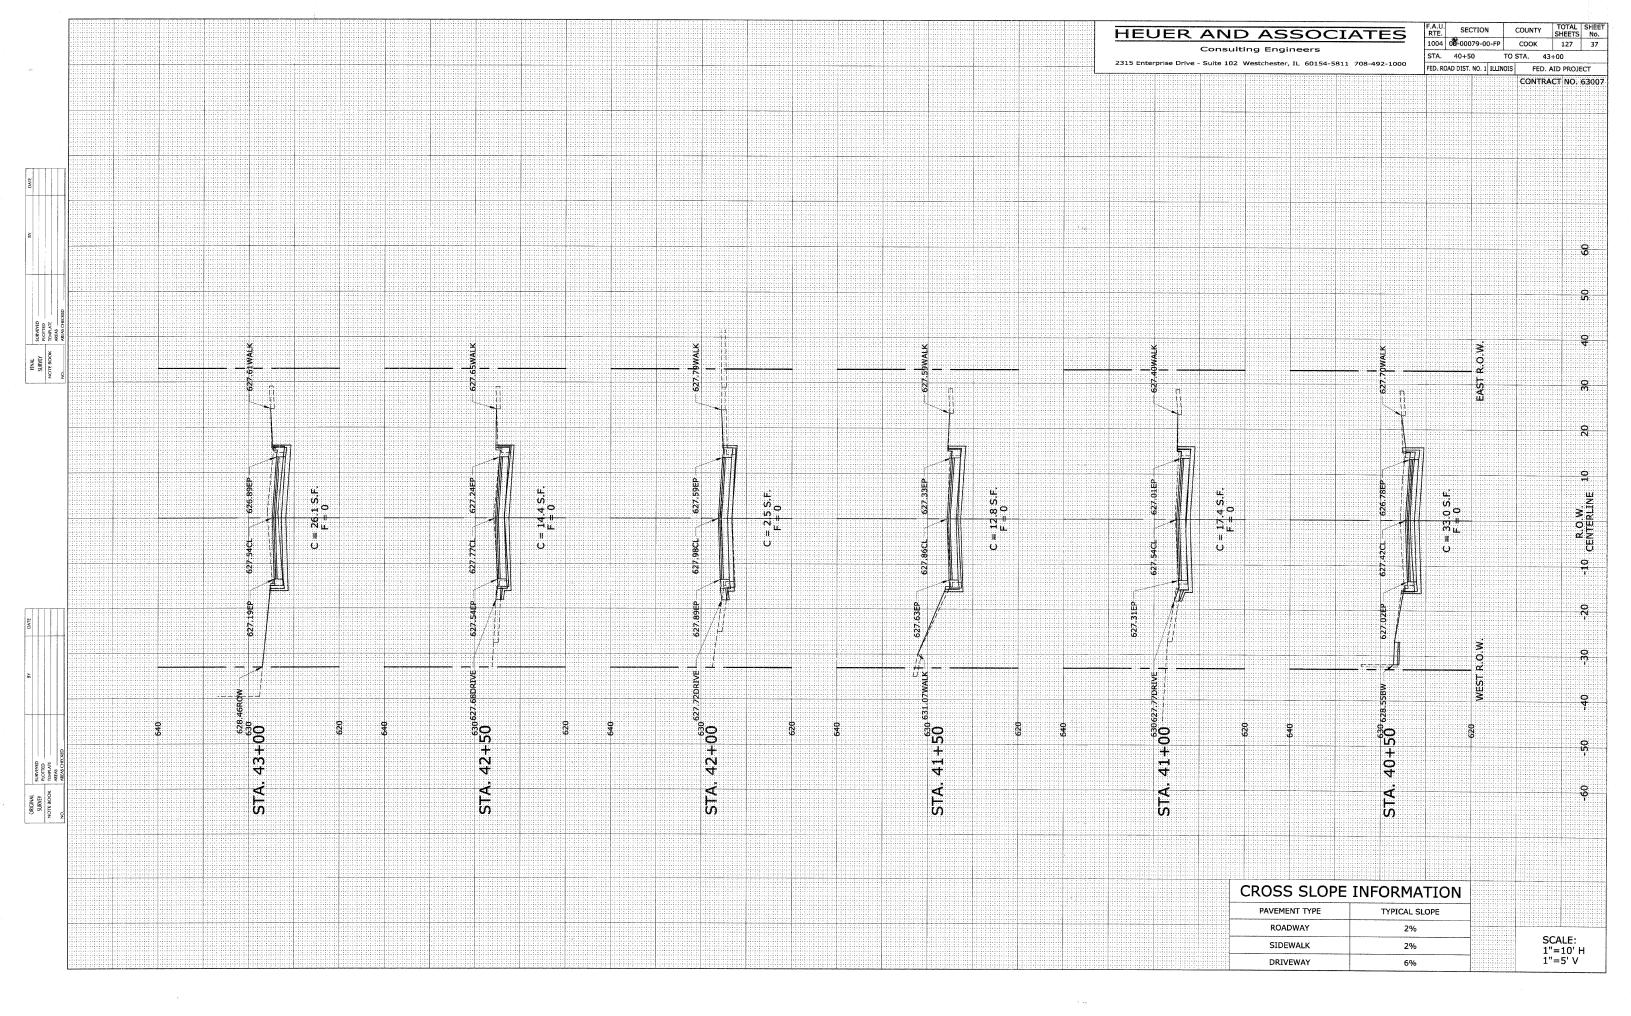

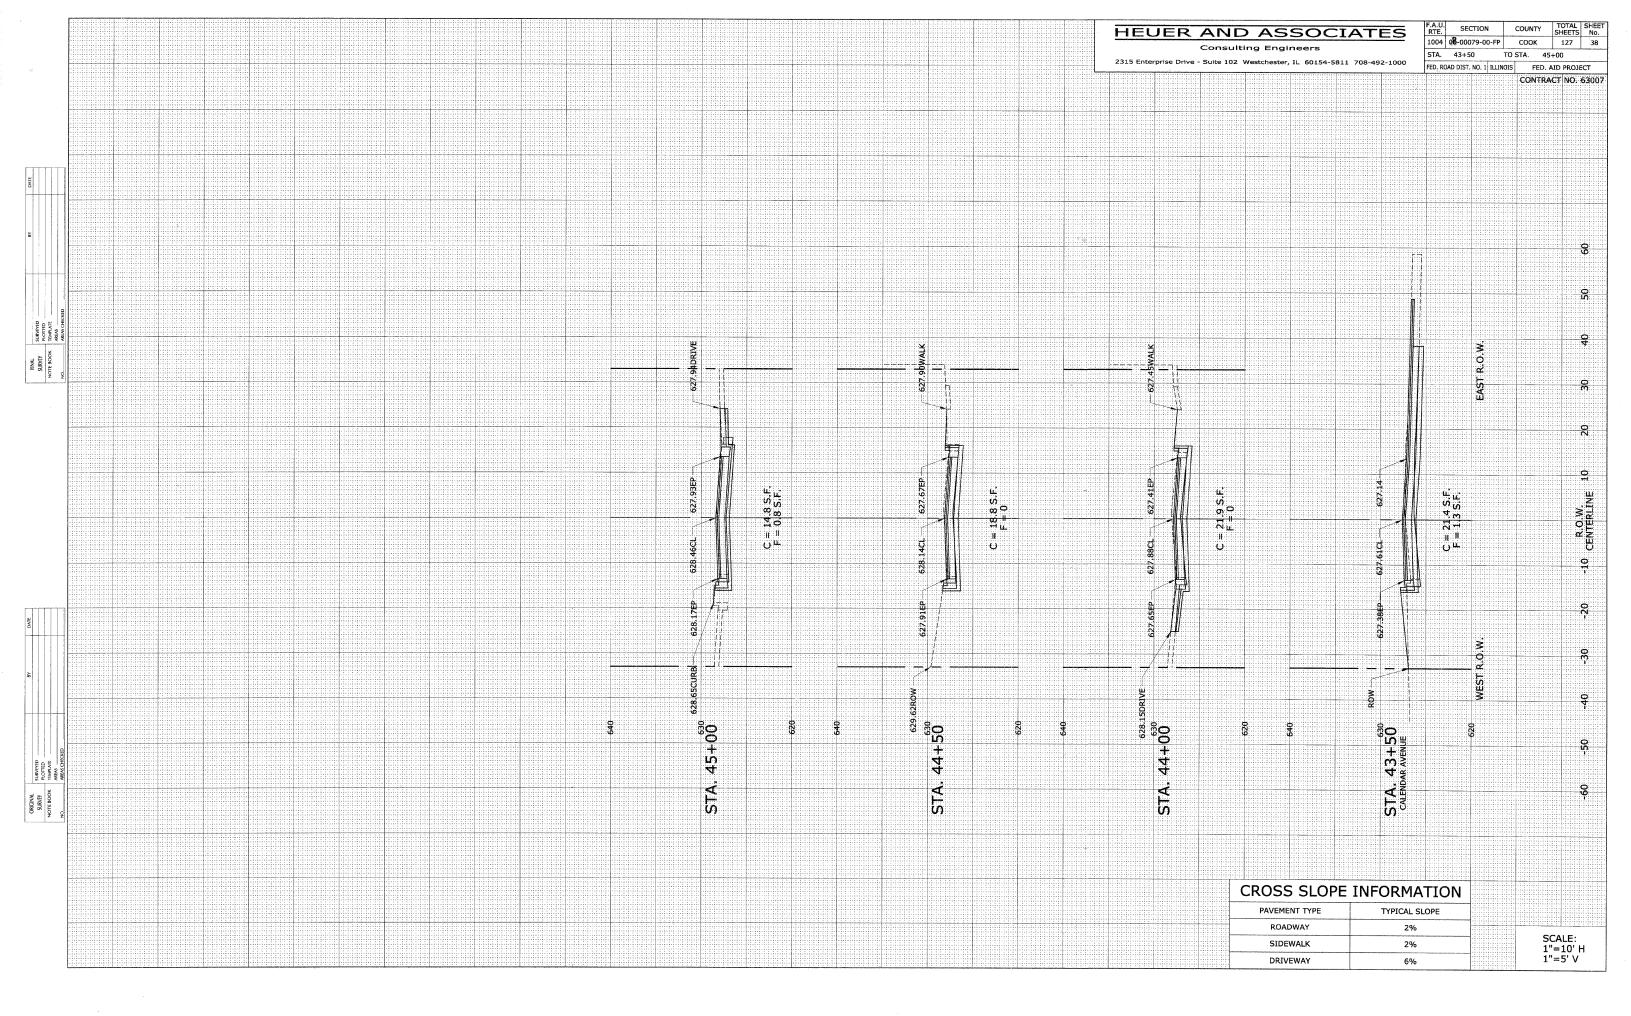

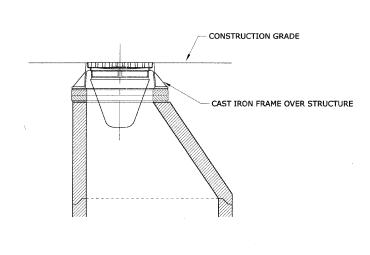

INLET FILTER INSTALLATION DETAIL

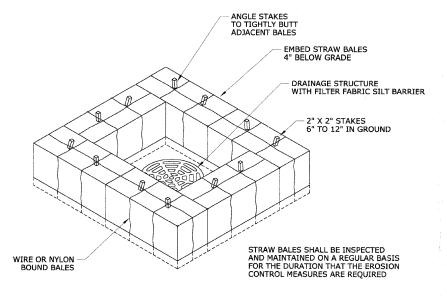

HEUER AND ASSOCIATES

Consulting Engineers

2315 Enterprise Drive - Suite 102 Westchester, IL 60154-5811 708-492-1000

COUNTY TOTAL SHEET No. SECTION 1004 08-00079-01-FP соок 46 39 TO STA. FED. ROAD DIST. NO. 1 ILLINOIS FED. AID PROJECT


CONTRACT No. 63007


STABILIZATION TYPE	JAN	FEB	MAR	APR	MAY	JUN	JUL	AUG	SEP	ост	NOV	DEC
PERMANENT SEEDING			₽			*	*		_			
DORMANT SEEDING	В		_								В	_
TEMPORARY SEEDING			ç_			*	D *		_			
SODDING			E**									
MULCHING -	F											

- A. KENTUCKY BLUEGRASS 90 LBS/AC MIXED WITH PERENNIAL RYEGRASS 30 LBS/AC
- B. KENTUCKY BLUEGRASS 135 LBS/AC MIXED WITH PERENNIAL RYEGRASS 45 LBS/AC + 2 TONS STRAW MULCH/AC
- C. SPRING OATS 100 LBS/AC
- D. WHEAT OR CEREAL RYE 150 LBS/AC
- E. SOD
- F. STRAW MULCH 2 TONS/AC
- * IRRIGATION NEEDED DURING JUNE AND JULY
- ** IRRIGATION NEEDED FOR 2 TO 3 WEEKS AFTER APPLYING SOD

SOIL PROTECTION CHART

STRAW BALE SURROUND DETAIL

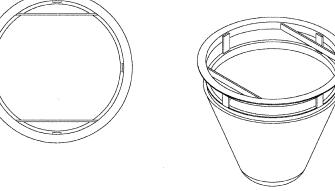


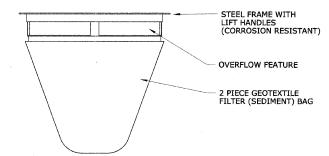

NOTES

- 1. INLET FILTER ASSEMBLY SHALL MEET IDOT'S PROVISIONAL SPECIFICATIONS (ISP 04-11).
- 2. MAINTENANCE/CLEANING OF THE INLET FILTER ASSEMBLY SHALL BE IN STRICT ACCORDANCE WITH THE SPECIAL PROVISIONS AND THE MANUFACTURER'S RECOMMENDATIONS AND WRITTEN SPECIFICATIONS.
- 3. PRIOR TO ORDERING MATERIALS, THE CONTRACTOR SHALL DETERMINE THE SIZE AND SHAPE OF THE VARIOUS DRAINAGE STRUCTURES BEING PROTECTED.
- 4. MANUFACTURER SHALL FURNISH A CERTIFICATION WITH EACH SHIPMENT STATING COMPLIANCE WITH IDOT REQUIREMENTS.
- 5. ASSEMBLY SHALL BE AS MANUFACTURED BY INLET AND PIPE PROTECTION, INC., MARATHON MATERIALS, OR APPROVED EQUAL.

INLET FILTER ASSEMBLY DETAIL

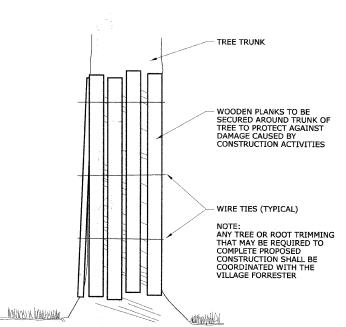

TREE TRUNK PROTECTION


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F.A.U. SECTION 1004 00-00079-01-FP HEUER AND ASSOCIATES 2315 Enterprise Drive - Suite 102 Westchester, IL 60154-5811 708-492-1000 FED. ROAD DIST. NO. 1 ILLINOIS FED. AID PROJECT


COUNTY

соок



	SURVEY M	ARKER DATA
SHEET NUMBER	BLOCK LOCATION	STAMPED REFERENCE NUMBER
20	4-216	43812-216

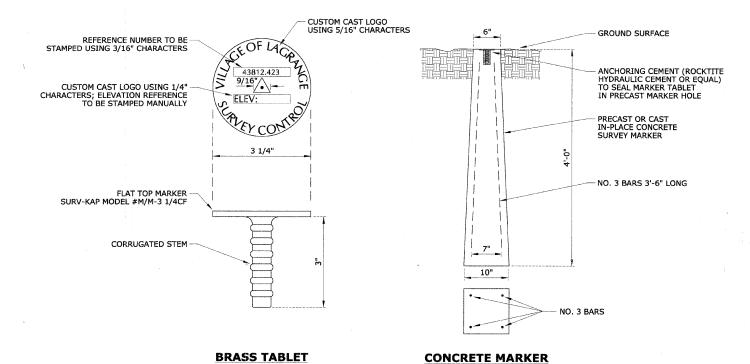PERMANENT SURVEY MARKER

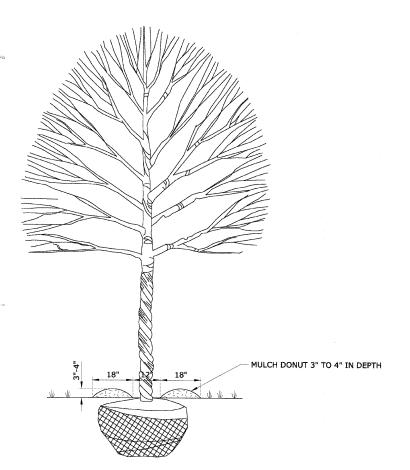

TREE MULCH DONUT DETAIL




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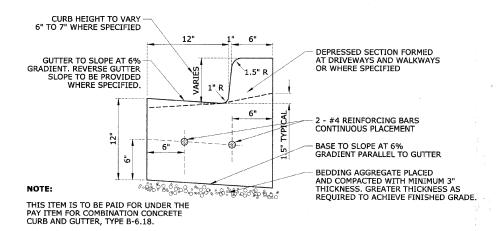
CURB HEIGHT TO VARY

SECTION 1004 08-00079-01-FP соок TO STA. 2315 Enterprise Drive - Suite 102 Westchester, IL 60154-5811 708-492-1000 FED. ROAD DIST. NO. 1 ILLINOIS FED. AID PROJECT

CONTRACT No. 63007

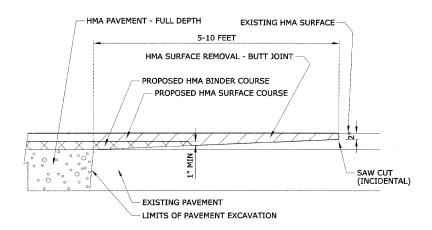


BUTT JOINT DETAIL



4" TO 8" WHERE SPECIFIED, GUTTER TO SLOPE AT 6% GRADIENT; REVERSE GUTTER SLOPE TO BE PROVIDED DEPRESSED SECTION FORMED AT DRIVEWAYS AND WALKWAYS OR WHERE SPECIFIED 2 - #4 REINFORCING BARS, CONTINUOUS PLACEMENT BASE TO SLOPE AT 6% GRADIENT - BEDDING AGGREGATE PLACED AND COMPACTED WITH MINIMUM 3" THICKNESS; GREATER THICKNESS AS REQUIRED TO ACHIEVE FINISHED GRADE


COMBINATION CONCRETE CURB AND GUTTER, TYPE B-6.12

COMBINATION CONCRETE CURB AND GUTTER, TYPE B-6.18

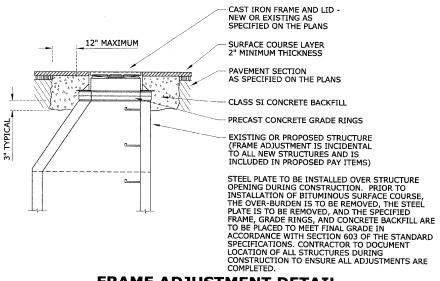

FRAME ADJUSTMENT DETAIL


REVISION NAME	DATE	BLUFF AVENUE STA	S DEPARTMENT OF TRANSPORTATION F AVENUE IMPROVEMENTS STAGE 1 TRUCTION DETAILS - SPECIAL	
		SCALE: NTS DATE 07/18/2008	DRAWN BY H&A CHECKED BY PFH	

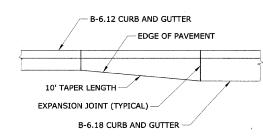


THIS ITEM IS TO BE PAID FOR UNDER THE PAY ITEM FOR COMBINATION CONCRETE CURB AND GUTTER, TYPE B-6.18.

TRANSITION LENGTH FROM B-6.12 TO B-6.18 CURB AND GUTTER


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PLOTTED
ALIGNMENT CHECKED
RT. OF WAY CHECKED
CADD FILE NAME

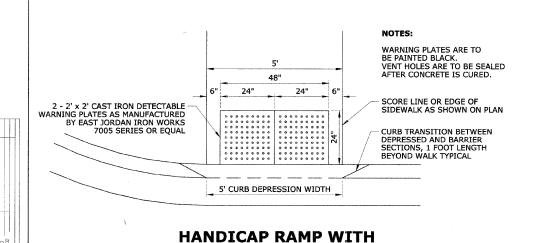


DETECTABLE WARNINGS

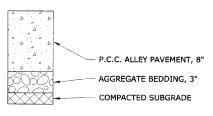


P.C.C. ALLEY PAVEMENT

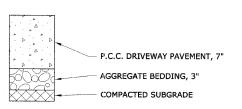

P.C.C. DRIVEWAY

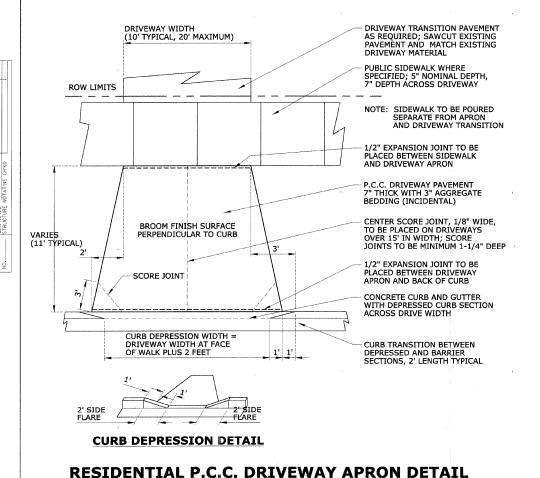

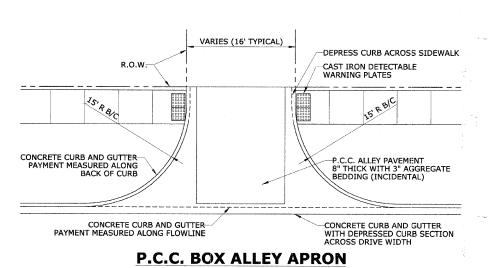

HEUER AND ASSOCIATES

Consulting Engineers


2315 Enterprise Drive - Suite 102 Westchester, IL 60154-5811 708-492-1000

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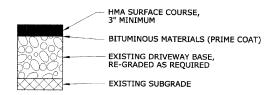
CONTRACT No. 63007



P.C.C. SIDEWALK

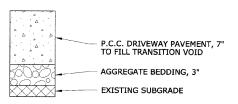

P.C.C. DRIVEWAY TRANSITION (CLASS C PATCH, 7" MIN. THICKNESS)




BITUMINOUS DRIVEWAY TRANSITION (CLASS D PATCH, 3" MIN. THICKNESS)

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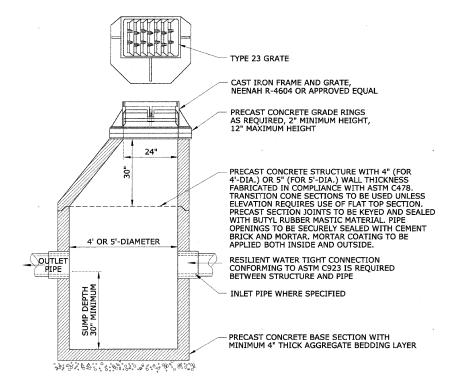
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	DATE 07/18/2008	CHECKED BY PFH






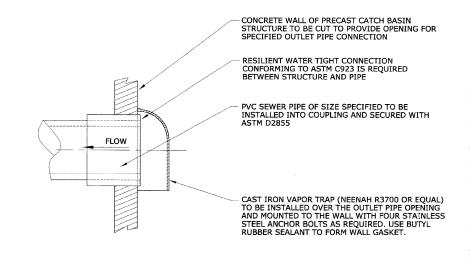


VAPOR TRAP



CATCH BASIN, TYPE A, 4' OR 5'-DIAMETER
WITH TYPE 23 FRAME AND GRATE

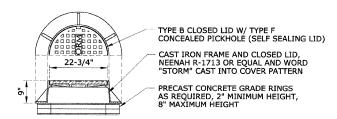

WITH TYPE 1 FRAME AND SELF SEALING CLOSED LID

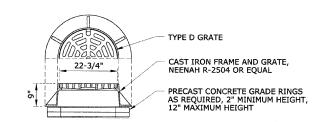

WITH TYPE 1 FRAME AND GRATE

ALTERNATIVE FRAMES AND GRATES/LIDS




Consulting Engineers

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CONTRACT No. 63007



INLET, TYPE A, 24" WITH TYPE 23 FRAME AND GRATE
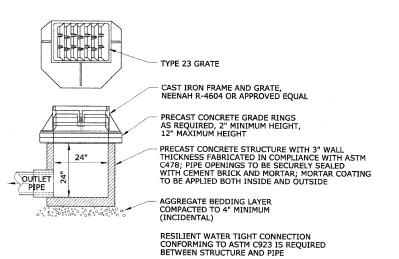
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		CONSTRUCTION	DETAILS - SPECIAL
		SCALE: NTS	DRAWN BY H&A
		DATE 07/18/2008	CHECKED BY PFH



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TEMPORARY AGGREGATE

(CONTRACTORS OPTION)

(INCIDENTAL)

MAXIMUM PAYMENT WIDTH OF TRENCH

OD + 18"

OD + 36"

(BOTTOM OF ROADWAY PAVEMENT AND TBF PAYMENT LIMIT)

SURFACE GRADE

ILLINOIS DEPARTMENT OF TRANSPORTATION

BLUFF AVENUE IMPROVEMENTS

STAGE 1


CONSTRUCTION DETAILS - SPECIAL

DRAWN BY H&A
CHECKED BY PFH


SCALE: NTS

SUBGRADE


CONTRACT No. 63007

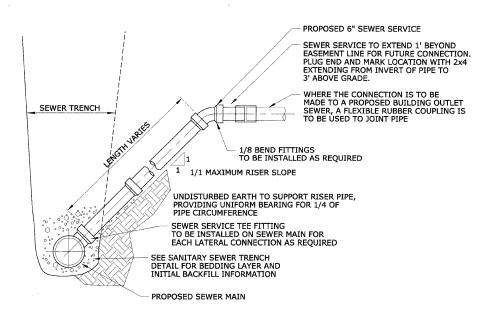

SEWER SERVICE TEE AND RISER

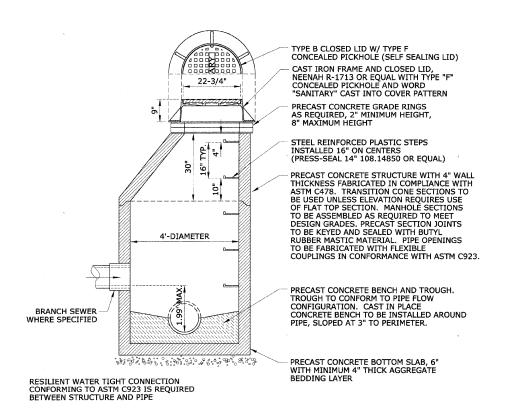

SANITARY MANHOLE, TYPE A, 4'-DIAMETER
WITH TYPE 1 FRAME AND CLOSED LID

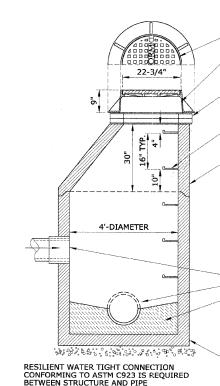

TYPE B CLOSED LID W/ TYPE F
CONCEALED PICKHOLE (SELF SEALING LID)

CAST IRON FRAME AND CLOSED LID,
NEENAH R-1713 OR EQUAL AND WORD
"STORM" CAST INTO COVER PATTERN

PRECAST CONCRETE GRADE RINGS AS REQUIRED, 2" MINIMUM HEIGHT, 8" MAXIMUM HEIGHT

TRENCH DEPTH / PROTECTION

5 FT AND LESS, W/O PROTECTION

5 FT AND LESS, W/ PROTECTION

GREATER THAN 5 FT

STEEL REINFORCED PLASTIC STEPS INSTALLED 16" ON CENTERS (PRESS-SEAL 14" 108.14850 OR EQUAL)


PRECAST CONCRETE STRUCTURE WITH 4" WALL THICKNESS FABRICATED IN COMPLIANCE WITH ASTM C478. TRANSITION CONE SECTIONS TO BE USED UNLESS ELEVATION REQUIRES USE OF FLAT TOP SECTION. MANHOLE SECTIONS TO BE ASSEMBLED AS REQUIRED TO MEET DESIGN GRADES. PRECAST SECTION JOINTS TO BE KEYED AND SEALED WITH BUTYL. RUBBER MASTIC MATERIAL. PIPE OPENINGS TO BE SECURELY SEALED WITH CEMENT BRICK AND MORTAR. MORTAR COATING TO BE APPLIED BOTH INSIDE AND OUTSIDE.

INLET PIPE WHERE SPECIFIED STORM SEWER PIPE (TYPICAL)

CAST IN PLACE CONCRETE BENCH TO BE INSTALLED AROUND PIPE, SLOPED AT 3" TO PERIMETER. PRECAST CONCRETE BENCH AND TROUGH. TROUGH TO CONFORM TO PIPE FLOW CONFIGURATION.

PRECAST CONCRETE BOTTOM SLAB, 6"
WITH MINIMUM 4" THICK AGGREGATE
BEDDING LAYER

STORM MANHOLE, TYPE A, 4'-DIAMETER WITH TYPE 1 FRAME AND CLOSED LID

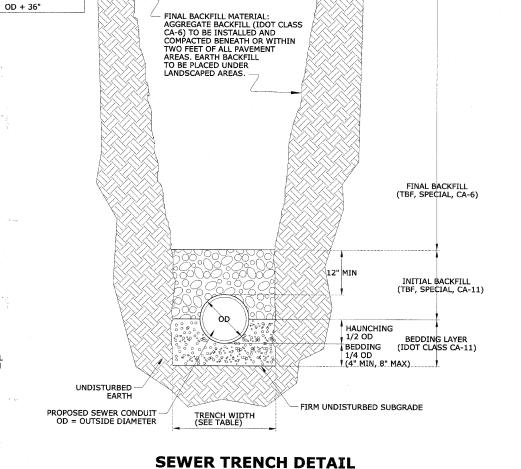

Consulting Engineers


2315 Enterprise Drive - Suite 102 Westchester, IL 60154-5811 708-492-1000

F.A.U. SECTION COUNTY TOTAL SHEET No. 1004 00-00079-01-FP COOK 46 45


STA. TO STA. FED PURP DIST NO. 1 III INDIS. FED AID PROJECT.

CONTRACT No. 63007


NOTE: FIRE HYDRANT TO CONFORM TO VILLAGE OF LA GRANGE STANDARDS

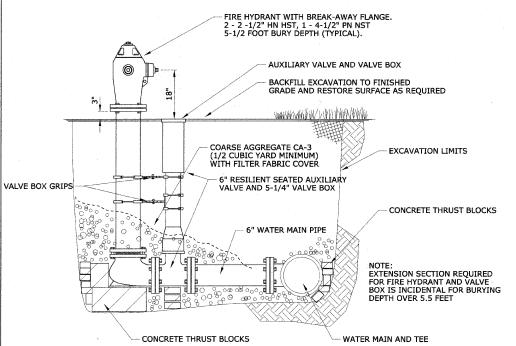

FIRE HYDRANT INSTALLATION DETAIL

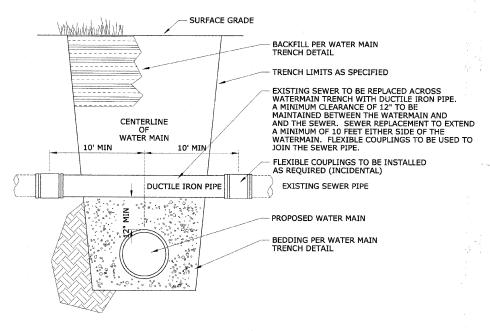

SEWER CROSSING DETAIL

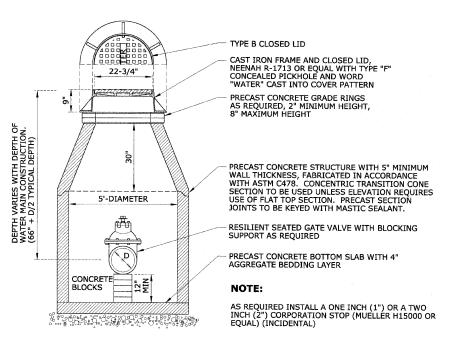


WATER VALVE VAULT, TYPE A, 5'-DIAMETER WITH RESILIENT SEATED GATE VALVE AND TYPE 1 FRAME AND CLOSED LID


REVISIONS		ILLINOIS DEPAR	TMENT OF TRANSPORTATION
NAME	DATE		
			NUE IMPROVEMENTS STAGE 1
		CONSTRUCT	ON DETAILS - SPECIAL
		SCALE: NTS	DRAWN BY H&A
		DATE 07/18/2008	CHECKED BY PFH

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SECTION COUNTY 1004 06-00079-01-FP соок TO STA. FED. ROAD DIST. NO. 1 ILLINOIS FED. AID PROJECT

CONTRACT No. 63007



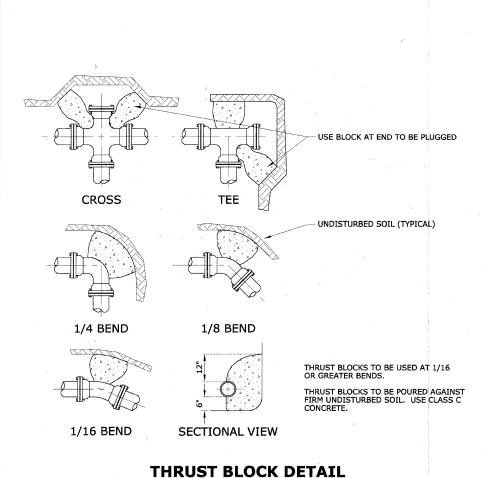

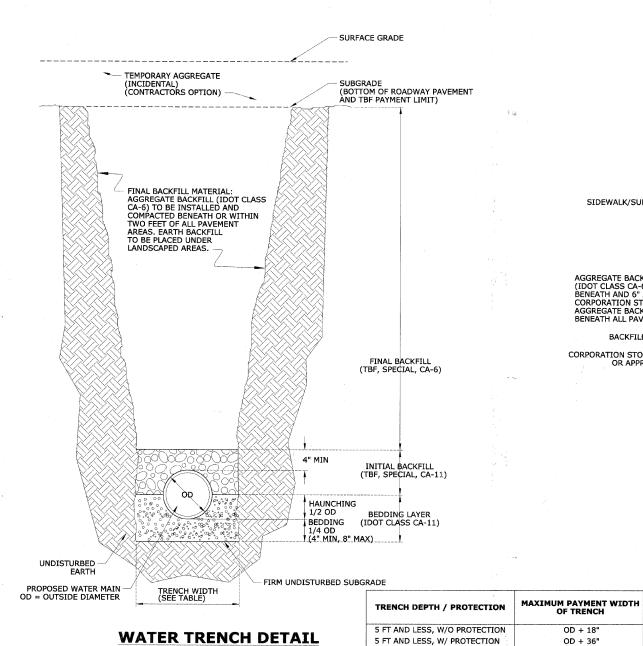BOX COVER PROPERTY LINE SIDEWALK/SURFACE GRADE -2.5' AGGREGATE BACKFILL MATERIAL (IDOT CLASS CA-6) TO BE PLACED BENEATH AND 6" ABOVE CORPORATION STOP, FULL DEPTH AGGREGATE BACKFILL TO BE USED BENEATH ALL PAVEMENT AREAS. - WATER SERVICE BOX TYLER 6500-95E, OR APPROVED EQUAL SERVICE CURB STOP McDONALD 6100, OR APPROVED EQUAL BACKFILL AGGREGATE CORPORATION STOP FORD F600, OR APPROVED EQUAL CONCRETE BLOCK COPPER TUBING, TYPE K, DIAMETER AS SPECIFIED, ONE INCH (1") TYPICAL

WATER SERVICE DETAIL

OD + 18"

OD + 36"

OD + 36"

GREATER THAN 5 FT

REVISIONS		ILLINOIS DEDARTME	INT OF TRANSCORTATION
NAME	DATE	BLUFF AVENUE IMPROVEMENTS STAGE 1	
		CONSTRUCTION DETAILS - SPECIAL	
		SCALE: NTS	DRAWN BY H&A
		DATE 07/18/2008	CHECKED BY PFH