| F.A.P. RTE. | SECTION | COUNTY | TOTAL SHEETS | SHEET NO. |
|----------------|---------------|---------------|-----------------|--------------|
| 876 | 9Y-RS-7 | WILL | 100 | 2 |
| STA. | | TO STA. | 1 1 1 | |
| FED. ROA | D DIST. NO. 1 | ILLINOIS FED. | AID PROJ | ECT |

INDEX OF SHEETS:

INDEX OF SHEETS, STANDARDS, AND GENERAL NOTES

BENCHMARKS AND TEMPORARY BENCHMARKS EXISTING AND PROPOSED ALIGNMENT & TIES

EXISTING AND PROPOSED ROADWAY PLANS

EXISTING AND PROPOSED PROFILE

EROSION CONTROL PLAN

66-70A. A LANDSCAPING AND PAVEMENT MARKING PLANS

DRAINAGE PLANS

BENCHING DETAIL

CROSS SECTIONS

SUE SHEETS

SUGGESTED MAINTENANCE OF TRAFFIC

RIGHT OF WAY PLATS (FOR INFORMATION ONLY)

OF CURB/EDGE OF SHOULDER >= 4.5M (15') PAVEMENT PATCHING FOR HMA SURFACED PAVEMENT

BUTT JOINT AND HMA TAPER DETAILS

AND STABILIZATION AT TBT TY. 1 SPL.

DISTRICT ONE TYPICAL PAVEMENT MARKINGS

ARTERIAL ROAD INFORMATION SIGN

DRIVEWAY DETAILS DISTANCE BETWEEN R.O.W. AND FACE

STEEL PLATE BEAM GUARDRAIL ADJACENT TO CURB AND GUTTER

PAVEMENT MARKINGS, LETTERS AND SYMBOLS FOR TRAFFIC STAGING

TRAFFIC CONTROL AND PROTECTION FOR SIDE ROADS, INTERSECTIONS, AND DRIVEWAYS

TYPICAL APPLICATIONS RAISED REFLECTIVE PAVEMENT MARKERS (SNOW-PLOW RESISTANT)

DESCRIPTION:

COVER SHEET

SUMMARY OF QUANTITIES

TYPICAL SECTIONS

SHEET NO.

3-4

10-13

14-19

20-23

24-32

42-49

50-59

60-65

71

72

73

75

81-100

32A,-41B.

542101-021

STATE STANDARDS:

| Δ | ~~ | |
|-----------|--------------------------|--|
| 1 | 000001-05 | STANDARD SYMBOLS, ABBREVIATIONS AND PATTERNS |
| | 001001-01 | AREAS OF REINFORCEMENT BARS |
| | 280001- <i>04</i> | TEMPORARY EROSION CONTROL SYSTEMS |
| 5 | 406201-01 | MAILBOX TURNOUT |
| (| 442201-03 | CLASS C AND D PATCHES |
| \rangle | 482001-02 | HMA SHOULDER ADJACENT TO FLEXIBLE PAVEMENT |
| | 542301-02 | PRECAST REINFORCED CONC. FLARED END SECTION |
| | 542311-01 | GRATING FOR CONC. FLARED END SECTION (FOR 600 mm (24") THRU 1300 mm (54") PIPE) |
| | 601001-03 | SUB-SURFACE DRAINS |
| | 601101-01 | CONCRETE HEADWALL FOR PIPE DRAIN |
| (| 602001-01 | CATCH BASIN, TYPE A |
| | 604036-02 | GRATE, TYPE 8 |
| | 630001-08 | STEEL PLATE BEAM GUARDRAIL |
| > | 635001-01 | DELINEATORS |
| (| 635006- <i>03</i> | REFLECTOR AND TERMINAL MARKER PLACEMENT |
| | 635011-02 | REFLECTOR MARKER AND MOUNTING DETAILS |
| | 701001-02 | OFF-ROAD OPERATIONS, 2L 2W, 4.5 m (15') MIN. AWAY, FOR SPEEDS >= 45 MPH |
| > | 701006-03 | OFF-ROAD OPERATIONS 2L. 2W. 4,5 m (15') TO PAVEMENT EDGE FOR SPEEDS >= 45 MPH |
| | 701011-02 | OFF-ROAD MOVING OPERATIONS 2L, 2W, DAY ONLY FOR SPEEDS >= 45 MPH |
| | 701201-03 | LANE CLOSURE, 2L, 2W, DAY ONLY ON-ROAD TO 600 mm (24") OFF-ROAD FOR SPEEDS >= 45 MPH |
| | 701301-03 | LANE CLOSURE, 2L, 2W, SHORT TIME OPERATIONS |
| | 701326-03 | LANE CLOSURE, 2L, 2W, PAVEMENT WIDENING FOR SPEEDS >= 45 MPH |
| / | 701336-05 | LANE CLOSURE, 2L, 2W, WORK AREAS IN SERIES |
| | 701416-06 | LANE CLOSURE, MULTILANE DIVIDED WITH CROSSOVER AND BARRIER FOR SPEEDS >= 45 MPH |
| | 701901-01 | TRAFFIC CONTROL DEVICES |
| } | Nonmania wa kata mata ka | |
| (| 781001-03 | TYPICAL APPLICATIONS RAISED REFLECTIVE PAVEMENT MARKERS |

GENERAL NOTES:

- BEFORE STARTING ANY EXCAVATION, THE CONTRACTOR SHALL CALL "JULIE" AT 800-892-0123 FOR FIELD LOCATIONS OF BURIED ELECTRIC, TELEPHONE, AND GAS FACILITIES. (48 HOUR NOTIFICATION REQUIRED)
- THE CONTRACTOR SHALL COORDINATE CONSTRUCTION ACTIVITIES WITH UTILITY COMPANIES, AND THE TOWNSHIP OF CRETE.
- THE CONTRACTOR WILL NOT BE ABLE TO SET UP A YARD OR FIELD OFFICE ON STATE PROPERTY WITHOUT WRITTEN PERMISSION FROM THE
- WHEN MILLED PAVEMENT IS OPEN TO TRAFFIC THE MAXIMUM GRADE DIFFERENTIAL BETWEEN PASSES OF THE MILLING MACHINE SHALL NOT EXCEED 38 MM WHERE THE SPEED LIMIT IS 70 KM OR LESS, AND 25 MM WHERE THE SPEED LIMIT IS GREATER THAN 70 KM. WITH WRITTEN APPROVAL FROM THE RESIDENT ENGINEER. A MAXIMUM GRADE DIFFERENTIAL OF 75 MM MAY BE ALLOWED IF THE EDGE OF THE MILLING IS SLOPED A MINIMUM 1:3 (V:H)
- BUTT JOINTS WILL BE INSTALLED AT THE ENDS OF ALL RESURFACING (WHERE RESURFACING MEETS EXISTING PAVEMENT), IN ACCORDANCE WITH THE "BUTT JOINT AND BITUMINOUS TAPER DETAILS" SHEET INCLUDED IN THE PLANS, UNLESS OTHERWISE SPECIFIED.
- CONTACT MS.CORA MATHIS AREA TRAFFIC FIELD ENGINEER AT (815)485-6475 TWO WEERS PRIOR TO INSTALLATION OF FINAL PAVEMENT MARKINGS
- 3 METER (10 FEET) TRANSITIONS SHALL BE USED TO MATCH PROPOSED CURB AND GUTTER AND MEDIAN ITEMS OF WORK TO EXISTING CURB & GUTTER AND MEDIANS IN THE FIELD, UNLESS OTHERWISE SHOWN. THE TRANSITIONS SHALL BE PAID FOR AT THE CONTRACT UNIT PRICE FOR THE PROPOSED ITEMS
- ALL STORM SEWER CONNECTIONS WITH PIPES 675 MM (27 INCHES) DIAMETER AND SMALLER SHALL BE MADE WITH PRECAST "TEE" OR "WYE" PIPES. FOR PROPOSED STORM SEWER PIPES LARGER THAN 675 MM (27 INCHES) DIAMETER, OPENINGS OF THE SPECIFIED DIAMETER SHALL BE MADE IN THE PIPE AT THE TIME IT IS MANUFACTURED. PRECAST "TEE" AND "WYE" PIPE CONNECTIONS FOR PROPOSED STORM SEWER WILL NOT BE PAID FOR SEPARATELY BUT WILL BE INCLUDED IN THE COST FOR THE STORM SEWERS.

REVISIONS ILLINOIS DEPARTMENT OF TRANSPORTATION NAME DATE F.A.P. 876: IL. 1 ELMSCOURT LN. TO GOODENOW RD. INDEX OF SHEET, LIST OF STATE STANDARDS, AND GENERAL NOTES DRAWN BY: RK DATE: 9/5/2008 CHECKED BY: CF

ARev. 1-5-09

| | SUMMARY OF QUANTITIES | | URBAN 80% FED. 20% STATE | | | CONSTRUCT | TION TYPE | CODE | Τ | | SUMMARY OF QUANTITIES | ** | URBAN BO! FED. 20/ STATE | | | CONSTRUCT | ION TYPE | CODE | \mathbf{T}^{\perp} |
|--------------------|---|----------------|--|--------------------------|----------|-------------------------------|-----------|------|---|--------------------------|--|------------------------|--------------------------------|--------------------|-------------------------|-----------|----------|------|----------------------|
| CODE NO | ITEM | UNIT | TOTAL QUANTITIES | ROADWAY IOOO-2A | | | | | | CODE NO | ITEM | UNIT | TOTAL QUANTITIES | ROADWAY 1000-2A | * | | | | |
| 428225 | CLASS D PATCHES, TYPE II, 225MM | SQ M | 490 | 490 | | | | | | M7030100 | SHORT-TERM PAVEMENT MARKING | METER | 1010 | 1010 | | | | | |
| 1428325 | CLASS D PATCHES, TYPE III, 225MM | SQ M | 250 | 250 | | | | | | M7030210 | TEMPORARY PAVEMENT MARKING - LETTERS AND SYMBOLS | SQ M | 17 | 17 | | | | | Y |
| 1430020 | STRIP REFLECTIVE CRACK CONTROL TREATMENT | METER | 468 | 468 | | ing sign Time Time sign | | | | M7030220 | TEMPORARY PAVEMENT MARKING | METER | 6615 | 6615 | | | | | 1 |
| 812000 | AGGREGATE SHOULDERS, TYPE B | M TON | 367 | 367 | | | | | | M7030240 | - LINE 100MM TEMPORARY PAVEMENT MARKING | METER | 382 | 382 | | | | | |
| 816000 | AGGREGATE WEDGE SHOULDER, TYPE B | M TON | 262 | 262 | ٠, ٠ | | | | | ,,000210 | - LINE 150MM | | | | | | | | |
| 820650 | HOT-MIX ASPHALT SHOULDERS, 250MM | SQ M | 788 | 788 | | | | | | M7030260 | TEMPORARY PAVEMENT MARKING - LINE 300MM | METER | 26 | 26 | | | | | |
| 1820680 542E116 | HOT-MIX ASPHALT SHOULDERS, 280MM PRECAST REINFORCED CONCRETE FLARED END | SQ M EACH | 2832 | 2832 | | | | | | M7030280 | TEMPORARY PAVEMENT MARKING - LINE 600MM | METER | 25 | 25 | | | | | |
| 12220 | SECTIONS 375MM | AUII | Control of the second of the s | t garde and and a second | Δ | | | | | M7031000 | WORK ZONE PAVEMENT MARKING REMOVAL | SQ M | 101 | 101 | | | | | |
| 42E120 | PRECAST REINFORCED CONCRETE FLARED END SECTIONS 450MM | EACH | 45 | | <i>)</i> | | | | | * M7800100 | THERMOPLASTIC PAVEMENT MARKING | SQ M | 17 | 17 | | | | | |
| 42E128 | PRECAST REINFORCED CONCRETE FLARED END SECTIONS 600MM | EACH | 5 | 5 | | | | | | * M7800105 | THERMOPLASTIC PAVEMENT MARKING | METER | 6615 | 6615 | | | | | |
| 426020 | GRATING FOR CONCRETE FLARED END SECTION 375MM | EACH | 9 | 9 | A e | | | | | * W7800115 | - LINE 100MM THERMOPLASTIC PAVEMENT MARKING | METER | 382 | 382 | | | | | |
| 42G025 | GRATING FOR CONCRETE FLARED END | EACH | 4 | 4 | | | | | | # M 000113 | - LINE 150MM | MC 151 | 002 | | and the second | | | | |
| | SECTION 450MM | | | _ | ** | | | | | * M7800125 | THERMOPLASTIC PAVEMENT MARKING - LINE 300MM | METER | 26 | 26 | | | | | |
| 542G035 | GRATING FOR CONCRETE FLARED END SECTION 600MM | EACH | 5 | 5 | | | | | | * M7800140 | THERMOPLASTIC PAVEMENT MARKING - LINE 600MM | METER | 25 | 25 | | | | | |
| 421025 | PIPE CULVERTS, CLASS A, TYPE 2 375MM | METER | 43 | 43 | * 1 | | | | | MX030199 | TEMPORARY PAVEMENT | SQ M | 2210 | 2210 | | | | | |
| 421030 | PIPE CULVERTS, CLASS A, TYPE 2 450MM | METER | 33 | 33 | 15-1 | | | | | MX030217 | PIPE CULVERT REMOVAL 375MM | METER | 5122 | 122 | Δ | | | | |
| 5421040 | PIPE CULVERTS, CLASS A, TYPE 2 600MM | METER | 23 . | 23 | A FRANCE | | | | | MX030218 | PIPE CULVERT REMOVAL 450MM | METER | 30 | 30 | | | | | |
| 5500440 5500450 | STORM SEWERS, CLASS A, TYPE 2 375MM STORM SEWERS, CLASS A, TYPE 2 450MM | METER METER | 185 × 37 | 185 37 | | | | | | MZ001050 | AGGREGATE SUBGRADE 300MM | SQ M | 11590 | 11590 | | | | | |
| 500460 | STORM SEWERS, CLASS A, TYPE 2 525MM | METER | 61 | 61 | | | - | | (| MZ014800 | CULVERT TO BE CLEANED | METER | 1 | 17 | $\triangleright \Delta$ | | | | |
| | STORM SEWERS, CLASS A, TYPE 2 600MM | METER | 31 | 31 | ' | | | | | MZ064800 | SELECTIVE CLEARING | UNIT | 3 | 3 | | | | | |
| | PIPE UNDERDRAINS, FABRIC LINED | METER | 200 | 200 | | | | | | X0323426 | SEDIMENT CONTROL, DRAINAGE STRUCTURE INLET FILTER CLEANING | EACH | 12 | 12 | | | | | |
| 5020140 | TRENCH 100MM CATCH BASINS, TYPE A, 1.2M DIAMETER, | EACH | 5 | . 5 | i e | | | | | X2800100 | TEMPORARY DITCH CHECKS, ROLLED EXCELSIOR | EACH | 45 | 45 | | | | | |
| | TYPE 8 GRATE | | | | | | | | | Z0013798 | CONSTRUCTION LAYOUT | L SUM | 1 | 1 | | | | | |
| 020440 | CATCH BASINS, TYPE A, 1.5M DIAMETER, TYPE 8 GRATE | EACH | 4 | 4 | | | | | | 3 | TRAINEES | HOUR | 1500 | 1500 | | | | | |
| 300100 | STEEL PLATE BEAM GUARD RAIL, TYPE A | METER | 38 | 38 | | | | | | M542T020 M542I050 | PIPE CULVERTS CLASS A, TYPE 1 375 mm (TEMPORARY) PIPE CULVERTS, CLASS A, TYPE 2 750 mm | METER METER | 22 | 22 | RA | | | | |
| 6320030 | GUARDRAIL REMOVAL | METER | 195 | 195 | | | | | | M542U025 M542F236 | PIPE CULVERTS CLASS A, TYPE 2 450 mm (TEMPORARY) CAST-IN-PLACE REINFORCED CONCRETE END SECTIONS 750 MM BOX CULVERT REMOVAL | METER EACH METER | 19 8 2 | 8 2 | 3 | | | | |
| | | 15 Apr 1 18 | - | | | | | | | * 72900100 * 72900110 | SIGN PANEL-TYPE 1 METAL POST - TYPE A | SQ M EACH | 9 26 | 19 9 26 | 3 | | | | |

* SPECIALTY ITEM

▲ 100% STATE

@ Y080

△ Rev. 1-5-09


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NAME DATE


SUMMA

ILLINOIS DEPARTMENT OF TRANSPORTATION
SUMMARY OF QUANTITIES


PLOT DATE: 9/5/2008

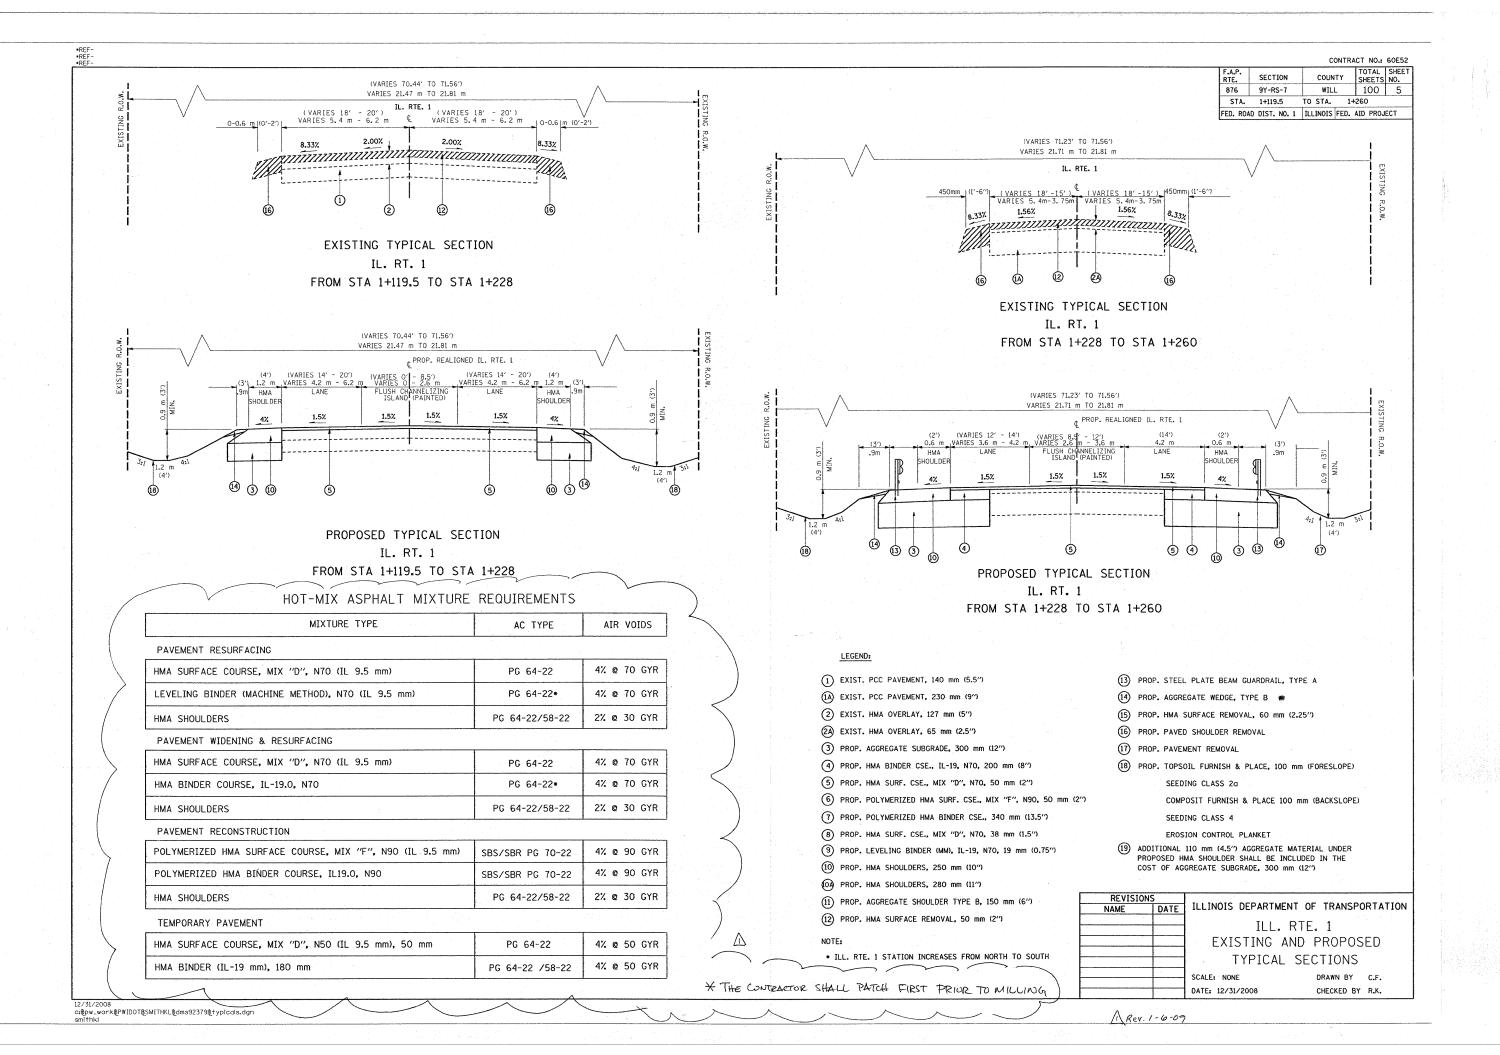

CONTRACT NO.: 60E52 TOTAL SHEET SECTION COUNTY SHEETS NO. 9Y-RS-7 WILL 876 100 8 STA. 1+700 TO STA. 2+500 FED. ROAD DIST. NO. 1 | ILLINOIS | FED. AID PROJECT 73.03′ 22.26 m 1.56%

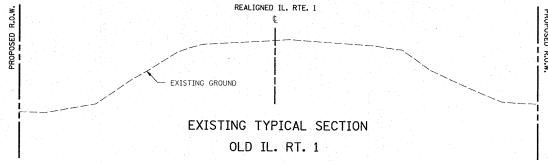

FROM STA 1+700 TO STA 1+875

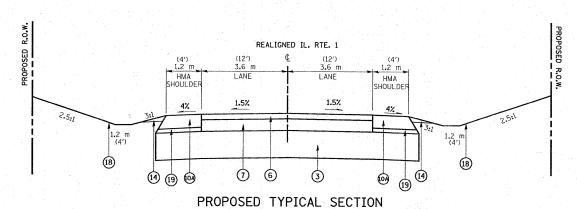

REALIGNED OLD IL. RT. 1 FROM STA 1+700 TO STA 1+875

- 1 EXIST. PCC PAVEMENT, 140 mm (5.5")
- (1A) EXIST. PCC PAVEMENT, 230 mm (9")
- (2) EXIST. HMA OVERLAY, 127 mm (5")
- (2A) EXIST. HMA OVERLAY, 65 mm (2.5")
- 3 PROP. AGGREGATE SUBGRADE, 300 mm (12")
- 4 PROP. HMA BINDER CSE., IL-19, N70, 200 mm (8")
- (5) PROP. HMA SURF. CSE., MIX "D", N70, 50 mm (2")
- 6 PROP. POLYMERIZED HMA SURF. CSE., MIX "F", N90, 50 mm (2")
- 7 PROP. POLYMERIZED HMA BINDER CSE., 340 mm (13.5")
- (8) PROP. HMA SURF. CSE., MIX "D", N70, 38 mm (1.5")
- 9 PROP. LEVELING BINDER (MM), IL-19, N70, 19 mm (0.75")
- (10) PROP. HMA SHOULDERS, 250 mm (10")
- (OA) PROP. HMA SHOULDERS, 280 mm (11")
- (11) PROP. AGGREGATE SHOULDER TYPE B, 150 mm (6")
- (12) PROP. HMA SURFACE REMOVAL, 50 mm (2")

* ILL. RTE. 1 STATION INCREASES FROM NORTH TO SOUTH


- 13 PROP. STEEL PLATE BEAM GUARDRAIL, TYPE A
- 14) PROP. AGGREGATE WEDGE, TYPE B
- (15) PROP. HMA SURFACE REMOVAL, 60 mm (2.25")
- 16 PROP. PAVED SHOULDER REMOVAL
- 17) PROP. PAVEMENT REMOVAL
- (18) PROP. TOPSOIL FURNISH & PLACE, 100 mm (FORESLOPE)

SEEDING CLASS 2a

COMPOSIT FURNISH & PLACE 100 mm (BACKSLOPE)

EROSION CONTROL PLANKET


(19) ADDITIONAL 110 mm (4.5") AGGREGATE MATERIAL UNDER PROPOSED HMA SHOULDER SHALL BE INCLUDED IN THE COST OF AGGREGATE SUBGRADE, 300 mm (12")

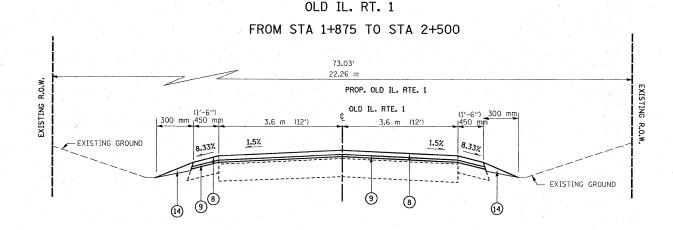

EXISTING TYPICAL SECTION

PROPOSED TYPICAL SECTION FOR OLD IL. RT. 1 FROM STA 1+875 TO STA 2+500

1 Rev. 1-6-09

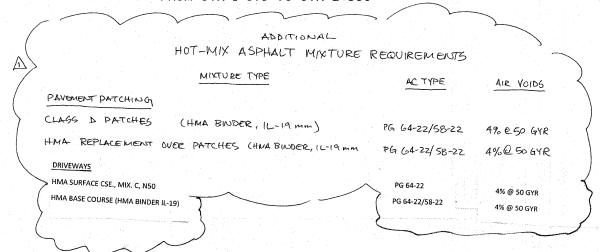


ILLINOIS DEPARTMENT OF TRANSPORTATION DATE ILL. RTE. 1 EXISTING AND PROPOSED TYPICAL SECTIONS SCALE: NONE DRAWN BY C.F. CHECKED BY R.K.

12-31-08-R

*REF-TOPOIO TOTAL SHEETS NO.
WILL 100 24 F.A.P. RTE. SECTION COUNTY 876 9Y-RS-7 STA. 1+100 TO STA. 1+475 FED. ROAD DIST. NO. 1 | ILLINOIS | FED. AID PROJECT CONTRACT NO. 60E52 Z IL ROUTE 1 STA. 1+109.151 = ¢ ELMSCOURT LANE ARLINGTON LANE PROJECT BEGINS TEMPORARY PAVEMENT MARKING -- WHITE, 100 mm (4") STA. 1+129.0 EXIST. C STA. 1+119.5 PROP. C IL ROUTE 1 ELMSCOURT/ 1+300 1+250 1+100 \Rightarrow 375 mm HMA 300 mm AAG ET TO TO TO TO TO TO TEMPORARY PAVEMENT STA, 1+377 TO STA, 1+450 PEREMENTER EROSION BARRIER TEMPORARY PAVEMENT MARKING LANE DOUBLE YELLOW, 100 mm (4") PROP. PIPE CULVERT, CL. A
TYPE 1, 375 mm, 8 m, 9 m OFFSET
PROP. PRE. REINF. CONC. FL. END SECTIONS
JTS mm, 2 EACH
INV. N - 232.869
INV. S - 232.910 W20-1 (0)48 ROAD ARLINGTON CONSTRUCTION AHEAD PROP. PIPE CULVERT, CL. A
TYPE 1, 375 mm, 8 m, 9 m OFFSET
PROP. PRE. REINF. CONC. FL. END SECTIONS
375 mm, 2 EACH
INV. N - 233.044
INV. S - 233.089 PLACE AT STA. 1+000 (RT) (ON ILLINOIS ROUTE 1) **LEGEND** PAVEMENT TO BE CONSTRUCTED WORK ZONE TEMPORARY PAVEMENT TRAFFIC FLOW DRUM OR TYPE II BARRICADE WITH STEADY BURN MONODIRECTIONAL LIGHTS @ 15m CTR'S., (8m CTR'S. IN TAPERS AND ON CURVES) ILLINOIS DEPARTMENT OF TRANSPORTATION TYPE III BARRICADE WITH FLASHING LIGHTS SUGGESTED MAINTENANCE OF TRAFFIC IL. 1 VERTICAL SIGN PANELS ON POSTS STAGE I SCALE 1:500 DRAWN BY DATE 1/2/2009 CHECKED BY A Revisheet 1-6-09

*REF-TOPOII COUNTY TOTAL SHEET NO. F.A.P. RTE. SECTION 876 9Y-RS-7 WILL 100 25 STA. 1+475 TO STA. 1+875 FED. ROAD DIST. NO. 1 | ILLINOIS | FED. AID PROJECT CONTRACT NO. 60E52 **LEGEND** PAVEMENT TO BE CONSTRUCTED WORK ZONE TEMPORARY PAVEMENT TRAFFIC FLOW DRUM OR TYPE II BARRICADE WITH STEADY BURN MONODIRECTIONAL LIGHTS @ 15m CTR'S., (8m CTR'S. IN TAPERS AND ON CURVES) TYPE III BARRICADE WITH FLASHING LIGHTS VERTICAL SIGN PANELS ON POSTS 35 MPH PROP. PIPE CULVERT, CL. A
TYPE 1, 375 mm, 6 m, 9.8 m OFFSET
PROP. PRE. REINF. CONC. FL. END SECTIONS
375 mm, 2 EACH
INV. N - 233.403
INV. S - 233.420 TEMPORARY PAVEMENT (300 mm HMA. BASE CRSE., 45 mm HMA SURF CRSE., PAVEMENT RECONSTRUCTION --- TEMPORARY PAVEMENT MARKING 35 TEMPORARY PAVEMENT MARKING DOUBLE YELLOW, 100 mm (4") OLD IL ROUTE 1 WHITE, 100 mm (4") MPH <u>√1+800</u> \nearrow PROP. R.O.W. TEMPORARY CULVERT EXTENSION —/
FROM PRF-STAGF PEREMENTER EROSION BARRIER ILLINOIS DEPARTMENT OF TRANSPORTATION SUGGESTED MAINTENANCE OF TRAFFIC IL. 1 STAGE I SCALE 1:500 DRAWN BY DATE 1/2/2009 CHECKED BY 1 Rev. Sheet 1-6.09

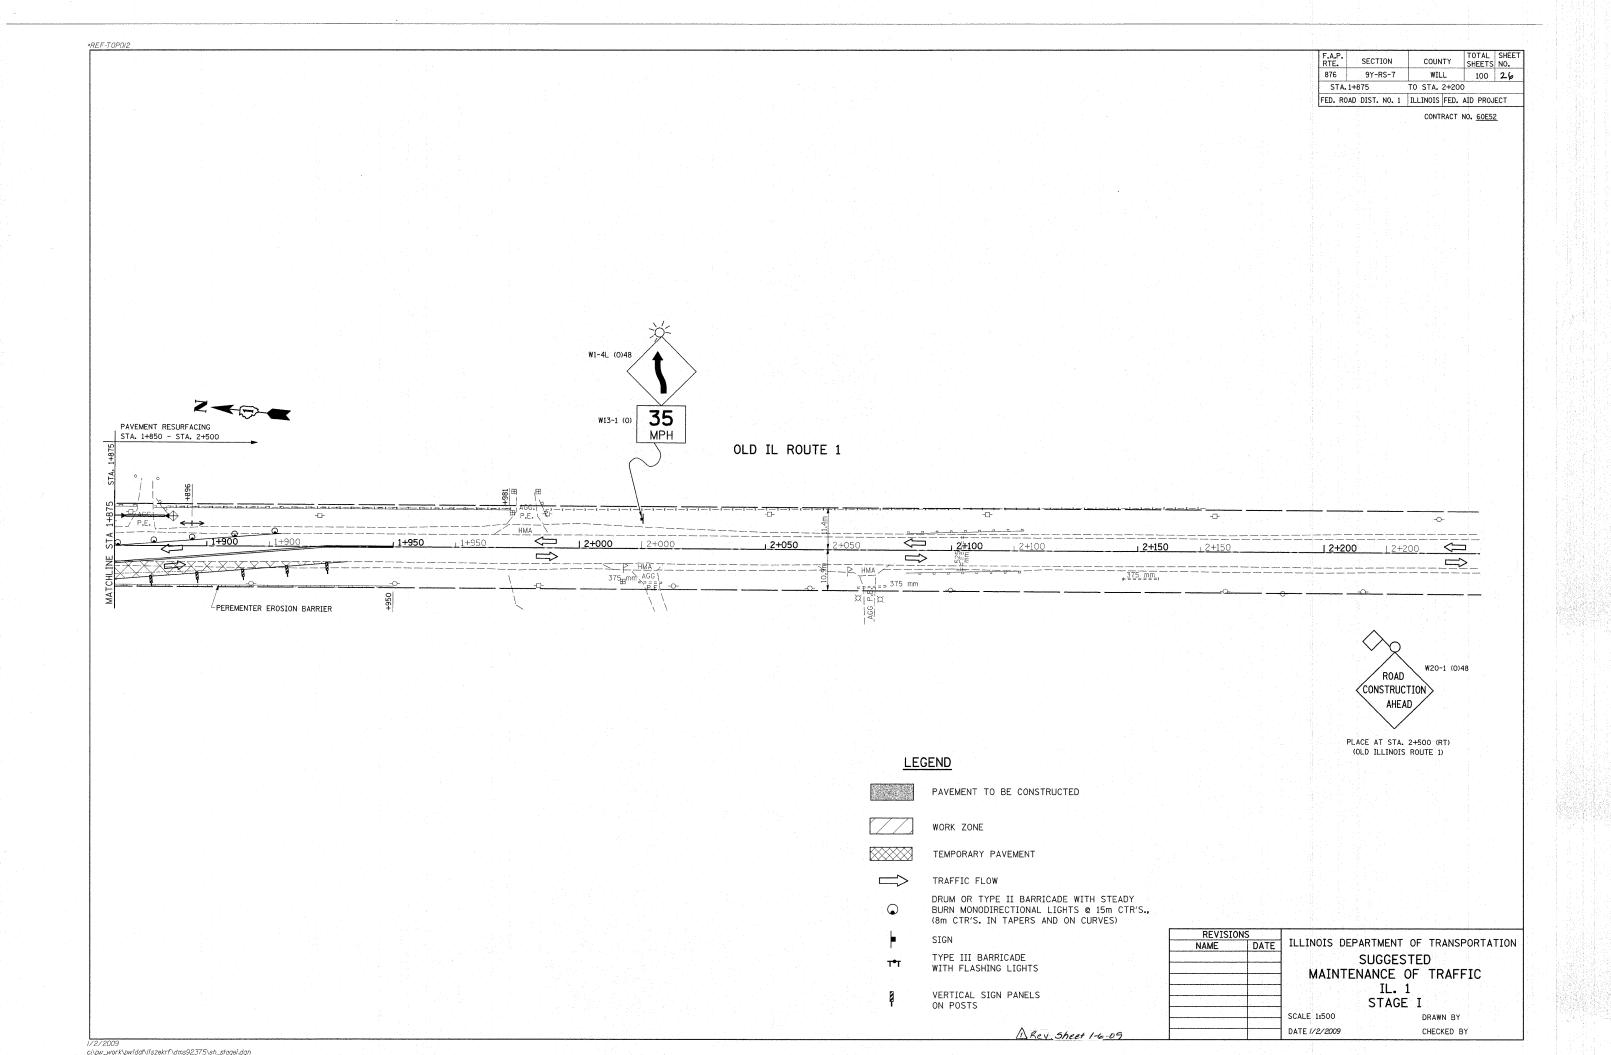

*REF-TOPOIO TOTAL SHEET SHEETS NO. F.A.P. RTE. SECTION COUNTY 876 9Y-RS-7 WILL 100 27 STA. 1+100 TO STA. 1+475 FED. ROAD DIST. NO. 1 | ILLINOIS | FED. AID PROJECT CONTRACT NO. 60E52 IL ROUTE 1 STA. 1+109.151 = ¢ ELMSCOURT LANE ARLINGTON LANE PROJECT BEGINS ELMSCOURT/ LANE STA. 1+129.0 EXIST. (STA. 1+119.5 PROP. C IL ROUTE 1 EXIST. R.O.W. 3.6 m < T.E. 4 TEMPORARY PAVEMENT FROM PREVIOUS STAGE TEMPORARY CULVERTS FROM -PREVIOUS STAGE ARLINGTON LANE W20-1 (0)48 ROAD CONSTRUCTION AHEAD, LEGEND PLACE AT STA. 1+000 (RT) (ON ILLINOIS ROUTE 1) PAVEMENT TO BE CONSTRUCTED WORK ZONE TEMPORARY PAVEMENT TRAFFIC FLOW DRUM OR TYPE II BARRICADE WITH STEADY BURN MONODIRECTIONAL LIGHTS @ 15m CTR'S., (8m CTR'S. IN TAPERS AND ON CURVES) TYPE III BARRICADE WITH FLASHING LIGHTS VERTICAL SIGN PANELS ON POSTS DATE ILLINOIS DEPARTMENT OF TRANSPORTATION SUGGESTED MAINTENANCE OF TRAFFIC IL. 1 STAGE II SCALE 1:500 DRAWN BY DATE 1/2/2009 CHECKED BY A Revisheet 1-6-09

*REF-TOPOII COUNTY TOTAL SHEET NO. WILL 100 28 SECTION 876 9Y-RS-7 TO STA. 1+875 STA. 1+475 FED. ROAD DIST. NO. 1 | ILLINOIS | FED. AID PROJECT CONTRACT NO. 60E52 **LEGEND** PAVEMENT TO BE CONSTRUCTED WORK ZONE TEMPORARY PAVEMENT TRAFFIC FLOW DRUM OR TYPE II BARRICADE WITH STEADY BURN MONODIRECTIONAL LIGHTS @ 15m CTR'S., (8m CTR'S. IN TAPERS AND ON CURVES) ROAD CLOSED R11-2 1200 X 750 mm TYPE III BARRICADE WITH FLASHING LIGHTS VERTICAL SIGN PANELS ON POSTS R3-5L PAVEMENT RECONSTRUCTION STA. 1+700 - STA. 1+850 35 W13-1 (0) OLD IL ROUTE 1 TEMPORARY PAVEMENT FROM — PREVIOUS STAGE TEMPORARY CULVERT EXTENSION —/
FROM PRE-STAGE REVISIONS NAME ILLINOIS DEPARTMENT OF TRANSPORTATION DATE SUGGESTED MAINTENANCE OF TRAFFIC IL. 1 STAGE II SCALE 1:500 DRAWN BY DATE 1/2/2009 CHECKED BY A Rev. Sheet 1-6-09

*REF-TOPOI2 COUNTY TOTAL SHEET NO. SECTION 876 WILL 100 29 STA.1+875 TO STA. 2+250 FED. ROAD DIST. NO. 1 ILLINOIS FED. AID PROJECT CONTRACT NO. 60E52 PAVEMENT RESURFACING W13-1 (0) STA. 1+850 - STA. 2+500 MPH OLD IL ROUTE 1 \Box 1+950 LEGEND PAVEMENT TO BE CONSTRUCTED WORK ZONE TEMPORARY PAVEMENT TRAFFIC FLOW DRUM OR TYPE II BARRICADE WITH STEADY BURN MONODIRECTIONAL LIGHTS @ 15m CTR'S., (8m CTR'S. IN TAPERS AND ON CURVES) REVISIONS NAME ILLINOIS DEPARTMENT OF TRANSPORTATION SUGGESTED TYPE III BARRICADE WITH FLASHING LIGHTS MAINTENANCE OF TRAFFIC IL. 1 VERTICAL SIGN PANELS ON POSTS STAGE II SCALE 1:500 DATE 1/2/2009 CHECKED BY 1 Rev. Sheet 1-6-09

*REF-TOPOIO COUNTY TOTAL SHEET SHEETS NO. SECTION 876 9Y-RS-7 WILL 100 30 STA. 1+100 TO STA, 1+875 FED. ROAD DIST. NO. 1 | ILLINOIS FED. AID PROJECT CONTRACT NO. 60E52 Z IL ROUTE 1 STA. 1+109.151 = ARLINGTON LANE TEMPORARY PAVEMENT MARKING WHITE, 100 mm (4") PROJECT BEGINS ELMSCOURT/ LANE STA. 1+129.0 EXIST. ¢ TEMPORARY PAVEMENT MARKING-STA. 1+119.5 PROP. C IL ROUTE 1 DOUBLE YELLOW, 100 mm (4") 1+100 / \Longrightarrow ARLINGTON LANE W20-1 (0)48 ROAD W1-4L (0)48 (CONSTRUCTION) AHEAD PLACE AT STA. 1+000 (RT) (ON ILLINOIS ROUTE 1) W13-1 (0) LEGEND PAVEMENT TO BE CONSTRUCTED WORK ZONE TEMPORARY PAVEMENT TRAFFIC FLOW DRUM OR TYPE II BARRICADE WITH STEADY BURN MONODIRECTIONAL LIGHTS @ 15m CTR'S., (8m CTR'S. IN TAPERS AND ON CURVES) REVISIONS ILLINOIS DEPARTMENT OF TRANSPORTATION TYPE III BARRICADE WITH FLASHING LIGHTS SUGGESTED MAINTENANCE OF TRAFFIC IL. 1 VERTICAL SIGN PANELS STAGE III ON POSTS SCALE 1:500 DRAWN BY DATE 1/2/2009 CHECKED BY A Rev. Sheed 1-6-09

I/2/2009 c:\pw_work\pwidof\liszekrf\dms92375\sh_stageIII.dgn liszekrf

COUNTY TOTAL SHEET NO. SECTION WILL 100 31 876 9Y-RS-7 STA. 1+475 TO STA. 1+875 FED. ROAD DIST. NO. 1 | ILLINOIS | FED. AID PROJECT CONTRACT NO. 60E52 **LEGEND** PAVEMENT TO BE CONSTRUCTED WORK ZONE TEMPORARY PAVEMENT TRAFFIC FLOW DRUM OR TYPE II BARRICADE WITH STEADY BURN MONODIRECTIONAL LIGHTS @ 15m CTR'S., (8m CTR'S. IN TAPERS AND ON CURVES) TYPE III BARRICADE WITH FLASHING LIGHTS VERTICAL SIGN PANELS ON POSTS ROAD R11-2 1200 X 750 mm W1-6 1200 X 600 mm IL ROUTE 1 Z PAVEMENT MARKING TAPE, TYPE III DOUBLE YELLOW, 100 mm (4"), 11' C-C (TYP.) STA. 1+377 TO STA. 1+752.5 PAVEMENT MARKING TAPE, TYPE III WHITE, 100 mm (4") STA. 1+377 TO STA. 1+752.5 (NB) PAVEMENT RECONSTRUCTION STA. 1+700 - STA. 1+850 TEMPORARY PAVEMENT MARKING TEMPORARY PAVEMENT MARKING DOUBLE YELLOW, 100 mm (4"), 11' C-C (TYP.) AGGREGATE SHOULDER, TYPE B WHITE, 100 mm (4"), 11' C-C (TYP.) STA. 1+377 TO STA. 1+600 (SB) OLD IL ROUTE 1 REVISIONS NAME ILLINOIS DEPARTMENT OF TRANSPORTATION SUGGESTED MAINTENANCE OF TRAFFIC IL. 1 STAGE III SCALE 1:500 DRAWN BY DATE 1/2/2009 CHECKED BY AREV Sheet 1-6-09

TOTAL SHEET SHEETS NO. SECTION COUNTY 876 9Y-RS-7 WILL 100 32 STA.1+875 TO STA. 2+250 FED. ROAD DIST. NO. 1 | ILLINOIS | FED. AID PROJECT CONTRACT NO. 60E52 W1-2R (0)48 PAVEMENT RESURFACING STA. 1+850 - STA. 2+500 OLD IL ROUTE 1 \leftarrow 2+000 \Rightarrow <u>LEGEND</u> PAVEMENT TO BE CONSTRUCTED WORK ZONE TEMPORARY PAVEMENT TRAFFIC FLOW DRUM OR TYPE II BARRICADE WITH STEADY BURN MONODIRECTIONAL LIGHTS @ 15m CTR'S., (8m CTR'S. IN TAPERS AND ON CURVES) TYPE III BARRICADE WITH FLASHING LIGHTS VERTICAL SIGN PANELS ON POSTS REVISIONS NAME ILLINOIS DEPARTMENT OF TRANSPORTATION SUGGESTED MAINTENANCE OF TRAFFIC IL. 1 STAGE III SCALE 1:500 DRAWN BY DATE 1/2/2009 CHECKED BY 1 Rev. Sheet 1-6-09

1/2/2009 c:\pw_work\pwidof\liszekrf\dms92375\sh_stagelii.dgn llszekrf THE CONTRACTOR WILL BE REQUIRED TO IMPLEMENT AND MAINTAIN EROSION CONTROL MEASURES IMMEDIATELY AFTER STRIPPING OF EXISTING VEGETATION.

NO RUNOFF FROM STRIPPED AREAS WILL LEAVE THE SITE OTHER THAN THROUGH SEDIMENTATION/STILLING BASINS. THE CONTRACTOR WILL ADJUST HIS OPERATIONS AND IMPLEMENT EROSION CONTROL MEASURES ACCORDINGLY.

THE QUANTITIES SHOWN SURROUND FOR TEMPORARY DITCH CHECKS ARE MEASURED AS EACH, REGARDLESS OF TYPE OR CONFIGURATION USED.

STRAW BALES WILL NOT BE CONSIDERED AS AN ACCEPTABLE FORM OF EROSION AND/OR SEDIMENT CONTROL.

THE CONTRACTOR SHALL SURROUND ALL EARTH STOCKPILES WITH SILT FENCE AND SHALL BE PAID FOR AS PERIMETER EROSION BARRIER, EROSION CONTROL MEASURES SHALL BE INSPECTED BY THE CONTRACTOR AND ENGINEER WITHIN 24 HOURS OR ANY STORM EXCEEDING 0.5 INCH OF PRECIPITATION.

STOCKPILES OF SOIL AND OTHER BUILDING MATERIALS TO REMAIN IN PLACE MORE THAN THREE (3) DAYS SHALL BE FURNISHED WITH EROSION AND SEDIMENT CONTROL MEASURES (I.E. PERIMETER SILT FENCE). STOCKPILES TO REMAIN IN PLACE FOR 21 DAYS OR MORE SHALL RECEIVE TEMPORARY SEEDING.

ALL CONSTRUCTION ACTIVITIES SHALL BE IN ACCORDANCE WITH THE NATIONAL POLLUTANT DISCHARGE ELIMINATION SYSTEM STORM WATER PERMIT.

THE CONTRACTOR SHALL TAKE ALL PRECAUTIONS TO PREVENT POLLUTION OF STORM WATER AND SHALL FOLLOW IEPA & IDOT CONSTRUCTION MEMORANDUM NO. 95-60.

EROSION CONTROL SHALL BE PROVIDED IN ACCORDANCE WITH SEQUENCE OF STAGE CONSTRUCTION.

STABILIZATION MEASURES SHALL BE INTIATED AS SOON AS PRACTICAL, BUT IN NO CASE EXCEED 14 DAYS AFTER CONSTRUCTION ACTIVITY IN THAT PORTION OF THE SITE HAS TEMPORARILY OR PERMANENTLY CEASED ON ALL DISTURBED PORTIONS OF THE SITE WHERE CONSTRUCTION ACTIVITY WILL NOT OCCUR FOR A PERIOD OF 21 OR MORE CALENDER DAYS.

THE CONTRACTOR SHALL APPLY TEMPORARY EROSION CONTROL SEEDING TO ALL ERODIBLE BARE EARTH AREAS WITHIN THE CONTRACT LIMITS EACH WEEK, REGARDLESS OF WEATHER CONDITIONS OR PROGRESS OF THE WORK. UNLESS OTHERWISE DIRECTED BY THE ENGINEER. ERODIBLE EMBANKMEN+AND EXCAVATION AREAS WHERE WORK IS IN PROGRESS SHALL BE INCLUDED ON THE AREAS TO BE SEEDED. SEE SPECIAL PROVISION FOR TEMPORARY EROSION CONTROL SEEDING.

ALL PERIMETER EROSION BARRIER SHALL BE PLACED IN STAGE I, IF REQUIRED IN STAGE II IT SHALL BE LEFT IN PLACE. IT SHALL ONLY BR REPLACED IF DAMAGED, AT THE DIRECTION OF THE ENGINEER.

REFER TO LANDSCAPING PLAN FOR AREA TO BE SEEDED.

THE WILL/SOUTH COOK SOIL AND WATER CONSERVATION DISTRICT (WSCSWCD) IS RESPONSIBLE FOR CONDUCTING SITE VISITS AND VERIFYING THAT THE PRACTICES ARE WORKING PROPERLY AND DETERMINE IF ADDITIONAL PRACTICES ARE NEEDED FOR BETTER SOIL EROSION AND SEDIMENT CONTROL. THE CONTRACTOR IS RESPONSIBLE FOR THE INSTALLATION OF ANY ADDITIONAL EROSION CONTROL MEASURES NECESSARY TO PREVENT EROSION AND SEDIMENTATION AS DETERMINED BY THE WSCSWCD.

WSCSWCD MUST BE NOTIFIED ONE WEEK PRIOR TO THE PRE-CONSTRUCTION CONFERENCE, ONE WEEK PRIOR TO THE COMMENCEMENT OF THE LAND DISTURBING ACTIVITIES, AND ONE WEEK PRIOR TO FINAL INSPECTION.

UNLESS OTHERWISE INDICATED, ALL VEGETATIVE AND STRUCTURAL EROSION AND SEDIMENT CONTROL PRACTICES WILL BE CONSTRUCTED ACCORDING TO MINIMUM STANDARDS AND SPECIFICATIONS IN THE ILLINOIS URBAN MANUAL REVISED FEBRUARY 2002.

A COPY OF THE APPROVED EROSION AND SEDIMENT CONTROL PLAN SHALL BE MAINTAINED ON THE SITE AT ALL TIMES.

PRIOR TO COMMENCING LAND-DISTUBING ACTIVITIES IN AREAS OTHER THAN INDICATED ON THESE PLANS (INCLUDING BUT NOT LIMITED TO, ADDITIONAL PHASES OF DEVELOPMENT AND OFF-SITE BORROW OR WASTE AREAS) A SUPPLEMENTARY EROSION CONTROL PLAN SHALL BE SUBMITTED TO THE OWNER FOR REVIEW BY THE WSCSWCD.

DURING DEWATERING OPERATIONS, WATER WILL BE PUMPED INTO SEDIMENT BASINS OR SILT TRAPS. DEWATERING INTO DRAIN TILES IS STRICTLY PROHIBITED. COMPROMISED DRAIN TILES SHOULD BE IMMEDIATELY REPAIRED OR INCORPORATED INTO STORM WATER FACILITIES.

ALL DROP INLETS ON AND ADJACENT TO THE SITE MUST HAVE A SEDIMENT TRAPPING OR CONTAINMENT DEVICE INSTALLED DURING CONSTRUCTION ACTIVITIES.

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ALL ADJACENT STREETS MUST BE KEPT CLEAR OF DEBRIS, INSPECTED DAILY AND CLEANED WHEN NECESSARY.

ISER NAME = smithkl

PLOT SCALE = 47.2223 '/ IN.

LOT DATE = 12/31/2008

FILE NAME =

ALL EROSION CONTROL MEASURES MUST BE INSPECTED WEEKLY AND AFTER EACH $1\!\!\!/_2\!\!\!/^{\!\!\!/}$ RAIN EVENT.

EROSION CONTROL BLANKET AND/OR STRAW MULCH WITH NETTING (DEPENDING ON SLOPE, SLOPE LENGTH, AND FLOW RATES) SHALL BE INSTALLED ON ALL SLOPES AND IN CRITICAL AREAS (I.E. DETENTION BASIN PERIMETERS, BERMS ETC.) IMMEDIATELY LIPON FINAL GRADING

PRIORITY SHALL BE GIVEN TO THE COMPLETION AND STABILIZATION OF THE DETENTION AREAS. WORK IN THESE AREAS SHALL NOT BE PROLONGED IN ATTEMPT THAT ALL FINAL GRADING AND STABILIZATION CAN TAKE PLACE AT ONE TIME.

THE CONDITION OF THE CONSTRUCTION SITE FOR WINTER SHUTDOWN SHALL BE ADDRESSED EARLY IN THE FALL GROWING SEASON SO THAT SLOPES AND OTHER BARE EARTH AREAS MAY BE STABILIZED WITH TEMPORARY AND/OR PERMANENT VEGETATIVE COVER FOR PROPER EROSION AND SEDIMENT CONTROL. ALL OPEN AREAS THAT ARE TO REMAIN IDLE THROUGHOUT THE WINTER SHALL RECEIVE TEMPORARY EROSION CONTROL MEASURES INCLUDING TEMPORARY SEEDING, MULCHING AND/OR EROSION CONTROL BLANKET PRIOR TO THE END OF THE FALL GROWING SEASON. THE AREAS TO BE WORKED BEYOND THE END OF THE GROWING SEASON MUST INCORPORATE SOIL STABILIZATION MEASURES THAT DO NOT RELY ON VEGETATIVE COVER SUCH AS EROSION CONTROL BLANKET AND HEAVY MULCHING.

SILT FENCE IS TO BE INSTALLED FOLLOWING THE COMPLETION AND STABILIZATION OF THE STORM WATER FACILITIES AND IS TO REMAIN IN PLACE UNTIL THE CONTRIBUTING AREA IS STABILIZED.

BERMS MUST BE STABILIZED IMMEDIATELY UPON RECEIVING FINAL GRADING. STRAW MULCH WITH NETTING OR EROSION CONTROL BLANKET SHALL BE USED ON SIDE SLOPES AND SIMMIT.

IN AREAS WHERE WORK IS COMPLETE, PERMANENT STABILIZATION SHALL OCCUR WITHIN 7 DAYS OF COMPLETION, AND IN AREAS WHERE WORK HAS TEMPORARILY CEASED FOR 21 DAYS OR MORE, TEMPORARY STABILIZATION SHALL OCCUR BY THE 14TH DAY AFTER WORK HAS CEASED.

COMPLETED SLOPES SHALL BE SEEDED AND MULCHED (OR BLANKETED, IF APPLICABLE) AS THE EXCAVATION PROCEEDS TO THE EXTENT CONSIDERED DESIRABLE AND PRACTICAL. PERMANENT SEEDING SHALL BE USED WHENEVER POSSIBLE. UNDER NO CIRCUMSTANCES SHALL THE CONTRACTOR PROLONG FINAL GRADING AND SHAPING SO THAT THE ENTIRE PROJECT CAN BE PERMANENTLY SEEDED AT ONE TIME. NO WORK SHALL BE PERFORMED IN FLOWING WATER. WATER IN AND NEAR THE CRITICAL AREAS SHOULD BE ISOLATED FROM CONCENTRATED FLOWS OR STREAM FLOW. THE STREAM BANKS SHOULD BE STABILIZED AT THE END OF EACH DAY. ONCE WORK IN THIS AREA BEGINS, PRIORITY SHALL BE GIVEN TO THE COMPLETION OF THE WORK AND FINAL STABILIZATION OF ALL DISTURBED AREAS.

A Added Sneet 1-6-09

CONTRACT NO. 60F52

PRECAST REIN. CONC. FLARED END SECTION, 600 mm DIA. WITH GRATING FOR CONC. FES, 600 mm STA. 1+267.775, 9.48m RT INV. 231.089

CB, 1.2m, TY A, W/ TY8 GRATE STA. 1+396.830, 9.112 RT T.G. 233.000 INV. 231.857 (N) INV. 231.761 (S)

PRECAST REIN. CONC. FLARED END SECTION, 375 mm DIA. WITH GRATING FOR CONC. FES, 375 mm STA. 1+730.604, 9.483m LT INV. 232.000

PRECAST REIN. CONC. FLARED END SECTION, 600 mm DIA. WITH GRATING FOR CONC. FES, 600 mm STA. 2+008.230, 9.000m RT

CB, 1.5m, TY A, W/ TY8 GRATE
STA. 1+279.60, 9.542 RT
T.G. 232.189
INV. 231.140 (N)
INV. 231.150 (S)

CB, 1.2m, TY A, W/ TY8 GRATE STA. 1+436.526, 8.955 RT T.G. 233.445 INV. 232.046 (N) INV. 232.052 (S) PRECAST REIN. CONC. FLARED END SECTION, 375 mm DIA. WITH GRATING FOR CONC. FES, 375 mm STA. 1+742.240, 25.314m LT INV. 230.450

PRECAST REIN. CONC. FLARED END SECTION, 375 mm DIA. WITH GRATING FOR CONC. FES, 375 mm STA. 2+056.180, 8.992m LT INV. 226.732

CB, 1.5m, TY A, W/ TY8 GRATE
STA, 1+296.54, 9.592 RT
T.G. 232.360
INV. 231.198 (N)
INV. 231.220 (S)

CB, 1.2m, TY A, W/ TY8 GRATE STA, 1+459.557, 9.105 RT T.G. 233.430 INV. 232.172 (N) INV. 232.171 (S) PRECAST REIN. CONC. FLARED END SECTION, 450 mm DIA. WITH GRATING FOR CONC. FES, 450 mm STA. 1+798.632, 9.060m RT INV. 229.961

PRECAST REIN. CONC. FLARED END SECTION, 375 mm DIA. WITH GRATING FOR CONC. FES, 375 mm STA. 2+066.332, 8.993m LT INV. 226.585

PRECAST REIN. CONC. FLARED END SECTION, 375 mm DIA. WITH GRATING FOR CONC. FES, 375 mm STA. 1+267.775, 9.48m LT

PRECAST REIN. CONC. FLARED END SECTION, 375 mm DIA.

WITH GRATING FOR CONC. FES, 375 mm

STA. 1+332.500, 9.302m LT

CB, 1.2m, TY A, W/ TY8 GRATE STA. 1+482.711, 10.625 RT T.G. 233.275 INV. 232.298 (N) INV. 232.402 (S)

INV. 230.581

PRECAST REIN. CONC. FLARED END SECTION, 450 mm DIA. WITH GRATING FOR CONC. FES, 450 mm STA. 1+799.182, 8.960m LT INV. 230.101

PRECAST REIN. CONC. FLARED END SECTION, 375 mm DIA. WITH GRATING FOR CONC. FES, 375 mm STA. 2+450
INV. 221.453

CB, 1.5m, TY A, W/ TY8 GRATE
STA. 1+316.694, 9.410 RT
T.G. 232.576
INV. 231.274 (N)
INV. 231.533 (S)

PRECAST REIN. CONC. FLARED END SECTION, 375 mm DIA. WITH GRATING FOR CONC. FES, 375 mm STA. 1+489.714, 9.302m RT

PRECAST REIN. CONC. FLARED END SECTION, 450 mm DIA. WITH GRATING FOR CONC. FES. 450 mm STA. 1+859.700, 8.108m LT

CB, 1.5 m, TY A, W/ TY8 GRATE STA. 2+500

PRECAST REIN, CONC. FLARED END SECTION, 600 mm DIA. WITH GRATING FOR CONC. FES, 600 mm STA. 1+732.540, 13.738m LT

PRECAST REIN. CONC. FLARED END SECTION, 450 mm DIA. WITH GRATING FOR CONC. FES, 450 mm STA. 1+878.330, 8.117m LT

PRECAST REIN. CONC. FLARED END SECTION, 375 mm DIA. WITH GRATING FOR CONC. FES, 375 mm STA. 2+542

INV. 231.759

INV. 231.691

INV. 218.497

INV. 219.875 (S)

CB, 1.2m, TY A, W/ TY8 GRATE STA. 1+359.840, 9.302 RT T.G. 233.125 INV. 231.743 (N)

INV. 231.749 (S)

PRECAST REIN. CONC. FLARED END SECTION, 600 mm DIA. WITH GRATING FOR CONC. FES, 600 mm STA. 1+736.730, 12.480m RT INV. 230.401

PRECAST REIN. CONC. FLARED END SECTION, 600 mm DIA. WITH GRATING FOR CONC. FES, 600 mm STA. 1+997.940, 9.000m RT

INV. 228.639

REVISIONS
NAME DATE

ILLINOIS DEPARTMENT OF TRANSPORTATION

ILL ROUTE 1

DRAINAGE STRUCTURE TABLE


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DATE: 9/5/2008 CHECKED BY R.K.


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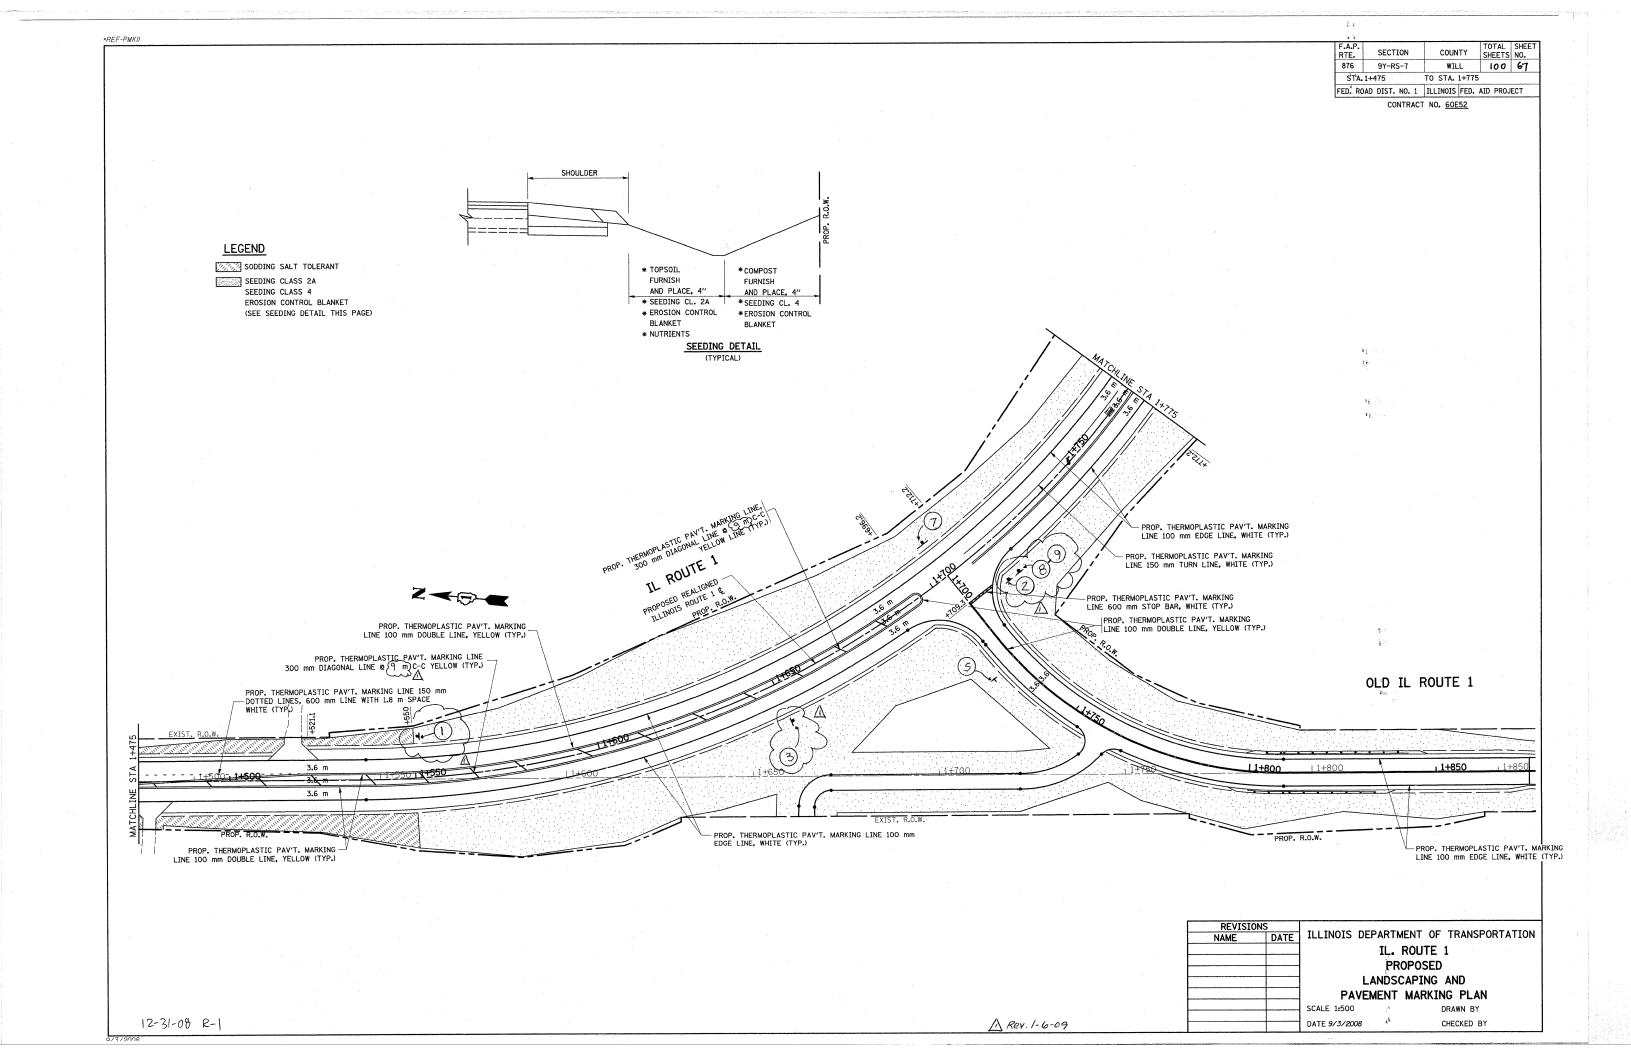
IN THE FIELD BY THE ENGINEER


1 Rev. Sheet 1-10-09


12-31-08-R1 9/5/2008 c:Bprojects&d136602&typicals.dgn




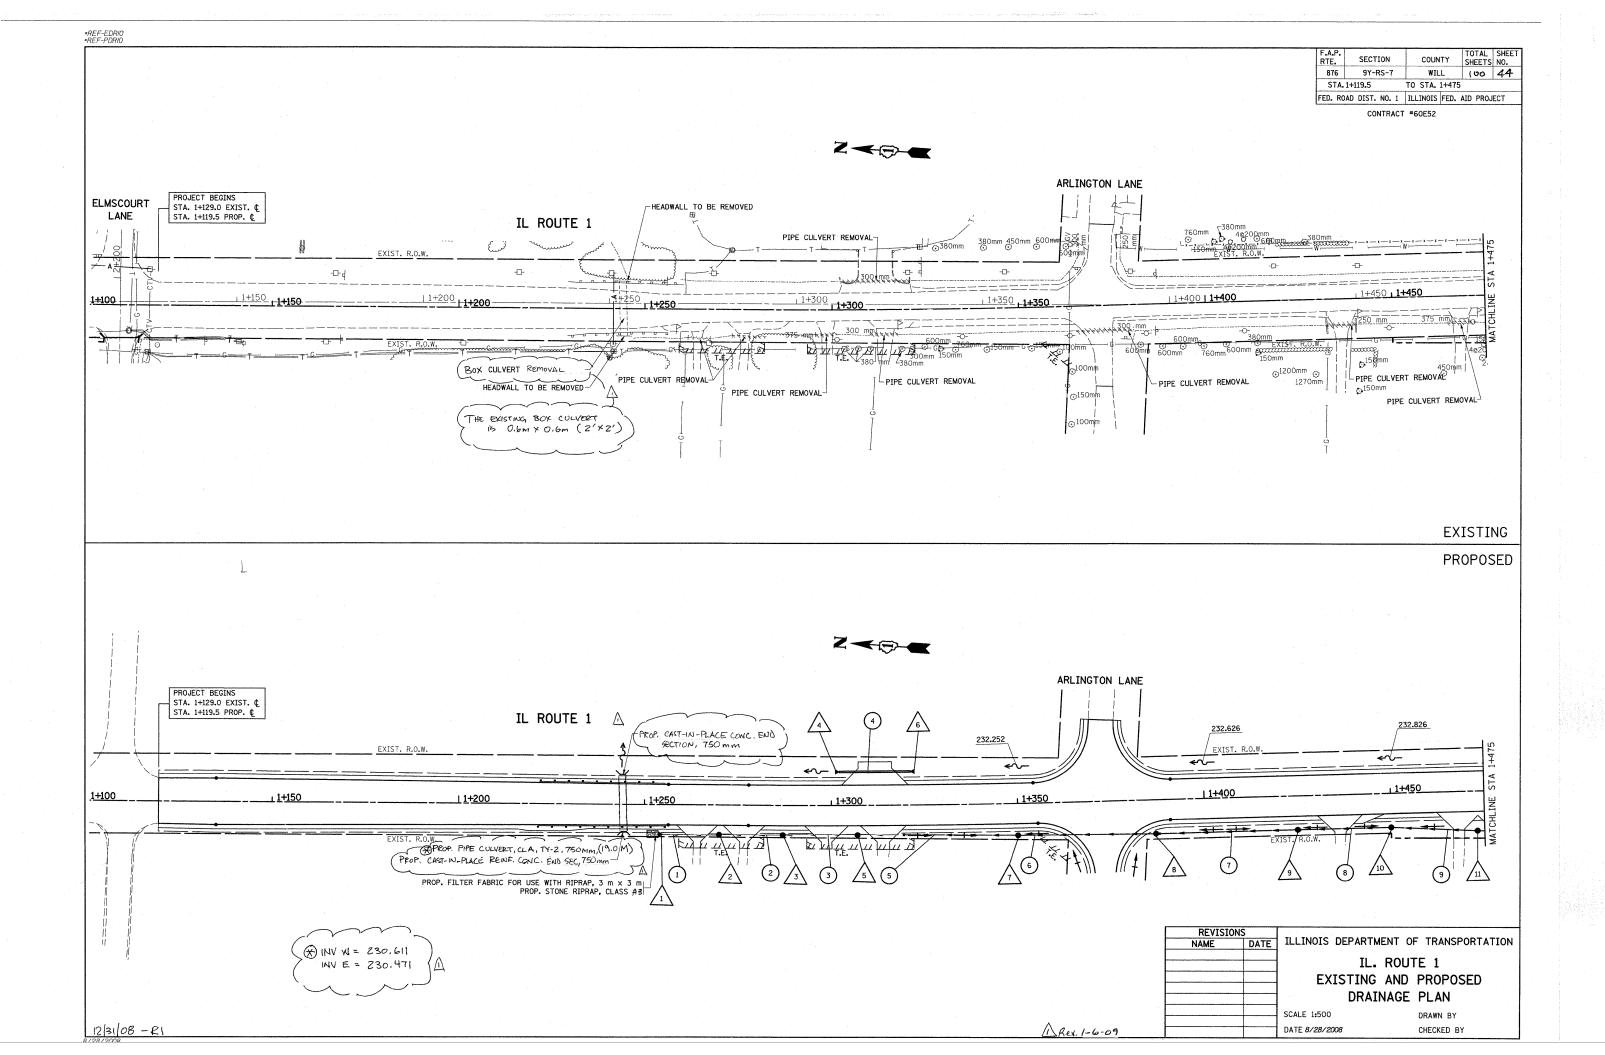


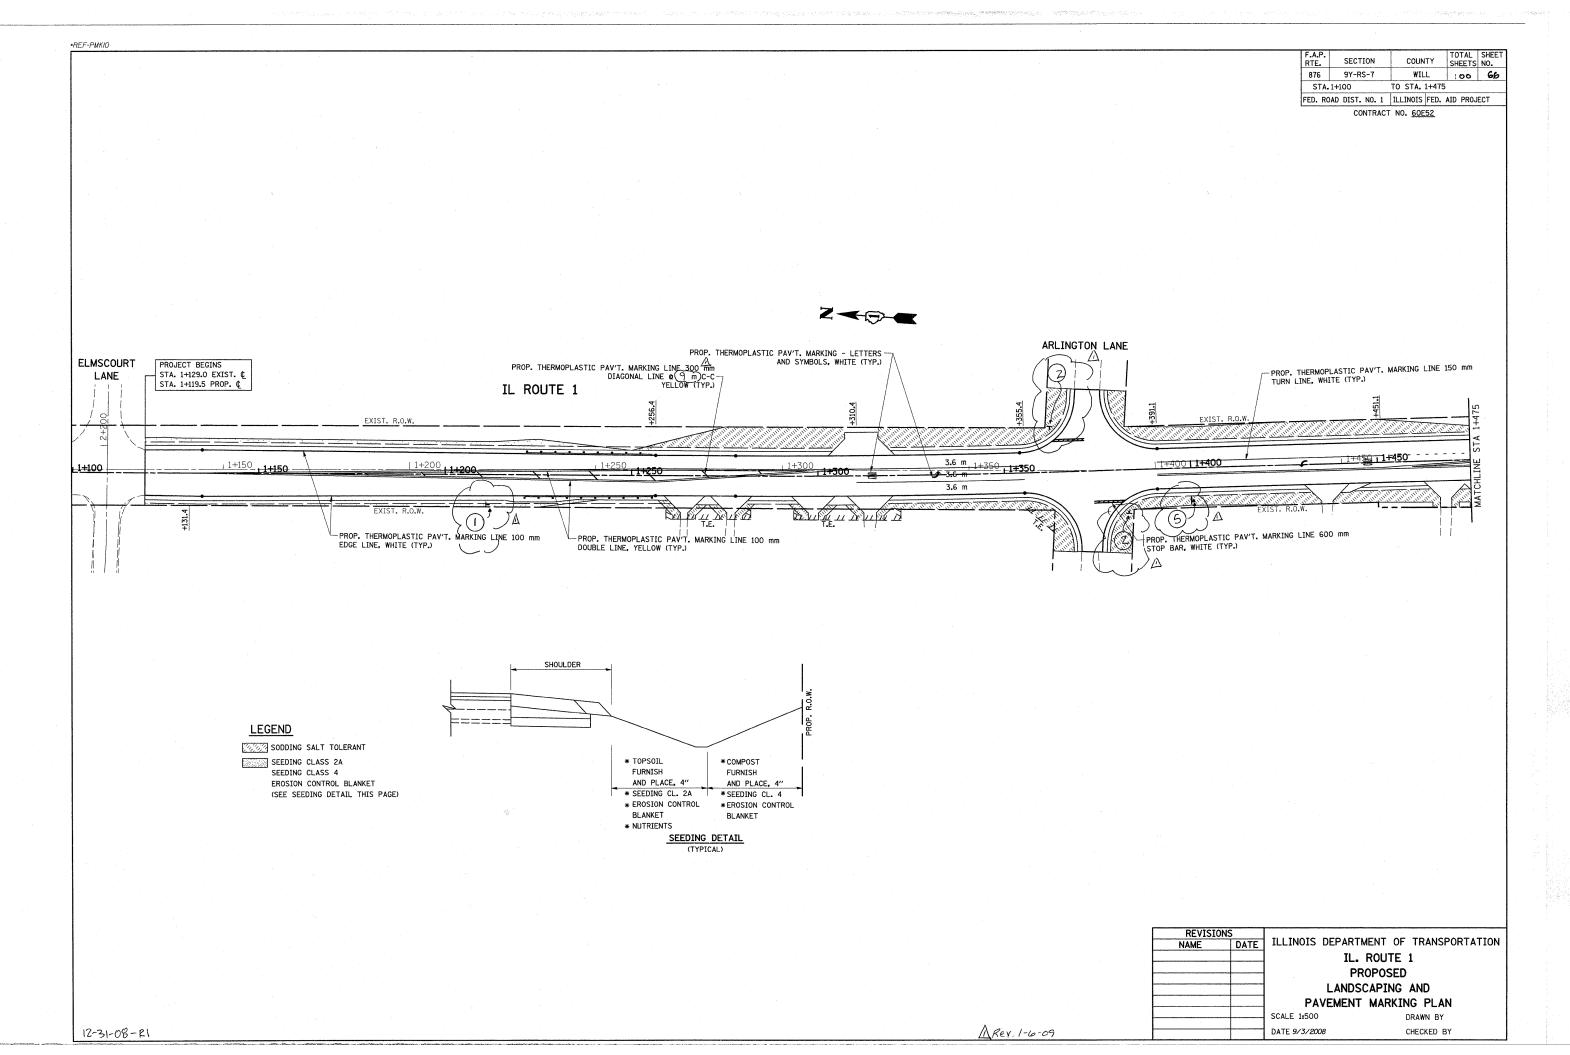


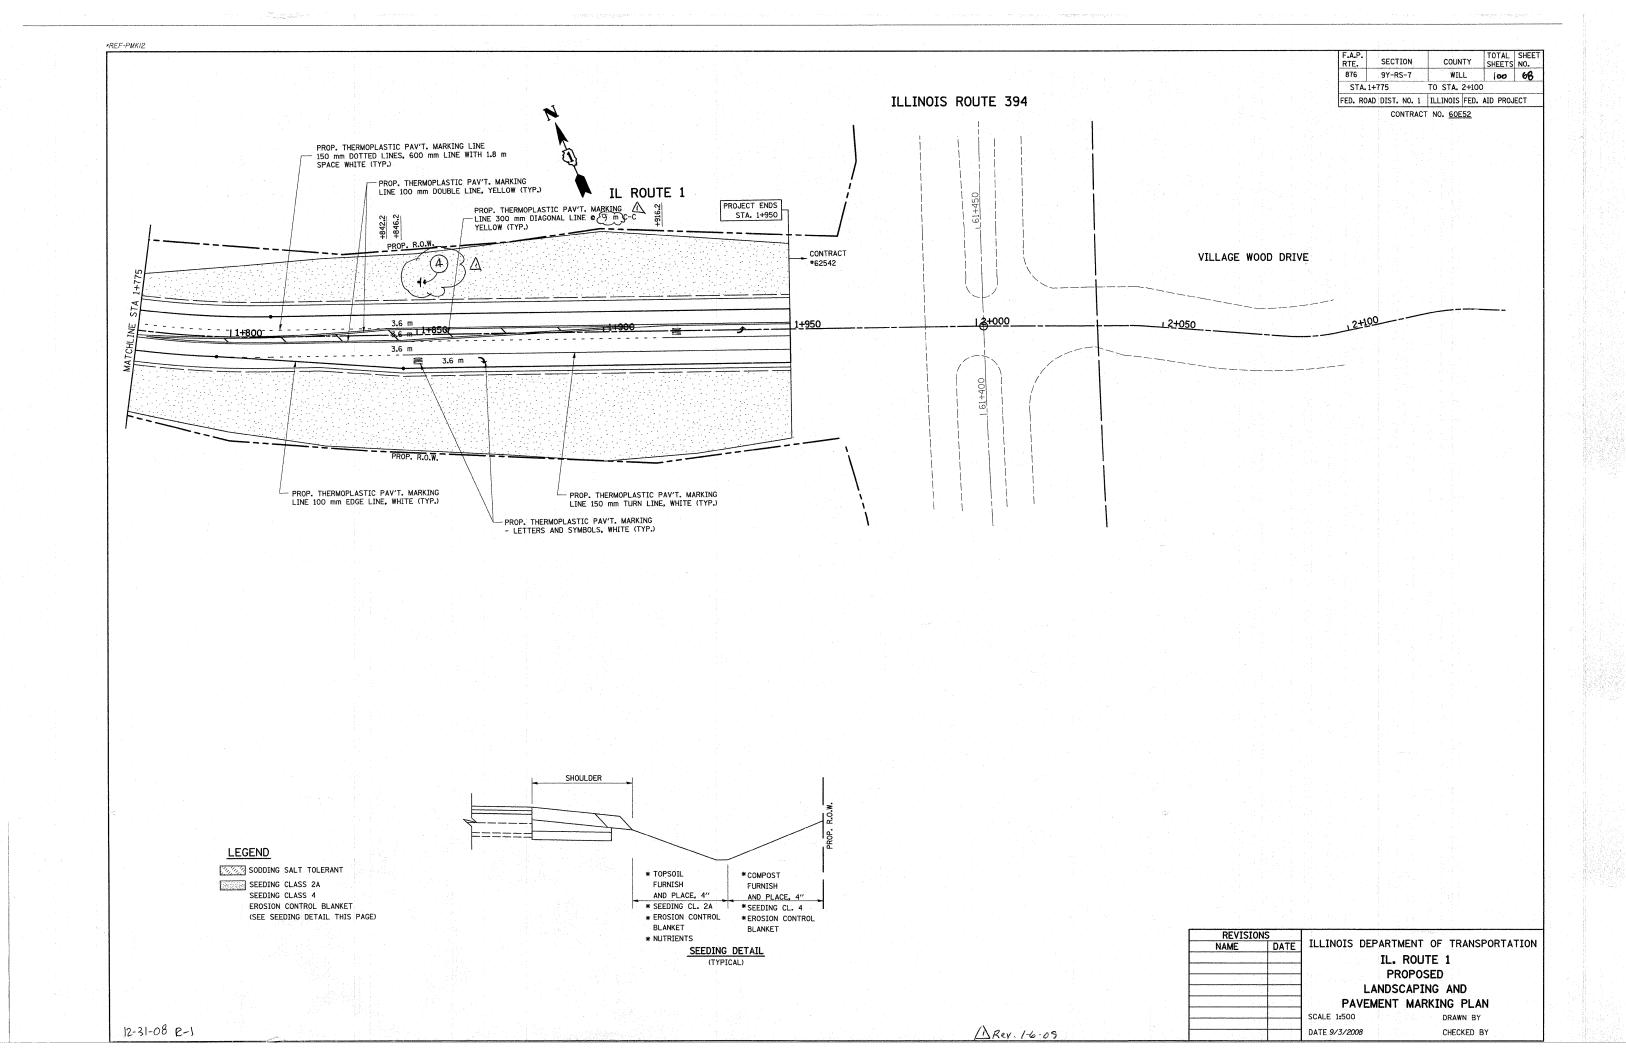


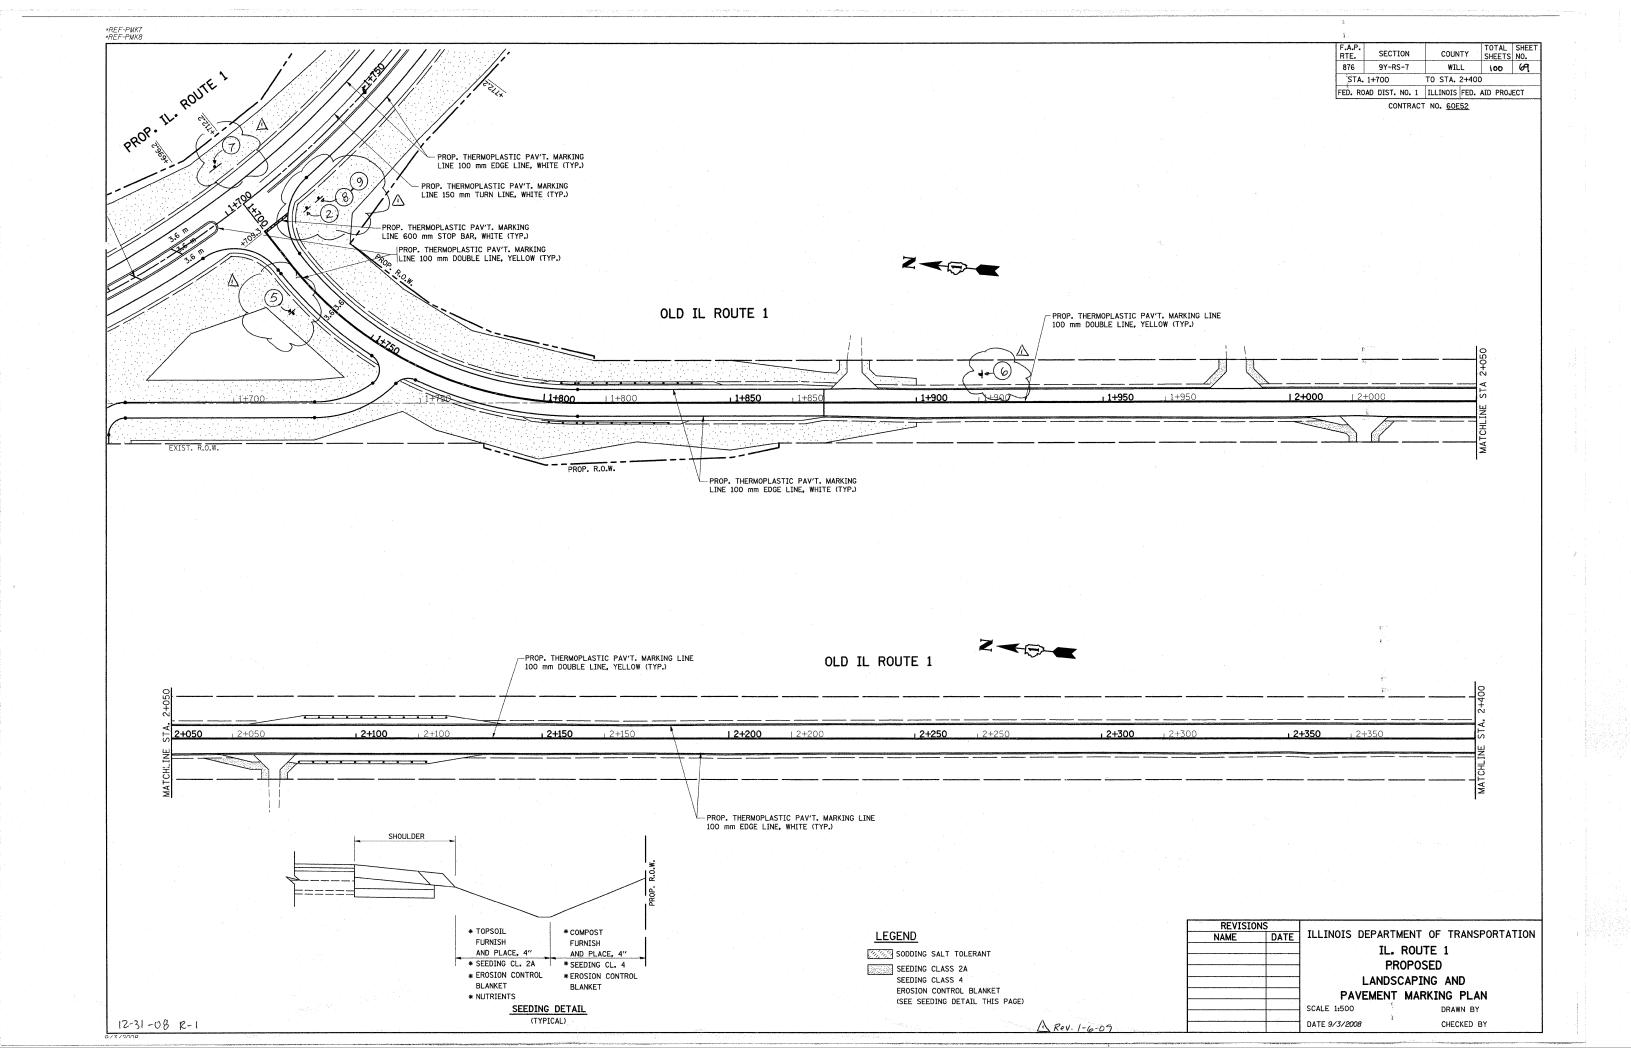


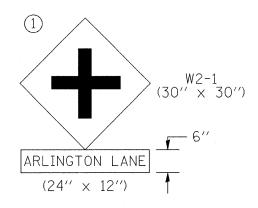


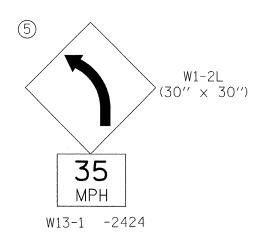


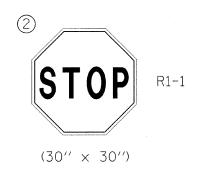


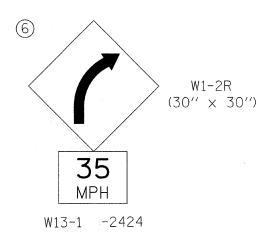

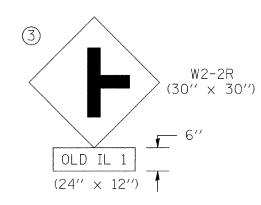

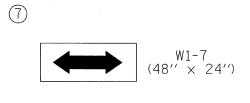

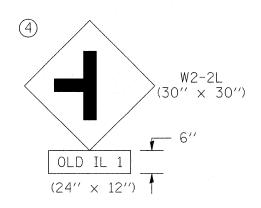


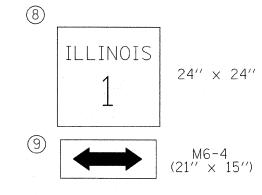

NOTE:

THE ENGINEER SHALL CONTACT THE BUREAU OF TRAFFIC FOR FINAL SIGN INFORMATION AND PLACEMENT OF THE NEW SIGNS.

| | | | | | | Added Sheet 1-6-09 | | | |
|--|-----------------------------|------------|-----------|------------------------------|--------|----------------------------------|--------|---------------|--------------------|
| FILE NAME = | USER NAME = smithkl | DESIGNED - | REVISED - | | | SIGNALING LEGEND | F.A.P. | SECTION | COUNTY TOTAL SHEET |
| c:\pw_work\PWIDOT\SMITHKL\dms92925\des | gn_aa.dgn | DRAWN - | REVISED - | STATE OF ILLINOIS | | SIGNALING LEGEND | 876 | 9Y-R5-7 | WILL 100 70A |
| | PLOT SCALE = 47.2222 '/ IN. | CHECKED - | REVISED - | DEPARTMENT OF TRANSPORTATION | * | IL 1 | | | CONTRACT NO. 60E52 |
| | PLOT DATE = 12/31/2008 | DATE - | REVISED - | | SCALE: | SHEET NO. OF SHEETS STA. TO STA. | | ILLINOIS FED. | AID PROJECT |

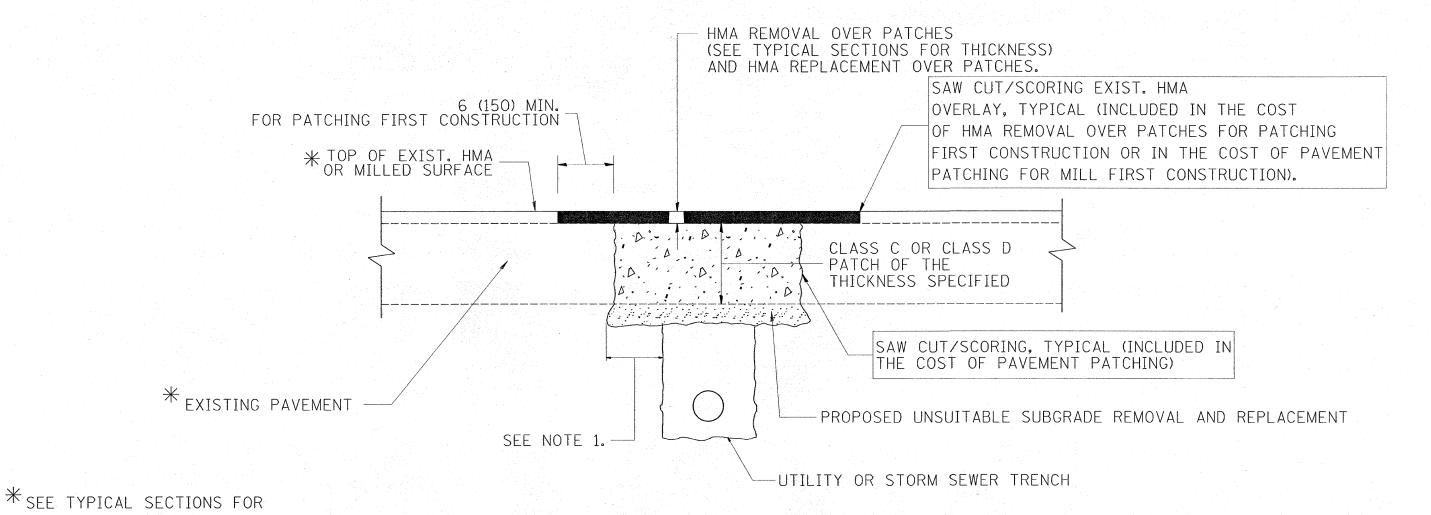

NOTES:

1. THE WIDTH OF THE FULL DEPTH PATCH OVER A TRENCH SHALL BE 12 (300) WIDER ON EACH SIDE OF THE TRENCH.

THICKNESS AND MATERIALS

2. FOR METHOD OF MEASUREMENT AND BASIS OF PAYMENT. SEE RECURRING SPECIAL PROVISION "PATCHING WITH HOT-MIX ASPHALT OVERLAY REMOVAL".

SEQUENCE OF CONSTRUCTION (PATCHING FIRST)

- 1. REMOVE THE EXISTING HMA MATERIAL OVER THE AREA TO BE PATCHED.
- 2. REMOVE AND REPLACE WITH CLASS C OR D PATCH.
- 3. REPLACE HMA MATERIAL OVER THE AREA TO BE PATCHED.

SEQUENCE OF CONSTRUCTION (MILLING FIRST)

- 1. MILL HMA FIRST IF THERE IS AT LEAST 4/2 INCHES OR MORE OF HMA MATERIAL ON TOP OF THE EXISTING PAVEMENT OR IF THE PAVEMENT IS FULL DEPTH HMA. A MINIMUM OF 2 INCHES OF HMA MATERIAL SHALL BE IN PLACE AFTER MILLING.
- 2. REMOVE AND REPLACE WITH FULL DEPTH CLASS D PATCHES TO TOP OF MILLED SURFACE.

ALL DIMENSIONS ARE IN INCHES (MILLIMETERS) UNLESS

| | | UI |
|---------------|-------------|----|
| REVISIONS | | Г |
| NAME | DATE | 1 |
| R. SHAH | 01/14/95 | |
| R. SHAH | 03/23/95 | |
| R. SHAH | 04/24/95 | l |
| A. HOUSEH | 03/15/96 | 1 |
| A. ABBAS | 03/21/97 | |
| A. ABBAS | 01/20/98 | 1 |
| ART ABBAS | 04/27/98 | |
| R. BORO | 01/01/07 | |
| D 0000 | 00 10 1 105 | |

ILLINOIS DEPARTMENT OF TRANSPORTATION

PAVEMENT PATCHING FOR HMA SURFACED PAVEMENT

SCALE: VERT. NONE

DRAWN BY CHECKED BY

A Rev. Sheet 1-6-09