01-15-2021 LETTING ITEM 160

FOR INDEX OF SHEETS, SEE SHEET NO. 2

**DESIGN DESIGNATION: MINOR COLLECTOR** 

**ROY AVENUE** 

STATE OF ILLINOIS **DEPARTMENT OF TRANSPORTATION DIVISION OF HIGHWAYS** 

# PLANS FOR PROPOSED FEDERAL AID HIGHWAY

**FAU ROUTE 2539 (ROY AVENUE) OVER ADDISON CREEK** BRIDGE SUPERSTRUCTURE REHABILITATION **SECTION NO.: 14-00087-00-BR** PROJECT NO.: YSD1(569) CITY OF NORTHLAKE **COOK COUNTY** C-91-072-18

R 12 E 3RD PM Z ARMITAGE AVENUE **END PROJECT** STA. 13 + 76.16**BRIDGE REHABILITATION ROY AVENUE OVER** ADDISON CREEK S.N. 016-7612 ADDISON CREEK **STATION 13 + 24.16 BEGIN PROJECT** STA. 12 + 72.16 LEYDEN TWSP PROJECT MANAGER: MARK WRZESZCZ (847) 823-0500

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CHRISTOPHER B. BURKE ENGINEERING, LTD. 9575 W. Higgins Road, Suite 600 Rosemont, Illinois 60018 (847) 823-0500

ENGINEERING SCALES, REDUCED SIZED PLANS WILL NOT CONFORM TO STANDARD SCALES. IN MAKING MEASUREMENTS ON REDUCED PLANS, THE ABOVE SCALES MAY BE USED.

JOINT UTILITY LOCATION INFORMATION FOR EXCAVATION

**LOCATION MAP** 

GROSS LENGTH = 84.00 FT. = 0.016 MILE NET LENGTH = 84.00 FT. = 0.016 MILE

PRINTED BY THE AUTHORITY OF THE STATE OF ILLINOIS



SECTION

14-00087-00-BR

2539

COUNTY

COOK 33

ILLINOIS CONTRACT NO. 61G88





RELEASING FOR BID DISTRICT 1 ENGINEER OF LOCAL ROADS AND STREETS REVIEW NOVEMBERIZ 20 20

REGIONAL ENGINEER

1-800-892-0123

OR 811

2018 AADT = 17502032 AADT = 1700DESIGN SPEED = 30 MPH POSTED SPEED = 25 MPH

NOT TO SCALE

**CONTRACT NO. 61G88** 

#### INDEX OF SHEETS

IIIDE/L OI	OHEE TO
HEET NO.	DESCRIPTION
1	COVER SHEET
2	INDEX OF SHEETS, LIST OF HIGHWAY STANDARDS, GENERAL NOTE
3	SUMMARY OF QUANTITIES
4 .	TYPICAL SECTIONS
5	ALIGNMENT, TIES, AND BENCHMARKS
6	REMOVAL PLANS
7	ROADWAY PLAN AND PROFILE ·
8	MAINTENANCE OF TRAFFIC / DETOUR
9 - 10	EROSION AND SEDIMENT CONTROL
11 - 15	ELECTRICAL PLANS - PROPOSED & EXISTING
16 - 28	STRUCTURAL SHEETS
29 - 32	DISTRICT DETAILS / STANDARDS
33	CROSS SECTIONS

#### INDEX OF HIGHWAY STANDARDS

STANDARD NO.	DESCRIPTION
000001-078	STANDARD SYMBOLS, ABBREVIATIONS AND PATTERNS
001001-02	AREAS OF REINFORCEMENT BARS
280001-07	TEMPORARY EROSION CONTROL SYSTEMS
420406	PAVEMENT CONNECTOR (HMA) FOR BRIDGE APPROACH SLAB
515001-04	NAME PLATE FOR BRIDGES
606001-07	CONCRETE CURB TYPE B AND COMBINATION CONCRETE CURB AND GUTTER
701001-02	OFF-ROAD OPERATIONS, 2L, 2W, MORE THAN 15' (4.5 M) AWAY
701006-05	OFF-ROAD OPERATIONS, 2L, 2W, 15' (4.5 M) TO 24" (600 MM) FROM PAVEMENT EDGE
701011-04	OFF-ROAD OPERATIONS, 2L, 2W, DAY ONLY
701301-04	LANE CLOSURE, 2L, 2W, SHORT TIME OPERATIONS
701311-03	LANE CLOSURE 2L, 2W MOVING OPERATIONS - DAY ONLY
701501-06	URBAN LANE CLOSURE, 2L, 2W, UNDIVIDED
701801-06	SIDEWALK, CORNER OR CROSSWALK CLOSURE
701901-08	TRAFFIC CONTROL DEVICES
720001-01	SIGN PANEL MOUNTING DETAILS
720006-04	SIGN PANEL ERECTION DETAILS

#### **GENERAL NOTES**

- 1. ALL CONSTRUCTION SHALL BE DONE IN ACCORDANCE WITH THE "DETAILS" IN THE PLANS, THE "SPECIAL PROVISIONS" INCLUDED IN THE CONTRACT DOCUMENTS, THE APRIL 1, 2016 EDITION OF THE "STANDARD SPECIFICATIONS FOR ROAD AND BRIDGE CONSTRUCTION", THE JANUARY 1, 2021 EDITION OF "SUPPLEMENTAL SPECIFICATIONS AND RECURRING SPECIAL PROVISIONS", THE 2009 EDITION AND JUNE 2014 REVISION OF THE "ILLINOIS MANUAL ON UNIFORM TRAFFIC CONTROL DEVICES FOR STREETS AND HIGHWAYS" (IMUTCD), THE AMERICANS WITH DISABILITIES ACT OF 1990 ACCESSIBILITY GUIDELINES, THE "DRAFT" REHABILITATION ACT OF 1973 (SECTION 504), AND THE LATEST PUBLIC RIGHT-OF-WAY ACCESSIBILITY GUIDELINES.
- THE CONTRACTOR SHALL COMPLY WITH ALL RULES AND REGULATIONS OF OSHA DURING CONSTRUCTION OF IMPROVEMENTS AND RESTORATION. NEITHER THE CITY, DEPARTMENT, NOR THE APPOINTED ENGINEER SHALL BE RESPONSIBLE FOR THE CONTRACTOR'S COMPLIANCE WITH OSHA.
- 3. THE CONTRACTOR SHALL GIVE NOTICES AND COMPLY WITH APPLICABLE LAWS, ORDINANCES, RULES, REGULATIONS AND LAWFUL ORDERS OF ALL PUBLIC AUTHORITIES BEARING ON SAFETY OF PERSONS OR PROPERTY OR THEIR PROTECTION FROM DAMAGE, INJURY OR LOSS.
- 4. IT IS THE CONTRACTORS RESPONSIBILITY TO VERIFY ALL DIMENSIONS AND CONDITIONS PRIOR TO ORDERING MATERIALS AND BEGINNING CONSTRUCTION. NO ADDITIONAL COMPENSATION WILL BE ALLOWED FOR FAILURE TO VERIFY EXISTING DIMENSIONS OR CONDITIONS.
- 5. THE CONTRACTOR SHALL LIMIT CONSTRUCTION ACTIVITIES TO THE WORK AREAS DESIGNATED ON THE PLANS. ANY DAMAGE TO AREAS OUTSIDE OF THESE LIMITS SHALL BE REPAIRED BY THE CONTRACTOR TO THE SATISFACTION OF THE ENGINEER.
- THE CONTRACTOR SHALL RELOCATE OR REMOVE AND REPLACE SIGNS THAT INTERFERE WITH CONSTRUCTION OPERATIONS, AND TO TEMPORARILY RESET ALL SUCH SIGNS DURING CONSTRUCTION OPERATIONS. IF EXISTING SIGNS ARE DAMAGED DURING THE REMOVAL AND REPLACEMENT PROCESS, THE SIGN SHALL BE REPLACED.
- 7. AT THE END OF EACH DAY, IT SHALL BE THE CONTRACTOR'S RESPONSIBILITY TO ASSURE THAT ALL STREETS ADJACENT TO THE PROJECT ARE FREE OF ALL CONSTRUCTION RELATED DEBRIS INCLUDING DIRT, STONE, NAILS, ETC. THE WORK SHALL BE DONE TO THE SATISFACTION OF THE ENGINEER AS COORDINATED WITH THE CITY OF NORTHLAKE.
- THE CONTRACTOR SHALL CONTACT THE DISTRICT ONE TRAFFIC CONTROL SUPERVISOR AT (847) 705-4470 A MINIMUM OF 72 HOURS IN ADVANCE OF BEGINNING WORK.

- 9. THE LOCATIONS OF EXISTING UNDERGROUND UTILITIES, SUCH AS: WATER MAIN, SEWERS, GAS LINES, ETC. AS SHOWN ON THE PLANS, HAVE BEEN DETERMINED FROM THE BEST AVAILABLE INFORMATION AND ONLY REPRESENT THE OPINION OF THE CITY OF NORTHLAKE AS TO THEIR LOCATIONS. THE PROVIDED LOCATIONS OF EXISTING UNDERGROUND UTILITIES IS GIVEN FOR THE CONVENIENCE OF THE BIDDER. THE CONTRACTOR SHALL BE RESPONSIBLE FOR HAVING THE UTILITY COMPANIES LOCATE THEIR FACILITIES IN THE FIELD PRIOR TO CONSTRUCTION. BEFORE STARTING ANY EXCAVATION, THE CONTRACTOR SHALL CALL JULIE AT (800) 892-0123 FOR FIELD LOCATIONS OF BURIED UTILITIES (48-HOUR NOTIFICATION IS REQUIRED).
- 10. THE CONTRACTOR SHALL BE RESPONSIBLE FOR THE PROTECTION OF ALL UNDERGROUND OR SURFACE UTILITIES EVEN THOUGH THEY MAY NOT BE SHOWN ON THE PLANS. ANY UTILITY THAT IS DAMAGED BY THE CONTRACTOR DURING CONSTRUCTION SHALL BE REPAIRED TO THE SATISFACTION OF THE ENGINEER.
- DRAINAGE: DURING THE CONSTRUCTION OPERATIONS WHEN ANY LOOSE MATERIAL IS DEPOSITED IN THE FLOW LINE OF DITCHES, GUTTERS OR DRAINAGE STRUCTURES SO THE NATURAL FLOW OF WATER IS OBSTRUCTED, THE MATERIAL SHALL BE REMOVED AT THE CLOSE OF EACH WORKING DAY. AT THE CONCLUSION OF THE CONSTRUCTION OPERATIONS ALL DRAINAGE STRUCTURES SHALL BE FREE FROM ALL DIRT AND DEBRIS CAUSED BY THE CONSTRUCTION.
- THE CONTRACTOR SHALL BE SOLELY RESPONSIBLE FOR JOB SITE SAFETY AS WELL AS SUPERVISION/ DIRECTION AND MEANS/METHODS OF CONSTRUCTION.
- 13. THE CONTRACTOR SHALL INSTALL/MAINTAIN/REMOVE INLET FILTERS IN ALL OPEN LID DRAINAGE STRUCTURES IN THE PAVEMENT THAT ARE WITHIN THE WORK ZONE OR ACCEPT STORMWATER THAT FLOWS OUT OF THE WORK ZONE, AND AT LOCATIONS AS DIRECTED BY THE ENGINEER.
- 14. AREAS OF PARKWAY RESTORATION ARE SHOWN ON THE PLANS. AREAS DISTURBED BY THE CONTRACTOR BEYOND THOSE SHOWN IN THE PLANS SHALL BE REPAIRED.
- THE CONTRACTOR SHALL COORDINATE CONSTRUCTION ACTIVITIES WITH UTILITY COMPANIES, LOCAL GOVERNMENT AGENCIES AND IDOT.
- SOIL STOCKPILES OR OTHER CONSTRUCTION MATERIALS SHALL NOT BE LOCATED WITHIN THE FLOOD PROTECTION AREA.
- NO SPOILS RESULTING FROM CONSTRUCTION ACTIVITES SHALL LEAVE THE SITE, ANY SPOILS RESULTING FROM CONSTRUCTION ACTIVITES SHALL BE PLACED AT THE LOCATION DESIGNATED ON THE PROPOSED ROADWAY PLAN OR AS DIRECTED BY THE ENGINEER AS COORDINATED WITH THE CITY, NO SPOILS SHALL BE PLACED IN THE FLOOD PLAIN.
- 18. VERICAL DATUM: NAVD 1988

#### **DISTRICT 1 DETAILS**

DETAIL NO.	DESCRIPTION
BD-24	CURB OR CURB AND GUTTER REMOVAL AND REPLACEMENT
BD-32	BUTT JOINT AND HMA TAPERS
TC-10	TRAFFIC CONTROL AND PROTECTION FOR SIDE ROADS, INTERSECTIONS, AND DRIVEWAYS
TC-21	DETOUR SIGNING FOR CLOSING STATE HIGHWAYS

#### **COMMITMENTS**

NONE.

	CHRISTOPHER B. BURKE ENGINEERING, LTD. 9575 W. Higgins Road, Suite 600	USER NAME	= doconnell	DESIGNED	-	DOC	REVISED	
_				DRAWN	-	DOC	REVISED	_
ğE	9575 W. Higgins Road, Suite 600 Rosemont, Minols 60018 (847) 823-0500	PLOT SCALE	= 1'	CHECKED	-	JMB	REVISED	
_		PLOT DATE	= 11/17/2020	DATE	-	11/17/2020	REVISED	٦.

STATE	0F	ILLINOIS
DEPARTMENT O	F T	RANSPORTATION

SCALE:

GENERAL NOTES AND INDEX OF SHEETS, STANDARDS, AND DETAILS		F.A.U RTE.	SECTION	COUNTY	TOTAL SHEETS	SHEET NO.			
		2539	2539 14-00087-00-BR		33	2			
	2 I AMDAM	חפי, אואח	DEIWIF				CONTRAC	T NO. 61	G88
SHEET	OF	SHEETS	STA.	TO STA.		ILLINOIS FED. A	ID PROJECT	.,,	

CHRISTOPHER B. BURKE ENGINEERING, LT 9575 W. Moyka Rasd, Suks 600 Roserrant, Micols 60016 (647) 823-0500

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	PLOT DATE = 11/17/2020	DATE	-	11/17/2020	REVISED	-

0013

TOTAL

QUANTITY

(80% Federa

20% Local)

10

167

150

150

1

2

110

4

45

5

167

5

150

30

67

167

100

459

1

UNIT

CU YD

SQ YD

SQ YD

SQ YO

UNIT

POUND

FOOT

EACH

SQ YD

CU YD

SQ YD

TON

POUND

SQ YD

SQ YD

SQ YD

FOOT

SQ FT

TTEM

20201200 REMOVAL AND DISPOSAL OF UNSUITABLE MATERIAL

21001000 GEOTECHNICAL FABRIC FOR GROUND STABILIZATION

21101615 TOPSOIL FURNISH AND PLACE, 4"

25200110 SODDING, SALT TOLERANT

25200200 SUPPLEMENTAL WATERING

28000400 PERIMETER EROSION BARRIER

28000510 INLET FILTERS

28000250 TEMPORARY EROSION CONTROL SEEDING

28001100 TEMPORARY EROSION CONTROL BLANKET

30300001 AGGREGATE SUBGRADE IMPROVEMENT

30300112 AGGREGATE SUBGRADE IMPROVEMENT 12"

40600290 BITUMINOUS MATERIALS (TACK COAT)

40600982 HOT-MIX ASPHALT SURFACE REMOVAL - BUTT JOINT

44000500 COMBINATION CURB AND GUTTER REMOVAL

50101500 REMOVAL OF EXISTING SUPERSTRUCTURES

42000070 PAVEMENT CONNECTOR (HMA) FOR BRIDGE APPROACH SLAB.

35800200 AGGREGATE BASE REPAIR

44000100 PAVEMENT REMOVAL

44000600 SIDEWALK REMOVAL

·						F.A.U RTE.	SECTION	COUNTY	SHEETS	NO.
		SUMMARY	OF QUA	ANTITIE	S	2539	14-00087-00-BR	соок	33	3
								CONTRACT	NO. 6	1G88
SCALE:	SHEET	OF	SHEETS	STA.	TO STA.		ILLINOIS FED.	AID PROJECT		
L										

0013

TOTAL

QUANTITY

(80% Federal

20% Local)

200

800

200

70

350

2

200

525

497

258

1

2

40

1

45

1

500

500

UNIT

FOOT

FOOT

FOOT

FOOT

FOOT

EACH

FOOT

SQ FT

SQ FT

SQ YD

L SUM

EACH

FOOT

LSUM

50 FT

L SUM

HOUR

HOUR

ITEM

\* 81702120 ELECTRIC CABLE IN CONDUIT, 600V (XLP-TYPE USE) 1/C NO. 8

★ 81702130 ELECTRIC CABLE IN CONDUIT, 600V (XLP-TYPE USE) 1/C.NO. 6

\* B1800415 AERIAL CABLE, 4-1/C #5 WITH MESSENGER WIRE

\* 89502300 REMOVE ELECTRIC CABLE FROM CONDUIT

X1700034 FORM LINER TEXTURED SURFACE, SPECIAL

X503030S CONCRETE WEARING SURFACE, 5"

XX009048 CURB AND GUTTER (SPECIAL)

Z0030850 TEMPORARY INFORMATION SIGNING

Z0033024 MAINTENANCE OF EXISTING LIGHTING SYSTEM

Z0076604 TRAINEES TRAINING PROGRAM GRADUATE

Z0013798 CONSTRUCTION LAYOUT

∆ # Z0076500 TRAINEES

X7010216 TRAFFIC CONTROL AND PROTECTION, (SPECIAL)

X4240490 PORTLAND CEMENT CONCRETE SIDEWALKS INCH, SPECIAL

XX006834 ELECTRICAL CONNECTION TO EXISTING LIGHTING SYSTEM

△ ★ X8130120 RELOCATE EXISTING JUNCTION BOX

X8951011 REMOVE AERIAL CABLE

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\* | X8430100 REMOVE EXISTING CONDUIT, ATTACHED TO STRUCTURE

TOTAL QUANTITY UNIT CODE NO. ITEM (80% Federal 20% Local) 16.7 CU YD 50102400 CONCRETE REMOVAL CUYD 45 50200100 STRUCTURE EXCAVATION Δ: Δ Δ. Δ. Δ.:

0013

CODE NO.


	noinman	PEROCIONE EXCHANITOR	1000	ر.,
	50300225	CÔNCRETE STRUCTURES-	cύ γρ	27.2
	50300255	CONCRETE SUPERSTRUCTURE	CU YO	38.3.
	50300260	BRIDGE DECK GROOVING	sq yp	185
	20300300	PROTECTIVE COAT	SQ YD	345
	50301350	CONCRETE SUPERSTRUCTURE (APPROACH SLAB)	CU YD.	43.5
	50400505	PRECAST PRESTRESSED CONCRETE DECK BEAMS (27" DEPTH)	SQFT	2,322
	50800205	REINFORCEMENT BARS, ÉPÖXÝ:CÖATED	PÖUNÖ	29,410
*	50900105	aluminum ratling, type L	FOOT	100
	51500100	NAME PLATES	EACH	Ž
	58600101	GRANULAR BACKFILL FOR STRUCTURES	CÚ AD	145
	67100100	MOBILIZATION.	LSUM	1
*	66900200	non-special waste disposal	ĆŅ ÁD	5.
*	66900530	SOIL DISPOSAL ANALYSIS	EACH	1
*	66901001	REGULATED SUBSTANCES PRE-CONSTRUCTION PLAN	LSUM	į
*	66901003	REGULATED SUBSTANCES FINAL CONSTRUCTION REPORT	LSUM	. 1
*	66901006	REGULATED SUBSTANCES MONITORING	CALDA	3
*	grinnann	CONDUIT, ATTACHED TO STRUCTURE GALVANIZED STEEL, 1 1/4" DIA.	FOÖT	70

#	0042
_	

*	SPECIALTY ITEMS
Δ	SPECIAL PROVISION

CODE NO.


STATE	OF	ILLINOIS
DEPARTMENT (	OF T	<b>TRANSPORTATION</b>

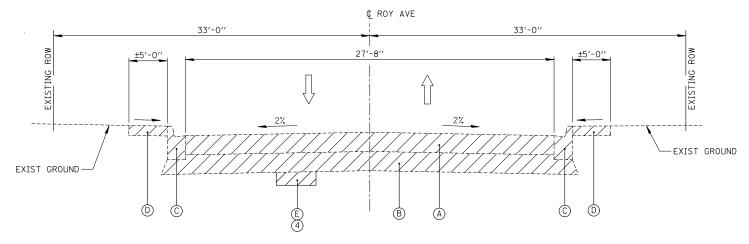

#### **EXISTING TYPICAL SECTION**

ROY AVENUE STA. 12+72.16 TO 13+76.16 BRIDGE OMISSION: 12+96.16 TO 13+52.16 SCALE: N.T.S.

NOTE: SEE STRUCTURAL PLAN SHEETS FOR TYPICAL APPROACH SLAB AND BRIDGE SECTIONS

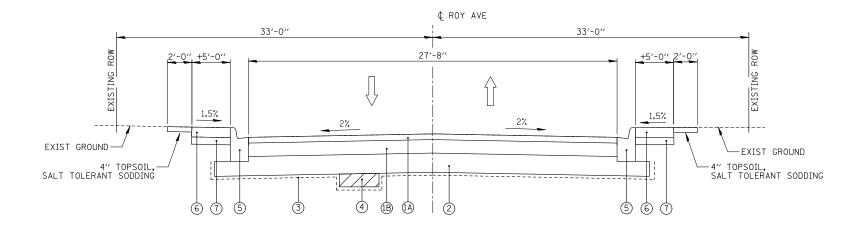

#### **PROPOSED TYPICAL SECTION**


ROY AVENUE STA. 12+72.16 TO 13+76.16 BRIDGE & APPROACH OMISSION: 12+82.16 TO 13+66.16 SCALE: N.T.S. NOTE: SEE STRUCTURAL PLAN SHEETS FOR TYPICAL APPROACH SLAB AND BRIDGE SECTIONS

#### **EXISTING LEGEND**

- (A) PAVEMENT REMOVAL
- B EARTH EXCAVATION
- C COMBINATION CURB AND GUTTER REMOVAL
- D SIDEWALK REMOVAL
- (E) REMOVAL AND DISPOSAL OF UNSUITABLE MATERIAL (SHALL BE DETERMINED BY ENGINEER IN THE FIELD)

#### PROPOSED LEGEND

- 1 PAVEMENT CONNECTOR:
- (A) 2" HOT-MIX ASPHALT SURFACE COURSE, MIX "D", N70
- (B) VARIABLE DEPTH HMA BINDER COURSE, IL-19.0, N70
- (2) AGGREGATE SUBGRADE IMPROVEMENT 12"
- 3 GEOTECHNICAL FABRIC FOR GROUND STABILIZATION
- (4) AGGREGATE SUBGRADE IMPROVEMENT (SHALL BE DETERMINED BY ENGINEER IN THE FIELD)
- 5 CONCRETE CURB AND GUTTER (SPECIAL)
- (6) PCC SIDEWALK 5", SPECIAL
- (INCLUDED IN THE COST OF PCC SIDEWALK 5", SPECIAL)

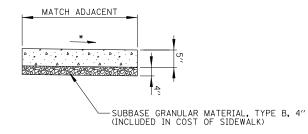

\* CROSS SLOPE 2% MAX OR AS SHOWN ON CROSS SECTIONS

#### P.C.C. SIDEWALK 5 INCH, SPECIAL

NOT TO SCALE

NOTE: ALL REQUIRED EARTH EXCAVATION TO CONSTRUCT P.C.C. SIDEWALK SHALL BE INCLUDED IN THE COST OF P.C.C. SIDEWALK 5 INCH, SPECIAL.

#### NOTE:

- 1. THE EXISTING PAVEMENT SECTION CONSISTS OF VARIABLE DEPTH  $\ensuremath{\mathsf{HMA}}\xspace.$
- 2. CONTRACTOR SHALL REMOVE AND REPLACE ANY UNSUITABLE MATERIAL UNDER SIDEWALK, CURB AND GUTTER REPLACEMENT AND PATCHING LOCATIONS AS DIRECTED BY THE ENGINEER. THIS WORK SHALL BE INCLUDED IN THE COST OF PCC SIDEWALK 5", SPECIAL OR CURB AND GUTTER (SPECIAL)
- 3. AGGREGATE BASE REPAIR (SUBBASE GRANULAR MATERIAL, TYPE B) UNDER SIDEWALKS, CURB AND GUTTER, AND PAVEMENT PATCHES WILL BE DETERMINED BY THE ENGINEER IN THE FIELD. COST SHALL BE INCLUDED IN AGGREGATE BASE REPAIR
- 4. ADDITIONAL STONE BACK FILLING SHALL BE INCLUDED IN THE COST FOR CURB AND GUTTER (SPECIAL).

#### **HOT - MIX ASHPHLAT MIXTURE REQUIREMENTS**

HOT PILK ASIT FILM ONE REGULATIONS					
MIXTURE TYPE	AIR VIODS (%) @ Ndes				
PAVEMENT CONNECTOR:	40				
HOT-MIX ASPHALT SURFACE COURSE, IL-9.5, MIX "D", N70	4% @ 70 GYR				
HOT-MIX ASPHALT BINDER COURSE, IL-9.5, N70	4% @ 70 GYR				

#### NOTES:

SCALE:


- 1. THE UNIT WEIGHT USED TO CALCULATE ALL HOT-MIX ASPHALT SURFACE QUANTITIES IS 112 LB/SQ TD/IN.
- 2. THE "AC TYPE" FOR POLYMERIZED HMA MIXES SHALL BE "SBS/SBR PG 76-22" AND FOR NON-POLYMERIZED HMA THE "AC TYPE" SHALL BE "PG 64-22" UNLESS MODIFIED BY SPECIAL PROVISIONS.
- 3. FOR USE OF RECYCLED MATERIALS SEE SPECIAL PROVISIONS.


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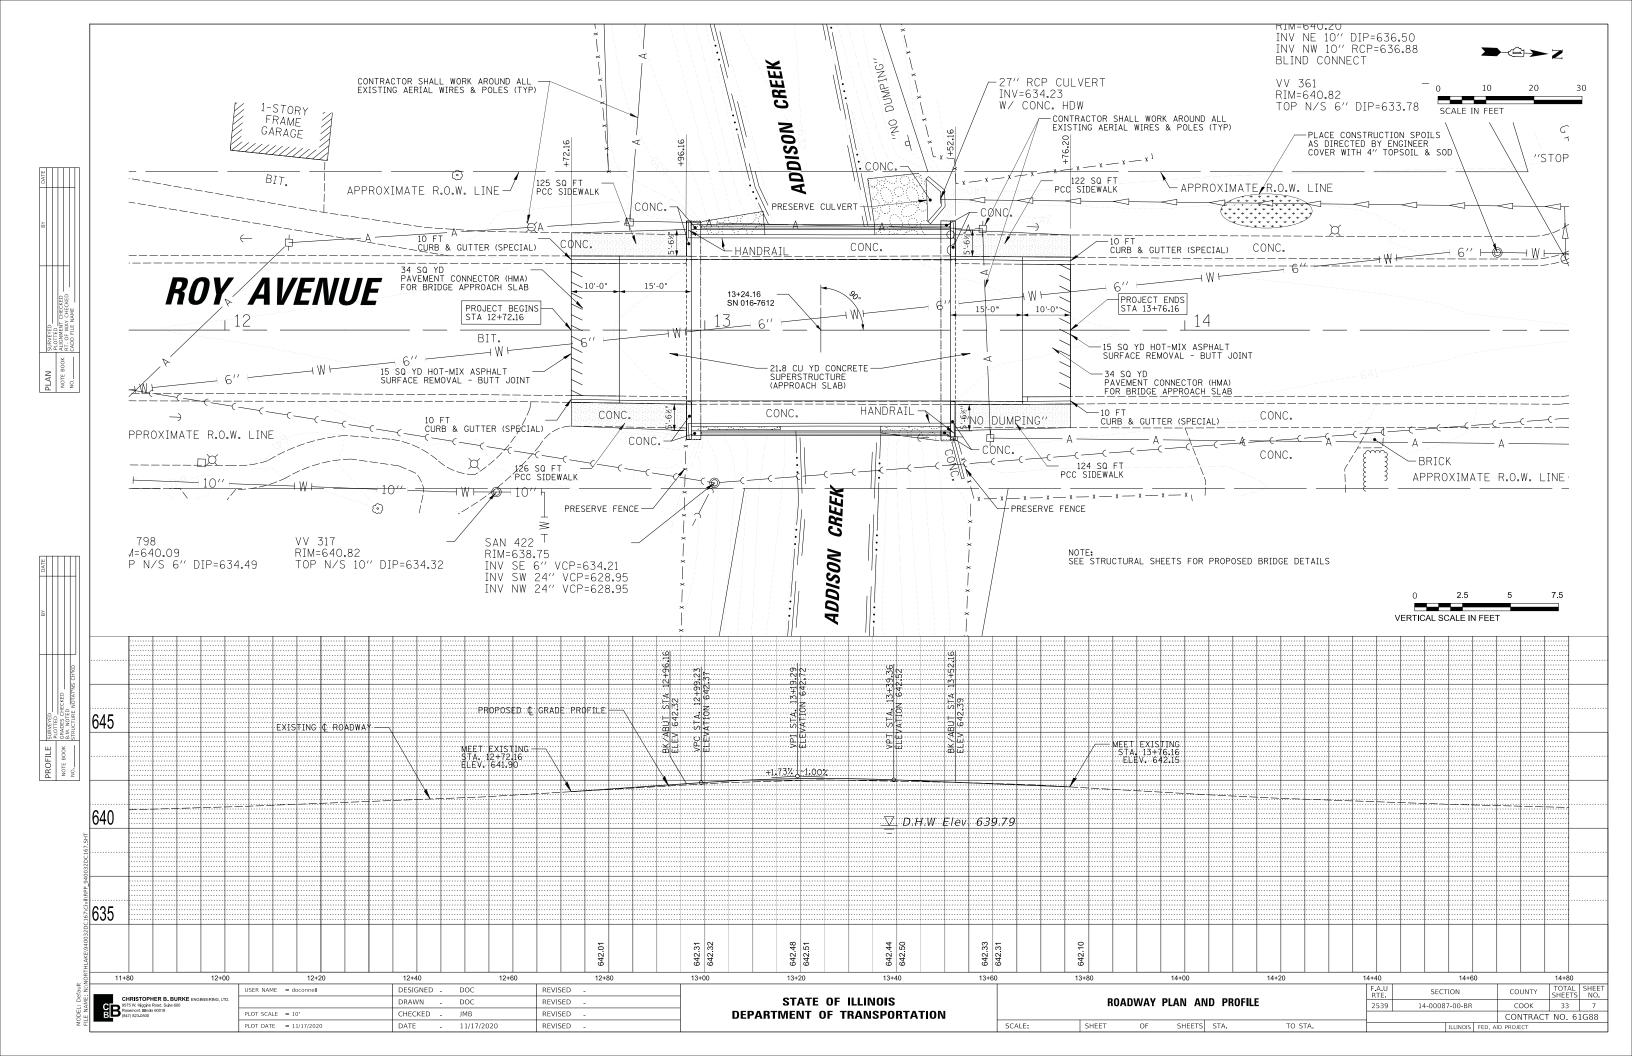
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PLOT DATE = 11/17/2020	DATE -	11/17/2020	REVISED -


STATE OF ILLINOIS
DEPARTMENT OF TRANSPORTATION


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					2539	14-0008	7-00-BR		COOK	33	4	
										CONTRACT	NO. 61	IG88
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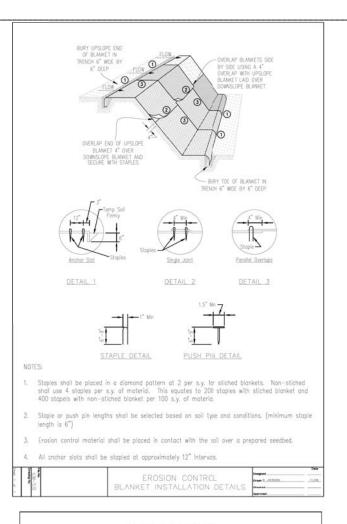





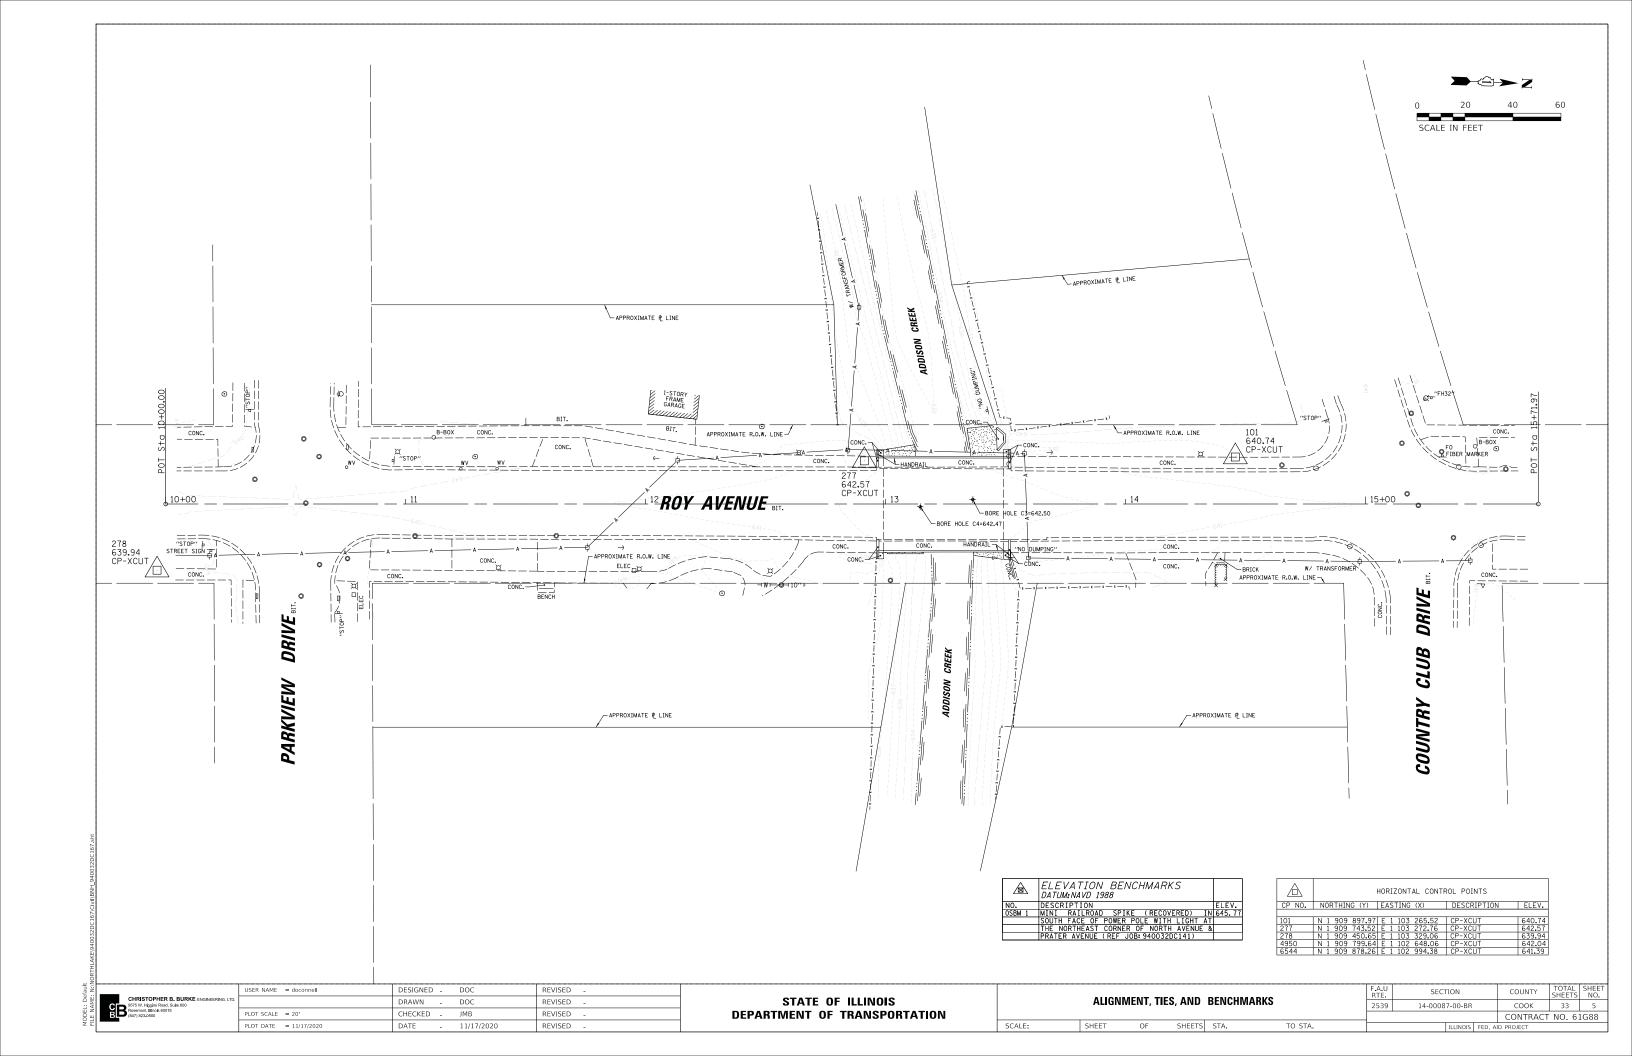


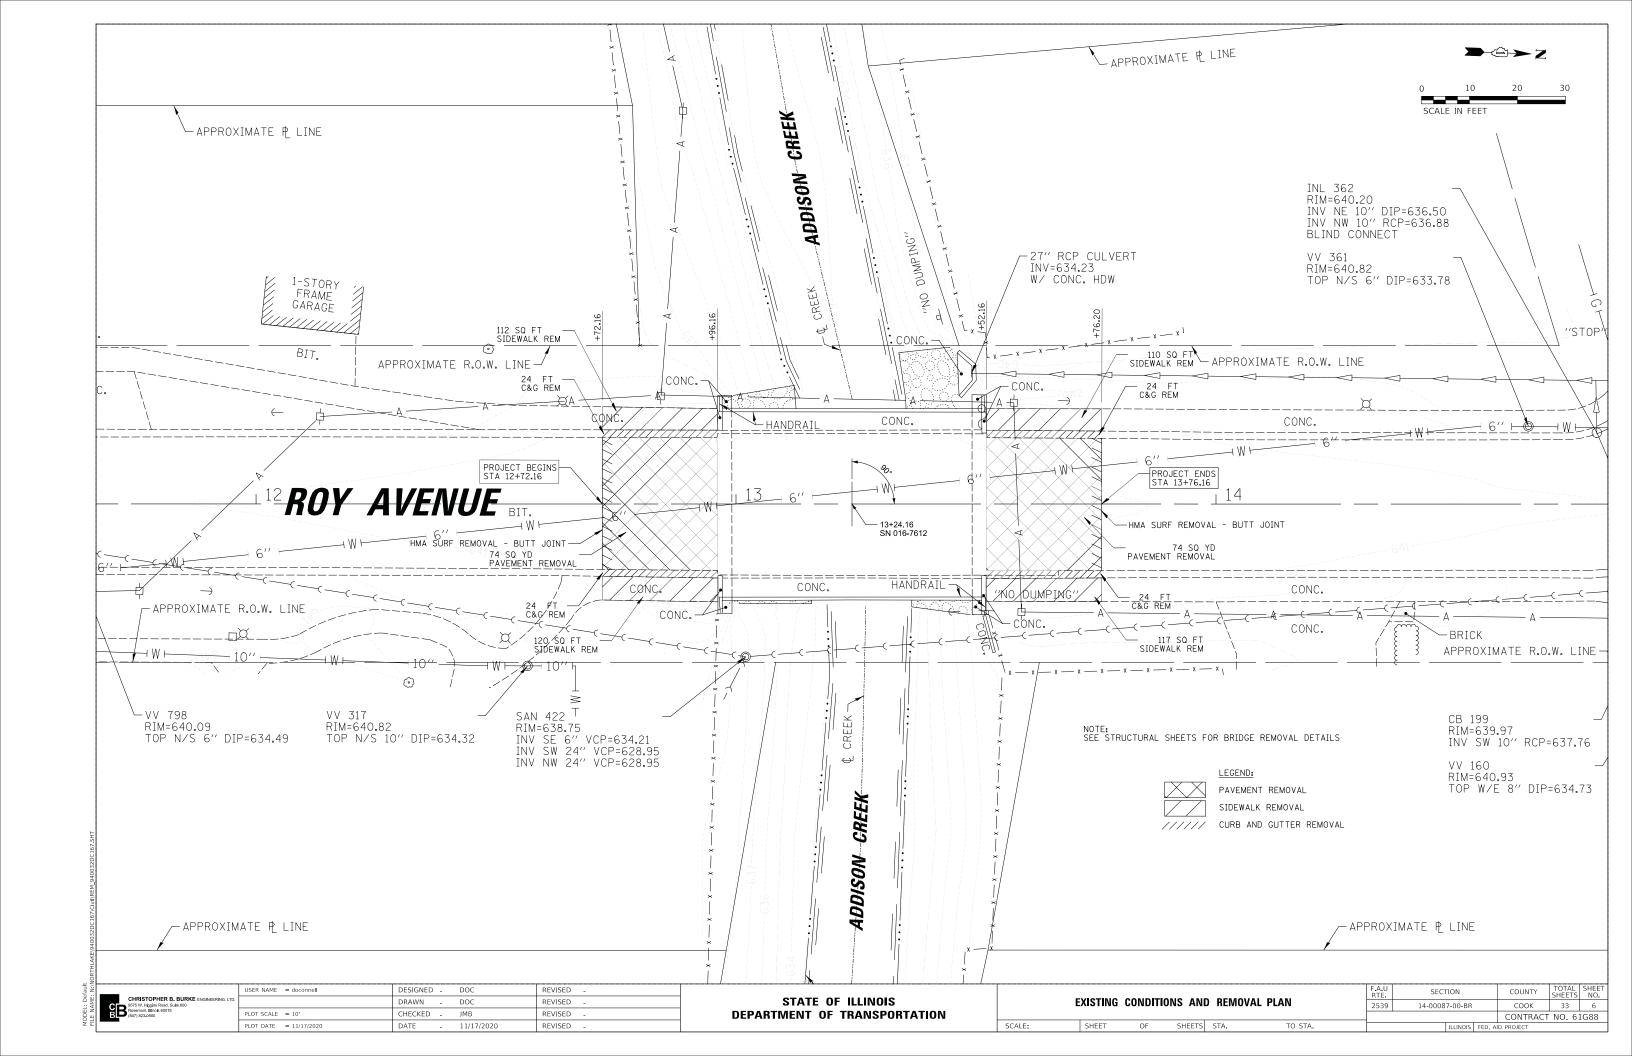


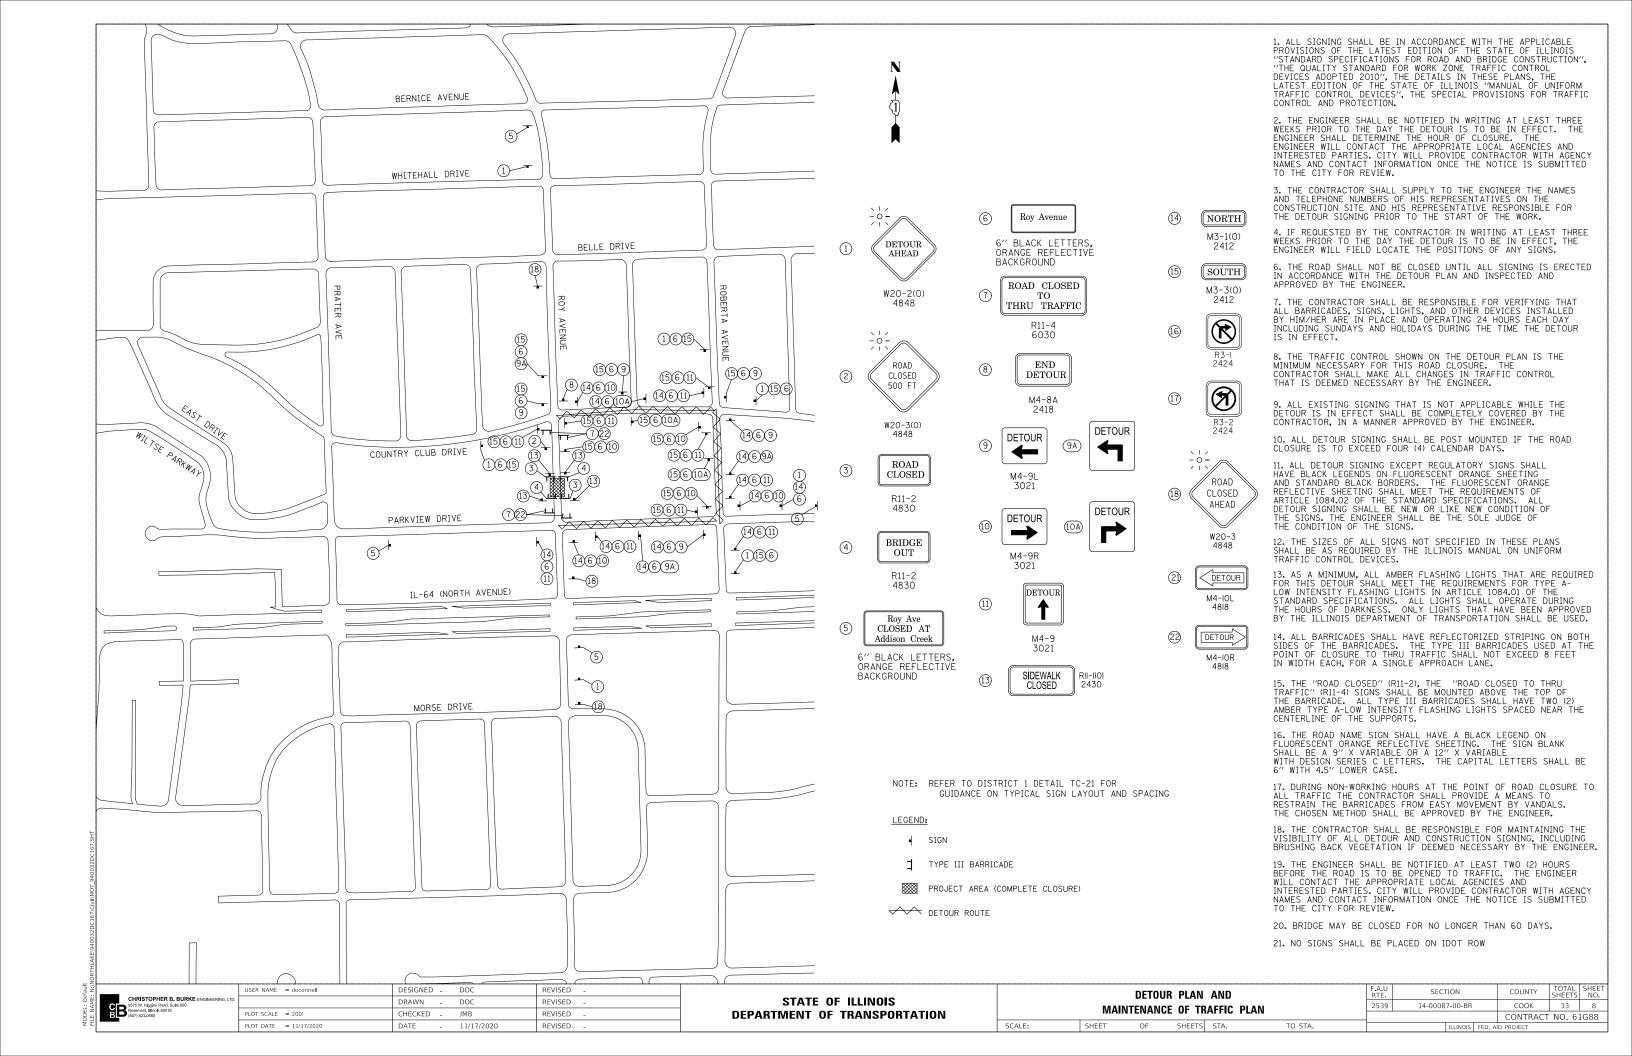


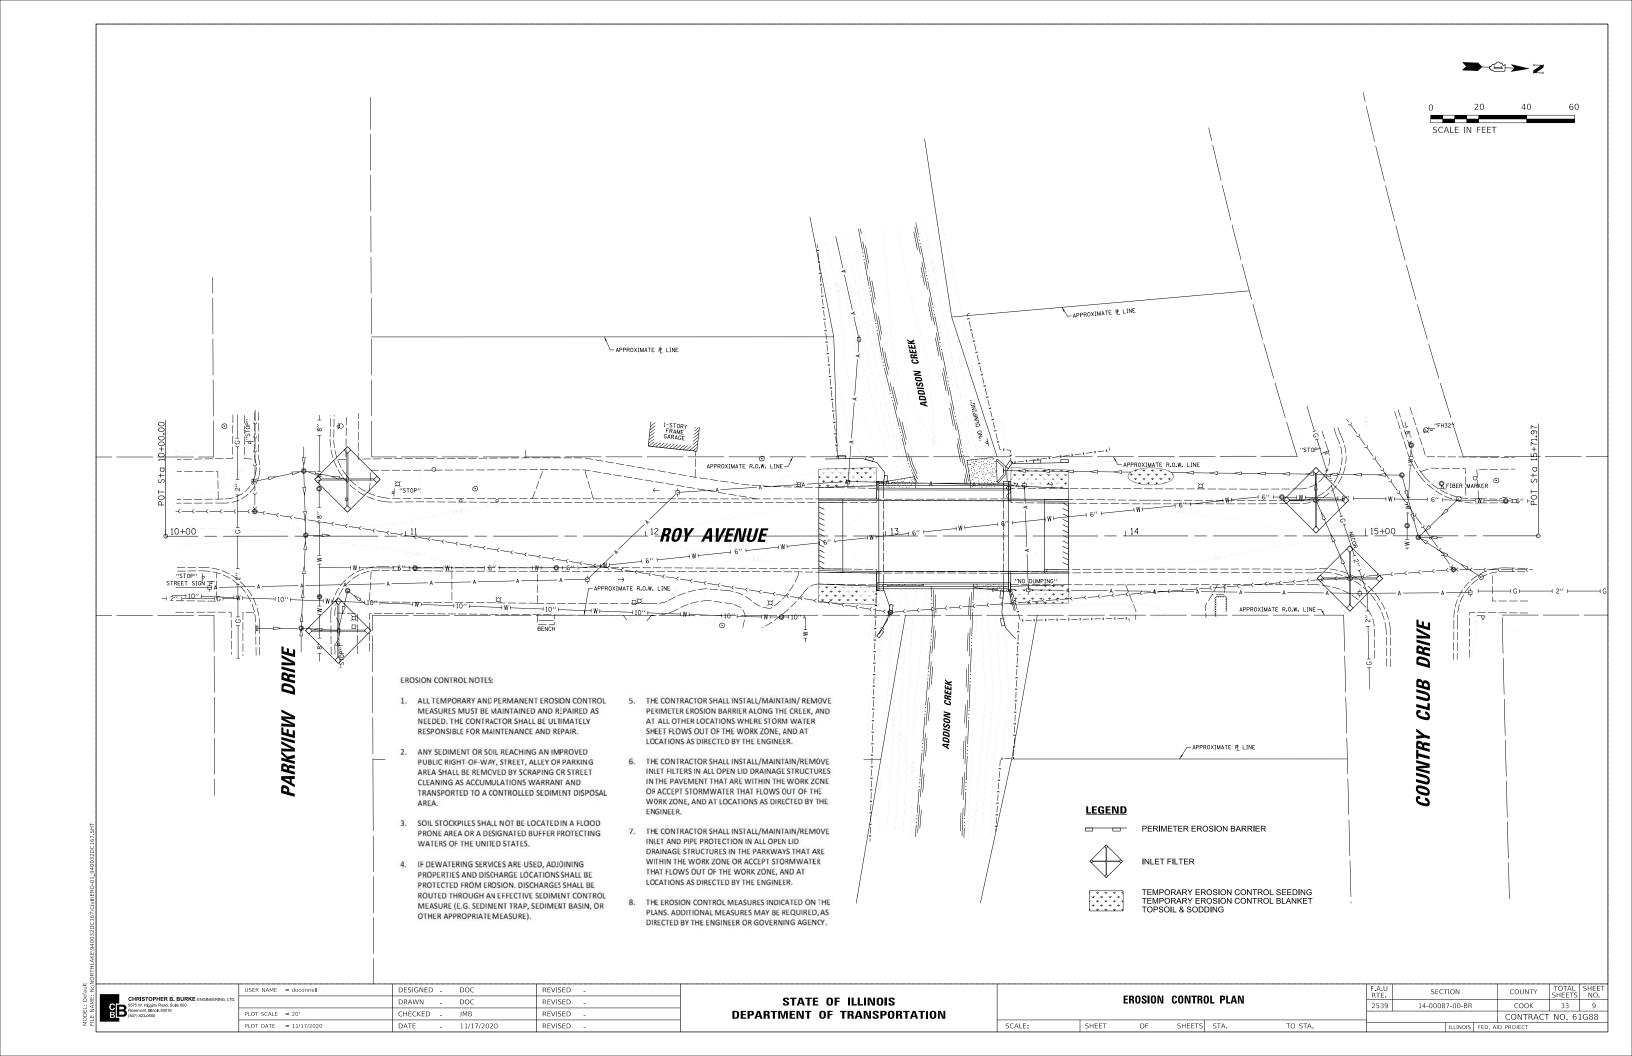

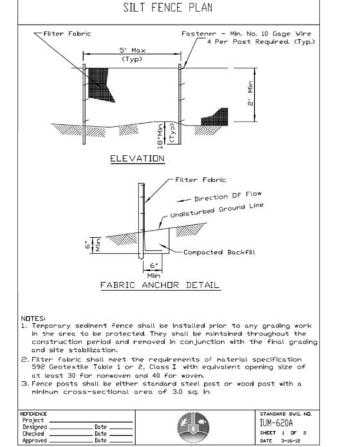

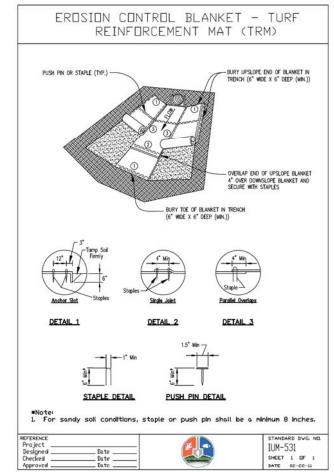

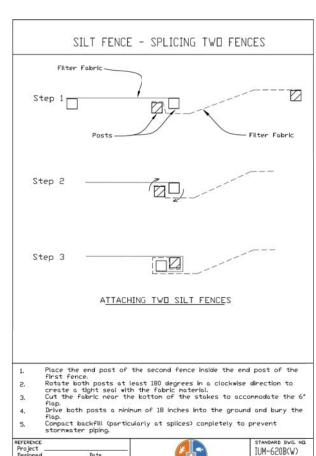


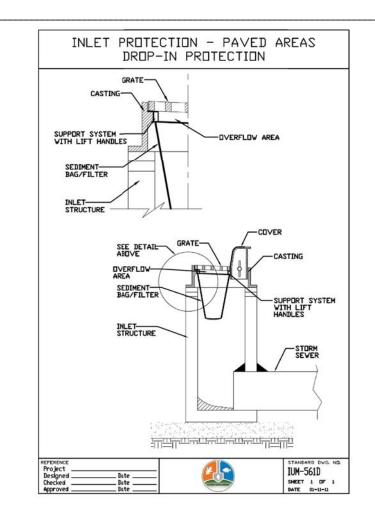


OTATE OF HARMON								SECTION	COUNTY	TOTAL SHEETS	SHEET NO.
STATE OF ILLINOIS	EROSION CONTROL DETAIL					2539	14-00087-00-BR	соок	33	10	
DEPARTMENT OF TRANSPORTATION									CONTRACT	NO. 61	G88
	SCALE:	SHEET	OF	SHEETS	STA.	TO STA.		ILLINOIS FED AL	D PROJECT		

USER NAME = doconnell	DESIGNED	-	DOC	REVISED	-
	DRAWN	-	DOC	REVISED	=
PLOT SCALE = 1'	CHECKED	-	JMB	REVISED	-
PLOT DATE = 11/17/2020	DATE	_	11/17/2020	REVISED	-

SHEET 1 DF 1

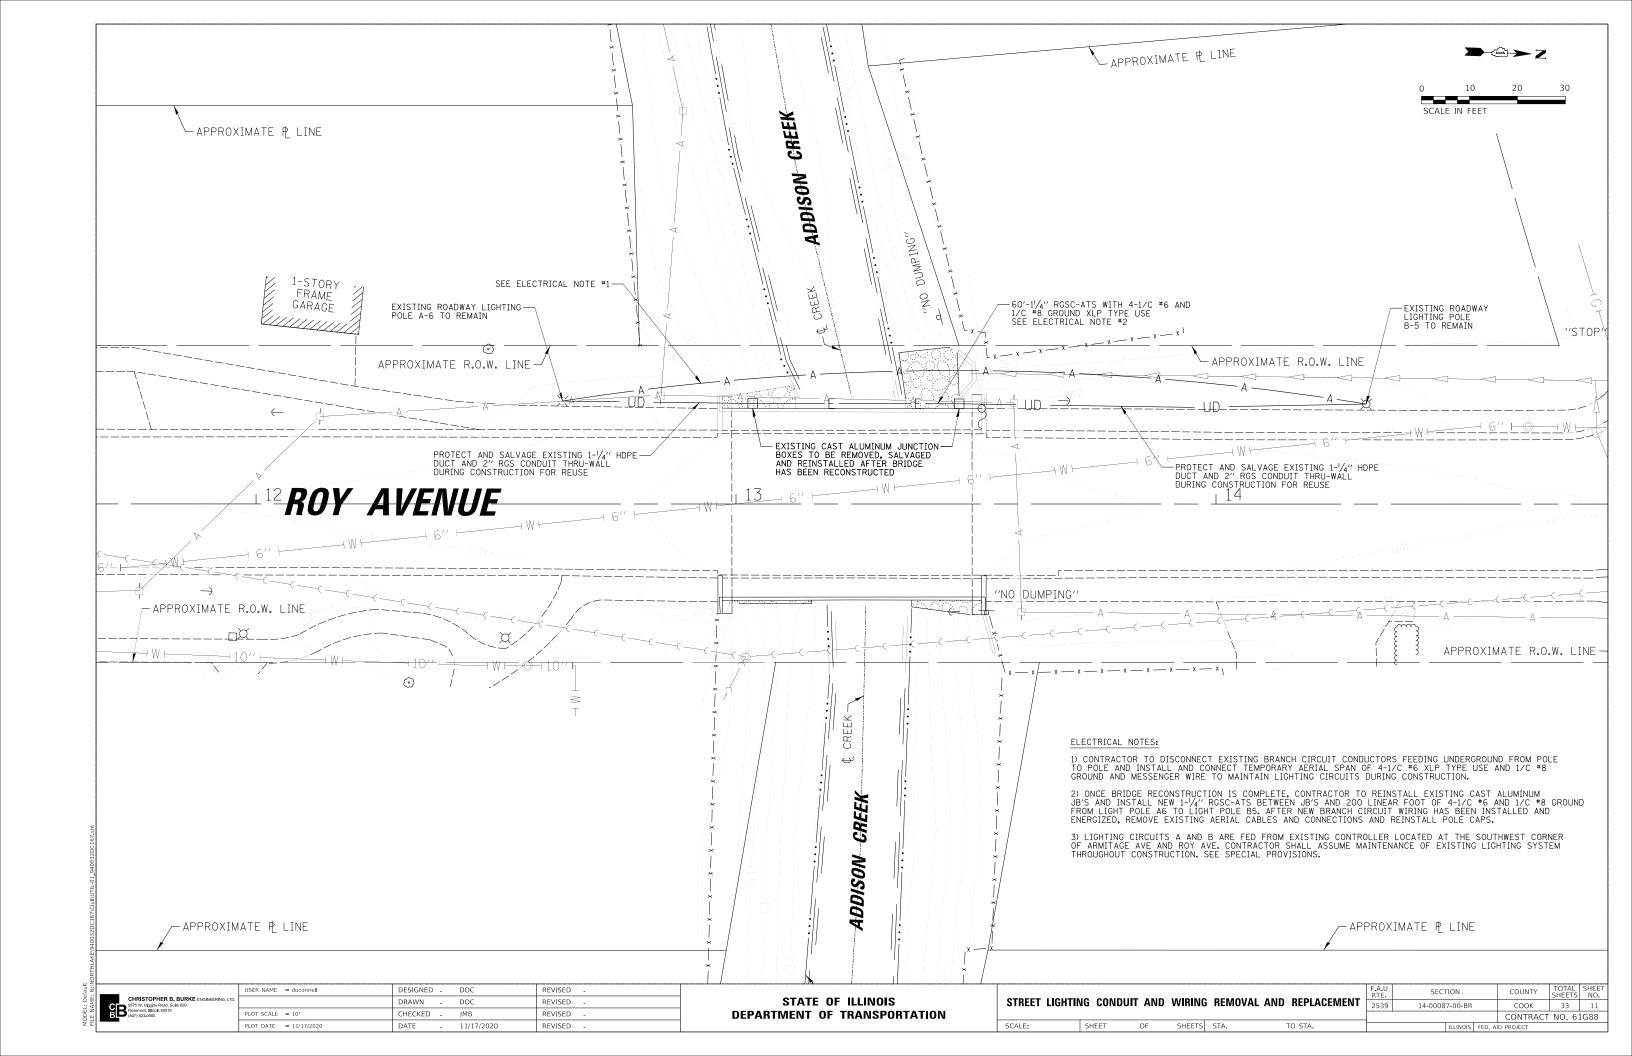

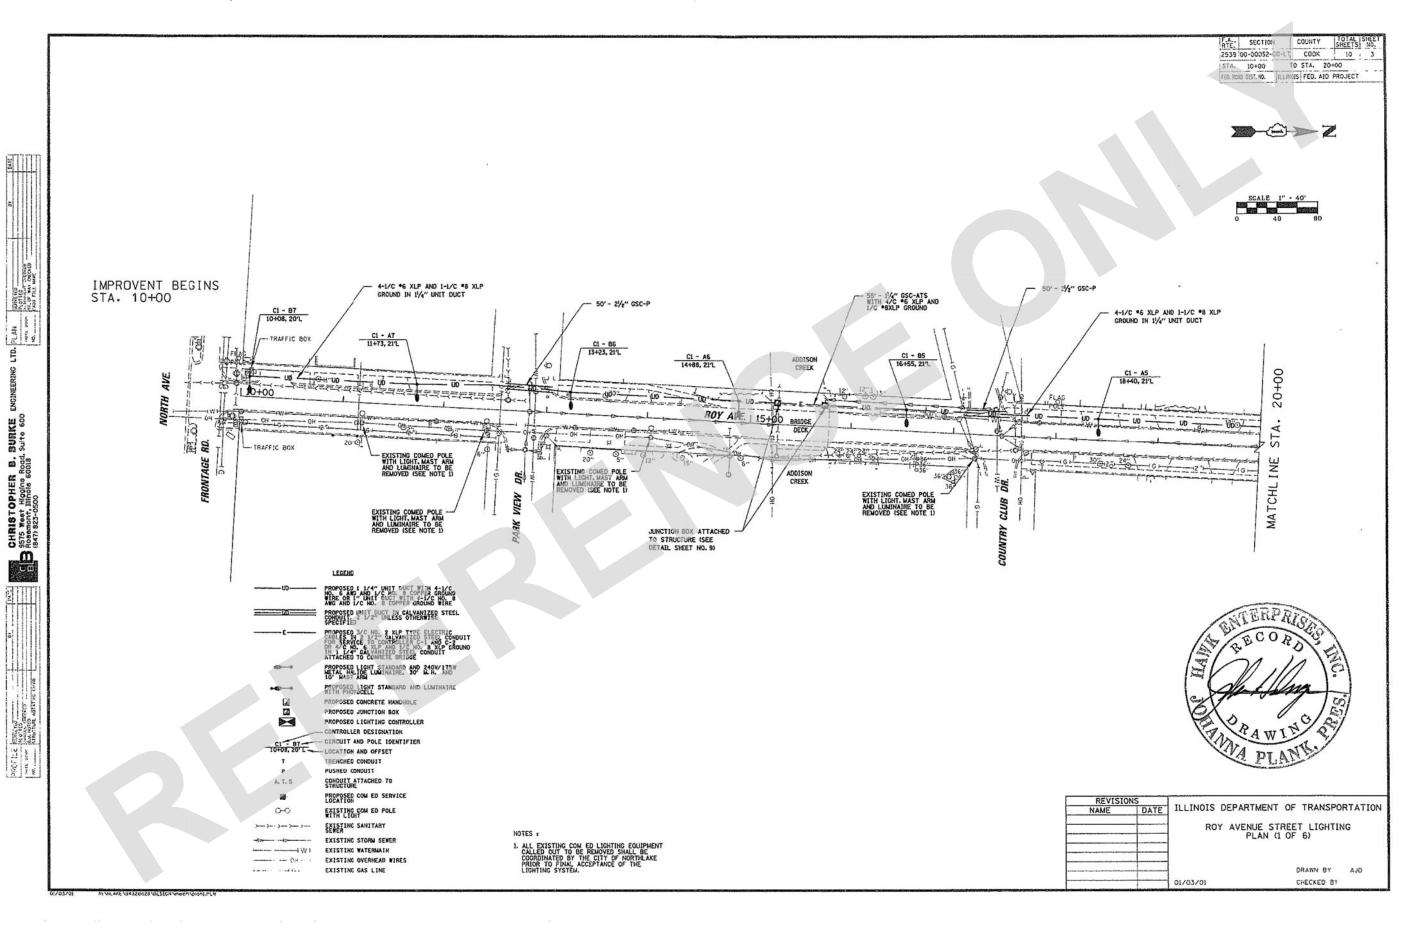


CHRISTOPHER B. BURKE ENGINEER
9575 W. Higgins Road, Suje 600
Rosemont, Illinole 60016
(847) 825-25000

STATE OF ILLINOIS DEPARTMENT OF TRANSPORTATION

SCALE:

| F.A.U | SECTION | COUNTY | STREET | SHEET |

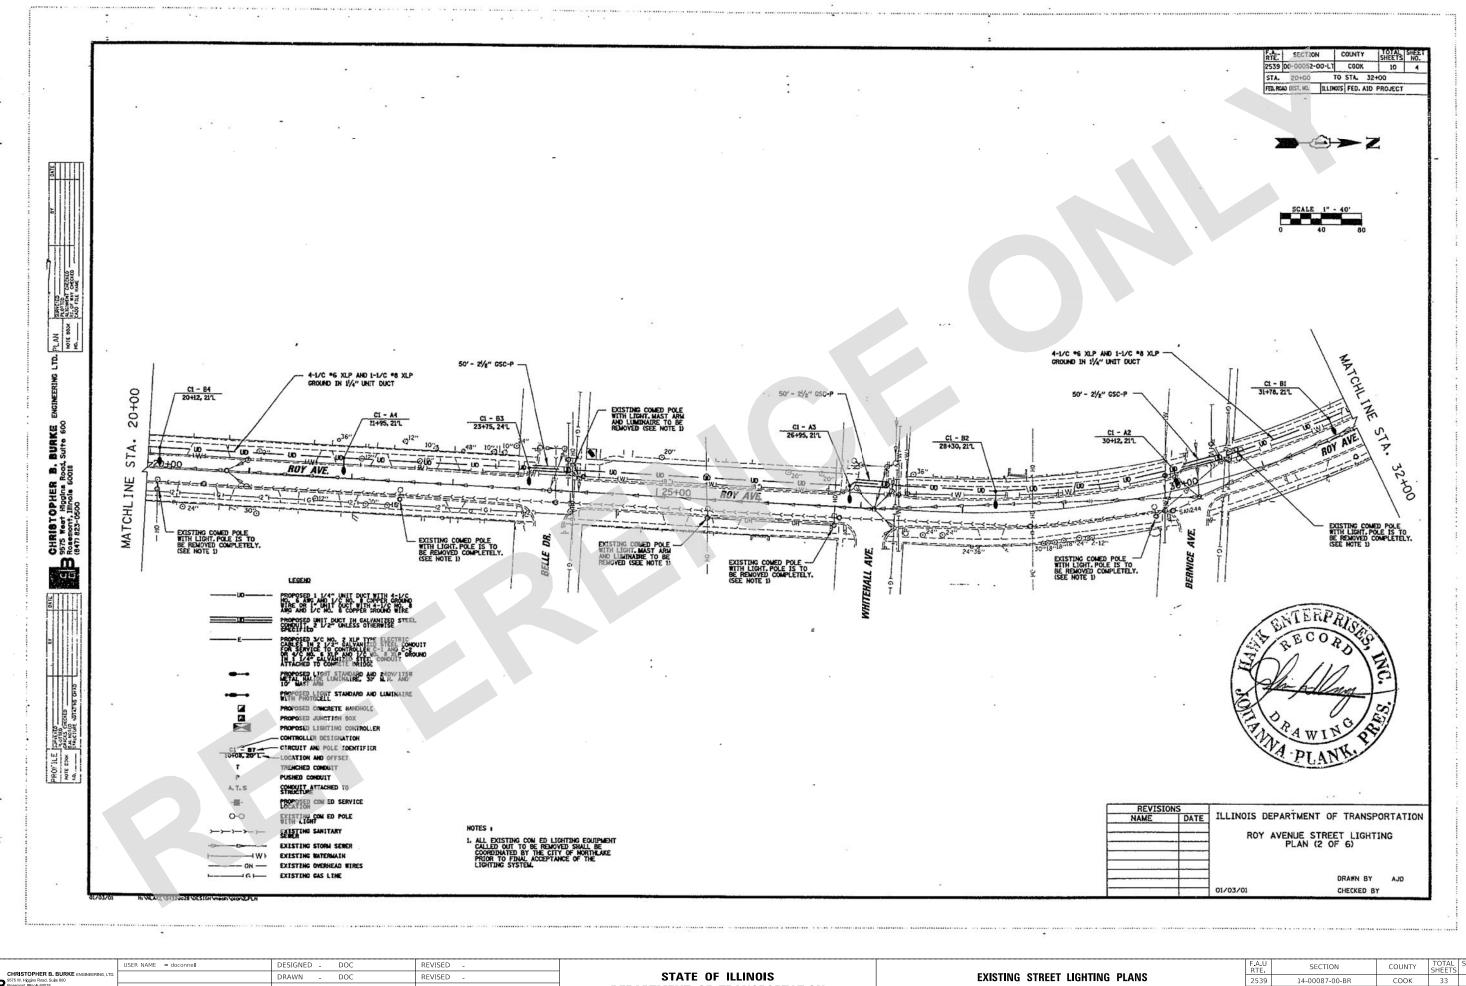


LOT SCALE = 1' CHECKED -REVISED

**DEPARTMENT OF TRANSPORTATION** 

OF SHEETS STA.

COUNTY TOTAL SHEET NO.
COOK 33 13 14-00087-00-BR CONTRACT NO. 61G88

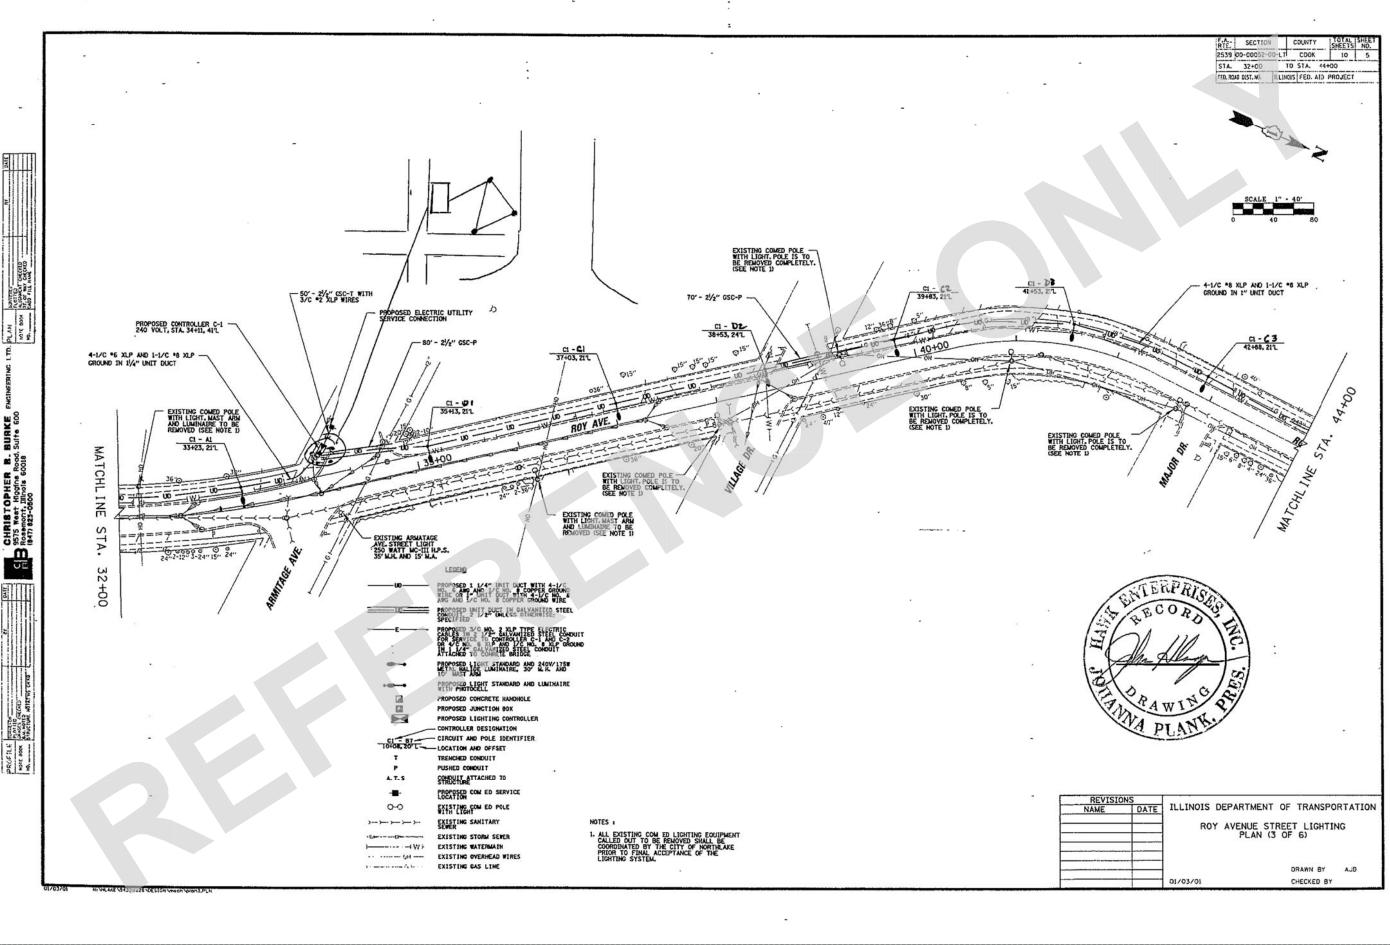


CHRISTOPHER B. BURKE ENGINEERIN
9575 W. Higgins Road, Suite 600
Rosemort, Illinois 60016
(847) 825-0500

STATE OF ILLINOIS DEPARTMENT OF TRANSPORTATION

SCALE:

 EXISTING STREET LIGHTING PLANS
 F.A.U. RTE.
 SE

 2539
 14-00

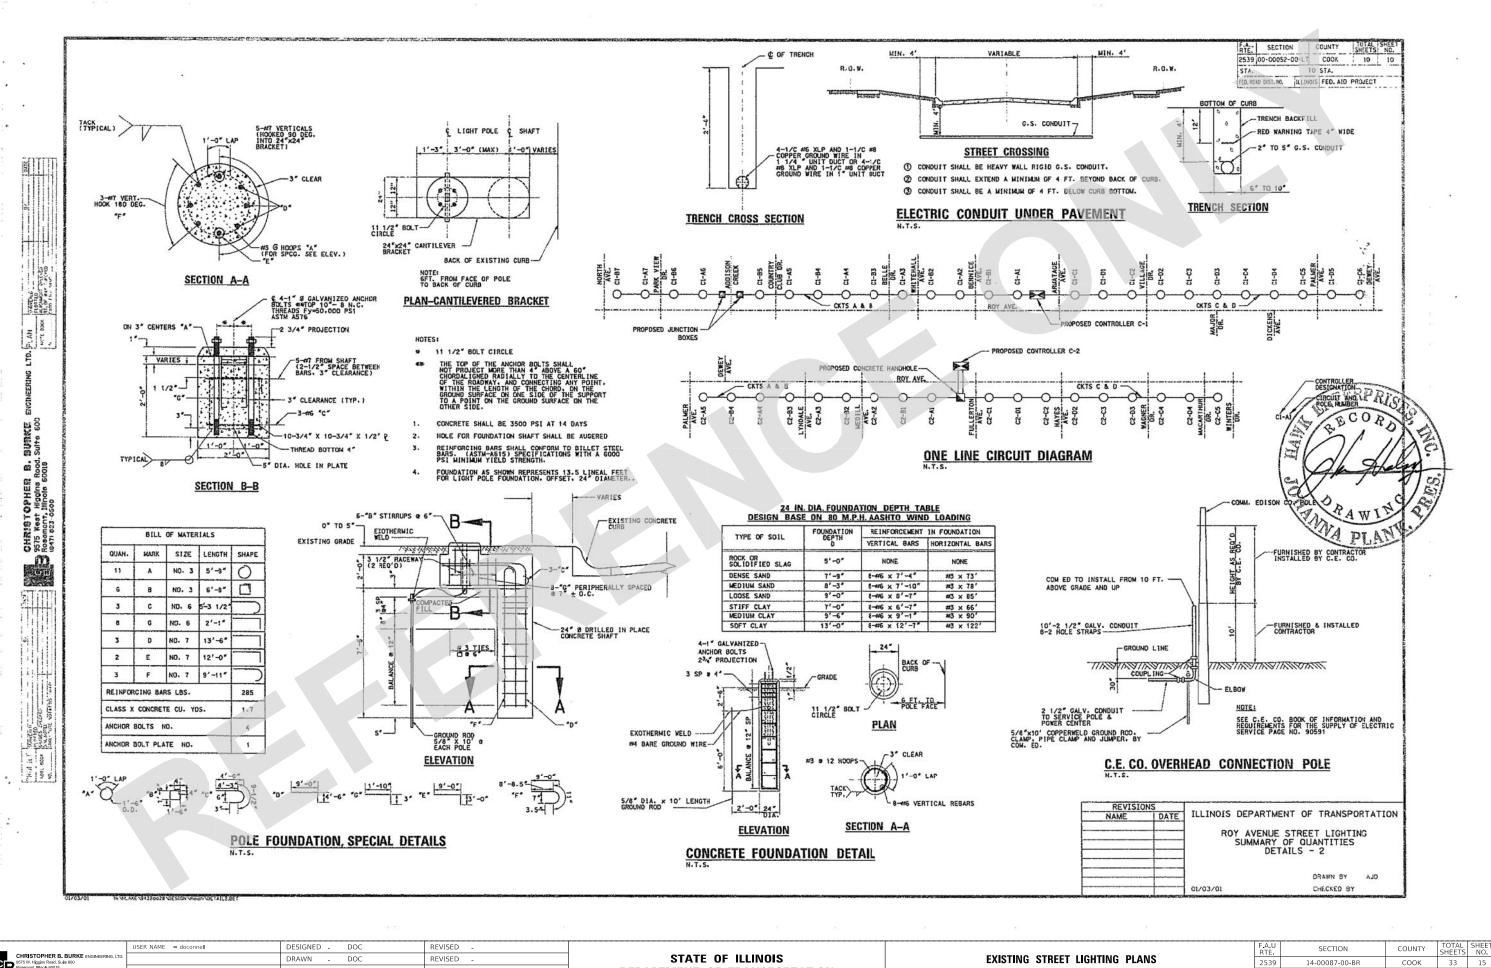


DRAWN DOC REVISED LOT SCALE = 1' CHECKED REVISED REVISED

STATE OF ILLINOIS **DEPARTMENT OF TRANSPORTATION** 


SCALE:

**EXISTING STREET LIGHTING PLANS** 14-00087-00-BR COOK CONTRACT NO. 61G88 SHEETS STA.

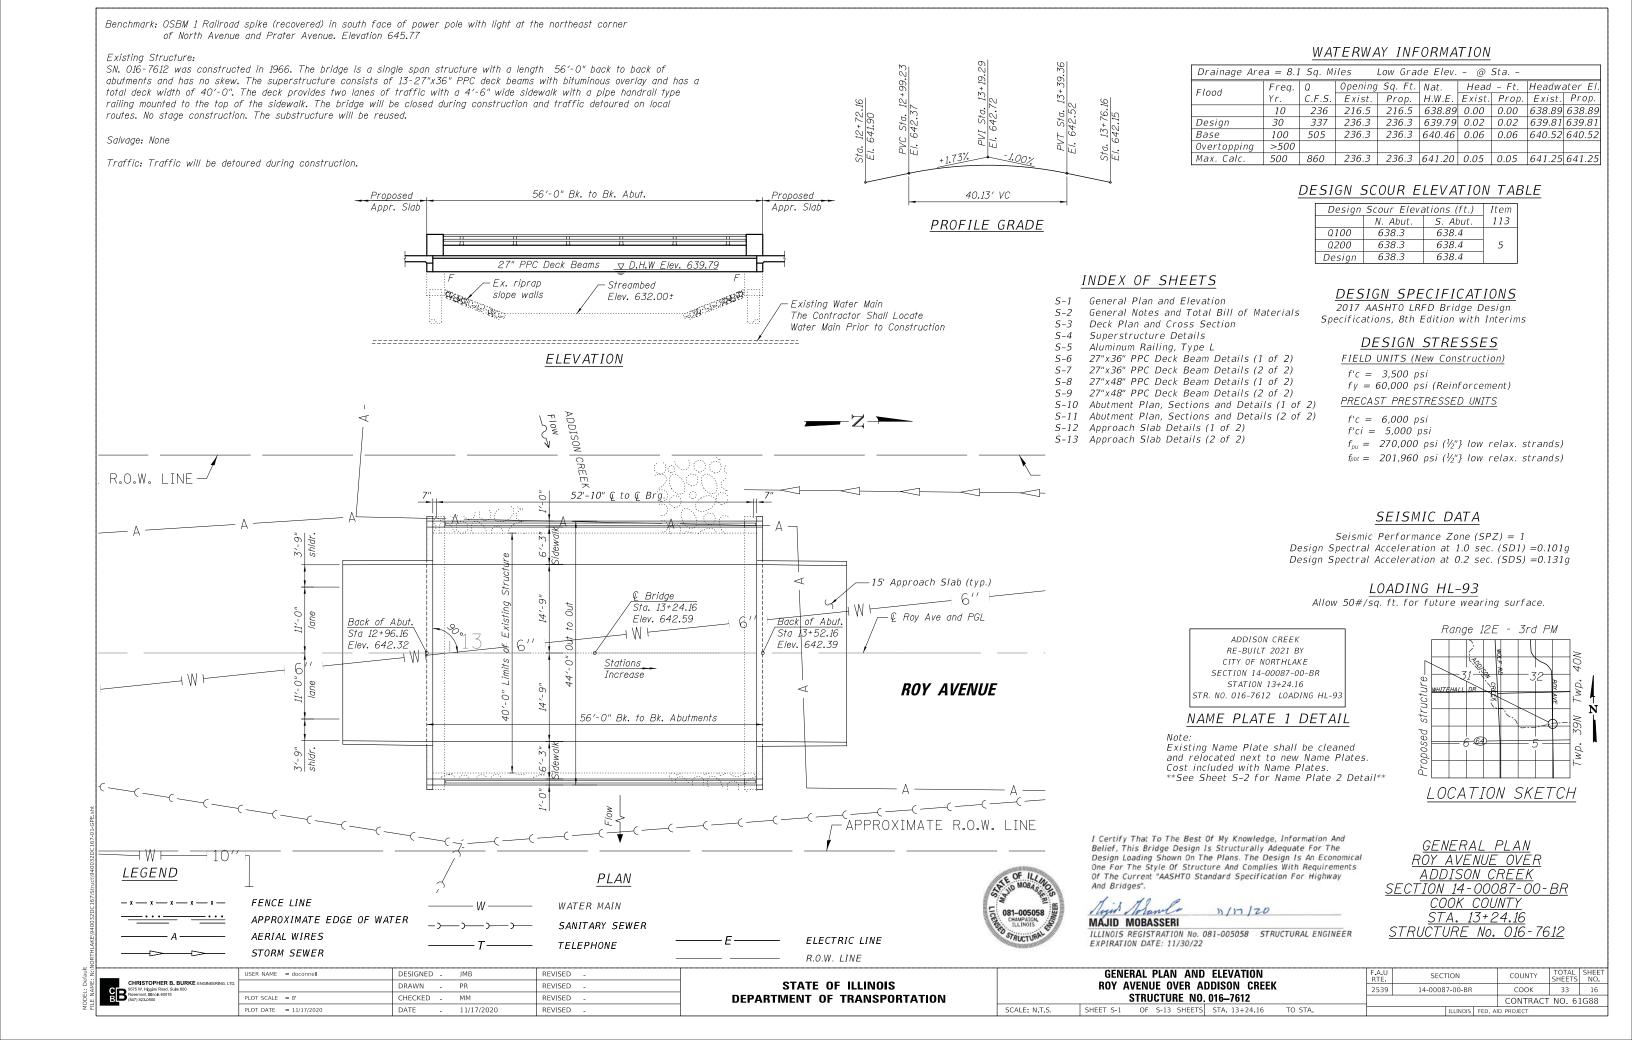

#### GENERAL NOTES


- 1. Reinforcement bars designated (E) shall be epoxy coated.
- 2. Plan dimensions and details relative to existing plans are subject to nominal construction variations. The Contactor shall field verify existing dimensions and details affecting new construction and make necessary approved adjustments prior to construction or ordering of materials. Such variations shall not be cause for additional compensation for a change in scope of the work; however, the Contractor will be paid for the quantity actually furnished at the unit price bid for the work.
- 3. Layout of the slope protection system may be varied to suit ground conditions in the field as directed by the Engineer.
- 4. Existing Name Plate shall be cleaned and relocated next to new Name Plate. Cost included with Name Plates.
- 5. Existing reinforcement shall be cleaned and incorporated into the new construction. Cost included with Concrete Removal.
- 6. Installation of concrete cap dowels to be included in "Concrete Structures".
- 7. See Special Provisions for form liner textured surface pattern and staining information. The pattern and stain shall be submitted to the City for review and approval.

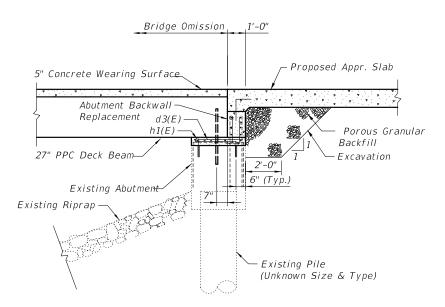

ABUTMENT SECTION - PROPOSED

#### TOTAL BILL OF MATERIAL

PAY ITEM	ITEM	UNIT	QUANTITY
50101500	Removal of Existing Superstructure	Each	1
50102400	Concrete Removal	Cu. Yd.	16.7
50200100	Structure Excavation	Cu. Yd.	45
50300225	Concrete Structures	Cu. Yd.	27.2
50300255	Concrete Superstructure	Cu. Yd.	38.3
50300260	Bridge Deck Grooving	Sq. Yd.	185
50300300	Protective Coat	Sq. Yd.	345
50301350	Concrete Superstructure (Approach Slab)	Cu. Yd.	43.5
50400505	Precast Prestressed Concrete Deck Beams (27" Depth)	Sq. Ft.	2,322
50800205	Reinforcement Bars, Epoxy Coated	Pound	29,410
50900105	Aluminum Railing, Type L	Foot	100
51500100	Name Plate	Each	2
58600101	Granular Backfill for Structures	Cu. Yd.	145
X1700034	Form Liner Textured Surface, Special	Sq. Ft.	525
X5030305	Concrete Wearing Surface, 5"	Sq. Yd.	258

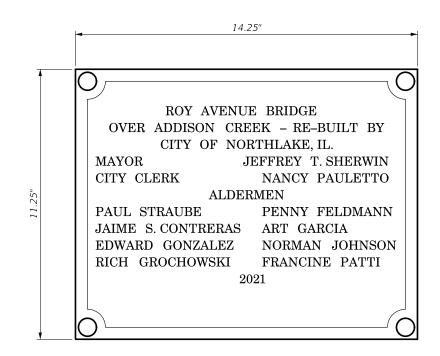


NAME PLATE 2 DETAIL


CHRISTOPHER B. BURKE ENGINEERING
PS75 W. Higgins Road, Suite 600
Rosemont, Illinois 60118
(847) 823-0500


USER NAME = doconnell	DESIGNED -	JMB	REVISED -
	DRAWN -	PR	REVISED -
PLOT SCALE = 1'	CHECKED -	MM	REVISED -
PLOT DATE = 11/17/2020	DATE -	11/17/2020	REVISED -

STATE OF ILLINOIS
DEPARTMENT OF TRANSPORTATION

(		S AND TOTAL			F. R					
	ROY AVENUE OVER ADDISON CREEK									
	STRUCTURE NO. 016-7612									
SCALE: N.T.S.	SHEET S-2	OF S-13 SHEETS	STA. 13+24.16	TO STA.						

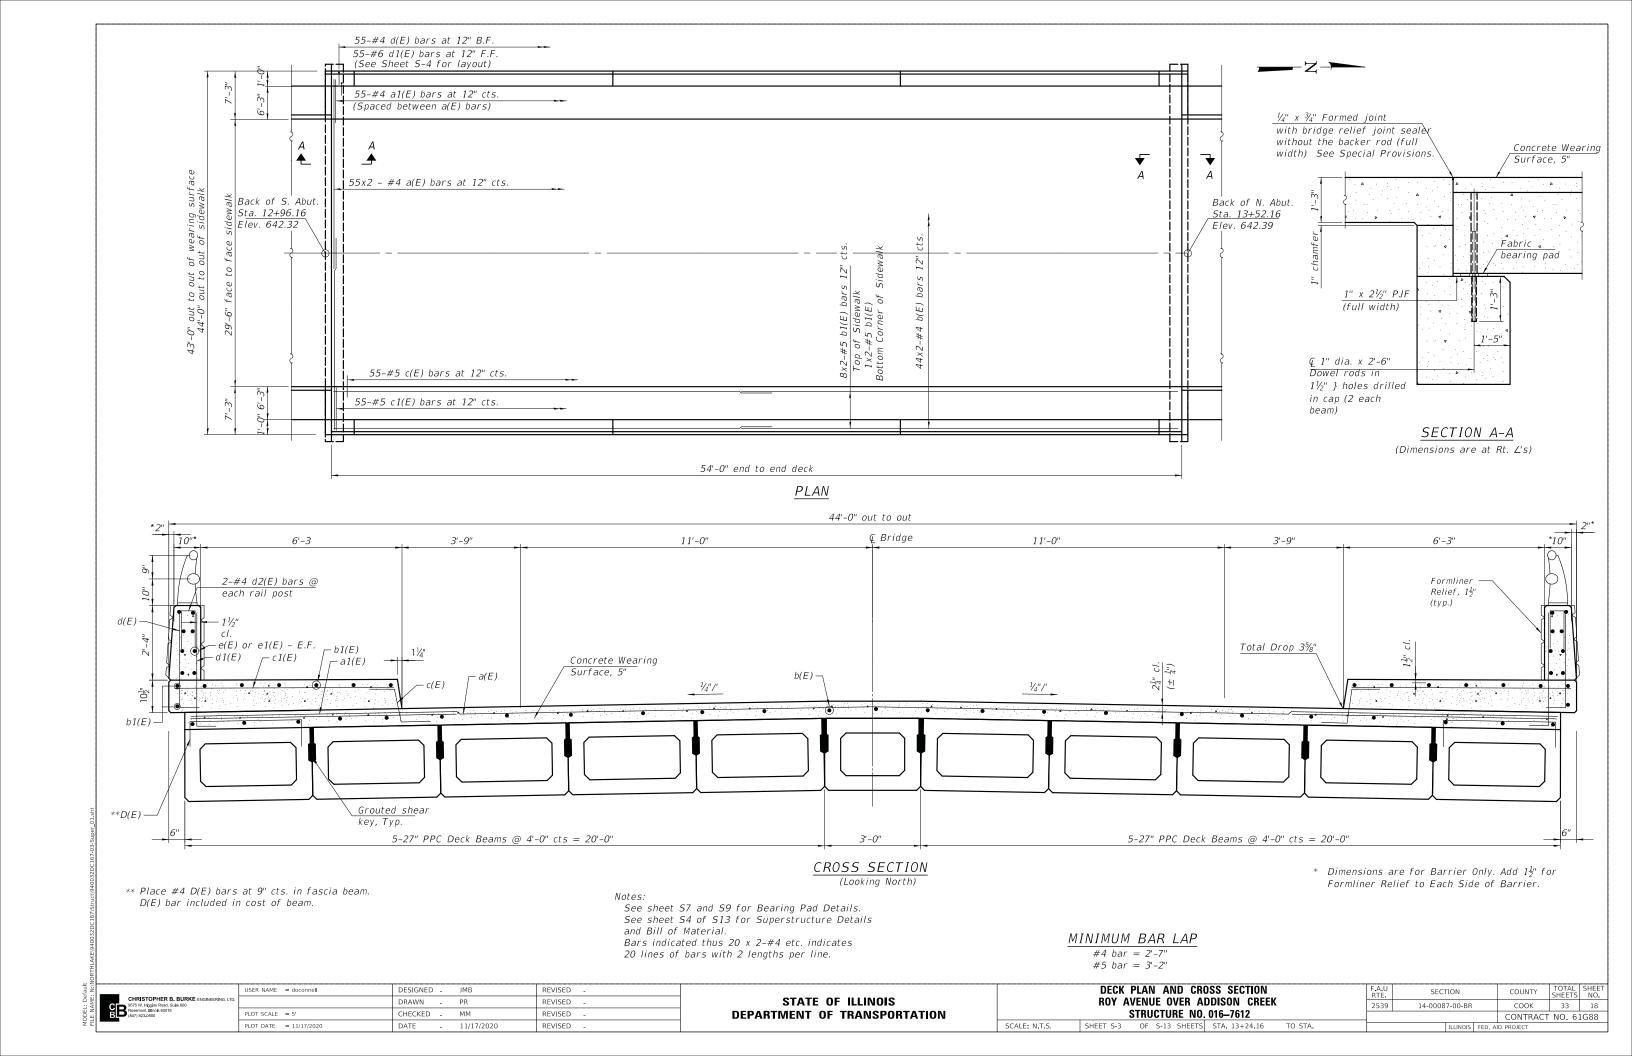

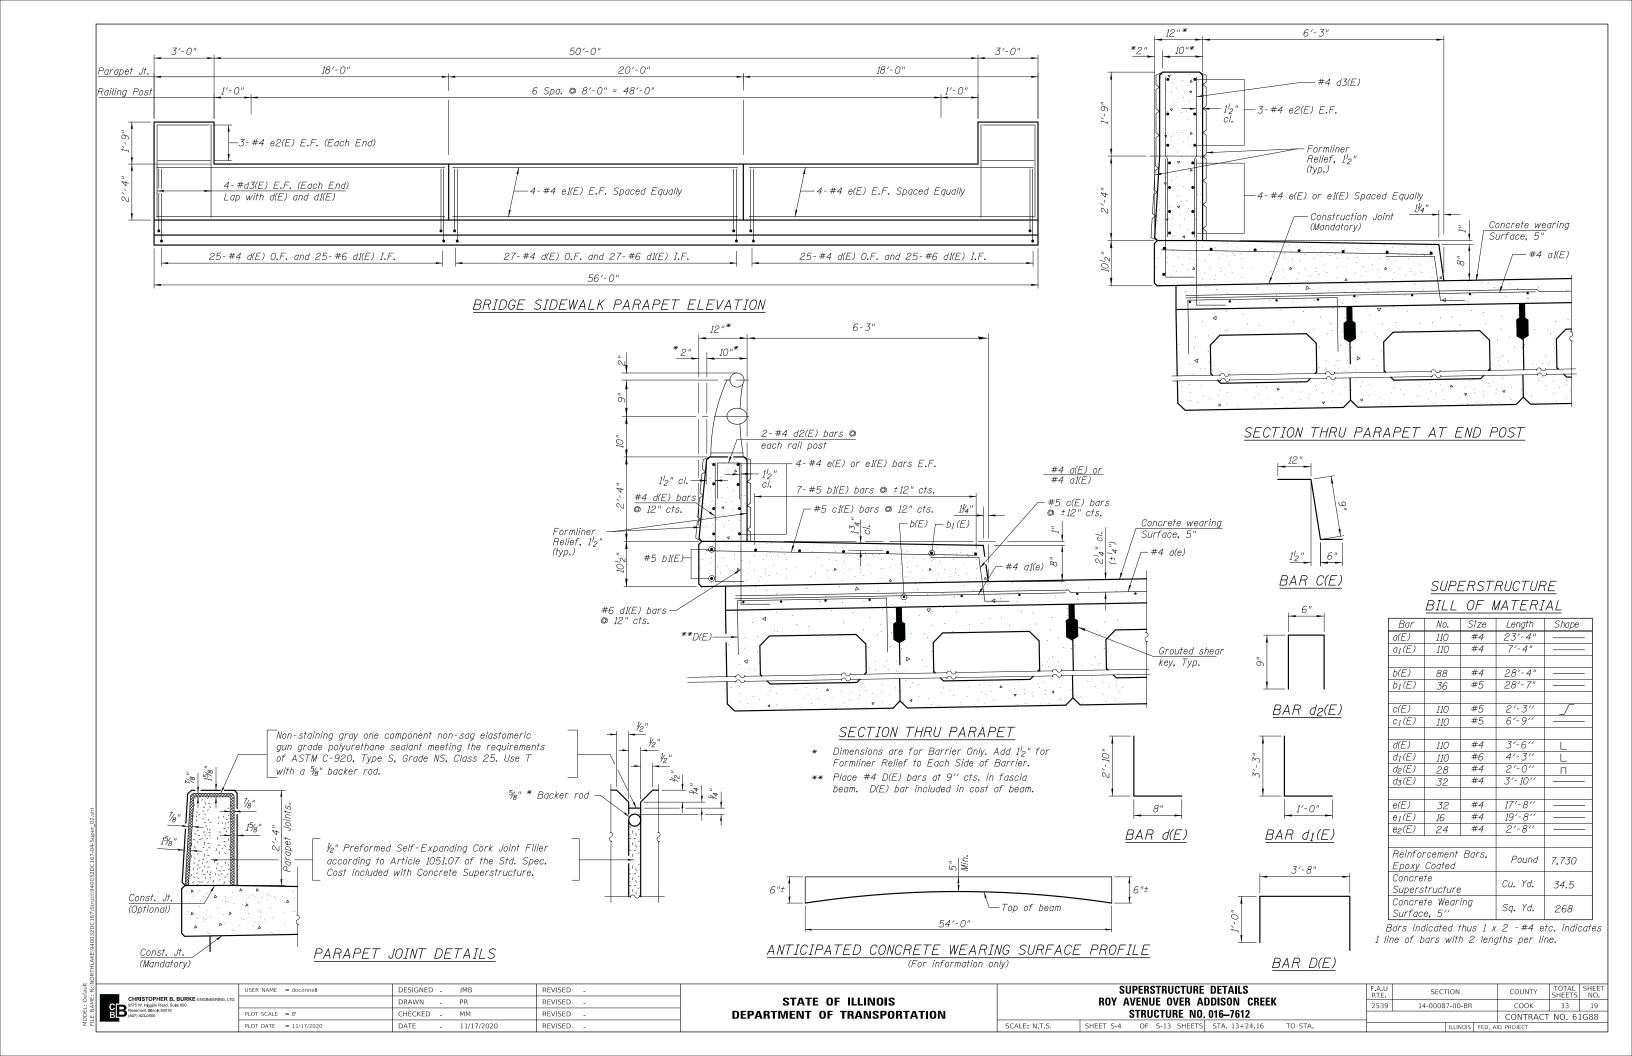

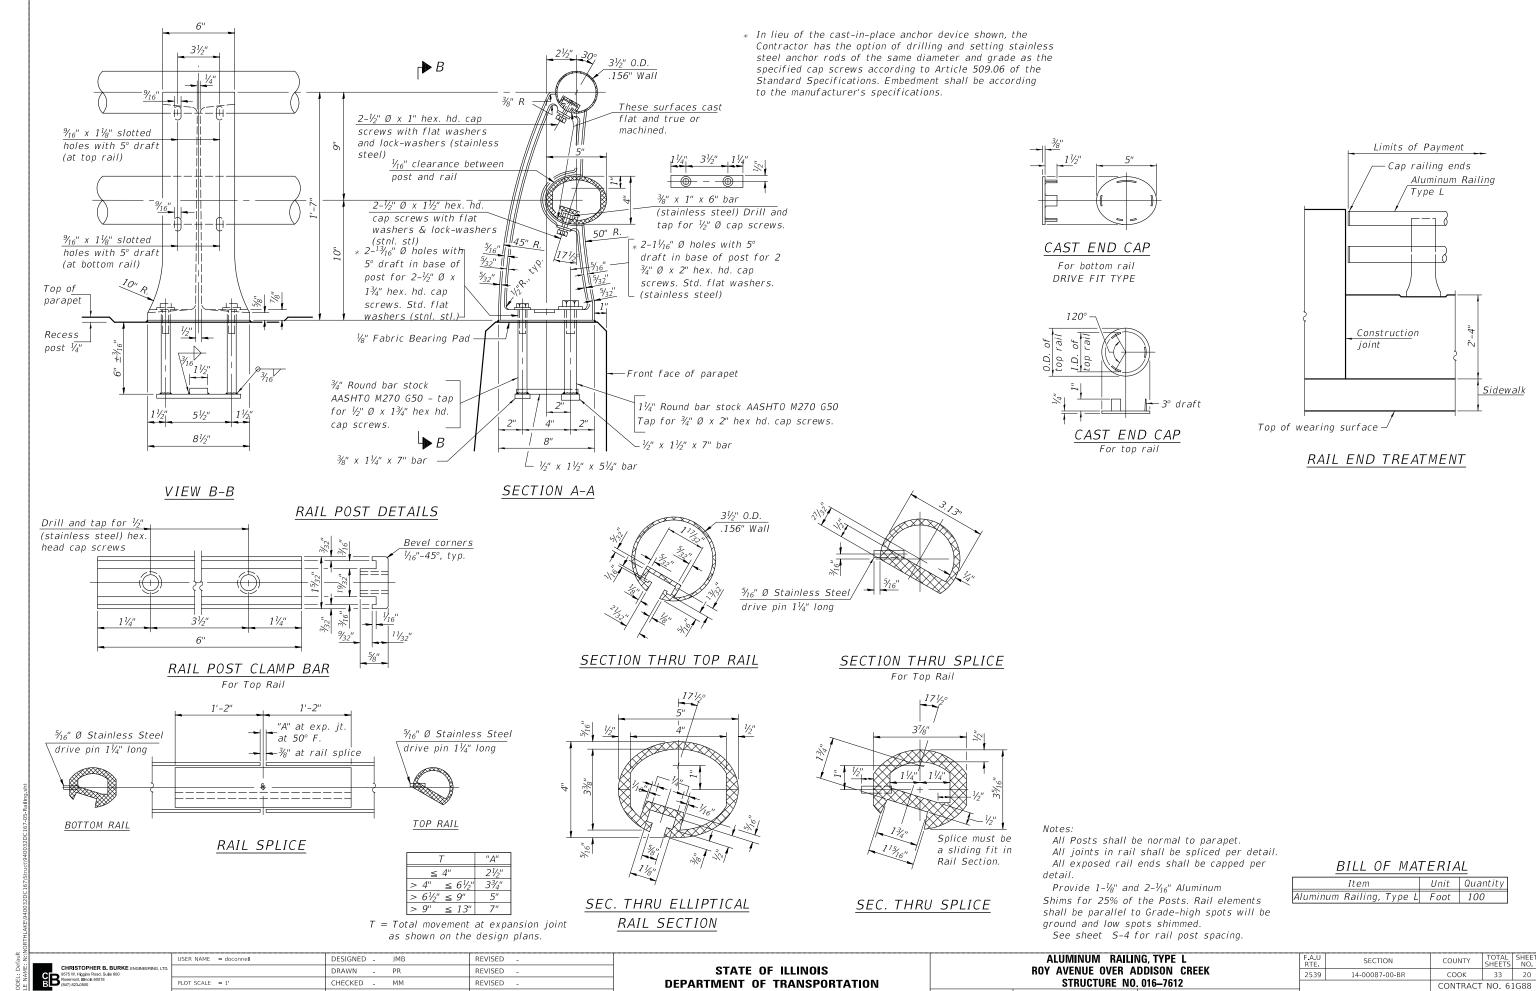

SCALE: N.T.S.


SHEET S-5 OF S-13 SHEETS STA. 13+24.16


PLOT DATE = 11/17/2020

DATE

11/17/2020

REVISED

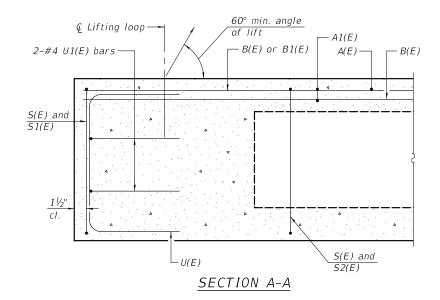


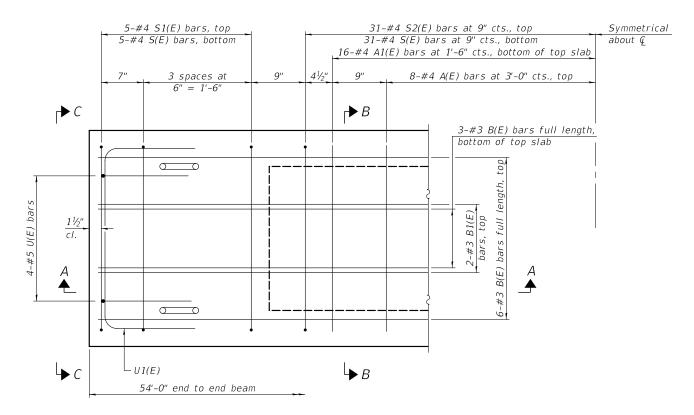


#### PLAN VIEW

Note:

Spacing of S(E) and S2(E) bars may be adjusted up to 4" in the immediate area of the transverse tie diaphragms to miss the block outs for the transverse ties.

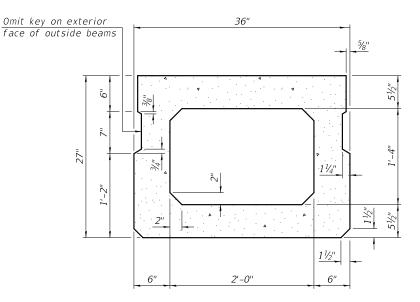



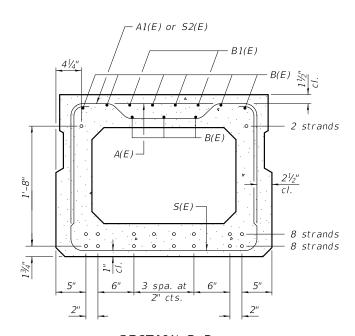


#### SECTION B-B

(Showing reinforcement and permissible strand locations)

Note: Place the number of strands specified in each row symmetrically about the centerline of beam in the permissible strand locations shown.

 $\frac{MINIMUM BAR LAP}{\#3 bar = 1'-6''}$ 

SCALE: N.T.S.

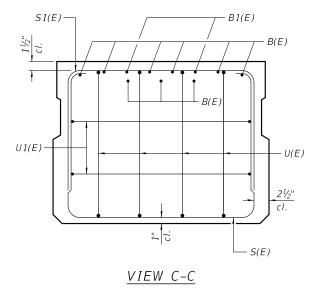

BAR LIST

ONE BEAM ONLY

(For information only)

Bar	No.	Size	Length	Shape
A(E)	16	#4	2'-7"	
A1(E)	32	#4	2'-10"	~~
B(E)	18	#3	27'-8"	
B1(E)	4	#3	10'-0"	
S(E)	72	#4	7'-5"	
S1(E)	10	#4	5'-11"	
52(E)	62	#4	6'-2"	
U(E)	8	#5	4'-6"	
U1(E)	4	#4	5'-0"	

CHRISTOPHER B. BURKE ENGINEERING SP75 W. Higgins Road, Suite 600 Rosemont, Illinois 60018 (947) 823-0500 
 USER NAME
 = document
 DESIGNED
 JMB
 REVISED

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 REVISED

 PLOT SCALE
 = 1'
 CHECKED
 MM
 REVISED

 PLOT DATE
 = 11/17/2020
 DATE
 11/17/2020
 REVISED

STATE OF ILLINOIS DEPARTMENT OF TRANSPORTATION


27"x36" PPC DECK BEAM DETAILS (1 OF 2)
ROY AVENUE OVER ADDISON CREEK
STRUCTURE NO. 016—7612


SHEET S-6 OF S-13 SHEETS STA. 13+24.16 TO STA.

 
 F.A.U RTE.
 SECTION
 COUNTY
 TOTAL SHEETS
 SHEETS NO.

 2539
 14-00087-00-BR
 COOK
 33
 21

 CONTRACT
 NO.
 61G88

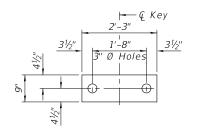

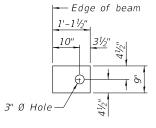


#### FABRIC BEARING PAD (Interior)


FABRIC BEARING PAD


#### FIXED

Notes:

All bearing pads shall be 1" thick. Omit holes when using expansion bearings. Expansion bearing pads shall be bonded to the substructure.

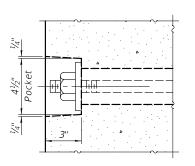


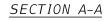


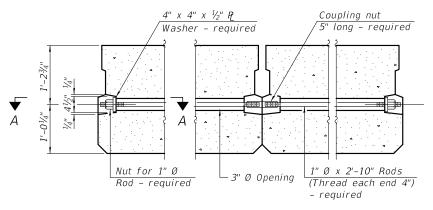


TYPICAL TRANSVERSE TIE ASSEMBLY

SCALE: N.T.S.

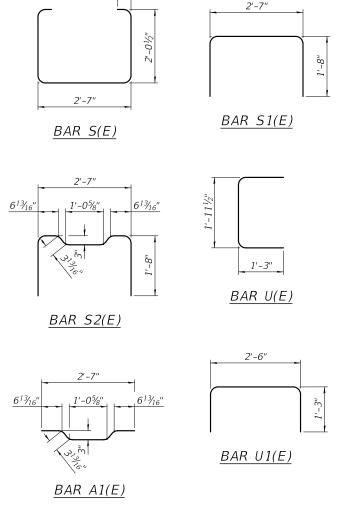

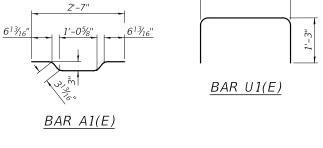

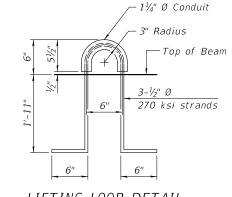

### LIFTING LOOP DETAIL

### NOTES

Prestressing steel shall be uncoated high strength, low relaxation 7-wire strand, Grade 270. The nominal diameter shall be  $lar{1}{2}$ " and the nominal cross-sectional area shall be 0.153 sq. in.

The 1" Ø rods in the transverse tie assembly shall be tightened to a snug fit and the threads set. Pockets on exterior faces of bridge shall be filled with grout after transverse tie assembly

Two  $\frac{1}{8}$ " fabric adjusting shims of the dimensions of the exterior bearing pad shall be provided for each bearing pad location.


A minimum  $2\frac{1}{2}$ " Ø lifting pin shall be used to engage the lifting loops during handling. Corrosion Inhibitor, per Article 1020.05(b)(10) and 1021.07 of the Standard Specifications, shall be used in the concrete for precast prestressed concrete deck beams.

Compressive strength of prestressed concrete, f'c, shall be 6000 psi. Compressive strength of prestressed concrete at release, f'ci, shall be 5000 psi.

### BILL OF MATERIAL

Precast Prestressed	162	Sa. Et.
Conc. Deck Bms. (27" depth)	102	34. Ft.

Note: Quantity is for 36" wide beam. See sheet S-9 for quantity of 48" wide beams. Total quantity for pay item is sum of 36" and 48" wide beam areas (2,322 Sq. Ft.)

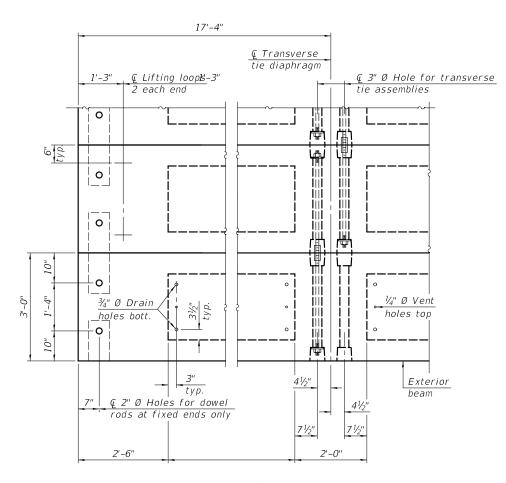



PLAN VIEW


Connect beams in pairs with the transverse tie configuration shown.

	USER NAME = doconnell	DESIGNED -	JMB	REVISED -
D.		DRAWN -	PR	REVISED -
	PLOT SCALE = 1'	CHECKED -	MM	REVISED -
	PLOT DATE = 11/17/2020	DATE -	11/17/2020	REVISED -

F.A.U RTE	SECTION	COUNTY	TOTAL SHEETS	SHEET NO.	
2539	14-00087-00-BF	соок	33	22	
		CONTRACT	NO. 6	1G88	
	ILLINOIS	FED. A	ID PROJECT		

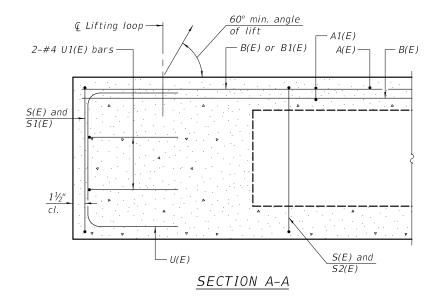

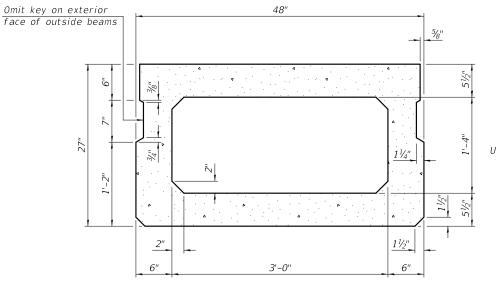

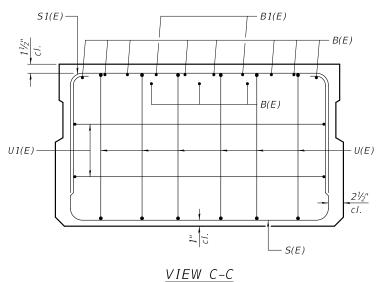


SECTION B-B (Showing dimensions)

5-#4 S1(E) bars, top 31-#4 S2(E) bars at 9" cts., top Symmetrical 5-#4 S(E) bars, bottom 31-#4 S(E) bars at 9" cts., bottom about @ 16-#4 A1(E) bars at 1'-6" cts., bottom of top slab 41/5" 8-#4 A(E) bars at 3'-0" cts., top 3 spaces at 6" = 1'-6" **₽**C  $\rightarrow B$ 3-#3 B(E) bars full length, bottom of top slab #5 U(E) bar 2-#3 B1(E) bars, top B(E) bars full cI. **1**  $\circ$ └─U1(E) 54'-0" end to end beam

PLAN VIEW

Spacing of S(E) and S2(E) bars may be adjusted up to 4" in the immediate area of the transverse tie diaphragms to miss the block outs for the transverse ties.

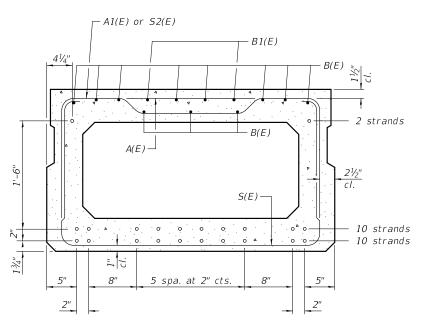

SECTION B-B

(Showing reinforcement and permissible strand locations)

Note: Place the number of strands specified in each row symmetrically about the centerline of beam in the permissible strand locations shown.

BAR LIST ONE BEAM ONLY (For information only)

Bar	No.	Size	Length	Shape
A(E)	16	#4	3'-7"	
A1(E)	32	#4	3'-10"	{
B(E)	22	#3	27'-8"	
B1(E)	4	#3	10'-0"	
S(E)	72	#4	8'-5"	
S1(E)	10	#4	6'-11"	
S2(E)	62	#4	7'-2"	]
U(E)	12	#5	4'-6"	
U1(E)	4	#4	6'-0"	

Note: See sheet S-4 for additional details for D(E) bars in exterior beams.

MINIMUM BAR LAP #3 bar = 1'-6"


SCALE: N.T.S.


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	DRAWN -	PR	REVISED -
PLOT SCALE = 1'	CHECKED -	MM	REVISED -
PLOT DATE = 11/17/2020	DATE -	11/17/2020	REVISED -


STATE OF ILLINOIS

2	27"x48" P	PC DECK	BEAM	DETAILS (1	OF 2)			
	ROY AVENUE OVER ADDISON CREEK							
STRUCTURE NO. 016-7612								
	CHEET CO	05 6	a curere	CTA 12:24 16	TO CT			

F.A.U RTE	SECT	ΓΙΟΝ		COUNTY	TOTAL SHEETS	SHEET NO.
2539	14-00087-00-BR			COOK	33	23
				CONTRACT NO. 61G88		
		ILLINOIS	FED, A	ID PROJECT		

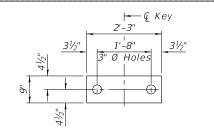

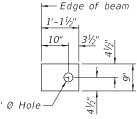

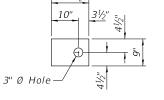


#### FABRIC BEARING PAD FABRIC BEARING PAD (Interior) (Exterior)

#### FIXED


Notes:

All bearing pads shall be 1" thick. Omit holes when using expansion bearings. Expansion bearing pads shall be bonded to the substructure.

SECTION A-A

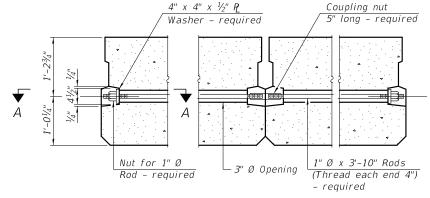


### TYPICAL TRANSVERSE TIE ASSEMBLY

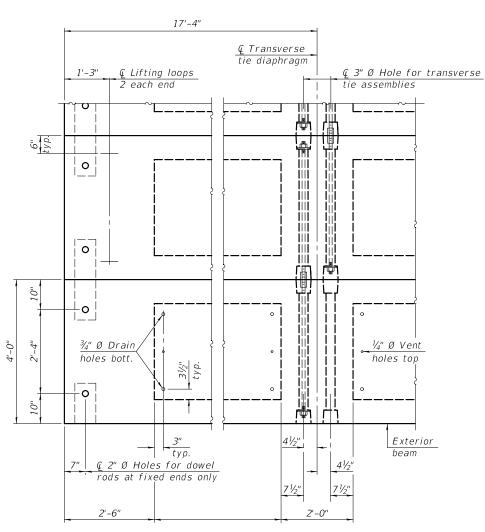

#### PLAN VIEW

Connect beams in pairs with the transverse tie configuration shown.

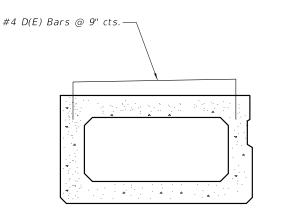

#### SECTION THRU FASCIA BEAMS WITH SIDEWALK REINFORCEMENT

(Opposite Fascia Beam Will Be Mirror Image.) See Sheet S-4 for reinfrcement details

#### NOTES

Prestressing steel shall be uncoated high strength, low relaxation 7-wire strand, Grade 270. The nominal diameter shall be  $lat{1}{2}$ " and the nominal cross-sectional area shall be 0.153 sq. in.


The 1" Ø rods in the transverse tie assembly shall be tightened to a snug fit and the threads set. Pockets on exterior faces of bridge shall be filled with grout after transverse tie assembly

Two  $\frac{1}{8}$  fabric adjusting shims of the dimensions of the exterior bearing pad shall be provided for each bearing pad location.

SCALE: N.T.S.

A minimum  $2\frac{1}{2}$ " Ø lifting pin shall be used to engage the lifting loops during handling. Corrosion Inhibitor, per Article 1020.05(b)(10) and 1021.07 of the Standard Specifications, shall be used in the concrete for precast prestressed concrete deck beams.

Compressive strength of prestressed concrete, f'c, shall be 6000 psi. Compressive strength of prestressed concrete at release, f'ci, shall be 5000 psi.

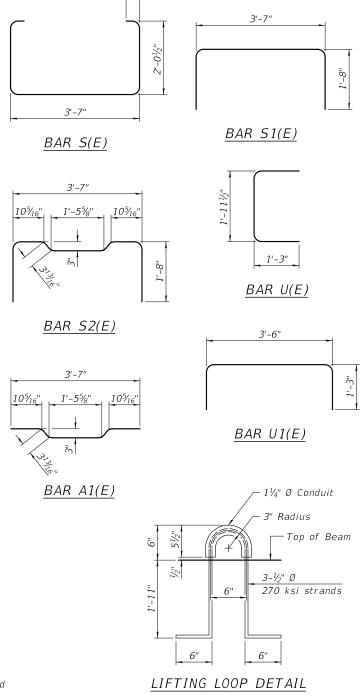

#### BILL OF MATERIAL


Precast Prestressed Conc. Deck Bms. (27" depth)

Note: Quantity is for 48" wide beam. See sheet S-7 for quantity of 36" wide beams. Total quantity for pay item is sum of 36" and 48" wide beam areas (2,322 Sq. Ft.)



USER NAME = doconnell	DESIGNED - JMB	REVISED -
	DRAWN - PR	REVISED -
PLOT SCALE = 1'	CHECKED - MM	REVISED -
PLOT DATE = 11/17/2020	DATE - 11/17/2020	REVISED -

F.A.U RTE	SECTION			COUNTY	TOTAL SHEETS	SHEET NO.
2539	14-00087-00-BR			соок	33	24
				CONTRACT	NO. 6	IG88
ILLINOIS FED. A			ID PROJECT			

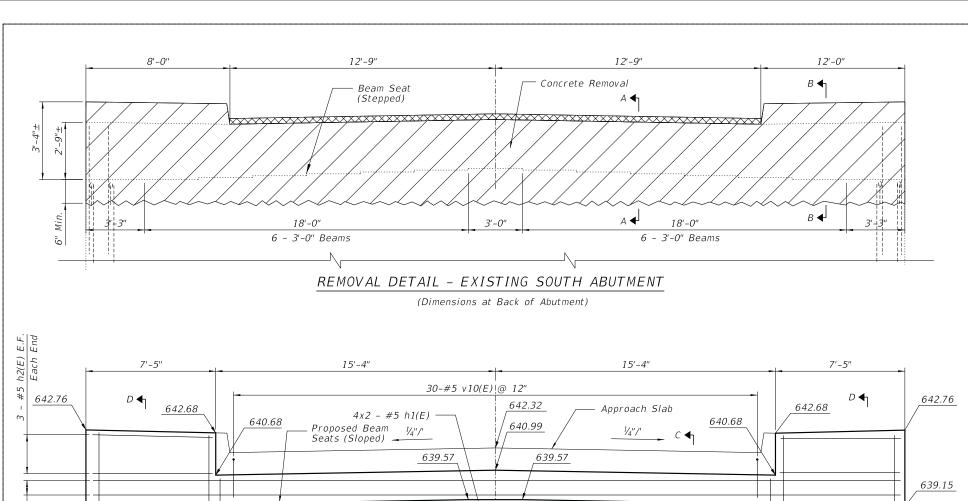


#### PROPOSED SECTION-SOUTH ABUTMENT

3'-0"

30-#5 d2(E) @ 12" E.F

45 - #5 d3(E) Alternate @ 12"

(Dimensions at Back of Abutment)

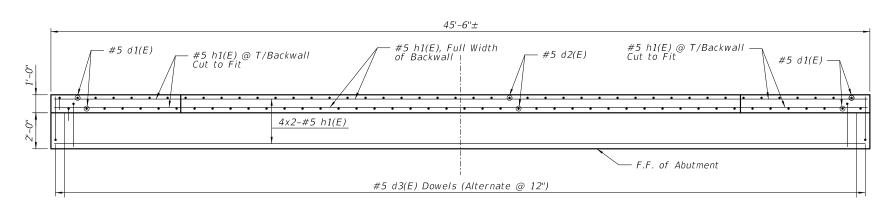

#### PLAN - PROPOSED SOUTH ABUTMENT


 $\frac{MINIMUM\ BAR\ LAP}{\#5\ bar\ =\ 3'-7''}$ 

8-#5 d1(E)


@ 12" E.F.


#### NOTES:

- Existing vertical reinforcement shall be cleaned and incorporated into the new construction. Cost included with "Concrete Removal".
- Any reinforcement bars that are damaged during concrete removal operation shall be repaired using an approved bar splicer or anchorage system. Cost included with "Concrete Removal".
- 3. Drilling and grouting dowel bars into the existing abutment shall be included in the cost of "Reinforcement Bars, Epoxy Coated". Minimum embedment is 6". Dowel bars shall have 4" cover from edges.
- 4. Stagger d1(E) and h2(E) bars.
- 5. Cut d1(E) and d2(E) to fit and paint cut end with epoxy paint, or increase embedment of bars to fit.

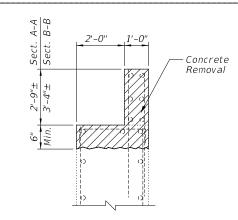


SECTION A-A & B-B EXISTING ABUTMENT TYPICAL SECTION

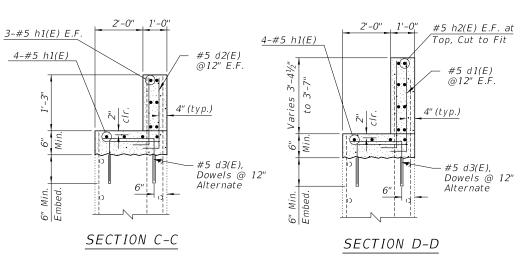

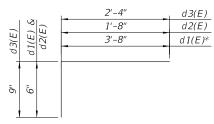

BARS d1(E), d2(E) & d3(E)

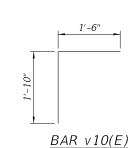

<u>ABUTMENT - BILL OF MATERIAL</u> (SOUTH ABUTMENT)

Bar	No.	Size	Length	Shape
d1(E)	32	#5	4'-3"	
d2(E)	60	#5	1'-11"	
d3(E)	90	#5	3'-1''	
h1(E)	24	#5	24'-5"	
h2(E)	110	#5	7'-1"	
v10(E)	30	#5	3'-4"	
Concre	ete Rem	ioval	Cu. Yd.	12.3
Struct Excava			Cu. Yd.	40
Concre	ete Stru	ıctures	Cu. Yd.	14.0
	rcemen Coated		Pound	2,080

Bars indicated thus  $1 \times 2$  -#4 etc. indicates 1 line of bars with 2 lengths per line.

	USER NAME = doconnell	DESIGNED - JMB	REVISED -
CHRISTOPHER B. BURKE ENGINEERING, LTD. 9575 W. Higgins Road, Suite 600		DRAWN - PR	REVISED -
Rosemont, Illinois 60018 (847) 823-0500	PLOT SCALE = 1'	CHECKED - MM	REVISED -
	PLOT DATE = 11/17/2020	DATE - 11/17/2020	REVISED -

5-27" PPC Deck Beams @ 4'-0" cts = 20'-0"

639.15

8-#5 d1(E)


@ 12" E.F

STATE OF ILLINOIS
DEPARTMENT OF TRANSPORTATION

5-27" PPC Deck Beams @ 4'-0" cts

SOUTH ABUTMENT PLAN, SECTIONS AND DETAILS ROY AVENUE OVER ADDISON CREEK STRUCTURE NO. 016–7612							
	SCALE: N.T.S.	SHEET S-10	OF	S-13	SHEETS	STA. 13+24.16	TO STA.

F.A.U RTE	SECTION	COUNTY	TOTAL SHEETS	SHEET NO.			
2539	14-00087-00-BR	соок	33	25			
		CONTRACT	NO. 6:	IG88			

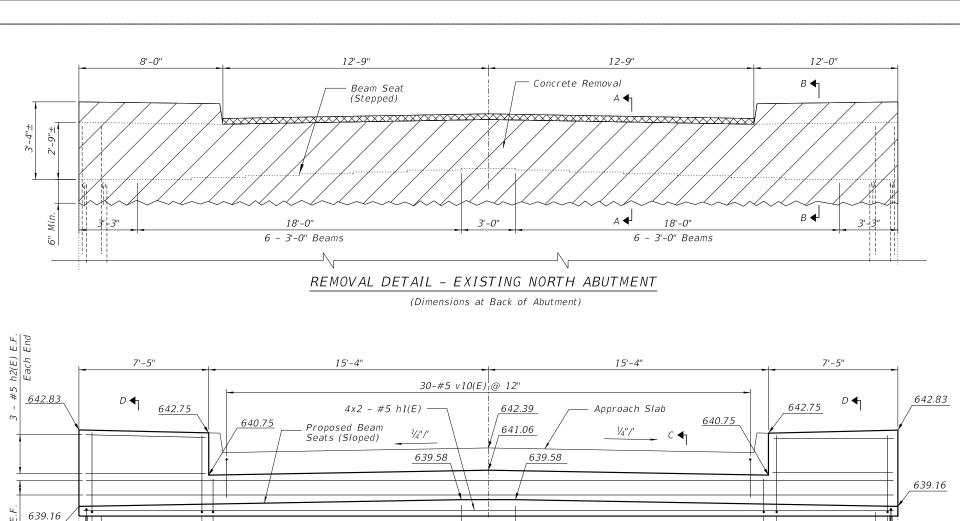


#### PROPOSED SECTION-NORTH ABUTMENT

3'-0"

30-#5 d2(E) @ 12" E.F

45 - #5 d3(E) Alternate @ 12"

(Dimensions at Back of Abutment)

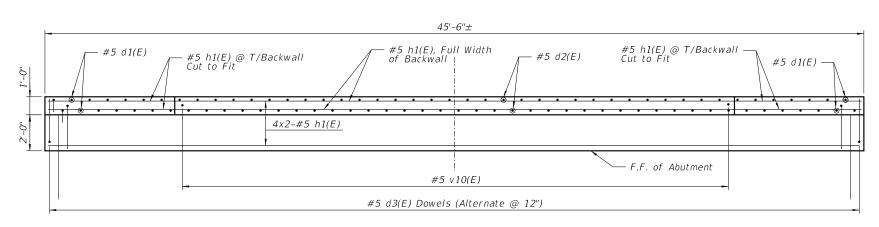

PLAN - PROPOSED NORTH ABUTMENT

 $\frac{MINIMUM\ BAR\ LAP}{\#5\ bar\ =\ 3'-7''}$ 


SCALE: N.T.S.

8-#5 d1(E)


@ 12" E.F.


#### NOTES:

- Existing vertical reinforcement shall be cleaned and incorporated into the new construction. Cost included with "Concrete Removal".
- Any reinforcement bars that are damaged during concrete removal operation shall be repaired using an approved bar splicer or anchorage system. Cost included with "Concrete Removal".
- 3. Drilling and grouting dowel bars into the existing abutment shall be included in the cost of "Reinforcement Bars, Epoxy Coated". Minimum embedment is 6". Dowel bars shall have 4" cover from edges.
- 4. Stagger d1(E) and h2(E) bars.
- 5. Cut d1(E) and d2(E) to fit and paint cut end with epoxy paint, or increase embedment of bars to fit.

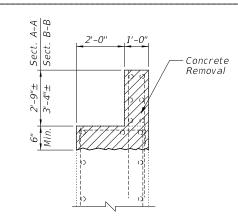


SECTION A-A & B-B EXISTING ABUTMENT TYPICAL SECTION

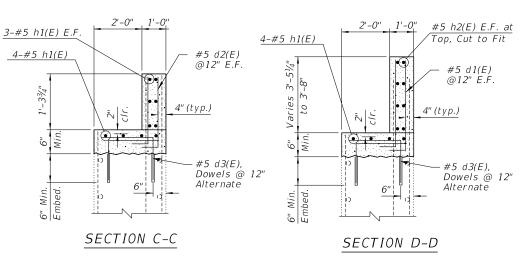

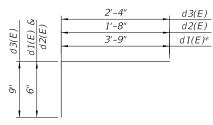

BARS d1(E), d2(E) & d3(E)

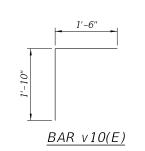

<u>ABUTMENT - BILL OF MATERIAL</u> (NORTH ABUTMENT)

Bar	No.	Size	Length	Shape
d1(E)	32	#5	4'-3"	
d2(E)	60	#5	1'-11"	
d3(E)	90	#5	3'-1''	
h1(E)	24	#5	24'-5"	
h2(E)	110	#5	7'-1"	
v10(E)	30	#5	3'-4"	
Concrete Removal			Cu. Yd.	12.3
Structure Excavation			Cu. Yd.	40
Concrete Structures			Cu. Yd.	14.0
Reinforcement Bars, Epoxy Coated			Pound	2,080

Bars indicated thus  $1 \times 2$  -#4 etc. indicates 1 line of bars with 2 lengths per line.

5-27" PPC Deck Beams @ 4'-0" cts = 20'-0"


8-#5 d1(E)

@ 12" E.F

STATE OF ILLINOIS
DEPARTMENT OF TRANSPORTATION

5-27" PPC Deck Beams @ 4'-0" cts

NORTH ABUTMENT PLAN, SECTIONS AND DETAILS
ROY AVENUE OVER ADDISON CREEK
STRUCTURE NO. 016–7612
SHEET S-11 OF S-13 SHEETS STA. 13+24.16 TO STA.

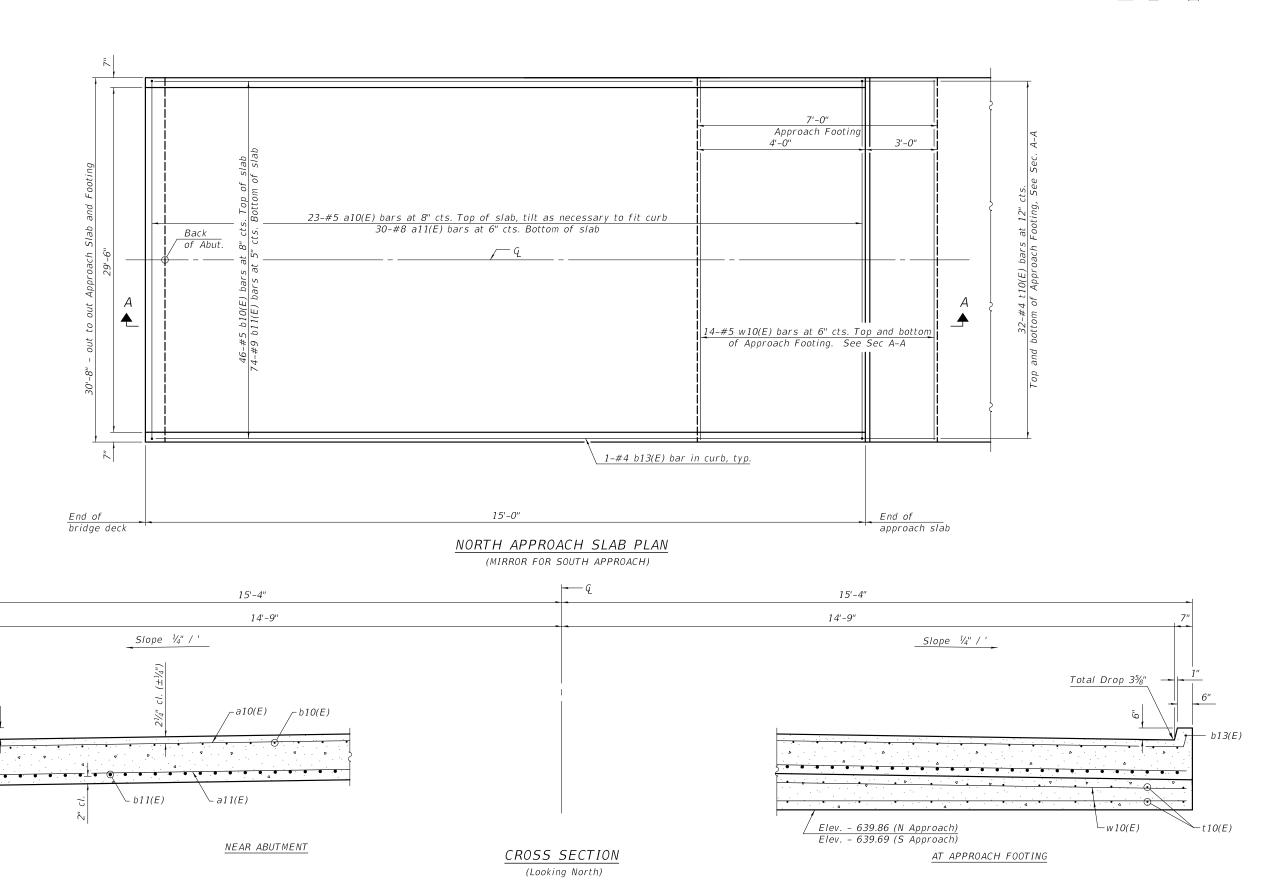

FILE NAME: N:\NOR

PHER B. BURKE ENGINEERING, is Road, Suite 600 ols 60018

b11(E)-


b13(E)

STATE OF ILLINOIS
DEPARTMENT OF TRANSPORTATION

APPROACH SLAB DETAILS (1 OF 2)
ROY AVENUE OVER ADDISON CREEK
STRUCTURE NO. 016-7612


SHEET S-12 OF S-13 SHEETS STA. 13+24.16 TO STA.

SCALE: N.T.S.

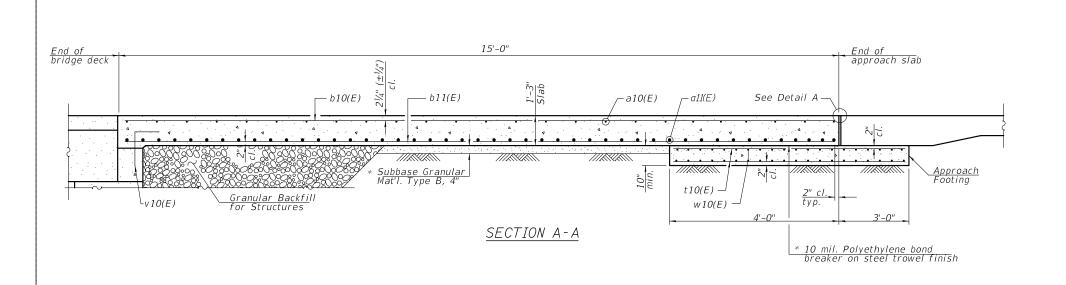

#### Notes:

Approach slab shall be paid for as Concrete Superstructure (Approach Slab). Approach footing concrete shall be paid for as Concrete Structures. The approach footing maximum applied service bearing pressure (Qmax) = 2.0 ksf. Cost of excavation for approach footing included with Concrete Structures.

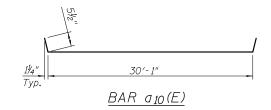

# TWO APPROACHES BILL OF MATERIAL


				•
Bar	No.	Size	Length	Shape
a10(E)	46	#5	31'-0"	
a11(E)	60	#8	30'-4"	
b10(E)	92	#5	14'-8"	
b11(E)	148	#9	14'-8"	
b13(E)	4	#4	14'-8"	
†10(E)	128	#4	6′-8"	
v10(E)	62	#5	3'-4"	
w10(E)	56	#5	30′-4"	
Concrete Superstructure			Cu. Yd.	43.5
(Approach Slab)			Cu. 10.	43.3
Concrete Structures			Cu. Yd.	13.2
Reinforcement Bars, Epoxy Coated			Pound	17,520

TICK NUMBER	βB	CHRISTOPHER B. BURKE ENGINEERING, 9575 W. Higgins Road, Suite 600 Rosement, Illinois 60018 (847) 823-0500
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	USER NAME = doconnell	DESIGNED -	JMB	REVISED -	
D.		DRAWN -	PR	REVISED -	
	PLOT SCALE = 1'	CHECKED -	MM	REVISED -	
	PLOT DATE = 11/17/2020	DATE -	11/17/2020	REVISED -	

SCALE: N.T.S.

A.U RTE	SECTION		COUNTY	TOTAL SHEETS	SHEET NO.	
2539	14-00087-00-BR			соок	33	28
				CONTRACT	NO. 63	1G88
ILLINOIS FED. AII				ID PROJECT		

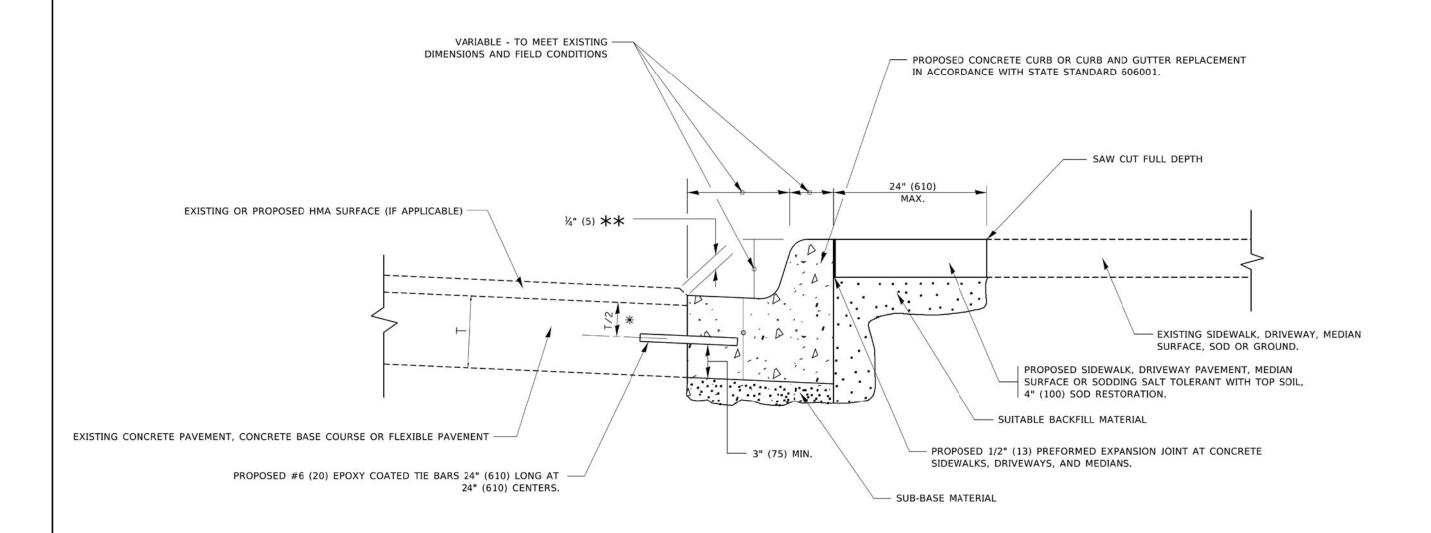

- $\star$  3" (75) MINIMUM FROM TOP AND BOTTOM OF THE CONCRETE PAVEMENT OR BASE COURSE.
- \*\* IF THE FINAL SURFACE OF THE PAVEMENT IS CONCRETE, THE GUTTER IS TO BE FLUSH WITH THE PAVEMENT.


## **CURB OR CURB AND GUTTER REMOVAL AND REPLACEMENT**

ALL DIMENSIONS ARE IN INCHES (MILLIMETERS) UNLESS OTHERWISE SHOWN.


USER NAME = footemj	DESIGNED - A. HOUSEH	REVISED	2	A. ABBAS 03-21-97
	DRAWN -	REVISED	-	M. GOMEZ 01-22-01
PLOT SCALE = 50.0000 ' / in.	CHECKED -	REVISED	*	R. BORO 12-15-09
PLOT DATE = 7/11/2019	DATE - 03-11-94	REVISED	- 12	K. SMITH 07-11-19

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SCALE: NONE

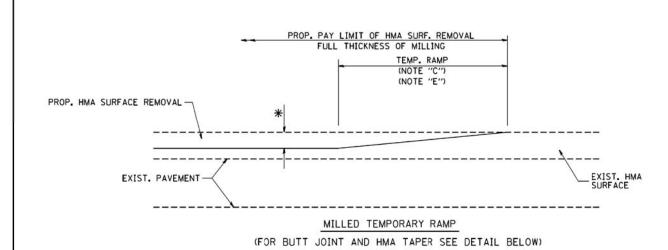


#### OPTION 1

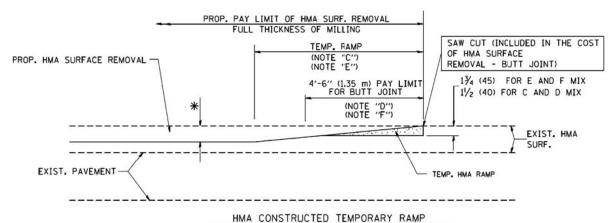

(FOR BUTT JOINT AND HMA TAPER SEE DETAIL BELOW)

#### OPTION 2

#### TYPICAL TEMPORARY RAMP

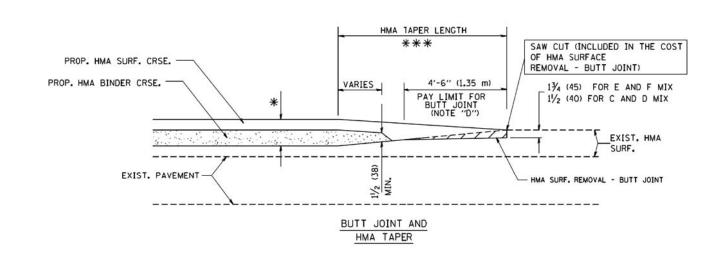

# TYPICAL BUTT JOINT AND HMA TAPER FOR MILLING AND RESURFACING


FILE NAME = USER NAME = goglionobt DESIGNED - M. DE YONG REVISED - R. SHAH 10-25-94


Wi\distatd\22x34\bd32.dgr DRAWN - REVISED - A. ABBAS 03-21-97

PLOT SCALE = 50.0000 '/ IN. CHECKED - REVISED - M. GOMEZ 04-06-01

PLOT DATE = 1/4/2008 DATE - 06-13-90 REVISED - R. BORO 01-01-07

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## TYPICAL BUTT JOINT AND HMA TAPER FOR RESURFACING ONLY

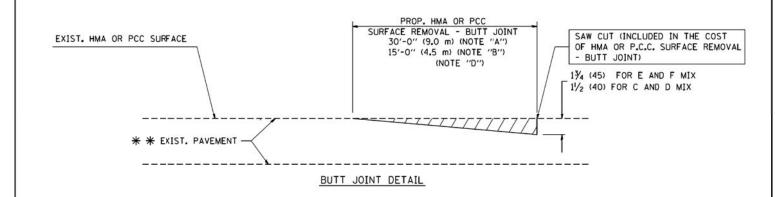\* \* PC CONCRETE, HMA OR HMA RESURFACED PAVEMENT.
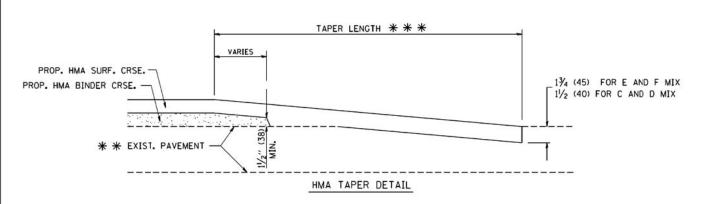
#### NOTES

- A: MAINLINE ROADWAYS AND MAJOR SIDE ROADS.
- B: MINOR SIDE ROADS.
- C: THE TEMP. RAMP SHALL BE CONSTRUCTED IMMEDIATELY UPON REMOVAL OF THE EXISTING HMA SURFACE.
- D: THE BUTT JOINT SHALL BE CONSTRUCTED IMMEDIATELY PRIOR TO PLACING THE PROPOSED HMA COURSES.
- E: TAPER THE TEMP. RAMP AT A RATE OF 3'-O" (900 mm) PER 1 INCH (25 mm) OF MILLING THICKNESS.
- F: INSTALLATION AND REMOVAL OF THE 4'-6" (1.35 m) TEMP. RAMP IS INCLUDED IN COST OF HMA SURFACE REMOVAL BUTT JOINT
- G: SEE ARTICLE 406.08 AND 406.14 OF THE STANDARD SPECIFICATIONS FOR "HMA AND/OR PCC SURFACE REMOVAL, BUTT JOINT".
- \* SEE TYPICAL SECTIONS FOR MILLING THICKNESS.


#### BASIS OF PAYMENT:

THE BUTT JOINT WILL BE PAID FOR AT THE CONTRACT UNIT PRICE PER SOUARE YARD (SOUARE METER)
FOR "HOT-MIX ASPHALT SURFACE REMOVAL - BUTT JOINT" OR FOR "PORTLAND CEMENT CONCRETE SURFACE REMOVAL- BUTT JOINT".

SCALE: NONE

ALL DIMENSIONS ARE IN INCHES (MILLIMETERS) UNLESS OTHERWISE SHOWN.

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#### NOTES:

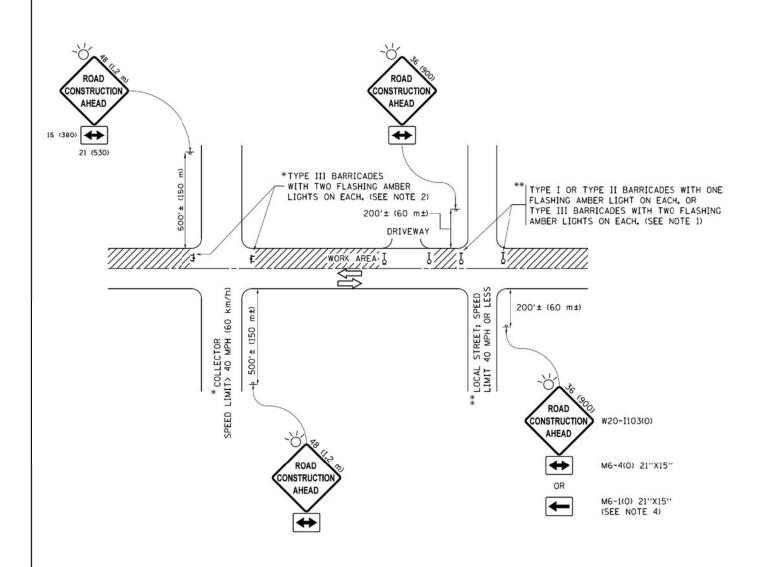- SIDE ROAD WITH A SPEED LIMIT OF 40 MPH (60 km/h) OR LESS AS SHOWN ON THE DRAWING AND AS DIRECTED BY THE ENGINEER:
  - a) ONE "ROAD CONSTRUCTION AHEAD" SIGN 36 x 36 (900x900) WITH A FLASHER MOUNTED ON IT APPROXIMATELY 200" (60 m) IN ADVANCE OF THE MAIN ROUTE.
  - b) THE CLOSED PORTION OF THE MAIN ROUTE SHALL BE PROTECTED BY BLOCKING WITH TYPE I, TYPE II OR TYPE III BARRICADES, 1/3 OF THE CROSS SECTION OF THE CLOSED PORTION.
- 2. SIDE ROAD WITH A SPEED LIMIT GREATER THAN 40 MPH (60 km/h) AS SHOWN ON THE DRAWING AND AS DIRECTED BY THE ENGINEER:
  - O) ONE "ROAD CONSTRUCTION AHEAD" SIGN 48 x 48 (1.2 m x 1.2 m) WITH A FLASHER MOUNTED ON IT APPROXIMATELY 500" (150 m) IN ADVANCE
  - b) THE CLOSED PORTION OF THE MAIN ROUTE SHALL BE PROTECTED BY BLOCKING WITH TYPE III BARRICADES, 1/2 OF THE CROSS SECTION OF THE CLOSED PORTION.
- 3. CONES MAY BE SUBSTITUTED FOR BARRICADES OR DRUMS AT HALF THE SPACING DURING DAY OPERATIONS. CONES SHALL BE A MINIMUM OF 28 (710)
- 4. WHEN THE SIDE ROAD LIES BETWEEN THE BEGINNING OF THE MAINLINE SIGNING AND THE WORK ZONE, A SINGLE HEADED ARROW (M6-1) SHALL BE USED IN LIEU OF THE DOUBLE HEADED ARROW (M6-4).

- 5. WHEN WORK IS BEING PERFORMED ON A SIDE ROAD OR DRIVEWAY, FOLLOW THE APPLICABLE STANDARD(S). THE DIRECTIONAL ARROW (M6-1 OR M6-4) SHALL BE COVERED OR REMOVED WHEN NO LONGER CONSISTENT WITH THE TRAFFIC CONTROL SET-UP.
- 6. ADVANCE WARNING SIGNS ARE TO BE OMITTED ON DRIVEWAYS UNLESS OTHERWISE SPECIFIED IN THE PLANS OR BY THE ENGINEER
- 7. THE TRAFFIC CONTROL AND PROTECTION FOR SIDE ROADS, INTERSECTIONS, AND DRIVEWAYS SHALL BE INCLUDED IN THE COST OF SPECIFIED TRAFFIC CONTROL STANDARDS OR ITEMS.

All dimensions are in inches (millimeters) unless otherwise shown.

STATE OF ILLINOIS
DEPARTMENT OF TRANSPORTATION

TRAFFIC CONTROL AND PROTECTION FOR SIDE ROADS, INTERSECTIONS, AND DRIVEWAYS

SCALE: NONE SHEET 1 OF 1 SHEETS STA. TO STA.

