

# STATE OF ILLINOIS DEPARTMENT OF TRANSPORTATION

#### 

# FOR INDEX OF SHEETS, SEE SHEET NO. 2 FOR LIST OF HIGHWAY STANDARDS SEE SHEET NO. 2

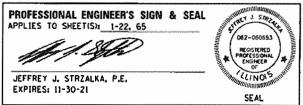


STRUCTURAL ENGINEER'S SIGN & SEAL APPLIES TO SHEET(SIs 23-57	ANDREW E
andy Underwage	UNDERWACER OBI-006218 A
ANDREW E. LANDERWAGER, S.E. EXPIRES: 11-30-20	STACTION OF
EN INCO. 11-30-20	SEAL

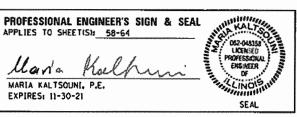

# PLANS FOR PROPOSED FEDERAL AID HIGHWAY

MUNDELEIN METRA STATION OVER CN RR BRIDGE SECTION: 12-00097-00-BR PROJECT: JFPP(620) VILLAGE OF MUNDELEIN LAKE COUNTY

JOB: C-91-333-16

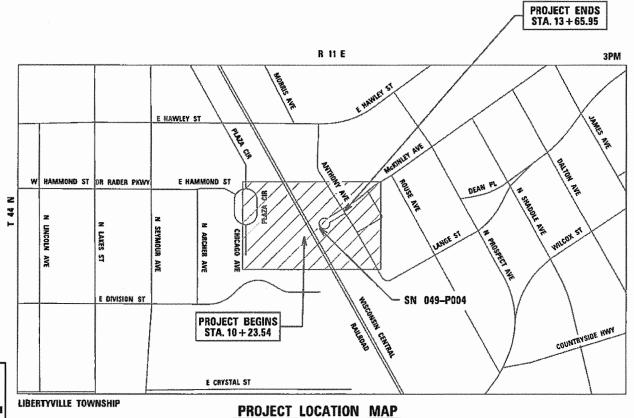

PROJECT LENGTH

NET AND GROSS LENGTH OF PROJECT = 342.41 FT. (0.07 MILES)

N.T.S.

STARE SHORT LET WAS DO PACE

OC. C

OC. C

OC. C

OC. S

O

STATE OF ILLINOIS
DEPARTMENT OF TRANSPORTATION

APPROVED OCTOBER 19, 20 20


VILLAGE OF MUNDELEIN

PASSED OCT 20, 20 20

DISTRICT ONE ENGINEER OF LOCAL ROADS AND STREETS
ELEASING FOR BID
ASSED ON LIMITED REVIEW OCTOBER 22, 20 20

REGIONAL ENGINEER

PRINTED BY THE AUTHORITY OF THE STATE OF ILLINOIS

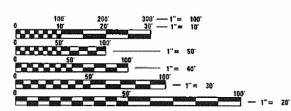

FULL SIZE PLANS HAVE BEEN PREPARED USING STANDARD ENGINEERING SCALES. REDUCED SIZED PLANS WILL NOT CONFORM TO STANDARD SCALES. IN MAKING MEASUREMENTS ON REDUCED PLANS, THE ABOVE SCALES MAY BE USED.



420 NORTH FRONT STREET, SUITE 100 | McHENRY, ILLINOIS 60050
Phone: 815,385,1778 | Totl Free: 800,728,7805 | Fax: 815,385,1781 | HRGreen.com
ILLINOIS PROFESSIONAL DESIGN FIRM #184-001322

Before You Dig

CHE-CALL SUSSIENS
Simply Call 811

Call

CONTRACT NO. 61F89

AID PROGRAM ENGINEER: CARMEN E.

0

0

0

0

		BY	DATE
FLAN	SURVEYED		
	PLOTTED		
NOTE BOOK	ALIGNMENT CHECKED		
2	RT, OF WAY CHECKED		
ģ	CADD FILE NAME		

DATE						
BY						
	L E SURVEYED	PLOTTED	GRADES CHECKED	B.M. NOTED	STRUCTURE NOTATINS CHIKD	

1	Index of Sheets
2	INDEX OF SHEETS, STATE STANDARDS,
3	GENERAL NOTES
4-7	SUMMARY OF QUANTITIES
8	TYPICAL SECTIONS
9	ALIGNMENT, TIES AND BENCHMARKS
10	SITE STAGING PLAN
11	EXISTING CONDITIONS PLAN
12	EROSION CONTROL PLAN
13	SITE REMOVAL PLAN
14	DRAINAGE AND UTILITY REMOVAL PLAN
15	PROPOSED SITE AND GRADING PLAN
16	McKINLEY AVENUE PLAN AND PROFILE
17	PROPOSED DRAINAGE AND UTILITY PLAN
18	PROPOSED DRAINAGE AND UTILITY TAGS
19	LANDSCAPE PLAN
20	LANDSCAPE NOTES
21 <b>-</b> 22	CONSTRUCTION DETAILS
23 <b>-</b> 57	STRUCTURAL PLANS
58-64	LIGHTING PLANS
65	MCKINLEY AVENUE CROSS SECTIONS

	State Standards
Standard No.	List of Description
000001-08	STANDARD SYMBOLS, ABBREVIATIONS & PATTERNS
001001-02	AREAS OF REINFORCEMENT BARS
280001-07	TEMPORARY EROSION CONTROL SYSTEMS
424001-11	PERPENDICULAR CURB RAMPS FOR SIDEWALKS
424021-06	DEPRESSED CORNER FOR SIDEWALKS
542301-03	PRECAST REINFORCED CONCRETE FLARED END SECTION
601001-05	PIPE UNDERDRAINS
602001-02	CATCH BASIN, TYPE A
602011-02	CATCH BASIN, TYPE C
602406-11	PRECAST MANHOLE, TYPE A, 6' DIAMETER
602416-09	PRECAST MANHOLE, TYPE A, 8' DIAMETER
602601-06	PRECAST REINFORCED CONCRETE FLAT SLAB TOP
602701-02	MANHOLE STEPS
604001-05	FRAMES & LIDS, TYPE 1
604036-03	GRATE TYPE 8
604051-04	FRAME & GRATE TYPE 11
606001-07	COMBINATION CONCRETE CURB AND GUTTER
701006-05	OFF RD OPERATIONS, 2L, 2W, 15' TO 24" FROM PAVEMENT
701301-04	LANE CLOSURE, 2L, 2W, SHORT TIME OPERATIONS
701311-03	LANE CLOSURE, 2L, 2W, MOVING OPERATIONS - DAY ONLY
701801-06	SIDEWALK CORNER OR CROSSWALK CLOSURE
701901-08	TRAFFIC CONTROL DEVICES

HRC PROJECT NO. 180756
HRC PROJECT NO. 180756
HRC PROME: RAME: R. 19076. S.P. Cennote. don
HRC NAME: R. 19076. S.P. Cennote. don
HRC NAME: R. 1. 1907. S.P. Cennote. don
HRC NAME: R. 1. 1907. S.P. Cennote. don
HRC LONG S.P. Cennote. don
H

KMII
Kaltsouni Mehdi, Inc.
ARCHITECTS = ENGINEERS
223 W.Jakson Brd., Sule 1010 Chiago, It. 60906
Tel.: (312/987-9800 Fax.: (312/987-9892

DESIGNED	-	JJS	REVISED -
DRAWN	-	WJH	REVISED -
CHECKED	-	JJS	REVISED -
DATE	-	10/5/2020	REVISED -

_	F.A.U RTE.	SECTIO	ON NO.			COUNTY	TOTAL SHEETS	SHEET NO.
S	N/A	12-0009	7-00-BF	₹		LAKE	65	2
						CONTRACT	NO. 6	51F89
	FED. RO	DAD DIST. NO.	ILLINOIS	FED.	AID	PROJECT		

TO STA.

#### **GENERAL NOTES**

- ALL REFERENCES TO "STANDARD SPECIFICATIONS" IN THESE GENERAL NOTES SHALL BE INTERPRETED TO MEAN THE "STANDARD SPECIFICATIONS FOR ROAD AND BRIDGE CONSTRUCTION" ADOPTED BY THE ILLINOIS DEPARTMENT OF TRANSPORTATION, APRIL 1, 2016. ALL WORK TO BE COMPLETED IN ACCORDANCE WITH THE STANDARD SPECIFICATIONS.
- ALL REFERENCES TO "ENGINEER" SHALL BE INTERPRETED TO MEAN THE RESIDENT ENGINEER.
- IT IS THE CONTRACTOR'S RESPONSIBILITY TO ASCERTAIN EXISTING FIELD CONDITIONS PRIOR TO BIDDING ON THE PROJECT.
- BEFORE STARTING ANY EXCAVATION, THE CONTRACTOR SHALL CALL "JULIE" (JOINT UTILITY LOCATION INFORMATION FOR EXCAVATION) AT 8-1-1 FOR FIELD LOCATIONS OF BURIED UTILITIES (48 HOURS NOTIFICATION IS REQUIRED).
- ALL ELEVATIONS SHOWN ON THE PLANS ARE ON THE NAVD88 DATUM.
- ALL RADII FOR PROPOSED CURB AND GUTTER ARE TO THE EDGE OF PAVEMENT, UNLESS OTHERWISE NOTED. CURB AND GUTTER ELEVATIONS SHOWN ALONG RETURNS AND AT POINTS OF CURVATURE, ETC. ARE TO THE EDGE OF PAVEMENT UNLESS OTHERWISE NOTED.
- DRIVEWAYS ARE TO BE CONSTRUCTED TO THE R.O.W. UNLESS OTHERWISE NOTED
- ABANDONED UNDERGROUND UTILITIES THAT CONFLICT WITH CONSTRUCTION SHALL BE DISPOSED OF OUTSIDE THE LIMITS OF THE RIGHT OF WAY ACCORDING TO ARTICLE 202.03 OF THE STANDARD SPECIFICATIONS AND AS DIRECTED BY THE ENGINEER.
- THE ELEVATIONS SHOWN ON THE PLANS ARE FINISHED GRADES OF PROPOSED PAVEMENT, UNLESS
- THE CONTRACTOR WILL NOT BE ALLOWED TO SET UP A YARD OR FIELD OFFICE ON VILLAGE OR STATE PROPERTY WITHOUT WRITTEN CONSENT FROM THE VILLAGE OF MUNDELEIN OR THE
- CONSTRUCTION WORK MAY BE PERFORMED MONDAY THRU FRIDAY DURING THE HOURS OF 7:00 A.M. TO 9:00 P.M. AND ON WEEKENDS FROM 8:00 A.M. TO 6:00 P.M. NO WORK MAY BE PERFORMED PRIOR OR BEYOND THIS PERIOD WITHOUT PRIOR WRITTEN APPROVAL FROM THE
- IT IS THE CONTRACTOR'S SOLE RESPONSIBILITY TO COORDINATE WITH THE WISCONSIN CENTRAL RAILROAD WHENEVER CONSTRUCTION ACTIVITY IS WITHIN 25 FEET OF THE RAILROAD ROW. THE CONTRACTOR SHALL RETAIN FLAGGERS EMPLOYED BY THE RAILROAD TO MONITOR ON-COMING TRAIN TRAFFIC, AND ADVISE CONTRACTOR PERSONNAL WHEN ACTIVITY ON OR NEAR THE RAILROAD ROW MAY PROCEED. THIS ITEM WILL BE PAID FOR ACCORDING TO ARTICLE 107.12 AND WILL BE REIMBURSED ACCORDING TO ARTICLE 109.05.

#### STORM SEWERS, WATER MAINS, AND UTILITIES

- THE CONTRACTOR SHALL BE RESPONSIBLE FOR CONTACTING THE OWNERS OF ALL UTILITIES PRIOR TO CONSTRUCTION TO DETERMINE THE LOCATION OF ALL UTILITY EQUIPMENT. THE CONTRACTOR SHALL COOPERATE WITH ALL UTILITY OWNERS IN ACCORDANCE WITH THE STANDARD SPECIFICATIONS IF UTILITY RELOCATION, ADJUSTMENT, OR PROTECTION IS NECESSARY.
- THE LOCATION OF EXISTING DRAINAGE STRUCTURES, STORM SEWERS, WATER MAINS, SANITARY SEWERS, AND ANY OTHER PUBLIC OR PRIVATE UTILITIES AS SHOWN ON THE PLANS IS APPROXIMATE AND THEIR EXACT LOCATION IS TO BE DETERMINED IN THE FIELD BY THE
- THE CONTRACTOR SHALL BE RESPONSIBLE FOR THE PROTECTION OF ALL UNDERGROUND AND SURFACE UTILITIES EVEN THOUGH THEY MIGHT NOT BE SHOWN ON THE PLANS. ANY UTILITY PROPERTY DAMAGED DURING CONSTRUCTION SHALL BE REPAIRED OR REPLACED TO THE
- THE CONTRACTOR SHALL COOPERATE WITH THE VILLAGE OF MUNDELEIN IF ANY UTILITY IMPROVEMENTS ARE REQUIRED BY THE VILLAGE WITHIN THE DURATION OF THE CONTRACT.
- OFFSET LOCATIONS GIVEN IN THE PLANS FOR STRUCTURES, EDGE OF PAVEMENT, ETC. ARE FROM THE ROADWAY BASE LINE.
- UNLESS OTHERWISE NOTED, OFFSETS FOR DRAINAGE STRUCTURES LOCATED IN CURB AND GUTTER ARE TO THE EDGE OF PAVEMENT AND OFFSETS FOR DRAINAGE STRUCTURES NOT LOCATED IN THE CURB AND GUTTER ARE TO THE CENTER OF THE STRUCTURE.
- WHERE NEW WORK MEETS EXISTING FEATURES TO REMAIN, FIELD CHECK ALL DIMENSIONS AND ELEVATIONS BEFORE PROCEEDING WITH CONSTRUCTION, NOTIFY ENGINEER IMMEDIATELY OF ANY
- ALL FRAMES, GRATES, LIDS, AND BOXES SCHEDULED TO BE REMOVED FROM EXISTING STRUCTURES SHALL REMAIN THE PROPERTY OF THE VILLAGE OF MUNDELEIN AND BE DELIVERED TO THE PUBLIC WORKS FACILITY AT 440 E. CRYSTAL STREET, AS APPLICABLE.
- THE INDISCRIMINATE USE OF FIRE HYDRANTS, EXISTING STREAMS, CREEKS, WETLANDS, OR PONDS IS STRICTLY PROHIBITED. THE CONTRACTOR SHALL PROVIDE A WATER TRUCK AND DRIVER AS REQUIRED TO OBTAIN AND TRANSPORT THIS WATER. THE CONTRACTOR SHALL BE RESPONSIBLE FOR OBTAINING WATER FROM AN APPROVED SOURCE. IF THIS WATER IS FROM A SOURCE OTHER THAN HIS YARD, WRITTEN APPROVAL FROM THE AGENCY HAVING JURISDICTION FOR THE SOURCE OF THE WATER MUST BE RECEIVED BY THE CONTRACTOR PRIOR TO THE USE
- USE OF VILLAGE WATER WILL BE AVAILABLE AT THE PUBLIC WORKS FACILITY AT 440 E. CRYSTAL STREET TO USE WATER FOR DUST CONTROL, MIXING MORTAR, LANDSCAPE WATERING, CLEANING SEWERS, ETC. THE CONTRACTOR WILL PAY FOR THE QUANTITY OF WATER USED AT THE CURRENT RATE OF BILLING AND WILL NOT BE REIMBURSED FOR THE USE OF VILLAGE WATER. THE CONTRACTOR SHALL NOTIFY THE PUBLIC WORKS DEPARTMENT 48 HOURS PRIOR TO THE NEED OF WATER. THE VILLAGE OF MUNDELEIN WILL REQUIRE A CERTIFICATE OF INSURANCE TO USE THE WATER FILLING STATION AND THE CONTRACTOR WILL BE REQUIRED TO SETUP AN ACCOUNT
- CONCRETE ADJUSTING RINGS WILL NOT BE PERMITTED. THE CONTRACTOR SHALL USE HDPE OR EPP IN ACCORDANCE WITH THE BDE SPECIAL PROVISION FOR ADJUSTING FRAMES AND GRATES

- PIPE UNDERDRAINS SHALL BE INSTALLED ACCORDING TO SECTION 601 OF THE STANDARD SPECIFICATIONS AND STANDARD 601001-05. TOP OF PIPE UNDERDRAINS SHALL BE PLACED A MINIMUM OF SIX INCHES (6") BELOW THE AGGREGATE SUBGRADE IMPROVEMENT LAYER. THE COST OF MAKING PIPE UNDERDRAIN CONNECTIONS TO DRAINAGE STRUCTURES SHALL BE INCLUDED IN THE COST OF THE PIPE UNDERDRAINS
- 13. STORM SEWERS SHALL BE BACKFILLED IN ACCORDANCE WITH ARTICLE 550.07, METHOD 1 ONLY.
- 14 TRENCH BACKFILL SHALL CONSIST OF CA-6 CRUSHED STONE OR CRUSHED AGGREGATE.
- PROVIDE TRENCH BACKFILL FOR ALL UTILITY LINES WITHIN 2' OF PAVED AREAS. ALL TRENCH 15. BACKFILL QUANTITIES FOR STORM SEWERS HAVE BEEN COMPUTED AND SHALL BE PAID FOR IN ACCORDANCE WITH THE STATE OF ILLINOIS DEPARTMENT OF TRANSPORTATION DIVISION OF HIGHWAYS BUREAU OF CONSTRUCTION TRENCH BACKFILL TABLE, BASED ON PIPE SIZE AND INVERT

#### EARTHWORK

- SUBGRADE SHALL BE PREPARED IN ACCORDANCE WITH ARTICLE 301.03 OF THE STANDARD SPECIFICATIONS BEFORE REMOVAL OF ANY UNSUITABLE MATERIAL
- PRIOR TO ANY EMBANKMENT PLACEMENT, ALL VEGETATION AND UNSTABLE MATERIAL SHOULD BE REMOVED TO DEPTH ENCOUNTERED AND REPLACED WITH SUITABLE EMBANKMENT MATERIAL AS APPROVED BY THE ENGINEER.
- THE SUBGRADE STABILITY SHALL BE VERIFIED BY PROOF ROLLING WITH A FULLY LOADED TANDEM-AXLE TRUCK.
- ANY AGGREGATE SUBGRADE IMPROVEMENT CONTAMINATED AND/OR DAMAGED BY THE CONTRACTOR'S VEHICLES AND/OR EQUIPMENT IS TO BE REMOVED AND REPLACED AS DIRECTED BY THE ENGINEER AT THE CONTRACTOR'S EXPENSE

#### SIGNING

- SIGNS SHALL NOT BE MOVED OR COVERED UNTIL PROGRESS OF WORK NECESSITATES IT.
- THE CONTRACTOR WILL BE REQUIRED TO TEMPORARILY RESET ALL SUCH SIGNS THAT INTERFERE WITH THEIR CONSTRUCTION OPERATIONS. ALL SUCH SIGNS MUST BE MAINTAINED STRAIGHT AND CLEAN FOR THE DURATION OF THE TEMPORARY SETTING AND MUST BE RE-ERECTED AT A TEMPORARY LOCATION IN A WORKMANLIKE MANNER AND BE VISIBLE TO THE TRAFFIC FOR WHICH

#### SEDIMENTATION AND EROSION CONTROL

- SOIL DISTURBANCE SHALL BE CONDUCTED IN SUCH A MANNER AS TO MINIMIZE EROSION. SOIL STABILIZATION MEASURES SHALL CONSIDER THE TIME OF YEAR, SITE CONDITIONS, AND THE USE OF TEMPORARY AND PERMANENT MEASURES.
- SOIL EROSION AND SEDIMENT CONTROL FEATURES SHALL BE CONSTRUCTED PRIOR TO THE COMMENCEMENT OF HYDROLOGIC DISTURBANCE OF UPLAND AREAS.
- TEMPORARY EROSION CONTROL SEEDING AND EROSION CONTROL BLANKET SHALL BE APPLIED ON ALL DISTURBED AREAS IN ACCORDANCE WITH SECTIONS 250 AND 251 OF THE STANDARD SPECIFICATIONS. SEEDING SHALL NOT BE PERMITTED AT ANY TIME WHEN THE GROUND IS FROZEN, WET, OR IN AN UNTILLABLE CONDITION. LOCATIONS TO BE SEEDED SHALL BE DETERMINED BY THE
- DISTURBED AREAS SHALL BE STABILIZED WITH TEMPORARY OR PERMANENT MEASURES WITHIN 14 CALENDAR DAYS OF THE END OF THE ACTIVE HYDROLOGIC DISTURBANCE, OR REDISTURBANCE IN ACCORDANCE WITH SECTIONS 250 AND 280 OF THE STANDARD SPECIFICATIONS.
- EROSION CONTROL SYSTEMS SHALL BE INSPECTED WEEKLY AND IMMEDIATELY FOLLOWING ANY STORM HAVING A RAINFALL EQUAL TO ONE-HALF INCH OR GREATER. ANY REQUIRED REPAIRS TO THE EROSION CONTROL SYSTEMS SHALL BE MADE IMMEDIATELY. ANY SILTATION OF CULVERTS, STRUCTURES, OR DITCHES SHALL BE CLEANED AND MAINTAINED BY THE CONTRACTOR UNTIL SEEDING HAS TAKEN HOLD, ALL WASHOUTS, GULLIES, ETC. WILL BE REGRADED AND RESEEDED BY
- ALL TEMPORARY EROSION CONTROL MEASURES SHALL BE REMOVED WITHIN 30 DAYS AFTER FINAL SITE STABILIZATION IS ACHIEVED OR AFTER THE TEMPORARY MEASURES ARE NO LONGER NEEDED AS DIRECTED BY THE ENGINEER.
- ANY SEDIMENT OR SOIL REACHING AN IMPROVED PUBLIC RIGHT-OF-WAY, STREET, ALLEY, OR PARKING AREA SHALL BE REMOVED BY SCRAPING OR STREET CLEANING AS ACCUMULATIONS WARRANT OR AS DIRECTED BY THE ENGINEER AND TRANSPORTED TO A CONTROLLED SEDIMENT
- SOIL STOCKPILES SHALL NOT BE LOCATED IN A FLOOD-PRONE AREA OR A DESIGNATED BUFFER PROTECTING WATERS OF THE UNITED STATES. IF DE-WATERING SERVICES ARE USED, ADJOINING PROPERTIES AND DISCHARGE LOCATIONS SHALL BE PROTECTED FROM EROSION. DISCHARGES SHALL BE ROUTED THROUGH AN EFFECTIVE SEDIMENT CONTROL MEASURE (SEDIMENT TRAP, SEDIMENT BASIN, OR OTHER APPROPRIATE MEASURE).
- THE EROSION CONTROL MEASURES INDICATED IN THE PLANS ARE THE MINIMUM REQUIREMENTS. ADDITIONAL MEASURES MAY BE REQUIRED, AS DIRECTED BY THE ENGINEER OR GOVERNING
- THE CONTRACTOR SHALL BE RESPONSIBLE FOR SWEEPING AND CLEANING STREETS OF ANY DEBRIS AND MATERIAL THAT HAS ACCUMULATED AS A RESULT OF THE CONSTRUCTION ACTIVITY. A MECHANICAL SWEEPER, MECHANICALLY DRIVEN AIR AND HANDWORK WITH SHOVEL AND BROOM SHALL BE UTILIZED TO PROVIDE A CLEAN STREET FOR THE MOTORING PUBLIC.

#### **LANDSCAPING**

- THE CONTRACTOR SHALL COORDINATE INSTALLATION OF ALL PLANT MATERIAL WITH THE INSTALLATION OF OTHER IMPROVEMENTS SUCH AS HARDSCAPE ELEMENTS AND UTILITIES. ANY DAMAGE TO EXISTING IMPROVEMENTS IS THE RESPONSIBILITY OF THE CONTRACTOR.
- THE CONTRACTOR SHALL STAKE ALL TREE AND SHRUB LOCATIONS AND THE PERIMETER OF LANDSCAPING BEDS PRIOR TO INSTALLATION AND CONTACT THE RESIDENT ENGINEER FOR APPROVAL. FINAL LOCATION AND STAKING OF ALL PLANT MATERIALS SHALL BE APPROVED BY THE RESIDENT ENGINEER IN ADVANCE OF PLANTING. IF CONFLICTS ARISE BETWEEN THE SIZE OF AREAS AND PLANS, THE CONTRACTOR IS REQUIRED TO CONTACT THE RESIDENT ENGINEER FOR RESOLUTION PRIOR TO INSTALLATION.
- ALL PLANTS SHALL BE NURSERY GROWN PLANTS MEETING AMERICAN NURSERY AND LANDSCAPE ALL PLANTS SHALL BE NURSERY GROWN PLANTS MEETING AMERICAN STANDARD FOR NURSERY STOCK"
  (ANSI Z60.1-2004), PLANTS ARE TO BE TYPICAL IN SHAPE AND SIZE FOR SPECIES, PLANTS PLANTED
  IN ROWS OR GROUPS SHALL BE MATCHED IN FORM, PLANTS SHALL NOT BE ROOT-BOUND OR
  LOOSE IN THEIR CONTAINERS. HANDLE ALL PLANTS WITH CARE IN TRANSPORTING, PLANTING AND MAINTENANCE UNTIL INSPECTION AND FINAL ACCEPTANCE.

#### SEQUENCE OF CONSTRUCTION

THE CONTRACTOR SHALL PERFORM HIS WORK IN A MANNER CAUSING MINIMAL INCONVENIENCE TO THE RESIDENTS AND MOTORING PUBLIC.

1433

**HRGreen** 

DESIGNED	-	JJS	REVISED	-
DRAWN	-	WJH	REVISED	-
CHECKED	-	JJS	REVISED	-
DATE	-	10/5/2020	REVISED	-

STATE	: OI	FILLINOIS
DEPARTMENT	0F	TRANSPORTATION

SCALE: NTS

SHEET 1

				F.A.U RTE.	SECTI	ON NO.		COUNTY	TOTAL SHEETS	SHEE1
GENE	RAL NO	IES		N/A	12-0009	7-00-BF	1	LAKE	65	3
								CONTRACT	NO.	61F89
OF 1	SHEETS	STA.	TO STA.	FED. R	OAD DIST. NO.	ILLINOIS	FED. AI	D PROJECT		

-	¥8	ď
PL AN	URVEYED	
	LOTTED	
NOTE ROOK	ALIGNMENT CHECKED	
	IT. OF WAY CHECKED	
92	ADD FILE NAME	

		BY	DATE
4CF ILE	PRUPILE SURVEYED		
	PLOTTED		
NOTE BOOK	GRADES CHECKED		
	B.M. NOTED		
9	STRUCTURE NOTATINS CHIKD		

RGreen	HRGreen.com Illinois Professional Design Fi # 184-001322

KAItsouni Mehdi, Inc. ARCHITECTS = ENGINEERS 223 W.Jakon Beld, Sith 100 Chapp, I. 50000 Tel.: (312)887-6503 Fax: (312)897-6992

DRAWN - WJH	DESIGNED	-	JJS	REVISED	=
	DRAWN	-	WJH	REVISED	-
DATE - 10/5/2020 REVISED -	CHECKED	-	JJS	REVISED	-
Divide Toron Education The Video	DATE	-	10/5/2020	REVISED	-

CODE NO.

20200100 EARTH EXCAVATION

STATE OF ILLINOIS
DEPARTMENT OF TRANSPORTATION

		SU	MMARY	OF QU	ANTITIES	
SCALE: NTS	SHEET	1	OF 4	SHEETS	STA.	TO STA.

CONSTRUCTION CODE CMAQ

80% FED/20% LOCAL

0021

400

TOTAL

QUANTITY

400

CU YD

		SPECIAL PRO SPECIALTY I		
F.A.U RTE.	SECTION NO.	COUNTY	TOTAL SHEETS	SHEET NO.
N/A	12-00097-00-BR	LAKE	65	4
		CONTRACT	NO. 1	61F89
FED. RO	IAD DIST. NO.   ILLINOIS FED. A	ID PROJECT		

20201200	REMOVAL AND DISPOSAL OF UNSUITABLE MATERIAL	CU YD	445	445
-				
20400800	FURNISHED EXCAVATION	CU YD	2,740	2,740
20700220	POROUS GRANULAR EMBANKMENT	CU YD	350	350
20700220	I OTOGO GRANDENT EMBANNIENT	CO 15	330	330
20000150				
20800150	TRENCH BACKFILL	CU YD	115	115
21101505	TOPSOIL EXCAVATION AND PLACEMENT	CU YD	811	811
21101615	TOPSOIL FURNISH AND PLACE, 4"	SQ YD	710.0	710.0
25200110	SODDING, SALT TOLERANT	SQ YD	9,890.0	9,890.0
25200200	SUPPLEMENTAL WATERING	UNIT	611	611
28000250	TEMPORARY EROSION CONTROL SEEDING	POUND	205	205
·····				
28000305	TEMPORARY DITCH CHECKS	FOOT	30.0	30.0
20000303	TENFORANT BITCH CILERS	1001	30.0	30.0
28000400	PERIMETER EROSION BARRIER	FOOT	1,070.0	1,070.0
28000510	INLET FILTERS	EACH	11	11
30300112	AGGREGATE SUBGRADE IMPROVEMENT 12"	SQ YD	1,565.0	1,565.0
35101600	AGGREGATE BASE COURSE, TYPE B 4"	SQ YD	1,115.0	1,115.0
40600275	BITUMINOUS MATERIALS (PRIME COAT)	POUND	4,580	4,580
40600290	BITUMINOUS MATERIALS (TACK COAT)	POUND	296	296
40603080	HOT-MIX ASPHALT BINDER COURSE, IL-19.0, N50	TON	235	235
40604060	HOT-MIX ASPHALT SURFACE COURSE, IL-9.5, MIX "D", N50	TON	170	170
+0004000	FIGURE STATES CONTROL COUNTY, IND. 19, 1900	1.014	1,0	1,0
42402222	PORTI AND CEMENT CONCRETE SIDEWALK SINGU	50.57	7.405.0	7.405.0
42400300	PORTLAND CEMENT CONCRETE SIDEWALK 6 INCH	SQ FT	7,495.0	7,495.0
42400800	DETECTABLE WARNINGS	SQ FT	75.0	75.0
44000100	PAVEMENT REMOVAL	SQ YD	1,245.0	1,245.0
44000500	COMBINATION CURB AND GUTTER REMOVAL	FOOT	850.0	850.0
			<u>'</u>	

ITEM

44000600	SIDEWALK REMOVAL		SQ FT	4,805.0	4,805.0
50200100	STRUCTURE EXCAVATION		CU YD	1,096	1,096
		,			
50200450	REMOVAL AND DISPOSAL OF UNSUITABLE MATE	RIAL FOR STRUCTURES	CU YD	350	350
50300225	CONCRETE STRUCTURES		CU YD	147	147
AHIE 4 - 14 A					
50300255	CONCRETE SUPERSTRUCTURE		CU YD	139	139
50300285	FORM LINER TEXTURED SURFACE		SQ FT	7,592	7,592
50300300	PROTECTIVE COAT		SQ YD	1,236.0	1,236.0
50800205	REINFORCEMENT BARS, EPOXY COATED		. POUND	92,451	. 92,451
51200957	FURNIISHING METAL SHELL PILES 12" X 0.250"		FOOT	40.0	40.0
	7 N. 25		1001	70,0	40.0
51200958	FURNIISHING METAL SHELL PILES 14" X 0.250"		FOOT	036.0	026.0
21200330	TOTALISTANO METAL SHELL FILES 14" X 0.250"		FOOT	936.0	936.0
E 1202225	DODANG DUES			070	
51202305	DRIVING PILES		FOOT	976.0	976.0
51203200	TEST PILE METAL SHELLS		EACH	2	2
52200500	MECHANICALLY STABILIZED EARTH RETAINING W	ALL	SQ FT	12,541.0	12,541.0
58700300	CONCRETE SEALER		SQ FT	99.0	99.0
54213669	PRECAST REINFORCED CONCRETE FLARED END	SECTIONS 24"	EACH	1	1
550A0050	STORM SEWERS, CLASS A, TYPE 1 12"		FOOT	123.0	123.0
550A0090	STORM SEWERS, CLASS A, TYPE 1 18"		FOOT	98.0	98.0
550A0410	STORM SEWERS, CLASS A, TYPE 2 24"		FOOT	299.0	299.0
55100500	STORM SEWER REMOVAL 12"		FOOT	139.0	139.0
55100900	STORM SEWER REMOVAL 18"		FOOT	104.0	104.0
			, 551	25/110	10-10
60108204	PIPE UNDERDRAINS, TYPE 2, 4"		FOOT	180.0	180.0
3310204			1,001	100.0	100.0
60201105	CATCH BASING TYPE A 41 DIAMETER TYPE 14 5	DAME AND CDATE	FACU	1	4
00201103	CATCH BASINS, TYPE A, 4'-DIAMETER, TYPE 11 F	EACH	1	1	
60707605	CATCH DACING TYPE C TYPE C CO.T.				
60207605	CATCH BASINS, TYPE C, TYPE 8 GRATE	EACH	1	1	
60207905	CATCH BASINS, TYPE C, TYPE 11 FRAME AND GI	EACH	3	3	
60223800	MANHOLES, TYPE A, 6'-DIAMETER, TYPE 1 FRAMI	CLOSED LID	EACH	1	1
DESIGNED	JJS REVISED -				
	NJH REVISED -	STATE OF ILLINOIS	l su	MMARY OF QUA	NTITIES

HEC PROJECT NO.; #6
HEC PROJECT NO.; #6
HEC PROJECT NO.; #6
PLOT NO. MEC. #6
PLOT NO. MEC.

HRGreen.com Illnols Professional Design Firm # 184-001322

Kaltsouni Mehdi, Inc.
ARCHITECTS ERKINEERS
223 W.Jadson-Bd., Sube 1000 Chiago, E. 50606
Tel.: (112/897-6902 Fax: (112/897-6902

REVISED -CHECKED - JJS

DATE - 10/5/2020 REVISED -REVISED -

STATE OF ILLINOIS
DEPARTMENT OF TRANSPORTATION

SUMMARY OF QUANTITIES SCALE: NTS SHEET 2 OF 4 SHEETS STA.

\* SPECIAL PROVISION + SPECIALTY ITEM COUNTY TOTAL SHEET NO.

LAKE 65 5

CONTRACT NO. 61F89

F.A.U RTE. N/A 12-00097-00-BR FED. ROAD DIST. NO. | ILLINOIS FED. AID PROJECT

SECTION NO.

TO STA.

ECT NO.: I. CONTACT: E: VER: E.	HRGreen.com	KMI		DESIGNED -	JJS	REVISED -		OF HIMOIC			MANADY OF OU	
11. 180 101. 180 11.1								AALLES Aa				
180756. Sht. 500.dgn 11pdf. bw. bitefg plotlabel. tbl			*	X0327487	TRIAXIAL GEOGRI	D REINFORCEMENT, TYPE I			sc	) YD	1,362.0	1,362.0
17.500.1 1.pltcfs 1bl								( # 100 # 20 # 20 # 20 # 20 # 20 # 20 # 2				
ngb 7			*	X0326864	BRICK SIDEWALK	REMOVAL			sc	) FT	1,565.0	1,565.0
			*	AU3268U6	WASHOUT BASIN				L	JUM	1	1
				X0326806	WASHOUT BASIN					SUM	1	1
			+ *	X0326672	PEDESTRIAN BRID	OGE LIGHTING SYSTEM		And the state of t	L L	SUM	1	1
			*	X0322508	PEDESTRIAN TRUS	SS SUPERSTRUCTURE			sc	) FT	1,234	1,234
NO.												
PROFILE NOTE BOOK			*	X0322463	CONNECTION TO	EXISTING SEWER			EA	\CH	3	3
SUR PLOT B.M. STRU												
SURVEYED PLOTING RADES CHECKED BAA. NOTED STRUCTURE NOTATINS CHYRD			+ *	K0012990	PERENNIAL PLANT	TS, ORNAMENTAL TYPE, GALLON PC	т	L. Mariana Mari	Ur	NIT	10	10
CCKED			·								-	
NS CH'K			+ *	D2003636	EVERGREEN, TAXI	US X MEDIA HICKSII (HICKS ANGLO	JAPANESE YEW), 3' WIDTH, BALLI	ED AND BURLAPPED	EA	кСН	48	48
			т <sup></sup>	C2000024	JAMOB, NOSA ME	OQUE (LINK MEIDILAND ROSE), 2	- TEIGHT, CONTAINEN		C.F		J.	
			+ *	C2008024	SHRUR ROSA ME	EIPOQUE (PINK MEIDILAND ROSE), 2	4" HEIGHT, CONTAINER		EA	\CH	56	56
			+ *	B2000767	BURLAPPED		_ ( 3 ) = ( 3 .		EA	ACH	6	6
			ية ي	P3000757	TREE, AMELANCH	IER X GRANDIFLORA AUTUMN BRIL	LÍANCE (AUTUMN BRILLIANCE SEF	RVICE BERRY), 8' HEIGHT, CLUMP FORM, BA	LLED AND	יכח	c	C
++++			+ *	A2006916	TREE, QUERCUS F	PALUSTRIS (PIN OAK), 2" CALIPER,	BALLED AND BURLAPPED		E.A	VCH	4	4
<del>                                     </del>												-
			+ *	A2000120	TREE, ACER X FR	EEMANII AUTUMN BLAZE (AUTUMN	BLAZE FREEMAN MAPLE), 2-1/2"	CALIPER, BALLED AND BURLAPPED	EA	/CH	6	6
			+ *	89502376	REBUILD EXISTING	G HANDHOLE			EA	\CH	1	1
			+	84200804	REMOVAL OF POL	LE FOUNDATION			EA	ACH	16	16
İ								***************************************				<del>- ·</del>
İ			+	84200500	REMOVAL OF LIG	HTING UNIT, SALVAGE		Market Ma	FA	ACH	14	14
<u> </u>			+ *	83600200	LIGHT POLE FOUN	NDATION, 24" DIAMETER			FC	OOT	153.0	153.0
PLAN NOTE BODK NO.				022222	LIGHT COLT TO	NDATION DAIL SYNTETE				NOT.	153.0	152.0
SUR SUR ALIG			+	82500350	LIGHTING CONTRO	OLLER, BASE MOUNTED, 240VOLT,	100AMP		EA	ACH	1	1
SURVEYED ALUSTED ALUSTED ALUSMENT CHECKED RT. OF WAY CHECKED CADD FILE NAME							***************************************					
CHECKEC	•		+ *.	80400100	ELECTRIC SERVIC	E INSTALLATION	•		EA	ACH ,	1	1 .
			*	70102640	TRAFFIC CONTRO	L AND PROTECTION, STANDARD 70	1801		LS	GUM	1	1
				67100100	MOBILIZATION				L	SUM	1	1
				67100100	MORIUZATION			1.1.114.00.00.00.00.00.00.00.00.00.00.00.00.00	f f	CUM	1	1
				67000400	ENGINEER'S FIELD	D OFFICE, TYPE A			CA	AL MO	12	12
				60603800	COMBINATION CO	DNCRETE CURB AND GUTTER, TYPE	B-6.12		FC	от	870.0	870.0
						<u></u>						
				60500040	REMOVING MANH	IOLES			E.A	ACH	6	6
				60255500	MANHOLES TO BI	L ADJUSTED			E/	4CF7	5	د ا
				60255500	MANUAL SE TO DE	F ADULTED				ACH	5	5
			*	60224020	MANHOLES, TYPE	A, 6'-DIAMETER, TYPE 11 FRAME A	AND GRATE	CANCELLA CONTROL OF THE CONTROL OF T	EA	ACH	1	1
					1	MAN THE PROPERTY OF THE PROPER						

\* SPECIAL PROVISION + SPECIALTY ITEM

KMI Mehdi, Inc.
ARCHITECTS = ENGINEERS
223 W.Jackson Bh-d, Sulto 100 CRicogo, I. SCE00
Tel: (1912/087-6800 Fax: (1912/087-6892)

DRAWN - WJH

CHECKED - JJS REVISED -REVISED -DATE - 10/5/2020 REVISED -

STATE OF ILLINOIS DEPARTMENT OF TRANSPORTATION

SUMMARY OF QUANTITIES SHEET 3 OF 4 SHEETS STA. TO STA. SCALE: NTS

	+ *	X0327808	PLANTING SOIL MIX FURNISH AND PLACE, 18"	SQ YD	70.0	70.0
	*	X2130010	EXPLORATION TRENCH, SPECIAL	FOOT	250.0	250.0
	*	X4240440	PORTLAND CEMENT CONCRETE SIDEWALK 6 INCH, SPECIAL	SQ FT	5,461.0	5,461.0
	*	X5030290	STAINING CONCRETE STRUCTURES	SQ FT	3,859	3,859
DATE						
	*	X6640200	TEMPORARY CHAIN LINK FENCE	FOOT	625.0	625.0
8	*	X8780105	CONCRETE FOUNDATIONS (SPECIAL)	EACH	8	8
	+ *	Z0007124	STEEL RAILING (SPECIAL)	FOOT	1,372.0	1,372.0
SURVEYED PLOTTED ALIONATED R. OF WAY CHECKED CAOD FILE NAME						
HECKED CHECKED	*	. Z0013798	CONSTRUCTION LAYOUT	L SUM	1	1
FED WAY I						
SURVE) PLOTTI ALIGNA RT. OF CADD F	*	Z0018800	DRAINAGE SYSTEM	L SUM	1	1
800k						
PLAN NOTE BOOK NO.	*	Z0022800	FENCE REMOVAL	FOOT	180.0	180.0
	*	Z0046304	PIPE UNDERDRAINS FOR STRUCTURES 4"	FOOT	940.0	940.0
	ж	Z0048665	RAILROAD PROTECTIVE LIABILITY INSURANCE	L SUM	1	1
	# *	Z0076600	TRAINEES	HOUR	500	500
	± *	Z0076604	TRAINEES TRAINING PROGRAM GRADUATE	HOUR	500	500
DATE	*	XX004951	CONCRETE STAIRS	L SUM	1	1
BY DATE	*	XX005283	BRICK PAVER CROSSWALK	SQ FT	500.0	500.0
	+ *	XX006751	STAIR RAILING	FOOT	240.0	240.0
,kD						
, NS CH	+ *	XX009361	MULCH, SPECIAL	SQ YD	480.0	480.0
TO THE TOTAL						

HRGreen.com
HRGreen.com
HRGreen.com
HRGreen.com
HRGreen.com
HRGreen.com

KMI Kaltsouni Mehdi, Inc. ARCHIECTS & ENGINEEZ 223 W.JASZO BAL, SUR DIC CACOO, I. 50506 Tel: (312)887-6902 Fax: (312)887-6992

DESIGNED - JJS DRAWN - WJH REVISED -CHECKED - JJS


DATE - 10/5/2020 REVISED -REVISED


STATE OF ILLINOIS
DEPARTMENT OF TRANSPORTATION

SUMMARY OF QUANTITIES SCALE: NTS SHEET 4 OF 4 SHEETS STA. TO STA. \* SPECIAL PROVISION + SPECIALTY ITEM

#0042

F.A.U RTE.	SECTIO	ON NO.			COUNTY	TOTAL	SHEET NO.
N/A	12-0009	7-00-BF	}		LAKE	65	7
					CONTRACT	NO.	51F89
FED. RO	AD DIST. NO.	ILLINOIS	FED.	AID	PROJECT		

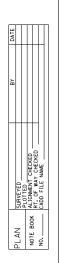

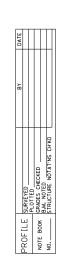



HRGreen.com HRGreen

KMI Kaltsouni Mehdi, Inc. ARCHITECTS = ENGINEERS 223 W.Jackson Blvd., Suite 1010 Chicago, IL 60606 Tel.: (312)987-9800 Fax.: (312)987-9892

DESIGNED - JJS REVISED DRAWN WJH REVISED CHECKED JJS REVISED DATE 10/5/2020 REVISED NOTES:

IT IS ANTICIPATED THE CONTRACTOR WILL USE THE EXISTING McKINLEY AVENUE PAVEMENT FOR TEMPORARY ACCESS DURING CONSTRUCTION.

THE AVERAGE DEPTH OF PAVEMENT REMOVAL IS 8" TO 11" AS SHOWN ON THE TYPICAL SECTIONS AND SOIL BORING RESULTS. HOWEVER NO ADDITIONAL COMPENSATION WILL BE GRANTED FOR PAVEMENT REMOVAL FOR VARIANCES IN THICKNESS/MATERIAL TYPES OR EXCAVATION AND DISPOSAL OF EXCESS MATERIALS.

SCALE: NTS

#### EXISTING LEGEND

- (A) HOT-MIX ASPHALT PAVEMENT; 3" TO 5"
- AGGREGATE BASE COURSE, 5" TO 6"
- COMBINATION CONCRETE CURB AND GUTTER
- EXISTING BRICK SIDEWALK
- E EXISTING GROUND
- (F) EXISTING PCC SIDEWALK; 6"
- EXISTING LANDSCAPED MEDIAN TO BE REMOVED



INDICATES PAVEMENT REMOVAL



INDICATES REMOVAL ITEM

### PROPOSED LEGEND

- 1) OMITTED
- 2 OMITTED
- COMBINATION CONCRETE CURB AND GUTTER, TYPE B-6.12 WITH 2-#4 BARS CONTUNUOUS (MINIMUM FLAG THICKNESS OF 10 INCHES)
- HMA SURFACE COURSE, IL-9.5, MIX "D", N50; 2"
- (5) HMA BINDER COURSE, IL-19.0, N50; 3"
- **(6)** PORTLAND CEMENT CONCRETE SIDEWALK 6 INCH
- 7 AGGREGATE BASE COURSE, TYPE B 4" (CA-6 CRUSHED GRAVEL OR CRUSHED STONE)
- AGGREGATE SUBGRADE IMPROVEMENT, 12" (SQ YD)
- 9 TRIAXIAL GEOGRID, TYPE I
- 10 SODDING, SALT TOLERANT TOPSOIL FURNISH AND PLACE, 4"

HOT-MIX ASPHALT MIXTURE REQUIREMENTS						
MIXTURE TYPE	AIR VOIDS @ Ndes					
RECONSTRUCTION						
HOT-MIX ASPHALT SURFACE COURSE, MIX "D", IL-9.5, N50; 2"	4.0% @ 50 GYR.					
HOT-MIX ASPHALT BINDER COURSE, IL-19.0, N50; 3"	4.0% @ 50 GYR.					
MULTI-USE PATH						
HOT-MIX ASPHALT SURFACE COURSE, MIX "D", IL-9.5, N50; 2"	4.0% @ 50 GYR.					
·						

THE UNIT WEIGHT TO CALCULATE ALL HMA SURFACE MIXTURE QUATITIES IS 112 LBS/SQ YD/IN.

THE "AC TYPE" FOR POLYMERIZED HMA MIXES SHALL BE "SBS/SBR PG 76-22" AND FOR NON-POLYMERIZED HMA THE "AC TYPE" SHALL BE "PG 64-22" UNLESS MODIFIED BY THE SPECIAL PROVISIONS

COUNTY

LAKE 65 8

CONTRACT NO. 61F89

FOR USE OF RECYCLED MATERIALS SEE SPECIAL PROVISIONS.

		100'			
50'				50'	
					EX ROW
ŀ	12'	32 i84'	12'	5' 7'	1'-9'
1'-9' 7' 5' VARIES 0 0 0 0 0 0 0 0 0 0 0 0 0 0 0 0 0 0 0	_1.5%_	(3) (8) (9) (3)	1.5%	1 TYP.	VARIES 1

EX Q

G

**EXISTING TYPICAL SECTION** 

MCKINLEY AVENUE STA. 11+57.79 TO STA. 13+51.91

EX & PR Q


В

50'

#### PROPOSED TYPICAL SECTION

MCKINLEY AVENUE STA. 11+83.69 TO STA. 13+51.91 \* DENOTES REVERSE GUTTER FLAG

STATE	OF ILLII	NOIS
DEPARTMENT	OF TRAN	ISPORTATION

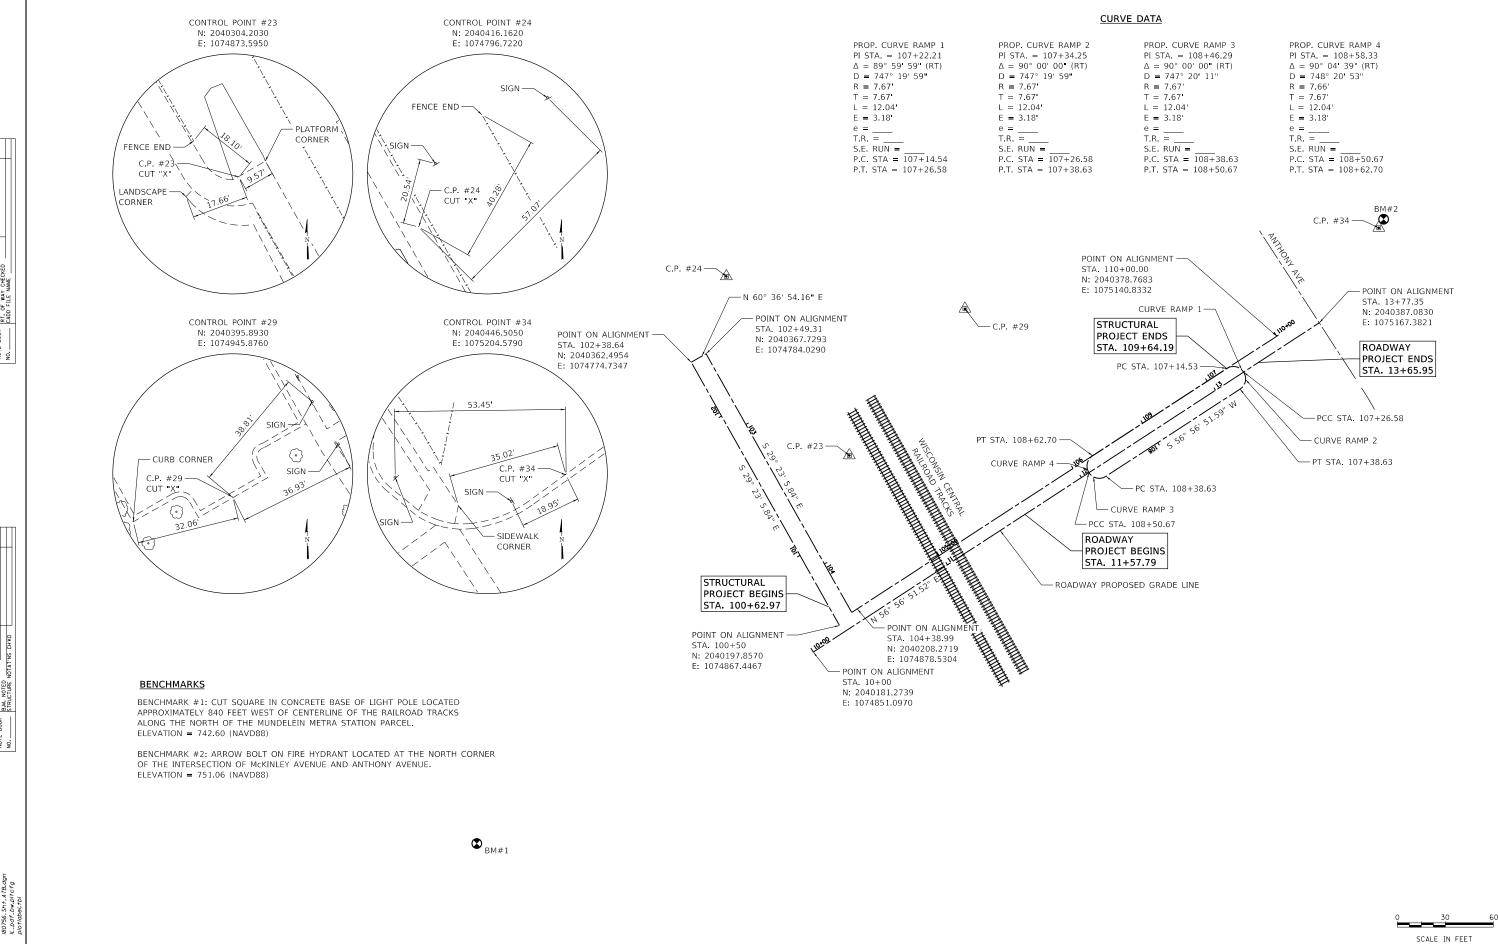

HRGreen

HRGreen.com 1433


**KMI** Kaltsouni Mehdi, Inc. ARCHITECTS ■ ENGINEERS 223 W.lackson Bhd., Suite 1010 Chicago, IL 60606 Tel.: (312)987-9800 Fax.: (312)987-9892


DESIGNED -REVISED JJS DRAWN WJH REVISED CHECKED JJS REVISED REVISED DATE 10/5/2020


STATE OF ILLINOIS **DEPARTMENT OF TRANSPORTATION** 


ALIGNMENT, TIES AND BENCHMARKS SCALE: 1"=30" SHEET 1 OF 1 SHEETS STA. TO STA. 6+45.30


SECTION NO. COUNTY N/A 12-00097-00-BR LAKE 65 9 CONTRACT NO. 61F89 FED. ROAD DIST. NO. ILLINOIS FED. AID PROJECT

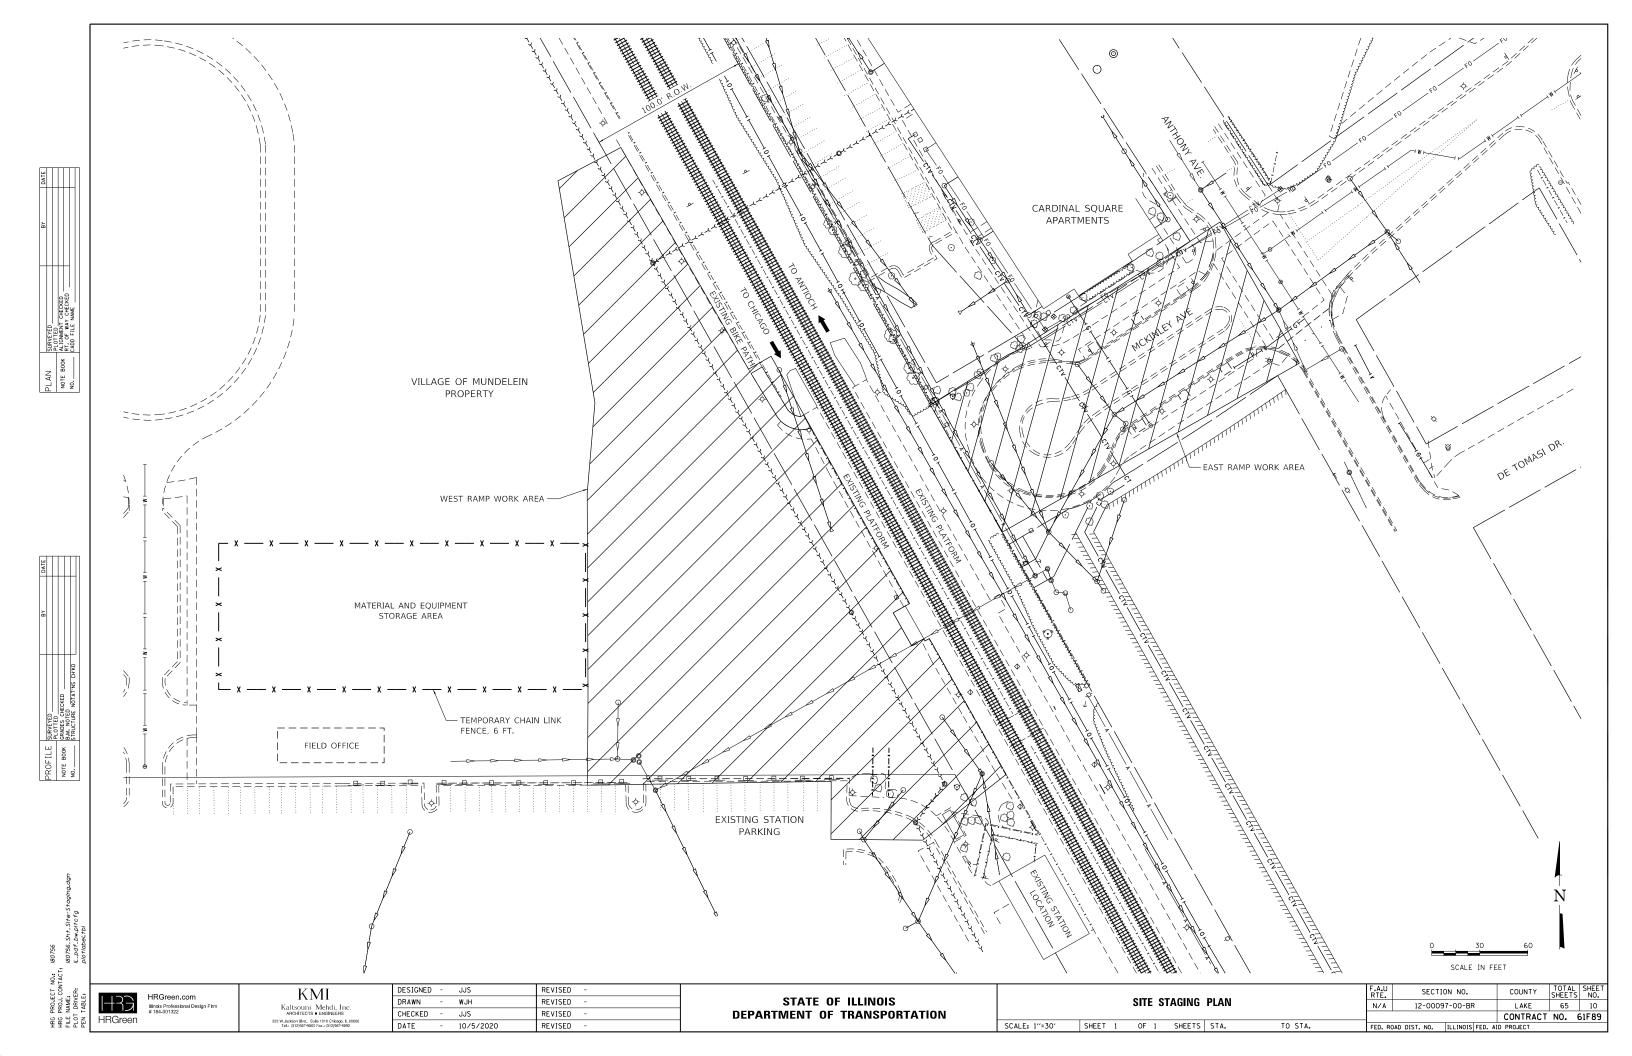


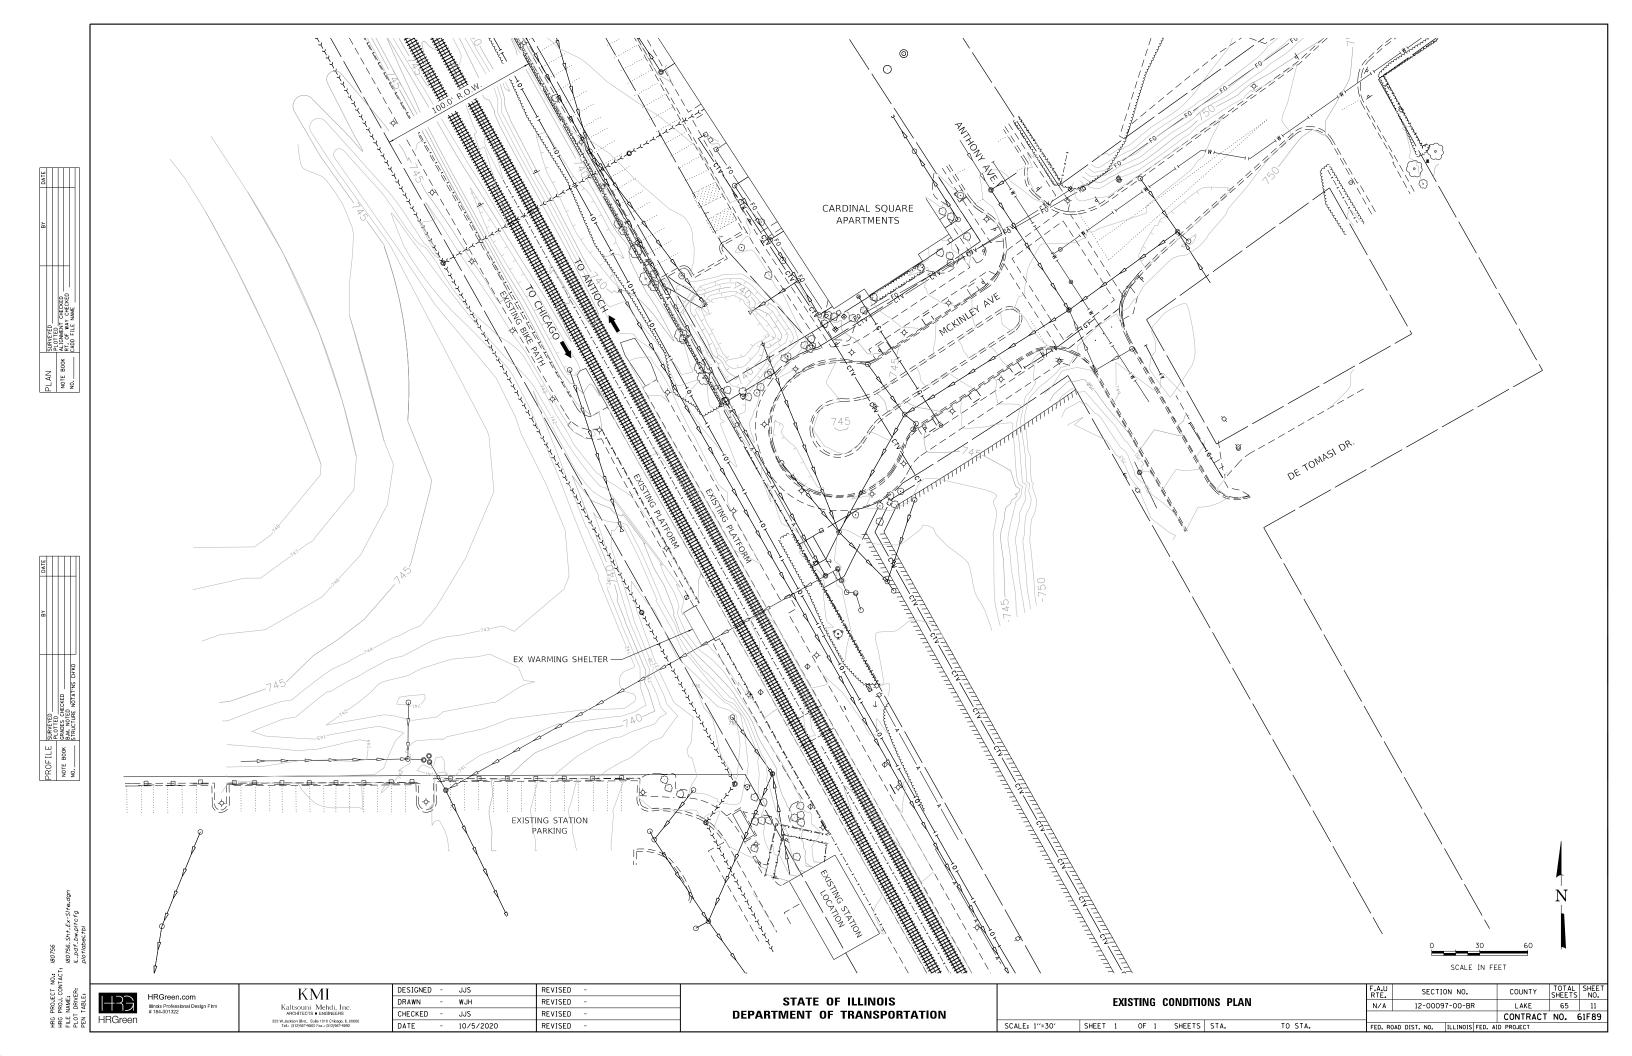


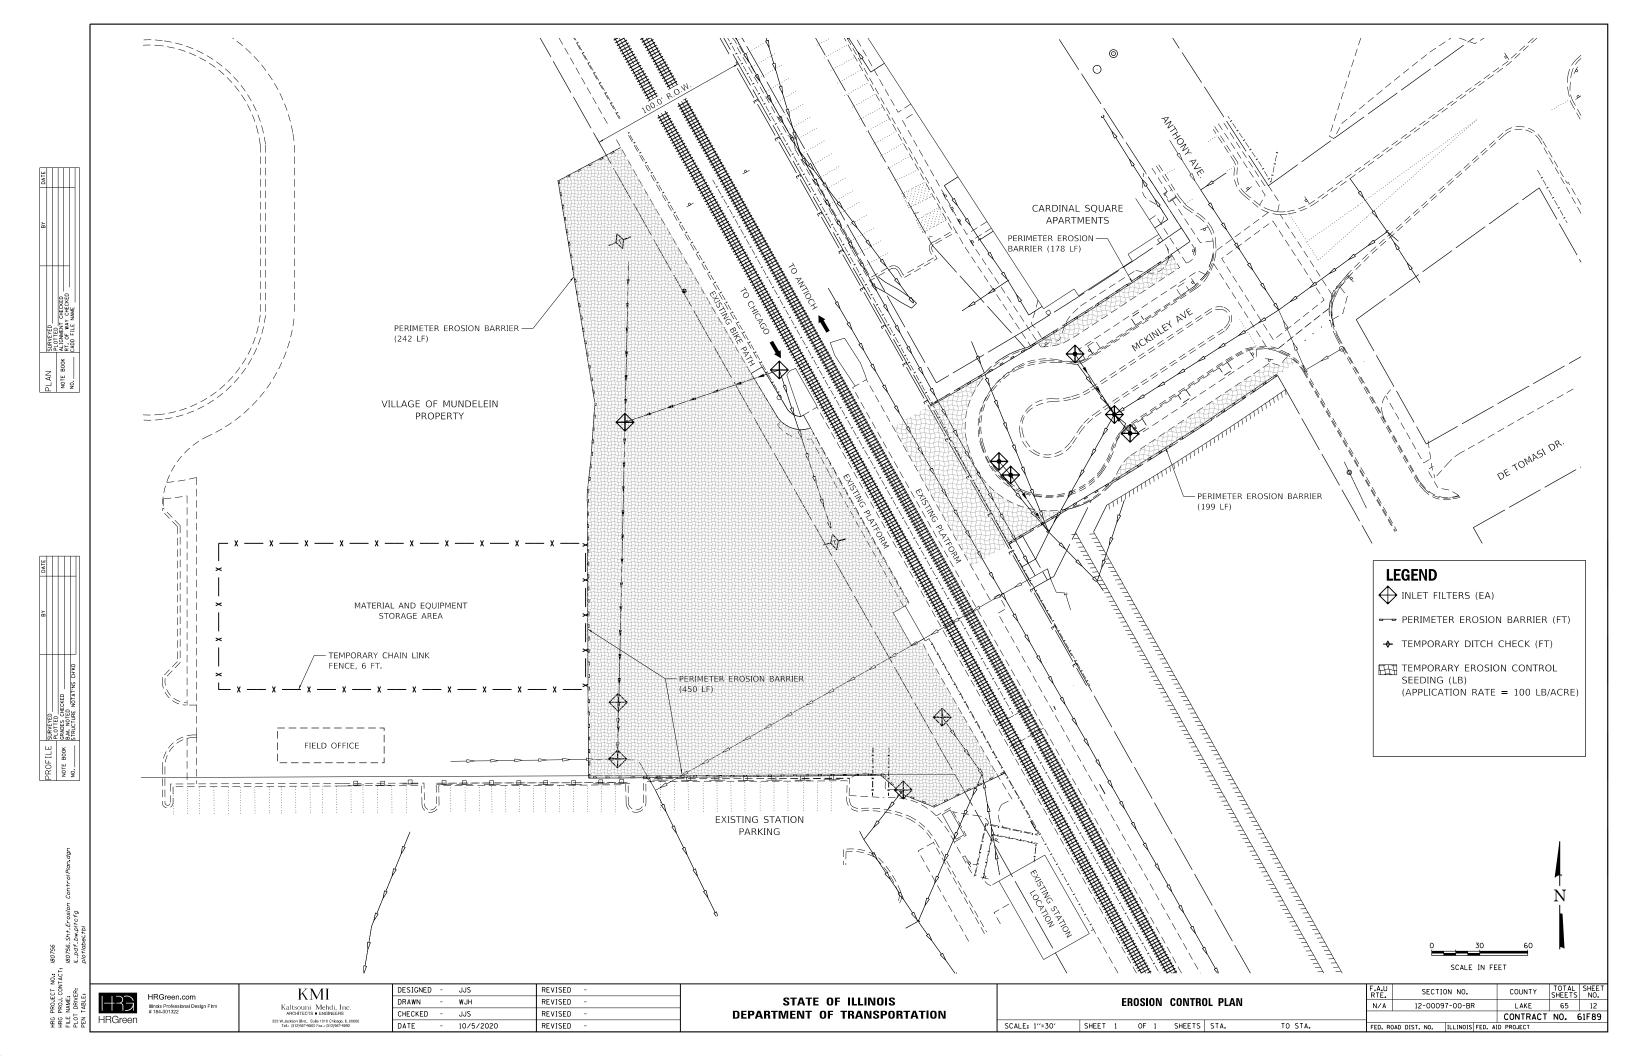


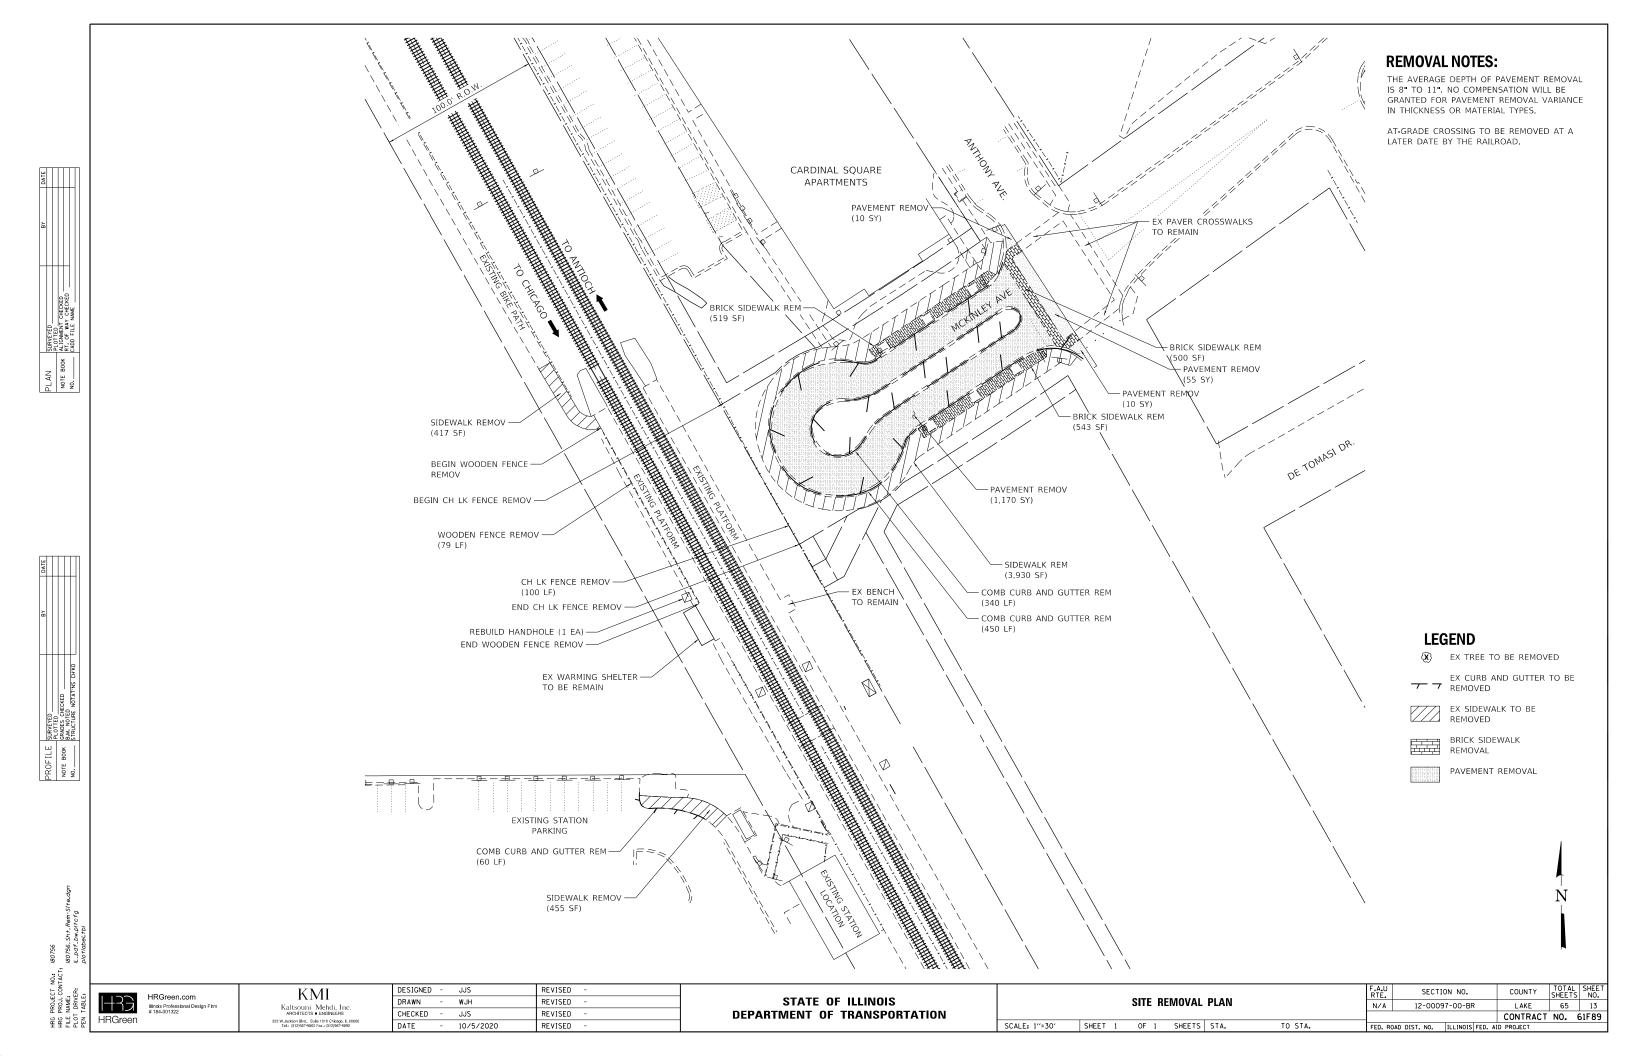

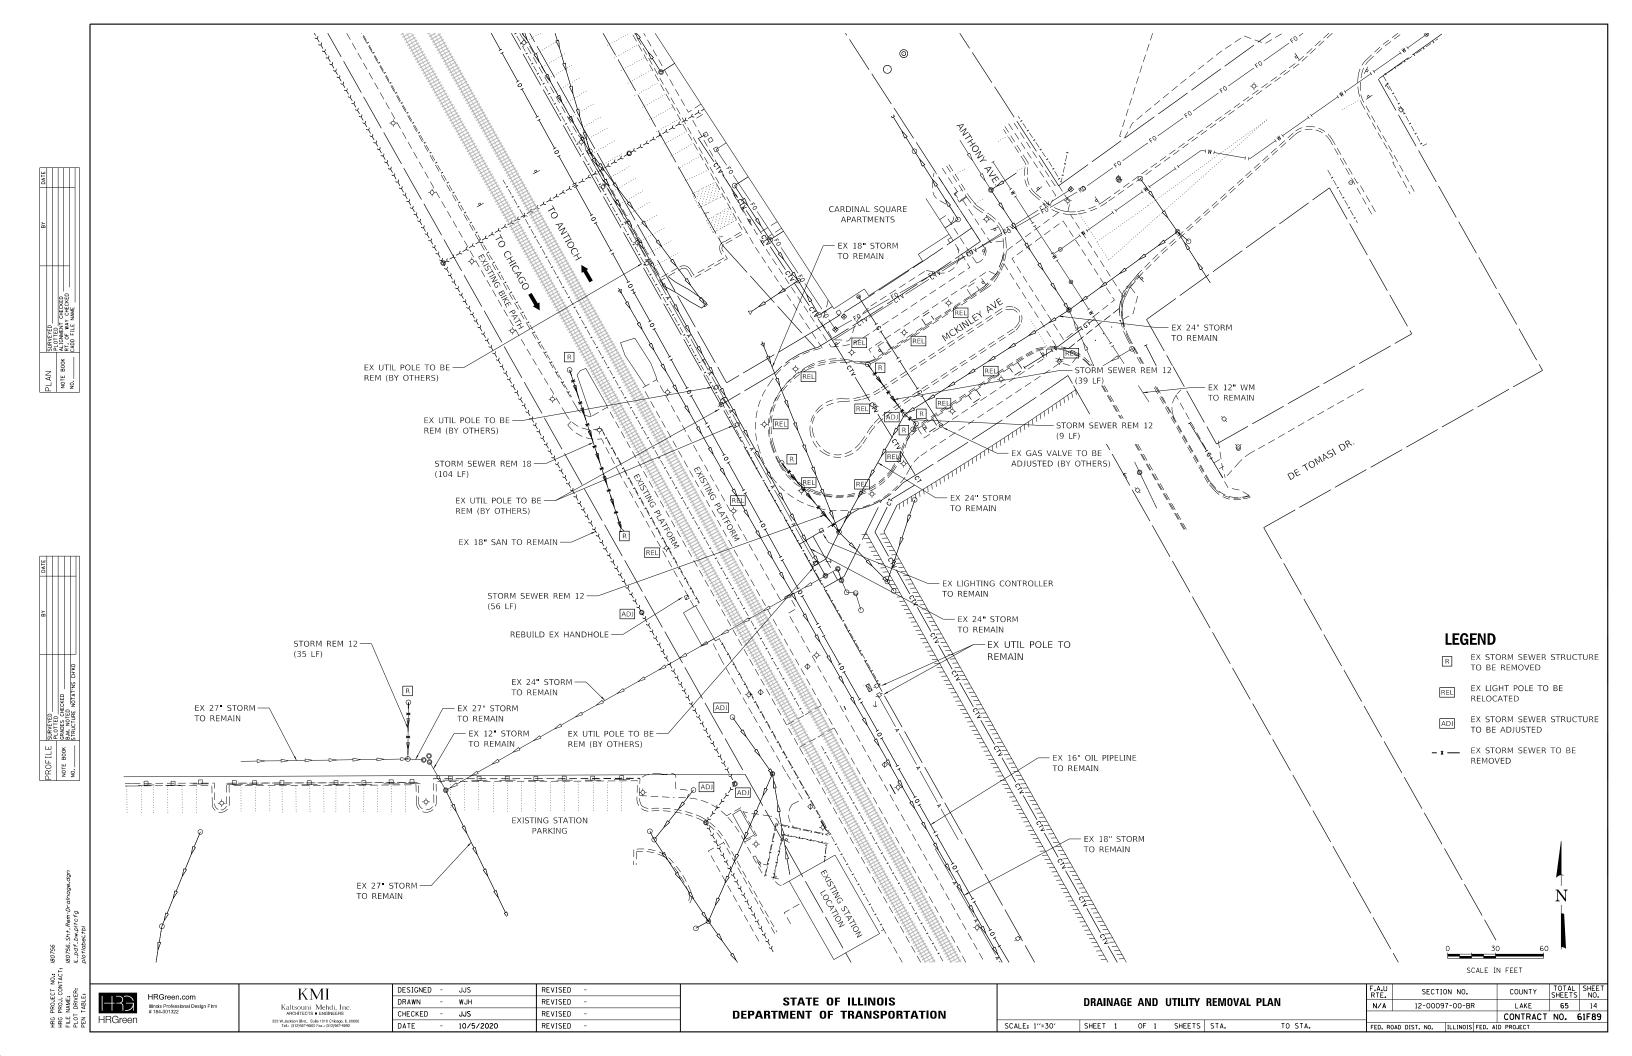

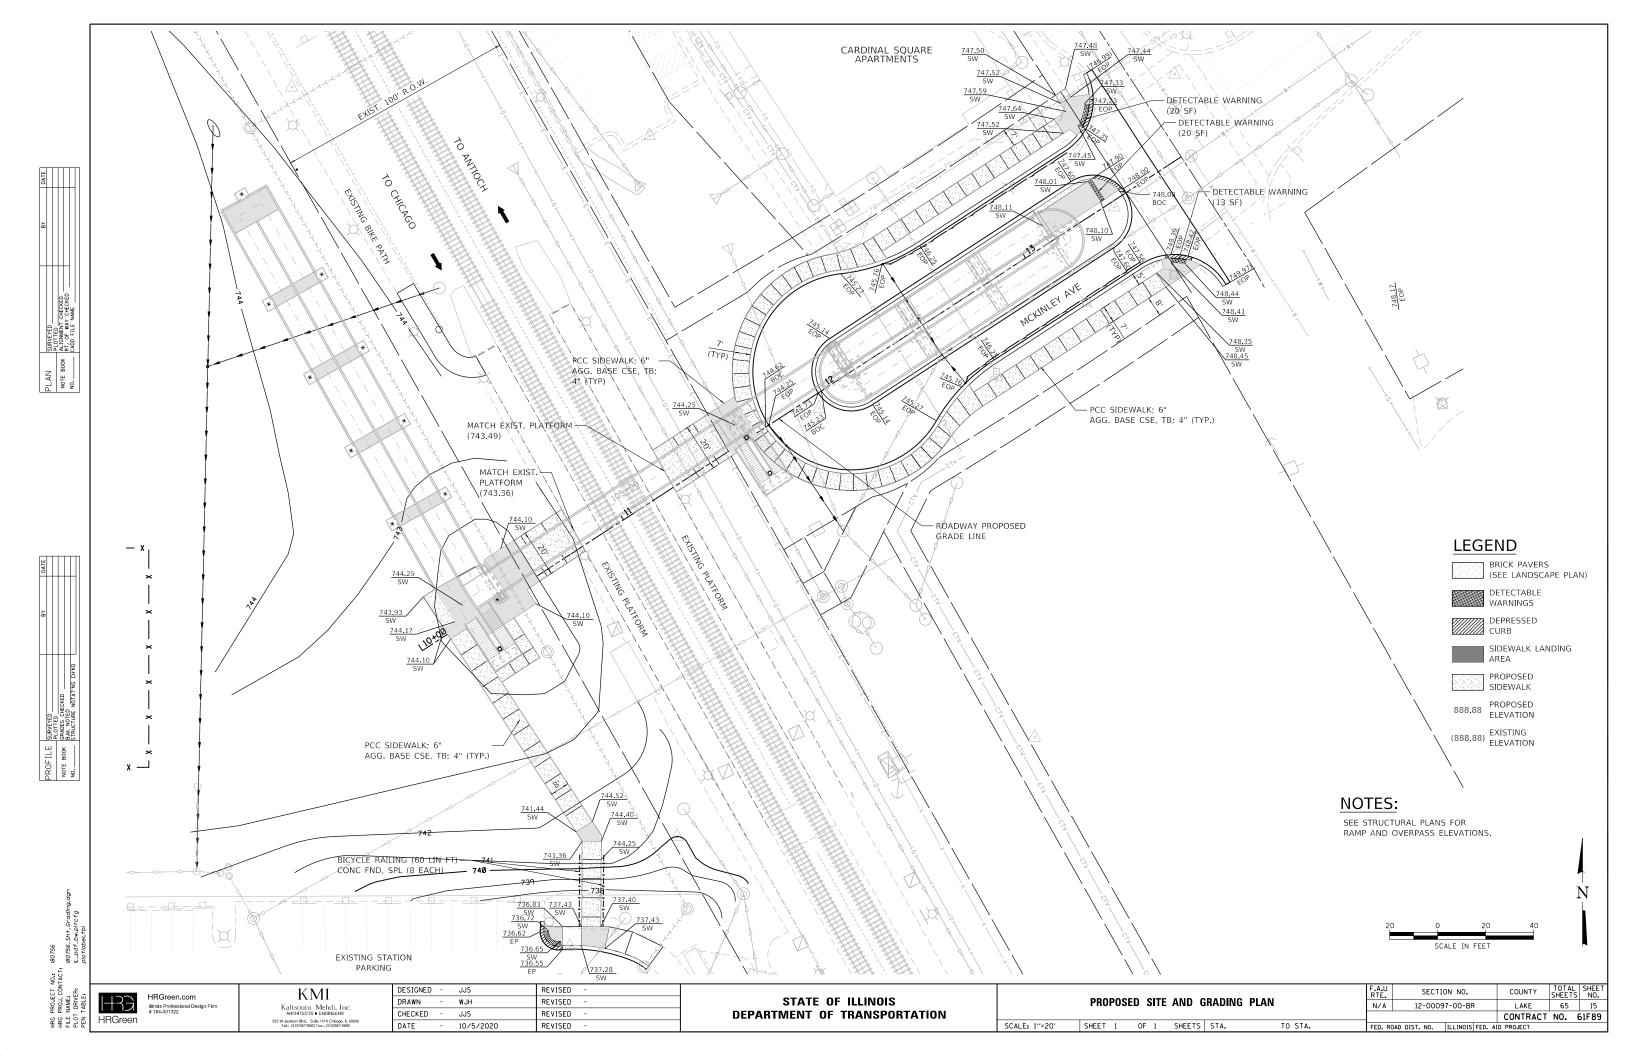

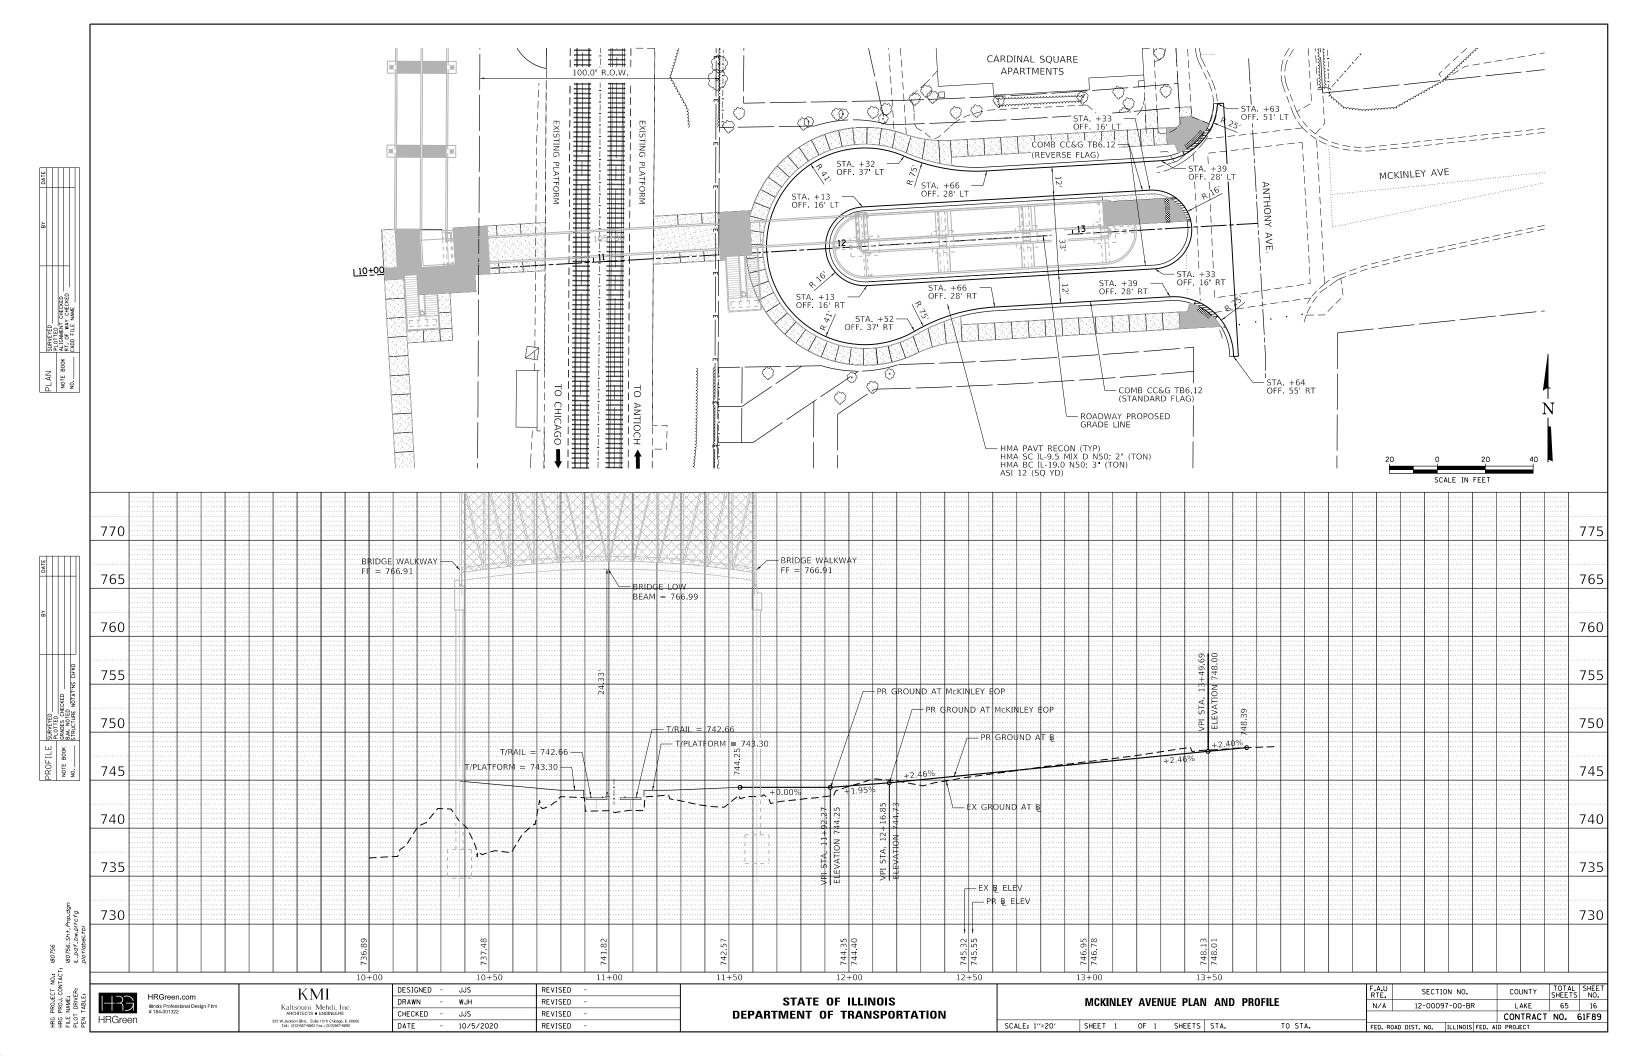

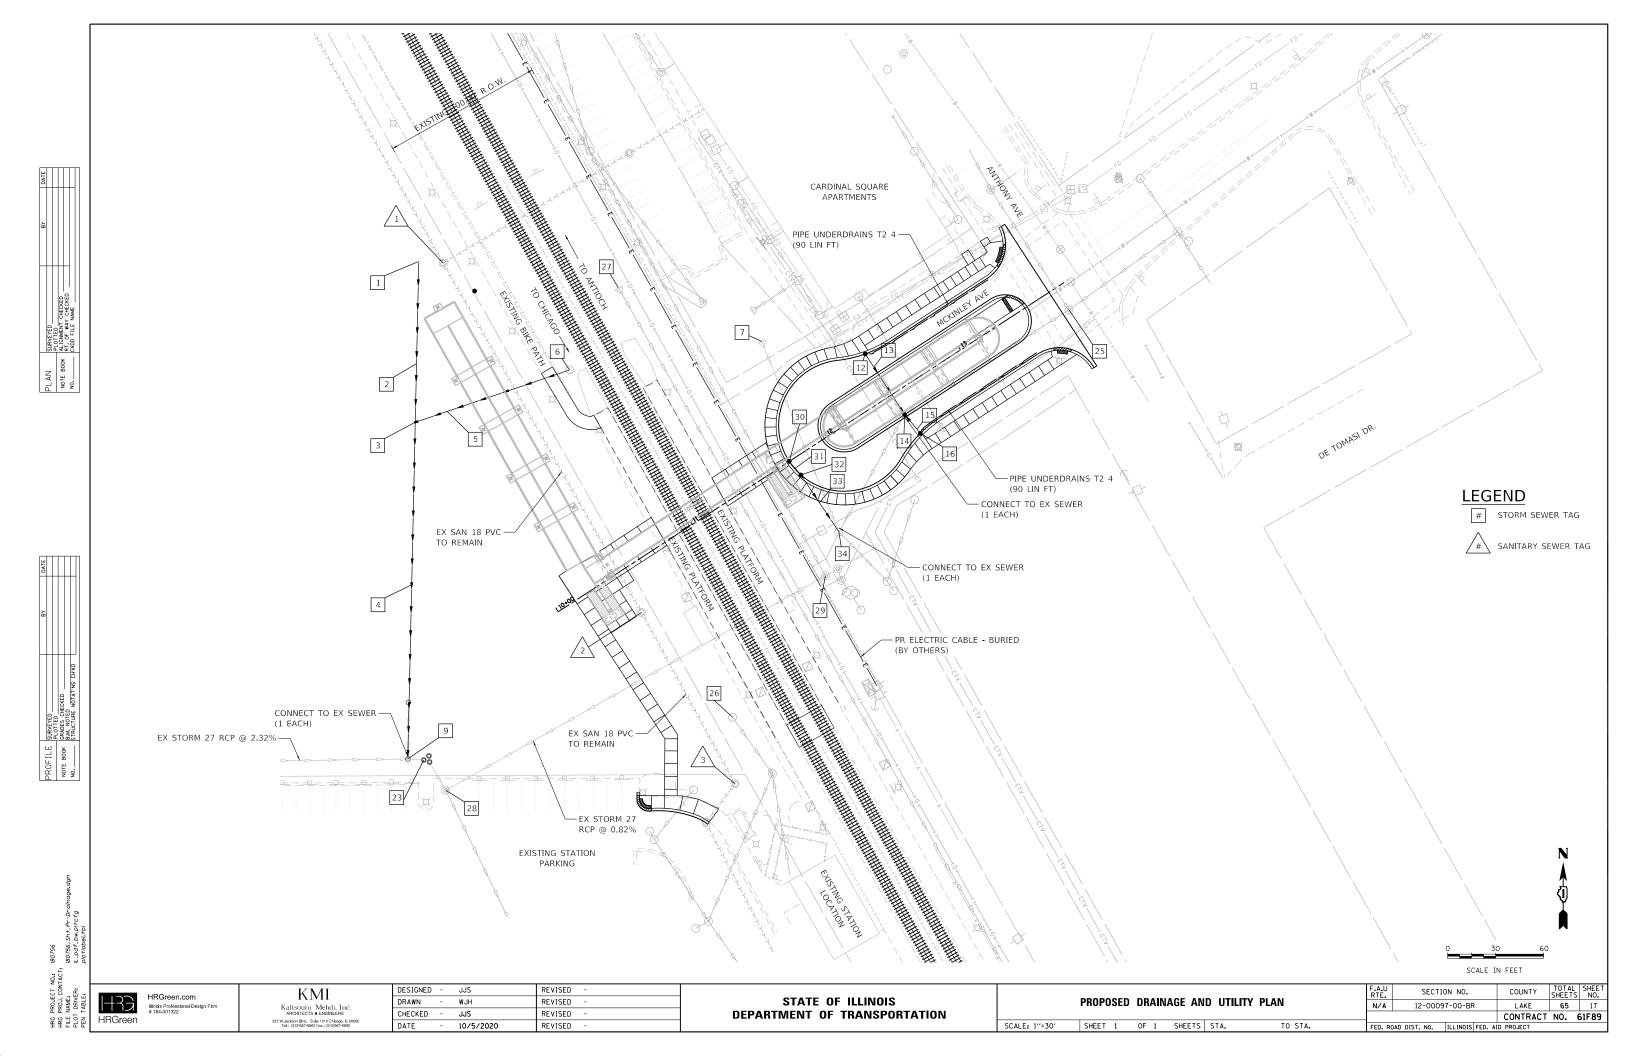

# SANITARY SEWER TAGS

	SANITARY STRUCTURE SCHEDULE										
							SANITARY INVERTS				
STR. ID	STATION	OFFSET	GEOPAK ALIGNMENT	STRUCTURE TYPE	MANHOLES, RIM EL.	NORTH	WEST	SOUTH	EAST		
1	10+58.6	-221.95	PR-MCK	EX SAN MH	743.81	723.67	735.15	723.67			
2	10+43.4	28.81	PR-MCK	EX SAN MH	736.11	722.36		722.36			
3	10+33.9	150.45	PR-MCK	EX SAN MH	736.25	720.13	720.13				

## STORM SEWER TAGS

	PROPOSED STORM STRUCTURE SCHEDULE										
					MANHOLES,		STORM SEW	ER INVERTS			
STR. ID	STATION	OFFSET	GEOPAK ALIGNMENT	STRUCTURE TYPE	CB & INLETS RIM ELEV.	NORTH	EAST	SOUTH	WEST	NOTES	
1	102+47.9	-38	RAMP_ALT3	PRC FES 24				742.50			
3	101+90.7	-42.2	RAMP_ALT3	MAN TA 6 DIA T1F CL	744.95	740.66	737.72	737.72			
6	103+21.4	-42.6	RAMP_ALT3	CB TC T8G	741.62				738.50		
7	11+98.8	-72.25	PR-MCK	EX FES 18		EX 738.14					
9	100+50	-149.5	RAMP_ALT3	EX CB	742.47	736.17	EX 731.82		EX 736.07	MAINTAIN EX NORTH INV. ENLARGE TO ACCOMMODATE PR 24" PIPE.	
12	12+48.76	-30.38	PR-MCK	CB TC T11 F&G	745.22			742.05			
14	12+48.76	14.77	PR-MCK	MAN TA 6 DIA T11 F&G	745.53	741.67	EX 734.17	741.67	EX 734.02	CONNECT TO EX (2)	
16	12+50.55	29.99	PR-MCK	CB TC T11 F&G	745.24			742.05			
23	0+74.07	-0.80	RAMP-W-MSE	EX RESTRICTOR MH	EX 741.31	731.61				EX INV (W) AT 731.61 TO BE PATCHED. RIM ADJUST TO 741.95	
25	13+70.5	16.04	PR-MCK	EX MH	748.69	734.44	735.69	744.59	734.40		
26	10+55.3	114.67	PR-MCK	EX CB	EX 734.97					RIM ADJUST TO 739.75	
27	11+41.93	-148.99	PR-MCK	EX FES 18		738.30					
28	0+87.77	18.18	RAMP-W-MSE	EX MH	EX 740.63	EX 730.81	EX 725.63	EX 725.33		RIM ADJUST TO 741.03	
29	11+52.3	72.25	PR-MCK	EX MH	EX 743.19	EX 732.49	EX 727.89		EX 727.84		
30	11+92.27		PR-MCK	CB TC T11 F&G	744.25			741.05			
32	11+93.78	11.1	PR-MCK	CB TA 4 DIA T11 F&G	744.35	740.87		740.87			
34	11+74.27	53.92	PR-MCK	EX MH	742.90	737.90	EX 733.80	EX 733.80	EX 737.90	EX INV (NW) AT 737.90 TO BE PATCHED	

PROPOSED STORM PIPE SCHEDULE									
				TRENCH	STORM	SEWERS	STORM SEWERS		
	LOCATION		SLOPE	BACKFILL	CLASS A	, TYPE 1	CLASS A, TYPE 2		
	UPSTREAM	DOWNSTREAM							
ID NUMBER	STRUCTURE	STRUCTURE	%		12"	18"	24"		
	ID NUMBER	ID NUMBER	%	(CU YD)	(FOOT)	(FOOT)	(FOOT)		
2	1	3	2.00%	41.4			92.0		
4	3	9	1.00%				207.0		
5	6	1	0.80%	44.1		98.0			
13	12	14	0.76%	11.8	45.0				
15	16	14	2.00%	4.5	15.0				
31	30	32	2.00%	2.1	9.0				
33	32	34	6.90%	10.2	54.0				
	TOTAL				123.0	98.0	299.0		

BY						
	SURVEYED	PLOTTED	GRADES CHECKED	B.M. NOTED	STRUCTURE NOTATINS CHIKD	
	PROFILE SURVEYED		NOTE BOOK	1	NO.	

HRC PROJECT NO. 180756
HRC PROJECT NO. 180756
HR PROJECT NO. 180756.57+LJHIHTY-Togs.dgn
PLOT DRIVER.
PLOT DRIVER.
PLOT DRI


KMI
Kaltsouni Mehdi, Inc.
/Jackson Blvd., Suite 1010 Chicago, IL 60606 Tel.: (312)987-9800 Fax.: (312)967-9892

DESIGNED	-	JJS	REVISED -
DRAWN	-	WJH	REVISED -
CHECKED	-	JJS	REVISED -
DATE	-	10/5/2020	REVISED -

STATE OF ILLINOIS	
EPARTMENT OF TRANSPORTATION	

SCALE: NTS

	DROBOCED DRAINAGE AND LITHETY TACC					F.A.U RTE. SECTION NO.			COUNTY	TOTAL SHEETS	SHEET NO.	
PROPOSED DRAINAGE AND UTILITY TAGS				N/A	N/A 12-00097-00-BR		LAKE	65	18			
										CONTRACT	NO.	61F89
	SHEET 1	OF 1	SHEETS	STA.	TO STA.	FED. RO	DAD DIST. NO.	ILLINOIS	FED. Al	D PROJECT		

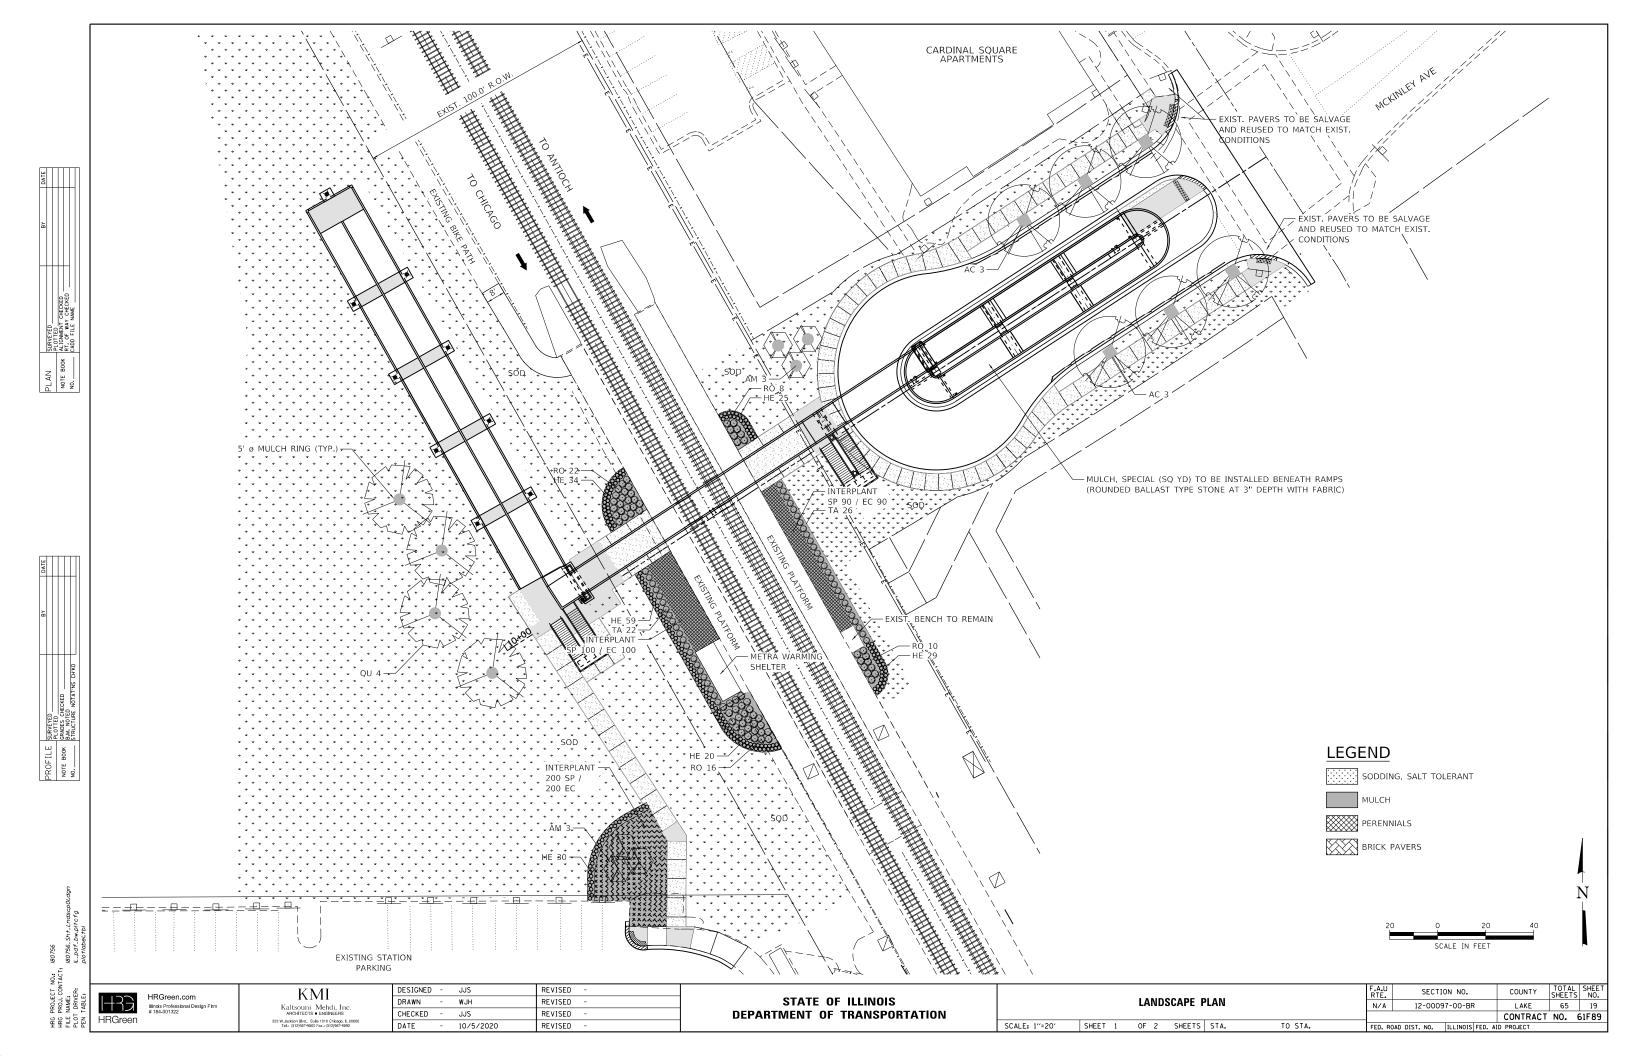

_					_	_
DATE						
BY						
	SURVEYED	PLOTTED	GRADES CHECKED	B.M. NOTED	STRUCTURE NOTATINS CHIKD	
	PROFILE SURVEYED		NOTE BOOK		NO.	

**HRGreen** 

HRGreen.com

- CONSTRUCTION SPECIFICATIONS: ILLINOIS DEPARTMENT OF TRANSPORTATION "STANDARD SPECIFICATIONS FOR ROAD AND BRIDGE CONSTRUCTION", CURRENT EDITION. SEE SPECIFICATIONS FOR STANDARD DETAILS AS REQUIRED FOR WORK.
- WHERE EXISTING UTILITY FIXTURES ARE SHOWN AS EXISTING ON PLANS OR ENCOUNTERED WITHIN THE CONSTRUCTION AREA, IT SHALL BE THE RESPONSIBILITY OF THE CONTRACTOR TO NOTIFY THE OWNER OR OWNER'S REPRESENTATIVE OF THOSE UTILITIES PRIOR TO BEGINNING CONSTRUCTION. THE CONTRACTOR SHALL ALLOW ACCESS TO THESE FACILITIES FOR NECESSARY MODIFICATION OF SERVICES. UNDERGROUND FACILITIES, STRUCTURES, AND UTILITIES HAVE BEEN PLOTTED FROM AVAILABLE SURVEYS AND RECORDS, AND THEREFORE THEIR LOCATIONS MUST BE CONSIDERED APPROXIMATE ONLY. IT IS POSSIBLE THERE MAY BE OTHERS, THE EXISTENCE OF WHICH IS NOT KNOWN OR SHOWN, IT IS THE CONTRACTORS RESPONSIBILITY TO LOCATE EXACT LOCATIONS OF THESE UTILITIES AND PREVENT DAMAGE THERETO. NO CLAIMS FOR ADDITIONAL COMPENSATION SHALL BE ALLOWED TO CONTRACTOR FOR ANY INTERFERENCE OR DELAY CAUSED BY SUCH WORK. CAUSED BY SUCH WORK.
- FIELD LOCATE UNDERGROUND UTILITIES PRIOR TO EXCAVATION FOR INSTALLATION OF SITE IMPROVEMENTS. IF A CONFLICT EXISTS BETWEEN PROPOSED SITE IMPROVEMENTS AND EXISTING OR PROPOSED UTILITIES, IMMEDIATELY ADVISE THE OWNER'S REPRESENTATIVE. CONTRACTOR SHALL USE CAUTION WHEN DIGGING TREE PITS IN THE VICINITY OF UTILITY LINES AND MAY NEED TO HAND DIG THE PITS IN MANY OF THESE INSTANCES. HAND DIGGING TREE PITS SHALL BE INCIDENTAL TO THE PAY ITEM PER EACH
- IT SHALL BE THE CONTRACTOR'S RESPONSIBILITY TO PROVIDE APPROVED WASTE AREAS OR DISPOSAL SITES FOR EXCESS MATERIAL (EXCAVATED MATERIAL, CLEARED MATERIAL, BROKEN ASPHALT/CONCRETE, ETC.) WHICH IS NOT DESIRABLE TO BE INCORPORATED INTO THE WORK INVOLVED WITH THIS PROJECT. WASTE MATERIAL MUST BE REMOVED FROM SITE PRIOR TO INITIAL INSPECTION AND ACCEPTANCE.
- DURING REMOVAL AND CONSTRUCTION, THE CONTRACTOR SHALL USE ALL MEANS NECESSARY TO CONTROL DUST SPREADING FROM ALL WORK AND STAGING AREAS. DUST CONTROL MEASURES SHALL BE IN ACCORDANCE WITH APPLICABLE SPECIFICATIONS AND APPROVED BY THE OWNER'S REPRESENTATIVE.
- EXISTING UTILITIES, TREES, STRUCTURES, AND PAVEMENT LOCATIONS SHOWN ARE APPROXIMATE. CONTRACTOR SHALL FIELD VERIFY THE EXACT LOCATIONS OF THESE OR ANY OTHER EXISTING FACILITIES AS REQUIRED FOR COMPLETION OF PROJECT.
- CONSTRUCTION ACTIVITIES SHALL BE SCHEDULED TO ALLOW FOR COMPLETION OF THE WORK AS SPECIFIED AND WITHIN THE REQUIRED PLANTING WINDOWS PER IDOT STANDARD SPECIFICATIONS.
- CONTRACTOR SHALL PRESERVE AND PROTECT EXISTING STRUCTURES, UTILITY POLES, FENCES, TREES AND SHRUBS TO REMAIN AND OTHER EXISTING FEATURES TO REMAIN DURING CONSTRUCTION. DAMAGE DUE TO CONSTRUCTION SHALL BE REPAIRED TO ORIGINAL CONDITION AT CONTRACTOR'S EXPENSE.

#### LANDSCAPE IMPROVEMENTS NOTES

- MASTER PLANT SCHEDULE: ALL TREES, SHRUBS, PERENNIALS, ETC. ARE LISTED IN THE MATERIALS SCHEDULE. IF THERE IS A CONFLICT BETWEEN THE QUANTITIES SHOWN ON THE PLANTING PLAN DRAWINGS AND THE QUANTITIES SHOWN IN THE PLANT SCHEDULE, THE QUANTITIES SHOWN IN THE PLANTING PLAN DRAWINGS SHALL PREVAIL.
- PLANTING LAYOUT: CONTRACTOR TO STAKE ALL TREE PLANTING LOCATIONS AND MARK THE PERIMETER OF SHRUB/PERENNIAL BEDS AND OBTAIN REVIEW OF THE OWNER'S REPRESENTATIVE PRIOR TO EXCAVATION OF PLANT PITS AND PLANT BEDS.
- CONTRACTOR IS TO PRESERVE AND PROTECT EXISTING PLANT MATERIAL TO REMAIN. TREE ROOT PRUNING SHALL BE PERFORMED ANYTIME EARTHWORK EXCAVATION OCCURS WITHIN THE CRITICAL ROOT ZONE. ROOT PRUNING SHALL BE CONSIDERED INCIDENTAL TO EARTHWORK. PLANT MATERIAL THAT IS DAMAGED SHALL BE REPLACED IN KIND AT
- SHREDDED HARDWOOD MULCH, FERTILIZING, STAKING, WATERING, PRUNING, MAINTENANCE AND PERIOD OF ESTABLISHMENT FOR INSTALLED PLANT MATERIAL, SHALL BE INCIDENTAL TO THE PLANT PAY ITEMS.
- ANY PLANTS THAT ARE NOT IN A LIVE, HEALTHY, GROWING CONDITION AT THE END OF THE PERIOD OF ESTABLISHMENT SHALL BE REPLACED BY THE CONTRACTOR AT THE CONTRACTOR'S EXPENSE.
- THE CONTRACTOR SHALL BE RESPONSIBLE FOR MAINTAINING AND WATERING THE PLANT MATERIAL AS NECESSARY, TO ENSURE GROWTH AND ESTABLISHMENT DURING THE PERIOD OF ESTABLISHMENT PER IDOT STANDARD SPECIFICATIONS. SUPPLEMENTAL WATERING SHALL OCCUR AS DEEMED NECESSARY BY THE OWNER'S REPRESENTATIVE AND PAID FOR SEPARATELY.
- 7. ALL PLANT MATERIALS DESIGNATED IN THE PLANTING SCHEDULE AS MATCHED SHALL BE OF UNIFORM SIZE, COLOR, BRANCHING HEIGHT, FORM, ETC. PLANTS WHICH DO NOT MATCH WILL BE REJECTED.

			LANDSCAPING MATERIALS SCHEDULE					
QTY	KEY	BOTANICAL NAME/ITEM	COMMON NAME	SIZE	COND	REMARKS		
DECIDU	OUS TRE	ES						
6	AC	ACER X FREEMANII 'JEFFERSRED'	AUTUMN BLAZE MAPLE	2.5" CAL.	B&B	CENTRAL LEADER; MATCHED		
6	AM	AMELANCHIER X GRANDIFLORA 'AUTUMN BRILLIANCE'	AUTUMN BRILLIANCE SERVICEBERRY	8' HT.	B&B	MULTI-STEM; MATCHED		
4	QU	QUERCUS PALUSTRIS	PIN OAK	2" CAL.	B&B	CENTRAL LEADER; MATCHED		
DECIDU	OUS SHE	RUBS						
56	RO	ROSA MEIPOQUE	PINK MEIDLAND ROSE	24" HT.	CONT.	3 O.C., MATCHED		
EVERGR	EEN SHI	RUBS						
48	TA	TAXUS X MEDIA 'HICKSII'	HICKS YEW	3' WIDTH	B&B	3' O.C.; MATCHED		
PERENN	IALS, GF	RASSES & GROUNDCOVER						
390	EC	ECHINACEA PALLIDA	PALE PURPLE CONEFLOWER	#1	CONT.	18" O.C., MATCHED		
197	HE	HEMEROCALLIS 'STELLA DE ORO'	DAYLILY	#1	CONT.	18" O.C., MATCHED		
390	SP	SPOROBOLUS HETEROLEPIS	PRAIRIE DROPSEED	#1	CONT.	18" O.C., MATCHED		
MISCELL	ANEOUS				•			
39	MULCH	DOUBLE SHREDDED HARDWOOD MULCH		CY		SEE IDOT SPECS		
480	MULCH	3" DEEP STONE MULCH		1"-3" DIA.	SY	ROUNDED. GRAY COLOR.		
9890	SOD	SODDING, SALT TOLERANT		SY				
GENERA	L NOTES	ō:			•			
1	1. PLANT MATERIAL AND SEEDING TO BE INSTALLED PER SECTIONS 250, 251, 253, 254 & 280 OF THE ILLINOIS DEPARTMENT OF TRANSPORTATION (IDOT) STANDARD 1. SPECIFICATIONS FOR ROAD AND BRIDGE CONSTRUCTION, MOST RECENT VERSION.							


KMI	DESIGNED	-	JJS	REVISED
Kaltsouni Mehdi, Inc.	DRAWN	-	WJH	REVISED
ARCHITECTS = ENGINEERS	CHECKED	-	JJS	REVISED
223 W.Jackson Blvd., Suite 1010 Chicago, IL 60606 Tel.: (312)987-9900 Fax.: (312)987-9892	DATE	-	10/5/2020	REVISED


STATE	OF	ILLINOIS
DEPARTMENT	0F	TRANSPORTATION


SCALE: NTS


SHEET


				.==.		F.A.U RTE.	SECTIO	ON NO.		COUNTY	TOTAL SHEETS	
	LAN	DS	CAPE N	OTES		N/A	12-0009	7-00-BF	₹	LAKE	65	20
										CONTRACT	NO.	61F8
2	OF :	2	SHEETS	STA.	TO STA.	FED. RO	DAD DIST. NO.	ILLINOIS	FED. Al	D PROJECT		

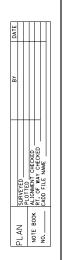


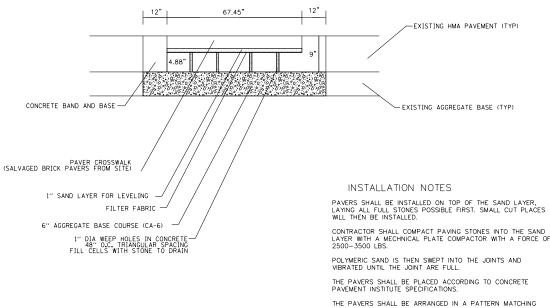


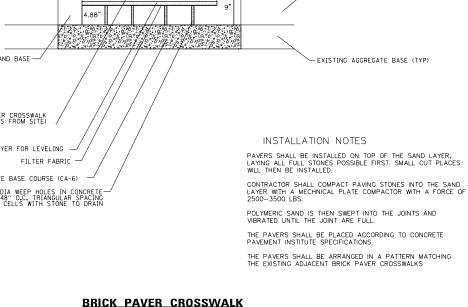

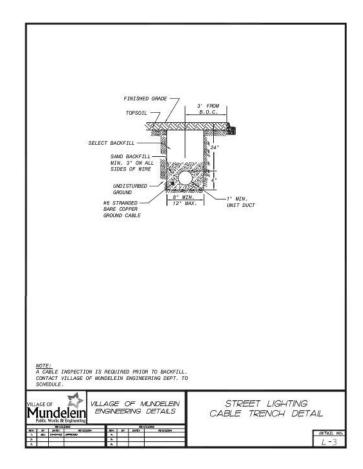

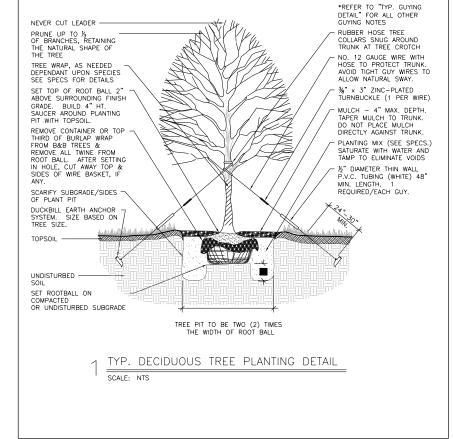


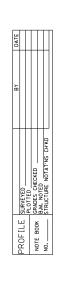

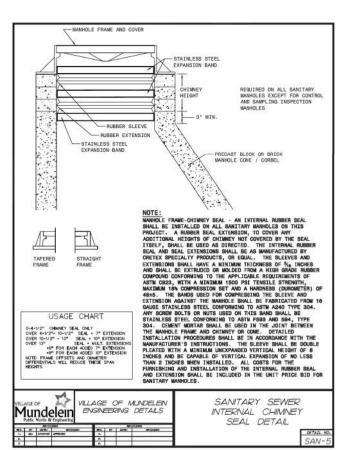

SCALE:

SHEET 1

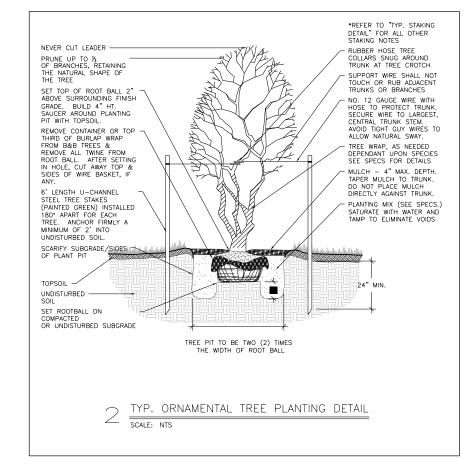


**HRGreen** 


HRGreen.com


KMI	DESIGNED	-	JJS	REVISED -
Kaltsouni Mehdi, Inc.	DRAWN	-	WJH	REVISED -
ARCHITECTS = ENGINEERS	CHECKED	-	JJS	REVISED -
223 W.Jackson Bhd., Suite 1010 Chicago, IL 60606 Tel.: (312)987-9900 Fax.: (312)987-9892	DATE	-	10/5/2020	REVISED -

STATE OF ILLINOIS **DEPARTMENT OF TRANSPORTATION** 


					SECTI	ON NO.	COUNTY	TOTAL SHEETS	SHEET NO.
CONSTRUCTION DETAILS				N/A	12-0009	7-00-BR	LAKE	65	21
							CONTRACT	NO.	61F89
OF 1	SHEETS	STA.	TO STA.	FED BO	AD DIST NO	TILINOIS FED. 4	ID PROJECT		

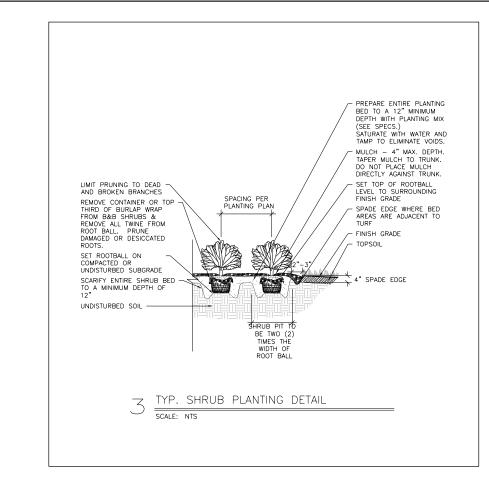

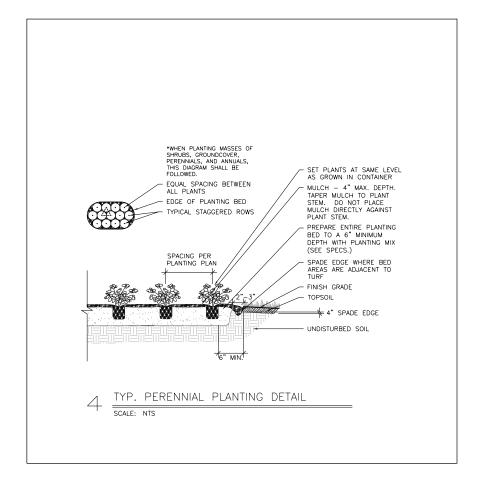

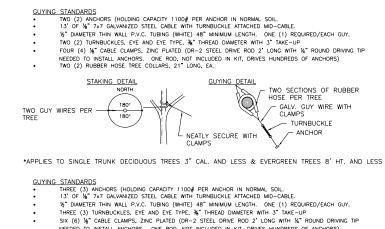


- NEEDED TO INSTALL ANCHORS. ONE ROD, NOT INCLUDED IN KIT, DRIVES HUNDREDS OF ANCHORS) THREE (3) RUBBER HOSE TREE COLLARS, 21" LONG, EA.

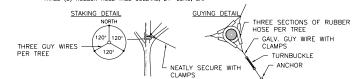

\*APPLIES TO SINGLE TRUNK DECIDUOUS TREES GREATER THAN 3" CAL. & EVERGREEN TREES GREATER THAN 8' HT.

TYP. GUYING DETAIL SCALE: NTS

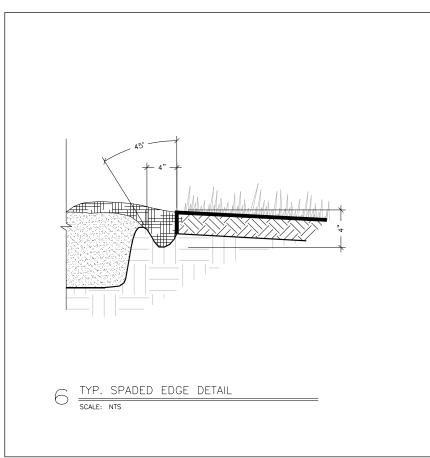

H33 HRGreen

CHECKED Y CHECKED NAME

HRGreen.com

KMI Kaltsouni Mehdi, Inc. ARCHITECTS = ENGINEERS

223 W.Jackson Bhd., Suite 1010 Chicago, IL 60606 Tel.: (312)987-9800 Fax.: (312)987-9892

DESIGNED	-	JJS	REVISED	-
DRAWN	-	WJH	REVISED	-
CHECKED	-	JJS	REVISED	-
DATE	-	10/5/2020	REVISED	-

STATE	: OI	F ILLINOIS
DEPARTMENT	0F	TRANSPORTATION

SCALE:

							F.A.U RTE.	SECTION NO.	COUNTY	TOTAL SHEETS	SHEET NO.
	C	CON	ISTR	UCTION	DETAILS		N/A	12-00097-00-BR	LAKE	65	22
									CONTRACT	NO.	61F89
SHEET	1	(	)F 1	SHEET	S STA.	TO STA.	FED. RO	DAD DIST. NO.   ILLINOIS FED. A	D PROJECT		

#### DESIGN SPECIFICATIONS

2017 AASHTO LRFD Bridge Design Specifications, 8th Edition. 2009 LRFD Guide Specifications for the Design of Pedestrian Bridges, 2nd Edition.

#### DESIGN STRESSES

FIELD UNITS 3,500 psi f'c = 4,000 psi (Superstructure)fy = 60,000 psi (Reinforcement)fy = 50,000 psi (M270 Grade 50W)PRECAST UNITS f'c = 4,500 psi (Precast Panels)

#### LOADING

H5 = (Maintenance Vehicle) Pedestrian Live Load = 90 psf

#### SEISMIC DATA


Seismic Performance Zone (SPZ) = 1 Design Spectral Acceleration at 1.0 sec. (SD1) = 0.078g Design Spectral Acceleration at 0.2 sec. (SDS) = 0.132gSoil Site Class = D

#### UTILITY LEGEND

----- Exist. Sanitary Sewer ------ Exist. Fence — 

Exist. Storm Sewer

—ıç⊢ Exist. Gas – cтv — Exist. Cable Television →o⊢ Exist. Underground Oil — ▲— Exist. Aerial Utility →w⊢ Exist. Underground Water -- Prop. Storm Sewer — E— Prop. Electrical Exist. Powerpole Exist. Handhole Exist. Controller Exist. Telephone Splice Box Exist. Light Ploe Exist. Flared End Section Exist. Manhole Exist. Catch Basin Indicates Work Point (See Table on Sheet S-4)

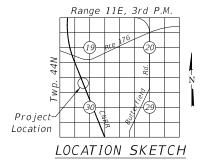

GENERAL PLAN MUNDELEIN METRA STATION OVER CN RAILROAD BRIDGE LAKE COUNTY M.P. 39.64 STATION 105+01.74 STRUCTURE NO. 049-P004

SHEET NO. S-1 OFS-35 SHEETS




KMI						
Kaltsouni Mehdi, Inc.						
223 W.Jackson Blvd., Suite 1010 Chicago, IL 60606 Tel.: (312)987-9800 Fax.: (312)987-9892						

	DESIGNED	-	JMW/OS	REVISED	-
	CHECKED	-	AEU	REVISED	-
-	DRAWN	-	WJH	REVISED	-
80808	DATE	-	10/5/2020	REVISED	-

STATE OF ILLINOIS **DEPARTMENT OF TRANSPORTATION** 

HRG FILE PLOI

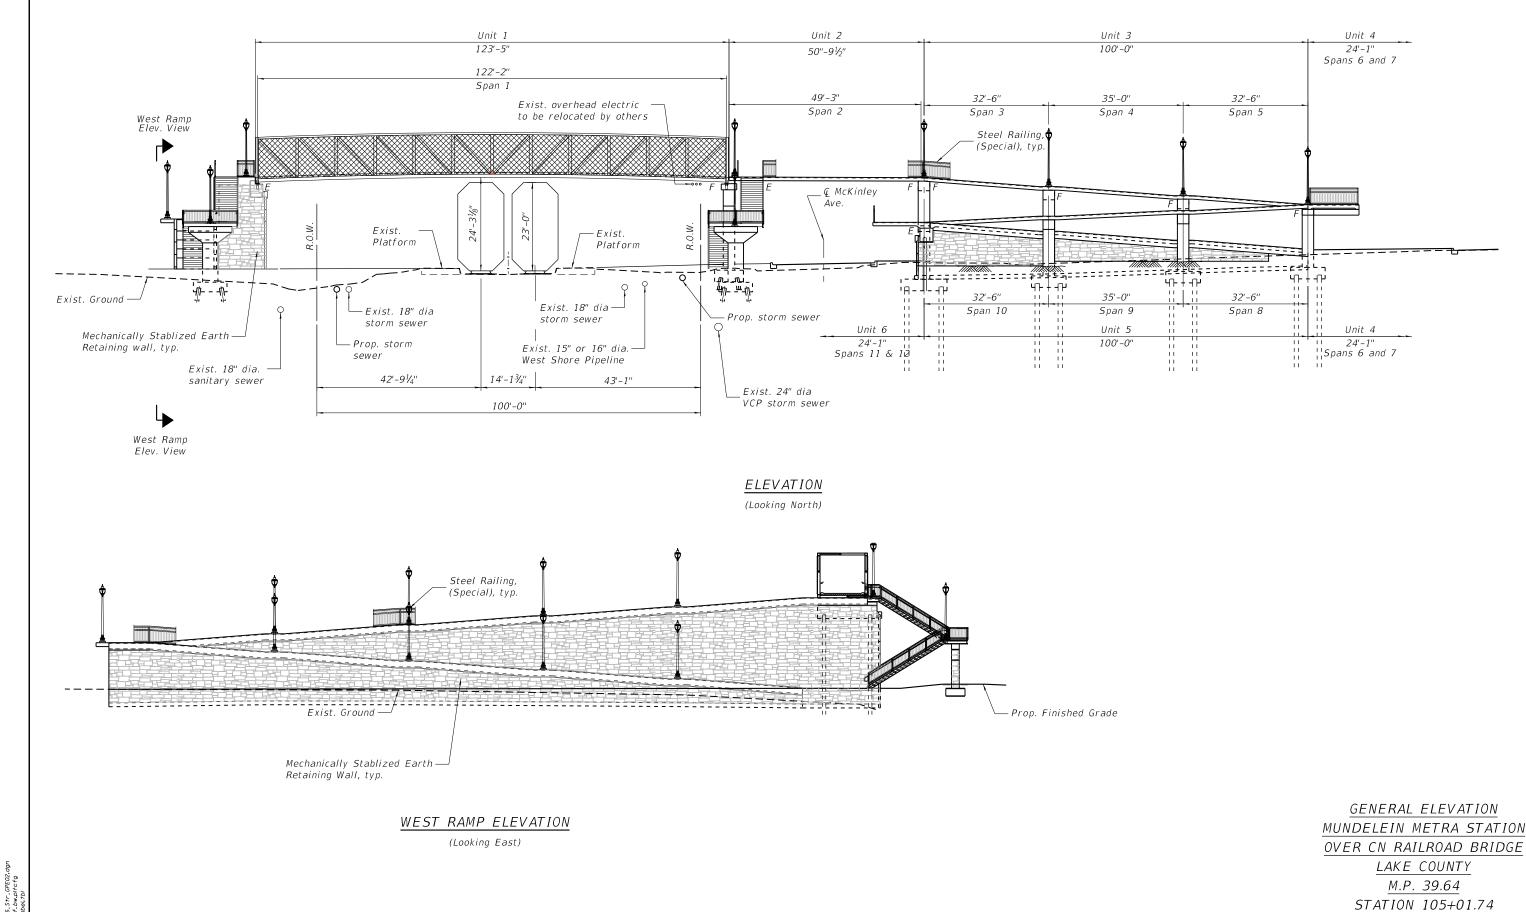

HRG PROJECT NO. 180756 HRG PROJ. CONTACT: FILE MAME: R. DA. 20176. STr. GPED2.dgn R. DAT. DW. 2017059.TD1 PLOT DRIVER: DOTOD9.1701

HRGreen.com

Inols Professional Design Firm
#184-001322

KMI Kaltsouni Mehdi, Inc. ARCHITEOTS • ENGINEERS 223 W.Jackson Blvd., Suite 1010 Chicago, IL 60008 Tel.: (312)987-9800 Fax.: (312)987-9852

STATE OF ILLINOIS
DEPARTMENT OF TRANSPORTATION

STRUCTURE NO. 049-P004

#### GENERAL NOTES

- 1. Reinforcement bars designated (E) shall be epoxy coated.
- 2. The Contractor shall make allowance for the deflection of forms, shrinkage and settlement of falsework, in addition to allowance for dead load deflection. Forms for deck slab shall be removed prior to placement of bridge approach slab.
- 3. Concrete Sealer shall be applied to the designated areas of the abutments, piers and MSE walls.
- 4. Protective coat shall be applied to the top surface of the concrete slab and inside and top surfaces of curb.

#### TOTAL BILL OF MATERIAL

ITEM NO.	ITEM	UNIT	SUPER	SUB	TOTAL QUANTITY
20700220	Porous Granular Embankment	Cu Yd		350	350
50200100	Structure Excavation	Cu Yd		1,096	1,096
50200450	Removal amd Disposal of Unsuitable Material for Structures	Cu Yd		350	350
50300225	Concrete Structures	Cu Yd		147.0	147.0
50300255	Concrete Superstructure	Cu Yd	139.0		139.0
50300285	Form Liner Textured Surface	Sq Ft	6,077	1,515	7,592
50300300	Protective Coat	Sq Yd	1,236		1,236
50800205	Reinforcement Bars, Epoxy Coated	Pound	49,220	43,231	92,451
<i>51200957</i>	Furnishing Metal Shell Piles 12" x 0.250"	Foot		40	40
51200958	Furnishing Metal Shell Piles 14" x 0.250"	Foot		936	936
51202305	Driving Piles	Foot		976	976
51203200	Test Pile Metal Shells	Each		2	2
52200500	Mechanically Stabilized Earth Retainng Wall	Sq Ft		12,541	12,541
58700300	Concrete Sealer	Sq Ft		99	99.00
X0322508	Pedestrian Truss Superstructure	Sq Ft	1,234		1,234
X4240440	Portland Cement Concrete Sidewalk 6 Inch, Special	Sq Ft		5,461	5,461
X5030290	Staining Concrete Structures	Sq Ft	2,472	1388	3,859
Z0007124	Steel Railing (Special)	Foot	1,372		1,372
Z0018800	Drainage System	L Sum	1		1
Z0046304	Pipe Underdrains For Structures 4"	Foot		940	940
XX004951	Concrete Stairs	L Sum	1		1
XX006751	Stair Railing	Foot	240		240

#### INDEX OF SHEETS

S-1	General Plan
S-2	General Elevation
S-3, S-4	General Data
S-5	Substructure Layout 1
S-6	Substructure Layout 2
S-7	Deck Plan and Details - Unit 2
S-8	Deck Plan and Details - Unit 3 & Unit 5
S-9	Deck Plan and Details - Unit 4 & Unit 6
S-10	Deck Details
S-11	West Ramp Railing Layout
S-12	East Ramp Railing Layout
S-13	Bridge Railing Details
S-14	Pedestrian Truss Superstructure - Unit 1
S-15	Stair Details I
S-16	Stair Details II
S-17	West Abutment
S-18	Pier 1
S-19	Pier 2
S-20	Piers 3 & 4
S-21	Pier 5
S-22	Piers 6 & 7
S-23	East Abutment
S-24	West MSE Wall Plan and Details
S-25	West MSE Wall Details
S-26	East MSE Wall Plan and Details
S-27	East MSE Wall Details
S-28	Architectural Details
S-29	Metal Shell Pile Details
S-30	Deck Drainage Plan
S-31, S-32	Deck Drainage Details
S-33 - S-35	Soil Boring Logs

STATION 105+01.74
BUILT BY
VILLAGE OF MUNDELEIN
Sec. 12-00097-00-BR
LOADING Ped. & H5
STRUCTURE NO.
049-P004

NAME PLATE
See Std. 515001

HRGreen.com

Inois Professional Dealgn Firm
#184-001322

KMI Kaltsouni Mehdi, Inc. ARCHITECTS - ENGINEERS 223 W.Jackson Blat. Subn 1010 Chicago, IL 60008 Tat.: (31/2897/9800 Fax.; 63/2987-8682

DESIGNED	-	JMW/OS	REVISED -
CHECKED	-	AEU	REVISED -
DRAWN	-	WJH	REVISED -
DATE	-	10/5/2020	REVISED -

$\cap \cap I$ $\cap I$
POINTS

	- :		
	Begin W. MSE Wall		ℚ W. Brg Pier 1
1	Sta. 100+62.97	10	Sta. 105+63.29
	Elev. 744.01		Elev. 766.91
	West Ramp Platform		⊈ of Pier 1
2	Sta. 102+32.97	1 1	Sta. 105+63.74
	Elev. 755.46		Elev. 766.91
	West Ramp Platform		Ç of Pier 2
3	Sta. 102+38.64	12	Sta. 106+14.53
	Elev. 755.46		Elev. 766.75
	West Ramp Platform		Ç of Pier 3
4	Sta. 102+49.31	13	Sta. 106+47.04
	Elev. 755.46		Elev. 764.41
	West Ramp Platform		♀ of Pier 4
5	Sta. 102+54.97	14	Sta. 106+82.04
	Elev. 755.46		Elev. 762.07
	€ of Railroad overpass		Ç of Pier 5
6	āt Ç or West Ramp	15	_
	Sta. 104+34.88	13	Sta. 107+14.53
	Elev. 766.91		Elev. 759.73
	Bk. West Abut.		Begin E. MSE Wall
7	Sta. 104+38.99	16	Sta. 108+59.52
	Elev. 766.91		Elev. N/A
	€ Brg. W. Abut.		Bk. E. Abut.
8	Sta. 104+40.95	17	Sta. 108+64.19
	Elev. 766.91		Elev. 754.43
	End W. MSE Wall		End E. MSE Wall
9	Sta. 104+43.57	18	Sta. 109+64.19
	Elev. 748.11		Elev. 748.11

DRAWN

DATE

WJH

10/5/2020

REVISED

REVISED

PROJECT NO.: //
PROJ. CONTACT: //
I. NAME: //
T. DRIVER: //


HRG FLE PLOT

HRGreen


#### CURVE DATA

$\begin{array}{llllllllllllllllllllllllllllllllllll$				
$\begin{array}{cccccccccccccccccccccccccccccccccccc$	PI STA. = 107+22.21 Δ = 89° 59' 59" (RT) D = 747° 19' 59"	PI STA. = $107+34.25$ $\Delta = 90^{\circ} \ 00' \ 00'' \ (RT)$ $D = 747^{\circ} \ 19' \ 59''$	PI STA. = $108+58.33$ $\Delta = 90^{\circ} \ 04' \ 39'' \ (RT)$ $D = 748^{\circ} \ 20' \ 53''$	PI STA. = $108+46.29$ $\Delta = 90^{\circ} \ 00' \ 00'' \ (RT)$ $D = 747^{\circ} \ 20' \ 11''$
T.R. = $T.R. = $ $T.R.$	T = 7.67' L = 12.04'	T = 7.67' L = 12.04'	T = 7.67' L = 12.04'	T = 7.67' L = 12.04'
	T.R. = S.E. RUN = P.C. STA = 107+14.54	T.R. = S.E. RUN = P.C. STA = 107+26.58	T.R. = S.E. RUN = P.C. STA = 108+50.67	S.E. RUN = P.C. STA = 108+38.63


SHEET NO. S-4 OF S-35 SHEETS

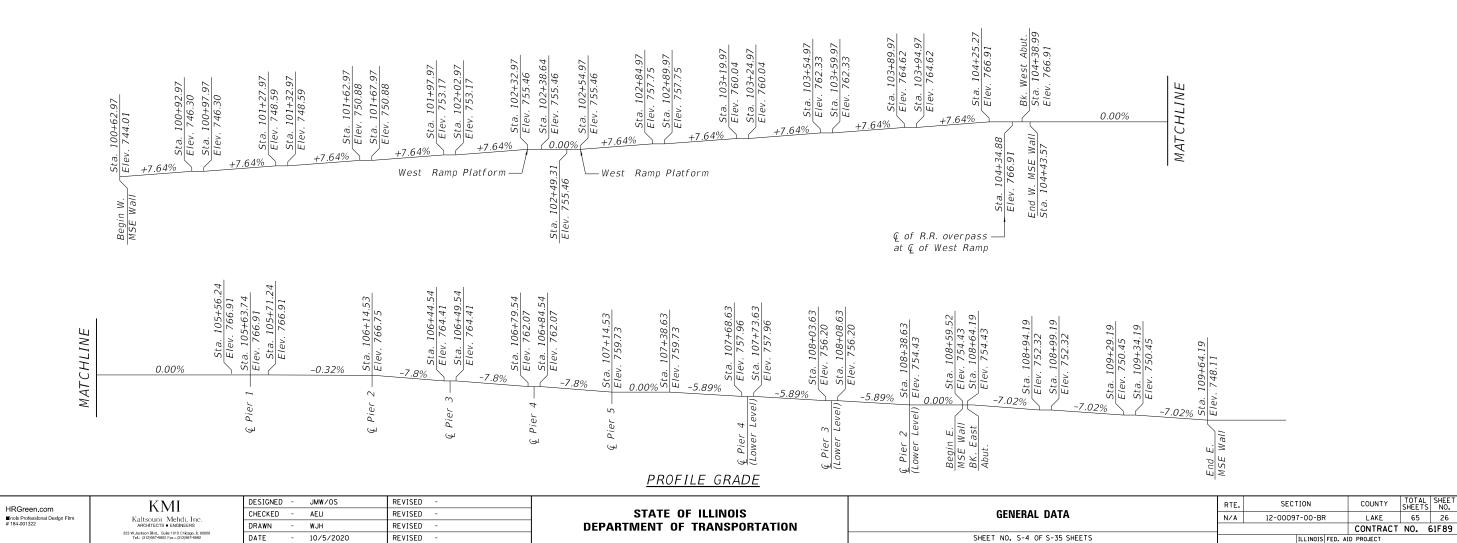



**DEPARTMENT OF TRANSPORTATION** 

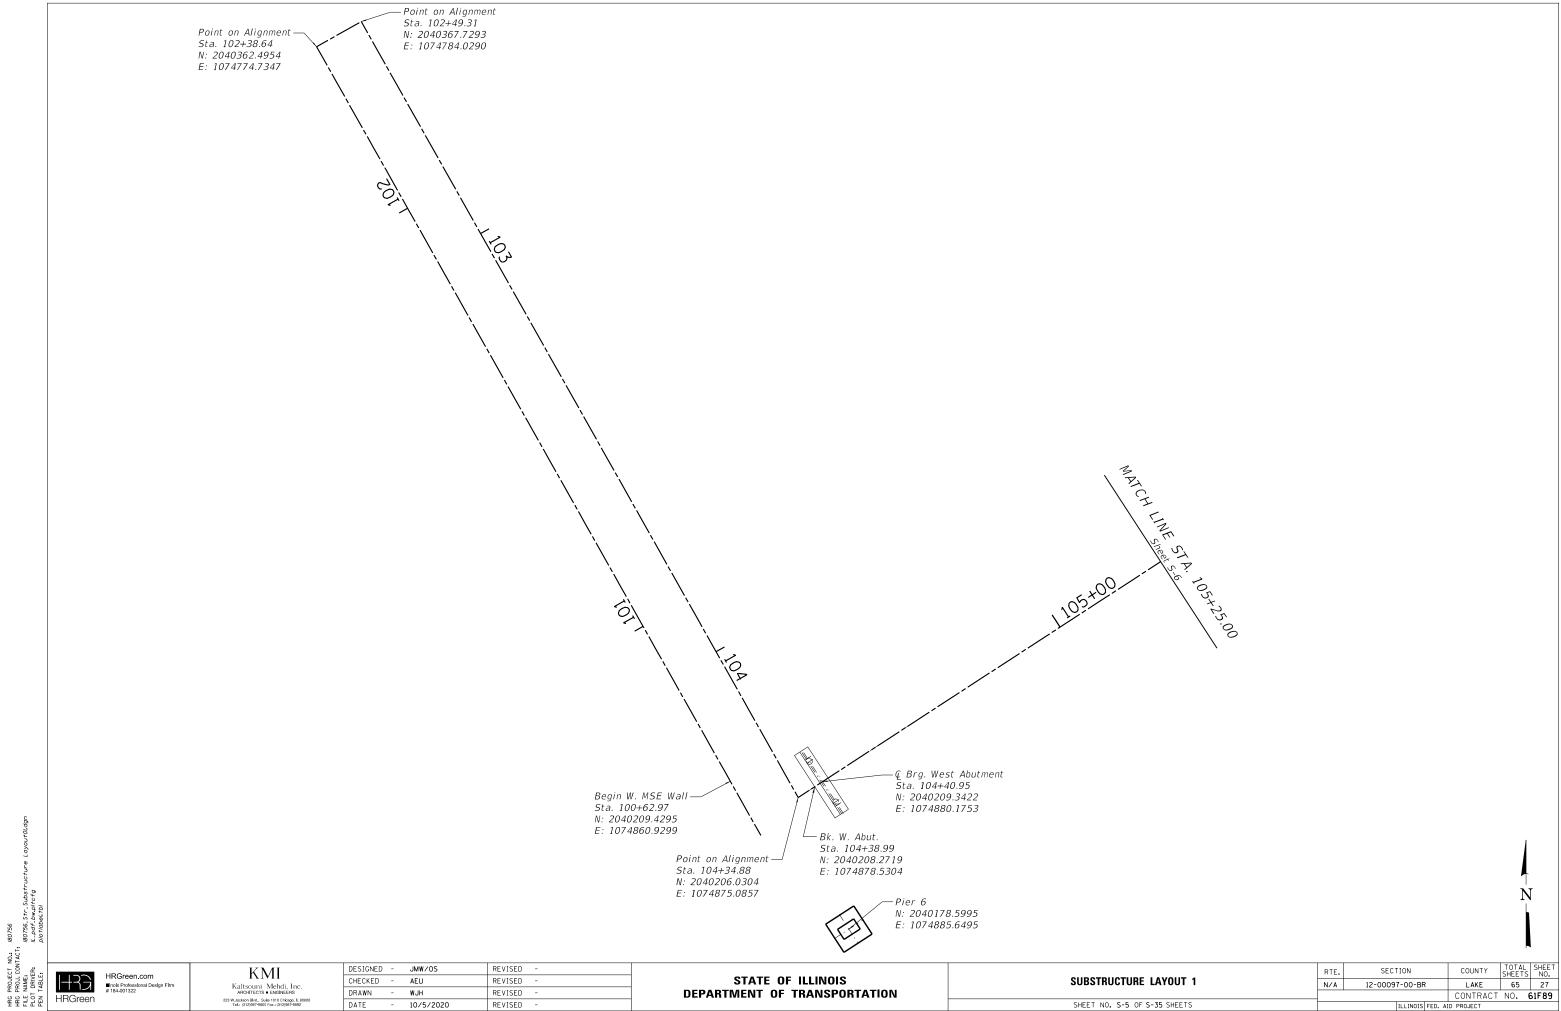


DATE 10/5/2020 REVISED ILLINOIS FED. AID PROJECT

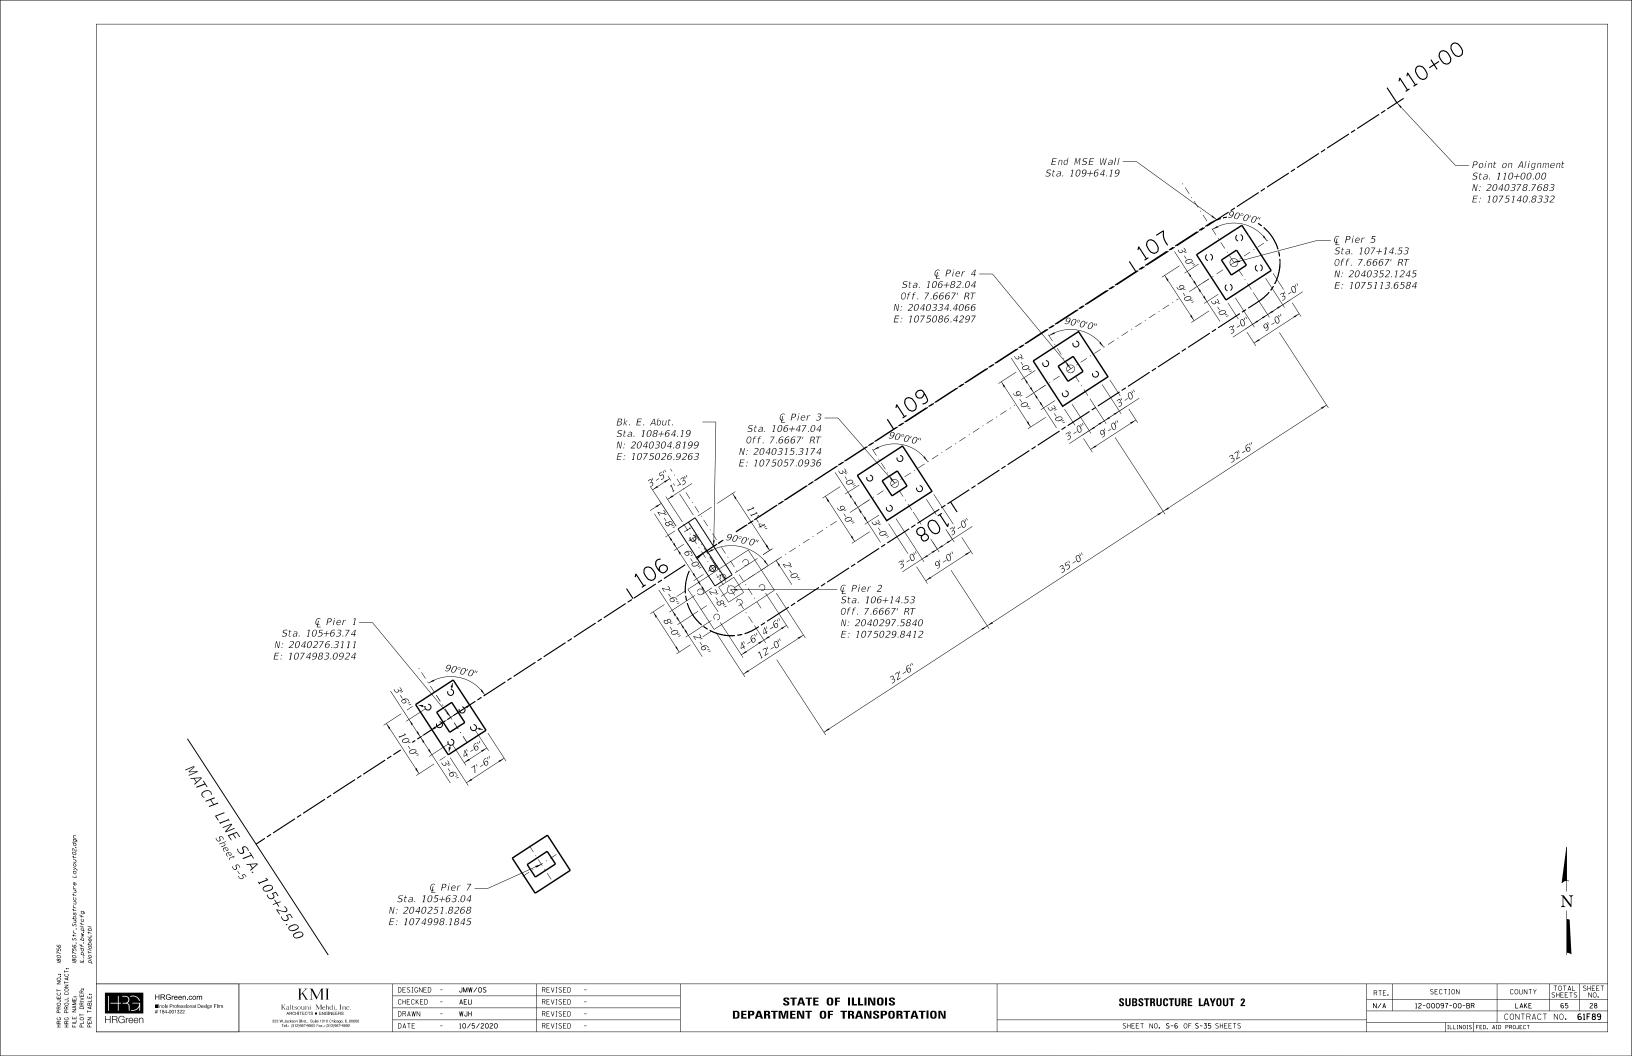

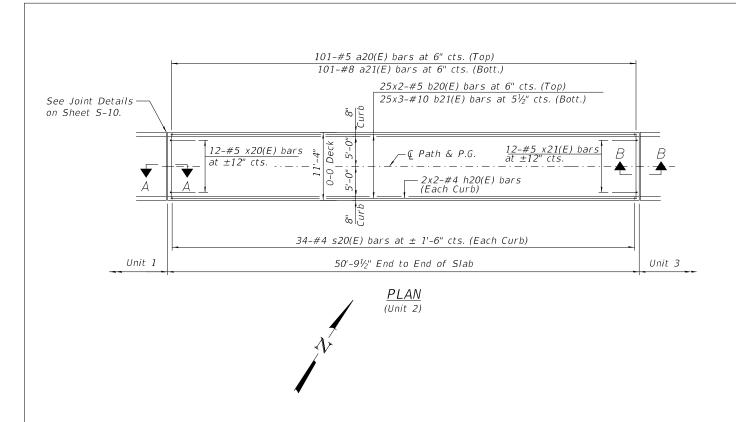

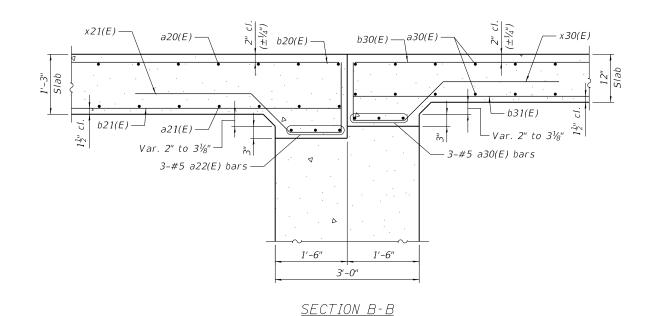


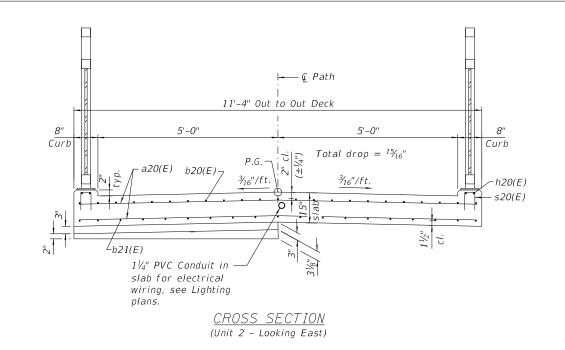

#### MINIMUM BAR LAP

#4 bar = 1'-10" #5 bar = 2'-7''#10 bar = 9'-6"

#### UNIT 2 <u>BILL OF MATERIAL</u>

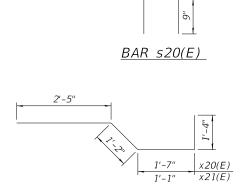

BARS x20(E) & x21(E)

NOTES:

For Section A-A, see Sheet S-10.

Bar	No.	Size	Length	Shape
a20(E)	101	#5	11'- 0"	
a21(E)	101	#8	11'- O"	
a22(E)	6	#5	11'- 0"	
b20(E)	50	#5	26'- 7"	
b21(E)	75	#10	23'- 3"	
h20(E)	8	#4	26'- 3"	
s20(E)	68	#4	1'- 11"	П
x20(E)	12	#5	6'- 6"	
x21(E)	12	#5	6'- 0"	
Concrete	Supers	tructure	Cu. Yd.	27.8
Reinforce Epoxy Co		ars,	Pound	13,470

Bars indicated thus 25x3-#10 etc. indicates 25 lines of bars with 3 lengths per line.


HRGreen.com HRGreen


KMI Kaltsouni Mehdi, Inc. ARCHITECTS ■ ENGINEERS 223 W.Jackson Blvd. Suite 1010 Chicago, IL 60606 Tel.: (312)987-9800 Fax.: (312)987-9892

DESIGNED -JMW/OS REVISED CHECKED -AEU REVISED DRAWN REVISED DATE 10/5/2020 REVISED


STATE OF ILLINOIS **DEPARTMENT OF TRANSPORTATION**  DECK PLAN AND DETAILS - UNIT 2 SHEET NO. S-7 OFS-35 SHEETS

SECTION COUNTY N/A 12-00097-00-BR LAKE 65 29 CONTRACT NO. 61F89 ILLINOIS FED. AID PROJECT

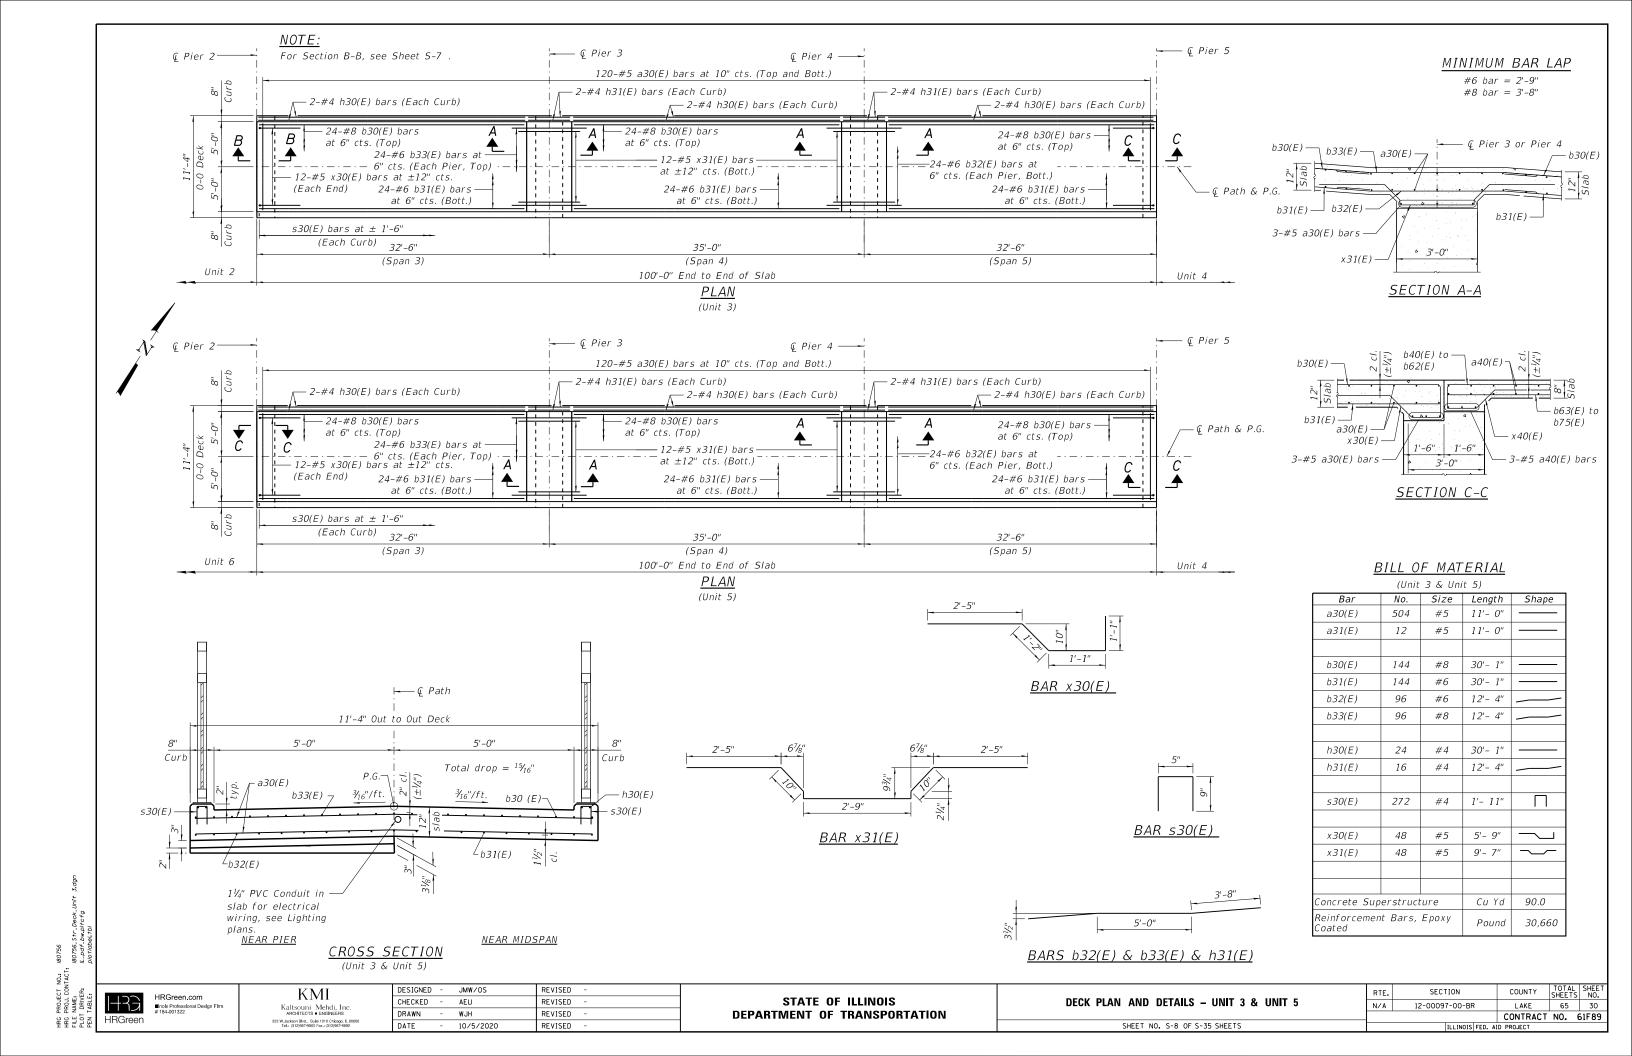


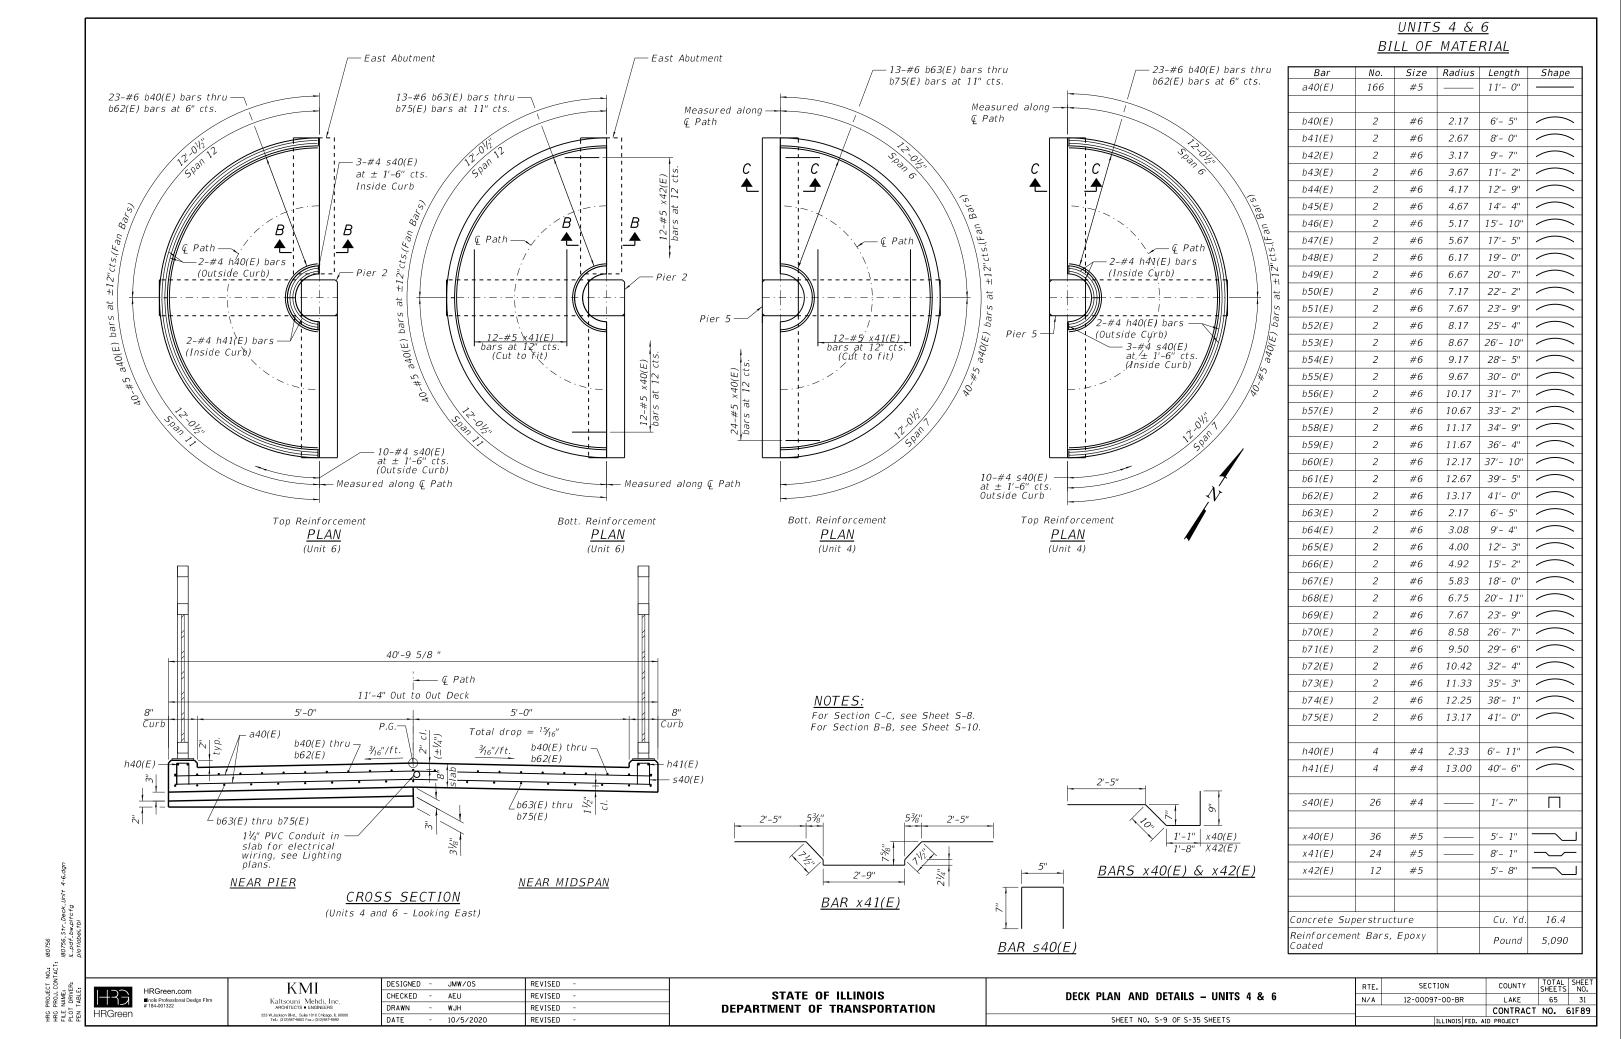


<u>SECTION AT EAST ABUTMENT</u> <u>SECTION B-B</u>

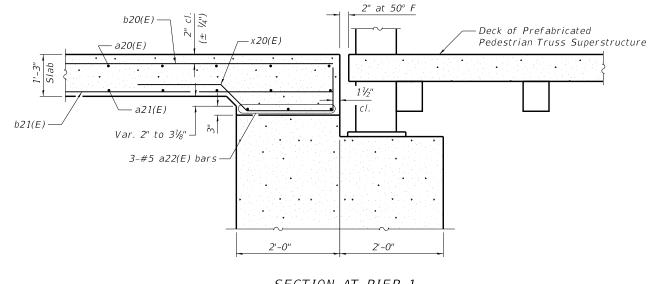

<u>SECTION AT PIER 1</u> <u>SECTION A-A</u>

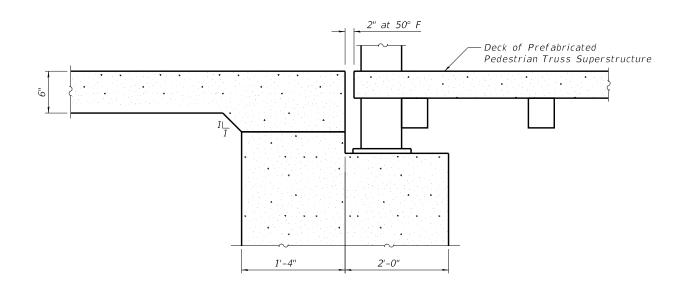

SECTION AT WEST ABUTMENT

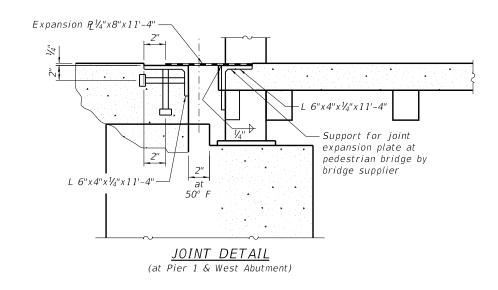

#### <u>NOTES:</u>

Work this sheet with sheets S-7 through S-10


HRGreen	HRGreen.com ■Inols Professional Design # 184-001322

KMI Kaltsouni Mehdi, Inc. ARCHTECTS & ENGINEERS 223 W.Jackson Bhd., Suite 1010 Chicago, IL 60006 Tal.: (312)697-9000 Fax: (312)697-8052

DESIGNED	-	JMW/OS	REVISED	-
CHECKED	-	AEU	REVISED	-
DRAWN	-	WJH	REVISED	-
DATE	-	10/5/2020	REVISED	-

STATE OF ILLINOIS	
DEPARTMENT OF TRANSPORTATION	ı

		SECTION	COUNTY	TOTAL SHEETS	SHEET NO.
DECK DETAILS	N/A 12-00097-00-BR		LAKE	65	32
			CONTRACT	NO. (	51F89
SHEET NO. S-10 OF S-35 SHEETS	ILLINOIS FED. AID PROJECT				

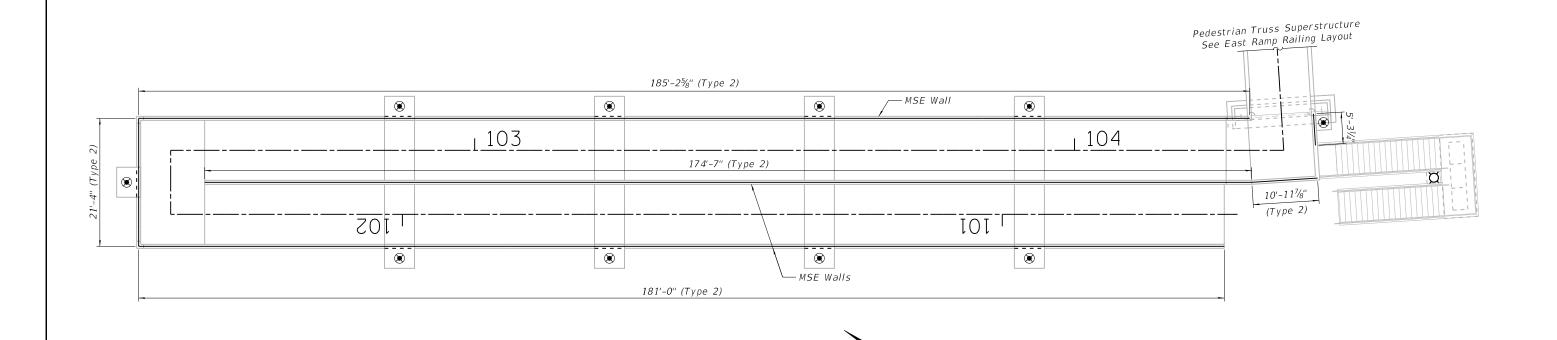

<u>PLAN</u>

CONTACT:
180756\_Str\_Ralling Layout\_West.dg.
1R: IL\_pdf\_bw.pitcfg
i plotlabel.tbl

HRGreen.com

Inols Professional Design
# 184-001322

KMI Kaltsouni Mehdi, Inc. ARCHITECTS = ENGINEERS 223 W.Jackson Bhd. Suire 1010 Chicago, II. 80908 Tel.: (312)987-9800 Fax.: (312)987-8882 
 DESIGNED
 JMW/OS
 REVISED

 CHECKED
 AEU
 REVISED

 DRAWN
 WJH
 REVISED

 DATE
 10/5/2020
 REVISED

STATE OF ILLINOIS
DEPARTMENT OF TRANSPORTATION

WEST RAMP RAILING LAYOUT

SHEET NO. S-11 OF S-35 SHEETS

 RTE.
 SECTION
 COUNTY
 TOTAL SHEETS NO.

 N/A
 12-00097-00-BR
 LAKE
 65
 33

 CONTRACT
 NO.
 61F89

lotes:

Type 1 Railing at Elevated Deck/Slab unless otherwise noted.


# KEY NOTES


(1) Recommended Rail Splice Location

Recommended
Expansion Joint
(Gap) in Rail
Location

Type 2 Railing at MSE Wall Locations unless otherwise noted.

Provide rail splice at no more than max. spacing limits per the railing details, with additional splice locations as noted in plan.

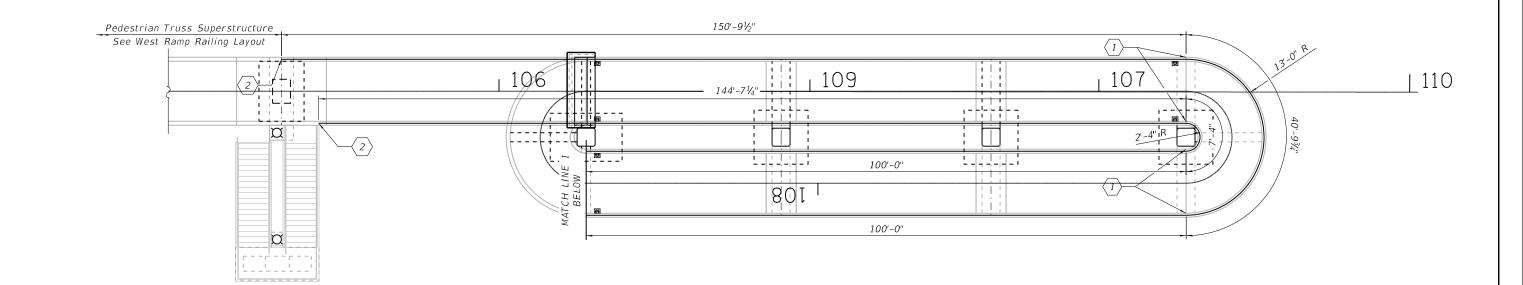

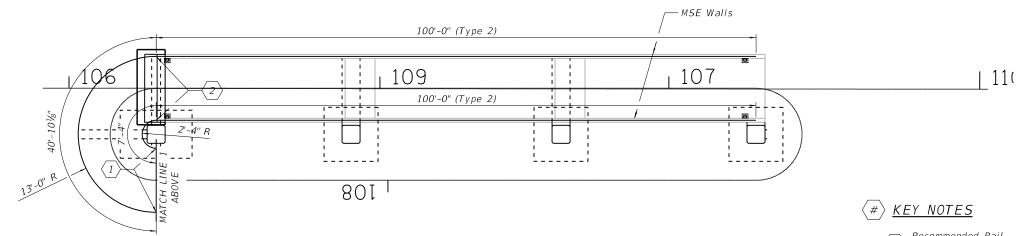

Recommended Rail Splice Location

Recommended
Expansion Joint
(Gap) in Rail
Location

#### <u>Notes:</u>

Type 1 Railing at Elevated
Deck/Slab unless otherwise
noted.

Type 2 Railing at MSE Wall Locations unless otherwise noted.

Provide rail splice at no more than max. spacing limits per the railing details, with additional splice locations as noted in plan.

PRGreen.com

INCO TO SANCE IN THE COMPANY OF THE CO

KMI Kaltsouni Mehdi, Inc. ARCHITECTS = ENGINEERS 223 W.Jackson BHJ., Suite 1010 Chicago, IL 80008 Tel: (312/887-8000 Fax: (312/887-8892

STATE OF ILLINOIS
DEPARTMENT OF TRANSPORTATION

 EAST RAMP RAILING LAYOUT
 RTE.
 SECTION

 N/A
 12-00097-00


SHEET NO. S-12 OF S-35 SHEETS

 RTE.
 SECTION
 COUNTY SHEETS
 TOTAL SHEETS NO.

 N/A
 12-00097-00-BR
 LAKE
 65
 34

 CONTRACT NO. 61F89

 |ILLINOIS | FED. AID | PROJECT

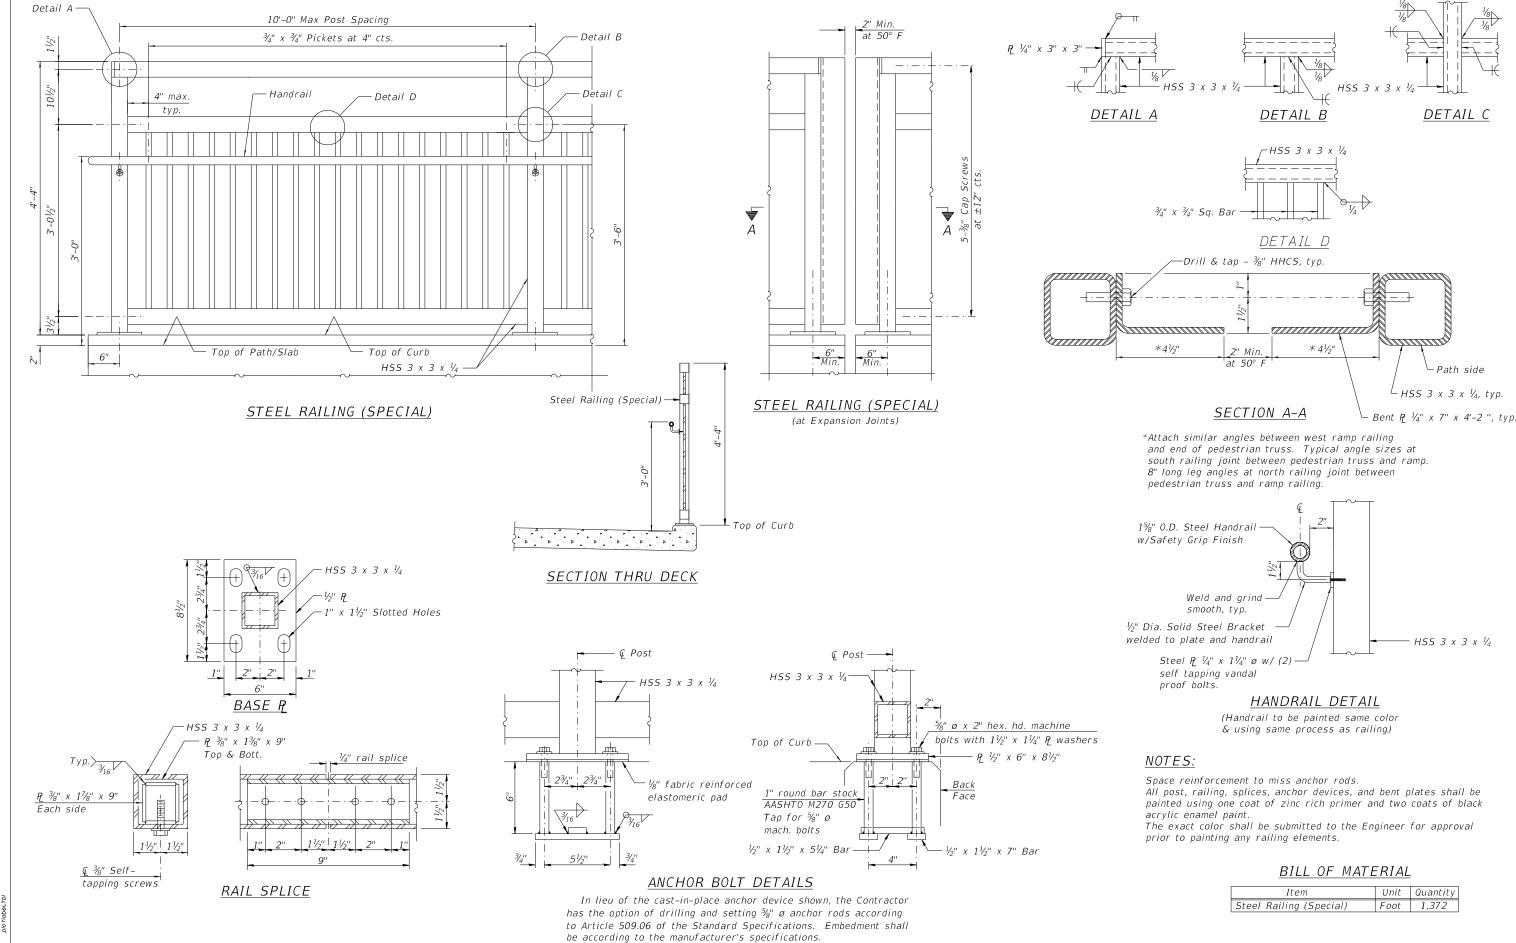

HRG HRG FILE PLO PEN

**HRGreen** 

KMI Kaltsouni Mehdi, Inc. ARCHITECTS = ENGINEERS 223 W.Rackson Blvd., Suite 1010 Chicago, IL 60606 Tel.: (312)687-6900 Fax.: (312)987-9892 DESIGNED -JMW/OS REVISED CHECKED -AFU REVISED REVISED DATE 10/5/2020 REVISED


#### STATE OF ILLINOIS **DEPARTMENT OF TRANSPORTATION**

**BRIDGE RAILING DETAILS** SHEET NO. S-13 OF S-35 SHEETS

SECTION COUNTY N/A 12-00097-00-BR LAKE 65 35 CONTRACT NO. 61F89 ILLINOIS FED. AID PROJECT


- Path side

#### ELEVATION

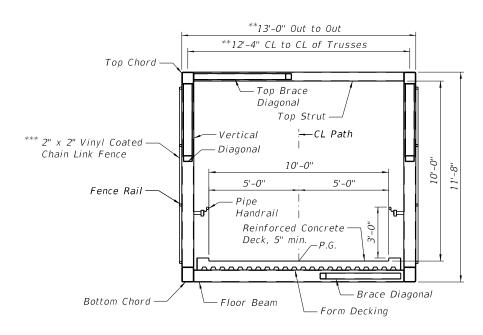

#### CROSS SECTION THRU TRUSS

- \*\*Subject to refinement per Truss Manufacturer. Structure depth does not include height of bearing. Truss supplier shall provide joint covers over open joints between span units. (2 locations).
- \*\*\* Fence to be Black Vinyl Coated per Section 1006.27(a)(1) of the Standard Specifications. Chain Link Fence material and installation shall be included in the unit price for Pedestrian Truss Superstructure.

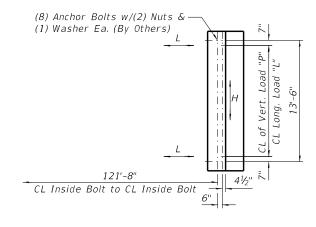

#### TRUSS REACTION TABLE

PLAN

	P (Lbs)	H (Lbs)	L (Lbs)
Dead Load	41,125		
Uniform Live Load	27,450		
Vehicle Load	5,000		
Wind Uplift (20psf)	-11,575		
Wind	± 13,210	24,230	
Thermal			6,170

- "P" Vertical Load at Each Base Plate (4 per Bridge) "H" - Horizontal Load at Each Footing (2 per Bridge)
- "L" Longitudinal Load at Each Bearing (4 per Bridge)
- + Downward Load
- Upward Load

#### TRUSS MANUFACTURER

The substructure is designed per AASHTO LRFD and based on the assumed truss loads (including deck) as shown on this sheet.

Truss manufacturer shall camber the truss as necessary to provide allowance for dead load deflection.

Bridge bearing seat elevations are subject to revision based on the approved pedestrian truss superstructure shop drawings.

Truss manufacturer shall provide the reinforced concrete deck design. Concrete deck to utilize stay-in-place galvanized forms. Reinforcement shall be epoxy coated. Contractor shall place the concrete deck after truss is set. Cost included with Pedestrian Truss Superstructure.

Design of pedestrian bridge shall accommodate anticipated dead and live load deflections so that no sag occurs within the bridge span. Pedestrian bridge profile must be either flat (when fully loaded), or have a slight upward camber.

Truss shall not use weathering steel, instead, steel shall meet the requirements for AASHTO M270 Grade 50. High strength bolts shall conform to ASTM A325 (Type 1). Where special provisions and these plans differ, these plans shall govern.

Truss and appurtenances shall be painted using a three coat system that conforms to Section 1008.05 of the Standard Specification. Finish color shall be black. The exact color shall be submitted to the Engineer for approval prior to painting any truss elements.

#### BILL OF MATERIAL

Item	Unit	Total
Pedestrian Truss Superstructure	SQ FT	1,234

TOTAL SHEE NO. 65 36

T NO. 61F89


HRGreen.com **HRGreen** 

KMI Kaltsouni Mehdi, Inc. ARCHITECTS ■ ENGINEERS 223 W.lackson Bhd., Suite 1010 Chicago, IL 60606 Tel.: (312)987-9800 Fax.: (312)987-9892

DESIGNED -JMW/OS REVISED CHECKED -AEU REVISED REVISED DATE 10/5/2020 REVISED

STATE OF ILLINOIS **DEPARTMENT OF TRANSPORTATION** 

PEDESTRIAN TRUSS SUPERSTRUCTURE – UNIT 1	RTE.	SECTION	COUNTY
	N/A	12-00097-00-BR	LAKE
			CONTRACT
CUEET NO C_14 OF C_35 CUEETC		TILL THOSE FED. A	IO DOO FOT

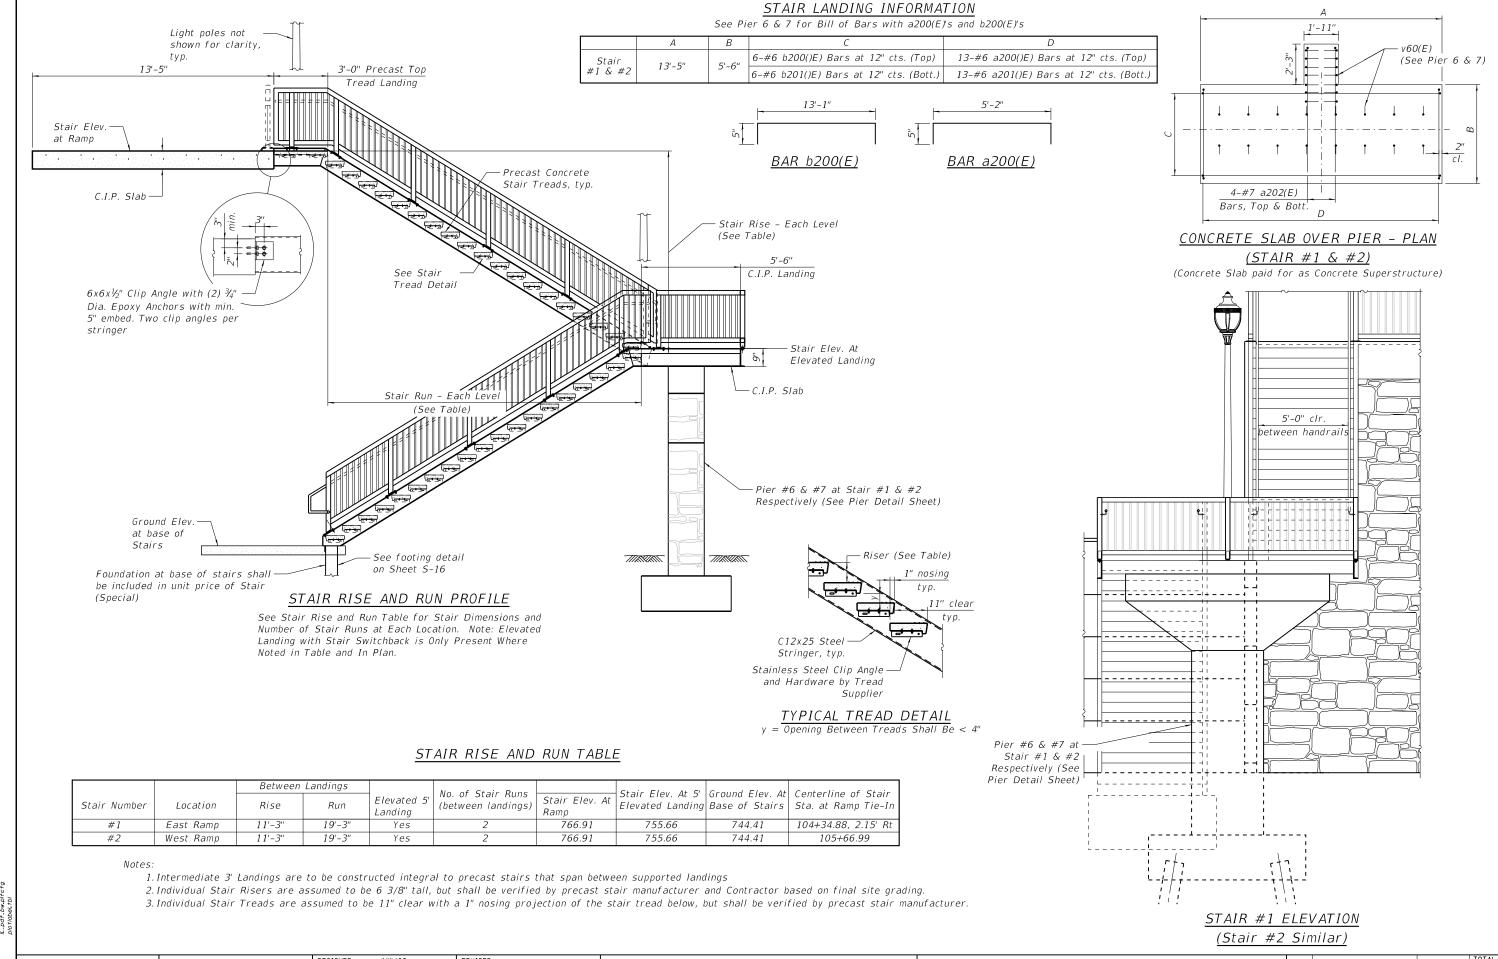

**HRGreen** 


KMI Kaltsouni Mehdi, Inc. ARCHITECTS ■ ENGINEERS 223 W.lackson Bhd. Suite 1010 Chicago, IL 60606 Tel.: (312)987-9800 Fax.: (312)987-9892

DESIGNED -JMW/0S REVISED CHECKED -AEU REVISED REVISED DATE REVISED 10/5/2020

STATE OF ILLINOIS **DEPARTMENT OF TRANSPORTATION** 

STAIR DETAILS I SHEET NO. S-15 OF S-35 SHEETS

SECTION COUNTY N/A 12-00097-00-BR LAKE 65 37 CONTRACT NO. 61F89

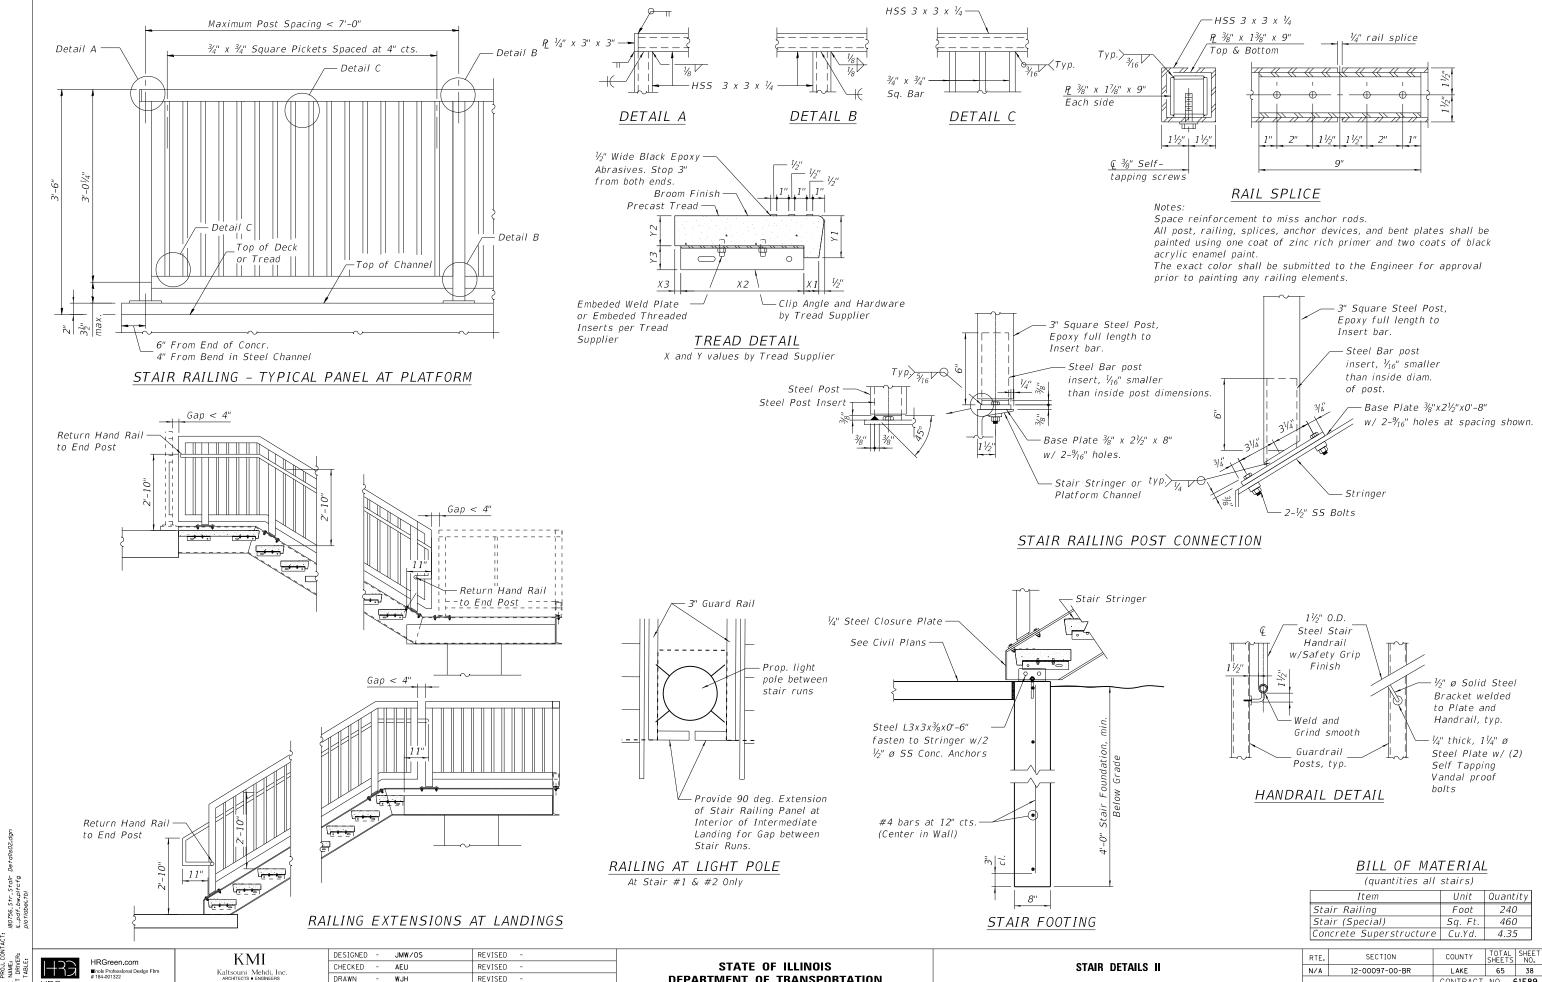

HRG HRG FILE PLO PEN

**HRGreen** 

Kaltsouni Mehdi, Inc. ARCHITECTS ■ ENGINEERS 223 W.lackson Bhd. Suite 1010 Chicago, IL 60606 Tel.: (312)987-9800 Fax.: (312)987-9892

DRAWN REVISED DATE 10/5/2020 REVISED

**DEPARTMENT OF TRANSPORTATION** 

SHEET NO. S-16 OF S-35 SHEETS

CONTRACT NO. 61F89 ILLINOIS FED. AID PROJECT

### **WEST ABUTMENT** BILL OF MATERIAL

Bar	No.	Size	Length	Shape
h(E)	3	#5	15'- 2"	
p(E)	10	#7	15'- 2"	
s(E)	18	#5	13'- 3"	
u(E)	8	#6	7'- 2"	
v(E)	16	#5	5'- 6"	
Concrete S	Structure.	5	Cu. Yd.	7.3
Reinforcer Coated	ment Bars	s, Ероху	Pound	784
Furnished Metal Shell Piles 14" dia. x 0.250 in.			Foot	114
Driving Piles			Foot	114
Concrete Sealer			Sq. Ft.	44
Staining C Structures			Sq. Ft.	55

### PILE DATA

Type & Size: Metal Shell-14 in. dia. x 0.250 in. walls Nominal Required Bearing: 359 Kips Factored Resistance Available: 197 Kips Est. Length: 57 ft.

No. Production Piles: 2 No. Test Piles: 0

> Pedestrian Truss Superstructure

Elev. 765.91

h(E) —

v(E)


s(E)


p(E)-

W. Abut.

1'-111/2"

1'-4"

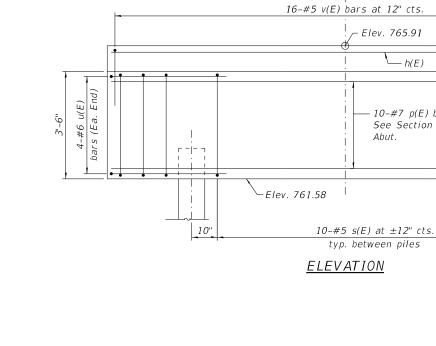

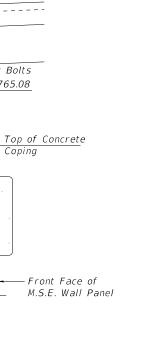

Anchor Bolts

Elev. 765.08


Coping

### SEC. THRU ABUT.

3'-4"

\* Piles shall be driven prior to placement of the reinforced select fill and coated with coal tar epoxy from the bottom of the select fill to 1" above the base of the abutment. The cost of the coal tar epoxy coating shall be included with the cost of "Furnishing Metal Shell Piles 14"x 0.250"".

1'-41/2"

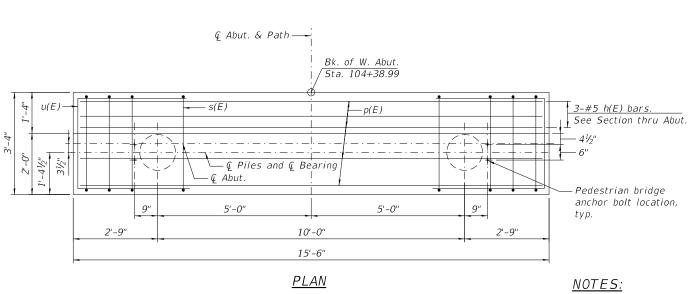

© Path at Bk. of W. Abut.

**└**— h(E)

- 10-#7 p(E) bars See Section thru.

10"

Abut.

4-#5 s(E) each end

> The M.S.E. wall supplier shall design the abutment soil reinforcement to resist a horizontal force of 0.34 kips/ft. of abutment.

See Sheet S-25 for M.S.E. Wall Details.

The metal shell piles shall be according to ASTM A 252 Grade 3.

HRGreen.com **HRGreen** 

P.C.C. Sidewalk 6", -

Special

KMI Kaltsouni Mehdi, Inc. ARCHITECTS ■ ENGINEERS

223 W.Jackson Blvd. Suite 1010 Chicago, IL 60606 Tel.: (312)987-9800 Fax.: (312)987-9892

\* & Piles

1'-111/2"

DATE	-	10/5/2020	REVISED	-
DRAWN	-	WJH	REVISED	-
CHECKED	-	AEU	REVISED	-
DESIGNED	-	JMW/OS	REVISED	-

STATE OF ILLINOIS **DEPARTMENT OF TRANSPORTATION** 

MATERIAL ADMINISTRA		SECTION	
WEST ABUTMENT	N/A	12-00097-00-1	
SHEET NO. S-17 OF S-35 SHEETS		ILL INO	

COUNTY LAKE 65 39 CONTRACT NO. 61F89 NOIS FED. AID PROJECT

3'-0"


BAR s(E)

BAR u(E)

1'-0"

BAR v(E)

HRG FLE PLO PEN

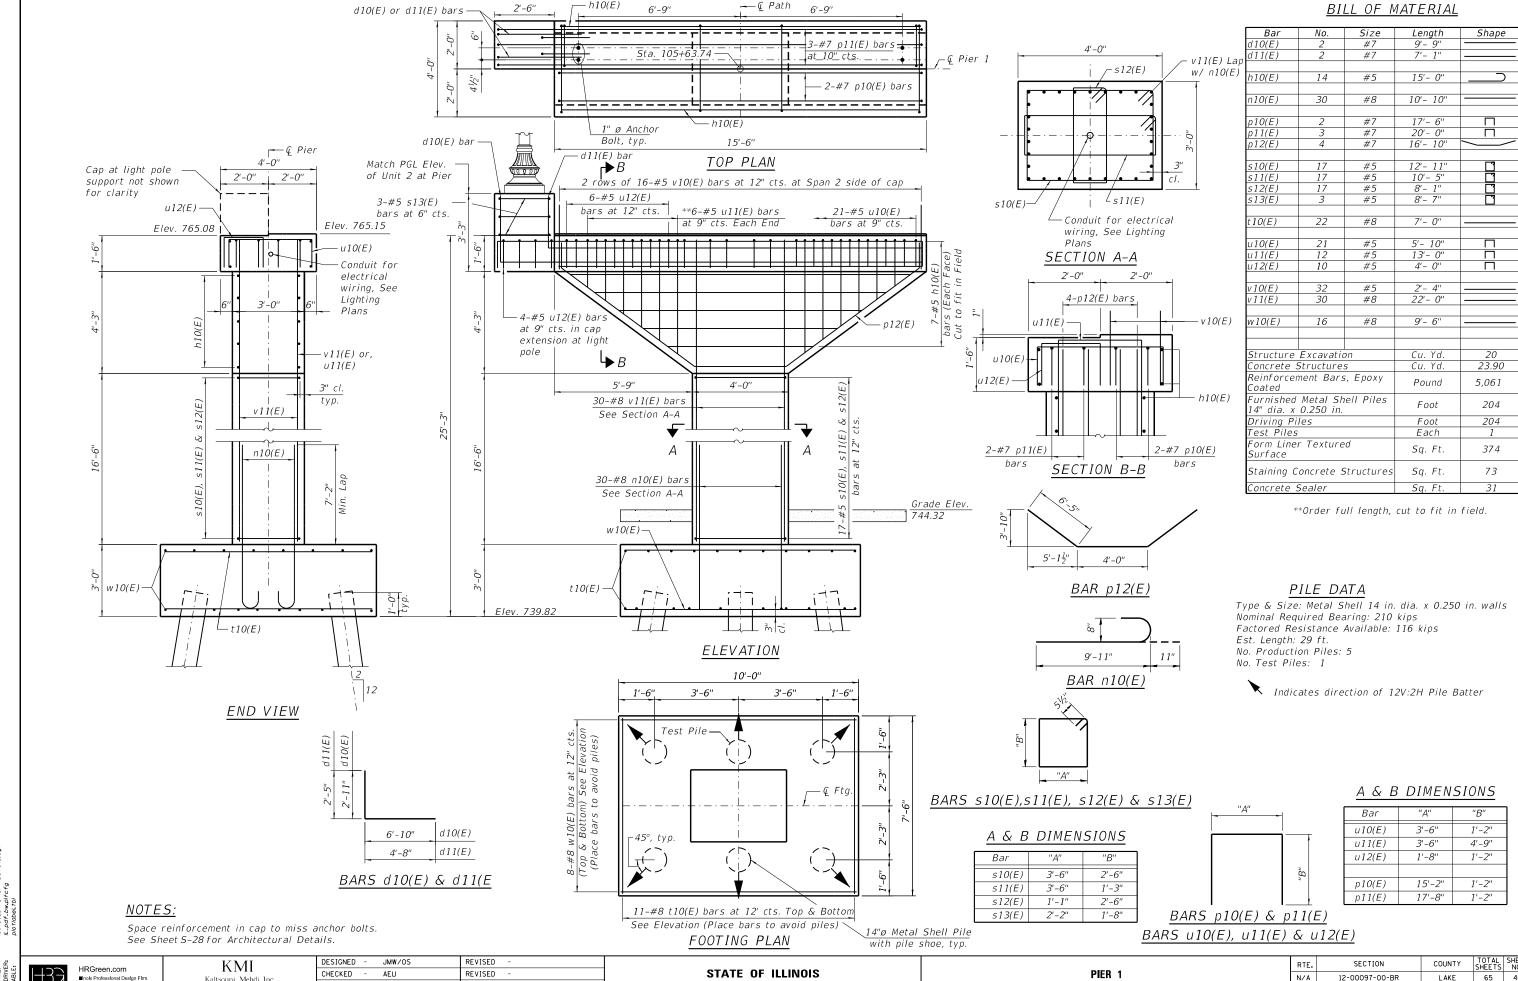

**-**— ♀ Path

-h10(E)

HRG HRG FILE

**HRGreer** 


Kaltsouni Mehdi, Inc. ARCHITECTS ■ ENGINEERS 223 W.lackson Bhd. Suite 1010 Chicago, IL 60606 Tel.: (312)987-9800 Fax.: (312)987-9892

DRAWN REVISED DATE 10/5/2020 REVISED

**DEPARTMENT OF TRANSPORTATION** 

SHEET NO. S-18 OF S-35 SHEETS

N/A 12-00097-00-BR LAKE 65 40 CONTRACT NO. 61F89

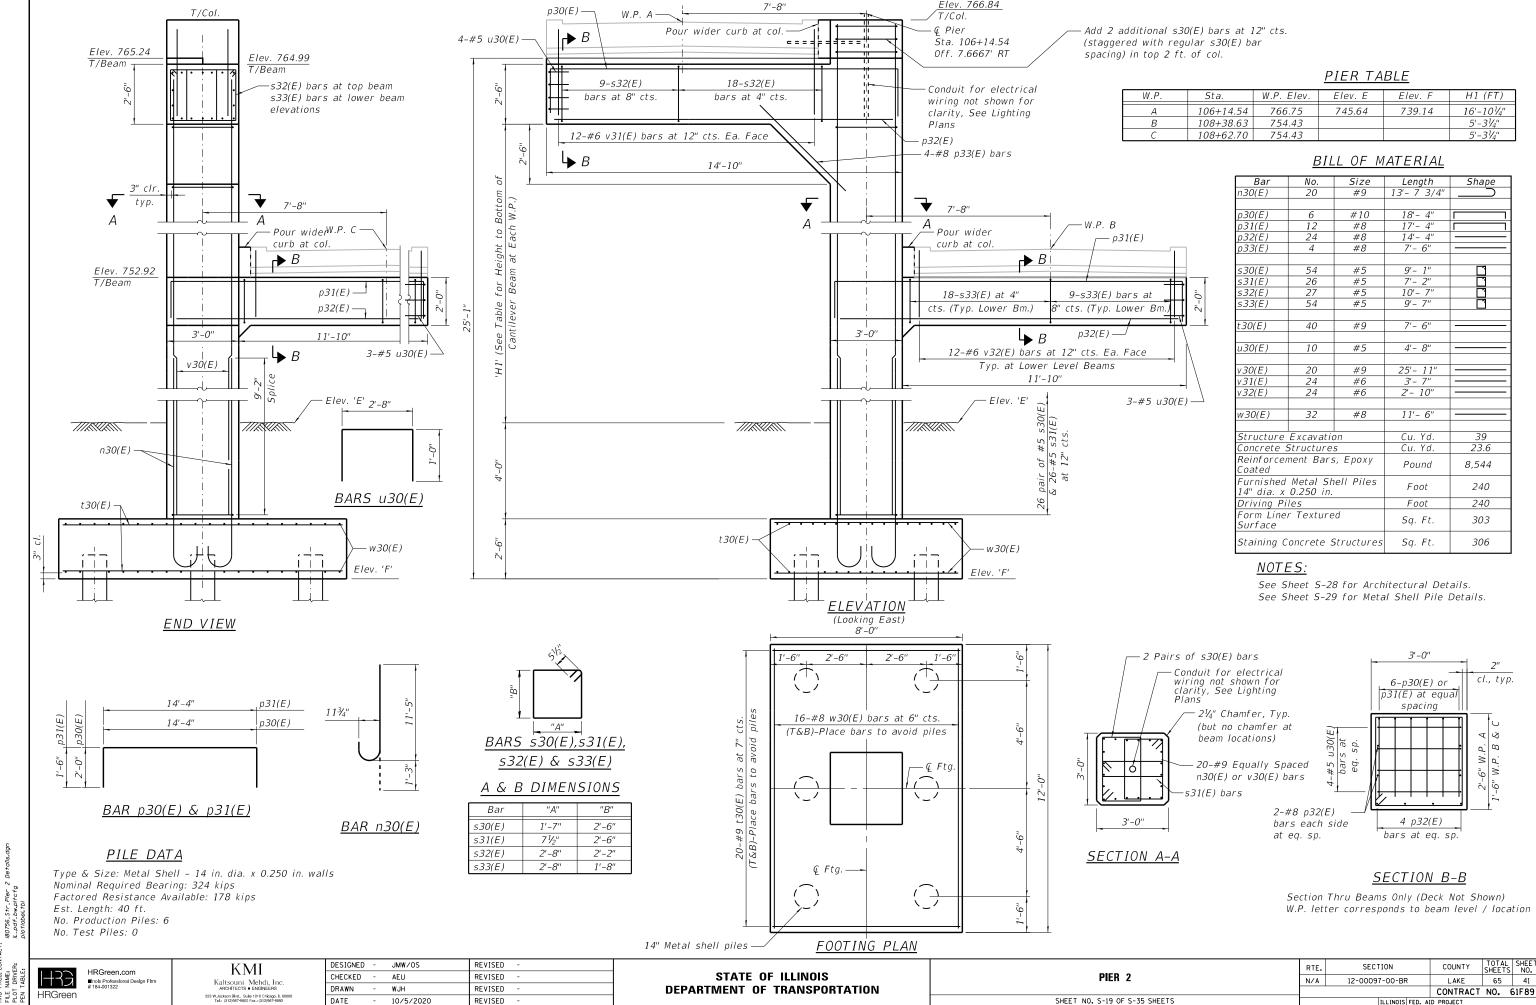


SHEET NO. S-19 OF S-35 SHEETS

HRG FILE PLOI

DATE

10/5/2020

REVISED

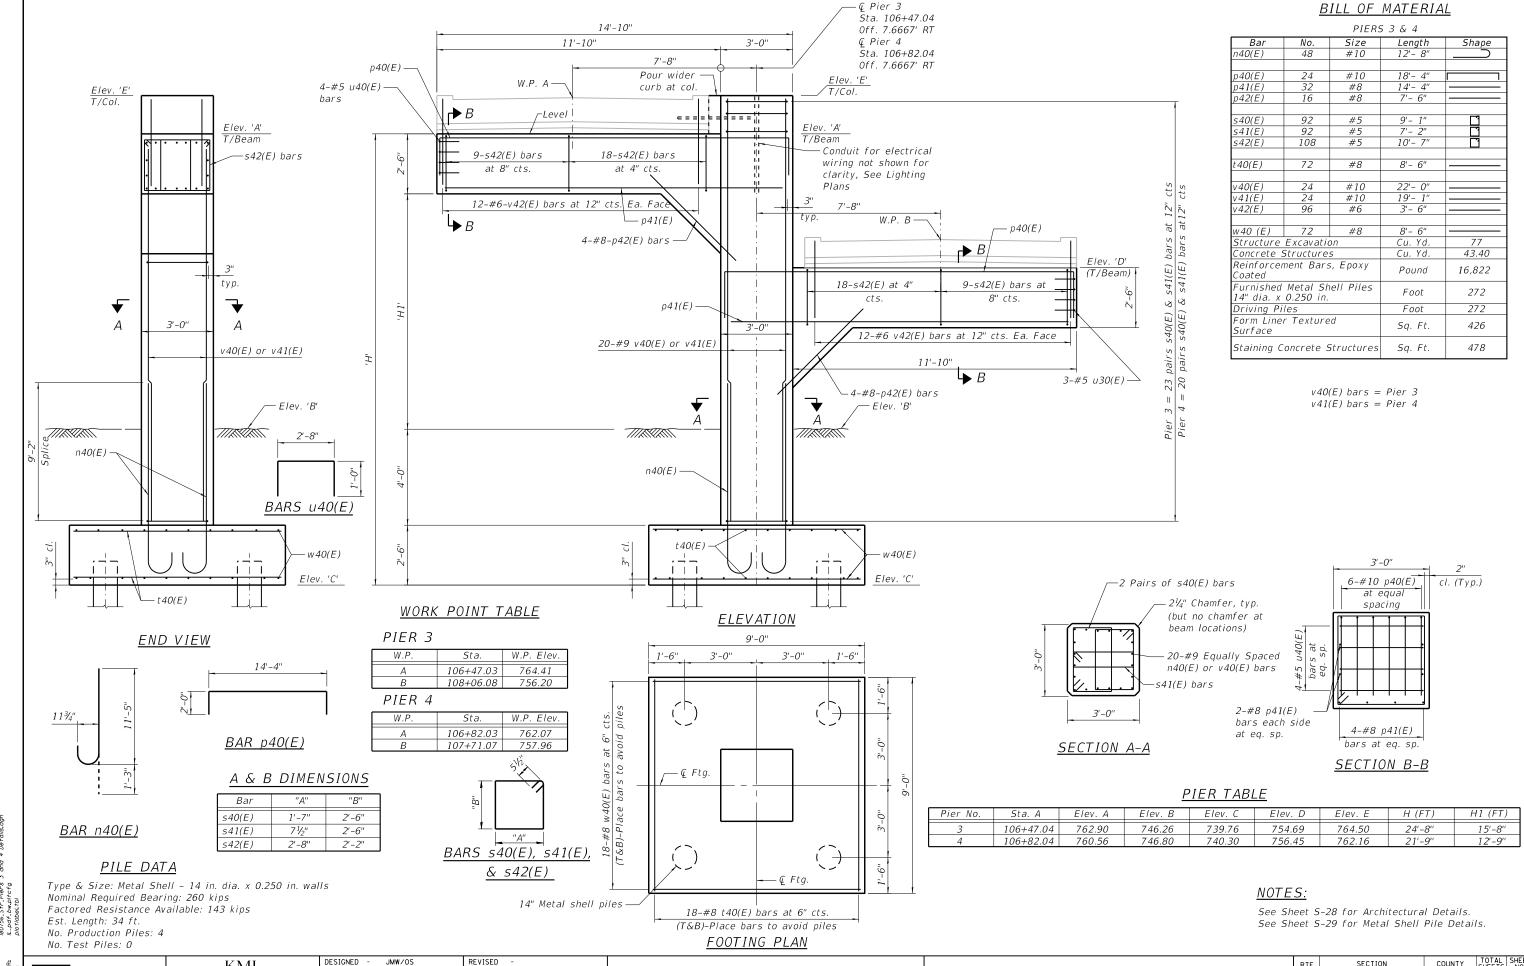


**HRGreen** 

KMI Kaltsouni Mehdi, Inc. ARCHITECTS ■ ENGINEERS 223 W.lackson Bhd. Suite 1010 Chicago, IL 60606 Tel.: (312)987-9800 Fax.: (312)987-9892

CHECKED AEU REVISED REVISED DATE 10/5/2020 REVISED

STATE OF ILLINOIS **DEPARTMENT OF TRANSPORTATION** 

PIERS 3 & 4 SHEET NO. S-20 OF S-35 SHEETS RTE. SECTION COUNTY N/A 12-00097-00-BR LAKE 65 42 CONTRACT NO. 61F89

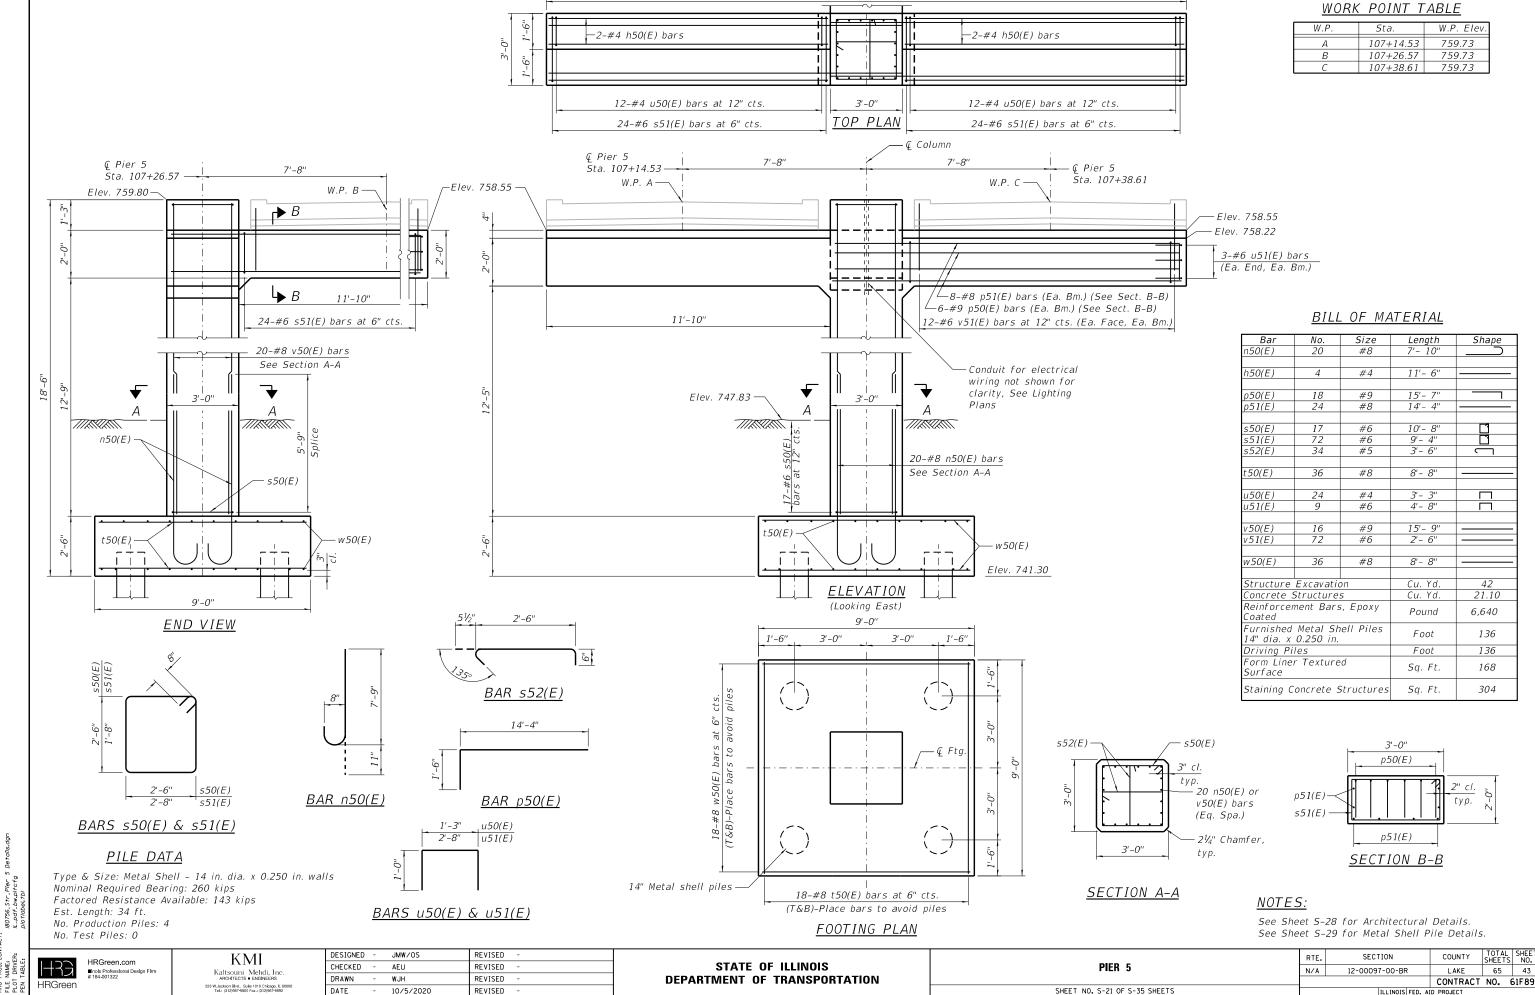

**DEPARTMENT OF TRANSPORTATION** 

SHEET NO. S-21 OF S-35 SHEETS

CONTRACT NO. 61F89

REVISED


REVISED

DATE

10/5/2020

26'-8"

**HRGreen** 

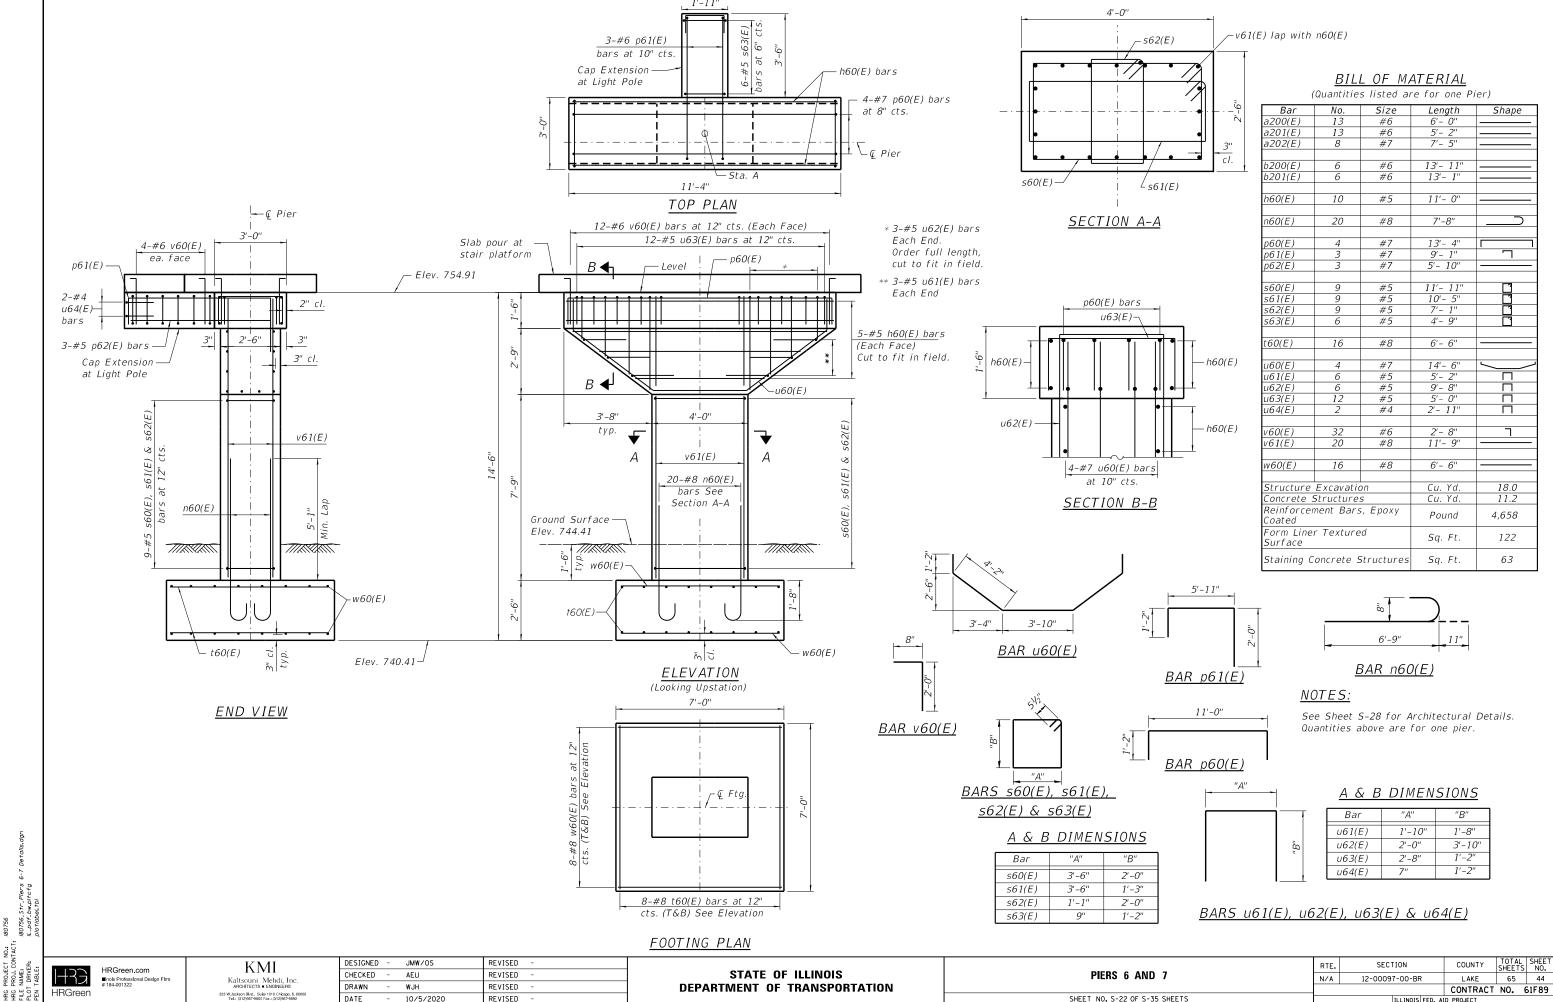

**HRGreen** 

Kaltsouni Mehdi, Inc. ARCHITECTS = ENGINEERS 223 W.Rackson Blvd., Suite 1010 Chicago, IL 60606 Tel.: (312)687-6900 Fax.: (312)987-9892

DATE REVISED 10/5/2020


SHEET NO. S-22 OF S-35 SHEETS

CONTRACT NO. 61F89


### PILE DATA

Type & Size: Metal Shell-12 in. dia. x 0.250 in. walls Nominal Required Bearing: 55 Kips Factored Resistance Available: 30 Kips Est. Length: 20 ft.

No. Production Piles: 2 No. Test Piles: 0

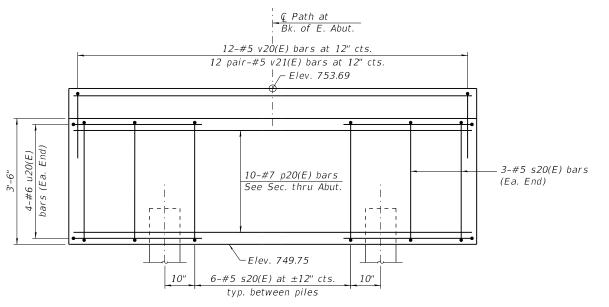

### ELEVATION

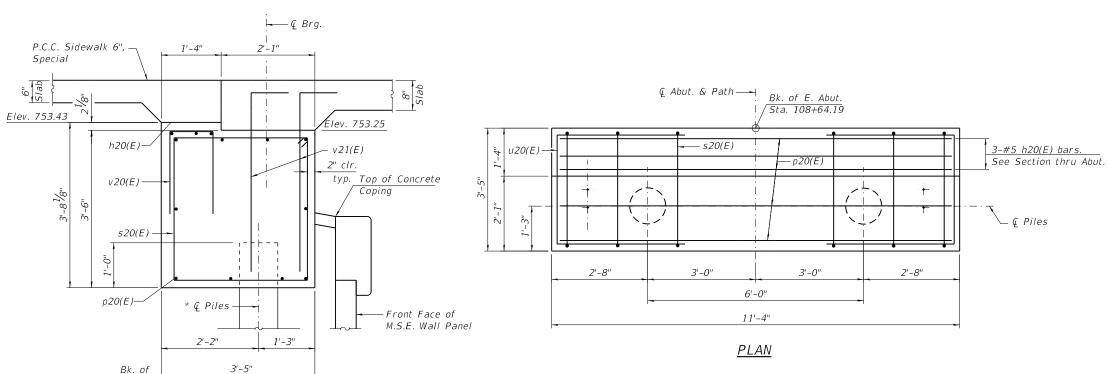


### SEC. THRU ABUT.

\* Piles shall be driven prior to placement of the reinforced select fill and coated with coal tar epoxy from the bottom of the select fill to 1" above the base of the abutment. The cost of the coal tar epoxy coating shall be included with the cost of "Furnishing Metal Shell Piles 12"x 0.250"".

### EAST ABUTMENT BILL OF MATERIAL

Bar	No.	Size	Length	Shape				
h20(E)	3	#6	11'- 0"					
p20(E)	10	#7	11'- 0"					
s20(E)	12	#5	13'- 5"					
u20(E)	8	#6	7'- 5"	J				
v20(E)	12	#5	5'- 6"					
v21(E)	24	#5	4'- 10"					
Concrete S	Structure.	5	Cu. Yd.	5.30				
Reinforcer Coated	ment Bars	s, Epoxy	Pound	722				
Furnished 12" dia. x		ell Piles	Foot	40				
Driving Pi	les		Foot	40				
Concrete S	Sealer		Sq. Ft.	24				
Staining C	oncrete S	Structures	Sq. Ft.	45				

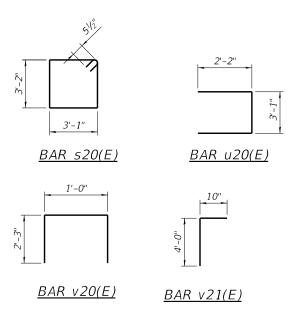

### NOTES:

The M.S.E. wall supplier shall design the abutment soil reinforcement to resist a horizontal force of 0.34 kips/ft. of abutment.

See Sheet S-27 for M.S.E. Wall Details.

The metal shell piles shall be according to ASTM A 252 Grade 3.



E. Abut.

KMI Kaltsouni Mehdi, Inc. ARCHITECTS ■ ENGINEERS


223 W.Jackson Blvd. Suite 1010 Chicago, IL 60606 Tel.: (312)987-9800 Fax.: (312)987-9892

DESIGNED	-	JMW/OS	REVISED -
CHECKED	-	AEU	REVISED -
DRAWN	-	WJH	REVISED -
DATE	-	10/5/2020	REVISED -

STATE OF ILLINOIS **DEPARTMENT OF TRANSPORTATION** 

		SECTION		COUNTY	TOTAL SHEETS	SHEET NO.
EAST ABUTMENT	N/A	12-00097-00-BR		LAKE	65	45
				CONTRACT	NO.	61F89
SHEET NO. S-23 OF S-35 SHEETS		ILLINOIS FE	ED. AII	PROJECT		

11'-4" Benchmark #1: Cut square in concrete base of light pole located DESIGN SPECIFICATIONS DESIGN STRESSES Pay limit for "Portland Cement approximately 840 feet west of centerline of the railroad tracks 2017 AASHTO LRFD Bridge Design along the north of the Mundelein Metra Station parcel. FIELD UNITS Concrete Sidewalk 6", Special" Specifications, 8th Edition Elevation = 742.60 (NAV D88) - Steel Railing (Special) f'c = 3,500 psi10'-0" Benchmark #2: Arrow bolt on fire hydrant located at the north corner fy = 60,000 psi (Reinforcement)5'-0" 5'-0" of the intersection of McKinley Avenue and Anthony Avenue. LOADING H5 AND PEDESTRIAN Elevation = 751.06 (NAVD88) PRECAST UNITS 90 psf Pedestrian Loading - Conduit for lighting MSE wall shall be designed for a min. surchage f'c = 4,500 psi (Precast Panels)P.G.L. & on same side as light ♀ Path of 85 psf and an equivalent fluid presure of 50 psf. pole locations 196'-8<sup>3</sup>/<sub>4</sub>'' 3/16"/ft.  $\frac{3}{16}$ "/ft. Steel Railing - MSE Wall at landing (Special) -Concrete Copina Sta. 104+34.88, #5 hars at 1'-6" cts to be Stained Off. 5'-8" Rt. #5 bars at 18" cts. Elev. 767.00 (Curb Elev.) #5 d1 (E) bars at 12" cts. TYPICAL SLAB SECTION -MSE Wall bump-out (Portland Cement Concrete Sidewalk 6 inch, Special) Cost of Reinforcement Bars, Epoxy Coated at abut. is included in the pay item "Portland Cement Concrete Sidewalk 6", Special". - Elev. 740.51 Top of Exposed — – Elev. 739.50 Prop. Ground Line Panel Line (Level) Elev. 740.00 at Front Face of Wall (Level) WEST MSE WALL ELEVATION (Higher wall elevation) BAR d1(E)- Reinforcement Similar (Looking at projected face of outside wall, middle wall nots shown) to Details on Sheet S-26 11'-4" - Begin MSE Wall 181'-1/8" Sta. 100+62.97 10'-0" LIGHT POLE BLISTER Elev. 744.01 Face to Face of Curb Steel Railing Top of MSE Wall 5'-0" AT PLATFORM (Special) Elev. 744.10 Concrete Coping Panel for Middle Curb Curb - P.G.L. & 11'-4" to be Stained Wall (Curb Elev.) ⊈ Path See Typical  $\frac{3}{16}$ "/ft. ¾<sub>16</sub>"/ft. Slab Section Top of Coping 10'-0" clr. (min.) P.C.C. Sidewalk Face of Curb to Coping 6", Special ℚ Path Prop. Ground Line ∠ Elev. 739.50 — Top of Leveling Pad, typ. at Front Face of Wall Top of Exposed — (Level) - Elev. 740.00 Panel Line Undercut existing soils 5 ft. below exist. grade. WEST MSE WALL ELEVATION (Level) for an area 10' wider than the footprint of the MSE walls Middle Wall, Top of Leveling Pad, (Lower wall elevation) Top of Exposed from south end of MSE wall to Sta. 101+15.00 Backfill varies per Wall Supplier's Design. (Looking at Front Face of Wall) Panel Line with Porous Granular Embankment up to the sub-grade Select Fill-Assume 3'-6" min. below PGL for level for the MSE wall fill. Precast Face quantities. \_\_\_\_5'-0" \_\_\_\_30'-0" \_\_\_\_ A ◀ — 5'-0" 30'-3½" Panel, typ. 30'-0" Soil Reinforcement, typ. Front Face -Exist. R.O.W. Panel, typ. End MSE Wall Sta. 104+43.27 Theoretical Top at Fc. ofCoping of Leveling Pad -Work Pad Elevation 0.70 x H (min.) ı 103 104 varies (min. 3'-6" See Supplier Shop below top of slab) Drawings for Lengths 8 SECTION A-A ZŌĪ 101 BILL OF MATERIAL -Front Face of ITEM UNITTotal @ Path and P.G.L Precast Wall -Bk. of West Abut Mechanically Stabilized Earth Retaining Wall Sq. Ft. 10.796 Panels Sta. 104+38.99 Structure Excavation Cu. Yd. 632 See Plan at Abut. on Sheet S-25for 30'-0' Portland Cement Concrete Sidewalk 6", Special Sq. Ft. 4,316 layout of landing at top of ramp 5'-0" 5'-0" Begin MSE Wall -Staining Concrete Structures Sq. Yd. 1,349 WEST MSE WALL PLAN NOTES: Sta. 100+62.97 Removal and Disposal of Unsuitable Material 350 Cu. Yd. Notes: See Sheet S-28 for Architectural Details. Wall offsets are measured from @ path Porous Granular Embankment Cu. Yd. 350 See Sheet S-25 for details. to front face of precast panels. DESIGNED - JMW/OS REVISED SECTION COUNTY **KMI** HRGreen.com STATE OF ILLINOIS CHECKED - AEU REVISED WEST MSE WALL PLAN AND DETAILS N/A 12-00097-00-BR LAKE 65 46 Kaltsouni Mehdi, Inc DRAWN WJH REVISED **DEPARTMENT OF TRANSPORTATION** CONTRACT NO. 61F89 **HRGreer** 223 W.Jackson Blvd., Suite 1010 Chicago, IL 60606 Tel.: (312)997-9900 Fax.: (312)967-9692 SHEET NO. S-24 OF S-35 SHEETS DATE REVISED 10/5/2020

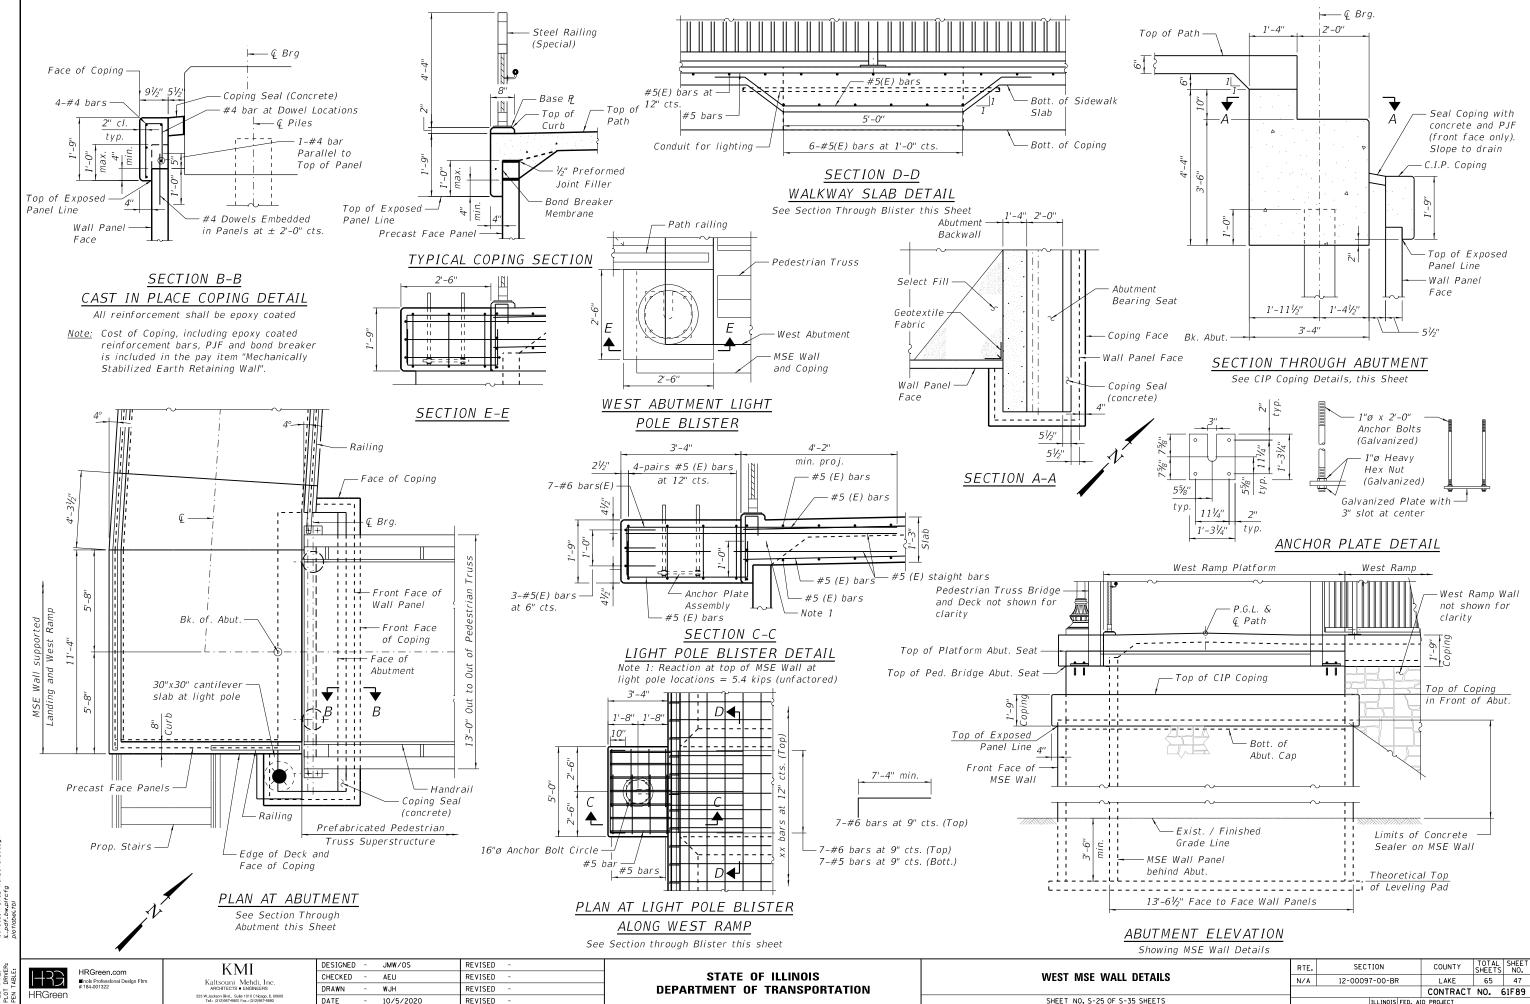

HRG HRG FILE

Benchmark #1: Cut square in concrete base of light pole located approximately 840 feet west of centerline of the railroad tracks along the north of the Mundelein Metra Station parcel. Elevation = 742.60 (NAVD88)

Benchmark #2: Arrow bolt on fire hydrant located at the north corner of the intersection of McKinley Avenue and Anthony Avenue. Elevation = 751.06 (NAVD88)

Existing Structure: None

### DESIGN SPECIFICATIONS 2017 AASHTO LRFD Bridge Design

Specifications, 8th Edition

### LOADING H5 AND PEDESTRIAN

90 psf Pedestrian Loading

MSE wall shall be designed for a min. surchage of 85 psf and an equivalent fluid presure of 50 psf.


### DESIGN STRESSES

FIELD UNITS

 $f'c = 3,500 \ psi$ fy = 60,000 psi (Reinforcement)


PRECAST UNITS

f'c = 4,500 psi (Precast Panels)

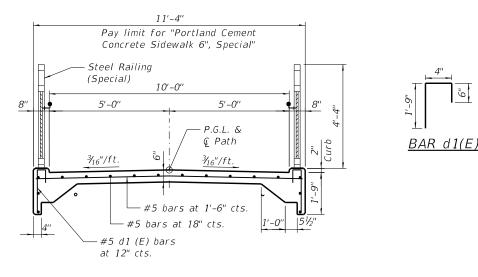

### TYPICAL SLAB SECTION

(Portland Cement Concrete Sidewalk 6 inch, Special) Cost of Reinforcement Bars, Epoxy Coated is included in the pay item "Portland Cement Concrete Sidewalk 6", Special".

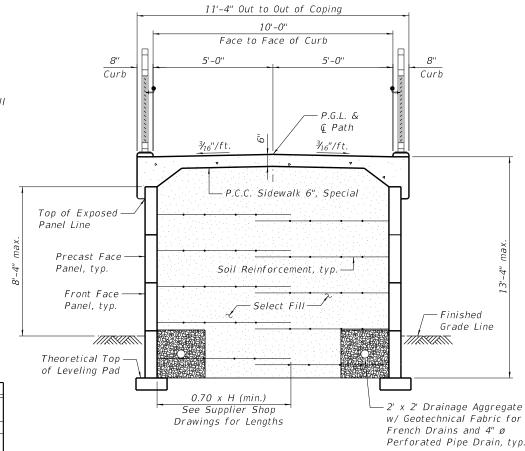

SECTION A-A (THRU MSE WALL)

Note: Wall Supplier and Contractor must space soil reinforcement to miss piers


COUNTY

LAKE 65 48

CONTRACT NO. 61F89

### Salvage: None Pier Columns and Elevated Ramps not shown for clarity 100'-0" Steel Railing End E. MSE Wall Concrete Coping (Special) Sta. 109+64.19 to be Stained Elev. 748.11 Top of Coping Elev. 748.03 (Curb Elev.) √-----<del>-</del> - Elev. 742.66 Begin E. MSE Wall - Elev. 742.16 (Level) Sta. 108+59.52 Top of Exposed Elev. 741.16 Panel Line (Level) - Sta. 109+30.00 Prop. Ground Line Elev. 745.80

### SOUTHEAST MSE WALL ELEVATION (Northeast Wall Similar) (Looking at Front Face of Wall)

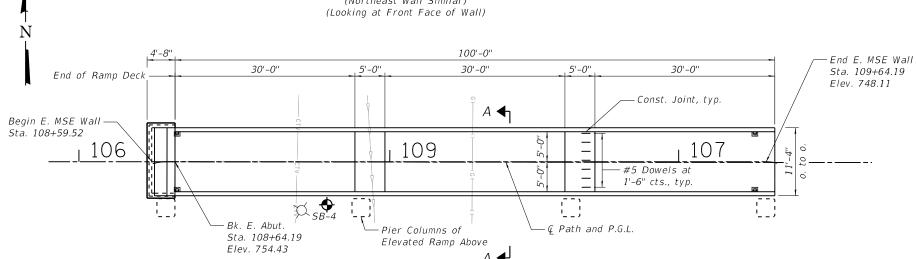

at Front Face of Wall

### EAST MSE WALL PLAN

Notes:

Wall offsets are measured from & path to front face of precast panels.

### BILL OF MATERIAL

ITEM	UNIT	Total
Mechanically Stabilized Earth Retaining Wall	Sq. Ft.	1,746
Structure Excavation	Cu. Yd.	251
Portland Cement Concrete Sidewalk 6", Special	Sq. Ft.	1,146
Staining Concrete Structures	Sq. Yd.	428

### NOTES:

- 1. See Sheet S-29 for Architectural Details.
- 2. See Sheet S-27 for details.

HRGreen.com **HRGreen** 


KMI Kaltsouni Mehdi, Inc. ARCHITECTS = ENGINEERS 223 W.Jackson Blvd. Suite 1010 Chicago, IL 60606 Tel.: (312)987-9800 Fax.: (312)987-9892


DESIGNED -JMW/0S REVISED CHECKED -AEU REVISED DRAWN REVISED DATE REVISED 10/5/2020

STATE OF ILLINOIS


	RTE.	SECTION		
AST MSE WALL PLAN AND DETAILS	N/A	12-00097-00-BR		
SHEET NO. S-26 OF S-35 SHEETS		ILLINOIS FE		

HRG HRG FILE

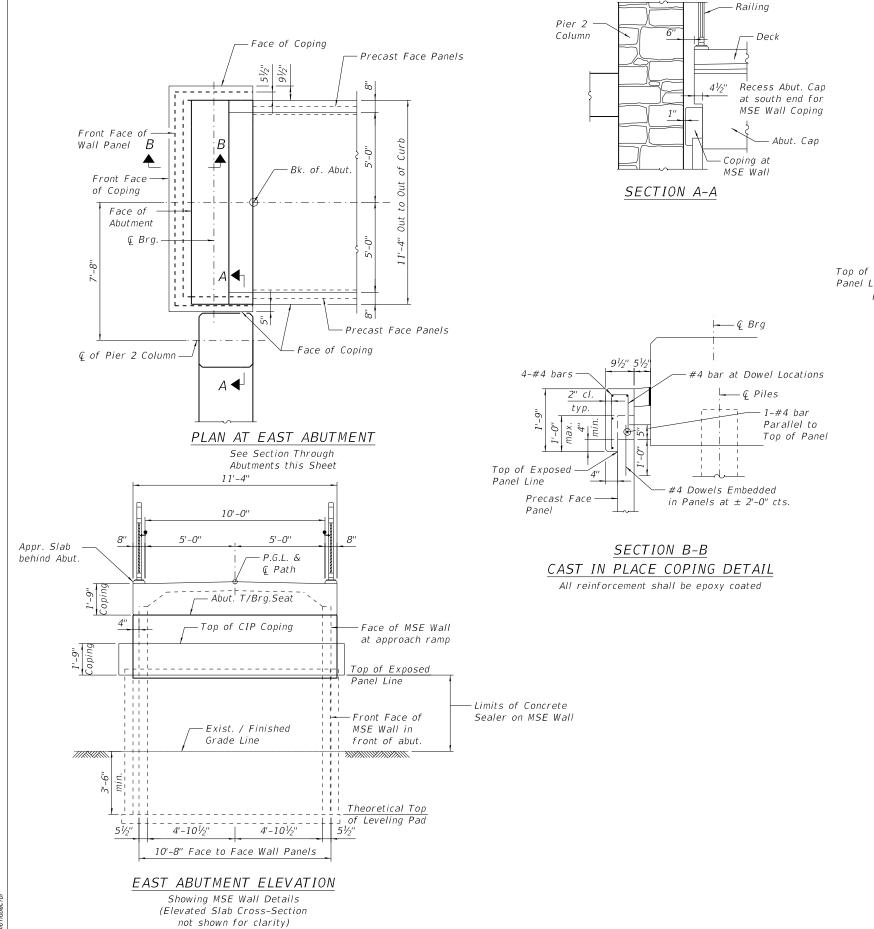

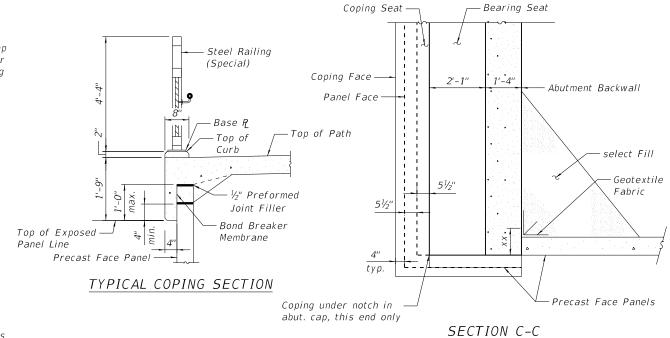

Note: Cost of Coping, including epoxy coated reinforcement bars, PJF and bond breaker is included in the pay item "Mechanically Stabilized Earth Retaining Wall".

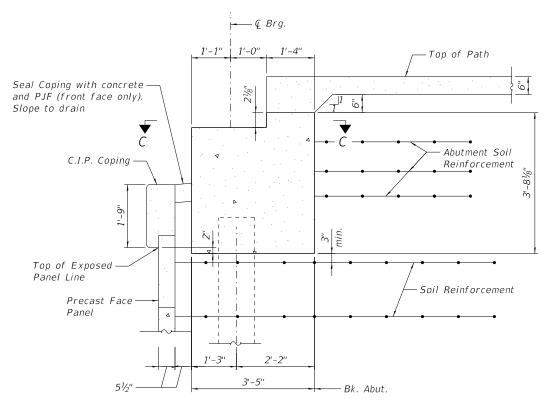

### SECTION THROUGH EAST ABUTMENTS

See CIP Coping Details, this Sheet



KIMI
Kaltsouni Mehdi, Inc.
ARCHITECTS • ENGINEERS
223 W.Jackson Bled. Suite 1010 Chicago, IL 60806
Tal.: (21/2897-9806 Fars.: (31/2987-8892

 DESIGNED
 JMW/OS
 REVISED

 CHECKED
 AEU
 REVISED


 DRAWN
 WJH
 REVISED

 DATE
 10/5/2020
 REVISED

STATE OF ILLINOIS
DEPARTMENT OF TRANSPORTATION

 EAST MSE WALL DETAILS
 RTE.
 SECTION

 SHEET NO. S-27 OF S-35 SHEETS
 II

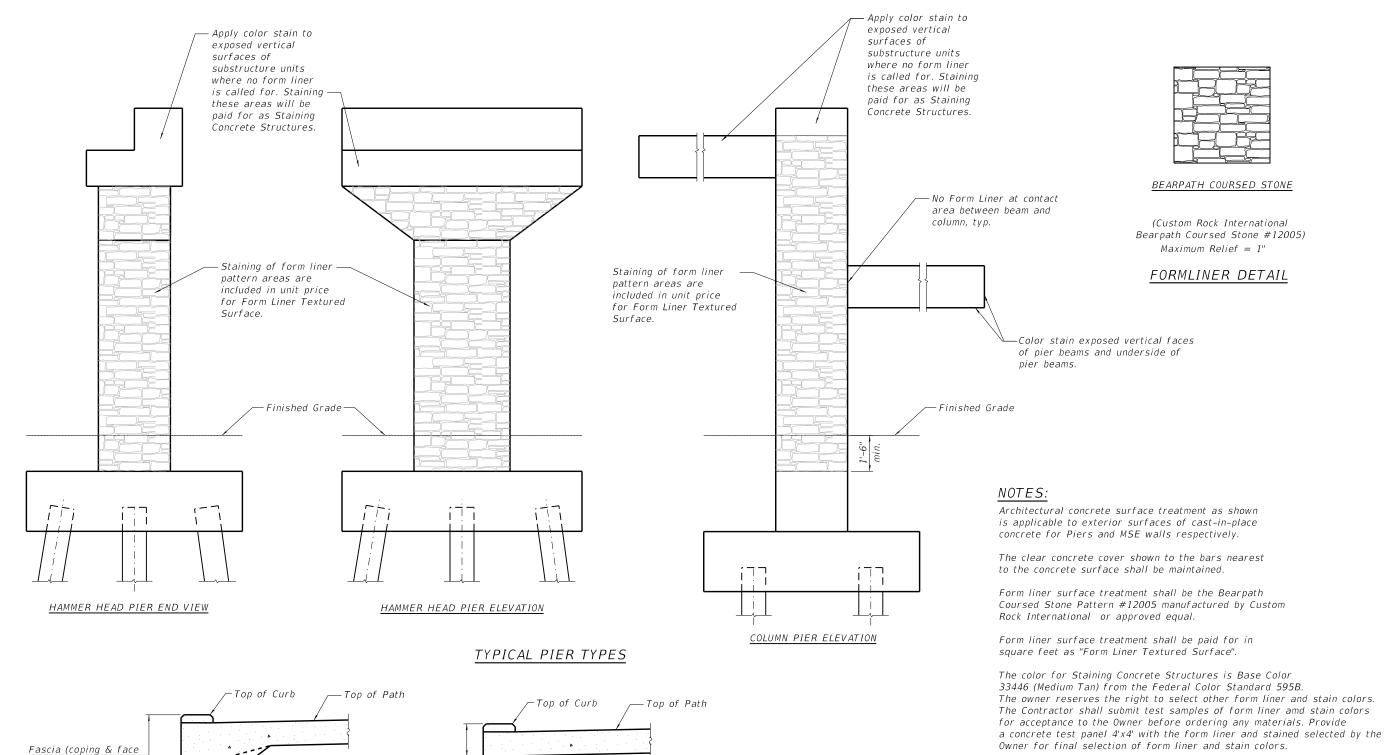

of curb) to be stained See special provision for Form Liner Textured Surface. Fascia (face of deck & See special provision for Staining Concrete Structures. curb) to be stained PARTIAL SECTION THRU DECK

(UNITS 2 THRU 6)

\*Precast Face Panels w/ form liner & staining

\*Paid for by pay item Mechanically Stabilized Earth Retaining Wall



KMI
Kaltsouni Mehdi, Inc.
223 W.Jackson Blvd., Suite 1010 Chicago, IL 60606 Tel.: (312)987-9800 Fax.: (312)967-9892

Top of Exposed

Panel Line

DESIGNED	-	JMW/OS	REVISED	-
CHECKED	-	AEU	REVISED	-
DRAWN	-	WJH	REVISED	-
DATE	-	10/5/2020	REVISED	-

STATE OI	F ILLINOIS
DEPARTMENT OF	TRANSPORTATION

ARCHITECTURAL DETAILS		SECTION		COUNTY	TOTAL SHEETS	SHEET NO.
		N/A 12-00097-00-BR		LAKE	65	50
				CONTRACT	NO.	61F89
SHEET NO. S-28 OF S-35 SHEETS		ILLINOIS FE	ED. AI	D PROJECT		

Staining of areas without form liner pattern such as the exposed vertical faces of decks, copings, curb, column caps

as Staining Concrete Structures.

and pier caps and pier beams as indicated shall be paid for

PARTIAL SECTION THRU MSE WALL





### METAL SHELL PILE TABLE

Designation and outside diameter	Wall thickness t	Weight per foot (Lbs./ft.)	Inside volume (yd.³/ft.)
PP12	0.250"	31.37	0.0267
PP14	0.250"	36.71	0.0368
PP14	0.312"	45.61	0.0361
PP16	0.312"	52.32	0.0478
PP16	0.375"	62.64	0.0470

END PLATE ATTACHMENT


jH)

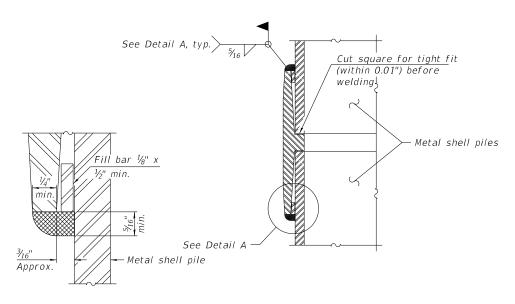

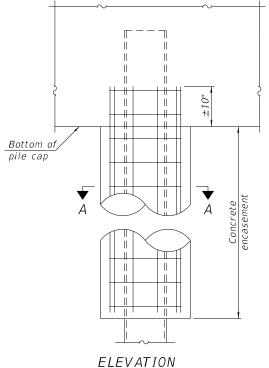

6" Horizontal bend, typ.

ELEVATION

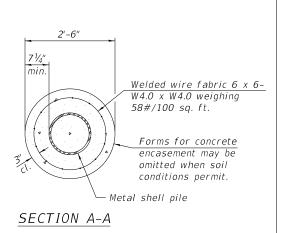

### DETAIL A

### Metal shell $\frac{1}{pile}$ $\frac{1}{\sqrt{3}}$ End plate $\frac{1}{\sqrt{5}}$ Shop or field weld $\frac{1}{\sqrt{5}}$ $\frac$

Metal shell pile **\_** 

> ∕ Shop or ∖ field weld

Pile shoe shape may vary. Shallower

pile shoes are allowed provided that the driving surface has an angle of

### WELDED COMMERCIAL SPLICE

Notes:

The ½" x ½" min. fill bar may be constructed of 2 bars with a ½" max. gap between them.

Pile segments shall be driven to solid contact with splicer before welding.

### INDIVIDUAL PILE CONCRETE ENCASEMENT (When specified)

## Field fabricated or commercial backing ring Metal shell pile $s = t - \frac{1}{16}$ $s = t - \frac{1}{16}$

### . <u>Bottom of</u> abutment Shop or iield weld

# PP12: 8-#7 bars PP14: 11-#7 bars PP16: 13-#7 bars (10'-6" long, typ.) #4 bar Spiral Metal Shell pile SECTION B-B

### PILE SHOE ATTACHMENT

(When called for on the plans, the Contractor shall furnish metal shell pile shoes consisting of a single piece conical pile point as shown. The pile shoes shall be cast in one piece steel according to either ASTM A 148 Grade 80-50 or AASHTO M 103 Grade 65-35 and shall provide full bearing over the full circumference of the metal shell pile. The pile shoe shall have tapered leads to assure proper alignment and fitting and shall be secured to the pile with a circumferential weld).

1-1-2020

### COMPLETE PENETRATION WELD SPLICE

\* Field fabricated backing ring may be made from pile shell by removing segment to allow reducing circumference and vertically rejoin with partial joint penetration weld.

### REINFORCEMENT AT ABUTMENTS

(Omit when concrete encasement is specified)

В

Note:

The metal shell piles shall be according to Article 1006.05 of the Standard Specifications.

### F\_MS

HRGreen.com

Inols Professional Desig
#184-001322

60° Angle of

inclination

KMI
Kaltsouni Mehdi, Inc.
ARCHITECTS • ENGINEERS

223 W.Jackson Bhd. Suin 1010 Chicago, II. 60606
Tal.: (312/987-9800 Fax.: (312/987-9892


STATE OF ILLINOIS
DEPARTMENT OF TRANSPORTATION

 METAL SHELL PILE DETAILS
 RTE.
 SECTION
 COUNTY SHEET NO.
 SHEET NO.

 N/A
 12-00097-00-BR
 LAKE
 65
 51

 SHEET NO. S-29 OF S-35 SHEETS
 IILLINOIS FED. ALD PROJECT
 NO.
 61F89

HRC FLE PLO PEN

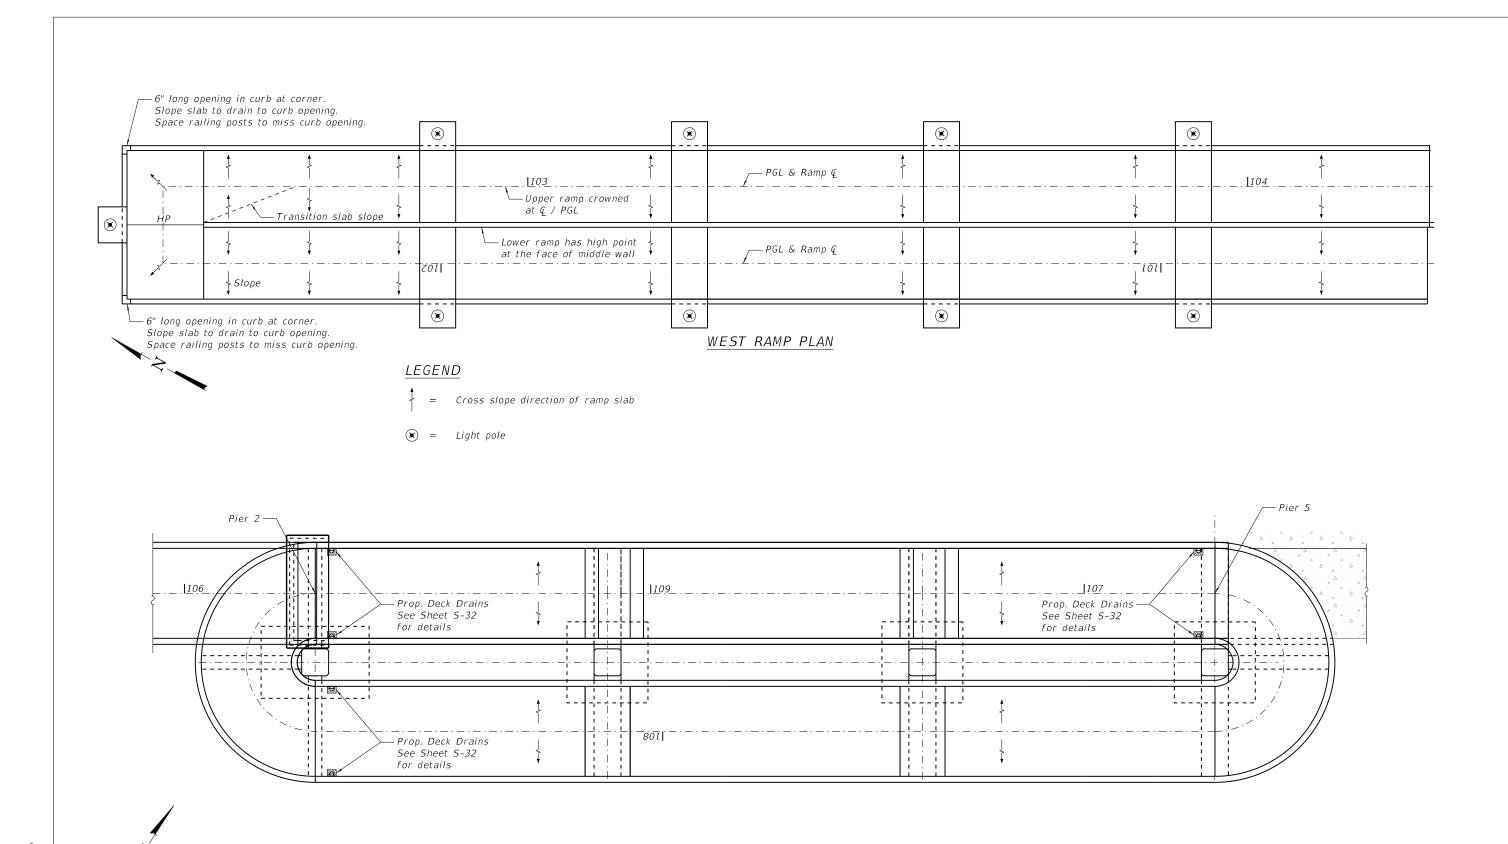

LE: plotlabel.tb

KMI Kaltsouni Mehdi, Inc. ARCHITECTS • ENGINEERS 223 W.Jackson Blvd., Suite 1010 Chicago, IL 60006 Tel.: (312/987-9900 Fax.: (312/987-9892 
 DESIGNED
 JMW/OS
 REVISED

 CHECKED
 AEU
 REVISED

 DRAWN
 WJH
 REVISED

 DATE
 10/5/2020
 REVISED

STATE OF ILLINOIS DEPARTMENT OF TRANSPORTATION

EAST RAMP PLAN

 DECK DRAINAGE PLAN
 RTE.
 SECTION


 N/A
 12-00097-00-1

 SHEET NO. S-30 OF S-35 SHEETS
 ||ILLINO

RTE. SECTION COUNTY SHEETS NO.

N/A 12-00097-00-BR LAKE 65 52

CONTRACT NO. 61F89

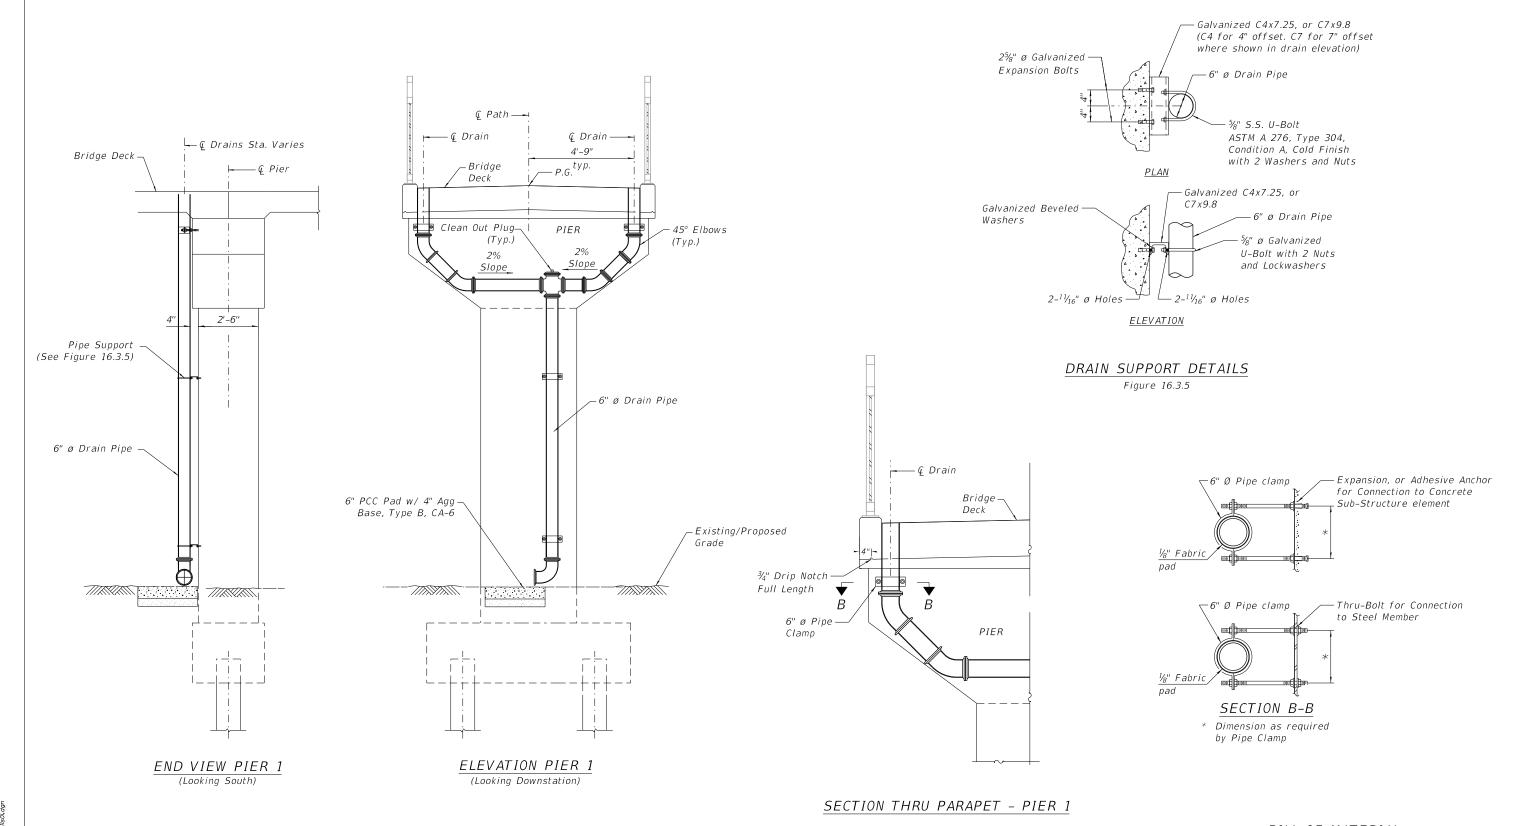

### BILL OF MATERIAL

Item	Unit	Quantity
Drainage System	L SUM	1




KMI Kaltsouni Mehdi, Inc. ARCHITECTS = ENGINEERS 223 W.Jackson Blvd. Suite 1010 Chicago, IL 60000 Tal.: (312)867-9000 Fan.: (312)867-8682

DESIGNED	-	JMW/OS	REVISED	-
CHECKED	-	AEU	REVISED	-
DRAWN	-	WJH	REVISED	-
DATE	-	10/5/2020	REVISED	-

STATE OF ILLINOIS
DEPARTMENT OF TRANSPORTATION

	RTE.	SECTION	COUNTY	TOTAL SHEETS	SHEET NO.
DECK DRAINAGE DETAILS	N/A	12-00097-00-BR	LAKE	65	53
			CONTRACT	NO. (	51F89
SHEET NO. S-31 OF S-35 SHEETS		ILLINOIS FED. A	D PROJECT		

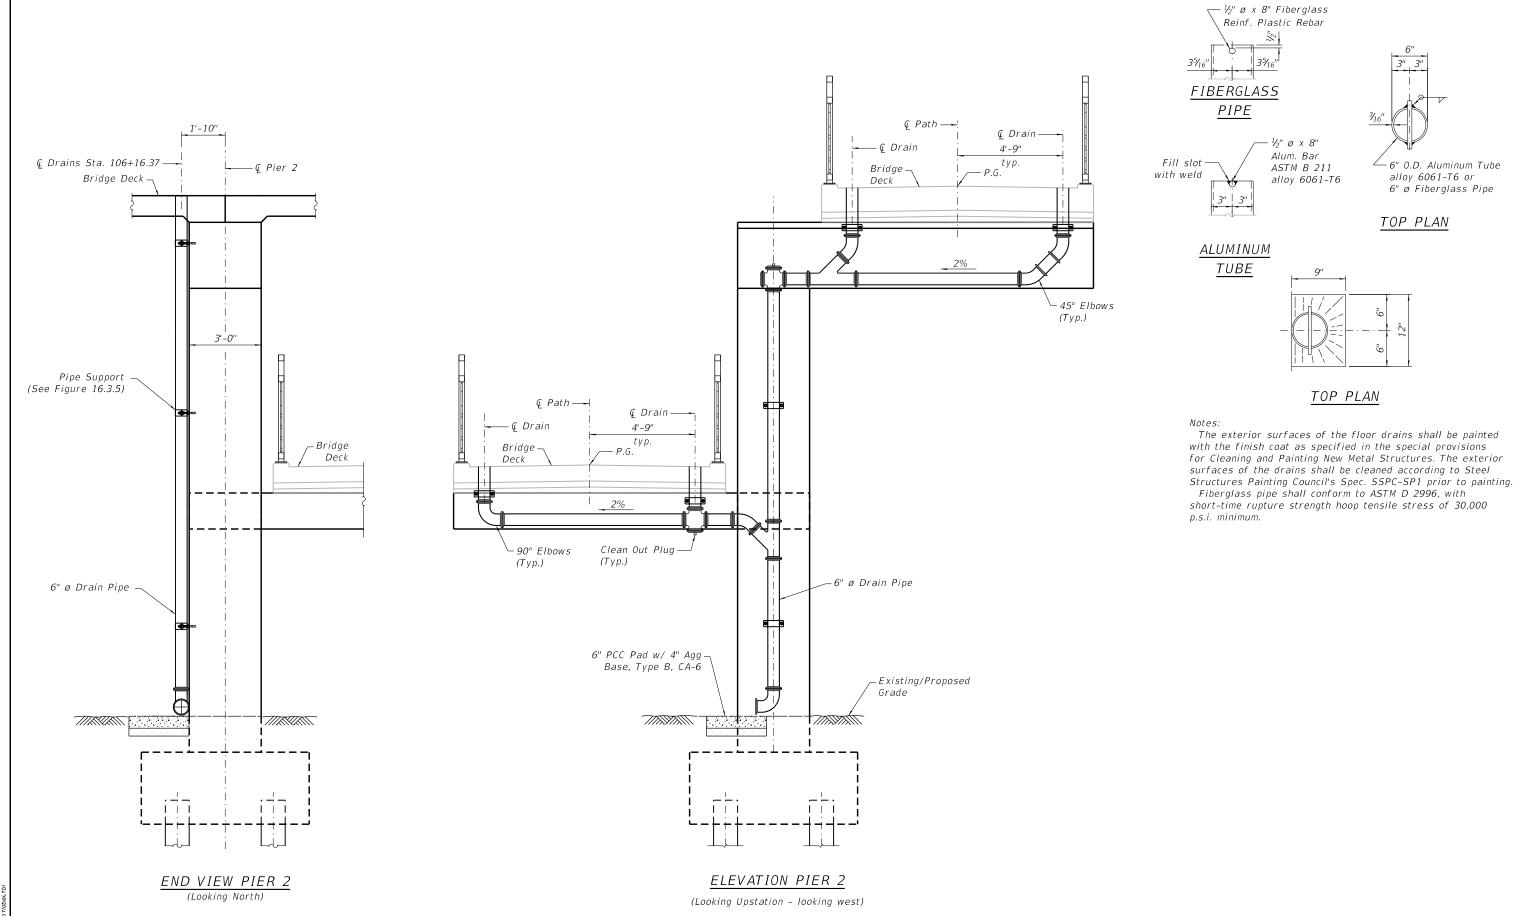

CONTACT:

180756\_Str\_Deck Drainage DetallsO2.

R: Plotbettbl

HE PROJECT NO. HE PROJECT NO. HE PROJECT NO. HE PROJ. CONT. OCT. HE PROJ. CONT. OCT. HE PROJ. HE PROJ. HE PROJ. TABLE:

HRGreen.com ■Inols Professional Design Firm # 184-001322 KMI
Kaltsouni Mehdi, Inc.
ARCHITEOTS = ENGINEERS
223 W.Jackson Bl.d. Suito 1010 Chicago, IL 00000
Tel.: 017/907-9000 Fax. (217/907-9000

 DESIGNED
 JMW/OS
 REVISED

 CHECKED
 AEU
 REVISED

 DRAWN
 WJH
 REVISED

 DATE
 10/5/2020
 REVISED

STATE OF ILLINOIS
DEPARTMENT OF TRANSPORTATION

DECK DRAINAGE DETAILS

SHEET NO. S-32 OF S-35 SHEETS

		NO.: 1	Cinley Street Pede	OG OF BO								age 1 of 2
						-37000000000000000000000000000000000000					Mundel	
BORIN	IG LOCA	TION: _	West	Boring	_						HR Green, In	ic.
DEPTH (feet)	SOIL		Material Descrip	tion	Elevation	TYPE/ INTERVAL 0	AMPL ON	N-VALUE Blows per ft.	Wc%	Dry Unit Weight, pcf	Unconfined Compressive Strength, 1sf	REMARKS
0			Brown & Black C y stiff to firm	Clay LOAM, A-	742.5	SS	1	5	15		2.75 Qp	
5 -						- SS	2	3	19	105	0.70	
			Brown Clay LC				3A 3B	10	29 21	86	1.5 Qp 1.11	
10 -		Brown	& Grey CLAY,	A-6, very stiff	734.5	- SS	4	13	16	115	3.80	
						SS	5	18	14	104	3.26	
15 -		Grey C	CLAY, A-6, hard	to very stiff	729.5	- SS	6	14	14	118	4.54	
-						SS	7	15	15	110	4.19	
20 -						- SS	8	17	17	104	2.21	\.
						SS	9	21	16	109	4.15	
25 <del>-</del>						- SS	10	17	17	108	3.76	
						SS	11	21	18	113	5.16	
30 -						- SS -	12	18	19	104	3.22	
35	<u>*</u>	-				- SS	13	20	20	106	3.61	
URING	DRILLING	FTER DRIL	₩ 56.0		$\mathbb{N}_{N}$	ISE7	Γ		BOF LOC	RING C	STARTED: COMPLETED: BY: METHOD:	5/23/18 5/23/18 MP CFA

Midland Standard Engineering & Testing, Inc. 410 Nolen Drive, South Elgin, Illinois 60177 (847) 844-1895 f(847) 844-3875

	NO.: 18332	LOG OF								ge 2 of 2
ROJECT: _	McKinley St	reet Pedestrian Bridg	<u>te</u>	SITE	LOC	ATIO	N: _		Mundele	in, IL
ORING LOCA	TION:	West Boring		CLIEN	NT:			ŀ	IR Green, Inc	
					AMPL	E			STS	
SOIL TYPE	Mater	ial Description	Elevation	TYPE/ INTERVAL	NO.	N-VALUE Blows per ft.	Wc%	Dry Unit Weight, pcf	Unconfined Compressive Strength, tsf	REMARKS
40	Grey CLAY, A	-6, very stiff to har	rd 702.5	- SS	14	17	22	103	3.53	
45				- SS	15	15	24	100	3.07	
50 -				- SS	16	15	23		2.95	
55 - 山東北			202	- SS	17	18	24		3.30	
60 –	Grey Sandy Li dense to dens	OAM, A-2-4, mediu e	m 686.5	- - SS	18	23	9			
65 _	End of Boring	at 65 Feet	677.5	- - SS	19	33	13			
ATER LEVEL O	BSERVATIONS, ft.	<del>▽</del> 56.0'	(19)						TARTED:	5/23/18 5/23/18

Midland Standard Engineering & Testing, Inc. 410 Nolen Drive, South Elgin, Illinois 60177 (847) 844-1895 f(847) 844-3875

KMI Kaltsouni Mehdi, Inc. ARCHITECTS = ENGINEERS 223 W.Heston Brd. Suite 1010 Chizago, II. 00006 Tel.: (312/987-9800 Fax.: (312/987-8852

DESIGNED	-	JMW/OS	REVISED	-
CHECKED	-	AEU	REVISED	-
DRAWN	-	WJH	REVISED	-
DATE	-	10/5/2020	REVISED	-

STATE OF ILLINOIS
DEPARTMENT OF TRANSPORTATION

COLL DODING 100	RTE.	SECTION	COUNTY	TOTAL SHEETS	SHEET NO.
SOIL BORING LOG		12-00097-00-BR	LAKE	65	55
			CONTRACT	NO. 6	51F89
SHEET NO. S-33 OF S-35 SHEETS		ILLINOIS FED. A	D PROJECT		

en en en en en en en en	sand and	T NO.: 18332 LOG OF BOR	IIV (					11000		age 1 of 2
	enconn com	McKinley Street Pedestrian Bridge							Mundel	
BORIN	IG LOCA	ATION: East Boring	_		-				HR Green, In	c.
200			_		AMPL				STS	
DEPTH (feet)	SOIL	Material Description	Elevation	TYPE/ INTERVAL	NO.	N-VALUE Blows per ft.	Wc%	Dry Unit Weight, pcf	Unconfined Compressive Strength, tsf	REMARKS
0		— Crushed Ct	743.0 741.8	-	1	7	18		3.5 Qр	
5 <del>-</del>		Brown & Grey CLAY, A-6, hard to very stiff	740.0	- SS	2	11	17	110	4.04	
				SS	3	12	16	115	3.49	
10 -				- - SS	4	14	23	99	4.42	
		Grey Silty LOAM, A-4, moist, 7 medium dense	32.5	SS	5	10	18			
15 -				- SS	6	14	23			
		Grey Clay LOAM to CLAY, A-6, very <sup>7</sup> stiff	27.5	SS	7	15	12		3.0 Ор	
20 -		cobble or boulder at 16'		- SS	8	11	19	105	2.02	
				SS	9	14	20	104	2.21	
25 -				- SS	10	11	19	104	2.41	
				SS	11	19	20	105	2.48	
30 -				- SS	12	13	20	104	2.99	
				- SS	13	13	21	101	2.33	
35										
DURING	DRILLIN	DBSERVATIONS, ft.  IG: \$\frac{\fint}{\fint}}}}}{\frac{\fir}{\frac{\frac{\frac{\frac{\frac{\frac{\frac{\frac{\frac{\frac{\fir}}}}}{\frac{\frac{\frac{\frac{\frac{\frac{\frac{\frac{\frac{\frac{\frac{\frac{\frac{\frac{\fir}{\frac{\frac{\frac{\frac{\fin}}}}{\firighta}}}}}{\frac{\frac{\f{\f{\frac{\frac{\f{\f{\f	D-,	1SET		T	BO		STARTED: COMPLETED: BY:	5/22/18 5/22/18 MP

Midland Standard Engineering & Testing, Inc. 410 Nolen Drive, South Elgin, Illinois 60177 (847) 844-1895 f(847) 844-3875

		No.: 18332 LOG OF		10000000	25.15-25-		0.			age 2 of 2	
		McKinley Street Pedestrian Brid	-	SITE	LOC	ATIO	N: _		Mundel	ein, IL	
BORIN	G LOCA	TION: East Boring		CLIE	CLIENT:			HR Green, Inc.			
				7.5	AMPL				STS		
DEPTH (feet)	SOIL	Material Description	Elevation	TYPE/ INTERVAL	NO.	N-VALUE Blows per ft.	Wc%	Dry Unit Weight, pcf	Unconfined Compressive Strength, tsf	REMARKS	
40		Grey CLAY, A-6, very stiff	703.0	- SS	14	19	23		3.41		
45 -				- SS	15	14	23	102	2.95	1	
50		Grey Clay LOAM, A-6, very stiff	693.0	- SS	16	19	23		3.41		
55 -				- - SS	17	18	15	7	3.0 Qp		
60 -		Grey CLAY, A-6, hard	685.0	- SS	18	26	17		4.19		
65_		End of Boring at 65 Feet	678.0	- SS	19	30	19	114	6.36		
URING	DRILLING ATELY AF	BSERVATIONS, ft.  G: \forall \text{None}{\text{TER DRILLING:}} \text{Pdry}  NG AFTER	W <sub>N</sub>	ISET	[		BOI LOC	RING C	STARTED: COMPLETED BY: METHOD:	5/22/18 : 5/22/18 MP CFA	

Midland Standard Engineering & Testing, Inc. 410 Nolen Drive, South Elgin, Illinois 60177 (847) 844-1895 f(847) 844-3875

HRGreen.com

White Court is the Court in the

KMI Kaltsouni Mehdi, Inc. ARCHITECTS & ENGINEERS 223 W.Heston Brd., Size 1010 Chizago, II. 00008 Tel.: (312/987-9800 Fax.: (312/987-8892

STATE OF ILLINOIS
DEPARTMENT OF TRANSPORTATION

PROJE	ECT: _	Pedestrian Bridge	over CNRR Access Ram	ps	SITE	LOC	IOITA	N: _		Mundelein,	Illinois
BORIN	IG LOC	ATION:	East Access Ramp		CLIE	NT:				HR Green, Inc.	
				1 200	S	AMPL			TE	STS	
DEPTH (feet)	SOIL	Mate	rial Description	Elevation	TYPE/ INTERVAL	NO.	N-VALUE Blows per ft.	Wc%	Dry Unit Weight, pcf	Unconfined Compressive Strength, 1sf	REMARKS
0		Topsoil FILL	Black CLAY (12*)	746.7							
		Black Clay LC trace RAP, A	OAM, trace Concrete, -6, hard Grey, trace Brown	745.7	ss	1	15	11		3.75 Qp	
4 -		FILL - Brown	Sandy LOAM with Brick, A-1-b, dense	742.7	_SS SS	2A 2B	10 39	14 13	113	7.10	
			Grey Clay LOAM to	741.2	SS	3	12	14	112	4.16	
8 -		Grey CLAY to	Clay LOAM, A-6, hard	738.2	- ss	4	14	14	113	4.50	
		to very stiff				35	3.7	1.7	110	4.50	
12-		₹ Sand seam at	12.2' wet		ss	5	12	14	116	4.31	
		20110 300111 0	, 1212 / 1101		- ss	6	14	12	116	3.14	
16-					SS	7	9	15	114	3.07	
20 -					SS	8	11	15		2.0 Qp	
20					SS	9	9	15	116	2.25	
		Auger Refusa Boulder)	I at 22.5' (Poss.	724.2							
DURING	DRILLIN	DBSERVATIONS, ft.	₩ 12.2° ₩ Dry		ISET		T	BOF		TARTED:	11/13/19 11/13/19 GPF

		1,000	· = :		- 8		- 5	50%	
0 6	TOPSOIL - Black CLAY (4")	744.5							
-8	FILL - Brown Sandy Clay LO trace Brick, A-6, very stiff	AM, 744.2	SS	1	6	14		2.5 (Qp)	
18	FILL - Brown, trace Dark Bro	wn Clay 741.5	-	2A	6	15	105	2.72	
1	LOAM, A-6, very stiff	740.5	. 33	2B	5	13333	103		
5-	Black to Brown, Grey and Bl		SS	ZB	5	29		2.5 (Qp)	
F	CLAY, A-7-6, very stiff	STATE I							
F	Brown and Grey CLAY, A-6,	738.5	SS	3	4	23	97	2.56	
E	stiff to hard	,							k
F			_				- 3		
B	///\dagger		SS	4	9	21	102	5.01	
10-	///	1							
P	///		SS	5	10			7.00	
Ł	///		22	5	16	22	101	7.26	
Ł	///								
Ł	///	anne a	SS	6	10	19	109	4.81	
15	moist at 14.5' to Dark Brow	n and					100		
-	Grey SAND (f-m), A-3, wet,	ollobate 729.0		7A	6	15			
1	dense	728.0	SS	7B	10	16	115	4.78	
1	Grey CLAY, A-6, hard to ver		00	,,,			110	4.70	
	///=	,		100	1929	200	10000	02002	
20-			SS	8	11	12	127	3.65	
207	///								
E	(//)		SS	9	14	17	112	4.62	
P	///				25.0	11	112	4.02	
P	///		6						
t	///	- 1	SS	10	14	16	111	3.26	
25	///	- 1							Hole Caved at
*	///	- 1			200	22		2.32	24.6'
Y	///		SS	11	11	18	110	3.10	
¥	///			1 1					
¥	///		SS	12	11	17	112	3.30	
30	///		5,000	12	1555	1.50	112	5.50	
	End of Boring at 30.0'	714.5							*
	1								
	1								
									<u> </u>
	EVEL OBSERVATIONS, ft.	(1)					1270000000	TARTED:	8/12/20
	DRILLING: \$\frac{\frac{15.5}{2}}{2}\$ 15.5' TELY AFTER DRILLING: \$\frac{\frac{15.5}{2}}{2}\$ 18.6'	(AM)						OMPLETED	: 8/12/20 GPF
	TELY AFTER DRILLING: \$\frac{18.6}{2}\$ (8.6)	V	ISET	Γ			GGED I	BY: METHOD:	HSA
	THEADING AFTER	- "		- 0		ы	ING I	IL THOU:	110/1

SITE LOCATION:

Page 1 of 1

REMARKS

Mundelein, IL

HR Green, Inc.

MSET PROJECT NO.: 20495 LOG OF BORING NO. SB-5

See Location Map

McKinley Street Bridge - West Ramp

BORING LOCATION:

			- 00	S	SAMPLE			TESTS			
DEPTH (feet)	SOIL	Material Description	Elevation	TYPE/ INTERVAL	NO.	N-VALUE Blows per ft.	Wc%	Dry Unit Weight, pcf	Unconfined Compressive Strength, tsf	REMARKS	
0	66666	TOPSOIL - Black CLAY (4")	743.5								
		FILL - Brown, trace Black Sandy Clay LOAM, trace Brick, A-6, hard	743.2	SS	1	8	14		4.5+ (Qp)		
5-		FILL - Brown, trace Dark Brown Clay LOAM, trace Organics, A-6, moist, very stiff Probable Cobble at 6.0'	740.5	SS	2	9	20		2.0 (Qp)		
				SS	3	26	10				
10-		Brown CLAY, A-6, hard	736.0	SS	4	11	19	103	6.52		
		Grey CLAY, A-6, very stiff to hard	732.5	SS	5	9	18		2.72		
15 -				SS	6	11	16	112	5.43		
				ss	7	9	17	109	3.03		
20 -				SS	8	10	17	110	4.85		
				SS	9	11	17	109	4.58		
25 -				SS	10	11	17	109	3.92		
				SS	11	10	19	106	4.31		
30_		End of Boring at 30.0'	713.5	SS	12	10	19	105	4.04		
DURING	DRILLIN	BSERVATIONS, ft. G: FTER DRILLING:	M)			T	BOI		STARTED: COMPLETED:	8/12/20 8/12/20 GPF	

SITE LOCATION:

CLIENT: \_

Page 1 of 1

HR Green, Inc.

MSET PROJECT NO.: 20495 LOG OF BORING NO. SB-6

McKinley Street Bridge - West Ramp

PROJECT: \_\_

BORING LOCATION:

KMI Kaltsouni Mehdi, Inc. ARCHITECTS = ENGINEERS

223 W.Jackson Blvd., Suite 1010 Chicago, IL 60008 Tel.: (312)987-9900 Fax.: (312)987-9992


DESIGNED - JMW/OS REVISED CHECKED - AEU REVISED DRAWN WJH REVISED DATE REVISED 10/5/2020


STATE OF ILLINOIS **DEPARTMENT OF TRANSPORTATION** 

 
 COUNTY
 TOTAL SHEET NO.

 LAKE
 65
 57


 CONTRACT NO.
 61F89
 SECTION SOIL BORING LOG N/A 12-00097-00-BR SHEET NO. S-35 OF S-35 SHEETS ILLINOIS FED. AID PROJECT

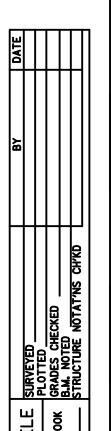

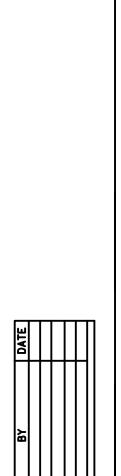

<u>G</u>	ENERAL NOTES:
1.	ALL ELECTRICAL DRAWINGS ARE TO BE READ IN CONJUNCTION WITH THE PROJECT SPECIFICATIONS AND ALL OTHER DRAWINGS RELATED TO THE PERFORMANCE OF THE WORK.
2.	THE CONTRACTOR RESPONSIBLE FOR THE EXECUTION OF THIS WORK SHALL BECOME THOROUGHLY FAMILIAR WITH THE PROJECT SPECIFICATIONS BEFORE

- COMMENCING ANY WORK. THE PROJECT SPECIFICATIONS AND DRAWINGS FORM THE BASIS OF THIS CONTRACT REQUIREMENTS AND INCLUDE THE TYPE AND GRADE OF MATERIALS TO BE USED, EQUIPMENT TO BE FURNISHED, THE MANNER BY WHICH TO BE INSTALLED AND WHERE TO BE LOCATED. IN THE EVENT OF A CONFLICT BETWEEN THE PROJECT SPECIFICATIONS AND DRAWINGS, SPECIFICATIONS GOVERN UNLESS THE ARCHITECT/ENGINEER DIRECTS OTHERWISE.
- 3. THE ELECTRICAL CONTRACTOR SHALL CHECK CAREFULLY ALL CONSTRUCTION DRAWINGS AND SPECIFICATIONS THAT ARE PART OF THIS PROJECT TO INSURE THAT NO FIXTURE, OUTLET, OR CONTROL AND POWER WIRING IS OMITTED. HE SHALL CONSULT ALL TRADES FURNISHING EQUIPMENT AND OBTAIN FROM THEM ALL DATA. IN SOME CASES EQUIPMENT, FIXTURES AND DEVICES ARE SHOWN ONLY. ASCERTAIN AND PROVIDE THE WIRING AND CONTROL STATIONS REQUIRED FOR THE PROPER FUNCTION OF BUILDING EQUIPMENT. NO EXTRA CHARGES SHALL BE ACCEPTED BY OWNER AFTER BIDDING FOR SUCH EQUIPMENT AND LABOR.
- 4. EQUIPMENT LABELS AND INSTRUCTIONS REGARDING THE APPLICATION AND INSTALLATION OF THE LISTED EQUIPMENT SHALL BE FOLLOWED TO INSURE THAT THE EQUIPMENT IS BEING USED IN ACCORDANCE WITH THE MANUFACTURER'S LISTING INSTRUCTIONS. THE TEMPERATURE RATING OF THE EQUIPMENT TERMINATIONS MUST BE CAREFULLY CORRELATED WITH THE CONDUCTOR CAPACITY TO PREVENT OVERHEATING AND PREMATURE FAILURE.
- COORDINATE WORK WITH OTHER TRADES AND INSTALL CONDUIT AND BOXES TO CLEAR EMBEDDED DUCTS, OPENINGS, AND OTHER STRUCTURAL FEATURES.
- ALL WORK IS TO BE DONE IN ACCORDANCE WITH THE LATEST REQUIREMENTS OF THE APPLICABLE CODES AND REGULATIONS.
- 7. ALL LIGHTING FIXTURES ARE TO BE LOCATED AS REQUIRED ON THE SITE TO CLEAR UNDERGROUND UTILITIES.
- 8. CONDUIT RUNS SHOWN ON DRAWINGS ARE DIAGRAMMATIC. ALL CONDUITS SHALL RUN CONCEALED, EXCEPT WHERE APPROVED BY OWNER.
- 9. FURNISH AND INSTALL EQUIPMENT DISCONNECT SWITCHES IN STRICT COMPLIANCE WITH CODE REQUIREMENTS.
- 10. ALL OUTDOOR OUTLETS SHALL BE W.P. AND THE GFI TYPE.
- 11. ALL OUTDOOR ENCLOSURES SHALL BE NEMA 3R AND GASKETED.
- 12. CONTRACTOR SHALL CONTACT AND COORDINATE WITH METRA 72 HOURS IN ADVANCE FOR THE RELOCATION OF ALL VOICE OF METRA EQUIPMENT AND LIGHT FIXTURES.
- 13. METRA/R.R. SHALL BE CONTACTED TO RELOCATE, INSTALL, AND WIRE ANY RAILROAD EQUIPMENT LOCATED WITHIN R.R. ROW.
- 14 R.R. FLAGGING IS REQUIRED WITHIN 25' OF RAILROAD TRACKS. CONTRACTOR SHALL COORDINATE WITH METRE/R.R. AND PAY FOR ALL R.R. FLAGGING.
- 15. LIGHTING CONTROL PHOTOCELL SHALL BE INSTALLED FACING NORTH.
- 16. ALL EMPTY CONDUITS SHALL BE PROVIDED WITH NYLON PULL CORD WITH THREE FEET PIGTAIL ON BOTH ENDS OF CONDUIT.
- 17. ALL WIRES SHALL BE INSTALLED AT THE TIME OF ROUGH INSPECTION, INCLUDING LOW VOLTAGE WIRING.
- 18. EXISTING ITEMS NOTED TO REMAIN SHALL BE LEFT IN PLACE AND IN OPERATION.
- 19. ALL TRENCHING EXCAVATIONS CAUSED BY NEW WORK SHALL BE BACKFILLED AND FINISHED TO MATCH EXISTING SURROUNDING.
- 20. ALL ELECTRICAL WORK SHALL BE IN ACCORDANCE WITH "INTERNATIONAL BUILDING CODE (IBC) 2015 EDITION", "THE NATIONAL ELECTRICAL CODE (NEC) 2014 EDITION", AND ALL AMENDMENTS OF THE VILLAGE OF MUNDELEIN BUILDING AND ELECTRICAL
- 21. A PRE-ENERGIZATION AND OPERATION TEST SHALL BE PERFORMED PER 225.56A AND A(6). TEST RESULTS SHALL BE PROVIDED TO THE VILLAGE.

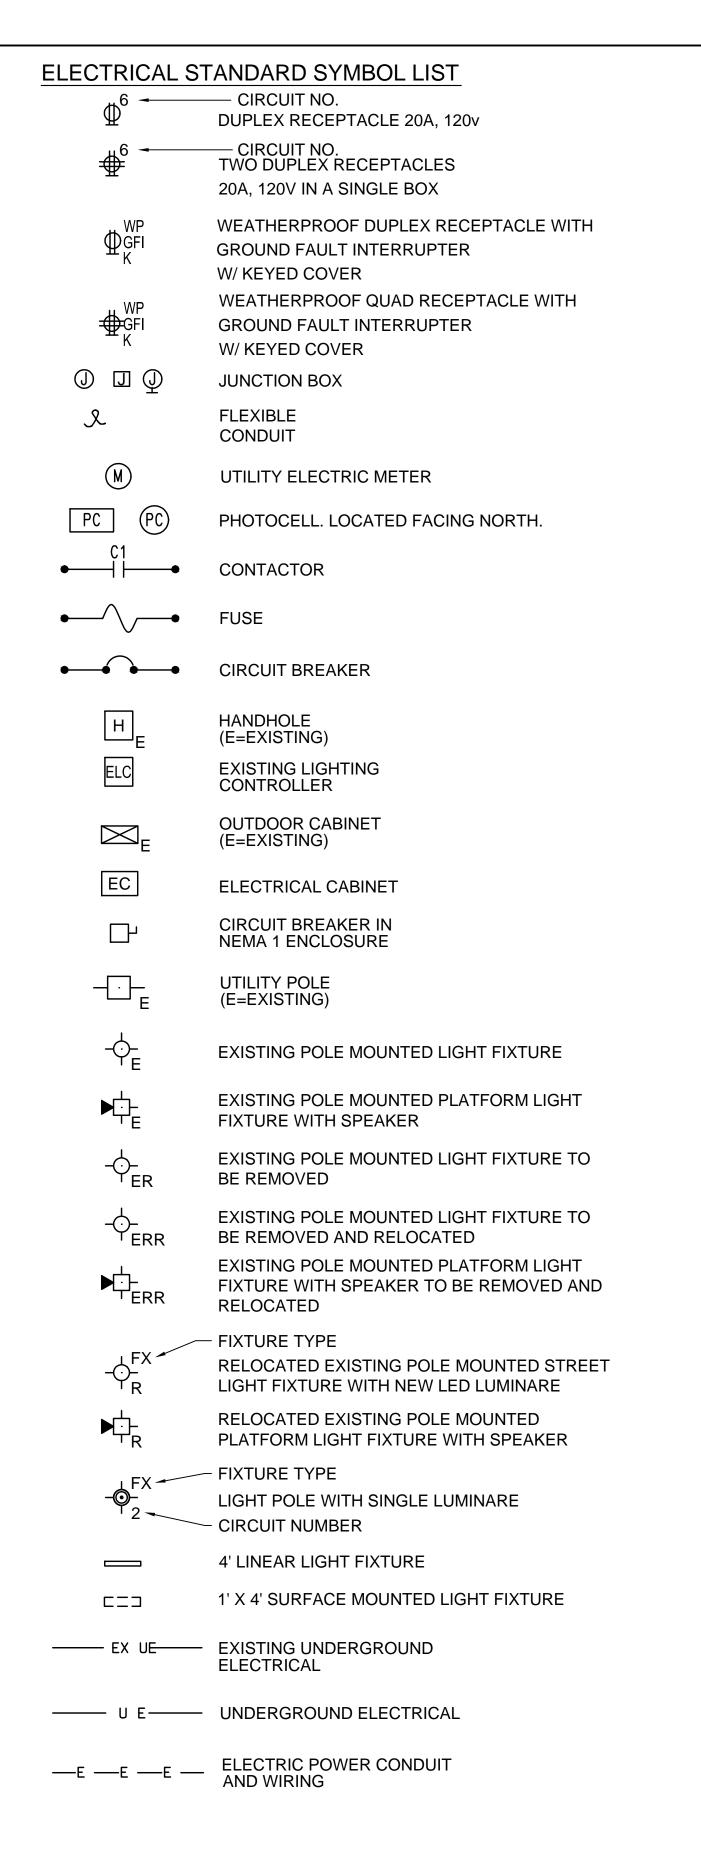

ABBREVIATIONS								
	AMPERE							
A.F.F.	ABOVE FINISHED FLOOR							
C.	CONDUIT							
C/B	CIRCUIT BREAKER							
CCT	CIRCUIT							
CF	CEILING FAN							
COL.	COLUMN							
	COMMONWEALTH EDISON							
DIA.	CONCRETE DIAMETER							
	DRAWING							
	EXISTING							
E								
EC	ELECTRICAL CABINET							
_	ELECTRIC							
	ELEVATOR							
	EQUAL							
	EXTERIOR							
	FIXTURE							
	GALVANIZED							
	GROUND FAULT INTERRUPTER							
GRD HP	GROUND HORSE POWER							
лР JB	JUNCTION BOX							
-								
KW	KILOWATT							
LP	LIGHTING PANEL							
MECH.	MECHANICAL							
MIN. MSE	MINIMUM MECHANICALLY STABILIZED EARTH							
	NATIONAL ELECTRIC							
IN.⊏.IVI.A.	MANUFACTURER ASSOCIATION							
No.	NUMBER							
N.O.	NORMALLY OPEN							
N.T.S.	NOT TO SCALE							
P.	POLE							
	PLUMBING CONTRACTOR							
POE	POWER OVER ETHERNET							
POS	POWER OVER ETHERNET SWITCH							
REF. RGS	REFERENCE RIGID GALVANIZED STEEL							
RSC	RIGID STEEL CONDUIT							
PVC	POLYVINYL CHLORIDE CONDUIT							
SCHED.	SCHEDULE							
SQ.	SQUARE							
S.S.	STAINLESS STEEL							
STD	STANDARD							
STR.	STRUCTURAL							
TYP.	TYPICAL							
V.	VOLTS							
v. V.A.	VOLTS VOLT-AMPERE							
v.A. V.I.F.	VERIFY IN FIELD							
V.I.I . VOM	VOICE OF METRA							
W.	WATTS							
WP	WEATHER PROOF							
ø, PH	PHASE							
<i>i</i> .								








KMI Kaltsouni Mehdi, Inc. ARCHITECTS ■ ENGINEERS 223 W.Jackson Blvd., Suite 1010 Chicago, IL 60606 Tel.: (312)987-9800 Fax.: (312)987-9892


DESIGNED	-	JM	REVISED -	-
DRAWN	-	KH	REVISED -	-
CHECKED	-	MK	REVISED -	-
DATE	-	02-20-2020	REVISED -	-


STATE OF ILLINOIS DEPARTMENT OF TRANSPORTATION

			ELECT	RICAL N	OTE	S, SY	MB	OLS, AND	ABBREVIATIONS		
								·			E00
I	SCALE:	AS	NOTED	SHEET	1	OF	7	SHEETS	STA TO	STA.	

TOTAL SHEET NO. SECTION NO. COUNTY 65 58 12-00097-00-BR LAKE CONTRACT NO. 61F89 FED. ROAD DIST. NO. \_ ILLINOIS FED. AID PROJECT

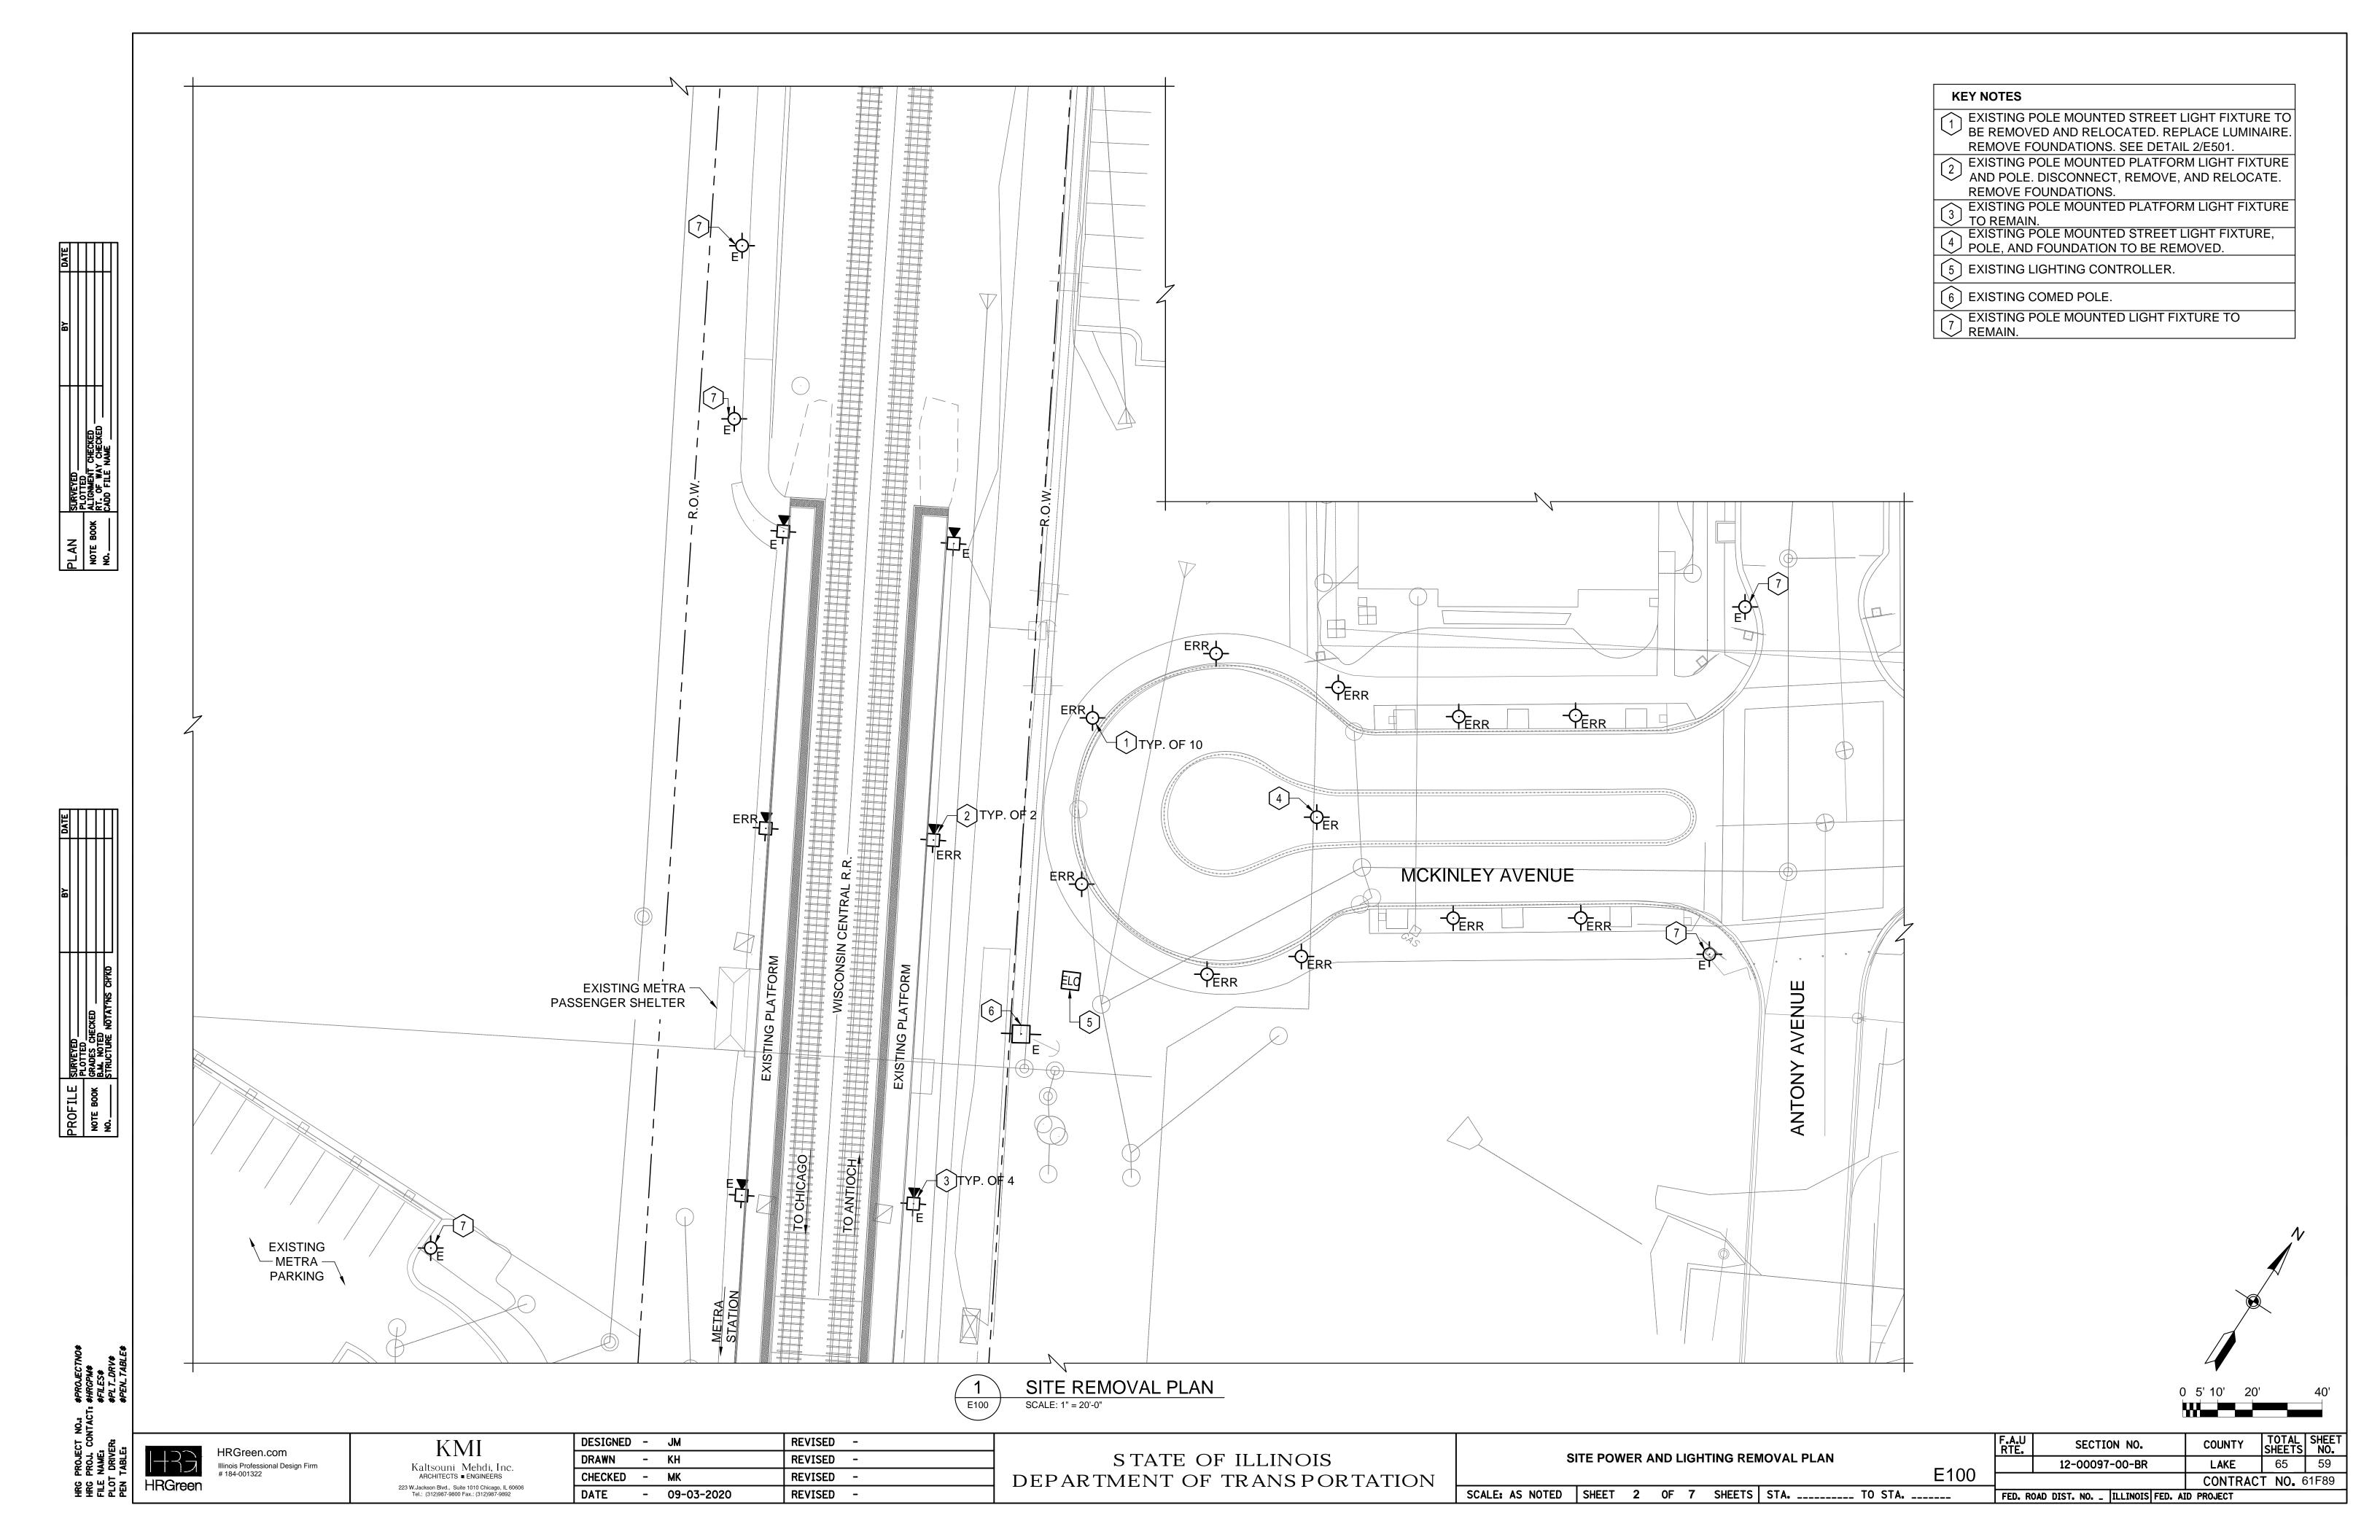

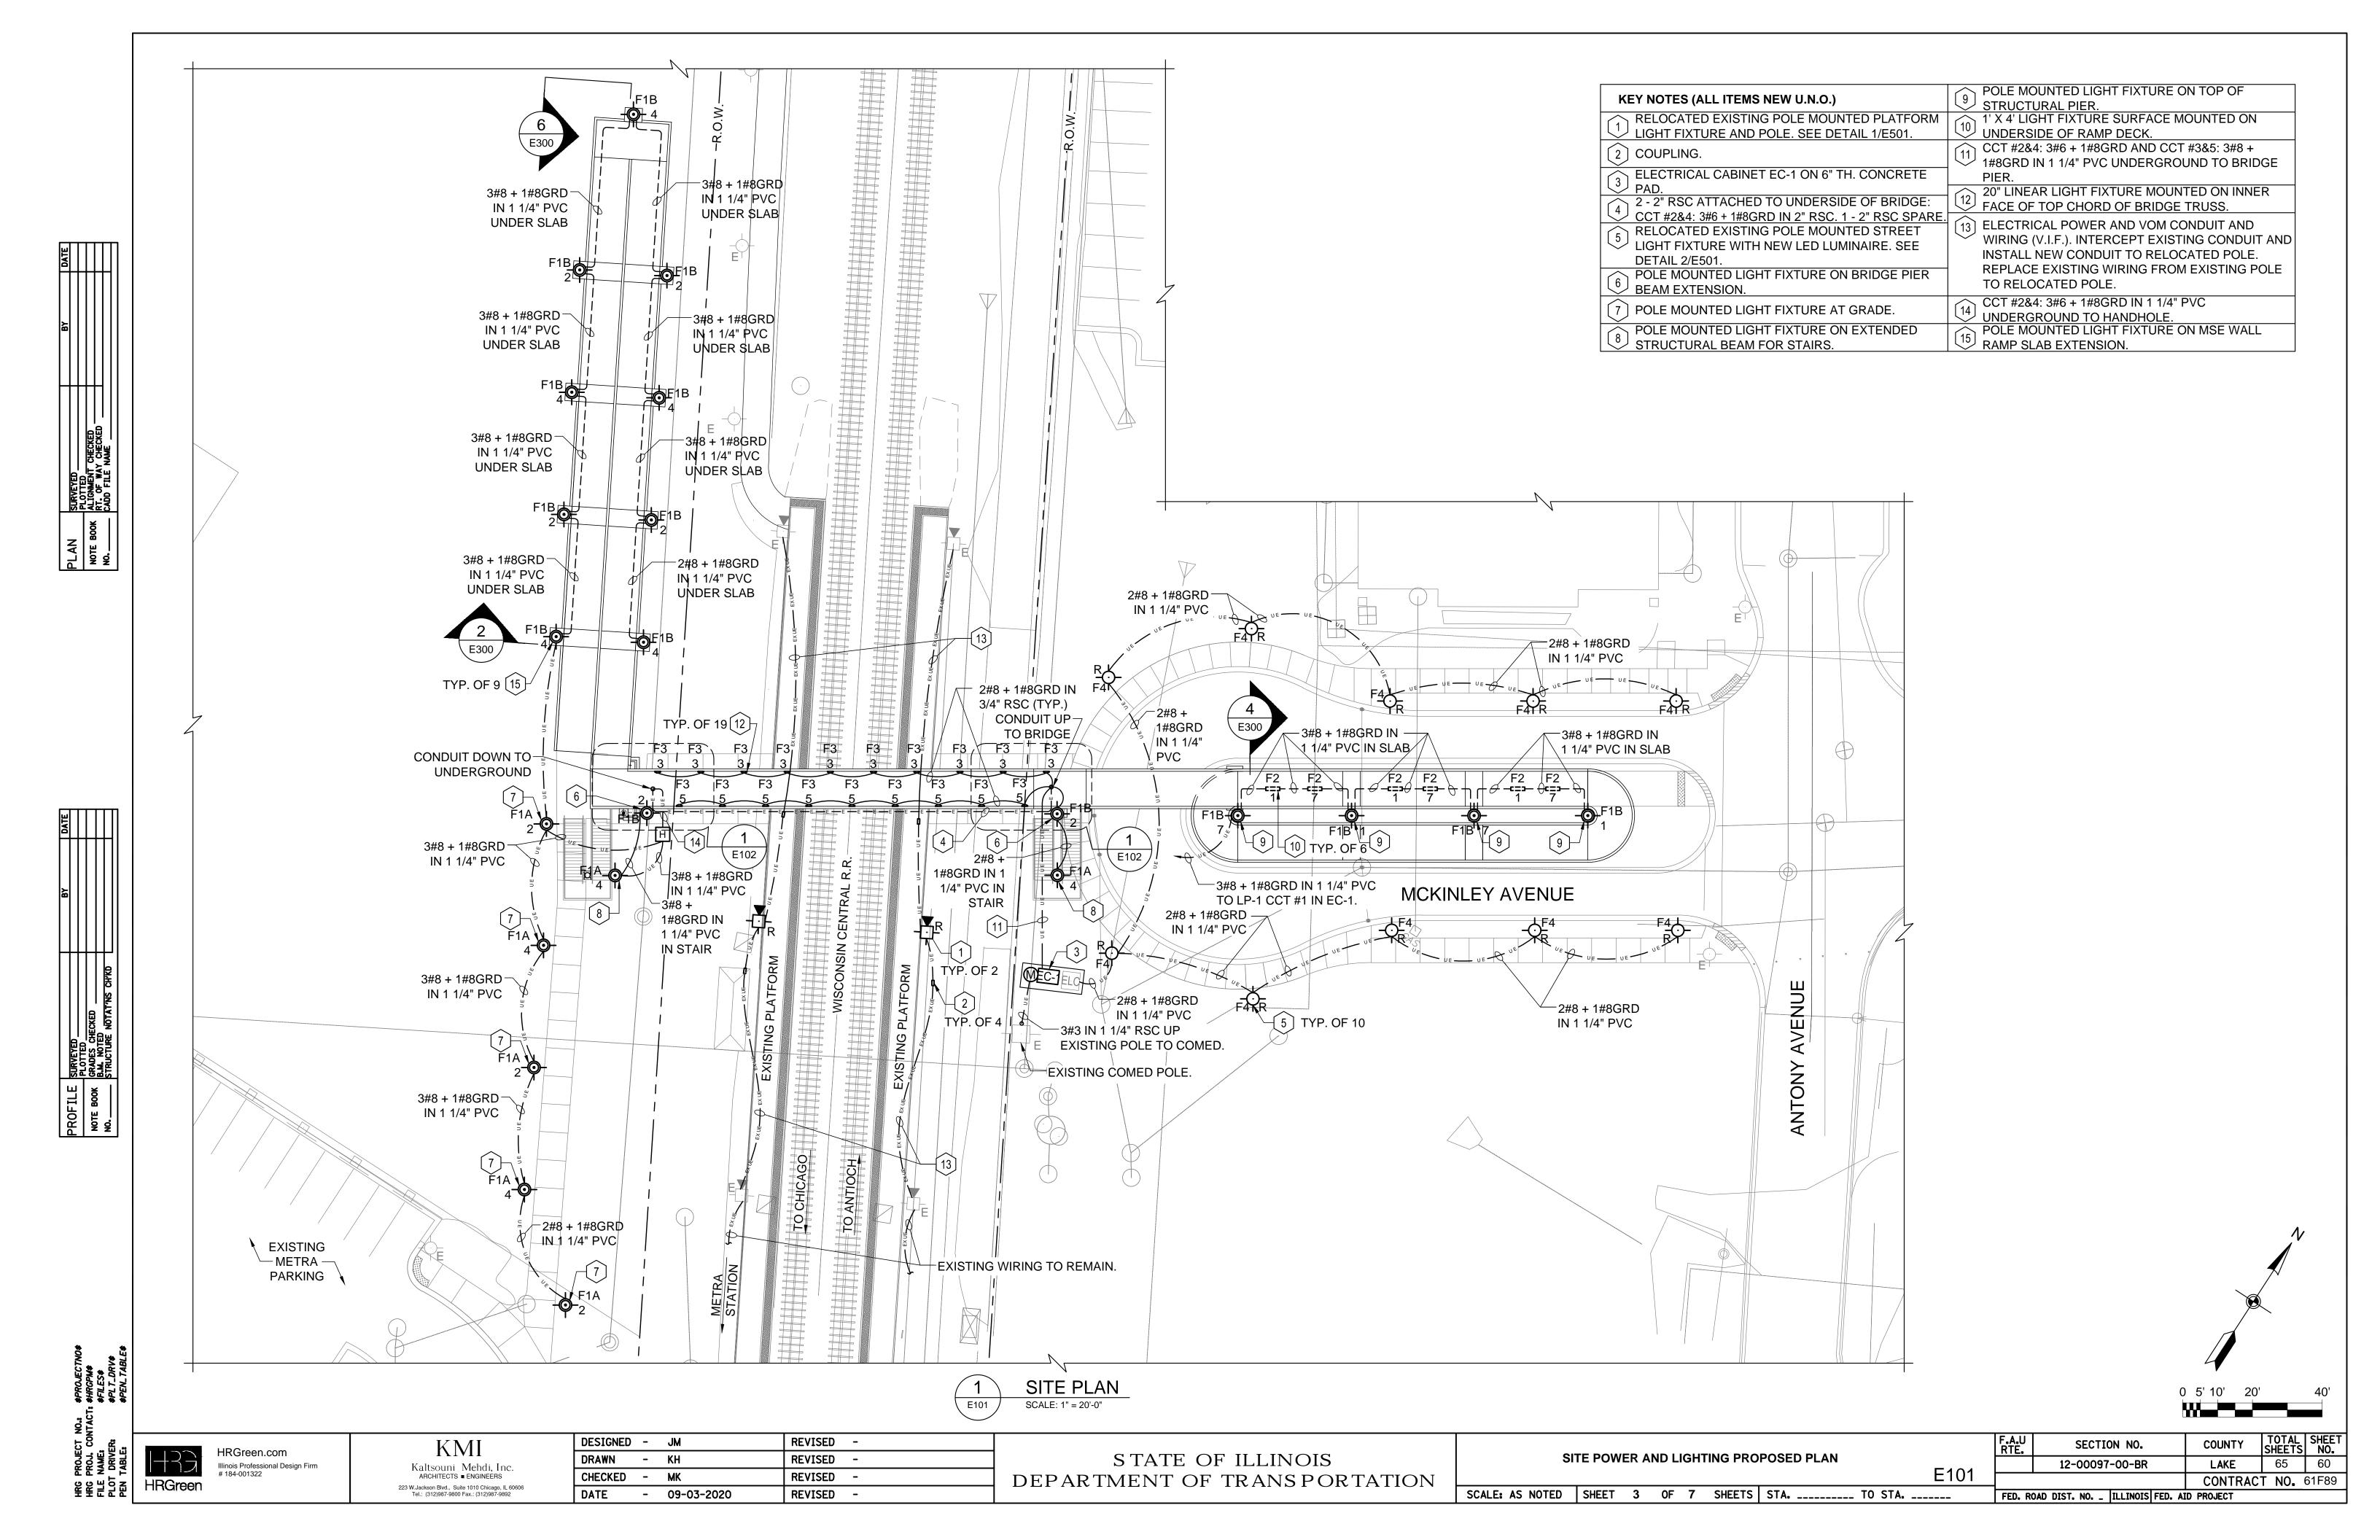

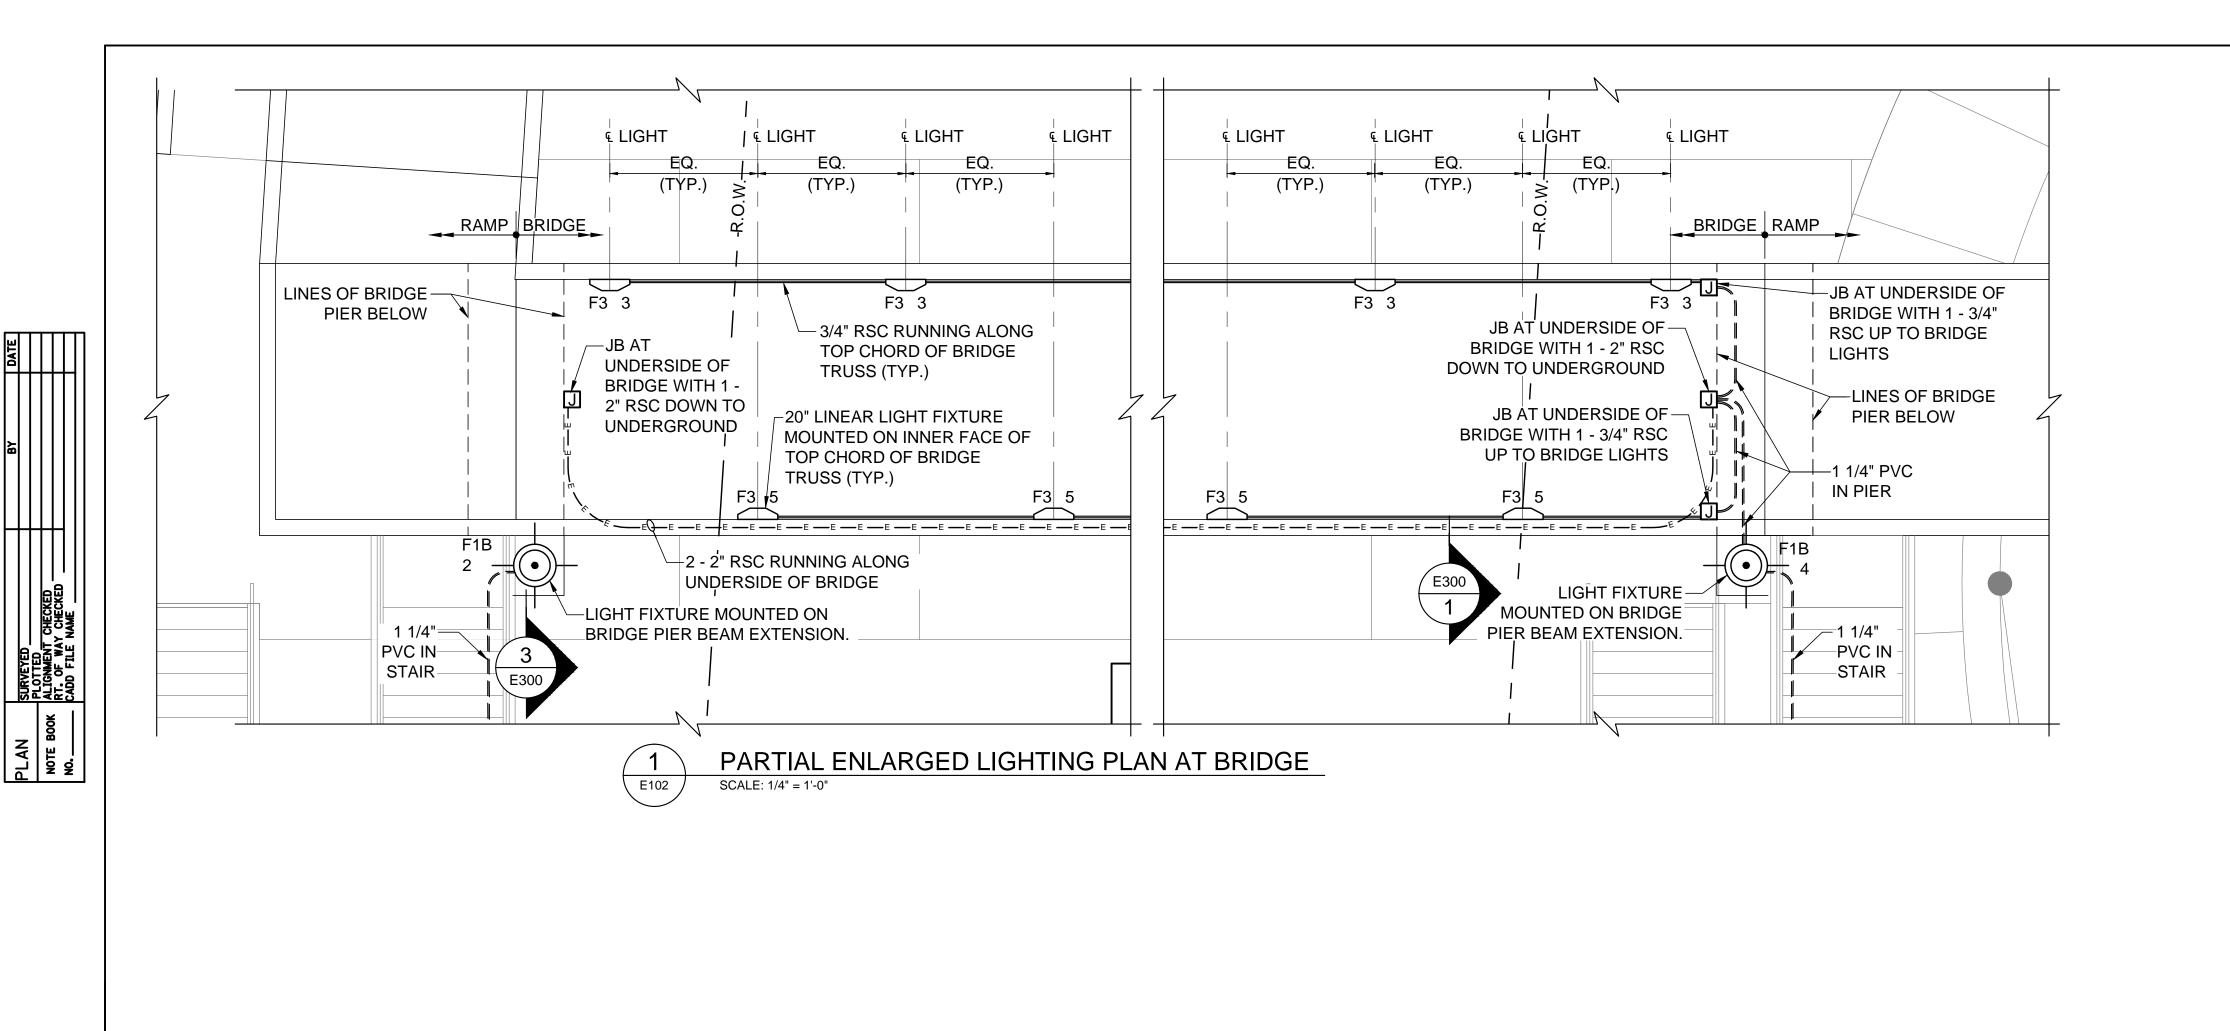

HRGreen.com Illinois Professional Design Firm # 184-001322 HRGreen

DRAWN


REVISED -- KH REVISED -- 09-03-2020 REVISED -


SCALE: AS NOTED SHEET 4 OF 7 SHEETS STA. \_\_\_\_\_ TO STA. \_\_\_\_\_

**ENLARGED PLAN** 

SECTION NO. 12-00097-00-BR E102 CONTRACT NO. 61F89 FED. ROAD DIST. NO. \_ ILLINOIS FED. AID PROJECT


DESIGNED - JM REVISED -KMI STATE OF ILLINOIS Kaltsouni Mehdi, Inc. CHECKED - MK DEPARTMENT OF TRANSPORTATION 223 W.Jackson Blvd., Suite 1010 Chicago, IL 60606 Tel.: (312)987-9800 Fax.: (312)987-9892

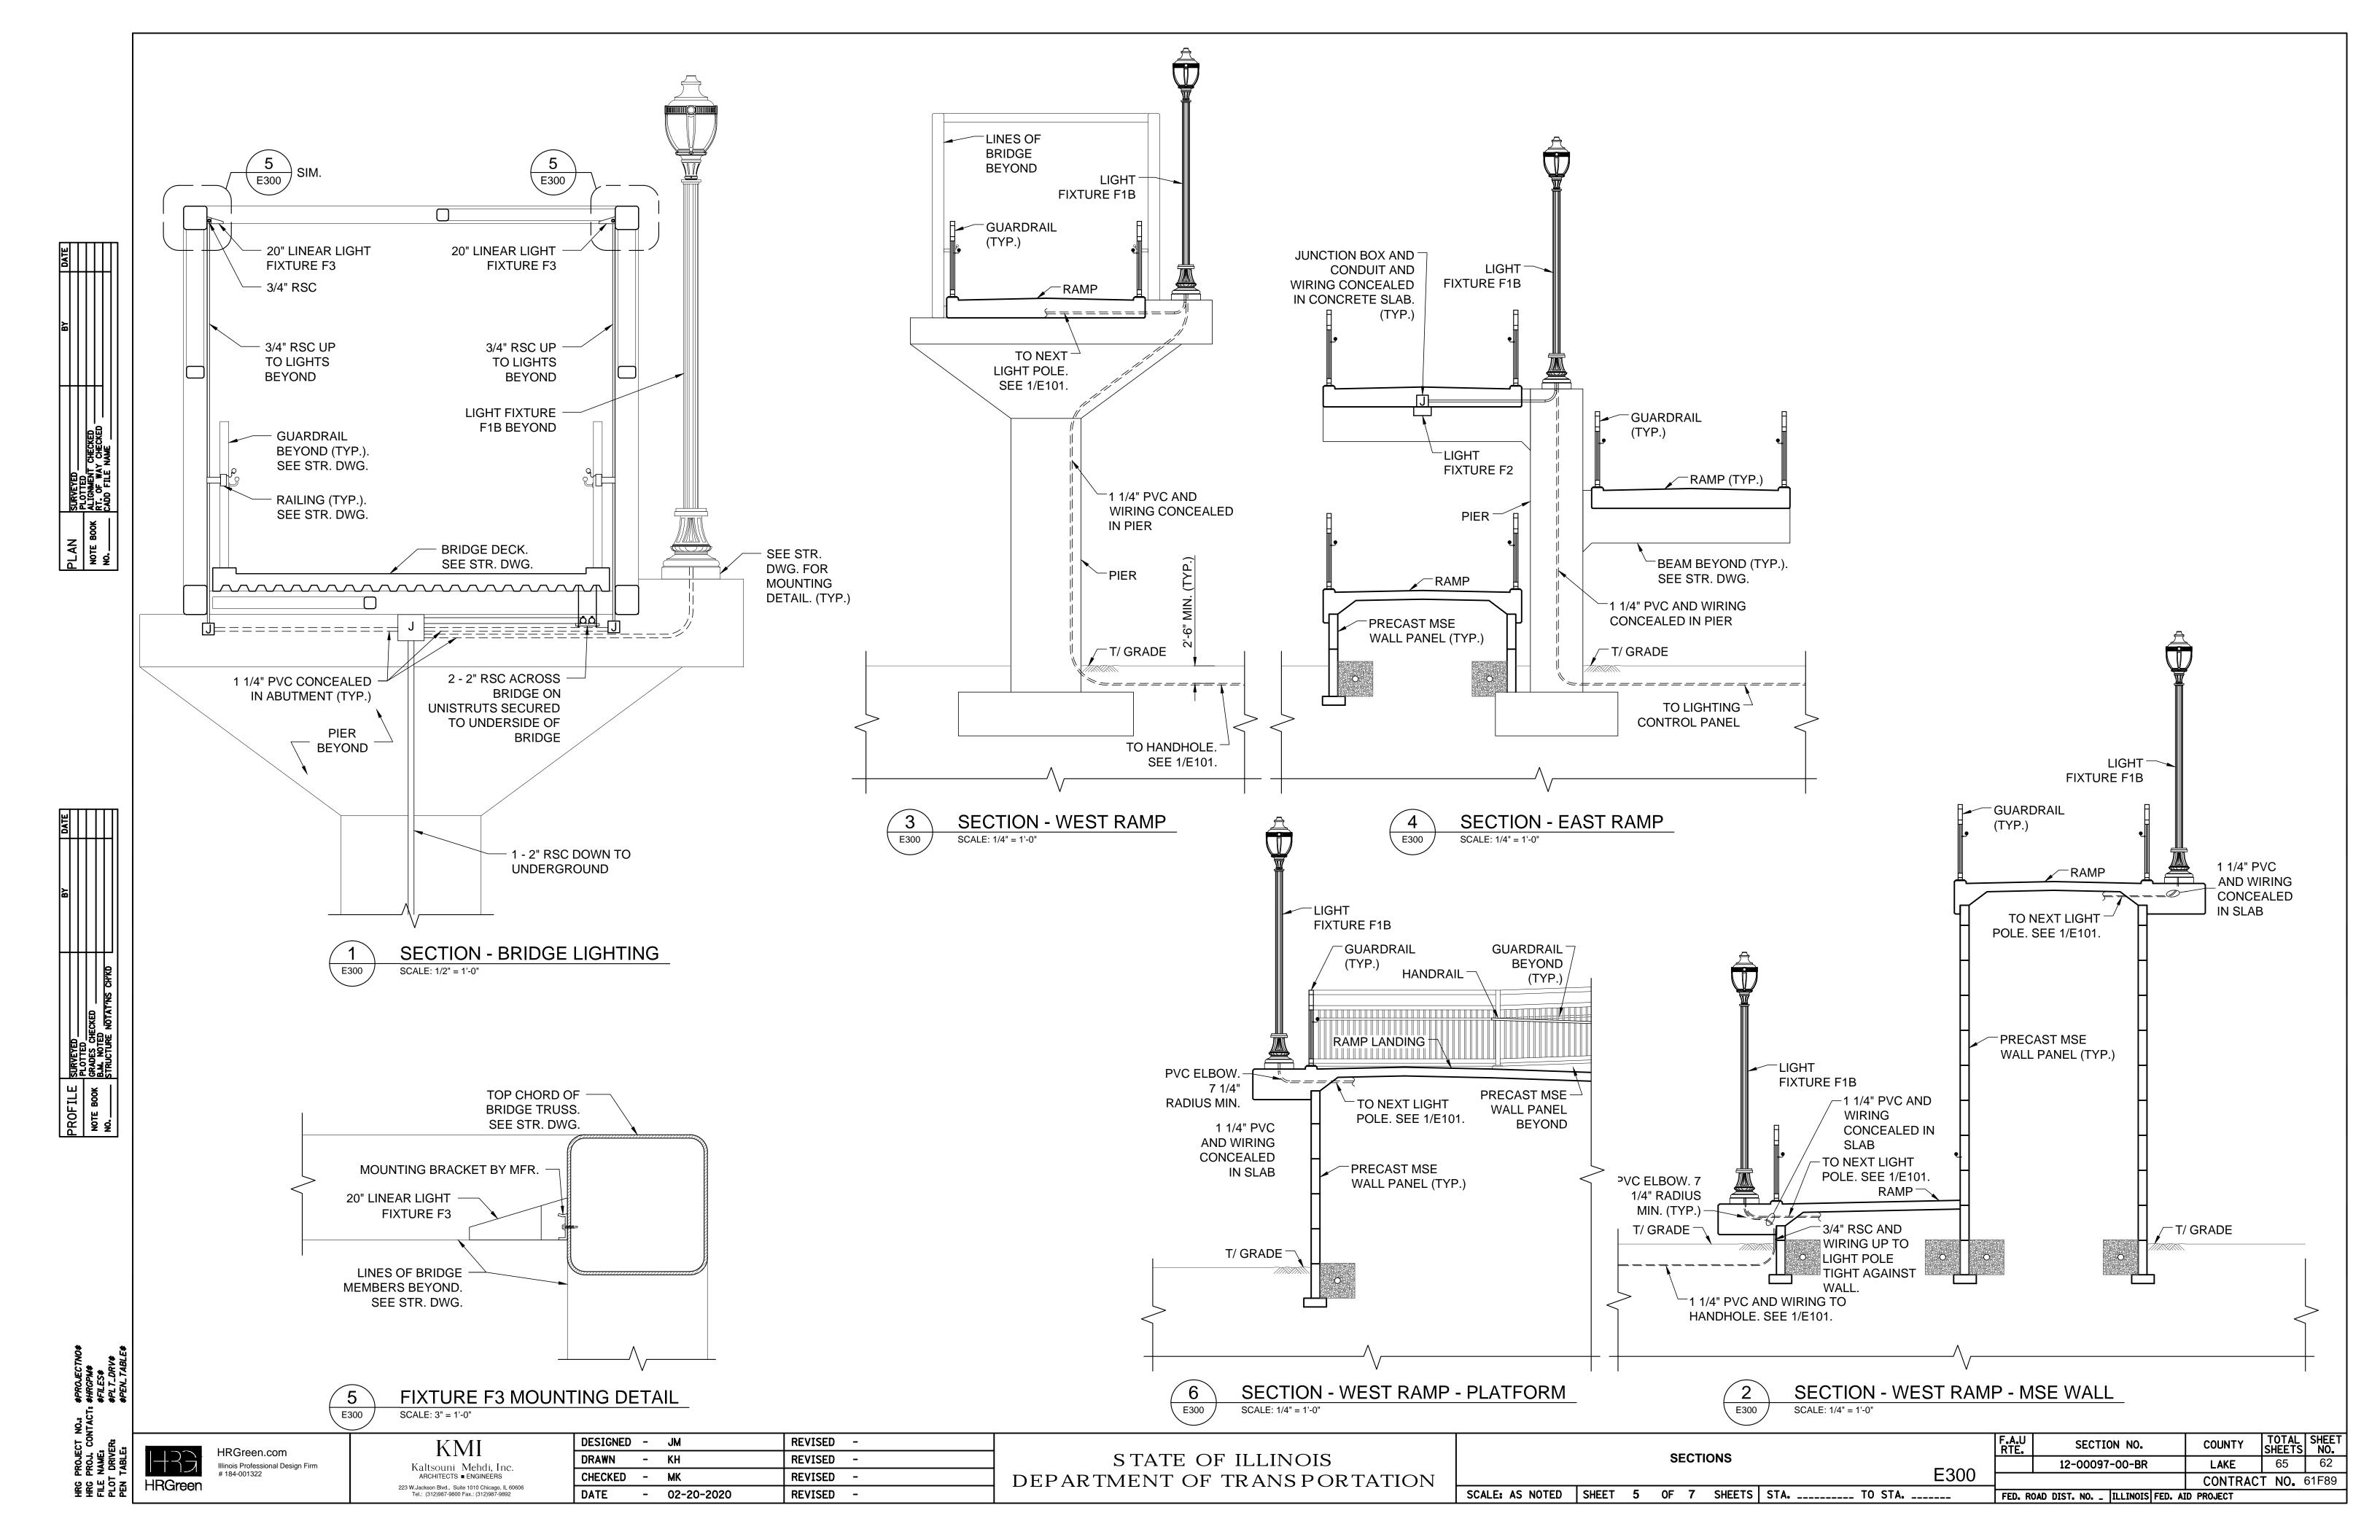


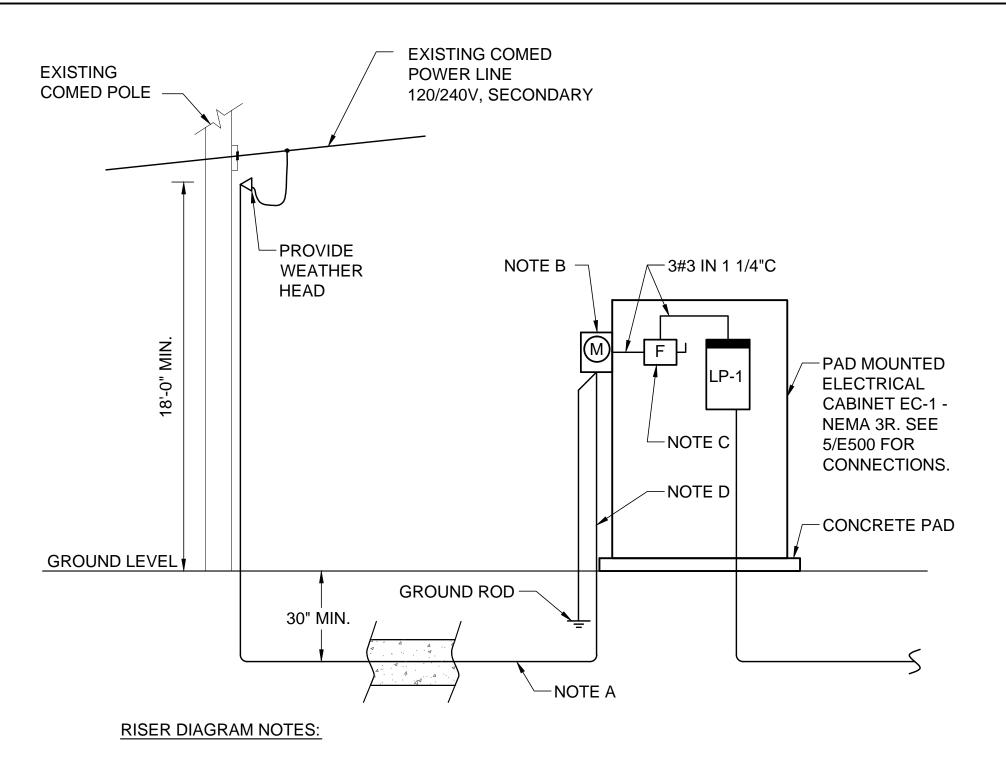


- A. 3#3 IN 1 1/4" RIGID STEEL CONDUIT IN 3" CONCRETE ENVELOPE THE ENTIRE RUN.
- B. PROVIDE OUTDOOR TYPE METER FITTING 120/240V, 1 PHASE., 3W PER COMED REQUIREMENTS.
- C. 100A, 2P, 240V, FUSED DISCONNECT SWITCH, SERVICE ENTRANCE RATED.
- D. 1#4 COPPER STRANDED GROUND CONDUCTOR IN 3/4"C TIED TO 3/4"x10'-0" STAINLESS STEEL GROUND ROD VIA EXOTHERMIC WELD. GROUND ROD SHALL BE DRIVEN TO GROUND VERTICALLY. TOP OF GROUND ROD SHALL BE 2'6" BELOW GRADE.



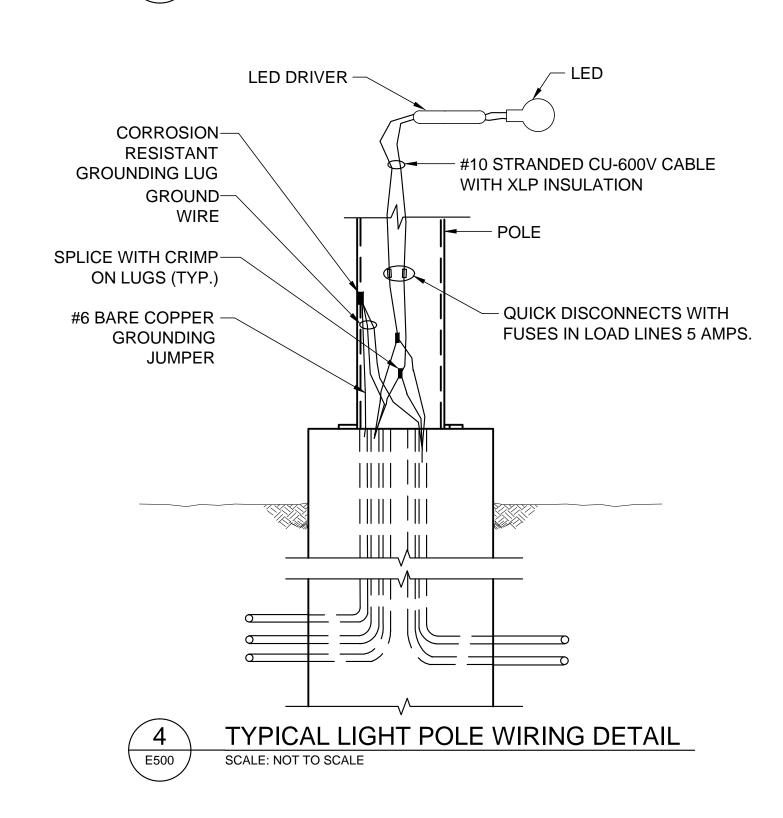

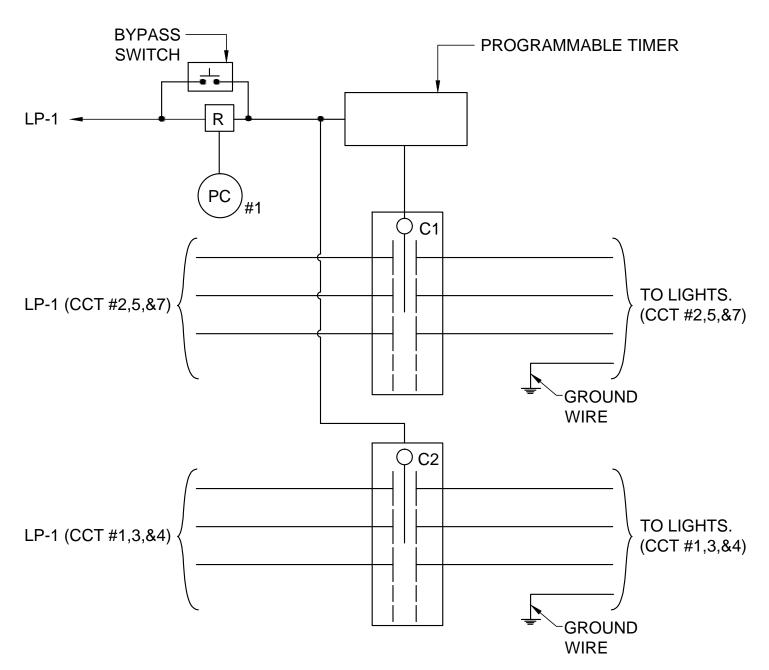

RAMP LIGHTING CONTROL WIRING DIAGRAM E500 SCALE: NOT TO SCALE

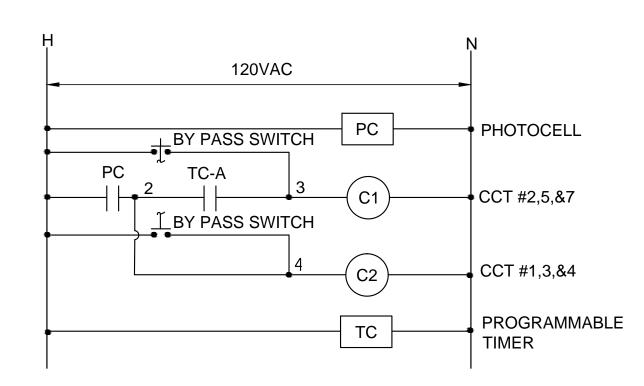

### NOTES:

1. LIGHTING SHALL OPERATE WITH TIME CLOCK (ASTRONOMICAL) AND PHOTO SENSOR OVERRIDE. SETTING OF TIMER TO BE DETERMINED BY VILLAGE.



RAMP LIGHTING CONTROL SCHEMATIC SCALE: NOT TO SCALE

### NOTES:

- WATT HOUR METER FOR 120V/240VAC,
- 1-PHASE, 3 WIRE SYSTEM. VERIFY WITH VILLAGE. 2 MAIN DISCONNECT SWITCH. 100AMP, 240VAC,
- 3 DISTRIBUTION PANEL "LP-1" 120/240V, 1-PHASE,
- 3W+GROUND, 12 CIRCUITS
- 4) PROGRAMMABLE TIMER.

1-PHASE, 60HZ.

- (5) PHOTOELECTRIC CELL BYPASS SWITCH.
- (6) 6-POLE CONTACTOR.
- 7 SURGE SUPPRESSOR.

POWER FEED FROM COMED 120/240V SERVICE  TO PHOTOELECTRIC CELL	OUTLINE OF PAD MOUNTED ELECTRICAL CABINET EC-1 - NEMA 3R BY ELECTRICAL CONTRACTOR.	
5	ELECTRICAL CABINET CONNECTION DIAG	iR.

RAM SCALE: NOT TO SCALE

PANEL TAG: LP-1 ISCA = 22,000 A (SYMMETRICAL)										
TYPE: C/B MAIN BREAKER: MLO INSTALLATION: SURFACE VOLTS: 120/240V 1¢, 3W + GRD. SIZE OF MAIN: 100A, 2P, MCB										
LOAD TYPE	LOAD	D(VA)	PF ⊠E			DEVICES □FUSES	LOAE	O(VA)	LOAD TYPE	
	Α	В		MPS (	4 E 7 Y	AMPS	Α	В	-	
LIGHT	336			1		2 40			LIGHT	
LIGHT		50		<u>3</u>	$\dashv$	40		297	LIGHT	
LIGHT	45		20-	5	$\vdash$	6			CONTROLS	
LIGHT		336	20-	7	$\dashv$	8 20			SPARE	
SPARE				9	$\vdash$	10 20				
SPARE			20-	11		12			•	

E500

	LIGHT FIXTURE SCHEDULE									
TYPE	DESCRIPTION NO.	DESCRIPTION	LAI	MP	VOLTO	MOUNTING	REMARKS			
ITE	DESCRIPTION NO.	DESCRIPTION	NO.	TYPE	VOLIS	MOUNTING	REIVIARRS			
F1A	A670TSRLED-NF/5PPT/5215FP5/6ARC45T3/ML/BK	POLE MOUNTED LED FIXTURE 5" DIA. X .188"TH. POLE W/ HANDHOLE	1	33W LED	120	POLE	MOUNTED ON 15' POLE; UL LISTED FOR WET LOCATIONS.			
F1B	A670TSRLED-NF/5PPT/5212FP5/6ARC45T3/ML/BK	POLE MOUNTED LED FIXTURE 5" DIA. X .188"TH. POLE W/ HANDHOLE	1	33W LED	120	POLE	MOUNTED ON 12' POLE; UL LISTED FOR WET LOCATIONS.			
F2	MLHA12-48-F-MB-PP-1-90L40K-DCC	1' X 4' LED LIGHT FIXTURE. MILLENIUM STRETCH 12".	1	90 W	120	SURFACE	SURFACE MOUNTED UNDER RAMP DECK; UL LISTED FOR WET LOCATIONS.			
F3	LUMINAIRE LED BLD/12IN/NODIM/5W/40K/MVOLT/DP/SIL/KO2	20" LED LIGHT FIXTURE WITH 0.160" THICK POLYCARBONATE LENS AND POWDER COATED ALUMINUM HOUSING	1	5W LED	120	SURFACE	SURFACE MOUNTED ON INNER FACE OF TOP CHORD OF BRIDGE TRUSS; UL LISTED FOR WET LOCATIONS.			
F4	A670TSRLED-NF/5PPT/6ARC45T3/ML/BK	POLE MOUNTED LED LUMINAIRE	1	33W LED	120	POLE	MOUNTED ON EXISTING POLE; UL LISTED FOR WET LOCATIONS.			



KMI Kaltsouni Mehdi, Inc. ARCHITECTS ■ ENGINEERS 223 W.Jackson Blvd., Suite 1010 Chicago, IL 60606 Tel.: (312)987-9800 Fax.: (312)987-9892 DESIGNED - JM REVISED -DRAWN - KH REVISED -REVISED CHECKED - MK - 02-20-2020 REVISED -

STATE OF ILLINOIS DEPARTMENT OF TRANSPORTATION

ELECTRICAL WIRING DIAGRAMS AND DETAILS AND LIGHT FIXTURE AND PANEL BOARD SCHEDULES SCALE: AS NOTED SHEET 6 OF 7 SHEETS STA. \_\_\_\_\_ TO STA. \_\_\_\_

TOTAL SHEET NO. SECTION NO. COUNTY 65 12-00097-00-BR CONTRACT NO. 61F89 FED. ROAD DIST. NO. \_ ILLINOIS FED. AID PROJECT

