

F.A.I. RTE.	SECTION	COUNTY	TOTAL SHEETS	SHEET NO.
55	2020-025-BR	DUPAGE	62	1
		ILLINOIS	CONTRACT NO. 62K96	

01- 5 - 2021 LETTING ITEM092

FOR INDEX OF SHEETS, SEE SHEET NO. 2

FOR LIST OF HIGHWAY STANDARDS, SEE SHEET NO. 2

PROJECT IS LOCATED IN THE VILLAGE OF BURR RIDGE

TRAFFIC DATA:

2018 ADT

I-55 (S.N. 022-0003) = 168,700

MADISON ST = 2,850

DESIGN CLASSIFICATION = I-55: INTERSTATE (URBAN)
MADISON ST: MAJOR COLLECTOR

DESIGN SPEED = I-55: 60 MPH (ASSUMED)
MADISON ST: 35 MPH (ASSUMED)

POSTED SPEED = I-55: 55 MPH
MADISON ST: 30 MPH

STATE OF ILLINOIS
DEPARTMENT OF TRANSPORTATION

**PROPOSED
HIGHWAY PLANS**

FAI ROUTE 55 (I-55) OVER S. MADISON ST
SECTION 2020-025-BR
PROJECT: NHPP-NCBK(060)
BRIDGE DECK OVERLAY AND JOINT REPAIR
DUPAGE COUNTY

C-91-214-20

D-91-364-18




LE LIN ENGINEERING, LTD.
Consulting Engineers
Westmont, Illinois

STATE OF ILLINOIS
DEPARTMENT OF TRANSPORTATION

SUBMITTED October 27, 2020
Anthony J. D'Amico / C.E. REGIONAL ENGINEER
December 4, 2020
Scott A. Elk
December 4, 2020
James J. [Signature] 13
DIRECTOR OF HIGHWAYS PROJECT IMPLEMENTATION

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OF THE STATE OF ILLINOIS

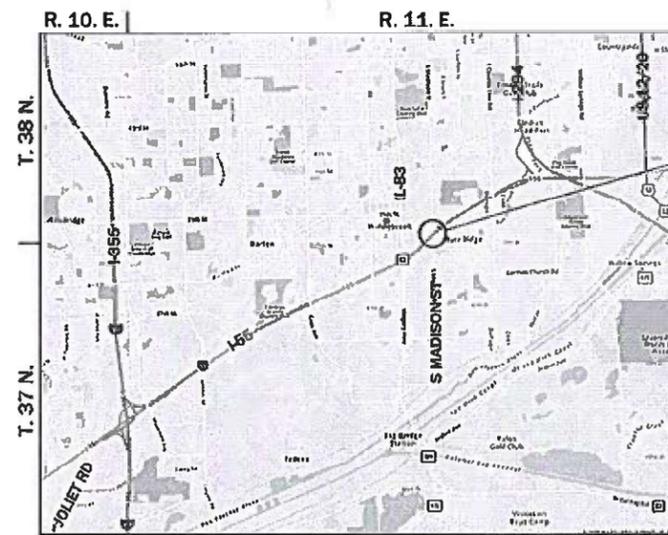

DOWNERS GROVE TOWNSHIP

LOCATION MAP


NOT TO SCALE

GROSS LENGTH = 392.00 FT. = 0.1 MILES
NET LENGTH = 392.00 FT. = 0.1 MILES



Shiraz Tarique
Illinois Registered Engineer No. 062-064219
Registration Expires Nov. 30, 2021

10/26/20
Date

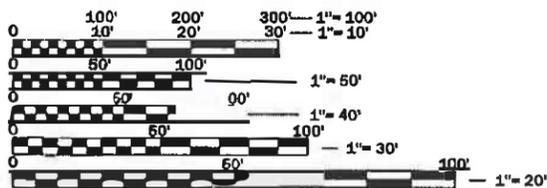

FULL SIZE PLANS HAVE BEEN PREPARED USING STANDARD ENGINEERING SCALES. REDUCED SIZED PLANS WILL NOT CONFORM TO STANDARD SCALES. IN MAKING MEASUREMENTS ON REDUCED PLANS, THE ABOVE SCALES MAY BE USED.

J.U.L.I.E.
JOINT UTILITY LOCATION INFORMATION FOR EXCAVATION
1-800-892-0123
OR 811

PROJECT ENGINEER: PRAVEEN KAINI, PE. (847-705-4237)
PROJECT MANAGER: J. ALAIN MIDY, PE., (847-221-3056)

CONTRACT NO. 62K96

INDEX OF SHEETS

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HIGHWAY STANDARDS

000001-08	STANDARD SYMBOLS, ABBREVIATIONS AND PATTERNS
001006	DECIMAL OF AN INCH AND OF A FOOT
630001-12	STEEL PLATE BEAM GUARDRAIL
630301-09	SHOULDER WIDENING FOR TYPE 1 (SPECIAL) GUARDRAIL TERMINALS
631011-10	TRAFFIC BARRIER TERMINAL, TYPE 2
631033-08	TRAFFIC BARRIER TERMINAL, TYPE 6B
631046-04	TRAFFIC BARRIER TERMINAL, TYPE 10
642001-02	SHOULDER RUMBLE STRIPS, 16 IN.
701006-05	OFF-ROAD OPERATIONS, 2L, 2W, 15''(4.5 M) TO 24''(600 MM) FROM PAVEMENT EDGE
701011-04	OFF-ROAD MOVING OPERATIONS, 2L, 2W, DAY ONLY
701106-02	OFF-ROAD OPERATIONS, MULTILANE, MORE THAN 15''(4.5 M) AWAY
701301-04	LANE CLOSURE, 2L, 2W, SHORT TIME OPERATIONS
701400-10	APPROACH TO LANE CLOSURE, FREEWAY/EXPRESSWAY
701401-12	LANE CLOSURE, FREEWAY/EXPRESSWAY
701411-09	LANE CLOSURE, MULTILANE, AT ENTRANCE OR EXIT RAMP, FOR SPEEDS ≥ 45 MPH
701428-01	TRAFFIC CONTROL SETUP AND REMOVAL FREEWAY/EXPRESSWAY
701446-11	TWO LANE CLOSURE, FREEWAY / EXPRESSWAY
701501-06	URBAN LANE CLOSURE, 2L, 2W, UNDIVIDED
701801-06	SIDEWALK, CORNER OR CROSSWALK CLOSURE
701901-08	TRAFFIC CONTROL DEVICES
704001-08	TEMPORARY CONCRETE BARRIER
725001-01	OBJECT AND TERMINAL MARKERS
780001-05	TYPICAL PAVEMENT MARKINGS
782006-01	GUARDRAIL AND BARRIER WALL REFLECTOR MOUNTING DETAILS

DISTRICT STANDARDS

TC-08	ENTRANCE AND EXIT RAMP CLOSURE DETAILS
TC-09	TRAFFIC CONTROL DETAILS FOR FREEWAY SINGLE AND MULTI-LANE WEAVE
TC-10	TRAFFIC CONTROL AND PROTECTION FOR SIDE ROADS, INTERSECTIONS, AND DRIVEWAYS
TC-11	TYPICAL APPLICATIONS RAISED REFLECTIVE PAVEMENT MARKERS (SNOW-LOW RESISTANT)
TC-12	MULTI-LANE FREEWAY PAVEMENT MARKING DETAILS
TC-13	DISTRICT ONE TYPICAL PAVEMENT MARKINGS
TC-17	TRAFFIC CONTROL DETAILS FOR FREEWAY SHOULDER CLOSURES AND PARTIAL RAMP CLOSURES
TC-18	FREEWAY/EXPRESSWAY SIGNING FOR FLAGGING OPERATIONS AT WORK ZONE OPENINGS ON FREEWAY/EXPRESSWAYS
TC-22	ARTERIAL ROAD INFORMATION SIGN
TC-25	TRAFFIC CONTROL DETAILS FOR FREEWAY CENTER LANE CLOSURE SHOULDER LANE

GENERAL NOTES

THE THICKNESS OF HMA SHOWN ON THE PLANS IS THE NOMINAL THICKNESS. DEVIATIONS FROM THE NOMINAL THICKNESS WILL BE PERMITTED WHEN SUCH DEVIATIONS OCCUR DUE TO IRREGULARITIES IN THE EXISTING SURFACE OR BASE ON WHICH THE HMA IS PLACED.

ANY REFERENCE TO A STANDARD IN THESE PLANS SHALL BE INTERPRETED TO MEAN THE EDITION AS INDICATED BY THE SUBNUMBER SHOWN IN THE LIST OF STANDARDS OR THE COPY INCLUDED IN THESE PLANS.

THE CONTRACTOR SHALL CALL "J.U.L.I.E" AT (800) 892-0123 OR 811 AT LEAST 48 HOURS PRIOR TO EXCAVATION TO DETERMINE WHICH BURIED ELECTRIC, TELEPHONE, AND GAS UTILITIES ARE IN THE AREA. 48 HOUR NOTIFICATION IS REQUIRED.

BEFORE BEGINNING ANY WORK, THE CONTRACTOR SHALL RETAIN AND RECORD FOR FUTURE REFERENCE, ALL EXISTING PAVEMENT MARKING LINES AND RAISED REFLECTIVE PAVEMENT MARKERS THAT CONFLICT WITH TEMPORARY MARKINGS, IN ORDER THAT THESE LOCATIONS CAN BE RE-ESTABLISHED FOR PROPOSED STRIPING AT THE COMPLETION OF THIS CONTRACT. EXACT LOCATIONS OF ALL PROPOSED PAVEMENT MARKINGS SHALL BE DIRECTED BY THE RESIDENT ENGINEER.

THE CONTRACTOR WILL NOT BE ABLE TO SET UP A YARD OR FIELD OFFICE ON STATE PROPERTY WITHOUT WRITTEN PERMISSION FROM THE DEPARTMENT.

IT SHALL BE THE CONTRACTORS RESPONSIBILITY TO VERIFY ALL DIMENSIONS AND CONDITIONS EXISTING IN THE FIELD PRIOR TO CONSTRUCTION AND ORDERING MATERIALS.

ALL DAMAGE TO EXISTING PAVEMENT MARKINGS OR RAISED REFLECTIVE PAVEMENT MARKERS OUTSIDE THE REMOVAL LINE SHOWN ON THE PLANS SHALL BE REPLACED AT NO ADDITIONAL COST TO THE DEPARTMENT.

THE CONTRACTOR SHALL COORDINATE CONSTRUCTION ACTIVITIES WITH AFFECTED UTILITY COMPANIES AND THE VILLAGE OF BURR RIDGE.

THE CONTRACTOR SHALL MAINTAIN ALL ROADWAYS OPEN TO TRAFFIC AS SHOWN ON THE MAINTENANCE OF TRAFFIC PLANS.

THE CONTRACTOR SHALL USE CARE NEAR ANY AND ALL EXISTING ITEMS THAT WILL NOT BE REMOVED. ANY DAMAGE DONE TO EXISTING ITEMS BY THE CONTRACTOR SHALL BE REPAIRED OR REPLACED TO THE SATISFACTION OF THE ENGINEER AT THE CONTRACTOR'S OWN EXPENSE.

DO NOT SCALE PLANS FOR CONSTRUCTION DIMENSIONS.

DURING CONSTRUCTION OPERATIONS, IF ANY LOOSE MATERIAL IS DEPOSITED IN THE FLOW LINE OF DRAINAGE STRUCTURES SUCH THAT THE NATURAL FLOW OF WATER IS OBSTRUCTED, THE MATERIAL SHALL BE REMOVED AT THE CLOSE OF EACH WORKDAY. AT THE CONCLUSION OF CONSTRUCTION OPERATIONS, ALL UTILITY STRUCTURES SHALL BE FREE FROM DUST AND DEBRIS. THE WORK SPECIFIED ABOVE WILL NOT BE PAID SEPARATELY BUT SHALL BE INCLUDED IN THE COST OF THE CONTRACT.

PERMANENT PAVEMENT MARKINGS SHALL BE AS SPECIFIED IN THE PLANS AND SHALL BE PLACED IN ACCORDANCE WITH THE "DISTRICT ONE TYPICAL PAVEMENT MARKINGS" DETAILS. (TC-13 AND TC-12)

THE CONTRACTOR SHALL REQUEST AND GAIN APPROVAL FROM THE ILLINOIS DEPARTMENT OF TRANSPORTATION'S EXPRESSWAY TRAFFIC OPERATIONS ENGINEER AT www.idotlcs.cm TWENTY-FOUR (24) HOURS IN ADVANCE OF ALL DAILY LANE, RAMP, AND SHOULDER CLOSURES AND 7 DAYS IN ADVANCE OF ALL PERMANENT AND WEEKEND CLOSURES ON ALL FREEWAYS AND/OR EXPRESSWAYS IN DISTRICT ONE. THIS ADVANCE NOTIFICATION IS CALCULATED BASED ON WORKWEEK OF MONDAY THROUGH FRIDAY AND SHALL NOT INCLUDE WEEKENDS OR HOLIDAYS.

COMMITMENTS

NONE.

HOT- MIX ASPHALT MIXTURE REQUIREMENTS		
MIXTURE TYPE	AIR VOIDS @ NDES	QUALITY MANAGEMENT PROGRAM (QMP)
BUTT JOINT		
POLY, HMA SURFACE COURSE, SMA, 9.5, MIX "F", N80	3.5% @ 80 GYR.	QC/QA
FILLING EXISTING RUMBLE STRIP		
HOT-MIX ASPHALT SURFACE COURSE, 1.5", MIX "D", N70, (IL-9.5)	4% @ 70 GYR.	QC/QA
QMP DESIGNATION: QUALITY CONTROL/QUALITY ASSURANCE; QUALITY CONTROL FOR PERFORMANCE (QCP)		

MIXTURE TABLE NOTES

1. THE UNIT WEIGHT USED TO CALCUALTE ALL HOT-MIX ASPHALT SURFACE MIXTURE QUANTITIES IS 112 LBS/SQYD/IN.
2. THE AC TYPE FOR POLYMERIZED HMA MIXES SHALL BE "SBS/SBR PG 76-22" AND FOR NON-POLYMERIZED HMA THE AC TYPE SHALL BE "PG 64-22" UNLESS MODIFIED BY SPECIAL PROVISIONS.
3. FOR USE OF RECYCLED MATERIALS SEE SPECIAL PROVISIONS.
4. QUALITY MANAGEMENT PROGRAM (QMP) IDENTIFIES THE PARTICULAR CONTROL SPECIFICATION THAT APPLIES TO THE HMA MIXTURE.

FACTORS FOR ESTIMATING PLAN QUANTITIES ARE AS FOLLOWS AND SHALL NOT BE USED FOR THE BASIS OF FINAL QUANTITIES:

SHORT TERM PAVEMENT MARKING	10 FT/100 FT
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USER NAME = rober	DESIGNED - RC	REVISED -
	DRAWN - RC	REVISED -
PLOT SCALE = 2.0000' / in.	CHECKED - ST	REVISED -
PLOT DATE = 11/4/2020	DATE - 11/2020	REVISED -

**STATE OF ILLINOIS
DEPARTMENT OF TRANSPORTATION**

**F.A.I. ROUTE 55 (I-55) OVER MADISON STREET
GENERAL NOTES**

SCALE: N.T.S. SHEET 1 OF 1 SHEETS STA. TO STA.

F.A.I. RTE.	SECTION	COUNTY	TOTAL SHEETS	SHEET NO.
55	2020-025-BR	DUPAGE	62	2
ILLINOIS FED. AID PROJECT			CONTRACT NO. 62K96	

REV-SEP

CODE NO.	ITEM	UNIT	TOTAL QUANTITY URBAN	CONSTRUCTION CODE	
				90% FED/10% STATE	SN 022-0003 0059 BRIDGE
40600290	BITUMINOUS MATERIALS (TACK COAT)	POUND	291	291	
40600982	HOT-MIX ASPHALT SURFACE REMOVAL - BUTT JOINT	SQ YD	646	646	
40600985	PORTLAND CEMENT CONCRETE SURFACE REMOVAL - BUTT JOINT	SQ YD	747	747	
48102100	AGGREGATE WEDGE SHOULDER, TYPE B	TON	67	67	
50102400	CONCRETE REMOVAL	CU YD	33.6	33.6	
50300255	CONCRETE SUPERSTRUCTURE	CU YD	36.7	36.7	
50300300	PROTECTIVE COAT	SQ YD	3,446	3,446	
50800205	REINFORCEMENT BARS, EPOXY COATED	POUND	5,290	5,290	
50800515	BAR SPLICERS	EACH	64	64	
52000110	PREFORMED JOINT STRIP SEAL	FOOT	368	368	
59000200	EPOXY CRACK INJECTION	FOOT	20	20	
59300100	CONTROLLED LOW-STRENGTH MATERIAL	CU YD	28	28	
* 63000001	STEEL PLATE BEAM GUARDRAIL, TYPE A, 6 FOOT POSTS	FOOT	625.0	625.0	
* 63100045	TRAFFIC BARRIER TERMINAL, TYPE 2	EACH	2	2	

* SPECIALTY ITEM



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**STATE OF ILLINOIS
DEPARTMENT OF TRANSPORTATION**

**F.A.I. ROUTE 55 (I-55) OVER MADISON STREET
SUMMARY OF QUANTITIES**

SCALE: N.T.S. SHEET 1 OF 6 SHEETS STA. TO STA.

F.A.I. RTE.	SECTION	COUNTY	TOTAL SHEETS	SHEET NO.
55	2020-025-BR		62	3
CONTRACT NO. 62K96			REV-SEP	
ILLINOIS FED. AID PROJECT				

CODE NO.	ITEM	UNIT	TOTAL QUANTITY URBAN	CONSTRUCTION CODE	
				90% FED/10% STATE	SN 022-0003
				0059	BRIDGE
* 63100089	TRAFFIC BARRIER TERMINAL, TYPE 6B	EACH	2	2	
* 63100105	TRAFFIC BARRIER TERMINAL, TYPE 10	EACH	2	2	
* 63100167	TRAFFIC BARRIER TERMINAL, TYPE 1 (SPECIAL) TANGENT	EACH	2	2	
63200310	GUARDRAIL REMOVAL	FOOT	859	859	
63301235	REMOVE AND REERECT STEEL PLATE BEAM GUARDRAIL, ATTACHED TO STRUCTURES	FOOT	40	40	
63800920	MODULAR GLARE SCREEN SYSTEM, TEMPORARY	FOOT	1,551	1,551	
67000400	ENGINEER'S FIELD OFFICE, TYPE A	CAL MO	12	12	
67100100	MOBILIZATION	L SUM	1	1	
70102620	TRAFFIC CONTROL AND PROTECTION, STANDARD 701501	L SUM	1	1	
70102640	TRAFFIC CONTROL AND PROTECTION, STANDARD 701801	L SUM	1	1	
70107025	CHANGEABLE MESSAGE SIGN	CAL DA	300	300	
70300100	SHORT TERM PAVEMENT MARKING	FOOT	5,202	5,202	
70300150	SHORT TERM PAVEMENT MARKING REMOVAL	SQ FT	17,338	17,338	
70300904	PAVEMENT MARKING TAPE, TYPE IV 4"	FOOT	41,224	41,224	

* SPECIALTY ITEM



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**STATE OF ILLINOIS
DEPARTMENT OF TRANSPORTATION**

**F.A.I. ROUTE 55 (I-55) OVER MADISON STREET
SUMMARY OF QUANTITIES**

SCALE: N.T.S. SHEET 2 OF 6 SHEETS STA. TO STA.

F.A.I. RTE.	SECTION	COUNTY	TOTAL SHEETS	SHEET NO.
55	2020-025-BR		62	4
			CONTRACT NO. 62K96	
			ILLINOIS FED. AID PROJECT	

REV-SEP

CODE NO.	ITEM	UNIT	TOTAL QUANTITY URBAN	CONSTRUCTION CODE	
				90% FED/10% STATE	SN 022-0003 0059 BRIDGE
70300905	PAVEMENT MARKING TAPE, TYPE IV 5"	FOOT	6,499	6,499	
70300908	PAVEMENT MARKING TAPE, TYPE IV 8"	FOOT	4,291	4,291	
70300912	PAVEMENT MARKING TAPE, TYPE IV 12"	FOOT	2,282	2,282	
70400100	TEMPORARY CONCRETE BARRIER	FOOT	2,425.0	2,425.0	
70400200	RELOCATE TEMPORARY CONCRETE BARRIER	FOOT	2,575.0	2,575.0	
70600255	IMPACT ATTENUATORS, TEMPORARY (FULLY REDIRECTIVE, NARROW), TEST LEVEL 2	EACH	4	4	
70600260	IMPACT ATTENUATORS, TEMPORARY (FULLY REDIRECTIVE, NARROW), TEST LEVEL 3	EACH	6	6	
70600322	IMPACT ATTENUATORS, RELOCATE (FULLY REDIRECTIVE, NARROW), TEST LEVEL 2	EACH	4	4	
70600332	IMPACT ATTENUATORS, RELOCATE (FULLY REDIRECTIVE, NARROW), TEST LEVEL 3	EACH	8	8	
* 72501000	TERMINAL MARKER - DIRECT APPLIED	EACH	2	2	
* 78000200	THERMOPLASTIC PAVEMENT MARKING - LINE 4"	FOOT	10,403	10,403	
* 78000500	THERMOPLASTIC PAVEMENT MARKING - LINE 8"	FOOT	1,197	1,197	
* 78000600	THERMOPLASTIC PAVEMENT MARKING - LINE 12"	FOOT	452	452	
* 78004354	PREFORMED PLASTIC PAVEMENT MARKING, TYPE D - INLAID - LINE 4"	FOOT	299	299	
* 78004355	PREFORMED PLASTIC PAVEMENT MARKING, TYPE D - INLAID - LINE 5"	FOOT	2,721	2,721	
* 78004358	PREFORMED PLASTIC PAVEMENT MARKING, TYPE D - INLAID - LINE 8"	FOOT	332	332	

* SPECIALTY ITEM



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**STATE OF ILLINOIS
DEPARTMENT OF TRANSPORTATION**

**F.A.I. ROUTE 55 (I-55) OVER MADISON STREET
SUMMARY OF QUANTITIES**

SCALE: N.T.S. SHEET 3 OF 6 SHEETS STA. TO STA.

F.A.I. RTE.	SECTION	COUNTY	TOTAL SHEETS	SHEET NO.
55	2020-025-BR		62	5
ILLINOIS FED. AID PROJECT			CONTRACT NO. 62K96	

REV-SEP

CODE NO.	ITEM	UNIT	TOTAL QUANTITY URBAN	CONSTRUCTION CODE	
				90% FED/10% STATE	SN 022-0003 0059 BRIDGE
* 78009004	MODIFIED URETHANE PAVEMENT MARKING - LINE 4"	FOOT	1,326	1,326	
* 78009012	MODIFIED URETHANE PAVEMENT MARKING - LINE 12"	FOOT	221	221	
* 78100100	RAISED REFLECTIVE PAVEMENT MARKER	EACH	312	312	
* 78200005	GUARDRAIL REFLECTORS, TYPE A	EACH	19	19	
* 78200011	BARRIER WALL REFLECTORS, TYPE C	EACH	198	198	
78300200	RAISED REFLECTIVE PAVEMENT MARKER REMOVAL	EACH	276	276	
X0323491	SLOPE WALL CRACK SEALING	FOOT	100	100	
X0325748	ACRYLIC COATING	SQ YD	95	95	
X0325749	FIBER WRAP	SQ FT	871	871	
X0326650	FILLING EXISTING RUMBLE STRIP	FOOT	10,565	10,565	
X0327980	PAVEMENT MARKING REMOVAL - WATER BLASTING	SQ FT	6,639	6,639	
X5030250	BRIDGE DECK GROOVING (LONGITUDINAL)	SQ YD	1,842	1,842	
X6030205	FRAMES AND GRATE TO BE ADJUSTED (SPECIAL)	EACH	1	1	
X7010216	TRAFFIC CONTROL AND PROTECTION, (SPECIAL)	L SUM	1	1	

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**STATE OF ILLINOIS
DEPARTMENT OF TRANSPORTATION**

**F.A.I. ROUTE 55 (I-55) OVER MADISON STREET
SUMMARY OF QUANTITIES**

SCALE: N.T.S. SHEET 4 OF 6 SHEETS STA. TO STA.

F.A.I. RTE.	SECTION	COUNTY	TOTAL SHEETS	SHEET NO.
55	2020-025-BR		62	6
			CONTRACT NO. 62K96	
ILLINOIS FED. AID PROJECT				

REV-SEP

CODE NO.	ITEM	UNIT	TOTAL QUANTITY URBAN	CONSTRUCTION CODE
				90% FED/10% STATE
				SN 022-0003
				0059
				BRIDGE
X7010237	CHANGEABLE MESSAGE SIGN, SPECIAL	CAL DA	25	25
X7011015	TRAFFIC CONTROL AND PROTECTION (EXPRESSWAY)	L SUM	1	1
X7013820	TRAFFIC CONTROL SURVEILLANCE, EXPRESSWAYS	CAL DA	60	60
X7040125	PINNING TEMPORARY CONCRETE BARRIER	EACH	582	582
* X7830070	GROOVING FOR RECESSED PAVEMENT MARKING 5"	FOOT	299	299
* X7830072	GROOVING FOR RECESSED PAVEMENT MARKING 6"	FOOT	2,721	2,721
* X7830076	GROOVING FOR RECESSED PAVEMENT MARKING 9"	FOOT	332	332
X8570001	SMART TRAFFIC MONITORING SYSTEM	CAL DA	25	25
Z0006014	BRIDGE DECK LATEX CONCRETE OVERLAY, 2 1/2 INCHES	SQ YD	3,368	3,368
Z0010400	CLEANING BRIDGE SEATS	SQ FT	1,159	1,159
Z0012130	BRIDGE DECK SCARIFICATION 3/4"	SQ YD	3,368	3,368
Z0012754	STRUCTURAL REPAIR OF CONCRETE (DEPTH EQUAL TO OR LESS THAN 5 INCHES)	SQ FT	594	594
Z0013798	CONSTRUCTION LAYOUT	L SUM	1	1

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DEPARTMENT OF TRANSPORTATION**

**F.A.I. ROUTE 55 (I-55) OVER MADISON STREET
SUMMARY OF QUANTITIES**

SCALE: N.T.S. SHEET 5 OF 6 SHEETS STA. TO STA.

F.A.I. RTE.	SECTION	COUNTY	TOTAL SHEETS	SHEET NO.
55	2020-025-BR		62	7
			CONTRACT NO. 62K96	
		ILLINOIS	FED. AID PROJECT	

REV-SEP

PAVEMENT SCHEDULE

FROM STATION	TO STATION	LT/RT	BITUMINOUS MATERIALS (TACK COAT)	HMA SURFACE REMOVAL BUTT JOINT	PCC SURFACE REMOVAL BUTT JOINT
			POUND	SQ YD	SQ YD
638+20.47	638+85.13	RT			189.04
638+20.47	639+03.32	RT	70.39	156.43	
638+20.47	638+50.63	RT	14.54	32.32	
638+93.05	639+22.99	LT	19.29	42.86	
638+93.05	639+56.73	LT			188.09
638+93.05	639+68.56	LT	44.08	97.95	
640+69.96	641+44.06	RT	40.89	90.87	
640+81.02	641+44.06	RT			185.36
641+14.00	641+44.06	RT	20.37	45.27	
641+34.08	642+12.40	LT	64.25	142.78	
641+50.26	642+12.40	LT			
641+82.56	642+12.40	LT	16.58	36.85	184.49
ROUNDED TOTAL			291	646	747

IMPACT ATTENUATORS, TEMPORARY (FULLY REDIRECTIVE, NARROW), TEST LEVEL 3

FROM STATION	LT/RT	EACH
STAGE 1		
636+71.49	RT	1
643+89.15	LT	1
TOTAL		2

IMPACT ATTENUATORS, TEMPORARY (FULLY REDIRECTIVE, NARROW), TEST LEVEL 2

FROM STATION	LT/RT	EACH
STAGE 1		
MADISON	LT	1
MADISON	RT	1
MADISON	LT	1
MADISON	RT	1
TOTAL		4

IMPACT ATTENUATORS, RELOCATE (FULLY REDIRECTIVE, NARROW), TEST LEVEL 3

FROM STATION	LT/RT	EACH
STAGE 2		
636+56.13	RT	1
643+76.71	LT	1
STAGE 3		
635+71.42	RT	1
644+38.24	LT	1
TOTAL		4

IMPACT ATTENUATORS, RELOCATE (FULLY REDIRECTIVE, NARROW), TEST LEVEL 2

FROM STATION	LT/RT	EACH
STAGE 3		
MADISON	LT	1
MADISON	RT	1
MADISON	LT	1
MADISON	RT	1
TOTAL		4

AGGREGATE WEDGE SHOULDER, TYPE B

FROM STATION	TO STATION	LT/RT	TON
636+47.17	638+56.56	RT	14.89
639+25.41	639+84.96	LT	4.45
640+52.93	641+63.65	RT	8.09
641+78.70	647+08.25	LT	39.02
ROUNDED TOTAL			67

MODULAR GLARE SCREEN SYSTEM, TEMPORARY

FROM STATION	TO STATION	LT/RT	FOOT
631+92.07	647+42.56	CL	1,550.50
ROUNDED TOTAL			1,551

TEMPORARY CONCRETE BARRIER

FROM STATION	TO STATION	LT/RT	FOOT
STAGE 1			
636+71.49	641+47.43	RT	475.00
638+91.16	643+89.15	LT	500.00
MADISON ST	-	LT	237.50
MADISON ST	-	RT	237.50
STAGE 2			
636+56.13	641+44.96	RT	487.50
638+91.48	643+76.71	LT	487.50
ROUNDED TOTAL			2,450.0

RELOCATE TEMPORARY CONCRETE BARRIER

FROM STATION	TO STATION	LT/RT	FOOT
STAGE 2			
636+56.13	641+44.96	RT	487.50
638+91.48	643+76.71	LT	487.50
STAGE 3			
635+71.42	641+48.16	RT	575.00
638+91.13	644+38.24	LT	550.00
MADISON ST	-	LT	237.50
MADISON ST	-	RT	237.50
ROUNDED TOTAL			2,575.0

TERMINAL MARKERS - DIRECT APPLIED

FROM STATION	LT/RT	EACH
636+81.06	RT	1
646+74.84	LT	1
TOTAL		2

STEEL PLATE BEAM GUARDRAIL, TYPE A, 6 FOOT POSTS

FROM STATION	TO STATION	LT/RT	FOOT
637+31.38	638+19.46	RT	87.50
639+47.78	639+84.95	LT	37.50
640+52.92	641+41.00	RT	87.50
642+15.39	646+25.16	LT	412.50
ROUNDED TOTAL			625.0

GUARDRAIL REMOVAL

FROM STATION	TO STATION	LT/RT	FOOT
636+81.06	638+71.68	RT	189.39
639+35.35	639+87.33	LT	52.31
640+50.60	641+53.58	RT	102.31
641+63.82	646+74.81	LT	514.39
ROUNDED TOTAL			859

BARRIER WALL REFLECTORS, TYPE C

FROM STATION	TO STATION	LT/RT	EACH
636+56.29	641+44.33	RT	40
636+71.39	641+47.39	RT	38
638+90.69	643+76.71	LT	40
638+91.17	643+89.24	LT	40
MADISON	-	LT	20
MADISON	-	RT	20
TOTAL			198

FILLING EXISTING RUMBLE STRIP

FROM STATION	TO STATION	LT/RT	FOOT
623+70.95	655+01.68	RT	3,128.04
625+84.19	655+64.89	LT	2,939.01
628+86.65	650+62.76	RT	2,166.56
629+56.99	65277.01	LT	2,330.41
ROUNDED TOTAL			10,565

TRAFFIC BARRIER TERMINAL, TYPE 2

FROM STATION	TO STATION	LT/RT	EACH
639+35.35	639+47.77	LT	1
641+41.00	641+53.58	RT	1
TOTAL			2

TRAFFIC BARRIER TERMINAL, TYPE 6B

FROM STATION	TO STATION	LT/RT	EACH
638+19.42	638+71.68	RT	1
641+63.83	642+15.38	LT	1
TOTAL			2

TRAFFIC BARRIER TERMINAL, TYPE 10

FROM STATION	TO STATION	LT/RT	EACH
639+85.03	639+87.33	LT	1
640+50.60	640+52.92	RT	1
TOTAL			2

TRAFFIC BARRIER TERMINAL, TYPE 1 (SPECIAL) TANGENT

FROM STATION	TO STATION	LT/RT	EACH
636+81.06	637+31.38	RT	1
646+25.16	646+74.81	LT	1
TOTAL			2

GUARDRAIL REFLECTORS, TYPE A

FROM STATION	TO STATION	LT/RT	EACH
636+81.06	638+71.68	RT	4
639+35.35	639+87.33	LT	4
640+50.60	641+53.58	RT	4
641+63.82	646+74.81	LT	7
TOTAL			19

FRAMES AND GRATES TO BE ADJUSTED (SPECIAL)

FROM STATION	LT/RT	EACH
640+59.31	RT	1
TOTAL		1

PAVEMENT MARKING TAPE, TYPE IV 4"

FROM STATION	TO STATION	LT/RT	FOOT
STAGE 1			
628+86.65	650+62.76	RT	2,166.56
628+86.65	650+62.76	RT	2,171.99
629+57.00	652+77.01	LT	2,330.41
629+57.00	652+77.01	LT	2,325.45
MADISON ST	-	LT	447.35
MADISON ST	-	RT	409.83
STAGE 2			
626+67.48	651+66.17	RT	2,497.12
626+67.48	629+93.64	RT	2,169.40
626+67.48	629+93.64	RT	2,166.23
627+35.56	651+66.17	RT	2,421.02
628+92.57	652+32.62	LT	2,350.36
628+92.57	649+27.90	LT	2,041.33
628+92.57	649+27.90	LT	2,038.31
628+92.57	652+32.62	LT	2,341.93
STAGE 3			
623+16.83	655+64.90	LT	3,254.07
623+70.95	655+00.37	RT	3,124.01
623+70.95	655+00.44	RT	3,128.04
625+84.19	655+64.90	LT	2,982.73
MADISON ST	-	LT	447.35
MADISON ST	-	RT	409.83
			ROUNDED TOTAL
			41,224

PAVEMENT MARKING TAPE, TYPE IV 5"

FROM STATION	TO STATION	LT/RT	FOOT
STAGE 1			
628+86.65	650+62.76	RT	542.21
628+86.65	650+62.76	RT	542.60
629+57.00	652+77.01	LT	582.35
629+57.00	652+77.01	LT	581.84
STAGE 2			
627+35.56	651+66.17	RT	605.65
628+92.57	652+32.62	LT	587.76
STAGE 3			
623+70.95	655+00.44	RT	781.44
623+70.95	655+00.44	RT	781.85
625+84.19	655+64.90	LT	746.40
625+84.19	655+64.90	LT	746.87
			ROUNDED TOTAL
			6,499

PINNING TEMPORARY CONCRETE BARRIER

FROM STATION	TO STATION	LT/RT	EACH
STAGE 1			
636+71.49	641+47.43	RT	114
638+91.16	643+89.15	LT	120
MADISON	-	LT	57
MADISON	-	RT	57
STAGE 2			
636+56.13	641+44.96	RT	117
638+91.48	643+76.71	LT	117
			ROUNDED TOTAL
			582

TEMPORARY INFORMATION SIGNING

STATION	LT/RT	TYPE	SQ FT
STAGE 1			
603+87.00	RT	END BUS 1/2 MI	18.00
626+87.00	RT	ALL TRAFFIC	32.00
626+87.00	RT	ALL TRAFFIC	32.00
628+87.00	RT	END BUS	12.00
652+77.00	LT	END BUS	12.00
654+77.00	LT	ALL TRAFFIC	32.00
654+77.00	LT	ALL TRAFFIC	32.00
677+77.00	LT	END BUS 1/2 MI	18.00
STAGE 3			
621+71.00	RT	ALL TRAFFIC	32.00
621+71.00	RT	ALL TRAFFIC	32.00
657+65.00	LT	ALL TRAFFIC	32.00
657+65.00	LT	ALL TRAFFIC	32.00
			ROUNDED TOTAL
			316

PAVEMENT MARKING TAPE, TYPE IV 8"

FROM STATION	TO STATION	LT/RT	FOOT
STAGE 2			
626+67.48	636+31.06	RT	1,927.15
644+01.63	652+32.62	LT	1,661.97
STAGE 3			
619+40.41	623+70.95	RT	436.14
623+17.00	625+84.00	LT	264.77
			ROUNDED TOTAL
			4,291

PAVEMENT MARKING REMOVAL - WATER BLASTING

FROM STATION	TO STATION	LT/RT	SQ FT
619+40.44	627+33.62	RT	534.49
621+09.19		RT	14.60
623+16.83	627+14.55	LT	263.14
623+70.95	638+15.44	RT	481.59
623+70.95	638+15.44	RT	150.49
623+70.95	638+15.44	RT	150.52
625+84.19	638+88.06	LT	434.84
625+84.19	638+88.06	LT	135.19
625+84.19	638+88.06	LT	135.08
626+01.54		LT	14.70
626+01.86		RT	14.60
626+01.86		RT	26.74
626+01.86		LT	26.66
627+14.55	638+88.06	LT	1,180.60
627+33.61	638+15.44	RT	360.04
631+03.67		LT	17.44
631+03.77		RT	26.69
631+03.89		LT	26.69
631+04.00		RT	17.44
636+04.04		LT	17.49
636+04.04		LT	26.45
636+04.04		RT	26.86
636+04.04		RT	17.28
641+49.07	655+00.44	RT	448.04
641+49.07	655+00.44	RT	449.58
641+49.07	655+00.44	RT	140.96
641+49.07	655+00.44	RT	140.79
642+17.38	655+64.86	LT	140.33
642+17.38	655+64.86	LT	139.98
642+17.38	655+64.86	LT	450.03
642+17.38	655+64.86	LT	451.56
645+61.20		LT	18.84
645+61.20		LT	26.71
645+61.20		RT	26.67
645+61.20		RT	17.45
650+61.20		LT	17.43
650+61.20		LT	26.72
650+61.20		RT	26.67
650+61.20		RT	17.45
			ROUNDED TOTAL
			6,639

PAVEMENT MARKING TAPE, TYPE IV 12"

FROM STATION	TO STATION	LT/RT	FOOT
626+67.48	636+31.06	RT	526.50
629+99.00	638+93.05	LT	643.68
641+44.06	649+21.78	RT	636.03
644+01.63	652+32.62	LT	475.41
			ROUNDED TOTAL
			2,282



USER NAME = rober
 PLOT SCALE = 2,000' / in.
 PLOT DATE = 11/24/2020

DESIGNED - NH
 DRAWN - NH
 CHECKED - ST
 DATE - 11/2020

REVISED -
 REVISED -
 REVISED -
 REVISED -

**STATE OF ILLINOIS
 DEPARTMENT OF TRANSPORTATION**

**F.A.I. ROUTE 55 (I-55) OVER MADISON STREET
 SCHEDULE OF QUANTITIES**

SCALE: N.T.S. SHEET 2 OF 3 SHEETS STA. TO STA.

F.A.I. RTE.	SECTION	COUNTY	TOTAL SHEETS	SHEET NO.
55	2020-025-BR	DUPAGE	62	10
			CONTRACT NO. 62K96	
ILLINOIS FED. AID PROJECT				

PAVEMENT MARKING SCHEDULE

FROM STATION	TO STATION	LT/RT	THERMOPLASTIC PAVEMENT MARKING			PREFORMED PLASTIC PAVEMENT MARKING, TYPE D			MODIFIED URETHANE PAVEMENT MARKING		RAISED REFLECTIVE PAVEMENT MARKER	RAISED REFLECTIVE PAVEMENT MARKER REMOVAL	GROOVING FOR RECESSED PAVEMENT MARKING 5"	GROOVING FOR RECESSED PAVEMENT MARKING 6"	GROOVING FOR RECESSED PAVEMENT MARKING 9"
			LINE 4"	LINE 8"	LINE 12"	LINE 4"	LINE 5"	LINE 8"	LINE 4"	LINE 12"					
			FOOT	FOOT	FOOT	FOOT	FOOT	FOOT	FOOT	FOOT					
619+40.44	627+33.62	RT		801.74		199.99							199.99		
621+09.19		RT			14.60										
623+16.83	627+14.55	LT		394.71		98.95							98.95		
623+70.95	638+20.47	RT	1,444.78				722.43			74	74			722.43	
625+84.19	638+93.05	LT	1,304.53				648.65							648.65	
625+92.42	638+93.05	LT								66	66				
626+01.86		LT			14.70										
626+01.86		RT			14.60										
626+01.86		RT			26.74										
626+01.86		LT			26.66										
627+14.55	638+93.05	LT	1,175.60												
627+33.61	638+20.47	RT	1,080.13												
631+03.67		LT			17.44										
631+03.77		RT			26.69										
631+03.89		LT			26.69										
631+04.00		RT			17.44										
636+04.04		LT			17.49										
636+04.04		LT			26.45										
636+04.04		RT			26.86										
636+04.04		RT			17.28										
638+20.47	641+44.06	RT					83.06	331.85		9					83.06
638+20.47	641+44.06	RT					83.15	332.96		9					83.15
638+57.44	640+58.52	RT					82.59	331.07	106.79						
638+93.05	642+12.40	LT					82.68	329.98		9					82.59
638+93.05	642+12.40	LT								9					82.68
639+73.69	641+72.63	LT							113.30						
641+44.06	655+00.44	RT	1,344.13				338.29			34	34			338.29	
641+44.06	655+00.44	RT	1,348.73				337.90			34	34			337.90	
642+12.40	655+64.86	LT	1,350.09				336.80							336.80	
642+12.40	655+64.86	LT	1,354.68				335.94			68	68			335.94	
645+61.20		LT			18.84										
645+61.20		LT			26.71										
645+61.20		RT			26.67										
645+61.20		RT			17.45										
650+61.20		LT			17.43										
650+61.20		LT			26.72										
650+61.20		RT			26.67										
650+61.20		RT			17.45										
ROUNDED TOTAL			10,403	1,197	452	299	2,721	332	1,326	221	312	276	299	2,721	332



USER NAME = rober	DESIGNED - NH	REVISED -
	DRAWN - NH	REVISED -
PLOT SCALE = 2,000' / in.	CHECKED - ST	REVISED -
PLOT DATE = 11/2/2020	DATE - 11/2020	REVISED -

STATE OF ILLINOIS
DEPARTMENT OF TRANSPORTATION


F.A.I. ROUTE 55 (I-55) OVER MADISON STREET
SCHEDULE OF QUANTITIES

SCALE: N.T.S. SHEET 3 OF 3 SHEETS STA. TO STA.

F.A.I. RTE.	SECTION	COUNTY	TOTAL SHEETS	SHEET NO.
55	2020-025-BR	DUPAGE	62	11
CONTRACT NO. 62K96			ILLINOIS FED. AID PROJECT	

LEGEND


- (A) EXISTING HMA PAVEMENT 5"
- (B) EXISTING P.C.C. PAVEMENT, 10"
- (C) EXISTING SUB-BASE MATL., 4"
- (D) EXISTING SHOULDER RUMBLE STRIP, 16"
- (E) EXISTING HMA SHOULDER, 10"
- (F) EXISTING HMA SHOULDER, 15"
- (G) EXISTING AGGREGATE SUBGRADE 12"
- (H) EXISTING PIPE UNDERDRAIN
- (I) EXISTING GUARDRAIL
- (J) PROPOSED P.C.C. BUTT JOINT
- (K) PROPOSED GUARDRAIL
- (L) PROPOSED AGGREGATE WEDGE SHOULDER, TYPE B
- (M) PROPOSED FILLING EXISTING RUMBLE STRIP
- (N) PROPOSED HMA BUTT JOINT

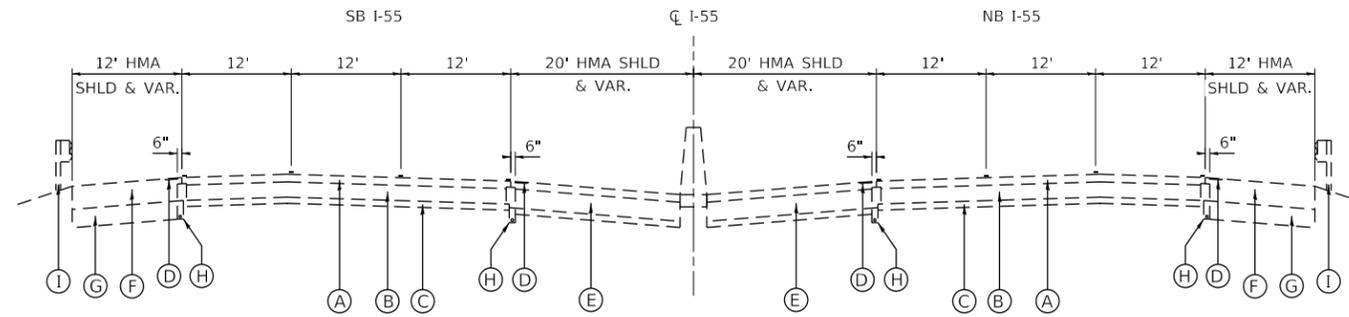

EXISTING TYPICAL SECTION

FAI-55 OVER MADISON ST
 LOOKING NORTHEAST
 STA 638+20.47 TO STA 638+67.91 RT
 STA 638+93.05 TO STA 639+39.90 LT
 STA 640+97.55 TO STA 641+44.06 RT
 STA 641+66.45 TO STA 642+12.40 LT

STRUCTURE AND BRIDGE
 APPROACH SLAB OMISSION
 STA 638+67.91 TO STA STA 640+97.55 RT
 STA 639+39.90 TO STA 641+66.45 LT

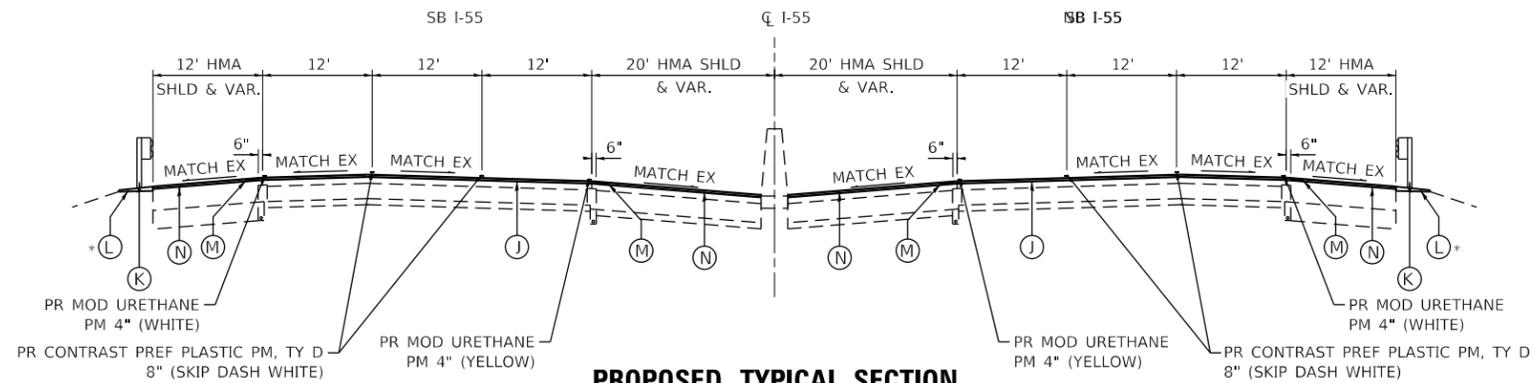

PROPOSED TYPICAL SECTION

*LIMITS OF PR GUARDRAIL:
 STA 639+35.34 TO STA 639+84.00
 STA 641+63.83 TO STA 646+74.85

FAI-55 OVER MADISON ST
 LOOKING NORTHEAST
 STA 638+20.47 TO STA 638+67.91 RT
 STA 638+93.05 TO STA 639+39.90 LT
 STA 640+97.55 TO STA 641+44.06 RT
 STA 641+66.45 TO STA 642+12.40 LT

STRUCTURE AND BRIDGE
 APPROACH SLAB OMISSION
 STA 638+67.91 TO STA STA 640+97.55 RT
 STA 639+39.90 TO STA 641+66.45 LT

*LIMITS OF PR GUARDRAIL:
 STA 636+81.06 TO STA 638+71.68
 STA 640+50.93 TO STA 641.+53.58

USER NAME = rober	DESIGNED - RC	REVISED -
	DRAWN - RC	REVISED -
PLOT SCALE = 20.0000' / in.	CHECKED - ST	REVISED -
PLOT DATE = 11/2/2020	DATE - 11/2020	REVISED -

F.A.I. RTE.	SECTION	COUNTY	TOTAL SHEETS	SHEET NO.
55	2020-025-BR	DUPAGE	62	12
			CONTRACT NO. 62K96	
ILLINOIS FED. AID PROJECT				

MAINTENANCE OR TRAFFIC GENERAL NOTES

1. THE MAINTENANCE OF TRAFFIC PLANS SHALL SERVE AS A GUIDE FOR THE SAFE DIVERSION OF TRAFFIC DURING THE EXECUTION OF THIS CONTRACT. THE CONTRACTOR MAY MODIFY THE MAINTENANCE OF TRAFFIC PLANS TO MEET CONSTRUCTION NEEDS BUT NOT AT THE EXPENSE OF PUBLIC SAFETY OR CONVENIENCE. ANY CHANGES TO THE TRAFFIC CONTROL PLANS SHALL BE SUBMITTED TO THE ENGINEER FOR APPROVAL.
2. EXISTING PAVEMENT MARKINGS THAT CONFLICT WITH TEMPORARY MARKINGS SHALL BE REMOVED. THIS WORK WILL BE PAID FOR AT THE CONTRACT UNIT PRICE PER SQUARE FOOT FOR PAVEMENT MARKING REMOVAL - WATER BLASTING.
3. EXISTING RAISED REFLECTIVE PAVEMENT MARKER REFLECTORS THAT CONFLICT WITH THE REVISED TRAFFIC PATTERN SHALL BE REMOVED FROM THE EXISTING CASTINGS LOCATED IN THE PAVEMENT. THIS WORK WILL BE PAID FOR AT THE CONTRACT UNIT PRICE EACH FOR RAISED REFLECTIVE PAVEMENT MARKER REMOVAL.
4. THE REMOVAL OF ALL PAVEMENT MARKING TAPE WILL BE PAID FOR AT THE CONTRACT UNIT PRICE SQUARE FOOT FOR SHORT TERM PAVEMENT MARKING REMOVAL.
5. PAVEMENT MARKING TAPE, TYPE IV SHALL BE USED FOR ANY SHORT TERM PAVEMENT MARKINGS ON FINAL SURFACES.
6. ALL TRAFFIC CONTROL DEVICES SHALL BE REFLECTORIZED PRIOR TO INSTALLATION AND CLEANED AS SPECIFIED IN THE TRAFFIC CONTROL SPECIAL PROVISIONS OR AS DIRECTED BY THE ENGINEER.
7. ALL DRUMS, VERTICAL PANELS, AND BARRICADES ADJACENT TO THE EDGE OF THE TRAVELED WAY SHALL BE EQUIPPED WITH MONO-DIRECTIONAL STEADY BURNING LIGHTS.
8. FOR STABILIZATION, ANY REQUIRED TYPE III BARRICADES SHALL REQUIRE A MINIMUM OF FOUR SAND BAGS PER BARRICADE.
9. EXISTING SIGNS WITHIN THE LIMITS OF TRAFFIC CONTROL WHICH ARE OBSTRUCTED BY OR OTHERWISE INTERFERED WITH BY CONSTRUCTION OPERATIONS OF DESIGNATED TRAFFIC CONTROL, SHALL BE COVERED OR REMOVED BY THE CONTRACTOR UNLESS SPECIFIED IN THE PLANS OR WHEN DIRECTED BY THE ENGINEER. THIS WORK SHALL BE AS SPECIFIED IN ARTICLE 107.25 OF THE STANDARD SPECIFICATIONS.
10. CHANGEABLE MESSAGE BOARDS WILL BE PLACED 2 WEEKS PRIOR TO START OF WORK, AT LOCATIONS DETERMINED BY THE ENGINEER, FOR ADVANCED WARNING.
11. SEE STRUCTURAL PLANS FOR BRIDGE DECK REPAIR INFORMATION.
12. THE CONTRACTOR SHALL CONTACT THE DISTRICT ONE EXPRESSWAY TRAFFIC CONTROL SUPERVISOR AT (847) 705-4155 A MINIMUM OF 72 HOURS IN ADVANCE OF BEGINNING ANY WORK.
13. THE CONTRACTOR SHALL CONTRACT THE DISTRICT ONE TRAFFIC CONTROL SUPERVISOR FOR ARTERIALS AT KALPANA.KANNAN-HOSADURGA@ILLINOIS.GOV AT LEAST 72 HOURS BEFORE BEGINNING WORK.
14. THE CONTRACTOR SHALL CONTACT RICK WILLMAN, PACE TRANSPORTATION ENGINEER, VIA EMAIL AT RICHARD.WILLMAN@PACEBUS.COM A MINIMUM OF 2 WEEKS IN ADVANCE OF BEGINNING ANY WORK.
15. THE ENGINEER SHALL CONTACT REGINA COOPER, AREA EXPRESSWAY TRAFFIC ENGINEER, VIA EMAIL AT REGINA.COOPER2@ILLINOIS.GOV A MINIMUM OF 2 WEEKS PRIOR TO PLACEMENT OF PERMANENT PAVEMENT MARKINGS.
16. DUE TO THE EXPECTED QUEUES IN THE NORTHBOUND AND SOUTHBOUND DIRECTIONS ALONG I-55 DURING STAGE 2 OF CONSTRUCTION, THE CONTRACTOR SHALL UTILIZE A SMART WORK ZONE TO MONITOR TRAFFIC DURING THIS STAGE. THE CONTRACTOR SHALL PLACE AN ADDITIONAL CHANGEABLE MESSAGE BOARD 1 MILE AND ½ MILE IN ADVANCE OF THE EXPECTED QUEUE AT A LOCATION DETERMINED BY THE ENGINEER.

SUGGESTED SEQUENCE OF OPERATIONS

PRE-STAGE

1. UTILIZE HIGHWAY STANDARDS 701400, 701401, AND 701428 TO CLOSE THE NB AND SB INSIDE SHOULDER AND LANE 1 DURING THE ALLOWABLE LANE CLOSURE HOURS.
2. RESURFACE EXISTING RUMBLE STRIPS ALONG NB AND SB INSIDE SHOULDERS AS DESCRIBED IN THE SPECIAL PROVISIONS.
3. UTILIZE HIGHWAY STANDARDS 701400, 701401, AND 701428 TO CLOSE THE NB AND SB OUTSIDE SHOULDERS AND LANE 3 DURING THE ALLOWABLE LANE CLOSURE HOURS.
4. RESURFACE EXISTING RUMBLE STRIPS ALONG NB AND SB OUTSIDE SHOULDERS AS DESCRIBED IN THE SPECIAL PROVISIONS.

STAGE 1

1. INSTALL TRAFFIC CONTROL DEVICES AND TEMPORARY PAVEMENT MARKINGS UTILIZING HIGHWAY STANDARDS 701400, 701401, 701428, & 701446 AS WELL AS DISTRICT STANDARDS TC-09, TC-17, & TC-25 AND AS SHOWN IN THE STAGE 1 STAGING PLANS.
2. SHIFT NB AND SB TRAFFIC ONTO THE OUTSIDE SHOULDER AND CLOSE NB AND SB INSIDE SHOULDERS AND LANE 1 UTILIZING DISTRICT STANDARD TC-09 AND AS SHOWN IN THE STAGE 1 STAGING PLANS.
3. PERFORM BRIDGE DECK REPAIRS ALONG INSIDE SHOULDER AND LANE 1 AS SHOWN IN THE STAGE 1 STAGING AND STRUCTURAL PLANS.
4. PERFORM PIER REPAIR ON PIERS 1 & 2 AND TEMPORARY SHORING BENEATH THE WORK ZONE AREA AT THE LOCATIONS SHOWN ON THE STRUCTURAL PLANS UTILIZING HIGHWAY STANDARD 701501, 701801 AS WELL AS DISTRICT STANDARD TC-10 AND AS SHOWN IN THE STAGE 1 STAGING PLANS FOR TRAFFIC CONTROL REQUIRED ALONG MADISON STREET.

STAGE 2

1. INSTALL TRAFFIC CONTROL DEVICES AND TEMPORARY PAVEMENT MARKINGS UTILIZING HIGHWAY STANDARDS 701400, 701401, 701428, & 701446 AS WELL AS DISTRICT STANDARDS TC-09, TC-17, & TC-25 AND AS SHOWN IN THE STAGE 2 STAGING PLANS.
2. SHIFT NB AND SB TRAFFIC IN LANE 1 ONTO THE INSIDE SHOULDER AND SHIFT NB AND SB IN LANES 2 AND 3 ONTO THE OUTSIDE SHOULDER AND LANE 3. CLOSE NB AND SB LANE 2 UTILIZING DISTRICT STANDARD TC-25 AND AS SHOWN IN THE STAGE 2 STAGING PLANS.
3. PERFORM BRIDGE DECK REPAIRS ALONG LANE 2 AS SHOWN IN THE STAGE 2 STAGING AND STRUCTURAL PLANS.

STAGE 3

1. INSTALL TRAFFIC CONTROL DEVICES AND TEMPORARY PAVEMENT MARKINGS UTILIZING HIGHWAY STANDARDS 701400, 701401, 701428, & 701446 AS WELL AS DISTRICT STANDARDS TC-09, TC-17, & TC-25 AND AS SHOWN IN THE STAGE 3 STAGING PLANS.
2. SHIFT NB AND SB TRAFFIC ONTO THE INSIDE SHOULDER AND CLOSE NB AND SB OUTSIDE SHOULDERS AND LANE 3 UTILIZING DISTRICT STANDARD TC-09 AND AS SHOWN IN THE STAGE 3 STAGING PLANS.
3. PERFORM BRIDGE DECK REPAIRS ALONG OUTSIDE SHOULDER AND LANE 3 AS SHOWN IN THE STAGE 3 STAGING AND STRUCTURAL PLANS.
4. PERFORM PIER REPAIR ON PIERS 1 & 2 BENEATH THE WORK ZONE AREA NEAR THE EXTERIOR BEAMS AT THE LOCATIONS SHOWN ON THE STRUCTURAL PLANS UTILIZING HIGHWAY STANDARD 701501, 701801 AS WELL AS DISTRICT STANDARD TC-10 AND AS SHOWN IN THE STAGE 3 STAGING PLANS FOR TRAFFIC CONTROL REQUIRED ALONG MADISON STREET.
5. ADJUST EXISTING DRAINAGE STRUCTURES AS REQUIRED.
6. REMOVE EXISTING GUARDRAIL AND INSTALL PROPOSED GUARDRAIL AS REQUIRED.

POST-STAGE

1. UTILIZE HIGHWAY STANDARDS 701400, 701401, 701428, AND 701446 AS WELL AS DISTRICT STANDARD TC-09 & TC-17 TO CLOSE THE NB AND SB INSIDE SHOULDER AND LANES 1 AND 2 DURING THE ALLOWABLE LANE CLOSURE HOURS.
2. PLACE PERMANENT PAVEMENT MARKINGS IN LANES 1 AND 2 AND RESURFACE EXISTING RUMBLE STRIPS ALONG NB AND SB INSIDE SHOULDERS AS DESCRIBED IN THE SPECIAL PROVISIONS.
3. UTILIZE HIGHWAY STANDARDS 701400, 701401, 701428, AND 701446 AS WELL AS DISTRICT STANDARD TC-09 & TC-17 TO CLOSE THE NB AND SB OUTSIDE SHOULDER AND LANES 2 AND 3 DURING THE ALLOWABLE LANE CLOSURE HOURS.
4. PLACE PERMANENT PAVEMENT MARKINGS IN LANES 2 AND 3 AND RESURFACE EXISTING RUMBLE STRIPS ALONG NB AND SB OUTSIDE SHOULDERS AS DESCRIBED IN THE SPECIAL PROVISIONS.




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	DRAWN - RC	REVISED -
PLOT SCALE = 100.0000 ' / in.	CHECKED - ST	REVISED -
PLOT DATE = 11/2/2020	DATE - 11/2020	REVISED -

**STATE OF ILLINOIS
DEPARTMENT OF TRANSPORTATION**

**F.A.I. ROUTE 55 (I-55) OVER MADISON STREET
STAGING GENERAL NOTES**


SCALE: N.T.S. SHEET 1 OF 13 SHEETS STA. TO STA.

F.A.I. RTE.	SECTION	COUNTY	TOTAL SHEETS	SHEET NO.
55	2020-025-BR	DUPAGE	62	13
			CONTRACT NO. 62K96	
		ILLINOIS	FED. AID PROJECT	

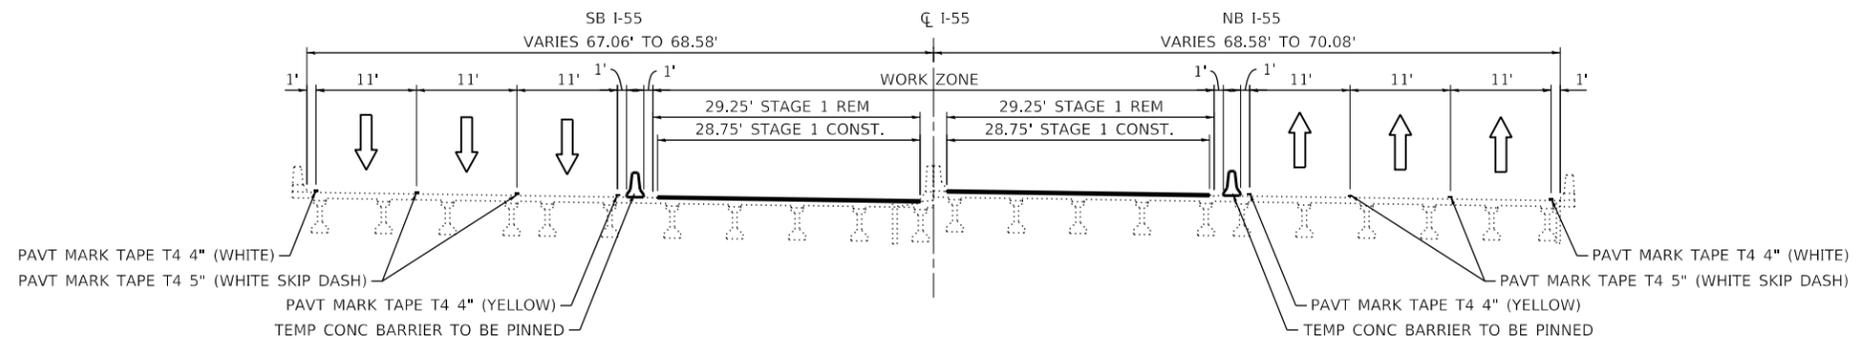


STAGE 1 TYPICAL SECTION – S.N. 022-0003

FAI-55 OVER MADISON ST
LOOKING NORTHEAST

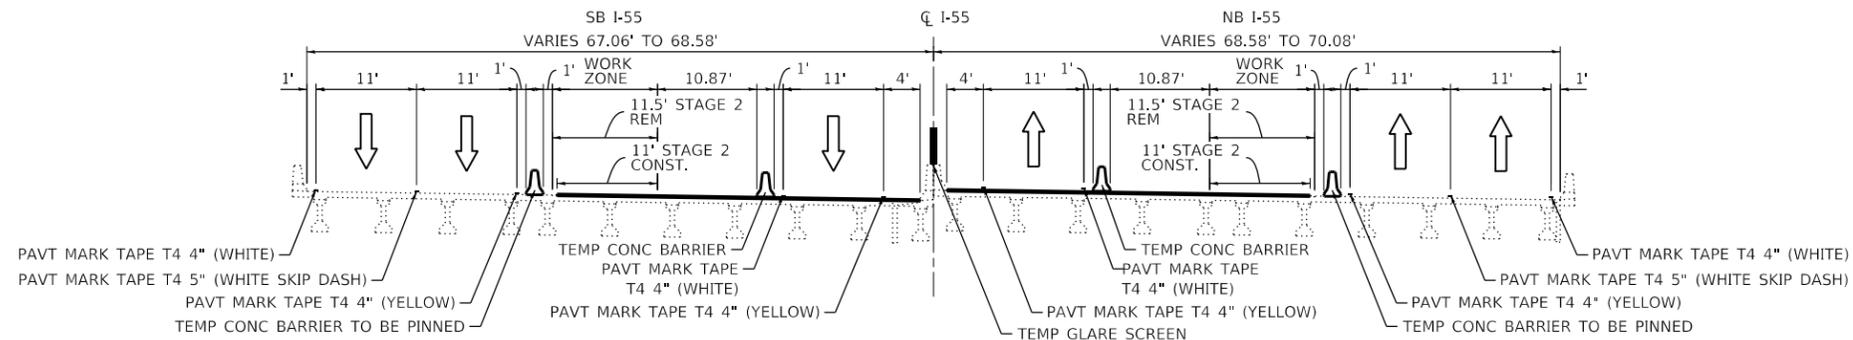

STAGE 2 TYPICAL SECTION – S.N. 022-0003

FAI-55 OVER MADISON ST
LOOKING NORTHEAST

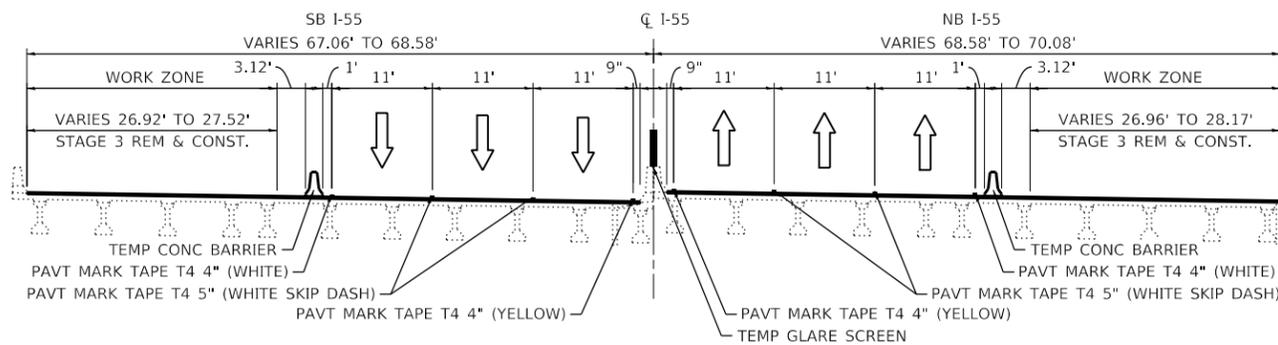

STAGE 3 TYPICAL SECTION – S.N. 022-0003


FAI-55 OVER MADISON ST
LOOKING NORTHEAST

USER NAME = rober	DESIGNED - RC	REVISED -
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PLOT DATE = 11/2/2020	DATE - 11/2020	REVISED -



F.A.I. RTE.	SECTION	COUNTY	TOTAL SHEETS	SHEET NO.
55	2020-025-BR	DUPAGE	62	14
ILLINOIS FED. AID PROJECT			CONTRACT NO. 62K96	

LEGEND

-  WORK ZONE
-  DIRECTION OF TRAFFIC
-  IMPACT ATTENUATOR, TEST LEVEL 3 (TEMPORARY)
-  TEMPORARY CONCRETE BARRIER
-  DRUMS WITH STEADY BURNING LIGHTS AT 50' (C-C)
-  SIGN

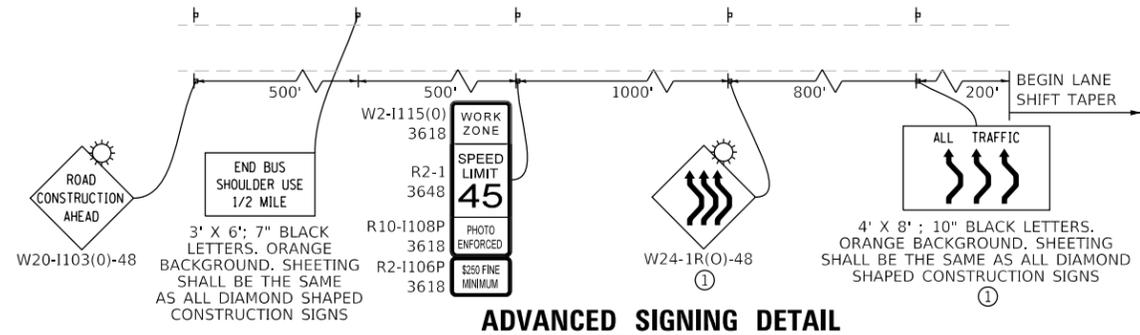

① THE NUMBER OF ARROWS ON THESE SIGNS SHALL MATCH THE NUMBER OF LANES OPEN TO TRAFFIC ALONG I-55 AND ENTRANCE RAMP.

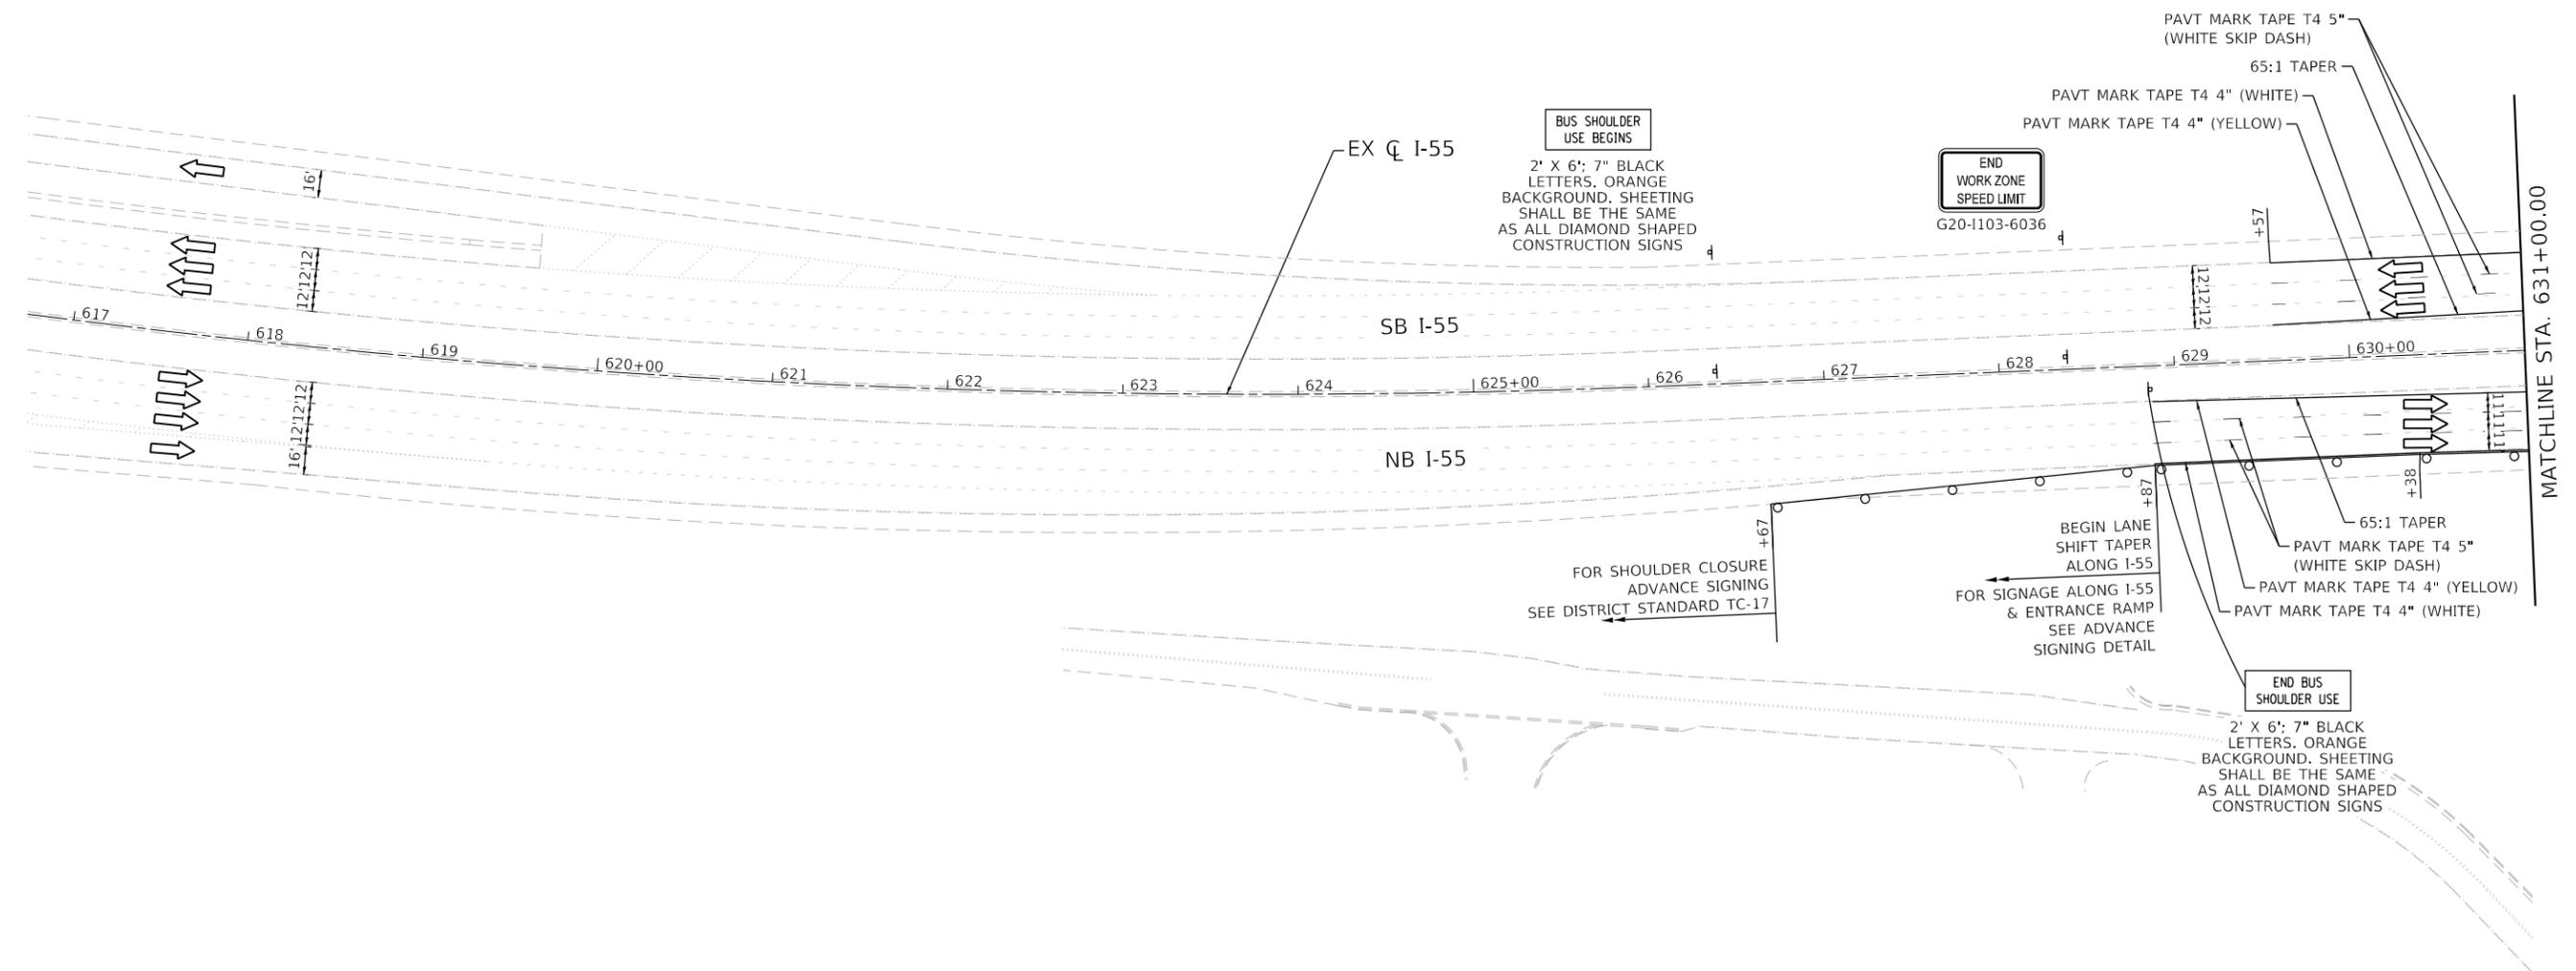
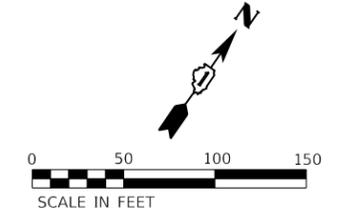


USER NAME = rober	DESIGNED - RC	REVISED -
	DRAWN - RC	REVISED -
PLOT SCALE = 100,0000' / in.	CHECKED - ST	REVISED -
PLOT DATE = 11/2/2020	DATE - 11/2020	REVISED -

F.A.I. RTE.	SECTION	COUNTY	TOTAL SHEETS	SHEET NO.
55	2020-025-BR	DUPAGE	62	15
CONTRACT NO. 62K96				
ILLINOIS FED. AID PROJECT				

LEGEND

-  WORK ZONE
-  DIRECTION OF TRAFFIC
-  IMPACT ATTENUATOR, TEST LEVEL 3 (TEMPORARY)
-  TEMPORARY CONCRETE BARRIER
-  DRUMS WITH STEADY BURNING LIGHTS AT 50' (C-C)
-  SIGN

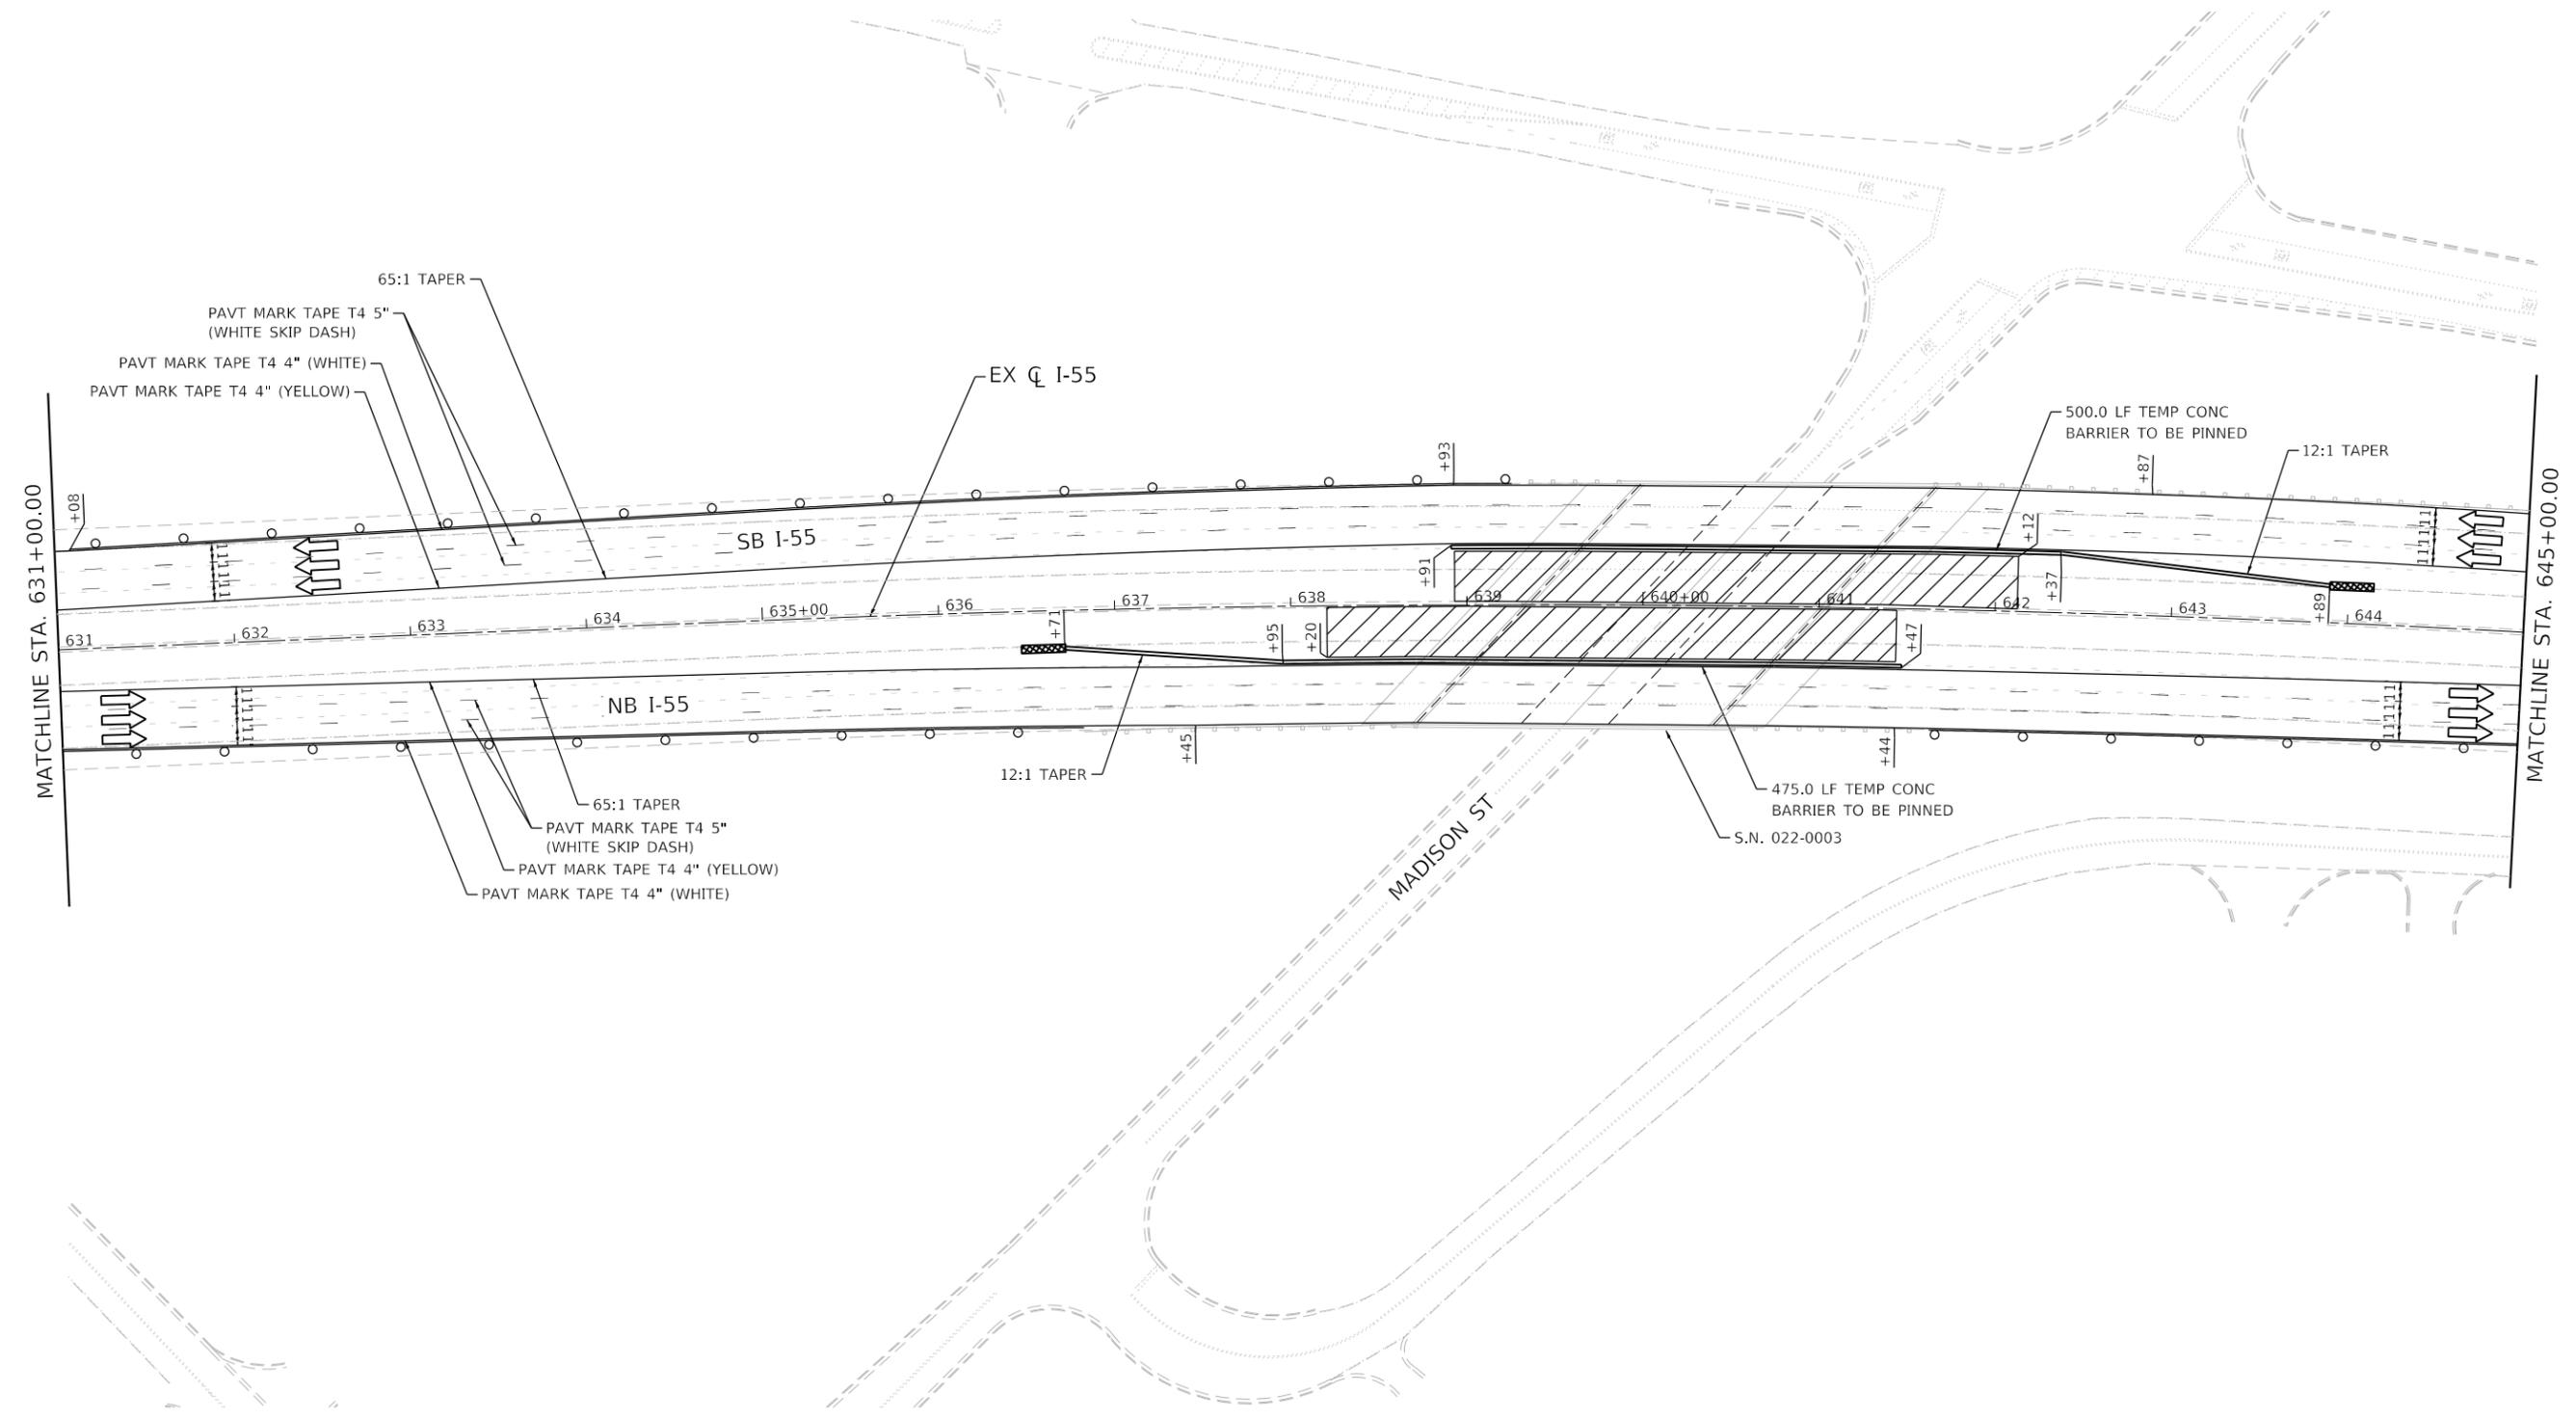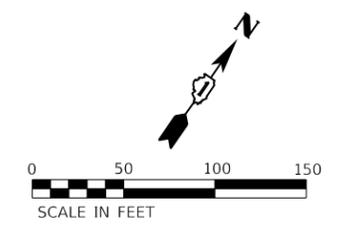

USER NAME = rober	DESIGNED - RC	REVISED -
	DRAWN - RC	REVISED -
PLOT SCALE = 100.0000' / in.	CHECKED - ST	REVISED -
PLOT DATE = 11/2/2020	DATE - 11/2020	REVISED -

**STATE OF ILLINOIS
DEPARTMENT OF TRANSPORTATION**




**F.A.I. ROUTE 55 (I-55) OVER MADISON STREET
STAGING PLAN - STAGE 1**

SCALE: 1"=50' SHEET 4 OF 13 SHEETS STA. 631+00.00 TO STA. 645+00.00

F.A.I. RTE.	SECTION	COUNTY	TOTAL SHEETS	SHEET NO.
55	2020-025-BR	DUPAGE	62	16
CONTRACT NO. 62K96				
ILLINOIS FED. AID PROJECT				

LEGEND

-  WORK ZONE
-  DIRECTION OF TRAFFIC
-  IMPACT ATTENUATOR, TEST LEVEL 3 (TEMPORARY)
-  TEMPORARY CONCRETE BARRIER
-  DRUMS WITH STEADY BURNING LIGHTS AT 50' (C-C)
-  SIGN

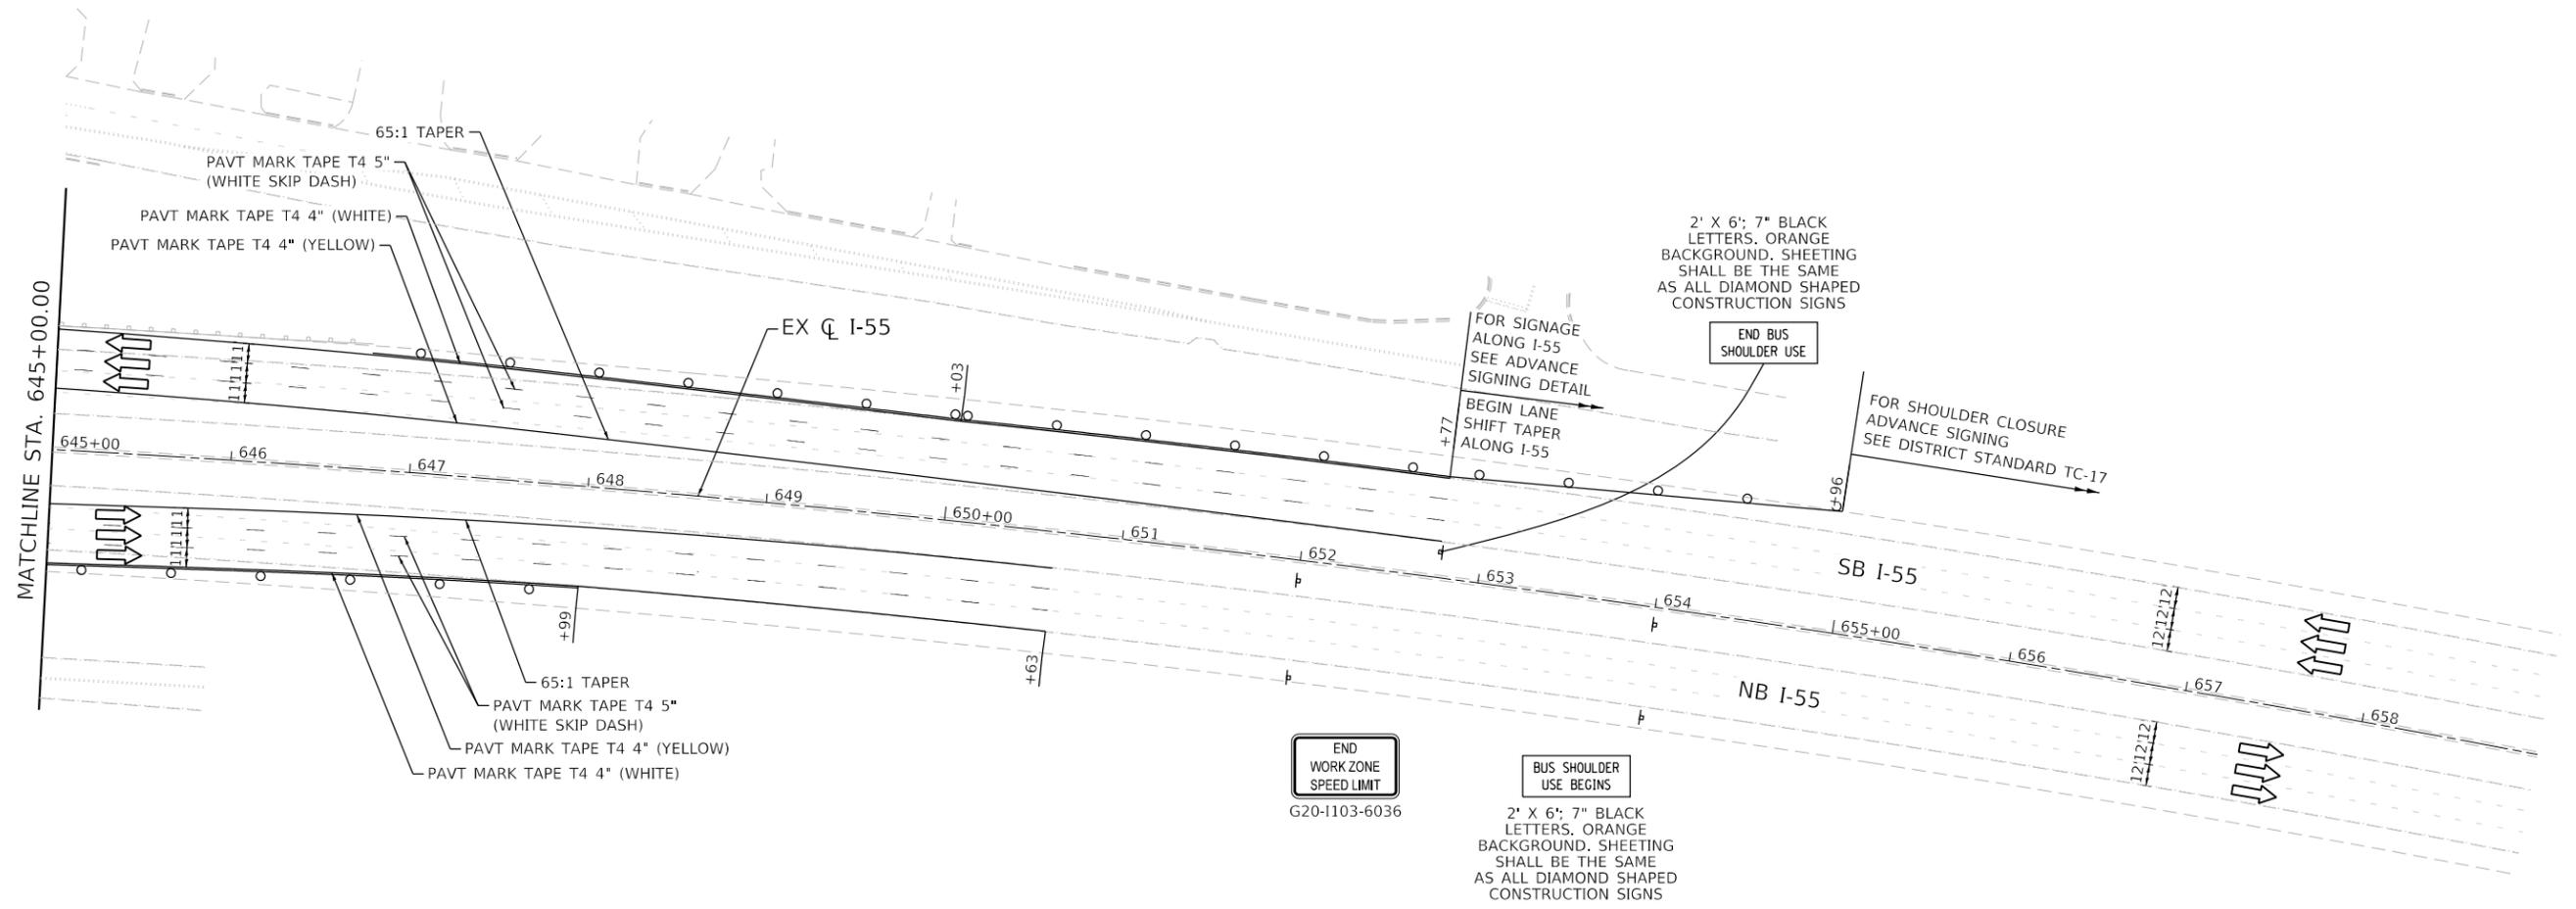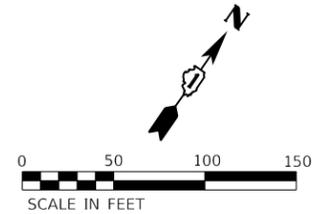
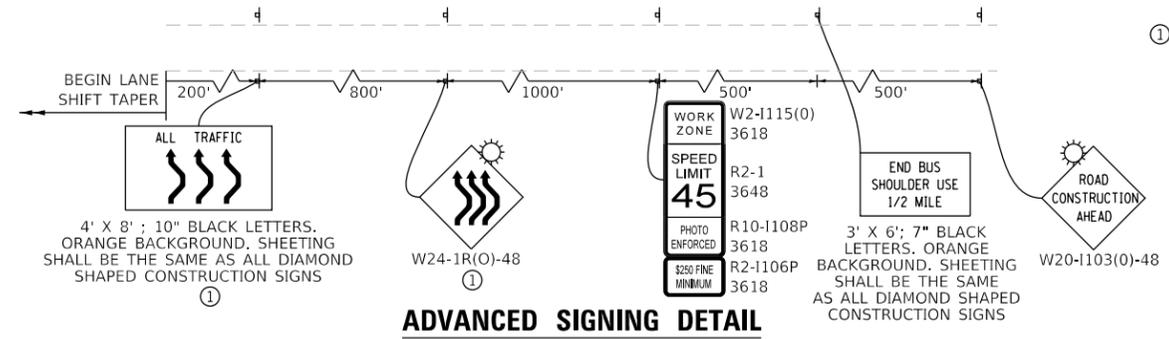


USER NAME = rober	DESIGNED - RC	REVISED -
	DRAWN - RC	REVISED -
PLOT SCALE = 100,000' / in.	CHECKED - ST	REVISED -
PLOT DATE = 11/2/2020	DATE - 11/2020	REVISED -

F.A.I. RTE.	SECTION	COUNTY	TOTAL SHEETS	SHEET NO.
55	2020-025-BR	DUPAGE	62	17
			CONTRACT NO. 62K96	
ILLINOIS FED. AID PROJECT				


LEGEND

-  WORK ZONE
-  DIRECTION OF TRAFFIC
-  IMPACT ATTENUATOR, TEST LEVEL 2 (TEMPORARY)
-  TEMPORARY CONCRETE BARRIER
-  DRUMS WITH STEADY BURNING LIGHTS AT 50' (C-C)
-  SIGN

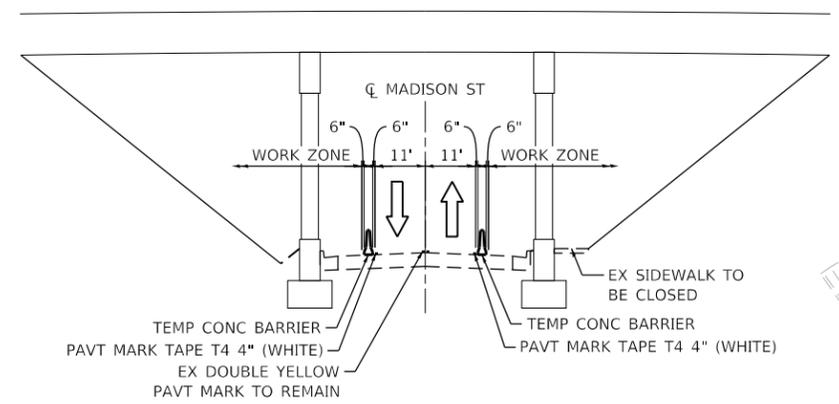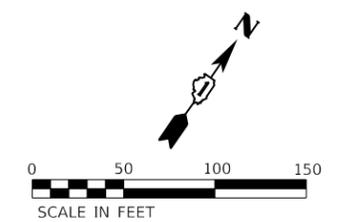


STAGE 1 TYPICAL SECTION - MADISON ST.

MADISON ST UNDER S.N. 022-0003
LOOKING NORTH
SEE STRUCTURAL PLANS FOR DETAILS OF PIER
REPAIR & TEMPORARY SHORING WORK

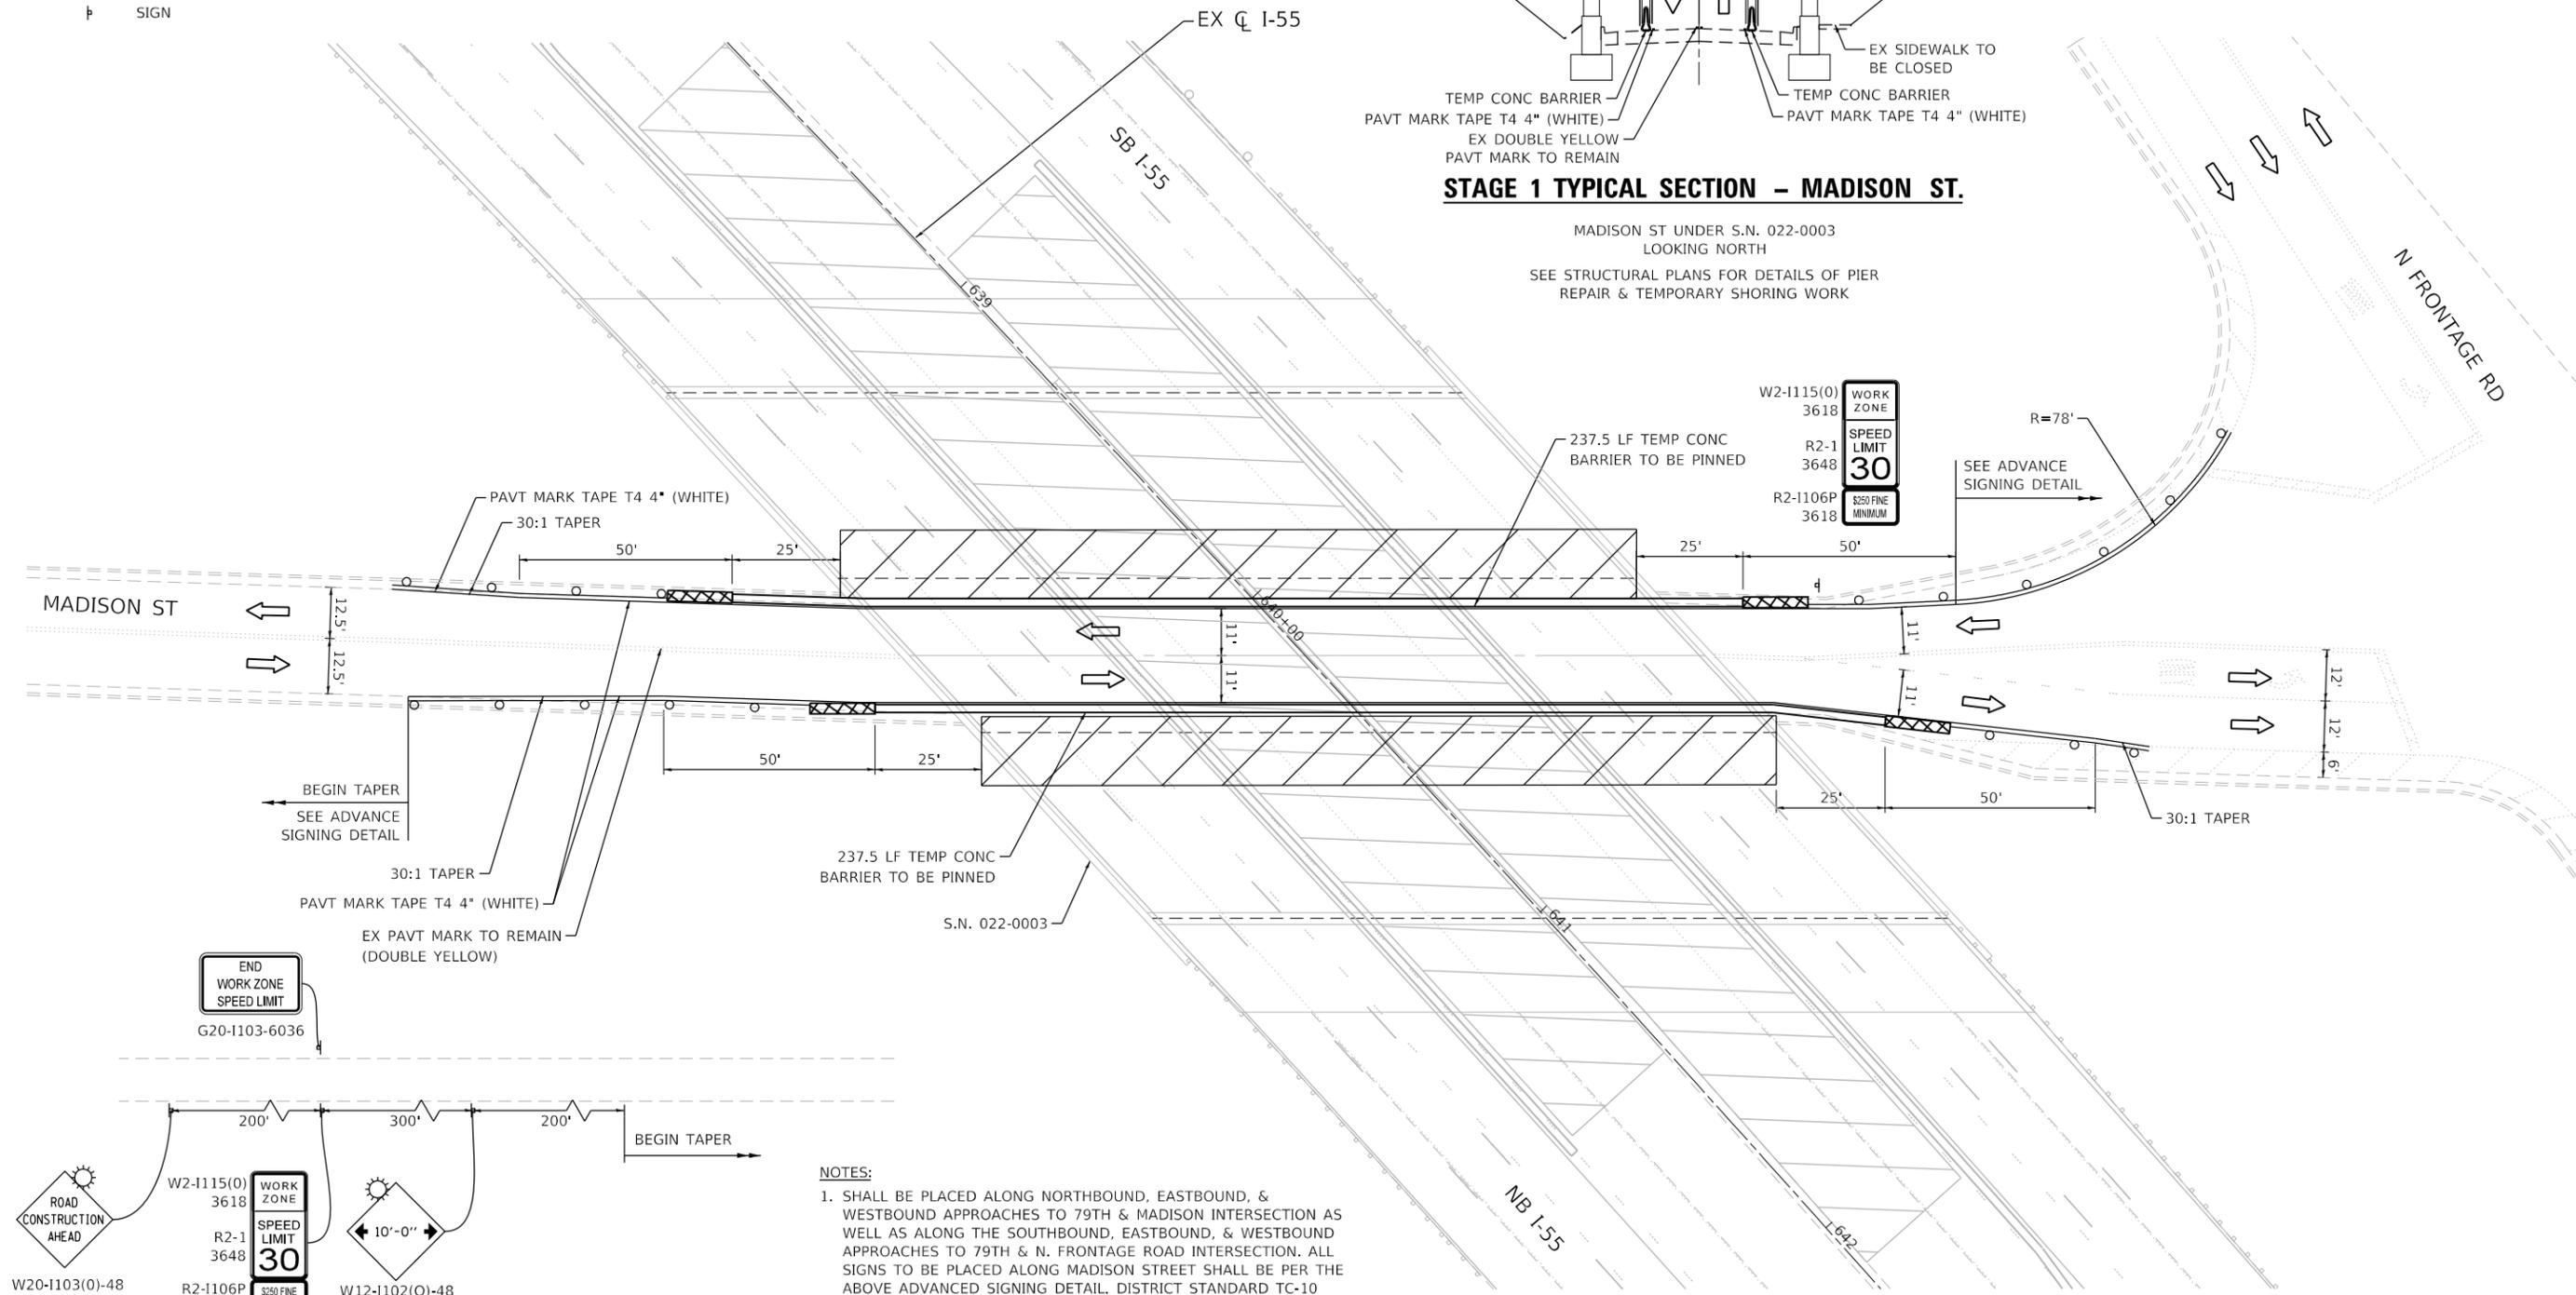

ADVANCED SIGNING DETAIL

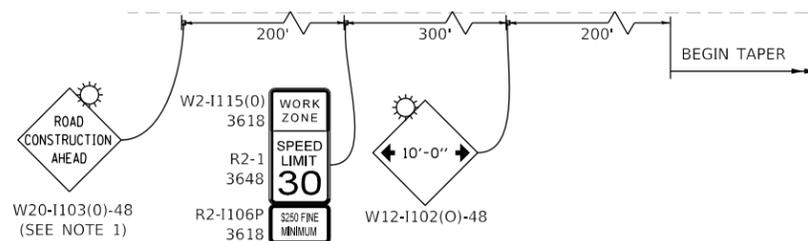


- NOTES:**
1. SHALL BE PLACED ALONG NORTHBOUND, EASTBOUND, & WESTBOUND APPROACHES TO 79TH & MADISON INTERSECTION AS WELL AS ALONG THE SOUTHBOUND, EASTBOUND, & WESTBOUND APPROACHES TO 79TH & N. FRONTAGE ROAD INTERSECTION. ALL SIGNS TO BE PLACED ALONG MADISON STREET SHALL BE PER THE ABOVE ADVANCED SIGNING DETAIL. DISTRICT STANDARD TC-10 SHOULD BE UTILIZE FOR ALL SIGNS TO BE PLACED ALONG THE SIDE ROADS.

USER NAME = 14nho	DESIGNED - RC	REVISED -
DRAWN - RC	REVISED -	
PLOT SCALE = 40.0000' / in.	CHECKED - ST	REVISED -
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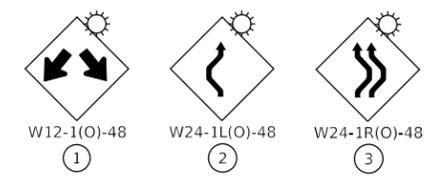
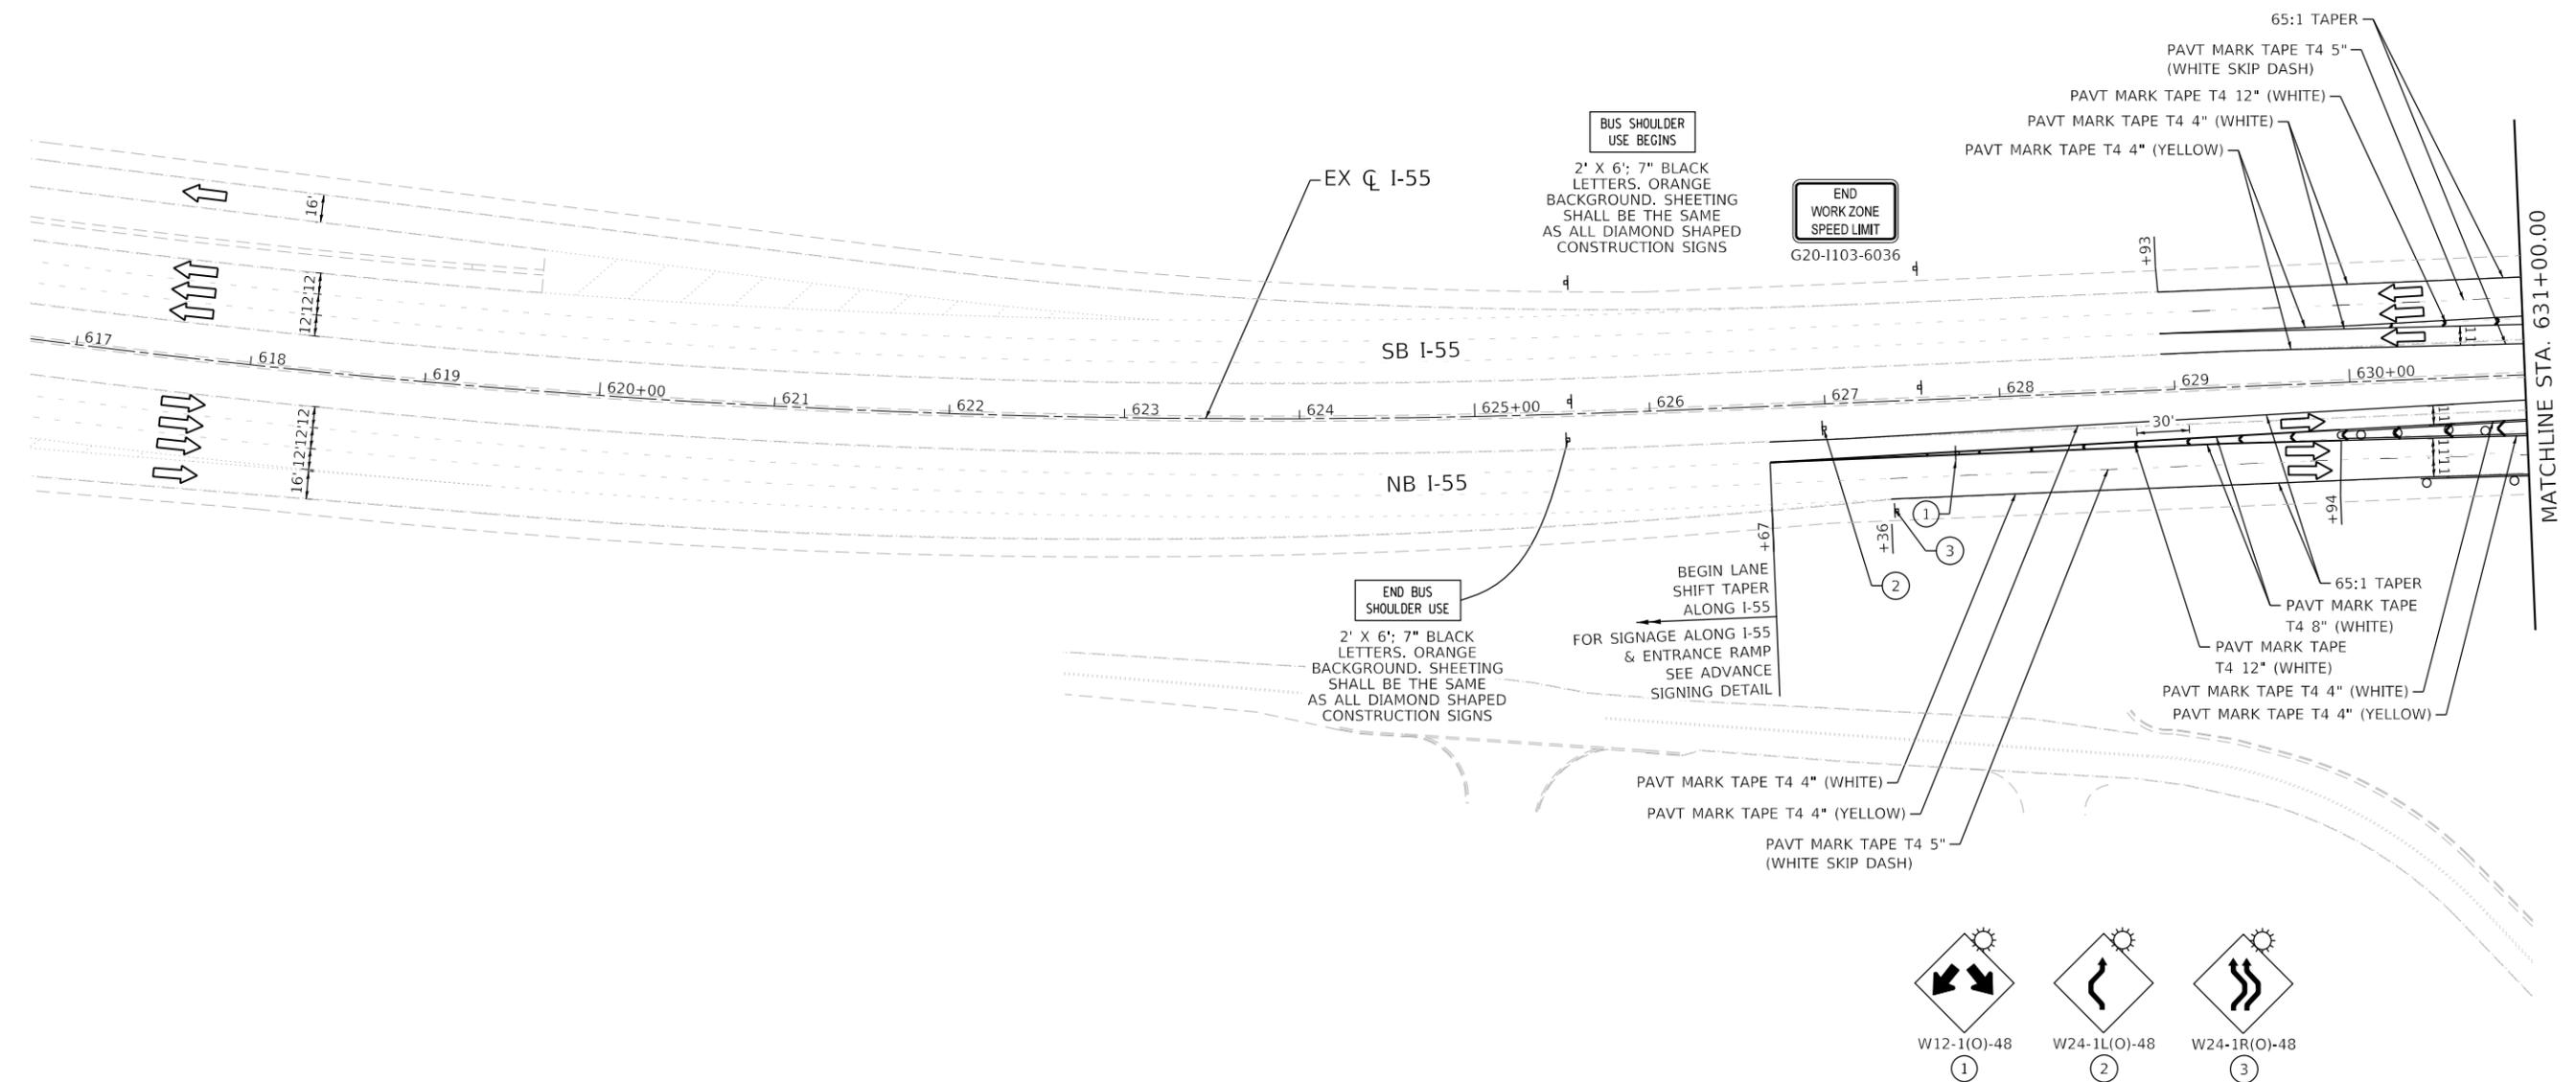
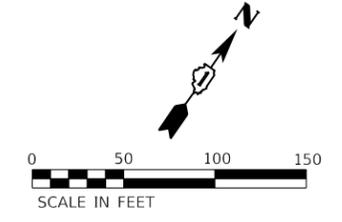
F.A.I. RTE.	SECTION	COUNTY	TOTAL SHEETS	SHEET NO.
55	2020-025-BR	DUPAGE	62	18
			CONTRACT NO. 62K96	
ILLINOIS FED. AID PROJECT				

LEGEND

-  WORK ZONE
-  DIRECTION OF TRAFFIC
-  IMPACT ATTENUATOR, TEST LEVEL 3 (TEMPORARY)
-  TEMPORARY CONCRETE BARRIER
-  DRUMS WITH STEADY BURNING LIGHTS AT 50' (C-C)
-  SIGN
-  ARROW BOARD
-  TYPE I CHECK BARRICADES AT 100' (C-C)

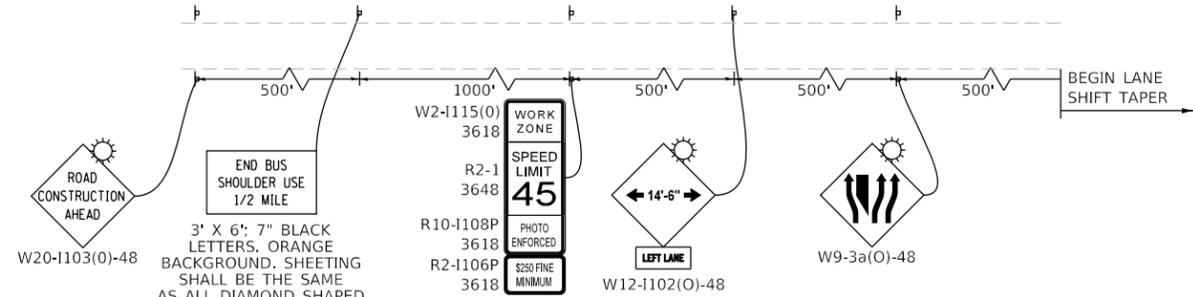

ADVANCED SIGNING DETAIL





USER NAME = rober	DESIGNED - RC	REVISED -
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PLOT SCALE = 100,0000' / in.	CHECKED - ST	REVISED -
PLOT DATE = 11/24/2020	DATE - 11/2020	REVISED -

F.A.I. RTE. 55	SECTION 2020-025-BR	COUNTY	TOTAL SHEETS 62	SHEET NO. 19
			CONTRACT NO. 62K96	
ILLINOIS FED. AID PROJECT				

LEGEND

-  WORK ZONE
-  DIRECTION OF TRAFFIC
-  IMPACT ATTENUATOR, TEST LEVEL 3 (TEMPORARY)
-  TEMPORARY CONCRETE BARRIER
-  DRUMS WITH STEADY BURNING LIGHTS AT 50' (C-C)
-  SIGN
-  ARROW BOARD
-  TYPE I CHECK BARRICADES AT 100' (C-C)

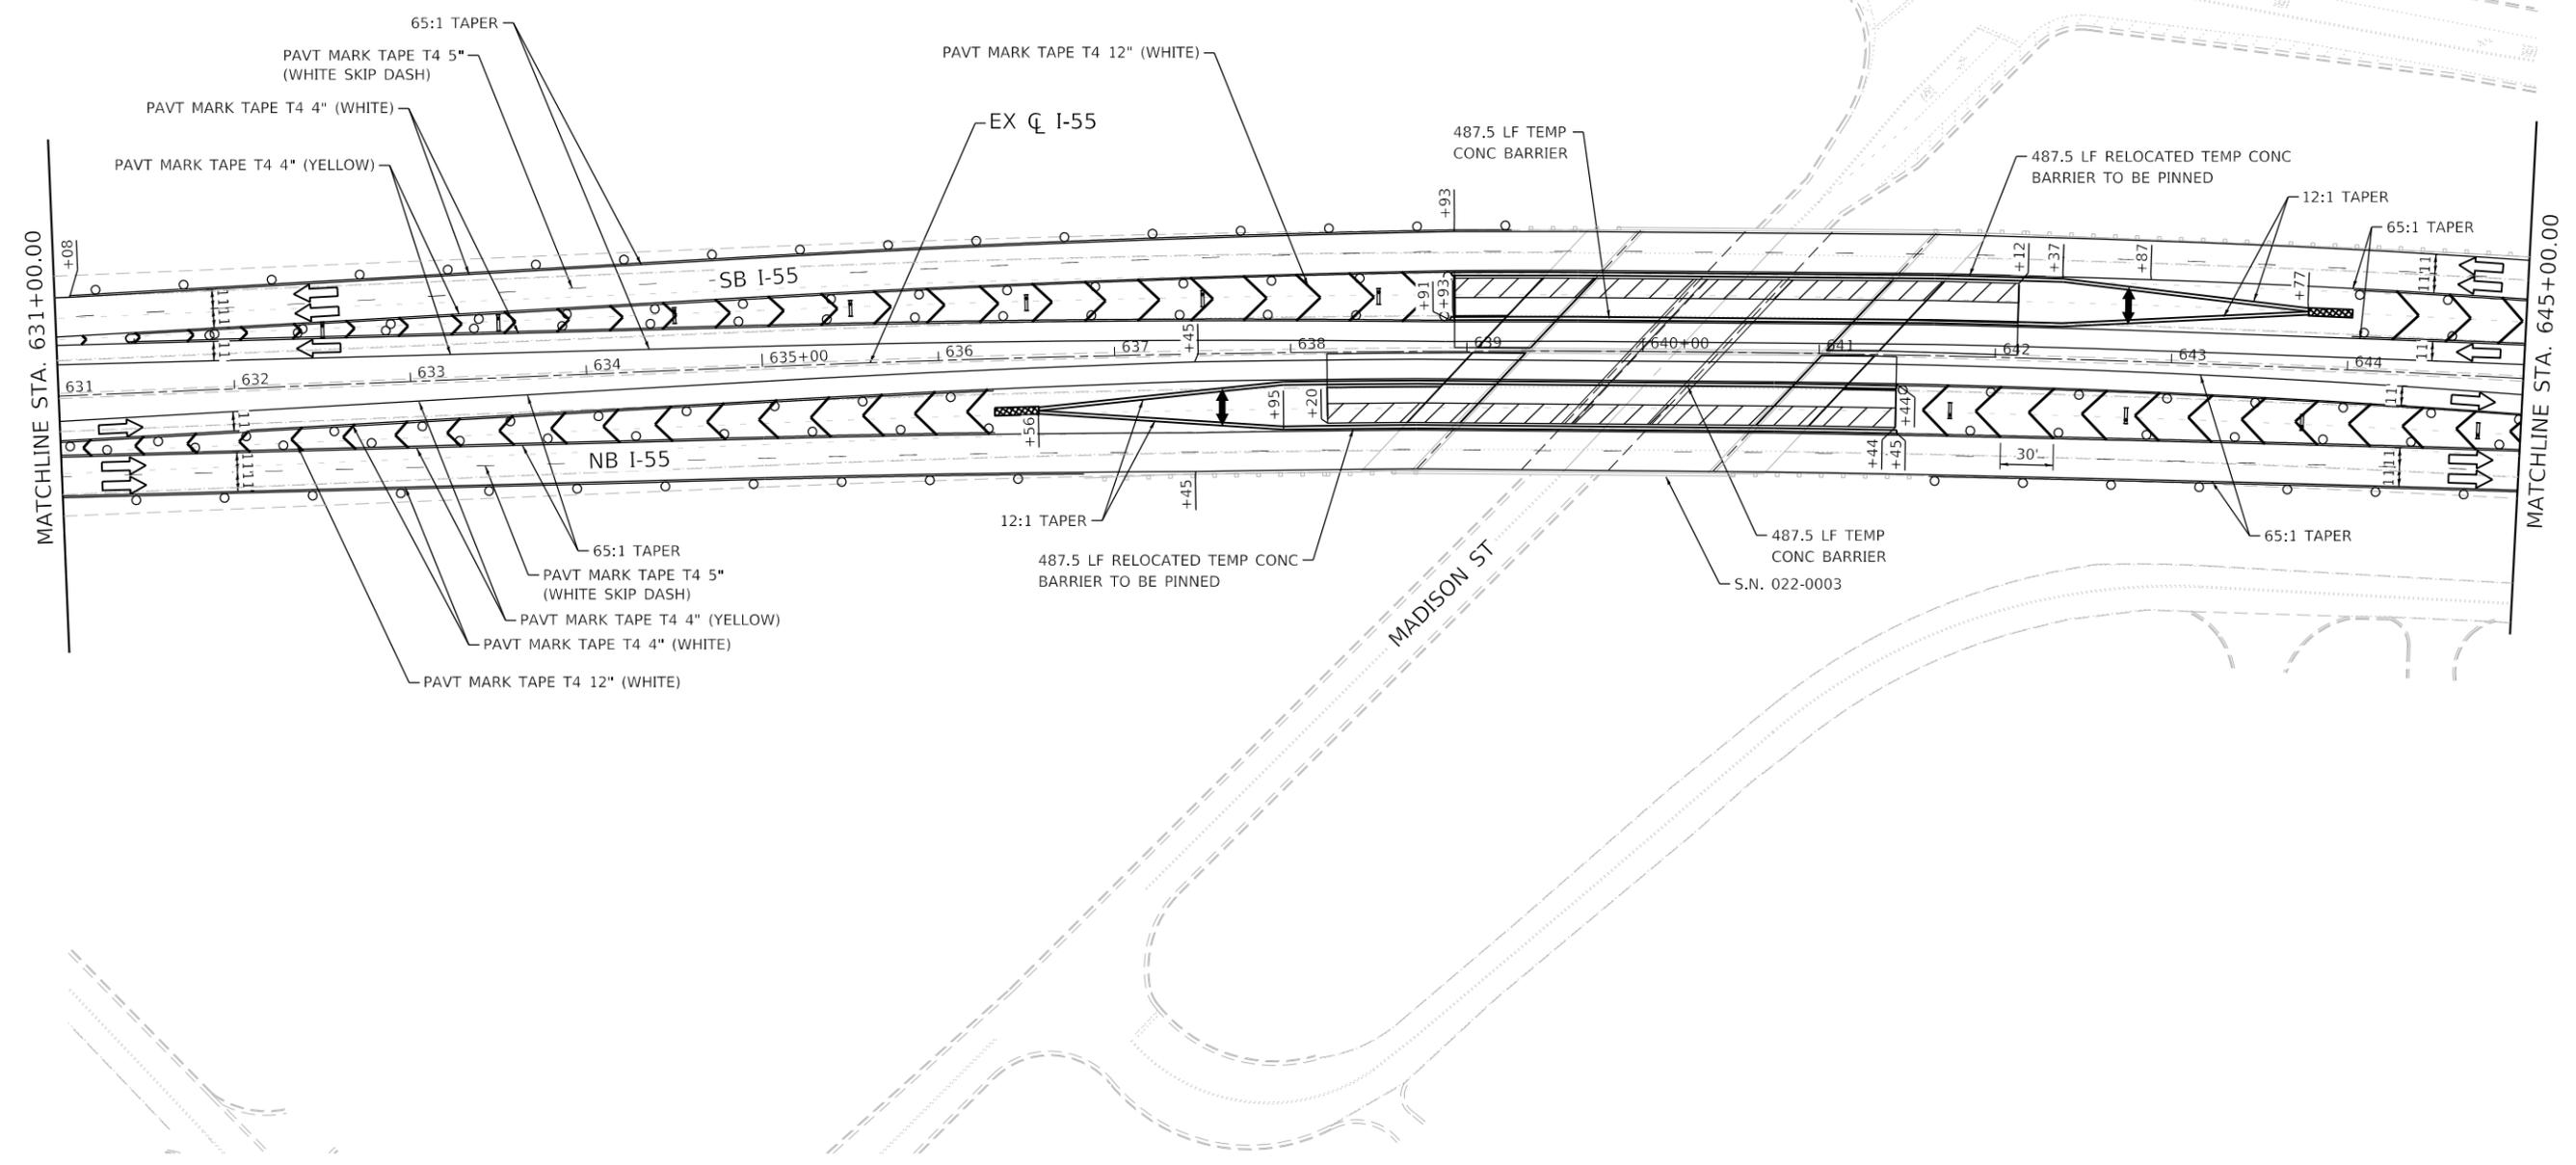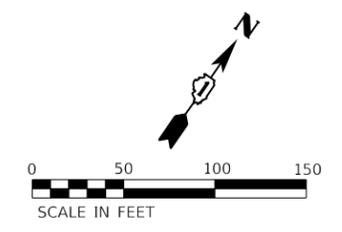

USER NAME = rober	DESIGNED - RC	REVISED -
	DRAWN - RC	REVISED -
PLOT SCALE = 100,0000' / in.	CHECKED - ST	REVISED -
PLOT DATE = 11/24/2020	DATE - 11/2020	REVISED -

**STATE OF ILLINOIS
DEPARTMENT OF TRANSPORTATION**



**F.A.I. ROUTE 55 (I-55) OVER MADISON STREET
STAGING PLAN - STAGE 2**

SCALE: 1"=50' SHEET 8 OF 13 SHEETS STA. 631+00.00 TO STA. 645+00.00



F.A.I. RTE.	SECTION	COUNTY	TOTAL SHEETS	SHEET NO.
55	2020-025-BR	DUPAGE	62	20
CONTRACT NO. 62K96				
ILLINOIS FED. AID PROJECT				

LEGEND

-  WORK ZONE
-  DIRECTION OF TRAFFIC
-  IMPACT ATTENUATOR, TEST LEVEL 3 (TEMPORARY)
-  TEMPORARY CONCRETE BARRIER
-  DRUMS WITH STEADY BURNING LIGHTS AT 50' (C-C)
-  SIGN
-  ARROW BOARD
-  TYPE I CHECK BARRICADES AT 100' (C-C)

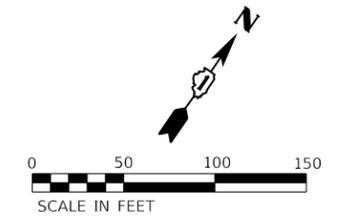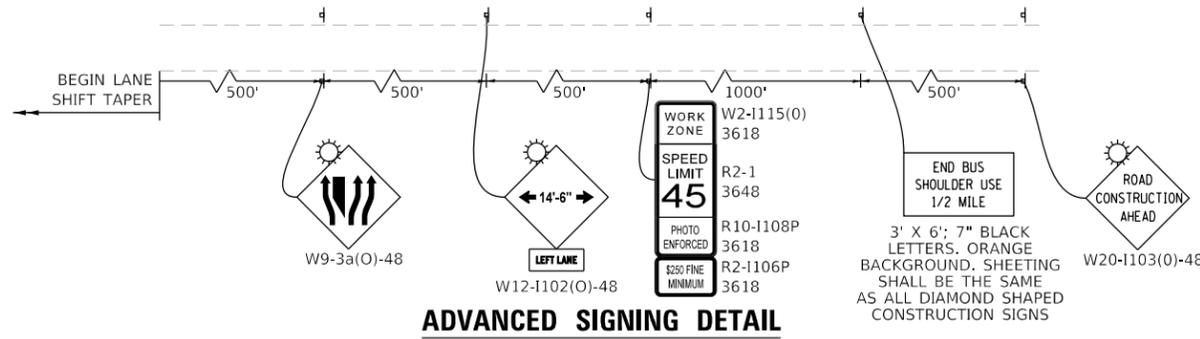

ADVANCED SIGNING DETAIL

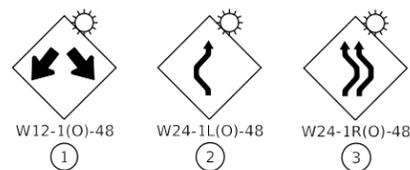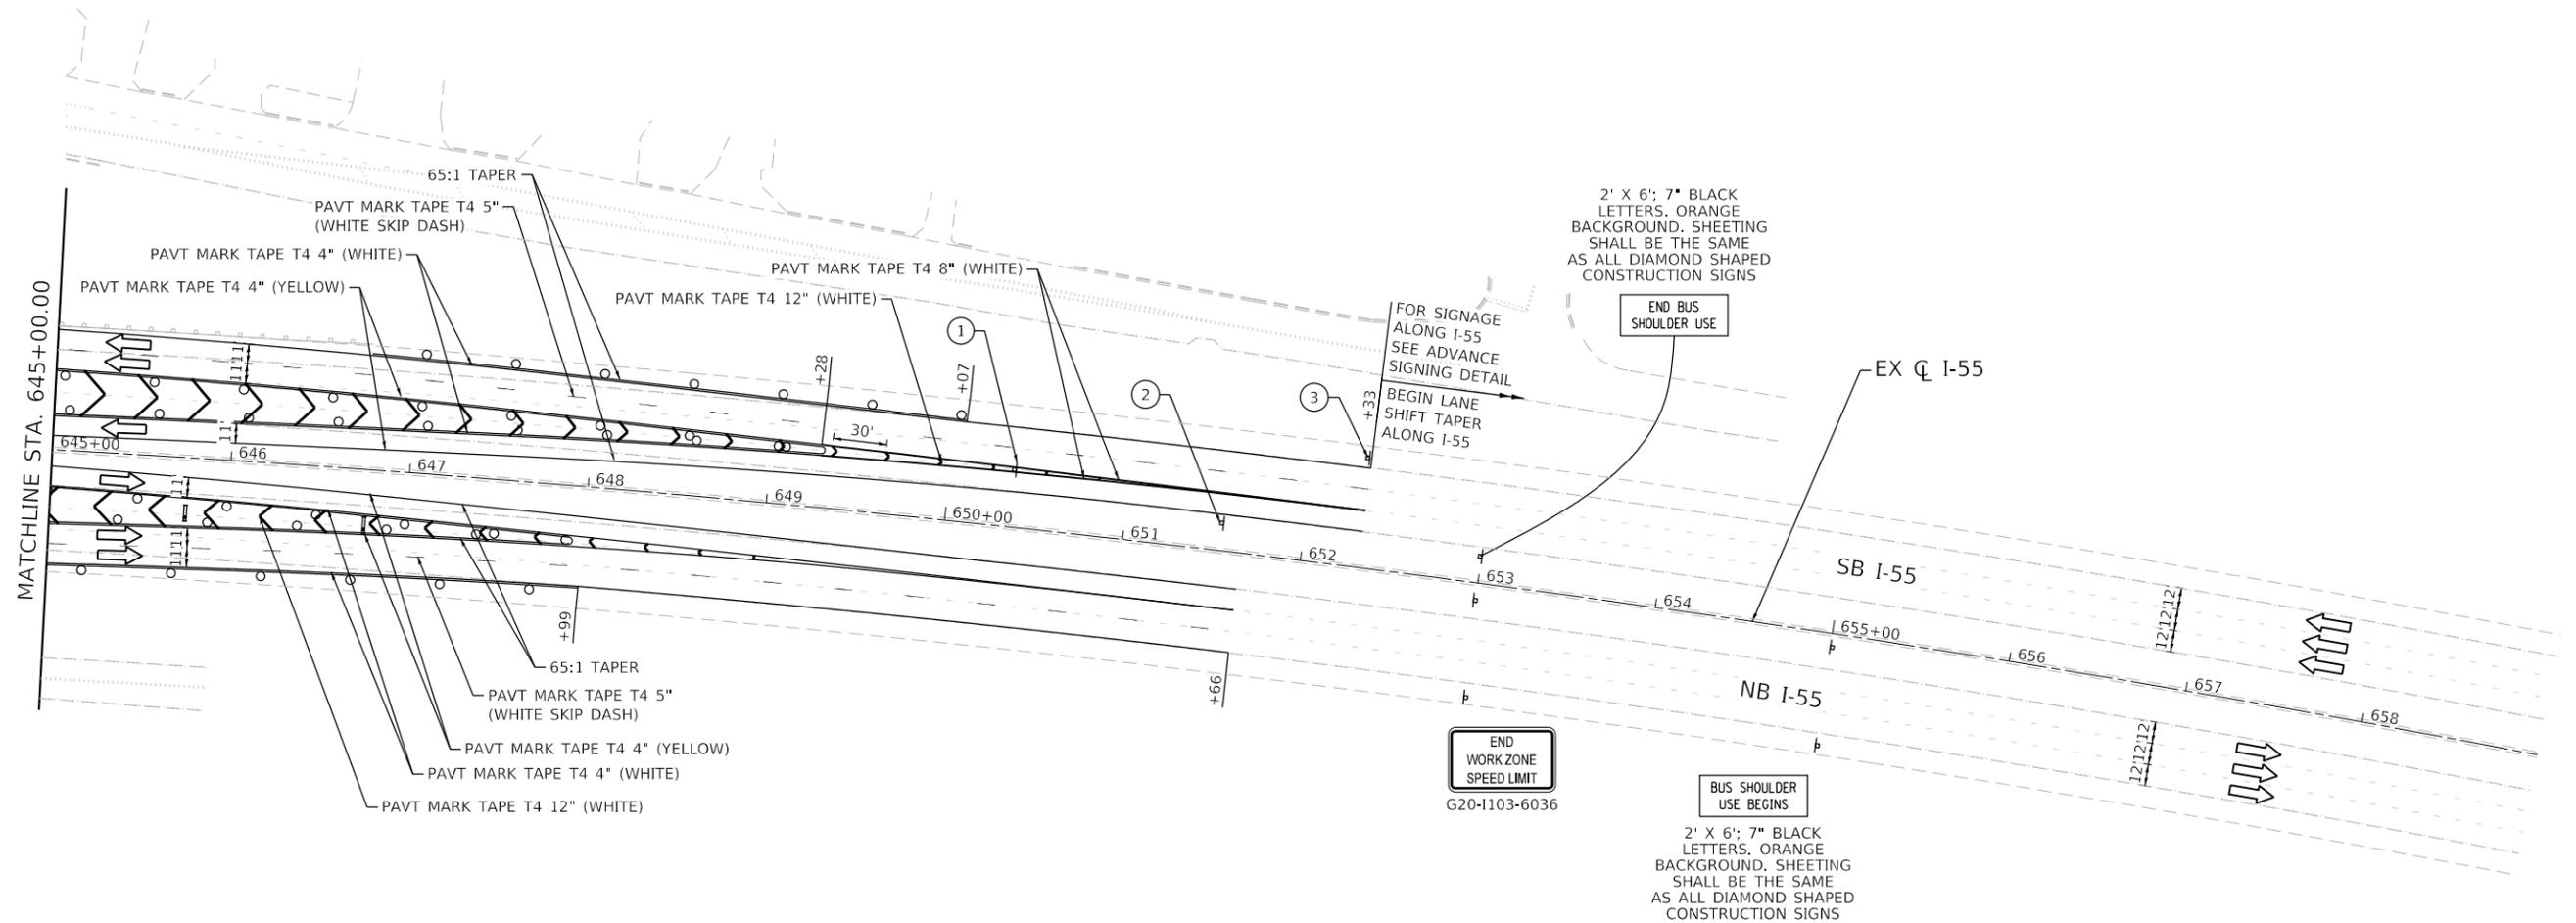


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PLOT DATE = 11/24/2020	CHECKED - ST	REVISED -
	DATE - 11/2020	REVISED -


F.A.I. RTE.	SECTION	COUNTY	TOTAL SHEETS	SHEET NO.
55	2020-025-BR	DUPAGE	62	21
CONTRACT NO. 62K96				
ILLINOIS FED. AID PROJECT				

LEGEND


-  WORK ZONE
-  DIRECTION OF TRAFFIC
-  IMPACT ATTENUATOR, TEST LEVEL 3 (TEMPORARY)
-  TEMPORARY CONCRETE BARRIER
-  DRUMS WITH STEADY BURNING LIGHTS AT 50' (C-C)
-  SIGN

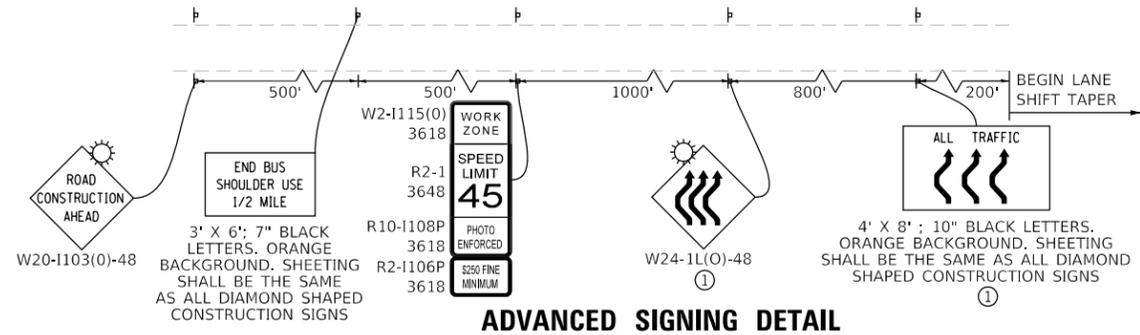

① THE NUMBER OF ARROWS ON THESE SIGNS SHALL MATCH THE NUMBER OF LANES OPEN TO TRAFFIC ALONG I-55 AND ENTRANCE RAMP.

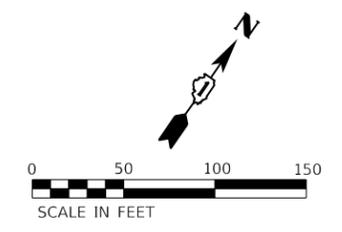

ADVANCED SIGNING DETAIL


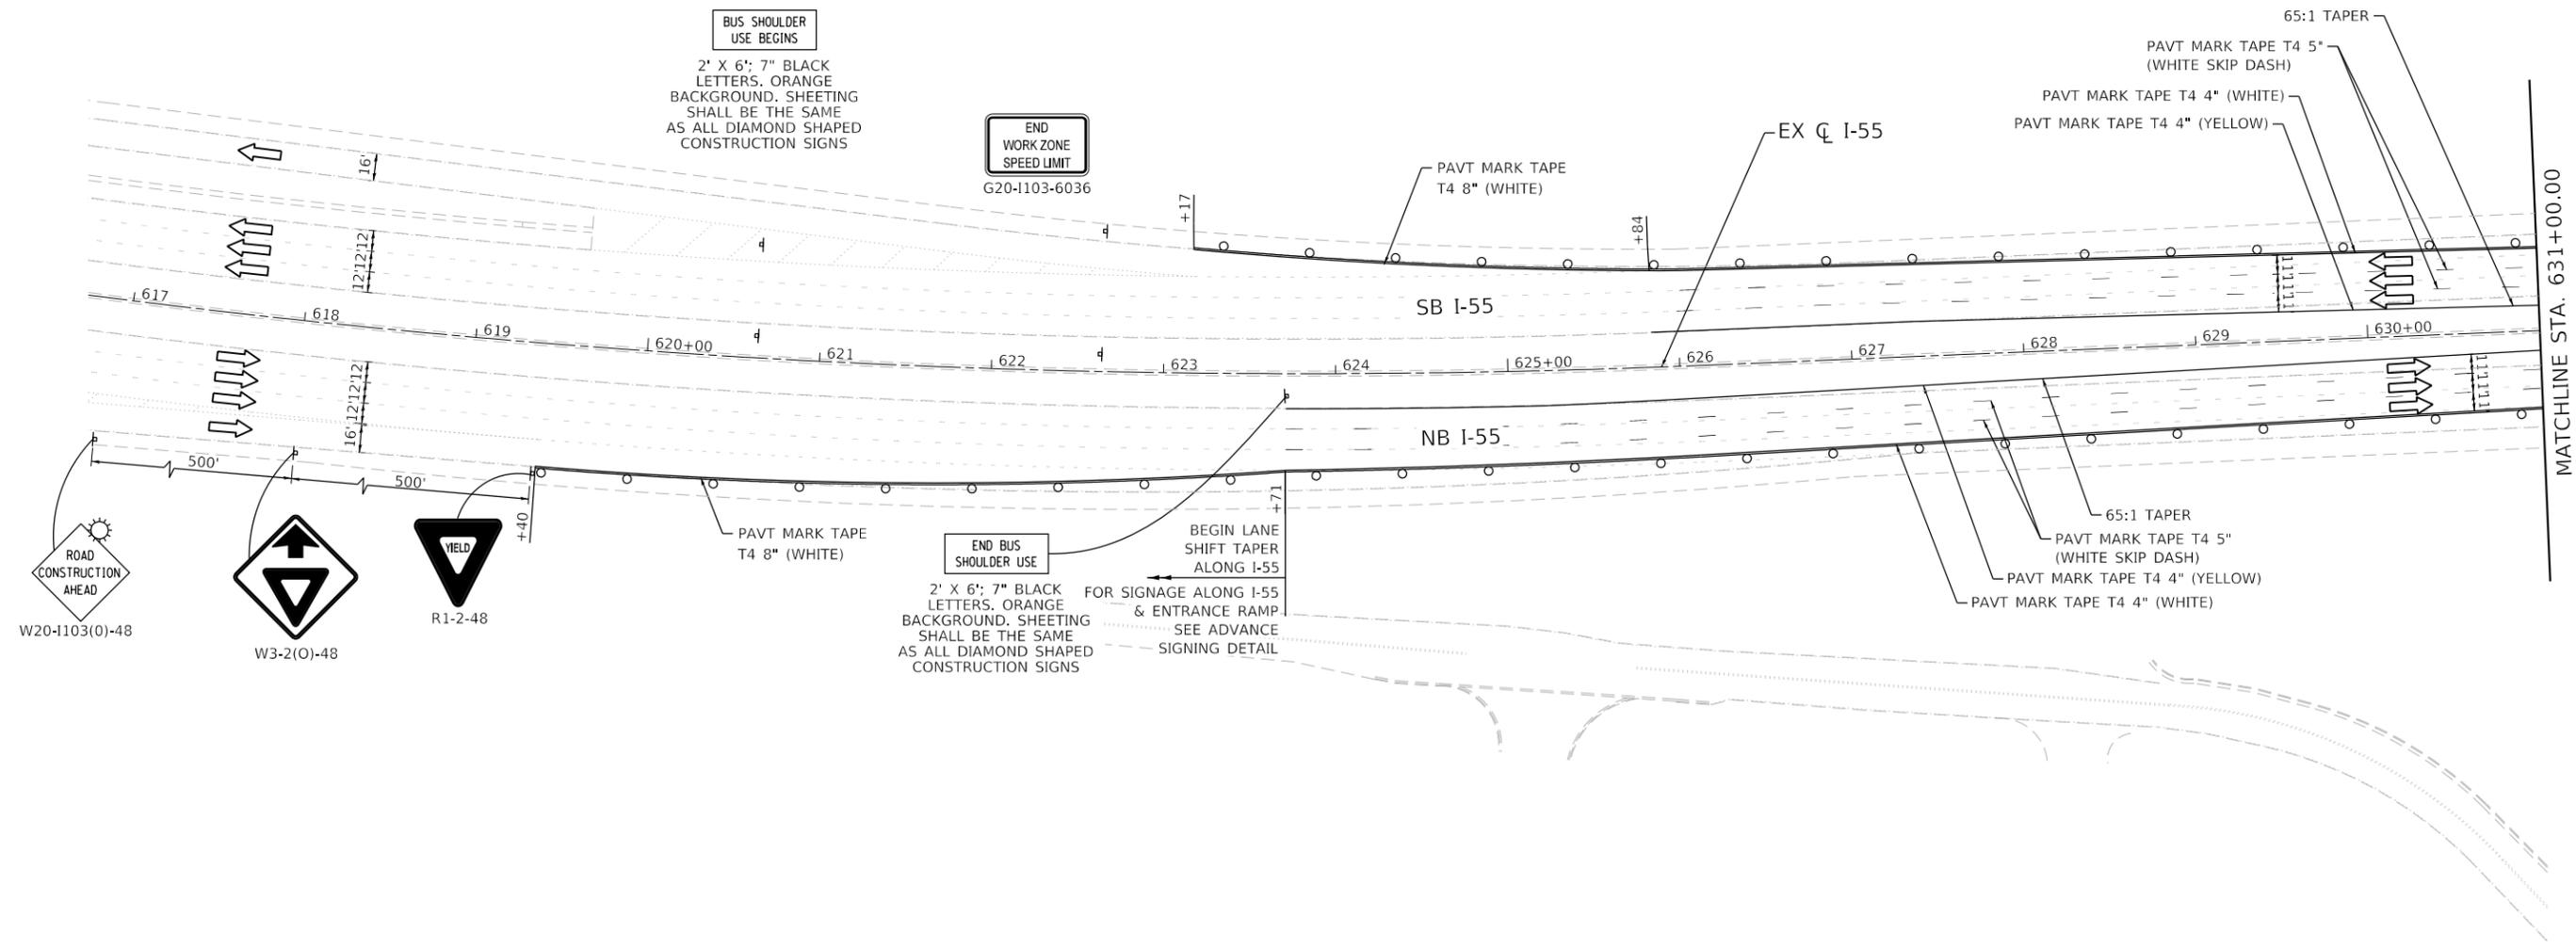


USER NAME = rober	DESIGNED - RC	REVISED -
	DRAWN - RC	REVISED -
PLOT SCALE = 100,0000' / in.	CHECKED - ST	REVISED -
PLOT DATE = 11/2/2020	DATE - 11/2020	REVISED -

F.A.I. RTE. 55	SECTION 2020-025-BR	COUNTY DUPAGE	TOTAL SHEETS 62	SHEET NO. 22
			CONTRACT NO. 62K96	
ILLINOIS FED. AID PROJECT				

LEGEND

-  WORK ZONE
-  DIRECTION OF TRAFFIC
-  IMPACT ATTENUATOR, TEST LEVEL 3 (TEMPORARY)
-  TEMPORARY CONCRETE BARRIER
-  DRUMS WITH STEADY BURNING LIGHTS AT 50' (C-C)
-  SIGN

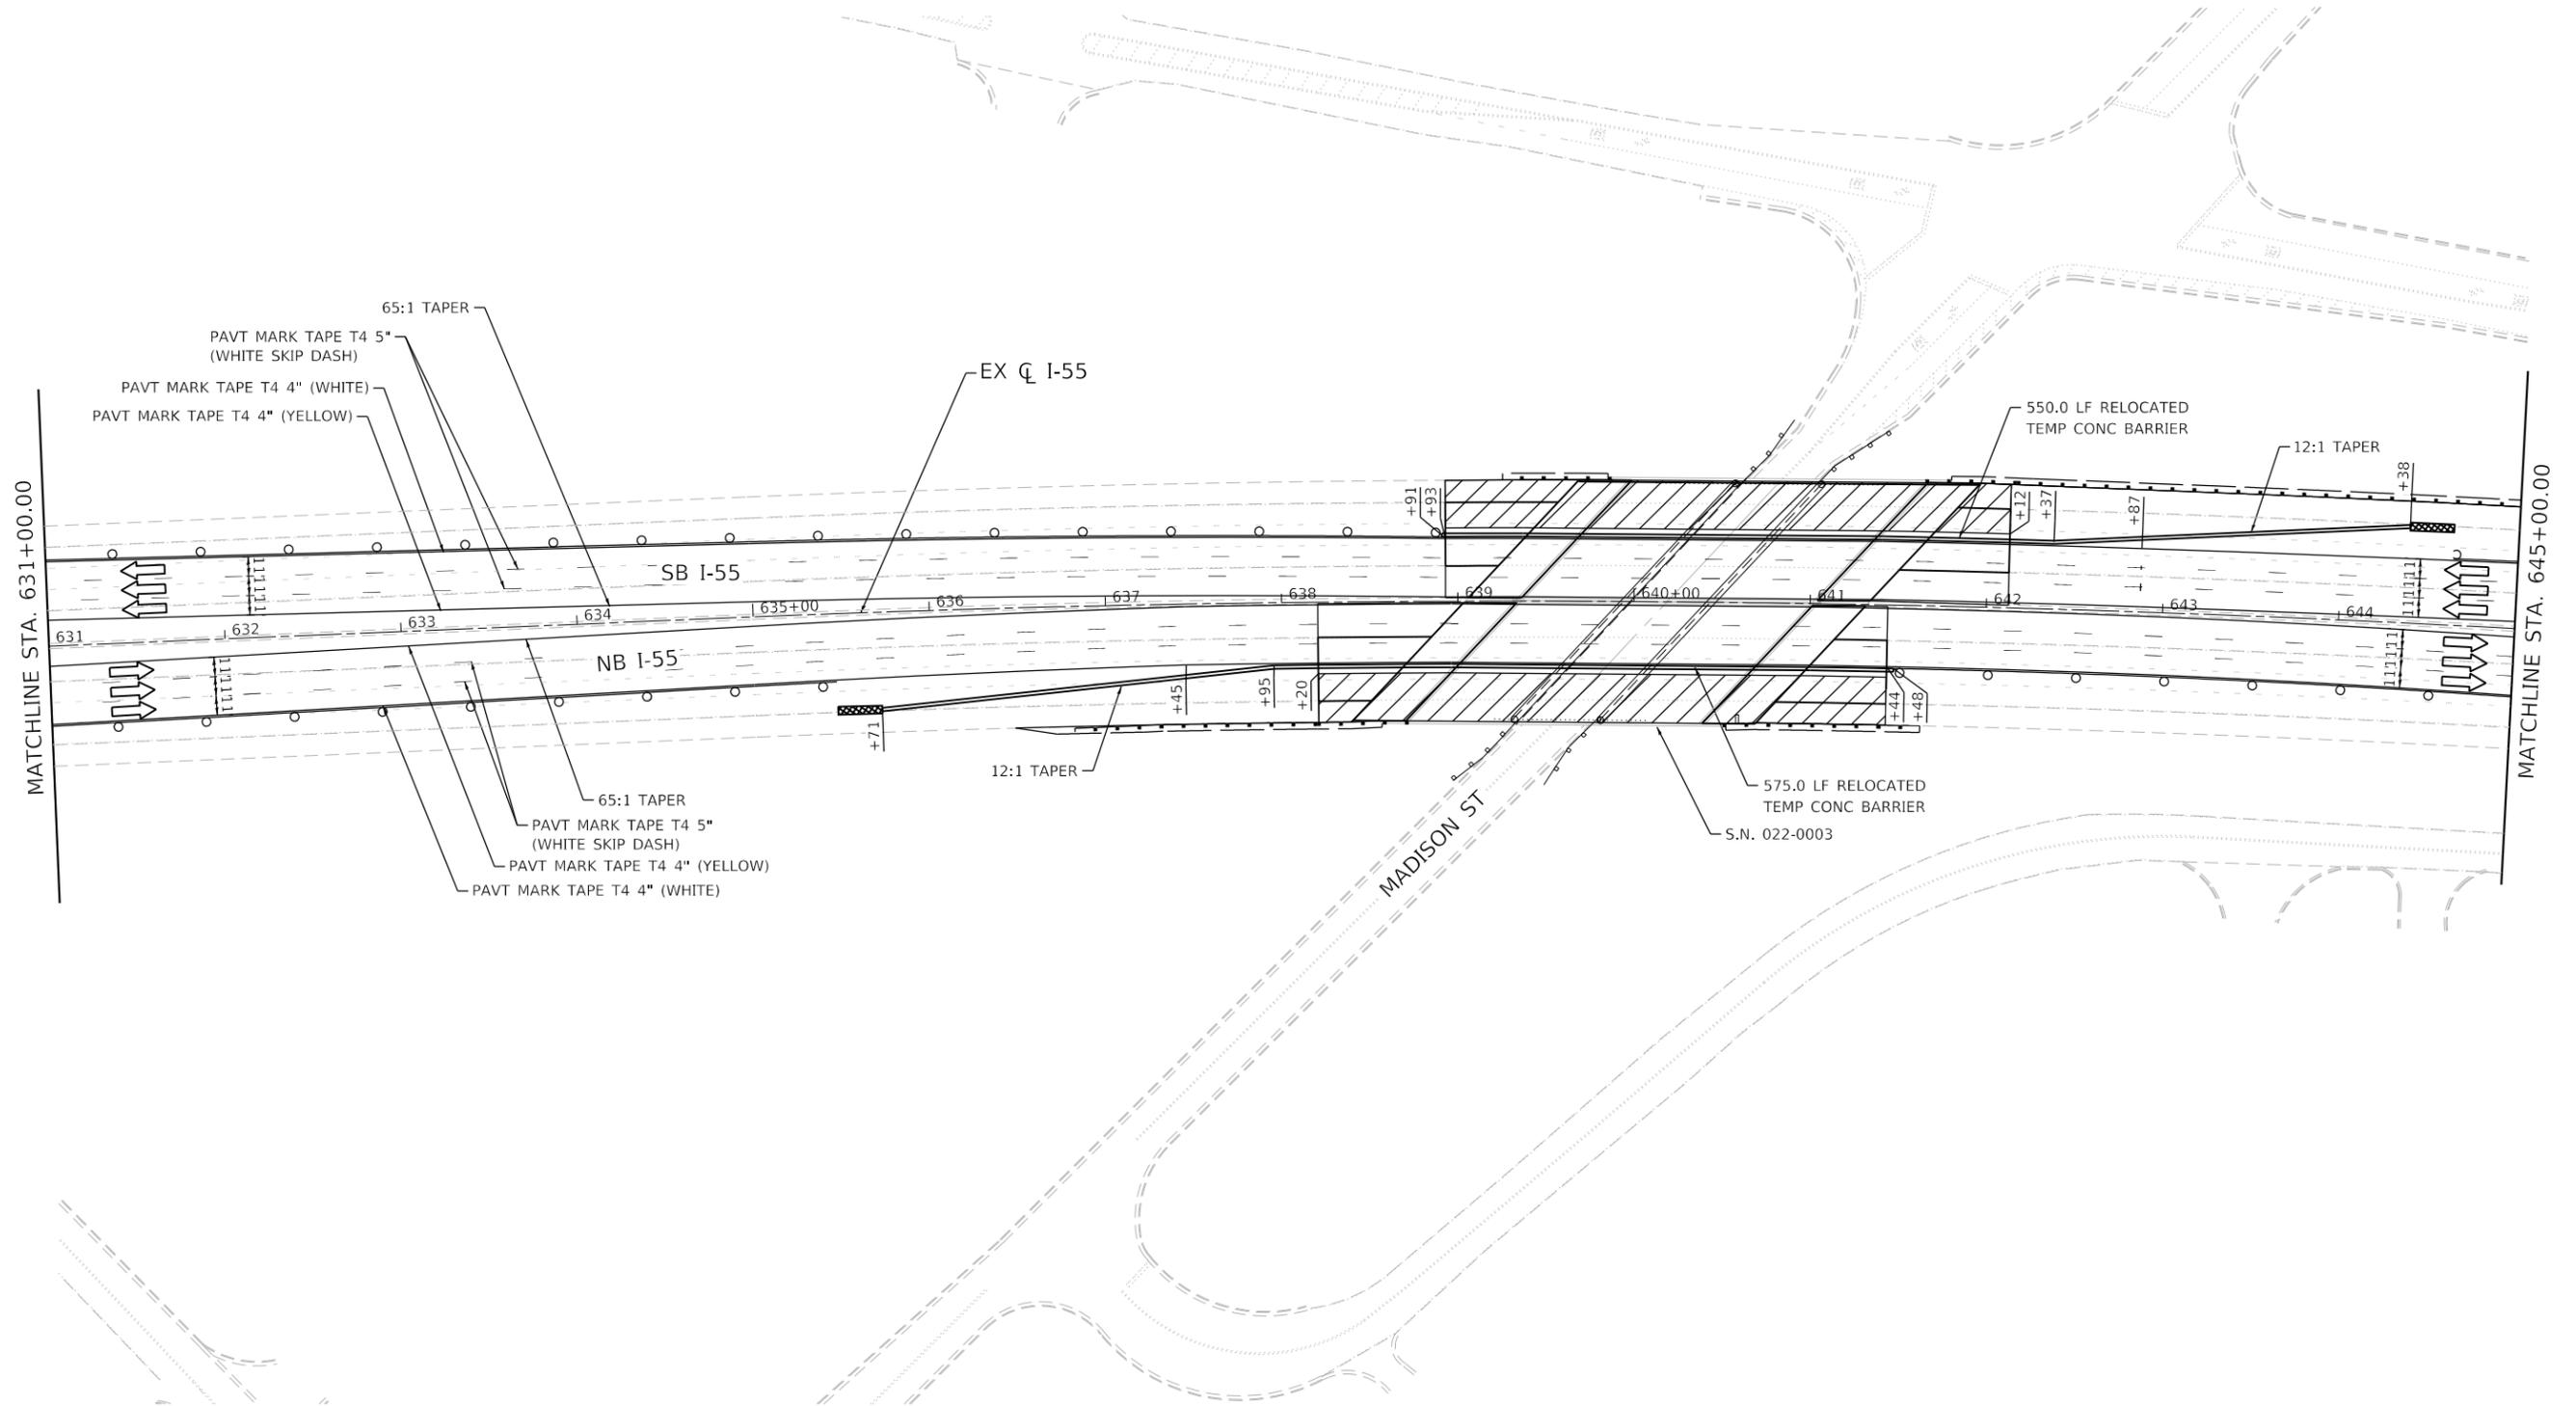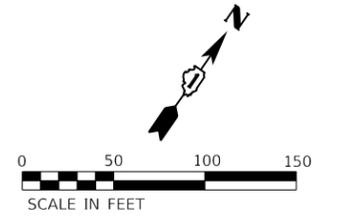

USER NAME = rober	DESIGNED - RC	REVISED -
	DRAWN - RC	REVISED -
PLOT SCALE = 100,0000' / in.	CHECKED - ST	REVISED -
PLOT DATE = 11/2/2020	DATE - 11/2020	REVISED -

**STATE OF ILLINOIS
DEPARTMENT OF TRANSPORTATION**


**F.A.I. ROUTE 55 (I-55) OVER MADISON STREET
STAGING PLAN - STAGE 3**

SCALE: 1"=50' SHEET 11 OF 13 SHEETS STA. 631+00.00 TO STA. 645+00.00



F.A.I. RTE.	SECTION	COUNTY	TOTAL SHEETS	SHEET NO.
55	2020-025-BR	DUPAGE	62	23
CONTRACT NO. 62K96				
ILLINOIS FED. AID PROJECT				

LEGEND

-  WORK ZONE
-  DIRECTION OF TRAFFIC
-  IMPACT ATTENUATOR, TEST LEVEL 3 (TEMPORARY)
-  TEMPORARY CONCRETE BARRIER
-  DRUMS WITH STEADY BURNING LIGHTS AT 50' (C-C)
-  SIGN

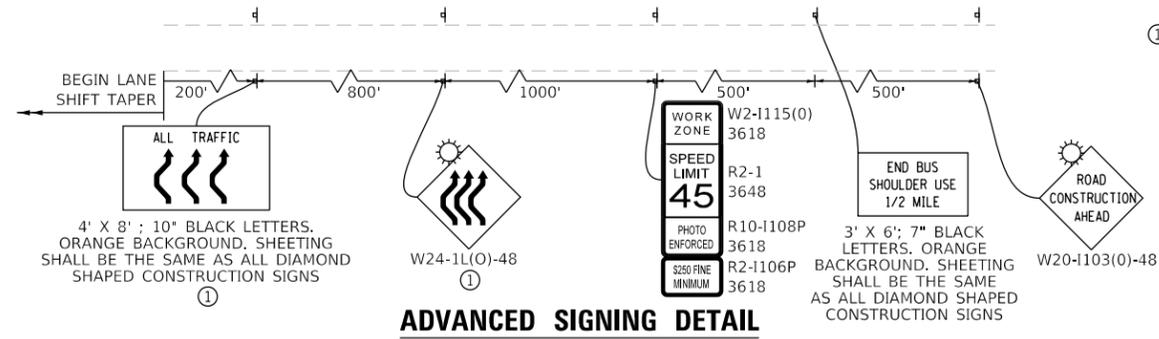

① THE NUMBER OF ARROWS ON THESE SIGNS SHALL MATCH THE NUMBER OF LANES OPEN TO TRAFFIC ALONG I-55 AND ENTRANCE RAMP.


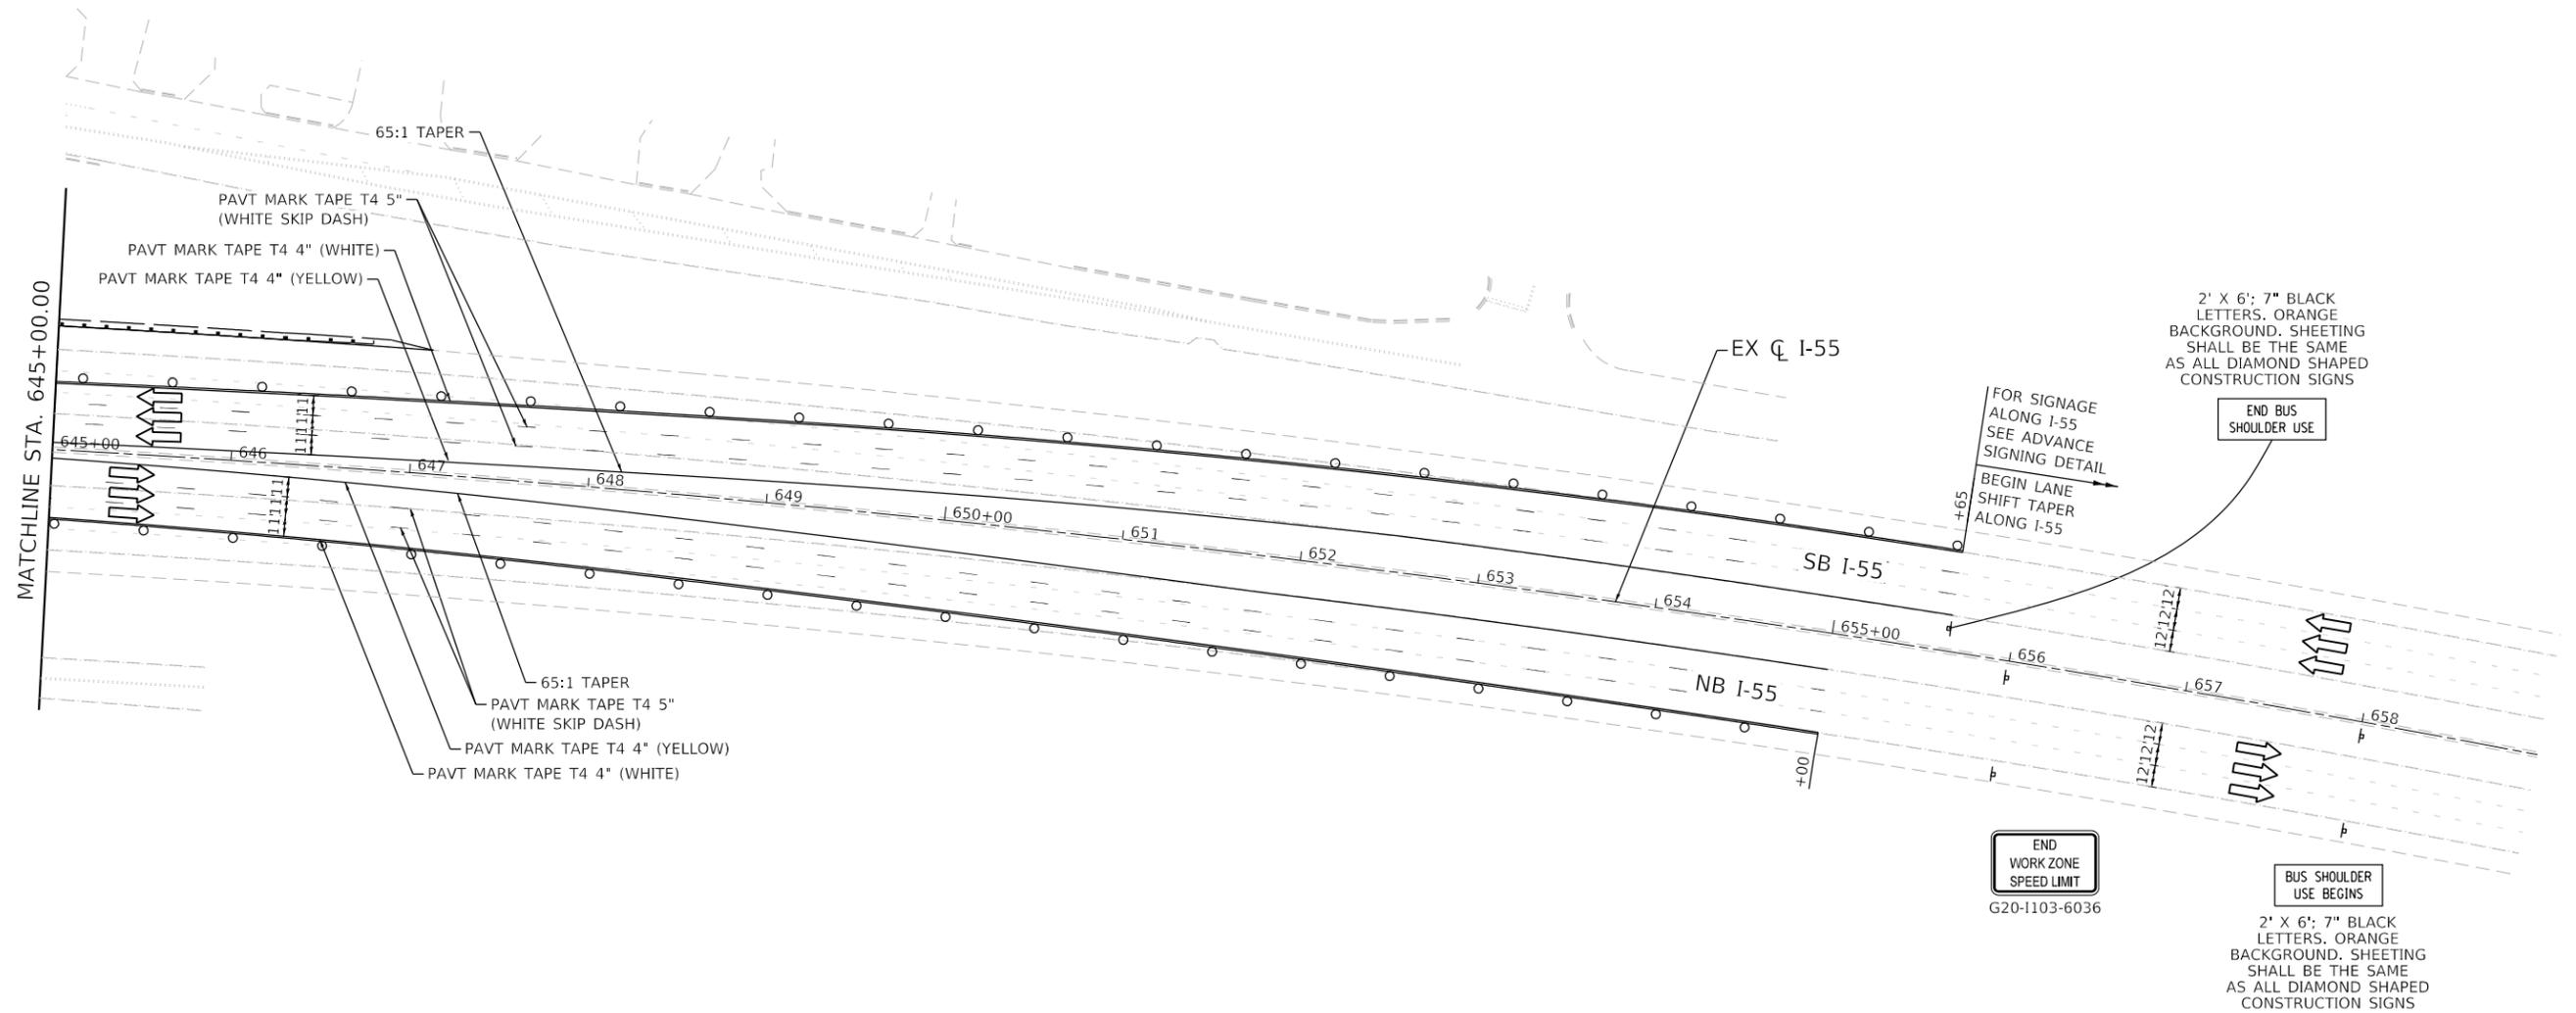
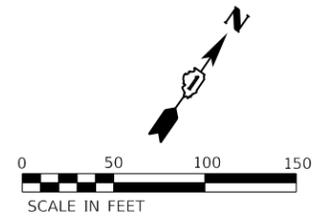


USER NAME = rober	DESIGNED - RC	REVISED -
	DRAWN - RC	REVISED -
PLOT SCALE = 100,0000' / in.	CHECKED - ST	REVISED -
PLOT DATE = 11/2/2020	DATE - 11/2020	REVISED -

F.A.I. RTE.	SECTION	COUNTY	TOTAL SHEETS	SHEET NO.
55	2020-025-BR	DUPAGE	62	24
			CONTRACT NO. 62K96	
ILLINOIS FED. AID PROJECT				

LEGEND

-  WORK ZONE
-  DIRECTION OF TRAFFIC
-  IMPACT ATTENUATOR, TEST LEVEL 2 (TEMPORARY)
-  TEMPORARY CONCRETE BARRIER
-  DRUMS WITH STEADY BURNING LIGHTS AT 50' (C-C)
-  SIGN

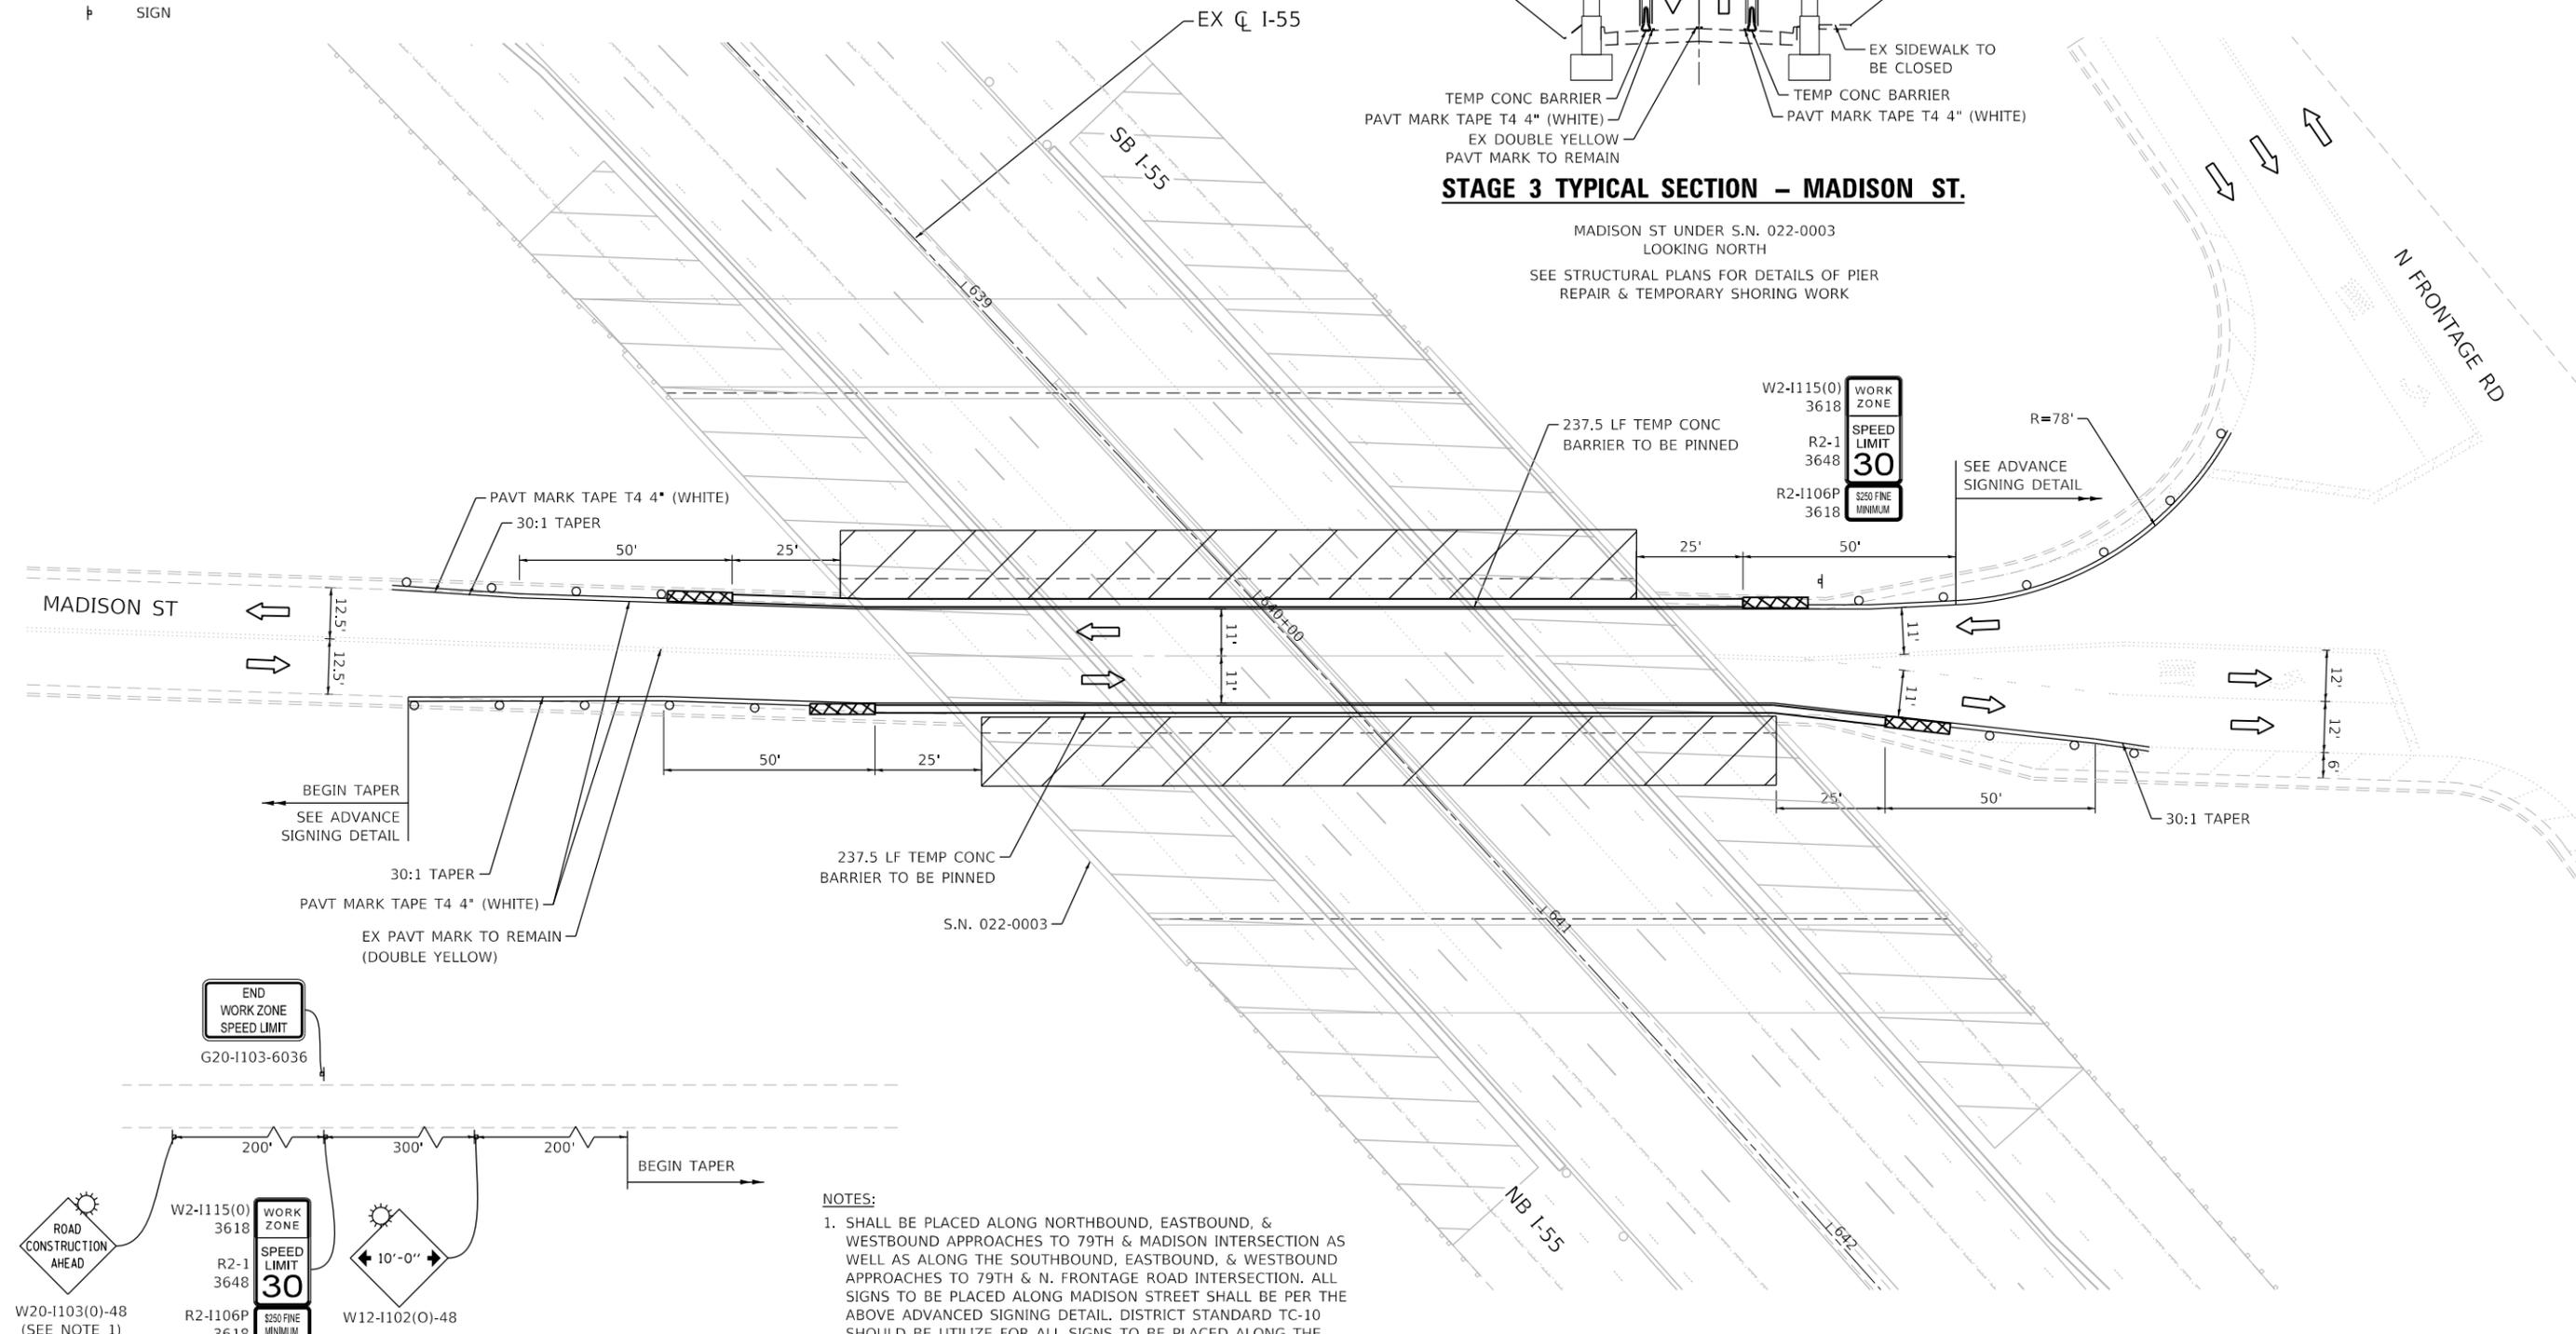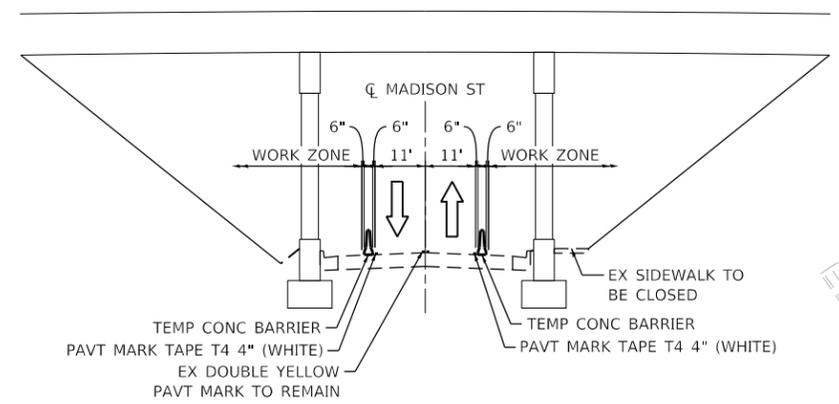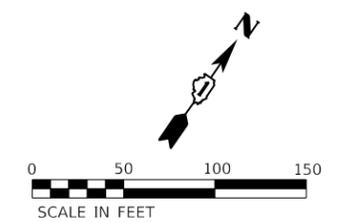

NOTES:

1. SHALL BE PLACED ALONG NORTHBOUND, EASTBOUND, & WESTBOUND APPROACHES TO 79TH & MADISON INTERSECTION AS WELL AS ALONG THE SOUTHBOUND, EASTBOUND, & WESTBOUND APPROACHES TO 79TH & N. FRONTAGE ROAD INTERSECTION. ALL SIGNS TO BE PLACED ALONG MADISON STREET SHALL BE PER THE ABOVE ADVANCED SIGNING DETAIL. DISTRICT STANDARD TC-10 SHOULD BE UTILIZE FOR ALL SIGNS TO BE PLACED ALONG THE SIDE ROADS.

ADVANCED SIGNING DETAIL





USER NAME = 14nho	DESIGNED - RC	REVISED -
PLOT SCALE = 40.0000' / in.	DRAWN - RC	REVISED -
PLOT DATE = 11/20/2020	CHECKED - ST	REVISED -
	DATE - 11/2020	REVISED -

**STATE OF ILLINOIS
DEPARTMENT OF TRANSPORTATION**

**F.A.I. ROUTE 55 (I-55) OVER MADISON STREET
STAGING PLAN - STAGE 3**

SCALE: 1"=50' SHEET 13 OF 13 SHEETS STA. TO STA.

F.A.I. RTE.	SECTION	COUNTY	TOTAL SHEETS	SHEET NO.
55	2020-025-BR	DUPAGE	62	25
			CONTRACT NO. 62K96	
ILLINOIS FED. AID PROJECT				

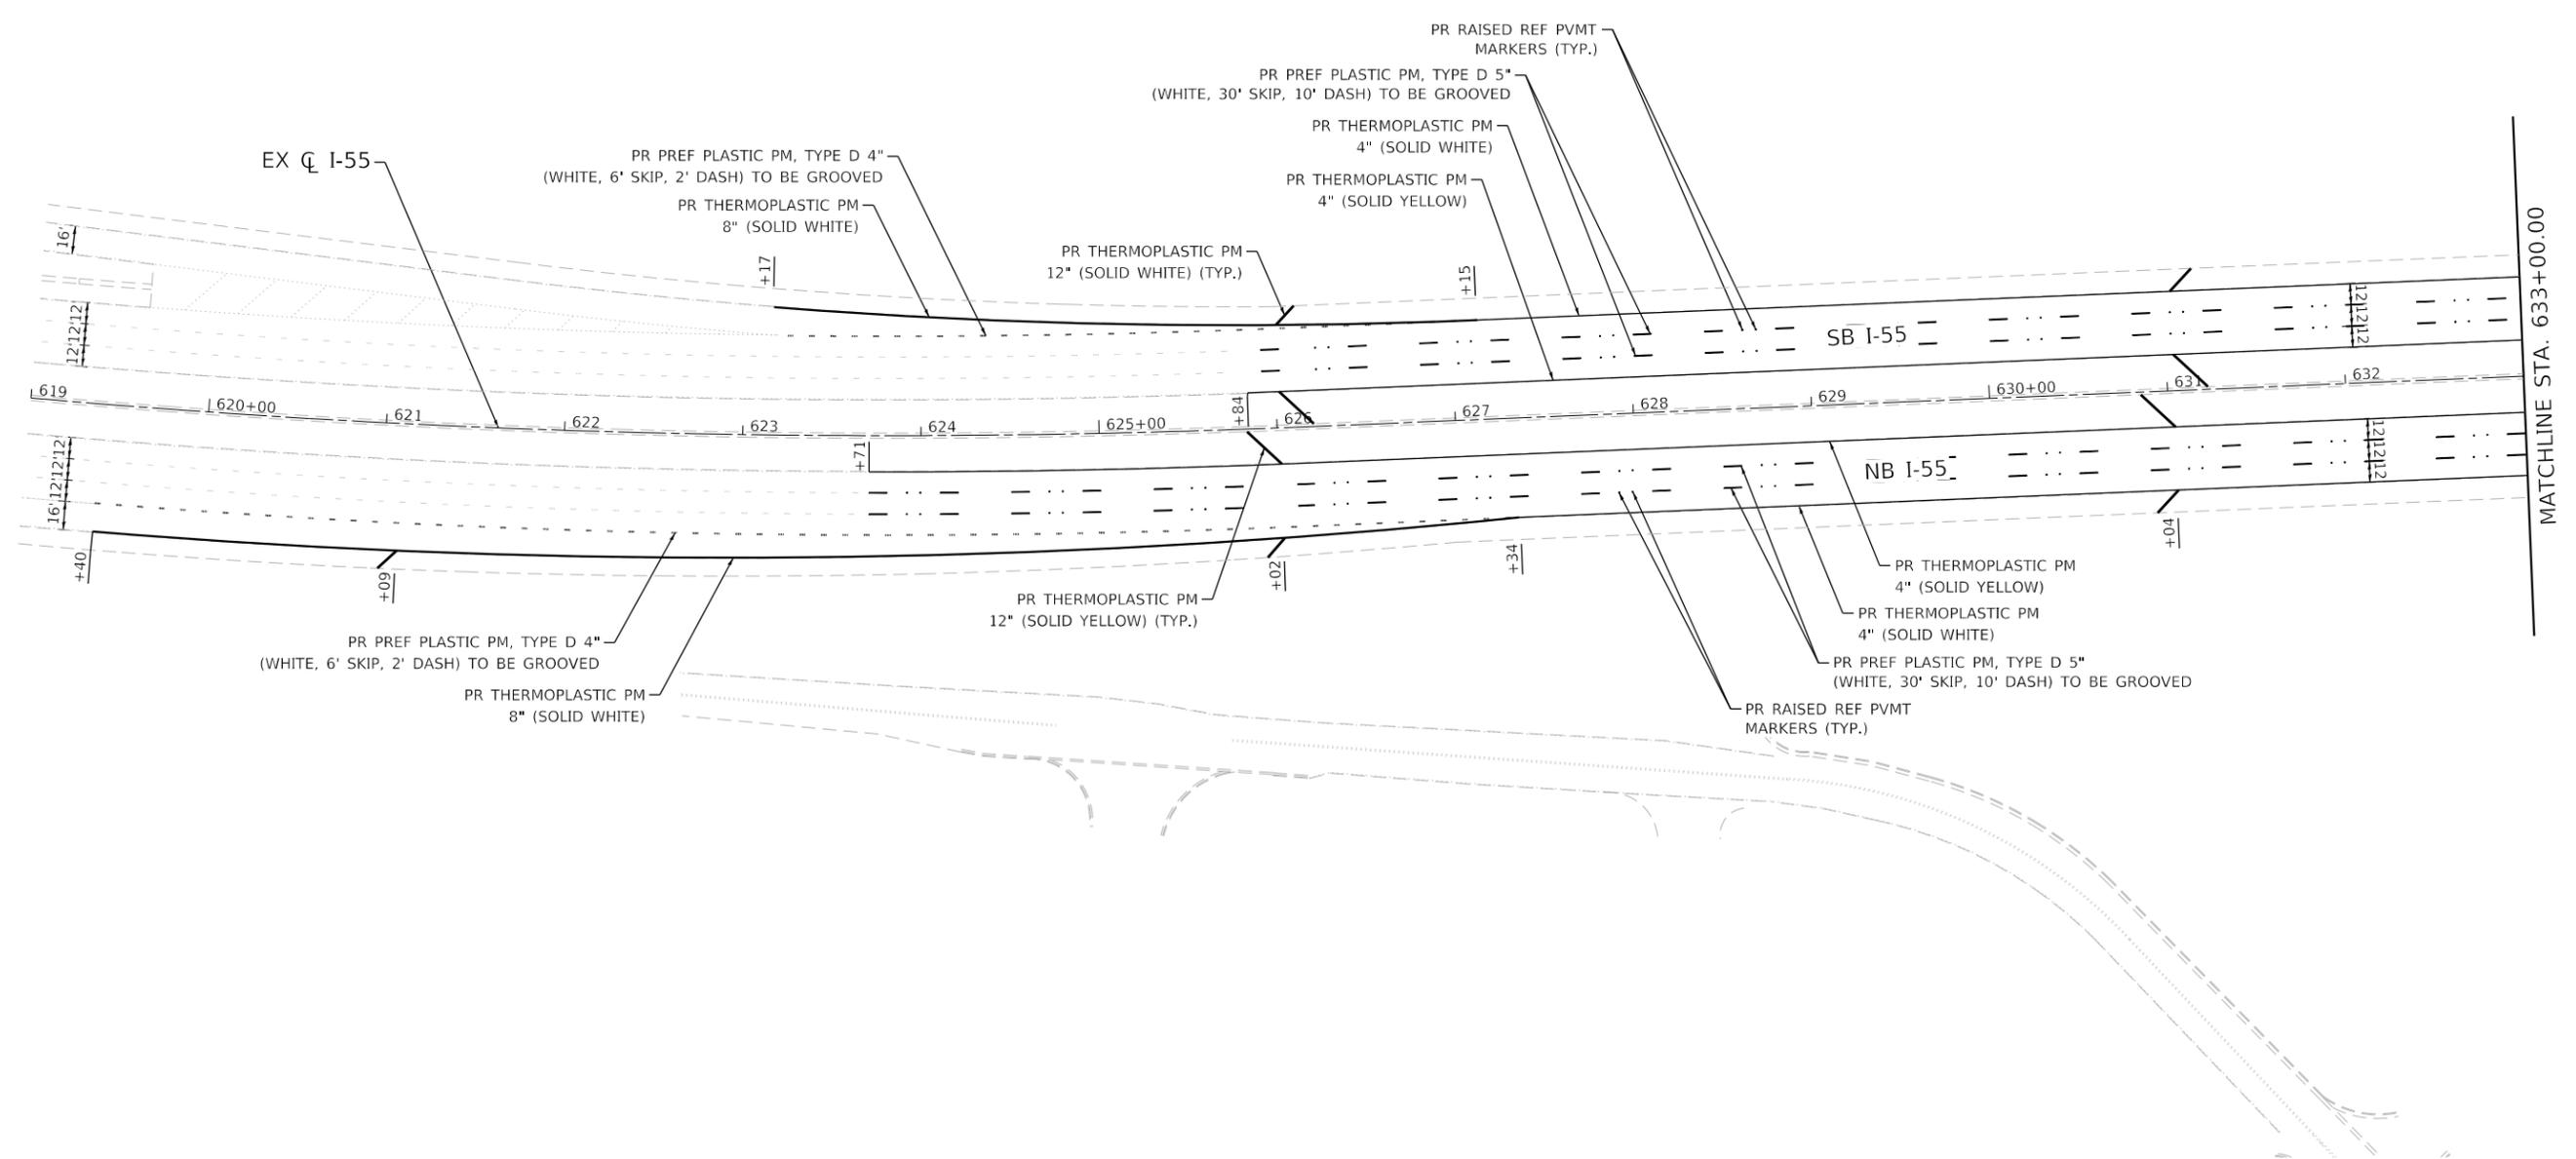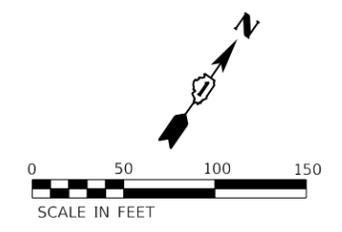



USER NAME = rober	DESIGNED - RC	REVISED -
	DRAWN - RC	REVISED -
PLOT SCALE = 100,0000' / in.	CHECKED - ST	REVISED -
PLOT DATE = 11/2/2020	DATE - 11/2020	REVISED -

**STATE OF ILLINOIS
DEPARTMENT OF TRANSPORTATION**

**F.A.I. ROUTE 55 (I-55) OVER MADISON STREET
ROADWAY PLAN**

SCALE: 1"=50' SHEET 1 OF 4 SHEETS STA. 619+40.00 TO STA. 633+00.00

F.A.I. RTE.	SECTION	COUNTY	TOTAL SHEETS	SHEET NO.
55	2020-025-BR		62	26
			CONTRACT NO. 62K96	
ILLINOIS FED. AID PROJECT				

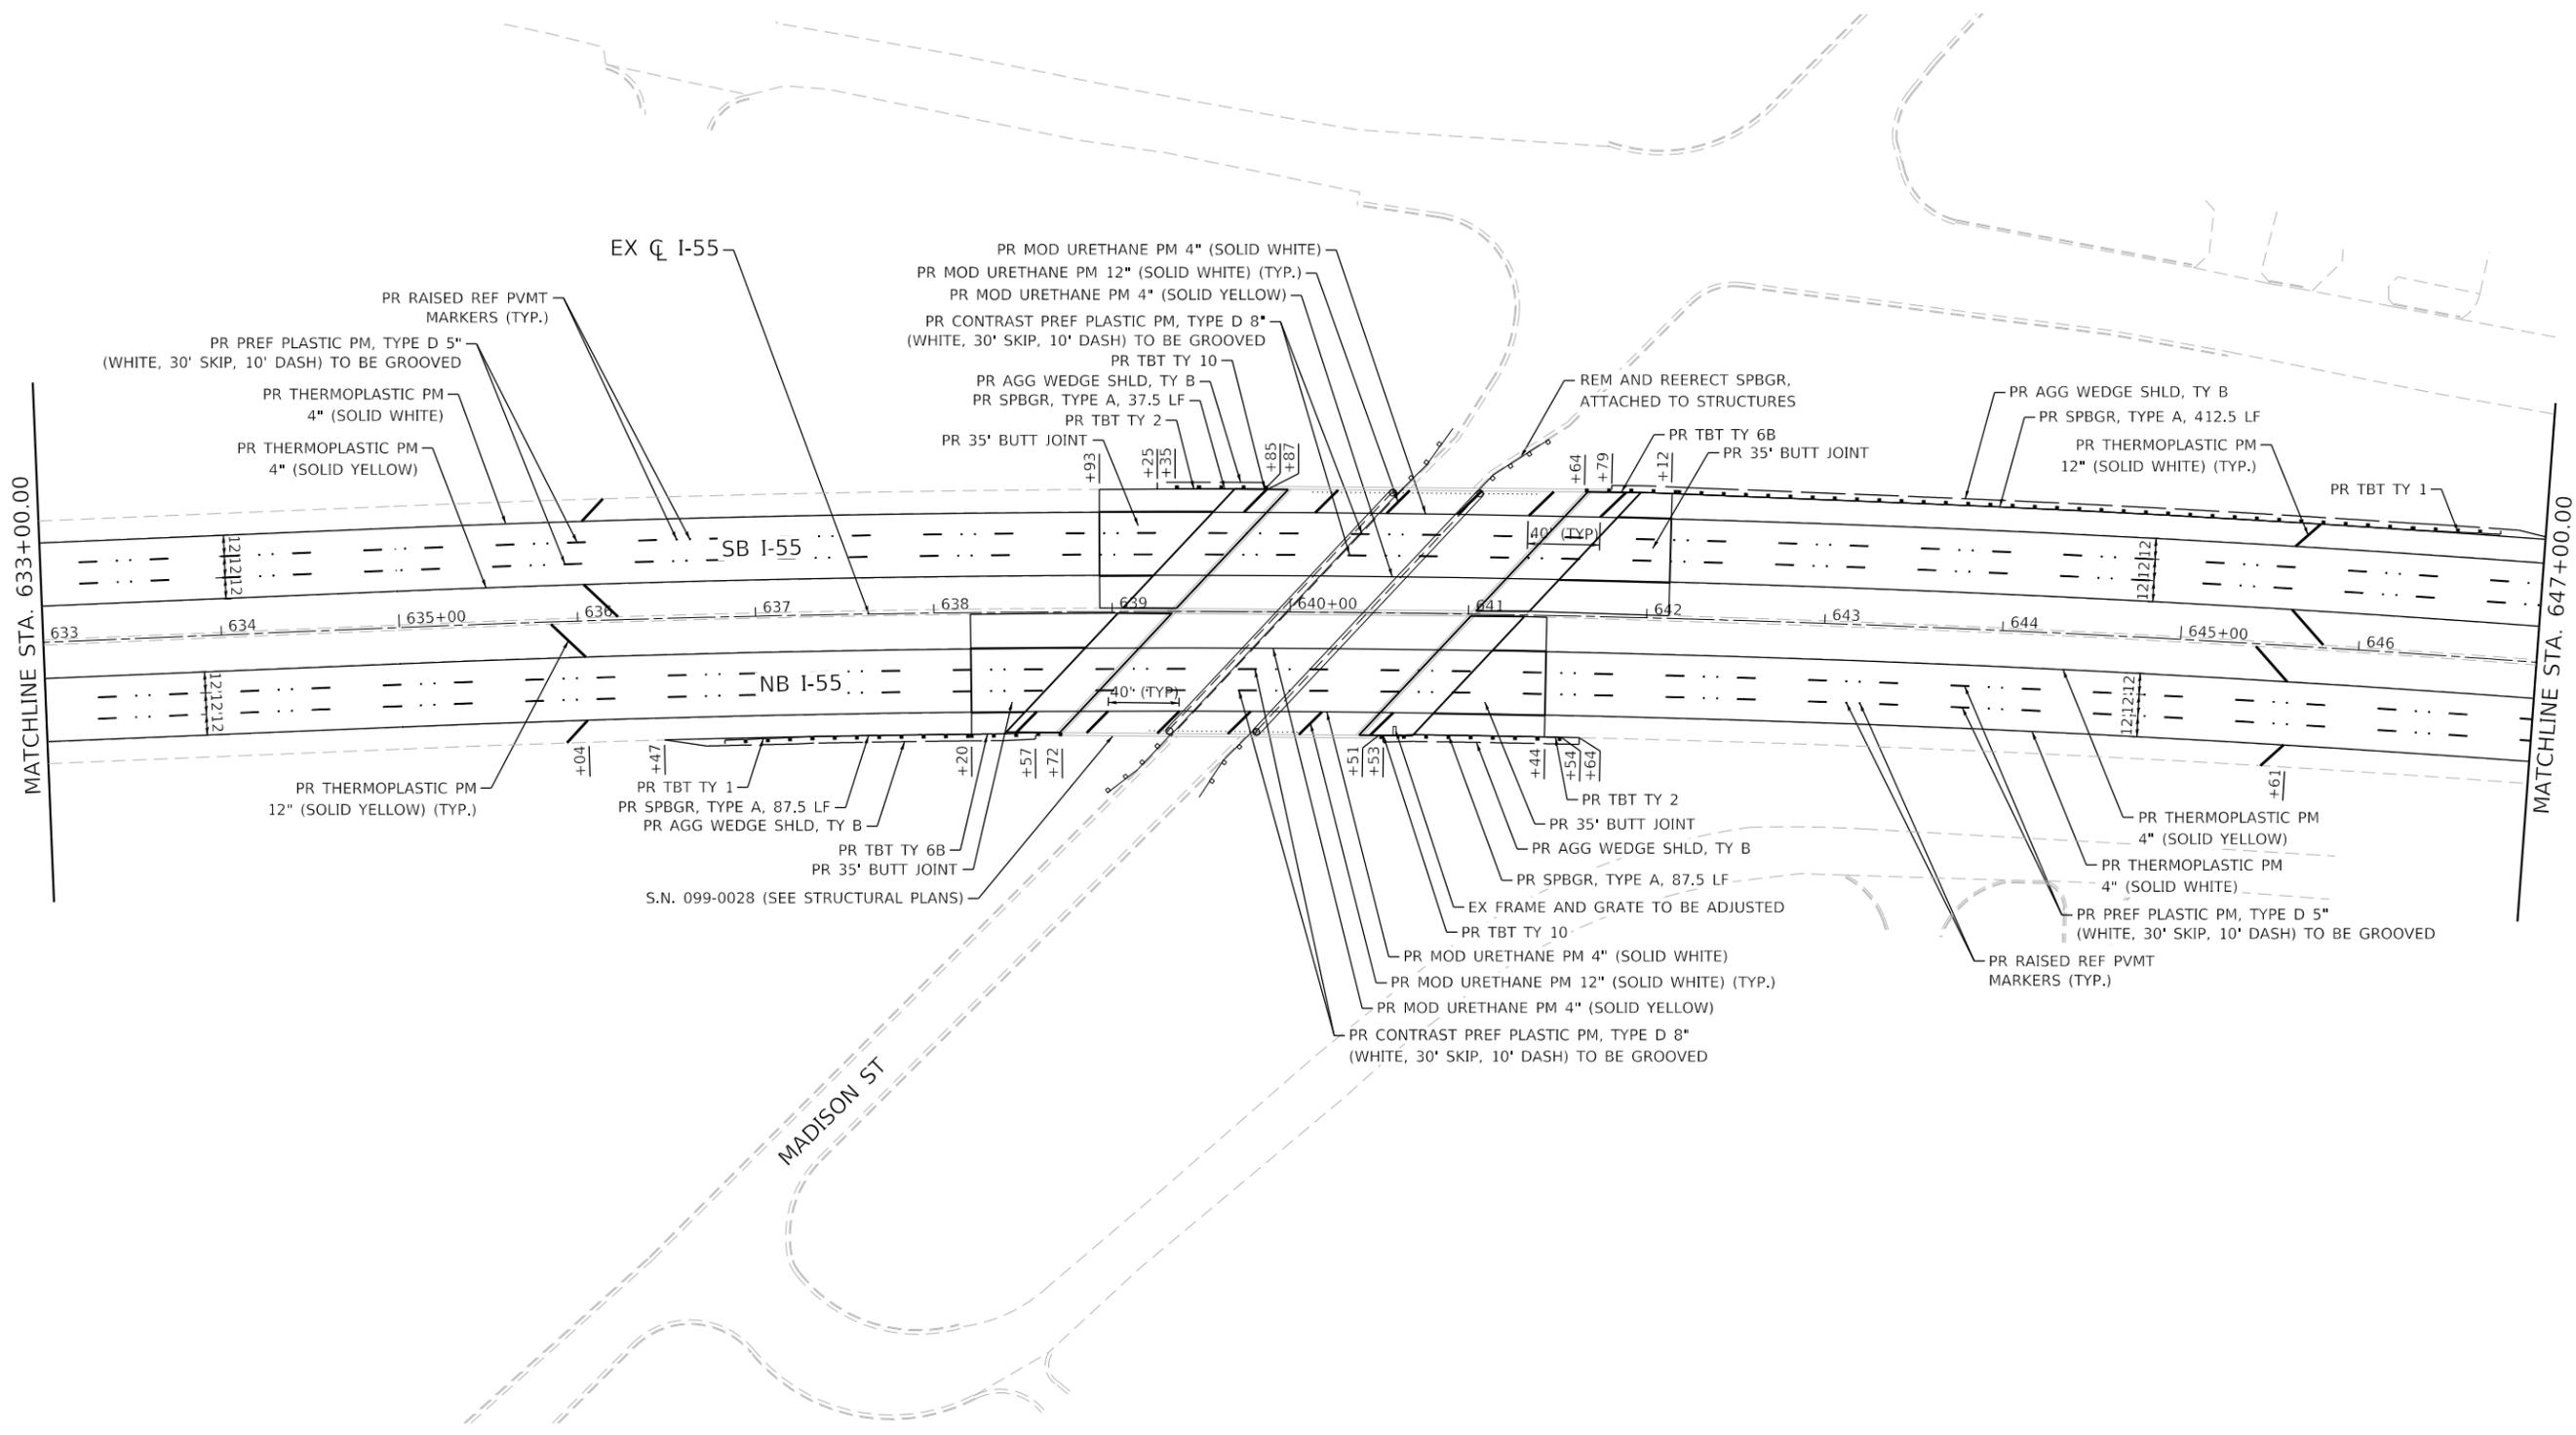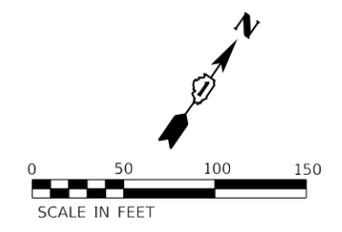



Lin Engineering, Ltd.
 Consulting Engineers
 Westmont, Illinois

USER NAME = rober	DESIGNED - RC	REVISED -
	DRAWN - RC	REVISED -
PLOT SCALE = 100,0000' / in.	CHECKED - ST	REVISED -
PLOT DATE = 11/2/2020	DATE - 11/2020	REVISED -

**STATE OF ILLINOIS
 DEPARTMENT OF TRANSPORTATION**

**F.A.I. ROUTE 55 (I-55) OVER MADISON STREET
 ROADWAY PLAN**
 SCALE: 1"=50' SHEET 2 OF 4 SHEETS STA. 633+00.00 TO STA. 647+00.00

F.A.I. RTE. 55	SECTION 2020-025-BR	COUNTY	TOTAL SHEETS 62	SHEET NO. 27
ILLINOIS FED. AID PROJECT			CONTRACT NO. 62K96	

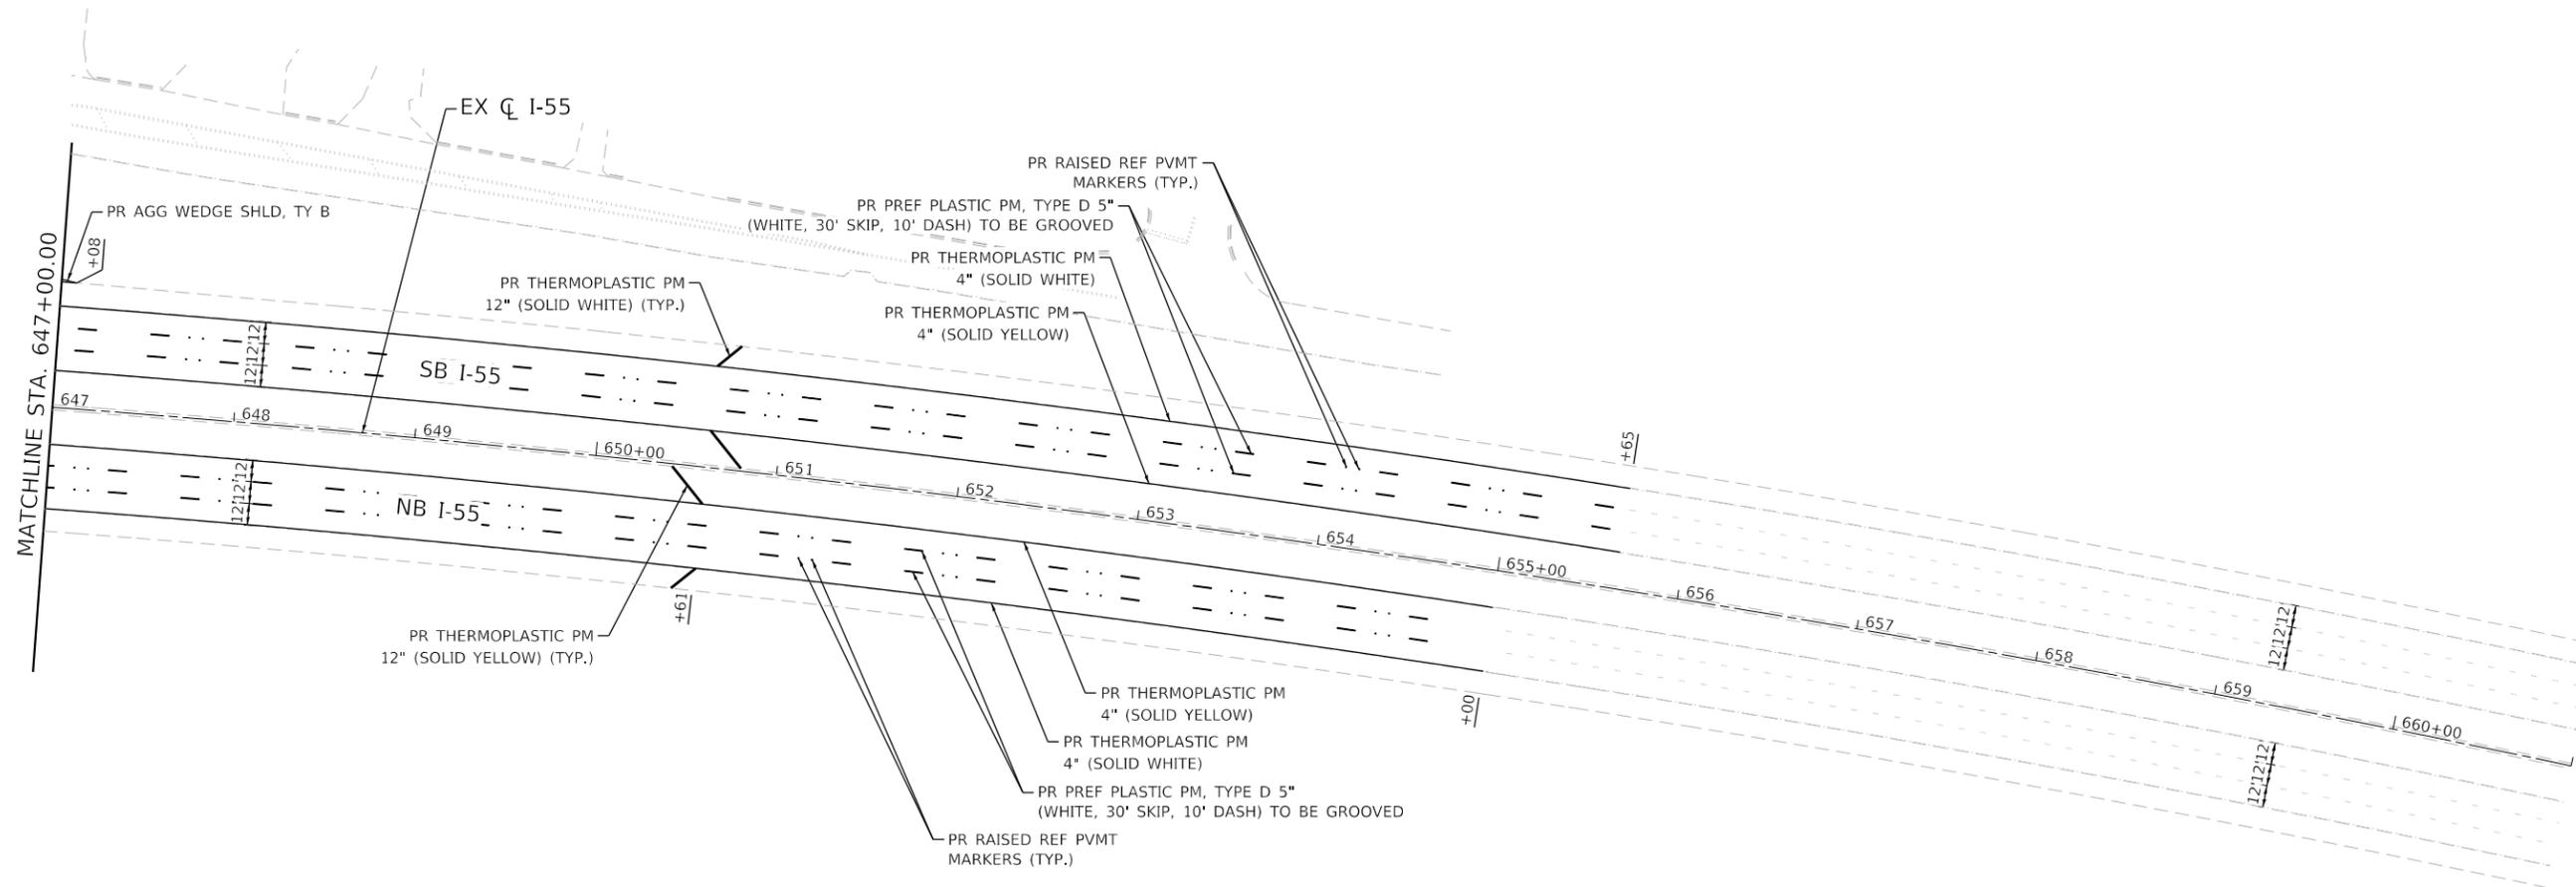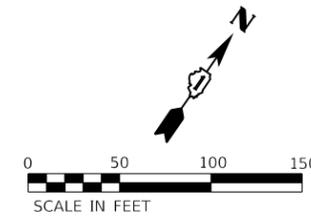


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**STATE OF ILLINOIS
DEPARTMENT OF TRANSPORTATION**

**F.A.I. ROUTE 55 (I-55) OVER MADISON STREET
ROADWAY PLAN**

SCALE: 1"=50' SHEET 3 OF 4 SHEETS STA. 647+00.00 TO STA. 655+65.00

F.A.I. RTE.	SECTION	COUNTY	TOTAL SHEETS	SHEET NO.
55	2020-025-BR	DUPAGE	62	28
ILLINOIS FED. AID PROJECT			CONTRACT NO. 62K96	

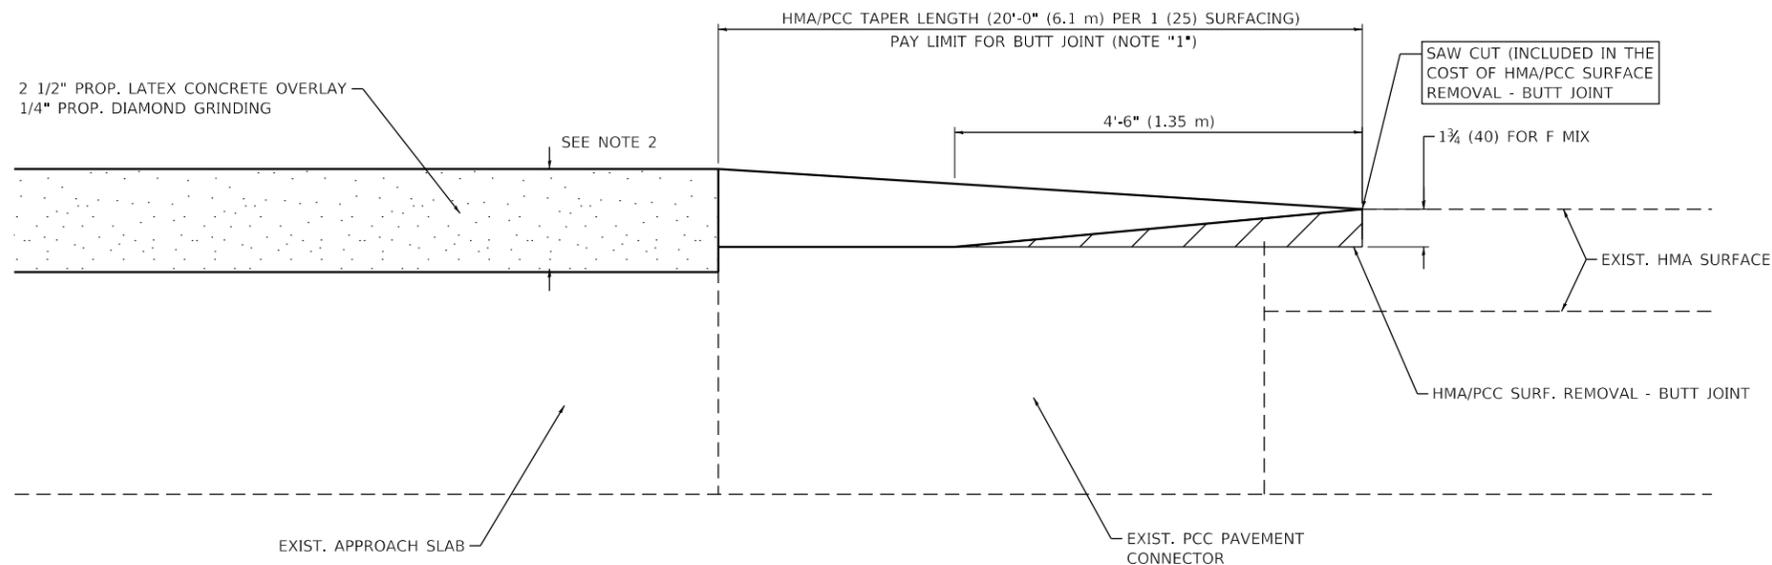

BUTT JOINT AND HMA/PCC TAPER FOR SCARIFICATION AND RESURFACING

NOTES:

1. THE BUTT JOINT SHALL BE CONSTRUCTED IMMEDIATELY PRIOR TO PLACING THE PROPOSED HMA COURSES.
2. SEE BRIDGE PLANS FOR SCARIFICATION THICKNESS.
3. SEE ARTICLE 406.08 AND 406.14 OF THE STANDARD SPECIFICATIONS FOR "HMA AND/OR PCC SURFACE REMOVAL, BUTT JOINT".
4. PORTIONS OF THE BUTT JOINT AND TAPER WILL EXTEND INTO THE EXISTING MAINLINE HMA PAVEMENT SURFACE BEYOND THE EXISTING PCC PAVEMENT CONNECTOR. LIMITS OF HMA/PCC BUTT JOINT SHALL BE VERIFIED BY THE FIELD ENGINEER.

ALL DIMENSIONS ARE IN INCHES (MILLIMETERS) UNLESS OTHERWISE SHOWN.



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	DRAWN - RC	REVISED -
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**STATE OF ILLINOIS
DEPARTMENT OF TRANSPORTATION**


**BUTT JOINT AND
HMA/PCC TAPER DETAILS**

SCALE: 1"=50' SHEET 4 OF 4 SHEETS STA. TO STA.


F.A.I. RTE.	SECTION	COUNTY	TOTAL SHEETS	SHEET NO.
55	2020-025-BR	DUPAGE	62	29
			CONTRACT NO. 62K96	
		ILLINOIS	FED. AID PROJECT	

Existing Structure: S.N. 022-0003 is a three span simple PPC I-Beam structure with a total length of 171'-11" and a total out to out width of 140'-4". The structure was constructed in 1959, rehabilitated and widened in 1978 under Section 22-1HB-1. The bridge deck was replaced and widened to its present width in 1995 under Contract 82453.

Traffic Control: Three lanes of mainline traffic in each direction will be maintained utilizing staged construction.

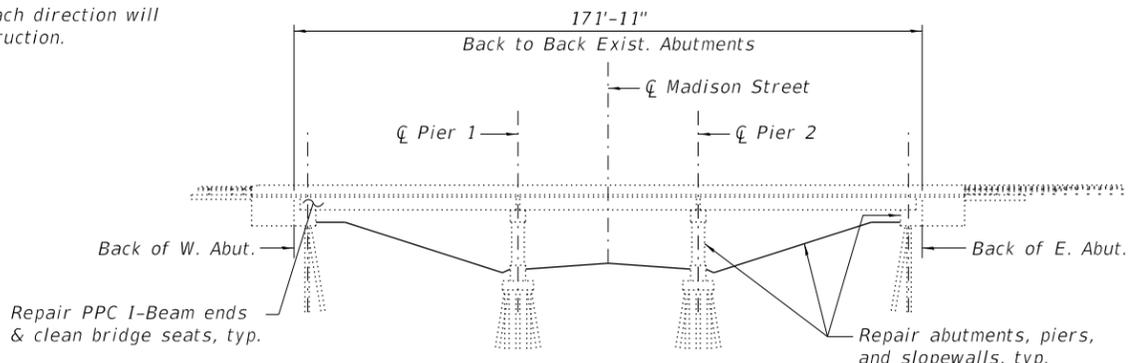

ELEVATION

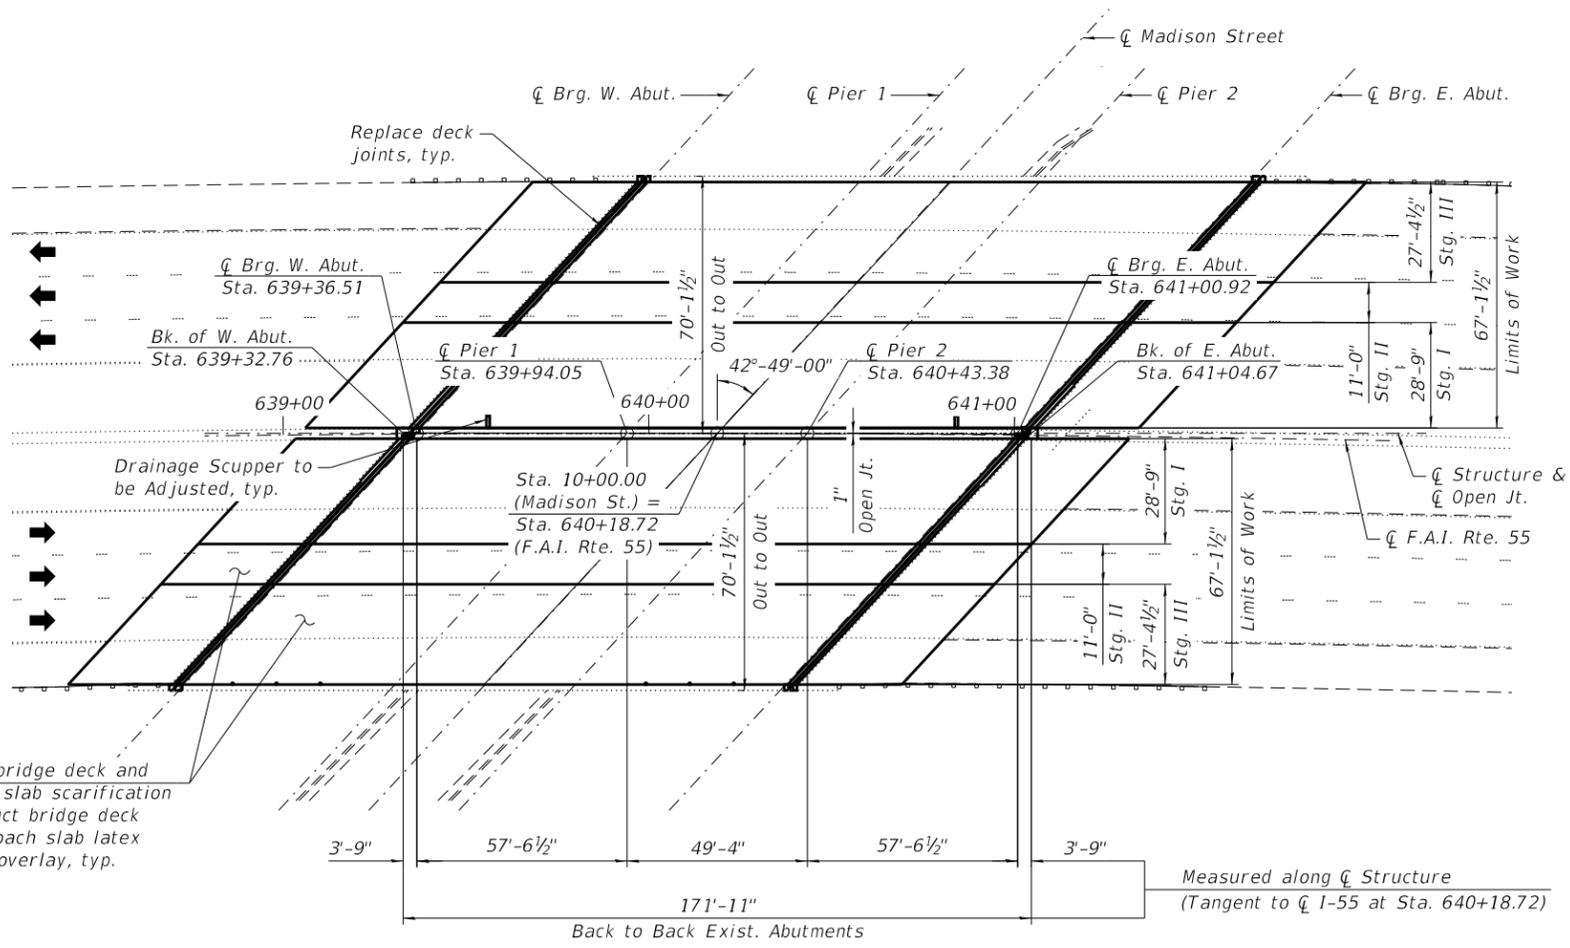

PLAN

Perform bridge deck and approach slab scarification & construct bridge deck and approach slab latex concrete overlay, typ.

SCOPE OF WORK

1. Perform bridge deck and approach slab scarification $\frac{3}{4}$ inch.
2. Remove concrete deck and parapets at the expansion joints in order to replace neoprene joints with preformed joint strip seal.
3. Repair bridge deck slab.
4. Construct bridge deck and approach slab latex concrete overlay, 2 1/2 inches.
5. Perform 1/4" diamond grinding.
6. Perform bridge deck grooving on traffic lanes.
7. Apply protective coat to overlay and parapets.
8. Perform PPC I-Beam repairs.
9. Remove debris and clean bridge seats.
10. Repair abutments, piers, and slopewalls.

INDEX OF SHEETS

1. General Plan & Elevation
2. General Data
3. Stage Construction
4. Temporary Concrete Barrier for Stage Construction
5. Deck Repair Plan
6. Adjusting Existing Scuppers Details
7. Joint Replacement I
8. Joint Replacement II
9. Joint Replacement III
10. Joint Replacement IV
11. Preformed Joint Strip Seal
12. Framing Plan
13. Beam Repair Details
14. West Abutment Repair
15. East Abutment Repair
16. Pier 1 Repair I
17. Pier 1 Repair II
18. Pier 1 Repair III
19. Pier 2 Repair I
20. Pier 2 Repair II
21. Pier 2 Repair III
22. Bar Splicer Assembly and Mechanical Splicer Details

DESIGN SPECIFICATIONS

2002 AASHTO Standard Specifications for Highway Bridges with Interims

LOADING HS-20 & ALT.

No allowance for future wearing surface.

DESIGN STRESSES

FIELD UNITS (NEW CONSTRUCTION)

f'c = 4,000 psi (Superstructure)
fy = 60,000 psi (Reinforcement)


FIELD UNITS (EXIST. CONSTRUCTION)

f'c = 3,500 psi
f'c = 5,000 psi (PPC Units)
fy = 60,000 psi (Reinforcement)
fy = 36,000 psi (M270 Grade 36)



Signed Patrick J. Laux
PATRICK J. LAUX, S.E. Il. Lic. No. 081-007655
Expires 11-30-2020.

Date 11/25/2020

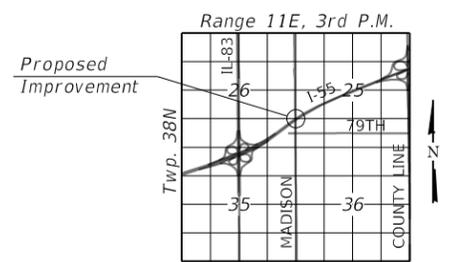

LOCATION SKETCH

CURVE DATA

P.I. Sta. = 650+76.45
Δ = 17°-13'-06" (Rt.)
D = 0°-33'-00"
R = 10,417.45'
T = 1,577.19'
L = 3,130.60'
E = ---
e = ---
T.R. = ---
S.E. Run = ---
P.C. Sta. = 634+99.26
P.T. Sta. = 666+29.86

GENERAL PLAN & ELEVATION
I-55 OVER MADISON STREET
F.A.I. RTE. 55 SECTION 2020-025-BR
DuPAGE COUNTY
STATION 640+18.72
S.N. 022-0003

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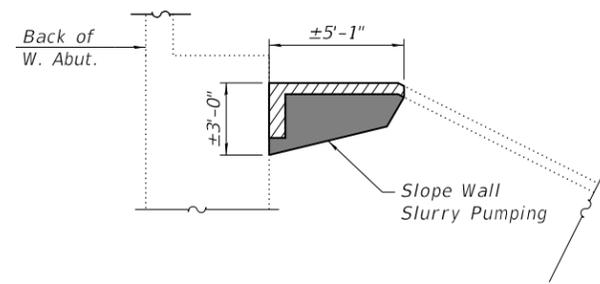
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STATE OF ILLINOIS
DEPARTMENT OF TRANSPORTATION


F.A.I. RTE.	SECTION	COUNTY	TOTAL SHEETS	SHEET NO.
55	2020-025-BR	DuPAGE	62	30
CONTRACT NO. 62K96				

GENERAL NOTES:

- No field welding is permitted except as specified in the contract documents.
- Reinforcement bars designated (E) shall be epoxy coated.
- Plan dimensions and details relative to existing plans are subject to nominal construction variations. The Contractor shall field verify existing dimensions and details affecting new construction and make necessary approved adjustments prior to construction or ordering materials. Such variations shall not be cause for additional compensation for a change in scope of the work, however, the Contractor will be paid for the quantity actually furnished at the unit price bid for the work.
- Existing reinforcement bars extending into the removal area shall be cleaned, straightened and incorporated into the new construction. Any reinforcement bars that are damaged during concrete removal shall be replaced with an approved bar splicer or anchorage system. Cost included with Concrete Removal.
- Areas of deck repair shown are estimated. The Engineer shall show actual locations of deck repairs on as-built plans.
- Protective coat shall be applied to inside and top faces of parapets and new overlay.
- Cost of removal and disposal of existing expansion joints shall be included in the cost of Concrete Removal.
- Joint openings shall be adjusted according to Article 520.04 of the Std. Specs. when the deck is poured at an ambient temperature other than 50°F.
- Expansion joints shall be fabricated to conform to the existing cross slope of the bridge.
- The Contractor shall exercise care during removal of existing joints to ensure that the slab, beams, and diaphragms' integrity will not be detrimentally impacted. The Contractor shall repair any damage(s) to the slab, beams, and diaphragms caused by his/her operation as directed by the Engineer at no additional cost to the Department.



SECTION A-A

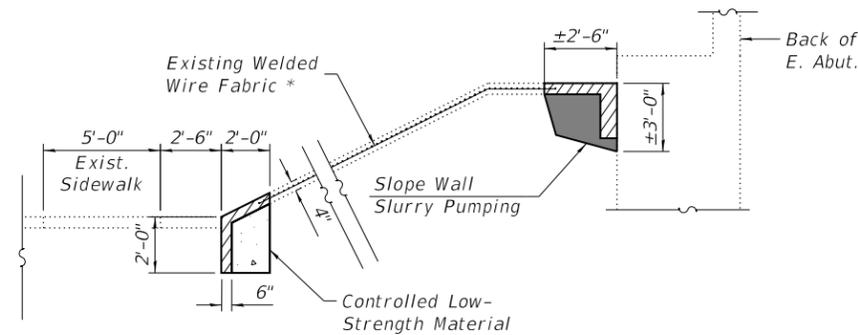


SECTION B-B

* Existing Welded Wire Fabric (WWF) shall extend 6" into the proposed Slope Wall Repair. The exposed 6" of WWF on either side shall be lapped with the proposed slope wall reinforcement.

LEGEND:

- Slope Wall Repair
- Controlled Low-Strength Material
- Slope Wall Slurry Pumping

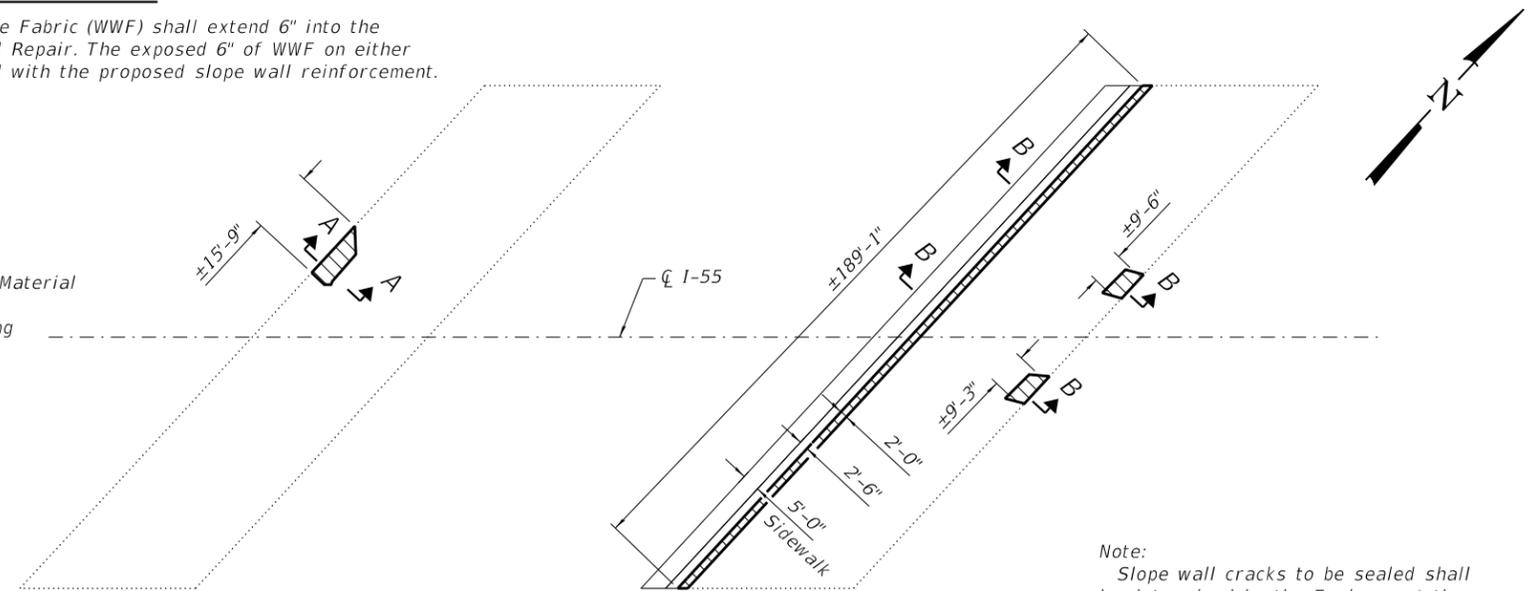

Note:
Slope wall cracks to be sealed shall be determined by the Engineer at the time of construction.

SLOPE WALL REPAIR PLAN

TOTAL BILL OF MATERIAL

ITEM	UNIT	SUPER	SUB	TOTAL
Concrete Removal	Cu. Yd.	33.6	-	33.6
Concrete Superstructure	Cu. Yd.	36.7	-	36.7
Protective Coat	Sq. Yd.	3,446	-	3,446
Reinforcement Bars, Epoxy Coated	Pound	5,290	-	5,290
Bar Splicers	Each	64	-	64
Preformed Joint Strip Seal	Foot	368	-	368
Epoxy Crack Injection	Foot	-	20	20
Controlled Low-Strength Material	Cu. Yd.	-	28	28
Slope Wall Crack Sealing	Foot	-	100	100
Acrylic Coating	Sq. Yd.	33	62	95
Fiber Wrap	Sq. Ft.	319	552	871
Bridge Deck Grooving (Longitudinal)	Sq. Yd.	1,842	-	1,842
Bridge Deck Latex Concrete Overlay, 2 1/2 Inches	Sq. Yd.	3,368	-	3,368
Cleaning Bridge Seats	Sq. Ft.	1,159	-	1,159
Bridge Deck Scarification, 3/4 Inch	Sq. Yd.	3,368	-	3,368
Structural Repair of Concrete (Depth Equal To or Less Than 5 Inches)	Sq. Ft.	-	594.0	594.0
Debris Removal	L. Sum	-	1	1
Deck Slab Repair (Full Depth, Type I)	Sq. Yd.	1	-	1
Drainage Scuppers to be Adjusted	Each	2	-	2
Diamond Grinding (Bridge Section)	Sq. Yd.	3,432	-	3,432
Precast Prestressed Concrete I-Beam Repair	Sq. Ft.	131	-	131
Slope Wall Repair	Sq. Yd.	-	57	57
Slope Wall Slurry Pumping	Cu. Yd.	-	11	11
Temporary Shoring and Cribbing	Each	-	28	28

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WSP USA Inc.
30 N. LASALLE STREET
SUITE 4200
CHICAGO, IL 60602
TEL: (312) 782-8150
FAX: (312) 782-1884


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DEPARTMENT OF TRANSPORTATION**


**GENERAL DATA
I-55 OVER MADISON STREET - STRUCTURE NO. 022-0003**

SHEET 2 OF 22 SHEETS


F.A.I. RTE.	SECTION	COUNTY	TOTAL SHEETS	SHEET NO.
55	2020-025-BR	DuPAGE	62	31
CONTRACT NO. 62K96				
ILLINOIS FED. AID PROJECT				

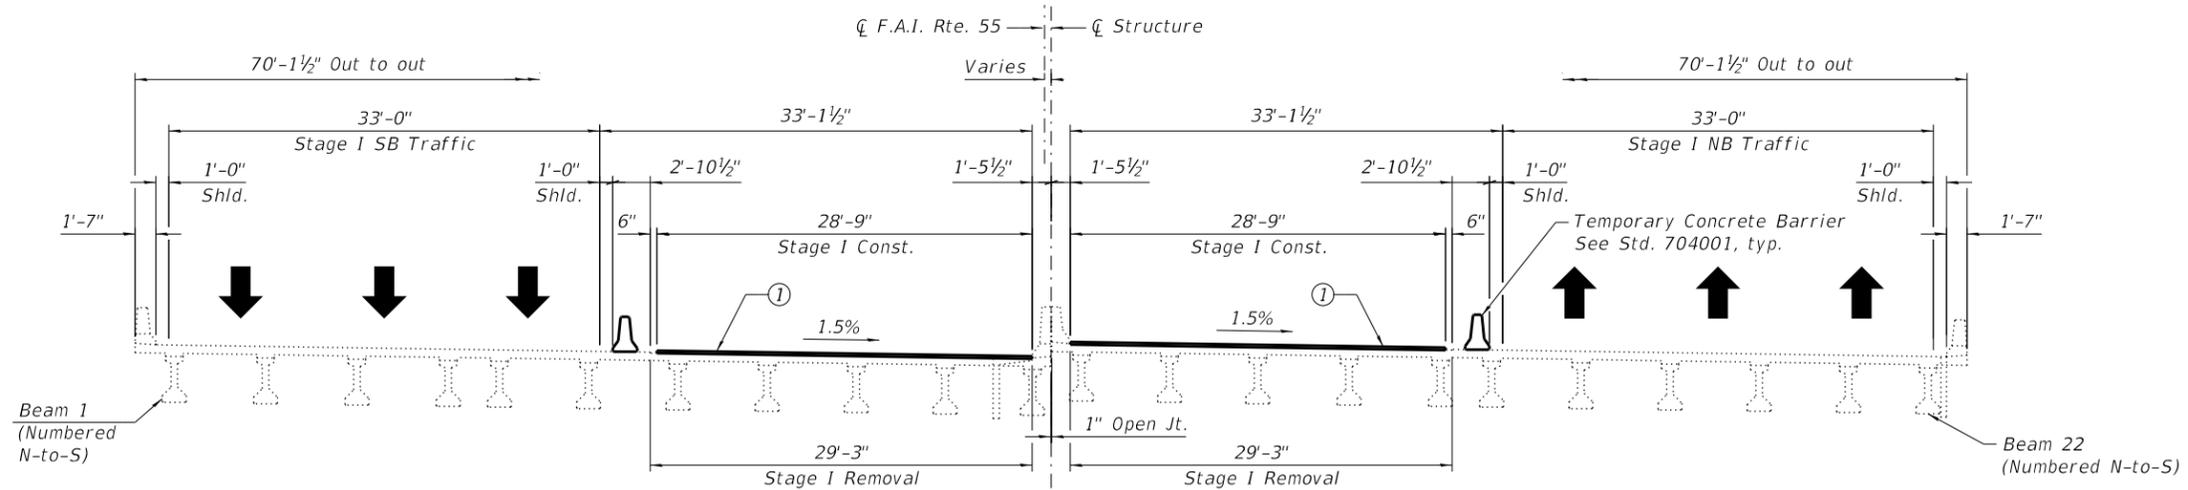

STAGE I CROSS SECTION
(Looking Northeast)

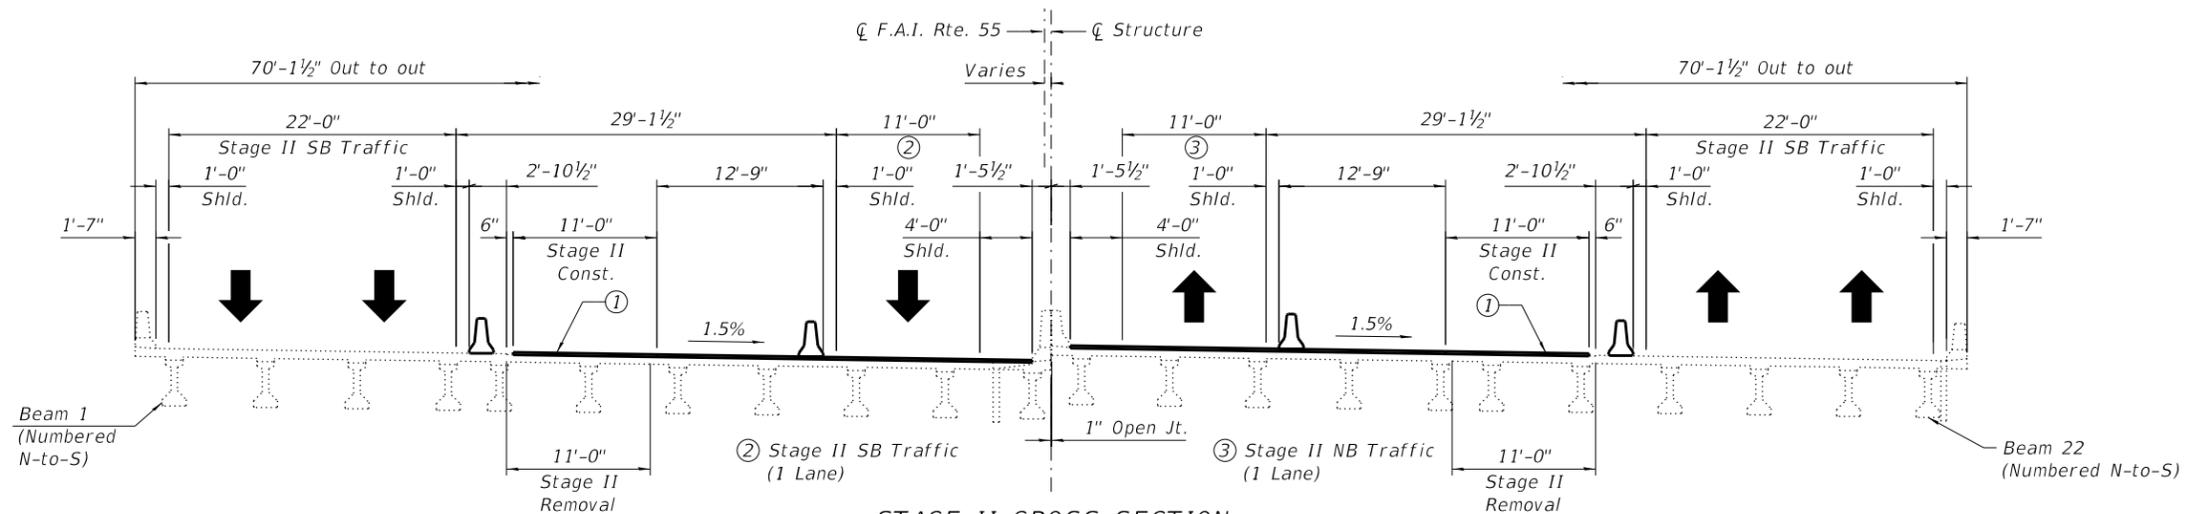

STAGE II CROSS SECTION
(Looking Northeast)

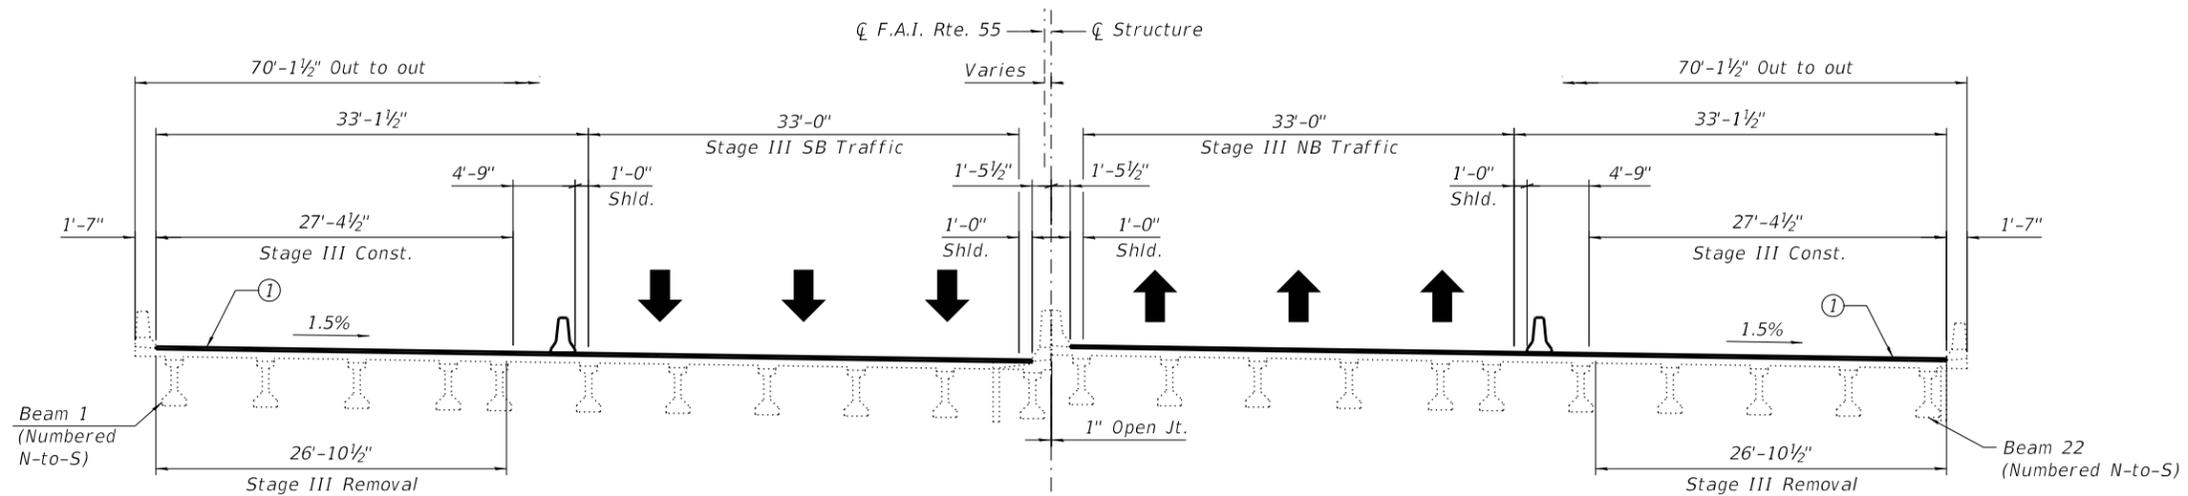

STAGE III CROSS SECTION
(Looking Northeast)

Notes:
All horizontal dimensions are measured perpendicular to ζ Structure, unless noted otherwise.
See sheet 4 of 22 for Temporary Concrete Barrier. For quantity of Temporary Concrete Barrier, see Roadway Plans.

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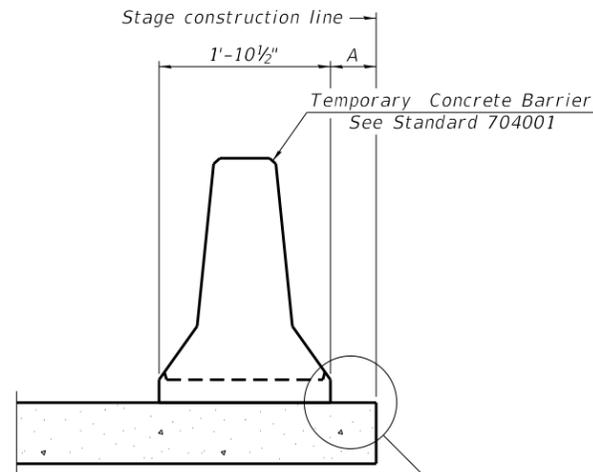
WSP USA Inc.
30 N. LASALLE STREET
SUITE 4200
CHICAGO, IL 60602
TEL: (312) 782-8150
FAX: (312) 782-1884

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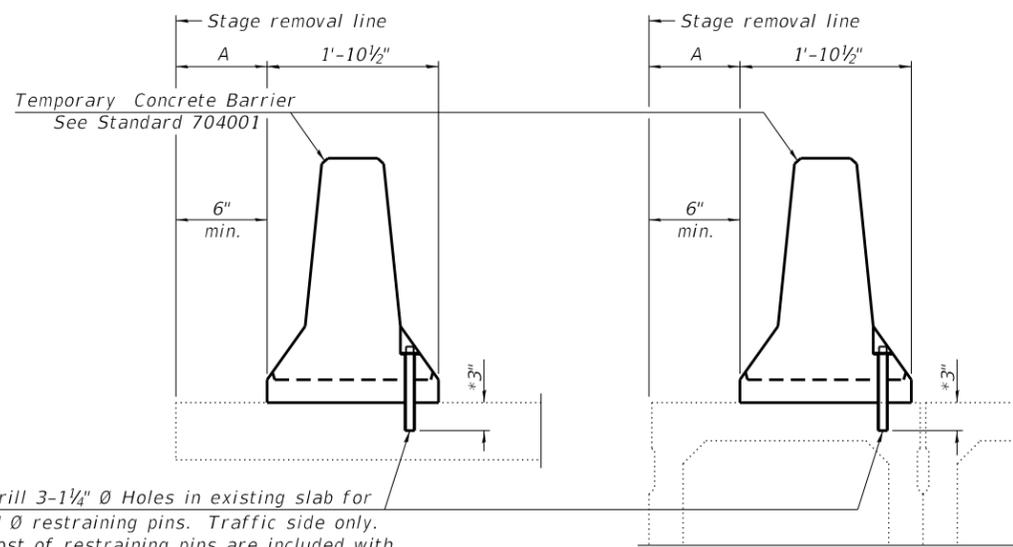
STAGE CONSTRUCTION
I-55 OVER MADISON STREET - STRUCTURE NO. 022-0003

F.A.I. RTE.	SECTION	COUNTY	TOTAL SHEETS	SHEET NO.
55	2020-025-BR	DuPAGE	62	32
CONTRACT NO. 62K96				
ILLINOIS FED. AID PROJECT				



When "A" is 3'-1" or less, the temporary concrete barrier shall be restrained to the new slab according to Detail I, II or III. No restraint is required when "A" is greater than 3'-1".

NEW SLAB OR NEW DECK BEAM




Drill 3-1/4" Ø Holes in existing slab for 1" Ø restraining pins. Traffic side only. Cost of restraining pins are included with Temporary Concrete Barrier. No restraint is required when "A" is greater than 3'-1".

EXISTING SLAB


* When hot-mix asphalt wearing surface is present, embedment shall be 3" plus the wearing surface depth.

EXISTING DECK BEAM

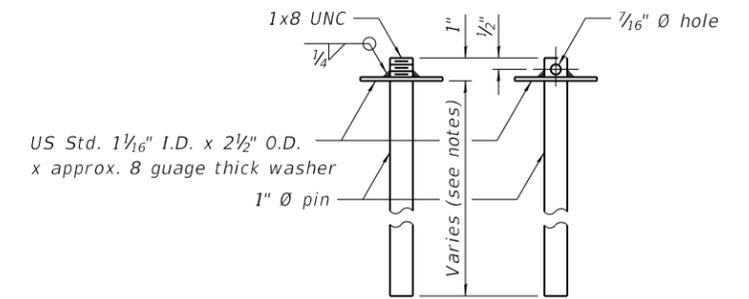


RESTRAINING PIN


SECTIONS THRU SLAB OR DECK BEAM

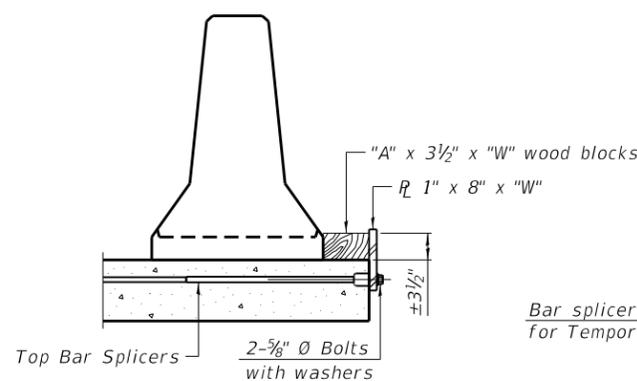


DETAIL I

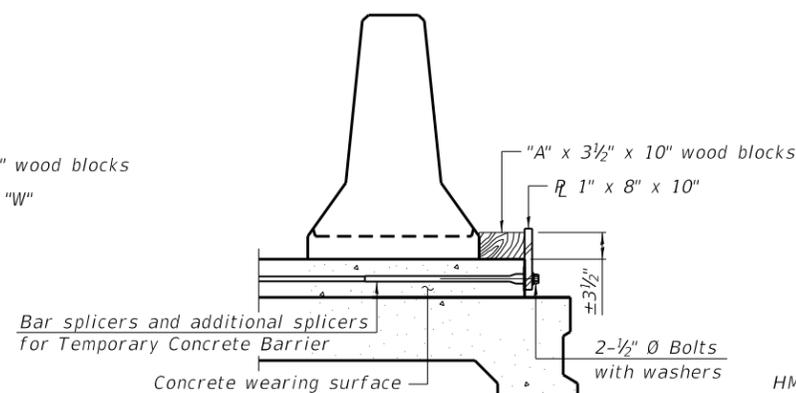


DETAIL II

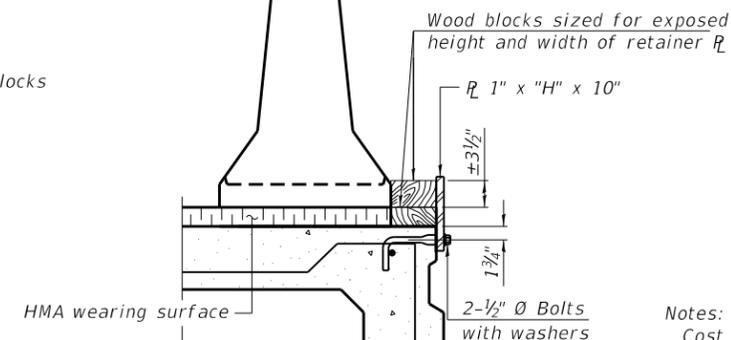


DETAIL III

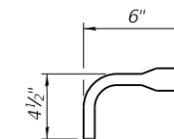

BAR SPLICER FOR #4 BAR - DETAIL III

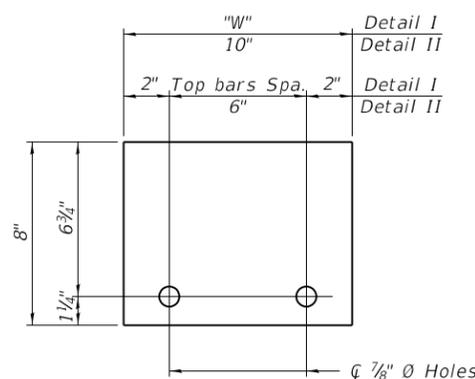

STEEL RETAINER 1" x 8" x "W"
(Detail I and II)

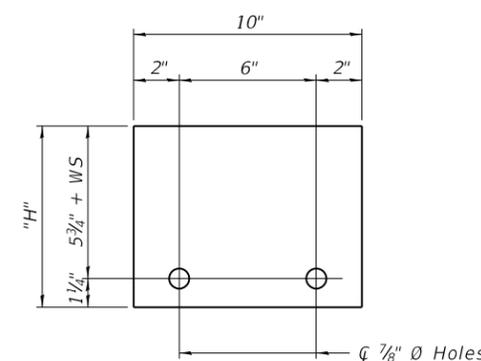

STEEL RETAINER 1" x "H" x 10"
(Detail III)

Notes:

- Cost of retainer assembly is included with Temporary Concrete Barrier.
- A retainer assembly shall be located at the approximate center of each temporary concrete barrier.
- The retainer plate shall not be removed until the concrete on the adjacent stage is ready to be poured. For Detail III applications the retainer plate shall not be removed until just prior to placing the adjacent beam.
- When the 'A' dimension is less than 1 1/2', the wood block shall be omitted and the barrier shall be placed in direct contact with the steel retainer plate.
- For deck beam applications the minimum required 'A' distance is 6" to accommodate the shear key clamping device.

Detail I - Installation for a new bridge deck or bridge slab.

Detail II - Installation for a new deck beam with an initial concrete wearing surface. Additional bar splicers shall be provided at 6'-0" centers and paired with the bar splicers of the concrete wearing surface reinforcement to accommodate the installation of the retainer assemblies. The cost of the additional bar splicers is included with the concrete wearing surface.

Detail III - Installation for a new deck beam with no initial wearing surface or with an initial hot-mix asphalt (HMA) wearing surface present. The deck beam directly beneath the temporary concrete barrier shall be fabricated with bar splicer inserts in the side of the beam, as detailed, to accommodate the installation of the retainer assemblies. A pair of bar splicers, 6" apart, shall be placed at 6'-0" centers along the length of the beam. The cost of the bar splicers is included with the deck beam.

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R-27

2-17-2017



WSP USA Inc.
30 N. LASALLE STREET
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CHICAGO, IL 60602
TEL: (312) 782-2150
FAX: (312) 782-1884



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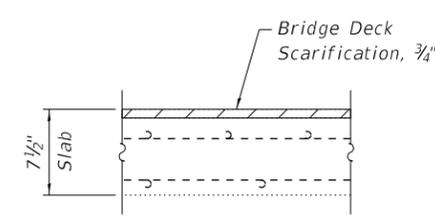
TEMPORARY CONCRETE BARRIER FOR STAGE CONSTRUCTION
I-55 OVER MADISON STREET - STRUCTURE NO. 022-0003

SHEET 4 OF 22 SHEETS


F.A.I. RTE.	SECTION	COUNTY	TOTAL SHEETS	SHEET NO.
55	2020-025-BR	DuPAGE	62	33
ILLINOIS FED. AID PROJECT			CONTRACT NO. 62K96	



DECK PLAN

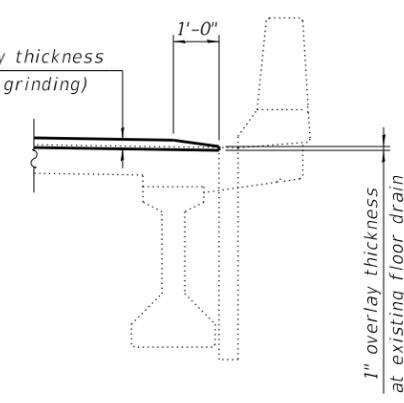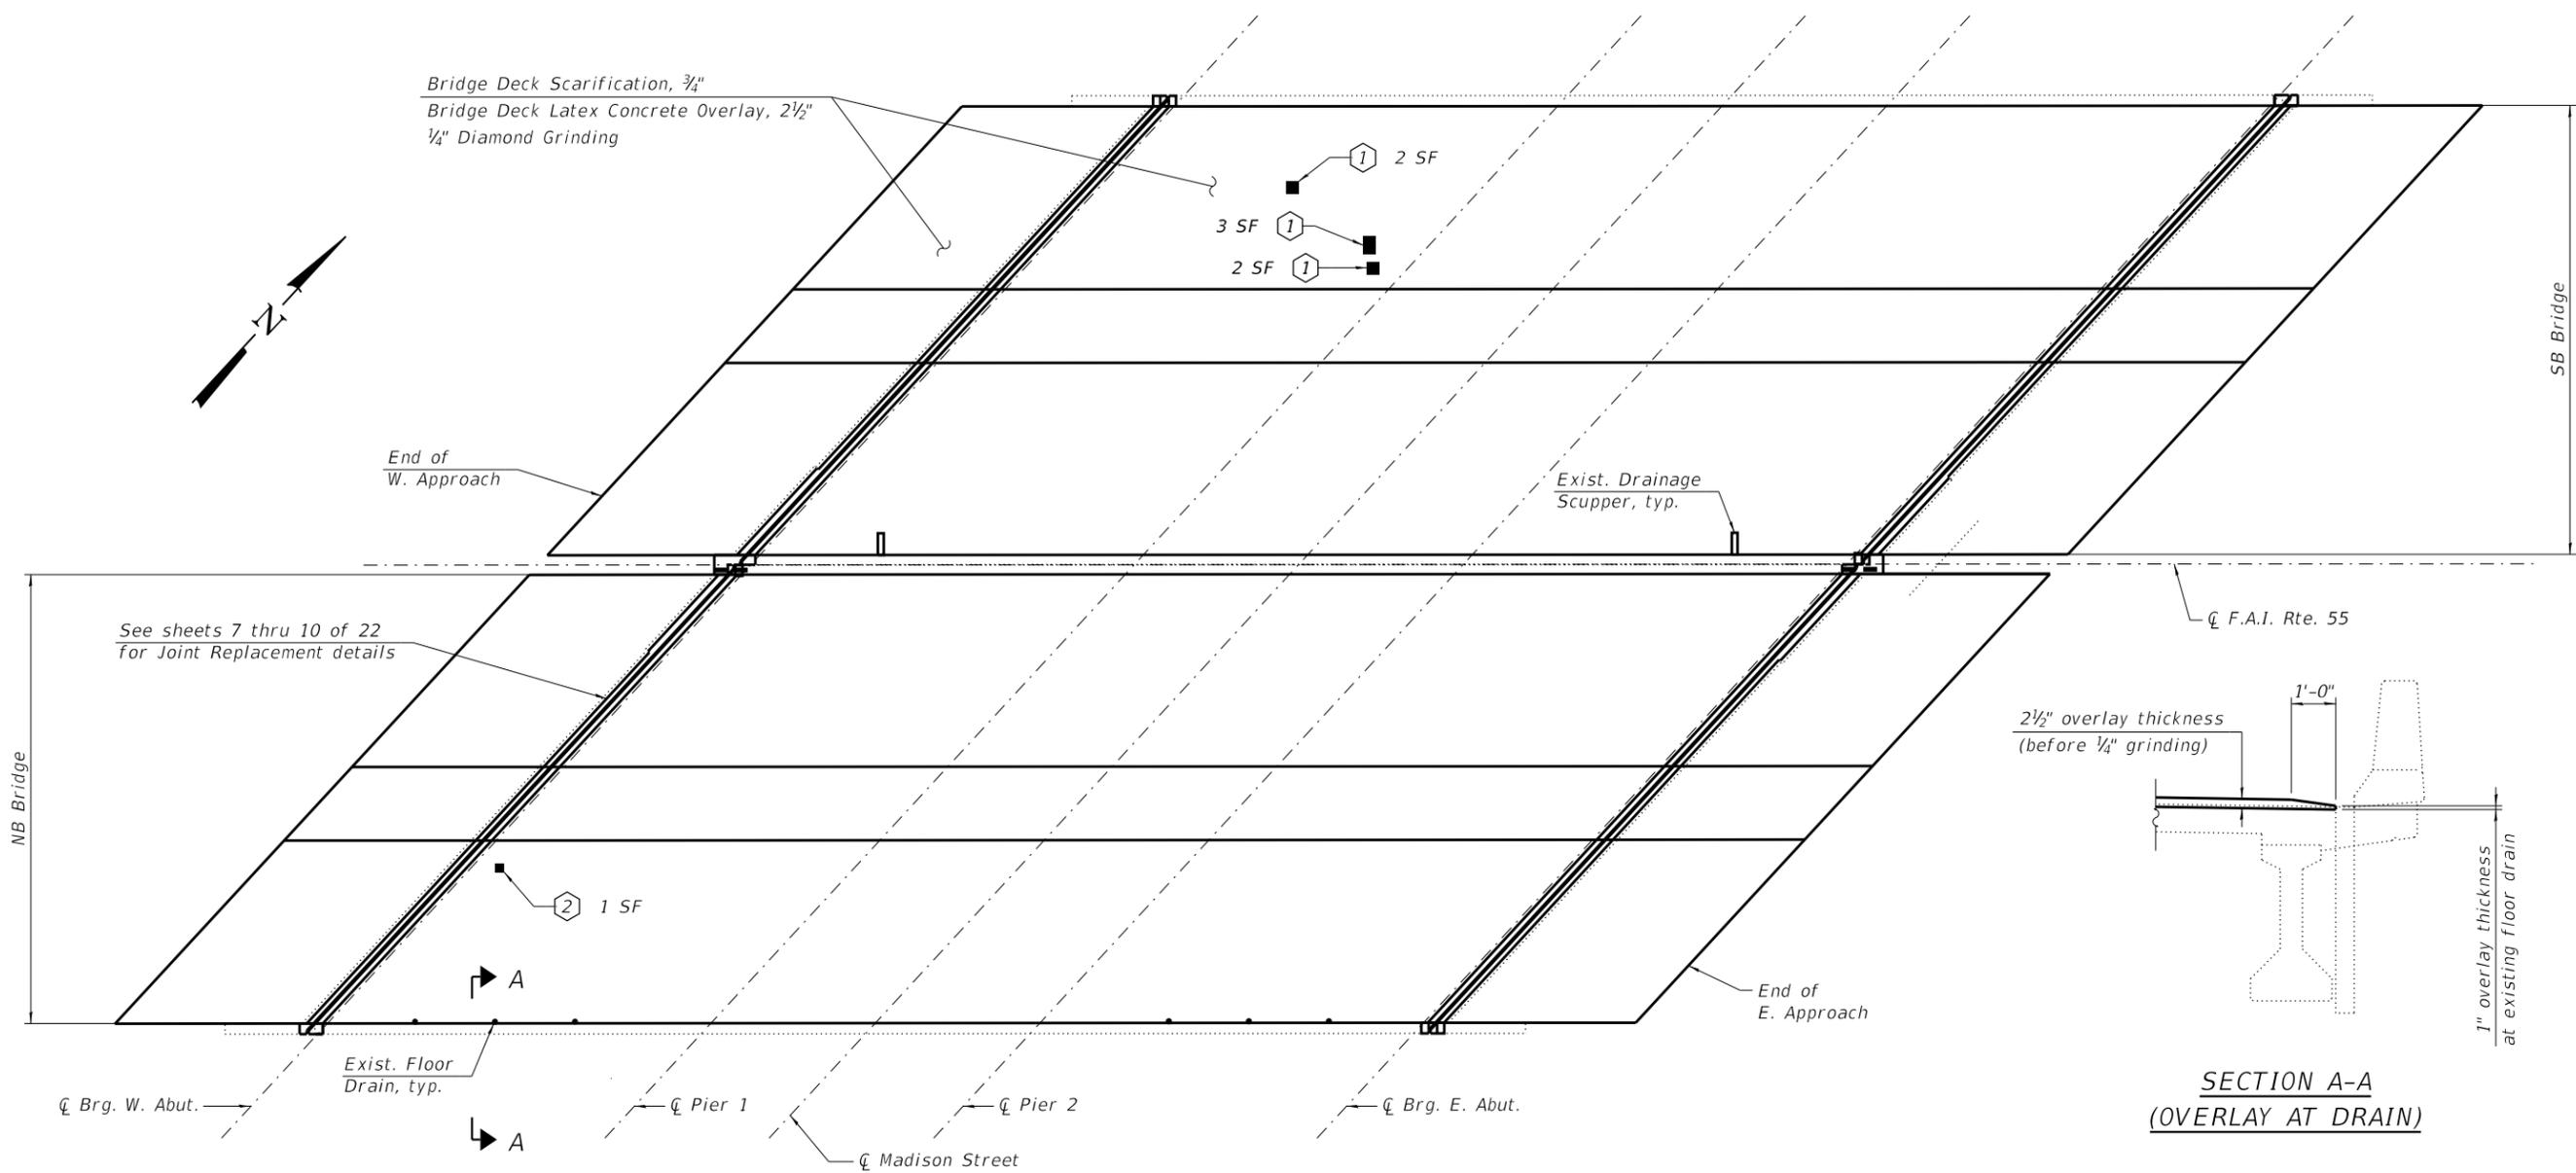

EXISTING BRIDGE DECK CROSS SECTION

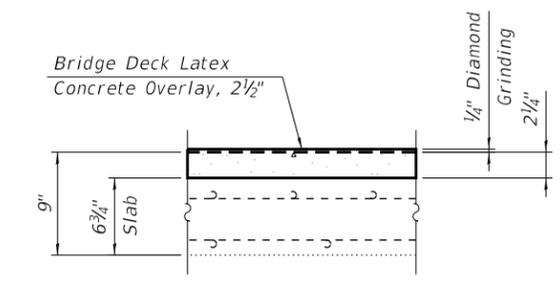

PROPOSED BRIDGE DECK CROSS SECTION

LEGEND

- ① Deck Slab Repair (Partial Depth) (For information only)
- ② Deck Slab Repair (Full Depth, Type I)
- SF - Square Feet

Notes:

Areas of deck repairs shown are estimated. The Engineer shall document actual locations of deck repairs on As-Built Plans. Quantity listed for Deck Slab Repair (Partial) is for information only. See Bridge Deck Latex Concrete Overlay Special Provisions.

BILL OF MATERIAL

ITEM	UNIT	QUANTITY
Deck Slab Repair (Partial Depth)	Sq. Yd.	1
Deck Slab Repair (Full Depth, Type I)	Sq. Yd.	1

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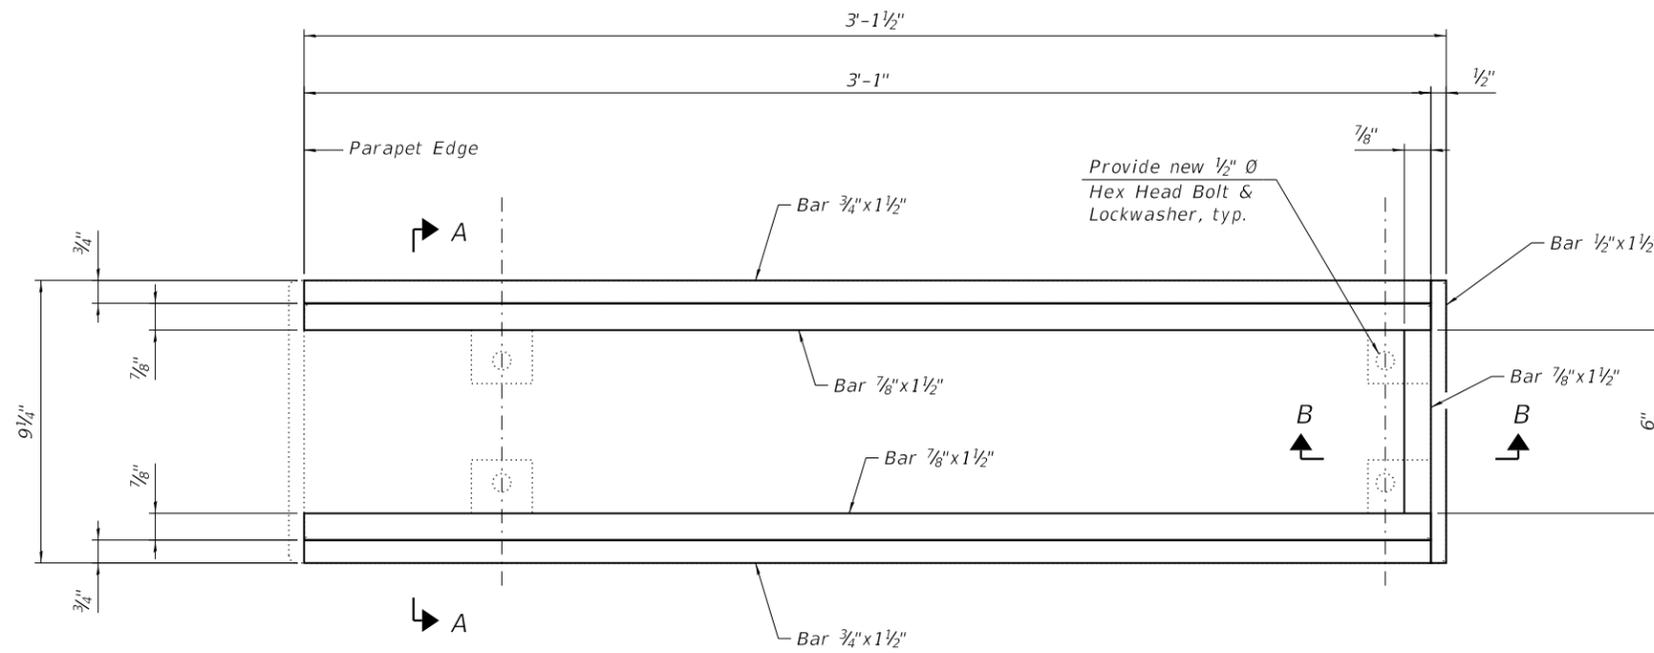
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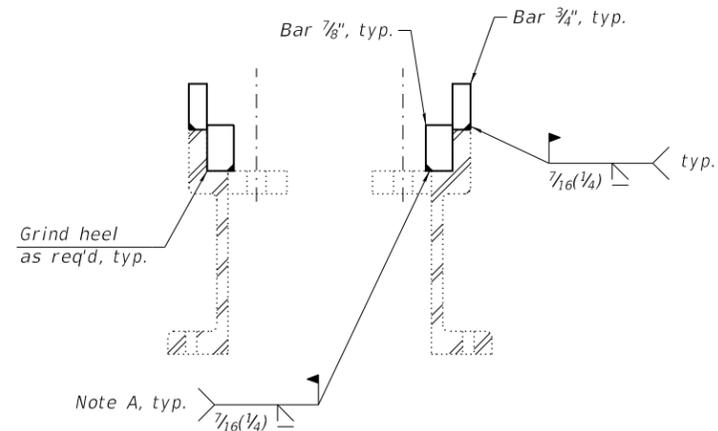
DECK REPAIR PLAN
I-55 OVER MADISON STREET - STRUCTURE NO. 022-0003

SHEET 5 OF 22 SHEETS


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55	2020-025-BR	DuPAGE	62	34
CONTRACT NO. 62K96				
ILLINOIS FED. AID PROJECT				



ADJUSTING SCUPPER RING - PLAN



SECTION A-A

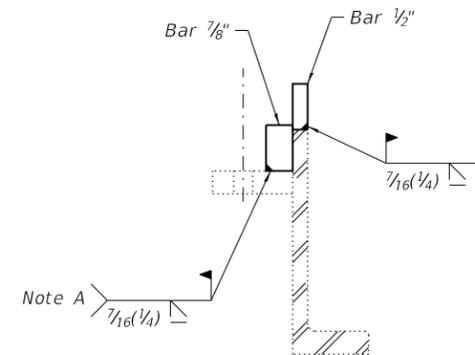

SECTION B-B

Note A:
Surface of weld shall be recessed 1/16\"/>

Notes:

1. The adjusting scupper ring shall be galvanized.
2. Bolts shall be 1/2\"/>

BILL OF MATERIAL

ITEM	UNIT	QUANTITY
Drainage Scupper to be Adjusted	Each	2

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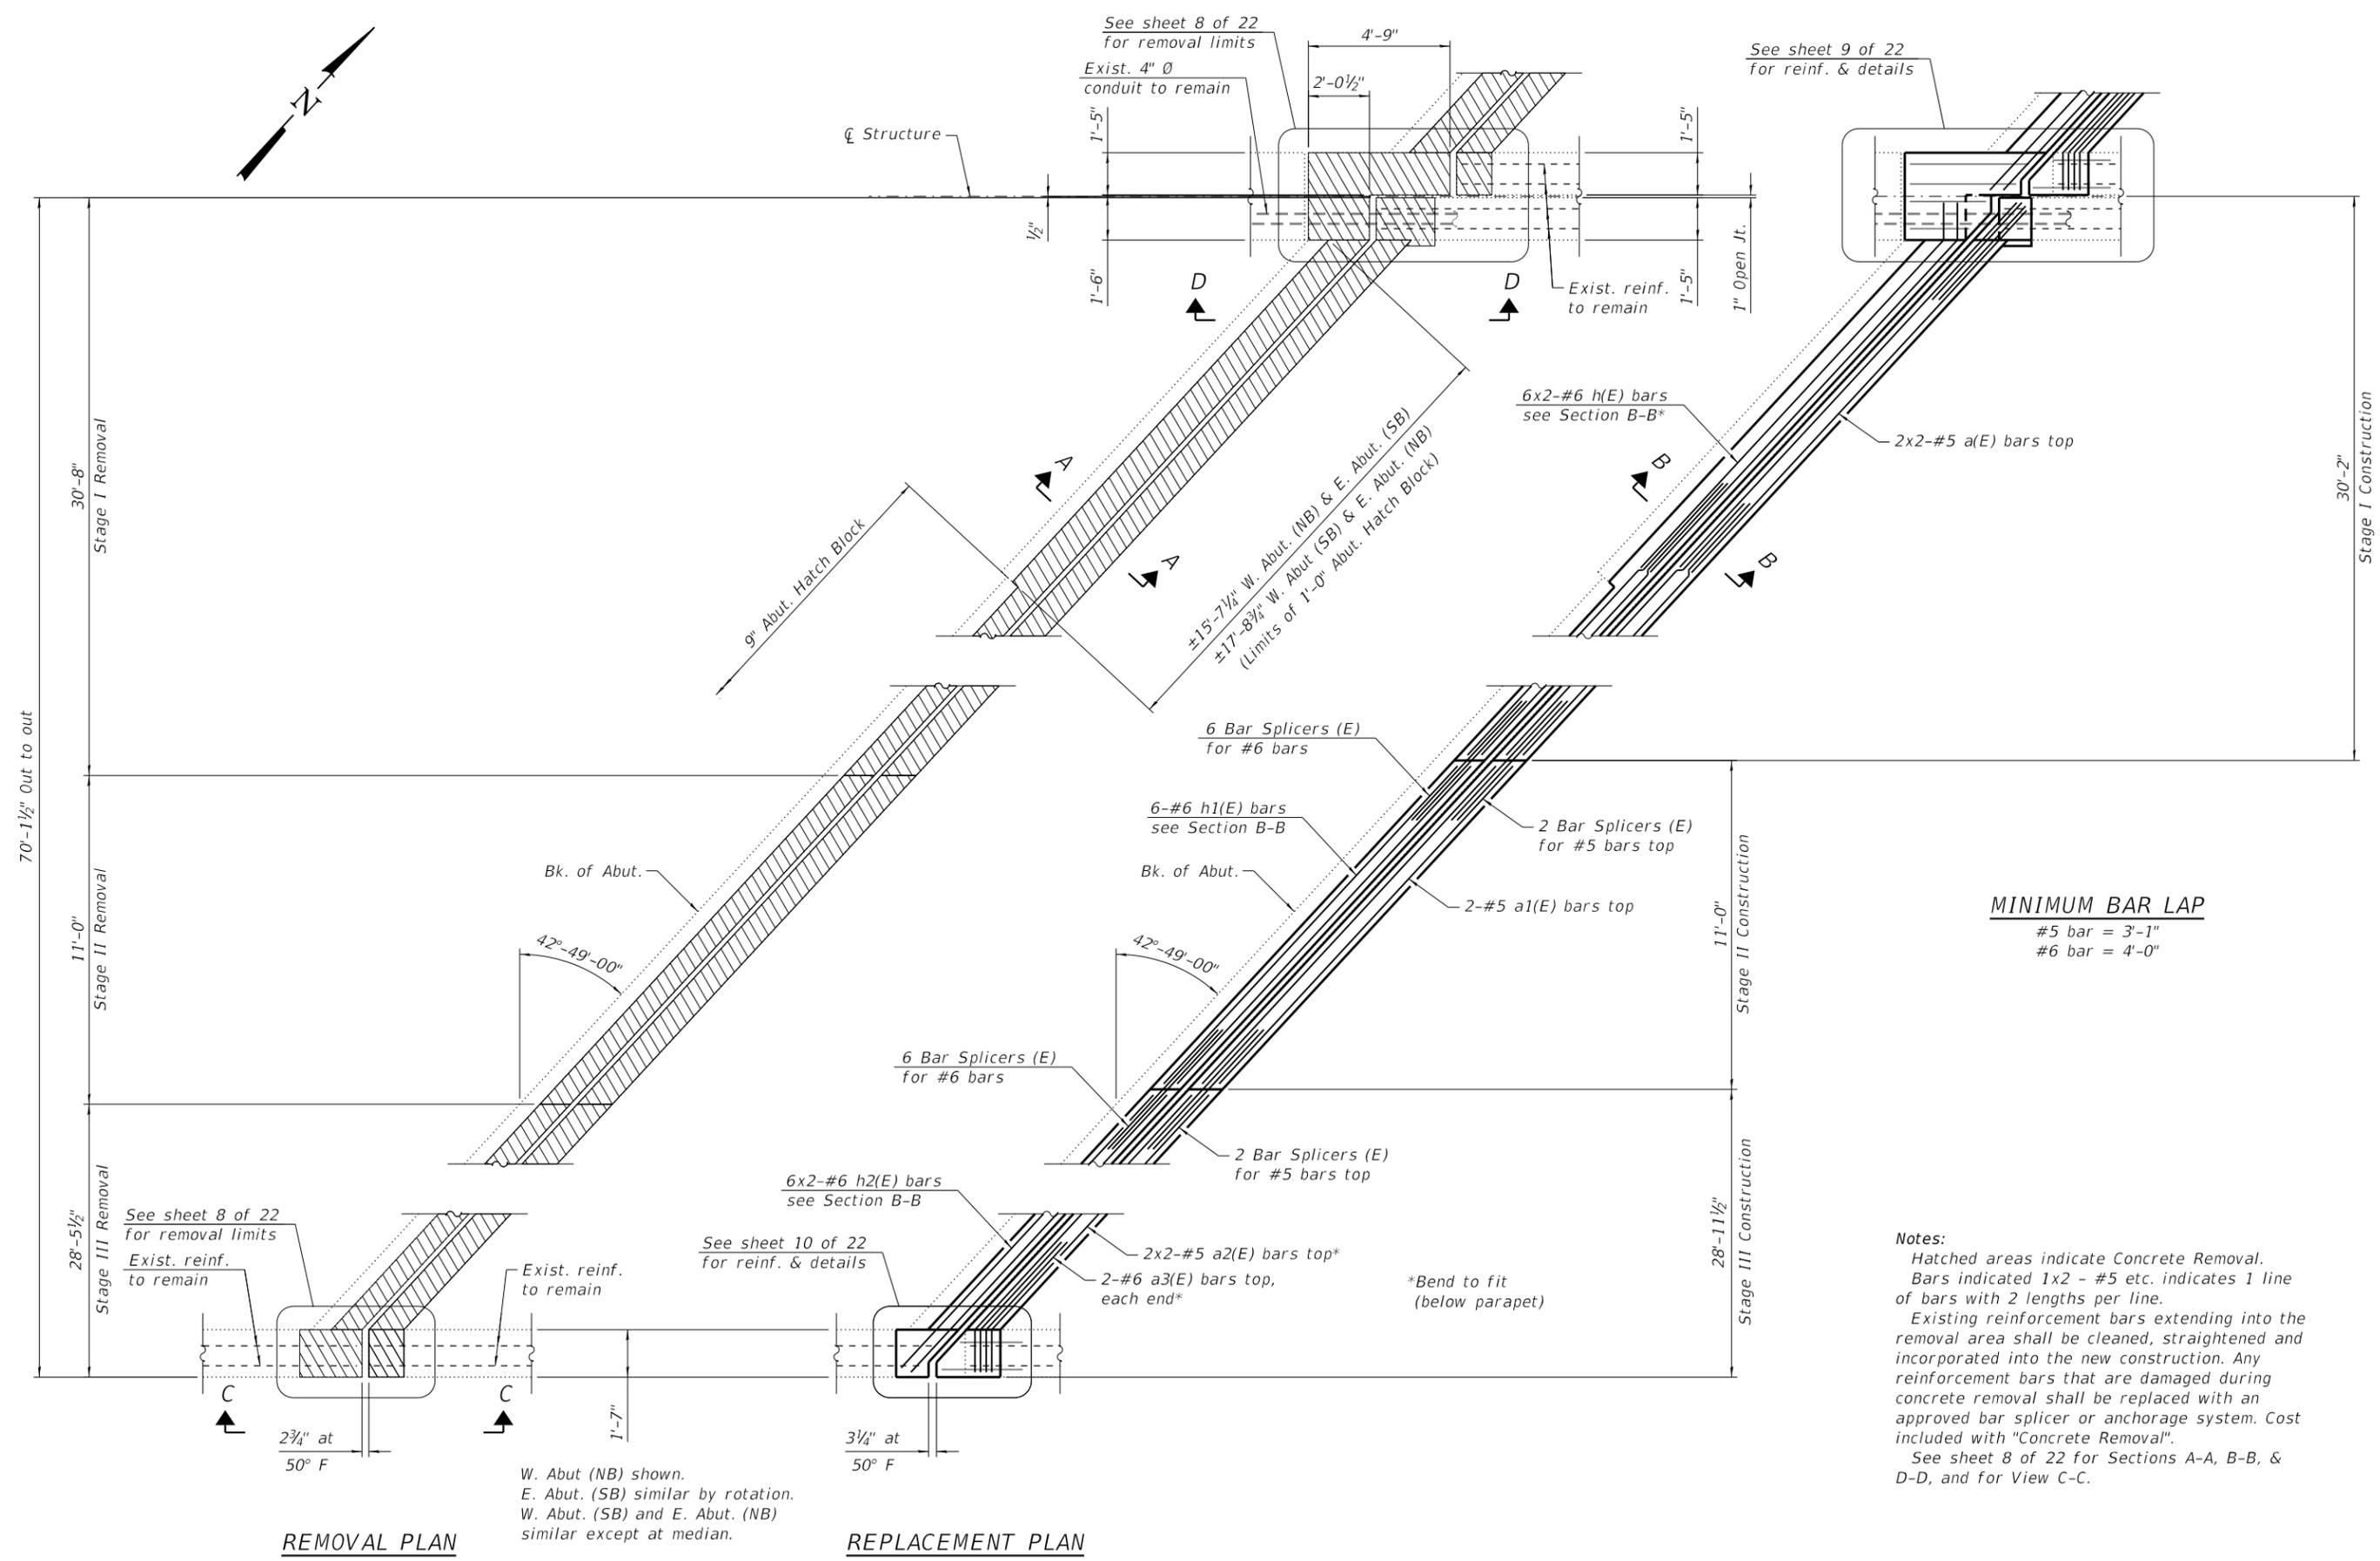
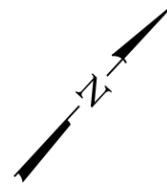
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PLOT DATE =	11/25/2020	CHECKED -	NBR	REVISED -	

**STATE OF ILLINOIS
DEPARTMENT OF TRANSPORTATION**

**ADJUSTING EXISTING SCUPPERS DETAILS
I-55 OVER MADISON STREET - STRUCTURE NO. 022-0003**

SHEET 6 OF 22 SHEETS

F.A.I. RTE.	SECTION	COUNTY	TOTAL SHEETS	SHEET NO.
55	2020-025-BR	DuPAGE	62	35
CONTRACT NO. 62K96				
		ILLINOIS	FED. AID PROJECT	



REMOVAL PLAN

REPLACEMENT PLAN

W. Abut. (NB) shown.
E. Abut. (SB) similar by rotation.
W. Abut. (SB) and E. Abut. (NB) similar except at median.

MINIMUM BAR LAP
#5 bar = 3'-1"
#6 bar = 4'-0"

Notes:
Hatched areas indicate Concrete Removal.
Bars indicated 1x2 - #5 etc. indicates 1 line of bars with 2 lengths per line.
Existing reinforcement bars extending into the removal area shall be cleaned, straightened and incorporated into the new construction. Any reinforcement bars that are damaged during concrete removal shall be replaced with an approved bar splicer or anchorage system. Cost included with "Concrete Removal".
See sheet 8 of 22 for Sections A-A, B-B, & D-D, and for View C-C.

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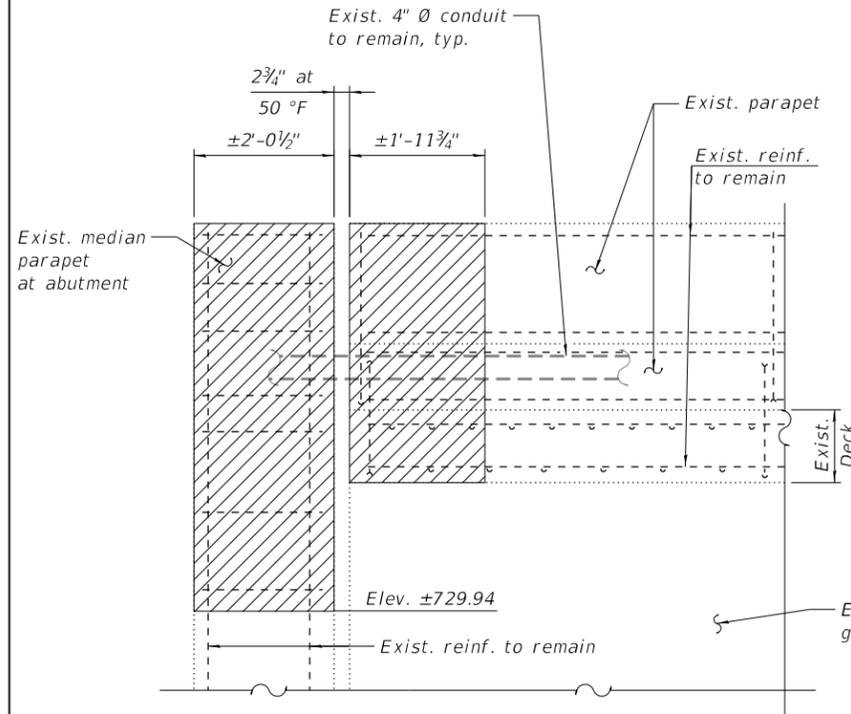
**STATE OF ILLINOIS
DEPARTMENT OF TRANSPORTATION**

**JOINT REPLACEMENT I
I-55 OVER MADISON STREET - STRUCTURE NO. 022-0003**


SHEET 7 OF 22 SHEETS

F.A.I. RTE.	SECTION	COUNTY	TOTAL SHEETS	SHEET NO.
55	2020-025-BR	DuPAGE	62	36
CONTRACT NO. 62K96				


ILLINOIS FED. AID PROJECT




SECTION D-D
W. ABUT. AT NB MEDIAN PARAPET
 (E. Abut. at SB Median Parapet is similar)

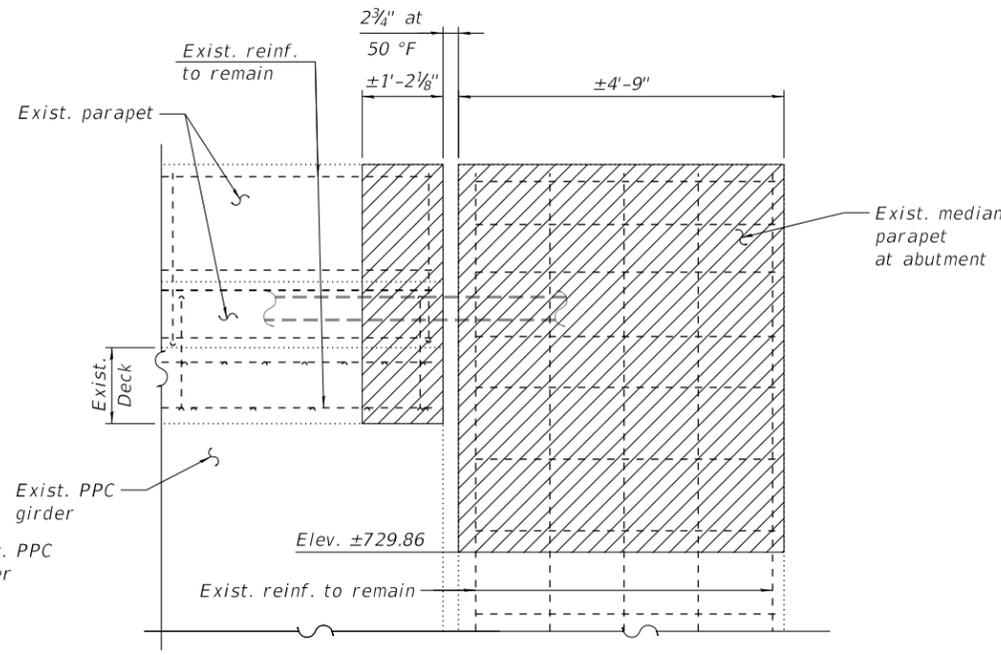


SECTION D-D
E. ABUT. AT NB MEDIAN PARAPET
 (W. Abut. at SB Median Parapet is similar)

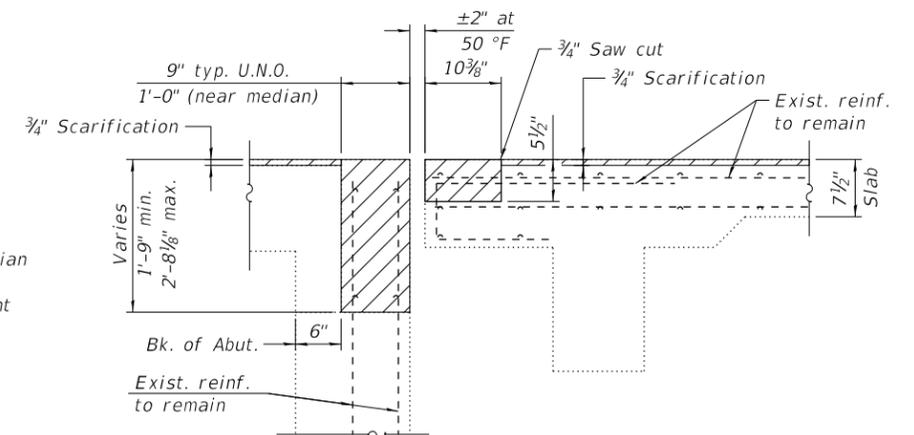


SECTION A-A

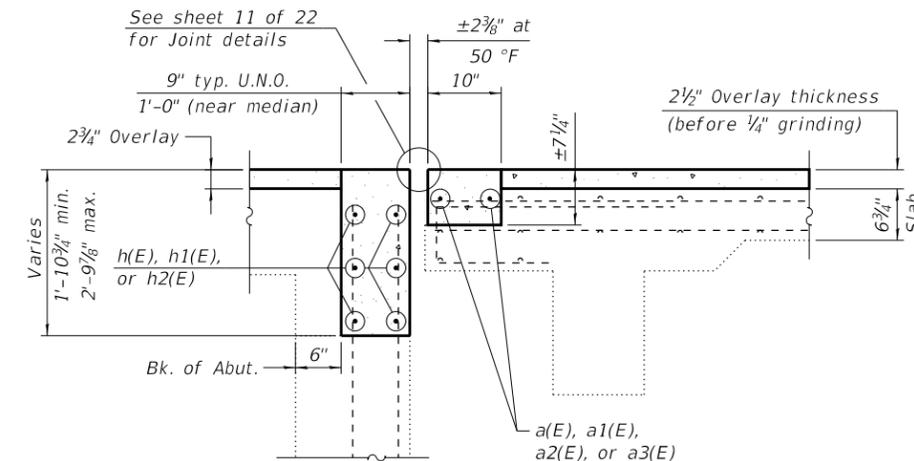

SECTION B-B

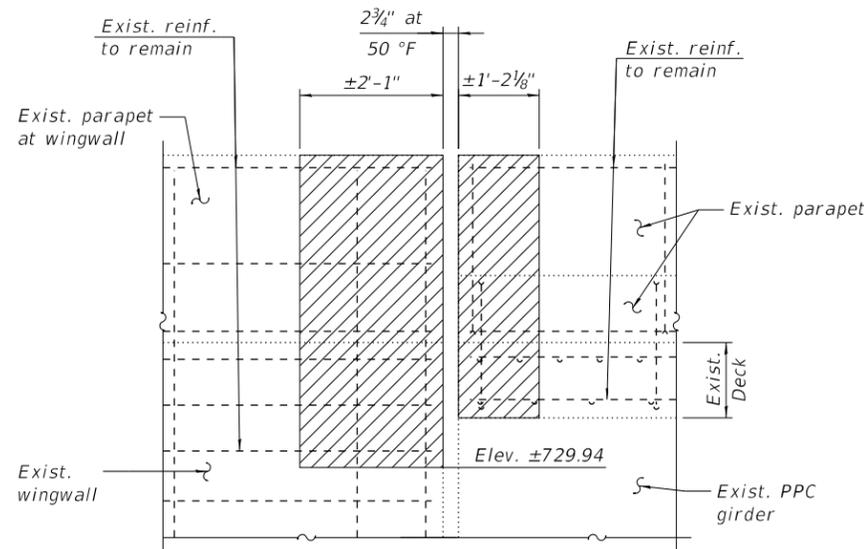

VIEW C-C
W. ABUT. AT NB OUTSIDE PARAPET
 (E. Abut. at SB Outside Parapet is similar)

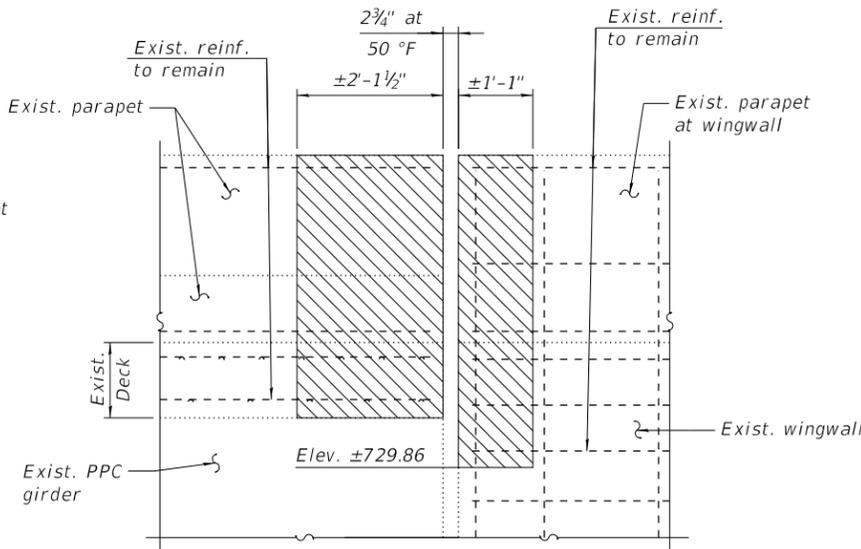

VIEW C-C
E. ABUT. AT NB OUTSIDE PARAPET
 (W. Abut. at SB Outside Parapet is similar)

Notes:
 Hatched areas indicate Concrete Removal.
 Existing reinforcement bars extending into the removal area shall be cleaned, straightened and incorporated into the new construction. Any reinforcement bars that are damaged during concrete removal shall be replaced with an approved bar splicer or anchorage system. Cost included with "Concrete Removal".

MODEL: Default
 FILE NAME: N:\116979\16979A-Struct_WD04\Cadd\0220003-62K96-008-JointRepl2.dgn



WSP USA Inc.
 30 N. LASALLE STREET
 SUITE 4200
 CHICAGO, IL 60602
 TEL: (312) 782-1150
 FAX: (312) 782-1884


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		CHECKED -	MI	REVISED -	
PLOT SCALE =	N.T.S.	DRAWN -	PJL	REVISED -	
PLOT DATE =	11/25/2020	CHECKED -	MI	REVISED -	

STATE OF ILLINOIS
DEPARTMENT OF TRANSPORTATION

JOINT REPLACEMENT II
I-55 OVER MADISON STREET - STRUCTURE NO. 022-0003

SHEET 8 OF 22 SHEETS

F.A.I. RTE.	SECTION	COUNTY	TOTAL SHEETS	SHEET NO.
55	2020-025-BR	DuPAGE	62	37
CONTRACT NO. 62K96				
ILLINOIS FED. AID PROJECT				

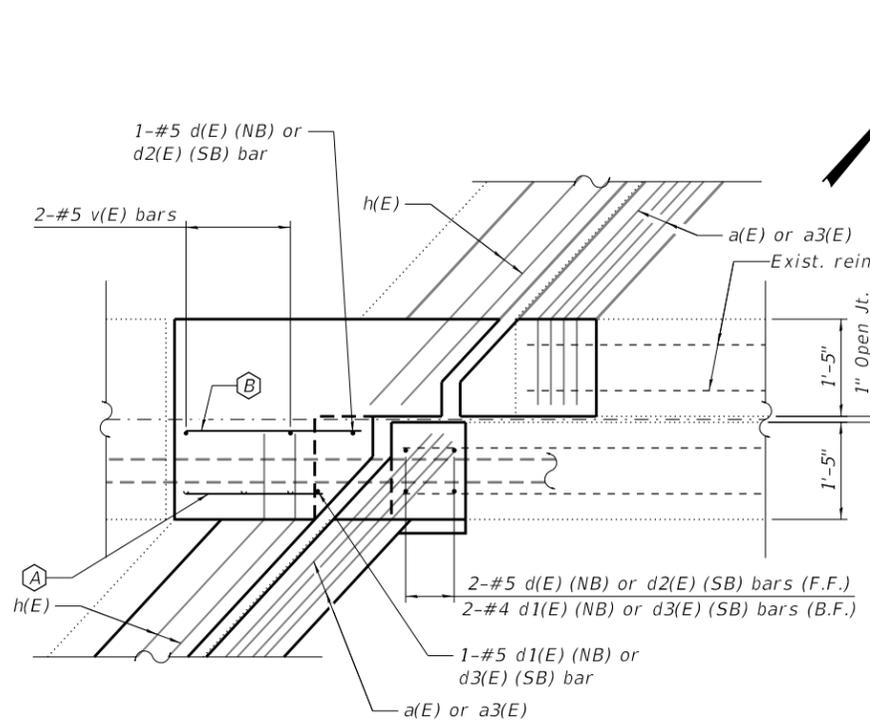


W. ABUT. AT NB MEDIAN PARAPET PLAN

(E. Abut. at SB Median Parapet is similar)

- A** 4-#5 h3(E) bars (NB Parapet)
5-#5 h3(E) bars (SB Parapet)
3-#5 h4(E) bars
(Cut to fit bars at front face as req'd,
see Section thru Median Parapets)

- B** 4-#5 h3(E) bars
(See Section thru
Median Parapets)

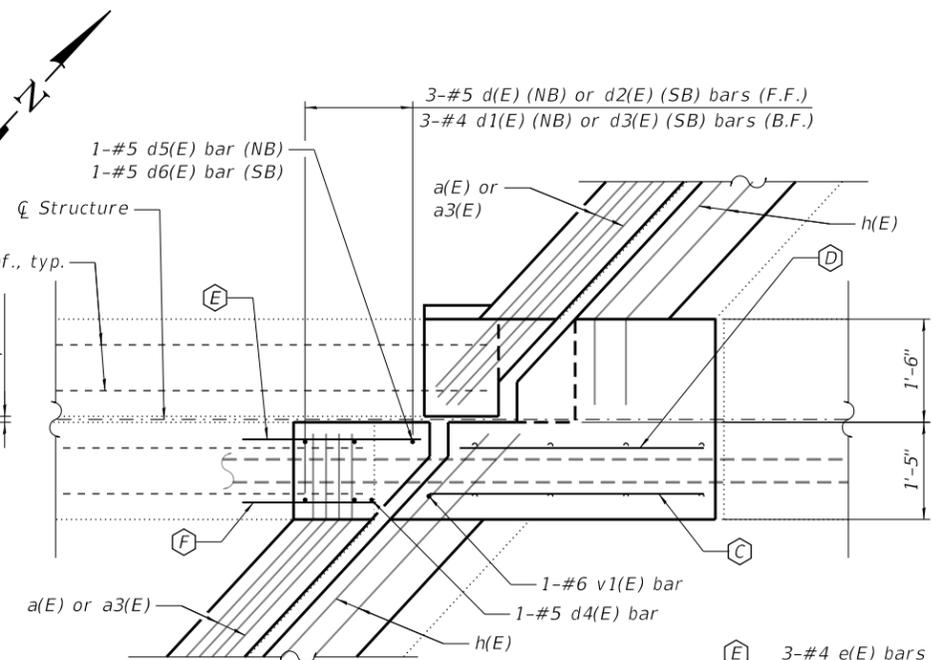

E. ABUT. AT NB MEDIAN PARAPET PLAN


(W. Abut. at SB Median Parapet is similar)

- C** 8-#5 h5(E) bars (NB Parapet)
7-#5 h5(E) bars (SB Parapet)
(See Section thru Median at Abut.)

- D** 7-#5 h5(E) bars
(Cut to fit bars at
back face as req'd,
see Section thru
Median at Abut.)


- E** 3-#4 e(E) bars (NB parapet)*
4-#4 e(E) bars (SB parapet)*
1-#8 e1(E) bar*
1-#5 e2(E) bar*
1-#5 b(E) bar*
1-#6 b1(E) bar*
(See Section thru
Median Parapets)

- F** 3-#4 e(E) bars (NB parapet)*
4-#4 e(E) bars (SB parapet)*
2-#5 e2(E) bar*
1-#5 b(E) bar*
1-#6 b1(E) bar*
(See Section thru
Median Parapets)

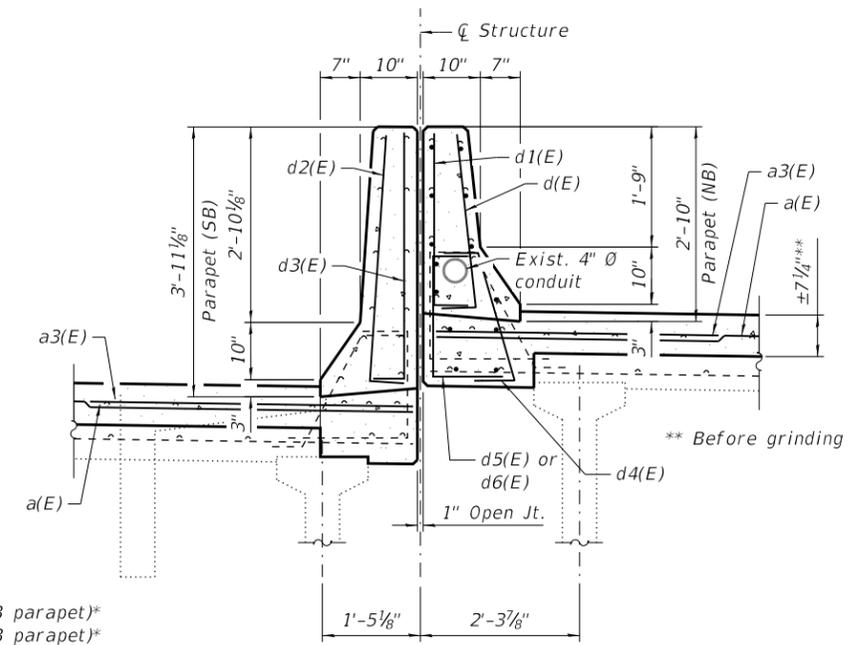


SECTION THRU MEDIAN PARAPETS

(Looking Northeast)

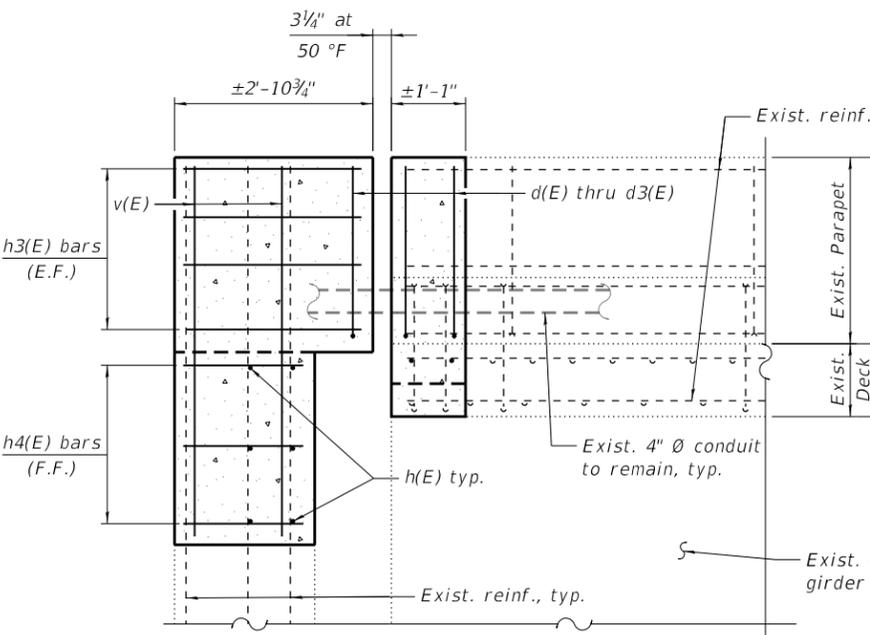


W. ABUT. AT NB MEDIAN PARAPET SECTION

(E. Abut. at SB Median Parapet is similar)

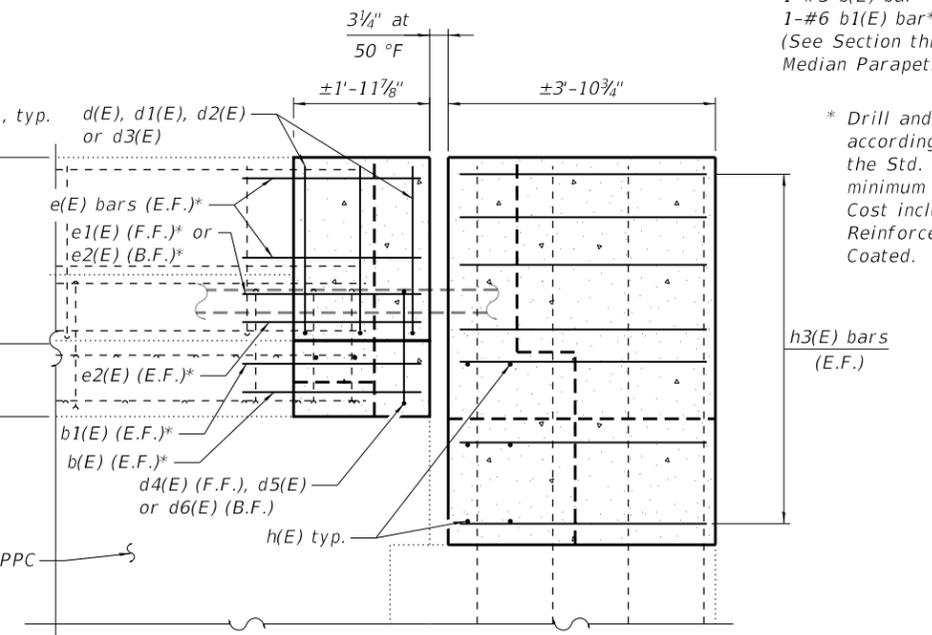

E. ABUT. AT NB MEDIAN PARAPET SECTION

(W. Abut. at SB Median Parapet is similar)

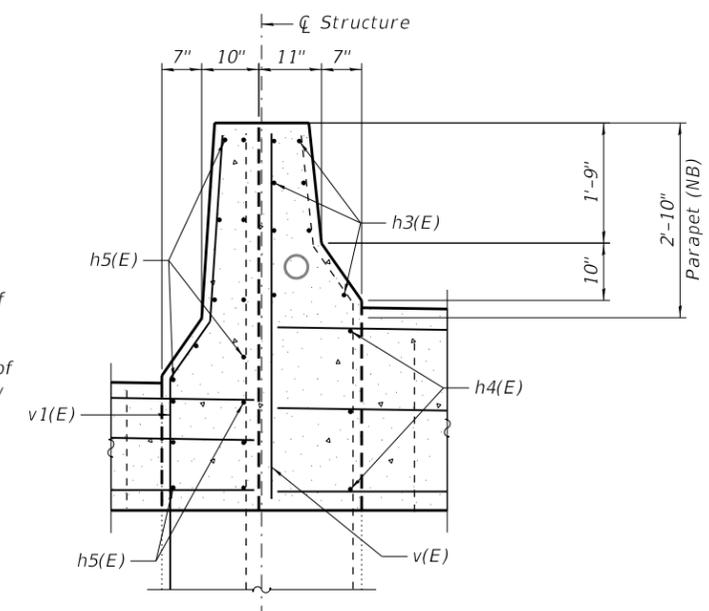

SECTION THRU MEDIAN AT ABUT.

(Looking Northeast)

* Drill and grout bars according to Article 584 of the Std. Specs., with a minimum embedment of 9". Cost included in the cost of Reinforcement Bars, Epoxy Coated.

MODEL: Default
FILE NAME: N:\116979\16979A-Struct_WD4\Cadd\0220003-62K96-009-JointRepl3.dgn



WSP USA Inc.
30 N. LASALLE STREET
SUITE 4200
CHICAGO, IL 60602
TEL: (312) 782-2150
FAX: (312) 782-1884

USER NAME =	SUSERS\$	DESIGNED -	PJL	REVISED -	
		CHECKED -	MI	REVISED -	
PLOT SCALE =	N.T.S.	DRAWN -	PJL	REVISED -	
PLOT DATE =	11/25/2020	CHECKED -	MI	REVISED -	

**STATE OF ILLINOIS
DEPARTMENT OF TRANSPORTATION**






**JOINT REPLACEMENT III
I-55 OVER MADISON STREET - STRUCTURE NO. 022-0003**

SHEET 9 OF 22 SHEETS

F.A.I. RTE.	SECTION	COUNTY	TOTAL SHEETS	SHEET NO.
55	2020-025-BR	DuPAGE	62	38
CONTRACT NO. 62K96				

ILLINOIS FED. AID PROJECT

11/25/2020 1:14:01 PM

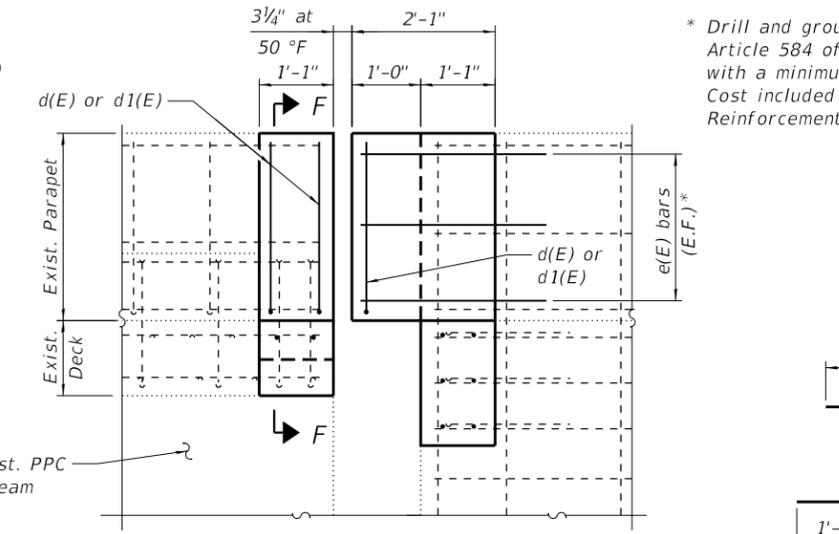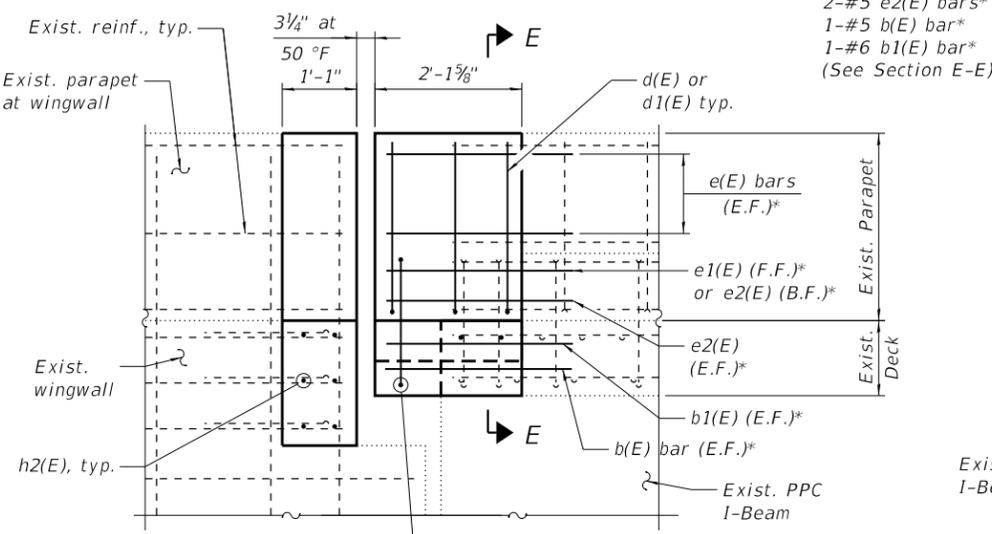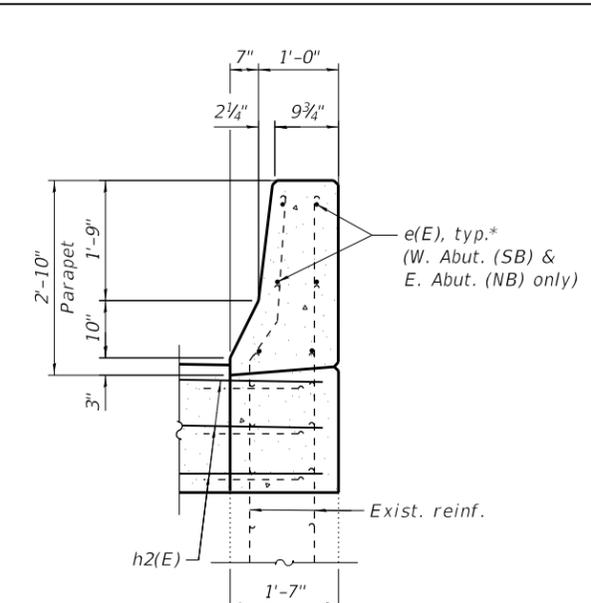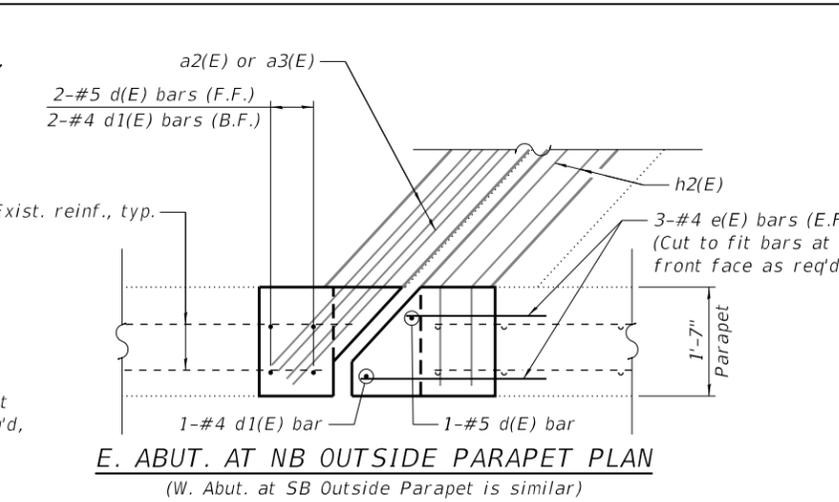
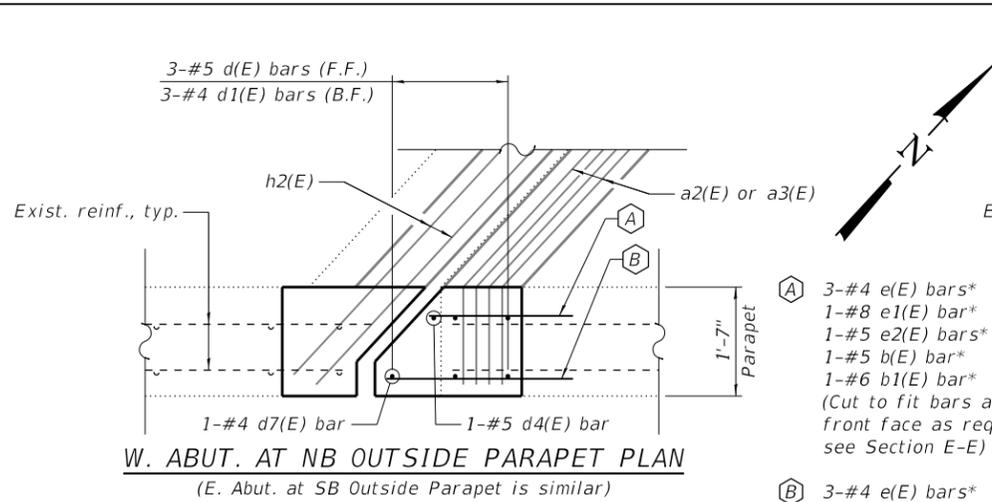


* Drill and grout bars according to Article 584 of the Std. Specs., with a minimum embedment of 9". Cost included in the cost of Reinforcement Bars, Epoxy Coated.

TYPICAL SECTION AT WINGWALL



W. ABUT. AT NB OUTSIDE PARAPET ELEVATION (E. Abut. at SB Outside Parapet is similar)

E. ABUT. AT NB OUTSIDE PARAPET ELEVATION (W. Abut. at SB Outside Parapet is similar)

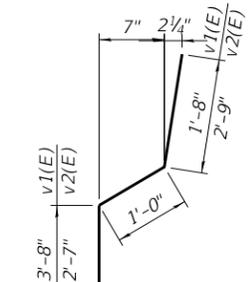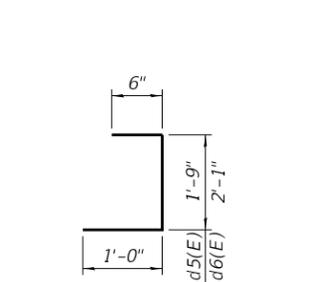



BARS d5(E) or d6(E)

BARS v1(E) or v2(E)

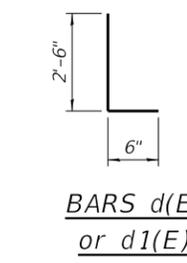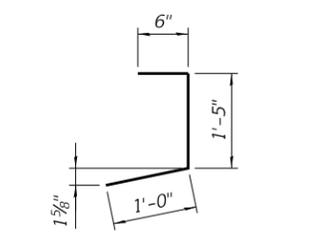

BAR d7(E)

BARS d(E) or d1(E)

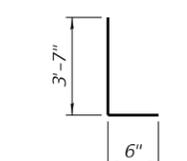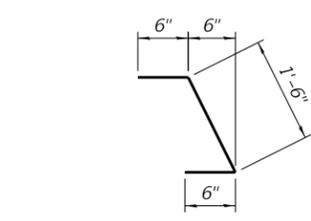


BAR d4(E)


BARS d2(E) or d3(E)

BILL OF MATERIAL

Bar	No.	Size	Length	Shape
a(E)	16	#5	22'-5"	—
a1(E)	8	#5	14'-8"	—
a2(E)	16	#5	21'-7"	—
a3(E)	16	#6	6'-6"	—
b(E)	8	#5	2'-9"	—
b1(E)	8	#6	2'-9"	—
d(E)	18	#5	3'-0"	—
d1(E)	18	#4	3'-0"	—
d2(E)	6	#5	4'-1"	—
d3(E)	6	#4	4'-1"	—
d4(E)	4	#5	2'-6"	—
d5(E)	1	#4	3'-3"	—
d6(E)	1	#4	3'-7"	—
d7(E)	2	#4	2'-11"	—
e(E)	26	#4	2'-9"	—
e1(E)	4	#8	2'-9"	—
e2(E)	12	#5	2'-9"	—
h(E)	48	#6	22'-5"	—
h1(E)	24	#6	14'-8"	—
h2(E)	48	#6	21'-10"	—
h3(E)	17	#5	2'-7"	—
h4(E)	6	#5	1'-9"	—
h5(E)	29	#5	4'-0"	—
v(E)	4	#6	5'-3"	—
v1(E)	1	#6	6'-4"	—
v2(E)	1	#6	6'-4"	—
Concrete Removal			Cu. Yd.	33.6
Reinforcement Bars, Epoxy Coated			Lbs.	5,290
Concrete Superstructures			Cu Yd.	36.7
Bar Splicers			Each	64

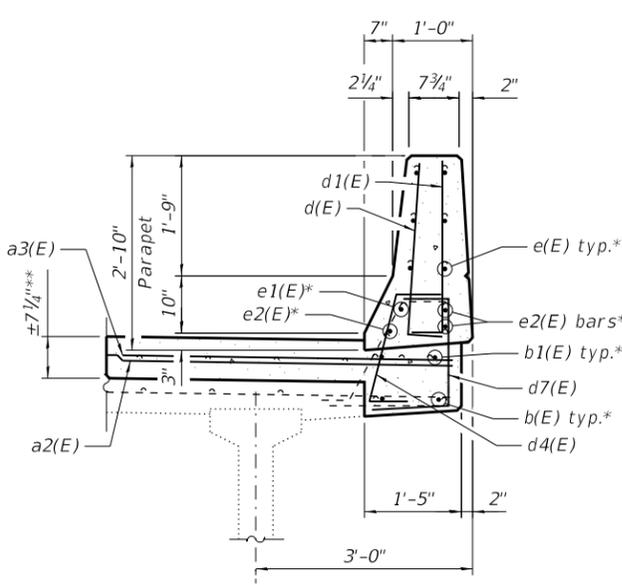

SECTION E-E

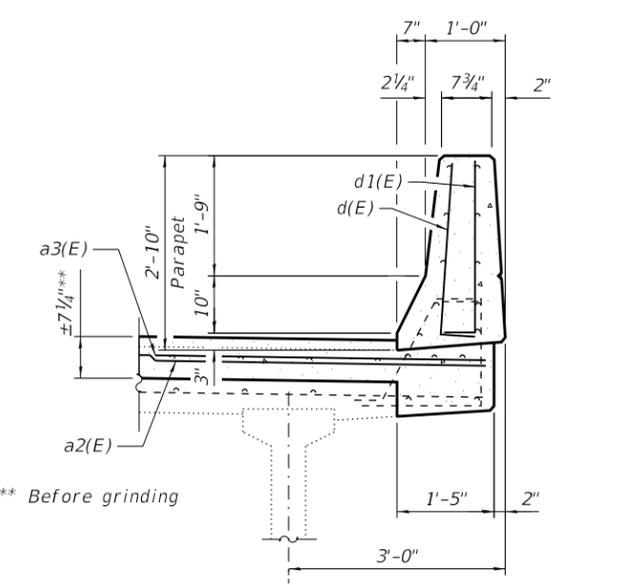

SECTION F-F

MODEL: Default
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11/25/2020 1:13:28 PM




WSP USA Inc.
30 N. LASALLE STREET
SUITE 4200
CHICAGO, IL 60602
TEL: (312) 782-8150
FAX: (312) 782-1884

USER NAME =	SUSERS\$	DESIGNED -	PJL	REVISED -	
CHECKED -	MI	CHECKED -	MI	REVISED -	
PLOT SCALE =	N.T.S.	DRAWN -	PJL	REVISED -	
PLOT DATE =	11/25/2020	CHECKED -	MI	REVISED -	

STATE OF ILLINOIS
DEPARTMENT OF TRANSPORTATION


JOINT REPLACEMENT IV
I-55 OVER MADISON STREET - STRUCTURE NO. 022-0003

F.A.I. RTE.	SECTION	COUNTY	TOTAL SHEETS	SHEET NO.
55	2020-025-BR	DuPAGE	62	39
			CONTRACT NO. 62K96	
		ILLINOIS FED. AID PROJECT		

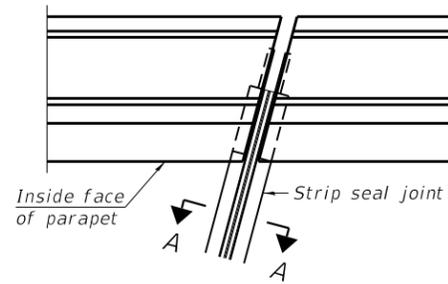


FOR SKEWS $\leq 30^\circ$


PLAN AT PARAPET

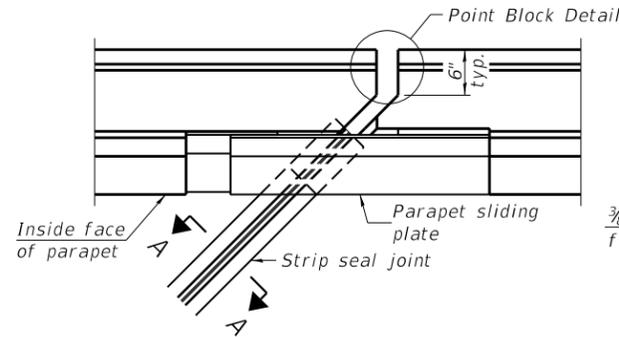

FOR SKEWS $> 30^\circ$

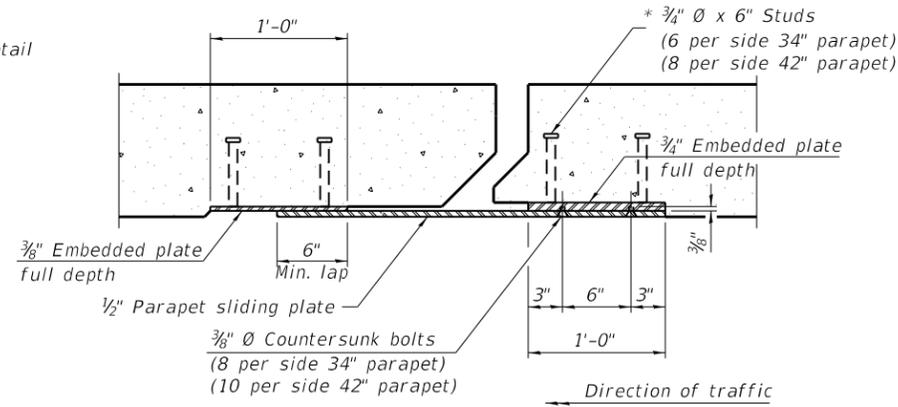


SECTION B-B

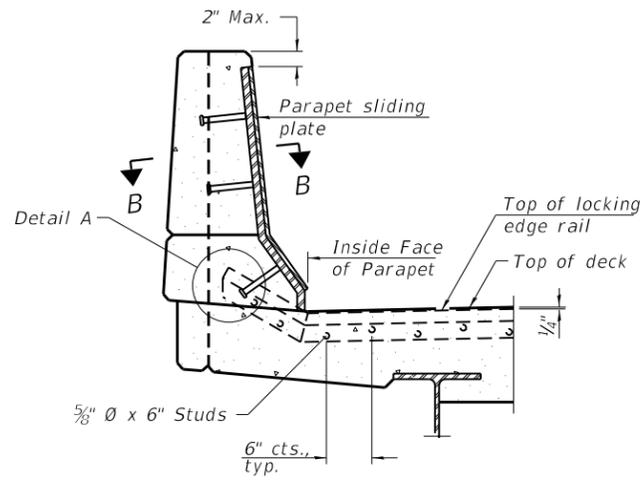


ELEVATION AT PARAPET


(Skews $> 30^\circ$ shown. Skews $\leq 30^\circ$ similar except as shown in plan view.)

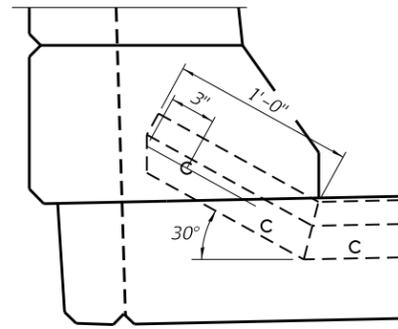

DETAIL A

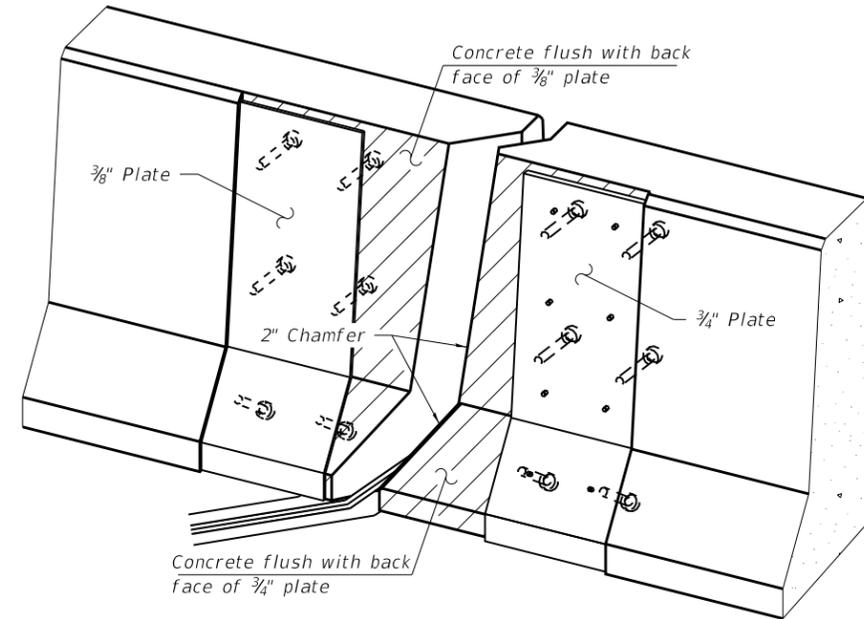


TRIMETRIC VIEW
(Showing embedded plates only)

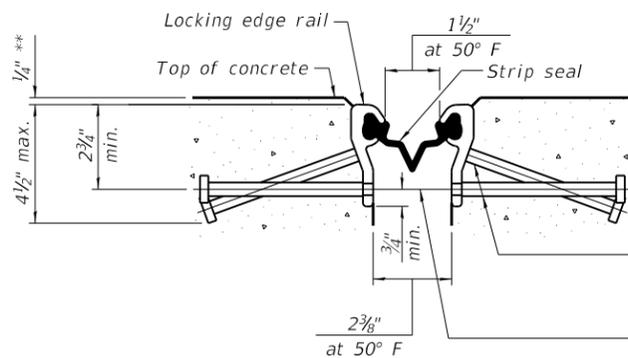


SHOWING ROLLED RAIL JOINT

* $5/8"$ ϕ x 6" studs @ 6" cts. (alternate angled/bent studs with horizontal studs)

$3/8"$ ϕ threaded rods in $7/16"$ ϕ holes at $\pm 4"-0"$ cts. for holding the proper joint opening based on the temperature during the deck pour. Place to miss studs. All rods shall be burned, or sawed off flush with the plates after concrete is set.

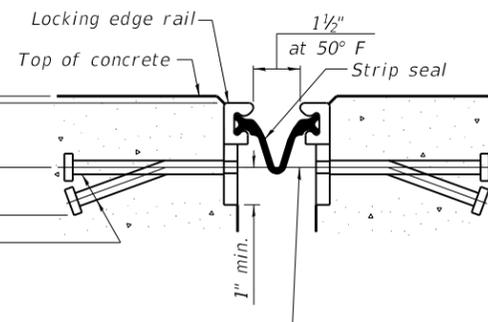


SHOWING WELDED RAIL JOINT

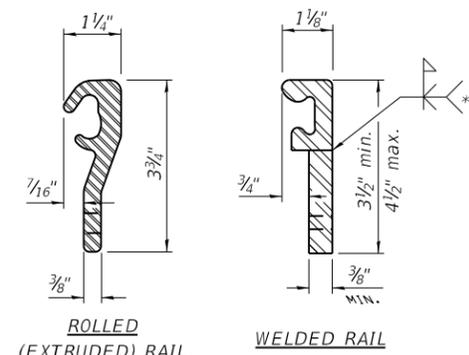

LOCKING EDGE RAILS

** Back gouge not required if complete joint penetration is verified by mock-up.

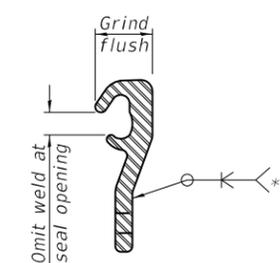

LOCKING EDGE RAIL SPLICE

The inside of the locking edge rail groove shall be free of weld residue. Rolled rail shown, welded rail similar.

BILL OF MATERIAL

Item	Unit	Total
Preformed Joint Strip Seal	Foot	368

MODEL: Default
FILE NAME: N:\16979\16979A-Struct_WD04\Cadd\0220003-62K96-011-Exp\jmt.dgn

WSP
WSP USA Inc.
30 N. LASALLE STREET
SUITE 4200
CHICAGO, IL 60602
TEL: (312) 782-8150
FAX: (312) 782-1884



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PLOT SCALE =	N.T.S.	CHECKED -	PJL	REVISED -	
PLOT DATE =	11/25/2020	DRAWN -	FB	REVISED -	
		CHECKED -	PJL	REVISED -	

STATE OF ILLINOIS
DEPARTMENT OF TRANSPORTATION

PREFORMED JOINT STRIP SEAL
I-55 OVER MADISON STREET - STRUCTURE NO. 022-0003

SHEET 11 OF 22 SHEETS

F.A.I. RTE.	SECTION	COUNTY	TOTAL SHEETS	SHEET NO.
55	2020-025-BR	DuPAGE	62	40
ILLINOIS FED. AID PROJECT			CONTRACT NO. 62K96	

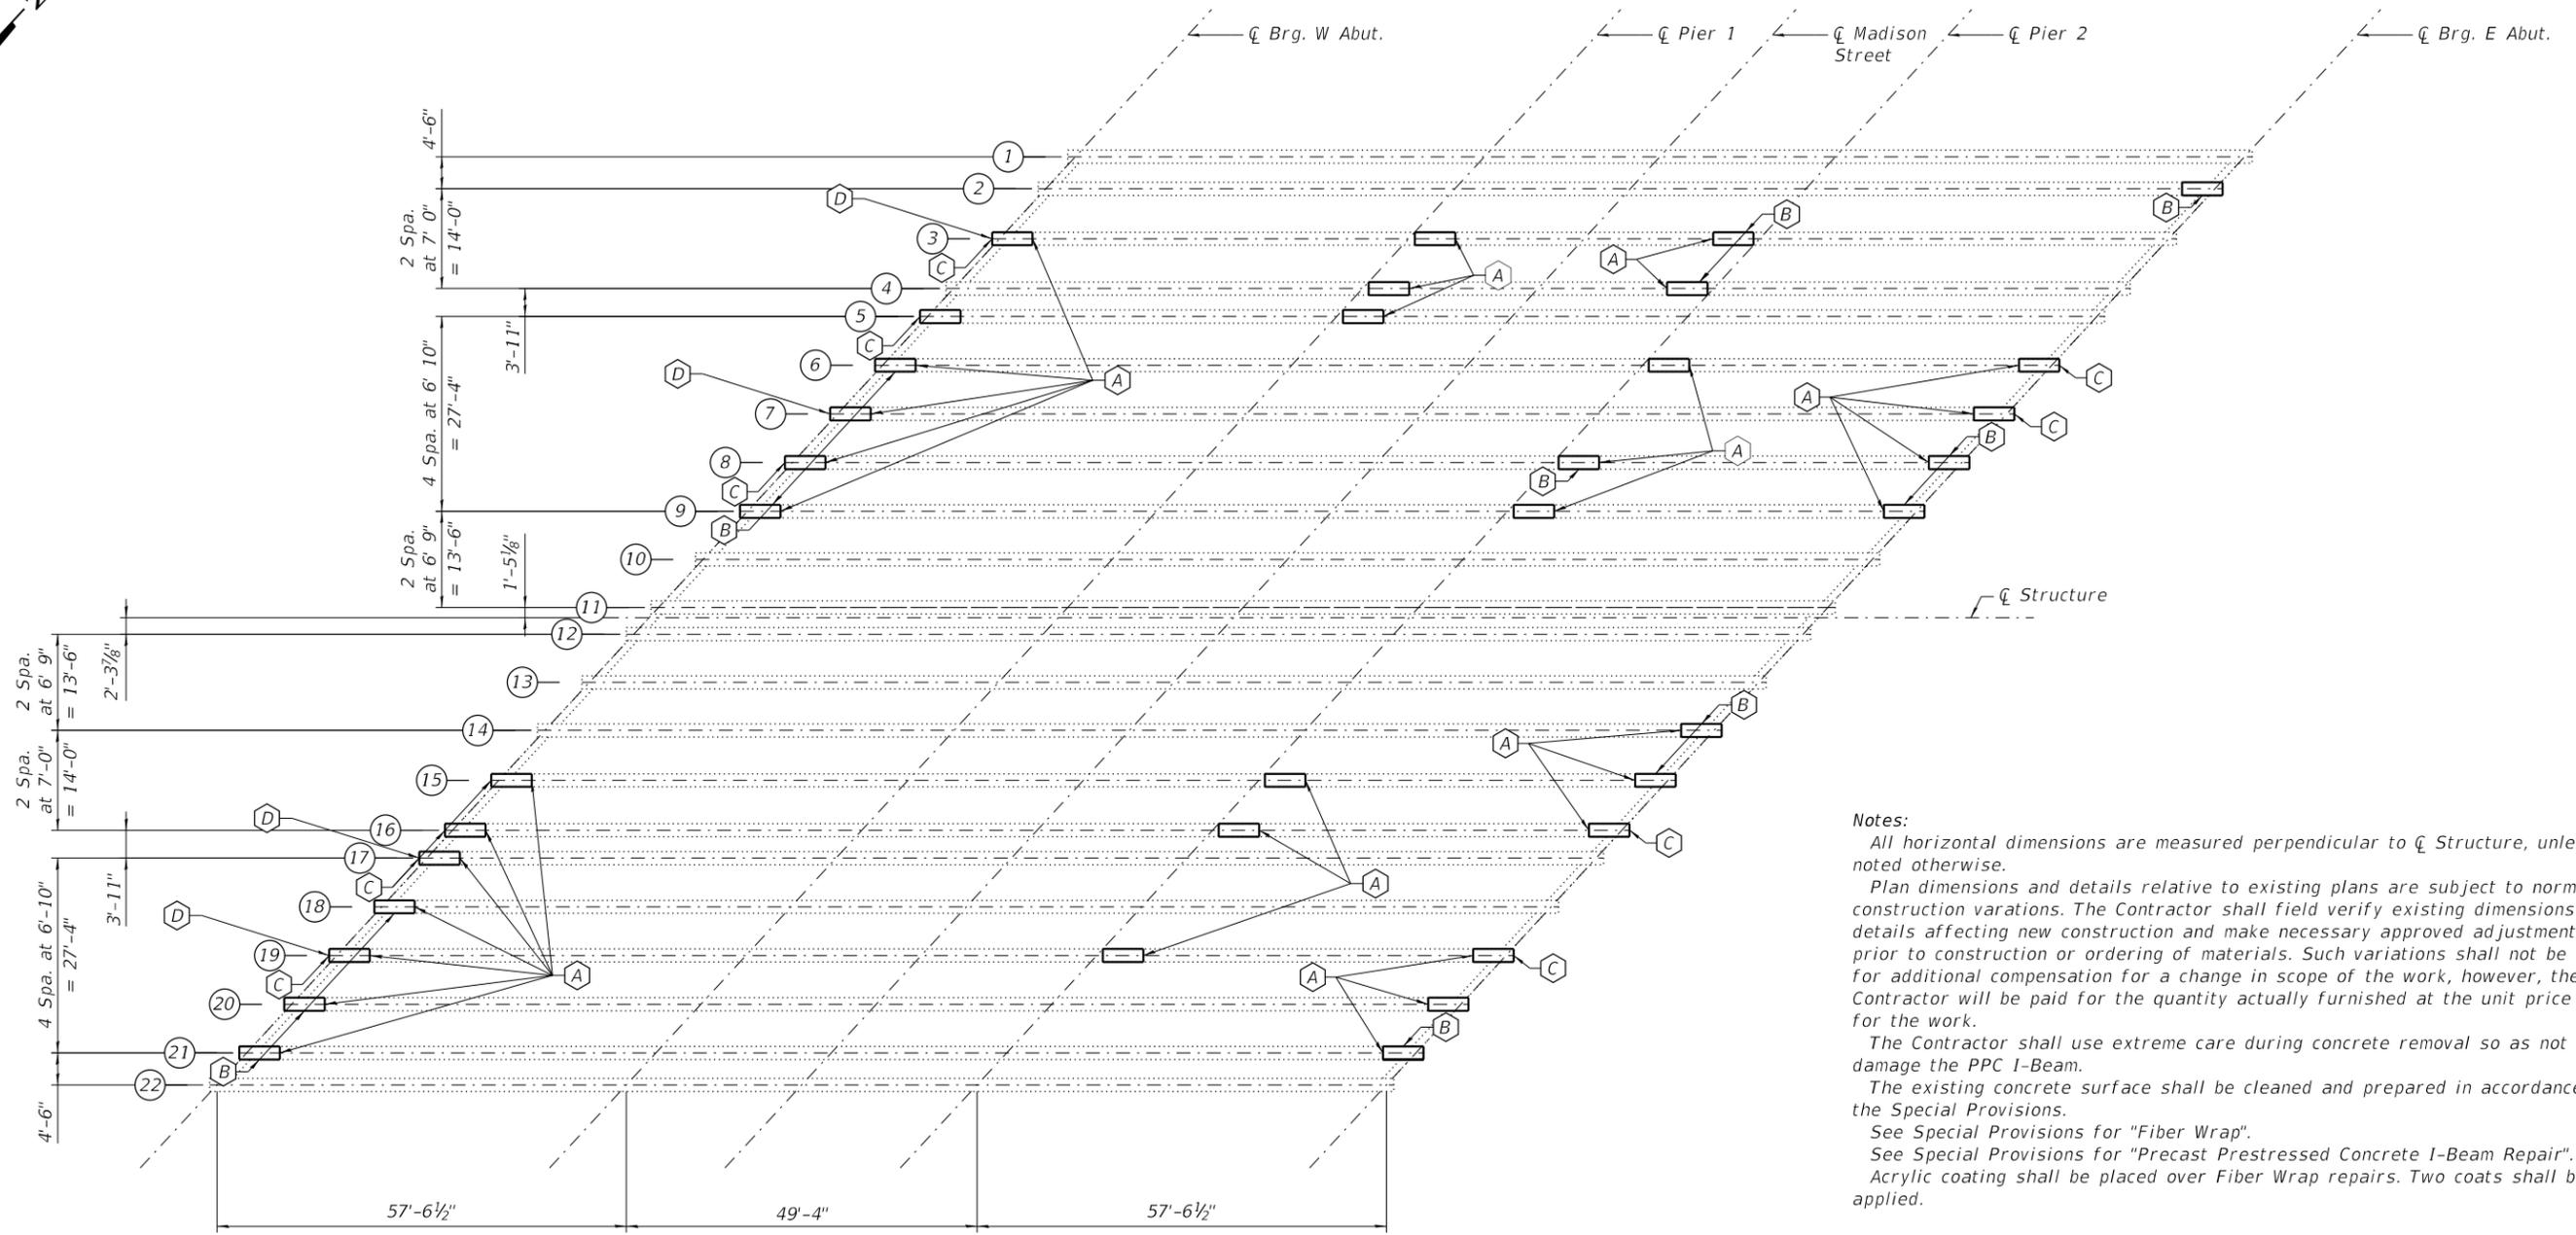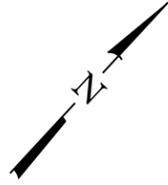

Notes:
 All horizontal dimensions are measured perpendicular to \bar{C} Structure, unless noted otherwise.
 Plan dimensions and details relative to existing plans are subject to normal construction variations. The Contractor shall field verify existing dimensions and details affecting new construction and make necessary approved adjustments prior to construction or ordering of materials. Such variations shall not be cause for additional compensation for a change in scope of the work, however, the Contractor will be paid for the quantity actually furnished at the unit price bid for the work.
 The Contractor shall use extreme care during concrete removal so as not to damage the PPC I-Beam.
 The existing concrete surface shall be cleaned and prepared in accordance with the Special Provisions.
 See Special Provisions for "Fiber Wrap".
 See Special Provisions for "Precast Prestressed Concrete I-Beam Repair".
 Acrylic coating shall be placed over Fiber Wrap repairs. Two coats shall be applied.

FRAMING PLAN

- (A) - Location of PPC I-Beam Repair A
- (B) - Location of PPC I-Beam Repair B
- (C) - Location of PPC I-Beam Repair C
- (D) - Location of PPC I-Beam Repair D

BILL OF MATERIAL

ITEM	UNIT	QUANTITY
Fiber Wrap	Sq. Ft.	319
Acrylic Coating	Sq. Yd.	33
Precast Prestressed Concrete I-Beam Repair	Sq. Ft.	131

MODEL: Default
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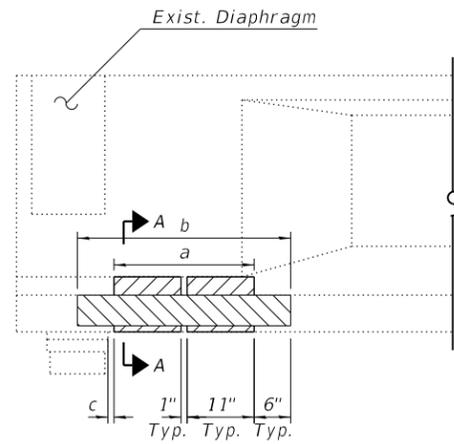
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		CHECKED -	PJL	REVISED -	
PLOT SCALE =	N.T.S.	DRAWN -	DB	REVISED -	
PLOT DATE =	11/25/2020	CHECKED -	PJL	REVISED -	

**STATE OF ILLINOIS
 DEPARTMENT OF TRANSPORTATION**


**FRAMING PLAN
 I-55 OVER MADISON STREET - STRUCTURE NO. 022-0003**

SHEET 12 OF 22 SHEETS


F.A.I. RTE.	SECTION	COUNTY	TOTAL SHEETS	SHEET NO.
55	2020-025-BR	DuPAGE	62	41
CONTRACT NO. 62K96				
ILLINOIS		FED. AID PROJECT		




REPAIR A
(37 Locations)

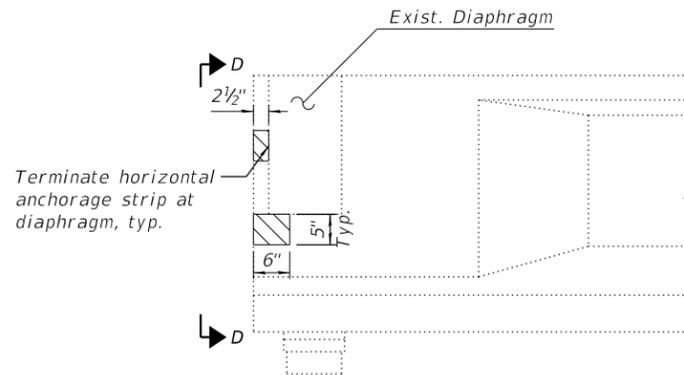


REPAIR D
(4 Locations)

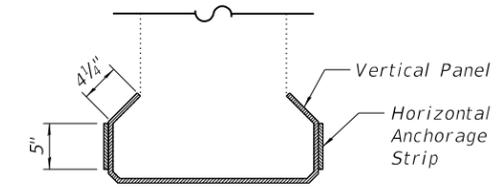


SECTION A-A

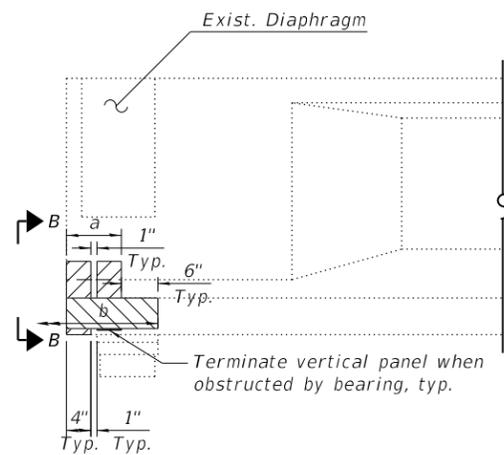


REPAIR B
(14 Locations)

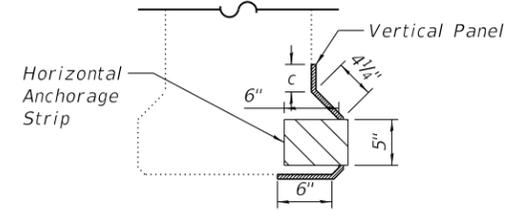


VIEW B-B

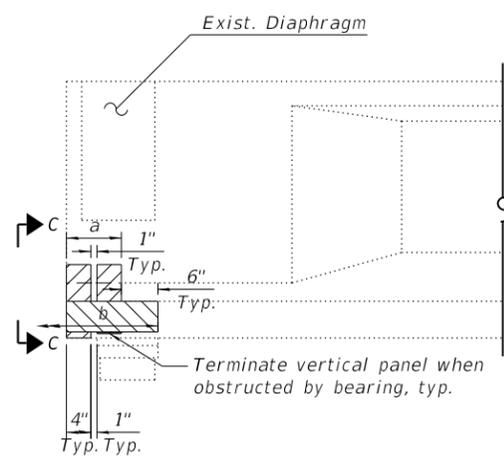


REPAIR C
(11 Locations)

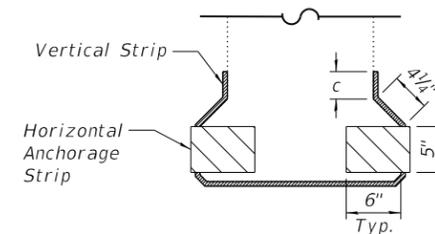

VIEW C-C

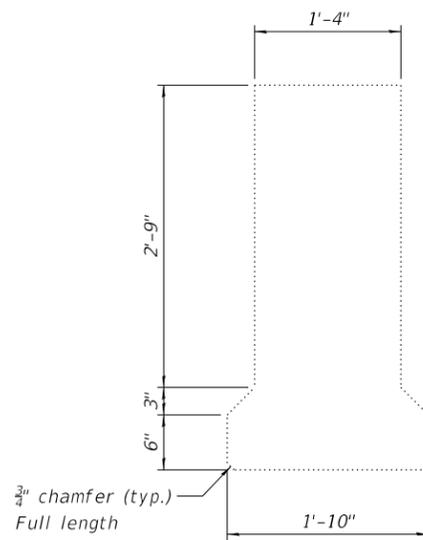

CROSS SECTION
(Showing dimensions at beam end)

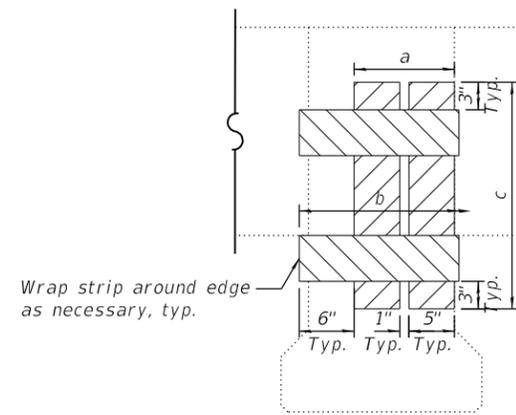

VIEW D-D

REPAIR TYPE	SPAN	LOCATION	BEAM	BEAM FACE	a (in.)	b (in.)	c (in.)
A	1	W. Abut.	3	-	11	23	1
			6	-	11	23	1
			7	-	35	47	1
			8	-	11	23	1
			9	-	11	23	1
			15	-	11	23	1
			16	-	11	23	1
			17	-	11	23	1
			18	-	11	23	1
			19	-	11	23	1
			20	-	23	35	1
			21	-	11	23	1
	2	Pier 1	3	-	71	83	1
			4	-	23	35	1
			5	-	11	23	12
		Pier 2	3	-	23	35	1
			4	-	23	35	1
	3	E. Abut.	6	-	23	35	1
			7	-	11	23	1
			8	-	11	23	1
			9	-	11	23	12
			14	-	11	23	1
			15	-	23	35	1
			16	-	11	23	1
			19	-	23	35	1
			20	-	11	23	1
			21	-	11	23	1
		Pier 2	6	-	11	23	6
			8	-	11	23	6
			8	-	11	23	60
			9	-	47	59	1
			9	-	11	23	96
			9	-	11	23	144
			15	-	59	71	24
			16	-	23	35	36
			16	-	11	23	72
			19	-	71	83	1
B	1	W. Abut.	6	S	4	16	0
			9	N	4	16	0
			18	S	4	16	3
			20	S	4	16	3
			21	S	4	16	0
	2	Pier 2	3	N	9	21	0
			4	N	9	21	0
	3	E. Abut.	2	S	4	16	12
			8	N	4	16	0
			9	N	4	16	0
			14	N	4	16	0
			15	N	4	16	0
			21	N	4	16	0
		Pier 2	8	S	9	21	3
C	1	W. Abut.	3	-	14	26	3
			5	-	4	16	0
			8	-	4	16	0
			15	-	4	16	0
			16	-	4	16	0
			17	-	4	16	0
			19	-	9	21	3
		Pier 2	6	-	9	21	3
			7	-	14	26	3
			16	-	4	16	0
			19	-	9	21	0
D	1	W. Abut.	3	-	5	17	36
			7	-	5	17	24
			17	-	11	23	24
			19	-	5	17	24

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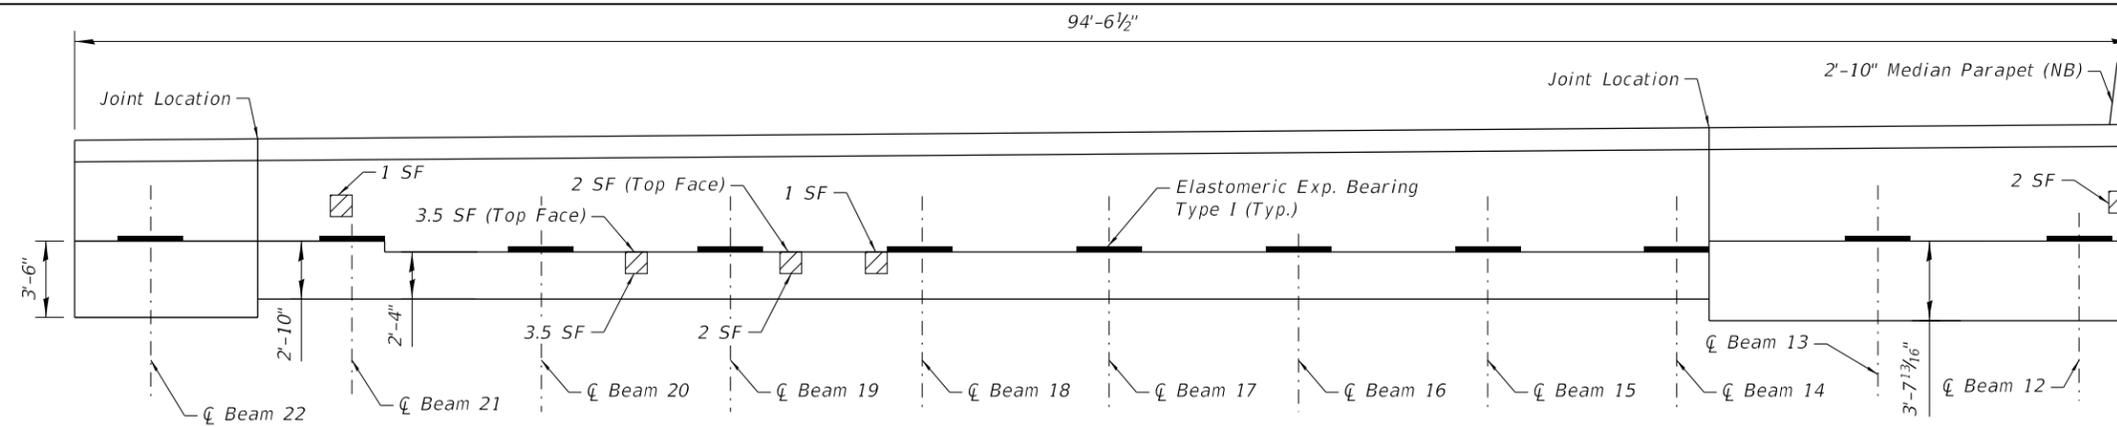


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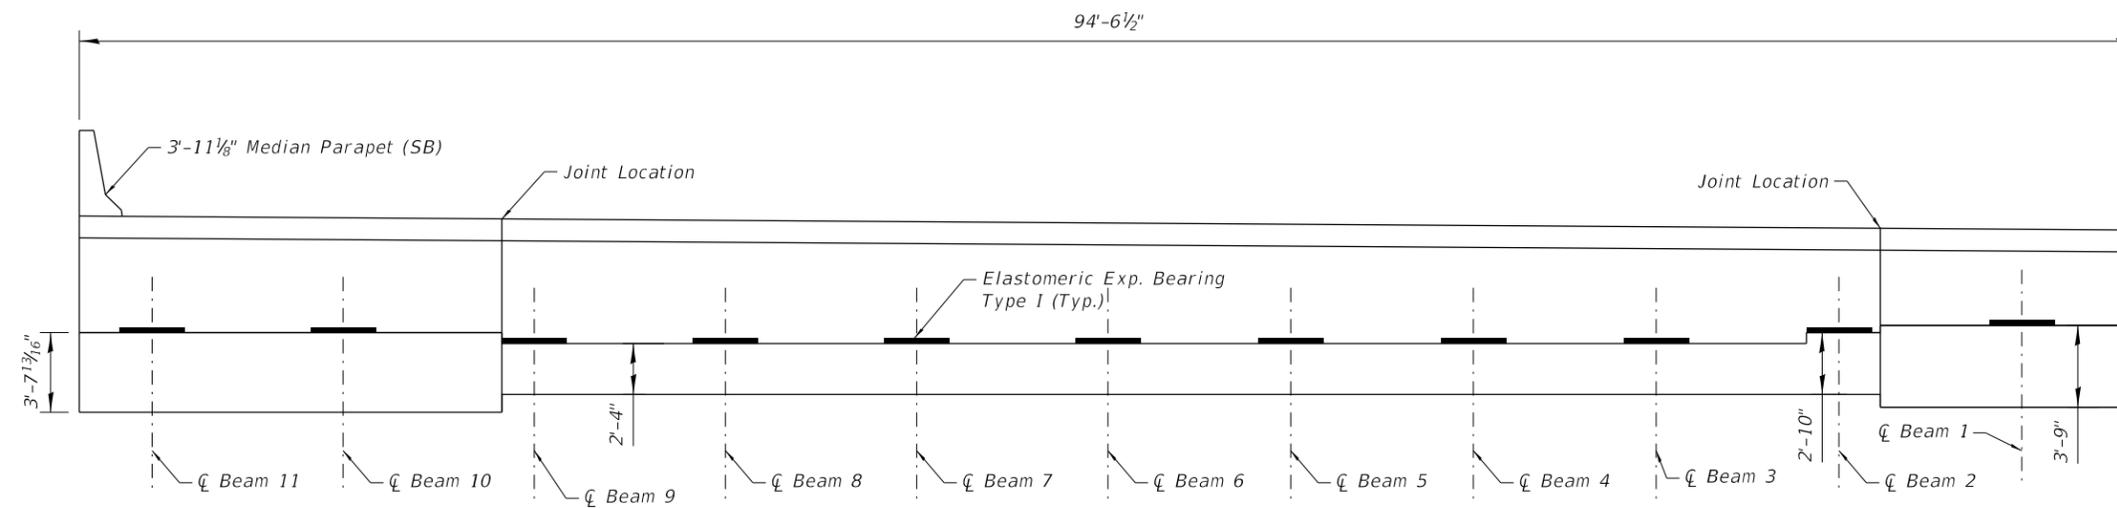
STATE OF ILLINOIS
DEPARTMENT OF TRANSPORTATION

BEAM REPAIR DETAILS
I-55 OVER MADISON STREET - STRUCTURE NO. 022-0003


F.A.I. RTE.	SECTION	COUNTY	TOTAL SHEETS	SHEET NO.
55	2020-025-BR	DuPAGE	62	42
ILLINOIS			FED. AID PROJECT	



WEST ABUTMENT ELEVATION
(South End)



WEST ABUTMENT ELEVATION
(North End)

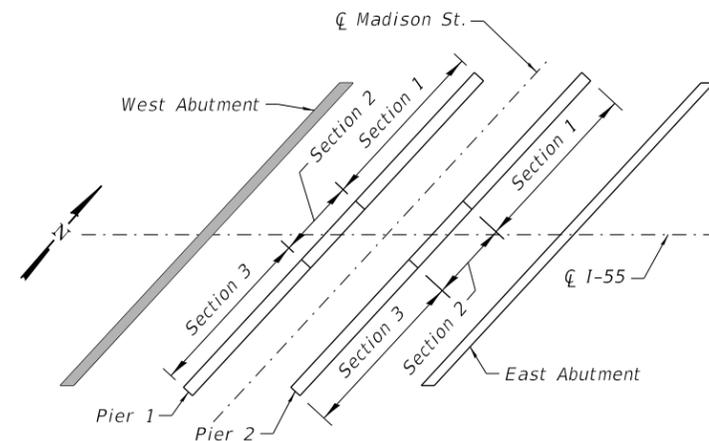

KEY PLAN

LEGEND

- Structural Repair of Concrete (Depth Equal To or Less Than 5in)
- SF - Square feet

BILL OF MATERIAL

ITEM	QUANT.	UNIT
Structural Repair of Concrete (Depth Equal To or Less Than 5in)	15	SF

Note:
Repair of existing abutments shall include but not be limited to the areas shown. The actual areas to be repaired shall be determined by the Engineer at the time of construction.

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WSP USA Inc.
30 N. LASALLE STREET
SUITE 4200
CHICAGO, IL 60602
TEL: (312) 782-8150
FAX: (312) 782-1884

USER NAME =	SUSERS\$	DESIGNED -	FB	REVISED -	
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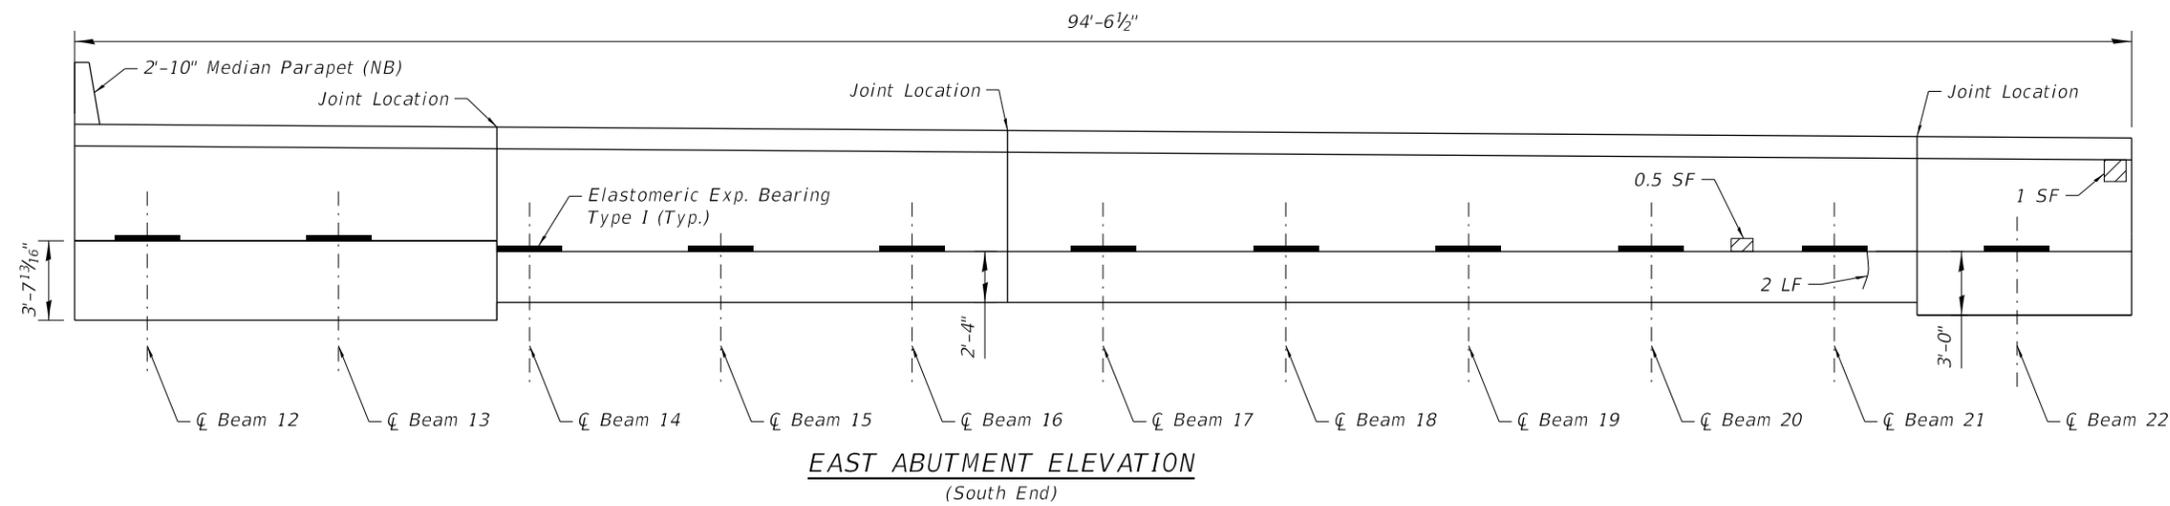
STATE OF ILLINOIS
DEPARTMENT OF TRANSPORTATION

WEST ABUTMENT REPAIR
I-55 OVER MADISON STREET - STRUCTURE NO. 022-0003

SHEET 14 OF 22 SHEETS

F.A.I. RTE.	SECTION	COUNTY	TOTAL SHEETS	SHEET NO.
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			CONTRACT NO. 62K96	

ILLINOIS FED. AID PROJECT




EAST ABUTMENT ELEVATION
(South End)

LEGEND


- Structural Repair of Concrete (Depth Equal To or Less Than 5in)
- SF - Square feet

BILL OF MATERIAL

ITEM	QUANT.	UNIT
Structural Repair of Concrete (Depth Equal To or Less Than 5in)	10.75	SF
Epoxy Crack Injection	20	LF

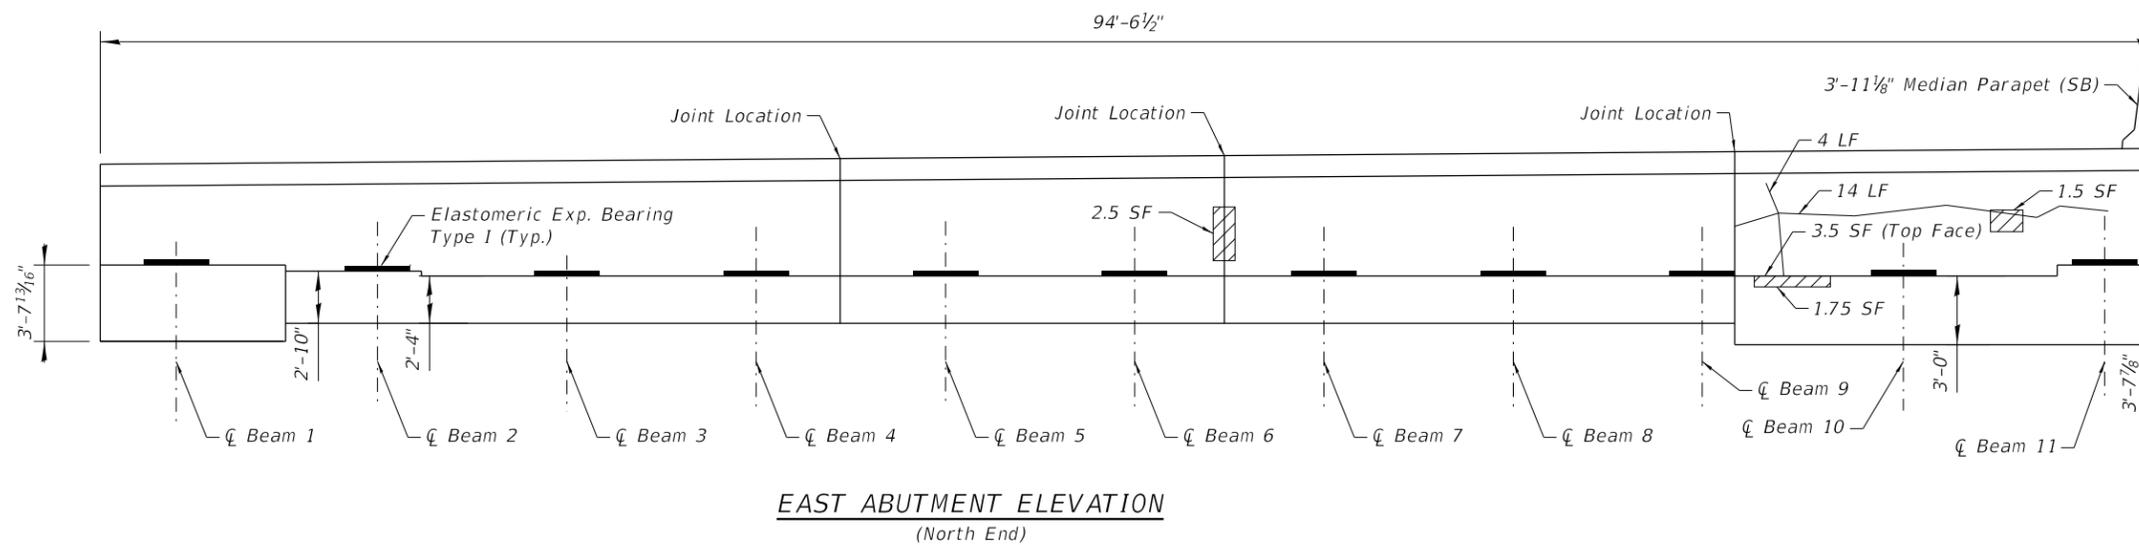

EAST ABUTMENT ELEVATION
(North End)

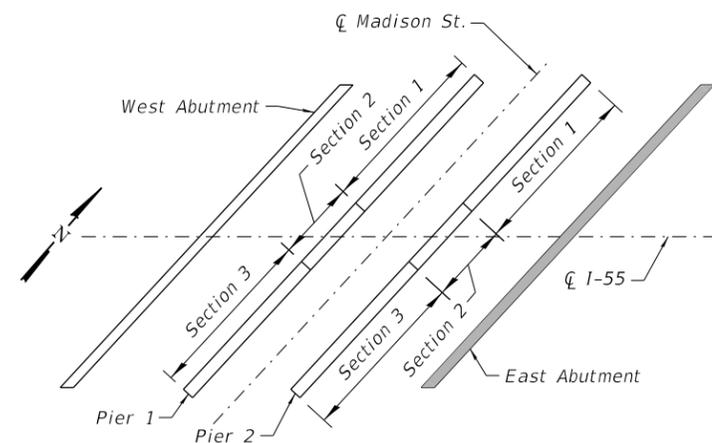

KEY PLAN

Note:
Repair of existing abutments shall include but not be limited to the areas shown. The actual areas to be repaired shall be determined by the Engineer at the time of construction.

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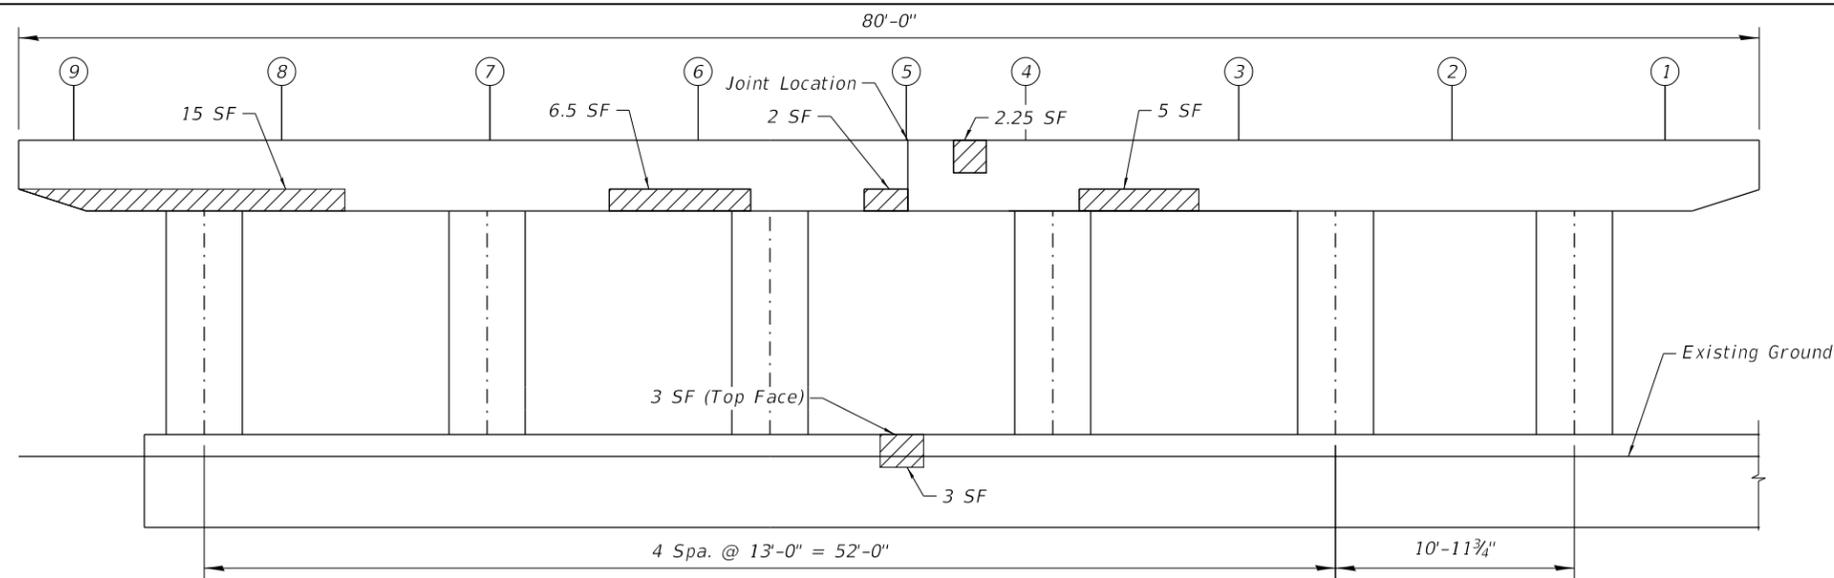
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STATE OF ILLINOIS
DEPARTMENT OF TRANSPORTATION


EAST ABUTMENT REPAIR
I-55 OVER MADISON STREET - STRUCTURE NO. 022-0003

SHEET 15 OF 22 SHEETS


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55	2020-025-BR	DuPAGE	62	44
			CONTRACT NO. 62K96	
			ILLINOIS FED. AID PROJECT	



PIER 1 SECTION 1 ELEVATION
(East Face)

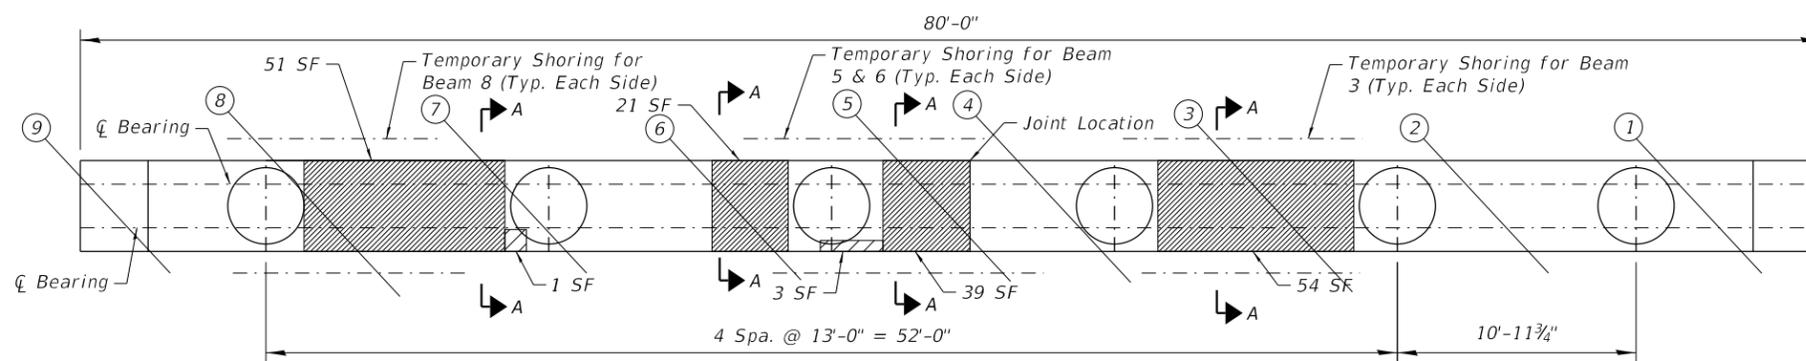

PIER 1 SECTION 1 PLAN
(Underside)

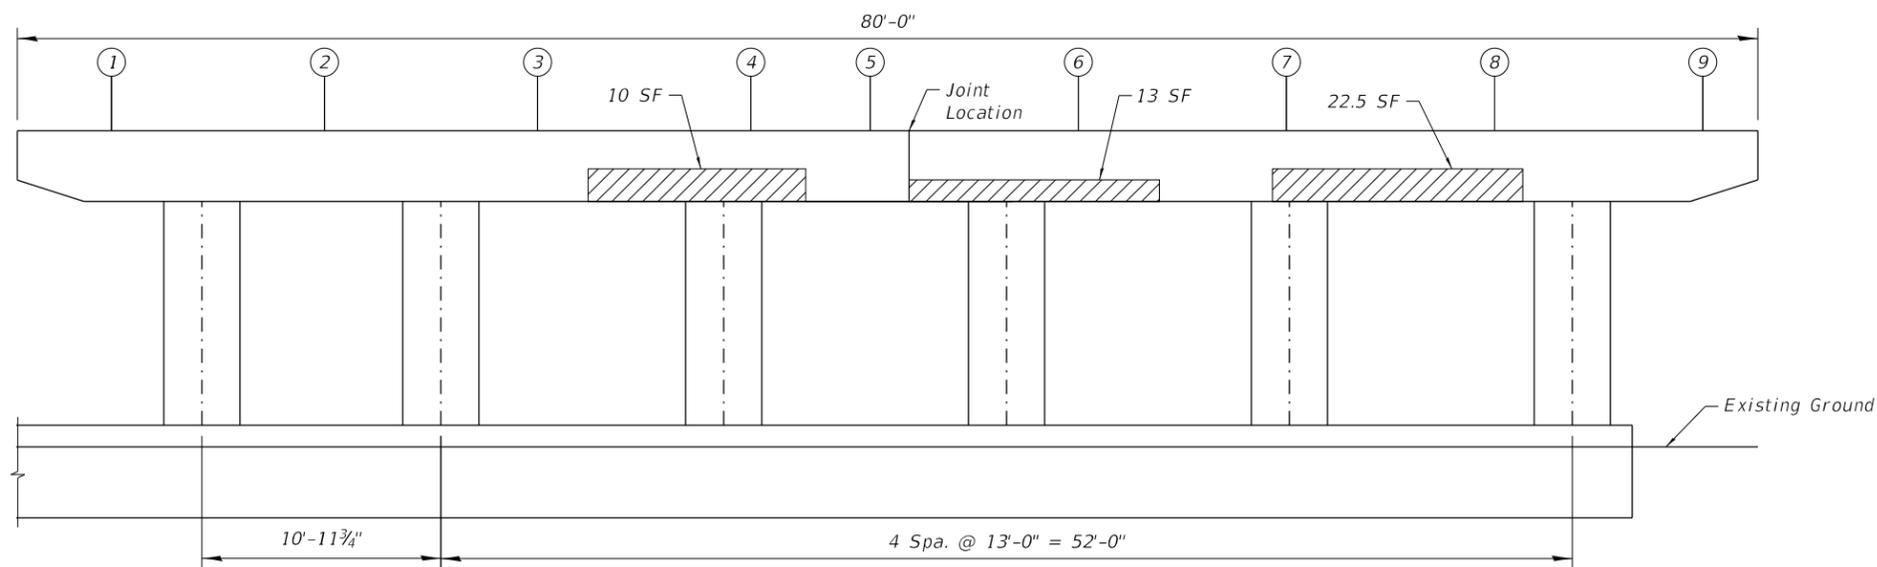


PIER 1 SECTION 1 ELEVATION
(West Face)

LEGEND


- Structural Repair of Concrete (Depth Equal To or Less Than 5in)
- Fiber Wrap
- SF - Square feet

BILL OF MATERIAL

ITEM	QUANT.	UNIT
Structural Repair of Concrete (Depth Equal To or Less Than 5in)	86.25	SF
Fiber Wrap	165	SF
Acrylic Coating	19	SY
Temporary Shoring and Cribbing	8	EA

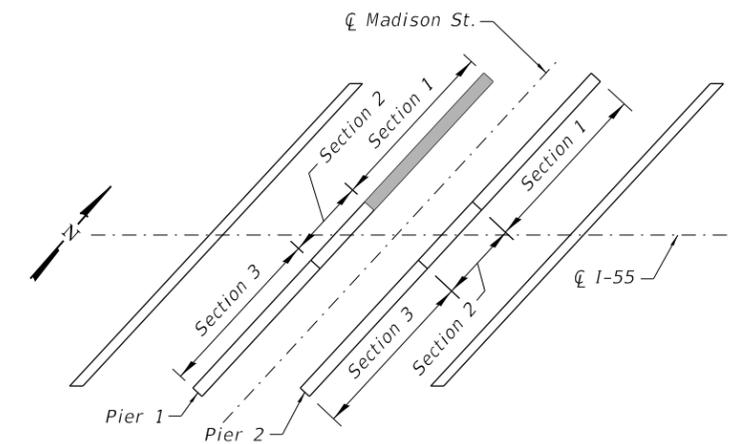

KEY PLAN

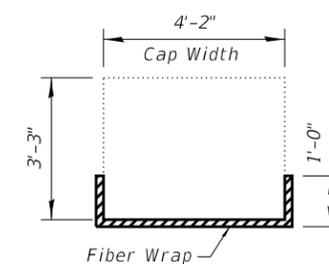

SECTION A-A

Notes:
 Repair of existing piers shall include but not be limited to the areas shown. The actual areas to be repaired shall be determined by the Engineer at the time of construction.
 See Special Provisions for "Fiber Wrap". Acrylic coating shall be placed over Fiber Wrap repairs. Two coats shall be applied.
 Temporary Shoring and Cribbing is required to support the existing beams affected by Fiber Wrap repair.
 For Reaction Table for Temporary Shoring and Cribbing, see sheet 18 of 22.

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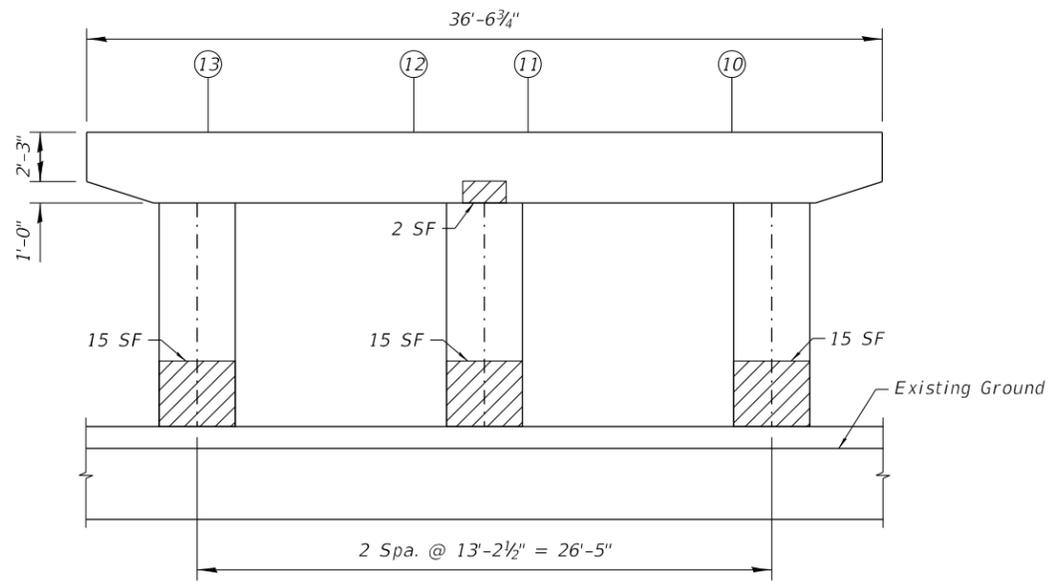
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STATE OF ILLINOIS
DEPARTMENT OF TRANSPORTATION


PIER 1 REPAIR I
I-55 OVER MADISON STREET - STRUCTURE NO. 022-0003

SHEET 16 OF 22 SHEETS


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55	2020-025-BR	DuPAGE	62	45
CONTRACT NO. 62K96				
ILLINOIS FED. AID PROJECT				



PIER 1 SECTION 2 ELEVATION
(East Face)

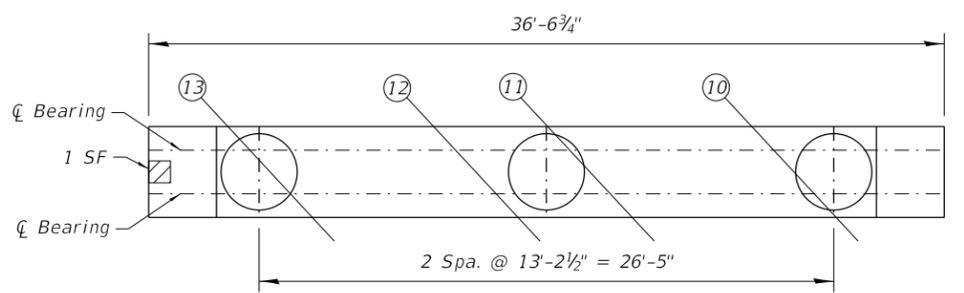

PIER 1 SECTION 2 PLAN
(Underside)

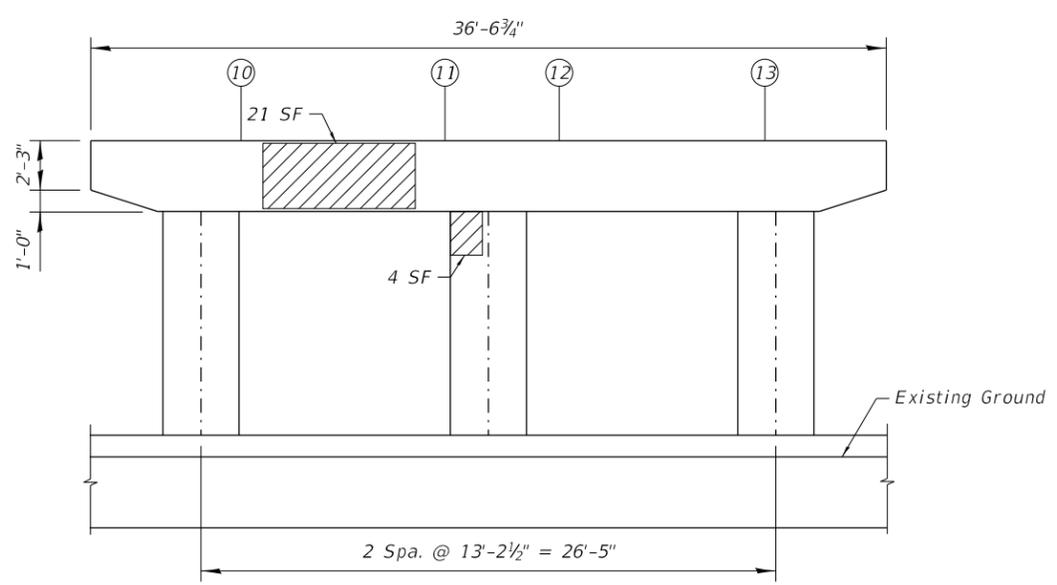


PIER 1 SECTION 2 ELEVATION
(West Face)

LEGEND

- Structural Repair of Concrete (Depth Equal To or Less Than 5in)
- SF - Square feet

BILL OF MATERIAL

ITEM	QUANT.	UNIT
Structural Repair of Concrete (Depth Equal To or Less Than 5in)	73	SF

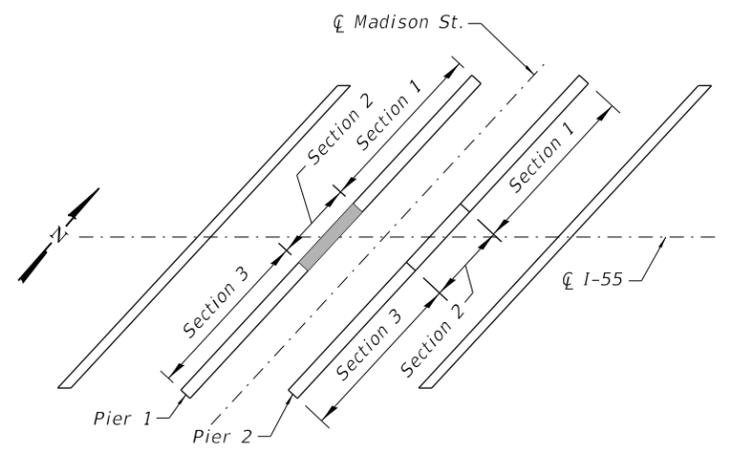

KEY PLAN

Note:
Repair of existing piers shall include but not be limited to the areas shown. The actual areas to be repaired shall be determined by the Engineer at the time of construction.

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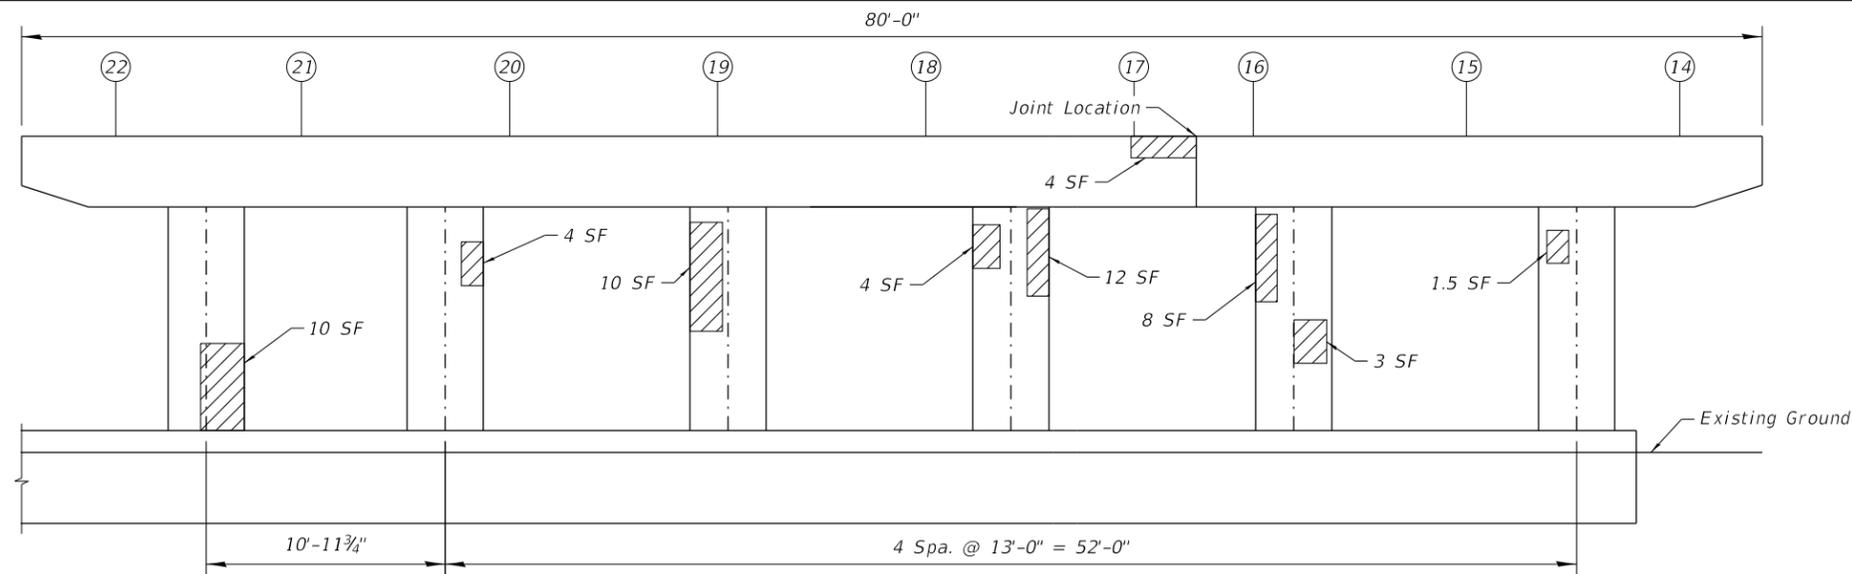
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STATE OF ILLINOIS
DEPARTMENT OF TRANSPORTATION


PIER 1 REPAIR II
I-55 OVER MADISON STREET - STRUCTURE NO. 022-0003

SHEET 17 OF 22 SHEETS


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55	2020-025-BR	DuPAGE	62	46
CONTRACT NO. 62K96				
ILLINOIS FED. AID PROJECT				



PIER 1 SECTION 3 ELEVATION
(East Face)

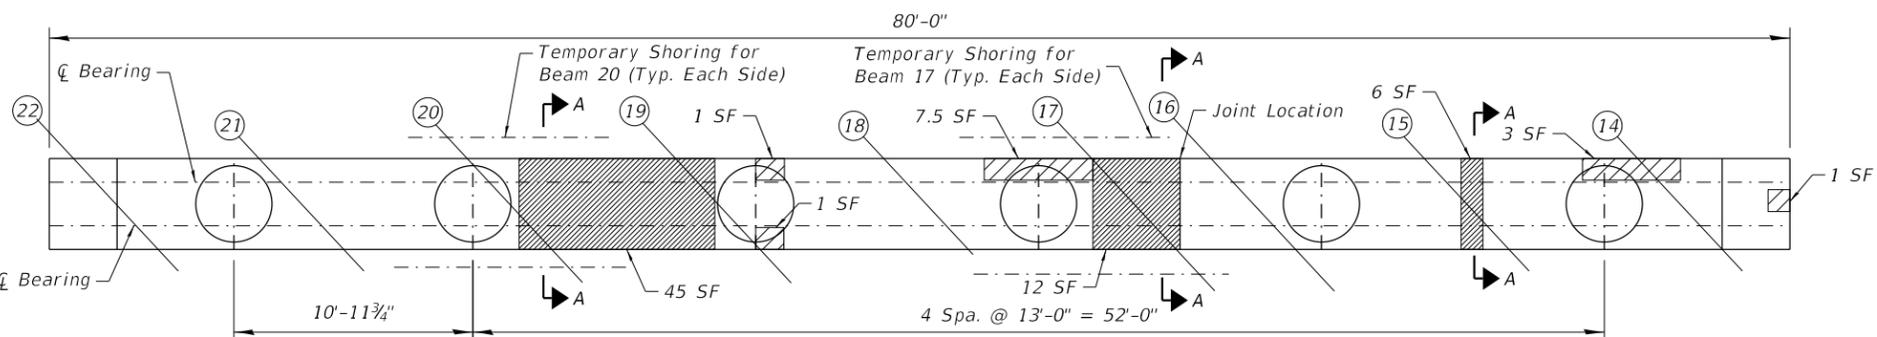

PIER 1 SECTION 3 PLAN
(Underside)

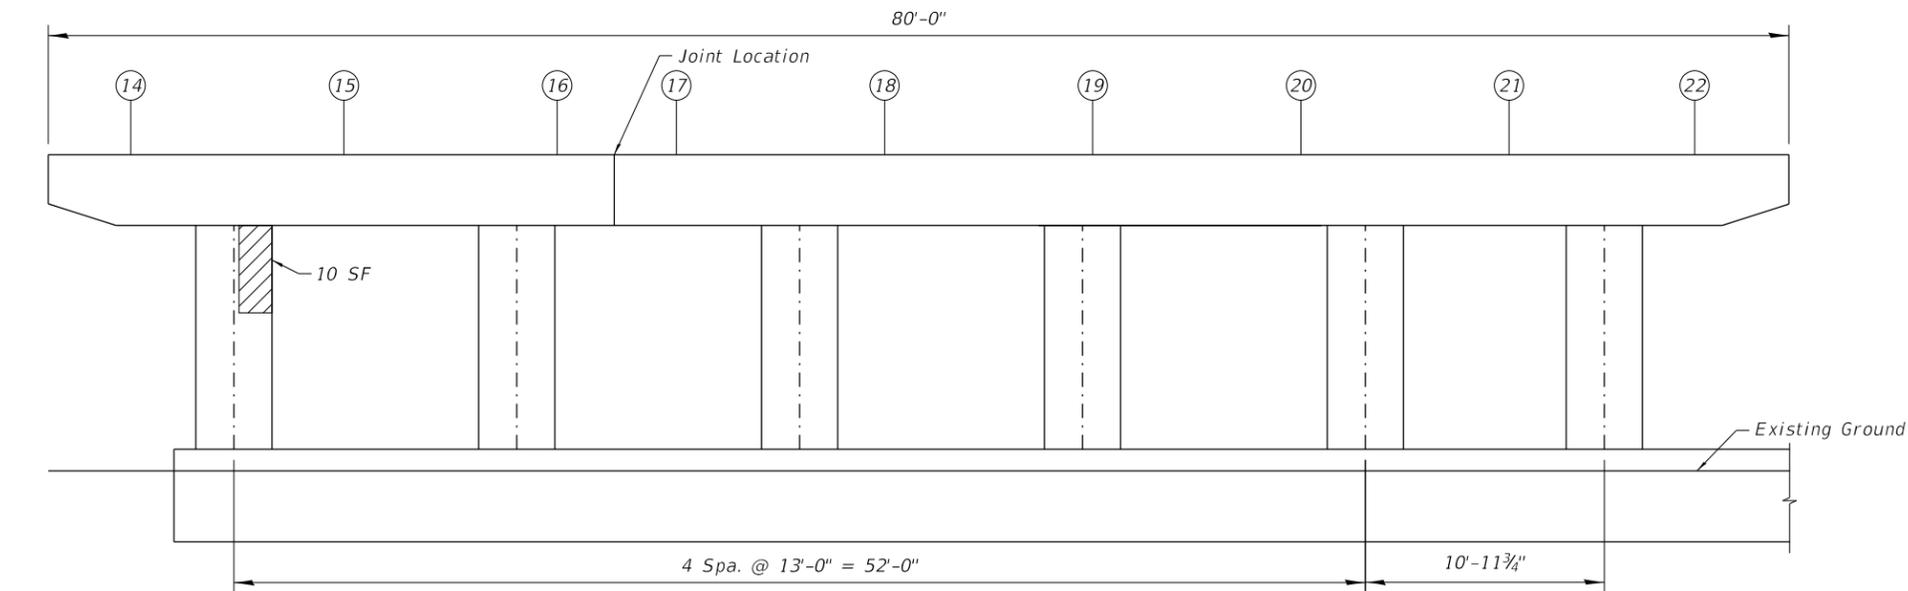


PIER 1 SECTION 3 ELEVATION
(West Face)

LEGEND

- Structural Repair of Concrete (Depth Equal To or Less Than 5in)
- Fiber Wrap
- SF - Square feet

BILL OF MATERIAL

ITEM	QUANT.	UNIT
Structural Repair of Concrete (Depth Equal To or Less Than 5in)	80	SF
Fiber Wrap	63	SF
Acrylic Coating	7	SY
Temporary Shoring and Cribbing	4	EA

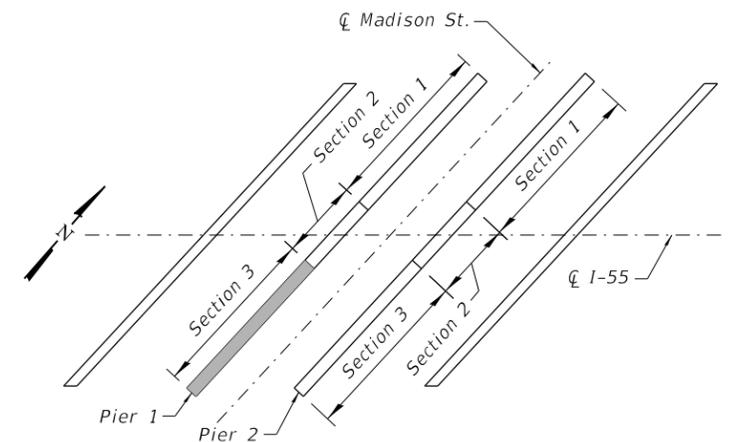

KEY PLAN

REACTION TABLE FOR TEMPORARY SHORING AND CRIBBING *

Location	Span 1, Pier 1 Span 3, Pier 2	Span 2, Pier 1 Span 2, Pier 2
DL (k)	52	46
LL (k)	55	55
IM (k)	16	15
Total (k)	123	116

* Reactions shown represent the maximum service reaction for a single beam.

Notes:
 Repair of existing piers shall include but not be limited to the areas shown. The actual areas to be repaired shall be determined by the Engineer at the time of construction.
 For Section A-A, see sheet 16 of 22.
 See Special Provisions for "Fiber Wrap". Acrylic coating shall be placed over Fiber Wrap repairs. Two coats shall be applied.
 Temporary Shoring and Cribbing is required to support the existing beams affected by Fiber Wrap repair.

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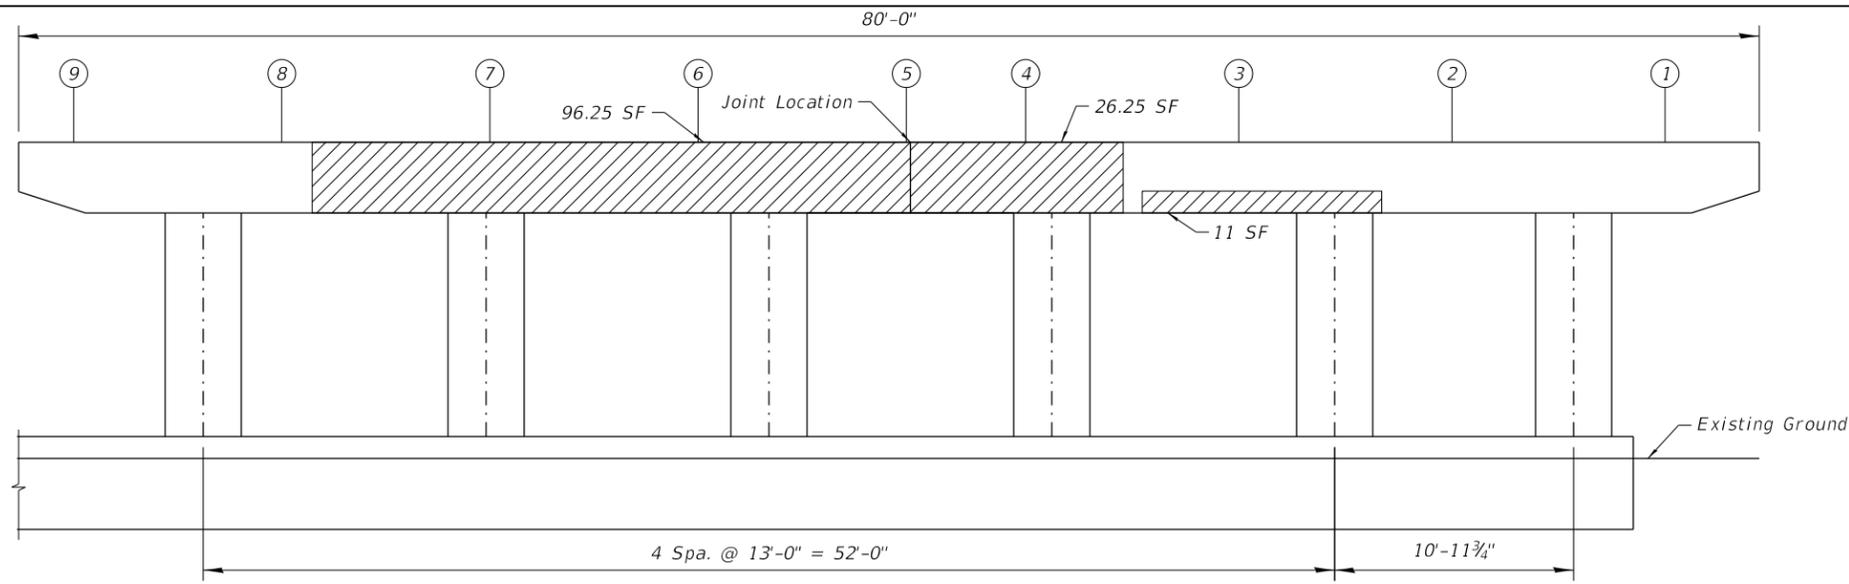
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**STATE OF ILLINOIS
DEPARTMENT OF TRANSPORTATION**


**PIER 1 REPAIR III
I-55 OVER MADISON STREET - STRUCTURE NO. 022-0003**

SHEET 18 OF 22 SHEETS


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55	2020-025-BR	DuPAGE	62	47
ILLINOIS FED. AID PROJECT			CONTRACT NO. 62K96	



PIER 2 SECTION 1 ELEVATION
(East Face)

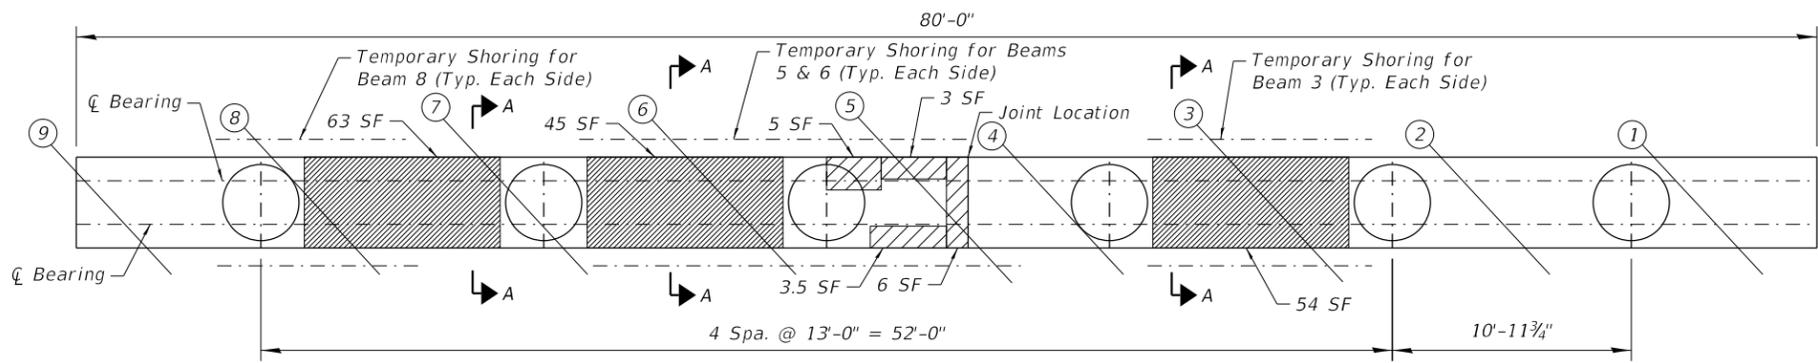

PIER 2 SECTION 1 PLAN
(Underside)

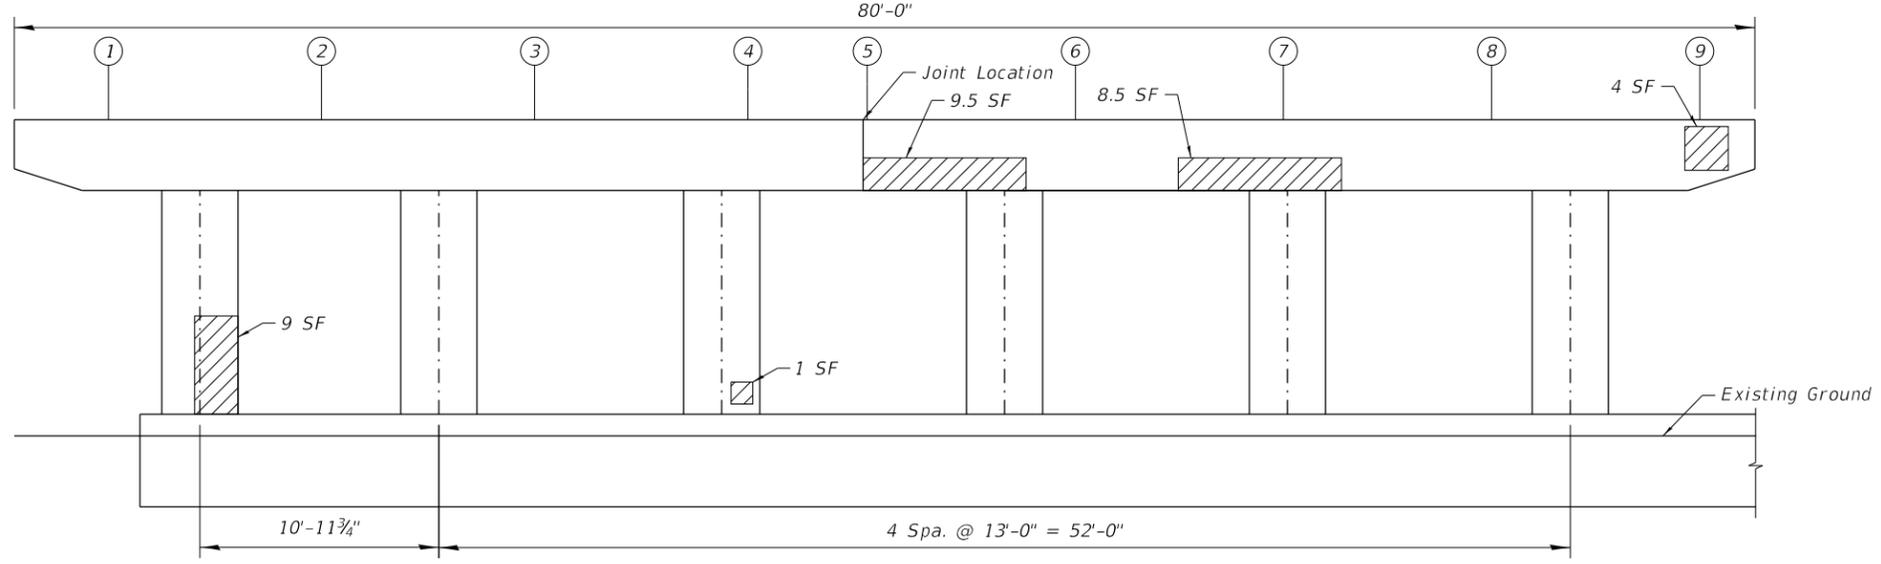


PIER 2 SECTION 1 ELEVATION
(West Face)

LEGEND

- Structural Repair of Concrete (Depth Equal To or Less Than 5in)
- Fiber Wrap
- SF - Square feet

BILL OF MATERIAL

ITEM	QUANT.	UNIT
Structural Repair of Concrete (Depth Equal To or Less Than 5in)	183	SF
Fiber Wrap	162	SF
Acrylic Coating	18	SY
Temporary Shoring and Cribbing	8	EA

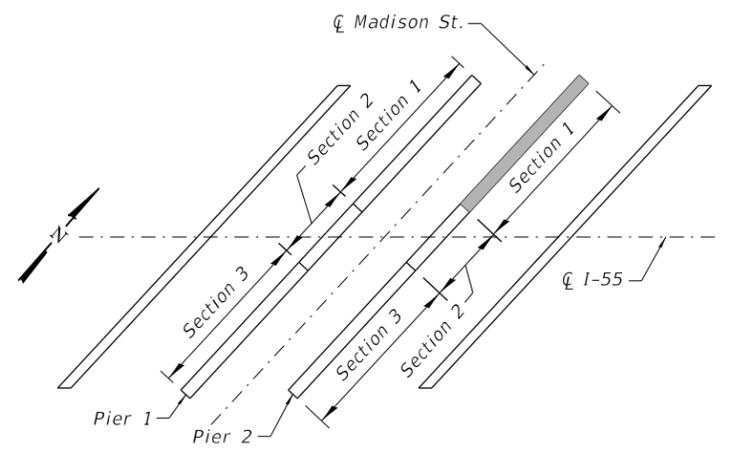

KEY PLAN

Notes:
 Repair of existing piers shall include but not be limited to the areas shown. The actual areas to be repaired shall be determined by the Engineer at the time of construction.
 For Section A-A, see sheet 16 of 22.
 See Special Provisions for "Fiber Wrap". Acrylic coating shall be placed over Fiber Wrap repairs. Two coats shall be applied.
 Temporary Shoring and Cribbing is required to support the existing beams affected by Fiber Wrap repair.
 For Reaction Table For Temporary Shoring and Cribbing, see sheet 18 of 22.

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WSP USA Inc.
 30 N. LASALLE STREET
 SUITE 4200
 CHICAGO, IL 60602
 TEL: (312) 782-8150
 FAX: (312) 782-1884


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STATE OF ILLINOIS
DEPARTMENT OF TRANSPORTATION


PIER 2 REPAIR I
I-55 OVER MADISON STREET - STRUCTURE NO. 022-0003

SHEET 19 OF 22 SHEETS


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55	2020-025-BR	DuPAGE	62	48
CONTRACT NO. 62K96				
ILLINOIS FED. AID PROJECT				

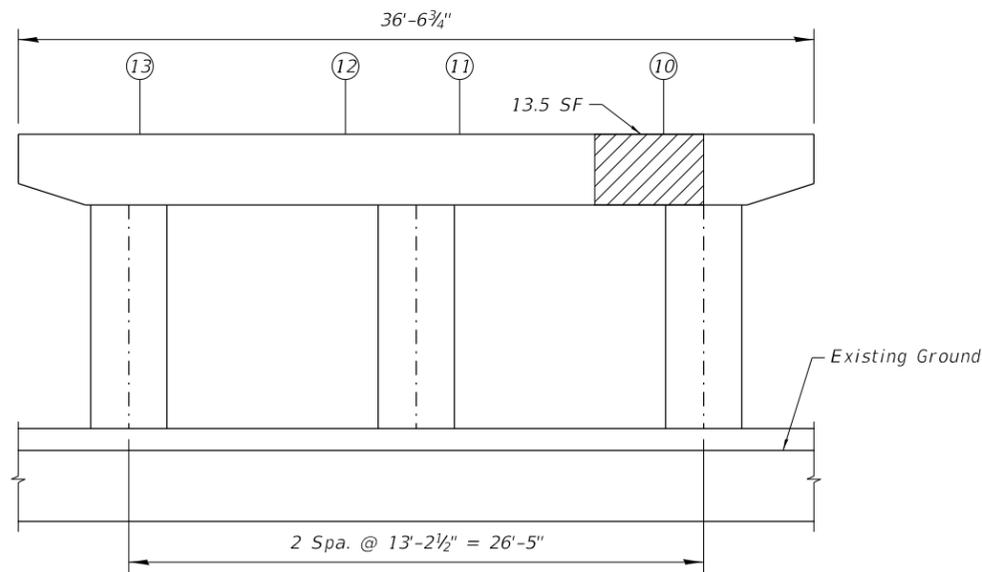

PIER 2 SECTION 2 ELEVATION
(East Face)

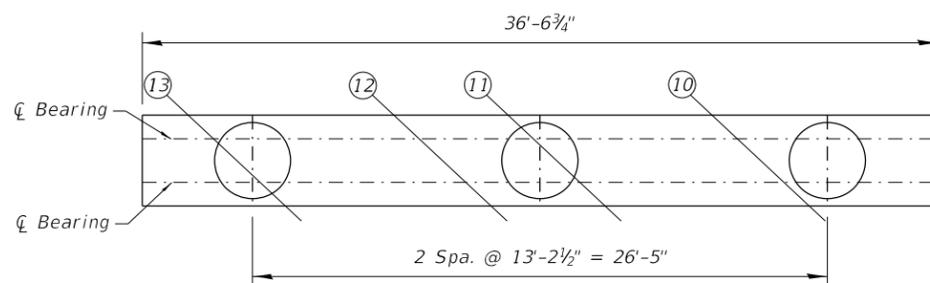

PIER 2 SECTION 2 PLAN
(Underside)

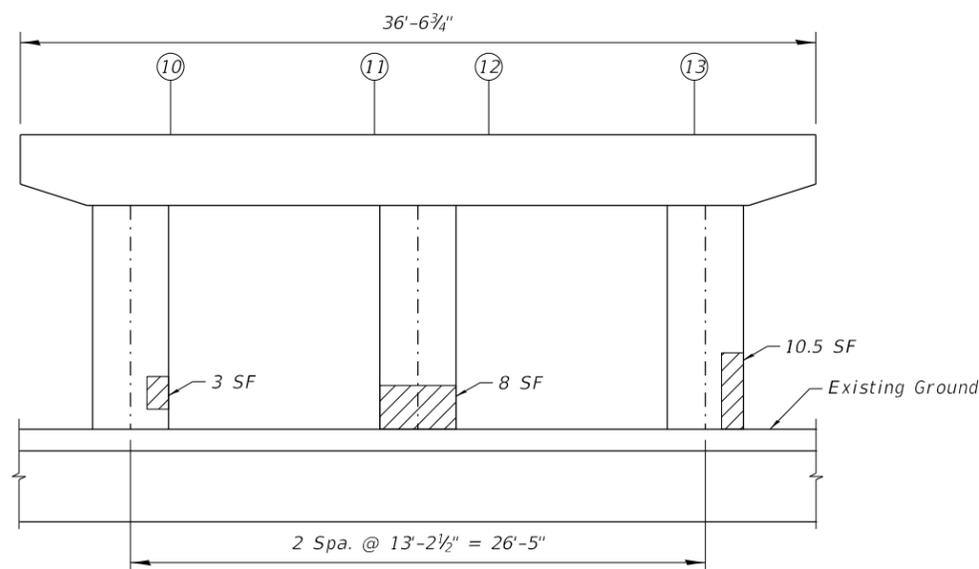


PIER 2 SECTION 2 ELEVATION
(West Face)

LEGEND

- Structural Repair of Concrete (Depth Equal To or Less Than 5in)
- SF - Square feet

BILL OF MATERIAL

ITEM	QUANT.	UNIT
Structural Repair of Concrete (Depth Equal To or Less Than 5in)	35	SF

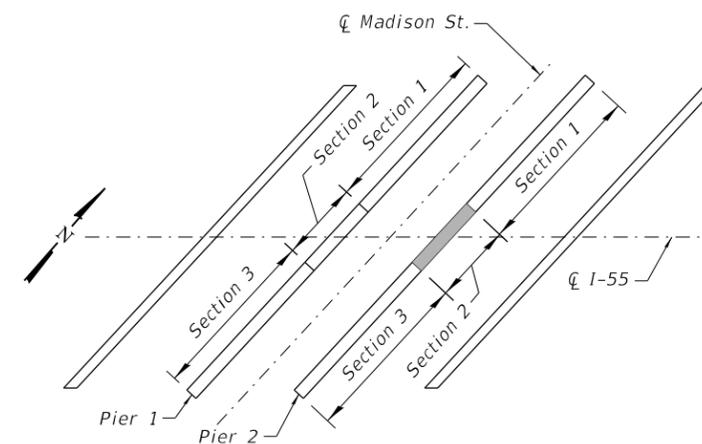

KEY PLAN

Note:
Repair of existing piers shall include but not be limited to the areas shown. The actual areas to be repaired shall be determined by the Engineer at the time of construction.

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WSP USA Inc.
 30 N. LASALLE STREET
 SUITE 4200
 CHICAGO, IL 60602
 TEL: (312) 782-8150
 FAX: (312) 782-1884


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**STATE OF ILLINOIS
DEPARTMENT OF TRANSPORTATION**


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I-55 OVER MADISON STREET - STRUCTURE NO. 022-0003**

SHEET 20 OF 22 SHEETS


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55	2020-025-BR	DuPAGE	62	49
CONTRACT NO. 62K96				
ILLINOIS FED. AID PROJECT				

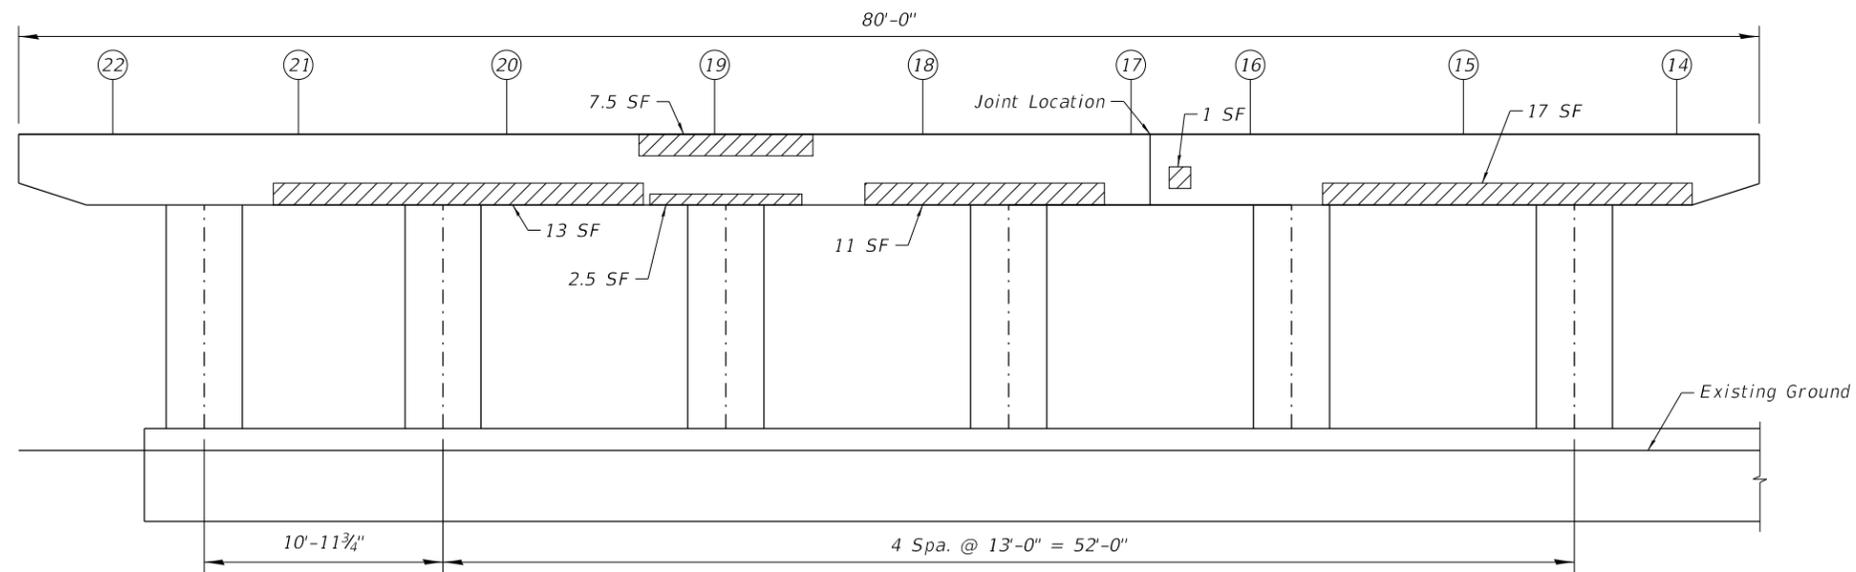

PIER 2 SECTION 3 ELEVATION
(East Face)

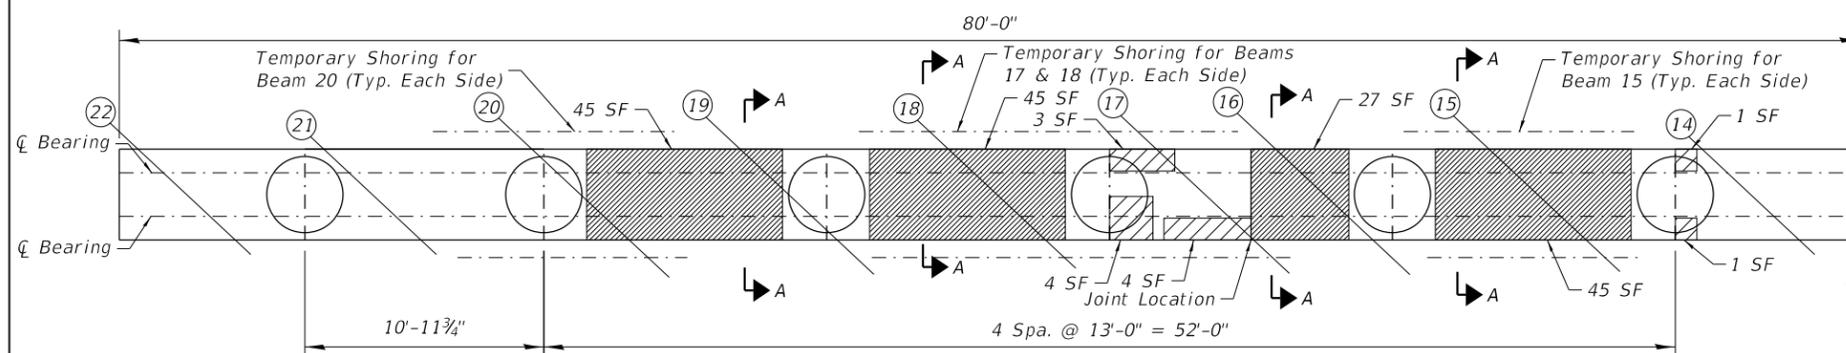

PIER 2 SECTION 3 PLAN
(Underside)

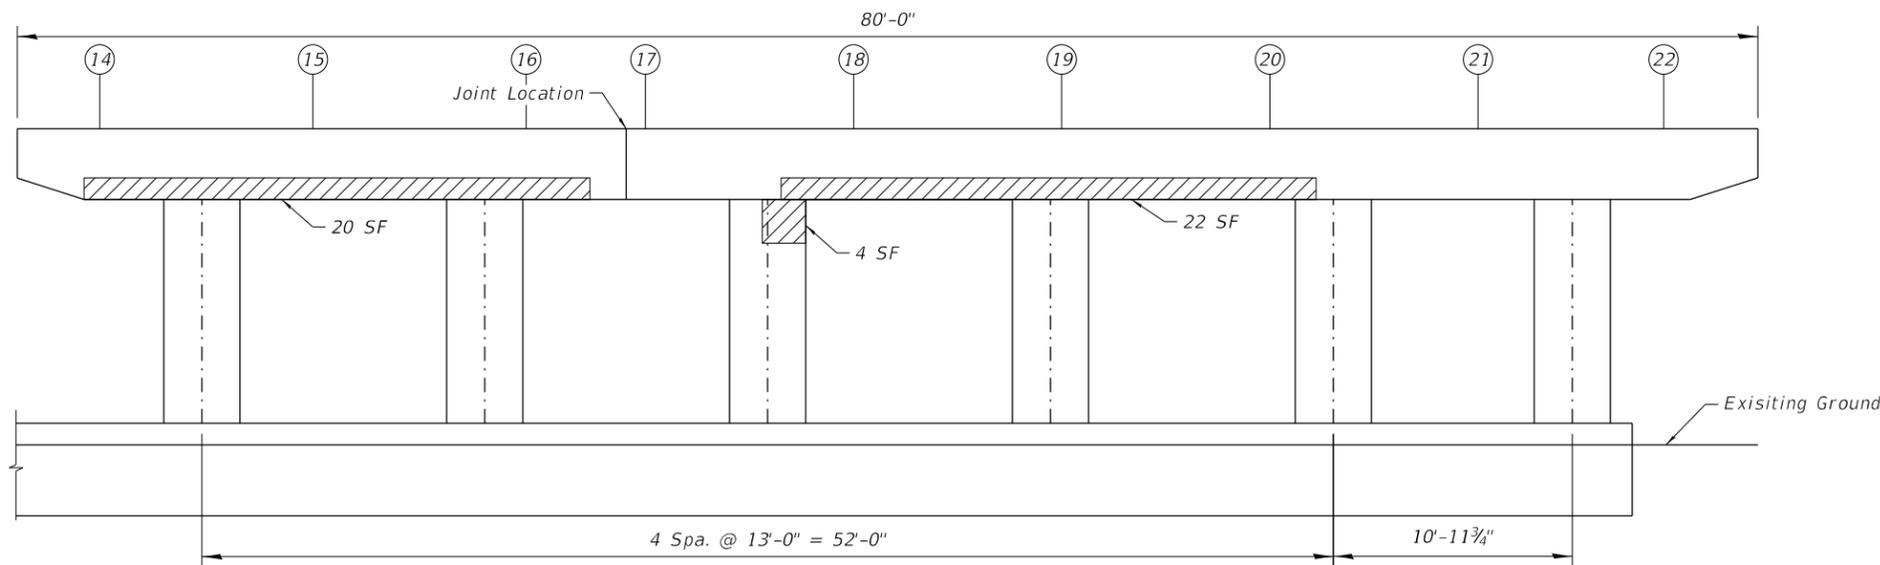


PIER 2 SECTION 3 ELEVATION
(West Face)

LEGEND

- Structural Repair of Concrete (Depth Equal To or Less Than 5in)
- Fiber Wrap
- SF - Square feet

BILL OF MATERIAL

ITEM	QUANT.	UNIT
Structural Repair of Concrete (Depth Equal To or Less Than 5in)	111	SF
Fiber Wrap	162	SF
Acrylic Coating	19	SY
Temporary Shoring and Cribbing	8	EA

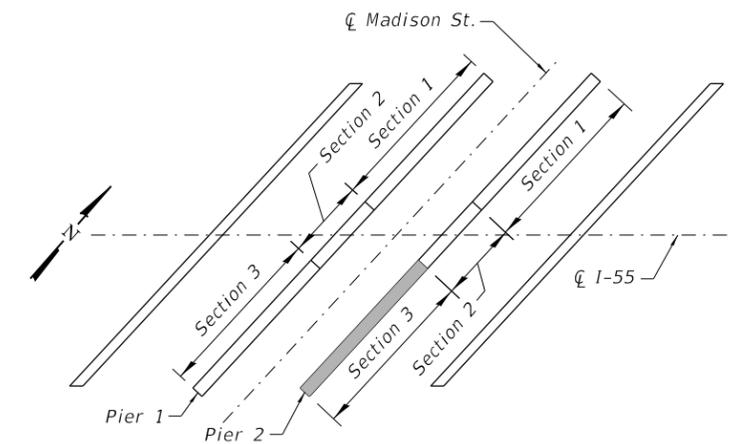

KEY PLAN

Notes:

Repair of existing piers shall include but not be limited to the areas shown. The actual areas to be repaired shall be determined by the Engineer at the time of construction.

For Section A-A, see sheet 16 of 22.

See Special Provisions for "Fiber Wrap". Acrylic coating shall be placed over Fiber Wrap repairs. Two coats shall be applied.

Temporary Shoring and Cribbing is required to support the existing beams affected by Fiber Wrap repair.

For Reaction Table for Temporary Shoring and Cribbing, see sheet 18 of 22.

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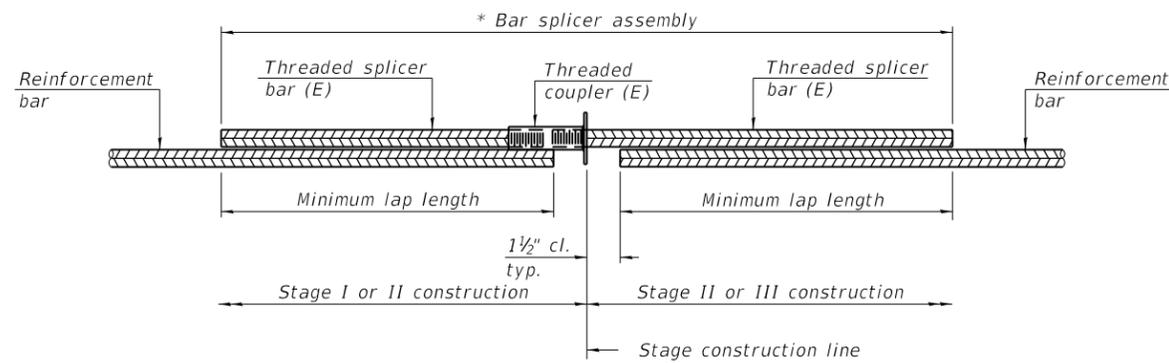
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STATE OF ILLINOIS
DEPARTMENT OF TRANSPORTATION

PIER 2 REPAIR III
I-55 OVER MADISON STREET - STRUCTURE NO. 022-0003

SHEET 21 OF 22 SHEETS

F.A.I. RTE.	SECTION	COUNTY	TOTAL SHEETS	SHEET NO.
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CONTRACT NO. 62K96				
ILLINOIS FED. AID PROJECT				




STANDARD BAR SPLICER ASSEMBLY PLAN
 (All components shall be provided from one supplier)

Threaded splicer bar length = min. lap length + 1 1/2" + thread length

* Epoxy not required on Bar Splicer Assembly components used in conjunction with black bars.

Location	Bar size	No. assemblies required	Minimum lap length
W. Abut (NB & SB)	#5	8	3'-1"
	#6	24	4'-0"
E. Abut (NB & SB)	#5	8	3'-1"
	#6	24	4'-0"

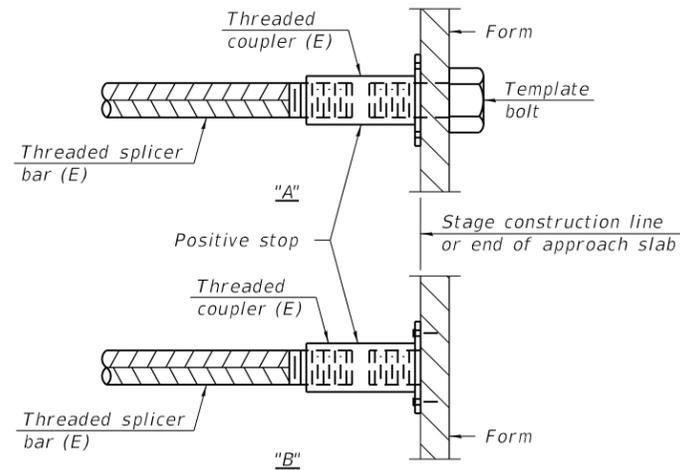


INSTALLATION AND SETTING METHODS

"A" : Set bar splicer assembly by means of a template bolt.

"B" : Set bar splicer assembly by nailing to wood forms or cementing to steel forms.

(E) : Indicates epoxy coating.

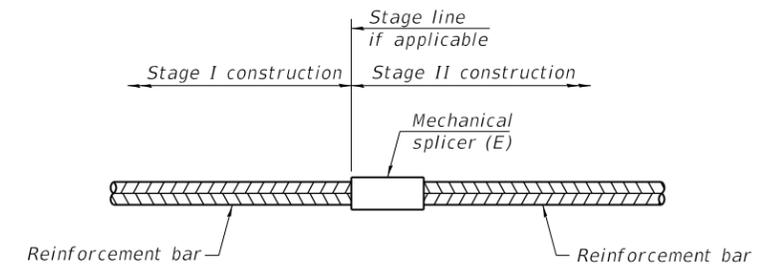

STANDARD MECHANICAL SPLICER

Location	Bar size	No. assemblies required

Notes:

Splicer bars shall be deformed with threaded ends and have a minimum 60 ksi yield strength.

All reinforcement shall be lapped and tied to the splicer bars.

Bar splicer assemblies shall be epoxy coated according to the requirements for reinforcement bars. See Section 508 of the Standard Specifications.

See approved list of bar splicer assemblies and mechanical splicers for alternatives.

MODEL: Default
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BSD-1

1-1-2020



WSP USA Inc.
 30 N. LASALLE STREET
 SUITE 4200
 CHICAGO, IL 60602
 TEL: (312) 782-8150
 FAX: (312) 782-1884

USER NAME =	SUSERS\$	DESIGNED -	PJL	REVISED -	
		CHECKED -	MI	REVISED -	
PLOT SCALE =	N.T.S.	DRAWN -	PJL	REVISED -	
PLOT DATE =	11/25/2020	CHECKED -	MI	REVISED -	


STATE OF ILLINOIS
 DEPARTMENT OF TRANSPORTATION

BAR SPLICER ASSEMBLY AND MECHANICAL SPLICER DETAILS
 I-55 OVER MADISON STREET - STRUCTURE NO. 022-0003

SHEET 22 OF 22 SHEETS

F.A.I. RTE.	SECTION	COUNTY	TOTAL SHEETS	SHEET NO.
55	2020-025-BR	DuPAGE	62	51
ILLINOIS			FED. AID PROJECT	

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 DATE: ...

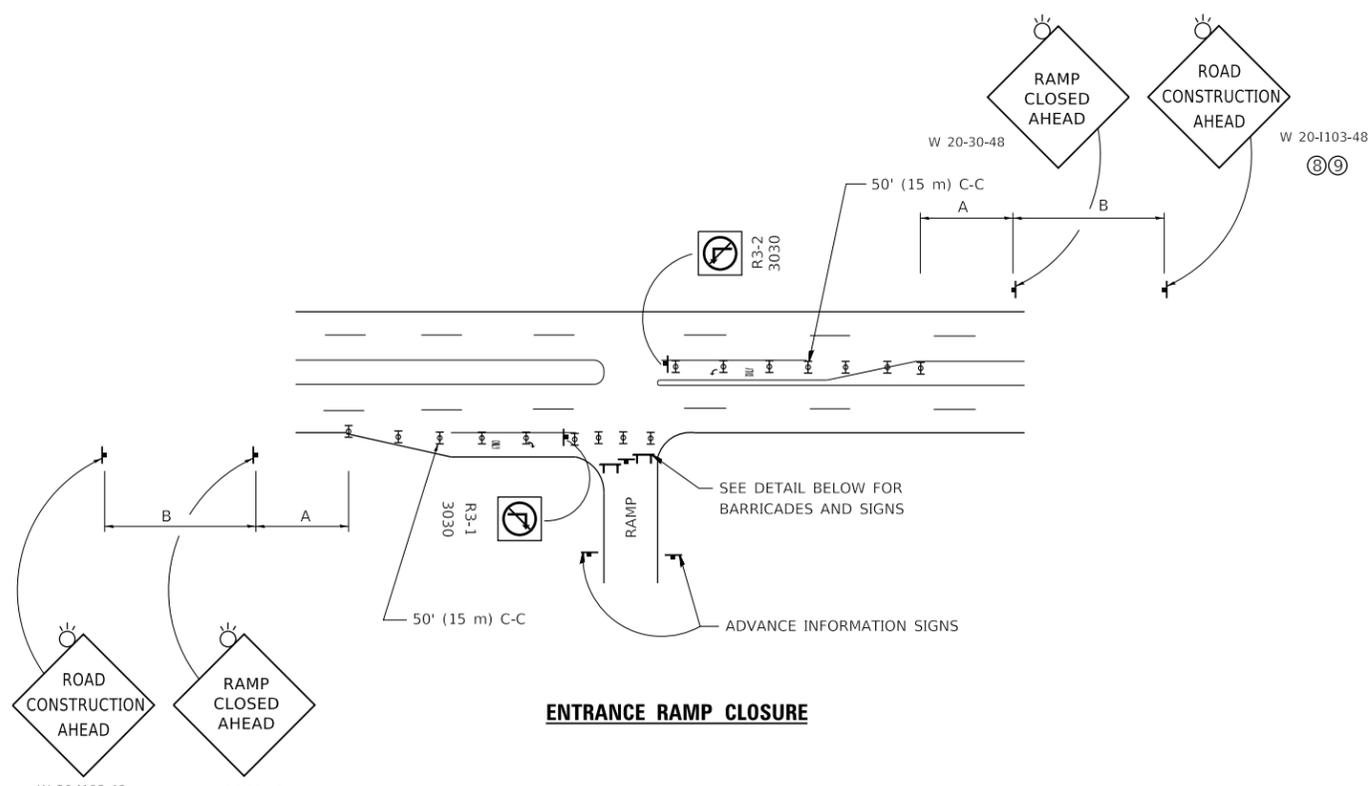


ENTRANCE RAMP CLOSURE

SIGN SPACING TABLE

FACILITY	DISTANCE BETWEEN SIGNS	
	A	B
EXPRESSWAY >24 HOURS	1000' (300 m)	1500' (450 m)
EXPRESSWAY ≤24 HOURS	500' (150 m)	500' (150 m)
ARTERIAL 55 MPH	500' (150 m)	500' (150 m)
ARTERIAL 50-45 MPH	350' (100 m)	350' (100 m)
ARTERIAL <45 MPH	200' (60 m)	200' (60 m)


DISTANCES MAY BE SHORTENED DEPENDING UPON THE PROXIMITY OF ADJACENT RAMPS OR INTERSECTIONS.

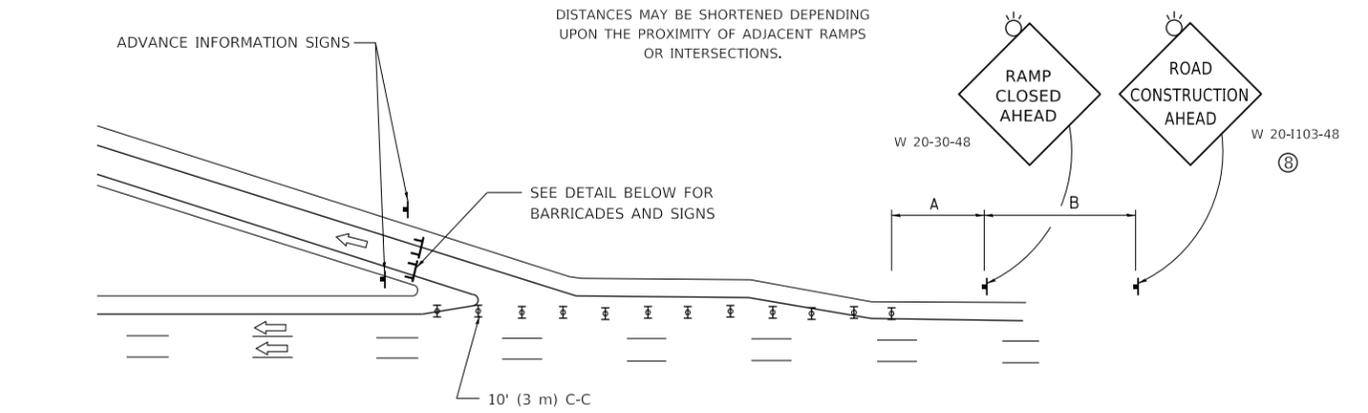

EXIT RAMP CLOSURE


SYMBOLS

- ☐ TYPE II BARRICADE OR DRUM
- ☐ TYPE III BARRICADE WITH 2 FLASHING LIGHTS

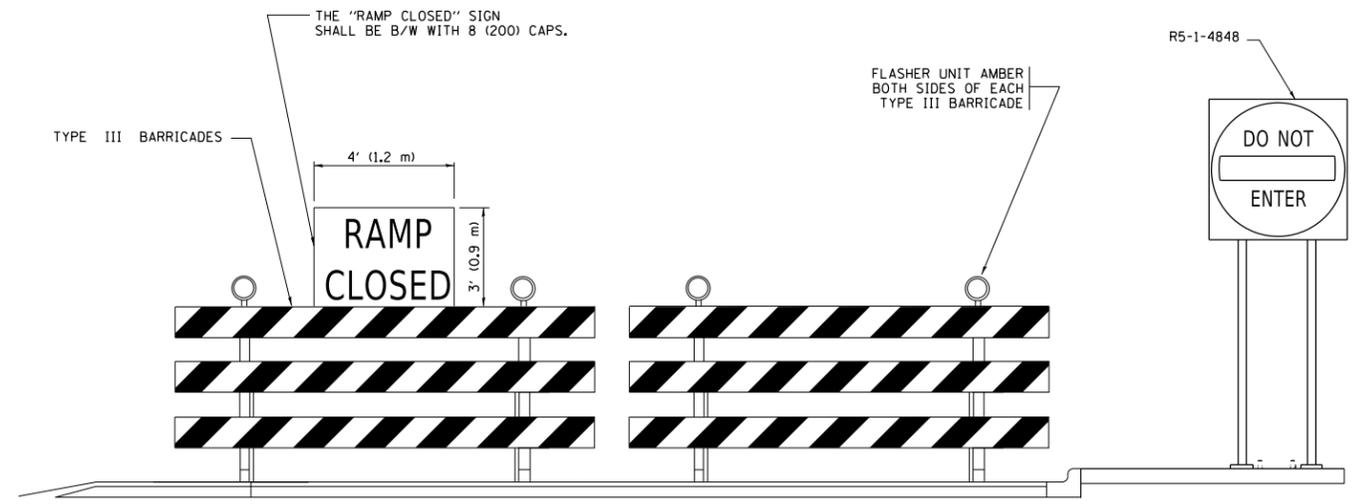


DETAIL FOR REQUIRED BARRICADES & SIGNS

RAMP CLOSURE ADVANCE WARNING SIGN

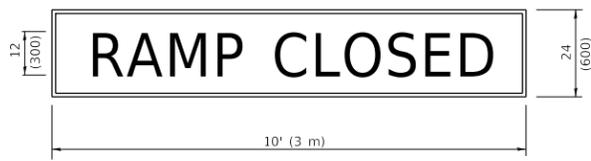

BLACK LEGEND ON ORANGE BACKGROUND MOUNTED DIAGONALLY
 E MOD FONT
 1 (25) BORDER
 THESE SIGNS ARE REQUIRED ON ALL THE EXIT GUIDE SIGNS FOR EXIT RAMPS THAT WILL BE CLOSED FOR MORE THAN FOUR (4) CONSECUTIVE DAYS.

RAMP CLOSURE ADVANCE INFORMATION SIGN

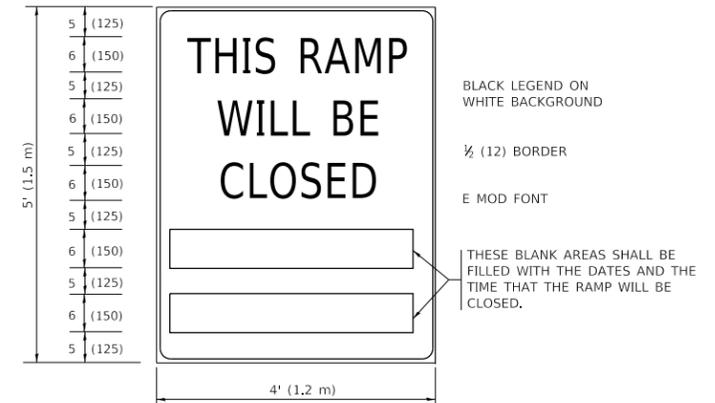

BLACK LEGEND ON WHITE BACKGROUND
 1/2 (12) BORDER
 E MOD FONT
 THESE BLANK AREAS SHALL BE FILLED WITH THE DATES AND THE TIME THAT THE RAMP WILL BE CLOSED.

THESE SIGNS ARE REQUIRED ON BOTH SIDES OF THE RAMP, MINIMUM OF 1 WEEK IN ADVANCE OF THE CLOSURE.
 THESE SIGNS SHALL BE FABRICATED AND PAID FOR ACCORDING TO THE TEMPORARY INFORMATION SIGNING SPECIAL PROVISION

GENERAL NOTES:

- ① CONES MAY BE SUBSTITUTED FOR DRUMS OR TYPE II BARRICADES DURING DAY OPERATIONS. CONES SHALL BE A MINIMUM OF 28 (700) HIGH.
- ② VERTICAL BARRICADES SHALL NOT BE USED FOR RAMP CLOSURES.
- ③ A FLAGGER SHALL BE POSITIONED AT EACH CLOSED RAMP THAT IS OPEN TO CONSTRUCTION VEHICLES, PRECEDED BY A W20-7 FLAGGER WARNING SIGN.
- ④ ALL ROUTE MARKERS AND TRAILBLAZER ASSEMBLIES WHICH DIRECT MOTORISTS TO A CLOSED ENTRANCE RAMP SHALL BE COVERED WHEN THE RAMP IS CLOSED FOR MORE THAN FOUR (4) DAYS.
- ⑤ THE SIGNING AND BARRICADING WHICH IS REQUIRED BY THIS DETAIL SHALL BE INCLUDED IN THE COST OF TRAFFIC CONTROL AND PROTECTION (EXPRESSWAYS).
- ⑥ AUTHORIZATION FROM THE DISTRICT'S BUREAU OF TRAFFIC IS REQUIRED FOR ALL RAMP CLOSURES.
- ⑦ THE RAMP CLOSURE ADVANCE INFORMATION SIGNS SHALL BE ERECTED IF THE CLOSURE TIME EXCEEDS TWENTY-FOUR (24) HOURS. ADDITIONAL ADVANCE WARNING SIGNS ON EXIT GUIDE SIGNING WILL BE REQUIRED FOR EXIT RAMP CLOSURES THAT EXCEED FOUR (4) DAYS IN LENGTH.
- ⑧ ROAD CONSTRUCTION AHEAD SIGNS MAY BE OMITTED WHEN THIS DETAIL IS USED IN CONJUNCTION WITH OTHER TRAFFIC CONTROL THAT ALREADY INCLUDES A ROAD CONSTRUCTION AHEAD SIGN.
- ⑨ ARTERIAL ROAD CONSTRUCTION AHEAD SIGNS SHALL BE INSTALLED ON THE LEFT SIDE OF TRAFFIC IF THE MEDIAN IS MORE THAN 10 FT WIDE.

ALL DIMENSIONS ARE IN INCHES (MILLIMETERS) UNLESS OTHERWISE SHOWN.

USER NAME = footemj	DESIGNED - D.W.S.	REVISED - S.P.B._01-07
DRAWN -	REVISED - S.P.B._12-09	
PLOT SCALE = 50.0000 ' / in.	CHECKED -	REVISED - M.D._06-13
PLOT DATE = 3/4/2019	DATE - 02-83	REVISED - M.D._01-18


**STATE OF ILLINOIS
 DEPARTMENT OF TRANSPORTATION**

**ENTRANCE AND EXIT RAMP
 CLOSURE DETAILS**


SCALE: NONE SHEET 1 OF 1 SHEETS STA. TO STA.

F.A.I RTE.	SECTION	COUNTY	TOTAL SHEETS	SHEET NO.
55	2020-025-BR	DUPAGE	62	52
TC-08			CONTRACT NO. 62K96	
ILLINOIS		FED. AID PROJECT		

SINGLE LANE WEAVE

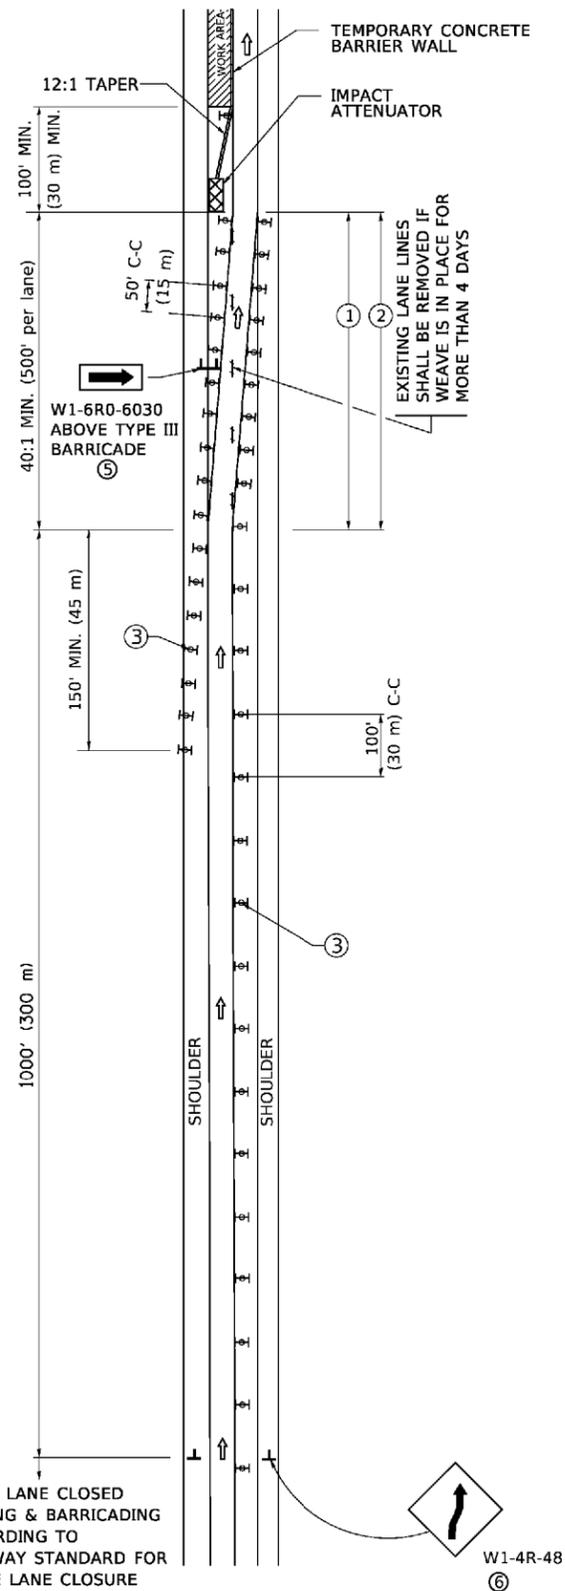


MULTI-LANE WEAVE

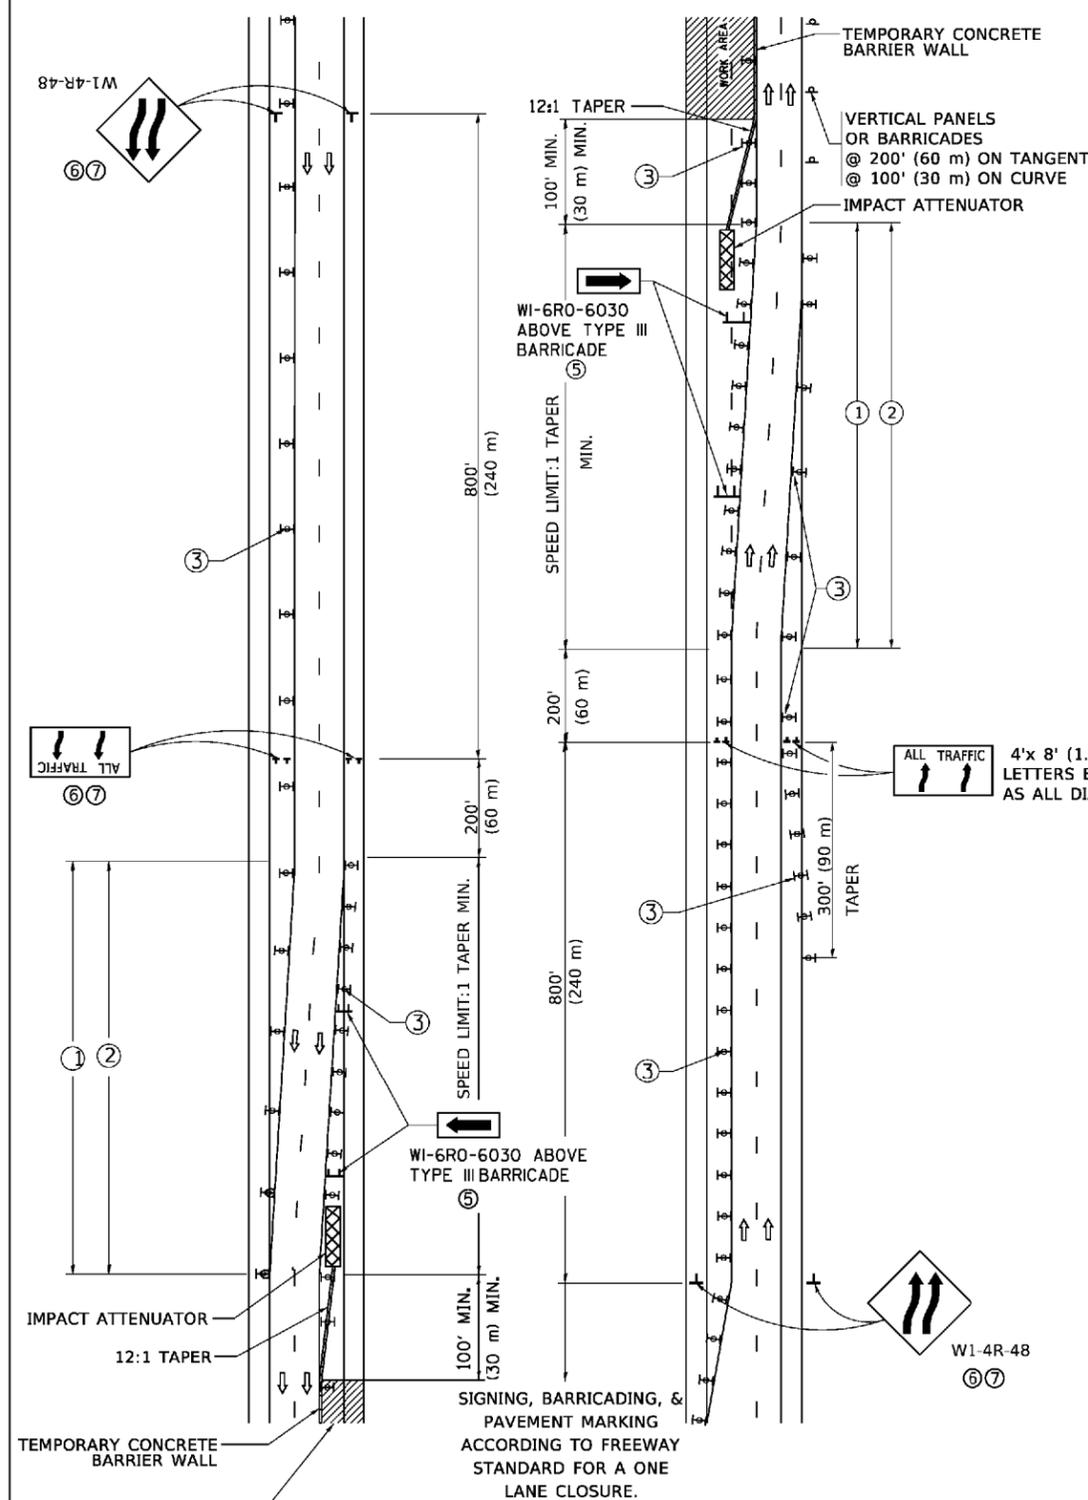

GENERAL NOTES:

- ① EXISTING CONFLICTING PAVEMENT MARKING LINES SHALL BE REMOVED. PAVEMENT MARKING REMOVAL SHALL NOT BE REQUIRED FOR SINGLE LANE WEAVES UNDER 4 DAYS IN DURATION.
- ② CONTINUOUS REFLECTIVE TEMPORARY PAVEMENT MARKING TAPE SHALL BE PLACED THROUGHOUT THE TAPER AND FOR 300' (90 m) ALONG SIDE THE WORK AREA WHERE THE CLOSURE TIME IS GREATER THAN FOURTEEN DAYS. THE LEFT EDGE LINE SHALL BE YELLOW AND THE RIGHT EDGE LINE SHALL BE WHITE. FOR MULTI-LANE WEAVES LANE LINES SHALL BE 5 INCH, 10'-30' (3 m-9 m) SKIP DASH, WHITE.
- ③ PLASTIC DRUMS WITH STEADY BURN LIGHTS AT 50' (15 m) C-C SPACING IN TAPERS AND 100' (30 m) C-C SPACING IN TANGENTS.
- ④ ALL SIGNS SHALL BE POST MOUNTED IF THE CLOSURE TIME EXCEEDS FOUR DAYS.
- ⑤ TYPE III BARRICADES MAY BE OMITTED FOR SINGLE-LANE WEAVES UNDER 24-HOURS IN DURATION. W1-6 SIGNS WILL STILL BE REQUIRED. IF THE WIDTH OF OFFSET IS LESS THAN 6' THEN THE TYPE III BARRICADE WITH ATTACHED ARROW SIGN PANEL CAN BE ELIMINATED IN THE TAPER AREAS.
- ⑥ WHEN THE LENGTH OF THE SHIFTED SEGMENT (DISTANCE BETWEEN WEAVE POINTS) IS LESS THAN 1500', DOUBLE REVERSE CURVE SIGNS (W24-1) SHOULD BE USED INSTEAD OF THE REVERSE CURVE (W1-4) SIGNS. ARROWS ON THE 4'X8' "ALL TRAFFIC" SIGNS SHALL BE THE SAME SHAPE.
- ⑦ THE NUMBER OF ARROWS ON THESE SIGNS SHALL MATCH THE NUMBER OF LANES OPEN TO TRAFFIC.

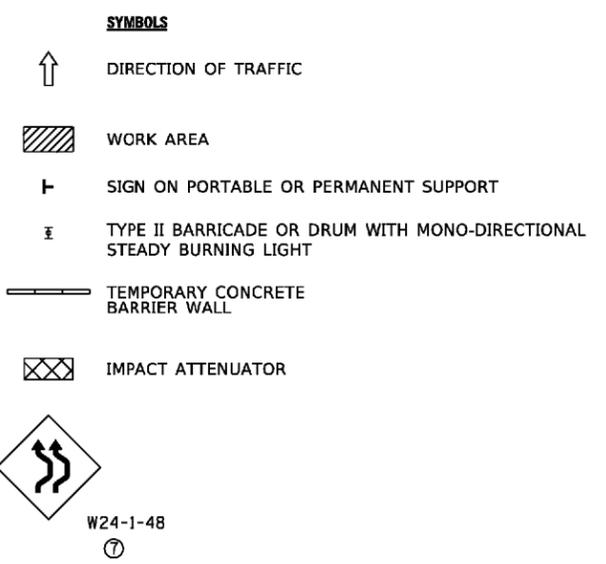

ALL DIMENSIONS ARE IN INCHES (MILLIMETERS) UNLESS OTHERWISE SHOWN


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	DRAWN -	REVISED - S.P.B. 01-07
PLOT SCALE = 2,000' / in.	CHECKED -	REVISED - S.P.B. 12-09
PLOT DATE = 11/2/2020	DATE - 02-87	REVISED - M.D. 06-13

STATE OF ILLINOIS
DEPARTMENT OF TRANSPORTATION

TRAFFIC CONTROL DETAILS FOR
FREEWAY SINGLE & MULTI-LANE WEAVE

SCALE: N.T.S. SHEET 1 OF 1 SHEETS STA. TO STA.

F.A.I. RTE.	SECTION	COUNTY	TOTAL SHEETS	SHEET NO.
55	2020-025-BR	DUPAGE	62	53
TC-09		CONTRACT NO. 62K96		
ILLINOIS FED. AID PROJECT				

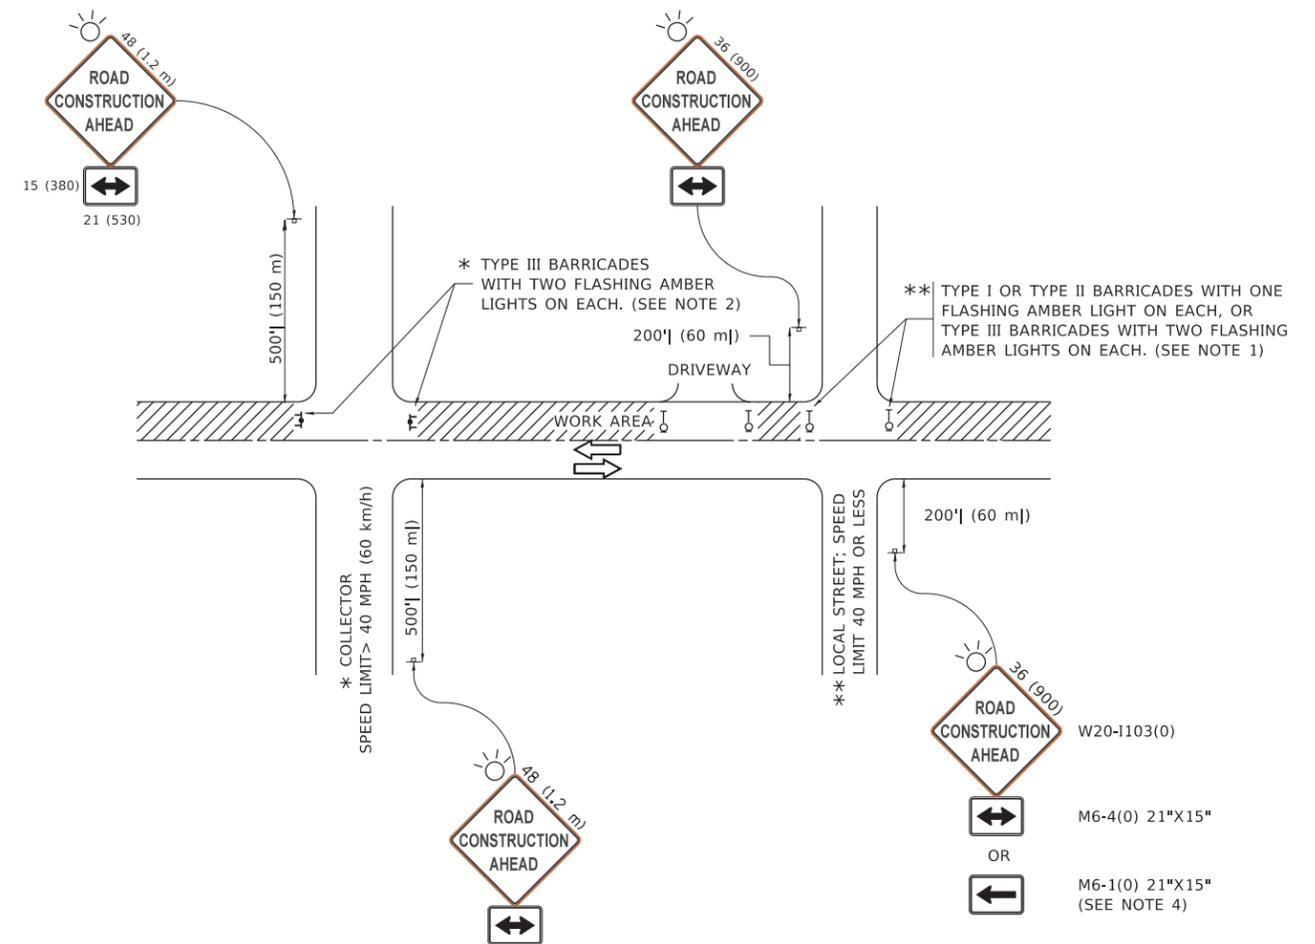

NOTES:

1. SIDE ROAD WITH A SPEED LIMIT OF 40 MPH (60 km/h) OR LESS AS SHOWN ON THE DRAWING AND AS DIRECTED BY THE ENGINEER:
 - a) ONE "ROAD CONSTRUCTION AHEAD" SIGN 36 x 36 (900x900) WITH A FLASHER MOUNTED ON IT APPROXIMATELY 200' (60 m) IN ADVANCE OF THE MAIN ROUTE.
 - b) THE CLOSED PORTION OF THE MAIN ROUTE SHALL BE PROTECTED BY BLOCKING WITH TYPE I, TYPE II OR TYPE III BARRICADES, 1/3 OF THE CROSS SECTION OF THE CLOSED PORTION.
2. SIDE ROAD WITH A SPEED LIMIT GREATER THAN 40 MPH (60 km/h) AS SHOWN ON THE DRAWING AND AS DIRECTED BY THE ENGINEER:
 - a) ONE "ROAD CONSTRUCTION AHEAD" SIGN 48 x 48 (1.2 m x 1.2 m) WITH A FLASHER MOUNTED ON IT APPROXIMATELY 500' (150 m) IN ADVANCE OF THE MAIN ROUTE.
 - b) BLOCKING WITH TYPE III BARRICADES, 1/2 OF THE CROSS SECTION OF THE CLOSED PORTION.
3. CONES MAY BE SUBSTITUTED FOR BARRICADES OR DRUMS AT HALF THE SPACING DURING DAY OPERATIONS. CONES SHALL BE A MINIMUM OF 28 (710) IN HEIGHT.
4. SIGNING AND THE WORK ZONE, A SINGLE HEADED ARROW (M6-1) SHALL BE USED IN LIEU OF THE DOUBLE HEADED ARROW (M6-4).
5. WHEN WORK IS BEING PERFORMED ON A SIDE ROAD OR DRIVEWAY, FOLLOW THE APPLICABLE STANDARD(S). THE DIRECTIONAL ARROW (M6-1 OR M6-4) SHALL BE COVERED OR REMOVED WHEN NO LONGER CONSISTENT WITH THE TRAFFIC CONTROL SET-UP.
6. ADVANCE WARNING SIGNS ARE TO BE OMITTED ON DRIVEWAYS UNLESS OTHERWISE SPECIFIED IN THE PLANS OR BY THE ENGINEER.
7. THE TRAFFIC CONTROL AND PROTECTION FOR SIDE ROADS, INTERSECTIONS, AND DRIVEWAYS SHALL BE INCLUDED IN THE COST OF SPECIFIED TRAFFIC CONTROL STANDARDS OR ITEMS.

All dimensions are in inches (millimeters) unless otherwise shown.

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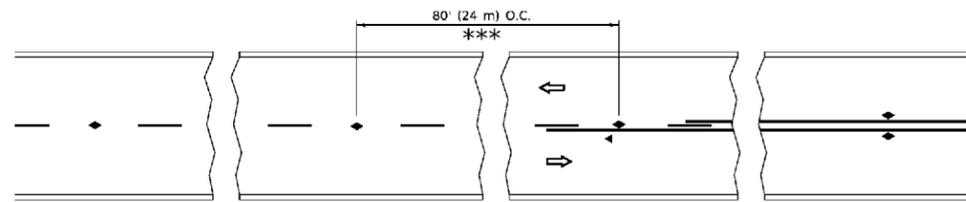
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PLOT DATE = 3/4/2019	DATE - 06-89	REVISED - A. SCHUETZE 07-01-13
		REVISED - A. SCHUETZE 09-15-16

**STATE OF ILLINOIS
DEPARTMENT OF TRANSPORTATION**

**TRAFFIC CONTROL AND PROTECTION FOR
SIDE ROADS, INTERSECTIONS, AND DRIVEWAYS**


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F.A.I. RTE.	SECTION	COUNTY	TOTAL SHEETS	SHEET NO.
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TC-10			CONTRACT NO. 62K96	
ILLINOIS FED. AID PROJECT				




*** REDUCE TO 40' (12 m) O.C. ON CURVES WITH POSTED OR ADVISORY SPEED 45 M.P.H. (70 km/h) OR LESS.


TWO-LANE/TWO-WAY

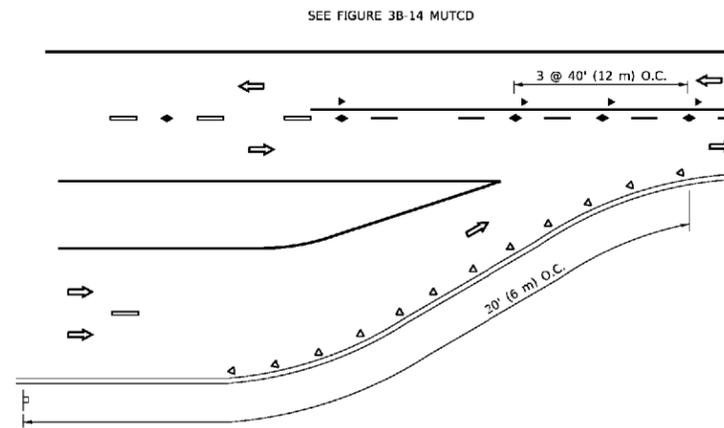


LANE REDUCTION TRANSITION

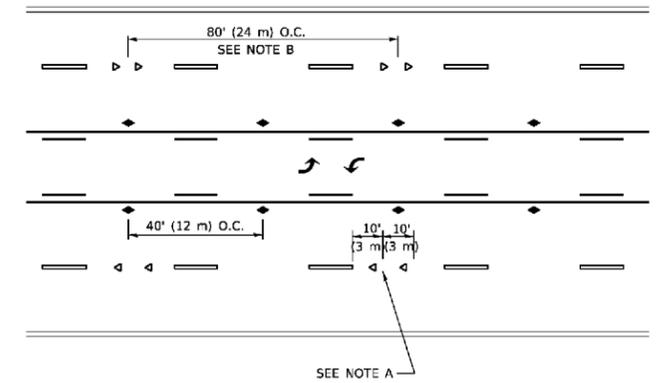

TWO-WAY LEFT TURN

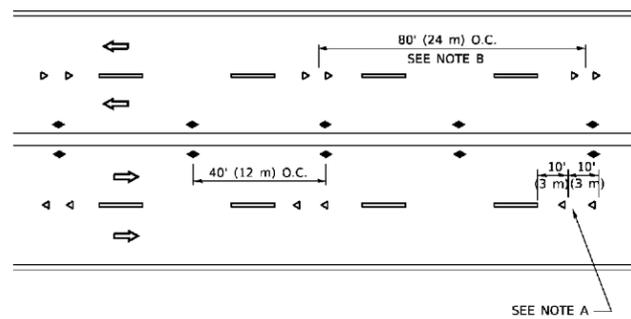

MULTI-LANE/UNDIVIDED

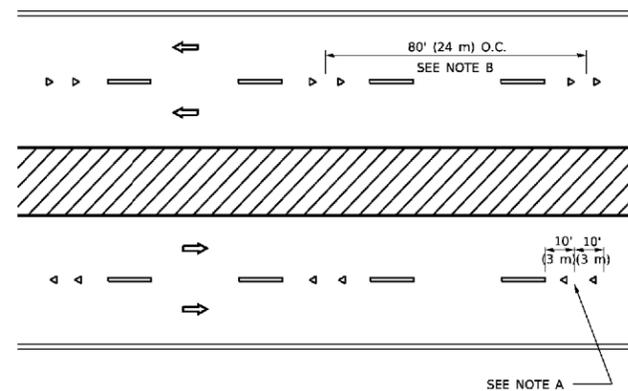

MULTI-LANE/DIVIDED

GENERAL NOTES

1. MARKERS USED WITH DASHED LINES SHALL BE CENTERED IN THE GAP BETWEEN SEGMENTS.
2. MARKERS USED ADJACENT TO SOLID LINES SHALL BE OFFSET 2 TO 3 (50 TO 75) TOWARD TRAFFIC AS SHOWN.
3. MARKERS THROUGH TANGENTS LESS THAN 500' (150 m) IN LENGTH BETWEEN CURVES SHALL BE INSTALLED AT THE LESSER OF THE TWO CURVE SPACINGS.
4. MARKERS ARE TO BE USED ADJACENT TO BOTH SOLID WHITE LINES IN DUAL LEFT TURN LANES.

SYMBOLS



- YELLOW STRIPE
- WHITE STRIPE
- ◀ ONE-WAY AMBER MARKER
- ◀ ONE-WAY CRYSTAL MARKER (W/O)
- ◆ TWO-WAY AMBER MARKER

LANE MARKER NOTES

- A. USE DOUBLE LANE LINE MARKERS SPACED AS SHOWN.
- B. REDUCE TO 40' (12 m) O.C. ON CURVES WHERE ADVISORY SPEEDS ARE 10 M.P.H (20 km/h) LOWER THAN POSTED SPEEDS.

DESIGN NOTES

1. DOUBLE LANE LINE MARKERS SHALL BE USED UNLESS SPECIFIED OTHERWISE.
2. EXCEPT AS SHOWN ON THE LANE REDUCTION TRANSITION AND FREEWAY EXIT RAMP DETAIL, MARKERS ARE NOT TO BE SPECIFIED ON RIGHT EDGE LINES.
3. THE EXACT MARKER LIMITS, SPACING, AND COLOR SHALL BE INCLUDED IN THE PLANS WHEN STANDARD SPECIFICATIONS ARE NOT BEING USED.
4. MARKERS SHOULD NOT BE USED ALONGSIDE CURBS EXCEPT FOR EXTREMELY SHORT SECTIONS OF CURBS WHERE NOT MORE THAN TWO MARKERS WOULD BE INVOLVED.

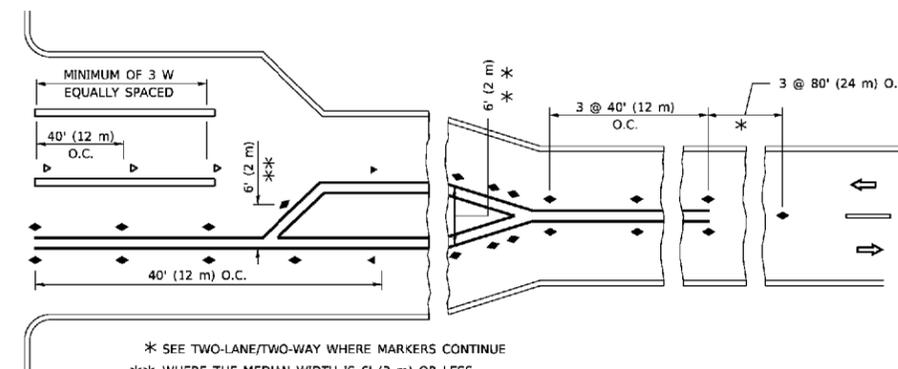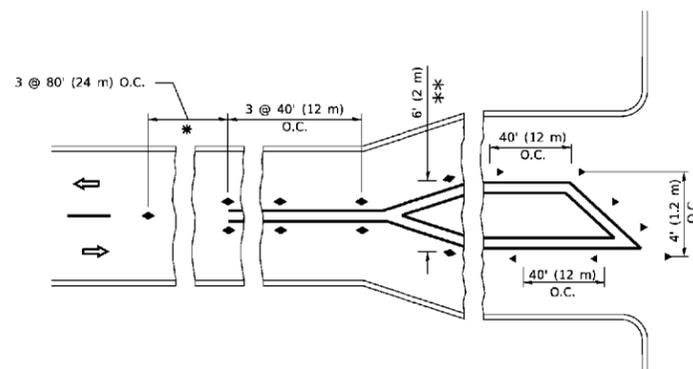


TURN LANES


* SEE TWO-LANE/TWO-WAY WHERE MARKERS CONTINUE
 ** WHERE THE MEDIAN WIDTH IS 6' (2 m) OR LESS USE TWO-WAY MARKERS.

All dimensions are in inches (millimeters) unless otherwise shown.


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	DRAWN -	REVISED - T. RAMMACHER 01-06-00		RAISED REFLECTIVE PAVEMENT MARKERS (SNOW-PLOW RESISTANT)		55	2020-025-BR	DUPAGE	62	55
PLOT SCALE = 2,0000' / in.	CHECKED -	REVISED - C. JUCIUS 09-09-09	SCALE: N.T.S.	SHEET 1 OF 1 SHEETS	STA. TO STA.	TC-11		CONTRACT NO. 62K96		
PLOT DATE = 11/2/2020	DATE -	REVISED - C. JUCIUS 07-01-13				ILLINOIS FED. AID PROJECT				

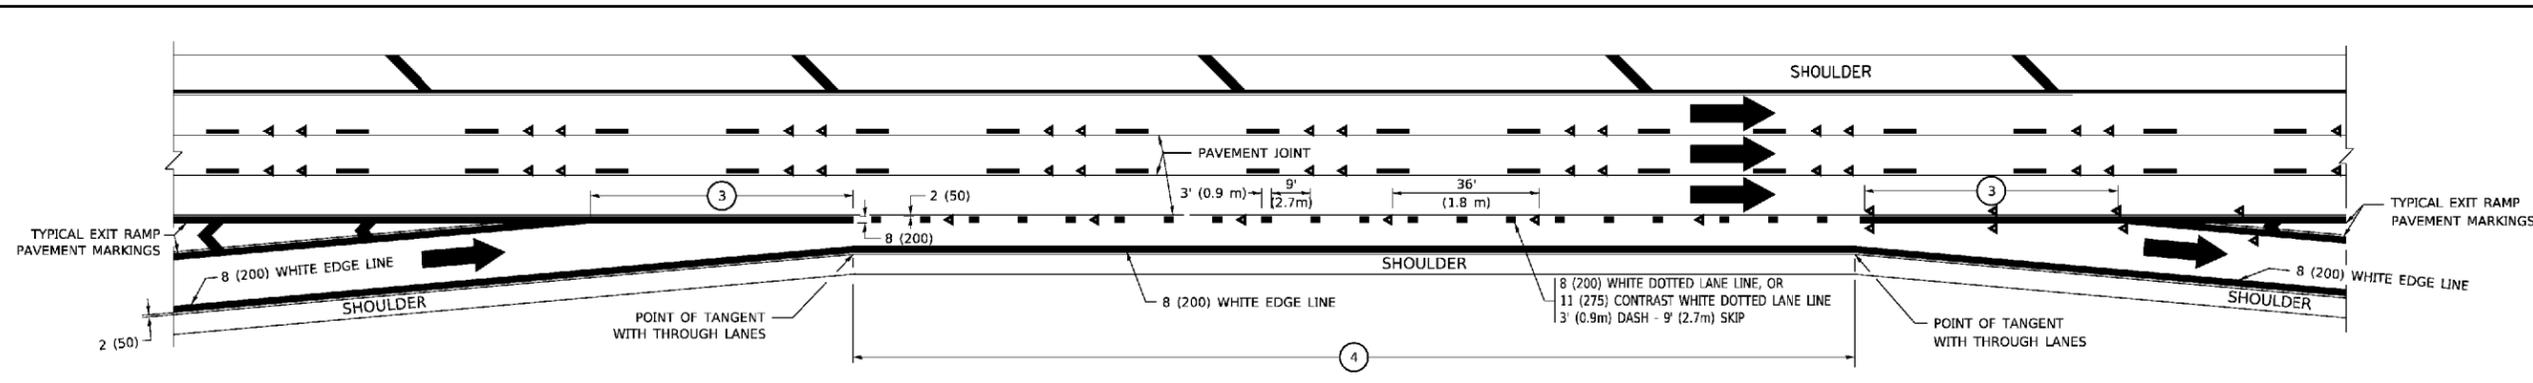


AUXILIARY LANE MARKINGS

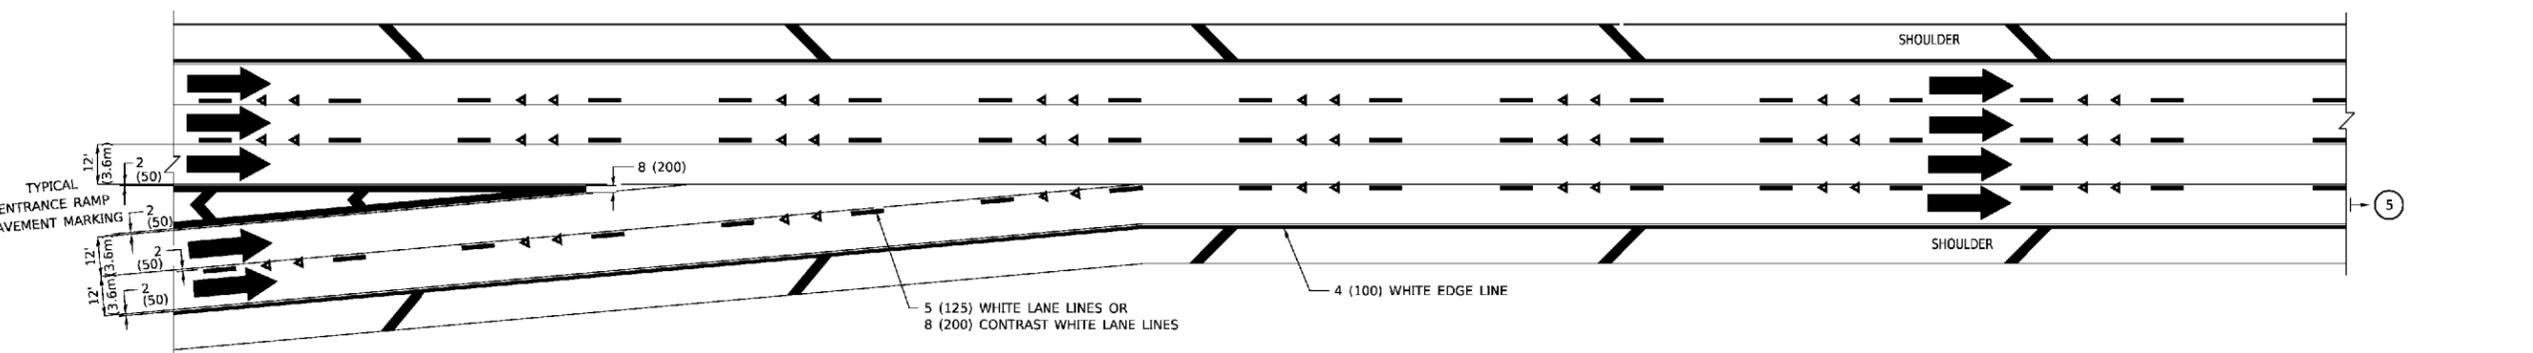

TWO LANE ENTRANCE RAMP WITH MERGE MARKINGS

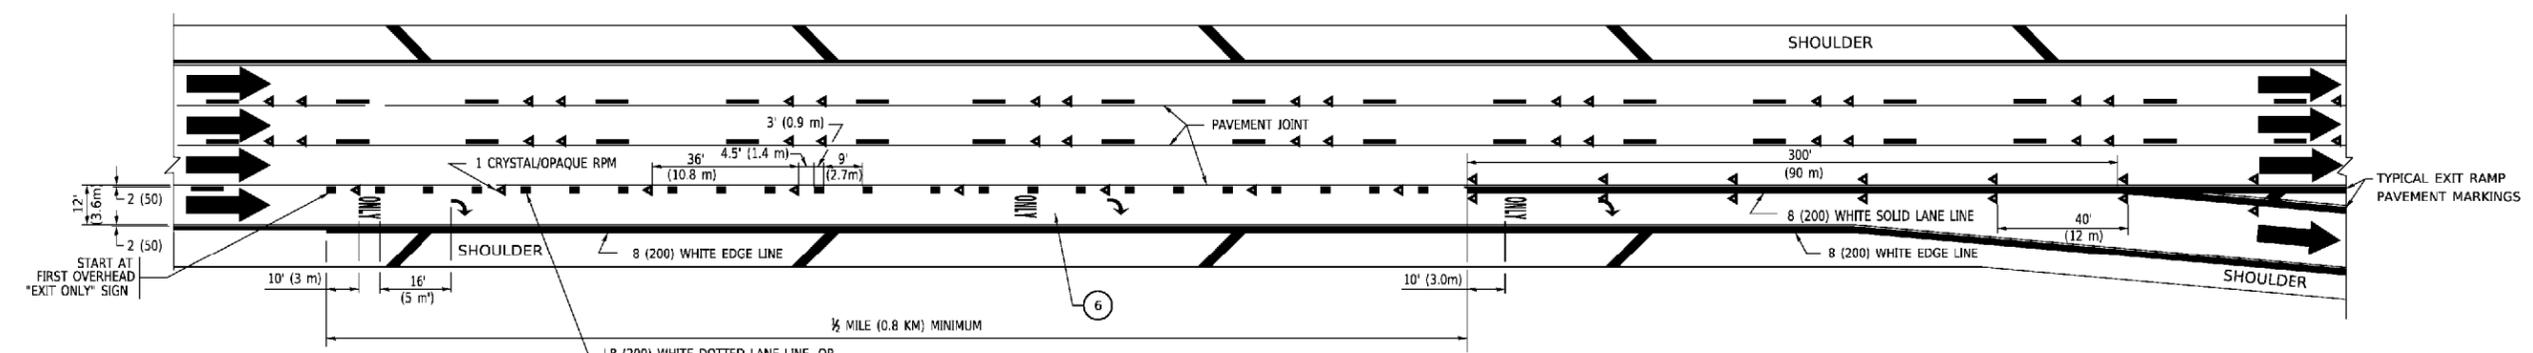

EXIT ONLY LANE MARKINGS

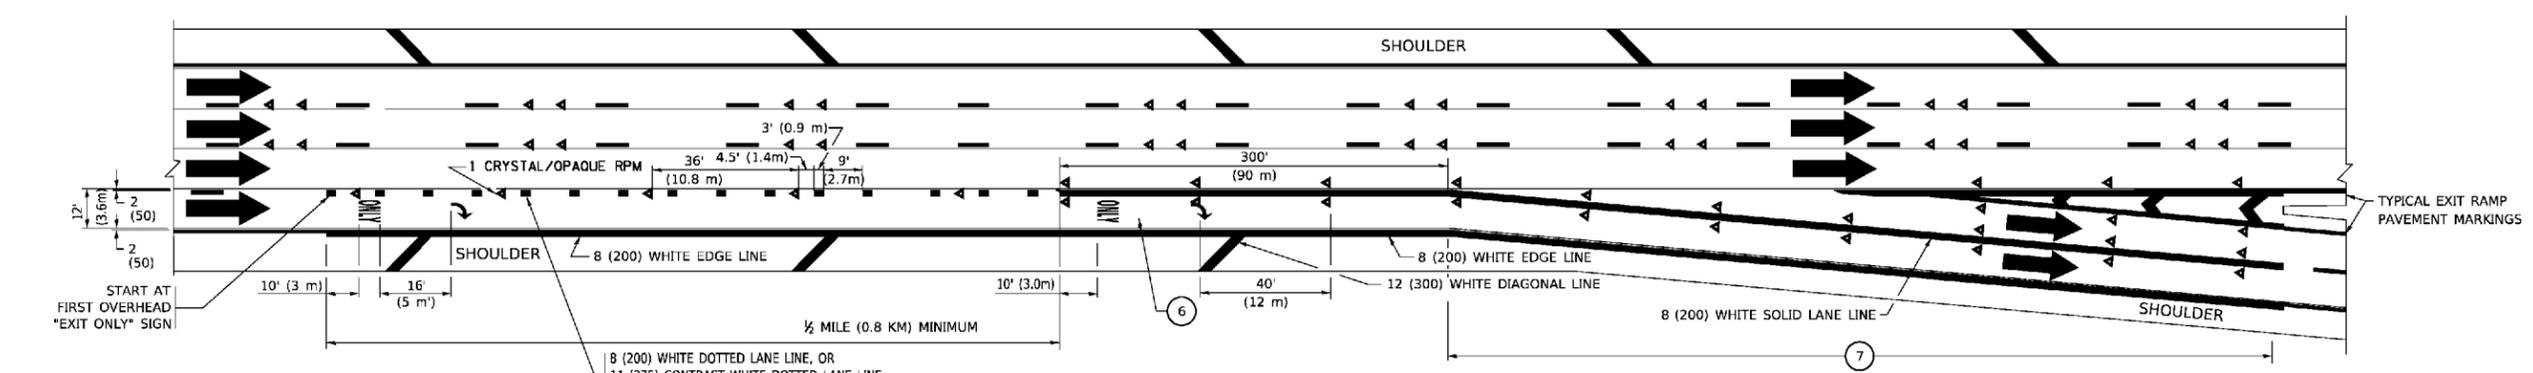

EXIT ONLY WITH OPTION LANE MARKINGS


- NOTES:**
- ③ OMIT WHEN LENGTH OF AUXILIARY LANE IS LESS THAN 500' (150 m).
 - ④ 8-INCH WIDE DOTTED LANE LINE MARKINGS SHALL BE USED WHEN THE LENGTH OF THE AUXILIARY LANE IS 2 MILES OR LESS.
 - ⑤ FOR TWO-LANE ENTRANCE RAMP, IF RIGHT LANE ENDS, USE TYPICAL ENTRANCE RAMP PAVEMENT MARKINGS.
 - ⑥ ONLY AND ARROWS EQUALLY SPACED, 500' (150 m) MAXIMUM SPACING. FULL SIZE LETTERS AND ARROW SHALL BE USED.
 - ⑦ CONTINUE 8" SOLID LANE LINE THROUGH EXIT TO END OF PAVED GORE.

USER NAME = rober	DESIGNED - D.W.S.	REVISED - J.A.F. 02-06
	DRAWN -	REVISED - S.P.B. 01-07
PLOT SCALE = 2,000' / in.	CHECKED -	REVISED - S.P.B. 01-10
PLOT DATE = 11/2/2020	DATE - 01-90	REVISED - M.D. 09-17


STATE OF ILLINOIS
DEPARTMENT OF TRANSPORTATION

MULTI-LANE FREEWAY PAVEMENT MARKING DETAILS	
SCALE: N.T.S.	SHEET 2 OF 2 SHEETS STA. TO STA.


F.A.I. RTE.	SECTION	COUNTY	TOTAL SHEETS	SHEET NO.
55	2020-025-BR	DUPAGE	62	57
TC-12		CONTRACT NO. 62K96		
ILLINOIS FED. AID PROJECT				

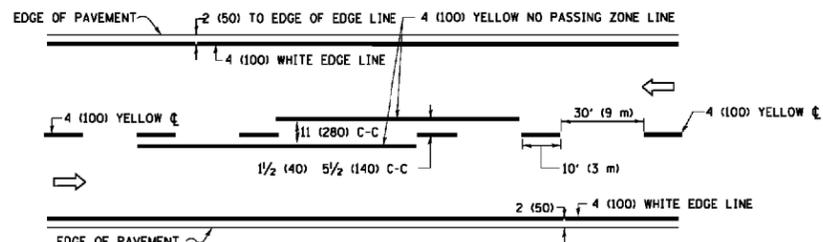

2-LANE ROADWAY

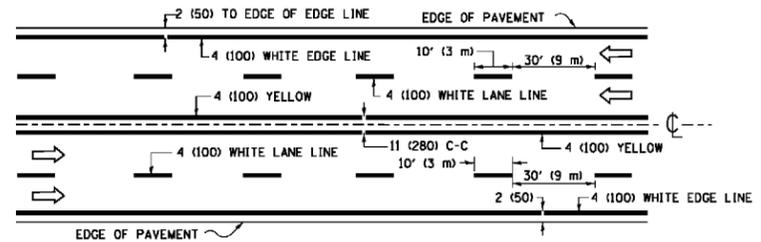


MULTI-LANE UNDIVIDED

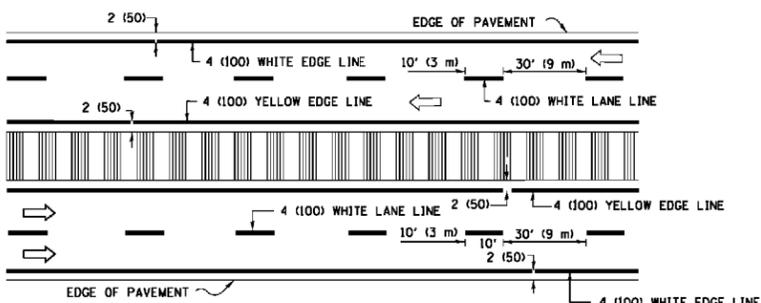


MULTI-LANE DIVIDED WITH MEDIAN

TYPICAL LANE AND EDGE LINE MARKING

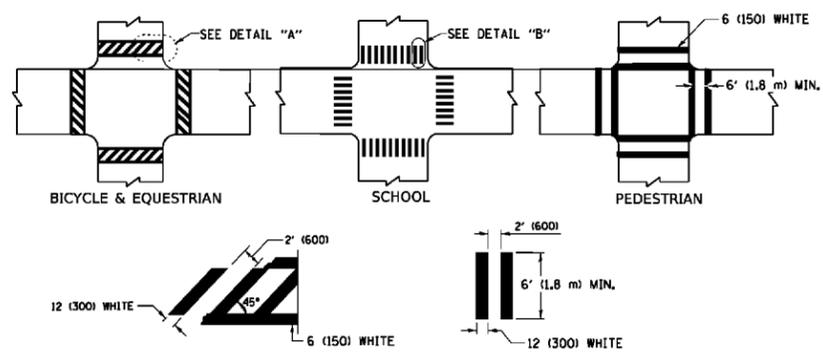


TYPICAL CROSSWALK MARKING


* MARKINGS SHALL BE INSTALLED PARALLEL TO THE CENTERLINE OF THE ROAD WHICH IT CROSSES

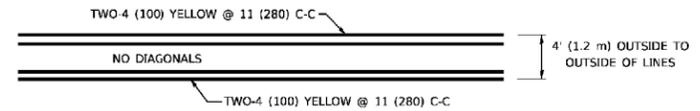


4' (1.2 m) WIDE MEDIANS ONLY

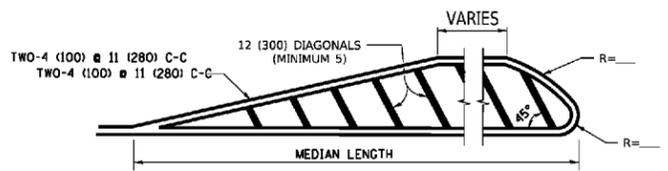

MEDIANS OVER 4' (1.2 m) WIDE

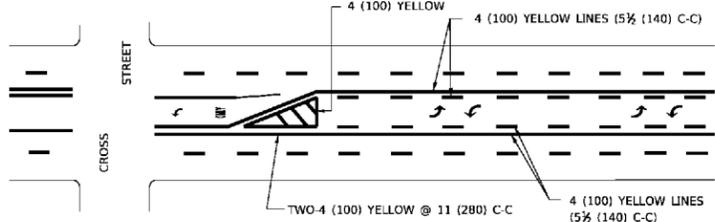


**MEDIAN WITH TWO-WAY LEFT TURN LANE
TYPICAL PAINTED MEDIAN MARKING**

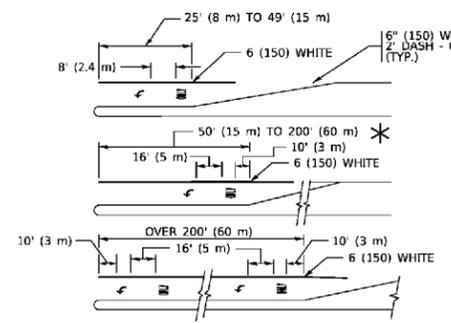


**TYPICAL LEFT (OR RIGHT) TURN LANE
TYPICAL TURN LANE MARKING**


FULL SIZE LETTERS 8' (2.4 m) AND ARROWS SHALL BE USED.
AREA = 15.6 SQ. FT. (1.5 m²) ONLY AREA = 20.8 SQ. FT. (1.9 m²)
* TURN LANES IN EXCESS OF 400' (120 m) IN LENGTH MAY HAVE AN ADDITIONAL SET OF ARROW - "ONLY" INSTALLED MIDWAY BETWEEN THE OTHER TWO SETS OF ARROW - "ONLY".

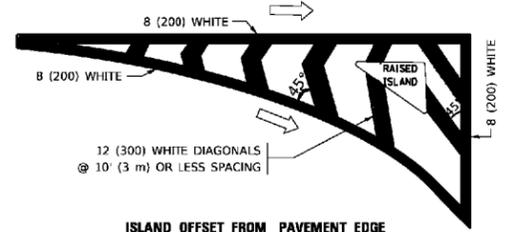


ISLAND OFFSET FROM PAVEMENT EDGE

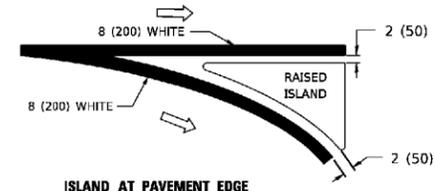

**ISLAND AT PAVEMENT EDGE
TYPICAL ISLAND MARKING**

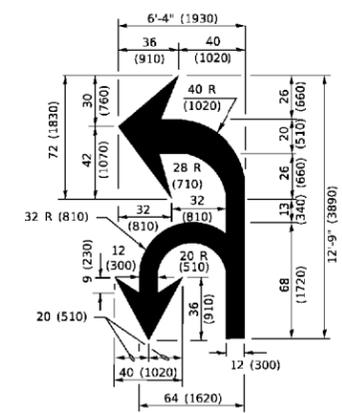

COMBINATION LEFT AND U-TURN

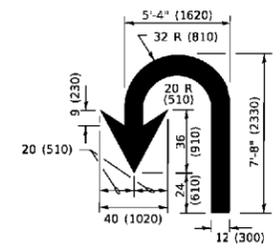

U-TURN

LANE REDUCTION TRANSITION
* LANE REDUCTION ARROWS REQUIRED AT SPEEDS OF 45 MPH OR GREATER OR WHEN SPECIFIED IN PLANS.

D(FT)	SPEED LIMIT
345	30
425	35
500	40
580	45
665	50
750	55

TYPE OF MARKING	WIDTH OF LINE	PATTERN	COLOR	SPACING / REMARKS
CENTERLINE ON 2 LANE PAVEMENT	4 (100)	SKIP-DASH	YELLOW	10' (3 m) LINE WITH 30' (9 m) SPACE
CENTERLINE ON MULTI-LANE UNDIVIDED PAVEMENT	2 @ 4 (100)	SOLID	YELLOW	11 (280) C-C
NO PASSING ZONE LINES: FOR ONE DIRECTION FOR BOTH DIRECTIONS	4 (100) 2 @ 4 (100)	SOLID SOLID	YELLOW YELLOW	5 1/2 (140) C-C FROM SKIP-DASH CENTERLINE 11 (280) C-C OMIT SKIP-DASH CENTERLINE BETWEEN
LANE LINES	4 (100) 5 (125) ON FREEWAYS	SKIP-DASH SKIP-DASH	WHITE WHITE	10' (3 m) LINE WITH 30' (9 m) SPACE
DOTTED LINES (EXTENSIONS OF CENTER, LANE OR TURN LANE MARKINGS)	SAME AS LINE BEING EXTENDED	SKIP-DASH	SAME AS LINE BEING EXTENDED	2' (600) LINE WITH 6' (1.8 m) SPACE
EDGE LINES	4 (100)	SOLID	YELLOW-LEFT WHITE-RIGHT	OUTLINE MEDIANS IN YELLOW
TURN LANE MARKINGS	6 (150) LINE; FULL SIZE LETTERS & SYMBOLS (8' (2.4m))	SOLID	WHITE	SEE TYPICAL TURN LANE MARKING DETAIL
TWO WAY LEFT TURN MARKING	2 @ 4 (100) EACH DIRECTION 8' (2.4m) LEFT ARROW	SKIP-DASH AND SOLID IN PAIRS	YELLOW WHITE	10' (3 m) LINE WITH 30' (9 m) SPACE FOR SKIP-DASH; 5 1/2 (140) C-C BETWEEN SOLID LINE AND SKIP-DASH LINE SEE TYPICAL TWO-WAY LEFT TURN MARKING DETAIL
CROSSWALK LINES (PEDESTRIAN) A. DIAGONALS (BIKE & EQUESTRIAN) B. LONGITUDINAL BARS (SCHOOL)	2 @ 6 (150) 12 (300) @ 45° 12 (300) @ 90°	SOLID SOLID SOLID	WHITE WHITE WHITE	NOT LESS THAN 6' (1.8 m) APART 2' (600) APART 2' (600) APART SEE TYPICAL CROSSWALK MARKING DETAILS.
STOP LINES	24 (600)	SOLID	WHITE	PLACE 4' (1.2 m) IN ADVANCE OF AND PARALLEL TO CROSSWALK, IF PRESENT. OTHERWISE, PLACE AT DESIRED STOPPING POINT. PARALLEL TO CROSSROAD CENTERLINE, WHERE POSSIBLE.
PAINTED MEDIANS	2 @ 4 (100) WITH 12 (300) DIAGONALS @ 45° NO DIAGONALS USED FOR 4' (1.2 m) WIDE MEDIANS	SOLID	YELLOW: TWO WAY TRAFFIC WHITE: ONE WAY TRAFFIC	11 (280) C-C FOR THE DOUBLE LINE SEE TYPICAL PAINTED MEDIAN MARKING.
GORE MARKING AND CHANNELIZING LINES	8 (200) WITH 12 (300) DIAGONALS @ 45°	SOLID	WHITE	DIAGONALS: 15' (4.5 m) C-C (LESS THAN 30MPH (50 km/h)) 20' (6 m) C-C (30 MPH (50 km/h) TO 45MPH (70 km/h)) 30' (9 m) C-C (OVER 45MPH (70 km/h))
RAILROAD CROSSING	24 (600) TRANSVERSE LINES: "RR" 15' 6" (1.8 m) LETTERS; 16 (400) LINE FOR "X"	SOLID	WHITE	SEE STATE STANDARD 780001 AREA OF: "R"=3.6 SQ. FT. (0.33 m ²) EACH "X"=54.0 SQ. FT. (5.0 m ²)
SHOULDER DIAGONALS (REQUIRED FOR SHOULDERS ≥ 8')	12 (300) @ 45°	SOLID	WHITE - RIGHT YELLOW - LEFT	50' (15 m) C-C (LESS THAN 30MPH (50 km/h)) 75' (25 m) C-C (30 MPH (50 km/h) TO 45MPH (70 km/h)) 150' (45 m) C-C (OVER 45MPH (70 km/h))
U TURN ARROW	SEE DETAIL	SOLID	WHITE	16.3 SF
2 ARROW COMBINATION LEFT AND U TURN	SEE DETAIL	SOLID	WHITE	30.4 SF

FOR FURTHER DETAILS ON PAVEMENT MARKING REFER TO STANDARD SPECIFICATIONS FOR ROAD AND BRIDGE CONSTRUCTION AND STATE STANDARD 780001.

All dimensions are in inches (millimeters) unless otherwise shown.

USER NAME = rober	DESIGNED - EVERS	REVISED - C. JUCIUS 09-09-09
	DRAWN -	REVISED - C. JUCIUS 07-01-13
PLOT SCALE = 2,0000' / in.	CHECKED -	REVISED - C. JUCIUS 12-21-15
PLOT DATE = 11/2/2020	DATE - 03-19-90	REVISED - C. JUCIUS 04-12-16


**STATE OF ILLINOIS
DEPARTMENT OF TRANSPORTATION**

**DISTRICT ONE
TYPICAL PAVEMENT MARKINGS**


SCALE: N.T.S. SHEET 1 OF 1 SHEETS STA. TO STA.

F.A.I. RTE.	SECTION	COUNTY	TOTAL SHEETS	SHEET NO.
55	2020-025-BR	DUPAGE	62	58
TC-13		CONTRACT NO. 62K96		
ILLINOIS		FED. AID PROJECT		


PARTIAL RAMP CLOSURE DETAILS

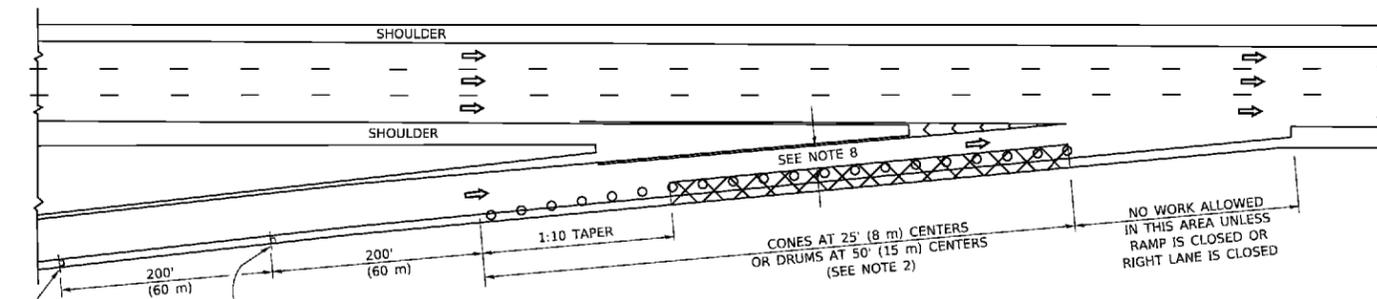

TYPICAL ENTRANCE RAMP

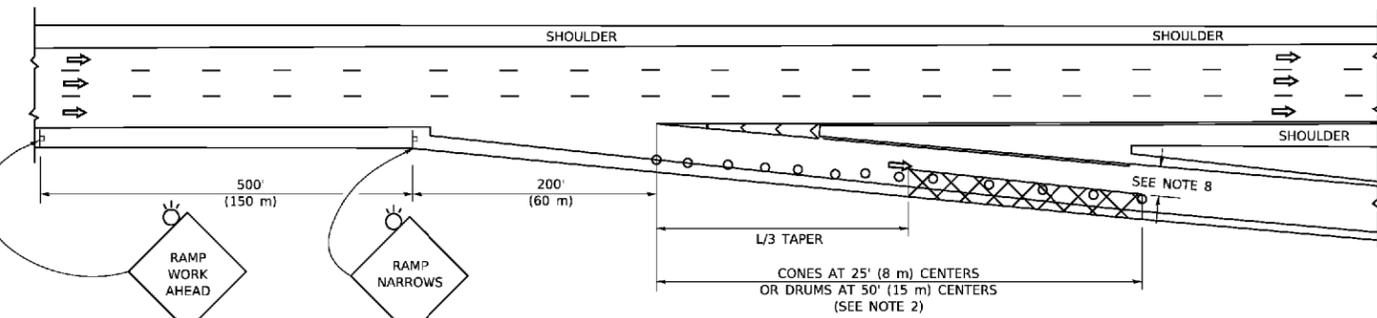

TYPICAL EXIT RAMP

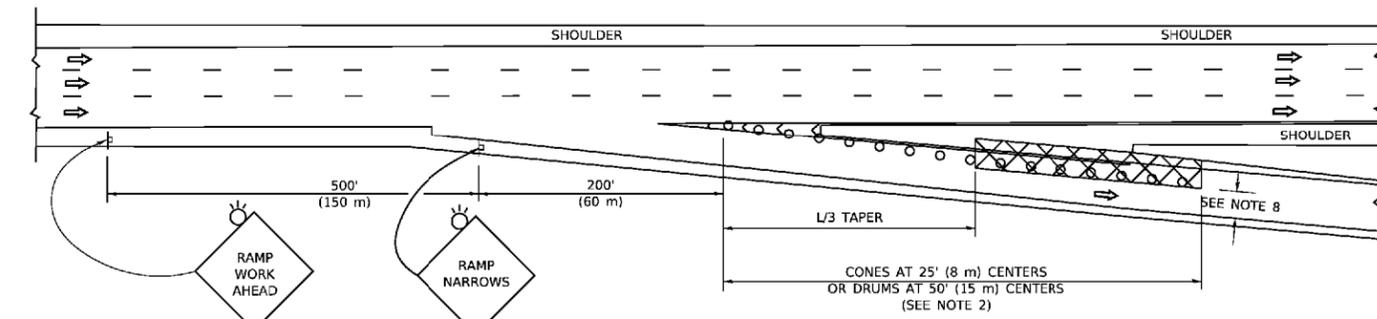

TYPICAL EXIT RAMP

SYMBOLS


- ACTIVE WORK AREA
- SIGN ON PORTABLE OR PERMANENT SUPPORT
- FLAGGER WITH CONTROL SIGN
- TYPE II BARRICADE OR DRUM
- CONE, DRUM OR BARRICADE
- IMPACT ATTENUATOR OF TYPE AND TEST LEVEL SPECIFIED

GENERAL NOTES:


1. THE "L" DISTANCE EQUALS:

SPEED LIMIT	FORMULAS
45 mph (80 km/h)	METRIC ENGLISH
OR GREATER:	$L=0.65(WXS)$ $L=(WXS)$
W = WIDTH OF OFFSET IN FEET (METERS)	
S = NORMAL POSTED SPEED MPH (KM/H)	
2. TYPE II BARRICADES OR DRUMS ARE REQUIRED FOR ALL NIGHTTIME CLOSURES. TYPE II BARRICADES OR DRUMS WITH MONODIRECTIONAL STEADY BURN LIGHTS ARE REQUIRED FOR DELINEATING OBSTACLES, EXCAVATIONS, OR HAZARDS EXCEEDING 100 FT (30m) IN LENGTH AT NIGHT.
3. ALL SIGNS SHALL BE POST MOUNTED IF THE CLOSURE TIME EXCEEDS FOUR DAYS.
4. FLASHING LIGHTS SHALL BE USED DURING THE HOURS OF DARKNESS AND SHALL BE INSTALLED ABOVE THE FIRST TWO SETS OF SIGNS.


SHOULDER CLOSURE DETAILS

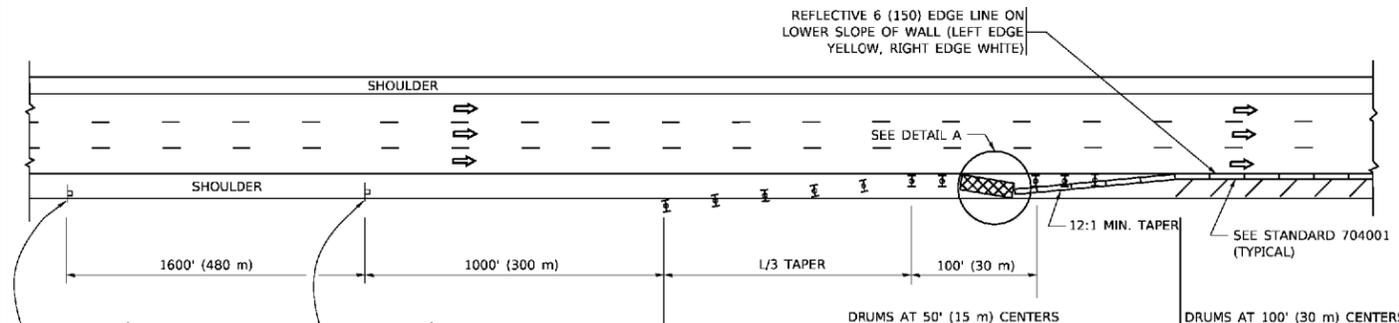

PERMANENT SHOULDER CLOSURE

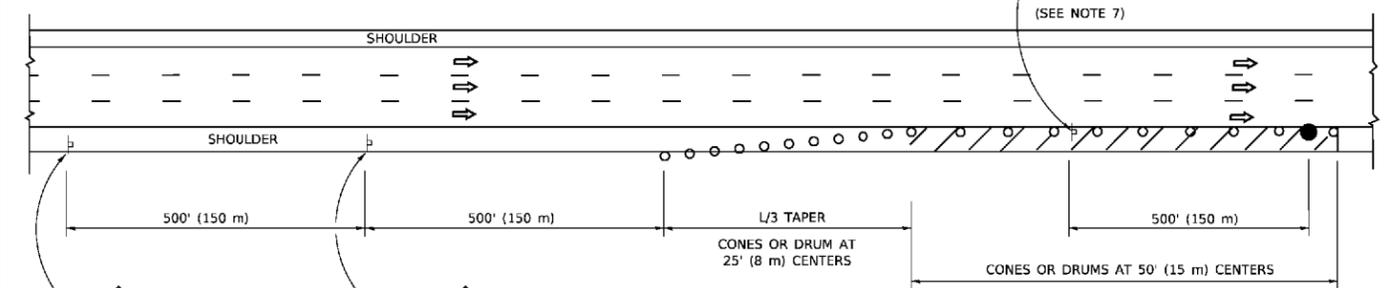

DAYTIME SHOULDER CLOSURE

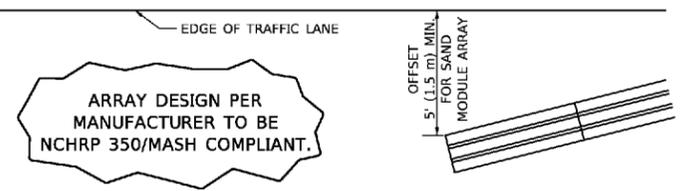

**DETAIL "A"
IMPACT ATTENUATOR, TEMPORARY
(SEE NOTE 5)**

5. THE IMPACT ATTENUATOR, TEMPORARY IS NOT REQUIRED WHEN THE TEMPORARY CONCRETE BARRIER WALL IS PROTECTED BY OR IS TIED INTO THE EXISTING GUARDRAIL. IF OFFSET IS LESS THAN 5 FEET USE NARROW USE TYPE DEVICE TO MEET NCHRP350/MASH.
6. AUTHORIZATION FROM THE DISTRICT'S BUREAU OF TRAFFIC IS REQUIRED FOR ALL FREEWAY CLOSURES.
7. THE FLAGGER AND FLAGGER SIGN ARE REQUIRED AT THE ABOVE WORK SITES WHEN:
 - a. FOUR OR MORE WORK VEHICLES ENTER THE TRAFFIC LANES IN A ONE HOUR PERIOD.
 - b. THE WORK AVTIVITY REQUIRES FREQUENT ENCROACHMENT INTO THE LANE OPEN TO TRAFFIC.
 THE FLAGGER SHALL BE STATIONED APPROXIMATELY 100' (30 m) TO 200' (60 m) IN ADVANCE OF THE WORKERS.
8. 12' MIN. WIDTH TANGENT SECTION
16' MIN. WIDTH CURVE SECTION.

ALL DIMENSIONS ARE IN INCHES (MILLIMETERS) UNLESS OTHERWISE SHOWN.

**STATE OF ILLINOIS
DEPARTMENT OF TRANSPORTATION**

**TRAFFIC CONTROL DETAILS FOR FREEWAY
SHOULDER CLOSURES AND PARTIAL RAMP CLOSURES**


USER NAME = rober	DESIGNED -	REVISED - S.P.B. 01-07
	DRAWN - D.W.S.	REVISED - S.P.B. 12-09
PLOT SCALE = 2,000' / in.	CHECKED -	REVISED - M.D. 06-13
PLOT DATE = 11/2/2020	DATE - 11-96	REVISED - M.D. 01-18

SCALE: N.T.S. SHEET 1 OF 1 SHEETS STA. TO STA.


F.A.I. RTE.	SECTION	COUNTY	TOTAL SHEETS	SHEET NO.
55	2020-025-BR	DUPAGE	62	59
TC-17		CONTRACT NO. 62K96		
ILLINOIS FED. AID PROJECT				

SIGNING FOR FLAGGING OPERATIONS AT WORK ZONE OPENINGS

WORK ZONE EXIT OPENING

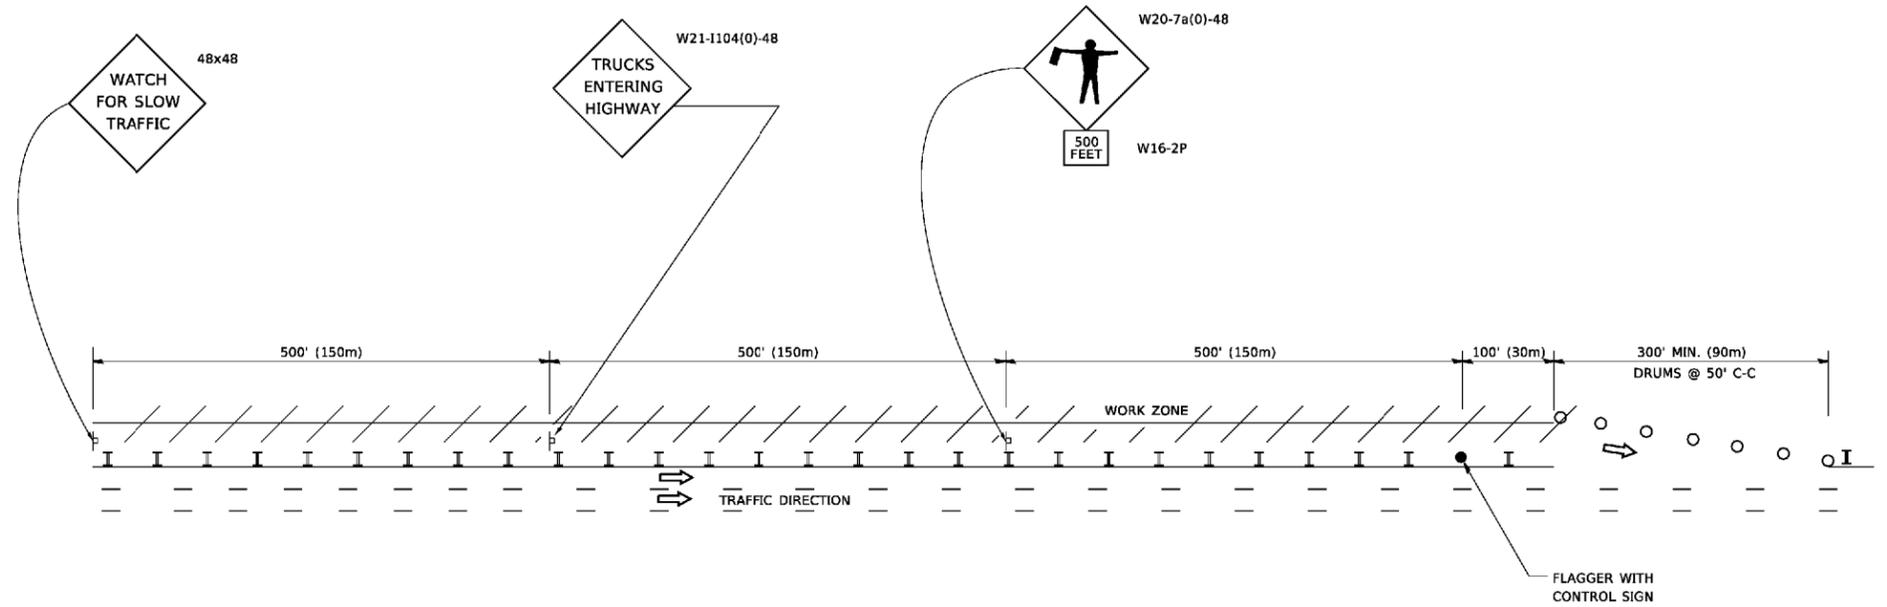

WORK ZONE ENTRY OPENING

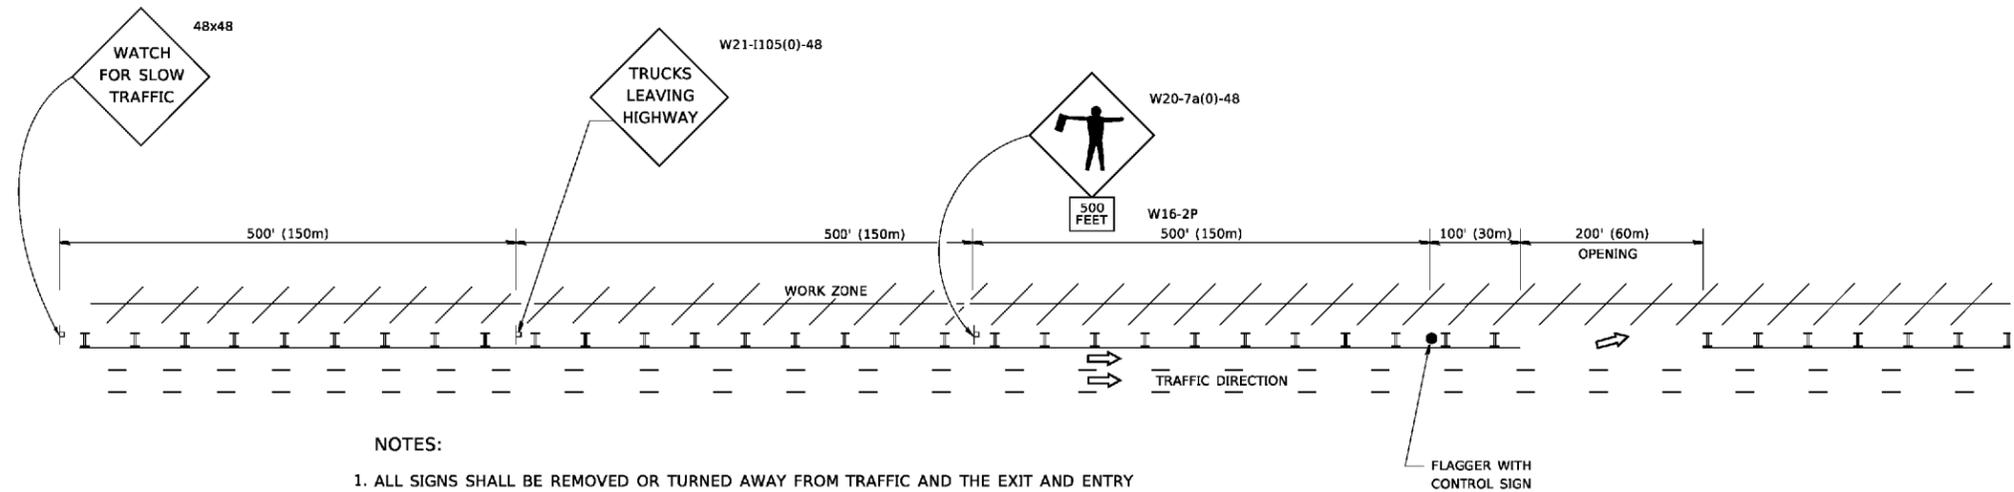

NOTES:

1. ALL SIGNS SHALL BE REMOVED OR TURNED AWAY FROM TRAFFIC AND THE EXIT AND ENTRY OPENINGS SHALL BE CLOSED WHEN THE FLAGGING OPERATION CEASES. NON OPERATING EQUIPMENT SHALL COMPLY WITH ARTICLE 701.11
2. WORK ZONE OPENINGS SHALL BE A MINIMUM OF ONE HALF MILE APART AND A MINIMUM OF ONE QUARTER MILE FROM ALL ENTRANCE AND EXIT RAMPS.
3. EXITING THE WORK ZONE AT ANY PLACE OTHER THAN AT A WORK ZONE EXIT OPENING WILL BE PROHIBITED.
4. ALL VEHICLES SHALL ENTER THE WORK ZONE AT ENTRY OPENINGS, USING THEIR TURN SIGNALS TO WARN MOTORISTS
5. FLAGGERS SHALL NOT STOP TRAFFIC OR DIRECT TRAFFIC INTO AN ADJACENT LANE.

ALL DIMENSIONS ARE IN INCHES (MILLIMETERS) UNLESS OTHERWISE SHOWN

USER NAME = rober	DESIGNED -
	DRAWN -
PLOT SCALE = 2,000' / in.	CHECKED -
PLOT DATE = 11/2/2020	DATE -


REVISED - J.A.F. 02-06
REVISED - S.P.B. 01-07
REVISED - S.P.B. 12-09
REVISED - M.D. 06-13

STATE OF ILLINOIS
DEPARTMENT OF TRANSPORTATION

FREEWAY/EXPRESSWAY SIGNING FOR FLAGGING OPERATIONS
AT WORK ZONE OPENINGS ON FREEWAYS/EXPRESSWAY

SCALE: N.T.S. SHEET 1 OF 1 SHEETS STA. TO STA.

F.A.I. RTE.	SECTION	COUNTY	TOTAL SHEETS	SHEET NO.
55	2020-025-BR	DUPAGE	62	60
TC-18		CONTRACT NO. 62K96		
ILLINOIS FED. AID PROJECT				

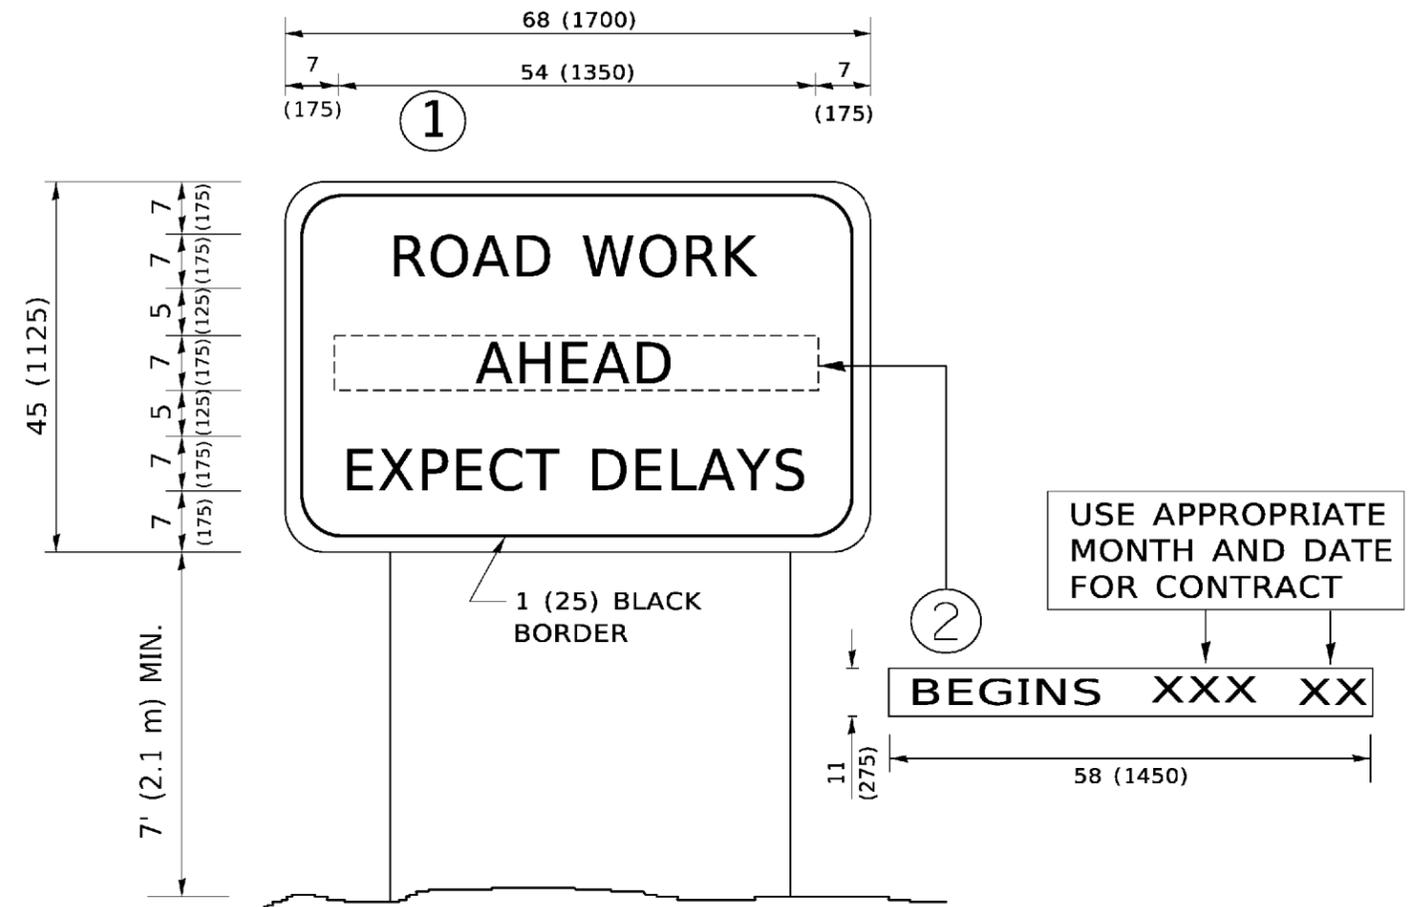


NOTES:

1. USE BLACK LETTERING ON ORANGE BACKGROUND.
2. ERECT SIGNS IN ADVANCE OF THE LOCATION FOR THE "ROAD CONSTRUCTION AHEAD" SIGN AT LOCATIONS AS DIRECTED BY THE ENGINEER.
3. ERECT SIGN ① WITH INSTALLED PANEL ② ONE WEEK PRIOR TO THE START OF CONSTRUCTION.
4. REMOVE PANEL ② SOON AFTER THE START OF CONSTRUCTION.
5. SEE SPECIAL PROVISION FOR "TEMPORARY INFORMATION SIGNING" FOR ADDITIONAL INFORMATION.
6. ONE SIGN ASSEMBLY EQUALS 25.70 SQ. FT. (2.3 SQ. M.)
7. SHALL BE PAID FOR AS TEMPORARY INFORMATION SIGNING.


ALL DIMENSIONS ARE IN INCHES (MILLIMETERS) UNLESS OTHERWISE SHOWN.

USER NAME = rober	DESIGNED -	REVISED - R. MIRS 09-15-97	STATE OF ILLINOIS DEPARTMENT OF TRANSPORTATION	ARTERIAL ROAD INFORMATION SIGN		F.A.I. RTE.	SECTION	COUNTY	TOTAL SHEETS	SHEET NO.
	DRAWN -	REVISED - R. MIRS 12-11-97		55	2020-025-BR	DUPAGE	62	61		
PLOT SCALE = 2,0000' / in.	CHECKED -	REVISED - T. RAMMACHER 02-02-99		TC-22		CONTRACT NO. 62K96				
PLOT DATE = 11/2/2020	DATE -	REVISED - C. JUCIUS 01-31-07		SCALE: N.T.S.	SHEET 1 OF 1 SHEETS	STA.	TO STA.	ILLINOIS FED. AID PROJECT		

CENTER LANE CLOSURE

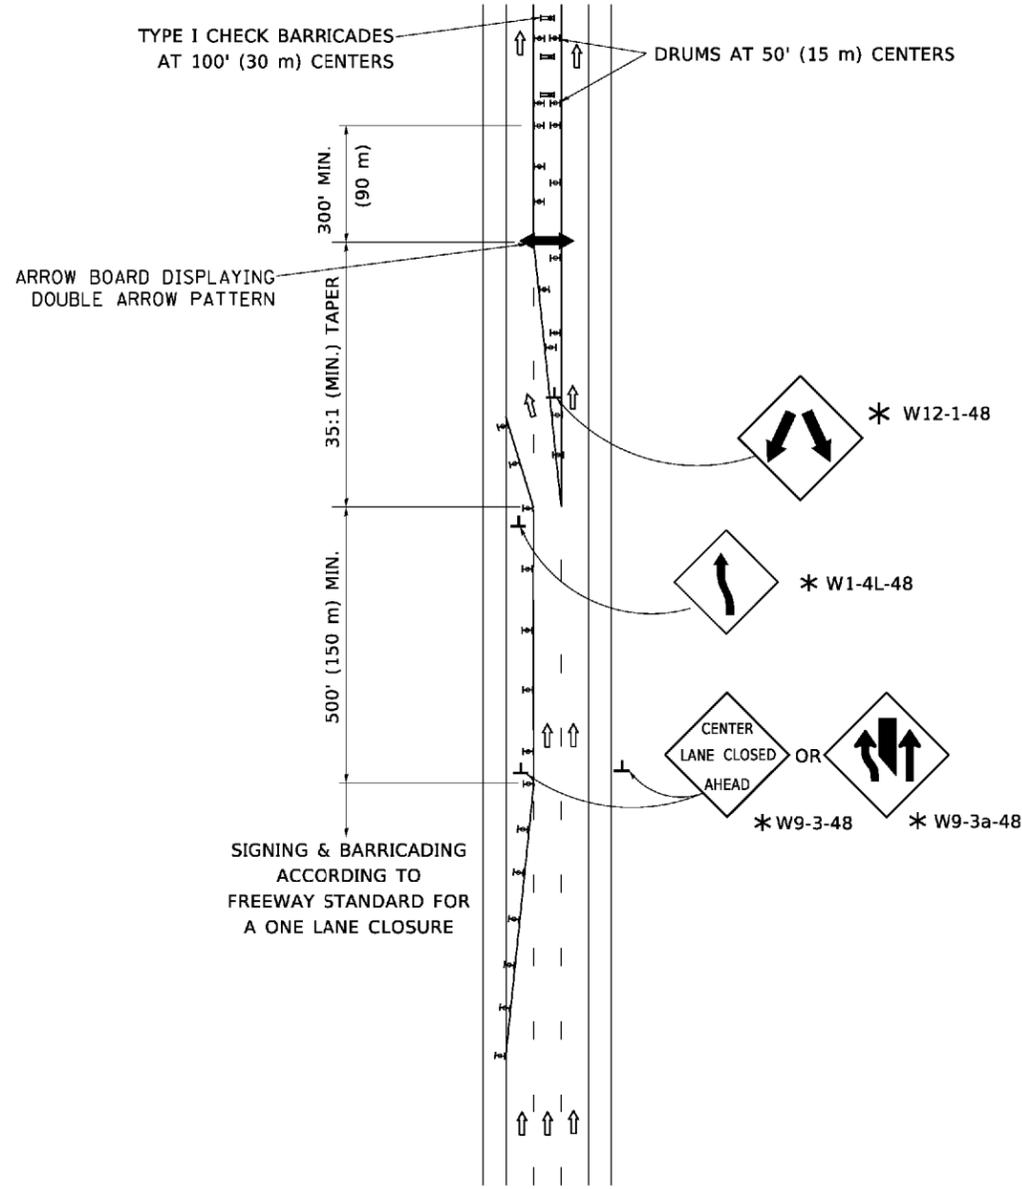

INSTALLATION SEQUENCE


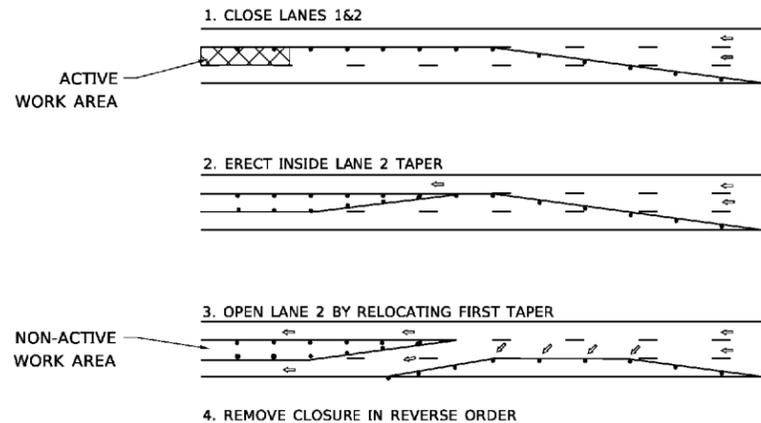


NOTES:

1. DRUMS WITH STEADY BURN LIGHTS SHALL BE USED AT 50' (15 m) CENTERS ON ALL TAPERS AND TANGENTS IN ADVANCE OF WORK AREA.
2. CLOSURE SHALL BE USED ONLY FOR OPERATIONS LASTING 72 HOURS OR LESS.
3. CENTER LANE CLOSURE CONFIGURATION IS NOT TO BE USED WITH WORKERS PRESENT.

SHOULDER LANE

NOTE:
CLOSURE SHALL BE USED ONLY FOR OPERATIONS LASTING 72 HOURS OR LESS.

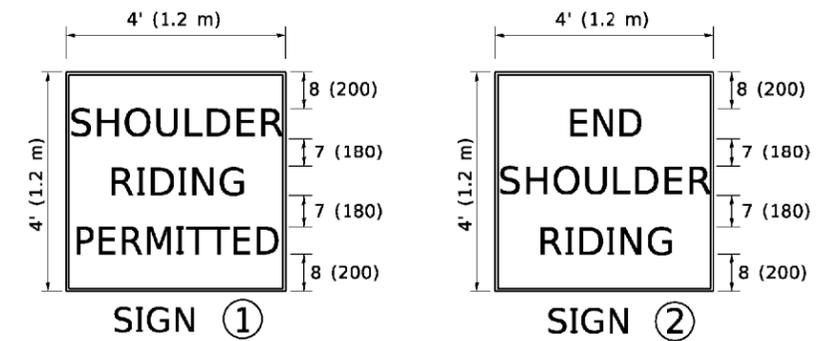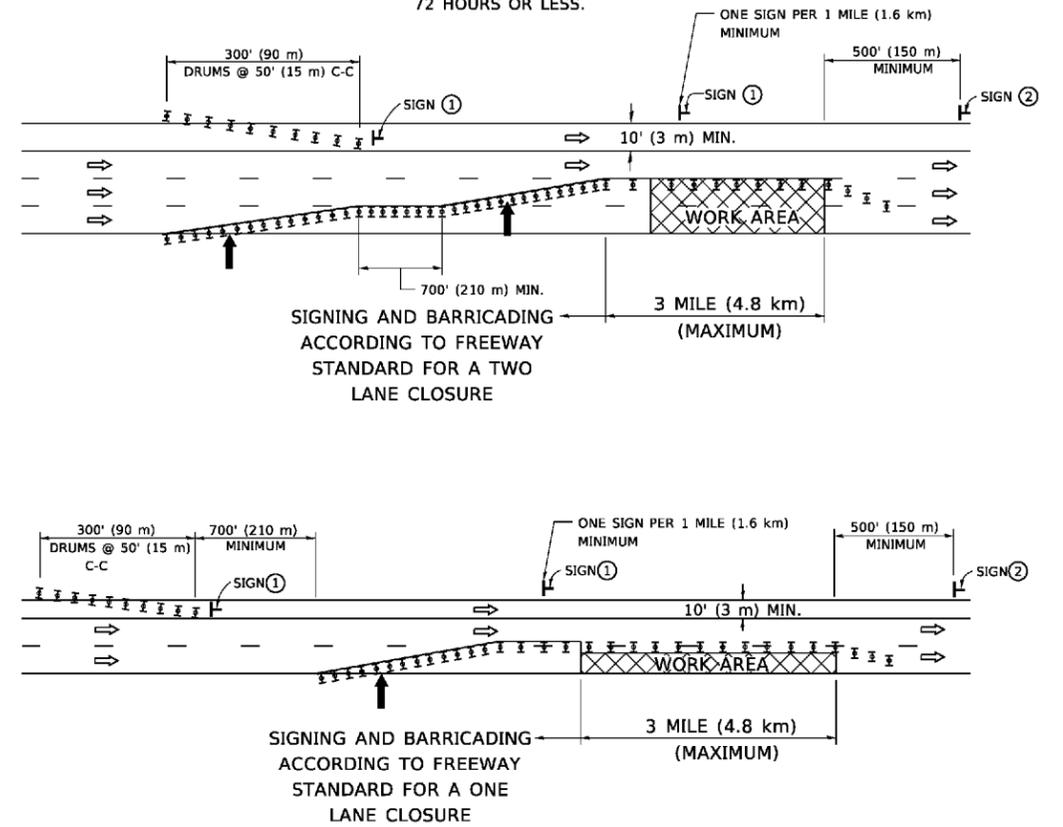

6 (150) SERIES "C" LEGEND
BLACK LEGEND
WHITE REFLECT. BACKGROUND
1 (25) BORDER

SYMBOLS

- ↑ DIRECTION OF TRAFFIC
- ➡ ARROWBOARD
- ▣ ACTIVE WORK AREA
- ⊥ SIGN ON PORTABLE OR PERMANENT SUPPORT *
- ⊥ TYPE II BARRICADE, OR DRUM WITH MONO-DIRECTIONAL STEADY BURN LIGHT

ALL DIMENSIONS ARE IN INCHES (MILLIMETERS) UNLESS OTHERWISE SHOWN

* ALL SIGNS SHALL BE MOUNTED AT A MINIMUM HEIGHT OF 5' (1.5 m).

USER NAME = rober	DESIGNED -	REVISED - J.A.F. 04-03
	DRAWN -	REVISED - S.P.B. 01-07
PLOT SCALE = 2,000' / in.	CHECKED -	REVISED - S.P.B. 12-09
PLOT DATE = 11/2/2020	DATE -	REVISED -

STATE OF ILLINOIS
DEPARTMENT OF TRANSPORTATION

TRAFFIC CONTROL DETAILS FOR FREEWAY
CENTER LANE CLOSURE SHOULDER LANE

SCALE: N.T.S. SHEET 1 OF 1 SHEETS STA. TO STA.

F.A.I. RTE.	SECTION	COUNTY	TOTAL SHEETS	SHEET NO.
55	2020-025-BR	DUPAGE	62	62
TC-25		CONTRACT NO. 62K96		
ILLINOIS FED. AID PROJECT				