


STATE OF ILLINOIS
DEPARTMENT OF TRANSPORTATION

F.A. RTE.	SECTION	COUNTY	TOTAL SHEETS	SHEET NO.
VAR.		ILLINOIS	14	1
CONTRACT NO. 70E36				

** 2021-1 SALT CONTAINMENT
VERMILION, CHAMPAIGN & DOUGLAS

P-95-010-20

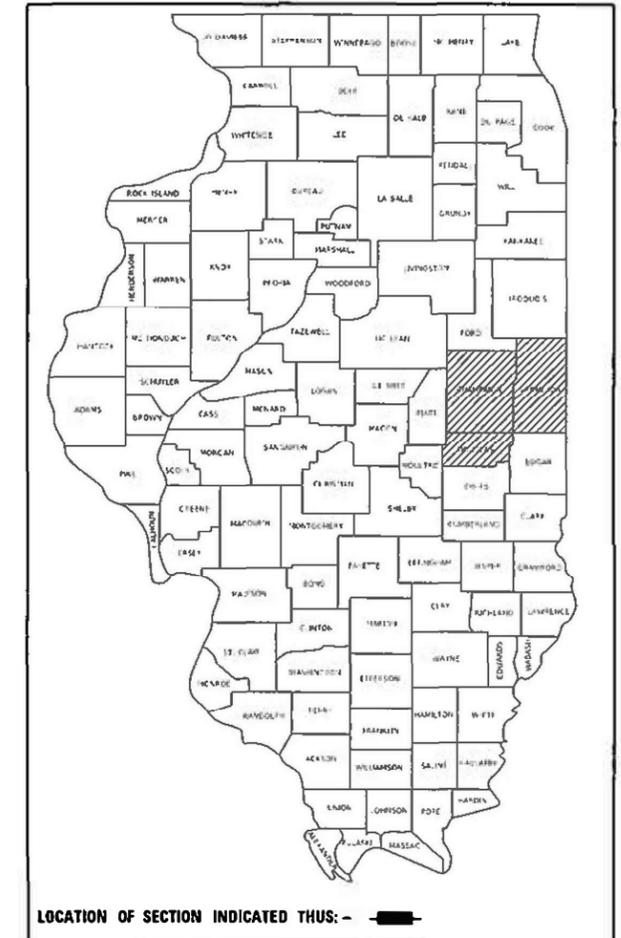

LOCATION OF SECTION INDICATED THUS: - [shaded area symbol]

FOR INDEX OF SHEETS, SEE SHEET NO. 2
FOR SUMMARY OF QUANTITIES, SEE SHEET NO. 3

PROPOSED
HIGHWAY PLANS


LEVERETT, TUSCOLA, FITHIAN STORAGE FACILITIES
SECTION 2021-1 SALT CONTAINMENT

MISCELLANEOUS PROJECTS
VERMILION, CHAMPAIGN, AND DOUGLAS COUNTIES

C-95-021-20

TOWNSHIPS


CHAMPAIGN: SOMER
DOUGLAS: TUSCOLA
VERMILION: OAKWOOD

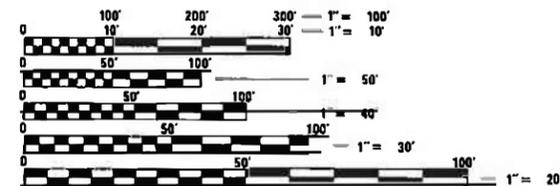

FULL SIZE PLANS HAVE BEEN PREPARED USING STANDARD
ENGINEERING SCALES. REDUCED SIZED PLANS WILL NOT
CONFORM TO STANDARD SCALES. IN MAKING MEASUREMENTS
ON REDUCED PLANS, THE ABOVE SCALES MAY BE USED.

J.U.L.I.E.
JOINT UTILITY LOCATION INFORMATION FOR EXCAVATORS
1-800-892-0123
OR 811

PROJECT ENGINEER: JASON STULTS, P.E.
PROJECT MANAGER: JASON GOBLE
PHONE: (217) 465-4181
CONTRACT NO. 70E36

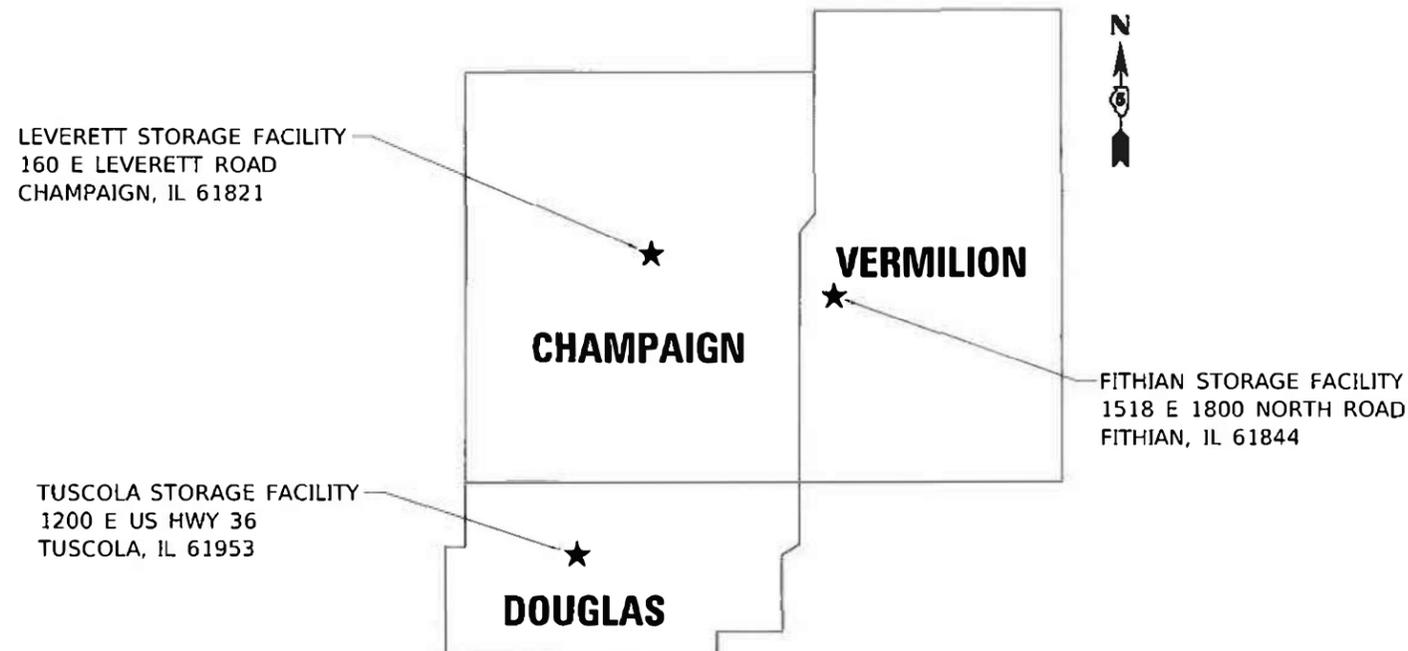

LEVERETT STORAGE FACILITY
160 E LEVERETT ROAD
CHAMPAIGN, IL 61821

FITHIAN STORAGE FACILITY
1518 E 1800 NORTH ROAD
FITHIAN, IL 61844

TUSCOLA STORAGE FACILITY
1200 E US HWY 36
TUSCOLA, IL 61953

SCALE FOR MAIN MAP: N-T-S

GROSS LENGTH = N/A FT. = N/A MILE
NET LENGTH = N/A FT. = N/A MILE

STATE OF ILLINOIS
DEPARTMENT OF TRANSPORTATION

SUBMITTED 10/15 2020
Kensila Hennetson
REGIONAL ENGINEER

December 4, 2020
Scott A. Elk
ENGINEER OF DESIGN AND ENVIRONMENT

December 4, 2020
James J. Gu
DIRECTOR OF HIGHWAYS PROJECT IMPLEMENTATION 13

PRINTED BY THE AUTHORITY
OF THE STATE OF ILLINOIS

SCHEDULE OF QUANTITIES

20200100 EARTH EXCAVATION

			20200100
LOCATION	DESCRIPTION	VOLUME (CU YD)	QUANTITY (CU YD)
CHAMPAIGN COUNTY (RURAL)			
LEVERETT	CONTAINMENT STRUCTURE	80.0	80.00
		SUB-TOTAL 1 =	80.00
		USE =	80.00
DOUGLAS COUNTY (RURAL)			
TUSCOLA	CONTAINMENT STRUCTURE	65.0	65.00
		SUB-TOTAL 2 =	65.00
		USE =	65.00
VERMILION COUNTY (RURAL)			
FITHIAN	CONTAINMENT STRUCTURE	65.0	65.00
		SUB-TOTAL 3 =	65.00
		USE =	65.00
		TOTAL =	210.00
		USE =	210.00
			CU YD

NOTE: SEE PLAN DETAIL SHEETS 11-13 FOR MORE INFO.

50300225 CONCRETE STRUCTURES

			50300225
LOCATION	DESCRIPTION	VOLUME (CU YD)	QUANTITY (CU YD)
CHAMPAIGN COUNTY (RURAL)			
LEVERETT	CONTAINMENT STRUCTURE	62.8	62.80
	STAIRS	0.2	0.20
		SUB-TOTAL 1 =	63.00
		USE =	63.00
DOUGLAS COUNTY (RURAL)			
TUSCOLA	CONTAINMENT STRUCTURE	56.8	56.80
	STAIRS	0.2	0.20
		SUB-TOTAL 2 =	57.00
		USE =	57.00
VERMILION COUNTY (RURAL)			
FITHIAN	CONTAINMENT STRUCTURE	56.8	56.80
	STAIRS	0.2	0.20
		SUB-TOTAL 3 =	57.00
		USE =	57.00
		TOTAL =	177.00
		USE =	177.00
			CU YD

NOTE: SEE PLAN DETAIL SHEETS 11-13 FOR ADDITIONAL INFO.

31100200 SUBBASE GRANULAR MATERIAL, TYPE A

			31100200
LOCATION	DESCRIPTION	VOLUME (CU YD)	QUANTITY (CU YD)
CHAMPAIGN COUNTY (RURAL)			
LEVERETT	CONTAINMENT STRUCTURE	69.0	69.00
		SUB-TOTAL 1 =	69.00
		USE =	69.00
DOUGLAS COUNTY (RURAL)			
TUSCOLA	CONTAINMENT STRUCTURE	61.0	61.00
		SUB-TOTAL 2 =	61.00
		USE =	61.00
VERMILION COUNTY (RURAL)			
FITHIAN	CONTAINMENT STRUCTURE	60.0	60.00
		SUB-TOTAL 3 =	60.00
		USE =	60.00
		TOTAL =	190.00
		USE =	190.00
			CU YD

NOTE: SEE PLAN DETAIL SHEETS 11-13 FOR ADDITIONAL INFO.

50500105 FURNISHING AND ERECTING STRUCTURAL STEEL

			50500105
LOCATION	DESCRIPTION	EST. QUANTITY (L SUM)	QUANTITY (L SUM)
CHAMPAIGN COUNTY (RURAL)			
LEVERETT	CONTAINMENT STRUCTURE	0.29	0.29
	STAIRS	0.05	0.05
		SUB-TOTAL 1 =	0.34
		USE =	0.34
DOUGLAS COUNTY (RURAL)			
TUSCOLA	CONTAINMENT STRUCTURE	0.28	0.28
	STAIRS	0.05	0.05
		SUB-TOTAL 2 =	0.33
		USE =	0.33
VERMILION COUNTY (RURAL)			
FITHIAN	CONTAINMENT STRUCTURE	0.28	0.28
	STAIRS	0.05	0.05
		SUB-TOTAL 3 =	0.33
		USE =	0.33
		TOTAL =	1.00
		USE =	1.00
			L SUM

NOTE: ESTIMATED (L SUM) AMOUNT FOR QUANTITY PURPOSES

MODEL: SPODLE.NAMES
 FILE NAME: I:\projects\2020\Documents\DOT_Civil\2020\11-13\50300225\Drawings\DOT\11-13\50300225.dwg

USER NAME	DESIGNED -	REVISED -
DRAWN -	CHECKED -	REVISED -
PLOT SCALE	DATE	REVISED -

**STATE OF ILLINOIS
DEPARTMENT OF TRANSPORTATION**

SCHEDULE OF QUANTITIES

SCALE: NTS SHEET 1 OF 2 SHEETS STA. TO STA.

F.A. SITE	SECTION	COUNTY	TOTAL SHEETS	SHEET NO.
VAR.	++	+	14	4
CONTRACT NO. 70E36				

SCHEDULE OF QUANTITIES

50800205 REINFORCEMENT BARS, EPOXY COATED

			50800205
LOCATION	DESCRIPTION	WEIGHT (POUND)	QUANTITY (POUND)
CHAMPAIGN COUNTY (RURAL)			
LEVERETT	CONTAINMENT STRUCTURE	5170.0	5170.00
	STAIRS	40.0	40.00
		SUB-TOTAL 1 =	5210.00
		USE =	5210.00
DOUGLAS COUNTY (RURAL)			
TUSCOLA	CONTAINMENT STRUCTURE	4850.0	4850.00
	STAIRS	40.0	40.00
		SUB-TOTAL 2 =	4890.00
		USE =	4890.00
VERMILION COUNTY (RURAL)			
FITHIAN	CONTAINMENT STRUCTURE	4850.0	4850.00
	STAIRS	40.0	40.00
		SUB-TOTAL 3 =	4890.00
		USE =	4890.00
		TOTAL =	14990.00
		USE =	14990.00
			POUND

NOTE: SEE PLAN DETAIL SHEETS 11-13 FOR ADDITIONAL INFO.

66900200 NON-SPECIAL WASTE DISPOSAL

			66900200
LOCATION	DESCRIPTION	VOLUME (CU YD)	QUANTITY (CU YD)
CHAMPAIGN COUNTY (RURAL)			
LEVERETT	CONTAINMENT STRUCTURE	80.0	80.00
		SUB-TOTAL 1 =	80.00
		USE =	80.00
DOUGLAS COUNTY (RURAL)			
TUSCOLA	CONTAINMENT STRUCTURE	65.0	65.00
		SUB-TOTAL 2 =	65.00
		USE =	65.00
VERMILION COUNTY (RURAL)			
FITHIAN	CONTAINMENT STRUCTURE	65.0	65.00
		SUB-TOTAL 3 =	65.00
		USE =	65.00
		TOTAL =	210.00
		USE =	210.00
			CU YD

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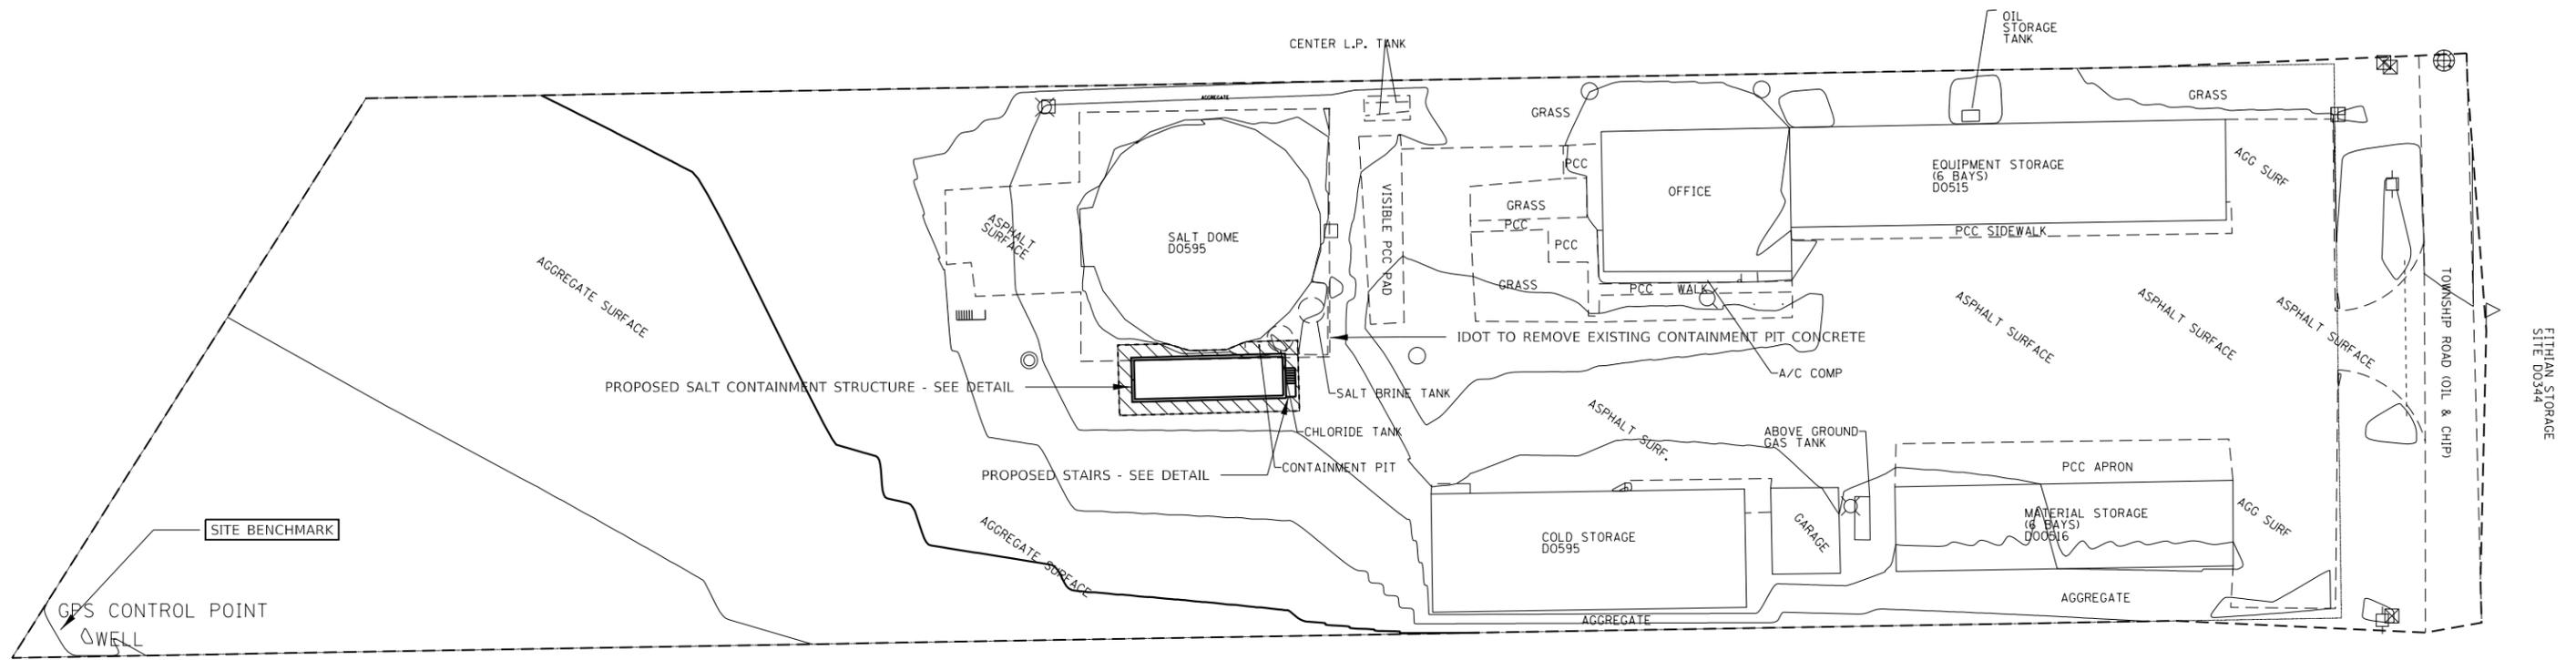
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DRAWN	CHECKED	REVISED
PLOT SCALE	DATE	REVISED

**STATE OF ILLINOIS
DEPARTMENT OF TRANSPORTATION**

SCHEDULE OF QUANTITIES

F.A. SITE	SECTION	COUNTY	TOTAL SHEETS	SHEET NO.
VAR.	**	+	14	5
CONTRACT NO. 70E36				

SCALE: NTS SHEET 2 OF 2 SHEETS STA. TO STA.



FITHIAN FACILITY ADDRESS:

1518 E. 1800 NORTH ROAD
 FITHIAN, IL 61844
 VERMILLION COUNTY

BENCHMARK:

CONCRETE MONUMENT IN SOUTHEAST CORNER OF YARD
 "FIT MAINT"
 ELEVATION = 662.78




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PLOT DATE = 10/14/2020	DATE - 10/13/2020	REVISED -

**STATE OF ILLINOIS
 DEPARTMENT OF TRANSPORTATION**

OVERALL SITE PLAN FITHIAN STORAGE FACILITY		
SCALE:	SHEET 1 OF 6 SHEETS	STA. TO STA.

SECTION	COUNTY	TOTAL SHEETS	SHEET NO.
2021-1 SALT CONTAINMENT	VARIOUS	14	6
CONTRACT NO. 70E36			
ILLINOIS FED. AID PROJECT			

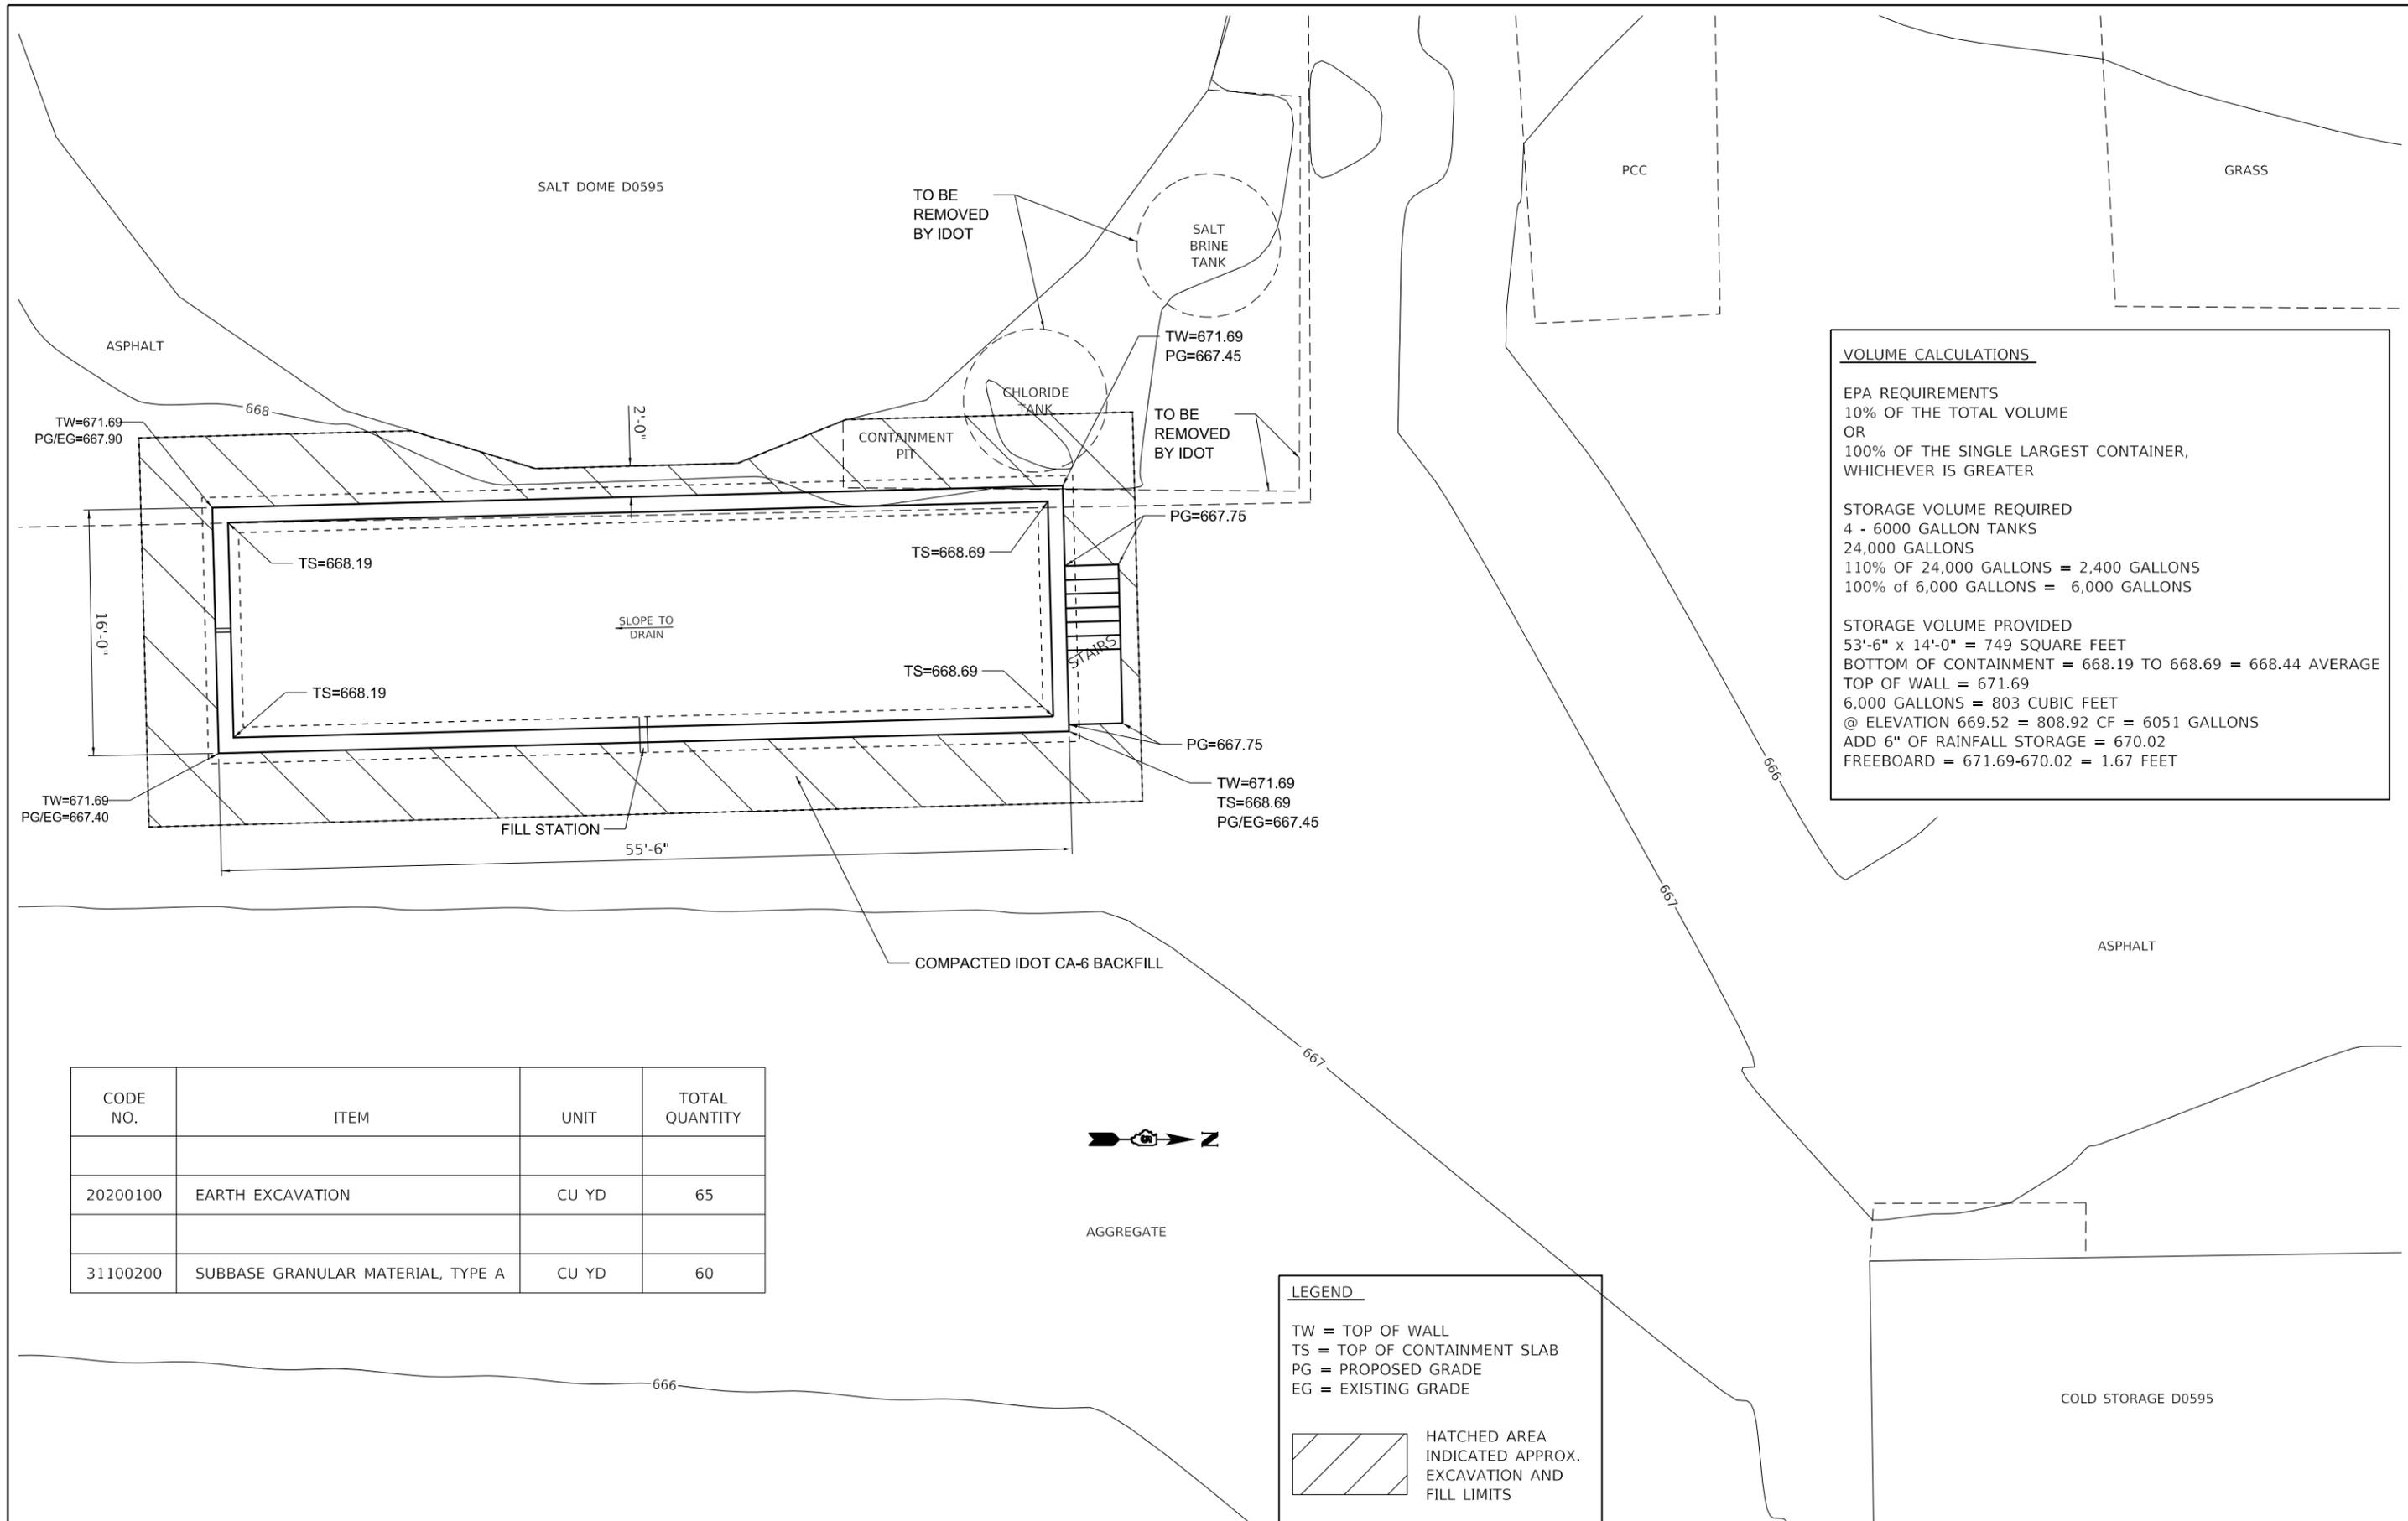

VOLUME CALCULATIONS

EPA REQUIREMENTS
 10% OF THE TOTAL VOLUME
 OR
 100% OF THE SINGLE LARGEST CONTAINER,
 WHICHEVER IS GREATER

STORAGE VOLUME REQUIRED
 4 - 6000 GALLON TANKS
 24,000 GALLONS
 110% OF 24,000 GALLONS = 2,400 GALLONS
 100% OF 6,000 GALLONS = 6,000 GALLONS

STORAGE VOLUME PROVIDED
 53'-6" x 14'-0" = 749 SQUARE FEET
 BOTTOM OF CONTAINMENT = 668.19 TO 668.69 = 668.44 AVERAGE
 TOP OF WALL = 671.69
 6,000 GALLONS = 803 CUBIC FEET
 @ ELEVATION 669.52 = 808.92 CF = 6051 GALLONS
 ADD 6" OF RAINFALL STORAGE = 670.02
 FREEBOARD = 671.69-670.02 = 1.67 FEET

CODE NO.	ITEM	UNIT	TOTAL QUANTITY
20200100	EARTH EXCAVATION	CU YD	65
31100200	SUBBASE GRANULAR MATERIAL, TYPE A	CU YD	60

LEGEND

TW = TOP OF WALL
 TS = TOP OF CONTAINMENT SLAB
 PG = PROPOSED GRADE
 EG = EXISTING GRADE

 HATCHED AREA INDICATED APPROX. EXCAVATION AND FILL LIMITS




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DRAWN - WMK	REVISED -	
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PLOT DATE = 10/14/2020	DATE - 10/13/2020	REVISED -

**STATE OF ILLINOIS
 DEPARTMENT OF TRANSPORTATION**

ENLARGED SITE PLAN FITHIAN STORAGE FACILITY	
SCALE:	SHEET 2 OF 6 SHEETS STA. TO STA.

SECTION	COUNTY	TOTAL SHEETS	SHEET NO.
2021-1 SALT CONTAINMENT	VARIOUS	14	7
CONTRACT NO. 70E36		ILLINOIS FED. AID PROJECT	

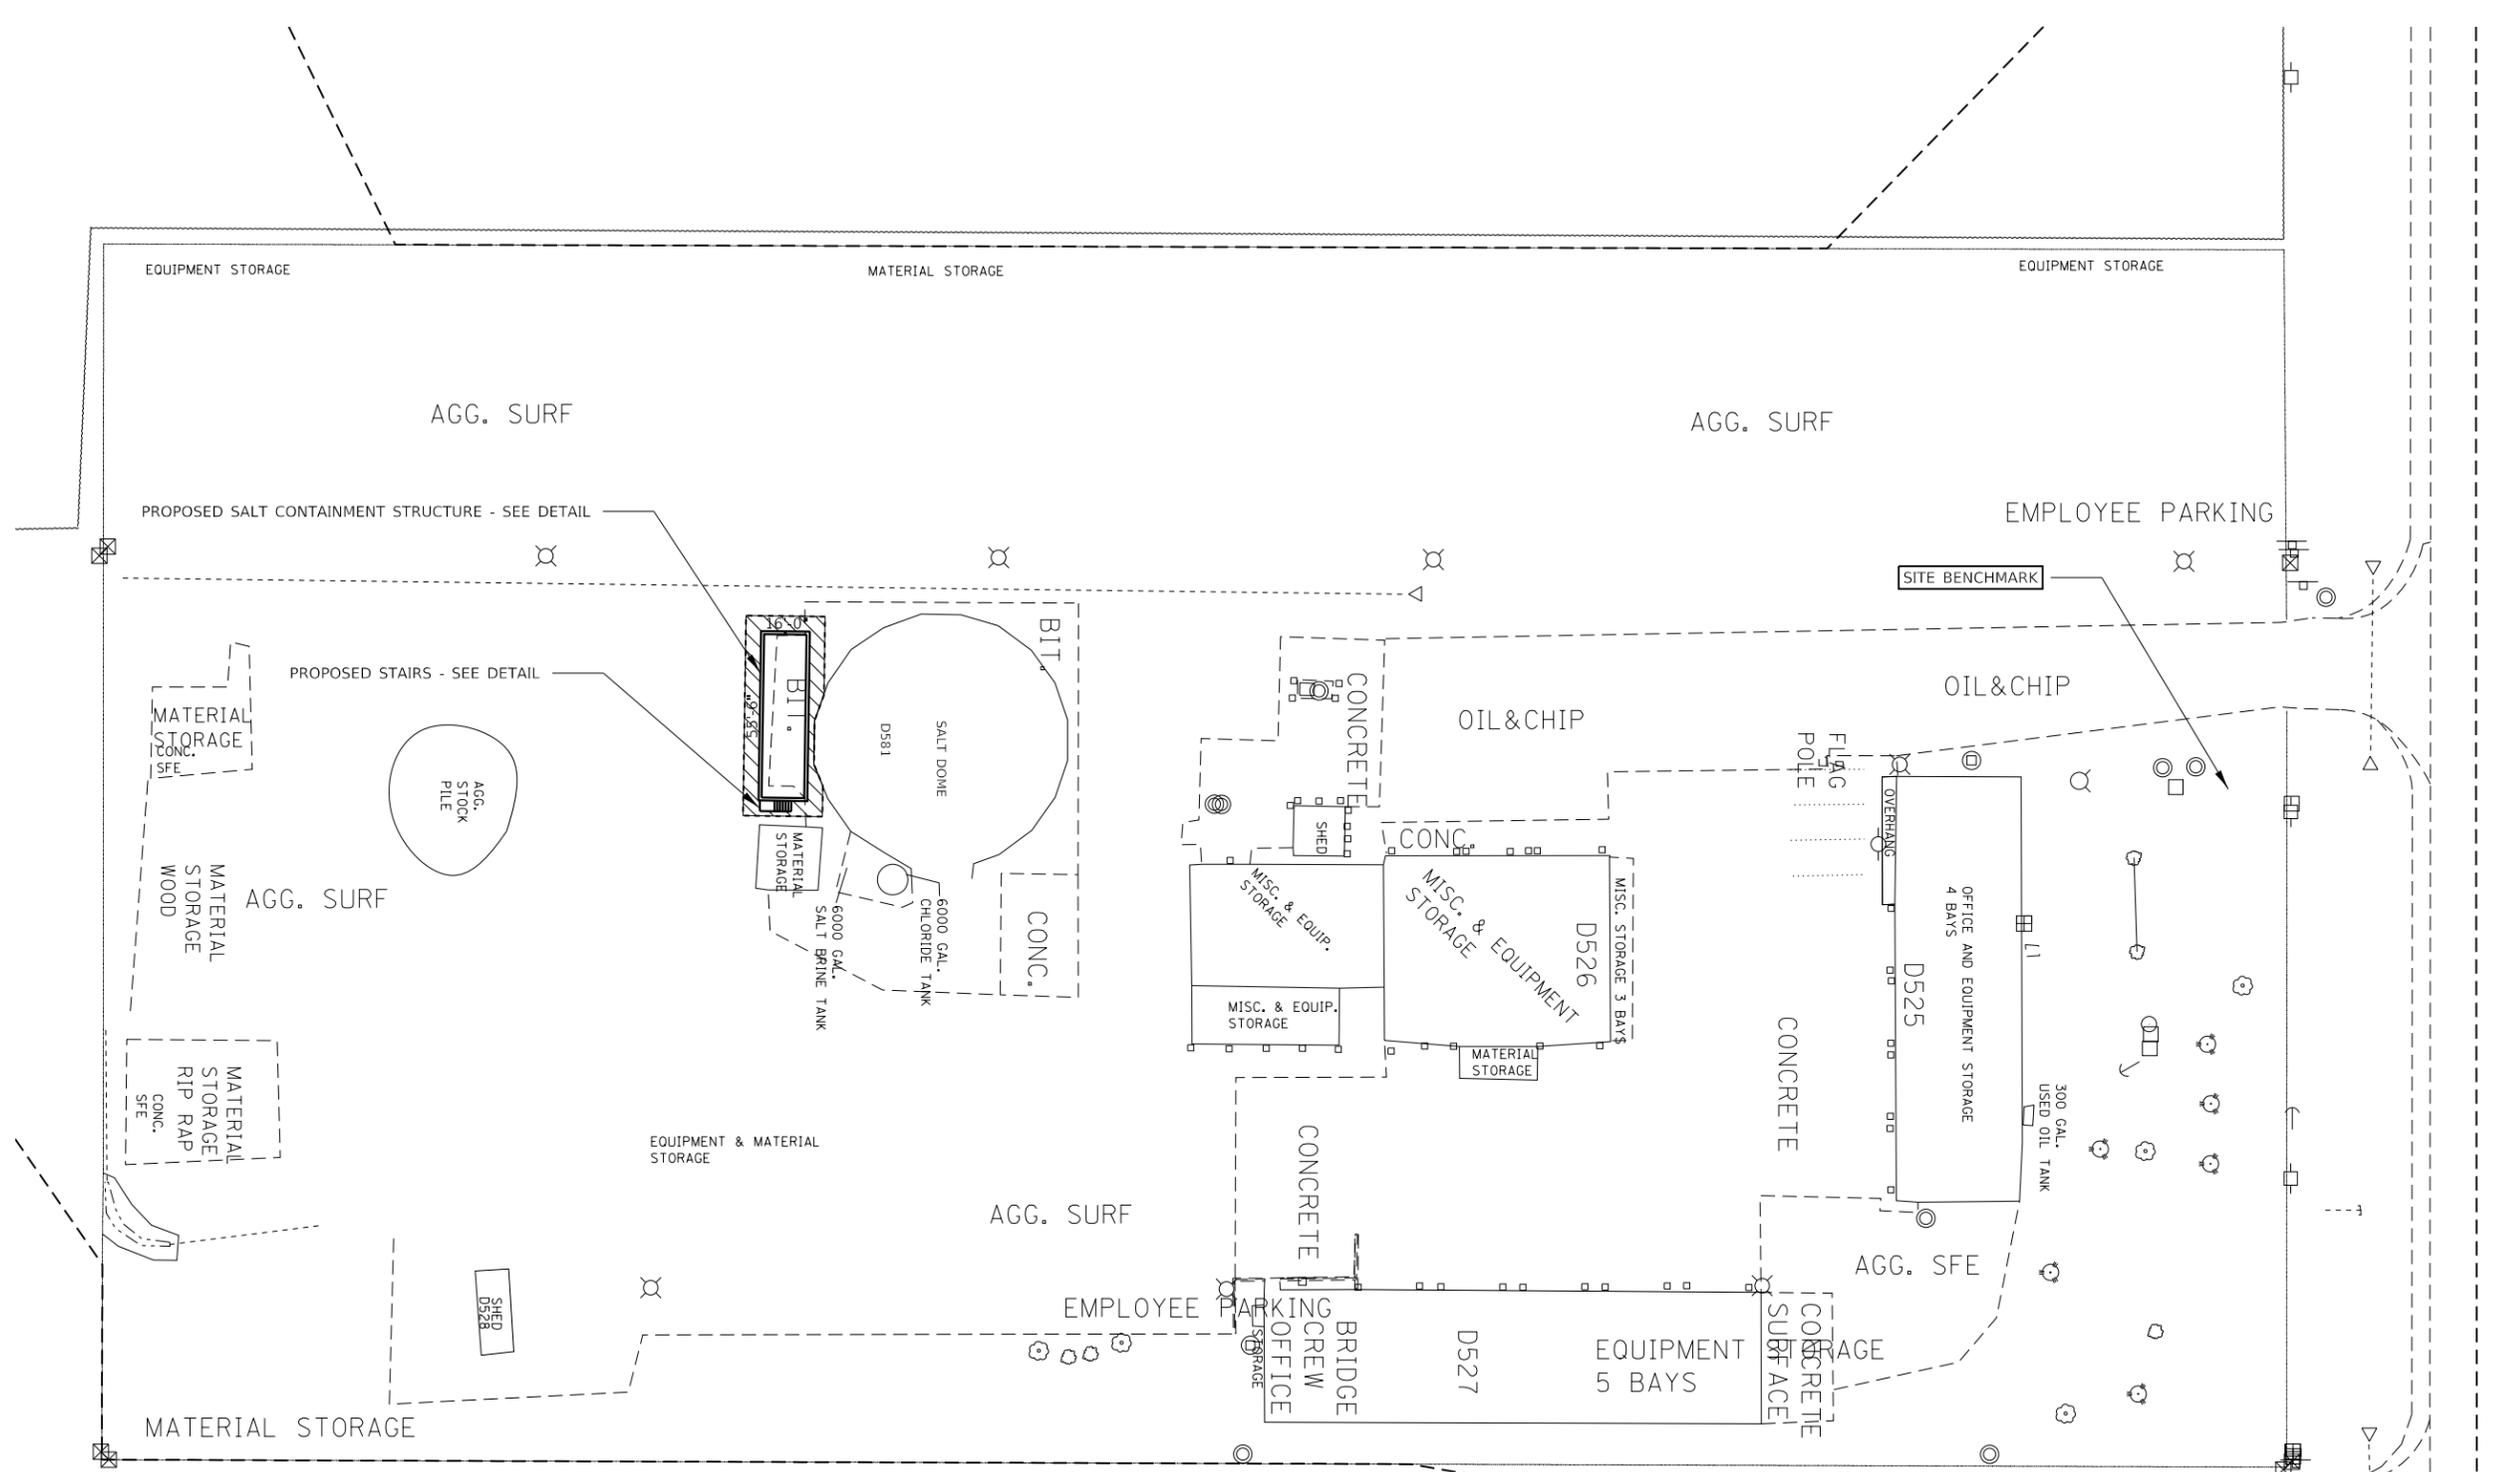

TUSCOLA FACILITY ADDRESS:

1200 EAST U.S. HWY. 36
 TUSCOLA, IL 61953
 DOUGLAS COUNTY

BENCHMARK:

CONCRETE MONUMENT IN EAST OF YARD ENTRANCE
 "TUS MAINT"
 ELEVATION = 647.16




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PLOT DATE = 10/14/2020	CHECKED - ADB	REVISED -
	DATE - 10/13/2020	REVISED -

**STATE OF ILLINOIS
 DEPARTMENT OF TRANSPORTATION**

**OVERALL SITE PLAN
 TUSCOLA STORAGE FACILITY**

SCALE: SHEET 3 OF 6 SHEETS STA. TO STA.

SECTION	COUNTY	TOTAL SHEETS	SHEET NO.
2021-1 SALT CONTAINMENT	VARIOUS	14	8
CONTRACT NO. 70E36			
ILLINOIS FED. AID PROJECT			

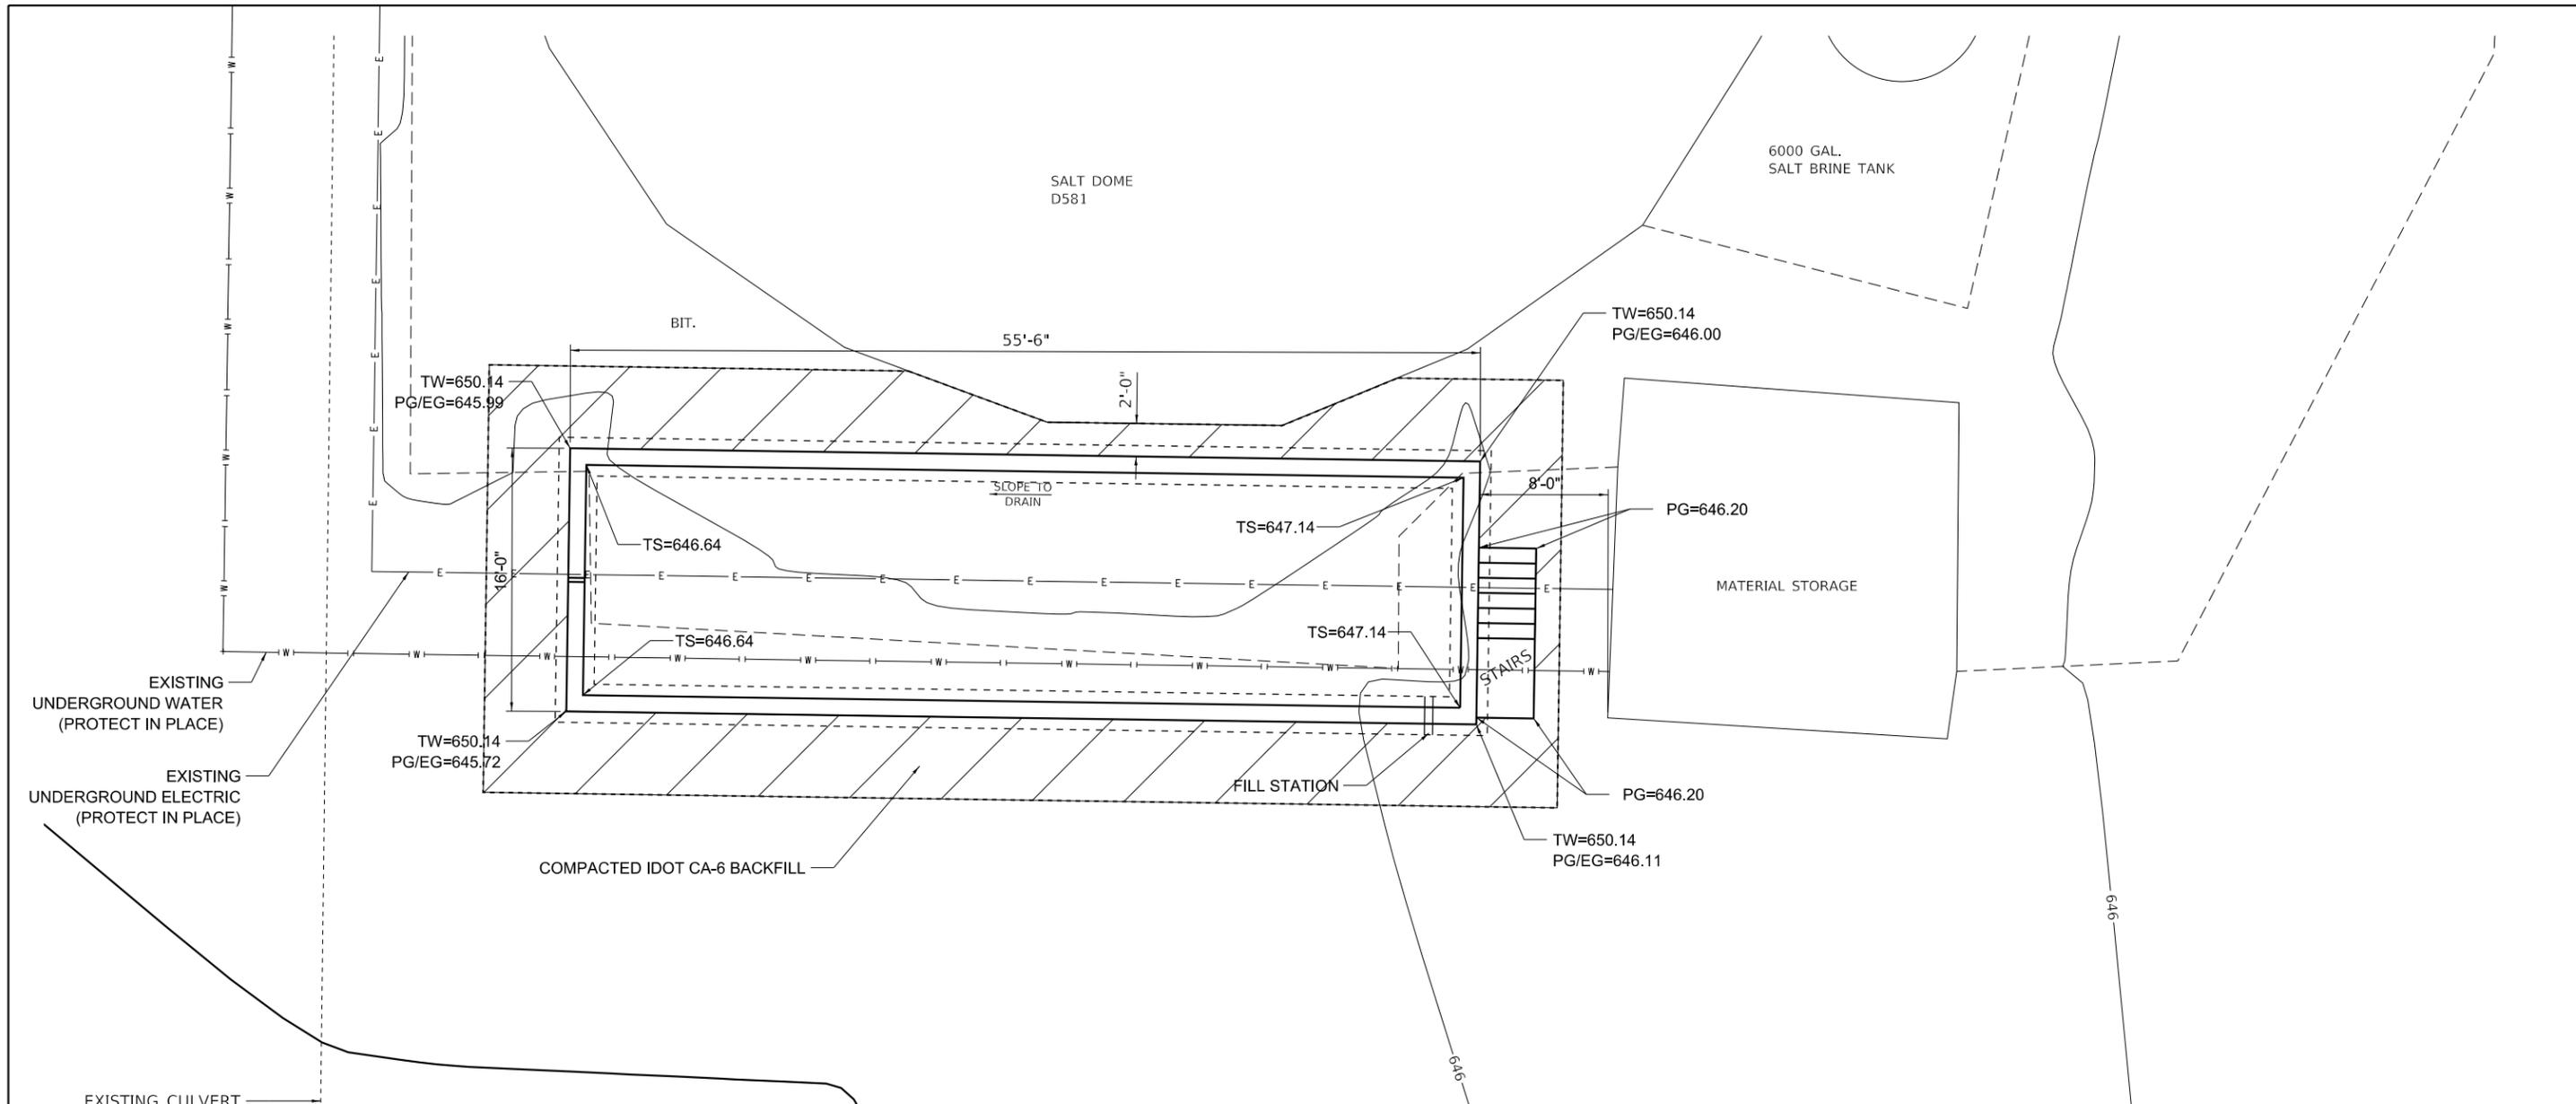

VOLUME CALCULATIONS

EPA REQUIREMENTS
 10% OF THE TOTAL VOLUME
 OR
 100% OF THE SINGLE LARGEST CONTAINER,
 WHICHEVER IS GREATER


STORAGE VOLUME REQUIRED
 4 - 6000 GALLON TANKS
 24,000 GALLONS
 110% OF 24,000 GALLONS = 2,400 GALLONS
 100% OF 6,000 GALLONS = 6,000 GALLONS

STORAGE VOLUME PROVIDED
 53'-6" x 14'-0" = 749 SQUARE FEET
 BOTTOM OF CONTAINMENT = 646.64 TO 647.14 = 646.89 AVERAGE
 TOP OF WALL = 650.14
 6,000 GALLONS = 803 CUBIC FEET
 @ ELEVATION 647.97 = 808.92 CF = 6051 GALLONS
 ADD 6" OF RAINFALL STORAGE = 648.47
 FREEBOARD = 650.14-648.47 = 1.67 FEET

CODE NO.	ITEM	UNIT	TOTAL QUANTITY
20200100	EARTH EXCAVATION	CU YD	65
31100200	SUBBASE GRANULAR MATERIAL, TYPE A	CU YD	61

LEGEND

TW = TOP OF WALL
 TS = TOP OF CONTAINMENT SLAB
 PG = PROPOSED GRADE
 EG = EXISTING GRADE

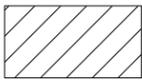 HATCHED AREA INDICATED APPROX. EXCAVATION AND FILL LIMITS




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DRAWN - WMK	REVISIONS -	
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PLOT DATE = 10/14/2020	DATE - 10/13/2020	REVISED -

**STATE OF ILLINOIS
 DEPARTMENT OF TRANSPORTATION**

ENLARGED SITE PLAN TUSCOLA STORAGE FACILITY	
SCALE:	SHEET 4 OF 6 SHEETS STA. TO STA.

SECTION	COUNTY	TOTAL SHEETS	SHEET NO.
2021-1 SALT CONTAINMENT	VARIOUS	14	9
CONTRACT NO. 70E36			
ILLINOIS FED. AID PROJECT			

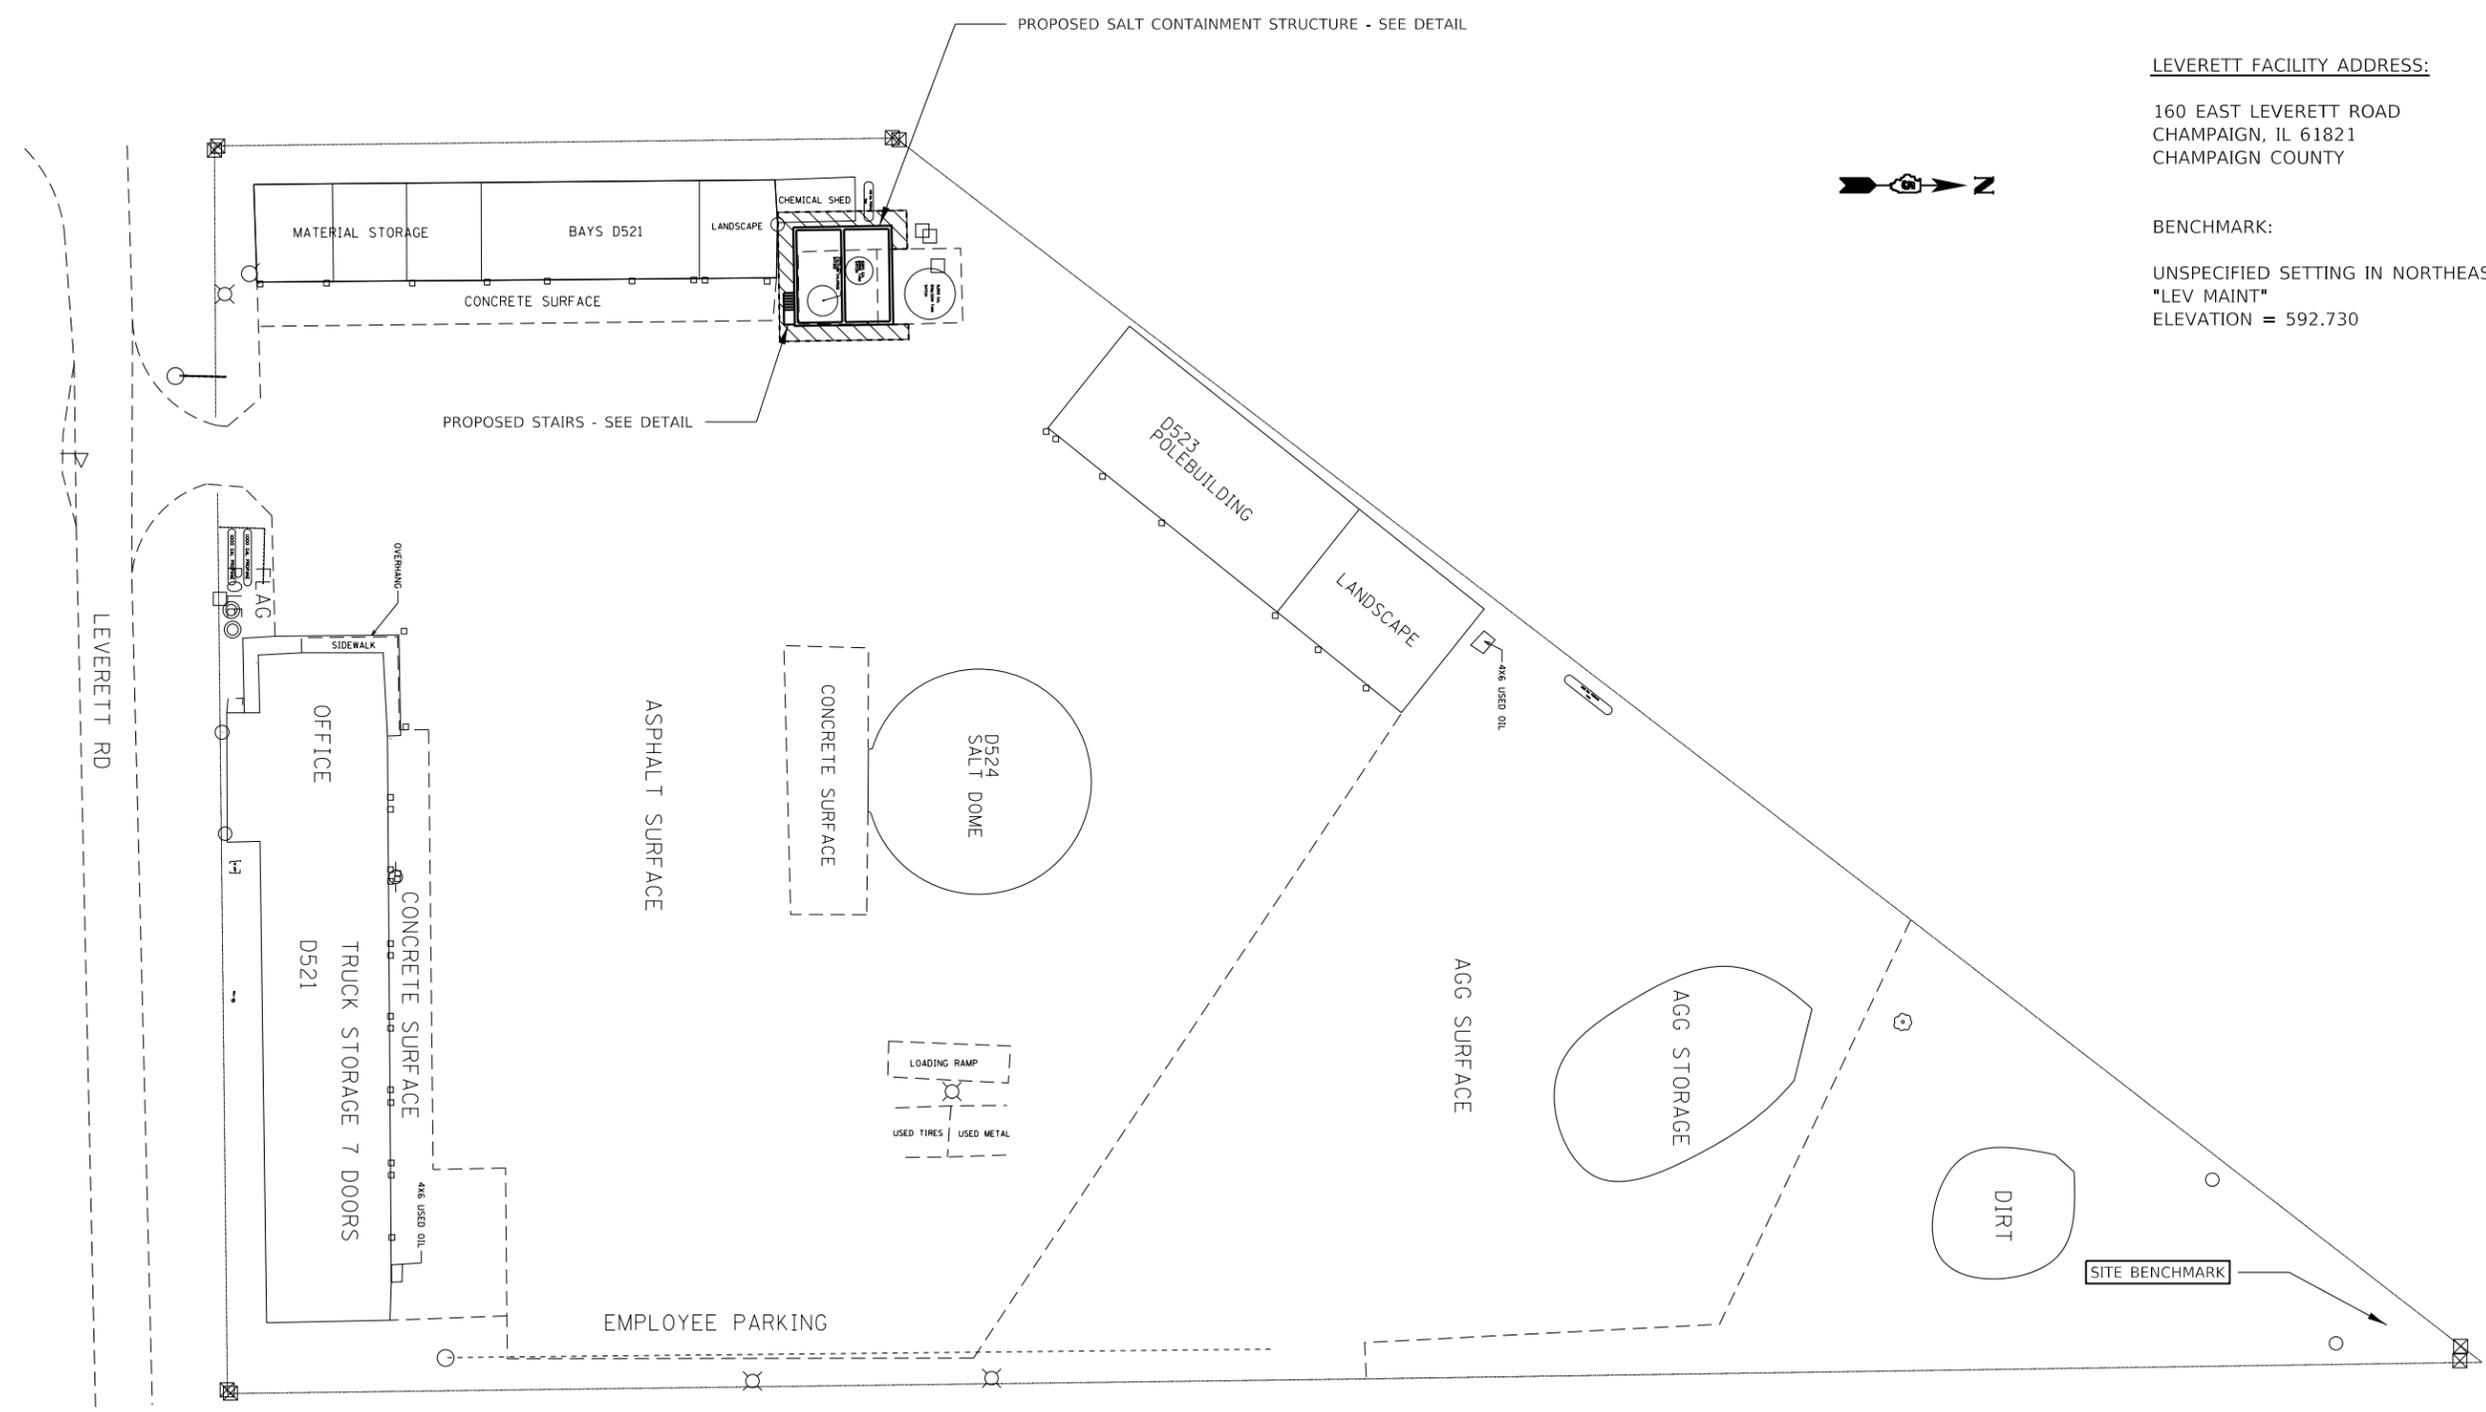

LEVERETT FACILITY ADDRESS:

160 EAST LEVERETT ROAD
 CHAMPAIGN, IL 61821
 CHAMPAIGN COUNTY

BENCHMARK:

UNSPECIFIED SETTING IN NORTHEAST CORNER OF YARD
 "LEV MAINT"
 ELEVATION = 592.730




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PLOT DATE = 10/14/2020	DATE - 10/13/2020	REVISED -

**STATE OF ILLINOIS
 DEPARTMENT OF TRANSPORTATION**

OVERALL SITE PLAN LEVERETT STORAGE FACILITY			
SCALE:	SHEET 5 OF 6 SHEETS	STA.	TO STA.

SECTION	COUNTY	TOTAL SHEETS	SHEET NO.
2021-1 SALT CONTAINMENT	VARIOUS	14	10
CONTRACT NO. 70E36			
ILLINOIS FED. AID PROJECT			

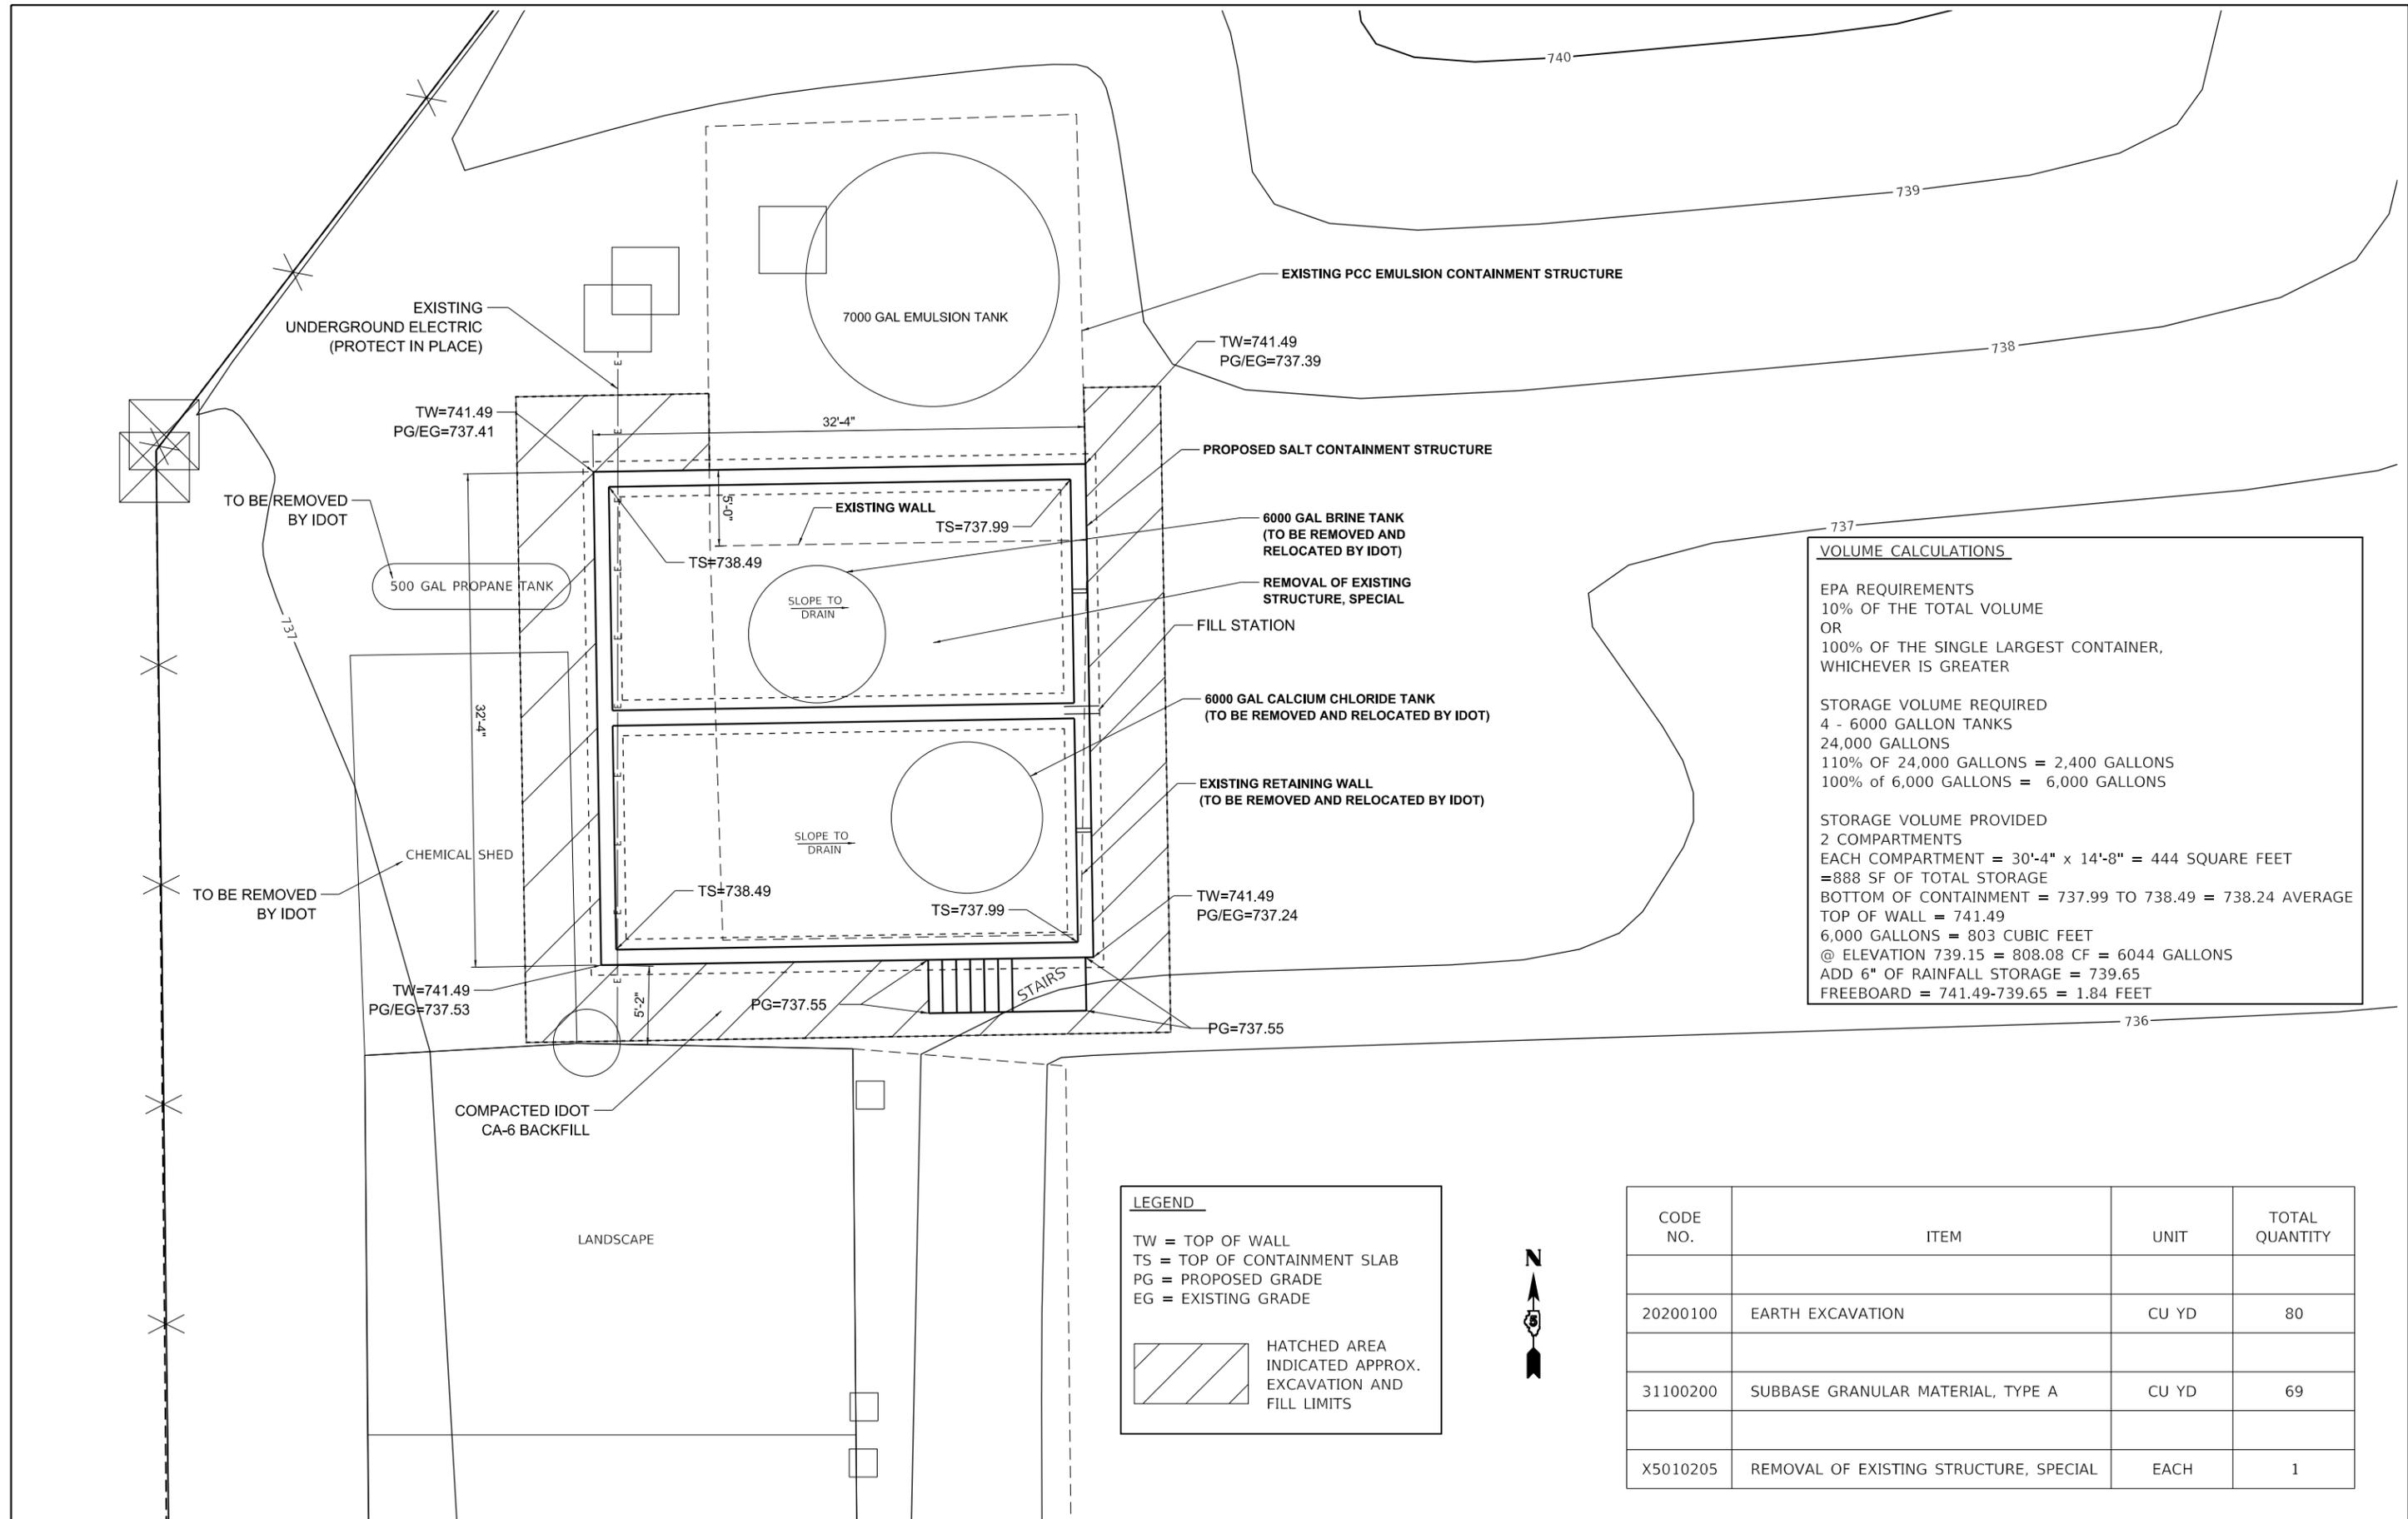

VOLUME CALCULATIONS

EPA REQUIREMENTS
 10% OF THE TOTAL VOLUME
 OR
 100% OF THE SINGLE LARGEST CONTAINER,
 WHICHEVER IS GREATER

STORAGE VOLUME REQUIRED
 4 - 6000 GALLON TANKS
 24,000 GALLONS
 110% OF 24,000 GALLONS = 2,400 GALLONS
 100% OF 6,000 GALLONS = 6,000 GALLONS

STORAGE VOLUME PROVIDED
 2 COMPARTMENTS
 EACH COMPARTMENT = 30'-4" x 14'-8" = 444 SQUARE FEET
 =888 SF OF TOTAL STORAGE
 BOTTOM OF CONTAINMENT = 737.99 TO 738.49 = 738.24 AVERAGE
 TOP OF WALL = 741.49
 6,000 GALLONS = 803 CUBIC FEET
 @ ELEVATION 739.15 = 808.08 CF = 6044 GALLONS
 ADD 6" OF RAINFALL STORAGE = 739.65
 FREEBOARD = 741.49-739.65 = 1.84 FEET

LEGEND

TW = TOP OF WALL
 TS = TOP OF CONTAINMENT SLAB
 PG = PROPOSED GRADE
 EG = EXISTING GRADE

 HATCHED AREA INDICATED APPROX. EXCAVATION AND FILL LIMITS



CODE NO.	ITEM	UNIT	TOTAL QUANTITY
20200100	EARTH EXCAVATION	CU YD	80
31100200	SUBBASE GRANULAR MATERIAL, TYPE A	CU YD	69
X5010205	REMOVAL OF EXISTING STRUCTURE, SPECIAL	EACH	1







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PLOT SCALE = 10.0000' / in.	DRAWN - WMK	REVISED -
PLOT DATE = 10/15/2020	CHECKED - ADB	REVISED -
	DATE - 10/13/2020	REVISED -

STATE OF ILLINOIS
 DEPARTMENT OF TRANSPORTATION

**ENLARGED SITE PLAN
 LEVERETT STORAGE FACILITY**


SCALE: _____ SHEET 6 OF 6 SHEETS STA. _____ TO STA. _____

SECTION	COUNTY	TOTAL SHEETS	SHEET NO.
2021-1 SALT CONTAINMENT	VARIOUS	14	11
CONTRACT NO. 70E36			
ILLINOIS FED. AID PROJECT			

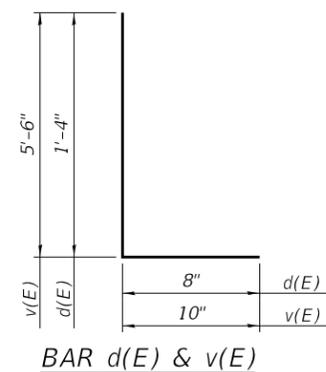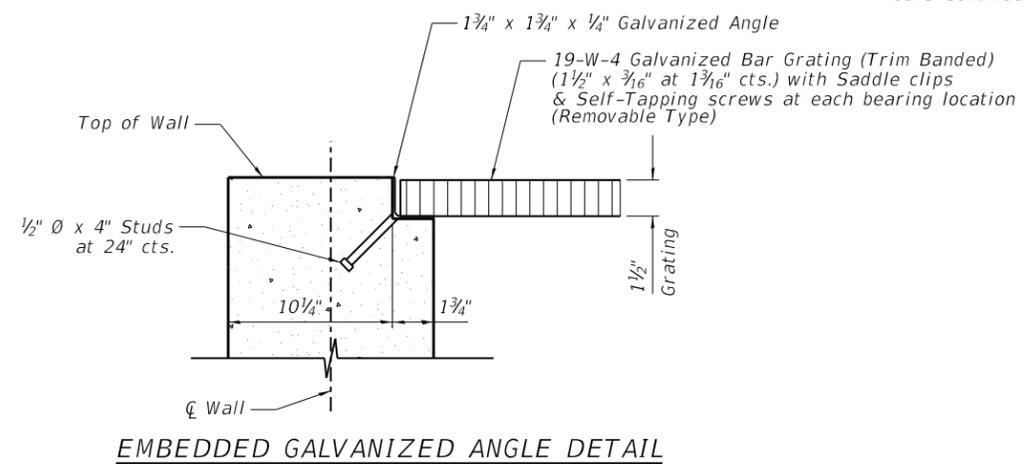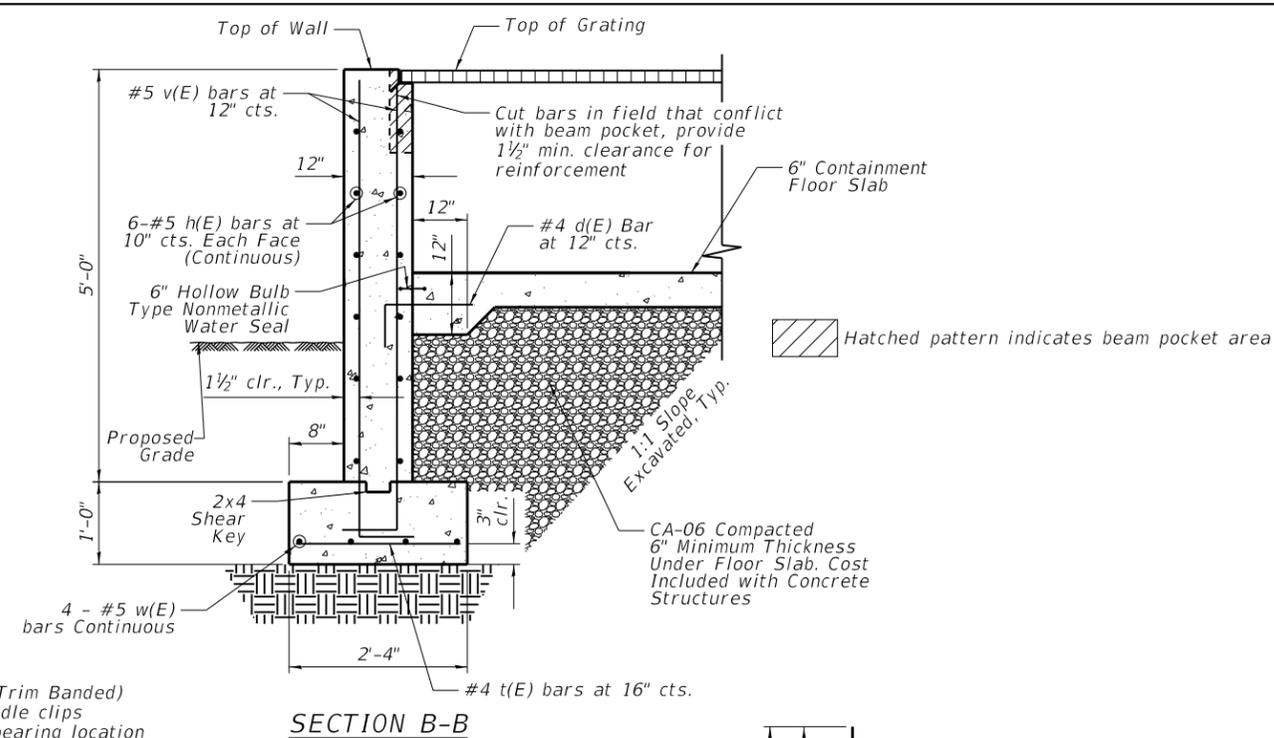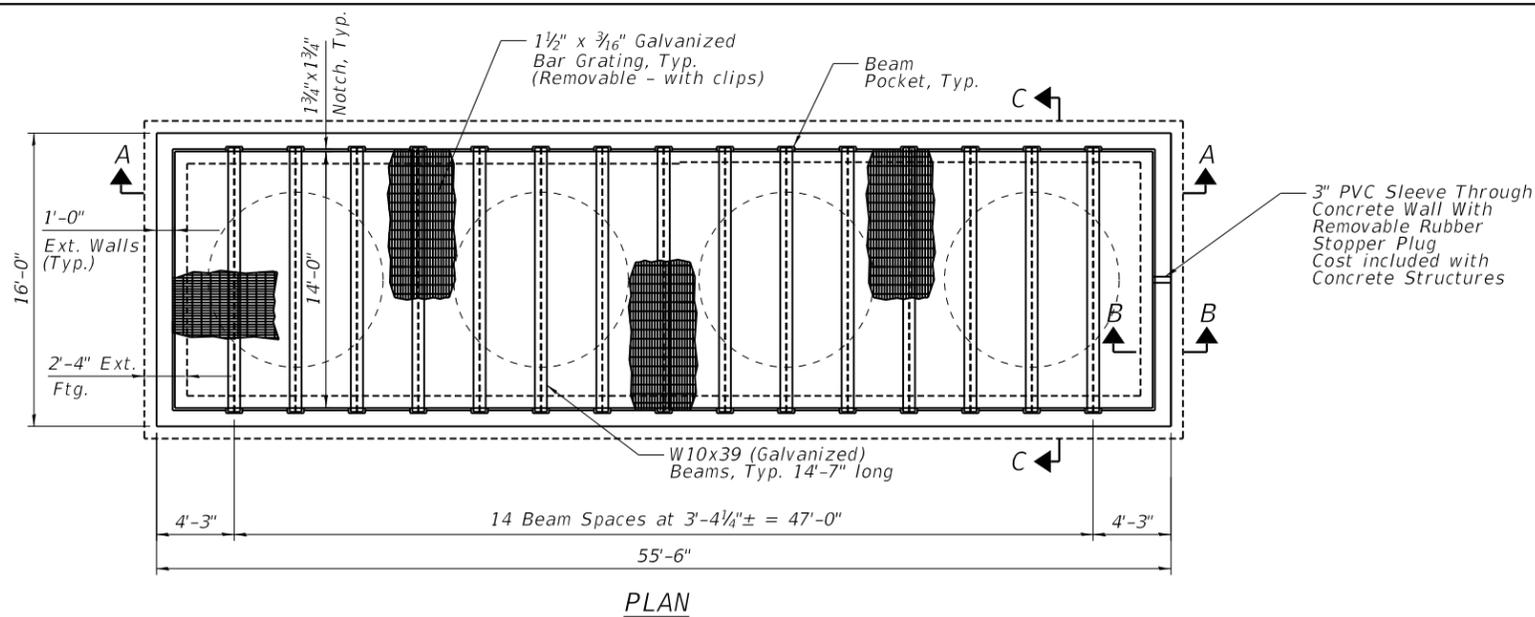

BILL OF MATERIAL
(Each Location)

Bar	No.	Size	Length	Shape
d(E)	136	#4	2'-0"	U
h(E)	120	#5	15'-8"	—
t(E)	108	#4	2'-0"	—
v(E)	280	#5	6'-4"	U
w(E)	40	#5	17'-0"	—
Furnishing and Erecting Structural Steel		L. Sum	0.28	
Concrete Structures		Cu. Yd.	56.8	
Reinforcement Bars, Epoxy Coated		Pound	4,850	

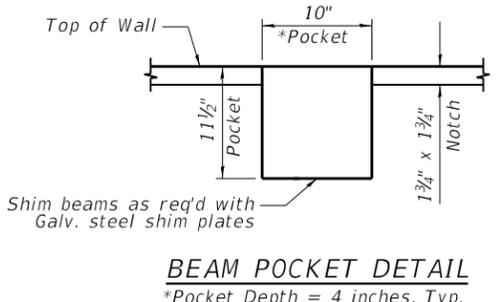



DESIGN STRESSES
FIELD UNITS
 $f'c = 3,500$ psi
 $f_y = 60,000$ psi (Reinforcement)
 $f_y = 36,000$ psi (ASTM A36, Angles)
 $f_y = 50,000$ psi (M270 Grade 50, beams)
Mini Bar Lap
 #5 Bar = 2'-4"

GENERAL NOTES

Calculated weight of Structural Steel (Per Site):
 Bar Grating for Concrete Containment Structure = 8,750 lbs.
 Steel Beams and Embedded Angles for Concrete Containment Structure = 8,930 lbs.
 All Structural Steel shall be AASHTO M 270 Grade 36 for plates, channels, and angles; AASHTO M 270 Grade 50 for the steel beams; & ASTM A500, Gr B for HSS.
 No field welding is permitted except as specified in the contract documents.
 Reinforcement bars designated (E) shall be epoxy coated.
 All Structural Steel, Bar Grating, and Hardware shall be galvanized according to AASHTO M111 or M232 as applicable.
 The Containment Floor Slab shall receive a light-broom finish, and the walls shall receive a normal finish in accordance with Article 503.15 of the Standard Specifications.



Adam Bohnhoff
 Signature: _____
 10-14-2020
 Date: _____
 Licensed Structural Engineer
 State of Illinois No.
 081-007431
 Expires 11-30-2020

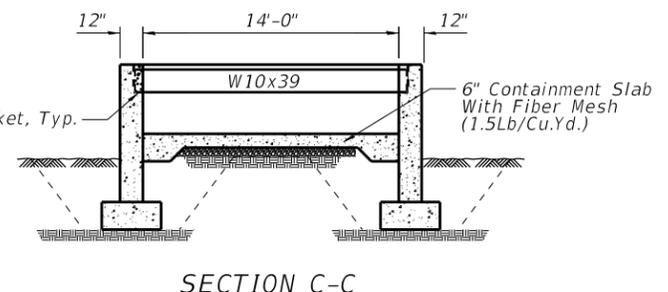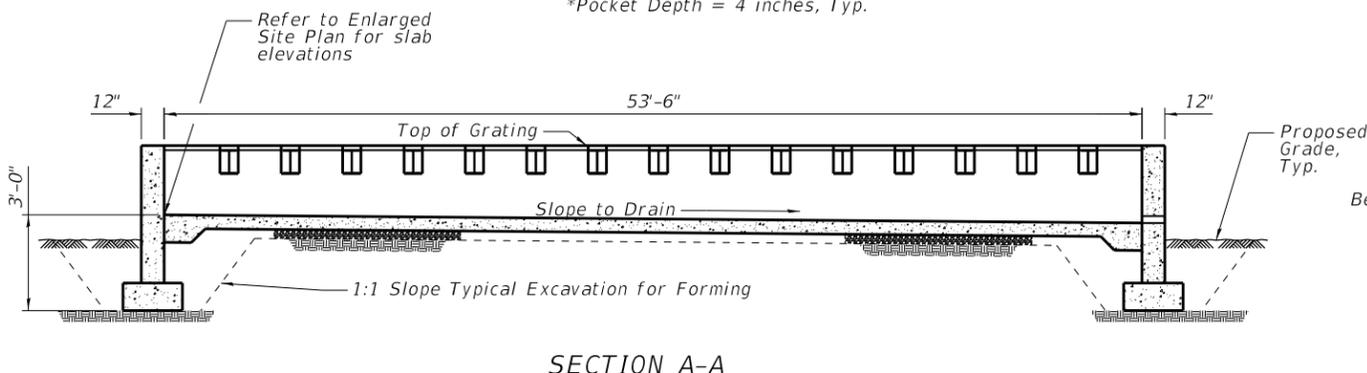


USER NAME = abohnhoff	DESIGNED - ADB	REVISED -
PLOT SCALE = 10:0.0000 '1' / in.	DRAWN - WMK	REVISED -
PLOT DATE = 10/14/2020	CHECKED - ADB	REVISED -
	DATE - 10/13/2020	REVISED -

STATE OF ILLINOIS
DEPARTMENT OF TRANSPORTATION

TUSCOLA AND FITHIAN STORAGE FACILITIES	
SCALE:	SHEET 1 OF 3 SHEETS STA. TO STA.


SECTION	COUNTY	TOTAL SHEETS	SHEET NO.
2021-1 SALT CONTAINMENT	VARIOUS	14	12
CONTRACT NO. 70E36			
ILLINOIS FED. AID PROJECT			

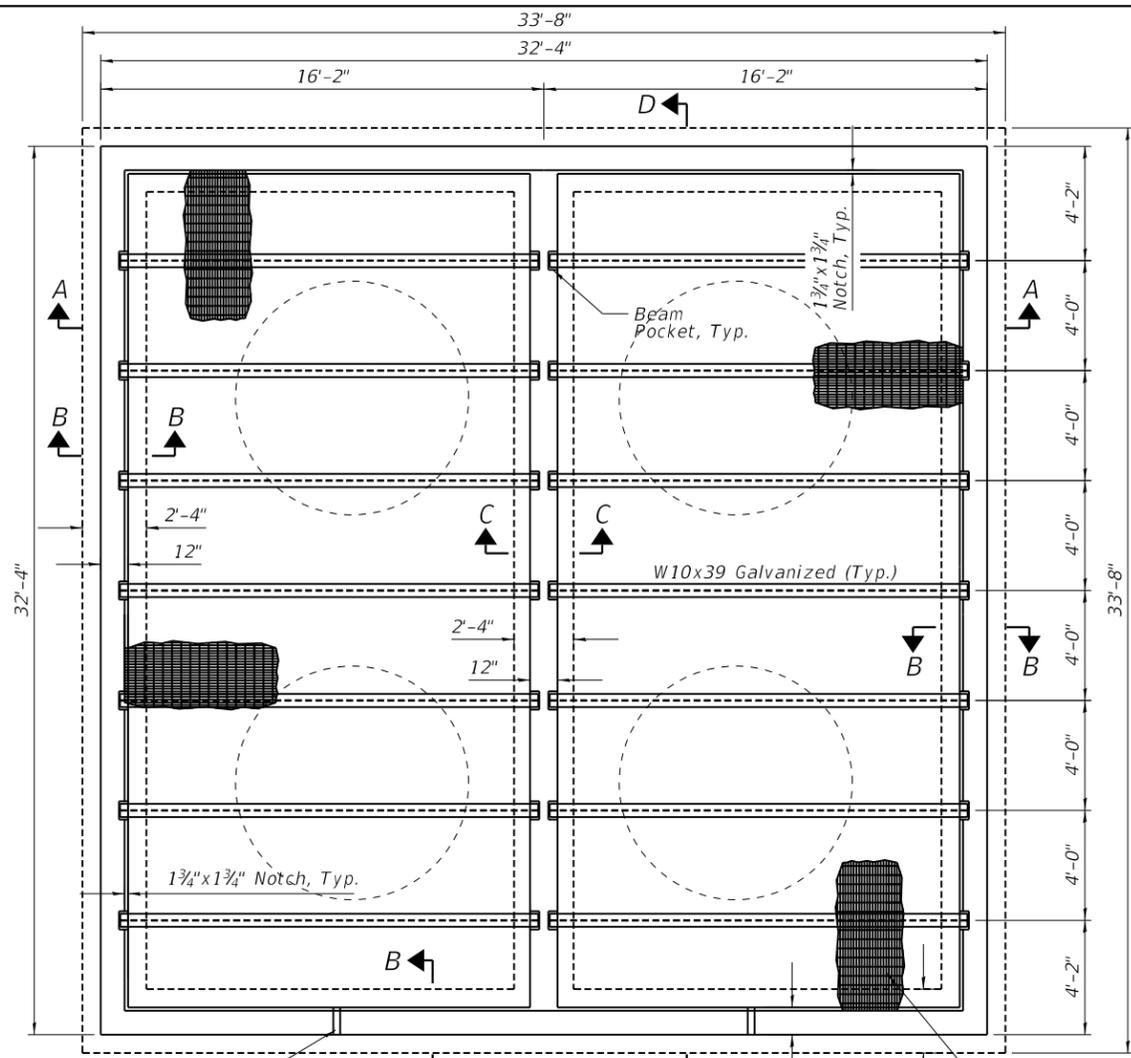


3" PVC Sleeve Through Concrete Wall With Removable Rubber Stopper Plug (2 Locations) Cost included with Concrete Structures

BILL OF MATERIAL
(Each Location)


Bar	No.	Size	Length	Shape
d(E)	186	#4	2'-0"	—
h(E)	48	#5	32'-0"	—
h1(E)	12	#5	30'-8"	—
t(E)	100	#4	2'-0"	—
t1(E)	22	#4	2'-0"	—
v(E)	256	#5	6'-4"	—
v1(E)	62	#5	6'-2"	—
w(E)	16	#5	33'-4"	—
w1(E)	4	#5	29'-4"	—
Furnishing and Erecting Structural Steel		L. Sum		0.29
Concrete Structures		Cu. Yd.		62.8
Reinforcement Bars, Epoxy Coated		Pound		5,170

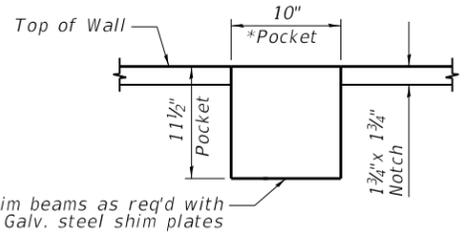


BEAM POCKET DETAIL
*Pocket Depth = 4 inches, Typ.

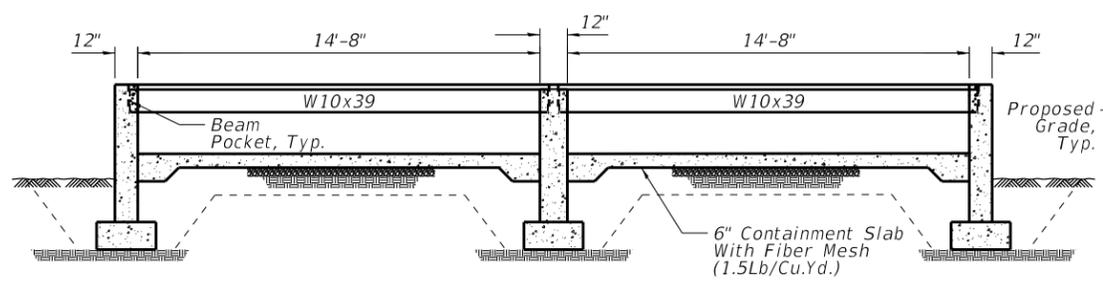

SECTION A-A

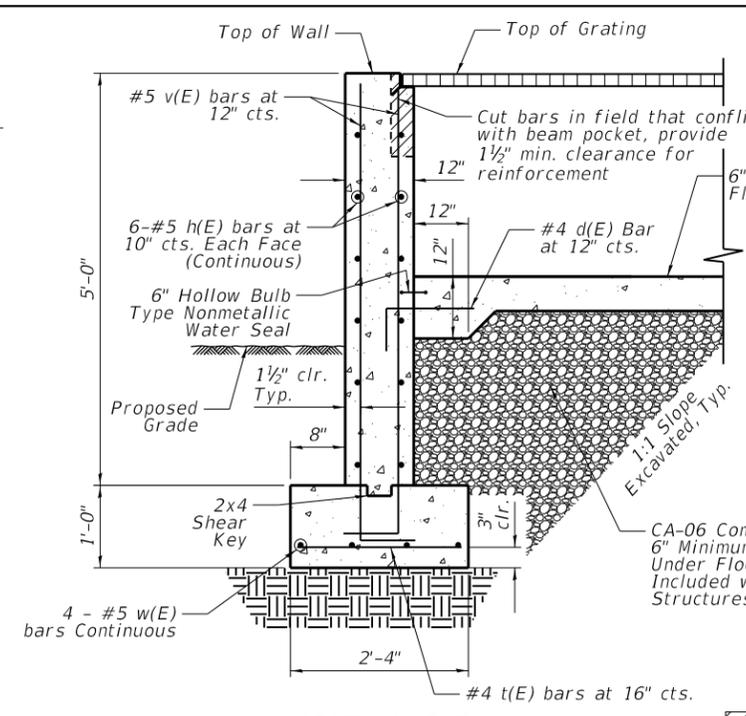

SECTION B-B

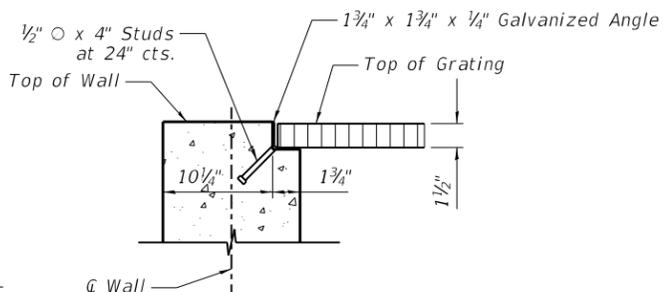


EMBEDDED GALVANIZED ANGLE DETAIL

DESIGN STRESSES


FIELD UNITS
 $f'_c = 3,500$ psi
 $f_y = 60,000$ psi (Reinforcement)
 $f_y = 36,000$ psi (ASTM A36, Angles)
 $f_y = 50,000$ psi (M270 Grade 50, beams)

Mini Bar Lap
#5 Bar = 2'-4"

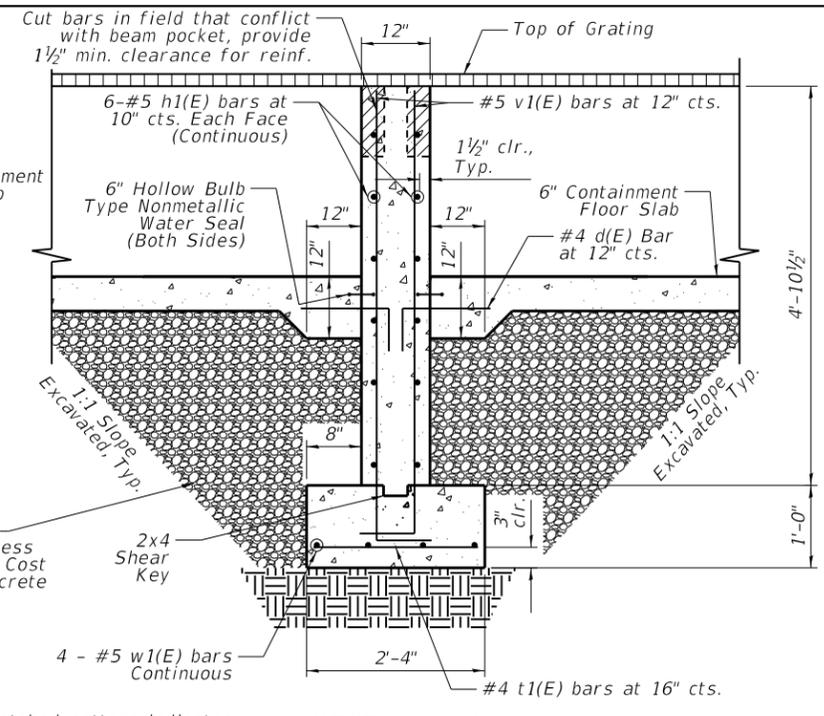


SECTION C-C

Hatched pattern indicates beam pocket area

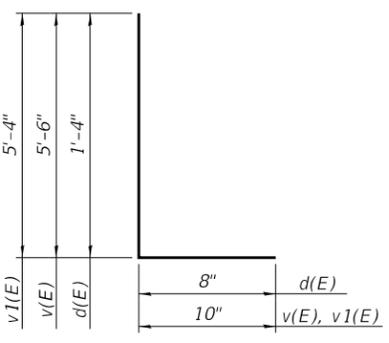


BAR d(E), v(E), v1(E)

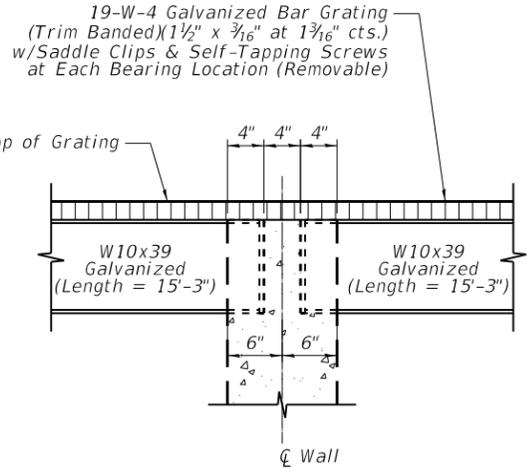

INTERIOR WALL BEARING DETAIL

GENERAL NOTES

Calculated weight of Structural Steel (Per Site):
 Bar Grating for Concrete Containment Structure = 9,610 lbs.
 Steel Beams and Embedded Angles for Concrete Containment Structure = 8,690 lbs.
 All Structural Steel shall be AASHTO M 270 Grade 36 for plates, channels, and angles; AASHTO M 270 Grade 50 for the steel beams; & ASTM A500, Gr B for HSS.
 No field welding is permitted except as specified in the contract documents.
 Reinforcement bars designated (E) shall be epoxy coated.
 All Structural Steel, Bar Grating, and Hardware shall be galvanized according to AASHTO M111 or M232 as applicable.
 The Containment Floor Slab shall receive a light-broom finish, and the walls shall receive a normal finish in accordance with Article 503.15 of the Standard Specifications.

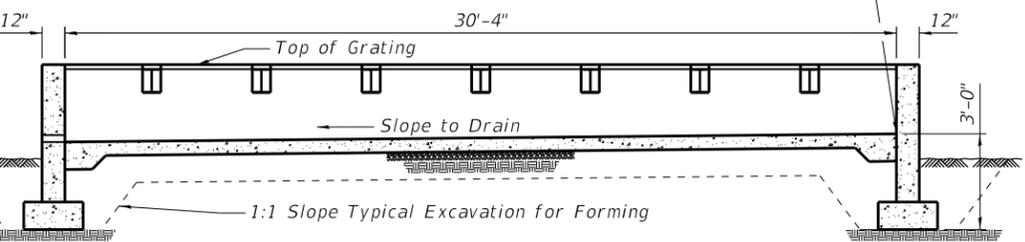

SECTION D-D



Signature: Adam Bohnhoff

Date: 10-14-2020

Date:

Licensed Structural Engineer
 State of Illinois No.
 081-007431
 Expires 11-30-2020



CIVIL DESIGN, INC.
 WBE / DBE
 EFFINGHAM, IL
 LICENSE #184.003222

USER NAME = abohnhoff	DESIGNED - ADB	REVISED -
PLOT SCALE = 10:0.0000 '1" / in.	DRAWN - WMK	REVISED -
PLOT DATE = 10/14/2020	CHECKED - ADB	REVISED -
	DATE - 10/13/2020	REVISED -

STATE OF ILLINOIS
 DEPARTMENT OF TRANSPORTATION

SCALE:	SHEET 2 OF 3 SHEETS	STA.	TO STA.
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LEVERETTE
 STORAGE FACILITY

SECTION	COUNTY	TOTAL SHEETS	SHEET NO.
2021-1 SALT CONTAINMENT	VARIOUS	14	13
CONTRACT NO. 70E36			
ILLINOIS FED. AID PROJECT			

GENERAL NOTES

Calculated weight of Structural Steel (Per Site):

Stair Assembly = 2,880 lbs.

All Structural Steel shall be AASHTO M 270 Grade 36 (or better) for plates, channels, and angles & ASTM A500, Gr B for HSS.

No field welding is permitted except as specified in the contract documents.

Reinforcement bars designated (E) shall be epoxy coated.

All Structural Steel, Railing, Bar Grating, and Hardware shall be galvanized according to AASHTO M111 or M232 as applicable.

DESIGN STRESSES

FIELD UNITS

$f'_c = 3,500$ psi

$f_y = 60,000$ psi (Reinforcement)





$f_y = 36,000$ psi (ASTM A36, Plates, Channel, Angles), or better

$f_y = 46,000$ psi (ASTM A500, Gr B., HSS)

BILL OF MATERIAL

(Each Location)

Bar	No.	Size	Length	Shape	
t2(E)	10	#4	2'-8"	○	
v2(E)	8	#4	3'-8"	—	
Furnishing and Erecting Structural Steel				L. Sum	0.05
Concrete Structures Reinforcement bars, Epoxy Coated				Cu. Yd.	0.2
				Pound	40

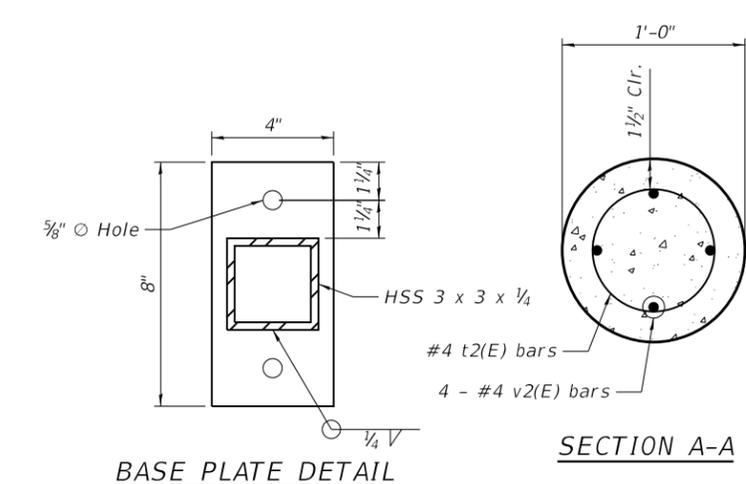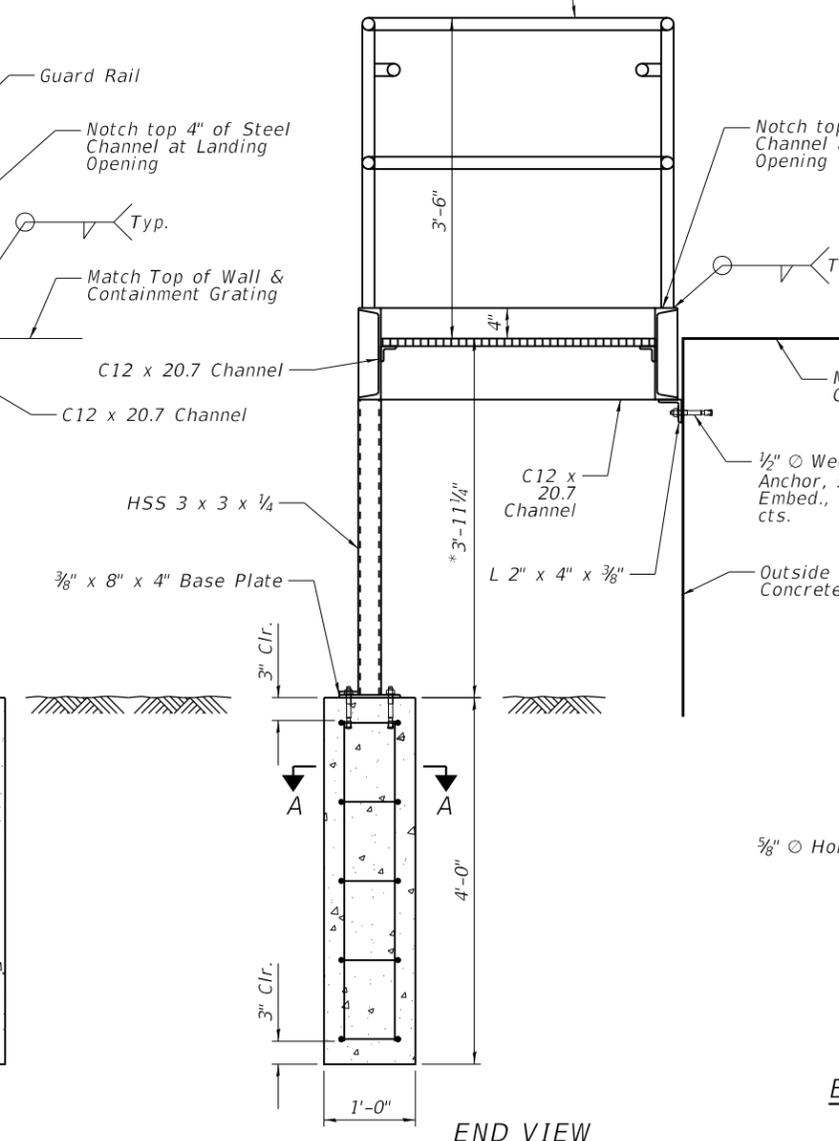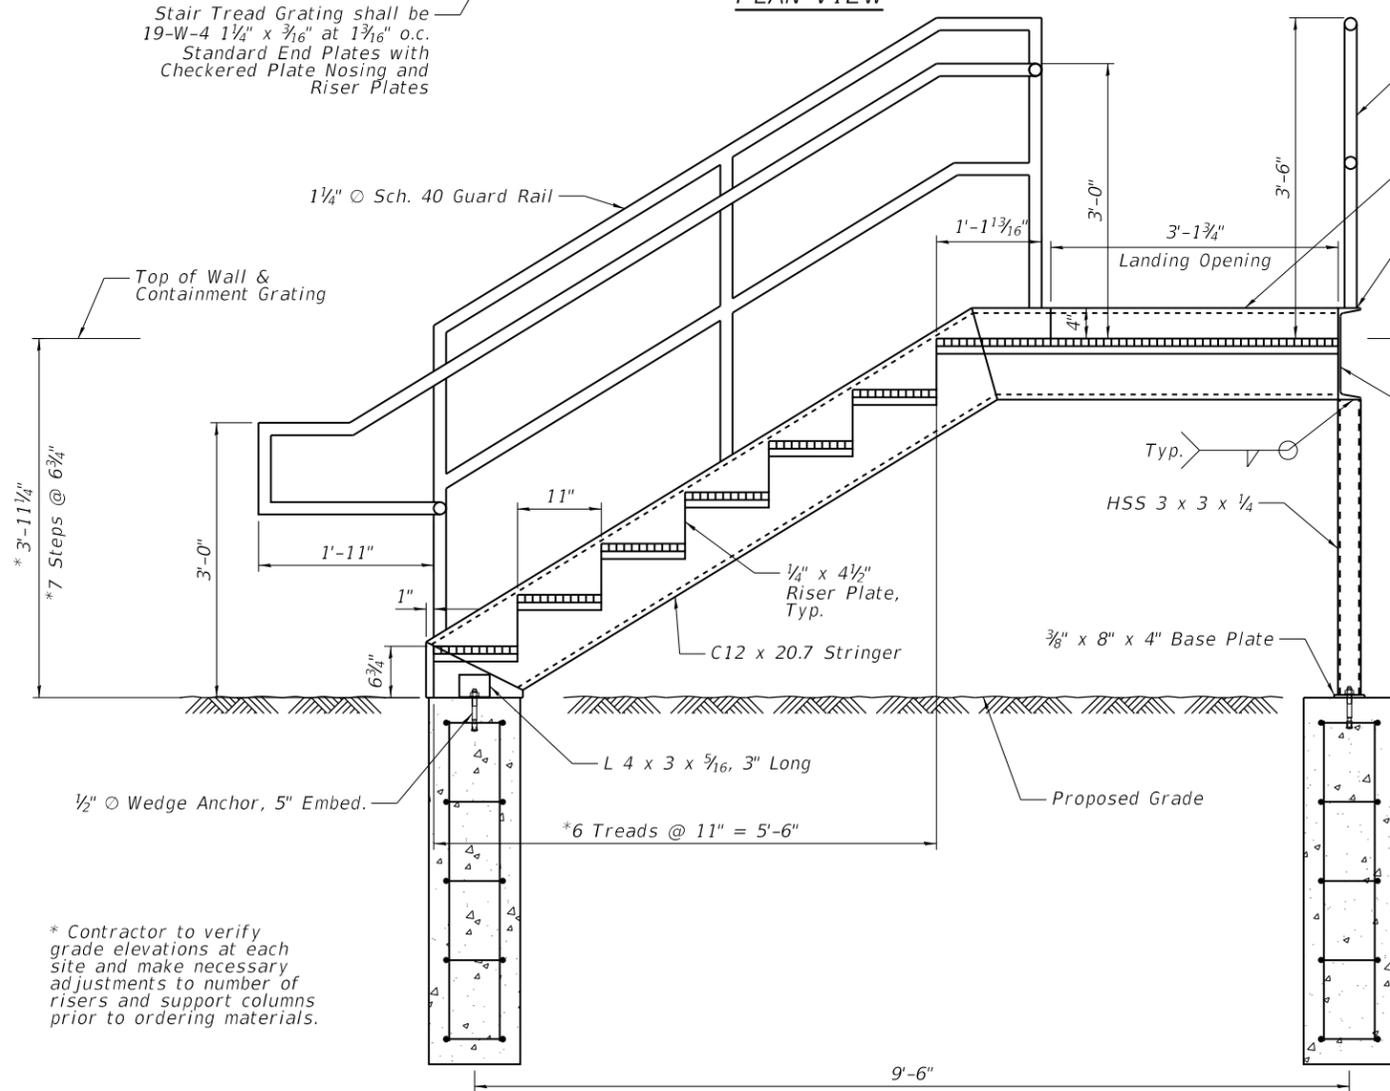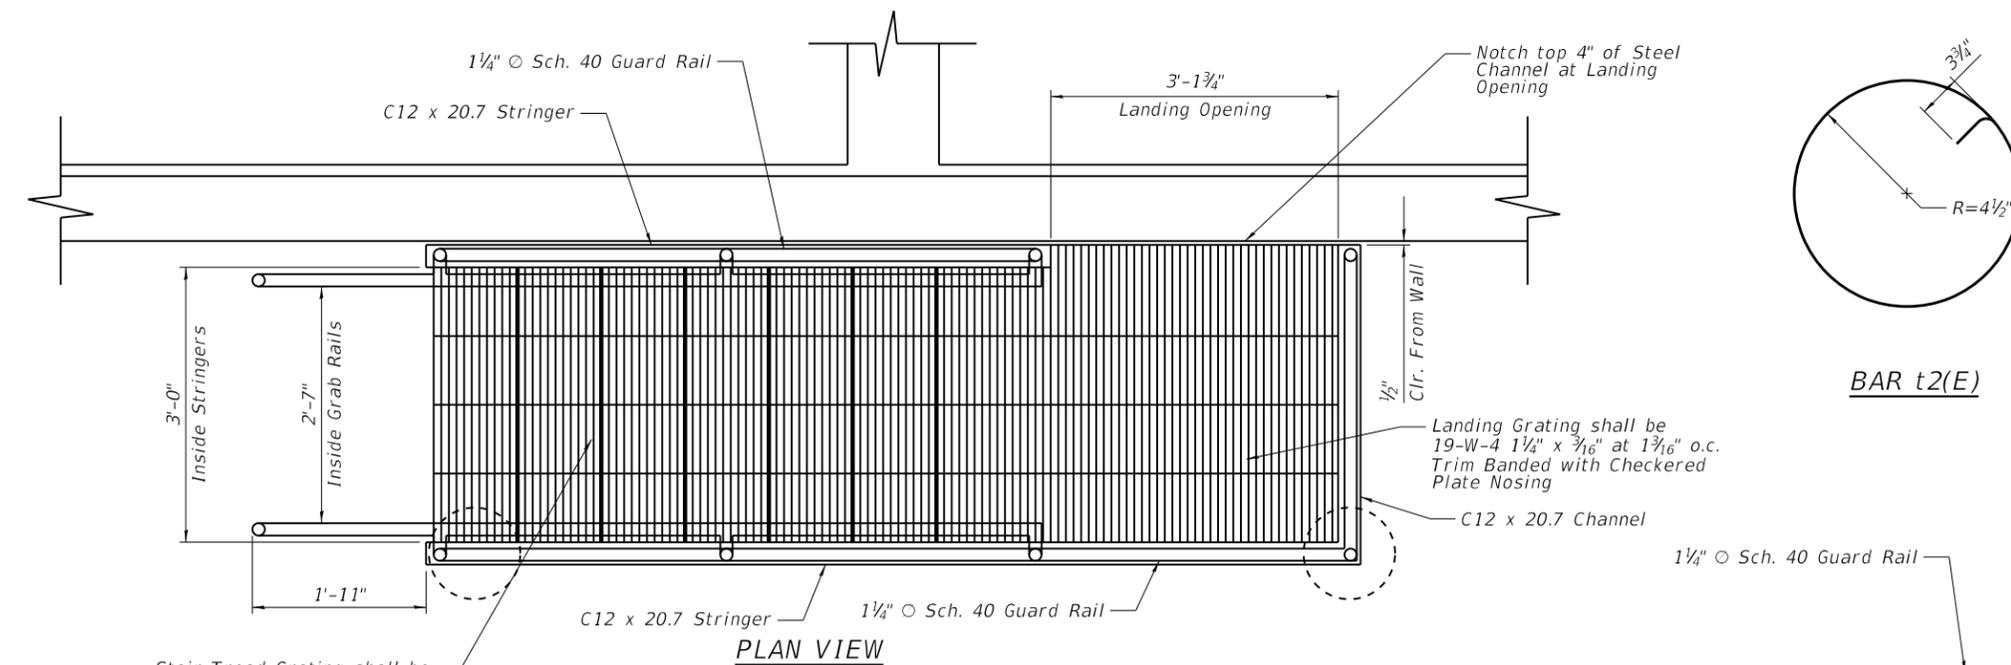

* Contractor to verify grade elevations at each site and make necessary adjustments to number of risers and support columns prior to ordering materials.



USER NAME = abohnhoff	DESIGNED - ADB	REVISED -
PLOT SCALE = 10:0.0000 '1' / in.	DRAWN - WMK	REVISED -
PLOT DATE = 10/14/2020	CHECKED - ADB	REVISED -
	DATE - 10/13/2020	REVISED -

**STATE OF ILLINOIS
DEPARTMENT OF TRANSPORTATION**

**LEVERETTE, TUSCOLA, AND FITHIAN
STORAGE FACILITIES**

SECTION	COUNTY	TOTAL SHEETS	SHEET NO.
2021-1 SALT CONTAINMENT	VARIOUS	14	14
CONTRACT NO. 70E36			
ILLINOIS FED. AID PROJECT			

SCALE: SHEET 3 OF 3 SHEETS STA. TO STA.