



SECTION 3, T20N, R6E, 3RD PM

SEE SCHEDULES OF REMOVAL SHEET(S) 51-52
 SEE SCHEDULES OF EROSION CONTROL SHEET(S) 59
 SEE SCHEDULES OF DRAINAGE SHEET(S) 68
 SEE GUARDRAIL DETAILS SHEET(S) 72
 SEE STRUCTURE PLANS SHEET(S) 86-109

EXIST. CURVE U.S. 150
 PI STA. = 291+82.95
 $\Delta = 8^\circ 27' 16''$ (RT)
 $D = 2^\circ 22' 05''$
 $R = 2,419.60'$
 $T = 178.84'$
 $L = 357.03'$
 $E = 6.60'$
 $e = \dots$
 $T.R. = \dots$
 $S.E. RUN = \dots$
 $P.C. STA. = 290+04.11$
 $P.T. STA. = 293+61.14$

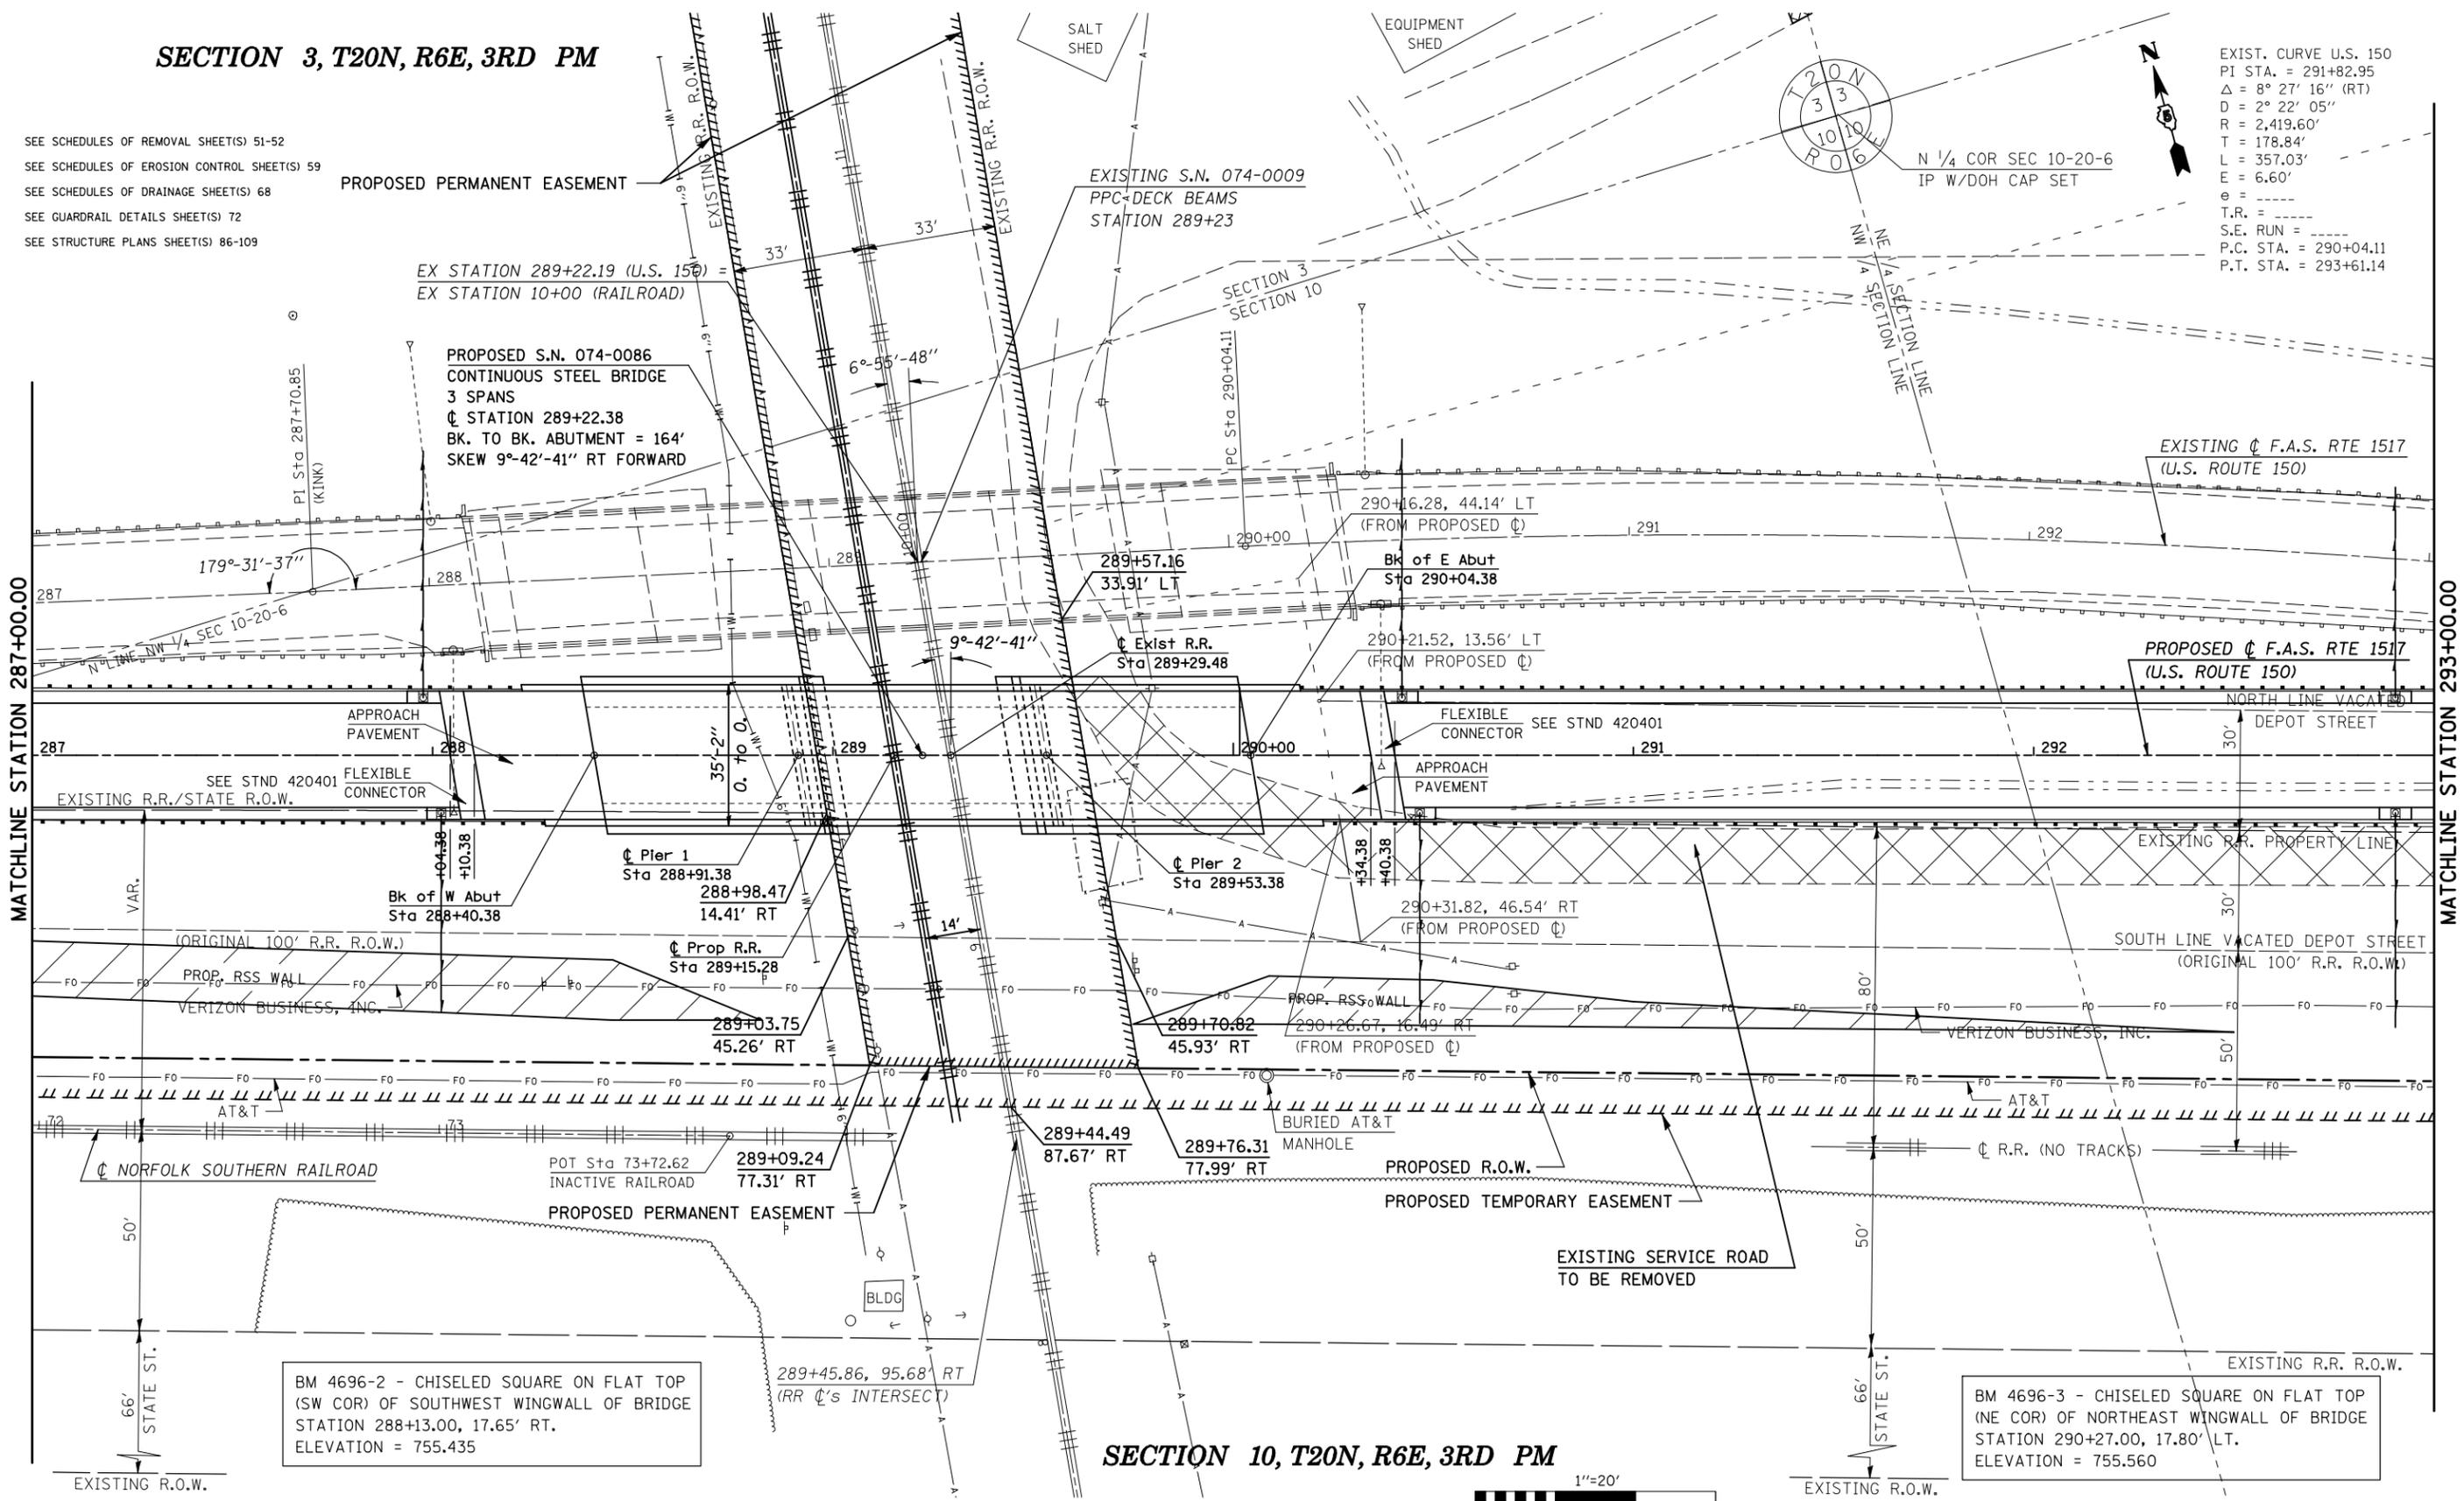

SECTION 10, T20N, R6E, 3RD PM

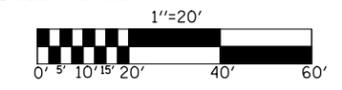

FILE NAME =	USER NAME = shererjm	DESIGNED - CMS	REVISED -
ct:\pw\work\PWID01\SHERERJM\dms86674\70888plansheets.dgn		DRAWN - JRP	REVISED -
PLOT SCALE = 40.0000' / IN.		CHECKED -	REVISED -
PLOT DATE = 10/13/2009		DATE - 03-25-2008	REVISED -

**STATE OF ILLINOIS
 DEPARTMENT OF TRANSPORTATION**

PLAN (U.S. ROUTE 150)

SCALE: 1" = 20' SHEET NO. 7 OF 12 SHEETS STA. 287+00.00 TO STA. 293+00.00

F.A.S. RTE.	SECTION	COUNTY	TOTAL SHEETS	SHEET NO.
1517	12VBR-1	PIATT	168	24
CONTRACT NO. 70388				
FED. ROAD DIST. NO. ILLINOIS FED. AID PROJECT				