
### STATE OF ILLINOIS

# DEPARTMENT OF TRANSPORTATION

# **DIVISION OF HIGHWAYS**

## PLANS FOR PROPOSED FEDERAL AID HIGHWAY

**FAU 0158 (DEERPATH DRIVE)** ILLINOIS ROUTE 132 (GRAND AVE) TO SAND LAKE RD LAPP RESURFACING SECTION 09-00026-00-RS PROJECT NO. ARA-9003 (458) LAKE COUNTY C-91-892-09

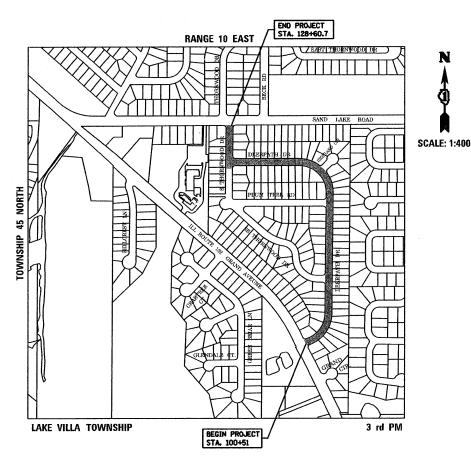

GROSS LENGTH = 2809.7 FT. = 0.532 MILE NET LENGTH = 2809.7 FT. = 0.532 MILE

## INDEX OF SHEETS

- **COVER SHEET**
- **GENERAL NOTES, HIGHWAY STANDARDS** AND SUMMARY OF QUANTITIES
- TYPICAL SECTION
- PLAN STA. 100 + 00 TO STA. 106 + 00
- PLAN STA, 106+00 TO STA, 115+00
- PLAN STA, 115+00 TO STA, 120+00
- PLAN STA, 120+00 TO STA, 128+71
- STANDARD DETAILS

#### TRAFFIC DATA ADT: 175 VPD(2007)

20 MPH (EXISTING)

25 MPH (EXISTING)

**DESIGN DESIGNATION: LOCAL** 

#### **HIGHWAY STANDARDS**

STANDARD SYMBOLS, ABBREVIATIONS, AND PATTERNS


442201-03 CLASS C AND D PATCHES

542401-01 METAL END SECTION FOR PIPE CULVERTS

701301-03 LANE CLOSURE, 2L 2M, SHORT TIME OPERATIONS

701311-03 LANE CLOSURE, 2L 2W, MOVING OPERAIONS-DAY ONLY

URBAN LANE CLOSURE, 2L 2W, UNDIVIDED 701501-05

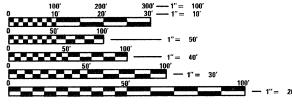

ENGINEERING SCALES. REDUCED SIZED PLANS WILL NOT CONFORM TO STANDARD SCALES. IN MAKING MEASUREMENTS ON REDUCED PLANS, THE ABOVE SCALES MAY BE USED.

JOINT UTILITY LOCATION INFORMATION FOR EXCAVATION 1-800-892-0123


OR 811


PROJECT ENGINEER : JOHN BRIGGS, P.E. PROJECT MANAGER: SCOTT REISINGER PROJECT NUMBER: ARA-9003(458)

**CONTRACT NUMBER: 63364** 

SECTION LAKE 8 1 09-00026- )0-RS TILINOIS CONTRACT NO. 63364



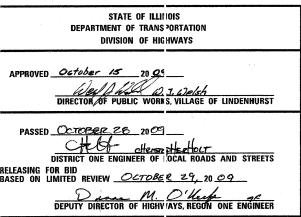

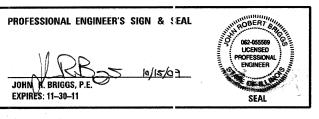

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#### **GENERAL NOTES**

- ALL CONSTRUCTION SHALL BE DONE IN ACCORDANCE WITH THE STATE OF JLLINOIS "STANDARD SPECIFICATIONS FOR ROAD AND BRIDGE CONSTRUCTION," LATEST ADDITION. THE "SUPPLEMENTAL SPECIFICATIONS AND RECURRING SPECIAL PROVISIONS", LATEST ADDITION. DETAILS IN THESE PLANS, AND THE CONTRACT DOCUMENTS.
- THE CONTRACTOR IS TO NOTIFY ALL UTILITY COMPANIES AT LEAST 48 HOURS PRIOR TO ANY CONSTRUCTION, THE JULIE TELEPHONE NUMBER FOR THIS AREA IS (800)892-0123, THE CONTRACTOR WILL NOTIFY THE OWNER AND ENGINEER AT LEAST 2 WORKING DAYS IN ADVANCE OF STARTING.
- 3. THE CONTRACTOR SHALL INDEMNIFY VILLAGE OF LINDENHURST, BONESTROO, THEIR AGENTS, ETC. FROM ALL LIABILITY INVOLVED WITH THE CONSTRUCTION, INSTALLATION AND TESTING OF WORK ON THIS PROJECT. THE CONTRACTOR SHALL TAKE OUT AND MAINTAIN DURING THE LIFE OF THIS CONTRACT, COMPREHENSIVE BODILY INJURY LIABILITY AND PROPERTY DAMAGE INSURANCE AS STIPULATED IN FORM LRIO7-4. VILLAGE OF LINDENHURST, AND BONESTROO SHALL BE NAMED AS ADDITIONAL INSUREDS ON THE CONTRACTOR'S COMPREHENSIVE LIABILITY POLICY.
- 4. THE CONTRACTOR SHALL PLAN THEIR WORK SO THAT THE STREET AND DRIVEWAYS ARE COMPLETELY BACKFILLED AND ACCESSIBLE TO TRAFFIC AT THE END OF EACH WORKDAY. PARTIAL CROSSINGS WILL NOT BE PERMITTED.
- ALL EXCAVATED MATERIAL SHALL BE REMOVED FROM THE PROJECT SITE AT THE END OF EACH WORKING DAY, EXCAVATED MATERIAL SHALL NOT BE STOCKPILED ON PROJECT SITE DURING NON-WORKING HOURS.
- 6. THE CONTRACTOR SHALL SUBMIT, IN WRITING FOR APPROVAL BY THE ENGINEER, A LIST OF ALL MATERIALS AND MATERIAL CERTIFICATIONS PROPOSED TO BE USED PRIOR TO ORDERING OR DELIVERY.
- 7. THE ENGINEER MAY ORDER TESTS OF ANY MATERIALS USED IN THE CONSTRUCTION, THE MATERIALS TO BE TESTED MAY BE TAKEN FROM THE SITE.
- 8. IN ACCORDANCE WITH VILLAGE NPDES STORM WATER ORDINANCE, THE GENERAL CONTRACTOR SHALL BE RESPONSIBLE FOR MAINTAINING ADEQUATE EROSION PROTECTION DURING CONSTRUCTION AS WELL AS PROVIDING ADEQUATE PROTECTION TO ADJOINING STREETS FROM MUD AND POLLUTED RUNOFF AS WELL AS KEEPING EXISTING PAVEMENT CLEAN OF MUD AND DEBRIS. ALL EROSION CONTROL MEASURES TO BE APPROVED BY THE ENGINEER.
- 9. THE CONTRACTOR SHALL BE RESPONSIBLE FOR INTERPRETING ALL SUBSURFACE INFORMATION REQUIRED FOR THIS PROJECT. COPIES OF PAVEMENT CORES ARE AVAILABLE FROM THE ENGINEER.
- 10. DUST CONTROL WATERING SHALL BE REQUIRED AT THE DIRECTION OF THE ENGINEER. USE OF VILLAGE WATER WILL BE AVAILABLE FROM THE VILLAGE OF LINDEMHURST AND CHARGED AT THE CURRENT RATE OF BILLINGS. THE CONTRACTOR SHALL NOTIFY THE PUBLIC WORKS DEPARTMENT 48 HOURS PRIOR TO THE NEED FOR WATER WITHDRAWAL FROM THE SYSTEM. AT NO TIME WILL THE CONTRACTOR BE ALLOWED TO OPERATE VALVES, HYDRANTS OR ANY OTHER PART OF THE VILLAGE WATER SYSTEM. THE USE OF TANKER TRUCKS SHALL BE THE RESPONSIBILITY OF THE CONTRACTOR. ALL EQUIPMENT, LABOR, MATERIALS, ETC., REQUIRED SHALL BE PAID FOR AT THE UNIT PRICE FOR DUST CONTROL WATERING OR SUPPLEMENTAL WATERING, AS MEASURED IN UNITS OF 1,000 GALLONS EACH.
- 11. THE CONTRACTOR SHALL BE RESPONSIBLE FOR THE INSTALLATION AND MAINTENANCE OF ADEQUATE SIGNS, TRAFFIC CONTROL DEVICES, AND WARNING DEVICES TO INFORM AND PROTECT THE PUBLIC DURING ALL PHASES OF CONSTRUCTION, BARRICADES AND WARNING SIGNS SHALL BE PROVIDED IN ACCORDANCE WITH THE FHWA "MANUAL OF UNIFORM TRAFFIC CONTROL DEVICES". ADEQUATE LIGHTING SHALL BE MAINTAINED FROM DUSK TO DAWN AT ALL LOCATIONS WHERE CONSTRUCTION OPERATIONS WARRANT, OR AS DESIGNATED BY THE VILLAGE, ALL TRAFFIC CONTROL WORK SHALL BE DONE IN ACCORDANCE WITH THE I.D.O.T. "HIGHWAY STANDARDS" AS SHOWN ON THE PLANS.
- 12. ALL TRENCHES CAUSED BY THIS CONSTRUCTION AROUND, UNDER AND/OR NEAR ANY PAVED SURFACE, STREETS, SIDEWALKS, DRIVEWAY, ETC. SHALL BE BACKFILLED WITH DESIGNATED MATERIAL, AND SHALL BE MECHANICALLY COMPACTED IN PLACE TO NINETY-FIVE PERCENT (95%) OF MAXIMUM DENSITY AT OPTIMUM MOISTURE AS DETERMINED BY THE STANDARD PROCTOR TEST. PAVEMENT, SIDE WALK, CURB AND GUTTERS, OR ANY OTHER RIGID SURFACE, SHALL BE BACKFILLED WITH DESIGNATED MATERIAL. WHERE THE EDGE OF THE TRENCH IS MORE THAN 2 FEET FROM THE EDGE OF AN EXISTING OR PROPOSED PAVED SURFACE TRENCH BACKFILL SHALL BE USED BELOW THE INTERSECTION OF ONE TO ONE (1:1) SLOPE LINE DRAWN FROM THE EDGE OF PAVEMENT TO THE NEAREST VERTICAL EDGE OF THE TRENCH.
- 13. BEFORE PLACEMENT OF ANY BASE COURSE MATERIALS, THE CONTRACTOR SHALL TREAT THE SUBGRADE AS PER ARTICLE 301.03 OF THE STANDARD SPECIFICATIONS.
- AGGREGATE BASE COURSE, AGGREGATE FOR DRIVES OR TEMPORARY ACCESS SHALL BE CA-6, GRADE 8, CRUSHED LIMESTONE.
- 15. THE CONTRACTOR SHALL REMOVE EXISTING BRICK PAVERS IN DRIVEWAY APRONS ONLY AS REQUIRED, RE-GRADE THE DRIVEWAY PROFILE AND REPLACE THE BRICK PAVERS USING THE SAME PATTERN THAT IS EXISTING, SUBGRADE PREPARTION AND MATERIALS SHALL BE GRANULAR, CONSISTENT WITH THE EXISTING MATERIALS. PAYMENT SHALL BE AT THE UNIT PRICE PER SQUARE FOOT FOR BRICK DRIVEWAY REMOVAL AND REPLACEMENT.
- 16. CONTRACTOR SHALL COMPACT/ HAND TAMP ALL BITUMINOUS DRIVEWAY EDGES TO PROVIDE A UNIFORM, FINISHED EDGE AS PART OF DRIVEWAY REPLACEMENT.
- 17. ALL MANHOLE STRUCTURES, VALVES, INLETS, ETC. SHALL BE MAINTIANED IN AN ACCESSABLE CONDITION AT ALL TIMES. NO PLATING OF MANHOLES WILL BE ALLOWED DURING CONSTRUCTION OPERATIONS.


#### GENERAL NOTES (ITEMS NOT PAID FOR)

- THE CONTRACTOR WILL BE REQUIRED TO REPLACE, IN KIND, ALL SURFACE FEATURES DAMAGED OR REMOVED INCLUDING, BUT NOT LIMITED TO: STREET PAYING, SIDEWALKS, DRIVES, LAWNS, TREES, FIRE HYDRANTS, PROPERTY PINS, DRAIN TILES, ETC. THE WORK SHALL BE INCLUDED IN THE COST OF CONSTRUCTION AND NO EXTRA COMPENSATION WILL BE PERMITTED, UNLESS SPECIFIC PAY ITEMS ARE ESTABLISHED.
- 2. DURING THE COURSE OF THE WORK, THE CONTRACTOR SHALL INSURE THAT AT THE CONCLUSION OF EACH DAY'S OPERATION, POSITIVE DRAINAGE IS ACHIEVED. SITE DRAINAGE MAY BE ACHIEVED BY DITCHING, GRADING OR ANY OTHER METHOD AGREEABLE TO THE ENGINEER. THE CONTRACTOR'S FAILURE TO PROVIDE ADEQUATE DRAINAGE SHALL CONSTITUTE NO SUBSEQUENT CLAIM FOR ADDED COMPENSATION DUE TO DELAYS OR UNSUITABLE MATERIALS RESULTING THEREOF.
- 3. UPON COMPLETION OF THE WORK, INCLUDING ANY RE-WORK, AND BEFORE ACCEPTANCE THEREOF, THE CONTRACTOR SHALL THOROUGHLY CLEAN THE AREAS OF HIS OPERATIONS AND REMOVE ALL SURPLUS CONSTRUCTION MATERIAL AND DEBRIS RESULTING FROM HIS WORK, CLEAN-UP SHALL BE INCLUDED THE COST OF THE CONTRACT.
- 4. ALL STRUCTURES (MANHOLES, VALVE VAULTS, AUXILARY VALVE BOXES, ETC) SHALL BE CLEANED OUT AT THE END OF THE PROJECT AND PRIOR TO ACCEPTANCE. STORM SEWER MAINS SHALL BE JET CLEANED IF EVIDENCE OF DEBRIS BUILD-UP IS PRESENT AT THE TIME OF ACCEPTANCE. WORK TO BE INCLUDED IN THE COST OF LITHITY CONSTRUCTION.
- 5. THE RIM ELEVATIONS SHOWN ON THE PLANS ARE APPROXIMATE ONLY AND THE CONTRACTOR WILL ADJUST ALL STRUCTURES TO GRADE WHEN FINAL GRADING IS COMPLETED. PRECAST ADJUSTMENT RINGS SHALL BE LIMITED TO NO MORE THAN 8 INCHES, PRECAST BARREL SECTIONS WILL BE ADDED TO THE MANHOLES WHEN THE ADJUSTMENT REQUIRED EXCEEDS 8 INCHES, NO ADDITIONAL COMPENSATION WILL BE ALLOWED FOR THIS ADJUSTMENT.
- 6. PAVEMENT SWEEPING SHALL BE PERFORMED A MINIMUM OF ONCE A WEEK, OR AT THE DIRECTION OF THE ENGINEER, ADDITIONAL DUST CONTROL MEASURES, SUCH AS CALCIUM CHLORIDE SHALL BE PROVIDED AS NEEDED, WORK SHALL BE INCLUDED IN THE COST OF CONSTRUCTION OPERATIONS.
- 7. EXISTING SUMP PUMPS, FIELD TILES, ETC. DISCHARGING INTO EXISTING STORM SEWERS SHALL BE PROTECTED AND MODIFIED (IF NECESSARY) WHEN INSTALLING NEW STORM SEWERS AND SHALL BE CONNECTED TO NEW STRUCTURES. COST OF PROTECTION/MODIFICATION SHALL BE INCLUDED THE UNIT PRICE FOR STORM SEWERS UNLESS OTHERWISE SPECIFIED.
- ALL DAMAGE CAUSED TO VALVES, VALVE BOXES AND B-BOXES SHALL BE REPAIRED BY CONTRACTOR AT THEIR EXPENSE. DAMAGE TO WATER SERVICES BY CONTRACTOR SHALL BE REPAIRED IMMEDIATELY UPON DAMAGE RETMG INCLIRATED.
- ALL DRAIN TILE AND/OR CULVERT REMOVAL SHALL INCLUDE REPLACEMENT WITH TRENCH BACKFILL, AS
  DESIGNATED IN THE SPECIFICATIONS, PAVEMENT RESTORATION, ETC. DRAIN TILE/CULVERT REMOVAL AND
  REPLACEMENT SHALL BE INCLUDED IN THE COST OF THE CONTRACT PRICE UNLESS IT IS OTHERWISE
  DESIGNATED IN THE PLANS AND IN THE SCHEDULE OF PRICES.


#### SUMMARY OF QUANTITIES

	SUMMENT OF QUANTITIES				
Pay Code	Item Description	Total	Units	ZOOO Participating	Y007 Non - Participating
208001	TRENCH BACKFILL	4	CU YD	4	CONTRACTOR
211016	TOPSOIL FURNISH AND PLACE, 4"	1450	SQ YD	1450	
214001	GRADING AND SHAPING DITCHES	100	FOOT		100
250001	SEEDING, CLASS I	0.30	ACRE	0.30	
250004	NITROGEN FERTILIZER NUTRIENT	27	POUND	27	
250005	PHOSPHORUS FERTILIZER NUTRIENT	27	POUND	27	
250006	POTASSIUM FERTILIZER NUTRIENT	27	POUND	27	******
251006	EROSION CONTROL BLANKET	1450	SQ YD	1450	
252002	SUPPLEMENTAL WATERING	5	UNIT	5	
402010	AGGREGATE FOR TEMPORARY ACCESS	60	TON	60	
406001	BITUMINOUS MATERIALS (PRIME COAT)	1050	GALLON	1050	
406003	AGGREGATE (PRIME COAT)	9	TON	9	
406006	LEVELING BINDER (MACHINE METHOD), N50	425	TON	425	
406009	HOT-MIX ASPHALT SURFACE REMOVAL - BUTT JOINT	150	SQ YD	150	
406033	HOT-MIX ASPHALT SURFACE COURSE, MIX "C", N50	825	TON	825	
440002	DRIVEWAY PAVEMENT REMOVAL	1500	SQ YD	1500	
442017	CLASS D PATCHES, TYPE II, 6 INCH	70	SQ YD	70	
442017	CLASS D PATCHES, TYPE III, 6 INCH	825	SQ YD	825	
442132	SAW CUTS	1250	FOOT	1250	
443003	AREA REFLECTIVE CRACK CONTROL TREATMENT, SYSTEM A	6600	SQ YD	6600	
481012	AGGREGATE SHOULDERS , TYPE B	190	TON	190	
501052	REMOVE EXISTING CULVERTS	100	FOOT		100
542155	METAL END SECTIONS 12"	8	EACH		8
542C02	PIPE CULVERTS, CLASS C, TYPE 1 12"	80	FOOT		80
565006	DOMESTIC WATER SERVICE BOXES TO BE ADJUSTED	5	EACH	5	
602555	MANHOLES TO BE ADJUSTED	4	EACH	4	
602666	VALVE BOXES TO BE ADJUSTED	3	EACH	3	
671001	MOBILIZATION	1	L SUM	1	
701026	TRAFFIC CONTROL AND PROTECTION, STANDARD 701501	1	L SUM	1	
X03215	SANITARY MANHOLES TO BE ADJUSTED	10	EACH	10	
XX0004	BRICK PAVER REMOVAL AND REPLACEMENT	135	SQ FT	135	
XX0006	RELOCATE EXISTING MAILBOX	70	EACH		70
XX0068	HOT-MIX ASPHALT DRIVEWAY PAVEMENT	1500	SQ YD	1500	
1 770000					

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Pt\1510\1510091530\CAD\Dwg\1510153SHT02.d	gn	DRAWN - JWL	REVISED -	STATE OF ILLINOIS					158	09-00026-00-RS	LAKE	8 2
	PLOT SCALE = 40.0000 '/ in.	CHECKED - JBR	REVISED	DEPARTMENT OF TRANSPORTATION	AND SUMMARY OF QUANTITIES				CONTRACT	NO. 63364		
	PLOT DATE = 10/15/2009	DATE -	REVISED		SCALE: N.T.S	SHEET NO. 1 OF 1 SHEETS	STA.	TO STA.	FED. ROA	D DIST. NO.   ILLINOIS FED. A	ID PROJECT	

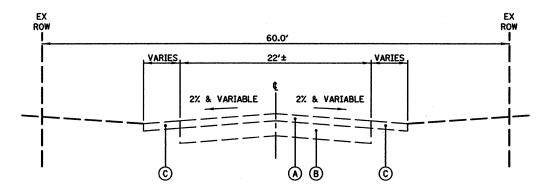

EXISTING PAVEMENT SECTION
NOT TO SCALE

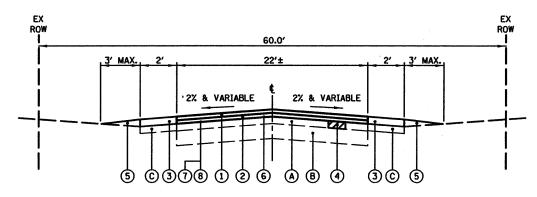

PROPOSED PAVEMENT SECTION

NOT TO SCALE

#### **EXISTING LEGEND**

- A ASPHALT PAVEMENT, 5"-6"±
- B AGGREGATE BASE
- C AGGREGATE SHOULDER

#### PROPOSED LEGEND

- 1) HOT MIX ASPHALT SURFACE COURSE, MIX C, N50, 2" THICKNESS
- (2) LEVELING BINDER COURSE, (MACHINE METHOD), N50, 1" THICKNESS
- (3) AGGREGATE SHOULDER, CA-6, TYPE B (GRADE 8 LIMESTONE)
- (4) HOT MIX ASPHALT PAVEMENT PATCHING, 6" (AS DIRECTED BY ENGINEER)
- 5 LANDSCAPE RESTORATION, TOPSOIL, SEED AND EROSION BLANKET
- 6 AREA REFLECTIVE CRACK CONTROL TREATMENT, TYPE A
- (7) BITUMINOUS MATERIALS (PRIME COAT)
- (B) AGGREGATE (PRIME COAT)

	MIXTURE TYPE	AIR VOIDS @ Ndes
PAVEMENT OVERLAY	HOT MIX ASPHALT SURFACE COURSE, MIX "C", N50 (IL 9.5mm), 2"	4% <b>@</b> 50 GYR
	LEVELING BINDER (MACHINE METHOD), N50, 1"	4% <b>e</b> 50 GYR
DRIVEWAYS	HOT MIX ASPHALT SURFACE COURSE, MIX "C", N50 (IL 9.5mm), 2"	4% <b>@</b> 50 GYR
PATCHING	HOT MIX ASPHALT PAVEMENT PATCHING, 6"	4% <b>e</b> 50 GYR

THE UNIT WEIGHT USED TO CALCULATE ALL HMA SURFACE MIXTURE QUANTITIES IS 112 LBS/ SQ. YD./IN.


THE "AC TYPE" FOR POLYMERIZED HMA MIXES SHALL BE "SB5/ SBR PG TO-22" AND FOR NON-POLYMERIZED HMA THE "AC TYPE" SHALL BE "PG 64-22" UNLESS MODIFIED BY DISTRICT ONE SPECIAL PROVISIONS. FOR "PERCENT OF RAP" SEE DISTRICT ONE SPECIAL PROVISIONS.


\*\* WHEN RAP EXCEEDS 20%, THE NEW ASPHALT BINDER IN THE MIX SHALL BE PG58-22.


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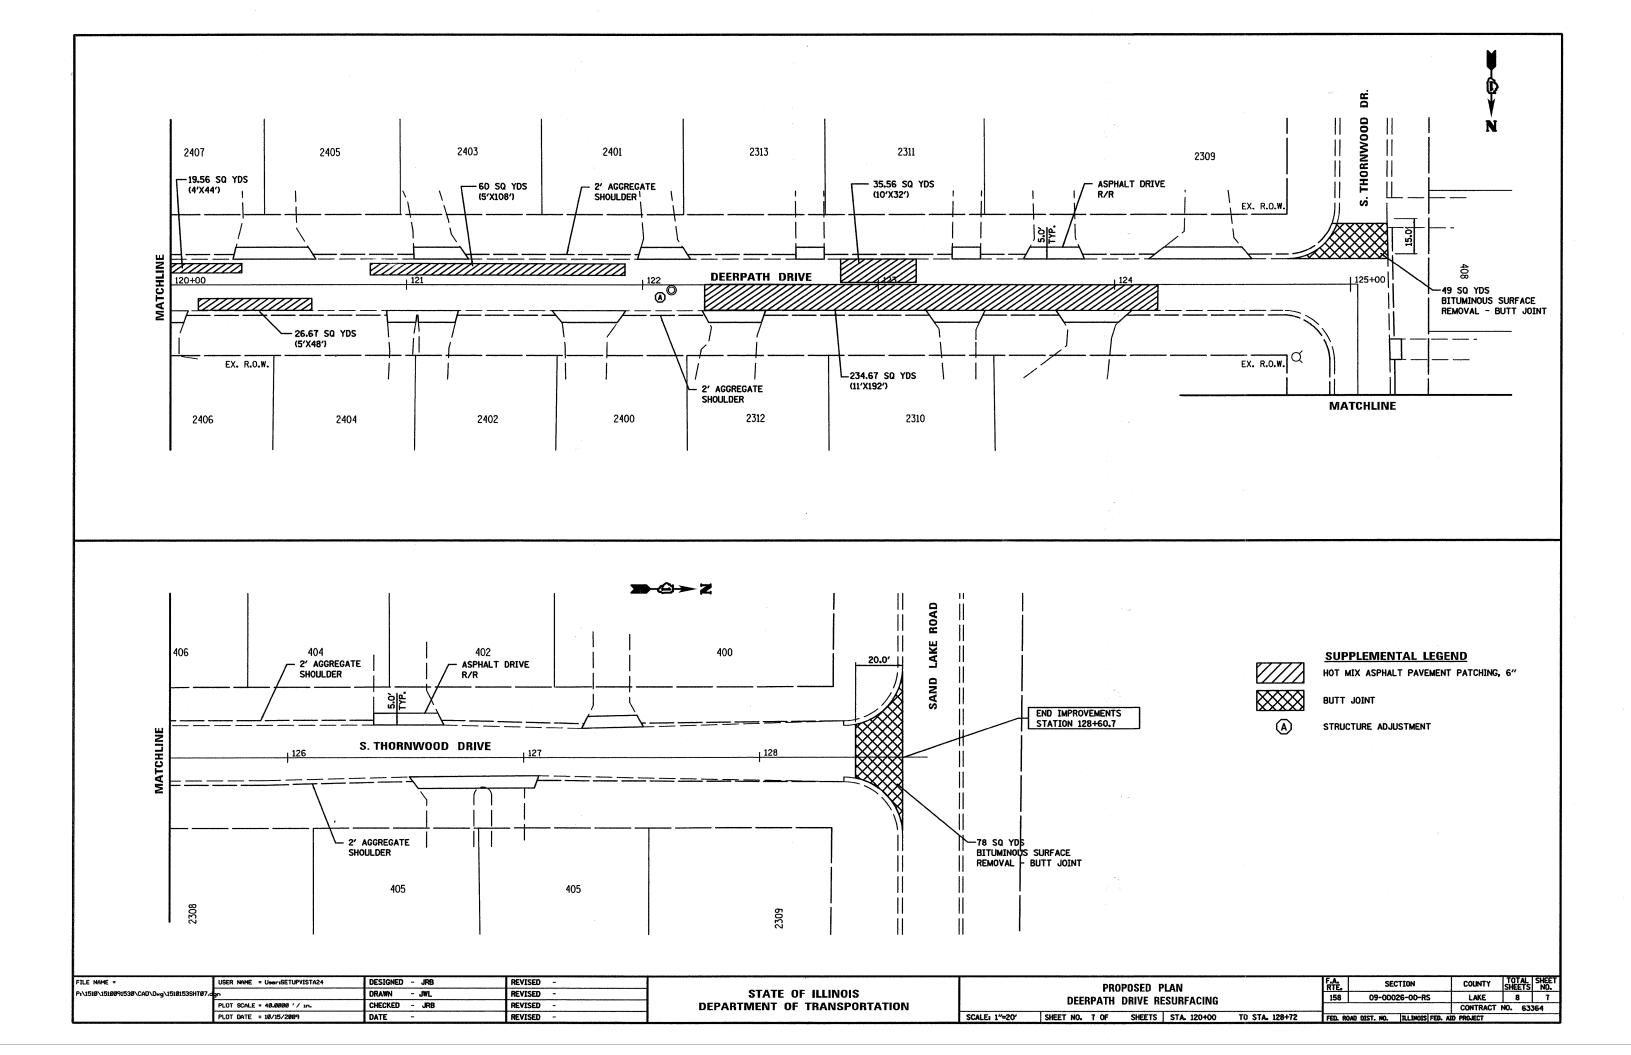
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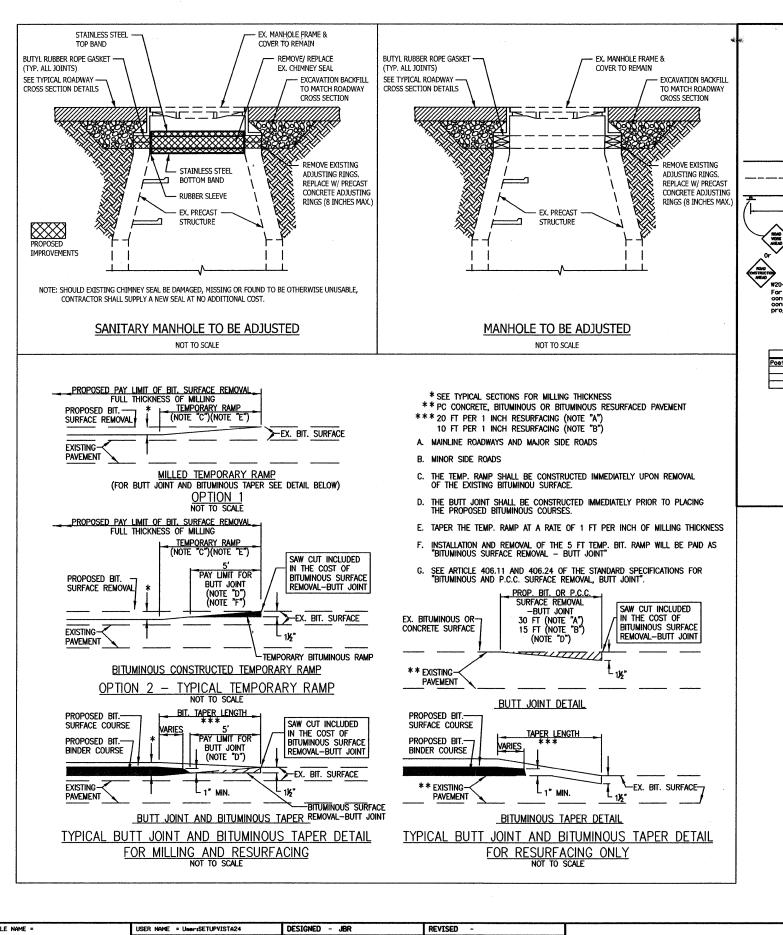
	٧			SECTION   COUNTY   TOTAL   SHEET   NO.				
	TOTAL OF STANK		F.A. RTE.	SECTION	COUNTY	SHEETS NO.		
	TYPICAL SECTIONS			09-00026-00-RS	LAKE	8	3	
					CONTRACT	NO. 633	64	
N.T.S	SHEET NO. 1 OF 1 SHEETS STA.	TO STA.	FED. RO	AD DIST, NO. ILLINOIS FED. AT	PROJECT			






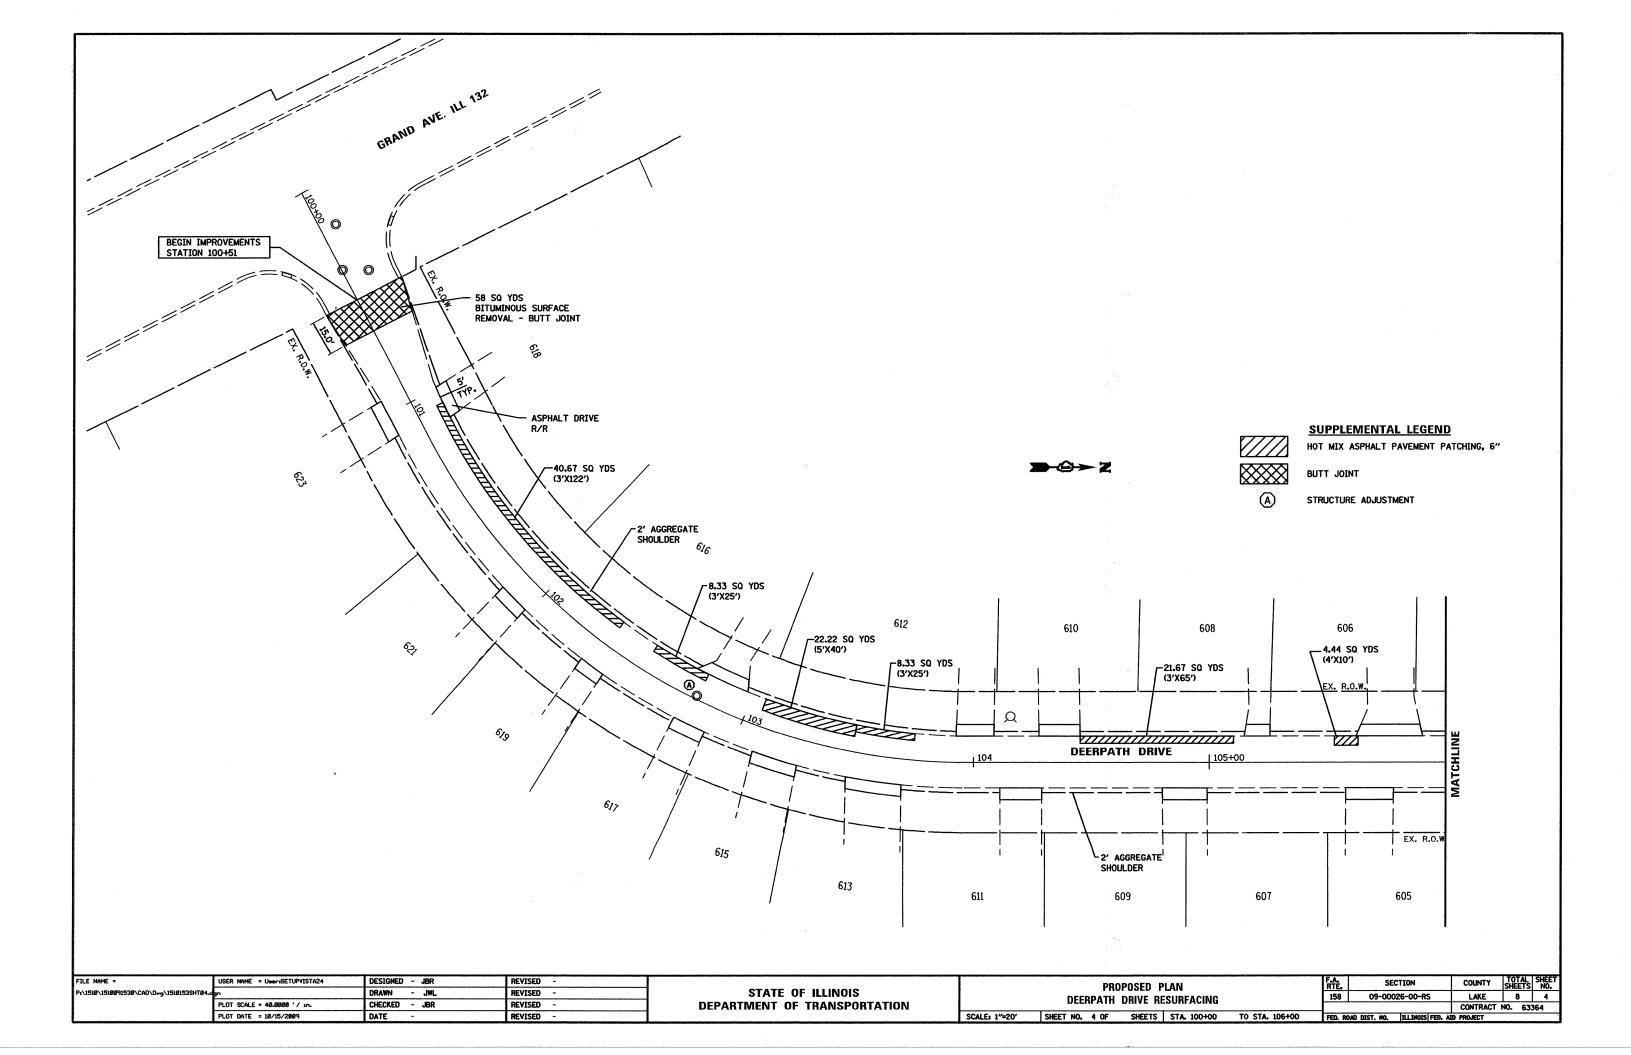

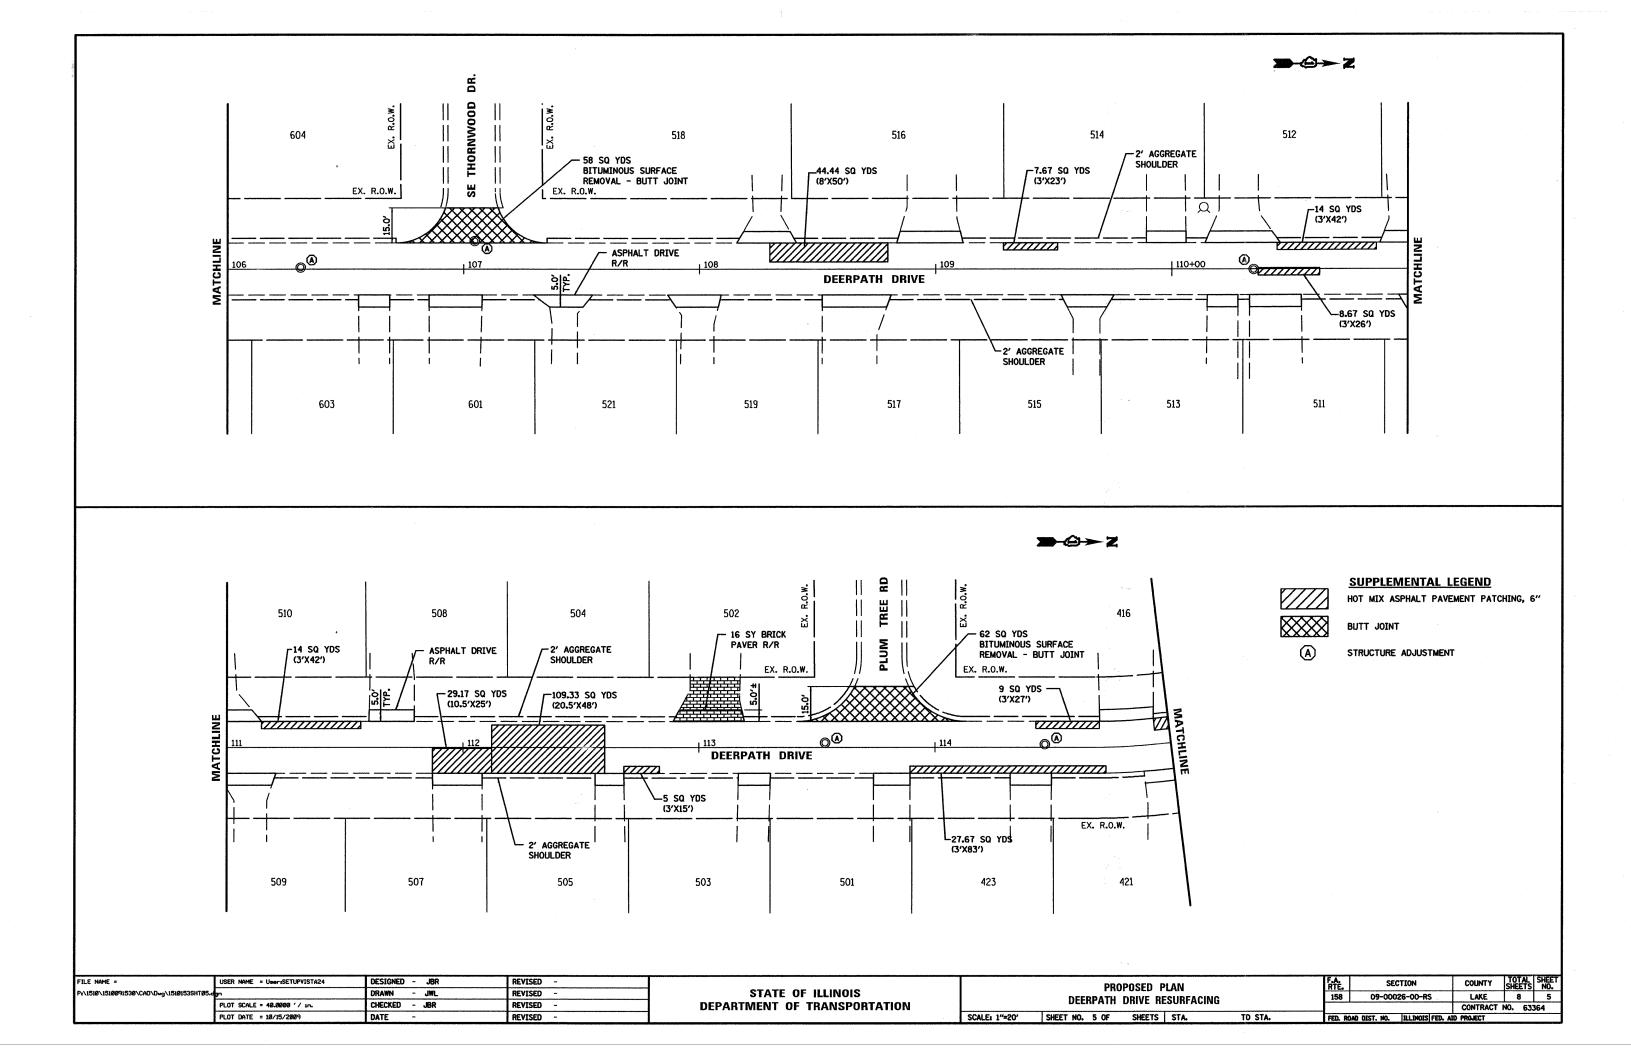

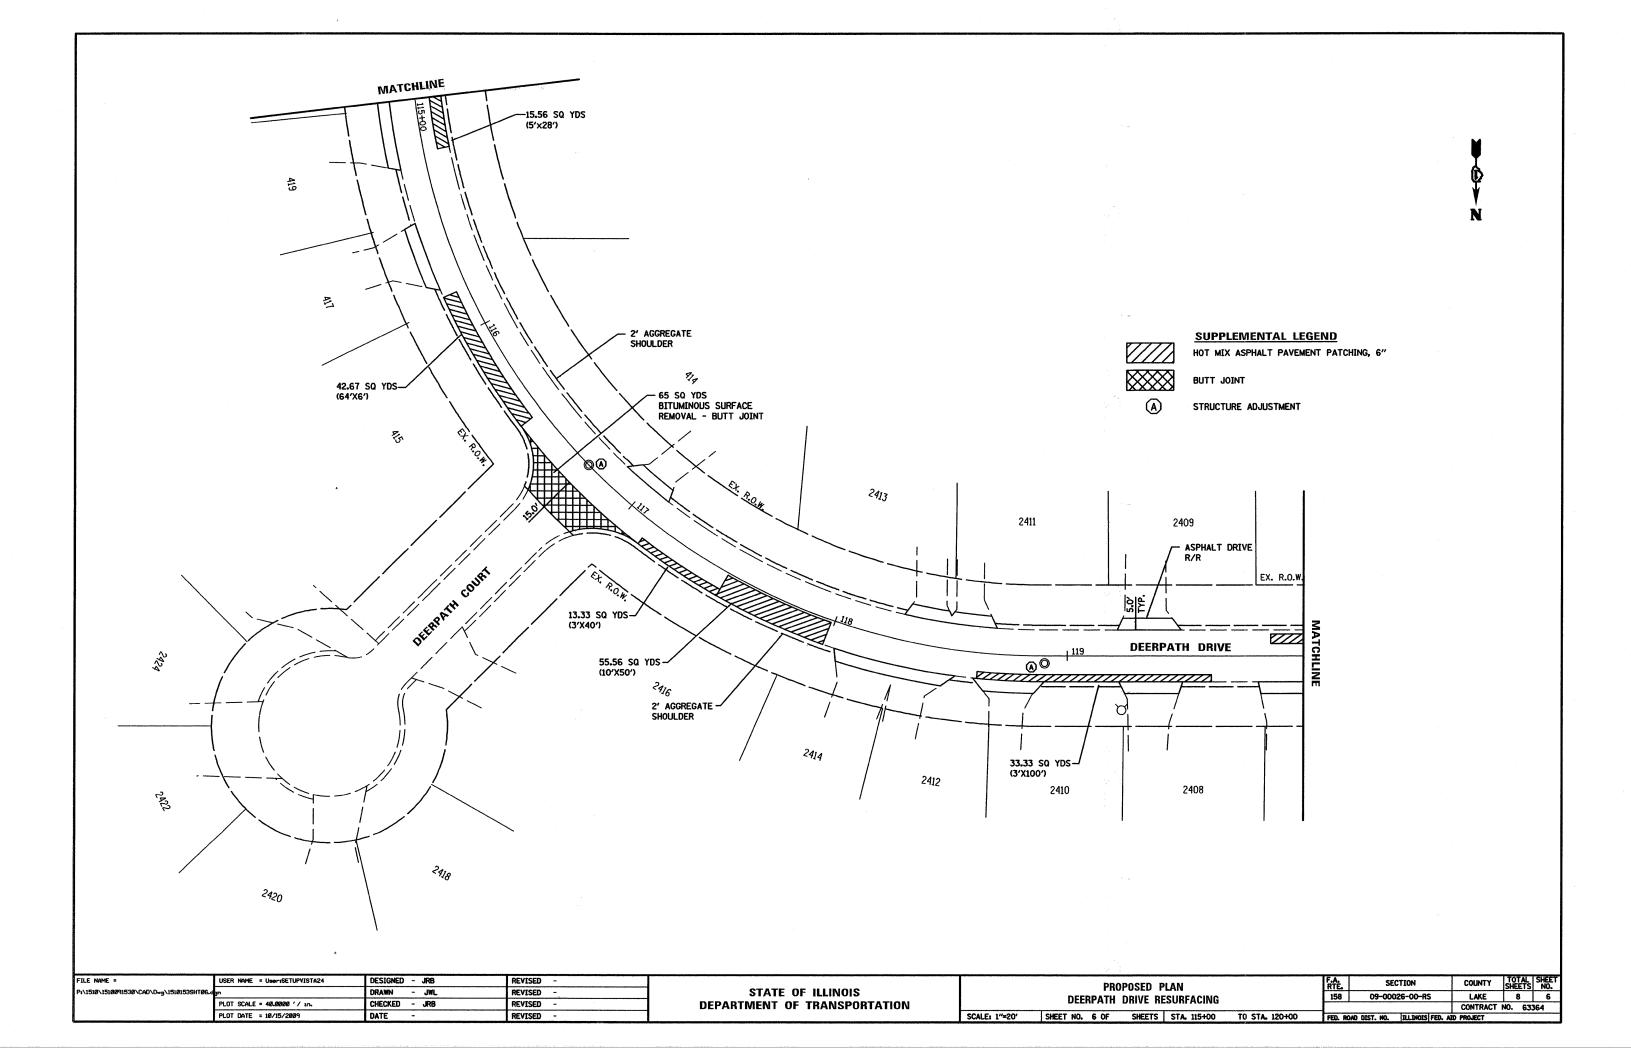

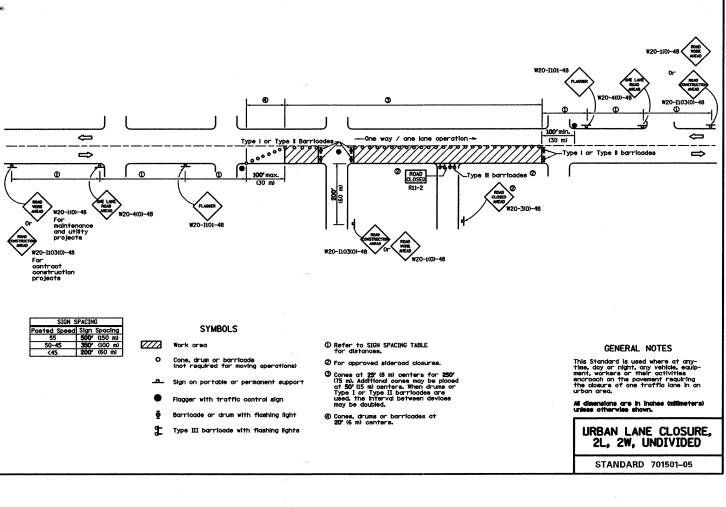

SCALE: N.T.S

FILE NAME = USER NAME = USER

	F.A. RTE.	SECTION	COUNTY	TOTAL	SHEET NO.
STANDARD DETAILS	158	09-00026-00-RS	LAKE	8	8
'			CONTRACT	NO. 63	364
SHEET NO. 1 OF 1 SHEETS STA. TO STA.	FED. R	OAD DIST. NO. ILLINOIS FED. A	D PROJECT		